REPLACE ROOF HOWERTON STATE OFFICE BUILDING JEFFERSON CITY, MISSOURI



OWNER:

STATE OF MISSOURI

MICHAEL L. PARSON, GOVERNOR

PROJECT

OFFICE OF ADMINISTRATION

MANAGEMENT: DIVISION OF FACILITIES

MANAGEMENT,

DESIGN AND CONSTRUCTION

DESIGNER:

ROBERT ROLLINGS ARCHITECTS, LLC

PROJECT NUMBER:

O2015-02

SITE NUMBER:

1025

ASSET NUMBER: 3101025001

GENERAL NOTES ARE INTENDED TO SUPPLEMENT THE DRAWINGS AND SPECIFICATIONS. NOT ALL NOTES APPLY TO THIS PROJECT. SPECIFIC TRADE NOTES TAKE PRECEDENCE OVER THESE GENERAL NOTES.

A: BUILDING CODE - 2015 IBC B: ROOF LIVE LOAD - 20 PSF

C: GROUND SNOW LOAD - 20 PSF D: WIND SPEED BASIC - 120 MPH

NOTE: THESE DRAWINGS ARE FOR THIS SPECIFIC BUILDING AND NO OTHER USE IS AUTHORIZED. SEE ARCHITECTURAL AND MECHANICAL DRAWINGS FOR EMBEDDED ITEMS NOT SHOWN HEREIN AND TO VERIFY SIZE AND LOCATION OF ALL OPENINGS. BEFORE EXECUTING ANYTHING HEREIN SHOWN, THE CONTRACTOR SHALL EXAMINE ACTUAL JOB CONDITIONS AND REPORT TO THE ARCHITECT ANY ERROR, OMISSION, OR DIFFICULTY AFFECTING THE WORK.

THESE DRAWINGS, ALONG WITH THE PROJECT SPECIFICATIONS, REPRESENT A UNIFIED SET OF CONSTRUCTION DOCUMENTS. ALL BIDDERS SHALL BE RESPONSIBLE FOR FAMILIARIZING THEMSELVES WITH ALL DRAWINGS IN THIS SET, REGARDLESS OF SHEET NUMBER AND DISCIPLINE, AND SHALL BE RESPONSIBLE FOR COORDINATING THEIR WORK WITH THE WORK OF OTHER TRADES. ANY APPARENT DISCREPANCIES BETWEEN DRAWINGS OR BETWEEN THE DRAWINGS AND SPECIFICATIONS SHALL BE BROUGHT TO THE ATTENTION OF THE ARCHITECT PRIOR TO BIDDING.

DO NOT BID FROM PARTIAL SETS OF BID DOCUMENTS.

BY SUBMITTING A BID, BIDDERS REPRESENT THAT THEY HAVE VISITED THE SITE, BECOME FAMILIAR WITH THE BID DOCUMENTS IN THEIR ENTIRETY AND WITH LOCAL CONDITIONS UNDER WHICH THE WORKS IS TO BE PERFORMED AND HAVE CORRELATED THE BIDDER'S PERSONAL OBSERVATIONS WITH THE REQUIREMENTS OF THE CONTRACT DOCUMENTS.

	CODE INFORMATION	2015 INTERNATIONAL BUILDING CODE (IBC)
T, H ND	NA	

DESIGN TEAM: ARCHITECT:

ROBERT ROLLINGS ARCHITECTS LLC 1806 WEST BROADWAY SEDALIA, MO 65301 660.829.9751 FAX: 660.829.9752

CIVIL ENGINEER BROADFOOT ENGINEERING 30277 CARPENTER RD. SEDALIA, MO 65301

NOTICE:

THE FOLLOWING:


DRAWING SHEETS: G-001, G-002, A-100, D-101, A-101, A-201, A-501, A-502, A-503


SPECIFICATION DIVISIONS 1 THROUGH 12


AND I HEREBY DISCLAIM ANY RESPONSIBILITY FOR ALL OTHER PLANS, SPECIFICATIONS, ESTIMATES, REPORTS, OR OTHER DOCUMENTS OR INSTRUMENTS RELATING TO OR USED FOR THIS PROJECT.

I HEREBY CERTIFY THAT THE DOCUMENTS INTENDED TO BE AUTHENTICATED BY MY SEAL ARE LIMITED TO



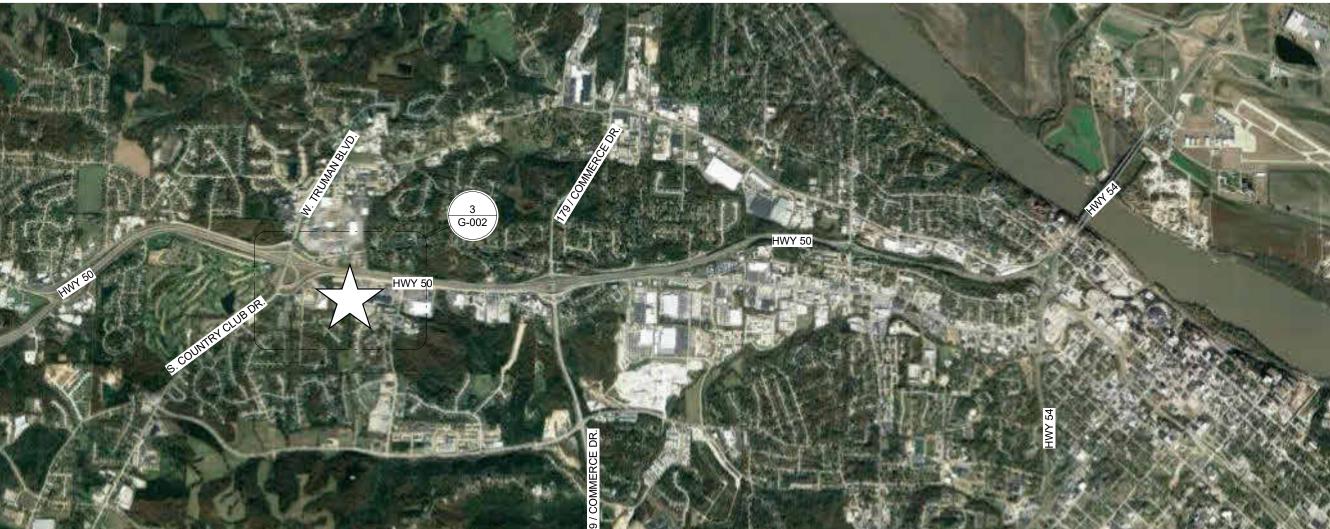

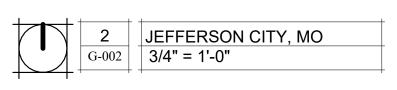

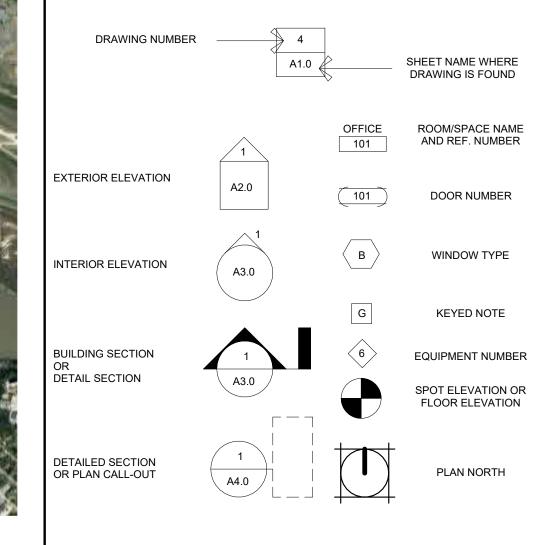

		SHEET ORDER	SHEET NUMBER	SHEET NAME	CAD
DISCIPLINE G GENERAL C CIVIL D DEMOLITION S STRUCTURAL A ARCHITECTURAL Q EQUIPMENT M MECHANICAL FG FUEL GAS P PLUMBING	SERIES SERIES 0 GENERAL INFORMATION 1 PLANS 2 EXTERIOR ELEVATIONS 3 BUILDING SECTIONS 4 LARGE SCALE VIEWS 5 DETAILS 6 SCHEDULES / DIAGRAMS 7 REFLECTED CEILING PLANS 8 USER DEFINED	1 2 3 4 5 6 7 8 9 10 11 12 13 14 15	G-001 G-002 C-001 C-100 C-101 C-102 C-501 C-502 D-101 A-100 A-101 A-201 A-501 A-502 A-503	COVER SHEET INFORMATION SHEET CIVIL COVER SHEET SITE LAYOUT PLAN EXISTING CONDITIONS & DEMOLITION PLAN GRADING & DRAINAGE & EROSION CONTROL PLAN DETAILS DETAILS ROOF DEMO PLAN ARCHITETURAL SITE PLAN ROOF PLAN ELEVATIONS TPO DETAILS TPO DETAILS EIFS DETAILS	G-01 G-02 C-03 C-SP-(C-SP-(C-DT-(A-DP-(A-SP-' A-RP-' A-EL-' A-DT-'
E <u>E</u> LECTRICAL 4 SHEET NAMING	9 3D REPRESENTATIONS G CONVENTION DO NOT DEFINE LIMITS OF WORK				
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GENERAL NOTES	

- A. DO NOT SCALE DRAWINGS.
- GENERAL CONTRACTOR AND ALL SUBCONTRACTORS SHALL THOROUGHLY FAMILIARIZE THEMSELVES TO ALL SITE SPECIFIC
- AND TEXTURE AND SHALL BE INSTALLED WITH MATCHING FACTORY MIXED COLORS. ORIGINAL INSTALLER, BROOKE DRYWALL OF 573-893-5977. ALL EIFS WORK SHALL BE PERFORMED BY A DRYVIT / TREMCO CERTIFIED INSTALLER, TYP.



- . VERIFY ALL DIMENSIONS IN FIELD.
- NOTIFY ARCHITECT OF ANY DISCREPANCIES BETWEEN PROJECT DOCUMENTS AND EXISTING CONDITIONS. ANY MODIFICATIONS DUE TO DIMENSIONAL CHANGES SHOULD BE PART OF THE PROJECT COST.
- REQUIREMENTS AND EXTENTS OF WORK PRIOR TO BIDDING. NO CHANGES IN THE CONTRACT WILL BE CONSIDERED FOR INFORMATION DISCERNABLE FROM THE PROJECT DOCUMENTS.
- CAULK ALL JOINTS BETWEEN DISSIMILAR MATERIALS FOR WEATHER TIGHT, WATER TIGHT, AIR TIGHT ETC. PERFORMANCE.

 EIFS PANEL FINISH REPLACEMENT SHALL MATCH EXISTING COLORS COLUMBIA, MO, UNDER GC SIRCAL CONSTRUCTION, CHRIS HENTGES.

STATE OF MISSOURI MICHAEL L. PARSON, **GOVERNOR**



Robert D. Rollings 2005001208, Certificate of Authority # A-2006003870



1806 West Broadway Boulevard Sedalia, MO 65301 660.829.9751



Broadfoot Engineering, LLC 30277 Carpenter Road Sedalia, MO 65301 Phone: 660-619-7001 broadfooteng@yahoo.com

OFFICE OF ADMINISTRATION DIVISION OF **FACILITIES** MANAGEMENT DESIGN AND CONSTRUCTION

REPLACE ROOF, **HOWERTON** STATE OFFICE BLDG.

615 HOWERTON CT. JEFFERSON CITY, MO 65109

PROJECT # O2015-02 SITE # 1025

ASSET # 3101025001

REVISION: DATE: REVISION: DATE: REVISION: DATE:

ISSUE DATE: 06/30/2023

CAD DWG FILE: G-02
DRAWN BY: AMK
CHECKED BY: RDR
DESIGNED BY: AMK


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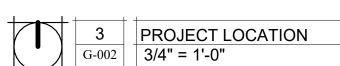
INFORMATION SHEET

SHEET NUMBER:

G-002

SHEET 2 OF 15 06/30/2023



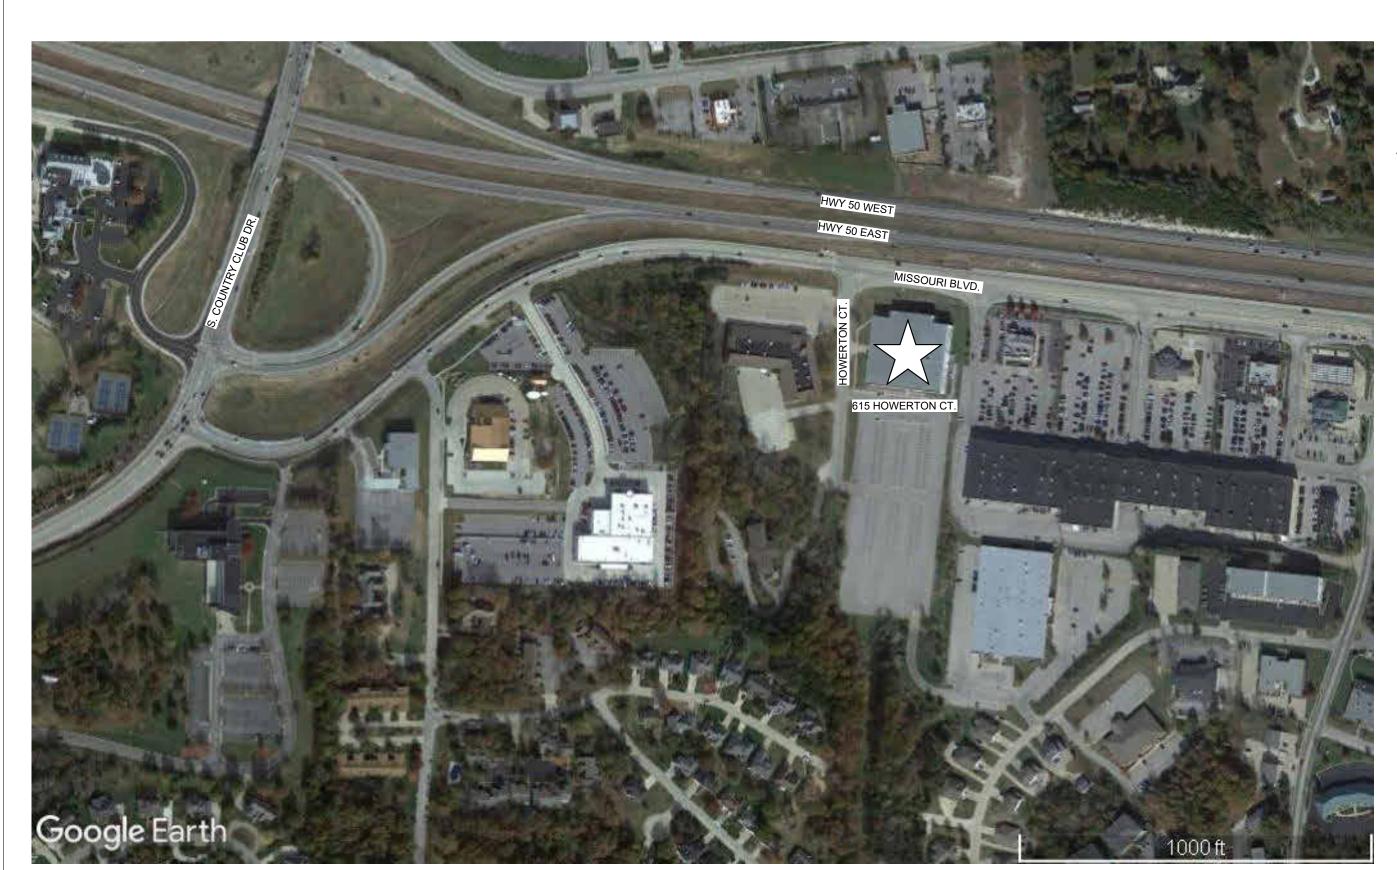

CONSTRUCTION NOTES

- 1. THE CONTRACTOR IS RESPONSIBLE FOR VERIFYING THE LOCATION OF EXISTING UTILITIES. CONTRACTOR SHALL REPAIR ALL UTILITIES DAMAGED BY CONTRACTOR'S ACTIVITIES AT NO EXPENSE TO THE OWNER.
- 2. CONTRACTOR IS RESPONSIBLE FOR SITE SAFETY.
- 3. ALL WORK WITHIN CITY RIGHT OF WAY SHALL BE DONE IN ACCORDANCE WITH CITY OF JEFFERSON CITY STANDARD DETAILS AND SPECIFICATIONS.
- 4. CONTRACTOR IS RESPONSIBLE FOR IMPLEMENTING BEST MANAGEMENT PRACTICE (BMP'S) AS SHOWN ON THE PLANS. BMP'S SHALL ME MAINTAINED AT ALL TIMES.
- 5. CONTRACTOR SHALL MAINTAIN ALL EROSION CONTROL MEASURES. REFER TO GRADING BID SET FOR
- 6. ALL PUBLIC ROADS MUST BE KEPT CLEAN AT ALL TIMES.
- 7. CONTRACTOR IS RESPONSIBLE FOR PATCHING ALL STREETS DAMAGED BY CONSTRUCTION ACTIVITIES OR
- 8. CONTRACTOR SHALL NOT INTERRUPT THE OWNERS CURRENT OPERATIONS.
- 9. CONTRACTOR SHALL BE RESPONSIBLE CONTROLLING DUST FROM JOBSITE ACTIVITIES.
- 10. ADJUST VALVE COVERS & UTILITY BOXES AS NECESSARY TO PROVIDE SMOOTH SURFACE.
- 11. ALL STORM PIPE OUTLETS TO HAVE RODENT SCREENS/ANIMAL BARRIERS.
- 12. ALL STORM STRUCTURES NYOPLAST UNLESS OTHERWISE SIZES NOTED FOR CONCRETE STRUCTURE.
- 13. ALL PIPE LENGTHS AND FLOW LINES TO CENTER OF STRUCTURE.

CONSTRUCTION QUALITY ASSURANCE REQUIREMENTS:

- 1. THE CONTRACTOR SHALL BE RESPONSIBLE FOR PROVIDING QUALITY ASSURANCE COMPACTION TESTING OF SUBGRADES AND CONTROLLED FILL MATERIALS AND FIELD SAMPLING AND TESTING.
- 2. STRIP A MINIMUM OF 12 INCHES OF TOPSOIL AND ROOT ZONES FROM ALL AREAS TO RECEIVE FILL.

3. ALL SITE FILL SHALL BE CONSTRUCTED IN UNIFORM HORIZONTAL LIFTS WITH A MAXIMUM LOOSE

- THICKNESS OF 8 INCHES. 4. ALL SUBGRADE SURFACES AND CONTROLLED FILL ARE TO BE COMPACTED TO A MINIMUM OF 95 PERCENT OF MAXIMUM DRY DENSITY AS DETERMINED IN ACCORDANCE WITH ASTM D 689 "STANDARD"
- POINTS ABOVE OPTIMUM MOISTURE CONTENT AS DETERMINED IN ACCORDANCE WITH ASTM D 698. 5. COMPACTION TESTS SHALL BE CONDUCTED IN ACCORDANCE WITH THE METHODS OF ASTM D 6938 OR

PROCTOR, AT A MOISTURE CONTENT BETWEEN 1 PERCENTAGE POINTS BELOW AND 5 PERCENTAGE

6. COMPACTION TESTS SHALL BE CONDUCTED AT THE RATE OF ONE TEST PER 10,000 SQUARE FEET OF SUBGRADE SURFACE AREA OR CONTROLLED FILL SURFACE AREA, WITH NO LESS THAN 2 TESTS PER EACH DAY'S SUBGRADE SURFACE AREA AND NOT LESS THAN 2 TESTS PER LIFT OF CONTROLLED FILL.

DEMOLITION NOTES:

- 1. CONTRACTOR SHALL COORDINATE ALL DEMOLITION WITH OWNER AND UTILITIES.
- 2. ALL OTHER ITEMS SHALL BE PROTECTED.
- 3. CONTRACTOR SHALL HAUL DISPOSAL ITEMS TO AN APPROVED LOCATION.

UTILITY NOTES

- 1. CONTRACTOR SHALL REFERENCE MEP PLANS FOR ADDITIONAL SITE UTILITY INFORMATION, INCLUDING UTILITY SERVICE CONNECTIONS TO BUILDING.
- 2. ALL CONSTRUCTION SHALL MEET APPLICABLE FEDERAL, STATE, AND LOCAL UTILITY REGULATIONS AND SPECIFICATIONS, MORE SPECIFICALLY CITY OF JEFFERSON CITY AND MISSOURI STATE REQUIREMENTS.
- 3. INSTALL CLEANOUTS AT ALL CHANGES IN ALIGNMENT AND AT A MAXIMUM SPACING OF 100 FEET.
- 4. CONTRACTOR IS RESPONSIBLE FOR ALL APPLICABLE FEES INCLUDING FOR BRINGING WATER TO SITE, TAPPING, INSTALLATION OF SERVICE LINE, PITS, BACKFLOW PREVENTER AND OTHER APPLICABLE REQUIREMENTS.
- 5. CUTTING AND REPAIRING/REPLACING STREET IS THE RESPONSIBILITY OF THE CONTRACTOR.
- 6. PIPE MATERIAL SHALL BE HDPE OR POLY.
- 7. ELECTRIC CONDUIT BY CONTRACTOR.
- 8. THE CONTRACTOR SHALL BE RESPONSIBLE FOR DETERMINING THE LOCATION OF EXISTING UTILITIES, AND FIELD VERIFY EXISTING FACILITY ALIGNMENTS, DEPTHS, AND ANGLES BEFORE BEGINNING WORK.

TEMPORARY TRAFFIC CONTROL NOTES:

- 2. ALL TRAFFIC CONTROL DEVICES AND TEMPORARY TRAFFIC CONTROL PLANS SHALL BE IN ACCORDANCE WITH THE MOST RECENT EDITION OF THE MANUAL ON UNIFORM TRAFFIC CONTROL DEVICES
- 3. THE CONTRACTOR IS SOLELY RESPONSIBLE FOR JOB SITE, WORKER, AND TRAFFIC SAFETY.

ALL UTILITIES SHOWN ARE BASED ON MARKINGS BY THE RESPECTIVE UTILITY COMPANIES,

PRIVATE WATER LINES WERE NOT MARKED BEYOND THE WATER METERS, AND IN SOME CASES, THE WATER COMPANY DID NOT MARK WATER MAINS, WHERE STRUCTURES WOULD

PRIVATE SANITARY SEWER LINES WERE NOT MARKED, BUT OBSERVABLE CLEAN-OUTS WERE LOCATED IN THE FIELD, AND ARE SHOWN. NO PUBLIC SEWER WAS MARKED WITHIN THE PROJECT LIMITS.

PRIVATE ELECTRIC, TELEPHONE, AND CATV LINES WERE NOT MARKED; BUT OBSERVABLE

ALL UTILITIES SHOULD BE LOCATED AND VERIFIED BEFORE ANY CONSTRUCTION SHOULD

PROPERTY OWNER

STATE OF MISSOURI 615 HOWERTON COURT JEFFERSON CITY, MO 65109

FLOODPLAIN NOTE

THIS PROPERTY IS LOCATED IN ZONE "X" AREAS DETERMINED TO BE OUTSIDE THE 0.2% ANNUAL CHANCE FLOODPLAIN, AS SHOWN BY FLOOD INSURANCE RATE MAP NUMBER 2902830005C, DATED JANUARY 5, 1996.

SURVEY CONTROL POINTS

POINT #	<u>NORTH</u>	<u>EAST</u>	ELEVATION	<u>DESCRIPTION</u>
CP1	1000654.14	1711824.43	767.97	NAIL LOCATED 28.99' EAST OF NE RET. WALL CORNER ON EAST SIDE OF BLDG
CP2	1000532.55	1711527.83	766.21	CUT CHISEL LOCATED 58.55' SOUTH OF SE BUILDING CORNER

IFCENID

LEGEN	ND
	STORM SEWER LINE SANITARY SEWER LINE GAS LINE UNDERGROUND TELEPHONE LINE UNDERGROUND ELECTRIC LINE
	PROPOSED SURFACE CONTOUR PROPOSED STORM SEWER LINE PROPOSED SANITARY SEWER LINE PROPOSED GAS LINE PROPOSED WATER LINE PROPOSED UNDERGROUND ELECTRIC LINE SILT FENCE
	SILI FENUE

TOP OF CURB ELEVATION
TOP OF PAVEMENT ELEVATION

- SHORTENED DIGIT DISPLAY)

PROPOSED CONCRETE PAVEMENT

FINISH GRADE ELEVATION (ADD 700

- 1. ALL TRAFFIC CONTROL SHALL BE PER CURRENT MUTCD REQUIREMENTS AND SHALL BE THE RESPONSIBILITY OF THE CONTRACTOR. A TRAFFIC CONTROL PLAN WILL BE REQUIRED FOR ANY WORK WITHIN THE RIGHT-OF-WAY.

THE OWNERS, AND BY OBSERVABLE SURFACE STRUCTURES, AS FOUND IN THE FIELD.

INDICATE ONE EXISTED (i.e. FIRE HYDRANT OR WATER VALVE).

PRIVATE UTILITIES WERE LOCATED IN THE FIELD, AND ARE SHOWN.

GOVERNOR

STATE OF MISSOURI MICHAEL L. PARSON,

Theron J. Broadfoot, PE-2009015435 MO CERTIFICATE OF AUTHORITY # 2018030429





660.829.9751

Broadfoot Engineering, LLC 30277 Carpenter Road Sedalia, MO 65301 Phone: 660-619-7001 broadfooteng@yahoo.com

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REPLACE ROOF, **HOWERTON** STATE OFFICE BLDG.

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PROJECT # O2015-02 SITE # 1025

ASSET # 3101025001

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DATE: ISSUE DATE: 06/30/2023


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DESIGNED BY: TJB SHEET TITLE:

CIVIL COVER SHEET

SHEET NUMBER:

SHEET 3 OF 15 06/30/2023



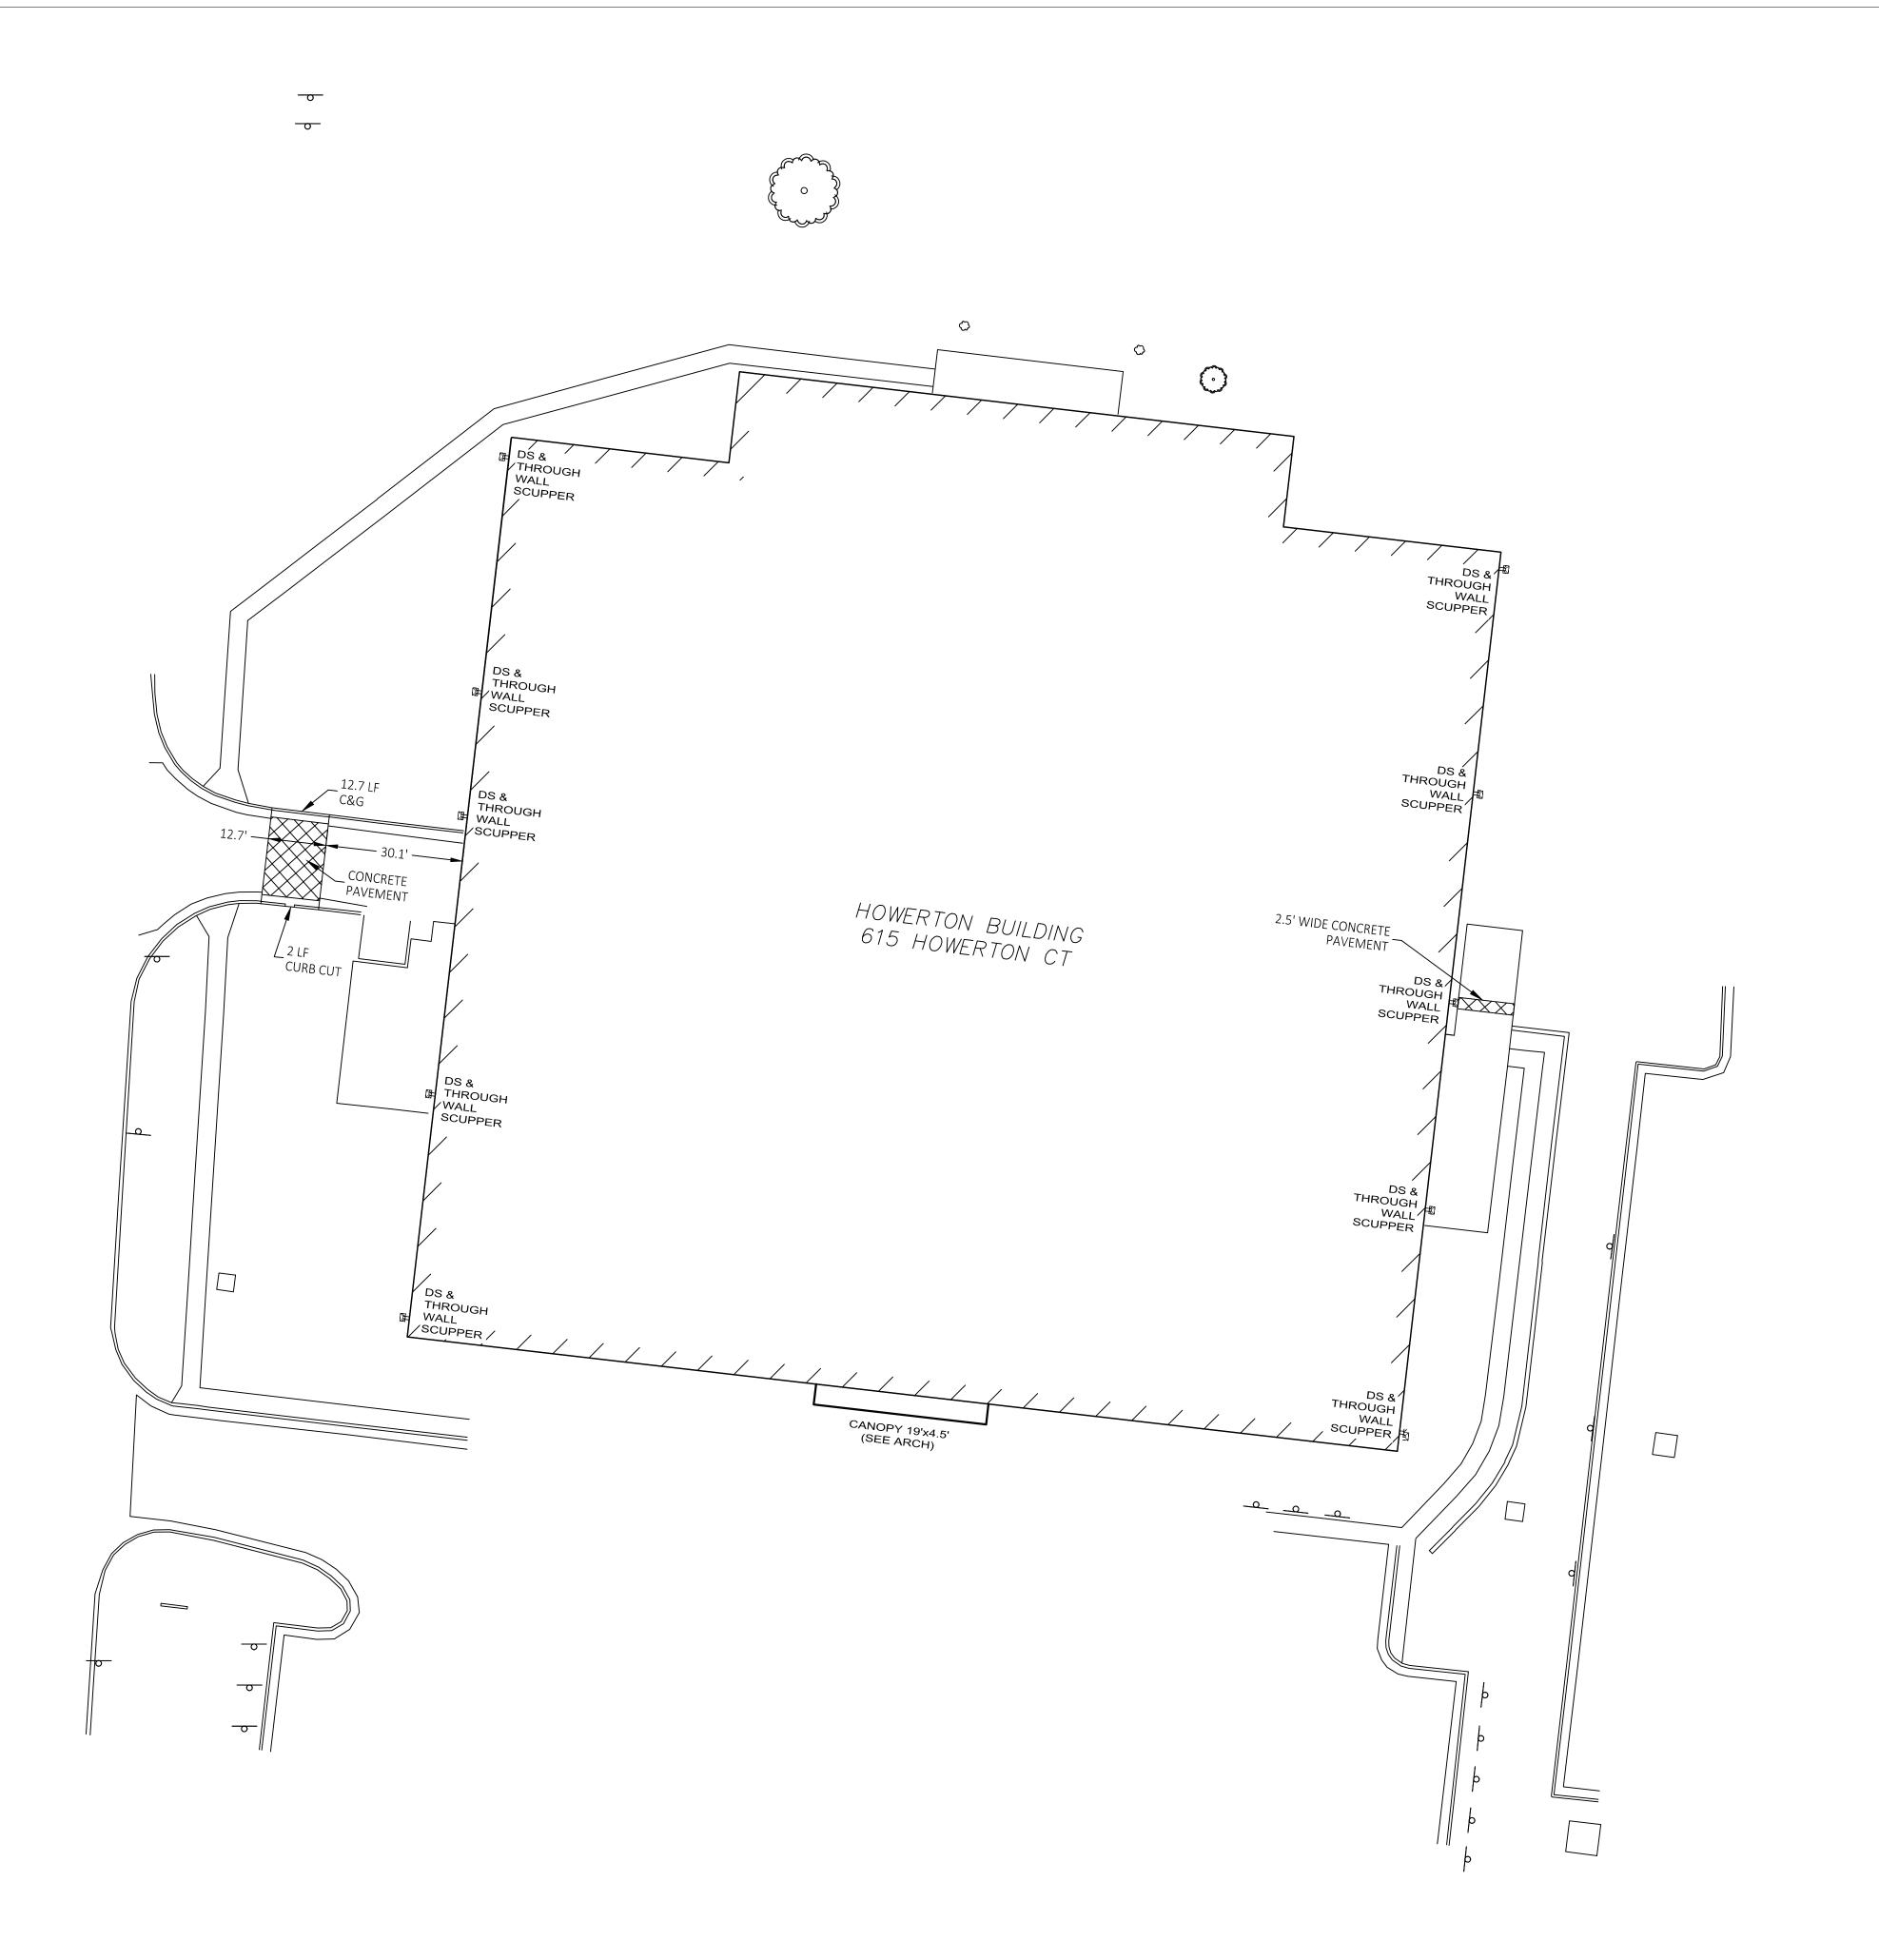



Theron J. Broadfoot, PE-2009015435 JUNE 30, MO CERTIFICATE OF AUTHORITY # 2018030429

SCALE 1" = 20'



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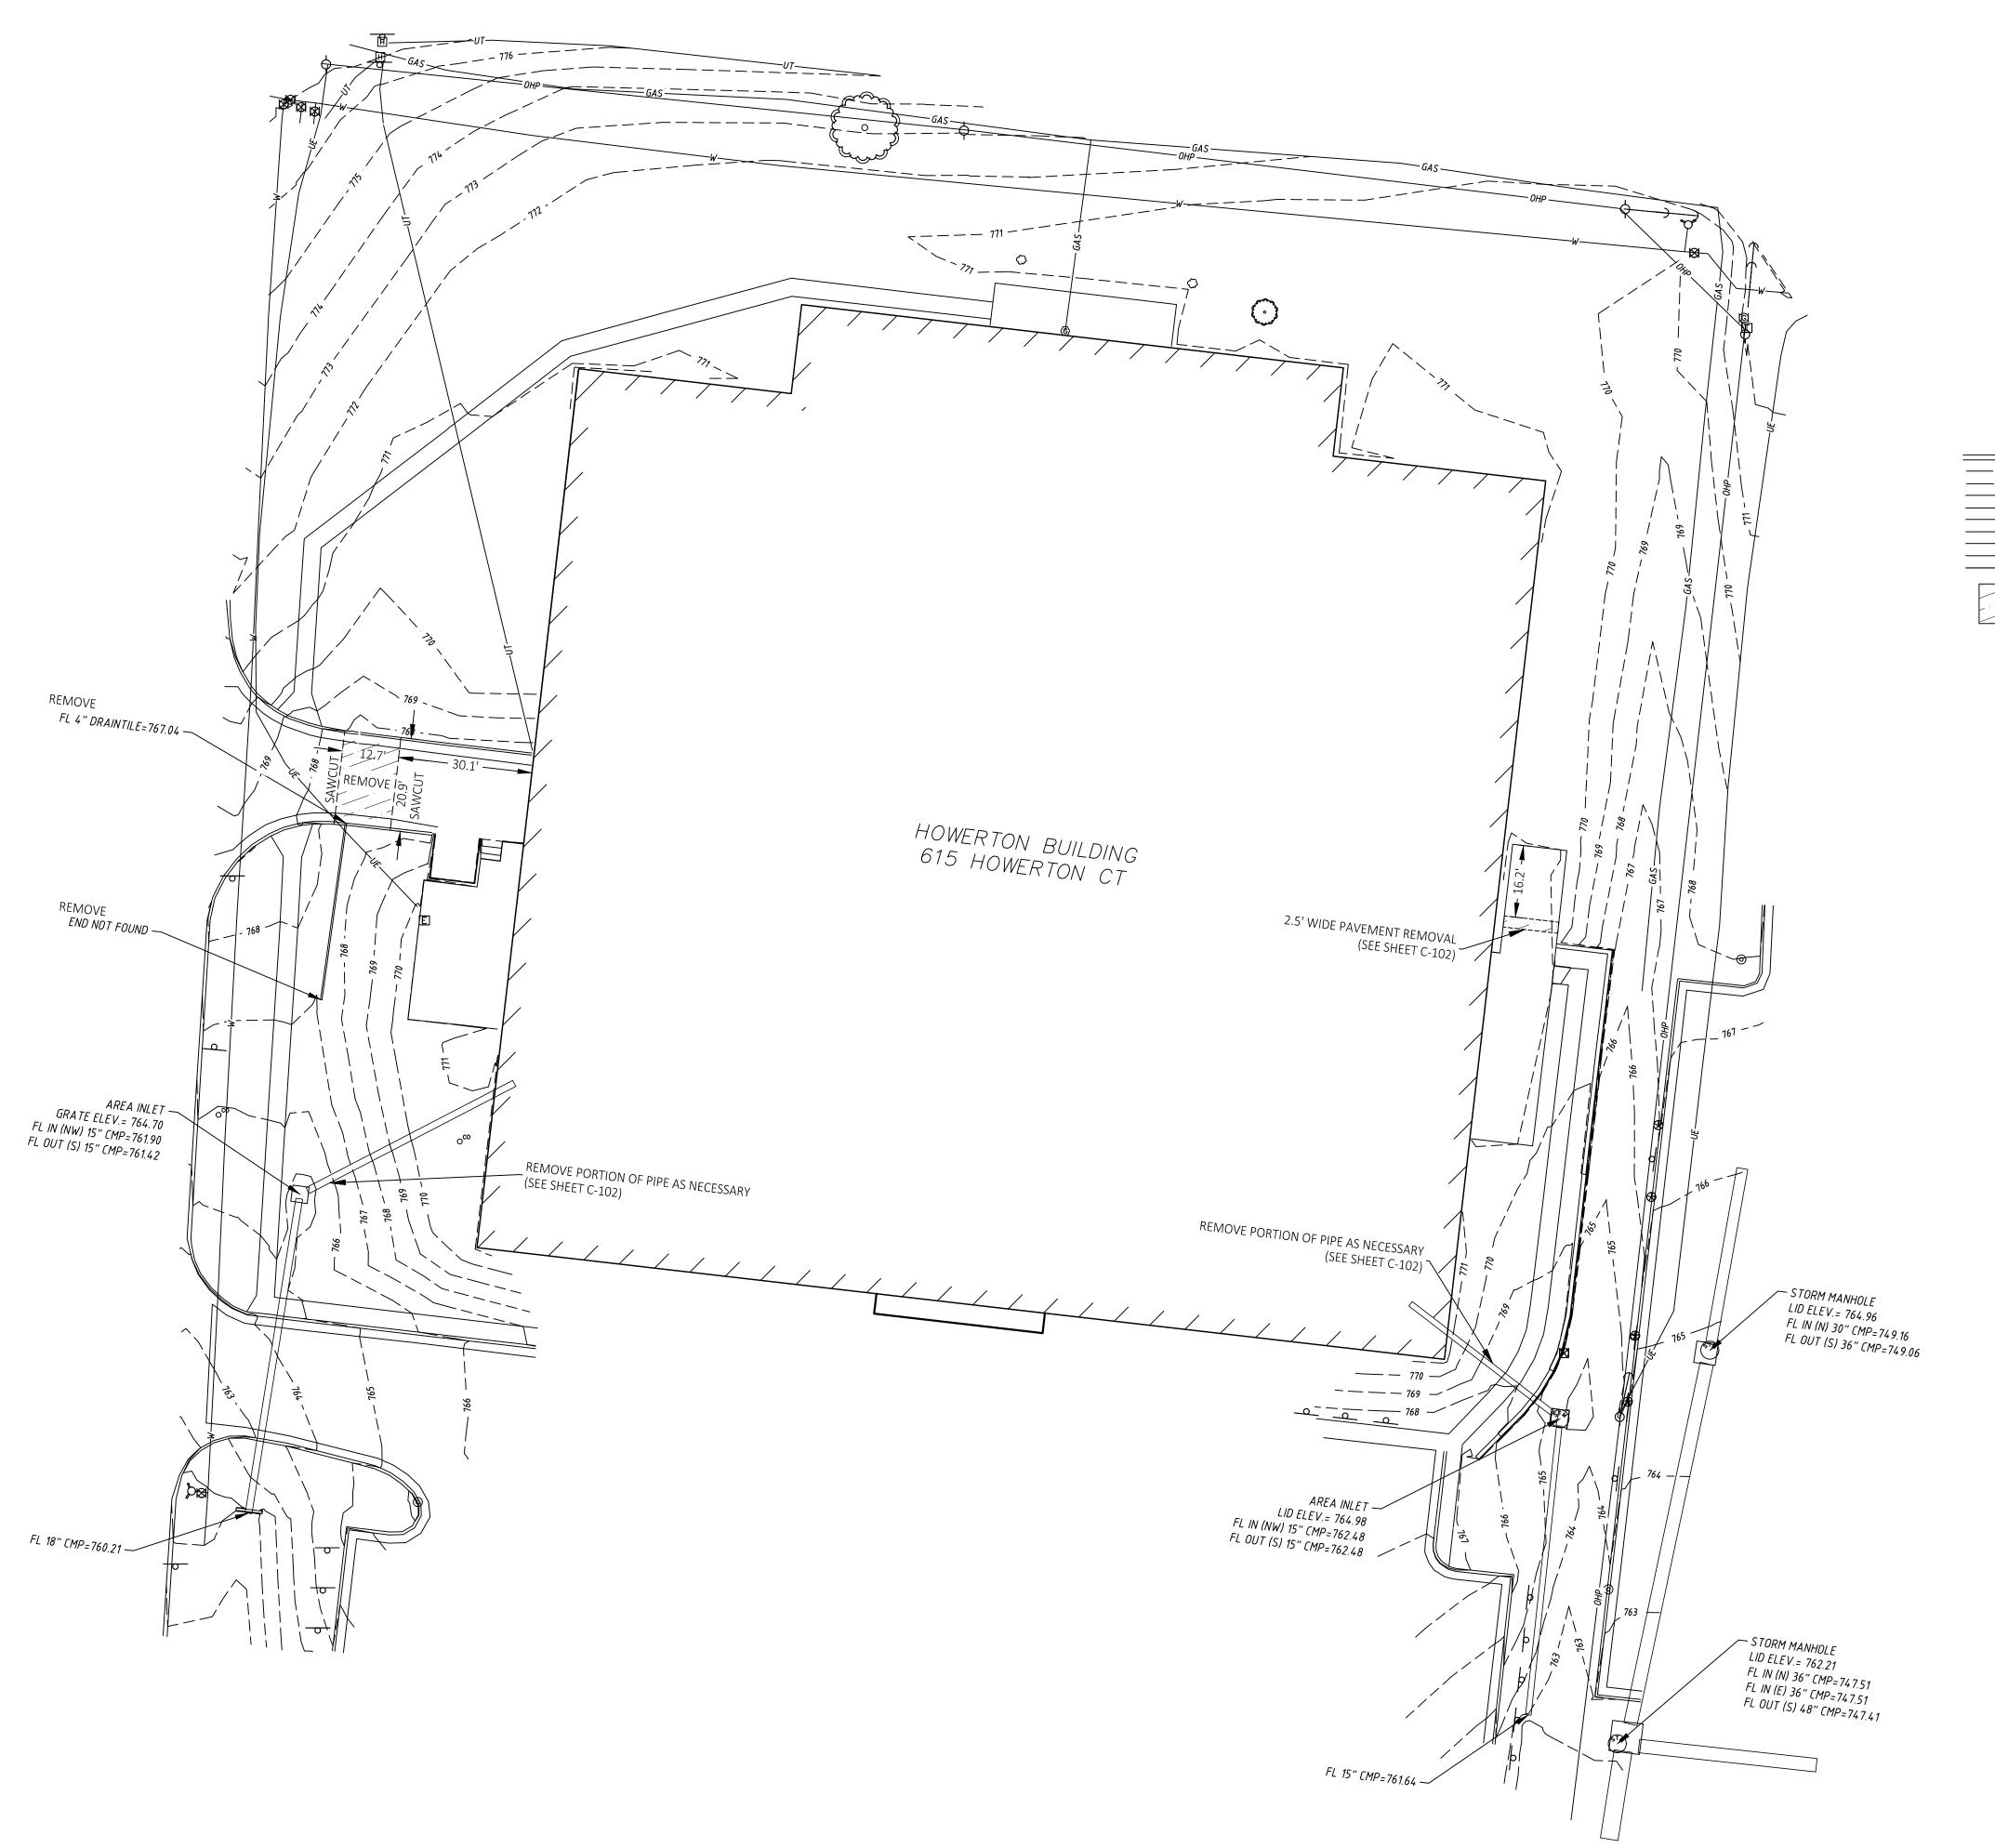
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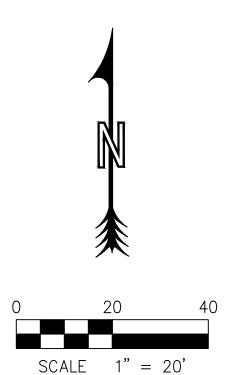
SITE LAYOUT PLAN

SHEET NUMBER:

C-100

SHEET 4 OF 15 06/30/2023





LEGEND

	<u> </u>
	EXISTING SURFACE FENCE LINE STORM SEWER LINE
SAN	SANITARY SEWER LINE GAS LINE UNDERGROUND TEL UNDERGROUND ELE WATER LINE
	SILT FENCE
	BASE BID DEMOLITI

CONTOUR ELEPHONE LINE LECTRIC LINE

ITION/ REMOVE CONCRETE PAVEMENT

DEMOLITION NOTES

- CONTRACTOR SHALL DEMOLITION PER PLANS AND IN COORDINATION WITH OWNER AND UTILITIES.
- 2. ALL OTHER ITEMS SHALL BE PROTECTED.
- CONTRACTOR SHALL HAUL DISPOSAL ITEMS TO AN APPROVED LOCATION.

UTILITY DISCLAIMER:
ALL UTILITIES SHOWN ARE BASED ON MARKINGS BY THE RESPECTIVE UTILITY
COMPANIES, THE OWNERS, AND BY OBSERVABLE SURFACE STRUCTURES, AS
FOUND IN THE FIELD.

PRIVATE WATER LINES WERE NOT MARKED BEYOND THE WATER METERS, AND IN SOME CASES, THE WATER COMPANY DID NOT MARK WATER MAINS, WHERE STRUCTURES WOULD INDICATE ONE EXISTED (i.e. FIRE HYDRANT OR WATER

PRIVATE SANITARY SEWER LINES WERE NOT MARKED, BUT OBSERVABLE CLEAN—OUTS WERE LOCATED IN THE FIELD, AND ARE SHOWN. NO PUBLIC SEWER WAS MARKED WITHIN THE PROJECT LIMITS.

PRIVATE ELECTRIC, TELEPHONE, AND CATV LINES WERE NOT MARKED; BUT OBSERVABLE PRIVATE UTILITIES WERE LOCATED IN THE FIELD, AND ARE SHOWN. ALL UTILITIES SHOULD BE LOCATED AND VERIFIED BEFORE ANY CONSTRUCTION SHOULD COMMENCE.

STATE OF MISSOURI MICHAEL L. PARSON, **GOVERNOR**



Theron J. Broadfoot, PE-2009015435 MO CERTIFICATE OF AUTHORITY # 2018030429



Robert Rollings Architects LLC 1806 West Broadway Boulevard Sedalia, MO 65301 660.829.9751



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DESIGNED BY: TJB—


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EXISTING CONDITIONS & DEMOLITION PLAN

SHEET NUMBER:

C-101


SHEET 5 OF 15 06/30/2023



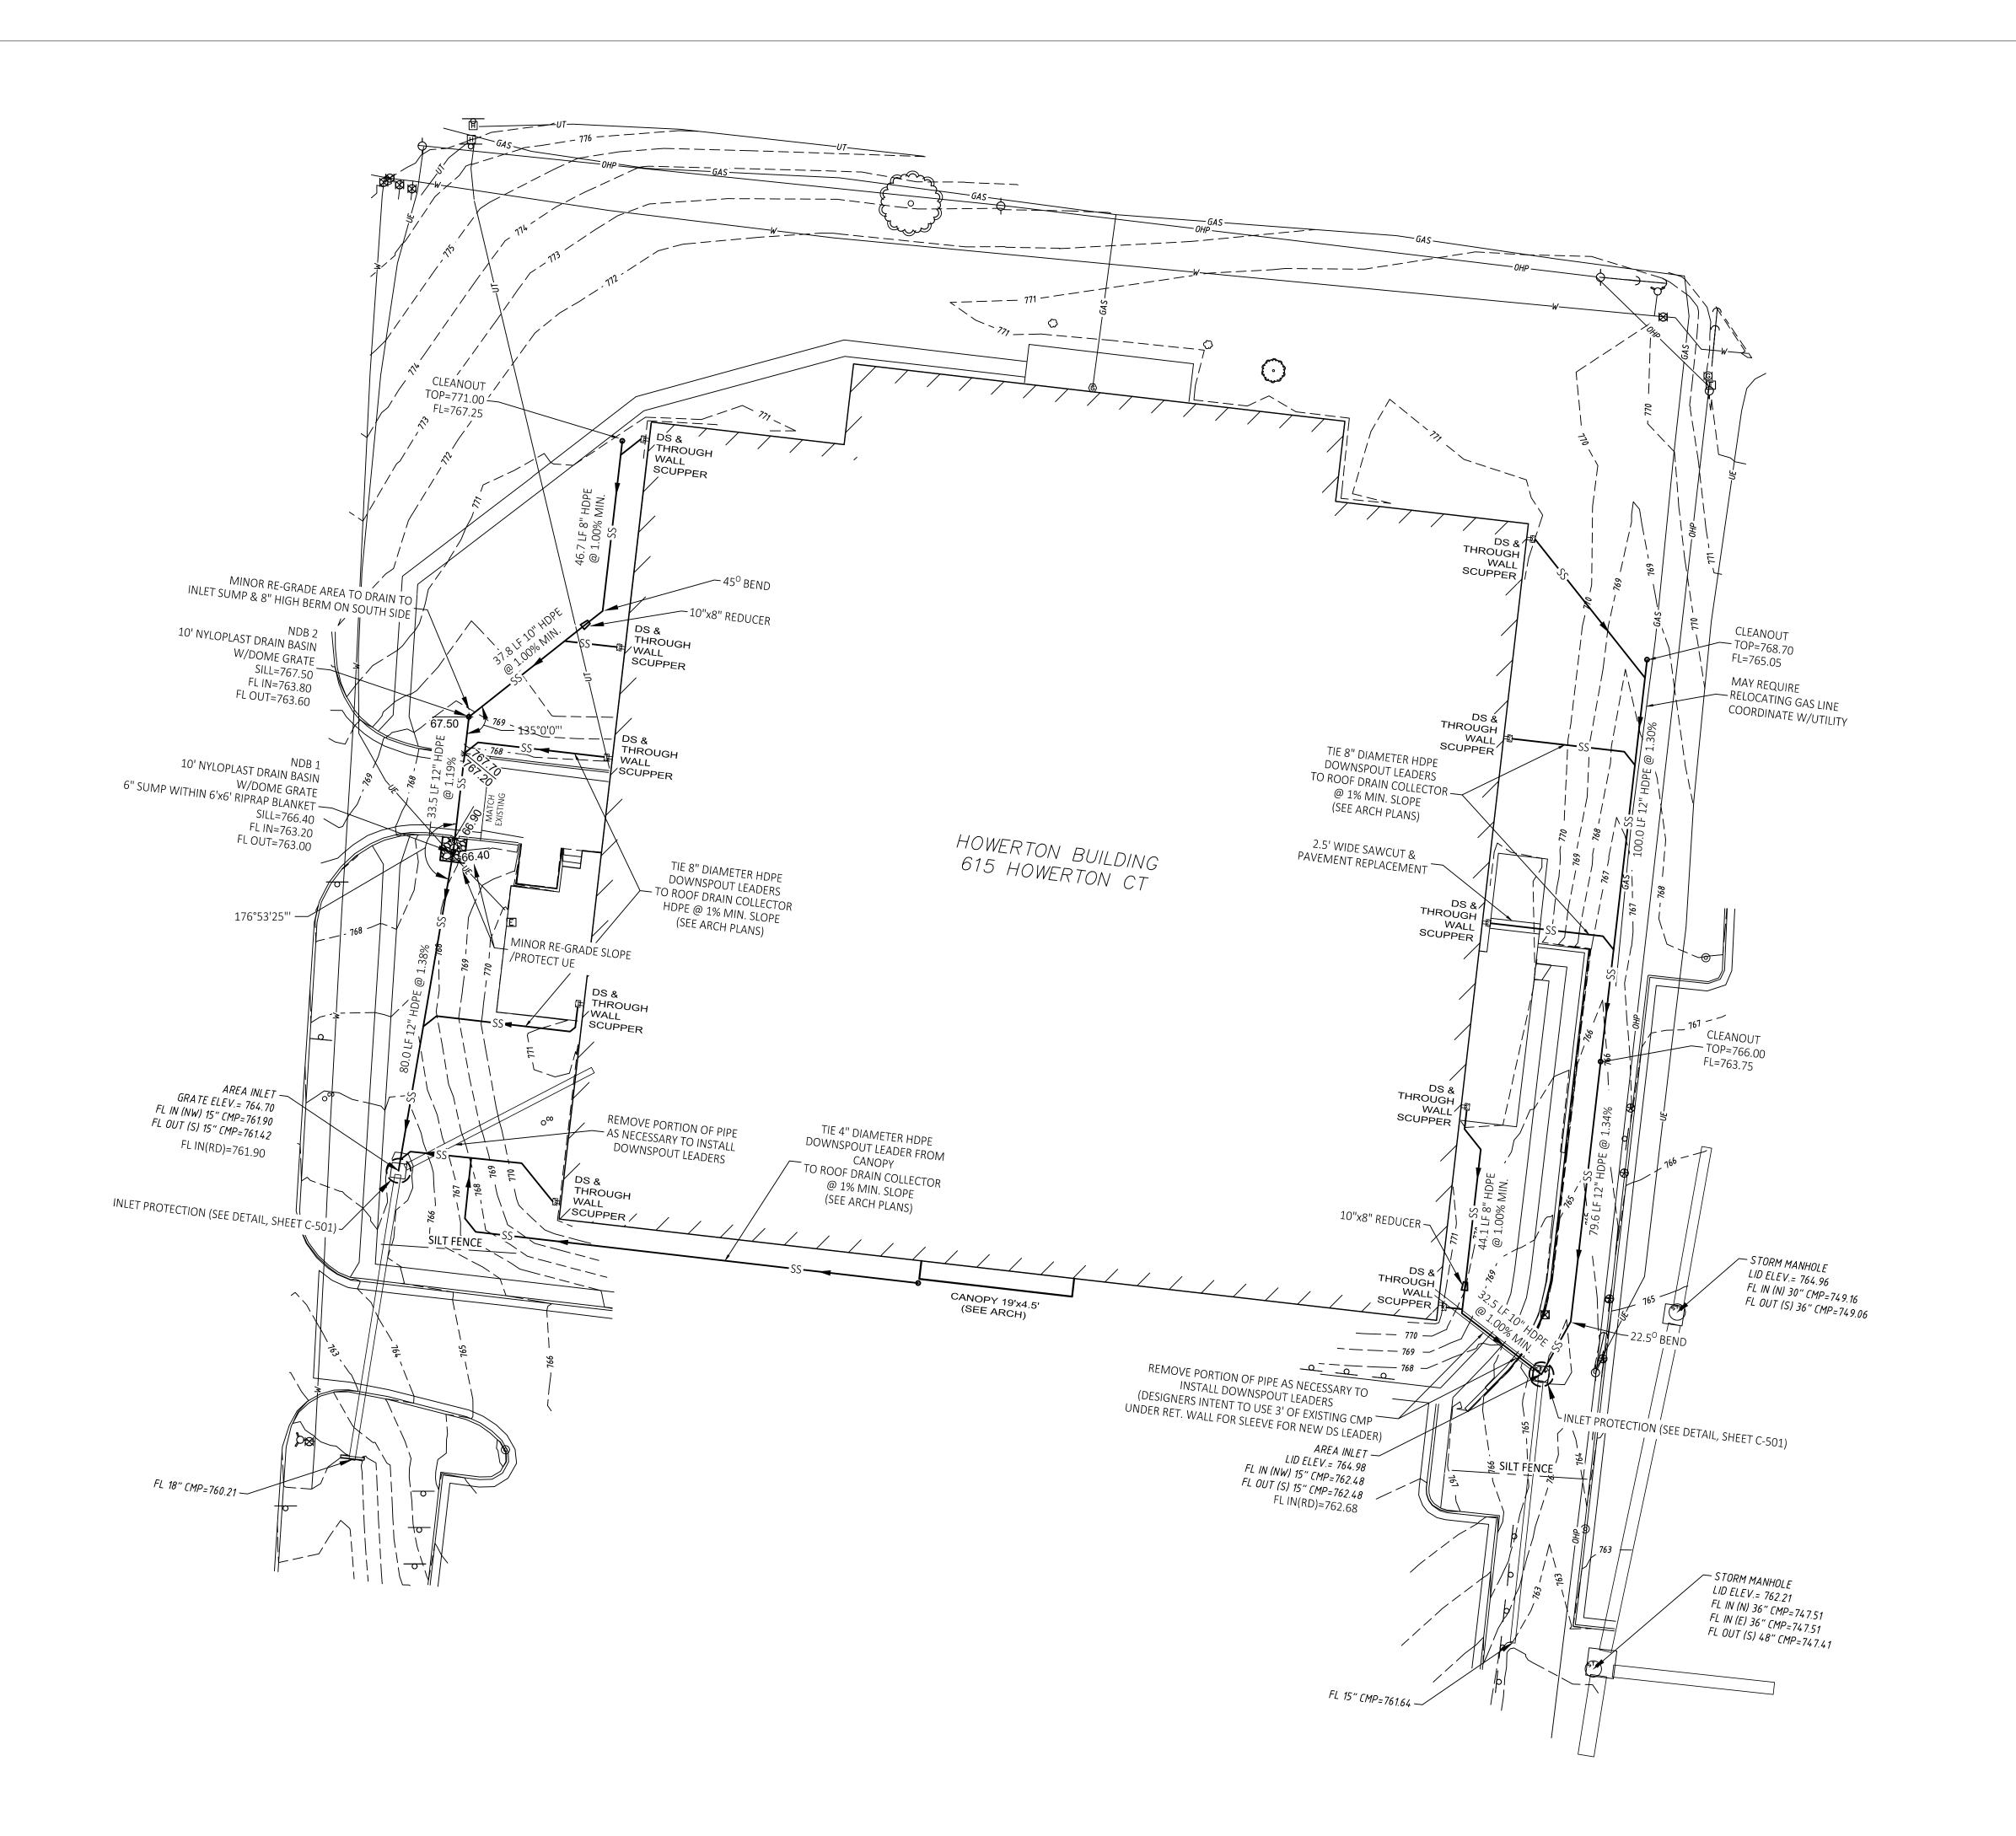

Theron J. Broadfoot, PE-2009015435 MO CERTIFICATE OF AUTHORITY # 2018030429

SCALE 1" = 20'

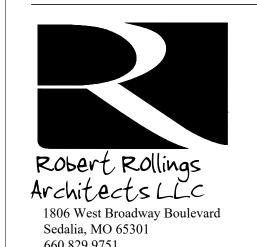



660.829.9751

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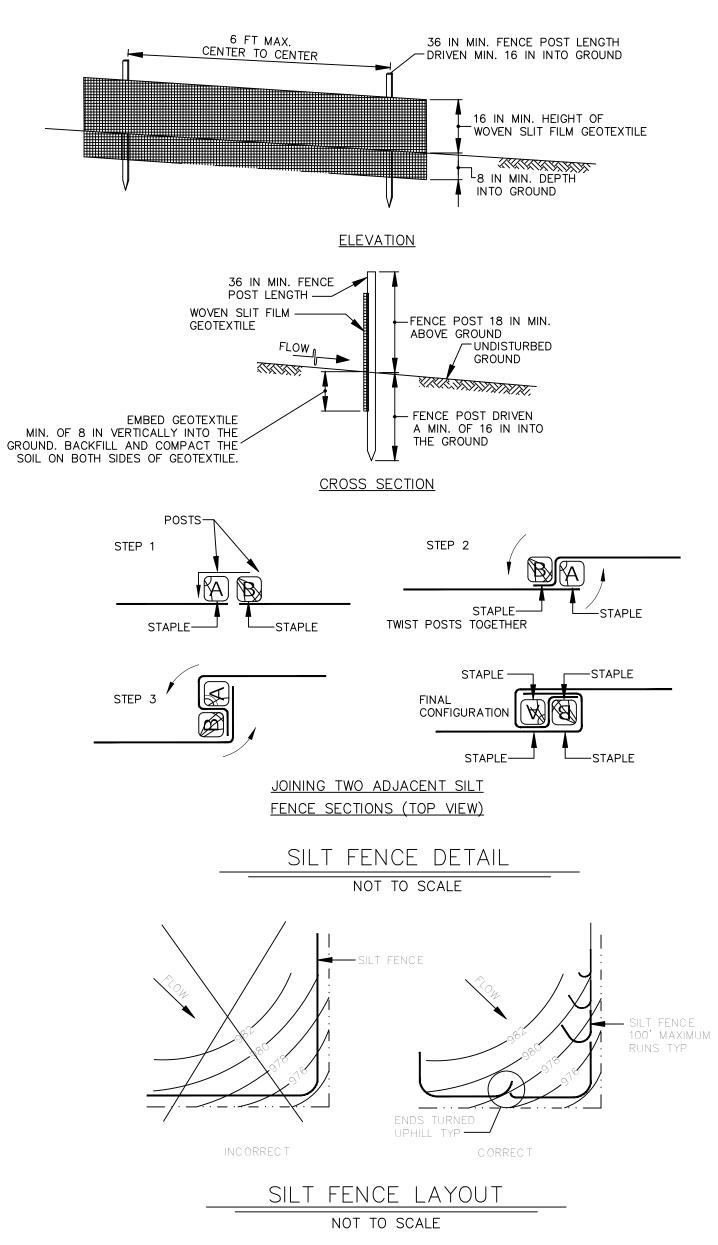
CAD DWG FILE:
DRAWN BY: TJB
CHECKED BY: TJB
DESIGNED BY: TJB

SHEET TITLE: GRADING & DRAINAGE & **EROSION CONTROL PLAN**

SHEET NUMBER:


C-102

SHEET 6 OF 15 06/30/2023



SILT FENCE SPECIFICATIONS

- 1. USE WOOD POSTS $1\frac{7}{4}$ X $1\frac{7}{4}$ \pm $\frac{7}{16}$ INCH (MINIMUM) SQUARE CUT OF SOUND QUALITY HARDWOOD. AS AN ALTERNATIVE TO WOODEN POST USE STANDARD "T" OR "U" SECTION STEEL POSTS WEIGHING NOT LESS THAN 1 POUND PER LINEAR FOOT.
- 2. USE 36 INCH MINIMUM POSTS DRIVEN 16 INCH MINIMUM INTO GROUND NO MORE THAN 6 FEET APART.
- 3. USE WOVEN SLIT FILM GEOTEXTILE AS SPECIFIED IN SECTION H-1 MATERIALS AND FASTEN GEOTEXTILE SECURELY TO UPSLOPE SIDE OF FENCE POSTS WITH WIRE TIES OR STAPLES AT TOP AND MID-SECTION.
- 4. PROVIDE MANUFACTURER CERTIFICATION TO THE AUTHORIZED REPRESENTATIVE OF THE INSPECTION/ENFORCEMENT AUTHORITY SHOWING THAT THE GEOTEXTILE USED MEETS THE REQUIREMENTS IN SECTION H-1 MATERIALS.
- 5. EMBED GEOTEXTILE A MINIMUM OF 8 INCHES VERTICALLY INTO THE GROUND. BACKFILL AND COMPACT THE SOIL ON BOTH SIDES OF FABRIC.
- 6. WHERE TWO SECTIONS OF GEOTEXTILE ADJOIN: OVERLAP, TWIST, AND STAPLE TO POST IN ACCORDANCE
- 7. EXTEND BOTH ENDS OF THE SILT FENCE A MINIMUM OF FIVE HORIZONTAL FEET UPSLOPE AT 45 DEGREES TO THE MAIN FENCE ALIGNMENT TO PREVENT RUNOFF FROM GOING AROUND THE ENDS OF THE SILT FENCE.
- 8. REMOVE ACCUMULATED SEDIMENT AND DEBRIS WHEN BULGES DEVELOP IN SILT FENCE OR WHEN SEDIMENT REACHES 25% OF FENCE HEIGHT. REPLACE GEOTEXTILE IF TORN. IF UNDERMINING OCCURS, REINSTALL

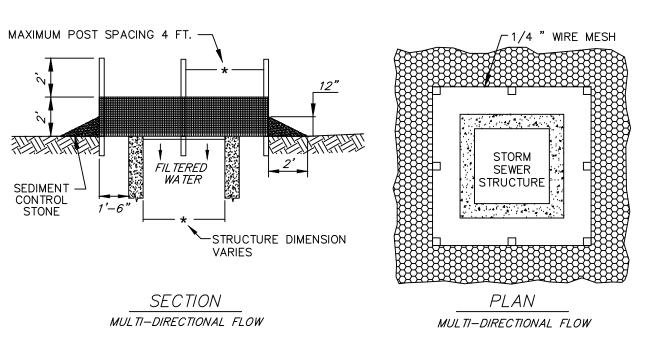

NOTES:


1. CONTRACTOR SHALL PROVIDE INLET PROTECTION PER DETAIL OR SUBMIT EQUAL TO BE APPROVED BY DESIGNER (FILTER SOCK, STRAW WATTLE, ETC.).

2. SEDIMENT CONTROL STONE SHALL BE 3/4" WASHED STONE.

- 3. WIRE MESH SHALL BE HARDWARE CLOTH 23 GAUGE MIN. AND SHALL HAVE 1/4 INCH MESH OPENINGS.
 4. TOP OF WIRE MESH SHALL BE A MINIMUM OF ONE FOOT BELOW THE SHOULDER OR ANY DIVERSION POINT.
 5. STEEL POST SHALL BE 5 FT. IN HEIGHT, BE INSTALLED 1.5 FT. DEEP MINIMUM, AND BE OF THE
- SELF—FASTENER ANGLE STEEL TYPE. 6. WOOD POST SHALL BE 6 FT. IN HEIGHT, BE INSTALLED TO 1.5 FT. DEEP MINIMUM, AND BE 3 INCHES IN
- 7. POST SPACING SHALL BE A MAXIMUM OF 4 FT.

INLET PROTECTION

NOT TO SCALE

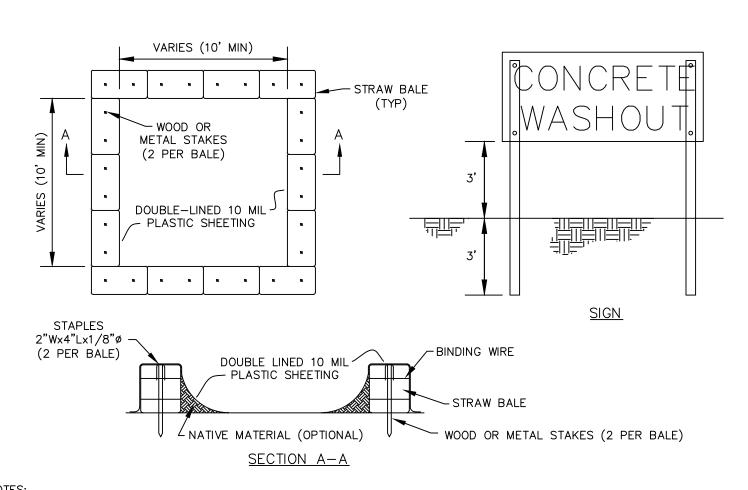


CONTRACTOR SHALL COORDINATE APPROPRIATE LOCATION IN THE FIELD WITH THE OWNER.
 ALL CONCRETE WASTE MATERIAL, INCLUDING WASHOUT WATER, SHALL BE TOTALLY CONTAINED.


- 3. UPON PROJECT COMPLETION CONTRACTOR SHALL REMOVE AND DISPOSE OF ALL CONCRETE WASTE FROM THE OWNER'S PROPERTY PER ALL APPLICABLE SOLID WASTE REGULATIONS.
- PROPERTY PER ALL APPLICABLE SOLID WASTE REGULATIONS.


 4. CONSTRUCT SIGN OF WEATHER PROOF MATERIALS OF A SIZE EASILY READABLE BY CONCRETE TRUCK DRIVERS. PLACE
- SIGN WITHIN 10' OF WASHOUT.
 5. CONTRACTOR SHALL CONTAIN WASHOUT WATERS AT ALL TIMES.


CONCRETE WASHOUT AREA

NOT TO SCALE

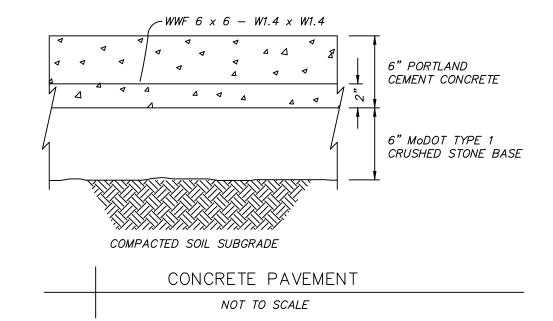

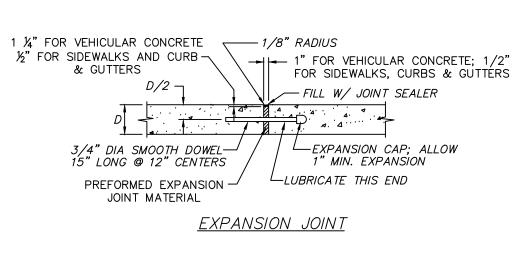

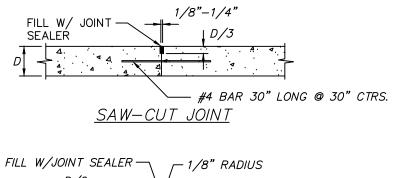

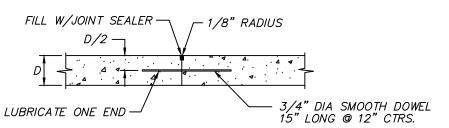

CONSTRUCTION JOINT

NOTES:
1. PRIOR TO CONSTRUCTION, CONTRACTOR SHALL SUBMIT A PAVEMENT JOINT PLAN OF ALL

- CONCRETE PAVEMENT FOR APPROVAL.

 2. CONCRETE PAVEMENT SHALL HAVE SAW—CUT OR CONSTRUCTION JOINTS EVERY 10 FEET FOR 4 INCH THICK PAVEMENT, 12 FEET FOR 5 INCH THICK PAVEMENT, AND 15 FEET FOR 6 INCH THICK PAVEMENT OR GREATER. PANELS SHALL BE CUT SUCH THAT PANELS ARE NEARLY SQUARE AND DO NOT EXCEED 1.4 LENGTH TO WIDTH RATIO. EXPANSION JOINTS SHALL BE PROVIDED AT ALL FIXED STRUCTURES, SUCH AS: LIGHT STANDARD FOUNDATIONS, SEWER STRUCTURES, BUILDINGS, WALLS, BOTTOM OF STAIRS, ROOF DRAINS, ETC., AND EVERY 150 FEET MAXIMUM. DOWEL BARS SHALL BE PROVIDED AT TRANSVERSE JOINTS IN ALL HEAVY DUTY PAVEMENT.
- THIS DETAIL APPLIES TO ALL CONCRETE PAVEMENT FOR PARKING LOTS, DRIVE/ACCESS AISLES, CURBS & GUTTERS, AND SIDEWALKS.
- 4. ALL 9 INCH THINK HEAVY DUTY CONCRETE PAVEMENT SHALL HAVE JOINTS PER MODOT DETAILS, INCLUDING 1.25 INCH SMOOTH DOWELS WITH DOWEL SUPPORT BASKETS PER MODOT DETAIL AND
- LONGITUDINAL JOINTS WITH #5 X 30" TIE BARS.
 5. INCLUDE BAR WITH TRANSVERSE SAW-CUT JOINTS FOR HEAVY DUTY PAVEMENT. OMIT BAR WITH
- SAW-CUT JOINTS FOR STANDARD DUTY PAVEMENT AND SIDEWALKS.
 6. PROVIDE CONSTRUCTION JOINT AT END OF DAYS WORK OR IF CONCRETE PLACEMENT IS
- SUSPENDED FOR MORE THAN 30 MINUTES.

 7. SAW-CUT JOINTS SHALL BE CUT WITHIN 12 HOURS OF INITIAL SET OF CONCRETE. RAVELED JOINTS
- WILL NOT BE ACCEPTED.

 8. ELASTOMERIC POLYURETHANE JOINT SEALANT IS REQUIRED FOR ALL JOINTS AND SHALL BE LIGHT
- GRAY IN COLOR.

 9. OMIT DOWEL BARS FOR EXPANSION JOINTS AT BUILDINGS, LIGHT STANDARDS, AND ROOF DRAINS.

CONCRETE PAVEMENT JOINTS

NOT TO SCALE

STATE OF MISSOURI MICHAEL L. PARSON, GOVERNOR



Theron J. Broadfoot, PE-2009015435 JUNE MO CERTIFICATE OF AUTHORITY # 2018030429





Broadfoot Engineering, LLC 30277 Carpenter Road Sedalia, MO 65301 Phone: 660-619-7001 broadfooteng@yahoo.com

OFFICE OF ADMINISTRATION DIVISION OF FACILITIES MANAGEMENT DESIGN AND CONSTRUCTION

REPLACE ROOF, HOWERTON STATE OFFICE BLDG.

615 HOWERTON CT. JEFFERSON CITY, MO 65109

PROJECT # O2015-02 SITE # 1025

ASSET # 3101025001

REVISION:
DATE:
REVISION:
DATE:
REVISION:
DATE:
REVISION:

ISSUE DATE: 06/30/2023

CAD DWG FILE:

DRAWN BY: TJB

CHECKED BY: TJB

DESIGNED BY: TJB


SHEET TITLE:

DETAILS

SHEET NUMBER:

C-501

SHEET 7 OF 15 06/30/2023

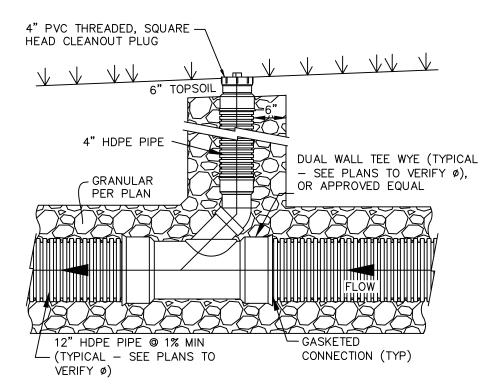

NON-TRAFFIC INSTALLATION

- 1. SEE PLANS TO DETERMINE IF FITTINGS AND JOINTS ARE SOIL TIGHT (ST) OR
- WATER TIGHT (WT). 2. INSTALL ALL PIPING PER SEPARATE DETAIL OR MANUFACTURER'S WRITTEN
- INSTRUCTIONS. 3. THIS DETAIL IS FOR GENERAL LAYOUT PURPOSES ONLY. ADDITIONAL COUPLERS, GASKETS, FITTINGS, ETC. MAY BE NECESSARY PER MANUFACTURER'S REQUIREMENTS.
- 4. CLEAN OUT PLUG SHALL BE SET FLUSH WITH FINISH GRADE. 5. TWO WAY CLEANOUT CONSTRUCTION SHALL INCLUDE INSTALLATION OF TWO
- CLEANOUTS AS SHOWN WITHIN 5' OF EACH OTHER, TEE WYE'S INSTALLED IN 6. SDR35 PVC PIPE MAY BE SUBSTITUTED FOR ANY HDPE PIPE UP TO 15" DIAMETER.
- TRAFFIC/PAVED INSTALLATION
- 1. SEE PLANS TO DETERMINE IF FITTINGS AND JOINTS ARE SOIL TIGHT (ST) OR WATER TIGHT (WT).

- CAST IRON INSPECTION FRAME AND LID

OR APPROVED EQUAL

CPAVEMENT PER PLAN

DUAL WALL TEE WYE (TYPICAL

- SEE PLANS TO VERIFY Ø),

CONNECTION (TYP)

2. INSTALL ALL PIPING PER SEPARATE DETAIL OR MANUFACTURER'S WRITTEN

FRAME SET IN -

24"x24"x6" THICK ↑ CONCRETE PAD ↑ 24"x24"x6" THICK

4" HDPE PIPE -

∠ GRANULAR

PER PLAN


-(TYPICAL - SEE PLANS TO

VERIFY Ø)

BITUMASTIC MATERIAL

- INSTRUCTIONS. 3. THIS DETAIL IS FOR GENERAL LAYOUT PURPOSES ONLY. ADDITIONAL COUPLERS,
- GASKETS, FITTINGS, ETC. MAY BE NECESSARY PER MANUFACTURER'S REQUIREMENTS. CAST IRON TOP SHALL BE SET FLUSH WITH FINISH GRADE.
- CONCRETE SHALL BE 4,000 PSI MIX, MINIMUM. TWO WAY CLEANOUT CONSTRUCTION SHALL INCLUDE INSTALLATION OF TWO
- CLEANOUTS AS SHOWN WITHIN 5' OF EACH OTHER, TEE WYE'S INSTALLED IN OPPOSITE DIRECTIONS. 7. SDR35 PVC PIPE MAY BE SUBSTITUTED FOR ANY HDPE PIPE UP TO 15" DIAMETER.
- HDPE STORM SEWER CLEANOUT

NOT TO SCALE

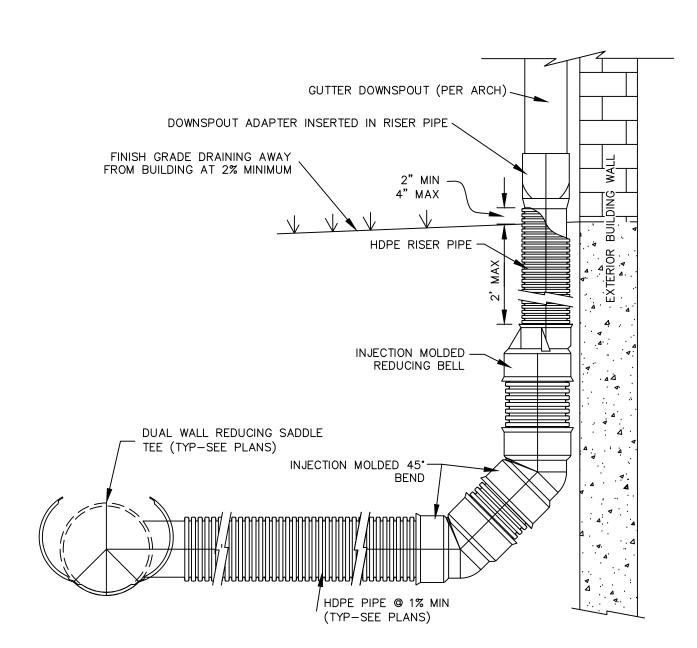


1. SEE PLANS TO DETERMINE IF FITTINGS AND JOINTS ARE SOIL TIGHT (ST) OR WATER TIGHT (WT).

- INSTALL ALL PIPING PER SEPARATE DETAIL OR MANUFACTURER'S WRITTEN INSTRUCTIONS. THIS DETAIL IS FOR GENERAL LAYOUT PURPOSES ONLY. ADDITIONAL COUPLERS, GASKETS, FITTINGS, ETC. MAY BE NECESSARY PER MANUFACTURER'S REQUIREMENTS. 4. IF GUTTER DOWNSPOUT SIZE EXCEEDS THE LARGEST AVAILABLE HANCOR DOWNSPOUT ADAPTER, THE HDPE PIPE SIZE
- SHALL BE INCREASED TO ACCOMMODATE THE DOWNSPOUT AND THE DOWNSPOUT ADAPTER SHALL BE REPLACED WITH AN HDPE END CAP PREFABRICATED OR CUT TO FIT THE DOWNSPOUT GUTTER AND UPSIZED HDPE PIPE. CAP/PIPE SHALL
- BE INSTALLED SO CAP IS 2" ABOVE FINISHED GRADE, MINIMUM. 5. SDR35 PVC PIPE MAY BE SUBSTITUTED FOR ANY HDPE PIPE UP TO 15" IN DIAMETER

GUTTER DOWNSPOUT CONNECTION

NOT TO SCALE

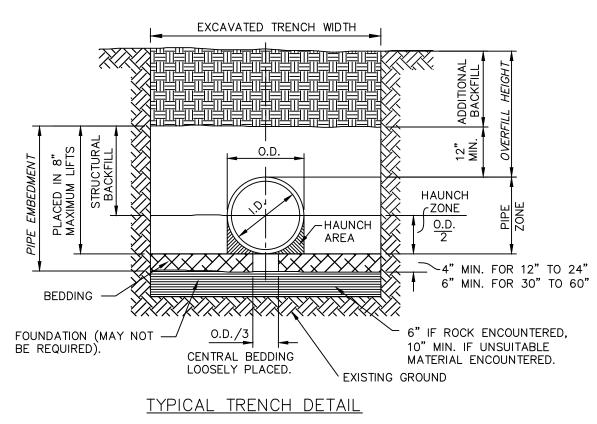

BACKFILL NOTES:

- 1. BEDDING, HAUNCH, AND STRUCTURAL BACKFILL SHALL BE IN CONFORMANCE WITH AASHTO M145 A1 OR A-3 COMPACTED TO A MINIMUM OF 95% OF THE MAXIMUM DRY DENSITY AS DEFINED BY ASTM D698.
- 2. ALL PIPE INSTALLATION SHALL BE IN ACCORDANCE WITH THE MANUFACTURER'S RECOMMENDATIONS AND ASTM D2321 LATEST ADDITION.
- 3. HAUNCH, STRUCTURAL, AND ADDITIONAL BACKFILL SHALL BE PLACED IN LIFTS NOT TO EXCEED 8 INCHES AND COMPACTED TO 95% OF THE MAXIMUM DRY DENSITY AS DEFINED BY ASTM D698.

MINIMU	M COVER F	FOR CONST	RUCTION LO	DADS
PIPE DIA. (IN.)	MINIMUM C	OVER (FT) FOI (THOUSANDS	R INDICATED A OF POUNDS)	XLE LOADS
	18-50	50-75	75–110	110-150
12-36	2.0	2.5	3.0	3.0
42-48	3.0	3.0	3.5	4.0
	3.0 SHALL PROVID DAM SURFACE MUST	3.0 DE MINIMUM CC AGE TO THE F	3.5 OVER PLUS AN' PIPE. IN UNPA	4.0 Y ADDITION

LEGEND

- I.D. = NORMAL INSIDE DIAMETER OF PIPE. O.D. = OUTSIDE DIAMETER OF PIPE. H = FILL COVER HEIGHT OVER PIPE (FEET). MIN. = MINIMUM
- MAX = MAXIMUM= UNDISTURBED SOIL
- CONSTRUCTION SEQUENCE:

 1. PLACE BEDDING MATERIAL TO GRADE. COMPACT BEDDING OUTSIDE THE MIDDLE THIRD OF THE PIPE.
- INSTALL PIPE TO GRADE. 4. PLACE AND COMPACT THE HAUNCH AREA UP TO THE SPRINGLINE. 5. COMPLETE BACKFILL ACCORDING TO SPECIFICATIONS.

					TAE	BLE I					
		CC	DRRUGATI	ED HDPE	AND PO	LYVINYL C	HLORIDE C	IRCULAR F	PIPE		
		HDPE MAX	POLYVINYL CHLORIDE MAX OVERFILL HEIGHT* (FT)			ADS N-12, N-12 ST, AND N-12 WT PIPE					TRENCH WIDTH
SPECIFIED DIA OF PIPE (IN.)	MIN OVERFILL HEIGHT (FT)	III OVEDEILI			VIRGIN RESIN (AASHTO M294) OVERFILL HEIGHT* (FT)			ENGINEERED COMPOUND (RECYCLED, ASTM F2648) OVERFILL HEIGHT* (FT)			
L (\dots.)		` ,	SDR 35#	SDR 26#	CLASS 1**	CLASS 2**	CLASS 3**	CLASS 1**	CLASS 2**	CLASS 3**	(IN.)
12	2	26	15	30	43	29	21	27	19	12	34
15	2	28	15	30	45	30	22	27	20	13	39
18	2	24	15	30	40	27	19	25	18	11	44
24	2	20	15	30	36	25	17	22	16	12	55
30	2.5	17	N/A	N/A	29	21	15	16	12	6	67
36	2.5	19	N/A	N/A	34	23	16	21	15	10	76
42	2.5	19	N/A	N/A	31	23	16	17	13	7	84
48	2.5	17	N/A	N/A	30	20	14	18	13	10	95
54	2.5	9	N/A	N/A	33	22	15	N/A	N/A	N/A	104
60	2.5	9	N/A	N/A	33	22	15	20	15	10	113

TABLE III						
PARALLE	L PIPE INST	ALLATION				
PIPE SIZE	S (IN.)	X (IN.)				
12	12	9				
15	12	9				
18	12	9				
24	12	10				
30	15	16				
36	18	18				
42	21	18				
48	24	18				

S = MINIMUM PIPE SEPARATION (IN) BETWEEN OUTSIDE WALLS OF PIPES. X = MINIMUM SEPARATION BETWEEN TRENCHWALL AND OUTSIDE WALL OF PIPE.

- TABLE ASSUMES STANDARD PROCTOR DENSITY OF 95%
- * MAXIMUM OVERFILL MEASURED FROM THE TOP OF PIPE TO SURFACE ** CLASS 1 - CRUSHED ROCK, ANGULAR; AASHTO M43 - 5, 6, 56, 57, 67
- ** CLASS 2 CLEAN, COURSE GRAINED SOILS TO BORDERLINE CLEAN FINES; AASHTO M43 5, 6, 56, 57, 67; AASHTO M145 A1, A3 ** CLASS 3 - COURSE GRAINED SOILS WITH FINES AND INORGANIC FINE-GRAINED SOILS; AASHTO M43 - GRAVEL AND SAND WITH <10% FINES;
- AASHTO M145 A-2-4, A-2-5, A-2-6, A-4, OR A-6 WITH >30% RETAINED ON #200 SIEVE ** REFER TO CURRENT ADS INC. DRAINAGE HANDBOOK FOR A COMPLETE LISTING OF SUITABLE MATERIALS
- # PER ASTM D-3034 FOR PIPE UP TO 15" AND ASTM F679 OVER 15"

EMBEDMENT OF PLASTIC STORM SEWER PIPE

NOT TO SCALE

STATE OF MISSOURI MICHAEL L. PARSON, **GOVERNOR**



Theron J. Broadfoot, PE-2009015435 JUNE 30, 2023 MO CERTIFICATE OF AUTHORITY # 2018030429





660.829.9751

Broadfoot Engineering, LLC 30277 Carpenter Road Sedalia, MO 65301 Phone: 660-619-7001 broadfooteng@yahoo.com

OFFICE OF **ADMINISTRATION** DIVISION OF **FACILITIES** MANAGEMENT DESIGN AND CONSTRUCTION

REPLACE ROOF, **HOWERTON** STATE OFFICE BLDG.

615 HOWERTON CT. JEFFERSON CITY, MO 65109

PROJECT # O2015-02 SITE # 1025

ASSET # 3101025001

REVISION: REVISION: DATE: **REVISION:** DATE:

ISSUE DATE: 06/30/2023

CAD DWG FILE: DRAWN BY: TJB CHECKED BY: _TJB DESIGNED BY: TJB

DETAILS

SHEET TITLE:

SHEET NUMBER:


SHEET 8 OF 15 06/30/2023



ROOF DEMO PLAN


3/32" = 1'-0"


D-101

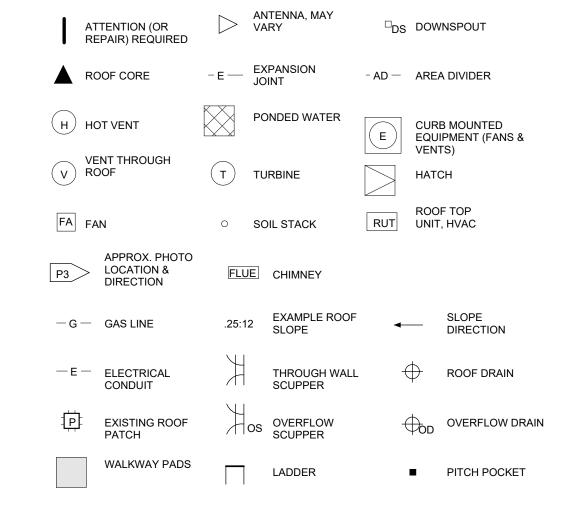

1. EIFS IS CURRENTLY UNDER MANUFACTURERS AND INSTALLERS WARRANTY. ORIGINAL INSTALLER, BROOKE DRYWALL OF COLUMBIA, MO, UNDER GC SIRCAL CONSTRUCTION, CHRIS HENTGES, 573-893-5977. ALL EIFS WORK SHALL BE

- PERFORMED BY A DRYVIT / TREMCO CERTIFIED INSTALLER. TYP. IF EIFS REPAIRS EXTEND BEYOND INDICATED SCOPE SEE SPECIFICATION SECTION 012200 UNIT PRICING. GC SHALL COORDINATE DEMOLITION EXTENTS AND INSTALLATION REQUIREMENTS FOR DOWNSPOUTS PRIOR TO BIDDING AND NOTIFY OWNER AND DESIGNER IF BASE BID AMOUNT IS INSUFFICIENT.
- THE AREAS ON THE FACADE AROUND THE NEWLY CUT OPENING FOR THE SCUPPERS WILL NEED TO HAVE SOME FOAM REMOVED IN ORDER FOR THE EDGE OF THE FOAM TO BE BACK WRAPPED. THIS WILL REQUIRE A NEW BASE AND FINISH COAT. NEW BASE AND FINISH COAT SHALL MATCH COLOR AND TEXTURAL
- APPEARANCE OF THE EXISTING. SEE A-201 FOR ELEVATIONS. 4. THE LOCATION OF THE SCUPPER PENETRATIONS MAY BE ADJUSTED SLIGHTLY TO LIMIT REPAIRS TO EIFS AND CENTER DOWNSPOUT BETWEEN STUDS FOR SECURE MOUNTING. ADJUST CRICKETS AS NECESSARY.
- PATCH ROOF AT DEMOLISHED CURB LOCATIONS PER "SCHEMATIC METAL ROOF PATCH DETAIL", THIS PAGE, TYP.
- IF REQUIRED TO ACHIEVE A MINIMUM 8" TO TOP OF CURB FROM NEW ROOF DECK EXTEND CURBS, VENTS, AND ROOF HATCH AND REINSTALL EQUIPMENT. GC SHALL DISCONNECT AND RE-INSTALL HVAC / MECHANICAL VENT UNITS AS NEEDED / REQUIRED BY NEW ROOF CONSTRUCTION. GC MAY UTILIZE HVAC
- CONTRACTOR OF THEIR CHOICE. THE CURRENT HVAC SERVICE PROVIDER FOR REPAIRS AND REPLACEMENTS FOR THE HOWERTON BUILDING IS ENVIRONMENTAL ENGINEERING, INC., P.O. BOX 104478, 2225 IDLEWOOD RD. JEFFERSON CITY, MO 65109, 573-636-3566, LARRY MORREAU.
- 8. GC SHALL VERIFY EXISTING ROOF TOP ITEMS TO REMAIN W/ OWNER PRIOR TO BEGRIMING DEMOLITION. 9. IT IS ANTICIPATED AT THIS TIME THAT GC WILL BE ABLE TO REUSE ALL EXISTING
- BLOCKING ALONG THE TOP OF THE PARAPET WALL. SEE SPECIFICATION SECTION 012200 UNIT PRICING IF REPLACEMENT BLOCKING IS NEEDED.

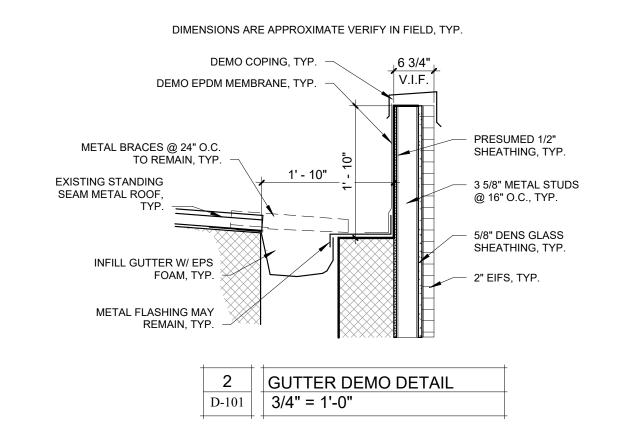

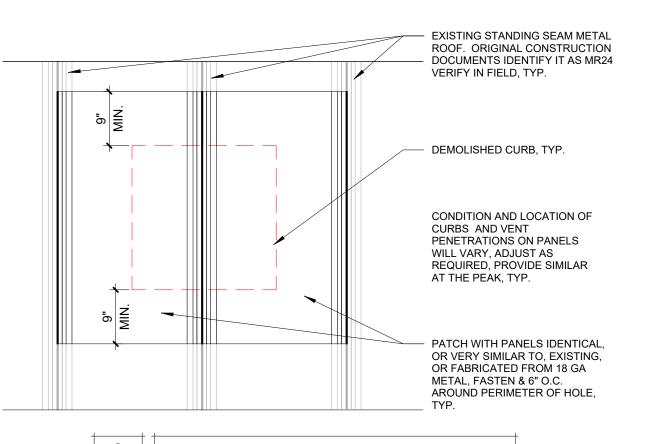

3 SCHEMATIC 3/4" = 1'-0" SCHEMATIC METAL ROOF PATCH DETAIL STATE OF MISSOURI MICHAEL L. PARSON, **GOVERNOR**



Robert D. Rollings 2005001208, Certificate of Authority # A-2006003870



1806 West Broadway Boulevard Sedalia, MO 65301 660.829.9751



Broadfoot Engineering, LLC 30277 Carpenter Road Sedalia, MO 65301

Phone: 660-619-7001 broadfooteng@yahoo.com

OFFICE OF ADMINISTRATION DIVISION OF **FACILITIES** MANAGEMENT DESIGN AND CONSTRUCTION

REPLACE ROOF, HOWERTON STATE OFFICE BLDG.

615 HOWERTON CT. JEFFERSON CITY, MO 65109

PROJECT # O2015-02 SITE # 1025

ASSET # 3101025001

REVISION: DATE: REVISION: DATE: REVISION: DATE:

ISSUE DATE: 06/30/2023 CAD DWG FILE:
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CHECKED BY: RDR


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ROOF DEMO PLAN


SHEET NUMBER:

D-101

SHEET 9 OF 15 06/30/2023

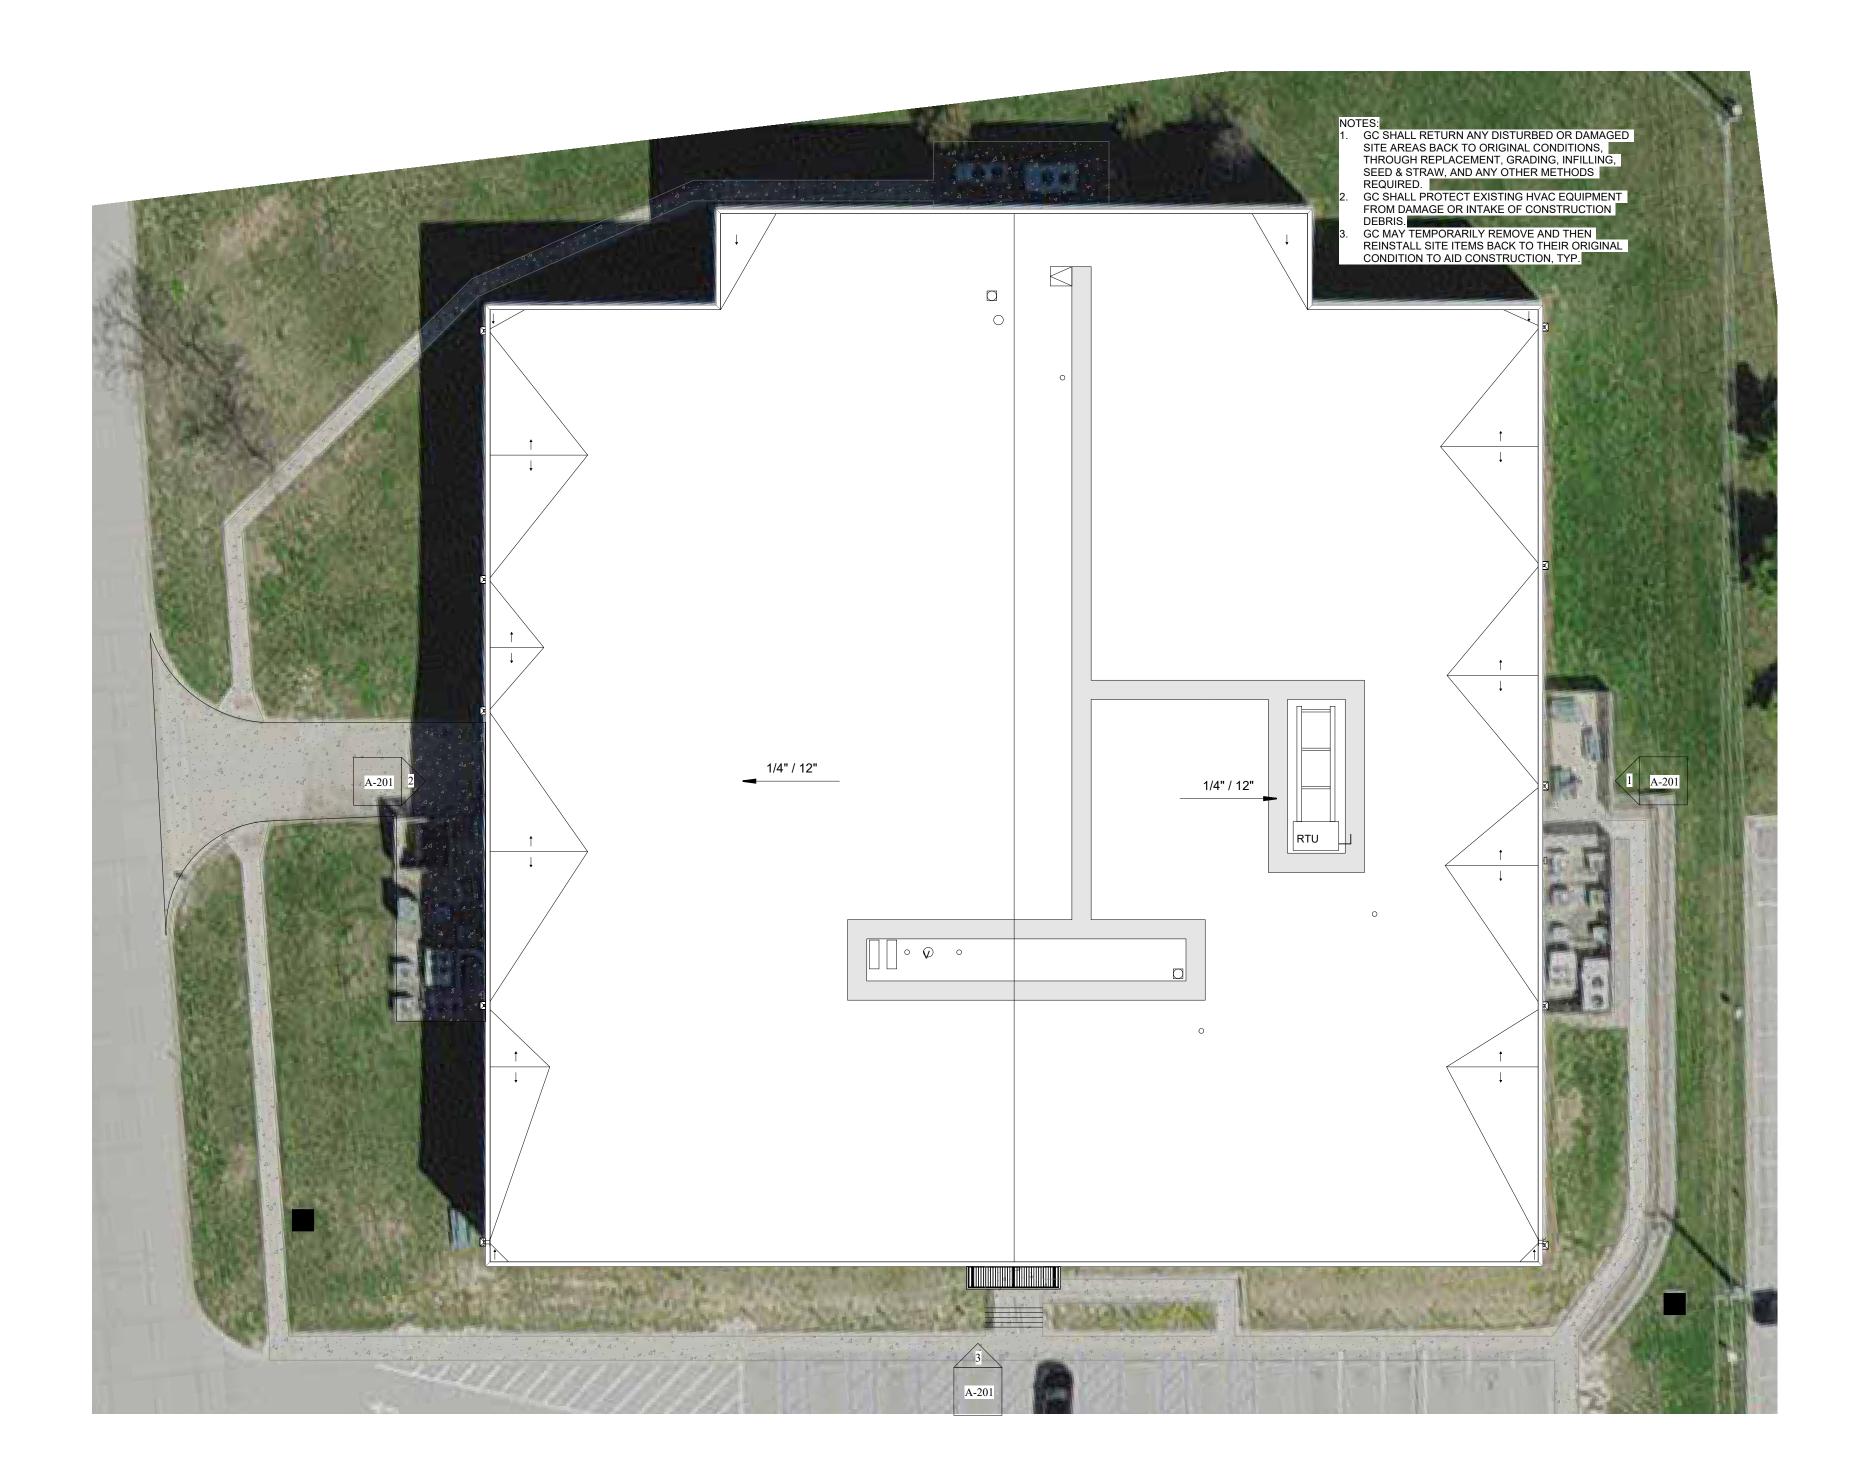

1 | SCHEMATIC ARCHITECTURAL SITE PLAN | 1" = 20'-0"

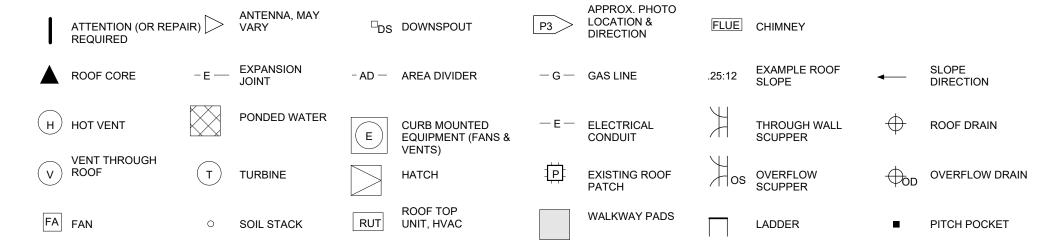

ROOF LEGEND: ALL SIZES SHALL BE NOTED, EXCEPT WHEN NOT APPLICABLE. DESCRIPTION MAY BE REQUIRED.

STATE OF MISSOURI MICHAEL L. PARSON, GOVERNOR



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OFFICE OF
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615 HOWERTON CT. JEFFERSON CITY, MO 65109

PROJECT # O2015-02 SITE # 1025

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ISSUE DATE: 06/30/2023

CAD DWG FILE: A-SP-10
DRAWN BY: AMK
CHECKED BY: RDR
DESIGNED BY: AMK


SHEET TITLE:

ARCHITETURAL SITE PLAN

SHEET NUMBER:

A-100

SHEET 10 OF 15 06/30/2023

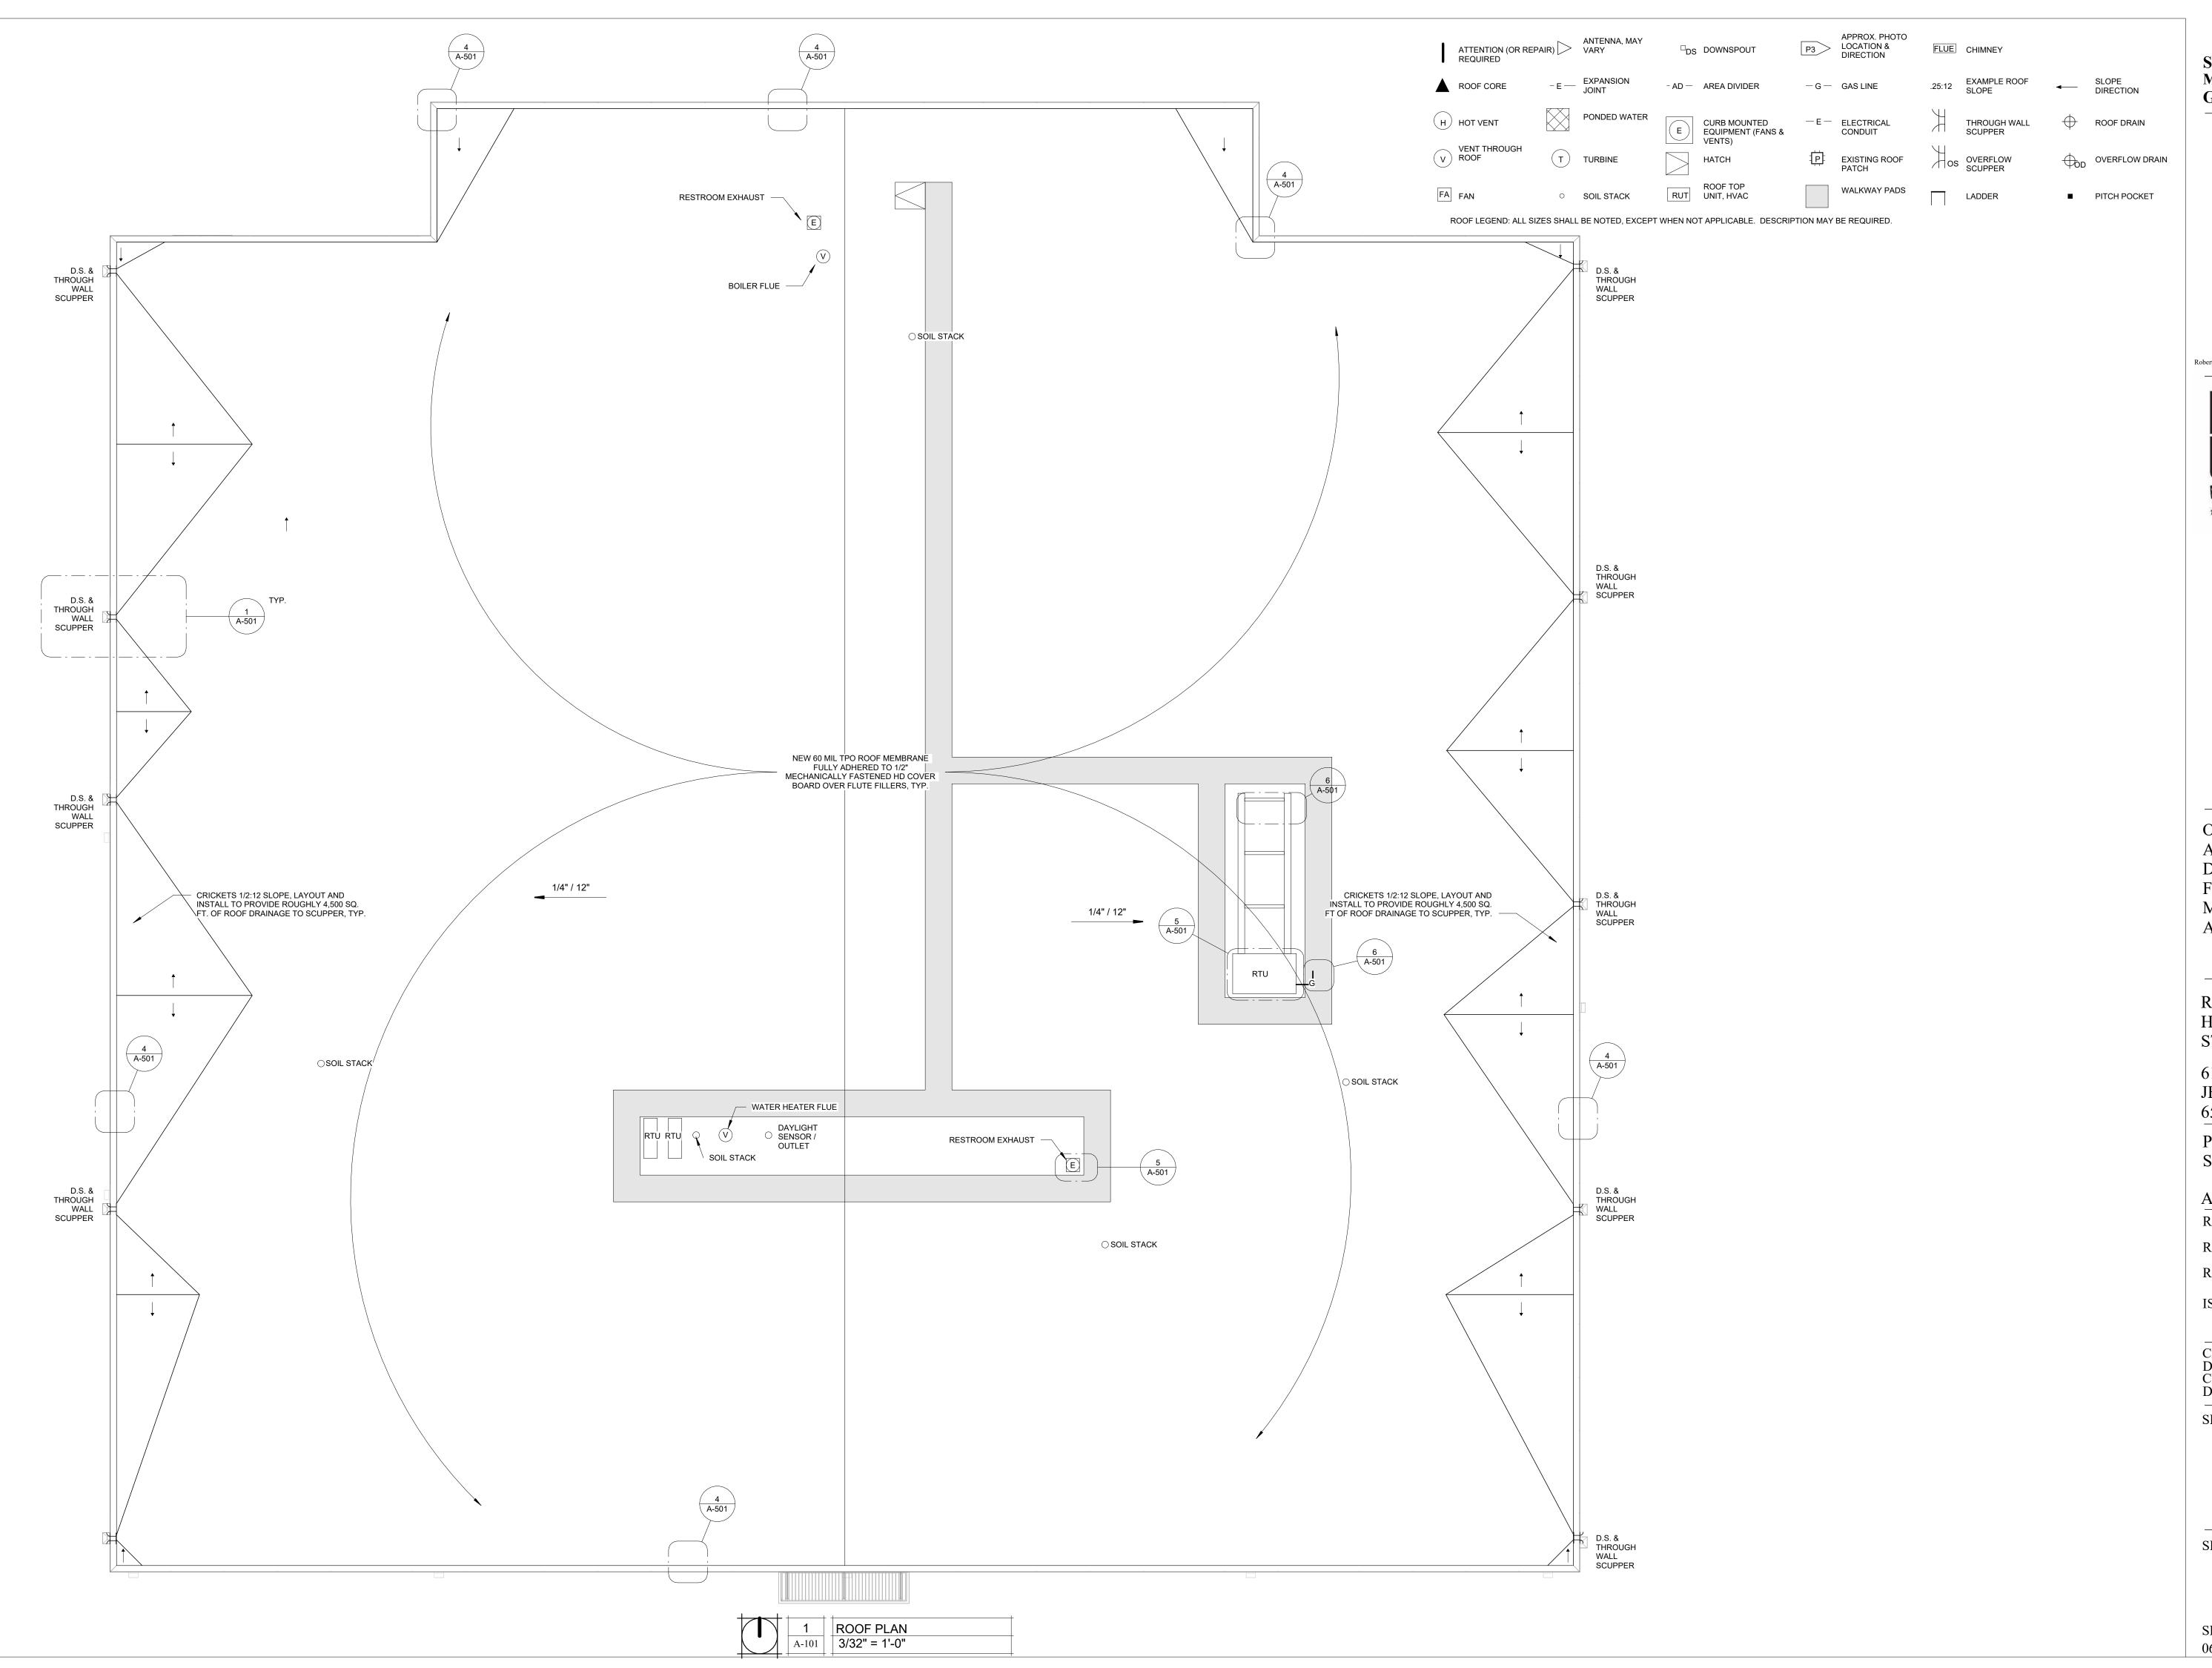



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OFFICE OF
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615 HOWERTON CT. JEFFERSON CITY, MO 65109

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ASSET # 3101025001

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ISSUE DATE: 06/30/2023

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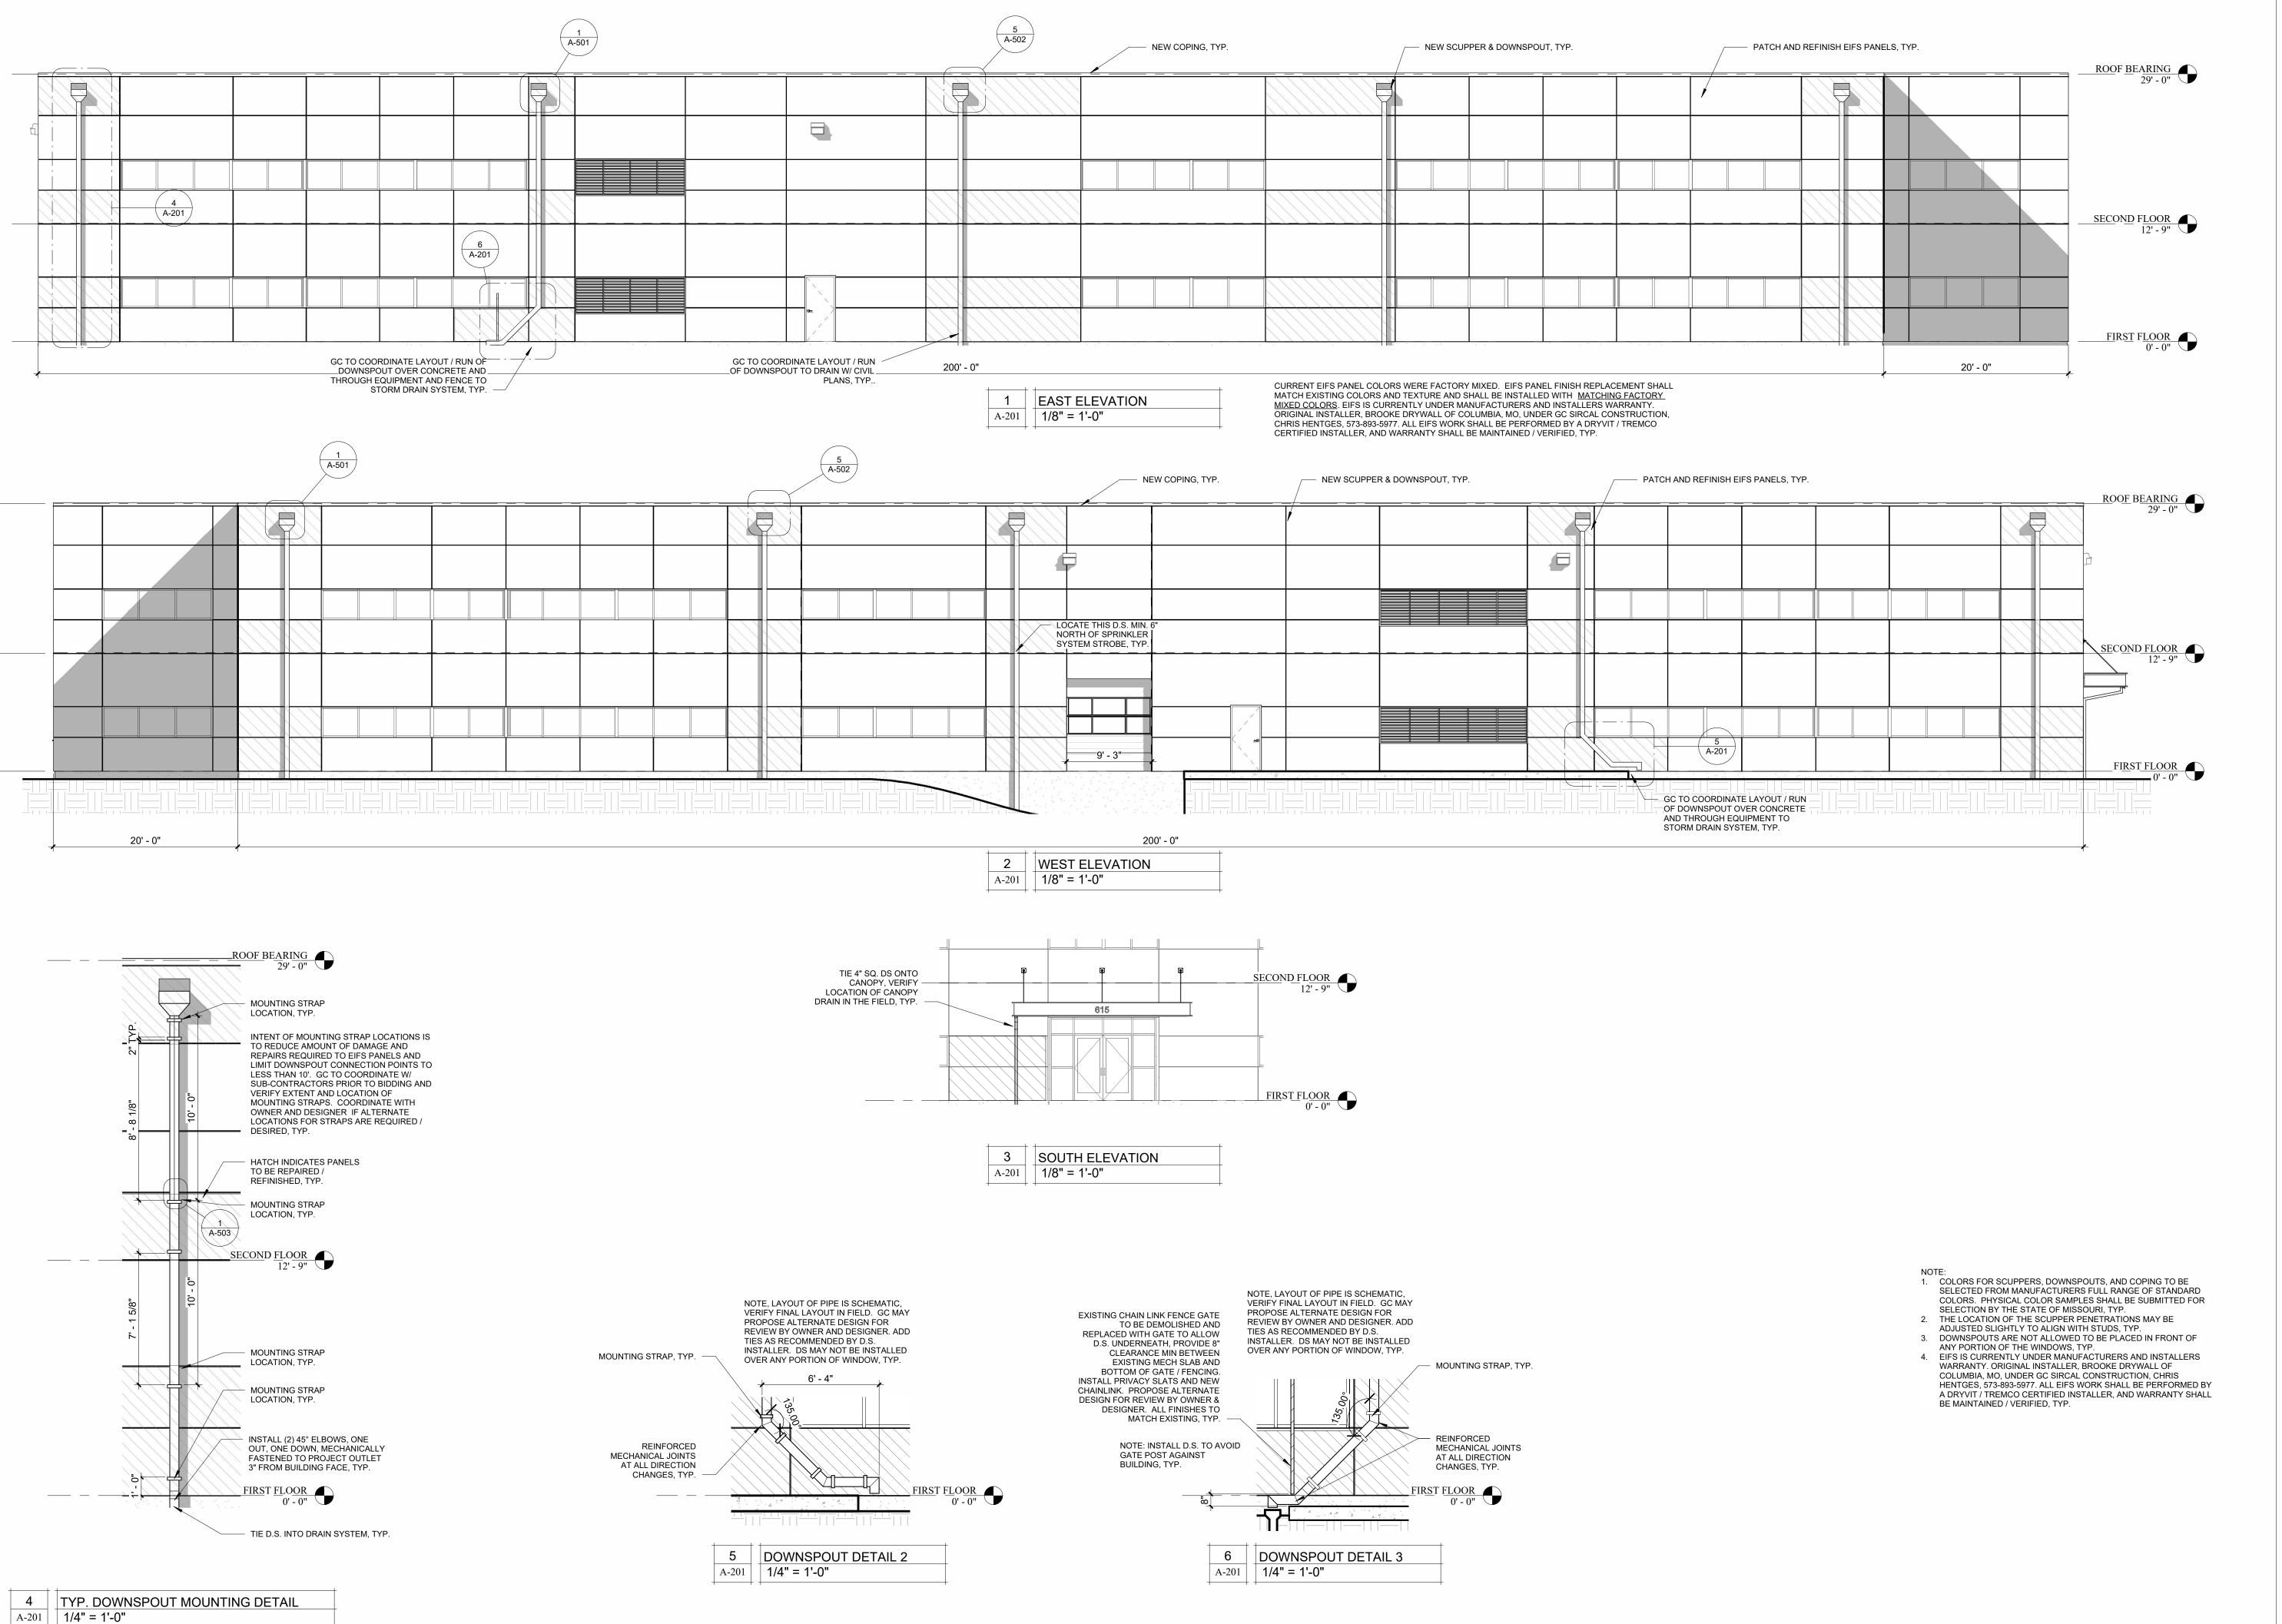
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ROOF PLAN

SHEET NUMBER:

A-101

SHEET 11 OF 15 06/30/2023





Robert D. Rollings 2005001208, Certificate of Authority # A-2006003870



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OFFICE OF
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REPLACE ROOF, HOWERTON STATE OFFICE BLDG.

615 HOWERTON CT. JEFFERSON CITY, MO 65109

PROJECT # O2015-02 SITE # 1025

ASSET # 3101025001

REVISION:
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REVISION:

ISSUE DATE: 06/30/2023

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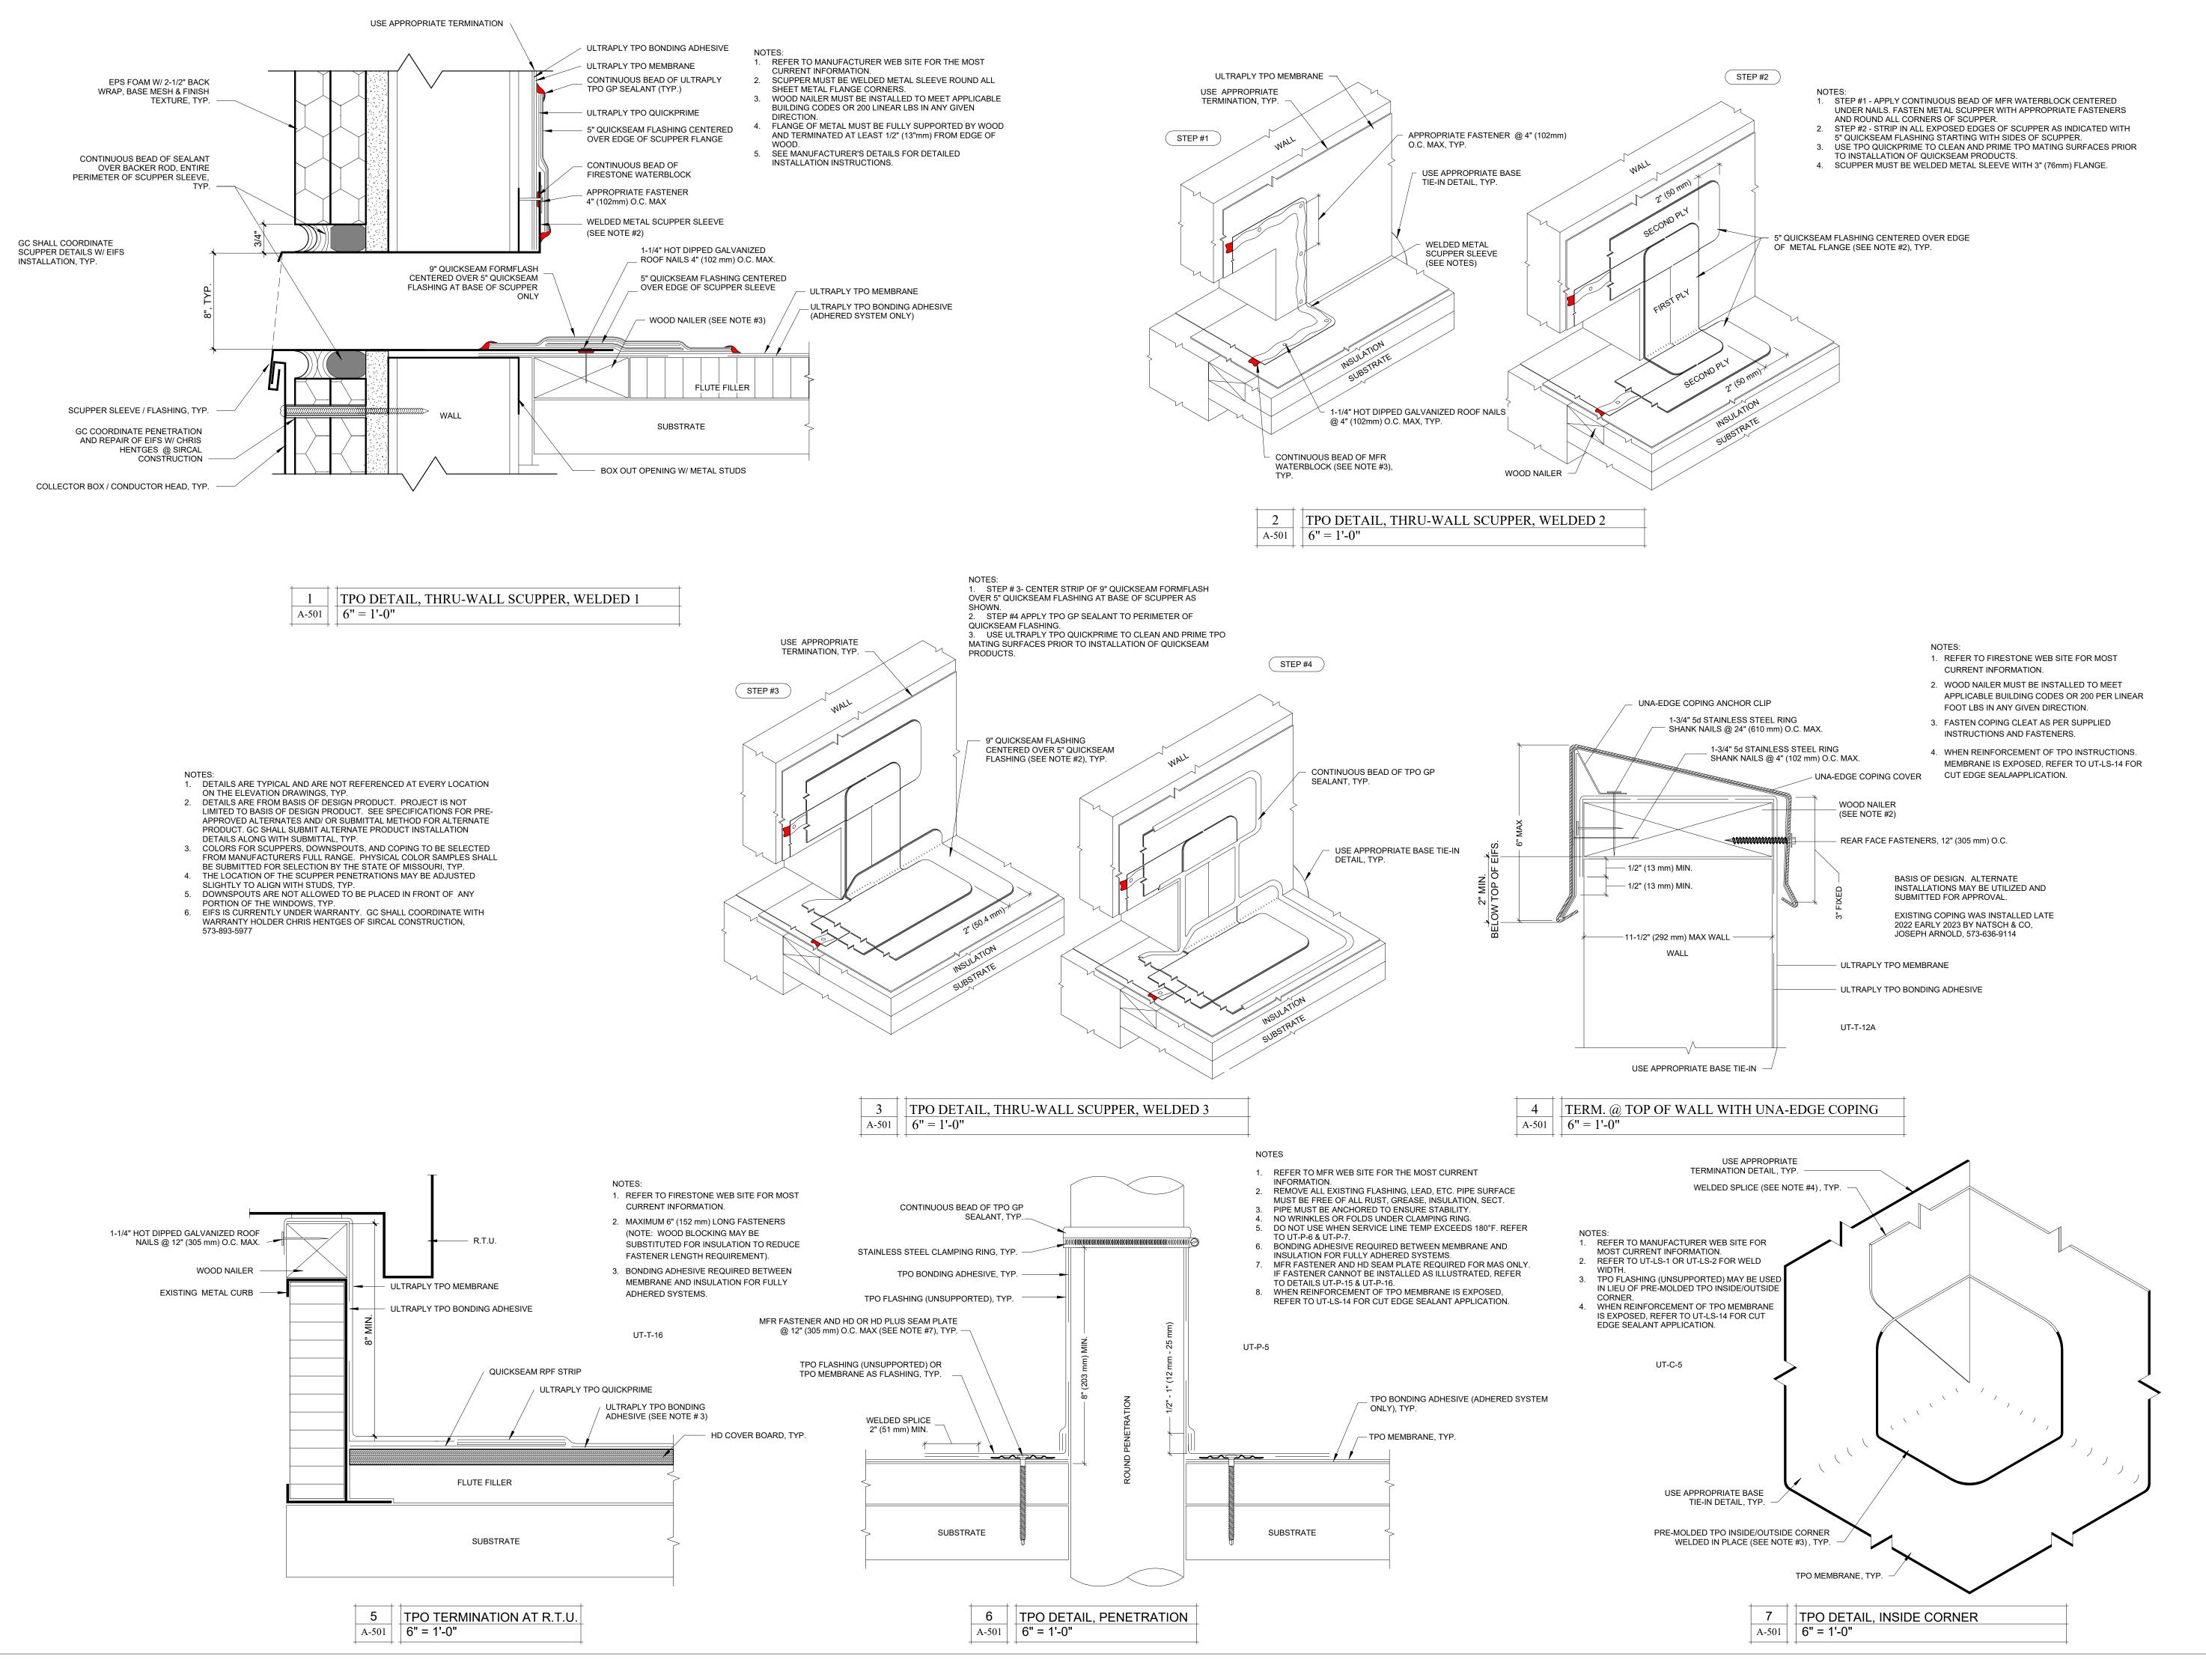
SHEET TITLE:

ELEVATIONS

SHEET NUMBER:

A-201

SHEET 12 OF 15 06/30/2023





Robert D. Rollings 2005001208, Certificate of Authority # A-2006003870



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broadfooteng@yahoo.com

Broadfoot Engineering, LLC 30277 Carpenter Road Sedalia, MO 65301 Phone: 660-619-7001

OFFICE OF ADMINISTRATION DIVISION OF FACILITIES MANAGEMENT DESIGN AND CONSTRUCTION

REPLACE ROOF, HOWERTON STATE OFFICE BLDG.

615 HOWERTON CT. JEFFERSON CITY, MO 65109

PROJECT # O2015-02 SITE # 1025

ASSET # 3101025001

REVISION:
DATE:
REVISION:
DATE:
REVISION:
DATE:
ISSUE DATE: 06/30/2023

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CHECKED BY: RDR

DESIGNED BY: AMK


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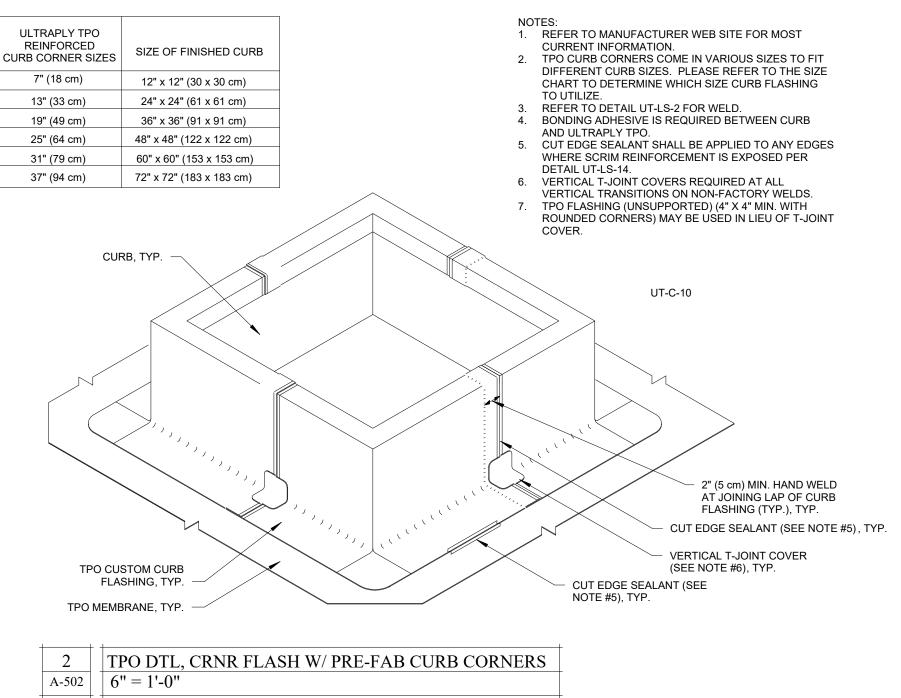
TPO DETAILS


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A-501

SHEET 13 OF 15 06/30/2023






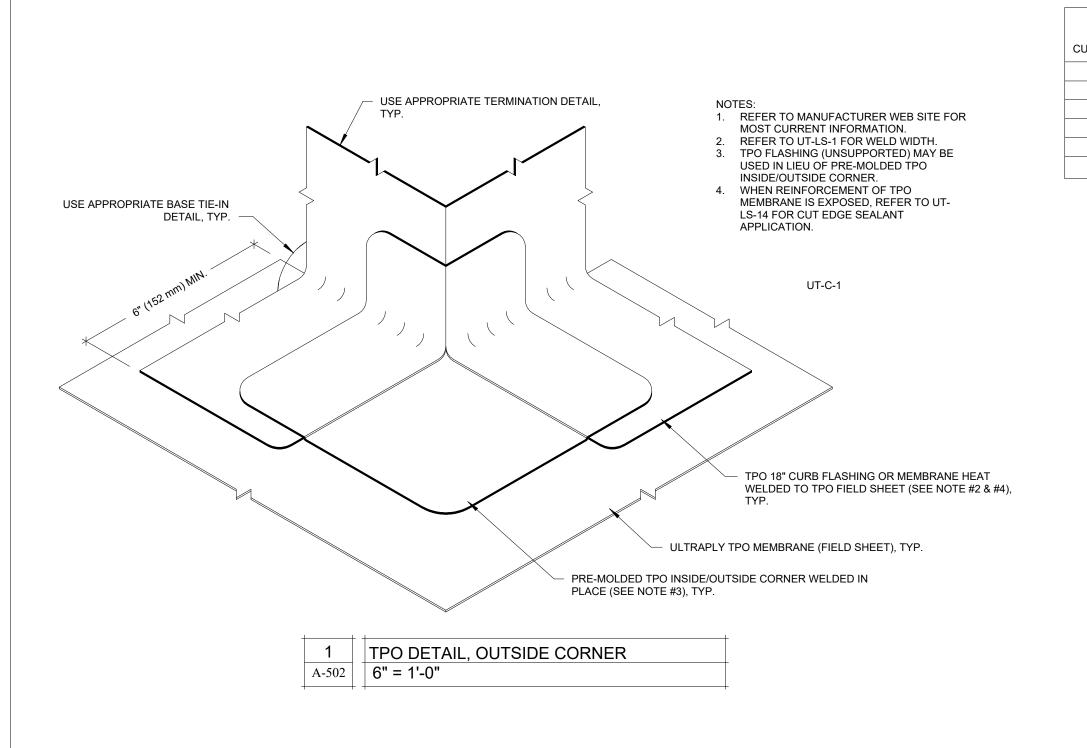

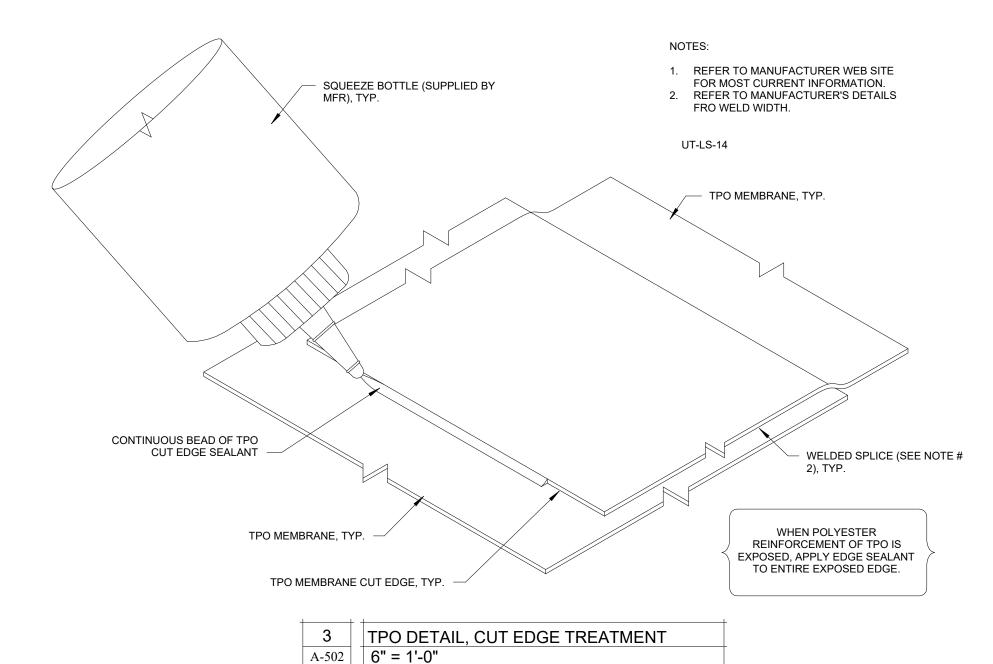1. REFER TO MANUFACTURER WEB SITE FOR MOST CURRENT INFORMATION. 1 1" (38 mm) MIN. WHEN POLYESTER REINFORCEMENT OF TPO IS EXPOSED, APPLY CUT EDGE TREATMENT TO ENTIRE EXPOSED EDGE. REFER TO UT-LS-14.

A-502 TPO DETAIL LAP SPLICE
6" = 1'-0"

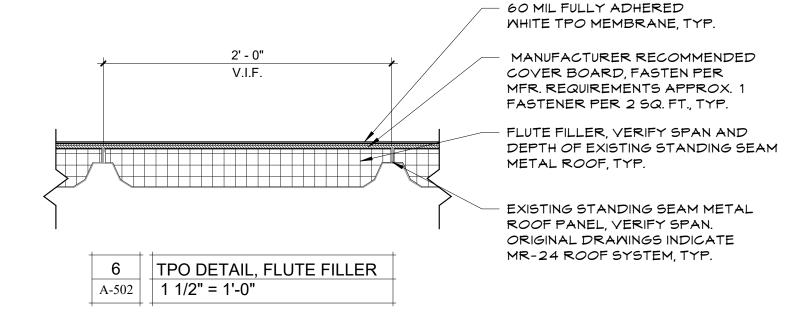

1. DETAILS ARE TYPICAL AND ARE NOT REFERENCED AT EVERY LOCATION ON THE ELEVATION DRAWINGS, TYP. 2. DETAILS ARE FROM BASIS OF DESIGN PRODUCT. PROJECT IS NOT LIMITED TO BASIS OF DESIGN PRODUCT. SEE SPECIFICATIONS FOR PRE-APPROVED ALTERNATES AND/ OR SUBMITTAL METHOD FOR ALTERNATE PRODUCT. GC SHALL SUBMITTAL TYPE

PRODUCT. GC SHALL SUBMITTAL TYPE

PRODUCT SOLON WITH SUBMITTAL TYPE

OF TAILS ALONG WITH SUBMITTAL TYPE

2. DETAILS ARE FROM BASIS OF DESIGN PRODUCT. PROJECT IS NOT PROJECT IS DETAILS ALONG WITH SUBMITTAL, TYP. 3. COLORS FOR SCUPPERS, DOWNSPOUTS, AND COPING TO BE SELECTED FROM MANUFACTURERS FULL RANGE. PHYSICAL COLOR SAMPLES SHALL BE SUBMITTED FOR SELECTION BY THE STATE OF MISSOURI, TYP. 4. THE LOCATION OF THE SCUPPER PENETRATIONS MAY BE ADJUSTED SLIGHTLY TO ALIGN WITH STUDS, TYP.

PORTION OF THE WINDOWS, TYP. 6. EIFS IS CURRENTLY UNDER WARRANTY. GC SHALL COORDINATE WITH WARRANTY HOLDER CHRIS HENTGES OF SIRCAL CONSTRUCTION,

24 GA. PRE-FINISHED METAL CONDUCTOR HEAD HOOKED BY SCUPPER AND FASTENED TO WALL W/ CORROSION RESISTANT SCREW SECURELY FASTENED TO FRAMING, (MIN. 6 PER COLLECTOR HEAD), TYP. — 1' - 0" 1'-6". DOWNSPOUT OUTLET, PER SPECS, TYP. COORDINATE W/ EIFS & TPO DETAILS IN DRAWINGS, TYP.

5 SCUPPER DETAILS 1" = 1'-0"

5. DOWNSPOUTS ARE NOT ALLOWED TO BE PLACED IN FRONT OF ANY

STATE OF MISSOURI MICHAEL L. PARSON, **GOVERNOR**



Robert D. Rollings 2005001208, Certificate of Authority # A-2006003870



1806 West Broadway Boulevard Sedalia, MO 65301



660.829.9751

Broadfoot Engineering, LLC 30277 Carpenter Road Sedalia, MO 65301 Phone: 660-619-7001 broadfooteng@yahoo.com

OFFICE OF ADMINISTRATION DIVISION OF **FACILITIES** MANAGEMENT DESIGN AND CONSTRUCTION

REPLACE ROOF, **HOWERTON** STATE OFFICE BLDG.

615 HOWERTON CT. JEFFERSON CITY, MO 65109

PROJECT # O2015-02 SITE # 1025

ASSET # 3101025001

REVISION: DATE: REVISION: DATE: REVISION: DATE:

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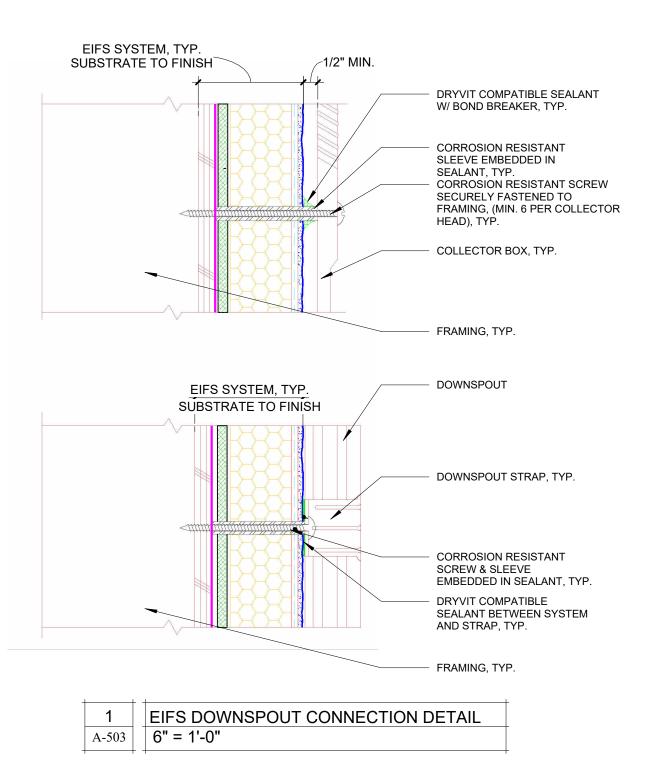
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DRAWN BY: AMK
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TPO DETAILS

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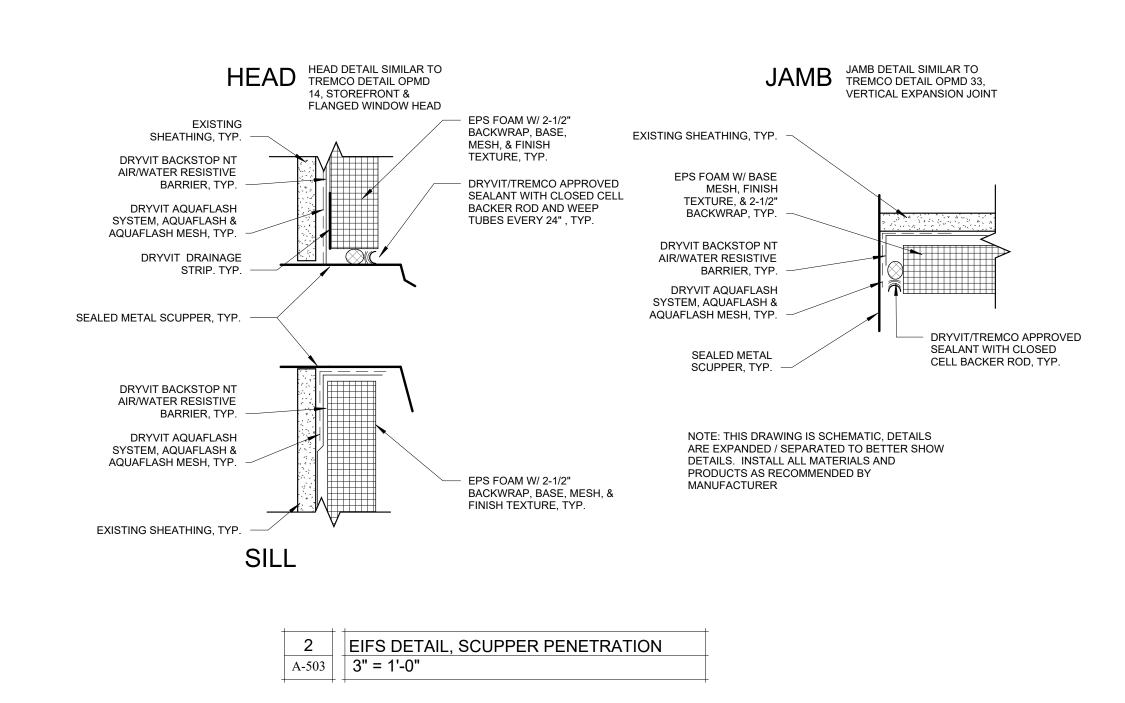
SHEET 14 OF 15 06/30/2023





1. DETAILS ARE TYPICAL AND ARE NOT REFERENCED AT EVERY LOCATION ON THE ELEVATION DRAWINGS, TYP. EIFS DETAILS ARE FROM BASIS OF DESIGN PRODUCT. SEE SPECIFICATIONS, NO ALTERNATE EIFS PRODUCTS


3. COLORS FOR SCUPPERS, DOWNSPOUTS, AND COPING TO BE SELECTED FROM MANUFACTURERS FULL RANGE. PHYSICAL COLOR SAMPLES SHALL BE SUBMITTED FOR SELECTION BY THE STATE OF MISSOURI, TYP. THE LOCATION OF THE SCUPPER PENETRATIONS MAY BE ADJUSTED SLIGHTLY TO ALIGN WITH STUDS, TYP.


DOWNSPOUTS ARE NOT ALLOWED TO BE PLACED IN FRONT OF ANY PORTION OF THE WINDOWS, TYP. EIFS PANEL FINISH REPLACEMENT SHALL MATCH EXISTING COLORS AND TEXTURE AND SHALL BE INSTALLED WITH MATCHING FACTORY MIXED COLORS. EIFS IS CURRENTLY UNDER MANUFACTURERS AND INSTALLERS WARRANTY. ORIGINAL INSTALLER, BROOKE DRYWALL OF COLUMBIA, MO, UNDER GC SIRCAL CONSTRUCTION, CHRIS HENTGES, 573-893-5977. ALL EIFS WORK SHALL BE PERFORMED BY A DRYVIT / TREMCO CERTIFIED INSTALLER, AND WARRANTY SHALL BE MAINTAINED / VERIFIED, TYP.




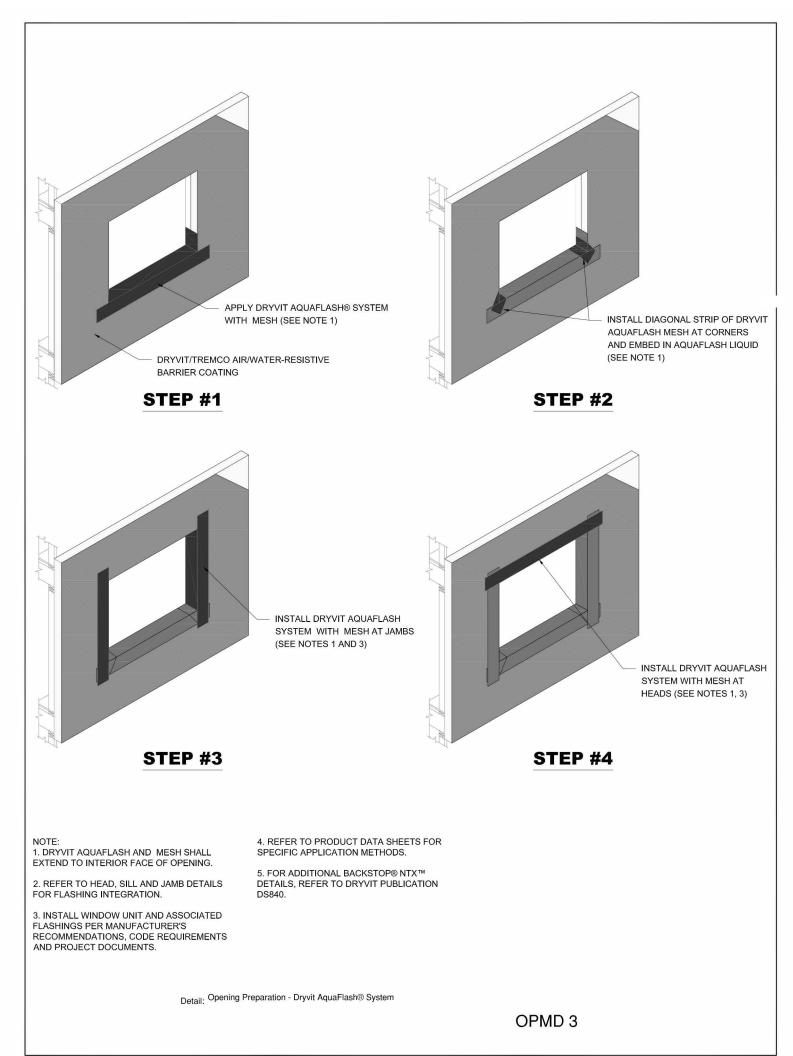


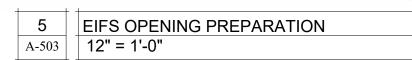

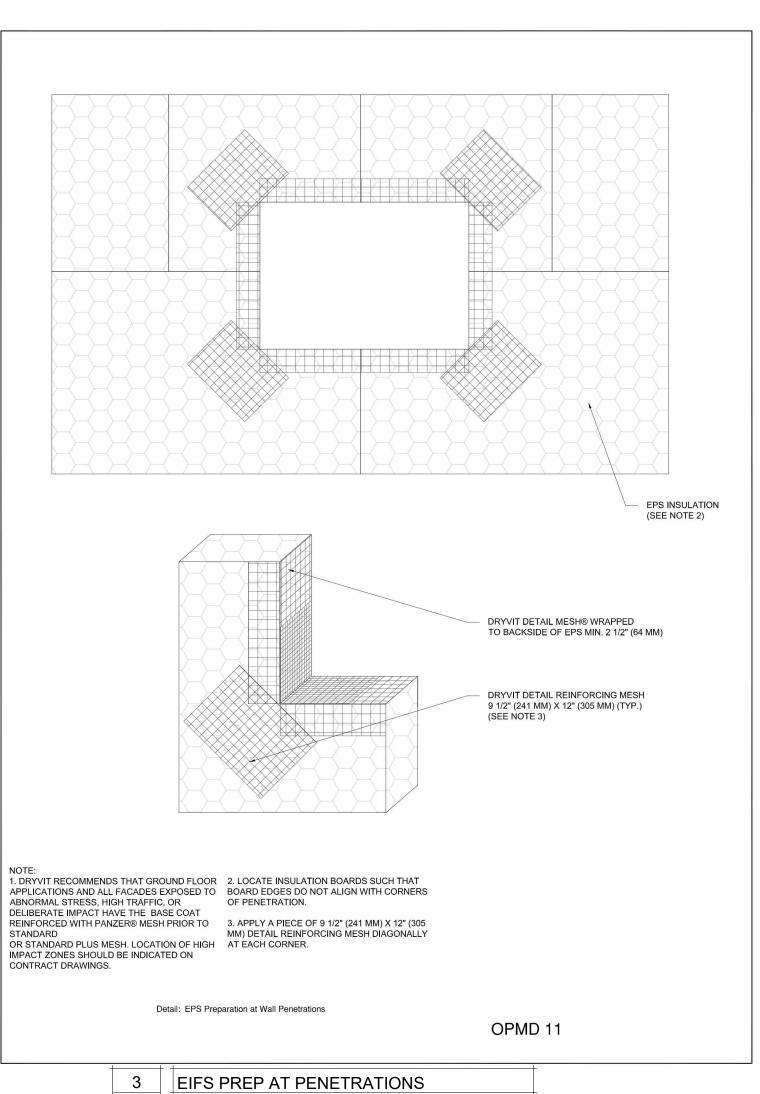

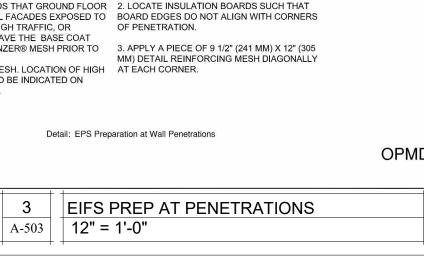

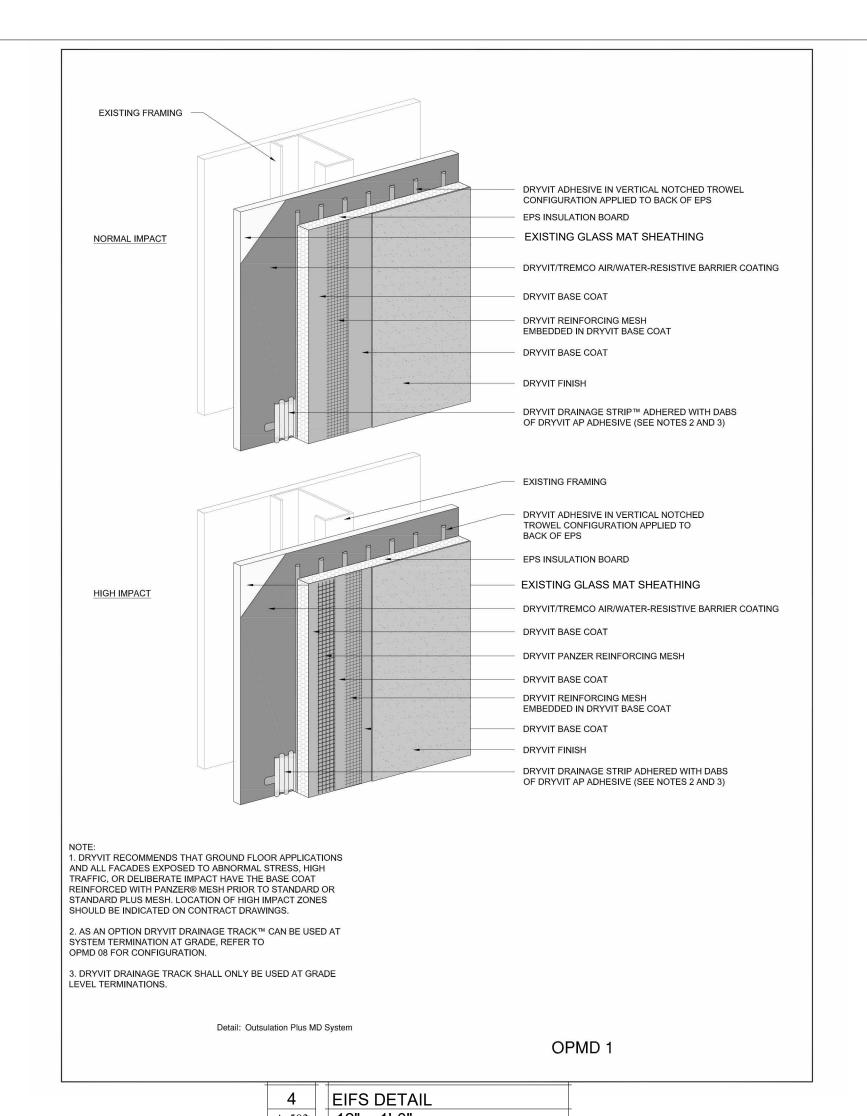

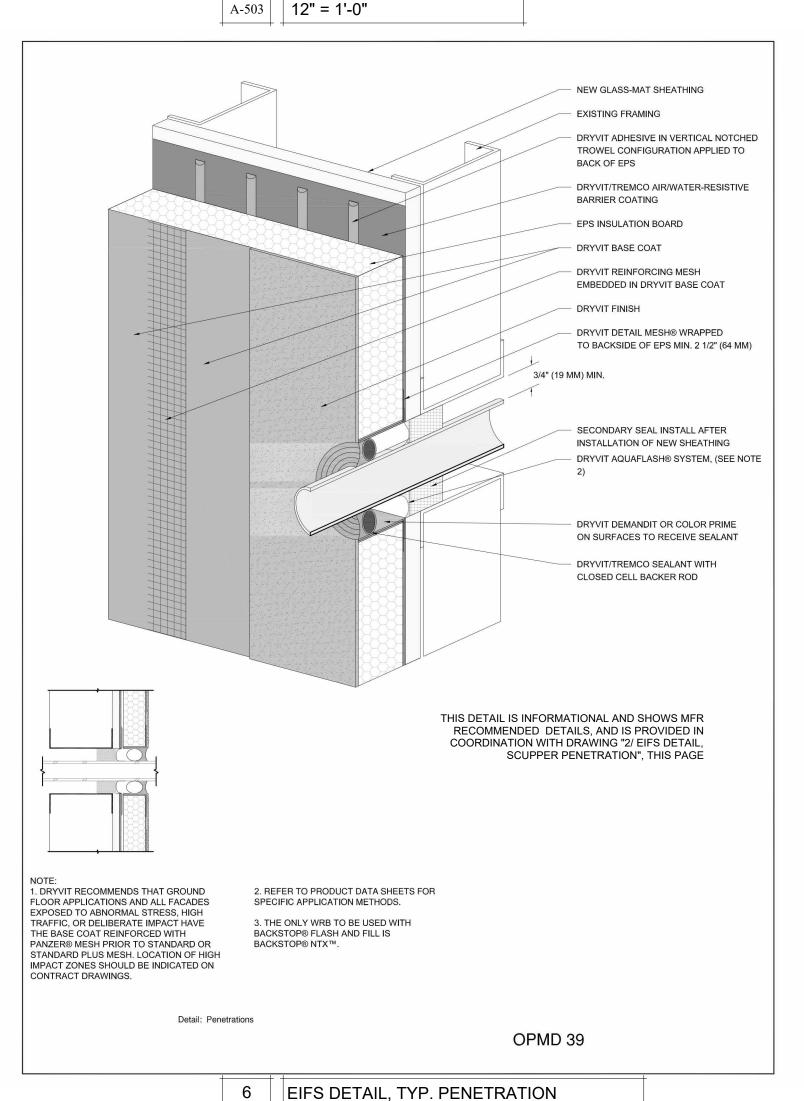

A-503 | 12" = 1'-0"


STATE OF MISSOURI MICHAEL L. PARSON, **GOVERNOR**



Robert D. Rollings 2005001208, Certificate of Authority # A-2006003870



1806 West Broadway Boulevard

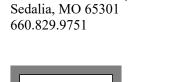



Broadfoot Engineering, LLC 30277 Carpenter Road Sedalia, MO 65301 Phone: 660-619-7001 broadfooteng@yahoo.com

OFFICE OF **ADMINISTRATION** DIVISION OF **FACILITIES** MANAGEMENT DESIGN AND CONSTRUCTION

REPLACE ROOF, HOWERTON STATE OFFICE BLDG.

615 HOWERTON CT. JEFFERSON CITY, MO 65109

PROJECT # O2015-02 SITE # 1025

ASSET # 3101025001

REVISION:
DATE:
REVISION:
DATE:
REVISION:
DATE:

ISSUE DATE: 06/30/2023

CAD DWG FILE: A-DT-15
DRAWN BY: AMK
CHECKED BY: RDR DESIGNED BY: AMK

SHEET TITLE:

EIFS DETAILS

SHEET NUMBER:

SHEET 15 OF 15 06/30/2023