3RD FLOOR RENOVATION EMPLOYMENT SECURITY CENTRAL OFFICE BUILDING (DOLIR) JEFFERSON, MISSOURI

OWNER: STATE OF MISSOURI

MICHAEL L. PARSON, GOVERNOR

DEPARTMENT OF

LABOR AND INDUSTRIAL RELATIONS

PROJECT OFFICE OF ADMINISTRATION

MANAGEMENT: DIVISION OF FACILITIES MANAGEMENT,

DESIGN AND CONSTRUCTION

APPLICABLE 2021 INTERNATIONAL BUILDING CODE

CODES: 2021 INTERNATIONAL EXISTING BUILDING CODE

2021 INTERNATIONAL FIRE CODE

2020 NATIONAL ELECTRICAL CODE (NFPA 70)

2010 AMERICAN WITH DISABILITIES ACT

ACCESSIBLE GUIDELINES



FACILITY ADDRESS: 421 E DUNKLIN ST., JEFFERSON CITY, MO 65101

DRAWING INDEX

G-001 COVER SHEET

D-101 DEMOLITION FLOOR PLAN & GENERAL NOTES

D-201 DEMOLITION REF. CLG. PLAN & GENERAL NOTES

A-101 RENOVATION FLOOR PLAN & GENERAL NOTES

A-201 RENOVATION REF. CLG. PLAN & GENERAL NOTES

A-601 RENOVATION FINISH PLAN & GENERAL NOTES

A-701 ENLARGED PLANS, INTERIOR ELEV'S. & DETAILS

A-702 DOOR AND WINDOW SCHEDULES, PROFILES AND NOTES

E-101 RENOVATION POWER & DATA PLAN & GENERAL NOTES

E-201 RENOVATION LIGHTING PLAN & GENERAL NOTES

I-201 RENOVATION FURNITURE PLAN & GENERAL NOTES

REFERENCE SHEET (ELECTRICAL DUCTS IN FLOOR)

DESIGNER: OFFICE OF ADMINISTRATION

FACILITIES MANAGEMENT, DESIGN AND CONSTRUCTION

301 W. HIGH STREET


SUITE 730


JEFFERSON CITY, MO 65102

PROJECT NUMBER: O22A201

ASSET NUMBER: 3101027001

SHEET NUMBER

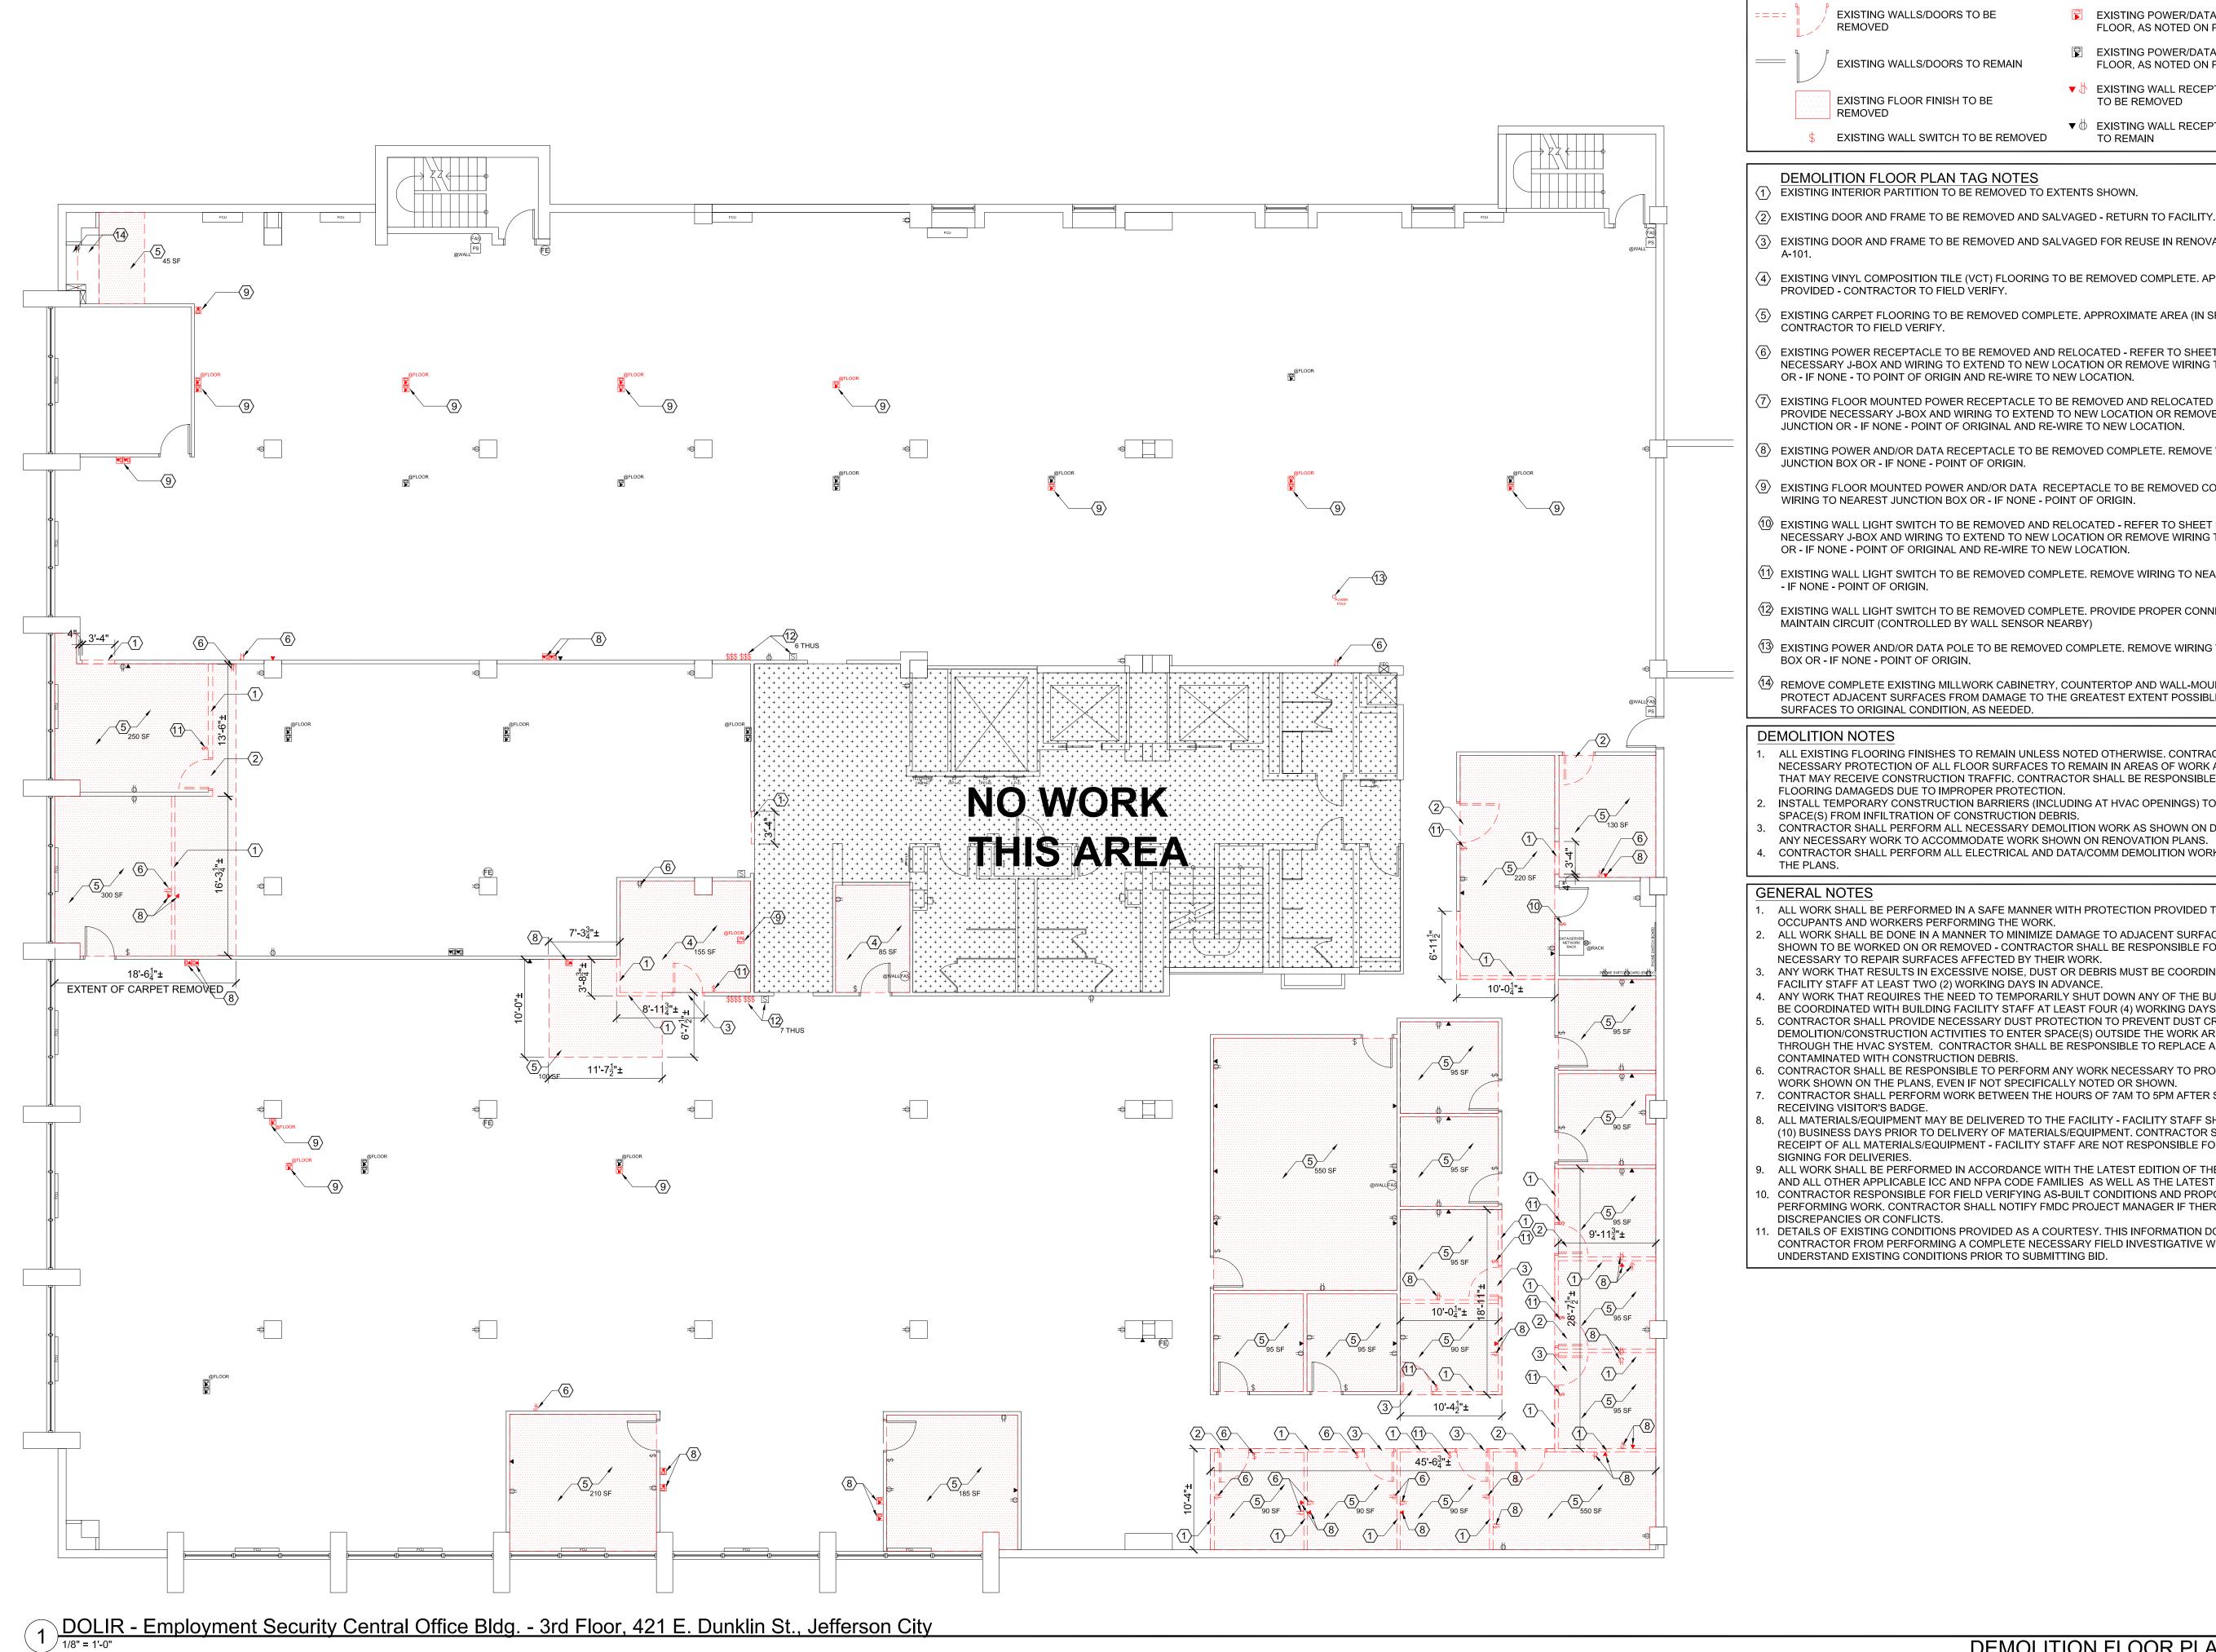

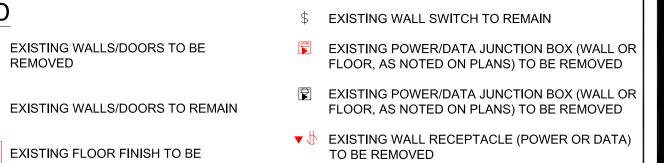

DEMOLITION FLOOR PLAN TAG NOTES

(1) EXISTING INTERIOR PARTITION TO BE REMOVED TO EXTENTS SHOWN.

\$ EXISTING WALL SWITCH TO BE REMOVED

(3) EXISTING DOOR AND FRAME TO BE REMOVED AND SALVAGED FOR REUSE IN RENOVATION - REFER TO SHEET

(4) EXISTING VINYL COMPOSITION TILE (VCT) FLOORING TO BE REMOVED COMPLETE. APPROXIMATE AREA (IN SF) PROVIDED - CONTRACTOR TO FIELD VERIFY.

(5) EXISTING CARPET FLOORING TO BE REMOVED COMPLETE. APPROXIMATE AREA (IN SF) PROVIDED -CONTRACTOR TO FIELD VERIFY.

6 EXISTING POWER RECEPTACLE TO BE REMOVED AND RELOCATED - REFER TO SHEET E-101. PROVIDE NECESSARY J-BOX AND WIRING TO EXTEND TO NEW LOCATION OR REMOVE WIRING TO NEAREST JUNCTION OR - IF NONE - TO POINT OF ORIGIN AND RE-WIRE TO NEW LOCATION.

7
angle EXISTING FLOOR MOUNTED POWER RECEPTACLE TO BE REMOVED AND RELOCATED - REFER TO SHEET E-101. PROVIDE NECESSARY J-BOX AND WIRING TO EXTEND TO NEW LOCATION OR REMOVE WIRING TO NEAREST JUNCTION OR - IF NONE - POINT OF ORIGINAL AND RE-WIRE TO NEW LOCATION.

8 EXISTING POWER AND/OR DATA RECEPTACLE TO BE REMOVED COMPLETE. REMOVE WIRING TO NEAREST JUNCTION BOX OR - IF NONE - POINT OF ORIGIN.

(9) EXISTING FLOOR MOUNTED POWER AND/OR DATA RECEPTACLE TO BE REMOVED COMPLETE. REMOVE WIRING TO NEAREST JUNCTION BOX OR - IF NONE - POINT OF ORIGIN.

(10) EXISTING WALL LIGHT SWITCH TO BE REMOVED AND RELOCATED - REFER TO SHEET E-201. PROVIDE NECESSARY J-BOX AND WIRING TO EXTEND TO NEW LOCATION OR REMOVE WIRING TO NEAREST JUNCTION OR - IF NONE - POINT OF ORIGINAL AND RE-WIRE TO NEW LOCATION.

EXISTING WALL LIGHT SWITCH TO BE REMOVED COMPLETE. REMOVE WIRING TO NEAREST JUNCTION BOX OR - IF NONE - POINT OF ORIGIN.

(12) EXISTING WALL LIGHT SWITCH TO BE REMOVED COMPLETE. PROVIDE PROPER CONNECTION OF WIRES TO MAINTAIN CIRCUIT (CONTROLLED BY WALL SENSOR NEARBY)

(13) EXISTING POWER AND/OR DATA POLE TO BE REMOVED COMPLETE. REMOVE WIRING TO NEAREST JUNCTION BOX OR - IF NONE - POINT OF ORIGIN.

REMOVE COMPLETE EXISTING MILLWORK CABINETRY, COUNTERTOP AND WALL-MOUNTED SHELVING. PROTECT ADJACENT SURFACES FROM DAMAGE TO THE GREATEST EXTENT POSSIBLE. REPAIR ADJACENT SURFACES TO ORIGINAL CONDITION, AS NEEDED.

DEMOLITION NOTES

LEGEND

ALL EXISTING FLOORING FINISHES TO REMAIN UNLESS NOTED OTHERWISE. CONTRACTOR SHALL PROVIDE NECESSARY PROTECTION OF ALL FLOOR SURFACES TO REMAIN IN AREAS OF WORK AND ADJACENT AREAS THAT MAY RECEIVE CONSTRUCTION TRAFFIC. CONTRACTOR SHALL BE RESPONSIBLE TO REPAIR/REPLACE FLOORING DAMAGEDS DUE TO IMPROPER PROTECTION.

INSTALL TEMPORARY CONSTRUCTION BARRIERS (INCLUDING AT HVAC OPENINGS) TO PROTECT ADJACENT

SPACE(S) FROM INFILTRATION OF CONSTRUCTION DEBRIS. CONTRACTOR SHALL PERFORM ALL NECESSARY DEMOLITION WORK AS SHOWN ON DEMOLITION PLANS AND

ANY NECESSARY WORK TO ACCOMMODATE WORK SHOWN ON RENOVATION PLANS. CONTRACTOR SHALL PERFORM ALL ELECTRICAL AND DATA/COMM DEMOLITION WORK A THE PLANS.

GENERAL NOTES

ALL WORK SHALL BE PERFORMED IN A SAFE MANNER WITH PROTECTION PROVIDED TO ANY BUILDING

ALL WORK SHALL BE DONE IN A MANNER TO MINIMIZE DAMAGE TO ADJACENT SURFACES THAT ARE NOT SHOWN TO BE WORKED ON OR REMOVED - CONTRACTOR SHALL BE RESPONSIBLE FOR ALL WORK

NECESSARY TO REPAIR SURFACES AFFECTED BY THEIR WORK.

CONTRACTOR RESPONSIBLE FOR FIELD VERIFYING AS-BUILT CONDITIONS AND PROPOSED LAYOUT PRIOR TO

DETAILS OF EXISTING CONDITIONS PROVIDED AS A COURTESY. THIS INFORMATION DOES NOT RELIEVE THE CONTRACTOR FROM PERFORMING A COMPLETE NECESSARY FIELD INVESTIGATIVE WORK TO FULLY UNDERSTAND EXISTING CONDITIONS PRIOR TO SUBMITTING BID.

STATE OF MISSOURI MICHAEL L. PARSON, **GOVERNOR**



OFFICE OF **ADMINISTRATION DIVISION OF FACILITIES** MANAGEMENT / DESIGN AND CONSTRUCTION

DEPARTMENT OF LABOR AND INDUSTRIAL RELATIONS

THIRD FLOOR RENOVATION WORKER'S COMP. AND LABOR STANDARDS

EMPLOYMENT SECURITY CENTRAL OFFICE BUILDING 421 E. DUNKLIN

JEFFERSON CITY, MO

PROJECT # O22A201

FACILITY # 02601773

REVISION: DATE: **REVISION** DATE: **REVISION**: DATE:

ISSUE DATE: 5/18/2022


CAD DWG FILE: DRAWN BY: PM CHECKED BY: PMV DESIGNED BY: PMV

SHEET TITLE:

DEMOLITION FLOOR PLAN & GENERAL NOTES

SHEET NUMBER:

DEMOLITION FLOOR PLAN

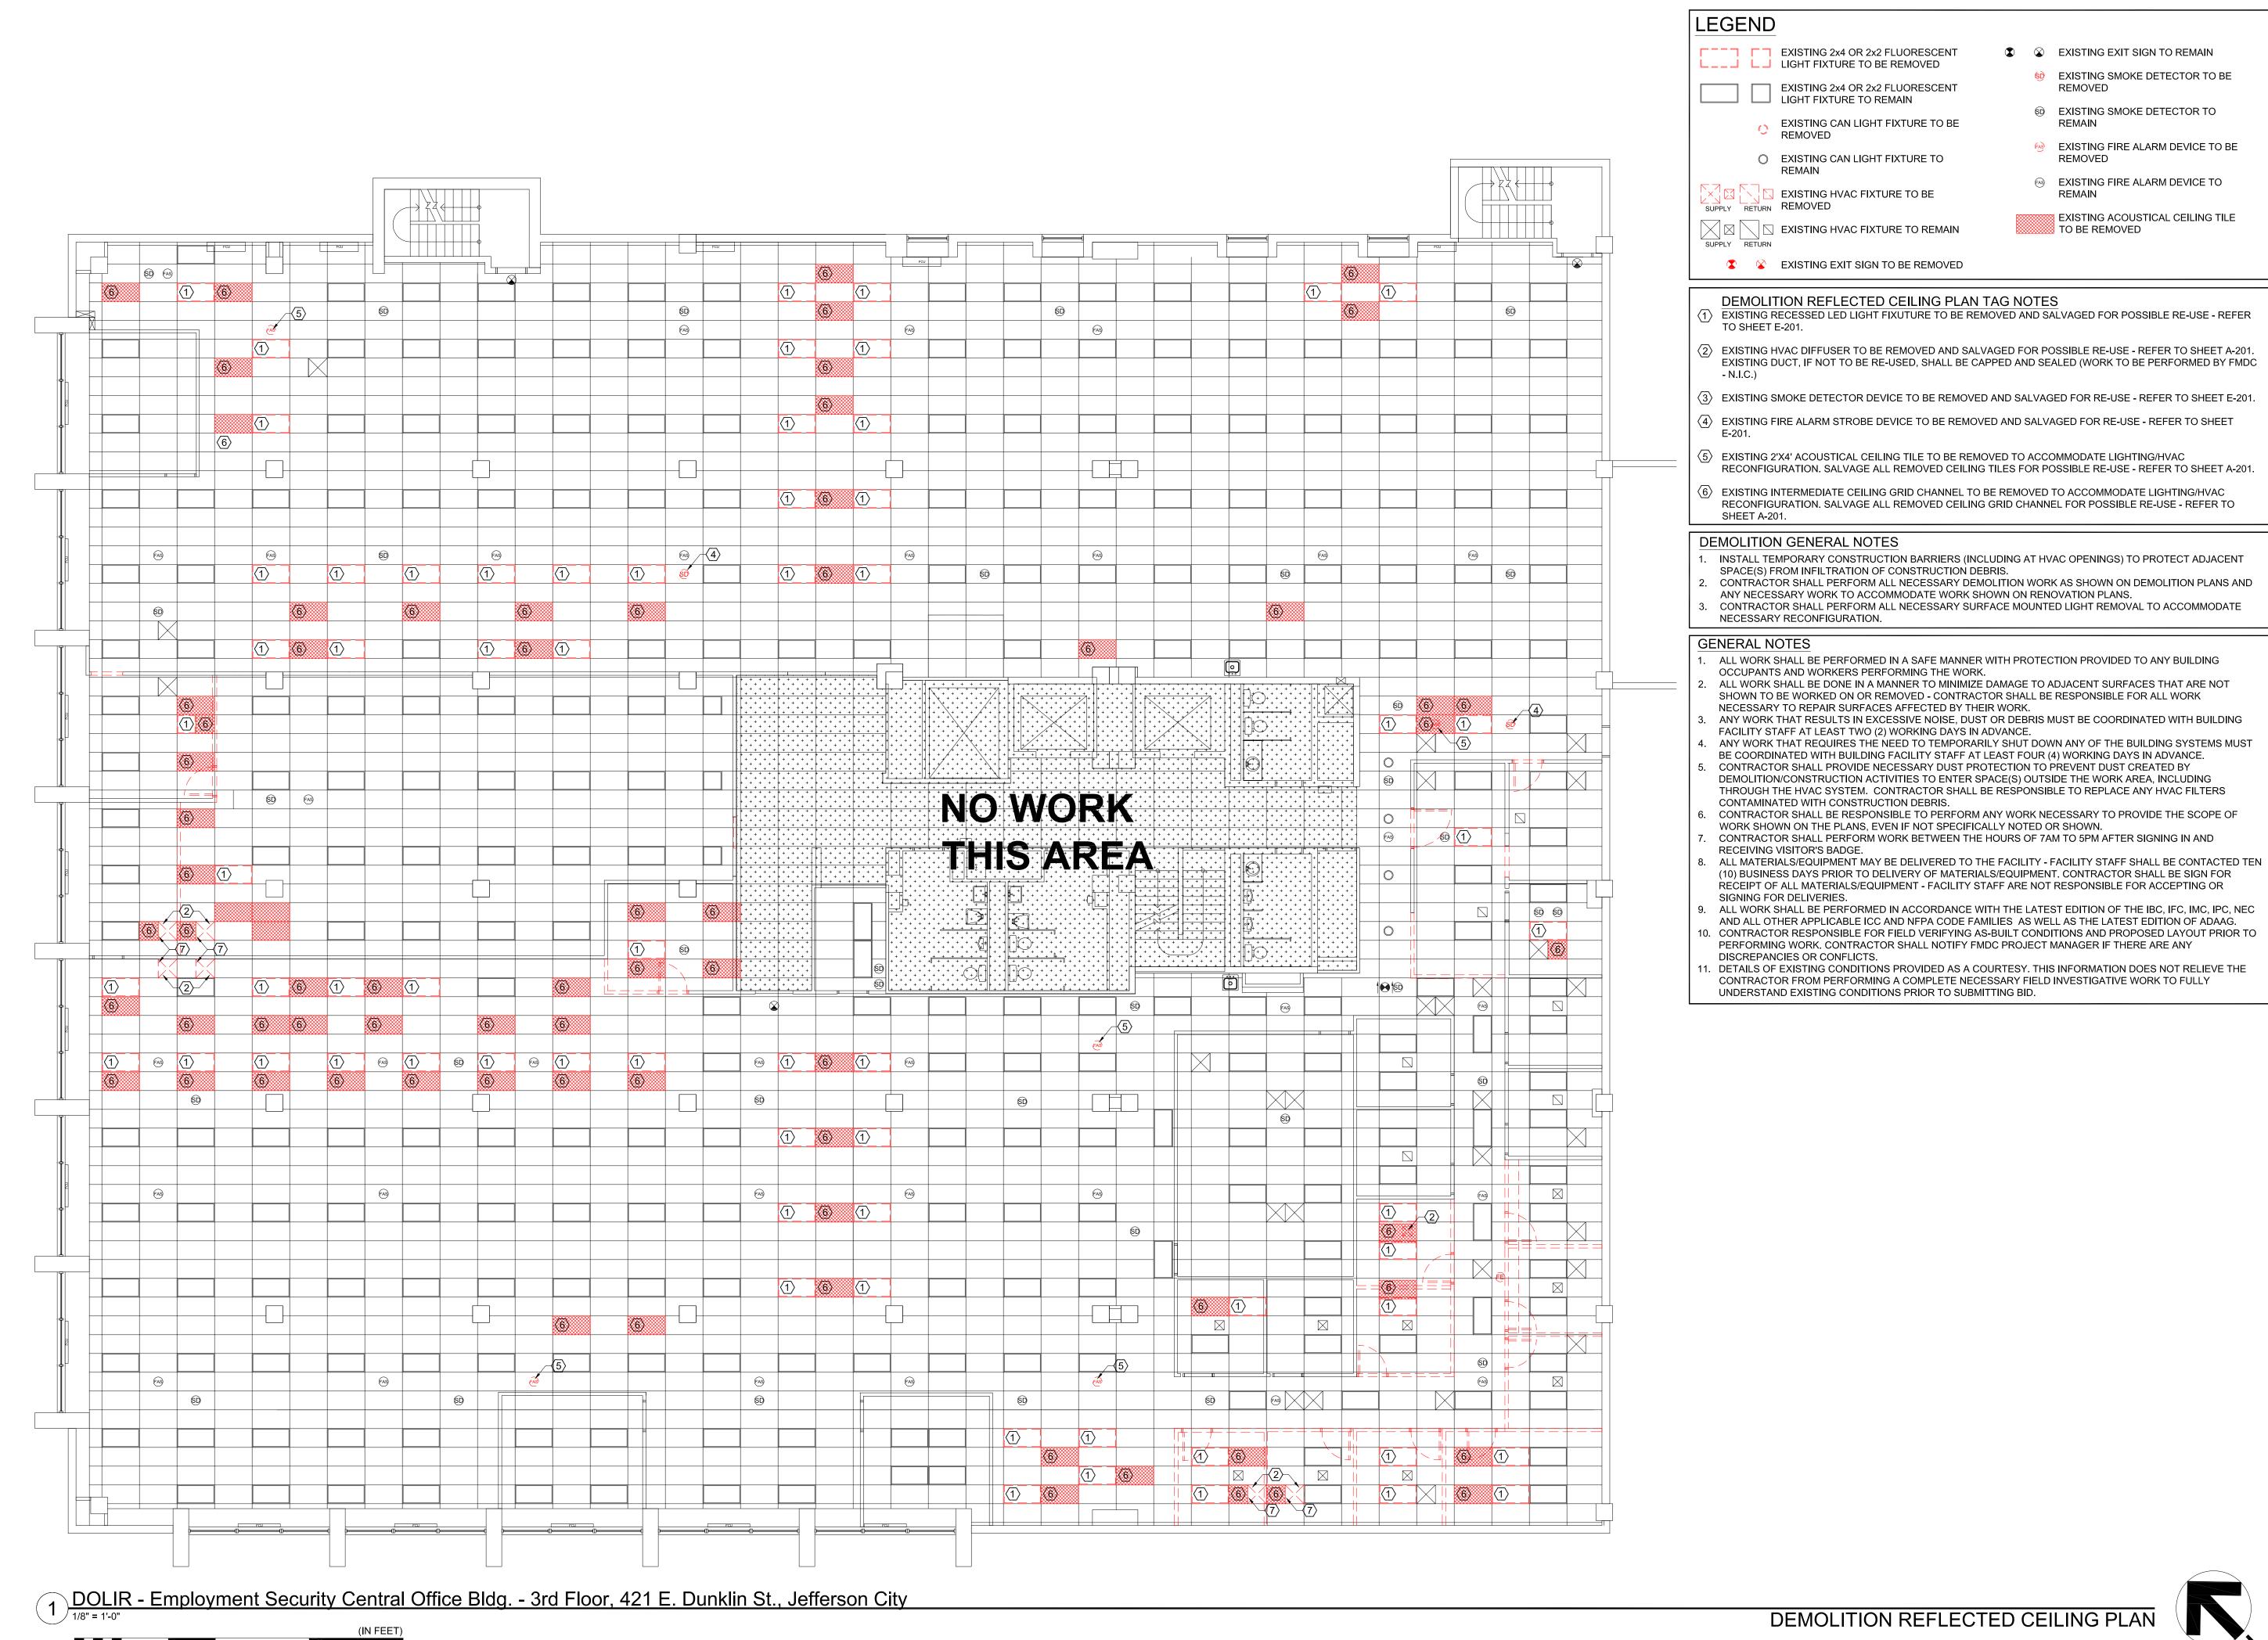

STATE OF MISSOURI MICHAEL L. PARSON, **GOVERNOR** EXISTING 2x4 OR 2x2 FLUORESCENT EXISTING EXIT SIGN TO REMAIN L___ LIGHT FIXTURE TO BE REMOVED EXISTING 2x4 OR 2x2 FLUORESCENT LIGHT FIXTURE TO REMAIN © EXISTING SMOKE DETECTOR TO EXISTING CAN LIGHT FIXTURE TO BE

EXISTING FIRE ALARM DEVICE TO BE

EXISTING ACOUSTICAL CEILING TILE

EXISTING FIRE ALARM DEVICE TO

REMOVED

▼ TO BE REMOVED

■ TO BE REMOVED

EXISTING CAN LIGHT FIXTURE TO

EXISTING HVAC FIXTURE TO BE

INTERIOR DESIGN

PROFESSIONAL SEAL

OFFICE OF ADMINISTRATION DIVISION OF FACILITIES MANAGEMENT / DESIGN AND CONSTRUCTION

LABOR AND INDUSTRIAL

DEPARTMENT OF

LABOR STANDARDS

RELATIONS

THIRD FLOOR RENOVATION WORKER'S COMP. AND

EMPLOYMENT SECURITY CENTRAL OFFICE BUILDING 421 E. DUNKLIN JEFFERSON CITY, MO

PROJECT # O22A201 FACILITY # 02601773

REVISION: REVISION: DATE: REVISION: DATE:

ISSUE DATE: 5/18/2022


CAD DWG FILE: DRAWN BY: PMV CHECKED BY: PMV DESIGNED BY: PMV


SHEET TITLE:

DEMOLITION REF. CLG. PLAN & GENERAL NOTES

SHEET NUMBER:

DEMOLITION REFLECTED CEILING PLAN

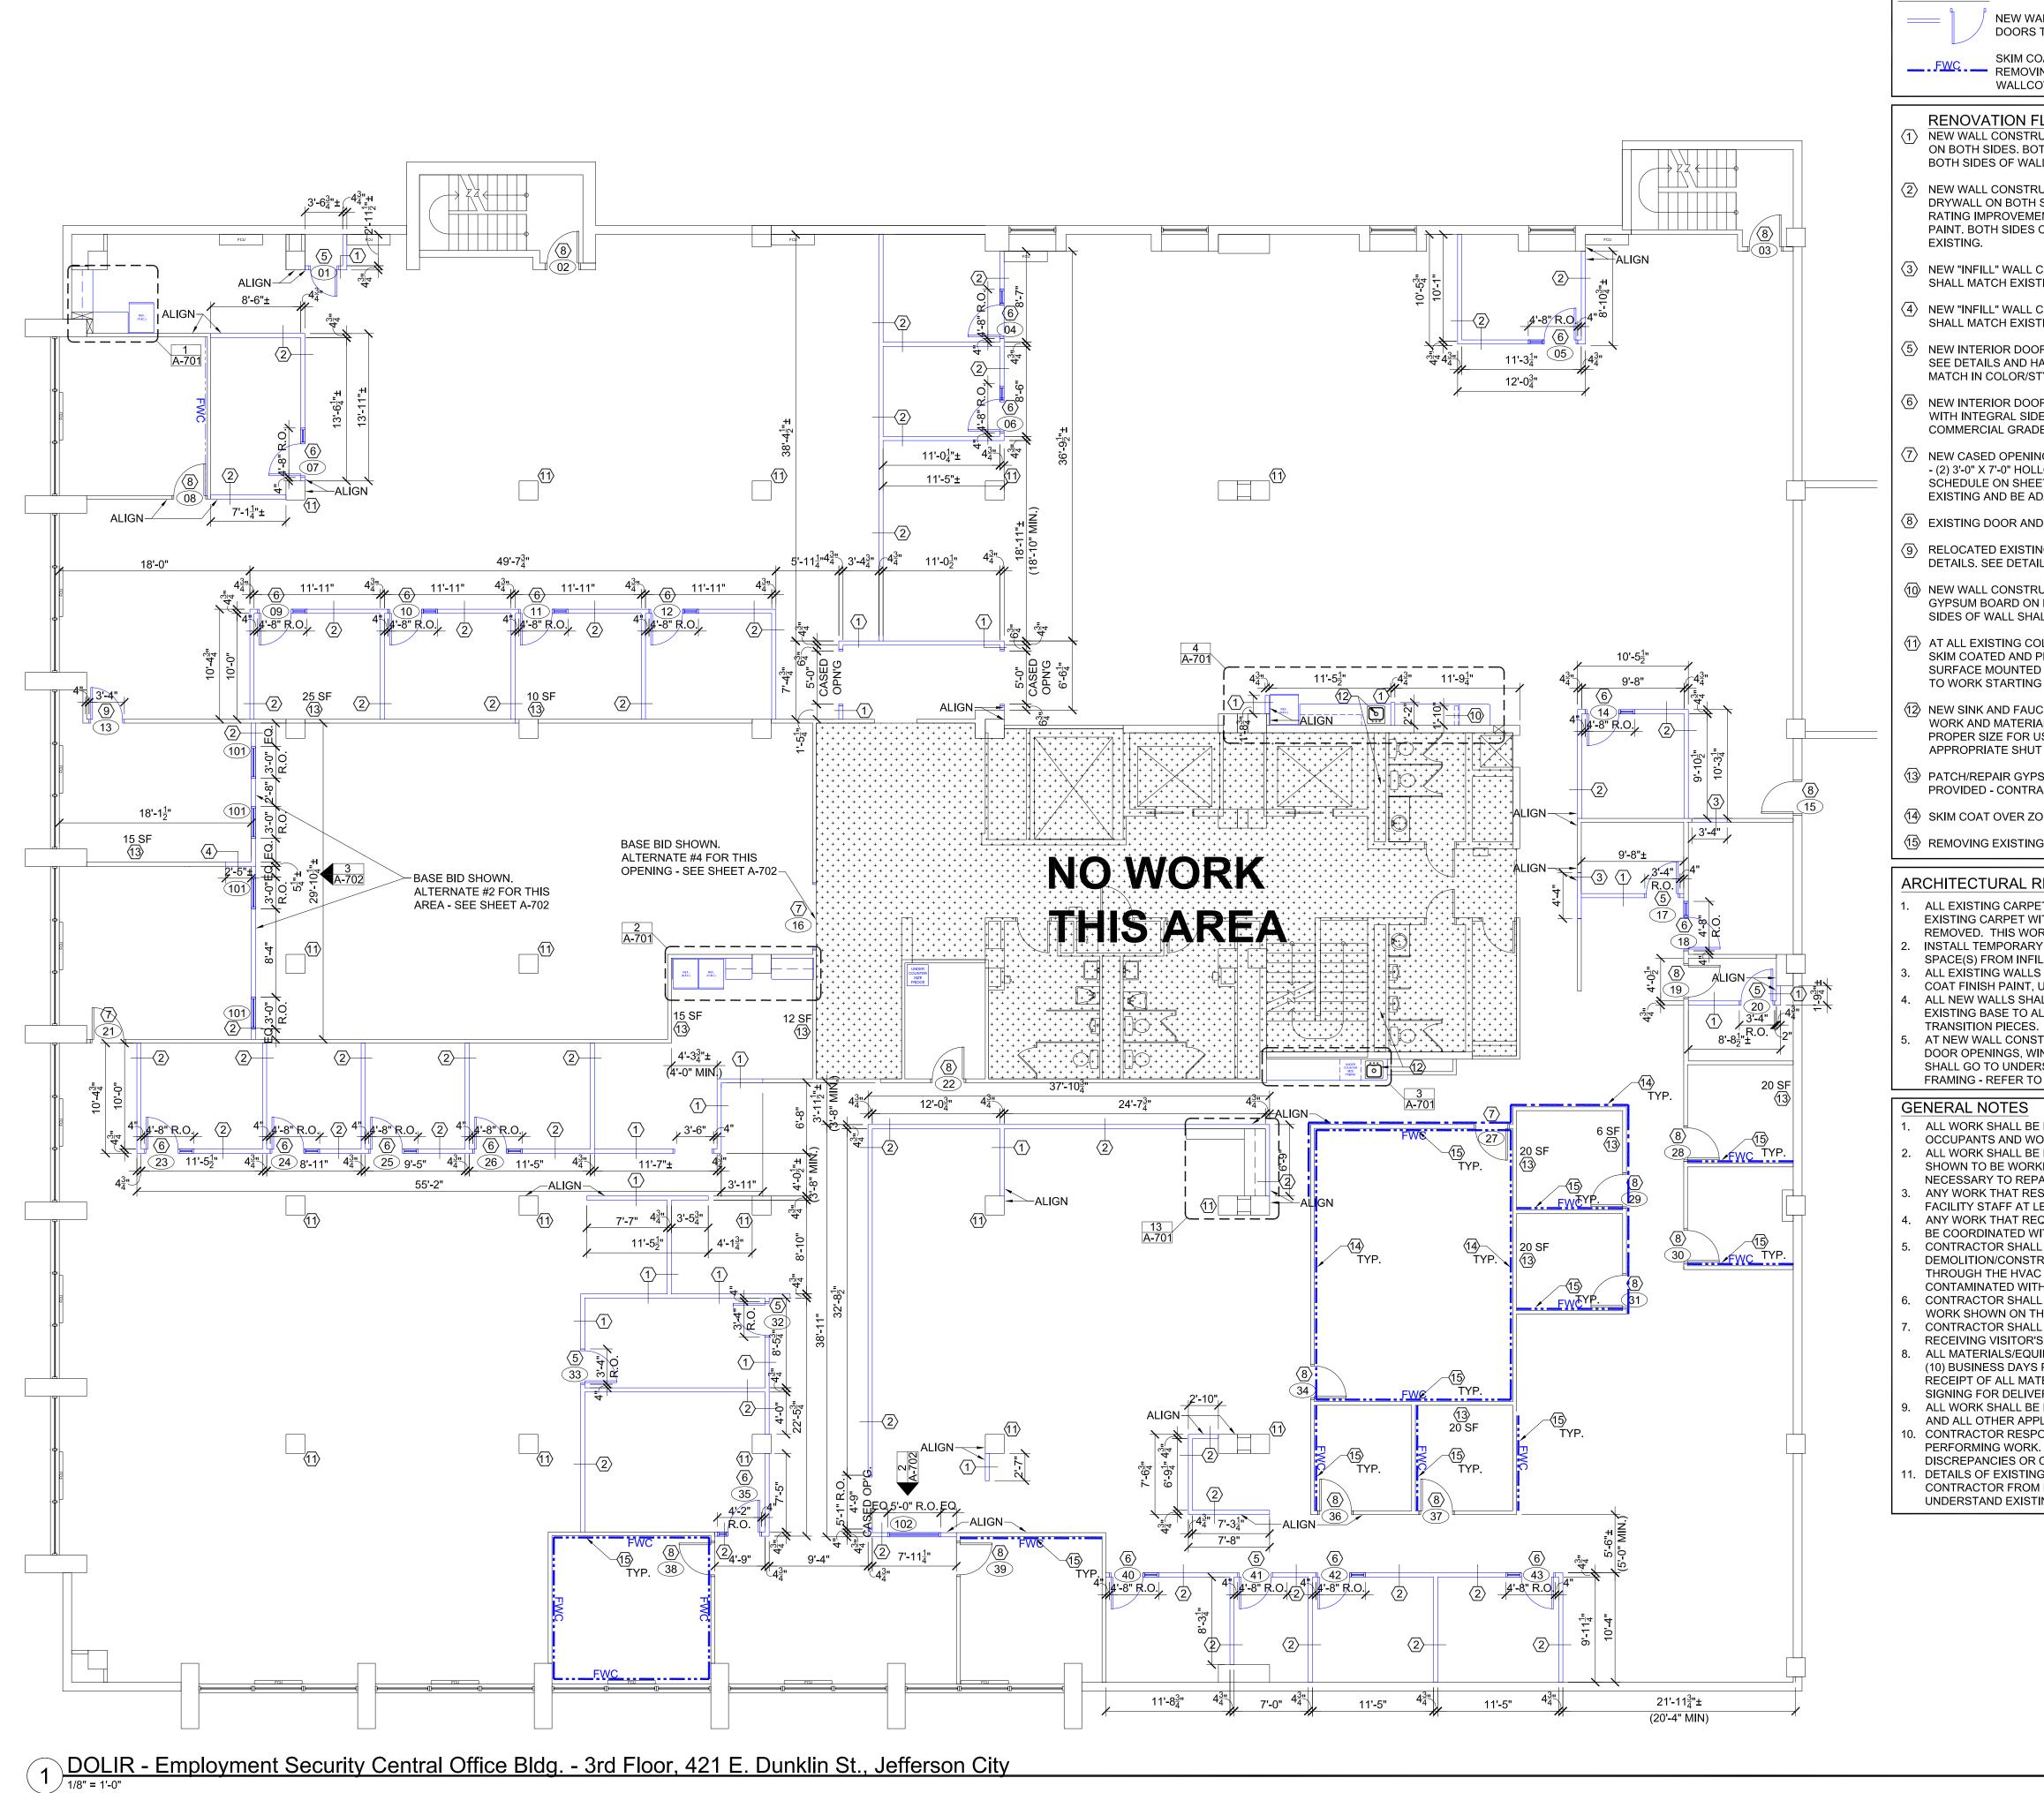

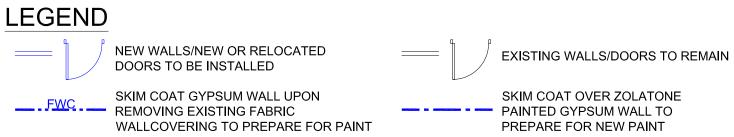

RENOVATION FLOOR PLAN TAG NOTES

- $\overline{1}$ NEW WALL CONSTRUCTION 25 GA., 3-1/2" METAL STUDS @ 16"O.C. WITH ONE (1) LAYER 5/8" GYPSUM BOARD ON BOTH SIDES. BOTH SIDES OF WALL SHALL BE PAINTED - (1) COAT PRIMER AND (2) COATS FINISH PAINT. BOTH SIDES OF WALL SHALL RECEIVE WALL BASE MATERIAL.
- NEW WALL CONSTRUCTION 25 GA., 3-1/2" METAL STUDS @ 16"O.C. WITH ONE (1) LAYER 5/8" GYPSUM BOARD DRYWALL ON BOTH SIDES. UNFACED SOUND BATT INSULATION IN WALL CAVITY (R-8 MIN. WITH 2-11 STC RATING IMPROVEMENT). BOTH SIDES OF WALL SHALL BE PAINTED - (1) COAT PRIMER AND (2) COATS FINISH PAINT. BOTH SIDES OF WALL SHALL RECEIVE WALL BASE MATERIAL - HEIGHT, PROFILE AND COLOR TO MATCH
- (3) NEW "INFILL" WALL CONSTRUCTION. EXISTING WALL THICKNESS IS APPROX. 4-1/4". "INFILL" CONSTRUCTION SHALL MATCH EXISTING TO THE GREATEST EXTENT POSSIBLE.
- 4 NEW "INFILL" WALL CONSTRUCTION. EXISTING WALL THICKNESS IS APPROX. 5-1/4". "INFILL" CONSTRUCTION SHALL MATCH EXISTING TO THE GREATEST EXTENT POSSIBLE.
- $\langle \underline{5}
 angle$ NEW INTERIOR DOOR AND FRAME 3'-0" X 7'-0" HOLLOW METAL DOOR AND METAL "KNOCK-DOWN" FRAME. SEE DETAILS AND HARDWARE SCHEDULE ON SHEET A-702. HARDWARE SHALL BE COMMERCIAL GRADE AND MATCH IN COLOR/STYLE AS EXISTING AND BE ADAAG 2010 COMPLIANT.
- $\langle 6 \rangle$ NEW INTERIOR DOOR AND FRAME 3'-0" X 7'-0" HOLLOW METAL DOOR AND METAL "KNOCK-DOWN" FRAME WITH INTEGRAL SIDELITE. SEE DETAILS AND HARDWARE SCHEDULE ON SHEET A-702. HARDWARE SHALL BE COMMERCIAL GRADE AND MATCH IN COLOR/STYLE AS EXISTING AND BE ADAAG 2010 COMPLIANT.
- 7 NEW CASED OPENING WITH PAINTED WOOD TRIM. (ALTERNATE #4 NEW INTERIOR DOUBLE DOOR AND FRAME - (2) 3'-0" X 7'-0" HOLLOW METAL DOORS AND METAL "KNOCK-DOWN" FRAME. SEE DETAILS AND HARDWARE SCHEDULE ON SHEET A-702. HARDWARE SHALL BE COMMERCIAL GRADE AND MATCH IN COLOR/STYLE AS EXISTING AND BE ADAAG 2010 COMPLIANT. SEE DETAILS ON SHEET A-702).
- \(\begin{aligned}
 & \text{STING DOOR AND FRAME TO REMAIN. SEE HARDWARE SCHEDULE ON SHEET A-702. \)
- (9) RELOCATED EXISTING HOLLOW METAL DOOR AND METAL FRAME. REFER TO SHEET D-101 FOR ADDITIONAL DETAILS. SEE DETAILS AND HARDWARE SCHEDULE ON SHEET A-702.
- NEW WALL CONSTRUCTION (UNDER COUNTER) 25 GA., 3-1/2" METAL STUDS @ 16"O.C. WITH ONE LAYER 5/8" GYPSUM BOARD ON BOTH SIDES. BOTH SIDES OF WALL SHALL BE PAINTED (1) COAT FINISH PAINT. BOTH SIDES OF WALL SHALL RECEIVE WALL BASE MATERIAL
- 们〉AT ALL EXISTING COLUMN ENCLOSURES WOOD TRIM TO BE REMOVED AND ALL EXISTING SURFACES TO BE SKIM COATED AND PREPARED FOR RE-PAINTING; (1) PRIME COAT AND (2) FINISH COATS. ALL EXISTING SURFACE MOUNTED DEVICES (SIGNAGE, FIRE EXTINGUISHERS, COVER PLATES, ETC.) TO BE REMOVED PRIOR TO WORK STARTING AND REINSTALLED UPON COMPLETION.
- (12) NEW SINK AND FAUCET PRODUCT/EQUIPMENT DETAILS ON SHEET A-701. PROVIDE NECESSARY PLUMBING WORK AND MATERIALS TO TIE TO NEARBY WATER (HOT AND COLD) AND WASTE LINES. NEW LINES TO BE OF PROPER SIZE FOR USE AND OF PROPER MATERIAL(S) TO EXTEND PLUMBING SYSTEMS. PROVIDE APPROPRIATE SHUT OFF VALVES AT NEW SINK LOCATION.
- 13 PATCH/REPAIR GYPSUM BOARD TO PREPARE SURFACE FOR NEW PAINT. APPROXIMATE AREA (IN SF) PROVIDED - CONTRACTOR TO FIELD VERIFY.
- (14) SKIM COAT OVER ZOLATONE PAINTED GYPSUM WALL AND REPAINT.
- (15) REMOVING EXISTING FABRIC WALLCOVERING. SKIM COAT GYPSUM WALL AND REPAINT

ARCHITECTURAL RENOVATION - GENERAL NOTES

- ALL EXISTING CARPET TO REMAIN, UNLESS NOTED OTHERWISE (SEE SHEET D-101). PROFESSIONALLY CLEAN EXISTING CARPET WITHIN WORK AREA. NOTIFY FMDC PROJECT MANAGER IF ANY STAINS ARE NOT ABLE TO BE
- INSTALL TEMPORARY CONSTRUCTION BARRIERS (INCLUDING AT HVAC OPENINGS) TO PROTECT ADJACENT SPACE(S) FROM INFILTRATION OF CONSTRUCTION DEBRIS ALL EXISTING WALLS IN AREA OF WORK SHALL BE PAINTED. ALL EXISTING WALLS SHALL RECEIVE ONE (1)
- COAT FINISH PAINT, UNLESS NOTED OTHERWISE. PAINT SHALL BE LOW VOC (LATEX).
- ALL NEW WALLS SHALL RECEIVE VINYL/RUBBER BASE. WHERE NEW WALLS INTERSECT EXISTING, CUT BACK
- DOOR OPENINGS, WINDOW OPENINGS OR WALL MOUNTED ACCESSORIES. ALL FRAMING AND GYPSUM BOARD SHALL GO TO UNDERSIDE OF EXISTING CEILING SURFACE (PROPERLY SECURE TOP PLATE TO CEILING FRAMING - REFER TO DETAILS ON SHEET A-701.

GENERAL NOTES

- ALL WORK SHALL BE PERFORMED IN A SAFE MANNER WITH PROTECTION PROVIDED TO ANY BUILDING
- OCCUPANTS AND WORKERS PERFORMING THE WORK.
- ALL WORK SHALL BE DONE IN A MANNER TO MINIMIZE DAMAGE TO ADJACENT SURFACES THAT ARE NOT SHOWN TO BE WORKED ON OR REMOVED - CONTRACTOR SHALL BE RESPONSIBLE FOR ALL WORK

- CONTRACTOR SHALL BE RESPONSIBLE TO PERFORM ANY WORK NECESSARY TO PROVIDE THE SCOPE OF WORK SHOWN ON THE PLANS, EVEN IF NOT SPECIFICALLY NOTED OR SHOWN.

- DISCREPANCIES OR CONFLICTS.
- DETAILS OF EXISTING CONDITIONS PROVIDED AS A COURTESY. THIS INFORMATION DOES NOT RELIEVE THE CONTRACTOR FROM PERFORMING A COMPLETE NECESSARY FIELD INVESTIGATIVE WORK TO FULLY UNDERSTAND EXISTING CONDITIONS PRIOR TO SUBMITTING BID.

STATE OF MISSOURI MICHAEL L. PARSON, **GOVERNOR**



PROFESSIONAL SEAL

OFFICE OF **ADMINISTRATION** DIVISION OF FACILITIES MANAGEMENT / DESIGN **AND CONSTRUCTION**

DEPARTMENT OF LABOR AND INDUSTRIAL **RELATIONS**

THIRD FLOOR RENOVATION WORKER'S COMP. AND LABOR STANDARDS

EMPLOYMENT SECURITY CENTRAL OFFICE BUILDING 421 E. DUNKLIN

JEFFERSON CITY, MO

PROJECT # O22A201

FACILITY # 02601773

REVISION: DATE: **REVISION**: DATE:

REVISION: DATE: ISSUE DATE: 5/18/2022

CAD DWG FILE: DRAWN BY: PM


CHECKED BY: PMV DESIGNED BY: PMV

SHEET TITLE:

RENOVATION FLOOR PLAN & GENERAL NOTES

SHEET NUMBER:

RENOVATION FLOOR PLAN

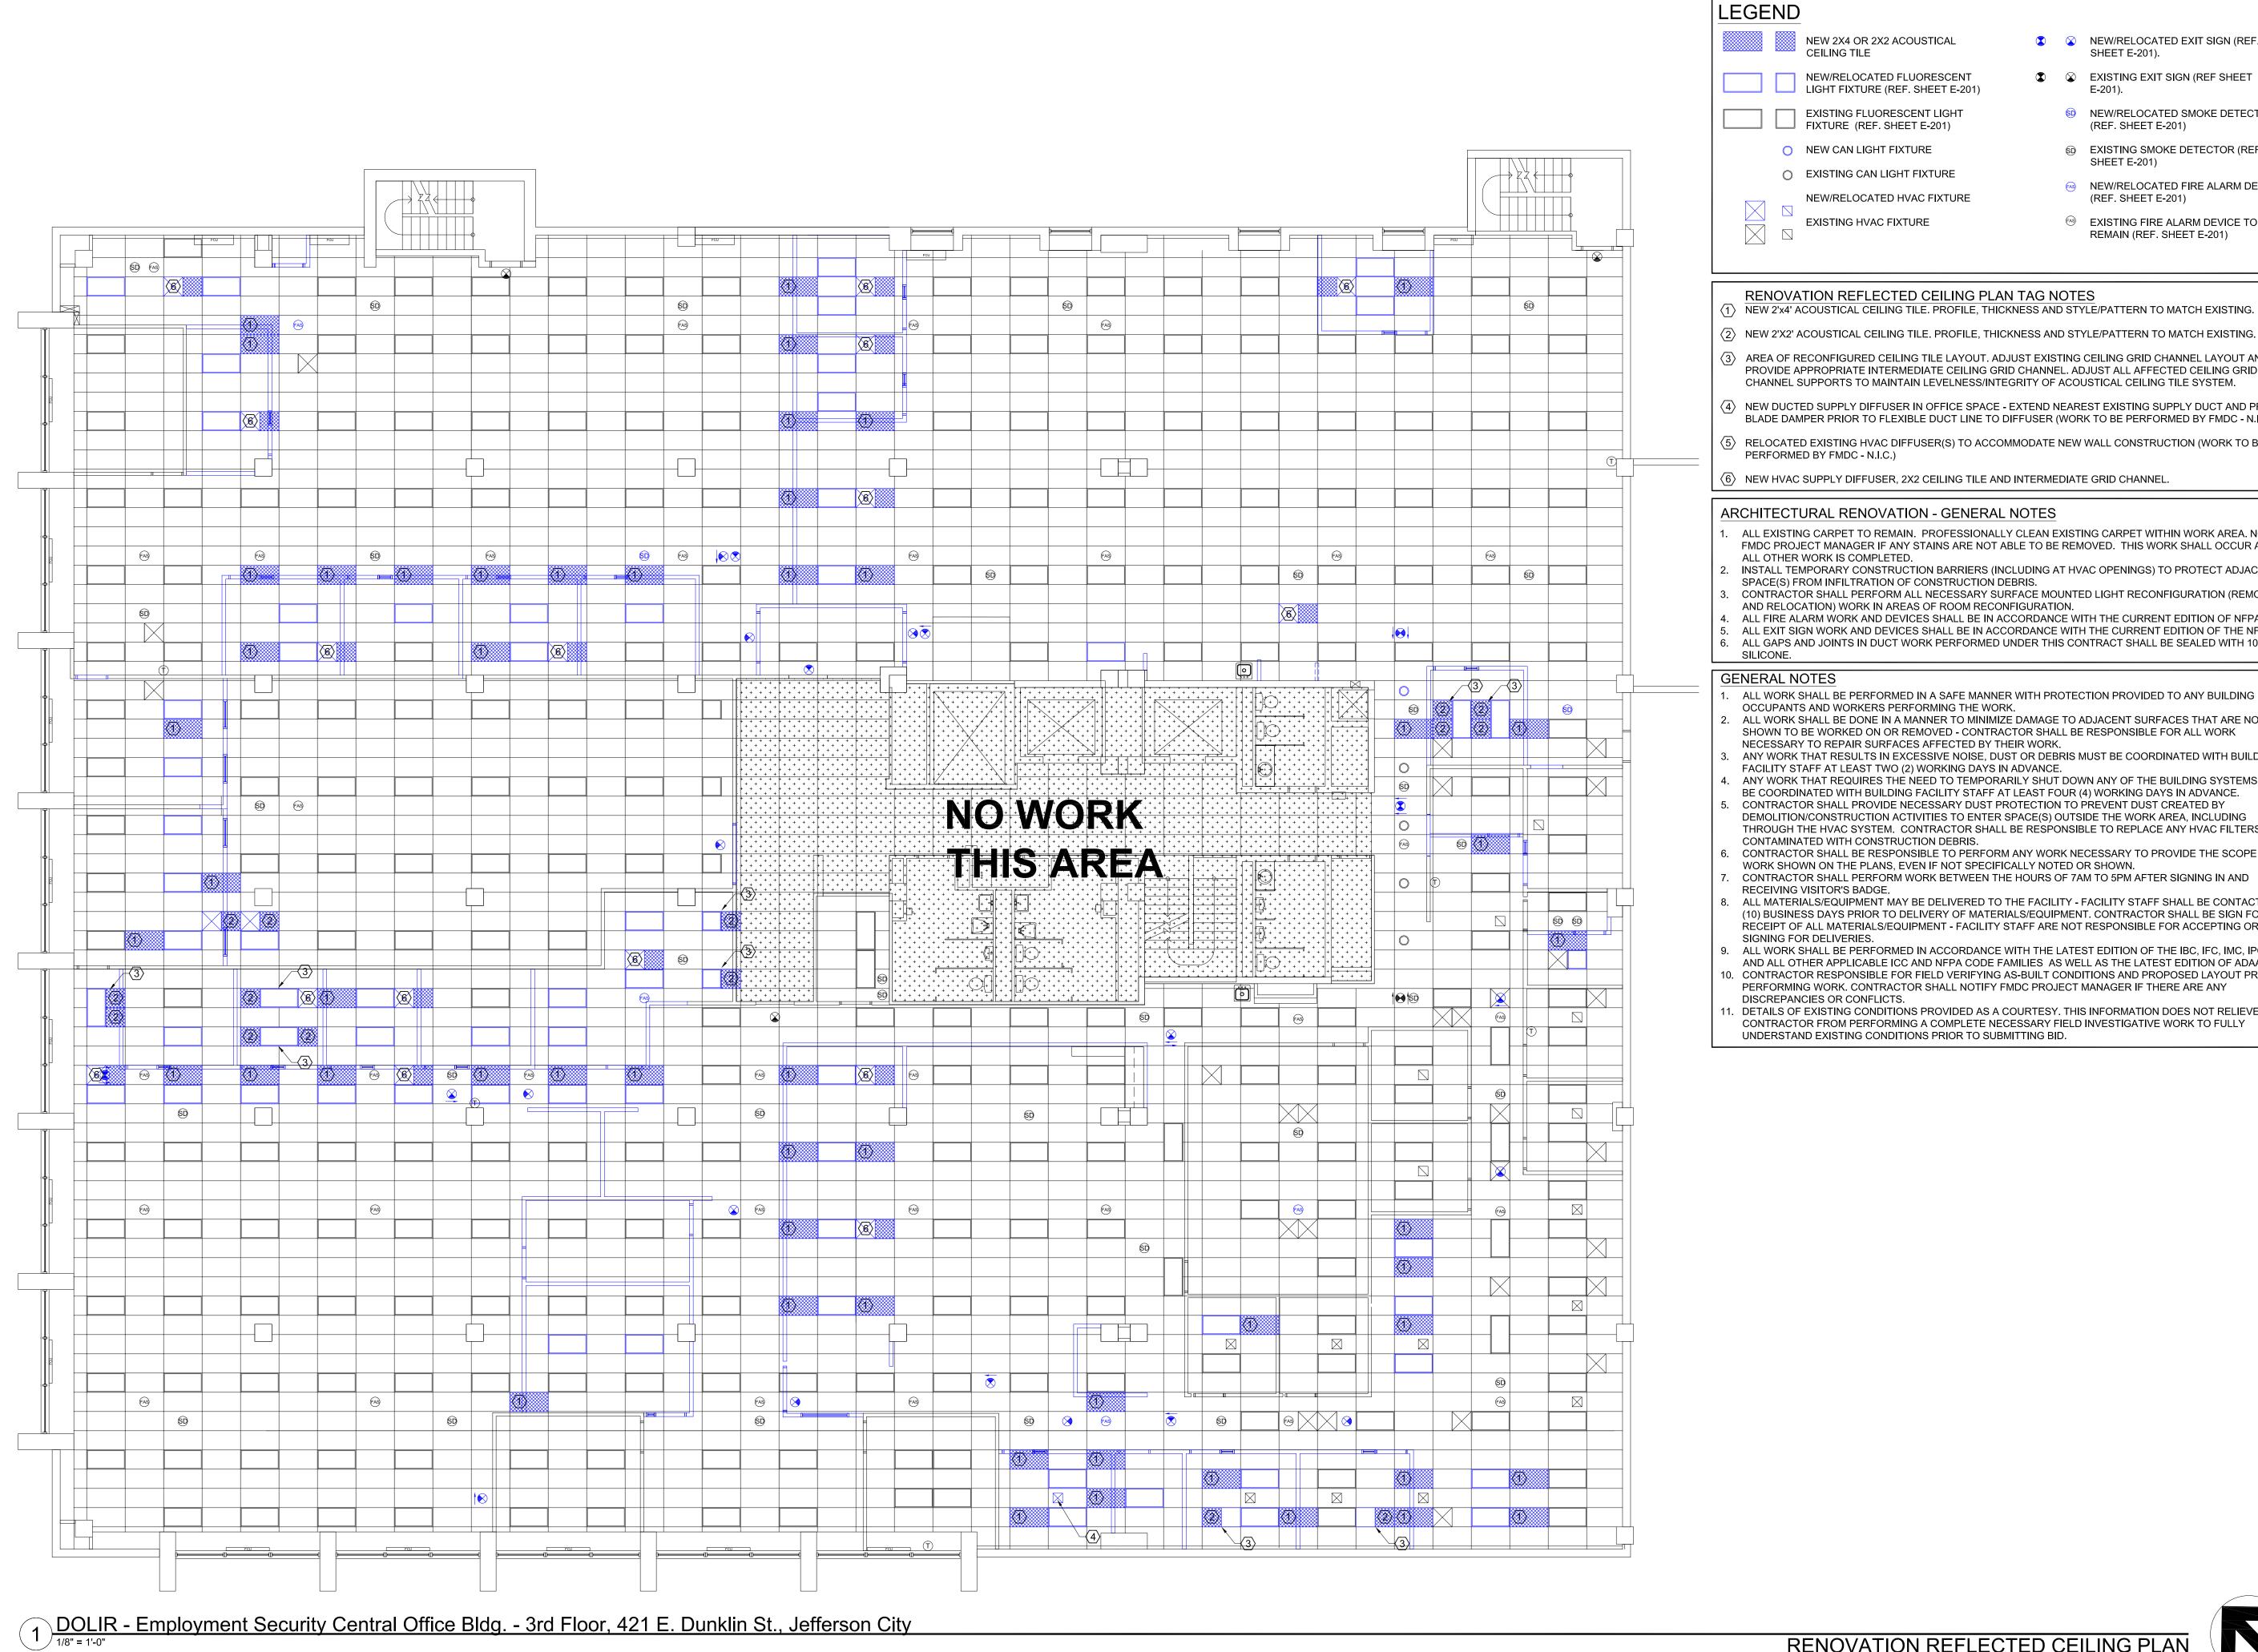

STATE OF MISSOURI MICHAEL L. PARSON, **GOVERNOR** NEW/RELOCATED EXIT SIGN (REF. SHEET E-201). EXISTING EXIT SIGN (REF SHEET)

90 NEW/RELOCATED SMOKE DETECTOR

NEW/RELOCATED FIRE ALARM DEVICE


© EXISTING SMOKE DETECTOR (REF.

 EXISTING FIRE ALARM DEVICE TO REMAIN (REF. SHEET E-201)

(REF. SHEET E-201)

(REF. SHEET E-201)

SHEET E-201)

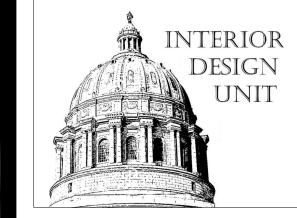

PROFESSIONAL SEAL

RENOVATION REFLECTED CEILING PLAN TAG NOTES

NEW 2X4 OR 2X2 ACOUSTICAL

NEW/RELOCATED FLUORESCENT

EXISTING FLUORESCENT LIGHT

EXISTING HVAC FIXTURE

LIGHT FIXTURE (REF. SHEET E-201)

CEILING TILE

NEW 2'x4' ACOUSTICAL CEILING TILE. PROFILE, THICKNESS AND STYLE/PATTERN TO MATCH EXISTING.

(3) AREA OF RECONFIGURED CEILING TILE LAYOUT. ADJUST EXISTING CEILING GRID CHANNEL LAYOUT AND PROVIDE APPROPRIATE INTERMEDIATE CEILING GRID CHANNEL. ADJUST ALL AFFECTED CEILING GRID CHANNEL SUPPORTS TO MAINTAIN LEVELNESS/INTEGRITY OF ACOUSTICAL CEILING TILE SYSTEM.

- (4) NEW DUCTED SUPPLY DIFFUSER IN OFFICE SPACE EXTEND NEAREST EXISTING SUPPLY DUCT AND PROVIDE BLADE DAMPER PRIOR TO FLEXIBLE DUCT LINE TO DIFFUSER (WORK TO BE PERFORMED BY FMDC - N.I.C.)
- (5) RELOCATED EXISTING HVAC DIFFUSER(S) TO ACCOMMODATE NEW WALL CONSTRUCTION (WORK TO BE PERFORMED BY FMDC - N.I.C.)
- (6) NEW HVAC SUPPLY DIFFUSER, 2X2 CEILING TILE AND INTERMEDIATE GRID CHANNEL.

ARCHITECTURAL RENOVATION - GENERAL NOTES

- ALL EXISTING CARPET TO REMAIN. PROFESSIONALLY CLEAN EXISTING CARPET WITHIN WORK AREA. NOTIFY FMDC PROJECT MANAGER IF ANY STAINS ARE NOT ABLE TO BE REMOVED. THIS WORK SHALL OCCUR AFTER ALL OTHER WORK IS COMPLETED.
- INSTALL TEMPORARY CONSTRUCTION BARRIERS (INCLUDING AT HVAC OPENINGS) TO PROTECT ADJACENT
- SPACE(S) FROM INFILTRATION OF CONSTRUCTION DEBRIS. CONTRACTOR SHALL PERFORM ALL NECESSARY SURFACE MOUNTED LIGHT RECONFIGURATION (REMOVAL
- AND RELOCATION) WORK IN AREAS OF ROOM RECONFIGURATION. ALL FIRE ALARM WORK AND DEVICES SHALL BE IN ACCORDANCE WITH THE CURRENT EDITION OF NFPA 72.
- ALL EXIT SIGN WORK AND DEVICES SHALL BE IN ACCORDANCE WITH THE CURRENT EDITION OF THE NFPA 101. 6. ALL GAPS AND JOINTS IN DUCT WORK PERFORMED UNDER THIS CONTRACT SHALL BE SEALED WITH 100% RTV

GENERAL NOTES

ALL WORK SHALL BE PERFORMED IN A SAFE MANNER WITH PROTECTION PROVIDED TO ANY BUILDING OCCUPANTS AND WORKERS PERFORMING THE WORK.

- ALL WORK SHALL BE DONE IN A MANNER TO MINIMIZE DAMAGE TO ADJACENT SURFACES THAT ARE NOT SHOWN TO BE WORKED ON OR REMOVED - CONTRACTOR SHALL BE RESPONSIBLE FOR ALL WORK
- NECESSARY TO REPAIR SURFACES AFFECTED BY THEIR WORK. ANY WORK THAT RESULTS IN EXCESSIVE NOISE, DUST OR DEBRIS MUST BE COORDINATED WITH BUILDING
- FACILITY STAFF AT LEAST TWO (2) WORKING DAYS IN ADVANCE.
- ANY WORK THAT REQUIRES THE NEED TO TEMPORARILY SHUT DOWN ANY OF THE BUILDING SYSTEMS MUST BE COORDINATED WITH BUILDING FACILITY STAFF AT LEAST FOUR (4) WORKING DAYS IN ADVANCE.
- CONTRACTOR SHALL PROVIDE NECESSARY DUST PROTECTION TO PREVENT DUST CREATED BY DEMOLITION/CONSTRUCTION ACTIVITIES TO ENTER SPACE(S) OUTSIDE THE WORK AREA, INCLUDING THROUGH THE HVAC SYSTEM. CONTRACTOR SHALL BE RESPONSIBLE TO REPLACE ANY HVAC FILTERS
- CONTAMINATED WITH CONSTRUCTION DEBRIS. CONTRACTOR SHALL BE RESPONSIBLE TO PERFORM ANY WORK NECESSARY TO PROVIDE THE SCOPE OF
- WORK SHOWN ON THE PLANS, EVEN IF NOT SPECIFICALLY NOTED OR SHOWN. CONTRACTOR SHALL PERFORM WORK BETWEEN THE HOURS OF 7AM TO 5PM AFTER SIGNING IN AND
- RECEIVING VISITOR'S BADGE. ALL MATERIALS/EQUIPMENT MAY BE DELIVERED TO THE FACILITY - FACILITY STAFF SHALL BE CONTACTED TEN (10) BUSINESS DAYS PRIOR TO DELIVERY OF MATERIALS/EQUIPMENT. CONTRACTOR SHALL BE SIGN FOR
- RECEIPT OF ALL MATERIALS/EQUIPMENT FACILITY STAFF ARE NOT RESPONSIBLE FOR ACCEPTING OR ALL WORK SHALL BE PERFORMED IN ACCORDANCE WITH THE LATEST EDITION OF THE IBC, IFC, IMC, IPC, NEC
- AND ALL OTHER APPLICABLE ICC AND NFPA CODE FAMILIES AS WELL AS THE LATEST EDITION OF ADAAG. CONTRACTOR RESPONSIBLE FOR FIELD VERIFYING AS-BUILT CONDITIONS AND PROPOSED LAYOUT PRIOR TO PERFORMING WORK. CONTRACTOR SHALL NOTIFY FMDC PROJECT MANAGER IF THERE ARE ANY DISCREPANCIES OR CONFLICTS.
- DETAILS OF EXISTING CONDITIONS PROVIDED AS A COURTESY. THIS INFORMATION DOES NOT RELIEVE THE CONTRACTOR FROM PERFORMING A COMPLETE NECESSARY FIELD INVESTIGATIVE WORK TO FULLY UNDERSTAND EXISTING CONDITIONS PRIOR TO SUBMITTING BID.

OFFICE OF ADMINISTRATION DIVISION OF FACILITIES MANAGEMENT / DESIGN AND CONSTRUCTION

DEPARTMENT OF LABOR AND INDUSTRIAL RELATIONS

THIRD FLOOR RENOVATION WORKER'S COMP. AND LABOR STANDARDS

EMPLOYMENT SECURITY CENTRAL OFFICE BUILDING 421 E. DUNKLIN JEFFERSON CITY, MO

PROJECT # O22A201 SITE# FACILITY # 02601773

REVISION: REVISION: DATE: REVISION: DATE:

CAD DWG FILE: DRAWN BY: PM

ISSUE DATE: 5/18/2022


CHECKED BY: PMV DESIGNED BY: PMV

SHEET TITLE:

RENOVATION REF. CLG. PLAN & GENERAL NOTES

SHEET NUMBER:

RENOVATION REFLECTED CEILING PLAN

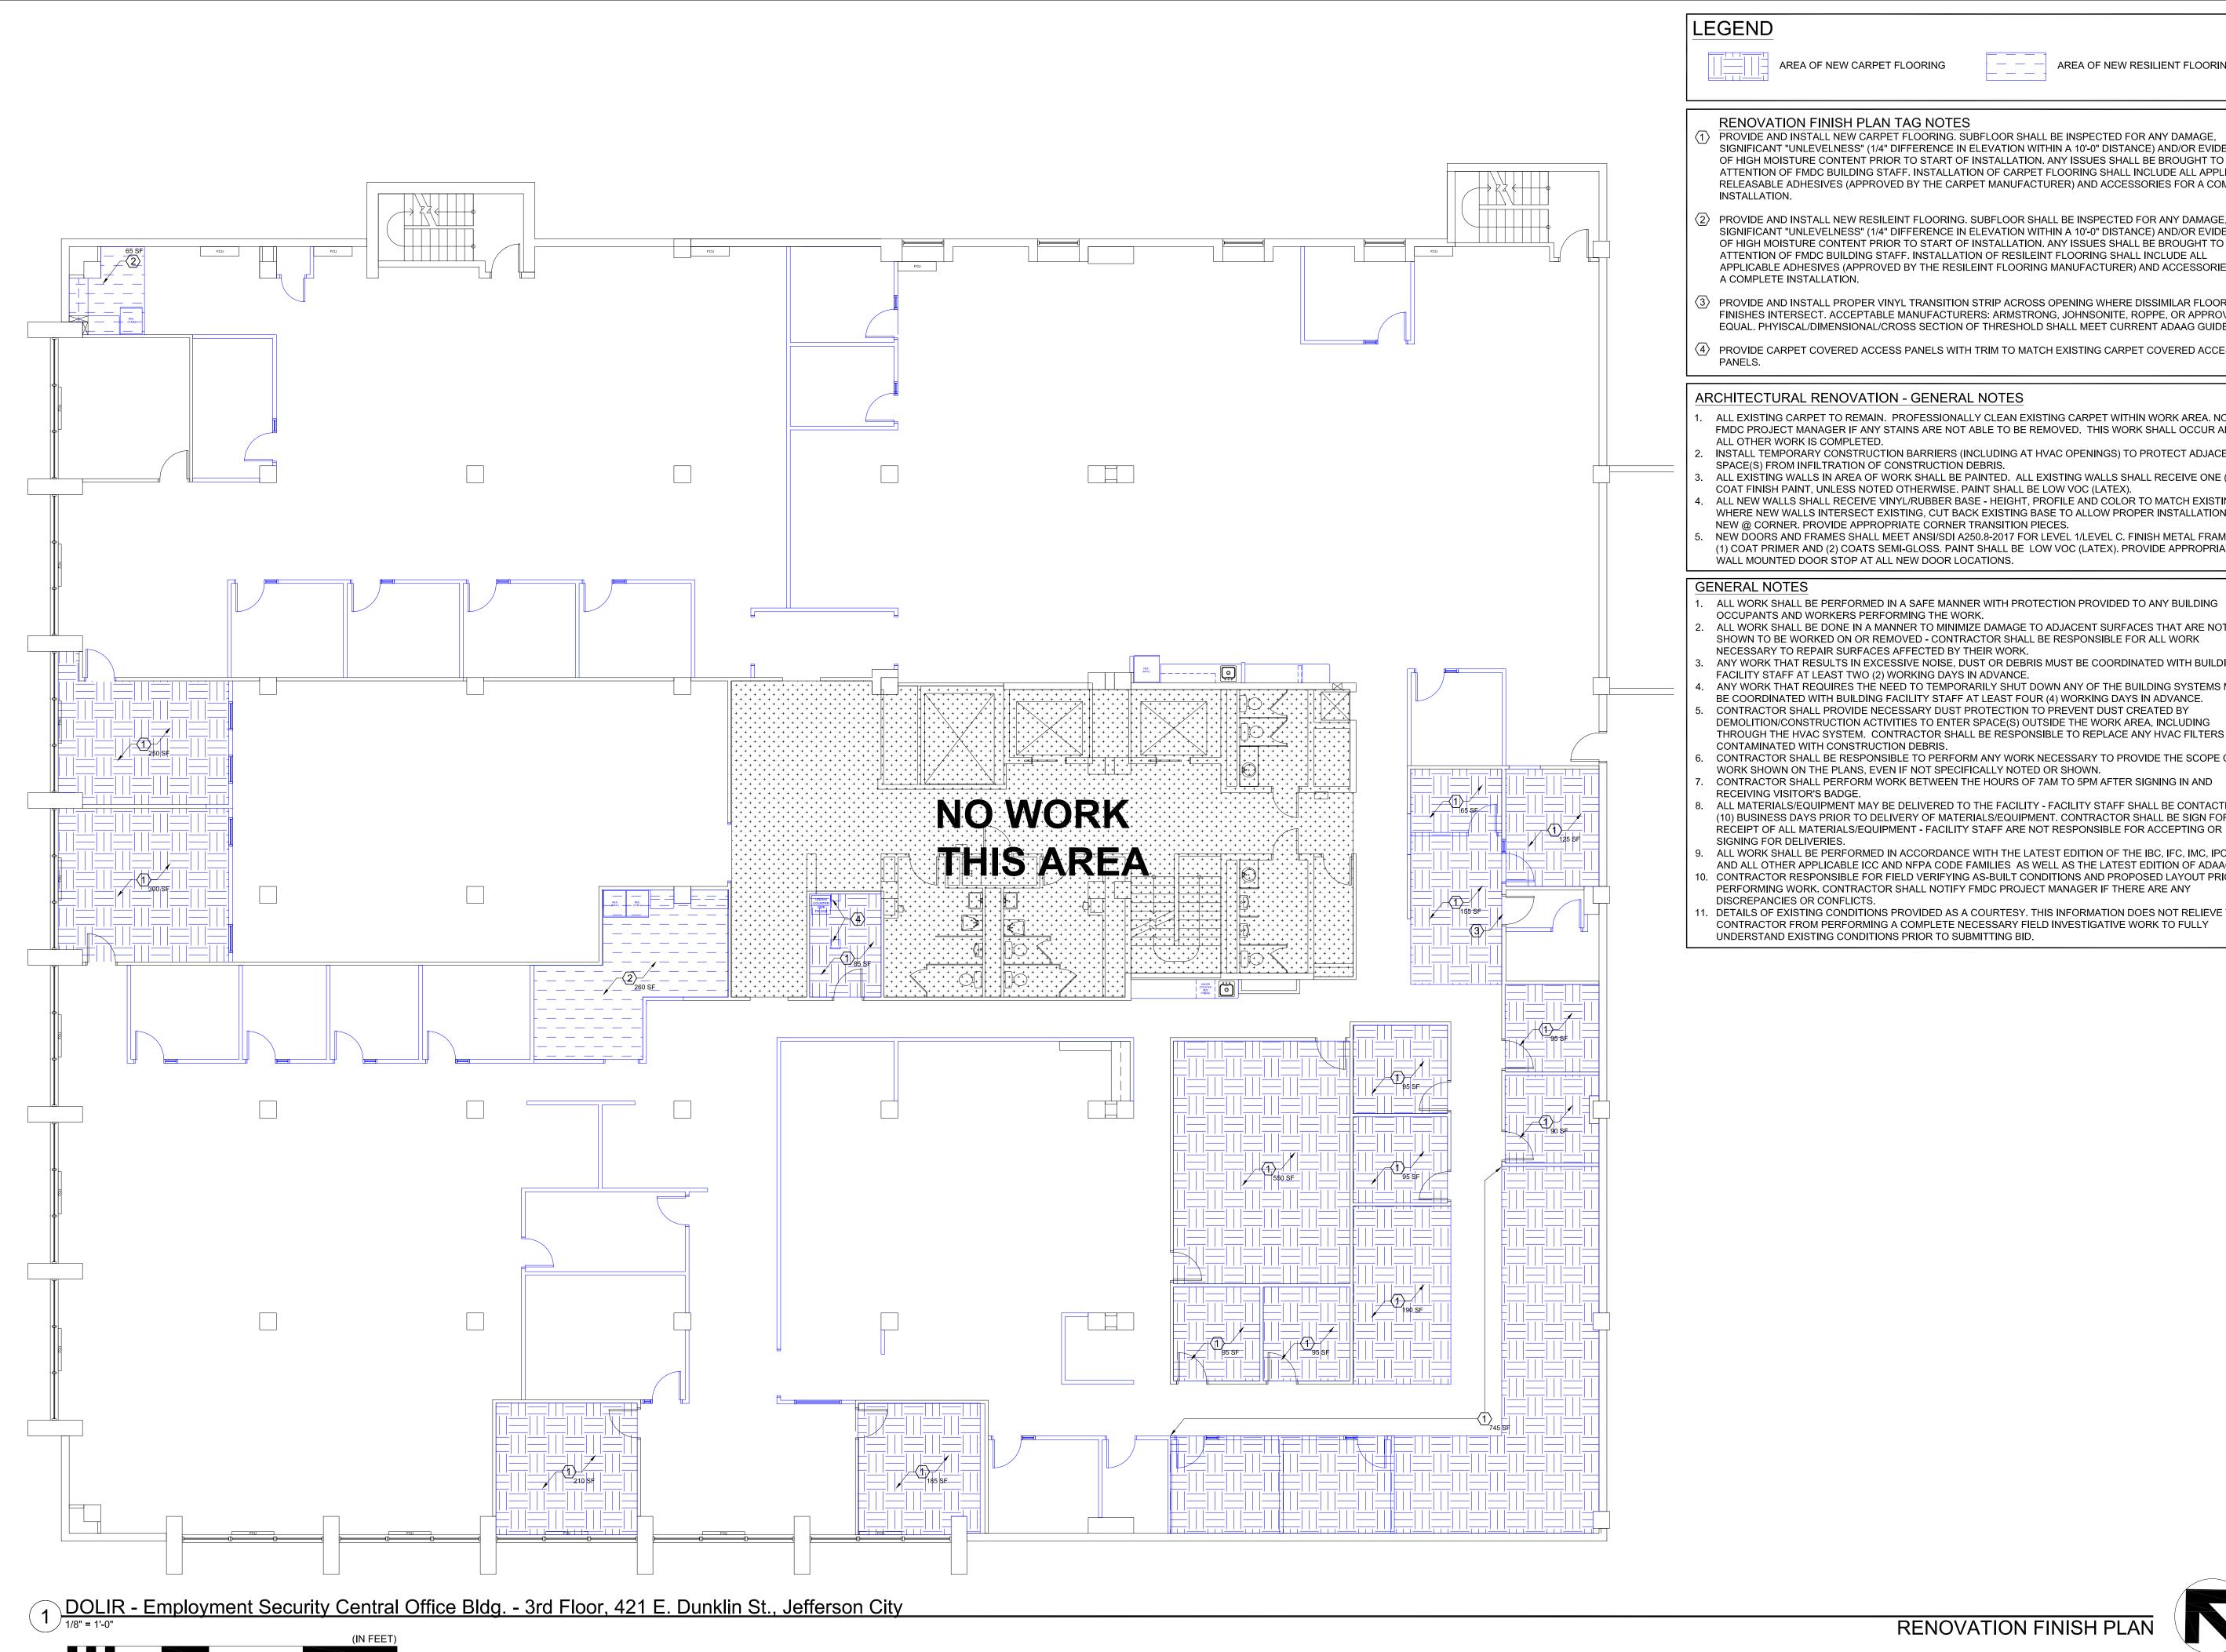



RENOVATION FINISH PLAN TAG NOTES

1> PROVIDE AND INSTALL NEW CARPET FLOORING. SUBFLOOR SHALL BE INSPECTED FOR ANY DAMAGE, SIGNIFICANT "UNLEVELNESS" (1/4" DIFFERENCE IN ELEVATION WITHIN A 10'-0" DISTANCE) AND/OR EVIDENCE OF HIGH MOISTURE CONTENT PRIOR TO START OF INSTALLATION. ANY ISSUES SHALL BE BROUGHT TO THE ATTENTION OF FMDC BUILDING STAFF. INSTALLATION OF CARPET FLOORING SHALL INCLUDE ALL APPLICABLE RELEASABLE ADHESIVES (APPROVED BY THE CARPET MANUFACTURER) AND ACCESSORIES FOR A COMPLETE

- $\langle 2
 angle$ PROVIDE AND INSTALL NEW RESILEINT FLOORING. SUBFLOOR SHALL BE INSPECTED FOR ANY DAMAGE, SIGNIFICANT "UNLEVELNESS" (1/4" DIFFERENCE IN ELEVATION WITHIN A 10'-0" DISTANCE) AND/OR EVIDENCE OF HIGH MOISTURE CONTENT PRIOR TO START OF INSTALLATION. ANY ISSUES SHALL BE BROUGHT TO THE ATTENTION OF FMDC BUILDING STAFF. INSTALLATION OF RESILEINT FLOORING SHALL INCLUDE ALL APPLICABLE ADHESIVES (APPROVED BY THE RESILEINT FLOORING MANUFACTURER) AND ACCESSORIES FOR A COMPLETE INSTALLATION.
- $\langle 3 \rangle$ PROVIDE AND INSTALL PROPER VINYL TRANSITION STRIP ACROSS OPENING WHERE DISSIMILAR FLOOR FINISHES INTERSECT. ACCEPTABLE MANUFACTURERS: ARMSTRONG, JOHNSONITE, ROPPE, OR APPROVED EQUAL. PHYISCAL/DIMENSIONAL/CROSS SECTION OF THRESHOLD SHALL MEET CURRENT ADAAG GUIDELINES.
- 4 PROVIDE CARPET COVERED ACCESS PANELS WITH TRIM TO MATCH EXISTING CARPET COVERED ACCESS

ARCHITECTURAL RENOVATION - GENERAL NOTES

- ALL EXISTING CARPET TO REMAIN. PROFESSIONALLY CLEAN EXISTING CARPET WITHIN WORK AREA. NOTIFY FMDC PROJECT MANAGER IF ANY STAINS ARE NOT ABLE TO BE REMOVED. THIS WORK SHALL OCCUR AFTER ALL OTHER WORK IS COMPLETED.
- INSTALL TEMPORARY CONSTRUCTION BARRIERS (INCLUDING AT HVAC OPENINGS) TO PROTECT ADJACENT SPACE(S) FROM INFILTRATION OF CONSTRUCTION DEBRIS.
- ALL EXISTING WALLS IN AREA OF WORK SHALL BE PAINTED. ALL EXISTING WALLS SHALL RECEIVE ONE (1)
- COAT FINISH PAINT, UNLESS NOTED OTHERWISE. PAINT SHALL BE LOW VOC (LATEX). ALL NEW WALLS SHALL RECEIVE VINYL/RUBBER BASE - HEIGHT, PROFILE AND COLOR TO MATCH EXISTING. WHERE NEW WALLS INTERSECT EXISTING, CUT BACK EXISTING BASE TO ALLOW PROPER INSTALLATION OF
- NEW @ CORNER. PROVIDE APPROPRIATE CORNER TRANSITION PIECES. NEW DOORS AND FRAMES SHALL MEET ANSI/SDI A250.8-2017 FOR LEVEL 1/LEVEL C. FINISH METAL FRAME WITH (1) COAT PRIMER AND (2) COATS SEMI-GLOSS. PAINT SHALL BE LOW VOC (LATEX). PROVIDE APPROPRIATE WALL MOUNTED DOOR STOP AT ALL NEW DOOR LOCATIONS.

GENERAL NOTES

- ALL WORK SHALL BE PERFORMED IN A SAFE MANNER WITH PROTECTION PROVIDED TO ANY BUILDING
- OCCUPANTS AND WORKERS PERFORMING THE WORK. ALL WORK SHALL BE DONE IN A MANNER TO MINIMIZE DAMAGE TO ADJACENT SURFACES THAT ARE NOT SHOWN TO BE WORKED ON OR REMOVED - CONTRACTOR SHALL BE RESPONSIBLE FOR ALL WORK
- NECESSARY TO REPAIR SURFACES AFFECTED BY THEIR WORK. ANY WORK THAT RESULTS IN EXCESSIVE NOISE, DUST OR DEBRIS MUST BE COORDINATED WITH BUILDING
- FACILITY STAFF AT LEAST TWO (2) WORKING DAYS IN ADVANCE. ANY WORK THAT REQUIRES THE NEED TO TEMPORARILY SHUT DOWN ANY OF THE BUILDING SYSTEMS MUST
- BE COORDINATED WITH BUILDING FACILITY STAFF AT LEAST FOUR (4) WORKING DAYS IN ADVANCE. CONTRACTOR SHALL PROVIDE NECESSARY DUST PROTECTION TO PREVENT DUST CREATED BY DEMOLITION/CONSTRUCTION ACTIVITIES TO ENTER SPACE(S) OUTSIDE THE WORK AREA, INCLUDING
- CONTAMINATED WITH CONSTRUCTION DEBRIS. CONTRACTOR SHALL BE RESPONSIBLE TO PERFORM ANY WORK NECESSARY TO PROVIDE THE SCOPE OF
- WORK SHOWN ON THE PLANS, EVEN IF NOT SPECIFICALLY NOTED OR SHOWN.
- CONTRACTOR SHALL PERFORM WORK BETWEEN THE HOURS OF 7AM TO 5PM AFTER SIGNING IN AND
- ALL MATERIALS/EQUIPMENT MAY BE DELIVERED TO THE FACILITY FACILITY STAFF SHALL BE CONTACTED TEN (10) BUSINESS DAYS PRIOR TO DELIVERY OF MATERIALS/EQUIPMENT. CONTRACTOR SHALL BE SIGN FOR RECEIPT OF ALL MATERIALS/EQUIPMENT - FACILITY STAFF ARE NOT RESPONSIBLE FOR ACCEPTING OR SIGNING FOR DELIVERIES.
- ALL WORK SHALL BE PERFORMED IN ACCORDANCE WITH THE LATEST EDITION OF THE IBC, IFC, IMC, IPC, NEC CONTRACTOR RESPONSIBLE FOR FIELD VERIFYING AS-BUILT CONDITIONS AND PROPOSED LAYOUT PRIOR TO
- DISCREPANCIES OR CONFLICTS. DETAILS OF EXISTING CONDITIONS PROVIDED AS A COURTESY. THIS INFORMATION DOES NOT RELIEVE THE CONTRACTOR FROM PERFORMING A COMPLETE NECESSARY FIELD INVESTIGATIVE WORK TO FULLY

STATE OF MISSOURI MICHAEL L. PARSON, **GOVERNOR**



PROFESSIONAL SEAL

OFFICE OF **ADMINISTRATION** DIVISION OF FACILITIES MANAGEMENT / DESIGN AND CONSTRUCTION

DEPARTMENT OF LABOR AND INDUSTRIAL RELATIONS

THIRD FLOOR RENOVATION WORKER'S COMP. AND LABOR STANDARDS

EMPLOYMENT SECURITY CENTRAL OFFICE BUILDING 421 E. DUNKLIN JEFFERSON CITY, MO

PROJECT # O22A201 FACILITY # 02601773

REVISION: DATE: **REVISION** DATE: **REVISION**: DATE:

ISSUE DATE: 05/18/2022


CAD DWG FILE: DRAWN BY: CHECKED BY: PMV
DESIGNED BY: PMV

SHEET TITLE:


RENOVATION FINISH PLAN & GENERAL NOTES

SHEET NUMBER:

RENOVATION FINISH PLAN

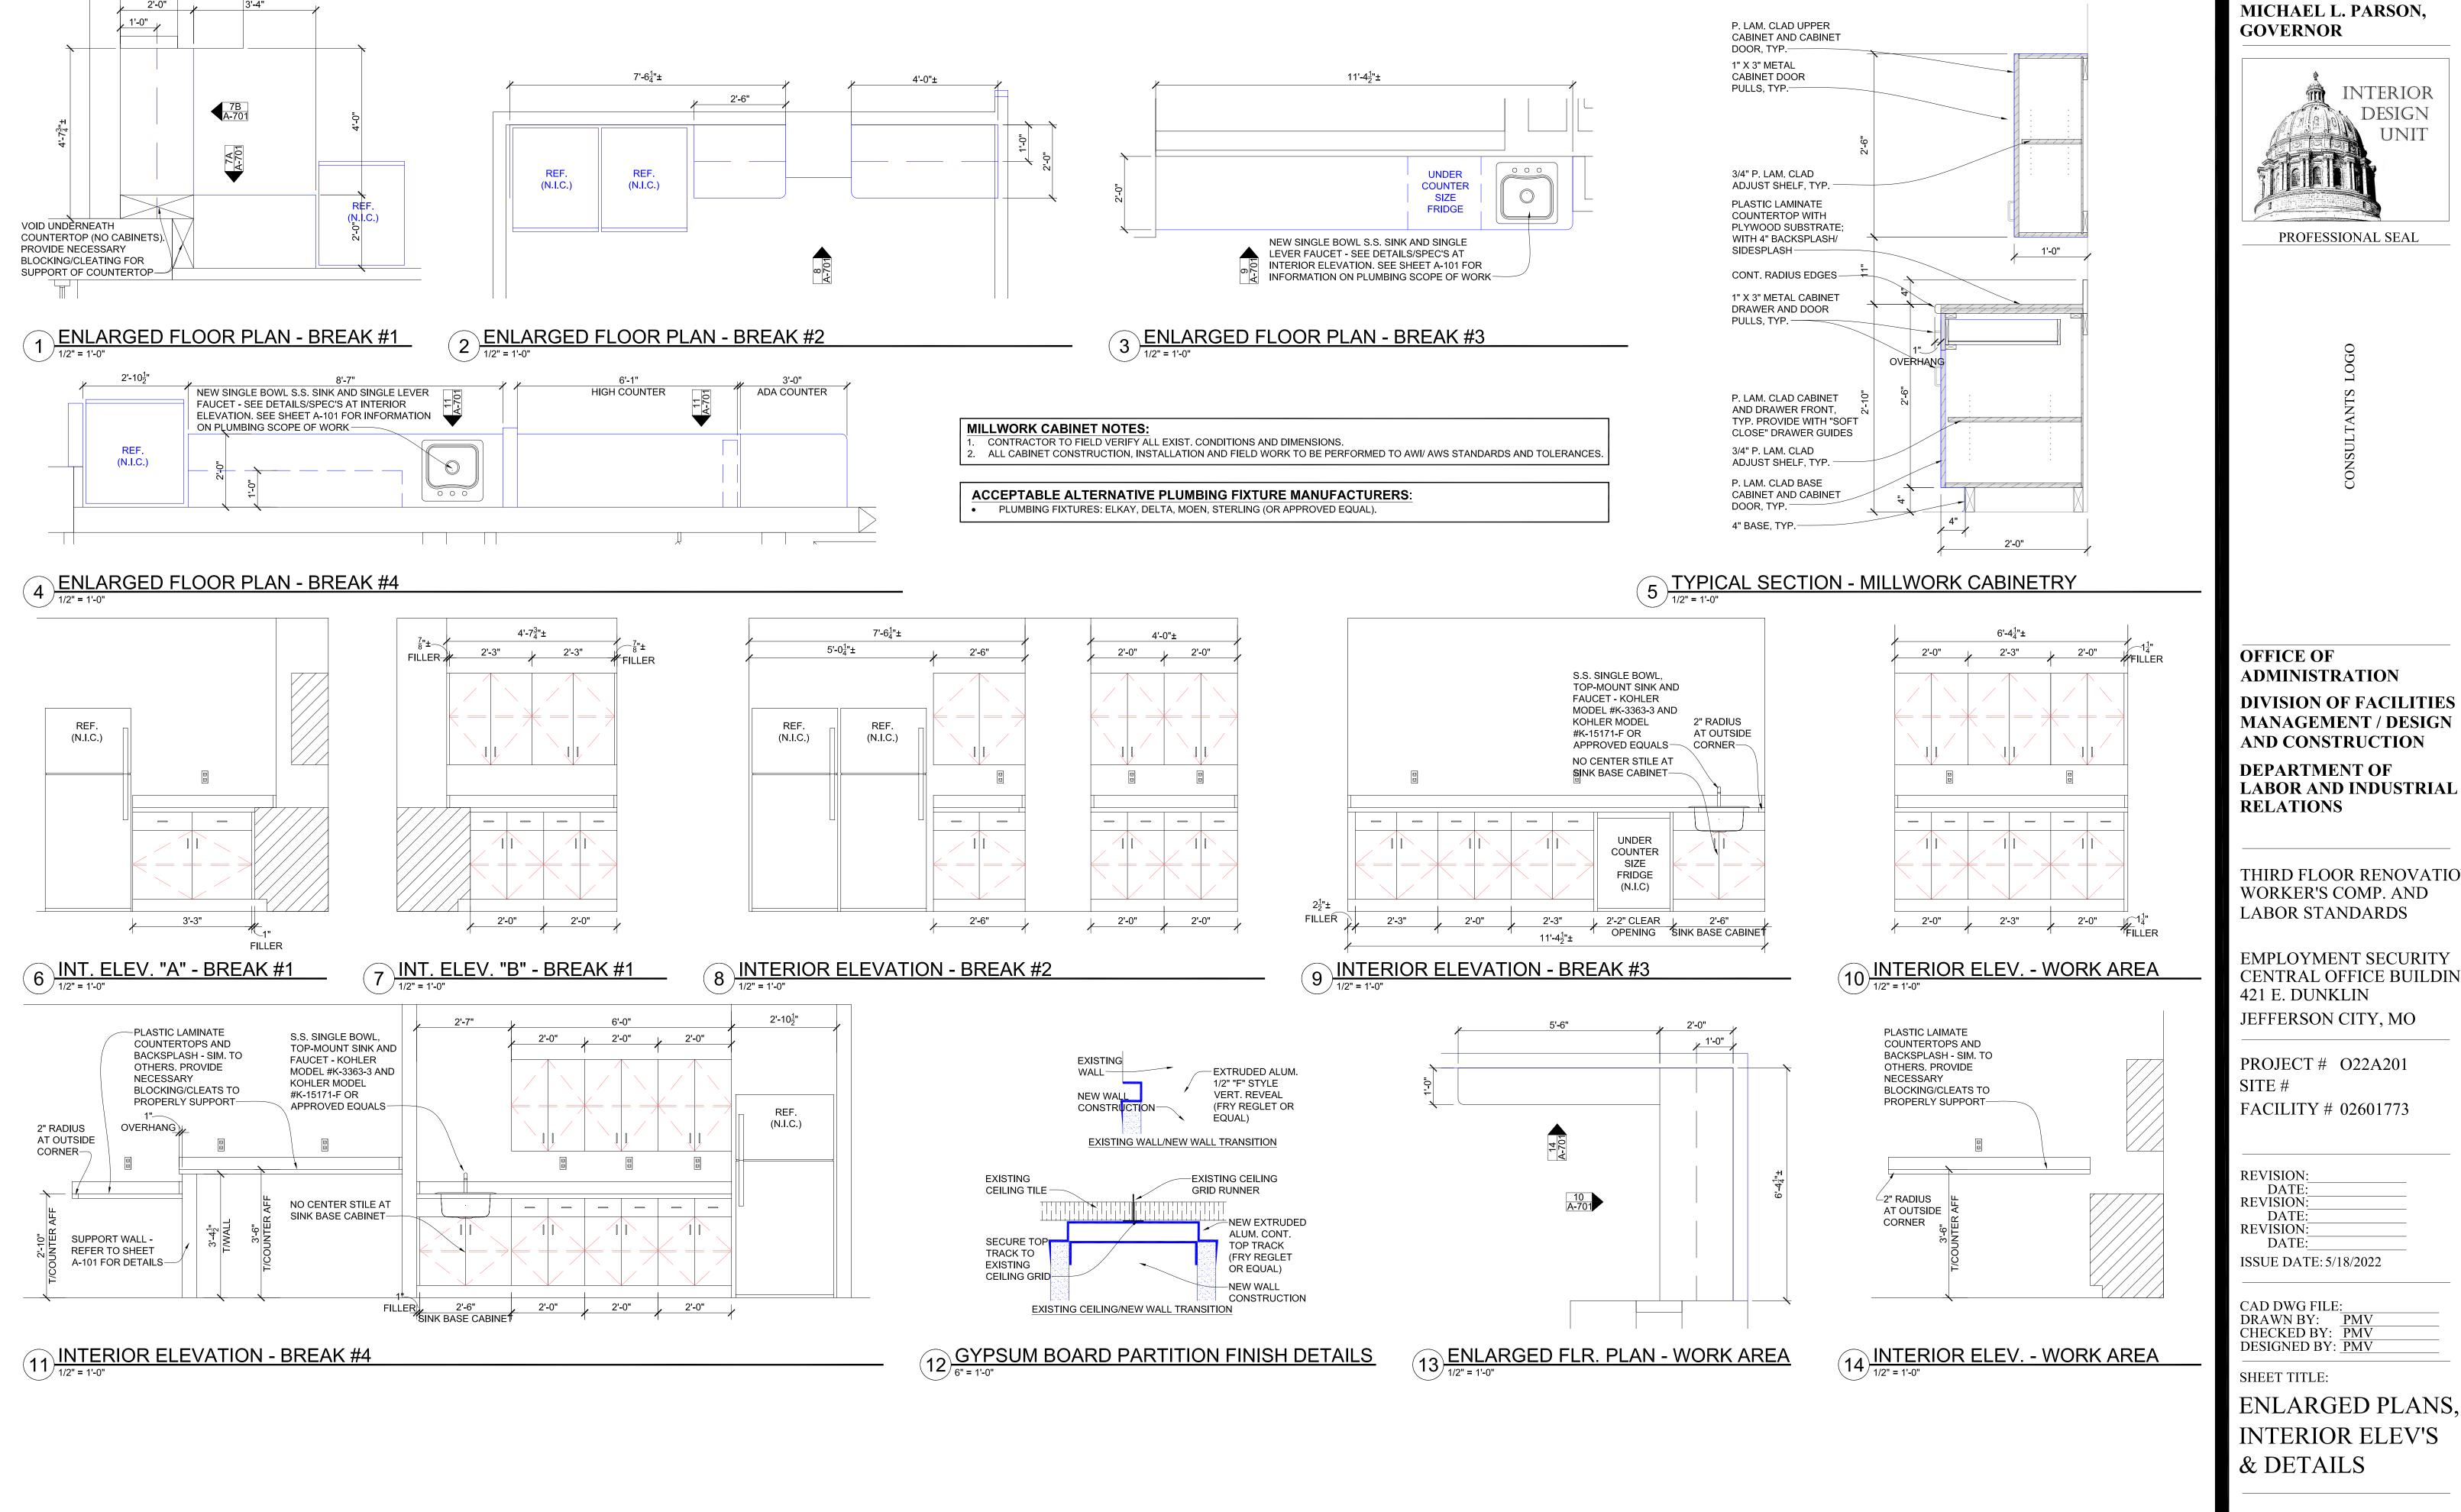

STATE OF MISSOURI MICHAEL L. PARSON,

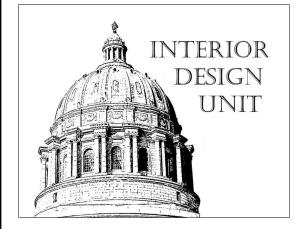

DIVISION OF FACILITIES MANAGEMENT / DESIGN **AND CONSTRUCTION**

THIRD FLOOR RENOVATION


EMPLOYMENT SECURITY CENTRAL OFFICE BUILDING

PROJECT # O22A201

ENLARGED PLANS, INTERIOR ELEV'S

SHEET NUMBER:

7 OF 11 SHEETS

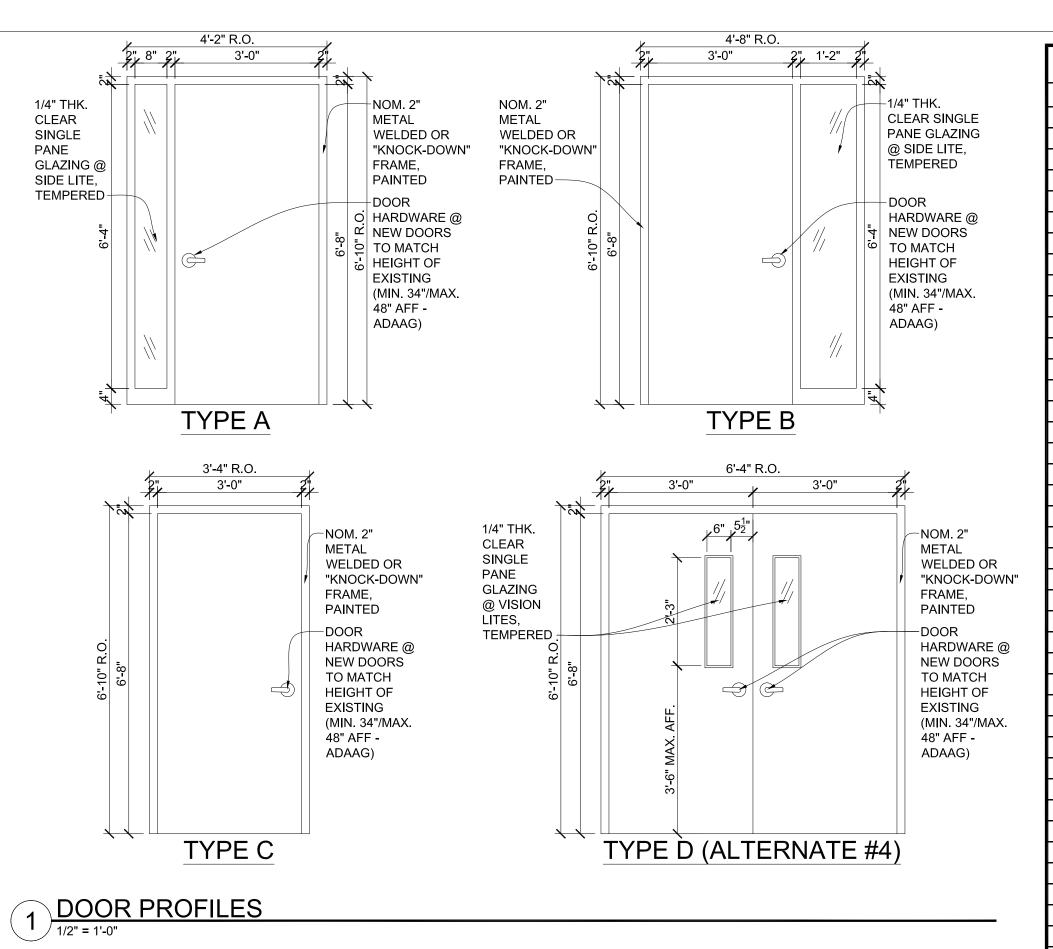

	DOOR SCHEDULE									
TAG	TYPE	NEW/EXISTING	DOOR SIZE	DOOR MATERIAL	FRAME MATERIAL	WALL THICKNESS	DOOR RATING	FRAME RATING	HARDWARE GROUP	NOTES
1	С	NEW	2'-6" x 7'-0"	HOLLOW METAL	METAL	4-3/4"	N/A	N/A	GROUP #3	RE: 1-A702; PAINT DOOR AND FRAME
2	-	EXISTING	EXISTING	EXISTING	EXISTING	EXISTING	EXISTING	EXISTING	EXISTING	EXISTING TO REMAIN; REPAINT INTERIOR FACE OF DOOR AND FRAME
3	-	EXISTING	EXISTING	EXISTING	EXISTING	EXISTING	EXISTING	EXISTING	EXISTING	EXISTING TO REMAIN; REPAINT INTERIOR FACE OF DOOR AND FRAME
4	В	NEW	3'-0" x 7'-0"	HOLLOW METAL	METAL	4-3/4"	N/A	N/A	GROUP #2	W/INTEGRAL 18" WIDE SIDELITE; RE: 1/A-702; PAINT DOOR AND FRAME
5	В	NEW	3'-0" x 7'-0"	HOLLOW METAL	METAL	4-3/4"	N/A	N/A	GROUP #2	W/INTEGRAL 18" WIDE SIDELITE; RE: 1/A-702; PAINT DOOR AND FRAME
6	В	NEW	3'-0" x 7'-0"	HOLLOW METAL	METAL	4-3/4"	N/A	N/A	GROUP #2	W/INTEGRAL 18" WIDE SIDELITE; RE: 1/A-702; PAINT DOOR AND FRAME
7	В	NEW	3'-0" x 7'-0"	HOLLOW METAL	METAL	4-3/4"	N/A	N/A	GROUP #2	W/INTEGRAL 18" WIDE SIDELITE; RE: 1/A-702; PAINT DOOR AND FRAME
8	-	EXISTING	EXISTING	EXISTING	EXISTING	EXISTING	EXISTING	EXISTING	GROUP #6	EXISTING TO REMAIN; REPAINT DOOR AND FRAME
9	В	NEW	3'-0" x 7'-0"	HOLLOW METAL	METAL	4-3/4"	N/A	N/A	GROUP #2	W/INTEGRAL 18" WIDE SIDELITE; RE: 1/A-702; PAINT DOOR AND FRAME
10	В	NEW	3'-0" x 7'-0"	HOLLOW METAL	METAL	4-3/4"	N/A	N/A	GROUP #2	W/INTEGRAL 18" WIDE SIDELITE; RE: 1/A-702; PAINT DOOR AND FRAME
(11)	В	NEW	3'-0" x 7'-0"	HOLLOW METAL	METAL	4-3/4"	N/A	N/A	GROUP #2	W/INTEGRAL 18" WIDE SIDELITE; RE: 1/A-702; PAINT DOOR AND FRAME
(12)	В	NEW	3'-0" x 7'-0"	HOLLOW METAL	METAL	4-3/4"	N/A	N/A	GROUP #2	W/INTEGRAL 18" WIDE SIDELITE; RE: 1/A-702; PAINT DOOR AND FRAME
(13)	С	EXIST. (RELOCATED)	3'-0" X 7'-0" (EX.)	EXISTING	EXISTING	4-1/4"	EXISTING	EXISTING	GROUP #5	EXISTING TO BE RELOCATED; REPAINT DOOR AND FRAME
14)	В	NEW	3'-0" x 7'-0"	HOLLOW METAL	METAL	4-3/4"	N/A	N/A	GROUP #2	W/INTEGRAL 18" WIDE SIDELITE; RE: 1/A-702; PAINT DOOR AND FRAME
(15)	-	EXISTING	EXISTING	EXISTING	EXISTING	EXISTING	EXISTING	EXISTING	EXISTING	EXISTING TO REMAIN; PROVIDE NEW WEATHERSTRIPPING - EXTRUDED ALUMINUM WITH HOLLOW BULB, SILICONE; REPAINT INTERIOR FACE OF DOOR AND FRAME
(16)	D	NEW	PR. 3'-0" x 7'-0"	HOLLOW METAL	METAL	4-3/4"	N/A	N/A	GROUP #4	ALTERNATE #4 - RE: 1-A702; PAINT DOOR AND FRAME / BASE BID - CASED OPENING ONLY
17	С	NEW	3'-0" x 7'-0"	HOLLOW METAL	METAL	4-3/4"	N/A	N/A	GROUP #3	RE: 1-A702; PAINT DOOR AND FRAME
(18)	В	NEW	3'-0" x 7'-0"	HOLLOW METAL	METAL	4-3/4"	N/A	N/A	GROUP #2	W/INTEGRAL 18" WIDE SIDELITE; RE: 1/A-702; PAINT DOOR AND FRAME
(19)	-	EXISTING	EXISTING	EXISTING	EXISTING	EXISTING	EXISTING	EXISTING	GROUP #7	EXISTING TO REMAIN; REPAINT DOOR AND FRAME
20	С	NEW	3'-0" x 7'-0"	HOLLOW METAL	METAL	4-3/4"	N/A	N/A	GROUP #3	RE: 1-A702; PAINT DOOR AND FRAME
21)	-	EXISTING	EXISTING	EXISTING	EXISTING	EXISTING	EXISTING	EXISTING	GROUP #5	EXISTING TO REMAIN; REPAINT DOOR AND FRAME
22	-	EXISTING	EXISTING	EXISTING	EXISTING	EXISTING	EXISTING	EXISTING	GROUP #6	EXISTING TO REMAIN; REPAINT DOOR AND FRAME
23	В	NEW	3'-0" x 7'-0"	HOLLOW METAL	METAL	4-3/4"	N/A	N/A	GROUP #2	W/INTEGRAL 18" WIDE SIDELITE; RE: 1/A-702; PAINT DOOR AND FRAME
24	В	NEW	3'-0" x 7'-0"	HOLLOW METAL	METAL	4-3/4"	N/A	N/A	GROUP #2	W/INTEGRAL 18" WIDE SIDELITE; RE: 1/A-702; PAINT DOOR AND FRAME
25	В	NEW	3'-0" x 7'-0"	HOLLOW METAL	METAL	4-3/4"	N/A	N/A	GROUP #2	W/INTEGRAL 18" WIDE SIDELITE; RE: 1/A-702; PAINT DOOR AND FRAME
26	В	NEW	3'-0" x 7'-0"	HOLLOW METAL	METAL	4-3/4"	N/A	N/A	GROUP #2	W/INTEGRAL 18" WIDE SIDELITE; RE: 1/A-702; PAINT DOOR AND FRAME
27	-	EXISTING	EXISTING	EXISTING	EXISTING	EXISTING	EXISTING	EXISTING	GROUP #5	EXISTING TO REMAIN; REPAINT DOOR AND FRAME
28	-	EXISTING	EXISTING	EXISTING	EXISTING	EXISTING	EXISTING	EXISTING	GROUP #6	EXISTING TO REMAIN; REPAINT DOOR AND FRAME
29	-	EXISTING	EXISTING	EXISTING	EXISTING	EXISTING	EXISTING	EXISTING	GROUP #6	EXISTING TO REMAIN; REPAINT DOOR AND FRAME
30	-	EXISTING	EXISTING	EXISTING	EXISTING	EXISTING	EXISTING	EXISTING	GROUP #6	EXISTING TO REMAIN; REPAINT DOOR AND FRAME
31)	-	EXISTING	EXISTING	EXISTING	EXISTING	EXISTING	EXISTING	EXISTING	GROUP #6	EXISTING TO REMAIN; REPAINT DOOR AND FRAME
32	С	NEW	3'-0" x 7'-0"	HOLLOW METAL	METAL	4-3/4"	N/A	N/A	GROUP #3	RE: 1-A702; PAINT DOOR AND FRAME
33	С	NEW	3'-0" x 7'-0"	HOLLOW METAL	METAL	4-3/4"	N/A	N/A	GROUP #3	RE: 1-A702; PAINT DOOR AND FRAME
34	-	EXISTING	EXISTING	EXISTING	EXISTING	EXISTING	EXISTING	EXISTING	GROUP #5	EXISTING TO REMAIN; REPAINT DOOR AND FRAME
35	Α	NEW	3'-0" x 7'-0"	HOLLOW METAL	METAL	4-3/4"	N/A	N/A	GROUP #1	W/INTEGRAL 12" WIDE SIDELITE; RE: 1/A-702; PAINT DOOR AND FRAME
36	-	EXISTING	EXISTING	EXISTING	EXISTING	EXISTING	EXISTING	EXISTING	GROUP #6	EXISTING TO REMAIN; REPAINT DOOR AND FRAME
37	-	EXISTING	EXISTING	EXISTING	EXISTING	EXISTING	EXISTING	EXISTING	GROUP #6	EXISTING TO REMAIN; REPAINT DOOR AND FRAME
38	-	EXISTING	EXISTING	EXISTING	EXISTING	EXISTING	EXISTING	EXISTING	GROUP #6	EXISTING TO REMAIN; REPAINT DOOR AND FRAME
39	-	EXISTING	EXISTING	EXISTING	EXISTING	EXISTING	EXISTING	EXISTING	GROUP #6	EXISTING TO REMAIN; REPAINT DOOR AND FRAME
40	В	NEW	3'-0" x 7'-0"	HOLLOW METAL	METAL	4-3/4"	N/A	N/A	GROUP #2	W/INTEGRAL 18" WIDE SIDELITE; RE: 1/A-702; PAINT DOOR AND FRAME
41	С	NEW	3'-0" x 7'-0"	HOLLOW METAL	METAL	4-3/4"	N/A	N/A	GROUP #3	RE: 1-A702; PAINT DOOR AND FRAME
42	В	NEW	3'-0" x 7'-0"	HOLLOW METAL	METAL	4-3/4"	N/A	N/A	GROUP #2	W/INTEGRAL 18" WIDE SIDELITE; RE: 1/A-702; PAINT DOOR AND FRAME
43	В	NEW	3'-0" x 7'-0"	HOLLOW METAL	METAL	4-3/4"	N/A	N/A	GROUP #2	W/INTEGRAL 18" WIDE SIDELITE; RE: 1/A-702; PAINT DOOR AND FRAME

WINDOW SCHEDULE								
WINDOW TAG	NEW/EXISTING	WINDOW SIZE	GLAZING TYPE	FRAME MATERIAL	WALL THICKNESS	WINDOW RATING	FRAME RATING	NOTES
101)	NEW	3'-0" x 2'-0"	TEMPERED	ALUM. STOREFRONT	4-3/4"	N/A		STOREFRONT WINDOW SYSTEM - PROFILES/COLOR TO MATCH EXISTING IN 1ST FLOOR H.R. SPACE; GLAZING TO HAVE "FROST" FILM; RE: 3/A-702 (ALTERNATE #2 - SEE ELEVATION 4/A-702 AND ENLARGED PLAN 5/A-702)
102	NEW	5'-0" x 4'-0"	TEMPERED	ALUM. STOREFRONT	4-3/4"	N/A	N/A	STOREFRONT WINDOW SYSTEM - PROFILES/COLOR TO MATCH EXISTING IN 1ST FLOOR H.R. SPACE; GLAZING TO HAVE "FROST" FILM; RE: 2/A-702

FILM @ EACH 2 WINDOW #102 PROFILE/ELEVATION

1/2" = 1'-0"

1/4" THK. CLEAR SINGLE

PANE


GLAZING @ WINDOWS,

TEMPERED


SURFACE APPLIED GLASS

PRIVACY/


"FROSTING"

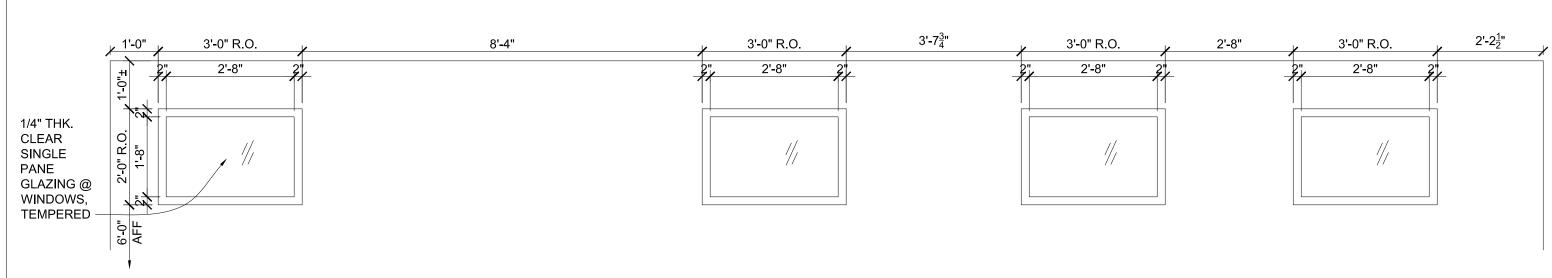

3 WINDOWS #101 PROFILE/ELEVATION (BASE BID)

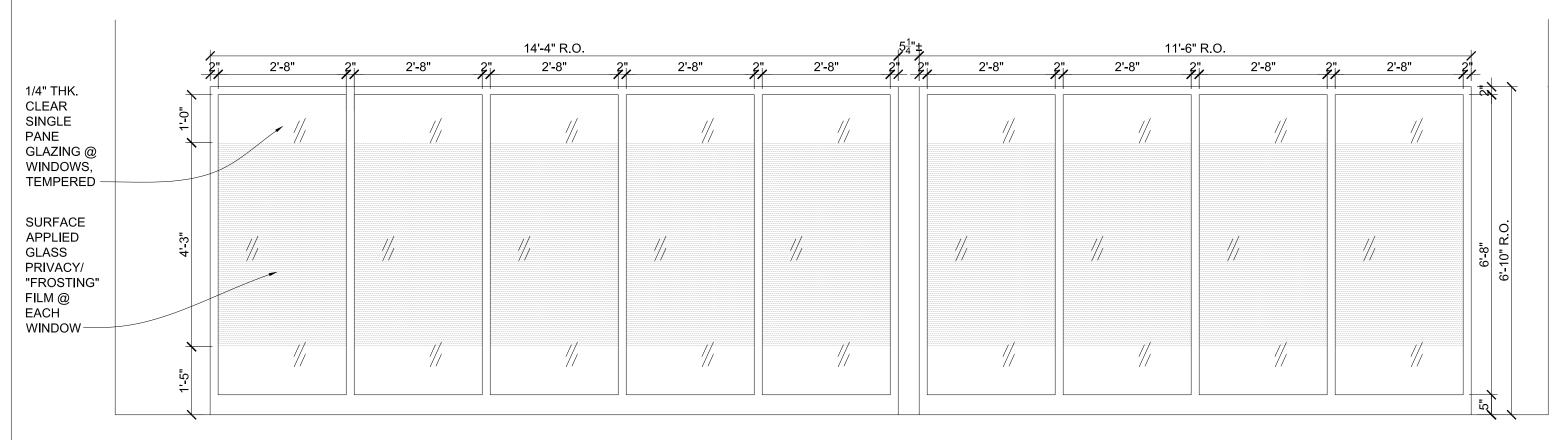


WINDOWS #101 PROFILE/FLEVATION (ALT	(FRNATE #2)
4 WINDOWS #101 PROFILE/ELEVATION (ALT	

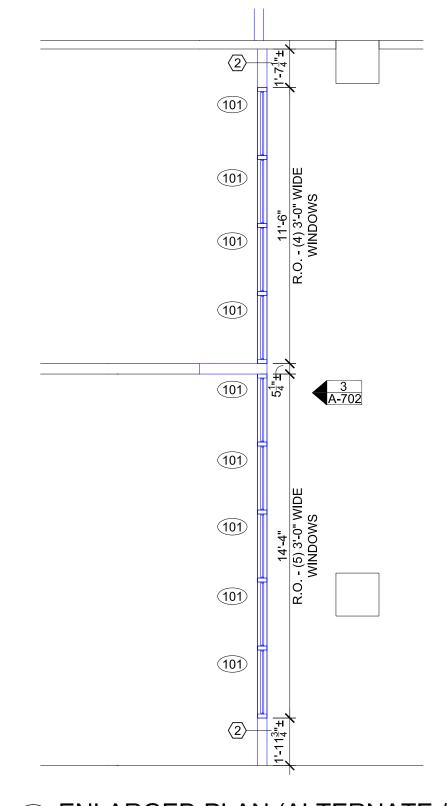

5 ENLARGED PLAN (ALTERNATE #2)

1/4" = 1'-0"

STATE OF MISSOURI MICHAEL L. PARSON, **GOVERNOR**

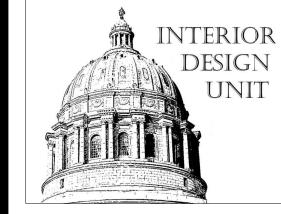

PROFESSIONAL SEAL

OFFICE OF **ADMINISTRATION** DIVISION OF FACILITIES MANAGEMENT / DESIGN AND CONSTRUCTION

LABOR AND INDUSTRIAL

DEPARTMENT OF

RELATIONS

THIRD FLOOR RENOVATION

LABOR STANDARDS EMPLOYMENT SECURITY CENTRAL OFFICE BUILDING

WORKER'S COMP. AND

PROJECT # O22A201

FACILITY # 02601773

JEFFERSON CITY, MO

421 E. DUNKLIN

REVISION:
DATE:
REVISION:
DATE:
REVISION:
DATE:
ISSUE DATE: 5/18/2022

CAD DWG FILE:
DRAWN BY: PMV
CHECKED BY: PMV
DESIGNED BY: PMV

SHEET TITLE:

DOOR AND WINDOW SCHEDULES, PROFILES & NOTES

SHEET NUMBER:

8 OF 11 SHEETS



LEGEND

- NEW/RELOCATED ELECTRIC RECEPTACLE
- EXISTING ELECTRIC RECEPTACLE
- NEW DATA RECEPTACLE LOCATION
- ▼ EXISTING DATA RECEPTACLE LOCATION

 NEW/RELOCATED "MONUMENT" MODULAR
- FURNITURE CONNECTION BOX (POWER, DATA OR BOTH).
- EXISTING "MONUMENT" MODULAR FURNITURE CONNECTION BOX (POWER, DATA OR BOTH).
- NEW/RELOCATED FIRE ALARM STROBE DEVICE
- EXISTING FIRE ALARM STROBE DEVICE

RENOVATION POWER/DATA PLAN TAG NOTES

NEW 20A DUPLEX RECEPTACLE OUTLET. CONNECT TO NEAREST AVAILABLE POWER CIRCUIT WITH AVAILABLE CAPACITY OR TO NEAREST EXISTING POWER PANEL WITH APPROPRIATE CAPACITY. MOUNT AT 15" AFF - OR HIGHER TO MATCH EXISTING - UNLESS NOTED OTHERWISE ON PLANS. RECEPTACLE SHALL BE GFCI PROTECTED, IF NOTED ON PLANS.

NEW/RELOCATED FIRE ALARM PULL

EXISTING FIRE ALARM PULL STATION

NEW/RELOCATED HVAC THERMOSTAT

♠ NEW/RELOCATED FIRE EXTINGUISHER

EXISTING FIRE EXTINGUISHER DEVICE

T EXISTING HVAC THERMOSTAT

STATION

DEVICE

- NEW 20A GFCI DUPLEX RECEPTACLE OUTLET ON DEDICATED CIRCUIT. CONNECT TO NEAREST AVAILABLE POWER PANEL WITH APPROPRIATE CAPACITY. MOUNT AT HEIGHT AS NOTED ON PLAN.
- (3) EXISTING DUPLEX RECEPTACLE OUTLET RELOCATED REFER TO SHEET D-101 FOR ADDITIONAL INFORMATION. MOUNT AT 15" AFF OR HIGHER TO MATCH EXISTING UNLESS NOTED OTHERWISE ON PLANS.
- 4 NEW DATA RECEPTACLE AT WALL LOCATIONS: PROVIDE JUNCTION BOX, CONDUIT (TO 4" ABOVE ACOUSTICAL CEILING TILE), AND PULL STRING. WIRING TO BE INSTALLED BY OTHERS.
- (5) EXISTING WALL MOUNTED FIRE ALARM DEVICE RELOCATED REFER TO SHEET D-101 FOR ADDITIONAL INFORMATION. MOUNT AT SAME HEIGHT AS PREVIOUS LOCATION.
- (6) EXISTING WALL OUTLET LOCATION TO REMAIN. REPLACE EXISTING RECEPTACLE WITH NEW GFCI PROTECTED RECEPTACLE (AMP RATING TO MATCH CIRCUIT AMPERAGE).
- (7) EXISTING WALL OUTLET LOCATION TO REMAIN. REPLACE EXISTING RECEPTACLE AND WIRING TO CREATE NEW 20A DEDICATED CIRCUIT. CONNECT TO NEAREST EXISTING POWER PANEL WITH APPROPRIATE
- 8 NEW 20A DEDICATED CIRCUIT DUPLEX RECEPTACLE OUTLET. CONNECT TO NEAREST AVAILABLE POWER CIRCUIT WITH AVAILABLE CAPACITY OR TO NEAREST EXISTING POWER PANEL WITH APPROPRIATE CAPACITY.
- EXISTING WALL OUTLET LOCATION TO BE CONVERTED TO RECEIVE MODULAR FURNITURE SYSTEM "WHIP" CONNECTION. CONTRACTOR TO MAKE CONNECTION TO BUILDING POWER SUPPLY UPON COMPLETION OF MODULAR FURNITURE INSTALLATION.
- NEW WALL OUTLET 20A OUTLET/DATA OUTLET TO RECEIVE MODULAR FURNITURE SYSTEM "WHIP" CONNECTION. CONTRACTOR TO MAKE CONNECTION TO BUILDING POWER SUPPLY UPON COMPLETION OF MODULAR FURNITURE INSTALLATION. DATA: PROVIDE JUNCTION BOX, CONDUIT (TO 4" ABOVE ACOUSTICAL CEILING TILE), AND PULL STRING. WIRING TO BE INSTALLED BY OTHERS.

ELECTRICAL RENOVATION - GENERAL NOTES

- 1. CONTRACTOR SHALL PERFORM ALL ELECTRICAL AND DATA/COMM WORK AS SHOWN/NOTED ON THE PLANS.
 THIS SHALL INCLUDE THE CONNECTION OF THE MODULAR FURNITURE TO THE BUILDING POWER SUPPLY WITH
 FMDC PROVIDED MODULAR FURNITURE ELECTRICAL WHIPS.
- 2. PER NFPA 70 USING 80% OF THE AVAILABLE AMPERAGE OF A 20 AMP CIRCUIT (=16AMPS) AND USING THE GENERAL USE AMPERAGE (PER OUTLET) OF 1.5 AMPS, A MAXIMUM OF 10 OUTLETS NOT INDICATED AS DEDICATED CAN BE ON A 20 AMP CIRCUIT.
- 3. CONTRACTOR SHALL FIELD VERIFY THE AMOUNT OF EXISTING CIRCUITS ABANDONED/NOT USED AFTER REMOVAL OF EXISTING WALL AND FLOOR MOUNTED OUTLETS (RE: SHEET D-101) THAT CAN BE USED FOR NEW ELECTRICAL POWER OUTLETS DISTRIBUTION SHOWN ON THIS SHEET.
- NEW ELECTRICAL POWER OUTLET DISTRIBUTION SHOWN ON THIS SHEET.

 4. ALL ELECTRICAL AND DATA/COMM WORK SHALL BE COMPLETED IN ACCORDANCE WITH THE CURRENT EDITION OF THE NEC.

GENERAL NOTES

- 1. ALL WORK SHALL BE PERFORMED IN A SAFE MANNER WITH PROTECTION PROVIDED TO ANY BUILDING
- OCCUPANTS AND WORKERS PERFORMING THE WORK.

 2. ALL WORK SHALL BE DONE IN A MANNER TO MINIMIZE DAMAGE TO ADJACENT SURFACES THAT ARE NOT SHOWN TO BE WORKED ON OR REMOVED CONTRACTOR SHALL BE RESPONSIBLE FOR ALL WORK NECESSARY TO REPAIR SURFACES AFFECTED BY THEIR WORK.
- FACILITY STAFF AT LEAST TWO (2) WORKING DAYS IN ADVANCE.
- 4. ANY WORK THAT REQUIRES THE NEED TO TEMPORARILY SHUT DOWN ANY OF THE BUILDING SYSTEMS MUST BE COORDINATED WITH BUILDING FACILITY STAFF AT LEAST FOUR (4) WORKING DAYS IN ADVANCE.
- 5. CONTRACTOR SHALL PROVIDE NECESSARY DUST PROTECTION TO PREVENT DUST CREATED BY DEMOLITION/CONSTRUCTION ACTIVITIES TO ENTER SPACE(S) OUTSIDE THE WORK AREA, INCLUDING THROUGH THE HVAC SYSTEM. CONTRACTOR SHALL BE RESPONSIBLE TO REPLACE ANY HVAC FILTER:
- 6. CONTRACTOR SHALL BE RESPONSIBLE TO PERFORM ANY WORK NECESSARY TO PROVIDE THE SCOPE OF WORK SHOWN ON THE PLANS, EVEN IF NOT SPECIFICALLY NOTED OR SHOWN.
- 7. CONTRACTOR SHALL PERFORM WORK BETWEEN THE HOURS OF 7AM TO 5PM AFTER SIGNING IN AND
- RECEIVING VISITOR'S BADGE.

 8. ALL MATERIALS/EQUIPMENT MAY BE DELIVERED TO THE FACILITY FACILITY STAFF SHALL BE CONTACTED TEN (10) BUSINESS DAYS PRIOR TO DELIVERY OF MATERIALS/EQUIPMENT. CONTRACTOR SHALL BE SIGN FOR
- SIGNING FOR DELIVERIES.

 9. ALL WORK SHALL BE PERFORMED IN ACCORDANCE WITH THE LATEST EDITION OF THE IBC, IFC, IMC, IPC, NEC AND ALL OTHER APPLICABLE ICC AND NFPA CODE FAMILIES AS WELL AS THE LATEST EDITION OF ADAAG.
- 10. CONTRACTOR RESPONSIBLE FOR FIELD VERIFYING AS-BUILT CONDITIONS AND PROPOSED LAYOUT PRIOR TO PERFORMING WORK. CONTRACTOR SHALL NOTIFY FMDC PROJECT MANAGER IF THERE ARE ANY DISCREPANCIES OR CONFLICTS.
- DETAILS OF EXISTING CONDITIONS PROVIDED AS A COURTESY. THIS INFORMATION DOES NOT RELIEVE THE CONTRACTOR FROM PERFORMING A COMPLETE NECESSARY FIELD INVESTIGATIVE WORK TO FULLY UNDERSTAND EXISTING CONDITIONS PRIOR TO SUBMITTING BID.

STATE OF MISSOURI MICHAEL L. PARSON, GOVERNOR



PROFESSIONAL SEAL

CONSULTANTS LOG

OFFICE OF ADMINISTRATION DIVISION OF FACILITIES MANAGEMENT / DESIGN AND CONSTRUCTION

DEPARTMENT OF LABOR AND INDUSTRIAL RELATIONS

THIRD FLOOR RENOVATION WORKER'S COMP. AND LABOR STANDARDS

EMPLOYMENT SECURITY CENTRAL OFFICE BUILDING 421 E. DUNKLIN

JEFFERSON CITY, MO

PROJECT # O22A201 SITE # FACILITY # 02601773

111012111 11 020017

REVISION:	
DATE:	
REVISION:	
DATE:	
REVISION:	
DATE.	

ISSUE DATE: 5/18/2022

CAD DWG FILE: DRAWN BY: PM

CHECKED BY: PMV
DESIGNED BY: PMV

SHEET TITLE:


RENOVATION
POWER & DATA PLAN
& GENERAL NOTES


SHEET NUMBER:

E-10

RENOVATION POWER & DATA PLAN

(IN FEET)

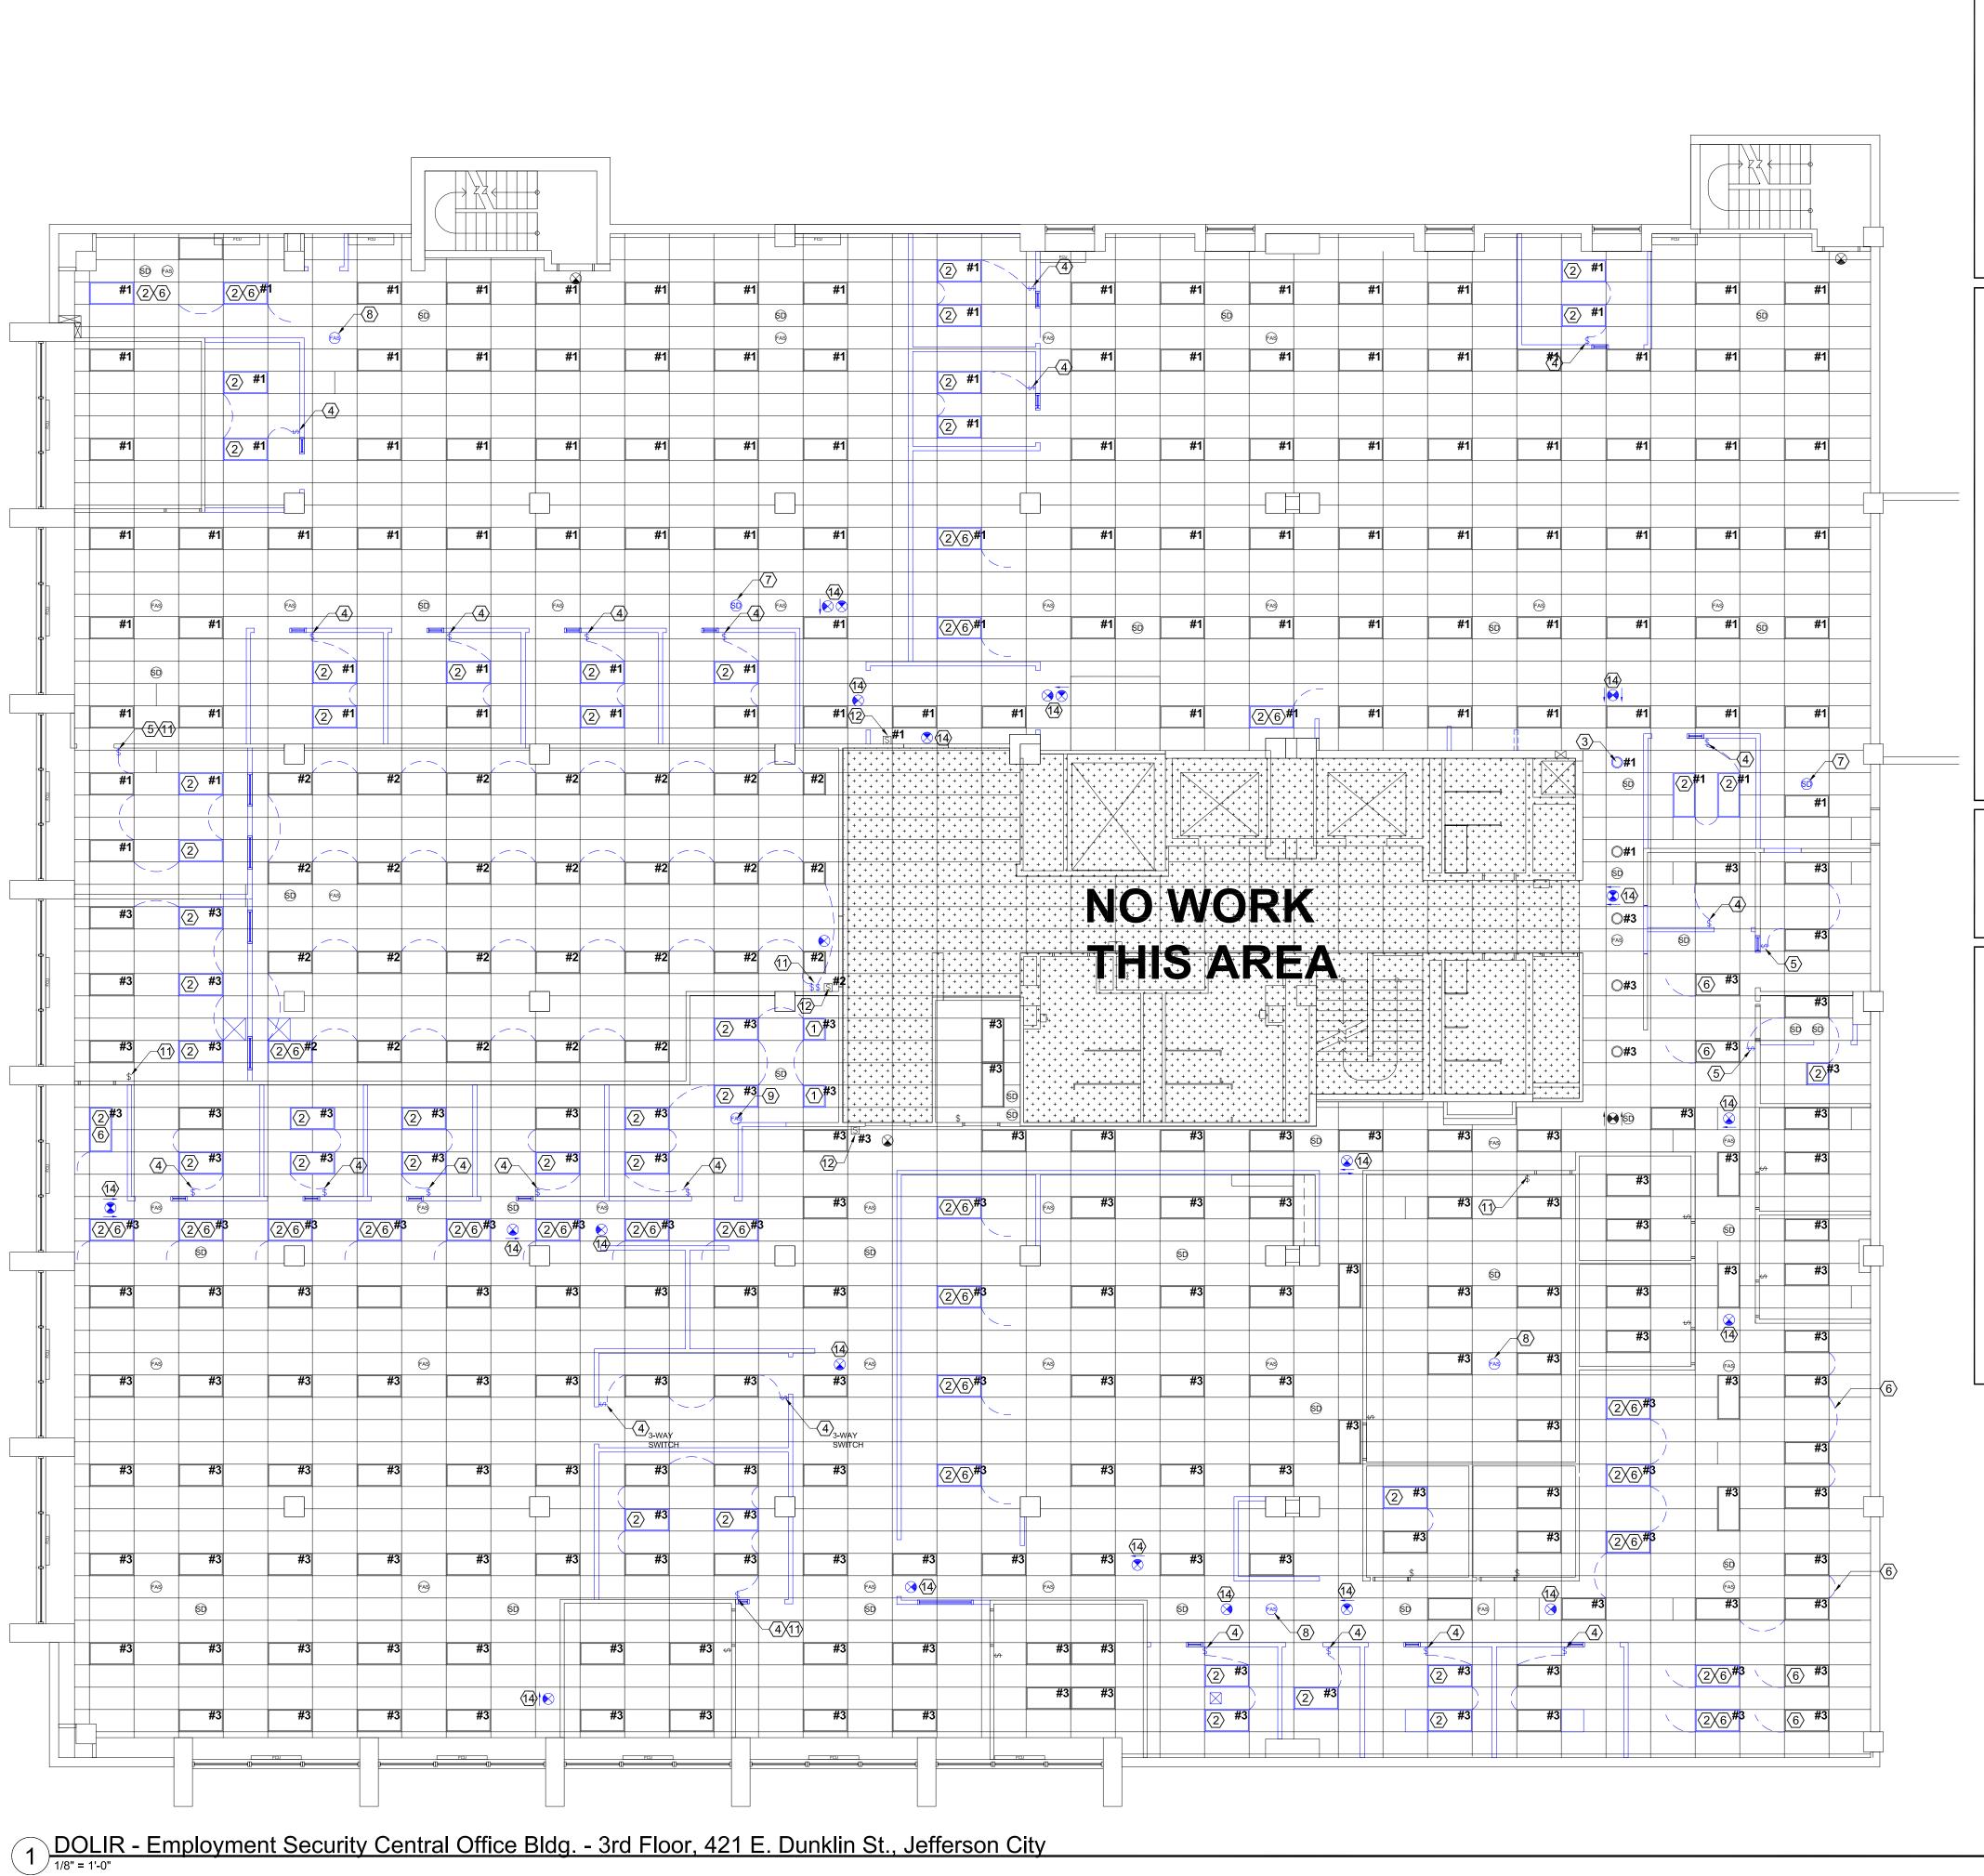

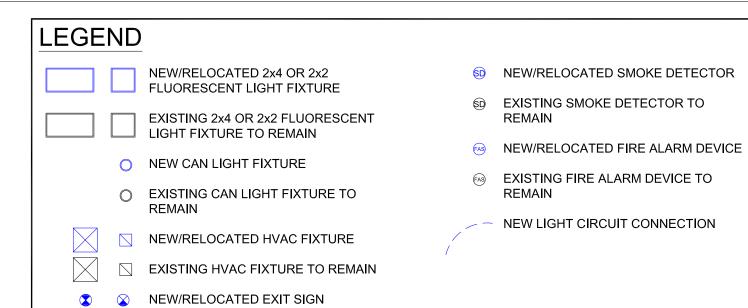

RENOVATION REFLECTED CEILING PLAN TAG NOTES

1 NEW DUAL 120v/277v 2x2 RECESSED LED LIGHT FIXTURE (TO MATCH EXISTING).

(2) EXISTING RECESSED LED LIGHT FIXUTURE RELOCATED.

EXISTING EXIT SIGN TO REMAIN

- ③ NEW DUAL 120v/277v RECESSED CAN LED LIGHT FIXTURE (TO MATCH EXISTING).
- (4) NEW WALL SWITCH TO CONTROL LIGHT FIXTURES SHOWN BY LIGHT CIRCUIT CONNECTION. DISCONNECT LIGHTS FROM GENERAL LIGHT CIRCUIT.
- (5) NEW WALL SWITCH TO CONTROL LIGHT FIXTURES SHOWN BY LIGHT CIRCUIT CONNECTION.
- 6 CONNECT/RECONNECT LIGHT FIXTURE TO NEAREST GENERAL LIGHT CIRCUIT.
- (7) RELOCATED CEILING MOUNTED SMOKE DETECTOR DEVICE. RECONNECT TO BUILDING ALARM SYSTEM.
- (8) RELOCATED CEILING MOUNTED FIRE ALARM STROBE DEVICE. RECONNECT TO BUILDING ALARM SYSTEM.
- 9 NEW CEILING MOUNTED FIRE ALARM STROBE DEVICE-MODEL, STYLE AND FUNCTION TO MATCH EXISTING. CONNECT TO BUILDING ALARM SYSTEM.
- 10 RELOCATED HVAC DIFFUSERS.
- PROVIDE INTEGRATED DIMMER IN NEW WALL SWITCH; AT EXISTING LOCATIONS, REPLACE EXISTING SWITCH WITH INTEGRATED DIMMER WALL SWITCH.
- EXISTING BUILDING AUTOMATION LIGHT RELAY CONTROL ALL LIGHT FIXTURES IN AREA SHALL CONTINUE TO BE CONTROLLED BY RELAY CONTROL (SEE NOTES @ RELAY CONTROL AND IN LIGHT FIXTURES). INDIVIDUAL SWITCHES IN OFFICES SHALL CONTROL INDIVIDUAL OFFICE LIGHTS WHEN RELAY CONTROL IS IN OPERATING/LIGHTING MODE.
- (13) EXISTING/NEW LIGHTS THAT SHALL BE INTERCONNECTED TO BUILDING AUTOMATION LIGHT RELAY CONTROL AS NOTED
- 14) NEW EXIT SIGN DEVICE. PROVIDE DIRECTIONAL ARROW ON SIGN, IF DENOTED AS SUCH ON PLANS.

ELECTRICAL RENOVATION - GENERAL NOTES

- 1. CONTRACTOR SHALL PERFORM ALL ELECTRICAL AND DATA/COMM WORK AS SHOWN/NOTED ON THE PLANS. THIS SHALL INCLUDE THE CONNECTION OF THE MODULAR FURNITURE TO THE BUILDING POWER SUPPLY WITH FMDC PROVIDED MODULAR FURNITURE ELECTRICAL WHIPS.
- ALL ELECTRICAL WORK SHALL BE COMPLETED IN ACCORDANCE WITH THE CURRENT EDITION OF THE NEC.
 ALL FIRE ALARM WORK AND DEVICES SHALL BE IN ACCORDANCE WITH THE CURRENT EDITION OF NFPA 72.
 ALL EXIT SIGN WORK AND DEVICES SHALL BE IN ACCORDANCE WITH THE CURRENT EDITION OF THE NFPA 101.

GENERAL NOTES

- . ALL WORK SHALL BE PERFORMED IN A SAFE MANNER WITH PROTECTION PROVIDED TO ANY BUILDING
- OCCUPANTS AND WORKERS PERFORMING THE WORK.

 2. ALL WORK SHALL BE DONE IN A MANNER TO MINIMIZE DAMAGE TO ADJACENT SURFACES THAT ARE NOT SHOWN TO BE WORKED ON OR REMOVED CONTRACTOR SHALL BE RESPONSIBLE FOR ALL WORK NECESSARY TO REPAIR SURFACES AFFECTED BY THEIR WORK.
- 3. ANY WORK THAT RESULTS IN EXCESSIVE NOISE, DUST OR DEBRIS MUST BE COORDINATED WITH BUILDING FACILITY STAFF AT LEAST TWO (2) WORKING DAYS IN ADVANCE.
- 4. ANY WORK THAT REQUIRES THE NEED TO TEMPORARILY SHUT DOWN ANY OF THE BUILDING SYSTEMS MUS
 BE COORDINATED WITH BUILDING FACILITY STAFF AT LEAST FOUR (4) WORKING DAYS IN ADVANCE.

 5. CONTRACTOR SHALL PROVIDE NECESSARY DUST PROTECTION TO PREVENT DUST CREATED BY

 DEMOLITION/CONSTRUCTION ACTIVITIES TO ENTER SPACE(S) OUTSIDE THE WORK AREA INCLUDING.
- DEMOLITION/CONSTRUCTION ACTIVITIES TO ENTER SPACE(S) OUTSIDE THE WORK AREA, INCLUDING THROUGH THE HVAC SYSTEM. CONTRACTOR SHALL BE RESPONSIBLE TO REPLACE ANY HVAC FILTERS CONTAMINATED WITH CONSTRUCTION DEBRIS.
- 6. CONTRACTOR SHALL BE RESPONSIBLE TO PERFORM ANY WORK NECESSARY TO PROVIDE THE SCOPE OF
- WORK SHOWN ON THE PLANS, EVEN IF NOT SPECIFICALLY NOTED OR SHOWN.

 7. CONTRACTOR SHALL PERFORM WORK BETWEEN THE HOURS OF 7AM TO 5PM AFTER SIGNING IN AND
- RECEIVING VISITOR'S BADGE.

 8. ALL MATERIALS/EQUIPMENT MAY BE DELIVERED TO THE FACILITY FACILITY STAFF SHALL BE CONTACTED

 (10) BUSINESS DAYS PRIOR TO DELIVERY OF MATERIALS/EQUIPMENT. CONTRACTOR SHALL BE SIGN FOR
- RECEIPT OF ALL MATERIALS/EQUIPMENT FACILITY STAFF ARE NOT RESPONSIBLE FOR ACCEPTING OR SIGNING FOR DELIVERIES.

 9. ALL WORK SHALL BE PERFORMED IN ACCORDANCE WITH THE LATEST EDITION OF THE IBC, IFC, IMC, IPC, NEO
- 10. CONTRACTOR RESPONSIBLE FOR FIELD VERIFYING AS-BUILT CONDITIONS AND PROPOSED LAYOUT PRIOR TO PERFORMING WORK. CONTRACTOR SHALL NOTIFY FMDC PROJECT MANAGER IF THERE ARE ANY DISCREPANCIES OR CONFLICTS.
- 11. DETAILS OF EXISTING CONDITIONS PROVIDED AS A COURTESY. THIS INFORMATION DOES NOT RELIEVE THE CONTRACTOR FROM PERFORMING A COMPLETE NECESSARY FIELD INVESTIGATIVE WORK TO FULLY UNDERSTAND EXISTING CONDITIONS PRIOR TO SUBMITTING BID.

STATE OF MISSOURI MICHAEL L. PARSON, GOVERNOR



CONSULIANIS LUGG

OFFICE OF ADMINISTRATION DIVISION OF FACILITIES MANAGEMENT / DESIGN AND CONSTRUCTION

DEPARTMENT OF LABOR AND INDUSTRIAL RELATIONS

THIRD FLOOR RENOVATION WORKER'S COMP. AND LABOR STANDARDS

EMPLOYMENT SECURITY CENTRAL OFFICE BUILDING 421 E. DUNKLIN

JEFFERSON CITY, MO

PROJECT # O22A201 SITE # FACILITY # 02601773

| TACILITT # 02001/

REVISION:	
DATE:	
REVISION:	
DATE:	
REVISION:	
DATE:	

ISSUE DATE: 5/18/2022

CAD DWG FILE:

DRAWN BY: PMV
CHECKED BY: PMV
DESIGNED BY: PMV

SHEET TITLE:

RENOVATION
LIGHTING PLAN &
& GENERAL NOTES

SHEET NUMBER:

E-20

RENOVATION LIGHTING PLAN




GENERAL RENOVATED FURNITURE PLAN NOTES

MODULAR FURNITURE LAYOUT/CONNECTION POINTS.

- MODULAR FURNITURE ASSEMBLY/RECONFIGURATION WORK TO BE COMPLETED BE COMPLETED BY STAFF, SHOWN/REQUIPED FOR CONTRACTOR REFERENCE ONLY.
- 2. FINAL LOCATION OF NEW/RELOCATED POWER SUPPLIES FOR MODULAR FURNITURI CONNECTION SHOWN/NOTED ON SHEET E-101 (LOCATIONS SHOWN HERE FOR REFERENCE). DOLIR SHALL NOTIFY FMDC OF ANY NECESSARY FIELD REVISIONS OF



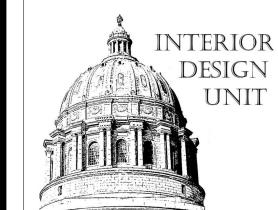

PROFESSIONAL SEAL

CONSOLIANIS LOGO

OFFICE OF ADMINISTRATION DIVISION OF FACILITIES MANAGEMENT / DESIGN AND CONSTRUCTION

DEPARTMENT OF LABOR AND INDUSTRIAL RELATIONS

THIRD FLOOR RENOVATION WORKER'S COMP. AND LABOR STANDARDS

EMPLOYMENT SECURITY CENTRAL OFFICE BUILDING 421 E. DUNKLIN JEFFERSON CITY, MO

PROJECT # O22A201 SITE # FACILITY # 02601773

REVISION:
DATE:
REVISION:
DATE:
REVISION:
DATE:
ISSUE DATE: 5/18/2022

CAD DWG FILE:
DRAWN BY: PMV
CHECKED BY: PMV
DESIGNED BY: PMV

SHEET TITLE:

RENOVATION
FURNITURE PLAN
& GENERAL NOTES

SHEET NUMBER:

I-10

11 OF 11 SHEETS

RENOVATION FURNITURE PLAN (REFERENCE ONLY)

- UNDERFLOOR DUCT, SIZE #4 (6-1/2" W x 1-1/2" D); WITHOUT INSERTS TO TELEPHONE TERMINAL CABINET. FURNISH 90° VERTICAL ELBOW FOR ENTRANCE INTO
- UNDERFLOOR DUCT, SIZE #2 (3-1/8" W x 1-1/4" D);
 WITHOUT INSERTS TO PANEL RP-3 FOR POWER WIRING.
 FURNISH 90° VERTICAL ELBOW FOR ENTRANCE INTO
- JUNCTION BOX, 2-1/2" HIGH, WITH (1) #2 DUCT AND
 (1) #4 DUCT OPENING EACH SIDE.
- BLANK UNDERFLOOR DUCT WITH NO INSERTS, #4 FOR TELEPHONE WIRING AND #2 FOR POWER WIRING. TYPICAL BETWEEN JUNCTION BOXES.
- 5 UNDERFLOOR DUCT WITH INSERTS, #4 FOR TELEPHONE WIRING AND #2 FOR POWER WIRING. (TYPICAL)

	NOTE:
	THE ELECTRICAL CONTRACTOR SHALL FURNISH 80 DUPLEX SERVICE FITTINGS AND 40 TELEPHONE SERVICE FITTINGS FOR UNDERFLOOR DUCT SYSTEM. FINAL LOCATION OF SERVICE FITTINGS TO BE DETERMINED BY OWNER PRIOR TO INSTALLATION.
Ī	

GENERAL NOTES

- A. All existing fixtures to be relocated are to be functioning properly after relocation. Any ballast, lamp, lens, housing, or other component, which is not in satisfactory condition shall be replaced prior to relocation of fixture.
- B. All existing 4 lamp fixtures currently operating with 2 lamps shall continue to operate with 2 lamps.
- C. In areas where walls or ceilings are to be refinished or modified, this contractor shall remove all existing electrical equipment in the area and reinstall equipment after work has been completed.
- D. Contractor is responsible for maintaining circuit continuity. Verify with owner reconnection or abandonment of any circuit found during demolition work which is not indicated as being disconnected.

