REPLACE ROOF SYSTEM KANSAS CITY DOLIR OFFICE BUILDING KANSAS CITY, MISSOURI

OWNER:

STATE OF MISSOURI

MICHAEL L. PARSON,

GOVERNOR

DEPARTMENT OF

LABOR AND INDUSTRIAL

RELATIONS

PROJECT

OFFICE OF ADMINISTRATION

DIVISION OF FACILITIES MANAGEMENT, MANAGEMENT:

DESIGN AND CONSTRUCTION

DESIGNER:

STATE OF MISSOURI - OFFICE OF ADMINISTRATION

DIVISION OF FACILITIES MANAGEMENT,

DESIGN AND CONSTRUCTION

301 W. HIGH STREET

JEFFERSON CITY, MO 65102

PROJECT NUMBER: 02325-01

ASSET NUMBER:

3101018001

GENERAL NOTES

PROTECT EXISTING WORK TO REMAIN. PERFORM CUTTING TO ACCOMPLISH REMOVALS NEATLY AND AS SPECIFIED FOR CUTTING NEW WORK. REPAIR ADJACENT CONSTRUCTION AND FINISH DAMAGED DURING REMOVAL WORK. PATCH AS SPECIFIED FOR PATCHING NEW WORK.

THE PREMISES WILL BE OCCUPIED AT ALL TIMES DURING THE CONSTRUCTION SCHEDULE. THE CONTRACTOR SHALL COORDINATE WITH THE OWNER REGARDING ALL INTERRUPTIONS OF UTILITIES, TEMPORARY EXITS, DELIVERIES, AND ALL OTHER JOB REQUIREMENTS. SEE SECTION 012100 FOR ALLOWANCES FOR FACILITY INTERUPTIONS.

REMOVE AND REINSTALL EXISTING LIGHTNING PROTECTION COMPONENTS TO MATCH EXISTING CONDITIONS, REPLACE ANY DAMAGED COMPONENTS AS REQUIRED TO ENSURE SYSTEM IS FUNCTIONAL CONTRACTOR TO OBTAIN A UL MASTER LABEL.

SHEET INDEX

GENERAL

COVER SHEET G-100 GENERAL INFORMATION

ARCHITECTURAL

ROOF DETAILS

ROOF DEMOLITION PLAN A-100 ROOF PLAN A A-101 ROOF PLAN B ROOF PLAN C A-102


PROJECT INFORMATION

STATE OF MISSOURI MICHAEL L. PARSON GOVERNOR


OA-FMDC DESIGNER:

PROJECT MANAGEMENT: OA-FMDC



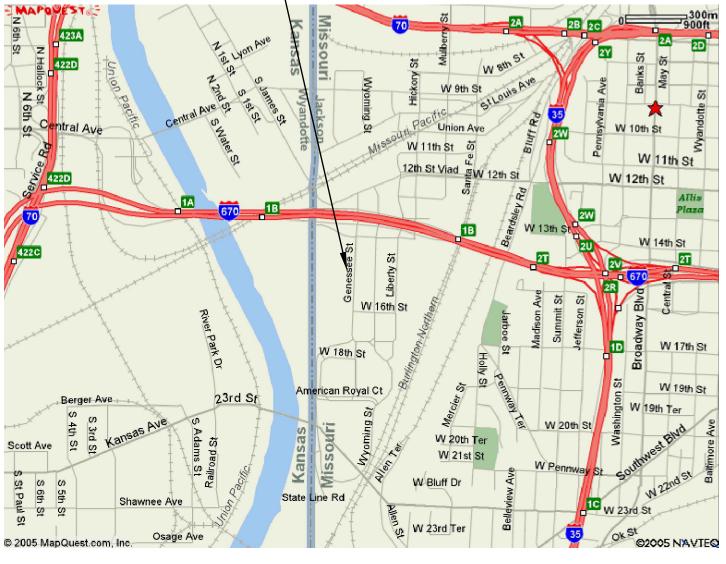


2 VICINITY MAP SCALE: NTS

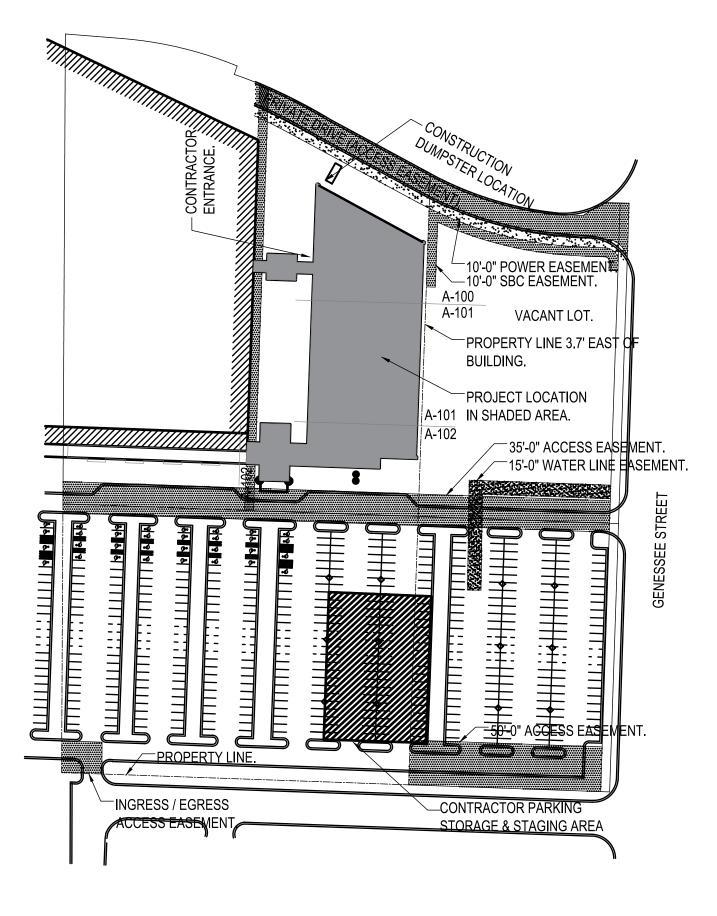

SITE/STAGING PLAN
SCALE: NTS



STATE OF MISSOURI MICHAEL L. PARSON, **GOVERNOR**

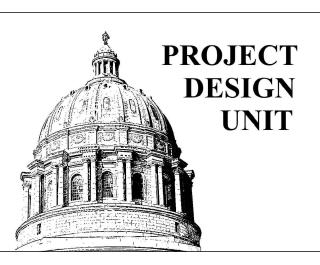

OFFICE OF ADMINISTRATION DIVISION OF FACILITIES MANAGEMENT, **DESIGN AND CONSTRUCTION**

DEPARTMENT OF LABOR AND INDUSTRIAL RELATIONS

REPLACE ROOF SYSTEM

KANSAS CITY DOLIR OFFICE BUILDING 1410 GENESSEE

KANSAS CITY, MISSOURI

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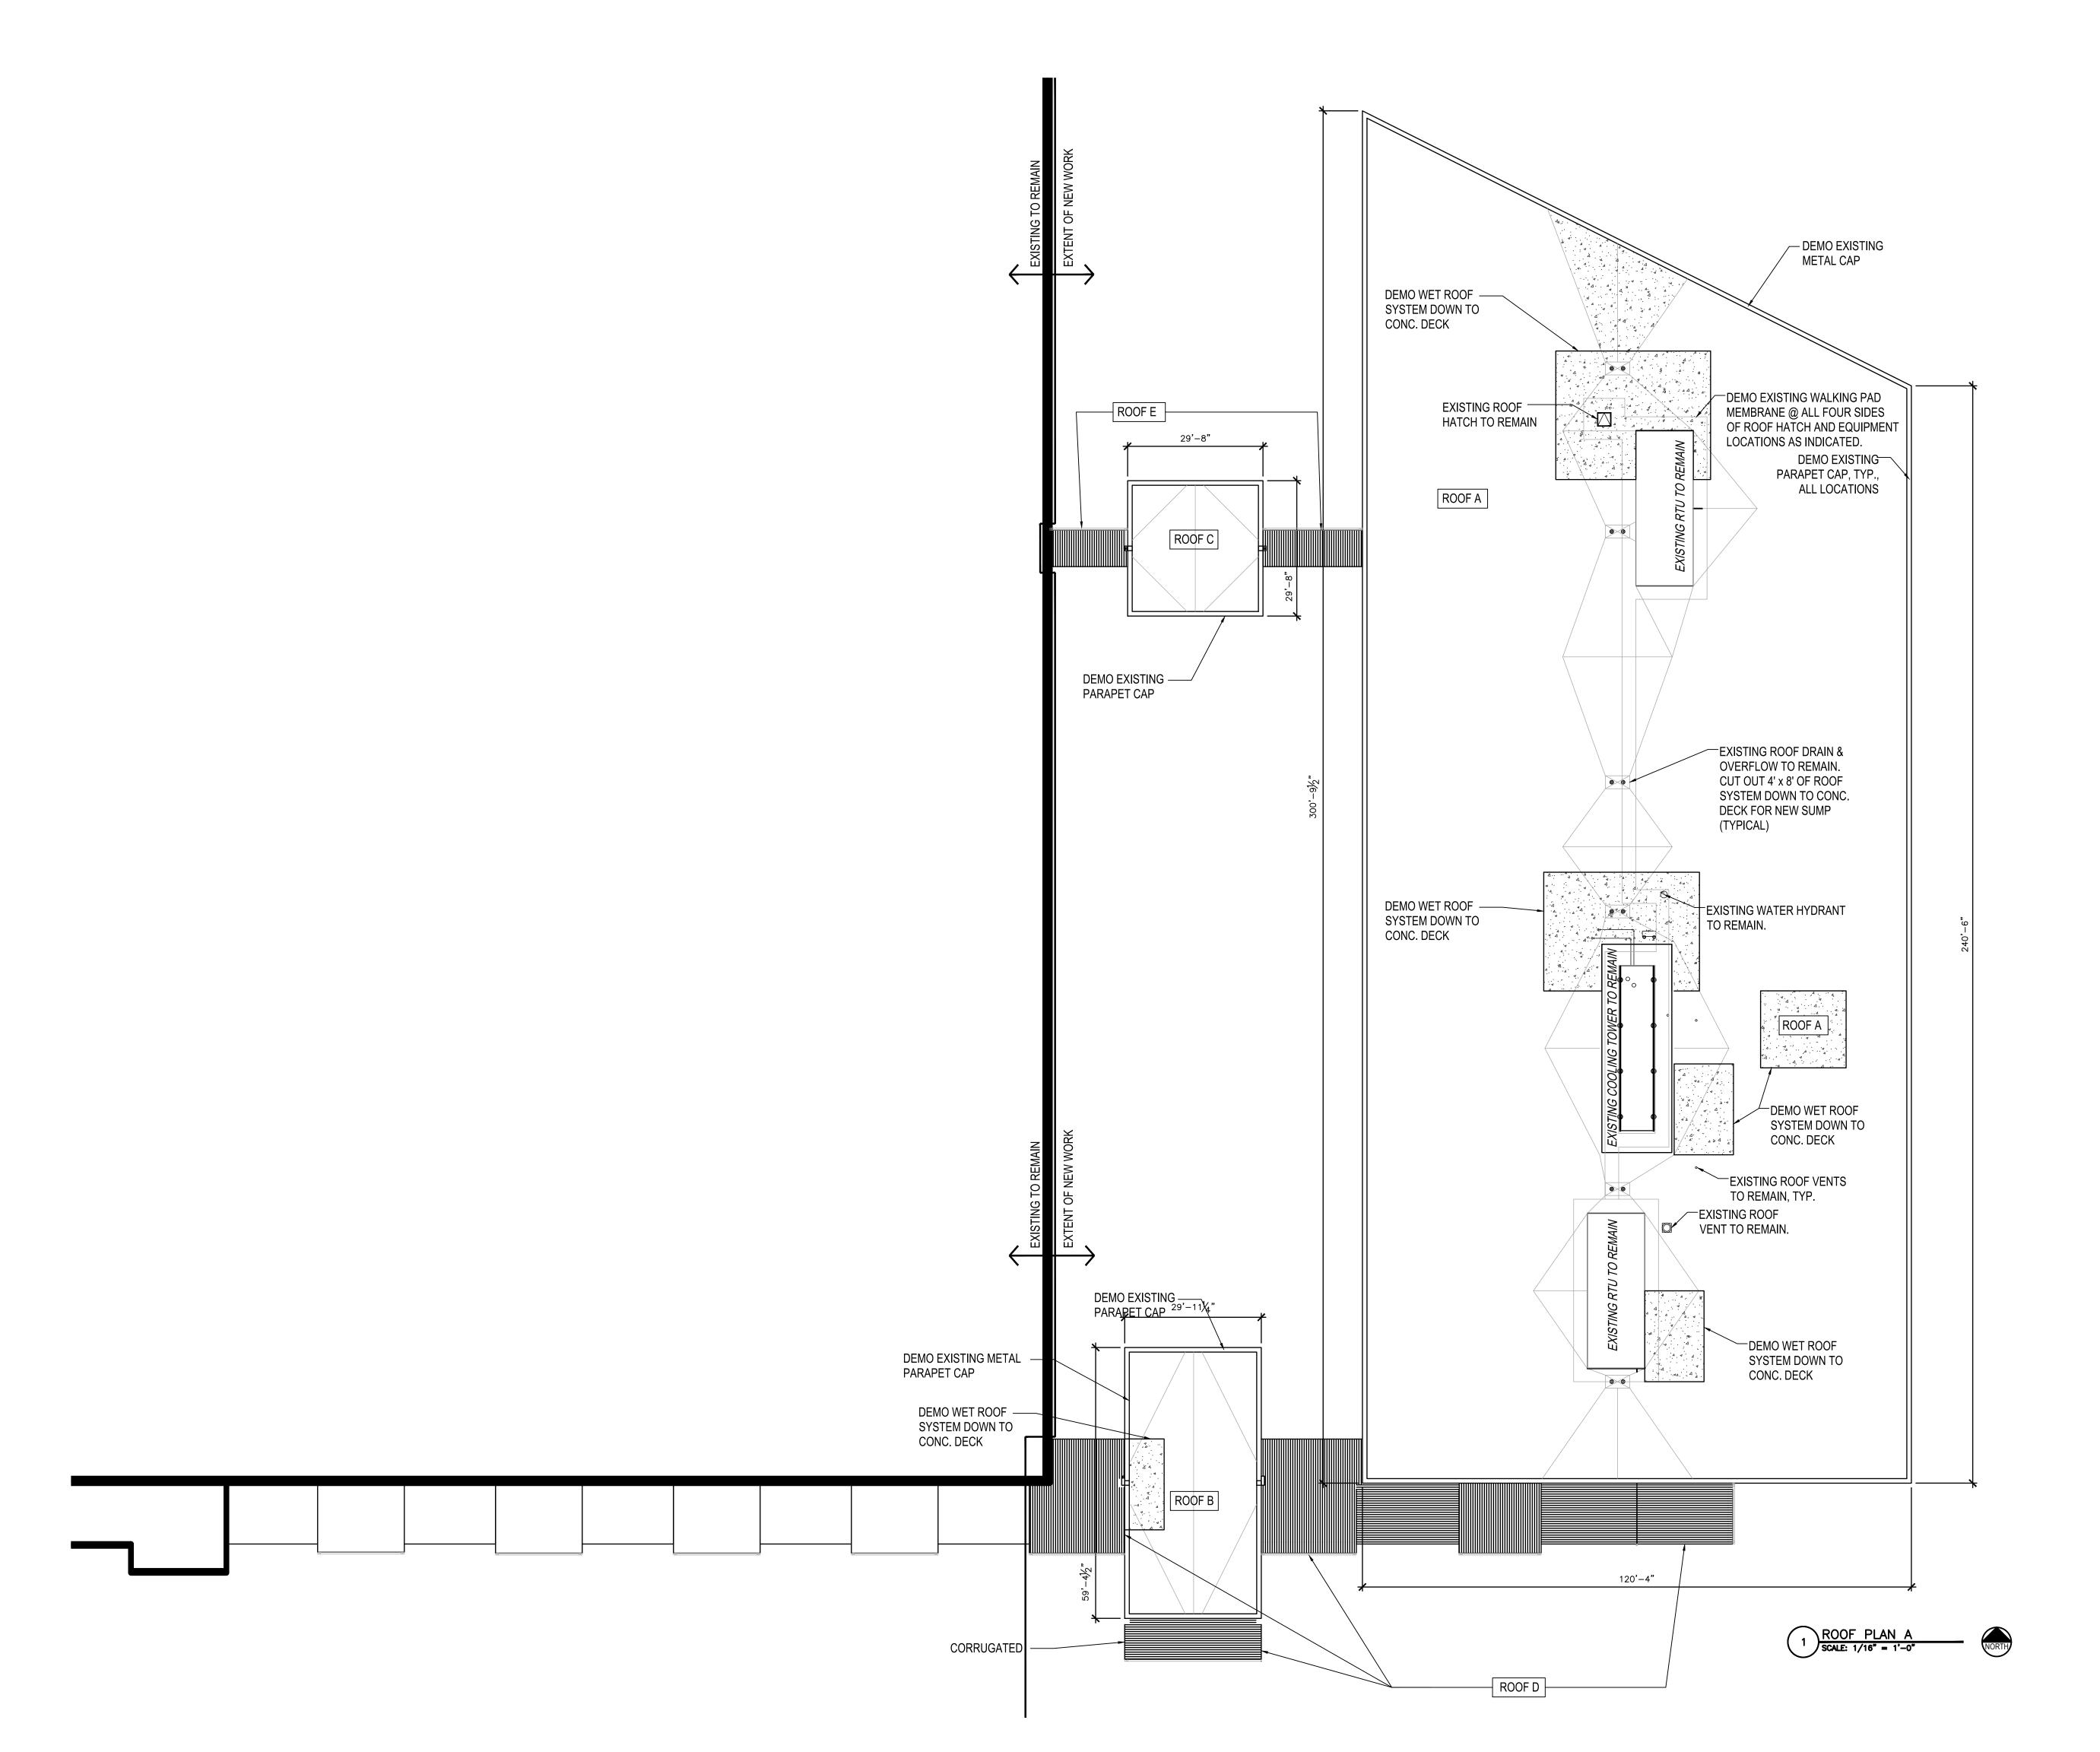
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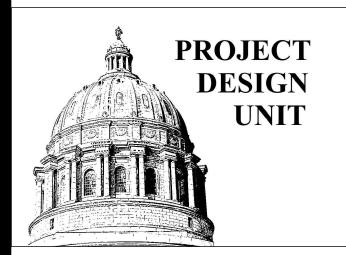
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GENERAL INFORMATION

SHEET NUMBER:



STATE OF MISSOURI MICHAEL L. PARSON, GOVERNOR



CONSTRUCTION DOCUMENTS

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DEPARTMENT OF LABOR AND INDUSTRIAL RELATIONS

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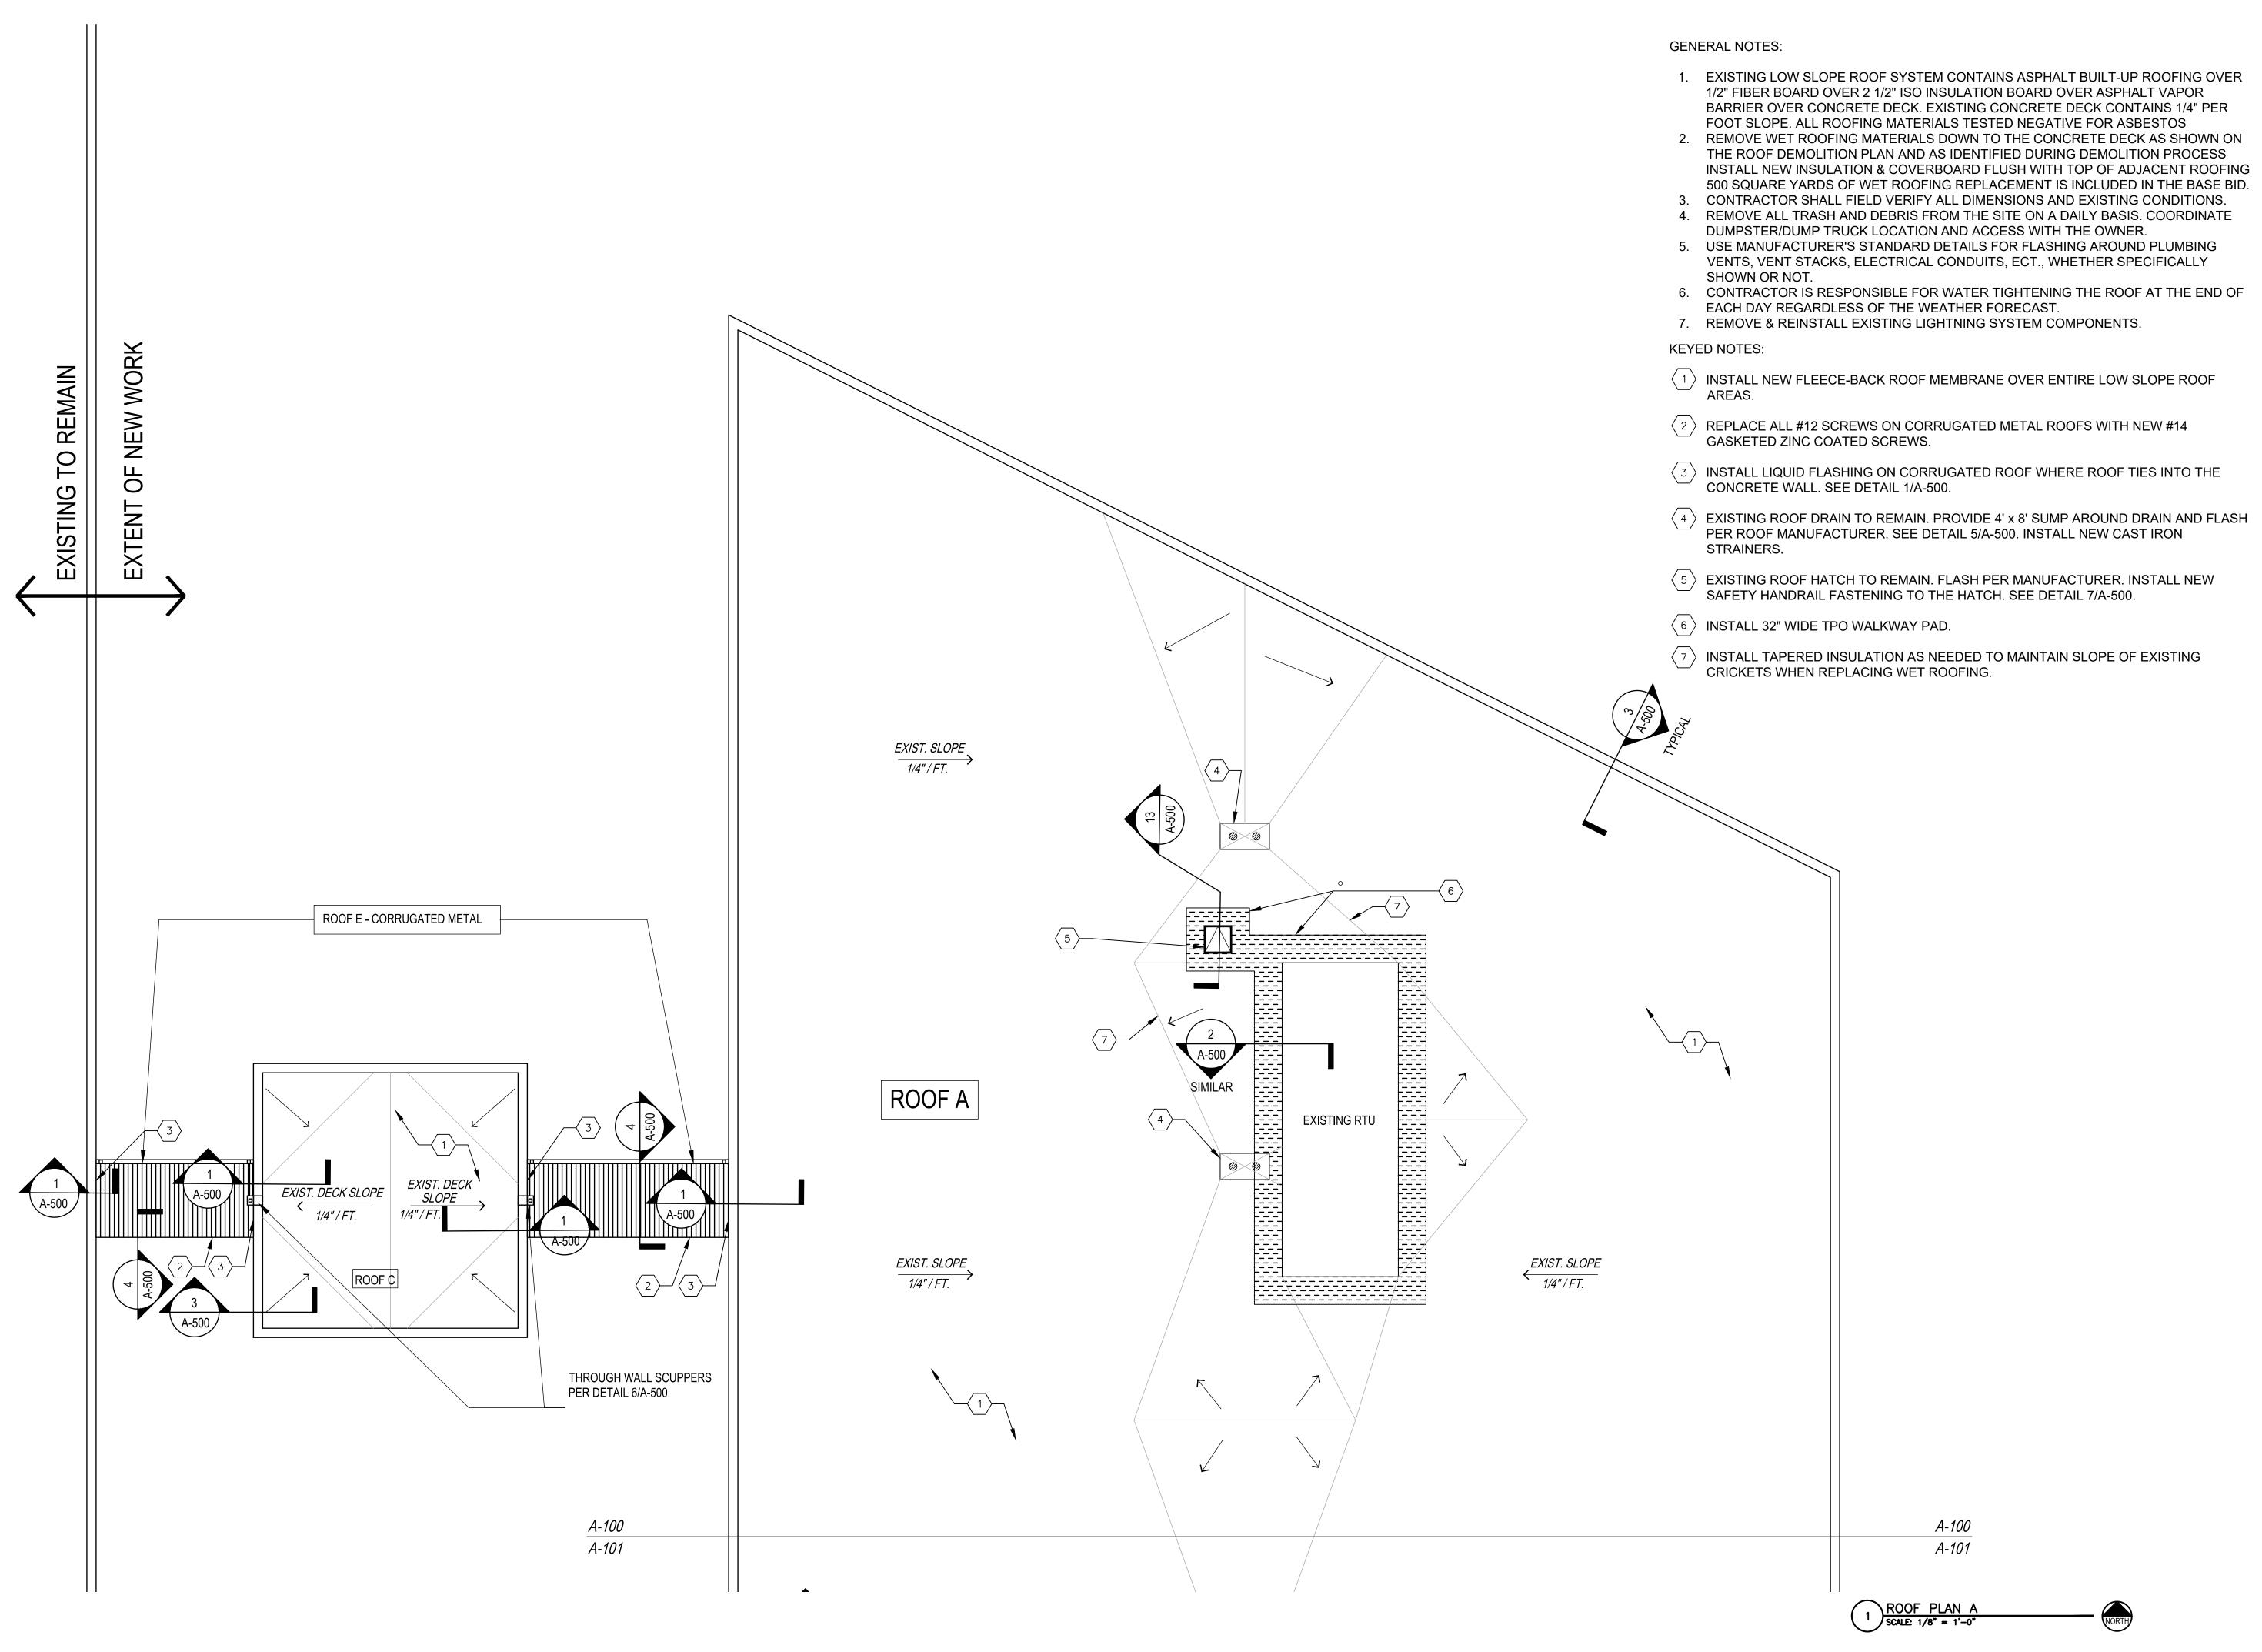
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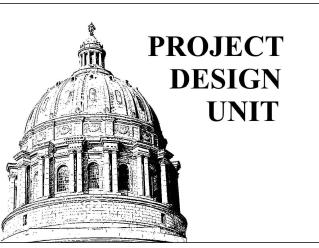
ROOF DEMOLITION PLAN

SHEET NUMBER:

D-100



STATE OF MISSOURI MICHAEL L. PARSON, GOVERNOR



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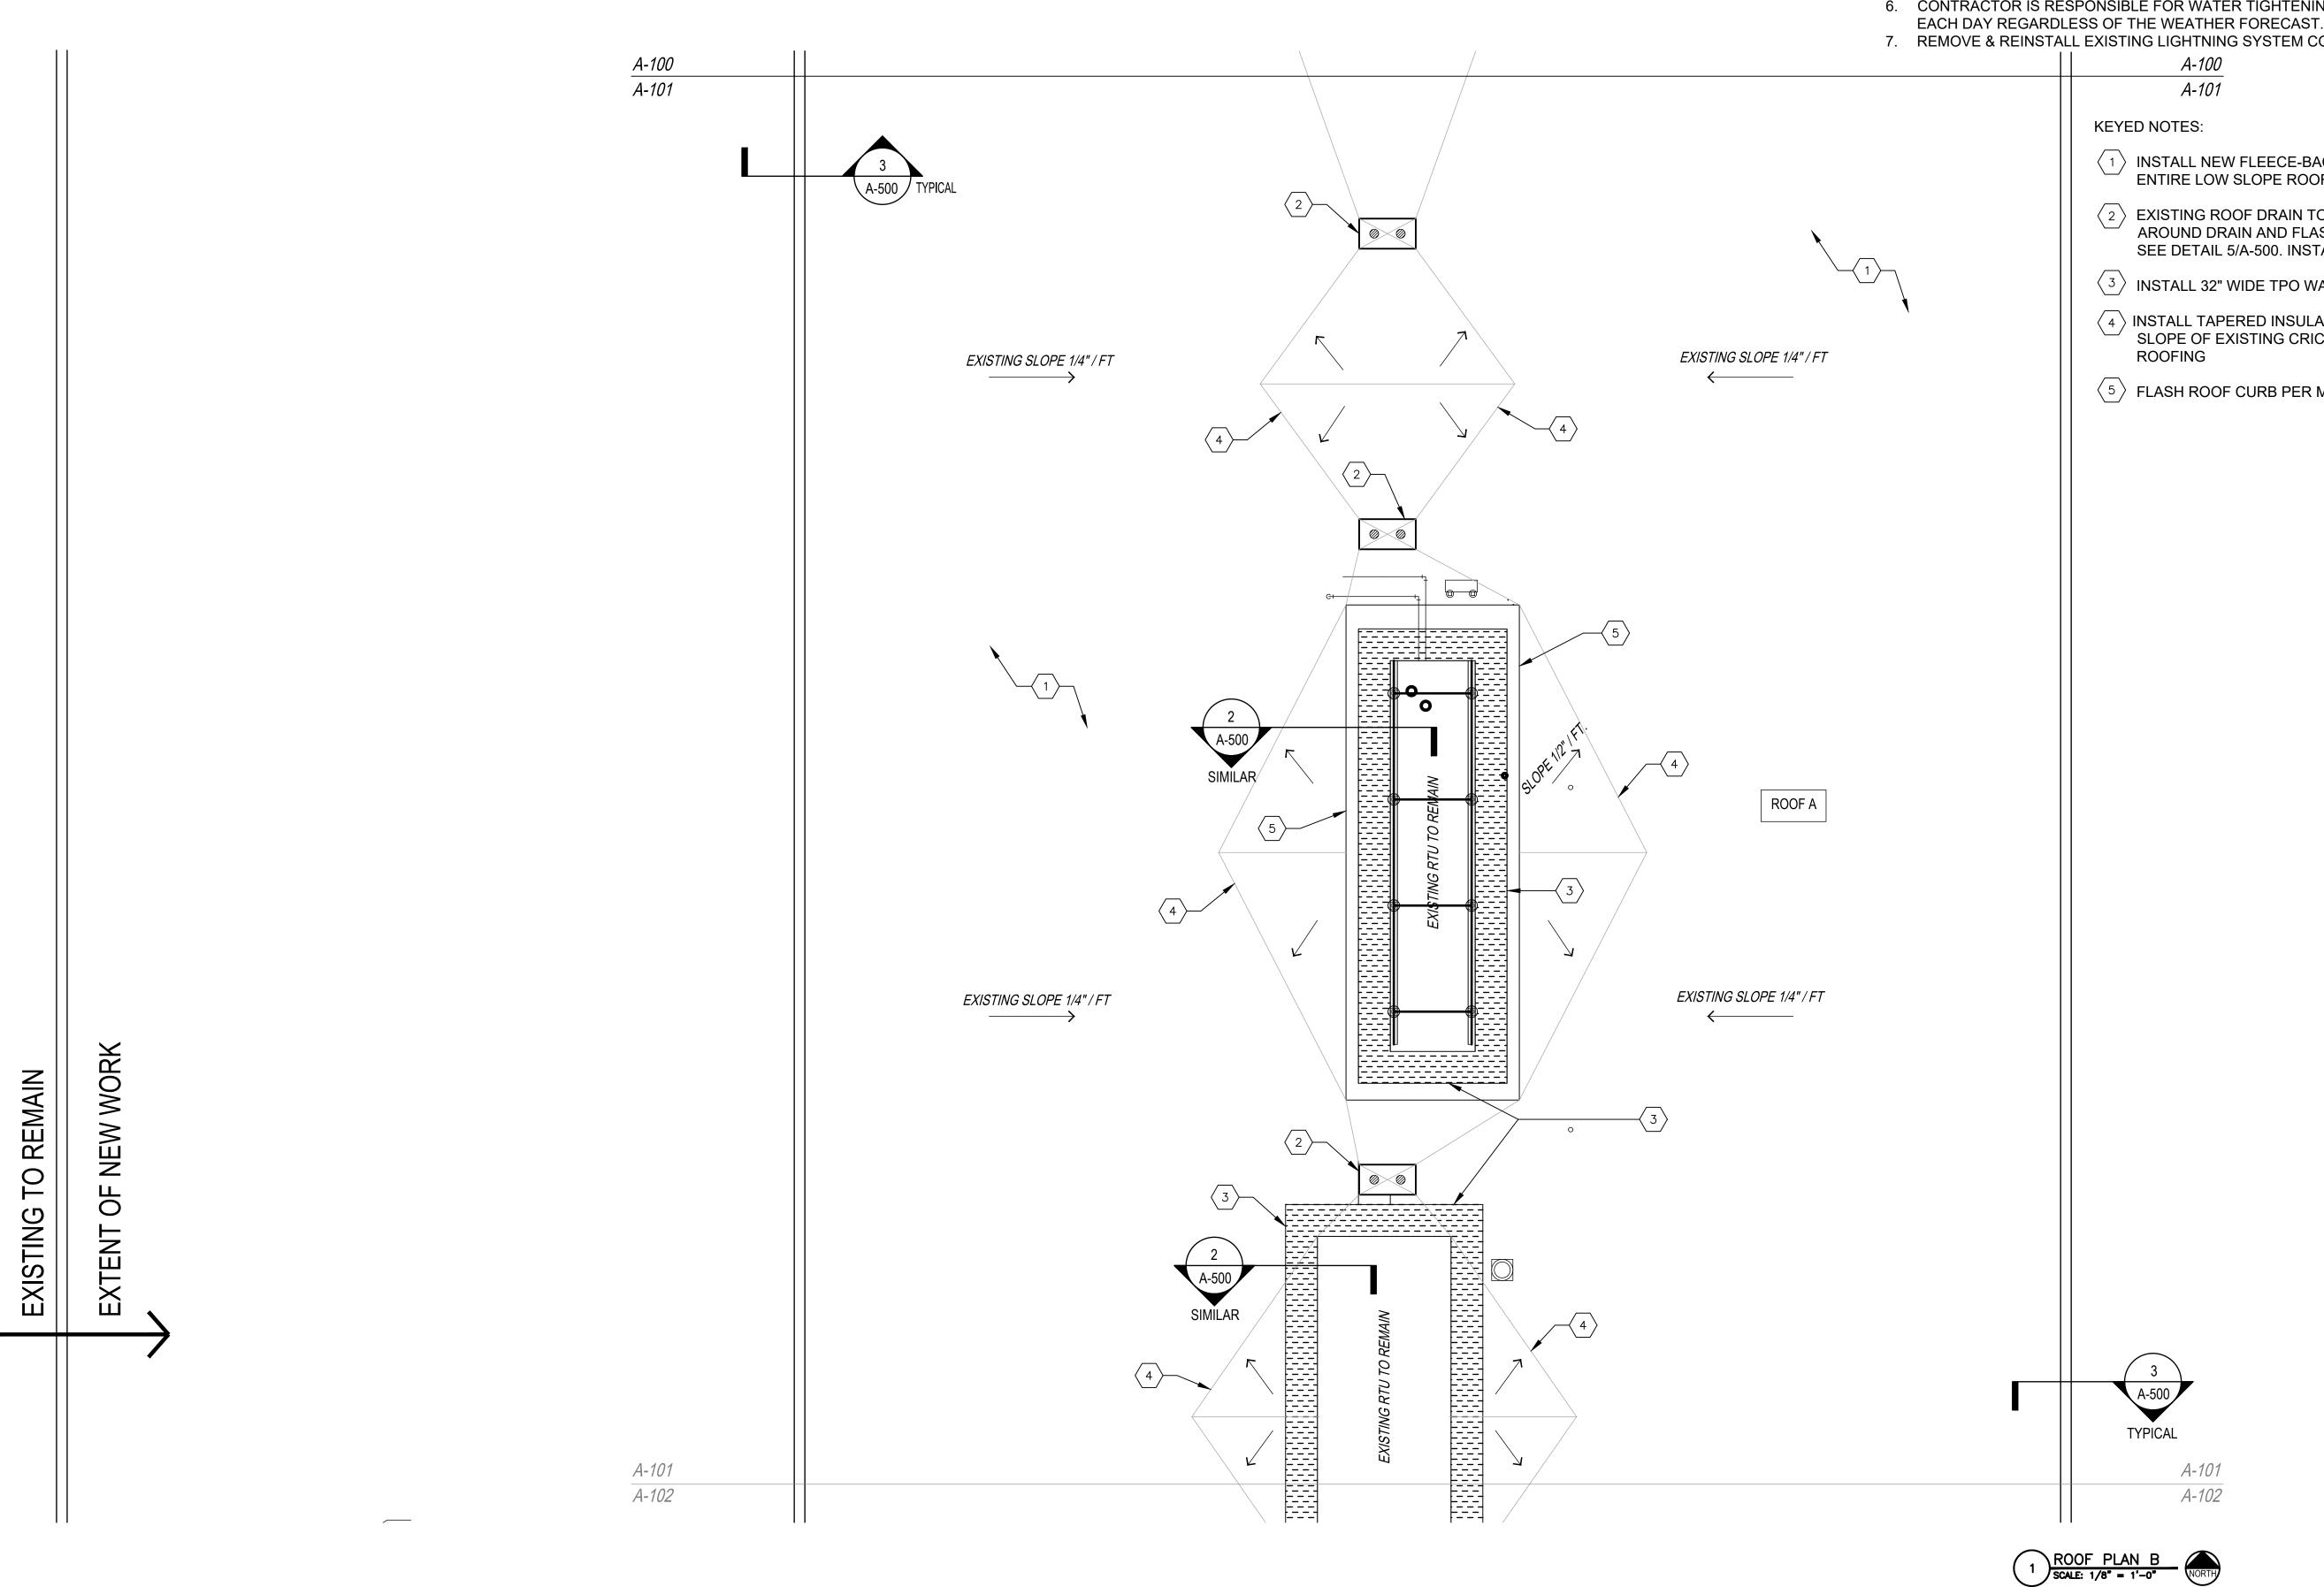
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DRAWN BY:
CHECKED BY:
DESIGNED BY: LJB

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ROOF PLAN A

SHEET NUMBER:

A-100




GENERAL NOTES:

- 1. EXISTING LOW SLOPE ROOF SYSTEM CONTAINS ASPHALT BUILT-UP ROOFING OVER 1/2" FIBER BOARD OVER 2 1/2" ISO INSULATION BOARD OVER ASPHALT VAPOR BARRIER OVER CONCRETE DECK. EXISTING CONCRETE DECK CONTAINS 1/4" PER FOOT SLOPE. ALL ROOFING MATERIALS TESTED NEGATIVE FOR ASBESTOS
- 2. REMOVE WET ROOFING MATERIALS DOWN TO THE CONCRETE DECK AS SHOWN ON THE ROOF DEMOLITION PLAN AND AS IDENTIFIED DURING DEMOLITION PROCESS INSTALL NEW INSULATION & COVERBOARD FLUSH WITH TOP OF ADJACENT ROOFING 5,000 SQUARE FEET OF WET ROOFING REPLACEMENT IS INCLUDED IN THE BASE BID.
- 3. CONTRACTOR SHALL FIELD VERIFY ALL DIMENSIONS AND EXISTING CONDITIONS.
- 4. REMOVE ALL TRASH AND DEBRIS FROM THE SITE ON A DAILY BASIS. COORDINATE DUMPSTER/DUMP TRUCK LOCATION AND ACCESS WITH THE OWNER.
- 5. USE MANUFACTURER'S STANDARD DETAILS FOR FLASHING AROUND PLUMBING
- VENTS, VENT STACKS, ELECTRICAL CONDUITS, ECT., WHETHER SPECIFICALLY SHOWN OR NOT.
- 6. CONTRACTOR IS RESPONSIBLE FOR WATER TIGHTENING THE ROOF AT THE END OF

7. REMOVE & REINSTALL EXISTING LIGHTNING SYSTEM COMPONENTS.

- (1) INSTALL NEW FLEECE-BACK ROOF MEMBRANE OVER ENTIRE LOW SLOPE ROOF AREAS.
- (2) EXISTING ROOF DRAIN TO REMAIN. PROVIDE 4' x 8' SUMP AROUND DRAIN AND FLASH PER ROOF MANUFACTURER. SEE DETAIL 5/A-500. INSTALL NEW CAST IRON STRAINERS.
- $\langle 3 \rangle$ INSTALL 32" WIDE TPO WALKWAY PAD.
- 4 INSTALL TAPERED INSULATION AS NEEDED TO MAINTAIN SLOPE OF EXISTING CRICKETS WHEN REPLACING WET
- (5) FLASH ROOF CURB PER MANUFACTURER

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REPLACE ROOF SYSTEM

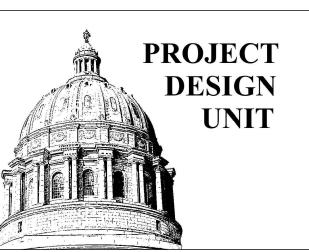KANSAS CITY DOLIR OFFICE BUILDING 1410 GENESSEE KANSAS CITY, MISSOURI

PROJECT # O2325-01

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REVISION: DATE: **REVISION: REVISION:** DATE: ISSUE DATE:

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ROOF PLAN B

SHEET NUMBER:

KEYED NOTES:

- 1) INSTALL NEW FLEECE-BACK ROOF MEMBRANE OVER ENTIRE LOW SLOPE ROOF AREAS.
- (2) REPLACE ALL #12 SCREWS ON CORRUGATED METAL ROOFS WITH NEW #14 GASKETED ZINC COATED SCREWS.
- 3 INSTALL LIQUID FLASHING ON CORRUGATED ROOF WHERE ROOF TIES INTO THE CONCRETE WALL. SEE DETAIL 1/A-500.
- EXISTING ROOF DRAIN TO REMAIN. PROVIDE 4' x 8' SUMP AROUND DRAIN AND FLASH PER ROOF MANUFACTURER. SEE DETAIL 5/A-500. INSTALL NEW CAST IRON STRAINERS.
- 5 INSTALL 32" WIDE TPO WALKWAY PAD.
- 6 INSTALL TAPERED INSULATION AS NEEDED TO MAINTAIN SLOPE OF EXISTING CRICKETS WHEN REPLACING WET ROOFING.
- 7 INSTALL ROOF TO ROOF ACCESS LADDER PER OSHA REQUIREMENTS. SEE DETAIL 8/A500.

GENERAL NOTES:

- EXISTING LOW SLOPE ROOF SYSTEM CONTAINS ASPHALT BUILT-UP ROOFING OVER 1/2" FIBER BOARD OVER 2 1/2" ISO INSULATION BOARD OVER ASPHALT VAPOR BARRIER OVER CONCRETE DECK. EXISTING CONCRETE DECK CONTAINS 1/4" PER FOOT SLOPE. ALL ROOFING MATERIALS TESTED NEGATIVE FOR ASBESTOS
- 2. REMOVE WET ROOFING MATERIALS DOWN TO THE CONCRETE DECK AS SHOWN ON THE ROOF DEMOLITION PLAN AND AS IDENTIFIED DURING DEMOLITION PROCESS INSTALL NEW INSULATION & COVERBOARD FLUSH WITH TOP OF ADJACENT ROOFING 5,000 SQUARE FEET OF WET ROOFING REPLACEMENT IS INCLUDED IN THE BASE BID.
- CONTRACTOR SHALL FIELD VERIFY ALL DIMENSIONS AND EXISTING CONDITIONS.
 REMOVE ALL TRASH AND DEBRIS FROM THE SITE ON A DAILY BASIS. COORDINATE
- DUMPSTER/DUMP TRUCK LOCATION AND ACCESS WITH THE OWNER.

 5. USE MANUFACTURER'S STANDARD DETAILS FOR FLASHING AROUND PLUMBING
- VENTS, VENT STACKS, ELECTRICAL CONDUITS, ECT., WHETHER SPECIFICALLY SHOWN OR NOT.
- 6. CONTRACTOR IS RESPONSIBLE FOR WATER TIGHTENING THE ROOF AT THE END OF EACH DAY REGARDLESS OF THE WEATHER FORECAST.
- 7. REMOVE & REINSTALL EXISTING LIGHTNING SYSTEM COMPONENTS.



STATE OF MISSOURI MICHAEL L. PARSON,

PROJECT

DESIGN

UNIT

GOVERNOR

OFFICE OF ADMINISTRATION DIVISION OF FACILITIES MANAGEMENT, DESIGN AND CONSTRUCTION

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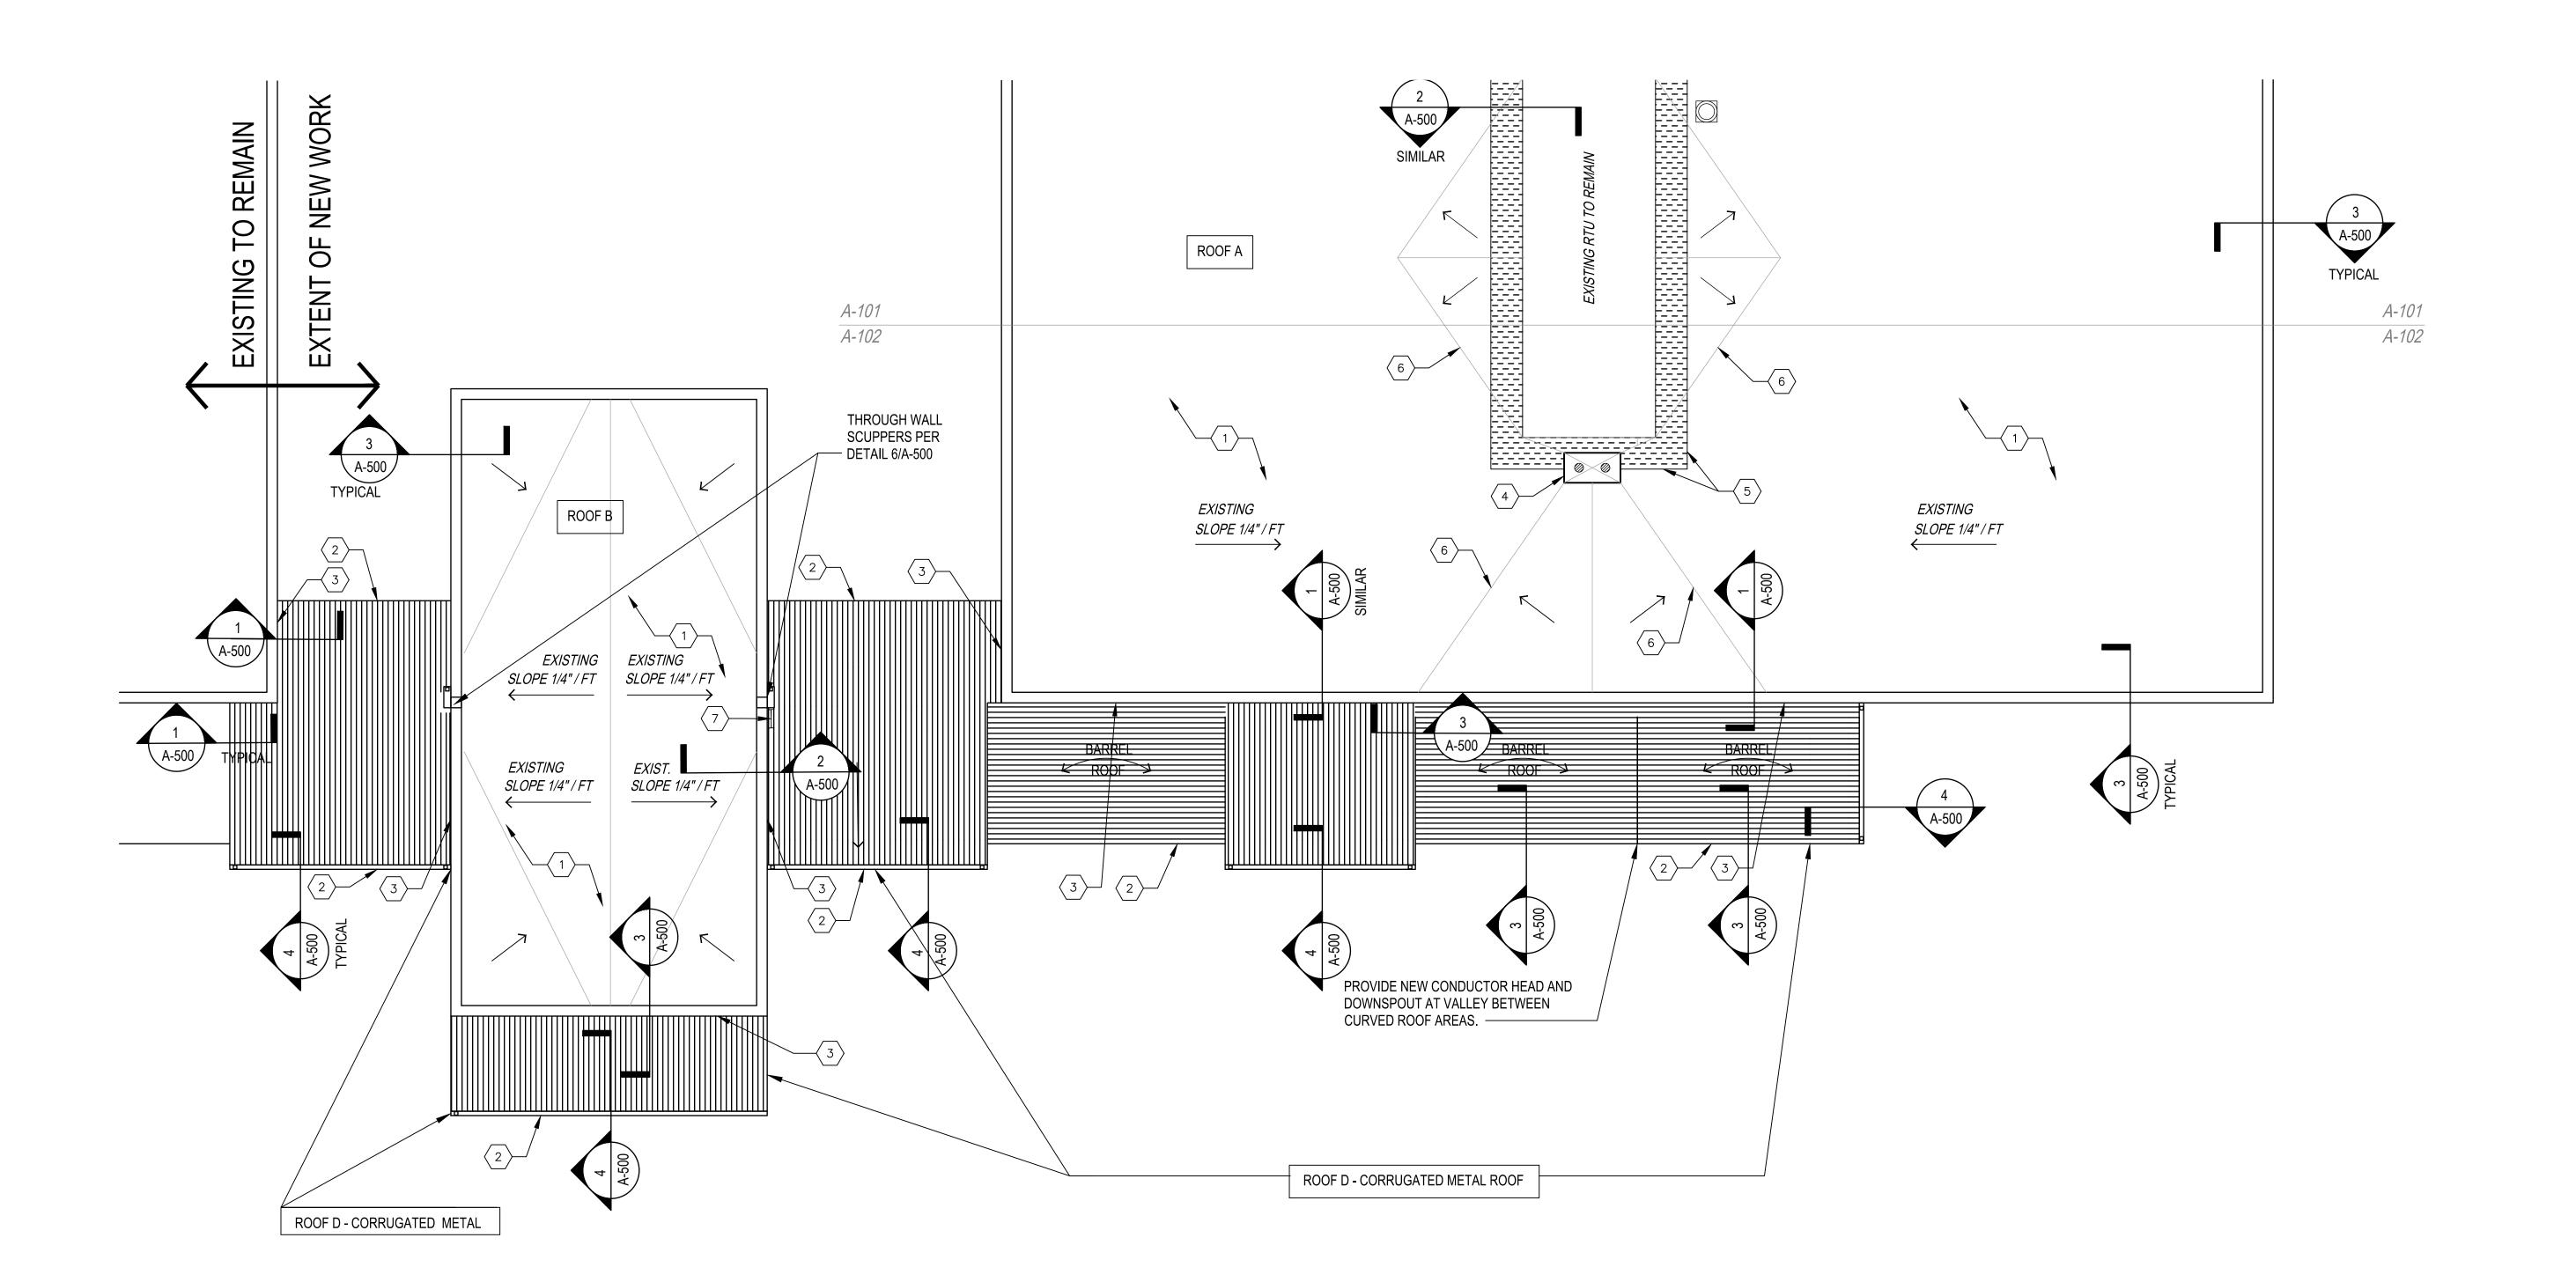
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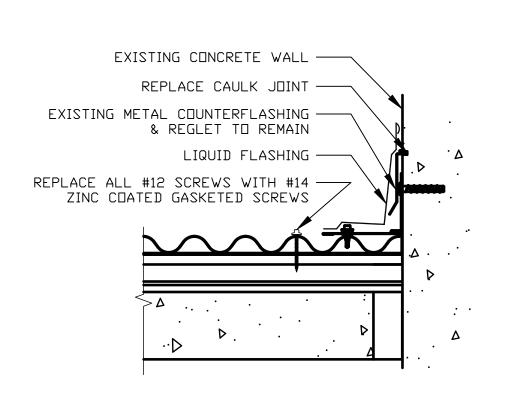
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ROOF PLAN C


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A-102






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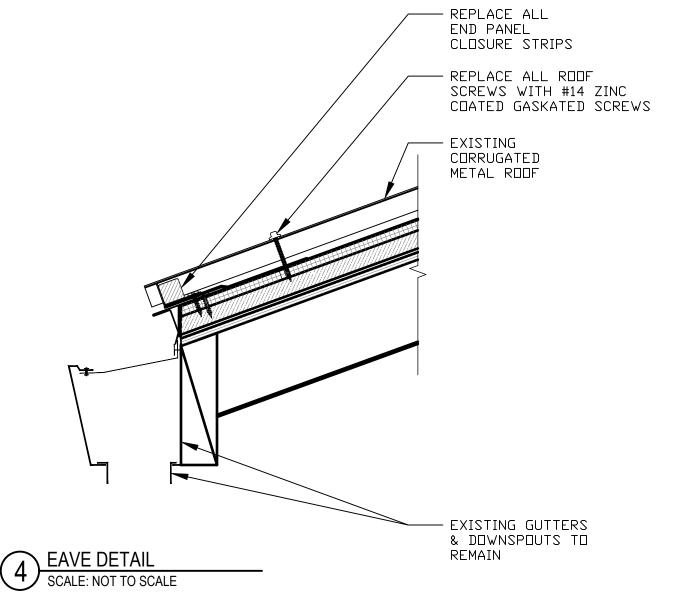



- TPO FLASHING

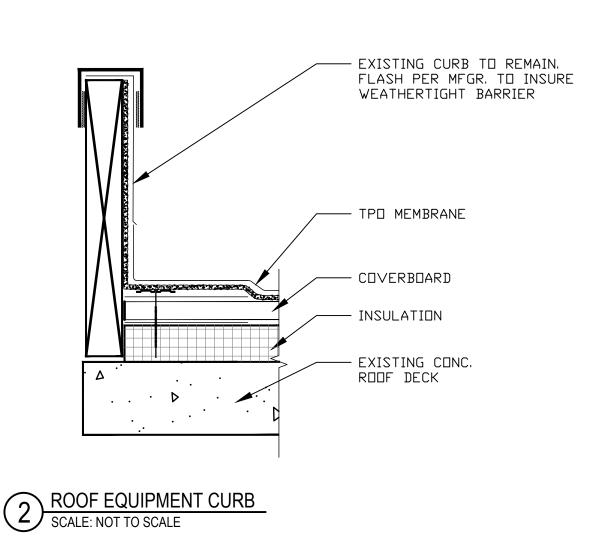— TP□ MEMBRANE

- COVERBOARD




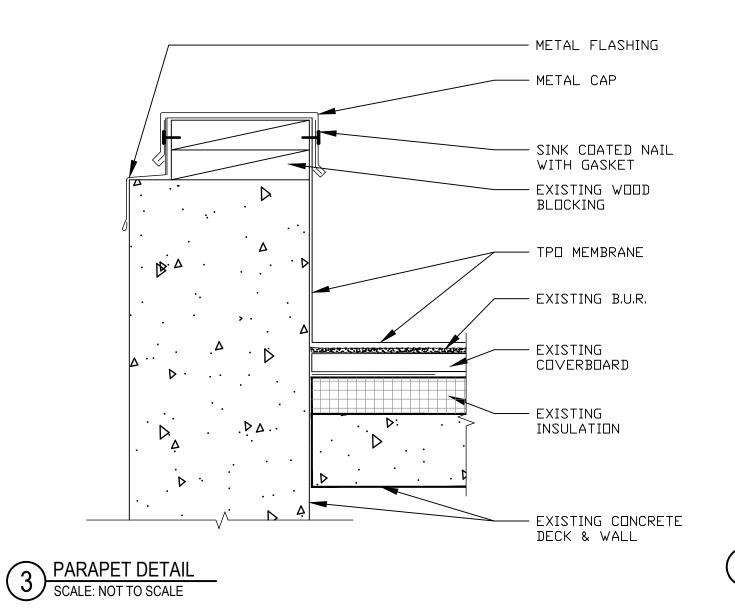

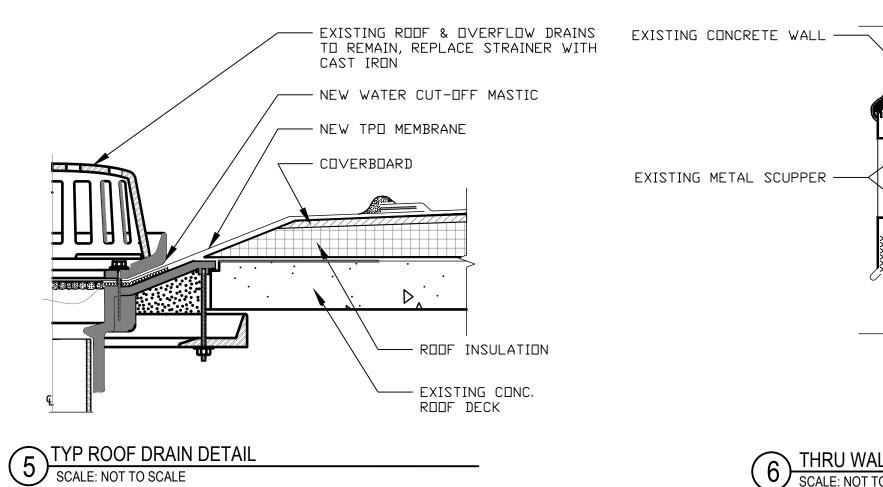


6 THRU WALL SCUPPER SCALE: NOT TO SCALE

EXISTING METAL SCUPPER —

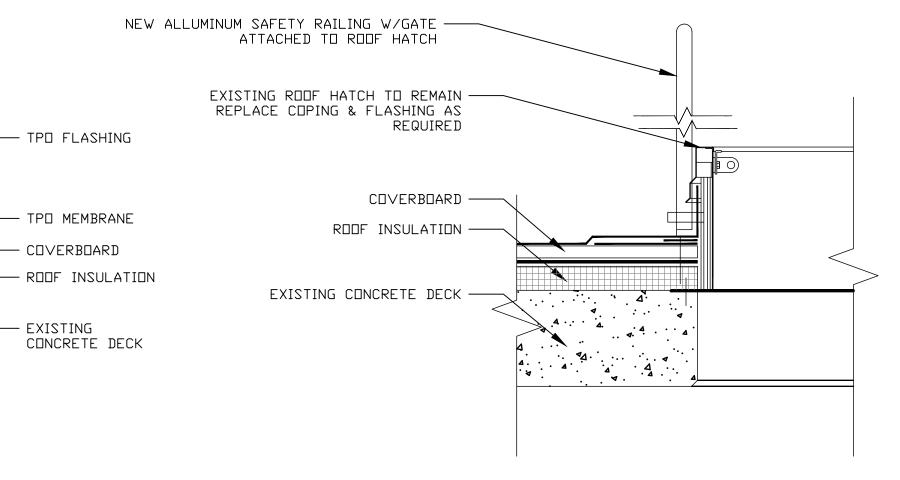

ROOF HATCH (EXISTING TO REMAIN)
SCALE: NOT TO SCALE

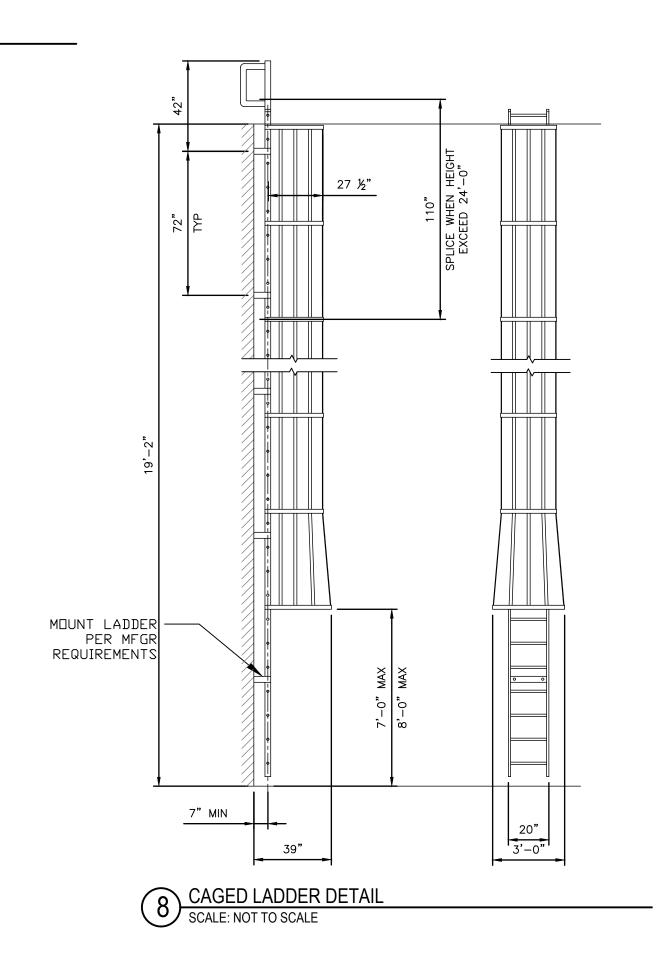

STATE OF MISSOURI MICHAEL L. PARSON, **GOVERNOR**



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ROOF DETAILS

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