
RENOVATE LOBBY AND RESTROOMS 1ST AND 2ND FLOOR HOWERTON STATE OFFICE BUILDING JEFFERSON CITY, MISSOURI

OWNER:

PROJECT MANAGEMENT:

STATE OF MISSOURI MIKE KEHOE, GOVERNOR

OFFICE OF ADMINISTRATION DIVISION OF FACILITIES MANAGEMENT. DESIGN AND CONSTRUCTION

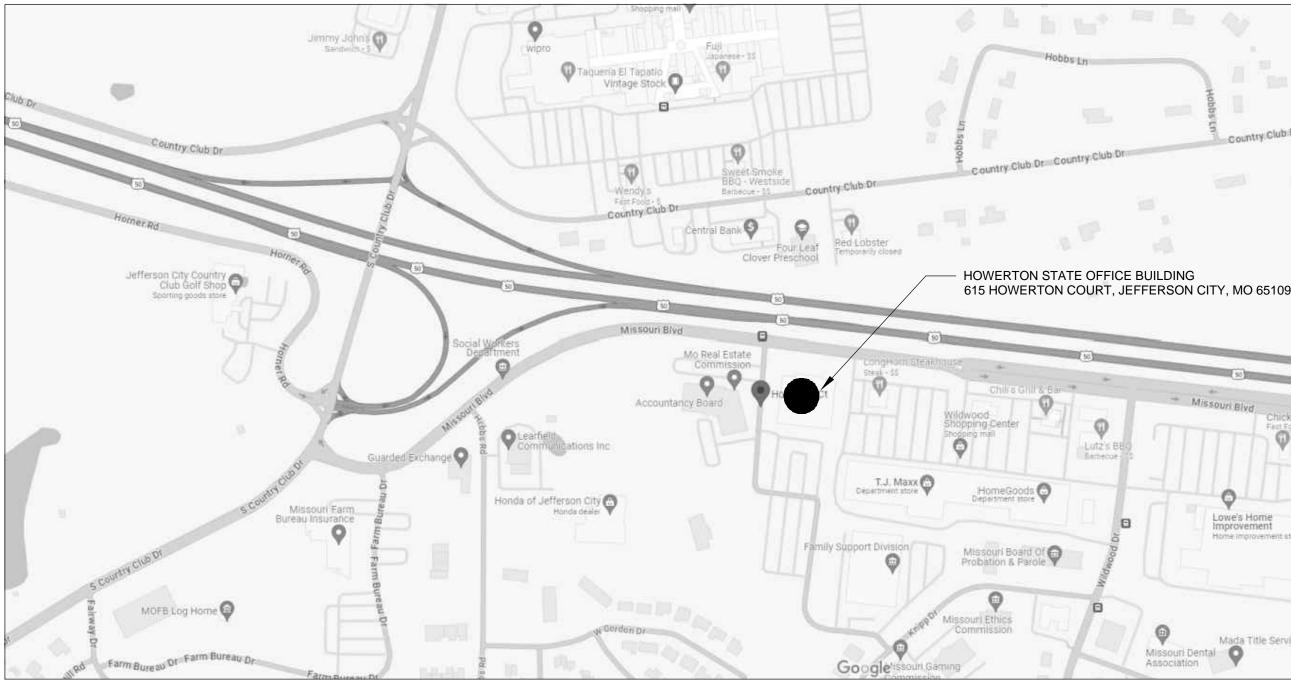

SITE LOCATIONS

BUILDING CODE NOTES

NEW WORK INSTALLATION TO FOLLOW: INTERNATIONAL BUILDING CODE 2021 EDITION (IBC) INTERNATIONAL MECHANICAL CODE 2021 EDITION (IMC) INTERNATIONAL PLUMBING CODE 2021 EDITION (IPC) NATIONAL ELECTRICAL CODE 2020 EDITION (NEC) NFPA 101 LIFE SAFETY CODE 2021 EDITION (NFPA)

GENERAL DEMOLITION NOTES

- DEMOLITION DRAWINGS AND PLANS ARE FROM FIELD TAKE-OFF FIELD VERIFYING EXISTING CONDITIONS PRIOR TO BIDDING AND/OR CONSTRUCTION.
- COVER ALL OPENINGS INTO THE BUILDING FROM THE WORK AREA. INSURE DEBRIS IS REMOVED FROM THE CONSTRUCTION IS RESPONSIBLE FOR REMOVAL AND DISPOSAL OF ALL DEMOLISHED MATERIAL.
- INSTALL TEMPORARY CAPS AT TERMINATION POINTS OF EXISTING DUCTWORK/PIPES TO REMAIN DURING DEMOLITION PHASES.


STATE OF MISSOURI -OFFICE OF ADMINISTRATION **DESIGNER**: DIVISION OF FACILITIES MANAGEMENT, DESIGN AND CONSTRUCTION: 301 W. HIGH STREET, JEFFERSON CITY, MO 65102 **PROJECT NUMBER:** 02339-01 **ASSET NUMBER:** 3101025001 - HOWERTON STATE OFFICE BUILDING SHEET LIST: G-001 COVER SHEET A-100 FIRST FLOOR LOBBY & RESTROOM DEMOLITION PLAN A-101 SECOND FLOOR LOBBY & RESTROOM DEMOLITION PLAN A-102 FIRST FLOOR LOBBY RENOVATION PLAN A-103 SECOND FLOOR LOBBY RENOVATION PLAN A-104 FIRST FLOOR RESTROOM RENOVATION PLAN A-105 SECOND FLOOR RESTROOM RENOVATION PLAN A-200 LOBBY FEATURE WALL ELEVATIONS AND DETAILS A-201 FIRST FL. WOMEN'S LOBBY RESTROOM ELEVATIONS A-202 FIRST FL. MEN'S LOBBY RESTROOM ELEVATIONS A-203 SECOND FL. WOMEN'S LOBBY RESTROOM ELEVATIONS A-204 SECOND FL. MEN'S LOBBY RESTROOM ELEVATIONS A-205 FIRST FL. WOMEN'S STAFF RESTROOM ELEVATIONS A-206 FIRST FL. MEN'S STAFF RESTROOM ELEVATIONS A-207 SECOND FL. WOMEN'S STAFF RESTROOM ELEVATIONS A-208 SECOND FL. MEN'S STAFF RESTROOM ELEVATIONS **GENERAL NOTES:** A-500 RESTROOM DETAILS ALL WORK SHALL BE PERFORMED IN A SAFE MANNER WITH PROTECTION PROVIDED TO ANY A-501 DOOR DETAILS BUILDING OCCUPANTS AND WORKERS PERFORMING THE WORK. ALL WORK SHALL BE DONE IN A MANNER TO MINIMIZE DAMAGE TO ADJACENT SURFACES THAT ARE A-700 FIRST FLOOR DEMOLITION RCP NOT SHOWN TO BE WORKED ON OR REMOVED - CONTRACTOR SHALL BE RESPONSIBLE FOR ALL WORK NECESSARY TO REPAIR SURFACES AFFECTED BY THEIR WORK. A-701 SECOND FLOOR DEMOLITION RCP ANY WORK THAT RESULTS IN EXCESSIVE NOISE, DUST OR DEBRIS MUST BE COORDINATED WITH BUILDING FACILITY STAFF AT LEAST TWO (2) WORKING DAYS IN ADVANCE. A-702 FIRST FLOOR RENOVATION RCP ANY WORK THAT REQUIRES THE NEED TO TEMPORARILY SHUT DOWN ANY OF THE BUILDING SYSTEMS MUST BE COORDINATED WITH BUILDING FACILITY STAFF AT LEAST FOUR (4) WORKING A-703 SECOND FLOOR RENOVATION RCP DAYS IN ADVANCE. CONTRACTOR SHALL PROVIDE NECESSARY DUST PROTECTION TO PREVENT DUST CREATED BY A-704 1ST & 2ND FLOOR STAFF RESTROOM RENOVATION RCP DEMOLITION/CONSTRUCTION ACTIVITIES TO ENTER SPACE(S) OUTSIDE THE WORK AREA. INCLUDING THROUGH THE HVAC SYSTEM. CONTRACTOR SHALL BE RESPONSIBLE TO REPLACE ANY F-101 FIRE PROTECTION PLAN - 1ST FLOOR HVAC FILTERS CONTAMINATED WITH CONSTRUCTION DEBRIS. CONTRACTOR SHALL BE RESPONSIBLE TO PERFORM ANY WORK NECESSARY TO PROVIDE THE F-102 FIRE PROTECTION PLAN - 2ND FLOOR SCOPE OF WORK SHOWN ON THE PLANS, EVEN IF NOT SPECIFICALLY NOTED OR SHOWN. CONTRACTOR SHALL PERFORM WORK BETWEEN THE HOURS OF 7AM TO 5PM AFTER SIGNING IN F-103 FIRE PROTECTION PLAN - STAFF RESTROOMS AND RECEIVING VISITOR'S BADGE. ALL MATERIALS/EQUIPMENT MAY BE DELIVERED TO THE FACILITY - FACILITY STAFF SHALL BE PD-101 PLUMBING DEMOLITION PLAN RESTROOMS CONTACTED TEN (10) BUSINESS DAYS PRIOR TO DELIVERY OF MATERIALS/EQUIPMENT. CONTRACTOR SHALL BE SIGN FOR RECEIPT OF ALL MATERIALS/EQUIPMENT - FACILITY STAFF ARE P-101 PLUMBING RENOVATION PLAN RESTROOMS NOT RESPONSIBLE FOR ACCEPTING OR SIGNING FOR DELIVERIES. ALL WORK SHALL BE PERFORMED IN ACCORDANCE WITH THE LATEST EDITION OF THE IBC, IFC, IMC P-601 PLUMBING SCHEDULES AND DETAILS IPC, NEC AND ALL OTHER APPLICABLE ICC AND NFPA CODE FAMILIES. 10. CONTRACTOR RESPONSIBLE FOR FIELD VERIFYING AS-BUILT CONDITIONS AND PROPOSED LAYOUT MED-101 MECH AND ELEC DEMOLITION PLAN 1ST FLOOR PRIOR TO PERFORMING WORK. CONTRACTOR SHALL NOTIFY FMDC PROJECT MANAGER AND ARCHITECT IF THERE ARE ANY DISCREPANCIES OR CONFLICTS. MED-102 MECH AND ELEC DEMOLITION PLAN 2ND FLOOR 1. DETAILS OF EXISTING CONDITIONS PROVIDED AS A COURTESY. THIS INFORMATION DOES NOT RELIEVE THE CONTRACTOR FROM PERFORMING A COMPLETE NECESSARY FIELD INVESTIGATIVE MED-103 MECH AND ELEC DEMOLITION PLAN STAFF RESTROOMS WORK TO FULLY UNDERSTAND EXISTING CONDITIONS PRIOR TO SUBMITTING BID. 12. DATA AND PHONE LINE WORK TO BE PERFORMED BY OTHERS (NIC). M-101 MECHANICAL RENOVATION PLAN 1ST FLOOR 13. CONTRACTOR SHALL MAINTAIN THE INTEGRITY OF ALL RATED PARTITIONS, CEILING ASSEMBLIES AND DOOR ASSEMBLIES. THE CONTRACTOR SHALL MAKE ALL NECESSARY REPAIRS WHERE ANY M-102 MECHANICAL RENOVATION PLAN 2ND FLOOR WORK PERFORMED BY THE CONTRACTOR AFFECTS THE INTEGRITY OF THESE ITEMS. 15. DIMENSIONS PROVIDED ARE MEASURED FROM FACE OF STUD AT NEW WALLS AND EXISTING M-103 MECHANICAL RENOVATION PLAN STAFF RESTROOMS DRYWALL FACE TO NEW DRYWALL FACE OF EXISTING WALLS UNLESS OTHERWISE NOTED. ALL DIMENSIONS RELATIVE TO EXISTING CONDITIONS ARE APPROXIMATE AND MAY E-101 ELECTRICAL RENOVATION PLAN 1ST FLOOR VARY.CONTRACTOR SHALL VERIFY ALL DIMENSIONS AND EXISTING CONDITIONS. MINOR DIFFERENCES BETWEEN WHAT IS SHOWN AND THE ACTUAL DIMENSIONS WILL NOT BE CONSIDERED E-102 ELECTRICAL RENOVATION PLAN 2ND FLOOR THE BASIS FOR A CONTRACT CHANGE.


AND ORIGINAL DRAWINGS. CONTRACTOR IS RESPONSIBLE FOR


AND DEMOLITION AREA AND AIR BORN DEBRIS IS NOT ALLOWED TO TRAVEL TO THE REMAINDER OF THE BUILDING. CONTRACTOR

COORDINATE WITH EXISTING SYSTEMS WHICH SHALL REMAIN IN OPERATION DURING DEMOLITION AND CONSTRUCTION PHASES.

E-103 ELECTRICAL RENOVATION PLAN STAFF RESTROOMS

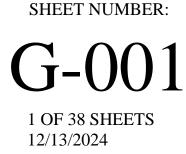

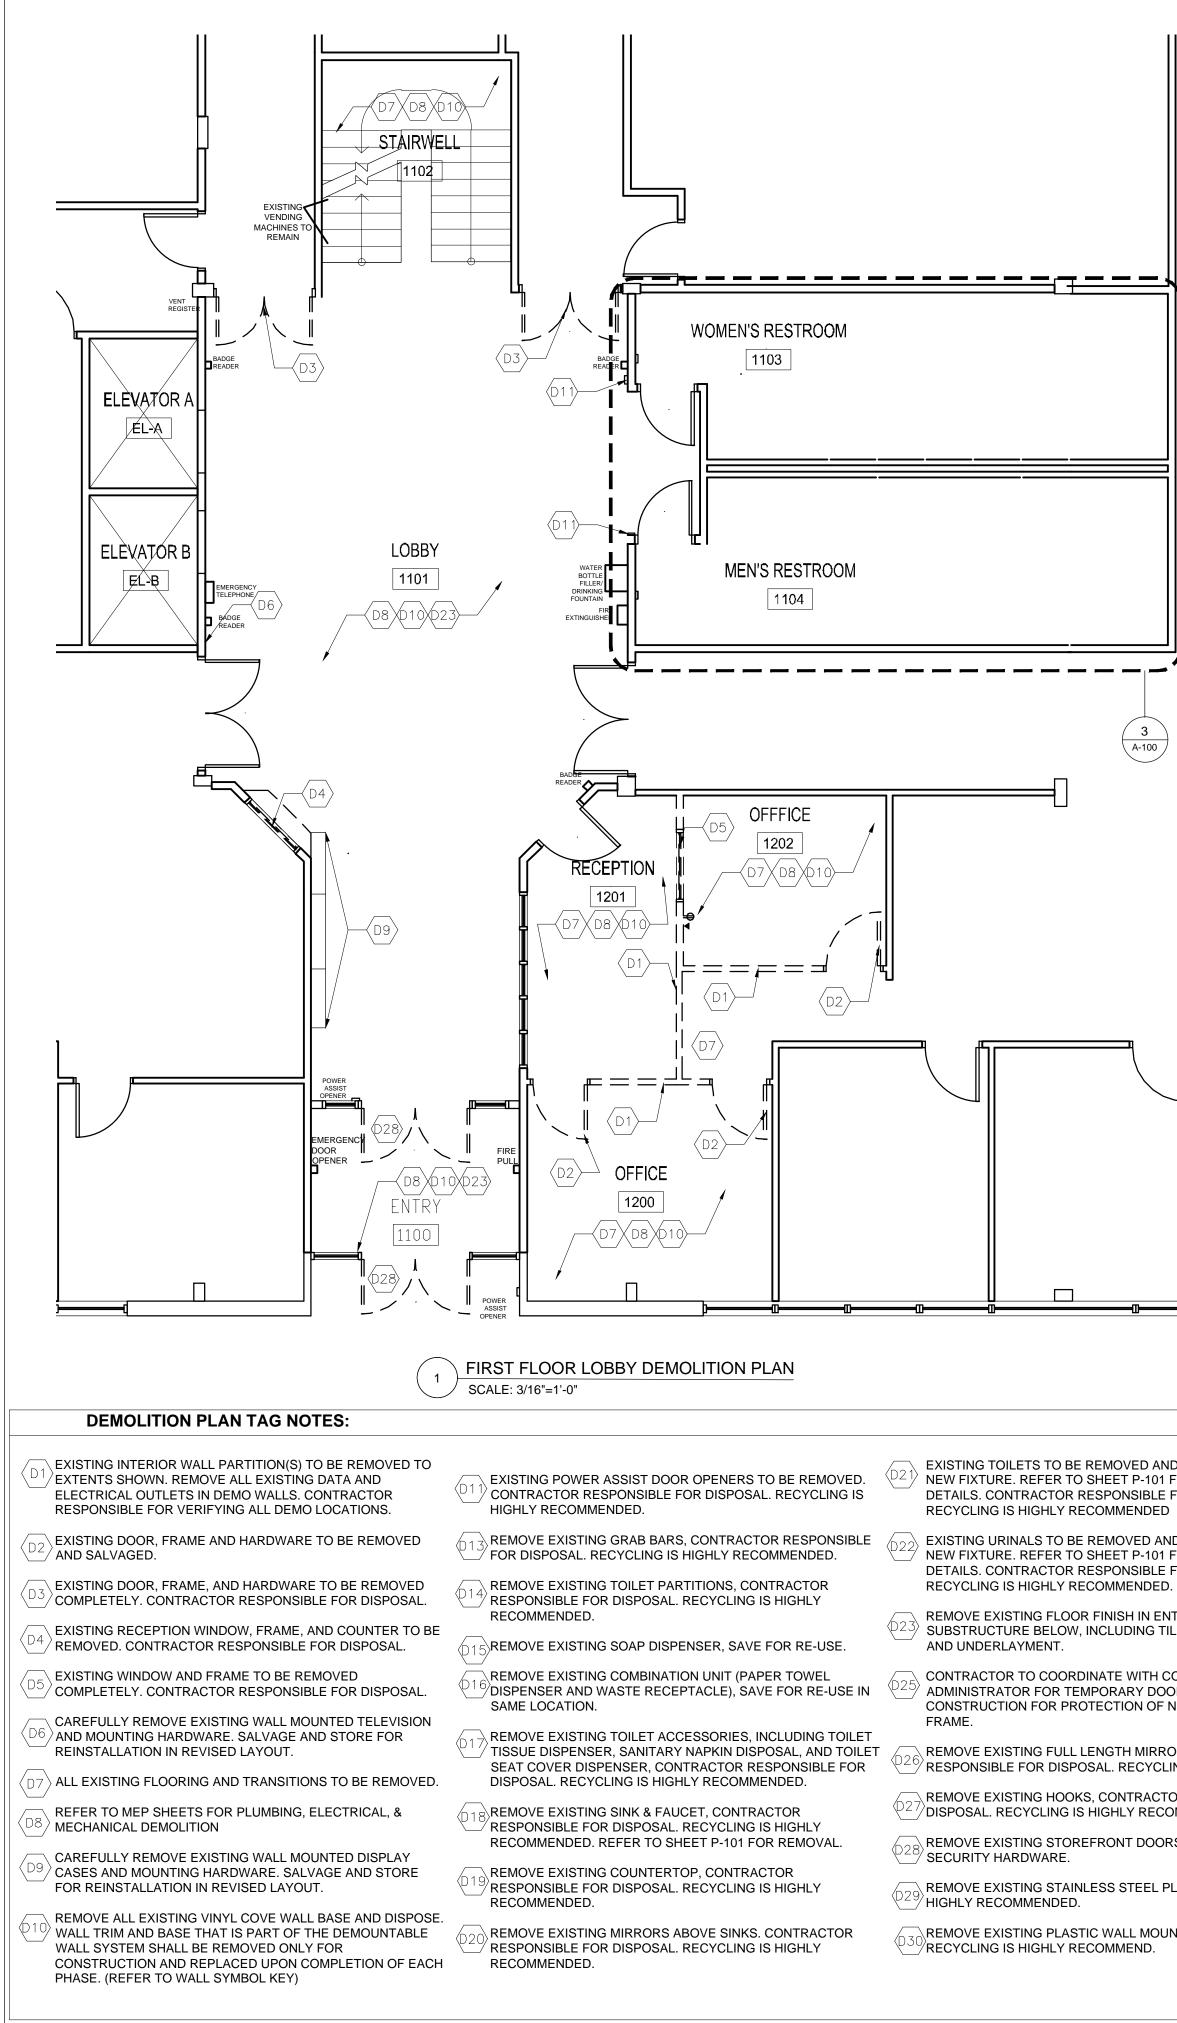

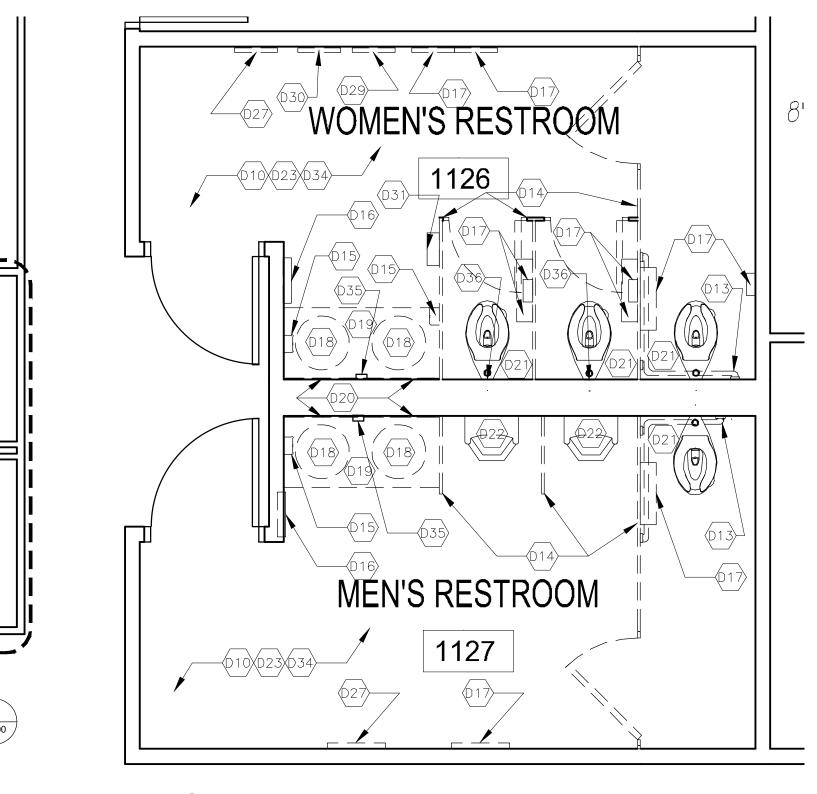


- FIRST FLOOR STAFF RESTROOM ENLARGED DEMOLITION PLAN SCALE: 3/8""=1'-0"
 - WALL SYMBOL KEY:
 - DE-MOUNTABLE WALLS (EXISTING BASE TRIM TO BE REUSED)
 - FIXED GYPSUM METAL STUDDED WALLS (VINYL BASE COVE TO BE REPLACED)
 - WALLS TO BE DEMOLISHED


- 4. ALL CONTRACTORS MUST FOLLOW OSHA GUIDELINES FOR THE ENTIRETY OF THE
- SHALL BE OSHA CERTIFIED.

- EXISTING TOILETS TO BE REMOVED AND REPLACED WITH NEW FIXTURE. REFER TO SHEET P-101 FOR PLUMBING DETAILS. CONTRACTOR RESPONSIBLE FOR DISPOSAL.
- EXISTING URINALS TO BE REMOVED AND REPLACED WITH [/] NEW FIXTURE. REFER TO SHEET P-101 FOR PLUMBING DETAILS. CONTRACTOR RESPONSIBLE FOR DISPOSAL.
- REMOVE EXISTING FLOOR FINISH IN ENTIRETY TO $^{
 m >}$ SUBSTRUCTURE BELOW, INCLUDING TILE, MASTIC, GROUT,
- CONTRACTOR TO COORDINATE WITH CONSTRUCTION ⁷ ADMINISTRATOR FOR TEMPORARY DOOR UNTIL THE END OF CONSTRUCTION FOR PROTECTION OF NEW DOOR AND
- REMOVE EXISTING FULL LENGTH MIRROR, CONTRACTOR IS $^{\prime\prime}$ RESPONSIBLE FOR DISPOSAL. RECYCLING IS RECOMMENDED.
- REMOVE EXISTING HOOKS, CONTRACTOR RESPONSIBLE FOR //DISPOSAL. RECYCLING IS HIGHLY RECOMMENDED.
- REMOVE EXISTING STOREFRONT DOORS AND DISCONNECT
- REMOVE EXISTING STAINLESS STEEL PLATE. RECYCLING IS
- REMOVE EXISTING PLASTIC WALL MOUNTED FILE HOLDER.

- REMOVE EXISTING PAPER TOWEL DISPENSER. RECYCLING IS ^{//} HIGHLY RECOMMENDED.
- REMOVE COMPLETE EXISTING MILLWORK CABINETRY, [/] COUNTERTOP, SINK, AND GARBAGE DISPOSAL. PROTECT ADJACENT SURFACES FROM DAMAGE TO THE GREATEST EXTENT POSSIBLE. REPAIR ADJACENT SURFACES TO ORIGINAL CONDITION, AS NEEDED.
- REFER TO SHEETS D-101 D-104 FOR PLUMBING, ELECTRICAL, MECHANICAL, AND FIRE PROTECTION DEMOLITION.
- REMOVE EXISTING SOAP DISH. CONTRACTOR RESPONSIBLE FOR DISPOSAL.
- CONTRACTOR TO COORDINATE WITH PLUMBER TO REMOVE $^{\circ}$ EXISTING SECTION OF VINYL COVER SHEET ROCK.

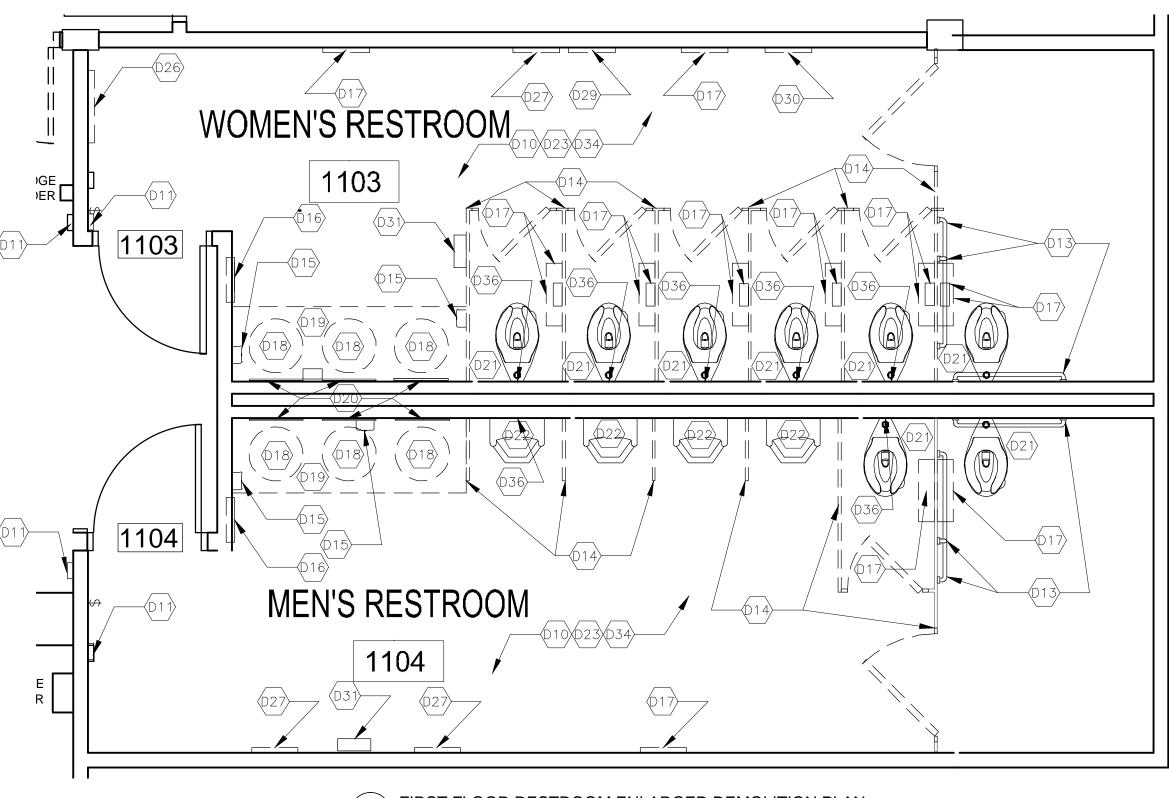

SCALE: 3/8""=1'-0"

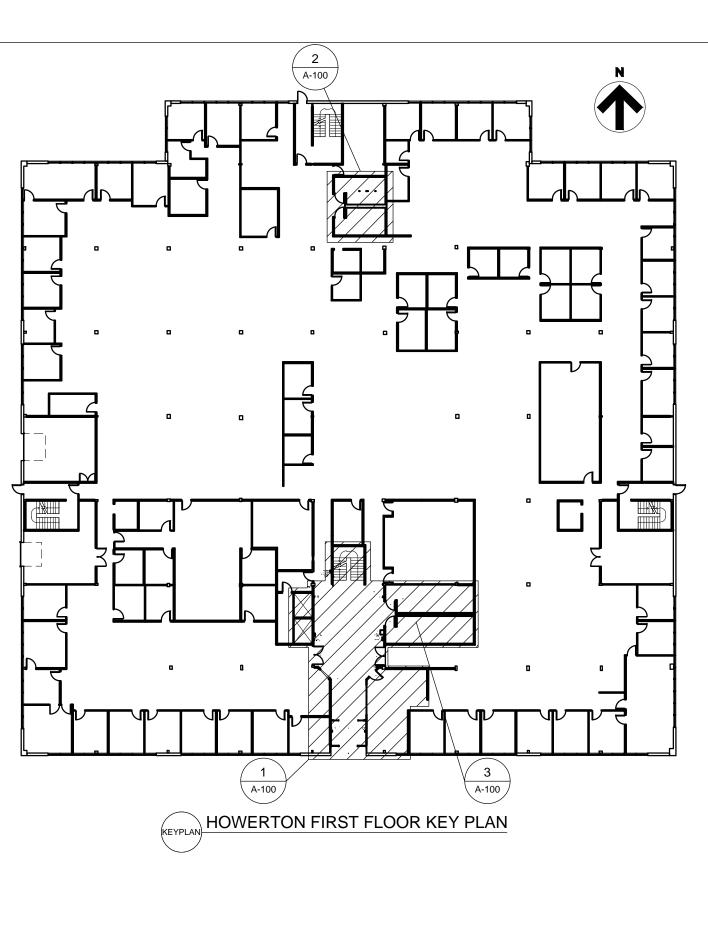

GENERAL NOTES:

1. VERIFY WITH OWNER BEFORE REINSTALLING SALVAGED FIXTURES.

2. DIMENSIONS ARE TO THE FACE OF FINISHED SURFACE UNLESS OTHERWISE NOTED.

3. CONTRACTOR TO FIELD VERIFY ALL EXISTING CONDITIONS AND DIMENSIONS.

CONSTRUCTION PROJECT THROUGH DEMOLITION AND RENOVATION WORK. CONTRACTORS

FIRST FLOOR RESTROOM ENLARGED DEMOLITION PLAN

STATE OF MISSOURI MICHAEL L. PARSON, GOVERNOR





OFFICE OF ADMINISTRATION **DIVISION OF FACILITIES MANAGEMENT / DESIGN** AND CONSTRUCTION **DEPARTMENT OF**

SOCIAL SERVICES

MULTI. DIVISION

HOWERTON STATE **OFFICE BUILDING**

RENOVATE LOBBY

AND RESTROOMS 1ST AND 2ND FLOOR 615 HOWERTON COURT JEFFERSON CITY, MO

PROJECT # 02339-01 SITE # 1025 FACILITY # 3101025001

REVISION: DATE: **REVISION**: DATE: **REVISION:** DATE: ISSUE DATE: 12/13/2024


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SHEET TITLE:


FIRST FLOOR LOBBY & RESTROOM **DEMOLITION PLAN**

SHEET NUMBER:

A-10 2 OF 38 SHEETS

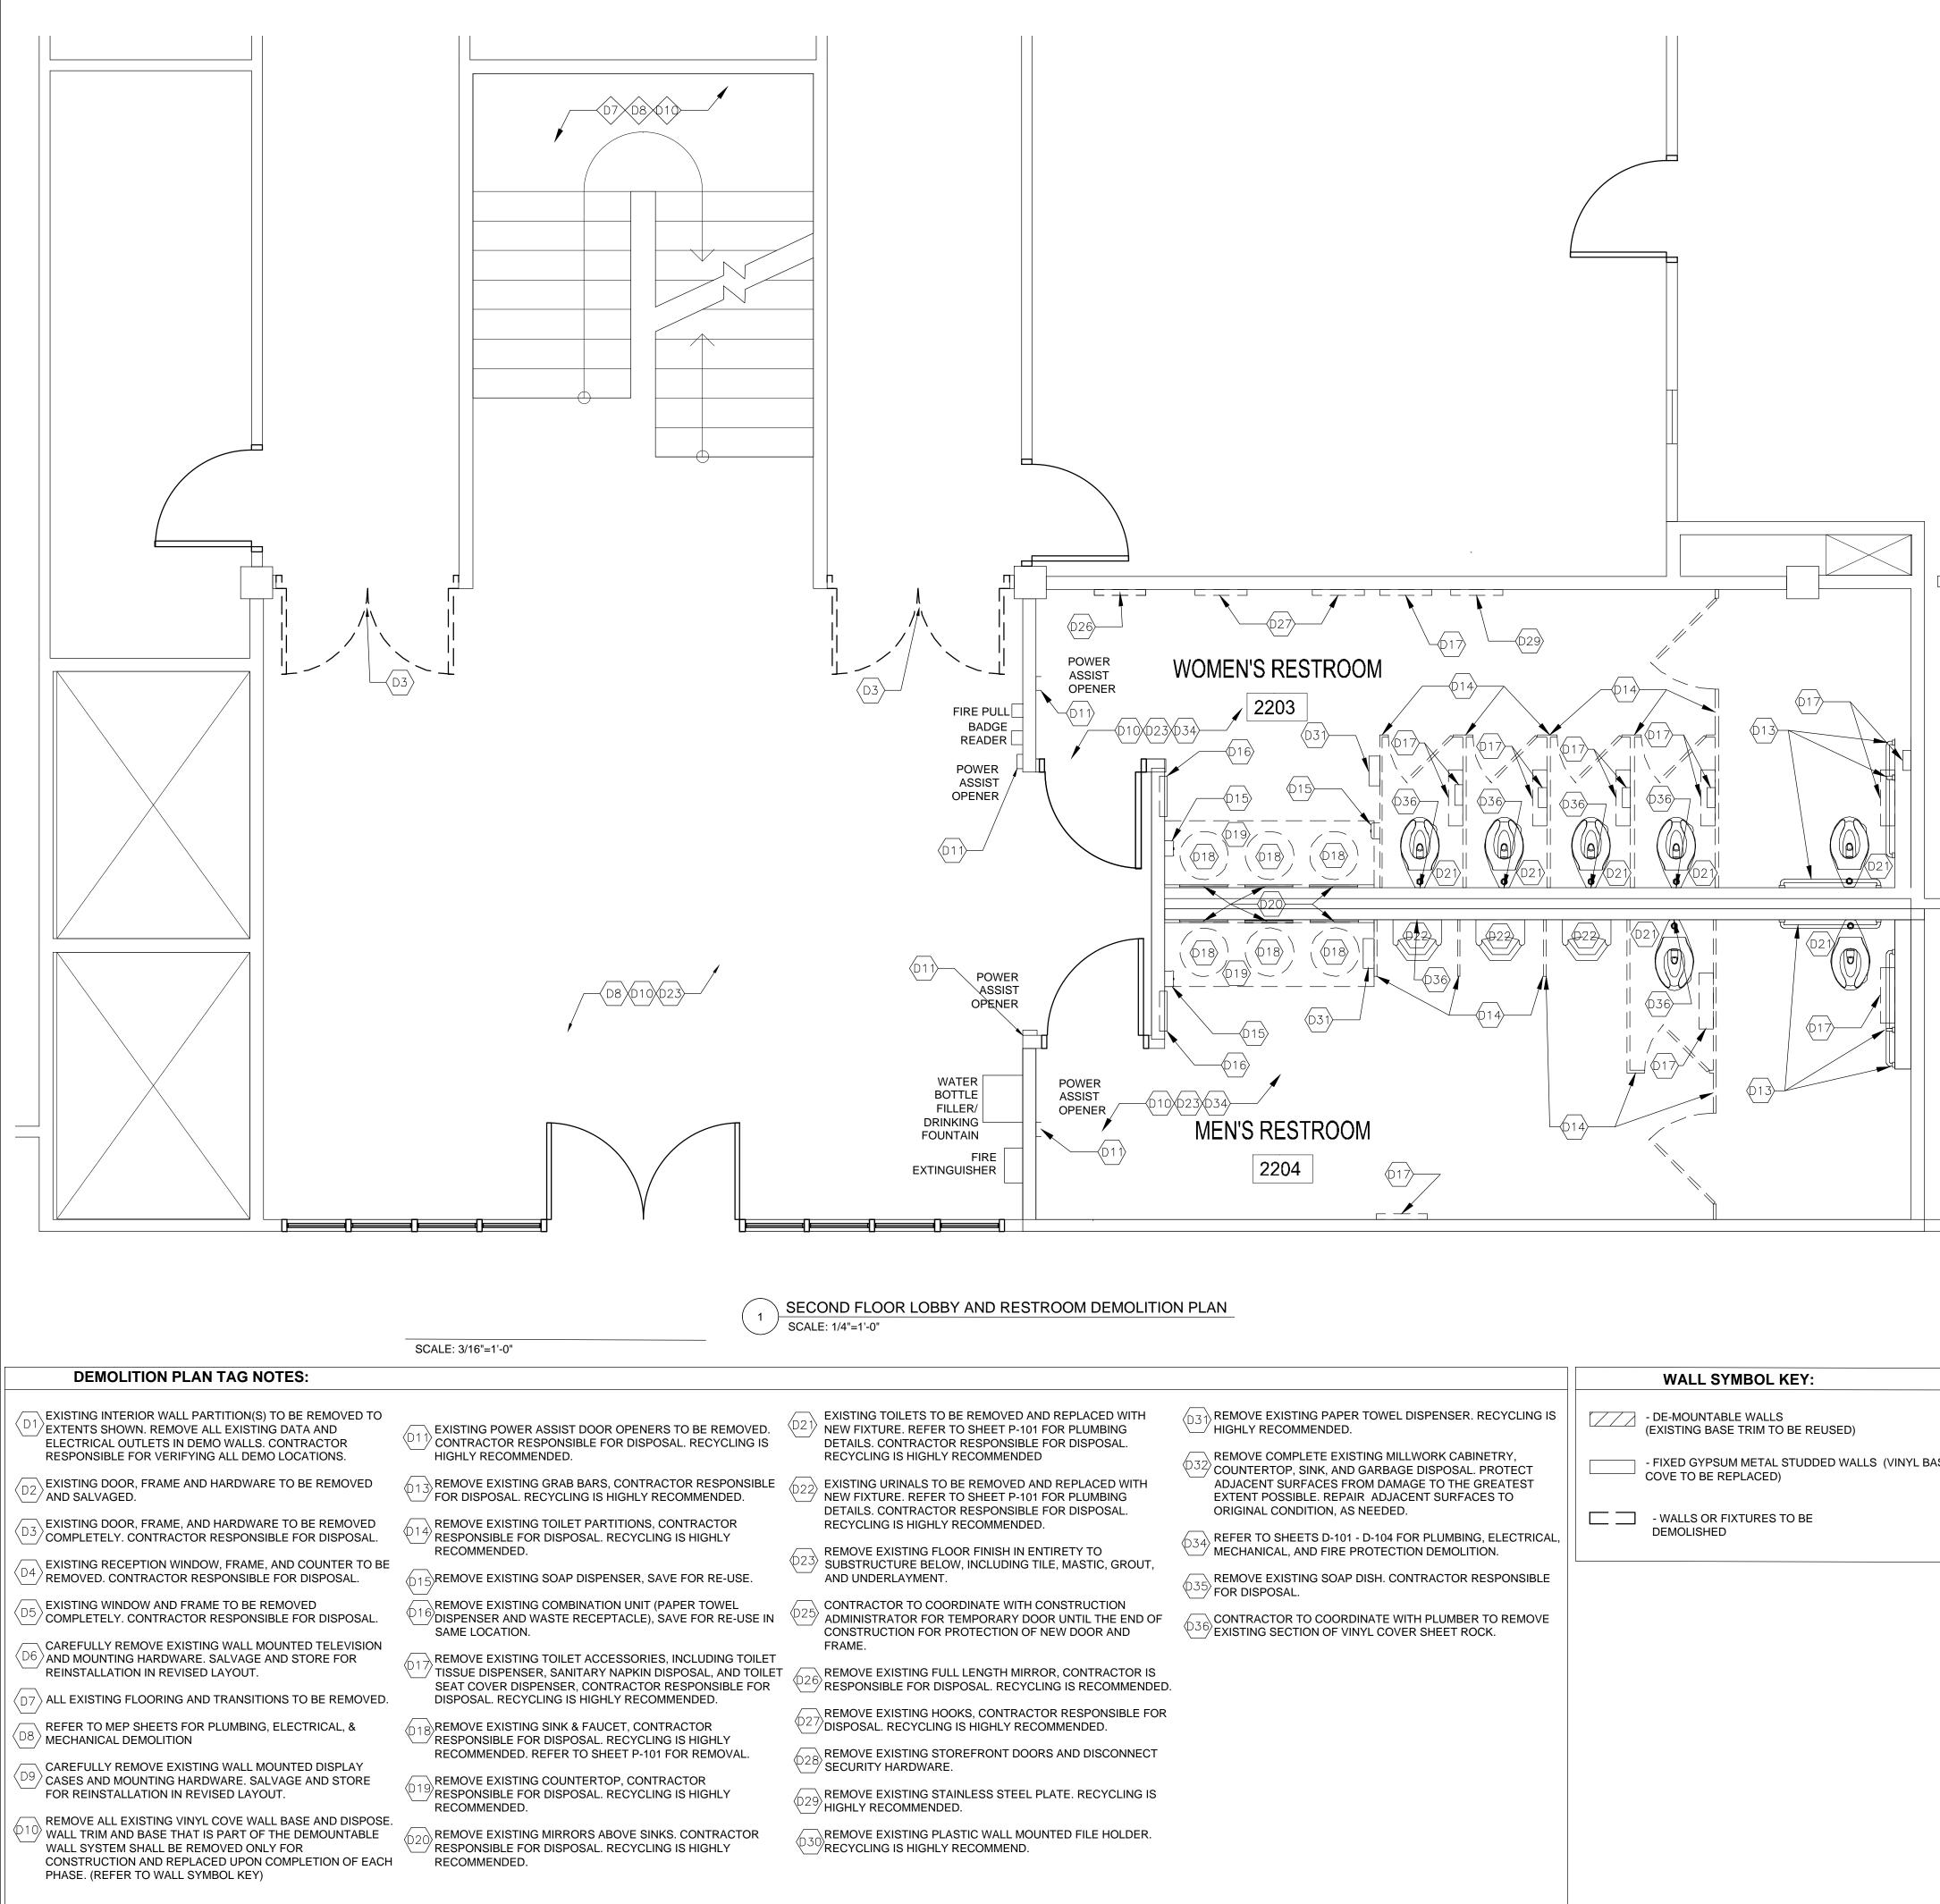

- FIXED GYPSUM METAL STUDDED WALLS (VINYL BASE

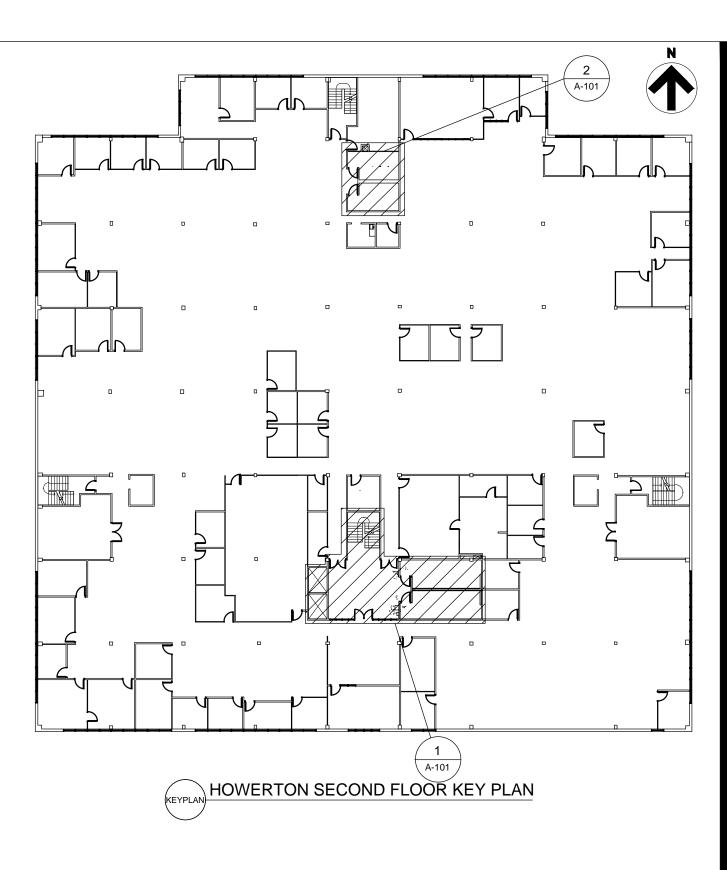


GENERAL NOTES:

1. VERIFY WITH OWNER BEFORE REINSTALLING SALVAGED FIXTURES

2. DIMENSIONS ARE TO THE FACE OF FINISHED SURFACE UNLESS OTHERWISE NOTED.

3. CONTRACTOR TO FIELD VERIFY ALL EXISTING CONDITIONS AND DIMENSIONS

4. ALL CONTRACTORS MUST FOLLOW OSHA GUIDELINES FOR THE ENTIRETY OF THE CONSTRUCTION PROJECT THROUGH DEMOLITION AND RENOVATION WORK. CONTRACTORS SHALL BE OSHA CERTIFIED.

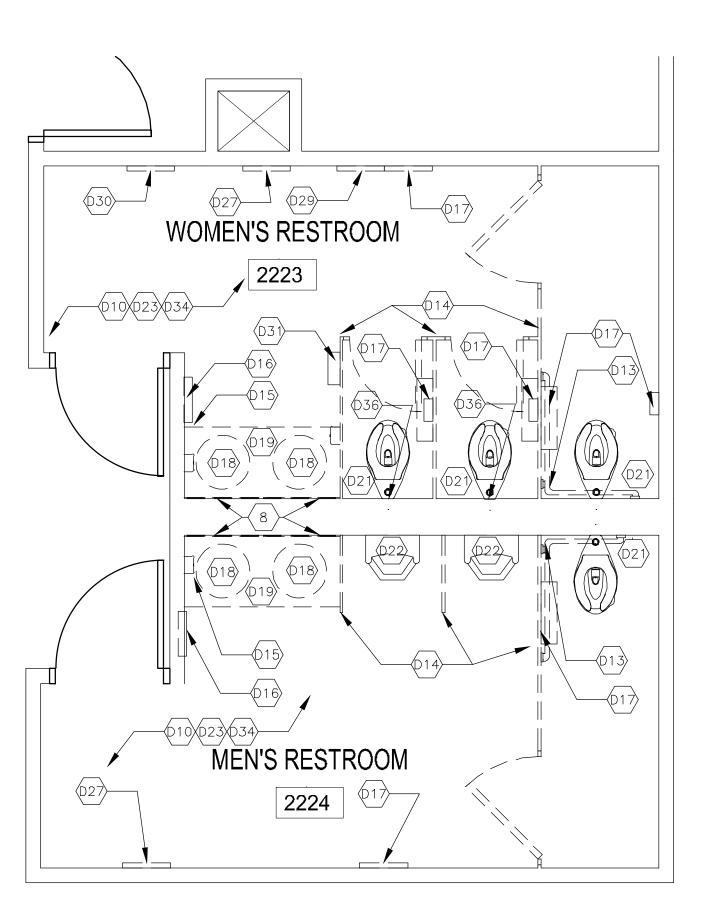

STATE OF MISSOURI MICHAEL L. PARSON, **GOVERNOR**



UMEN BID

OFFICE OF ADMINISTRATION **DIVISION OF FACILITIES** MANAGEMENT / DESIGN AND CONSTRUCTION **DEPARTMENT OF**

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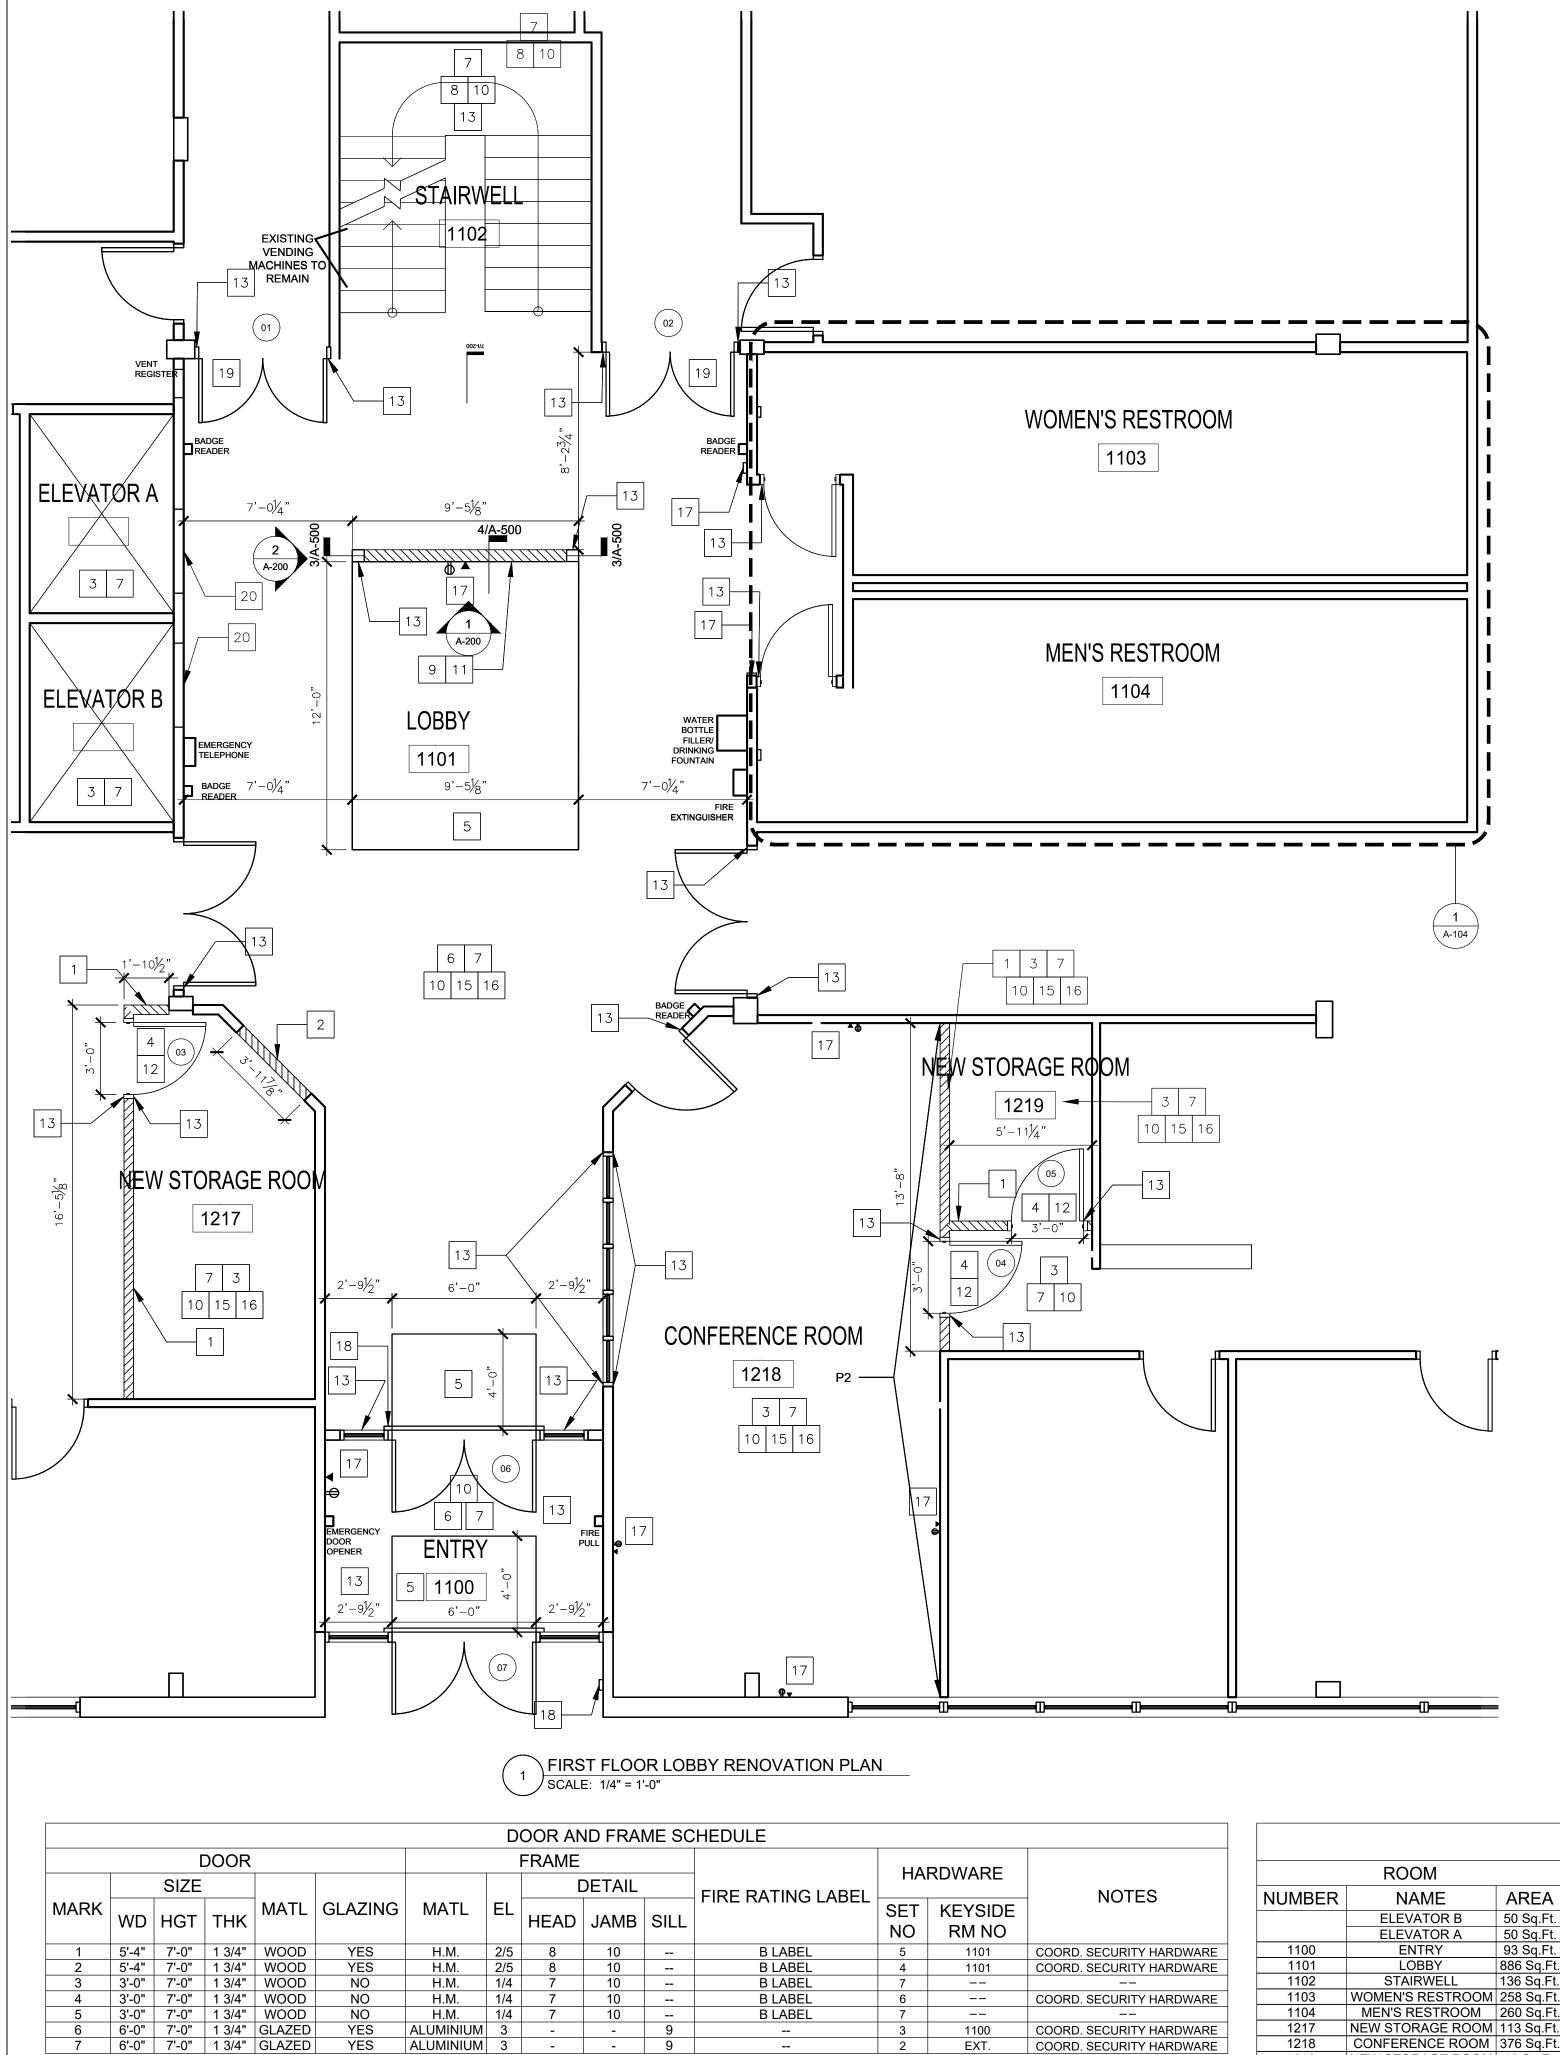
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SHEET TITLE: SECOND FLOOR

LOBBY & RESTROOM **DEMOLITION PLAN**

SHEET NUMBER:

A-103 OF 38 SHEETS




2

REFER TO SHEET A-501 FOR DOOR DETAILS AND HARDWARE.

	REVISED PLAN TAG NOTES:
1	PROVIDE, BUILD, AND INSTALL WALLS SHOWN WITH HATCH. NEW DEMOUNTABLE WALL WITH - 25 GA., 3-1/2" METAL STUDS @ 16"O.C. BOTH SIDES OF WALL SHALL BE PAINTED - (1) COAT PRIMER AND (2) COATS FINISH PAINT. (P1) BOTH SIDES OF WALL SHALL RECEIVE NEW WALL BASE MATERIAL.
2	INSTALL NEW DEMOUNTABLE WALL, AS SHOWN, TO INFILL EXISTING WINDOW OPENING. NEW DEMOUNTABLE WALL SHALL MATCH EXISTING TO THE GREATEST EXTENT POSSIBLE.
3	INSTALL NEW <u>CUSTOMER-OWNED</u> SHAW CARPET PLANK TILES (18" X 36") IN A ASHLAR PATTERN WITH <u>CUSTOMER-OWNED</u> CARPET ADHESIVE. (C1) APPLY ACCORDING TO MANUFACTURER'S INSTRUCTIONS. CARPET STORED AT PORITE WAREHOUSE. <u>CONTRACTOR RESPONSIBLE FOR PICKUP AND DELIVERY TO SITE</u> .
4	INSTALL EXISTING SALVAGED DOOR, HARDWARE AND DOOR FRAME IN LOCATIONS SHOWN.
5	PROVIDE AND INSTALL WALK-OFF CARPET IN ENTRY 1100 AND LOBBY 1101. ACCORDING TO MANUFACTURERS SPECIFICATIONS (C2).
6	PROVIDE AND INSTALL CERAMIC TILE. LAY IN BRICK PATTERN. GROUT TO BE LATICRETE #78 STERLING SILVER.
7	PROVIDE AND INSTALL VINYL BASE ACCORDING TO MANUFACTURER'S SPECIFICATIONS. (B1). REINSTALL DEMOUNTABLE WALL BASE AFTER PAINTING AND FLOORING HAS GONE DOWN.
8	PROVIDE AND INSTALL STAIR TREAD/STAIR NOSING ON STAIRS (ST1). ACCORDING TO MANUFACTURER'S SPECIFICATIONS.
9	MOUNT CUSTOMER-OWNED TV ON FEATURE WALL. REFER TO SHEET I-200.
10	PAINT ALL WALLS. ACCENT COLOR ON STAIRWELL WALLS AND WHERE SHOWN ON PLANS. (P1, P2, & P3)
11	PROVIDE, BUILD, AND INSTALL FEATURE WALL. SEE ELEVATIONS ON SHEET A-201. (W1)
12	PROVIDE AND INSTALL DOOR HARDWARE AND LOCKS ON NEW STORAGE ROOMS. HARDWARE TO MATCH EXISTING BUILDING STANDARD. SEE MAINTENANCE STAFF.
13	PAINT DOOR FRAME TO MATCH BUILDING STANDARD.
14	REFER TO SHEETS P-101 & P-601 FOR PLUMBING DETAILS/RENOVATION PLANS.
15	REFER TO SHEETS M-101 - M-103 FOR MECHANICAL RENOVATION PLANS.
16	REFER TO SHEETS E-101 - E-103 FOR ELECTRICAL RENOVATION PLANS.
17	INSTALL NEW ELECTRICAL OUTLETS AND DATA LINES WHERE SHOWN.
18	PROVIDE AND INSTALL NEW POWER ASSIST OPENERS.
19	PROVIDE AND INSTALL NEW DOORS, FRAMES, AND HARDWARE WHERE SHOWN, COORDINATE WITH CONSTRUCTION ADMINISTRATOR . REFER TO SHEET A-501 FOR FOR FRAME DETAILS AND FOR DOOR AND FRAME SCHEDULE.
20	PAINT ELEVATOR DOORS AND TRIM, WINDOW TRIM AND MULLIONS, DOOR FRAMES, STEEL TUBING, STAIR RAILING AND VENT REGISTERS. (P3)
	FINISH SPECIFICATIONS:
(AC1)	<u>ACOUSTICAL CEILING TILES:</u> ARMSTRONG CEILING SOLUTIONS, STYLE - CALLA, 1" THICK SQUARE LAY-IN, TEGULAR, COLOR - WHITE.
(B1)	<u>WALL BASE:</u> JOHNSONITE, STYLE - 4" STRAIGHT (TOELESS) VINYL BASE, COLOR - WHISPERING MIST, VL2
(C1)	<u>CARPET TILE:</u> SHAW CONTRACT, STYLE - KNOTTED TILE 5T301, COLOR - SILVER 01535, ADHESIVE - SHAW LOKWORX+ CARPET TILE ADHESIVE
(C2)	<u>WALK OFF CARPET TILE:</u> SHAW CONTRACT, STYLE - PORTAL TILE 5T035, COLOR - LAVA 34549 ADHESIVE - SHAW LOKWORX+ CARPET TILE ADHESIVE
(CT1)	<u>CERAMIC TILE:</u> DALTILE, STYLE - ARTICULO, COLOR - FEATURE BEIGE AR07, GROUT - LATICRETE #78 STERLING SILVER
(ST1)	<u>STAIR NOSING/STAIR TREAD:</u> NORA BY INTERFACE, STYLE - NORAMENT ARAGO TREAD (ONE PIECE,
	INCLUDES STAIR RISER, NOSING, AND TREAD). COLOR - STAMINA 5172, ADHESIVE - USE MANUFACTURER'S RECOMMENDED ADHESIVE FOR
(T1)	INSTALLATION. <u>TRANSITION - CARPET TILE TO CERAMIC TILE:</u> FUTURA, 4.5 MM TO 7MM LVT RAMP, ITEM#: 402081 LVT 121 MF
(T2)	TRANSITION - CARPET TILE TO CONCRETE: FUTURA, CARPET TILE TO LVT/ NOTHING, ITEM# 402006 LVT 160 EA
(T3)	<u>TRANSITION - CARPET TILE TO LVT:</u> FUTURA, 3MM TO 4.5 MM LVT NO-LIP RAMP, ITEM# 402021 LVT 125 MF
	ALL PAINT SHALL HAVE AN EGG-SHELL FINISH. ALL DOORS, DOOR AND WINDOW ES SHALL HAVE A SATIN LATEX ENAMEL WITH A WASHABLE/SCRUB-ABLE FINISH.
(P1)	<u>PAINT 1:</u> PPG PITTSBURG PAINTS, SW7043 WORLDLY GRAY, FINISH: SATIN (PRIMARY PAINT)
(P2)	<u>PAINT 2: (</u> ACCENT PAINT) PPG PITTSBURG PAINTS, SW6515 LEISURE BLUE, FINISH: SATIN (ACCENT PAINT)
(P3)	<u>PAINT 3:</u> PPG PITTSBURG PAINTS, SW6991 BLACK MAGIC, FINISH: SATIN (STAIRWELL AND WINDOW FRAMES)
(W1)	<u>FEATURE WALL:</u> STACKED WOOD, GEOMETRY COLLECTION, RHOMBUS PLAY, 14" X 48.5" PANELS
	IRES CALLED OUT IN DRAWINGS ARE BASIS OF DESIGN ONLY. SEE FICATIONS FOR FURTHER DETAILS.

					ROO	OM FINISH SC	CHEDULE				
OWARE			ROOM			FINISH					
NOTES		NUMBER	NAME	AREA	PAINT	FLOORING	WALL BASE	NOTES			
KEYSIDE			ELEVATOR B	50 Sq.Ft.		C1	B1	ELEVATOR DOORS AND TRIM TO BE P3.			
RM NO			ELEVATOR A	50 Sq.Ft.		C1	B1	ELEVATOR DOORS AND TRIM TO BE P3.			
1101	COORD. SECURITY HARDWARE	1100	ENTRY	93 Sq.Ft.	P1	C2/CT1	B1				
1101	COORD. SECURITY HARDWARE	1101	LOBBY	886 Sq.Ft.	P1	C1/CT1	B1	FLOORING TRANSITION TO BE T1.			
		1102	STAIRWELL	136 Sq.Ft.	P2	ST1	B1	STAIR STRINGERS AND BALUSTERS TO BE F			
	COORD. SECURITY HARDWARE	1103	WOMEN'S RESTROOM	258 Sq.Ft.	P1	CT1	B1				
		1104	MEN'S RESTROOM	260 Sq.Ft.	P1	CT1	B1				
1100	COORD. SECURITY HARDWARE	1217	NEW STORAGE ROOM	113 Sq.Ft.	P1	C1	B1				
EXT.	COORD. SECURITY HARDWARE	1218	CONFERENCE ROOM	376 Sq.Ft.	?	?	?	?			
		1219	NEW STORAGE ROOM	49 Sq.Ft.	P1	C1	B1				

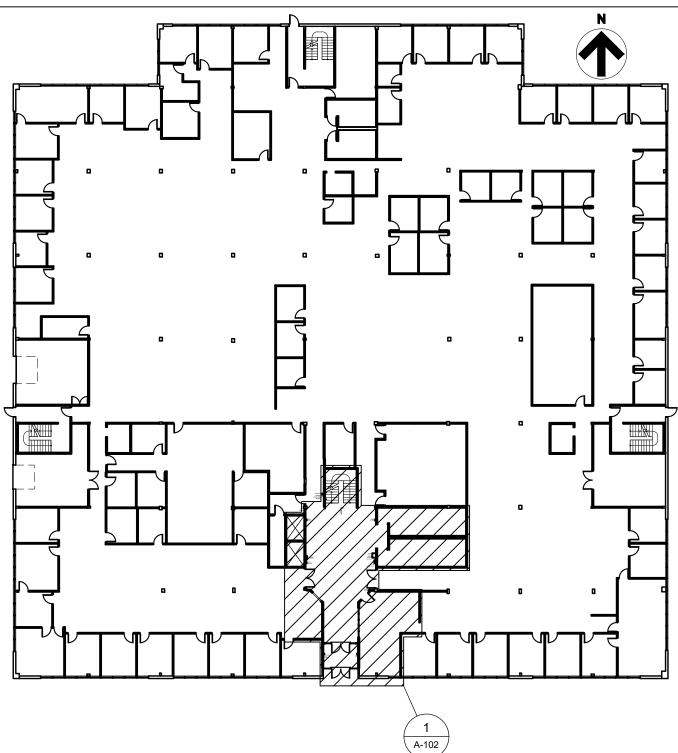

HOWERTON FIRST FLOOR KEY PLAN

GENERAL CONSTRUCTION NOTES:

- 1. ALL WORK SHALL BE PERFORMED IN A SAFE MANNER WITH PROTECTION PROVIDED TO ANY BUILDING OCCUPANTS AND WORKERS PERFORMING THE WORK.
- 2. ALL WORK SHALL BE DONE IN A MANNER TO MINIMIZE DAMAGE TO ADJACENT SURFACES THAT ARE NOT SHOWN TO BE WORKED ON OR REMOVED - CONTRACTOR SHALL BE RESPONSIBLE FOR ALL WORK NECESSARY TO REPAIR SURFACES AFFECTED BY THEIR WORK. 3. ANY WORK THAT RESULTS IN EXCESSIVE NOISE, DUST OR DEBRIS MUST BE COORDINATED WITH BUILDING FACILITY STAFF AT LEAST TWO (2) WORKING DAYS IN ADVANCE.
- ANY WORK THAT REQUIRES THE NEED TO TEMPORARILY SHUT DOWN ANY OF THE BUILDING SYSTEMS MUST BE COORDINATED WITH BUILDING FACILITY STAFF AT LEAST FOUR (4) WORKING DAYS IN ADVANCE 5. CONTRACTOR SHALL PROVIDE NECESSARY DUST PROTECTION TO PREVENT DUST CREATED
- BY DEMOLITION/CONSTRUCTION ACTIVITIES TO ENTER SPACE(S) OUTSIDE THE WORK AREA, INCLUDING THROUGH THE HVAC SYSTEM. CONTRACTOR SHALL BE RESPONSIBLE TO REPLACE ANY HVAC FILTERS CONTAMINATED WITH CONSTRUCTION DEBRIS. 6. CONTRACTOR SHALL BE RESPONSIBLE TO PERFORM ANY WORK NECESSARY TO PROVIDE THE
- SCOPE OF WORK SHOWN ON THE PLANS, EVEN IF NOT SPECIFICALLY NOTED OR SHOWN. CONTRACTOR SHALL PERFORM WORK BETWEEN THE HOURS OF 7AM TO 5PM AFTER SIGNING IN AND RECEIVING VISITOR'S BADGE. 8. ALL MATERIALS/EQUIPMENT MAY BE DELIVERED TO THE FACILITY - FACILITY STAFF SHALL BE
- CONTACTED TEN (10) BUSINESS DAYS PRIOR TO DELIVERY OF MATERIALS/EQUIPMENT. CONTRACTOR SHALL BE SIGN FOR RECEIPT OF ALL MATERIALS/EQUIPMENT - FACILITY STAFF ARE NOT RESPONSIBLE FOR ACCEPTING OR SIGNING FOR DELIVERIES.
- 9. ALL WORK SHALL BE PERFORMED IN ACCORDANCE WITH THE LATEST EDITION OF THE IBC, IFC, IMC, IPC, NEC AND ALL OTHER APPLICABLE ICC AND NFPA CODE FAMILIES. 10. CONTRACTOR RESPONSIBLE FOR FIELD VERIFYING AS-BUILT CONDITIONS AND PROPOSED LAYOUT PRIOR TO PERFORMING WORK. CONTRACTOR SHALL NOTIFY FMDC PROJECT
- MANAGER IF THERE ARE ANY DISCREPANCIES OR CONFLICTS. 11. DETAILS OF EXISTING CONDITIONS PROVIDED AS A COURTESY. THIS INFORMATION DOES NOT
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- 13. CONTRACTOR SHALL MAINTAIN THE INTEGRITY OF ALL RATED PARTITIONS, CEILING ASSEMBLIES AND DOOR ASSEMBLIES. THE CONTRACTOR SHALL MAKE ALL NECESSARY REPAIRS WHERE ANY WORK PERFORMED BY THE CONTRACTOR AFFECTS THE INTEGRITY OF
- THESE ITEMS. 14. DIMENSIONS PROVIDED ARE MEASURED FROM EXISTING DRYWALL FACE TO NEW DRYWALL FACE UNLESS OTHERWISE NOTED.
- 15. CONTRACTOR TO FIELD VERIFY DIMENSIONS AND WALL COMPONENTS FOR NEW DOOR FRAME INSTALLATION.
- 16. CONTRACTOR TO FIELD VERIFY DIMENSIONS FOR NEW SOLID SURFACE COUNTERTOP INSTALLATION.

WALL LEGEND:

- DE-MOUNTABLE WALLS (EXISTING BASE TRIM TO BE REUSED)

- FIXED GYPSUM METAL STUDDED WALLS (VINYL BASE COVE TO BE REPLACED)
- EXISTING WALLS
- WALLS TO BE DEMOLISHED

STATE OF MISSOURI MICHAEL L. PARSON, **GOVERNOR**



\mathbf{T} BID

OFFICE OF ADMINISTRATION **DIVISION OF FACILITIES MANAGEMENT / DESIGN** AND CONSTRUCTION **DEPARTMENT OF** SOCIAL SERVICES

MULTI. DIVISION

HOWERTON STATE OFFICE BUILDING

RENOVATE LOBBY

AND RESTROOMS 1ST AND 2ND FLOOR 615 HOWERTON COURT JEFFERSON CITY, MO

PROJECT # 02339-01 1025 SITE # FACILITY # 3101025001

REVISION:

DATE: **REVISION**: DATE: **REVISION:** DATE: ISSUE DATE: 12/13/2024


CAD DWG FILE:A-102 O2409 01 DRAWN BY: CHECKED BY: BMS DESIGNED BY: EI

SHEET TITLE: FIRST FLOOR

LOBBY **RENOVATION PLAN**

SHEET NUMBER:

|A-102|4 OF 38 SHEETS

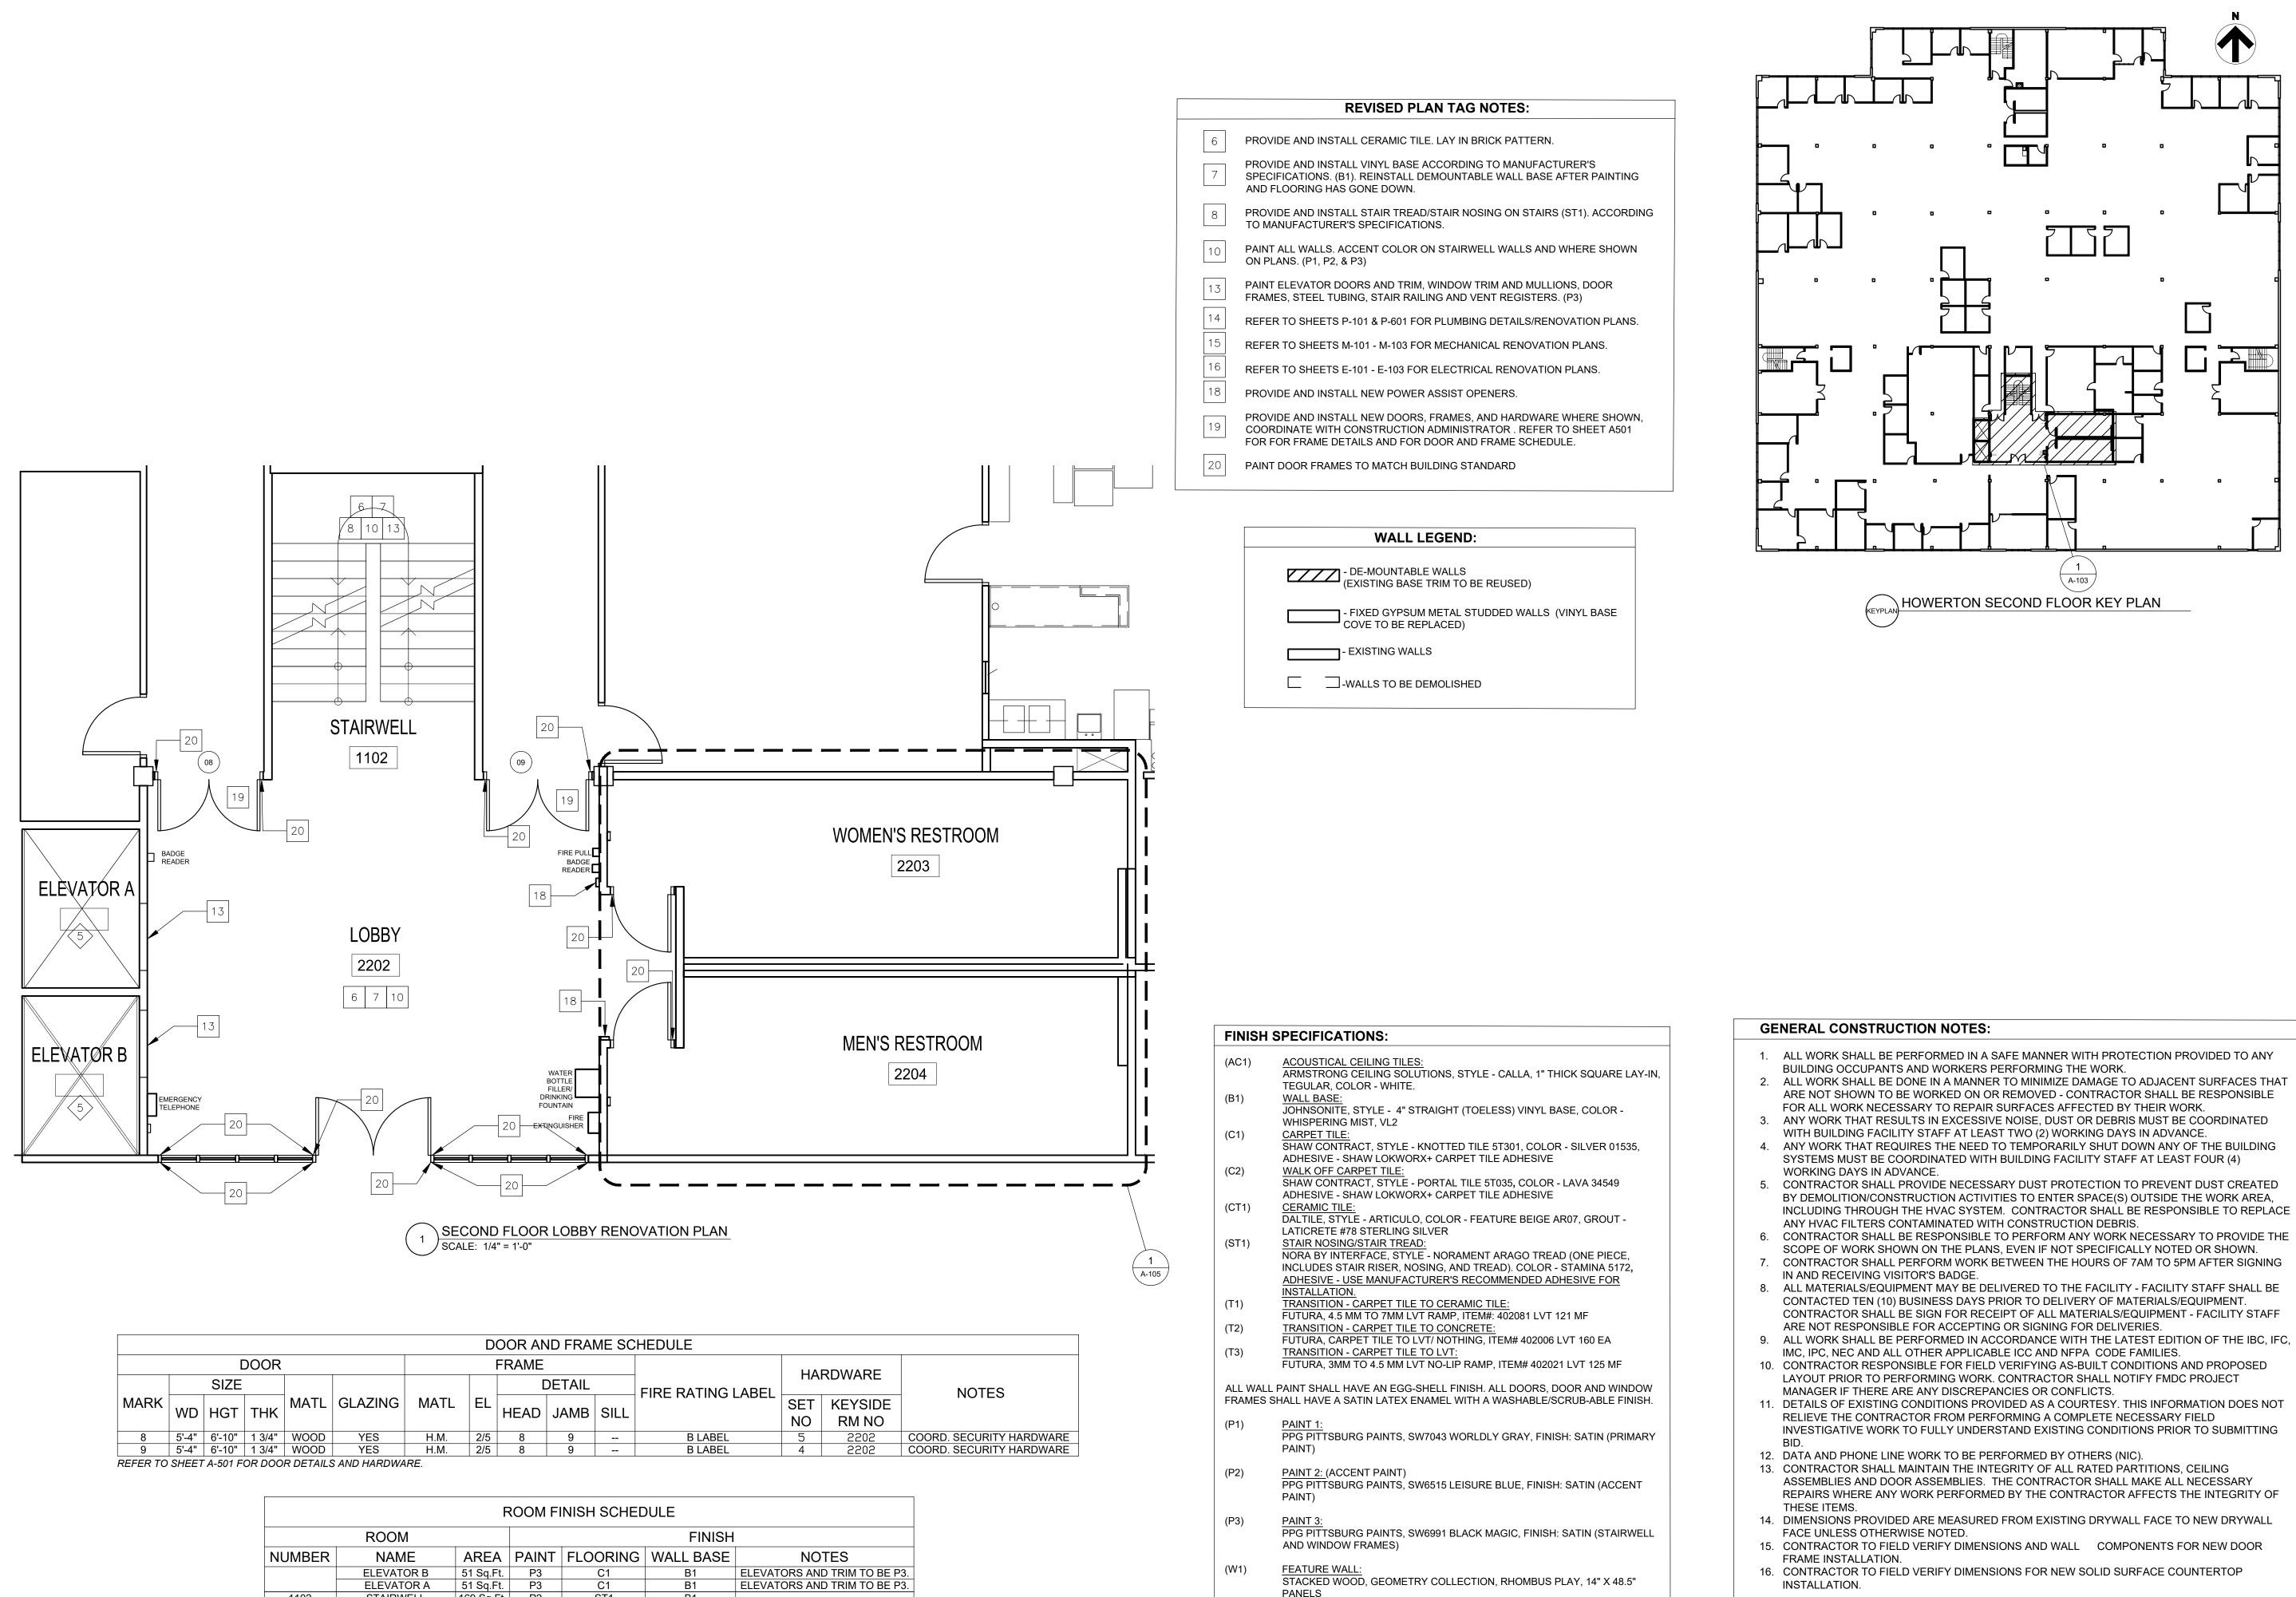

DOOR AND FRAME SCHEDULE													
DOOR						FRAME						HAR	
		SIZE						DETAIL			FIRE RATING LABEL	ПА	Г
MARK	WD	HGT	тнк	MATL	GLAZING	MATL	EL	HEAD	JAMB	SILL		SET NO	
8	5'-4"	6'-10"	1 3/4"	WOOD	YES	H.M.	2/5	8	9		B LABEL	5	
9	5'-4"	6'-10"	1 3/4"	WOOD	YES	H.M.	2/5	8	9		B LABEL	4	
REFER TO	SHEET	Δ_501 E		R DETAIL		ARE							

	ROOM FINISH SCHEDULE								
	ROOM				FINISH				
NUMBER	NAME	AREA	PAINT	FLOORING	WALL BASE	NOT			
	ELEVATOR B	51 Sq.Ft.	P3	C1	B1	ELEVATORS AND			
	ELEVATOR A	51 Sq.Ft.	P3	C1	B1	ELEVATORS AND			
1102	STAIRWELL	169 Sq.Ft.	P2	ST1	B1				
2202	LOBBY	493 Sq.Ft.	P1	C1/CT1	B1	FLOORING TRANS			
2203	WOMEN'S RESTROOM	241 Sq.Ft.	P1	CT1	B1				
2204	MEN'S RESTROOM	242 Sq.Ft.	P1	CT1	B1				

SITION TO BE T

NOTE: ALL AREAS ARE APPROXIMATE. CONTRACTOR TO FIELD VERIFY

*FIXTURES CALLED OUT IN DRAWINGS ARE BASIS OF DESIGN ONLY. SEE

SPECIFICATIONS FOR FURTHER DETAILS.

STATE OF MISSOURI MICHAEL L. PARSON, GOVERNOR





OFFICE OF ADMINISTRATION **DIVISION OF FACILITIES** MANAGEMENT / DESIGN AND CONSTRUCTION **DEPARTMENT OF**

MULTI. DIVISION

SOCIAL SERVICES

HOWERTON STATE OFFICE BUILDING

RENOVATE LOBBY

AND RESTROOMS 1ST AND 2ND FLOOR 615 HOWERTON COURT JEFFERSON CITY, MO

PROJECT # 02339-01 SITE # 1025 FACILITY # 3101025001

REVISION: DATE **REVISION**: DATE **REVISION:** DATE:


ISSUE DATE: 12/13/2024

CAD DWG FILE:A-103 02409 0 DRAWN BY: CHECKED BY: BMS DESIGNED BY: E

SHEET TITLE:

SECOND FLOOR LOBBY **RENOVATION PLAN**

SHEET NUMBER:

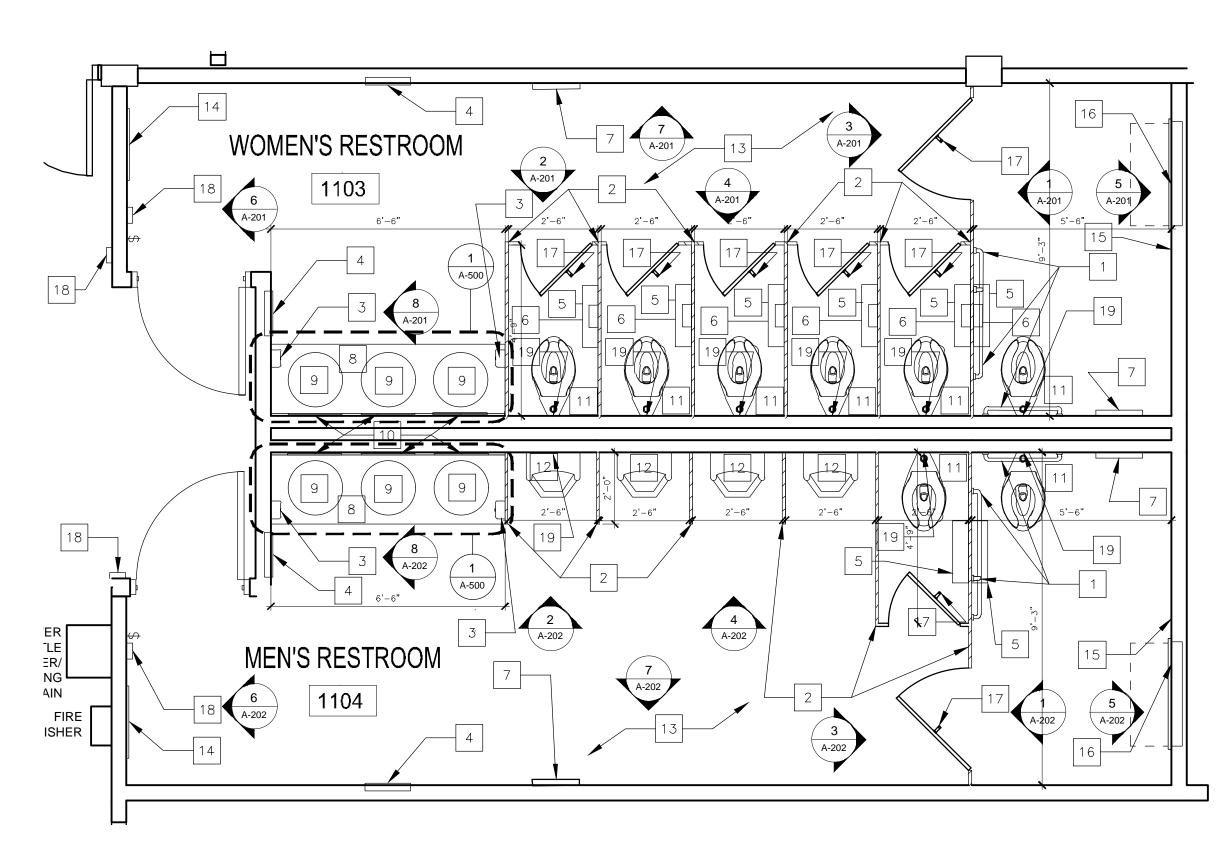


FIRST FLOOR - RESTROOM RENOVATION PLAN / SCALE: 3/8" = 1'-0"

	ROOM FINISH SCHEDULE										
	ROOM				FINISH						
NUMBEF	R NAME	PERIMETER	AREA	PAINT	FLOORING	CEILING	COUNTERTOP	TOILET PARTITIONS	WALL BASE	CEILING HEIGHT	NOTES
1103	WOMEN'S RESTROOM	79'-4"	271 Sq.Ft.	P-1	CT-1	ACT-1	SS-1	SS-2	B-1	8'-8"	
1104	MEN'S RESTROOM	79'-4"	275 Sq.Ft.	P-1	CT-1	ACT-1	SS-1	SS-2	B-1	8'-8"	
1126	WOMEN'S RESTROOM	51'-3"	136 Sq.Ft.	P-1	CT-1	ACT-1	SS-1	SS-2	B-1	8'-8"	
1127	MEN'S RESTROOM	52'-3"	144 Sq.Ft.	P-1	CT-1	ACT-1	SS-2	SS-2	B-1	8'-8"	
P-1	PPG PAINT, COLOR MATCH:	: SHERWIN WILLIAN	AS SW7003 I	NORLDLY	GRAY						
CT-1	CT-1 DALTILE, ARTICULO, FEATURE BEIGE, 12" X 24"										
ACT-1	ACT-1 ARMSTRONG, CALLA 1" THICK SQUARE LAY-IN, TEGULAR , WHITE ACOUSTICAL CEILING TILE, 24" X 24"										
SS-1											

SS-2 PRIVACY PLUS PARTITIONS, CEILING HUNG, CORIAN, GRAY ONYX

JOHNSONITE, TRADITIONAL VINYL $\frac{1}{8}$ " WALL BASE, WHISPERING MIST B-1

		RESTROOM FIXTURE SCHE	DULE		
MARK	PRODUCT	DESCRIPTION	MANUFACTURER	QTY	REMARKS
GB-1	GRAB BAR	36" LONG, 1-1/2" DIAMETER, STRAIGHT GRAB BAR, B-6806X24	BOBRICK	2	SPECIFICATIONS SECTION 102800
GB-2	GRAB BAR	42" LONG, 1-1/2" DIAMETER, STRAIGHT GRAB BAR, B-6806X42	BOBRICK	2	SPECIFICATIONS SECTION 102800
GB-3	GRAB BAR	18" LONG, 1-1/2" DIAMETER, STRAIGHT GRAB BAR, B-6806X18	BOBRICK	2	SPECIFICATIONS SECTION 102800
LAV-1	LAVATORY	OVALYN LARGE UNDER COUNTER SINK	AMERICAN STANDARD	6	SPECIFICATIONS SECTION 224000
TA-1	TOILET TISSUE DISPENSER	MODEL B-2888, CLASSIC SERIES, SURFACE MOUNTED MULTI-ROLL	BOBRICK	8	SPECIFICATIONS SECTION 102800
TA-2	SANITARY NAPKIN DISPOSAL	MODEL B-254, CLASSIC SERIES, SURFACE MOUNTED, SATIN-FINISH STAINLESS STEEL	BOBRICK	6	SPECIFICATIONS SECTION 102800
TA-3	TOILET SEAT COVER DISPENSER	MODEL B-221, CLASSIC SERIES, SURFACE MOUNTED SEAT COVER DISPENSER, SATIN-FINISH STAINLESS STEEL, $15\frac{3}{4}$ " W X 11" X 2" D	BOBRICK	4	SPECIFICATIONS SECTION 102800
TA-4	BABY CHANGING STATION	MODEL 962, RECESSED, STAINLESS STEEL	BRADLEY	2	SPECIFICATIONS SECTION 102800
TA-5	SOAP DISPENSER	MODEL SPA9757, SPARTAN SOAP DISPENSER IN BLACK	SPARTAN	4	SPECIFICATIONS SECTION 102800
TA-6	COMBINATION UNIT	MODEL B-3940, CLASSIC SERIES, RECESSED CONVERTIBLE PAPER TOWEL DISPENSER AND WASTE RECEPTACLE	BOBRICK	4	SPECIFICATIONS SECTION 102800
TA-7	COAT HOOK	MODEL B-9542, FINO COLLECTION, SURFACE MOUNTED COAT HOOK, SATIN FINISH STAINLESS STEEL	BOBRICK	8	SPECIFICATIONS SECTION 102800
TA-8	MIRROR	WELDED-FRAME MIRROR, MATTE BLACK, 24" X 36", B-290	BOBRICK	6	SPECIFICATIONS SECTION 102800
TA-9	MIRROR	WELDED-FRAME MIRROR, MATTE BLACK, 24" X 72", B-290	BOBRICK	2	SPECIFICATIONS SECTION 102800
TA-10	FAUCET	MODEL K-800T20-5AKA, WIDESPREAD BATHROOM SINK FAUCET	KOHLER	6	SPECIFICATIONS SECTION 224000
WC-1	TOILET	MODEL K-96057, HIGHCLIFF ULTRA TOP SPUD FLUSHOMETER BOWL	KOHLER	8	SPECIFICATIONS SECTION 224000
WC-2	TOILET FLUSHOMETER	MODEL G2 8111, G2 SENSOR FLUSHOMETER	SLOAN	8	SPECIFICATIONS SECTION 224000
U-1	URINAL	MODEL Z5758-U, "THE RETROFIT PINT" ¹ / ₈ GPF ECOVANTAGE, ULTRA LOW CONSUMPTION URINAL	ZURN	4	SPECIFICATIONS SECTION 224000
U-2	URINAL FLUSHOMETER	MODEL G2 8180, G2 EXPOSED SENSOR URINAL FLUSHOMETER	SLOAN	4	SPECIFICATIONS SECTION 224000
WC-2 U-1 U-2	URINAL URINAL FLUSHOMETER	MODEL G2 8111, G2 SENSOR FLUSHOMETER MODEL Z5758-U, "THE RETROFIT PINT" ¹ / ₈ GPF ECOVANTAGE, ULTRA LOW CONSUMPTION URINAL	SLOAN ZURN	4	SPECIFICATIONS SECTION 224000 SPECIFICATIONS SECTION 224000

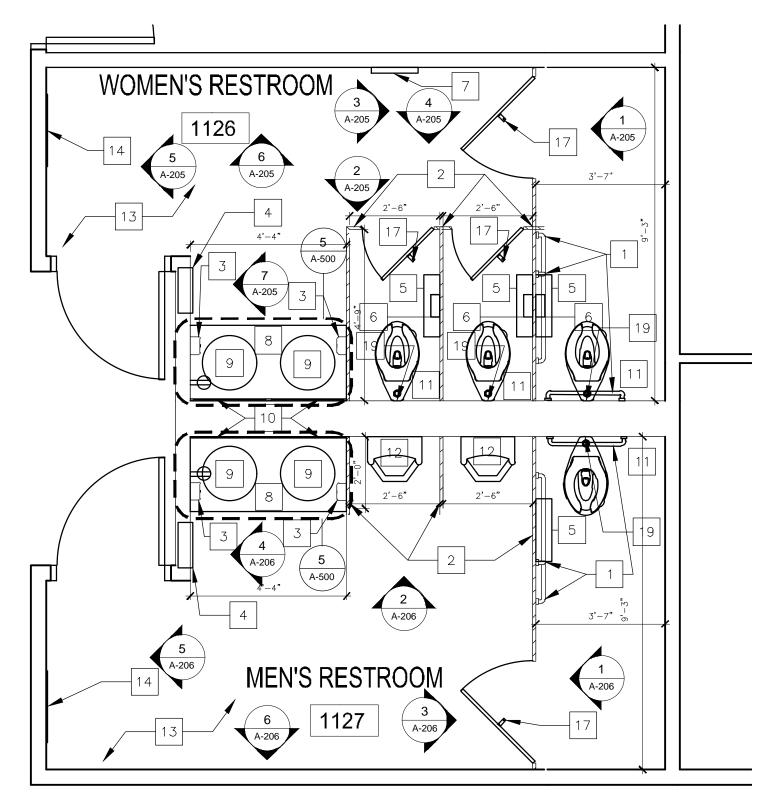


FIRST FLOOR - STAFF RESTROOM RENOVATION PLAN SCALE: 3/8" = 1'-0"

*FIXTURES CALLED OUT IN DRAWING ARE BASIS-OF-DESIGN ONLY. SEE SPECIFICATIONS FOR FURTHER DETAILS.

G.C. TO VERIFY ALL DIMENSIONS AND CONDITIONS SHOWN ON THE DRAWINGS AT THE JOB SITE. NOTIFY ARCHITECT OF ANY OMISSIONS, DISCREPANCIES, AND/OR CONFLICTS BEFORE PROCEEDING WITH THE JOB.

GENERAL NOTES:

- REFER TO DRAWINGS FOR ALL NEW PARTITIONS TYPES UNLESS OTHERWISE NOTED IN ARCHITECTURAL PLANS AND/OR ENLARGED PLANS.
- 3. REFER TO INTERIOR, MECHANICAL, ELECTRICAL, AND PLUMBING SHEETS FOR DETAILS. NOTIFY ARCHITECT OF ANY DISCPREPANCIES.
- 4. PARTITIONS ARE DIMENSIONED TO FACE OF STUD UNLESS NOTED OTHERWISE.
- 5. ALL GYPSUM BOARD AT WET WALL LOCATIONS TO BE MOISTURE RESISTANT. REFER TO SPECIFICATIONS
- 6. EDGE OF DOORS SHALL BE LOCATED 5" OFF PERPENDICULAR WALL UNLESS OTHERWISE NOTED.
- ALL CONCEALED AND SURFACE-MOUNTED WOOD BLOCKING TO SECURE CABINETS, MARKER BOARDS, MONITOR MOUNTS, ECT. TO PARTITIONS TO BE FIRE RETARDANT WOOD BLOCKING.
- 8. DO NOT SCALE DRAWINGS. DIMENSIONS GOVERN. LARGE SCALE DETAILS GOVERN OVER SMALL SCALE.
- 9. ACCESSIBILITY IS DESIGNED AND SHALL BE IN ACCORDANCE WITH IBC AND ICC/ANS 117.1, WHICHEVER STANDARD PROVIDES THE GREATEST DEGREE OF ACCESSIBILITY FOR ANY GIVEN BUILDING ELEMENT.
- 10. EACH GLAZING UNIT SHALL BEAR THE MANUFACTURES LABEL DESIGNATING THE TYPE AND THICKNESS OF GLASS. GLAZING LOCATED WITHIN 24" OF A DOOR AND LESS THAN 60" ABOVE WALKING SURFACE SHALL BE SAFETY GLAZED.
- 11. REFER TO AWI STANDARDS FOR MILLWORK CONSTRUCTION. REFER TO INTERIOR DRAWINGS AND SPECIFICATIONS
- 12. ALL MATERIALS AND COMPONENTS OF FIRE-RATED ASSEMBLIES SHALL BE APPROVED BY U.L. OR OTHER RECOGNIZED STANDARD FOR USE IN SUCH ASSEMBLIES.
- 13. ALL FIRESTOP SYSTEMS TO MEET U.L. TESTED SYSTEMS. SYSTEMS MUST BE SUBMITTED TO AND APPROVED BY ARCHITECT PRIOR TO INSTALLATION. G.C. IS TO KEEP A COPY OF ALL APPROVED SYSTEMS ON SITE FOR DURATION OF PROJECT. ALL INSTALLED SYSTEMS MUST BE LABELED AND DOCUMENTED. DOCUMENTATION IS TO BE SUBMITTED TO OWNER AND ARCHITECT UPON COMPLETION OF PROJECT.
- 14. FIRE SPRINKLER APPROVALS ARE NOT INCLUDED UNDER THESE DESIGN DOCUMENTS. BEFORE COMMENCING ANY WORK ON THE SPRINKLER SYSTEM, PLANS MUST BE SUBMITTED BY ENGINEER AND APPROVED BY THE OWNER. THE SYSTEM MUST BE INSPECTED AND APPROVED BY BUILDING SAFETY INSPECTION PRIOR TO OCCUPANCY.
- 15. INSTALL SOUND BATT INSULATION WITHIN NEW WALLS.
- 16. DOOR AND BUILDING SECURITY SYSTEM HARDWARE AND WIRING TO BE PROVIDED BY OWNER. COORDINATE WITH OWNER'S FORCES PRIOR TO CONSTRUCTION.
- 17. REFER TO SUMMARY OF WORK SPECIFICATION SECTION 011000 FOR PHASING SCHEDULE AND COMPLETION DATES

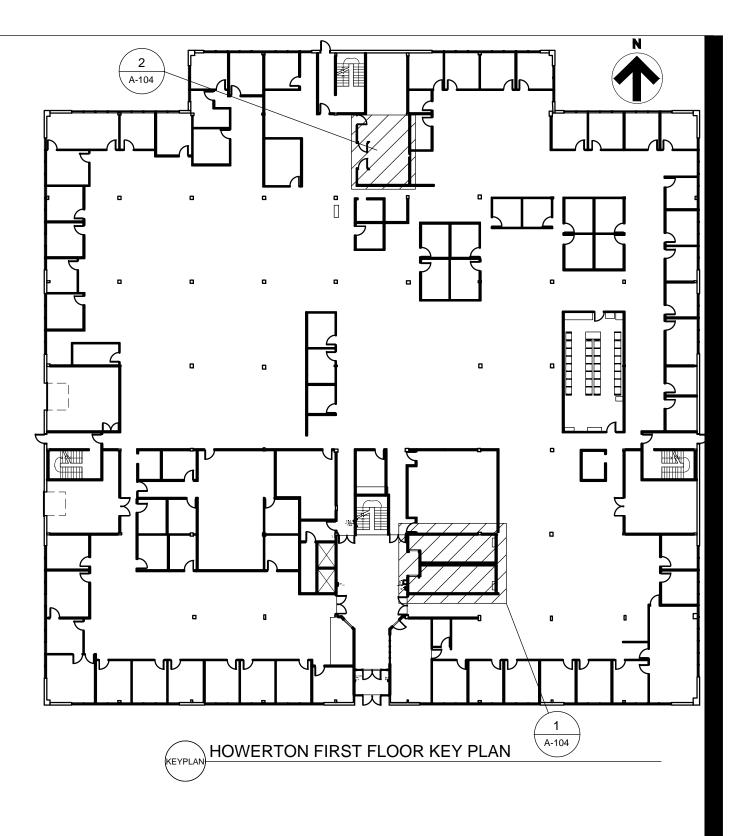

RENOVATION NOTES

1. CONTRACTOR TO FIELD VERIFY DIMENSIONS FOR NEW SOLID SURFACE COUNTERTOP INSTALLATION.

2. ADA 606.5 EXPOSED PIPES AND SURFACES. WATER SUPPLY AND DRAIN PIPES UNDER LAVATORIES AND SINKS SHALL BE INSULATED OR OTHERWISE CONFIGURED TO PROTECT AGAINST CONTACT. THERE SHALL BE NO SHARP OR ABRASIVE SURFACES UNDER LAVATORIES AND SINKS.

RENOVATION KEYNOTES:

INSTALL NEW GRAB BARS (GB-1, GB-2, & GB-3) AS SPECIFIED (SECTION 102800), TO LOCATION SHOWN.

INSTALL NEW CEILING HUNG PARTITIONS (SS-2) AS SPECIFIED (SECTION 102113.19), TO LOCATION SHOWN. REFER TO A-201 AND A-202 FOR ELEVATIONS.

INSTALL NEW SOAP DISPENSER (TA-5) AS SPECIFIED (SECTION 102800), TO LOCATION SHOWN. REFER TO A-201 AND A-202 FOR ELEVATIONS.

INSTALL NEW COMBINATION UNIT (TA-6) (PAPER TOWEL DISPENSER AND WASTE RECEPTACLE) AS SPECIFIED (SECTION 102800) TO LOCATION SHOWN.

INSTALL NEW TOILET TISSUE DISPENSER (TA-1) AS SPECIFIED (SECTION 102800), TO LOCATION SHOWN.

INSTALL NEW SANITARY NAPKIN DISPOSAL (TA-2) AS SPECIFIED (SECTION 102800), TO LOCATION SHOWN.

INSTALL NEW TOILET SEAT COVER DISPENSER (TA-3) AS SPECIFIED (SECTION 102800), TO LOCATION SHOWN.

INSTALL NEW COUNTERTOP (SS-1) AS SPECIFIED (SECTION 123661.16), TO LOCATION SHOWN. SEE DETAILS ON SHEET A-500.

INSTALL NEW UNDERMOUNT SINKS (LAV-1) AND FAUCETS (TA-11) AS SPECIFIED (SECTION 224000) TO LOCATIONS SHOWN. WRAP PIPES FOR ADA - SEE SHEET A-500 FOE ELEVATIONS. REFER TO SHEET P-101 FOR PLUMBING DETAILS.

INSTALL NEW MIRRORS (TA-8) ABOVE SINKS AS SPECIFIED (SECTION 102800), TO LOCATION SHOWN.

INSTALL TOILET (WC-1) AND FLUSHOMETER (WC-2) AS SPECIFIED (SECTION 224000), TO LOCATION SHOWN. REFER TO SHEET P-101 FOR PLUMBING DETAILS.

INSTALL URINALS (U-1) AND FLUSHOMETER (U-2) AS SPECIFIED (SECTION 224000), TO LOCATION SHOWN. REFER TO SHEET P-101 FOR PLUMBING DETAILS.

INSTALL NEW FLOOR TILE (CT-1) WITH $\frac{1}{4}$ " GROUT SPACING THROUGHOUT ENTIRE BATHROOM, AS SPECIFIED (SECTION 093000). REFER TO SPECIFICATIONS FOR WATERPROOF MEMBRANE AND GROUT INFORMATION.

INSTALL NEW FULL LENGTH MIRROR (TA-9) AS SPECIFIED (SECTION 102800), TO LOCATION SHOWN. BOTTOM OF MIRROR SHALL BE 4" AFF. REFER TO SHEET A-201 AND A-202 FOR ELEVATIONS.

BLOCK AND FRAME NEW WALL PER MANUFACTURER'S INSTRUCTIONS TO ACCOMMODATE WALL MOUNTED BABY CHANGING STATION. WOOD DOUBLE STUD BLOCKING. ROUGH-IN: 35 ⁵/₈" WIDTH BY 19 ⁵/₈" HEIGHT.

INSTALL NEW BABY CHANGING STATION(TA-4) AS SPECIFIED (SECTION 102800), TO LOCATION SHOWN. REFER TO SHEET A-201 AND A-202 FOR ELEVATIONS.

INSTALL NEW HOOKS (TA-7) AS SPECIFIED (SECTION 102800), TO LOCATION SHOWN. 18 INSTALL NEW POWER ASSIST OPENERS (SECTION 087113), TO LOCATION SHOWN.

COORDINATE WITH PLUMBER TO REMOVE VINYL COVER SHEET ROCK FROM WALLS BEHIND PLUMBING FIXTURES. REUSE UNDAMAGED PANELS. REPLACE PANELS NEEDING NEW CUTOUTS TO ACCOMMODATE NEW PLUMBING FIXTURES

STATE OF MISSOURI MICHAEL L. PARSON, GOVERNOR





OFFICE OF ADMINISTRATION **DIVISION OF FACILITIES MANAGEMENT / DESIGN** AND CONSTRUCTION **DEPARTMENT OF**

SOCIAL SERVICES

MULTI. DIVISION

HOWERTON STATE OFFICE BUILDING

RENOVATE LOBBY

AND RESTROOMS 1ST AND 2ND FLOOR 615 HOWERTON COURT JEFFERSON CITY, MO

PROJECT # 02339-01 SITE # 1025 FACILITY # 3101025001

REVISION: DATE: **REVISION:** DATE: **REVISION:** DATE:


ISSUE DATE: 12/13/2024

CAD DWG FILE:A-104_02409_01 DRAWN BY: CHECKED BY: BMS DESIGNED BY: EL

SHEET TITLE: FIRST FLOOR RESTROOM **RENOVATION PLAN**

SHEET NUMBER:



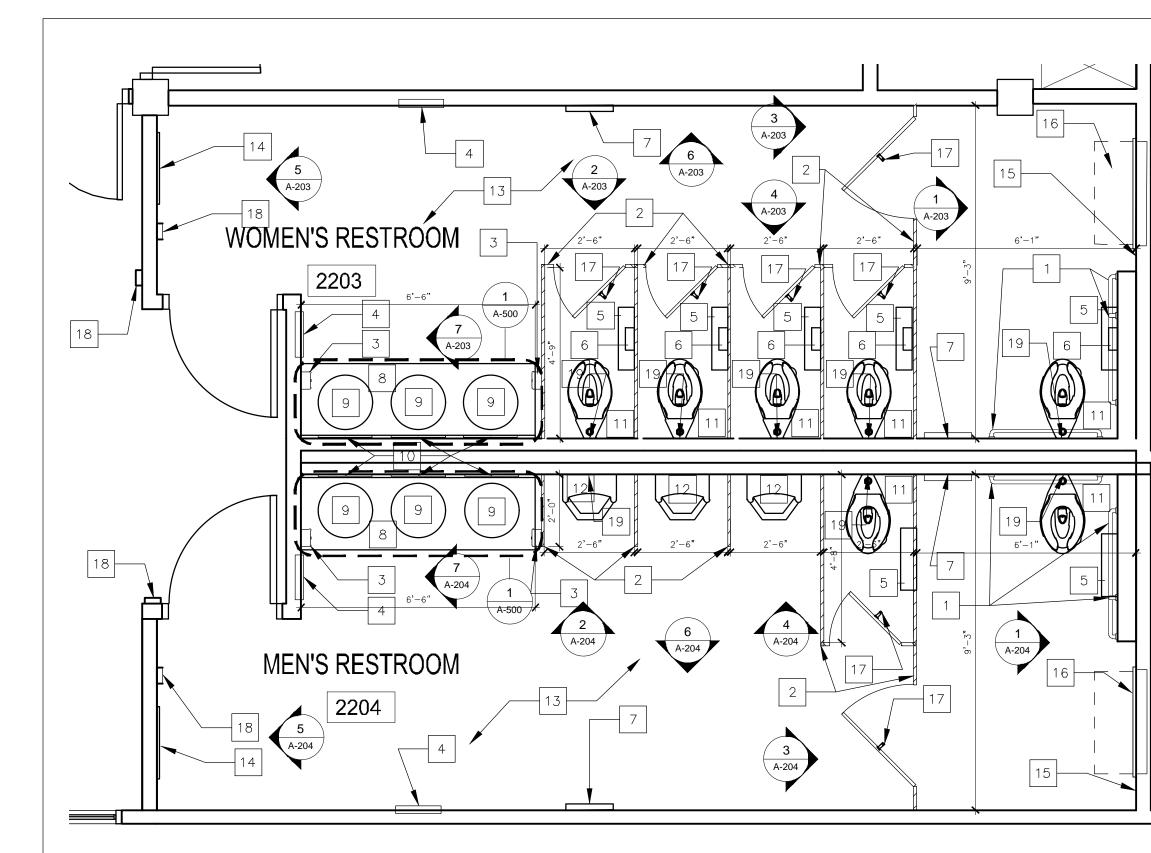


SECOND FLOOR - LOBBY RESTROOM RENOVATION PLAN / SCALE: 3/8" = 1'-0"

					RO	OM FINISH	I SCHEDULE						
	ROOM				FINISH								
NUMBER	NAME	PERIMETER	AREA	PAINT	FLOORING	CEILING	COUNTERTOP	TOILET PARTITIONS	W				
2203	WOMEN'S RESTROOM	72'-10"	235 Sq.Ft.	P-1	CT-1	ACT-1	SS-1	SS-2					
2204	MEN'S RESTROOM	72'-10"	235 Sq.Ft.	P-1	CT-1	ACT-1	SS-1	SS-2					
2223	WOMEN'S RESTROOM	54'-7"	156 Sq.Ft.	P-1	CT-1	ACT-1	SS-1	SS-2					
2224	MEN'S RESTROOM	55'-7"	164 Sq.Ft.	P-1	CT-1	ACT-1	SS-1	SS-2					
P-1	PPG PAINT, COLOR MATC	H: SHERWIN WILLI	AMS SW700	03 WORLDL	Y GRAY								
CT-1	DALTILE, ARTICULO, FEATURE BEIGE, 12" X 24"												
ACT-1	ARMSTRONG, CALLA 1" THICK SQUARE LAY-IN, TEGULAR , WHITE ACOUSTICAL CEILING TILE, 24" X 24"												
SS-1	CORIAN, DOMINO TERAZZO												


SS-2 PRIVACY PLUS PARTITIONS, CEILING HUNG, CORIAN, GRAY ONYX

JOHNSONITE, TRADITIONAL VINYL¹/₈" WALL BASE, WHISPERING MIST B-1

		RESTROOM FIXTURE SCHE	DULE		
MARK	PRODUCT	DESCRIPTION	MANUFACTURER	QTY	REMARKS
GB-1	GRAB BAR	36" LONG, 1-1/2" DIAMETER, STRAIGHT GRAB BAR, B-6806X24	BOBRICK	2	SPECIFICATIONS SECTION 102800
GB-2	GRAB BAR	42" LONG, 1-1/2" DIAMETER, STRAIGHT GRAB BAR, B-6806X42	BOBRICK	2	SPECIFICATIONS SECTION 102800
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LAV-1	LAVATORY	OVALYN LARGE UNDER COUNTER SINK	AMERICAN STANDARD	6	SPECIFICATIONS SECTION 224000
TA-1	TOILET TISSUE DISPENSER	MODEL B-2888, CLASSIC SERIES, SURFACE MOUNTED MULTI-ROLL	BOBRICK	8	SPECIFICATIONS SECTION 102800
TA-2	SANITARY NAPKIN DISPOSAL	MODEL B-254, CLASSIC SERIES, SURFACE MOUNTED, SATIN-FINISH STAINLESS STEEL	BOBRICK	6	SPECIFICATIONS SECTION 102800
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TA-4	BABY CHANGING STATION	MODEL 962, RECESSED, STAINLESS STEEL	BRADLEY	2	SPECIFICATIONS SECTION 102800
TA-5	SOAP DISPENSER	MODEL SPA9757, SPARTAN SOAP DISPENSER IN BLACK	SPARTAN	4	SPECIFICATIONS SECTION 102800
TA-6	COMBINATION UNIT	MODEL B-3940, CLASSIC SERIES, RECESSED CONVERTIBLE PAPER TOWEL DISPENSER AND WASTE RECEPTACLE	BOBRICK	4	SPECIFICATIONS SECTION 102800
TA-7	СОАТ НООК	MODEL B-9542, FINO COLLECTION, SURFACE MOUNTED COAT HOOK, SATIN FINISH STAINLESS STEEL	BOBRICK	8	SPECIFICATIONS SECTION 102800
TA-8	MIRROR	WELDED-FRAME MIRROR, MATTE BLACK, 24" X 36", B-290	BOBRICK	6	SPECIFICATIONS SECTION 102800
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U-1	URINAL	MODEL Z5758-U, "THE RETROFIT PINT" ¹ / ₈ GPF ECOVANTAGE, ULTRA LOW CONSUMPTION URINAL	ZURN	4	SPECIFICATIONS SECTION 224000
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-IXTURES C	ALLED OUT IN SCHEDULE ARE BASIS-OF	-DESIGN ONLY. SEE SPECIFICATIONS FOR FURTHER DETAILS.		I	1

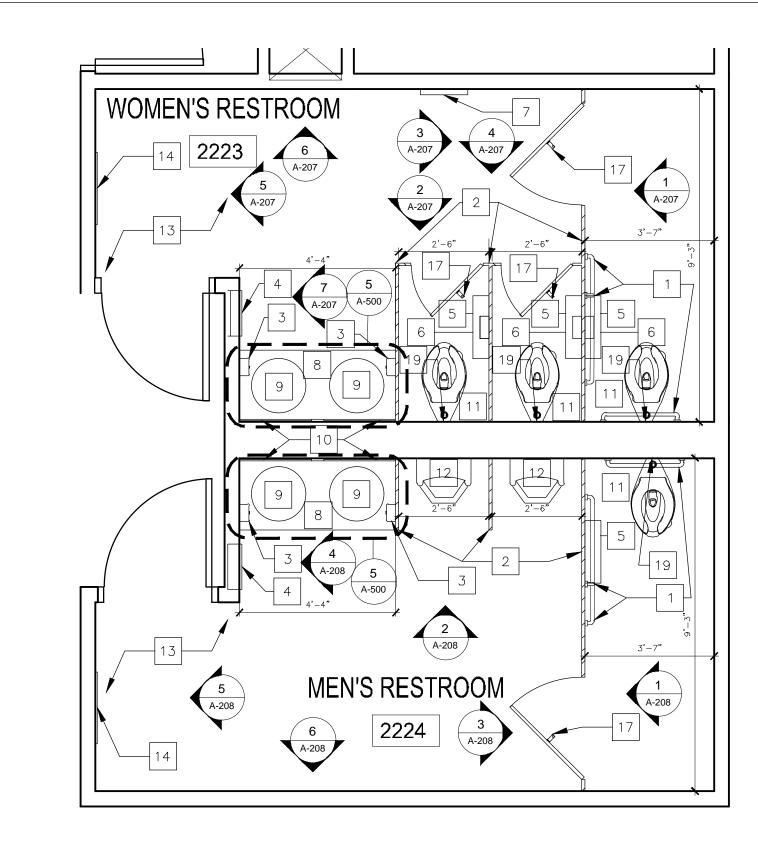


SECOND FLOOR - STAFF RESTROOM RENOVATION PLAN SCALE: 3/8" = 1'-0"

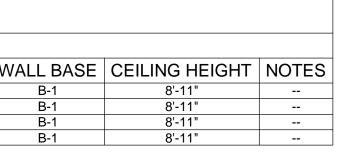

WALL LEGEND:
- EXISTING WALLS
DEMO WALLS

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- 17. REFER TO SUMMARY OF WORK SPECIFICATION SECTION 011000 FOR PHASING SCHEDULE AND COMPLETION DATES

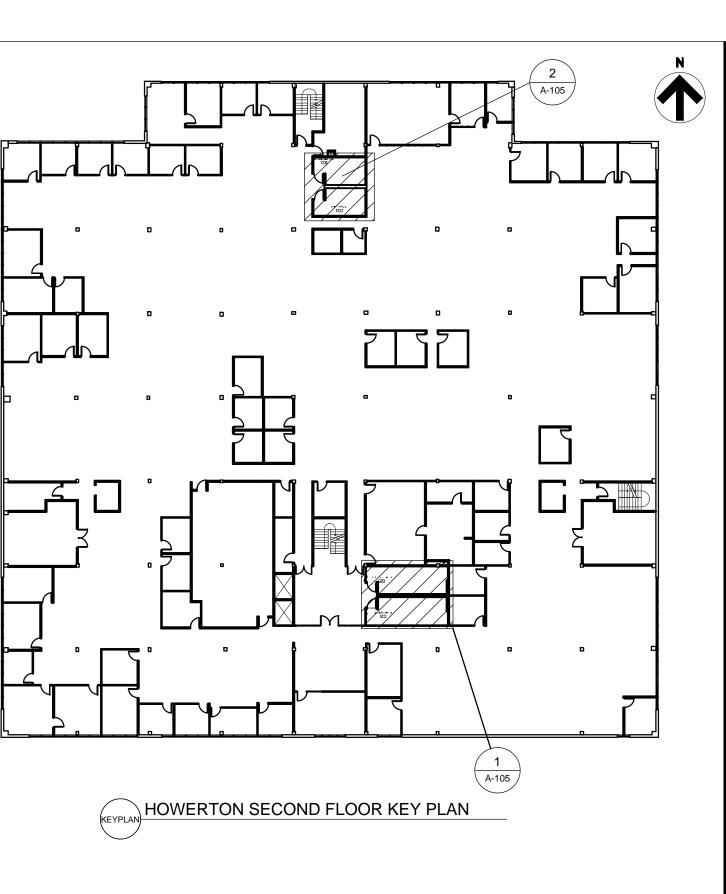

RENOVATION NOTES:

1. CONTRACTOR TO FIELD VERIFY DIMENSIONS FOR NEW SOLID SURFACE COUNTERTOP INSTALLATION.

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RENOVATION KEYNOTES:

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INSTALL NEW SANITARY NAPKIN DISPOSAL (TA-2) AS SPECIFIED (SECTION 102800), TO LOCATION SHOWN.

INSTALL NEW TOILET SEAT COVER DISPENSER (TA-3) AS SPECIFIED (SECTION 102800), TO LOCATION SHOWN.

INSTALL NEW COUNTERTOP (SS-1) AS SPECIFIED (SECTION 123661.16), TO LOCATION SHOWN. SEE DETAILS ON SHEET A-500.

INSTALL NEW UNDERMOUNT SINKS (LAV-1) AND FAUCETS (TA-11) AS SPECIFIED (SECTION 224000) 9 TO LOCATIONS SHOWN. WRAP PIPES FOR ADA - SEE SHEET A-500 FOE ELEVATIONS. REFER TO SHEET P-101 FOR PLUMBING DETAILS.

INSTALL NEW MIRRORS (TA-8) ABOVE SINKS AS SPECIFIED (SECTION 102800), TO LOCATION SHOWN.

INSTALL TOILET (WC-1) AND FLUSHOMETER (WC-2) AS SPECIFIED (SECTION 224000), TO LOCATION SHOWN. REFER TO SHEET P-101 FOR PLUMBING DETAILS.

INSTALL URINALS (U-1) AND FLUSHOMETER (U-2) AS SPECIFIED (SECTION 224000), TO LOCATION SHOWN. REFER TO SHEET P-101 FOR PLUMBING DETAILS.

INSTALL NEW FLOOR TILE (CT-1) WITH $\frac{1}{4}$ " GROUT SPACING THROUGHOUT ENTIRE BATHROOM, AS SPECIFIED (SECTION 093000). REFER TO SPECIFICATIONS FOR WATERPROOF MEMBRANE AND GROUT INFORMATION.

INSTALL NEW FULL LENGTH MIRROR (TA-9) AS SPECIFIED (SECTION 102800), TO LOCATION SHOWN. BOTTOM OF MIRROR SHALL BE 4" AFF. REFER TO SHEET A-201 AND A-202 FOR ELEVATIONS.

BLOCK AND FRAME NEW WALL PER MANUFACTURER'S INSTRUCTIONS TO ACCOMMODATE WALL MOUNTED BABY CHANGING STATION. WOOD DOUBLE STUD BLOCKING. ROUGH-IN: 35 ⁵/₈" WIDTH BY 19 ⁵/₈" HEIGHT.

INSTALL NEW BABY CHANGING STATION(TA-4) AS SPECIFIED (SECTION 102800), TO LOCATION SHOWN. REFER TO SHEET A-201 AND A-202 FOR ELEVATIONS.

INSTALL NEW HOOKS (TA-7) AS SPECIFIED (SECTION 102800), TO LOCATION SHOWN.

18 INSTALL NEW POWER ASSIST OPENERS (SECTION XXXXXX), TO LOCATION SHOWN.

COORDINATE WITH PLUMBER TO REMOVE VINYL COVER SHEET ROCK FROM WALLS BEHIND 19 PLUMBING FIXTURES. REUSE UNDAMAGED PANELS. REPLACE PANELS NEEDING NEW CUTOUTS TO ACCOMMODATE NEW PLUMBING FIXTURES.

STATE OF MISSOURI MICHAEL L. PARSON, GOVERNOR





OFFICE OF ADMINISTRATION **DIVISION OF FACILITIES MANAGEMENT / DESIGN** AND CONSTRUCTION

SOCIAL SERVICES

DEPARTMENT OF

MULTI. DIVISION

HOWERTON STATE OFFICE BUILDING

RENOVATE LOBBY

AND RESTROOMS 1ST AND 2ND FLOOR 615 HOWERTON COURT JEFFERSON CITY,MO

PROJECT # 02339-01 SITE # 1025 FACILITY # 3101025001

REVISION: DATE: **REVISION:** DATE:


REVISION: DATE: ISSUE DATE: 12/13/2024

CAD DWG FILE:A-105_02409_01 DRAWN BY: CHECKED BY: BMS DESIGNED BY: EL


SHEET TITLE:

SECOND FLOOR RESTROOM **RENOVATION PLAN**


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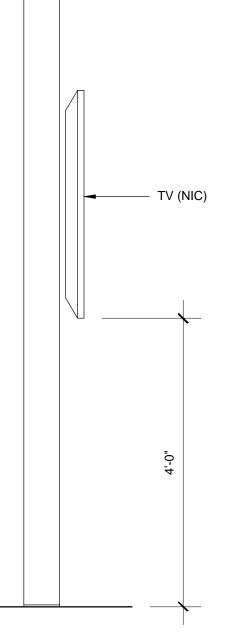


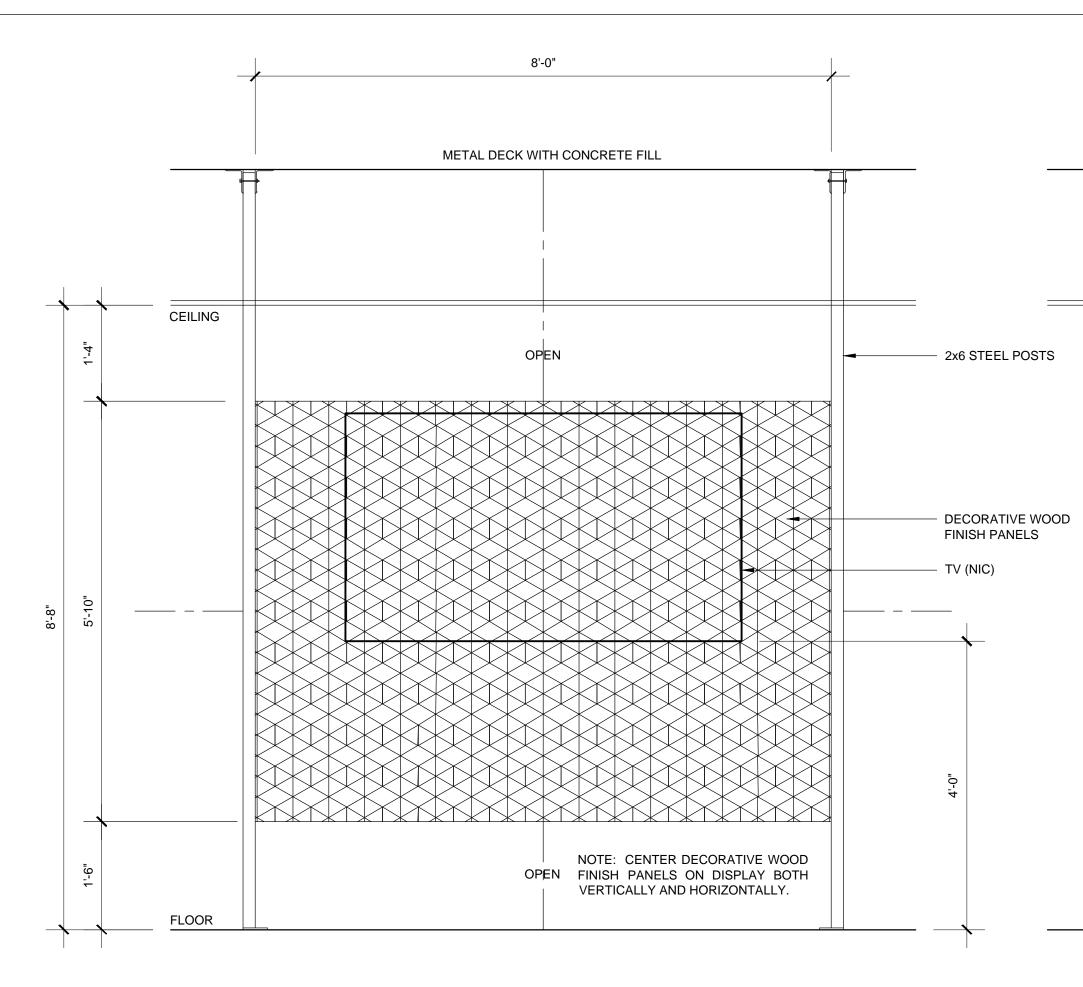FRONT ELEVATION / SCALE: 3/4" = 1'-0"

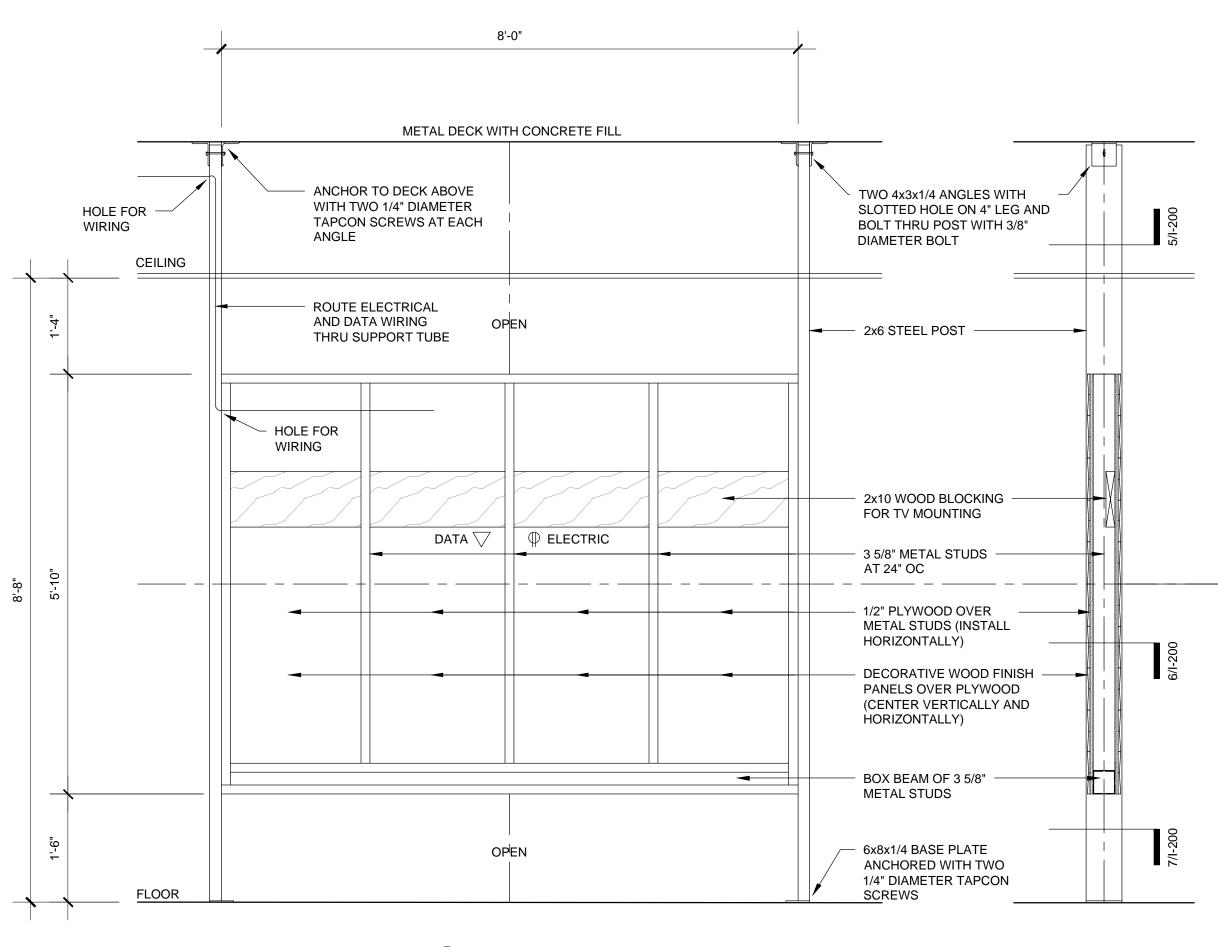

FRAMING PLAN / SCALE: 3/4" = 1'-0"



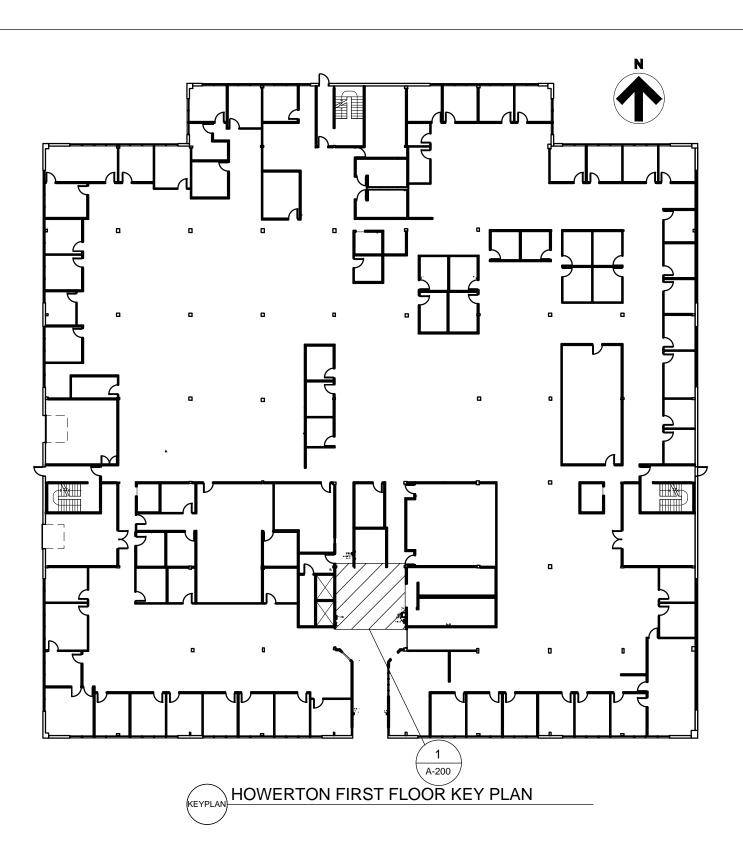





WOOD TYPE AND FINISH

FEATURE WALL TO BE STACKED WOOD, GEOMETRY COLLECTION, RHOMBUS PLAY, PANEL SIZE 14" X 48.5"

STEEL TUBING SHOULD BE BOLTED TO THE CONCRETE FLOOR AND OVERHEAD CONCRETE DECKING.

FINISH STEEL TUBING WITH PAINT, GLOSS FINISH, SW_____

CONTRACTOR TO RUN ELECTRICAL AND DATA FROM CEILING, THROUGH STEEL TUBING, TO OUTLET FOR TV.

ATTACH WOOD FRAMING TO STEEL TUBING.

ATTACH PLYWOOD TO WOOD FRAMING.

APPLY MANUFACTURER'S RECOMMENDED ADHESIVES TO PLYWOOD AND ATTACH DECORATIVE WOOD PANELS.

ATTACH TV TO FLOATING WALL. SEE DESIGNER FOR SPECIFICS.


TV MONITOR PROVIDED BY AGENCEY

TV MONITOR BRACKET PROVIDED BY AGENCY. MOUNT BRACKET TO ALLOW BOTTOM OF TV MONITOR TO BE 60" A.F.F.

2X8 SUPPORTS TO BE ADDED TO STUDDED WALL TO ATTACH TV MONITOR TO. (PLACEMENT OF SUPPORTS A.F.F. MAY NEED TO BE ADJUSTED FOR SIZE OF TV

MONITOR)

DUPLEX ELECTRICAL OUTLET TO BE INSTALLED IN WALL BEHIND TV MONITOR. INSTALL DATA LINE OUTLET BEHIND TV MONITOR.

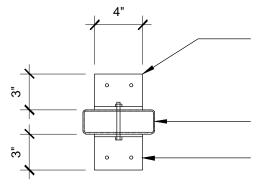

TWO 4x3x1/4 ANGLES WITH SLOTTED HOLE ON 4" LEG AND BOLT THRU POST WITH 3/8" DIAMETER BOLT

2x6 STEEL TUBE

ANCHOR TO DECK ABOVE WITH TWO 1/4" DIAMETER TAPCON SCREWS AT EACH ANGLE

DECORATIVE WOOD FINISH PANELS 1/2" PLYWOOD

3 5/8" METAL

STUDS AT 24" OC

SCREW TO STEEL

TUBE STEEL TUBE

2x6 STEEL TUBE

PANEL ATTACHMENT

SCALE: 1 1/2"" = 1'-0"


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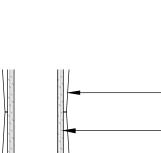
BASE ATTACHMENT / SCALE: 1 1/2" = 1'-0"


6x8x1/4 BASE PLATE SCREWS


ANCHORED WITH TWO 1/4" DIAMETER TAPCON


2x6 STEEL TUBE




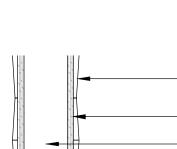


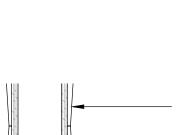

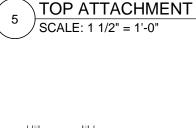

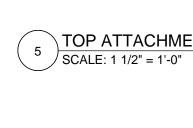

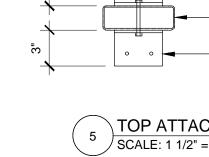

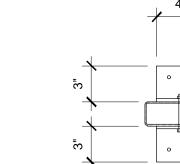

SIDE SECTION SCALE: 3/4" = 1'-0"

GENERAL CONSTRUCTION NOTES:

- 1. ALL WORK SHALL BE PERFORMED IN A SAFE MANNER WITH PROTECTION PROVIDED TO ANY BUILDING OCCUPANTS AND WORKERS PERFORMING THE WORK. 2. ALL WORK SHALL BE DONE IN A MANNER TO MINIMIZE DAMAGE TO ADJACENT SURFACES THAT ARE NOT SHOWN TO BE WORKED ON OR REMOVED - CONTRACTOR SHALL BE RESPONSIBLE FOR ALL WORK NECESSARY TO REPAIR SURFACES AFFECTED BY THEIR WORK. 3. ANY WORK THAT RESULTS IN EXCESSIVE NOISE, DUST OR DEBRIS MUST BE COORDINATED WITH BUILDING FACILITY STAFF AT LEAST TWO (2) WORKING DAYS IN ADVANCE. 4. ANY WORK THAT REQUIRES THE NEED TO TEMPORARILY SHUT DOWN ANY OF THE BUILDING
- SYSTEMS MUST BE COORDINATED WITH BUILDING FACILITY STAFF AT LEAST FOUR (4) WORKING DAYS IN ADVANCE.
- 5. CONTRACTOR SHALL PROVIDE NECESSARY DUST PROTECTION TO PREVENT DUST CREATED BY DEMOLITION/CONSTRUCTION ACTIVITIES TO ENTER SPACE(S) OUTSIDE THE WORK AREA, INCLUDING THROUGH THE HVAC SYSTEM. CONTRACTOR SHALL BE RESPONSIBLE TO REPLACE ANY HVAC FILTERS CONTAMINATED WITH CONSTRUCTION DEBRIS. 6. CONTRACTOR SHALL BE RESPONSIBLE TO PERFORM ANY WORK NECESSARY TO PROVIDE THE
- SCOPE OF WORK SHOWN ON THE PLANS, EVEN IF NOT SPECIFICALLY NOTED OR SHOWN. 7. CONTRACTOR SHALL PERFORM WORK BETWEEN THE HOURS OF 7AM TO 5PM AFTER SIGNING IN AND RECEIVING VISITOR'S BADGE.
- 8. ALL MATERIALS/EQUIPMENT MAY BE DELIVERED TO THE FACILITY FACILITY STAFF SHALL BE CONTACTED TEN (10) BUSINESS DAYS PRIOR TO DELIVERY OF MATERIALS/EQUIPMENT. CONTRACTOR SHALL BE SIGN FOR RECEIPT OF ALL MATERIALS/EQUIPMENT - FACILITY STAFF ARE NOT RESPONSIBLE FOR ACCEPTING OR SIGNING FOR DELIVERIES.
- 9. ALL WORK SHALL BE PERFORMED IN ACCORDANCE WITH THE LATEST EDITION OF THE IBC, IFC, IMC, IPC, NEC AND ALL OTHER APPLICABLE ICC AND NFPA CODE FAMILIES. 10. CONTRACTOR RESPONSIBLE FOR FIELD VERIFYING AS-BUILT CONDITIONS AND PROPOSED LAYOUT PRIOR TO PERFORMING WORK. CONTRACTOR SHALL NOTIFY FMDC PROJECT MANAGER IF THERE ARE ANY DISCREPANCIES OR CONFLICTS.
- 11. DETAILS OF EXISTING CONDITIONS PROVIDED AS A COURTESY. THIS INFORMATION DOES NOT RELIEVE THE CONTRACTOR FROM PERFORMING A COMPLETE NECESSARY FIELD INVESTIGATIVE WORK TO FULLY UNDERSTAND EXISTING CONDITIONS PRIOR TO SUBMITTING BID.
- 12. DATA AND PHONE LINE WORK TO BE PERFORMED BY OTHERS (NIC). 13. CONTRACTOR SHALL MAINTAIN THE INTEGRITY OF ALL RATED PARTITIONS, CEILING ASSEMBLIES AND DOOR ASSEMBLIES. THE CONTRACTOR SHALL MAKE ALL NECESSARY REPAIRS WHERE ANY WORK PERFORMED BY THE CONTRACTOR AFFECTS THE INTEGRITY OF THESE ITEMS.
- 14. EXISTING CEILING ASSEMBLY PRESUMED TO BE ONE HOUR RATED (SINGLE LAYER OF 5/8", TYPE X OVER VAPOR BARRIER WITH R-30 BATT INSULATION IN ATTIC SPACE). CONTRACTOR SHALL MAINTAIN INTEGRITY OF RATED ASSEMBLY. 15. DIMENSIONS PROVIDED ARE MEASURED FROM EXISTING DRYWALL FACE TO NEW DRYWALL FACE UNLESS OTHERWISE NOTED.
 - 8 OF 38 SHEETS

STATE OF MISSOURI MICHAEL L. PARSON, **GOVERNOR**



ME BID

OFFICE OF ADMINISTRATION **DIVISION OF FACILITIES**

MANAGEMENT / DESIGN AND CONSTRUCTION **DEPARTMENT OF**

SOCIAL SERVICES MULTI. DIVISION

HOWERTON STATE OFFICE BUILDING

RENOVATE LOBBY

AND RESTROOMS 1ST AND 2ND FLOOR 615 HOWERTON COURT JEFFERSON CITY, MO

PROJECT # 02339-01 1025 SITE # FACILITY # 3101025001

REVISION:

DATE: **REVISION**: DATE: **REVISION:** DATE: ISSUE DATE: 3/7/2025


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SHEET TITLE:

LOBBY FEATURE WALL ELEVATIONS AND DETAILS

SHEET NUMBER:



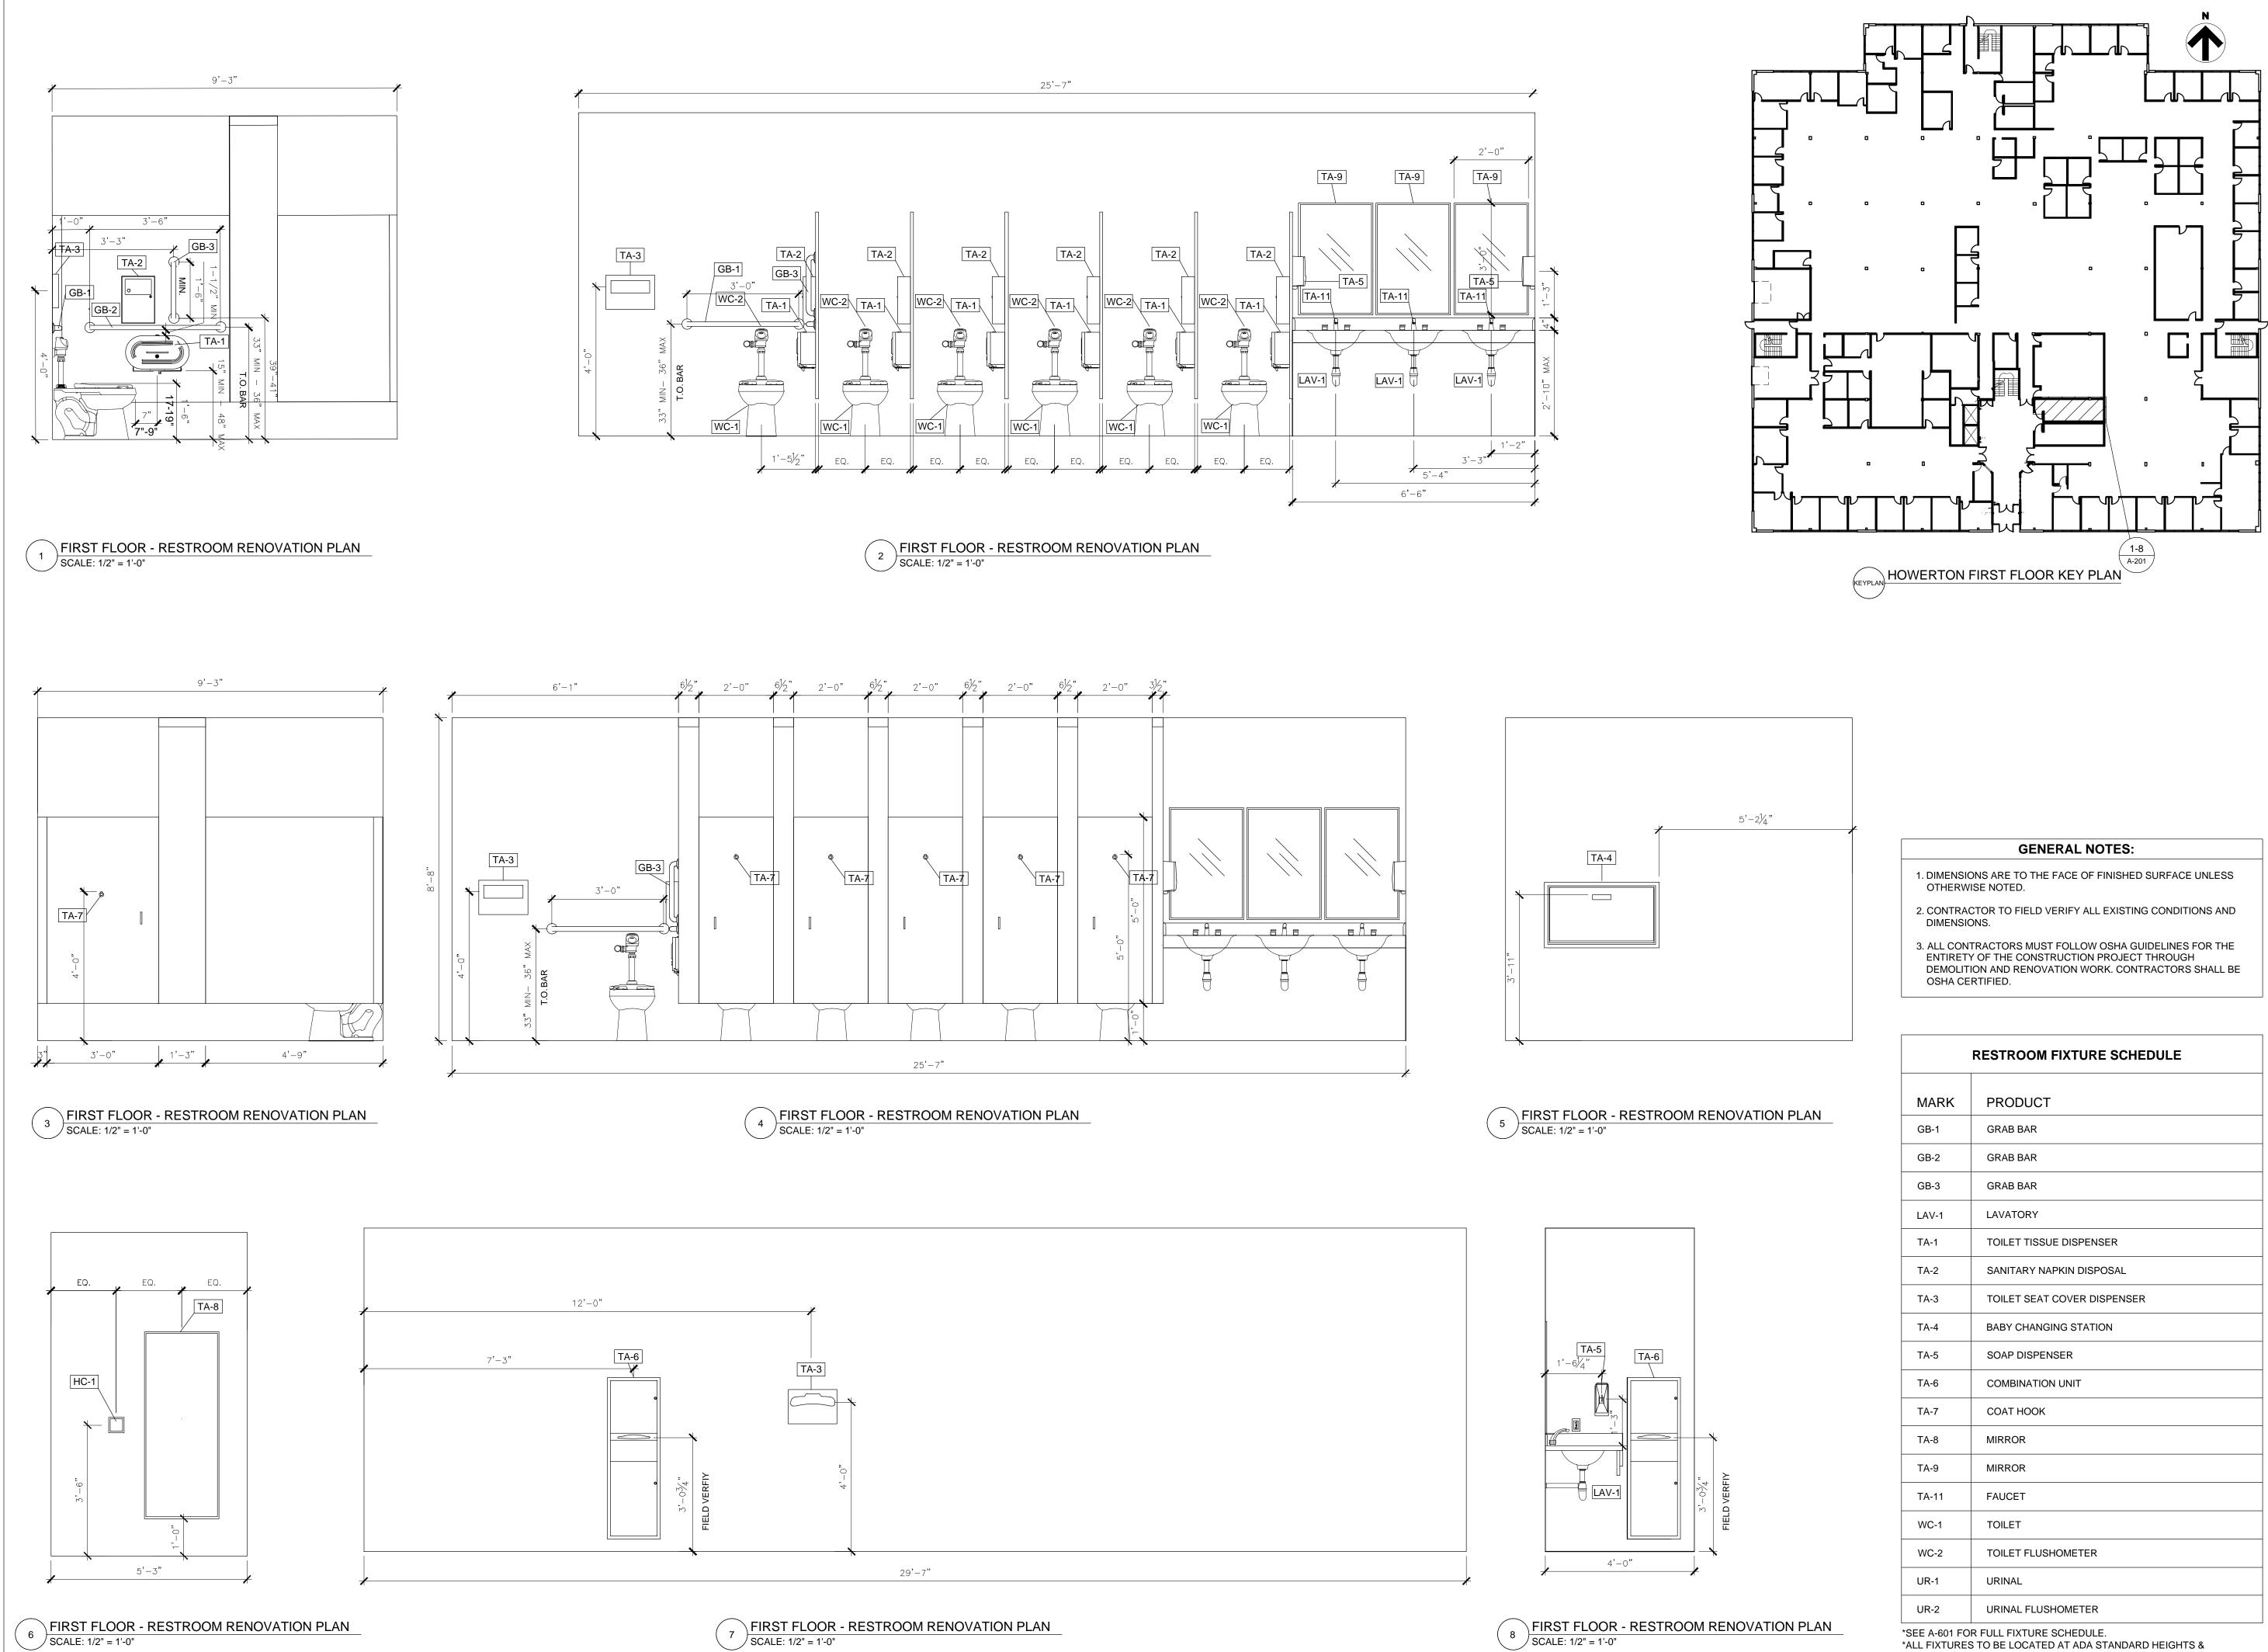

	RESTROOM FIXTURE SCHEDULE
MARK	PRODUCT
GB-1	GRAB BAR
GB-2	GRAB BAR
GB-3	GRAB BAR
LAV-1	LAVATORY
TA-1	TOILET TISSUE DISPENSER
TA-2	SANITARY NAPKIN DISPOSAL
TA-3	TOILET SEAT COVER DISPENSER
TA-4	BABY CHANGING STATION
TA-5	SOAP DISPENSER
TA-6	COMBINATION UNIT
TA-7	СОАТ НООК
TA-8	MIRROR
TA-9	MIRROR
TA-11	FAUCET
WC-1	TOILET
WC-2	TOILET FLUSHOMETER
UR-1	URINAL
UR-2	URINAL FLUSHOMETER

SETBACKS.

STATE OF MISSOURI MICHAEL L. PARSON, GOVERNOR



\mathbf{v} UMENT BID DO

OFFICE OF ADMINISTRATION **DIVISION OF FACILITIES** MANAGEMENT / DESIGN AND CONSTRUCTION

DEPARTMENT OF SOCIAL SERVICES

MULTI. DIVISION

HOWERTON STATE OFFICE BUILDING

RENOVATE LOBBY

AND RESTROOMS 1ST AND 2ND FLOOR 615 HOWERTON COURT JEFFERSON CITY, MO

PROJECT # 02339-01 1025 SITE # FACILITY # 3101025001

REVISION: DATE: **REVISION**: DATE: **REVISION**: DATE:

ISSUE DATE: 12/13/2024


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SHEET TITLE:


FIRST FL. WOMEN'S LOBBY RESTROOM ELEVATIONS

SHEET NUMBER:

A-201 9 OF 38 SHEETS



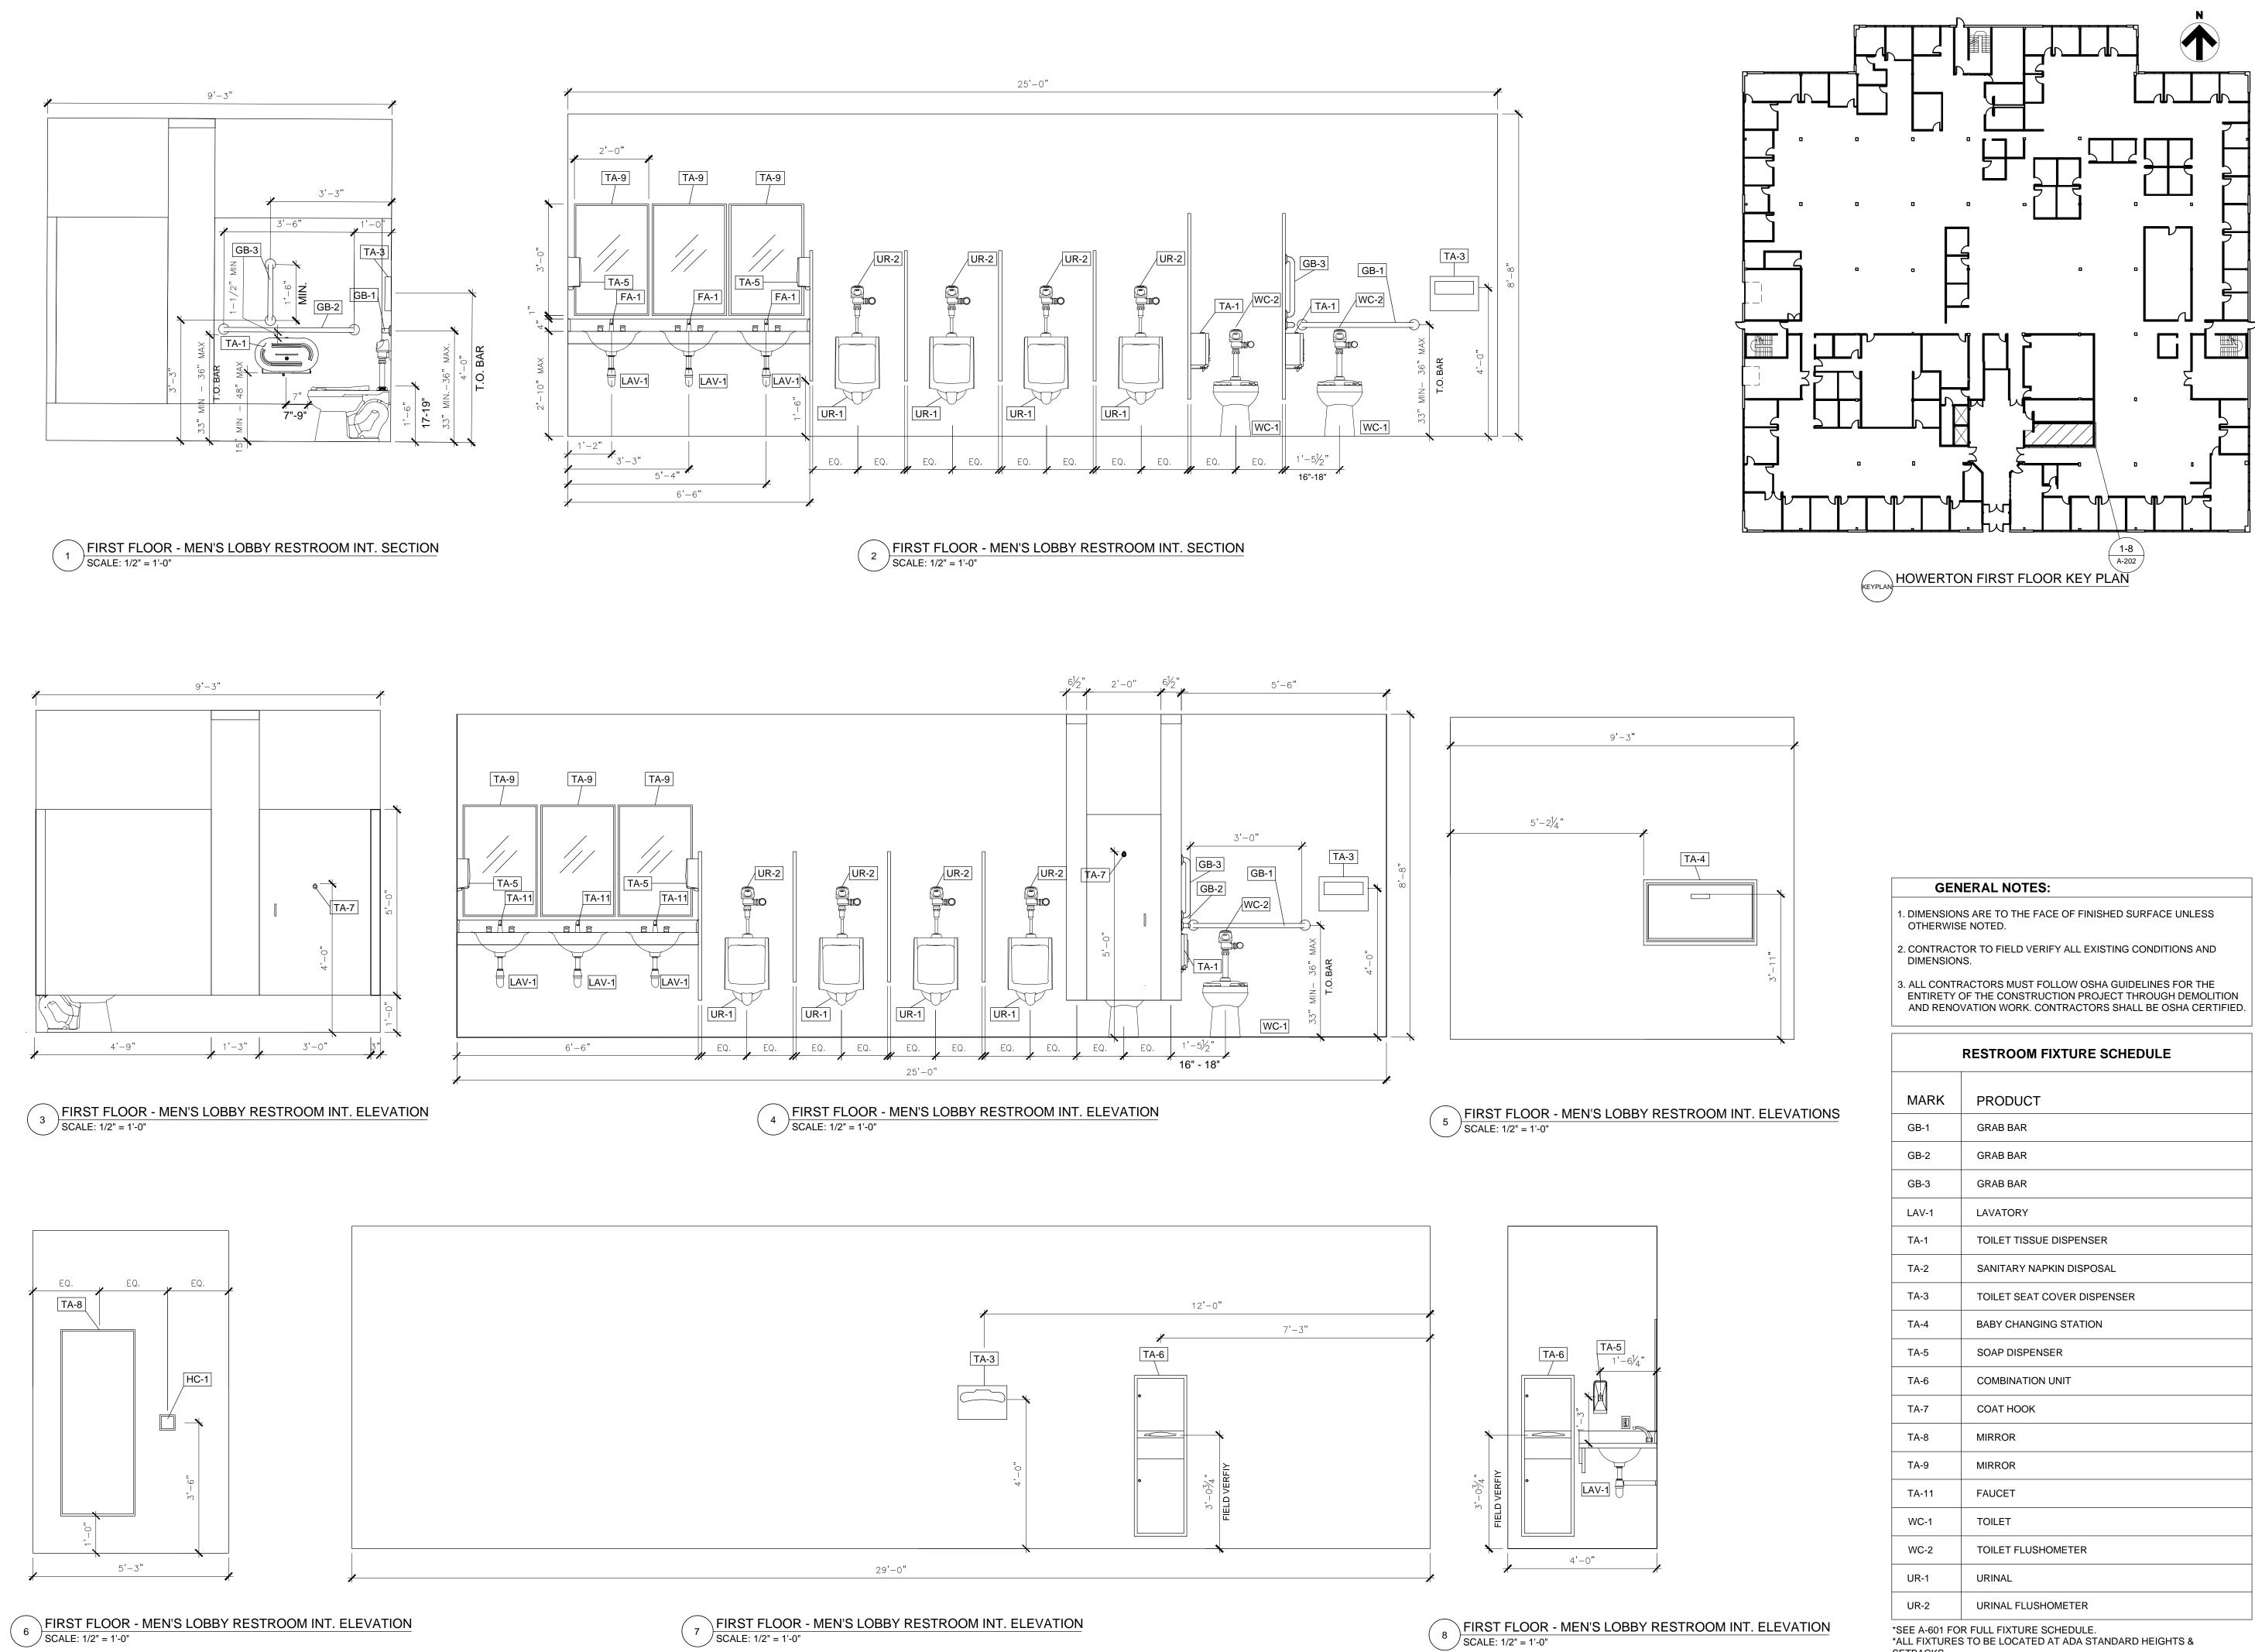

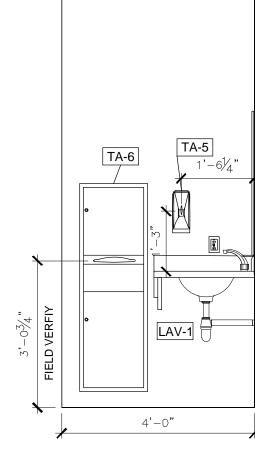

MARK	PRODUCT
GB-1	GRAB BAR
GB-2	GRAB BAR
GB-3	GRAB BAR
LAV-1	LAVATORY
TA-1	TOILET TISSUE DISPENSER
TA-2	SANITARY NAPKIN DISPOSAL
TA-3	TOILET SEAT COVER DISPENSER
TA-4	BABY CHANGING STATION
TA-5	SOAP DISPENSER
TA-6	COMBINATION UNIT
TA-7	СОАТ НООК
TA-8	MIRROR
TA-9	MIRROR
TA-11	FAUCET
WC-1	TOILET
WC-2	TOILET FLUSHOMETER
UR-1	URINAL
UR-2	URINAL FLUSHOMETER

SETBACKS.

BRADMICHAI SCHAEFER Brad M. Schaefer - Architect MO# A-2009027294 UMENT BID DO **OFFICE OF** ADMINISTRATION **DIVISION OF FACILITIES** MANAGEMENT / DESIGN AND CONSTRUCTION DEPARTMENT OF SOCIAL SERVICES **MULTI. DIVISION** HOWERTON STATE OFFICE BUILDING **RENOVATE LOBBY** AND RESTROOMS 1ST AND 2ND FLOOR 615 HOWERTON COURT JEFFERSON CITY, MO PROJECT # 02339-01 1025 SITE # FACILITY # 3101025001 **REVISION:**

STATE OF MISSOURI MICHAEL L. PARSON,

GOVERNOR

DATE: **REVISION**: DATE: **REVISION**: DATE:

ISSUE DATE: 12/13/2024


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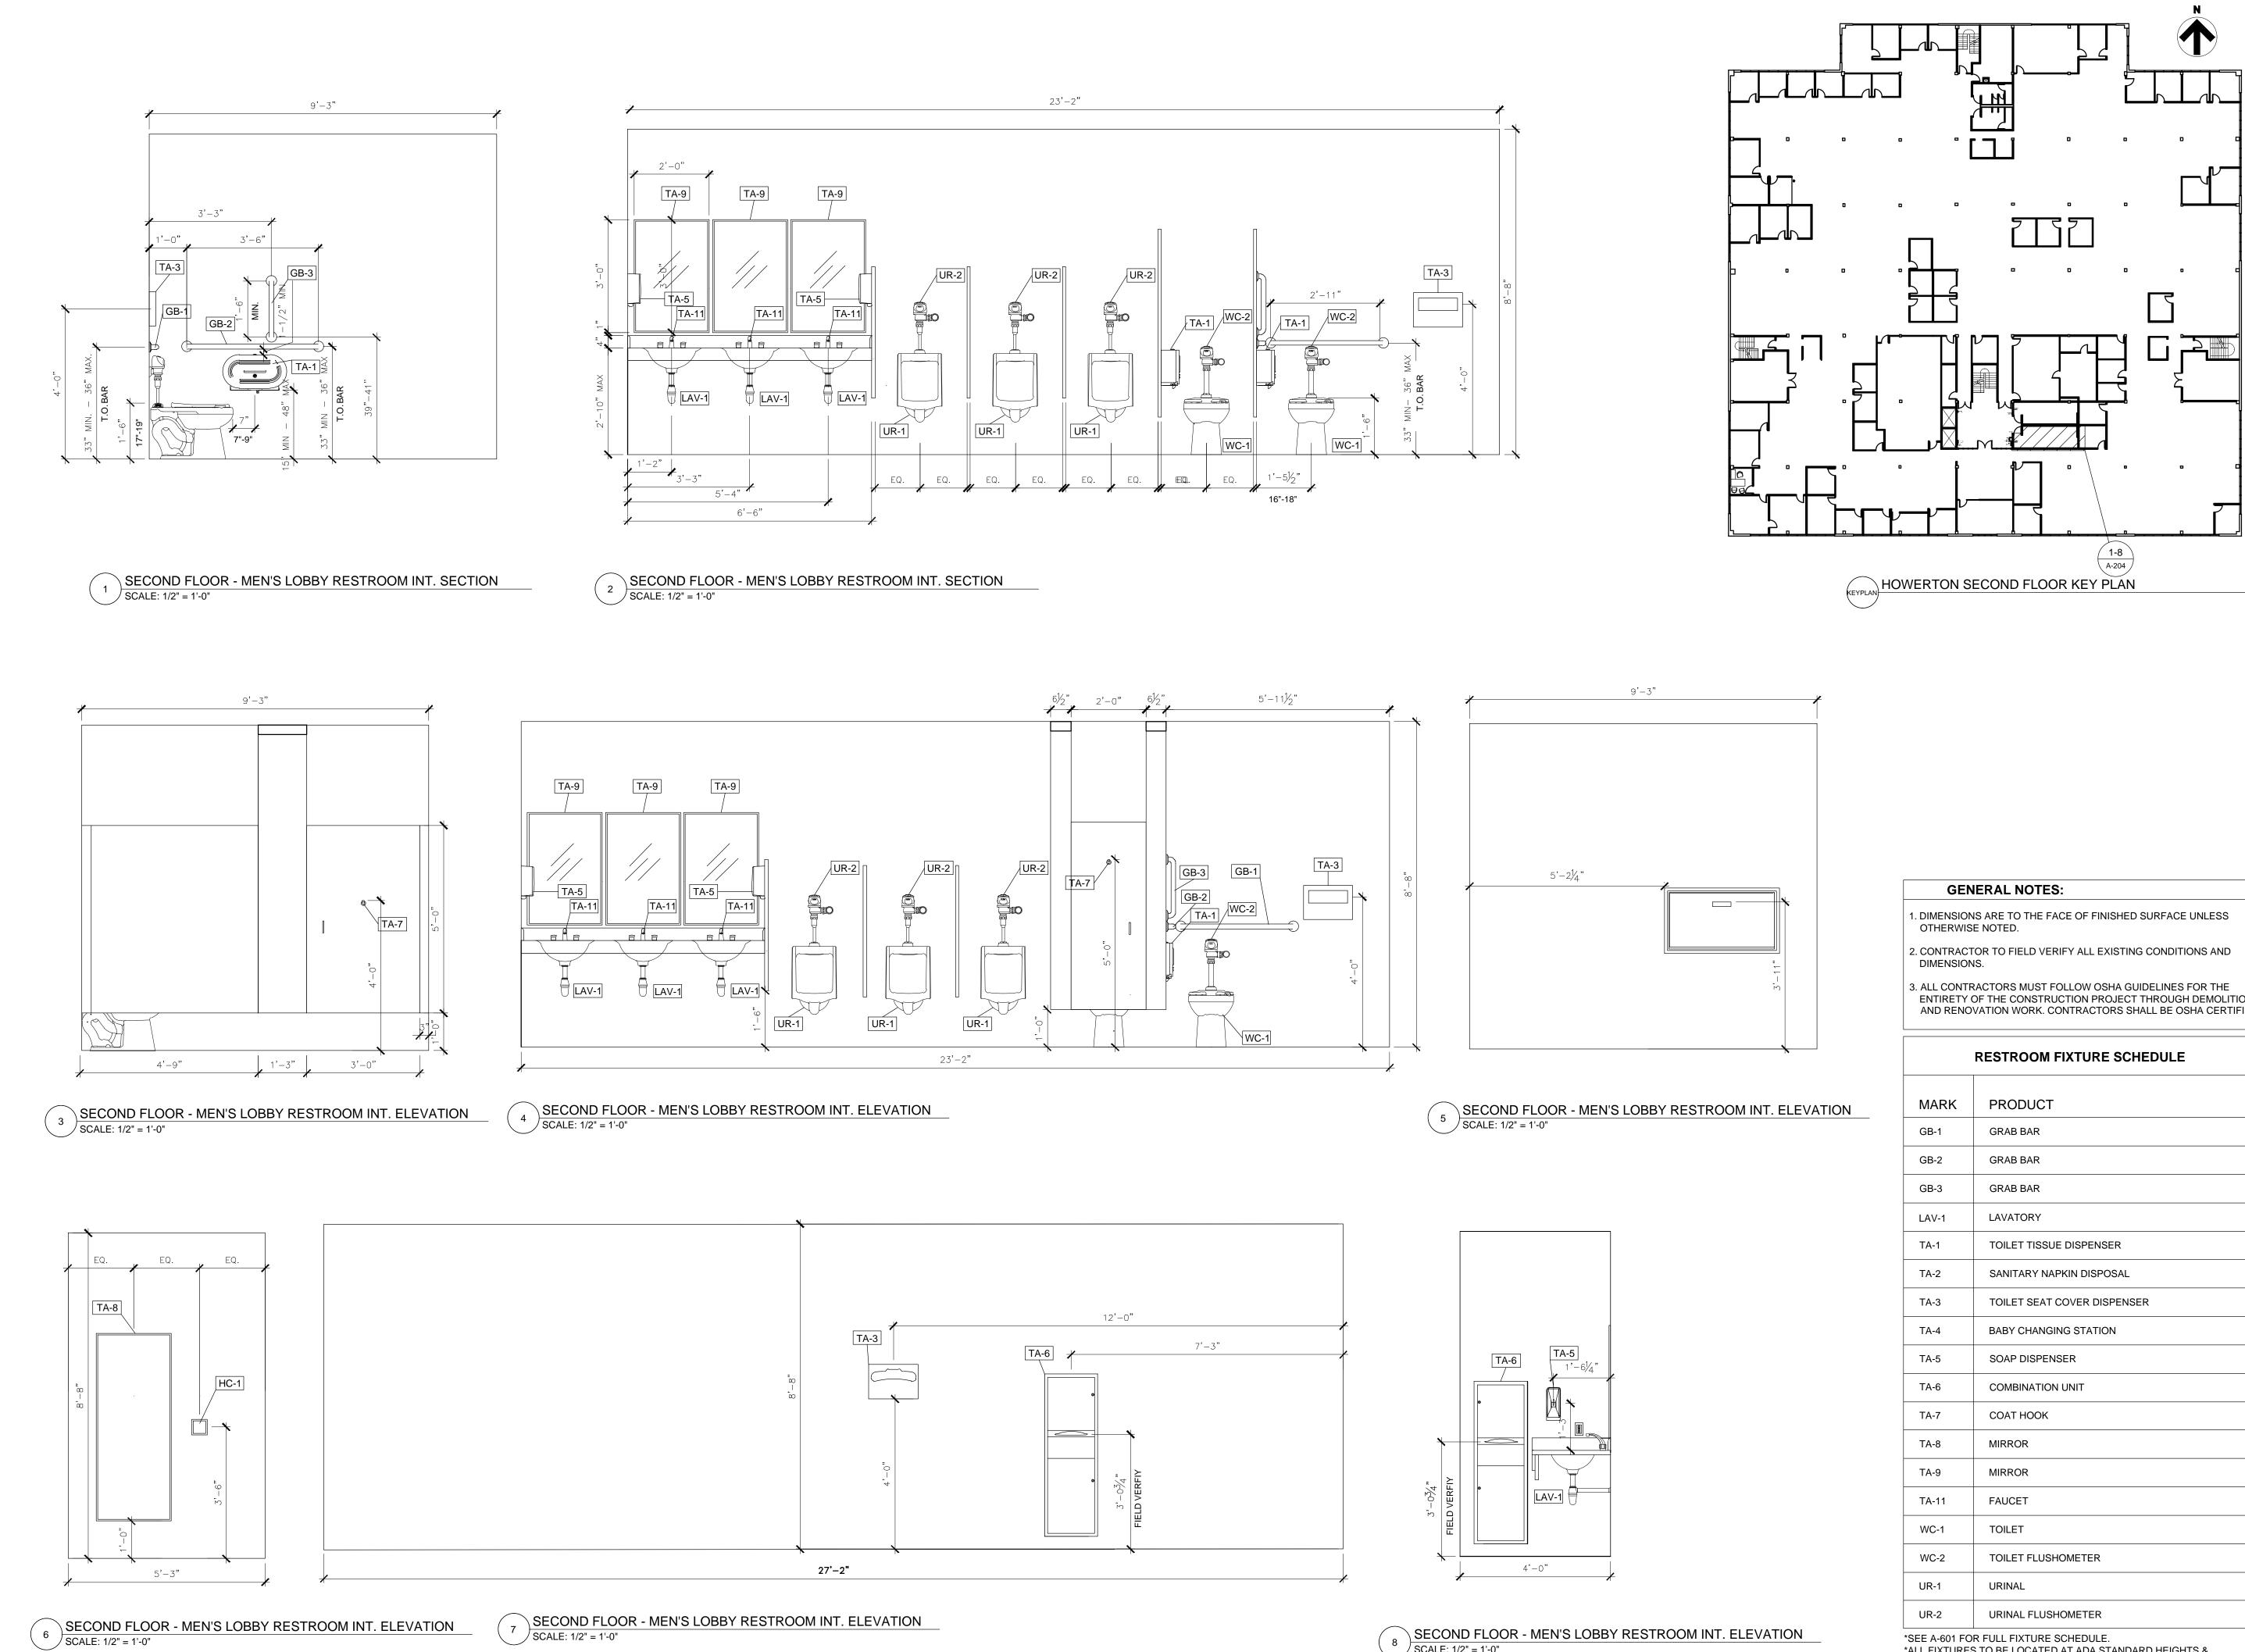
FIRST FL. MEN'S LOBBY RESTROOM ELEVATIONS

SHEET NUMBER:





SETBACKS.

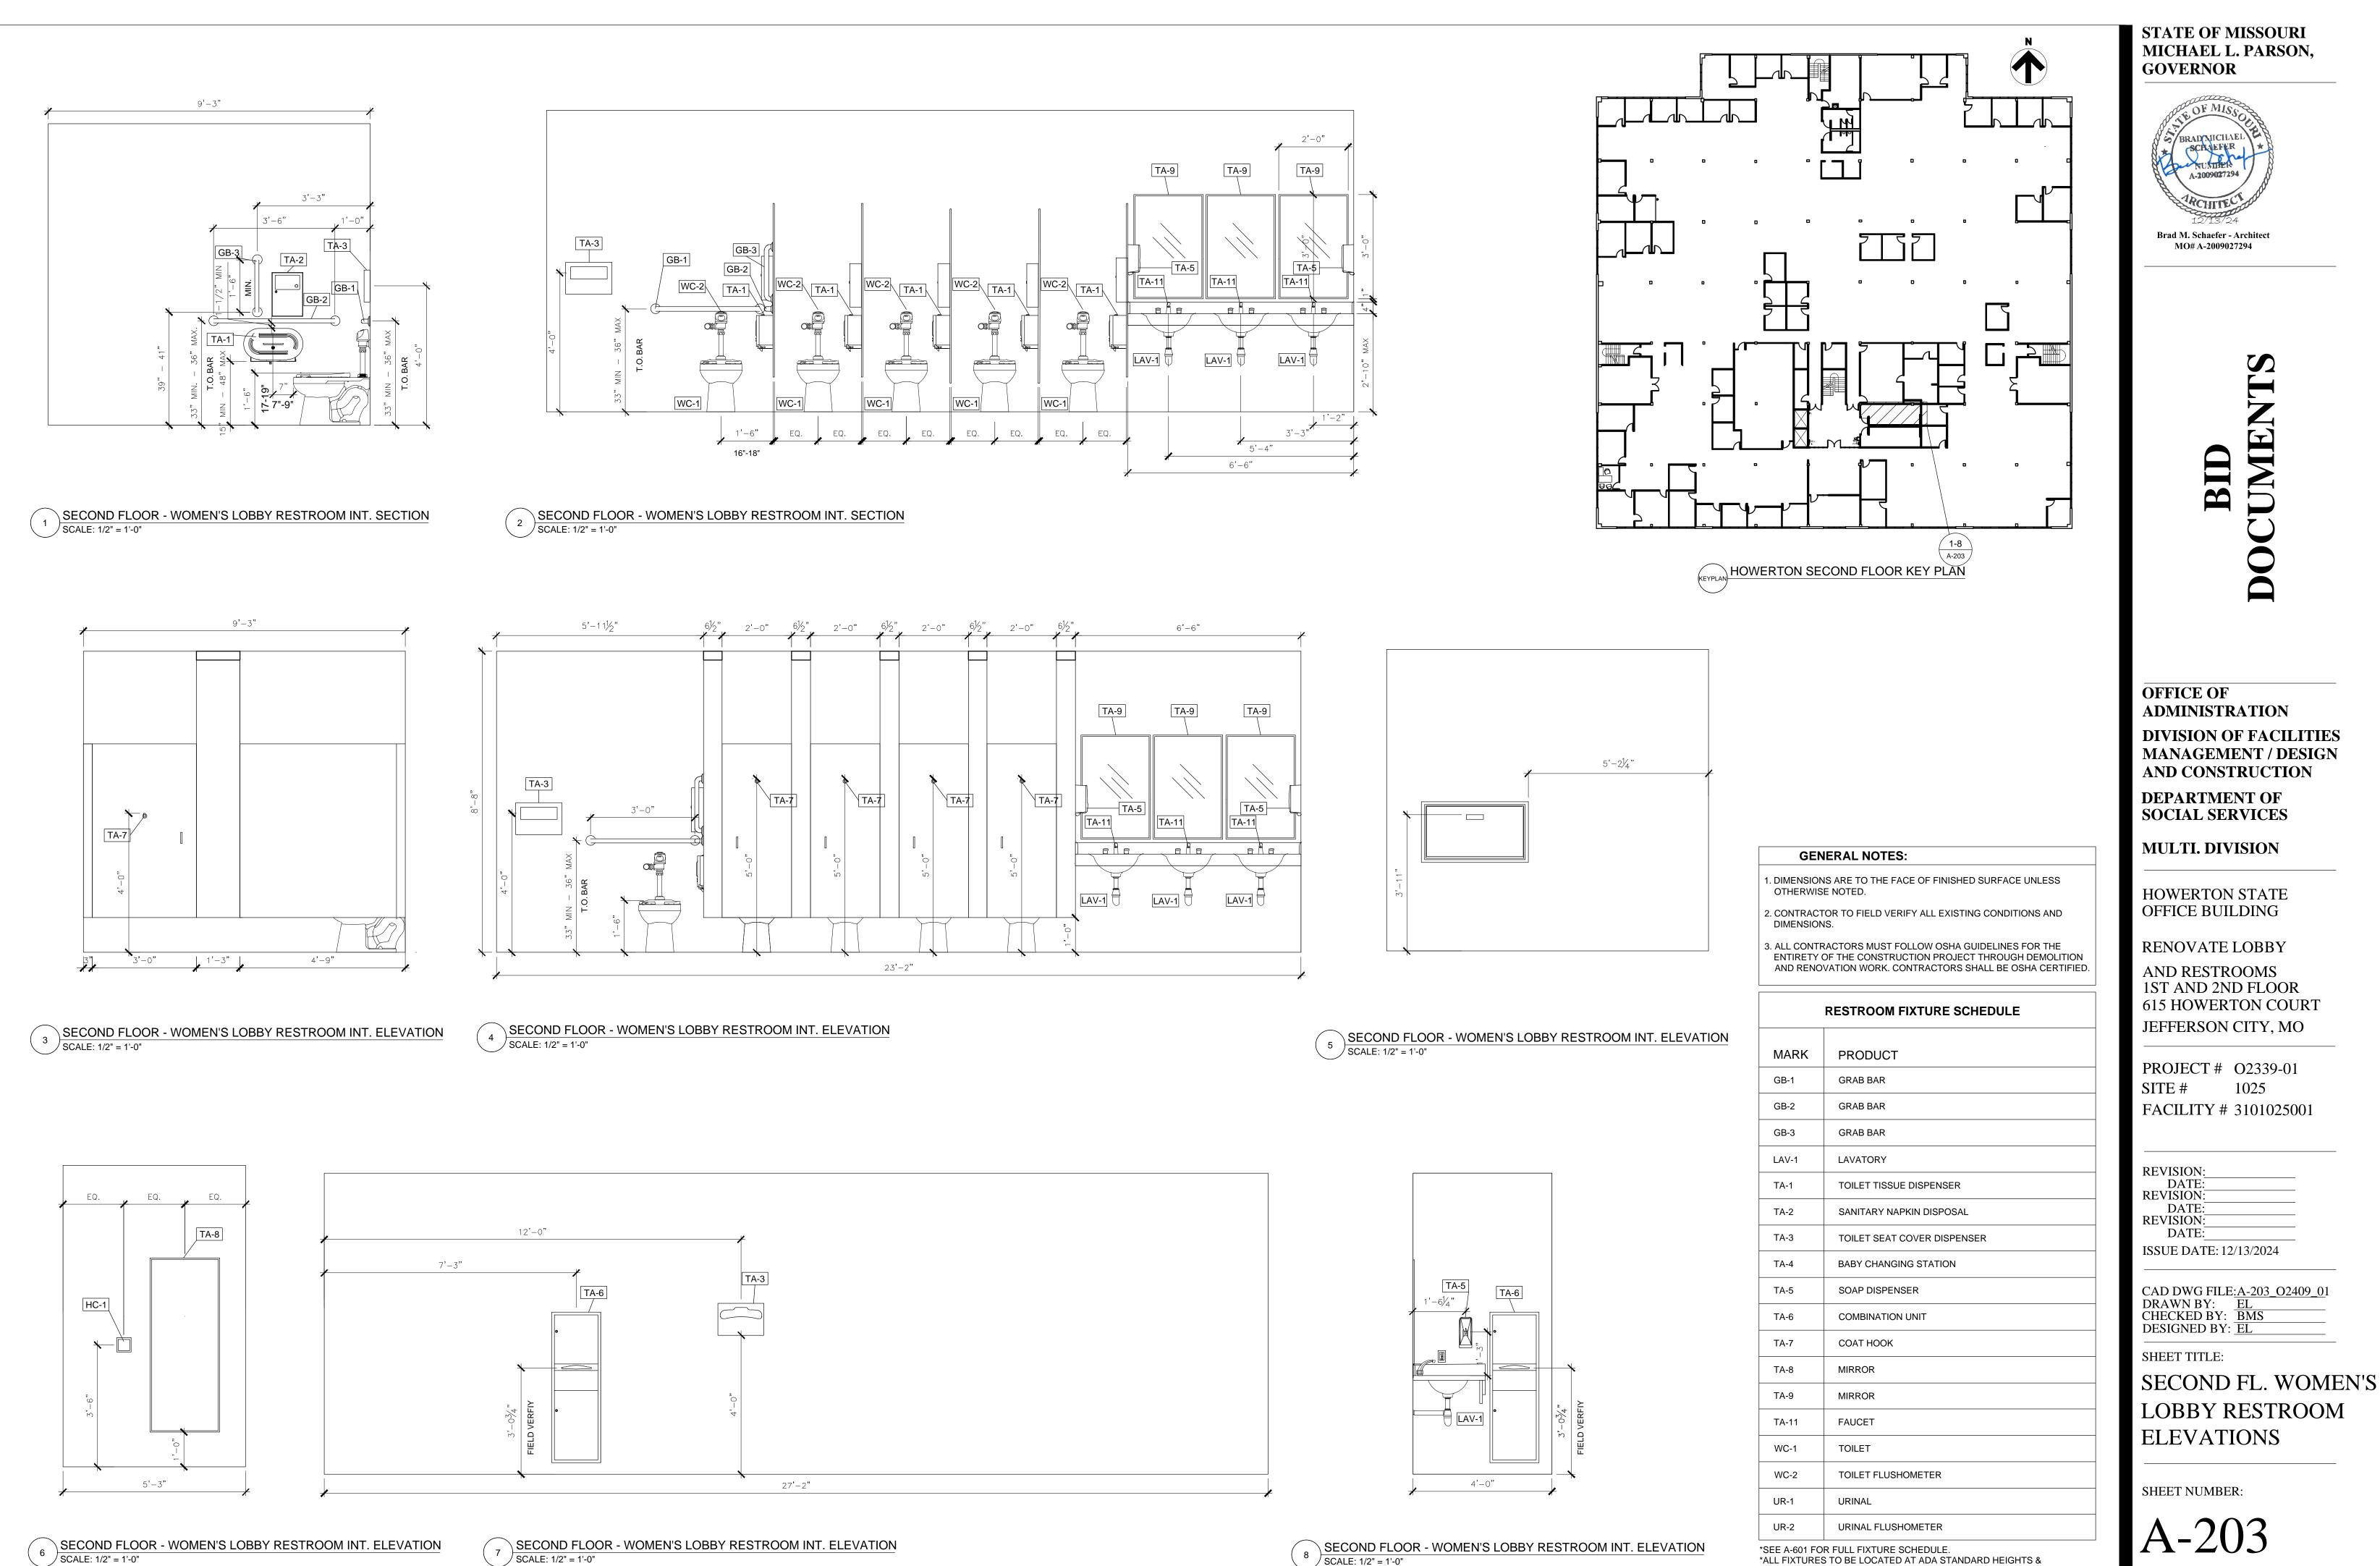

SECOND FLOOR - MEN'S LOBBY RESTROOM INT. ELEVATION 8 SCALE: 1/2" = 1'-0"

ENTIRETY OF THE CONSTRUCTION PROJECT THROUGH DEMOLITION AND RENOVATION WORK. CONTRACTORS SHALL BE OSHA CERTIFIED.


MARK	PRODUCT
GB-1	GRAB BAR
GB-2	GRAB BAR
GB-3	GRAB BAR
LAV-1	LAVATORY
TA-1	TOILET TISSUE DISPENSER
TA-2	SANITARY NAPKIN DISPOSAL
TA-3	TOILET SEAT COVER DISPENSER
TA-4	BABY CHANGING STATION
TA-5	SOAP DISPENSER
TA-6	COMBINATION UNIT
TA-7	СОАТ НООК
TA-8	MIRROR
TA-9	MIRROR
TA-11	FAUCET
WC-1	TOILET
WC-2	TOILET FLUSHOMETER
UR-1	URINAL
UR-2	URINAL FLUSHOMETER

*SEE A-601 FOR FULL FIXTURE SCHEDULE. *ALL FIXTURES TO BE LOCATED AT ADA STANDARD HEIGHTS & SETBACKS.


MICHAEL L. PARSON, GOVERNORImage: Schere Brack Schere Brac
BBD DOCUMENTS
OFFICE OF ADMINISTRATION DIVISION OF FACILITIES MANAGEMENT / DESIGN AND CONSTRUCTION DEPARTMENT OF SOCIAL SERVICES MULTI. DIVISION HOWERTON STATE OFFICE BUILDING RENOVATE LOBBY AND RESTROOMS IST AND 2ND FLOOR 615 HOWERTON COURT JEFFERSON CITY, MO
REVISION: DATE: SUE DATE: 12/13/2024 CAD DWG FILE: A-204_02409_01 DRAWN BY: DRAWN BY: EL CHECKED BY: BMS DESIGNED BY: EL SHEET TITLE: SECOND FL. MEN'S LOBBY RESTROOMS ELEVATIONS SHEET NUMBER:
A-204

12 OF 38 SHEETS


STATE OF MISSOURI

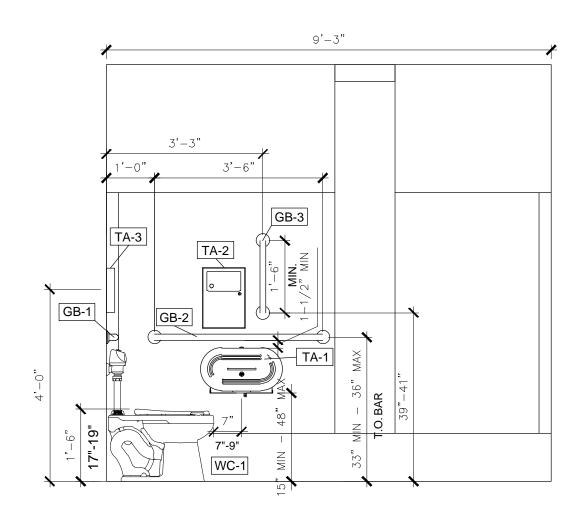




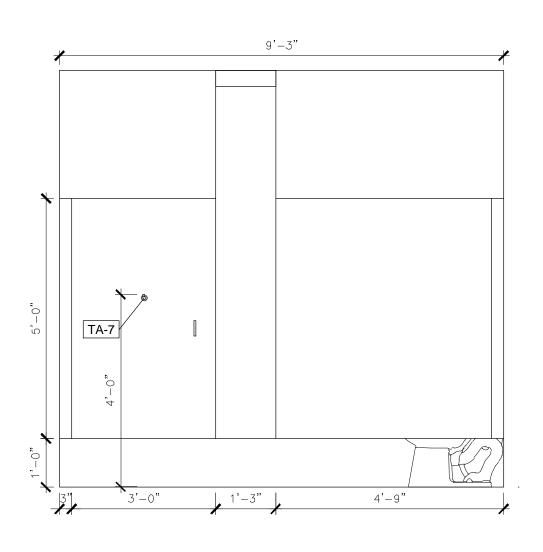


3 FIRST FLOOR - WOMEN'S STAFF RESTROOM INT. ELEVATION SCALE: 1/2" = 1'-0"

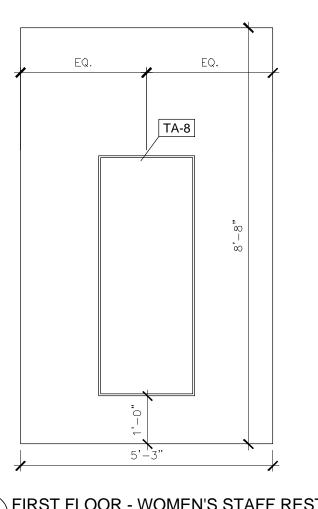


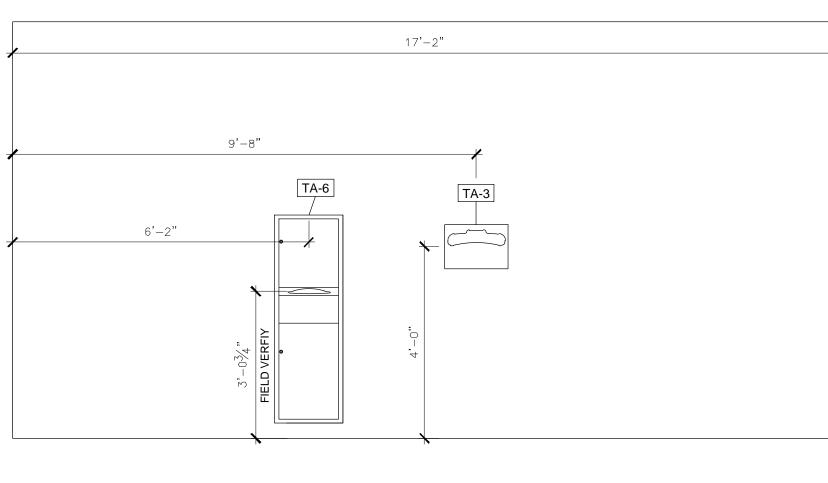

5 FIRST FLOOR - WOMEN'S STAFF RESTROOM INT. ELEVATION SCALE: 1/4" = 1'-0"

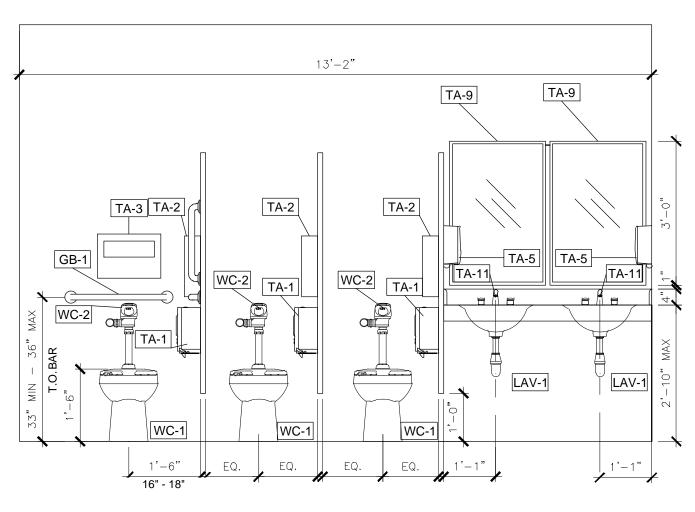


2 FIRST FLOOR - WOMEN'S STAFF RESTROOM INT. SECTION SCALE: 1/2" = 1'-0"

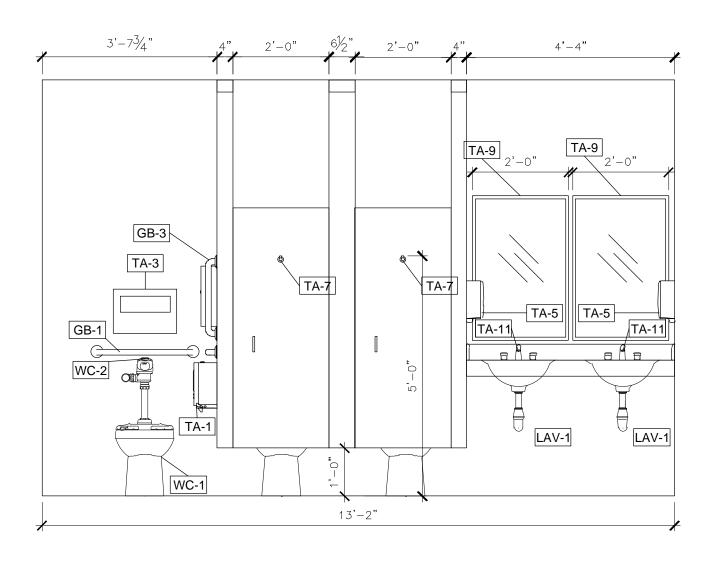


4 FIRST FLOOR - WOMEN'S STAFF RESTROOM INT. ELEVATION SCALE: 1/2" = 1'-0"



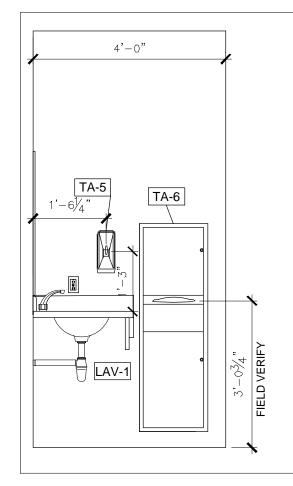

7 FIRST FLOOR - WOMEN'S STAFF RESTROOM INT. ELEVATION SCALE: 1/4" = 1'-0"

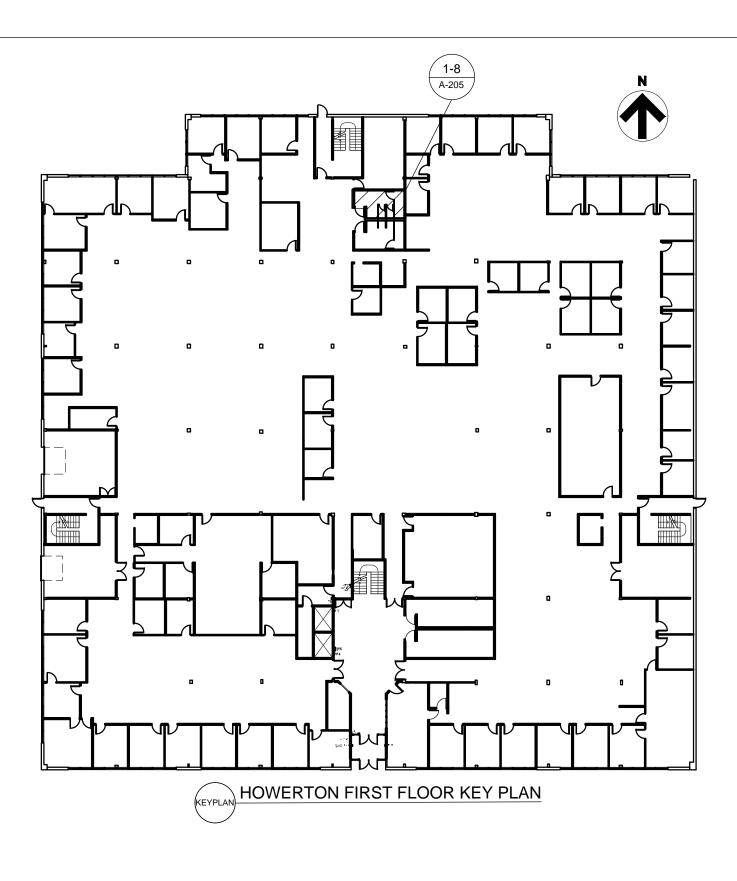

GENERAL NOTES:

1. DIMENSIONS ARE TO THE FACE OF FINISHED SURFACE UNLESS OTHERWISE NOTED.


2. CONTRACTOR TO FIELD VERIFY ALL EXISTING CONDITIONS AND DIMENSIONS.

3. ALL CONTRACTORS MUST FOLLOW OSHA GUIDELINES FOR THE ENTIRETY OF THE CONSTRUCTION PROJECT THROUGH DEMOLITION AND RENOVATION WORK. CONTRACTORS SHALL BE OSHA CERTIFIED.


RESTROOM FIXTURE SCHEDULE	
MARK	PRODUCT
GB-1	GRAB BAR
GB-2	GRAB BAR
GB-3	GRAB BAR
LAV-1	LAVATORY
TA-1	TOILET TISSUE DISPENSER
TA-2	SANITARY NAPKIN DISPOSAL
TA-3	TOILET SEAT COVER DISPENSER
TA-4	BABY CHANGING STATION
TA-5	SOAP DISPENSER
TA-6	COMBINATION UNIT
TA-7	COAT HOOK
TA-8	MIRROR
TA-9	MIRROR
TA-11	FAUCET
WC-1	TOILET
WC-2	TOILET FLUSHOMETER
UR-1	URINAL
UR-2	URINAL FLUSHOMETER
*SEE A-601 FOR FULL FIXTURE SCHEDULE.	

*SEE A-601 FOR FULL FIXTURE SCHEDULE. *ALL FIXTURES TO BE LOCATED AT ADA STANDARD HEIGHTS & SETBACKS.


STATE OF MISSOURI MICHAEL L. PARSON, GOVERNOR
BRADINICHAEL BRADINICHAEL NUMBER A-2009027294 A-2009027294 Brad M. Schaefer - Architect MO# A-2009027294
BID DOCUMENTS
OFFICE OF ADMINISTRATION DIVISION OF FACILITIES MANAGEMENT / DESIGN AND CONSTRUCTION DEPARTMENT OF SOCIAL SERVICES MULTI. DIVISION
HOWERTON STATE OFFICE BUILDING RENOVATE LOBBY AND RESTROOMS 1ST AND 2ND FLOOR 615 HOWERTON COURT JEFFERSON CITY, MO
PROJECT # 02339-01 SITE # 1025 FACILITY # 3101025001
REVISION: DATE: REVISION: DATE: DATE: REVISION: DATE: ISSUE DATE: 12/13/2024
CAD DWG FILE: <u>A-205_02409_01</u> DRAWN BY: <u>EL</u> CHECKED BY: <u>BMS</u> DESIGNED BY: <u>EL</u> SHEET TITLE: FIRST FL. WOMEN'S STAFF RESTROOM ELEVATIONS
SHEET NUMBER: $A-205$

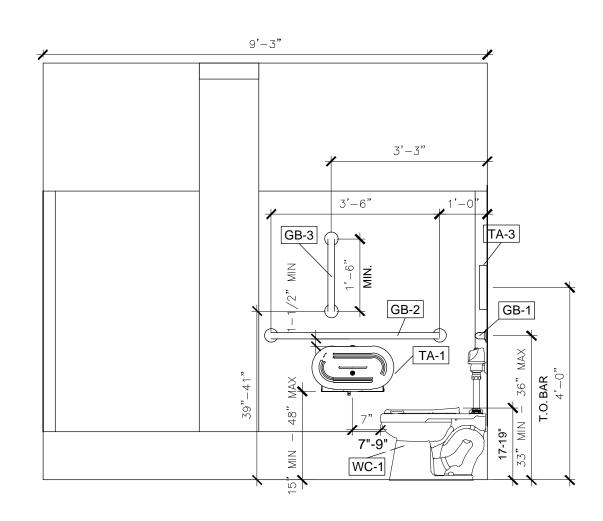




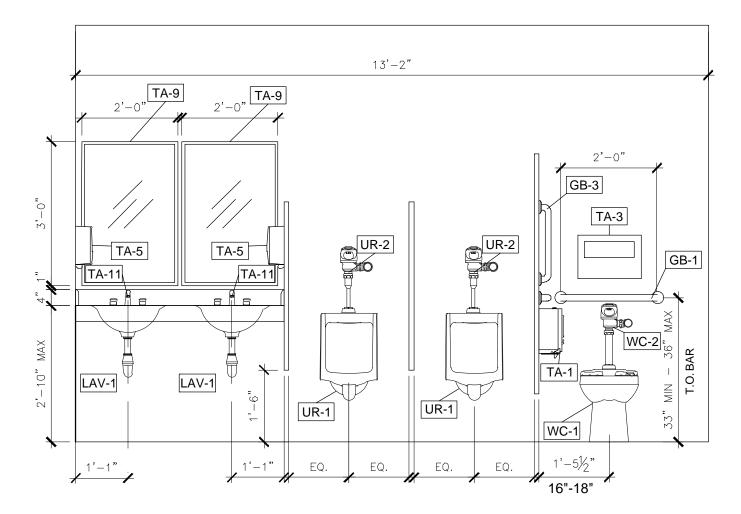


2 FIRST FLOOR - MEN'S STAFF RESTROOM INT. SECTION SCALE: 1/2" = 1'-0"

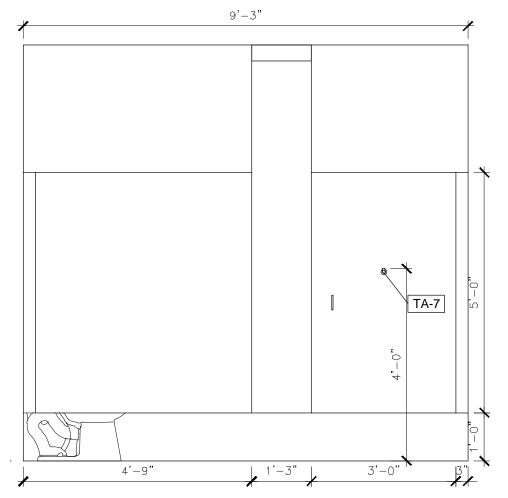




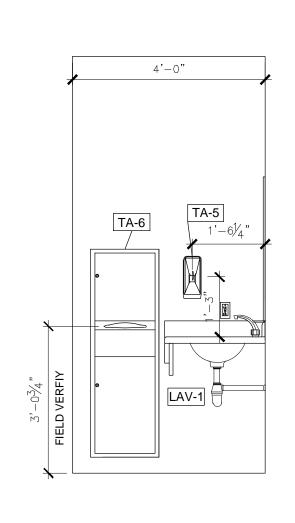




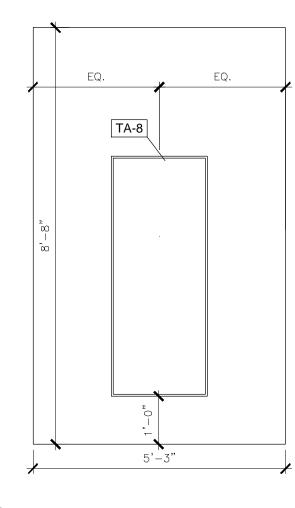




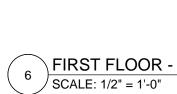

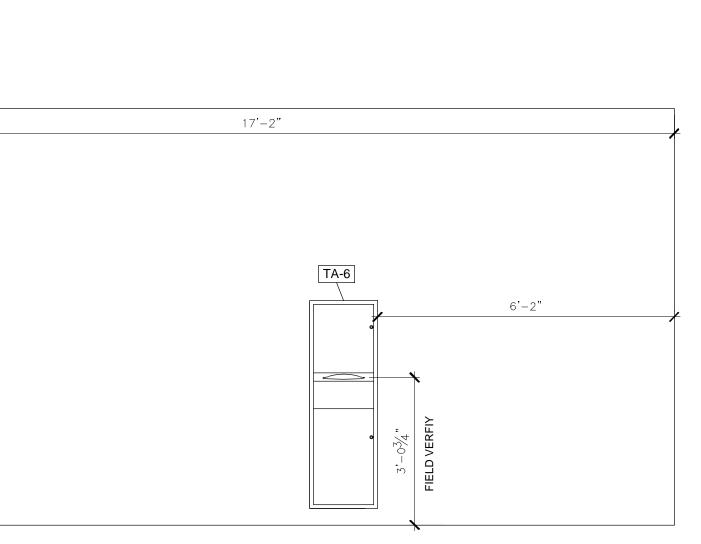

6 FIRST FLOOR - MEN'S STAFF RESTROOM INT. ELEVATION SCALE: 1/2" = 1'-0"

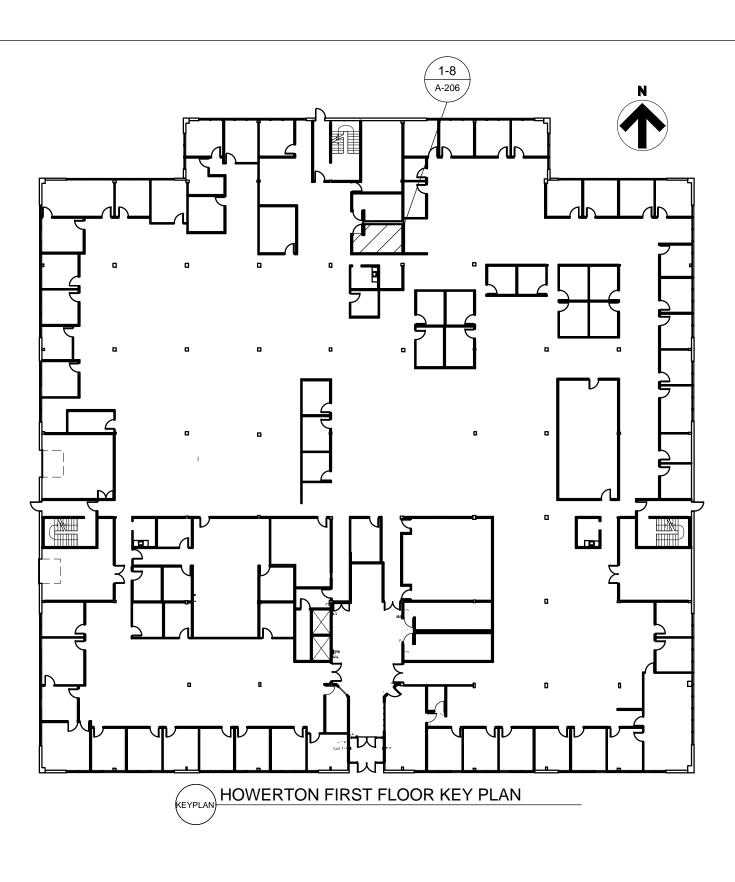

GENERAL NOTES:

1. DIMENSIONS ARE TO THE FACE OF FINISHED SURFACE UNLESS OTHERWISE NOTED.


2. CONTRACTOR TO FIELD VERIFY ALL EXISTING CONDITIONS AND DIMENSIONS.


3. ALL CONTRACTORS MUST FOLLOW OSHA GUIDELINES FOR THE ENTIRETY OF THE CONSTRUCTION PROJECT THROUGH DEMOLITION AND RENOVATION WORK. CONTRACTORS SHALL BE OSHA CERTIFIED.


RESTROOM FIXTURE SCHEDULE	
MARK	PRODUCT
GB-1	GRAB BAR
GB-2	GRAB BAR
GB-3	GRAB BAR
LAV-1	LAVATORY
TA-1	TOILET TISSUE DISPENSER
TA-2	SANITARY NAPKIN DISPOSAL
TA-3	TOILET SEAT COVER DISPENSER
TA-4	BABY CHANGING STATION
TA-5	SOAP DISPENSER
TA-6	COMBINATION UNIT
TA-7	СОАТ НООК
TA-8	MIRROR
TA-9	MIRROR
TA-11	FAUCET
WC-1	TOILET
WC-2	TOILET FLUSHOMETER
UR-1	URINAL
UR-2	URINAL FLUSHOMETER

*SEE A-601 FOR FULL FIXTURE SCHEDULE. *ALL FIXTURES TO BE LOCATED AT ADA STANDARD HEIGHTS & SETBACKS.


STATE OF MISSOURI MICHAEL L. PARSON, GOVERNOR
BRADMICHAEL BRADMICHAEL NUMBER A-2009027294 ACHITECTURE 12/13/24 Brad M. Schaefer - Architect MO# A-2009027294
BID DOCUMENTS
OFFICE OF ADMINISTRATION DIVISION OF FACILITIES MANAGEMENT / DESIGN AND CONSTRUCTION DEPARTMENT OF SOCIAL SERVICES MULTI. DIVISION
HOWERTON STATE OFFICE BUILDING RENOVATE LOBBY AND RESTROOMS 1ST AND 2ND FLOOR 615 HOWERTON COURT JEFFERSON CITY, MO
PROJECT # 02339-01 SITE # 1025 FACILITY # 3101025001 REVISION:
CAD DWG FILE: A-206_02409_01 DRAWN BY: EL CHECKED BY: BMS DESIGNED BY: EL SHEET TITLE: FIRST FL. MEN'S STAFF RESTROOM ELEVATIONS SHEET NUMBER:
A-206

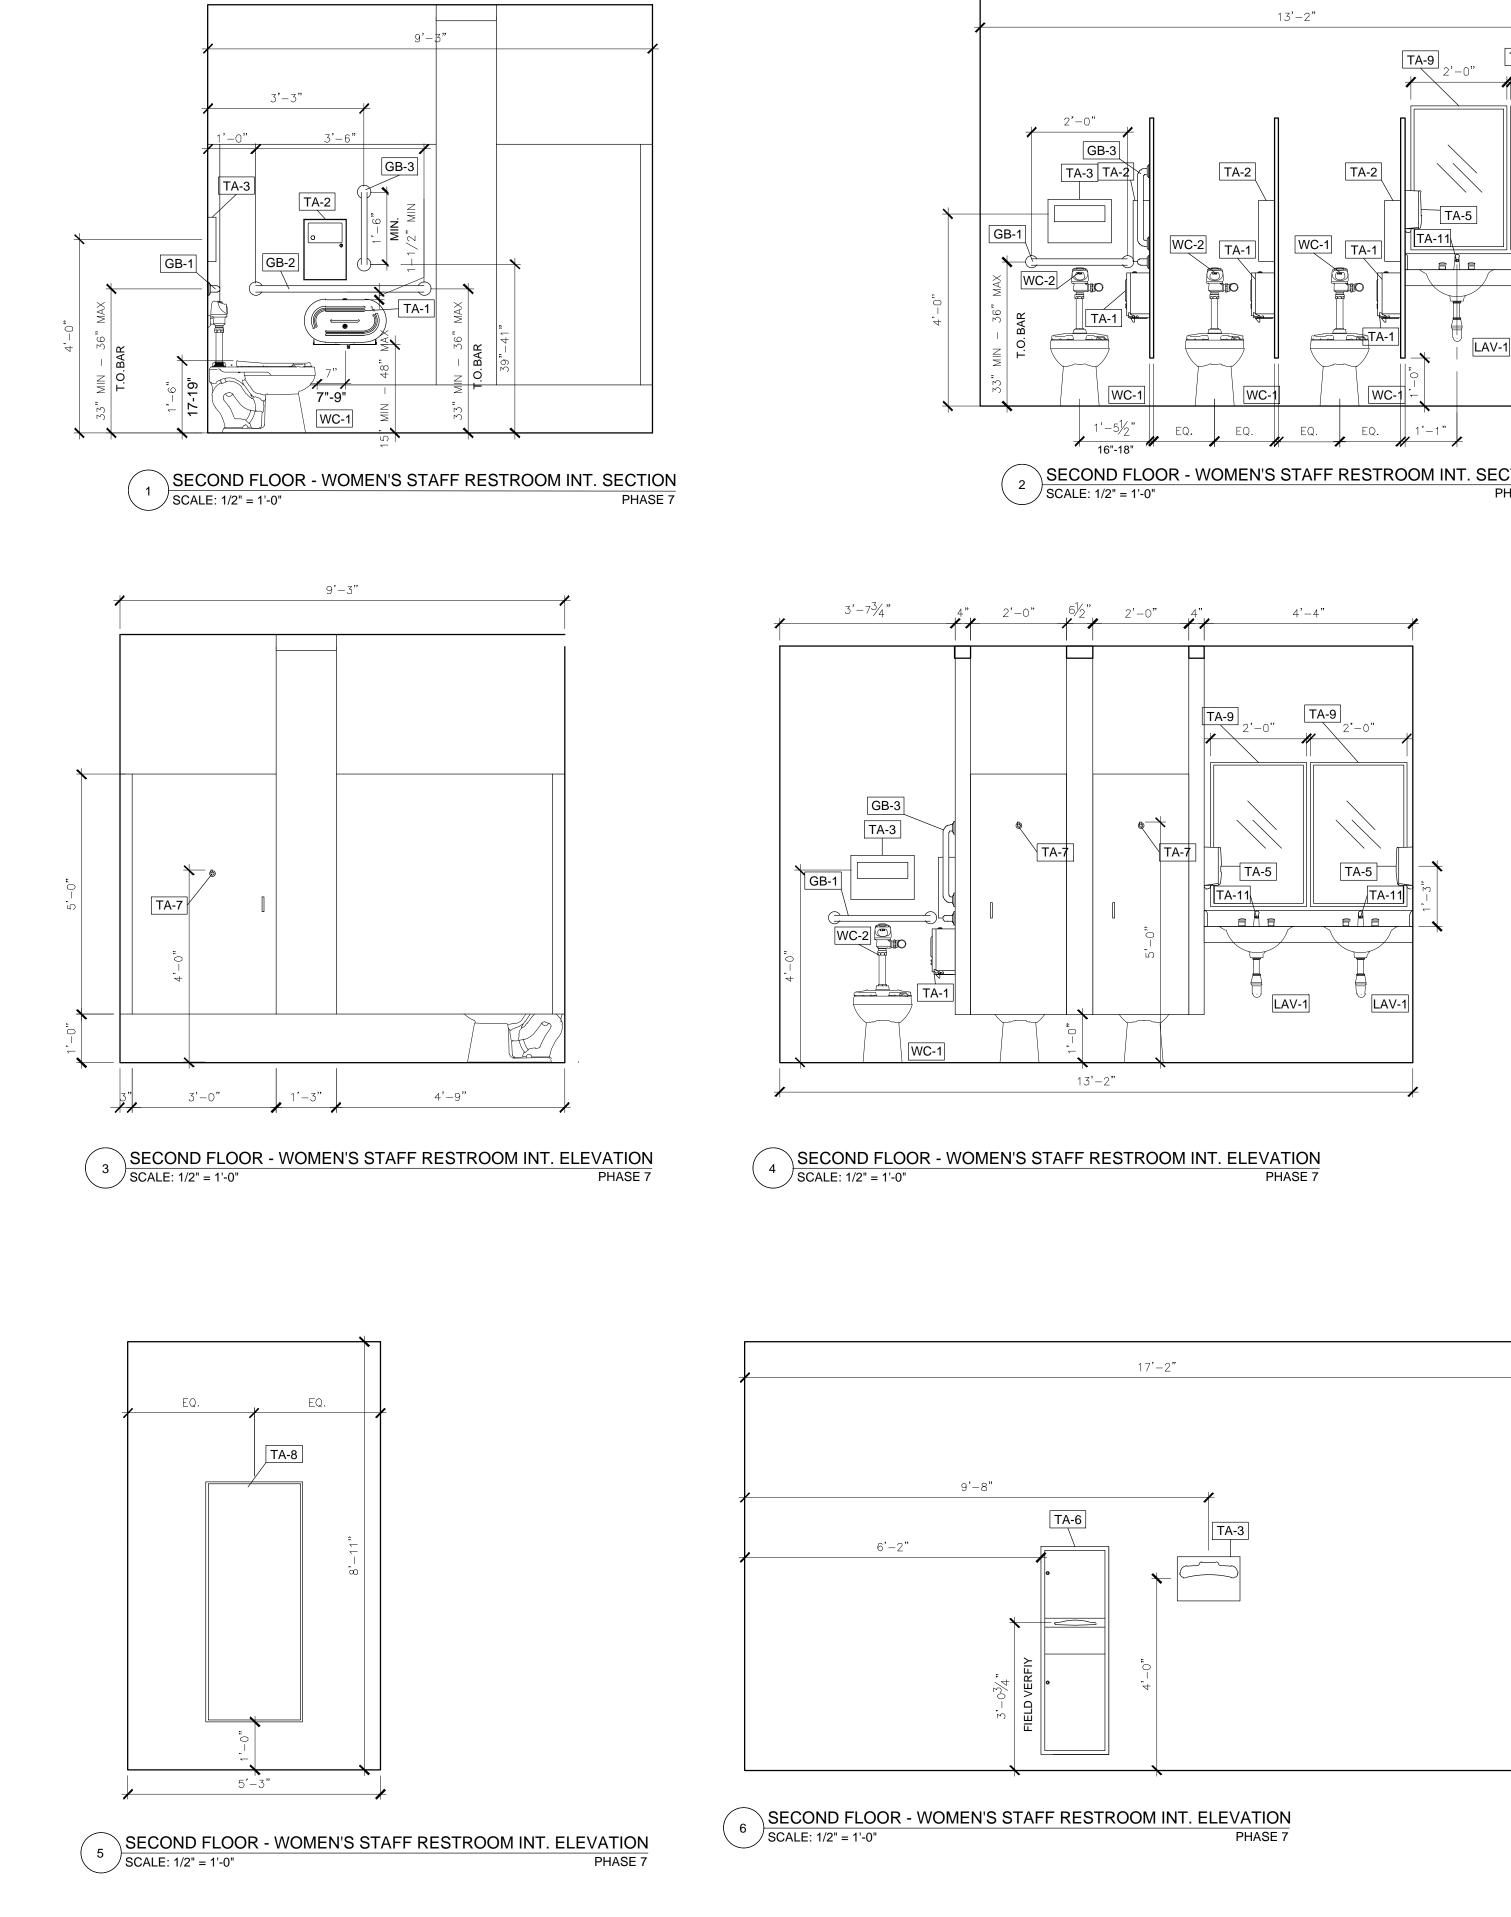

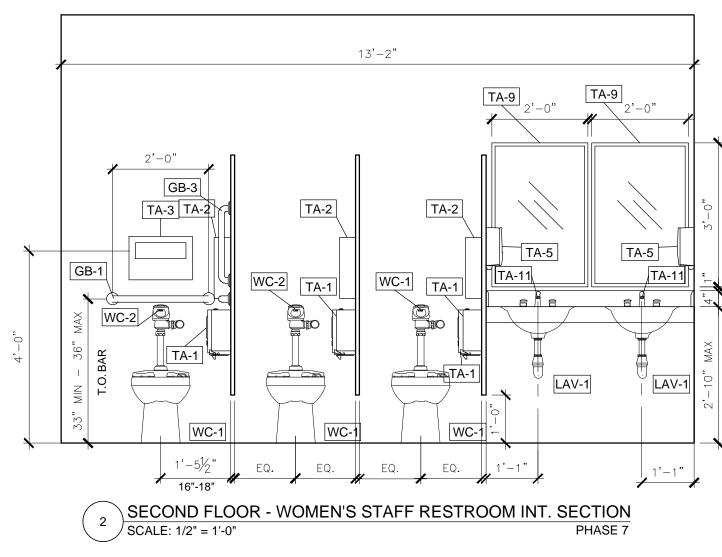

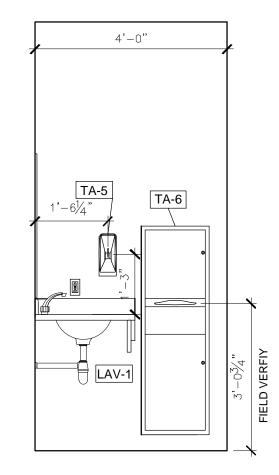

SECOND FLOOR - WOMEN'S STAFF RESTROOM INT. ELEVATION 7 SCALE: 1/2" = 1'-0"

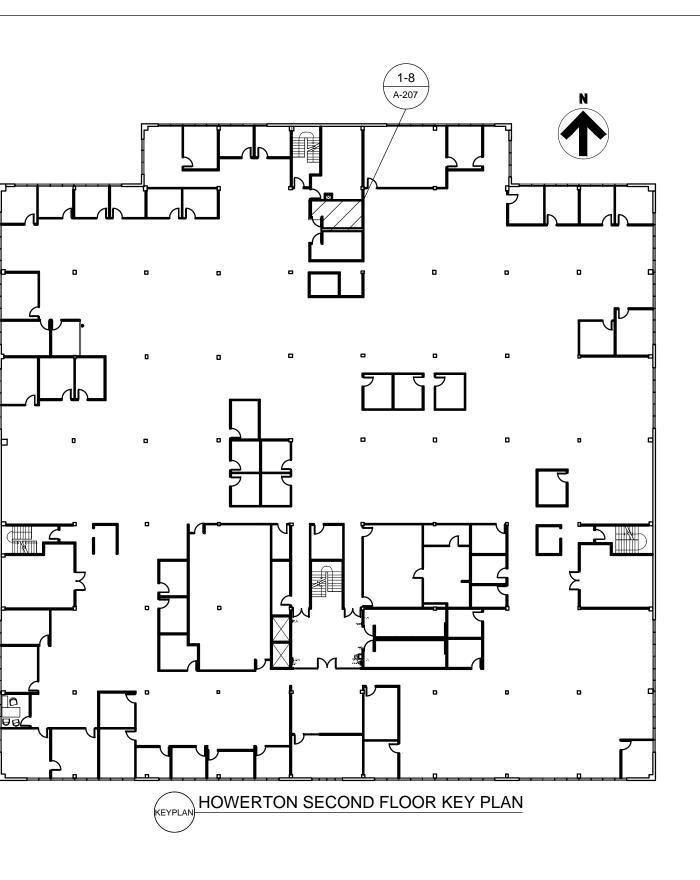

1. DIMENSIONS ARE TO THE FACE OF FINISHED SURFACE UNLESS OTHERWISE NOTED.

2. CONTRACTOR TO FIELD VERIFY ALL EXISTING CONDITIONS AND DIMENSIONS.


3. ALL CONTRACTORS MUST FOLLOW OSHA GUIDELINES FOR THE ENTIRETY OF THE CONSTRUCTION PROJECT THROUGH DEMOLITION AND RENOVATION WORK. CONTRACTORS SHALL BE OSHA CERTIFIED.

RESTROOM FIXTURE SCHEDULE	
MARK	PRODUCT
GB-1	GRAB BAR
GB-2	GRAB BAR
GB-3	GRAB BAR
LAV-1	LAVATORY
TA-1	TOILET TISSUE DISPENSER
TA-2	SANITARY NAPKIN DISPOSAL
TA-3	TOILET SEAT COVER DISPENSER
TA-4	BABY CHANGING STATION
TA-5	SOAP DISPENSER
TA-6	COMBINATION UNIT
TA-7	СОАТ НООК
TA-8	MIRROR
TA-9	MIRROR
TA-11	FAUCET
WC-1	TOILET
WC-2	TOILET FLUSHOMETER
UR-1	URINAL
UR-2	URINAL FLUSHOMETER


*SEE A-601 FOR FULL FIXTURE SCHEDULE. *ALL FIXTURES TO BE LOCATED AT ADA STANDARD HEIGHTS & SETBACKS.

STATE OF MISSOURI MICHAEL L. PARSON, GOVERNOR
BRAIDNICHAEL BRAIDNICHAEL BRAIDNICHAEL SCHAEFER A-2009027294 A-2009027294 Brad M. Schaefer - Architect MO# A-2009027294
BID DOCUMENTS
OFFICE OF ADMINISTRATION DIVISION OF FACILITIES MANAGEMENT / DESIGN AND CONSTRUCTION DEPARTMENT OF SOCIAL SERVICES MULTI. DIVISION
HOWERTON STATE OFFICE BUILDING RENOVATE LOBBY AND RESTROOMS 1ST AND 2ND FLOOR 615 HOWERTON COURT JEFFERSON CITY, MO
PROJECT # 02339-01 SITE # 1025 FACILITY # 3101025001
REVISION: DATE: DATE: ISSUE DATE: 12/13/2024 CAD DWG FILE:A-207_02409_01 DRAWN BY: EL CHECKED BY: BMS DESIGNED BY: EL SHEET TITLE:
SECOND FL. WOMEN'S STAFF RESTROOM ELEVATIONS $$ Sheet number: $A-207$


PHASE 7

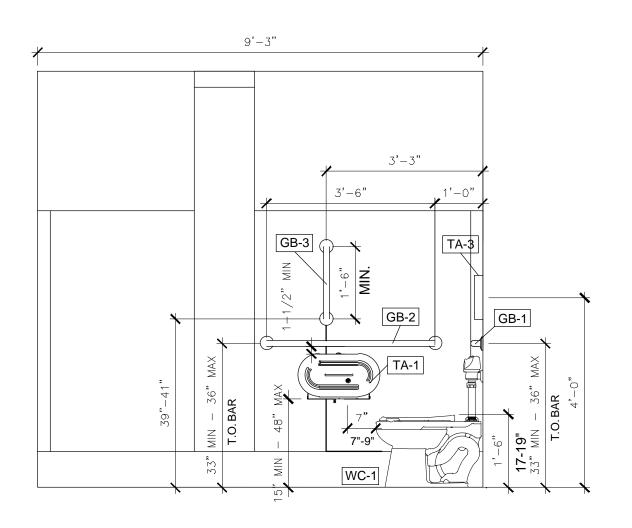


1 SECOND FLOOR - MEN'S STAFF RESTROOM INT. SECTION SCALE: 1/2" = 1'-0"

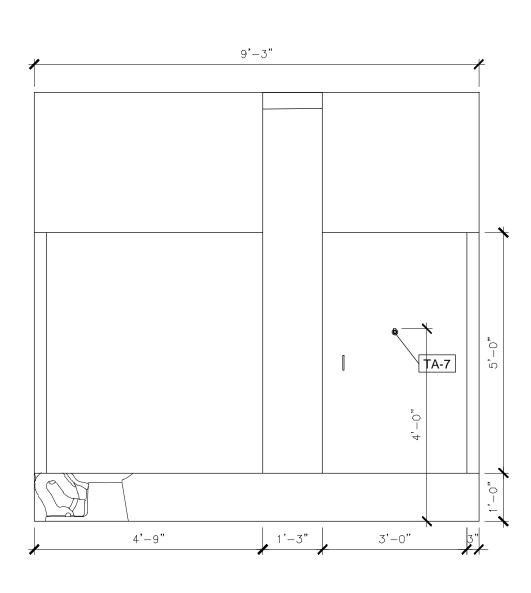


3 SECOND FLOOR - MEN'S STAFF RESTROOM INT. ELEVATION SCALE: 1/2" = 1'-0"

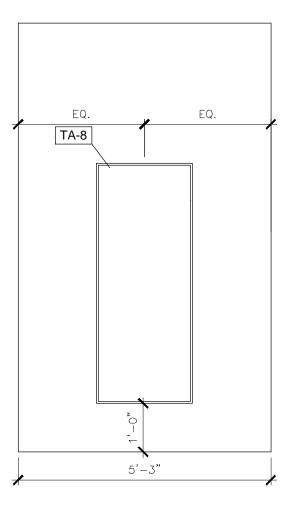


5 SECOND FLOOR - MEN'S STAFF RESTROOM INT. ELEVATION SCALE: 1/2" = 1'-0"

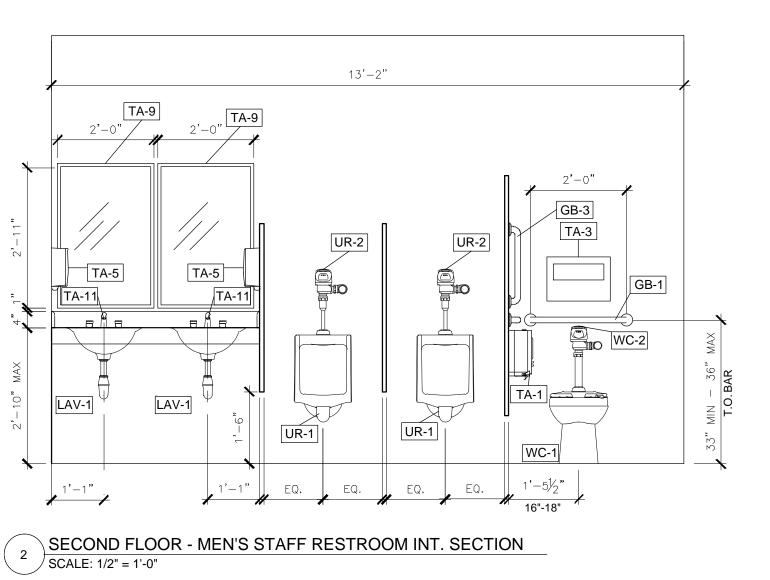


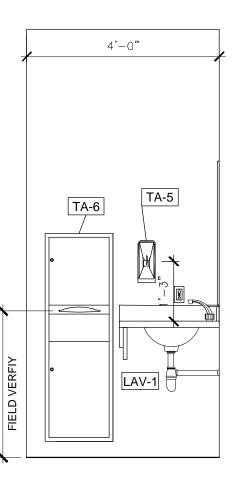

4 SECOND FLOOR - MEN'S STAFF RESTROOM INT. ELEVATION SCALE: 1/2" = 1'-0"

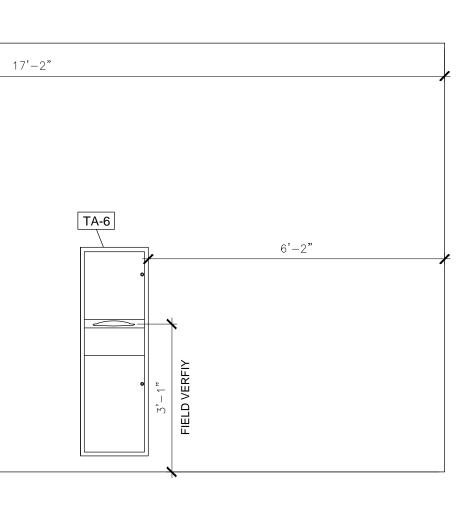

5 SECOND FLOOR - MEN'S STAFF RESTROOM INT. ELEVATION SCALE: 1/2" = 1'-0"

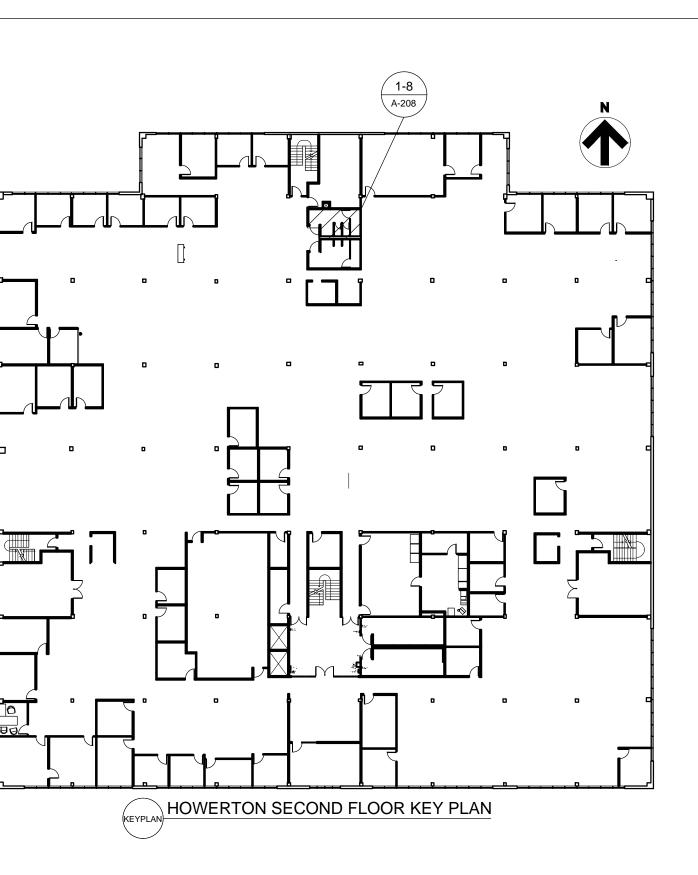

GENERAL NOTES:

1. DIMENSIONS ARE TO THE FACE OF FINISHED SURFACE UNLESS OTHERWISE NOTED.

2. CONTRACTOR TO FIELD VERIFY ALL EXISTING CONDITIONS AND DIMENSIONS.


3. ALL CONTRACTORS MUST FOLLOW OSHA GUIDELINES FOR THE ENTIRETY OF THE CONSTRUCTION PROJECT THROUGH DEMOLITION AND RENOVATION WORK. CONTRACTORS SHALL BE OSHA CERTIFIED.

	RESTROOM FIXTURE SCHEDULE	
MARK	PRODUCT	
GB-1	GRAB BAR	
GB-2	GRAB BAR	
GB-3	GRAB BAR	
LAV-1	LAVATORY	
TA-1	TOILET TISSUE DISPENSER	
TA-2	SANITARY NAPKIN DISPOSAL	
TA-3	TOILET SEAT COVER DISPENSER	
TA-4	BABY CHANGING STATION	
TA-5	SOAP DISPENSER	
TA-6	COMBINATION UNIT	
TA-7	COAT HOOK	
TA-8	MIRROR	
TA-9	MIRROR	
TA-11	FAUCET	
WC-1	TOILET	
WC-2	TOILET FLUSHOMETER	
UR-1	URINAL	
UR-2	URINAL FLUSHOMETER	


*SEE A-601 FOR FULL FIXTURE SCHEDULE. *ALL FIXTURES TO BE LOCATED AT ADA STANDARD HEIGHTS & SETBACKS.

STATE OF MISSOURI MICHAEL L. PARSON, GOVERNOR
BRADMICHAEL BRADMICHAEL SCHLEFER NUMBER A-2009027294 PCHITECTURE 12/13/24 Brad M. Schaefer - Architect MO# A-2009027294
BID DOCUMENTS
OFFICE OF ADMINISTRATION DIVISION OF FACILITIES MANAGEMENT / DESIGN AND CONSTRUCTION DEPARTMENT OF SOCIAL SERVICES MULTI. DIVISION
HOWERTON STATE OFFICE BUILDING RENOVATE LOBBY AND RESTROOMS 1ST AND 2ND FLOOR 615 HOWERTON COURT JEFFERSON CITY, MO
PROJECT # 02339-01 SITE # 1025 FACILITY # 3101025001
DATE: REVISION: DATE: DATE: ISSUE DATE: 12/13/2024 CAD DWG FILE: A-208_02409_01 DRAWN BY: EL CHECKED BY: BMS DESIGNED BY: EL
SHEET TITLE: SECOND FL. MEN'S STAFF RESTROOM ELEVATIONS
A-208


LOBBY RESTROOM DETAILS

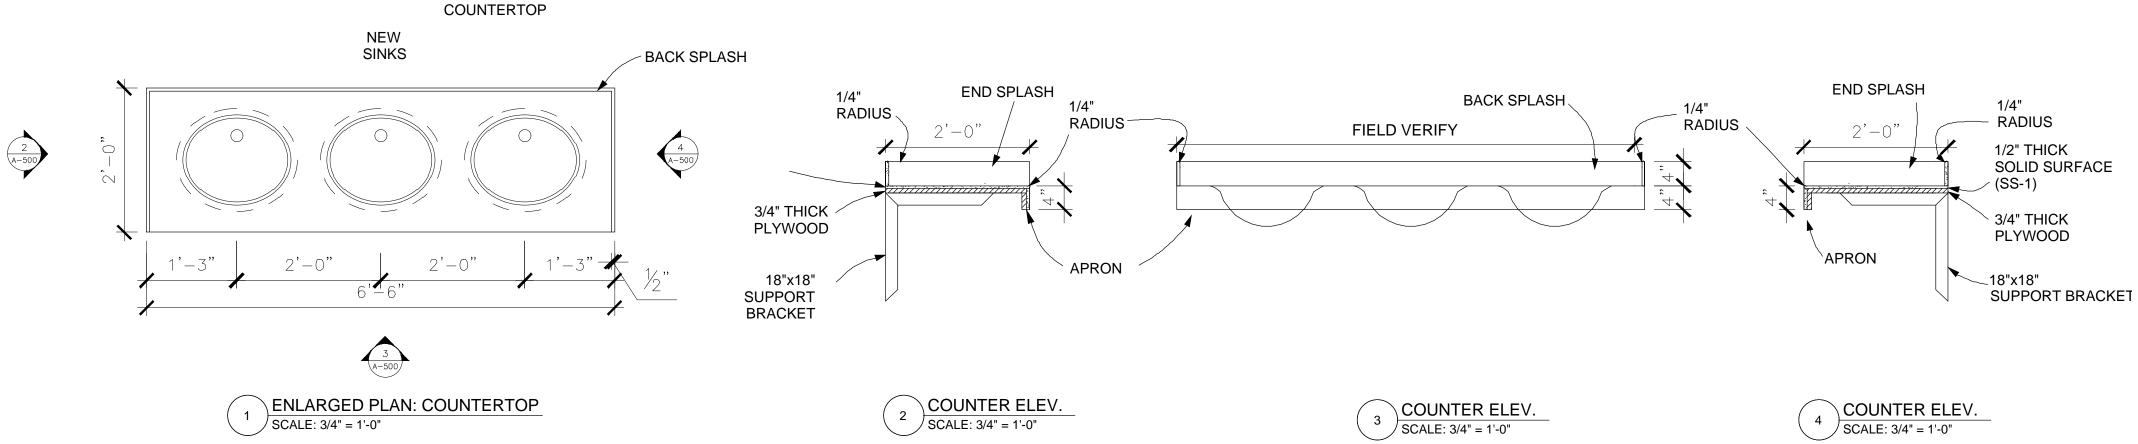

STAFF RESTROOM DETAILS

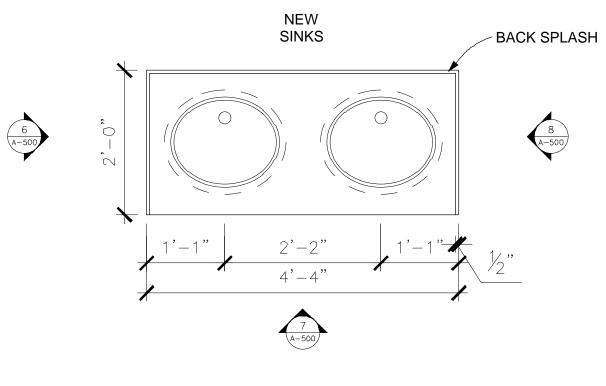

ENLARGED PLAN: COUNTERTOP / SCALE: 3/4" = 1'-0"

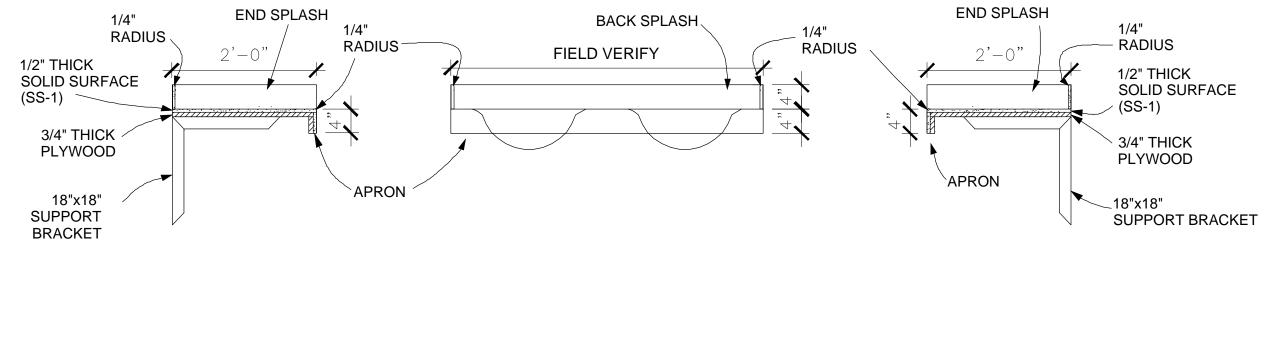

COUNTER ELEV. / SCALE: 3/4" = 1'-0"

COUNTER ELEV. / SCALE: 3/4" = 1'-0"

BID.

COUNTER ELEV. 8 SCALE: 3/4" = 1'-0"

GENERAL CONSTRUCTION NOTES:

1. ALL WORK SHALL BE PERFORMED IN A SAFE MANNER WITH PROTECTION PROVIDED TO ANY BUILDING OCCUPANTS AND WORKERS PERFORMING THE WORK. 2. ALL WORK SHALL BE DONE IN A MANNER TO MINIMIZE DAMAGE TO ADJACENT SURFACES THAT ARE NOT SHOWN TO BE WORKED ON OR REMOVED - CONTRACTOR SHALL BE RESPONSIBLE FOR ALL WORK NECESSARY TO REPAIR SURFACES AFFECTED BY THEIR WORK. 3. ANY WORK THAT RESULTS IN EXCESSIVE NOISE, DUST OR DEBRIS MUST BE COORDINATED

WITH BUILDING FACILITY STAFF AT LEAST TWO (2) WORKING DAYS IN ADVANCE. 4. ANY WORK THAT REQUIRES THE NEED TO TEMPORARILY SHUT DOWN ANY OF THE BUILDING SYSTEMS MUST BE COORDINATED WITH BUILDING FACILITY STAFF AT LEAST FOUR (4) WORKING DAYS IN ADVANCE.

5. CONTRACTOR SHALL PROVIDE NECESSARY DUST PROTECTION TO PREVENT DUST CREATED BY DEMOLITION/CONSTRUCTION ACTIVITIES TO ENTER SPACE(S) OUTSIDE THE WORK AREA, INCLUDING THROUGH THE HVAC SYSTEM. CONTRACTOR SHALL BE RESPONSIBLE TO REPLACE ANY HVAC FILTERS CONTAMINATED WITH CONSTRUCTION DEBRIS. 6. CONTRACTOR SHALL BE RESPONSIBLE TO PERFORM ANY WORK NECESSARY TO PROVIDE THE

SCOPE OF WORK SHOWN ON THE PLANS, EVEN IF NOT SPECIFICALLY NOTED OR SHOWN. 7. CONTRACTOR SHALL PERFORM WORK BETWEEN THE HOURS OF 7AM TO 5PM AFTER SIGNING IN AND RECEIVING VISITOR'S BADGE.

8. ALL MATERIALS/EQUIPMENT MAY BE DELIVERED TO THE FACILITY - FACILITY STAFF SHALL BE CONTACTED TEN (10) BUSINESS DAYS PRIOR TO DELIVERY OF MATERIALS/EQUIPMENT. CONTRACTOR SHALL BE SIGN FOR RECEIPT OF ALL MATERIALS/EQUIPMENT - FACILITY STAFF ARE NOT RESPONSIBLE FOR ACCEPTING OR SIGNING FOR DELIVERIES. 9. ALL WORK SHALL BE PERFORMED IN ACCORDANCE WITH THE LATEST EDITION OF THE IBC, IFC,

IMC, IPC, NEC AND ALL OTHER APPLICABLE ICC AND NFPA CODE FAMILIES. 10. CONTRACTOR RESPONSIBLE FOR FIELD VERIFYING AS-BUILT CONDITIONS AND PROPOSED LAYOUT PRIOR TO PERFORMING WORK. CONTRACTOR SHALL NOTIFY FMDC PROJECT

MANAGER IF THERE ARE ANY DISCREPANCIES OR CONFLICTS. 11. DETAILS OF EXISTING CONDITIONS PROVIDED AS A COURTESY. THIS INFORMATION DOES NOT RELIEVE THE CONTRACTOR FROM PERFORMING A COMPLETE NECESSARY FIELD INVESTIGATIVE WORK TO FULLY UNDERSTAND EXISTING CONDITIONS PRIOR TO SUBMITTING

12. DATA AND PHONE LINE WORK TO BE PERFORMED BY OTHERS (NIC).

13. CONTRACTOR SHALL MAINTAIN THE INTEGRITY OF ALL RATED PARTITIONS, CEILING ASSEMBLIES AND DOOR ASSEMBLIES. THE CONTRACTOR SHALL MAKE ALL NECESSARY REPAIRS WHERE ANY WORK PERFORMED BY THE CONTRACTOR AFFECTS THE INTEGRITY OF THESE ITEMS.

14. EXISTING CEILING ASSEMBLY PRESUMED TO BE ONE HOUR RATED (SINGLE LAYER OF 5/8", TYPE X OVER VAPOR BARRIER WITH R-30 BATT INSULATION IN ATTIC SPACE). CONTRACTOR SHALL MAINTAIN INTEGRITY OF RATED ASSEMBLY. 15. DIMENSIONS PROVIDED ARE MEASURED FROM EXISTING DRYWALL FACE TO NEW DRYWALL FACE UNLESS OTHERWISE NOTED.

STATE OF MISSOURI MICHAEL L. PARSON, GOVERNOR





OFFICE OF ADMINISTRATION **DIVISION OF FACILITIES** MANAGEMENT / DESIGN AND CONSTRUCTION

DEPARTMENT OF SOCIAL SERVICES

MULTI. DIVISION

HOWERTON STATE OFFICE BUILDING

RENOVATE LOBBY

AND RESTROOMS 1ST AND 2ND FLOOR 615 HOWERTON COURT JEFFERSON CITY, MO

PROJECT # 02339-01 1025 SITE # FACILITY # 3101025001

REVISION: DATE:

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DATE:
ISSUE DATE: 12/13/24


CAD DWG FILE:A-500_02409_01 DRAWN BY: CHECKED BY: BMS DESIGNED BY: EL

SHEET TITLE:

RESTROOM DETAILS

SHEET NUMBER:

A-500 17 OF 38 SHEETS

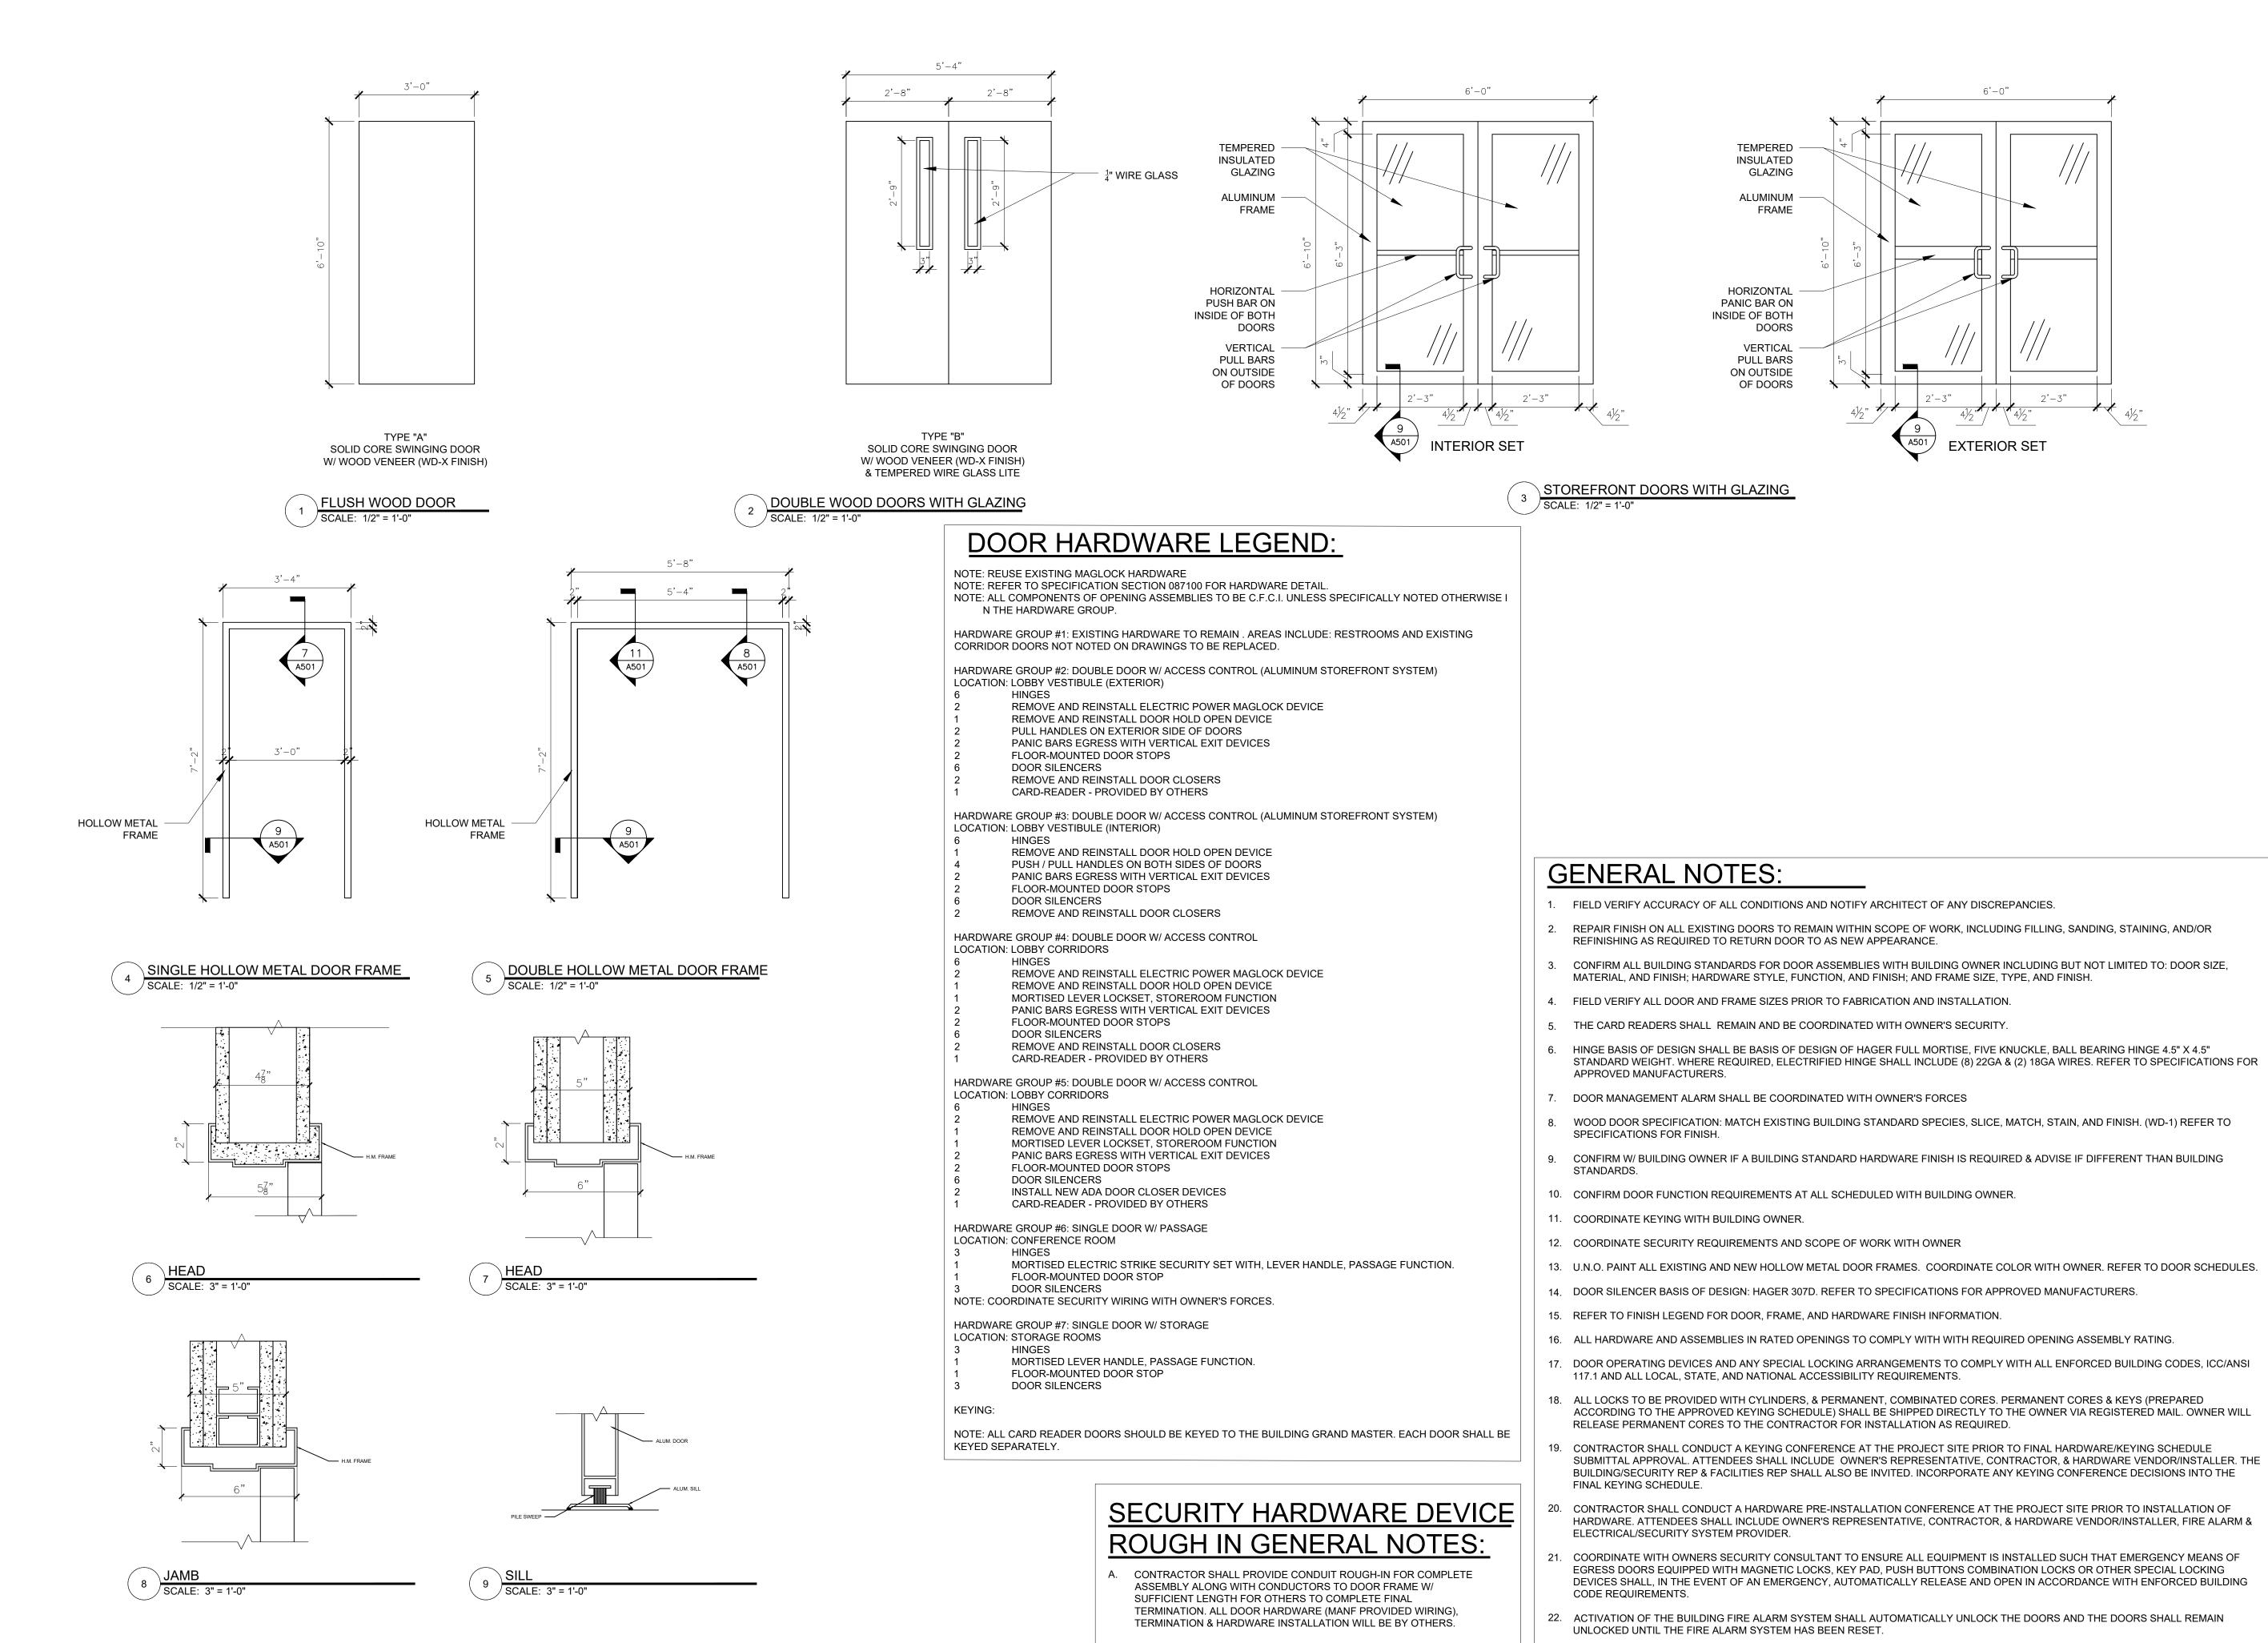

- ON PROJECTS WITH EXITING DOOR ASSEMBLIES, SOME COMPONENTS OF SECURITY DOOR HARDWARE MAY REMAIN. COORDINATE W/ ARCHITECT & SECURITY VENDOR.
- REMAIN UNLOCKED UNTIL THE FIRE ALARM SYSTEM HAS BEEN RESET.

23. ACTIVATION OF THE BUILDING AUTOMATIC SPRINKLER SYSTEM SHALL AUTOMATICALLY UNLOCK THE DOORS AND THE DOORS SHALL

SHEET NUMBER

18 OF 38 SHEETS

DETAILS

DESIGNED BY: SHEET TITLE: DOOR

CAD DWG FILE:A-501 O2409 DRAWN BY: CHECKED BY: BMS

DATE DATE **REVISION:** DATE: ISSUE DATE: 12/13/24

REVISION: REVISION:

0001 FACILITY # 3101025001

SITE #

JEFFERSON CITY, MO PROJECT # 02339-01

RENOVATE LOBBY AND RESTROOMS 1ST AND 2ND FLOOR 615 HOWERTON COURT

OFFICE BUILDING

HOWERTON STATE

MULTI. DIVISION

DIVISION OF FACILITIES MANAGEMENT / DESIGN AND CONSTRUCTION **DEPARTMENT OF** SOCIAL SERVICES

ADMINISTRATION


OFFICE OF



STATE OF MISSOURI MICHAEL L. PARSON, **GOVERNOR** BRADMICHAI SCHAEFER 4.2009027

Brad M. Schaefer - Architect

MO# A-2009027294

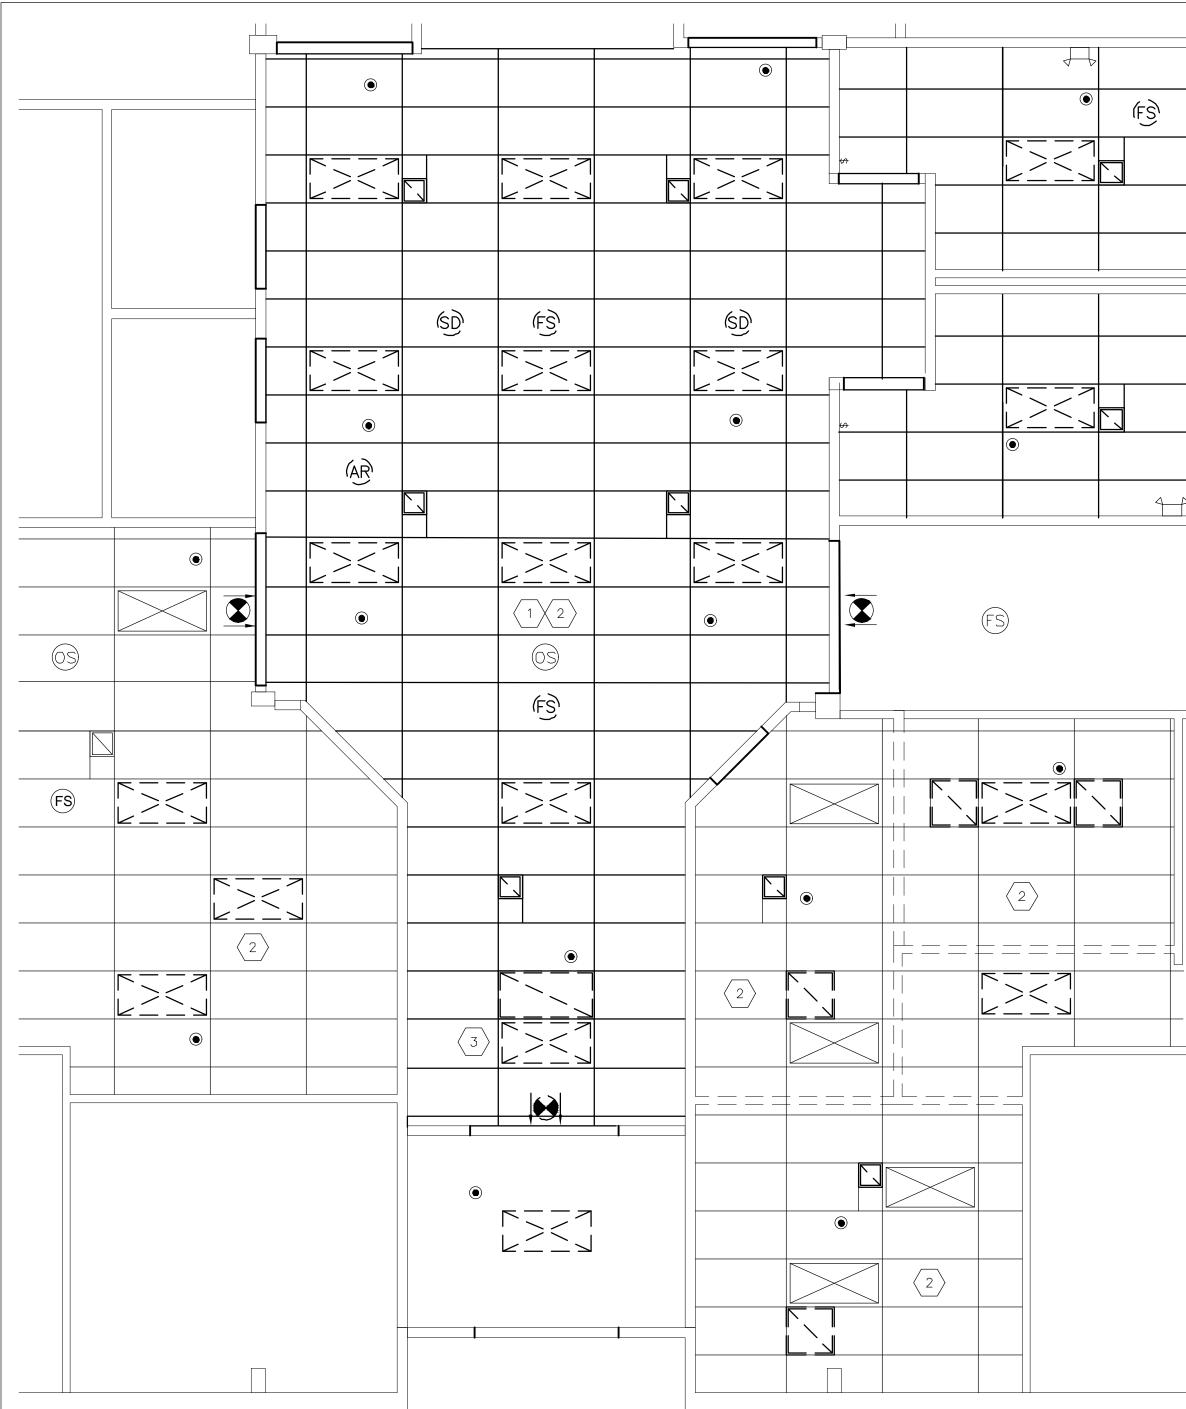

\uparrow FIRST FLOOR LOBBY & RESTROOM DEMOLITION REFLECTED CEILING PLAN / SCALE: 1/4" = 1'-0"

LEGEND	
	PENDENT FIRE SPRINKLER HEAD/ESCUTCHEON
	DIRECTIONAL EXIT SIGN
	WALL MOUNTED EMERGENCY LIGHT TO REMAIN
\$	WALL SWITCH
FS	FIRE ALARM STROBE
SD	SMOKE DETECTOR
OS	OCCUPANCY SENSOR
AR	AREA OF REFUGE SIGN
	LIGHT FIXTURE
	HVAC RETURN/SUPPLY


GENERAL NOTES:


- START OF EACH PHASE.
- CONTRACTOR.

- HOWERTON BUILDING.

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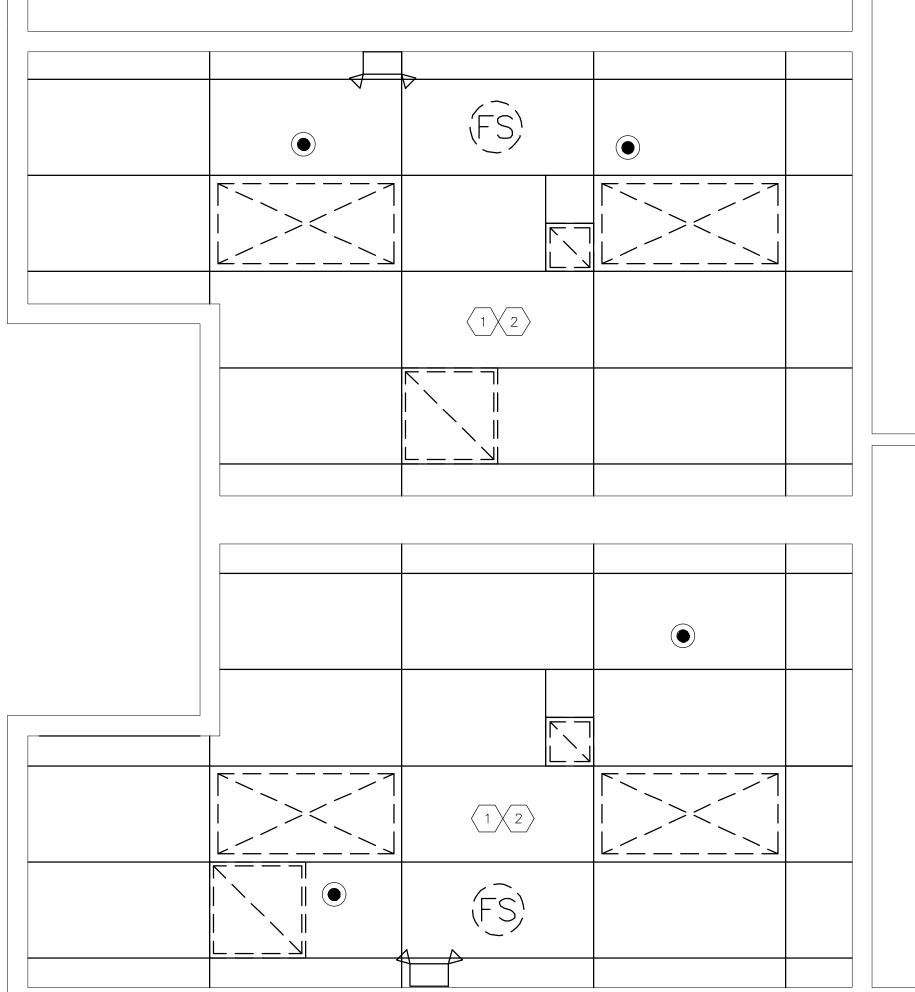



11. TECHNICAL ITEMS SUCH AS BUT NOT LIMITED TO WHITEBOARDS, DIGITAL DISPLAYS AND MEDIA INSTALLATIONS ARE TO BE REMOVED AND REPLACED BY THE AGENCY AND COORDINATED WITH THE CONSTRUCTION ADMINISTRATOR.

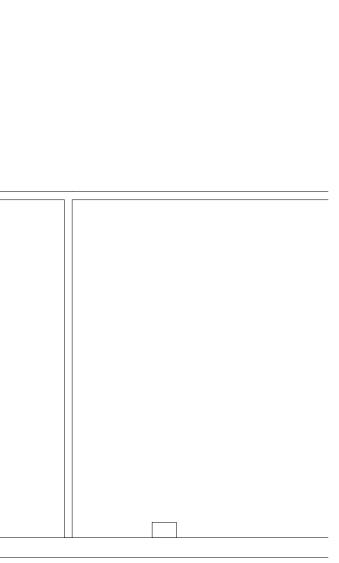


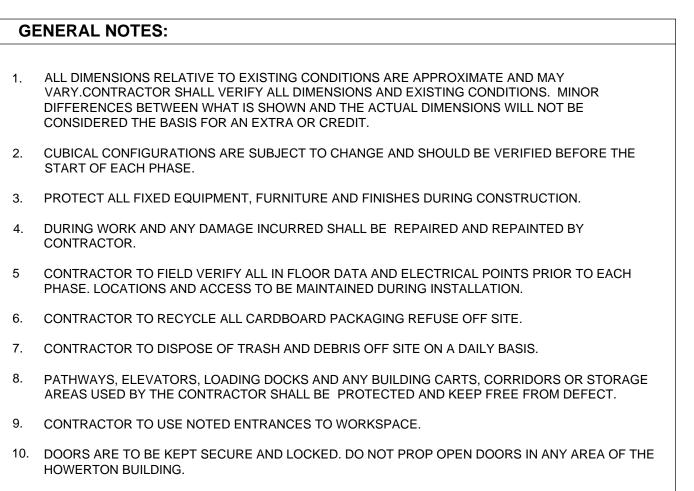REMOVE EXISTING CEILING GRID AND ACOUSTICAL TILES ONLY IN THE LOBBY AND RESTROOMS. CONTRACTOR RESPONSIBLE FOR DISPOSAL.

REFER TO SHEET D-102 FOR MECHANICAL AND ELECTRICAL DEMOLITION.



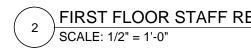

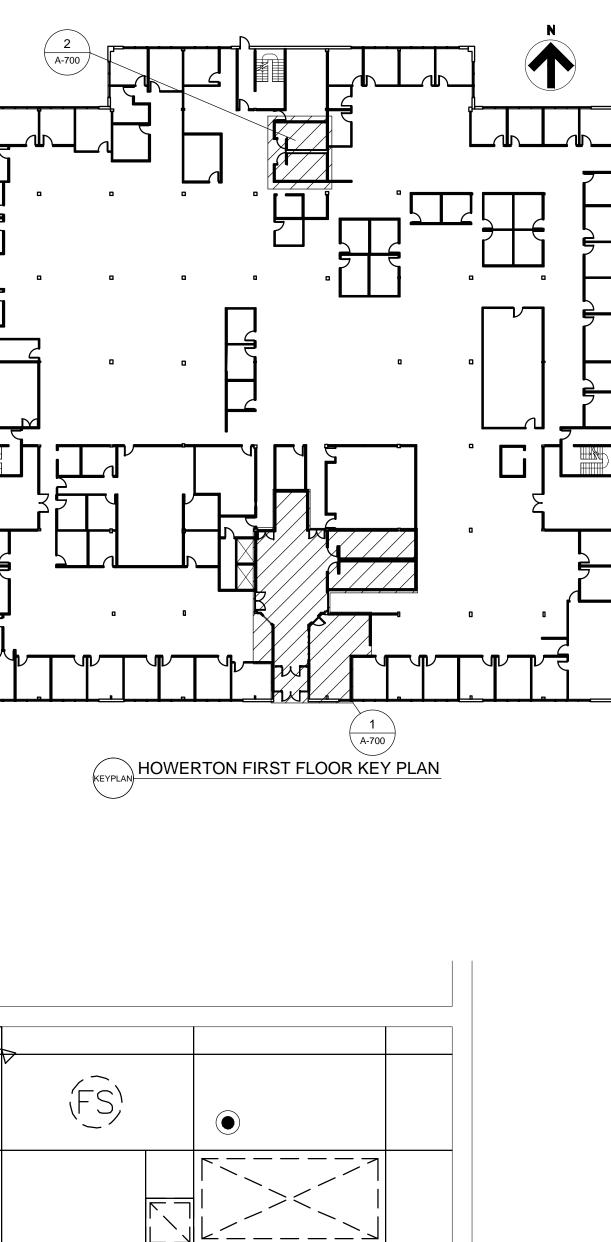

GOVERNOR
BRADINICHAEL SCRAEFER A-2009027294 ACHITECT 12/13/24 Brad M. Schaefer - Architect MO# A-2009027294
BID B
OFFICE OF ADMINISTRATION DIVISION OF FACILITIES MANAGEMENT / DESIGN AND CONSTRUCTION DEPARTMENT OF SOCIAL SERVICES MULTI. DIVISION
HOWERTON STATE OFFICE BUILDING
RENOVATE LOBBY AND RESTROOMS 1ST AND 2ND FLOOR 615 HOWERTON COURT JEFFERSON CITY, MO
PROJECT #O2339-01SITE #1025FACILITY #3101025001
REVISION: DATE: REVISION: DATE: REVISION: DATE: DATE: ISSUE DATE: 12/13/24
CAD DWG FILE:A-700_02409_01 DRAWN BY: EL CHECKED BY: BMS DESIGNED BY: EL SHEET TITLE:
FIRST FLOOR DEMOLITION RCP
SHEET NUMBER:

STATE OF MISSOURI MICHAEL L. PARSON,

A-700 19 OF 38 SHEETS

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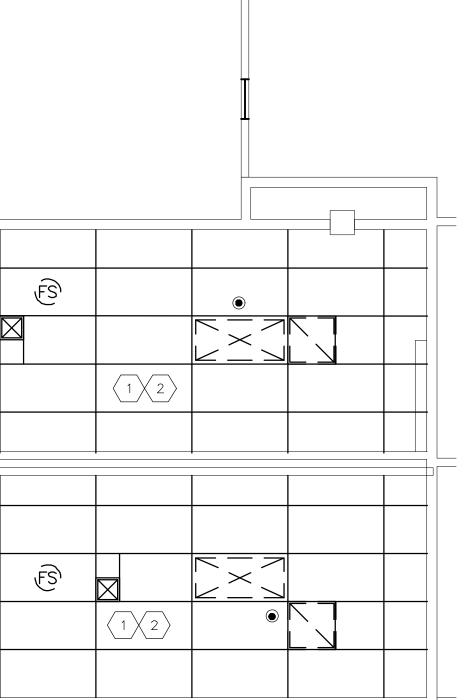
SECOND FLOOR LOBBY & RESTROOM DEMOLITION REFLECTED CEILING PLAN SCALE: 1/4" = 1'-0"

- PROCEEDING WITH THE JOB.
- PROCEEDING WITH CONSTRUCTION.
- AREA.

- 6. ALL EXPOSED CEILING EDGES TO BE FINISHED.

- ROOM, WITH OWNER.
- INSTALLATION.
- INFORMATION.
- BEFORE PROCEEDING WITH CONSTRUCTION.
- NEVER SURFACE MOUNTED OR EXPOSED.

LEGEND	
	PENDENT FIRE SPRINKLER HEAD/ESCUTCHEON
	DIRECTIONAL EXIT SIGN
	WALL MOUNTED EMERGENCY LIGHT TO REMAIN
\$	WALL SWITCH
FS	FIRE ALARM STROBE
SD	SMOKE DETECTOR
OS	OCCUPANCY SENSOR
AR	AREA OF REFUGE SIGN
	LIGHT FIXTURE
	HVAC RETURN/SUPPLY





GENERAL CEILING NOTES:

1. G.C. TO VERIFY ALL DIMENSIONS AND CONDITIONS SHOWN ON THE DRAWINGS AT THE JOB SITE. NOTIFY ARCHITECT OF ANY OMISSIONS, DISCREPANCIES, AND/OR CONFLICTS BEFORE

REVIEW CEILING LAYOUT AS SHOWN AND NOTIFY ARCHITECT OF ANY CONFLICTS WITH STRUCTURAL, ELECTRICAL, MECHANICAL, PIPE WORK, FIRE PROTECTION SYSTEMS, ETC. BEFORE

3. INSTALL NEW SUSPENDED ACOUSTICAL CEILING TILE SYSTEM THROUGHOUT SCOPE OF WORK

4. U.N.O. INSTALL SQUARE OR RECTANGULAR DIFFUSERS IN ALL CEILINGS. RE: MECH.

5. COORDINATE AND VERIFY LOCATION OF LIGHT SWITCHES, THERMOSTATS, FIRE ALARMS, ETC. WITH ARCHITECT BEFORE INSTALLATION. REFER MECH.

7. ELECTRICAL CONTRACTOR TO COORDINATE SWITCHING AND DIMMING REQUIREMENTS AND LOCATIONS WITH ARCHITECT PRIOR TO INSTALLATION.

8. U.N.O. LIGHTING IN EACH ROOM TO BE SWITCHED FROM ONE LOCATION WITHIN THAT ROOM.

9. U.N.O. ALL LIGHT FIXTURE TYPES WITHIN EACH ROOM OR OPEN OFFICE AREA TO BE SWITCHED SEPARATELY. GANG ALL SWITCHES IN EACH ROOM UNDER A SINGLE COVER PLATE. PROVIDE OCCUPANCY SENSOR/SWITCH COMBO IN WALL BOX FOR OFFICES, CONFERENCE, BREAK, ETC & CEILING-MOUNTED OCCUPANCY SENSORS IN OPEN OFFICE AREAS.

10. U.N.O. ALL CAN LIGHT FIXTURES SHALL BE CONNECTED TO OTHER LIGHTING WITHIN THE SAME ROOM/AREA. COORDINATE VOLTAGE AS REQUIRED TO ACCOMPLISH.

11. ELECTRICAL CONTRACTOR TO COORDINATE COVER PLATE COLOR/FINISH, IN EACH SPECIFIC

12. IDENTIFY AND COORDINATE LOCATIONS FOR ALL CEILING ELEMENTS INCLUDING LIGHTING, MECHANICAL DIFFUSERS, RETURN AIR GRILLES, FIRE PROTECTION DEVICES, ACCESS PANELS, EXIT SIGNS, AUDIOVISUAL EQUIPMENT, SECURITY DEVICES, ETC. WITH ARCHITECT BEFORE

13. REFER TO G.C. GENERATED DESIGN/BUILD FIRE PROTECTION DRAWINGS FOR ADDITIONAL

14. NOTIFY ARCHITECT OF ANY REQUIREMENTS FOR ACCESS PANELS NOT SHOWN ON DOCUMENTS

15. REFER TO MECHANICAL DRAWINGS FOR ADDITIONAL INFORMATION.

16. ALL CONDUIT, VOICE/DATA CABLING, SPRINKLER PIPING, ETC. TO BE ABOVE CEILING PLANE,

17. WHERE APPLICABLE, ANY EXISTING SPRAY-ON FIRE-PROOFING (SOFP) ON STEEL BEAMS TO REMAIN. ANY SOFP THAT IS DISLODGED OR REMOVED TO BE REPLACED.

18. EGRESS/EMERGENCY LIGHTING SHALL BE ACCOMPLISHED BY PROVIDING AN ADDITIONAL EMERGENCY CIRCUIT TO THE FIXTURES. COORDINATE SPECIFICS WITH LIGHTING VENDOR & REFERENCE MECH AND ELEC. DRAWINGS FOR FIXTURE LOCATIONS.


DEMOLITION FLOOR PLAN TAG NOTES:

REFER TO SHEET D-102 FOR MECHANICAL AND ELECTRICAL


RESPONSIBLE FOR DISPOSAL.

REMOVE EXISTING CEILING GRID AND ACOUSTICAL TILES ONLY IN THE LOBBY AND RESTROOMS. CONTRACTOR


DEMOLITION.

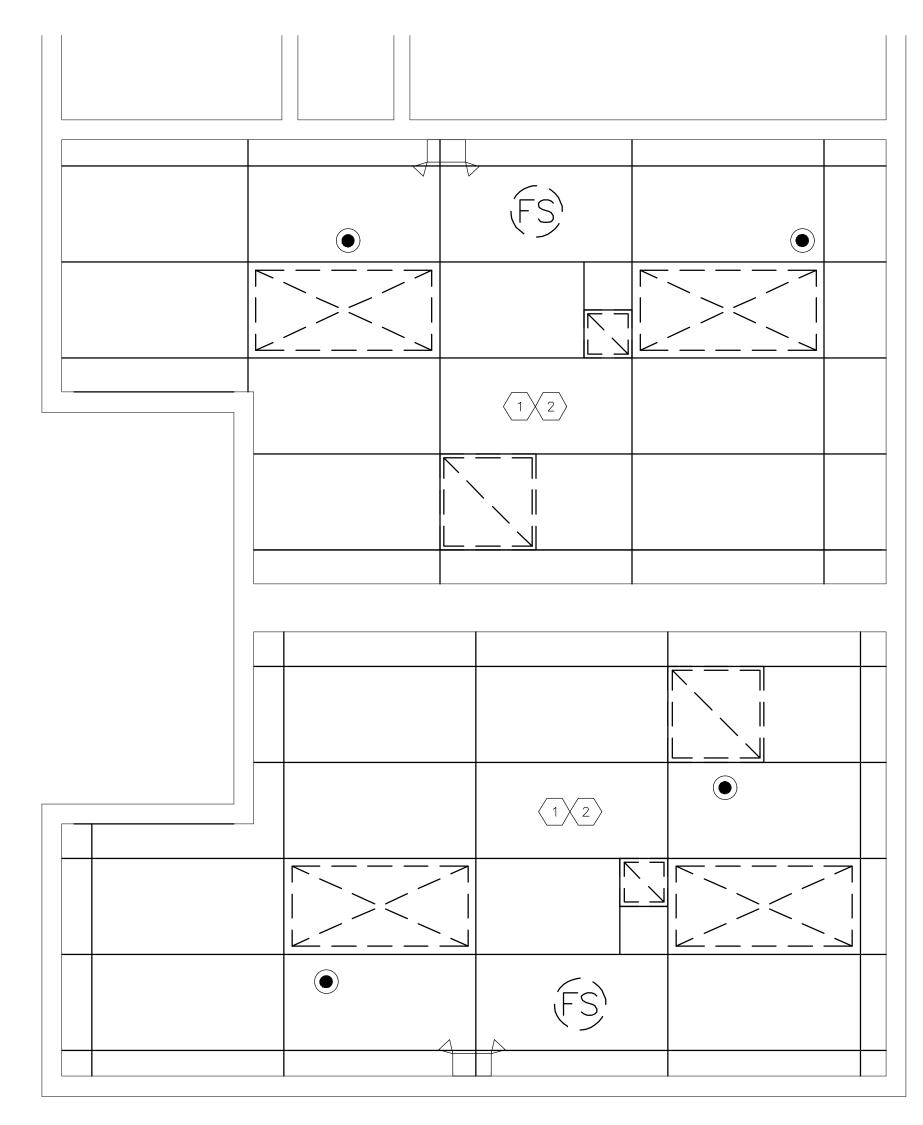

SECOND FLOOR STAFF RESTROOM DEMOLITION REFLECTED CEILING PLAN / SCALE: 1/2" = 1'-0"

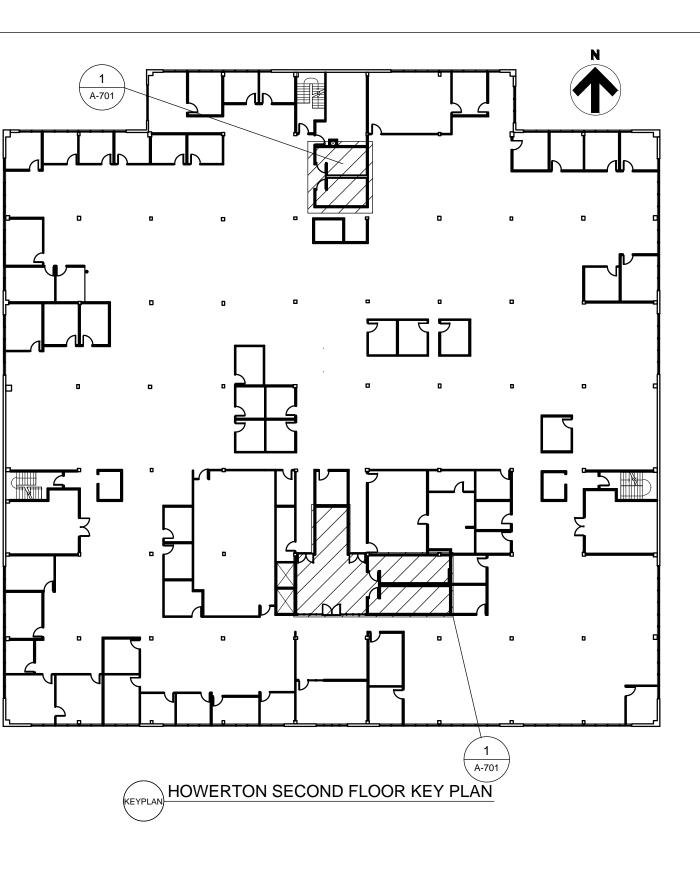



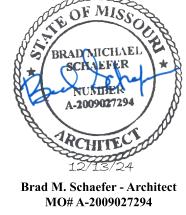



OFFICE OF ADMINISTRATION **DIVISION OF FACILITIES** MANAGEMENT / DESIGN AND CONSTRUCTION **DEPARTMENT OF**

SOCIAL SERVICES

MULTI. DIVISION

HOWERTON STATE **RENOVATE LOBBY**

RENOVATE LOBBY

AND RESTROOMS 1ST AND 2ND FLOOR 615 HOWERTON COURT JEFFERSON CITY, MO

PROJECT # 02339-01 1025 SITE # FACILITY # 3101025001


REVISION:
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ISSUE DATE: 12/13/24

CAD DWG FILE:A-701_02409_01 DRAWN BY: CHECKED BY: BMS DESIGNED BY: EL

SHEET TITLE:

SECOND FLOOR DEMOLITION RCP

SHEET NUMBER:

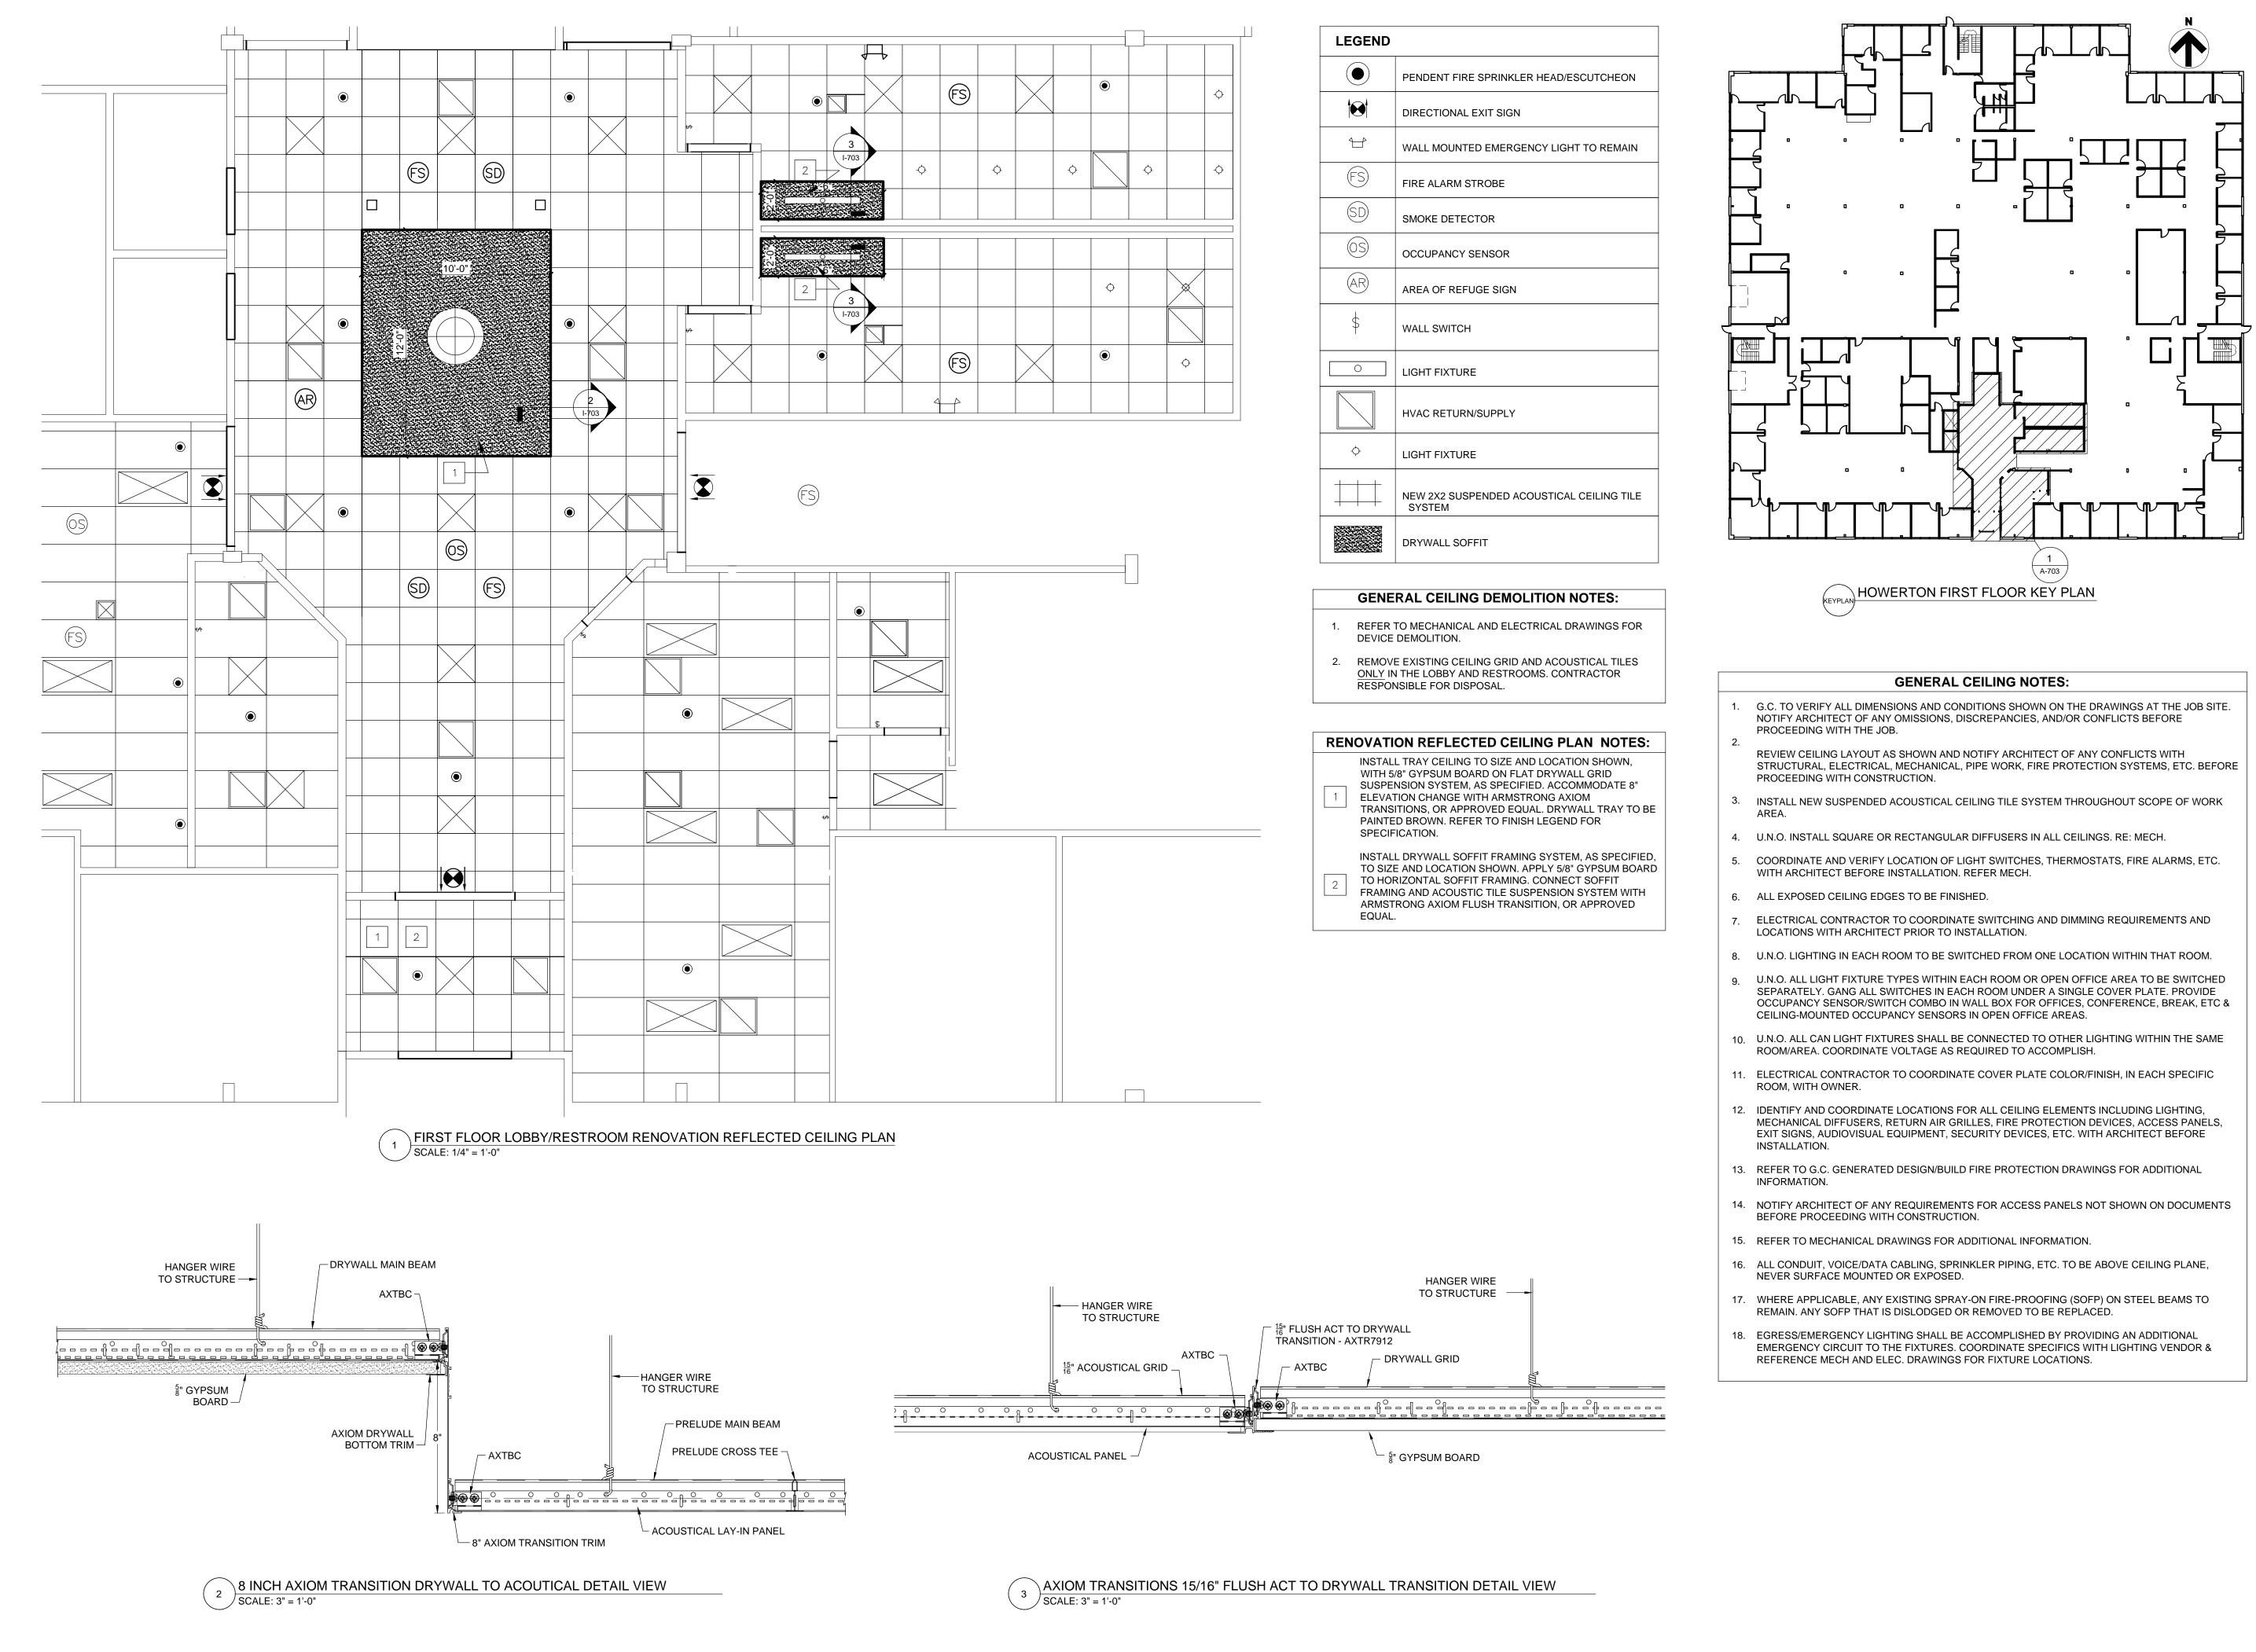

STATE OF MISSOURI MICHAEL L. PARSON, GOVERNOR





OFFICE OF ADMINISTRATION **DIVISION OF FACILITIES** MANAGEMENT / DESIGN AND CONSTRUCTION

SOCIAL SERVICES

DEPARTMENT OF

MULTI. DIVISION

HOWERTON STATE OFFICE BUILDING

RENOVATE LOBBY

AND RESTROOMS 1ST AND 2ND FLOOR 615 HOWERTON COURT JEFFERSON CITY, MO

PROJECT # 02339-01 1025 SITE # FACILITY # 3101025001


REVISION: DATE: **REVISION:** DATE: **REVISION:** DATE:

ISSUE DATE: 12/13/24


CAD DWG FILE:A-702_02409_01 DRAWN BY: CHECKED BY: BMS DESIGNED BY: EL

SHEET TITLE: FIRST FLOOR **RENOVATION RCP**

SHEET NUMBER:

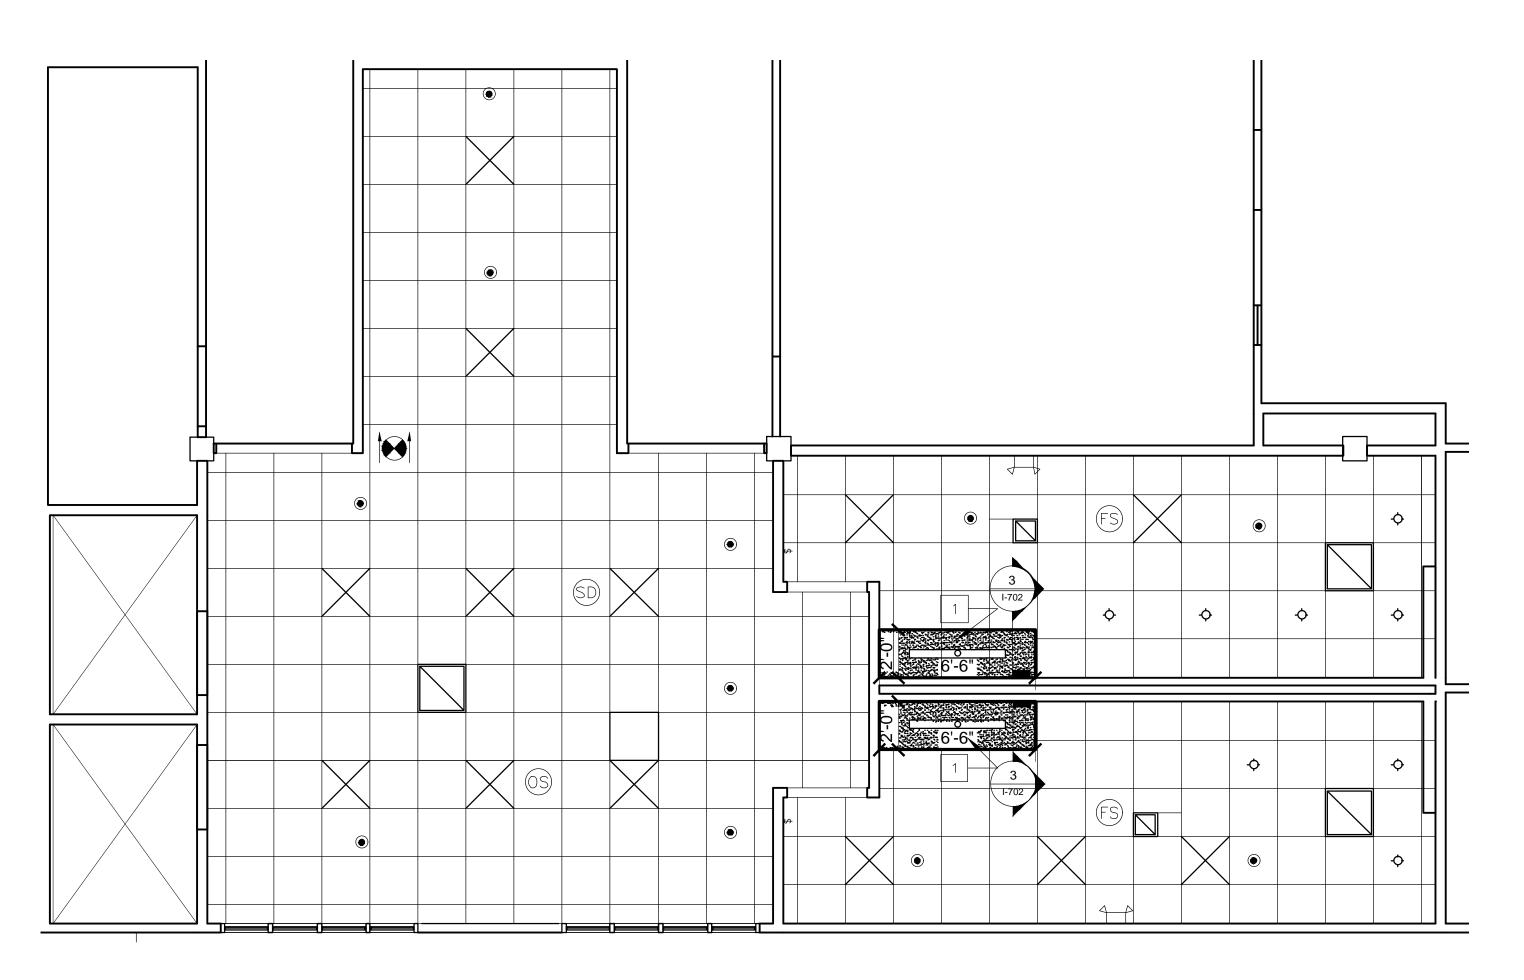

1 SECOND FLOOR LOBBY/RESTROOM RENOVATION REFLECTED CEILING PLAN SCALE: 1/4" = 1'-0"

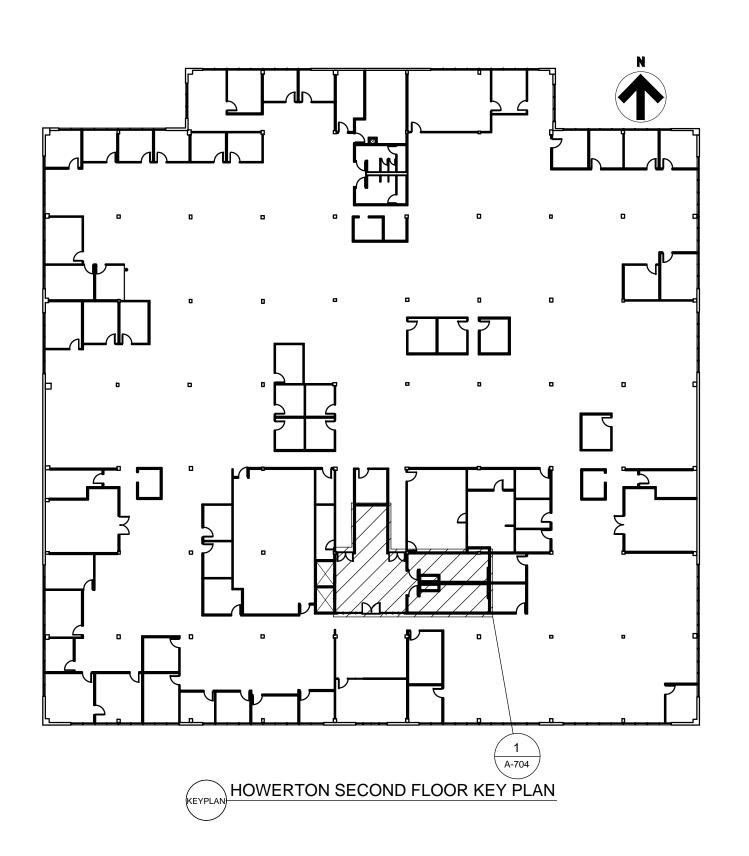


LEGEND	
	PENDENT FIRE SPRINKLER HEAD/ESCUTCHEON
	DIRECTIONAL EXIT SIGN
	WALL MOUNTED EMERGENCY LIGHT TO REMAIN
FS	FIRE ALARM STROBE
SD	SMOKE DETECTOR
\bigcirc	OCCUPANCY SENSOR
AR	AREA OF REFUGE SIGN
\$	WALL SWITCH
0	LIGHT FIXTURE
	HVAC RETURN/SUPPLY
¢	LIGHT FIXTURE
	NEW 2X2 SUSPENDED ACOUSTICAL CEILING TILE SYSTEM
	DRYWALL SOFFIT
GEN	ERAL CEILING DEMOLITION NOTES:
	TO MECHANICAL AND ELECTRICAL DRAWINGS FOR

- REFER TO MECHANICAL AND ELECTRICAL DRAWINGS FOR DEVICE DEMOLITION.
 REMOVE EXISTING CEILING GRID AND ACOUSTICAL TILES
- 2. REMOVE EXISTING CEILING GRID AND ACOUSTICAL TILES <u>ONLY</u> IN THE LOBBY AND RESTROOMS. CONTRACTOR RESPONSIBLE FOR DISPOSAL.

RENOVATION REFLECTED CEILING PLAN NOTES:

INSTALL DRYWALL SOFFIT FRAMING SYSTEM, AS SPECIFIED, TO SIZE AND LOCATION SHOWN. APPLY 5/8" GYPSUM BOARD TO HORIZONTAL SOFFIT FRAMING. CONNECT SOFFIT FRAMING AND ACOUSTIC TILE SUSPENSION SYSTEM WITH ARMSTRONG AXIOM FLUSH TRANSITION, OR APPROVED EQUAL.

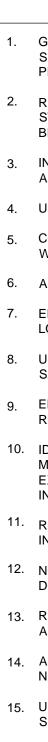

GENERAL CEILING NOTES:

1. G.C. TO VERIFY ALL DIMENSIONS AND CONDITIONS SHOWN ON THE DRAWINGS AT THE JOB SITE. NOTIFY ARCHITECT OF ANY OMISSIONS, DISCREPANCIES, AND/OR CONFLICTS BEFORE PROCEEDING WITH THE JOB.

2. REVIEW CEILING LAYOUT AS SHOWN AND NOTIFY ARCHITECT OF ANY CONFLICTS WITH STRUCTURAL, ELECTRICAL, MECHANICAL, PIPE WORK, FIRE PROTECTION SYSTEMS, ETC. BEFORE PROCEEDING WITH CONSTRUCTION.

3. INSTALL NEW 2X2 SUSPENDED ACOUSTICAL CEILING TILE SYSTEM THROUGHOUT LOBBIES AND RESTROOMS AS SPECIFIED (SECTION 095113).

4. U.N.O. INSTALL SQUARE OR RECTANGULAR DIFFUSERS IN ALL CEILINGS. RE: MECH.

5. COORDINATE AND VERIFY LOCATION OF LIGHT SWITCHES, THERMOSTATS, FIRE ALARMS, ETC. WITH ARCHITECT BEFORE INSTALLATION. REFER MECH.

6. ALL EXPOSED CEILING EDGES TO BE FINISHED.

7. ELECTRICAL CONTRACTOR TO COORDINATE SWITCHING AND DIMMING REQUIREMENTS AND LOCATIONS WITH ARCHITECT PRIOR TO INSTALLATION.

8. U.N.O. ALL CAN LIGHT FIXTURES SHALL BE CONNECTED TO OTHER LIGHTING WITHIN THE SAME ROOM/AREA. COORDINATE VOLTAGE AS REQUIRED TO ACCOMPLISH.

9. ELECTRICAL CONTRACTOR TO COORDINATE COVER PLATE COLOR/FINISH, IN EACH SPECIFIC ROOM, WITH OWNER.

 IDENTIFY AND COORDINATE LOCATIONS FOR ALL CEILING ELEMENTS INCLUDING LIGHTING, MECHANICAL DIFFUSERS, RETURN AIR GRILLES, FIRE PROTECTION DEVICES, ACCESS PANELS, EXIT SIGNS, AUDIOVISUAL EQUIPMENT, SECURITY DEVICES, ETC. WITH ARCHITECT BEFORE INSTALLATION.

^{11.} REFER TO G.C. GENERATED DESIGN/BUILD FIRE PROTECTION DRAWINGS FOR ADDITIONAL INFORMATION.

12. NOTIFY ARCHITECT OF ANY REQUIREMENTS FOR ACCESS PANELS NOT SHOWN ON DOCUMENTS BEFORE PROCEEDING WITH CONSTRUCTION.

13. REFER TO MECHANICAL, ELECTRICAL, AND PLUMBING SHEETS FOR DETAILS. NOTIFY ARCHITECT OF ANY DISCREPANCIES.

14. ALL CONDUIT, VOICE/DATA CABLING, SPRINKLER PIPING, ETC. TO BE ABOVE CEILING PLANE, NEVER SURFACE MOUNTED OR EXPOSED.

15. U.N.O. ALL GYPSUM BOARD CEILINGS TO BE PAINTED WHITE. REFER TO FINISH SCHEDULE FOR SPECIFICATION.

STATE OF MISSOURI MICHAEL L. PARSON, GOVERNOR
BID BID DOCUMENTS
OFFICE OF ADMINISTRATION DIVISION OF FACILITIES MANAGEMENT / DESIGN AND CONSTRUCTION DEPARTMENT OF SOCIAL SERVICES
MULTI. DIVISION
HOWERTON STATE OFFICE BUILDING
RENOVATE LOBBY AND RESTROOMS 1ST AND 2ND FLOOR 615 HOWERTON COURT JEFFERSON CITY, MO
PROJECT # 02339-01 SITE # 1025 FACILITY # 3101025001
REVISION: DATE: REVISION: DATE: REVISION: DATE: DATE: ISSUE DATE: 12/13/24
CAD DWG FILE: <u>A-703_02409_01</u> DRAWN BY: <u>EL</u> CHECKED BY: <u>BMS</u> DESIGNED BY: <u>EL</u>


SECOND FLOOR RENOVATION RCP

SHEET NUMBER:

22 OF 38 SHEETS

A-703

\`FIRST FLOOR - STAFF RESTROOM RENOVATION REFLECTED CEILING PLAN \` \ SCALE: 1/2" = 1'-0"

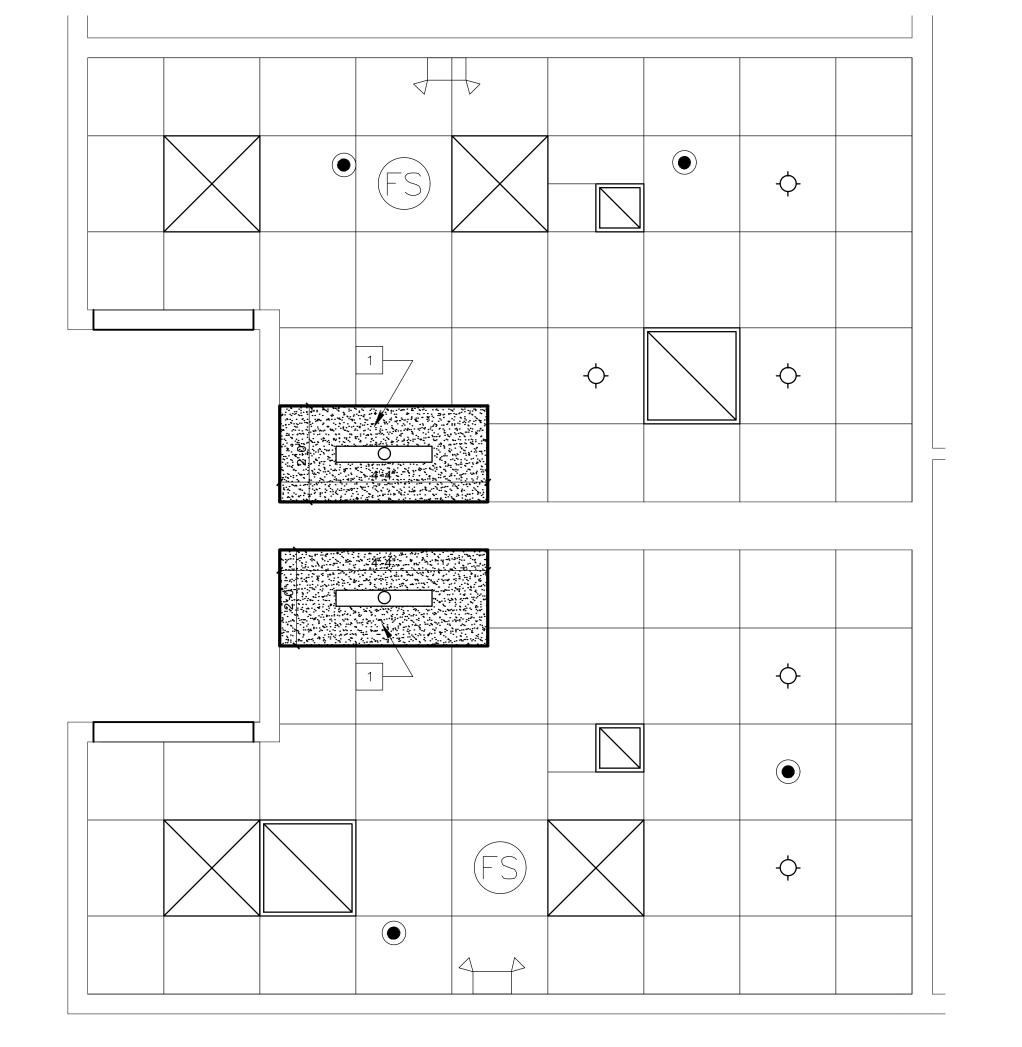

- 18. EGRESS/EMERGENCY LIGHTING SHALL BE ACCOMPLISHED BY PROVIDING AN ADDITIONAL EMERGENCY CIRCUIT TO THE FIXTURES. COORDINATE SPECIFICS WITH LIGHTING VENDOR & REFERENCE MECH AND ELEC. DRAWINGS FOR FIXTURE LOCATIONS.
- GRILLES, FIRE PROTECTION DEVICES, ACCESS PANELS, EXIT SIGNS, AUDIOVISUAL EQUIPMENT, SECURITY DEVICES, ETC. WITH ARCHITECT BEFORE INSTALLATION. 13. REFER TO G.C. GENERATED DESIGN/BUILD FIRE PROTECTION DRAWINGS FOR ADDITIONAL INFORMATION. 14. NOTIFY ARCHITECT OF ANY REQUIREMENTS FOR ACCESS PANELS NOT SHOWN ON DOCUMENTS BEFORE PROCEEDING WITH

12. IDENTIFY AND COORDINATE LOCATIONS FOR ALL CEILING ELEMENTS INCLUDING LIGHTING, MECHANICAL DIFFUSERS, RETURN AIR

11. ELECTRICAL CONTRACTOR TO COORDINATE COVER PLATE COLOR/FINISH, IN EACH SPECIFIC ROOM, WITH OWNER.

CONSTRUCTION.

2.

REFER MECH.

INSTALLATION.

REQUIRED TO ACCOMPLISH.

6. ALL EXPOSED CEILING EDGES TO BE FINISHED.

- 15. REFER TO MECHANICAL DRAWINGS FOR ADDITIONAL INFORMATION.

- 16. ALL CONDUIT, VOICE/DATA CABLING, SPRINKLER PIPING, ETC. TO BE ABOVE CEILING PLANE, NEVER SURFACE MOUNTED OR EXPOSED.
- 17. WHERE APPLICABLE, ANY EXISTING SPRAY-ON FIRE-PROOFING (SOFP) ON STEEL BEAMS TO REMAIN. ANY SOFP THAT IS DISLODGED OR
- REMOVED TO BE REPLACED.

G.C. TO VERIFY ALL DIMENSIONS AND CONDITIONS SHOWN ON THE DRAWINGS AT THE JOB SITE. NOTIFY ARCHITECT OF ANY OMISSIONS, DISCREPANCIES, AND/OR CONFLICTS BEFORE PROCEEDING WITH THE JOB.

REVIEW CEILING LAYOUT AS SHOWN AND NOTIFY ARCHITECT OF ANY CONFLICTS WITH STRUCTURAL, ELECTRICAL, MECHANICAL, PIPE

7. ELECTRICAL CONTRACTOR TO COORDINATE SWITCHING AND DIMMING REQUIREMENTS AND LOCATIONS WITH ARCHITECT PRIOR TO

9. U.N.O. ALL LIGHT FIXTURE TYPES WITHIN EACH ROOM OR OPEN OFFICE AREA TO BE SWITCHED SEPARATELY. GANG ALL SWITCHES IN

GENERAL CEILING NOTES:


WORK, FIRE PROTECTION SYSTEMS, ETC. BEFORE PROCEEDING WITH CONSTRUCTION.

8. U.N.O. LIGHTING IN EACH ROOM TO BE SWITCHED FROM ONE LOCATION WITHIN THAT ROOM.

BREAK, ETC & CEILING-MOUNTED OCCUPANCY SENSORS IN OPEN OFFICE AREAS.

4. U.N.O. INSTALL SQUARE OR RECTANGULAR DIFFUSERS IN ALL CEILINGS. RE: MECH.

3. INSTALL NEW SUSPENDED ACOUSTICAL CEILING TILE SYSTEM THROUGHOUT SCOPE OF WORK AREA.

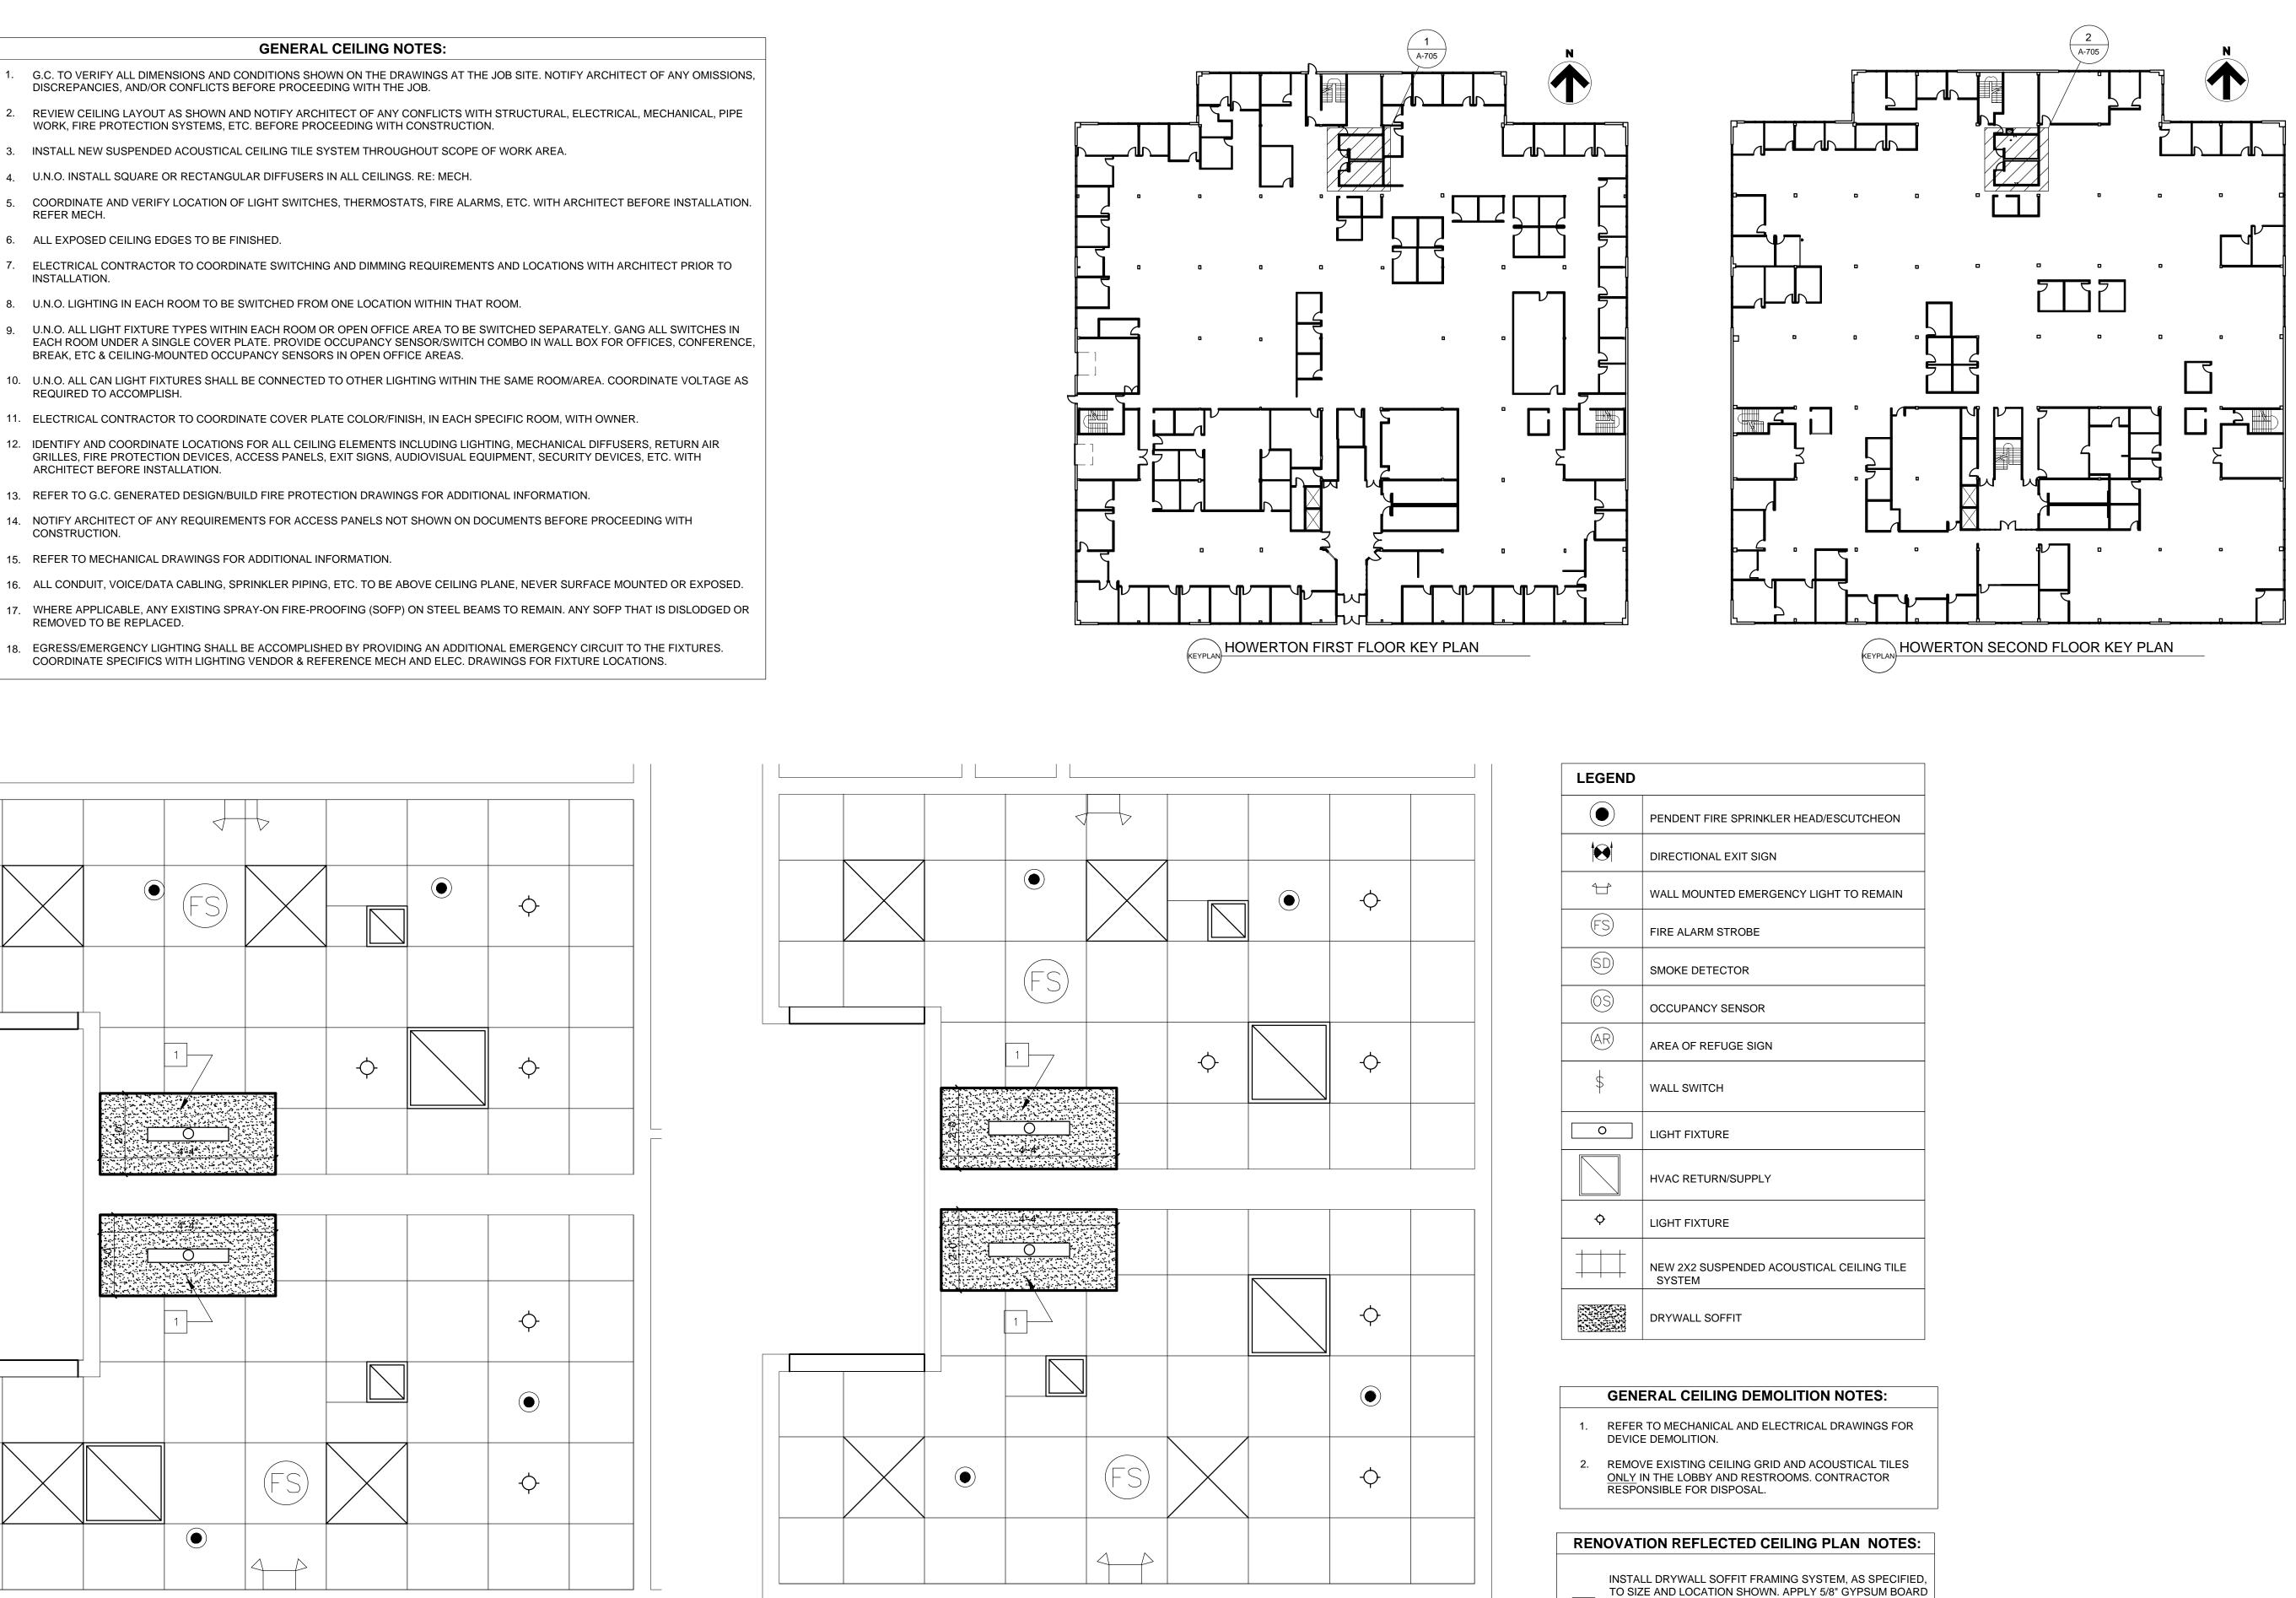

SECOND FLOOR - STAFF RESTROOM RENOVATION REFLECTED CEILING PLAN 2 SCALE: 1/2" = 1'-0"

TO HORIZONTAL SOFFIT FRAMING. CONNECT SOFFIT FRAMING AND ACOUSTIC TILE SUSPENSION SYSTEM WITH ARMSTRONG AXIOM FLUSH TRANSITION, OR APPROVED

EQUAL.

STATE OF MISSOURI MICHAEL L. PARSON, GOVERNOR





OFFICE OF ADMINISTRATION **DIVISION OF FACILITIES** MANAGEMENT / DESIGN AND CONSTRUCTION **DEPARTMENT OF**

SOCIAL SERVICES

MULTI. DIVISION

HOWERTON STATE OFFICE BUILDING

RENOVATE LOBBY

AND RESTROOMS 1ST AND 2ND FLOOR 615 HOWERTON COURT JEFFERSON CITY, MO

PROJECT # 02339-01 1025 SITE # FACILITY # 3101025001

REVISION: DATE: **REVISION:** DATE: **REVISION**: DATE: ISSUE DATE: 12/13/24


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SHEET TITLE:

1ST & 2ND FLOOR STAFF RESTROOM **RENOVATION RCP**

SHEET NUMBER:

|A-704

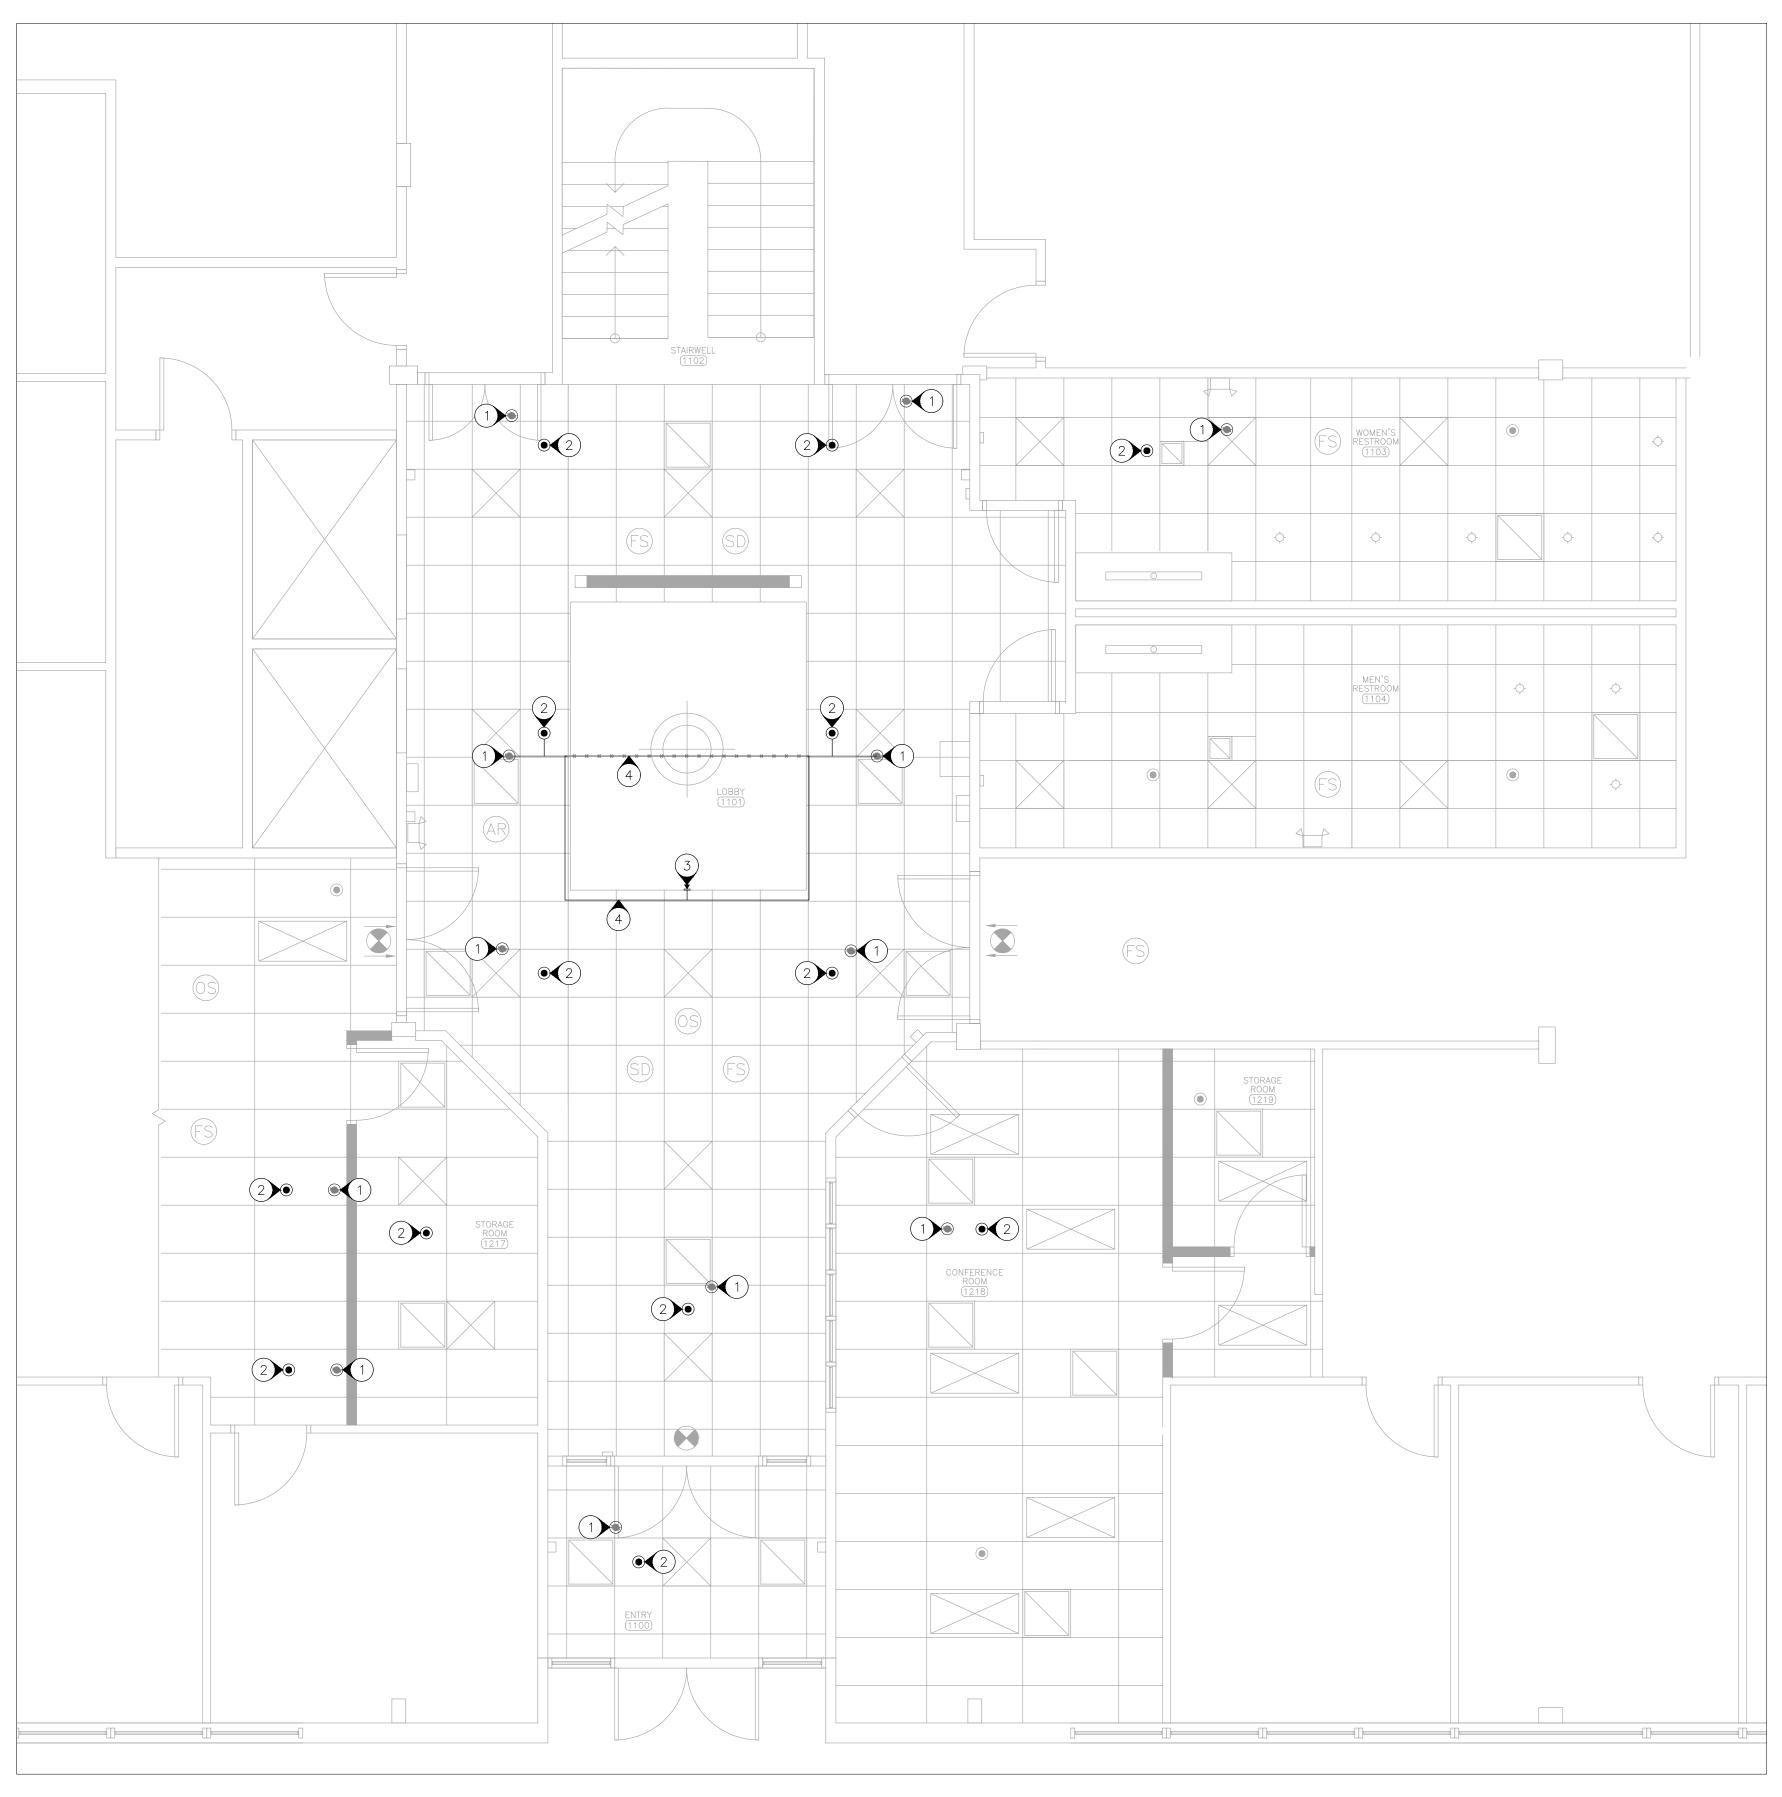

\FIRE PROTECTION PLAN - 1ST FLOOR \int SCALE: 1/4" = 1'-0"

GENERAL NOTES


NOTES

AREA OF WORK AREA MAP - 1ST FLOOR NORTH

- 1 FABRICATION, INSTALLATION AND TESTING OF ALL FIRE PROTECTION DEVICES SHALL BE DONE IN ACCORDANCE WITH THE LATEST VERSION OF NATIONAL FIRE PROTECTION ASSOCIATION'S STANDARD FOR THE INSTALLATION OF SPRINKLER SYSTEMS (NFPA-13), NATIONAL ELECTRIC CODE (NEC) AND ALL MANUFACTURER INSTALLATION GUIDELINES.
- 2 DRAWINGS AND PLANS ARE FROM FIELD TAKE-OFF AND ORIGINAL DRAWINGS. CONTRACTOR IS RESPONSIBLE FOR FIELD VERIFYING PRIOR TO BIDDING AND/OR CONSTRUCTION.
- 3 CONTRACTOR IS RESPONSIBLE FOR REMOVAL AND DISPOSAL OF ALL DEMOLISHED MATERIAL, AS WELL AS REPAIRING ANY DAMAGE TO ANY SURFACE IN THE AREA OF CONSTRUCTION THAT IS A RESULT OF CONSTRUCTION ACTIVITY. SURFACE SHALL BE REPAIRED AND FINISHED TO MATCH EXISTING CONDITIONS.
- 4 COORDINATE WITH OWNER TO SHUT OFF FIRE ALARMS AND FIRE SUPPRESSION SYSTEM IN WORK AREA PRIOR TO BEGINNING CONSTRUCTION. CONSTRUCTION SHALL BE DONE SUCH THAT THE FIRE ALARM AND FIRE SUPPRESSION SYSTEMS ARE ACTIVE OVERNIGHT.
- 5 DELEGATED DESIGN: LOCATION OF NEW SPRINKLER HEADS ARE FOR REFERENCE ONLY. FIRE PROTECTION CONTRACTOR IS RESPONSIBLE FOR DESIGNING AND PROVIDING A COMPLETE, FUNCTIONAL, AND CODE COMPLIANT SYSTEM.

(N) INDICATES KEYED NOTES

(1) DEMOLISH PENDENT TYPE FIRE SPRINKLER HEAD. CAP PIPE WHERE HEAD IS REMOVED OR EXTEND PIPE TO NEW SPRINKLER HEAD LOCATION AS NEEDED. IF PIPE NO LONGER SERVES A SPRINKLER HEAD, REMOVE PIPE AND ALL ASSOCIATED HANGERS BACK TO MAIN AND CAP AT MAIN. 2 PROVIDE AND INSTALL NEW PENDENT TYPE FIRE SPRINKLER HEAD, ESCUTCHEON AND ALL REQUIRED PIPE. ALL MATERIALS SHALL MATCH EXISTING FINISH AND PERFORMANCE. 3 PROVIDE AND INSTALL NEW SIDE-WALL TYPE FIRE SPRINKLER HEAD, ESCUTCHEON AND ALL REQUIRED PIPE. ALL MATERIALS SHALL MATCH EXISTING FINISH AND PERFORMANCE. (4) REROUTE EXISTING SPRINKLER PIPE TO ACCOMMODATE CEILING CHANGES.

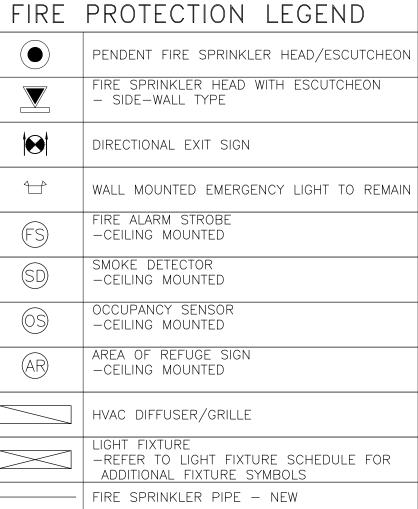

STATE OF MISSOURI MICHAEL L. PARSON, GOVERNOR



Tracie L. Siebeneck - Engineer MO# PE-2013019114



OFFICE OF ADMINISTRATION DIVISION OF FACILITIES MANAGEMENT, **DESIGN AND CONSTRUCTION**

DEPARTMENT OF SOCIAL SERVICES

MULTI. DIVISON

HOWERTON STATE OFFICE BUILDING RENOVATE LOBBY AND RESTROOM 1ST & 2ND FLOOR

615 HOWERTON COURT JEFFERSON CITY, MO 65010

PROJECT # 02339-01 SITE # 1025 3101025001 ASSET #

REVISION: DATE: **REVISION:** DATE: **REVISION**: DATE: **ISSUE DATE:**


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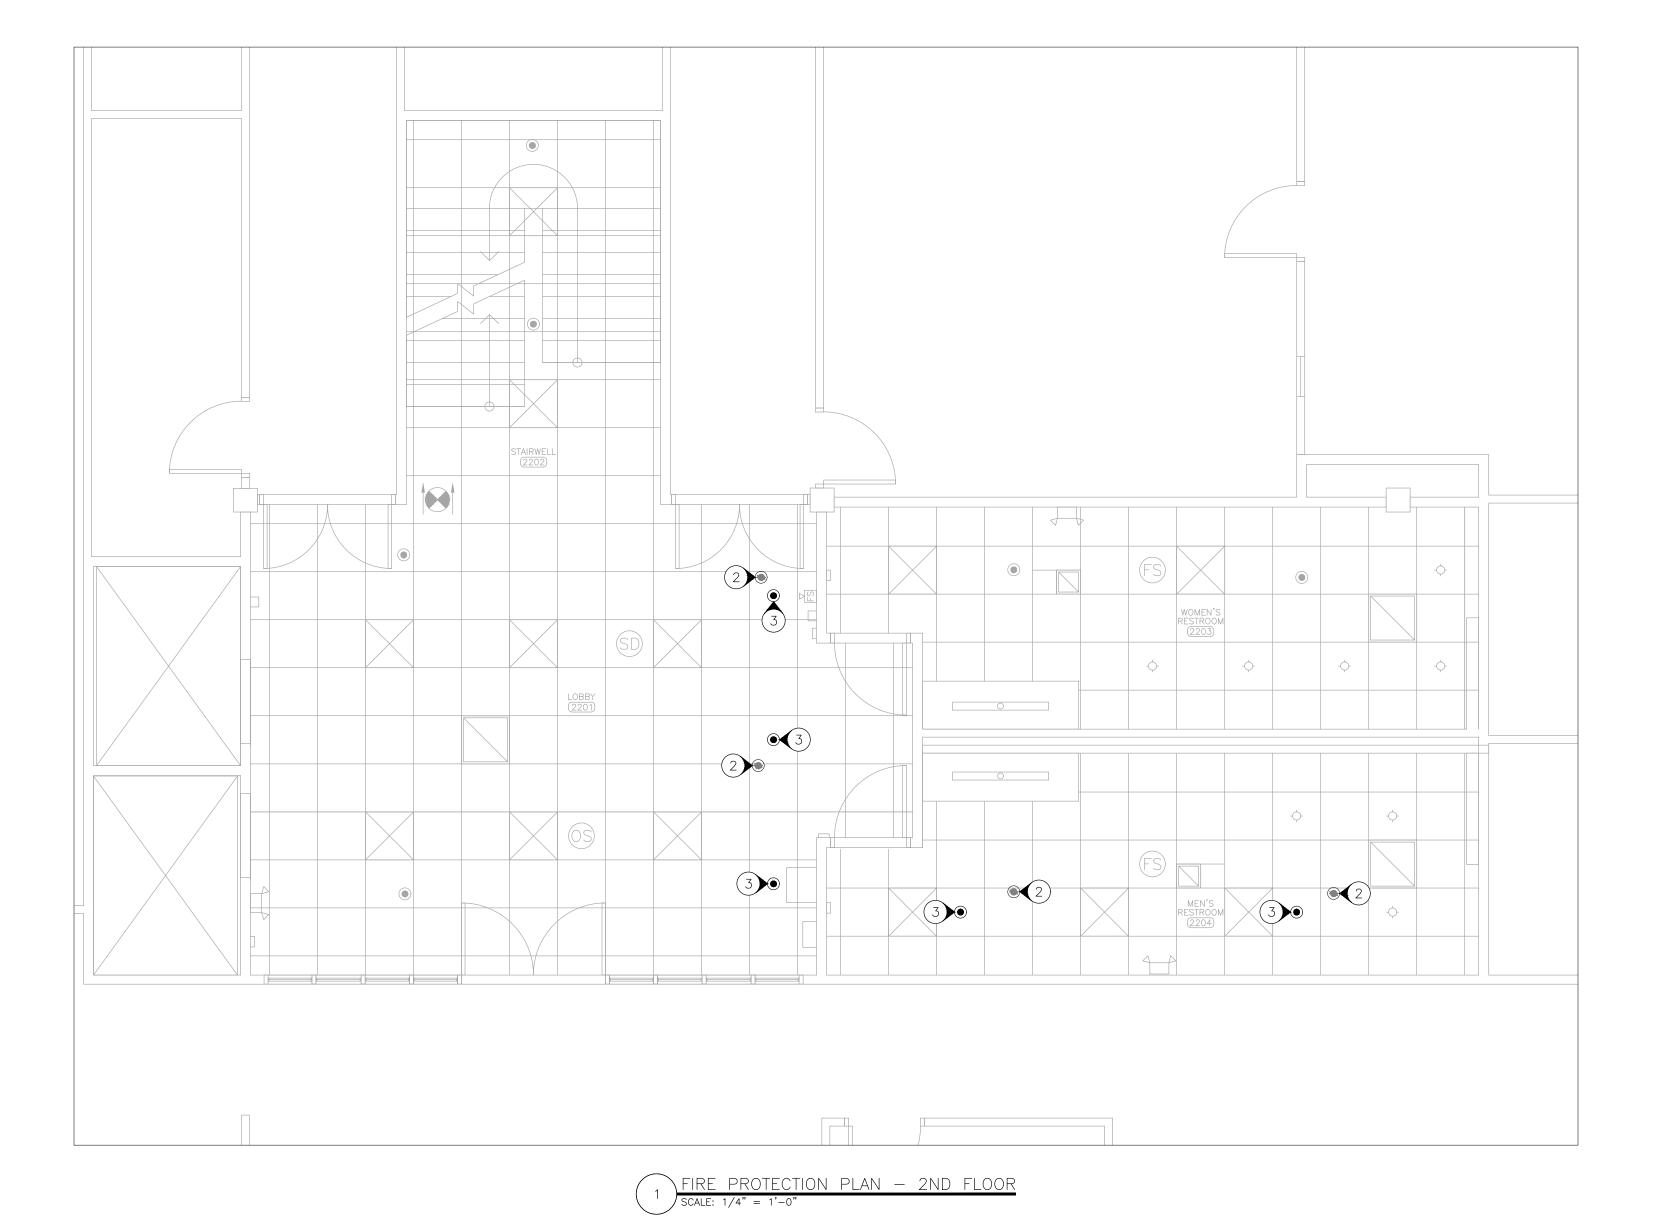
SHEET TITLE:

FIRE PROTECTION PLAN - 1ST FLOOR


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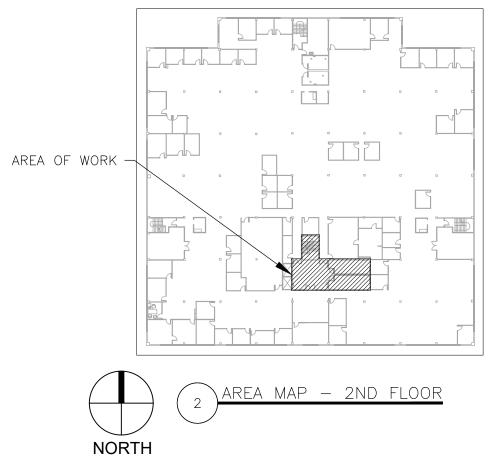
F-10 24 OF 38 SHEETS 12/13/2024



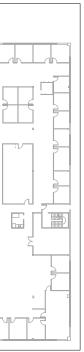

NOTES



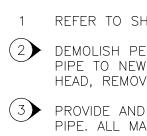


1 REFER TO SHEET F-101 FOR GENERAL NOTES. (2) DEMOLISH PENDENT TYPE FIRE SPRINKLER HEAD. CAP PIPE WHERE HEAD IS REMOVED OR EXTEND PIPE TO NEW SPRINKLER HEAD LOCATION AS NEEDED. IF PIPE NO LONGER SERVES A SPRINKLER HEAD, REMOVE PIPE AND ALL ASSOCIATED HANGERS BACK TO MAIN AND CAP AT MAIN.

3 PROVIDE AND INSTALL NEW PENDENT TYPE FIRE SPRINKLER HEAD, ESCUTCHEON AND ALL REQUIRED PIPE. ALL MATERIALS SHALL MATCH EXISTING FINISH AND PERFORMANCE.





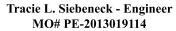



OFFICE OF ADMINISTRATION DIVISION OF FACILITIES MANAGEMENT, **DESIGN AND CONSTRUCTION**

DEPARTMENT OF SOCIAL SERVICES

MULTI. DIVISON

HOWERTON STATE OFFICE BUILDING RENOVATE LOBBY AND **RESTROOM 1ST & 2ND FLOOR**

615 HOWERTON COURT JEFFERSON CITY, MO 65010

O2339-01
1025
3101025001

REVISION:	
DATE:	
REVISION:	
DATE:	
REVISION:	
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ISSUE DATE:	

CAD DWG FILE:<u>MEP_02339-01</u> DRAWN BY: <u>RG/MP</u> CHECKED BY: <u>TS</u> DESIGNED BY: <u>TS/AH</u>


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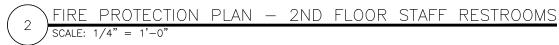
FIRE PROTECTION PLAN - 2ND FLOOR


SHEET NUMBER:

F-102 25 OF 38 SHEETS 12/13/2024

FIRE	PROTECTION LEGEND
	PENDENT FIRE SPRINKLER HEAD/ESCUTCHEON
	DIRECTIONAL EXIT SIGN
	WALL MOUNTED EMERGENCY LIGHT TO REMAIN
FS	FIRE ALARM STROBE —CEILING MOUNTED
∇ FS	FIRE ALARM STROBE —WALL MOUNTED
SD	SMOKE DETECTOR -CEILING MOUNTED
OS	OCCUPANCY SENSOR —CEILING MOUNTED
	HVAC DIFFUSER/GRILLE
	LIGHT FIXTURE -REFER TO LIGHT FIXTURE SCHEDULE FOR ADDITIONAL FIXTURE SYMBOLS




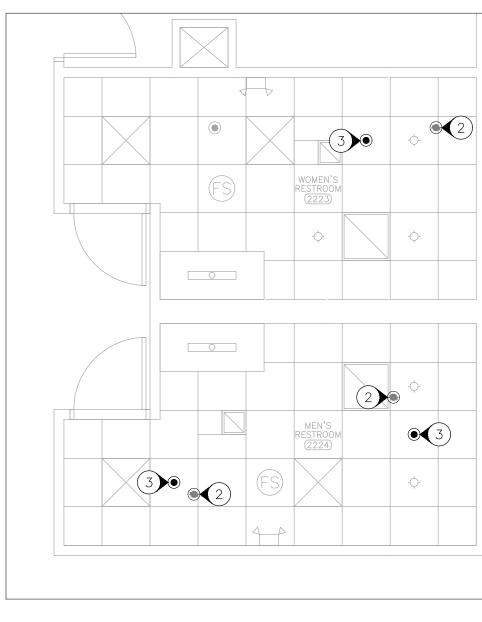

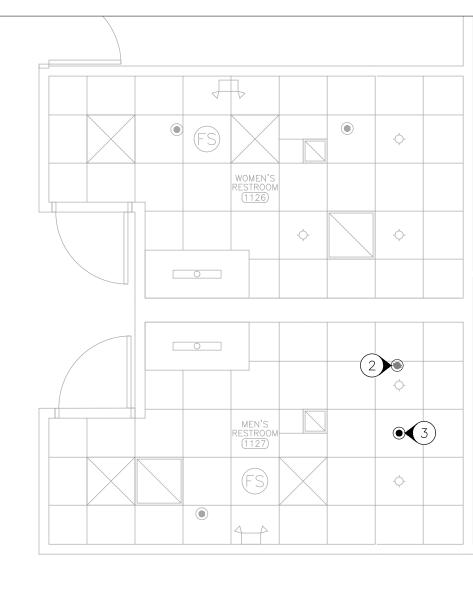



) SCALE: 1/4" = 1'-0"

NOTES

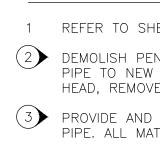



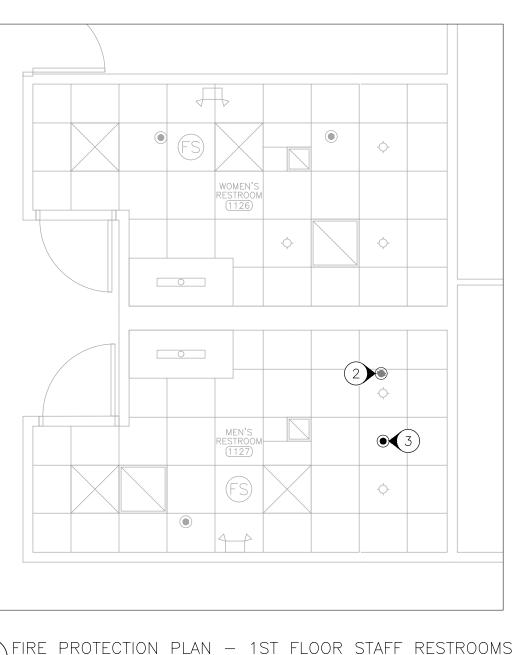

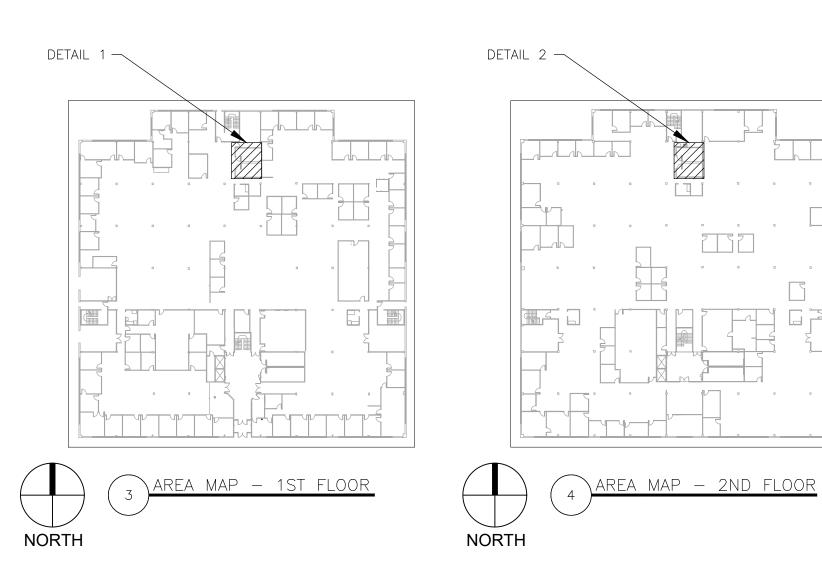

1 REFER TO SHEET F-101 FOR GENERAL NOTES.

2 DEMOLISH PENDENT TYPE FIRE SPRINKLER HEAD. CAP PIPE WHERE HEAD IS REMOVED OR EXTEND PIPE TO NEW SPRINKLER HEAD LOCATION AS NEEDED. IF PIPE NO LONGER SERVES A SPRINKLER HEAD, REMOVE PIPE AND ALL ASSOCIATED HANGERS BACK TO MAIN AND CAP AT MAIN. 3 PROVIDE AND INSTALL NEW PENDENT TYPE FIRE SPRINKLER HEAD, ESCUTCHEON AND ALL REQUIRED PIPE. ALL MATERIALS SHALL MATCH EXISTING FINISH AND PERFORMANCE. **STATE OF MISSOURI** MICHAEL L. PARSON, GOVERNOR



Tracie L. Siebeneck - Engineer MO# PE-2013019114



OFFICE OF ADMINISTRATION DIVISION OF FACILITIES MANAGEMENT, **DESIGN AND CONSTRUCTION**

DEPARTMENT OF SOCIAL SERVICES

MULTI. DIVISON

HOWERTON STATE OFFICE BUILDING RENOVATE LOBBY AND **RESTROOM 1ST & 2ND FLOOR**

615 HOWERTON COURT JEFFERSON CITY, MO 65010

PROJECT # 02339-01 1025 SITE # 3101025001 ASSET #

REVISION: DATE: **REVISION:** DATE: **REVISION:** DATE: **ISSUE DATE:**

CAD DWG FILE:<u>MEP_02339-01</u> DRAWN BY: <u>RG/MP</u> CHECKED BY: <u>TS</u> DESIGNED BY: TS/AH

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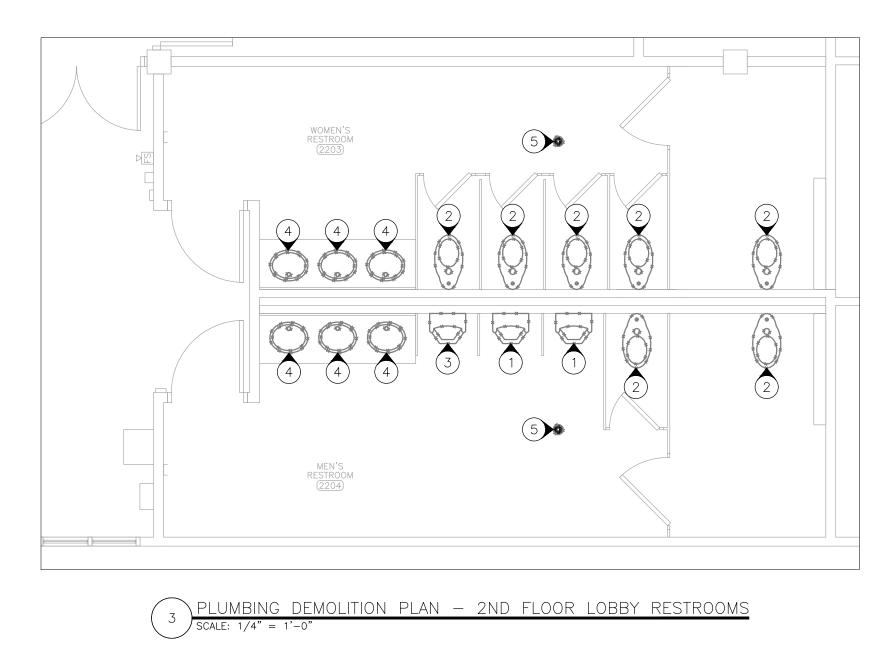
FIRE PROTECTION PLAN - STAFF RESTROOMS


SHEET NUMBER:

F-103 26 OF 38 SHEETS 12/13/2024



FIRE PROTECTION LEGEND (lacksquarePENDENT FIRE SPRINKLER HEAD/ESCUTCHEON WALL MOUNTED EMERGENCY LIGHT TO REMAIN FIRE ALARM STROBE -CEILING MOUNTED FS HVAC DIFFUSER/GRILLE LIGHT FIXTURE -REFER TO LIGHT FIXTURE SCHEDULE FOR ADDITIONAL FIXTURE SYMBOLS



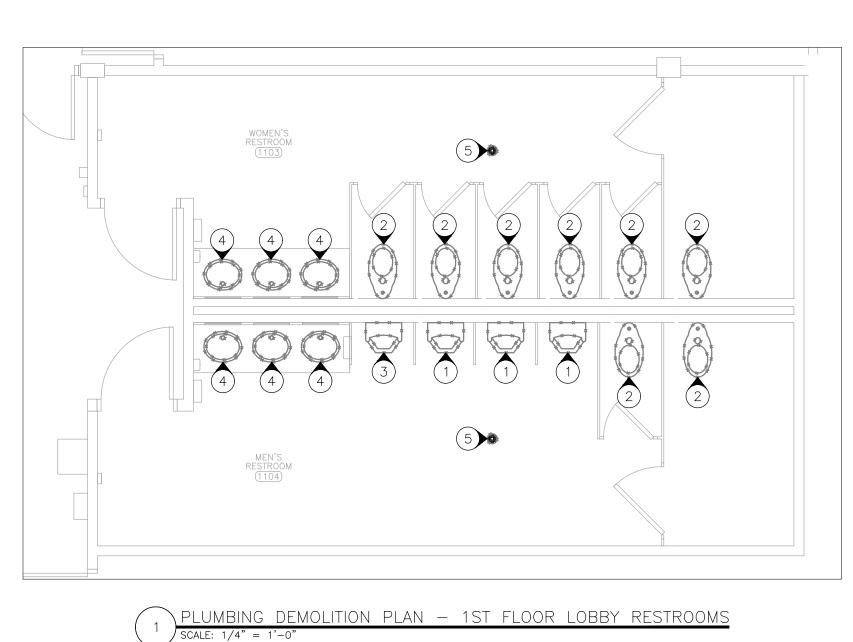


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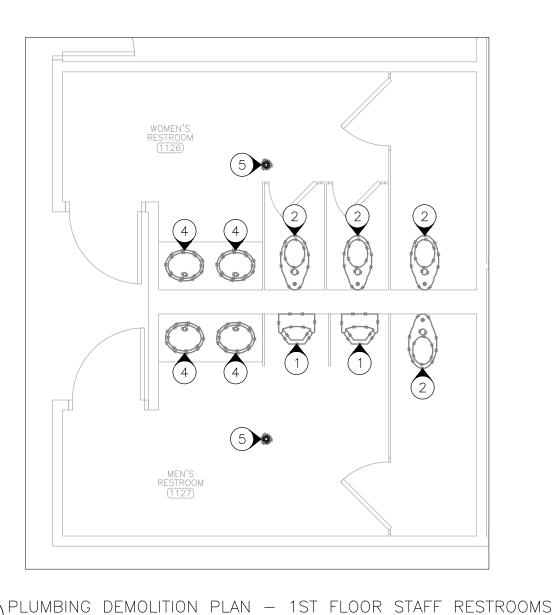
GENERAL NOTES

- ALL DEMOLISHED MATERIAL.

DEMOLITION NOTES

- WORK.
- WORK.
- (5) DEMOLISH FLOOR DRAIN. ASSOCIATED PIPE TO REMAIN FOR USE IN NEW CONSTRUCTION.



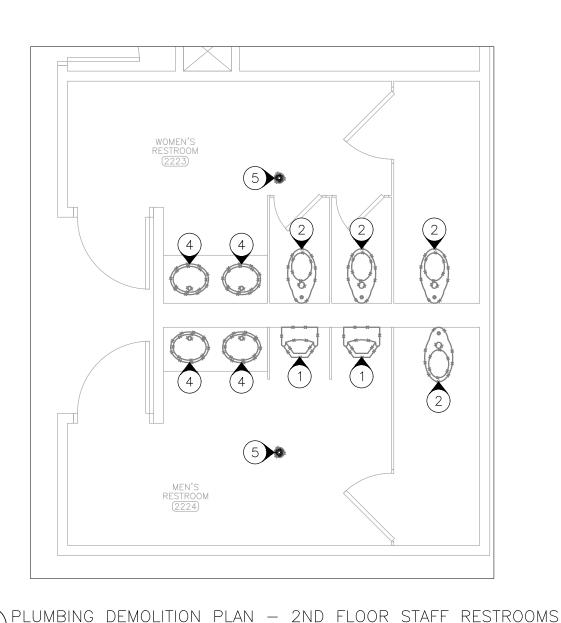

DETAIL 1 AREA MAP - 1ST FLOOR NORTH

1 DEMOLITION DRAWINGS AND PLANS ARE FROM FIELD TAKE-OFF AND ORIGINAL DRAWINGS. CONTRACTOR IS RESPONSIBLE FOR FIELD VERIFYING PRIOR TO BIDDING AND/OR CONSTRUCTION.

2 COVER ALL OPENINGS INTO THE BUILDING FROM THE WORK AREA. ENSURE DEBRIS IS REMOVED FROM THE CONSTRUCTION AND DEMOLITION AREA AND AIR BORN DEBRIS IS NOT ALLOWED TO TRAVEL TO THE REMAINDER OF THE BUILDING. CONTRACTOR IS RESPONSIBLE FOR REMOVAL AND DISPOSAL OF

3 COORDINATE WITH EXISTING SYSTEMS WHICH SHALL REMAIN IN OPERATION DURING DEMOLITION AND CONSTRUCTION PHASES. INSTALL TEMPORARY CAPS AT TERMINATION POINTS OF EXISTING PIPE TO REMAIN DURING DEMOLITION PHASES.

4 CONTRACTOR IS RESPONSIBLE FOR REPAIRING ANY DAMAGE TO ANY SURFACE IN THE AREA OF CONSTRUCTION THAT IS A RESULT OF CONSTRUCTION ACTIVITY. SURFACE SHALL BE REPAIRED AND FINISHED TO MATCH EXISTING CONDITIONS.

5 COORDINATE WITH FACILITY MAINTENANCE STAFF FOR ANY WATER SUPPLY SHUTDOWN REQUIRED. SHUTDOWN SHALL ONLY OCCUR BETWEEN THE HOURS OF 5:30 PM AND 6:30 AM.

6 ENSURE WORK IS PERFORMED SUCH THAT AT LEAST ONE MEN'S AND ONE WOMEN'S RESTROOM ARE IN OPERATION AT ALL TIMES FOR STAFF USE.

(N) INDICATES KEYED NOTES


(1) DEMOLISH URINAL AND ASSOCIATED FLUSHOMETER. WATER SUPPLY AND SANITARY DRAIN LOCATIONS TO REMAIN FOR USE IN NEW CONSTRUCTION.

2 DEMOLISH WATER CLOSET AND ASSOCIATED FLUSHOMETER. WATER SUPPLY PIPE TO BE MODIFIED. SANITARY DRAIN LOCATION TO REMAIN FOR USE IN NEW CONSTRUCTION. COORDINATE WITH GENERAL CONTRACTOR TO REMOVE SECTIONS OF VINYL COVERED SHEET ROCK AS NEEDED TO COMPLETE THE

(3) DEMOLISH URINAL AND ASSOCIATED FLUSHOMETER. WATER SUPPLY PIPE TO BE MODIFIED. SANITARY DRAIN LOCATION TO REMAIN FOR USE IN NEW CONSTRUCTION. COORDINATE WITH GENERAL CONTRACTOR TO REMOVE SECTIONS OF VINYL COVERED SHEET ROCK AS NEEDED TO COMPLETE THE

(4) DEMOLISH LAVATORY, FAUCET, RISERS AND SUPPLY STOPS. HOT AND COLD WATER SUPPLY AND SANITARY DRAIN LOCATIONS TO REMAIN FOR USE IN NEW CONSTRUCTION.



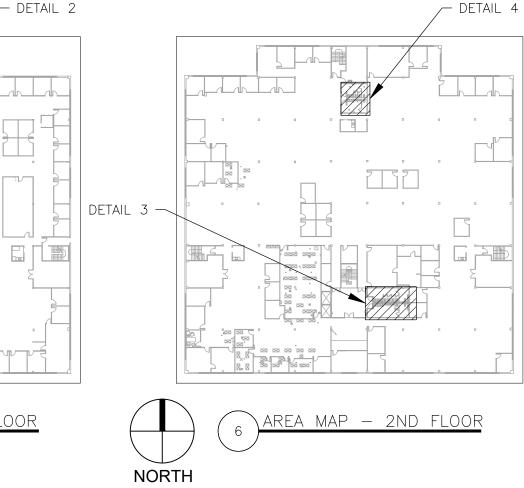

STATE OF MISSOURI MICHAEL L. PARSON, GOVERNOR



Tracie L. Siebeneck - Engineer MO# PE-2013019114



OFFICE OF ADMINISTRATION DIVISION OF FACILITIES MANAGEMENT, **DESIGN AND CONSTRUCTION**

DEPARTMENT OF SOCIAL SERVICES

MULTI. DIVISON

HOWERTON STATE OFFICE BUILDING RENOVATE LOBBY AND RESTROOM 1ST & 2ND FLOOR

615 HOWERTON COURT JEFFERSON CITY, MO 65010

PROJECT # 02339-01 1025 SITE # 3101025001 ASSET #


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CAD DWG FILE:<u>MEP_02339-01</u> DRAWN BY: <u>RG/MP</u> CHECKED BY: <u>TS</u> DESIGNED BY: TS/AH

SHEET TITLE: PLUMBING DEMOLITION PLAN RESTROOMS

SHEET NUMBER:

PD-101 27 OF 38 SHEETS 12/13/2024

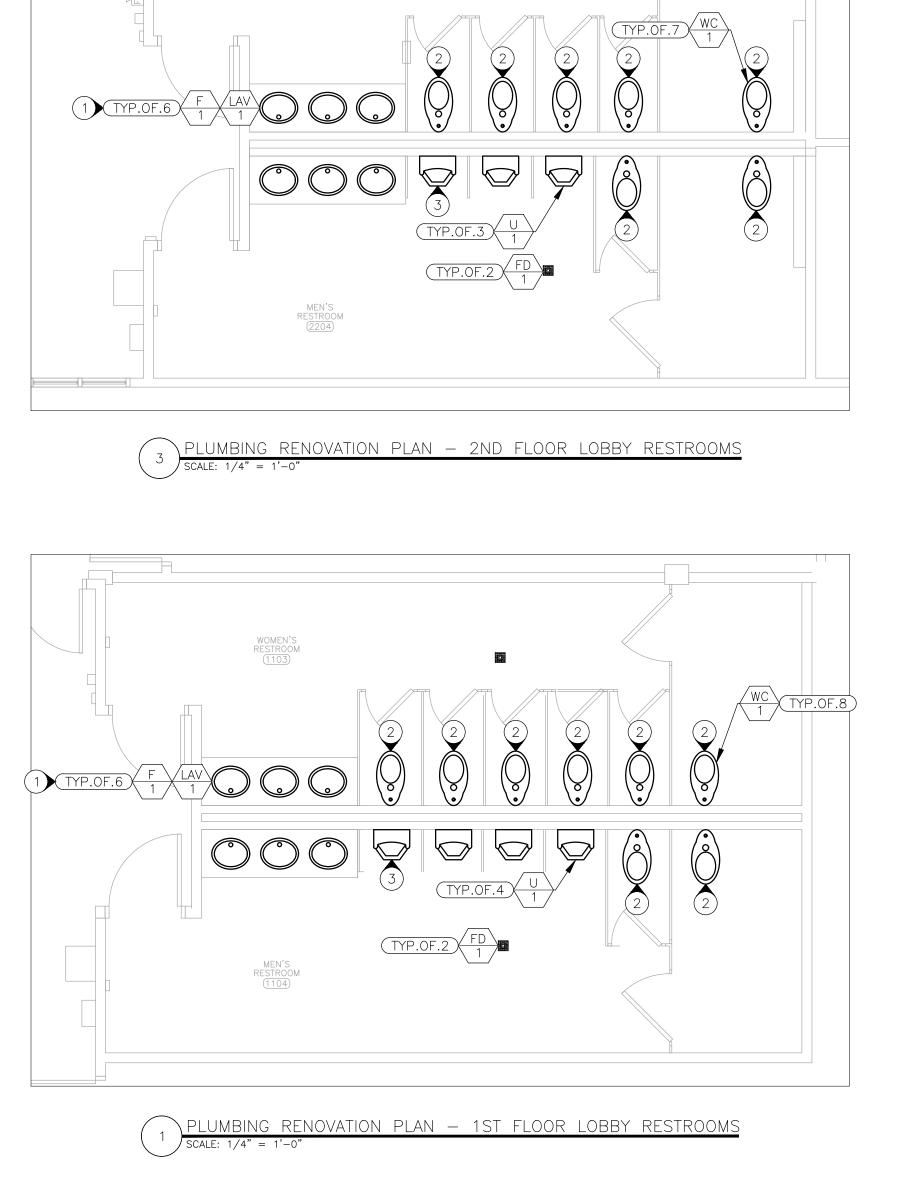


WOMEN'S RESTROOM

GENERAL NOTES


1	FABRICATION, THE LATEST V INSTALLATION
2	ALL PIPE SHA STANDARDS.
3	PROVIDE SUIT. FOLLOW ALL I

1	COORDINATE V DRAIN IN ACC
2	RAISE SUPPLY REPAIR WALL
7	IOWER SUPPI


SHEETS.

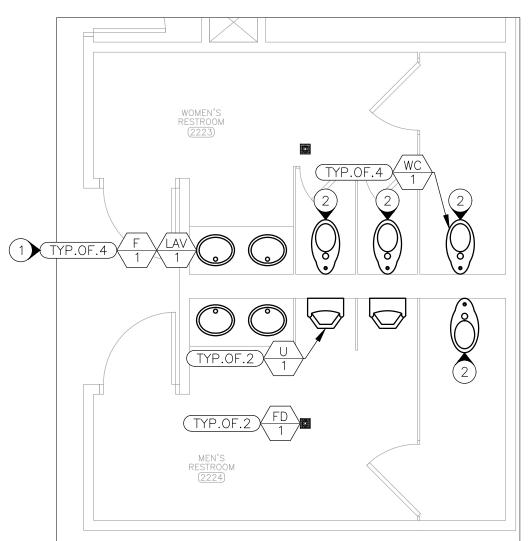

PLUMBING RENOVATION PLAN - 2ND FLOOR STAFF RESTROOMSSCALE: 1/4" = 1'-0"

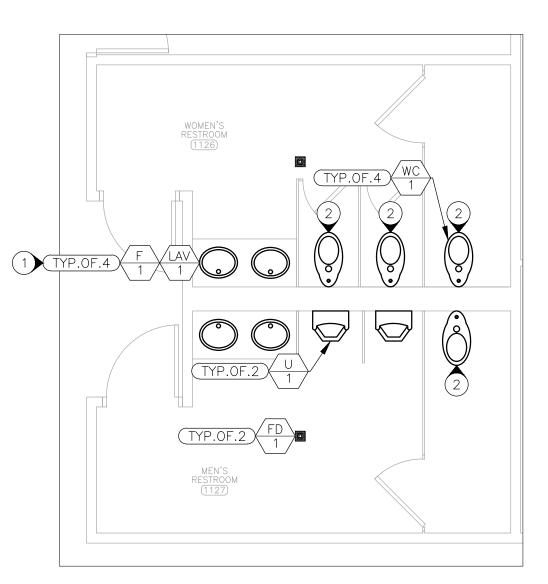

\PLUMBING RENOVATION PLAN - 1ST FLOOR STAFF RESTROOMS

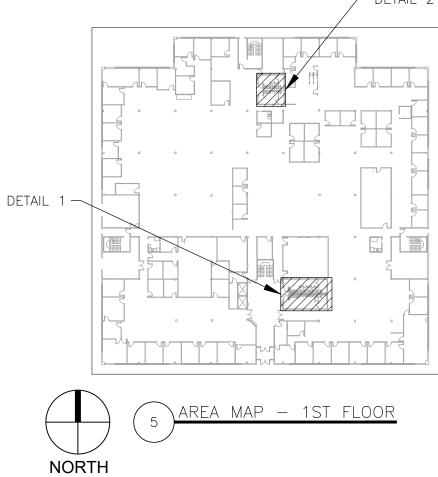

INSTALLATION AND TESTING OF ALL PLUMBING SYSTEMS SHALL BE IN ACCORDANCE WITH VERSION OF THE INTERNATIONAL PLUMBING CODE (IPC) AND ALL MANUFACTURER GUIDELINES.

HALL BE CONSTRUCTED AND INSTALLED AS SPECIFIED IN THE IPC AND ANSI CONSTRUCTION

JITABLE SUPPORTS FOR STABILITY OF ALL PLUMBING FIXTURES, EQUIPMENT AND PIPE. _ MANUFACTURER INSTALLATION GUIDELINES.

4 HOT AND COLD WATER PIPE MATERIAL SHALL BE TYPE L COPPER.

RENOVATION NOTES

WITH GENERAL CONTRACTOR TO INSTALL LAVATORY, FAUCET, SUPPLY STOPS, RISERS AND CORDANCE WITH ADA REQUIREMENTS.

WATER INLET TO MANUFACTURER RECOMMENDED HEIGHT. GENERAL CONTRACTOR TO AND FINISH PER ARCHITECTURAL SHEETS.

3 LOWER SUPPLY WATER INLET SUCH THAT FLUSH CONTROL HEIGHT IS NOT MORE THAN 44 INCHES ABOVE THE FINISH FLOOR. GENERAL CONTRACTOR TO REPAIR WALL AND FINISH PER ARCHITECTURAL





Tracie L. Siebeneck - Engineer MO# PE-2013019114

(N) INDICATES KEYED NOTES



OFFICE OF ADMINISTRATION DIVISION OF FACILITIES MANAGEMENT, **DESIGN AND CONSTRUCTION**

DEPARTMENT OF SOCIAL SERVICES

MULTI. DIVISON

HOWERTON STATE OFFICE BUILDING RENOVATE LOBBY AND RESTROOM 1ST & 2ND FLOOR

615 HOWERTON COURT JEFFERSON CITY, MO 65010

PROJECT #	O2339-01
SITE #	1025
ASSET #	3101025001

REVISION:
DATE:
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ISSUE DATE:

CAD DWG FILE:<u>MEP_02339-01</u> DRAWN BY: <u>RG/MP</u> CHECKED BY: <u>TS</u> DESIGNED BY: <u>TS/AH</u>


SHEET TITLE: PLUMBING **RENOVATION PLAN** RESTROOMS

SHEET NUMBER:

P-101 28 OF 38 SHEETS 12/13/2024

PLUMBING LEGEND TYP.OF.# TYPICAL OF # LIKE DEVICES THIS GROUP / aa \ \ N / DEVICE SCHEDULE TAG



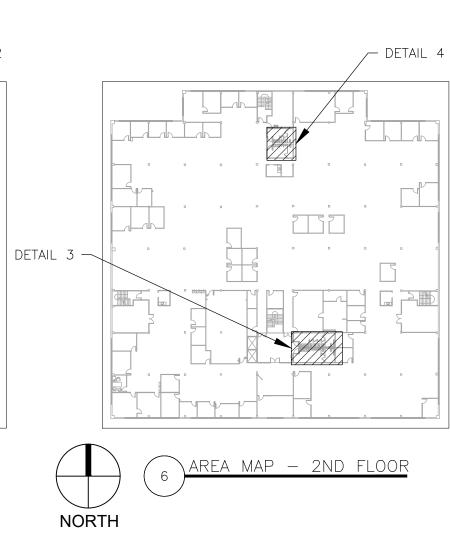

FLOOR DRAIN SCHEDLILE

FLOU	R DRAIN SCH	EDULE				
MARK	MANUFACTURER	MODEL	FACE SIZE (INCHxINCH)	DESCRIPTION	SPECIFICATION	NOTES
FD-1	ZURN	EZ-PV2-ST-SS-TSP	5x5		BODY: PVC SOLVENT WELD; GRATE: POLISHED STAINLESS	1,2
NOTES				DRAIN	STEEL TOP	
1						

1 PROVIDE 2 INCH NO-HUB OUTLET

2 PROVIDE TRAP SEAL PROTECTIVE DEVICE ZURN MODEL Z1072 OR EQUAL AND MATCH SIZE TO DRAIN OUTLET

FAUCET SCHEDULE

TAUCE	IJCHLDOLL				
MARK	MANUFACTURER	MODEL	CONNECTIONS	DESCRIPTION	NOTES
F-1	KOHLER	TRITON BOWE K-800T20-5AKA	1/2" HOT/COLD	TYPE: COUNTER MOUNT WIDE SPREAD LAVATORY FAUCET, 5-1/2" SPOUT REACH W/VANDAL RESISTANT AERATED FLOW, FLEXIBLE UNDERBODY; FINISH: POLISHED CHROME; CONSTRUCTION: SOLID BRASS; HANDLES: WRIST BLADE LEVER HANDLES WITH BLUE AND RED COLOR INDEXES; VALVE: 1/4 TURN CERAMIC DISC	1
NOTES	•				
1	PROVIDE STAINLESS	STEEL WATER SUPPL	LY CONNECTORS AN	D MULTI-TURN ANGLE STOPS	

LAVA	LAVATORY SCHEDULE					
MARK	MANUFACTURER	MODEL	DIMENSIONS	DESCRIPTION	NOTES	
LAV-1	AMERICAN STANDARD	OVALYN 497221.02	19"L x 15.375"W 7.5"D	TYPE: OVAL UNDERCOUNTER MOUNT; MATERIAL: WHITE VITREAOUS CHINA; DRAIN: 2-3/16" SOLID BRASS W/ OVERFLOW	1,2,3	
NOTES						
1	PROVIDE LAV GUARI TREATMENT	D2 MODEL #102 E-Z:	ADA COMPLIANT, N	IOLDED VINYL WASTE AND SUPPLY PIPE COVERS WITH ANTI-	MICROBIAL	
2	PROVIDE AMERICAN	STANDARD MODEL	2411.015 1-1/4 INC	H BRASS GRID DRAIN WITH OVERFLOW AND POLISHED CHRO	ME FINISH	
2						

URINA	AL SCHEDULE			
MARK	MANUFACTURER	MODEL	DESCRIPTION	NOTES
U-1	ZURN	Z5758-U	TYPE: WALL MOUNT; MATERIAL: WHITE VITREOUS CHINA; INLET: 3/4" TOP SPUD; OUTLET: 2" FLANGE AND RUBBER GASKET W/ INTEGRAL TRAP AND VANDAL RESISTANT OUTLET STRAINER	1
NOTES				
1	PROVIDE ZURN ELECTRONIC SENSOR OPERATED FLUSHOMETER MODEL ZER6003AV-SM-ULF; 0.125 GPF			

WATER CLOSET SCHEDULE				
MARK	MANUFACTURER	MODEL	DESCRIPTION	NOTES
WC-1	KOHLER	HIGHCLIFF ULTRA K-96057	TYPE: FLOOR MOUNT; MATERIAL: WHITE VITREOUS CHINA; INLET: 1-1/2" TOP SPUD; OUTLET: 2-1/8" FULLY GLAZED TRAPWAY; BOWL: ELONGATED; BOWL HEIGHT: 16-5/8"	1,2
NOTES				
1	PROVIDE KOHLER STRONGHOLD MODEL K-4731-CA-0, HEAVY DUTY SEAT, OPEN FRONT, LESS COVER WITH ANTI-MICROBIAL TREATMENT			
2	PROVIDE ZURN ELECTRONIC SENSOR OPERATED FLUSHOMETER MODEL ZER6000AV-SM-WS1; 1.6 GPF			

3 PROVIDE DEARBORN BRASS MODEL 700-1; BRASS TUBULAR 1-1/4 INCH P-TRAP WITHOUT CLEANOUT

STATE OF MISSOURI MICHAEL L. PARSON, GOVERNOR



Tracie L. Siebeneck - Engineer MO# PE-2013019114

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OFFICE OF ADMINISTRATION DIVISION OF FACILITIES MANAGEMENT, **DESIGN AND CONSTRUCTION**

DEPARTMENT OF SOCIAL SERVICES

MULTI. DIVISON

HOWERTON STATE OFFICE BUILDING RENOVATE LOBBY AND **RESTROOM 1ST & 2ND FLOOR**

615 HOWERTON COURT JEFFERSON CITY, MO 65010

PROJECT #	O2339-01
SITE #	1025
ASSET #	3101025001


REVISION: DATE: REVISION: DATE: REVISION: DATE: ISSUE DATE:

CAD DWG FILE:<u>MEP_02339-01</u> DRAWN BY: <u>RG/MP</u> CHECKED BY: <u>TS</u> DESIGNED BY: <u>TS/AH</u>

SHEET TITLE: PLUMBING SCHEDULES AND DETAILS

SHEET NUMBER:

P-601 29 OF 38 SHEETS . 12/13/2024

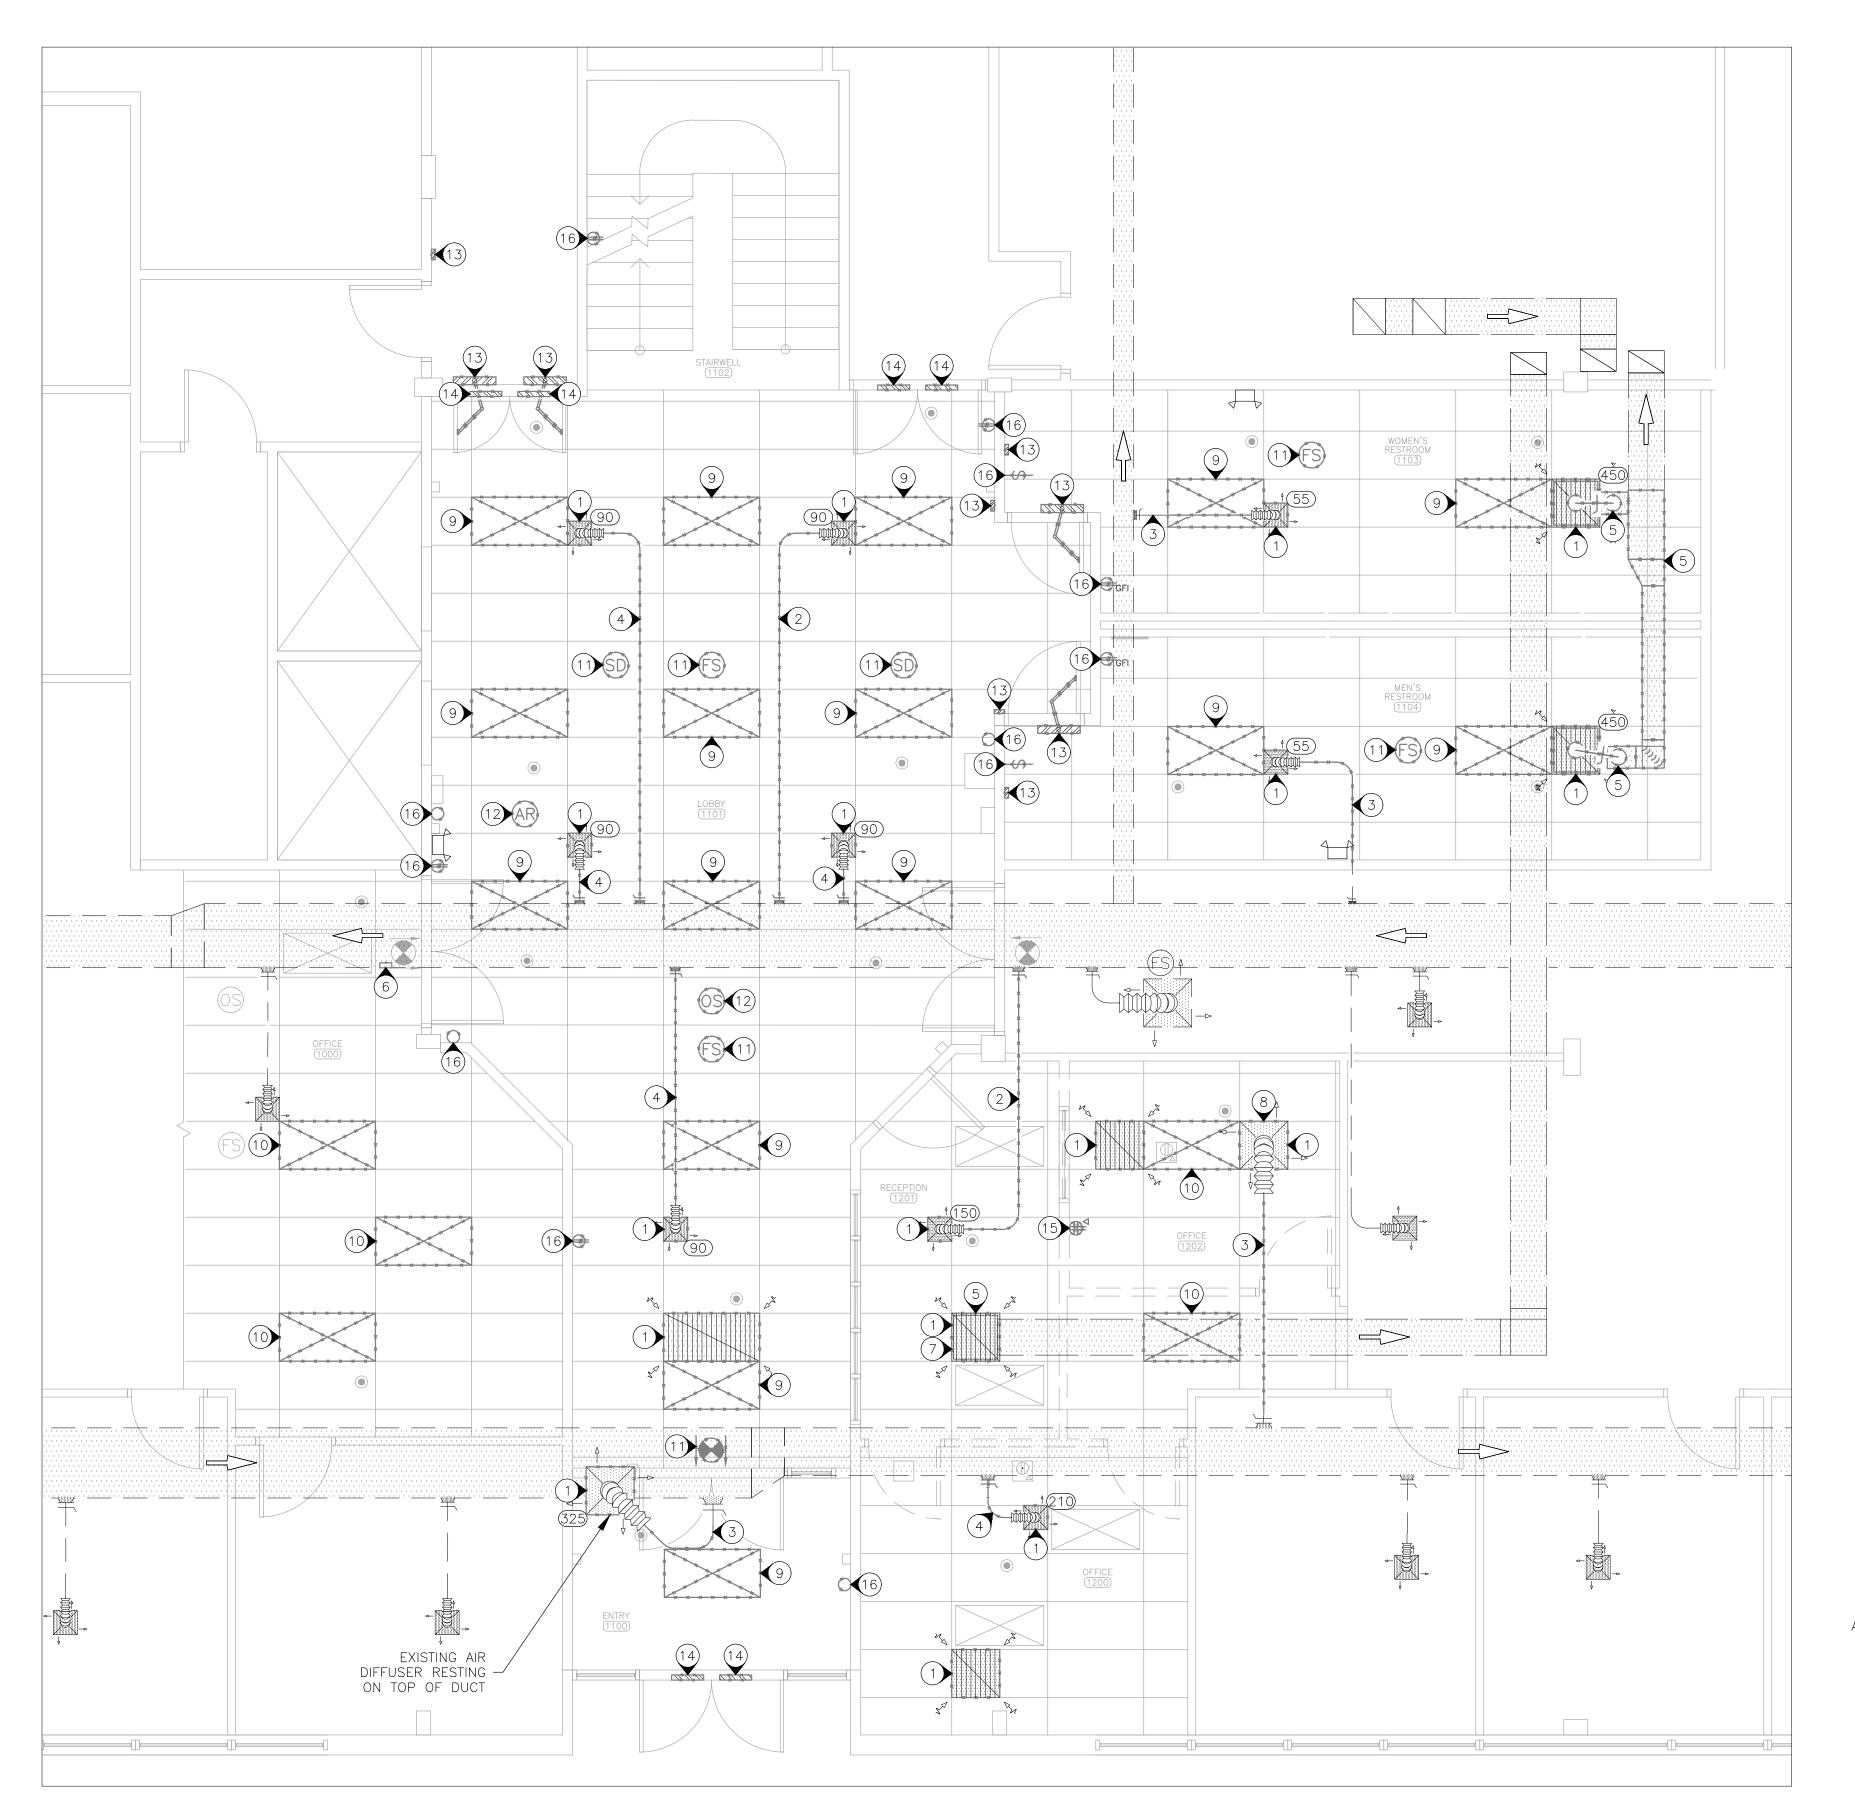

MECHANICAL AND ELECTRICAL DEMOLITION PLAN - 1ST FLOOR SCALE: 1/4" = 1'-0

GENERAL NOTES


- ALL DEMOLISHED MATERIAL.

DEMOLITION NOTES

- CONSTRUCTION.

- AIRFLOW TO ENGINEER.

- USE IN NEW CONSTRUCTION.

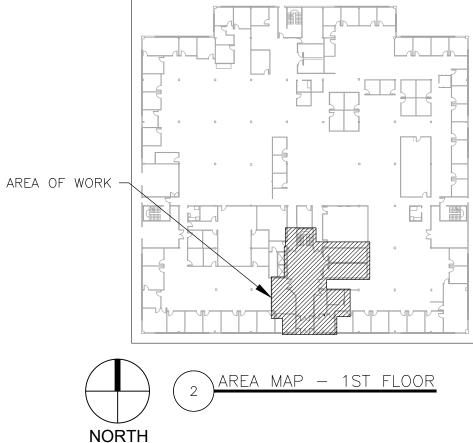

1 DEMOLITION DRAWINGS AND PLANS ARE FROM FIELD TAKE-OFF AND ORIGINAL DRAWINGS. CONTRACTOR IS RESPONSIBLE FOR FIELD VERIFYING PRIOR TO BIDDING AND/OR CONSTRUCTION.

2 COVER ALL OPENINGS INTO THE BUILDING FROM THE WORK AREA. ENSURE DEBRIS IS REMOVED FROM THE CONSTRUCTION AND DEMOLITION AREA AND AIR BORN DEBRIS IS NOT ALLOWED TO TRAVEL TO THE REMAINDER OF THE BUILDING. CONTRACTOR IS RESPONSIBLE FOR REMOVAL AND DISPOSAL OF

3 CONTRACTOR IS RESPONSIBLE FOR REPAIRING ANY DAMAGE TO ANY SURFACE IN THE AREA OF CONSTRUCTION THAT IS A RESULT OF CONSTRUCTION ACTIVITY. SURFACE SHALL BE REPAIRED AND FINISHED TO MATCH EXISTING CONDITIONS.

4 TESTING AND BALANCING CONTRACTOR SHALL TEST EXISTING AIRFLOW PRIOR TO DEMOLITION ACTIVITIES AND RECORD VALUES. NOTIFY ENGINEER IF VALUES DIFFER FROM SPECIFIED BY MORE THAN $\pm 10\%$. TEST AND BALANCE ALL SYSTEMS TO THESE VALUES WHEN CONSTRUCTION IS COMPLETE AND PREPARE A BALANCE REPORT PER ASHRAE STANDARD 111 OR EQUAL. REPORT SHALL BE SENT TO THE ENGINEER FOR APPROVAL PRIOR TO FINAL COMPLETION.

(N) INDICATES KEYED NOTES

(1) MECHANICAL CONTRACTOR TO DEMOLISH AIR DEVICE.

2 MECHANICAL CONTRACTOR TO DEMOLISH FLEXIBLE DUCT AND PATCH DUCT AT BRANCH TAKE-OFF. PROVIDE AIR TIGHT SEAL AND INSULATE TO MATCH EXISTING.

(3) MECHANICAL CONTRACTOR TO DEMOLISH FLEXIBLE DUCT. TAKE-OFF TO REMAIN FOR USE IN NEW

(4) MECHANICAL CONTRACTOR TO DEMOLISH FLEXIBLE DUCT. EXPAND TAKE-OFF PENETRATION TO MATCH SIZE OF NEW TAKE-OFF. REFER TO SHEET M-101 FOR TAKE-OFF SIZE.

(5) MECHANICAL CONTRACTOR TO DEMOLISH DUCT AS SHOWN OR AS NEEDED TO THE COMPLETE WORK. REFER TO SHEET M-101 FOR NEW WORK.

(6) MECHANICAL CONTRACTOR TO CREATE PENETRATION IN EXISTING DUCT FOR NEW TAKE-OFF. REFER TO SHEET M-101 FOR PENETRATION SIZE.

(7) NO TESTING AND BALANCING REQUIRED FOR AIR DEVICE.

(8) EXISTING AIRFLOW IS NOT KNOWN, TESTING AND BALANCING CONTRACTOR SHALL PROVIDE MEASURED

(9) ELECTRICAL CONTRACTOR TO DEMOLISH LIGHT FIXTURE.

(10) ELECTRICAL CONTRACTOR TO REMOVE AND RETAIN LIGHT FIXTURE FOR USE IN NEW CONSTRUCTION.

(1) ELECTRICAL CONTRACTOR TO DEMOLISH FIRE STROBE/SMOKE DETECTOR/EXIT SIGN.

12 ELECTRICAL CONTRACTOR TO REMOVE AND RETAIN OCCUPANCY SENSOR/AREA OF REFUGE SIGN FOR

(13) ELECTRICAL CONTRACTOR TO DEMOLISH ADA DOOR OPERATOR AND ASSOCIATED ACTIVATION DEVICE. CONDUIT AND CONDUCTORS TO REMAIN FOR USE IN NEW CONSTRUCTION.

(14) ELECTRICAL CONTRACTOR TO REMOVE AND RETAIN SECURITY DEVICES AS REQUIRED FOR DOOR REPLACEMENT. CONDUIT AND CONTROLS WIRING TO REMAIN FOR USE IN NEW CONSTRUCTION. COORDINATE WITH GENERAL CONTRACTOR TO IDENTIFY DEVICES TO BE REMOVED.

(15) ELECTRICAL CONTRACTOR TO DEMOLISH RECEPTACLE, DATA ACCESS POINT AND WALL BOX. DEMOLISH CONDUIT AND CONDUCTORS BACK TO JUNCTION BOX LOCATED ABOVE CEILING FOR USE IN NEW CONSTRUCTION. REMOVE AND RETAIN DATA WIRE FOR USE IN NEW CONSTRUCTION.

(16) ELECTRICAL CONTRACTOR TO DEMOLISH BLANK COVER PLATE, DUPLEX RECEPTACLE, OR WALL SWITCH. WALL BOX, CONDUIT AND CONDUCTORS TO REMAIN FOR USE IN NEW CONSTRUCTION.

LEGEND					
	PENDENT FIRE SPRINKLER HEAD/ESCUTCHEON				
	DIRECTIONAL EXIT SIGN				
	WALL MOUNTED EMERGENCY LIGHT TO REMAIN				
æ,	2 GANG FLOOR BOX W/ DATA				
\$	WALL SWITCH				
€GFI	DUPLEX RECEPTACLE 120V GROUND FAULT TYPE				
Ð	DUPLEX RECEPTACLE				
₽	QUAD RECEPTACLE WITH DATA				
0	BLANK COVER PLATE				
FS	FIRE ALARM STROBE —CEILING MOUNTED				
SD	SMOKE DETECTOR -CEILING MOUNTED				
OS	OCCUPANCY SENSOR —CEILING MOUNTED				
AR	AREA OF REFUGE SIGN -CEILING MOUNTED				
(350)	AIR FLOW (CUBIC FEET PER MINUTE)				
	DIRECTION OF FLOW				
	LIGHT FIXTURE				
	SUPPLY AIR – EXISTING				
	EXHAUST AIR – EXISTING				
	EXISTING MATERIALS TO BE REMOVED				



STATE OF MISSOURI MICHAEL L. PARSON, **GOVERNOR**



Tracie L. Siebeneck - Engineer MO# PE-2013019114

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OFFICE OF ADMINISTRATION DIVISION OF FACILITIES MANAGEMENT, **DESIGN AND CONSTRUCTION**

DEPARTMENT OF SOCIAL SERVICES

MULTI. DIVISON

HOWERTON STATE OFFICE BUILDING RENOVATE LOBBY AND RESTROOM 1ST & 2ND FLOOR

615 HOWERTON COURT JEFFERSON CITY, MO 65010

PROJECT #	O2339-01
SITE #	1025
ASSET #	3101025001

REVISION: DATE: **REVISION:** DATE: **REVISION:** DATE: **ISSUE DATE:**

CAD DWG FILE:<u>MEP_02339-01</u> DRAWN BY: <u>RG/MP</u> CHECKED BY: <u>TS</u> DESIGNED BY: TS/AH


SHEET TITLE:

MECH AND ELEC DEMOLITION PLAN **1ST FLOOR**

SHEET NUMBER:

MED-101


30 OF 38 SHEETS 12/13/2024

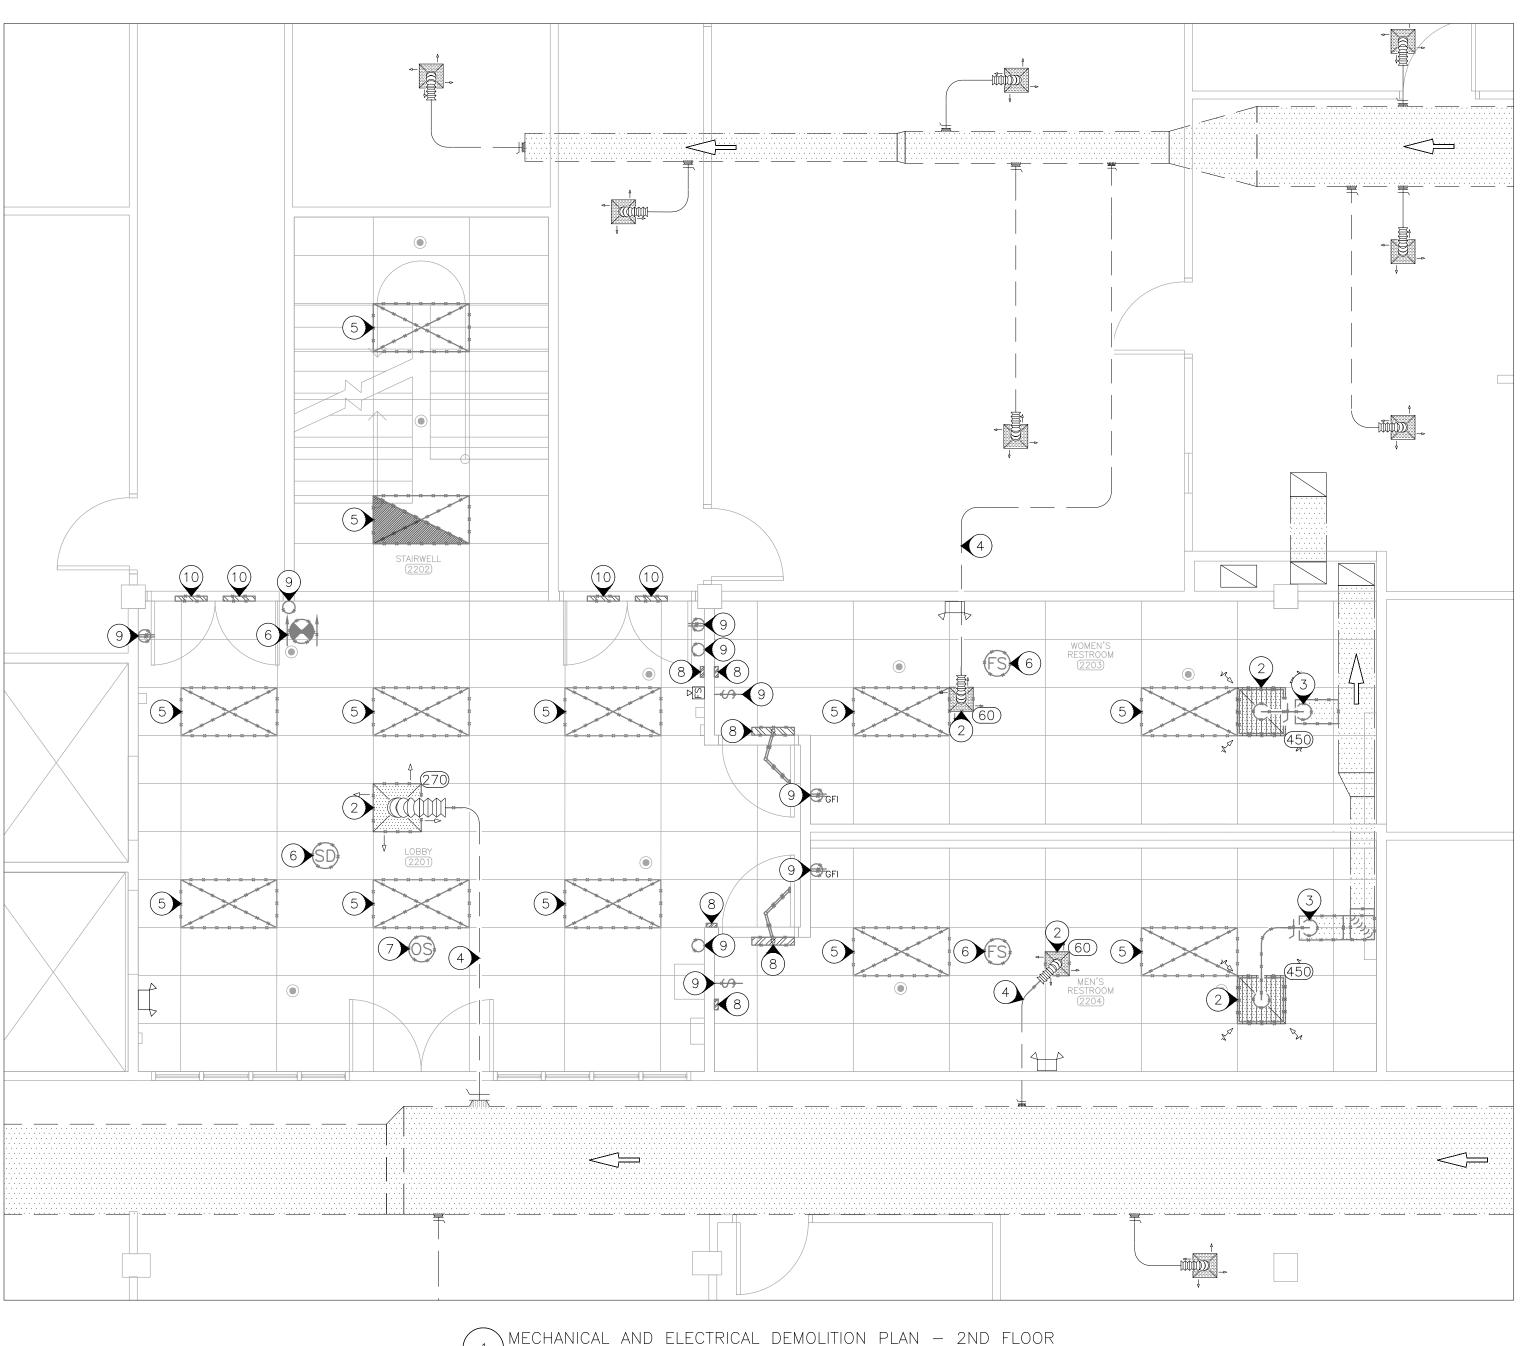

 $\int SCALE: 1/4" = 1'-0'$

DEMOLITION NOTES

1	REFER TO SH
2	MECHANICAL (
3	MECHANICAL (M-102 FOR N
4	FLEXIBLE DUC
5	ELECTRICAL C
6	ELECTRICAL C
7	ELECTRICAL C
8	ELECTRICAL C CONDUIT AND
9	ELECTRICAL C WALL BOX, CO
10	ELECTRICAL C REPLACEMENT

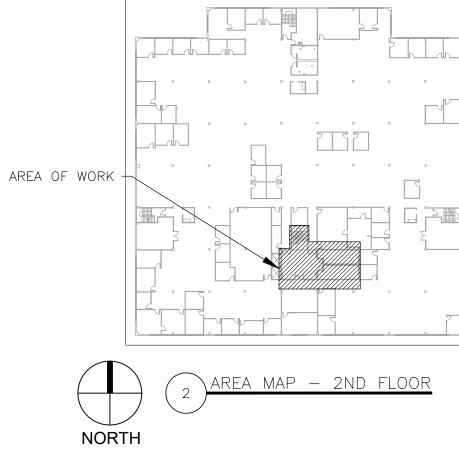

N INDICATES KEYED NOTES

SHEET MED-101 FOR GENERAL DEMOLITION NOTES.

CONTRACTOR TO DEMOLISH AIR DEVICE.

CONTRACTOR TO DEMOLISH DUCT AS NEEDED TO COMPLETE THE WORK. REFER TO SHEET NEW WORK.

JCT TO REMAIN FOR USE IN NEW CONSTRUCTION.

CONTRACTOR TO DEMOLISH LIGHT FIXTURE.

CONTRACTOR TO DEMOLISH FIRE STROBE/SMOKE DETECTOR/EXIT SIGN.

LEGEND

PENDENT FIRE SPRINKLER HEAD/ESCUTCHEON

WALL MOUNTED EMERGENCY LIGHT TO REMAIN

DIRECTIONAL EXIT SIGN

DUPLEX RECEPTACLE 120V GROUND FAULT TYPE

DUPLEX RECEPTACLE

BLANK COVER PLATE

FIRE ALARM STROBE -CEILING MOUNTED

FIRE ALARM STROBE -WALL MOUNTED

SMOKE DETECTOR

-CEILING MOUNTED

OCCUPANCY SENSOR

-CEILING MOUNTED

DIRECTION OF FLOW

EMERGENCY LIGHT FIXTURE

EXHAUST AIR – EXISTING

LIGHT FIXTURE

AIR FLOW (CUBIC FEET PER MINUTE)

WALL SWITCH

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FS

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SD

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(350)

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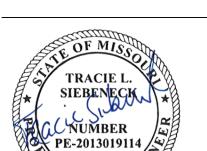
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CONTRACTOR TO REMOVE AND RETAIN OCCUPANCY SENSOR FOR USE IN NEW

CONTRACTOR TO DEMOLISH ADA DOOR OPERATOR AND ASSOCIATED ACTIVATION DEVICE. CONDUCTORS TO REMAIN FOR USE IN NEW CONSTRUCTION.

CONTRACTOR TO DEMOLISH BLANK COVER PLATE, DUPLEX RECEPTACLE OR WALL SWITCH. ONDUIT AND CONDUCTORS TO REMAIN FOR USE IN NEW CONSTRUCTION.

CONTRACTOR TO REMOVE AND RETAIN SECURITY DEVICES AS REQUIRED FOR DOOR . CONDUIT AND CONTROLS WIRING TO REMAIN FOR USE IN NEW CONSTRUCTION. COORDINATE WITH GENERAL CONTRACTOR TO IDENTIFY DEVICES TO BE REMOVED.



STATE OF MISSOURI

GOVERNOR

MICHAEL L. PARSON,

Tracie L. Siebeneck - Engineer MO# PE-2013019114

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MULTI. DIVISON

HOWERTON STATE OFFICE BUILDING RENOVATE LOBBY AND RESTROOM 1ST & 2ND FLOOR

615 HOWERTON COURT JEFFERSON CITY, MO 65010

PROJECT # 02339-01 1025 SITE # 3101025001 ASSET #

REVISION: DATE: **REVISION:** DATE: **REVISION**: DATE: **ISSUE DATE:**

CAD DWG FILE:<u>MEP_02339-01</u> DRAWN BY: <u>RG/MP</u> CHECKED BY: TS DESIGNED BY: TS/AH

SHEET TITLE:

MECH AND ELEC DEMOLITION PLAN 2ND FLOOR


SHEET NUMBER:




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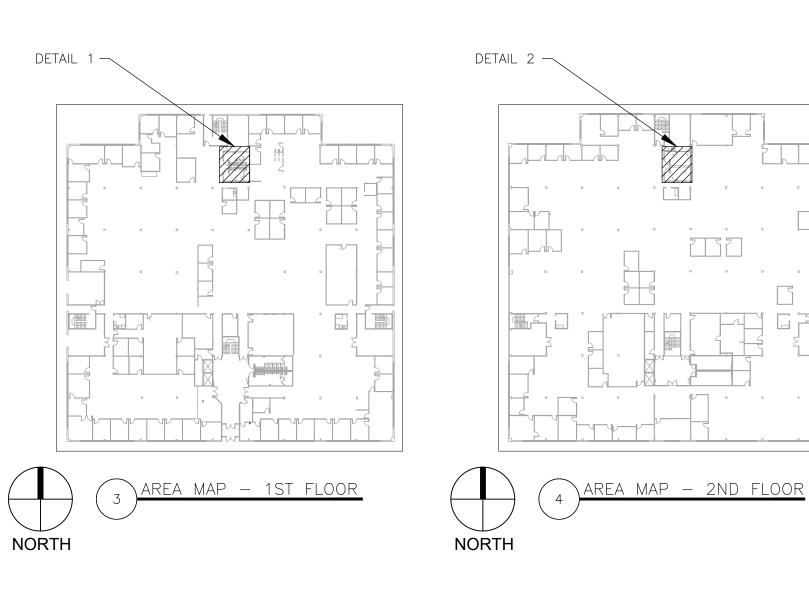




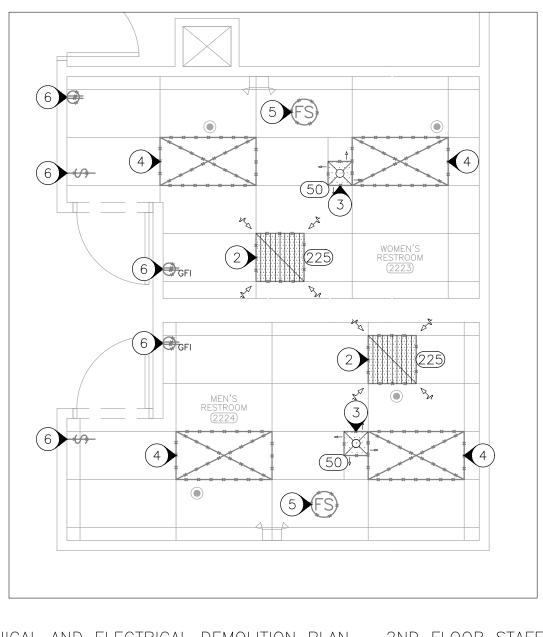

DEMOLITION NOTES

1	REFER TO SH
2	MECHANICAL (WORK.
3	MECHANICAL C
4	ELECTRICAL C
5	ELECTRICAL C
6	ELECTRICAL C

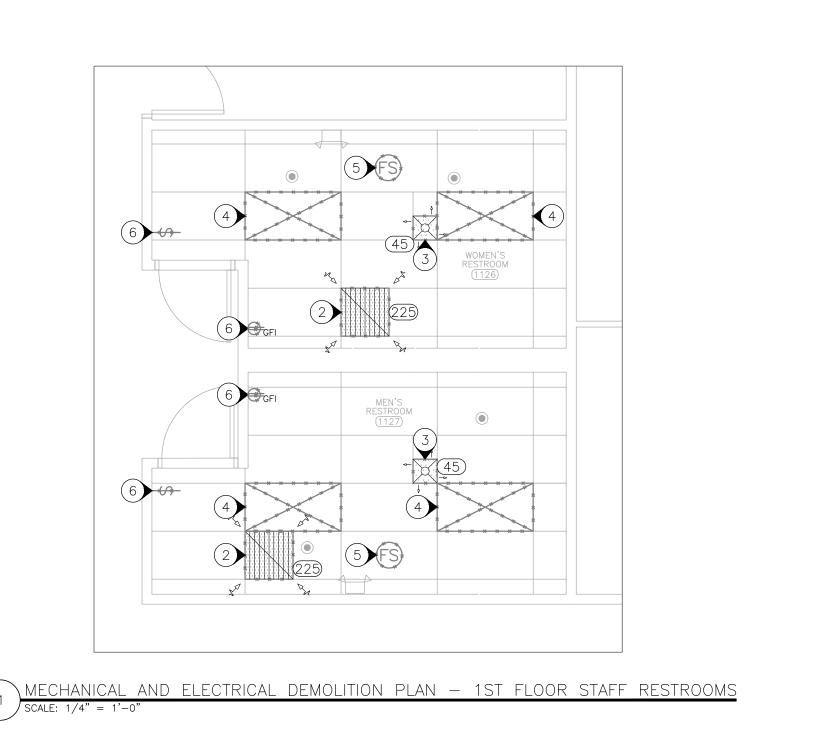

SHEET MED-101 FOR GENERAL DEMOLITION NOTES. CONTRACTOR TO DEMOLISH AIR DEVICE. DEMOLISH DUCT AS NEEDED TO COMPLETE THE

CONTRACTOR TO DEMOLISH AIR DEVICE. FLEXIBLE DUCT TO REMAIN FOR USE IN NEW

CONTRACTOR TO DEMOLISH LIGHT FIXTURE.

CONTRACTOR TO DEMOLISH FIRE STROBE

ELECTRICAL CONTRACTOR TO DEMOLISH DUPLEX RECEPTACLE OR WALL SWITCH. WALL BOX, CONDUIT AND CONDUCTORS TO REMAIN FOR USE IN NEW CONSTRUCTION.





Tracie L. Siebeneck - Engineer MO# PE-2013019114



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HOWERTON STATE OFFICE BUILDING RENOVATE LOBBY AND **RESTROOM 1ST & 2ND FLOOR**

615 HOWERTON COURT JEFFERSON CITY, MO 65010

PROJECT #	O2339-01
SITE #	1025
ASSET #	310102500

REVISION: DATE: **REVISION:** DATE: **REVISION:** DATE: ISSUE DATE:

CAD DWG FILE:<u>MEP_02339-01</u> DRAWN BY: <u>RG/MP</u> CHECKED BY: <u>TS</u> DESIGNED BY: TS/AH

SHEET TITLE:

MECH AND ELEC DEMOLITION PLAN STAFF RESTROOMS


SHEET NUMBER:

MED-103

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LEGEND		
	PENDENT FIRE SPRINKLER HEAD/ESCUTCHEOI	
	WALL MOUNTED EMERGENCY LIGHT TO REMAIL	
FS	FIRE ALARM STROBE -CEILING MOUNTED	
\$	WALL SWITCH	
€GFI	DUPLEX RECEPTACLE 120V GROUND FAULT TYPE	
Ð	DUPLEX RECEPTACLE	
350	AIR FLOW (CUBIC FEET PER MINUTE)	
	LIGHT FIXTURE	
_ 	EXISTING MATERIALS TO BE REMOVED	



SCALE: 1/4" = 1'-0"

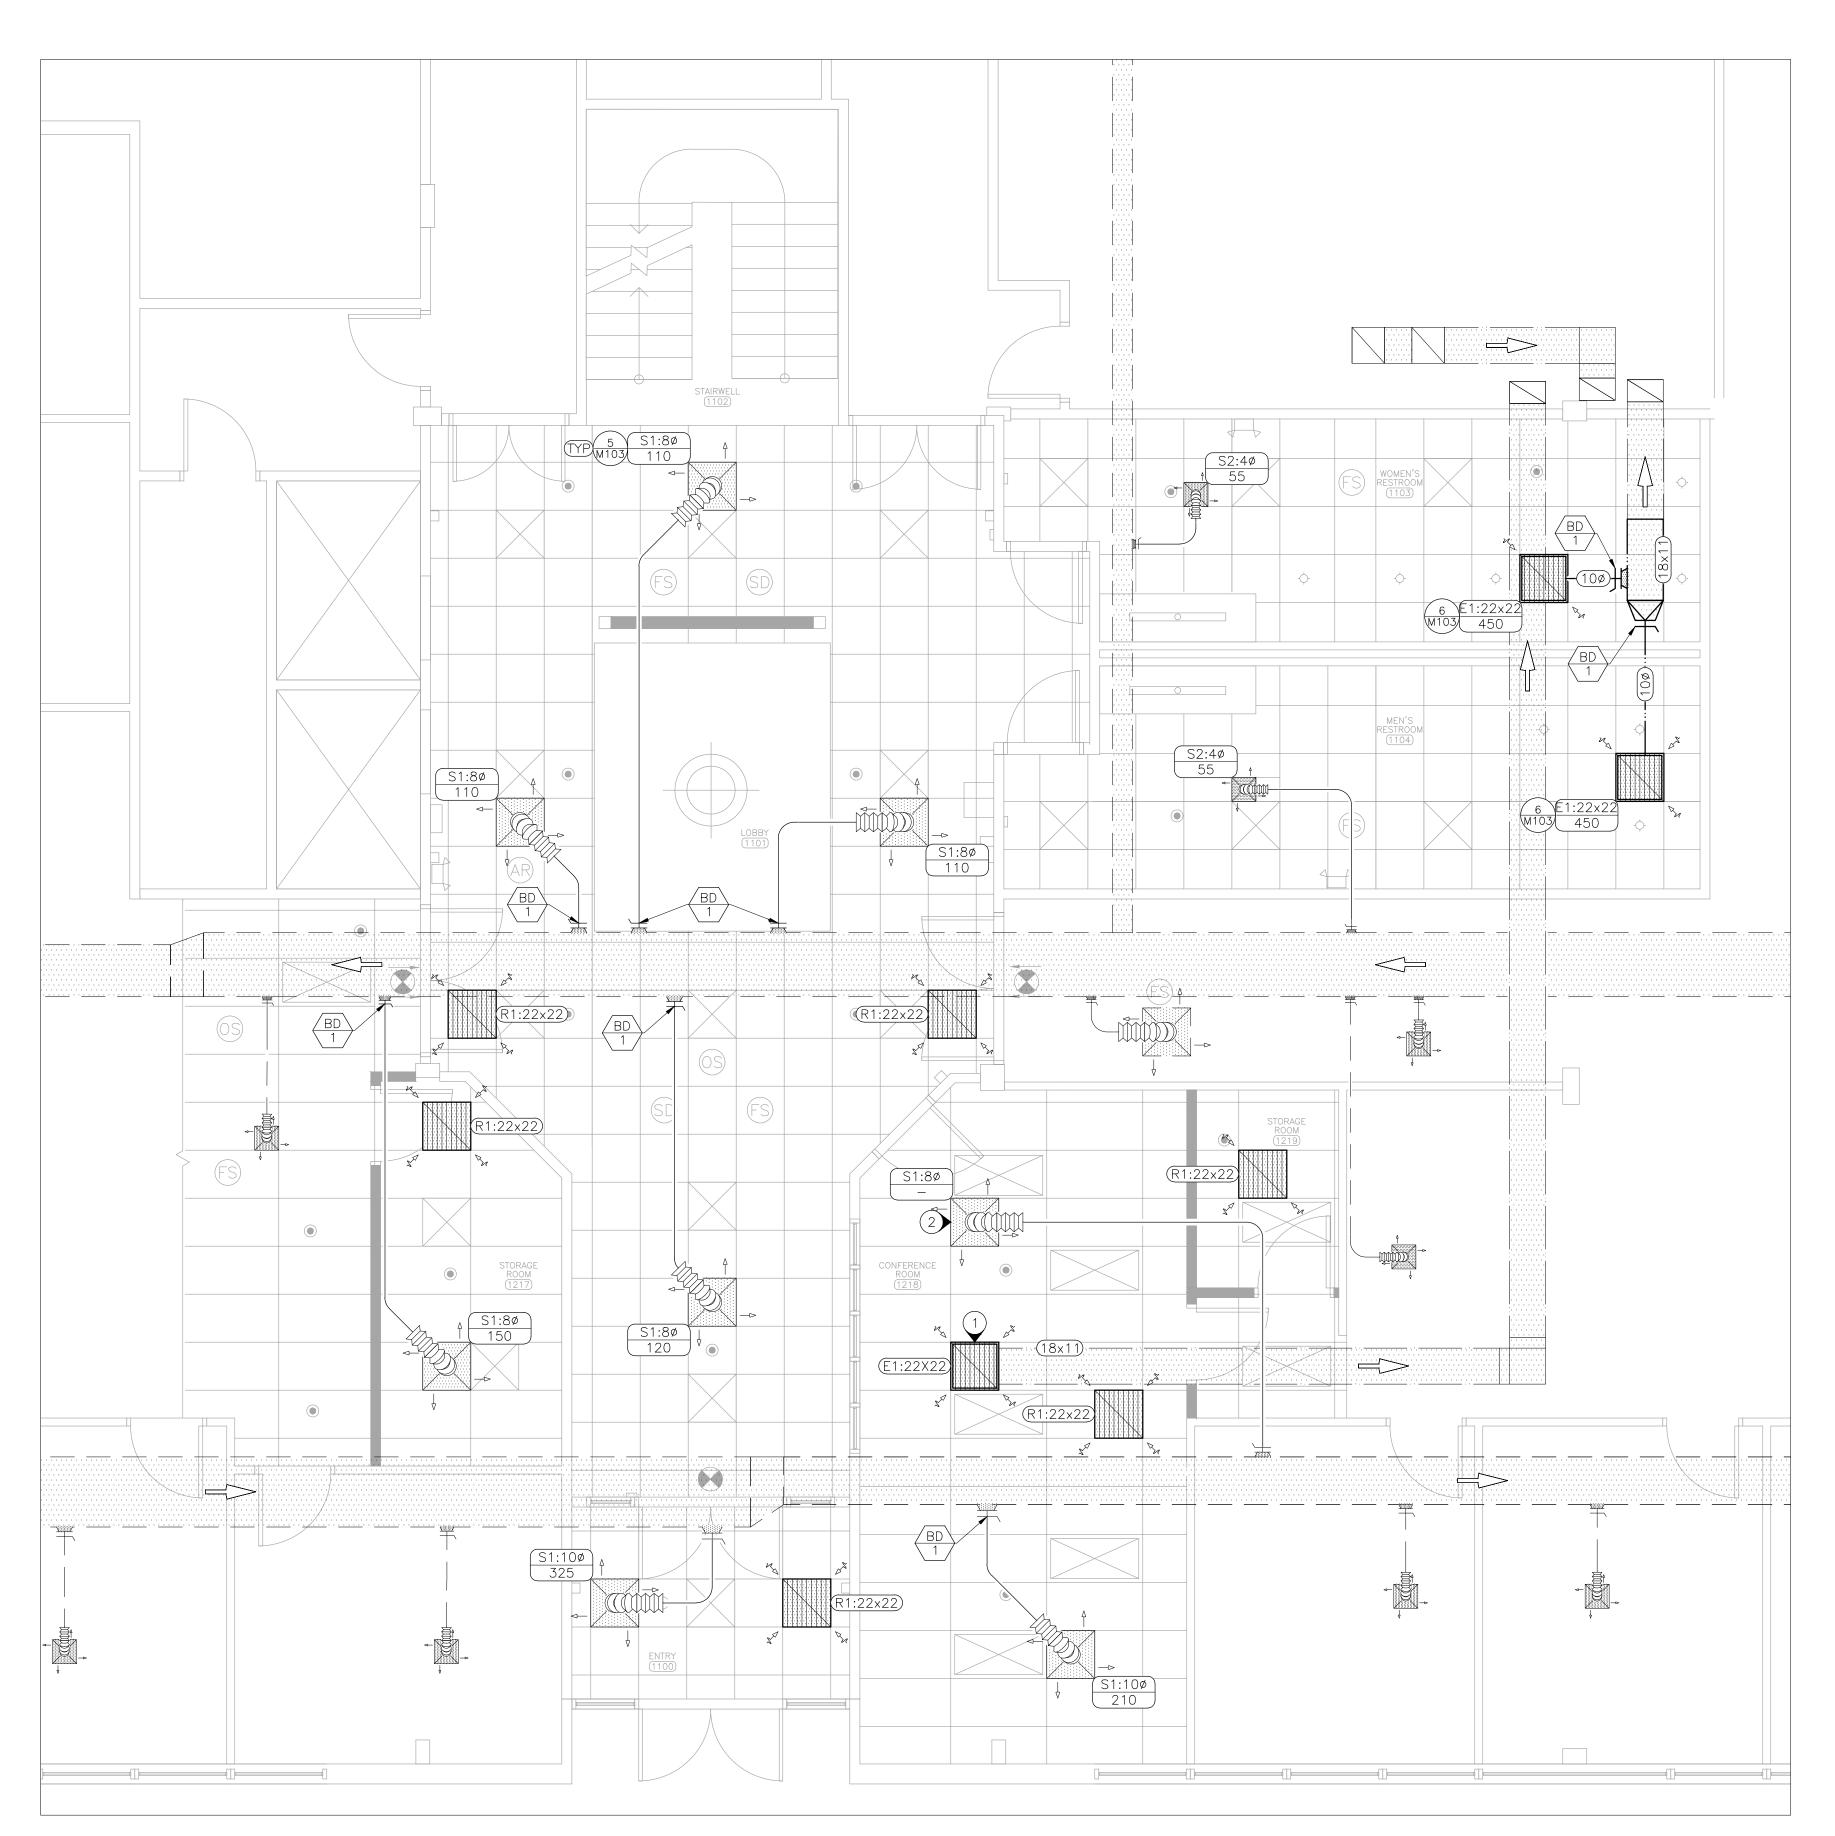MECHANICAL RENOVATION PLAN - 1ST FLOOR


GENERAL NOTES

- INSTALLATION GUIDELINES.

RENOVATION NOTES

DEMOLITION PHASE.



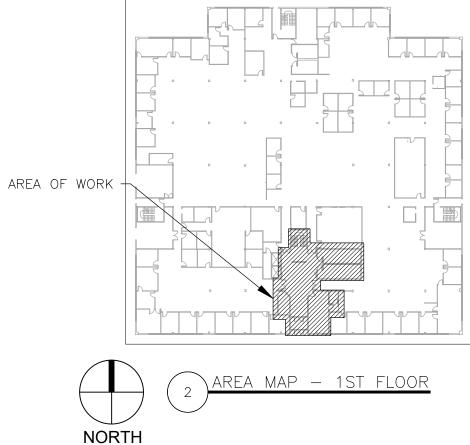

1 FABRICATION, INSTALLATION AND TESTING OF ALL HVAC SYSTEMS SHALL BE IN ACCORDANCE WITH THE LATEST VERSION OF THE INTERNATIONAL MECHANICAL CODE (IMC) AND ALL MANUFACTURER

2 ALL METALLIC AND FLEXIBLE DUCTS SHALL BE CONSTRUCTED AND INSTALLED AS SPECIFIED IN THE IMC AND SMACNA HVAC DUCT CONSTRUCTION STANDARDS.

3 DUCT HAS BEEN DESIGNED TO FIT IN THE SPACE AVAILABLE AND TO AVOID CONFLICTS. CONTRACTOR SHALL FIELD VERIFY FOR ANY UNFORESEEN CONFLICTS PRIOR TO FABRICATING DUCT. CONTRACTOR SHALL COORDINATE WITH OTHER DISCIPLINES TO ENSURE ADEQUATE SPACE IS AVAILABLE FOR DUCT. IF DUCT IS ROUTED ABOVE OTHER DUCT, COORDINATE ELEVATION OF EACH DUCT PRIOR TO INSTALLATION TO ENSURE IT WILL FIT IN THE SPACE AVAILABLE.

4 THIRD PARTY, AABC OR NEBB CERTIFIED TESTING, ADJUSTING AND BALANCING CONTRACTOR SHALL TEST AND BALANCE ALL SYSTEMS TO SPECIFIED VALUES AND PREPARE A BALANCE REPORT PER ASHRAE STANDARD 111 OR EQUAL. REPORT SHALL BE SENT TO THE ENGINEER FOR APPROVAL PRIOR TO FINAL COMPLETION. BALANCE DAMPERS ARE REQUIRED ON ALL SUPPLY AIR DEVICES.

5 ALL DUCTWORK WITH TWO DIMENSION <WxD> INDICATES RECTANGULAR DUCT. ALL <DØ> INDICATES ROUND DUCT. DIMENSIONS ARE INCHES MEASURED INSIDE. ROUND DUCT SHALL MAINTAIN A CENTERLINE TURNING RADIUS OF 1.5 X DUCT DIAMETER. FLEXIBLE DUCT SHALL BE 5 FEET MAXIMUM LENGTH AND BE SUPPORTED TO MINIMIZE STATIC PRESSURE DROP.

6 ALL INSULATION SHALL MEET THE ASTM E 84 FLAME/SMOKE SPREAD INDEX OF 25/50 MAXIMUM. DUCT SEAMS SHALL BE SEALED: • SUPPLY DUCT ABOVE THE CEILING: EXTERNAL INSULATION; INSTALLED R-VALUE: R-6.0; MINIMUM THERMAL CONDUCTIVITY OF 0.25 BTU-IN/HR/SF/°F WITH VAPOR BARRIER. • FLEXIBLE DUCT: R-6.0 INSULATION.

7 PROVIDE SUITABLE SUPPORTS FOR STABILITY OF ALL HVAC DEVICES AND DUCT.

(N) INDICATES KEYED NOTES

(1) NO TESTING AND BALANCING REQUIRED FOR AIR DEVICE (2) TAB CONTRACTOR SHALL BALANCE TO AIRFLOW PROVIDED FOR ASSOCIATED TAKE OFF DURING

HVAC	LEGEND
	PENDENT FIRE SPRINKLER HEAD/ESCUTCHEON
$\mathbf{\Theta}$	DIRECTIONAL EXIT SIGN
TYP	TYPICAL OF ALL LIKE DEVICES THIS GROUP
FS	FIRE ALARM STROBE —CEILING MOUNTED
SD	SMOKE DETECTOR -CEILING MOUNTED
OS	OCCUPANCY SENSOR —CEILING MOUNTED
AR	AREA OF REFUGE SIGN CEILING MOUNTED
	DIRECTION OF FLOW
####	DETAIL REFERENCE, NUMBER/SHEET
AA #	DEVICE SCHEDULE TAG
S1:6ø 50	AIR DEVICE: NECK SIZE (INCHES)/CFM
(R1:18x30)	AIR DEVICE: NECK SIZE (INCHES)
(12x12)	DUCT SIZE-RECTANGULAR (INCHES X INCHES)
(8ø)	DUCT SIZE-ROUND (INCHES DIAMETER)
	LIGHT FIXTURE -REFER TO LIGHT FIXTURE SCHEDULE FOR ADDITIONAL FIXTURE SYMBOLS
	SUPPLY AIR - NEW
	SUPPLY AIR – EXISTING
	RETURN AIR – NEW
	EXHAUST AIR – NEW
	EXHAUST AIR – EXISTING
· · ·	EXHAUST AIR – EXISTING

STATE OF MISSOURI MICHAEL L. PARSON, GOVERNOR



Tracie L. Siebeneck - Engineer MO# PE-2013019114

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OFFICE OF ADMINISTRATION DIVISION OF FACILITIES MANAGEMENT, **DESIGN AND CONSTRUCTION**

DEPARTMENT OF SOCIAL SERVICES

MULTI. DIVISON

HOWERTON STATE OFFICE BUILDING RENOVATE LOBBY AND RESTROOM 1ST & 2ND FLOOR

615 HOWERTON COURT JEFFERSON CITY, MO 65010

PROJECT # 02339-01 1025 SITE # 3101025001 ASSET #

REVISION: DATE: **REVISION:** DATE: **REVISION:** DATE: **ISSUE DATE:**


CAD DWG FILE:<u>MEP_02339-01</u> DRAWN BY: <u>RG/MP</u> CHECKED BY: <u>TS</u> DESIGNED BY: TS/AH

SHEET TITLE:

MECHANICAL **RENOVATION PLAN 1ST FLOOR**


SHEET NUMBER:

M-101 33 OF 38 SHEETS 12/13/2024

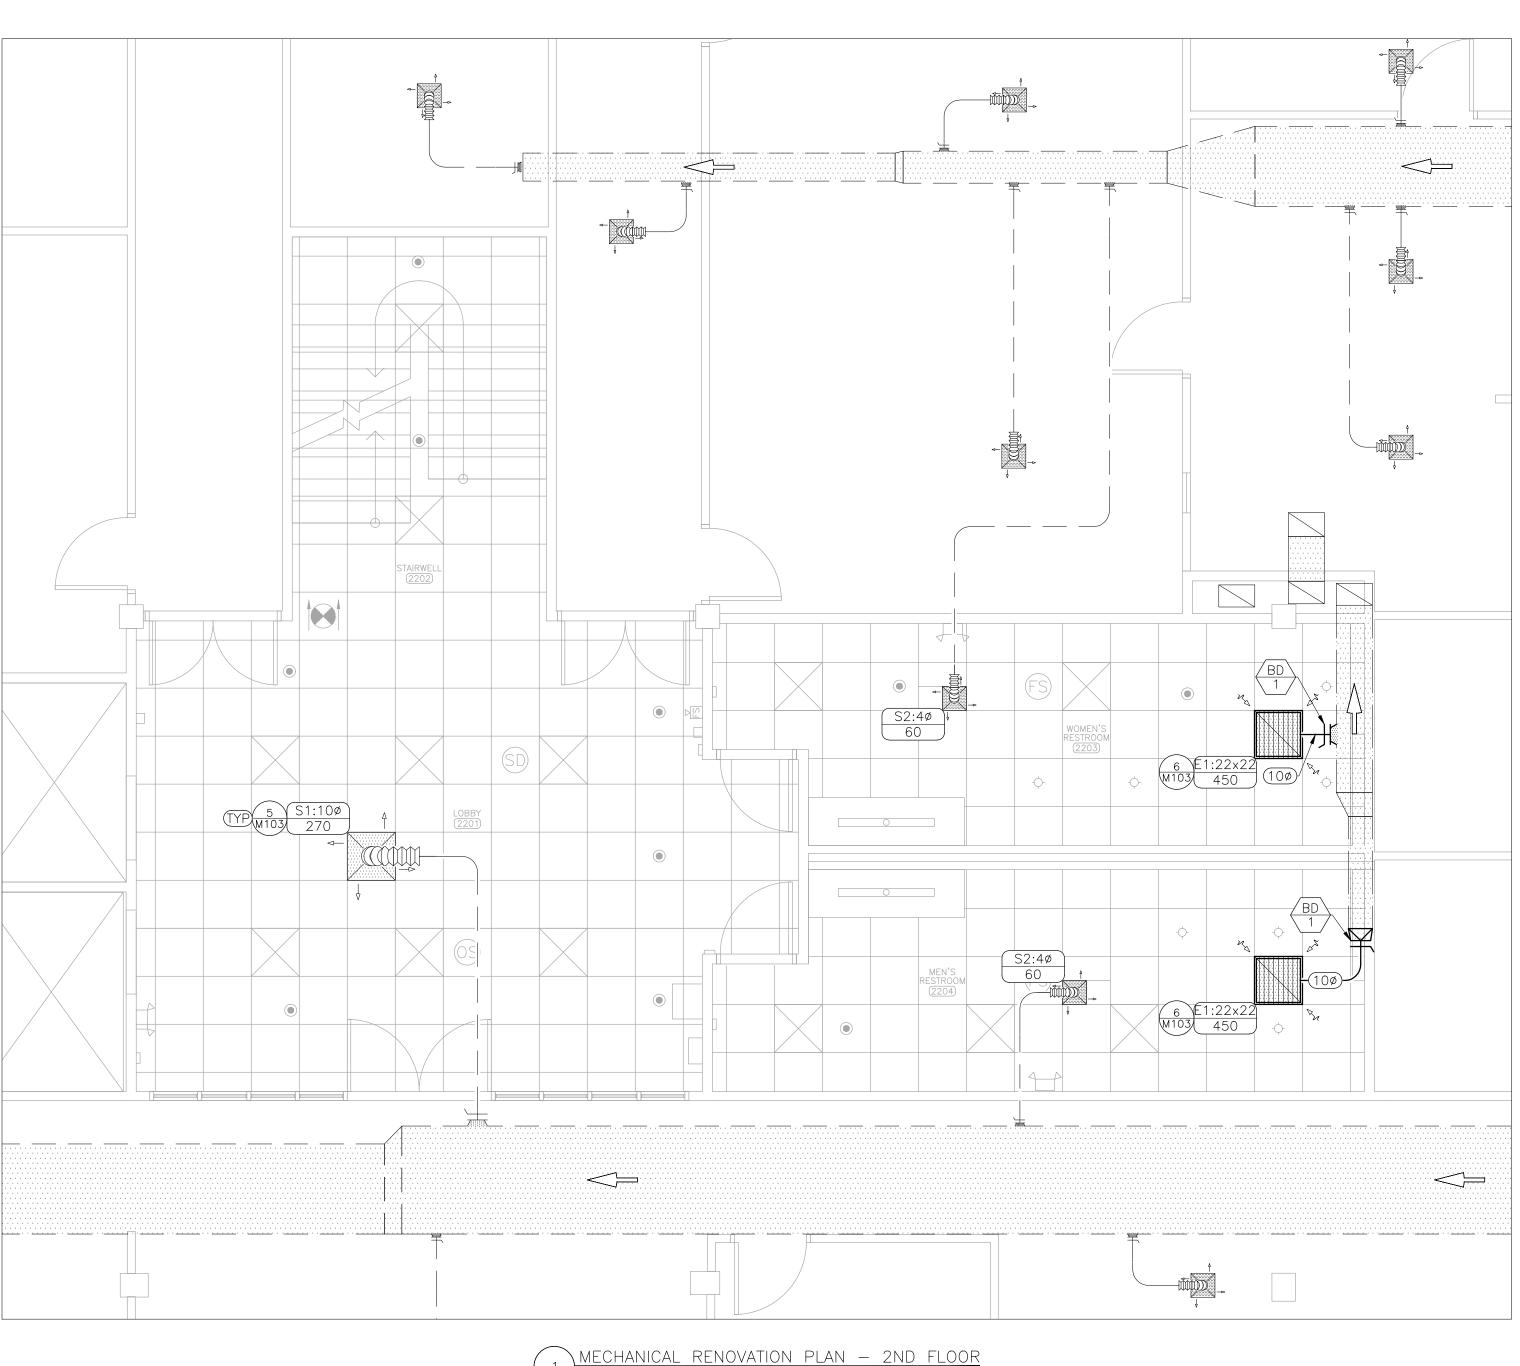

 $\int \frac{1}{3} = 1' - 0''$

RENOVATION NOTES

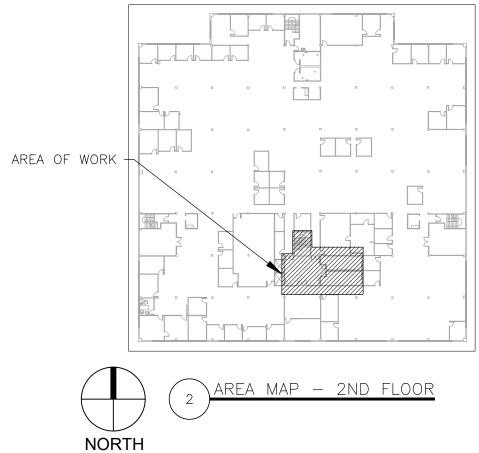

1 REFER TO SHEET M-101 FOR GENERAL RENOVATION NOTES.

STATE OF MISSOURI MICHAEL L. PARSON, GOVERNOR



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SHEET TITLE:

MECHANICAL **RENOVATION PLAN** 2ND FLOOR

SHEET NUMBER:

M-102 34 OF 38 SHEETS 12/13/2024

FIRE ALARM STROBE ∇ FS -WALL MOUNTED SMOKE DETECTOR -CEILING MOUNTED SD 05 OCCUPANCY SENSOR -CEILING MOUNTED \leq DIRECTION OF FLOW # ### DETAIL REFERENCE, NUMBER/SHEET AA # DEVICE SCHEDULE TAG S1:6Ø 50 AIR DEVICE: NECK SIZE (INCHES)/CFM (12x12) DUCT SIZE-RECTANGULAR (INCHES X INCHES) (8Ø) DUCT SIZE-ROUND (INCHES DIAMETER) LIGHT FIXTURE -REFER TO LIGHT FIXTURE SCHEDULE FOR ADDITIONAL FIXTURE SYMBOLS SUPPLY AIR - NEW ------ EXHAUST AIR - NEW

------ EXHAUST AIR - EXISTING

HVAC LEGEND

DIRECTIONAL EXIT SIGN

FIRE ALARM STROBE -CEILING MOUNTED

 (\bullet)


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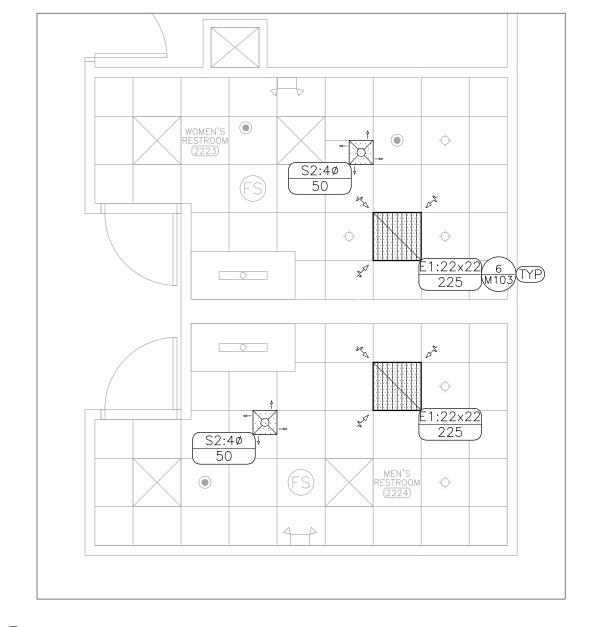
TYP

FS


PENDENT FIRE SPRINKLER HEAD/ESCUTCHEON

TYPICAL OF ALL LIKE DEVICES THIS GROUP



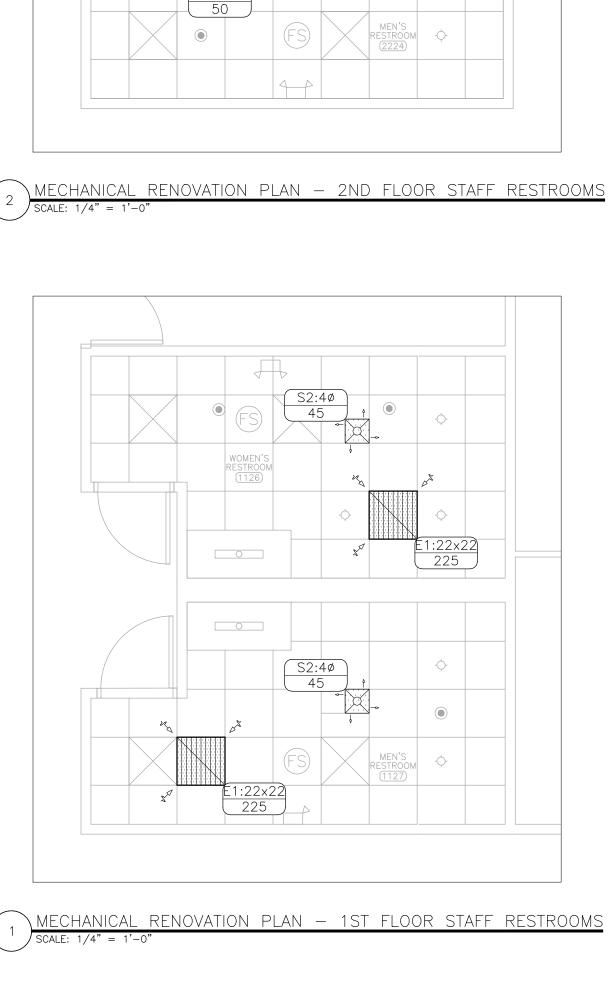

RENOVATION NOTES

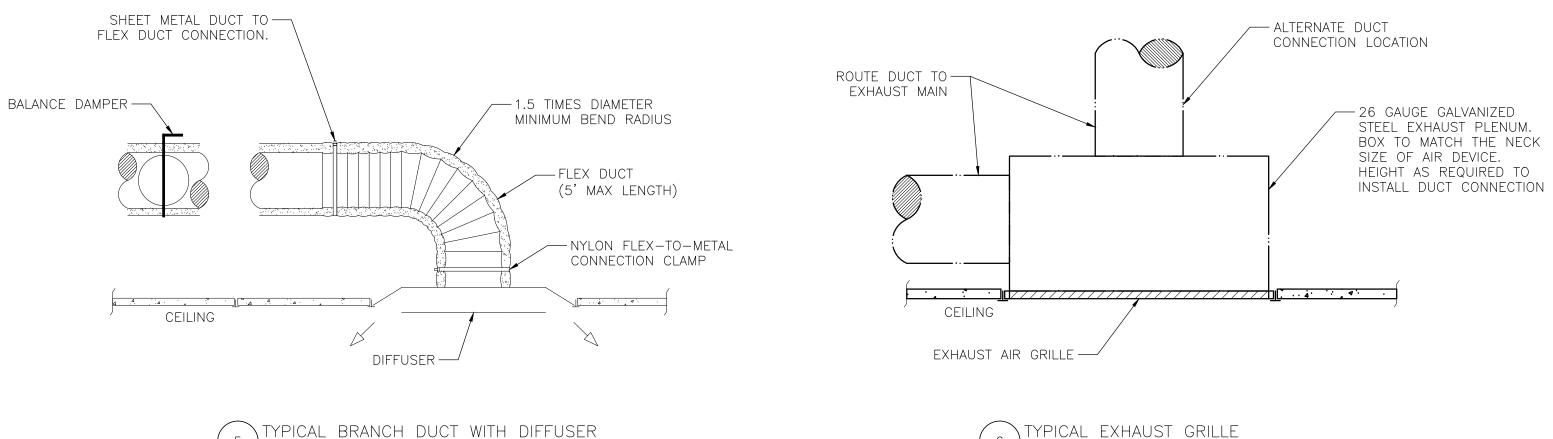


BALANCE DAMPER SCHEDULE


MARK	MANUFACTURER	MODEL	TYPE	SPECIFICATION
				FRAME: 2"x16 GAUGE GALVANIZED STEEL; BLADES: 14
			BALANCE DAMPER	GAUGE GALVANIZED STEEL ROUND; AXLES: 1/2"
BD-1	POTTORFF	CD-21R	SINGLE BLADE	DIAMETER PLATED STEEL; LINKAGE: CONCEALED IN
			ROUND	FRAME; BEARINGS: SYNTHETIC; CONTROL SHAFT: 1/2"x3"
				DRIVE AXLE

AIR DEVICE SCHEDULE

NO SCALE

AIR DEVICE SCHEDULE					
MARK	MANUFACTURER	MODEL	TYPE	SPECIFICATION	NOTES
S1	PRICE	SPD	SUPPLY LAYIN MOUNT	FRAME: STEEL, WHITE; INLET: ROUND; TYPE: SMOOTH FACE PLAQUE; FINISH: WHITE; FACE SIZE: 24 INCHES BY 24 INCHES	
S2	PRICE	SPD	SUPPLY LAYIN MOUNT	FRAME: STEEL, WHITE; INLET: ROUND; TYPE: SMOOTH FACE PLAQUE; FINISH: WHITE; FACE SIZE: 12 INCHES BY 12 INCHES	
R1	PRICE	PDDR	RETURN LAYIN MOUNT	FRAME: STEEL, WHITE; TYPE: PERFORATED; FINISH: WHITE; FACE SIZE: 24 INCHES BY 24 INCHES	1
E1	PRICE	PDDR	EXHAUST LAYIN MOUNT	FRAME: STEEL, WHITE; TYPE: PERFORATED; FINISH: WHITE; FACE SIZE: 24 INCHES BY 24 INCHES	
NOTES			•		
1	PROVIDE LIGHT SHIE	LD			

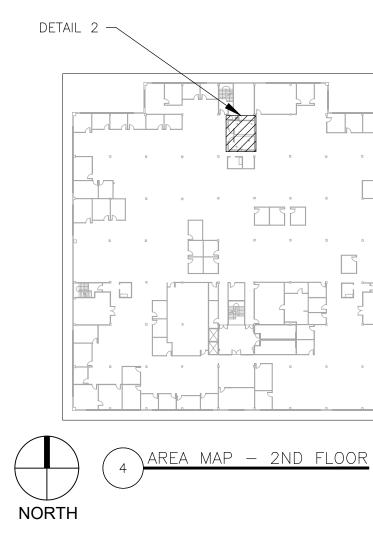

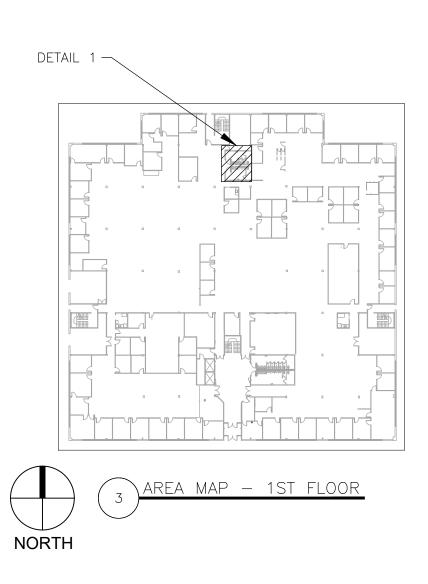


1 REFER TO SHEET M-101 FOR GENERAL RENOVATION NOTES.






HVAC	LEGEND
	PENDENT FIRE SPRINKLER HEAD/ESCUTCHEON
	WALL MOUNTED EMERGENCY LIGHT TO REMAIN
TYP	TYPICAL OF ALL LIKE DEVICES THIS GROUP
FS	FIRE ALARM STROBE —CEILING MOUNTED
# ####	DETAIL REFERENCE, NUMBER/SHEET
S1:6ø 50	AIR DEVICE: NECK SIZE (INCHES)/CFM
	LIGHT FIXTURE -REFER TO LIGHT FIXTURE SCHEDULE FOR ADDITIONAL FIXTURE SYMBOLS

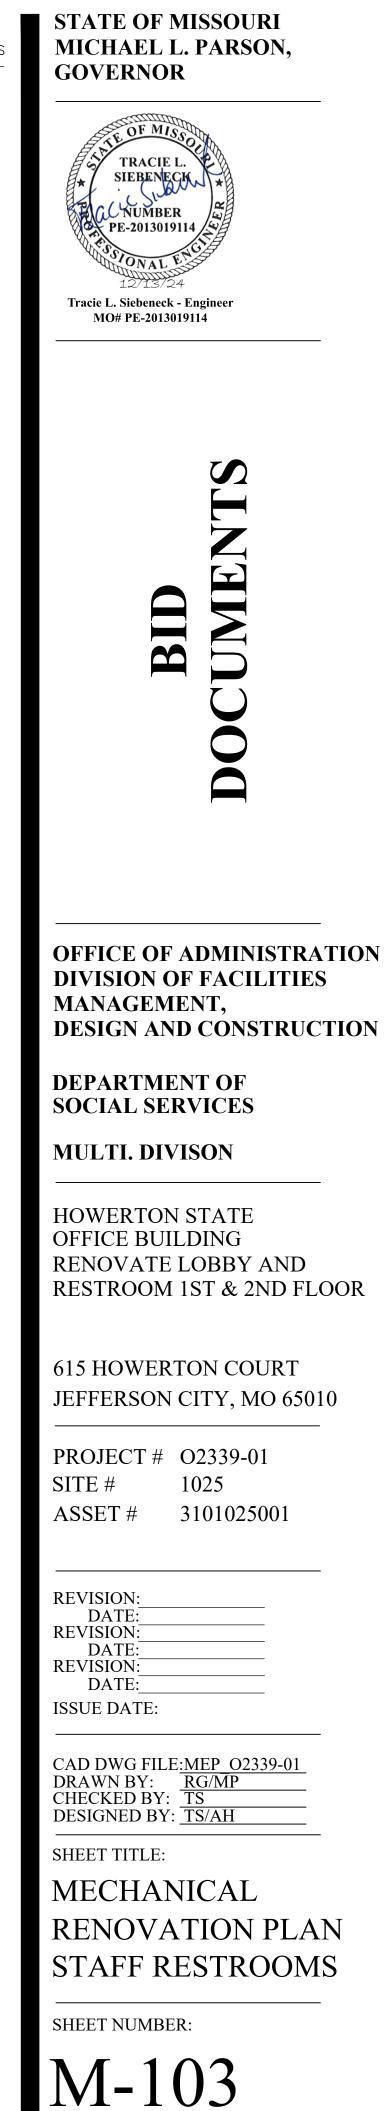

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ELECTRICAL RENOVATION PLAN - 1ST FLOOR SCALE: 1/4" = 1'-0"

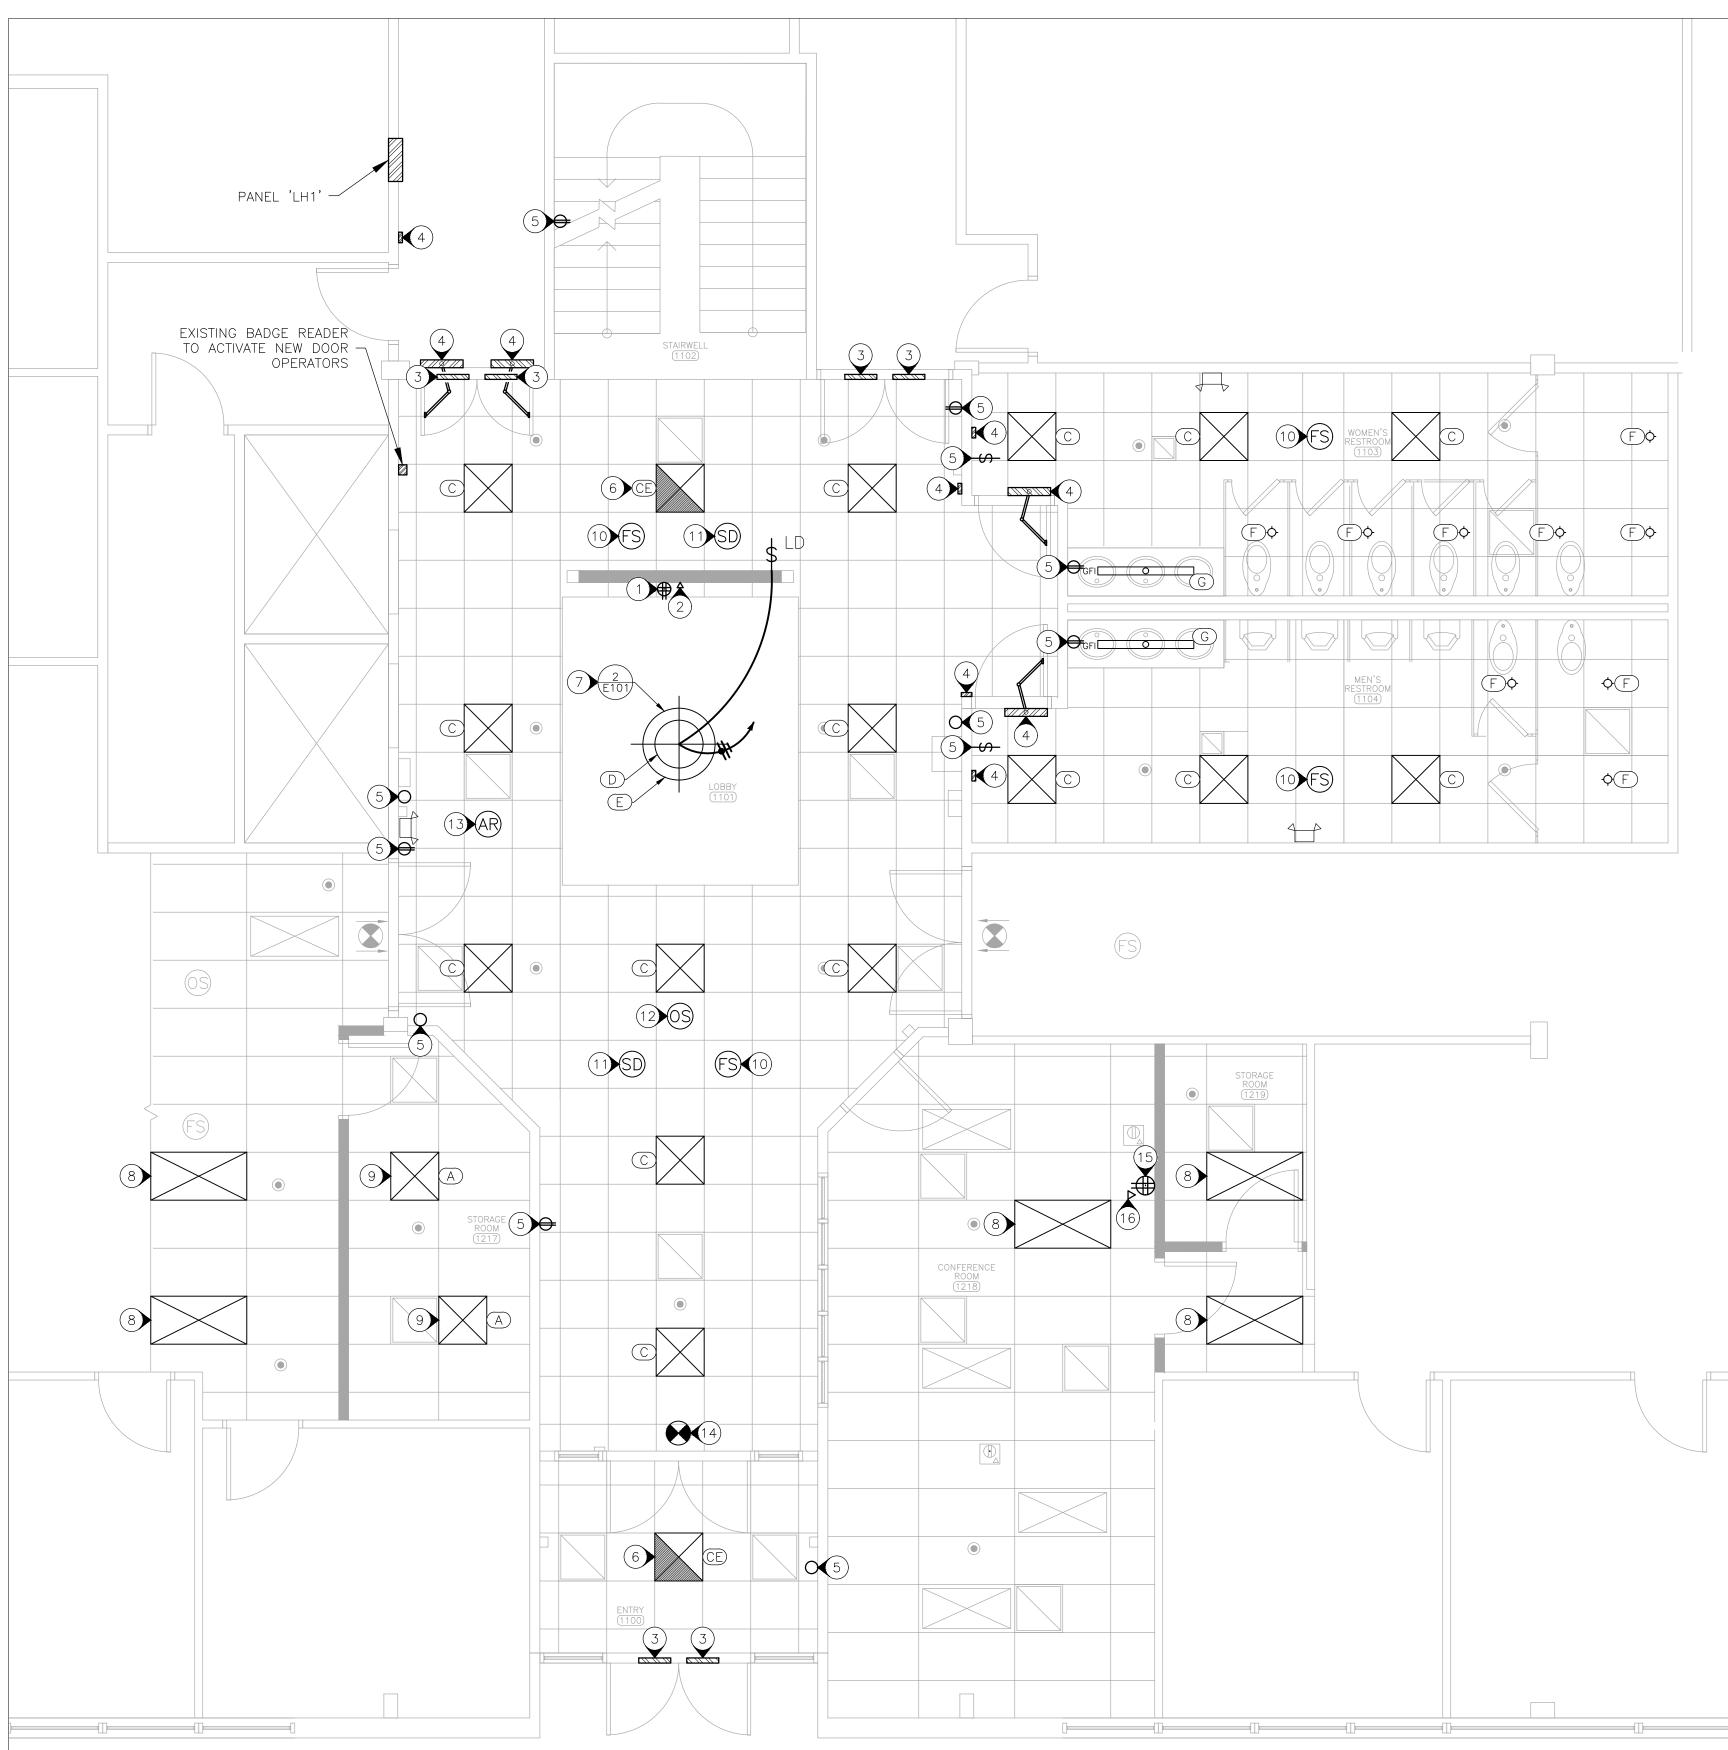



- 1 ALL ELECTRICAL WORK SHALL BE IN ACCORDANCE WITH THE LATEST EDITION OF THE NATIONAL ELECTRIC CODE (NEC) AND ALL MANUFACTURER INSTALLATION GUIDELINES.
- 2 ELECTRICAL CONTRACTOR SHALL BE RESPONSIBLE FOR PROVIDING ALL MATERIALS REQUIRED TO COMPLETE THE WORK. ALL EXPOSED LINE VOLTAGE WIRING SHALL BE PULLED IN PROPERLY SIZED CONDUIT (EMT) WITH APPROVED FITTINGS. PROVIDE AND INSTALL ALL CONDUIT FOR LOW VOLTAGE WIRING.
- 3 WHEN POSSIBLE REUSE EXISTING CONDUIT. ANY CONDUIT LEFT UNUSED SHALL BE REMOVED AND DISPOSED OF. EXTEND CONDUIT AND CONDUCTORS AS NEEDED TO INCORPORATE NEW LIGHT FIXTURES INTO LIGHTING CIRCUIT

RENOVATION NOTES

	PROVIDE AND IN THROUGH HOLLO MECHANICAL ROO LOCATED BEHINE COORDINATE FIN
2	PROVIDE AND IN METAL COLUMN INSTALL DATA W
3	INSTALL RETAINE WIRING.
4	PROVIDE AND IN PUSH PLATES A EXISTING CONDU EXISTING CONDIT
5	PROVIDE AND IN WALL BOX, CON
6	PROVIDE AND IN PRIMARY POWER
7	PROVIDE AND IN ON NEW FEATUR BREAKER IN BRI
8	INSTALL RETAINE
9	PROVIDE AND IN WITH GENERAL (
10	PROVIDE AND IN PROTECTION CON FIRE PROTECTION
11	PROVIDE AND IN PROTECTION CON FIRE PROTECTION
12	INSTALL RETAINE SENSOR SHALL
13	INSTALL RETAINE NEEDED TO COM
	PROVIDE AND IN PEALE-SR-EM-
\sim	

- NEW LOCATION.

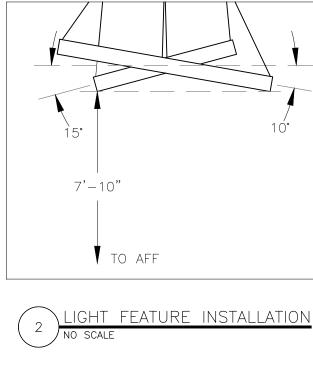

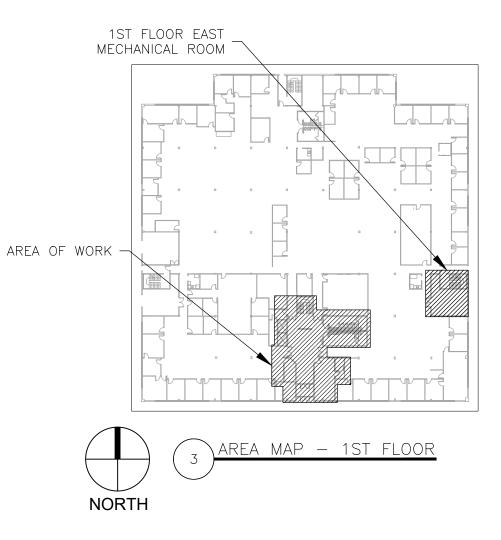

(1) PROVIDE AND INSTALL WALL MOUNTED QUAD RECEPTACLE. ROUTE CONDUIT AND CONDUCTORS LOW METAL COLUMN TO SPARE LOCATED ON PANEL 'RL1E2 SEC. 2' IN 1ST FLOOR EAST DOM. COORDINATE WITH GENERAL CONTRACTOR TO INSTALL SUCH THAT IT WILL BE ND THE WALL MOUNTED TV. TV TO BE PROVIDED AND INSTALLED BY OWNER. NAL LOCATION WITH OWNER.

> NSTALL LOW VOLTAGE MOUNTING BRACKET. ROUTE $\frac{3}{4}$ INCH CONDUIT THROUGH HOLLOW TO ABOVE SUSPENDED CEILING AND PROVIDE BUSHING FOR OWNER TO PROVIDE AND WIRE. INSTALL BEHIND TV WITH NEARBY RECEPTACLE.

ED SECURITY DEVICES ON NEW DOOR. CONNECT EXISTING POWER AND CONTROLS

NSTALL NEW NABCO SWING OPERATOR MODEL 630, ASSOCIATED RECESSED MOUNT AND AN INFRARED SAFETY SENSOR ON SWING SIDE OF DOOR. CONNECT POWER TO UIT AND CONDUCTORS. COORDINATE WITH OWNER TO VERIFY OPERATION IS EQUAL TO TIONS.

NSTALL BLANK COVER PLATE, DUPLEX RECEPTACLE, OR WALL SWITCH. REUSE EXISTING NDUIT AND CONDUCTORS.

NSTALL LIGHT FIXTURE. LIGHT FIXTURE TO BE USED AS AN EMERGENCY LIGHT. ROUTE TO BREAKER SLOT 27 ON PANEL 'LH1'.

NSTALL CHANDELIER. LIGHT FIXTURE TO BE CONTROLLED BY LIGHT DIMMER MOUNTED IRE WALL. ROUTE POWER TO PANEL 'LH1'. PROVIDE AND INSTALL 20 AMP 1 POLE REAKER SLOT 31. LABEL PANEL SCHEDULE: 'LOBBY CHANDELIER'.

IED LIGHT FIXTURE IN NEW LOCATION. ROUTE POWER TO NEAREST LIGHTING CIRCUIT. NSTALL NEW LIGHT FIXTURE. ROUTE POWER TO NEAREST LIGHTING CIRCUIT. COORDINATE

CONTRACTOR TO MODIFY EXISTING CEILING TILES AND T-BAR. NSTALL FIRE HORN STROBE, MODEL TO BE EQUAL TO EXISTING. COORDINATE WITH FIRE

NTRACTOR TO PERFORM ALL WORK NECESSARY TO INTEGRATE STROBE INTO EXISTING ON SYSTEM. ADJUST CANDELA SETPOINT TO BE IN COMPLIANCE WITH NFPA 72.

INSTALL SMOKE DETECTOR, MODEL TO BE EQUAL TO EXISTING. COORDINATE WITH FIRE DNTRACTOR TO PERFORM ALL WORK NECESSARY TO INTEGRATE DETECTOR INTO EXISTING DN SYSTEM.

ED OCCUPANCY SENSOR IN NEW LOCATION. UNLESS OTHERWISE SPECIFIED, OCCUPANCY CONTROL ALL LIGHT FIXTURES LOCATED WITHIN LOBBY.

ED AREA OF REFUGE SIGN IN NEW LOCATION. EXTEND CONDUIT AND CONDUCTORS AS MPLETE THE WORK.

INSTALL PROGRESS LIGHTING THIN DIE-CAST LED EMERGENCY EXIT SIGN MODEL -16 OR EQUAL. ROUTE POWER TO NEAREST EMERGENCY EXIT SIGN. (15) PROVIDE AND INSTALL RECEPTACLE AND WALL BOX. EXTEND CIRCUIT RETAINED FROM DEMOLITION TO

(16) PROVIDE AND INSTALL LOW VOLTAGE MOUNTING BRACKET. EXTEND CONDUIT TO ABOVE CEILING FOR OWNER TO PROVIDE AND INSTALL DATA WIRE.

ELEC	FRICAL LEGEND
	PENDENT FIRE SPRINKLER HEAD/ESCUTCHEON
$\mathbf{\Theta}$	DIRECTIONAL EXIT SIGN
${\color{black} \bullet}$	NON-DIRECTIONAL EXIT SIGN -INSTALL PARALLEL TO DOOR
# E###	DETAIL REFERENCE, NUMBER/SHEET
	WALL MOUNTED EMERGENCY LIGHT TO REMAIN
B	2 GANG FLOOR BOX W/ DATA
FS	FIRE ALARM STROBE -CEILING MOUNTED
SD	SMOKE DETECTOR -CEILING MOUNTED
OS	OCCUPANCY SENSOR -CEILING MOUNTED
AR	AREA OF REFUGE SIGN -CEILING MOUNTED
(AA)	LIGHT FIXTURE MARK
	HOME RUN-SHORT STROKES INDICATE PHASE OR SWITCHED WIRES, LONG STROKE INDICATE NEUTRAL, LONG WITH DOT INDICATE GROUND
\$	WALL SWITCH
\$ LD	LIGHT DIMMER – WALL BOX MOUNTED – SLIDE TYPE W/ SEPARATE TOGGLE SWITCH
€GFI	DUPLEX RECEPTACLE 120V GROUND FAULT TYPE
Ð	DUPLEX RECEPTACLE
₽	QUAD RECEPTACLE WITH DATA
0	BLANK COVER PLATE
	HVAC DIFFUSER/GRILLE
	LIGHT FIXTURE -REFER TO LIGHT FIXTURE SCHEDULE FOR ADDITIONAL FIXTURE SYMBOLS
	WIRE/CONDUIT - NEW





Tracie L. Siebeneck - Engineer MO# PE-2013019114

> BID

OFFICE OF ADMINISTRATION DIVISION OF FACILITIES MANAGEMENT, **DESIGN AND CONSTRUCTION**

DEPARTMENT OF SOCIAL SERVICES

MULTI. DIVISON

HOWERTON STATE OFFICE BUILDING RENOVATE LOBBY AND RESTROOM 1ST & 2ND FLOOR

615 HOWERTON COURT JEFFERSON CITY, MO 65010

PROJECT # 02339-01 1025 SITE # ASSET # 3101025001


REVISION: DATE: **REVISION:** DATE: **REVISION:** DATE: **ISSUE DATE:**

CAD DWG FILE:<u>MEP_02339-01</u> DRAWN BY: <u>RG/MP</u> CHECKED BY: <u>TS</u> DESIGNED BY: TS/AH

SHEET TITLE: ELECTRICAL **RENOVATION PLAN 1ST FLOOR**


SHEET NUMBER:

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RENOVATION NOTES

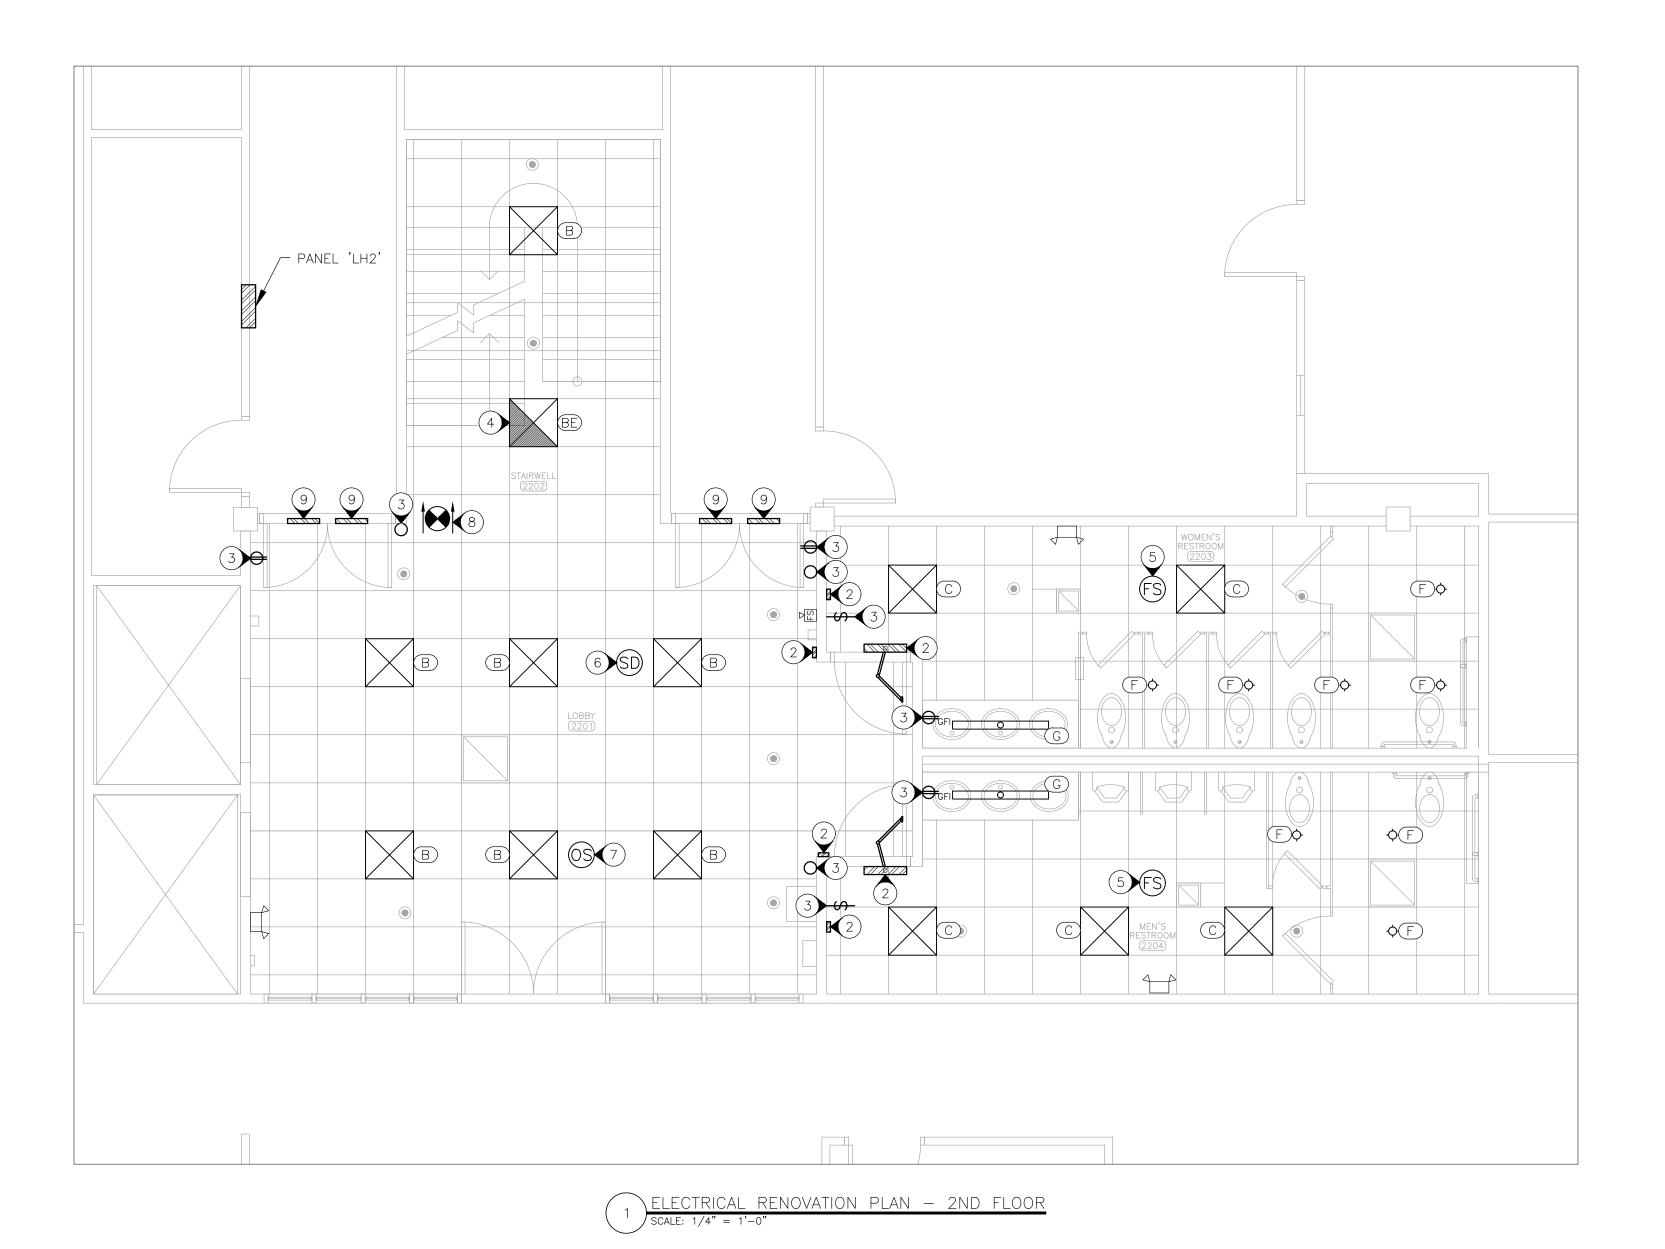1	REFER TO SHEET E-101 FOR GENERAL RENOVATION NOTES.
2	 PROVIDE AND INSTALL NEW NABCO SWING OPERATOR MODEL 630, ASSOCIATED RECE PUSH PLATES AND AN INFRARED SAFETY SENSOR ON SWING SIDE OF DOOR. CONNE EXISTING CONDUIT AND CONDUCTORS. COORDINATE WITH OWNER TO VERIFY OPERATIO EXISTING CONDITIONS.
3	 PROVIDE AND INSTALL BLANK COVER PLATE, DUPLEX RECEPTACLE, OR WALL SWITCH. WALL BOX, CONDUIT AND CONDUCTORS.
4	 PROVIDE AND INSTALL LIGHT FIXTURE. LIGHT FIXTURE TO BE USED AS AN EMERGENO PRIMARY POWER TO BREAKER 27 ON PANEL 'LH2'.
5	 PROVIDE AND INSTALL FIRE HORN STROBE, MODEL TO BE EQUAL TO EXISTING. COOF PROTECTION CONTRACTOR TO PERFORM ALL WORK NECESSARY TO INTEGRATE STROB FIRE PROTECTION SYSTEM. ADJUST CANDELA SETPOINT TO BE IN COMPLIANCE WITH
6	 PROVIDE AND INSTALL SMOKE DETECTOR, MODEL TO BE EQUAL TO EXISTING. COORD PROTECTION CONTRACTOR TO PERFORM ALL WORK NECESSARY TO INTEGRATE DETECT FIRE PROTECTION SYSTEM.
7	 INSTALL RETAINED OCCUPANCY SENSOR IN NEW LOCATION. UNLESS OTHERWISE SPEC SENSOR SHALL CONTROL ALL LIGHT FIXTURES LOCATED WITHIN LOBBY.
8	 PROVIDE AND INSTALL PROGRESS LIGHTING THIN DIE-CAST LED EMERGENCY EXIT SIGN PEALE-DR-EM-16 OR EQUAL. ROUTE POWER TO NEAREST EMERGENCY EXIT SIGN.



1 REFER TO SHEET E-101 FOR GENERAL RENOVATION NOTES.

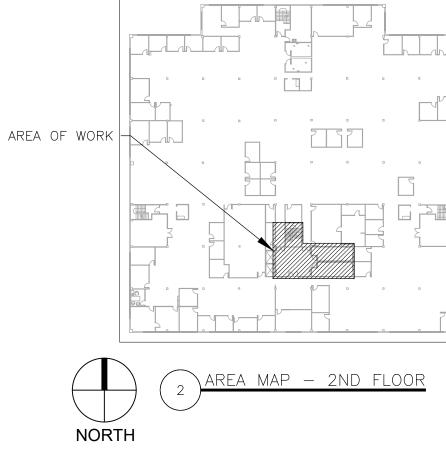INSTALL NEW NABCO SWING OPERATOR MODEL 630, ASSOCIATED RECESSED MOUNT AND AN INFRARED SAFETY SENSOR ON SWING SIDE OF DOOR. CONNECT POWER TO NDUIT AND CONDUCTORS. COORDINATE WITH OWNER TO VERIFY OPERATION IS EQUAL TO NDITIONS.

INSTALL BLANK COVER PLATE, DUPLEX RECEPTACLE, OR WALL SWITCH. REUSE EXISTING CONDUIT AND CONDUCTORS. INSTALL LIGHT FIXTURE. LIGHT FIXTURE TO BE USED AS AN EMERGENCY LIGHT. ROUTE

WER TO BREAKER 27 ON PANEL 'LH2'. INSTALL FIRE HORN STROBE, MODEL TO BE EQUAL TO EXISTING. COORDINATE WITH FIRE

CONTRACTOR TO PERFORM ALL WORK NECESSARY TO INTEGRATE STROBE INTO EXISTING CTION SYSTEM. ADJUST CANDELA SETPOINT TO BE IN COMPLIANCE WITH NFPA 72.

INSTALL SMOKE DETECTOR, MODEL TO BE EQUAL TO EXISTING. COORDINATE WITH FIRE CONTRACTOR TO PERFORM ALL WORK NECESSARY TO INTEGRATE DETECTOR INTO EXISTING TION SYSTEM.

AINED OCCUPANCY SENSOR IN NEW LOCATION. UNLESS OTHERWISE SPECIFIED, OCCUPANCY ALL CONTROL ALL LIGHT FIXTURES LOCATED WITHIN LOBBY. INSTALL PROGRESS LIGHTING THIN DIE-CAST LED EMERGENCY EXIT SIGN MODEL

9 INSTALL RETAINED SECURITY DEVICES ON NEW DOOR. CONNECT EXISTING POWER AND CONTROLS WIRING.

ELECI	ELECTRICAL LEGEND		
	PENDENT FIRE SPRINKLER HEAD/ESCUTCHEON		
	DIRECTIONAL EXIT SIGN		
	WALL MOUNTED EMERGENCY LIGHT TO REMAIN		
FS	FIRE ALARM STROBE -CEILING MOUNTED		
∇ FS	FIRE ALARM STROBE —WALL MOUNTED		
SD	SMOKE DETECTOR -CEILING MOUNTED		
OS	OCCUPANCY SENSOR -CEILING MOUNTED		
(AA)	LIGHT FIXTURE MARK		
\$	WALL SWITCH		
€GFI	DUPLEX RECEPTACLE 120V GROUND FAULT TYPE		
\Rightarrow	DUPLEX RECEPTACLE		
0	BLANK COVER PLATE		
	HVAC DIFFUSER/GRILLE		
	LIGHT FIXTURE -REFER TO LIGHT FIXTURE SCHEDULE FOR ADDITIONAL FIXTURE SYMBOLS		





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DEPARTMENT OF SOCIAL SERVICES

MULTI. DIVISON

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615 HOWERTON COURT JEFFERSON CITY, MO 65010

PROJECT # 02339-01 SITE # 1025 3101025001 ASSET #

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CAD DWG FILE:<u>MEP_02339-01</u> DRAWN BY: <u>RG/MP</u> CHECKED BY: <u>TS</u> DESIGNED BY: <u>TS/AH</u>


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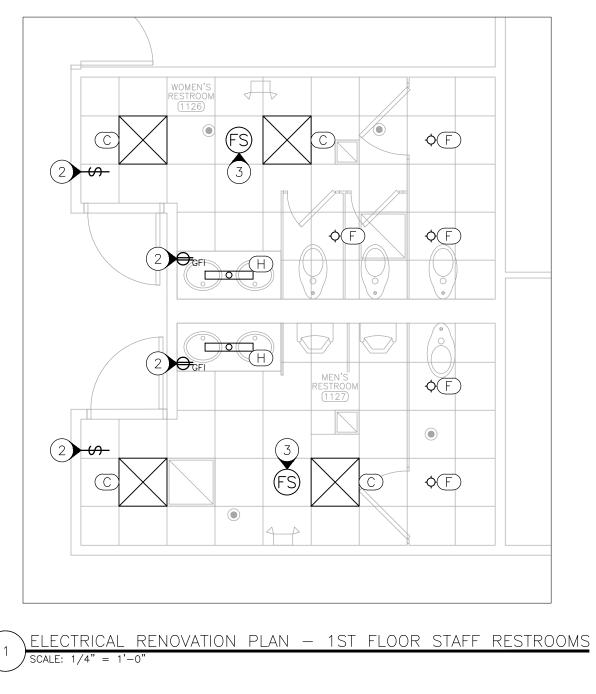
ELECTRICAL **RENOVATION PLAN** 2ND FLOOR

SHEET NUMBER:


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PE-2013019114 44 PE-2013019114 44 PE-201301914 44 PE-2014 44 PE-2013019114 44 PE-2013019114 44 PE-2013019114 44 PE-2013019114 44 PE-2013019114 44 PE-2013019114 44 PE-2013019114 44 PE-2014 P
Tracie L. Siebeneck - Engineer
MO# PE-2013019114



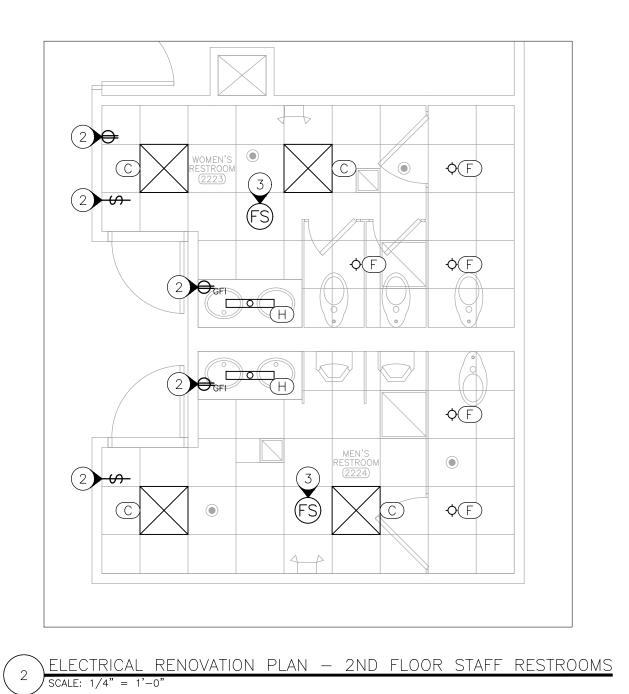

RENOVATION NOTES

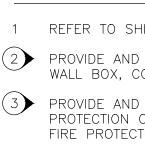


LIGHTING FIXTURE SCHEDULE

LIGHII	ING FIXTURE S	SCHEDULE						
MARK	FIXTURE LEGEND	MANUFACTURER	MODEL	DESCRIPTION	SIZE	LUMENS TYPE/CRI	WATTS VOLTAGE	NOTES
A		COLUMBIA LIGHTING	LJT22-35VLG-FSA12- EU	LED PRISMATIC LENSED TROFFER	2'x2'	4265 3500°K, LED/80	42 277	1
В		COLUMBIA LIGHTING	LCAT22-35VLG-EU	LED ARCHITECTURAL TROFFER	2'x2'	4741 3500°K, LED/80	35.1 277	1
BE		COLUMBIA LIGHTING	LCAT22-35VLG-EU- ELL14	LED ARCHITECTURAL TROFFER	2'x2'	4741 3500°K, LED/80	35.1 277	1,2
С		COLUMBIA LIGHTING	LCAT22-35HLG-EU	LED ARCHITECTURAL TROFFER	2'x2'	4239 3500°K, LED/80	33.1 277	1
CE		COLUMBIA LIGHTING	LCAT22-35HLG-EU- ELL14	LED ARCHITECTURAL TROFFER	2'x2'	4239 3500°K, LED/80	33.1 277	1,2
D		LUMOS ARCHITECTURAL LIGHTING	RPM-UP-DN-24-SO- 835-DIM-SPC	MINI RING UP/DOWNLIGHT	24"Ø	2682 3500°K, LED/80	37.2 277	3,4
E	\bigcirc	LUMOS ARCHITECTURAL LIGHTING	RPM-UP-DN-36-SO- 835-DIM-SPC	MINI RING UP/DOWNLIGHT	36"Ø	4022.34 3500°K, LED/80	55.9 277	3,4
F	¢	COLUMBIA LIGHTING	LTR-4RD-H-SL15L- DM1	ROUND DOWNLIGHT RECESSED	4"Ø	1474 3500°K, LED/80	18.6 277	5,6,7
G	· · · · · · · · · · · · · · · · · · ·	COLUMBIA LIGHTING	CWW4-35XWF- 2WW-EU	CONTEMPORARY LED WALL WASH	4'	2699 3500°K, LED/80	25 277	1
Н		COLUMBIA LIGHTING	CWW2-35LWF- 2WW-EU	CONTEMPORARY LED WALL WASH	2'	2670 3500°K, LED/80	27 277	1
NOTES								
1	PROVIDE WHITE FINISH							
2	PROVIDE EMERGENCY BATTERY PACK MODEL ELL14 OR EQUAL							


3 PROVIDE 0-10V DIMMING CAPABLIITY, SINGLE POINT CANOPY PENDANT MOUNTING 4 FINISH TO BE SELECTED BY ARCHITECT 5 PROVIDE SEMI-SPECULAR REFLECTOR WITH WHITE FLANGE

6 PROVIDE BAR HANGERS MODEL: B24 FOR T-BAR CEILING

7 PROVIDE TRIM MODEL: LTR-4RD-T-SL35K8XW-SSWT

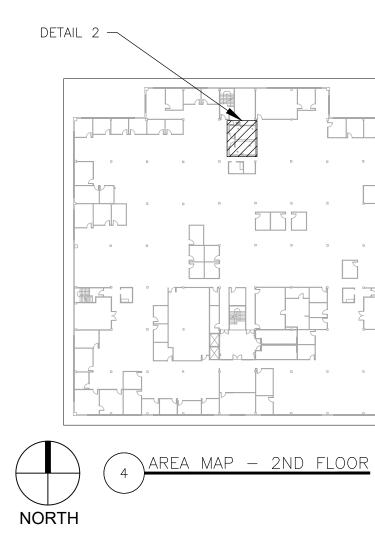



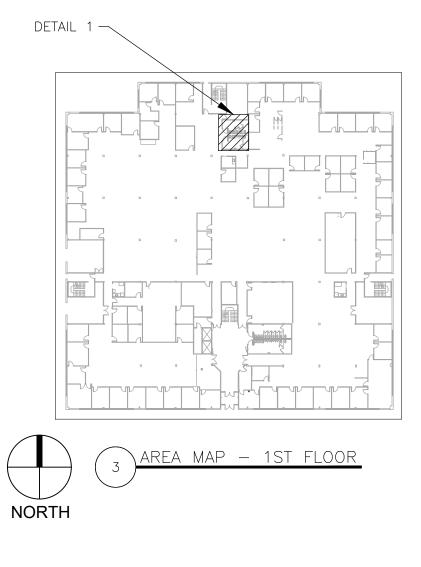

1 REFER TO SHEET E-101 FOR GENERAL RENOVATION NOTES.

2 PROVIDE AND INSTALL DUPLEX RECEPTACLE OR WALL SWITCH WITH COVER PLATE. REUSE EXISTING WALL BOX, CONDUIT AND CONDUCTORS.

3 PROVIDE AND INSTALL FIRE HORN STROBE, MODEL TO BE EQUAL TO EXISTING. COORDINATE WITH FIRE PROTECTION CONTRACTOR TO PERFORM ALL WORK NECESSARY TO INTEGRATE STROBE INTO EXISTING FIRE PROTECTION SYSTEM. ADJUST CANDELA SETPOINT TO BE IN COMPLIANCE WITH NFPA 72.



ELECTRICAL LEGEND						
	PENDENT FIRE SPRINKLER HEAD/ESCUTCHEON					
	WALL MOUNTED EMERGENCY LIGHT TO REMAIN					
FS	FIRE ALARM STROBE -CEILING MOUNTED					
ÂA	LIGHT FIXTURE MARK					
\$	WALL SWITCH					
€GFI	DUPLEX RECEPTACLE 120V GROUND FAULT TYPE					
\ominus	DUPLEX RECEPTACLE					
	HVAC DIFFUSER/GRILLE					
	LIGHT FIXTURE -REFER TO LIGHT FIXTURE SCHEDULE FOR ADDITIONAL FIXTURE SYMBOLS					





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ASSET #	3101025001

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SHEET TITLE:

ELECTRICAL **RENOVATION PLAN** STAFF RESTROOMS

SHEET NUMBER:

E-103 38 OF 38 SHEETS 12/13/2024