Supreme Court Generator Missouri Supreme Court State Office Building Jefferson City, Missouri



MECHANICAL, ELECTRICAL AND PLUMBING DESIGN

OWNER: STATE OF MISSOURI

MICHAEL L. PARSON,

GOVERNOR

PROJECT OFFICE OF ADMINISTRATION

MANAGEMENT: DIVISION OF FACILITIES MANAGEMENT,

DESIGN AND CONSTRUCTION

DESIGNER: MIDWEST ENGINEERING AND DESIGN

3100 BROWN STATION RD, SUITE C

COLUMBIA, MISSOURI 65202

PROJECT NUMBER: 02366-01

SITE NUMBER: 1001

ASSET NUMBER: 3101001056

SHEET INDEX

1 G-001 COVER SHEET

2 G-002 DRAWING INDEX, AND LOCATION MAP

3 E-101EXISTING UTILITY SITE PLAN

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10 E-601 ELECTRICAL UTILITY RISER



SUPREME COURT STATE OFFICE **BUILDING 207 WEST HIGH STREET** JEFFERSON CITY, MO 65101

GENERAL CONSTRUCTION NOTES

- 1 THESE DRAWINGS SHALL NOT BE SCALED. REFER TO DIMENSIONS INDICATED OR WHERE NO DIMENSIONS ARE GIVEN, CONTRACTOR SHALL VERIFY THE ACTUAL SIZE AND LOCATION THROUGH FIELD VERIFICATION. THE EXISTING CONDITIONS SHOWN ON THESE DRAWINGS WERE DERIVED FROM OBSERVATIONS AND MEASUREMENTS TAKEN DURING SITE VISITS AND FROM ARCHIVE INFORMATION PROVIDED BY THE OWNER AND MAY NOT BE TOTALLY ACCURATE. THE CONTRACTOR SHALL BE RESPONSIBLE TO FIELD VERIFY ANY CRITICAL DIMENSIONS PRIOR TO BIDDING AND/OR FABRICATION AND INSTALLATION OF THE WORK.
- IT IS THE RESPONSIBILITY OF THE GENERAL CONTRACTOR AND EACH SUBCONTRACTOR TO REVIEW THE DRAWINGS TO ASSURE COORDINATION OF ALL WORK AFFECTING EACH TRADE. FAILURE TO REVIEW ALL CONTRACT DOCUMENTS FOR APPLICABLE ITEMS OF WORK SHALL NOT RELIEVE THE RESPONSIBLE PARTY FROM PERFORMING ALL WORK REQUIRED BY THE CONTRACT DOCUMENTS.
- COORDINATION THE GENERAL CONTRACTOR SHALL COORDINATE REQUIREMENTS OF ALL TRADES TO ALLOW FOR TIMELY INCLUSION IN THE WORK SO AS NOT TO DELAY THE WORK OR THE WORK OF ANY
- PRECAUTIONS CONTRACTOR SHALL IMMEDIATELY REPORT ANY UNFORESEEN STRUCTURAL CONDITIONS WHICH COULD RESULT IN DAMAGE TO THE STRUCTURE OR INJURY TO ITS OCCUPANTS. REPORT ANY SUCH CONDITION IMMEDIATELY TO THE OWNER AND ENGINEER. TAKE PRECAUTIONS NECESSARY TO PROPERLY SUPPORT THE STRUCTURE AND PROTECT THE OCCUPANTS.
- 5 SITE USAGE USE OF THE SITE FOR ANY CONSTRUCTION STAGING OR OTHER OPERATIONS SHALL BE COORDINATED WITH THE OWNER AND CONSTRUCTION ADMINISTRATOR. THE CONTRACTOR'S OPERATIONS SHALL NOT OBSTRUCT OR ADVERSELY AFFECT ANY PUBLIC OR ADJACENT OWNER AREAS.
- 6 EXIT ACCESS MAINTAIN FREE, SAFE, AND APPROVED MEANS OF EGRESS IN AND OUT OF PROJECT LOCATION AND EXISTING OCCUPIED BUILDINGS IN ACCORDANCE WITH REQUIREMENTS OF APPLICABLE REGULATORY AGENCIES.
- 7 GENERAL CONTRACTOR SHALL BE RESPONSIBLE FOR SUBMITTING RED LINE "AS-BUILT" DRAWINGS AT THE END OF THE PROJECT ALONG WITH ALL OPERATING MANUALS OF NEW SYSTEMS INSTALLED.

8 ALL MATERIALS MUST BE IN THE CONTRACTORS POSSESSION PRIOR TO ANY UTILITY INTERRUPTIONS.

CONTRACTOR SHALL BE RESPONSIBLE FOR LOCATING ANY UNDERGROUND UTILITIES PRIOR TO EXCAVATION. THE UTILITIES SHOWN ARE A ROUGH ESTIMATE AND SHOULD NOT BE CONSIDERED ACCURATE.

STATE OF MISSOURI MICHAEL L. PARSON, **GOVERNOR**





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Missouri State Certificate of Authority #2010032467

OFFICE OF ADMINISTRATION DIVISION OF FACILITIES MANAGEMENT, DESIGN AND CONSTRUCTION

DEPARTMENT OF Office Of Administration Facilities Management
Design And Construction

SUPREME COURT GENERATOR

SUPREME COURT STATE OFFICE BUILDING 207 WEST HIGH STREET, JEFFERSON CITY, MISSOURI

PROJECT # O2366-01 1001 FACILITY # 3101001056

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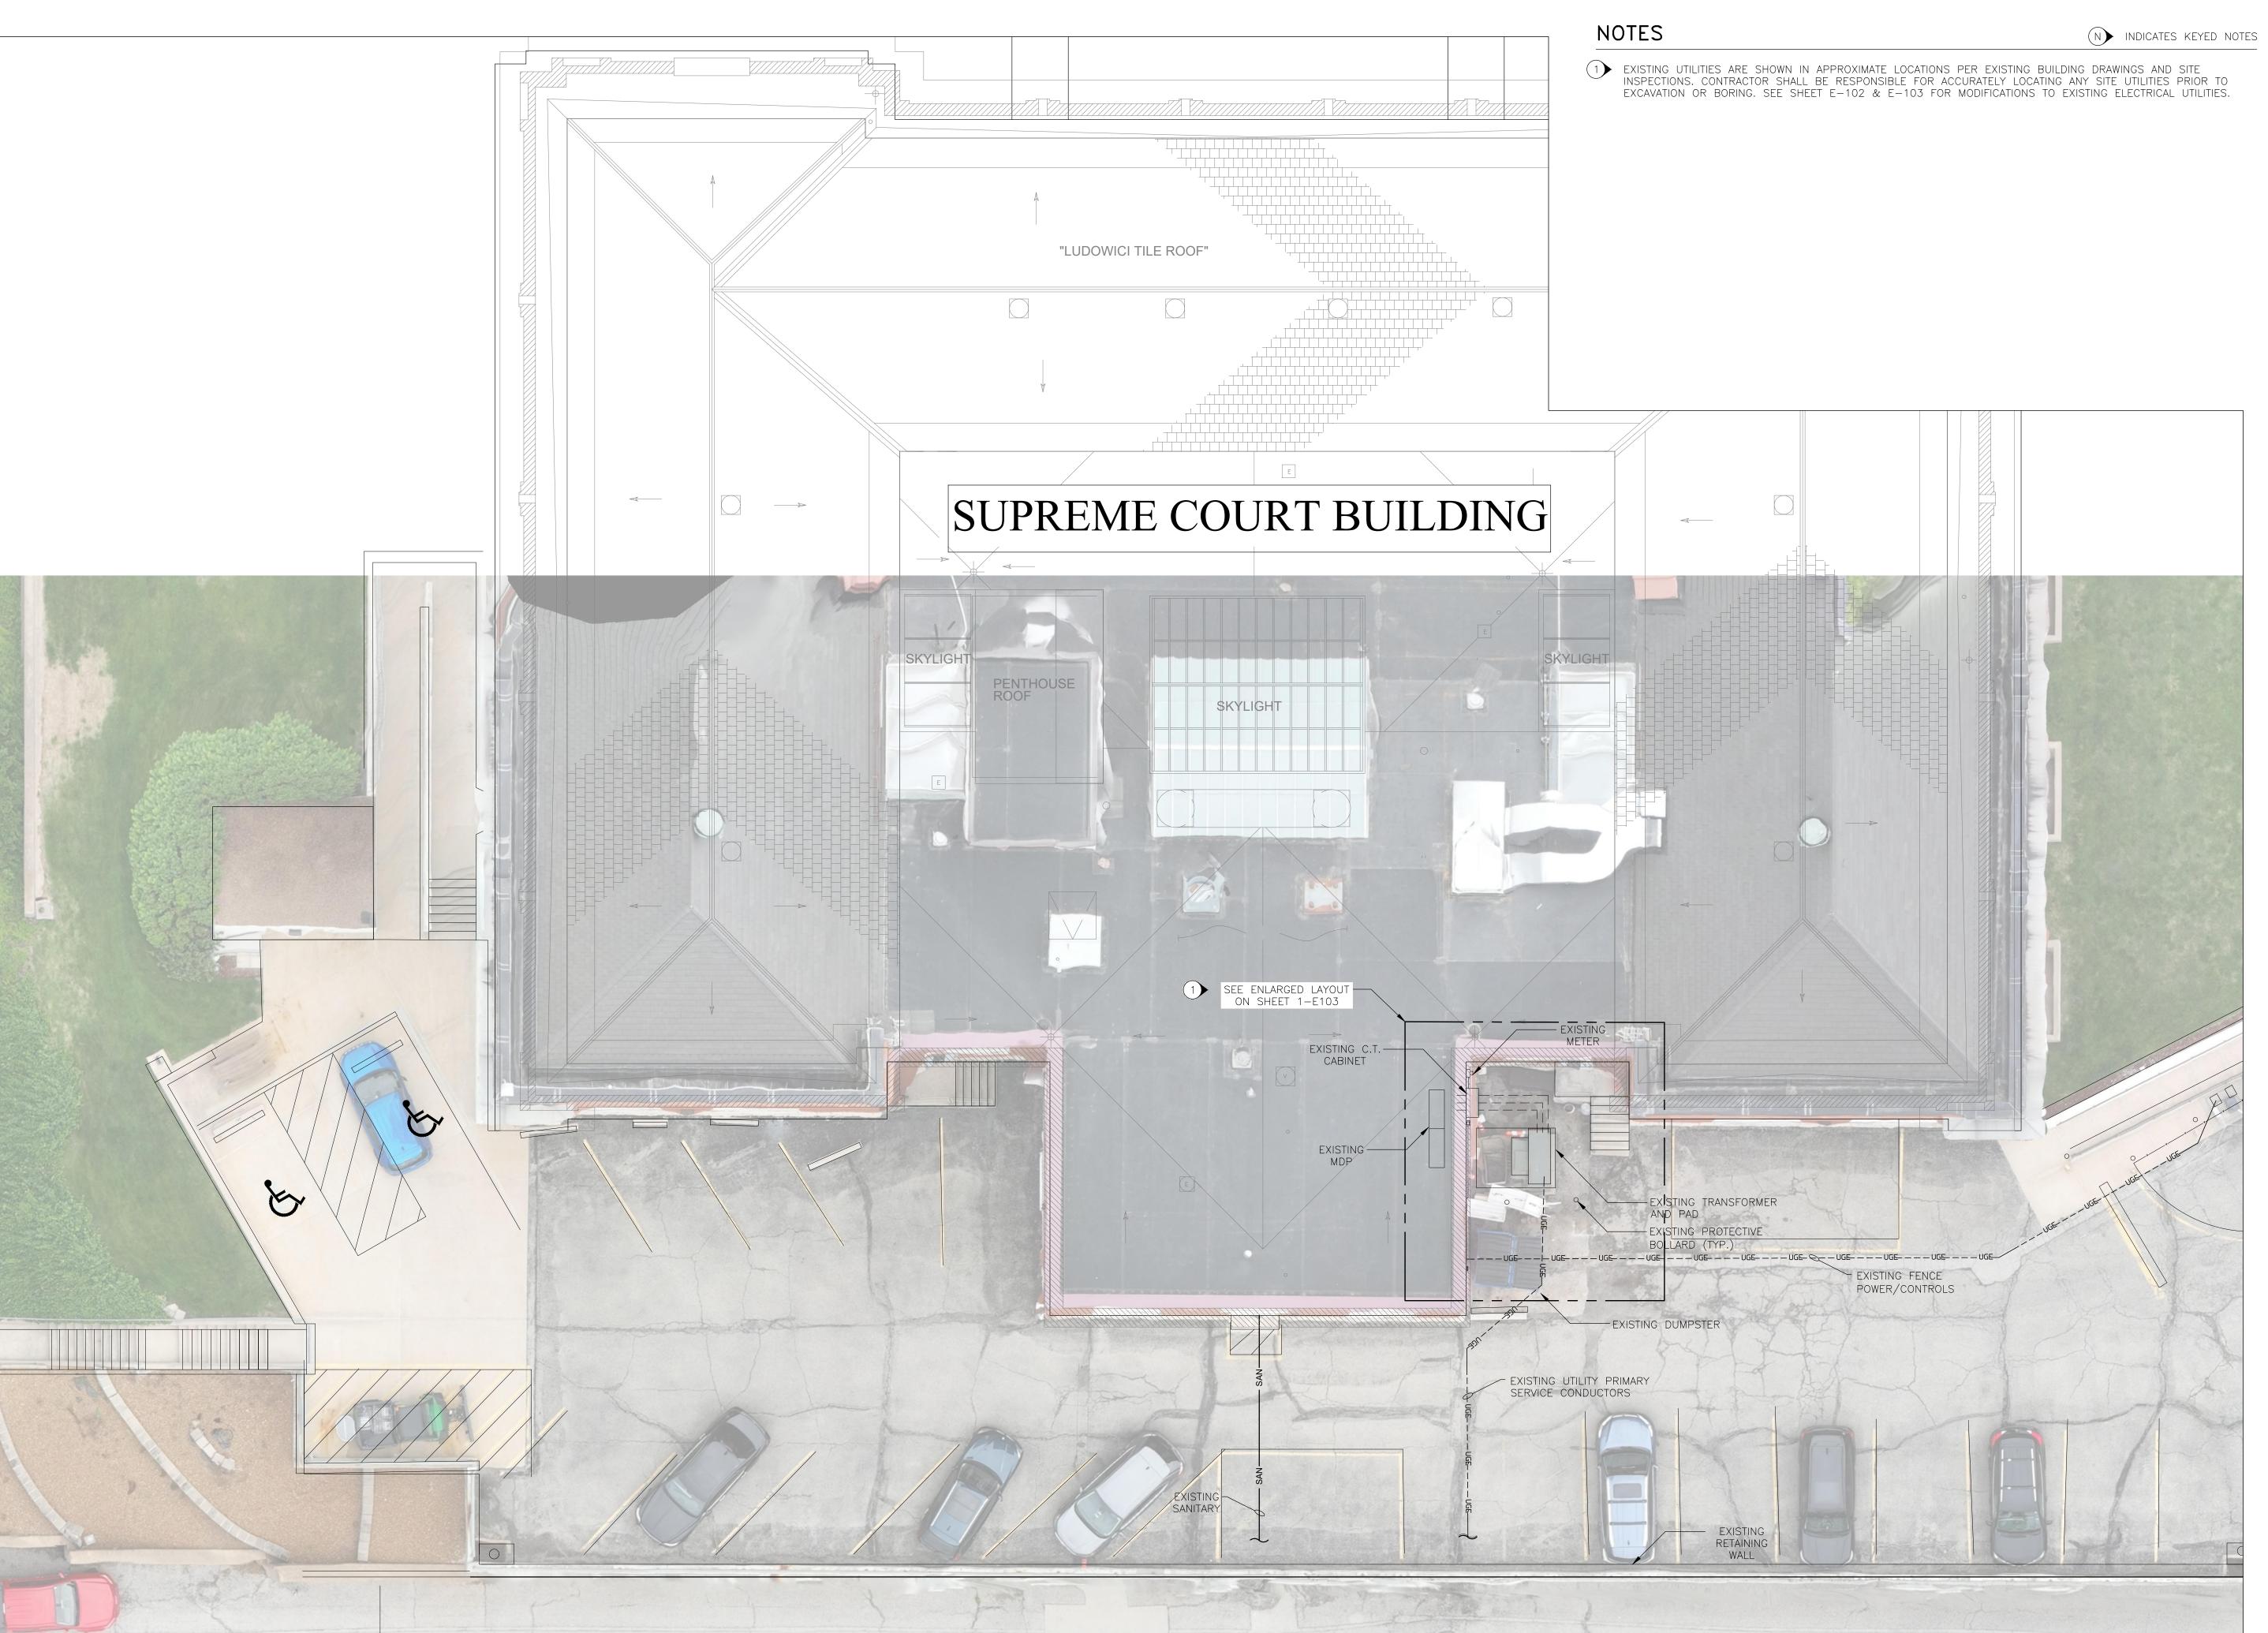
ISSUE DATE: 09/24/2024

CAD DWG FILE:SCBG-e.dwg
DRAWN BY: JJS/SAK
CHECKED BY: JLD DESIGNED BY: JJS/SAK


SHEET TITLE:

DRAWING INDEX AND LOCATION MAP

SHEET NUMBER:



STATE OF MISSOURI
MICHAEL L. PARSON,
GOVERNOR

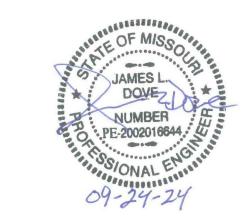



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DEPARTMENT OF
Office Of Administration
Facilities Management
Design And Construction

SUPREME COURT GENERATOR

SUPREME COURT
STATE OFFICE BUILDING
207 WEST HIGH STREET,
JEFFERSON CITY, MISSOURI

PROJECT # O2366-01 SITE # 1001 FACILITY # 3101001056

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CAD DWG FILE:SCBG-e.dwg
DRAWN BY: JJS/SAK
CHECKED BY: JLD
DESIGNED BY: JJS/SAK

SHEET TITLE:

EXISTING UTILITY SITE PLAN

SHEET NUMBER:

E-101

3 OF 10 SHEETS
09/24/2024

STATE OF MISSOURI MICHAEL L. PARSON, GOVERNOR





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SUPREME COURT GENERATOR

SUPREME COURT STATE OFFICE BUILDING 207 WEST HIGH STREET, JEFFERSON CITY, MISSOURI

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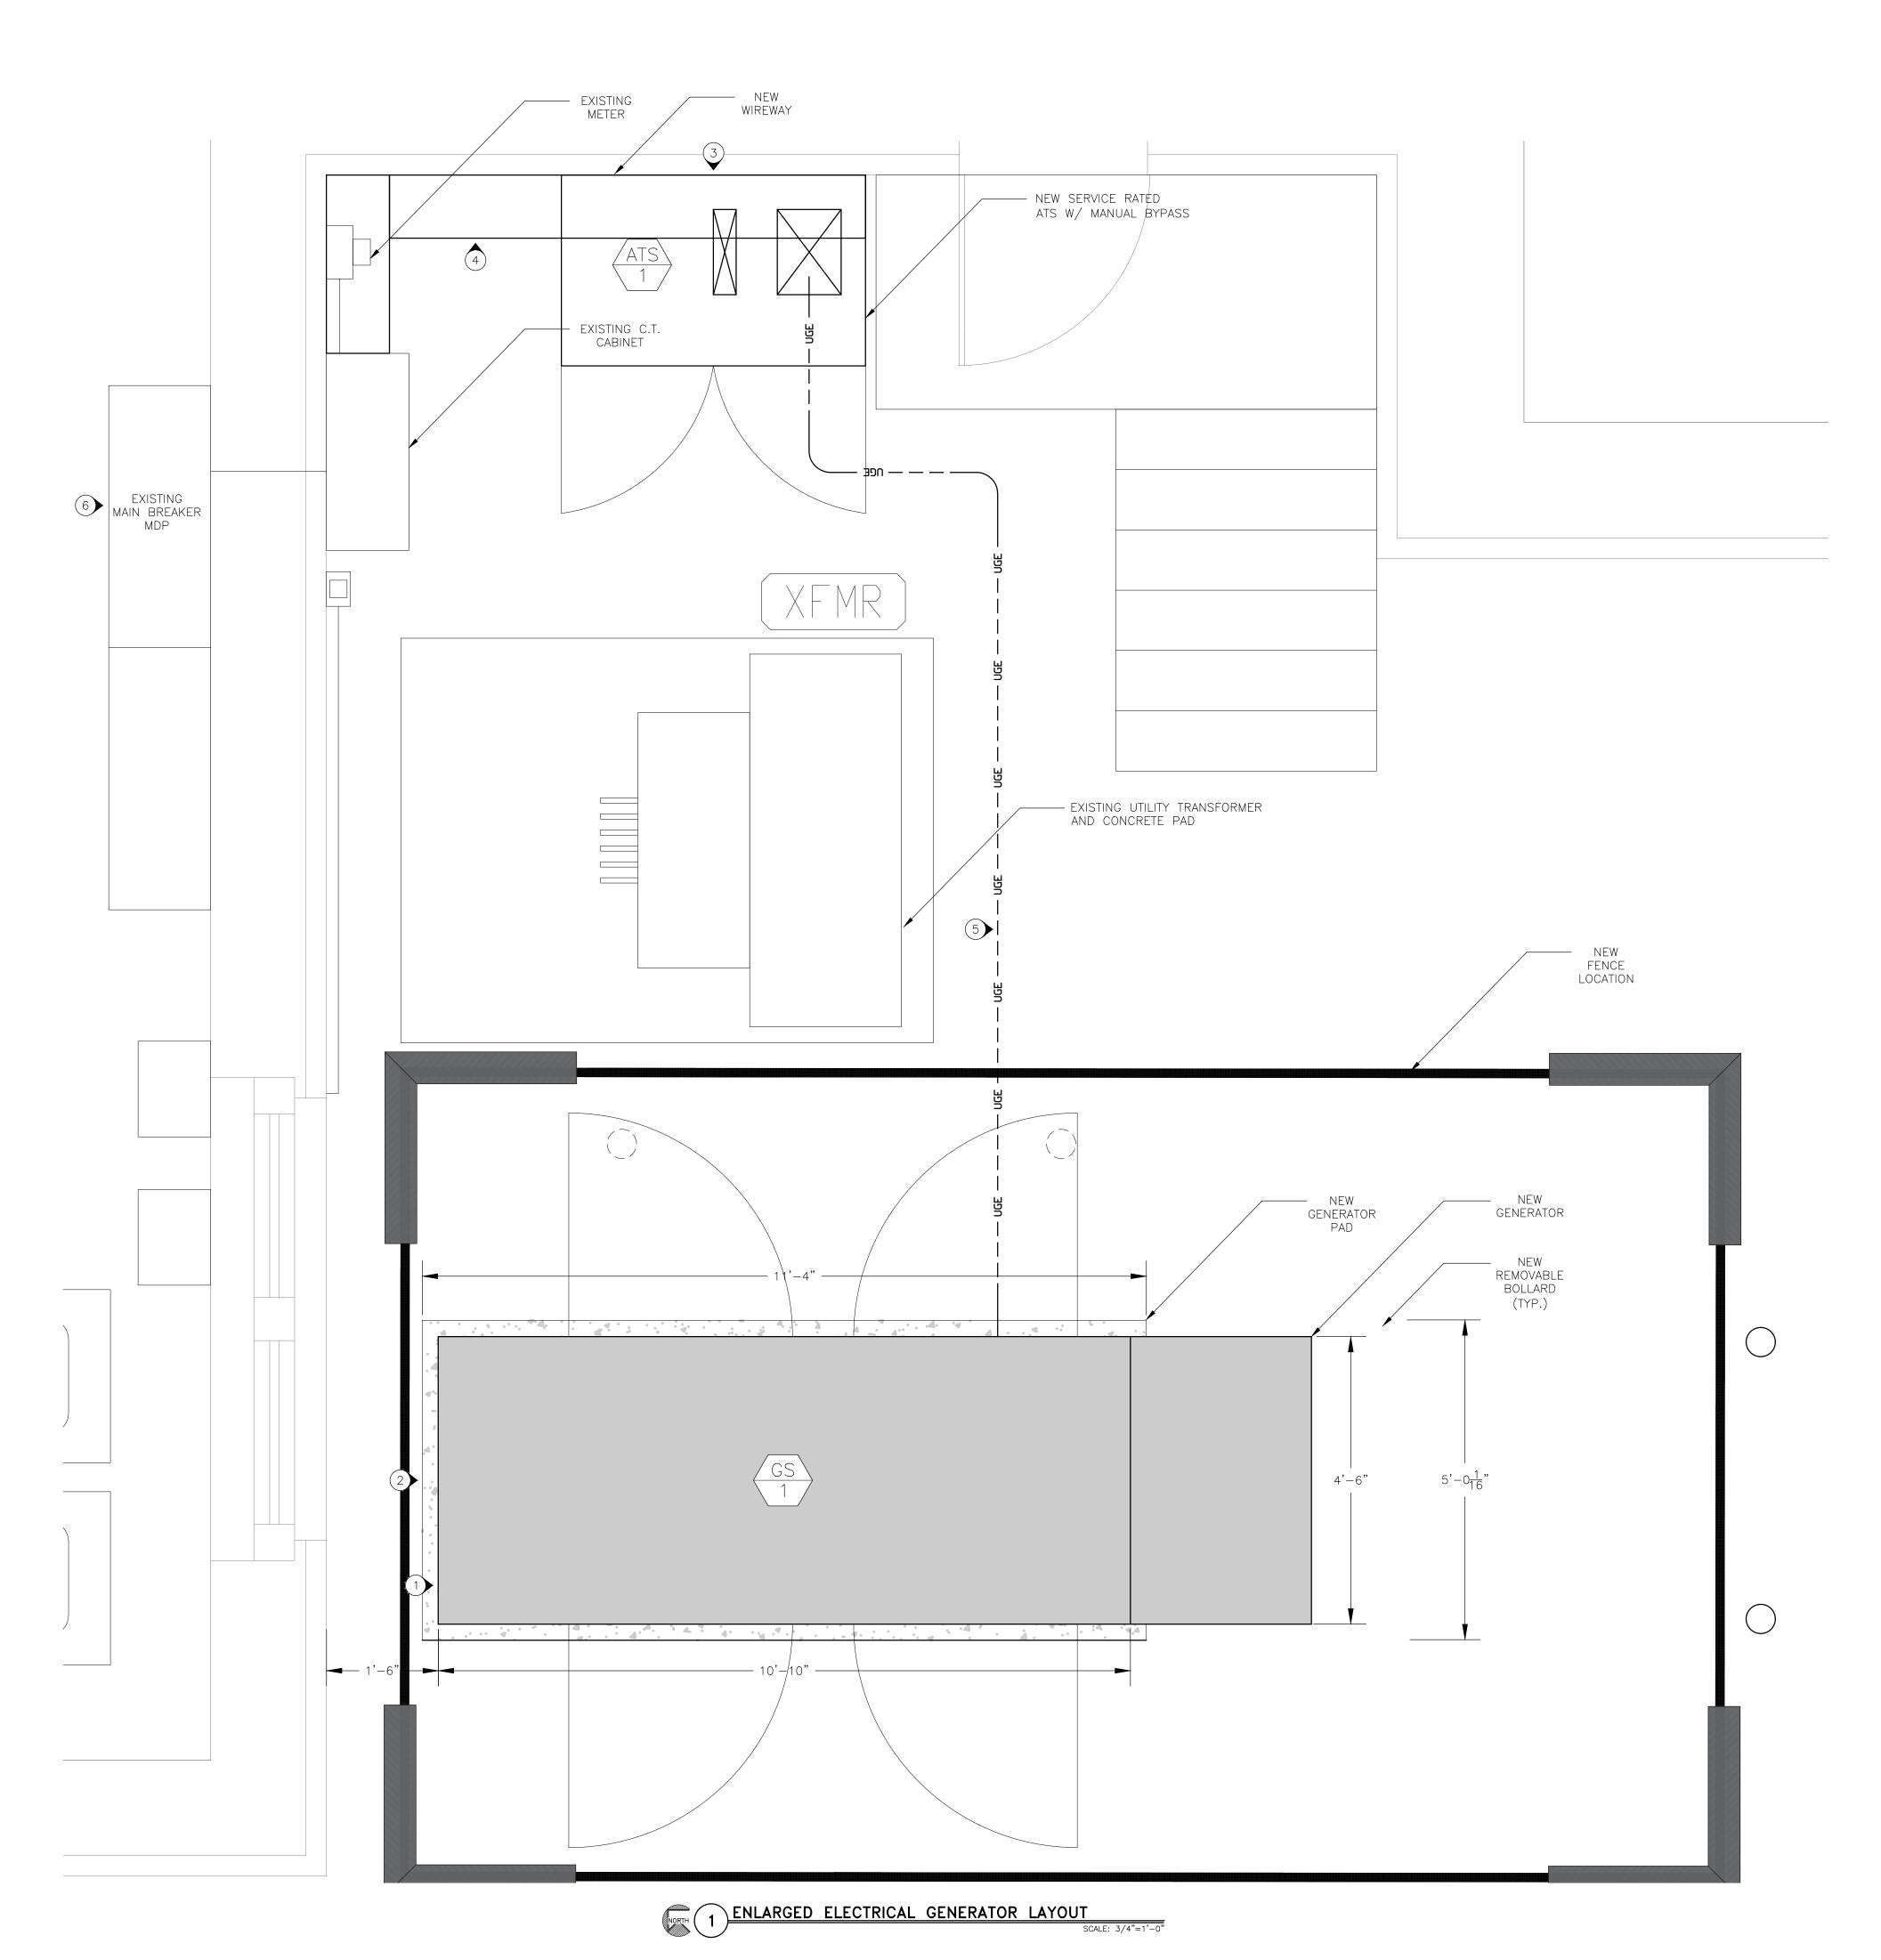
SHEET TITLE:

NEW UTILITY SITE PLAN

SHEET NUMBER:

E-102

4 OF 10 SHEETS
09/24/2024




NOTES

(N) INDICATES KEYED NOTES

- 1) INSTALL NEW 200 kW DIESEL GENERATOR GS-1 ON TOP OF A 24 HOUR FUEL TANK.
- 2 INSTALL NEW GENERATOR CONCRETE PAD (12"X12'X5") WITH ~18" CLARENCE FROM BLDG FOUNDATION. NEW PAD IS TO BE SET 6" BELOW GRADE, DUE TO PRIMARY TRANSFORMER CONDUCTORS LOCATED BELOW.
- 3 INSTALL NEW SERVICE RATED NEMA 3R, 600A, 208V, 3Ø, 4W, ATS W/ MANUAL BYPASS. MOUNT WITH 3 FEET WORKING CLEARANCE IN FRONT TO PROVIDE EASY ACCESSIBILITY.
- INSTALL WIREWAY FROM NEW ATS TO EXISTING C.T. CABINET. WIREWAY SHOULD BE INSTALLED TO PROVIDE A WIRE PATHWAY INTO THE BOTTOM OF NEW ATS. WIREWAY WILL SERVE TO ROUTE CONDUCTORS FROM CT TO ATS AND ATS TO MDP IN BASEMENT.
- INSTALL (2) 1" HDPE AND (1) 4" HDPE CONDUITS FROM GENERATOR TO ATS. CONDUIT IS TO BE HYDRO EXCAVATED DUE TO EXISTING UTILITIES IN THE AREA. IN THE 4" CONDUIT INSTALL (2) SETS OF (3)-350 CU THWN, (1) 300 CU THWN, & (1) 2/0 CU THWN GRND. IN THE FIRST 1" CONDUIT INSTALL (6) #14 CU THWN & 1 BELDON 9841 TWISTED, SHIELDED CONDUCTOR FOR REMOTE ANNUNCIATOR, EMERGENCY STOP, AND START/STOP SIGNAL. IN THE SECOND 1" CONDUIT INSTALL (4) #12 CU THWN & (1) #12 CU THWN GRND FOR BATTERY CHARGER & ENGINE BLOCK HEATER.
- REPLACE EXISTING MDP CUTLER HAMMER 1200A (12NES1200T) MAIN BREAKER DIGITRIP RMS 310 RATING PLUG WITH NEW 600A (12NES600T) DIGITRIP 310 RATING PLUG. THE MAIN BREAKER IS NOT REQUIRED TO BE REPLACED, ONLY THE ELECTRONIC TRIP UNIT.
- 7 INSTALL 3/4" EMT CONDUIT FROM PANEL L4 TO ATS FOR (2) 20A 120V CIRCUITS, ONE FOR GENERATOR BATTERY CHARGER AND ONE FOR GENERATOR BLOCK HEATER. INSTALL (4) #12 CU THWN, (1) #12 CU THWN GRND FROM PANEL L4 TO GENERATOR. SEE DETAIL 2 THIS SHEET.
- 8 INSTALL (1) 3/4" EMT CONDUIT FROM ATS TO RM B-25 FOR REMOTE ANNUNCIATOR. INSTALL BELDON 9841 TWISTED, SHIELDED PAIR FOR COMMUNICATIONS AND (2) #14 CU THWN FOR 12/24V DC POWER TO ANNUNCIATOR. SEE DETAIL 2 BELOW FOR POTENTIAL CONDUIT ROUTING. SEE DETAIL 2 THIS SHEET.

ELECTRICAL LEGEND		
\bigcirc	EXISTING BOLLARD (TO BE REMOVED)	
0	NEW BOLLARD	
	NEW UNDERGROUND ELECTRIC	
	ATS BOTTOM CONDUIT ENTRANCE	

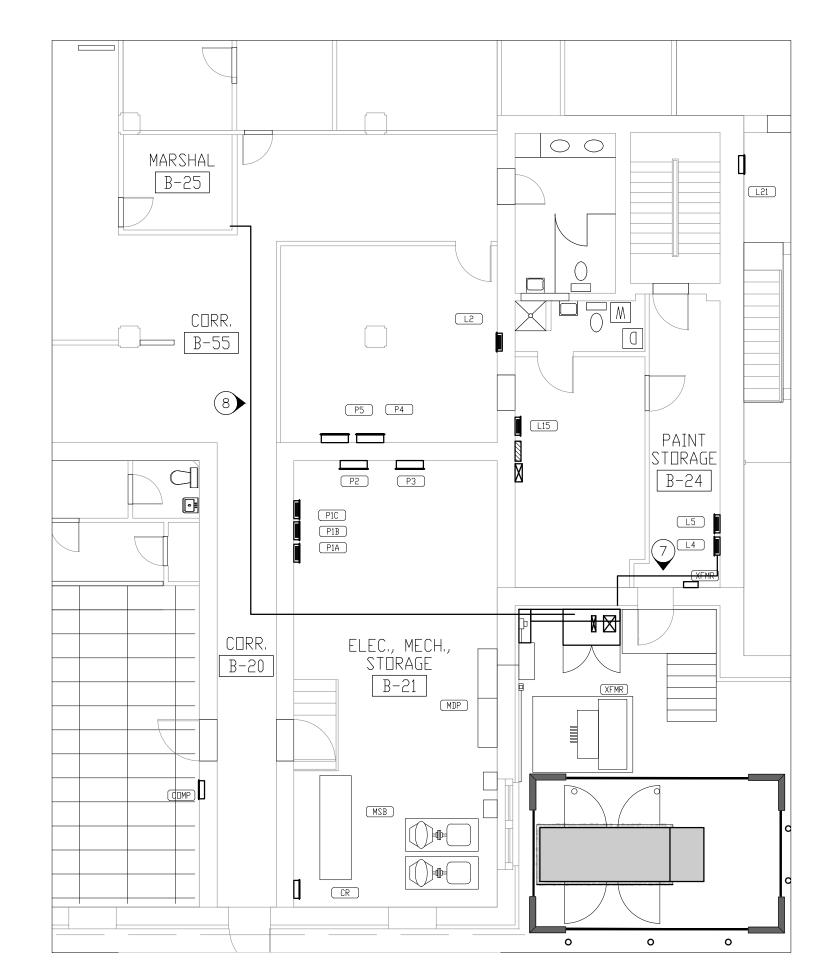



STATE OF MISSOURI MICHAEL L. PARSON, GOVERNOR





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OFFICE OF ADMINISTRATION DIVISION OF FACILITIES MANAGEMENT, DESIGN AND CONSTRUCTION

DEPARTMENT OF
Office Of Administration
Facilities Management
Design And Construction

SUPREME COURT GENERATOR

SUPREME COURT STATE OFFICE BUILDING 207 WEST HIGH STREET, JEFFERSON CITY, MISSOURI

PROJECT # O2366-01 SITE # 1001 FACILITY # 3101001056

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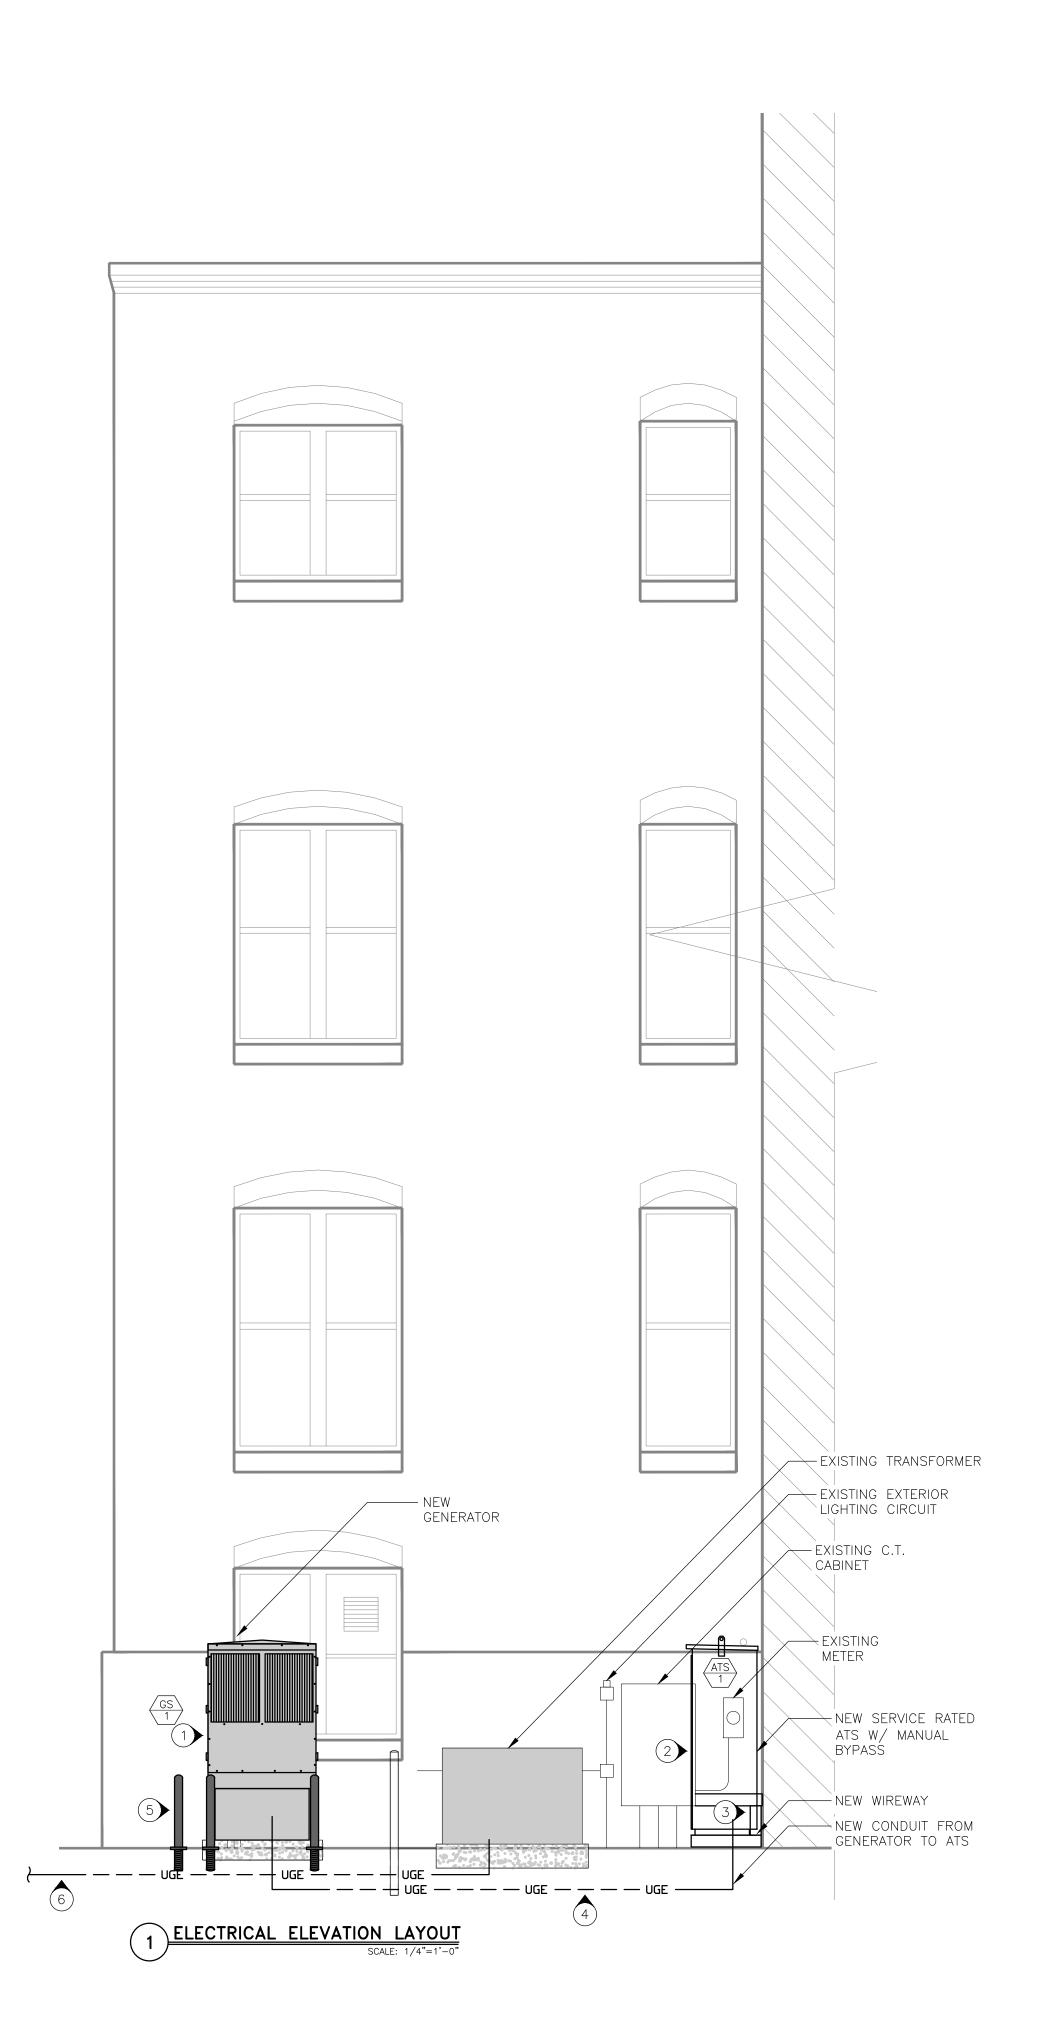
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DESIGNED BY: JJS/SAK


SHEET TITLE:

ENLARGED ELECTRICAL PLAN

SHEET NUMBER:

E-103



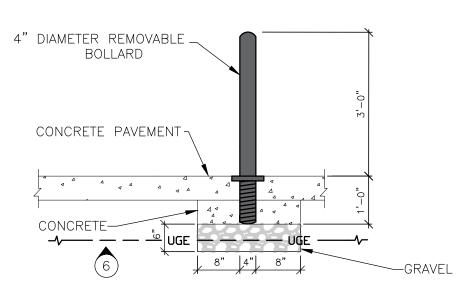



NOTES

N INDICATES KEYED NOTES

1 NEW 200 KW GENERATOR ON TOP OF A 24 HOUR TANK AND GENERATOR PAD. SEE PAD DETAILS BELOW.

NEW SERVICE RATED NEMA 3R ATS. SWITCH TO BE 600A, 208V, 3Ø, 4W WITH MANUAL BYPASS. MOUNT ON TOP OF WIREWAY THAT INTERCONNECTS IT WITH THE EXISTING CT CABINET. MOUNT SWITCH WITH 3 FEET OF CLEARANCE IN FRONT TO PROVIDE EASY ACCESSIBILITY.

- INSTALL NEW SURFACE MOUNTED GUTTER BETWEEN NEW ATS AND C.T. CABINET. ENSURE GUTTER LANDS BELOW ATS CONDUIT AREA.
- INSTALL (1) 1" CONDUIT FOR BATTERY CHARGER/BLOCK HEATER CIRCUIT, INSTALL (1) -1" CONDUIT FOR LOW VOLTAGE LINES FROM GENERATOR TO ATS AND REMOTE ANNUNCIATER, AND (1) 4" LINE FOR GENERATOR POWER TO THE ATS. USE HYDRO EXCAVATION TO TRENCH LINES DUE TO UTILITIES IN THE AREA.
- INSTALL FIVE NEW REMOVABLE BOLLARDS. THREE ON LONG SIDE OF NEW GENERATOR AND TWO IN FRONT OF NEW GENERATOR ON SHORT SIDE. RECOMMEND USING GLOBAL INDUSTRIAL MODEL WB670517 REMOVABLE BOLLARD. SEE BOLLARD DETAIL FOR DIMENSIONS.
- 6 UNDERGROUND UTILITIES APPROXIMATELY TWO FEET BELOW SURFACE. USE CAUTION WHEN INSTALLING BOLLARDS OR EXCAVATING FOR NEW GENERATOR EQUIPMENT PAD.

STATE OF MISSOURI MICHAEL L. PARSON, **GOVERNOR**





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SUPREME COURT GENERATOR

SUPREME COURT STATE OFFICE BUILDING 207 WEST HIGH STREET, JEFFERSON CITY, MISSOURI

PROJECT # O2366-01 FACILITY # 3101001056

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DATE:
ISSUE DATE: 09/24/2024

CAD DWG FILE:SCBG-e.dwg
DRAWN BY: JJS/SAK
CHECKED BY: JLD DESIGNED BY: JJS/SAK

SHEET TITLE:

ELECTRICAL **ELEVATION PLAN**

SHEET NUMBER:





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OFFICE OF ADMINISTRATION **DIVISION OF FACILITIES** MANAGEMENT, **DESIGN AND CONSTRUCTION**

DEPARTMENT OF Office Of Administration Facilities Management **Design And Construction**

SUPREME COURT GENERATOR

SUPREME COURT STATE OFFICE BUILDING 207 WEST HIGH STREET, JEFFERSON CITY, MISSOURI

PROJECT # O2366-01 FACILITY # 3101001056

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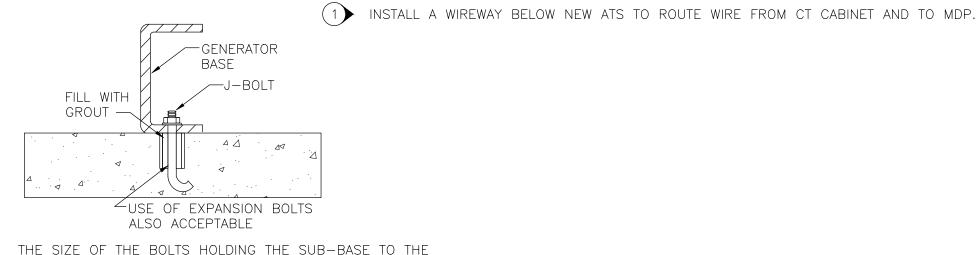
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SHEET TITLE:

ELECTRICAL **SUPPLEMENTAL DETAILS**

SHEET NUMBER:



THE SIZE OF THE BOLTS HOLDING THE SUB-BASE TO THE FOUNDATION SHOULD BE SIZED TO FIT THE MOUNTING HOLES GIVEN IN THE INSTALLATION MANUAL.

THREE-INCH IRON PIPE SLEEVES SHOULD BE PLACED AROUND THE BOLTS IN THE FOUNDATION TO ALLOW FOR ANY MIS-LOCATION OF THE BOLTS AFTER THE FOUNDATION HARDENS. "J" OR "L" TYPE BOLTS ARE RECOMMENDED FOR THE FOUNDATION BOLTS. AFTER THE FOUNDATION IS CURED AND THE GENERATOR IS LOCATED, THE SLEEVES ARE FILLED

COORDINATE WITH INSTALLATION MANUAL ON MOUNTING BOLT LOCATIONS.

GENERATOR ANCHORING DETAIL

3" CLR. TYP. -4. 4. 4. UNDISTURBED EARTH

FOUNDATION SECTION NOTES:

BE REMOVED.

#4 BARS @ 8"O.C. EACH

1. CONCRETE SHALL MEET A MINIMUM 28-DAY COMPRESSIVE STRENGTH OF 3,000 PSI.

3. ALLOW 3" CLEAR FROM EDGE OF REINFORCING STEEL TO ANY OPENING OR END OF SLAB.


2. THE NEW CONCRETE GENERATOR PAD SHALL BE PLACED ON COMPACTED SOIL. ANY UNSUITABLE MATERIAL SHALL


UNDISTURBED

EARTH

3" CLR. TYP. →

GENERATOR FOUNDATION END SECTION

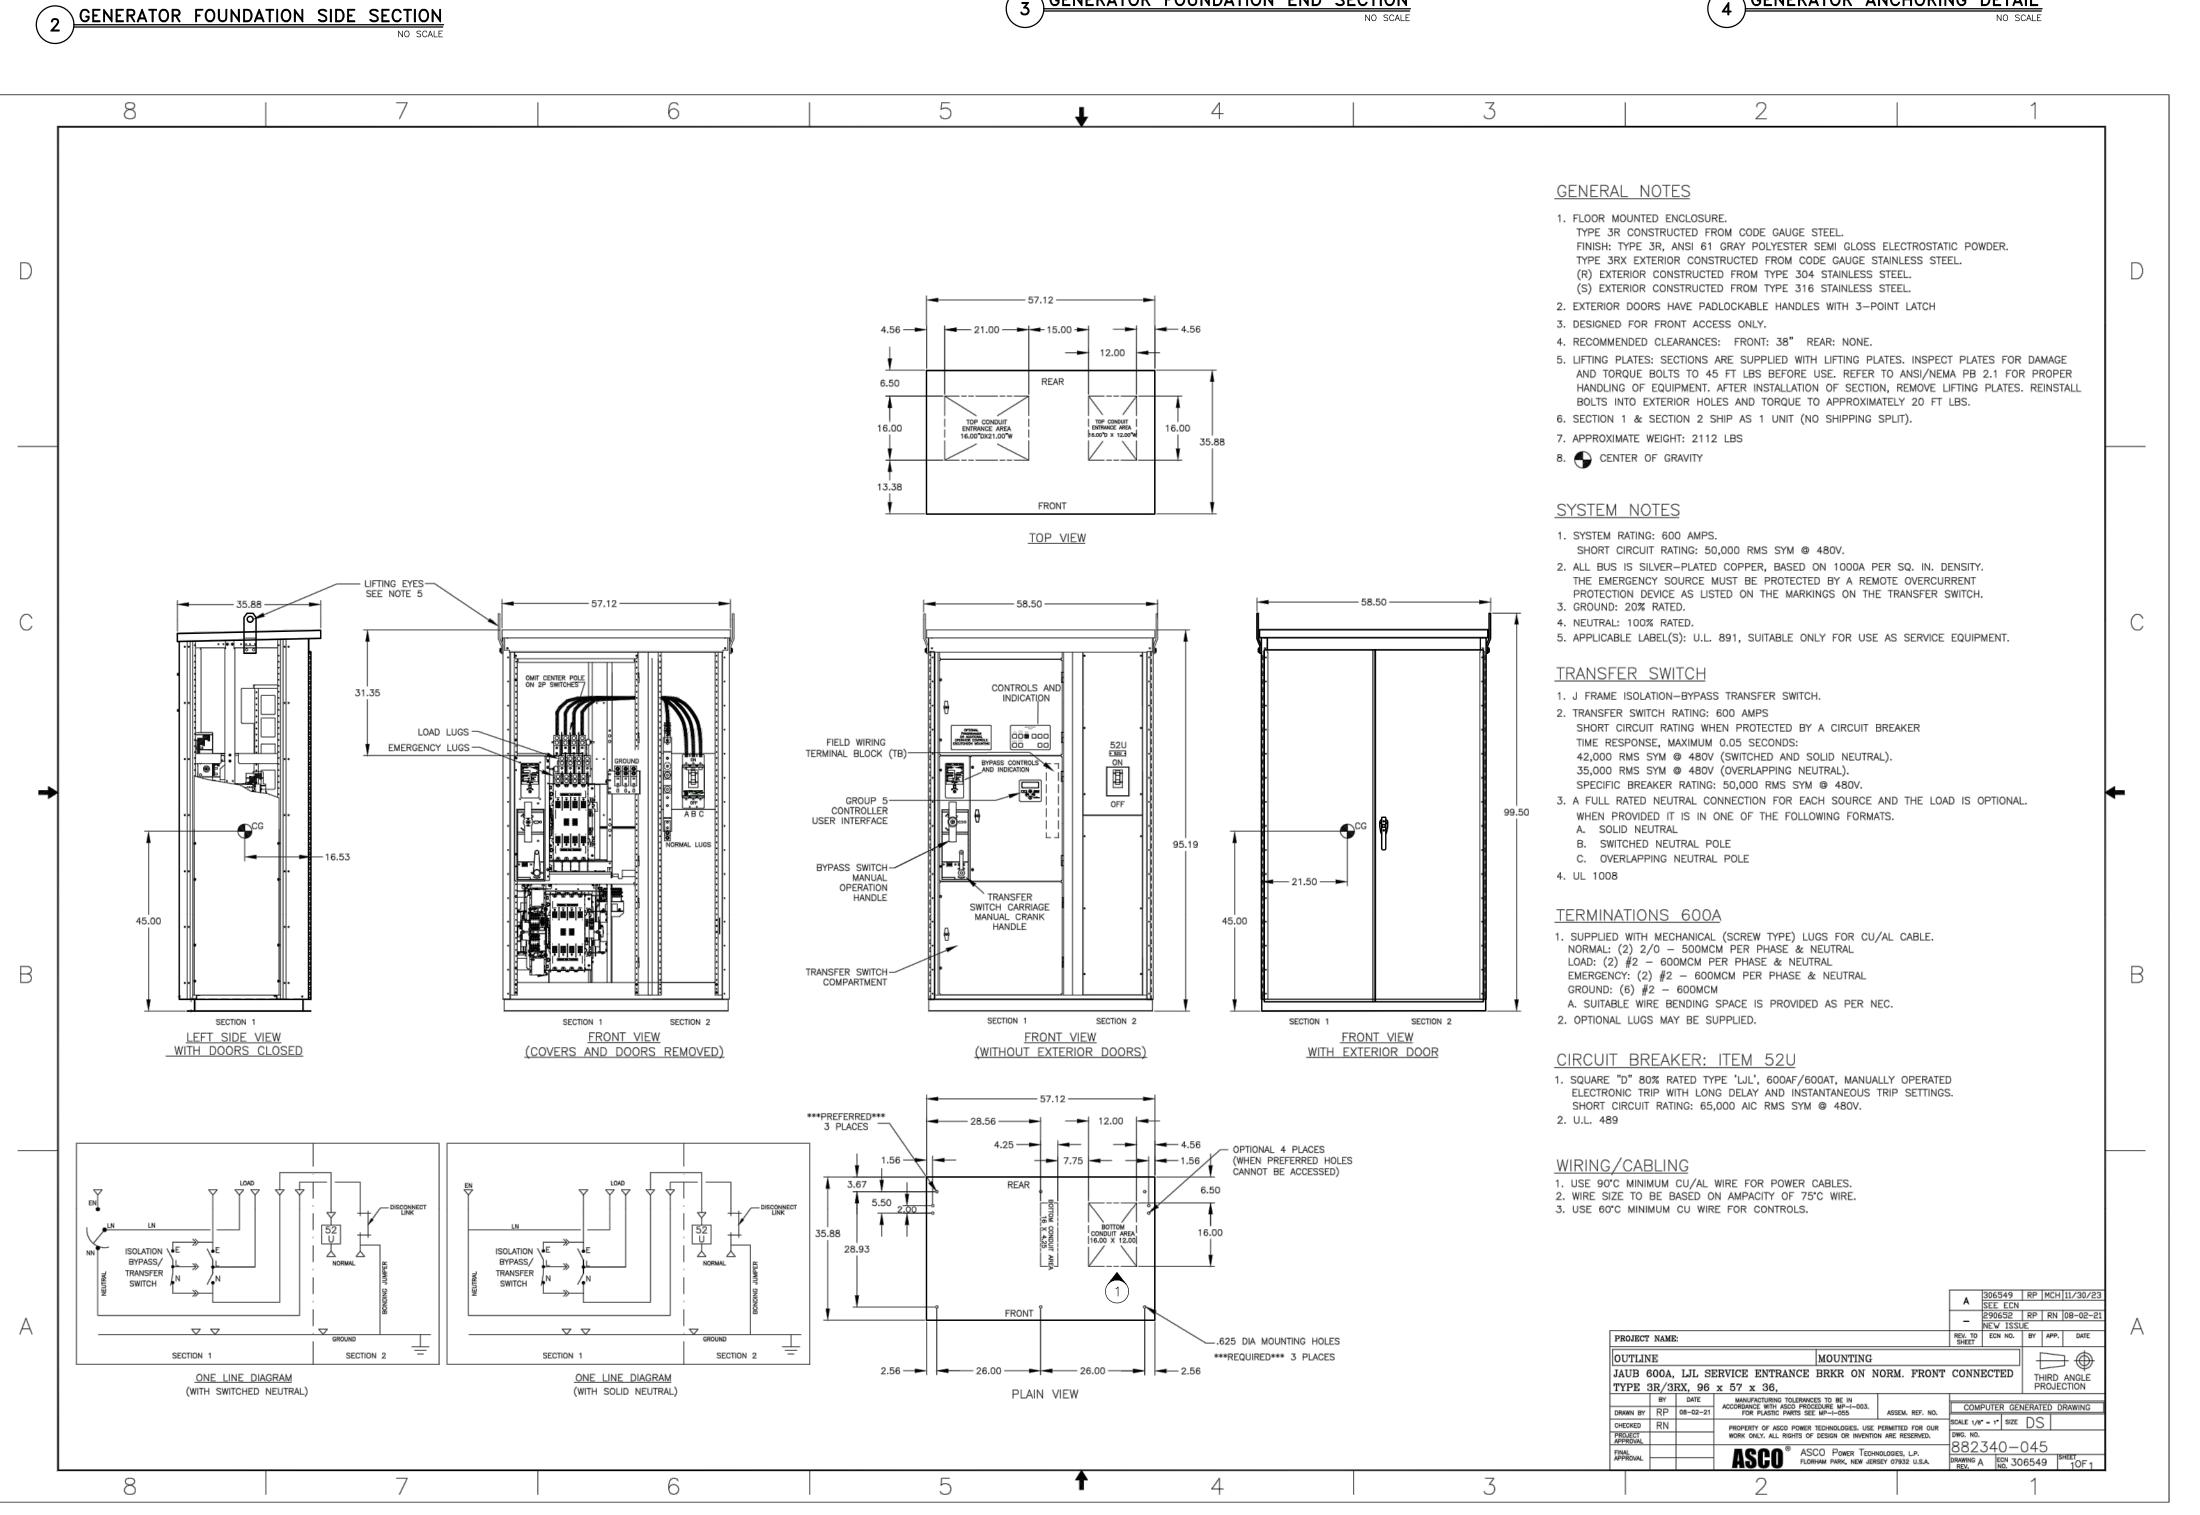

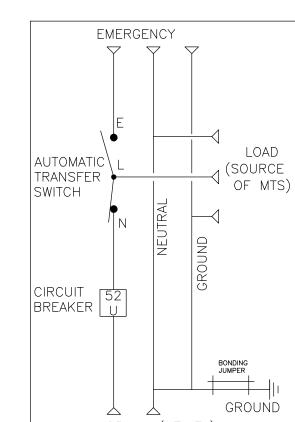

NORMAL (UTILITY) ATS (WITH SOLID NEUTRAL)

1 ASCO 600A SERVICE RATED ATS

5 NEW ATS CONFIGURATION 7 OF 10 SHEETS 09/24/2024

BLUE ST*R Power Systems Inc.

Diesel Product Line	208-600 Volt
PD200-01	60 Hz / 1800 RPM
200 kWe	Standby

Ratings

natings					
	240V	208V	240V	480V	600V
Phase	1	3	3	3	3
PF	1.0	0.8	0.8	0.8	0.8
Hz	60	60	60	60	60
Generator Model	S4L1D-E41	UCDI274J1	UCDI274J1	UCI274H	UCI274H
Connection	12 LEAD DD	12 LEAD WYE	12 LEAD DELTA	12 LEAD WYE	4 LEAD WYE
kWe	200	200	200	200	200
AMPS	833	695	602	301	241
Temp Rise	125°C / 40°C	125°C / 40°C	125°C / 40°C	125°C / 40°C	125°C / 40°C
Temp Rise	125 C / 40 C	125 0 7 40 0	125 0 / 40 0	12507400	125 C /

Standard Equipment

Radiator Cooled Unit Mounted (50°C)

- Radiator Duct Flange (OPU Only)

- Blower Fan & Fan Drive Starter & Alternator Oil Pump & Filter
- Oil Drain Extension w/Valve Governor - Electronic Isochronous
- 12V Battery System & Cables Air Cleaner (Dry Single Stage)
- Critical Grade Silencer Mounted Flexible Fuel Connector
- EPA Certified Tier 3

- Brushless Single Bearing Single Source Supplier Automatic Voltage Regulator
- UL 2200 & cUL Listed ± 1% Voltage Regulation CSA Certified
- Seismic Certified to IBC 2021 4 Pole, Rotating Field 125°C Standby Temperature Rise - NFPA 110 / CSA C282 Compliant
- 100% of Rated Load One Step - Microprocessor Based Digital Control Panel - 5% Maximum Harmonic Content Mounted in NEMA 12 Enclosure
 - Base Formed Steel - Main Line Circuit Breaker Mounted & Wired
 - Battery Charger 12V 6 Amp Jacket Water Heater -20°F 2000W 240V
 - w/Isolation Valves - Vibration Isolation Mounts
 - 2 Year / 2000 Hour Standby Warranty
 - Standard Colors White / Gray

PD200-01	1 of 4

NEMA MG 1, IEEE and ANSI

Standards Compliance for

Temperature Rise

Diesel Product Line

BLUE ST R
Power Systems Inc.

Standby

Application Data

Exhaust System

PD200-01

200 kWe


Engine			
Manufacturer:	Perkins	Displacement - Cu. In. (lit):	428 (7.01)
Model:	1106D-E70TAG5	Bore - in. (cm) x Stroke - in. (cm):	4.13 (10.5) x 5.31 (13.5)
Type:	4-Cycle	Compression Ratio:	16.8:1
Aspiration:	Turbo Charged, CAC	Rated RPM:	1800
Cylinder Arrangement:	6 Cylinder Inline	Max HP Stby (kWm):	315 (235)


-	
Gas Temp. (Stack): °F (°C)	1,027 (553)
Gas Volume at Stack Temp: CFM (m³/min)	1,353 (38.3)
Maximum Allowable Exhaust Restriction: in. H ₂ O (kPa)	40.0 (10.0)
Cooling System	
Ambient Capacity of Radiator: °F (°C)	122 (50.0)
Maximum Allowable Static Pressure on Rad. Exhaust: in. H ₂ O (kPa)	0.50 (0.12)
Water Pump Flow Rate: GPM (lit/min)	44.9 (170)
Heat Rejection to Coolant: BTUM (kW)	5,251 (91.9)
Heat Rejection to CAC: BTUM (kW)	2,709 (47.4)
Heat Radiated to Ambient: BTUM (kW)	4,020 (70.4)
Air Requirements	
Aspirating: CFM (m³/min)	597 (16.9)
Air Flow Required for Rad. Cooled Unit: CFM (m³/min)	10,161 (288)
Air Flow Required for Heat Exchanger/Rem. Rad. CFM (m³/min)	Consult Factory For Remote Cooled Applications

Air Requirements	
Aspirating: CFM (m³/min)	597 (16.9)
Air Flow Required for Rad. Cooled Unit: CFM (m³/min)	10,161 (288)
Air Flow Required for Heat Exchanger/Rem. Rad. CFM (m³/min)	Consult Factory For Remote Cooled Applications
Fuel Consumption	
At 100% of Power Rating: gal/hr (lit/hr)	14.8 (55.9)
At 75% of Power Rating: gal/hr (lit/hr)	12.3 (46.4)
At 50% of Power Rating: gal/hr (lit/hr)	8.48 (32.1)
Fluids Capacity	
Total Oil Systems, and /lith	4 62 (17 5)

Total Oil System: gal (lit) 4.62 (17.5) 2.51 (9.50) Engine Jacket Water Capacity: gal (lit) 5.55 (21.0) System Coolant Capacity: gal (lit)

Deration Factors: Rated Power is available up to 1640ft (500m) at ambient temperatures to 122°F (50°C). Consult factory for site conditions above these parameters.

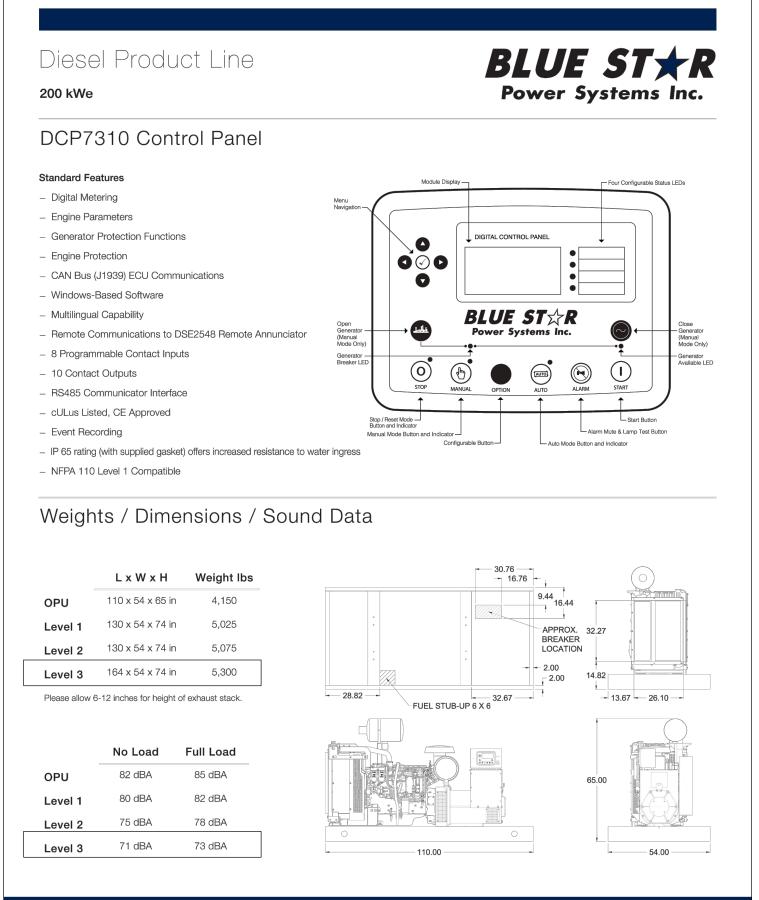

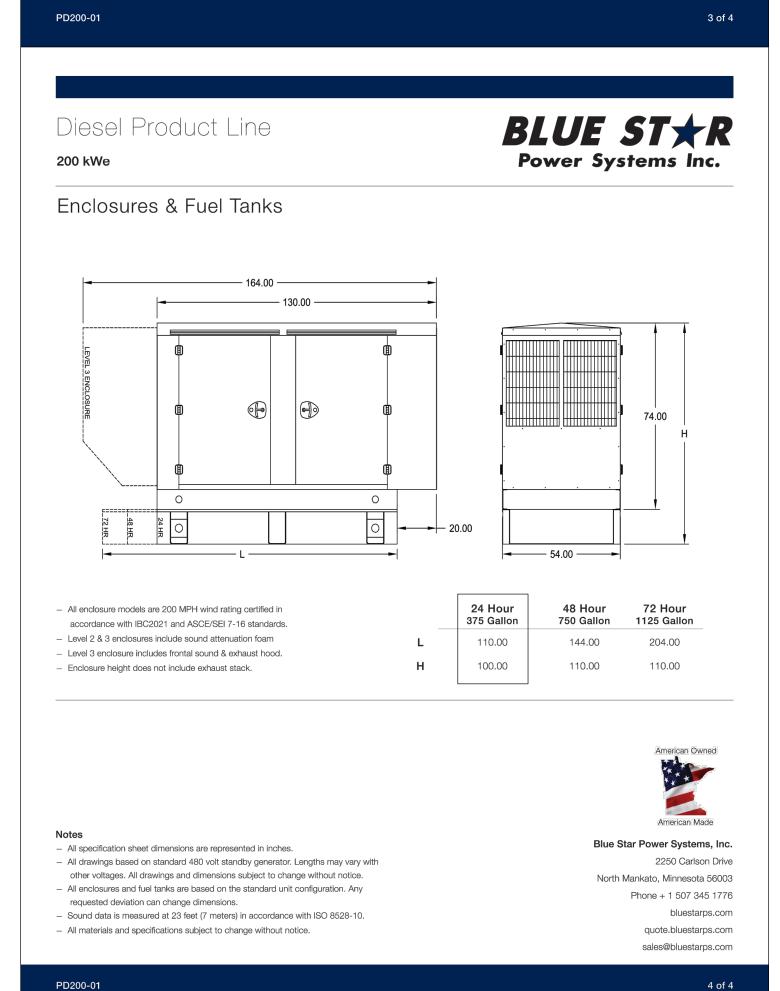

BLUE STAR 200kWe DIESEL GENERATOR
SCALE: NONE

2 of 4

NOTES N INDICATES KEYED NOTES

1 BLUE STAR IS THE BASIS OF DESIGN, SEE SPECIFICATIONS FOR SUBSTITUTIONS.

STATE OF MISSOURI MICHAEL L. PARSON, **GOVERNOR**



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SUPREME COURT GENERATOR

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PROJECT # O2366-01 FACILITY # 3101001056


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SHEET TITLE:

ELECTRICAL **SUPPLEMENTAL INFORMATION**

SHEET NUMBER:



ALUMINUM FENCE LOCATION

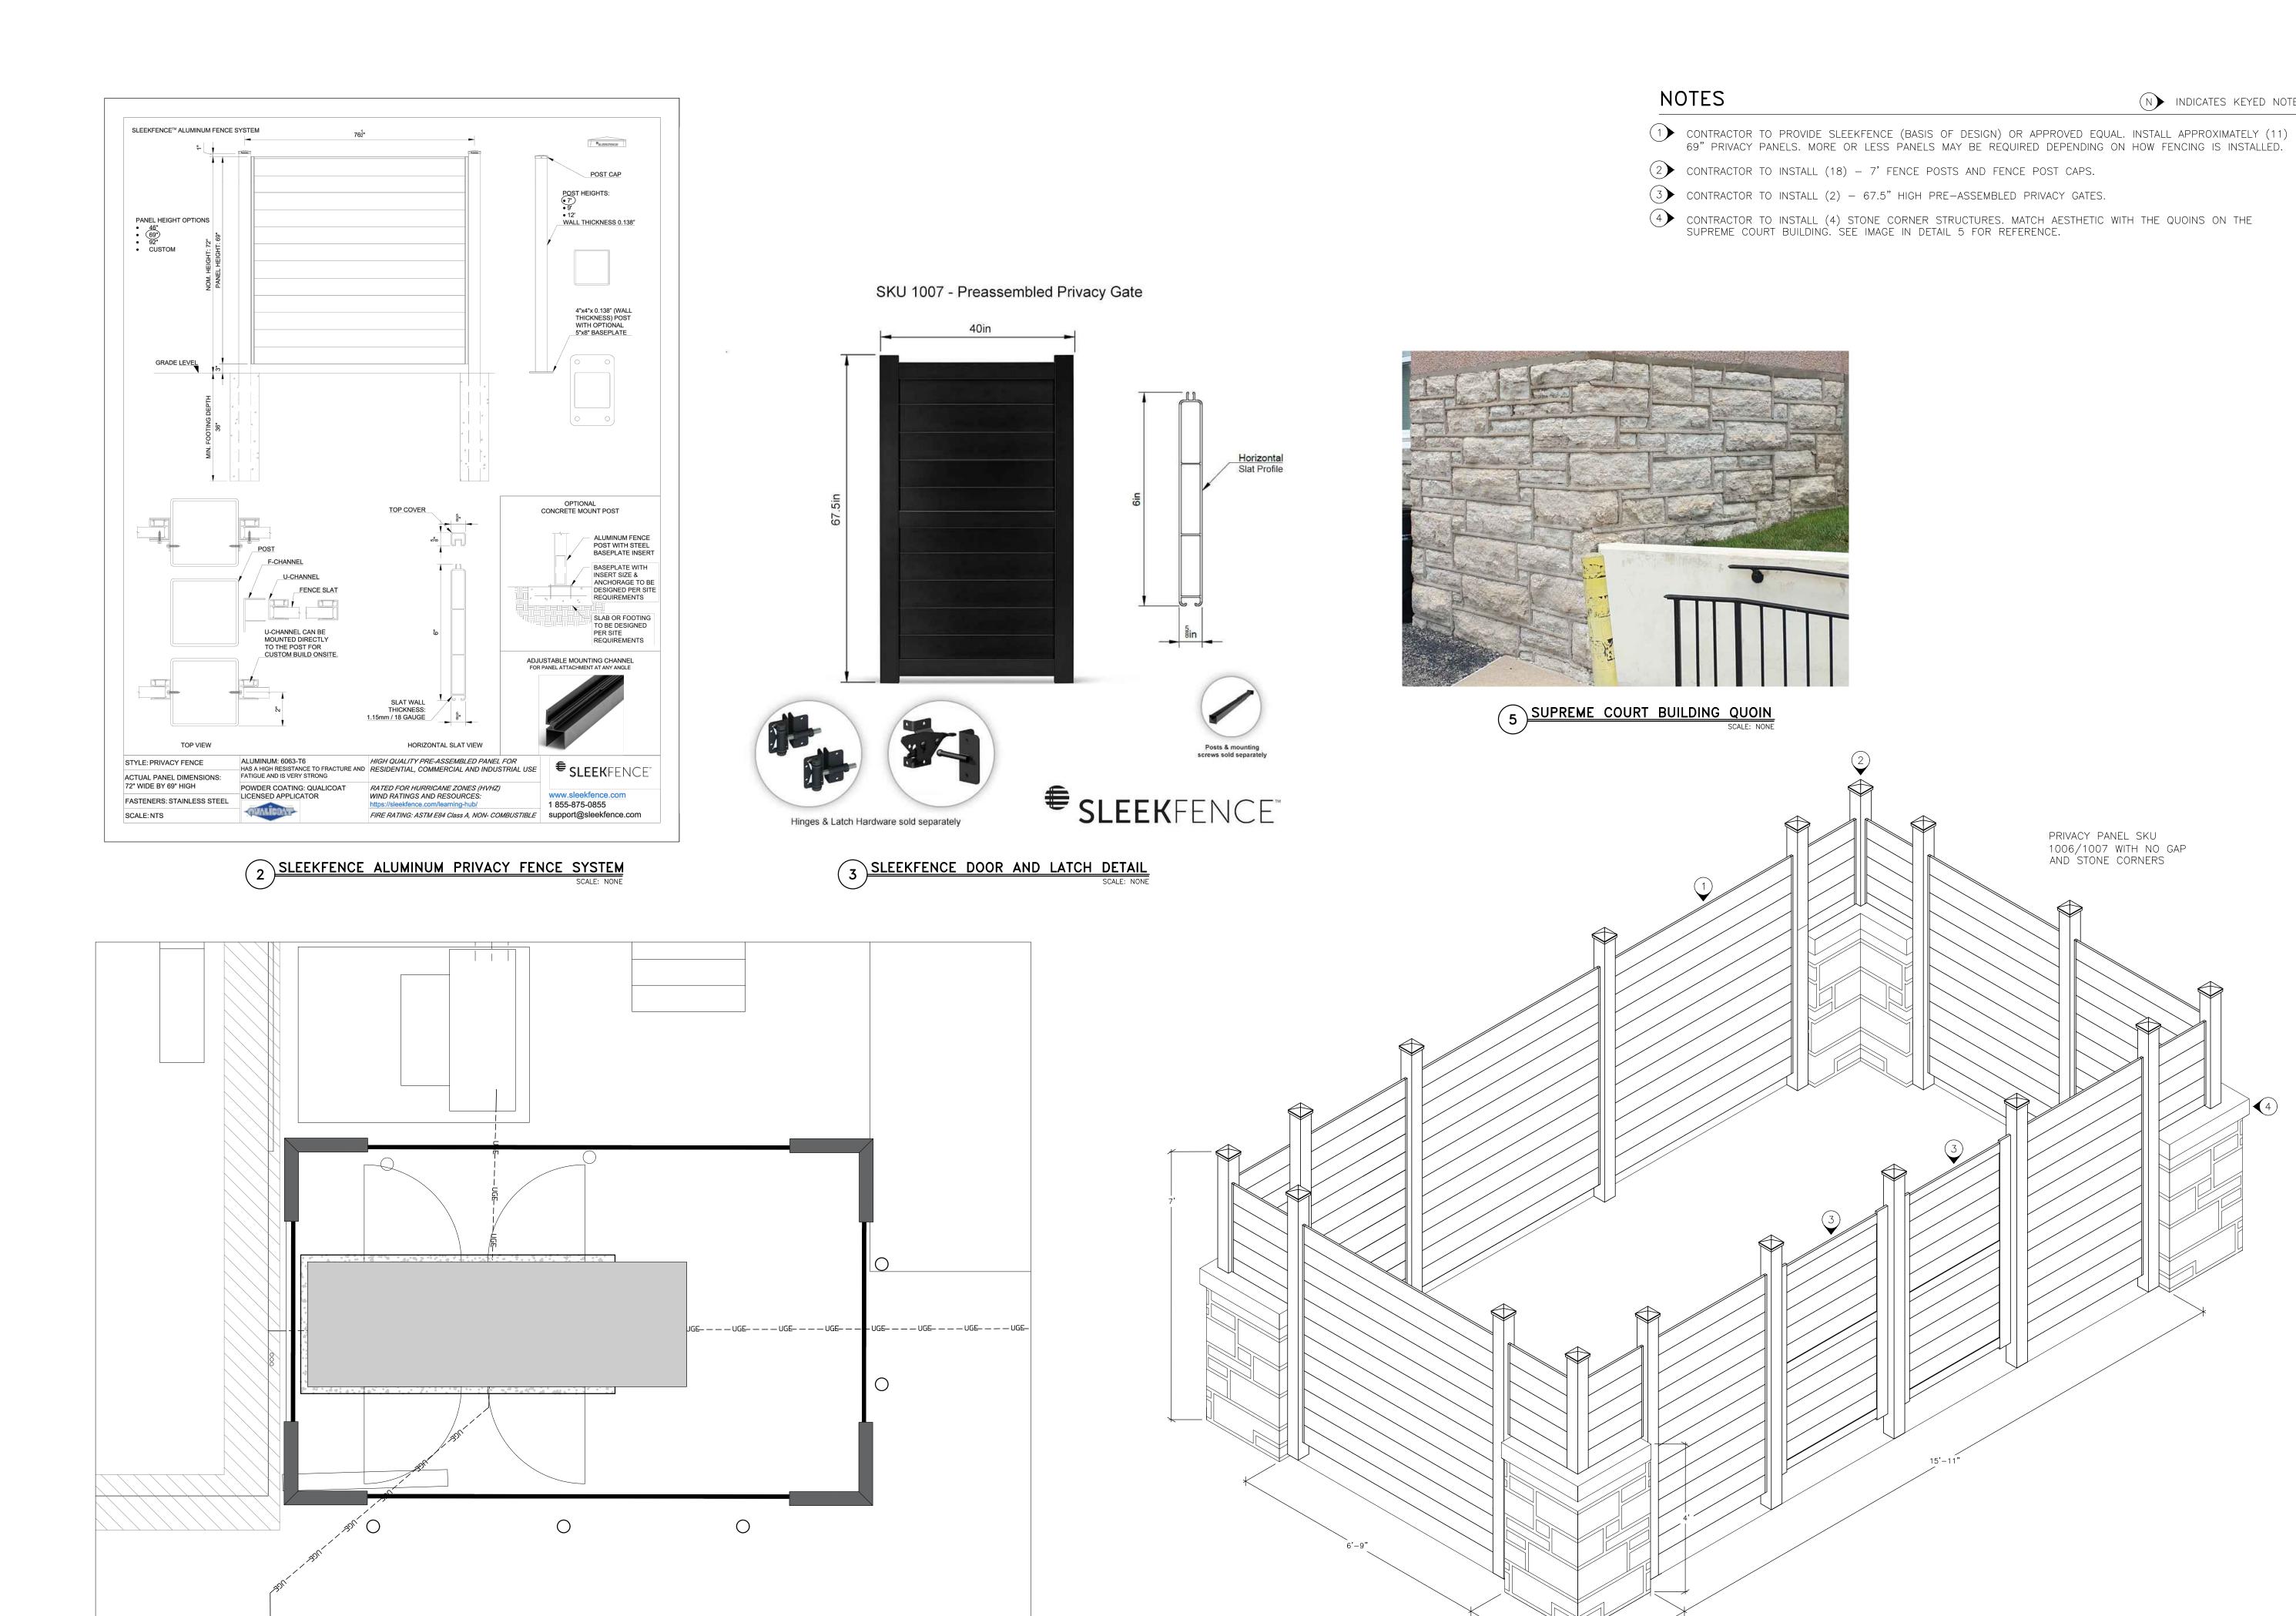3/8" = 1'-0"

4 ALUMINUM SLAT FENCE WITH STONE CORNERS

1/2" = 1'-0"

STATE OF MISSOURI N INDICATES KEYED NOTES MICHAEL L. PARSON, **GOVERNOR**





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SUPREME COURT GENERATOR

SUPREME COURT STATE OFFICE BUILDING 207 WEST HIGH STREET, JEFFERSON CITY, MISSOURI

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SHEET TITLE:

FENCING **DETAILS**

SHEET NUMBER:

N INDICATES KEYED NOTES

1 BLUE STAR AND ASCO WERE USED FOR THE BASIS OF DESIGN, SEE SPECIFICATIONS FOR SUBSTITUTIONS.

(2) INSTALL A NEW 200KW STANDBY DIESEL GENERATOR WITH 24HR FUEL TANK.

(3) INSTALL A NEW GENERATOR PAD.


4 INSTALL CONDUIT FROM GENERATOR TO NEW ATS, SEE NOTES ON E-201 FOR WIRE AND CONDUIT

5) INSTALL A NEW 600A, NEMA 3R SERVICE RATED ATS WITH MANUAL BYPASS. INSTALL A NEW GROUND ROD AND BOND GROUND AND NEUTRAL AT THIS POINT.

(6) INSTALL A NEW SURFACE MOUNTED WIREWAY BETWEEN CT CABINET AND ATS. WIRE WAY IS TO ALLOW THE ROUTING OF OUTPUT OF CT TO UTILITY SIDE OF ATS AND THE OUTPUT OF ATS TO MAIN BREAKER OF MDP. REMOVE ANY EXCESS WIRES FROM CT TO MDP.

REPLACE EXISTING MDP CUTLER HAMMER 1200A (12NES1200T) MAIN BREAKER DIGITRIP RMS 310 RATING PLUG WITH NEW 600A (12NES600T) DIGITRIP 310 RATING PLUG. THE MAIN BREAKER IS NOT REQUIRED TO BE REPLACED.


	ELE	CTRICAL	DEVICE	E SCHEDULE	
	TAG	MFG	DESCRIPTION	MODEL NUMBER	REMARK
2	GS 1	BLUE STAR	GENERATOR SET	PD200-01	200KW, 120/208V, 60 HZ, 3 PHASE, 4 WIRE ENGINE: DIESEL MANUFACTURE: PERKINS
	RC 1	BLUE STAR	REMOTE CONTROL PANEL	DCP-7310	REMOTE PANEL WITH EVENT LOGGING, FUEL USAGE MONITOR AND LOW FUEL ALARMS, LOAD MONITORING, POWER MONITORING, REMOTE TRANSFER.
5	ATS 1	ASCO	AUTOMATIC TRANSFER SWITCH	J07AUBA30600N50M	JAUB, LJL, SERVICE ENTRANCE BRKR ON NORM. FRONT CONNECTED TYPE 3R/3RX 96 x 57 X 36

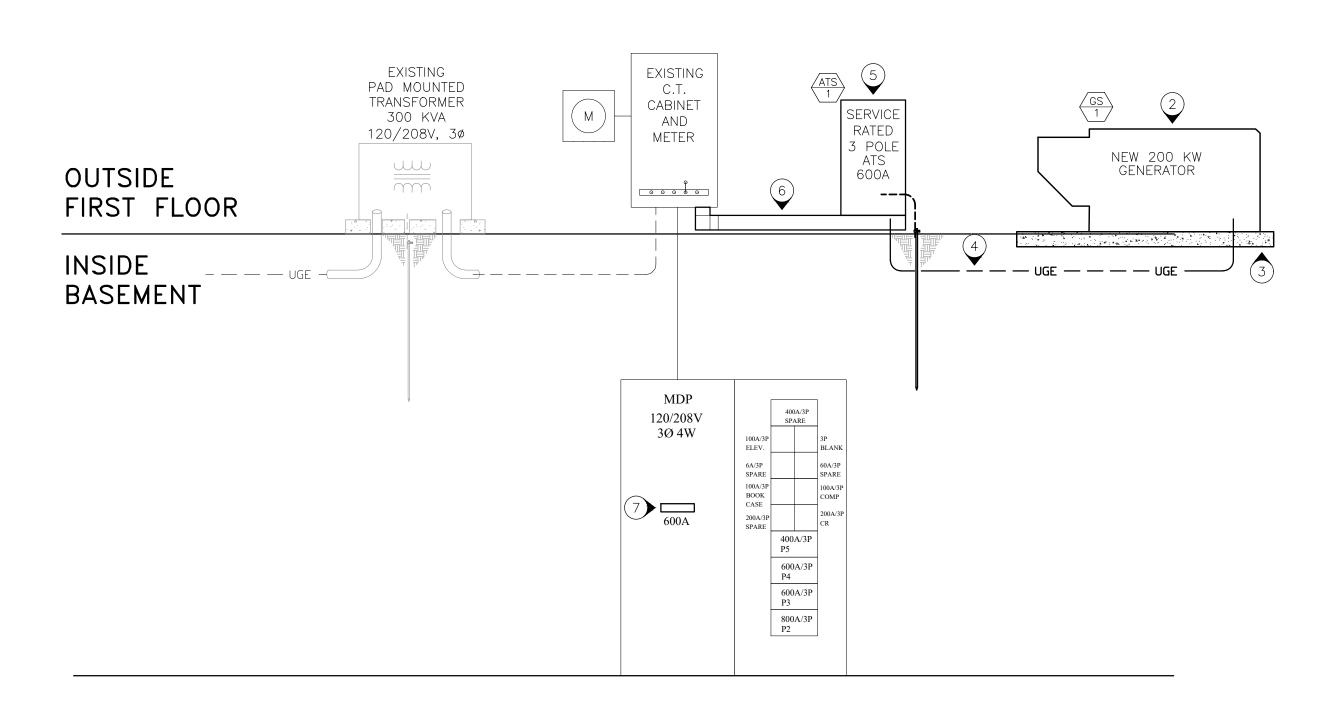

(2) MODIFIED 600A ELECTRICAL RISER (PARTIAL)

NO SCALE

STATE OF MISSOURI MICHAEL L. PARSON, **GOVERNOR**

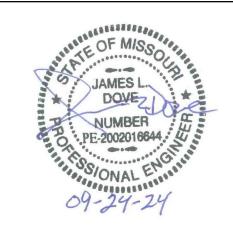

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OFFICE OF ADMINISTRATION DIVISION OF FACILITIES MANAGEMENT, DESIGN AND CONSTRUCTION

DEPARTMENT OF Office Of Administration Facilities Management
Design And Construction

SUPREME COURT GENERATOR

SUPREME COURT STATE OFFICE BUILDING 207 WEST HIGH STREET, JEFFERSON CITY, MISSOURI

PROJECT # O2366-01 1001 FACILITY # 3101001056

REVISION:
DATE:
REVISION:
DATE:
REVISION:
DATE:
ISSUE DATE: 09/24/2024

CAD DWG FILE:SCBG-e.dwg
DRAWN BY: JJS/SAK
CHECKED BY: JLD

DESIGNED BY: JJS/SAK

SHEET TITLE:

ELECTRICAL UTILITY RISER

SHEET NUMBER:

10 OF 10 SHEETS 09/24/2024



EXISTING
PAD MOUNTED
TRANSFORMER
300 KVA
120/208V, 3ø

OUTSIDE

INSIDE

BASEMENT

FIRST FLOOR

EXISTING C.T. CABINET AND METER

00000

MDP

120/208V

3Ø 4W

400A/3P P5 600A/3P P4 600A/3P P3 800A/3P P2