RENOVATE ECONOMIC DEVELOPMENT OFFICES **SUITE 770** JEFFERSON CITY, MISSOURI

OWNER:

STATE OF MISSOURI MICHAEL L. PARSON, GOVERNOR

DEPARTMENT OF OFFICE OF ADMINISTRATION

PROJECT MANAGEMENT:

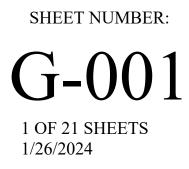
OFFICE OF ADMINISTRATION DIVISION OF FACILITIES MANAGEMENT, DESIGN AND CONSTRUCTION

DESIGNER:

STATE OF MISSOURI - OFFICE OF ADMINISTRATION DIVISION OF FACILITIES MANAGEMENT DESIGN AND CONSTRUCTION: 301 W. HIGH STREET, JEFFERSON CITY, MO. 65102

PROJECT NUMBER: 02403-01

ASSET NUMBER: 3101001050






WAREHOUSE






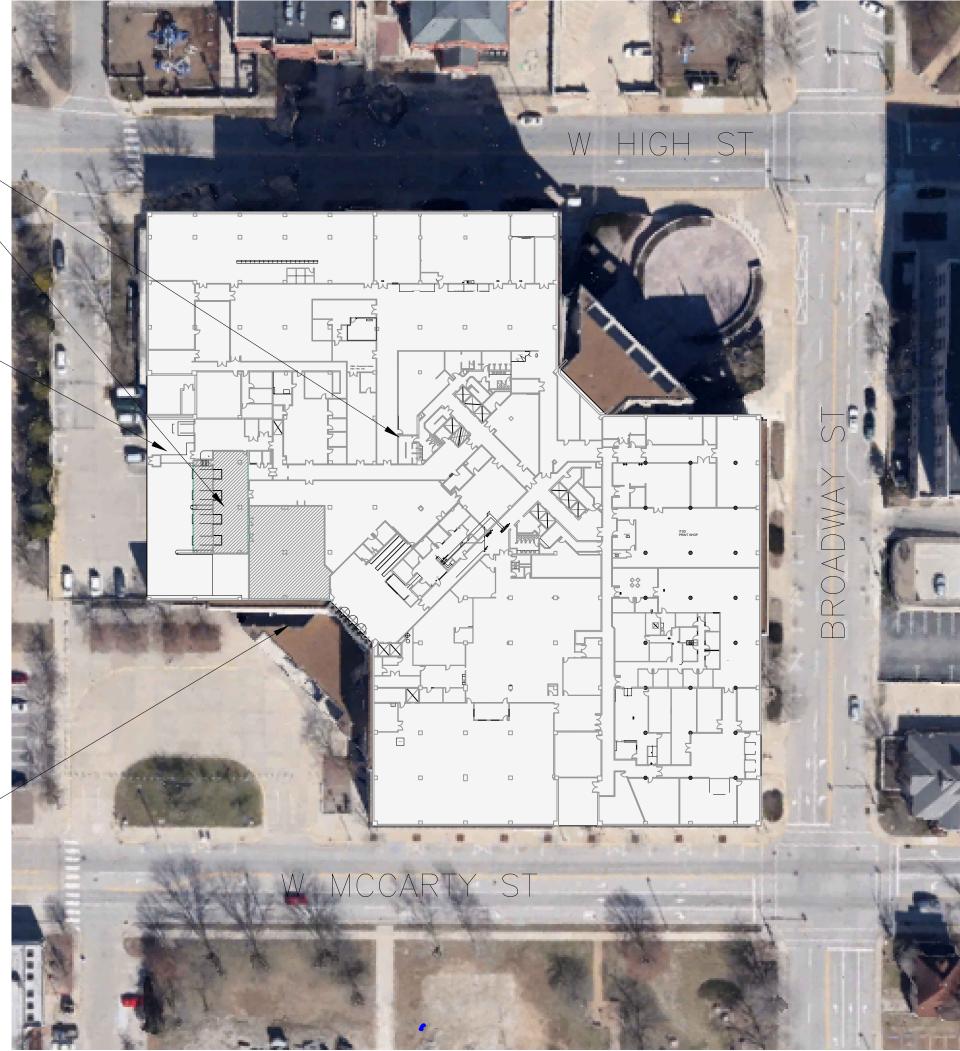

PUBLIC BUILDING ENTRANCE -

FIRST FLOOR SITE DIAGRAM

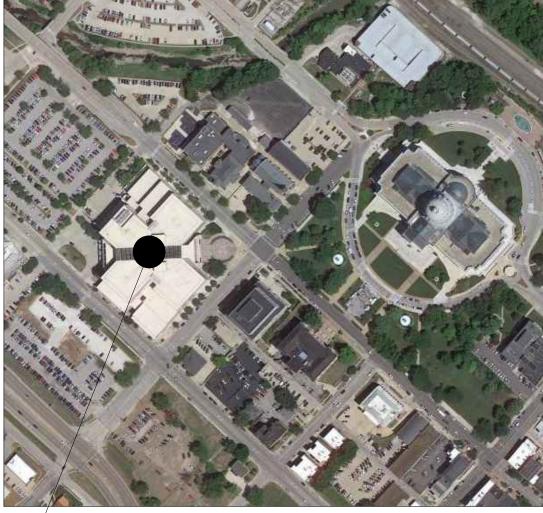HARRY S. TRUMAN STATE OFFICE BUILDING -----



----- HARRY S. TRUMAN STATE OFFICE BUILDING HST BUILDING LOCATION PLAN

APPLICABLE CODES:

- GENERAL CONSTRUCTION: INTERNATIONAL BUILDING CODE 2021
- 2010 ADA STANDARDS FOR ACCESSIBLE DESIGN
- FIRE PROTECTION:
- NFPA 13: STANDARD FOR THE INSTALLATION OF SPRINKLER SYSTEMS
- NFPA 70: NATIONAL ELECTRIC CODE (NEC) AS PERTAINING TO SPRINKLER SYSTEMS
- MECHANICAL: LATEST VERSION OF THE INTERNATIONAL MECHANICAL CODE
- ELECTRICAL:
- NFPA 70: NATIONAL ELECTRIC CODE (NEC) • NFPA 101: LIFE SAFETY CODE AS PERTAINING TO EMERGENCY EXIT SIGNS AND LIGHTING ALONG THE PATH OF EGRESS

DRAWING INDEX

| G-001 G-002 | COVER SHEET DRAWING INDEX, GENERAL NOTES, AND SITE MAPS |
|---|--|
| AD-102 AD-103 AD-201 A-101 A-102 A-103 | ENLARGED FLOOR PLAN & INTERIOR ELEVATIONS ENLARGED FLOOR PLAN DOOR SCHEDULE |
| | FIRE PROTECTION PLAN - WEST FIRE PROTECTION PLAN - EAST |
| MD-102 M-101 | MECHANICAL DEMOLITION PLAN - WEST MECHANICAL DEMOLITION PLAN - EAST MECHANICAL RENOVATION PLAN - WEST MECHANICAL RENOVATION PLAN - EAST |
| ED-102 | ELECTRICAL DEMOLITION PLAN - WEST ELECTRICAL DEMOLITION PLAN - EAST ELECTRICAL RENOVATION PLAN - WEST ELECTRICAL RENOVATION PLAN - EAST |

GENERAL NOTES:

ALL DIMENSIONS RELATIVE TO EXISTING CONDITIONS ARE APPROXIMATE AND MAY VARY.CONTRACTOR SHALL VERIFY ALL DIMENSIONS AND EXISTING CONDITIONS. MINOR DIFFERENCES BETWEEN WHAT IS SHOWN AND THE ACTUAL DIMENSIONS WILL NOT BE CONSIDERED THE BASIS FOR A CONTRACT CHANGE.

2. CUBICAL REMOVAL AND STORAGE AND STAGING OF CUBICAL PIECES AND PARTS WILL BE PERFORMED BY OWNER.

3. PROTECT ALL FIXED EQUIPMENT, FURNITURE AND FINISHES DURING CONSTRUCTION.

4. CONTRACTOR IS RESPONSIBLE FOR REMOVAL AND DISPOSAL OF ALL DEMOLISHED MATERIAL, AS WELL AS REPAIRING ANY DAMAGE TO ANY SURFACE IN THE AREA OF CONSTRUCTION THAT IS A RESULT OF CONSTRUCTION ACTIVITY. SURFACE SHALL BE REPAIRED AND FINISHED TO MATCH EXISTING CONDITIONS.

5 RETURN ALL SALVAGED MATERIALS TO OWNER AS REQUESTED IN BID DOCUMENTS.

OWNER TO SELF PERFORM ALL IN FLOOR ELECTRICAL AND DATA UNLESS OTHERWISE STATED WITHIN CONSTRUCTION DOCUMENTS.

7. CONTRACTOR TO RECYCLE ALL APPLICABLE RECYCLABLE REFUSE OFF SITE.

8. CONTRACTOR TO DISPOSE OF TRASH AND DEBRIS OFF SITE ON A DAILY BASIS.

9. PATHWAYS, ELEVATORS, LOADING DOCKS AND ANY BUILDING CARTS, CORRIDORS OR STORAGE AREAS USED BY THE CONTRACTOR SHALL BE PROTECTED AND KEEP FREE FROM DEFECT.

10. CONTRACTOR TO USE NOTED ENTRANCES TO HARRY S. TRUMAN BUILDING AND OWNER

DESIGNATED MATERIAL LOADING DOCKS.

11. AREA OF CONSTRUCTION SHALL BE KEPT SECURE AT ALL TIMES AND SHALL BE LOCKED WHEN THE AREA IS VACATED BY CONSTRUCTION PERSONNEL. OWNER'S REPRESENTATIVE SHALL BE PROVIDED WITH A KEY OR COMBINATION TO LOCK AS APPLICABLE.. DO NOT PROP OPEN DOORS IN ANY AREA OF THE HARRY S. TRUMAN BUILDING.

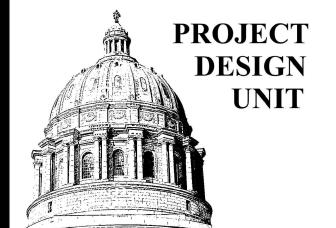
12. TECHNICAL ITEMS SUCH AS BUT NOT LIMITED TO WHITEBOARDS, DIGITAL DISPLAYS AND MEDIA INSTALLATIONS ARE TO BE REMOVED AND REPLACED BY THE AGENCY AND COORDINATED WITH THE CONSTRUCTION ADMINISTRATOR.

13. OWNER PROVIDED MATERIALS INCLUDE:

NEW CARPET TILE AND MASTIC FOR CONFERENCE ROOM AND ADJACENT OFFICES, SUBFLOOR REPLACEMENT RAISED FLOOR PANELS, CEILING TILE FOR MODIFICATIONS AND REPAIR, SELECT DOORS AND HARDWARE (NOT INCLUDING KNOCK DOWN FRAMES), AND OWNER IS SELF PERFORMING DATA, IN FLOOR ELECTRICAL, AND CUBICAL MODIFICATIONS AND ALL MATERIALS NEEDED FOR THOSE INSTALLATIONS.

14. CONTRACTOR IS RESPONSIBLE FOR TRANSPORTATION OF OWNER PROVIDED MATERIALS AND SALVAGED MATERIALS TO AND FROM THE WAREHOUSE SHOWN.

STATE OF MISSOURI MICHAEL L. PARSON, GOVERNOR



BID

OFFICE OF ADMINISTRATION DIVISION OF FACILITIES MANAGEMENT, **DESIGN AND CONSTRUCTION**

DEPARTMENT OF THE OFFICE OF ADMINISTRATION

RENOVATE ECONOMIC DEVELOPMENT OFFICES, **SUITE 770**

HARRY S. TRUMAN STATE OFFICE BUILDING 301 W HIGH STREET JEFFERSON CITY, MO 65102

PROJECT # 02403-01 SITE # 0001 ASSET # 3101001050

REVISION: DATE **REVISION:** DATE **REVISION:** DATE ISSUE DATE: 01/26/2024

CAD DWG FILE:02403-01 DRAWN BY: CHECKED BY: B DESIGNED BY: CG

SHEET TITLE:

DRAWING INDEX GENERAL NOTES AND SITE MAPS


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DEMOLITION NOTES

- ALL EXISTING FLOORING FINISHES TO REMAIN UNLESS NOTED OTHERWISE. CONTRACTOR SHALL PROVIDE NECESSARY PROTECTION OF ALL FLOOR SURFACES TO REMAIN IN AREAS OF WORK AND ADJACENT AREAS THAT MAY RECEIVE CONSTRUCTION TRAFFIC. CONTRACTOR SHALL BE RESPONSIBLE TO REPAIR/REPLACE FLOORING DAMAGEDS DUE TO IMPROPER PROTECTION.
- WORK TO ACCOMMODATE WORK SHOWN ON RENOVATION PLANS.
- CONTRACTOR PERFORMED.
- EXISTING ELECTRICAL SHOWN FOR REFERENCE ONLY. CONTRACTOR TO FIELD VERIFY.
- WORKERS PERFORMING THE WORK.
- THEIR WORK. ANY WORK THAT RESULTS IN EXCESSIVE NOISE, DUST OR DEBRIS MUST BE COORDINATED WITH BUILDING FACILITY STAFF AT
- LEAST TWO (2) WORKING DAYS IN ADVANCE.
- WITH BUILDING FACILITY STAFF AT LEAST FOUR (4) WORKING DAYS IN ADVANCE.
- RESPONSIBLE TO REPLACE ANY HVAC FILTERS CONTAMINATED WITH CONSTRUCTION DEBRIS. 10. CONTRACTOR SHALL BE RESPONSIBLE TO PERFORM ANY WORK NECESSARY TO PROVIDE THE SCOPE OF WORK SHOWN ON THE PLANS, EVEN IF NOT SPECIFICALLY NOTED OR SHOWN.
- BADGE.
- MATERIALS/EQUIPMENT FACILITY STAFF ARE NOT RESPONSIBLE FOR ACCEPTING OR SIGNING FOR DELIVERIES. 13. ALL WORK SHALL BE PERFORMED IN ACCORDANCE WITH THE LATEST EDITION OF THE IBC, IFC, IMC, IPC, NEC AND ALL OTHER APPLICABLE ICC AND NFPA CODE FAMILIES.
- WORK. CONTRACTOR SHALL NOTIFY FMDC PROJECT MANAGER IF THERE ARE ANY DISCREPANCIES OR CONFLICTS. SUBMITTING BID.
- INTEGRITY OF THESE ITEMS.



CONTRACTOR SHALL PERFORM ALL NECESSARY DEMOLITION WORK AS SHOWN ON DEMOLITION PLANS AND ANY NECESSARY

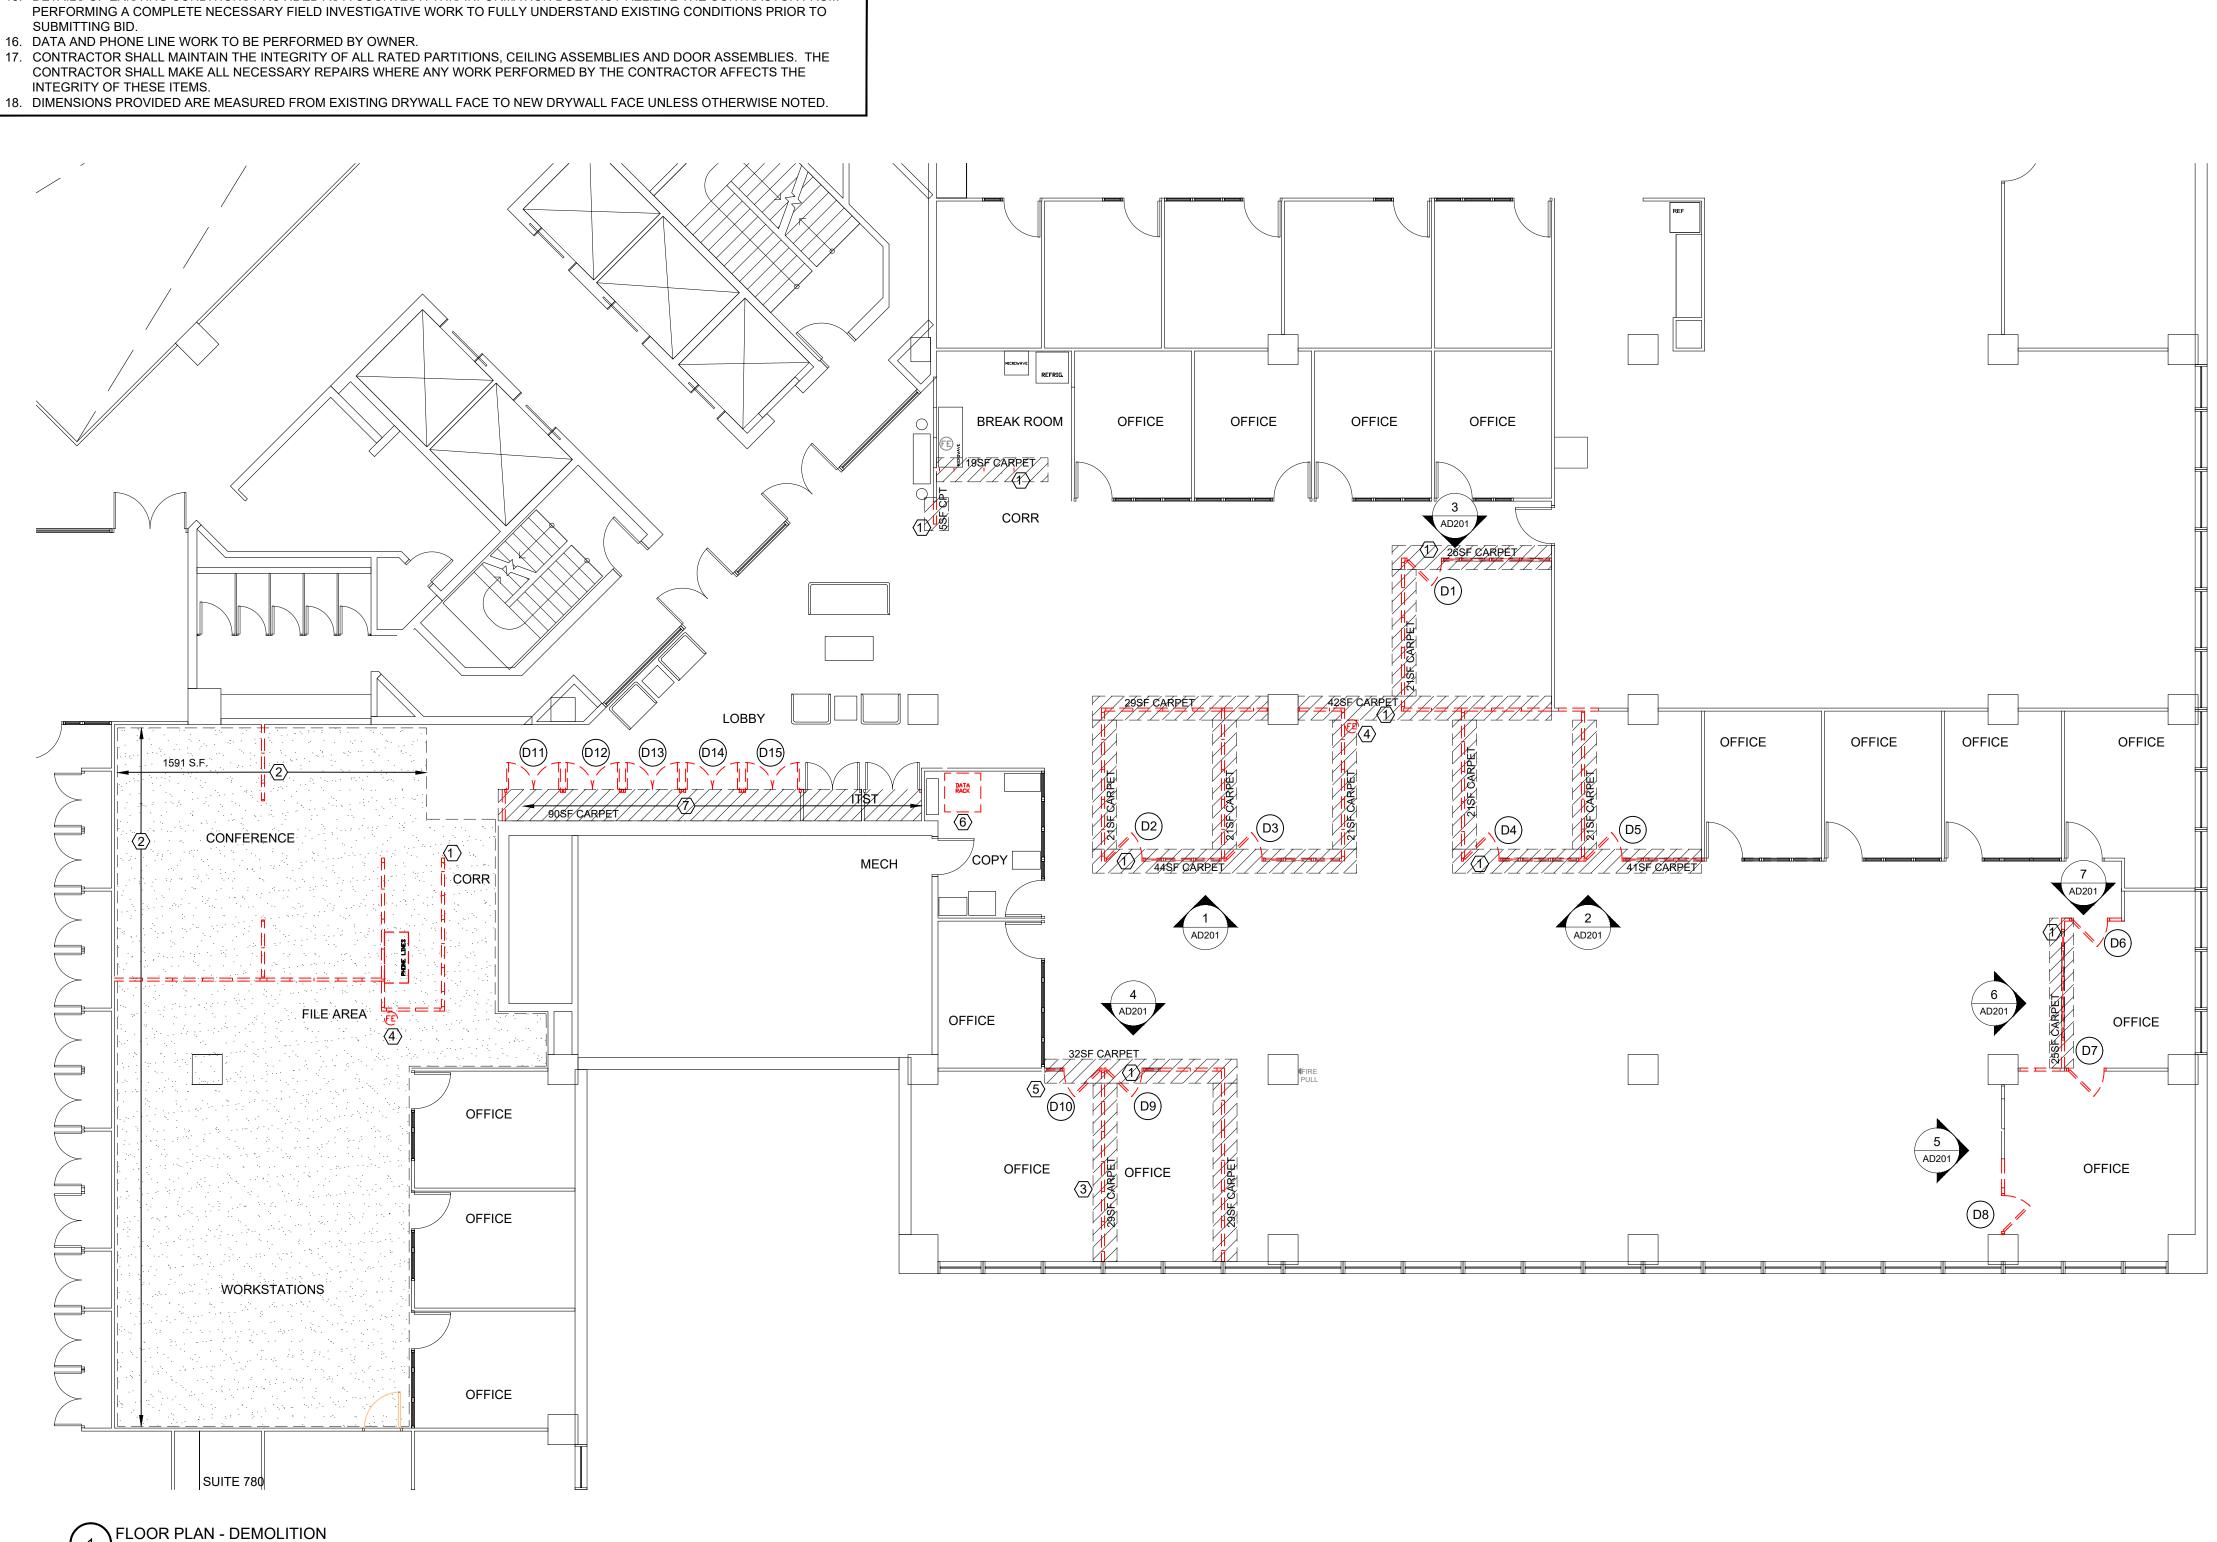OWNER SHALL PERFORM ALL ELECTRICAL AND DATA/COMM DEMOLITION WORK UNLESS NOTED ON MEP DRAWINGS AS

5. ALL WORK SHALL BE PERFORMED IN A SAFE MANNER WITH PROTECTION PROVIDED TO ANY BUILDING OCCUPANTS AND

6. ALL WORK SHALL BE DONE IN A MANNER TO MINIMIZE DAMAGE TO ADJACENT SURFACES THAT ARE NOT SHOWN TO BE WORKED ON OR REMOVED - CONTRACTOR SHALL BE RESPONSIBLE FOR ALL WORK NECESSARY TO REPAIR SURFACES AFFECTED BY

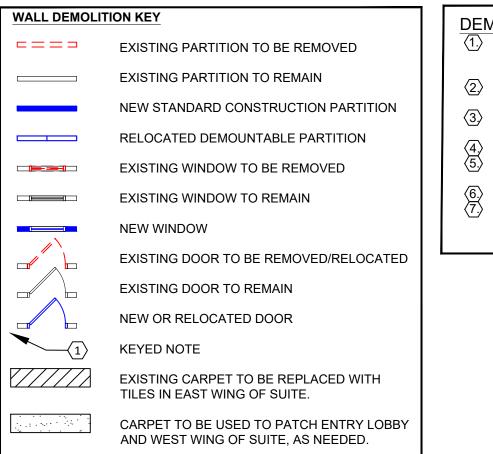
ANY WORK THAT REQUIRES THE NEED TO TEMPORARILY SHUT DOWN ANY OF THE BUILDING SYSTEMS MUST BE COORDINATED

CONTRACTOR SHALL PROVIDE NECESSARY DUST PROTECTION TO PREVENT DUST CREATED BY DEMOLITION/CONSTRUCTION ACTIVITIES TO ENTER SPACE(S) OUTSIDE THE WORK AREA, INCLUDING THROUGH THE HVAC SYSTEM. CONTRACTOR SHALL BE

11. CONTRACTOR SHALL PERFORM WORK BETWEEN THE HOURS OF 7AM TO 5PM AFTER SIGNING IN AND RECEIVING VISITOR'S

12. ALL MATERIALS/EQUIPMENT MAY BE DELIVERED TO THE FACILITY - FACILITY STAFF SHALL BE CONTACTED TEN (10) BUSINESS DAYS PRIOR TO DELIVERY OF MATERIALS/EQUIPMENT. CONTRACTOR SHALL BE PRESENT TO SIGN FOR RECEIPT OF ALL

14. CONTRACTOR RESPONSIBLE FOR FIELD VERIFYING AS-BUILT CONDITIONS AND PROPOSED LAYOUT PRIOR TO PERFORMING 15. DETAILS OF EXISTING CONDITIONS PROVIDED AS A COURTESY. THIS INFORMATION DOES NOT RELIEVE THE CONTRACTOR FROM



DEMOLITION KEYNOTES

- SALVAGED FOR REUSE IN RENOVATION.
- JUNCTION BOX. MATCH EXISTING SWITCH SIZE & COLOR.

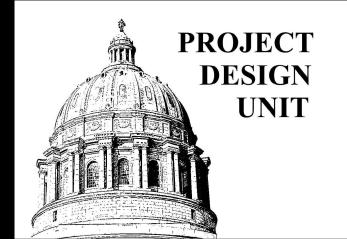
(1.) REMOVE AND DISPOSE OF ANY CARPET TILES DAMAGED FROM THE INSTALLATION/REMOVAL OF THE DEMOUNTABLE PARTITION - REFER TO A101 PLAN FOR APPROXIMATE SF AREA. REFER TO ENLARGED PLANS FOR DIMENSIONED LAYOUT OF EXISTING INTERIOR DEMOUNTABLE PARTITION TO BE REMOVED AND SALVAGED FOR REUSE IN RENOVATION. (2) EXISTING CARPET TILES TO BE REMOVED AND SALVAGED FOR REUSE TO PATCH DAMAGED FLOOR COVERING FROM THE INSTALLATION/REMOVAL OF THE DEMOUNTABLE PARTITION. PREPARE SURFACE TO RECEIVE NEW CARPET TILE. (3) EXISTING CEILING MOUNTED TV MONITOR BRACKET TO BE REMOVED COMPLETE. TV MONITOR TO BE REMOVED AND

(4) EXISTING FIRE EXTINGUISHER TO BE REMOVED AND SALVAGED FOR REUSE IN RENOVATION. RELOCATE EXISTING LIGHT SWITCH AS INDICATED ON PLANS. REFER TO A700, E101, & E102. INSTALL BLANK PLATE OVER

(6) DATA RACK TO BE RELOCATED INTO NEW LOCATION- COORDINATE WITH FMDC STAFF.

> EXISTING CLOSET DOUBLE DOORS AND FRAME TO BE REMOVED AND SALVAGED - RETURN TO FACILITY. EXISTING ORANGE CARPET TILE TO BE REMOVED. NEW CARPET TILE AT AREAS WHERE WALLS ARE BEING REMOVED TO RELOCATE OFFICES AND CLOSETS. APPROXIMATE AREA (IN SF) PROVIDED - CONTRACTOR TO FIELD VERIFY.

STATE OF MISSOURI MICHAEL L. PARSON, GOVERNOR



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RENOVATE ECONOMIC DEVELOPMENT OFFICES, **SUITE 770**

HARRY S. TRUMAN STATE OFFICE BUILDING **301 W HIGH STREET** JEFFERSON CITY, MO 65102

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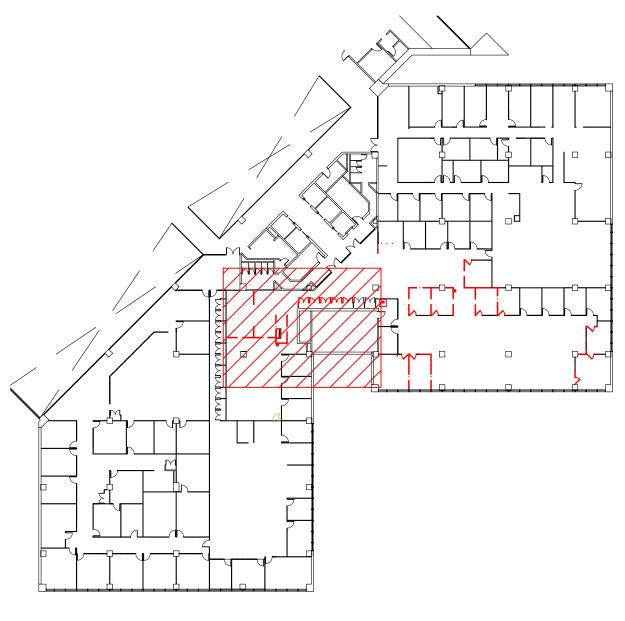
CAD DWG FILE:<u>O2403-01</u> DRAWN BY: <u>RTG</u> CHECKED BY: DESIGNED BY: CG

SHEET TITLE:

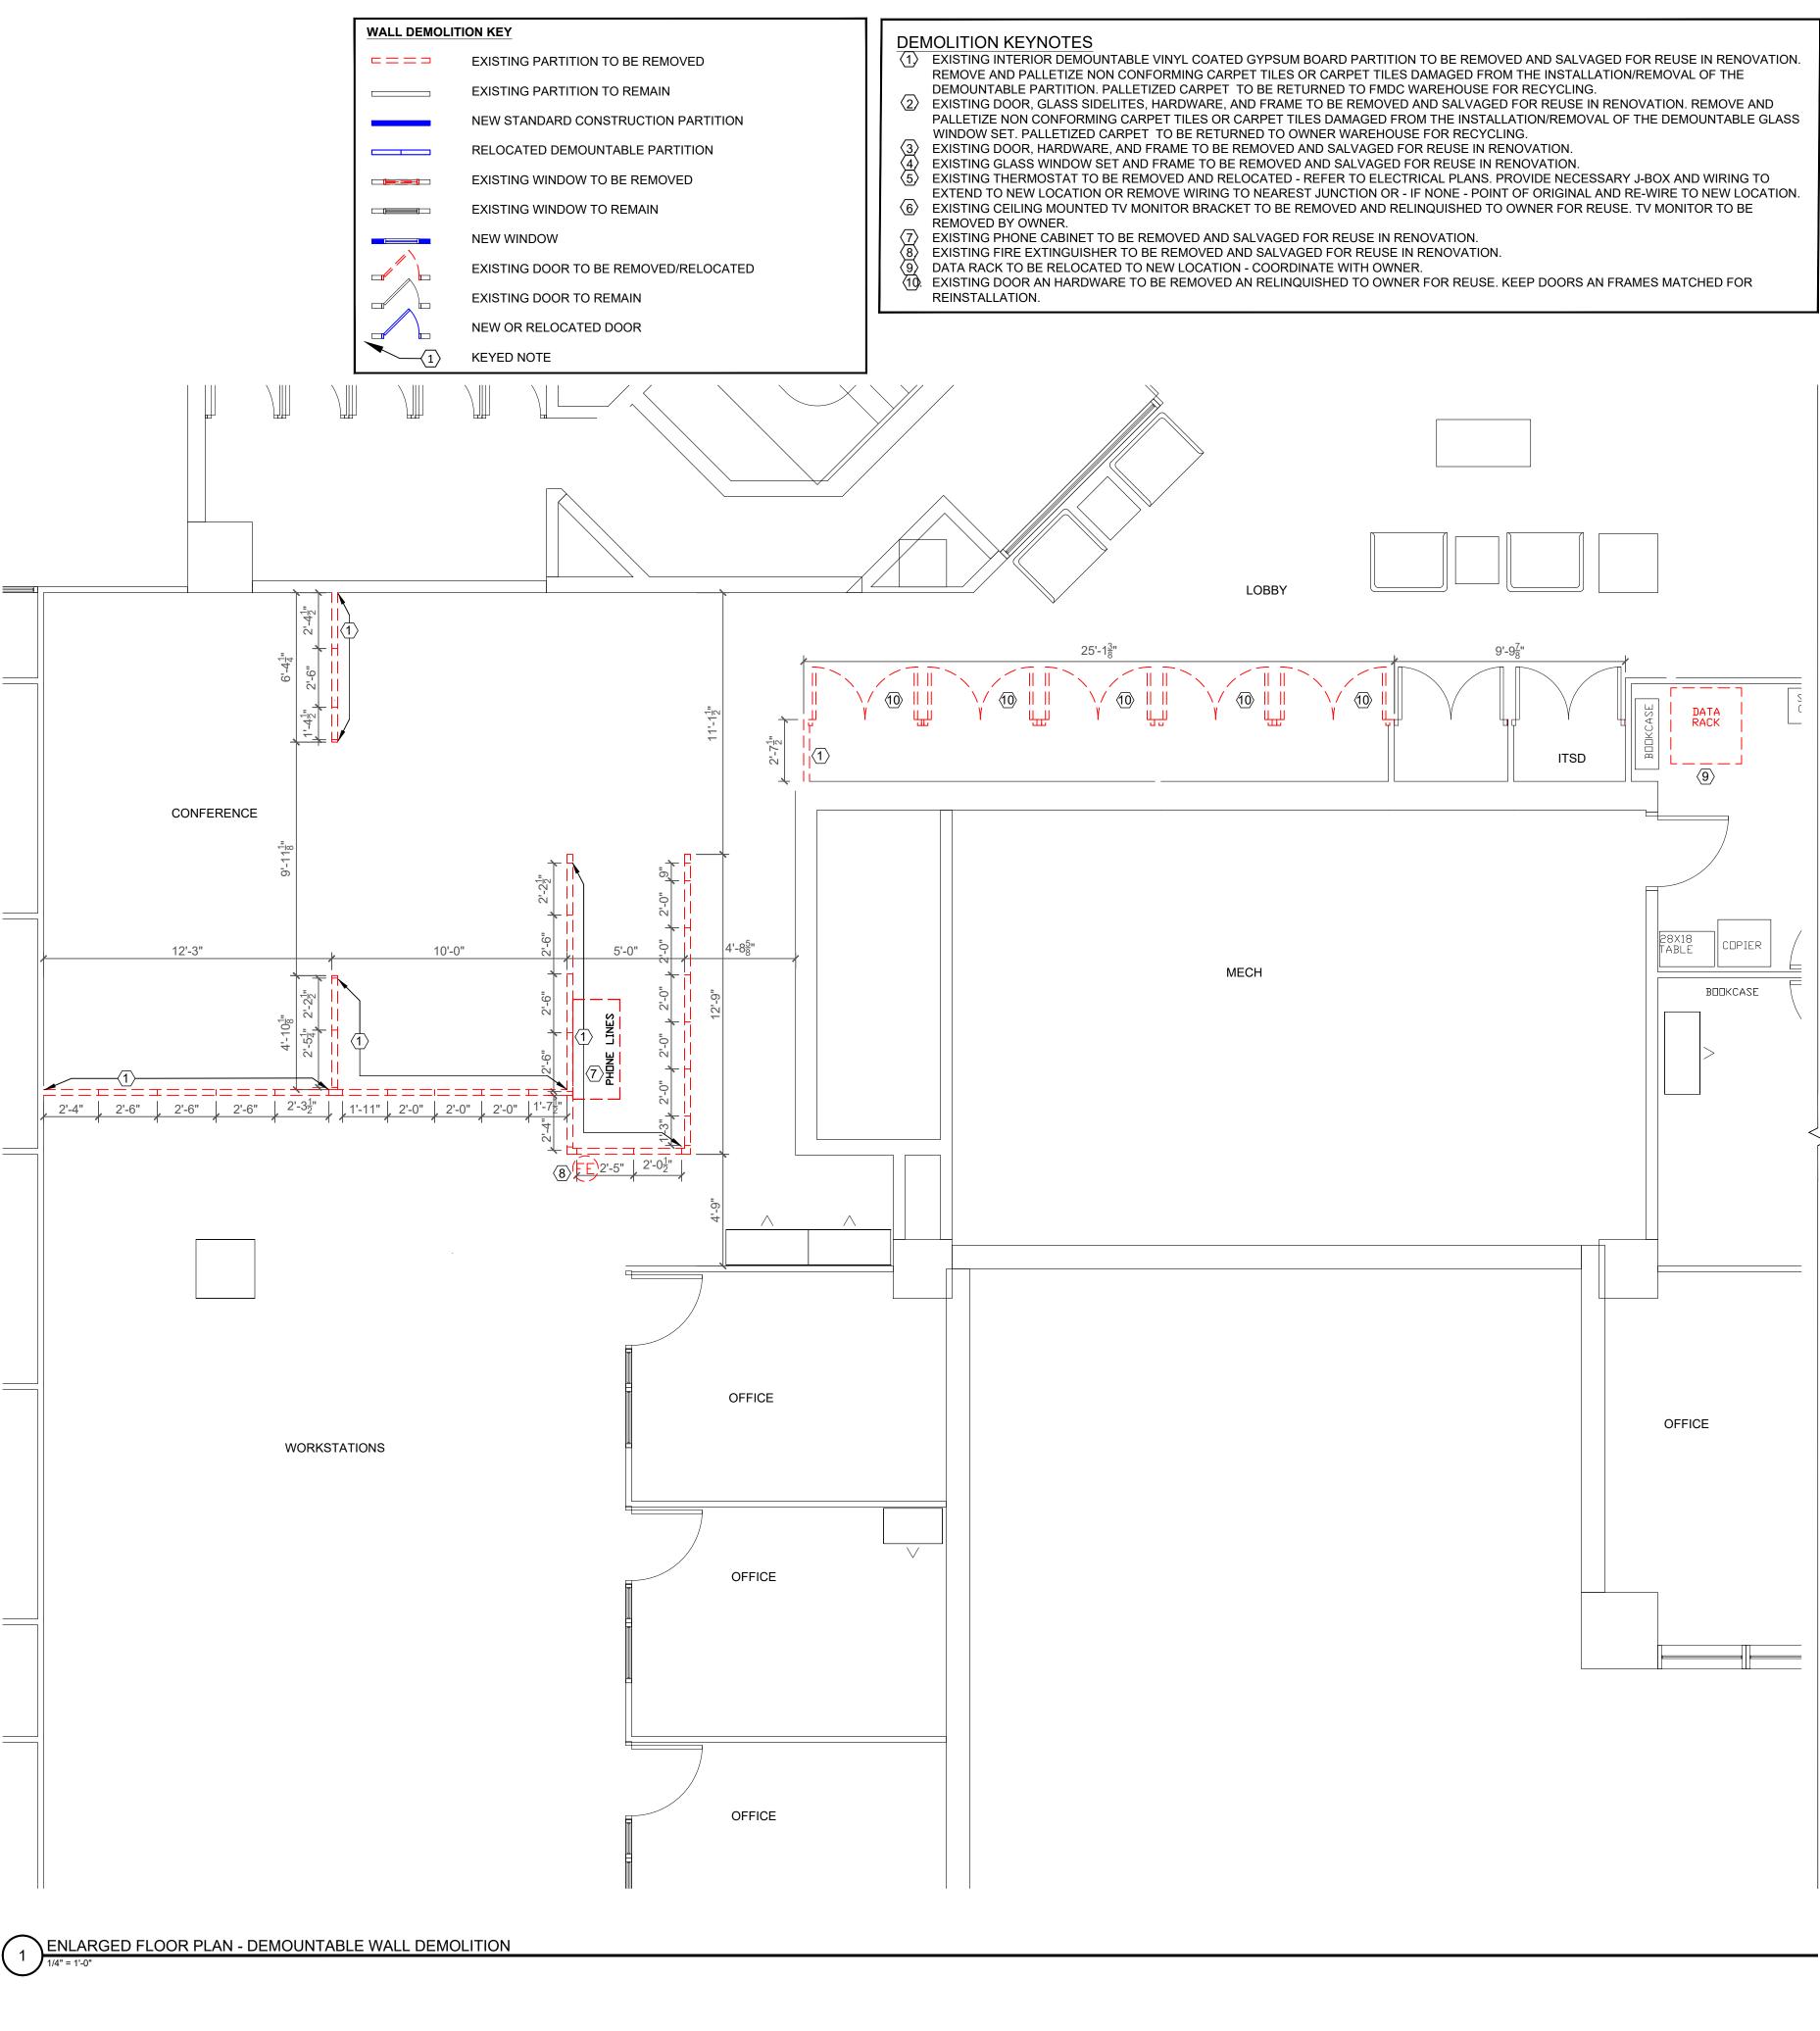
DEMOLITION FLOOR PLAN

SHEET NUMBER:

AD-101 3 OF 21 SHEETS 1/26/2024



AREA MAP- HSTB 7TH FLOOR SOUTH




PROJECT DESIGN UNIT U \mathbf{F} BID NN **OFFICE OF ADMINISTRATION DIVISION OF FACILITIES** MANAGEMENT, **DESIGN AND CONSTRUCTION** DEPARTMENT OF THE OFFICE OF ADMINISTRATION **RENOVATE ECONOMIC** DEVELOPMENT OFFICES, **SUITE 770** HARRY S. TRUMAN STATE OFFICE BUILDING 301 W HIGH STREET JEFFERSON CITY, MO 65102 PROJECT # 02403-01 0001 SITE # 3101001050 ASSET # **REVISION:** DATE: **REVISION:** DATE: REVISION DATE: ISSUE DATE: 01/26/2024 CAD DWG FILE:O2403-01 DRAWN BY: <u>RTG</u> CHECKED BY: <u>BS</u> DESIGNED BY: CG SHEET TITLE: ENLARGED FLOOR PLAN DEMOLITION SHEET NUMBER:


STATE OF MISSOURI MICHAEL L. PARSON,

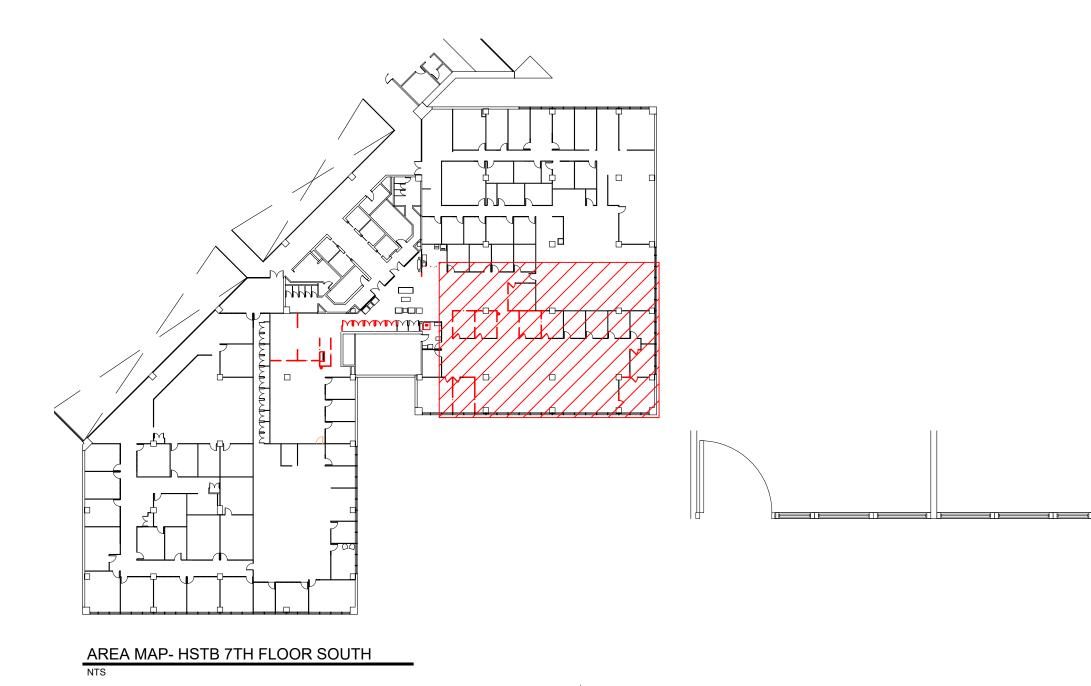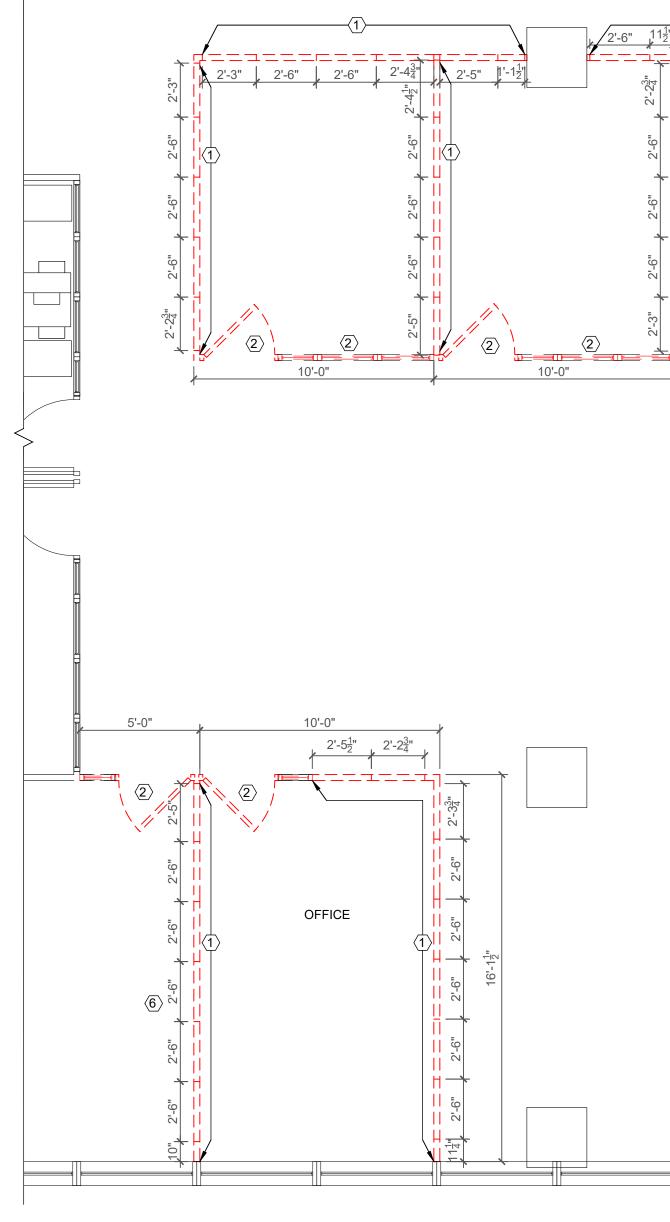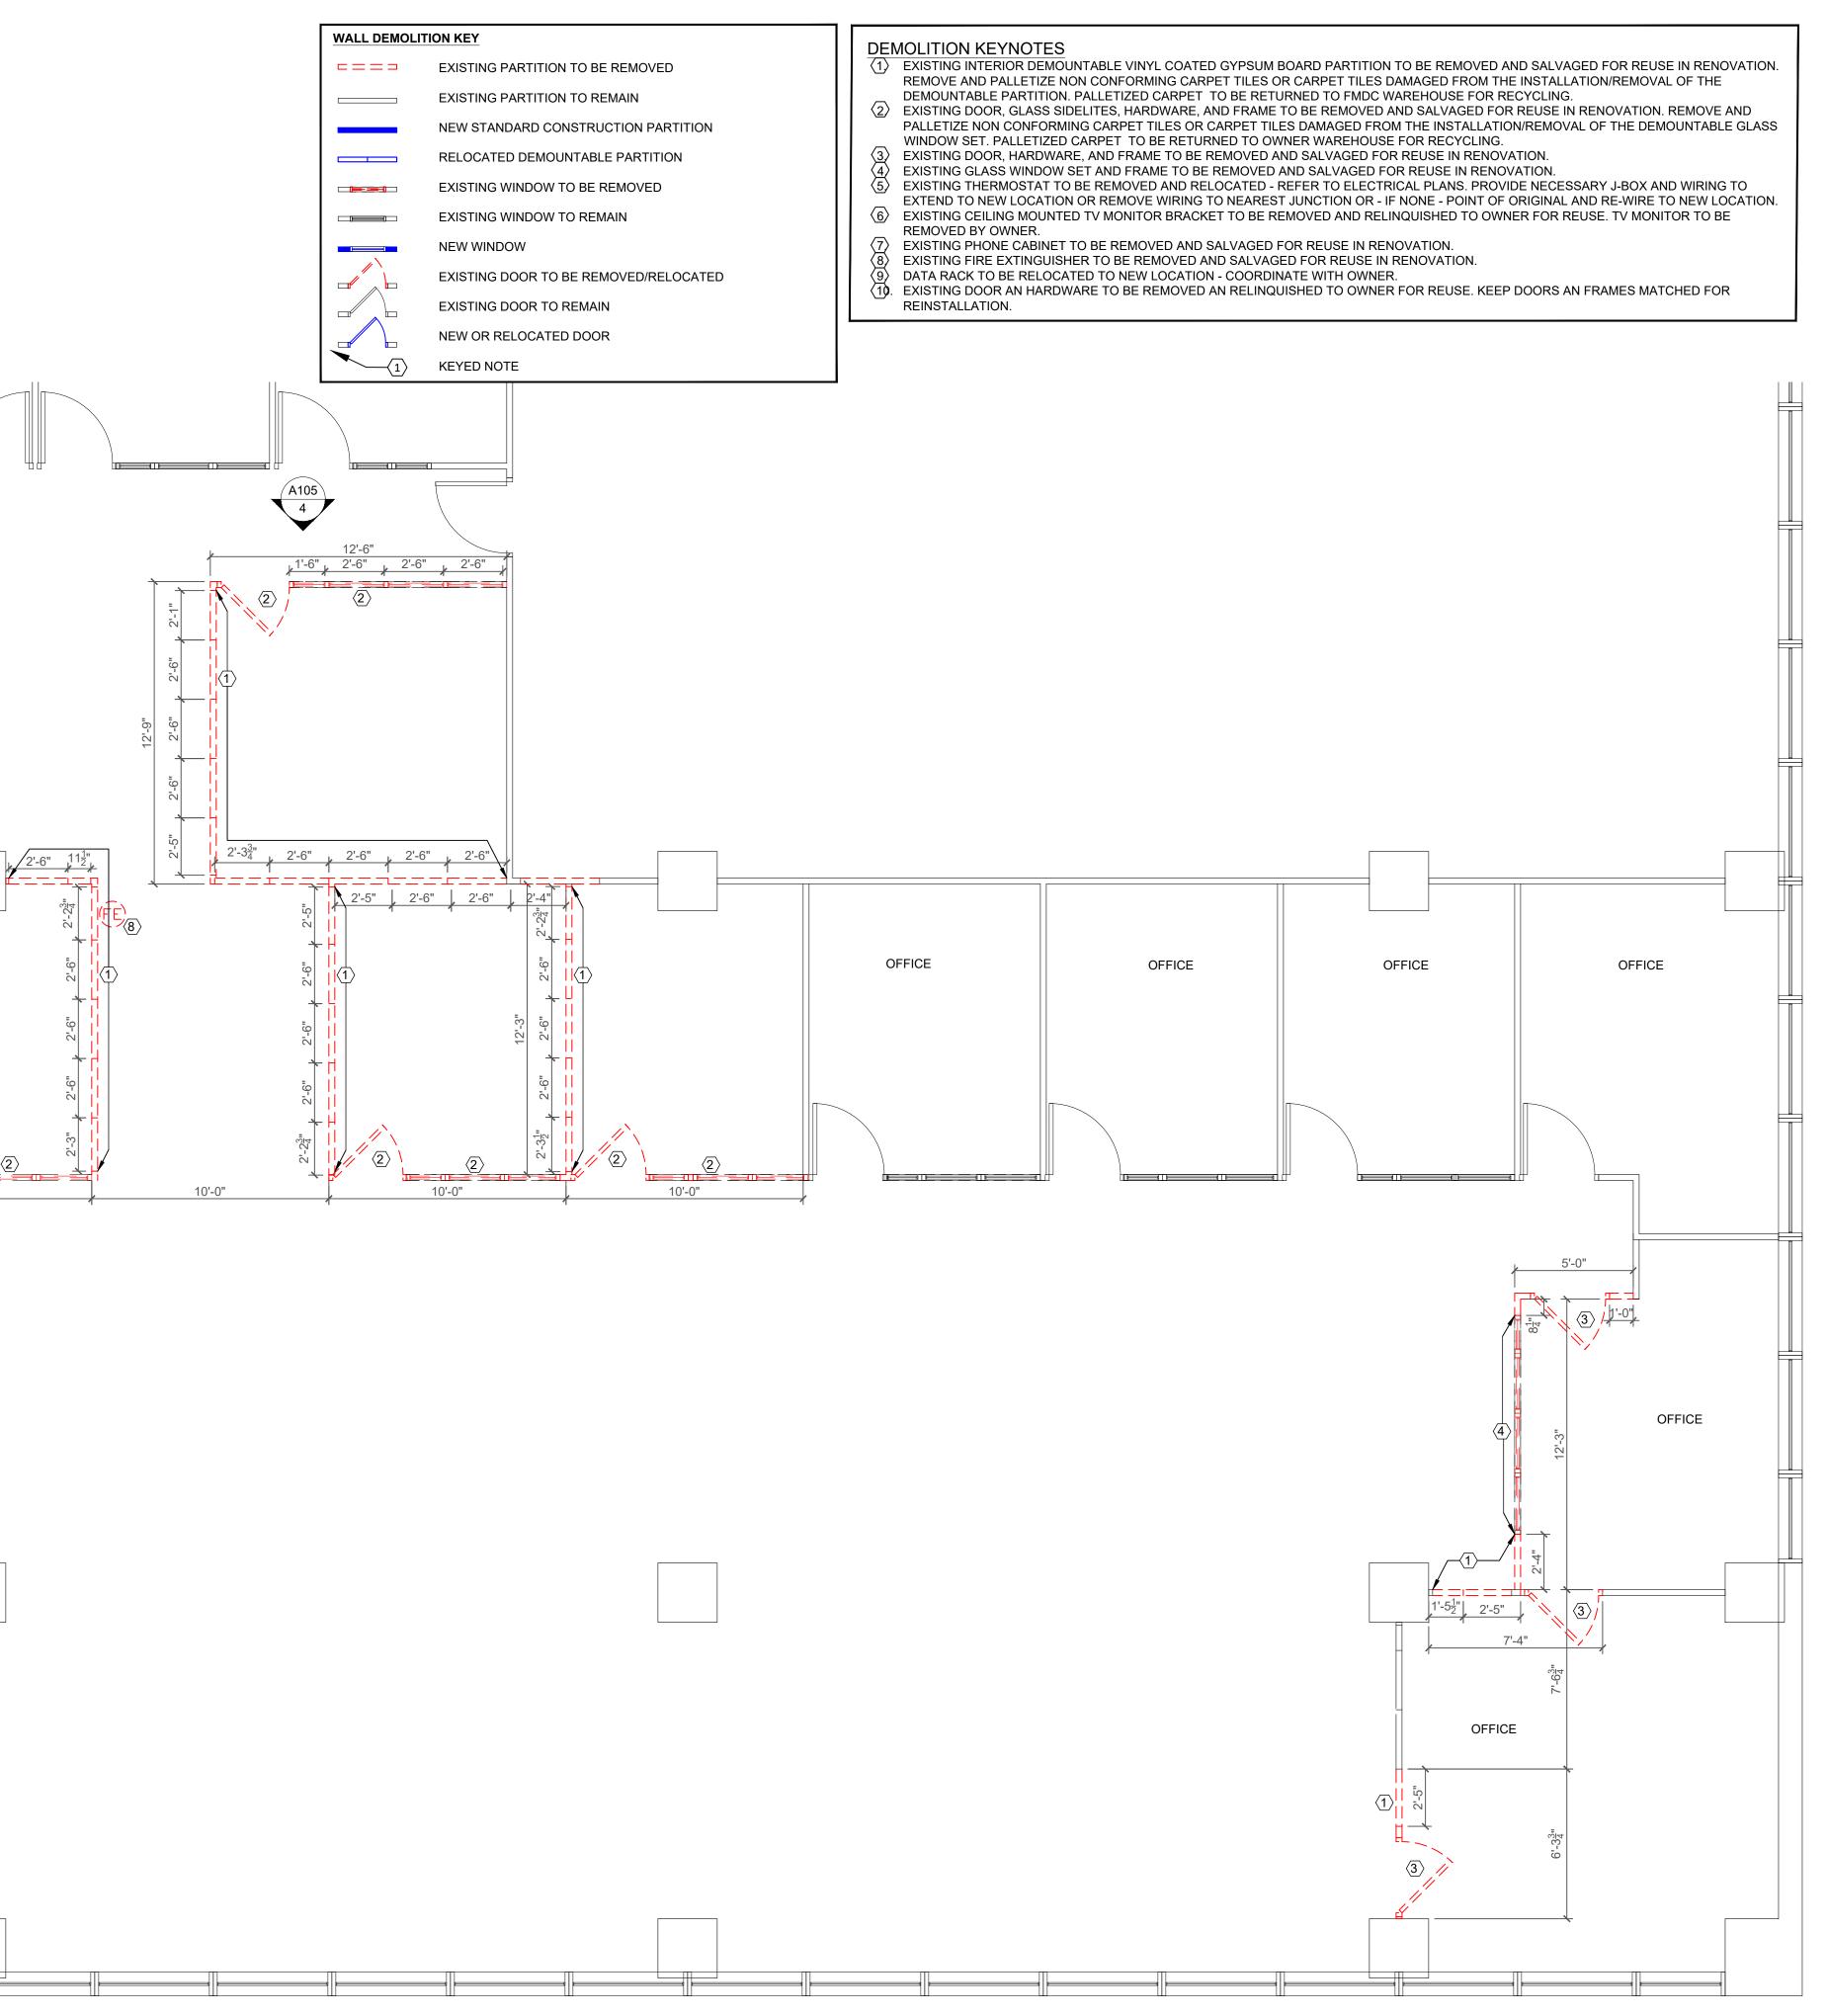
GOVERNOR

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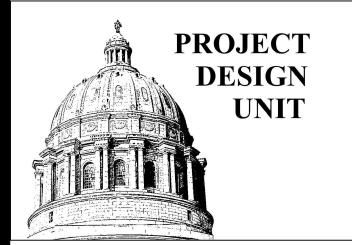
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STATE OF MISSOURI MICHAEL L. PARSON, GOVERNOR



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HARRY S. TRUMAN STATE OFFICE BUILDING 301 W HIGH STREET JEFFERSON CITY, MO 65102

| PROJECT # | O2403-01 |
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| SITE # | 0001 |
| ASSET # | 3101001050 |

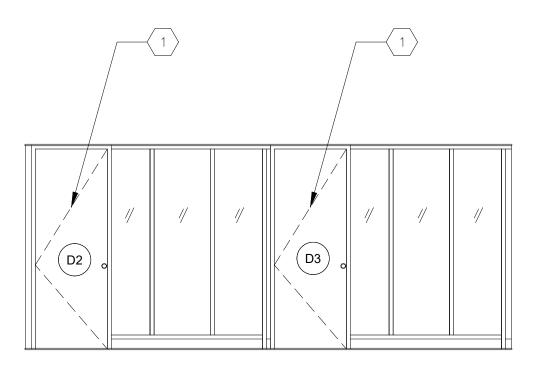
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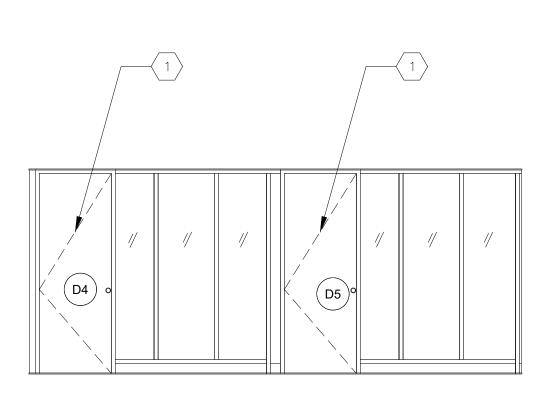
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SHEET NUMBER:


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3 INTERIOR ELEVATION- DEMO


RENOVATION KEYNOTES

- SELECTIVELY DEMO EXISTING OFFICES KEEPING EXISTING DOOR, FRAME, AND HARDWARE ASSEMBLY PAIRED AND ADJACENT SITE LITES MATCHED TO ASSEMBLY PARTS TO RELOCATE. SEE SHEETS A-104 AND A-202.
- 2. CONTACT OWNER IF ANY DOORS, FRAMES, HARDWARE, PANELS OR SIDE LITES ARE DAMAGED BEYOND USE DURING DEMOLITION

| | DOOR | FRAME | REMARKS |
|-----|---------------------------------------|----------|---|
| 10. | SIZE | TYPE | |
| D1 | 3'-0x8'-4" | EXISTING | DISASSEMBLE & RELOCATE AS SHOWN. KEEP DOOR, FRAME, & HARDWARE PAIRING INTAC |
| D2 | 3'-0x8'-4" | EXISTING | DISASSEMBLE & RELOCATE AS SHOWN. KEEP DOOR, FRAME, & HARDWARE IN TACT. |
| D3 | 3'-0x8'-4" | EXISTING | DISASSEMBLE & RELOCATE AS SHOWN. KEEP DOOR, FRAME, & HARDWARE IN TACT. |
| D4 | 3'-0x8'-4" | EXISTING | DISASSEMBLE & RELOCATE AS SHOWN. KEEP DOOR, FRAME, & HARDWARE IN TACT. |
| D5 | 3'-0x8'-4" | EXISTING | DISASSEMBLE & RELOCATE AS SHOWN. KEEP DOOR, FRAME, & HARDWARE IN TACT. |
| D6 | 3'-0x8'-4" | EXISTING | DISASSEMBLE & RELOCATE AS SHOWN. KEEP DOOR, FRAME, & HARDWARE IN TACT. |
| D7 | 3'-0x8'-4" | EXISTING | DISASSEMBLE & RELOCATE AS SHOWN. KEEP DOOR, FRAME, & HARDWARE IN TACT. |
| 08 | 3'-0x8'-4" | EXISTING | DISASSEMBLE & RELOCATE AS SHOWN. KEEP DOOR, FRAME, & HARDWARE IN TACT. |
| 09 | 3'-0x8'-4" | EXISTING | DISASSEMBLE & RELOCATE AS SHOWN. KEEP DOOR, FRAME, & HARDWARE IN TACT. |
| 010 | 3'-0x8'-4" | EXISTING | DISASSEMBLE & RELOCATE AS SHOWN. KEEP DOOR, FRAME, & HARDWARE IN TACT. DOOR AN HARDWARE TO BE REMOVED AN RELINQUISHED TO OWNER FOR REUSE. KEEP |
| D11 | 3'-0x8'-4" | - | DOORS AN FRAMES MATCHED FOR REINSTALLATION.DOOR AN HARDWARE TO BE REMOVED AN RELINQUISHED TO OWNER FOR REUSE. KEEP |
| 12 | 3'-0x8'-4" | - | DOORS AN FRAMES MATCHED FOR REINSTALLATION. DOOR AN HARDWARE TO BE REMOVED AN RELINQUISHED TO OWNER FOR REUSE. KEEP |
| 013 | 3'-0x8'-4" | | DOORS AN FRAMES MATCHED FOR REINSTALLATION.DOOR AN HARDWARE TO BE REMOVED AN RELINQUISHED TO OWNER FOR REUSE. KEEP |
| 014 | 3'-0x8'-4" | - | DOORS AN FRAMES MATCHED FOR REINSTALLATION.DOOR AN HARDWARE TO BE REMOVED AN RELINQUISHED TO OWNER FOR REUSE. KEEP |
| 015 | 3'-0x8'-4" 3'-0x8'-4" FIELD VERIFY | - NEW | DOORS AN FRAMES MATCHED FOR REINSTALLATION. DOOR & HARDWARE PROVIDED BY OWNER. FIELD VERIFY OWNER PROVIDED MATERIALS |
| 017 | | - | AND ORDER NEW KNOCK DOWN FRAME TO FIT. FINISH TO MATCH EXISTING - |
| 018 | 3'-0x8'-4" FIELD VERIFY | NEW | DOOR & HARDWARE PROVIDED BY OWNER. FIELD VERIFY OWNER PROVIDED MATERIALS |
| 019 | 3'-0x8'-4" | NEW | AND ORDER NEW KNOCK DOWN FRAME TO FIT. FINISH TO MATCH EXISTING DOOR, FRAME AND HINGES PROVIDED BY CONTRACTOR. DOOR HARDWARE PROVIDED BY OWNER. FIELD VERIFY AND ORDER NEW SOLID WOOD DOOR TO MATCH EXISTING AND KNOCK DOWN FRAME . FINISH TO MATCH EXISTING |
| 20 | 3'-0x8'-4" | NEW | DOOR, FRAME AND HINGES PROVIDED BY CONTRACTOR. DOOR HARDWARE PROVIDED BY OWNER. FIELD VERIFY AND ORDER NEW SOLID WOOD DOOR TO MATCH EXISTING AND |
| | | | |
| | | | PRESENT IN EXISTING |


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7 INTERIOR ELEVATION- DEMO

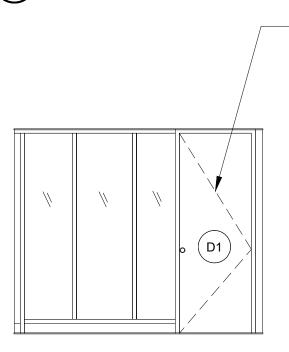

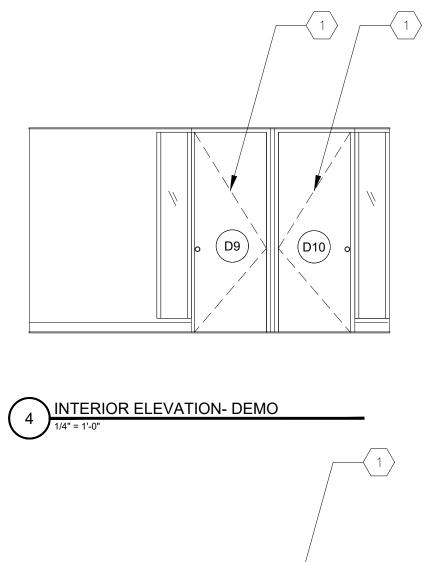5 INTERIOR ELEVATION- DEMO

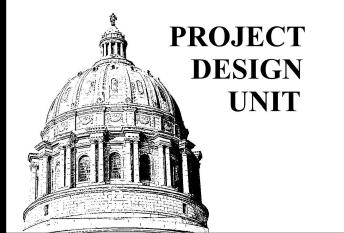STATE OF MISSOURI MICHAEL L. PARSON, GOVERNOR



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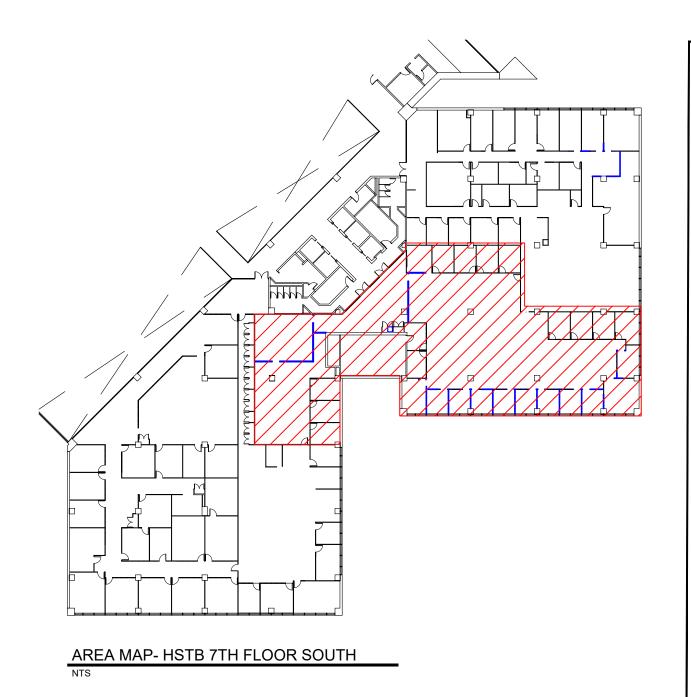
CAD DWG FILE:<u>O2403-01</u> DRAWN BY: <u>RTG</u> CHECKED BY: <u>BS</u> DESIGNED BY: CG

SHEET TITLE: DEMOLITION DOOR SCHEDULE

SHEET NUMBER:


AD-201

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ARCHITECTURAL RENOVATION - GENERAL NOTES . ALL EXISTING WALLS IN AREA OF WORK SHALL BE PAINTED. ALL EXISTING WALLS SHALL RECEIVE ONE PRIMER COAT OF PAINT AND (2) FINISH COATS OF PAINT, UNLESS NOTED OTHERWISE. PAINT SHALL BE LOW VOC (LATEX).

- PAINT 4' WIDE X 8'-6" HIGH SWATCH. APPROVAL BY OA-FMDC DESIGNER AND/OR PROJECT MANAGER REQUIRED PRIOR TO PLACING PAINT ORDER FOR ENTIRE SUITE.
- ALL NEW WALLS SHALL RECEIVE VINYL/RUBBER BASE. WHERE NEW WALLS INTERSECT EXISTING, CUT BACK EXISTING BASE TO ALLOW PROPER INSTALLATION OF NEW AT CORNER. PROVIDE APPROPRIATE CORNER TRANSITION PIECES.
- AT NEW WALL CONSTRUCTION PROVIDE PROPER FRAMING AND/OR BLOCKING AT ALL LOCATIONS OF NEW DOOR OPENINGS, WINDOW OPENINGS OR WALL MOUNTED ACCESSORIES. ALL FRAMING AND GYPSUM BOARD SHALL GO TO UNDERSIDE OF EXISTING CEILING SURFACE.
- ALL WORK SHALL BE PERFORMED IN A SAFE MANNER WITH PROTECTION PROVIDED TO ANY BUILDING OCCUPANTS AND WORKERS PERFORMING THE WORK
- 6. ALL WORK SHALL BE DONE IN A MANNER TO MINIMIZE DAMAGE TO ADJACENT SURFACES THAT ARE NOT SHOWN TO BE WORKED ON OR REMOVED -CONTRACTOR SHALL BE RESPONSIBLE FOR ALL WORK NECESSARY TO REPAIR SURFACES AFFECTED BY THEIR WORK.
- ANY WORK THAT RESULTS IN EXCESSIVE NOISE, DUST OR DEBRIS MUST BE COORDINATED WITH BUILDING FACILITY STAFF AT LEAST TWO (2) WORKING DAYS IN ADVANCE.
- ANY WORK THAT REQUIRES THE NEED TO TEMPORARILY SHUT DOWN ANY OF THE BUILDING SYSTEMS MUST BE COORDINATED WITH BUILDING FACILITY STAFF AT LEAST FOUR (4) WORKING DAYS IN ADVANCE. CONTRACTOR SHALL PROVIDE NECESSARY DUST PROTECTION TO PREVENT DUST CREATED BY DEMOLITION/CONSTRUCTION ACTIVITIES TO ENTER
- SPACE(S) OUTSIDE THE WORK AREA, INCLUDING THROUGH THE HVAC SYSTEM. CONTRACTOR SHALL BE RESPONSIBLE TO REPLACE ANY HVAC FILTERS CONTAMINATED WITH CONSTRUCTION DEBRIS. 10. CONTRACTOR SHALL BE RESPONSIBLE TO PERFORM WORK NECESSARY TO PROVIDE THE SCOPE OF WORK SHOWN ON THE PLANS, EVEN IF NOT
- SPECIFICALLY NOTED OR SHOWN. 11. CONTRACTOR SHALL PERFORM WORK BETWEEN THE HOURS OF 7AM TO 5PM AFTER SIGNING IN AND RECEIVING VISITOR'S BADGE. 12. ALL MATERIALS/EQUIPMENT MAY BE DELIVERED TO THE FACILITY - FACILITY STAFF SHALL BE CONTACTED TEN (10) BUSINESS DAYS PRIOR TO
- DELIVERY OF MATERIALS/EQUIPMENT. CONTRACTOR SHALL BE SIGN FOR RECEIPT OF ALL MATERIALS/EQUIPMENT FACILITY STAFF ARE NOT RESPONSIBLE FOR ACCEPTING OR SIGNING FOR DELIVERIES. 13. ALL WORK SHALL BE PERFORMED IN ACCORDANCE WITH THE LATEST EDITION OF THE IBC, IFC, IMC, IPC, NEC AND ALL OTHER APPLICABLE ICC AND NFPA CODE FAMILIES.
- 14. CONTRACTOR RESPONSIBLE FOR FIELD VERIFYING AS-BUILT CONDITIONS AND PROPOSED LAYOUT PRIOR TO PERFORMING WORK. CONTRACTOR SHALL NOTIFY FMDC PROJECT MANAGER IF THERE ARE ANY DISCREPANCIES OR CONFLICTS.
- 15. DETAILS OF EXISTING CONDITIONS PROVIDED AS A COURTESY. THIS INFORMATION DOES NOT RELIEVE THE CONTRACTOR FROM PERFORMING A COMPLETE NECESSARY FIELD INVESTIGATIVE WORK TO FULLY UNDERSTAND EXISTING CONDITIONS PRIOR TO SUBMITTING BID.
- 16. DATA AND PHONE LINE WORK TO BE PERFORMED BY OWNER.
- PRODUCTS.
- AND THEREIN REFERENCED APPENDIX. CONTRACTOR SHALL TRANSPORT OWNER SUPPLIED MATERIALS FROM WAREHOUSE LOCATION AND PROVIDE FEEDBACK TO OWNER ON PARTS USED FROM STOCK.



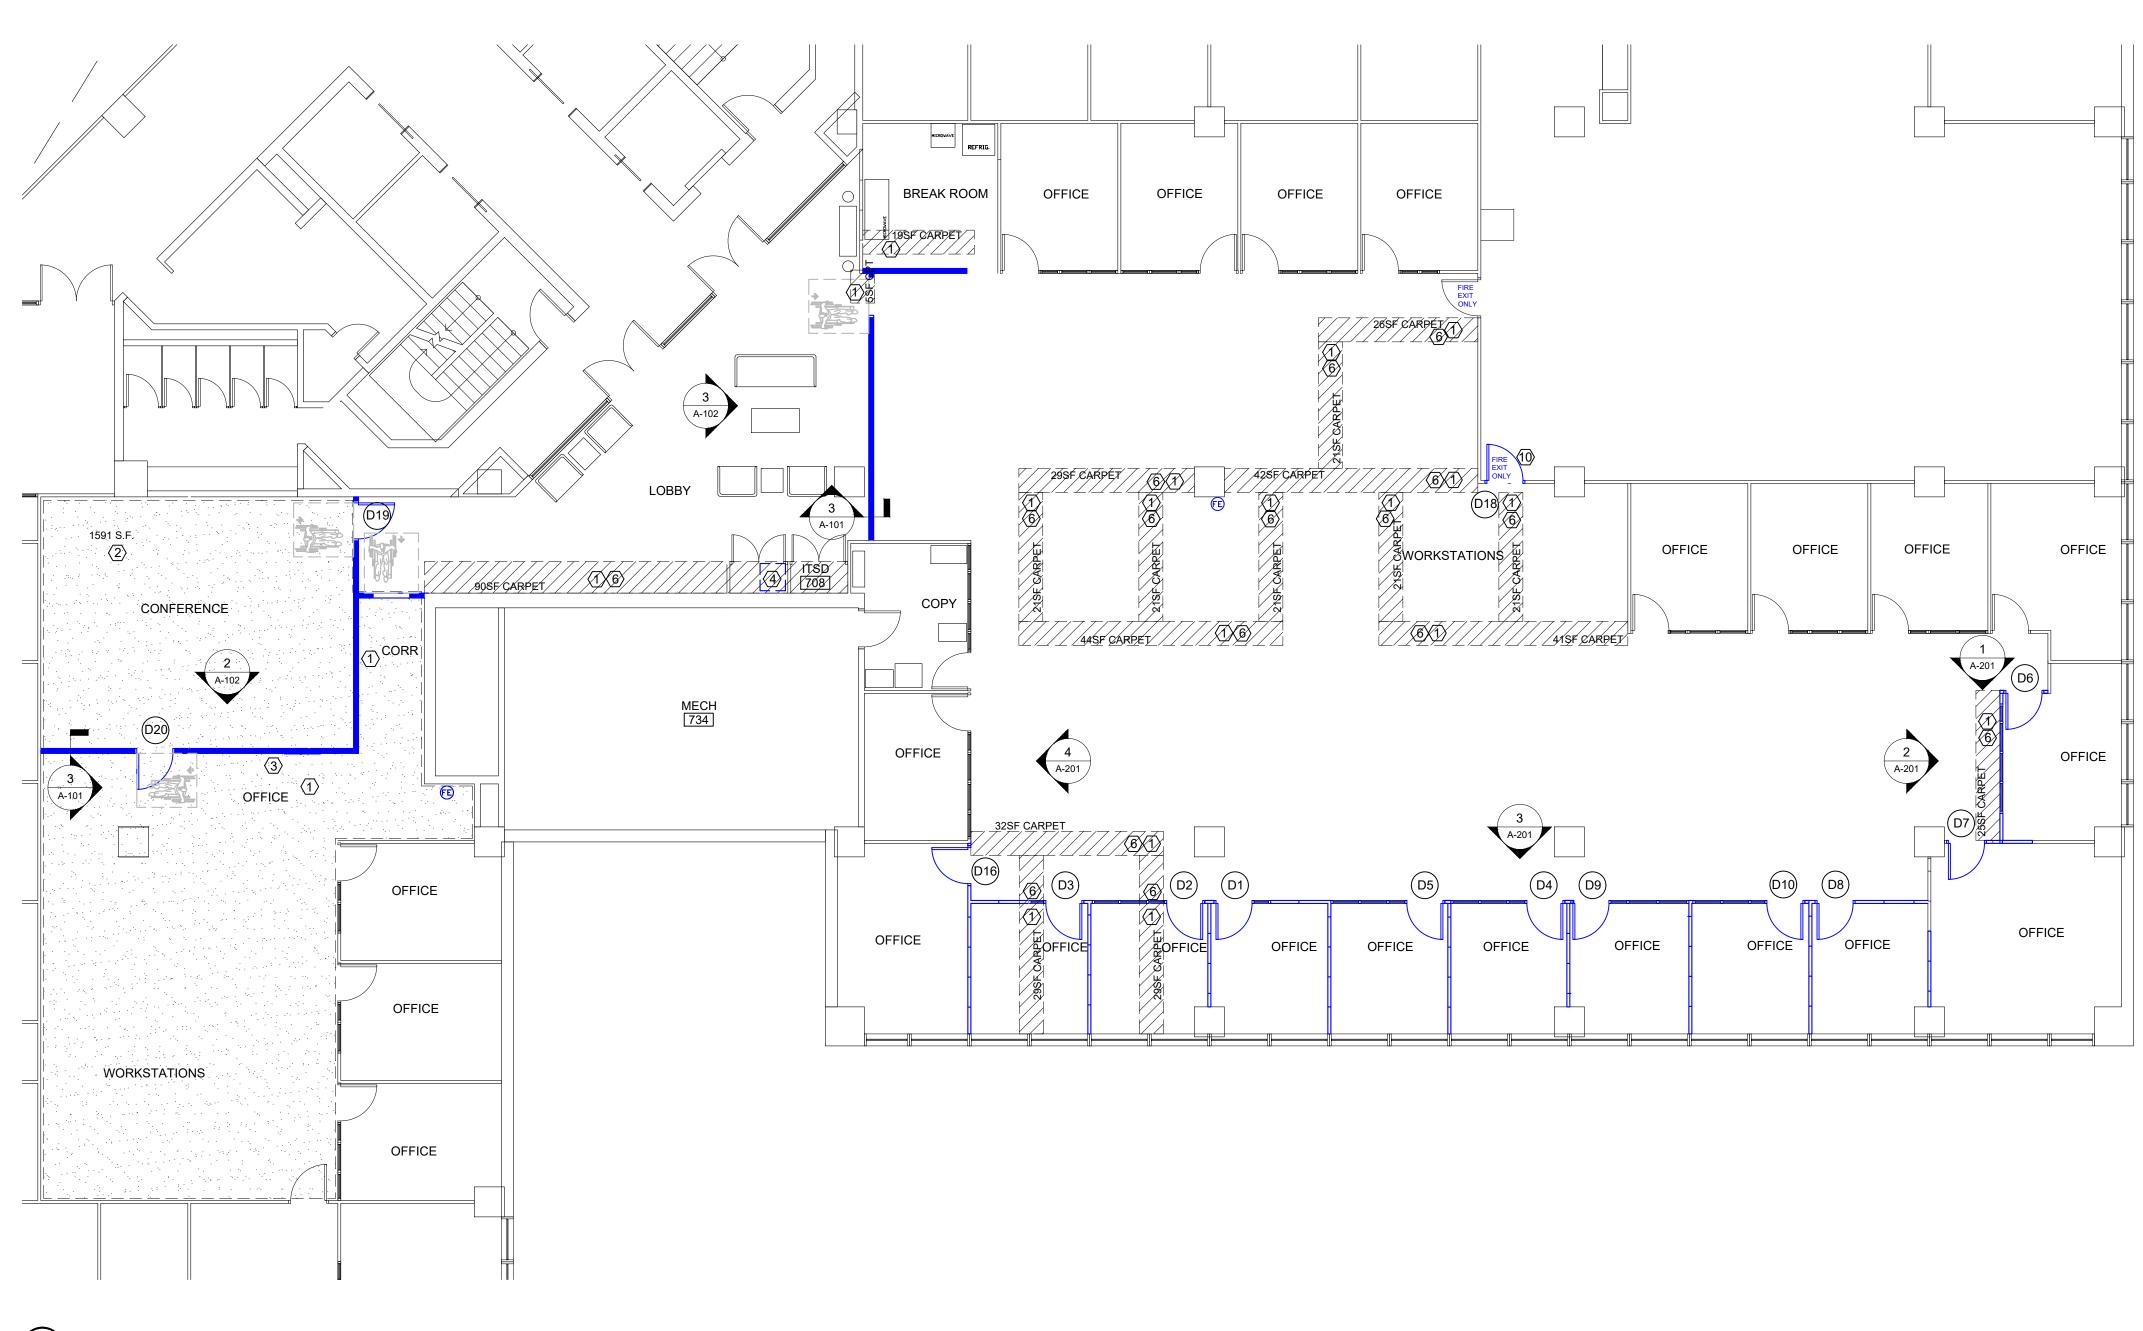FLOOR PLAN

SYMBOL KEY EXISTING PARTITION TO BE REMOVED EXISTING PARTITION TO REMAIN NEW STANDARD CONSTRUCTION PARTITION RELOCATED DEMOUNTABLE PARTITION EXISTING WINDOW TO BE REMOVED EXISTING WINDOW TO REMAIN (3) RELOCATED PHONE CABINET. NEW WINDOW EXISTING DOOR TO BE REMOVED/RELOCATED EXISTING DOOR TO REMAIN NEW OR RELOCATED DOOR -(1)KEYED NOTE EXISTING CARPET TO BE REPLACED WITH TILES IN EAST WING OF SUITE. CARPET TO BE USED TO PATCH ENTRY LOBBY AND WEST WING OF SUITE, AS NEEDED.

17. CONTRACTOR SHALL MAINTAIN THE INTEGRITY OF ALL RATED PARTITIONS, CEILING ASSEMBLIES AND DOOR ASSEMBLIES. THE CONTRACTOR SHALL MAKE ALL NECESSARY REPAIRS WHERE ANY WORK PERFORMED BY THE CONTRACTOR AFFECTS THE INTEGRITY OF THESE ITEMS. 18. DIMENSIONS PROVIDED ARE MEASURED FROM EXISTING DRYWALL FACE TO NEW DRYWALL FACE UNLESS OTHERWISE NOTED. 19. MATERIALS & BRANDS CALLED OUT ON THIS DRAWING ARE FOR BASIS OF DESIGN ONLY. REFERENCE SPECIFICATIONS FOR ADDITIONAL APPROVED

20. QUANTITIES OF MATERIALS ARE APPROXIMATE, AND SHOWN FOR REFERENCE. CONTRACTOR TO VERIFY PRIOR TO INSTALLATION. 21. CONTRACTOR IS RESPONSIBLE FOR RAISED SUB FLOOR REPAIR AND REPLACEMENT WITH OWNER SUPPLIED MATERIALS. SEE SPECIFICATION 096933

RENOVATION KEYNOTES

(1.) REPLACE ANY DAMAGED CARPET TILES WITH SALVAGED CARPET TILE FROM SUITE TO MATCH EXISTING DYE LOT/PATTERN. SUBFLOOR SHALL BE INSPECTED FOR ANY DAMAGE. ANY ISSUES SHALL BE BROUGHT TO THE ATTENTION OF FMDC BUILDING STAFF. INSTALLATION OF CARPET FLOORING SHALL INCLUDE ALL APPLICABLE RELEASABLE ADHESIVES (APPROVED BY THE CARPET MANUFACTURER) AND ACCESSORIES FOR A COMPLETE INSTALLATION. REPAIR SUBFLOOR AS NEEDED SEE GENERAL NOTES AND SPECIFICATION 096933. INSTALL NEW STATE OF MISSOURI PROVIDED 1591SF OF CARPET FLOORING IN CONFERENCE ROOM, CORRIDOR, AND WORKSTATIONS AS INDICATED ON PLAN. COORDINATE WITH OA-FMDC STAFF. SUBFLOOR SHALL BE INSPECTED FOR ANY DAMAGE. ANY ISSUES SHALL BE BROUGHT TO THE ATTENTION OF FMDC BUILDING STAFF. INSTALLATION OF CARPET FLOORING SHALL INCLUDE ALL APPLICABLE RELEASABLE ADHESIVES (APPROVED BY THE CARPET MANUFACTURER) AND ACCESSORIES FOR A COMPLETE INSTALLATION.

RELOCATED DATA RACK INSTALLED BY OWNER.

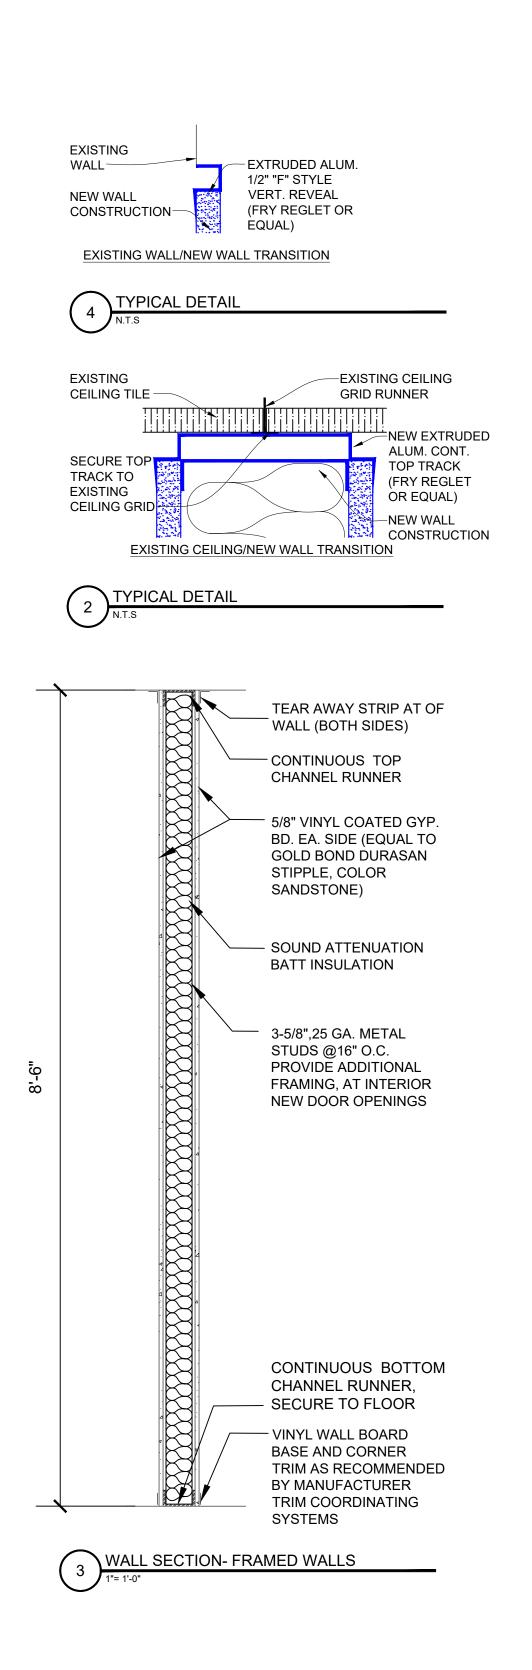
INSTALL NEW KNOCK DOWN FRAME, FIELD MEASURE EXISTING DOOR & HARDWARE PROVIDED BY FMDC. INCLUDE/COORDINATE ALL FIRE PROTECTION HARDWARE WITH OWNER.

(6.) INSTALL SALVAGED CARPET TILE FROM SUITE TO MATCH EXISTING DYE LOT/PATTERN, IF ALTERNATE FOR


REMOVAL OF CLOSETS IN LOBBY #707 IS ACCEPTED. SUBFLOOR SHALL BE INSPECTED FOR ANY DAMAGE. ANY ISSUES SHALL BE BROUGHT TO THE ATTENTION OF FMDC BUILDING STAFF. INSTALLATION OF CARPET FLOORING SHALL INCLUDE ALL APPLICABLE RELEASABLE ADHESIVES (APPROVED BY THE CARPET MANUFACTURER) AND ACCESSORIES FOR A COMPLETE INSTALLATION. (7) PAINT ALL WALL SURFACES IN SUITE. OFFICES AND KITCHEN SHALL BE TRUMAN GRAY, LOBBY AND MEDIA WALL

IN CONFERENCE ROOM SHALL BE LEISURE BLUE, AND ALL OTHER WALL AND INTERIOR CUBICAL FACING SURFACES, INCLUDING COLUMNS SHALL BE CREAMY WHITE.

(8) APPLY NEW 4" VINYL TRIM TO ALL EXTERIOR GYPSUM BOARD WALLS AND COLUMNS, COLOR TO BE SELECTED BY DESIGNER FROM MANUFACTURERS FULL RANGE.



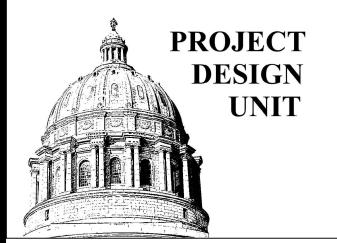STATE OF MISSOURI MICHAEL L. PARSON, GOVERNOR



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OFFICE OF ADMINISTRATION DIVISION OF FACILITIES MANAGEMENT, **DESIGN AND CONSTRUCTION**

DEPARTMENT OF THE OFFICE OF ADMINISTRATION

RENOVATE ECONOMIC DEVELOPMENT OFFICES, **SUITE 770**

HARRY S. TRUMAN STATE OFFICE BUILDING **301 W HIGH STREET** JEFFERSON CITY, MO 65102

PROJECT # 02403-01 SITE # 0001 3101001050 ASSET #

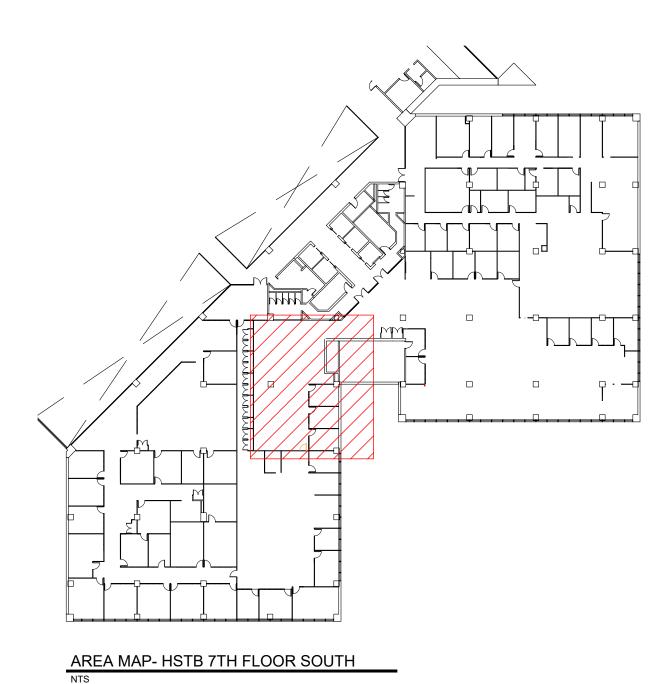
REVISION DATE REVISION DATE REVISION DATE ISSUE DATE: 01/26/2024

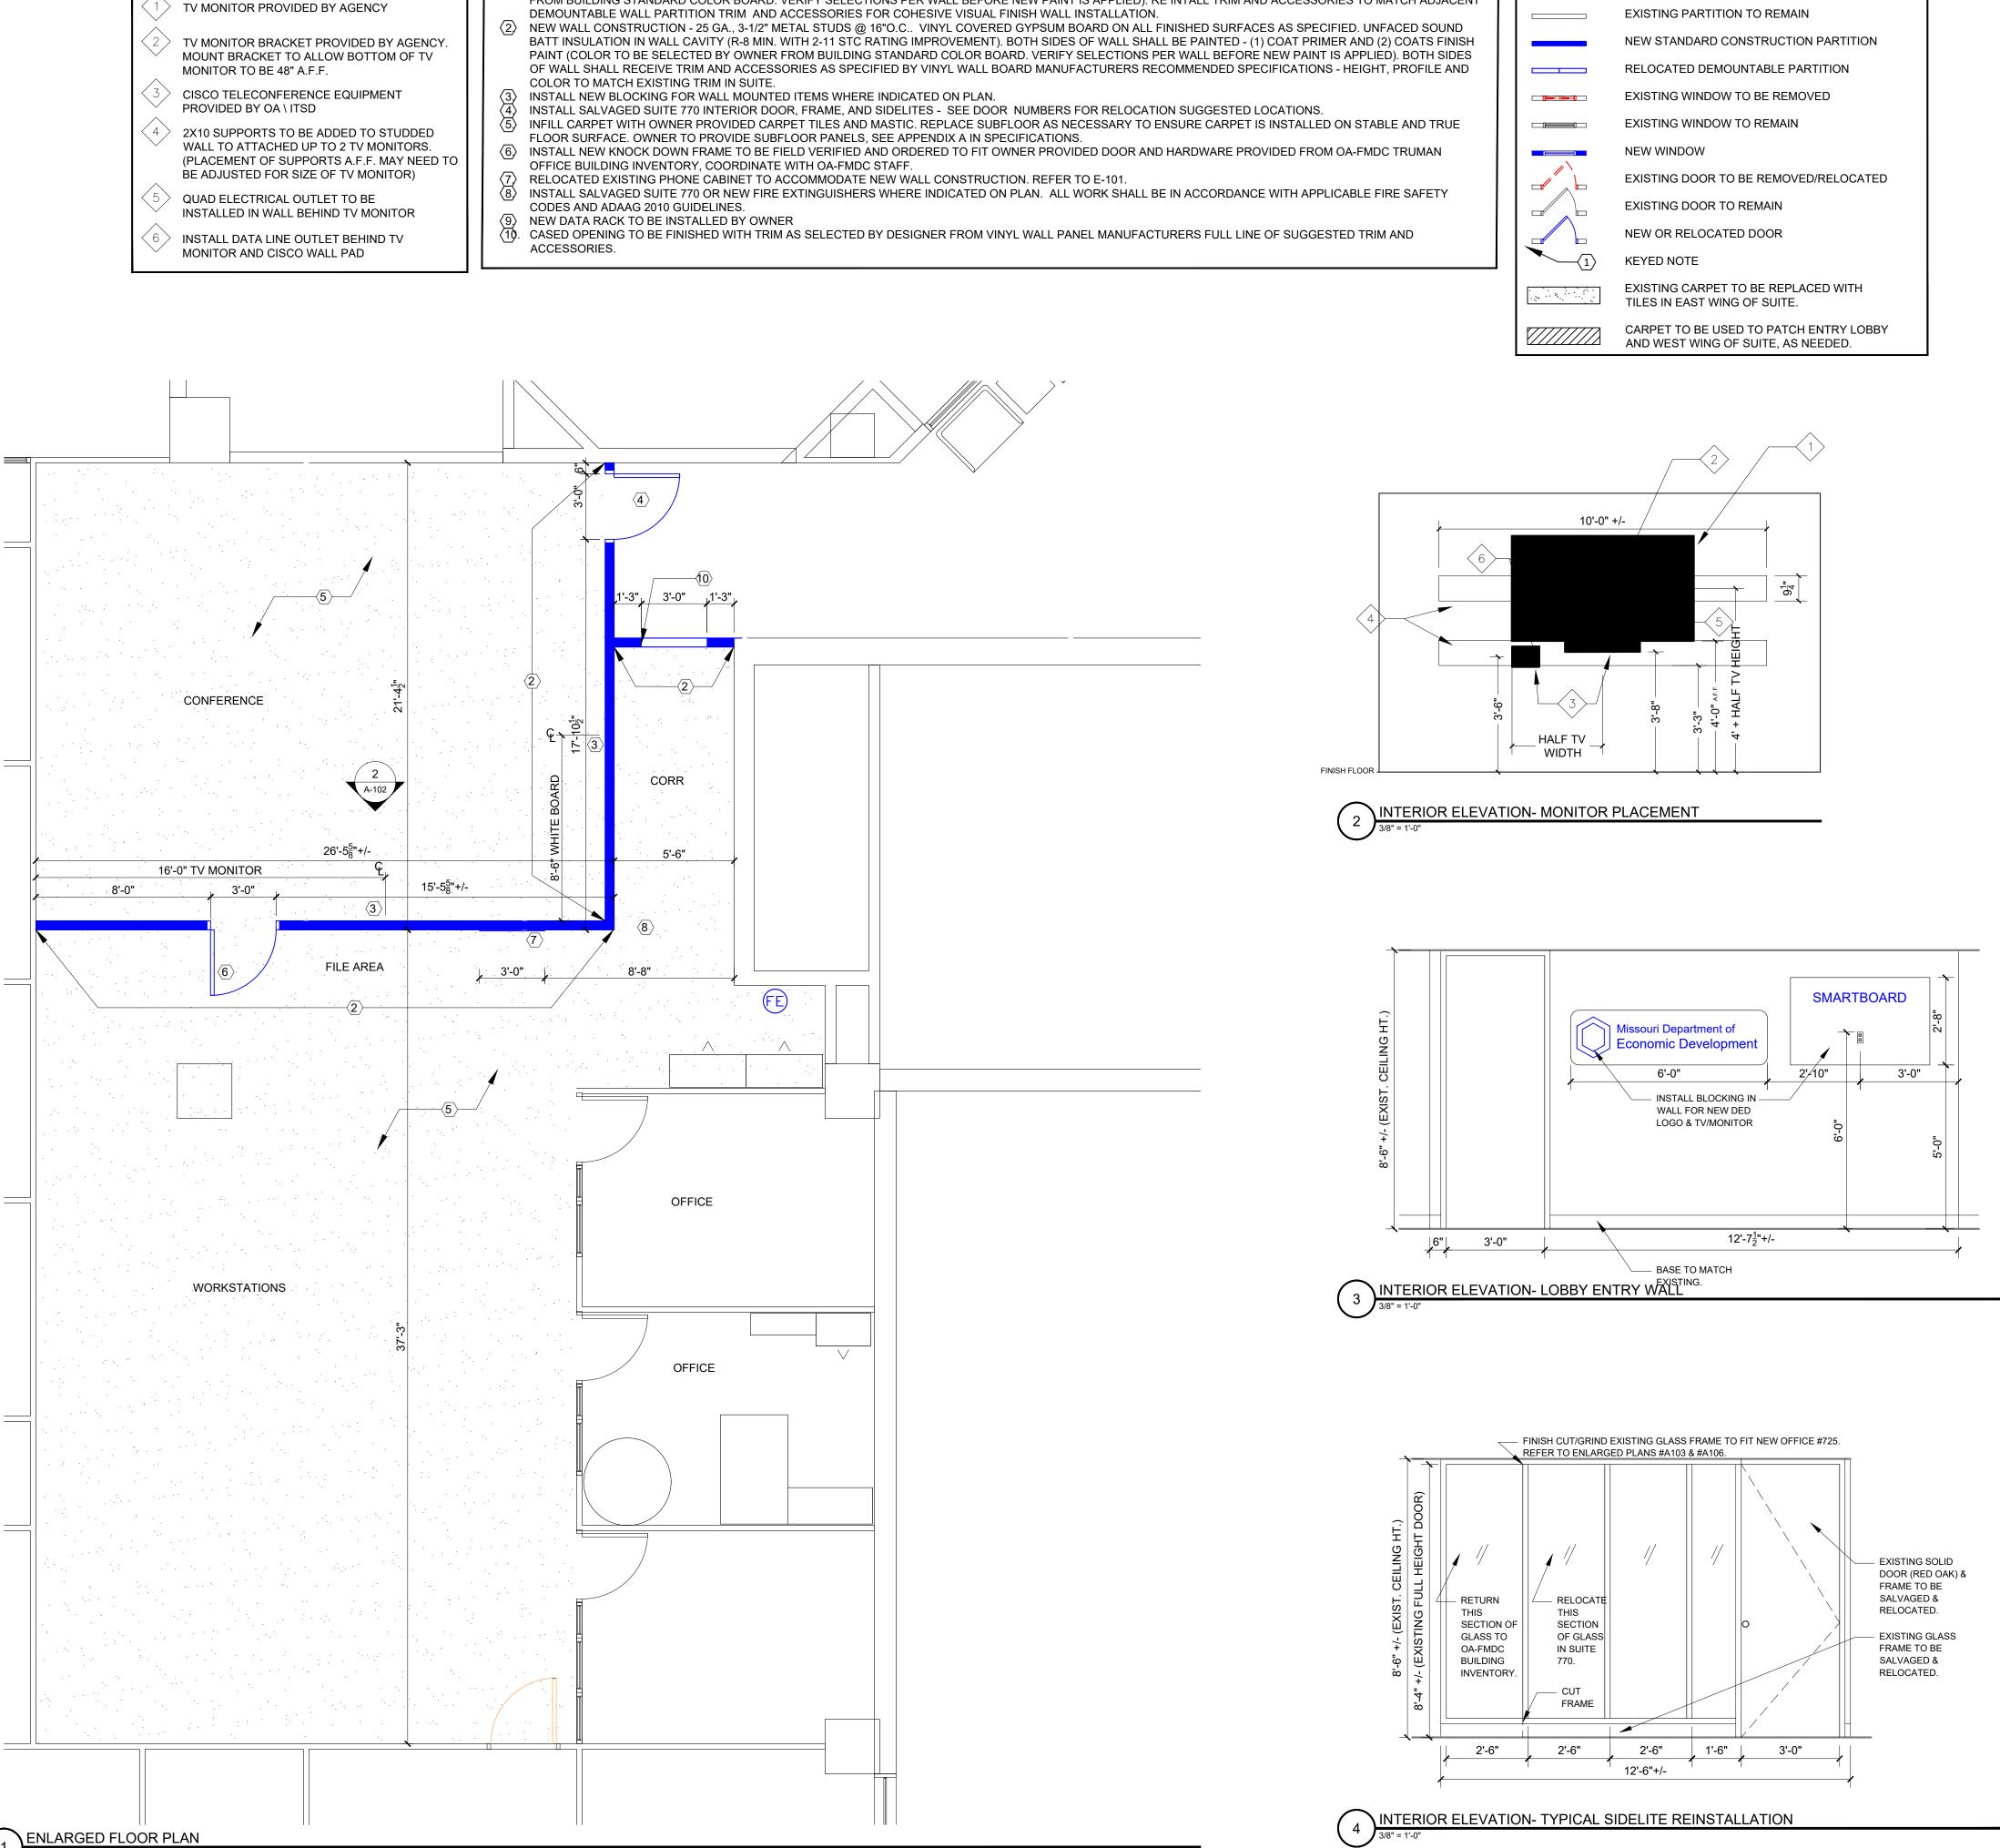
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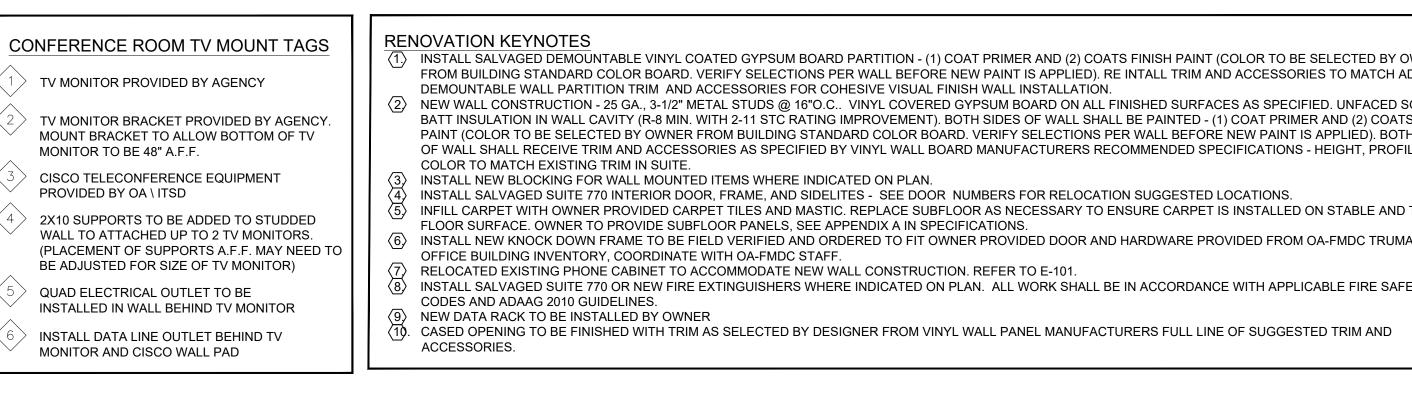
SHEET TITLE: FLOOR PLAN AND WALL SECTION

SHEET NUMBER:

A-107 OF 21 SHEETS 1/26/2024







| | SYMBOL KEY | |
|--------------------------------|------------|--|
| OWNER ADJACENT | ==== | EXISTING PARTITION TO BE REMOVED |
| | | EXISTING PARTITION TO REMAIN |
| SOUND TS FINISH TH SIDES | | NEW STANDARD CONSTRUCTION PARTITION |
| FILE AND | | RELOCATED DEMOUNTABLE PARTITION |
| | | EXISTING WINDOW TO BE REMOVED |
| D TRUE | | EXISTING WINDOW TO REMAIN |
| IAN | | NEW WINDOW |
| | | EXISTING DOOR TO BE REMOVED/RELOCATED |
| FETY | | EXISTING DOOR TO REMAIN |
| | | NEW OR RELOCATED DOOR |
| | | KEYED NOTE |
| | | EXISTING CARPET TO BE REPLACED WITH TILES IN EAST WING OF SUITE. |
| | | CARPET TO BE USED TO PATCH ENTRY LOBBY AND WEST WING OF SUITE, AS NEEDED. |

BID **OFFICE OF ADMINISTRATION DIVISION OF FACILITIES** MANAGEMENT, **DESIGN AND CONSTRUCTION DEPARTMENT OF** THE OFFICE OF ADMINISTRATION **RENOVATE ECONOMIC** DEVELOPMENT OFFICES, ROOM 770 HARRY S. TRUMAN STATE OFFICE BUILDING **301 W HIGH STREET** JEFFERSON CITY, MO 65102 PROJECT # 02403-01 0001 SITE # 3101001050 ASSET # **REVISION:** DATE: REVISION DATE: REVISION DATE: ISSUE DATE: 01/26/2024 CAD DWG FILE:02403-01 DRAWN BY: CHECKED BY: DESIGNED BY: CG SHEET TITLE: ENLARGED FLOOR PLAN AND INTERIOR ELEVATIONS

STATE OF MISSOURI MICHAEL L. PARSON,

PROJECT

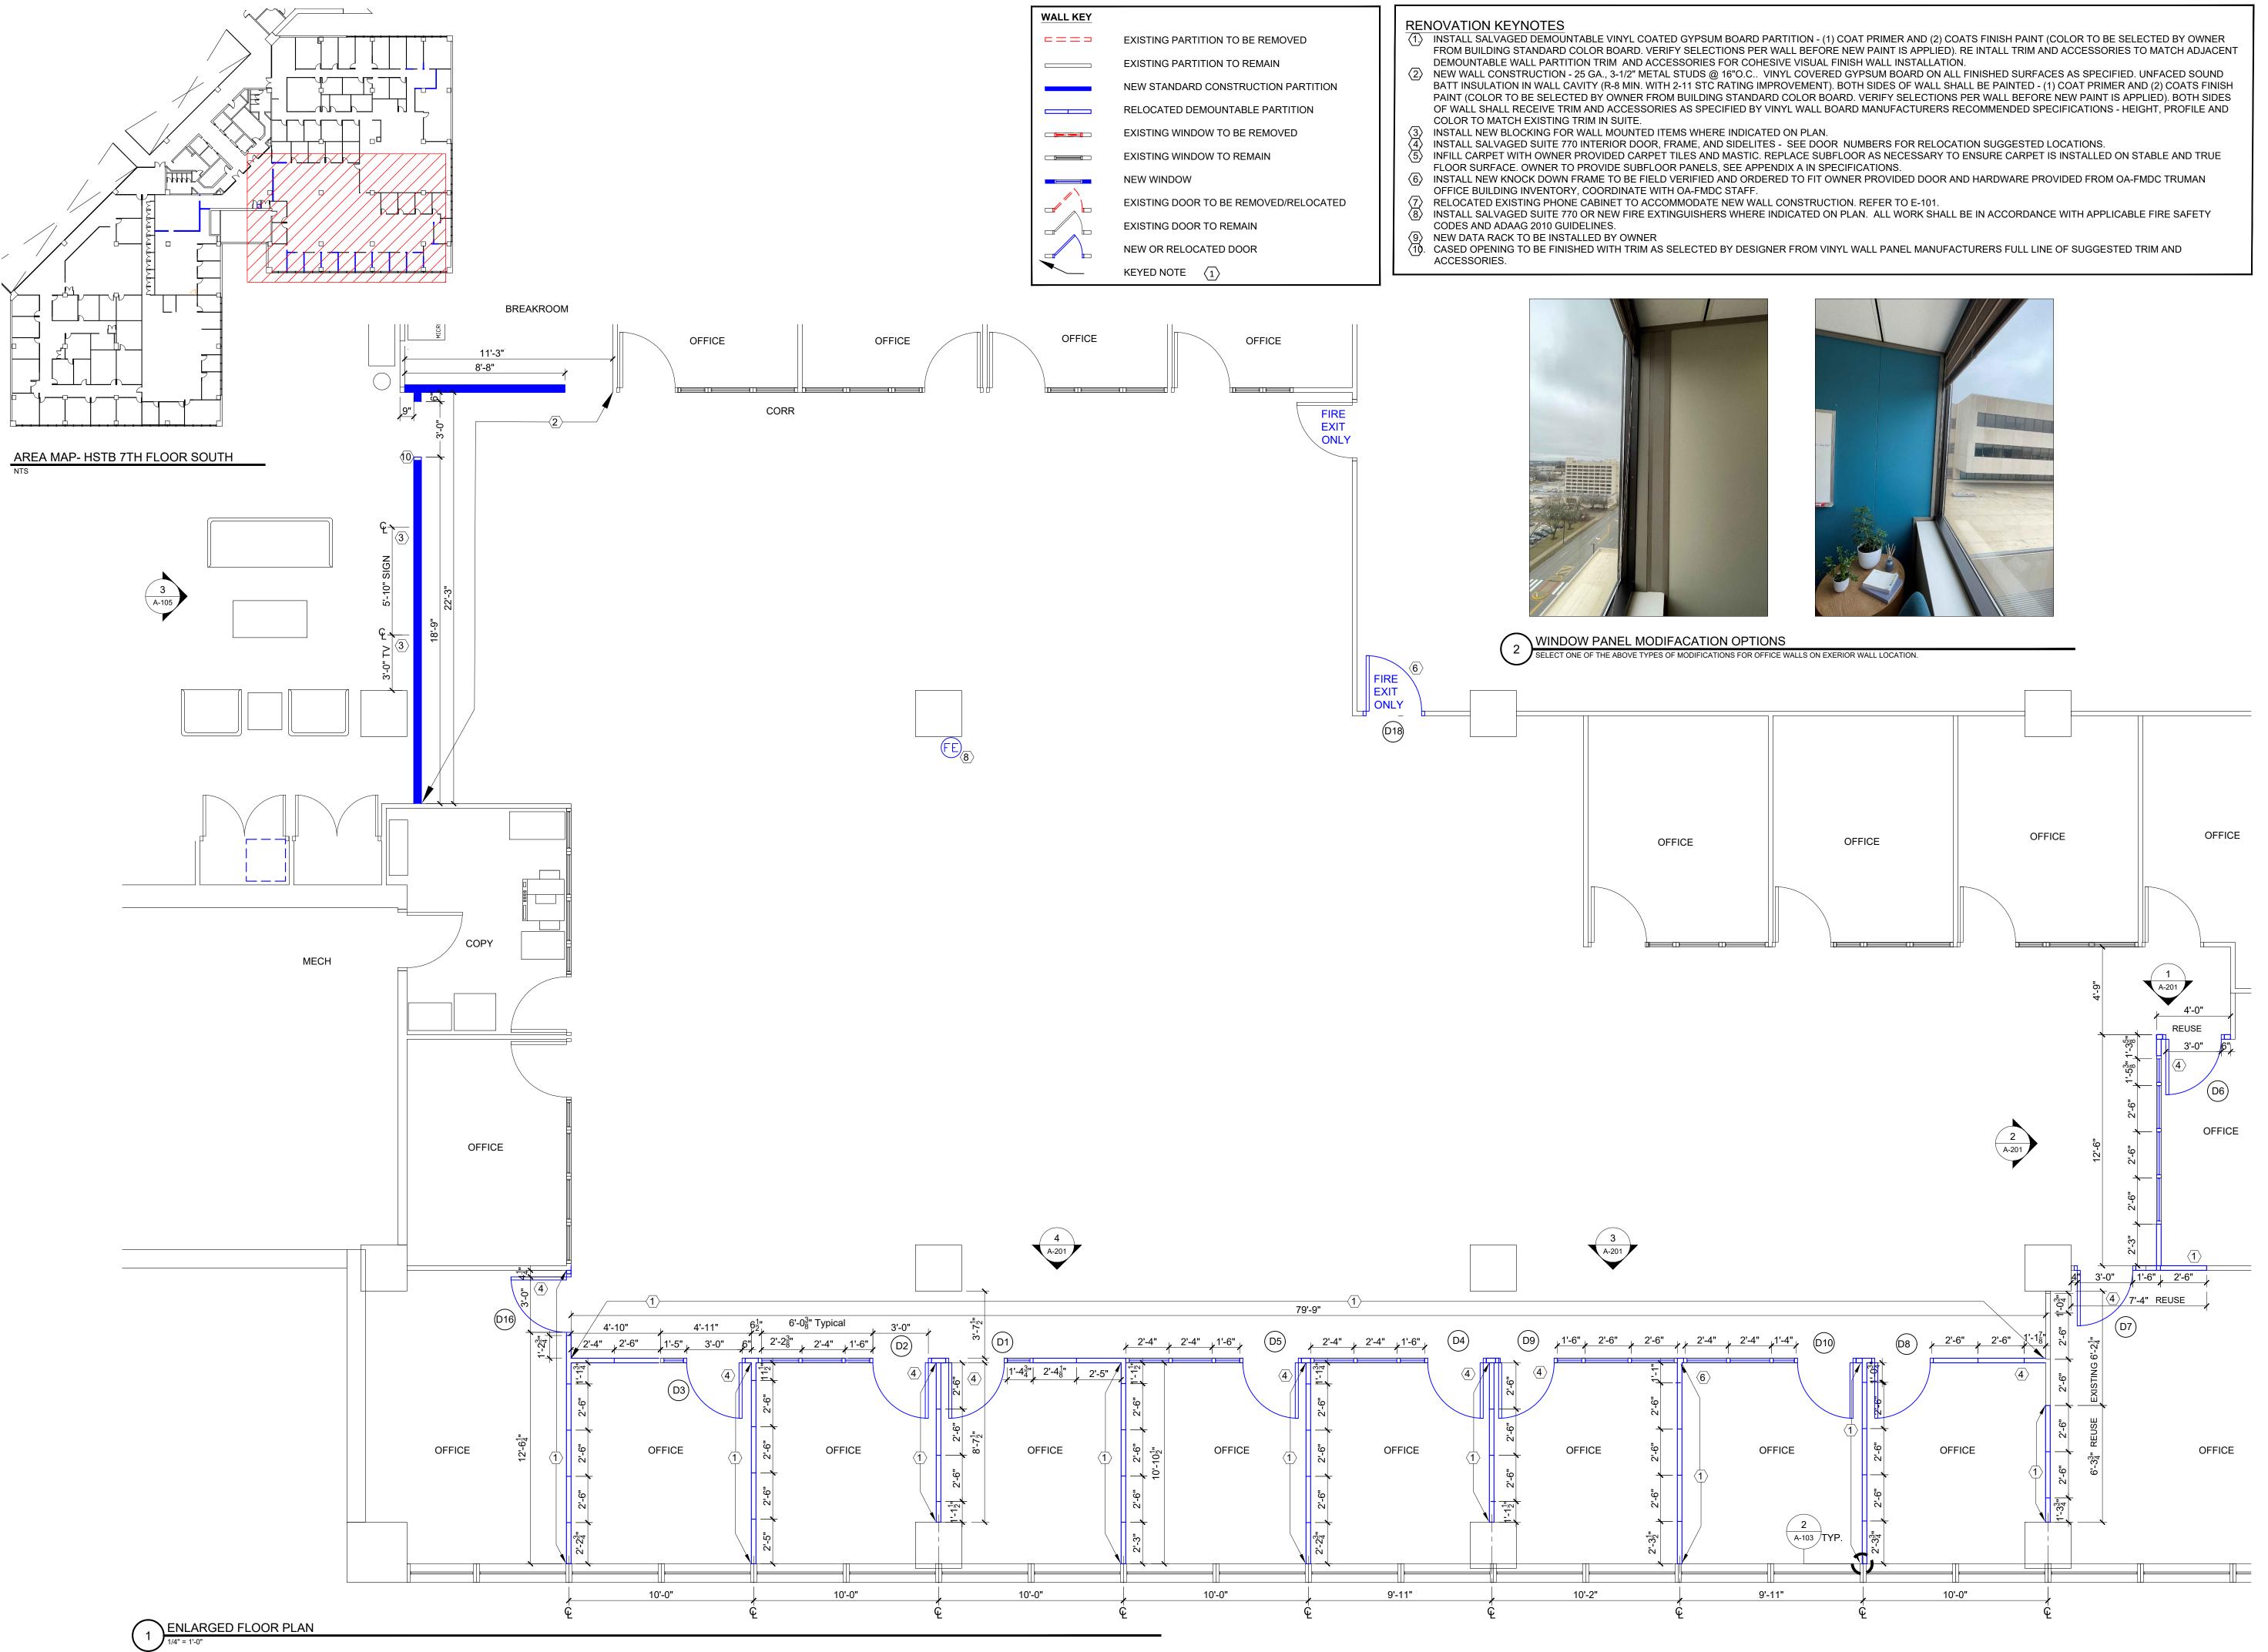
DESIGN

UNIT

GOVERNOR


SHEET NUMBER:

A-102 8 OF 21 SHEETS 1/26/2024





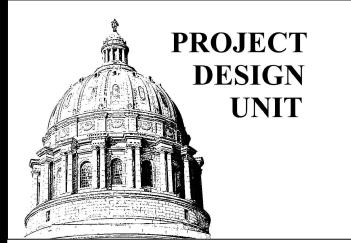STATE OF MISSOURI MICHAEL L. PARSON, GOVERNOR



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OFFICE OF ADMINISTRATION DIVISION OF FACILITIES MANAGEMENT, **DESIGN AND CONSTRUCTION**

DEPARTMENT OF THE OFFICE OF ADMINISTRATION

RENOVATE ECONOMIC DEVELOPMENT OFFICES, SUITE 770

HARRY S. TRUMAN STATE OFFICE BUILDING 301 W HIGH STREET JEFFERSON CITY, MO 65102

| PROJECT # | O2403-01 |
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| SITE # | 0001 |
| ASSET # | 3101001050 |

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| ISSUE DATE: 01/26/2024 |

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SHEET TITLE:

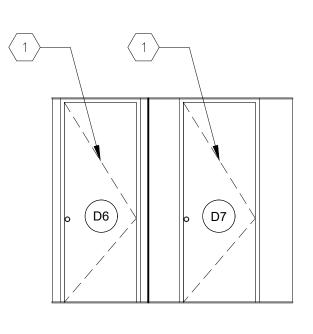
ENLARGED FLOOR PLAN

SHEET NUMBER:

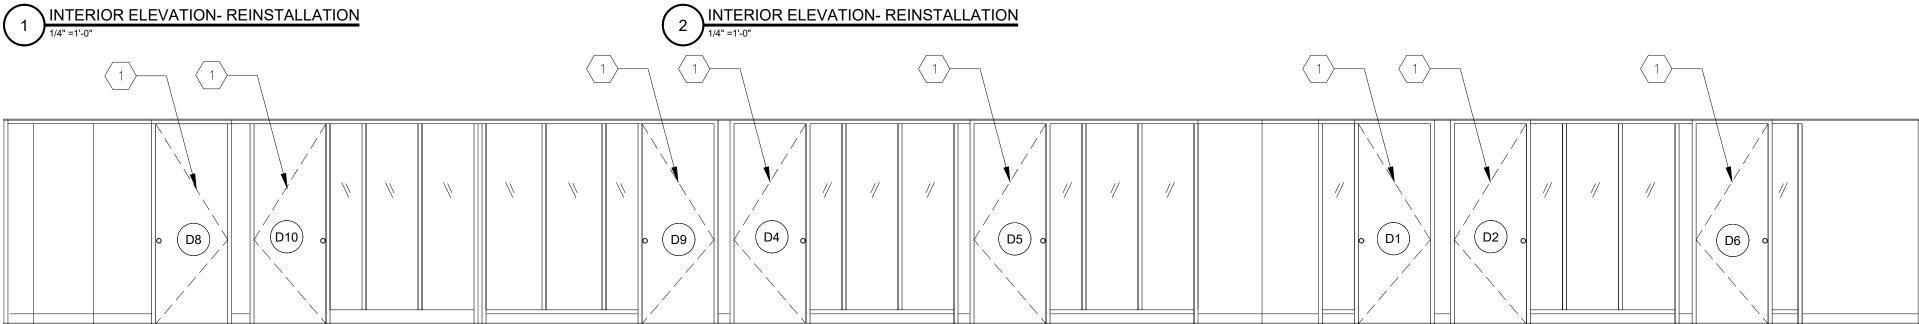
A-103 9 OF 21 SHEETS 1/26/2024

RENOVATION KEYNOTES

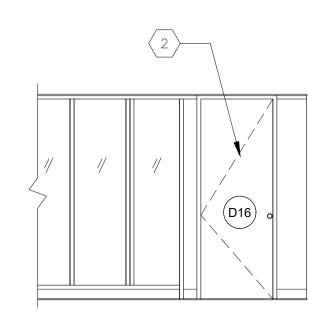
- (1.) RELOCATE EXISTING DOOR, FRAME, AND HARDWARE ASSEMBLY TO NEW LOCATION.
- 2 REUSED OWNER PROVIDED DOOR AND HARDWARE. VERIFY ALL COMPONENTS AND ORDER KNOCK DOWN FRAME TO MATCH EXISTING FRAMES IN STYLE, FINISH AND MATERIAL.
- 3. CONTACT OWNER FOR ADDITIONAL PARTS AND PIECES OF ANY FRAME, GLASS, PANEL OR DOOR TO CHECK OWNER STOCK BEFORE ORDERING NEW.













4 INTERIOR ELEVATION- REINSTALLATION

| DOOR SCHEDULE | | | | |
|---------------|-------------------------|----------|--|--|
| DOOR | | FRAME | REMARKS | |
| NO. | SIZE | TYPE | | |
| D1 | 3'-0x8'-4" | EXISTING | DISASSEMBLE & RELOCATE AS SHOWN. KEEP DOOR, FRAME, & HARDWARE PAIRING INTAC | |
| D2 | 3'-0x8'-4" | EXISTING | DISASSEMBLE & RELOCATE AS SHOWN. KEEP DOOR, FRAME, & HARDWARE IN TACT. | |
| D3 | 3'-0x8'-4" | EXISTING | DISASSEMBLE & RELOCATE AS SHOWN. KEEP DOOR, FRAME, & HARDWARE IN TACT. | |
| D4 | 3'-0x8'-4" | EXISTING | DISASSEMBLE & RELOCATE AS SHOWN. KEEP DOOR, FRAME, & HARDWARE IN TACT. | |
| D5 | 3'-0x8'-4" | EXISTING | DISASSEMBLE & RELOCATE AS SHOWN. KEEP DOOR, FRAME, & HARDWARE IN TACT. | |
| D6 | 3'-0x8'-4" | EXISTING | DISASSEMBLE & RELOCATE AS SHOWN. KEEP DOOR, FRAME, & HARDWARE IN TACT. | |
| D7 | 3'-0x8'-4" | EXISTING | DISASSEMBLE & RELOCATE AS SHOWN. KEEP DOOR, FRAME, & HARDWARE IN TACT. | |
| D8 | 3'-0x8'-4" | EXISTING | DISASSEMBLE & RELOCATE AS SHOWN. KEEP DOOR, FRAME, & HARDWARE IN TACT. | |
| D9 | 3'-0x8'-4" | EXISTING | DISASSEMBLE & RELOCATE AS SHOWN. KEEP DOOR, FRAME, & HARDWARE IN TACT. | |
| D10 | 3'-0x8'-4" | EXISTING | DISASSEMBLE & RELOCATE AS SHOWN. KEEP DOOR, FRAME, & HARDWARE IN TACT. | |
| D11 | 3'-0x8'-4" | - | DOOR AN HARDWARE TO BE REMOVED AN RELINQUISHED TO OWNER FOR REUSE. KEEP DOORS AN FRAMES MATCHED FOR REINSTALLATION. | |
| D12 | 3'-0x8'-4" | - | DOOR AN HARDWARE TO BE REMOVED AN RELINQUISHED TO OWNER FOR REUSE. KEEP DOORS AN FRAMES MATCHED FOR REINSTALLATION. | |
| D13 | 3'-0x8'-4" | - | DOOR AN HARDWARE TO BE REMOVED AN RELINQUISHED TO OWNER FOR REUSE. KEEP DOORS AN FRAMES MATCHED FOR REINSTALLATION. | |
| D14 | 3'-0x8'-4" | - | DOOR AN HARDWARE TO BE REMOVED AN RELINQUISHED TO OWNER FOR REUSE. KEEP DOORS AN FRAMES MATCHED FOR REINSTALLATION. | |
| D15 | 3'-0x8'-4" | - | DOOR AN HARDWARE TO BE REMOVED AN RELINQUISHED TO OWNER FOR REUSE. KEEP DOORS AN FRAMES MATCHED FOR REINSTALLATION. | |
| D16 | 3'-0x8'-4" FIELD VERIFY | NEW | DOOR & HARDWARE PROVIDED BY OWNER. FIELD VERIFY OWNER PROVIDED MATERIALS AND ORDER NEW KNOCK DOWN FRAME TO FIT. FINISH TO MATCH EXISTING | |
| D17 | | - | - | |
| D18 | 3'-0x8'-4" FIELD VERIFY | NEW | DOOR & HARDWARE PROVIDED BY OWNER. FIELD VERIFY OWNER PROVIDED MATERIALS AND ORDER NEW KNOCK DOWN FRAME TO FIT. FINISH TO MATCH EXISTING | |
| D19 | 3'-0x8'-4" | NEW | DOOR, FRAME AND HINGES PROVIDED BY CONTRACTOR. DOOR HARDWARE PROVIDED BY OWNER. FIELD VERIFY AND ORDER NEW SOLID WOOD DOOR TO MATCH EXISTING AND KNOCK DOWN FRAME . FINISH TO MATCH EXISTING | |
| D20 | 3'-0x8'-4" | NEW | DOOR, FRAME AND HINGES PROVIDED BY CONTRACTOR. DOOR HARDWARE PROVIDED BY OWNER. FIELD VERIFY AND ORDER NEW SOLID WOOD DOOR TO MATCH EXISTING AND KNOCK DOWN FRAME . FINISH TO MATCH EXISTING | |

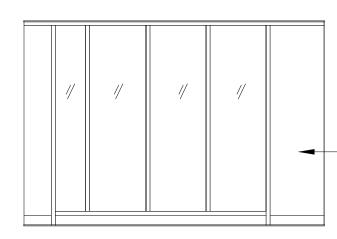

NO DOOR PRESENT IN NEW ELEVATION INSTALL GLASS LITES TO MATCH EXISTING RE-CONSTRUCTION IN SUITE.

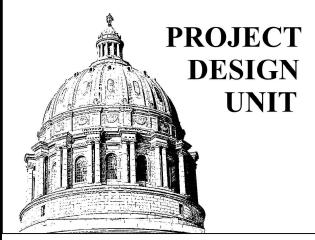STATE OF MISSOURI MICHAEL L. PARSON, GOVERNOR



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DEPARTMENT OF THE OFFICE OF ADMINISTRATION

RENOVATE ECONOMIC DEVELOPMENT OFFICES, SUITE 770

HARRY S. TRUMAN STATE OFFICE BUILDING 301 W HIGH STREET JEFFERSON CITY, MO 65102

PROJECT # 02403-01 SITE # 0001 ASSET # 3101001050

REVISION:


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| ISSUE DATE: 01/26/2024 |

CAD DWG FILE:<u>O2403-01</u> DRAWN BY: <u>RTG</u> CHECKED BY: <u>BS</u> DESIGNED BY: CG


SHEET TITLE: DOOR SCHEDULE

SHEET NUMBER:

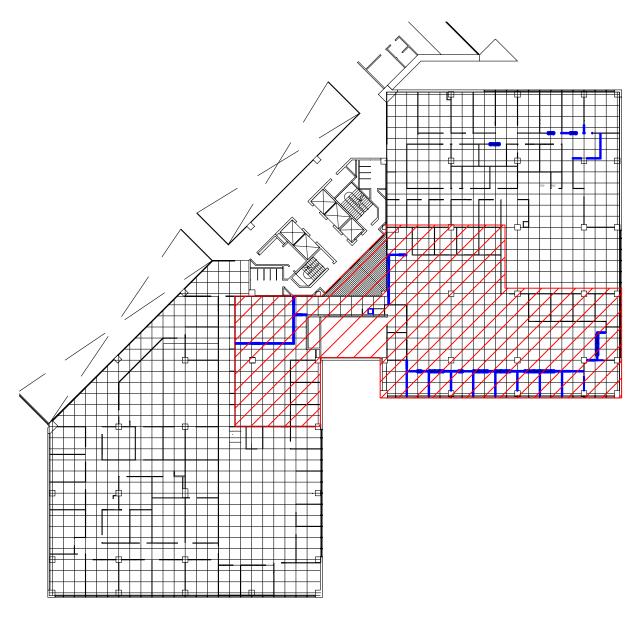A-201 10 OF 21 SHEETS 1/26/2024



AREA MAP- HSTB 7TH FLOOR SOUTH

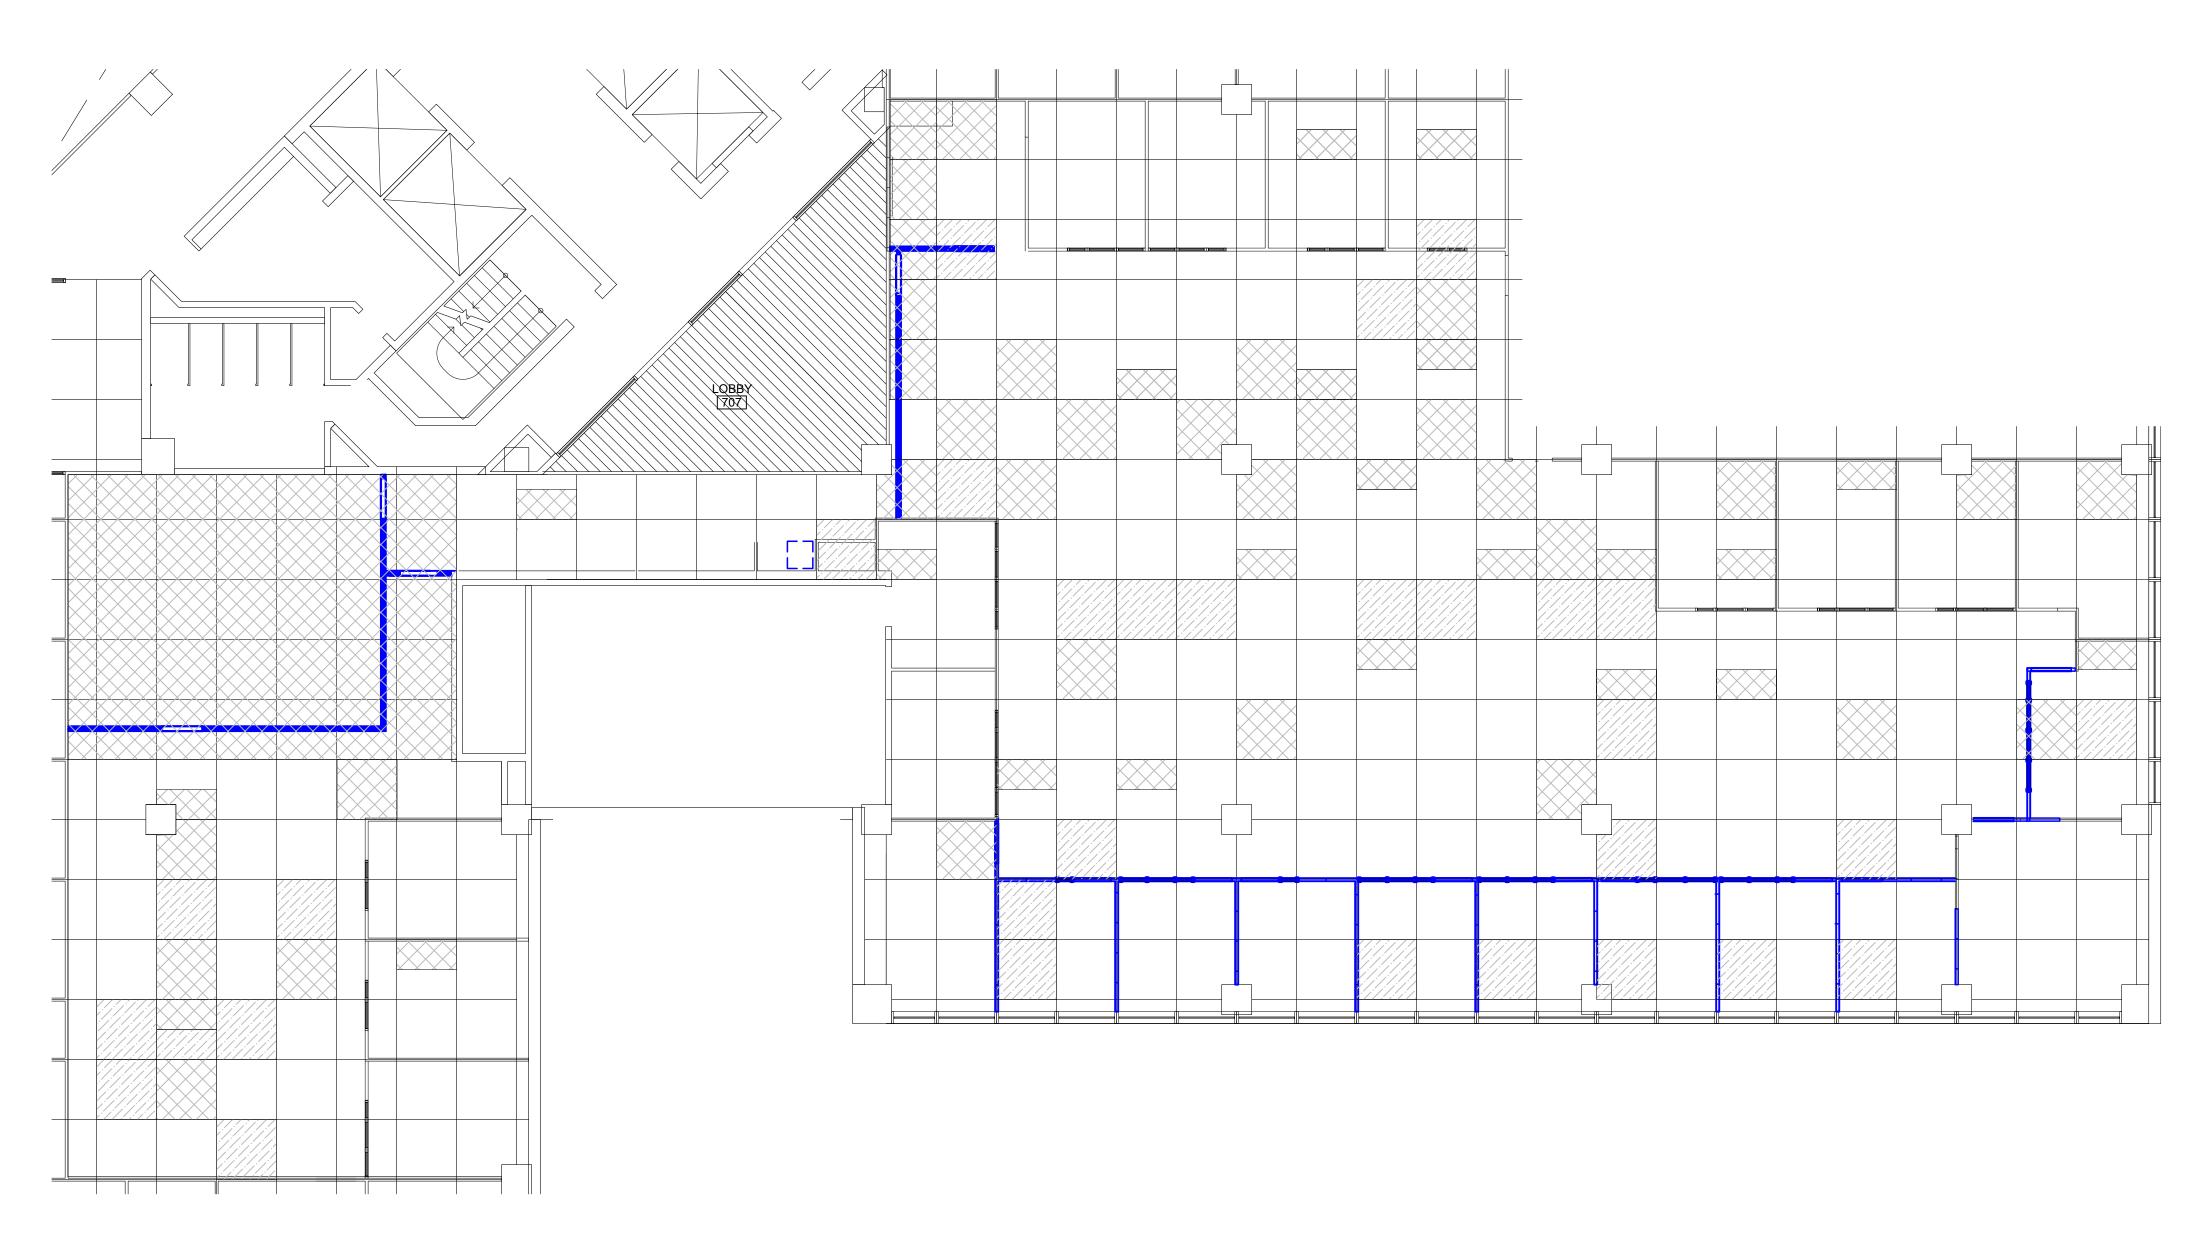


1 REFLECTED CEILING PLAN 1/8" = 1'-0"


NOTES:

- 1. SALVAGE ALL LIGHTS AND FIXTURES FOR REUSE AS NOTED ON MECHANICAL AND ELECTRICA
- 2. SALVAGE AND REUSE ANY REMOVED INSULATED CEILING PANELS IN LIKE NEW CONDITION FOR WORK INSTALLATION.
- 3. COORDINATE DIAGRAM BELOW WITH MECHANICAL, ELECTRICAL, AND PROPOSED FIRE PROTECTION PLAN DRAWINGS
- 4. EXITING LIGHT FIXTURES ARE ABUTTED WITH LIGHT GAUGE PAINTED METAL PANEL. CONTRACTOR IS RESPONSIBLE FOR PROCURING AND INSTALLING ANY NEW PARTS AND PIECES INCLUDING THIS PANEL AND CEILING GRID TO ACCOMMODATE NEW FIXTURES AS NOTED ON ELECTRICAL SHEETS.
- 5. NEW CEILING GRID AND METAL PANELS TO MATCH EXITING IN FINISH AND COLOR.
- 6. REPORT CEILING TILE USAGE TO OWNER ON A WEEKLY BASIS FOR RESTOCKING PURPOSES. CEILING TILES WILL BE PROVIDED BY OWNER.
- 7. COORDINATING FIRE PROTECTION PLAN IS AN ESTIMATE AND IS TO BE VERIFIED BY CONSULTING CONTRACTOR AT RISK.

| CAL SHEETS. | |
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STATE OF MISSOURI MICHAEL L. PARSON, GOVERNOR

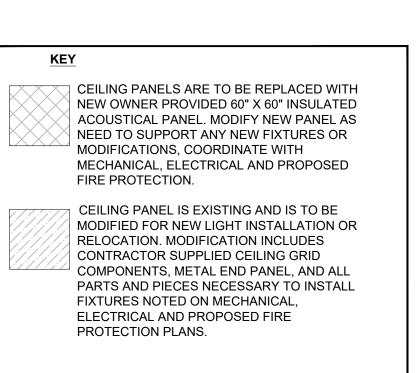

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DEPARTMENT OF THE OFFICE OF ADMINISTRATION

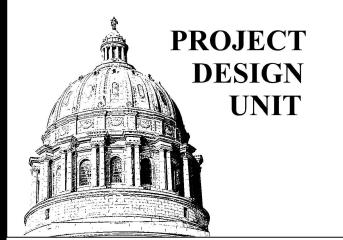RENOVATE ECONOMIC DEVELOPMENT OFFICES, SUITE 770

HARRY S. TRUMAN STATE OFFICE BUILDING 301 W HIGH STREET JEFFERSON CITY, MO 65102

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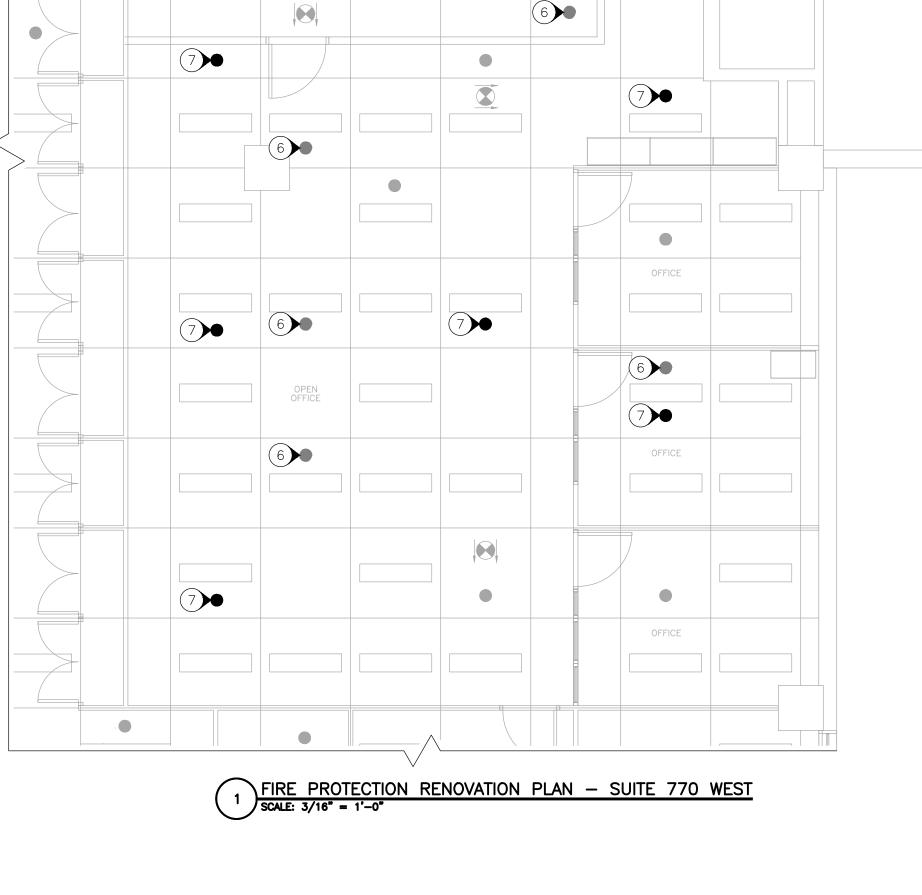
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| ISSUE DATE: 01/26/2024 |

CAD DWG FILE:<u>O2403-01</u> DRAWN BY: <u>RTG</u> CHECKED BY: <u>BS</u> DESIGNED BY: <u>CG</u>

SHEET TITLE: REFLECTED CEILING PLAN

SHEET NUMBER:

A-700 11 OF 21 SHEETS 1/26/2024



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6

CONFERENCE ROOM

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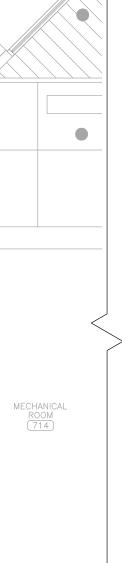
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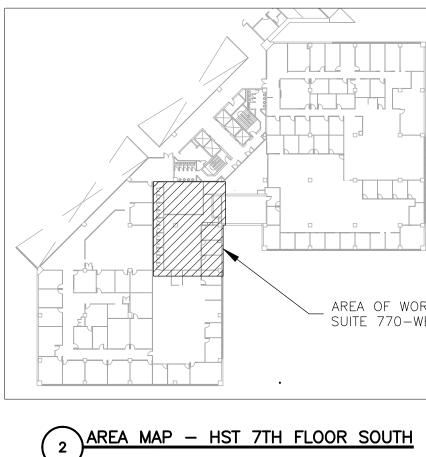
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NOTES





N INDICATES KEYED NOTES

1 FABRICATION, INSTALLATION, AND TESTING OF ALL FIRE PROTECTION DEVICES SHALL BE DONE IN ACCORDANCE WITH THE LATEST VERSION OF NATIONAL FIRE PROTECTION ASSOCIATION'S STANDARD FOR THE INSTALLATION OF SPRINKLER SYSTEMS (NFPA-13), NATIONAL ELECTRIC CODE (NEC) AND ALL MANUFACTURER INSTALLATION GUIDELINES.

2 RENOVATION DRAWINGS AND PLANS ARE FROM FIELD TAKE-OFF AND ORIGINAL DRAWINGS. CONTRACTOR IS RESPONSIBLE FOR FIELD VERIFYING PRIOR TO BIDDING AND/OR CONSTRUCTION.

3 CONTRACTOR IS RESPONSIBLE FOR REMOVAL AND DISPOSAL OF ALL DEMOLISHED MATERIAL, AS WELL AS REPAIRING ANY DAMAGE TO ANY SURFACE IN THE AREA OF CONSTRUCTION THAT IS A RESULT OF CONSTRUCTION ACTIVITY. SURFACE SHALL BE REPAIRED AND FINISHED TO MATCH EXISTING CONDITIONS.

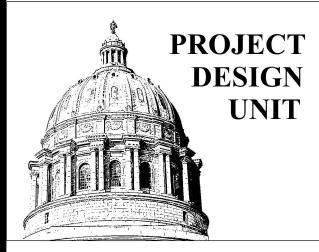
4 COORDINATE WITH OWNER TO SHUT OFF FIRE ALARMS AND FIRE SUPPRESSION SYSTEM IN WORK AREA PRIOR TO BEGINNING CONSTRUCTION. CONSTRUCTION SHALL BE DONE SUCH THAT THE FIRE SUPPRESSION SYSTEM IS ACTIVE OVERNIGHT.

5 DELEGATED DESIGN: LOCATION OF NEW SPRINKLER HEADS ARE FOR REFERENCE ONLY. FIRE PROTECTION CONTRACTOR IS RESPONSIBLE FOR DESIGNING AND PROVIDING A COMPLETE, FUNCTIONAL, AND CODE COMPLIANT SYSTEM.

6 REMOVE AND DISPOSE OF PENDENT TYPE FIRE SPRINKLER HEAD. CAP PIPE WHERE HEAD IS REMOVED OR EXTEND PIPE TO NEW SPRINKLER HEAD LOCATION AS NEEDED. IF PIPE NO LONGER SERVES A SPRINKLER HEAD, REMOVE PIPE AND ALL ASSOCIATED HANGERS BACK TO MAIN AND CAP AT MAIN.

PROVIDE AND INSTALL NEW PENDENT TYPE FIRE SPRINKLER HEAD, ESCUTCHEON AND ALL REQUIRED PIPE. ALL MATERIALS SHALL MATCH EXISTING FINISH AND PERFORMANCE.





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OFFICE OF ADMINISTRATION DIVISION OF FACILITIES MANAGEMENT, **DESIGN AND CONSTRUCTION**

DEPARTMENT OF THE OFFICE OF ADMINISTRATION

RENOVATE ECONOMIC DEVELOPMENT OFFICES, SUITE 770

HARRY S TRUMAN STATE OFFICE BUILDING **301 W HIGH STREET** JEFFERSON CITY, MO 65102

PROJECT # 02403-01 1001 SITE # 3101001050 ASSET #

REVISION: DATE: **REVISION:** DATE: **REVISION:** DATE: ISSUE DATE: 01/26/2024

CAD DWG FILE:<u>MEP_02403-01</u> DRAWN BY: <u>AH/RG</u> CHECKED BY: <u>TS</u> DESIGNED BY: AH

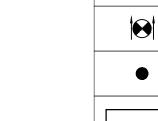
SHEET TITLE: FIRE PROTECTION PLAN - WEST

SHEET NUMBER:

F-101 12 OF 21 SHEETS 01/26/2024




AREA OF WORK SUITE 770-WEST



FIRE PROTECTION LEGEND DIRECTIONAL EXIT SIGN PENDENT FIRE SPRINKLER HEAD/ESCUTCHEON

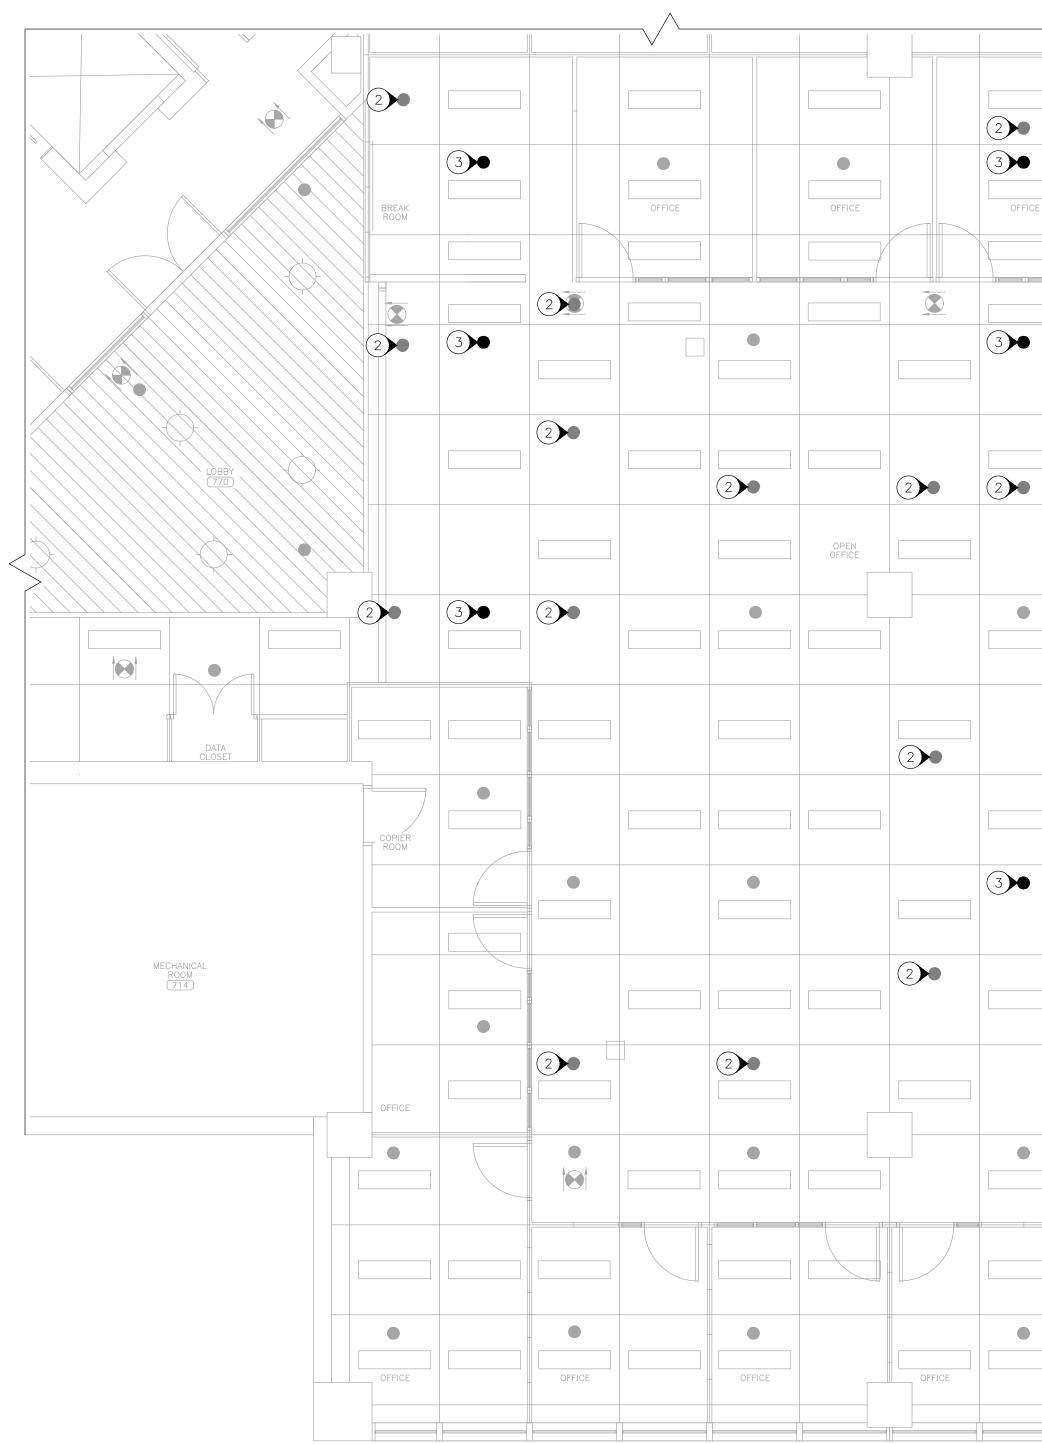LIGHT FIXTURE



$1 \underbrace{FIRE \ PROTECTION \ PLAN \ - \ SUITE \ 770 \ EAST}_{SCALE: \ 3/16" \ = \ 1'-0"}$

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STATE OF MISSOURI


1 REFER TO SHEET F-101 FOR GENERAL NOTES.

2 REMOVE AND DISPOSE OF PENDENT TYPE FIRE SPRINKLER HEAD. CAP PIPE WHERE HEAD IS REMOVED OR EXTEND PIPE TO NEW SPRINKLER HEAD LOCATION AS NEEDED. IF PIPE NO LONGER SERVES A SPRINKLER HEAD, REMOVE PIPE AND ALL ASSOCIATED HANGERS BACK TO MAIN AND CAP AT MAIN. 3 PROVIDE AND INSTALL NEW PENDENT TYPE FIRE SPRINKLER HEAD, ESCUTCHEON AND ALL REQUIRED PIPE. ALL MATERIALS SHALL MATCH EXISTING FINISH AND PERFORMANCE.




01/26/2024

| FIRE | PROTECTION LEGEND |
|------|--|
| | DIRECTIONAL EXIT SIGN |
| | PENDENT FIRE SPRINKLER HEAD/ESCUTCHEON |
| | LIGHT FIXTURE |

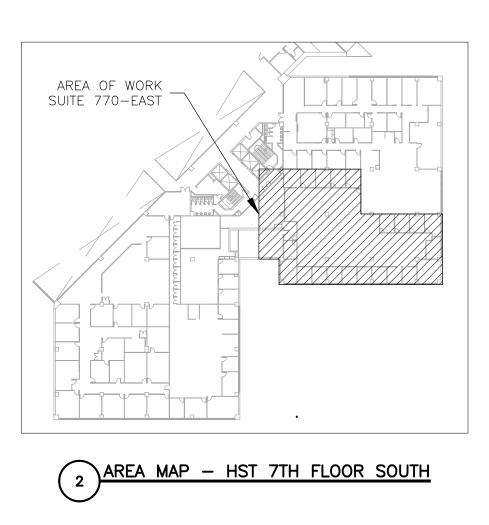



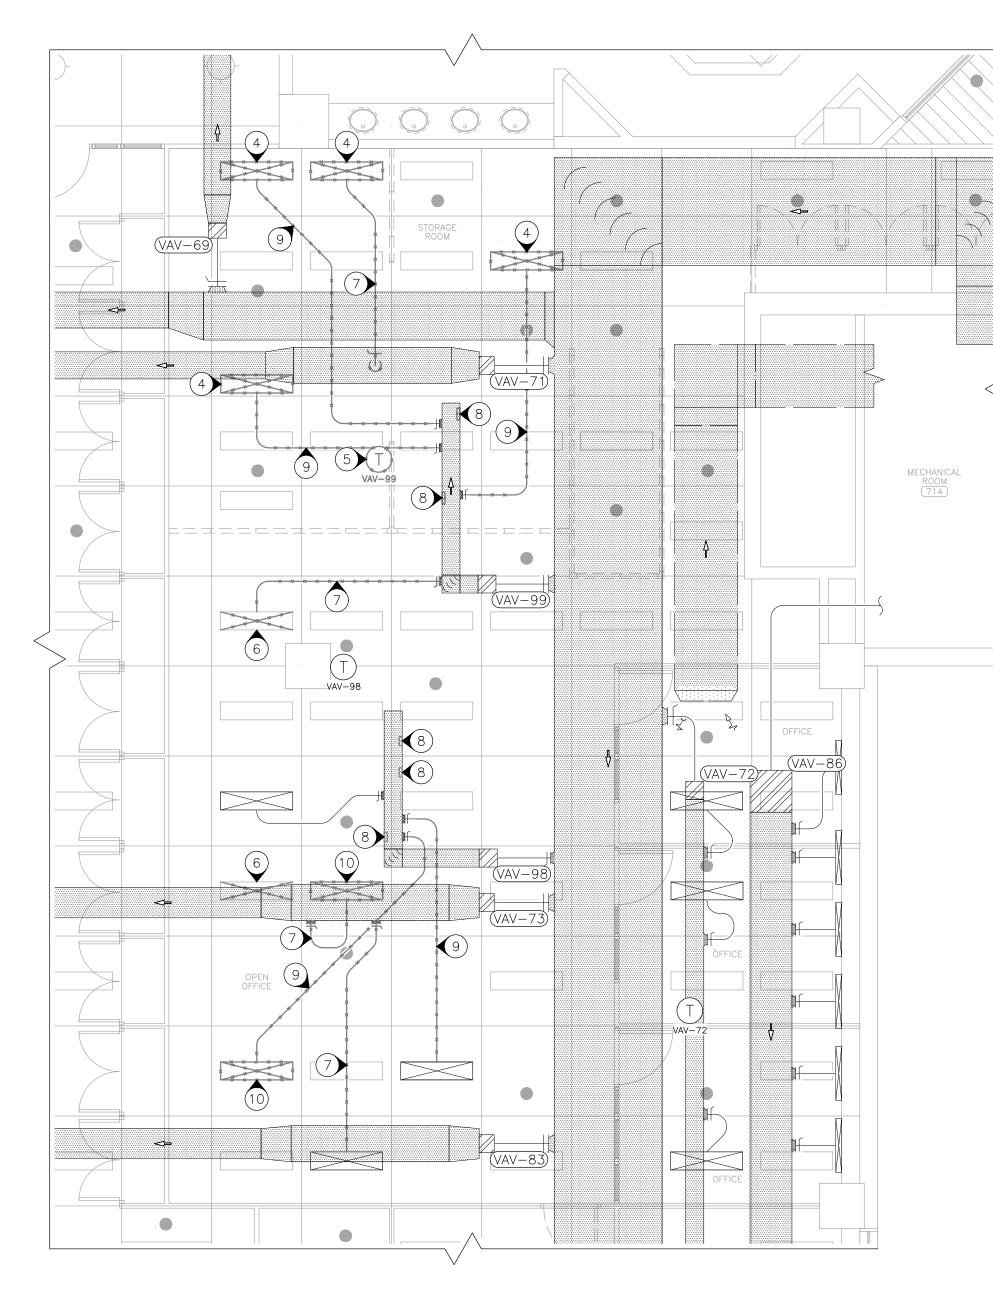
1 MECHANICAL DEMOLITION PLAN - SUITE 770 WEST SCALE: 3/16" = 1'-0"



DEMOLITION NOTES

| 1 | DEMOLITION D IS RESPONSIB |
|---|---|
| 2 | ENSURE DEBR IS NOT ALLOW REMOVAL AND |
| 3 | CONTRACTOR CONSTRUCTION FINISHED TO I |
| 4 | DETACH LIGHT COORDINATE V |
| 5 | REMOVE AND REFER TO SH |
| 6 | DETACH LIGHT CONSTRUCTION |

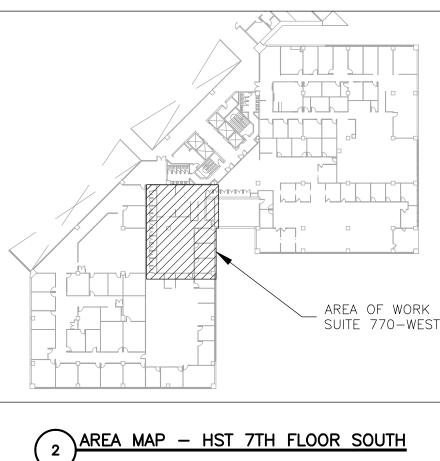7 REMOVE AND DISPOSE OF FLEXIBLE DUCT AND PATCH DUCT AT BRANCH TAKE-OFF. PROVIDE AIR TIGHT SEAL AND INSULATE TO MATCH EXISTING. (8) CREATE PENETRATION IN EXISTING DUCT FOR NEW 6 INCH ROUND TAKE-OFF.



DRAWINGS AND PLANS ARE FROM FIELD TAKE-OFF AND ORIGINAL DRAWINGS. CONTRACTOR IBLE FOR FIELD VERIFYING PRIOR TO BIDDING AND/OR CONSTRUCTION.

BRIS IS REMOVED FROM THE CONSTRUCTION AND DEMOLITION AREA AND AIR BORN DEBRIS DWED TO TRAVEL TO THE REMAINDER OF THE BUILDING. CONTRACTOR IS RESPONSIBLE FOR DISPOSAL OF ALL DEMOLISHED MATERIAL.

R IS RESPONSIBLE FOR REPAIRING ANY DAMAGE TO ANY SURFACE IN THE AREA OF ION THAT IS A RESULT OF CONSTRUCTION ACTIVITY. SURFACE SHALL BE REPAIRED AND MATCH EXISTING CONDITIONS.

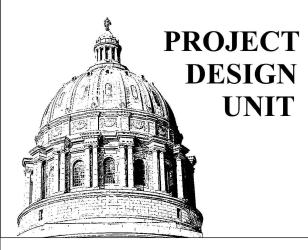
MOUNTED SUPPLY DUCT BOOT AND RETAIN FOR USE IN NEW CONSTRUCTION. WITH ELECTRICAL CONTRACTOR TO REMOVE AND RETAIN LIGHT.

RETAIN THERMOSTAT AND ASSOCIATED JUNCTION BOX FOR USE IN NEW CONSTRUCTION. HEET M-101 FOR NEW LOCATION.

MOUNTED SUPPLY DUCT BOOT FROM LIGHT FIXTURE AND RETAIN FOR USE IN NEW ON. LIGHT FIXTURE TO REMAIN.

(9) REMOVE AND DISPOSE OF FLEXIBLE DUCT. TAKE-OFF TO REMAIN FOR USE IN NEW CONSTRUCTION. (1) COORDINATE WITH ELECTRICAL CONTRACTOR TO REMOVE AND RETAIN LIGHT AND LIGHT MOUNTED SUPPLY DUCT BOOT FOR USE IN NEW CONSTRUCTION.





BI

OFFICE OF ADMINISTRATION DIVISION OF FACILITIES MANAGEMENT, **DESIGN AND CONSTRUCTION**

DEPARTMENT OF THE OFFICE OF ADMINISTRATION

RENOVATE ECONOMIC DEVELOPMENT OFFICES, SUITE 770

HARRY S TRUMAN STATE OFFICE BUILDING 301 W HIGH STREET JEFFERSON CITY, MO 65102

PROJECT # 02403-01 SITE # 1001 3101001050 ASSET #

REVISION: DATE: **REVISION:** DATE: **REVISION**: DATE: ISSUE DATE: 01/26/2024

CAD DWG FILE:<u>MEP_02403-01</u> DRAWN BY: <u>AH/RG</u> CHECKED BY: <u>TS</u> DESIGNED BY: AH

SHEET TITLE: MECHANICAL DEMOLITION PLAN - WEST

SHEET NUMBER:

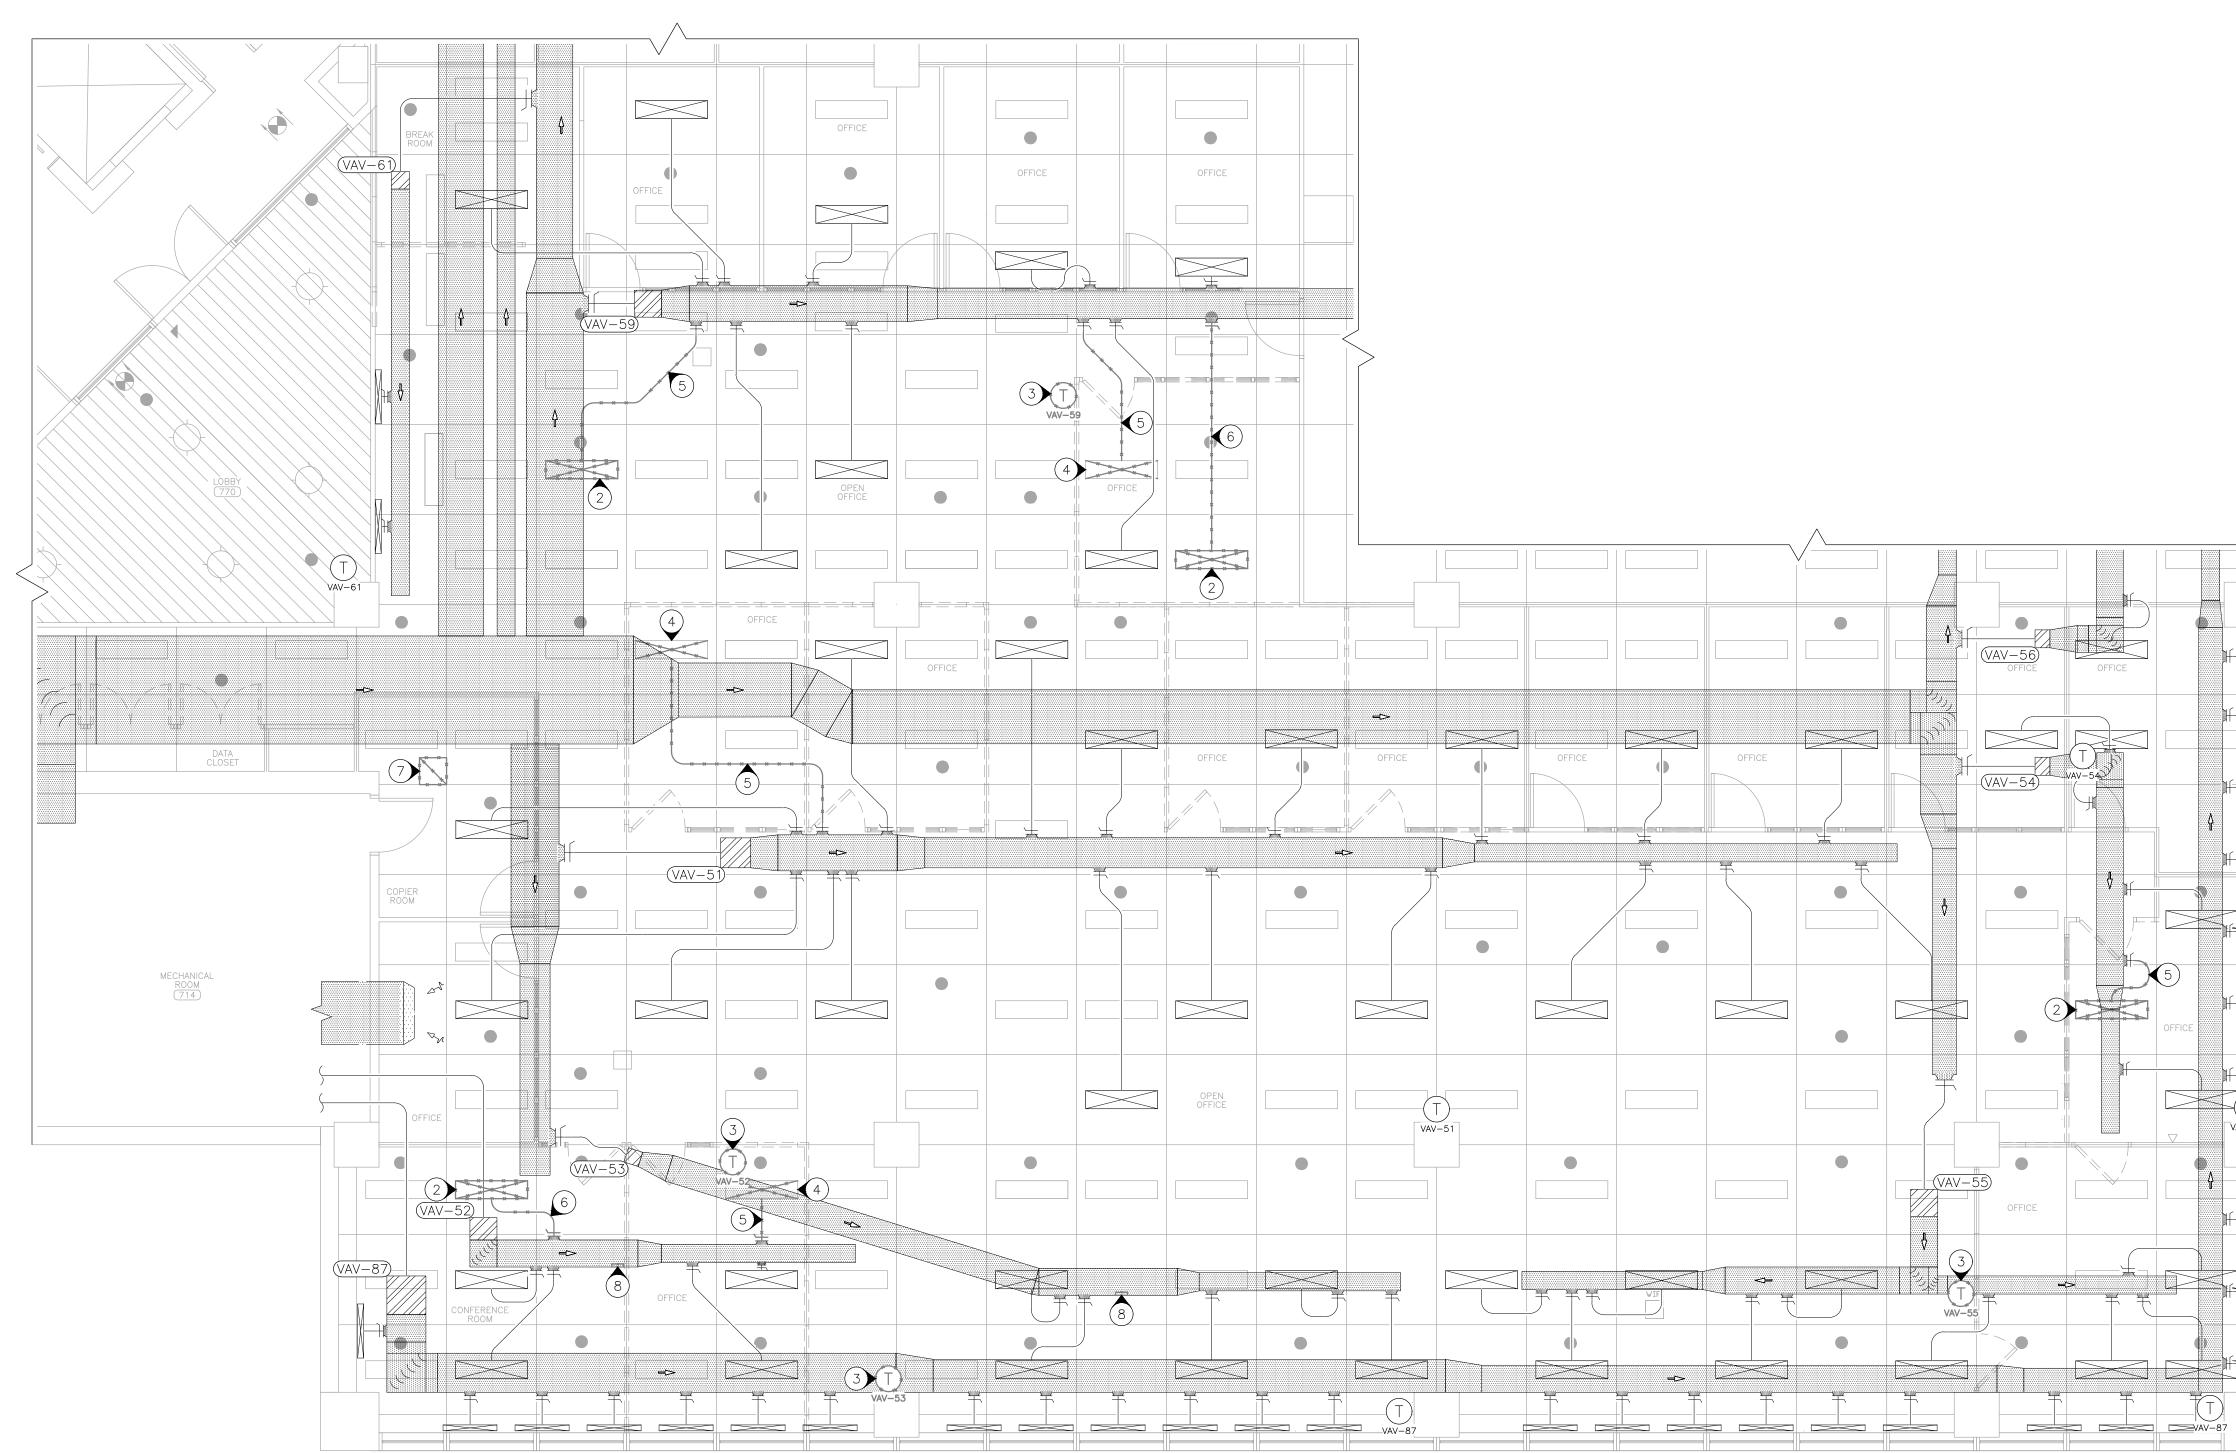
01/26/2024

MD-101 14 OF 21 SHEETS

HVAC LEGEND

•

PENDENT FIRE SPRINKLER HEAD/ESCUTCHEON $\left(\begin{array}{c} T \\ VAV-N \end{array} \right)$ THERMOSTAT WITH EQUIPMENT LABEL (VAV-NN) EXISTING EQUIPMENT LABEL DIRECTION OF FLOW SUPPLY AIR - EXISTING RETURN AIR – EXISTING _____ · ____





DEMOLITION NOTES

| REFER TO SH |
|------------------------------|
| COORDINATE V SUPPLY DUCT |
| REMOVE AND REFER TO SH |
| DETACH LIGHT CONSTRUCTION |
| REMOVE AND |
| REMOVE AND TIGHT SEAL A |
| REMOVE AND EXCESS T—BA |
| |

1 MECHANICAL DEMOLITION PLAN - SUITE 770 EAST SCALE: 3/16" = 1'-0"

SHEET MD-101 FOR GENERAL DEMOLITION NOTES.

WITH ELECTRICAL CONTRACTOR TO REMOVE AND RETAIN LIGHT AND LIGHT MOUNTED BOOT FOR USE IN NEW CONSTRUCTION.

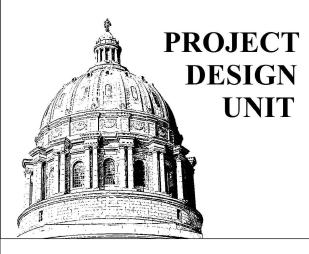
RETAIN THERMOSTAT AND ASSOCIATED JUNCTION BOX FOR USE IN NEW CONSTRUCTION. HEET M-102 FOR NEW LOCATION.

HT MOUNTED SUPPLY DUCT BOOT FROM LIGHT FIXTURE AND RETAIN FOR USE IN NEW ION. LIGHT FIXTURE TO REMAIN.

DISPOSE OF FLEXIBLE DUCT. TAKE-OFF TO REMAIN FOR USE IN NEW CONSTRUCTION. D DISPOSE OF FLEXIBLE DUCT AND PATCH DUCT AT BRANCH TAKE-OFF. PROVIDE AIR AND INSULATE TO MATCH EXISTING.

D DISPOSE OF RETURN GRILLE. COORDINATE WITH GENERAL CONTRACTOR TO REMOVE BAR GRID AND REPLACE WITH FULL OWNER PROVIDED CEILING TILE. (8) CREATE PENETRATION IN EXISTING DUCT FOR NEW 6 INCH ROUND TAKE-OFF.





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RENOVATE ECONOMIC DEVELOPMENT OFFICES, SUITE 770

HARRY S TRUMAN STATE OFFICE BUILDING 301 W HIGH STREET JEFFERSON CITY, MO 65102

PROJECT # 02403-01 1001 SITE # ASSET # 3101001050

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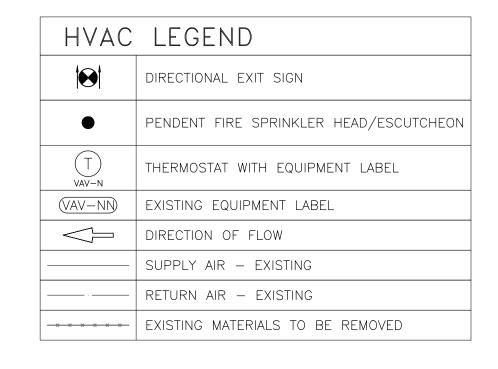
SHEET TITLE:


MECHANICAL DEMOLITION PLAN - EAST


SHEET NUMBER:


MD-102

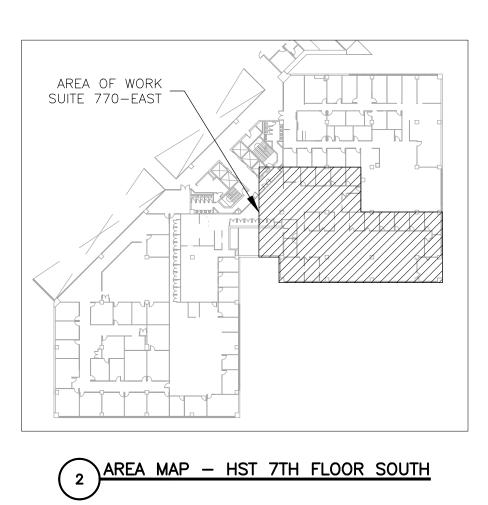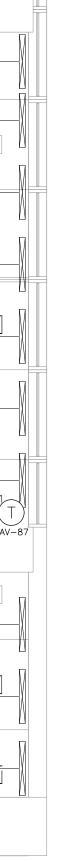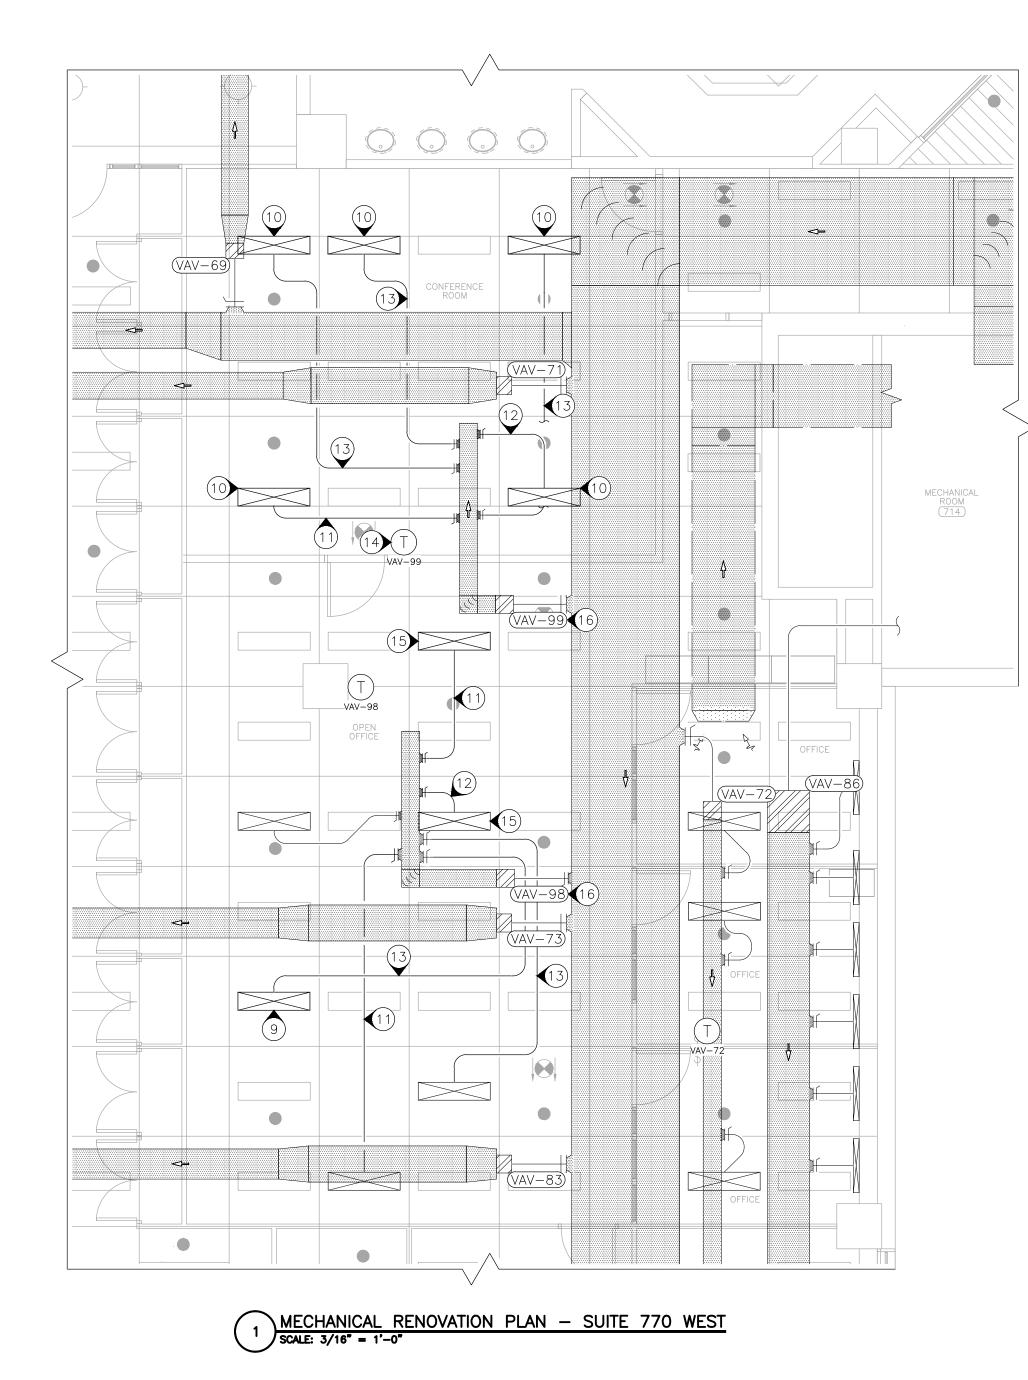15 OF 21 SHEETS 01/26/2024










RENOVATION NOTES

- INSTALLATION GUIDELINES.
- INCHES.

- DUCT SEAMS SHALL BE SEALED. BARRIER.

- SUPPLY DUCT BOOT.
- FIXTURE.

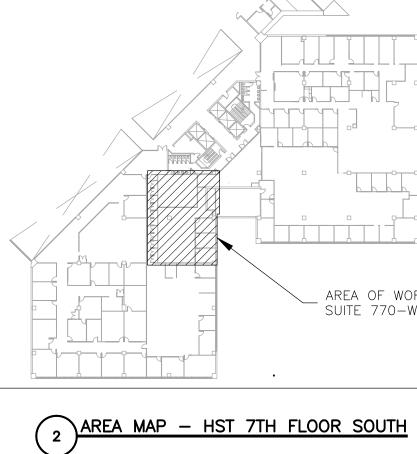- FINISHED FLOOR.



1 FABRICATION, INSTALLATION AND TESTING OF ALL HVAC SYSTEMS SHALL BE IN ACCORDANCE WITH THE LATEST VERSION OF THE INTERNATIONAL MECHANICAL CODE (IMC) AND ALL MANUFACTURER

2 ALL METALLIC AND FLEXIBLE DUCTS SHALL BE CONSTRUCTED AND INSTALLED AS SPECIFIED IN THE IMC AND SMACNA HVAC DUCT CONSTRUCTION STANDARDS.

3 DUCT HAS BEEN DESIGNED TO FIT IN THE SPACE AVAILABLE AND TO AVOID CONFLICTS. CONTRACTOR SHALL FIELD VERIFY FOR ANY UNFORESEEN CONFLICTS PRIOR TO FABRICATING DUCT. CONTRACTOR SHALL COORDINATE WITH OTHER DISCIPLINES TO ENSURE ADEQUATE SPACE IS AVAILABLE FOR DUCT. IF DUCT IS ROUTED ABOVE OTHER DUCT, COORDINATE ELEVATION OF EACH DUCT PRIOR TO INSTALLATION TO ENSURE IT WILL FIT IN THE SPACE AVAILABLE. DESIGN INSULATION THICKNESS IS 1.5

4 THIRD PARTY, AABC OR NEBB CERTIFIED TESTING, ADJUSTING, AND BALANCING CONTRACTOR SHALL TEST AND BALANCE ALL SYSTEMS TO SPECIFIED VALUES AND PREPARE A BALANCE REPORT PER ASHRAE STANDARD 111 OR EQUAL. REPORT SHALL BE SENT TO THE ENGINEER FOR APPROVAL PRIOR TO FINAL COMPLETION. BALANCE DAMPERS ARE REQUIRED ON ALL SUPPLY AIR DEVICES. REFERENCE SPECIFICATIONS FOR ADDITIONAL INFORMATION.

5 DIMENSIONS ARE INCHES MEASURED INSIDE. ROUND DUCT SHALL MAINTAIN A CENTERLINE TURNING RADIUS OF 1.5 X DUCT DIAMETER. FLEXIBLE DUCT SHALL BE 5 FEET MAXIMUM LENGTH AND BE SUPPORTED TO MINIMIZE STATIC PRESSURE DROP.

6 ALL INSULATION SHALL MEET THE ASTM E 84 FLAME/SMOKE SPREAD INDEX OF 25/50 MAXIMUM.

• SUPPLY DUCT LOCATED ABOVE THE CEILING: EXTERNAL INSULATION; INSTALLED THICKNESS OF 1.5 INCHES WITH MINIMUM THERMAL CONDUCTIVITY OF 0.25 BTU-IN/HR/SF/°F (R6) WITH VAPOR

• FLEXIBLE DUCT: 1 INCH THICK FACTORY INSTALLED.

7 PROVIDE SUITABLE SUPPORTS FOR STABILITY OF ALL HVAC DEVICES AND DUCT.

8 UNLESS OTHERWISE SPECIFIED ALL AIR DEVICES AND THERMOSTATS ARE TO BE REUSED FROM MATERIAL REMOVED AND RETAINED DURING DEMOLITION.

(9) COORDINATE WITH ELECTRICAL CONTRACTOR TO INSTALL RETAINED LIGHT FIXTURE WITH LIGHT MOUNTED

(10) COORDINATE WITH ELECTRICAL CONTRACTOR TO INSTALL RETAINED SUPPLY DUCT BOOT ON NEW LIGHT

(1) INSTALL NEW TAKE-OFF AND ROUTE 6 INCH GALVANIZED DUCT FROM NEW TAKE-OFF AND EXTEND TO SUPPLY DUCT BOOT AS SHOWN. PROVIDE NEW FLEXIBLE DUCT AT SUPPLY DUCT BOOT FOR FINAL CONNECTION AND PROVIDE AIR TIGHT SEAL.

(12) INSTALL NEW TAKE-OFF AND ROUTE 6 INCH FLEXIBLE DUCT FROM NEW TAKE-OFF AND EXTEND TO SUPPLY DUCT BOOT AS SHOWN AND PROVIDE AIR TIGHT SEAL.

(13) PROVIDE AND INSTALL 6 INCH ROUND GALVANIZED DUCT FROM EXISTING SUPPLY TAKE-OFF AT MAIN AND EXTEND TO SUPPLY DUCT BOOT AS SHOWN. PROVIDE NEW FLEXIBLE DUCT AT SUPPLY DUCT BOOT FOR FINAL CONNECTION AND PROVIDE AIR TIGHT SEAL.

(14) INSTALL RETAINED THERMOSTAT IN NEW LOCATION. INSTALL AT A HEIGHT OF 60 INCHES FROM

(15) ATTACH RETAINED SUPPLY DUCT BOOT ON TO EXISTING LIGHT FIXTURE.

(16) COORDINATE WITH OWNER TO PLACE SYSTEM INTO MAXIMUM COOLING PRIOR TO TESTING AND BALANCING PROCEDURE. ADJUST VAV DAMPER TO 100% AND MEASURE AIRFLOW. ADJUST SUPPLY AIR DIFFUSERS SUCH THAT AIRFLOW IS EVENLY DISTRIBUTED.




AREA OF WORK SUITE 770-WEST

| HVAC | LEGEND |
|------------|--|
| | DIRECTIONAL EXIT SIGN |
| • | PENDENT FIRE SPRINKLER HEAD/ESCUTCHEON |
| T VAV-N | THERMOSTAT WITH EQUIPMENT LABEL |
| (VAV-NN) | EXISTING EQUIPMENT LABEL |
| | DIRECTION OF FLOW |
| | SUPPLY AIR |
| | SUPPLY AIR – EXISTING |

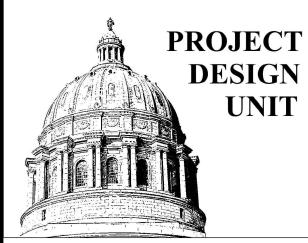RETURN AIR – EXISTING





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RENOVATE ECONOMIC DEVELOPMENT OFFICES, SUITE 770

HARRY S TRUMAN STATE OFFICE BUILDING 301 W HIGH STREET JEFFERSON CITY, MO 65102

PROJECT # 02403-01 1001 SITE # 3101001050 ASSET #

REVISION: DATE: **REVISION:** DATE: **REVISION:** DATE: ISSUE DATE: 01/26/2024

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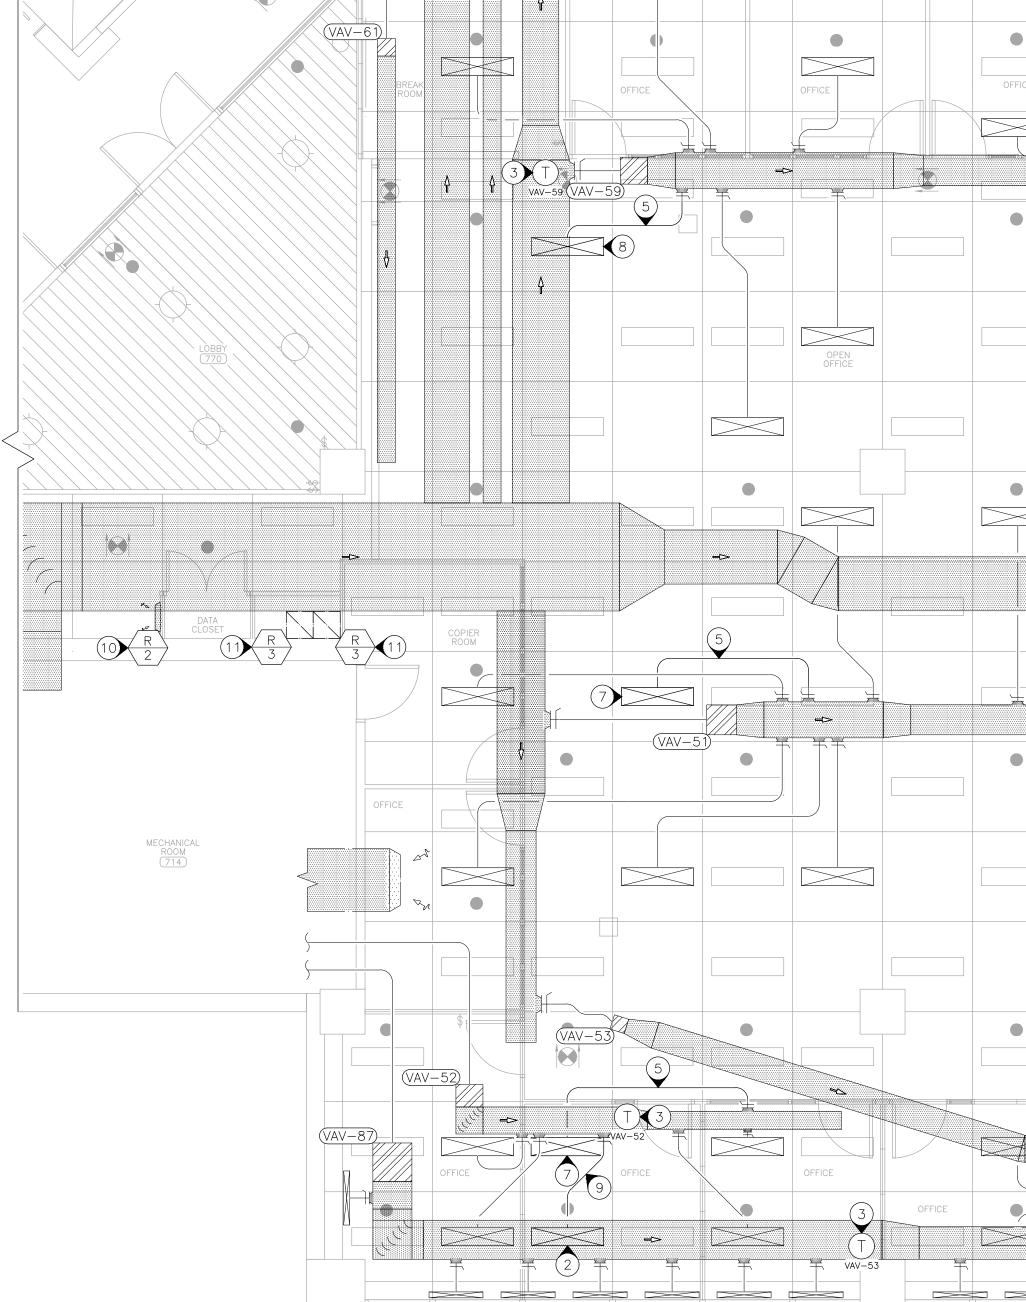
SHEET TITLE: MECHANICAL RENOVATION

PLAN - WEST

SHEET NUMBER:

M-101 16 OF 21 SHEETS 01/26/2024







|)E | VICE SCHEDU | ILE | | | | | | | |
|----|--|--------------------|---|--|-------|--|--|--|--|
| | MANUFACTURER | MODEL | ТҮРЕ | SPECIFICATION | NOTES | | | | |
| | PRICE | TBR150 | RETURN LAYIN MOUNT T-BAR DIFFUSER | 1-1/2" SLOT T-BAR DIFFUSER WITH EXTRUDED ALUMINUM CENTER TEE AND COATED STEEL PLENUM | 1,2,3 | | | | |
| | PRICE | 535 | RETURN SURFACE MOUNT | STEEL, WHITE, LOUVER FACE, 45° DEFLECTION, 1/2 INCH BLADE SPACING, BLADES PARALLEL TO LONG DIMENSION | 3,4 | | | | |
| | PRICE | 80 | RETURN LAYIN MOUNT EGG CRATE | FRAME: EXTRUDED ALUMINUM; MESH: 1 INCH SQUARE | 3,4 | | | | |
| | _ | | | | | | | | |
| | PROVIDE 2 SLOTS AND A LENGTH OF 5 FEET | | | | | | | | |
| | PROVIDE COATED FI | BERGLASS INSULATIO | DN | | | | | | |
| | PROVIDE BAKED ENAMEL WHITE FINISH | | | | | | | | |
| | | | | | | | | | |

4 PROVIDE A FACE SIZE OF 22 INCH x 22 INCH

RENOVATION NOTES

| 1 | REFER TO SHEE |
|---|--|
| 2 | COORDINATE WIT SUPPLY DUCT E |
| 3 | INSTALL RETAINE FINISHED FLOOR |
| 4 | PROVIDE AND IN MODIFY EXISTING |
| 5 | PROVIDE AND IN AND EXTEND TO BOOT FOR FINA |
| 6 | PROVIDE AND IN EXTEND TO SUP |
| 7 | ATTACH RETAINE TO INSTALL FIX ⁻ |
| 8 | ATTACH RETAINE |
| 9 | INSTALL NEW TA |

6 👌 \wedge (VAV-56) OFFICE OFFICE (VAV-54) الک 6 T VAV-51 (VAV-55 3 T VAV-55 $-(\top)$ VAV-87

1 MECHANICAL RENOVATION PLAN - SUITE 770 EAST SCALE: 3/16" = 1'-0"

EET M-101 FOR GENERAL RENOVATION NOTES.

WITH ELECTRICAL CONTRACTOR TO INSTALL RETAINED LIGHT FIXTURE WITH LIGHT MOUNTED BOOT.

NED THERMOSTAT IN NEW LOCATION. INSTALL AT A HEIGHT OF 60 INCHES FROM

INSTALL NEW RETURN AIR GRILLE (R-1). COORDINATE WITH GENERAL CONTRACTOR TO NG CEILING TILES TO ACCOMMODATE NEW AIR DEVICE.

INSTALL 6 INCH ROUND GALVANIZED DUCT FROM EXISTING SUPPLY TAKE-OFF AT MAIN TO SUPPLY DUCT BOOT AS SHOWN. PROVIDE NEW FLEXIBLE DUCT AT SUPPLY DUCT VAL CONNECTION AND PROVIDE AIR TIGHT SEAL.

INSTALL 6 INCH FLEXIBLE DUCT FROM EXISTING SUPPLY TAKE-OFF AT MAIN AND UPPLY DUCT BOOT AS SHOWN. PROVIDE AIR TIGHT SEAL.

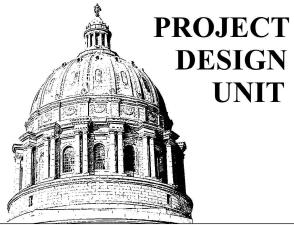
NED SUPPLY DUCT BOOT TO LIGHT FIXTURE. COORDINATE WITH ELECTRICAL CONTRACTOR IXTURE IN NEW LOCATION.

NED SUPPLY DUCT BOOT TO EXISTING LIGHT FIXTURE.

(9) INSTALL NEW TAKE-OFF AND ROUTE 6 INCH FLEXIBLE DUCT FROM NEW TAKE-OFF AND EXTEND TO SUPPLY DUCT BOOT AS SHOWN AND PROVIDE AIR TIGHT SEAL.

(10) PROVIDE AND INSTALL RETURN AIR GRILLE AT A HEIGHT OF 5 INCHES FROM FINISHED FLOOR. (11) COORDINATE WITH GENERAL CONTRACTOR TO MODIFY EXISTING CEILING TILE TO ACCOMMODATE NEW RETURN AIR GRILLE.





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OFFICE OF ADMINISTRATION DIVISION OF FACILITIES MANAGEMENT, **DESIGN AND CONSTRUCTION**

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RENOVATE ECONOMIC DEVELOPMENT OFFICES, SUITE 770

HARRY S TRUMAN STATE OFFICE BUILDING 301 W HIGH STREET JEFFERSON CITY, MO 65102

| PROJECT # | O2403-01 |
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| SITE # | 1001 |
| ASSET # | 3101001050 |

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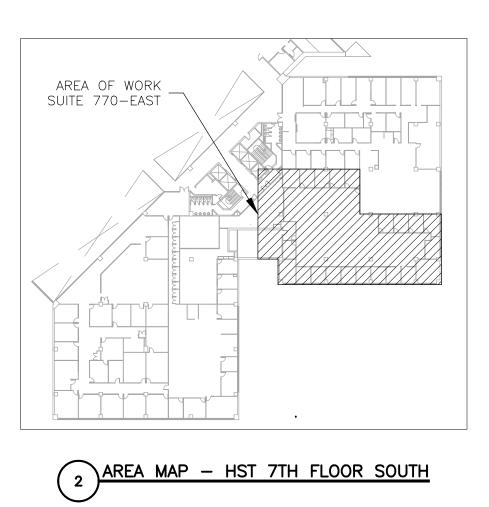
SHEET TITLE:

MECHANICAL RENOVATION PLAN - EAST

SHEET NUMBER:

M-102 17 OF 21 SHEETS 01/26/2024

| HVAC | LEGEND |
|--------------|--|
| | DIRECTIONAL EXIT SIGN |
| • | PENDENT FIRE SPRINKLER HEAD/ESCUTCHEON |
| (T) VAV-N | THERMOSTAT WITH EQUIPMENT LABEL |
| (VAV-NN) | EXISTING EQUIPMENT LABEL |
| | DIRECTION OF FLOW |
| AA N | DEVICE SCHEDULE TAG |
| | SUPPLY AIR |
| · · | RETURN AIR |
| | SUPPLY AIR – EXISTING |
| · | RETURN AIR – EXISTING |




ELECTRICAL DEMOLITION PLAN - SUITE 770 WEST SCALE: 3/16" = 1'-0"


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| | | | | | 6 | 3 | | | |
| | | 6 | | STORAGE ROOM | ٠ | | | PANEL | , |
| | | 3 | 3 | 3 | 3 | 3 | | P7A-III | |
| | 3 | | | | | • | | | ANICAL DOM 714 |
| | | | | | | | | PANEL _/ P7A-IV | |
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| | | | 3 | | 7 | | | | |
| | 7 | | • | | | . 6 | OFFICE | | |
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| | | | • | OPEN OFFICE | 8 | | OFFICE | | |
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DEMOLITION NOTES

| 1 | DEMOLITION D IS RESPONSIB |
|---|--|
| 2 | CONTRACTOR AS REPAIRING CONSTRUCTION |
| 3 | REMOVE AND |
| 4 | REMOVE AND COORDINATE V |
| 5 | MECHANICAL (REMAIN. |
| 6 | REMOVE AND CONTRACTOR NEW LOCATION |
| 7 | LIGHT FIXTURE CIRCUIT. |
| ~ | |



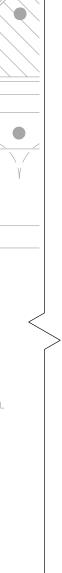

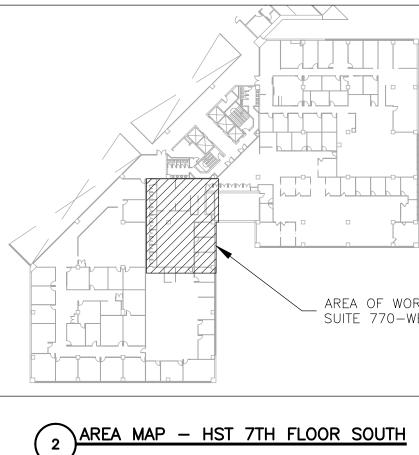DRAWINGS AND PLANS ARE FROM FIELD TAKE-OFF AND ORIGINAL DRAWINGS. CONTRACTOR IBLE FOR FIELD VERIFYING PRIOR TO BIDDING AND/OR CONSTRUCTION.

R IS RESPONSIBLE FOR REMOVAL AND DISPOSAL OF ALL DEMOLISHED MATERIAL AS WELL NG ANY DAMAGE TO ANY SURFACE IN THE AREA OF CONSTRUCTION THAT IS A RESULT OF ON ACTIVITY. SURFACE SHALL BE REPAIRED AND FINISHED TO MATCH EXISTING CONDITIONS. RETAIN LIGHT FIXTURE FOR USE IN NEW CONSTRUCTION.

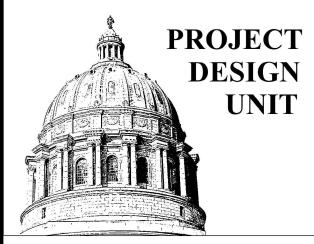
D RETAIN LIGHT FIXTURE AND SUPPLY DUCT BOOT FOR USE IN NEW CONSTRUCTION. E WITH MECHANICAL CONTRACTOR TO REMOVE ASSOCIATED DUCT. CONTRACTOR TO DETACH SUPPLY DUCT BOOT FROM LIGHT FIXTURE. LIGHT FIXTURE TO

D RETAIN LIGHT FIXTURE FOR USE IN NEW CONSTRUCTION. COORDINATE WITH MECHANICAL R TO REMOVE THE ASSOCIATED SUPPLY DUCT BOOT. SUPPLY DUCT BOOT TO BE USED IN ON PER MECHANICAL PLANS.

IRE TO REMAIN IN CURRENT LOCATION. DISCONNECT LIGHT FIXTURE FROM EMERGENCY

8 DISCONNECT LIGHT FIXTURE FROM LIGHTING CIRCUIT. LIGHT FIXTURE TO REMAIN FOR USE IN NEW CONSTRUCTION.





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OFFICE OF ADMINISTRATION DIVISION OF FACILITIES MANAGEMENT, **DESIGN AND CONSTRUCTION**

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PROJECT # 02403-01 SITE # 1001 ASSET # 3101001050

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CAD DWG FILE:<u>MEP_02403-01</u> DRAWN BY: <u>AH/RG</u> CHECKED BY: <u>TS</u> DESIGNED BY: AH

SHEET TITLE: ELECTRICAL DEMOLITION PLAN - WEST


SHEET NUMBER:

ED-101 18 OF 21 SHEETS 01/26/2024

| AREA OF WORK SUITE 770-WEST | |
|--------------------------------|--|

| ELECTRICAL LEGEND | | | | | | | |
|-------------------|--|--|--|--|--|--|--|
| • | PENDENT FIRE SPRINKLER HEAD/ESCUTCHEON | | | | | | |
| \$ | LIGHT SWITCH | | | | | | |
| | LIGHT FIXTURE | | | | | | |
| | LIGHT FIXTURE W/ SUPPLY DUCT BOOT | | | | | | |
| | EMERGENCY LIGHT FIXTURE | | | | | | |
| | EMERGENCY LIGHT FIXTURE W/ DUCT BOOT | | | | | | |
| | EXISTING MATERIALS TO BE REMOVED | | | | | | |

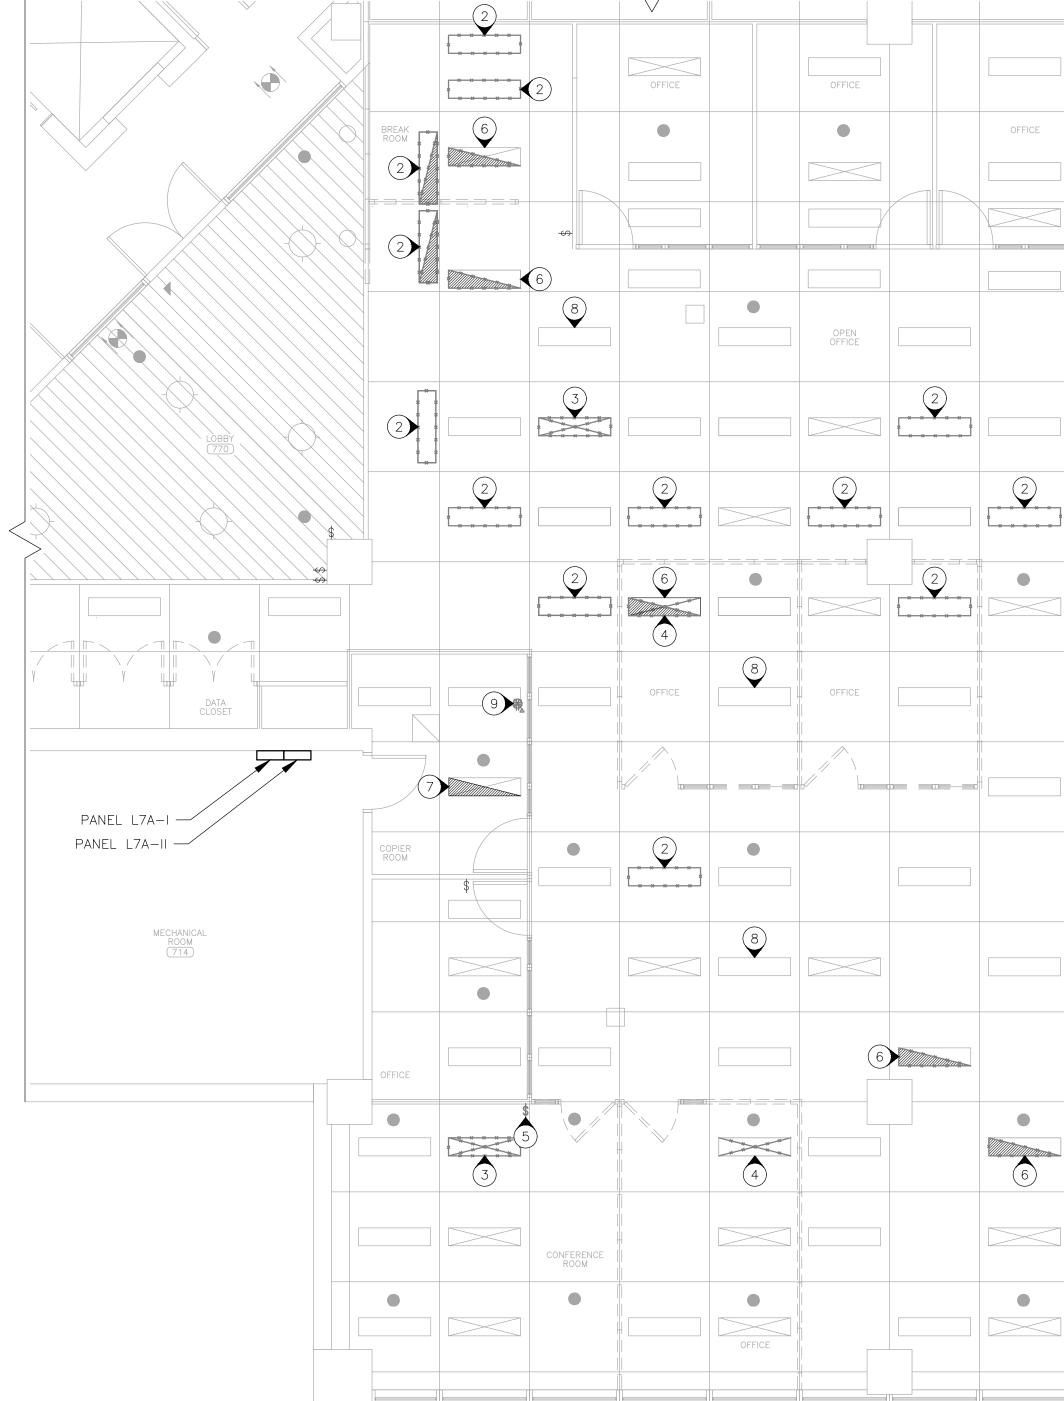1 <u>ELECTRICAL DEMOLITION PLAN – SUITE 770 EAST</u> SCALE: 3/16" = 1'-0"



| | | OFFICE | | | | | | | | | | |
|---|--------|----------------|-----|--------|--------|---|--------|---|--------|--------|--------|--|
| | | | | | | | | | | | | |
| 2 | OFFICE | | (2) | | | 2 | | | | | | |
| | | OFFICE | | OFFICE | OFFICE | | OFFICE | | OFFICE | | OFFICE | |
| | | | | (8) | | | | | | | | |
| | | OPEN OFFICE | | | | | | | | | OFFICE | |
| | | | | | | | | | | OFFICE | | |
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DEMOLITION NOTES

| TO SH |
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| /E AND |
| /E AND DINATE V |
| ANICAL (N. |
| /E AND SE OF L |
| FIXTURE |
| |

D RETAIN LIGHT SWITCH COVER PLATE FOR USE IN NEW CONSTRUCTION. REMOVE AND LIGHT SWITCH AND ASSOCIATED JUNCTION BOX. IRE TO REMAIN IN CURRENT LOCATION. DISCONNECT FIXTURE FROM EMERGENCY CIRCUIT.

(7) EMERGENCY LIGHT FIXTURE TO REMAIN.

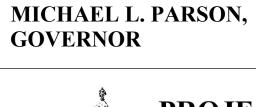
B DISCONNECT LIGHT FIXTURE FROM LIGHTING CIRCUIT. LIGHT FIXTURE TO REMAIN FOR USE IN NEW CONSTRUCTION.

SHEET ED-101 FOR GENERAL DEMOLITION NOTES.


RETAIN LIGHT FIXTURE FOR USE IN NEW CONSTRUCTION.

D RETAIN LIGHT FIXTURE AND SUPPLY DUCT BOOT FOR USE IN NEW CONSTRUCTION. WITH MECHANICAL CONTRACTOR TO REMOVE ASSOCIATED DUCT. CONTRACTOR TO DETACH SUPPLY DUCT BOOT FROM LIGHT FIXTURE. LIGHT FIXTURE TO

9 REMOVE AND DISPOSE OF FLOOR BOX. TERMINATE REMAINING FLEXIBLE CONDUIT AND WIRE INTO NEW JUNCTION BOX AND 20 AMP, TYPE 5-20R FEDERAL SPECIFICATION GRADE, RECEPTACLE WITH COVER PLATE. EXISTING DATA CABLE TO BE REMOVED AND DISPOSED OF BY OWNER.



STATE OF MISSOURI

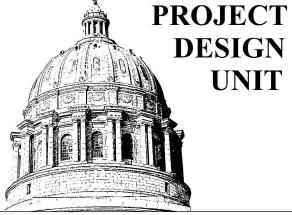

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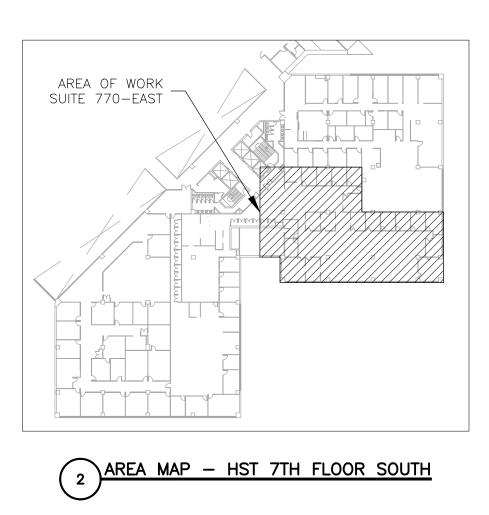
SHEET TITLE: ELECTRICAL DEMOLITION

PLAN - EAST

SHEET NUMBER:

ED-102 19 OF 21 SHEETS 01/26/2024

| ELECI | ELECTRICAL LEGEND | | | | | | | | |
|-------|--|--|--|--|--|--|--|--|--|
| | DIRECTIONAL EXIT SIGN | | | | | | | | |
| • | PENDENT FIRE SPRINKLER HEAD/ESCUTCHEON | | | | | | | | |
| \$ | LIGHT SWITCH | | | | | | | | |
| | LIGHT FIXTURE | | | | | | | | |
| | LIGHT FIXTURE W/ SUPPLY DUCT BOOT | | | | | | | | |
| | EMERGENCY LIGHT FIXTURE | | | | | | | | |
| | EMERGENCY LIGHT FIXTURE W/ DUCT BOOT | | | | | | | | |
| | EXISTING MATERIALS TO BE REMOVED | | | | | | | | |
| | | | | | | | | | |



1) ELECTRICAL RENOVATION PLAN - SUITE 770 WEST SCALE: 3/16" = 1'-0"

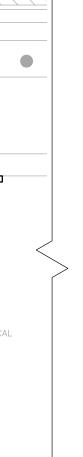
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|----|---|----------------|--------------------|---|-------------------|--------|-------------------------------------|-----------------------------|
| | 7 | 5 | 5 | 5 | 1) 1 | | | |
| | 5 | 5 | CONFERENCE ROOM | 5 | | | | |
| | | | 6 | | | 8 | PANEL/ P7A-III | |
| | 7 | | 5 | | 7 7A-IV: 12 | | PANEL/ P7A-I PANEL/ P7A-II | MECHANICAL ROOM (714) |
| | | | 13 | | | | PANEL/ P7A-IV | |
| | | | 10 | 9 | | | | |
| | | | | | | • | | |
| | | | 12 | | P7A-IV: 10 | OFFICE | | ī |
| | | OPEN OFFICE | | | | | | |
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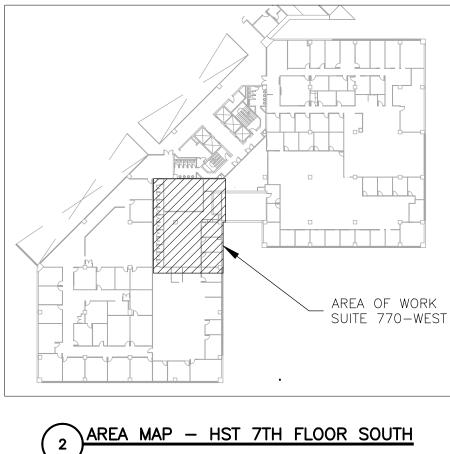
RENOVATION NOTES

- GUIDELINES.

- AS A 24/7 LIGHT.







1 FABRICATION, INSTALLATION AND TESTING OF ALL ELECTRICAL SYSTEMS SHALL BE IN ACCORDANCE WITH THE LATEST VERSION OF THE NATIONAL ELECTRIC CODE (NEC) AND ALL MANUFACTURER INSTALLATION

2 ELECTRICAL CONTRACTOR SHALL BE RESPONSIBLE FOR PROVIDING ALL MATERIALS REQUIRED TO COMPLETE THE WORK. ALL EXPOSED LINE VOLTAGE WIRING SHALL BE PULLED IN PROPERLY SIZED CONDUIT (EMT) WITH APPROVED FITTINGS. REUSE EXISTING CONDUIT AND WIRING WHERE POSSIBLE. (3) INSTALL RETAINED LIGHT FIXTURE IN NEW LOCATION.

(4) INSTALL RETAINED LIGHT FIXTURE WITH LIGHT MOUNTED SUPPLY DUCT BOOT IN NEW LOCATION.

(5) INSTALL NEW OWNER PROVIDED LIGHT FIXTURE. REMOVE AND DISPOSE OF FLUORESCENT BULB AND ASSOCIATED BALLAST WITHIN OWNER PROVIDED FIXTURE. CONTRACTOR SHALL PROVIDE AND INSTALL NEW EIKO LED12WT8/48/840-DBL-A LIGHT BULB OR EQUAL, ENSURE COMPATIBILITY WITH OWNER PROVIDED FIXTURE. 1 BULB PER FIXTURE. CONNECT LIGHT FIXTURE TO NEAREST LIGHTING CIRCUIT.

(6) INSTALL NEW OWNER PROVIDED LIGHT FIXTURE. REMOVE AND DISPOSE OF FLUORESCENT BULB AND ASSOCIATED BALLAST WITHIN OWNER PROVIDED FIXTURE. CONTRACTOR SHALL PROVIDE AND INSTALL NEW EIKO LED12WT8/48/840-DBL-A LIGHT BULB OR EQUAL, ENSURE COMPATIBILITY WITH OWNER PROVIDED FIXTURE. 1 BULB PER FIXTURE. CONNECT LIGHT FIXTURE TO EMERGENCY CIRCUIT FOR USE

(7) MECHANICAL CONTRACTOR TO ATTACH RETAINED SUPPLY DUCT BOOT.

(8) INSTALL RETAINED LIGHT FIXTURE IN NEW LOCATION. CONNECT LIGHT FIXTURE TO EMERGENCY CIRCUIT FOR USE AS A 24/7 LIGHT.

(9) CONNECT EXISTING LIGHT FIXTURE TO EMERGENCY CIRCUIT FOR USE AS A 24/7 LIGHT.

(10) CONNECT EXISTING LIGHT FIXTURE TO NEAREST LIGHTING CIRCUIT.


(1) PROVIDE AND INSTALL RECESSED EDGE-LIT ALUMINUM EXIT SIGN WITH BATTERY PACK, MODEL NUMBER: RELZXTE-2RCAEM-2C-277 OR EQUAL. CONNECT TO EMERGENCY CIRCUIT.

(12) PROVIDE AND INSTALL FLOOR BOX WITH 2 GANG RECEPTACLE AND RJ45 KEYSTONE COUPLER FOR OWNER PROVIDED AND INSTALLED DATA CABLE. FLOOR BOX TO BE USED AS A DEDICATED CIRCUIT. PROVIDE AND INSTALL CONDUIT REQUIRED AND ROUTE BACK TO PANEL P7A-IV LOCATED IN MECHANICAL ROOM 714. REMOVE AND DISPOSE OF 20 AMP, 2 POLE, BREAKER AND REPLACE WITH TWO 20 AMP, 1 POLE, BREAKERS.

13 PROVIDE AND INSTALL WALL MOUNTED QUAD RECEPTACLE. PROVIDE AND INSTALL CONDUIT AND WIRE REQUIRED AND ROUTE BACK TO PANEL P7A-IV IN MECHANICAL ROOM 714, AND USE 20 AMP, 1 POLE, BREAKER TO BE INSTALLED PER KEY NOTE 12. COORDINATE WITH GENERAL CONTRACTOR TO INSTALL RECEPTACLE AT A HEIGHT NO LESS THAN 54 INCHES FROM FINISHED FLOOR AND SUCH THAT IT WILL APPEAR BEHIND THE WALL MOUNTED TV. TV TO BE PROVIDED AND INSTALLED BY OWNER. COORDINATE FINAL LOCATION WITH OWNER.

| ELEC1 | FRICAL LEGEND |
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| Θ | DIRECTIONAL EXIT SIGN |
| • | PENDENT FIRE SPRINKLER HEAD/ESCUTCHEON |
| | HOME RUN-SHORT STROKES INDICATE PHASE OR SWITCHED WIRES, LONG STROKE INDICATE NEUTRAL, LONG WITH DOT INDICATE GROUND |
| \$ | EXISTING WALL SWITCH |
| \bigoplus | QUAD RECEPTACLE |
| ® , | 2 GANG FLOOR BOX W/ DATA |
| | LIGHT FIXTURE |
| | LIGHT FIXTURE W/ SUPPLY DUCT BOOT |
| | EMERGENCY LIGHT FIXTURE |
| | EMERGENCY LIGHT FIXTURE W/ DUCT BOOT |



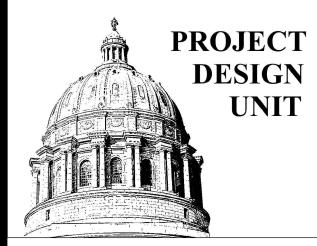

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OFFICE OF ADMINISTRATION DIVISION OF FACILITIES MANAGEMENT, **DESIGN AND CONSTRUCTION**

DEPARTMENT OF THE OFFICE OF ADMINISTRATION

RENOVATE ECONOMIC DEVELOPMENT OFFICES, SUITE 770

HARRY S TRUMAN STATE OFFICE BUILDING 301 W HIGH STREET JEFFERSON CITY, MO 65102

PROJECT # 02403-01 1001 SITE # 3101001050 ASSET #

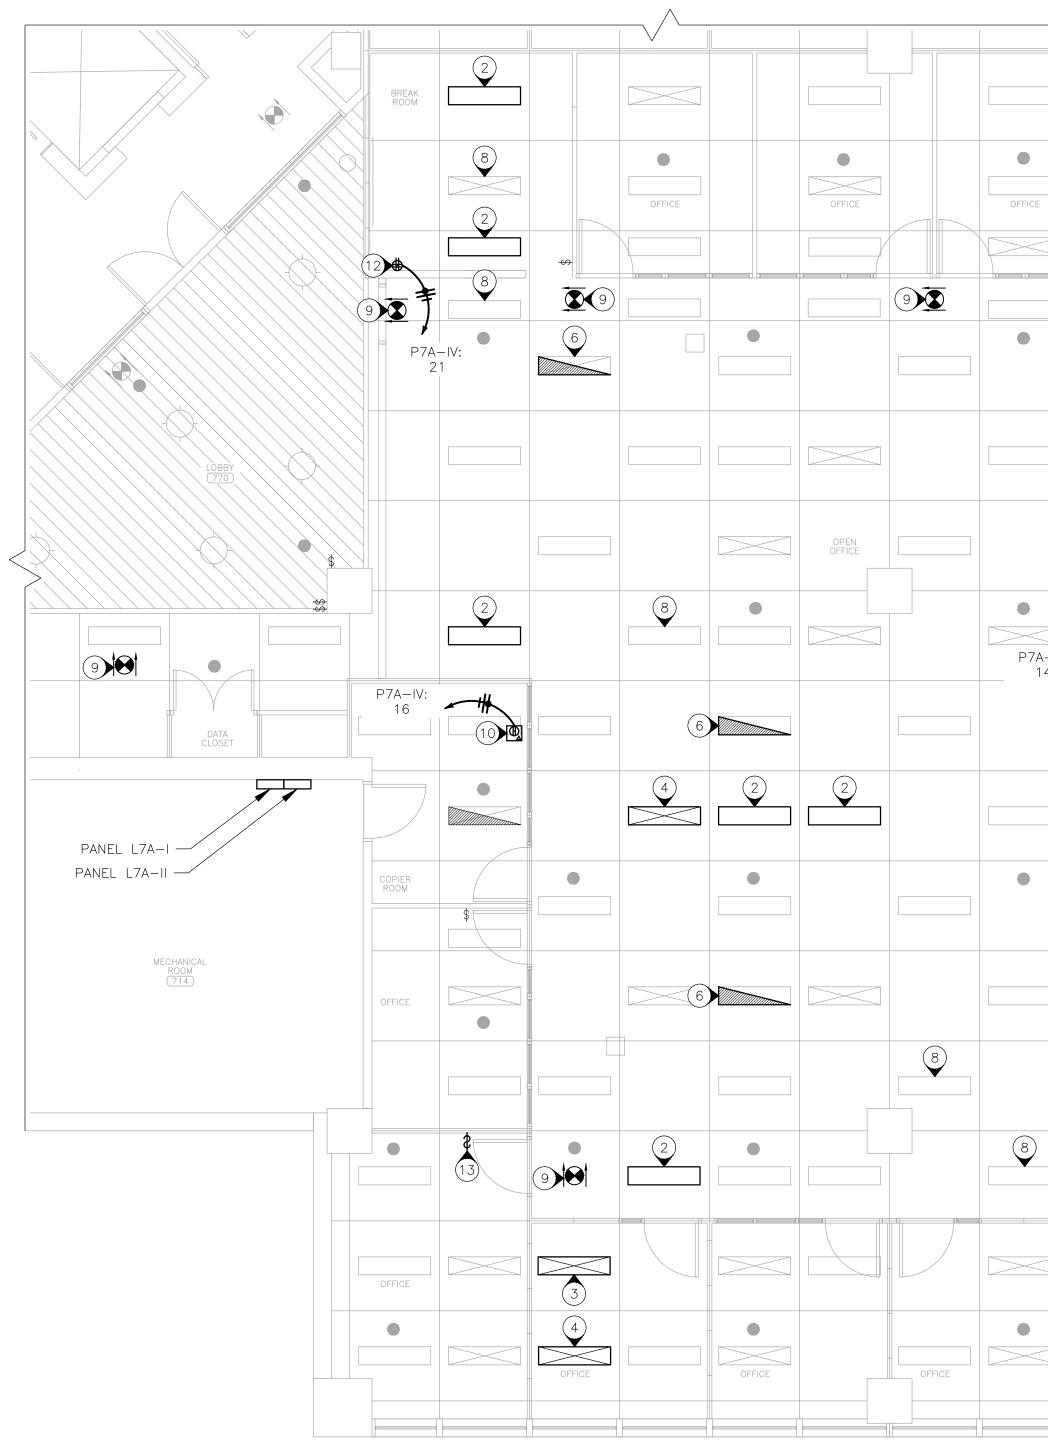
REVISION: DATE: **REVISION:** DATE: **REVISION**: DATE: ISSUE DATE: 01/26/2024

CAD DWG FILE:<u>MEP_02403-01</u> DRAWN BY: <u>AH/RG</u> CHECKED BY: <u>TS</u> DESIGNED BY: AH

SHEET TITLE: ELECTRICAL RENOVATION PLAN - WEST

SHEET NUMBER:

E-101 20 OF 21 SHEETS 01/26/2024





RENOVATION NOTES

| | | | | | | | | | | | | 9 PI | ROVIDE AND JMBER: RELZ |
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|) | | | | | | | | | | | | 13 PI LI | ROVIDE AND I EIGHT OF 48 GHT SWITCH |
| CE | | OFFICE | | | | | | | | | | | |
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| 7A–IV: 14 | 10 | | (6) (6) | | | | | | | | | | |
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|) | | | • | 3 | | ٠ | | | • | | • | | |
| | | | 6 | | | | | | 7 | | | - OFFICE | 3 |
| | | OPEN OFFICE | | | | | | | | | 8 | | |
| | 8 | | • | | 2 | • | | | P7 | ZA-IV: 8 | | | |
| | | | | 3 | | | | | | | - OFFICE | | |
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| | OFFICE | | OFFICE | | OFFICE | | _ OFFICE | | OFFICE | | | | |
| | | | | | | | | | | | | | |

1) ELECTRICAL RENOVATION PLAN - SUITE 770 EAST SCALE: 3/16" = 1'-0"

1 REFER TO SHEET E-101 FOR GENERAL RENOVATION NOTES.

(2) INSTALL RETAINED LIGHT FIXTURE IN NEW LOCATION.

(3) INSTALL RETAINED LIGHT FIXTURE WITH LIGHT MOUNTED SUPPLY DUCT BOOT IN NEW LOCATION. (4) INSTALL RETAINED LIGHT FIXTURE IN NEW LOCATION. MECHANICAL CONTRACTOR TO ATTACH RETAINED SUPPLY DUCT BOOT.

5 INSTALL RETAINED LIGHT FIXTURE IN NEW LOCATION. CONNECT LIGHT FIXTURE TO EMERGENCY CIRCUIT FOR USE AS A 24/7 LIGHT. MECHANICAL CONTRACTOR TO ATTACH RETAINED SUPPLY DUCT BOOT.

(6) CONNECT EXISTING LIGHT FIXTURE TO EMERGENCY CIRCUIT FOR USE AS A 24/7 LIGHT.

(7) INSTALL RETAINED LIGHT FIXTURE IN NEW LOCATION. CONNECT LIGHT FIXTURE TO EMERGENCY CIRCUIT FOR USE AS A 24/7 LIGHT.

(8) CONNECT EXISTING LIGHT FIXTURE TO NEAREST LIGHTING CIRCUIT.

(9) PROVIDE AND INSTALL RECESSED EDGE-LIT ALUMINUM EXIT SIGN WITH BATTERY PACK, MODEL ELZXTE-2RCAEM-2C-277 OR EQUAL. CONNECT TO EMERGENCY CIRCUIT.


> INSTALL FLOOR BOX WITH 2 GANG RECEPTACLE AND RJ45 KEYSTONE COUPLER FOR WIDED AND INSTALLED DATA CABLE. FLOOR BOX TO BE USED AS A DEDICATED CIRCUIT. INSTALL CONDUIT REQUIRED AND ROUTE BACK TO PANEL P7A-IV LOCATED IN ROOM 714. REMOVE AND DISPOSE OF 50 AMP, 2 POLE, BREAKER AND REPLACE WITH P, 1 POLE, BREAKERS.

INSTALL FLOOR BOX WITH 2 GANG RECEPTACLE AND RJ45 KEYSTONE COUPLER FOR VIDED AND INSTALLED DATA CABLE. FLOOR BOX TO BE USED AS A DEDICATED CIRCUIT. INSTALL CONDUIT REQUIRED AND ROUTE BACK TO PANEL P7A-IV LOCATED IN ROOM 714. REMOVE AND DISPOSE OF 20 AMP, 1 POLE, BREAKER AND PROVIDE A NEW POLE, BREAKER.


D INSTALL WALL MOUNTED DUPLEX RECEPTACLE. INSTALL RECEPTACLE AT A HEIGHT OF 48 CEPTACLE TO BE USED AS A DEDICATED CIRCUIT, PROVIDE AND INSTALL CONDUIT ND ROUTE BACK TO PANEL P7A-IV LOCATED IN MECHANICAL ROOM 714. REMOVE AND 20 AMP, 1 POLE, BREAKER AND PROVIDE NEW 20 AMP, 1 POLE, BREAKER.

INSTALL NEW LIGHT SWITCH WITH ASSOCIATED JUNCTION BOX IN NEW LOCATION AT A 48 INCHES FROM FINISHED FLOOR. INSTALL RETAINED COVER PLATE AND MATCH NEW H FINISH TO EXISTING.

| ELECT | FRICAL LEGEND |
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| | DIRECTIONAL EXIT SIGN |
| • | PENDENT FIRE SPRINKLER HEAD/ESCUTCHEON |
| | HOME RUN-SHORT STROKES INDICATE PHASE OR SWITCHED WIRES, LONG STROKE INDICATE NEUTRAL, LONG WITH DOT INDICATE GROUND |
| \$ | LIGHT SWITCH |
| æ, | 2 GANG FLOOR BOX W/ DATA |
| ـ | 2 GANG FLOOR BOX |
| | LIGHT FIXTURE |
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ELECTRICAL RENOVATION PLAN - EAST
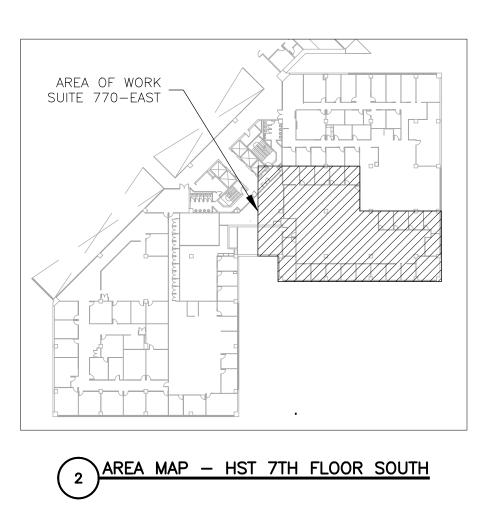
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E-102 21 OF 21 SHEETS 01/26/2024

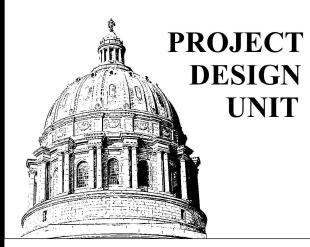