REPLACE ROOFS MULTIPLE SITES AND ASSETS ST. LOUIS REGION ST. LOUIS , MISSOURI

OWNER: STATE OF MISSOURI MIKE KEHOE, GOVERNOR

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OFFICE OF ADMINISTRATION DIVISION OF FACILITIES MANAGEMENT, DESIGN AND CO

> JENNINGS STATE OFFICE BUILDING 8501 LUCAS AND HUNT ROAD JENNINGS, MO 63136

ST. LOUIS COUNTY

SITE NUMBER: 1021 ASSET NUMBER: 3101021001

| | DESIGNER: | STATE OF MISSOUR OA-FMDC PROJECT 301 WEST HIGH STR JEFFERSON CITY, N |
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| ONSTRUCTION | PROJECT NUMBER: | O2513-01 |
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| | NT, MO 63033 | ST. LO |
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| ST. LOUIS | COUNTY | |
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| | HEET AND SHEET INDEX LOCATION MAPS | |
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| | DUNTY SERVICE CENTER | |

NORTH STL COUNTY ROOF PLAN

KEATHLEY STATE OFFICE BUILDINGA341KEATHLEY ROOF PLANA342KEATHLEY ROOF DETAILS

NORTH STL COUNTY ROOF DETAILS

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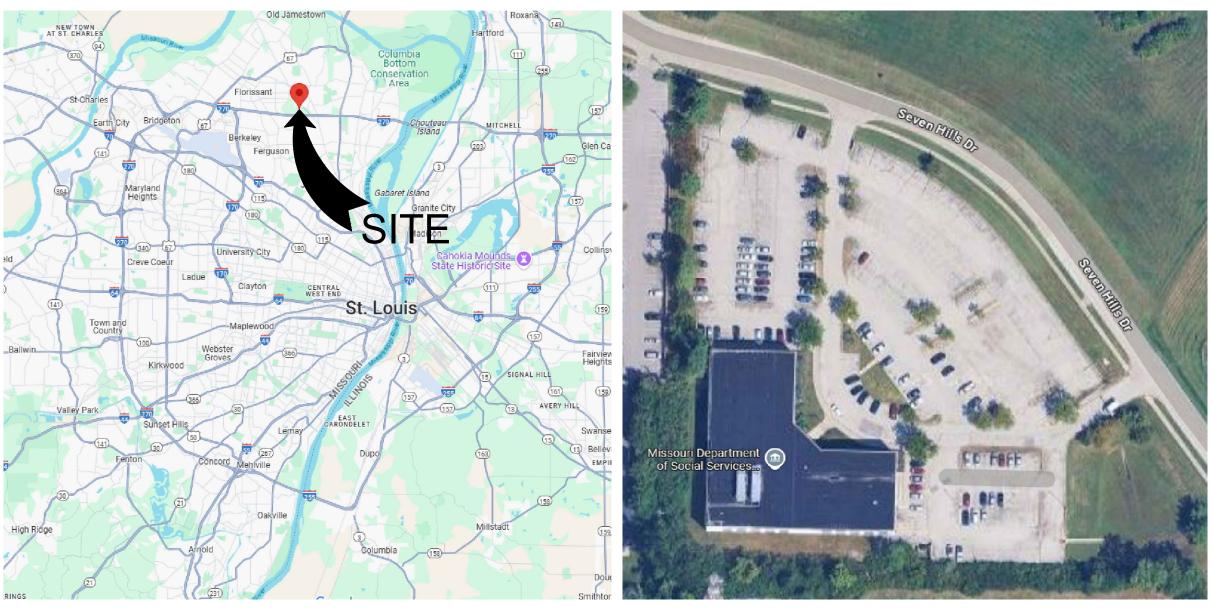
THLEY TE OFFICE BUILDING CHOUTEAU AVENUE LOUIS, MO 63103

LOUIS CITY

E NUMBER: 1022 ASSET /IBER: 3101022001



NORTH ST. LOUIS COUNTY SERVICE CENTER 4040 SEVEN HILLS DRIVE FLORISSANT, MO 63033 ST. LOUIS COUNTY





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GENERAL NOTES:

- 1. FIELD VERIFY ALL EXISTING DIMENSIONS AND SLOPES.
- 2. VERIFY SIZE AND THICKNESS OF ALL NEW MATERIALS TO BE USED.
- 3. FIELD VERIFY ALL EXISTING CONDITIONS TO ENSURE PROPER COMPLETION OF THE NEW WORK.
- 4. REMOVE AND DISPOSE OF EXISTING MATERIALS SHOWN TO BE REMOVED.
- 5. EXTEND EXISTING VENTS AS REQUIRED TO ACCOMMODATE NEW ROOF INSULATION THICKNESS. 6. BUILD UP EXISTING CURBS AS REQUIRED TO ACCOMMODATE NEW ROOF INSULATION THICKNESS.
- 7. REPLACE ANY DETERIORATED EXISTING TREATED WOOD BLOCKING AS REQUIRED. 8. REPLACE EXISTING TREATED WOOD SLEEPERS UNDER ROOFTOP CONDENSING UNIT
- EQUIPMENT WITH EQUIPMENT RAILS. 9. FLASH PLUMBING VENTS, AND ANY OTHER ROOF PENETRATIONS, AS REQUIRED TO PROVIDE A WATER-TIGHT SEAL.
- 10. FLASH ROOF AT EDGES, VERTICAL WALLS, AND COPINGS AS REQUIRED TO PROVIDE A WATER-TIGHT SEAL
- 11. INSTALL TPO RETROFIT ROOF DRAINS AT ALL EXISTING ROOF DRAIN LOCATIONS.

JENNINGS STATE OFFICE BUILDING 8501 LUCAS AND HUNT ROAD JENNINGS, MO 63136 ST. LOUIS COUNTY





 $\bigoplus 20 \, \underline{{\sf LOCATION MAP}}_{{\sf NOT TO SCALE}}$

KEATHLEY STATE OFFICE BUILDING 3101 CHOUTEAU AVENUE ST. LOUIS, MO 63103 ST. LOUIS COUNTY

$31 \; \underset{\text{not to scale}}{\text{SITE AERIAL}}$

40 LOCATION MAP NORTH

SITE

12. PROVIDE PIPE SUPPORTS FOR ANY EXPOSED CONDENSATE PIPING. ROOF SUPPORTS SHALL HAVE CHANNEL MOUNTED CLIPS AND REST ON THE FINISHED ROOF SURFACE. FASTEN CONDENSATE PIPING TO SUPPORTS. LOCATE SUPPORTS AT MINIMUM OF 4'-0" SPACING AND AT CORNERS OF PIPING CONNECTIONS.

AT ST. CHARLES

- 13. EXTEND CONDENSATE PIPING TO ROOF DRAINS OR GUTTERS. INSTALL AN ELBOWS AT THE DRAIN END OF EACH CONDENSATE PIPE TO DIRECT DRAINAGE INTO THE ROOF DRAIN OR THE GUTTER.
- 14. PROVIDE ALL MATERIALS AND ACCESSORIES NECESSARY FOR A COMPLETE INSTALLATION. 15. INSTALLATION OF ALL NEW MATERIALS SHALL BE IN STRICT ACCORDANCE WITH
- MANUFACTURER'S INSTRUCTIONS. 16. DO NOT IMPEDE THE OPERATION OF THE FACILITY IN ANY MANNER WHILE CONSTRUCTION IS UNDERWAY.
- 17. STORE MATERIALS ONLY IN APPROVED AREAS ON THE SITE.
- 18. THOROUGHLY CLEAN ROOFS AND SITE UPON COMPLETION OF ROOFING WORK. PICK UP AND PROPERLY DISPOSE OF ALL FASTENERS, DEBRIS, AND EXTRA MATERIAL NOT MEANT TO BE LEFT WITH THE OWNER.
- 19. REPAIR ANY DAMAGE MADE TO THE BUILDINGS AND GROUNDS BY CONSTRUCTION ACTIVITIES.



- 4.
- 5.
- WHERE SHOWN.

 $\bigoplus 21 \; \underline{\text{SITE AERIAL}}_{\text{NOT TO SCALE}}$

41 SITE AERIAL NOT TO SCALE

SCOPE OF WORK AT EACH LOCATION (INCLUDES BUT IS NOT LIMITED TO THE FOLLOWING)

REMOVAL OF ALL EXISTING ROOFING, COVER BOARD, INSULATION, UNDERLAYMENTS, FLASHINGS, AND FASTENERS DOWN TO THE EXISTING DECK. INSPECTION OF ALL EXISTING DECK FOR DAMAGE OR DETERIORATION. PREPARATION OF ROOF AS REQUIRED TO RECEIVE NEW ROOF SYSTEM. INSTALLATION OF BLOCKING, CURB EXTENSIONS, VENT EXTENSIONS, AND AN OTHER PREPARATORY WORK AS REQUIRED FOR NEW WORK. INSTALLATION OF NEW INSULATION, COVER BOARD, AND TPO MEMBRANE. 6. INSTALLATION OF NEW FLASHINGS AND TRIM. REINSTALL EXISTING FLASHINGS AND TRIM

INSTALLATION OF ROOF ACCESSORIES AND TPO RETROFIT ROOF DRAINS 8. EXTEND CONDENSATE LINES TO ROOF DRAINS OR GUTTERS.

STATE OF MISSOURI MIKE KEHOE, GOVERNOR



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OFFICE OF ADMINISTRATION DIVISION OF FACILITIES MANAGEMENT, **DESIGN AND CONSTRUCTION**

DEPARTMENT OF OFFICE OF **ADMINISTRATION**

REPLACE ROOFS AT VARIOUS LOCATIONS AROUND THE ST. LOUIS AREA

JENNINGS OFFICE BUILDING NORTH STL COUNTY KEATHLEY OFFICE BUILDING

| PROJECT # | O2513-01 |
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| SITE # | MULTIPLE |
| ASSET # | MULTIPLE |
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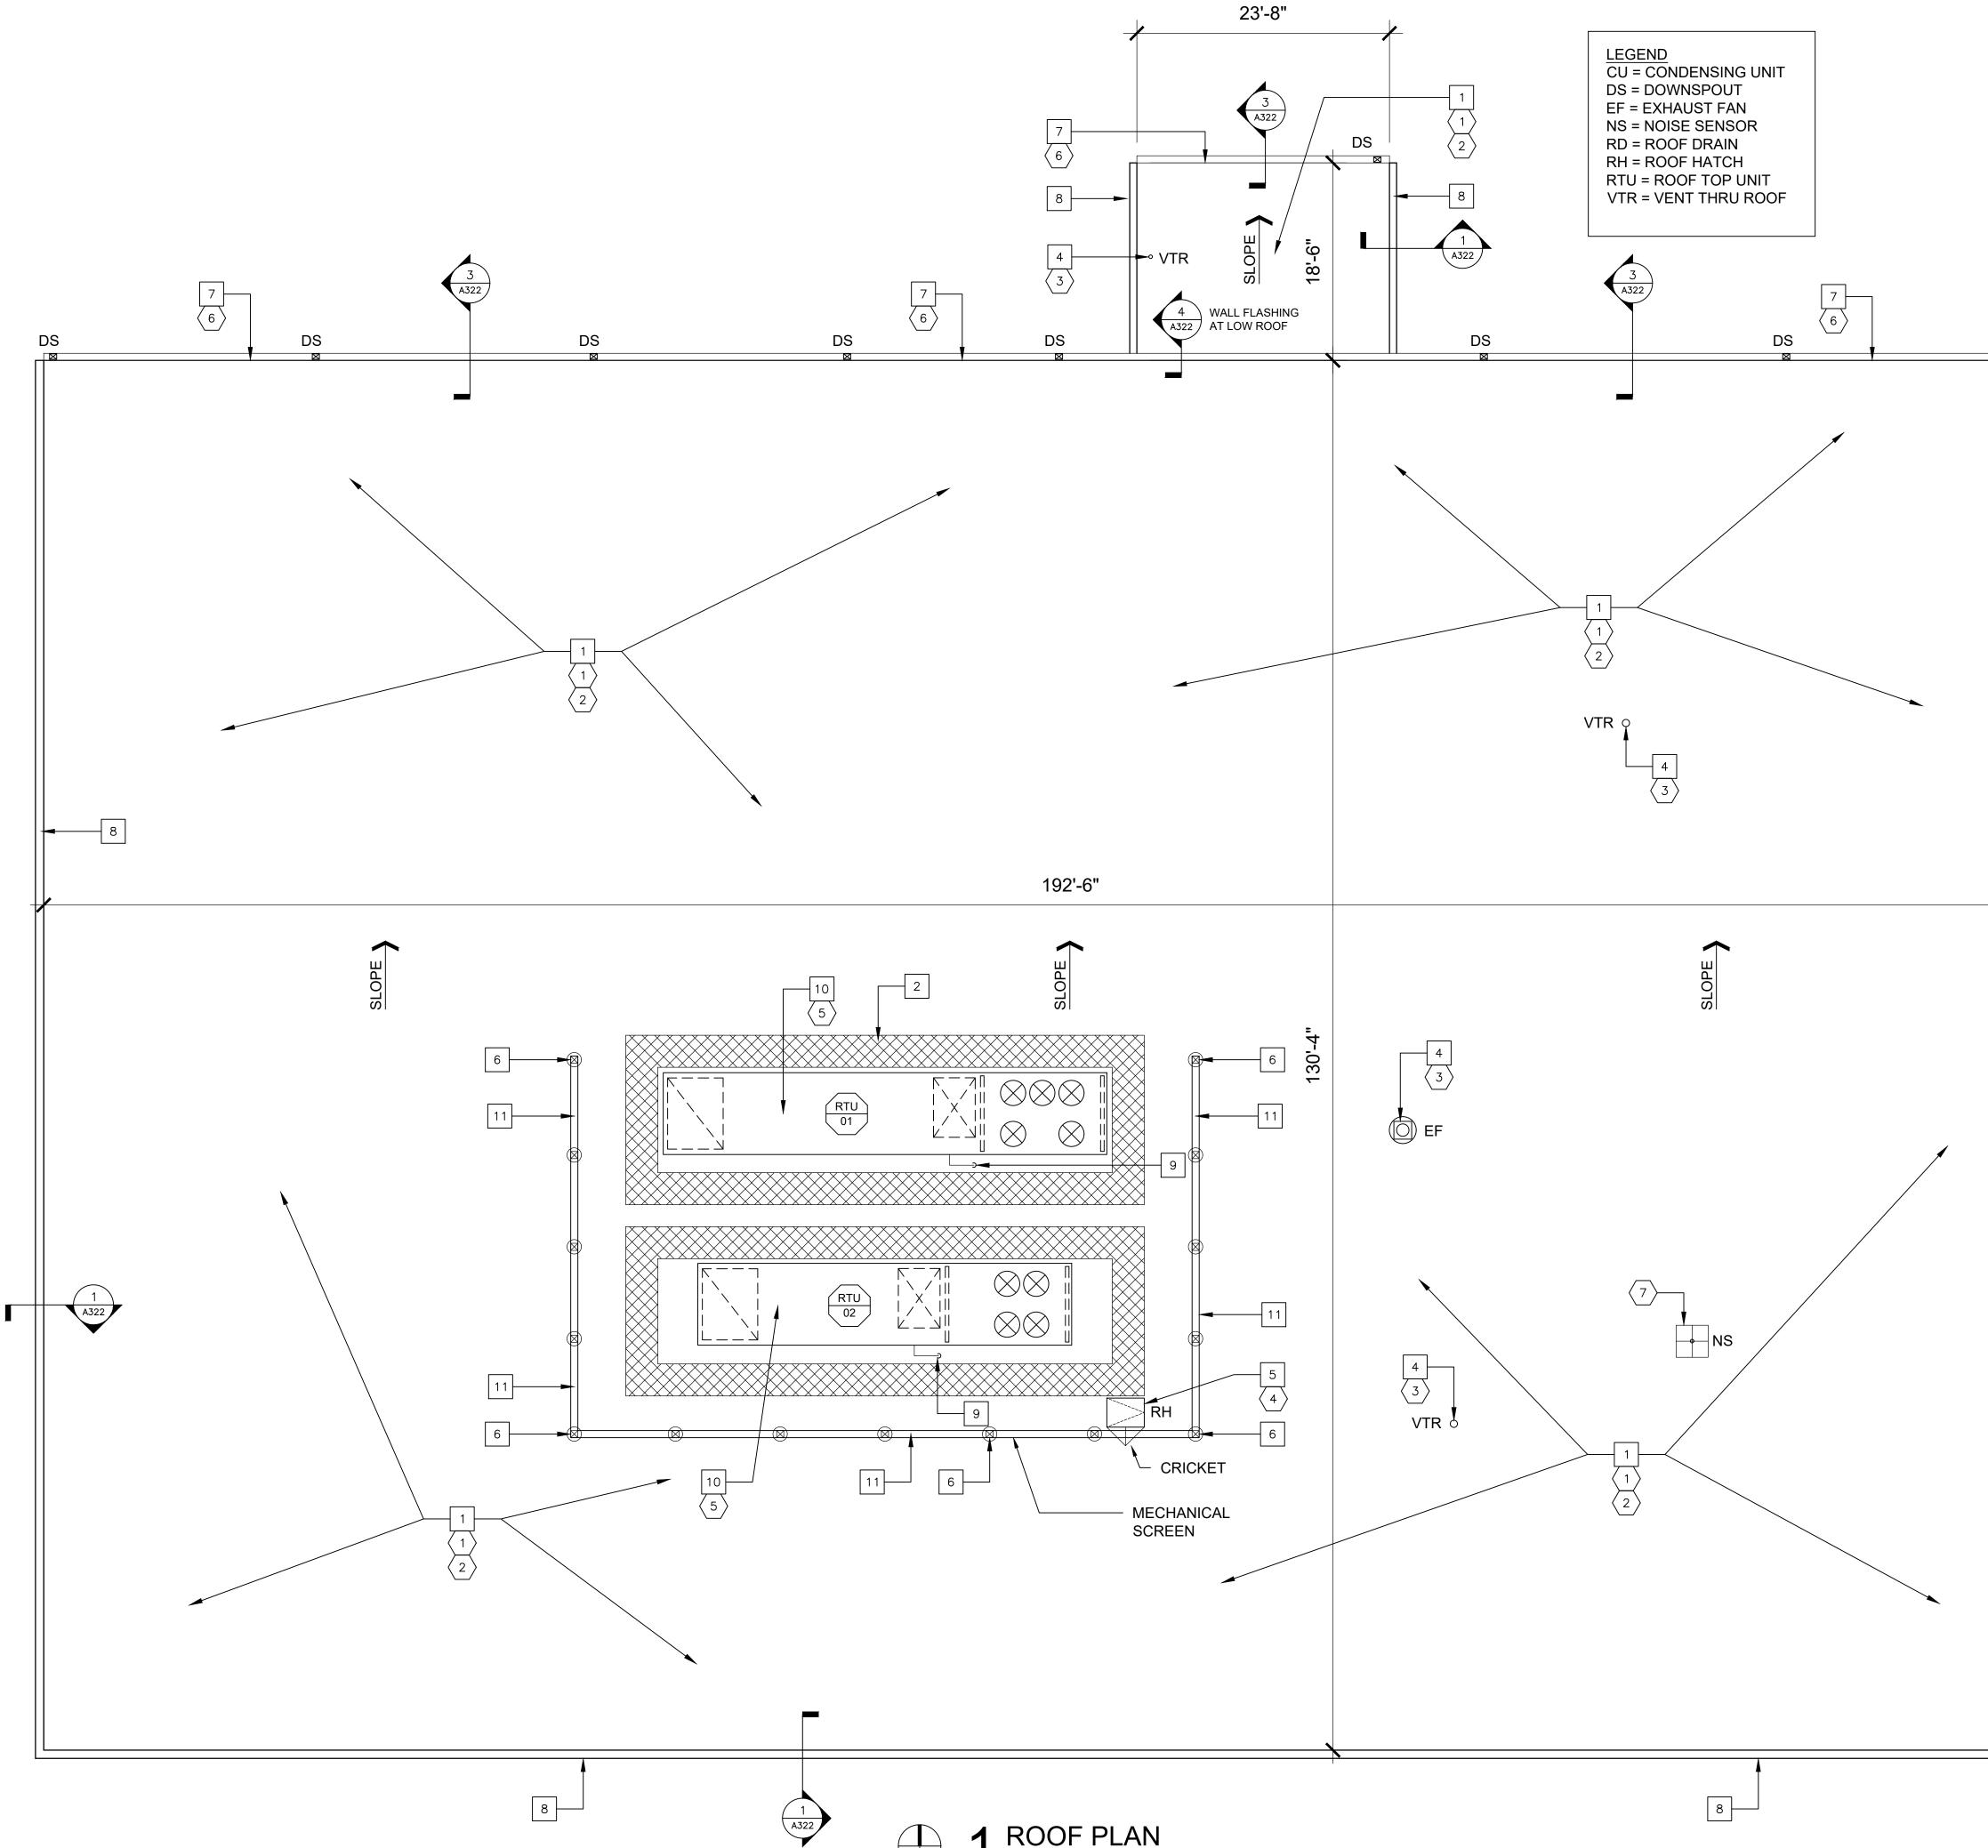
CAD DWG FILE: O2513-01 **DRAWN BY:** CHECKED BY DESIGNED BY:

SHEET TITLE:

FACILITY LOCATION MAPS

SHEET NUMBER:

G010 2 OF 8 SHEETS 06/06/2025



1 ROOF PLAN 3/32"=1'-0"

HAZARDOUS MATERIAL NOTES:

DS

1 A322

8

THE ROOF HAS BEEN TESTED FOR ASBESTOS MATERIAL AND NONE WAS FOUND.

| GEN | NERAL ROOFING NOTES: | | , |
|----------------|--|------------|------------------|
| 1. | ALL ROOFING SHALL BE DONE IN ACCORDANCE WITH THE LATEST ADDITION OF THE NATIONAL ROOFING CONTRACTORS ASSOCIATION (NRCA) ROOFING MANUAL AND ASHRAE AS IT SIMILARLY RELATES TO ARCHITECTURAL METAL ROOFING AND EQUIPMENT. | | |
| 2. | EXISTING CONDITIONS AND DIMENSIONS AS SHOWN ON THESE DRAWINGS ARE APPROXIMATIONS. ACTUAL CONDITIONS AND DIMENSIONS MAY VARY. CONTRACTORS SHALL VERIFY EXISTING CONDITIONS AND DIMENSIONS TO THE EXTENT THAT IT WOULD MAKE A DIFFERENCE TO THEIR BID. NO ADDITIONAL COST TO THE OWNER WILL BE CONSIDERED BASED UPON ANY MINOR VARIATIONS. | | |
| 3. | THE CONTRACTOR IS TO VISIT THE SITE DURING THE BIDDING PERIOD AND IS TO ADVISE THE ARCHITECT OF ANY SITUATION OR DISCREPANCY WHICH WILL NOT ALLOW SUCCESSFUL COMPLETION OF THE WORK. | | |
| 4. | ALL ROOF SLOPES ARE APPROXIMATELY 1/4"/FT UNLESS OTHERWISE INDICATED ON DRAWINGS. | | |
| 5. | DEMOLITION SHALL INCLUDE THE COMPLETE REMOVAL OF ROOF MEMBRANE, INSULATION, COVERBOARD, UNDERLAYMENTS, FASTENERS, AND FLASHINGS AS INDICATED DOWN TO THE EXISTING DECK. PROPERLY DISPOSE OF ALL MATERIALS WHICH ARE NOT MEANT TO BE REUSED. | | |
| 6. | CONTRACTOR IS RESPONSIBLE FOR ANY INCIDENTAL DAMAGE DONE TO BUILDING AND GROUNDS DURING COURSE OF DEMOLITION AND CONSTRUCTION AND SHALL RESTORE BUILDING AND GROUNDS TO EXISTING CONDITIONS UPON COMPLETION OF ROOFING PROJECT. | | |
| 7. | CONTRACTOR SHALL THOROUGHLY CLEAN ROOF AND SITE UPON COMPLETION OF PROJECT. PICK-UP, REMOVE AND PROPERLY DISPOSE OF ALL FASTENERS, DEBRIS AND SCRAP MATERIALS. | | |
| 8. | ALL MANUFACTURED ARTICLES, MATERIALS AND EQUIPMENT SHALL BE APPLIED, INSTALLED, CONNECTED, ERECTED, CLEANED, AND CONDITIONED AS DIRECTED BY THE MANUFACTURER, UNLESS INDICATED OTHERWISE. | | |
| 9. | THE CONTRACTOR SHALL COORDINATE WITH THE FACILITY TO ESTABLISH PROCEDURES FOR THE CONTROLLED ENTRY OF WORKERS AND MATERIALS INTO THE WORK AREA AND SHALL COMPLY WITH ALL RULES AND REGULATIONS ESTABLISHED BY THE FACILITY. THE INTERRUPTION OF SECURITY AND COMMUNICATIONS WILL NOT BE PERMITTED. CONTRACTOR SHALL INFORM AND COORDINATE WITH SECURITY OFFICIALS 48 HOURS IN ADVANCE OF ANY WORK RELATED TO SECURITY OR COMMUNICATIONS. | OF | FIC |
| 10. | AT MECHANICAL/ELECTRICAL ROOF EQUIPMENT AND VENTS, PROVIDE FLASHING PER ROOFING MANUFACTURER FOR WATERTIGHT ROOF INSTALLATION. | DI MA | VIS NA SIG |
| 11. | EXISTING GUTTERS AND DOWNSPOUTS TO REMAIN. REWORK EDGE DETAIL AS REQUIRED. | | |
| 12. | SEAL ROOF PENETRATIONS AS REQUIRED PER ROOFING MANUFACTURER'S STANDARD PRINTED SPECIFICATIONS AND DETAILS. | | PA FIC MI |
| 13. | EXTEND VENTS THROUGH THE ROOF (VTRs) TO A MINIMUM OF 12" ABOVE THE FINISH ROOF SURFACE. | | |
| 14. | USE TAPERED INSULATION TO CREATE CRICKETS AND TO PROVIDE POSITIVE DRAINAGE AS REQUIRED. | RE | PLA |
| D | EMOLITION KEY NOTES: | | |
| (1 | REMOVE AND PROPERLY DISPOSE OF ALL EXISTING ROOFING MATERIAL, INSULATION, COVERBOARD, UNDERLAYMENTS, FLASHINGS AND FASTENERS DOWN TO THE EXISTING DECK. | OF | NNI FIC |
| $\langle 2$ | ONCE EXISTING ROOFING IS REMOVED, CAREFULLY INSPECT ALL EXISTING DECK FOR DAMAGE OR DETERIORATION. | |)1 L NNI |
| $\overline{3}$ | | | OJE |
| 4 5 | EXISTING ROOFTOP MECHANICAL EQUIPMENT AND SUPPORTS | | ЪЕ Е# |
| 6 | TO REMAIN. | AS | SET |
| 7 | $\left. \begin{array}{c} \begin{array}{c} \\ \end{array} \right\} \text{ REMOVE AND REINSTALL EXISTING NOISE SENSOR.} \end{array} \right\}$ | | |
| NI | | | /ISIC DA |
| | EW ROOFING KEY NOTES: NEW FULLY ADHERED TPO ROOF ON COVERBOARD OVER 5 1/2" | | /ISIC DA' |
| 1 | RIGID POLYISO INSULATION (AVERAGE R-30). SEE DETAILS ON SHEET A322. | REV | DA |
| 2 | INSTALL 36" WIDE WALKWAY PADS AROUND ROOF HATCHES AND HVAC UNITS AS INDICATED. | ISSU | JEL |
| 3 | NEW BOOT FLASHING AROUND EXISTING VENT PIPING. SEE DETAIL 5/A322. | CAI DRA | |
| 4 | | CHI | ECK |
| 5 | NEW FLASHING AROUND EXISTING ROOF ACCESS HATCH. | SHE | EET ' |
| 6 | FLASH AND SEAL COLUMN SUPPORTS FOR MECHANICAL | | NI |
| 7 | EXISTING GUTTERS AND DOWNSPOUTS TO BE REMAIN. | | C |
| 8 | NEW PREFINISHED METAL FLASHING ON PARAPET EDGE. SEE | SHE | ET I |
| 9 | FLASH AND SEAL SUPPORTS OF EXISTING MECHANICAL | | |
| 1(| EQUIPMENT. | 3 O | F 8 S |
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STATE OF MISSOURI MIKE KEHOE, GOVERNOR





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| PROJECT # | O2513-01 |
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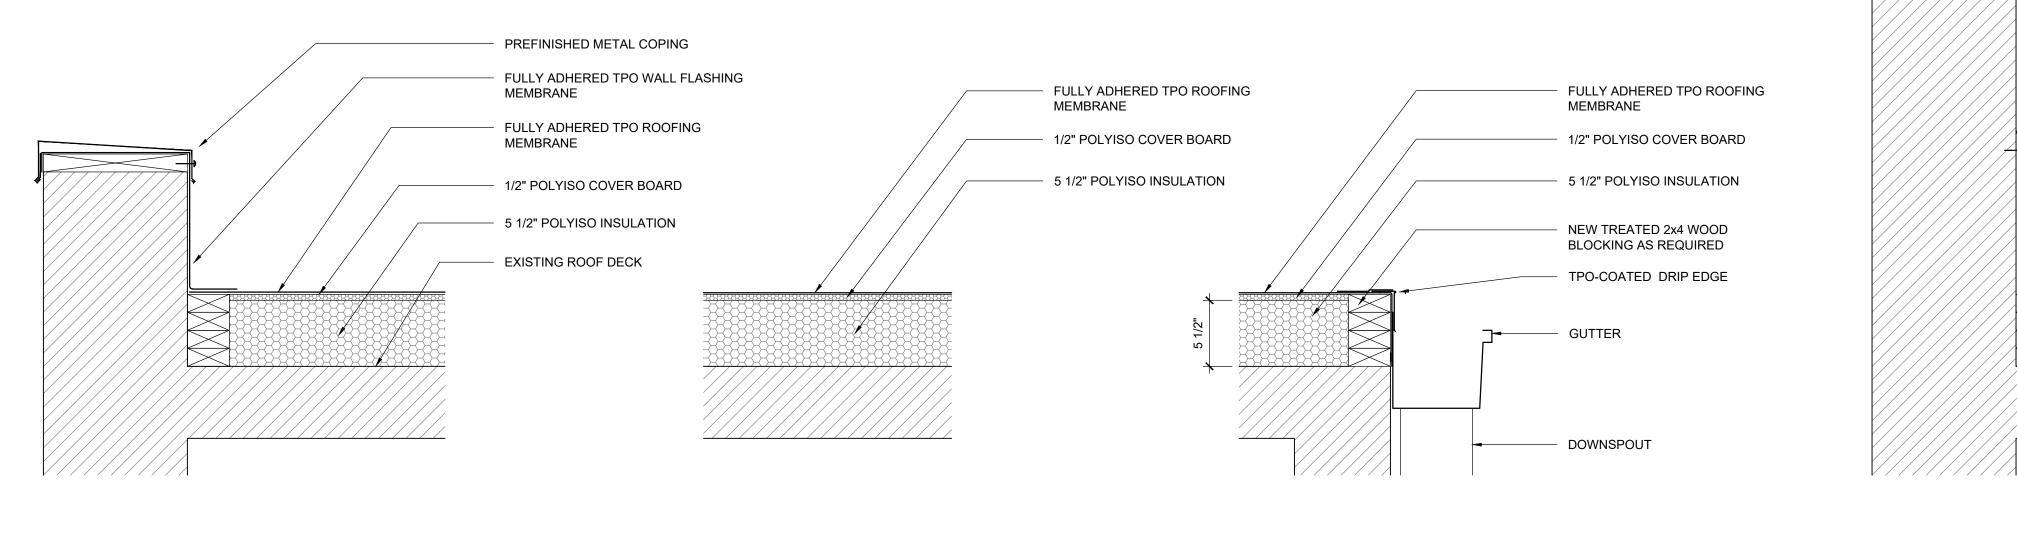
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| ISSUE DATE: | 06/06/2025 |

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| DESIGNED BY: | MLB |


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3 OF 8 SHEETS 06/06/2025



1 PARAPET WALL DETAIL




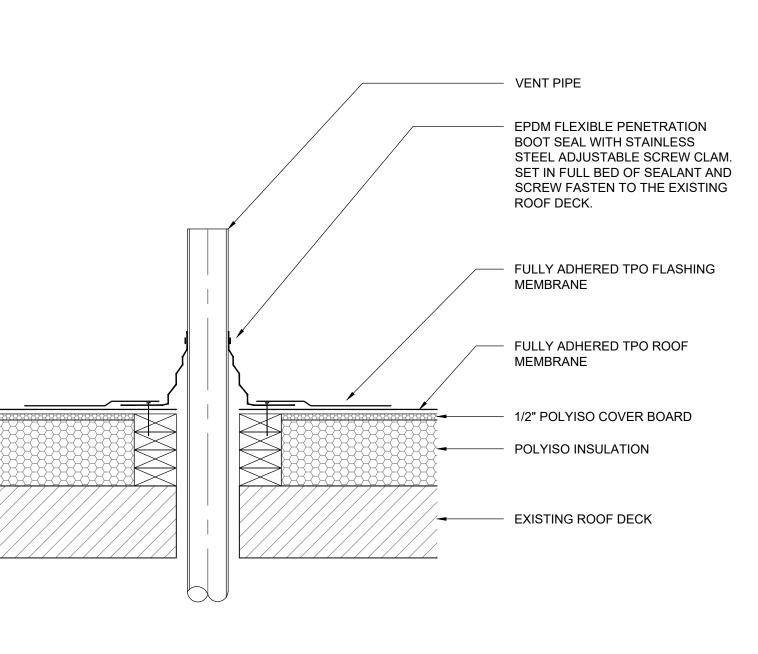


$2 \frac{\text{ROOF SYSTEM}}{\frac{1}{1/2"=1'-0"}}$





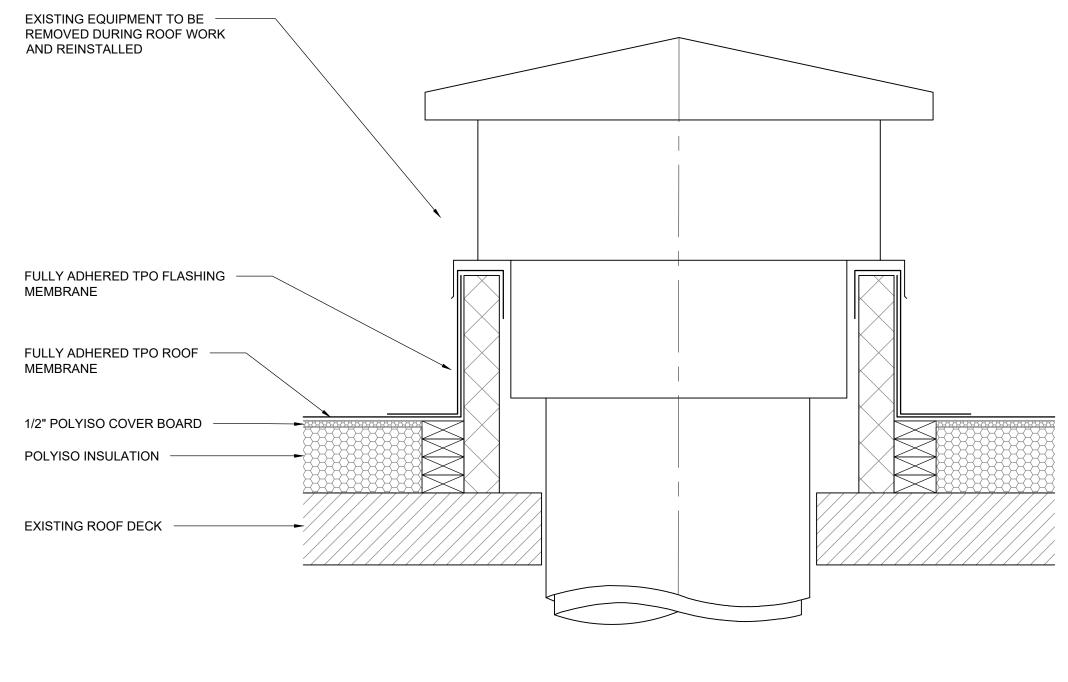



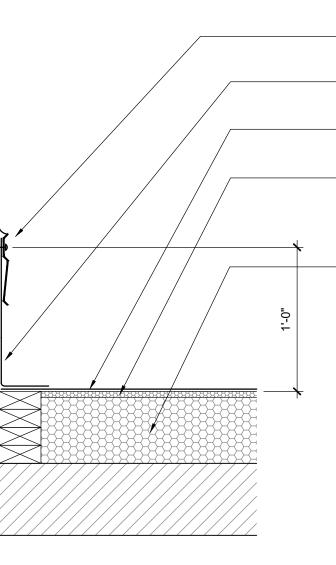


4 WALL FLASHING DETAIL $\frac{1}{1}$

SURFACE FLASHING AND SEALANT

FULLY ADHERED TPO WALL FLASHING MEMBRANE FULLY ADHERED TPO ROOFING MEMBRANE 1/2" POLYISO COVER BOARD

- 5 1/2" POLYISO INSULATION

STATE OF MISSOURI MIKE KEHOE, GOVERNOR

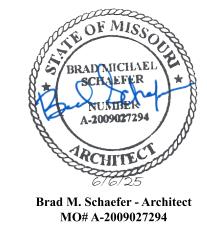

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OFFICE OF ADMINISTRATION DIVISION OF FACILITIES MANAGEMENT, **DESIGN AND CONSTRUCTION**

DEPARTMENT OF OFFICE OF **ADMINISTRATION**

REPLACE ROOF

JENNINGS STATE OFFICE BUILDILNG 8501 LOCUST & HUNT JENNINGS, MO 63136

PROJECT # SITE # ASSET #

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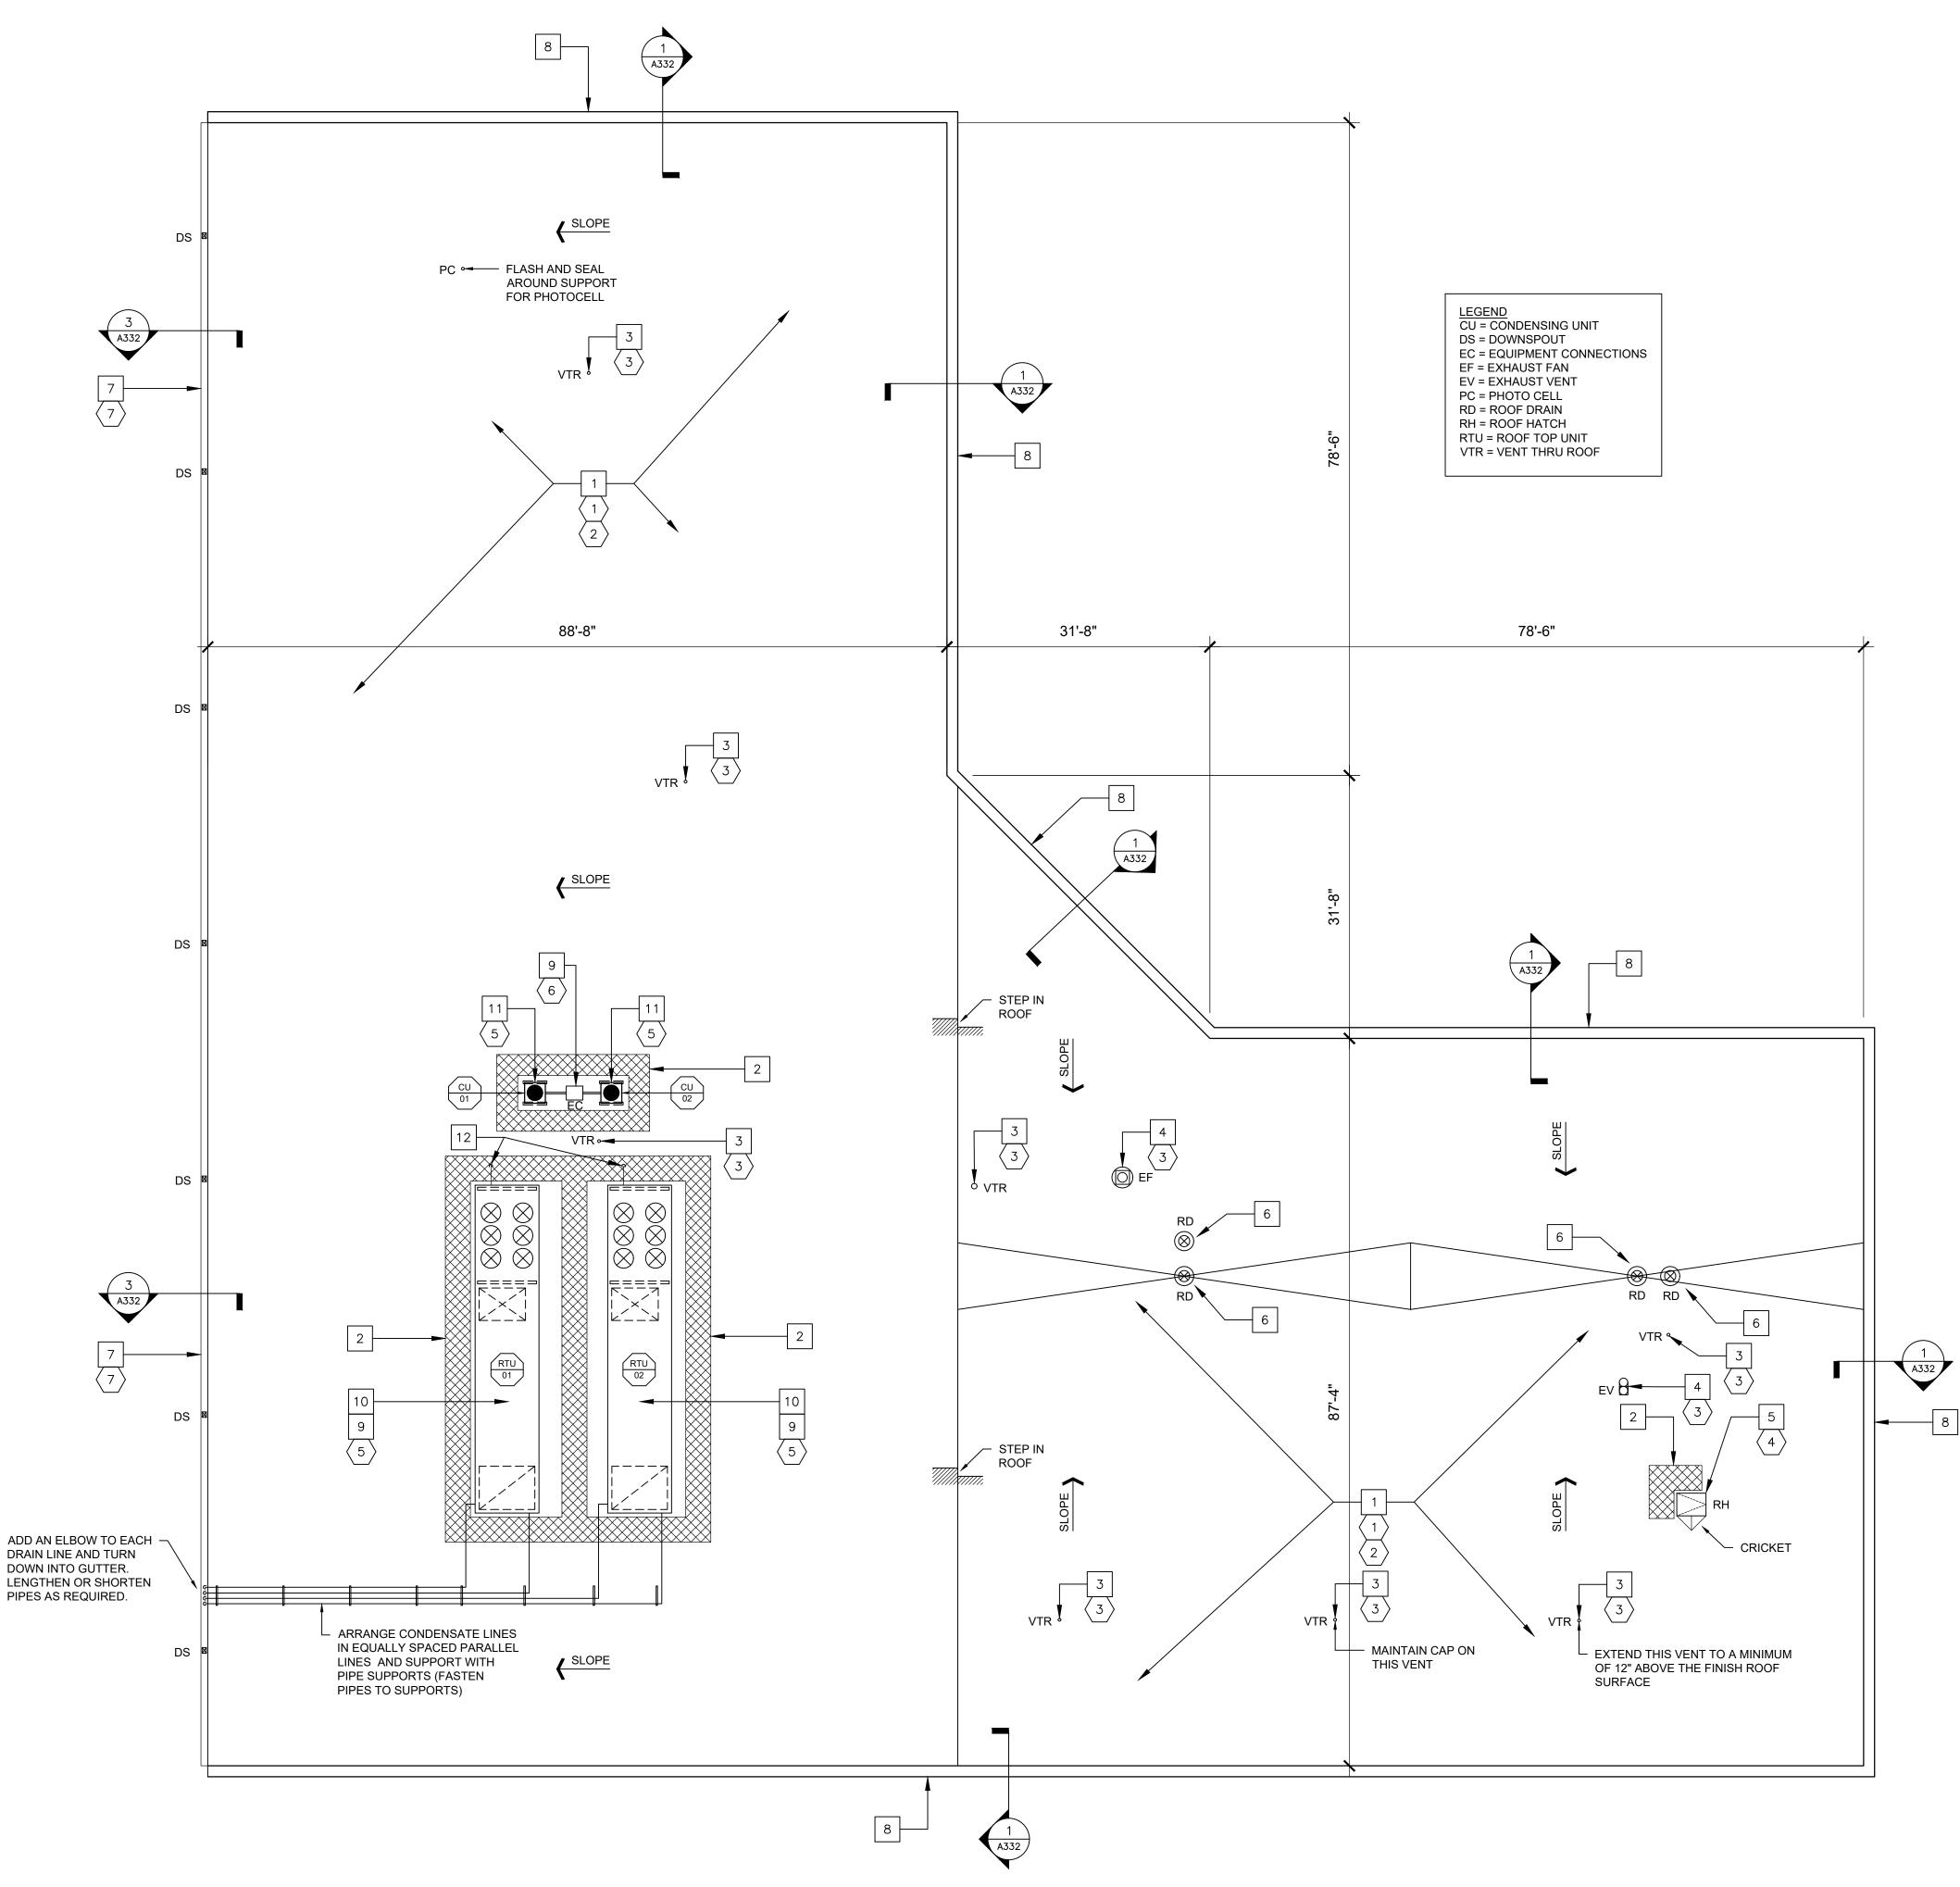
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CAD DWG FILE: DRAWN BY: CHECKED BY: O2513-01 **DESIGNED BY:**

SHEET TITLE: JENNINGS **ROOF DETAILS**

SHEET NUMBER:





NORTH

ROOF PLAN 3/32"=1'-0"

HAZARDOUS MATERIAL NOTES:

THE ROOF HAS BEEN TESTED FOR ASBESTOS MATERIAL AND NONE WAS FOUND.

GENERAL ROOFING NOTES:

- 1. ALL ROOFING SHALL BE DONE IN ACCORDANCE WITH THE LATEST ADDITION OF THE NATIONAL ROOFING CONTRACTORS ASSOCIATION (NRCA) ROOFING MANUAL AND ASHRAE AS IT SIMILARLY RELATES TO ARCHITECTURAL METAL ROOFING AND EQUIPMENT.
- EXISTING CONDITIONS AND DIMENSIONS AS SHOWN ON THESE DRAWINGS ARE APPROXIMATIONS. ACTUAL CONDITIONS AND DIMENSIONS MAY VARY. CONTRACTORS SHALL VERIFY EXISTING CONDITIONS AND DIMENSIONS TO THE EXTENT THAT IT WOULD MAKE A DIFFERENCE TO THEIR BID. NO ADDITIONAL COST TO THE OWNER WILL BE CONSIDERED BASED UPON ANY MINOR VARIATIONS.
- THE CONTRACTOR IS TO VISIT THE SITE DURING THE BIDDING PERIOD AND IS TO ADVISE THE ARCHITECT OF ANY SITUATION OR DISCREPANCY WHICH WILL NOT ALLOW SUCCESSFUL COMPLETION OF THE WORK.
- 4. ALL ROOF SLOPES ARE APPROXIMATELY 1/4"/FT UNLESS OTHERWISE INDICATED ON DRAWINGS.
- DEMOLITION SHALL INCLUDE THE COMPLETE REMOVAL OF ROOF MEMBRANE, INSULATION, COVERBOARD, UNDERLAYMENTS, FASTENERS, AND FLASHINGS AS INDICATED DOWN TO THE EXISTING DECK. PROPERLY DISPOSE OF ALL MATERIALS WHICH ARE NOT MEANT TO BE REUSED.
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- CONTRACTOR SHALL THOROUGHLY CLEAN ROOF AND SITE UPON COMPLETION OF PROJECT. PICK-UP, REMOVE AND PROPERLY DISPOSE OF ALL FASTENERS, DEBRIS AND SCRAP MATERIALS.
- 8. ALL MANUFACTURED ARTICLES, MATERIALS AND EQUIPMENT SHALL BE APPLIED, INSTALLED, CONNECTED, ERECTED, CLEANED, AND CONDITIONED AS DIRECTED BY THE MANUFACTURER, UNLESS INDICATED OTHERWISE.
- THE CONTRACTOR SHALL COORDINATE WITH THE FACILITY TO ESTABLISH PROCEDURES FOR THE CONTROLLED ENTRY OF WORKERS AND MATERIALS INTO THE WORK AREA AND SHALL COMPLY WITH ALL RULES AND REGULATIONS ESTABLISHED BY THE FACILITY. THE INTERRUPTION OF SECURITY AND COMMUNICATIONS WILL NOT BE PERMITTED. CONTRACTOR SHALL INFORM AND COORDINATE WITH SECURITY OFFICIALS 48 HOURS IN ADVANCE OF ANY WORK RELATED TO SECURITY OR COMMUNICATIONS.
- 10. AT MECHANICAL/ELECTRICAL ROOF EQUIPMENT AND VENTS, PROVIDE FLASHING PER ROOFING MANUFACTURER FOR WATERTIGHT ROOF INSTALLATION.
- 11. EXISTING GUTTERS AND DOWNSPOUTS TO REMAIN. REWORK EDGE DETAIL AS REQUIRED
- 12. SEAL ROOF PENETRATIONS AS REQUIRED PER ROOFING MANUFACTURER'S STANDARD PRINTED SPECIFICATIONS AND DETAILS.
- 13. EXTEND VENTS THROUGH THE ROOF (VTRs) TO A MINIMUM OF 12" ABOVE THE FINISH ROOF SURFACE.
- 14. USE TAPERED INSULATION TO CREATE CRICKETS AND TO PROVIDE POSITIVE DRAINAGE AS REQUIRED.

DEMOLITION KEY NOTES:

| | DEMOLITION RET NOTES. | | | |
|---------------------------------|--|--|--|--|
| 1 | REMOVE AND PROPERLY DISPOSE OF ALL EXISTING ROOFING MATERIAL, INSULATION, COVERBOARD, UNDERLAYMENTS, FLASHINGS AND FASTENERS DOWN TO THE EXISTING DECK. | | | |
| 2 | ONCE EXISTING ROOFING IS REMOVED, CAREFULLY INSPECT ALL EXISTING DECK FOR DAMAGE OR DETERIORATION. | | | |
| $\left(3 \right)$ | EXISTING ROOF VENT TO REMAIN | | | |
| 4 | EXISTING ROOF HATCH TO REMAIN | | | |
| 5 | EXISTING ROOFTOP MECHANICAL EQUIPMENT TO REMAIN; REMOVE 4x4 WOOD SUPPORTS. | | | |
| 6 | REMOVE EXISTING FLASHING FOR ROOFTOP EQUIPMENT CONNECTIONS TO HVAC CONDENSING UNITS. | | | |
| 7 | REPLACE EXISTING TREATED WOOD BLOCKING AS REQUIRED. | | | |
| | | | | |
| NEV | ROOFING KEY NOTES: | | | |
| | | | | |
| 1 | NEW FULLY ADHERED TPO ROOF ON COVERBOARD OVER 5 1/2" RIGID POLYISO INSULATION (AVERAGE R-30). SEE DETAILS ON SHEET A332. | | | |
| 1 | | | | |
| | (AVERAGE R-30). SEE DETAILS ON SHEET A332. | | | |
| 2 | (AVERAGE R-30). SEE DETAILS ON SHEET A332. INSTALL 36" WIDE WALKWAY PADS AROUND ROOF HATCHES AND HVAC UNITS AS INDICATED. | | | |
| 2 3 | (AVERAGE R-30). SEE DETAILS ON SHEET A332. INSTALL 36" WIDE WALKWAY PADS AROUND ROOF HATCHES AND HVAC UNITS AS INDICATED. NEW BOOT FLASHING AROUND EXISTING VENT PIPING. SEE DETAIL 8/A332. | | | |
| 2 3 4 | (AVERAGE R-30). SEE DETAILS ON SHEET A332. INSTALL 36" WIDE WALKWAY PADS AROUND ROOF HATCHES AND HVAC UNITS AS INDICATED. NEW BOOT FLASHING AROUND EXISTING VENT PIPING. SEE DETAIL 8/A332. NEW FLASHING AT ROOF TOP VENT EQUIPMENT. SEE DETAIL 5/A332. | | | |
| 2 3 4 5 | (AVERAGE R-30). SEE DETAILS ON SHEET A332. INSTALL 36" WIDE WALKWAY PADS AROUND ROOF HATCHES AND HVAC UNITS AS INDICATED. NEW BOOT FLASHING AROUND EXISTING VENT PIPING. SEE DETAIL 8/A332. NEW FLASHING AT ROOF TOP VENT EQUIPMENT. SEE DETAIL 5/A332. NEW FLASHING AROUND EXISTING ROOF ACCESS HATCH. SIMILAR TO DETAIL 5/A332. REWORK ALL ROOF DRAINS. TAPER INSULATION TO PROVIDE DRAINAGE TO ROOF DRAIN AND CREATE A 4' SUMP AROUND EACH DRAIN. INSTALL NEW TPO RETROFIT ROOF DRAINS. | | | |
| 2 3 4 5 6 | (AVERAGE R-30). SEE DETAILS ON SHEET A332. INSTALL 36" WIDE WALKWAY PADS AROUND ROOF HATCHES AND HVAC UNITS AS INDICATED. NEW BOOT FLASHING AROUND EXISTING VENT PIPING. SEE DETAIL 8/A332. NEW FLASHING AT ROOF TOP VENT EQUIPMENT. SEE DETAIL 5/A332. NEW FLASHING AROUND EXISTING ROOF ACCESS HATCH. SIMILAR TO DETAIL 5/A332. REWORK ALL ROOF DRAINS. TAPER INSULATION TO PROVIDE DRAINAGE TO ROOF DRAIN AND CREATE A 4' SUMP AROUND EACH DRAIN. INSTALL NEW TPO RETROFIT ROOF DRAINS. SEE DETAIL 4/A332. EXISTING GUTTERS AND DOWNSPOUTS TO BE REMAIN. THOROUGHLY CLEAN GUTTERS AND FLUSH DOWNSPOUTS OF DEBRIS AND DIRT. INSTALL ADDITIONAL TREATED WOOD | | | |
| 2 3 4 5 6 7 | (AVERAGE R-30). SEE DETAILS ON SHEET A332. INSTALL 36" WIDE WALKWAY PADS AROUND ROOF HATCHES AND HVAC UNITS AS INDICATED. NEW BOOT FLASHING AROUND EXISTING VENT PIPING. SEE DETAIL 8/A332. NEW FLASHING AT ROOF TOP VENT EQUIPMENT. SEE DETAIL 5/A332. NEW FLASHING AROUND EXISTING ROOF ACCESS HATCH. SIMILAR TO DETAIL 5/A332. REWORK ALL ROOF DRAINS. TAPER INSULATION TO PROVIDE DRAINAGE TO ROOF DRAIN AND CREATE A 4' SUMP AROUND EACH DRAIN. INSTALL NEW TPO RETROFIT ROOF DRAINS. SEE DETAIL 4/A332. EXISTING GUTTERS AND DOWNSPOUTS TO BE REMAIN. THOROUGHLY CLEAN GUTTERS AND FLUSH DOWNSPOUTS OF DEBRIS AND DIRT. INSTALL ADDITIONAL TREATED WOOD BLOCKING AS REQUIRED. INSTALL NEW TPO METAL DRIP EDGE. SEE DETAIL 3/A332. | | | |
| 2 3 4 5 6 7 8 | (AVERAGE R-30). SEE DETAILS ON SHEET A332. INSTALL 36" WIDE WALKWAY PADS AROUND ROOF HATCHES AND HVAC UNITS AS INDICATED. NEW BOOT FLASHING AROUND EXISTING VENT PIPING. SEE DETAIL 8/A332. NEW FLASHING AT ROOF TOP VENT EQUIPMENT. SEE DETAIL 5/A332. NEW FLASHING AROUND EXISTING ROOF ACCESS HATCH. SIMILAR TO DETAIL 5/A332. REWORK ALL ROOF DRAINS. TAPER INSULATION TO PROVIDE DRAINAGE TO ROOF DRAIN AND CREATE A 4' SUMP AROUND EACH DRAIN. INSTALL NEW TPO RETROFIT ROOF DRAINS. SEE DETAIL 4/A332. EXISTING GUTTERS AND DOWNSPOUTS TO BE REMAIN. THOROUGHLY CLEAN GUTTERS AND FLUSH DOWNSPOUTS OF DEBRIS AND DIRT. INSTALL ADDITIONAL TREATED WOOD BLOCKING AS REQUIRED. INSTALL NEW TPO METAL DRIP EDGE. SEE DETAIL 3/A332. NEW PREFINISHED METAL FLASHING ON PARAPET EDGE. SEE DETAIL 1/A332. NEW PIPE CHASE FOR MECHANICAL PIPING AND ELECTRICAL WIRING THROUGH THE ROOF | | | |

- 11 NEW EQUIPMENT RAILS FOR EXISTING HVAC CONDENSING UNITS. SEE DETAIL 7/A332.
- NEW BOOT FLASHING AROUND ELECTRICAL CONDUIT FOR ROOFTOP UNIT ELECTRICAL CONNECTION. SIMILAR TO DETAIL 8/A332.

STATE OF MISSOURI MIKE KEHOE, GOVERNOR



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OFFICE OF ADMINISTRATION DIVISION OF FACILITIES MANAGEMENT, **DESIGN AND CONSTRUCTION**

DEPARTMENT OF OFFICE OF ADMINISTRATION

REPLACE ROOF SYSTEMS MULTIPLE SITES AND ASSETS ST. LOUIS AREA

NORTH ST LOUIS COUNTY SERVICE CENTER 4040 7 HILLS DRIVE FLOISSANT, MO 63033

O2513-01 PROJECT # 1019 SITE # ASSET # 3101019001

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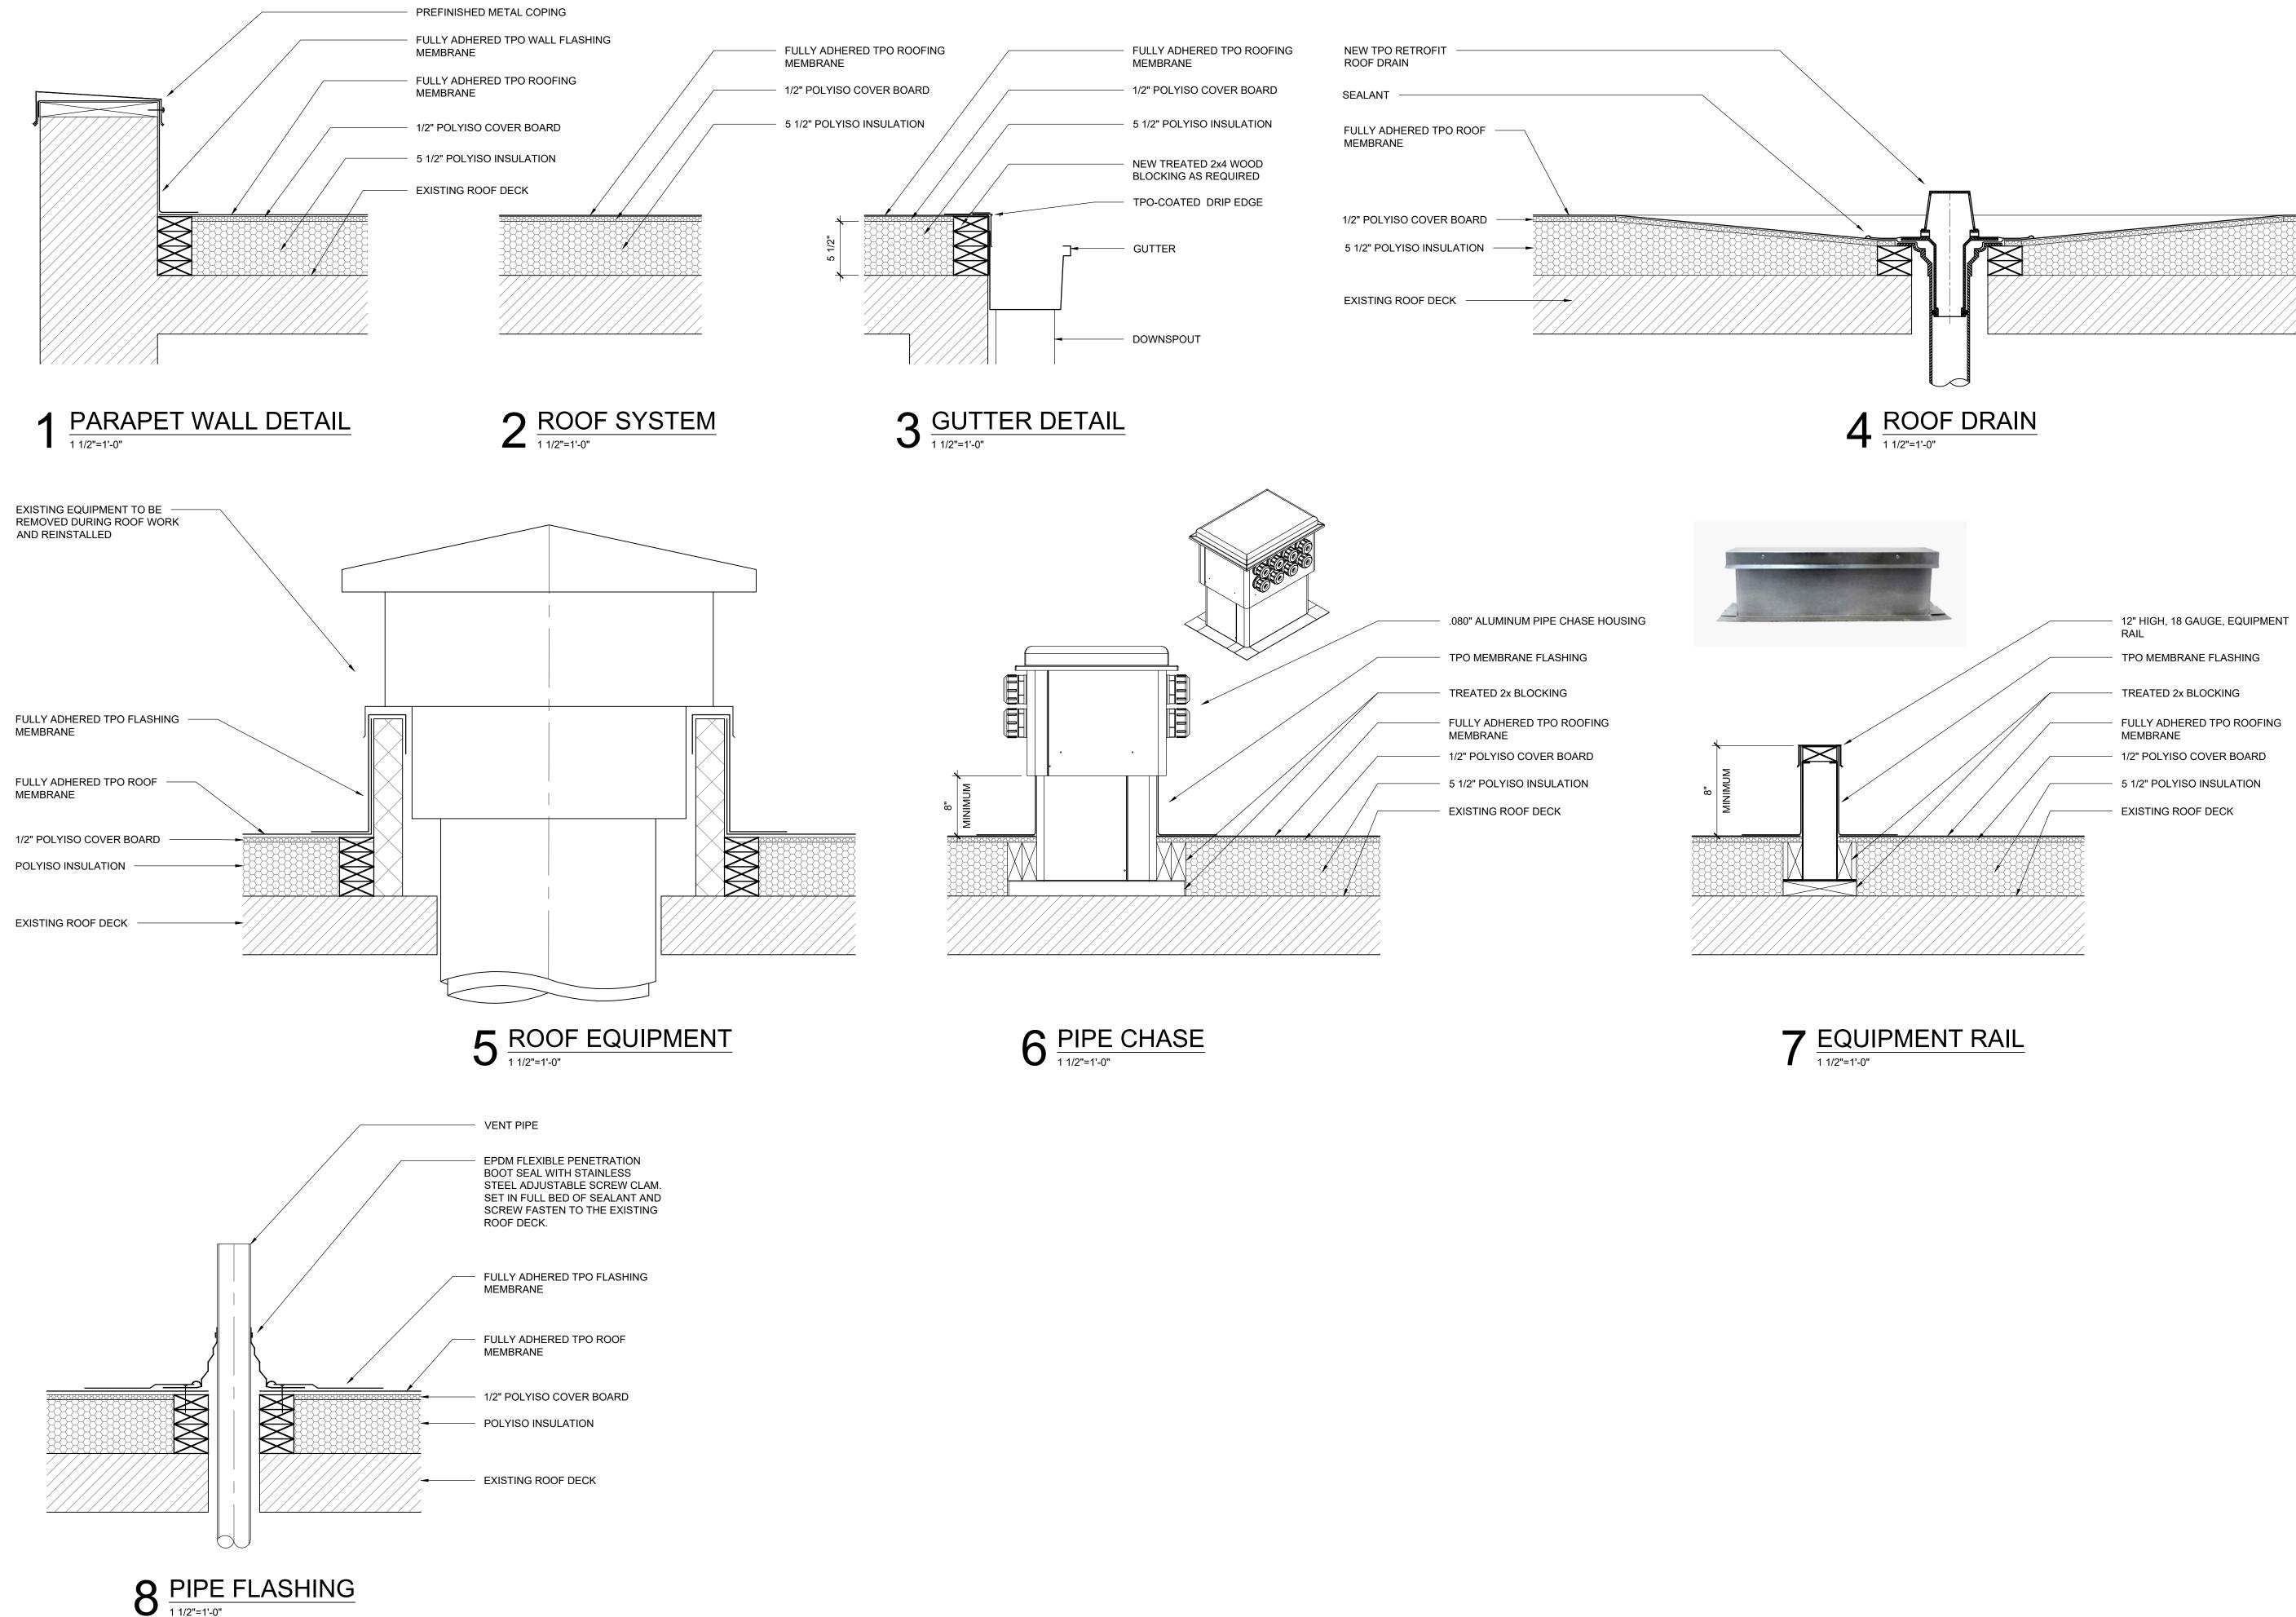
CAD DWG FILE 02513-0 DRAWN BY: CHECKED BY **DESIGNED BY:**

SHEET TITLE:

NORTH STL COUNTY ROOF PLAN

SHEET NUMBER:

5 OF 8 SHEETS 06/06/2025



STATE OF MISSOURI MIKE KEHOE, GOVERNOR

OF MIS BRADMICHAE SCHAEFER NUMBER A-2009027294 CHITE Brad M. Schaefer - Architect

MO# A-2009027294

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OFFICE OF ADMINISTRATION DIVISION OF FACILITIES MANAGEMENT, **DESIGN AND CONSTRUCTION**

DEPARTMENT OF OFFICE OF ADMINISTRATION

REPLACE ROOF SYSTEMS MULTIPLE SITES AND ASSETS ST. LOUIS AREA

NORTH ST LOUIS COUNTY SERVICE CENTER 4040 7 HILLS DRIVE FLOISSANT, MO 63033

PROJECT # SITE # ASSET #

O2513-01 1019 3101019001


REVISION: DATE: **REVISION:** DATE: **REVISION**: DATE: **ISSUE DATE:** 06/06/2025

O2513-01 CAD DWG FILE: DRAWN BY: CHECKED BY: **DESIGNED BY:**

SHEET TITLE: NORTH STL COUNTY **ROOF DETAILS**

SHEET NUMBER:

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NORTH

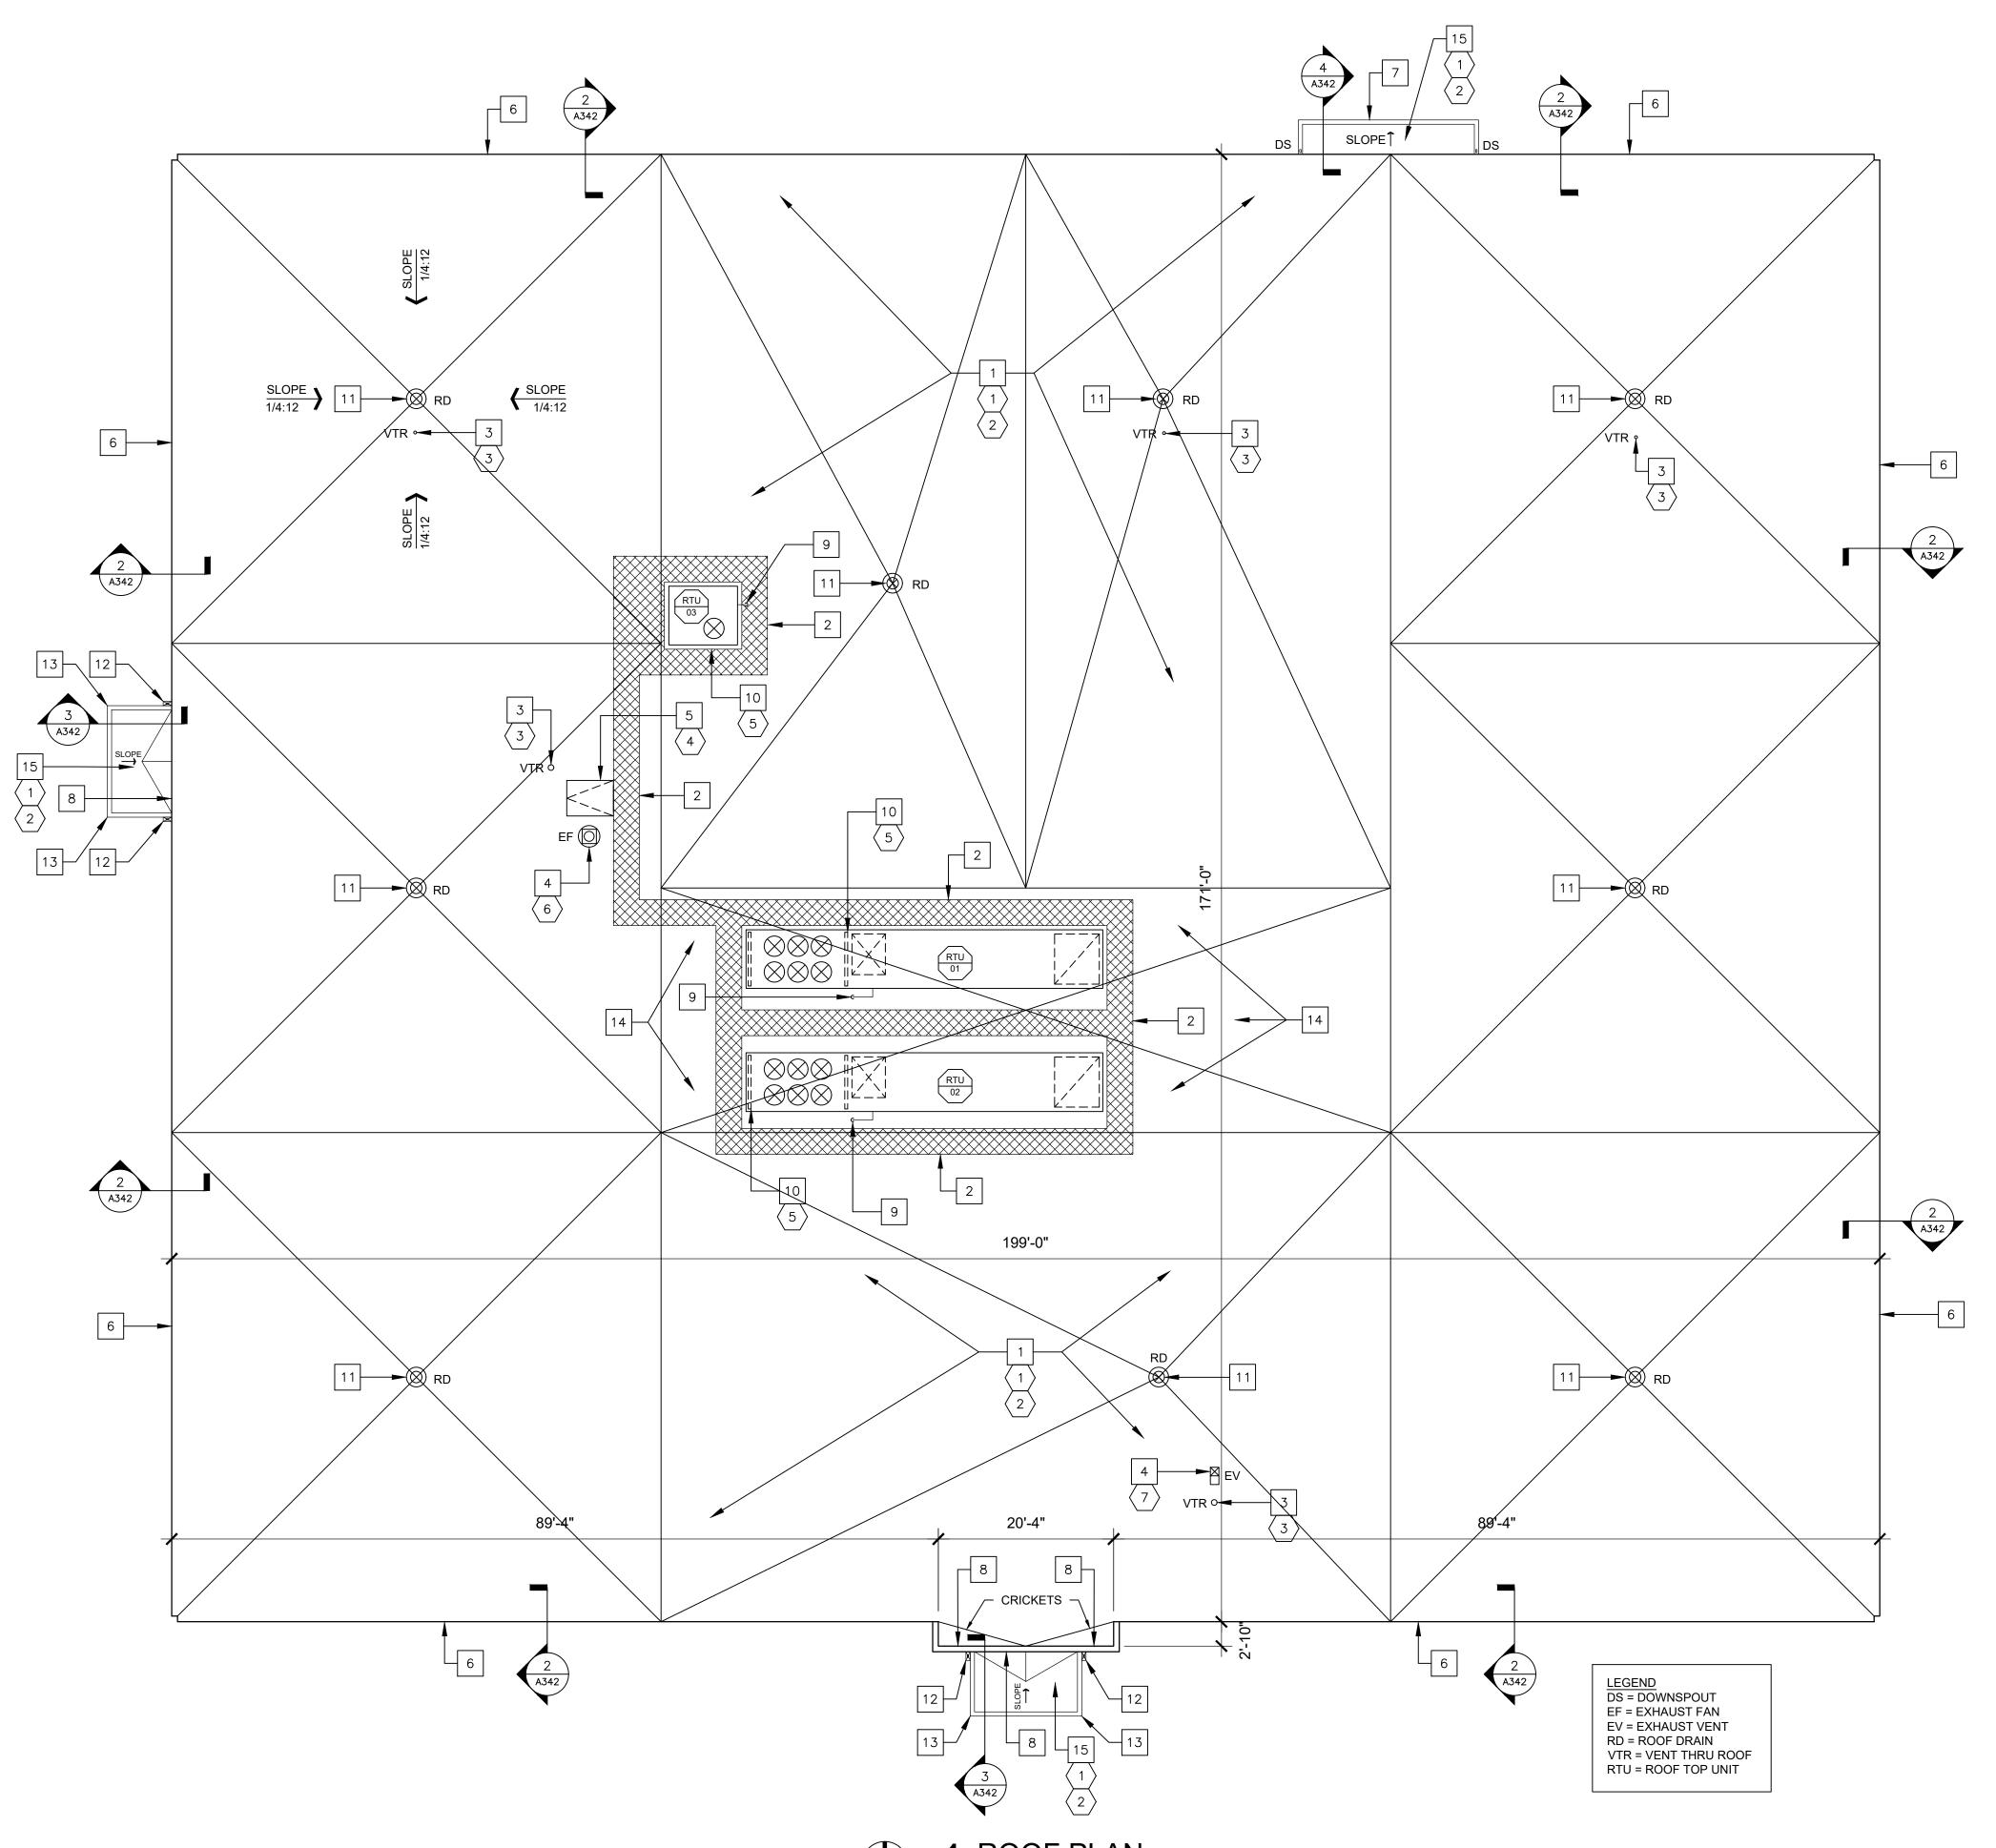HAZARDOUS MATERIAL NOTE:

THE ROOF HAS BEEN TESTED FOR ASBESTOS MATERIAL AND NONE WAS FOUND.

GENERAL ROOFING NOTES:

- ALL ROOFING SHALL BE DONE IN ACCORDANCE WITH THE LATEST ADDITION OF THE NATIONAL ROOFING CONTRACTORS ASSOCIATION (NRCA) ROOFING MANUAL AND ASHRAE AS IT SIMILARLY RELATES TO ARCHITECTURAL METAL ROOFING AND EQUIPMENT.
- EXISTING CONDITIONS AND DIMENSIONS AS SHOWN ON THESE DRAWINGS ARE APPROXIMATIONS. ACTUAL CONDITIONS AND DIMENSIONS MAY VARY. CONTRACTORS SHALL VERIFY EXISTING CONDITIONS AND DIMENSIONS TO THE EXTENT THAT IT WOULD MAKE A DIFFERENCE TO THEIR BID. NO ADDITIONAL COST TO THE OWNER WILL BE CONSIDERED BASED UPON ANY MINOR VARIATIONS.
- THE CONTRACTOR IS TO VISIT THE SITE DURING THE BIDDING PERIOD AND IS TO ADVISE THE ARCHITECT OF ANY SITUATION OR DISCREPANCY WHICH WILL NOT ALLOW SUCCESSFUL COMPLETION OF THE WORK.
- ALL ROOF SLOPES ARE APPROXIMATELY 1/4"/FT UNLESS OTHERWISE INDICATED ON DRAWINGS.
- DEMOLITION SHALL INCLUDE THE COMPLETE REMOVAL OF STONE BALLAST, ROOFING MEMBRANE, INSULATION, COVERBOARD, UNDERLAYMENTS, FASTENERS, AND FLASHINGS AS INDICATED DOWN TO THE EXISTING DECK. PROPERLY DISPOSE OF ALL MATERIALS WHICH ARE NOT MEANT TO BE REUSED.
- CONTRACTOR IS RESPONSIBLE FOR ANY INCIDENTAL DAMAGE DONE TO BUILDING AND GROUNDS DURING COURSE OF DEMOLITION AND CONSTRUCTION AND SHALL RESTORE BUILDING AND GROUNDS TO EXISTING CONDITIONS UPON COMPLETION OF ROOFING PROJECT.
- CONTRACTOR SHALL THOROUGHLY CLEAN ROOF AND SITE UPON COMPLETION OF PROJECT. PICK-UP, REMOVE AND PROPERLY DISPOSE OF ALL FASTENERS, DEBRIS AND SCRAP MATERIALS.
- ALL MANUFACTURED ARTICLES, MATERIALS AND EQUIPMENT SHALL BE APPLIED, INSTALLED, CONNECTED, ERECTED, CLEANED, AND CONDITIONED AS DIRECTED BY THE MANUFACTURER, UNLESS INDICATED OTHERWISE.
- THE CONTRACTOR SHALL COORDINATE WITH THE FACILITY TO ESTABLISH PROCEDURES FOR THE CONTROLLED ENTRY OF WORKERS AND MATERIALS INTO THE WORK AREA AND SHALL COMPLY WITH ALL RULES AND REGULATIONS ESTABLISHED BY THE FACILITY. THE INTERRUPTION OF SECURITY AND COMMUNICATIONS WILL NOT BE PERMITTED. CONTRACTOR SHALL INFORM AND COORDINATE WITH SECURITY OFFICIALS 48 HOURS IN ADVANCE OF ANY WORK RELATED TO SECURITY OR COMMUNICATIONS.
- 10. AT MECHANICAL/ELECTRICAL ROOF EQUIPMENT AND VENTS, PROVIDE FLASHING PER ROOFING MANUFACTURER FOR WATERTIGHT ROOF INSTALLATION.
- 11. EXISTING GUTTERS AND DOWNSPOUTS TO REMAIN. REWORK EDGE DETAIL AS REQUIRED.
- 12. REPLACE PITCH POCKETS AS REQUIRED PER ROOFING MANUFACTURER'S STANDARD PRINTED SPECIFICATIONS AND DETAILS.
- 13. EXTEND VENTS THROUGH THE ROOF (VTRs) TO A MINIMUM OF 12" ABOVE THE FINISH ROOF SURFACE.
- 14. USE TAPERED INSULATION TO CREATE CRICKETS AND TO PROVIDE POSITIVE DRAINAGE AS REQUIRED.

DEMOLITION KEY NOTES:

| 1 | REMOVE EXISTING STONE BALLAST, WALKWAY PADS, EPDM MEMBRANE, COVER BOARD, INSULATION, UNDERLAYMENTS, FLASHINGS, AND FASTENERS DOWN TO THE EXISTING DECK. PROPERLY DISPOSE OF ALL MATERIALS REMOVED. |
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| 2 | ONCE EXISTING ROOFING IS REMOVED, CAREFULLY INSPECT ALL EXISTING DECK FOR DAMAGE OR DETERIORATION. |
| 3 | EXISTING ROOF VENT TO REMAIN. |
| 4 | EXISTING ROOF HATCH TO REMAIN. |
| 5 | EXISTING ROOFTOP MECHANICAL EQUIPMENT AND SUPPORTS TO REMAIN. |

- (6) EXISTING EXHAUST FAN TO REMAIN.
- 7 > EXISTING EXHAUST VENT TO REMAIN.

NEW ROOFING KEY NOTES:

| 1 | NEW FULLY ADHERED TPO ROOF ON COVERBOARD OVER 5 1/2" RIGID POLYISO ROOF INSULATION (AVERAGE R-30). SEE DETAILS ON A342. |
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| 2 | INSTALL 36" WIDE WALKWAY PADS AROUND ROOF HATCHES AND HVAC UNITS AS INDICATED. |
| 3 | NEW BOOT FLASHING AROUND EXISTING VENT PIPING |
| 4 | NEW FLASHING AT VENT EQUIPMENT. SEE DETAIL 5/A342. |
| 5 | NEW FLASHING AROUND EXISTING ROOF ACCESS HATCH. SIMILAR TO DETAIL 5/A342. |
| 6 | EXISTING BRONZE ANODIZED ALUMINUM GRAVEL STOP TO REMAIN. INSTALL NEW WOOD BLOCKING AND TPO GRAVEL STOP AS SHOWN. SEE DETAIL 2/A342. |
| 7 | EXISTING GUTTERS AND DOWNSPOUTS TO REMAIN. INSTALL NEW TPO DRIP EDGE. SEE DETAIL 4/A342. |
| 8 | EXISTING BRONZE ANODIZED WALL FLASHING TO BE REUSED AND SEALED. |
| 9 | SEAL GAS AND MECHANICAL PIPING THROUGH ROOF DECK. |
| 10 | FLASH AND SEAL SUPPORTS OF EXISTING MECHANICAL EQUIPMENT. FLASH AND SEAL EXISTING MECHANICAL EQUIPMENT CURBS. |
| 11 | REWORK ALL DRAINS. TAPER INSULATION TO PROVIDE 4' SUMP AROUND DRAINS. INSTALL NEW TPO RETROFIT ROOF DRAINS. |
| 12 | EXISTING BRONZE ANODIZED ALUMINUM SCUPPER, LEADER HEAD, AND DOWNSPOUT TO REMAIN. |
| 13 | EXISTING BRONZE ANODIZED ALUMINUM COPING TO REMAIN. |
| 14 | TAPERED POLYISO INSULATION IN THIS AREA TO DRAIN AWAY FROM MECHANICAL EQUIPMENT. |
| | NEW FULLY ADHERED TPO BOOF ON COVERBOARD OVER 2" RIGID POLYISO BOOF |

15 NEW FULLY ADHERED TPO ROOF ON COVERBOARD OVER 2" RIGID POLYISO ROOF INSULATION. INSTALL CRICKETS AS REQUIRED FOR POSITIVE ROOF DRAINAGE TO SCUPPERS. SEE DETAILS ON A342.

STATE OF MISSOURI MIKE KEHOE, GOVERNOR





OFFICE OF ADMINISTRATION DIVISION OF FACILITIES MANAGEMENT, **DESIGN AND CONSTRUCTION**

DEPARTMENT OF OFFICE OF ADMINISTRATION

REPLACE ROOF

KEATHLEY STATE OFFICE BUILDING 3101 CHOTEAU AVENUE ST. LOUIS, MO 63103

PROJECT # SITE # ASSET #

O2513-01 1022 3101022001

REVISION: DATE: **REVISION:** DATE: **REVISION**: DATE: 06/06/2025 ISSUE DATE:

CAD DWG FILE: O2513-01

| RAWN BY: | MLB |
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| HECKED BY: | BMS |
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SHEET TITLE: KEATHLEY **ROOF PLAN**

SHEET NUMBER:

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