# Upgrade/Relocate Rooftop Units Springfield DOLIR Office Building Springfield, Missouri



**OWNER:** 

STATE OF MISSOURI

MIKE KEHOE, GOVERNOR E ST LOUIS ST.

E MCDANIEL ST.

WALNUT

PROJECT SITE
505 E WALNUT ST
SPRINGFIELD MO, 65806

SITE MAP

**PROJECT** 

OFFICE OF ADMINISTRATION

MANAGEMENT: DIVISION OF FACILITIES MANAGEMENT

**DESIGN AND CONSTRUCTION** 

**DESIGNER:** Interpres Building solutions

1201 S Campbell Ave Springfield, MO 65807

PROJECT NUMBER: 02516-01

SITE NUMBER: 1032

FACILITY NUMBER: 3101032001



				SCHEDULE OF M	ANUFACTURERS	3		
	DIVISION 22	- PLUMBING		DIVISION 23 -	DIVISION 26 - ELECTRICAL			
3. GR 4. TOL 5. UNI 1. PAT 2. HR 3. THY 1. ERI 2. MIF 3. MIC 1. AM 2. AN 3. KIN 4. KOI 5. MA 6. TOL 7. VIB 220700 1. AR 2. JOH 3. OW 221100 1. CEF 2. CH 3. MIC 4. RE	HANGERS SUPPORTS AND VIBRATION ISOLATION FOR PLUMBING PIPING AND EQUIPMENT  HANGERS AND SUPPORTS  WIL -LINE SYSTEMS RINNELL DICCO NISTRUT  ROOF EQUIPMENT RAILS  ATE RANEC HYCURB  PIPE STANDS  RICO IRO INDUSTRIES IICHIGAN HANGER CO VIBRATION ISOLATORS  MBER BOOTH WIL NINI NETICS NOISE CONTROL DREUND ASON INDUSTRIES DICCO BRATION ELIMINATOR.  PLUMBING INSULATION  RMACELL HINS MANSVILLE WENS CORNING  FACILITY PIPING AND SPECIALTIES PIPING COPPER  ERRO HASE UELLER EVERE COPPER  FITTINGS COPPER	TRANSITION FITTINGS  1. CHARLOTTE PIPE 2. IPEX 3. KBI 4. NIBCO 5. SIOUX CHIEF  DIELECTRIC FITTINGS  1. CALIPCO 2. CAPITOL MANUFACTURING 3. CENTRAL PLASTICS 4. HART INDUSTRIES 5. LOCHINVAR 6. PERFECTION 7. PIPELINE SEAL AND INSULATOR 8. SIOUX CHIEF 9. WATTS VICTAULIC 10. ZURN  ALIGNMENT GUIDES AND ANCHORS  1. FLEXHOSE CO 2. FLEXICRAFT INDUSTRIES 3. METRAFLEX	1. ASHCROFT 2. MARSH 3. MUELLER 4. WATTS 5. WEISS  230523 VALVES FOR MECHANICAL PIPING  BALL, BUTTERFLY, GATE AND GLOBE VALVE  1. APOLLO 2. CENTERLINE 3. CRANE 4. HAMMOND 5. KENNEDY 6. KEYSTONE 7. NIBCO 8. NEXUS 9. POWELL 10. VICTAULIC 11. WATTS  BALANCE AND FLOW CONTROL VALVES  1. BELL AND GOSSETT 2. FLOW DESIGN 3. FLOWSET 4. HAYS 5. ILLINOIS 6. NEXUS 7. PAGENT 8. SIEMENS 9. TACO 10. THRUSH  SWING AND CHECK VALVES  1. CRANE 2. HAMMOND 3. MILLYAUKEE 4. WATTS  230514 VARIABLE FREQUENCY DRIVE  1. YASKAWA 2. ABB 3. DANFOSS	HANGERS SUPPORTS AND   VIBRATION ISOLATION FOR   PLUMBING PIPING AND EQUIPMENT	AMTROL	235216 CONDENSING BOILERS  1. ABRCO 2. FUNDAMAR  238126 AIR COOLED CONDENSERS  1. AAON 3. TSI 4. TRANE	260519 CONDUCTORS AND CABLES  1. ALAN-WIRE 2. ALCON 3. ENCORE 4. GENERAL CABLE CORP 5. SOUTHWIRE  260533 RACEWAYS AND BOXES FOR ELECTRICAL SYSTEMS  METALLIC CONDUIT  1. AFC CABLE 2. ALFLEX 3. ALLED TUBE AND CONDUIT 4. ANAMET ELECTRICAL 5. CROUSE HINDS 6. ELECTRICAL 7. MANIMET ELECTRICAL 7. CROUSE HINDS 8. ELECTRICAL 8. MANIMET ELECTRICAL 9. OZ GEDNEY 9. OZ GEDNEY 9. OZ GEDNEY 1. ABB INSTALLATION 1. CROUSE HINDS 8. ELECTRICAL 9. LIMSON AND SESSIONS 10. MANIMATRAY (CDT) COLE FLEX 11. RACO  WIREWAY 1. B LINE 2. HOFFMAN 1. SQUARE D  SURFACE RACEWAY 1. ABB INSTALLATION 2. CROUSE HINDS 3. HUBBELL 4. PANDUIT 5. WALKER SYSTEMS 6. WIREWOLD  BOXES ENCLOSURES AND CABINETS 1. ABB INSTALLATION 2. COOPER 3. MAPILON ELECTRIC 4. RACO 9. WALKER 9. W	PANELBOARDS PANELBOARDS  1. EATONELECTRIC 2. GENERAL ELECTRIC 3. SISMENS 4. SQUARE D

#### **SHEET INDEX:**


**COVER SHEET** 

MEP100 - SCHEDULE OF MANUFACTURERS

MEP200 - DEMOLITION PLAN MEP300 - ROOF MEP PLAN **MECHANICAL PLAN MECHANICAL PLAN MECHANICAL DETAILS** MECHANICAL SCHEDULES

E100 -**ELECTRICAL PLAN** 

**ELECTRICAL SCHEDULES AND DETAILS** 

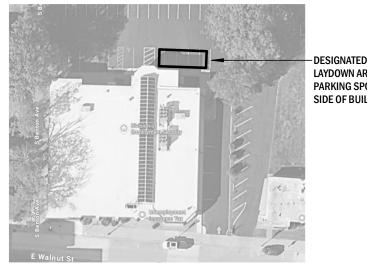

— DESIGNATED CONTRACTOR LAYDOWN AREA IN FOUR PARKING SPOTS ON NORTH SIDE OF BUILDING




#### **ALTERNATE DESCRIPTIONS**

ALTERNATE #1 REPLACE BOILER WITH TWO NEW CONDENSING HIGH EFFICIENCY BOILERS AND PROVIDE NEW PUMPS PIPING, FLUES AND ELECTRICAL CIRCUITING AS SHOWN. ALTERNATE #2 REPLACE FAN IN MULTIZONE AIR HANDLER WITH NEW FAN WALL AND VARIABLE FREQUENCY DRIVES ALTERNATE #3 PROVIDE NEW UV FILTERS IN EXISTING MULTIZONE AIR HANDLERS.

### **PHASING NOTES**

CONTRACTOR SHALL NOT REMOVE EXISTING EQUIPMENT UNTIL NEW EQUIPMENT IS SECURED AND DELIVERED TO CONTRACTORS LOCAL POSSESSION. THIS IS SO THAT BUILDING IS NOT WITHOUT HEATING OR COOLING WHILE UNIT PRODUCTION/SHIPPING IS IN PROGRESS.

#### STATE OF MISSOURI MICHAEL KEHOE **GOVERNOR**

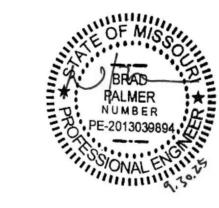

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UPGRADE/RELOCATE ROOFTOP UNITS

SPRINGFIELD DOLIR OFFICE BUILDING

SPRINGFIELD, MO

PROJECT# O2516-01 1032 SITE# FACILITY # 3101032001


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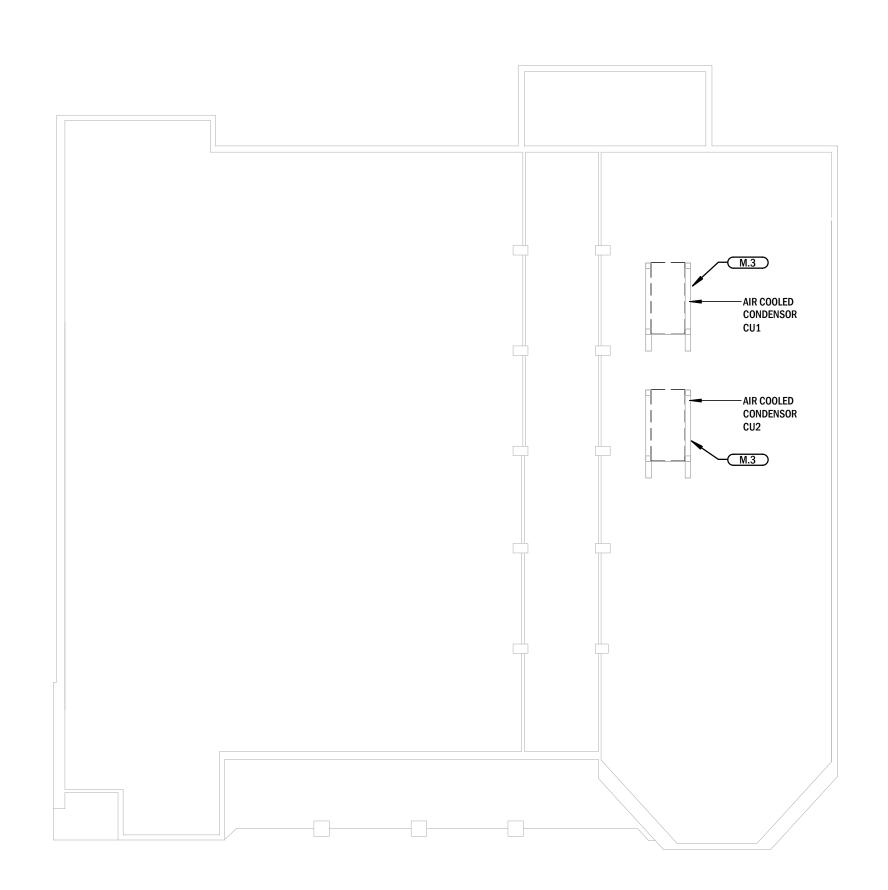
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DRAWN BY: BRP
CHECKED BY: BRP
DESIGNED BY: BRP

SHEET TITLE:

SCHEDULE OF **MANUFACTURERS** 


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ROOF MEP DEMOLITION PLAN

Scale: 1/16" = 1'-0"

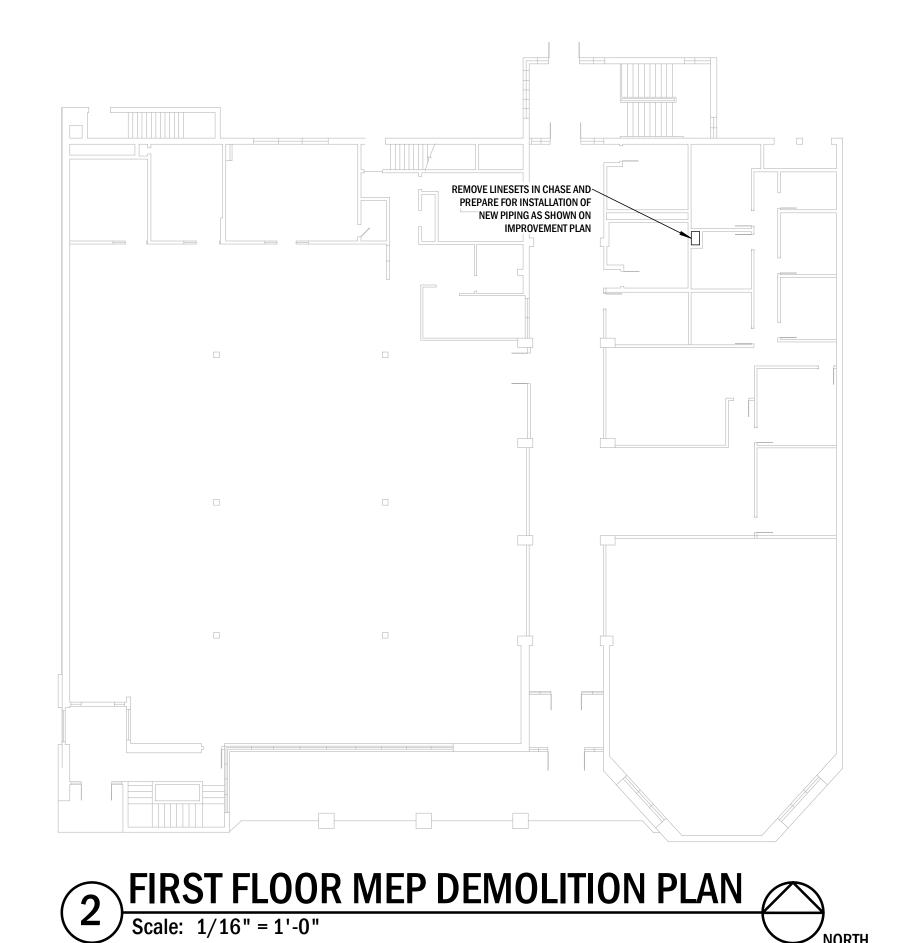


#### **KEYNOTES**

1 EXISTING MULTIZONE UNIT SHALL REMAIN. PREPARE FOR REPLACEMENT OF COMPONENTS IN BASE BID AND BID ALTERNATES AS DETAILED ON IMPROVEMENT PLAN AND IN SPECIFICATIONS.

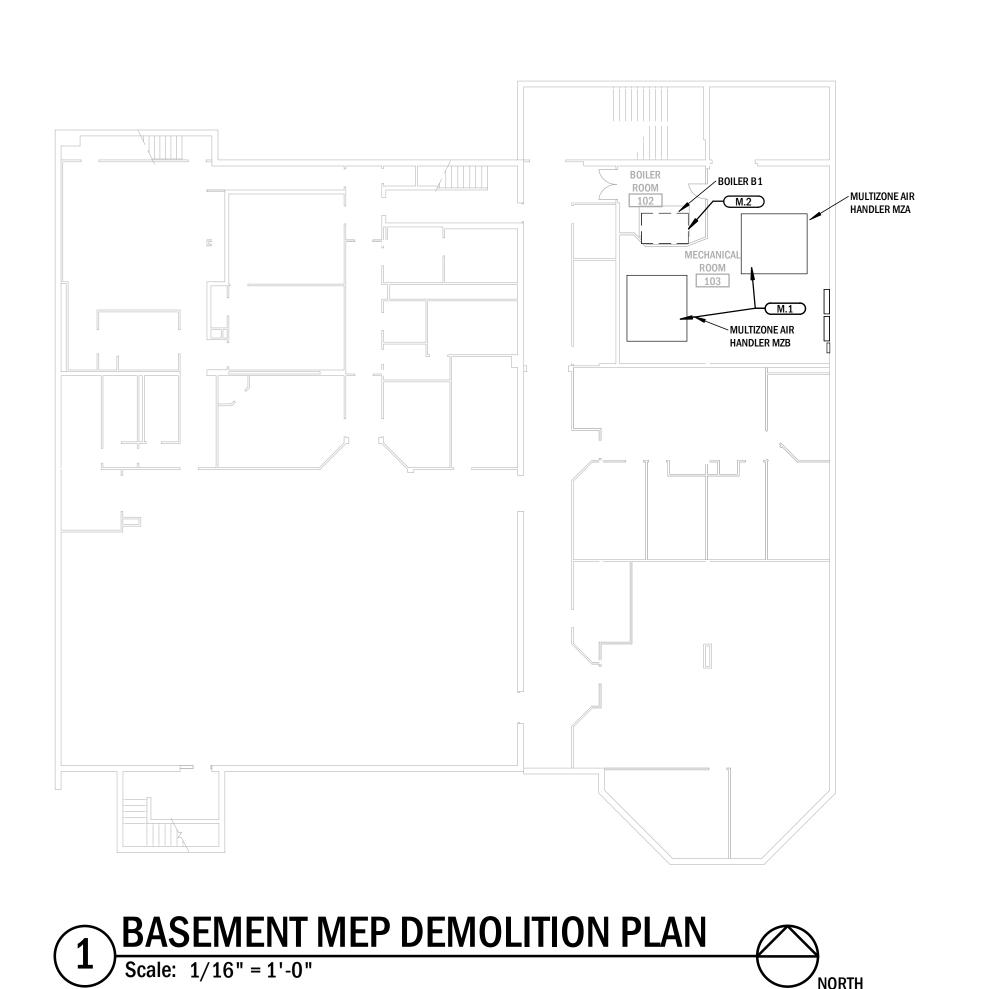M.2 ALTERNATE 1: REMOVE BOILER AND PREPARE PIPING AND ELECTRICAL CONNECTIONS FOR INSTALLATION OF NEW BOILERS AND CONNECTION TO EXISTING PIPING, POWER AND FLUES.

M.3 REMOVE AIR COOLED CONDENSER AND ASSOCIATED REFRIGERANT PIPING AND PREPARE FOR INSTALLATION OF NEW UNIT AS DETAILED ON IMPROVEMENT PLAN.



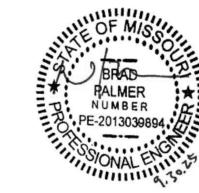

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CAD DWG FILE: MEP200
DRAWN BY: BRP
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SHEET TITLE:

DEMOLITION PLANS

SHEET NUMBER:

MEP200

# EXISTING ROOF ACCESS LADDER SHALL REMAIN NEW LIQUID, SUCTION, AND HOT GAS REFRIGERANT LINESET AIR COOLED CONDENSER CU1 NEW LIQUID, SUCTION AND HOT GAS REFRIGERANT LINESET AIR COOLED CONDENSER CU2

#### PHOTGRAPHIC DOCUMENTATION

CONTRACTOR SHALL DOCUMENT EXISTING ROOF CONDITION PRIOR TO COMMENCEMENT OF CONSTRUCTION AND THROUGHOUT THE CONSTRUCTION PROCESS. SEE SPECIFICATIONS FOR PHOTOGRAPHIC REQUIREMENTS.

#### **KEYNOTES**

E.2 PROVIDE NEW 400A, NON FUSED, NEMA 3R DISCONNECT FOR CONDENSER.

E.7 PROVIDE NEW 300A CIRCUIT BREAKER IN EXISTING PANEL PDPA AND WIRE NEW CONDENSER TO EXISTING CIRCUIT. PREVIOUS UNITS ARE FED FROM A 300A CIRCUIT. REMOVE EXISTING BREAKER TO ACCOMODATE NEW UNIT. CONTRACTOR SHALL HAVE OPTION TO REUSE EXISTING CONDUIT FOR NEW FEEDERS TO EXISTING PANEL.

M.6 ROUTE REFRIGERANT LINES DOWN IN CHASE TO MECHANICAL ROOM BELOW. PROVIDE NEW WEATHERPROOF DOGHOUSE, NEW ROOF FLASHING AND REPAIR ROOF AT NEW PIPING

WEATHERPROOF DOGHOUSE, NEW ROOF FLASHING AND REPAIR ROOF AT NEW PIPING
PENETRATION. SEAL PENETRATIONS AND KEEP WEATHER TIGHT.

M.40
PROVIDE DAVIT CRANE EQUAL TO 0Z LIFTING PRODUCTS ALUMI-LITE 500LB DAVIT CRANE WITH HAND WENCH, PROVIDE BASE FOR INSTALLATION ON ROOF TOP

#### STATE OF MISSOURI MIKE KEHOE GOVERNOR



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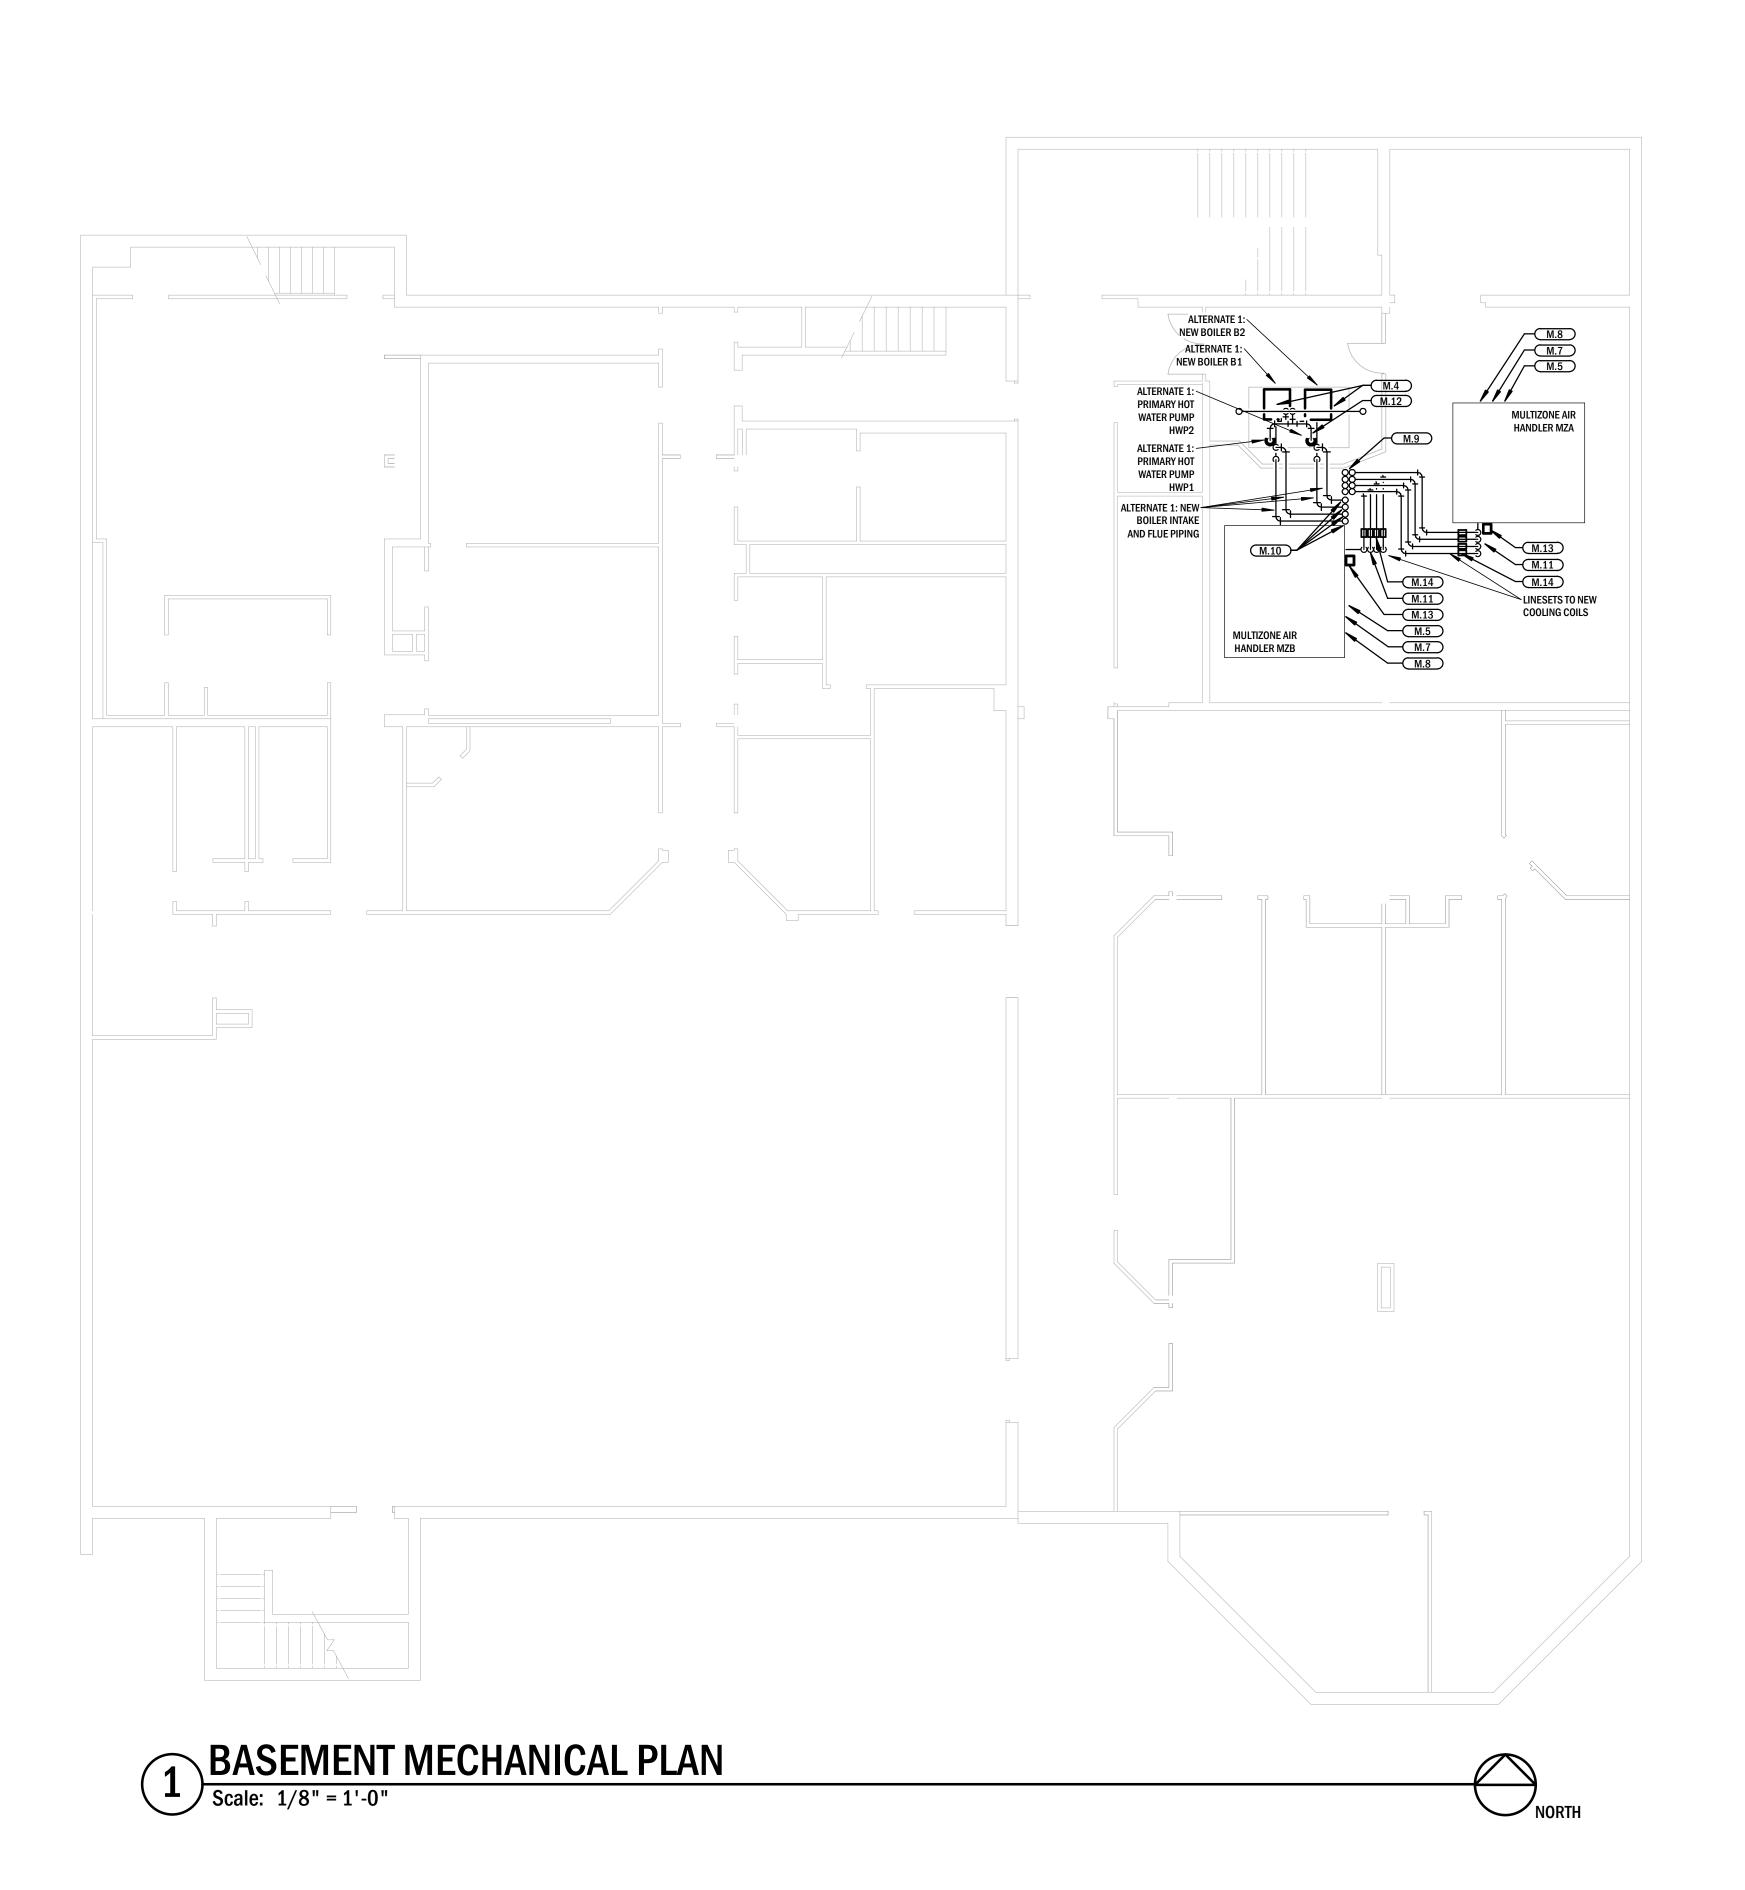
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SHEET TITLE:

ROOF MEP PLAN

SHEET NUMBER:

MEP300



#### **KEYNOTES**

ALTERNATE 1: PROVIDE NEW BOILERS AND PUMPS. SEE HOT WATER LOOP IMPROVEMENT DIAGRAM .FOR ADDITIONAL DETAILS. ALTERATE 2: EXISTING MULTIZONE UNIT SHALL BE REFURBISHED WITH NEW FAN WALL AND VFD

ALTERNATE 3: PROVIDE NEW UV FILTRATION ON DISCHARGE FACE OF COOLING COIL. SEE AIR HANDLER UPGRADE DETAIL. PROVIDE NEW EVAPORATOR COIL IN AIR HANDLER CONNECTED TO NEW AIR COOLED

ROUTE REFRIGERANT PIPING UP IN CHASE ABOVE.

ALTERNATE 1: ROUTE 8" FLUES UP THROUGH FLOORS ABOVE IN CHASE. ROUTE REFRIGERANT LINESETS DOWN TO NEW EVAPORATER COILS IN EXISTING AIR HANDLER

ALTERNATE 1: NEW PIPING CONNECTION FOR BOILERS TO EXISTING HOT WATER PIPING LOOP. SEE HOT WATER LOOP DIAGRAMS FOR SIZING AND PIPING REQUIREMENTS.

REFRIGERANT LEAK DETECTION. CONNECT TO BUILDING MANAGEMENT SYSTEM. SEE SEQUENCE OF OPERATIONS FOR DETECTION OPERATION REQUIREMENTS. REFRIGERANT CONTROL SOLENOID VALVES FOR REFRIGERANT SHUTOFF.

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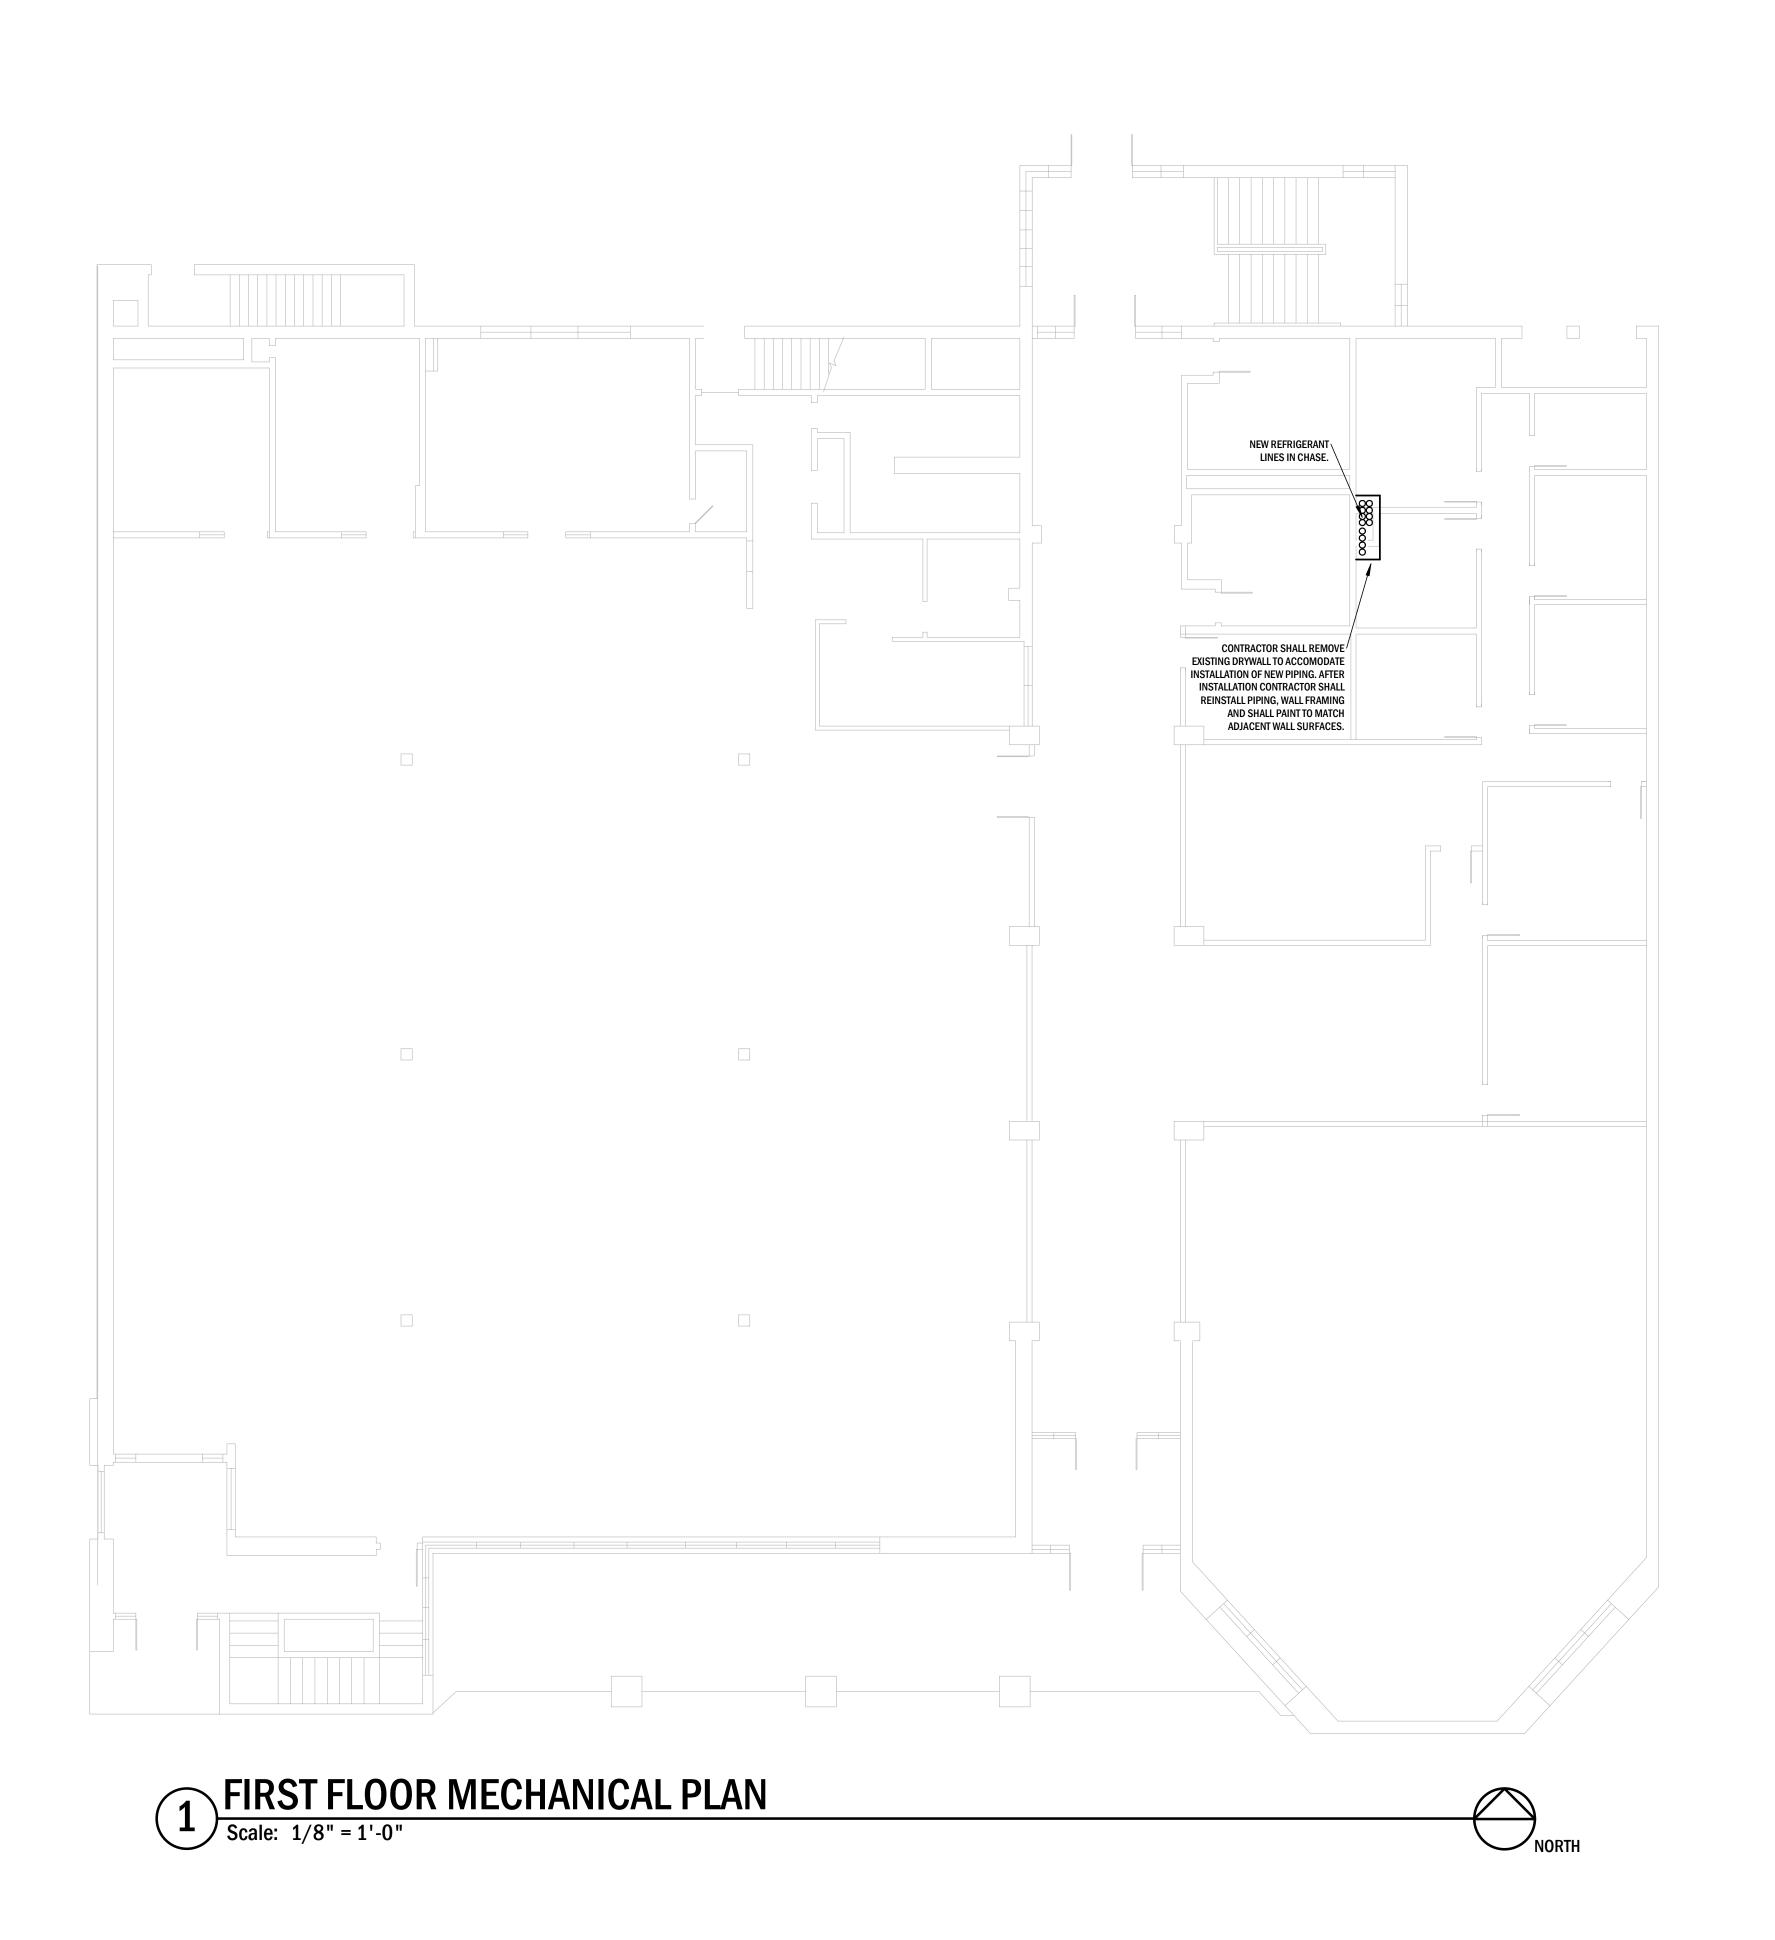
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DESIGNED BY: BRP

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MECHANICAL **PLAN** 

SHEET NUMBER:

M100



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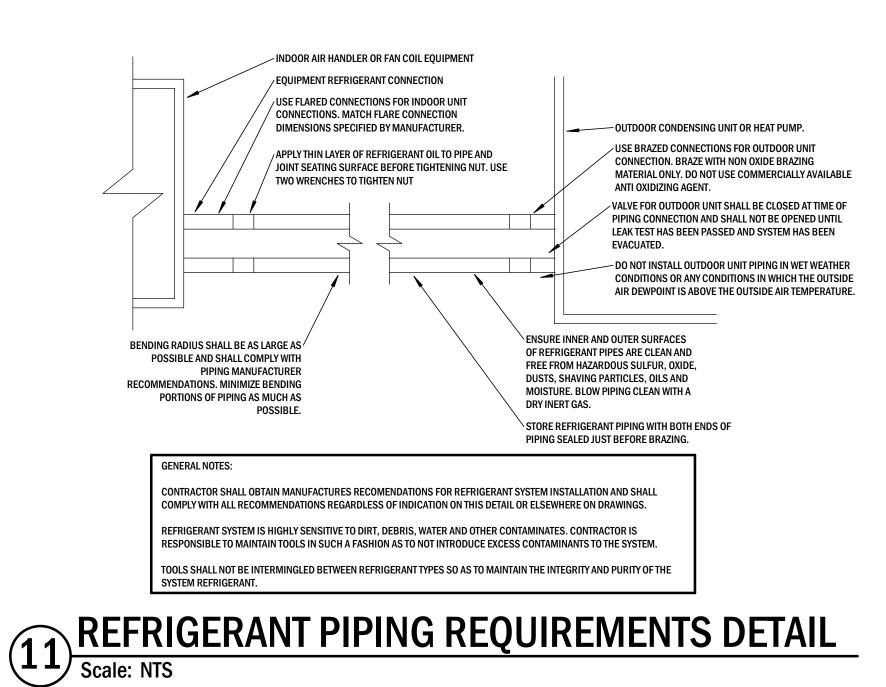
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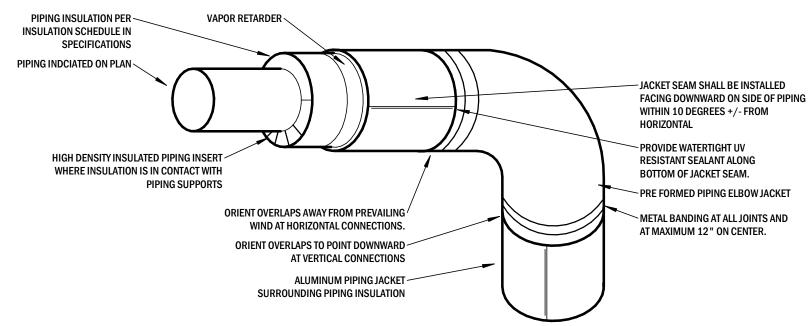
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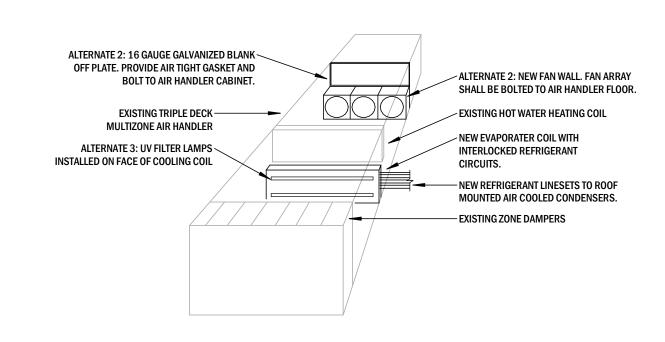
M101







# EXTERIOR PIPING INSULATION DETAIL Scale: NTS



9 MULTIZONE AIR HANDLER UPGRADE DETAIL

SET DIMENSION TO MAXIMIZE CRANE REACH
OVER PARAPET WALL WHILE ACCOMODATING
INSTALLATION OF STEEL PLATE BELOW ROOF
DECK.


DAVIT CRANE. SEE PLANS FOR BASIS OF
DESIGN MODEL.
PROVIDE PEDESTAL MOUNTING STAND FOR
CRANE SUPPORT.

PROVIDE THREADED BOLTS WASHER AND NUTS TO FASTEN
CRANE. PROVIDE FASTENERS PER CRANE MANUFACTURER
INSTALLATION REQUIREMENTS.


PATCH ROOFING MATERIAL AND PROVIDE
SUPPORT PAD BELOW PLATE TO DISTRIBUTE
LOAD AND PROTECT ROOFING.

PROVIDE STEEL PLATE BELOW ROOF DECK. MATCH OUTER
DIMENSIONS OF CRANE BASE PLATE AND PROVIDE
MATCHING BOLT HOLES TO ALIGN WITH PLATE ABOVE.
PLATE SHALL MATCH GAUGE OF CRANE BASE PLATE


### 8 ROOF MOUNTED DAVIT CRANE DETAIL Scale: NTS

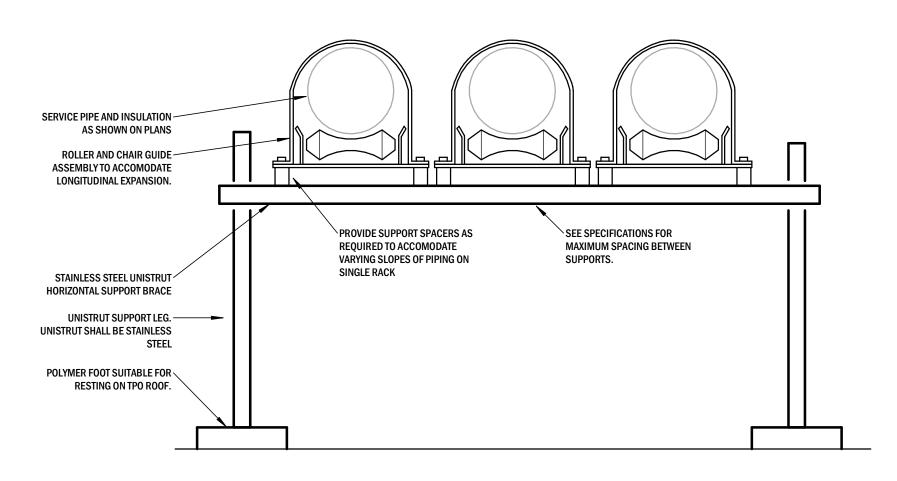

7 PIPING SUPPORT STAND DETAIL
Scale: NTS

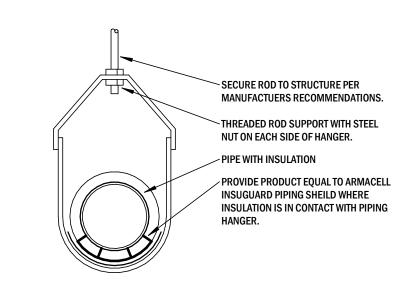


# 6 CLEVIS PIPE HANGER DETAIL Scale: NTS

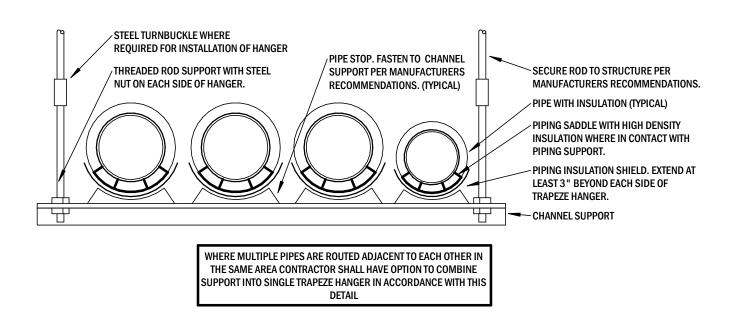


MULTIPLE PIPE TRAPEZE HANGER DETAIL

Scale: NTS

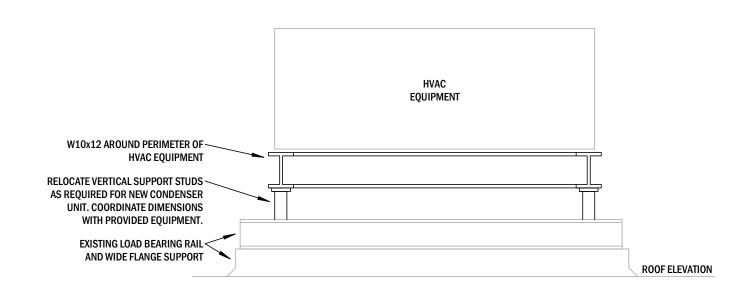


## ROOF CONDENSER SUPPORT FRAME Scale: NTS

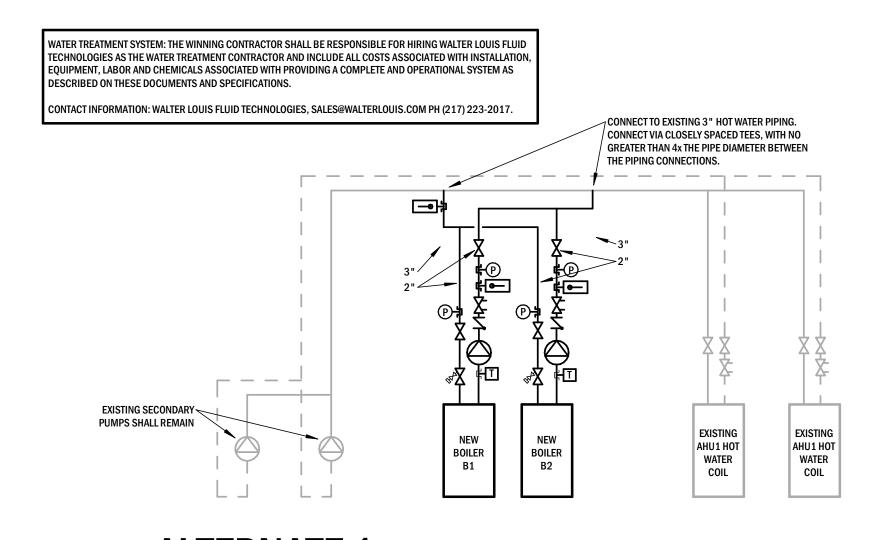

### **ALTERNATE 1:**


HOT WATER LOOP IMPROVEMENT DIAGRAM

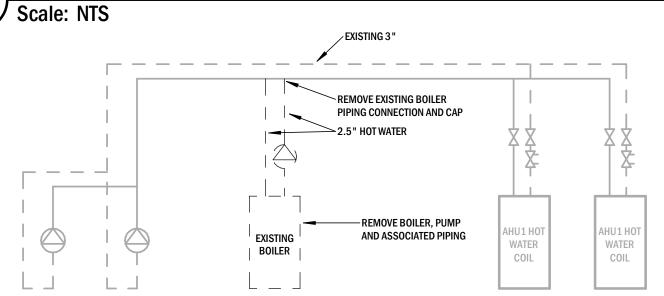

### **ALTERNATE 1:**

HOT WATER LOOP DEMOLITION DIAGRAM

Scale: NTS

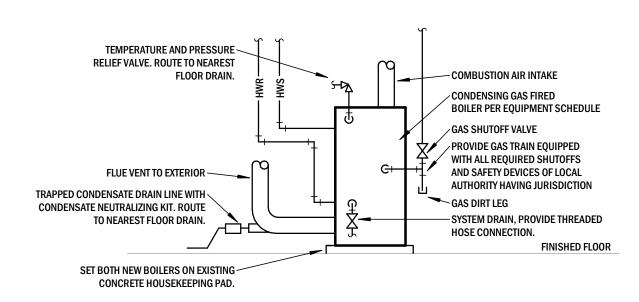

ALTERNATE 1: BOILER DETAIL

Scale: NTS

#### STATE OF MISSOURI MIKE KEHOE GOVERNOR



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MECHANICAL DETAILS

SHEET NUMBER:

M200

POINTS LIST: AIP: LOOP TEMPERATURE AIP: HEATING TEMPERATURE SETPOINT • AOP: BOILER CAPACITY (PERCENTAGE) BOP: BOILER STATUS • BOP: BOILER ALARM STATUS SEQUENCE OF OPERATIONS: UPON A CALL FOR HEATING, BOILER PRIMARY PUMP SHALL ENERGIZE AND, UPON PROOF OF FLOW, BOILER GAS VALVE SHALL OPEN AND SHALL FIRE AND MODULATE POSITION TO MAINTAIN LOOP SETPOINT TEMPERATURE. SETPOINT SHALL BE MODULATED THROUGH THE BAS. FACTORY CASCADE CONTROLLER SHALL STAGE SECOND BOILER ON AS REQUIRED TO MAINTAIN

#### **ALTERNATE 1: BOILER CONTROL SEQUENCE**

LOOP SETPOINT 180°F (ADJUSTABLE) AND SHALL ALTERNATE INITIAL FIRE SEQUENCE SO THAT

BOILERS OPERATE IN ALTERNATING LEAD-LAG OPERATION TO MAINTAIN EQUIVALENT RUNTIME ON

### POINTS LIST:

 ALL EXISTING POINTS SHALL REMAIN • AIP: SUPPLY FAN SPEED (EACH FAN)

PRIMARY PUMPS AND BOILERS.

- AIP: SUPPLY FAN START/STOP AIP: DUCT DIFFERENTIAL PRESSURE
- BIP: SUPPLY FAN STATUS BOP: UV FILTER ENABLE/DISABLI
- BASE BID AIP: MECHANICAL ROOM REFRIGERANT DETECTION DEVICE BASE BID BOP: REFRIGERANT LEAK ALARM

BASEBID: NEW REFRIGERANT LEAK DETECTION DEVICES SHALL BE PROVIDED IN MECHANICAL ROOM AND SHALL SOUND ALARM, INITIATE ALARM AT BAS, AND SHUT DOWN CONDENSERS UPON

ALTERNATE #2: NEW FAN WALL PLUG FANS SHALL BE CYCLE TO MAINTAIN DIFFERENTIAL PRESSURE SETPOINT IN SUPPLY AIR DUCT. FANS SEQUENCE SHALL BE OPTIMIZED FOR EFFICIENCY BASED FAN PERFORMANCE.

ALTERNATE #3: NEW EVAPORATOR COILS SHALL BE EQUIPPED WITH UV FILTERS. WHEN COOLING COIL IS IN OPERATION. UV LAMPS SHALL ENERGIZE AND SHALL OPERATE CONTINUOUSLY.

EXISTING UNIT IS EQUIPPED WITH INTERLOCKED ZONE ACTUATORS THAT DIVERT AIR FLOW BETWEEN COLD. HOT AND NEUTRAL DECKS TO DELIVER REQUIRED AIR TO ASSOCIATED ZONE BASED ON THERMOSTAT SETPOINT. EXISTING ACTUATORS SHALL REMAIN, AND NO NEW WORK IS ASSOCIATED WITH EXISTING ZONE DAMPERS AS PART OF THIS PROJECT SCOPE.

XISTING HOT WATER COIL AND CONTROL VALVES SHALL REMAIN. VALVE OPENS TO MAINTAIN THE DISCHARGE AIR TEMPERATURE IN THE HOT DECK. NO NEW WORK IS ASSOCIATED WITH EXISTING HOT WATER VALVES AS PART OF THIS PROJECT SCOPE.

#### MULTIZONE AIR HANDLING UNIT

#### POINTS LIST:

- AIP: COOLING COIL DISCHARGE AIR TEMPERATURE AIP: SATURATED SUCTION TEMPERATURE
- BOP: COMPRESSOR STATUS (EACH OF THREE COMPRESSORS) BOP: UNIT ALARM STATUS
- SEQUENCE OF OPERATIONS:

JPON A CALL FOR COOLING FROM THE MULTIZONE UNIT, EACH REFRIGERANT CIRCUIT SHALL STAGE ON TO PROVIDE 55°F (ADJUSTABLE) SUPPLY AIR DISCHARGE TEMPERATURE FROM EVAPORATER COOLING COIL. PROVIDE TEMPERATURE SENSOR DOWNSTREAM OF COOLING COIL

#### AIR COOLED CONDENSER SEQUENCE

CONTACT C&C GROUP - BRIAN SCHEPERS FOR CONTROLS SCOPE.

EMAIL - BSCHEPERS@C-CGROUP.COM MOBILE - 573-291-5425

PIPING MATERIAL SCHEDULE									
	TEST PAR	TEST PARAMETERS		TING	LABEL COLOR				
ТҮРЕ	SIZE	MATERIAL	PRESSURE	TIME	MATERIAL	TYPE	BACKGROUND	TEXT	
HOT WATER SUPPLY AND RETURN	3" AND SMALLER	TYPE L COPPER	150 PSI	1 HR	CP	SL	GREEN	WHITE	
HOT WATER SUPPLY AND RETURN	LARGER THAN 3"	SCHEDULE 40 BLACK STEEL	150 PSI	1 HR	ST	WE	GREEN	WHITE	
CONDENSATE DRAIN	ALL	TYPE L COPPER TUBING	5 PSI	1 HR	WC-DWV	SL			
REFRIGERANT PIPING	ALL	ACR COPPER TUBING - TYPE L	600 PSI	24 HR	СР	BZ	YELLOW	BLACK	

CIRCUITS/ARR

EVAPORATOR ROWS

FACE VELOCITY

SENSIBLE CAPACITY

ENTERING AIR DB/WI

EVAP SUCTION TEMP

FPM: FEET PER MINUTE

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ABBREVIATIONS: ABBREVIATIONS: BF: BUTT FUSION GR: GROOVED BZ: BRAZED - NO FLUX RS: RESIN SOCKET CI: CAST IRON SL: SOLDERED CP: COPPER SW: SOLVENT WELD

MI: MALLEABLE IRON

PE: HIGH DENSITY POLYETHYLENE

DWV: DRAINAGE WASTE AND VENT WC: WROUGHT COPPER FSFL: FORGED STEEL FLANGES WE: WELDED MAT: MATERIAL WF: WELDED AND FLANGED

ALTERNATE	2: FAN WALL	SCHEDULE
		=

Γ		MARK	FW1 - MZA	FW2 - MZB		
		MANUFACTURER	NORTEK	NORTEK		
		MODEL NUMBER	22-65-182T-36x36x27-			
		FUNCTION	SUPPLY FAN	SUPPLY FAN		
		QUANTITY	3	3		
	,	ARRAY (ROWS/COILS)	1 ROW X 3 COILS	1 ROW X 3 COILS		
	INL	ET CONE LOCATION/TYPE	UPSTREAM REMOVABLE	UPSTREAM REMOVABL		
		CELL SIZE	36x36x27x32	36x36x27x32		
	N	MOTOR WHEEL WEIGHT	177 LB	177 LB		
		FAN CELL WEIGHT	321 LB	321 LB		
		CELL MATERIAL	ALUMINUM/STEEL	ALUMINUM/STEEL		
		BLANK OFF MATERIAL	16 GAUGE STEEL	16 GAUGE STEEL		
	1.	WHEEL TYPE	HPF-A100	HPF-A100		
	FAN WHEEL	DIAMETER	22	22		
	N	WIDTH	65	65		
	7	MAX RPM	3166	3166		
		MANUFACTURER	TOSHIBA	TOSHIBA		
		MODEL	40A003L1ZVS210	40A003L1ZVS210		
		HP EACH/TOTAL	3.5/10.5	3.5/10.5		
		POLES/RPM	4-P0LE/1750	4-P0LE/1750		
	Ä	FRAME/CASING	182T/TEA0	182T/TEA0		
	MOTOR	EFFICIENCY	88.5	88.5		
	Σ	SERVICE FACTOR	1.15	1.15		
		SHAFT ISOLATION	CERAMIC BEARINGS	CERAMIC BEARINGS		
		FLA EACH/TOTAL	9/26 AMPS	9/26 AMPS		
		MOTOR HP SF	3.0 %	3.0 %		
L		VOLTAGE/PHASE	240/3	240/3		
			ISL.RC.BL.CPI.BD.	ISL.RC.BL.CPLBD.		

VFD, CP

INPUT

MIN INPUT FIRE

OUTPUT

FLOW

DESIGN PRESSURE

VOLTAGE/PHASE

MCA

ABBREVIATIONS:

VK: VENT AND INTAKE KIT

CK: CONDENSATE NEUTRALIZATION KIT

PTRV: PRESSURE TEMPERATURE RELIEF PC: PRIMARY PUMP CONTROL LOW WATER CUTOFF

48 GPM

120/1

ACCESSORIES VK, CK, PC, LC, PTRV, VK, CK, PC, LC, PTRV,

CASCADE CONTROLLER TO CONTROL EACH BOILER,

BALANCE RUNTIME AND STAGE AS REQUIRED FOR THE SEQUENCE OF OPERATIONS. CONTROLLER SHALL BE COMPATIBLE WITH SCHNEIDER CONTROLS

cc cc

ABBREVIATIONS: ISL: PROVIDE ISOLATORS RC: REMOVABLE INLET CONE

ACCESORIES

BL: CONTRACTOR SHALL PROVIDE STEEL BLANK OFF AROUND PERIMETER OF FANS CPI: COPLANAR INSULATION BD: BACKDRAFT DAMPERS

MOTOR STATUS LIGHTS

SF: SAFETY FACTOR VFD: VFD FOR MOTOR CONTROL BY MECHANICAL

CONTRACTOR REMOTE MOUNTED CONTROL PANEL WITH NEMA 1 ENCLOSURE, POWDER COAT FINISH,

⊠interpres

VFD, CP

#### REMOTE AVERAGING TEMPERATURE SENSOR ⊠inťerpres # AT 8x8 || 100 **□**FD AIR COOLED CONDENSER SCHEDULE **□**SD SMOKE DAMPER MOTORIZED DAMPER MANUFACTURER **□** BD BALANCE DAMPER 20A0LM54-3 20A0LM54-3 GBD GRAVITY BACKDRAFT DAMPER **EFFICIENCY** 11.8 EER 11.8 EER REFRIG CIRCUITS —— C —— | CONDENSATE DRAIN TONS/CIRCUIT TOTAL CAPACITY 645.6 MBH 645.6 MBH — HPWS — | HEAT PUMP WATER SUPPLY 105 DEG F 105 DEG F — HPWR — | HEAT PUMP WATER RETURN R454B WEIGHT — CHWS — CHILLED WATER SUPPLY 88"Wx180"Lx63"H — CHWR — | CHILLED WATER RETURN VOLTAGE 240/3 58D40.5X108-12-4-W-Z-R 58D40.5X108-12-4-W-Z-R

3/INTERTWINED

523 FPM

645.6 MBH

489.5 MBH

55.1/54.1

BUILDING MANAGEMENT SYSTEM AND

REFRIGERANT TEMPERATURES

COMP SUCTION TEMP ACCESSORIES SP,BMS,CPT BHP: BRAKE HORSEPOWER SP: SINGLE POINT POWER CONNECTION HP: HORSEPOWER BMS: INTEGRATED WITH SCHNEIDER CONTROL SYSTEM TEMP: TEMPERATURE CPT: NEW COMPRESSOR CONTROL BOARD FOR ARR: ARRANGEMENT STAGING OF CIRCUITS BASED ON CALL FROM

3/INTERTWINED

523 FPM

489.5 MBH

149.4 LBS/HR

84/68

55.1/54.1

301	ILDULL	
MARK	UVF1-MZA	UVF1-MZB
MANUFACTURER	UV RESOURCES	UV RESOURCES
MODEL NUMBER	RLM (X)	RLM (X)
STYLE	COIL DISINFECTION	COIL DISINFECTION
PLENUM DIMS (INCHES)	51x115	51x115
COIL DIMS (INCHES)	40x108	40x108
LAMPS PER ROW	2	2
NUMBER OF ROWS	2	2
LAMP LENGTH (INCHES)	61	61
WATTS PER LAMP	145	145
TOTAL WATTS	740	740
LAMP WATTS/SF OF COIL AREA	19.33	19.33
SERVICE VOLTAGE	120-277V	120-277V

⊠inťerpres

⊠inťerpres

ABBREVIATIONS

AFF ABOVE FINISHED FLOOR

AFG ABOVE FINISHED GRADE

OFCI OWNER FURNISHED CONTRACTOR INSTALLED

AHU AIR HANDLING UNIT

CU CONDENSING UNIT

HP HEAT PUMP

EF EXHAUST FAN

OA OUTSIDE AIR RA RETURN AIR

SA SUPPLY AIR

DN DOWN

### TEMPERATURE OVERRIDE SENSOR DIFFUSER TAG - LETTER AND CEILING DESIGNATION, NECK SIZE AND CFM REFRIGERANT LINESET (LIQUID, SUCTION AND HEAT RECOVERY WHERE APPLICABLE) — HWR — HOT WATER RETURN SHUTOFF VALVE BALANCE VALVE TEMPERATURE AND PRESSURE RELIEF VALVE **⊸**\$— TWO WAY CONTROL VALVE. MODULATING UNLESS OTHERWISE NOTED AS TWO POSITION. THREE WAY CONTROL VALVE. MODULATING UNLESS OTHERWISE NOTED AS TWO POSITION. PRESSURE INDEPENDENT TWO WAY MODULATING CONTROL VALVE PRESSURE INDEPENDENT THREE WAY MODULATING CONTROL VALVE **─**₩— THROTTLING VALVE PRESSURE GAUGE UNION/FLANGE TEMPERATURE SENSOR WITH WELL FILLED TYPE THERMOMETER WITH WELL MANUAL AIR VENT WYE STRAINER AND HOSE CONNECTION CAP SUCTION DIFFUSER **—////** FLEXIBLE CONNECTION

HIGH CAPACITY AIR VENT. PIPE DISCHARGE TO DRAIN OR FILL TANK.

**HVAC SYMBOLS** 

DIFFUSER OR GRILLE WITH FLEX DUCT. SIZE OF FLEX DUCT SHALL EQUAL SIZE OF UPSTREAM DUCT

**CEILING SUPPLY GRILLE** 

**⊐∕**⊠

CEILING RETURN/EXHAUST GRILLE

LINEAR SUPPLY/RETURN GRILLE

WALL SUPPLY/RETURN/EXHAUST GRILLE OR REGISTER

INDICATES CONNECTION TO EXISTING SYSTEM

UPGRADE/RELOCATE **ROOFTOP UNITS** 

OFFICE OF ADMINISTRATION

DESIGN AND CONSTRUCTION

DIVISION OF FACILITIES

MANAGEMENT

STATE OF MISSOURI

MIKE KEHOE

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SPRINGFIELD DOLIR OFFICE BUILDING

SPRINGFIELD, MO

PROJECT# O2516-01 SITE# 1032 FACILITY # 3101032001

> **REVISION:** DATE: REVISION: DATE: **REVISION:** DATE:

ISSUE DATE:

CAD DWG FILE: M300 DRAWN BY: BRP CHECKED BY: BRP

DESIGNED BY: BRP SHEET TITLE:

**MECHANICAL SCHEDULES** 

SHEET NUMBER:

8 OF 10 SHEETS 9/30/2025

#### **ALTERNATE 1: BOILER SCHEDULE ALTERNATE 3: UV FILTER** SCHEDULE MANUFACTURER FULTON FULTON MODEL NUMBER EXE-500 500 MBH 500 MBH 50 MBH 50 MBH 486 MBH 486 MBH 48 GPM PRESSURE DROP 0.9 PSI @ 48 GPM 0.9 PSI @ 48 GPM 160 PSI 160 PSI 120/1

MARK	UVF1-MZA	UVF1-MZB
MANUFACTURER	UV RESOURCES	UV RESOURCES
MODEL NUMBER	RLM (X)	RLM (X)
STYLE	COIL DISINFECTION	COIL DISINFECTION
PLENUM DIMS (INCHES)	51x115	51x115
COIL DIMS (INCHES)	40x108	40x108
LAMPS PER ROW	2	2
NUMBER OF ROWS	2	2
LAMP LENGTH (INCHES)	61	61
WATTS PER LAMP	145	145
TOTAL WATTS	740	740
LAMP WATTS/SF OF COIL AREA	19.33	19.33
SERVICE VOLTAGE	120-277V	120-277V

	AL	TERNATE	1: PUMP S	SCHEDUL	Ε	
MARK	HWP1	HWP2				
DESCRIPTION	HHW	HHW				
MANUFACTURER	B&G	B&G				
MODEL	PL-130/2"	PL-130/2"				
TYPE	IL	IL				
DESIGN FLOW (GPM)	48	48				
DESIGN HEAD (FT.)	16	16				
WETTED MATERIAL	BR	BR				
WORK. CLASS (PSI)	150	150				
MOTOR TYPE	-	-				
MOTOR POWER	2/5 HP	2/5 HP				
RPM	3200	3200				
VOLTAGE/PHASE	230/1	230/1				
TRIPLE DUTY VALVE						
SUCTION DIFFUSER						
FLUID TEMP. RANGE (F)	40-225	40-225				
VCCESSUDIES						

ABBREVIATIONS: IN-LINE IL: IN-LINE
WR: WET ROTOR
BMES: BASE MOUNTED END SUCTION BMHSC: BASE MOUNTED HORIZONTAL SPLIT CASE BMVSC: BASE MOUNTED VERTICAL SPLIT CASE BMCCES: BASE MOUNTED CLOSE COUPLED END SUCTION B&G: BELL AND GOSSETT BRONZE/BRASS

STAINLESS STEEL

IRON

ABBREVIATIONS: VSC: VARIABLE SPEED CONTROL

PPC: PROPORTIONAL PRESSURE CURVE CONTROL CPC: CONSTANT PRESSURE CURVE CONTROL DTC: DIFFERENTIAL TEMPERATURE CONTROL BP: HEAVY DUTY BASEPLATE HHW: HYDRONIC HEATING HOT WATER

AS: AQUASTAT WITH TIMECLOCK AND CORD AND PLUG EFF: EFFLUENT SP: SUMP PIT AS DETAILED OR PER MANUFACTURER RECOMMENDATIONS OM: OIL MINDER

⊠inťerpres

# /ALTERNATE 1: NEW BOILER B1 /IALTERNATE 1: NEW BOILER B2 ALTERNATE 1:~ PUMP HWP1 MULTIZONE AIR HANDLER MZA PUMP HWP2 MULTIZONE AIR ALTERNATE 2 \ALTERNATE 2 HANDLER MZB NEW PANEL PDPC NEW PANEL PDPB EXISTING PANEL PDPA 240V, 3ø EXISTING PANEL LDPA — 120/240, 1ø EXISTING PANEL LPB — 120/240, 1ø BASEMENT ELECTRICAL PLAN | Scale: 1/8" = 1'-0"

#### **KEYNOTES**

ALTERNATE 1: CONNECT TO EXISTING CIRCUIT BREAKER PREVIOUSLY SERVING BOILER.

ALTERNATE 2: FAN WALL VFD WITH DISCONNECT. VFD SHALL BE FURNISHED BY MECHANICAL CONTRACTOR.

CONTRACTOR.

ALTERNATE 1: BOILER PUMP MOTOR STARTER. PROVIDE NEMA 00, 20A, 240, COMBINATION MOTOR STARTER WITH 30A, 2 POLE DISCONNECT, HAND/OFF/AUTO SELECTOR AND PILOT LIGHTS. COORDINATE COIL VOLTAGE WITH BUILDING MANAGEMENT SYSTEM.

ALTERNATE 1: WIRE TO NEW 2 POLE 20A CIRCUIT BREAKER IN PANEL PDPA.

ALTERNATE 1: WIRE BOILER TO EXISTING 20A 1 POLE SPARE CIRCUIT IN EXISTING PANEL LPB.

#### STATE OF MISSOURI MIKE KEHOE GOVERNOR



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UPGRADE/RELOCATE ROOFTOP UNITS

SPRINGFIELD DOLIR OFFICE BUILDING

SPRINGFIELD, MO

PROJECT# O2516-01 SITE # 1032 FACILITY # 3101032001

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ISSUE DATE:

CAD DWG FILE: E100
DRAWN BY: BRP
CHECKED BY: BRP
DESIGNED BY: BRP

SHEET TITLE:

ELECTRICAL PLAN

SHEET NUMBER:


E100

#### **ALTERNATE 2** CIRCUIT BREAKER PANEL SCHEDULE C/B AMPS WIRE C/B LOAD SIZE ACC (VA) LOAD (VA) C/B WIRE ACC SIZE C/B AMPS LOAD DESCRIPTION LOAD DESCRIPTION 12 12 1 FAN WALL FAN 1 20 1080 1460 20 UV FILTERS 2 3 12 2 12 1080 1080 20 SPARE 6 7 FAN WAL FAN 2 20 1080 20 SPARE 8 12 1080 SPARE 10 12 1080 1080 20 12 1080 1080 20 SPARE 12 SPARE 14 13 FAN WALL FAN 3 1080 1080 1080 SPARE 16 12 1080 1080 20 SPARE 18 3620 3620 3240 AIC RATING 10000 PDPC VOLTAGE 120/240 PHASE 3 AMPERAGE 125 30 MAXIMUM AMPS MAIN CIRCUIT BREAKER | MLO ENCLOSURE NEMA 1 PANEL TYPE NQOD

CKT NO	LOAD DESCRIPTION	C/B AMPS	WIRE SIZE	C/B ACC	LOAD (VA)	A	В	С	LOAD (VA)	C/B ACC	WIRE SIZE	C/B AMPS	LOAD DESCRIPTION	CK1 NO
1	FAN WALL FAN 1	20	12		1080	1460			380		12	20	UV FILTERS	2
3		3	12		1080		1460		380		12	2	11	4
5		3	12		1080			1080				20	SPARE	6
7	FAN WAL FAN 2	20	12		1080	1080						20	SPARE	8
9		3	12		1080		1080					20	SPARE	10
11		3	12		1080			1080				20	SPARE	12
13	FAN WALL FAN 3	20	12		1080	1080						20	SPARE	14
15	11	3	12		1080		1080					20	SPARE	16
17	11	3	12		1080			1080				20	SPARE	18
						3620	3620	3240						
	AIC RATING	10000											PDPB	
	VOLTAGE	120/240											1 01 0	
	PHASE	3												
	AMPERAGE	125										30	MAXIMUM AMPS	
	MAIN CIRCUIT BREAKER	MLO												
	POLES	18												
	ENCLOSURE	NEMA 1												
	PANEL TYPE	NQOD												


	ELECTRICAL SYMBOLS
	FOR LIGHT SWITCH TYPES SEE LIGHTING CONTROL SCHEDULE.
#	120V, 20A DUPLEX RECEPTACLE
	DEVICE MOUNTED IN FLOOR BOX. REFERENCE SPECIFICATIONS
₩	DEVICE MOUNTED IN BOX AT CEILING OR IN STRUCTURE
NEMA#	VOLTAGE AND AMPERAGE CORRESPONDING TO NEMA NUMBER SHOWN
<sup>AC</sup> <b>←</b>	DEVICE INSTALLED ABOVE COUNTER
GF⊕	GROUND FAULT CIRCUIT INTERRUPTER RECEPTACLE
WP <b>←</b>	WEATHER PROOF WHILE IN USE COVER AND GROUND FAULT CIRCUIT INTERRUPTER RECEPTACLE
₽	TAMPER PROOF RECEPTACLE
4€	120, 20A QUADPLEX RECEPTACLE
υ <del>Φ</del>	120, 20A DUPLEX RECEPTACLE WITH USB CHARGING
$\nabla$	DATA DEVICE
$\dot{\Box}$	CONCEALED SERVICE FLOOR BOX WITH DEVICE SHOWN
s	SURFACE SERVICE FLOOR BOX WITH DEVICE SHOWN
	FIRE RATED POKE THROUGH, SURFACE SERVICE FLOOR BOX WITH DEVICE SHOWN
<u> </u>	FIRE ALARM VISUAL STROBE
$\frac{\chi}{\kappa}$	
	FIRE ALARM AUDIBLE VISUAL SPEAKER STROBE
FAA	REMOTE FIRE ALARM ANNUNCIATOR
FACP	MAIN FIRE ALARM PANEL
	MAGNETIC DOOR HOLD OPEN
E .	FIRE ALARM MANUAL PULL STATION
OSD	SMOKE DETECTOR
O <sup>H</sup>	HEAT DETECTOR
	DUCT SMOKE DETECTOR
PP	OCCUPANCY SENSOR LIGHTING CONTROL POWER PACK
д	ROUGH-IN FOR WALL MOUNT THERMOSTAT. COORDINATE WITH MECHANICAL DRAWINGS
	DISCONNECT SWITCH
T	TIMESWITCH. SEE SCHEDULE FOR SPECIFICATIONS.
Р	PHOTOCELL PHOTOCELL
L	LIGHTING CONTACTOR
	EMERGENCY LIGHT. WALL MOUNTED WHEN SHOWN TOUCHING WALL
0	PENDANT LIGHT FIXTURE. SIZES VARY
0	RECESSED CAN LIGHT
$\overset{\smile}{\longleftarrow}$	SURFACE MOUNT OR SUSPENDED LINEAR FIXTURE
otan	
	RECESSED LINEAR FIXTURE
	INDICATES NIGHT LIGHT FIXTURE
	OVERHEAD ELECTRICAL CONDUCTOR
	UNDERGROUND ELECTRICAL CONDUCTOR
- COMM -	COMMUNICATIONS CONDUIT/CABLING
*	HOMERUN, NEW RACEWAY AND WIRING TO DESIGNATED PANEL. PROVIDE QUANTITY AND SIZE OF WIRING AS REQUIRED FOR CIRCUIT BREAKER AND DESIGNATED IN PANEL SCHEDULE.
A+-2	NEW RACEWAY AND WIRING FOR ELECTRICAL DEVICE TERMINATED AS NOTED. PROVIDE QUANTITY AND SIZE OF WIRING AS REQUIRED FOR CONNECTED ELECTRICAL DEVICE AND OCPD.
ABBREVIA	TIONS
60"	DIMENSIONS NEXT TO ANY SYMBOL OR FIXTURE INDICATES MOUNTING HEIGHT TO CENTERLINE OF DEVI
AC	ABOVE COUNTER ABOVE FINISHED FLOOR
AFF AFG	ABOVE FINISHED FLOOR ABOVE FINISHED GRADE
ASC	AVAILABLE SHORT CIRCUIT CURRENT
GFCI OFCI	GROUND FAULT CURRENT INTERRUPTER OWNER FURNISHED CONTRACTOR INSTALLED
OI OI	
(TIE)	REPRESENTS PARTIAL HOMERUN WITH REST OF CONNECTED DEVICES LOCATED ELSEWHERE ON PLANS

	FEEDER SCHEDULE	1>
1	3-#1 AND 1-#6 GROUND IN 1.5" CONDUIT	

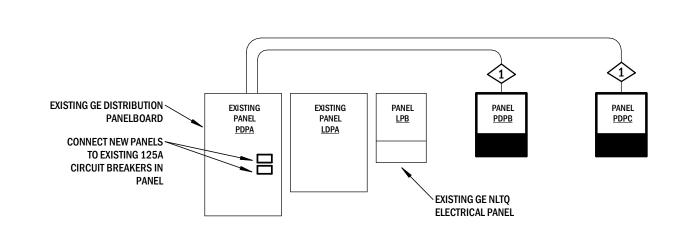

ELECTRICAL RISER DIAGRAM
Scale: NTS

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ISSUE DATE:

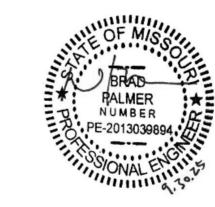CAD DWG FILE: E200
DRAWN BY: BRP
CHECKED BY: BRP
DESIGNED BY: BRP

SHEET TITLE:

ELECTRICAL SCHEDULES AND DETAILS

SHEET NUMBER:

E200