

Addendum No. 03

TO: PLANS AND SPECIFICATIONS FOR:

Renovation Int/Ext & Install Generator – Multi Assets-General Headquarters Complex
MO State Highway Patrol
1510 E. Elm, Jefferson City, MO
PROJECT NO. R2502-01

Bid Opening Date: 1:30 PM, Thursday, February 19, 2026 (Not Changed)

Bidders are hereby informed that the construction plans and/or specifications are modified as follows:

SPECIFICATION CHANGES:

1. Section 075423 – THERMOPLASTIC POLYOLEFIN (TOP) ROOFING

DELETE: 1.1.A.5

DELETE: 1.3.E

DELETE: 1.3.F “FM”

DELETE: 2.2.A.2 “or the “Resistance to Foot Traffic in FM Approvals 4470”

DELETE: 2.2.C “FM Approvals 4474”

DELETE: 2.2.D

DELETE: 2.2.E

DELETE: 2.5.A

DELETE: 2.5.C

DELETE: 2.9

DELETE: 3.4

DRAWING CHANGES:

1. C-101 – SITE & UTILITY PLAN

ADD: (at note EXISTING SIDEWALK TO BE REMOVED) “TO THE NEAREST CONCRETE JOINT AND REPLACED WITH 4”, UNREINFORCED CONCRETE SLAB SURFACE – TYP..”

2. S-102 – DORM SECOND FLOOR FRAMING PLAN

ADD: Shaded area of excavation between columns C and A (matching sheet A-102) and Note: “NEW CONCRETE FLOOR REINFORCED W/6X6-W1.4XW1.4 W.W.F. PLACED TO 1 1/2” FROM SLAB SURFACE – TYP.”

3. A-101 – DORM DEMO FIRST FLOOR PLAN

ADD: DEMO FIRST FLOOR KEYED NOTES: 05 & 07. "IF DAMAGED DURING DEMO", PATCH AND REPAIR....

4. A-102 – DORM DEMO SECOND FLOOR PLAN

ADD: DEMO FIRST FLOOR KEYED NOTES: 03 & 04. "IF DAMAGED DURING DEMO", PATCH AND REPAIR....

5. A-103 – DORM DEMO THIRD FLOOR PLAN

ADD: DEMO FIRST FLOOR KEYED NOTES: 03 & 04. "IF DAMAGED DURING DEMO", PATCH AND REPAIR....

6. A-106 - DORM SECOND FLOOR PLAN (SEE ATTACHED ADD 3 DETAILS)

ADD: Detail 1 – SECOND FLOOR PLAN, at EXIST CLEAN LINEN 237, added keyed note 18 at the mechanical chase.

ADD: SECOND FLOOR KEYED NOTES: "18. (2) LAYERS OF TYPE X GYWB OVER 7/8" HAT CHANNEL. SEE DETAIL 5/A-406

7. A-107 – DORM THIRD FLOOR PLAN (SEE ATTACHED ADD 3 DETAILS)

ADD: Detail 1 – THIRD FLOOR PLAN, at EXIST CLEAN LINEN 337, added keyed note 11 at the mechanical chase.

ADD: THIRD FLOOR KEYED NOTES: "11. (2) LAYERS OF TYPE X GYWB OVER 7/8" HAT CHANNEL. SEE DETAIL 5/A-406

8. A-113 – ADMINISTRATION DEMO ROOF ALTERNATE #4 (ATTACHED REVISED SHEET)

DELETE: Entire sheet

ADD: Attached revised sheet

9. A-114 – ADMINISTRATION BUILDING DEMO ROOF ALTERNATE #4 (SEE ATTACHED REVISED SHEET)

DELETE: Entire sheet

ADD: Attached revised sheet

10. A-123 – PHYSICAL TRAINING DEMO ROOF ALTERNATE #4 (SEE ATTACHED REVISED SHEET)

DELETE: Entire sheet

ADD: Attached revised sheet

11. A-124 – PHYSICAL TRAINING ROOF PLAN AND DETAILS ALTERNATE #4 (SEE ATTACHED REVISED SHEET)

DELETE: Entire Sheet

ADD: Attached revised sheet

12. A-406 – DORM PARTITION TYPES & MISC. DETAILS (SEE ATTACHED ADD 3 DETAILS)

ADD: Detail 5 – SECTION THRU MECH. CHASE

13. A-501 – DETAILS 2,3,4 (SEE ATTACHED ADD 3 DETAILS)

DELETE: Reroof down to substrate board

ADD: Revised to recover roof only

14. A-511 – ADMIN. ROOF DETAILS ALTERNATE #4 (SEE ATTACHED REVISED SHEET)

DELETE: Entire sheet

ADD: Attached revised sheet

15. A-512 – ADMIN. ROOF DETAILS ALTERNATE #4 (SEE ATTACHED REVISED SHEET)

DELETE: Entire sheet

ADD: Attached revised sheet

16. A-603 - DORM FINISH SCHEDULE (SEE ATTACHED REVISED SHEET)

ADD: FINISH / MATERIAL SCHEDULE – “SIGN TYP.” column.

ADD: COMMENTS: “8. REFER TO STANDARD ACCESSIBILITY DETAILS FOR ADDITIONAL SIGNAGE INFORMATION.”

DELETE: from ADMIN BASE BID FINISH NOTES: - “ADMIN BASE BID”

ADD: “ALT. 1” to first two notes.

ADD: to FINISH NOTES: “AT LOCATIONS WHERE EXISTING PLASTER HAS BEEN REMOVED FOR IN-WALL WORK (INCLUDING BUT NOT LIMITED TO PLUMBING AND ELECTRICAL MODIFICATIONS), PROVIDE NEW GYPSUM BOARD TO INFILL REMOVED AREAS AS REQUIRED TO MATCH EXISTING WALL THICKNESS AND SUBSTRATE CONDITIONS. WHERE NEW GYPSUM BOARD WALLS ABUT OR CONNECT TO EXISTING PLASTER WALLS, CAREFULLY TRANSITION AND BLEND FINISHES TO ENSURE A SMOOTH, CONTINUOUS SURFACE. CONTRACTOR SHALL PROPERLY SECURE, TAPE, AND FINISH GYPSUM BOARD, FEATHERING AND BLENDING ALL JOINTS AND EDGES WITH ADJACENT PLASTER. FINAL WALL FINISH SHALL BE UNIFORM IN TEXTURE AND APPEARANCE, WITH NO VISIBLE JOINTS, RIDGES, OR EVIDENCE OF PATCHING. PREPARE PATCHED AND TRANSITION AREAS TO RECEIVE SPECIFIED FINISH MATERIALS IN ACCORDANCE WITH PROJECT SPECIFICATIONS.”

17. M-423 – P.T. ROOF PLAN

ADD: Existing to remain, air intake hoods added to roof plan, just north of the existing make up unit.

ATTACHMENTS:

Pre Bid Sign-In Sheet

ADD 6 Details, 1/A-106, 1/A-107, 5/A-406, 2/A-501, 3/A-50, 4/A501

A-113 – ADMINISTRATION DEMO ROOF ALTERNATE #4

A-114 – ADMINISTRATION BUILDING DEMO ROOF ALTERNATE #4

A-123 – PHYSICAL TRAINING DEMO ROOF ALTERNATE #4

A-124 – PHYSICAL TRAINING ROOF PLAN AND DETAILS ALTERNATE #4

A-406 – DORM PARTITION TYPES & MISC. DETAILS

A-511 – ADMIN. ROOF DETAILS ALTERNATE #4

A-512 – ADMIN. ROOF DETAILS ALTERNATE #4

A-603 - DORM FINISH SCHEDULE

By the Order of:

Andy Carroll, R.A.

Office of Administration

Division of Facilities Management, Design and
Construction

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END OF ADDENDUM 03

February 12, 2026

**Pre Bid Meeting
Renovations to Interior/Exterior & Install
Emergency Generator – Multiple Assets
Project Number R2502-01
January 29, 2026**


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	Tucker Hebner	FABICK CAT	636-577-2144	Tucker.Hebner@fabickcat.com




SECOND FLOOR KEYED NOTES #

18 (2) LAYERS OF TYPE X GWB OVER 7/8" HAT CHANNEL. SEE DETAIL 5/A-406.

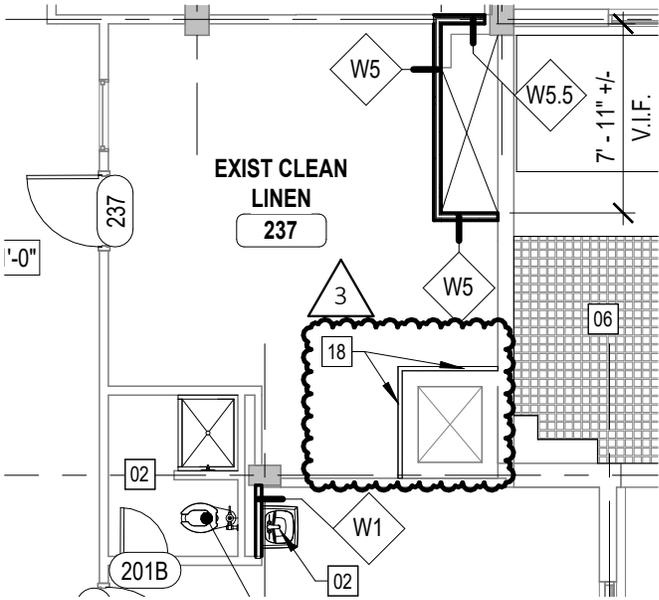


NEW CONSTRUCTION PLAN LEGEND

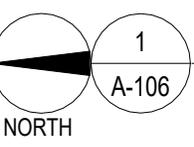


SECOND FLOOR PLAN

SCALE: 1/8" = 1'-0"

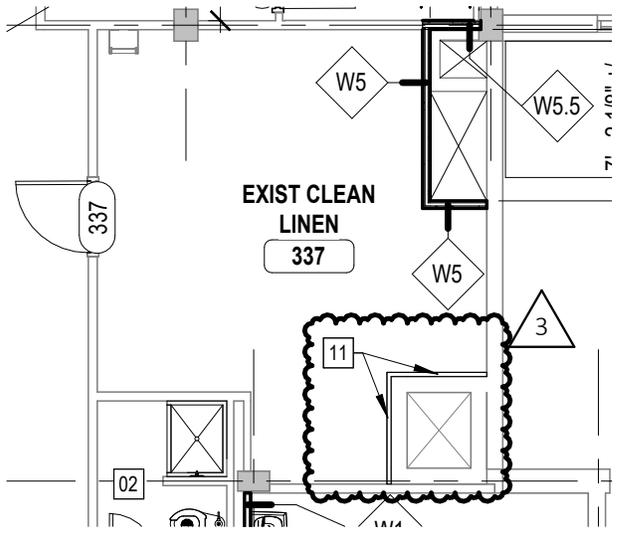

THIRD FLOOR KEYED NOTES #

11 (2) LAYERS OF TYPE X GWB OVER 7/8" HAT CHANNEL. SEE DETAIL 5/A-406.

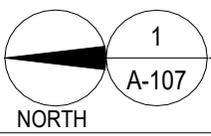

THIRD FLOOR PLAN

SCALE: 1/8" = 1'-0"

EXIST CLEAN LINEN
THIRD FLOOR

CHASE

EXISTING CONC.
FLOOR / DECK

MECH. CONTRACTOR TO
USE EXIST. CONC. SLAB
FOR INSTALLATION OF
DUCT SUPPORTS.

EXIST CLEAN LINEN
SECOND FLOOR

FIRESTOP SEALANT, TOP
& BOTTOM OF WALLS


REMOVE & DISPOSE OF
FIRE BRICK, MINIMAL
REMOVAL FOR ACCESS

REMOVE MINIMAL NUMBER
OF BLOCKS TO ACCESS
CHASE. REINSTALL
REMOVED CONC. BLOCKS
AT COMPLETION OF
MECHANICAL WORK

7/8", 20 GAUGE, METAL
FURRING ATTACH TO
EXISTING 4" BLOCK

(2) TYPE 'X' GYPSUM BOARD
STAGERED, FLOOR TO
CONC. DECK ABOVE. PAINT
PER FINISH SCHEDULE.

REMOVE 4 BLOCKS HIGH (FROM DECK DOWN)
X2 BLOCKS WIDE

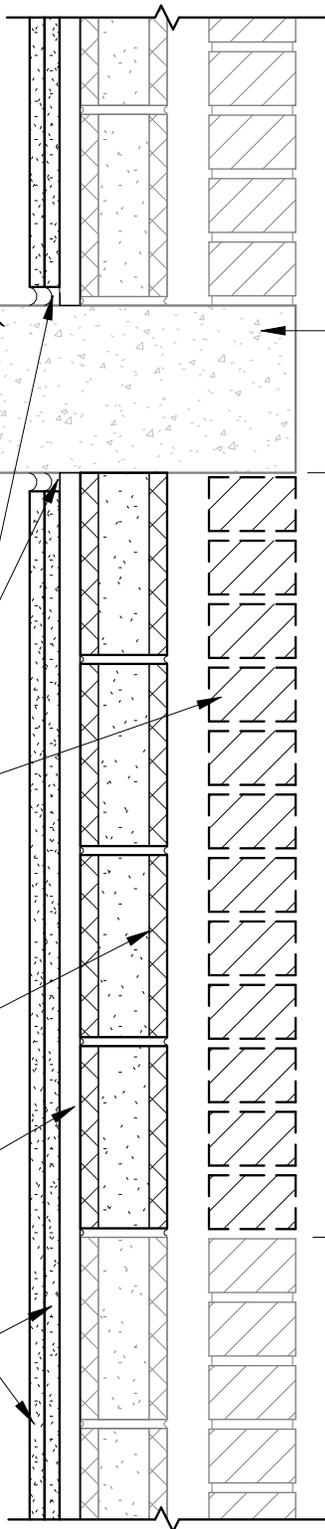

5

SECTION THRU MECH. CHASE


A-406

SCALE: 1 1/2" = 1'-0"

ROOF DRAIN. SEE PLUMBING DRAWINGS FOR ADDITIONAL INFORMATION.


(2) 1/2" COVER BOARD

EXISTING INSULATION
PROVIDE ANGLE SECTION AT DRAIN CLAMP BOLT LOCATIONS.

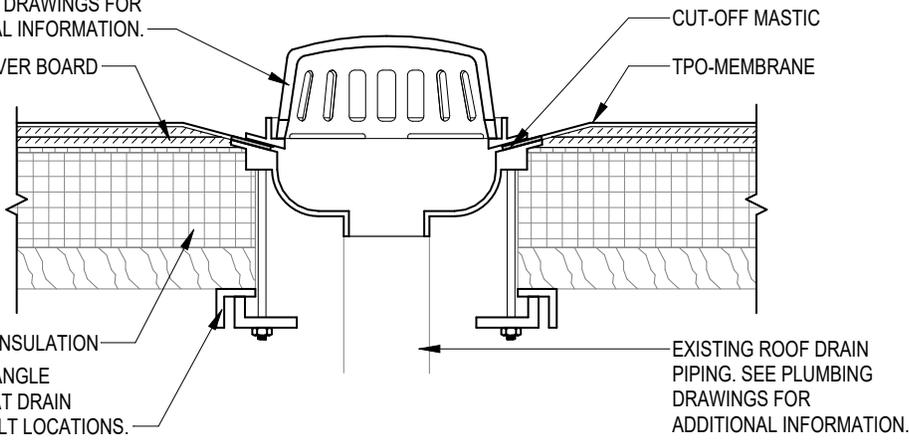


2 ROOF DRAIN

A-501 SCALE: 1 1/2" = 1'-0"

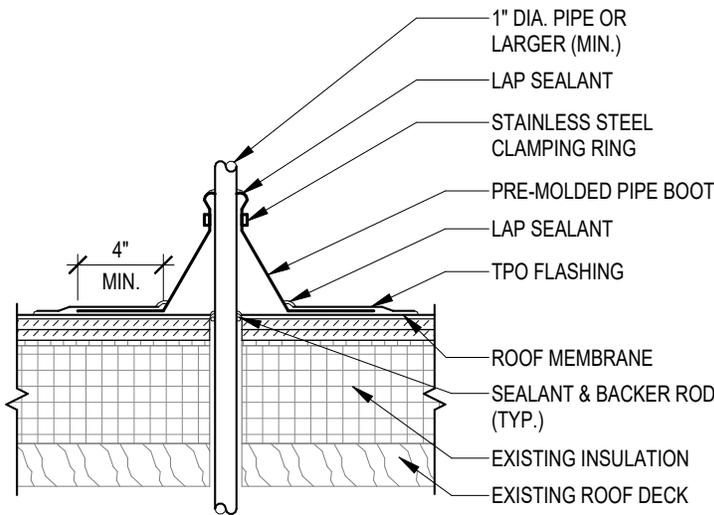

3 HOSE BIB OR PIPE PENETRATION


A-501 SCALE: 1 1/2" = 1'-0"

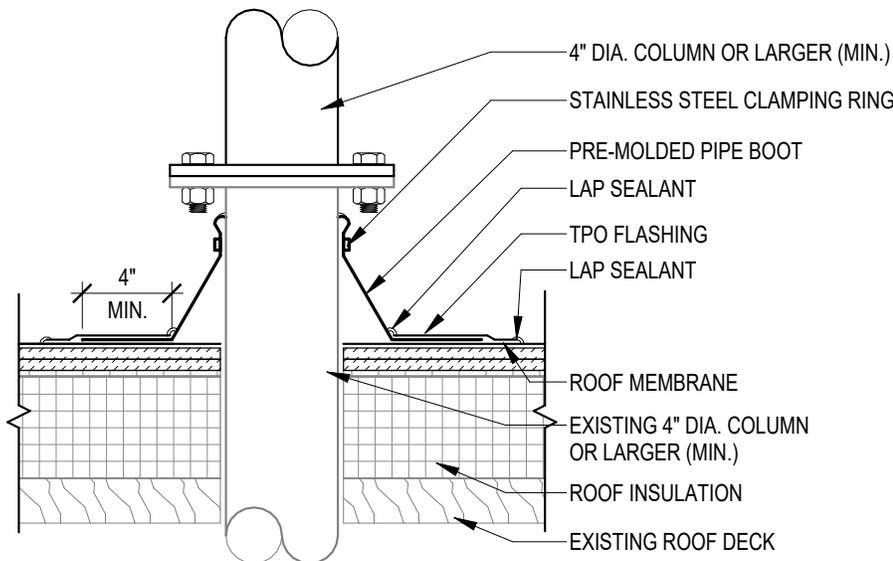

4 COLUMN ROOF PENETRATION

A-501 SCALE: 1 1/2" = 1'-0"

ADD 3 DETAILS
02/12/2026

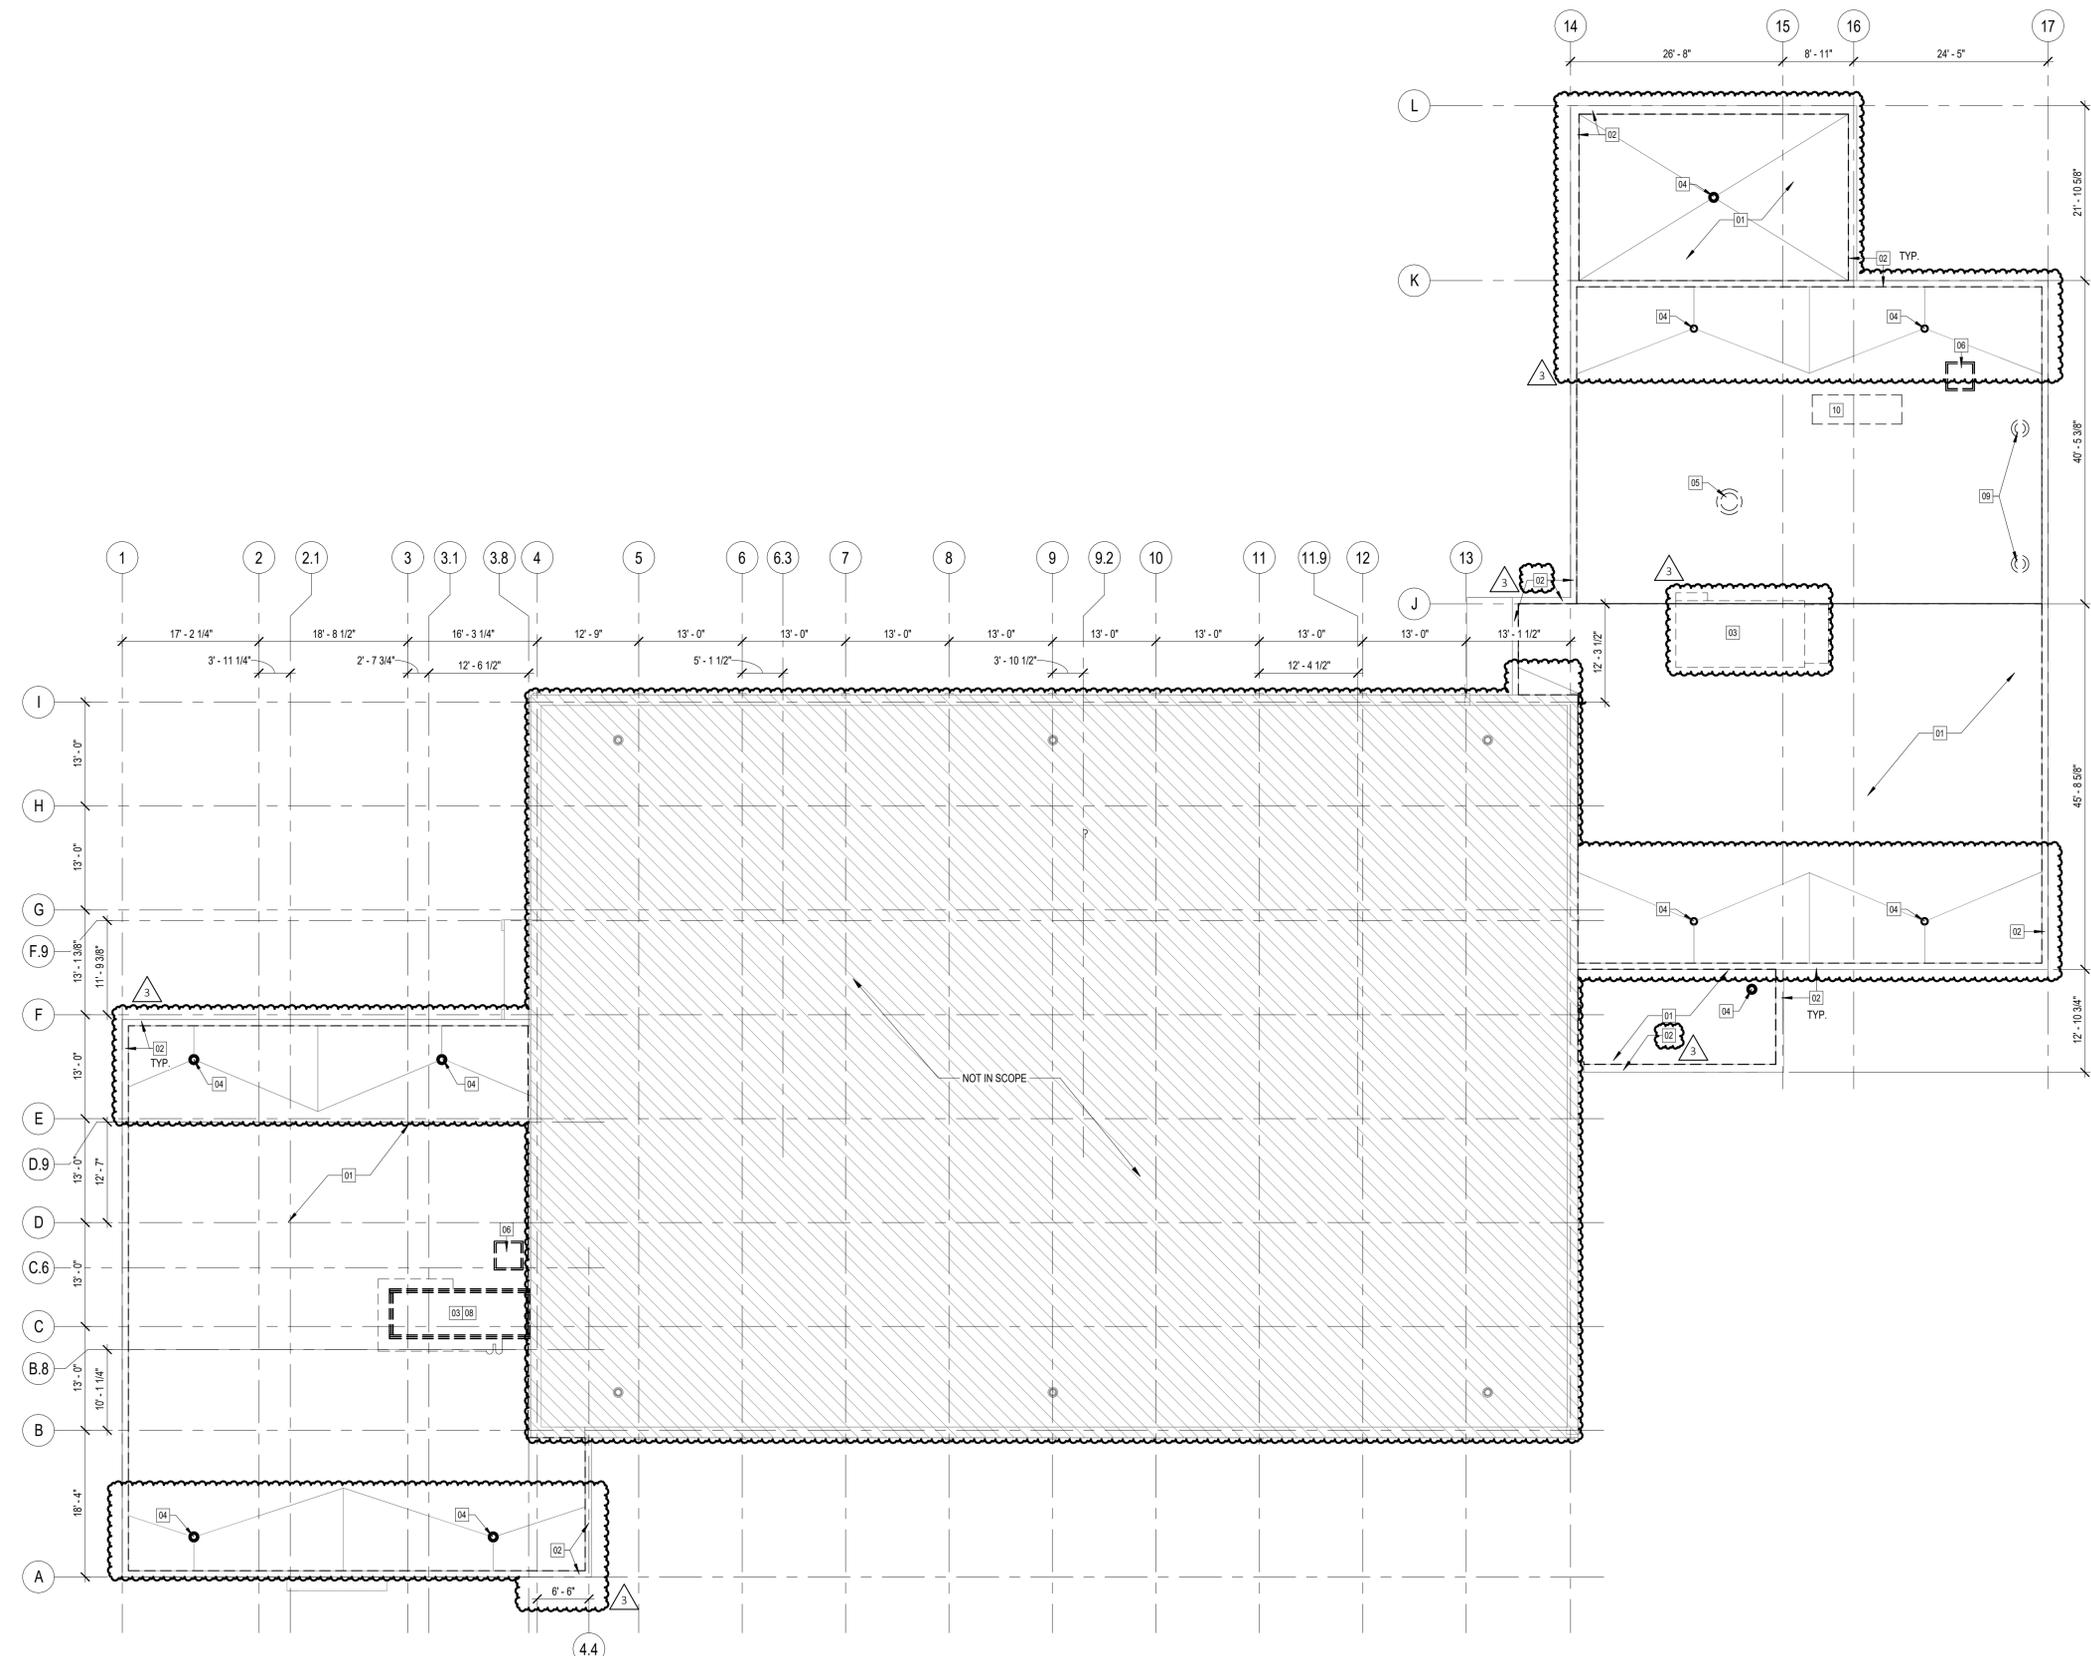

GENERAL ROOF PLAN NOTES:

1. THE CONTRACTOR SHALL ENSURE THE ROOF IS WATER TIGHT AT THE END OF EACH WORK DAY.
2. SEE MECHANICAL SHEETS FOR MECHANICAL EQUIPMENT INFORMATION, GAS LINES, CONDENSATE LINES, ETC.
3. IT IS THE RESPONSIBILITY OF THE GENERAL CONTRACTOR TO CROSS-CHECK THE M.E.P. DRAWINGS WITH THE ARCHITECTURAL DRAWINGS PRIOR TO THE ORDERING/ INSTALLATION OF MECHANICAL, ELECTRICAL, AND PLUMBING WORK. ANY DISCREPANCIES BETWEEN ARCHITECTURAL AND M.E.P. DRAWINGS SHALL BE BROUGHT TO THE ARCHITECT'S ATTENTION FOR IMMEDIATE CLARIFICATION.
4. WHERE EXISTING CONDITIONS ARE CUT OR DISTURBED TO PERMIT INSTALLATION OF NEW WORK, MATCH AND PATCH EXISTING DISTURBED CONSTRUCTION TO ORIGINAL CONDITION.
5. REFER TO DETAIL 13/A-501 FOR CURB FLASHING.
6. REPLACE DAMAGED EXISTING INSULATION AND CONCRETE FIBEROUS ROOF DECK AS REQUIRED.
7. THIS ALTERNATE SHALL INCLUDE COST ASSOCIATED WITH REPLACING UP TO TEN (10) 4'-0" x 8'-0" TECTUM DECKING PANELS (CONSIDERED DETERIORATED OR DAMAGED BEYOND REUSE AS DETERMINED BY CONTRACTOR AND ARCHITECT/ OWNER).
8. THIS ALTERNATE SHALL INCLUDE COSTS ASSOCIATED WITH THERMOGRAPHIC ROOF SCAN TO DETERMINE IF THERE IS MOISTURE WITHIN THE EXISTING INSULATION. THE CONTRACTOR SHALL SUPPLY A ROOFING SCAN REPORT TO THE ARCHITECT/OWNER PRIOR TO PROCEEDING WITH ROOF WORK.
9. EXISTING ROOF SLOPES ARE INTENDED TO REMAIN. CRICKETS SHOWN ARE DIAGRAMMATIC AND APPROXIMATE. CONTRACTOR SHALL FIELD VERIFY EXISTING CONDITIONS (SLOPES AND CRICKETS), IF DEFICIENT SLOPES, PONDING CONDITIONS, OR IMPROPER DRAINAGE ARE IDENTIFIED, CONTRACTOR SHALL NOTIFY ARCHITECT/ OWNER PRIOR TO PROCEEDING WITH ANY SLOPE MODIFICATIONS OR CORRECTIVE WORK.

DEMO ROOF PLAN KEYED NOTES [1]

- 01 THE EXISTING ROOF MEMBRANE SHALL BE REMOVED IN ITS ENTIRETY. PRIOR TO REMOVAL, THE ROOF SHALL BE SCANNED IN ACCORDANCE WITH GENERAL NOTE #8 TO IDENTIFY AREAS OF MOISTURE OR WATER INTRUSION. ANY DAMAGED OR WET INSULATION OR SUBSTRATE DISCOVERED DURING DEMOLITION SHALL NOT BE REPLACED UNDER THE BASE CONTRACT. IF REPLACEMENT IS REQUIRED, THE OWNER/ARCHITECT WILL COORDINATE WITH THE CONTRACTOR TO DETERMINE THE EXTENT OF REPLACEMENT WHICH WILL BE ADDRESSED AS AN ADDITIONAL SERVICE.
- 02 EXISTING FLASHING TO BE REMOVED COMPLETE. G.C. TO PREPARE ROOF PARAPET FOR NEW FINISHES.
- 03 G.C. TO REMOVE EXISTING AIR HANDLING UNIT AND ASSOCIATED DUCTWORK. AIR HANDLING UNIT IS TO BE STORED AND PROTECTED FOR REUSE. G.C. TO REPLACE ANY MOUNTING HARDWARE THAT IS DAMAGED. SEE MECHANICAL FOR ADDITIONAL INFORMATION.
- 04 EXISTING ROOF STRAINER TO BE REMOVED FOR INSTALLATION OF NEW ROOFING. REFER TO SPECS FOR ADDITIONAL INFORMATION.
- 05 CONTRACTOR IS TO COORDINATE INSTALLATION OF NEW EXHAUST FAN (ALT. #3) WITH MECHANICAL CONTRACTOR PRIOR TO DEMO AND INSTALLATION OF NEW ROOFING MATERIALS.
- 06 REMOVE AND DISPOSE OF EXISTING ROOF HATCH.
- 07 NOT USED
- 08 G.C. TO MODIFY EXISTING AIR HANDLING UNIT DUNNAGE FOR NEW DUNNAGE HEIGHT. REFER TO STRUCTURAL AND MECHANICAL DRAWINGS FOR ADDITIONAL INFORMATION.
- 09 G.C. TO REMOVE EXISTING EXTERIOR FAN AND ASSOCIATED ACCESSORIES. EXTERIOR FAN IS TO BE STORED AND PROTECTED FOR REUSE. G.C. TO REPLACE ANY MOUNTING HARDWARE THAT IS DAMAGED. SEE MECHANICAL DRAWINGS FOR ADDITIONAL INFORMATION.
- 10 CONTRACTOR IS TO COORDINATE INSTALLATION OF NEW MAKE-UP AIR UNIT (ALT. #3) WITH MECHANICAL CONTRACTOR PRIOR TO DEMO AND INSTALLATION OF NEW ROOFING MATERIALS.

DEMOLITION PLAN LEGEND

- EXISTING CONSTRUCTION TO BE REMAIN
- EXISTING ROOF TO BE REMOVED
- AREA NOT IN SCOPE



REVISIONS

No.	Description	Date
3	ADDENDUM 3	02/12/26

ISSUE DATE: 12/16/25


DWG FILE #: 2404694
DRAWN BY: LAA
CHECKED BY: JVR
DESIGNED BY: RAR

SHEET TITLE:
ADMINISTRATION DEMO ROOF
ALTERNATE #4

SHEET NUMBER:

A-113

SHEET 29 OF 148
12/16/25

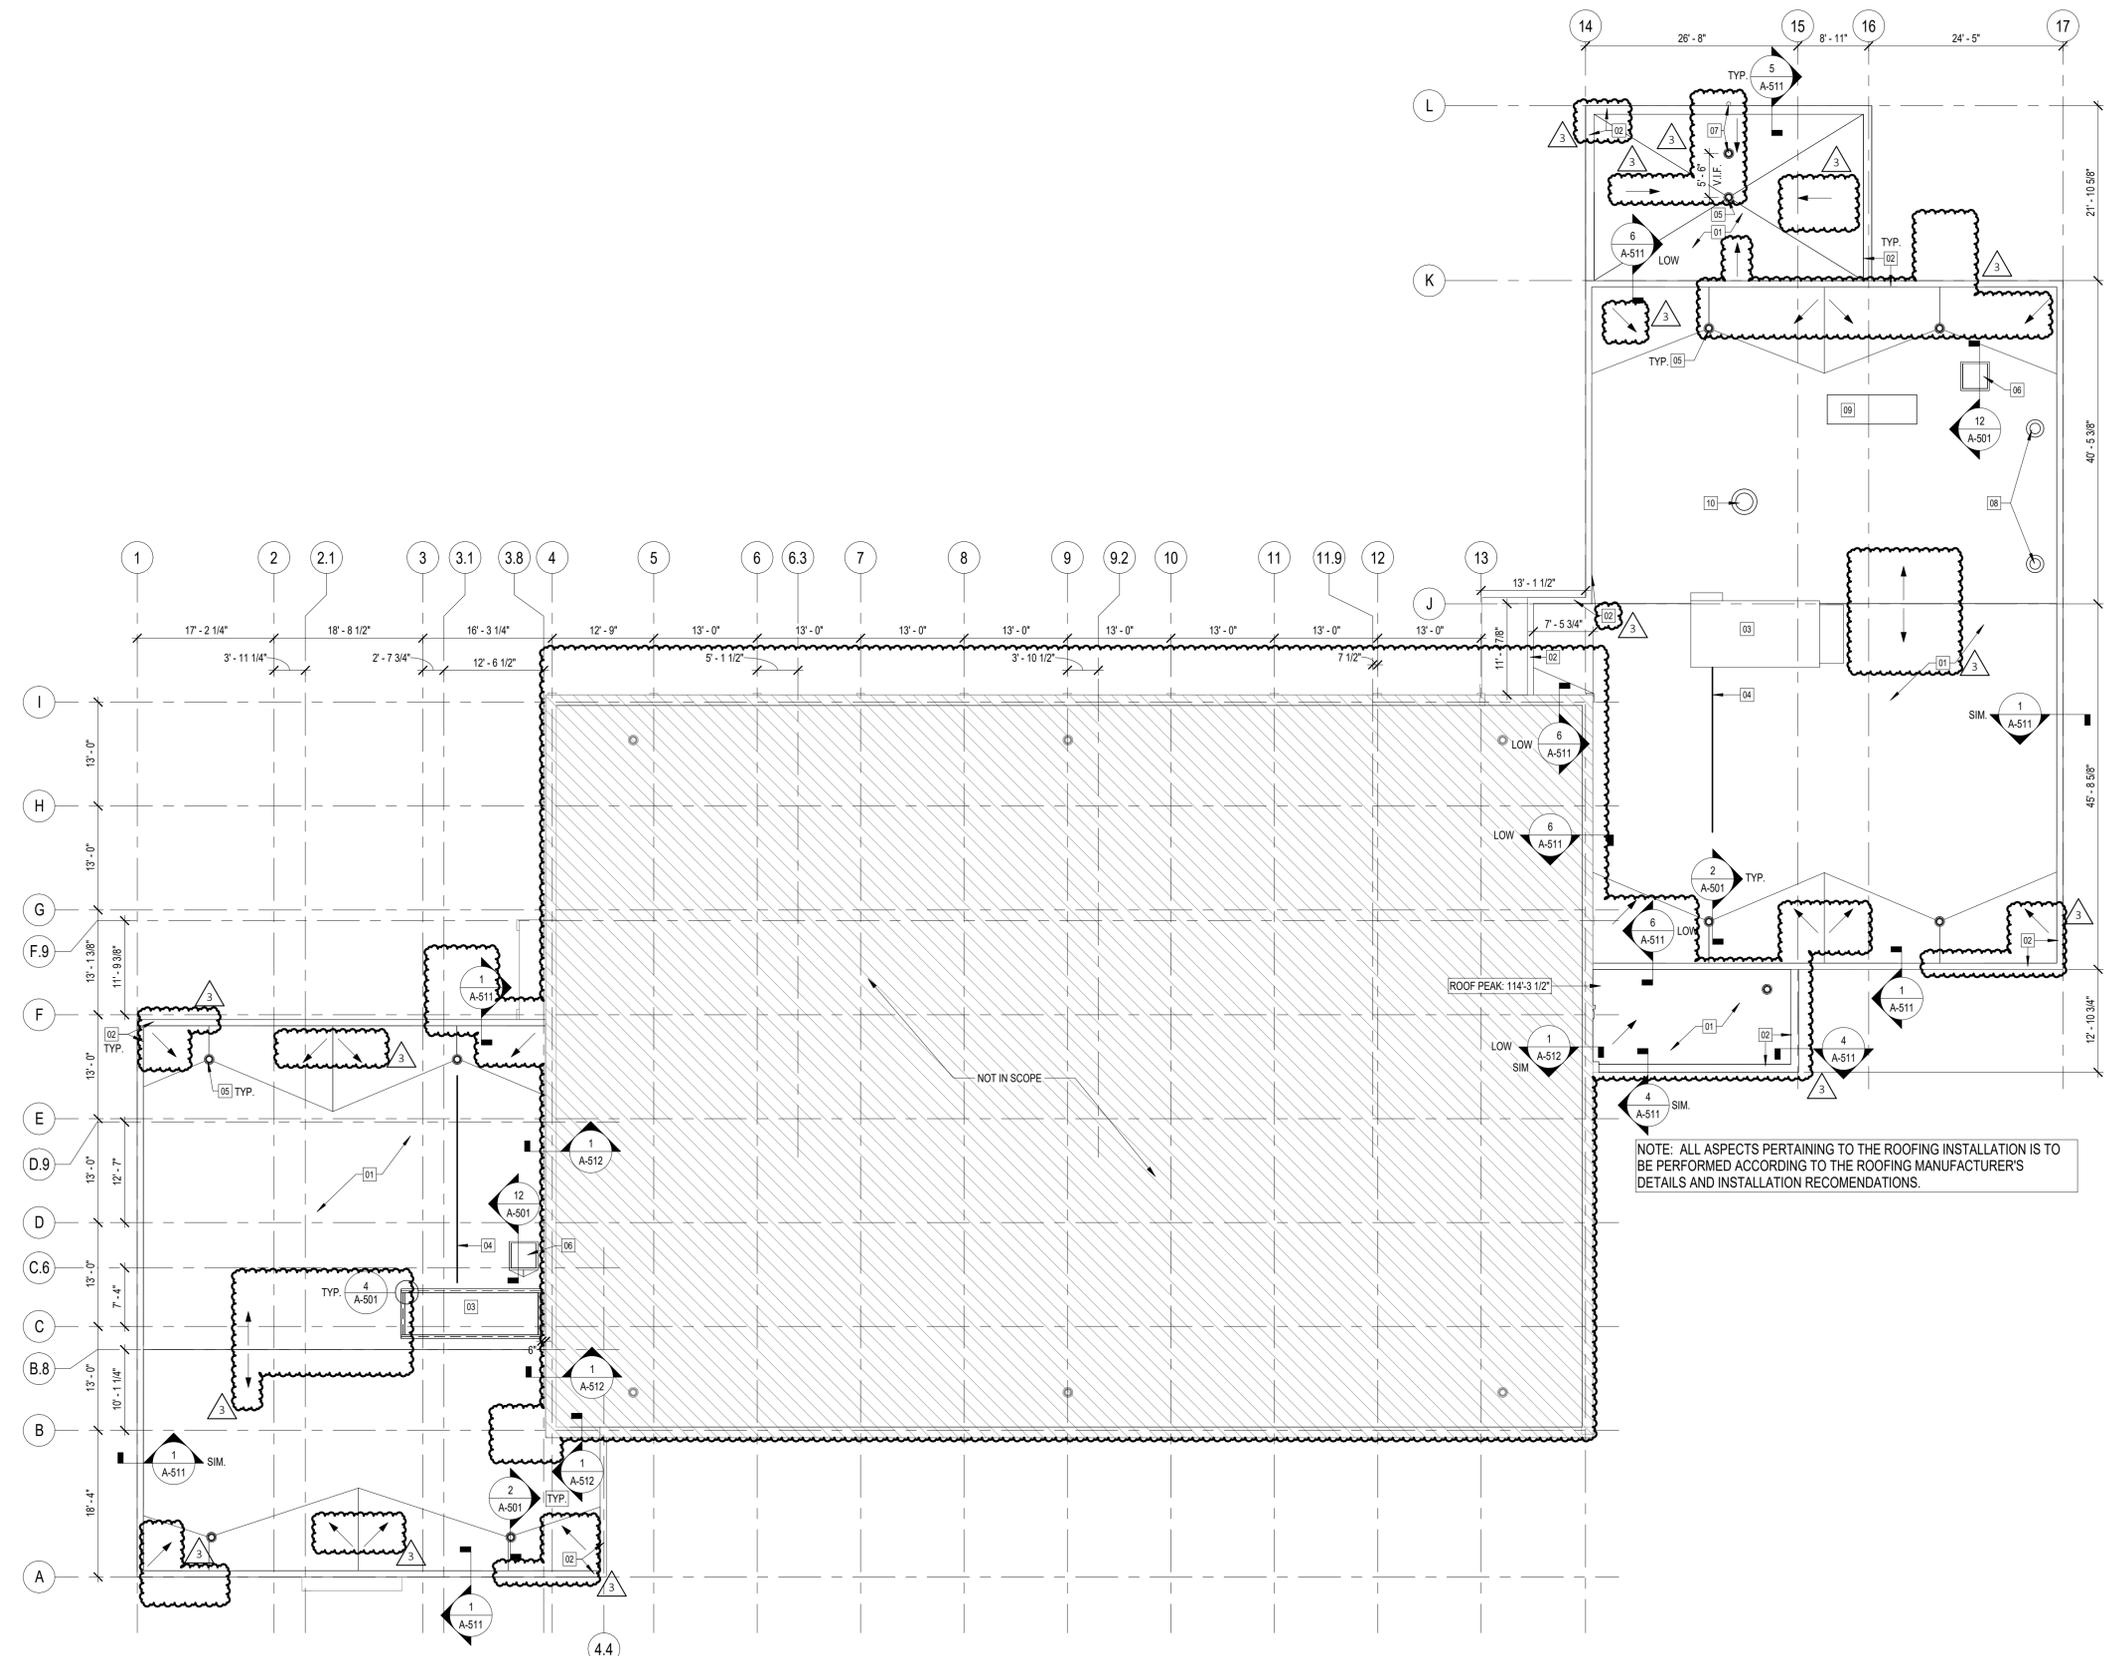

GENERAL ROOF PLAN NOTES:

1. THE CONTRACTOR SHALL ENSURE THE ROOF IS WATER TIGHT AT THE END OF EACH WORK DAY.
2. SEE MECHANICAL SHEETS FOR MECHANICAL EQUIPMENT INFORMATION, GAS LINES, CONDENSATE LINES, ETC.
3. IT IS THE RESPONSIBILITY OF THE GENERAL CONTRACTOR TO CROSS-CHECK THE M.E.P. DRAWINGS WITH THE ARCHITECTURAL DRAWINGS PRIOR TO THE ORDERING/ INSTALLATION OF MECHANICAL, ELECTRICAL, AND PLUMBING WORK. ANY DISCREPANCIES BETWEEN ARCHITECTURAL AND M.E.P. DRAWINGS SHALL BE BROUGHT TO THE ARCHITECT'S ATTENTION FOR IMMEDIATE CLARIFICATION.
4. WHERE EXISTING CONDITIONS ARE CUT OR DISTURBED TO PERMIT INSTALLATION OF NEW WORK, MATCH AND PATCH EXISTING DISTURBED CONSTRUCTION TO ORIGINAL CONDITION.
5. REFER TO DETAIL 13/A-501 FOR CURB FLASHING.
6. REPLACE DAMAGED EXISTING INSULATION AND CONCRETE FIBEROUS ROOF DECK AS REQUIRED.
7. THIS ALTERNATE SHALL INCLUDE COST ASSOCIATED WITH REPLACING UP TO TEN (10) 4'-0" x 8'-0" TECTUM DECKING PANELS (CONSIDERED DETERIORATED OR DAMAGED BEYOND REUSE AS DETERMINED BY CONTRACTOR AND ARCHITECT/ OWNER).
8. THIS ALTERNATE SHALL INCLUDE COSTS ASSOCIATED WITH THERMOGRAPHIC ROOF SCAN TO DETERMINE IF THERE IS MOISTURE WITHIN THE EXISTING INSULATION. THE CONTRACTOR SHALL SUPPLY A ROOFING SCAN REPORT TO THE ARCHITECT/OWNER PRIOR TO PROCEEDING WITH ROOF WORK.
9. EXISTING ROOF SLOPES ARE INTENDED TO REMAIN. CRICKETS SHOWN ARE DIAGRAMMATIC AND APPROXIMATE. CONTRACTOR SHALL FIELD VERIFY EXISTING CONDITIONS (SLOPES AND CRICKETS), IF DEFICIENT SLOPES, PONDING CONDITIONS, OR IMPROPER DRAINAGE ARE IDENTIFIED, CONTRACTOR SHALL NOTIFY ARCHITECT/ OWNER PRIOR TO PROCEEDING WITH ANY SLOPE MODIFICATIONS OR CORRECTIVE WORK.

ROOF PLAN KEYED NOTES

- 01 THE EXISTING ROOF MEMBRANE SHALL BE REMOVED IN ITS ENTIRETY. PRIOR TO REMOVAL, THE ROOF SHALL BE SCANNED IN ACCORDANCE WITH GENERAL NOTE #8 TO IDENTIFY AREAS OF MOISTURE OR WATER INTRUSION. ANY DAMAGED OR WET INSULATION OR SUBSTRATE DISCOVERED DURING DEMOLITION SHALL NOT BE REPLACED UNDER THE BASE CONTRACT. IF REPLACEMENT IS REQUIRED, THE OWNER/ARCHITECT WILL COORDINATE WITH THE CONTRACTOR TO DETERMINE THE EXTENT OF REPLACEMENT, WHICH WILL BE ADDRESSED AS AN ADDITIONAL SERVICE.
- 02 INSTALL NEW FLASHING. SEE SPECIFICATIONS.
- 03 G.C. TO REMOVE EXISTING AIR HANDLING UNIT AND ASSOCIATED DUCTWORK. AIR HANDLING UNIT IS TO BE STORED AND PROTECTED FOR REUSE. G.C. TO REPLACE ANY MOUNTING HARDWARE THAT IS DAMAGED. SEE MECHANICAL FOR ADDITIONAL INFORMATION.
- 04 RUN NEW CONDENSATE LINES TO ROOF DRAINS.
- 05 NEW ROOF STRAINERS SEE SPECS FOR ADDITIONAL INFORMATION.
- 06 INSTALL NEW ROOF HATCH IN THE ORIGINAL ROOF HATCH LOCATION. G.C. TO ENSURE NEW ROOF HATCH IS PROPERLY SEALED, SECURED, AND FULLY OPERATIONAL. SEE INDICATED SECTION FOR ADDITIONAL INFORMATION.
- 07 NEW ROOF OVERFLOW DRAIN AND STRAINER. SEE DETAIL 7/A-511. SEE SPECS FOR ADDITIONAL INFORMATION.
- 08 INSTALL PREVIOUSLY REMOVED AND STORED EXTERIOR FAN AND ASSOCIATED ACCESSORIES. REFER TO MECHANICAL DRAWINGS FOR ADDITIONAL INFORMATION.
- 09 INSTALL NEW MAKE-UP AIR UNIT. REFER TO MECHANICAL DRAWINGS AND ALTERNATE #3 FOR ADDITIONAL INFORMATION.
- 10 INSTALL NEW EXTERIOR FAN AND ASSOCIATED ACCESSORIES. REFER TO MECHANICAL DRAWINGS AND ALTERNATE #3 FOR ADDITIONAL INFORMATION.

NEW CONSTRUCTION PLAN LEGEND

- EXISTING CONSTRUCTION TO BE REMAIN
- NEW ROOF, UNITS, ETC.
- ▨ AREA NOT IN SCOPE



REVISIONS

No.	Description	Date
3	ADDENDUM 3	02/12/26


ISSUE DATE: 12/16/25

DWG FILE #: 2404694
DRAWN BY: LAA
CHECKED BY: JVR
DESIGNED BY: RAR

SHEET TITLE:
ADMINISTRATION ROOF PLAN
ALTERNATE #4

SHEET NUMBER:

A-114
SHEET 30 OF 148
12/16/25

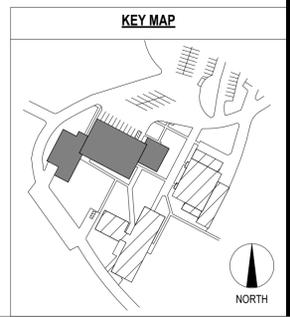

1 ROOF PLAN
A-114 SCALE: 3/32" = 1'-0"
NORTH



REVISIONS

No.	Description	Date
3	ADDENDUM 3	02/12/26

ISSUE DATE: 12/16/25

DWG FILE #: 2404694
DRAWN BY: LAA
CHECKED BY: JVR
DESIGNED BY: RAR

SHEET TITLE:
PHYSICAL TRAINING DEMO
ROOF ALTERNATE #4

SHEET NUMBER:

A-123
SHEET 33 OF 148
12/16/25

GENERAL ROOF PLAN NOTES:


- THE CONTRACTOR SHALL ENSURE THE ROOF IS WATER TIGHT AT THE END OF EACH WORK DAY.
- ROOF WORK AT EXISTING TPO AREAS REQUIRES THE USE OF A ROOFER THAT IS APPROVED BY THE MANUFACTURE IN ORDER TO NOT VOID WARRANTIES IN PLACE. SEE SPECS FOR ROOF WARRANTY INFO.
- SEE MECHANICAL SHEETS FOR MECHANICAL EQUIPMENT INFORMATION, GAS LINES, CONDENSATE LINES, ETC.
- IT IS THE RESPONSIBILITY OF THE GENERAL CONTRACTOR TO CROSS-CHECK THE M.E.P. DRAWINGS WITH THE ARCHITECTURAL DRAWINGS PRIOR TO THE ORDERING/ INSTALLATION OF MECHANICAL, ELECTRICAL, AND PLUMBING WORK. ANY DISCREPANCIES BETWEEN ARCHITECTURAL AND M.E.P. DRAWINGS SHALL BE BROUGHT TO THE ARCHITECT'S ATTENTION FOR IMMEDIATE CLARIFICATION.
- WHERE EXISTING CONDITIONS ARE CUT OR DISTURBED TO PERMIT INSTALLATION OF NEW WORK, MATCH AND PATCH EXISTING DISTURBED CONSTRUCTION TO ORIGINAL CONDITION.
- NOT USED
- CRICKETS WITH A MINIMUM OF 1/4" PER FOOT, REFER TO CONSTRUCTION PLANS FOR LOCATIONS.
- REPLACE DAMAGED EXISTING INSULATION AND CONCRETE FIBEROUS ROOF DECK AS REQUIRED.
- THIS ALTERNATE SHALL INCLUDE COST ASSOCIATED WITH REPLACING UP TO TEN (10) 4'-0" x 8'-0" TECTUM DECKING PANELS (CONSIDERED DETERIORATED OR DAMAGED BEYOND REUSE AS DETERMINED BY CONTRACTOR AND ARCHITECT/ OWNER).
- THIS ALTERNATE SHALL INCLUDE COSTS ASSOCIATED WITH THERMOGRAPHIC ROOF SCAN TO DETERMINE IF THERE IS MOISTURE WITHIN THE EXISTING INSULATION. THE CONTRACTOR SHALL SUPPLY A ROOFING SCAN REPORT TO THE ARCHITECT/OWNER PRIOR TO PROCEEDING WITH ROOF WORK.
- EXISTING ROOF SLOPES ARE INTENDED TO REMAIN. CRICKETS SHOWN ARE DIAGRAMMATIC AND APPROXIMATE. CONTRACTOR SHALL FIELD VERIFY EXISTING CONDITIONS (SLOPES AND CRICKETS). IF DEFICIENT SLOPES, PONDING CONDITIONS, OR IMPROPER DRAINAGE ARE IDENTIFIED, CONTRACTOR SHALL NOTIFY ARCHITECT/ OWNER PRIOR TO PROCEEDING WITH ANY SLOPE MODIFICATIONS OR CORRECTIVE WORK.

DEMO ROOF PLAN KEYED NOTES #

- THE EXISTING ROOF MEMBRANE SHALL BE REMOVED IN ITS ENTIRETY. PRIOR TO REMOVAL, THE ROOF SHALL BE SCANNED IN ACCORDANCE WITH GENERAL NOTE #10 TO IDENTIFY AREAS OF MOISTURE OR WATER INTRUSION. ANY DAMAGED OR WET INSULATION OR SUBSTRATE DISCOVERED DURING DEMOLITION SHALL NOT BE REPLACED UNDER THE BASE CONTRACT. IF REPLACEMENT IS REQUIRED, THE OWNER/ARCHITECT WILL COORDINATE WITH THE CONTRACTOR TO DETERMINE THE EXTENT OF REPLACEMENT, WHICH WILL BE ADDRESSED AS AN ADDITIONAL SERVICE.
- EXISTING FLASHING TO BE REMOVED COMPLETE. G.C. TO PREPARE ROOF PARAPET FOR NEW FINISHES.
- THE EXISTING AIR HANDLING UNIT IS INSTALLED ON STRUCTURAL DRAINAGE WITH SUPPLY AND RETURN DUCTWORK EXTENDING THROUGH AN EXISTING CURB/ADAPTER ASSEMBLY. TO FACILITATE PROPER INSTALLATION AND WATERTIGHT TERMINATION OF THE NEW TPO ROOFING SYSTEM, THE GENERAL CONTRACTOR SHALL COORDINATE TEMPORARY DISCONNECTION AND REMOVAL OF THE EXISTING AHU AS REQUIRED. REMOVE AND REPLACE EXISTING SUPPLY AND RETURN DUCTWORK AS NECESSARY TO PROVIDE CONTINUOUS, CODE-COMPLIANT, AND MANUFACTURER-COMPLIANT ROOFING TERMINATIONS AND FLASHING AT THE EXISTING CURB CONDITION. MODIFY OR REPLACE THE EXISTING CURB/ADAPTER ASSEMBLY AS REQUIRED TO ACHIEVE A FULL WATERTIGHT INSTALLATION IN ACCORDANCE WITH ROOFING MANUFACTURER REQUIREMENTS. UPON COMPLETION OF ROOFING WORK, REINSTALL THE AHU AND RECONNECT DUCTWORK, ENSURING PROPER ALIGNMENT, SUPPORT, AND WEATHER-TIGHT CONDITIONS. THE CONTRACTOR SHALL VERIFY ALL EXISTING CONDITIONS IN THE FIELD AND IS RESPONSIBLE FOR COORDINATION WITH MECHANICAL TRADES.
- EXISTING OVERFLOW TO REMAIN.
- EXISTING ROOF STRAINER TO BE REMOVED FOR INSTALLATION OF NEW ROOFING. REFER TO SPECS FOR ADDITIONAL INFORMATION.
- EXISTING ROOF HATCH TO BE REMOVED FOR INSTALLATION OF NEW ROOFING.
- NOT USED
- EXISTING GUTTER AND DOWNSPOUTS TO BE REMOVED COMPLETE.
- CONTRACTOR IS TO COORDINATE INSTALLATION OF MAKE-UP UNIT (BASE-BID) WITH MECHANICAL CONTRACTOR PRIOR TO DEMO AND INSTALLATION OF NEW ROOFING MATERIALS.
- G.C. TO REMOVE EXISTING INTAKE HOODS AND ASSOCIATED ACCESSORIES IN PREPARATION FOR FLASHING AT CURBS. STORE/PROTECT FOR REUSE. G.C. TO REPLACE ANY MOUNTING HARDWARE AS REQUIRED FOR REINSTALLATION.


DEMOLITION PLAN LEGEND

- EXISTING CONSTRUCTION TO BE REMAIN
- EXISTING WALLS, DOORS, ETC. TO BE REMOVED
- AREA NOT IN SCOPE






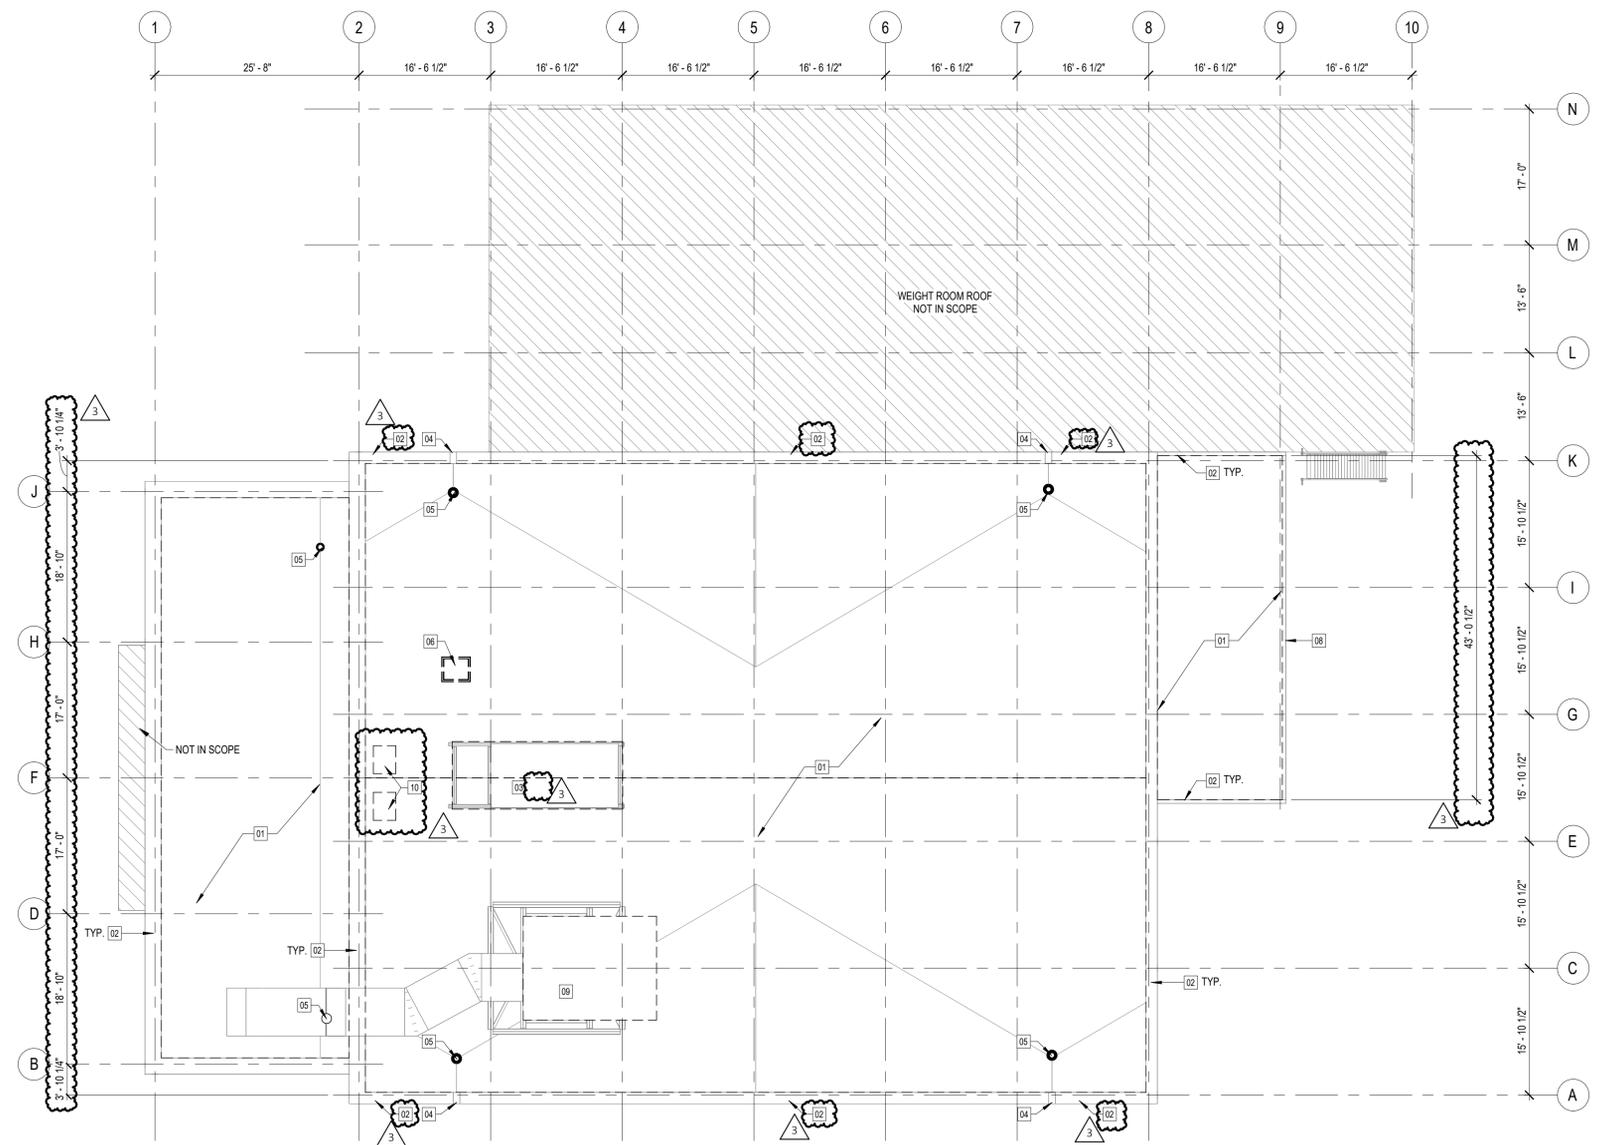


1
A-123
SCALE: 3/32" = 1'-0"
NORTH

KEY MAP

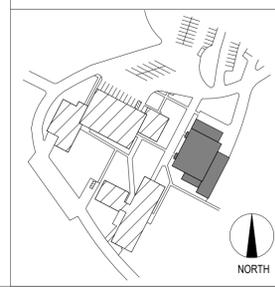

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STATE OF MISSOURI
MIKE KEHOE
GOVERNOR

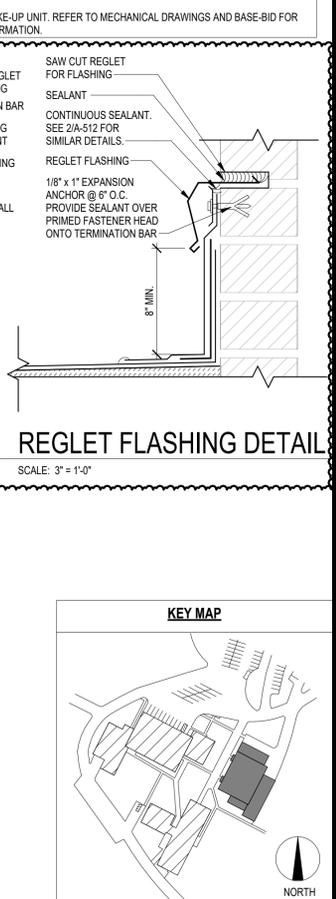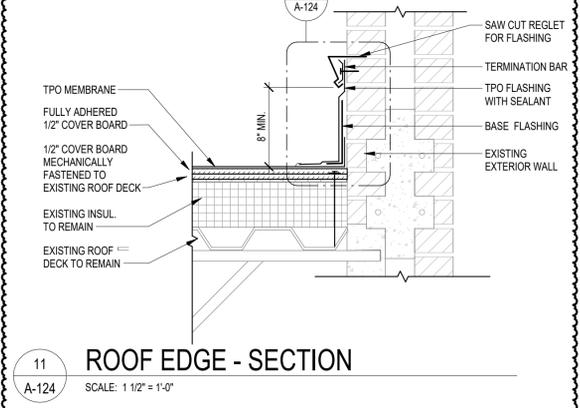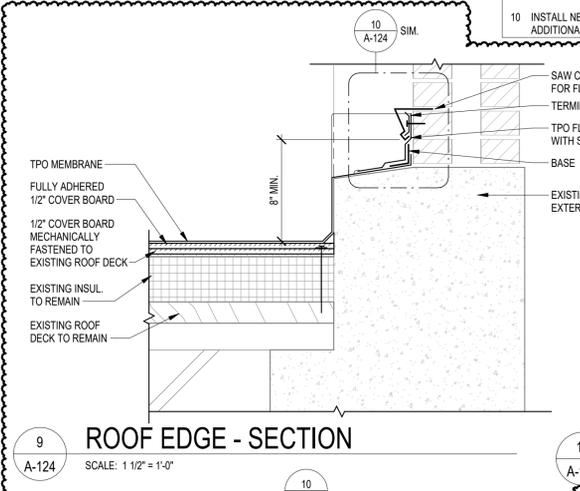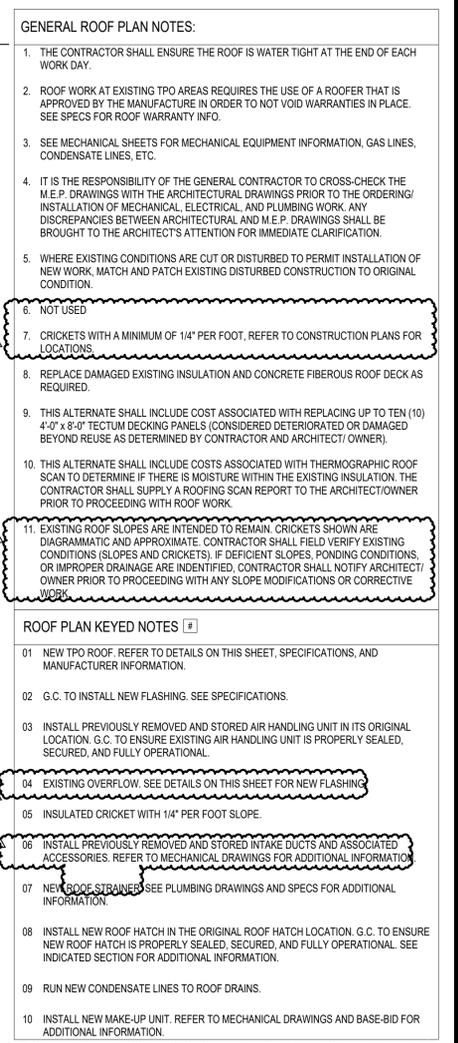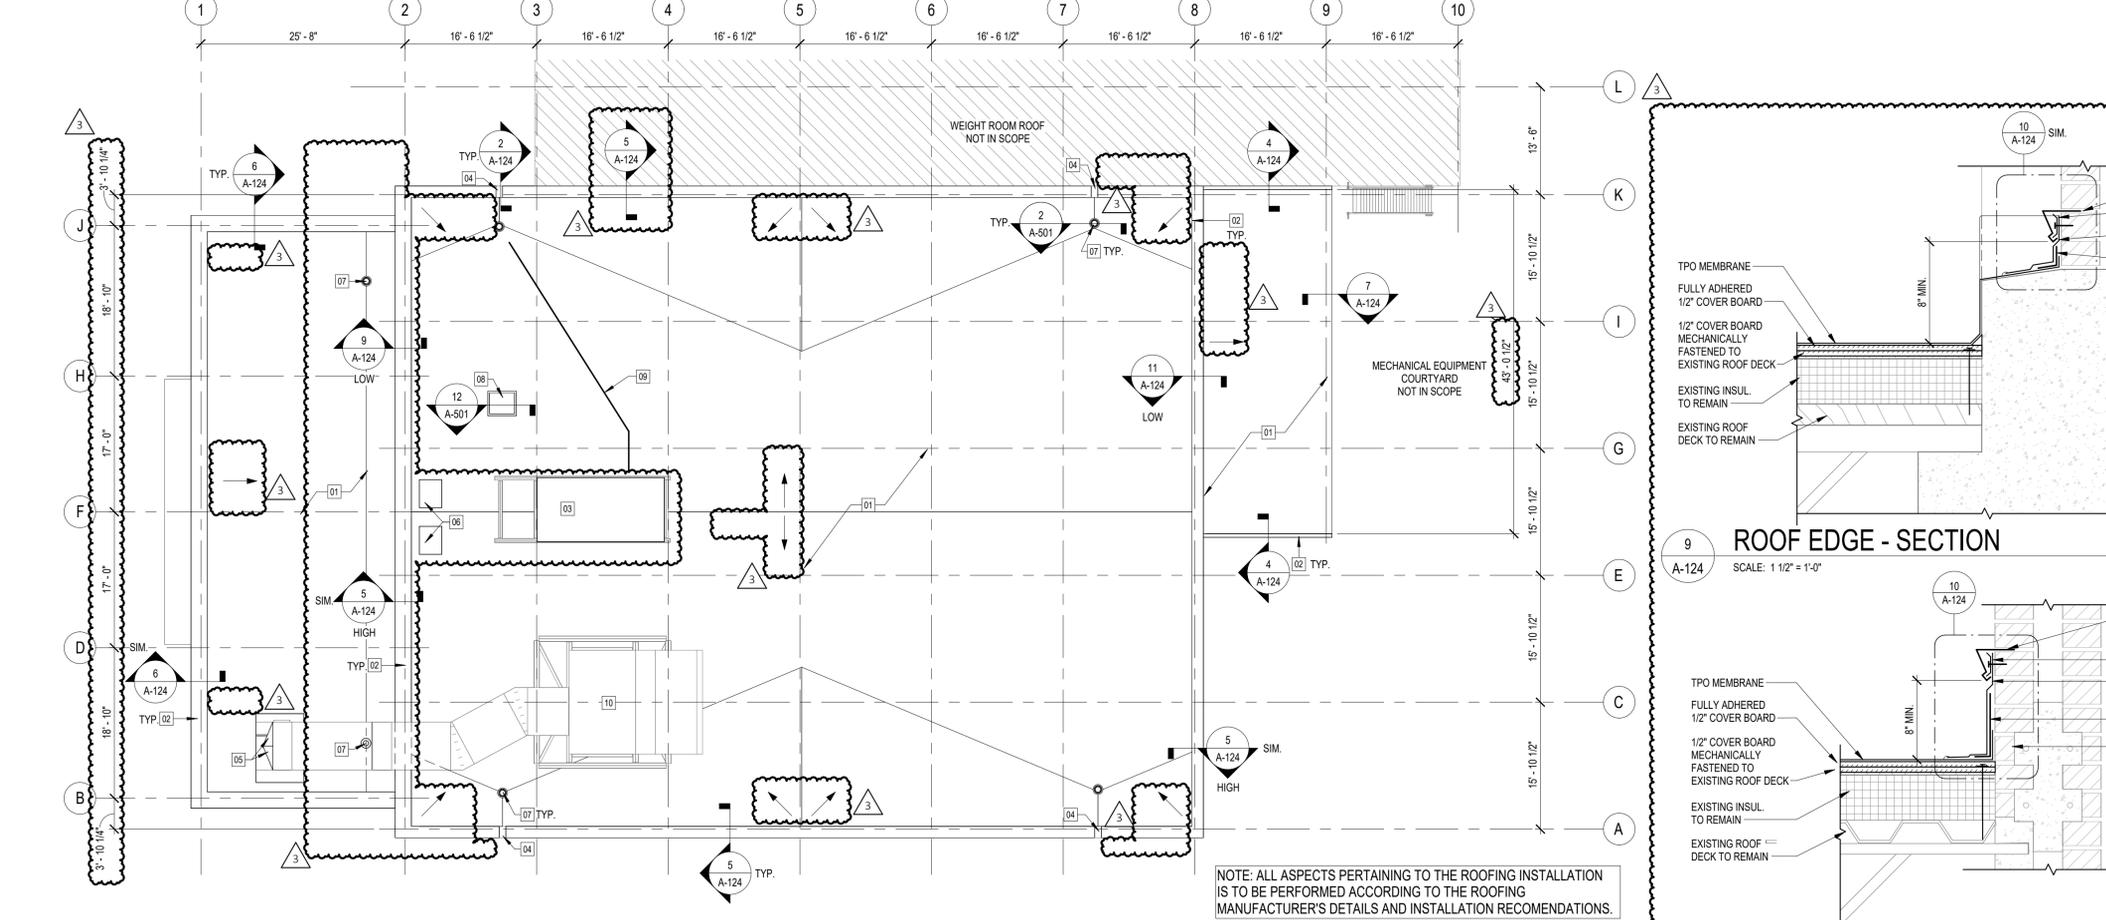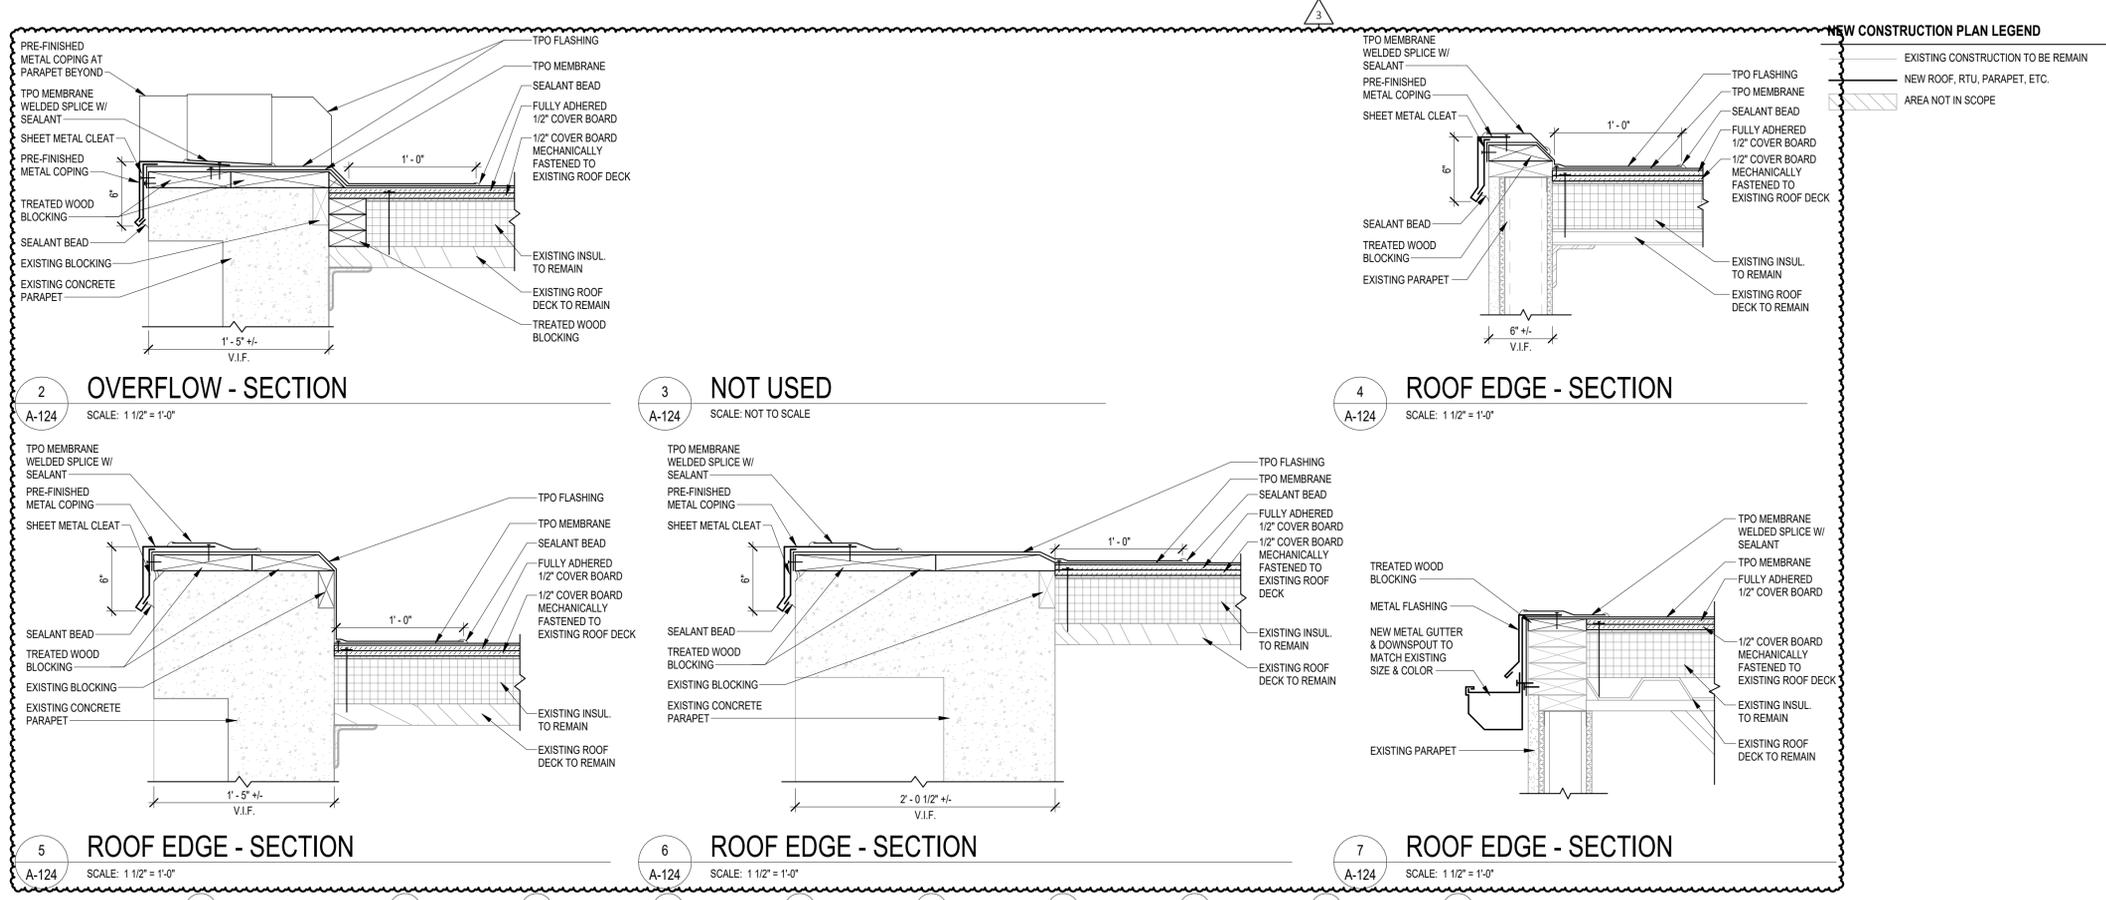CASCO DIVERSIFIED CORPORATION
ARCHITECTURAL
LICENSE # 003029
EXP. DATE: 12/31/26



Professional of Record:
MICHAEL S. SUNDERMEYER
LICENSE # 2014026855
EXP. DATE: 12/31/26

CASCO
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OFFICE OF ADMINISTRATION
DIVISION OF FACILITIES
MANAGEMENT,
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HIGHWAY PATROL

RENOVATIONS TO
INTERIOR/EXTERIOR & INSTALL
EMERGENCY GENERATOR,
MULTIPLE ASSETS
MSHP GENERAL
HEADQUARTERS COMPLEX
1510 E. ELM STREET
JEFFERSON CITY, MO 65101

PROJECT # R2502-01
SITE # 6001
FACILITY #8136001003

REVISIONS

No.	Description	Date
3	ADDENDUM 3	02/12/26

ISSUE DATE: 12/16/25

DWG FILE #: 2404694
DRAWN BY: LAA
CHECKED BY: JVR
DESIGNED BY: RAR


SHEET TITLE:
PHYSICAL TRAINING ROOF
PLAN AND DETAILS
ALTERNATE #4

SHEET NUMBER:


A-124

SHEET 34 OF 148
12/16/25


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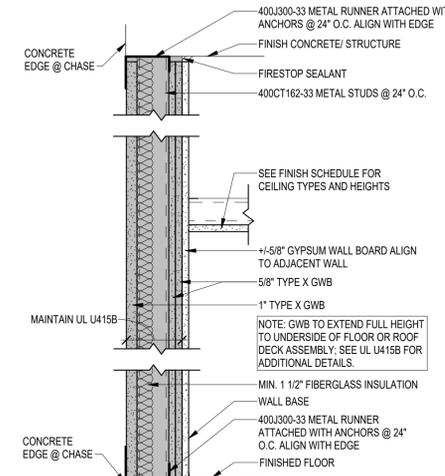
W5.1 - 2 HOUR RATED CHASE WALL. (1) LAYER OF 1" TYPE X GWB ON CHASE SIDE AND (2) LAYERS OF 5/8" TYPE X GWB ON OPPOSITE SIDE. ALIGN FINISH WITH ADJACENT WALL WITH +/- 5/8" GWB.

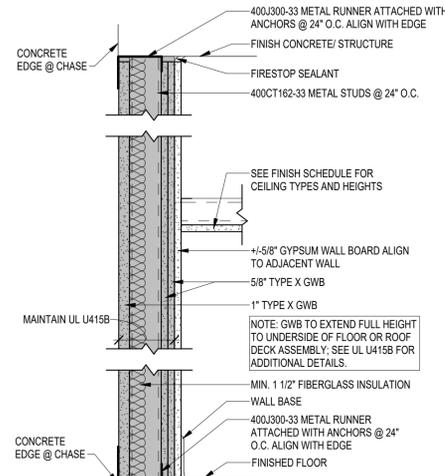


W5.2 - 2 HOUR RATED CHASE WALL. (1) LAYER OF 1" TYPE X GWB ON CHASE SIDE AND (2) LAYERS OF 5/8" TYPE X GWB ON OPPOSITE SIDE. STACK (2) LAYERS OF 1/2" GYP WALL BOARD. ALIGN FINISH WITH ADJACENT WALL WITH +/- 5/8" GWB.

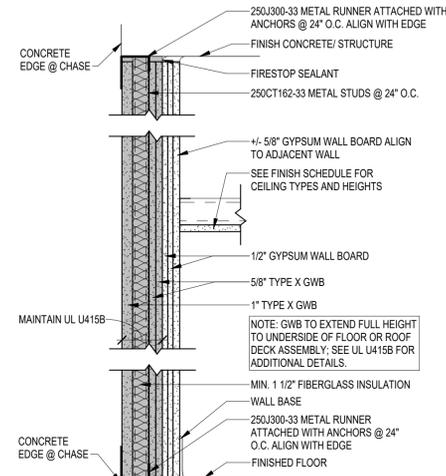

W5.3 - 2 HOUR RATED CHASE WALL. (1) LAYER OF 1" TYPE X GWB ON CHASE SIDE AND (2) LAYERS OF 5/8" TYPE X GWB ON OPPOSITE SIDE. STACK (2) LAYERS OF 1/2" GYP WALL BOARD. ALIGN FINISH WITH ADJACENT WALL WITH +/- 3/8" GWB.

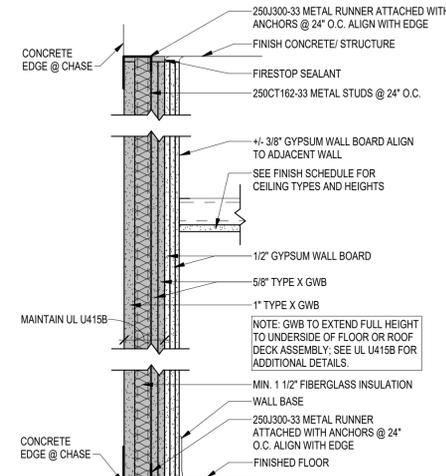


W5.4 - 2 HOUR RATED CHASE WALL. (1) LAYER OF 1" TYPE X GWB ON CHASE SIDE AND (2) LAYERS OF 5/8" TYPE X GWB ON OPPOSITE SIDE. ALIGN FINISH WITH ADJACENT WALL WITH +/- 3/8" GWB.

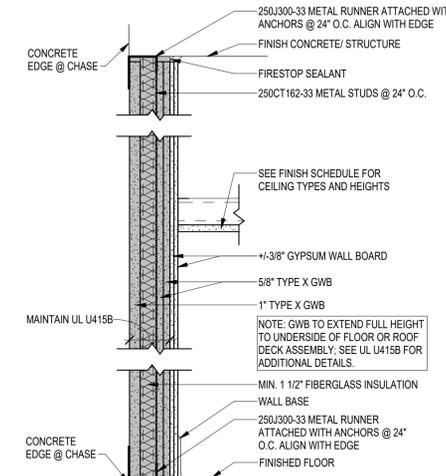


W5.5 - 2 HOUR RATED CHASE WALL. (1) LAYER OF 1" TYPE X GWB ON CHASE SIDE AND (2) LAYERS OF 5/8" TYPE X GWB ON OPPOSITE SIDE. ALIGN FINISH WITH ADJACENT WALL WITH STACKED (2) LAYERS OF +/- 3/8" GWB.

1 SPECIAL CONDITIONS PARTITIONS
SCALE: 1 1/2" = 1'-0"

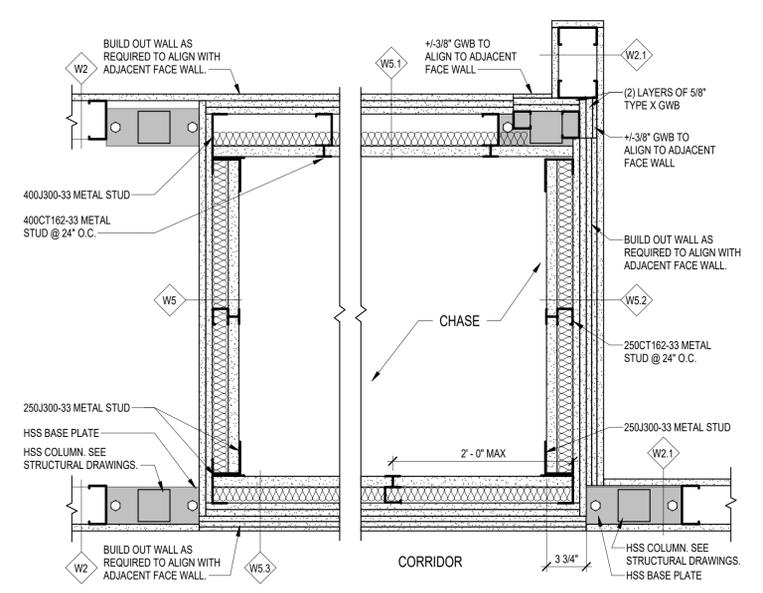


NOTE: MAINTAIN THE FULL 2HR FIRE RATING AT ALL SIDES OF THE CHASE PER UL U415B. ANY NON RATED BUILD OUTS FOR ALIGNMENT MUST OCCUR OUTSIDE THE COMPLETE 2HR RATED ASSEMBLY. SEAL TOP AND BOTTOM OF THE 2 HR FIRE RATED ASSEMBLY WITH FIRE STOP. SEE UL U415B FOR ADDITIONAL INFORMATION.

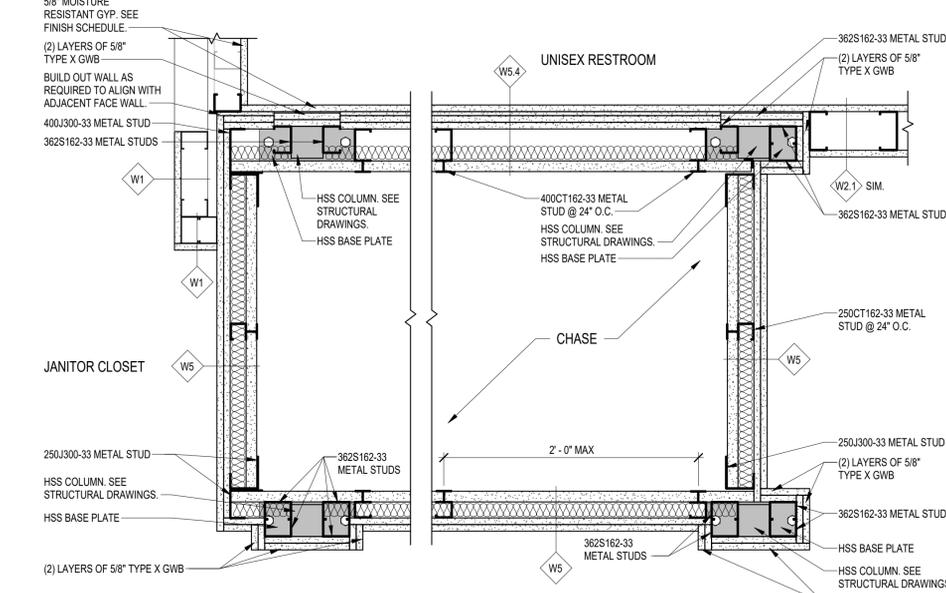


NOTE: MAINTAIN THE FULL 2HR FIRE RATING AT ALL SIDES OF THE CHASE PER UL U415B. ANY NON RATED BUILD OUTS FOR ALIGNMENT MUST OCCUR OUTSIDE THE COMPLETE 2HR RATED ASSEMBLY. SEAL TOP AND BOTTOM OF THE 2 HR FIRE RATED ASSEMBLY WITH FIRE STOP. SEE UL U415B FOR ADDITIONAL INFORMATION.

2 STEEL COLUMN TO TYPE X GWB CHASE (SUITE)
SCALE: 1 1/2" = 1'-0"

3 STEEL COLUMN TO TYPE X GWB CHASE (BATHROOM)
SCALE: 1 1/2" = 1'-0"

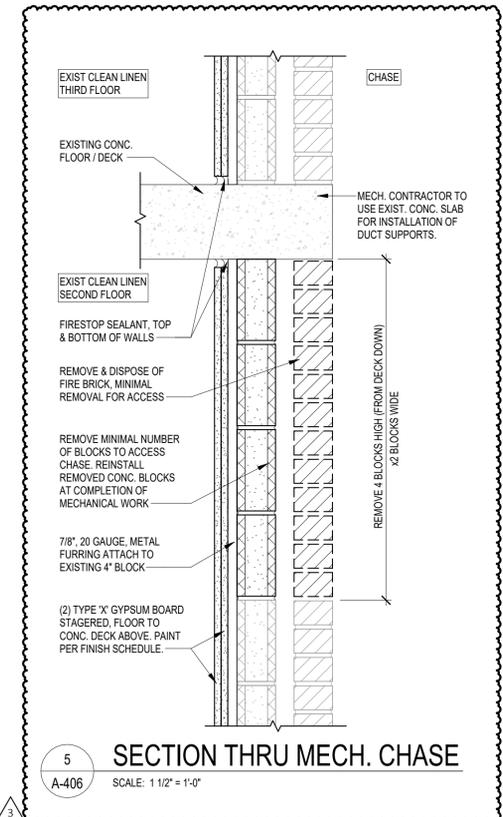

5 SECTION THRU MECH. CHASE
SCALE: 1 1/2" = 1'-0"

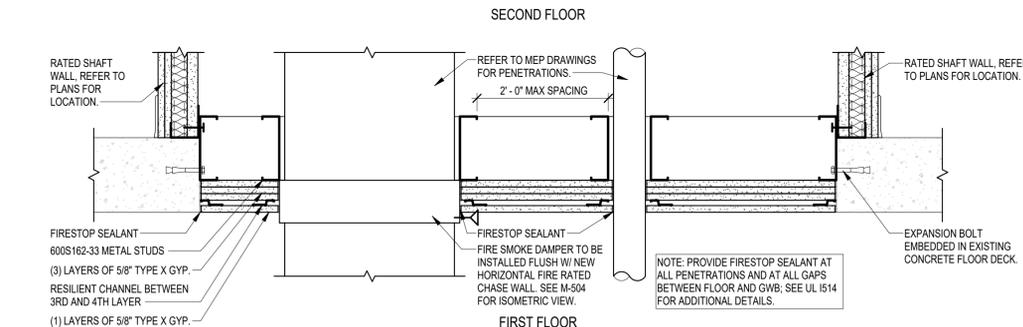

NOTE: PROVIDE FIRESTOP SEALANT AT ALL PENETRATIONS AND AT ALL GAPS BETWEEN FLOOR AND GWB; SEE UL 1514 FOR ADDITIONAL DETAILS.

4 HORIZONTAL FIRE RATED CHASE
SCALE: 1 1/2" = 1'-0"



REVISIONS

No.	Description	Date
3	ADDENDUM 3	02/12/26


ISSUE DATE: 12/16/25

DWG FILE #: 2404694
DRAWN BY: LAA
CHECKED BY: JVR
DESIGNED BY: RAR

SHEET TITLE:
DORM PARTITION TYPES &
MISC. DETAILS

SHEET NUMBER:


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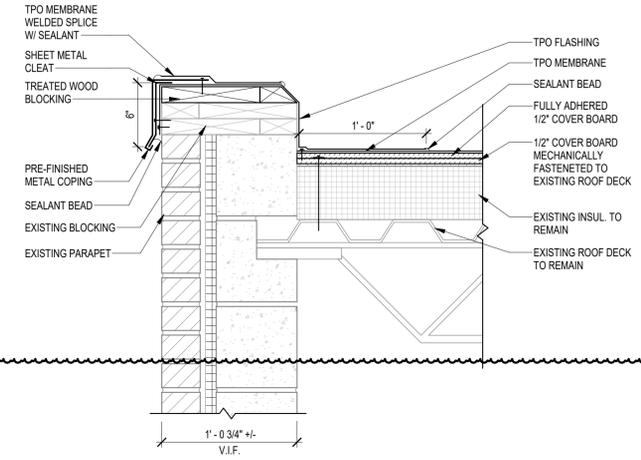
1 ROOF EDGE - SECTION
 A-511 SCALE: 1 1/2" = 1'-0"

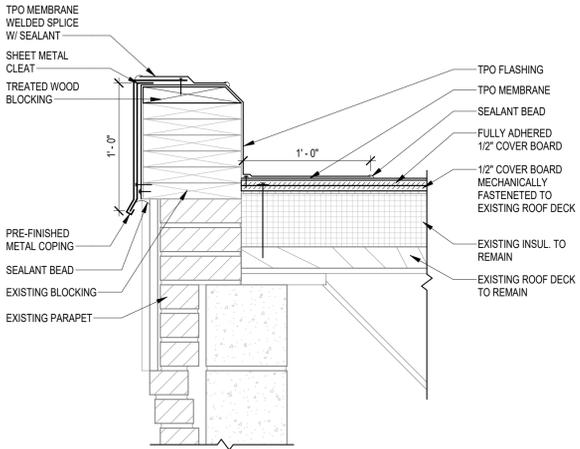2 NOT USED
 A-511 SCALE: 1 1/2" = 1'-0"


3 NOT USED
 A-511 SCALE: 1 1/2" = 1'-0"




4 ROOF EDGE - SECTION
 A-511 SCALE: 1 1/2" = 1'-0"

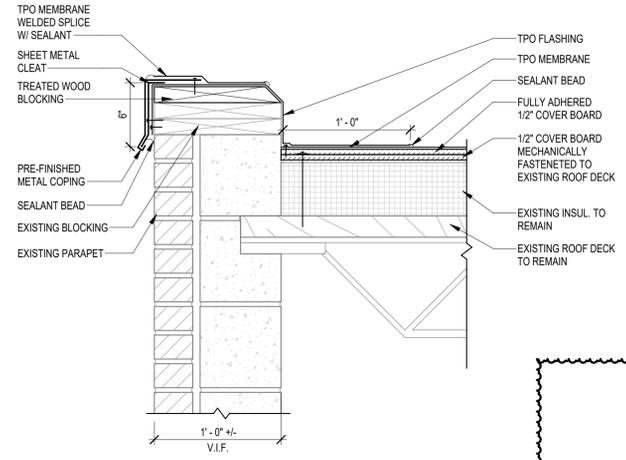

5 ROOF EDGE - SECTION
 A-511 SCALE: 1 1/2" = 1'-0"

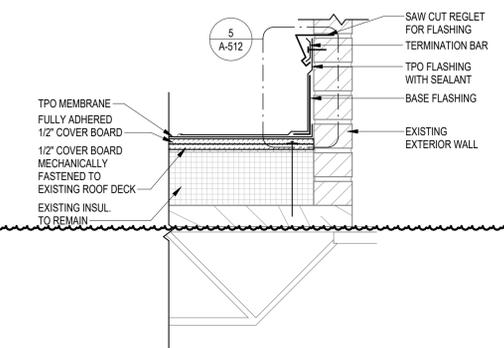


6 ROOF EDGE - SECTION
 A-511 SCALE: 1 1/2" = 1'-0"

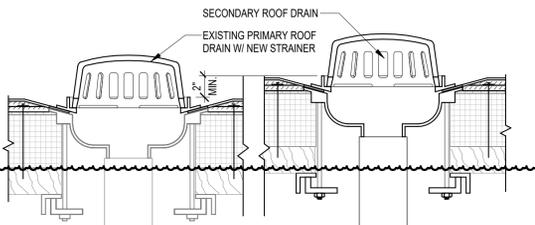

7 OVERFLOW DRAIN - SECTION
 A-511 SCALE: 1 1/2" = 1'-0"

NOTE: DISCHARGE OF THE SECONDARY ROOF DRAIN SHALL BE ABOVE GRADE IN A LOCATION THAT WOULD NORMALLY BE OBSERVED BY THE BUILDING OCCUPANTS OR MAINTENANCE PERSONNEL. 2024 IPC SECTION 1108.2

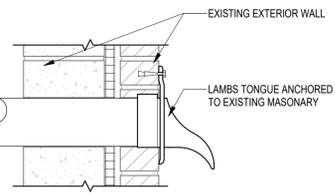

STATE OF MISSOURI
 MIKE KEHOE
 GOVERNOR

CASCO DIVERSIFIED CORPORATION
 ARCHITECTURAL
 LICENSE #: 000329
 EXP. DATE: 12/31/26



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 T 314.451.1100

OFFICE OF ADMINISTRATION
 DIVISION OF FACILITIES
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DEPARTMENT OF
 MISSOURI STATE
 HIGHWAY PATROL

RENOVATIONS TO
 INTERIOR/EXTERIOR & INSTALL
 EMERGENCY GENERATOR,
 MULTIPLE ASSETS
 MSHP GENERAL
 HEADQUARTERS COMPLEX
 1510 E. ELM STREET
 JEFFERSON CITY, MO 65101

PROJECT # R2502-01
 SITE # 6001
 FACILITY #8136001006

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SHEET TITLE:
 ADMIN. ROOF DETAILS
 ALTERNATE #4

SHEET NUMBER:

A-511

SHEET 43 OF 148
 12/16/25



REVISIONS

No.	Description	Date
3	ADDENDUM 3	02/12/26

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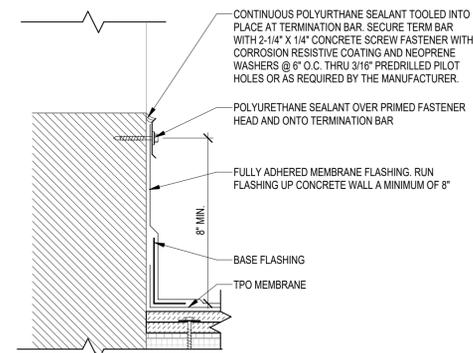
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DRAWN BY: AMB
CHECKED BY: JVR
DESIGNED BY: RAR

SHEET TITLE:
ADMIN. ROOF DETAILS
ALTERNATE #4

SHEET NUMBER:


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SHEET 44 OF 148
12/16/25




2
A-512
SCALE: 3" = 1'-0"

3
A-512
SCALE: 1 1/2" = 1'-0"

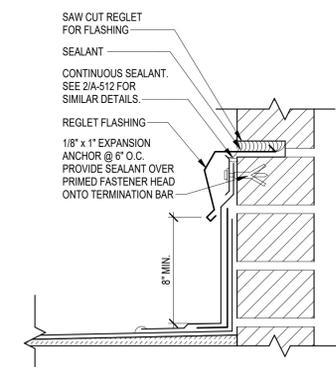

5
A-512
SCALE: 3" = 1'-0"

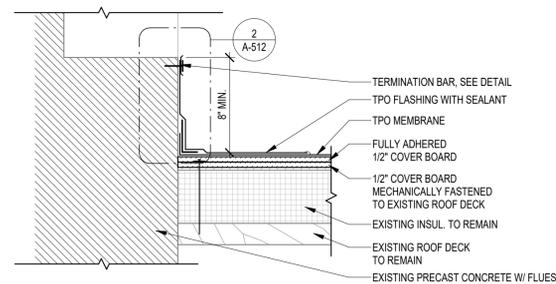

1
A-512
SCALE: 1 1/2" = 1'-0"

4
A-512
SCALE: 3" = 1'-0"

FINISH / MATERIAL SCHEDULE

ROOM	ROOM NUMBER	WALLS				FLOOR		CEILING			SIGN TYPE	COMMENTS
		NORTH	WEST	SOUTH	EAST	FLOOR	FLOOR BASE	MATERIAL	FINISH	HEIGHT		
EXIST DORM	101	PT-1	PT-1WT-2	PT-1	PT-2	LVT-1T-1	WB-1	EXP/GBC	PT-3	EXISTING/7'-0" SOFFIT	ROOM NUMBER SIGN	1.8
EXIST RR	101B	PT-4	PT-4	SP-1PT-4	SP-1	T-1	CB-1	GBC	PT-3	7'-0"	ROOM ID	8
EXIST LAUNDRY ROOM	102	PT-1	PT-1	PT-1	PT-1	EXIST	EXIST	EXP	-	EXISTING	ROOM ID	8
EXIST DORM	103	PT-1	PT-1WT-2	PT-1	PT-2	LVT-1T-1	WB-1	EXP/GBC	PT-3	EXISTING/7'-0" SOFFIT	ROOM NUMBER SIGN	1.8
SINGLE BEDROOM	104	PT-1	PT-2	PT-1	PT-1	LVT-1	WB-1	EXP	PT-3	7'-0"	ROOM ID	8
FOYER	104A	PT-1	PT-1	PT-1	PT-1	LVT-1	WB-1	EXP	PT-3	7'-0"	ROOM ID	8
PRIVATE RR	104B	PT-4/SP-1	SP-1PT-4	PT-4/WT-1SP-1	PT-4	T-1	CB-1	GBC	PT-3	7'-0"	ROOM NUMBER SIGN	1.8
EXIST DORM	105	PT-1	PT-1WT-2	PT-1	PT-2	LVT-1T-1	WB-1	EXP/GBC	PT-3	EXISTING/7'-0" SOFFIT	ROOM NUMBER SIGN	1.8
EXIST RR	105B	PT-4	PT-4	SP-1PT-4	SP-1	T-1	CB-1	GBC	PT-3	7'-0"	ROOM NUMBER SIGN	1.8
EXIST DORM	107	PT-1	PT-1WT-2	PT-1	PT-2	LVT-1T-1	WB-1	EXP/GBC	PT-3	EXISTING/7'-0" SOFFIT	ROOM NUMBER SIGN	1.8
EXIST DORM	109	PT-1	PT-1WT-2	PT-1	PT-2	LVT-1T-1	WB-1	EXP/GBC	PT-3	EXISTING/7'-0" SOFFIT	ROOM NUMBER SIGN	1.8
EXIST RR	109B	PT-4	PT-4	SP-1PT-4	SP-1	T-1	CB-1	GBC	PT-3	7'-0"	ROOM ID	8
STORAGE	110	EXIST	EXIST	EXIST	EXIST	EXIST	WB-1	EXP	-	EXISTING	ROOM NUMBER SIGN	1.8
EXIST DORM	111	PT-1	PT-1WT-2	PT-1	PT-2	LVT-1T-1	WB-1	EXP/GBC	PT-3	EXISTING/7'-0" SOFFIT	ROOM NUMBER SIGN	1.8
VESTIBULE	112	PT-1	PT-1	PT-1	PT-1	LVT-1	WB-1	EXP	PT-3	EXISTING	ROOM ID	8
KITCHENETTE	113	PT-1WT-1	PT-1	PT-1	PT-1	LVT-1	WB-1	ACT-1	-	8'-0"	ROOM ID	8
STORAGE	114	PT-1	PT-1	PT-1	PT-1	EXIST	WB-1	ACT-1	-	8'-0"	ROOM ID	8
EXIST UNISEX RR	115	PT-4	PT-4WT-1	PT-4	PT-4WT-1	T-1	CB-1	GBC	PT-3	8'-0"	UNISEX RESTROOM ROOM ID	8
EXIST JANITOR RM	116	PT-1	PT-1	PT-1	PT-1	EXIST	WB-1	EXP	PT-3	EXISTING	ROOM ID	8
OFFICE	117	PT-2	PT-1	PT-1	PT-1	LVT-1	WB-1	ACT-1	-	8'-0"	ROOM ID	8
OFFICE	118	PT-2	PT-1	PT-1	PT-1	LVT-1	WB-1	ACT-1	-	8'-0"	ROOM ID	8
CONFERENCE RM	119	PT-1	PT-1	PT-1	PT-1	LVT-1	WB-1	ACT-1	-	8'-0"	ROOM ID	8
OFFICE	120	PT-1	PT-1WT-2	PT-1	PT-2	LVT-1T-1	WB-1	ACT-1	-	8'-0"	ROOM ID	4.8
RR	120B	PT-4	PT-4	SP-1PT-4	SP-1	T-1	CB-1	GBC	PT-3	8'-0"	ROOM ID	4.8
CONFERENCE ROOM	121	PT-1	PT-2	PT-1	PT-1	LVT-1	WB-1	ACT-1	-	8'-0"	ROOM ID	4.8
OFFICE	122	PT-1	PT-1WT-2	PT-1	PT-2	LVT-1T-1	WB-1	ACT-1	-	8'-0"	ROOM ID	4.8
OFFICE	123	PT-1	PT-1WT-2	PT-1	PT-2	LVT-1T-1	WB-1	ACT-1	-	8'-0"	ROOM ID	4.8
RR	123B	PT-4	PT-4	SP-1PT-4	SP-1	T-1	CB-1	GBC	PT-3	8'-0"	ROOM ID	4.8
EXIST STORAGE	124	PT-1	PT-1	PT-1	PT-1	EXIST	WB-1	EXP	-	EXISTING	ROOM ID	4.8
OFFICE	125	PT-1	PT-1WT-2	PT-1	PT-2	LVT-1T-1	WB-1	ACT-1	-	8'-0"	ROOM ID	4.8
OFFICE	126	PT-1	PT-1WT-2	PT-1	PT-2	LVT-1T-1	WB-1	ACT-1	-	8'-0"	ROOM ID	4.8
RR	126B	PT-4	PT-4	SP-1PT-4	SP-1	T-1	CB-1	GBC	PT-3	8'-0"	ROOM ID	4.8
EXIST CLASSROOM	127	PT-1	PT-2	PT-1	PT-1	LVT-1	WB-1	ACT-1	-	8'-0"	ROOM ID	4.8
OFFICE	128	PT-1	PT-1WT-2	PT-1	PT-2	LVT-1T-1	WB-1	ACT-1	-	8'-0"	ROOM ID	4.8
EXIST MECHANICAL	129	EXIST	EXIST	EXIST	EXIST	EXIST	EXIST	EXIST	-	EXISTING	ROOM ID	6
CORRIDOR	130	PT-1	PT-1	PT-1	PT-1	LVT-1	WB-1	ACT-1	-	8'-0"	ROOM ID	6
CORRIDOR	131	PT-1	PT-1	PT-1	PT-1	LVT-1	WB-1	ACT-1	-	8'-0"	ROOM ID	6
CORRIDOR	132	PT-1	PT-1	PT-1	PT-1	LVT-1	WB-1	EXP	PT-3	EXISTING	ROOM ID	6
CORRIDOR	133	PT-1	PT-1	PT-1	PT-1	LVT-1	WB-1	EXP	PT-3	EXISTING	ROOM ID	6
LOBBY	134	PT-1	PT-1	PT-1	PT-1	LVT-1	WB-1	EXP	PT-3	EXISTING	ROOM ID	6
EXIST DORM	201	PT-1WT-2	PT-1	PT-2	PT-1	CPT-1T-1	WB-1	EXP/GBC	PT-3	EXISTING/7'-0" SOFFIT	ROOM NUMBER SIGN	1.8
EXIST RR	201B	PT-4	PT-4	SP-1	PT-4/SP-1	T-1	CB-1	GBC	PT-3	7'-0"	ROOM NUMBER SIGN	1.8
EXIST DORM	202	PT-2	PT-1	PT-1WT-2	PT-1	CPT-1T-1	WB-1	EXP/GBC	PT-3	EXISTING/7'-0" SOFFIT	ROOM NUMBER SIGN	1.8
EXIST RR	202B	SP-1	PT-4/SP-1	PT-4	PT-4	T-1	CB-1	GBC	PT-3	7'-0"	ROOM NUMBER SIGN	1.8
EXIST DORM	203	PT-1WT-2	PT-1	PT-2	PT-1	CPT-1T-1	WB-1	EXP/GBC	PT-3	EXISTING/7'-0" SOFFIT	ROOM NUMBER SIGN	1.8
EXIST RR	203B	PT-4	PT-4	SP-1	PT-4/SP-1	T-1	CB-1	GBC	PT-3	7'-0"	ROOM NUMBER SIGN	1.8
EXIST DORM	204	PT-2	PT-1	PT-1WT-2	PT-1	CPT-1T-1	WB-1	EXP/GBC	PT-3	EXISTING/7'-0" SOFFIT	ROOM NUMBER SIGN	1.8
EXIST DORM	205	PT-1WT-2	PT-1	PT-2	PT-1	CPT-1T-1	WB-1	EXP/GBC	PT-3	EXISTING/7'-0" SOFFIT	ROOM NUMBER SIGN	1.8
EXIST DORM	206	PT-2	PT-1	PT-1WT-2	PT-1	CPT-1T-1	WB-1	EXP/GBC	PT-3	EXISTING/7'-0" SOFFIT	ROOM NUMBER SIGN	1.8
EXIST RR	206B	SP-1	PT-4/SP-1	PT-4	PT-4	T-1	CB-1	GBC	PT-3	7'-0"	ROOM NUMBER SIGN	1.8
EXIST DORM	207	PT-1WT-2	PT-1	PT-2	PT-1	CPT-1T-1	WB-1	EXP/GBC	PT-3	EXISTING/7'-0" SOFFIT	ROOM NUMBER SIGN	1.8
EXIST RR	207B	PT-4	PT-4	SP-1	PT-4/SP-1	T-1	CB-1	GBC	PT-3	7'-0"	ROOM NUMBER SIGN	1.8
EXIST DORM	208	PT-2	PT-1	PT-1WT-2	PT-1	CPT-1T-1	WB-1	EXP/GBC	PT-3	EXISTING/7'-0" SOFFIT	ROOM NUMBER SIGN	1.8
EXIST DORM	209	PT-1WT-2	PT-1	PT-2	PT-1	CPT-1T-1	WB-1	EXP/GBC	PT-3	EXISTING/7'-0" SOFFIT	ROOM NUMBER SIGN	1.8
EXIST DORM	210	PT-1	PT-1WT-2	PT-1	PT-2	CPT-1T-1	WB-1	EXP/GBC	PT-3	EXISTING/7'-0" SOFFIT	ROOM NUMBER SIGN	1.8
EXIST RR	210B	PT-4	PT-4	SP-1	PT-4/SP-1	T-1	CB-1	GBC	PT-3	7'-0"	ROOM NUMBER SIGN	1.8
EXIST DORM	211	PT-1	PT-2	PT-1	PT-1WT-2	CPT-1T-1	WB-1	EXP/GBC	PT-3	EXISTING/7'-0" SOFFIT	ROOM NUMBER SIGN	1.8
EXIST RR	211B	PT-4/SP-1	SP-1	PT-4	PT-4	T-1	CB-1	GBC	PT-3	7'-0"	ROOM NUMBER SIGN	1.8
EXIST DORM	212	PT-1	PT-1WT-2	PT-1	PT-2	CPT-1T-1	WB-1	EXP/GBC	PT-3	EXISTING/7'-0" SOFFIT	ROOM NUMBER SIGN	1.8
EXIST DORM	213	PT-1	PT-2	PT-1	PT-1WT-2	CPT-1T-1	WB-1	EXP/GBC	PT-3	EXISTING/7'-0" SOFFIT	ROOM NUMBER SIGN	1.8
EXIST DORM	214	PT-1	PT-1WT-2	PT-1	PT-2	CPT-1T-1	WB-1	EXP/GBC	PT-3	EXISTING/7'-0" SOFFIT	ROOM NUMBER SIGN	1.8
EXIST RR	214B	PT-4	PT-4	SP-1PT-4	SP-1	T-1	CB-1	GBC	PT-3	7'-0"	ROOM NUMBER SIGN	1.8
PRIVATE DORM	215	PT-1	PT-2	PT-1	PT-1WT-2	CPT-1T-1	WB-1	EXP/GBC	PT-3	EXISTING/7'-0" SOFFIT	ROOM NUMBER SIGN	1.8
RR	215B	SP-1	PT-4/SP-1	PT-4	PT-4	T-1	CB-1	GBC	PT-3	7'-0"	ROOM NUMBER SIGN	1.8
EXIST DORM	216	PT-1	PT-1WT-2	PT-1	PT-2	CPT-1T-1	WB-1	EXP/GBC	PT-3	EXISTING/7'-0" SOFFIT	ROOM NUMBER SIGN	1.8
EXIST DORM	217	PT-1	PT-2	PT-1	PT-1WT-2	CPT-1T-1	WB-1	EXP/GBC	PT-3	EXISTING/7'-0" SOFFIT	ROOM NUMBER SIGN	1.8
EXIST RR	217B	PT-4/SP-1	SP-1	PT-4	PT-4	T-1	CB-1	GBC	PT-3	7'-0"	ROOM NUMBER SIGN	1.8
EXIST DORM	218	PT-1	PT-1WT-2	PT-1	PT-2	CPT-1T-1	WB-1	EXP/GBC	PT-3	EXISTING/7'-0" SOFFIT	ROOM NUMBER SIGN	1.8
EXIST RR	218B	PT-4	PT-4	SP-1PT-4	SP-1	T-1	CB-1	GBC	PT-3	7'-0"	ROOM NUMBER SIGN	1.8
EXIST DORM	219	PT-1	PT-2	PT-1	PT-1WT-2	CPT-1T-1	WB-1	EXP/GBC	PT-3	EXISTING/7'-0" SOFFIT	ROOM NUMBER SIGN	1.8
EXIST DORM	220	PT-1	PT-1WT-2	PT-1	PT-2	CPT-1T-1	WB-1	EXP/GBC	PT-3	EXISTING/7'-0" SOFFIT	ROOM NUMBER SIGN	1.8
EXIST DORM	221	PT-1	PT-1WT-2	PT-1	PT-2	CPT-1T-1	WB-1	EXP/GBC	PT-3	EXISTING/7'-0" SOFFIT	ROOM NUMBER SIGN	1.8
EXIST RR	221B	PT-4	PT-4	SP-1PT-4	SP-1	T-1	CB-1	GBC	PT-3	7'-0"	ROOM NUMBER SIGN	1.8
EXIST DORM	222	PT-1	PT-2	PT-1	PT-1WT-2	CPT-1T-1	WB-1	EXP/GBC	PT-3	EXISTING/7'-0" SOFFIT	ROOM NUMBER SIGN	1.8
EXIST RR	222B	PT-4/SP-1	SP-1	PT-4	PT-4	T-1	CB-1	GBC	PT-3	7'-0"	ROOM NUMBER SIGN	1.8
EXIST DORM	223	PT-1	PT-1WT-2	PT-1	PT-2	CPT-1T-1	WB-1	EXP/GBC	PT-3	EXISTING/7'-0" SOFFIT	ROOM NUMBER SIGN	1.8
EXIST DORM	224	PT-1	PT-2	PT-1	PT-1WT-2	CPT-1T-1	WB-1	EXP/GBC	PT-3	EXISTING/7'-0" SOFFIT	ROOM NUMBER SIGN	1.8
EXIST DORM	225	PT-1	PT-1WT-2	PT-1	PT-2	CPT-1T-1	WB-1	EXP/GBC	PT-3	EXISTING/7'-0" SOFFIT	ROOM NUMBER SIGN	1.8
EXIST RR	225B	PT-4	PT-4	SP-1PT-4	SP-1	T-1	CB-1	GBC	PT-3	7'-0"	ROOM NUMBER SIGN	1.8
EXIST ACCESSIBLE DORM	226	PT-1	PT-2	PT-1	PT-1WT-2	CPT-1T-1	WB-1	EXP/GBC	PT-3	EXISTING/7'-0" SOFFIT	ROOM NUMBER SIGN	5.8
EXIST ACCESSIBLE RR	226B	PT-4	PT-4/SP-1	SP-1	PT-4	T-1	CB-1	GBC	PT-3	7'-0"	ROOM ID	5
EXIST DORM	227	PT-1	PT-1WT-2	PT-1	PT-2	CPT-1T-1	WB-1	EXP/GBC	PT-3	EXISTING/7'-0" SOFFIT	ROOM NUMBER SIGN	1.8
EXIST DORM	228	PT-1	PT-2	PT-1	PT-1WT-2	CPT-1T-1	WB-1	EXP/GBC	PT-3	EXISTING/7'-0" SOFFIT	ROOM NUMBER SIGN	1.8
EXIST RR	228B	PT-4/SP-1	SP-1	PT-4	PT-4	T-1	CB-1	GBC	PT-3	7'-0"	ROOM NUMBER SIGN	1.8
EXIST DORM	229	PT-1	PT-1WT-2	PT-1	PT-2	CPT-1T-1	WB-1	EXP/GBC	PT-3	EXISTING/7'-0" SOFFIT	ROOM NUMBER SIGN	1.8
EXIST RR	229B	PT-4	PT-4	SP-1PT-4	SP-1	T-1	CB-1	GBC	PT-3	7'-0"	ROOM NUMBER SIGN	1.8
EXIST DORM	230	PT-1	PT-2	PT-1	PT-1WT-2	CPT-1T-1	WB-1	EXP/GBC	PT-3	EXISTING/7'-0" SOFFIT	ROOM NUMBER SIGN	1.8
EXIST DORM	231	PT-1	PT-1WT-2	PT-1	PT-2	CPT-1T-1	WB-1	EXP/GBC	PT-3	EXISTING/7'-0" SOFFIT	ROOM NUMBER SIGN	1.8
LIVING ROOM	232	PT-1WT-1	PT-1	PT-2	PT-1	CPT-1T-1	WB-1	EXP/GBC	PT-3	EXISTING/7'-0" SOFFIT	ROOM NUMBER SIGN	7.8
BEDROOM	232A	PT-2	PT-1	PT-1	PT-1	CPT-1	WB-1	EXP/GBC	PT-3	EXISTING	ROOM ID	7
RR	232B	PT-4	SP-1PT-4	PT-4	SP-1PT-4	T-1	CB-1	GBC	PT-3	7'-0"	ROOM ID	7
AREA OF REFUGE	233	PT-1	PT-1	PT-1	PT-1	EXIST	EXIST	EXP	PT-3	EXISTING	ROOM ID	8
UNISEX RR	234	PT-4	PT-4	WT-1PT-4	PT-4	T-1	CB-1	GBC	PT-3	7'-0"	UNISEX RESTROOM ROOM ID	8
AREA OF REFUGE	235	PT-1	PT-1	PT-1	PT-1	EXIST	EXIST	EXP	PT-3	EXISTING	ROOM ID	8
JAN. CL.	236	PT-1	PT-1	PT-1	PT-1	LVT-1	WB-1	EXP	PT-3	EXISTING	ROOM ID	8
EXIST CLEAN LINEN	237	PT-1	PT-1	PT-1	PT-1	LVT-1	WB-1	EXP	PT-3	EXISTING	ROOM ID	8
EXIST STORAGE	238	EXIST	EXIST	EXIST	EXIST	LVT-1	WB-1	EXIST	-	EXISTING	ROOM ID	8
CORRIDOR	239	PT-1	PT-1	PT-1	PT-1	LVT-1	WB-1	EXP	PT-3	EXISTING/7'-0" SOFFIT	ROOM ID	8
CORRIDOR	240	PT-1	PT-1	PT-1	PT-1	CPT-1	WB-1	EXP	PT-3	EXISTING/7'-0" SOFFIT	ROOM ID	8

FINISH / MATERIAL SCHEDULE

ROOM	ROOM NUMBER	WALLS				FLOOR		CEILING			SIGN TYPE	COMMENTS
		NORTH	WEST	SOUTH	EAST	FLOOR	FLOOR BASE	MATERIAL	FINISH	HEIGHT		
EXIST DORM	301	PT-1WT-2	PT-1	PT-2	PT-1	CPT-1T-1	WB-1	EXP/GBC	PT-3	EXISTING/7'-0" SOFFIT	ROOM NUMBER SIGN	1.8
EXIST RR	301B	PT-4	PT-4	SP-1	PT-4/SP-1	T-1	CB-1	GBC	PT-3	7'-0"	ROOM NUMBER SIGN	1.8
EXIST DORM	302	PT-2	PT-1	PT-1WT-2	PT-1	CPT-1T-1	WB-1	EXP/GBC	PT-3	EXISTING/7'-0" SOFFIT	ROOM NUMBER SIGN	1.8
EXIST RR	302B	SP-1	PT-4/SP-1	PT-4	PT-4	T-1	CB-1	GBC	PT-3	7'-0"	ROOM NUMBER SIGN	1.8
EXIST DORM	303	PT-1WT-2	PT-1	PT-2	PT-1	CPT-1T-1	WB-1	EXP/GBC	PT-3	EXISTING/7'-0" SOFFIT	ROOM NUMBER SIGN	1.8
EXIST RR	303B	PT-4	PT-4	SP-1	PT-4/SP-1	T-1	CB-1	GBC	PT-3	7'-0"	ROOM NUMBER SIGN	1.8
EXIST DORM	304	PT-2	PT-1									