INSTALL ROOF MOUNTED SOLAR PANEL ARRAY & LED LIGHTING FMS BUILDING- READINESS CENTER CAPE GIRARDEAU, MISSOURI

OWNER:

STATE OF MISSOURI MICHAEL L. PARSON,

GOVERNOR

DEPARTMENT OF PUBLIC SAFETY OFFICE OF THE ADJUTANT GENERAL

MISSOURI NATIONAL GUARD

FACILITIES DIVISION

PROJECT

OFFICE OF ADMINISTRATION

MANAGEMENT: I

DIVISION OF FACILITIES MANAGEMENT,

DESIGN AND CONSTRUCTION

DESIGNER:

ETEGRA

PROJECT NUMBER: T2032-01

ASSET NUMBER:

8136308002



1121 OLIVETTE EXECUTIVE PARKWAY, SUITE 100 OLIVETTE, MO 63132 (314) 533-2200 | WWW.ETEGRA.COM

DRAWING INDEX

GENERAL

ELECTRICAL

E-001 ELECTRICAL SYMBOLS ABBREVIATIONS AND NOTES

ED-101 DEMOLITION LIGHTING PLAN

E-101 LIGHTING PLAN
E-102 ROOF SOLAR PANEL PLAN

E-501 DETAILS AND SCHEMATICS


E-601 LIGHTING FIXTURE SCHEDULE



1 VICINITY MAP



07/15/2022

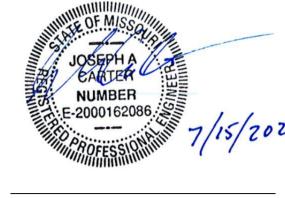

ETEGRA 1121 OLIVETTE EXECUTIVE PARKWAY, SUITE 100 | OLIVETTE, MO 63 (314) 533-2200 | WWW.ETEGRA.COM



OFFICE OF ADMINISTRATION DIVISION OF FACILITIES MANAGEMENT, DESIGN AND CONSTRUCTION

DEPARTMENT OF PUBLIC SAFETY MISSOURI ARMY NATIONAL GUARD

INSTALL ROOF MOUNTED SOLAR PANEL ARRAY & LED LIGHTING FMS BUILDING -READINESS CENTER

2626 INDEPENDENCE DR. CAPE GIRARDEAU, MO 63703

PROJECT # T2032-01 ASSET # 8136308002

REVISION:	
DATE:	
REVISION:	
DATE:	
ISSUE DATE:	: 07/15/2022
CAD DWG FI	LE:E-001.DWG
	DED

CAD DWG FILE:E-001.DWG
DRAWN BY: DFP
CHECKED BY: JCF
DESIGNED BY: JAC


REVISION:_ DATE:_ REVISION:_

SHEET TITLE:
ELECTRICAL
SYMBOLS
ABBREVIATIONS
AND NOTES


SHEET NUMBER:

E-00

		ELECTRIC	CAL SYMBOLS				ABBREVIATIONS	GENERAL NOTES
L	LIGHTING		OWER	ONE-L	INE DIAGRAM	A-AMP AC	AMPERE ABOVE COUNTER AMP FUSE; AMP FRAME	MOUNTING HEIGHTS FOR DEVICES SHALL BE MEASURED FROM FINAL FINISH FLOOR TO CENTER OF BOX.
SYMBOL	DESCRIPTION	SYMBOL	DESCRIPTION	SYMBOL	DESCRIPTION	AFF AFG	ABOVE FINISHED FLOOR ABOVE FINISHED GRADE	2. CONDUCTOR SIZES FOR TYPICAL 20 AMP, BRANCH CIRCUITS SHALL BE (2) #12AWG, (1) #12AWG GND, 3/4"C, UNLESS NOTED OTHERWISE.
	LIGHT FIXTURE - 2x4 LED SURFACE MOUNT		CONDUIT ROUTING ABOVE GRADE		MECHANICAL EQUIPMENT TAG	AL AIC	ALUMINUM AMPS INTERRUPTING CAPACITY (SYM RMS)	3. ALL DISCONNECT SWITCHES SHALL BE RATED HEAVY DUTY, 240V, THREE PHASE WITH GROUNDING LUG UNLESS NOTED OTHERWISE.
	LIGHT FIXTURE - 2x4 LED RECESSED		CONDUIT ROUTING BELOW GRADE (DIRECT BURIED)	\triangle	DELTA CONNECTION	AT ATS	AMP TRIP AUTOMATIC TRANSFER SWITCH	4. ALL INTERIOR ELECTRICAL DEVICES SHALL BE RATED AS NEMA 1, UNLESS NOTED OTHERWISE.
	LIGHT FIXTURE - 2x2 LED SURFACE MOUNT	-EEE	UNDERGROUND DUCT BANK	<u></u>	TRANSFORMER ONE-LINE DIAGRAM	AWG AUX BAS	AMERICAN WIRE GAGE AUXILIARY BUILDING AUTOMATION SYSTEM	5. ALL EXTERIOR ELECTRICAL DEVICES SHALL BE RATED AS NEMA 3R, UNLESS NOTED OTHERWISE.
	LIGHT FIXTURE - 2x2 LED RECESSED	⊕	CLOCK HANGER RECEPTACLE DUPLEX RECEPTACLE WALL MOUNTED @ 18" A.F.F.		WYE CONNECTION	BLDG C CB	BUILDING CONDUIT CIRCUIT BREAKER	ONLEGG NOTED OTHERWISE.
	LIGHT FIXTURE - 1X4 LED SURFACE MOUNT	\oplus	DUPLEX RECEPTACLE	<u> </u>	EARTH GROUND	CKT CL	CIRCUIT CENTER LINE	
	LIGHT FIXTURE - 1X4 LED RECESSED	<u> </u>	FLOOR MOUNTED DUPLEX RECEPTACLE ON	——————————————————————————————————————	FUSE NUMBER = FUSE RATING	CONT COR	CONTINUOUS CONTRACTING OFFICER'S REPRESENTATIVES	
	LIGHT FIXTURE - 1X8 LED SURFACE MOUNT	=	EMERGENCY POWER WALL MOUNTED @ 18" A.F.F.	 	NORMALLY CLOSED RELAY CONTACT	CPT CT CU	CONTROL POWER TRANSFORMER CURRENT TRANSFORMER COPPER	
	LIGHT FIXTURE - 1X8 LED RECESSED	GFCI	DUPLEX RECEPTACLE WITH GROUND FAULT CIRCUIT INTERRUPTER WALL MOUNTED @ 18" A.F.F.	<u> </u>	NORMALLY OPEN RELAY CONTACT	DEMO DET	DEMOLITION DETAIL	
0 0	LIGHT FIXTURE - LED, PENDANT	⊕	QUADRAPLEX RECEPTACLE WALL MOUNTED @ 18" A.F.F.	Ö	CIRCUIT BREAKER	DIM DISC DWG	DIMENSION DISCONNECT DRAWING	
-	LIGHT FIXTURE - LED, CAN SURFACE MOUNT	\oplus	QUADRAPLEX RECEPTACLE FLOOR MOUNTED	-+	BATTERY	E ECB	EAST ENCLOSED CIRCUIT BREAKER	
	LIGHT FIXTURE - CAN, RECESSED	Θ	EXPLOSION-PROOF SINGLE RECEPTACLE WALL MOUNTED @ 24"A.F.F.		CAPACITOR	ELEC ENCL EQUIP	ELECTRICAL OR ELECTRIC ENCLOSURE EQUIPMENT	
€	WALL/CEILING MOUNT SINGLE/DOUBLE	\bigotimes	SPECIAL PURPOSE RECEPTACLE WALL MOUNTED @ 18" A.F.F.	• ∞	LIGHTNING ARRESTOR	EWC EXIST	ELECTRIC WATER COOLER EXISTING	
	FACE EXIT LIGHT SINGLE LAMP EMERGENCY LIGHT	$\bigoplus_{\widehat{\mathbf{S}}}$	SWITCHED DUPLEX RECEPTACLE WALL MOUNTED @ 18" A.F.F.	T2 TO X	INVERTER	EXT FAAP FACP	EXTERIOR FIRE ALARM ANNUNCIATOR PANEL FIRE ALARM CONTROL PANEL	
	MULTI LAMP EMERGENCY LIGHT	⊕ AFCI	ARC FAULT RECEPTACLE WALL MOUNTED @ 18" AFF	SPD	SURGE VOLTAGE PROTECTOR	FIG FIN	FIGURE FINISH	
	WALL/CEILING MOUNT SINGLE/DOUBLE	⊕ USB	DUPLEX RECEPTACLE W/ (2) USB CHARGING PORTS SURFACE MOUNTED @ 18" AFF	UPS	UNINTERRUPTIBLE POWER SUPPLY	FLEX FOUO FUT	FLEXIBLE FOR OFFICIAL USE ONLY FUTURE	
	FACE EXIT LIGHT LETTER DENOTES TYPE STREET LIGHT WITH BRACKET		FLOORBOX	}	CONTROL POWER TRANSFORMER # INDICATES RATIO	GFCI	GROUND FAULT CIRCUIT INTERRUPTER	
	LIGHTING POST - TWO ARMS, TWO HEADS	- -	CEILING MOUNTED PULL SWITCH	600/5 M	ELECTRICAL METER	GND OR GRD GOVT	GROUND GOVERNMENT	
X	LIGHT POST WITHOUT ARM	т#	TRANSFORMER	(11)	LLEOTRICAL WILTER	GRC HID IT	GALVANIZED RIGID STEEL CONDUIT HOST INTERFACE DEVICE INFORMATION TECHNOLOGY	
Ÿ.	EXTERIOR BUILDING LIGHTING SWITCH - SINGLE POLE	ТТТ	UNDERFLOOR DUCT		PHOTOVOLTAIC MODULE (SOLAR	J-BOX K	JUNCTION BOX KEY	
\$	WALL MOUNTED @ 48" A.F.F. SWITCH - DOUBLE POLE	J	JUNCTION BOX		PANEL), ROOF MOUNTED	KAIC KCMIL	KILO-AMP INTERRUPTING CAPACITY THOUSANDS CIRCULAR MILS	
\$ ₂	WALL MOUNTED @ 48" A.F.F. SWITCH - THREE WAY	ССС	CABLE TRAY			KV KVA KW	KILOVOLTS KILOVOLT AMPERES KILOWATT	
\$ ₃	WALL MOUNTED @ 48" A.F.F. SWITCH - FOUR WAY	РВ	PULL BOX			KWH KVAR	KILOWATT HOURS KILOVOLT AMPERES REACTIVE	
\$4	WALL MOUNTED @ 48" A.F.F. SWITCH - KEY OPERATED	WW	WIREWAY			LTG MDP MGB	LIGHTING MAIN DISTRIBUTION PANEL MAIN GROUND BAR	
^{\$} к	WALL MOUNTED @ 48" A.F.F. SWITCH - LOW VOLTAGE MASTER	ВВВ	BUSWAY			MH MSB	MANHOLE MAIN SWITCHBOARD	
\$ _{LM}	WALL MOUNTED @ 48" A.F.F. SWITCH WITH OCCUPANCY SENSOR	M	METER			MSS MTS N	MAIN SWITCH STATION MANUAL TRANSFER SWITCH NORTH	
\$os	WALL MOUNTED @ 48" A.F.F. SWITCH - TIMER OPERATED	S	SUBSTATION			NEC NEMA	NATIONAL ELECTRICAL CODE NATIONAL ELECTRICAL MANUFACTURERS	
\$ _T	WALL MOUNTED @ 48" A.F.F. SWITCH WITH VACANCY SENSOR	G	GENERATOR			NIC NO	ASSOCIATION NOT IN CONTRACT NORMALLY OPEN, NUMBER	
\$ _{VS}	WALL MOUNTED @ 48" A.F.F. SWITCH WITH PILOT LIGHT		SINGLE OR THREE PHASE MOTOR			OD O.C. PCR	OUTSIDE DIAMETER ON CENTER PROXIMITY CARD READER	
\$ _P	WALL MOUNTED @ 48" A.F.F.		NON-FUSED DISCONNECT SWITCH			PIV PNL	PERSONAL IDENTITY VERIFICATION PANEL	
\$ _D	SWITCH - DIMMER WALL MOUNTED @ 48" A.F.F.		FUSED DISCONNECT SWITCH			PF PH POE+	POWER FACTOR PHASE POWER OVER ETHERNET PLUS	
(OS)	OCCUPANCY SENSOR - CEILING MOUNTED		COMBINATION STARTER WITH DISCONNECT SWITCH			PSS PVC	PRIMARY SWITCH STATION POLYVINYL CHLORIDE	
DS	DAYLIGHT SENSOR - CEILING MOUNTED		WALL MOUNTED @ 48" A.F.F.			RECP REF REQD	RECEPTACLE REFERENCE REQUIRED	
PC	PHOTO CELL SENSOR		STARTER/MOTOR CONTROLLER WALL MOUNTED @ 48" A.F.F.			RM S	ROOM SOUTH	
LIGHT FIXT	URE DESIGNATION		PUSH BUTTON WALL MOUNTED @ 48" A.F.F.			SEC SPEC SW	SECONDARY SPECIFICATIONS SWITCH	
	FIXTURE TYPE		DISTRIBUTION PANEL - SURFACE MOUNTED			SWGR SYM	SWITCHGEAR SYMMETRICAL	
	FIXTURE TIPE		DISTRIBUTION PANEL - FLUSH MOUNTED RP = RECEPTACLE PANEL PP = GENERAL POWER PANEL			SYS TEL	SYSTEM TELEPHONE	
A #a	SWITCH CIRCUIT		(MECH LOADS) LP = LIGHTING PANEL			TGB TMGB	TELECOMMUNICATIONS GROUNDING BUSBAR TELECOMMUNICATIONS MAIN GROUNDING BUSBAR	
	FILLED REGION INDICATES EMERGENCY		TP = TELECOMMUNICATIONS POWER UP = UPS BACKED PANEL			TP TYP	TAMPER PROOF TYPICAL	
			DATA ROUGH-IN, PROVIDE 2-GANG BOX AT 24" AFF WITH 1" CONDUIT WITH			UG UON	UNDERGROUND UNLESS OTHERWISE NOTED	
		▼	PULLWIRE ROUTED TO TELECOMMUNICATIONS CABINET. BACKBOX SHALL BE PROVIDED WITH			UP UPS V	UTILITY POLE UNINTERRUPTIBLE POWER SUPPLY VOLT	
			THREADED ENTRIES FOR NPT-THREADED CONDUIT AND FITTINGS			VA VT	VOLT AMPERE VOLTAGE TRANSFORMER	
						W WAP	WEST WIRELESS APPLICATION PROTOCOL	
						WP WPF	WEATHERPROOF WATER PROOF TRANSFORMER	
						XMFR	TRANSFORMER	

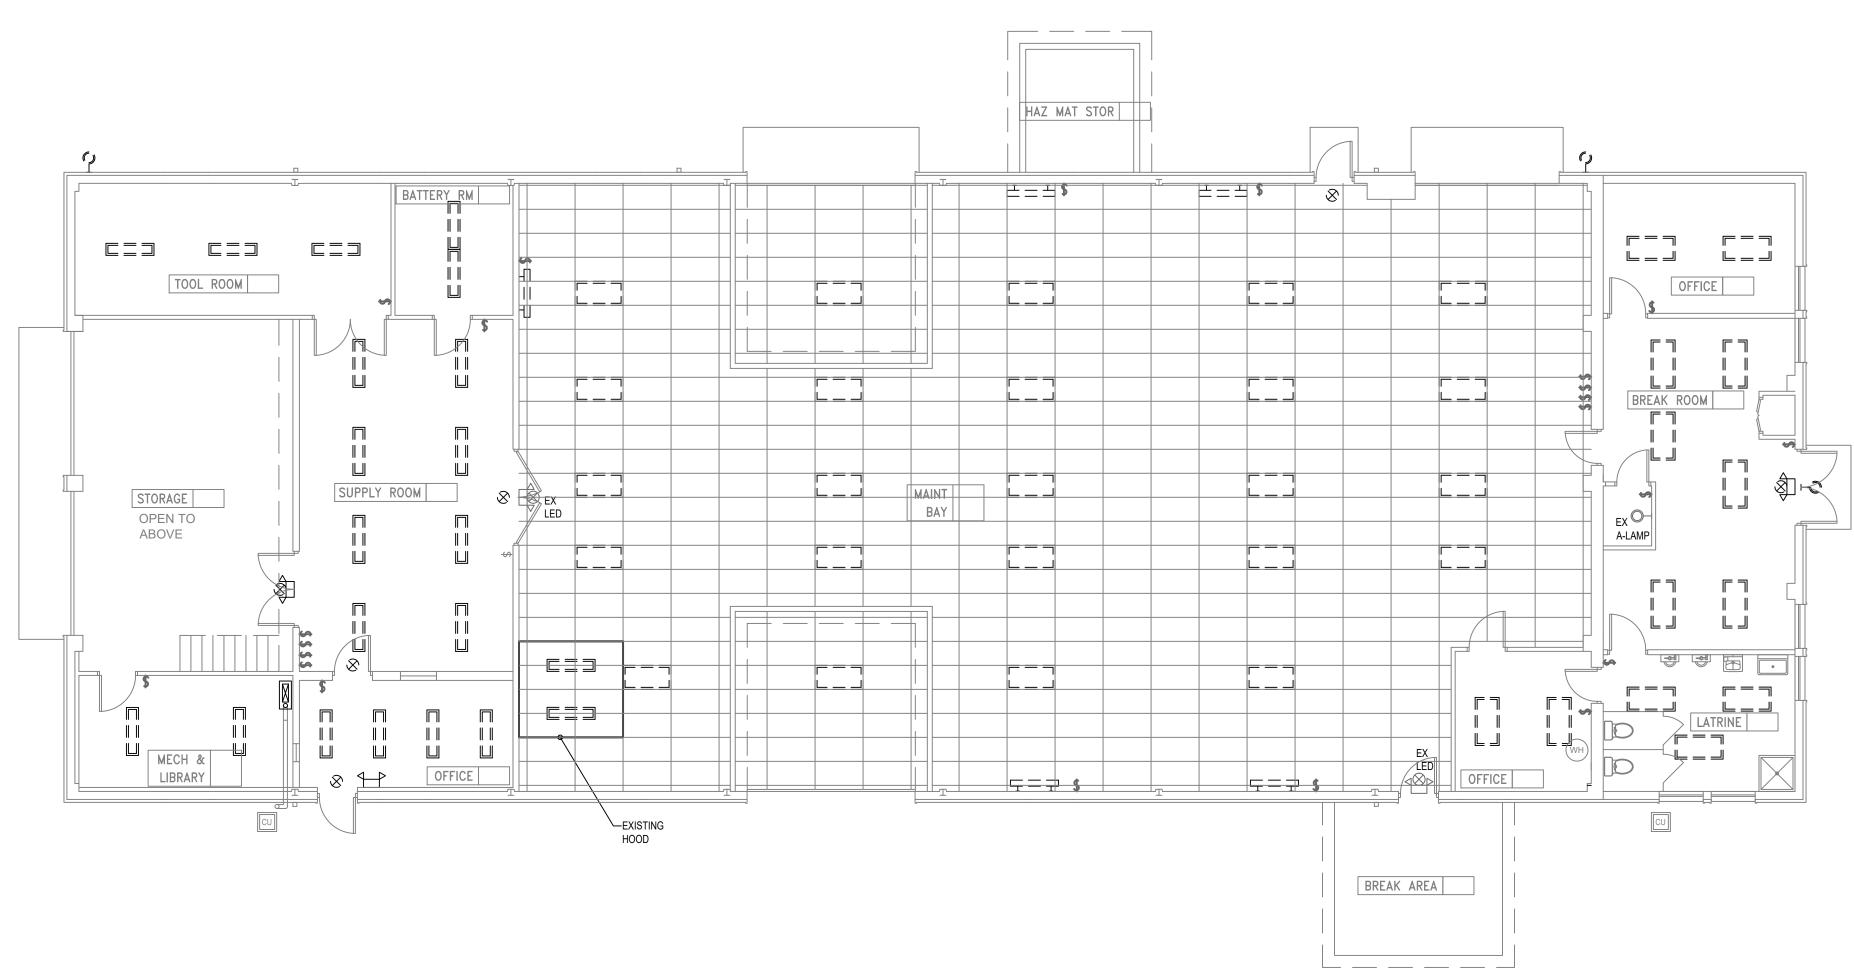

DEMOLITION LIGHTING PLAN

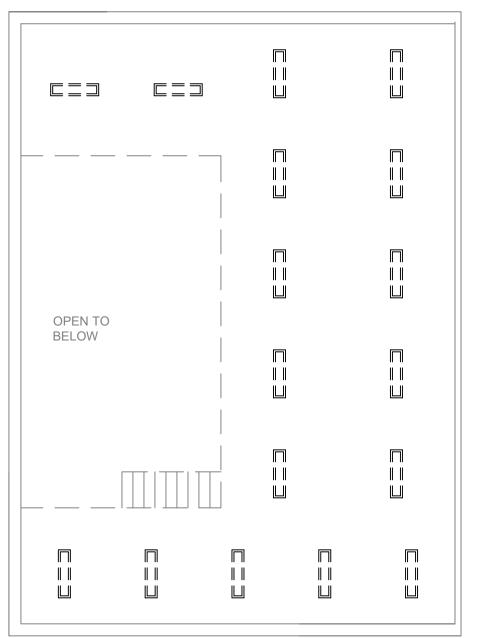

MEZZANINE DEMOLITION LIGHTING PLAN SCALE: 1/8"=1'-0"

GENERAL SHEET NOTES

- . EXISTING LIGHT FIXTURES TO BE REPLACED-IN-PLACE. MAINTAIN EXISTING CIRCUITRY FOR REUSE.
- 2. SCREENED DEVICES ARE EXISTING TO REMAIN. DARK, DASHED DEVICES ARE TO BE DEMOLISHED.

STATE OF MISSOURI MICHAEL L. PARSON, **GOVERNOR**





OFFICE OF ADMINISTRATION DIVISION OF FACILITIES MANAGEMENT, DESIGN AND CONSTRUCTION

DEPARTMENT OF PUBLIC SAFETY MISSOURI ARMY NATIONAL GUARD

INSTALL ROOF MOUNTED SOLAR PANEL ARRAY & LED LIGHTING FMS BUILDING -READINESS CENTER

2626 INDEPENDENCE DR. CAPE GIRARDEAU, MO 63703

PROJECT # T2032-01 ASSET # 8136308002

REVISION:
DATE:
REVISION:
DATE:
REVISION:
DATE:
ISSUE DATE: 07/15/2022

CAD DWG FILE:ED-101.DWG
DRAWN BY: DFP
CHECKED BY: JCF

DESIGNED BY: JAC


SHEET TITLE: DEMOLITION LIGHTING PLAN


SHEET NUMBER:




3 OF 7 SHEETS

07/15/2022

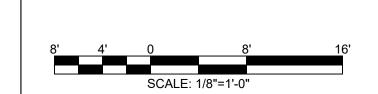


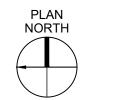

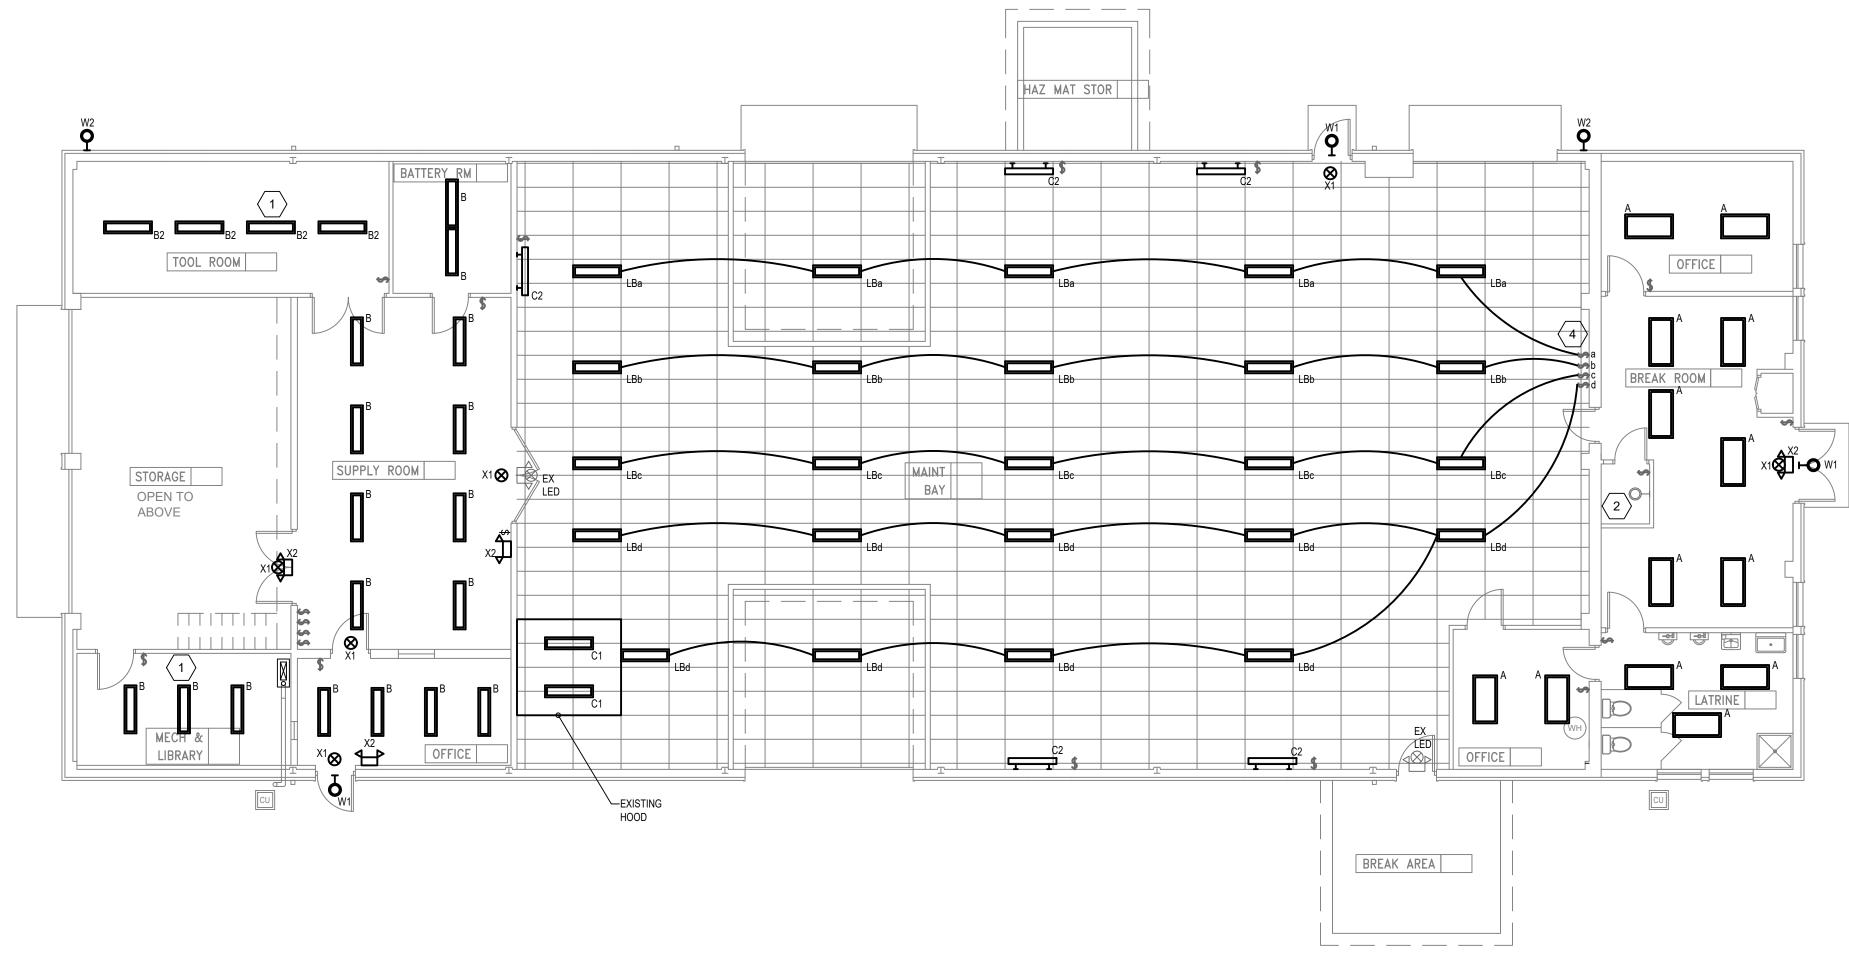

1 LIGHTING PLAN

SCALE: 1/8"=1'-0"

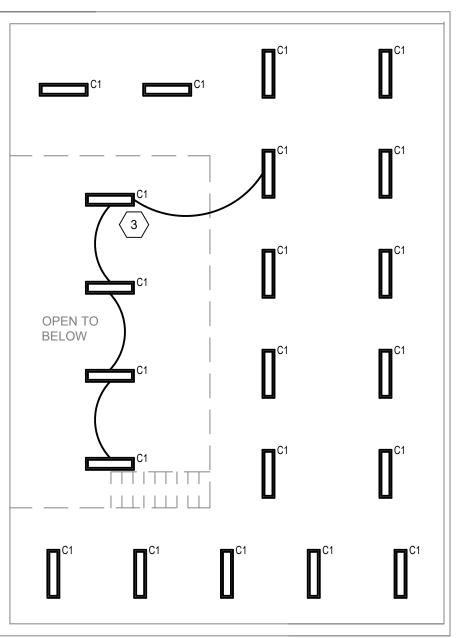

2 MEZZANINE LIGHTING PLAN

SCALE: 1/8"=1'-0"

GENERAL SHEET NOTES

1. ADDITIONAL FIXTURE ADDED TO EXISTING LAYOUT.

2. EXISTING A-19 INCANDESCENT LAMP. PROVIDE 60W LED EQUIVALENT.

4. RE-CIRCUIT LIGHTING SUCH THAT EACH SWITCH CONTROLS A ROW AS

3. EXTEND CIRCUIT TO NEW FIXTURES. NEW LIGHTING SHALL BE CONTROLLED BY SAME SWITCH AS MEZZANINE LIGHTS.

- EXISTING LIGHT FIXTURES TO BE REPLACED-IN-PLACE. REUSE EXISTING
 CIRCUITRY
- 2. NEW FIXTURES SHOW DARK, EXISTING FIXTURES ARE LABELED "EX".
- 3. <u>LIGHTING AUTOMATIC CONTROLS</u> ALL NEW LIGHTS SHALL CONTAIN INTEGRAL OCCUPANCY SENSOR. LIGHTING IN VEHICLE MAINTENANCE BAYS SHALL HAVE NO AUTOMATIC CONTROL DUE TO SAFETY OF MECHANIC.

STATE OF MISSOURI MICHAEL L. PARSON, GOVERNOR



ETEGRA

IVETTE EXECUTIVE PARKWAY, SUITE 100 | OLIVETTE, MO 6



OFFICE OF ADMINISTRATION DIVISION OF FACILITIES MANAGEMENT, DESIGN AND CONSTRUCTION

DEPARTMENT OF PUBLIC SAFETY MISSOURI ARMY NATIONAL GUARD

INSTALL ROOF MOUNTED SOLAR PANEL ARRAY & LED LIGHTING FMS BUILDING -READINESS CENTER

2626 INDEPENDENCE DR. CAPE GIRARDEAU, MO 63703

PROJECT # T2032-01 ASSET # 8136308002

REVISION:
DATE:
REVISION:
DATE:
REVISION:
DATE:
REVISION:
DATE:
ISSUE DATE: 07/15/2022

CAD DWG FILE:E-101.DWG
DRAWN BY: DFP
CHECKED BY: JCF
DESIGNED BY: JAC

SHEET TITLE:
LIGHTING PLAN


SHEET NUMBER:




PLAN NORTH

4 OF 7 SHEETS 07/15/2022



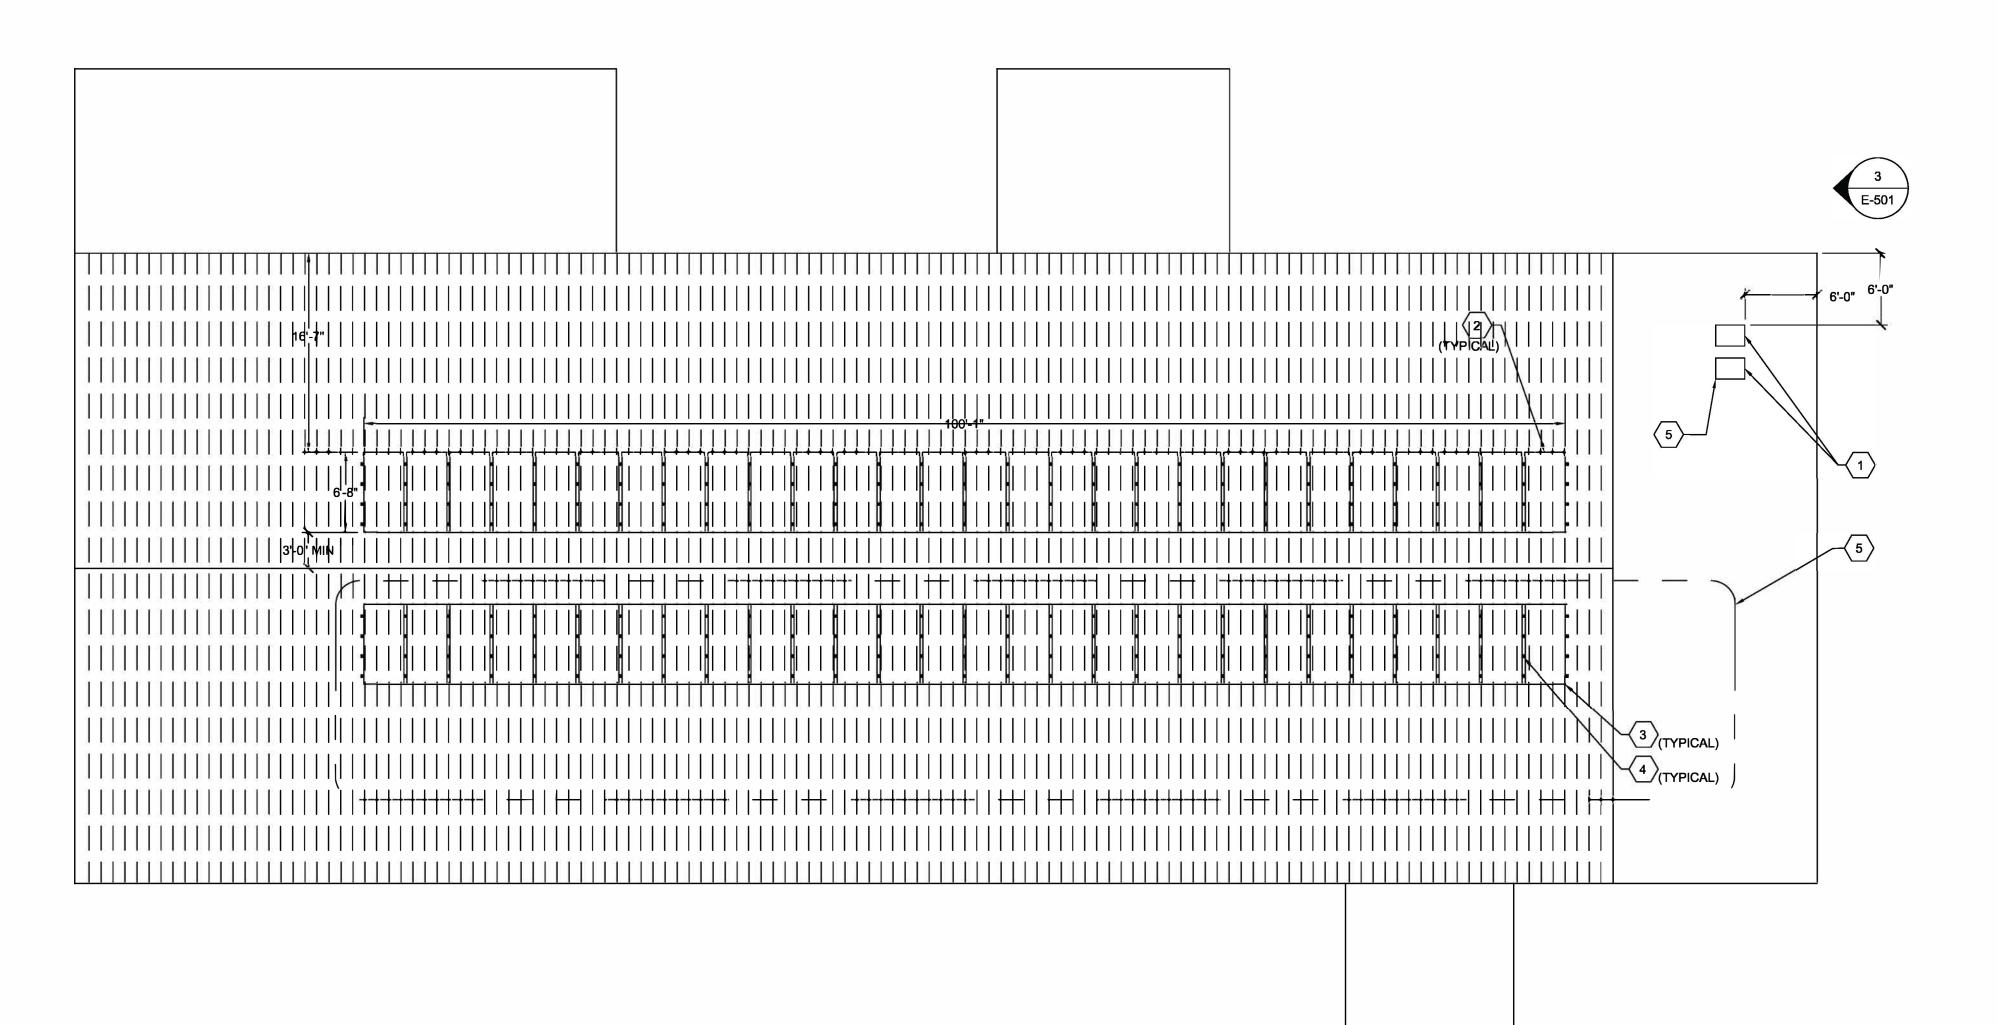



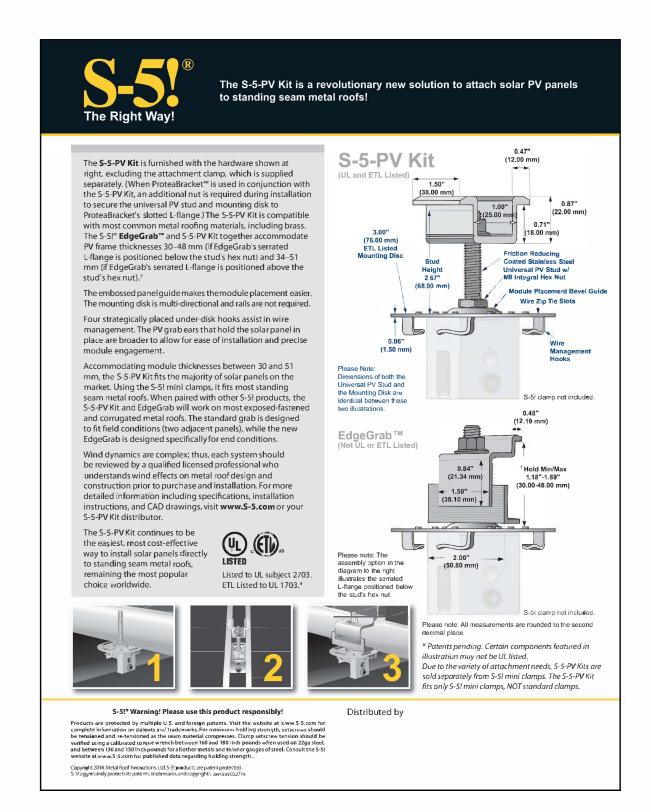



GENERAL SHEET NOTES

- 1. THE SOLAR ARRAY IS ASSUMED TO ADD 2% OF THE STRUCTURE WEIGHT WHICH IS BELOW THE 5% MAXIMUM ALLOWED BY CODE. THE SPACING OF THE PANELS TO STRADDLE THE ROOF PEAK WILL PROVIDE EVEN WEIGHT DISTRIBUTION ACROSS THE ROOF TRUSSES. IT IS ASSUMED THERE IS NO SIGNIFICANT DETERIORATION OF THE BUILDING STRUCTURE AND THE ROOF IS IN RELATIVELY GOOD CONDITION. IF THE CONTRACTOR DISCOVERS THIS TO BE INCORRECT, SOLAR PANEL INSTALLATION SHALL CEASE AND THE CONTRACTOR SHOULD REACH OUT TO THE ARCHITECT FOR FURTHER DIRECTION. LIMITED BUILDING STRUCTURAL INFORMATION OBTAINED FROM ORIGINAL DRAWINGS DATED MAY 28, 1953. BASIS OF DESIGN SHOWS (28) 50.3 LB PANELS PER ROW, TOTALING 1,408 LBS. ACTUAL ROW SHALL NOT EXCEED 1,500 LBS.
- 2. CONTRACTOR SHALL REVIEW NEC 690 SOLAR PHOTOVOLTAIC (PV) SYSTEMS AND PROVIDE PROPER GROUNDING, RAPID SHUTDOWN, ETC. FOR SAFE, RELIABLE, AND COMPLETE SYSTEM.
- 3. DESIGN IS PERFORMANCE BASED. PHOTOVOLTAIC SYSTEM TO PROVIDE 20KW OF TOTAL AC POWER. EACH DC MODULE STRING SHALL BE A MINIMUM OF 115% OF INVERTER RATING. BASIS OF DESIGN SHOWS (28) 410W MODULES PER STRING, TOTALING 11.5KW WHICH FEEDS A 10KW INVERTER.

○ SHEET KEY NOTES

- MOUNT INVERTER ON ROOF. BASIS OF DESIGN IS FRONIUS SYMO 10.0-3
 208-240, 10 KW, 208V/3-PHASE. SEE SPECIFICATIONS FOR APPROVED
 MANUFACTURERS.
- 2. MOUNT SOLAR MODULES ON ROOF. PROVIDE PV CLIPS TO STANDING SEAMS OF ROOF. BASIS OF DESIGN IS TRINASOLAR TALLMAX TSM-410 DE15M(II), 410W, (28) PER 10 KW INVERTER. STRING DESIGN FOR DC INPUT KW TO BE 115% MINIMUM OF INVERTER RATING. SEE SPECIFICATIONS FOR APPROVED MANUFACTURERS.
- 3. PROVIDE CLIPS ATTACHING SOLAR MODULES TO STANDING SEAM ROOF. PROVIDE QUANTITY AND PLACEMENT AS DIRECTED BY MANUFACTURER. SEE DETAIL 2/E-102 FOR REFERENCE INFORMATION. BASIS OF DESIGN IS S-5! S-5-PV KIT AND EDGE GRAB. SEE SPECIFICATIONS FOR APPROVED MANUFACTURERS.
- 4. PROVIDE CLIPS ATTACHING SOLAR MODULES TO EACH OTHER. PROVIDE QUANTITY AND PLACEMENT AS DIRECTED BY MANUFACTURER. SEE DETAIL 2/E-102 FOR REFERENCE INFORMATION. BASIS OF DESIGN IS S-5! S-5-PV KIT AND EDGE GRAB. SEE SPECIFICATIONS FOR APPROVED MANUFACTURERS.
- 5 <u>ALTERNATE BID</u> PROVIDE AN ALTERNATE BID FOR (28) SOLAR MODULES ON THE WEST SIDE OF THE ROOF AND INVERTER.

STATE OF MISSOURI MICHAEL L. PARSON, GOVERNOR



LIVETTE EXECUTIVE PARKWAY, SUITE 100 | OLIVETTE, MO (314) 533-2200 | WWW.ETEGRA.COM



OFFICE OF ADMINISTRATION DIVISION OF FACILITIES MANAGEMENT, DESIGN AND CONSTRUCTION

DEPARTMENT OF PUBLIC SAFETY MISSOURI ARMY NATIONAL GUARD

INSTALL ROOF MOUNTED SOLAR PANEL ARRAY & LED LIGHTING FMS BUILDING -READINESS CENTER

2626 INDEPENDENCE DR. CAPE GIRARDEAU, MO 63703

PROJECT # T2032-01 ASSET # 8136308002

REVISION:
DATE:
REVISION:
DATE:
REVISION:
DATE:
IGGLIE DATE: 07/15/2022

ISSUE DATE: 07/ 15/ 2022

CAD DWG FILE:E-102.DWG
DRAWN BY: DFP
CHECKED BY: JCF
DESIGNED BY: JAC


SHEET TITLE:
ROOF SOLAR
PANEL PLAN


SHEET NUMBER:



5 OF 7 SHEETS 07/ 15/ 2022



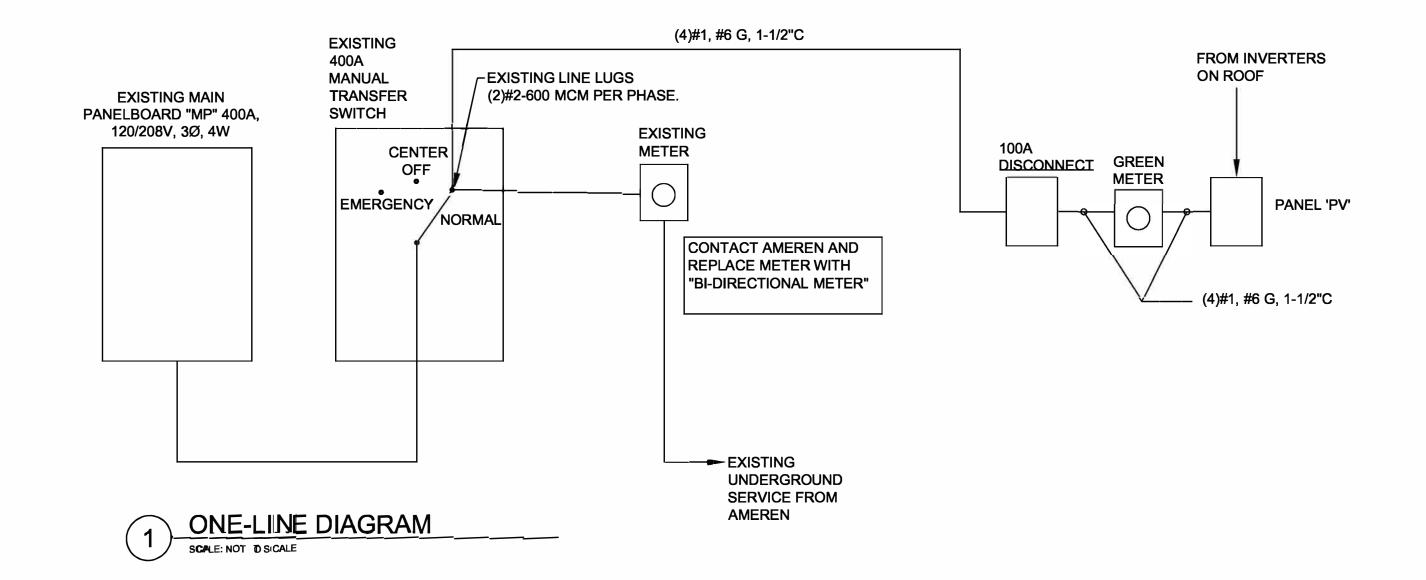

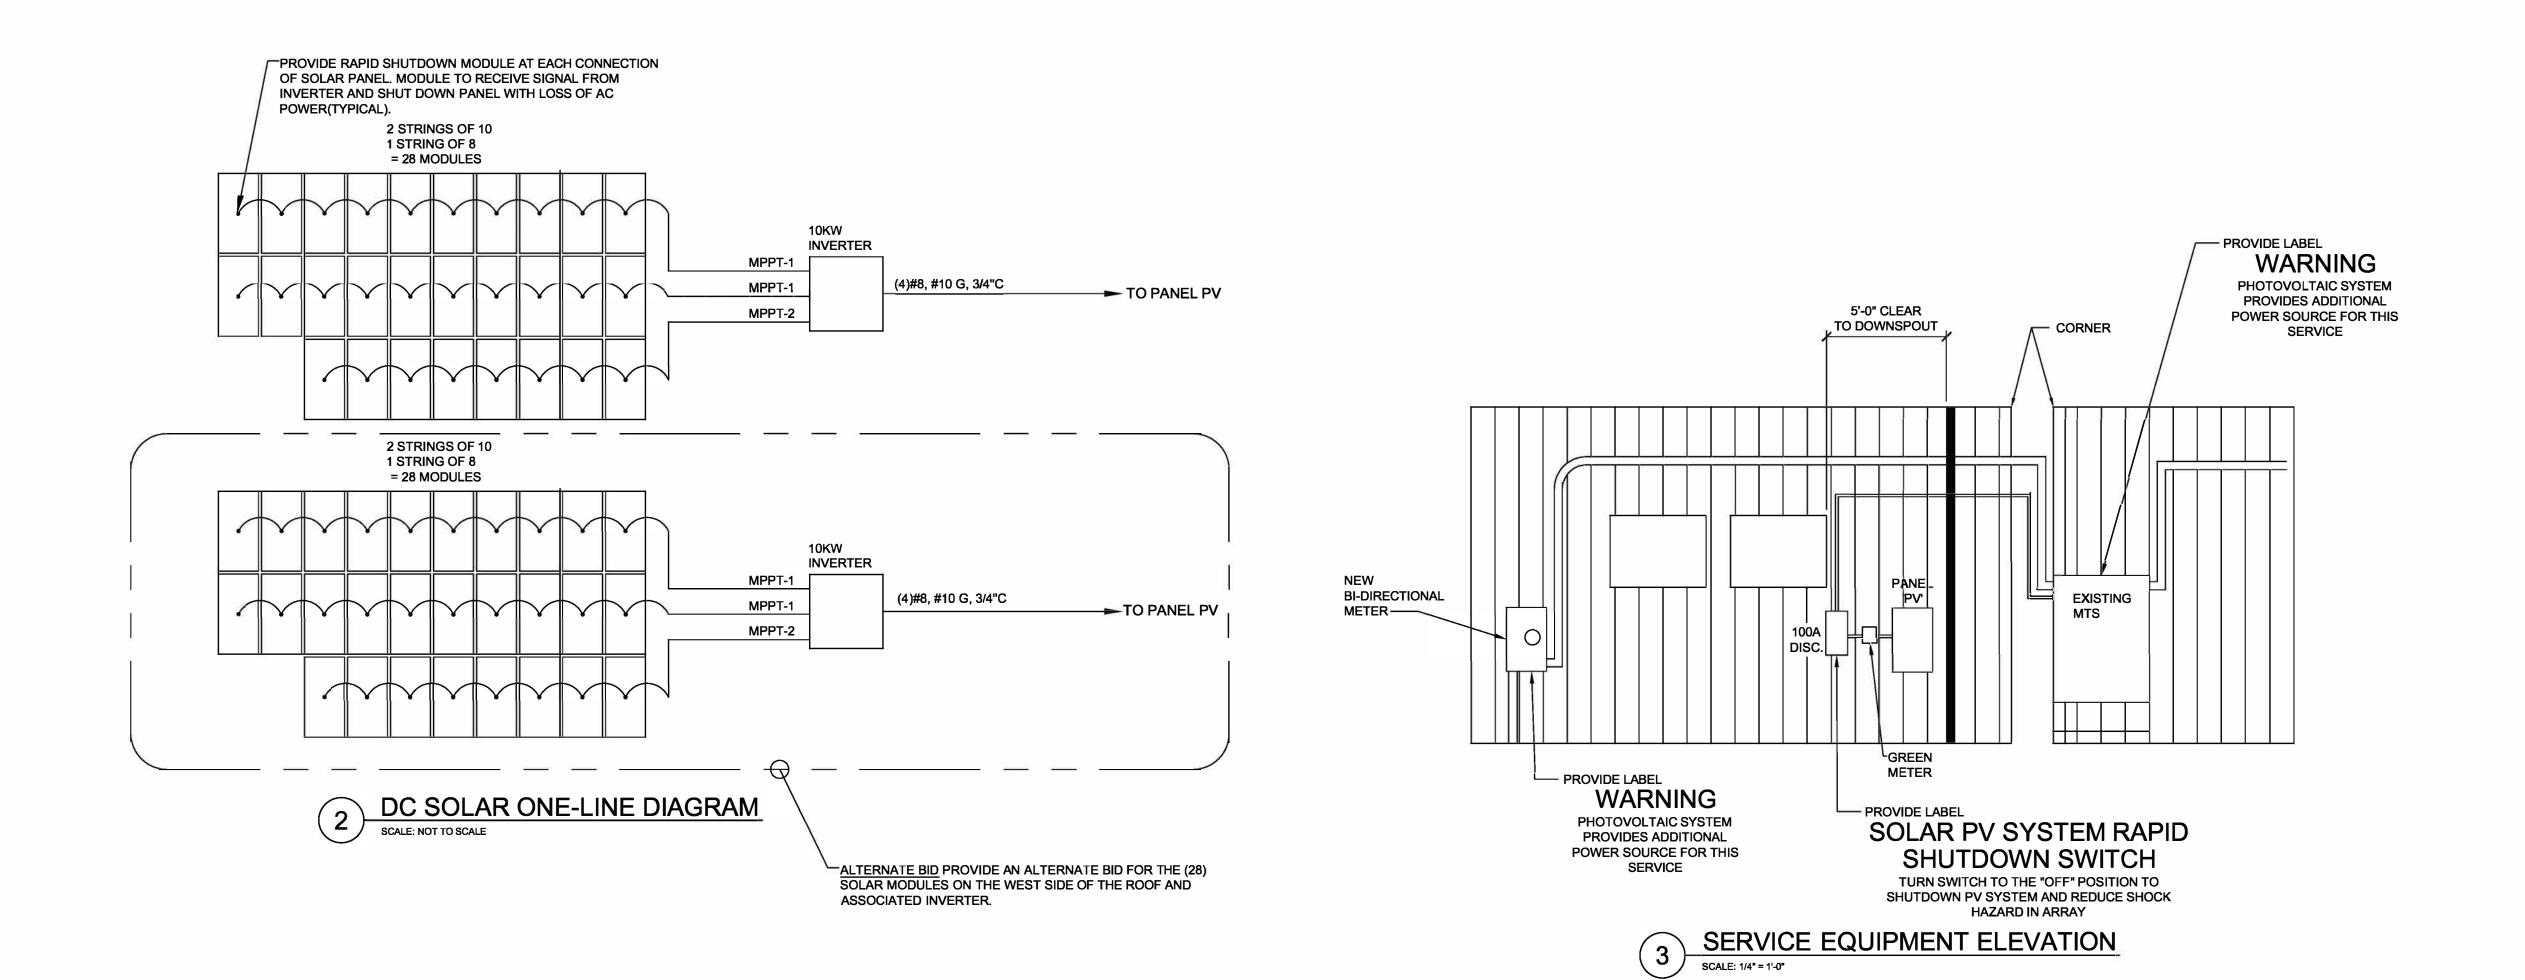

STATE OF MISSOURI MICHAEL L. PARSON, GOVERNOR



ETEGRA21 OLIVETTE EXECUTIVE PARKWAY, SUITE 100 | OLIVETTE, MO 6313
(314) 533-2200 | WWW.ETEGRA.COM



OFFICE OF ADMINISTRATION DIVISION OF FACILITIES MANAGEMENT, DESIGN AND CONSTRUCTION

DEPARTMENT OF PUBLIC SAFETY MISSOURI ARMY NATIONAL GUARD

INSTALL ROOF MOUNTED SOLAR PANEL ARRAY & LED LIGHTING FMS BUILDING -READINESS CENTER

2626 INDEPENDENCE DR. CAPE GIRARDEAU, MO 63703

PROJECT # T2032-01 ASSET # 8136308002

REVISION:
DATE:
REVISION:
DATE:
REVISION:
DATE:
ISSUE DATE: 07/15/2022

ISSUE DATE: 07/15/2022

CAD DWG FILE:E-501.DWG
DRAWN BY: DFP
CHECKED BY: JCF
DESIGNED BY: JAC

SHEET TITLE:
DETAILS AND
SCHEMATICS

SHEET NUMBER:

E-50

6 OF 7 SHEETS 07/15/2022

ERAL DESCRIPTION TROFFER, VOLUMETRIC X 4 LED VOLUMETRIC	MANUFACTURER (NOTE 1) LITHONIA LITHONIA	CATALOG # 2BLT4R 30L ADP EZ1 LP835 MSDPDT7ADCX	MOUNTING	LIGHT S	SOURCE DATA LED DELIVERED LUMENS (NOMINAL)	POWER VOLTAGE	DATA WATTAGE	COLOR (K)	CRI	NOTES
TROFFER, VOLUMETRIC	(NOTE 1)			LAMP TYPE		VOLTAGE	WATTAGE	COLOR (K)	CRI	NOTES
<u> </u>		2BLT4R 30L ADP EZ1 LP835 MSDPDT7ADCX	RECESSED				WATTAGE			NOTES
X 4 LED VOLUMETRIC	LITHONIA			LED	3000	MVOLT	30	3500	80	OFFICE AREA GRID CEILINGS, INTEGRAL OCCUPANCY SENSOR
		BLWP4 20L ADP EZ1 LP835 MSDPDT7ADCX	CEILING	LED	2000	MVOLT	16	3500	80	OFFICE AREA WITH HARD CEILINGS, INTEGRAL OCCUPANCY SENSOR
X 4 LED VOLUMETRIC	LITHONIA	BLWP4 30L ADP EZ1 LP835 MSDPDT7ADCX	WALL	LED	3000	MVOLT	25	3500	80	WALL MOUNT ABOVE SINKS IN RESTROOMS, INTEGRAL OCCUPANCY SENSOR
STRIP WITH REFLECTOR	LITHONIA	CLX L48 3000LM SEF FDL MVOLT EZ1 35K 80CRI WH REFLECTOR - CLXRW48	CEILING	LED	3000	MVOLT	20	3500	80	MEZZANINE STORAGE
4' LED STRIP	LITHONIA	CLX L48 4000LM SEF FDL MVOLT EZ1 35K 80CRI WH	WALL	LED	4000	MVOLT	28	3500	80	MAINTENANCE AREA WALLS
1 X 4 LED LOW BAY	LITHONIA	UFIT L48 8000LM SEF MVOLT GZ10 35K 80CRI WH	CEILING	LED	8000	MVOLT	60	3500	80	MAINTENANCE AREA CEILING
DISCHARGE EMERGENCY LIGHT	LITHONIA	TWH LED 10C 1000 40K T3M MVOLT PE ELCW DDBXD	WALL	LED	3400	MVOLT	39	4000	70	ADDITIONAL EXTERIOR WALL PACK FOR EMERGENCY EXIT DISCHARGE
WALL PACK	LITHONIA	TWR1 LED P2 50K MVOLT DDBTXD	WALL	LED	3500	MVOLT	28	5000	80	REPLACES EXISTING 175W MH FIXTURE
NGLE FACE EXIT LIGHT	LITHONIA	LQM S W 3 R 120/277 EL N M6	WALL	LED	NA	MVOLT	1	NA	NA	SINGLE FACE, WHITE WITH RED LETTERS
	LITHONIA	ELM6L UVOLT LTP SDRT	WALL	LED	1100	MVOLT	11	NA	NA	EMERGENCY LIGHT WITH (2) 5.3W LED LAMPS PER HEAD. HEADS SHALL BE ADJUSTABLE.
	WALL PACK	WALL PACK LITHONIA E FACE EXIT LIGHT LITHONIA	WALL PACK LITHONIA TWR1 LED P2 50K MVOLT DDBTXD E FACE EXIT LIGHT LITHONIA LQM S W 3 R 120/277 EL N M6	WALL PACK LITHONIA TWR1 LED P2 50K MVOLT DDBTXD WALL E FACE EXIT LIGHT LITHONIA LQM S W 3 R 120/277 EL N M6 WALL	WALL PACK LITHONIA TWR1 LED P2 50K MVOLT DDBTXD WALL LED E FACE EXIT LIGHT LITHONIA LQM S W 3 R 120/277 EL N M6 WALL LED	WALL PACK LITHONIA TWR1 LED P2 50K MVOLT DDBTXD WALL LED 3500 E FACE EXIT LIGHT LITHONIA LQM S W 3 R 120/277 EL N M6 WALL LED NA	WALL PACK LITHONIA TWR1 LED P2 50K MVOLT DDBTXD WALL LED 3500 MVOLT E FACE EXIT LIGHT LITHONIA LQM S W 3 R 120/277 EL N M6 WALL LED NA MVOLT	WALL PACK LITHONIA TWR1 LED P2 50K MVOLT DDBTXD WALL LED 3500 MVOLT 28 E FACE EXIT LIGHT LITHONIA LQM S W 3 R 120/277 EL N M6 WALL LED NA MVOLT 1	WALL PACK LITHONIA TWR1 LED P2 50K MVOLT DDBTXD WALL LED 3500 MVOLT 28 5000 E FACE EXIT LIGHT LITHONIA LQM S W 3 R 120/277 EL N M6 WALL LED NA MVOLT 1 NA	WALL PACK LITHONIA TWR1 LED P2 50K MVOLT DDBTXD WALL LED 3500 MVOLT 28 5000 80 E FACE EXIT LIGHT LITHONIA LQM S W 3 R 120/277 EL N M6 WALL LED NA MVOLT 1 NA NA

				-			PANE	EL S	3C	HEI	DUL	.E						
MOUNT: SURFACE 120/208		/208	3-PHASE, 4W	P	PANEL P				CAPACITY:	100A		INT CAP: 10KA						
OCA	TION:	EXTE	RIOR W	ALL		NEMA 4X	LU	IGS:		MLC)							
CKT	LTG	REC	HVAC	MISC	NP	DESCRIPTION	AMP	POLE	ф	AM P	POLE	DESCRIPTION	LTG	REC	HVAC	MISC	NP	СКТ
1				3333		INVERTER 1			Α			INVERTER 2			2	3333	(**	2
3				3333]	35	3	В	35	3	NOTE B				3333		4
5	1		8	3333		1			С						2	3333		6
7						PROVISIONS		1	Α		1	PROVISIONS						8
9						PROVISIONS		1	В		1	PROVISIONS						10
11						PROVISIONS		1	С		1	PROVISIONS						12
13						PROVISIONS		1	Α		1	PROVISIONS						14
15						PROVISIONS		1	В		1	PROVISIONS						16
17		5	8	8 8		PROVISIONS	88	. 1 ,	С		. 1	PROVISIONS			S			18
LOAD TYPE		TYPE	CONNECTED	200	DEMAND			DEMAND FORMULA					TOTAL LOAD					
PHASE BALANCE LIGHTIN			ITING	0VA	30	0VA			LOAD X 125% NEC 210.19 CONTINUOUS					ECTED	DEMAND			
Ф	LO	AD		RECEP	TACLE	0VA		0V	VA 10KVA + 50% REMAINDER NEC 220.44 20,000VA						OVA	20,000VA		
Α	6666.	7 KVA		HV	'AC	0VA		0V	A		LOAD X 80% (USED MCA IN CALCULATION) 55.5A 55					55	.5A	
В	6666.7 KVA MISC 20,000VA 20,000VA LOAD X 100% NEC 210.19 NON-CONT. FILENAM							AME:	AME:									
C 6666.7 KVA NP 0VA 0V						0V	A		0 NONCOINCIDENTAL LOADS NEC 220.60 PACE Cape Girardeau.xls									

STATE OF MISSOURI MICHAEL L. PARSON, **GOVERNOR**





OFFICE OF ADMINISTRATION DIVISION OF FACILITIES MANAGEMENT, DESIGN AND CONSTRUCTION

DEPARTMENT OF PUBLIC SAFETY MISSOURI ARMY NATIONAL GUARD

INSTALL ROOF MOUNTED SOLAR PANEL ARRAY & LED LIGHTING FMS BUILDING -READINESS CENTER

2626 INDEPENDENCE DR. CAPE GIRARDEAU, MO 63703

PROJECT # T2032-01 ASSET # 8136308002

REVISION:
DATE:
REVISION:
DATE:
REVISION:
DATE:

ISSUE DATE: 07/ 15/ 2022

CAD DWG FILE:E-601.DWG
DRAWN BY: DFP
CHECKED BY: JCF
DESIGNED BY: JAC

SHEET TITLE:
LIGHTING FIXTURE SCHEDULE

SHEET NUMBER:

7 OF 7 SHEETS 07/ 15/ 2022

NOTES:
A. LOAD REPRESENTS POWER PROVIDED BY PHOTOVOLTAIC SYSTEM B. <u>ALTERNATE BID</u> 35A/3P CIRCUIT BREAKER WILL BE "SPARE" IN BASE BID.