

# Solar Array, Interior LED and Vehicle Exhaust System Marshall Field Maintenance Shop Marshall, Missouri

## BID DOCUMENTS

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CLARK &  
ENERSEN

**OWNER:** STATE OF MISSOURI  
MICHAEL L. PARSON,  
GOVERNOR

MISSOURI NATIONAL GUARD

**PROJECT  
MANAGEMENT:** OFFICE OF ADMINISTRATION  
DIVISION OF FACILITIES  
MANAGEMENT, DESIGN AND  
CONSTRUCTION

**DESIGNER:** THE CLARK ENERSEN PARTNERS

**PROJECT NUMBER:** T2044-01  
**A/E PROJECT NUMBER:** 050-005-20

**SITE NUMBER:** 6265  
**ASSET NUMBER:** 8136265009




Project Location  
475 S Davis Ave  
Marshall, MO 65340

SHEET NUMBER:

**G-000**

03/22/2023



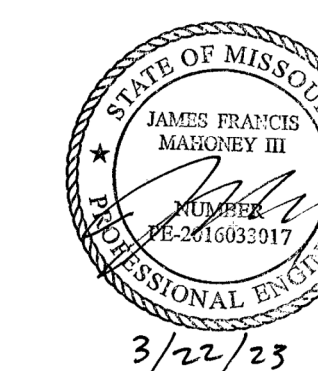

PROFESSIONAL SEAL

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OFFICE OF  
ADMINISTRATION  
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MANAGEMENT, DESIGN  
AND CONSTRUCTION

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SOLAR ARRAY, INTERIOR  
LED LIGHTING AND  
EXHAUST SYSTEM

MARSHALL FIELD  
MAINTENANCE SHOP

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CHECKED BY: JM  
DESIGNED BY: AR


SHEET TITLE:  
**Mechanical  
Abbreviations, Symbols  
& Notes**

SHEET NUMBER:

# M-000

FAN SCHEDULE													
MARK:	SERVES:	TYPE:	CFM:	S.P. IN. WG.:	DRIVE:	RPM:	SONES:	HP (W):	ELECTRICAL DATA:			MANUFACTURER AND MODEL NUMBER:	REMARKS:
									V:	PH:	HZ:		
EF-1	VEHICLE BAY	MIXED FLOW BELT DRIVE	4,000	4.5	BELT	2,472	23	5	240	1	60	GREENHECK MODEL QEI-15 OR APPROVED EQUIVALENT	1,2,3,4
REMARKS: 1. PROVIDE DISCONNECT SWITCH. 2. PROVIDE WITH GRAVITY BACKDRAFT DAMPER. 3. INTERLOCK OPERATION WITH EXISTING OUTSIDE AIR LOUVERS. 4. MANUFACTURER NOTED IS BASIS-OF-DESIGN. SEE SPEC SECTION 23 34 23 FOR ADDITIONAL MANUFACTURERS.													

EXHAUST HOSE REEL SCHEDULE			
MARK:	FUNCTION:	REEL:	MANUFACTURER AND MODEL:
VEHR-1	VEHICLE EXHAUST HOSE REEL		CAR-MON TSR-P36 TUBE STORAGE REEL OR EQUIVALENT, 25' HOSE CAPACITY 7" TYPE HTC FLEX HOSE, CTA-7 ADAPTER & FLANGE SET, HANGING PENDANT SWITCH 1/6 HP, 120/1/60 V/PHZ MANUFACTURER LISTED IS BASIS-OF-DESIGN. SEE SPECIFICATION SECTION 23 37 00 FOR ADDITIONAL MANUFACTURERS.

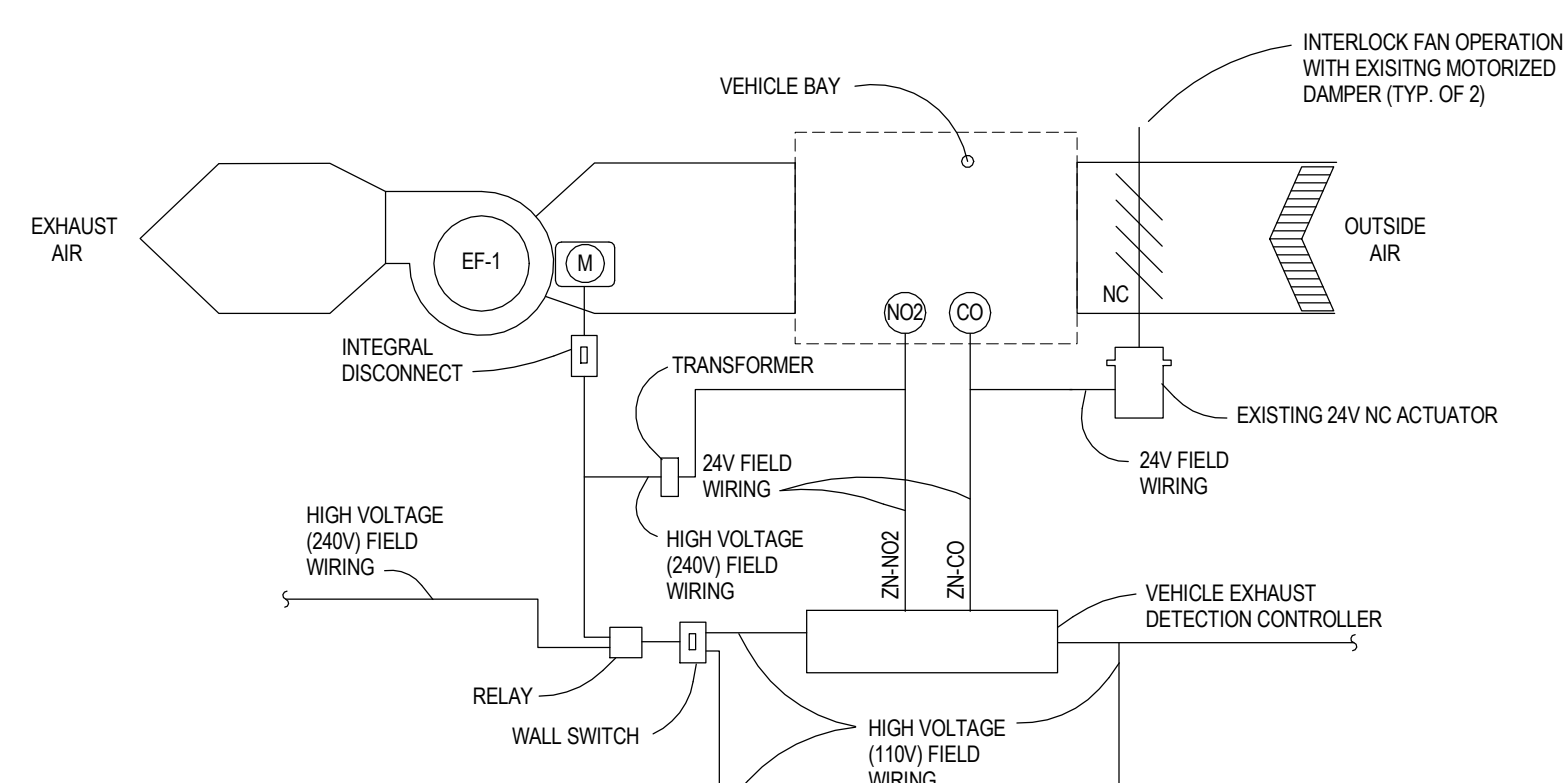


## 1 EF-1 CONTROLS SCHEMATIC

NO SCALE

### GENERAL NOTES:

1. ALL LOW VOLTAGE WIRING TO BE PROVIDED BY MECHANICAL CONTRACTOR. ROUTE ALL EXPOSED LOW VOLTAGE WIRING IN STEEL CONDUIT.
2. ALL HIGH VOLTAGE WIRING TO BE PROVIDED BY ELECTRICAL CONTRACTOR.
3. PROVIDE ALL TRANSFORMERS AND RELAYS REQUIRED FOR FULLY OPERATIONAL SYSTEM AS DESCRIBED BY SEQUENCE OF OPERATIONS.

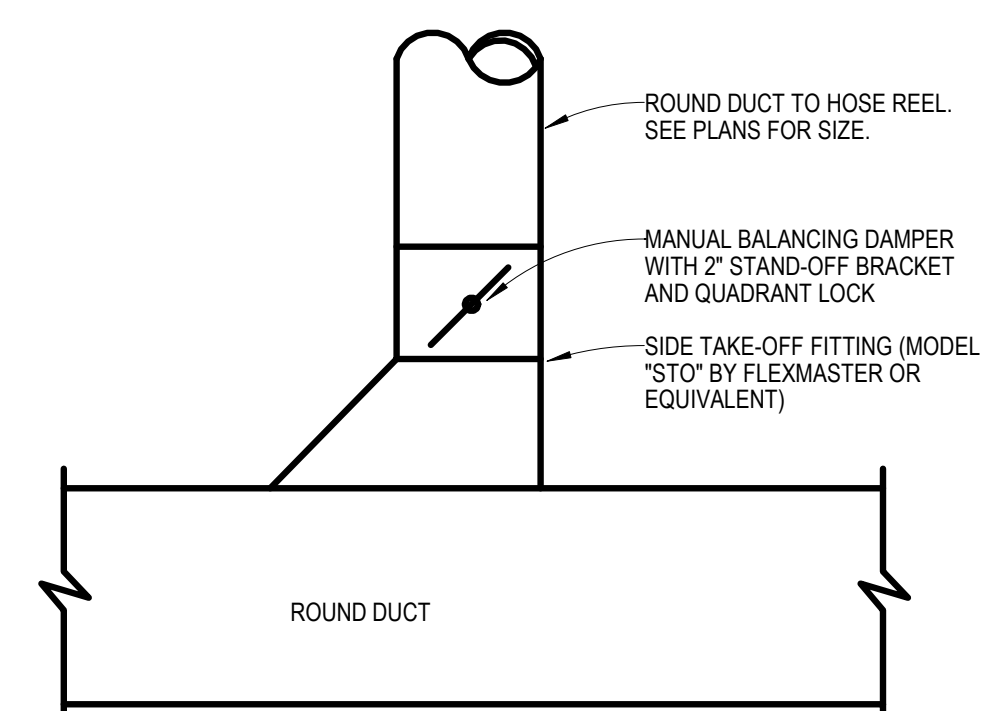

# MECHANICAL ABBREVIATIONS AND SYMBOLS LEGEND

ABBREVIATIONS		PIPING	
AFF	ABOVE FINISHED FLOOR	6	BALL VALVE
BTU	BRITISH THERMAL UNIT		
CW	DOMESTIC COLD WATER		
DW	DOMESTIC WATER		
EA	EXHAUST AIR		
EC	ELECTRICAL CONTRACTOR		
EMCS	ENERGY MANAGEMENT AND CONTROL SYSTEM		
ESP	EXTERNAL STATIC PRESSURE		
FL	FLOW LINE		
G	GAS		
GC	GENERAL CONTRACTOR		
HP	HORSEPOWER		
HR	HOUR		
HW	DOMESTIC HOT WATER		
HWC	DOMESTIC HOT WATER CIRCULATING		
LAT	LAY IN TILE		
MC	MECHANICAL CONTRACTOR		
MD	MOTORIZED DAMPER		
NIC	NOT IN CONTRACT		
OBD	MANUAL OPPOSED BLADE BALANCING DAMPER		
RA	RETURN AIR		
REL A	RELIEF AIR		
SA	SUPPLY AIR		
SP	STATIC PRESSURE		
TAB	TEST, ADJUST AND BALANCE		
TOD	TOP OF DUCT		
T/P	TEMPERATURE/PRESSURE		
TSP	TOTAL STATIC PRESSURE		
V	VEHICLE		
W	SANITARY WASTE PIPING (INSIDE BUILDING)		
WB	WET BULB		
X/N	NEW EQUIPMENT, DEVICE, ETC.		
X (R)	EXISTING CONDITION TO BE REMOVED OR RELOCATED		
XXX-1	EQUIPMENT MARK - SEE MECHANICAL OR PLUMBING EQUIP. SCHEDULES (E.G. AHU-1 - AIR HANDLING UNIT)		
X (E)	EXISTING CONDITION, GENERAL		
			<b>SHEET METAL</b>
			RECTANGULAR DUCT - FIRST NUMBER INDICATES SIZE SHOWN
			ROUND DUCT
			OVAL DUCT - FIRST NUMBER INDICATES SIZE SHOWN
			FLEX DUCT
			TURNING VANES
			POSITIVE PRESSURE DUCT UP
			POSITIVE PRESSURE DUCT DOWN
			NEGATIVE PRESSURE DUCT UP
			NEGATIVE PRESSURE DUCT DOWN
			CEILING DIFFUSER - EQUIP. MARK, SIZE, CFM
			SIDEWALL REGISTER - EQUIP. MARK, SIZE, CFM, HEIGHT AFF
			CEILING RETURN GRILLE - EQUIP. MARK, SIZE, CFM
			<b>GENERAL</b>
			CONNECTION - NEW TO EXISTING
			PIPE OR ROUND DUCT RISER
			PIPE OR ROUND DUCT DROP
			DIRECTION OF FLOW
			DOWNWARD PIPE OR DUCT PITCH
			SECTION IDENTIFICATION: SECTION NUMBER SHEET NUMBER
			DETAIL IDENTIFICATION: SECTION NUMBER SHEET NUMBER
			ELECTRICAL MOTOR
			ARCHITECTURAL ELEVATION
			ENGINEER ELEVATION
			ELECTRICAL PANEL
			VARIABLE FREQUENCY DRIVE PANEL - EQUIP. MARK
			EXISTING PIPING, DUCTWORK, EQUIPMENT, ETC.

## GENERAL MECHANICAL NOTES:

### 1. GENERAL

1.1 THESE NOTES SHALL APPLY TO ALL MECHANICAL/PLUMBING PLANS.

1.2 NOTE THAT THE MECHANICAL PLANS ARE TO A GREAT EXTENT SCHEMATIC IN NATURE AND THAT THE INFORMATION PRESENTED IS EXACT AS COULD BE SECURED. THE CONTRACTOR SHALL OBTAIN EXACT LOCATIONS, MEASUREMENTS, LEVELS, ETC., AT THE SITE AND SHALL SATISFACTORILY ADAPT HIS WORK TO THE ACTUAL CONDITIONS AT THE PROJECT SITE.

1.3 THE CONTRACTOR IS RESPONSIBLE FOR PROPER SUPPORT OF ALL EQUIPMENT, PIPING, DUCTWORK, ETC. COORDINATE INSTALLATION OF ALL EQUIPMENT, PIPING, DUCTWORK, ETC. WITH OTHER BUILDING TRADES.


1.4 SEE SPECIFICATION SECTIONS 22 05 00 AND 23 05 00 FOR OTHER GENERAL MECHANICAL REQUIREMENTS.

1.5 THE LOCATION AND SIZE OF ALL ITEMS SHOWN AS EXISTING WERE OBTAINED FROM PREVIOUS DRAWINGS AND SITE VISITS, AND ARE SHOWN FOR THE CONVENIENCE OF THE CONTRACTOR. ACCURACY OF THE INFORMATION SHOWN IS NOT GUARANTEED. THE CONTRACTOR IS RESPONSIBLE FOR THE VERIFICATION OF ALL EXISTING CONDITIONS PRIOR TO SUBMITTING THE PROJECT BID. NO ADDITIONAL COMPENSATION WILL BE ALLOWED FOR CHANGES WHICH OCCUR AFTER BIDS ARE SUBMITTED WHICH ARE A RESULT OF EXISTING CONDITIONS. SITE VISITS PRIOR TO SUBMISSION OF BIDS MUST BE FULLY COORDINATED WITH THE OWNER.

1.6 ALL EXPOSED MECHANICAL ITEMS WILL BE FIELD-PAINTED. ALL ITEMS SHALL BE PROPERLY ORDERED AND PREPARED TO ACCEPT PAINT. COORDINATE EXACT REQUIREMENTS WITH PAINTING CONTRACTOR. SEE ARCHITECTURAL AND FINISH DRAWINGS AND SPECIFICATIONS FOR AREAS AND ITEMS THAT WILL BE PAINTED.

1.7 ALL ACCESS PANELS LOCATIONS SHALL BE COORDINATED WITH THE OWNER PRIOR TO FINAL INSTALLATION. ENSURE FINAL INSTALLATION LOCATION PROVIDES REQUIRED ACCESS TO ALL MECHANICAL EQUIPMENT AND ASSOCIATED COMPONENTS.

1.8 THE OWNER WILL OCCUPY PORTIONS OF THE BUILDING THROUGHOUT CONSTRUCTION. MECHANICAL SYSTEMS SERVING OCCUPIED PORTIONS OF THE FACILITY MUST REMAIN IN OPERATION. THE CONTRACTOR MUST COORDINATE ALL PHASING REQUIREMENTS WITH THE OWNER AND MUST PROVIDE ALL NECESSARY EQUIPMENT, SYSTEMS, AND CONNECTIONS TO ENSURE PHASING AND OWNER OCCUPANCY REQUIREMENTS ARE SATISFIED. ALL BIDS SHOULD INCORPORATE THIS REQUIREMENT. NO ADDITIONAL COMPENSATION WILL BE ALLOWED FOR ISSUES AND CHANGES WHICH OCCUR AS A RESULT OF PHASING AND OWNER OCCUPANCY REQUIREMENTS.

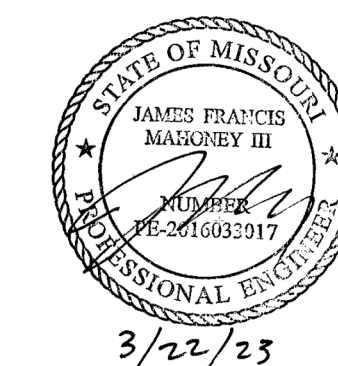

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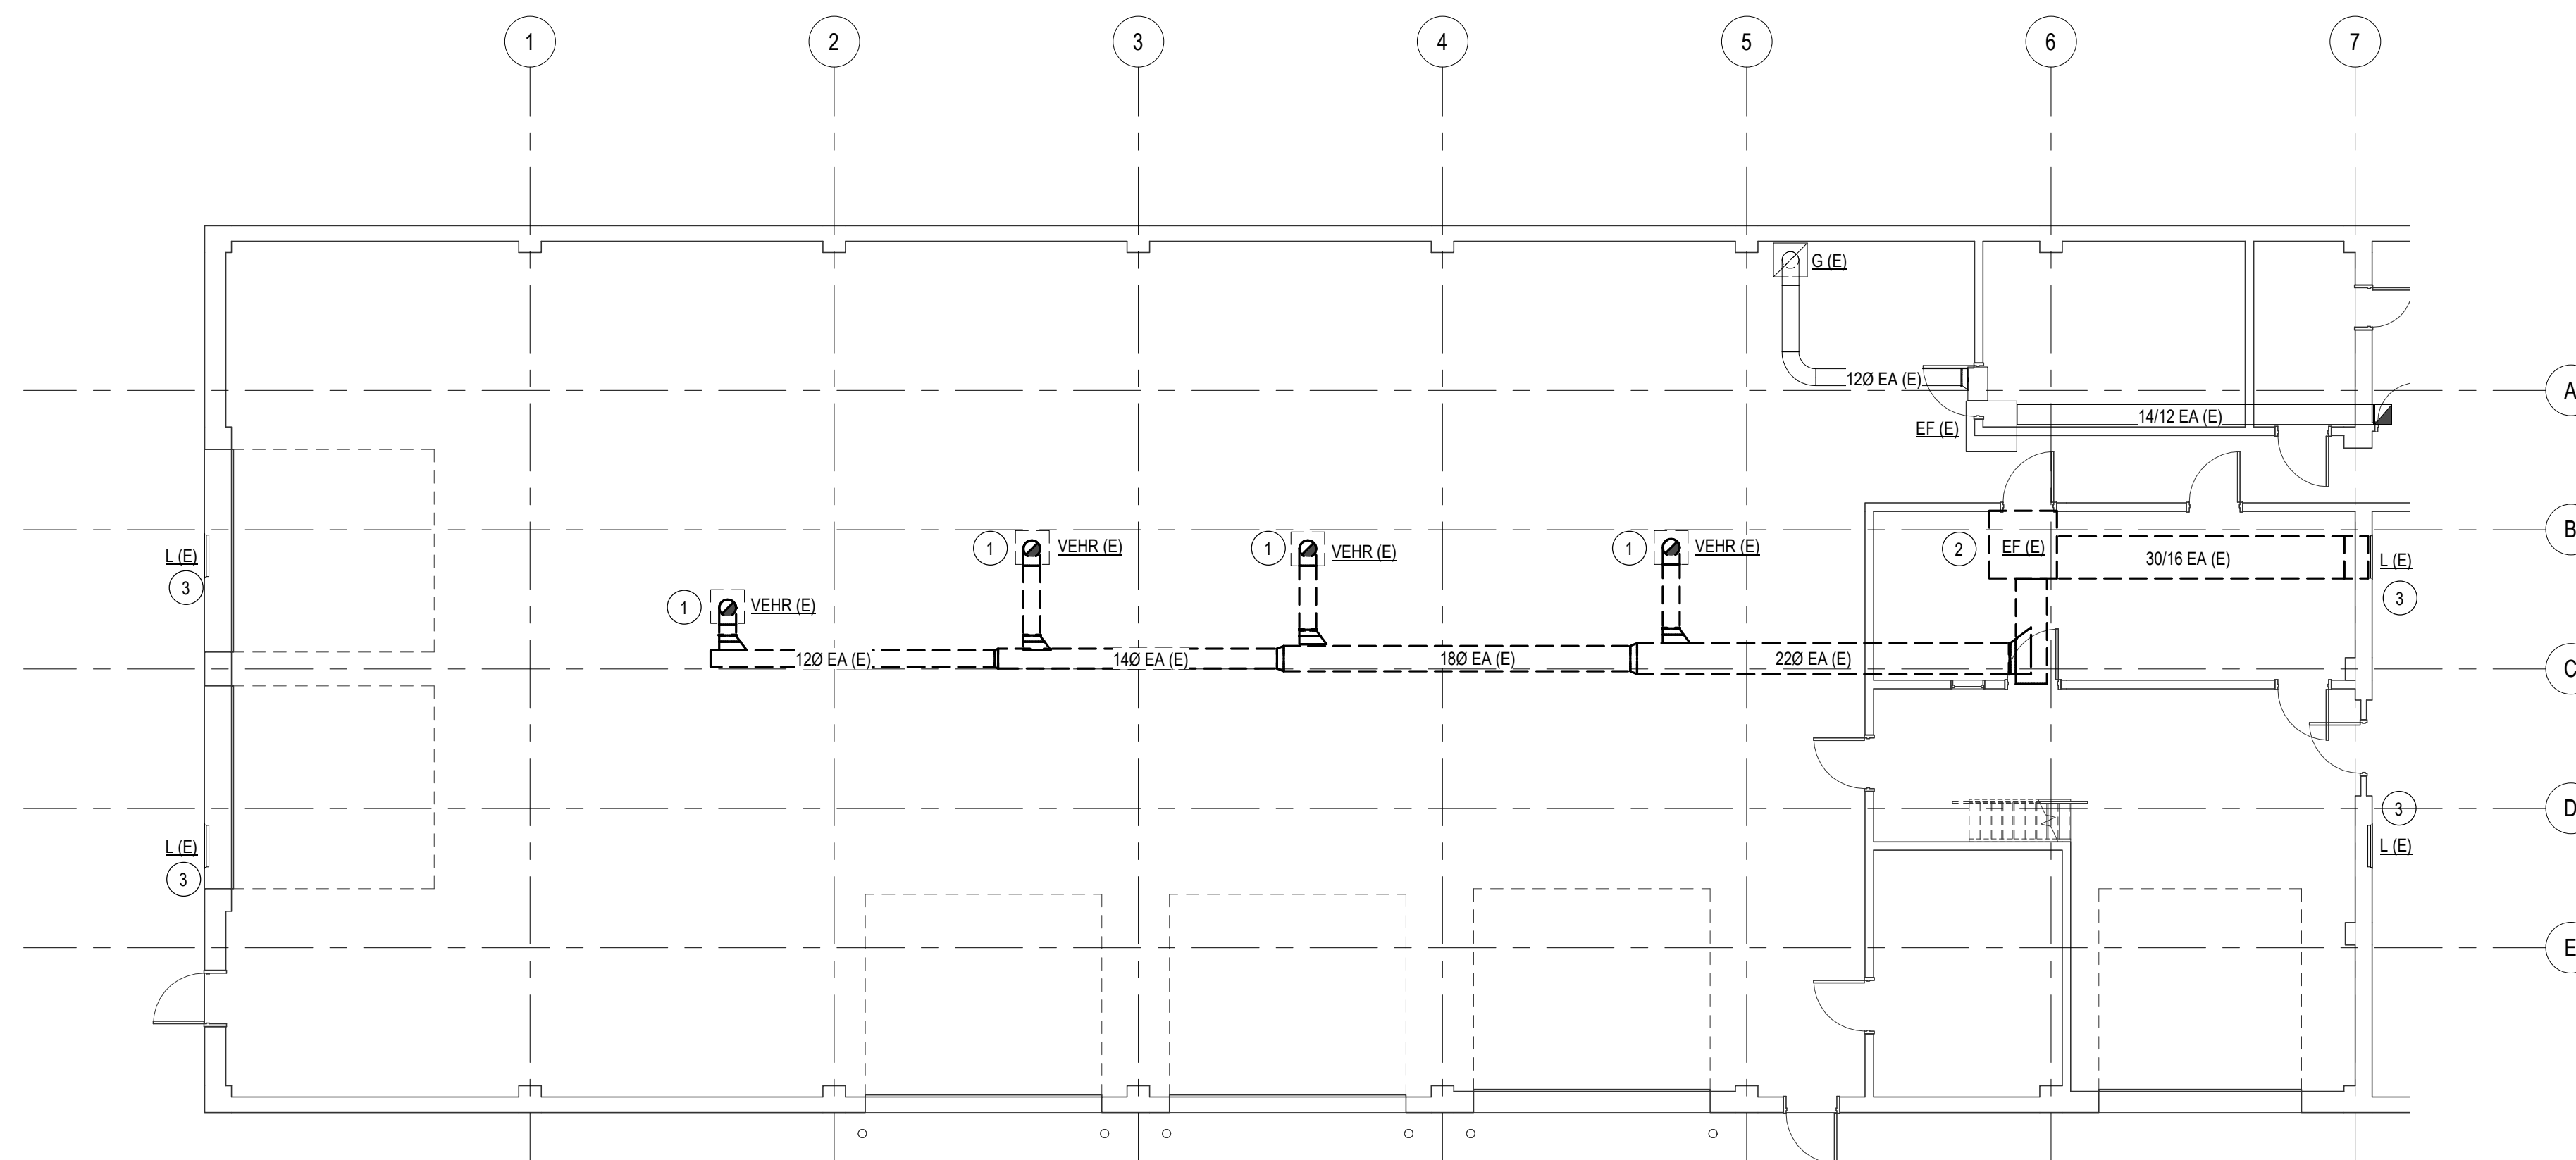
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CHECKED BY: JM  
DESIGNED BY: AR

SHEET TITLE:  
First Floor HVAC Plan

SHEET NUMBER:

**M-101**

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03/22/2023



**FIRST FLOOR HVAC DEMO PLAN**  
SCALE: 1/8" = 1'-0"


GENERAL NOTES:

1. ALL WORK TO BE DEMOLISHED IS SHOWN IN HEAVY, DASHED LINEWEIGHT. ALL WORK TO REMAIN AS EXISTING IS SHOWN IN LIGHT LINEWEIGHT.

2. REMOVE CEILING TILE AND GRID AS REQUIRED FOR EXHAUST DUCTWORK/HOSE REEL INSTALLATION.

KEY NOTES:

- ① CONTRACTOR TO REMOVE EXISTING VEHICLE EXHAUST HOSE REEL. VEHICLE EXHAUST HOSE REELS TO BE SALVAGED IF ALTERNATE #1 IS NOT ACCEPTED. SEE FIRST FLOOR HVAC PLAN FOR NEW LOCATION OF SALVAGED HOSE REELS.
- ② EXISTING EXHAUST FAN AND ASSOCIATED CONTROLS TO BE DEMOLISHED.
- ③ EXISTING LOUVERS TO REMAIN. PREPARE CONTROLS FOR NEW EXHAUST FAN.

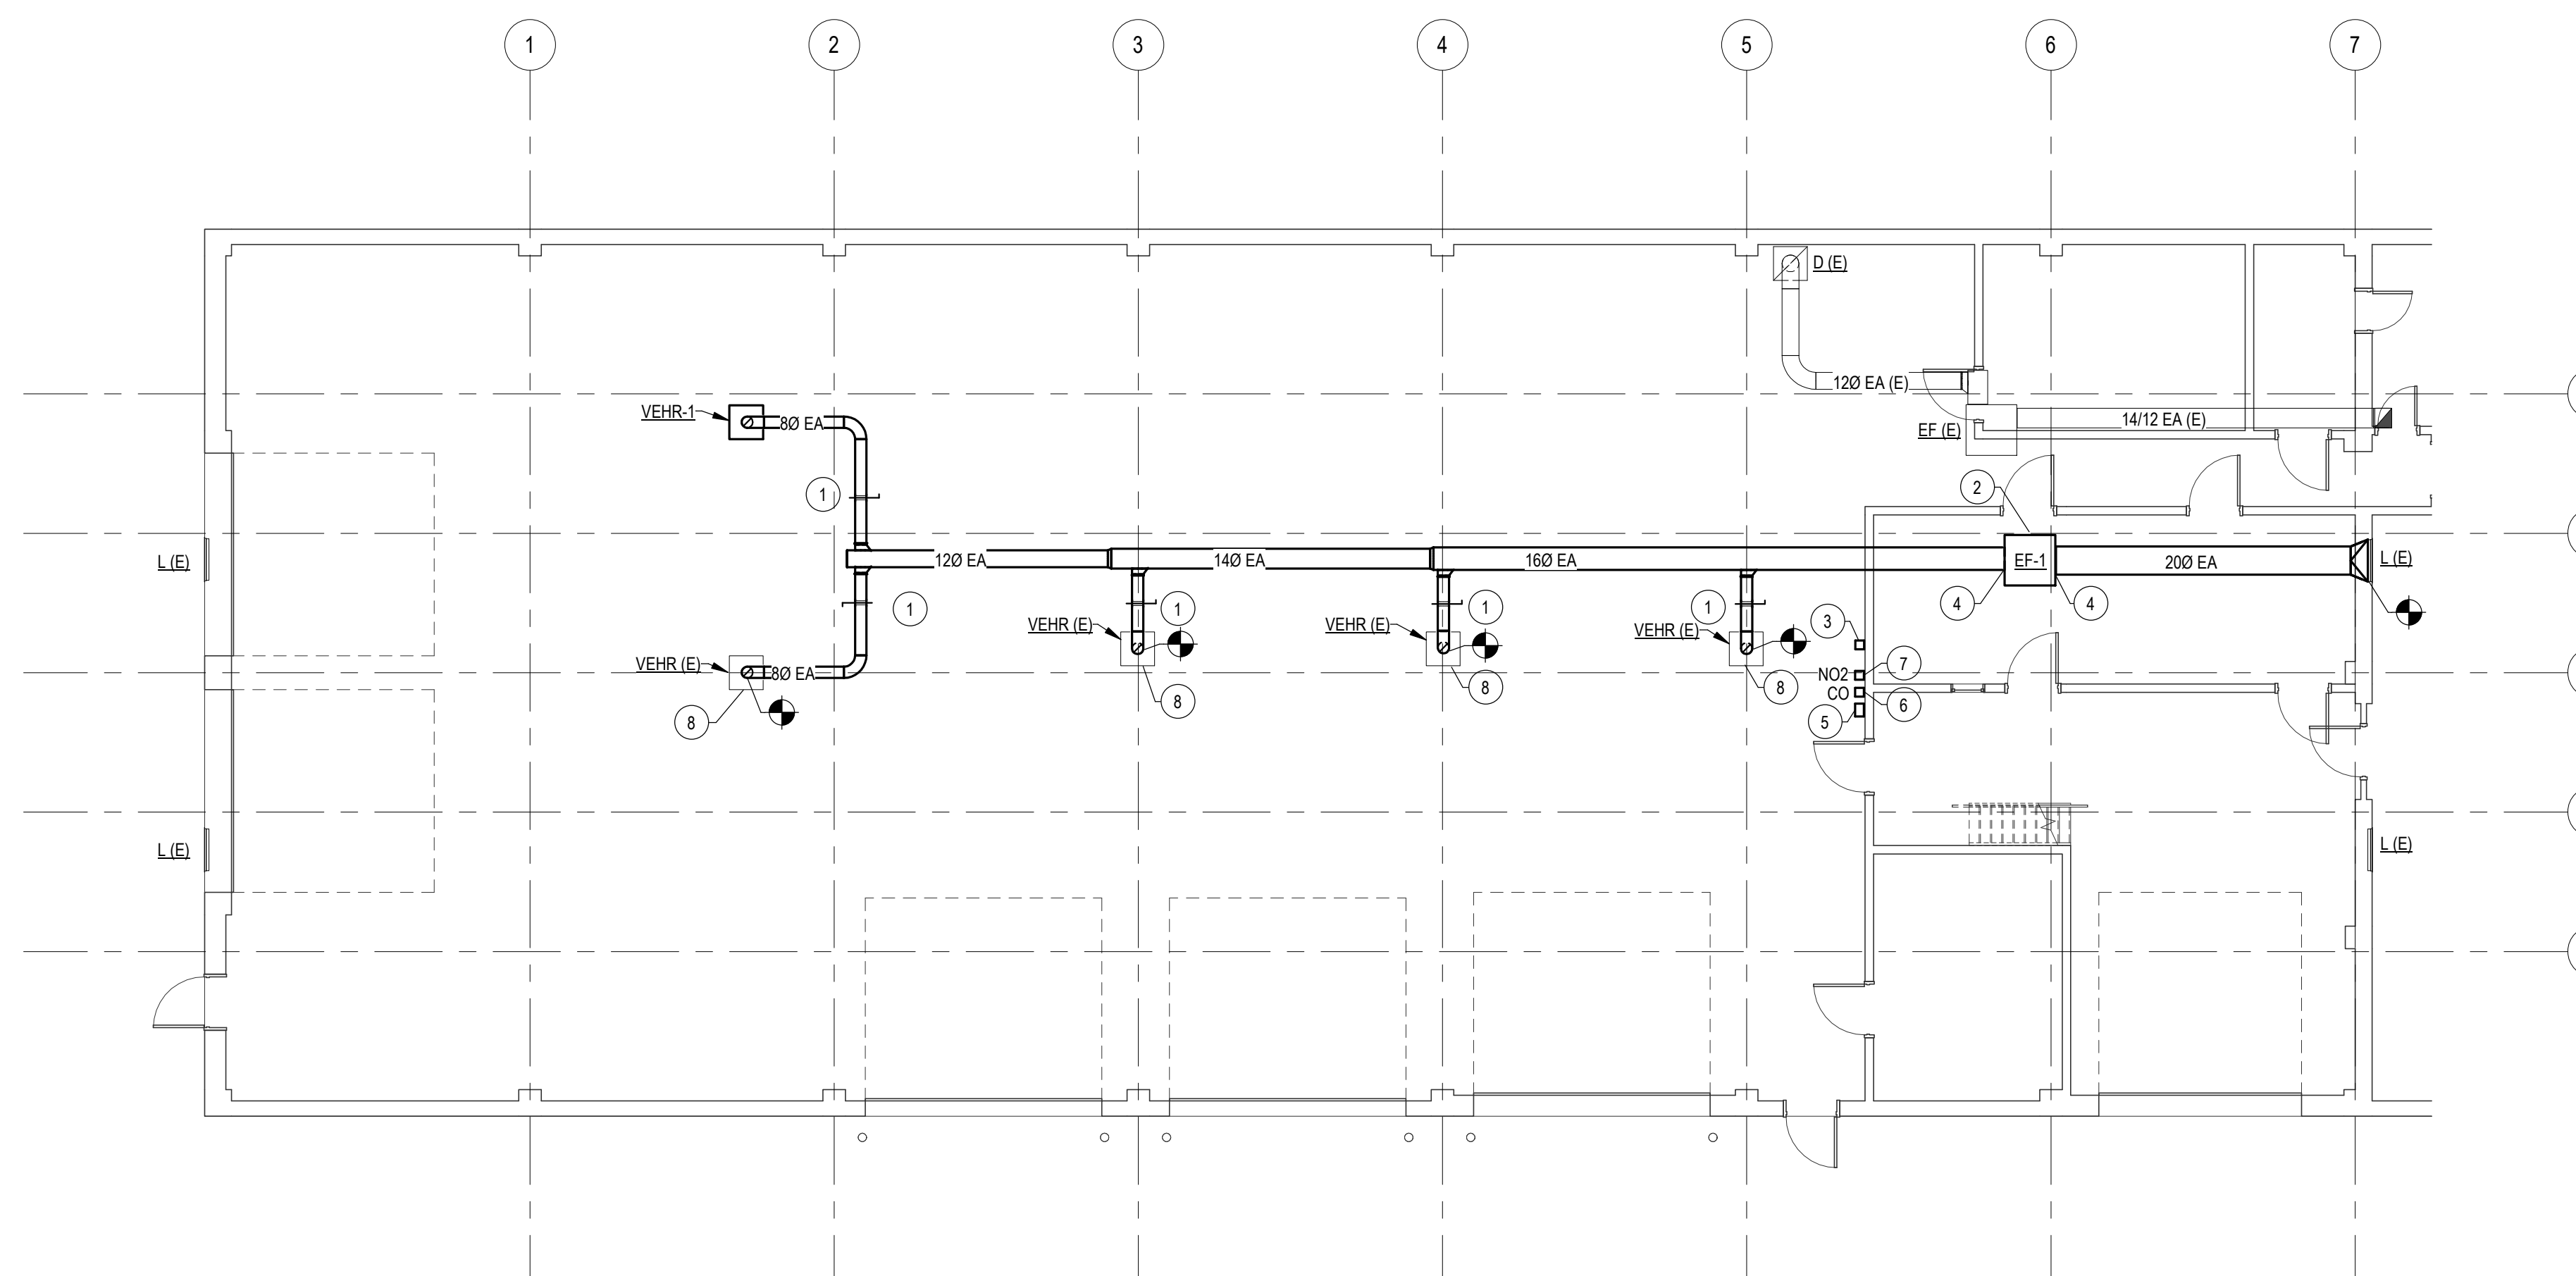

**FIRST FLOOR HVAC PLAN**  
SCALE: 1/8" = 1'-0"

GENERAL NOTES:

1. ALL NEW WORK IS SHOWN IN HEAVY LINEWEIGHT. ALL WORK TO REMAIN AS EXISTING IS SHOWN IN LIGHT LINEWEIGHT.

2. REMOVE AND SALVAGE EXISTING CEILING GRID AND ACOUSTICAL CEILING TILE AS NECESSARY TO INSTALL NEW OVERHEAD DUCTWORK. CEILING GRID MAIN TEES SHALL BE CUT TO GAIN ACCESS TO ABOVE CEILING AREAS AND SHALL BE SPLICED BACK TO CREATE A LIKE-NEW APPEARANCE. REINSTALL CEILING TILES UPON COMPLETION OF DUCTWORK INSTALLATION. REPLACE ANY CEILING TILES DAMAGED DURING CONSTRUCTION WITH A CEILING TILE PRODUCT THAT MATCHES THE EXISTING IN APPEARANCE AND COORDINATES WITH EXISTING GRID TEE SYSTEM.

KEY NOTES:

- ① BALANCE EXHAUST REEL TO 800 CFM.
- ② CONTRACTOR SHALL INSTALL EF-1 USING THE EXISTING STRUCTURE THAT PREVIOUSLY SUPPORTED THE DEMOLISHED EXHAUST FAN. FIELD VERIFY FINAL LOCATION AND MAKE MODIFICATIONS TO STRUCTURE/ROUTING AS NEEDED.
- ③ INSTALL EF-1 START/STOP PUSH BUTTON.
- ④ CONTRACTOR TO FIELD VERIFY FINAL CONNECTION SIZE INTO EF-1.
- ⑤ VEHICLE EXHAUST DETECTION CONTROL UNIT. TOXALERT MODEL #GVU-6 FOR CONTROL OF EF-1. REFER TO EF-1 CONTROL SCHEMATIC.
- ⑥ CARBON MONOXIDE SENSOR. TOXALERT MODEL #GVU-CO. MOUNT 46" AFF.
- ⑦ NITROGEN DIOXIDE SENSOR. TOXALERT MODEL #GVU-NO2. MOUNT 46" AFF.
- ⑧ IF ALTERNATE #1 IS ACCEPTED, CONTRACTOR IS TO PROVIDE AND INSTALL VEHR-1 IN PLACE OF VEHR (E). IF ALTERNATE #1 IS NOT ACCEPTED, CONTRACTOR IS TO REINSTALL SALVAGED HOSE REELS. VEHR (E) AS NOTED ON FIRST FLOOR HVAC DEMO PLAN. COORDINATE FINAL LOCATIONS OF HOSE REEL WITH END USER.

# ELECTRICAL ABBREVIATIONS AND SYMBOLS LEGEND

ABBREVIATIONS	LIGHTING	ELECTRICAL DISTRIBUTION	MOTOR CONTROL & MOTOR CONTROL EQUIPMENT
AFF ABOVE FINISHED FLOOR	POLE MOUNTED EXTERIOR LIGHT FIXTURE. LETTER INDICATES FIXTURE AND POLE TYPE.	S SINGLE POLE SWITCH	MOTOR - HORSEPOWER AS INDICATED ON DRAWINGS
AFG ABOVE FINISH GRADE	LINEAR FIXTURE. LETTERNUMBER DENOTES FIXTURE TYPE.	S <sub>2</sub> TWO POLE SWITCH	NON-FUSED DISCONNECT SWITCH, ASSUME 30A/3P UNLESS OTHERWISE NOTED.
C SUBSCRIPT 'C' ADJACENT TO ANY DEVICE INDICATES CEILING.	LINEAR FIXTURE WITH EMERGENCY BATTERY BACKUP AND/OR ON EM CIRCUIT. LETTERNUMBER DENOTES FIXTURE TYPE.	S <sub>3</sub> THREE WAY SWITCH	FUSED DISCONNECT SWITCH, FUSE SIZE AS NOTED ON DRAWINGS, ASSUME 30A/3P UNLESS OTHERWISE NOTED.
CATV CABLE TELEVISION	2 X 4 TROFFER. LETTERNUMBER DENOTES FIXTURE TYPE.	S <sub>4</sub> FOUR WAY SWITCH	COMBINATION FVNR MAGNETIC MOTOR STARTER WITH HOA SELECTOR SWITCH AND NON-FUSED DISCONNECT SWITCH, ASSUME NEMA SIZE 1 STARTER AND 30A/3P SWITCH UNLESS OTHERWISE NOTED.
CCTV CLOSED CIRCUIT TELEVISION	1 X 4 TROFFER. LETTERNUMBER DENOTES FIXTURE TYPE.	S <sub>P</sub> SINGLE POLE SWITCH WITH PILOT LIGHT	COMBINATION FVNR MAGNETIC MOTOR STARTER WITH HOA SELECTOR SWITCH AND FUSED DISCONNECT SWITCH, ASSUME NEMA SIZE 1 STARTER AND 30A/3P SWITCH UNLESS OTHERWISE NOTED.
DAS DISTRIBUTED ANTENNA SYSTEM	2 X 2 TROFFER WITH EMERGENCY BATTERY BACKUP AND/OR ON EM CIRCUIT. LETTERNUMBER DENOTES FIXTURE TYPE.	S <sub>D</sub> DIMMER SWITCH	MECHANICAL EQUIPMENT STARTER/DISCONNECT PROVIDED BY OTHERS, INSTALLED AND CONNECTED BY THE ELECTRICAL CONTRACTOR. FULLY COORDINATE ALL INSTALLATION AND CONNECTION DETAILS WITH THE MECHANICAL CONTRACTOR.
(E) SUBSCRIPT 'E' ADJACENT TO ANY DEVICE INDICATES EXISTING.	1 X 4 TROFFER WITH EMERGENCY BATTERY BACKUP AND/OR ON EM CIRCUIT. LETTERNUMBER DENOTES FIXTURE TYPE.	S <sub>MC</sub> MOMENTARY CONTACT SWITCH	FVNR MAGNETIC MOTOR STARTER WITH HOA SELECTOR SWITCH, ASSUME NEMA SIZE 1 STARTER UNLESS OTHERWISE NOTED.
EPO EMERGENCY POWER OFF	2 X 2 TROFFER WITH EMERGENCY BATTERY BACKUP AND/OR ON EM CIRCUIT. LETTERNUMBER DENOTES FIXTURE TYPE.	S <sub>TE</sub> THERMAL ELEMENT SWITCH	OCCUPANCY SENSING SWITCH, WATTSTOPPER #DW-100-G
(ER) SUBSCRIPT 'ER' ADJACENT TO ANY DEVICE INDICATES EXISTING TO BE RELOCATED.	2 X 2 TROFFER WITH EMERGENCY BATTERY BACKUP AND/OR ON EM CIRCUIT. LETTERNUMBER DENOTES FIXTURE TYPE.	S <sub>K</sub> KEYPAD SWITCH	LINE VOLTAGE DIGITAL TIMER SWITCH, WATTSTOPPER #TS-400
EWC ELECTRIC WATER COOLER	2 X 2 TROFFER WITH EMERGENCY BATTERY BACKUP AND/OR ON EM CIRCUIT. LETTERNUMBER DENOTES FIXTURE TYPE.	S <sub>Q</sub> SPST EXPLOSION PROOF SWITCH	LINE VOLTAGE 3-WAY DIGITAL TIMER SWITCH, WATTSTOPPER #TS-400
F SUBSCRIPT 'F' ADJACENT TO ANY DEVICE INDICATES FLOOR.	2 X 4 SURFACE OR PENDANT MOUNTED FIXTURE. LETTERNUMBER DENOTES FIXTURE TYPE. REFER TO DRAWINGS FOR FIXTURE MOUNTING HEIGHT.	S <sub>X</sub> SPST EXPLOSION PROOF SWITCH	SPST EXPLOSION PROOF SWITCH
GFI GROUND FAULT INTERRUPTER	2 X 4 SURFACE OR PENDANT MOUNTED FIXTURE WITH EMERGENCY BATTERY BACKUP AND/OR ON EM CIRCUIT. LETTERNUMBER DENOTES FIXTURE TYPE. REFER TO DRAWINGS FOR FIXTURE MOUNTING HEIGHT.	S <sub>2X</sub> DPST EXPLOSION PROOF SWITCH	DPST EXPLOSION PROOF SWITCH
H HAND-OFF-AUTO	2 X 4 TROFFER WITH EMERGENCY BATTERY BACKUP AND/OR ON EM CIRCUIT. RECESSED IN GWB OR PLASTER CEILING. LETTER DENOTES FIXTURE TYPE.	DIGITAL DENOTES CONNECTION TO EQUIPMENT	VARIABLE FREQUENCY DRIVE PROVIDED BY OTHERS, INSTALLED AND CONNECTED BY THE ELECTRICAL CONTRACTOR. FULLY COORDINATE ALL INSTALLATION AND CONNECTION DETAILS WITH THE MECHANICAL CONTRACTOR.
NE NON-FUSED	2 X 4 TROFFER WITH EMERGENCY BATTERY BACKUP AND/OR ON EM CIRCUIT. RECESSED IN GWB OR PLASTER CEILING. LETTER DENOTES FIXTURE TYPE.	BRANCH CIRCUIT HOMERUN TO PANEL (NUMBER OF ARROWS INDICATES NUMBER OF CIRCUITS. NUMBER OF TICK MARKS INDICATES NUMBER OF WIRES) (NUMBER 12AWG MINIMUM UNLESS OTHERWISE NOTED). # NO TICK MARKS ARE SHOWN, ASSUME 3- NUMBER 12 AWG IN 3/4" CONDUIT.	CONDUIT AND WIRE CONCEALED. NUMBER OF TICK MARKS INDICATES NUMBER OF WIRES (NUMBER 12AWG MINIMUM UNLESS OTHERWISE NOTED) IF NO TICK MARKS ARE SHOWN, ASSUME 3-NUMBER 12 IN 3/4" CONDUIT.
NIC NOT IN CONTRACT	SURFACE OR PENDANT MOUNTED FIXTURE. LETTERNUMBER DENOTES FIXTURE TYPE. REFER TO DRAWINGS FOR FIXTURE MOUNTING HEIGHT.	CONDUIT RISER UP	CONDUIT RISER DOWN
OHE OVERHEAD ELECTRICAL	SURFACE OR PENDANT MOUNTED FIXTURE WITH EMERGENCY BATTERY BACKUP AND/OR ON EM CIRCUIT. LETTERNUMBER DENOTES FIXTURE TYPE. REFER TO DRAWINGS FOR FIXTURE MOUNTING HEIGHT.	CONDUIT RISER DOWN	INDICATES BUSH AND CAP
OHT OVERHEAD TELEPHONE	2 X 2 SURFACE OR PENDANT MOUNTED FIXTURE. LETTERNUMBER DENOTES FIXTURE TYPE. REFER TO DRAWINGS FOR FIXTURE MOUNTING HEIGHT.	CONDUIT SEAL FITTING FOR HAZARDOUS AREAS	CONDUIT STUBBED UP 6" AFF AND CAPPED
PVC POLYVINYL CHLORIDE	2 X 2 SURFACE OR PENDANT MOUNTED FIXTURE WITH EMERGENCY BATTERY BACKUP AND/OR ON EM CIRCUIT. LETTERNUMBER DENOTES FIXTURE TYPE. REFER TO DRAWINGS FOR FIXTURE MOUNTING HEIGHT.	JUNCTION BOX - CEILING, FLOOR, AND WALL MOUNTING. WALL MOUNTED DEVICES SHALL BE FLUSH MOUNTED AT 18" AFF UNLESS OTHERWISE NOTED.	
(R) SUBSCRIPT 'R' ADJACENT TO ANY DEVICE INDICATES THE RELOCATED POSITION OF AN EXISTING DEVICE	WALL MOUNTED FIXTURE. LETTERNUMBER DENOTES FIXTURE TYPE. REFER TO DRAWINGS FOR FIXTURE MOUNTING HEIGHT.	LIGHTING AND APPLIANCE PANEL	
RGS RIGID GALVANIZED STEEL	WALL MOUNTED FIXTURE WITH EMERGENCY BATTERY BACKUP AND/OR ON EM CIRCUIT. LETTERNUMBER DENOTES FIXTURE TYPE. REFER TO DRAWINGS FOR FIXTURE MOUNTING HEIGHT.	(LIGHTING) RELAY PANEL	
(S) SUBSCRIPT 'S' ADJACENT TO ANY DEVICE INDICATES THE DEVICE IS TO BE SURFACE MOUNTED.	WALL MOUNTED FIXTURE WITH EMERGENCY BATTERY BACKUP AND/OR ON EM CIRCUIT. LETTERNUMBER DENOTES FIXTURE TYPE. REFER TO DRAWINGS FOR FIXTURE MOUNTING HEIGHT.	MOTOR CONTROL CENTER OR SWITCHBOARD	
TR TAMPER RESISTANT	1 X 4 TROFFER WITH EMERGENCY BATTERY BACKUP AND/OR ON EM CIRCUIT. RECESSED IN GWB OR PLASTER CEILING. LETTER DENOTES FIXTURE TYPE.	POWER PANEL (DISTRIBUTION)	
UGE UNDERGROUND ELECTRICAL	1 X 4 TROFFER WITH EMERGENCY BATTERY BACKUP AND/OR ON EM CIRCUIT. RECESSED IN GWB OR PLASTER CEILING. LETTER DENOTES FIXTURE TYPE.	TRANSFORMER	
USB UNIVERSAL SERIAL BUS	STRIP FIXTURE. LETTER DENOTES FIXTURE TYPE. REFER TO DRAWINGS FOR FIXTURE MOUNTING HEIGHT.	CIRCUIT BREAKER	
HVE UNDERGROUND MEDIUM OR HIGH VOLTAGE ELECTRICAL	STRIP FIXTURE WITH EMERGENCY BATTERY BACKUP AND/OR ON EM CIRCUIT. LETTER DENOTES FIXTURE TYPE. REFER TO DRAWINGS FOR FIXTURE MOUNTING HEIGHT.	FUSIBLE SWITCH	
UGT UNDERGROUND TELEPHONE	RECESSED, SURFACE OR PENDANT MOUNTED FIXTURE. LETTER DENOTES FIXTURE TYPE. REFER TO DRAWINGS FOR MOUNTING DETAILS AND MOUNTING HEIGHT.	AUTOMATIC TRANSFER SWITCH	
WAP WIRELESS ACCESS POINT	RECESSED, SURFACE OR PENDANT MOUNTED FIXTURE WITH EMERGENCY BATTERY BACKUP AND/OR ON EM CIRCUIT. LETTER DENOTES FIXTURE TYPE. REFER TO DRAWINGS FOR MOUNTING DETAILS AND HEIGHT.	POTENTIAL TRANSFORMER	
WG WIRE GUARD	WALL MOUNTED FIXTURE. LETTER DENOTES FIXTURE TYPE. REFER TO DRAWINGS FOR MOUNTING HEIGHT.	CURRENT TRANSFORMER	
WP WEATHERPROOF	BATTERY POWERED EMERGENCY LIGHT FIXTURE. REFER TO FIXTURE SCHEDULE ON DRAWINGS FOR FIXTURE TYPE. REFER TO DRAWINGS FOR FIXTURE MOUNTING HEIGHT.	GROUND	
WPU WEATHERPROOF IN-USE TYPE	WALL MOUNTED EXIT SIGN. PROVIDE DIRECTIONAL ARROWS AS SHOWN ON DRAWINGS. REFER TO FIXTURE SCHEDULE FOR FIXTURE TYPE. (DARKENED PORTION OF FIXTURE INDICATES ILLUMINATED FACES.)	ENGINE GENERATOR	
////// CROSS-HATCHING INDICATES REMOVAL	CEILING MOUNTED EXIT SIGN. PROVIDE DIRECTIONAL ARROWS AS SHOWN ON DRAWINGS. REFER TO FIXTURE SCHEDULE FOR FIXTURE TYPE. (DARKENED PORTION OF FIXTURE INDICATES ILLUMINATED FACES.)	REMOTE GENERATOR ANNUNCIATOR	
	<div style="border: 1px solid black; padding: 5px; width: fit-content; margin: auto;">REFERENCE LIGHTING SHEETS FOR ADDITIONAL LIGHTING CONTROL SYSTEM SYMBOLS</div>	METER	PANELBOARD TAG. SEE THE CORRESPONDING PANELBOARD SCHEDULE AND/OR ONE LINE DIAGRAM FOR ADDITIONAL INFORMATION.

## PROJECT GENERAL ELECTRICAL NOTES

### GENERAL DEMOLITION NOTES:

- ALL OF THE DEVICES SHOWN ON THE DEMOLITION PLANS ARE EXISTING. THE LOCATIONS OF EXISTING EQUIPMENT AND DEVICES WERE OBTAINED FROM PREVIOUS DRAWINGS AND SITE VISITS. THE LOCATIONS OF EXISTING EQUIPMENT AND DEVICES ARE SHOWN FOR THE CONVENIENCE OF THE CONTRACTOR. ACCURACY OF THE INFORMATION SHOWN IS NOT GUARANTEED. THE CONTRACTOR IS RESPONSIBLE FOR THE VERIFICATION OF ALL EXISTING CONDITIONS PRIOR TO SUBMITTING THE PROJECT BID. NO ADDITIONAL COMPENSATION WILL BE ALLOWED FOR CHANGES WHICH OCCUR AFTER BIDS ARE SUBMITTED WHICH ARE A RESULT OF EXISTING CONDITIONS. SITE VISITS PRIOR TO SUBMISSION OF BIDS MUST BE FULLY COORDINATED WITH THE OWNER.
- THE CONTRACTOR MUST FIELD VERIFY EXISTING CIRCUITING PRIOR TO COMMENCING ANY WORK. ALL BIDS MUST INCORPORATE THIS REQUIREMENT.
- DEVICES SHOWN WITH CROSS HATCHING, DASHED AND/OR SO NOTED SHALL BE REMOVED. ALL OTHER DEVICES SHALL BE RELOCATED. SHALL REMAIN, OR SHALL BE ABANDONED AS SHOWN, OR AS FOLLOWS:  
DEVICES SHALL BE COMPLETELY REMOVED FROM WALLS THAT ARE ALSO SHOWN TO BE REMOVED. DEVICES SHOWN TO BE REMOVED ON DRYWALL OR PLASTER TYPE WALLS THAT ARE TO REMAIN SHALL HAVE THE WALL SURFACE PATCHED TO MATCH THE EXISTING FINISH. FLUSH TYPE DEVICES SHOWN TO BE REMOVED ON CONCRETE OR BRICK TYPE WALLS THAT ARE TO REMAIN SHALL HAVE THE DEVICES REMOVED AND BOXES PROVIDED WITH BLANK COVER PLATES.
- CONDUITS SHALL BE COMPLETELY REMOVED FROM WALLS THAT ARE ALSO SHOWN TO BE REMOVED. CONCEALED CONDUITS MAY BE ABANDONED IN WALLS THAT ARE TO REMAIN. ALL CONDUITS AND BOXES THAT ARE SURFACE MOUNTED AND NO LONGER REQUIRE ACTIVE CIRCUITS SHALL BE REMOVED.
- THE CONDUCTORS FOR DEVICES SHOWN TO BE REMOVED SHALL BE DISCONNECTED AND REMOVED BACK TO THE PANEL, OR BACK TO THE NEXT DEVICE SHOWN TO REMAIN OR AS REQUIRED BY ACTUAL CIRCUITING. ACTUAL CIRCUITING MUST BE DETERMINED IN THE FIELD. ALL BIDS SHOULD INCORPORATE THIS REQUIREMENT. NO ADDITIONAL COMPENSATION WILL BE ALLOWED FOR CHANGES WHICH OCCUR AS A RESULT OF EXISTING CIRCUITING. CONTINUITY OF CIRCUITING SHALL BE MAINTAINED FOR ALL EXISTING CIRCUITS AS REQUIRED. CONTRACTOR SHALL PROVIDE ALL NECESSARY WIRE, CONDUIT, DEVICES AND CONNECTIONS TO ENSURE CIRCUIT CONTINUITY TO ALL NEW AND EXISTING EQUIPMENT.
- THE OWNER HAS THE RIGHT TO RETAIN ALL SALVAGEABLE MATERIAL. ANY MATERIAL THE OWNER CHOOSES NOT TO ACCEPT SHALL BE REMOVED FROM THE SITE AND DISPOSED OF BY THE CONTRACTOR.
- THE OWNER WILL OCCUPY PORTIONS OF THE FACILITY THROUGHOUT CONSTRUCTION. ELECTRICAL SYSTEMS TO OCCUPIED PORTIONS OF THE FACILITY MUST REMAIN IN OPERATION. THE ELECTRICAL CONTRACTOR MUST COORDINATE ALL PHASING REQUIREMENTS WITH THE GENERAL CONTRACTOR AND THE OWNER, AND MUST PROVIDE ALL NECESSARY DEVICES, EQUIPMENT, WIRE, CONDUIT, AND CONNECTIONS TO ENSURE PHASING AND OWNER OCCUPANCY REQUIREMENTS ARE SATISFIED. ALL BIDS SHOULD INCORPORATE THIS REQUIREMENT. NO ADDITIONAL COMPENSATION WILL BE ALLOWED FOR ISSUES AND CHANGES WHICH OCCUR AS A RESULT OF PHASING AND OWNER OCCUPANCY REQUIREMENTS.

### GENERAL LIGHTING NOTES:

- COORDINATE THE INSTALLATION OF LIGHTING FIXTURES WITH ALL OTHER TRADES.
- COORDINATE THE INSTALLATION OF ALL RECESSED LIGHTING FIXTURES WITH ACTUAL CEILING TYPES. REFER TO ARCHITECTURAL FINISH SCHEDULES FOR ADDITIONAL DETAILS.
- SUPPORT ALL RECESSED AND PENDANT MOUNTED FIXTURES FROM STRUCTURE IN ACCORDANCE WITH APPLICABLE BUILDING CODE REQUIREMENTS. SUSPENDED CEILING MOUNTING SYSTEMS SHALL NOT BE USED TO SUPPORT FIXTURES OR RACKWAYS.
- ROUTE ALL WIRE AND CONDUIT CONCEALED UNLESS OTHERWISE NOTED. PATCH ALL EXISTING SURFACES AFTER WIRE AND CONDUIT INSTALLATION, AS REQUIRED. REFER TO THE SPECIFICATION FOR CUTTING AND PATCHING REQUIREMENTS. ALL COSTS ASSOCIATED WITH ABOVE REQUIREMENTS MUST BE INCLUDED IN THE PROJECT BID.
- FLUSH MOUNT ALL NEW WIRING DEVICES IN NEW OR EXISTING SURFACES. THE OWNER HAS THE RIGHT TO RETAIN ALL SALVAGEABLE MATERIAL. ANY MATERIAL THE OWNER CHOOSES NOT TO ACCEPT SHALL BE REMOVED FROM THE SITE AND DISPOSED OF BY THE CONTRACTOR.
- IN ROOMS WHERE NO FIXTURES ARE SHOWN, THE EXISTING LIGHTING LAYOUT AND CIRCUITING TO REMAIN.
- A DEDICATED NEUTRAL CONDUCTOR IS REQUIRED FOR ALL DIMMABLE CIRCUITS.
- BOX AROUND RECESSED LIGHTING FIXTURES AS REQUIRED SO THAT ALL CODE REQUIRED CLEARANCES BETWEEN COMBUSTIBLE MATERIALS, THERMAL INSULATION, ETC AND LIGHTING FIXTURES ARE MAINTAINED. FULLY COORDINATE ALL REQUIREMENTS WITH THE GENERAL CONTRACTOR.
- PROVIDE ENCLOSURES OVER RECESSED LIGHTING FIXTURES INSTALLED IN RATED CEILINGS SO ALL CODE REQUIRED RATINGS ARE MAINTAINED. REFER TO ARCHITECTURAL DRAWINGS FOR CEILING TYPES AND RATINGS. FULLY COORDINATE ALL REQUIREMENTS WITH THE GENERAL CONTRACTOR.
- SEAL AROUND ALL CONDUIT AND CABLE PENETRATIONS THROUGH WALLS, CEILINGS, AND FLOORS TO MAINTAIN CODE REQUIRED RATINGS. REFER TO ARCHITECTURAL DRAWINGS FOR ADDITIONAL INFORMATION.
- REFER TO THE LIGHTING FIXTURE SCHEDULE FOR ADDITIONAL INFORMATION.


### GENERAL POWER & AUXILIARY SYSTEMS NOTES:


- FULLY COORDINATE THE INSTALLATION OF ALL ELECTRICAL DEVICES WITH THE WORK OF OTHER TRADES.
- UNLESS OTHERWISE NOTED, ELECTRICAL DEVICES ARE TO BE FLUSH MOUNTED AND ALL WIRE AND CONDUIT IS TO BE ROUTED CONCEALED. FULLY COORDINATE INSTALLATION WITH EXISTING CONDITIONS, AND INCLUDE PATCHING AND REFINISHING OF EXISTING SURFACES TO ACCOMMODATE THIS REQUIREMENT.
- SEAL AROUND ALL CONDUIT AND CABLE PENETRATIONS THROUGH WALLS, CEILINGS AND FLOORS TO MAINTAIN CODE REQUIRED RATINGS. REFER TO ARCHITECTURAL DRAWINGS FOR ADDITIONAL INFORMATION.
- FULLY COORDINATE THE LOCATION OF ALL HVAC EQUIPMENT WITH THE MECHANICAL AND CONTROLS CONTRACTORS. PROVIDE ALL DEVICES (I.E. STARTERS, SWITCHES, CONTACTS, ETC.) REQUIRED TO ENSURE SATISFACTORY OPERATION OF ALL SYSTEMS AND EQUIPMENT. (CONTROL WIRING TO BE PROVIDED BY MECHANICAL CONTRACTOR). COORDINATE DEVICE REQUIREMENTS WITH ACTUAL EQUIPMENT.
- FOR ALL HVAC CONTROL DEVICES PROVIDED BY THE ELECTRICAL CONTRACTOR, PROVIDE ALL NECESSARY AUXILIARY COMPONENTS AND CONTACTS TO ENSURE PROPER SYSTEM CONTROL FUNCTIONS. FULLY COORDINATE ALL REQUIREMENTS WITH THE MECHANICAL AND CONTROLS CONTRACTORS.

### GENERAL PHOTOVOLTAIC SYSTEM NOTES:

- THIS PHOTOVOLTAIC (PV) SYSTEM SHALL COMPLY WITH THE NATIONAL ELECTRICAL CODE (NEC) ARTICLE 690. ALL MANUFACTURERS LISTING AND INSTALLATION INSTRUCTIONS, AND THE RELEVANT CODES AS SPECIFIED BY THE AUTHORITY HAVING JURISDICTIONS (AHJ) APPLICABLE CODES.
- GROUND FAULT DETECTION AND INTERRUPTION DEVICE IS INTEGRATED WITH THE INVERTER IN ACCORDANCE WITH NEC 690.5(A).
- UTILITY INTERCONNECTION MUST BE REVIEWED AND APPROVED. CONTRACTOR TO COORDINATE PV SYSTEM INSPECTION WITH UTILITY PROVIDER PRIOR TO PARALLEL OPERATION.
- LOAD-SIDE INTERCONNECTION SHALL BE IN ACCORDANCE WITH NEC 90.6(4)(B).
- ALL PV SYSTEM COMPONENTS, MODULES, UTILITY-INTERACTIVE INVERTERS, AND SOURCE CIRCUIT COMBINER BOXES ARE IDENTIFIED AND LISTED FOR USE IN PV SYSTEM AS REQUIRED BY NEC 690.4 & NEC 690.50.

UNLESS OTHERWISE INDICATED PROVIDE DEDICATED NEUTRAL CONDUCTORS FOR ALL BRANCH CIRCUITS. NEUTRAL CONDUCTORS SHALL NOT BE SHARED BETWEEN CIRCUITS. WHERE THE DRAWINGS INDICATE SHARED NEUTRAL CONDUCTORS FOR A MULTIWIRE BRANCH CIRCUIT, GROUP BREAKERS TOGETHER IN ACCORDANCE WITH CODE.

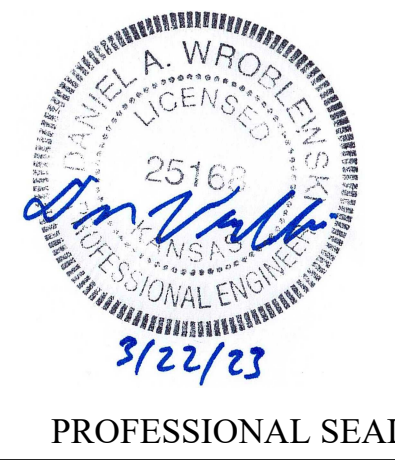

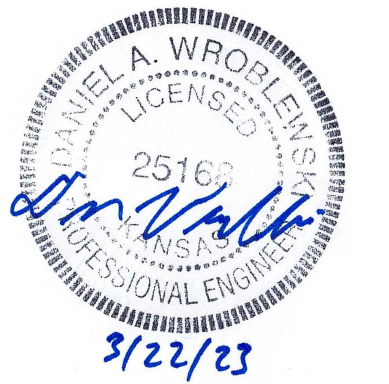

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SOLAR ARRAY, INTERIOR  
LED LIGHTING AND  
EXHAUST SYSTEM

MARSHALL FIELD  
MAINTENANCE SHOP

475 S. DAVIS AVE.  
MARSHALL, MO 65340

PROJECT #: T2044-01

SITE #: 6265

ASSET #: 8136265009

REVISION: \_\_\_\_\_  
DATE: \_\_\_\_\_  
REVISION: \_\_\_\_\_  
DATE: \_\_\_\_\_  
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DATE: \_\_\_\_\_


ISSUE DATE: 03/22/2023

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DESIGNED BY: AS

SHEET TITLE:  
Electrical Site  
Plan

SHEET NUMBER:

**E-001**

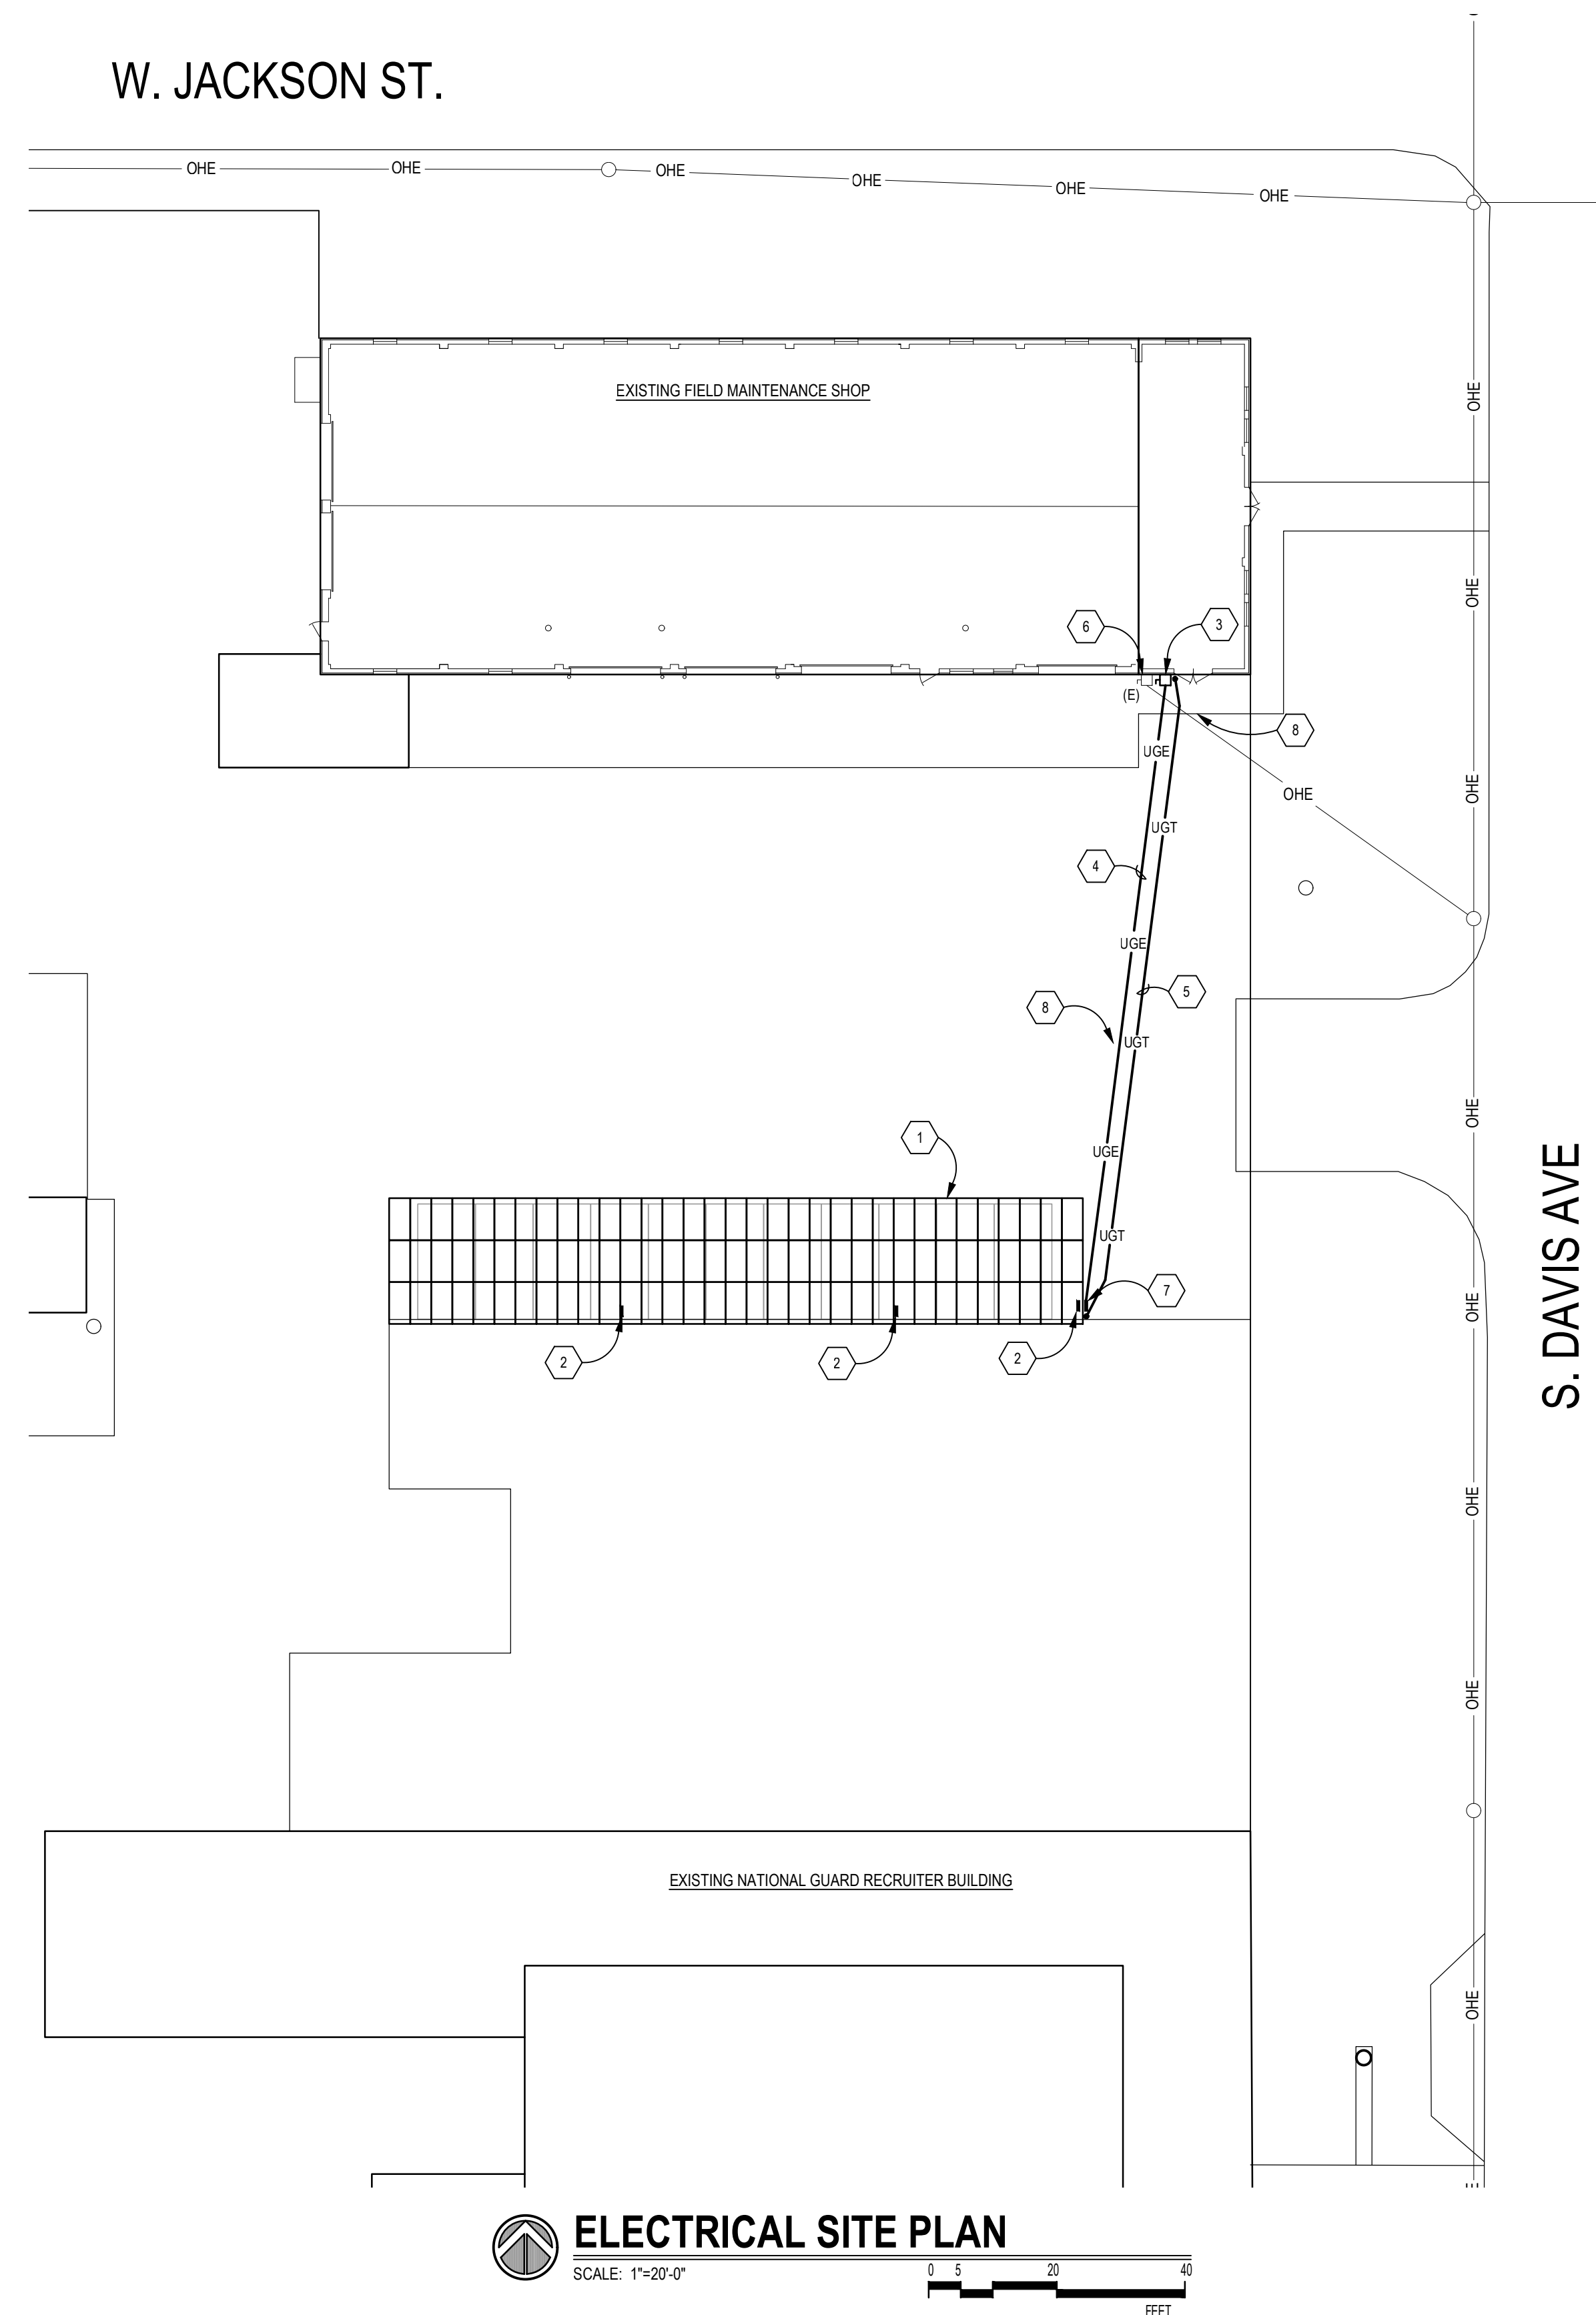

ELECTRICAL SITE PLAN NOTES	
KEY NOTE	DESCRIPTION
1	LOCATION OF 37.1 KW CANOPY MOUNT PV SYSTEM. CANOPY TO ACCOMMODATE 10' WIDE VEHICLE PARKING STALLS WITH COLUMNS 20'-0" ON CENTER. COORDINATE EXACT LOCATION WITH OWNER. SEE THE ELECTRICAL ONE-LINE DIAGRAM AND SPECIFICATIONS FOR MORE INFORMATION.
2	LOCATION OF SURFACE MOUNT PV SYSTEM INVERTER. SEE CANOPY PV MOUNTING DETAIL, ELECTRICAL ONE-LINE DIAGRAM, AND SPECIFICATIONS FOR MORE INFORMATION.
3	LOCATION OF PV SYSTEM SAFETY DISCONNECT MOUNTED ADJACENT TO EXISTING ELECTRICAL SERVICE TRANSFER SWITCH. COORDINATE EXACT LOCATION, SEE THE ELECTRICAL ONE-LINE DIAGRAM AND SPECIFICATIONS FOR MORE INFORMATION.
4	PV SYSTEM SERVICE FEEDERS. BURY A MINIMUM OF 36" BELOW GRADE. PROVIDE WARNING TAPE 12" ABOVE. COORDINATE ROUTING WITH OWNER. SEE THE ELECTRICAL ONE-LINE DIAGRAM FOR ADDITIONAL INFORMATION.
5	1" SCH 40 PVC CONDUIT FOR ROUTING OF COMMUNICATION CABLING. STUB CONDUIT 6" ABOVE FINISHED GRADE AND PROVIDE WITH PULL STRING. COORDINATE ROUTING WITH OWNER.
6	LOCATION OF EXISTING ELECTRICAL UTILITY SERVICE TRANSFER SWITCH. SEE ELECTRICAL ONE-LINE DIAGRAM FOR EXTENT OF WORK AND MORE INFORMATION.
7	LOCATION OF AGGREGATION PANEL. PROVIDE UNISTRUT MOUNTING AS APPLICABLE. SEE ELECTRICAL ONE-LINE DIAGRAM FOR MORE INFORMATION.
8	DEMOLISH EXISTING CONCRETE (APPROX. 45 SQFT) AND ASPHALT (APPROX. 200 SQ FT) AS REQUIRED FOR INSTALLATION OF NEW UNDERGROUND CONDUITS AND PV STRUCTURAL SYSTEM. PROVIDE WITH NEW PAVING TO MATCH EXISTING.



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PROJECT #: T2044-01

SITE #: 6265  
ASSET #: 8136265009

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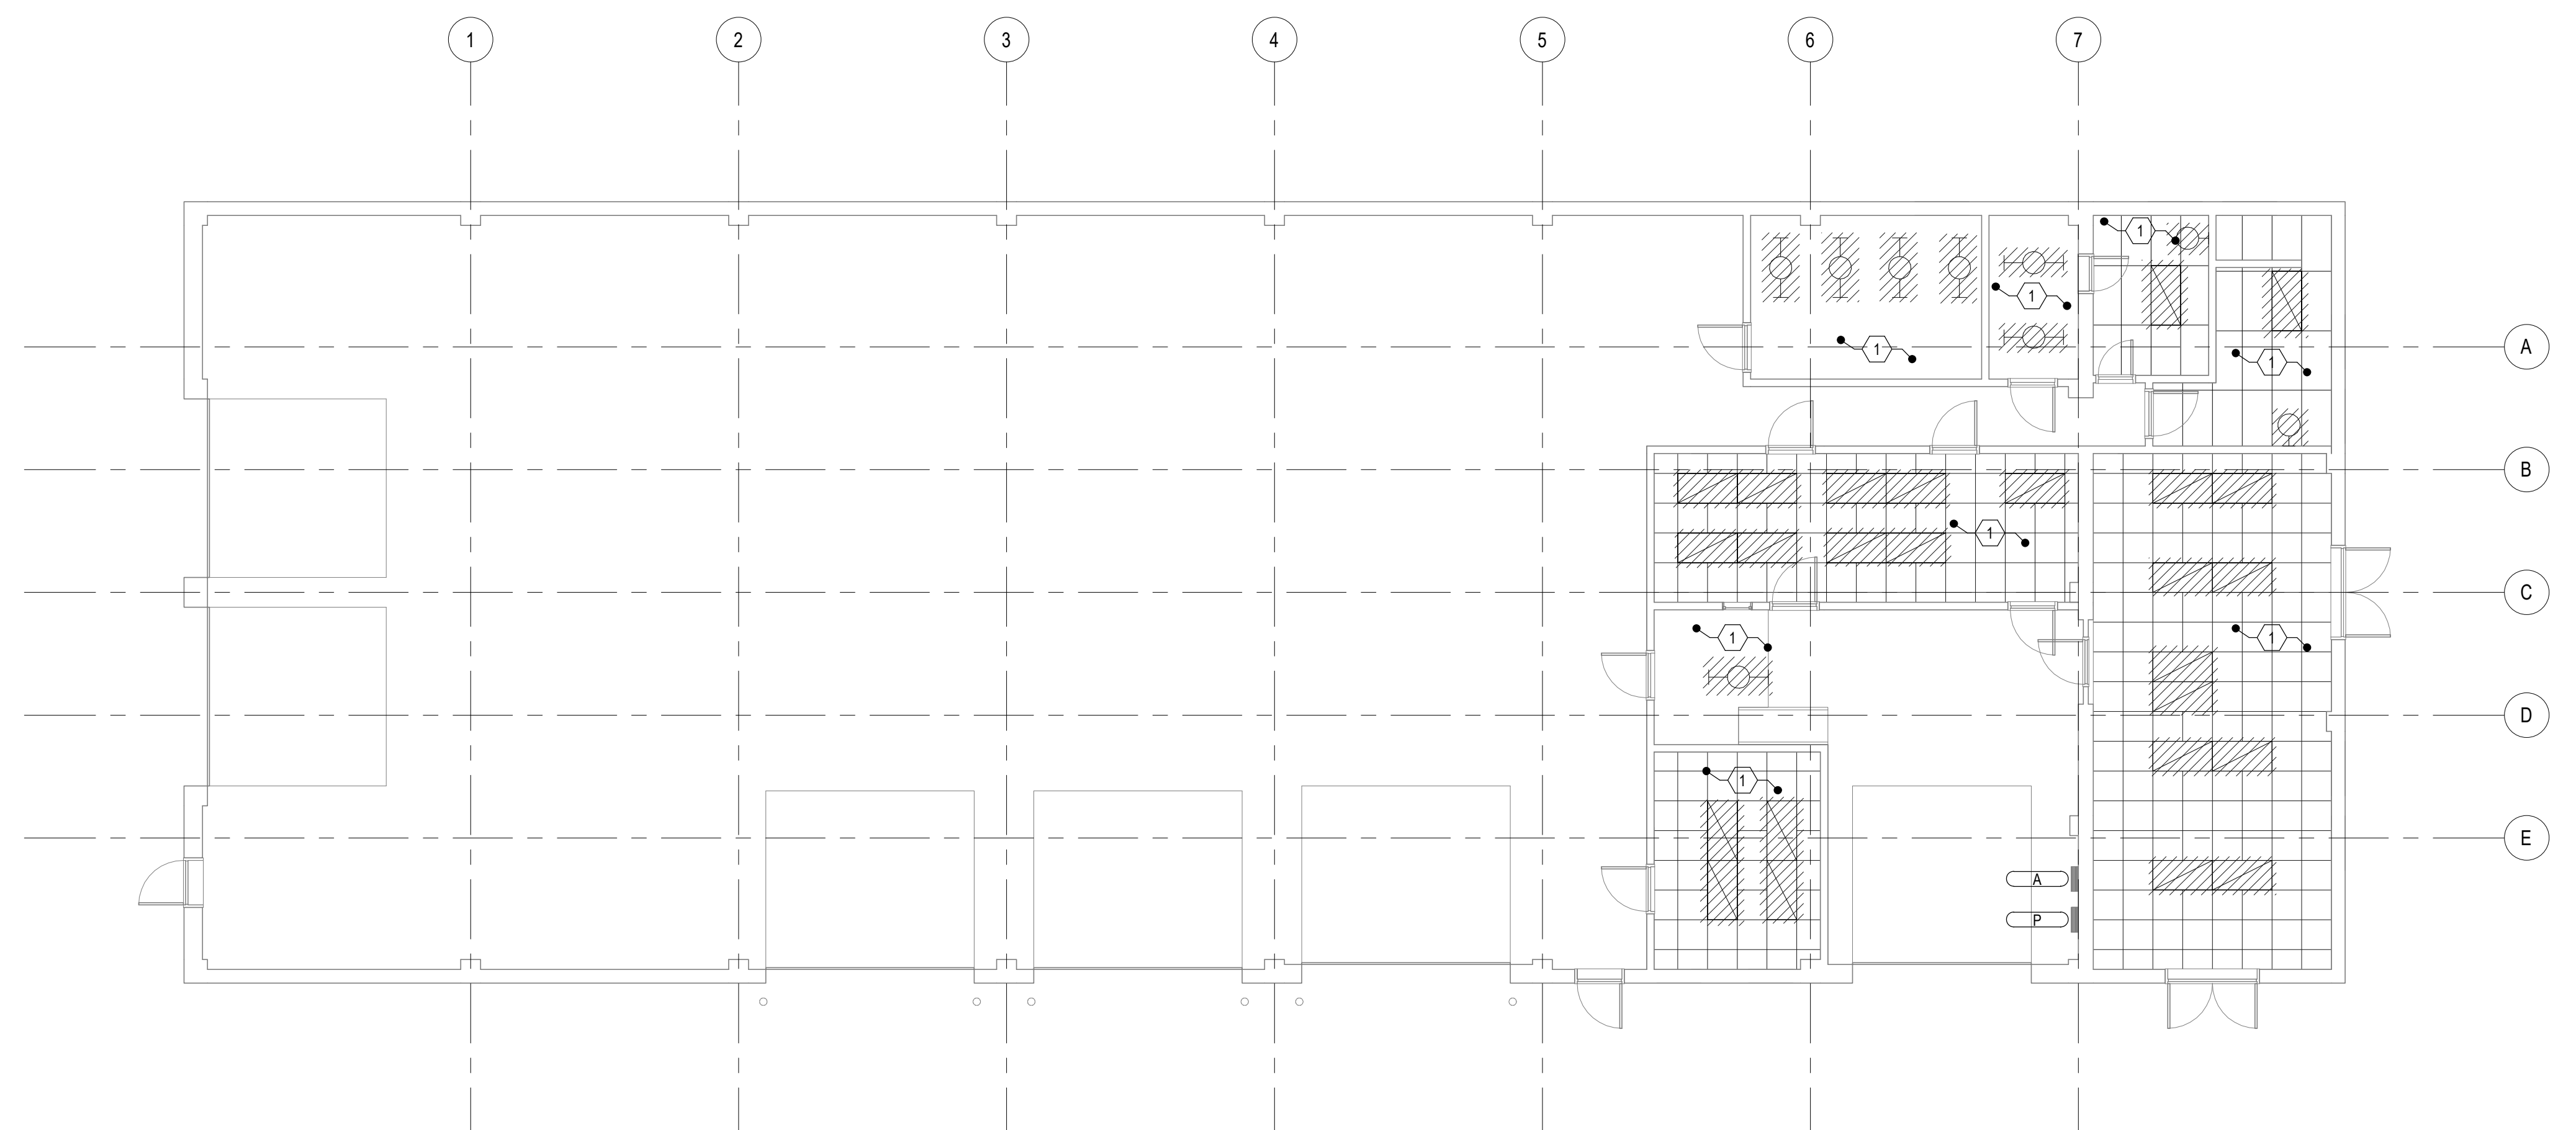
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SHEET TITLE:  
Electrical Demolition  
Plans

SHEET NUMBER:

## E-010

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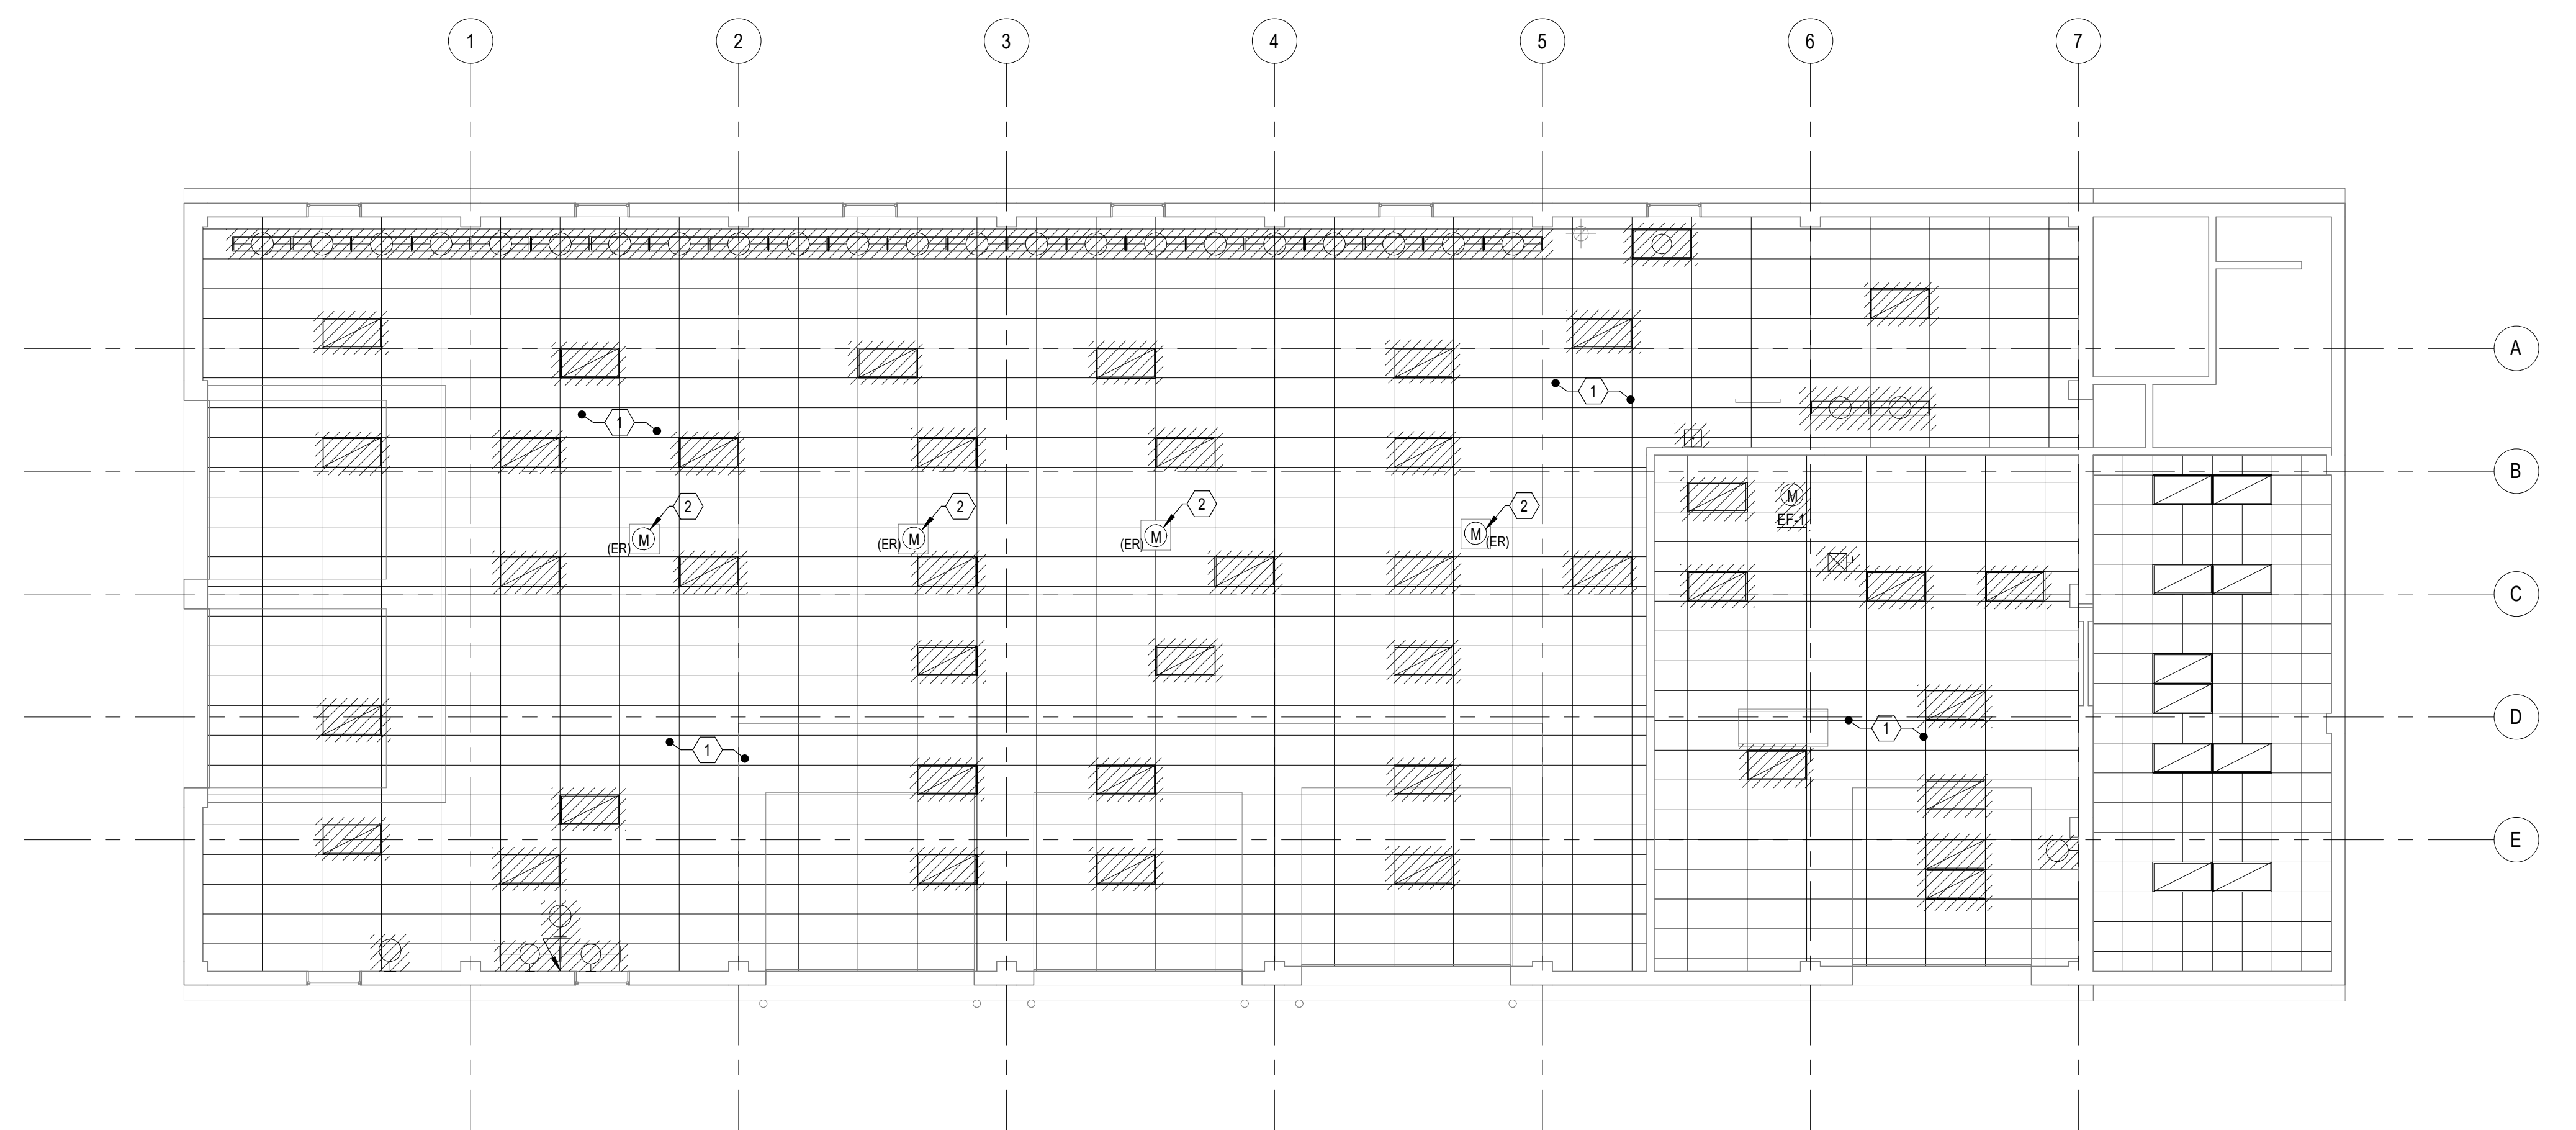
FIRST FLOOR ELECTRICAL DEMOLITION PLAN NOTES	
KEY NOTE	DESCRIPTION
①	EXISTING LIGHT FIXTURES TO BE DEMOLISHED ONLY. EXISTING LIGHTING CONTROLS AND CIRCUITRY TO REMAIN FOR RE-UTILIZATION. REFER TO GENERAL DEMOLITION NOTES FOR FURTHER INFORMATION.

**FIRST FLOOR LIGHTING DEMOLITION PLAN**

SCALE: 1/8" = 1'-0"



ALL DEVICES SHOWN 'DARK' AND HATCHED ARE TO BE DEMOLISHED. ALL DEVICES SHOWN 'LIGHT' ARE EXISTING TO REMAIN.



SECOND FLOOR ELECTRICAL DEMOLITION PLAN NOTES	
KEY NOTE	DESCRIPTION
①	EXISTING LIGHT FIXTURES TO BE DEMOLISHED ONLY. EXISTING LIGHTING CONTROLS AND CIRCUITRY TO REMAIN FOR RE-UTILIZATION. REFER TO GENERAL DEMOLITION NOTES FOR FURTHER INFORMATION.
②	REMOVE ELECTRICAL CONNECTIONS TO HOSE REEL. SALVAGE CIRCUIT FOR RECONNECTION AT NEW HOSE REEL LOCATION. REFERENCE SECOND FLOOR POWER & AUXILIARY SYSTEMS PLAN FOR ADDITIONAL INFORMATION. EXISTING HOSE REEL TO BE SALVAGED AND RELOCATION; SHALL BE BID AS BASE BID. EXISTING HOSE REEL TO BE DEMOLISHED AND REPLACED; SHALL BE BID AS PART OF ALTERNATE #1.

**SECOND FLOOR ELECTRICAL DEMOLITION PLAN**

SCALE: 1/8" = 1'-0"





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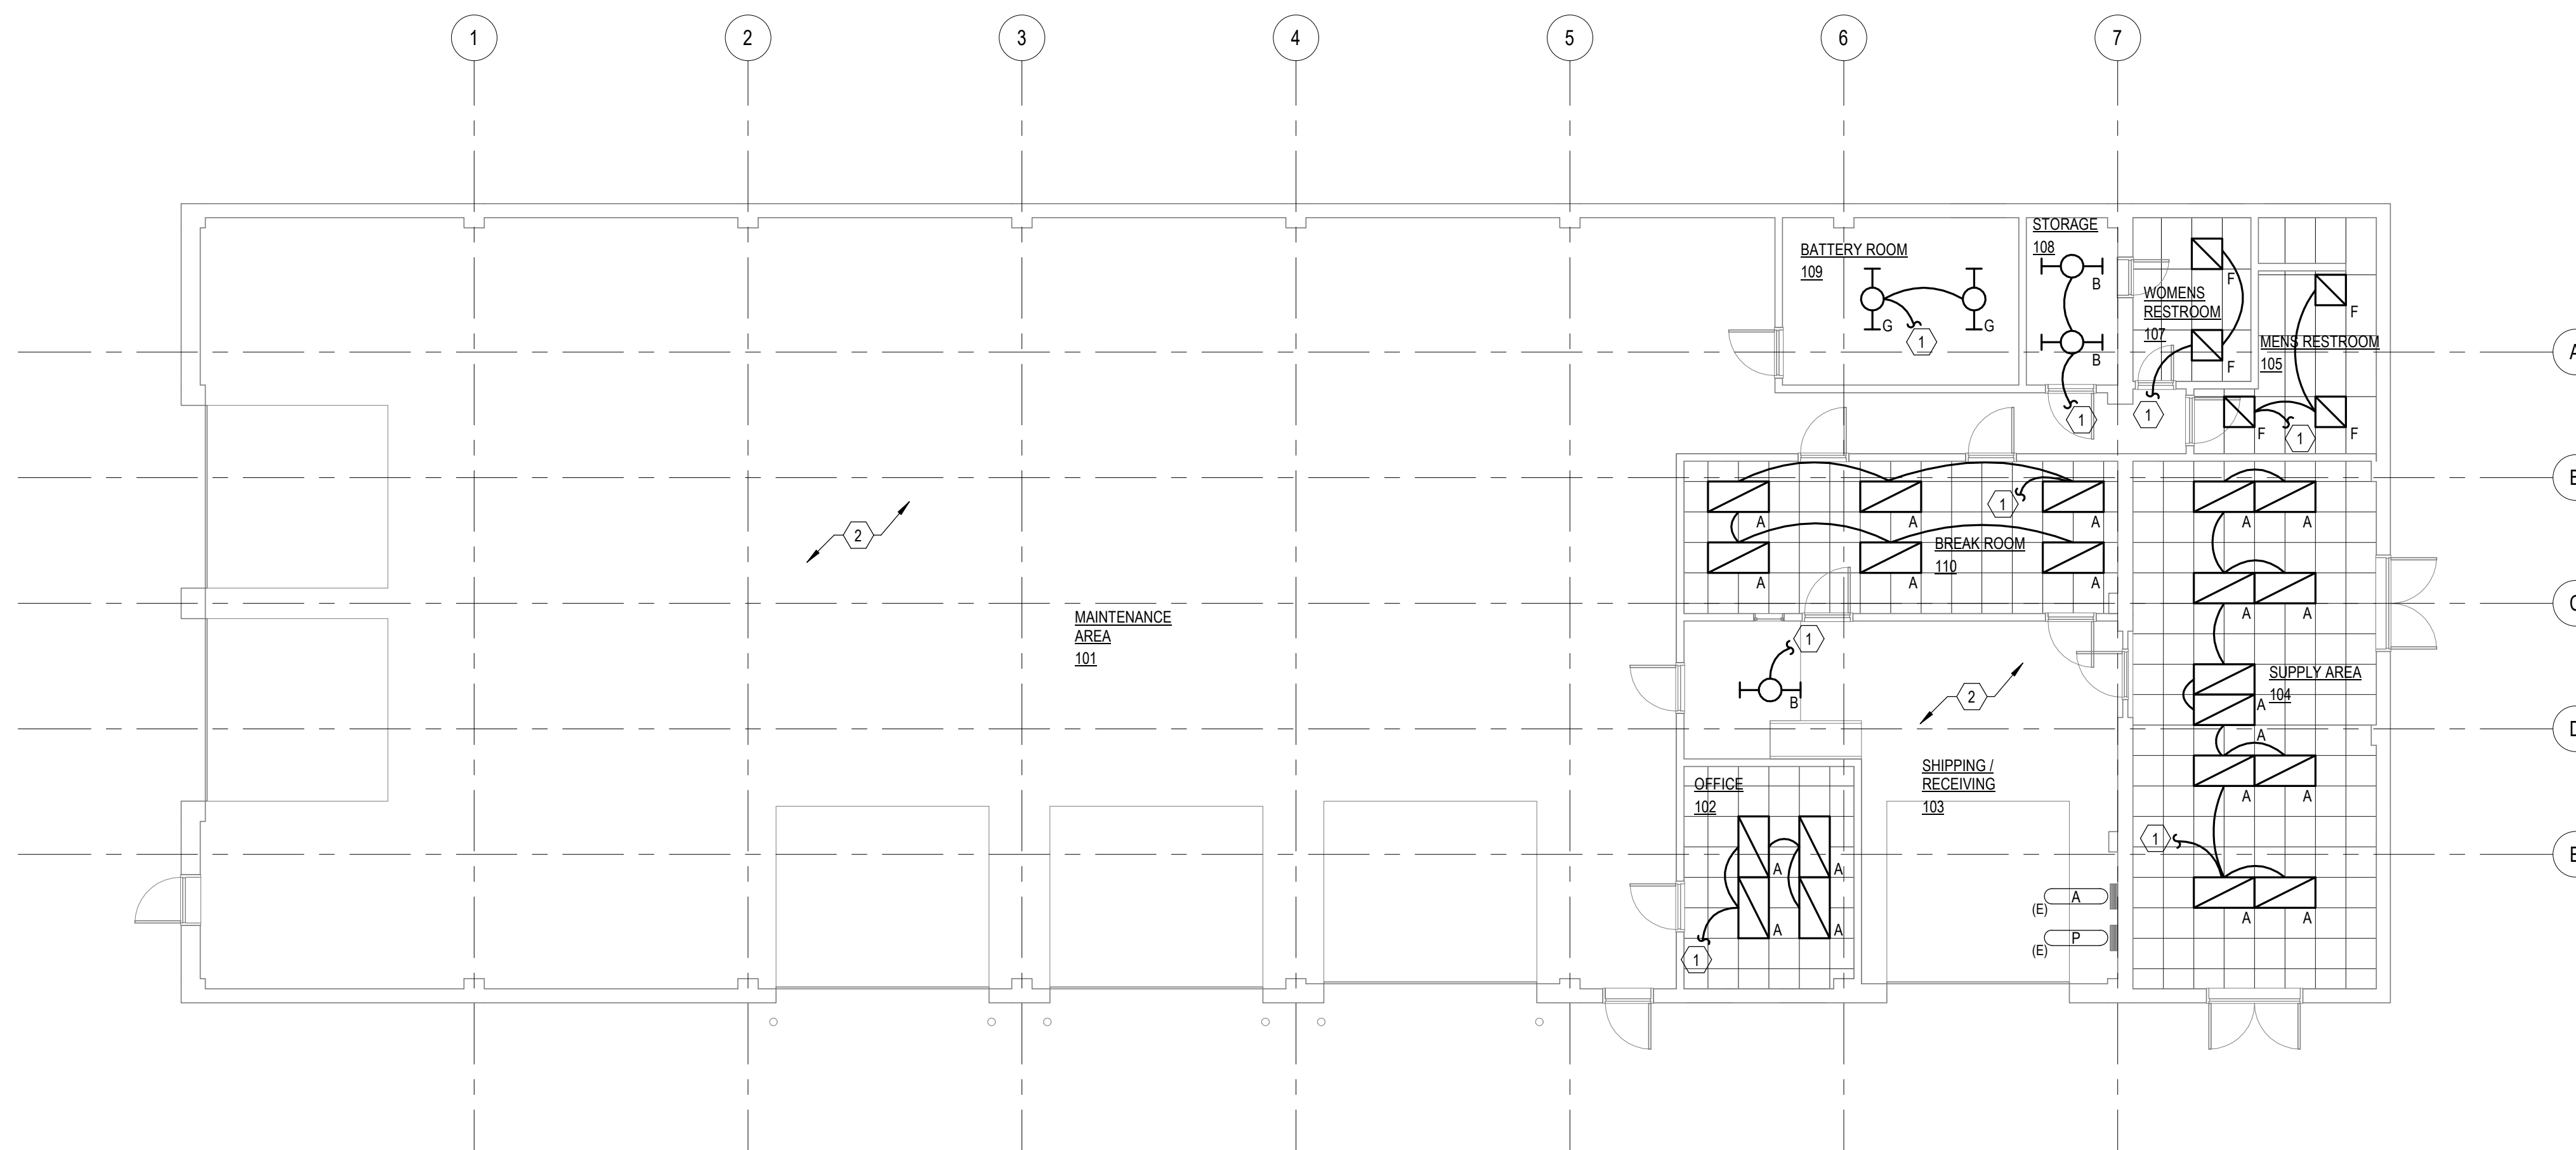
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SHEET TITLE:  
Lighting Plans

SHEET NUMBER:

**E-101**

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03/22/2023





FIRST FLOOR LIGHTING PLAN NOTES	
KEY NOTE	DESCRIPTION
①	CONNECT NEW LIGHT FIXTURES TO EXISTING SWITCHED LIGHTING CIRCUIT PREVIOUSLY SERVING THE AREA. RECONNECT SWITCHES/CONTROLS AS REQUIRED FOR COMPLETE FUNCTIONALITY. INTERCEPT, EXTEND, AND RECONNECT EXISTING CIRCUITRY AS REQUIRED.
②	FIXTURES AND/OR DEVICES IN THIS AREA ARE LOCATED ABOVE. REFER TO SECOND FLOOR LIGHTING PLAN, THIS SHEET, FOR MORE INFORMATION.

CONTRACTOR TO FIELD VERIFY AND COORDINATE NEW LIGHT FIXTURES WITH EXISTING OVERHEAD EQUIPMENT AS NECESSARY. COORDINATE ALL FIXTURE RELOCATIONS WITH OWNER AND ENGINEER.

REMOVE, SALVAGE AND REINSTALL CEILING TILE AS REQUIRED FOR INSTALLATION OF NEW LIGHTING. REPLACE ANY CEILING TILES DAMAGED DURING CONSTRUCTION WITH A CEILING TILE PRODUCT THAT MATCHES THE EXISTING IN APPEARANCE AND COORDINATES WITH EXISTING GRID TEE SYSTEM.

**FIRST FLOOR LIGHTING PLAN**

SCALE: 1/8" = 1'-0"

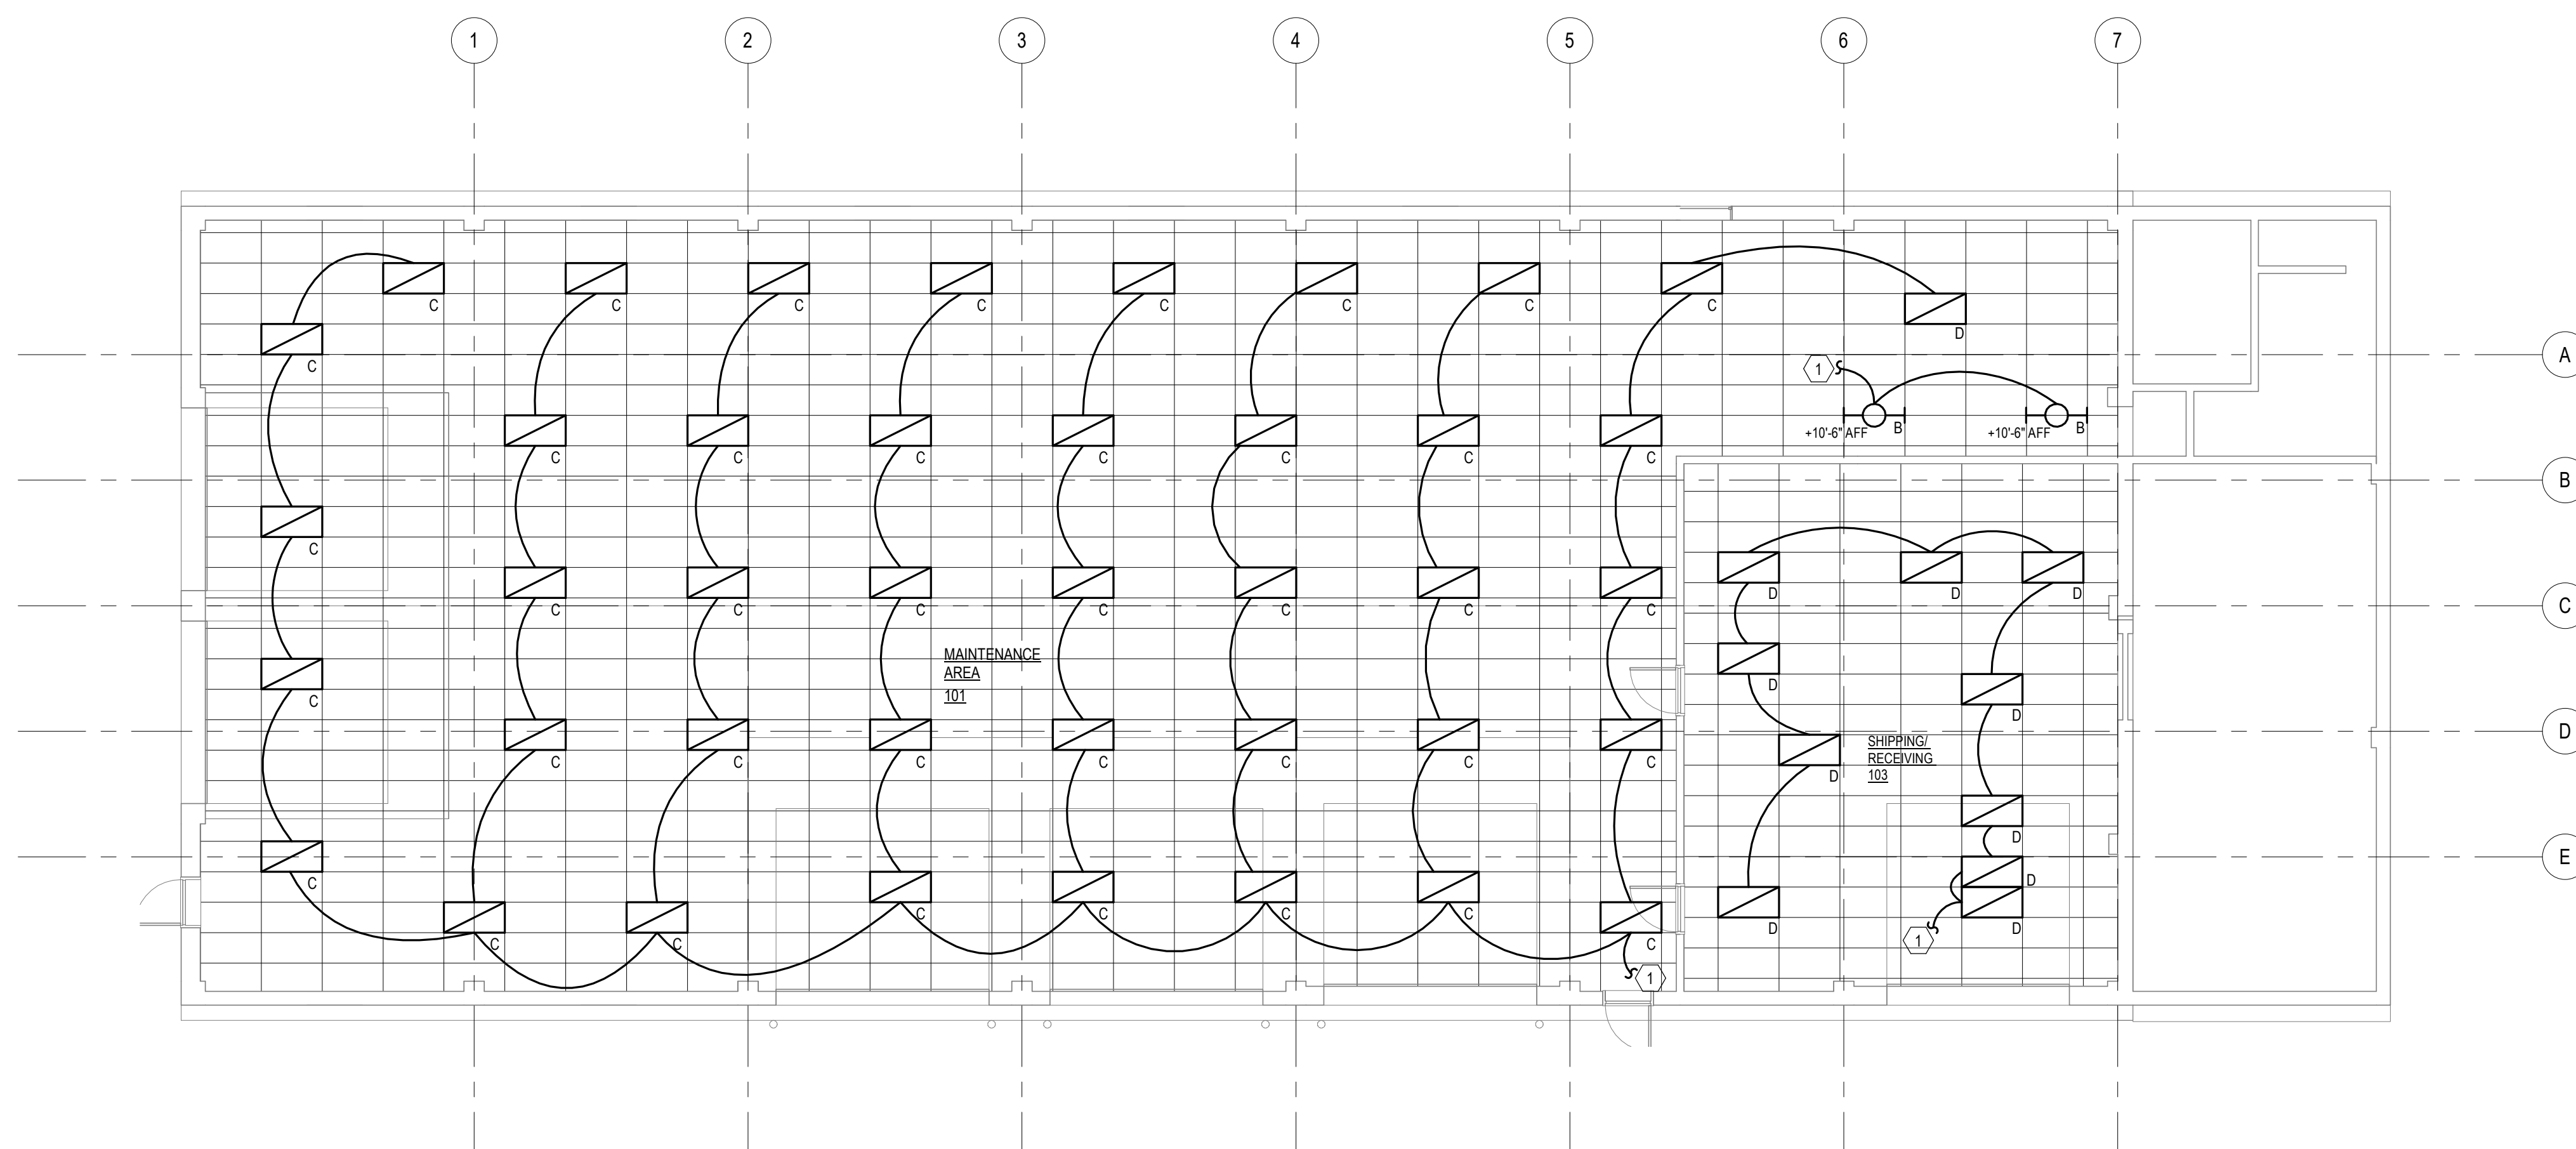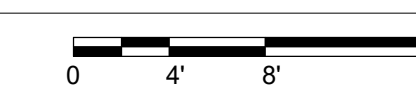


SECOND FLOOR LIGHTING PLAN NOTES	
KEY NOTE	DESCRIPTION
①	CONNECT NEW LIGHT FIXTURES TO EXISTING SWITCHED LIGHTING CIRCUIT PREVIOUSLY SERVING THE AREA. RECONNECT SWITCHES/CONTROLS AS REQUIRED FOR COMPLETE FUNCTIONALITY. INTERCEPT, EXTEND, AND RECONNECT EXISTING CIRCUITRY AS REQUIRED.

CONTRACTOR TO FIELD VERIFY AND COORDINATE NEW LIGHT FIXTURES WITH EXISTING OVERHEAD EQUIPMENT AS NECESSARY. COORDINATE ALL FIXTURE RELOCATIONS WITH OWNER AND ENGINEER.

REMOVE, SALVAGE AND REINSTALL CEILING TILE AS REQUIRED FOR INSTALLATION OF NEW LIGHTING. REPLACE ANY CEILING TILES DAMAGED DURING CONSTRUCTION WITH A CEILING TILE PRODUCT THAT MATCHES THE EXISTING IN APPEARANCE AND COORDINATES WITH EXISTING GRID TEE SYSTEM.

**SECOND FLOOR LIGHTING PLAN**

SCALE: 1/8" = 1'-0"

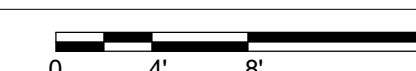





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PROJECT #: T2044-01

SITE #: 6265

ASSET #: 8136265009

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DATE: \_\_\_\_\_  
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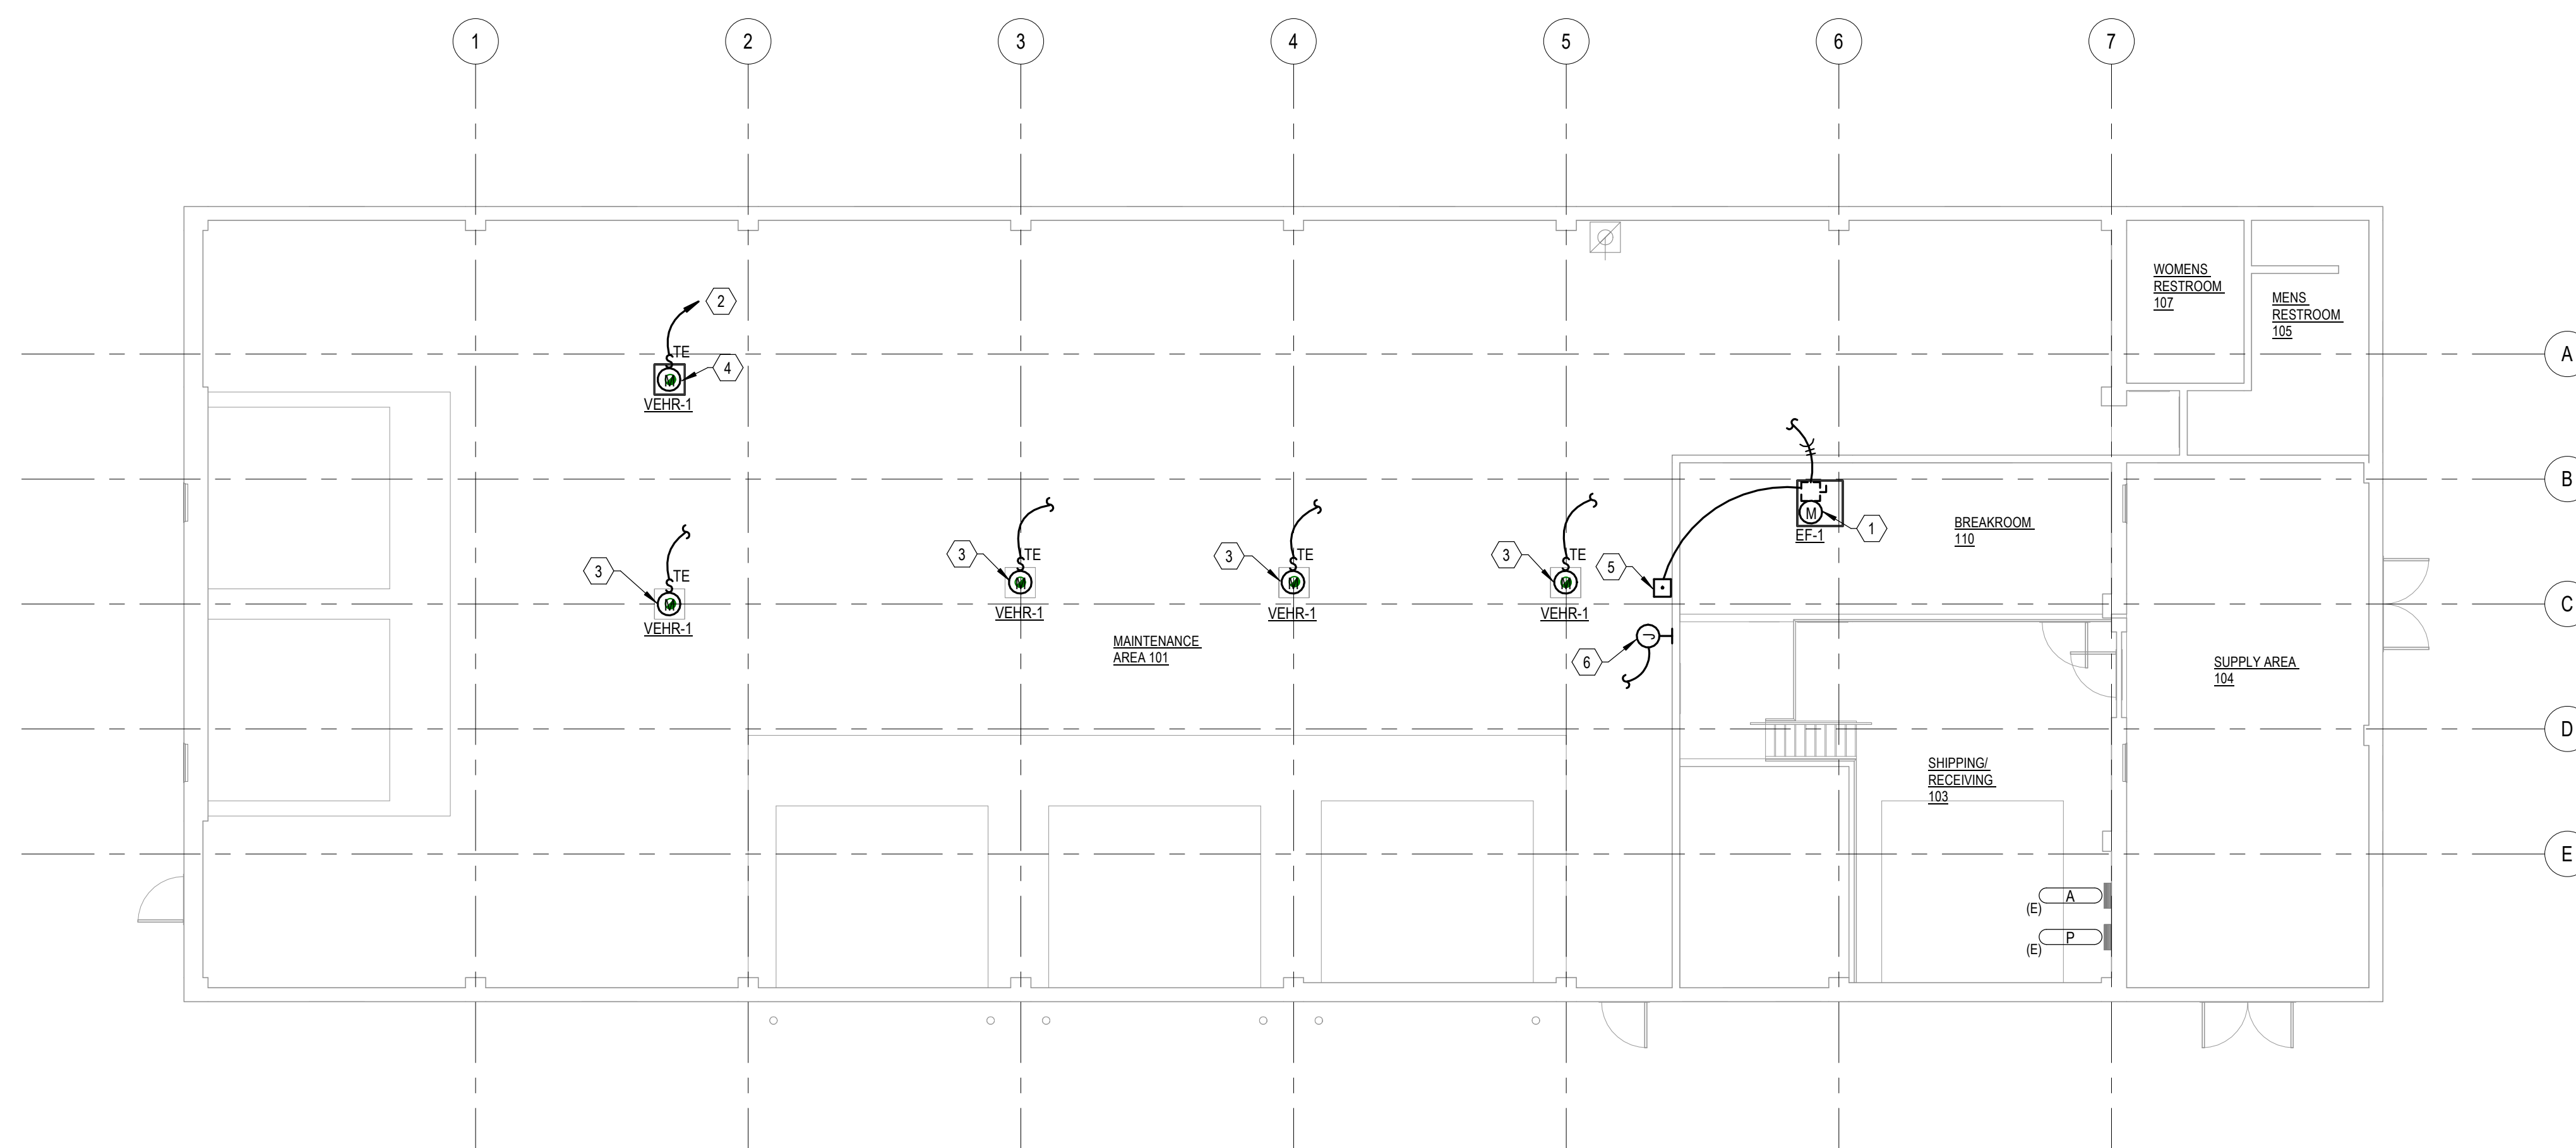
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SHEET TITLE:  
Second Floor Power &  
Auxiliary Systems Plan

SHEET NUMBER:


## E-102

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03/22/2023




### SECOND FLOOR POWER & AUXILIARY SYSTEMS PLAN

SCALE: 1/8" = 1'-0"

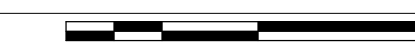

SECOND FLOOR POWER & AUXILIARY SYSTEMS PLAN NOTES	
KEY NOTE	DESCRIPTION
①	ELECTRICAL CONNECTION TO EF-1. COORDINATE INSTALLATION AND REQUIREMENTS WITH THE MECHANICAL CONTRACTOR. SEE THE MECHANICAL PLANS AND SCHEMATICS FOR ADDITIONAL INFORMATION. DISCONNECT PROVIDED BY MECHANICAL. CONNECT EXHAUST FAN TO EXISTING CIRCUIT PREVIOUSLY SERVING THE DEMOLISHED EXHAUST FAN. INTERCEPT, EXTEND, AND RECONNECT EXISTING CIRCUITRY AS REQUIRED.
②	PROVIDE NEW 20A/1P BREAKER IN EXISTING PANELBOARD A. NEW CIRCUIT BREAKER SHALL BE FULLY COMPATIBLE WITH EXISTING PANELBOARD AND SHALL MAINTAIN THE INTERRUPT RATING AND UL LISTING.
③	PROVIDE ELECTRICAL CONNECTION TO NEW MOTORIZED HOSE REEL. COORDINATE EXACT LOCATION AND OTHER REQUIREMENTS WITH THE MECHANICAL CONTRACTOR. SEE THE MECHANICAL PLANS FOR ADDITIONAL INFORMATION. CONNECT MOTORIZED HOSE REEL TO EXISTING CIRCUIT PREVIOUSLY SERVING THE DEMOLISHED MOTORIZED HOSE REEL. INTERCEPT, EXTEND, AND RECONNECT EXISTING CIRCUITRY AS REQUIRED.
④	PROVIDE ELECTRICAL CONNECTION TO NEW MOTORIZED HOSE REEL. COORDINATE EXACT LOCATION AND OTHER REQUIREMENTS WITH THE MECHANICAL CONTRACTOR. SEE THE MECHANICAL PLANS FOR ADDITIONAL INFORMATION.
⑤	EXHAUST FAN START/STOP PUSHBUTTON TO BE PROVIDED BY MECHANICAL. VERIFY EXACT LOCATION WITH OWNER AND ARCHITECT. PROVIDE SINGLE GANG JUNCTION BOX AND ALL NECESSARY CONNECTIONS REQUIRED. SEE THE MECHANICAL PLANS AND SCHEMATICS FOR ADDITIONAL INFORMATION.
⑥	ELECTRICAL CONNECTION TO VEHICLE EXHAUST DETECTION CONTROLLER. COORDINATE THE EXACT LOCATION AND REQUIREMENTS WITH THE MECHANICAL CONTRACTOR. PROVIDE INTERCONNECTIONS BETWEEN THE CONTROLLER AND SENSORS AS REQUIRED. SEE THE MECHANICAL PLANS AND SCHEMATICS FOR ADDITIONAL INFORMATION. PROVIDE 120V POWER FROM THE CLOSEST GENERAL PURPOSE RECEPTACLE CIRCUIT IN THE AREA, CONTRACTOR TO FIELD VERIFY CIRCUITS LOAD PRIOR TO CONSTRUCTION.

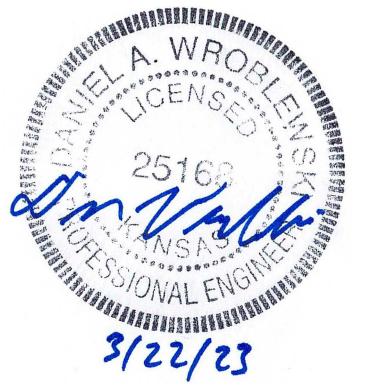

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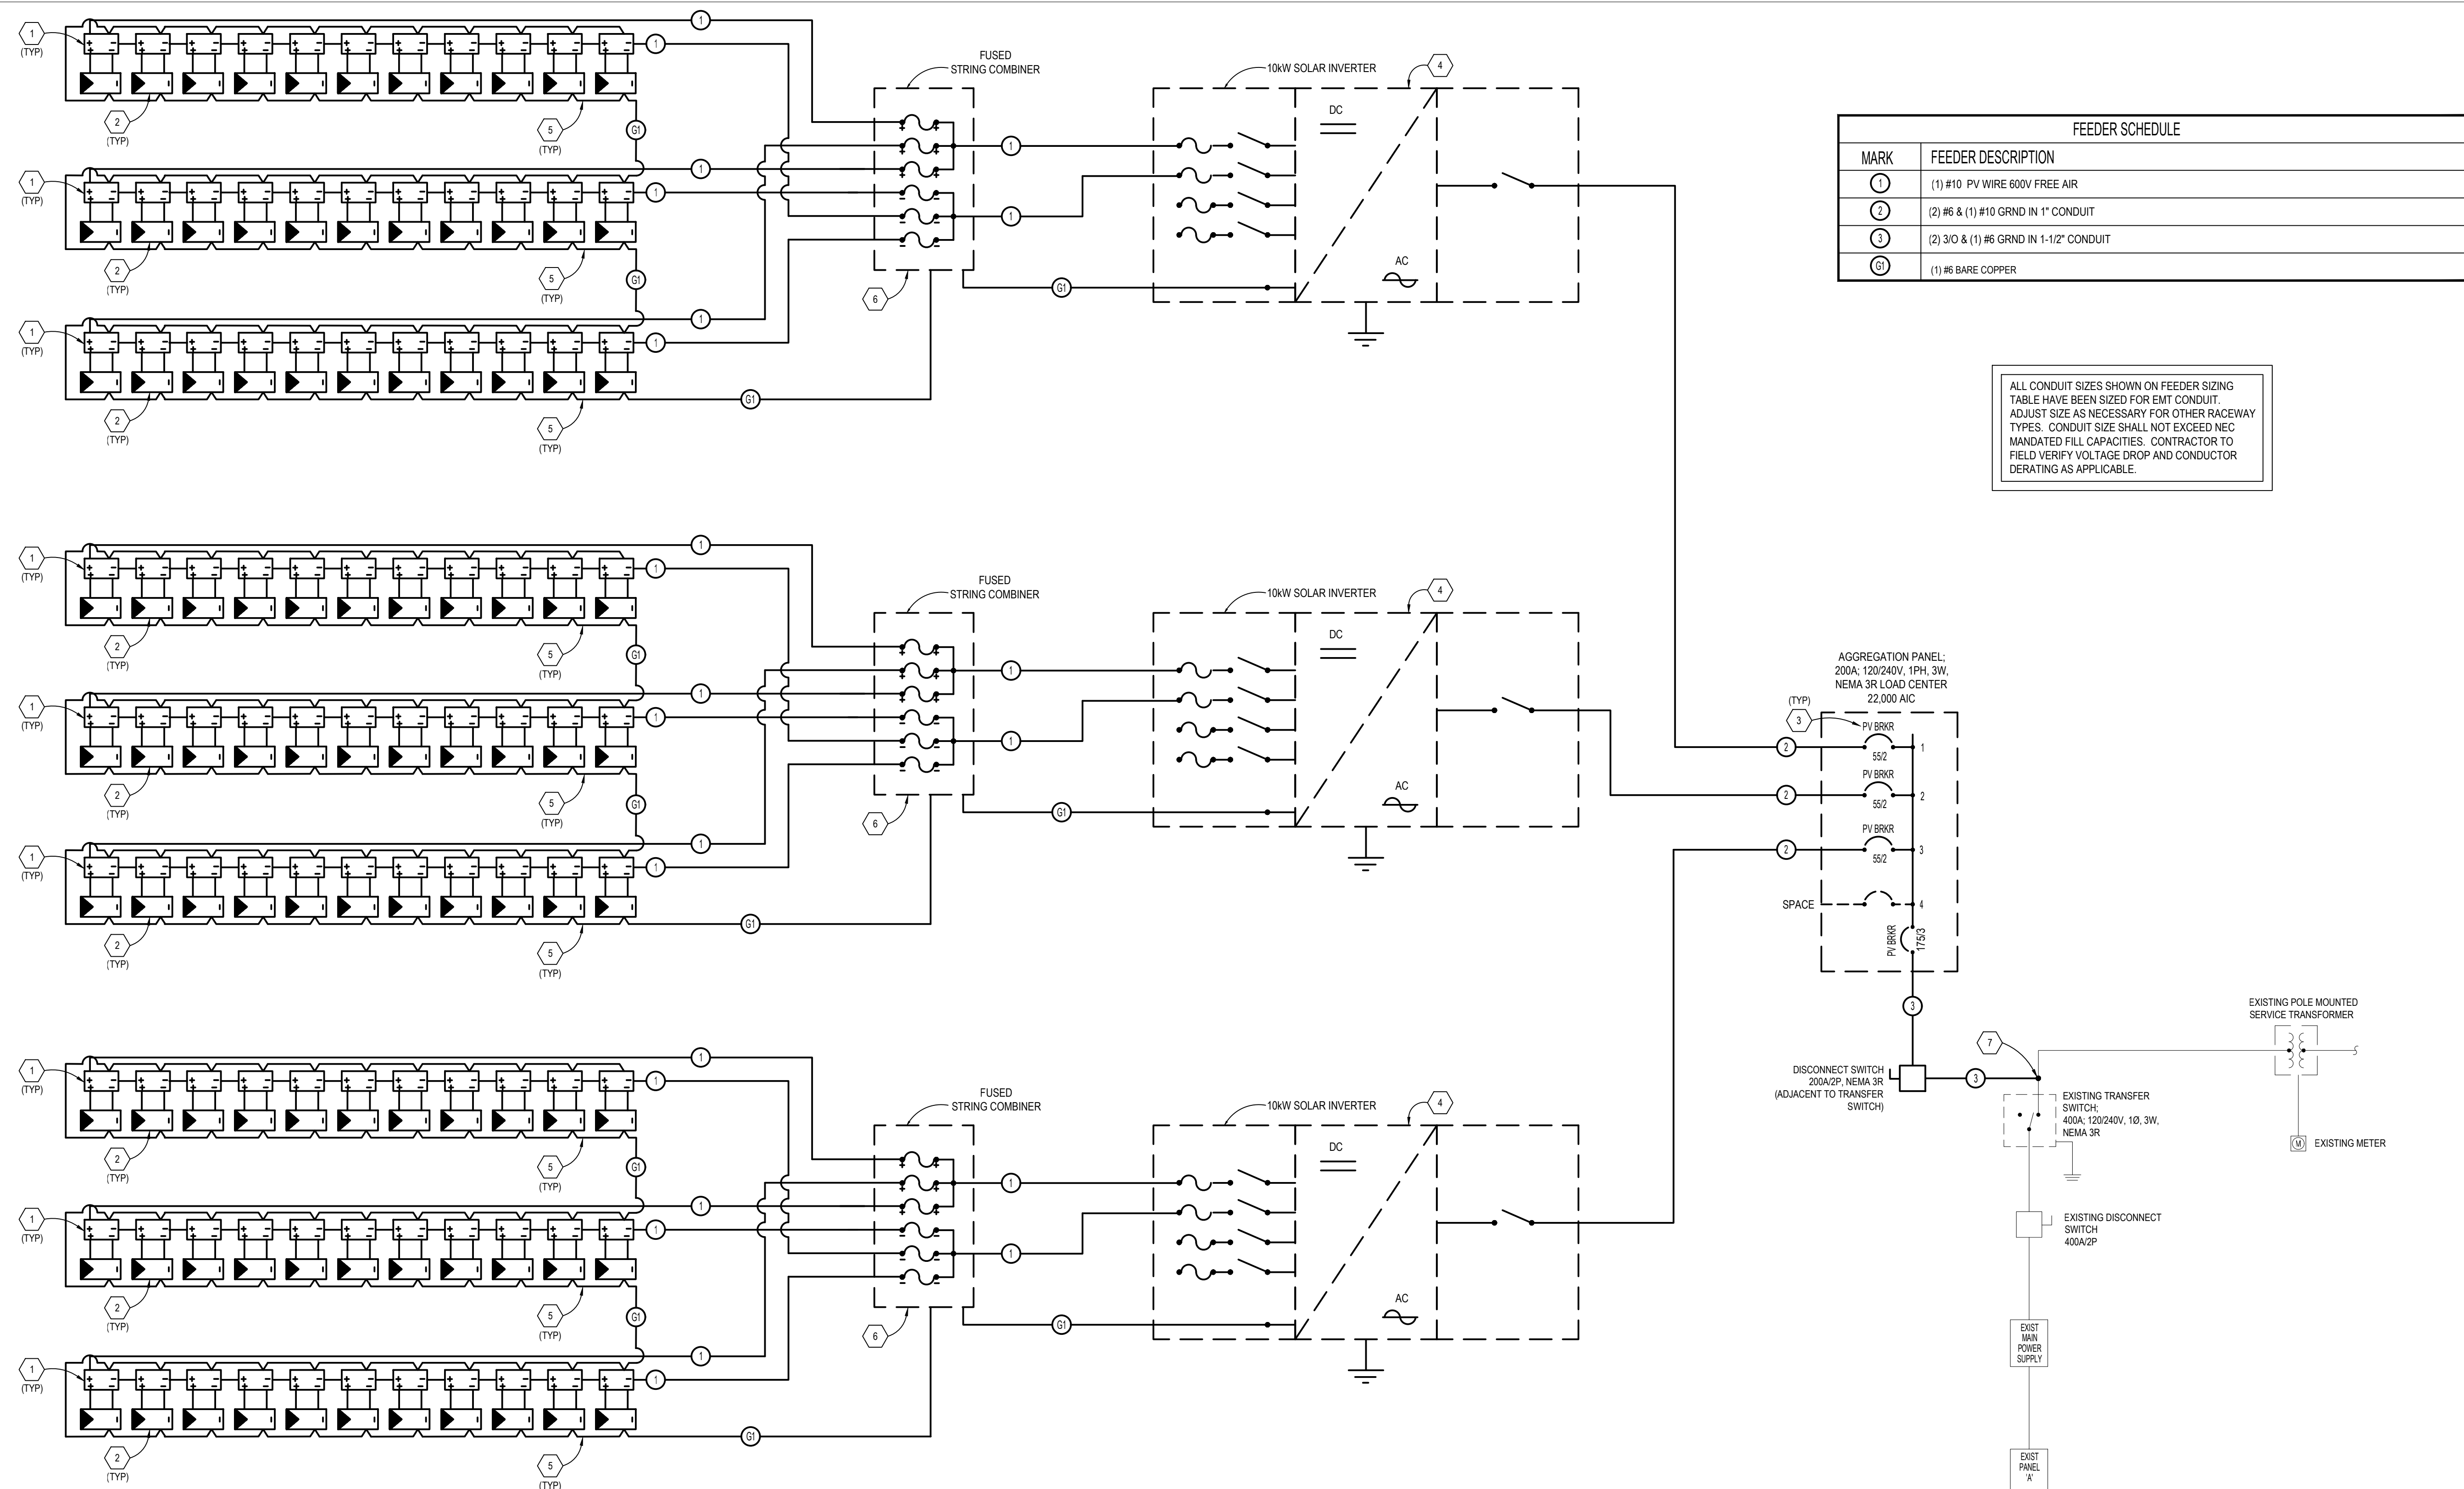
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SHEET TITLE:  
Electrical One-line  
Diagram

SHEET NUMBER:



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FEEDER SCHEDULE	
MARK	FEEDER DESCRIPTION
1	(1) #10 PV WIRE 600V FREE AIR
2	(2) #6 & (1) #10 GRND IN 1" CONDUIT
3	(2) 3/0 & (1) #6 GRND IN 1-1/2" CONDUIT
6	(1) #6 BARE COPPER

ALL CONDUIT SIZES SHOWN ON FEEDER SIZING TABLE HAVE BEEN SIZED FOR EMT CONDUIT. ADJUST SIZE AS NECESSARY FOR OTHER RACEWAY TYPES. CONDUIT SIZE SHALL NOT EXCEED NEC MANDATED FILL CAPACITIES. CONTRACTOR TO FIELD VERIFY VOLTAGE DROP AND CONDUCTOR DERATING AS APPLICABLE.



**ELECTRICAL ONE LINE DIAGRAM**

NO SCALE

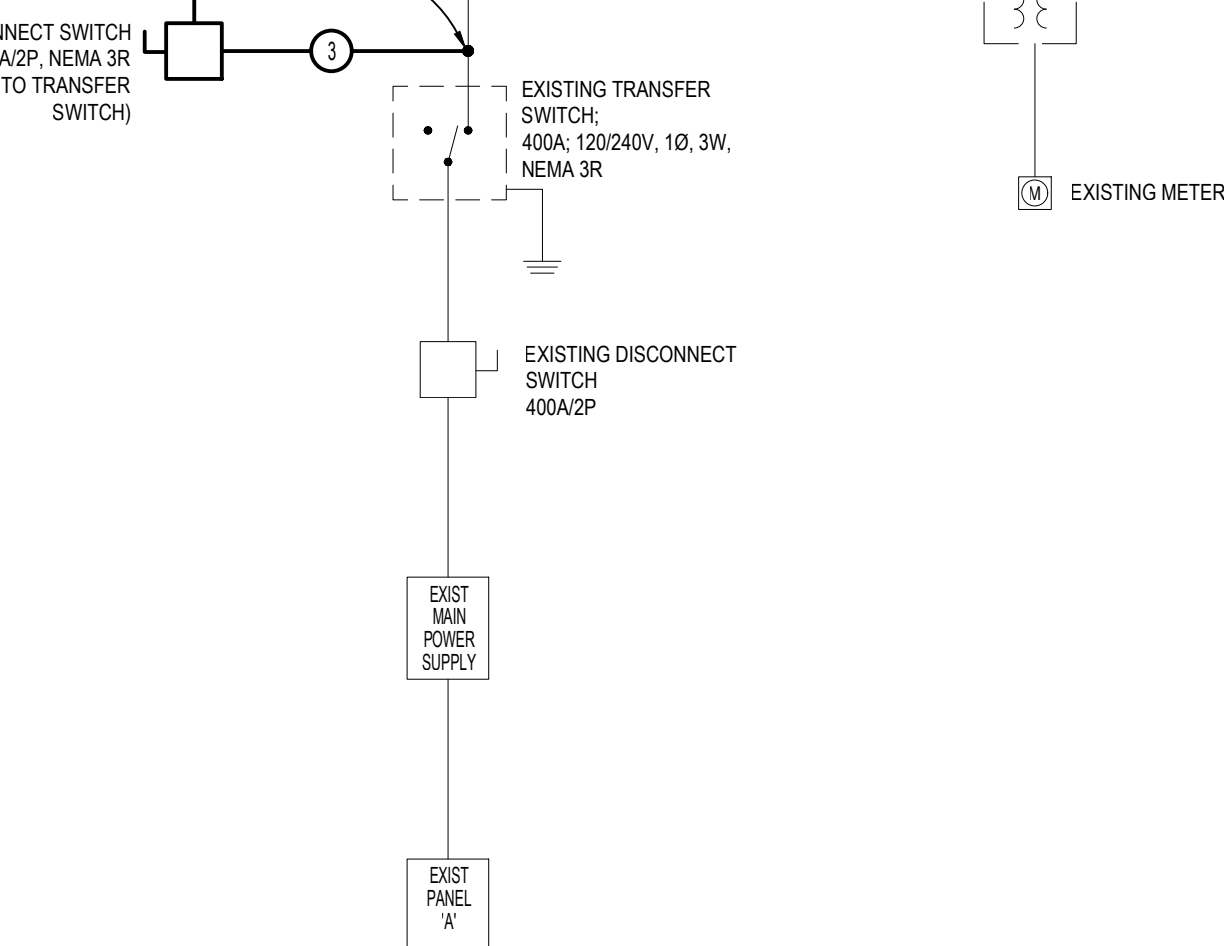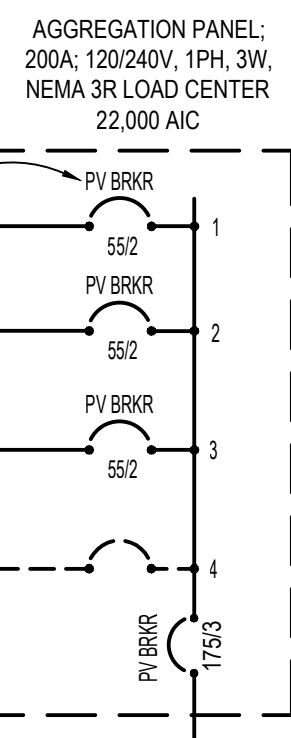ELECTRICAL ONE-LINE DIAGRAM NOTES	
KEY NOTE	DESCRIPTION
1	(11) POWER OPTIMIZERS. MODULES TO BE UL LISTED.
2	(11) 375W PHOTOVOLTAIC MODULES. 1 STRING OF 11 MODULES WITH A TOTAL SUB-ARRAY WATTAGE OF 4,125W. PHOTOVOLTAIC MODULES SHALL BE UL LISTED.
3	ALL PV BREAKERS SHALL BE UL LISTED AND SUITABLE FOR BACK / REVERSE FEED USE.
4	ARC FAULT AND GROUND FAULT PROTECTION SHALL BE INTEGRAL TO INVERTER.
5	ALL SOLAR COMPONENTS TO BE GROUNDED.
6	PROVIDE FUSED 600VDC 3 STRING COMBINER BOX WITH NEMA 3R ENCLOSURE. COORDINATE EXACT MOUNTING LOCATION WITH PV CAR CANOPY STRUCTURE.

ELECTRICAL ONE-LINE DIAGRAM NOTES: CONTINUED	
KEY NOTE	DESCRIPTION
7	CONTRACTOR TO PROVIDE CONNECTION TO LOAD SIDE OF UTILITY METER, AHEAD OF TRANSFER SWITCH. CONNECTIONS TO BE MADE WITHIN EXISTING TRANSFER SWITCH.

PV INVERTER SCHEDULE (MODULE RATINGS @ STC)											
			INPUT PARAMETERS (DC)					OUTPUT PARAMETERS (AC)			
MANUFACTURER	MODEL	QUANTITY	P <sub>max</sub> (W)	V <sub>max</sub> (Voc)	V <sub>mp</sub> (Voc)	I <sub>sc</sub> (A)	I <sub>mp</sub> (A)	P <sub>max</sub> (W)	V <sub>max</sub> (Voc)	I <sub>max</sub> (A)	F <sub>max</sub> (Hz)
SOLAR EDGE	SE10000H-US	3	15,500	480	400	45.0	27	10,000	120/240	42	60

PV POWER OPTIMIZER SCHEDULE (MODULE RATINGS @ STC)											
			INPUT PARAMETERS (DC)					OUTPUT PARAMETERS (DC)			
MANUFACTURER	MODEL	QUANTITY	P <sub>max</sub> (W)	V <sub>max</sub> (Voc)	V <sub>mp</sub> (Voc)	I <sub>sc</sub> (A)	I <sub>mp</sub> (A)	V <sub>max</sub> (Voc)	I <sub>sc</sub> (A)		
SOLAR EDGE	P400	99	400	80	8-80	10.1	12.65	60	15		

PV MODULE SCHEDULE (MODULE RATINGS @ STC)									
MANUFACTURER	MODEL	QUANTITY	P <sub>max</sub> (W)	V <sub>mp</sub> (Voc)	I <sub>mp</sub> (A)	V <sub>oc</sub> (Voc)	I <sub>sc</sub> (A)		
LG SOLAR	LG375Q1C-V6	99	375	37.1	7.61	42.8	10.83		

PHOTOVOLTAIC SYSTEM COMPONENTS ARE TO SERVE AS BASIS OF DESIGN. SEE SPECIFICATIONS FOR MORE INFORMATION.

AT INTERVALS OF NO MORE THAN TEN FEET AND WITHIN ONE FOOT OF TURNS, BENDS OR PENETRATIONS, IDENTIFY ALL INTERIOR AND EXTERIOR DC PV WIRING SYSTEM COMPONENTS (CONDUIT, RACEWAYS, ENCLOSURES, OTHER WIRING METHODS, COVERS, OR ENCLOSURES OF PULL BOXES AND JUNCTION BOXES, CONDUIT BODIES IN WHICH ANY OF THE AVAILABLE CONDUIT OPENINGS ARE UNUSED) WITH THE FOLLOWING REFLECTIVE LABEL:

WARNING: PHOTOVOLTAIC POWER SOURCE

LABEL INVERTER WITH THE FOLLOWING 3 PLACARDS:

**INVERTER**  
 OPERATING CURRENT: 27 A  
 OPERATING VOLTAGE: 400 VDC  
 MAXIMUM SYSTEM VOLTAGE: 480 VDC  
 SHORT CIRCUIT CURRENT: 45 A

**WARNING!**  
 ELECTRIC SHOCK HAZARD  
 DO NOT TOUCH TERMINALS.  
 TERMINALS ON BOTH THE  
 LINE AND LOAD SIDES MAY BE  
 ENERGIZED IN THE OPEN POSITION

**WARNING!**  
 ELECTRIC SHOCK HAZARD  
 IF A GROUND FAULT IS INDICATED,  
 NORMALLY GROUND CONDUCTORS MAY  
 BE UNGROUNDED AND ENERGIZED

LABEL PV AGGREGATION PANEL WITH THE FOLLOWING 4 PLACARDS:

**WARNING!**  
 DUAL POWER SOURCE PANEL  
 MAIN BREAKER AND PV BREAKER  
 SHALL BE DISCONNECTED  
 FOR POWER DISCONNECT

SOLAR PHOTOVOLTAIC SOURCE  
 NOMINAL AC VOLTAGE: 240V  
 MAXIMUM AC CURRENT: 135A

**WARNING!**  
 ELECTRIC SHOCK HAZARD  
 DO NOT TOUCH TERMINALS.  
 TERMINALS ON BOTH THE  
 LINE AND LOAD SIDES MAY BE  
 ENERGIZED IN THE OPEN POSITION

**WARNING!**  
 ELECTRIC SHOCK HAZARD  
 IF A GROUND FAULT IS INDICATED,  
 NORMALLY GROUND CONDUCTORS MAY  
 BE UNGROUNDED AND ENERGIZED

LABEL MAIN SERVICE METER WITH THE FOLLOWING 3 PLACARDS:

**WARNING!**  
 THIS SERVICE METER IS ALSO  
 SERVED BY A PHOTOVOLTAIC SYSTEM

**WARNING!**  
 ELECTRIC SHOCK HAZARD  
 DO NOT TOUCH TERMINALS.  
 TERMINALS ON BOTH THE LINE AND LOAD SIDES  
 MAY BE ENERGIZED IN THE OPEN POSITION

SOLAR PHOTOVOLTAIC SOURCE  
 NOMINAL AC VOLTAGE: 240V  
 MAXIMUM AC CURRENT: 135A


PHOTOVOLTAIC SYSTEM EQUIPPED  
 WITH RAPID SHUTDOWN

LABEL SOLAR SERVICE DISCONNECTING MEANS WITH THE FOLLOWING 2 PLACARDS:

SOLAR POWER DISCONNECT  
 FOR UTILITY OPERATION.

MARKING AND LABELING GENERAL NOTES:

- A. MARKING AND LABELING SHALL COMPLY WITH NEC 690 AND IFC 605.
- B. ALL PLACARDS, SIGNAGE AND LABELS SHALL BE PERMANENTLY ATTACHED.
- C. ALL PLACARDS AND SIGNAGE SHALL BE MADE OF RIGID LAMINATE MATERIAL WITH ENGRAVED LETTERS.
- D. ALL PLACARDS, SIGNAGE AND LABELS SHALL BE RED WITH WHITE LETTERING.
- E. ALL LETTERING SHALL BE A MINIMUM OF 3/8" IN HEIGHT.
- F. ALL LETTERING SHALL BE CAPITAL LETTERS, ARIAL OR SIMILAR FONT, NON-BOLD.
- G. ALL FIELD-INSTALLED PLACARDS, SIGNAGE AND LABELS SHALL BE VISIBLE AFTER INSTALLATION.
- H. ALL PLACARDS, SIGNAGE, AND LABELS SHALL BE SUITABLE FOR THE ENVIRONMENT WHERE THEY ARE INSTALLED.
- I. PROVIDE A PLACARD, SIGN OR LABEL SHOWING THE LOCATION OF THE SERVICE DISCONNECTING MEANS AND THE LOCATION OF THE PHOTOVOLTAIC DISCONNECTS MEANS.
- J. A PERMANENT PLACARD OR DIRECTORY, DENOTING ALL ELECTRIC POWER SOURCES ON OR IN THE PREMISES, SHALL BE INSTALLED AT EACH SERVICE EQUIPMENT LOCATION AND AT LOCATIONS OF ALL ELECTRIC POWER PRODUCTION SOURCES CAPABLE OF BEING INTERCONNECTED.
- K. THE SITE DIRECTORY SHALL INCLUDE WORDING SIMILAR TO THE FOLLOWING: "CAUTION - THE POWER TO THIS SITE IS ALSO SUPPLIED FROM THE FOLLOWING SOLAR PV AND UTILITY SOURCES WITH DISCONNECTS LOCATED AS SHOWN."

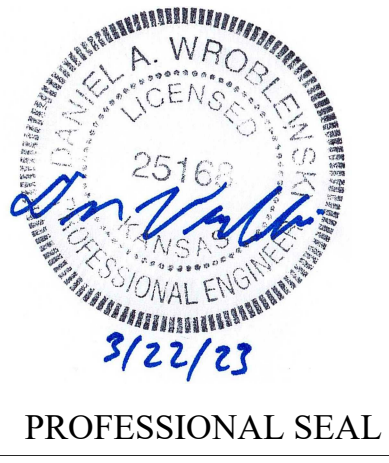

2020 Baltimore Ave.  
 Suite 300  
 Kansas City, MO 64108  
 p. 816-474-8237

OFFICE OF  
 ADMINISTRATION  
 DIVISION OF FACILITIES,  
 MANAGEMENT, DESIGN  
 AND CONSTRUCTION

MISSOURI  
 NATIONAL GUARD

SOLAR ARRAY, INTERIOR  
 LED LIGHTING AND  
 EXHAUST SYSTEM

MARSHALL FIELD  
 MAINTENANCE SHOP

475 S. DAVIS AVE.  
 MARSHALL, MO 65340

PROJECT #: T2044-01

SITE #: 6265  
 ASSET #: 8136265009

REVISION: \_\_\_\_\_  
 DATE: \_\_\_\_\_  
 REVISION: \_\_\_\_\_  
 DATE: \_\_\_\_\_  
 REVISION: \_\_\_\_\_  
 DATE: \_\_\_\_\_

ISSUE DATE: 03/22/2023


DRAWN BY: AS  
 CHECKED BY: DW  
 DESIGNED BY: AS

SHEET TITLE:  
 Electrical Details and  
 Schedules

SHEET NUMBER:

E-301

LIGHTING FIXTURE SCHEDULE										
Fixture Type	Manufacturers	Catalog Numbers	Description	No. of Lamps	Lamp Type	Volt	VA	Mounting	Remarks	
A	HE WILLIAMS LITHONIA AXIS LTG	AT1-24-L40-835-DMA-EM/10WLP-DIM-UNV 2ALL4 40L MVOLT E21 LP835 DIALED 24 4500 80 35 W UNV DP 1 'XX	2' X 4' LED TROFFER	N/A	LED 3500K	UNV	48	RECESSED	PROVIDE ALL NECESSARY COMPONENTS FOR FIXTURE MOUNTING. COORDINATE MOUNTING WITH ALL OTHER TRADES IN THE SPACE. FIXTURE IS TO BE MOUNTED IN A NEAT AND TIDY FASHION. SEE THE LIGHTING PLANS FOR ADDITIONAL INFORMATION. SEE LIGHTING PLANS FOR ADDITIONAL INFORMATION.	
B	HE WILLIAMS LITHONIA COLUMBIA LTG	75L-4-L38-835-DMA-DIM-UNV CSS L48 4000LM MVOLT 35K 80CRI CSL4-4035	4' LED LINEAR STRIP	N/A	LED 3500K	UNV	31	SURFACE	PROVIDE ALL NECESSARY COMPONENTS FOR FIXTURE MOUNTING. COORDINATE MOUNTING WITH ALL OTHER TRADES IN THE SPACE. FIXTURE IS TO BE MOUNTED IN A NEAT AND TIDY FASHION. UNLESS OTHERWISE INDICATED, SEE THE LIGHTING PLANS FOR ADDITIONAL INFORMATION.	
C	HE WILLIAMS LITHONIA METALLUX	50 G S 2 4 L130 8 35 S AF12125 2GTL 4 140L G210 LP835 24GR-LD5-130-F1-UNV-L835-CD	2' X 4' LED TROFFER	N/A	LED 3500K	UNV	101	RECESSED	PROVIDE ALL NECESSARY COMPONENTS FOR FIXTURE MOUNTING. COORDINATE MOUNTING WITH ALL OTHER TRADES IN THE SPACE. FIXTURE IS TO BE MOUNTED IN A NEAT AND TIDY FASHION. SEE THE LIGHTING PLANS FOR ADDITIONAL INFORMATION. SEE LIGHTING PLANS FOR ADDITIONAL INFORMATION.	
D	HE WILLIAMS LITHONIA METALLUX	50 G S 2 4 L33 8 35 S AF12125 2GTL 4 40L G210 LP835 24GR-LD5-34-F1-UNV-L835-CD	2' X 4' LED TROFFER	N/A	LED 3500K	UNV	25	RECESSED	PROVIDE ALL NECESSARY COMPONENTS FOR FIXTURE MOUNTING. COORDINATE MOUNTING WITH ALL OTHER TRADES IN THE SPACE. FIXTURE IS TO BE MOUNTED IN A NEAT AND TIDY FASHION. SEE THE LIGHTING PLANS FOR ADDITIONAL INFORMATION. SEE LIGHTING PLANS FOR ADDITIONAL INFORMATION.	
F	HE WILLIAMS LITHONIA METALLUX	50 G S 2 2 L28 8 35 S AF12125 2GTL 2 33L G210 LP835 22GR-LD5-28-F1-UNV-L835-CD	2' X 2' LED TROFFER	N/A	LED 3500K	UNV	21	RECESSED	PROVIDE ALL NECESSARY COMPONENTS FOR FIXTURE MOUNTING. COORDINATE MOUNTING WITH ALL OTHER TRADES IN THE SPACE. FIXTURE IS TO BE MOUNTED IN A NEAT AND TIDY FASHION. SEE THE LIGHTING PLANS FOR ADDITIONAL INFORMATION. SEE LIGHTING PLANS FOR ADDITIONAL INFORMATION.	
G	LDPI SONARAY RED SKY LIGHTING	LEXS L2 V1 S V110 D EX4 060M WW 7 50 LG U LNT 40 100-277 5000K 110 DIFF GREY YOKE	4' LED LINEAR STRIP	N/A	LED 4000K	UNV	80	SURFACE	PROVIDE ALL NECESSARY COMPONENTS FOR FIXTURE MOUNTING. COORDINATE MOUNTING WITH ALL OTHER TRADES IN THE SPACE. FIXTURE IS TO BE MOUNTED IN A NEAT AND TIDY FASHION. UNLESS OTHERWISE INDICATED, SEE THE LIGHTING PLANS FOR ADDITIONAL INFORMATION.	

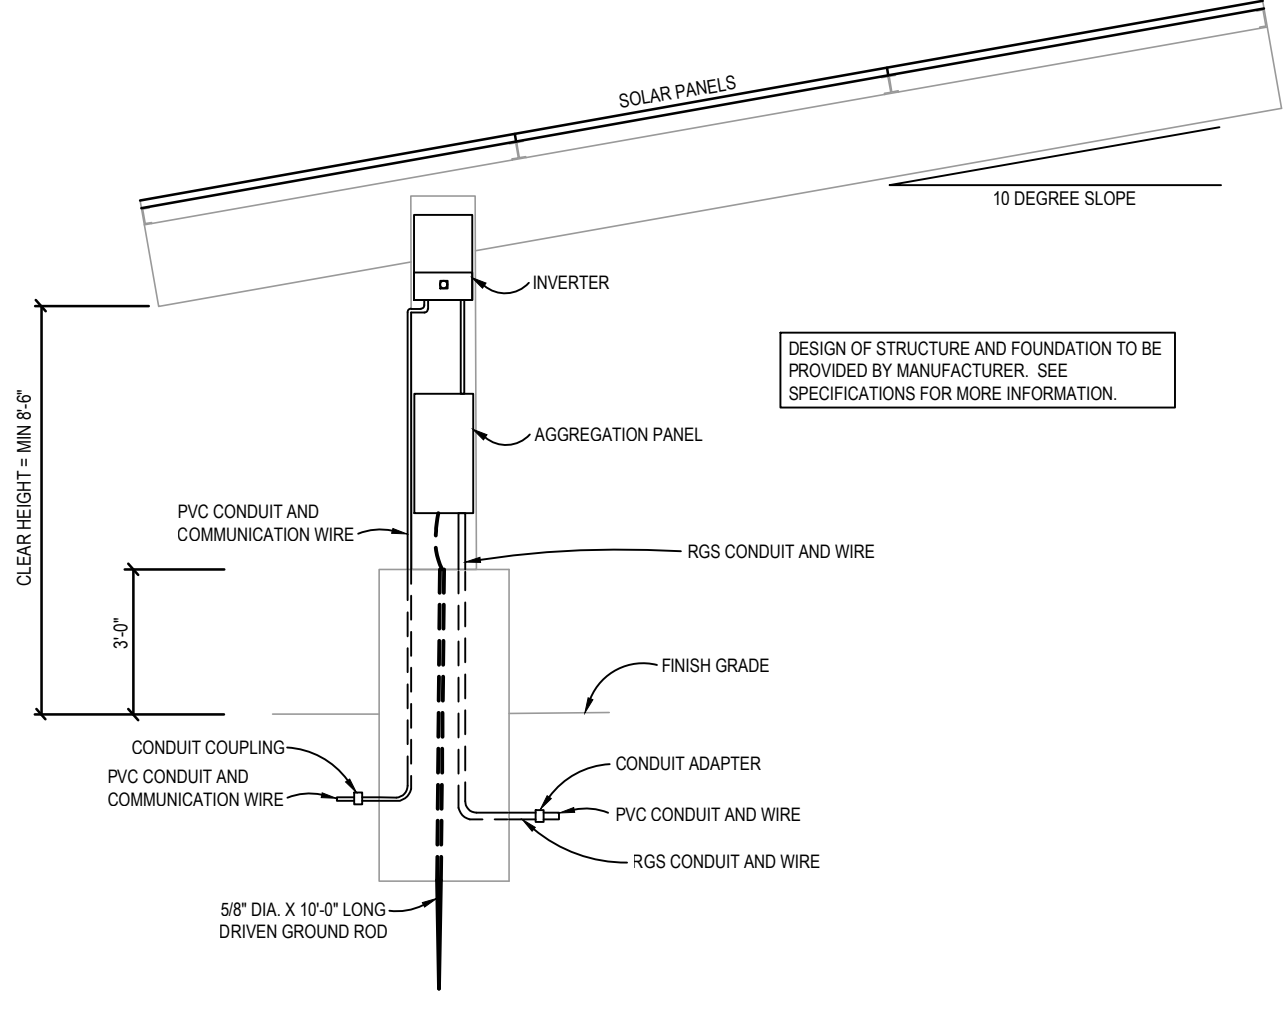

1 PV CANOPY MOUNTING DETAIL  
 NO SCALE