Construct New 60 Soldier Barracks Wappapello Training Site Wappapello, Missouri

ARCHITECT

Buddy Webb & Company Architects - Consultants 3057 EAST CAIRO STREET

(417) 877-1385 PHONE

CIVIL **ENGINEER**

Bartlett&West 1801 W. NORTON, SUITE 309A SPRINGFIELD, MISSOURI 65803 PHONE: (417) 429-0611

STRUCTURAL ENGINEER

MECHANICAL / ELECTRICAL **ENGINEER**



Engineering | Energy | Innovation

2101 West Chesterfield Boulevard, Suite B-105A, Springfield, MO 65807

STATE OF MISSOURI OWNER:

SPRINGFIELD. MISSOURI 65802

MICHAEL L. PARSON,

GOVERNOR

DEPARTMENT OF PUBLIC SAFETY MISSOURI ARMY NATIONAL GUARD

PROJECT OFFICE OF ADMINISTRATION

DIVISION OF FACILITIES MANAGEMENT, MANAGEMENT:


DESIGN AND CONSTRUCTION

DESIGNER: Buddy Webb & Company, Inc. Architects / Consultants

> PROJECT NUMBER: T2124-01

6325 SITE NUMBER: 8136325016 ASSET NUMBER:

BUILDING NUMBER:

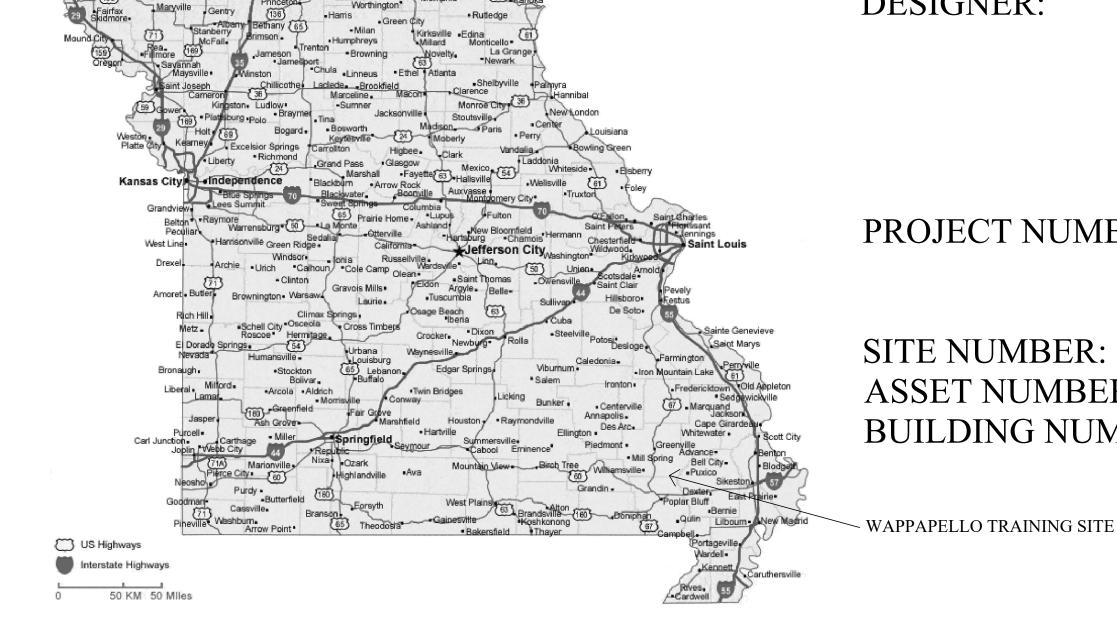

SITE LOCATION



	S	C	OF	E	0	F WORK	
PROJECT MANUAL (CSI)	SECTION NAME REFERENCE (SECTIONS OWNER FURNISHED AND	HED BY ACTOR	LED BY ACTOR	HED BY JER	CONTACT INFORMAT		TION
SECTION REF. NUMBER	INSTALLED NOT INCLUDED IN PROJECT MANUAL - FOR REFERENCE ONLY)	FURNISHED BY CONTRACTOR	INSTALLED BY CONTRACTOR	FURNISHED I OWNER	INSTALLED I OWNER	COMPANY & ADDRESS	POINT OF CONTACT, PHONE (P), CELL (C), OR EMAIL (E)
01 11 00	SUMMARY OF WORK GENERAL BUILDING PERMIT (NOT REQUIRED) STATE DEPARTMENT OF NATURAL RESOURCES PERMIT (NOT REQUIRED)			х		STATE OF MISSOURI OFFICE OF ADMINISTRATION DIVISION OF FACILITIES MANAGEMENT DESIGN & CONSTRUCTION HARRY S TRUMAN STATE OFFICE BUILDING RM. 730 JEFFERSON CITY, MO 65102	CHRISTOPHER LLOYD, PROJECT MANAGER (O): (573) 526-0160 (C): (573) 395-6793 (E): Christopher.Lloyd@oa.mo.gov
01 11 00	SUMMARY OF WORK (ALL TRADE PERMITS, UTILITY IMPACT AND CONNECTION FEES, OR PERMITS AND FEES REQUIRED FOR PROJECT COMPLETION)	Х				(TO BE DETERMINED)	(TO BE DETERMINED)
01 45 33	SPECIAL INSPECTIONS AND PROCEDURES (REFER TO SECTION FOR ADDITIONAL REQUIREMENTS)		Х	х		SMITH & COMPANY ENGINEERS, INC. 901 VINE STREET P.O. BOX 72 POPLAR BLUFF, MISSOURI 63902	RANDY THURMAN (E): RANDYT@SHSMITHCO.COM PHONE: (573) 785-9621
08 71 00	DOOR HARDWARE (LOCK CORES AND KEYS - CONTRACTOR TO SUBMIT LIST OF MATERIALS REQUIRED FOR OWNER TO SUBMIT ORDER TO HARDWARE MANUFACTURER. COST OF MATERIALS AND DELIVERY BY CONTRACTOR)	х	х			STATE OF MISSOURI DEPARTMENT OF PUBLIC SAFETY MISSOURI ARMY NATIONAL GUARD CONSTRUCTION AND FACILITIES MANAGEMENT OFFICE 6819 NORTH BOUNDARY ROAD JEFFERSON CITY, MISSOURI 65101	JOSEPH SCHAEFER, DESIGN PROJECT MANAGER (P): (573) 638-9500, EXT. 39692 (C): (573) 690-4945 (E): joseph.e.schaefer10.nfg@mail.mil
11 20 00	COMMERCIAL EQUIPMENT (VENDING EQUIPMENT & ICE MACHINE)			х	х	(TO BE DETERMINED)	OWNER'S DESIGNATED PROJECT MANAGER
12 44 16	SHOWER CURTAINS (SHOWER CURTAINS AND HOOKS)			Х	Х	STATE OF MISSOURI DEPARTMENT OF PUBLIC SAFETY MISSOURI ARMY NATIONAL GUARD CONSTRUCTION AND FACILITIES MANAGEMENT OFFICE 6819 NORTH BOUNDARY ROAD JEFFERSON CITY, MISSOURI 65101	JOSEPH SCHAEFER, DESIGN PROJECT MANAGER (P): (573) 638-9500, EXT. 39692 (C): (573) 690-4945 (E): joseph.e.schaefer10.nfg@mail.mil
12 56 43	DORMITORY FURNITURE (BEDS, NIGHT STANDS, LOCKERS, SEATING, TABLES, RECYCLING CONTAINERS, FREE STANDING WASTE CONTAINERS)			х	Х	(TO BE DETERMINED)	OWNER'S DESIGNATED PROJECT MANAGER
25 00 00	INTERGRATED AUTOMATION (ENERGY MANAGEMENT SYSTEM - HARDWARE, CONDUIT, WIRING, EQUIPMENT, CELLULAR SERVICE CONTRACT)	Х	Х			PELICAN WIRELESS SYSTEMS	PELICAN WIRELESS SYSTEMS SANDERS SUPPLY SPRINGDALE, ARKANSAS 72762 (479) 750-2665
25 00 00	INTEGRATED AUTOMATION (ENERGY MANAGEMENT SYSTEM - COORDINATION TO EXISTING SITE SYSTEM)			Х	Х	STATE OF MISSOURI DEPARTMENT OF PUBLIC SAFETY MISSOURI ARMY NATIONAL GUARD CONSTRUCTION AND FACILITIES MANAGEMENT OFFICE 6819 NORTH BOUNDARY ROAD JEFFERSON CITY, MISSOURI 65101	JOSEPH SCHAEFER, DESIGN PROJECT MANAGER (P): (573) 638-9500, EXT. 39692 (C): (573) 690-4945 (E): joseph.e.schaefer10.nfg@mail.mil
27 10 00	COMMUNICATIONS SYSTEMS STRUCTURED CABLING (CONDUIT, HARDWARE, WIRING, EQUIPMENT)	Х	Х			(TO BE DETERMINED)	OWNER'S DESIGNATED PROJECT MANAGER
27 10 00	COMMUNICATIONS SYSTEMS STRUCTURED CABLING (FIBER CABLING)			X	X	STATE OF MISSOURI DEPARTMENT OF PUBLIC SAFETY MISSOURI ARMY NATIONAL GUARD CONSTRUCTION AND FACILITIES MANAGEMENT OFFICE 6819 NORTH BOUNDARY ROAD JEFFERSON CITY, MISSOURI 65101	JOSEPH SCHAEFER, DESIGN PROJECT MANAGER (P): (573) 638-9500, EXT. 39692 (C): (573) 690-4945 (E): joseph.e.schaefer10.nfg@mail.mil
28 46 00	FIRE DETECTION AND ALARM (ENTIRE SYSTEM INCLUDING HARDWARE, CONDUIT, WIRING, EQUIPMENT)	Х	Х			(TO BE DETERMINED)	(TO BE DETERMINED)
28 46 00	FIRE DETECTION AND ALARM (REMOTE MONITORING SERVICE)			Х	X	STATE OF MISSOURI DEPARTMENT OF PUBLIC SAFETY MISSOURI ARMY NATIONAL GUARD CONSTRUCTION AND FACILITIES MANAGEMENT OFFICE 6819 NORTH BOUNDARY ROAD JEFFERSON CITY, MISSOURI 65101	AT ADMINISTRATION BUILDING JOSEPH SCHAEFER, DESIGN PROJECT MANAGER (P): (573) 638-9500, EXT. 39692 (C): (573) 690-4945 (E): joseph.e.schaefer10.nfg@mail.mil

SCOPE OF WORK SCHEDULE NOTES:
1. CONTRACTOR TO COORDINATE WORK SCHEDULE WITH OWNER FURNISHED MATERIALS.

SHEET INDEX


SHEET	NO. SHEET NAME
G-001	COVER SHEET
G-002	SHEET INDEX / SCOPE OF WORK SCHEDULE
G-101	CODE ANALYSIS PLAN
C-101	TOPOGRAPHIC SURVEY
C-102	SITE DEMOLITION PLAN
	SITE DEVELOPMENT PLAN (ALTERNATE NO. 2)
C-104	SITE GRADING / EROSION CONTROL PLAN
	SITE GRADING / EROSION CONTROL PLAN (ALTERNATE NO. 2)
C-105	SITE UTILITY PLAN
C-501	SITE DEVELOPMENT DETAILS
C-502	MISCELLANEOUS SITE DETAILS
S-001	STRUCTURAL NOTES
S-101 S-102	FOUNDATION PLAN INTERIOR FRAMING PLAN
S-102 S-301	FOUNDATION DETAILS
A-101	
A-101 A-102	FLOOR PLAN (ALTERNATE NO. 1) ROOF PLAN
A-102 A-201	EXTERIOR ELEVATIONS
A-301	BUILDING SECTIONS (ALTERNATE NO. 1)
A-401	WALL SECTIONS (ALTERNATE NO. 1)
A-402	WALL SECTIONS (ALTERNATE NO. 1)
A-403	WALL SECTIONS
A-404	ENLARGED PLAN, INTERIOR ELEVATIONS (ALTERNATE NO. 1)
A-501	MISCELLANEOUS DETAILS
A-601	DOOR AND WINDOW SCHEDULES (ALTERNATE NO. 1)
A-701	REFLECTED CEILING PLAN (ALTERNATE NO. 1)
I-101	INTERIOR FINISH PLAN(ALTERNATES NO. 1 & NO. 3)
SE-101	SITE ELECTRICAL PLAN
P-101	UNDERFLOOR PLUMBING PLAN (ALTERNATE NO. 1)
P-102	PLUMBING PLAN
P-401	ENLARGED PLUMBING PLAN AND SCHEDULES (ALTERNATE NO. 1)
M-101	HVAC PLAN (ALTERNATE NO. 1)
E-101	LIGHTING PLAN (ALTERNATE NO. 1)
E-102	POWER PLAN (ALTERNATE NO. 1)
E-103 E-601	FIRE ALARM SYSTEM PLAN
⊑- 00 i	ELECTRICAL DETAILS AND SCHEDULES

GENERAL NOTES

- rack A REFER TO PROJECT MANUAL FOR ADDITIONAL REQUIREMENTS.
- (B) THE ARCHITECT AND ENGINEER'S RESPONSIBILITY IS ONLY FOR THE INFORMATION INCLUDED WITHIN THE CONSTRUCTION DOCUMENTS. ALL OTHER DOCUMENTS AND INSTRUMENTS REQUIRED FOR COMPLETION OF THE PROJECT SHALL BE THE RESPONSIBILITY OF OTHERS AND ARE HEREBY DISCLAIMED.
- $\langle \mathtt{c}
 angle$ quality standard and building code all contractors shall BE RESPONSIBLE FOR KNOWING THE QUALITY AND PUBLIC SAFETY REGULATIONS SET FORTH IN THE GOVERNING CODES AND OTHER APPLICABLE REGULATIONS OF LOCAL AND STATE AGENCIES HAVING JURISDICTION WHICH GOVERN EACH CONTRACTOR'S WORK.
- (D) THE ARCHITECT AND ENGINEER IS NOT RESPONSIBLE FOR FIELD ACTIVITIES ON THIS PROJECT WITHOUT DIRECT INSPECTION OF THE WORK IN PROGRESS. IF FIELD CONDITIONS ARE UNCOVERED THAT REQUIRE A CHANGE OR ADDITIONAL INFORMATION, THE ARCHITECT AND ENGINEER DOES NOT DELEGATE THEIR AUTHORITY TO ANYONE ELSE FOR DETERMINING THE MEANING OF THEIR PLANS OR SPECIFICATIONS.
- $\langle \mathsf{E} \rangle$ FIELD VERIFY EXISTING CONDITIONS BY DETAILED INSPECTION PRIOR TO SUBMITTING BID AND BEGINNING WORK. NOTIFY ARCHITECT AND ENGINEER IF EXISTING CONDITIONS DEVIATE SUBSTANTIALLY FROM THOSE INDICATED HEREIN.

STATE OF MISSOURI MICHAEL L. PARSON,

GOVERNOR

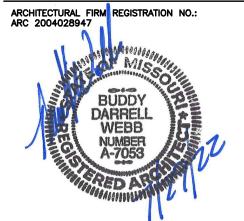

SHEETS BEARING THIS SEAL ARE AUTHENTICATED, RESPONSIBILITY FOR ALL OTHER PLANS, SPECIFICATIONS OR INSTRUMENTS ARE DISCLAIMED.

OFFICE OF ADMINISTRATION DIVISION OF FACILITIES MANAGEMENT, DESIGN AND CONSTRUCTION

DEPARTMENT OF PUBLIC SAFETY MISSOURI ARMY NATIONAL GUARD

CONSTRUCT NEW 60 SOLDIER BARRACKS

WAPPAPELLO TRAINING SITE 461 COUNTY ROAD 517 WAPPAPELLO, MISSOURI

PROJECT # T2124-01 6325 SITE# ASSET # 8136325016

REVISION: DATE: REVISION: DATE:_ REVISION:_ DATE:


ISSUE DATE: 07/29/2022CAD DWG FILE:T124-01-6325-8136325016-G-002 DRAWN BY: BW-AP CHECKED BY: BDW DESIGNED BY: BW-AP

SHEET INDEX / SCOPE OF WORK SCHEDULE

07/29/2022

ABBREVIATIONS LEGEND

					OFFICE OF ADM
AFF AC	ABOVE FINISHED FLOOR ACOUSTICAL	INSUL INT	INSULATE INTERIOR		DIVISION OF FA
A/C	AIR CONDITIONING	JST	JOIST		
ALT AL	ALTERNATE ALUMINUM	JT JNT	JOINT JOINT		MANAGEMENT,
ALUM AB	ALUMINUM ANCHOR BOLT	KIT LH	KITCHEN LEFT HAND		DESIGN AND CO
ARCH	ARCHITECT (URAL)	LF	LINEAL FOOT		DESIGN III (D CC
BSMT BRG	BASEMENT BEARING	LTL L	LENGTH LINTEL		
ВМ	BENCH MARK	LL	LIVE LOAD		DEPARTMENT
BEL BLK	BELOW BLOCK	MACH MH	MACHINE MANHOLE		PUBLIC SAFE
BLKG BD	BLOCKING BOARD	MFR MAS	MANUFACTURER MASONRY		
BW	BOTH WAYS	MO	MASONRY OPENING		MISSOURI AR
BOT BF	BOTTOM BOTTOM OF FOOTING	MAX MECH	MAXIMUM MECHANIC(AL)		NATIONAL GU
BOF	BOTTOM OF FOOTING	MED	MEDIUM		
BRK BLDG	BRICK BUILDING	MBR MET	MODIFIED BITUMEN ROOFING METAL		-
BUR CAB	BUILT-UP ROOFING CABINET	MTL	METAL METER(S)		CONCEDITOR
CAB	CEILING	M MWK	METER(S) MILLWORK		CONSTRUCT N
CL C/O	CENTER LINE CENTER OF	MIN MISC	MINIMUM MISCELLANEOUS		60 SOLDIER BA
CC	CENTER TO CENTER	MT	MOUNT(ED), (ING)		
CLR COL	CLEAR COLUMN	NOM N	NOMINAL NORTH		
CONC	CONCRETE	NIC	NOT IN CONTRACT		
CMU CONST	CONCRETE MASONRY UNIT CONSTRUCTION	NTS OC	NOT TO SCALE ON CENTER(S)		
CONTR CONT	CONTRACTOR CONTINUOUS	OPG OPH	OPENING OPPOSITE HAND		WAPPAPELLO
CNTR	COUNTER	OD	OUTSIDE DIAMETER		TRAINING SITI
CFL CISK	COUNTER FLASHING COUNTERSUNK	OO OA	OUT TO OUT OVERALL		461 COUNTY R
CRS	COURSE(S)	ОН	OVERHEAD		
CF CY	CUBIC FOOT CUBIC YARD	PC PNT	PIECE PAINT(ED)		WAPPAPELLO,
DL DEM	DEAD LOAD DEMOLISH, DEMOLITION	PTD PKG	PAINT(ED) PARKING		
DTL	DETAIL	PLAM	PLASTIC LAMINATE		
DIAG DIAM	DIAGONAL DIAMETER	PL PWD	PLATE PLYWOOD		PROJECT # T2
DIM	DIMENSION	PVC	POLYVINYL CHLORIDE		
DR DS	DOOR DOWN SPOUT	PSF PSI	POUNDS PER SQUARE FT. POUNDS PER SQUARE IN.		SITE # 63
D DWG	DRAIN DRAWING	PT PL	PRESSURE TREATED PROPERTY LINE		ASSET # 81
)F	DRINKING FOUNTAIN	REM	REMOVE		
E EIFS	EAST EXTERIOR INSULATION AND FINISH SYSTEM	RET RH	RETURN RIGHT HAND		BUILDING # 3
ELEC EWC	ELECTRIC(AL) ELECTRIC WATER COOLER	RD RFG	ROOF DRAIN ROOFING		
EL	ELEVATION	RM	ROOM		
LEV	ELEVATION ELEVATOR	RO SNT	ROUGH OPENING SEALANT		REVISION:
EMER	EMERGENCY	SLNT	SEALANT		DATE:
EQ EXG	EQUAL EXISTING	SEC SECT	SECTION SECTION		REVISION:
XIST XP	EXISTING EXPOSED	SHTHG SHT	SHEATHING SHEET		DATE:
EXT	EXTERIOR	SIM	SIMILAR		REVISION:
OF O	FACE OF FINISH FACE OF	SC S	SOLID CORE SOUTH		DATE:
OM	FACE OF MASONRY	SF	SQUARE FOOT		ISSUE DATE: 07
OS IN	FACE OF STUDS FINISH(ED)	SI SY	SQUARE INCH SQUARE YARD		
FE	FINISHED FLOOR ELEV.	STD	STANDARD		
FL E	FINISHED FLOOR LINE FIRE EXTINGUISHER	STO SUS	STORAGE SUSPENDED		CAD DWG FILE:T12
EC T	FIRE EXTINGUISHER CABINET FIRE TREATED	SYM TEL	SYMMETRY, (ICAL) TELEPHONE		DRAWN BY: BV
LG	FLASHING	TV	TELEVISION		CHECKED BY: BD
ELR ED	FLOOR FLOOR DRAIN	THK T&G	THICK(NESS) TONGUE & GROOVE		DESIGNED BY: BV
TG	FOOTING	TM	TOP OF MASONRY		
-DN -NDN	FOUNDATION FOUNDATION	TOM TS	TOP OF MASONRY TOP OF STEEL		SHEET TITLE:
FUR GA	FURRED(ING) GAGE, GAUGE	TOS TW	TOP OF STEEL TOP OF WALL		SHEET HILE.
GV	GALVANIZED	TOW	TOP OF WALL		SHEET IND
GALV GC	GALVANIZED GENERAL CONTRACT(OR)	TYP UON	TYPICAL UNLESS OTHERWISE NOTED		OTTER I HAF
GL	GLASS, GLAZING	UNO	UNLESS NOTED OTHERWISE		CCODE OE
GP GYP	GYPSUM GYPSUM	VERT VT	VERTICAL VINYL TILE		SCOPE OF
GWB	GYPSUM WALL BOARD	WSCT	WAINSCOT		COMEDIA
HTG HVAC	HEATING HEATING/VENTILATING/AIR COND.	WC WWF	WATER CLOSET WELDED WIRE FABRIC		SCHEDULE
HT HC	HEIGHT HOLLOW CORE	W W	WEST WIDTH, WIDE		
HM	HOLLOW METAL	WIN	WINDOW		
HK HOR	HOOK(S) HORIZONTAL	WO W/O	WITHOUT WITHOUT		SHEET NUMBER:
ΗВ	HOSE BIBB	WD	WOOD		
INS	INSULATE(D), (ION)				$\sim \sim \sim \sim \sim$
				_	

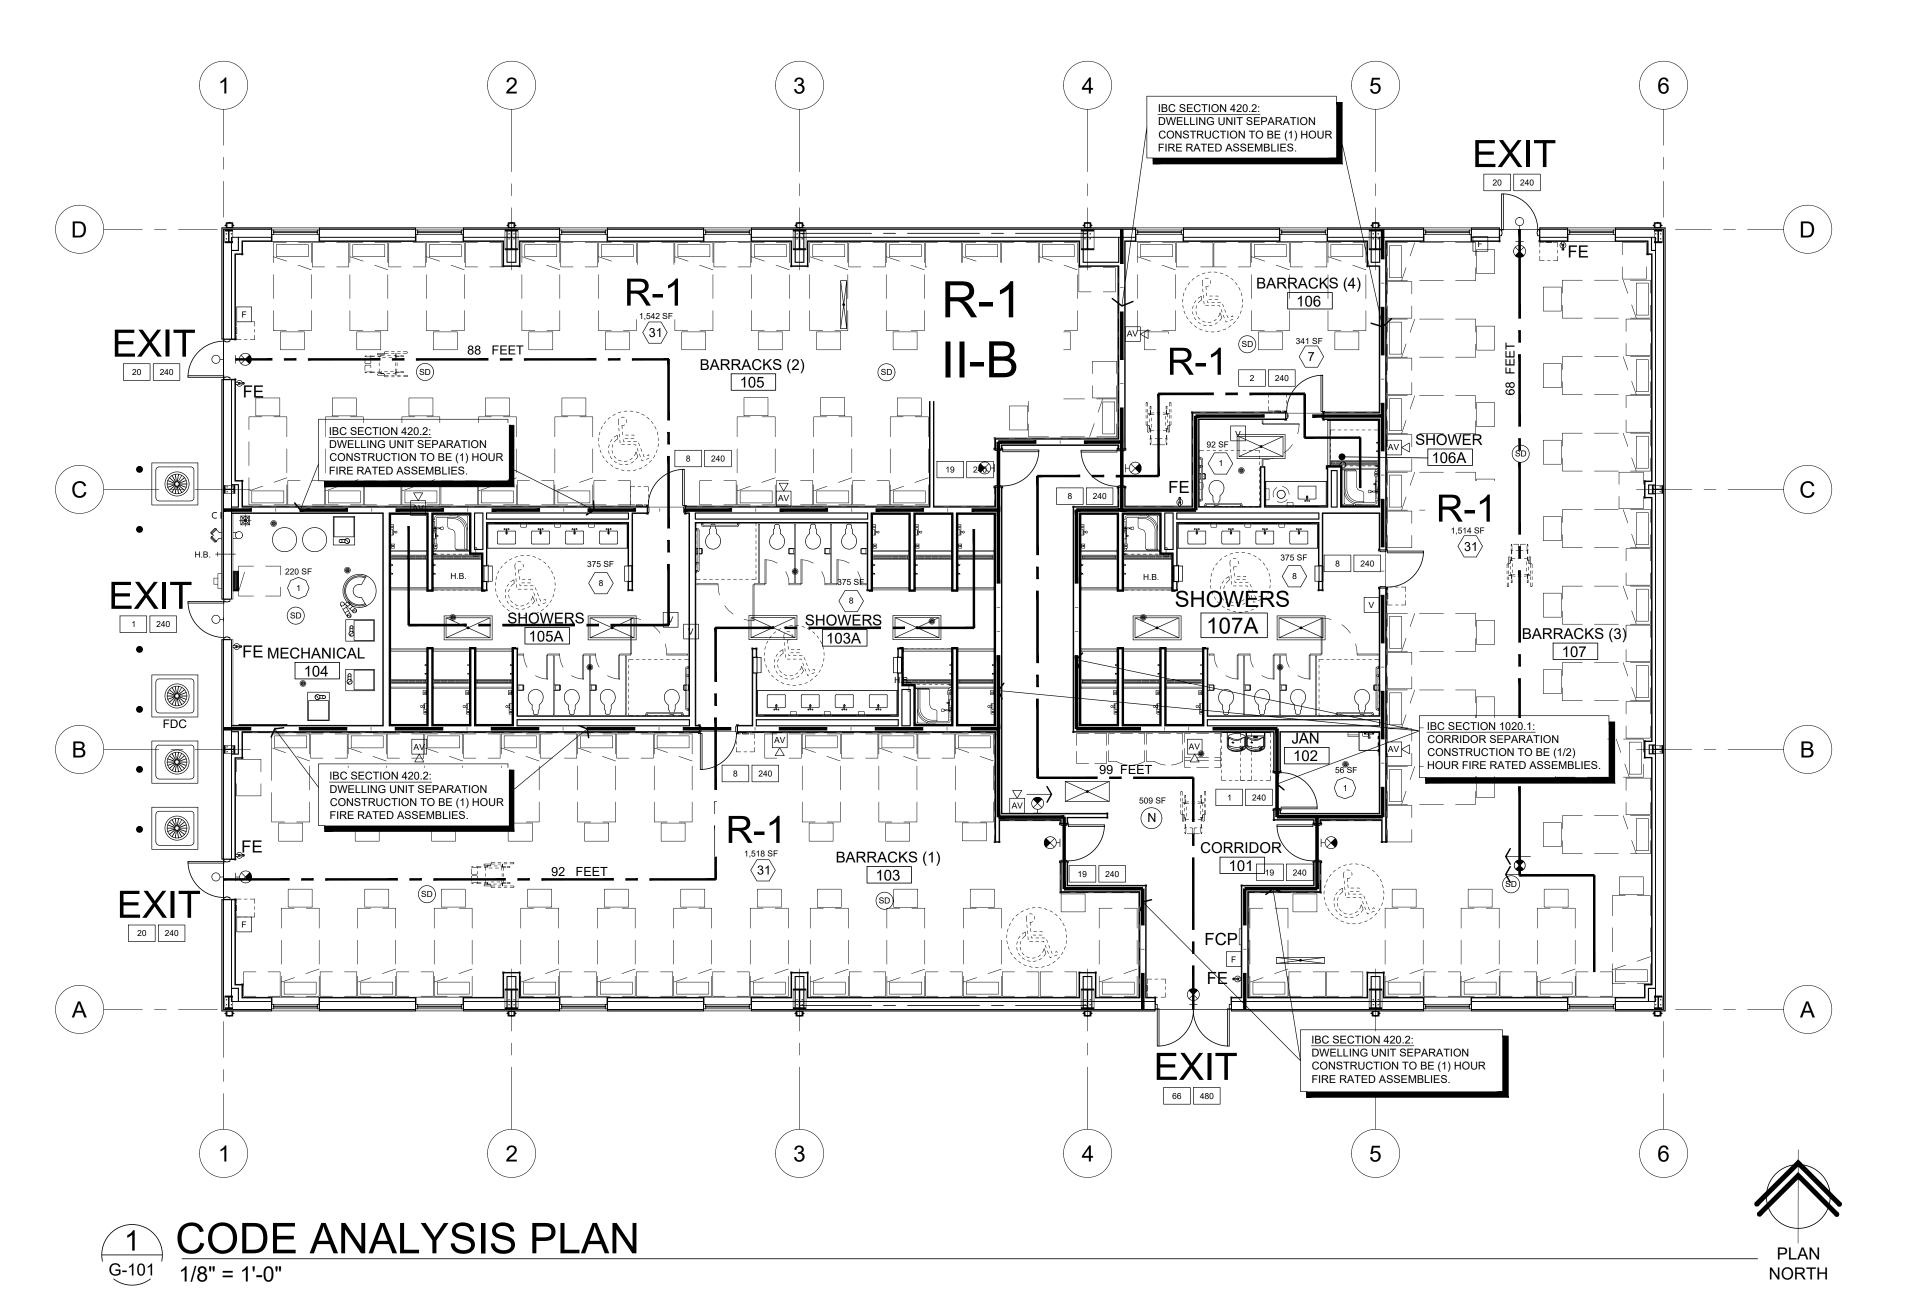

OCCUPANCY LOAD SUMMARY

OOM OR AREA	AREA PER	OCCUPANTS
REFER TO FLOOR PLAN)	OCCUPANT(S.F.)	(QTY.)
01 - CORRIDOR	0	0
)2 - JANITOR	300	1
03 - BARRACKS (1)	50	31
03A - SHOWERS	50	8
04 - MECHANICAL	300	1
05 - BARRACKS (2)	50	31
05A - SHOWERS	50	8
06 - BARRACKS (4)	50	7
06A - SHOWERS Ó	50	1
07 - BARRACKS (3)	50	31
)7A - SHOWERS (50	8

TOTAL OCCUPANCY

BUILDIN	G CODE
JURISDICTION:	MISSOURI OFFICE OF ADMINISTRATION - FACILITIES MANAGEMENT DESIGN & CONSTRUCTION
CITY: COUNTY: ZIP CODE:	WAPPAPELLO, MISSOURI BUTLER 63966
GOVERNING CODES AND STANDARDS	
BUILDING CODE: PLUMBING CODE: MECHANICAL CODE: ELECTRICAL CODE: FIRE CODE: FUEL / GAS CODE: ENERGY CODE: ACCESSIBLE CODE: ACCESSIBLITY CODE:	2018 IBC 2018 IPC 2018 IMC 2017 NEC 2018 IFC 2018 IFGC 2018 IECC 2009 ICC A117.1 2010 ADA
USE GROUP & CONSTRUCTION TYPE PRIMARY USE GROUP: MIXED USE AND OCCUPANCY: CONSTRUCTION TYPE:	R-1 (RESIDENTIAL) SEPARATED II-B (NON-COMBUSTIBLE / UNPROTECTED)
AREA MODIFICATIONS FRONTAGE INCREASE: AUTOMATIC SPRINKLER INCREASE:	NOT APPLIED PROVIDED
ALLOWABLE BUILDING HEIGHT & ARE	<u>A</u>
HEIGHT (S): NUMBER OF STORIES (S): AREA (S1):	75'-0" 5 STORIES 64,000 SQ. FT.
ACTUAL BUILDING HEIGHT & AREA HEIGHT: NO. OF STORIES: AREA:	16'-8" 1 STORY 7,800 SQ. FT.
FIRE PROTECTION SYSTEMS AUTOMATIC SPRINKLER SYSTEM: PORTABLE FIRE EXTINGUISHERS: MANUAL FIRE ALARM: AUTOMATIC SMOKE DETECTION:	REQUIRED (IBC 903.2.8) PROVIDED (IBC 906.1) REQUIRED (IBC 907.2.8.1) REQUIRED (IBC 907.2.8.2)
STRUCTURAL DESIGN (REFER TO STRUCTURAL DRAWINGS)	
,	20.0 0.00
1. ROOF LIVE LOAD 2. ROOF DEAD/COLLATERAL LOADS A. DEAD LOAD (DOES NOT INCLUDE PR	20.0 PSF RECAST) 20.0 PSF
B. SPRINKLER SYSTEM UNIFORM BRANCH PIPE LOAD:	1.0 PSF

1. ROOF LIVE LOAD		20.0 PSF
2. ROOF DEAD/COLLATERAL LOADS A. DEAD LOAD (DOES NOT INCLUDE PRE B. SPRINKLER SYSTEM	CAST)	20.0 PSF
UNIFORM BRANCH PIPE LOAD:		1.0 PSF
LINEAL LOOP / TEE MAIN PIPE LOAD:		25.0 PLF
C. SHOWER CEILING:		20.0 PSF
3. SNOW LOADS	Ce = 1.0	Ct = 1.0
GROUND LOAD (Pg):		15 PSF
MINIMUM ROOF SNOW LOAD (Pf):		10.5 PSF
IMPORTANCE FACTOR (Is):		1.0
4 WIND LOADS	GO	pi = ±0.18
BASIC WIND SPEED:		105 MPH
		81.3 MPH
EXPOSURE:		С
GCpi:		±0.18
Kzt:		1.0
Kd:		0.85
5. SEISMIC		
Ss:		0.987
S1:		0.340
Sds:		0.790
Sd1:		0.340
IMPORTANCE FACTOR (Ie):		1.0

COMMERCIAL ENERGY EFFICIENCY CODE

SITE CLASS:

DESIGN CATEGORY:

COMPLIANCE WITH BUILDING ENERGY EFFICIENCY REQUIREMENTS BASED UPON APPLICABLE ENERGY CODE (PERFORMANCE METHOD). REFER TO PROJECT MANUAL

PLUMBING FIXTURE SUMMARY

GENERAL IPC TABLE 403.1 PRIMARY OCCUPANCY: TOTAL OCCUPANCY:	R-1 (RESIDENTIAL) 127
MINIMUM PLUMBING FACILITIES REQUIR CALCULATED BY RATIO BASED UPON AG FEMALE: MALE:	
PLUMBING FIXTURES WATER CLOSETS (URINALS): REQUIRED FOR FEMALE: PROVIDED FOR FEMALE: REQUIRED FOR MALE: PROVIDED FOR MALE:	1 PER 100 8 / 10 = 1 1 119 / 10 = 12 12
LAVATORIES: REQUIRED FOR FEMALE: PROVIDED FOR FEMALE: REQUIRED FOR MALE: PROVIDED FOR MALE:	1 PER 100 8 / 10 = 1 1 119 / 10 = 12 12
SHOWERS: REQUIRED FOR FEMALE: PROVIDED FOR FEMALE: REQUIRED FOR MALE: PROVIDED FOR MALE:	8 / 8 = 1 1 119 / 8 = 15 15
DRINKING FOUNTAINS: REQUIRED: PROVIDED:	1 PER 100 127 / 100 = 2 2
SERVICE SINK REQUIRED:	1

SERVICE SINK PROVIDED:

GENERAL NOTES

STATE OF MISSOURI MICHAEL L. PARSON,

GOVERNOR

SHEETS BEARING THIS SEAL ARE AUTHENTICATED, RESPONSIBILITY FOR ALL OTHER PLANS, SPECIFICATIONS OR INSTRUMENTS ARE DISCLAIMED.

OFFICE OF ADMINISTRATION

DESIGN AND CONSTRUCTION

DIVISION OF FACILITIES

MANAGEMENT,

DEPARTMENT OF PUBLIC SAFETY

MISSOURI ARMY

NATIONAL GUARD

CONSTRUCT NEW

WAPPAPELLO

ASSET#

REVISION:

REVISION: DATE:

REVISION:

DATE:

SHEET TITLE:

CODE

PLAN

BUILDING # 3

TRAINING SITE

60 SOLDIER BARRACKS

461 COUNTY ROAD 517

PROJECT # T2124-01

ISSUE DATE: 07/29/2022

CHECKED BY: BDW DESIGNED BY: BW-AP

CAD DWG FILE: <u>T2124-01-6325-8136325</u>016-G-101 DRAWN BY: <u>BW-AP</u>

WAPPAPELLO, MISSOURI

6325

8136325016

ARCHITECTURAL FIRM REGISTRATION NO.: ARC 2004028947

- $\langle A \rangle$ REFER TO PROJECT MANUAL FOR ADDITIONAL REQUIREMENTS.
- $\langle \mathtt{B} \rangle$ REFER TO PLANS, SECTIONS, AND DETAILS FOR CONSTRUCTION OF FIRE RATED ASSEMBLIES. WHERE UNDERWRITERS LABORATORY (UL) TEST NUMBERS ARE REFERENCED, CONTRACTOR SHALL PROVIDE CONSTRUCTION MATERIALS, MEANS AND METHODS TO COMPLY WITH TESTED ASSEMBLY.
- © REFER TO FIRE ALARM, MECHANICAL, AND ELECTRICAL DRAWINGS FOR ADDITIONAL REQUIREMENTS.
- (D) OWNER FURNISHED AND INSTALLED FURNISHINGS AND FIXTURES SHOWN FOR REFERENCE ONLY.
- ⟨E⟩ CONTRACTOR TO PROVIDE PORTABLE FIRE EXTINGUISHERS DURING CONSTRUCTION AS REQUIRED TO PROTECT THE WORK AREA AND EACH STORAGE UNIT AND JOB TRAILER PER THE FIRE
- \langle F \rangle CONTRACTOR TO SUBMIT FIRE SPRINKLER SYSTEM ENGINEERING SUBMITTALS FOR REVIEW AND APPROVAL.
- G SURFACE MOUNTED PORTABLE FIRE EXTINGUISHERS SHALL BE UL LISTED ABC TYPE, WITH 10 LBS. CAPACITY.
- $\langle \mathsf{H} \rangle$ EXIT DISCHARGE DOORS, PROVIDE TACTILE EXIT SIGNS STATING "EXIT" WITH BRAILLE LETTERING. SIGN AND MOUNTING TO COMPLY WITH ANSI A117.1. REFER TO FLOOR PLAN FOR LOCATIONS.

SPECIAL INSPECTIONS

1. REFER TO PROJECT MANUAL - SECTION 01 45 33 SPECIAL INSPECTIONS AND PROCEDURES FOR REQUIREMENTS.

2. THE OWNER SHALL PROVIDE THE SERVICES OF AN INDEPENDENT TESTING LABORATORY TO PERFORM TESTING AND SPECIAL INSPECTIONS UNLESS OTHERWISE INDICATED.

SYMBOLS LEGEND

PRIMARY USE GROUP: (RESIDENTAIL) CONSTRUCTION TYPE: (NON-COMBUSTIBLE/UNPROTECTED) ROOM SQUARE FOOTAGE: 325 SF OCCUPANT LOAD SERVED BY EXIT BUT NOT COUNTED IN TOTAL OCCUPANT LOAD: (1/2) HOUR FIRE RATED ASSEMBLY EXTENDS UP TO DECK, FIRE SEAL COMPLETELY: (1) HOUR FIRE RATED ASSEMBLY EXTENDS UP

- ROOM OCCUPANT LOAD AT 15 SQ. FT. NET PER PERSON:
- ROOM OCCUPANT LOAD AT 20 SQ. FT. NET PER PERSON: ROOM OCCUPANT LOAD AT 50 SQ. FT. GROSS PER PERSON:
- ROOM OCCUPANT LOAD AT 300 SQ. FT GROSS PER

FIRE DEPARTMENT CONNECTION

FIRE ALARM PULL STATION

FIRE ALARM AUDIO / VISUAL DEVICE

SMOKE DETECTOR

FIRE EXTINGUISHER (SURFACE MOUNTED WITH BRACKET)

— – EXIT ACCESS TRAVEL DISTANCE (LENGTH IN FEET) ACCESSIBLE CLEAR FLOOR AREA

SHEET NUMBER:

ANALYSIS

3 OF 36 SHEETS 07/29/2022


DESIGN OCCUPANT LOAD SERVED BY EXIT:
MAXIMUM ALLOWABLE CAPACITY: (EXAMPLE: 36"/0.15 = 240)


TÓ DECK, FIRE SEAL COMPLETELY:


FIRE ALARM CONTROL PANEL

FIRE VISUAL ALARM

EMERGENCY EXIT LIGHTING

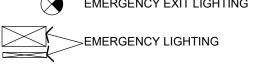


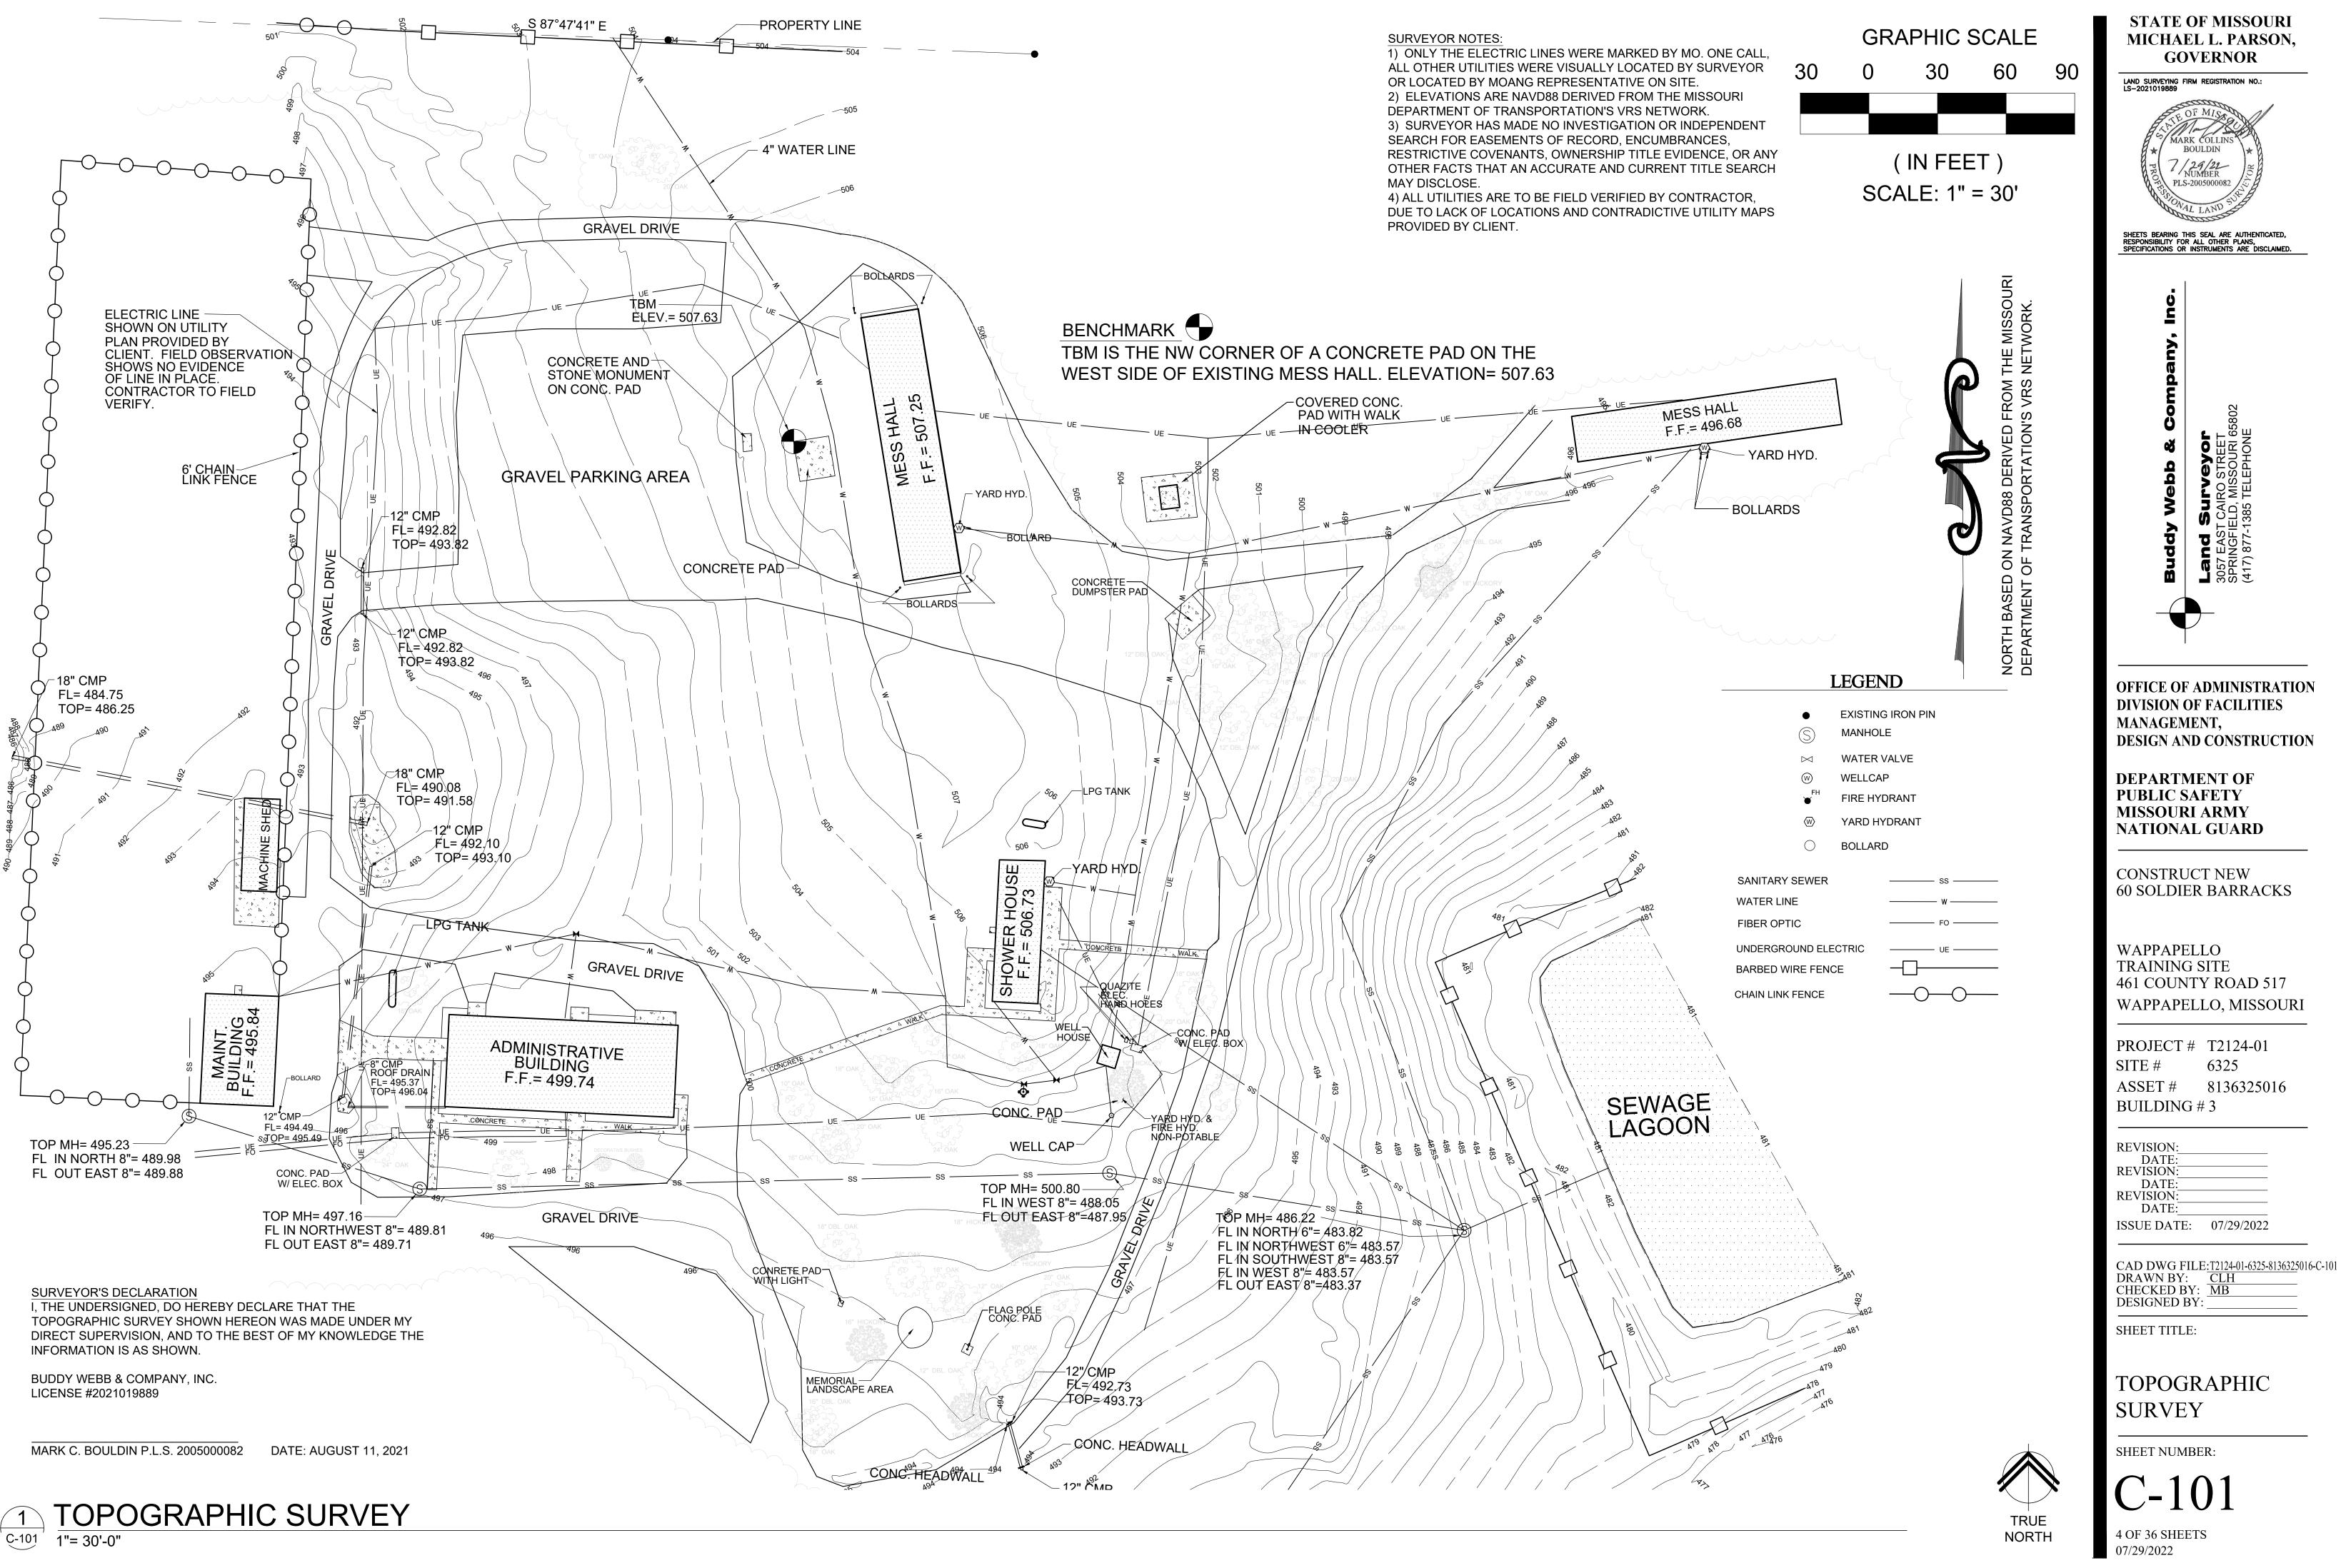

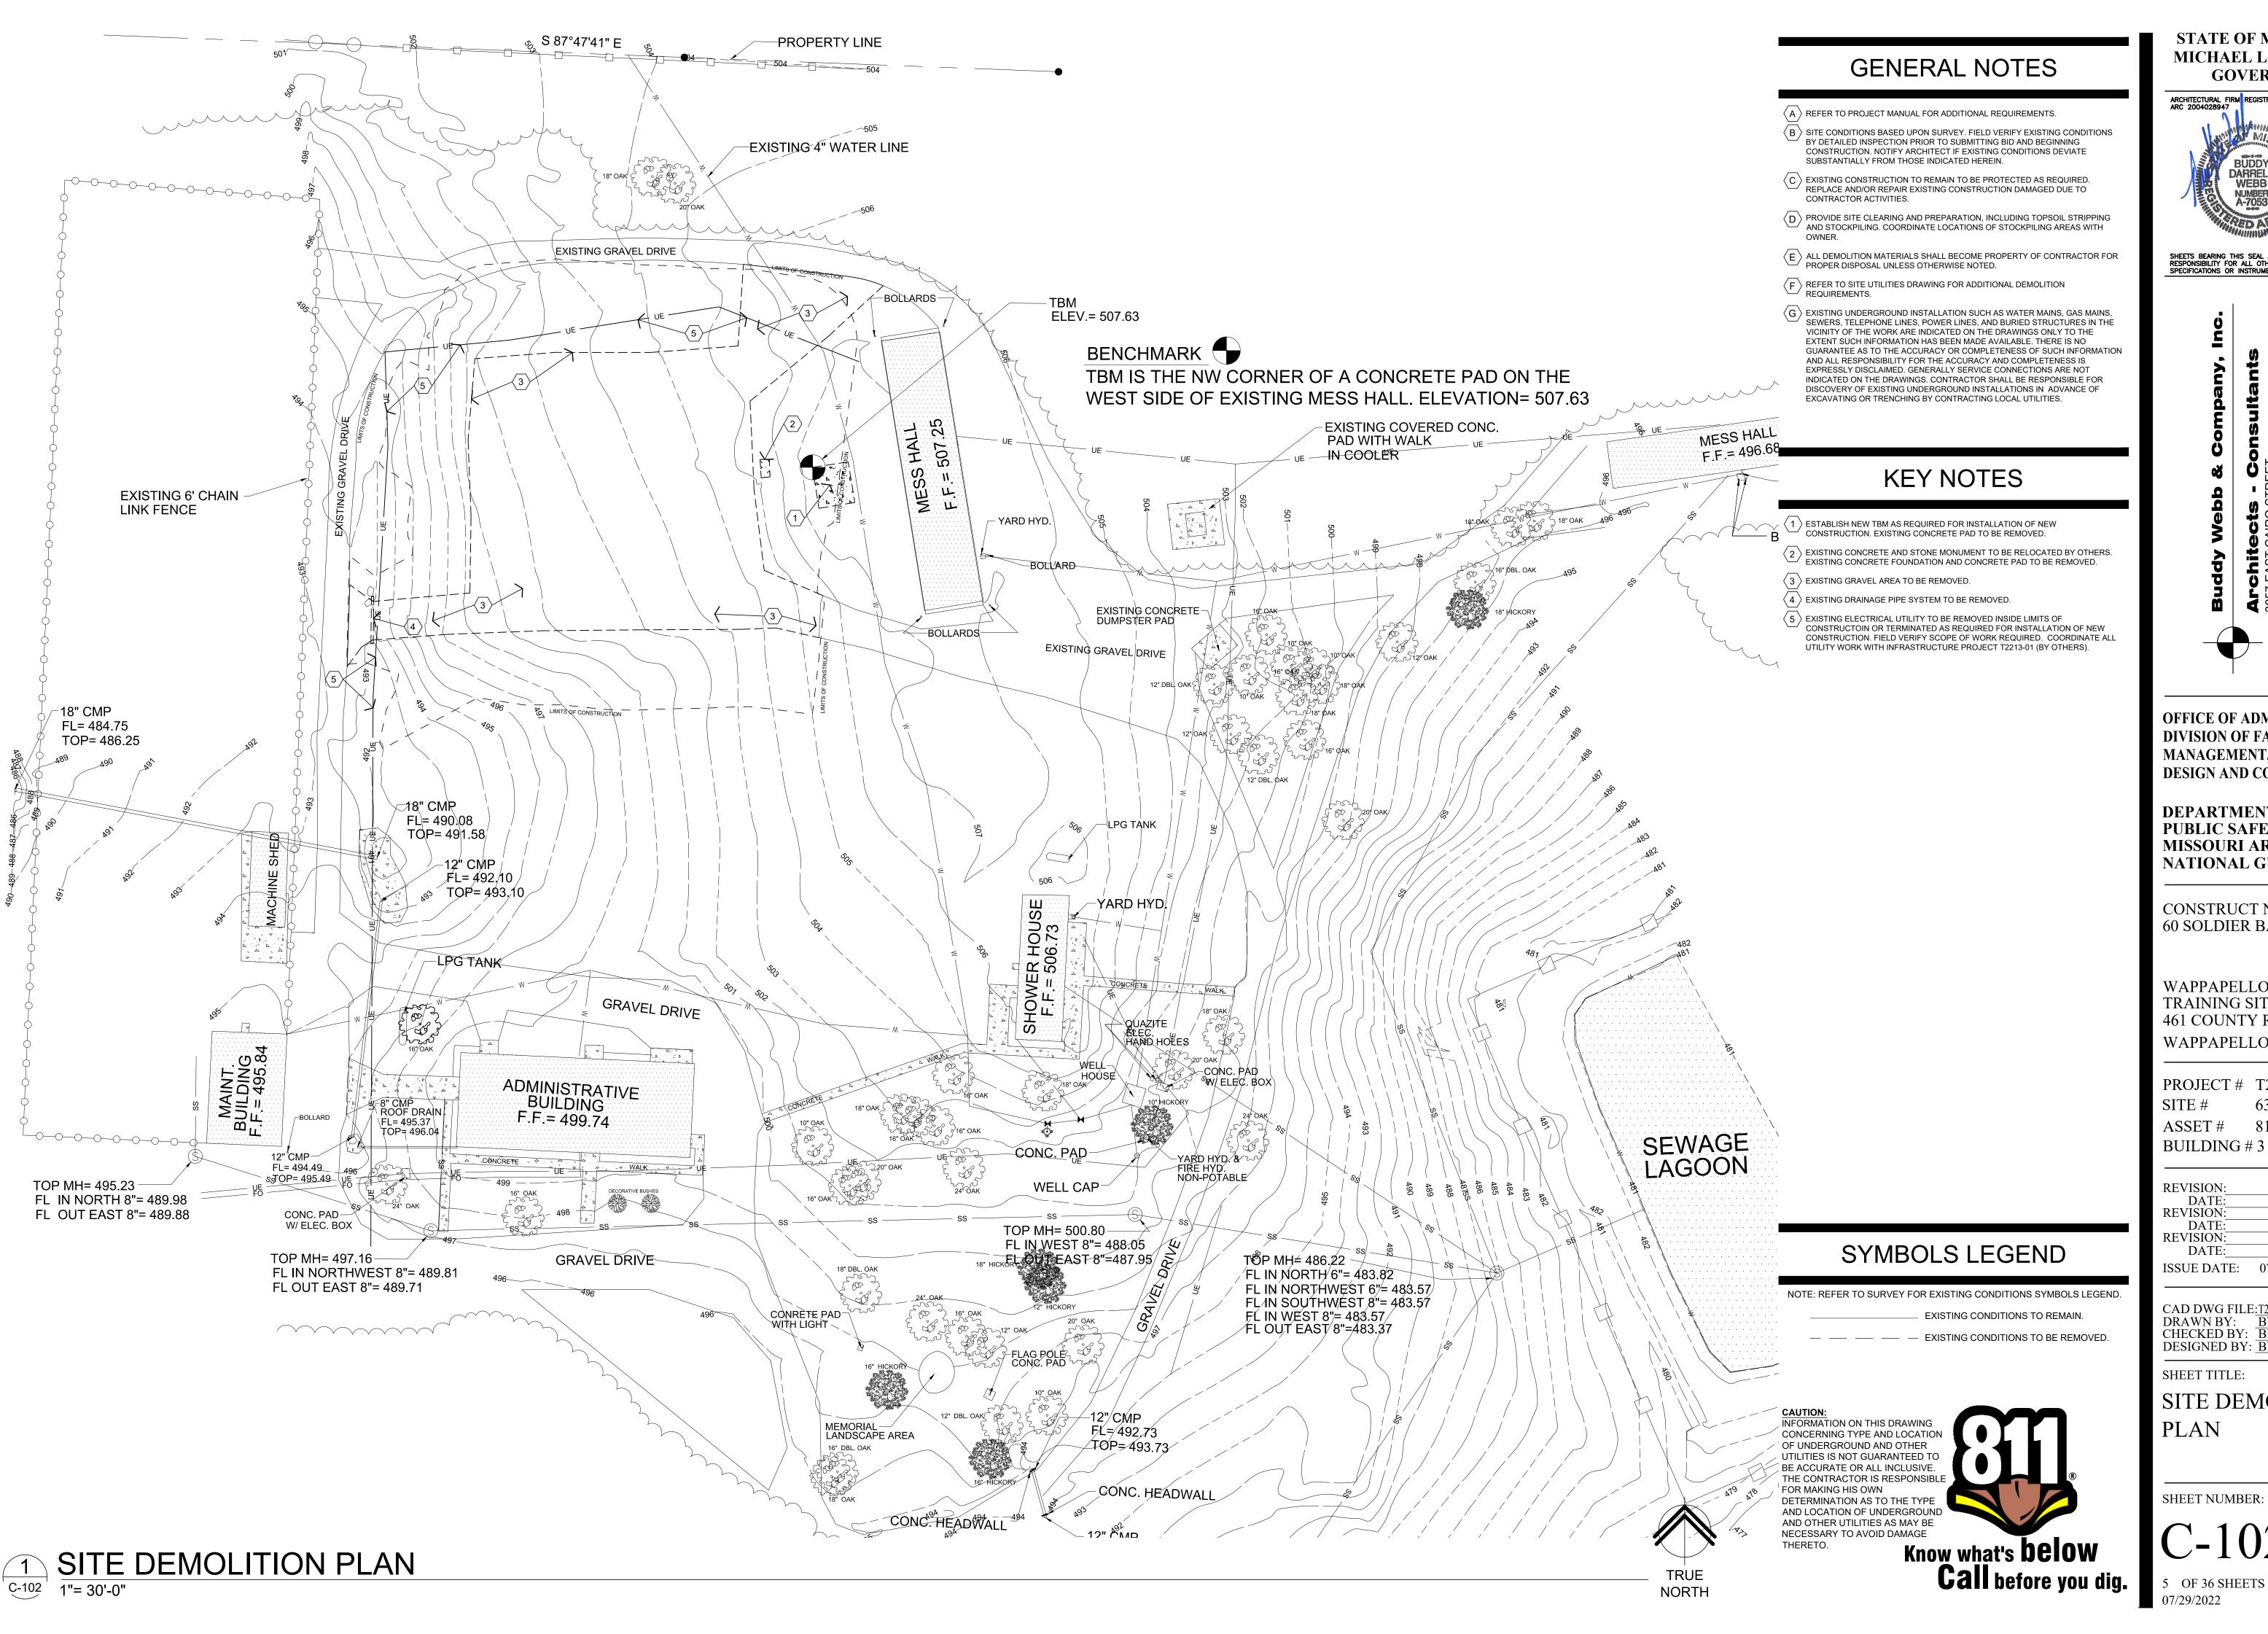

STATE OF MISSOURI MICHAEL L. PARSON,

GOVERNOR ARCHITECTURAL FIRM REGISTRATION NO.: ARC 2004028947

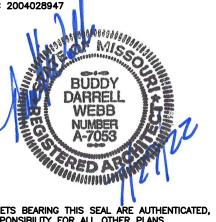

SHEETS BEARING THIS SEAL ARE AUTHENTICATED, RESPONSIBILITY FOR ALL OTHER PLANS, SPECIFICATIONS OR INSTRUMENTS ARE DISCLAIMED.

OFFICE OF ADMINISTRATION DIVISION OF FACILITIES MANAGEMENT, **DESIGN AND CONSTRUCTION**

DEPARTMENT OF PUBLIC SAFETY MISSOURI ARMY NATIONAL GUARD

CONSTRUCT NEW 60 SOLDIER BARRACKS

WAPPAPELLO TRAINING SITE 461 COUNTY ROAD 517 WAPPAPELLO, MISSOURI

PROJECT # T2124-01 6325 8136325016 ASSET#

REVISION: DATE: **REVISION:** DATE: **REVISION:**

DATE: ISSUE DATE: 07/29/2022


CAD DWG FILE: <u>T2124-01-6325-81363</u>25016-C-102 DRAWN BY: <u>BW-AP</u> CHECKED BY: BDW DESIGNED BY: BW-AP

SHEET TITLE:


SITE DEMOLITION PLAN

SHEET NUMBER:

C-102

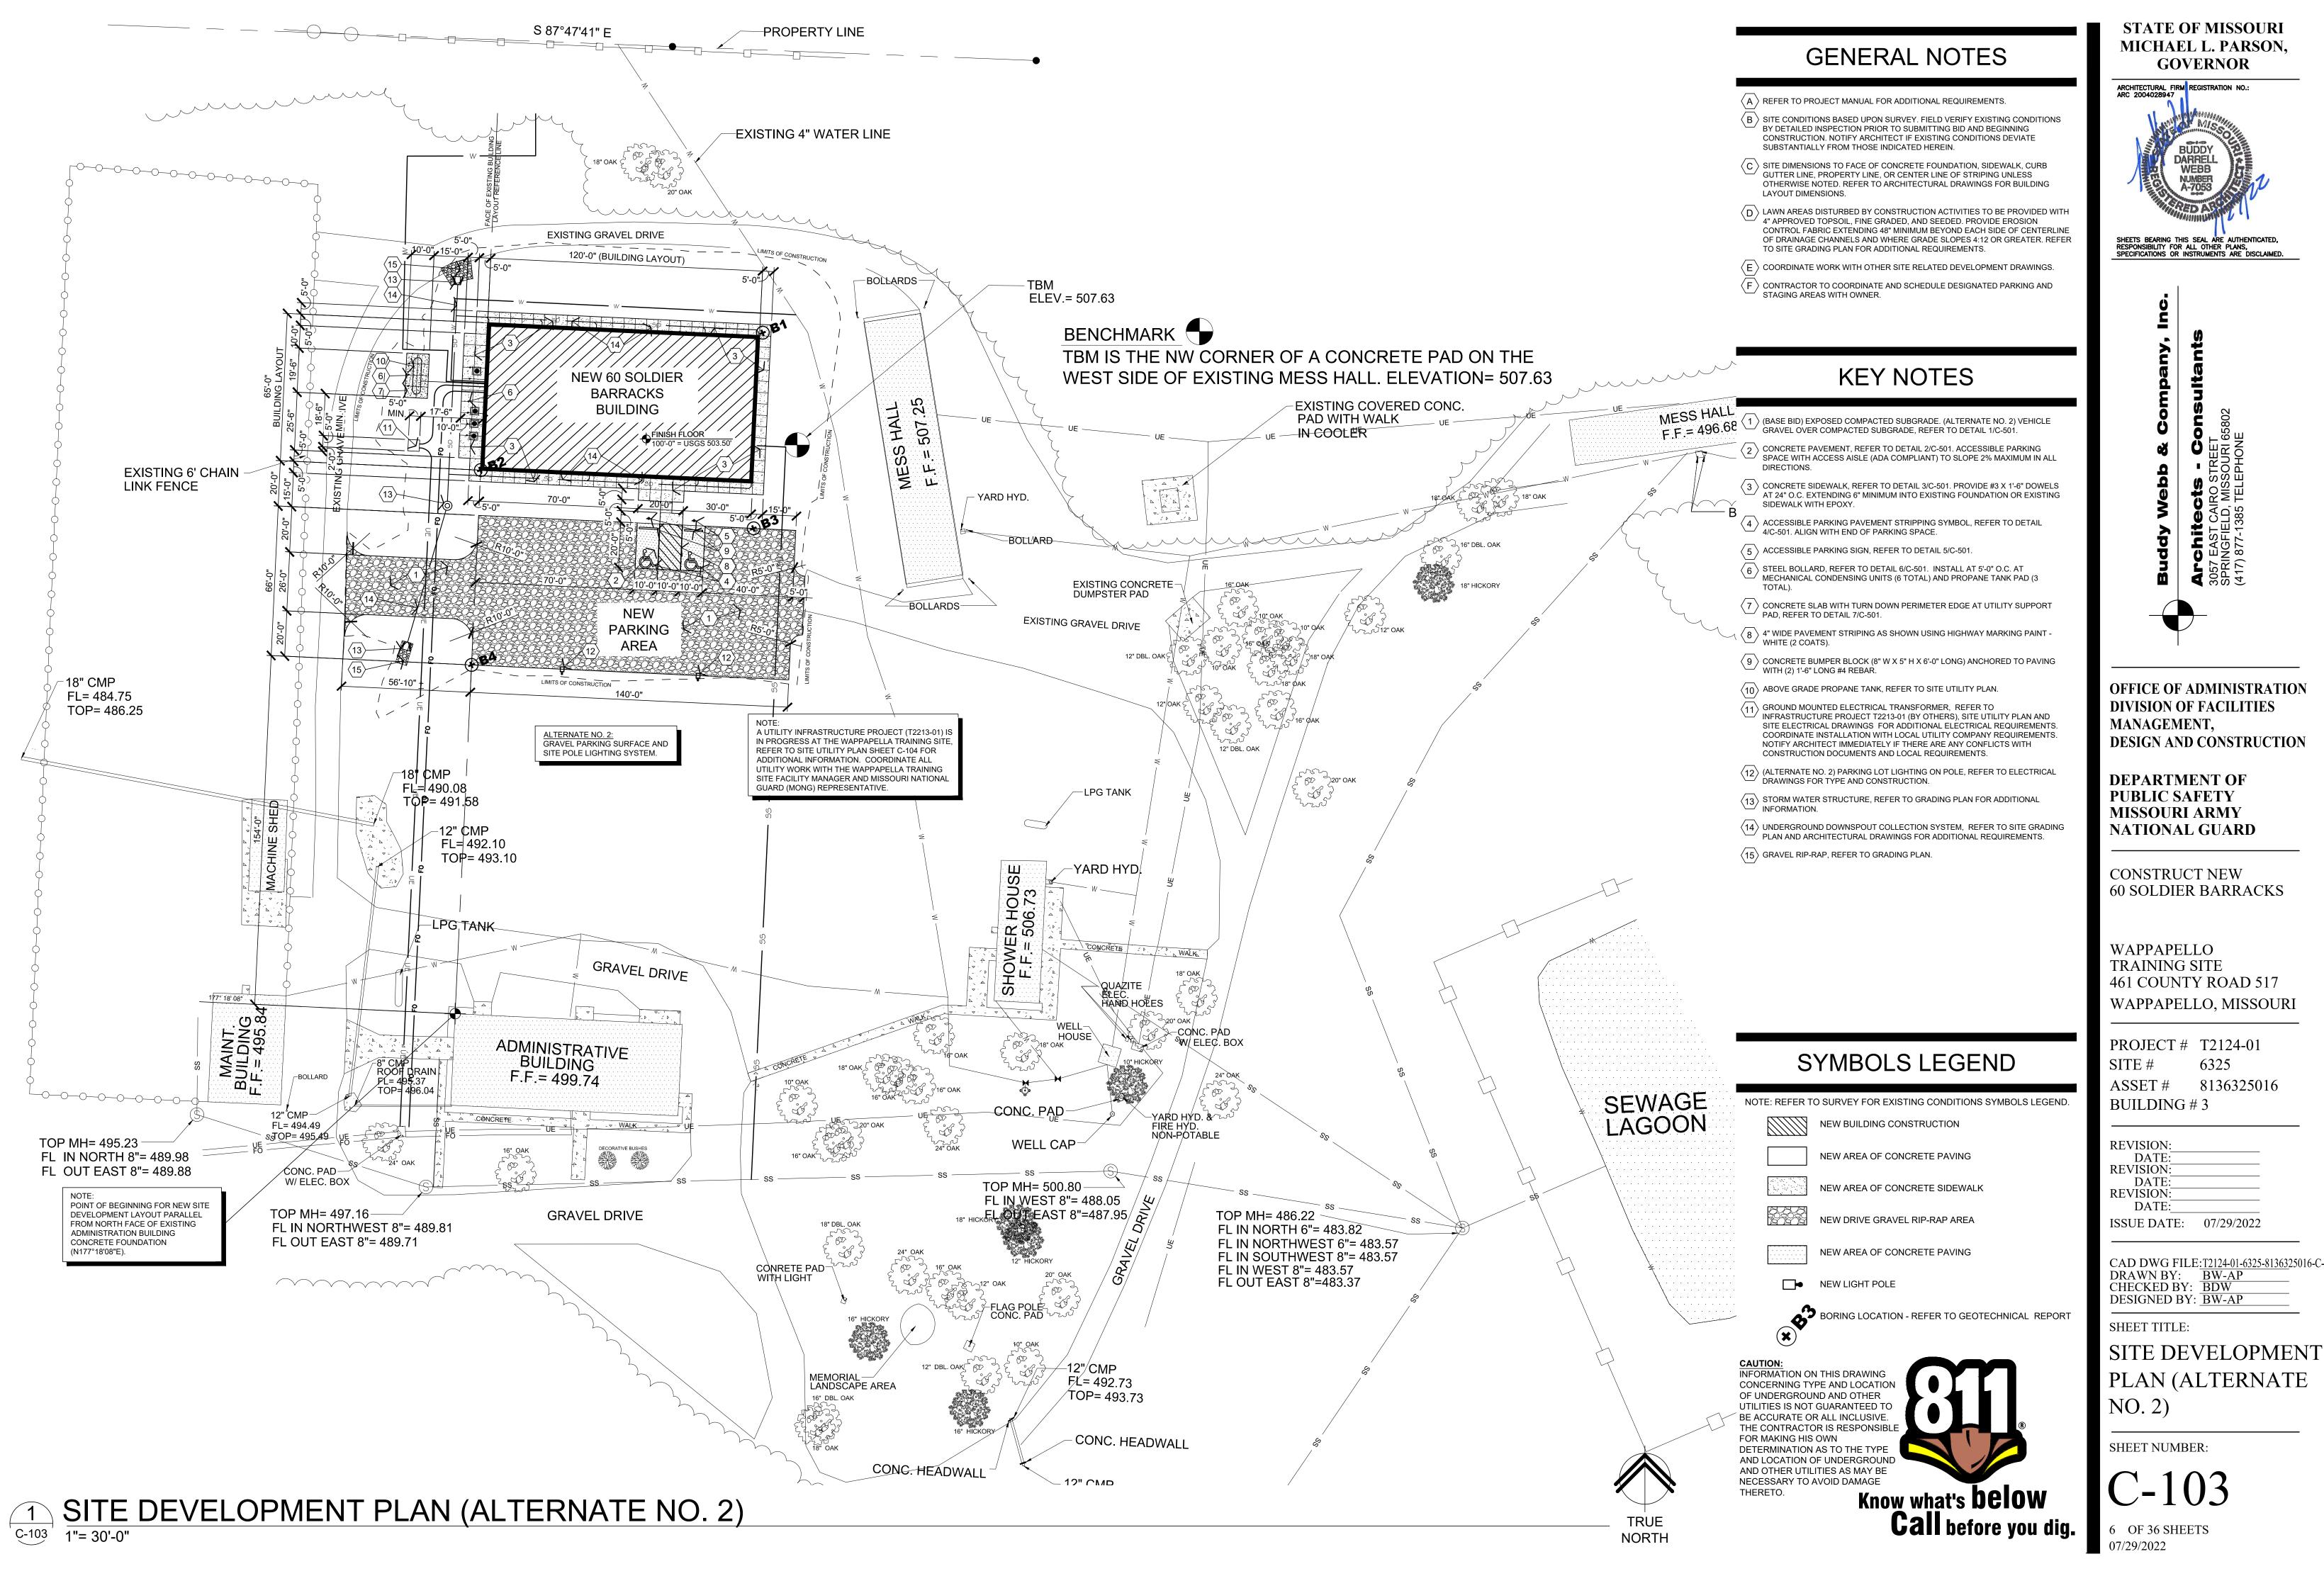

CAD DWG FILE:<u>T2124-01-6325-81363</u>25016-C-103 DRAWN BY: <u>BW-AP</u>

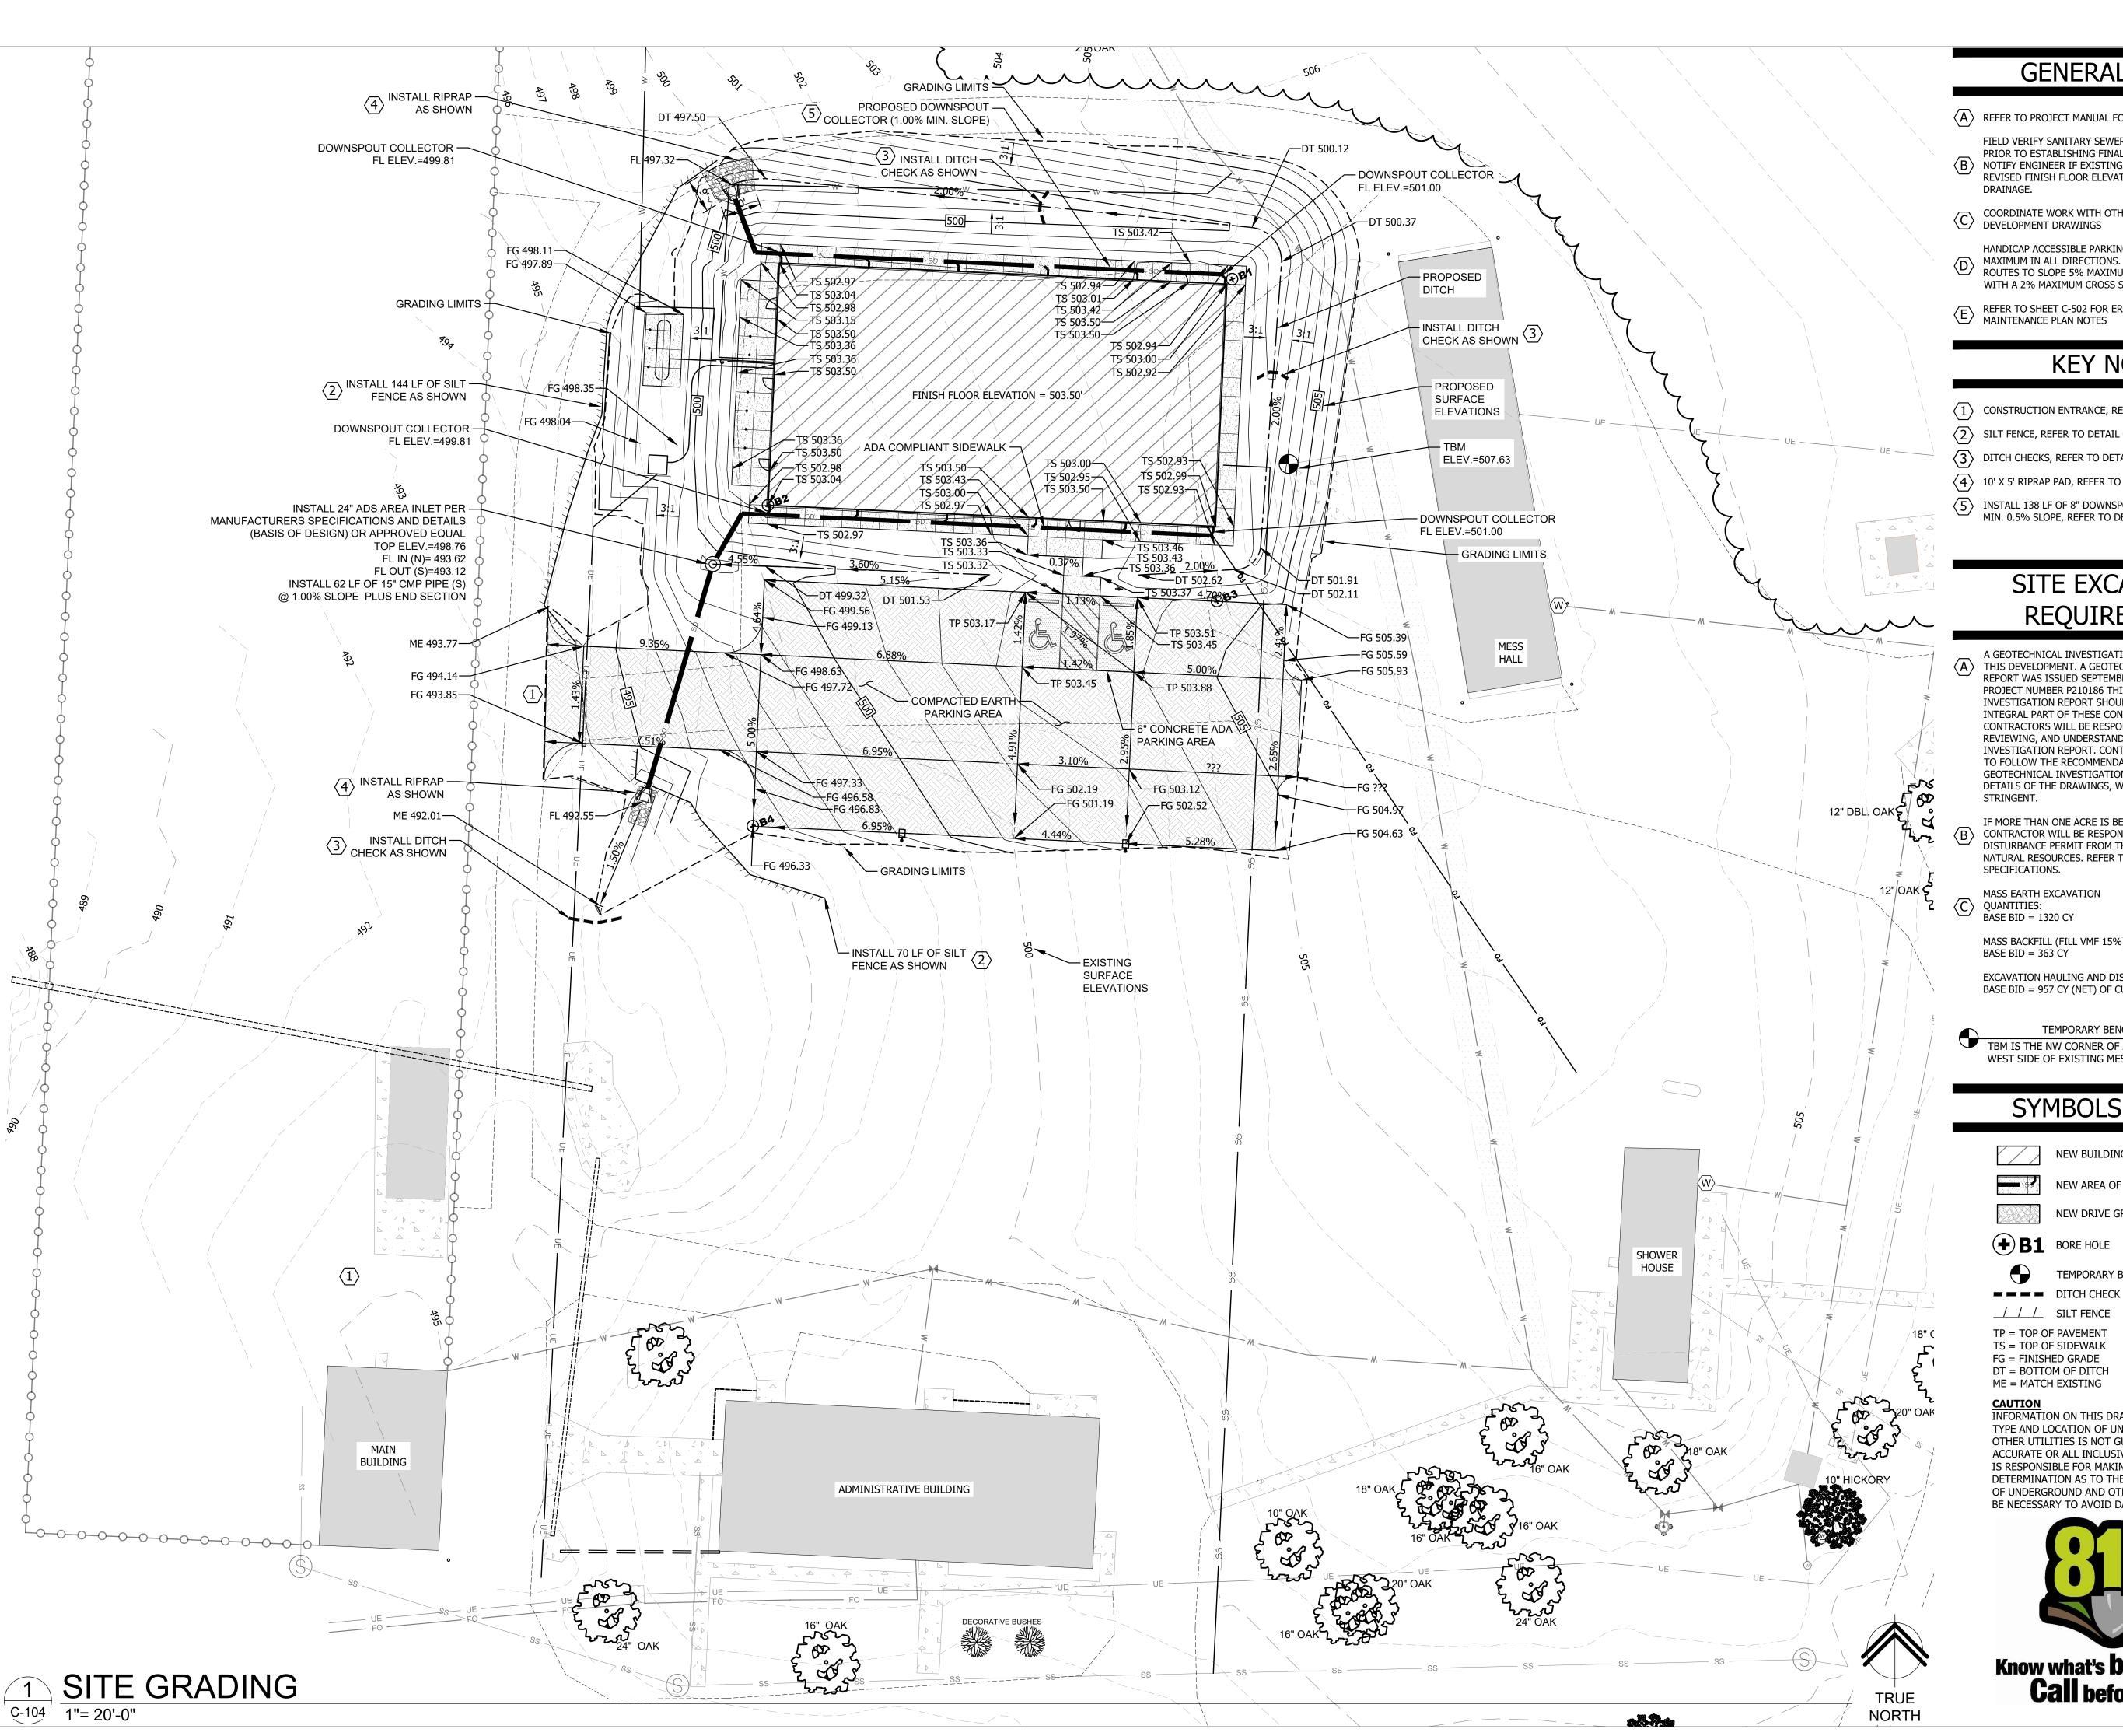

GENERAL NOTES

- (A) REFER TO PROJECT MANUAL FOR ADDITIONAL REQUIREMENTS
- FIELD VERIFY SANITARY SEWER SERVICE CONNECTION INVERT PRIOR TO ESTABLISHING FINAL FINISH FLOOR ELEVATION. (B) NOTIFY ENGINEER IF EXISTING CONDITIONS REQUIRE REVISED FINISH FLOOR ELEVATION TO PROVIDE PROPER
- COORDINATE WORK WITH OTHER SITE RELATED DEVELOPMENT DRAWINGS
- HANDICAP ACCESSIBLE PARKING AREAS TO SLOPE 2% MAXIMUM IN ALL DIRECTIONS. DESIGNATED ACCESSIBLE ROUTES TO SLOPE 5% MAXIMUM IN DIRECTION OF TRAFFIC WITH A 2% MAXIMUM CROSS SLOPE.
- REFER TO SHEET C-502 FOR EROSION CONTROL AND MAINTENANCE PLAN NOTES

KEY NOTES

- $\langle 1 \rangle$ Construction entrance, refer to detail on C-502.
- 2 SILT FENCE, REFER TO DETAIL ON C-502.
- 3 DITCH CHECKS, REFER TO DETAIL ON C-502.
- 4 10' X 5' RIPRAP PAD, REFER TO DETAIL ON C-502.
- (5) INSTALL 138 LF OF 8" DOWNSPOUT COLLECTION SYSTEM AT MIN. 0.5% SLOPE, REFER TO DETAIL ON C-502.

SITE EXCAVATION REQUIREMENTS

- A GEOTECHNICAL INVESTIGATION WAS CONDUCTED WITHIN THIS DEVELOPMENT. A GEOTECHNICAL INVESTIGATION REPORT WAS ISSUED SEPTEMBER 23, 2021, SMITH & CO. INTEGRAL PART OF THESE CONTRACT DOCUMENTS. GEOTECHNICAL INVESTIGATION REPORT AND THE NOTES AND DETAILS OF THE DRAWINGS, WHICHEVER IS MOST
- IF MORE THAN ONE ACRE IS BEING DISTURBED THE CONTRACTOR WILL BE RESPONSIBLE FOR OBTAINING A LAND DISTURBANCE PERMIT FROM THE MISSOURI DEPARTMENT OF NATURAL RESOURCES. REFER TO SECTION 01 57 00 OF THE
- MASS EARTH EXCAVATION

MASS BACKFILL (FILL VMF 15%) QUANTITIES:


EXCAVATION HAULING AND DISPOSAL QUANTITIES: BASE BID = 957 CY (NET) OF CUT

TEMPORARY BENCHMARK TBM IS THE NW CORNER OF A CONCRETE PAD ON THE WEST SIDE OF EXISTING MESS HALL. ELEVATION=507.63

SYMBOLS LEGEND

NEW BUILDING CONSTRUCTION

NEW AREA OF CONCRETE SIDEWALK

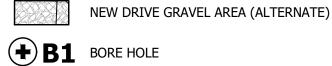

TEMPORARY BENCHMARK


- // / SILT FENCE TP = TOP OF PAVEMENT
- TS = TOP OF SIDEWALK FG = FINISHED GRADE
- DT = BOTTOM OF DITCH ME = MATCH EXISTING

INFORMATION ON THIS DRAWING CONCERNING TYPE AND LOCATION OF UNDERGROUND AND OTHER UTILITIES IS NOT GUARANTEED TO BE ACCURATE OR ALL INCLUSIVE. THE CONTRACTOR IS RESPONSIBLE FOR MAKING HIS OWN DETERMINATION AS TO THE TYPE AND LOCATION OF UNDERGROUND AND OTHER UTILITIES AS MAY BE NECESSARY TO AVOID DAMAGE THERETO.



Know what's **below. Call** before you dig.

STATE OF MISSOURI MICHAEL L. PARSON **GOVERNOR**

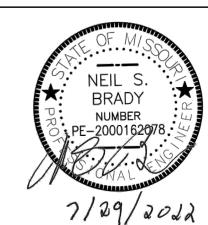

60

OFFICE OF ADMINISTRATION DIVISION OF FACILITIES MANAGEMENT, **DESIGN AND CONSTRUCTION**

DEPARTMENT OF PUBLIC SAFETY MISSOURI ARMY **NATIONAL GUARD**

CONSTRUCT NEW 60 SOLDIER BARRACKS

WAPPAPELLO TRAINING SITE 461 COUNTY ROAD 517

WAPPAPELLO, MISSOURI PROJECT # T2124-01

SITE # 6325 ASSET # 8136325016 BUILDING #3

REVISION:	
DATE:	
REVISION:	
DATE:	
REVISION:	
DATE:	
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ISSUE DATE: 07/29/2022

CAD DWG FILE: T2124-01-6325-8136325016_C-104 **DESIGNED BY: PAB** DRAWN BY: PAB
APPROVED BY: NSB


SHEET TITLE:

SITE GRADING / **EROSION CONTROL**

SHEET NUMBER:

|C-104|7 of 36 SHEETS

07/29/2022

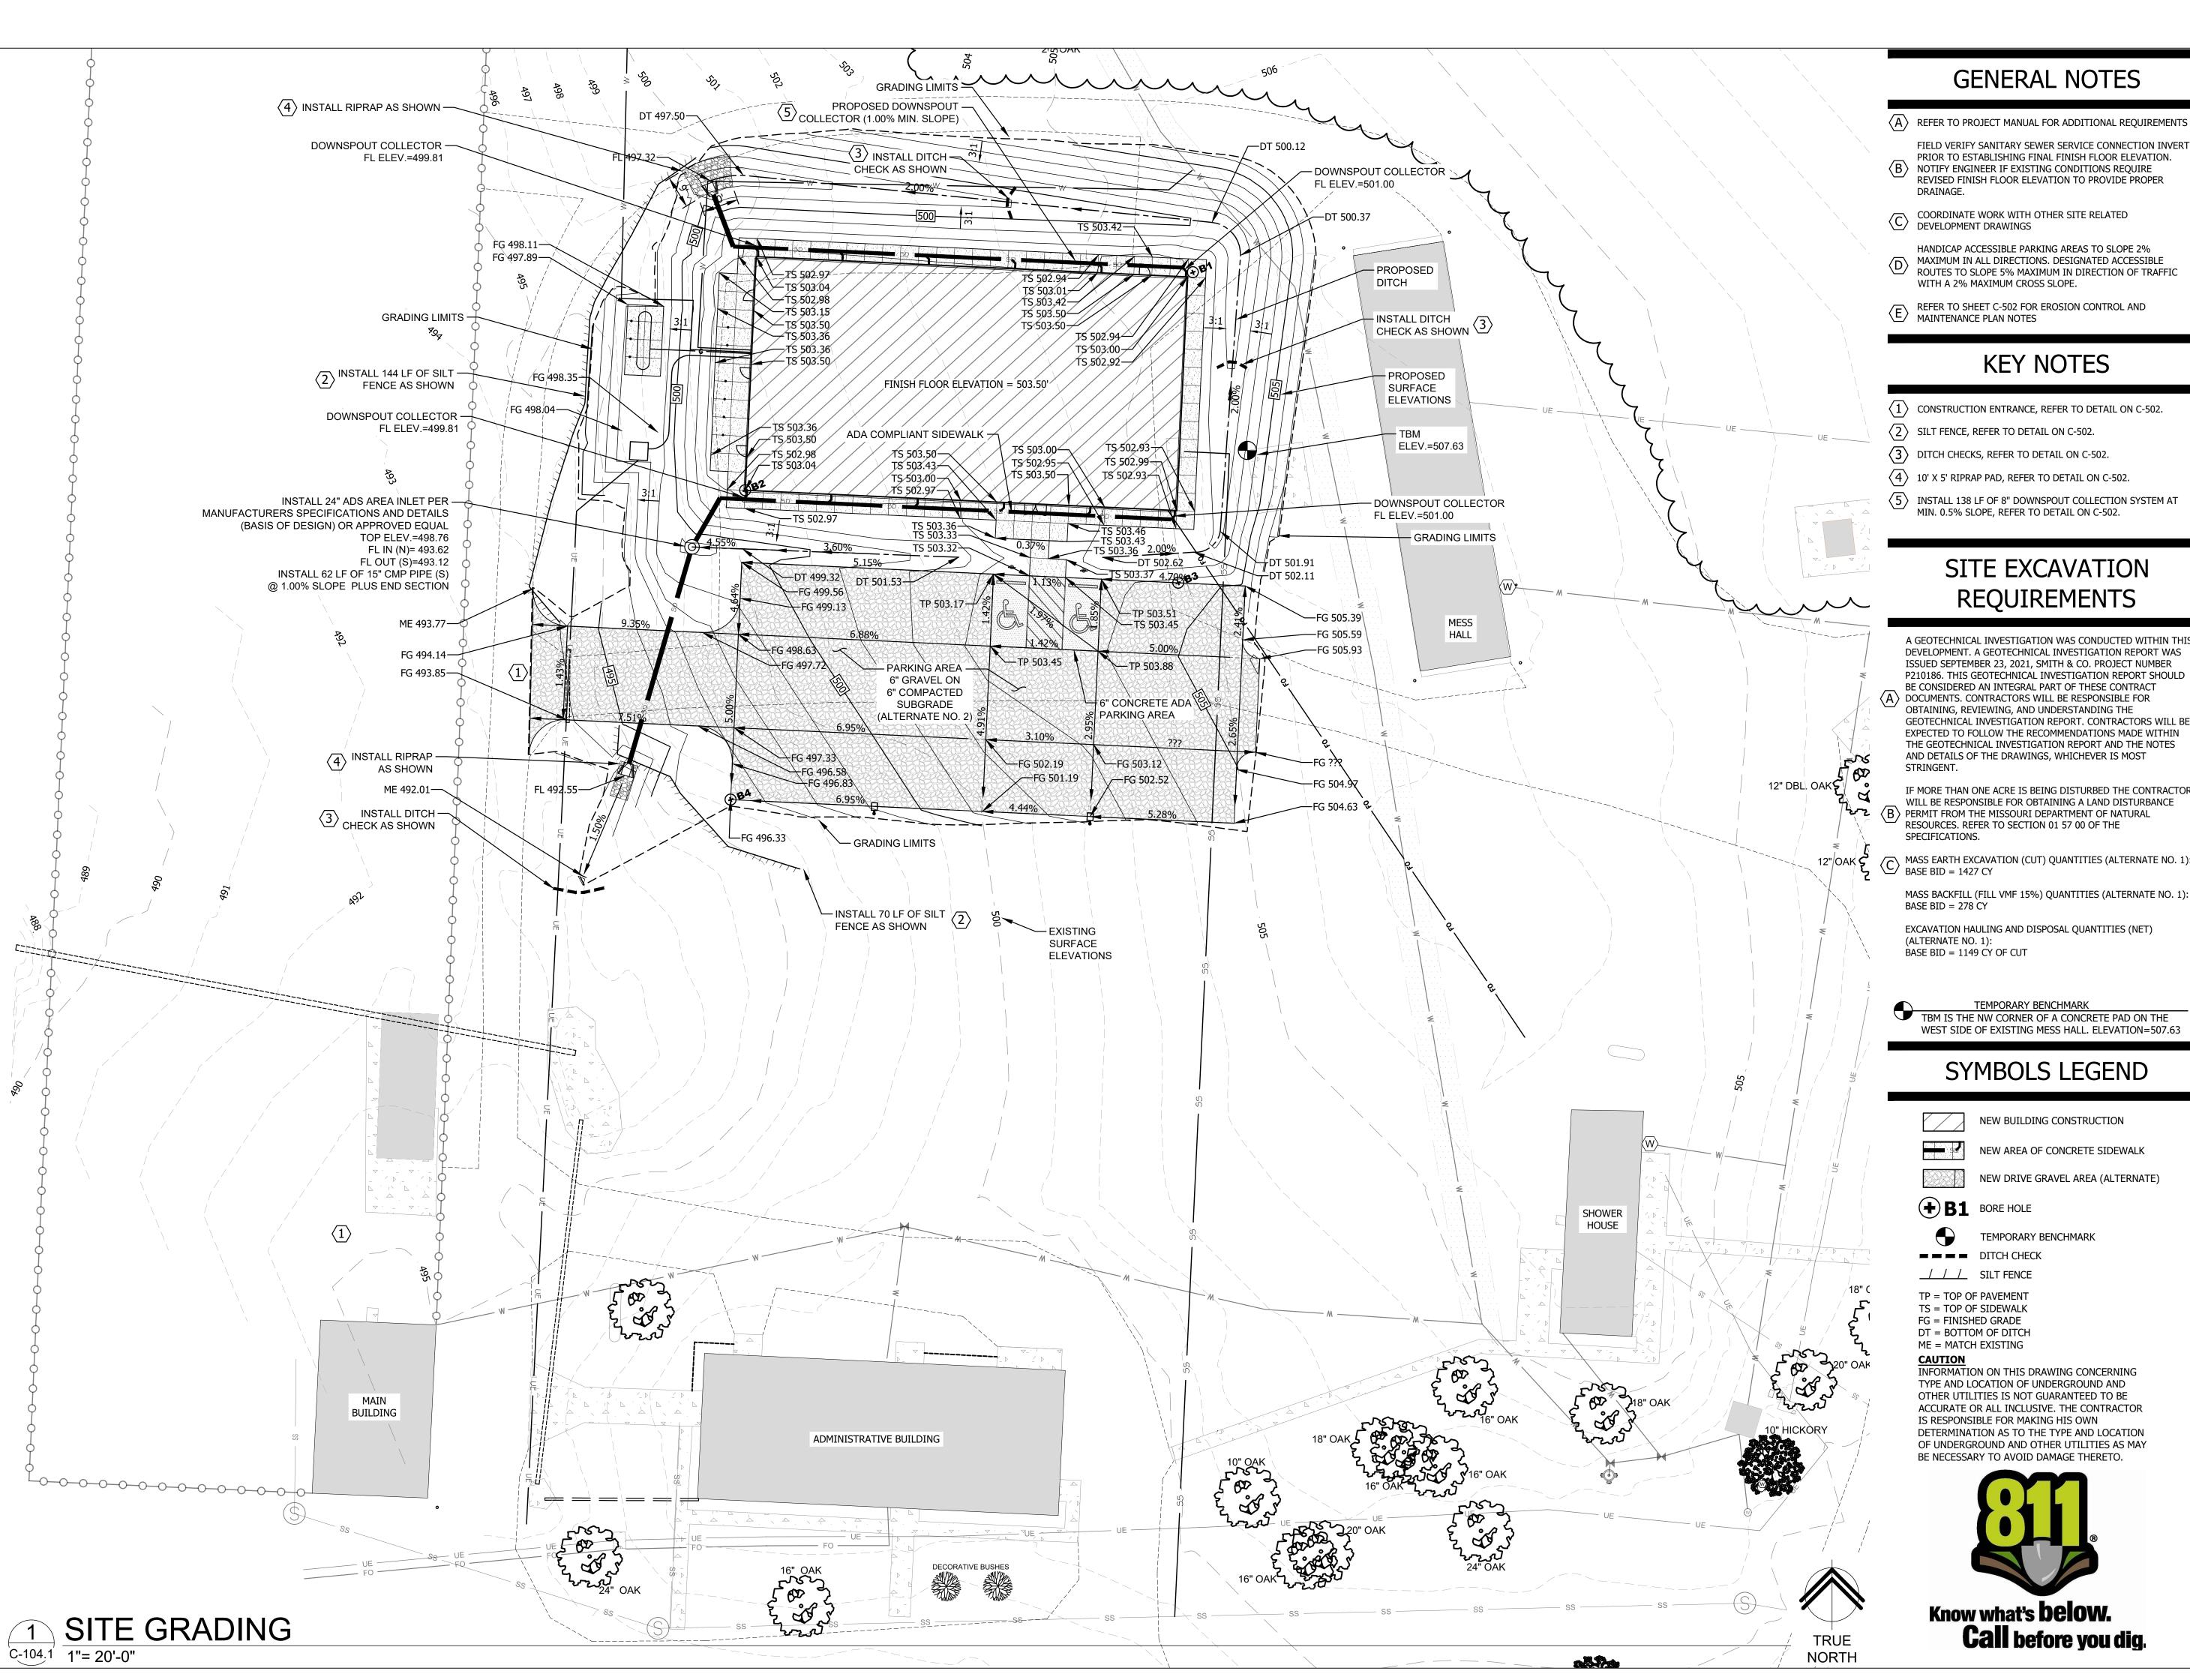

GENERAL NOTES

- $\langle A \rangle$ refer to project manual for additional requirements
- PRIOR TO ESTABLISHING FINAL FINISH FLOOR ELEVATION. NOTIFY ENGINEER IF EXISTING CONDITIONS REQUIRE REVISED FINISH FLOOR ELEVATION TO PROVIDE PROPER
- COORDINATE WORK WITH OTHER SITE RELATED DEVELOPMENT DRAWINGS
- HANDICAP ACCESSIBLE PARKING AREAS TO SLOPE 2% MAXIMUM IN ALL DIRECTIONS. DESIGNATED ACCESSIBLE ROUTES TO SLOPE 5% MAXIMUM IN DIRECTION OF TRAFFIC
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KEY NOTES

- $\langle 1 \rangle$ construction entrance, refer to detail on C-502.
- 2 SILT FENCE, REFER TO DETAIL ON C-502.
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- (5) INSTALL 138 LF OF 8" DOWNSPOUT COLLECTION SYSTEM AT MIN. 0.5% SLOPE, REFER TO DETAIL ON C-502.

SITE EXCAVATION REQUIREMENTS

DEVELOPMENT. A GEOTECHNICAL INVESTIGATION REPORT WAS ISSUED SEPTEMBER 23, 2021, SMITH & CO. PROJECT NUMBER $\langle A \rangle$ documents. Contractors will be responsible for OBTAINING, REVIEWING, AND UNDERSTANDING THE GEOTECHNICAL INVESTIGATION REPORT. CONTRACTORS WILL E

EXPECTED TO FOLLOW THE RECOMMENDATIONS MADE WITHIN THE GEOTECHNICAL INVESTIGATION REPORT AND THE NOTES AND DETAILS OF THE DRAWINGS, WHICHEVER IS MOST

IF MORE THAN ONE ACRE IS BEING DISTURBED THE CONTRACTOR WILL BE RESPONSIBLE FOR OBTAINING A LAND DISTURBANCE B PERMIT FROM THE MISSOURI DEPARTMENT OF NATURAL RESOURCES. REFER TO SECTION 01 57 00 OF THE

12" OAK S EARTH EXCAVATION (CUT) QUANTITIES (ALTERNATE NO. 1)
BASE BID = 1427 CY

MASS BACKFILL (FILL VMF 15%) QUANTITIES (ALTERNATE NO. 1 BASE BID = 278 CY

EXCAVATION HAULING AND DISPOSAL QUANTITIES (NET) (ALTERNATE NO. 1): BASE BID = 1149 CY OF CUT

TEMPORARY BENCHMARK

TBM IS THE NW CORNER OF A CONCRETE PAD ON THE

SYMBOLS LEGEND

NEW BUILDING CONSTRUCTION

NEW AREA OF CONCRETE SIDEWALK

NEW DRIVE GRAVEL AREA (ALTERNATE)

TEMPORARY BENCHMARK **———** DITCH CHECK

//_ SILT FENCE


TP = TOP OF PAVEMENT TS = TOP OF SIDEWALK FG = FINISHED GRADE

DT = BOTTOM OF DITCH ME = MATCH EXISTING

INFORMATION ON THIS DRAWING CONCERNING TYPE AND LOCATION OF UNDERGROUND AND OTHER UTILITIES IS NOT GUARANTEED TO BE ACCURATE OR ALL INCLUSIVE. THE CONTRACTOR IS RESPONSIBLE FOR MAKING HIS OWN DETERMINATION AS TO THE TYPE AND LOCATION OF UNDERGROUND AND OTHER UTILITIES AS MAY BE NECESSARY TO AVOID DAMAGE THERETO.



STATE OF MISSOURI MICHAEL L. PARSON **GOVERNOR**

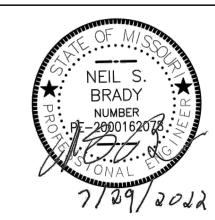

60

OFFICE OF ADMINISTRATION DIVISION OF FACILITIES MANAGEMENT, **DESIGN AND CONSTRUCTION**

DEPARTMENT OF PUBLIC SAFETY MISSOURI ARMY NATIONAL GUARD

CONSTRUCT NEW 60 SOLDIER BARRACKS

WAPPAPELLO TRAINING SITE 461 COUNTY ROAD 517 WAPPAPELLO, MISSOURI

PROJECT # T2124-01 SITE # 6325

ASSET # 8136325016 BUILDING #3

REVISION: DATE: **REVISION:** DATE: **REVISION:** DATE:

ISSUE DATE: 07/29/2022

CAD DWG FILE: T2124-01-6325-8136325016_C-104 DESIGNED BY: PAB
DRAWN BY: PAB
APPROVED BY: NSB


SHEET TITLE:

SITE GRADING / **EROSION CONTROL** (ALTERNATE NO. 2)

SHEET NUMBER:

C-104.1

8 of 36 SHEETS 07/29/2022

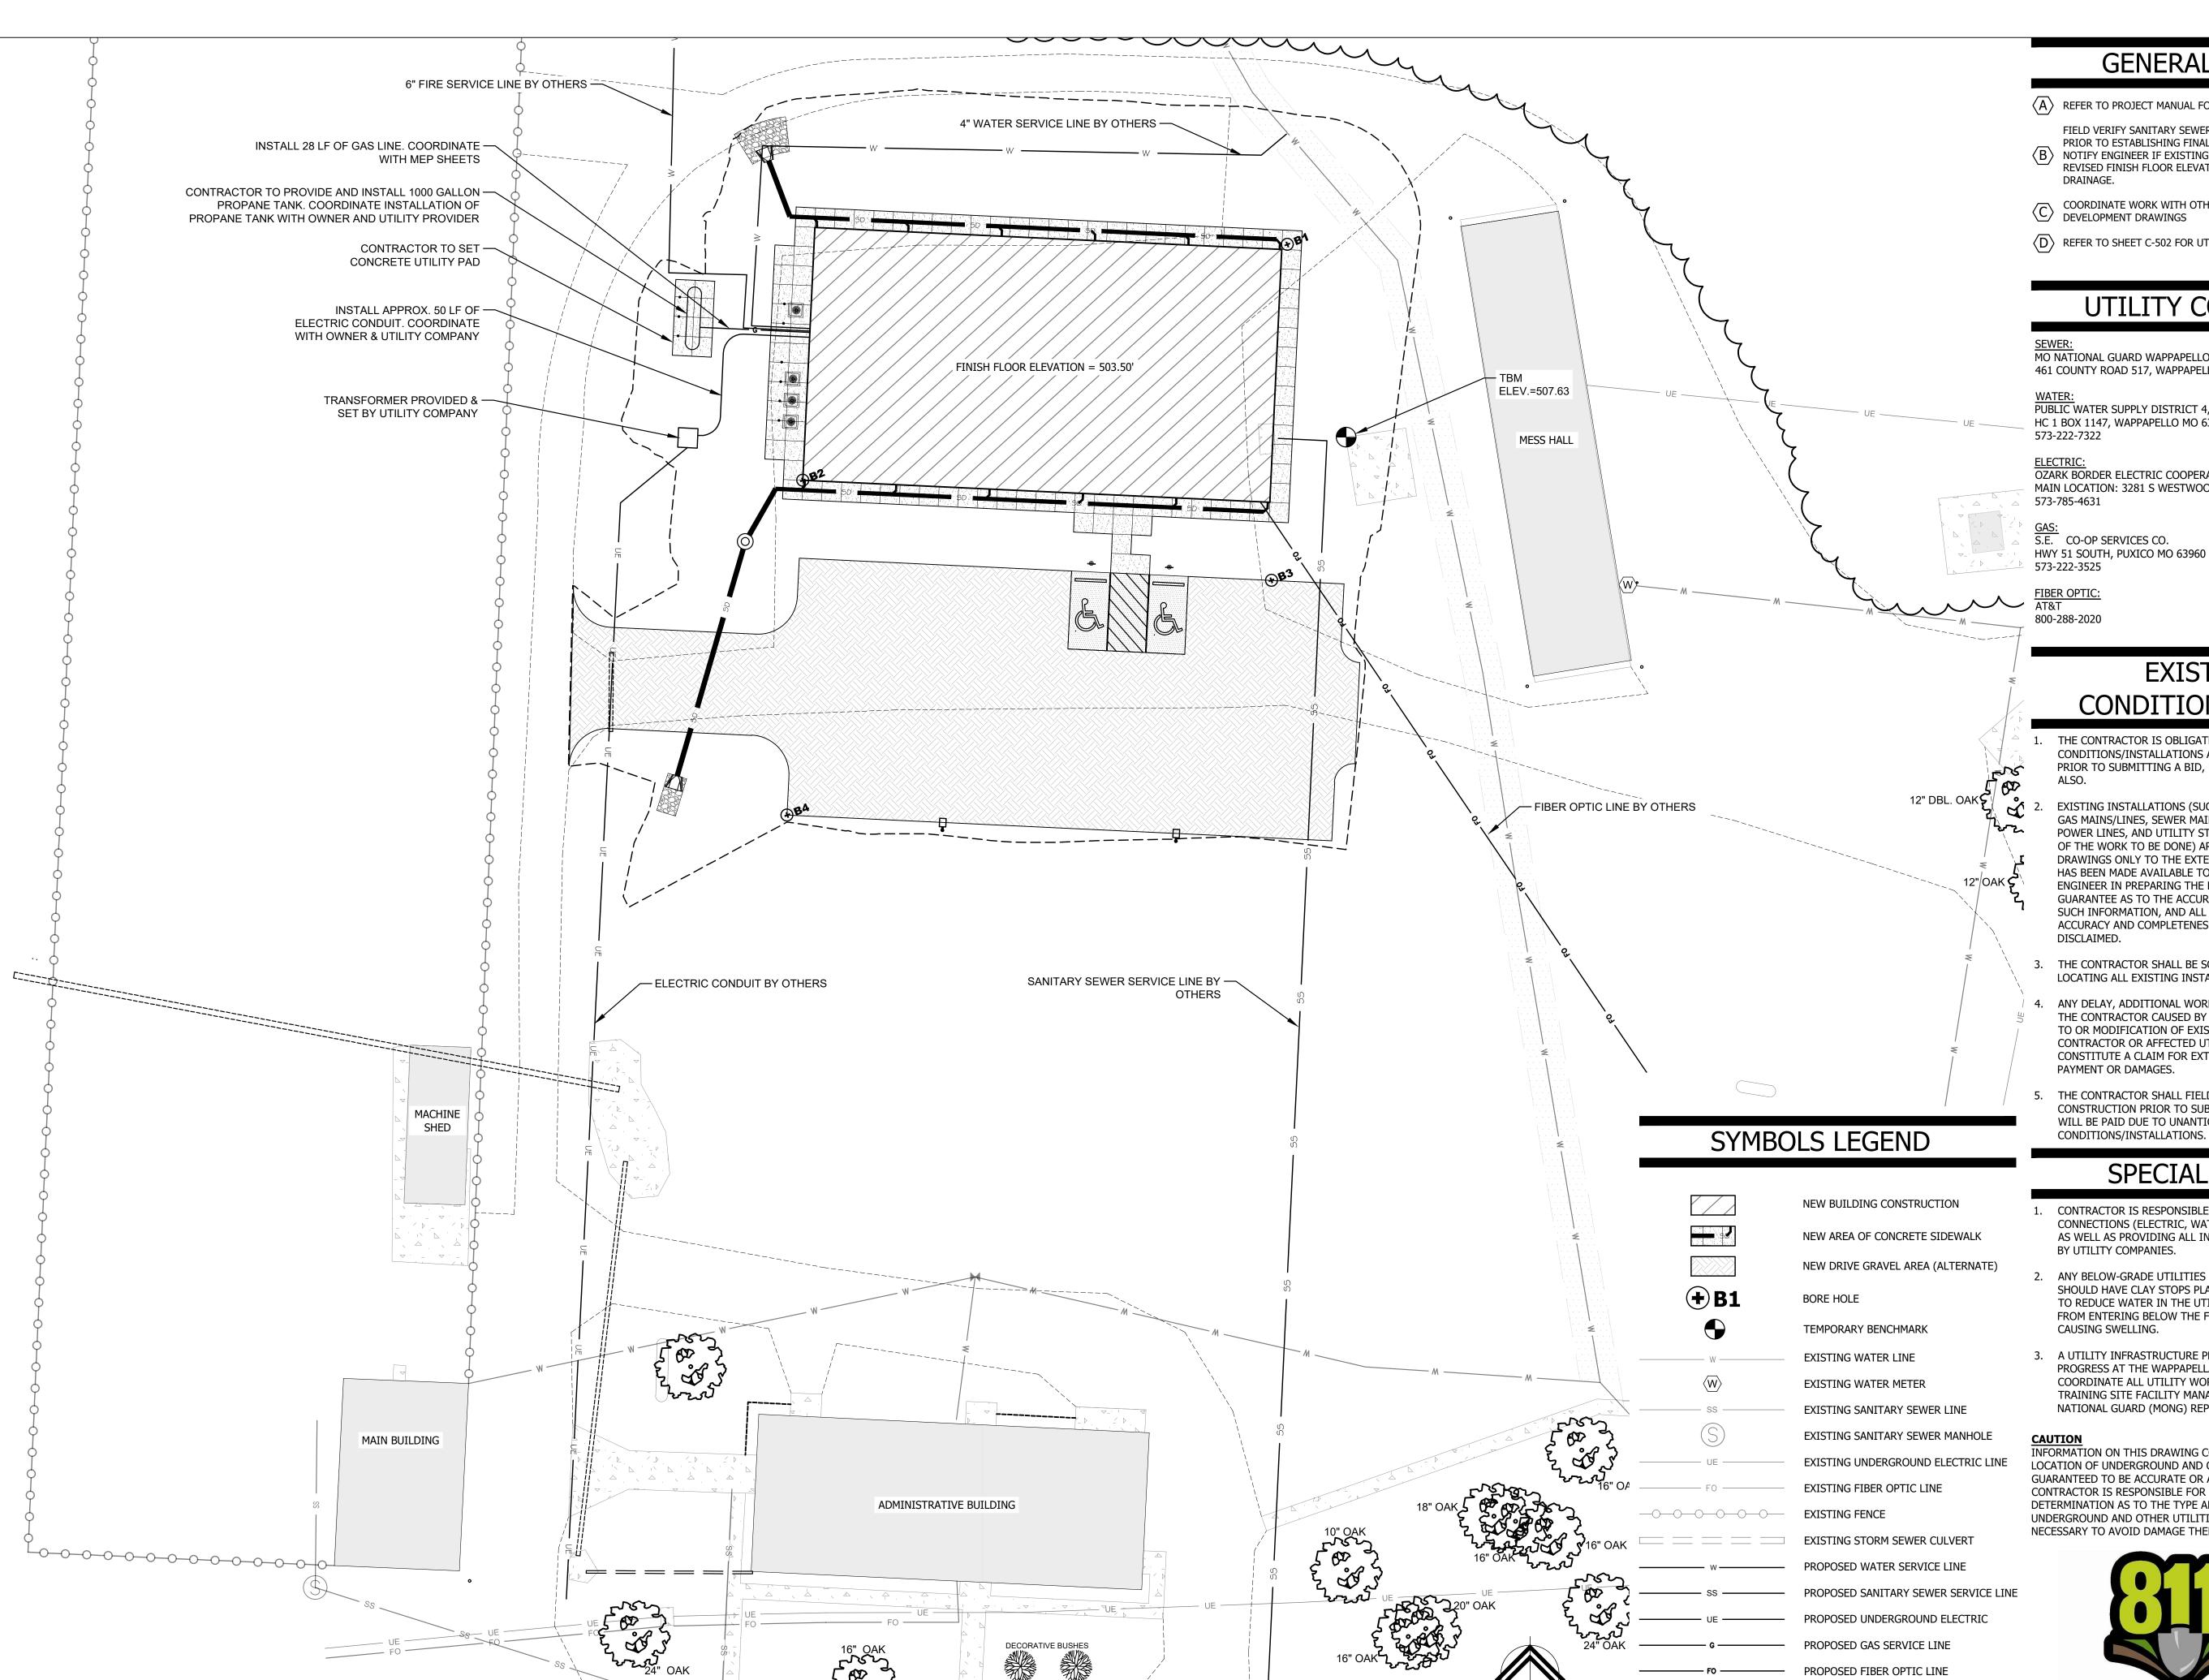

1 UTILITY PLAN

C-105 1"= 20'-0"

GENERAL NOTES

- $\langle \mathsf{A}
 angle$ refer to project manual for additional requirements
- FIELD VERIFY SANITARY SEWER SERVICE CONNECTION INVERT PRIOR TO ESTABLISHING FINAL FINISH FLOOR ELEVATION. NOTIFY ENGINEER IF EXISTING CONDITIONS REQUIRE REVISED FINISH FLOOR ELEVATION TO PROVIDE PROPER
- COORDINATE WORK WITH OTHER SITE RELATED DEVELOPMENT DRAWINGS
- (D) REFER TO SHEET C-502 FOR UTILITY DETAILS

UTILITY CONTACTS

MO NATIONAL GUARD WAPPAPELLO TRAINING SITE 461 COUNTY ROAD 517, WAPPAPELLO MO

WATER:
PUBLIC WATER SUPPLY DISTRICT 4, WAPPAPELLO MO HC 1 BOX 1147, WAPPAPELLO MO 63966

OZARK BORDER ELECTRIC COOPERATIVE MAIN LOCATION: 3281 S WESTWOOD, POPULAR BLUFF MO 63901

HWY 51 SOUTH, PUXICO MO 63960

EXISTING CONDITIONS NOTES

- 1. THE CONTRACTOR IS OBLIGATED TO INSPECT FOR EXISTING CONDITIONS/INSTALLATIONS AND AVAILABLE INFORMATION PRIOR TO SUBMITTING A BID, REFER TO SPECIFICATION
- 2. EXISTING INSTALLATIONS (SUCH AS WATER MAINS/LINES, GAS MAINS/LINES, SEWER MAINS/LINES, TELEPHONE LINES, POWER LINES, AND UTILITY STRUCTURES IN THE VICINITY OF THE WORK TO BE DONE) ARE INDICATED ON THE DRAWINGS ONLY TO THE EXTENT THAT SUCH INFORMATION HAS BEEN MADE AVAILABLE TO OR DISCOVERED BY THE ENGINEER IN PREPARING THE DRAWINGS. THERE IS NO GUARANTEE AS TO THE ACCURACY OR COMPLETENESS OF SUCH INFORMATION, AND ALL RESPONSIBILITY FOR THE ACCURACY AND COMPLETENESS THEREOF IS EXPRESSLY
 - 3. THE CONTRACTOR SHALL BE SOLELY RESPONSIBLE FOR LOCATING ALL EXISTING INSTALLATIONS.
 - 4. ANY DELAY, ADDITIONAL WORK, FEES OR EXTRA COST TO THE CONTRACTOR CAUSED BY OR RESULTING FROM DAMAGE TO OR MODIFICATION OF EXISTING INSTALLATIONS BY THE CONTRACTOR OR AFFECTED UTILITY COMPANY SHALL NOT CONSTITUTE A CLAIM FOR EXTRA WORK, ADDITIONAL PAYMENT OR DAMAGES.
 - THE CONTRACTOR SHALL FIELD VERIFY ALL EXISTING CONSTRUCTION PRIOR TO SUBMITTING HIS BID. NO EXTRAS WILL BE PAID DUE TO UNANTICIPATED EXISTING

SPECIAL NOTES

- 1. CONTRACTOR IS RESPONSIBLE FOR ALL PUBLIC UTILITY CONNECTIONS (ELECTRIC, WATER, GAS, SEPTIC, SEWER) AS WELL AS PROVIDING ALL INFRASTRUCTURE REQUIRED
- ANY BELOW-GRADE UTILITIES ENTERING THE BUILDING SHOULD HAVE CLAY STOPS PLACED AROUND THE UTILITY TO REDUCE WATER IN THE UTILITY TRENCH BACKFILL FROM ENTERING BELOW THE FOOTING AND/OR SLAB CAUSING SWELLING.
- 3. A UTILITY INFRASTRUCTURE PROJECT (T2213-01) IS IN COORDINATE ALL UTILITY WORK WITH THE WAPPAPELLA TRAINING SITE FACILITY MANAGER AND MISSOURI NATIONAL GUARD (MONG) REPRESENTATIVE.

LOCATION OF UNDERGROUND AND OTHER UTILITIES IS NOT CONTRACTOR IS RESPONSIBLE FOR MAKING HIS OWN DETERMINATION AS TO THE TYPE AND LOCATION OF UNDERGROUND AND OTHER UTILITIES AS MAY BE



PROPOSED LIGHT FIXTURE

TEMPORARY BENCHMARK TBM IS THE NW CORNER OF A CONCRETE PAD ON THE


WEST SIDE OF EXISTING MESS HALL. ELEVATION=507.63

TRUE

NORTH

Know what's **below. Call** before you dig.

STATE OF MISSOURI MICHAEL L. PARSON **GOVERNOR**

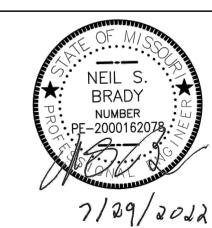

60

OFFICE OF ADMINISTRATION DIVISION OF FACILITIES MANAGEMENT, **DESIGN AND CONSTRUCTION**

DEPARTMENT OF PUBLIC SAFETY **MISSOURI ARMY NATIONAL GUARD**

CONSTRUCT NEW 60 SOLDIER BARRACKS

WAPPAPELLO TRAINING SITE 461 COUNTY ROAD 517

WAPPAPELLO, MISSOURI PROJECT # T2124-01

SITE # 6325 ASSET # 8136325016 BUILDING #3

REVISION:
DATE:
REVISION:
DATE:
REVISION:
DATE:

ISSUE DATE: 07/29/2022

CAD DWG FILE: T2124-01-6325-8136325016_C-104 **DESIGNED BY: PAB** DRAWN BY: PAE APPROVED BY: NSB


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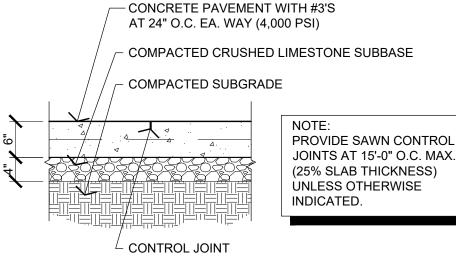
SITE UTILITY **PLAN**


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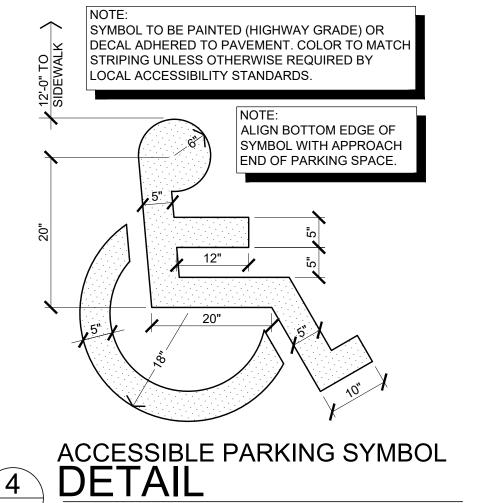
C-105

9 of 36 SHEETS 07/2 9/2022






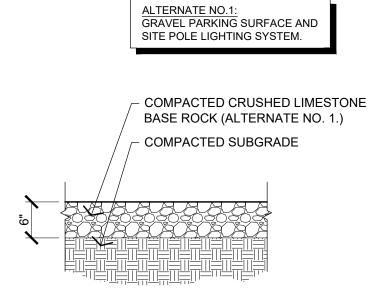


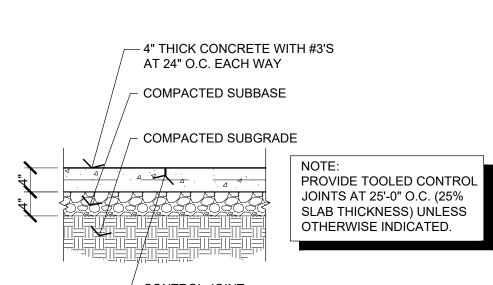


NOT TO SCALE



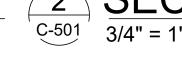

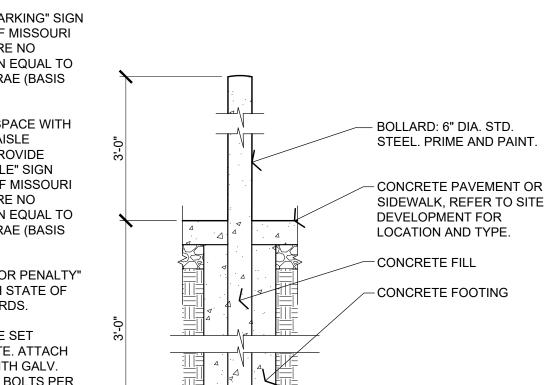

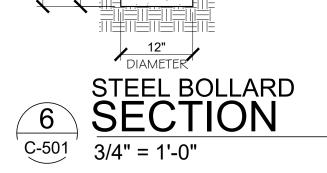

GENERAL NOTES

- \langle A \rangle REFER TO PROJECT MANUAL FOR ADDITIONAL REQUIREMENTS.
- \langle B \rangle REFER TO SITE DEVELOPMENT PLANS FOR LAYOUT AND LOCATIONS OF CONSTRUCTION.

STATE OF MISSOURI MICHAEL L. PARSON, **GOVERNOR**



SHEETS BEARING THIS SEAL ARE AUTHENTICATED, RESPONSIBILITY FOR ALL OTHER PLANS, SPECIFICATIONS OR INSTRUMENTS ARE DISCLAIMED.

OFFICE OF ADMINISTRATION DIVISION OF FACILITIES MANAGEMENT, DESIGN AND CONSTRUCTION

DEPARTMENT OF **PUBLIC SAFETY MISSOURI ARMY** NATIONAL GUARD

CONSTRUCT NEW 60 SOLDIER BARRACKS

WAPPAPELLO TRAINING SITE 461 COUNTY ROAD 517 WAPPAPELLO, MISSOURI

PROJECT # T2124-01 6325 ASSET # 8136325016 BUILDING # 3

REVISION: DATE: **REVISION:** REVISION: DATE:


ISSUE DATE: 07/29/2022


CAD DWG FILE: T2124-01-6325-8136325016-C-501
DRAWN BY: BW-AP
CHECKED BY: BDW DESIGNED BY: BW-AP


SHEET TITLE:

SITE DEVELOPMENT DETAILS

SHEET NUMBER:

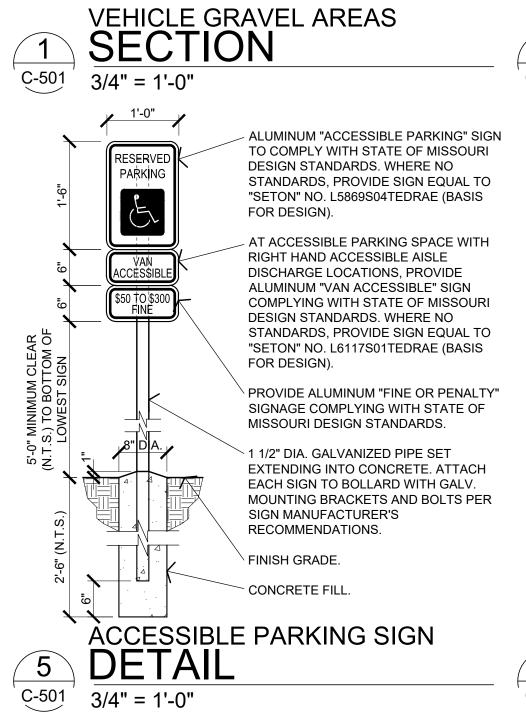

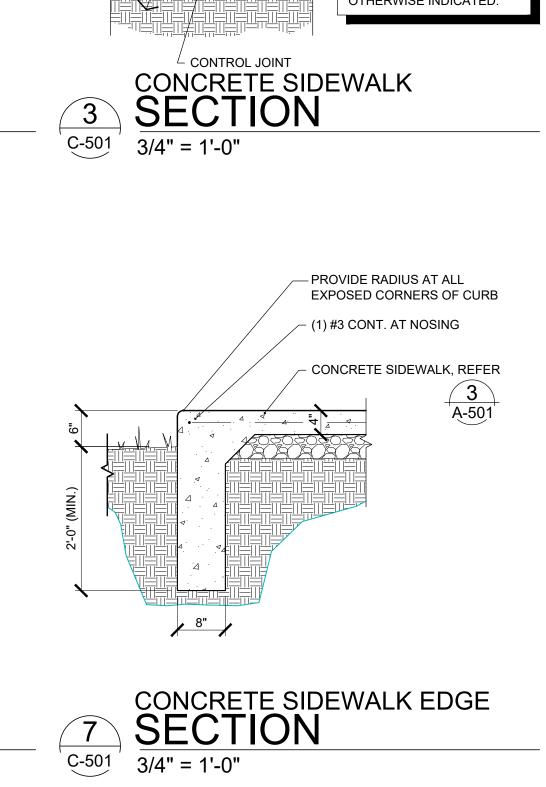


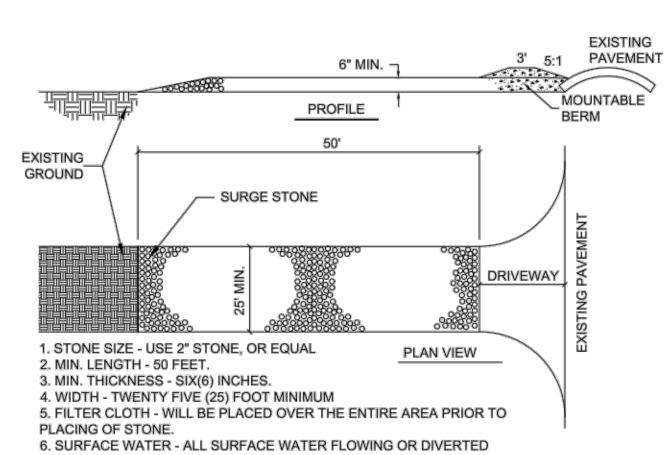

TOWARD CONSTRUCTION ENTRANCES SHALL BE PIPED ACROSS THE ENTRANCE. 7. MAINTENANCE - THE ENTRANCE SHALL BE MAINTAINED IN A CONDITION WHICH WILL PREVENT TRACKING OR FLOWING OF SEDIMENT ONTO PUBLIC RIGHTS-OF-WAY. THIS MAY REQURE PERIODIC TOP DRESSING WITH ADDITIONAL STONE AS CONDITIONS DEMAND, AND REPAIR AND/OR CLEANOUT OF ANY MEASURES USED TO TRAP SEDIMENT. ALL SEDIMENT

SPILLED, DROPPED, WASHED OR TRACKED ONTO PUBLIC RIGHTS-OF-WAY MUST BE REMOVED IMMEDIATELY.




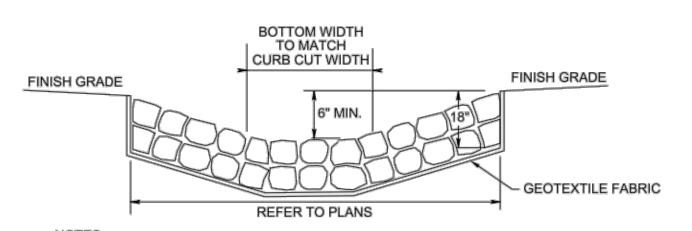

HAND PLACE RIP-RAP IN ALL PLACES AS INDICATED ON THE


- 2. THE STONE FOR RIP-RAP SHALL CONSIST OF FIELD STONE OR ROUGH UNHEWN QUARRY STONE AS NEARLY AS UNIFORM, IN SECTION AS PRACTICAL.
- 3. THE STONES SHALL BE DENSE, RESISTANT TO THE ACTION OF AIR AND WATER, AND SUITABLE IN ALL ASPECTS FOR THE PURPOSE INTENDED UNLESS OTHERWISE SPECIFIED.
- 4. ALL STONES USED AS RIP-RAP SHALL WEIGH BETWEEN 50-150 POUNDS EACH, AND AT LEAST 60 PERCENT OF THE STONES SHALL WEIGH MORE THAN 100 POUNDS EACH.
- 5. STONES SHALL BE A MINIMUM OF 12" IN DIAMETER AND PLACED A MINIMUM OF 18" BELOW FINISH GRADE.
- 6. RIPRAP PAD SHALL HAVE NO SLOPE FOR THE LENGTH OF THE
- 7. FINISHED GRADE ADJACENT TO THE RIPRAP PAD SHALL BE A MINIMUM OF 6" ABOVE THE RIRPRAP PAD BOTTOM.



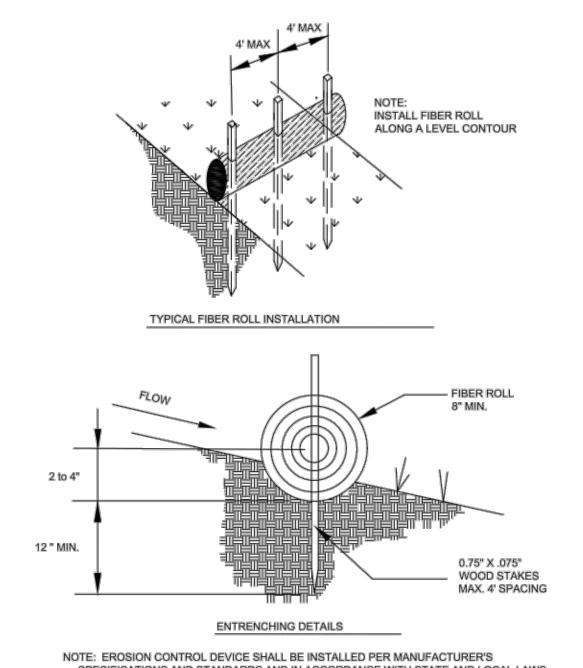

SPECIFICATIONS AND STANDARDS AND IN ACCORDANCE WITH STATE AND LOCAL LAWS.

FIBER ROLLS AND SOCKS SCALE: NOT TO SCALE

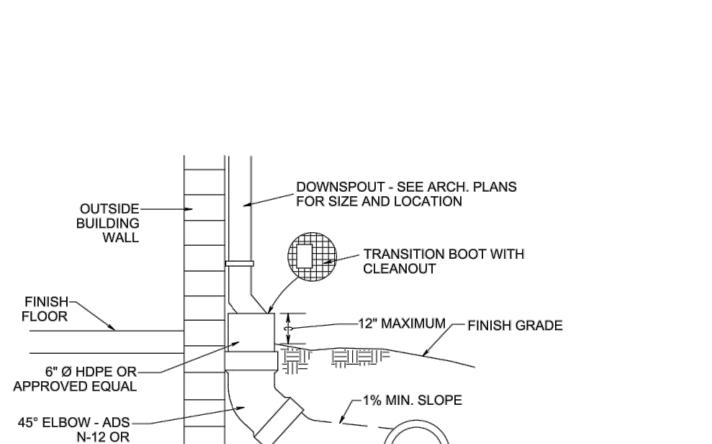

CONNECTION-FITTINGS AS REQ'D. DOWNSPOUT COLLECTOR SCALE: NOT TO SCALE

WATER TIGHT

WATER TIGHT


CONNECTION

SEE PLAN FOR


-SIZE AND TYPE

OF COLLECTOR

APPROVED EQUAL

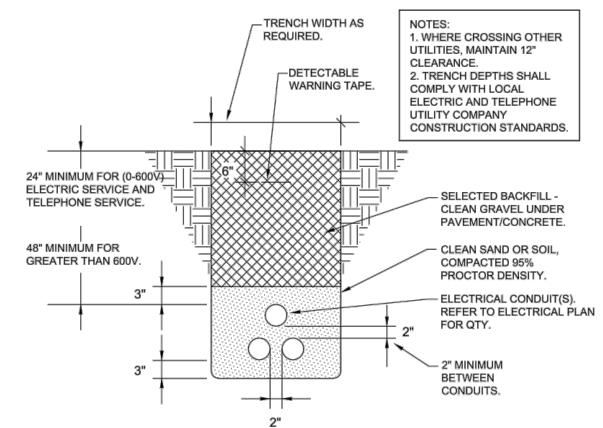



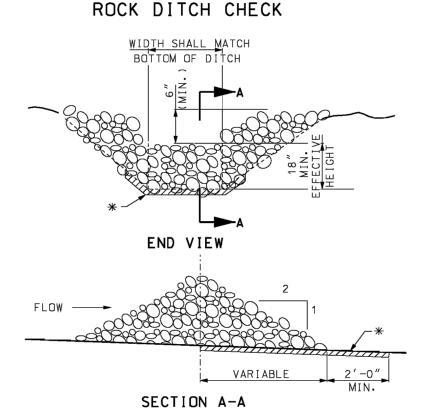

ROCK DITCH CHECK SCALE: NOT TO SCALE

DETECTABLE PLASTIC -

INSTALLATION

DEPTH

WITH THE

LOCAL

AUTHORITIES

C502

NOTE: ROCK DITCH CHECK IN THE CLEAR ZONE SHALL BE REMOVED OR LEVELED (IF ALLOWABLE) AFTER THE VEGETATION HAS SUFFICIENTLY MATURED TO PROTECT THE DITCH OR SWALE. EXAMPLE DITCH CHECK SPACING FOR STANDARD HEIGHTS DITCH & SPACING FOR SPACING FOR SLOPE % 9" EFF. HEIGHT 18" EFF. HEIG 2.0 2.5 4.5 5.0 5.5 6.5 * GEOTEXTILE LINING MAY BE INSTALLED AS REQUIRED BY THE ENGINEER. 8.0

8.5

9.0

9.5

USE MINIMUM 12 IN. DIAMETER LOG/SOCK. USE 2 FT. WOODEN STAKES WITH A 2 IN. BY 2 IN. NOMINAL CROSS INSTALL LOG/SOCK TO A HEIGHT IN DITCH SO FLOW WILL NOT WASH AROUND LOG/SOCK AND SCOUR DITCH SLOPES OR AS DIRECTED BY ENGINEER. INSTALL A MINIMUM OF 2 UPSLOPE STAKES AND 4 DOWNSLOPE STAKES AT AN ANGLE TO WEDGE LOG/SOCK TO BOTTOM OF DITCH. EROSION CONTROL BLANKET SHALL BE ANCHORED ACCORDING TO THE MANUFACTURER'S RECOMMENDATIONS. SPACING OF DITCH CHECK
MEASURED CENTER TO CENTER MINIMUM DITCH CHECK SPACING

OFFICE OF ADMINISTRATION DIVISION OF FACILITIES MANAGEMENT, **DESIGN AND CONSTRUCTION** DEPARTMENT OF

PUBLIC SAFETY MISSOURI ARMY NATIONAL GUARD

60

STATE OF MISSOURI MICHAEL L. PARSON

NEIL

BRADY

NUMBER .PE-200016207

GOVERNOR

CONSTRUCT NEW 60 SOLDIER BARRACKS

WAPPAPELLO TRAINING SITE 461 COUNTY ROAD 517 WAPPAPELLO, MISSOURI

PROJECT # T2124-01 SITE # 6325 ASSET # 8136325016

BUILDING #3

REVISION: DATE: **REVISION:** DATE: **REVISION:** DATE:

ISSUE DATE: 07/29/2022 CAD DWG FILE: T2124-01-6325-8136325016 C-104 **DESIGNED BY: PAB** DRAWN BY:

APPROVED BY: NSB

SHEET TITLE:

MISCELLANEOUS SITE DETAILS

SHEET NUMBER:

11 of 36 SHEETS

25. SILT FENCE SHALL BE PLACED AROUND ALL SOIL SPOIL PILES TO PREVENT EROSION. 26. REFER TO SECTION 01 57 00 OF THE SPECIFICATIONS

EROSION CONTROL & MAINTENANCE PLAN NOTES:

SCALE: NOT TO SCALE

1. CONTRACTOR TO RETAIN FLOATABLE WIND BLOWN MATERIALS ON SITE BY STORING ALL TRASH AND BUILDING MATERIAL WASTE IN ENCLOSURES UNTIL PROPER DISPOSAL AT OFF-SITE FACILITIES. CHECK ADJACENT AREAS DAILY AND PICK UP CONSTRUCTION WASTE MATERIALS AND DEBRIS THAT HAVE BLOWN OR WASHED OFF SITE.

PIPE INSTALLATION DETAIL

CLEAN GRAVEL UNDER

-1/2" LIMESTONE GRAVEL.

2. PERMANENTLY STABILIZE ALL SURFACE AREA WITHIN AND ADJACENT TO THIS SITE THAT IS DISTURBED BY VEHICLES, GRADING AND OTHER CONSTRUCTION FOR THE PROPOSED FACILITY. STABILIZATION IS OBTAINED WHEN THE DISTURBED SURFACE IS COVERED WITH STRUCTURES. PAVING AND OR PERENNIAL VEGETATION HAVING A UNIFORM COVERAGE

DENSITY OF AT LEAST 70%. STABILIZATION OF ALL DISTURBED AREA IS REQUIRED BEFORE TERMINATING MAINTENANCE AND REMOVAL OF EROSION CONTROL MEASURES.

- 3. CONTRACTORS SHALL INSPECT POLLUTION CONTROL MEASURES AT LEAST ONCE EVERY 7 DAYS AND WITHIN 24 HOURS AFTER A STORM EVENT OF 1/2 INCH OR GREATER. DAMAGED MEASURES THAT PROVE TO BE INEFFECTIVE SHALL BE REPLACED WITH MORE EFFECTIVE MEASURES OR ADDITIONAL MEASURES WITHIN SEVEN DAYS. REPEATED FAILURE OF A CONTROL MEASURE REQUIRES INSTALLATION OF A MORE SUITABLE DEVICE TO PREVENT DISCHARGE OF POLLUTANTS FROM THE CONSTRUCTION SITE.
- 4. INSTALLATION OF ADDITIONAL EROSION CONTROL MEASURES MAY BE REQUIRED BY THE CITY OR STATE. CONTRACTOR TO VERIFY REQUIREMENTS PRIOR TO BEGINNING ANY WORK ON
- 5. CARE SHALL BE TAKEN TO ELIMINATE TO THE MAXIMUM EXTENT POSSIBLE THE ENCROACHMENT OF SEDIMENT INTO ALL STORM DRAIN APPURTENANCES, PUBLIC STREETS, AND ONTO PRIVATE PROPERTY UNTIL IMPERVIOUS MATERIAL (ROAD/PARKING AREA SURFACE) IS APPLIED OR UNTIL PROPOSED LANDSCAPE HAS BEEN ESTABLISHED. 6. REMOVE SEDIMENT DEPOSITS AS NECESSARY AFTER EACH STORM TO PROVIDE ADEQUATE STORAGE VOLUME FOR THE NEXT RAIN AND TO REDUCE PRESSURE ON THE FENCE. CARE
- NEEDS TO BE TAKEN TO AVOID UNDERMINING THE FENCE WHEN REMOVING SEDIMENT. SEDIMENT IS TO BE REAPPLIED TO THE SITE AND STABILIZED. 7. ALL GRASS SLOPES WHICH EXCEED 3:1 (H:V) AND SELECT PIPE OUTFALLS SHALL UTILIZE CONTECH CONSTRUCTION PRODUCTS PERMANENT TURF REINFORCEMENT MATS 450 OR
- APPROVED EQUAL. MATS SHALL BE INSTALLED PER MANUFACTURER'S SPECIFICATIONS AND STANDARDS. CONTRACTOR SHALL COORDINATE INSTALLATION INSPECTION WITH MANUFACTURER
- 8. CONSTRUCTION METHODS AND MATERIALS SHALL CONFORM TO THE LATEST REVISIONS OF THE STANDARD GENERAL CONIDTIONS AND TECHNICAL SPECIFICATION FOR CONSTRUCTION
- 9. APPLICABLE PERMITS MUST BE OBTAINED FROM THE CITY, STATE AND COUNTY PRIOR TO EXCAVATION WITHIN ANY RIGHT-OF-WAY, AND PRIOR TO ANY CONSTRUCTION. 10. IT SHALL BE THE CONTRACTOR'S RESPONSIBILITY TO DETERMINE THE LOCATION OF ANY UNDERGROUND UTILITIES OR OTHER OBSTRUCTIONS AND TO BE LIABLE FOR DAMAGE AND CONSEQUENT REPAIR TO SUCH IN THE COURSE OF HIS OPERATIONS.
- 11. THE CONTRACTOR AND/OR BUILDER WILL KEEP THE SUBDIVISION NEAT AND ORDERLY AT ALL TIMES WHILE CONSTRUCTION IS TAKING PLACE. ALL CITY STREETS ADJACENT TO THE DEVELOPMENT SHALL BE KEPT CLEAR OF MUD, ROCK, DIRT, DEBRIS, PAPER AND WASTE MATERIAL AT ALL TIMES. THE PROPER AMOUNT OF INSPECTION SHALL BE CALLED FOR AT
- THEIR PROPER TIMES, OR ANY AND ALL WORK MAY BE REJECTED.
- 12. IF ANY WORK OR ACCESS TO ANY ADJOINING PROPERTY IS DONE, IT IS THE FULL RESPONSIBILITY FOR THE APPLICANT/OWNER TO OBTAIN PROPER RELEASES FROM ADJOINING PROPERTY OWNERS AND ASSUME ALL LIABILITY FOR ACTION TAKEN DURING ALL CONSTRUCTION. 13. ALL DISTURBED AREAS ARE TO BE RESEEDED IN ACCORDANCE WITH THE CURRENT REQUIREMENTS OF THE STATE OF MISSOURI DESIGN STANDARDS FOR PUBLIC IMPROVEMENTS.
- 14. PROVIDE TEMPORARY EROSION CONTROL TO CONTAIN ALL SOILS ON SITE. COMPLY WITH GOVERNING REGULATIONS PERTAINING TO ENVIRONMENTAL PROTECTION. 15. THE DETENTION BASIN, ALL WATER QUALITY MEASURES AND STORMWATER CHANNELS(PIPES) SHALL BE FUNCTIONING PRIOR TO STARTING ANY OTHER CONSTRUCTION ACTIVITIES. I.E., ONLY CONSTRUCTION ACTIVITIES REQUIRED TO INSTALL THE DETENTION BASIN, ALL WATER QUALITY MEASURES AND STORMWATER CHANNELS(PIPES) ARE ALLOWED UNTIL THESE ITEMS
- 16. CONSTRUCTION ACCESS TO THE SITE SHALL BE LIMITED TO THE APPROVED TEMPORARY CONSTRUCTION ENTRANCE AS SHOWN ON THE STORMWATER POLLUTION PREVENTION PLAN.
- 17. PRIOR TO CONSTRUCTION, THE OWNER SHALL CONVENE A PRE-CONSTRUCTION MEETING BETWEEN THE STATE OF MISSOURI, CONSULTING ENGINEER, CONTRACTOR(S) AND ANY OTHER
- 18. EROSION CONTROL DEVICES SHALL BE MAINTAINED DURING THE WHOLE CONSTRUCTION PERIOD BY THE CONTRACTOR. 19. CONTRACTOR TO PROTECT ANY STORM INLETS THAT RECEIVE STORM WATER FROM THE AREA OF CONSTRUCTION FROM SEDIMENT
- 20 CONTRACTOR TO TAKE CARE NOT TO DAMAGE ANY EXISTING STREET, CURB AND GUTTER, SIDEWALK AND DRIVEWAYS
- 21. THE CONTRACTOR SHALL HAVE A SET OF PLANS FILED WITH THE STATE OF MISSOURI ON SITE. THE CONTRACTOR SHALL HAVE ON THE PROJECT AT ALL TIMES, AS HIS AGENT, A COMPETENT SUPERINTENDENT CAPABLE OF READING AND THOROUGHLY UNDERSTAND THE PLANS AND SPECIFICATIONS AND THOROUGHLY EXPERIENCE IN THE TYPE WORK BEING
- PERFORMED WHO SHALL RECEIVE INSTRUCTIONS FROMTHE ENGINEER OR HIS AUTHORIZED REPRESENTATIVE. 22. THE CONTRACTOR SHALL NOTIFY THE INSPECTOR OF ANY NEW SINKHOLES DISCOVERED DURING CONSTRUCTION. 23. TEMPORARY CONSTRUCTION ENTRANCE TO HAVE SHOT ROCK FOR ITS SURFACE.
- 24. THE INSTALLATION OF SILT FENCE FOR CONSTRUCTION IS TO BE INSTALLED BY THE CONTRACTOR AND IN PLACE BEFORE BEGINNING SITE CONSTRUCTION. SIMILAR DEVICES MAY BE USED BY THE CONTRACTOR TO MEET THE REQUIREMENTS OF THE ENGINEER. DEVICES TO BE IN PLACE AS SHOWN ON THE PLANS. ADJUSTMENT OF THE LOCATION BY THE CONTRACTOR MAY BE DONE TO MEET EXISTING FIELD CONDITIONS. ALL CONTROLS ARE TO BE LACED WITHIN OWNER'S PROPERTY. ACCUMULATED SEDIMENT IN BASINS WILL REQUIRE REMOVAL DURING CONSTRUCTION OR AFTER EACH RAIN EVENT AND AT THE END OF CONSTRUCTION. EACH BASIN SHALL BE CHECKED AFTER EACH RAIN EVENT. CONTRACTOR TO MINIMIZE THE AREA DISTURBED BY CONSTRUCTION ACTIVITIES AT ANY ONE TIME AND TO PROMPTLY REVEGETATE (OR MECHANICALLY STABILIZE) ARE DISTURBED BY CONSTRUCTION

STRUCTURAL NOTES 1. FOOTINGS & FOUNDATION EXCAVATION: A. A GEOTECHNICAL ANALYSIS HAS BEEN PERFORMED ON THIS SITE. SEE PROJECT MANUAL FOR GEOTECHNICAL INFORMATION. APPROPRIATE RECOMMENDATIONS STATED IN THE GEOTECHNICAL REPORT ISSUED BY SMITH & CO. ENGINEERS DATED SEPTEMBER 23, 2021 SHALL BE FOLLOWED. THESE FOUNDATIONS HAVE BEEN DESIGNED FOR A SOIL BEARING OF 3500 PSF FOR CONTINUOUS AND ISOLATED FOOTINGS. C. FOUNDATIONS SHALL BEAR ON IN-SITU SOILS OR ON PROPERLY PLACED AND COMPACTED STRUCTURAL FILL. SEE GEOTECHNICAL REPORT FOR SPECIFIC REQUIREMENTS REGARDING EXCAVATION AND PREPARATION OF SUBGRADE. A GEOTECHNICAL ENGINEER SHALL BE PRESENT TO DIRECT THE REMOVAL OF UNSUITABLE SOILS AND TO DETERMINE THE ADEQUACY OF THE BEARING SURFACE PRIOR TO PLACEMENT OF THE REINFORCEMENT AND CONCRETE. D. FOOTING WIDTHS TO BE AS SHOWN ON PLANS AND DETAILS. BOTTOM OF FOOTING IS TO BE EXCAVATED SQUARE AND TRUE. WHERE ANY OPEN TRENCH HAS BEEN EXPOSED TO RAIN, SNOW OR ICE PRIOR TO POURING CONCRETE, ALL REINFORCING IN THAT TRENCH SHALL BE REMOVED AND THE BOTTOM OF THE TRENCH SHALL BE DRAINED OF ALL WATER AND CLEANED OF MUD, SNOW OR ICE. A GEOTECHNICAL ENGINEER OR HIS TECHNICAL REPRESENTATIVE SHALL INSPECT THE BOTTOM OF THE TRENCH AND OBSERVE THE RE-COMPACTION OF SOILS PRIOR TO PLACING REINFORCEMENT AND POURING F. ALL STRIP FOOTINGS SHALL BE CENTERED UNDER WALLS BEING SUPPORTED AND ALL ISOLATED FOOTINGS SHALL BE CENTERED UNDER COLUMNS, UNLESS NOTED G. MINIMUM EXTERIOR FOOTING DEPTH SHALL BE AS INDICATED ON THE FOUNDATION PLAN AND FOUNDATION DETAILS. H. IN THE EVENT THAT UNACCEPTABLE SOIL OR UNCOMPACTED FILL IS FOUND BELOW FOOTINGS OR FLOOR SLABS, IT SHALL BE REMOVED AND REPLACED WITH SELECT FILL, COMPACTED IN ACCORDANCE WITH THE GEOTECHNICAL REPORT. STRUCTURAL FILL SHOULD BE PLACED IN NO GREATER THAN 8" LOOSE LIFTS AND COMPACTED IN ACCORDANCE WITH THE GEOTECHNICAL REPORT. ADEQUATE DENSITY AND MOISTURE CONTENT TESTS SHOULD BE PERFORMED TO INSURE COMPLIANCE WITH PROJECT SPECIFICATIONS. SUBGRADE INSPECTION AND FILL TESTING UNDER CONTROLLED CONDITIONS IS CONSIDERED ESSENTIAL IF THE FOOTINGS ARE TO BE FOUNDED IN FILL. CONCRETE: A. ALL READY MIX CONCRETE SHALL BE 4000 psi FOR ALL CONCRETE PLACEMENT. DO NOT ADD WATER TO THE MIX DESIGN AFTER DELIVERY TO THE PROJECT SITE. EXPOSED EXTERIOR CONCRETE SHALL BE AIR-ENTRAINED. INTERIOR CONCRETE SHALL NOT BE AIR-ENTRAINED. UNLESS NOTED OTHERWISE, CONCRETE COVER OVER STEEL REINFORCEMENT SHALL CONFORM TO THE MINIMUM REQUIREMENT BY ACI 318. REINFORCEMENT DETAILING AND PLACEMENT SHALL CONFORM TO ACI 318 AND ACI 315, EXCEPT WHERE OTHERWISE INDICATED. HOT OR COLD WEATHER CONCRETING SHALL BE IN ACCORDANCE WITH ACI 305-89 AND ACI 306-1-90, RESPECTIVELY. ANY CONCRETE PLACED BY MEANS OF PUMPING SHALL BE DONE IN ACCORDANCE WITH ACI 304.2R (82). G. CEMENT SHALL CONFORM TO A.S.T.M. C-150 TYPE I OR TYPE I/II. H. AGGREGATES SHALL CONFORM TO A.S.T.M. C-33 FOR NORMAL WEIGHT CONCRETE & A.S.T.M. C-330 FOR LIGHTWEIGHT CONCRETE. READY MIX CONCRETE SHALL BE MIXED AND DELIVERED IN ACCORDANCE WITH A.S.T.M. C-94. ADMIXTURES MAY BE USED WITH THE APPROVAL OF THE STRUCTURAL ENGINEER. ADMIXTURES USED TO INCREASE THE WORKABILITY OF THE CONCRETE SHALL NOT BE CONSIDERED TO REDUCE THE CEMENT CONTENT. NO CALCIUM CHLORIDE ADMIXTURES ALLOWED.

A. FLOOR SLABS ARE TO BE PLACED AND FINISHED IN ACCORDANCE WITH ACI 302 (SEE PROJECT MANUAL FOR ADDITIONAL INFORMATION).

B. THICKNESS TOLERANCE FOR ALL SLABS IS TO BE PER ACI 117 AND IS TO BE NO MORE THAN +3/8" (THICKER) AND NO MORE THAN -1/4" (THINNER) FROM THE DESIGN THICKNESS.

A. REINFORCING BARS SHALL BE BILLET STEEL. ASTM A 615. GRADE 60. PROVIDE CONTINUOUS BENT BARS AT FOOTING STEPS AND 90 DEGREE BENT TIES AT CORNERS. UNLESS OTHERWISE NOTED, LAP SPLICES OR EMBEDMENT LENGTHS SHALL CONFORM TO CLASS B SPLICE (SEE SPLICE TABLE). ADJACENT BAR SPLICES IN WALLS AND FOOTINGS TO BE ALTERNATED. ALL FOOTINGS SHALL REQUIRED HOOKED REINFORCING PROJECTED INTO WALLS, PILASTERS OR COLUMNS. THE SIZE AND

SPACING OF DOWELS ARE TO MATCH VERTICAL REINFORCING. REINFORCING DETAILING, BENDING, AND PLACING SHALL CONFORM TO ACI 315.

MINIMUM CONCRETE COVERAGE:THE MINIMUM CLEAR DISTANCES BETWEEN REINFORCING STEEL AND FACE OF CONCRETE SHALL BE MAINTAINED UNLESS NOTED OTHERWISE:

SLABS ON EARTH. ..CENTER OF SLAB CONCRETE BELOW GRADE, FORMED

CONCRETE BELOW GRADE, UNFORMED AND POURED AGAINST EARTH....

A. FABRICATOR QUALIFICATIONS: FABRICATOR MUST PARTICIPATE IN THE AISC QUALITY CONTROL PROGRAM AND BE DESIGNATED AN AISC-CERTIFIED PLANT

B. MATERIALS (UNLESS NOTED OTHERWISE): STRUCTURAL STEEL ASTM A992, GRADE 50 PLATES, ANGLES, CHANNELS, AND MISCELLANEOUS STEEL ..ASTM F1554, GRADE 36 HIGH STRENGTH BOLTS. **ASTM F3125**

WELDING ELECTRODES ...AWS A5.1 (E70XX) 6. LIGHT GAUGE STEEL (JOISTS & STUDS): SHALL CONFORM TO AISI (LATEST EDITION) AND THE FOLLOWING:

A. ALL LIGHT GAUGE METAL STUDS, JOISTS AND HEADERS ARE TO MEET OR EXCEED INDUSTRY STANDARDS AS SET FORTH BY THE STEEL STUDS MANUFACTURER'S

B. LIGHT GAUGE STEEL MEMBER DESIGNATIONS SHOWN ON THE CONSTRUCTION DOCUMENTS ARE SSMA STANDARD DESIGNATIONS.

C. ALL LIGHT GAUGE STEEL JOISTS SPANNING MORE THAN 8' SHALL HAVE 18ga RUNNER TRACK SOLID BLOCKING AT A MAXIMUM OF 8' O.C. D. ALL LIGHT GAUGE STEEL WALLS SHALL BE LATERALLY BRACED AT 48" O.C. (VERTICALLY) USING 2"x20ga FLAT STRAP BRACING ATTACHED TO EACH STUD FLANGE.

SOLID BLOCKING WITHIN THE PLANE OF THE STRAP BRACING MUST BE PROVIDED AT EACH END OF WALL, ADJACENT TO WALL OPENINGS, AND AT 8' O.C. MAXIMUM. ALL BRIDGING AND BRACING IS TO BE POSITIVELY CONNECTED TO STUDS. MINIMUM TRACK GAUGE TO MEET OR EXCEED GAUGE OF SUPPORTED STUDS.

BOTTOM TRACK FASTENERS TO BE SPACED AT EACH END OF WALL, ADJACENT TO WALL OPENINGS, AND AT 24" O.C. MAXIMUM.

G. POWDER ACTUATED FASTENERS SHALL BE DS HEAVY DUTY 0.177Øx1½" LONG MANUFACTURED FROM MODIFIED AISI 1061 STEEL AUSTEMPERED TO A HARDNESS OF 52-56 HRC AND ZINC PLATED IN ACCORDANCE WITH ASTM B633,SC1, TYPE III. FASTENERS SHALL BE INSTALLED BY A QUALIFIED OPERATOR IN ACCORDANCE WITH THE MANUFACTURER'S RECOMMENDATIONS. POWDER ACTUATED FASTENERS SHALL BE AS MANUFACTURED BY "HILTI FASTENING SYSTEMS" (BASIS OF DESIGN) OR EQUIVALENT.

H. ALL LOAD BEARING STUDS TO BE SEATED SQUARELY INTO TOP AND BOTTOM WALL TRACKS WITH NO MORE THAN A $\frac{1}{16}$ " GAP.

7. LUMBER: A. TREATED LUMBER

IN LOCATIONS WHERE TREATED LUMBER IS SHOWN ON DRAWINGS, THE APPROVED PRESSURE TREATED WOODS ARE ACQ-D(CARBONATE) OR CA-B TREATED WOODS WITHOUT AMMONIA CARRIERS. THE CHEMICAL RETENTION LEVELS ARE TO BE NO GREATER THAN 0.4 PCF FOR ACQ-2, 0.21 PCF FOR CA-B. ALL METAL CONNECTORS ARE TO HAVE A GALVANIZED COATING OF NO LESS THAN 1.85 OUNCES OF ZINC PER SQUARE FOOT PER ASTM A653. ALL BOLTS, SCREWS NAILS AND OTHER FASTENERS ARE TO BE GALVANIZED PER ASTM A153. WHERE TREATED LUMBER IS SHOWN IN EXTERIOR INSTALLATIONS WITH NO ROOF COVERINGS TO PREVENT DIRECT EXPOSURE TO RAIN, USE HOT DIP GALVANIZED CONNECTORS PER ASTM A123.

B. FIRE RETARDANT TREATED (FRT) PLYWOOD

1. ¾" FRT SHEATHING TO BE FASTENED AT 6" O.C. AT PERIMETER OF SHEETS AND 12" O.C. AT INTERMEDIATE SUPPORTS WITH (MIN) #8 SCREWS.

A. CONTRACTOR HAS SOLE RESPONSIBILITY TO COMPLY WITH ALL OSHA REGULATIONS.

B. THE STRUCTURAL DESIGN OF THE BUILDING IS BASED UPON THE FULL INTERACTION OF ALL ITS COMPONENT PARTS, WITH NO PROVISION MADE FOR CONDITIONS OCCURRING DURING CONSTRUCTION. THE STRUCTURE IS STABLE ONLY IN ITS COMPLETED FORM. THE CONTRACTOR SHALL PROVIDE ADEQUATE BRACING DURING CONSTRUCTION. TEMPORARY SUPPORTS REQUIRED FOR STABILITY DURING ALL INTERMEDIATE STAGES OF CONSTRUCTION SHALL BE DESIGNED, FURNISHED AND INSTALLED BY THE CONTRACTOR. THE CONTRACTOR IS RESPONSIBLE FOR CONSTRUCTIBILITY ANALYSIS AND ERECTION PROCEDURES, INCLUDING DESIGN AND ERECTION OF FALSEWORK, TEMPORARY BRACING, ETC. THE STRUCTURAL ENGINEER ASSUMES NO LIABILITY FOR THE STRUCTURE DURING CONSTRUCTION.

C. CORRECTIONS DUE TO UNFORESEEN FIELD CONDITIONS OR DIMENSIONAL DISCREPANCIES ON CONSTRUCTION DOCUMENTS MUST BE BROUGHT TO THE ATTENTION OF THE PROJECT ARCHITECT FOR REVIEW AND AUTHORIZATION PRIOR TO CORRECTIVE MEASURES BEING IMPLEMENTED.

D. STRUCTURAL DRAWINGS ARE TO BE USED IN CONJUNCTION WITH ARCHITECTURAL. MECHANICAL, AND ELECTRICAL DRAWINGS.

NOTES AND DETAILS ON DRAWINGS SHALL TAKE PRECEDENCE OVER THESE GENERAL NOTES.

F. ALL SHOP DRAWINGS SHALL BE REVIEWED AND APPROVED BY THE PROJECT ARCHITECT/ENGINEER PRIOR TO SUBMITTING TO THE BUILDING DEPARTMENT FOR REVIEW AND APPROVAL.

9. SPECIAL INSPECTIONS REQUIREMENTS: A. OWNER SHALL ENGAGE ONE OR MORE QUALIFIED SPECIAL INSPECTORS AND/OR TESTING AGENCIES TO CONDUCT STRUCTURAL TESTS, CONSTRUCTION MATERIAL TESTING, AND SPECIAL INSPECTIONS SPECIFIED IN THE "STATEMENT OF SPECIAL INSPECTIONS".

B. FOR THE SPECIFIC RESPONSIBILITY OF THE OWNER, CONTRACTOR, AND SPECIAL INSPECTOR REFER TO THE PROJECT MANUAL.

DESIGN CRITERIA

20.0 psf

10.0 psf

BUILDING CODE: 2018 INTERNATIONAL BUILDING CODE

DESIGN LOADS: ROOF LIVE LOAD.. .. 20.0 psf SEE PEMB ROOF DEAD LOAD... ROOF COLLATERAL LOAD.. . 4.0 psf SPRINKLER LOADS UNIFORM BRANCH PIPE LOAD. .. 1.0 psf LINEAL LOOP/TEE MAIN PIPE LOAD... . 25.0 plf

SNOW LOAD:

 $P_{0} = 15 \text{ psf}$ $P_{\rm f}^{"}$ = 10.5 psf $C_{\rm e}$ = 1.0 $C_t = 1.0$ $I_{\rm s} = 1.0$

SHOWER CEILING LIVE LOAD.

SHOWER CEILING DEAD LOAD.

WIND CALCULATION METHOD: ENVELOPE $V_{\text{nlt}} = 105 \text{ mph}$ $V_{\text{asd}} = 81.3 \text{ mph}$ EXPOSURE = "C" RISK CATEGORY = II BUILDING, ENCLOSED GC, = ±0.18 Kzt = 1.0Kd = 0.85

MAIN FORCE RESISTING SYSTEM: WALL AND ROOFS q = 13.1 psf

WIND COMPONENTS & CLADDING: All Wind Pressures & Forces in "ASD" (Wind pressures below were used by JS Smith Consulting Engineers, P.C. for design. Components designed by others for use in this project will require wind pressures derived by that supplier.)

> WALL AREAS 10 SQUARE FEET OR LESS = 20.7 psf WALL INTERIOR ZONES = 12.7 psf & -14.0 psf WALL END ZONES = 12.7 psf & -15.2 psf ROOF INTERIOR ZONES = 10.0 psf & -17.7 psf ROOF EDGE ZONES = 10.0 psf & -23.6 psf ROOF CORNER ZONES = 10.0 psf & -26.5 psf

BASE SHEAR:

WIND = 7.8 kSEISMIC = 47.6 kWIND = $17.5 \, \text{k}$ SEISMIC = 44.2 k

SEISMIC DESIGN: EQUIVALENT FORCE PROCEDURE

 $s_1 = 0.340$ $S_{DS} = 0.790$ $S_{D1} = 0.340$

 $S_s = 0.987$

SITE CLASS = C SEISMIC DESIGN CATEGORY = D

SEISMIC FORCE RESISTING SYSTEM:

ORDINARY STEEL MOMENT FRAMES R = 3.50 $C_S = 0.226$

 $\rho = 1.30$

STEEL CONCENTRICALLY BRACED FRAMES R = 3.25 $C_S = 0.243$

 $\Omega_{\rm O}$ = 2.00 $C_d = 3.25$ ρ = 1.30

 $\Omega_{\rm O}$ = 3.00

 $C_d = 3.00$

SPLICE TABLE 1 (UNLESS NOTED OTHERWISE)						
BAR	LAP SPLIC	CES (in.) ²	EMB	D LENGTH	(in.)	
SIZE	TOP BARS ³ Class B	OTHERS Class B	TOP BARS ³	OTHERS Id	HOOKS ⁵ Idh	
#3	26	20	20	16	8	
#4	35	27	27	21	11	
#5	43	33	33	26	13	
#6	52	40	40	31	16	
#7	75	58	58	45	18	

SPLICE TABLE IS BASED ON THE FOLLOWING:

A. CONCRETE f'c = 4000 psi B. GRADE 60 REBAR

C. BAR SPACING NOT LESS THAN 2 BAR DIAMETERS OR 1"


D. CONCRETE COVER NOT LESS THAN ONE BAR DIAMETER 2. LAP LENGTHS SHOWN ARE FOR CLASS "B" TENSION SPLICES PER ACI 318-11 CHAPTER 12.

3. TOP BARS ARE DEFINED AS HORIZONTAL REINFORCEMENT PLACED SO THAT MORE THAN 12" OF CONCRETE IS

CAST BELOW THE REINFORCEMENT IN THAT MEMBER. 4 STANDARD 90° HOOKS:

A. RADIUS = 4 BAR DIAMETERS FOR #3 THRU #8 B. LENGTH = 12 BAR DIAMETERS

5. HOOK LENGTH MAY BE REDUCED IN ACCORDANCE WITH ACI 318-11 CHAPTER 12.5

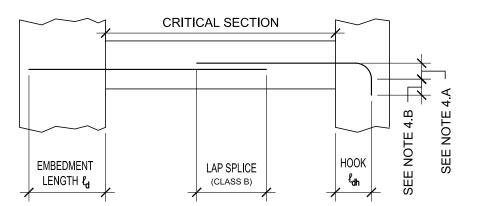

STATE OF MISSOURI MICHAEL L. PARSON, **GOVERNOR**



RESPONSIBILITY FOR ALL OTHER PLANS,
SPECIFICATIONS OR INSTRUMENTS ARE DISCLAIMED.

OFFICE OF ADMINISTRATION **DIVISION OF FACILITIES MANAGEMENT DESIGN AND CONSTRUCTION**

DEPARTMENT OF PUBLIC SAFETY MISSOURI ARMY NATIONAL GUARD

CONSTRUCT NEW 60 SOLDIER BARRACKS

WAPPAPELLO TRAINING SITE 461 COUNTY ROAD 517 WAPPAPELLO, MISSOURI

PROJECT # T2124-01 ASSET # 8136325016

REVISION DATE REVISION: DATE REVISION: DATE:

BUILDING #3

ISSUE DATE: 07/29/2022 CAD DWG FILE:T2124-01-6325-8136325016-S-001


CHECKED BY: BTJ, AS DESIGNED BY: BTJ

SHEET TITLE:

DRAWN BY: MW

STRUCTURAL **NOTES**

SHEET NUMBER:

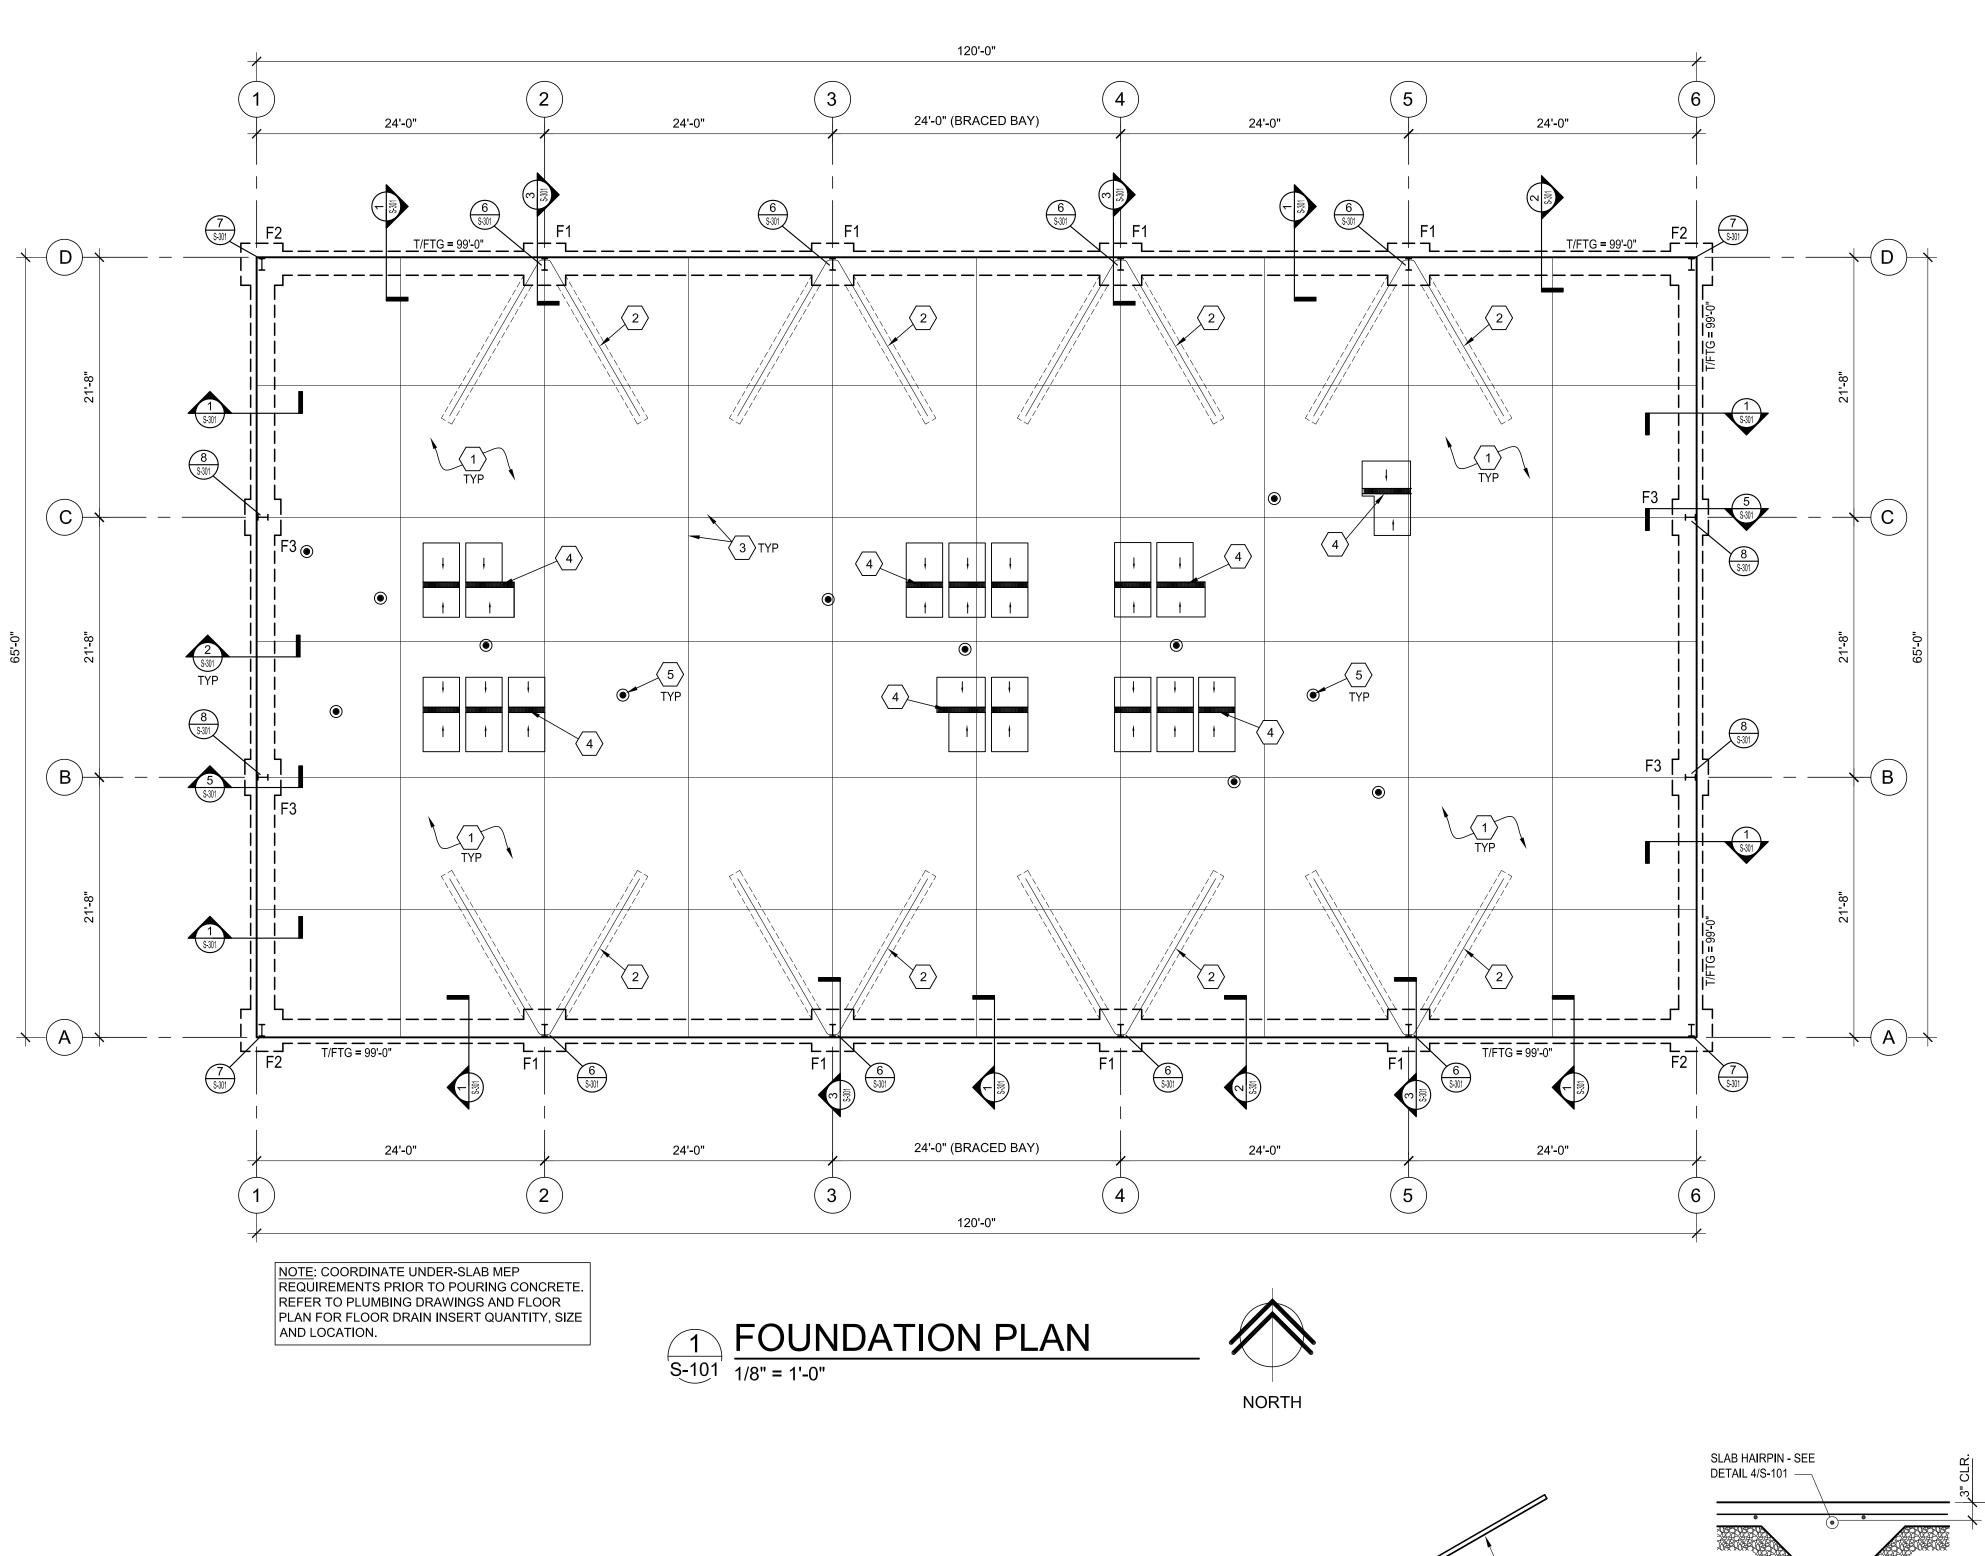


TYP. CONSTRUCTION
JOINT DETAIL
3
S-101

SLAB CONTROL JOINT (SAWN).

CONTROL JOINT TO BE 1/8"x1" DEEP.

SEE FOUNDATION PLAN FOR JOINT

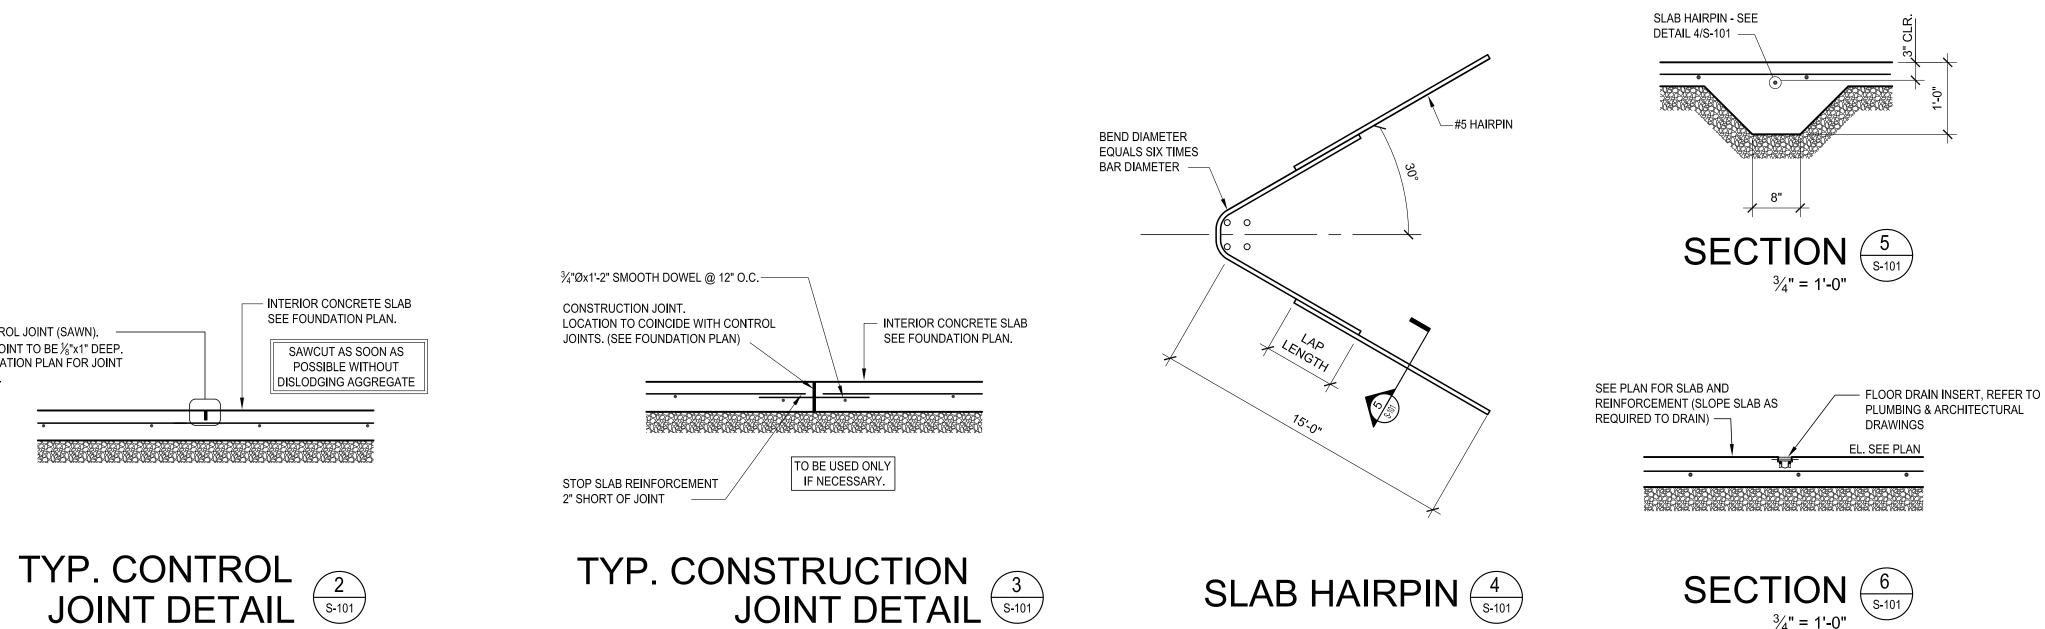

SLAB HAIRPIN (4) s-101)

SECTION 6
S-101


FOUNDATION KEY NOTES:

- 4" THICK CONCRETE SLAB REINFORCED W/ #3's @ 18" O.C. EACH WAY (PLACED AT MID-HEIGHT OF SLAB) OVER 10 MIL. POLYETHYLENE VAPOR RETARDER OVER COMPACTED SUB-BASE MATERIAL (AS DIRECTED BY THE GEOTECHNICAL REPORT OR ONSITE GEOTECHNICAL ENGINEER) OVER PROPERLY PREPARED SUBGRADE. FINISH FLOOR EL. = 100'-0" (SITE PLAN EQUIVALENT = 503.50'). COORDINATE INSTALLATION OF DRAINS AND UNDER SLAB MECHANICAL, ELECTRICAL AND PLUMBING SYSTEMS WITH MEP AND ARCHITECTURAL DRAWINGS.
- $\langle 2 \rangle$ SLAB HAIR PIN, REFER TO DETAIL 4/S-101
- \langle $_3$ \rangle CONTROL OR CONSTRUCTION JOINT SEE DETAILS 2 & 3/S-101
- SEE DETAIL 6/S-101 AT SHOWER DRAIN INSERT LOCATIONS, REFER TO PLUMBING DRAWINGS FOR QUANTITY, TYPE AND EXACT LOCATIONS. SLOPE SLAB AS REQUIRED FOR POSITIVE DRAINAGE AT
- $\langle 5 \rangle$ FLOOR DRAIN INSERTS, REFER TO PLUMBING DRAWINGS FOR QUANTITY, TYPE AND EXACT LOCATIONS

FOUNDATION SCHEDULE						
FOOTING SIZE (W x L x T)	REINFOR	CEMENT	TOP OF FOOTING ELEVATION	MARK		
4'-0"x4'-0"x2'-0"	(6) #4's EACI	H WAY (T&B)	99'-0"	F1		
3'-6"x3'-6"x2'-0"	(5) #4's EACH WAY (T&B)		99'-0"	F2		
3'-6"x3'-6"x2'-0"	(5) #4's EACI	H WAY (T&B)	99'-0"	F3		
	FOOTING SIZE (W x L x T) 4'-0"x4'-0"x2'-0" 3'-6"x3'-6"x2'-0"	FOOTING SIZE (W x L x T) (E.W. TOP 8 4'-0"x4'-0"x2'-0" (6) #4's EACH 3'-6"x3'-6"x2'-0" (5) #4's EACH	FOOTING SIZE (W x L x T) FOOTING REINFORCEMENT (E.W. TOP & BOTTOM) 4'-0"x4'-0"x2'-0" (6) #4's EACH WAY (T&B) 3'-6"x3'-6"x2'-0" (5) #4's EACH WAY (T&B)	FOOTING SIZE (W x L x T) FOOTING REINFORCEMENT (E.W. TOP & BOTTOM) 4'-0"x4'-0"x2'-0" (6) #4's EACH WAY (T&B) 99'-0" 3'-6"x3'-6"x2'-0" (5) #4's EACH WAY (T&B) 99'-0"		

. ALL ANCHOR BOLTS SHALL BE SIZE, QUANTITY AND SPACING AS SPECIFIED BY THE PRE-ENGINEERED METAL BUILDING MANUFACTURER. MAINTAIN 3" MINIMUM CONCRETE COVER AROUND BOLTS. TIES SHALL WRAP AROUND ANCHOR BOLTS.

- 2. COLUMN BASE PLATES ARE TO REST ON TOP OF SLAB. PROVIDE LEVEL BEARING SURFACE FOR
- B. COLUMN FOOTING REINFORCEMENT TO BE INTEGRAL WITH CONTINUOUS FOUNDATION
- REINFORCEMENT (WHERE APPLICABLE). 4. ALL SPREAD FOOTINGS ARE TO BE CENTERED BENEATH COLUMNS UNLESS NOTED OTHERWISE

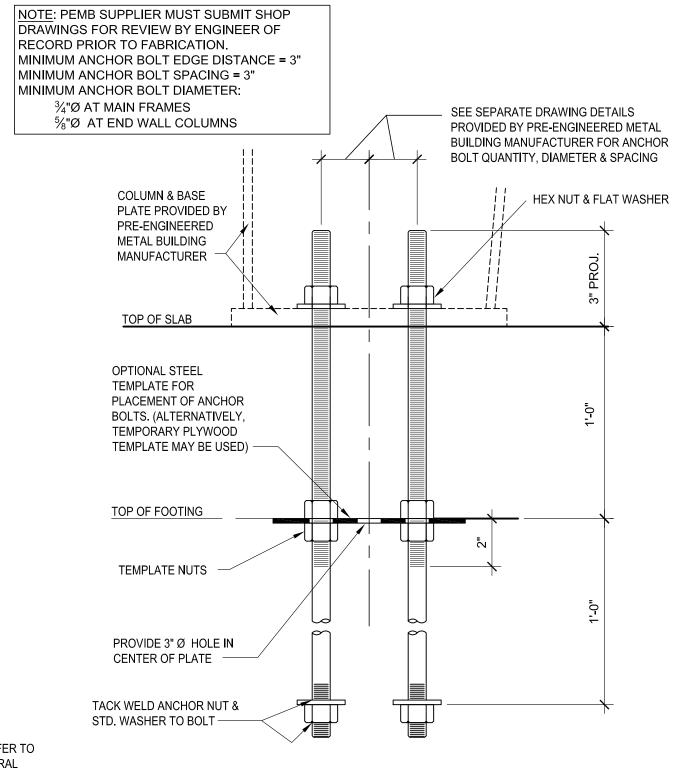


TYP. ANCHOR BOLT ASSEMBLY (S-101)

NOTE: GENERAL CONTRACTOR PROVIDED ANCHOR BOLT ASSEMBLY TO BE PLACED

IN FORM PRIOR TO POURING CONCRETE. BOLT MATERIAL MAY BE F1554 GR. 36, OR

CONTINUOUSLY THREADED A36 ROD. ALL ANCHOR BOLTS SHALL BE CLEAN AND FREE OF ALL OIL, GREASE, ICE, ETC.

STATE OF MISSOURI MICHAEL L. PARSON, **GOVERNOR**

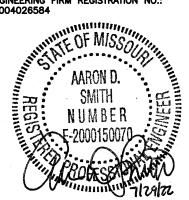

SHEETS BEARING THIS SEAL ARE AUTHENTICATED, RESPONSIBILITY FOR ALL OTHER PLANS, SPECIFICATIONS OR INSTRUMENTS ARE DISCLAIMED.

OFFICE OF ADMINISTRATION DIVISION OF FACILITIES MANAGEMENT, **DESIGN AND CONSTRUCTION**

DEPARTMENT OF PUBLIC SAFETY MISSOURI ARMY NATIONAL GUARD

CONSTRUCT NEW 60 SOLDIER BARRACKS

WAPPAPELLO TRAINING SITE 461 COUNTY ROAD 517 WAPPAPELLO, MISSOURI

PROJECT # T2124-01 6325 ASSET # 8136325016

BUILDING #3

REVISION: DATE REVISION: DATE **REVISION:** DATE:

ISSUE DATE: 07/29/2022 CAD DWG FILE: T2124-01-6325-8136325016-S-101


DRAWN BY: MW CHECKED BY: BTJ, AS DESIGNED BY: BTJ

SHEET TITLE:

FOUNDATION PLAN

SHEET NUMBER:

13 OF 36 SHEETS

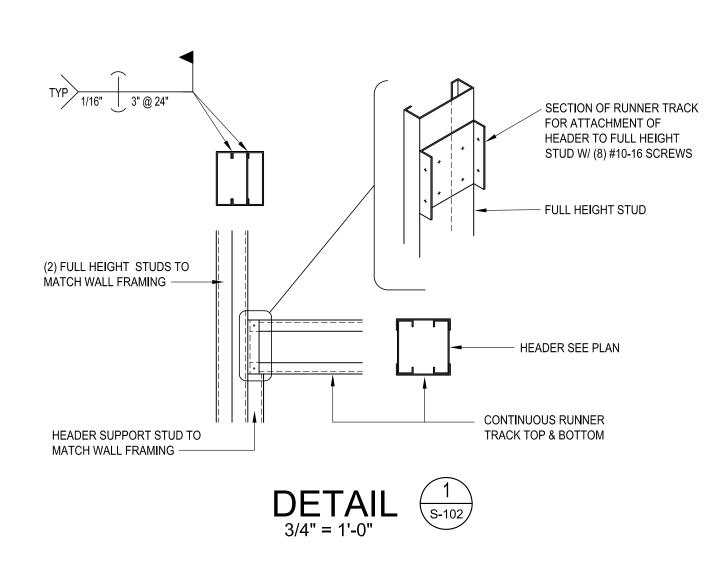

MIN 35/8" METAL STUD BLOCKING


3/4" FIRE RATED PLYWOOD,

REFER TO STRUCTURAL

AT EACH JOIST SPACE FOR


NOTES

DECKING ATTACHMENT

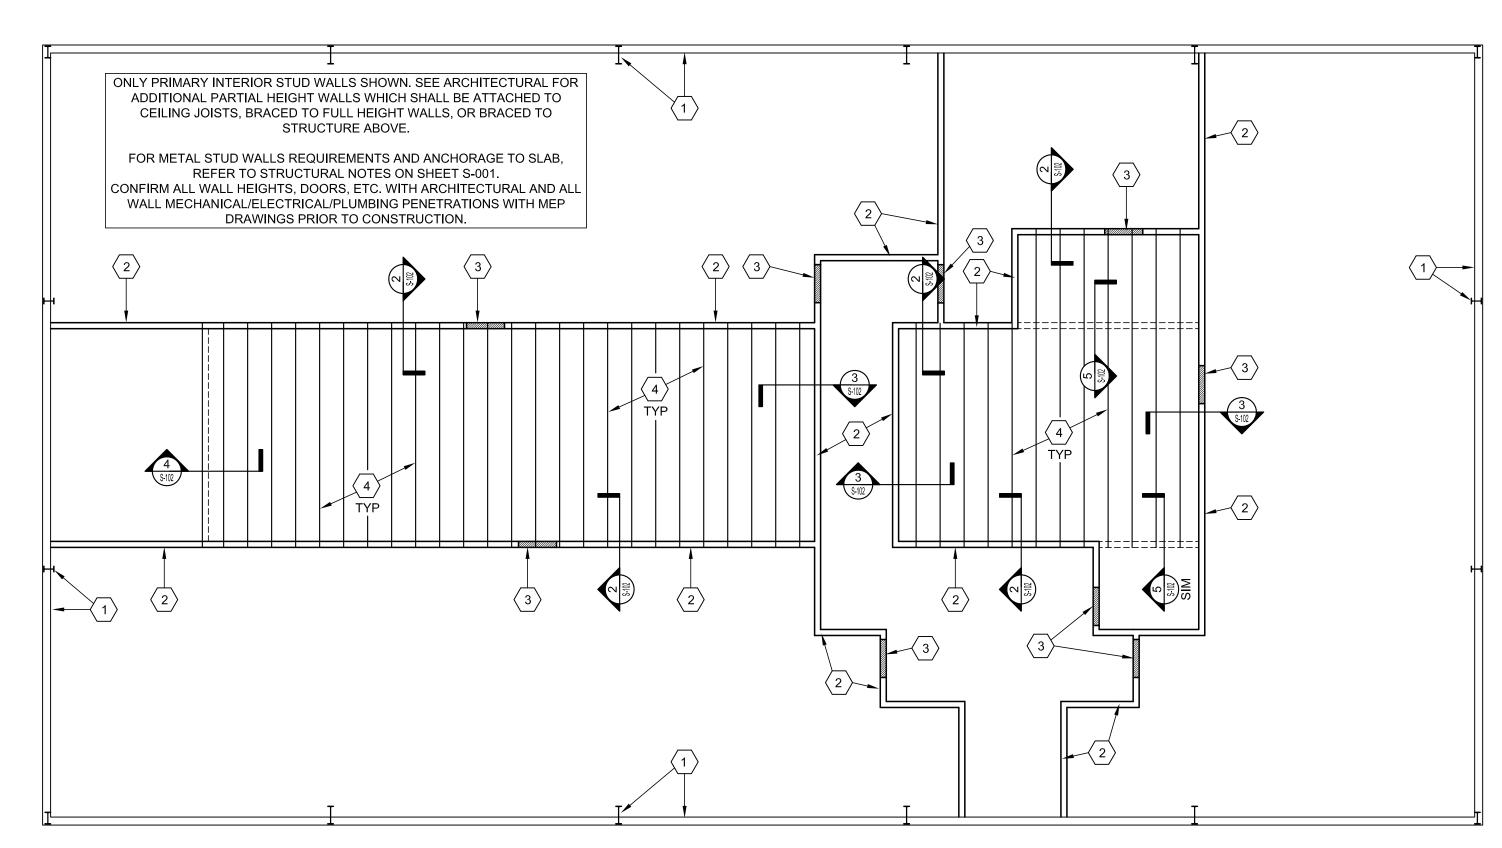

INTERIOR FRAMING PLAN KEY NOTES:

- γ PRE-ENGINEERED METAL BUILDING FRAME AND WALL GIRT SYSTEM. REFER TO PEMB ERECTION DRAWINGS FOR ADDITIONAL INFORMATION
- $\frac{-}{2}$ 6"x20 ga (600S162-33) METAL STUDS @ 24" O.C. EXTENDING TO ROOF DECK. SEE SECTIONS 6 & 7/S-102 FOR TYPICAL CONNECTIONS. PROVIDE ADDITIONAL STUDS AT SHOWER LOCATIONS AS INDICATED ON ARCHITECTURAL DRAWINGS. REFER TO STRUCTURAL NOTES SHEET S-001 FOR ADDITIONAL COLD-FORMED STEEL
- \bigcirc (MINIMUM (2) 8"x16 ga (800S162-54) BOXED HEADER AT ALL OPENINGS IN FULL HEIGHT \bigcirc STUD WALLS (INCLUDING ALL MECHANICAL PENETRATIONS LARGER THAN 18"). REFER TO DETAIL 1/S-102 FOR TYPICAL HEADER BEARING CONDITIONS. SEE ARCHITÉCTURAL FOR OPENING SIZE AND LOCATION REQUIREMENTS.
- 4 ¾" FIRE RETARDANT TREATED PLYWOOD SHEATHING OVER 8"x16 ga (800S162-54) METAL JOISTS @ 24" O.C. SEE STRUCTURAL NOTES SHEET S-001 FOR ADDITIONAL COLD-FORMED

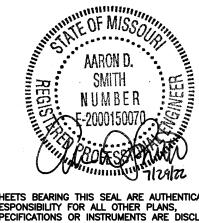

ENGINEERING FIRM REGISTRATION NO.: E2004026584

STATE OF MISSOURI MICHAEL L. PARSON, **GOVERNOR**

RESPONSIBILITY FOR ALL OTHER PLANS,
SPECIFICATIONS OR INSTRUMENTS ARE DISCLAIMED.

OFFICE OF ADMINISTRATION DIVISION OF FACILITIES MANAGEMENT, **DESIGN AND CONSTRUCTION**

DEPARTMENT OF PUBLIC SAFETY MISSOURI ARMY NATIONAL GUARD

CONSTRUCT NEW 60 SOLDIER BARRACKS

WAPPAPELLO TRAINING SITE 461 COUNTY ROAD 517 WAPPAPELLO, MISSOURI

PROJECT # T2124-01 6325 ASSET # 8136325016

REVISION: DATE REVISION: DATE: REVISION: DATE:

BUILDING #3

ISSUE DATE: 07/29/2022

CAD DWG FILE:T2124-01-6325-8136325016-S-102 DRAWN BY: \overline{MW} CHECKED BY: BTJ, AS DESIGNED BY: BTJ

SHEET TITLE:

INTERIOR FRAMING **PLAN**

SHEET NUMBER:

14 OF 36 SHEETS

07/29/2022





6"x20 ga METAL STUDS @


SEE ARCHITECTURAL DRAWINGS FOR


FIRE STOPS AND FLASHING


INFORMATION -

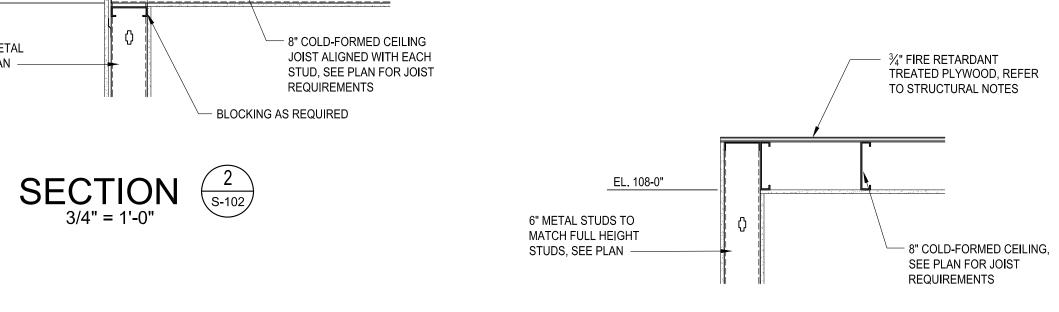


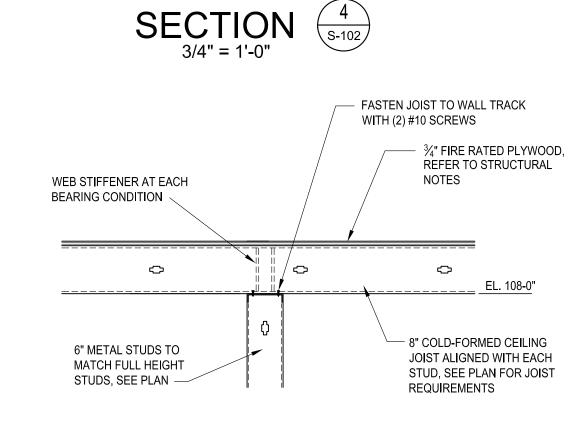

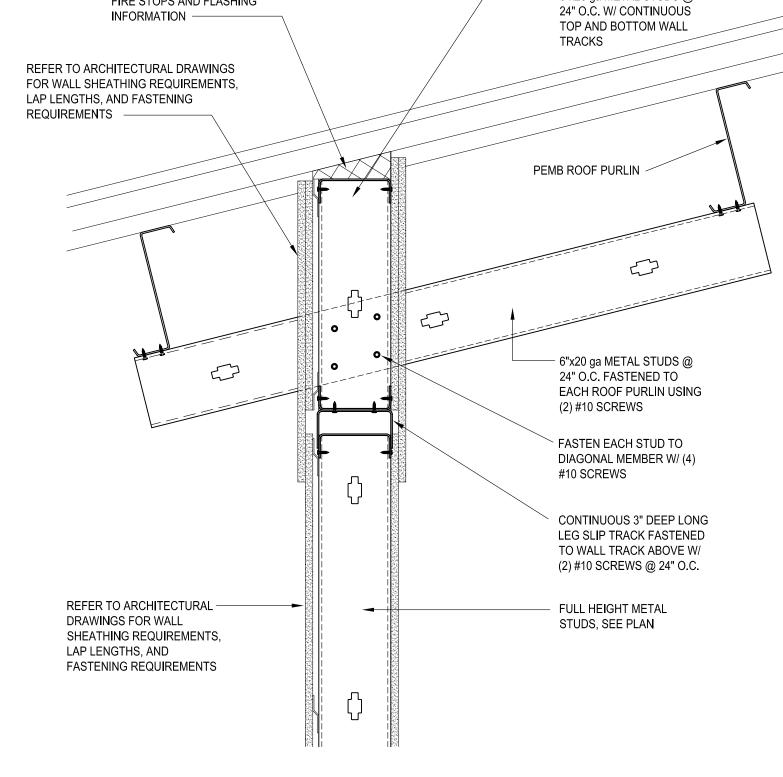

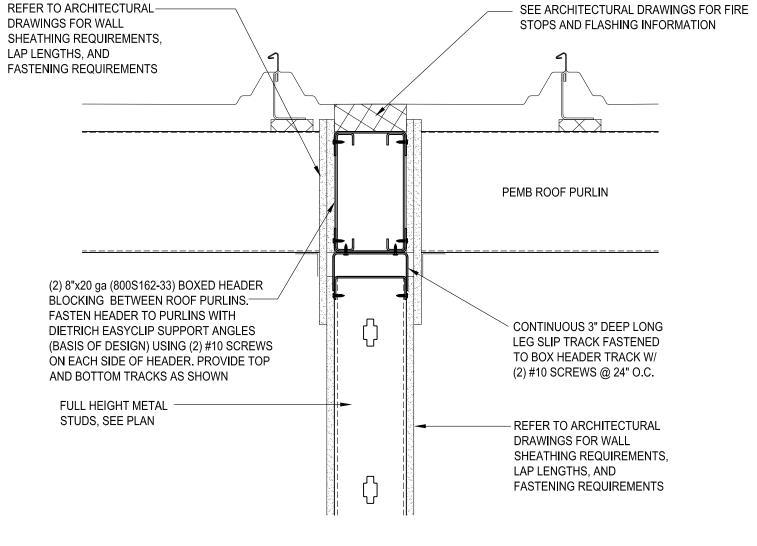

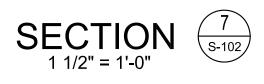

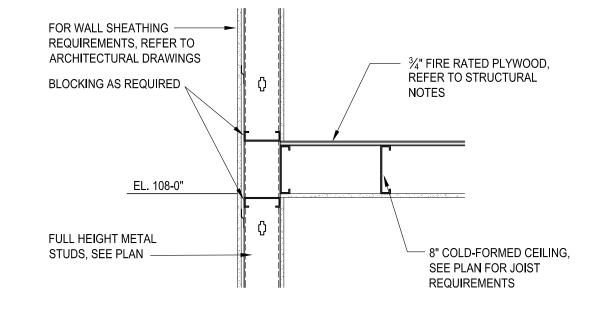

FOR WALL SHEATHING -

REQUIREMENTS, REFER TO

ARCHITECTURAL DRAWINGS

MINIMUM (4) #10 SCREWS

TO EACH STUD -


FULL HEIGHT METAL


STUDS, SEE PLAN







SECTION 6 1 1/2" = 1'-0"

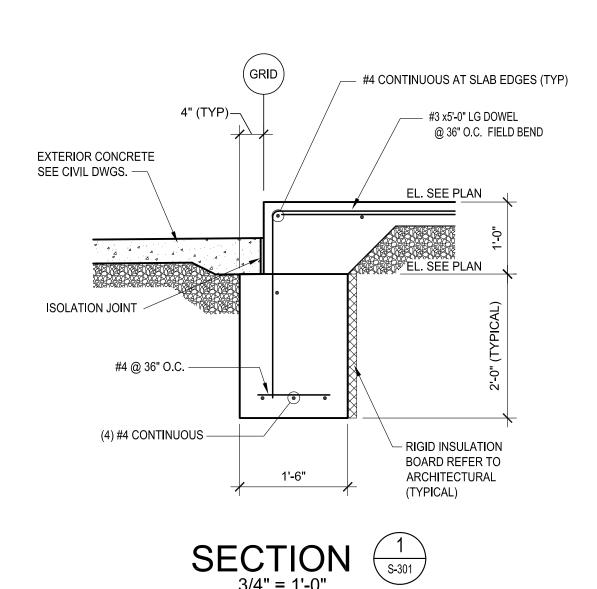


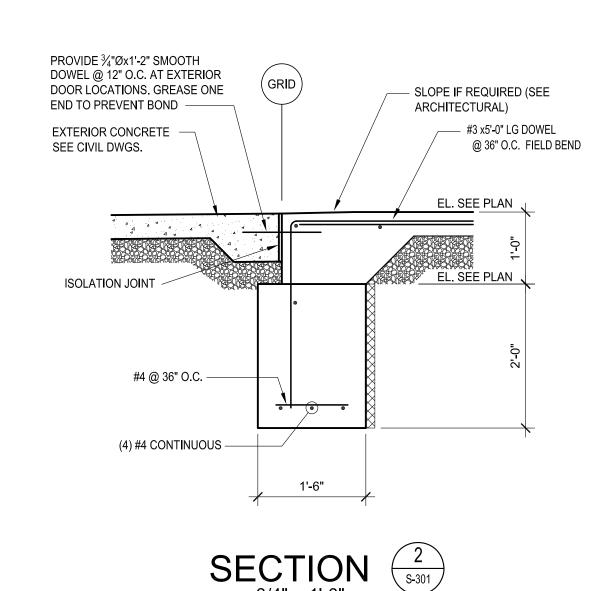


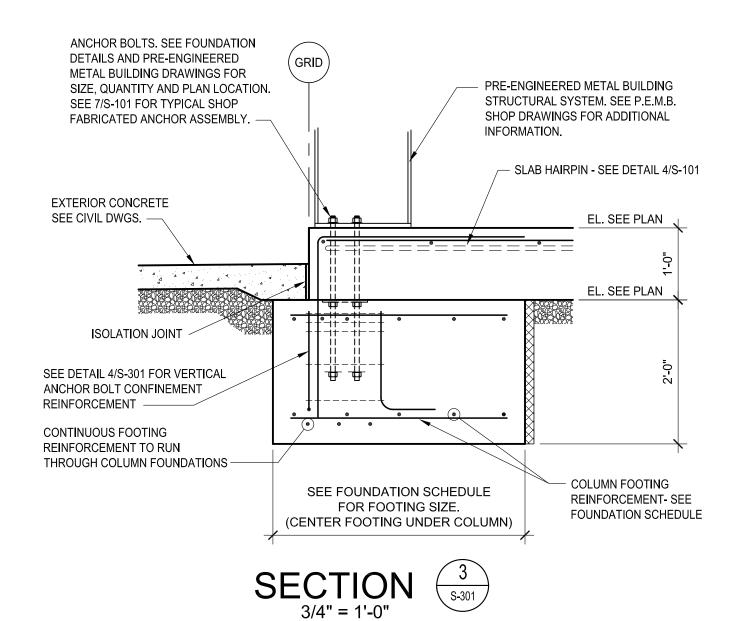


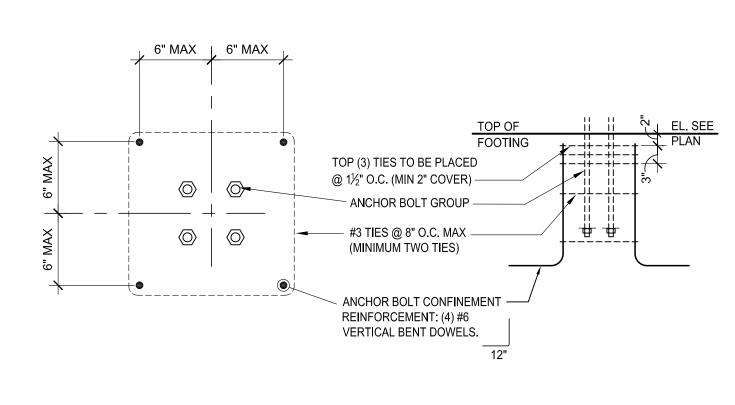




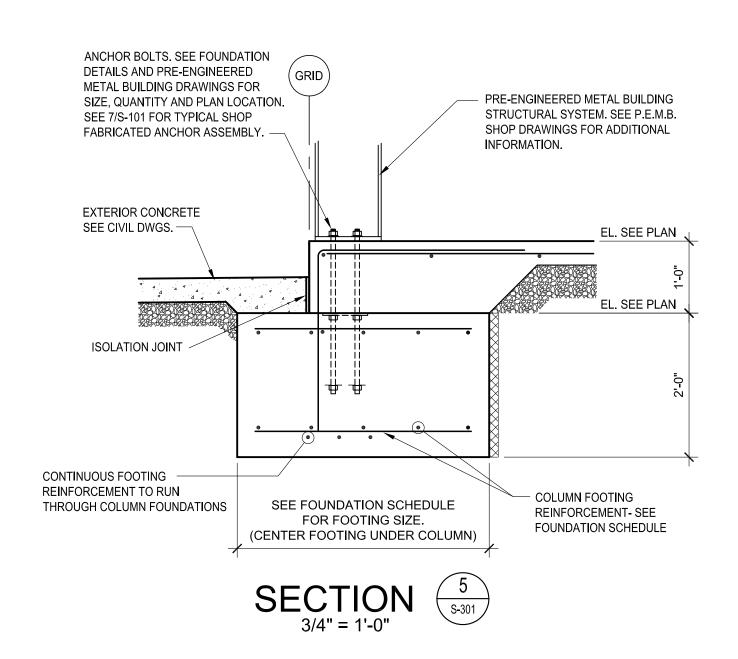

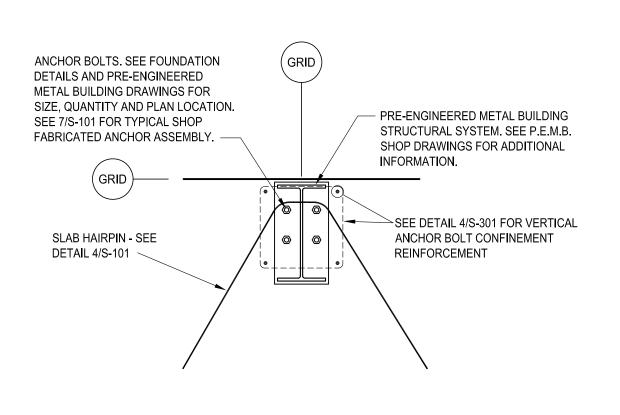

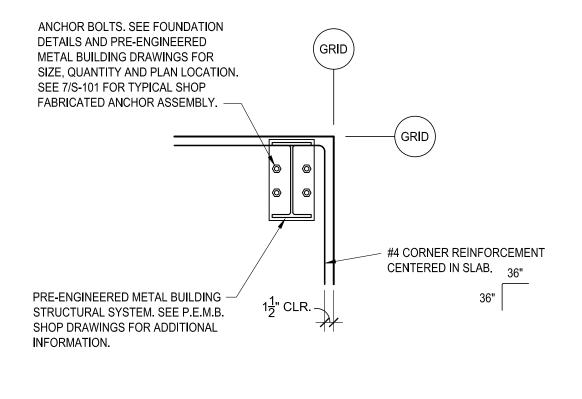

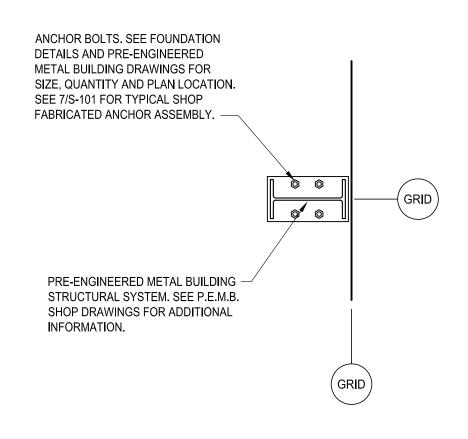


DETAIL 6

3/4" = 1'-0"

DETAIL (7)
3/4" = 1'-0"

DETAIL 8
3/4" = 1'-0"

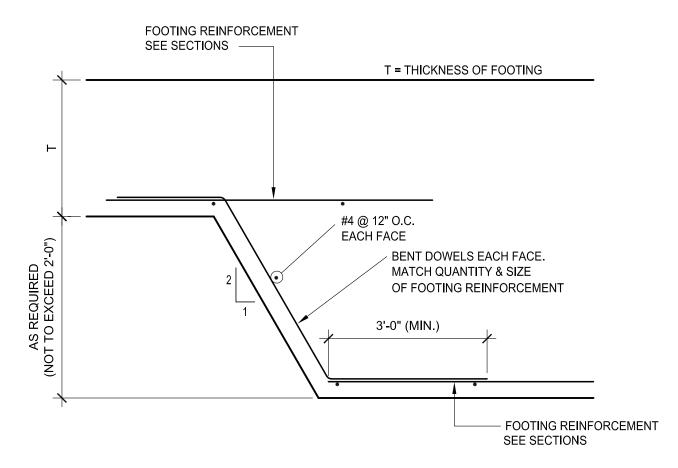

TYPICAL FOOTING STEP 9
(IF REQUIRED)

STATE OF MISSOURI MICHAEL L. PARSON, **GOVERNOR**

NUMBER

SHEETS BEARING THIS SEAL ARE AUTHENTICATED, RESPONSIBILITY FOR ALL OTHER PLANS, SPECIFICATIONS OR INSTRUMENTS ARE DISCLAIMED.

OFFICE OF ADMINISTRATION DIVISION OF FACILITIES MANAGEMENT. **DESIGN AND CONSTRUCTION**

DEPARTMENT OF PUBLIC SAFETY MISSOURI ARMY NATIONAL GUARD

CONSTRUCT NEW 60 SOLDIER BARRACKS

WAPPAPELLO TRAINING SITE 461 COUNTY ROAD 517 WAPPAPELLO, MISSOURI

PROJECT # T2124-01 6325 ASSET # 8136325016

REVISION: DATE REVISION: DATE: REVISION: DATE: ISSUE DATE: 07/29/2022

BUILDING #3

CAD DWG FILE: T2124-01-6325-8136325016-S-301 DRAWN BY: MW

CHECKED BY: BTJ, AS DESIGNED BY: BTJ


SHEET TITLE:

FOUNDATION DETAILS

SHEET NUMBER:

15 OF 36 SHEETS

07/29/2022

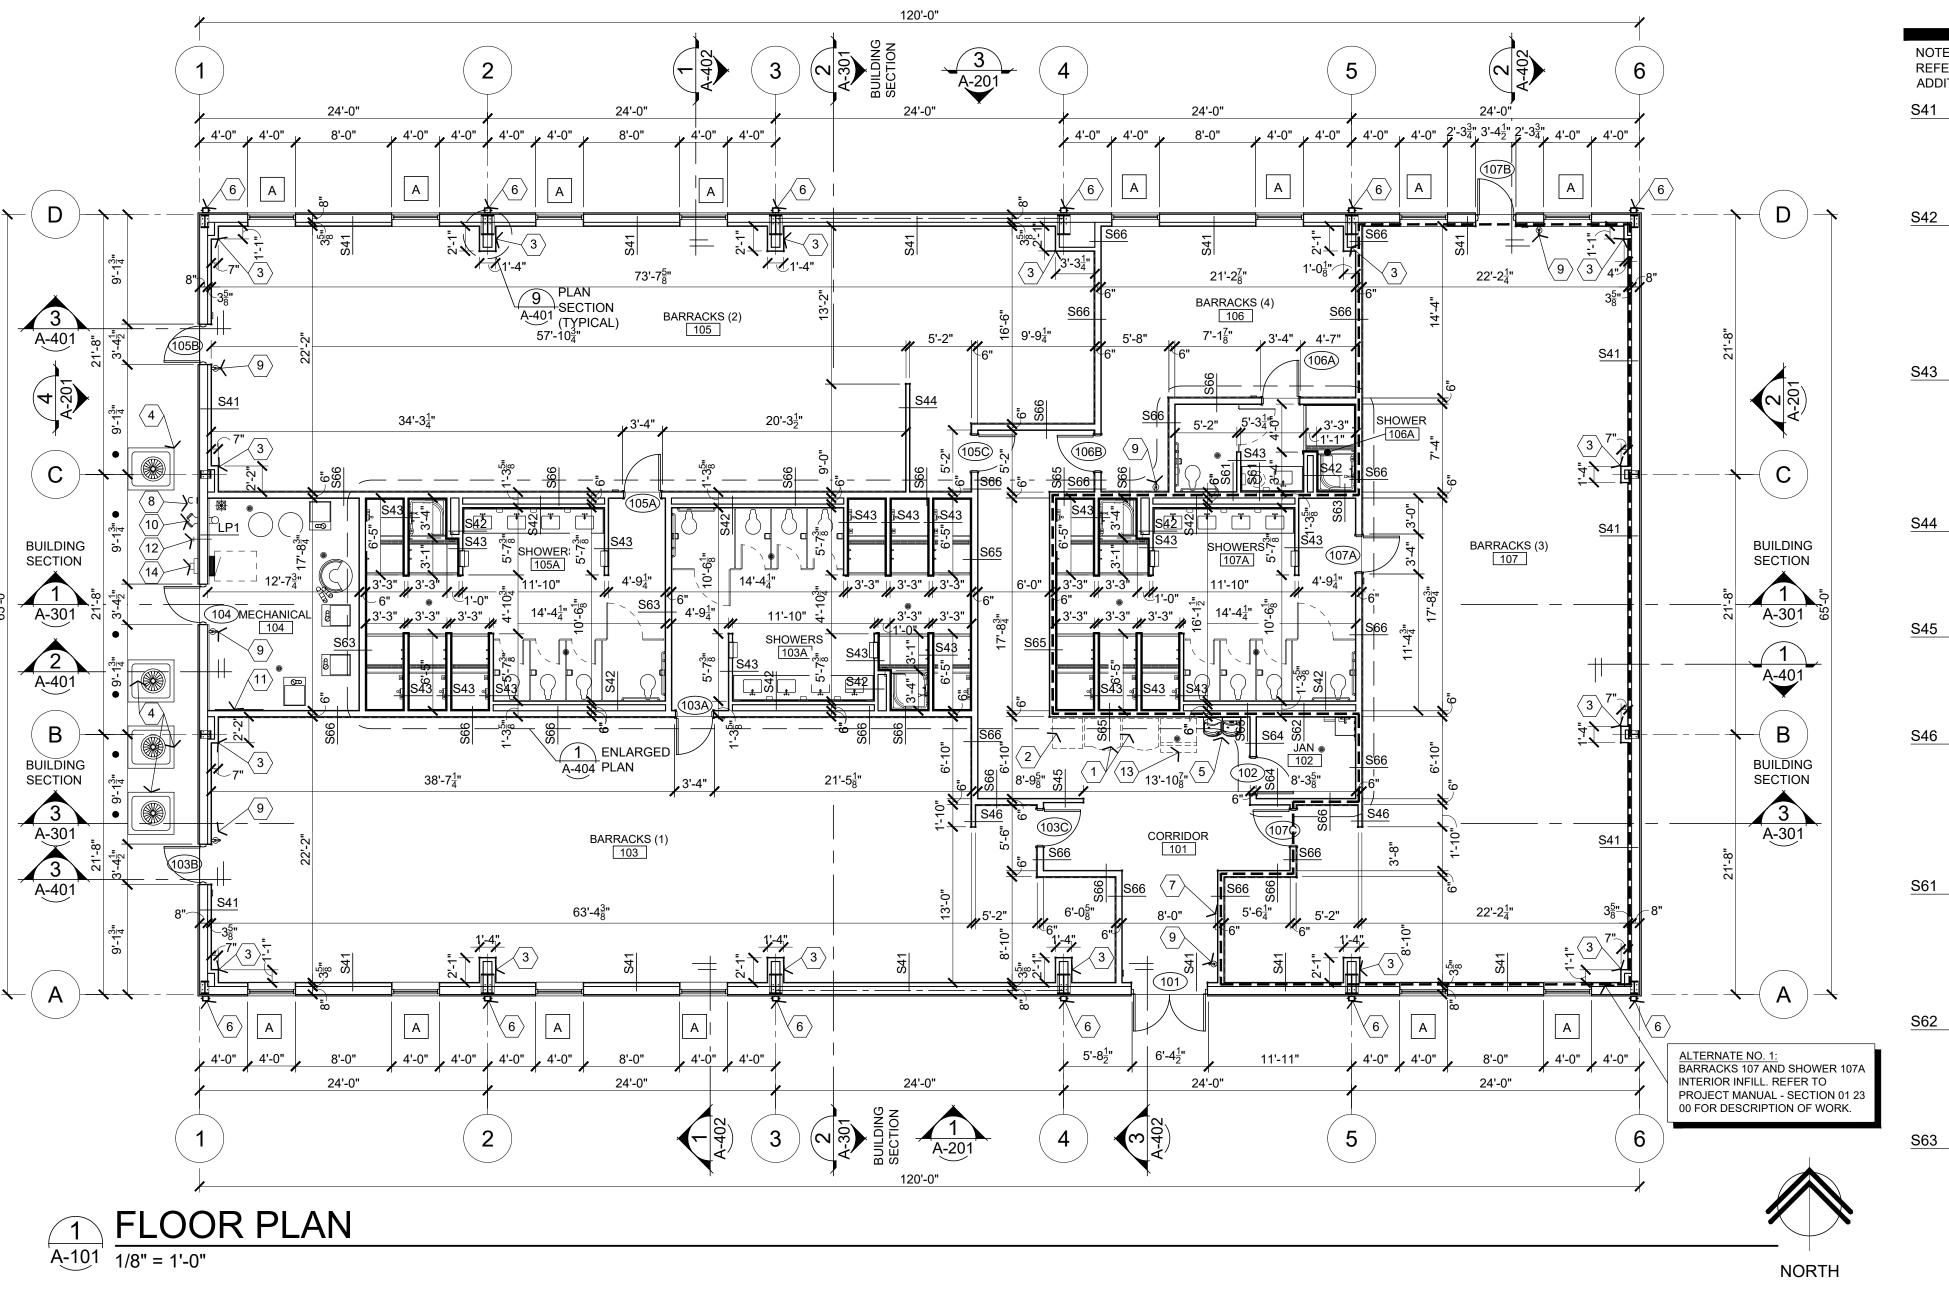

SYMBOLS LEGEND


WALL TYPE, REFER TO WALL TYPES

AREA OF ALTERNATE NO. 1

DOOR MARK, REFER TO DOOR SCHEDULE, KEY NOTE, REFER TO KEY NOTES WINDOW MARK, REFER TO WINDOW SCHEDULE BARRACKS (3) ROOM MARK 107

WALL TYPES

REFER TO INTERIOR WALL AND CEILING GENERAL NOTES FOR ADDITIONAL REQUIREMENTS.

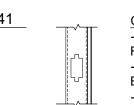

COLD FORM METAL FRAMING WALL: -362S162-33 (3 5/8"-20 GA.) COLD FORM METAL STUD FRAMING AT 24" O.C. -ONE LAYER 5/8" TYPE "X" GYPSUM BOARD ON EXPOSED SIDE.

-EXTEND ASSEMBLY TO 10'-6" ABOVE FINISH FLOOR. -362S162-33 (3 5/8"-20 GA.) COLD FORM METAL STUD FRAMING AT 24" O.C. AND 16" O.C. AT CEMENT

BACKING BOARD LOCATIONS. -ONE LAYER 5/8" TYPE "X" GYPSUM BOARD ON EXPOSED SIDE. (PROVIDE 5/8" CEMENT BACKING BOARD AT SHOWER ENCLOSURE SURFACES IN LIEU OF GYPSUM BOARD) -EXTEND ASSEMBLY TO 8'-0" ABOVE FINISH FLOOR.

COLD FORM METAL FRAMING WALL -362S162-33 (3 5/8"-20 GA.) COLD FORM METAL STUD FRAMING AT 24" O.C. AND 16" O.C. AT CEMENT **BACKING BOARD LOCATIONS.** -ONE LAYER 5/8" TYPE "X" GYPSUM BOARD ON BOTH SIDES. (PROVIDE 5/8" CEMENT BACKING BOARD AT SHOWER ENCLOSURE SURFACES IN LIEU OF

GYPSUM BOARD). -EXTEND ASSEMBLY TO 8'-0" ABOVE FINISH FLOOR.

COLD FORM METAL FRAMING WALL

COLD FORM METAL FRAMING WALL

-362S162-33 (3 5/8"-20 GA.) COLD FORM METAL STUD FRAMING AT 24" O.C. -ONE LAYER 5/8" TYPE "X" GYPSUM BOARD ON BOTH -EXTEND ASSEMBLY TO 10'-6" ABOVE FINISH FLOOR.

-362S162-33 (3 5/8"-20 GA.) COLD FORM METAL STUD FRAMING AT 24" O.C. -ONE LAYER 5/8" TYPE "X" GYPSUM BOARD ON BOTH

-EXTEND ASSEMBLY TO 9'-6" ABOVE FINISH FLOOR.

COLD FORM METAL FRAMING WALL -362S162-33 (3 5/8"-20 GA.) COLD FORM METAL STUD FRAMING AT 24" O.C. -50F125-18 (1/2"-25 GA.) COLD FORM RESILIENT

CHANNELS HORIZONTAL AT 24" O.C. ON ONE SIDE WITH OUTSIDE LEG UP. -ONE LAYER 5/8" TYPE "X" GYPSUM BOARD ON BOTH

-EXTEND ASSEMBLY TO 10'-6" ABOVE FINISH FLOOR.

COLD FORM METAL FRAMING WALL -600S162-33 (6"-20 GA.) COLD FORM METAL STUD FRAMING AT 24" O.C.

-6" UNFACED SOUND ATTENUATION BATT INSULATION IN CAVITY. -ONE LAYER 5/8" TYPE "X" GYPSUM BOARD ON EXPOSED SIDE. -EXTEND ASSEMBLY TO 8'-0" ABOVE FINISH FLOOR.

COLD FORM METAL FRAMING WALL -600S162-33 (6"-20 GA.) COLD FORM METAL STUD FRAMING AT 24" O.C. -ONE LAYER 5/8" TYPE "X" GYPSUM BOARD ON

-EXTEND ASSEMBLY TO 8'-0" ABOVE FINISH FLOOR.

COLD FORM METAL FRAMING WALL: -600S162-33 (6"-20 GA.) COLD FORM METAL STUD

FRAMING AT 24" O.C. AND 16" O.C. AT CEMENT BACKING BOARD LOCATIONS) -6" UNFACED SOUND ATTENUATION BATT INSULATION IN CAVITY. -ONE LAYER 5/8" TYPE "X" GYPSUM BOARD ON BOTH SIDES. (PROVIDE 5/8" CEMENT BACKING BOARD AT

SHOWER ENCLOSURE SURFACES IN LIEU OF GYPSUM BOARD) -EXTEND ASSEMBLY TO 8'-0" ABOVE FINISH FLOOR.

COLD FORM METAL FRAMING WALL:

-600S162-33 (6"-20 GA.) COLD FORM METAL STUD FRAMING AT 24" O.C. AND 16" O.C. AT CEMENT BACKING BOARD LOCATIONS. -ONE LAYER 5/8" TYPE "X" GYPSUM BOARD ON BOTH SIDES. (PROVIDE 5/8" CEMENT BACKING BOARD AT SHOWER ENCLOSURE SURFACES IN LIEU OF

GYPSUM BOARD) -EXTEND ASSEMBLY TO BOTTOM OF ROOF DECK. -(1) HOUR FIRE RATED PARTITION EQUAL TO UL DESIGN NO. U419 ASSEMBLY.

COLD FORM METAL FRAMING WALL:

-600S162-33 (6"-20 GA.) COLD FORM METAL STUD FRAMING AT 24" O.C. AND 16" O.C. AT CEMENT BACKING BOARD LOCATIONS) -6" UNFACED SOUND ATTENUATION BATT INSULATION IN CAVITY. -ONE LAYER 5/8" TYPE "X" GYPSUM BOARD ON BOTH SIDES. (PROVIDE 5/8" CEMENT BACKING BOARD AT SHOWER ENCLOSURE SURFACES IN LIEU OF GYPSUM BOARD) -EXTEND ASSEMBLY TO BOTTOM OF ROOF DECK. -(1) HOUR FIRE RATED PARTITION EQUAL TO UL

DESIGN NO. U419 ASSEMBLY. COLD FORM METAL FRAMING WALL:

-600S162-33 (6"-20 GA.) COLD FORM METAL STUD FRAMING AT 24" O.C. AND 16" O.C. AT CEMENT BACKING BOARD LOCATIONS. -50F125-18 (1/2"-25 GA.) COLD FORM RESILIENT CHANNELS HORIZONTAL AT 24" O.C. ON ONE SIDE WITH OUTSIDE LEG UP. -6" UNFACED SOUND ATTENUATION BATT

INSULATION IN CAVITY. -ONE LAYER 5/8" TYPE "X" GYPSUM BOARD ON BOTH SIDES. (PROVIDE 5/8" CEMENT BACKING BOARD AT SHOWER ENCLOSURE SURFACES IN LIEU OF GYPSUM BOARD)

-EXTEND ASSEMBLY TO BOTTOM OF ROOF DECK. -(1) HOUR FIRE RATED PARTITION EQUAL TO UL DESIGN NO. U419 ASSEMBLY -SOUND TRANSMISSION RATING STC 50 MINIMUM.

PRE-ENGINEERED METAL BUILDING WALL: -PRE-ENGINEERED METAL BUILDING EXTERIOR WALL SYSTEM (REFER TO WALL SECTIONS). -PRE-ENGINEERED METAL BUILDING INTERIOR

SHEET METAL (28 GA.) LINER PANEL SYSTEM TO 7'-4" ABOVE FINISH FLOOR.

GENERAL NOTES

- $\langle \mathsf{A} \rangle$ REFER TO PROJECT MANUAL FOR ADDITIONAL REQUIREMENTS.
- \langle $_{\sf B}$ angle DIMENSION ARE TO ROUGH FACE OF FOUNDATION, PRE-ENGINEERED METAL BUILDING GIRTS, COLD-FORM METAL FRAMING, OR CENTERLINE OF STRUCTURE, UNLESS OTHERWISE INDICATED. NOTE INTERIOR 3 5/8" COLD-FORM METAL STUD WALL DIMENSIONS NOT
- angle REFER TO SCOPE OF WORK SCHEDULE FOR ADDITIONAL REQUIREMENTS. OWNER'S FURNISHED AND INSTALLED FURNITURE AND EQUIPMENT SHOW FOR REFERENCE ONLY (N.I.C.).
- $\langle { t D}
 angle$ REFER TO CODE ANALYSIS DRAWING FOR ADDITIONAL
- $\langle E \rangle$ REFER TO DRAWING A-601 FOR DOOR AND WINDOW SCHEDULES.
- F > REFER TO EXTERIOR AND INTERIOR FINISH SCHEDULES FOR
- G REFER TO PRE-ENGINEERED METAL BUILDING SUBMITTALS FOR ADDITIONAL REQUIREMENTS. EXTERIOR WALL GIRTS TO BE 8" WIDE

KEY NOTES

 \langle 1 angle VENDING MACHINE LOCATION (BY OTHERS).

ADDITIONAL REQUIREMENTS.

- \langle 2 \rangle DEDICATED RECYCLING CONTAINER (BY OTHERS).
- \langle 3 angle PRE-ENGINEERED METAL BUILDING STEEL COLUMN. PROVIDE WALL TYPE "S41" UNLESS OTHERWISE NOTED, AND HOLD FRAMING AS CLOSE AS POSSIBLE. REFER TO PLAN SECTION 9/A-401 (TYPICAL).
- \langle 4 angle CONDENSING UNIT, REFER TO MECHANICAL DRAWINGS.
- \langle 5 angle DRINKING FOUNTAIN, REFER TO PLUMBING DRAWINGS.
- 6 PRE-ENGINEERED METAL BUILDING DOWNSPOUT SYSTEM, REFER TO ROOF PLAN AND CIVIL DRAWINGS FOR ADDITIONAL REQUIREMENTS.
- \langle 7 angle FIRE ALARM SYSTEM CONTROL PANEL, REFER TO ELECTRICAL
- \langle 8 \rangle GAS SERVICE ENTRANCE REFER TO UTILITY AND PLUMBING
- $\overline{\langle 9 \rangle}$ SURFACE MOUNTED FIRE EXTINGUISHER. FIRE EXTINGUISHERS SHALL BE UL LISTED ABC TYPE, MULTIPURPOSE DRY CHEMICAL, 10 LBS. MINIMUM CAPACITY, REFER TO DETAIL 3/A-501 FOR TYPICAL MOUNTING REQUIREMENTS.
- $\langle 10 \rangle$ FIRE DEPARTMENT CONNECTION (FDC), REFER TO PLUMBING DRAWINGS FOR ADDITIONAL INFORMATION.
- 11 8'-0" x 4'-0" x 3/4" FIRE TREATED PLYWOOD TELEPHONE BOARD MECHANICALLY ATTACHED TO WALL. COORDINATE WITH TELECOMMUNICATION AND DATA CONTRACTOR, REFER TO ELECTRICAL DRAWINGS.
- $\langle 12 \rangle$ HOSE BIB, REFER TO PLUMBING DRAWINGS.
- $\langle 13 \rangle$ FUTURE ICE MACHINE (BY OTHERS).
- (14) ELECTRICAL METER, REFER TO ELECTRICAL DRAWINGS.

INTERIOR WALL & CEILING NOTES

A. REFER TO CODE SUMMARY DRAWINGS FOR ADDITIONAL INFORMATION ON LOCATIONS OF FIRE RATED ASSEMBLIES. EXTEND ASSEMBLIES TO INSIDE FACE OF EXTERIOR WALL OR ROOF PANELS.

B. REFER TO INTERIOR FINISH PLANS AND SCHEDULES FOR ADDITIONAL WALL FINISH MATERIAL APPLICATIONS.

A. REFER TO STRUCTURAL DRAWINGS FOR ADDITIONAL COLD FORM METAL FRAMING REQUIREMENTS.

B. WHERE FRAMING DOES NOT EXTEND TO BOTTOM OF DECK OR STRUCTURE, PROVIDE LATERALLY BRACE TOP OF PARTITION WALL FRAMING WITH STUDS AT 4'-0" O.C. ALTERNATING DIAGONALLY EXTENDING TO STRUCTURAL FRAMING

C. WHERE WALL FRAMING EXTENDS TO BOTTOM OF ROOF DECK OR STRUCTURE, PROVIDE DEFLECTION CHANNELS AT TOP TRACK FOR 2" MAXIMUM DEFLECTION.

D. PROVIDE FIRE TREATED 2X BLOCKING AS REQUIRED FOR INSTALLATION OF ACCESSORIES, PER MANUFACTURER'S RECOMMENDATIONS.

E. REFER TO OPENING HEAD, JAMB AND SILL DETAILS FOR ADDITIONAL FRAMING REQUIREMENTS. F. PROVIDE HORIZONTAL STUD BRIDGING AT 4'-0" O.C. VERTICAL.

G. WHERE INDICATED, INSTALL RESILIENT CHANNELS WITH MOUNTING LEG

TURNED DOWN, EXCEPT AT FLOOR OR PERIMETER CONDITIONS.

3. GYPSUM AND BACKING BOARD: A. EXPANSION/CONTROL JOINTS: INSTALL EXPANSION/CONTROL JOINTS IN CEILINGS EXCEEDING 2500 SQ. FT. IN AREA AND IN PARTITION WALL LENGTHS EXCEEDING 30 FEET. DO NOT EXCEED A DISTANCE OF 50 FEET IN ANY DIRECTION BETWEEN CEILING JOINTS. INSTALL CONTROL JOINTS WHERE FRAMING OR FURRING CHANGES DIRECTION.

B. PROVIDE "J" MOLDING OR CORNER BEAD AT ALL DISSIMILAR WALL MATERIAL

C. PROVIDE CEMENT BACKING BOARD AT WALL TILE FINISH LOCATIONS. SET BOTTOM FRAMING TRACK IN SOLID BED OF MASTIC. PROVIDE WATERPROOFING MEMBRANE OVER CEMENT BACKER BOARD.

D. PROVIDE MOISTURE RESISTANT TYPE "X" GYPSUM BOARD AT WET WALL AND CEILING LOCATIONS (SHOWERS AND JANITORS SINK AREAS).


A. INSULATION SHALL HAVE A FLAME SPREAD RATING OF 0-25 AND A SMOKE DEVELOPMENT RATING OF 0 - 450. B. PROVIDE SEALANT AND/OR FOAM IN PLACE ACOUSTICAL INSULATION ON

INSULATED INTERIOR WALLS.

A. PROVIDE FIRE STOPPING AND FIRE SEALANT MATERIALS AS REQUIRED AT ALL FIRE RATED ASSEMBLY TRANSITIONS AND PENETRATIONS. RATING TO BE EQUAL TO RATED ASSEMBLY.

BOTH SIDES OF FRAMING PERIMETER (TOP, BOTTOM, ENDS) OF ACOUSTICAL

STATE OF MISSOURI MICHAEL L. PARSON, **GOVERNOR**

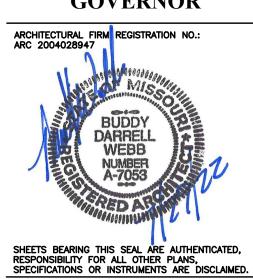

OFFICE OF ADMINISTRATION DIVISION OF FACILITIES MANAGEMENT, **DESIGN AND CONSTRUCTION**

DEPARTMENT OF PUBLIC SAFETY MISSOURI ARMY NATIONAL GUARD

CONSTRUCT NEW **60 SOLDIER BARRACKS**

WAPPAPELLO TRAINING SITE 461 COUNTY ROAD 517 WAPPAPELLO, MISSOURI

PROJECT # T2124-01

6325 ASSET # 8136325016 BUILDING # 3

REVISION: DATE **REVISION:**

DATE: **REVISION:** DATE: ISSUE DATE: 07/29/2022


DESIGNED BY: BW-AP

CAD DWG FILE:T2124-01-6325-8136325016-A-101 DRAWN BY: BW-AP CHECKED BY: BDW

SHEET TITLE:

FLOOR PLAN (ALTERNATE NO. 1)

SHEET NUMBER:

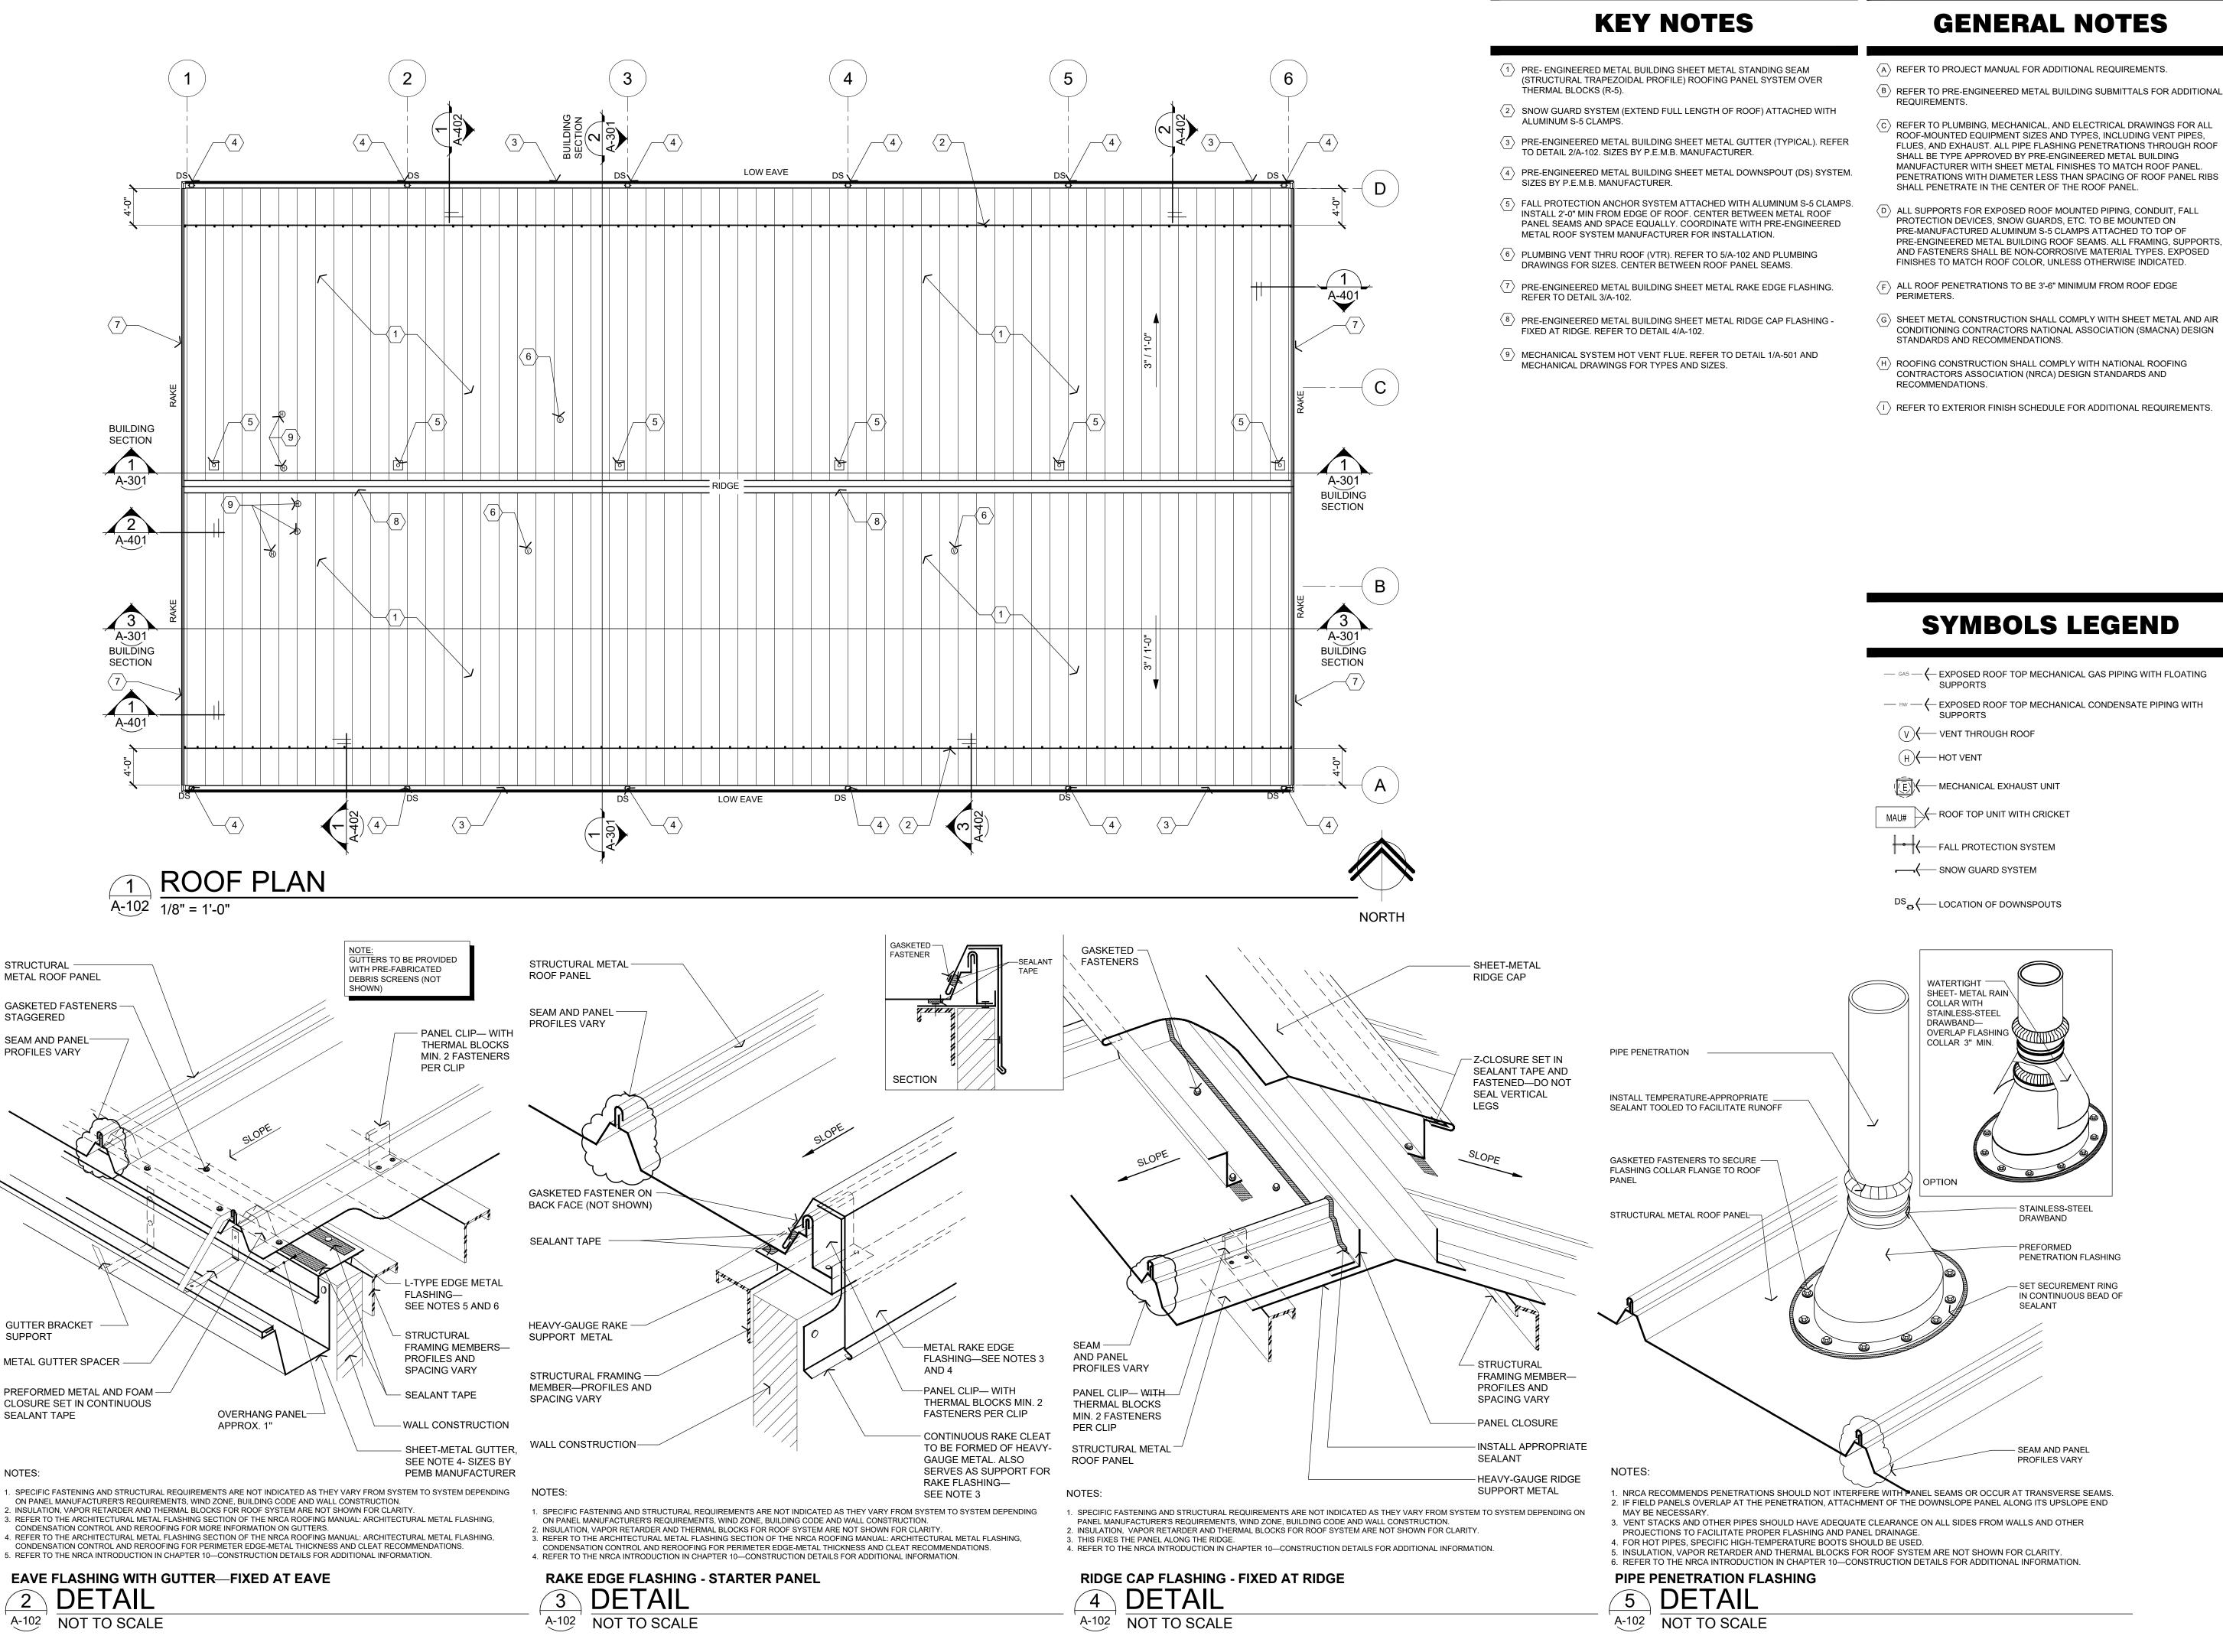

SUPPORT

- (A) REFER TO PROJECT MANUAL FOR ADDITIONAL REQUIREMENTS.
- (B) REFER TO PRE-ENGINEERED METAL BUILDING SUBMITTALS FOR ADDITIONAL
- © REFER TO PLUMBING, MECHANICAL, AND ELECTRICAL DRAWINGS FOR ALL ROOF-MOUNTED EQUIPMENT SIZES AND TYPES, INCLUDING VENT PIPES, FLUES, AND EXHAUST. ALL PIPE FLASHING PENETRATIONS THROUGH ROOF
- D ALL SUPPORTS FOR EXPOSED ROOF MOUNTED PIPING, CONDUIT, FALL PROTECTION DEVICES, SNOW GUARDS, ETC. TO BE MOUNTED ON PRE-MANUFACTURED ALUMINUM S-5 CLAMPS ATTACHED TO TOP OF PRE-ENGINEERED METAL BUILDING ROOF SEAMS. ALL FRAMING, SUPPORTS, AND FASTENERS SHALL BE NON-CORROSIVE MATERIAL TYPES. EXPOSED
- (F) ALL ROOF PENETRATIONS TO BE 3'-6" MINIMUM FROM ROOF EDGE
- $\langle \overline{\mathsf{G}}
 angle$ SHEET METAL CONSTRUCTION SHALL COMPLY WITH SHEET METAL AND AIR CONDITIONING CONTRACTORS NATIONAL ASSOCIATION (SMACNA) DESIGN
- (H) ROOFING CONSTRUCTION SHALL COMPLY WITH NATIONAL ROOFING CONTRACTORS ASSOCIATION (NRCA) DESIGN STANDARDS AND
- (I) REFER TO EXTERIOR FINISH SCHEDULE FOR ADDITIONAL REQUIREMENTS.

- GAS EXPOSED ROOF TOP MECHANICAL GAS PIPING WITH FLOATING
- HW EXPOSED ROOF TOP MECHANICAL CONDENSATE PIPING WITH

WAPPAPELLO TRAINING SITE 461 COUNTY ROAD 517

WAPPAPELLO, MISSOURI

60 SOLDIER BARRACKS

OFFICE OF ADMINISTRATION

DESIGN AND CONSTRUCTION

DIVISION OF FACILITIES

MANAGEMENT,

DEPARTMENT OF

NATIONAL GUARD

CONSTRUCT NEW

PUBLIC SAFETY MISSOURI ARMY

STATE OF MISSOURI MICHAEL L. PARSON,

GOVERNOR

SHEETS BEARING THIS SEAL ARE AUTHENTICATED, RESPONSIBILITY FOR ALL OTHER PLANS, SPECIFICATIONS OR INSTRUMENTS ARE DISCLAIMED.

ARCHITECTURAL FIRM REGISTRATION NO. ARC 2004028947

PROJECT # T2124-01

ASSET # 8136325016 BUILDING # 3

REVISION

REVISION

DATE: ISSUE DATE: 07/29/2022


CAD DWG FILE: T2124-01-6325-8136325016-A DRAWN BY: BW-AP CHECKED BY: BDW

SHEET TITLE:

ROOF PLAN

DESIGNED BY: BW-AP

SHEET NUMBER:

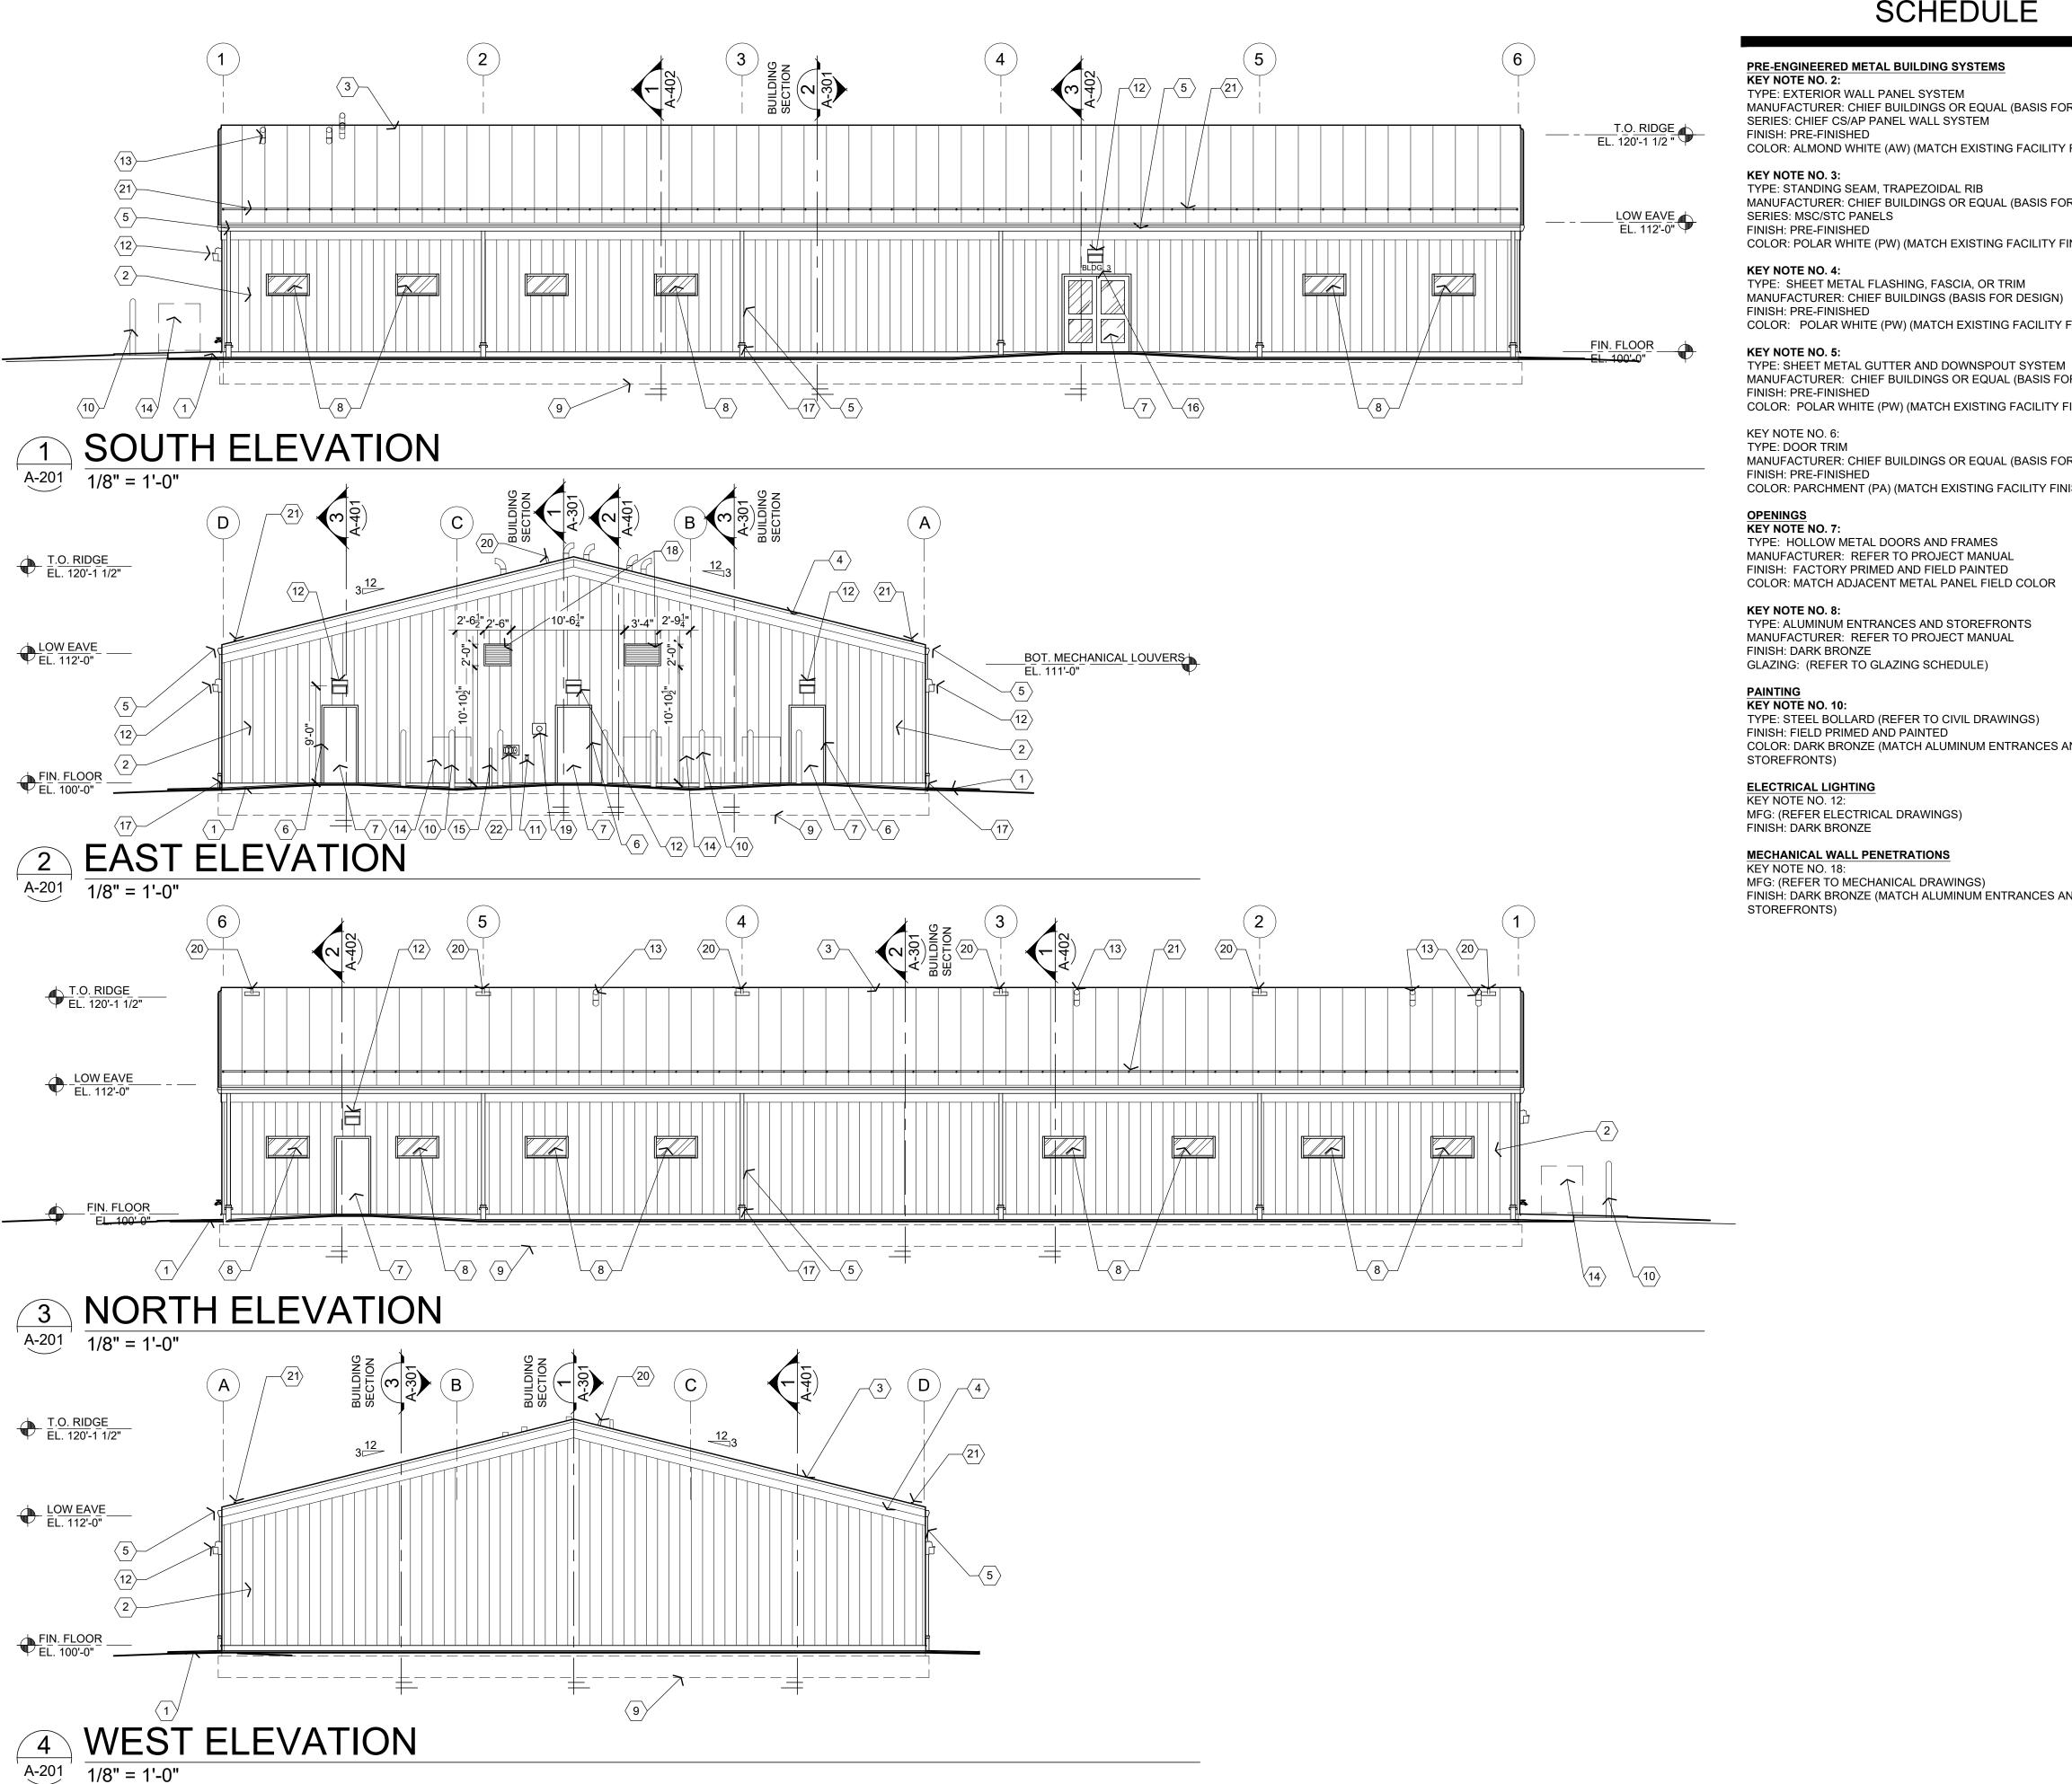

EXTERIOR FINISH SCHEDULE

PRE-ENGINEERED METAL BUILDING SYSTEMS

KEY NOTE NO. 2:

TYPE: EXTERIOR WALL PANEL SYSTEM MANUFACTURER: CHIEF BUILDINGS OR EQUAL (BASIS FOR DESIGN) SERIES: CHIEF CS/AP PANEL WALL SYSTEM FINISH: PRE-FINISHED

COLOR: ALMOND WHITE (AW) (MATCH EXISTING FACILITY FINISHES)

KEY NOTE NO. 3: TYPE: STANDING SEAM, TRAPEZOIDAL RIB MANUFACTURER: CHIEF BUILDINGS OR EQUAL (BASIS FOR DESIGN)

FINISH: PRE-FINISHED COLOR: POLAR WHITE (PW) (MATCH EXISTING FACILITY FINISHES)

KEY NOTE NO. 4: TYPE: SHEET METAL FLASHING, FASCIA, OR TRIM

FINISH: PRE-FINISHED COLOR: POLAR WHITE (PW) (MATCH EXISTING FACILITY FINISHES)

KEY NOTE NO. 5: TYPE: SHEET METAL GUTTER AND DOWNSPOUT SYSTEM MANUFACTURER: CHIEF BUILDINGS OR EQUAL (BASIS FOR DESIGN) FINISH: PRE-FINISHED COLOR: POLAR WHITE (PW) (MATCH EXISTING FACILITY FINISHES)

KEY NOTE NO. 6: TYPE: DOOR TRIM

MANUFACTURER: CHIEF BUILDINGS OR EQUAL (BASIS FOR DESIGN) FINISH: PRE-FINISHED COLOR: PARCHMENT (PA) (MATCH EXISTING FACILITY FINISHES)

KEY NOTE NO. 7:

TYPE: HOLLOW METAL DOORS AND FRAMES MANUFACTURER: REFER TO PROJECT MANUAL FINISH: FACTORY PRIMED AND FIELD PAINTED COLOR: MATCH ADJACENT METAL PANEL FIELD COLOR

KEY NOTE NO. 8:

TYPE: ALUMINUM ENTRANCES AND STOREFRONTS MANUFACTURER: REFER TO PROJECT MANUAL FINISH: DARK BRONZE GLAZING: (REFER TO GLAZING SCHEDULE)

KEY NOTE NO. 10:

TYPE: STEEL BOLLARD (REFER TO CIVIL DRAWINGS) FINISH: FIELD PRIMED AND PAINTED COLOR: DARK BRONZE (MATCH ALUMINUM ENTRANCES AND

ELECTRICAL LIGHTING KEY NOTE NO. 12:

MFG: (REFER ELECTRICAL DRAWINGS) FINISH: DARK BRONZE

MECHANICAL WALL PENETRATIONS

KEY NOTE NO. 18: MFG: (REFER TO MECHANICAL DRAWINGS) FINISH: DARK BRONZE (MATCH ALUMINUM ENTRANCES AND STOREFRONTS)

GENERAL NOTES

- $\overline{\mathsf{A}}$ REFER TO PROJECT MANUAL FOR ADDITIONAL REQUIREMENTS.
- \langle B \rangle REFER TO PRE-ENGINEERED METAL BUILDING SUBMITTALS FOR ADDITIONAL REQUIREMENTS.
- C FOR DOOR AND WINDOW TYPES, REFER TO FLOOR PLANS AND
- \langle D angle REFER TO EXTERIOR FINISH SCHEDULE FOR ADDITIONAL REQUIREMENTS FINAL MATERIAL COLORS, PATTERNS AND FINISHES TO BE SELECTED FROM MANUFACTURER'S FULL RANGE OF CUSTOM COLORS.
- (E) REFER TO CIVIL DRAWINGS FOR ADJACENT SITE DEVELOPMENT CONSTRUCTION.
- $\overline{\langle \mathsf{F} \rangle}$ REFER TO PLUMBING, MECHANICAL AND ELECTRICAL DRAWINGS FOR SYSTEM TYPES.
- $\langle \mathsf{G} \rangle$ REFER TO WALL SECTIONS AND DETAILS FOR ADDITIONAL REQUIREMENTS.
- (H) PAINT ALL EXPOSED METAL SURFACES TO MATCH ADJACENT MATERIAL COLORS, UNLESS OTHERWISE INDICATED.

KEY NOTES

- \langle 1 \rangle CAST IN PLACE CONCRETE SLABS OR SIDEWALKS, REFER TO
- 2 PRE-ENGINEERED METAL BUILDING EXTERIOR WALL PANEL
- $\langle \overline{3} \rangle$ PRE-ENGINEERED BUILDING SHEET METAL ROOFING SYSTEM.
- \langle $_4$ angle PRE-ENGINEERED METAL BUILDINGS SHEET METAL FLASHING, ─ FASCIA, CLOSURE, OR TRIM.
- 5 PRE-ENGINEERED METAL BUILDING SHEET METAL GUTTER AND DOWNSPOUT SYSTEM. REFER TO ROOF PLAN
- 6 PRE-ENGINEERED METAL BUILDING SHEET METAL OPENING TRIM
- \langle 7 \rangle EXTERIOR DOOR AND FRAME SYSTEM, REFER TO FLOOR PLAN AND DOOR SCHEDULE FOR TYPE.
- \langle 8 \rangle EXTERIOR WINDOW SYSTEM, REFER TO FLOOR PLAN AND WINDOW SCHEDULE FOR TYPES.
- 9 APPROXIMATE LINE OF FOUNDATION, REFER TO STRUCTURAL DRAWINGS.
- $\langle 10 \rangle$ STEEL BOLLARD, REFER TO CIVIL DRAWINGS.
- $\langle _{11} \rangle$ HOSE BIB, REFER TO PLUMBING DRAWINGS.
- $\langle 12
 angle$ LIGHT FIXTURE (CENTER OF FIXTURE AT 9'-0" A.F.F.), REFER TO ELECTRICAL DRAWINGS.
- MECHANICAL/PLUMBING ROOF MOUNTED EQUIPMENT OR ROOF PENETRATIONS, REFER TO ROOF PLAN.
- 14 MECHANICAL CONDENSING UNITS, REFER TO MECHANICAL DRAWINGS.
- $\langle 15 \rangle$ GAS PIPING (PROPANE) REFER TO PLUMBING DRAWINGS.
- BUILDING ADDRESS IDENTIFICATION NUMBER "T.B.D." SIGN IN 6" HIGH HELVETICA BOLD CHARACTERS ATTACHED TO THE BUILDING.
- (17) DOWNSPOUT COLLECTION SYSTEM, REFER TO CIVIL
- $\langle 18
 angle$ MECHANICAL WALL PENETRATION, REFER TO MECHANICAL DRAWINGS AND DETAIL 5/A-201. PROVIDE FRAMING, FLASHING, ANCHORS AND SEALANT AS REQUIRED FOR COMPLETE
- $\langle 19 \rangle$ ELECTRICAL METER, REFER TO ELECTRICAL DRAWINGS.
- $\langle 20
 angle$ FALL PROTECTION ANCHORS. REFER TO ROOF PLAN.
- $\langle 21
 angle$ CONTINUOUS ICE GUARD, REFER TO PROJECT MANUAL.
- 22 FIRE DEPARTMENT CONNECTION (FDC), REFER TO PLUMBING

ARCHITECTURAL FIRM REGISTRATION NO.: ARC 2004028947

STATE OF MISSOURI MICHAEL L. PARSON,

GOVERNOR

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OFFICE OF ADMINISTRATION **DIVISION OF FACILITIES** MANAGEMENT, **DESIGN AND CONSTRUCTION**

DEPARTMENT OF PUBLIC SAFETY **MISSOURI ARMY** NATIONAL GUARD

CONSTRUCT NEW 60 SOLDIER BARRACKS

WAPPAPELLO TRAINING SITE 461 COUNTY ROAD 517 WAPPAPELLO, MISSOURI

PROJECT # T2124-01 6325

ASSET # 8136325016 BUILDING # 3

REVISION: REVISION: REVISION:


DATE: ISSUE DATE: 07/29/2022

CAD DWG FILE:T2124-01-6325-8136325016-A-201 DRAWN BY: BW-AP CHECKED BY: BDW DESIGNED BY: BW-AP

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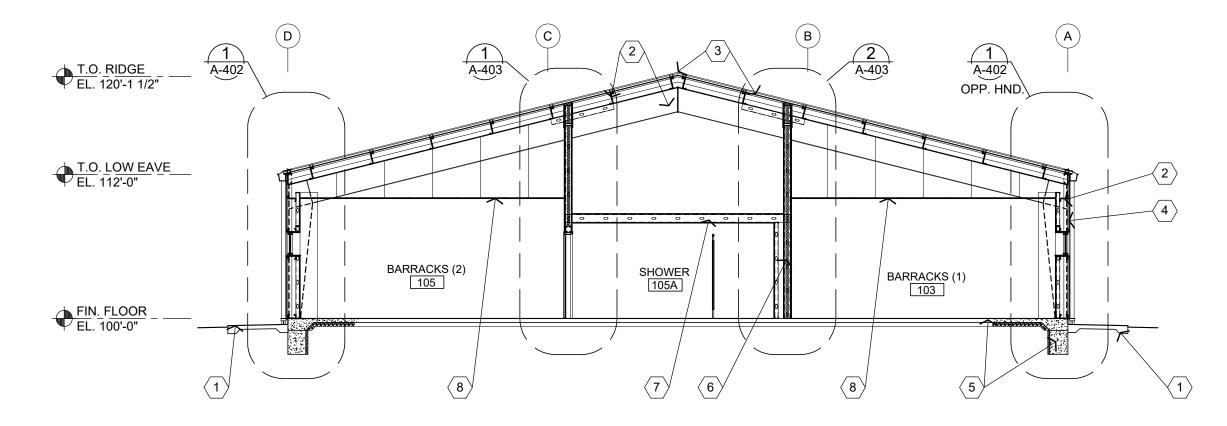
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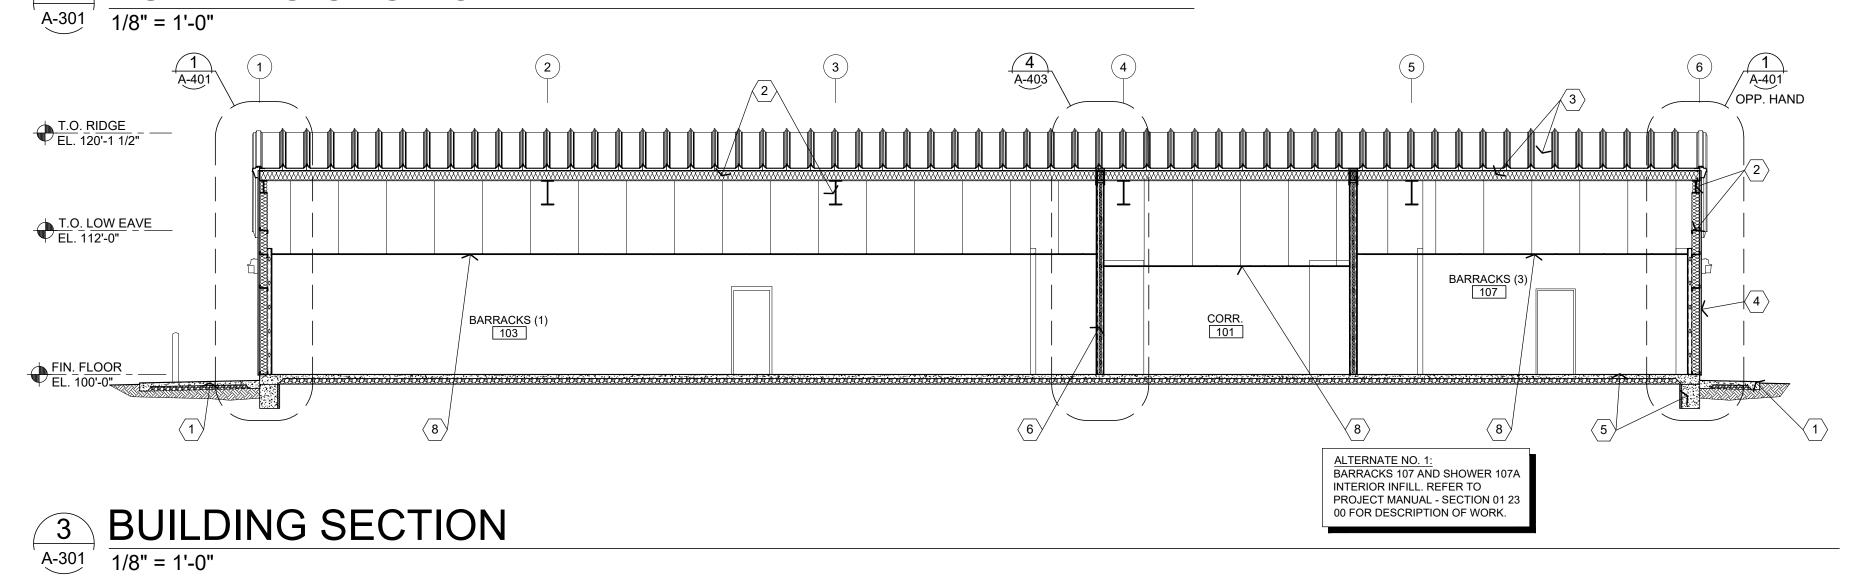


1 BUILDING SECTION

A-301 1/8" = 1'-0"

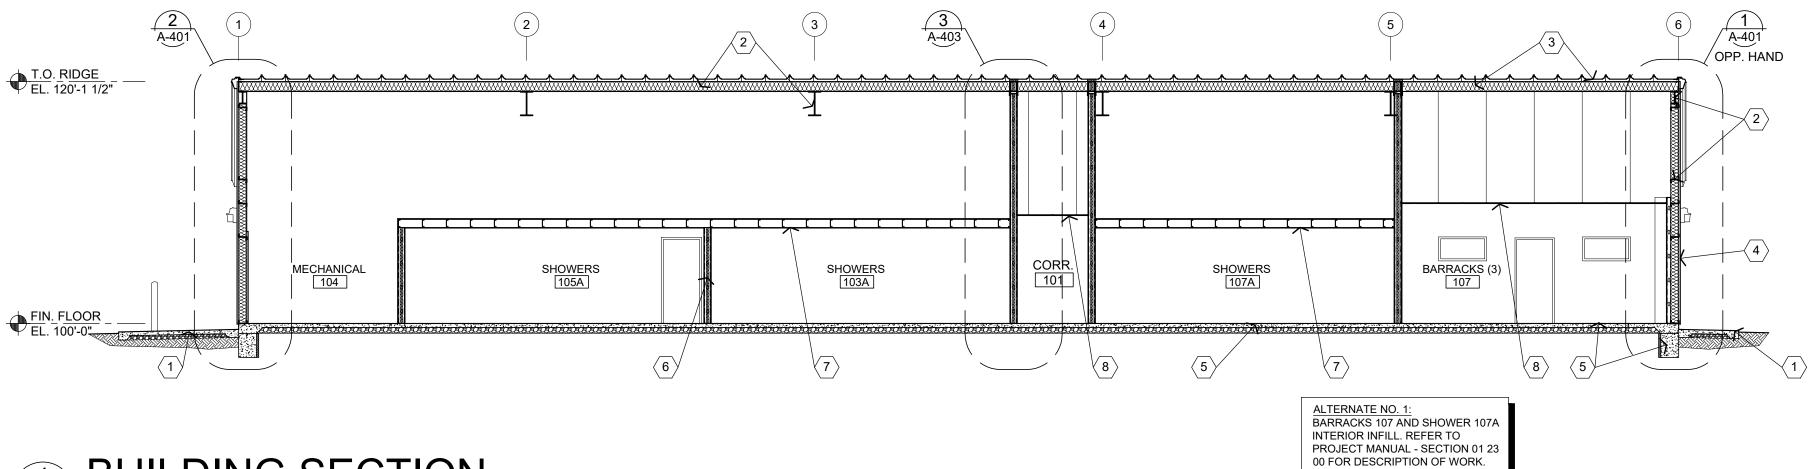

2 BUILDING SECTION




GENERAL NOTES

- (A) REFER TO PROJECT MANUAL FOR ADDITIONAL REQUIREMENTS.
- B REFER TO CIVIL, STRUCTURAL, MECHANICAL, ELECTRICAL AND PLUMBING DRAWINGS FOR ADDITIONAL REQUIREMENTS.
- © REFER TO PRE-ENGINEERED METAL BUILDING SUBMITTALS FOR ADDITIONAL REQUIREMENTS.
- D REFER TO EXTERIOR AND INTERIOR FINISH SCHEDULES FOR FINISH TYPES AND LOCATIONS.

KEY NOTES

- 1 CAST IN PLACE CONCRETE SLAB OR SIDEWALK, REFER TO CIVIL DRAWINGS.
- 2 PRE-ENGINEERED METAL BUILDING PRIMARY AND SECONDARY STRUCTURAL, REFER TO WALL SECTIONS AND SUBMITTALS.
- 3 PRE-ENGINEERED ROOF SYSTEM, REFER TO ROOF PLAN AND SUBMITTALS.
- PRE-ENGINEERED METAL BUILDING WALL PANEL SYSTEM. REFER TO WALL SECTIONS AND SUBMITTALS.
- 5 CONCRETE SLAB ON GRADE AND FOOTINGS, REFER TO STRUCTURAL DRAWINGS.
- $\langle 6 \rangle$ INTERIOR PARTITIONS, REFER TO FLOOR PLANS.
- 7 COLD FORM FRAMING AND GYPSUM BOARD CEILING SYSTEM, REFER TO REFLECTED CEILING PLAN AND STRUCTURAL DRAWINGS FOR ADDITIONAL INFORMATION.
- (8) SUSPENDED ACOUSTICAL CEILING SYSTEM, REFER TO REFLECTED CEILING PLAN.

STATE OF MISSOURI MICHAEL L. PARSON, GOVERNOR

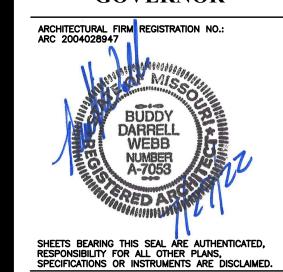

uddy Webb & Company, Inc.

rchitects - Consultants
57 EAST CAIRO STREET
RINGFIELD, MISSOURI 65802
7) 877-1385 TELEPHONE

OFFICE OF ADMINISTRATION DIVISION OF FACILITIES MANAGEMENT, DESIGN AND CONSTRUCTION

DEPARTMENT OF PUBLIC SAFETY MISSOURI ARMY NATIONAL GUARD

CONSTRUCT NEW 60 SOLDIER BARRACKS

WAPPAPELLO TRAINING SITE 461 COUNTY ROAD 517 WAPPAPELLO, MISSOURI

PROJECT # T2124-01 SITE # 6325 ASSET # 8136325016

REVISION:
DATE:
REVISION:
DATE:
REVISION:
DATE:

BUILDING # 3

ISSUE DATE: 07/29/2022


CAD DWG FILE:T2124-01-6325-8136325016-A
DRAWN BY:
BW-AP
BDW
DESIGNED BY:
BW-AP

SHEET TITLE:

BUILDING
SECTIONS
(ALTERNATE NO. 1)

SHEET NUMBER:

A-301

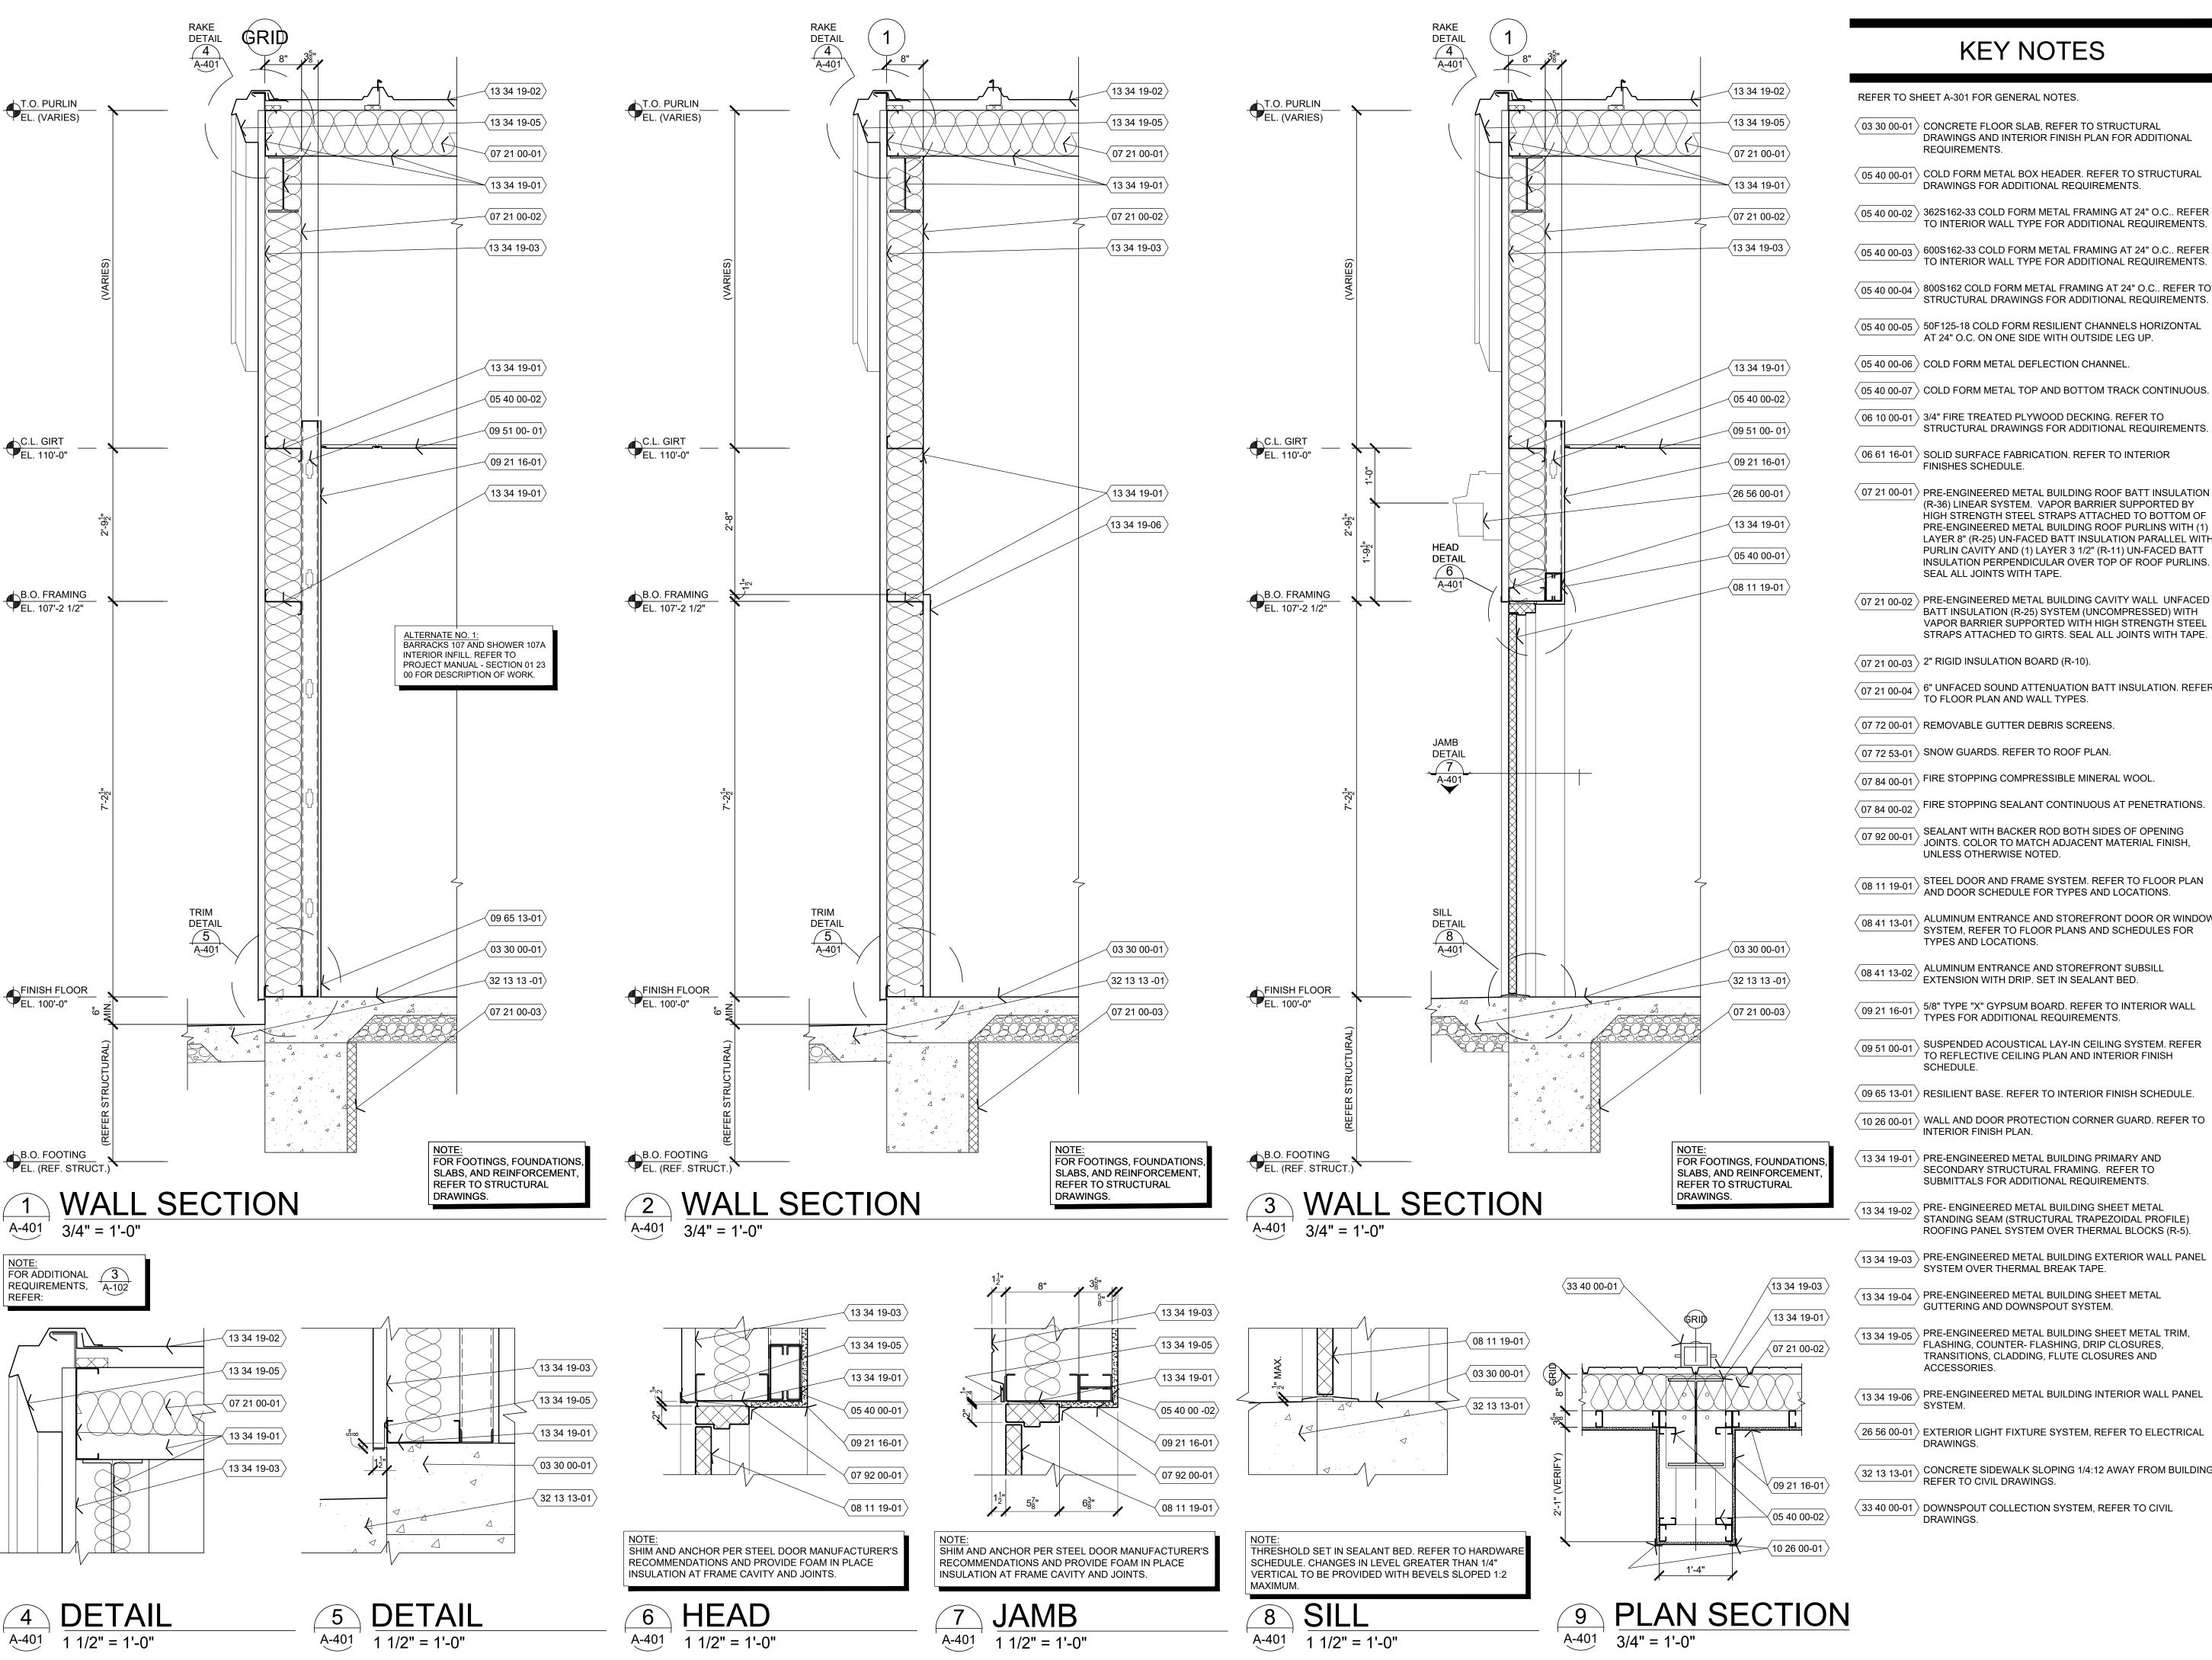

KEY NOTES

 \langle 03 30 00-01 \rangle CONCRETE FLOOR SLAB, REFER TO STRUCTURAL DRAWINGS AND INTERIOR FINISH PLAN FOR ADDITIONAL

 \langle $_{05\,40\,00\text{-}01}
angle$ COLD FORM METAL BOX HEADER. REFER TO STRUCTURAL DRAWINGS FOR ADDITIONAL REQUIREMENTS.

 \langle 05 40 00-02 \rangle 362S162-33 COLD FORM METAL FRAMING AT 24" O.C.. REFER TO INTERIOR WALL TYPE FOR ADDITIONAL REQUIREMENTS.

 $\langle 054000-03 \rangle$ 600S162-33 COLD FORM METAL FRAMING AT 24" O.C.. REFER TO INTERIOR WALL TYPE FOR ADDITIONAL REQUIREMENTS.

 $\langle 054000-04 \rangle$ 800S162 COLD FORM METAL FRAMING AT 24" O.C.. REFER TO

 \langle 05 40 00-05 \rangle 50F125-18 COLD FORM RESILIENT CHANNELS HORIZONTAL

 \langle 05 40 00-06 angle COLD FORM METAL DEFLECTION CHANNEL

 \langle 05 40 00-07 \rangle COLD FORM METAL TOP AND BOTTOM TRACK CONTINUOUS.

 \langle 06 10 00-01 \rangle 3/4" FIRE TREATED PLYWOOD DECKING. REFER TO

(06 61 16-01) SOLID SURFACE FABRICATION. REFER TO INTERIOR

(07 21 00-01) PRE-ENGINEERED METAL BUILDING ROOF BATT INSULATION (R-36) LINEAR SYSTEM. VAPOR BARRIER SUPPORTED BY HIGH STRENGTH STEEL STRAPS ATTACHED TO BOTTOM OF PRE-ENGINEERED METAL BUILDING ROOF PURLINS WITH (1) LAYER 8" (R-25) UN-FACED BATT INSULATION PARALLEL WITH PURLIN CAVITY AND (1) LAYER 3 1/2" (R-11) UN-FACED BATT INSULATION PERPENDICULAR OVER TOP OF ROOF PURLINS.

 \langle 07 21 00-02 \rangle PRE-ENGINEERED METAL BUILDING CAVITY WALL UNFACED BATT INSULATION (R-25) SYSTEM (UNCOMPRESSED) WITH VAPOR BARRIER SUPPORTED WITH HIGH STRENGTH STEEL STRAPS ATTACHED TO GIRTS. SEAL ALL JOINTS WITH TAPE.

 $\langle 07 \ 21 \ 00-03 \rangle$ 2" RIGID INSULATION BOARD (R-10).

 $\fbox{07\ 21\ 00\text{-}04}$ 6" UNFACED SOUND ATTENUATION BATT INSULATION. REFER TO FLOOR PLAN AND WALL TYPES.

SEALANT WITH BACKER ROD BOTH SIDES OF OPENING JOINTS. COLOR TO MATCH ADJACENT MATERIAL FINISH,

STEEL DOOR AND FRAME SYSTEM. REFER TO FLOOR PLAN

AND DOOR SCHEDULE FOR TYPES AND LOCATIONS.

08 41 13-01 ALUMINUM ENTRANCE AND STOREFRONT DOOR OR WINDOW SYSTEM, REFER TO FLOOR PLANS AND SCHEDULES FOR TYPES AND LOCATIONS.

(08 41 13-02) ALUMINUM ENTRANCE AND STOREFRONT SUBSILL EXTENSION WITH DRIP. SET IN SEALANT BED.

09 21 16-01 5/8" TYPE "X" GYPSUM BOARD. REFER TO INTERIOR WALL TYPES FOR ADDITIONAL REQUIREMENTS.

09 51 00-01 SUSPENDED ACOUSTICAL LAY-IN CEILING SYSTEM. REFER TO REFLECTIVE CEILING PLAN AND INTERIOR FINISH

 \langle 09 65 13-01 angle RESILIENT BASE. REFER TO INTERIOR FINISH SCHEDULE.

(10 26 00-01) WALL AND DOOR PROTECTION CORNER GUARD. REFER TO INTERIOR FINISH PLAN.

 \langle 13 34 19-01 \rangle PRE-ENGINEERED METAL BUILDING PRIMARY AND SECONDARY STRUCTURAL FRAMING. REFER TO

(13 34 19-02) PRE- ENGINEERED METAL BUILDING SHEET METAL STANDING SEAM (STRUCTURAL TRAPEZOIDAL PROFILE) ROOFING PANEL SYSTEM OVER THERMAL BLOCKS (R-5).

PRE-ENGINEERED METAL BUILDING EXTERIOR WALL PANEL SYSTEM OVER THERMAL BREAK TAPE.

 $\langle 13\ 34\ 19-05 \rangle$ PRE-ENGINEERED METAL BUILDING SHEET METAL TRIM, FLASHING, COUNTER- FLASHING, DRIP CLOSURES, TRANSITIONS, CLADDING, FLUTE CLOSURES AND

13 34 19-06 PRE-ENGINEERED METAL BUILDING INTERIOR WALL PANEL

 \langle 26 56 00-01 angle EXTERIOR LIGHT FIXTURE SYSTEM, REFER TO ELECTRICAL

 \langle 33 40 00-01 \rangle DOWNSPOUT COLLECTION SYSTEM, REFER TO CIVIL

STATE OF MISSOURI MICHAEL L. PARSON, **GOVERNOR**

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OFFICE OF ADMINISTRATION **DIVISION OF FACILITIES** MANAGEMENT, **DESIGN AND CONSTRUCTION**

DEPARTMENT OF PUBLIC SAFETY MISSOURI ARMY NATIONAL GUARD

CONSTRUCT NEW 60 SOLDIER BARRACKS

WAPPAPELLO TRAINING SITE 461 COUNTY ROAD 517 WAPPAPELLO, MISSOURI

PROJECT # T2124-01 6325

ASSET # 8136325016 BUILDING # 3

REVISION: DATE **REVISION: REVISION:** DATE:

ISSUE DATE: 07/29/2022

CAD DWG FILE: T2124-01-6325-8136325016-A-401 DRAWN BY: BW-AP


SHEET TITLE:

CHECKED BY: BDW

DESIGNED BY: BW-AP

WALL SECTIONS (ALTERNATE NO. 1)

SHEET NUMBER:

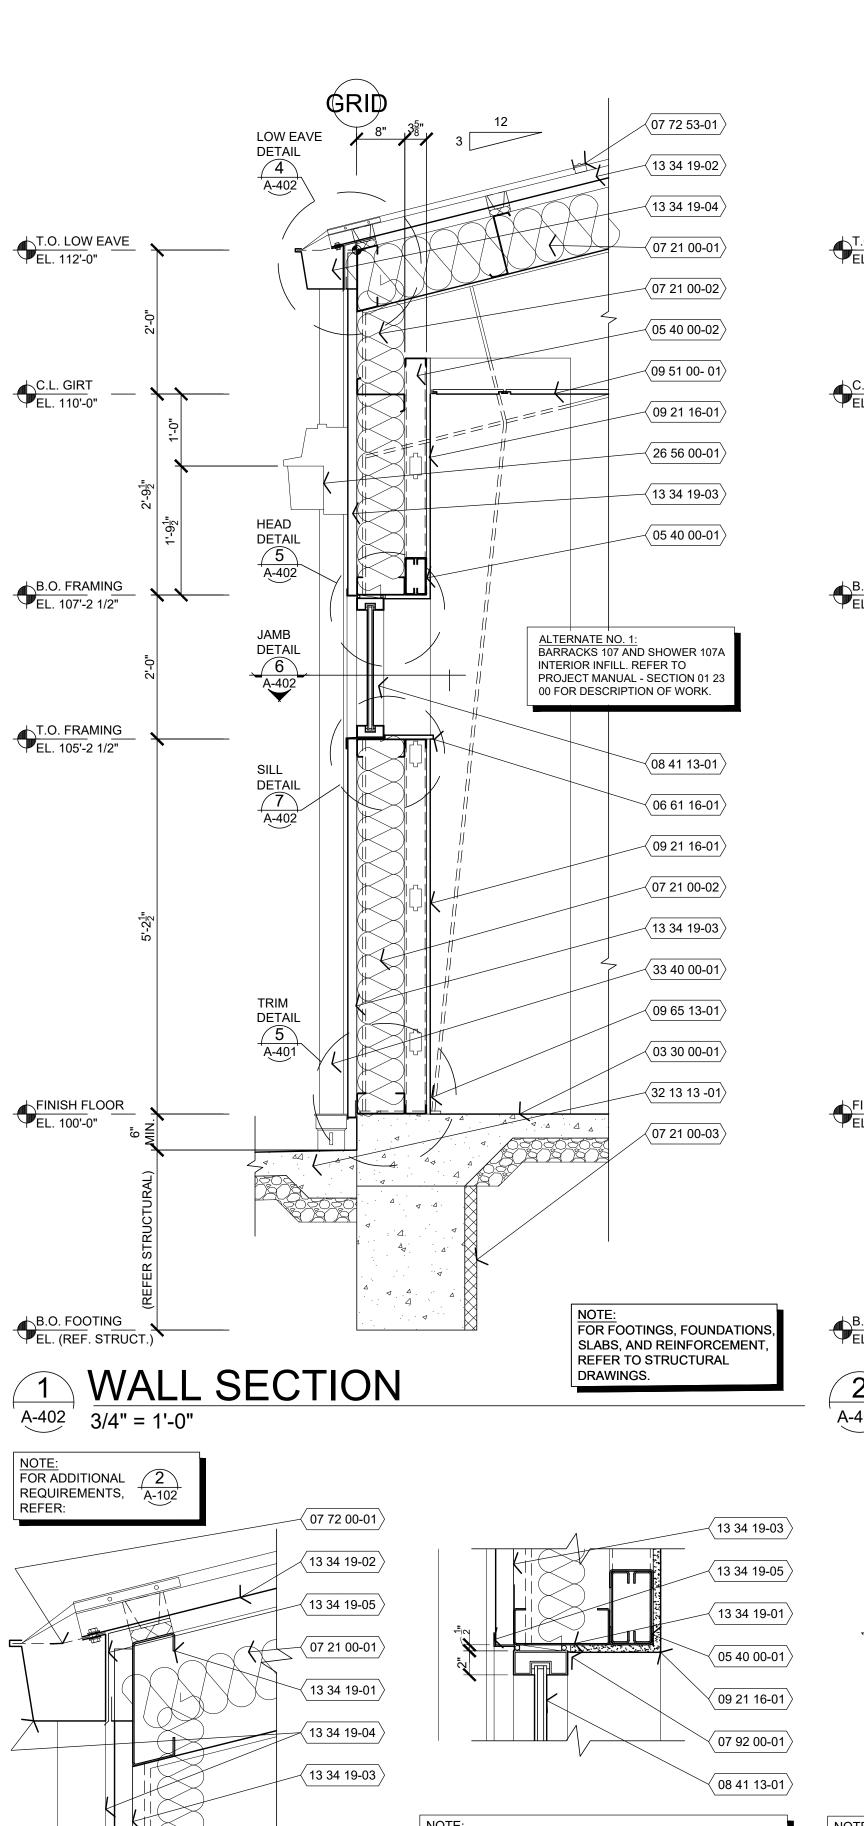


SHIM AND ANCHOR PER WINDOW MANUFACTURER'S


RECOMMENDATIONS AND PROVIDE FOAM IN PLACE

INSULATION AT FRAME JOINTS.

HEAD

DETAIL
1 1/2" = 1'-0"

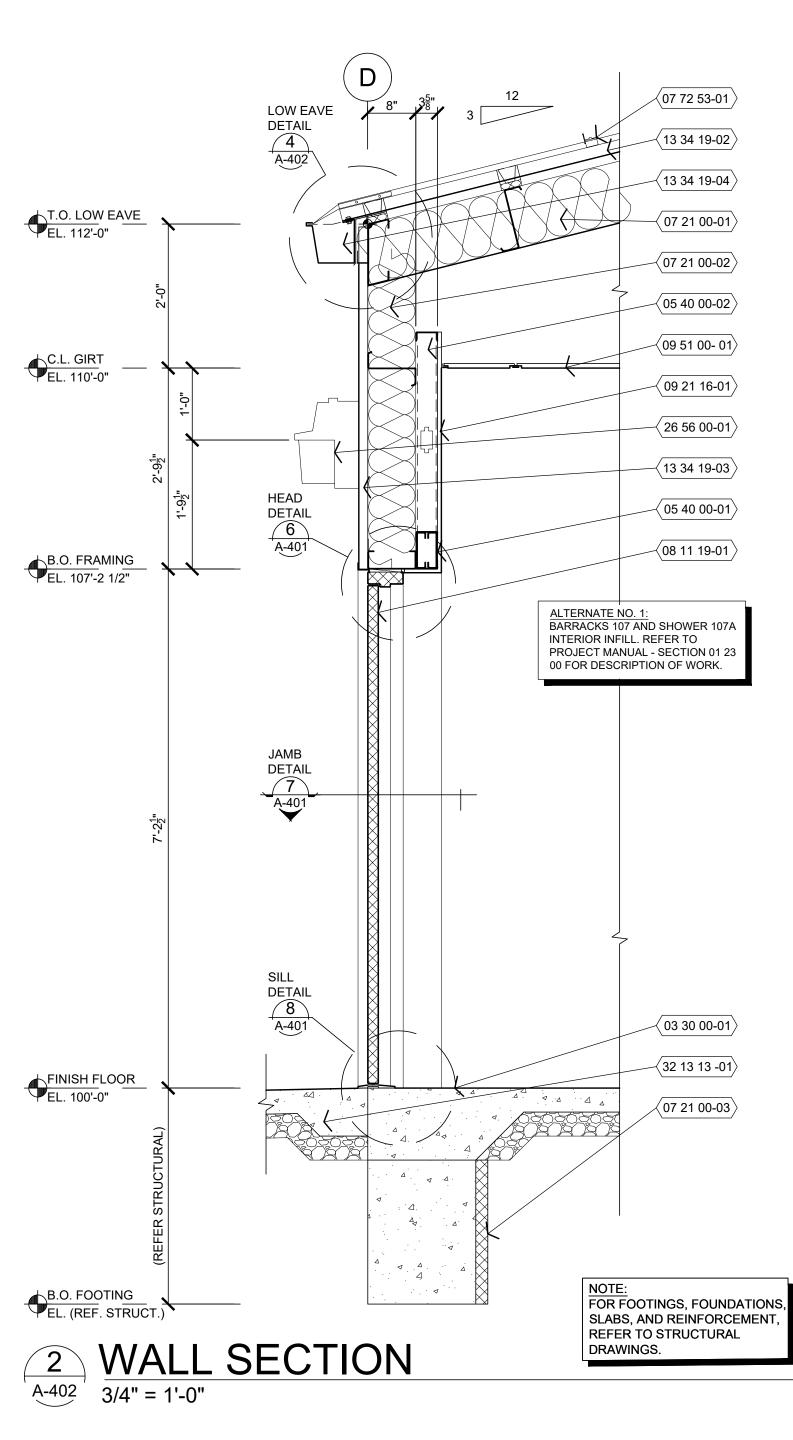

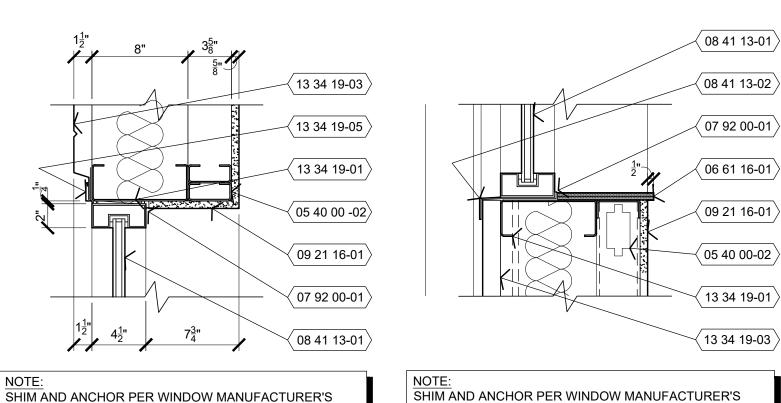



RECOMMENDATIONS AND PROVIDE FOAM IN PLACE


INSULATION AT FRAME JOINTS.

6 JAMB

1 1/2" = 1'-0"

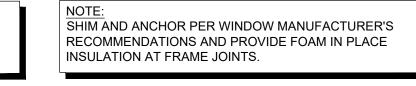

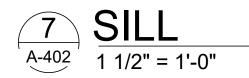

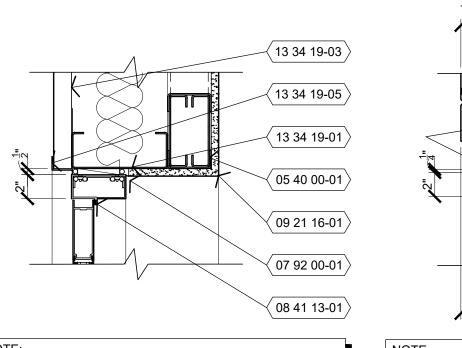

3 WALL SECTION

LOW EAVE DETAIL

4 A-402

DETAIL

DETAIL

DETAIL

8 A-401

SIMILAR

T.O. LOW EAVE EL. 112'-0"

C.L. GIRT EL. 110'-0"

B.O. FRAMING EL. 107'-2 1/2"


FINISH FLOOR EL. 100'-0"

B.O. FOOTING EL. (REF. STRUCT.)

3/4" = 1'-0"

SHIM AND ANCHOR PER DOOR MANUFACTURER'S RECOMMENDATIONS AND PROVIDE FOAM IN PLACE INSULATION AT FRAME JOINTS.

HEAD
1 1/2" = 1'-0"

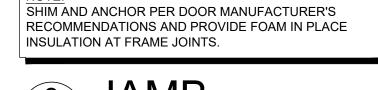

KEY NOTES

REFER TO SHEET A-301 FOR GENERAL NOTES.

 $\left<$ 07 72 53-01 $\left>$

 \langle 13 34 19-02angle

 \langle 13 34 19-04 angle

 \langle 07 21 00-01angle

 \langle 07 21 00-02angle

 \langle 05 40 00-02angle

 \prec 09 51 00- 01angle

 $\left($ 09 21 16-01 $\left
angle$

 \langle 26 56 00-01angle

 \langle 13 34 19-03 angle

 \langle 05 40 00-01angle

 \langle 08 41 13-01 angle

 \prec 03 30 00-01angle

 \langle 32 13 13 -01angle

 $\left<$ 07 21 00-03 $\left>$

FOR FOOTINGS, FOUNDATIONS

SLABS, AND REINFORCEMENT

REFER TO STRUCTURAL

DRAWINGS.

Δ. Δ. Δ Δ

 \langle 03 30 00-01 angle CONCRETE FLOOR SLAB, REFER TO STRUCTURAL DRAWINGS AND INTERIOR FINISH PLAN FOR ADDITIONAL REQUIREMENTS

 \langle $_{05\,40\,00\text{-}01}
angle$ COLD FORM METAL BOX HEADER. REFER TO STRUCTURAL DRAWINGS FOR ADDITIONAL REQUIREMENTS.

 \langle 05 40 00-02 \rangle 362S162-33 COLD FORM METAL FRAMING AT 24" O.C.. REFER TO INTERIOR WALL TYPE FOR ADDITIONAL REQUIREMENTS.

 \langle $_{05\,40}$ $\overline{_{00\text{-}03}}$ \rangle 600S162-33 COLD FORM METAL FRAMING AT 24" O.C.. REFER TO INTERIOR WALL TYPE FOR ADDITIONAL REQUIREMENTS.

 \langle $_{05\ 40\ 00\text{-}04}$ angle \rangle 800S162 COLD FORM METAL FRAMING AT 24" O.C.. REFER TO STRUCTURAL DRAWINGS FOR ADDITIONAL REQUIREMENTS.

 \langle 05 40 00-05 \rangle 50F125-18 COLD FORM RESILIENT CHANNELS HORIZONTAL AT 24" O.C. ON ONE SIDE WITH OUTSIDE LEG UP.

 \langle 05 40 00-06 angle COLD FORM METAL DEFLECTION CHANNEL

 \langle 05 40 00-07 \rangle COLD FORM METAL TOP AND BOTTOM TRACK CONTINUOUS.

 \langle 06 10 00-01 \rangle 3/4" FIRE TREATED PLYWOOD DECKING. REFER TO STRUCTURAL DRAWINGS FOR ADDITIONAL REQUIREMENTS.

(06 61 16-01) SOLID SURFACE FABRICATION. REFER TO INTERIOR FINISHES SCHEDULE.

(07 21 00-01) PRE-ENGINEERED METAL BUILDING ROOF BATT INSULATION (R-36) LINEAR SYSTEM. VAPOR BARRIER SUPPORTED BY HIGH STRENGTH STEEL STRAPS ATTACHED TO BOTTOM OF PRE-ENGINEERED METAL BUILDING ROOF PURLINS WITH (1) LAYER 8" (R-25) UN-FACED BATT INSULATION PARALLEL WITH PURLIN CAVITY AND (1) LAYER 3 1/2" (R-11) UN-FACED BATT INSULATION PERPENDICULAR OVER TOP OF ROOF PURLINS. SEAL ALL JOINTS WITH TAPE.

 \langle 07 21 00-02 \rangle PRE-ENGINEERED METAL BUILDING CAVITY WALL UNFACED BATT INSULATION (R-25) SYSTEM (UNCOMPRESSED) WITH VAPOR BARRIER SUPPORTED WITH HIGH STRENGTH STEEL STRAPS ATTACHED TO GIRTS. SEAL ALL JOINTS WITH TAPE.

 $\langle 07 21 \overline{00-03} \rangle$ 2" RIGID INSULATION BOARD (R-10).

 $\fbox{07\ 21\ 00\text{-}04}$ 6" UNFACED SOUND ATTENUATION BATT INSULATION. REFER TO FLOOR PLAN AND WALL TYPES.

 \langle 07 72 00-01 angle REMOVABLE GUTTER DEBRIS SCREENS.

 \langle 07 72 53-01 \rangle SNOW GUARDS. REFER TO ROOF PLAN.

 \langle 07 84 00-01 \rangle FIRE STOPPING COMPRESSIBLE MINERAL WOOL.

FIRE STOPPING SEALANT CONTINUOUS AT PENETRATIONS.

SEALANT WITH BACKER ROD BOTH SIDES OF OPENING JOINTS. COLOR TO MATCH ADJACENT MATERIAL FINISH, UNLESS OTHERWISE NOTED.

STEEL DOOR AND FRAME SYSTEM. REFER TO FLOOR PLAN AND DOOR SCHEDULE FOR TYPES AND LOCATIONS.

08 41 13-01 ALUMINUM ENTRANCE AND STOREFRONT DOOR OR WINDOW SYSTEM, REFER TO FLOOR PLANS AND SCHEDULES FOR TYPES AND LOCATIONS.

(08 41 13-02) ALUMINUM ENTRANCE AND STOREFRONT SUBSILL EXTENSION WITH DRIP. SET IN SEALANT BED.

09 21 16-01 5/8" TYPE "X" GYPSUM BOARD. REFER TO INTERIOR WALL TYPES FOR ADDITIONAL REQUIREMENTS.

09 51 00-01 SUSPENDED ACOUSTICAL LAY-IN CEILING SYSTEM. REFER TO REFLECTIVE CEILING PLAN AND INTERIOR FINISH SCHEDULE.

 \langle 09 65 13-01 angle RESILIENT BASE. REFER TO INTERIOR FINISH SCHEDULE.

 \langle 10 26 $\overline{)$ 00-01 \rangle WALL AND DOOR PROTECTION CORNER GUARD. REFER TO INTERIOR FINISH PLAN.

 \langle 13 34 19-01 \rangle PRE-ENGINEERED METAL BUILDING PRIMARY AND SECONDARY STRUCTURAL FRAMING. REFER TO SUBMITTALS FOR ADDITIONAL REQUIREMENTS.

(13 34 19-02) PRE- ENGINEERED METAL BUILDING SHEET METAL STANDING SEAM (STRUCTURAL TRAPEZOIDAL PROFILE) ROOFING PANEL SYSTEM OVER THERMAL BLOCKS (R-5).

13 34 19-03 PRE-ENGINEERED METAL BUILDING EXTERIOR WALL PANEL SYSTEM OVER THERMAL BREAK TAPE.

(13 34 19-04) PRE-ENGINEERED METAL BUILDING SHEET METAL **GUTTERING AND DOWNSPOUT SYSTEM.**

13 34 19-05 PRE-ENGINEERED METAL BUILDING SHEET METAL TRIM, FLASHING, COUNTER- FLASHING, DRIP CLOSURES, TRANSITIONS, CLADDING, FLUTE CLOSURES AND ACCESSORIES.


13 34 19-06 PRE-ENGINEERED METAL BUILDING INTERIOR WALL PANEL SYSTEM.

 \langle 26 56 00-01 angle EXTERIOR LIGHT FIXTURE SYSTEM, REFER TO ELECTRICAL

(32 13 13-01) CONCRETE SIDEWALK SLOPING 1/4:12 AWAY FROM BUILDING, REFER TO CIVIL DRAWINGS.

 \langle 33 40 00-01 \rangle DOWNSPOUT COLLECTION SYSTEM, REFER TO CIVIL

STATE OF MISSOURI MICHAEL L. PARSON, **GOVERNOR**

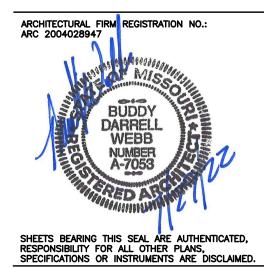

OFFICE OF ADMINISTRATION **DIVISION OF FACILITIES** MANAGEMENT, **DESIGN AND CONSTRUCTION**

DEPARTMENT OF PUBLIC SAFETY MISSOURI ARMY NATIONAL GUARD

CONSTRUCT NEW 60 SOLDIER BARRACKS

WAPPAPELLO TRAINING SITE 461 COUNTY ROAD 517 WAPPAPELLO, MISSOURI

PROJECT # T2124-01 6325

ASSET # 8136325016 BUILDING # 3

REVISION: DATE **REVISION: REVISION:** DATE:

ISSUE DATE: 07/29/2022 CAD DWG FILE: T2124-01-6325-8136325016-A-402 DRAWN BY: BW-AP

DESIGNED BY: BW-AP


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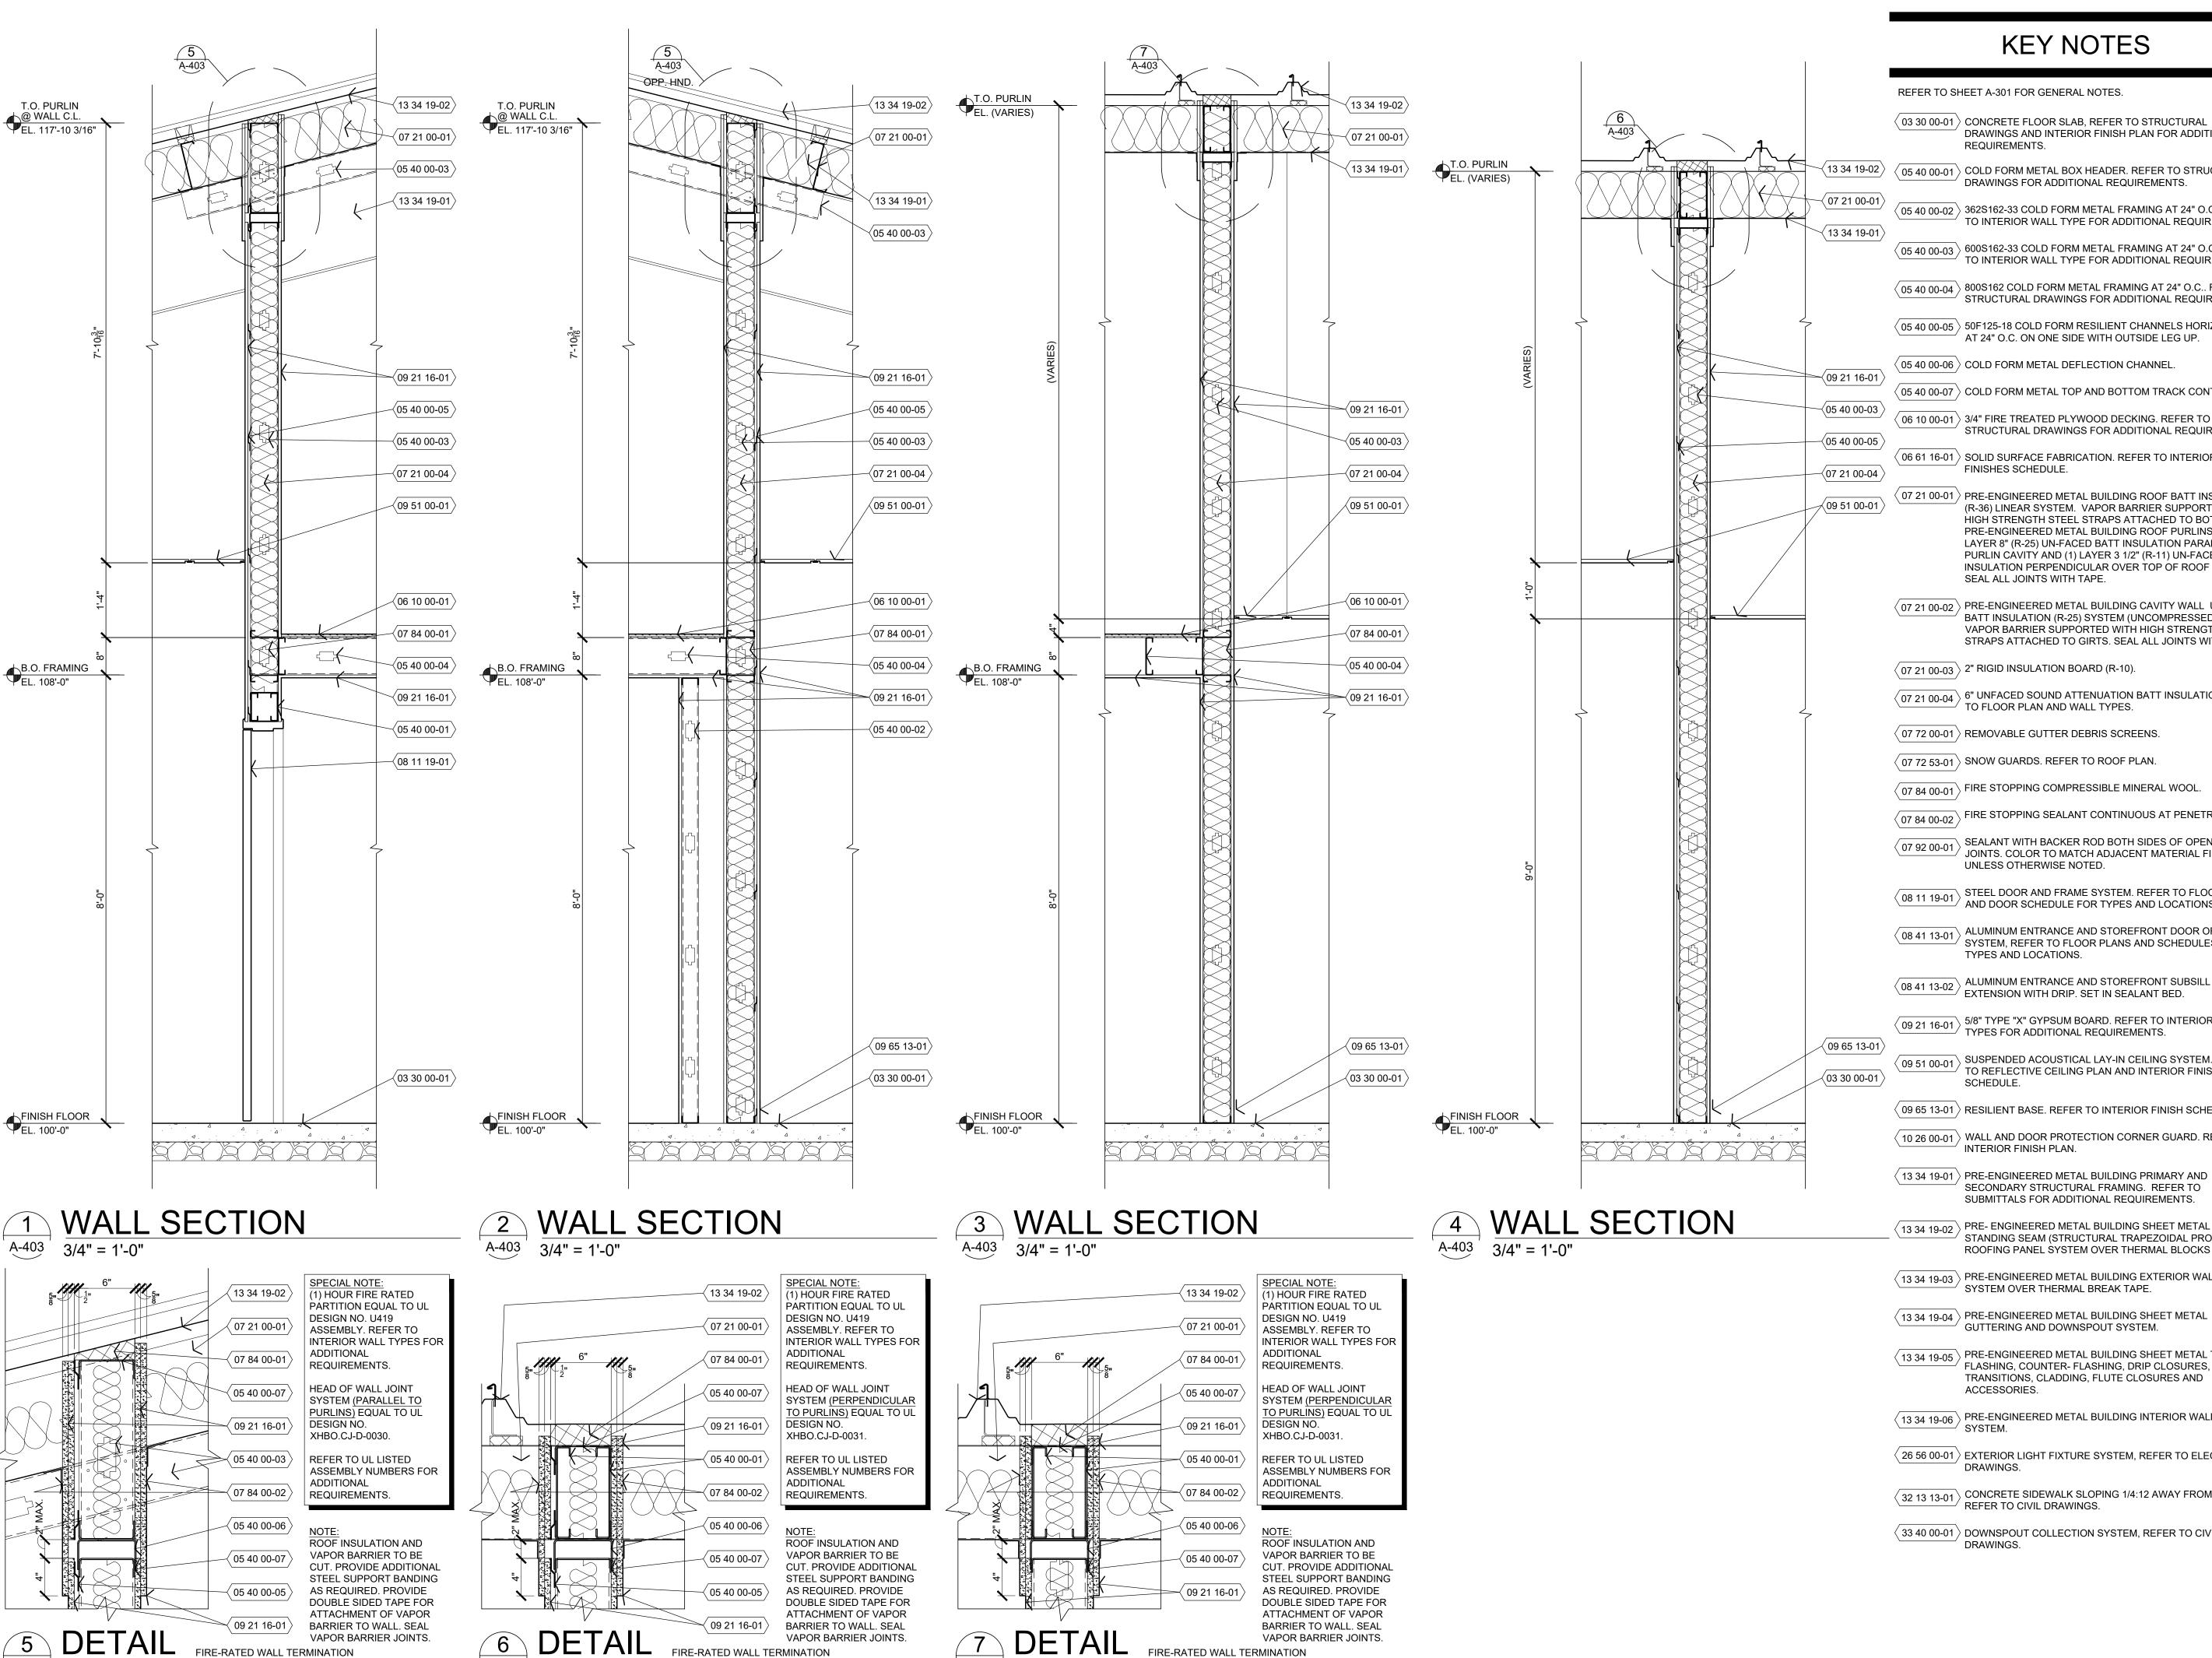
WALL SECTIONS (ALTERNATE NO. 1)

SHEET NUMBER:

21 OF 36 SHEETS 07/29/2022



9 JAMB 1 1/2" = 1'-0"

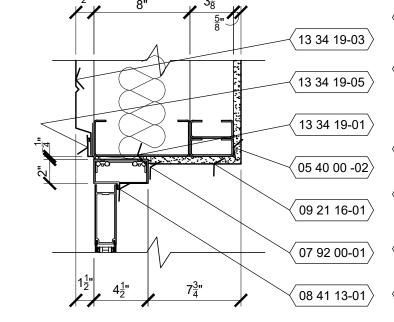

(PARALLEL TO ROOF PURLINS)

(PARALLEL TO ROOF PURLINS)

(PARALLEL TO ROOF PURLINS)

KEY NOTES

REFER TO SHEET A-301 FOR GENERAL NOTES.

 \langle 03 30 00-01 \rangle CONCRETE FLOOR SLAB, REFER TO STRUCTURAL DRAWINGS AND INTERIOR FINISH PLAN FOR ADDITIONAL REQUIREMENTS

 \langle 05 40 00-01 angle COLD FORM METAL BOX HEADER. REFER TO STRUCTURAL DRAWINGS FOR ADDITIONAL REQUIREMENTS.

 \langle 05 40 00-02 \rangle 362S162-33 COLD FORM METAL FRAMING AT 24" O.C.. REFER TO INTERIOR WALL TYPE FOR ADDITIONAL REQUIREMENTS.

 \langle 05 40 $\overline{\,$ 00-03 \rangle 600S162-33 COLD FORM METAL FRAMING AT 24" O.C.. REFER TO INTERIOR WALL TYPE FOR ADDITIONAL REQUIREMENTS.

 \langle $_{05\ 40\ 00\text{-}04}$ angle \rangle 800S162 COLD FORM METAL FRAMING AT 24" O.C.. REFER TO STRUCTURAL DRAWINGS FOR ADDITIONAL REQUIREMENTS.

 \langle 05 40 00-05 \rangle 50F125-18 COLD FORM RESILIENT CHANNELS HORIZONTAL AT 24" O.C. ON ONE SIDE WITH OUTSIDE LEG UP.

 \langle 05 40 00-06 angle COLD FORM METAL DEFLECTION CHANNEL.

 \langle 05 40 00-07 angle COLD FORM METAL TOP AND BOTTOM TRACK CONTINUOUS.

 \langle 06 10 00-01 \rangle 3/4" FIRE TREATED PLYWOOD DECKING. REFER TO STRUCTURAL DRAWINGS FOR ADDITIONAL REQUIREMENTS.

 \langle 06 61 16-01 \rangle SOLID SURFACE FABRICATION. REFER TO INTERIOR FINISHES SCHEDULE.

(07 21 00-01) PRE-ENGINEERED METAL BUILDING ROOF BATT INSULATION (R-36) LINEAR SYSTEM. VAPOR BARRIER SUPPORTED BY HIGH STRENGTH STEEL STRAPS ATTACHED TO BOTTOM OF PRE-ENGINEERED METAL BUILDING ROOF PURLINS WITH (1) LAYER 8" (R-25) UN-FACED BATT INSULATION PARALLEL WITH PURLIN CAVITY AND (1) LAYER 3 1/2" (R-11) UN-FACED BATT INSULATION PERPENDICULAR OVER TOP OF ROOF PURLINS. SEAL ALL JOINTS WITH TAPE.

 \langle 07 21 00-02 \rangle PRE-ENGINEERED METAL BUILDING CAVITY WALL UNFACED BATT INSULATION (R-25) SYSTEM (UNCOMPRESSED) WITH VAPOR BARRIER SUPPORTED WITH HIGH STRENGTH STEEL STRAPS ATTACHED TO GIRTS. SEAL ALL JOINTS WITH TAPE.

 $\langle 0721\overline{00-03} \rangle$ 2" RIGID INSULATION BOARD (R-10).

 $\left\langle$ 07 21 00-04 $\left\rangle \right\rangle$ 6" UNFACED SOUND ATTENUATION BATT INSULATION. REFER $^{\prime}$ TO FLOOR PLAN AND WALL TYPES.

 \langle 07 72 00-01 angle REMOVABLE GUTTER DEBRIS SCREENS.

 \langle 07 72 53-01 \rangle SNOW GUARDS. REFER TO ROOF PLAN.

 \langle 07 84 00-01 \rangle FIRE STOPPING COMPRESSIBLE MINERAL WOOL.

FIRE STOPPING SEALANT CONTINUOUS AT PENETRATIONS.

SEALANT WITH BACKER ROD BOTH SIDES OF OPENING JOINTS. COLOR TO MATCH ADJACENT MATERIAL FINISH,

(08 11 19-01) STEEL DOOR AND FRAME SYSTEM. REFER TO FLOOR PLAN AND DOOR SCHEDULE FOR TYPES AND LOCATIONS.

 \langle 08 41 13-01 \rangle ALUMINUM ENTRANCE AND STOREFRONT DOOR OR WINDOW SYSTEM, REFER TO FLOOR PLANS AND SCHEDULES FOR TYPES AND LOCATIONS.

 $\left\langle 08\,41\,13\text{-}02\right
angle$ ALUMINUM ENTRANCE AND STOREFRONT SUBSILL EXTENSION WITH DRIP. SET IN SEALANT BED.

 $\langle 09\ 21\ 16\text{-}01 \rangle$ 5/8" TYPE "X" GYPSUM BOARD. REFER TO INTERIOR WALL

 $\left\langle 09\ 51\ 00\text{-}01 \right
angle$ SUSPENDED ACOUSTICAL LAY-IN CEILING SYSTEM. REFER TO REFLECTIVE CEILING PLAN AND INTERIOR FINISH SCHEDULE.

 \langle 09 65 13-01 angle RESILIENT BASE. REFER TO INTERIOR FINISH SCHEDULE.

 \langle 10 26 00-01 \rangle WALL AND DOOR PROTECTION CORNER GUARD. REFER TO

 \langle 13 34 19-01 \rangle PRE-ENGINEERED METAL BUILDING PRIMARY AND SECONDARY STRUCTURAL FRAMING. REFER TO SUBMITTALS FOR ADDITIONAL REQUIREMENTS.

(13 34 19-02) PRE- ENGINEERED METAL BUILDING SHEET METAL STANDING SEAM (STRUCTURAL TRAPEZOIDAL PROFILE) ROOFING PANEL SYSTEM OVER THERMAL BLOCKS (R-5).

 \langle 13 34 19-03 \rangle PRE-ENGINEERED METAL BUILDING EXTERIOR WALL PANEL SYSTEM OVER THERMAL BREAK TAPE.

GUTTERING AND DOWNSPOUT SYSTEM.

13 34 19-05 PRE-ENGINEERED METAL BUILDING SHEET METAL TRIM, FLASHING, COUNTER- FLASHING, DRIP CLOSURES, TRANSITIONS, CLADDING, FLUTE CLOSURES AND ACCESSORIES.

 $\left\langle 13\,34\,19\text{-}06 \right
angle$ PRE-ENGINEERED METAL BUILDING INTERIOR WALL PANEL SYSTEM.

 \langle 26 56 00-01 angle EXTERIOR LIGHT FIXTURE SYSTEM, REFER TO ELECTRICAL

 $\left\langle 32\ 13\ 13\text{-}01 \right
angle$ CONCRETE SIDEWALK SLOPING 1/4:12 AWAY FROM BUILDING, REFER TO CIVIL DRAWINGS.

 \langle 33 40 00-01 \rangle DOWNSPOUT COLLECTION SYSTEM, REFER TO CIVIL DRAWINGS.

STATE OF MISSOURI MICHAEL L. PARSON, **GOVERNOR**

ARCHITECTURAL FIRM REGISTRATION NO.: ARC 2004028947 RESPONSIBILITY FOR ALL OTHER PLANS, SPECIFICATIONS OR INSTRUMENTS ARE DISCLAIMED.

OFFICE OF ADMINISTRATION DIVISION OF FACILITIES MANAGEMENT, **DESIGN AND CONSTRUCTION**

DEPARTMENT OF PUBLIC SAFETY MISSOURI ARMY NATIONAL GUARD

CONSTRUCT NEW 60 SOLDIER BARRACKS

WAPPAPELLO TRAINING SITE 461 COUNTY ROAD 517 WAPPAPELLO, MISSOURI

PROJECT # T2124-01 6325

ASSET # 8136325016 BUILDING # 3

REVISION: DATE **REVISION:** DATE: **REVISION:** DATE:


ISSUE DATE: 07/29/2022

CAD DWG FILE:T2124-01-6325-8136325016-A-403 DRAWN BY: BW-AP CHECKED BY: BDW DESIGNED BY: BW-AP

SHEET TITLE:

WALL SECTIONS

SHEET NUMBER:

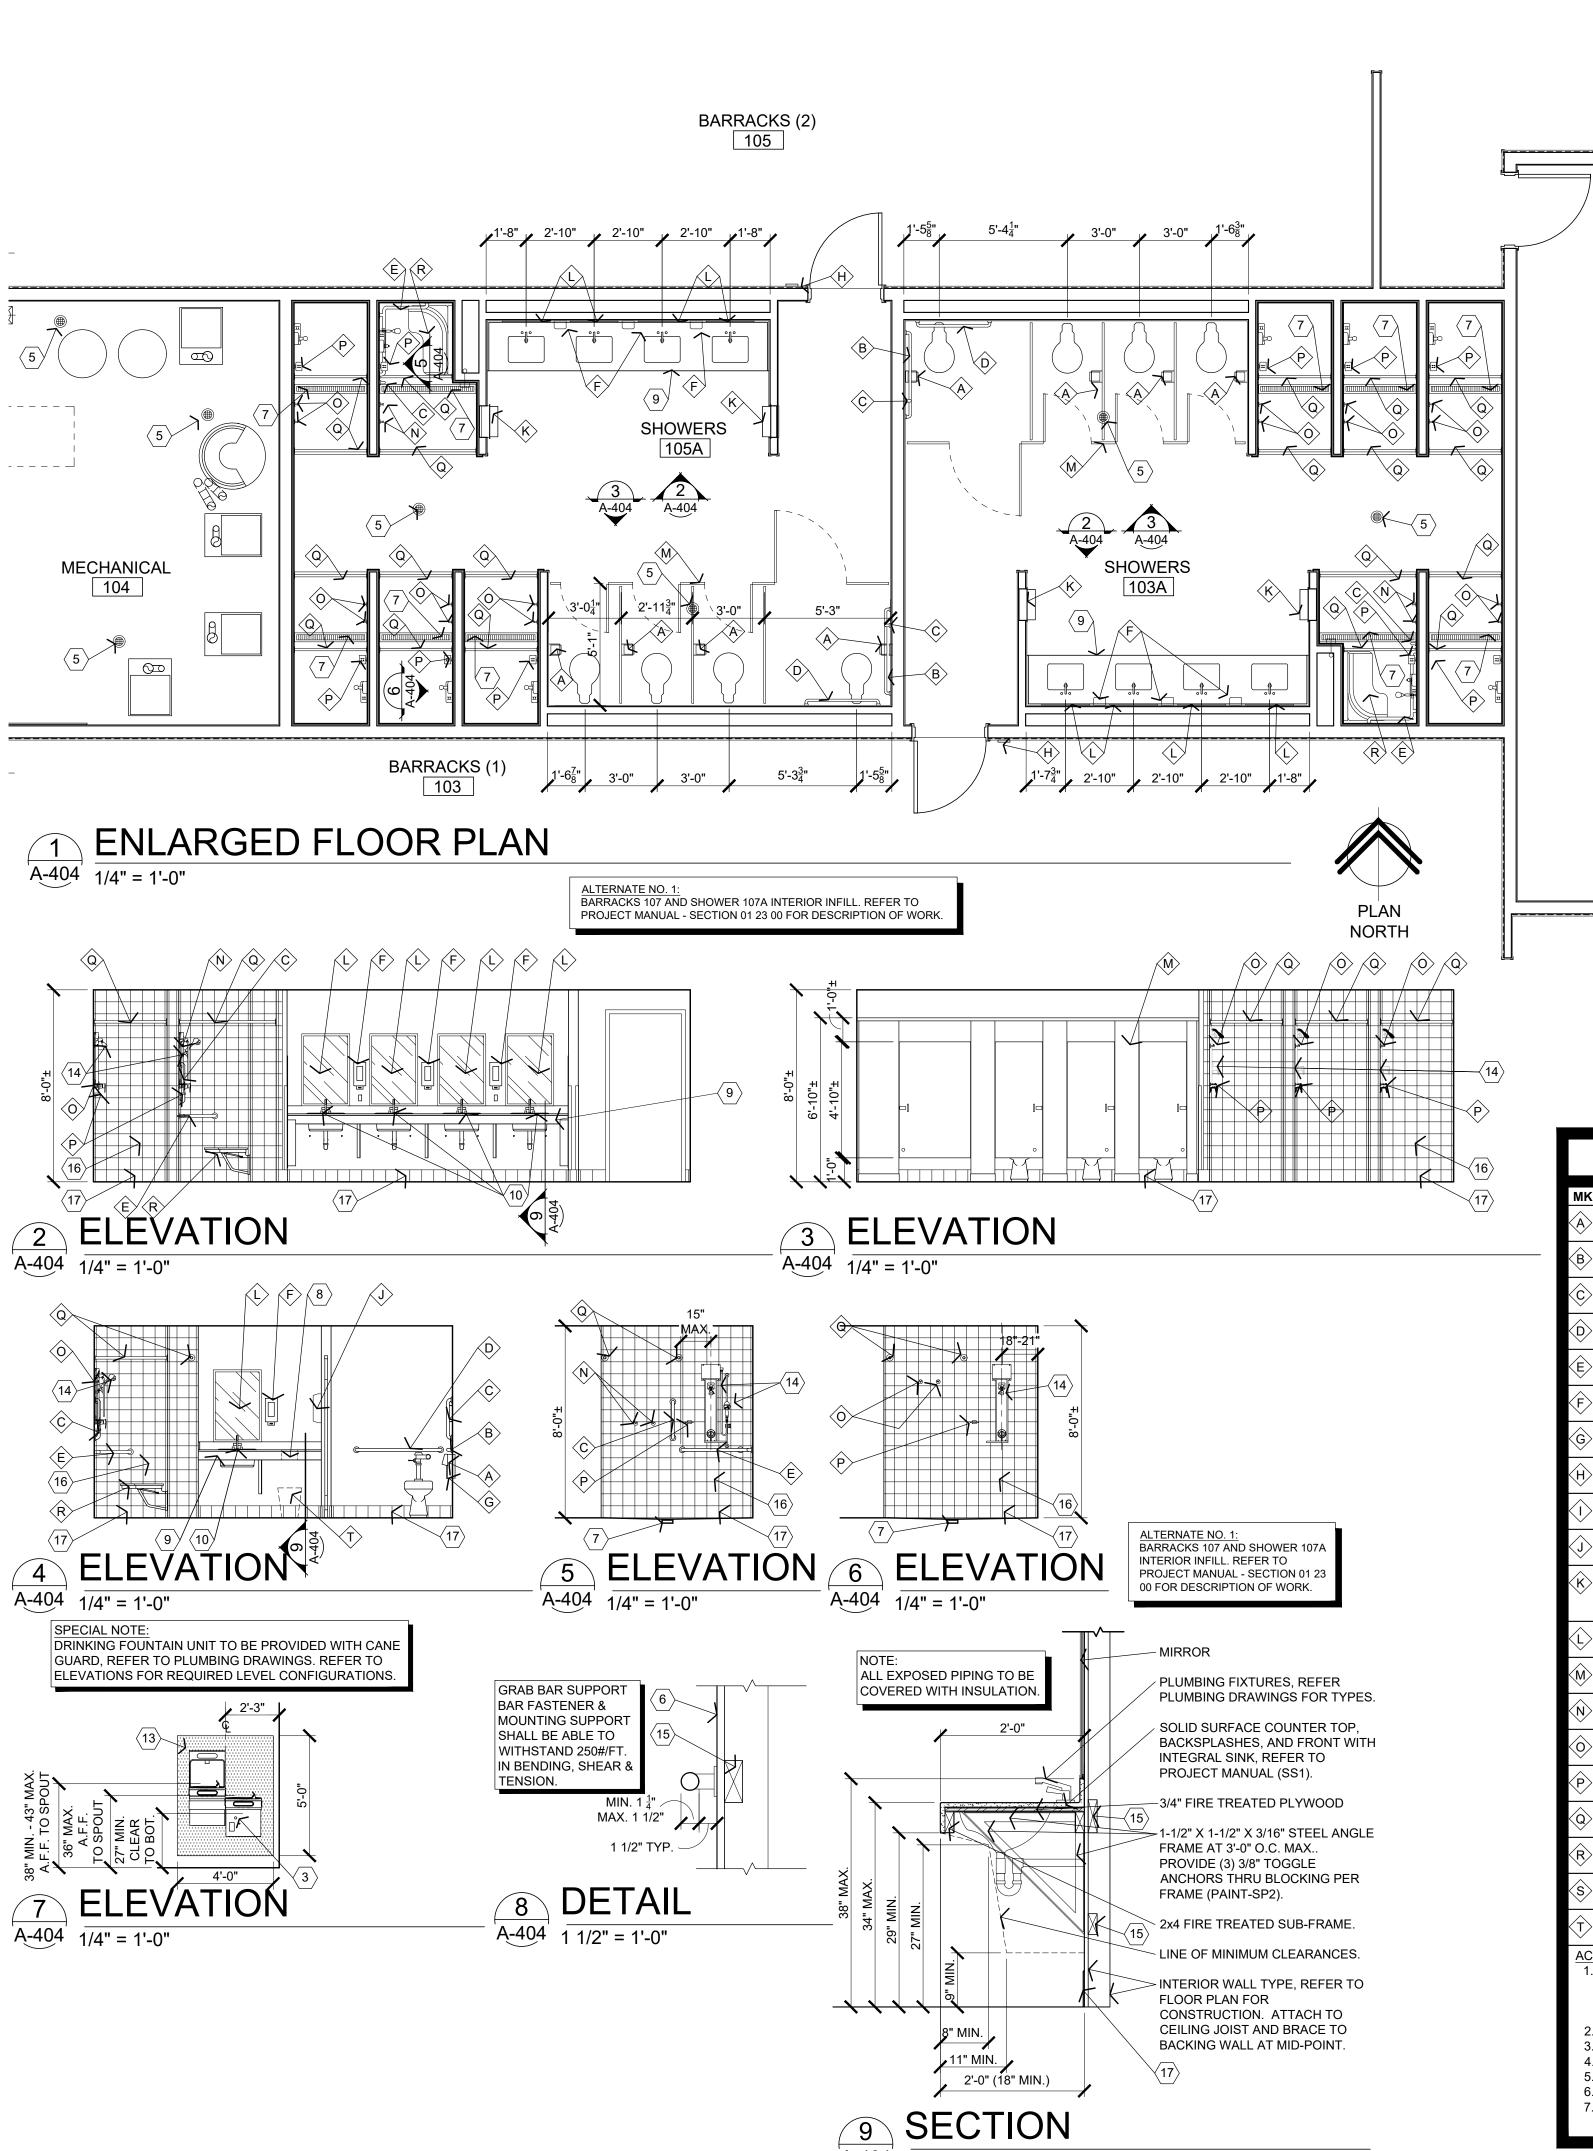

GENERAL NOTES

- A REFER TO PROJECT MANUAL FOR ADDITIONAL REQUIREMENTS.
- \langle B \rangle ALL DIMENSIONS ARE TO ROUGH FACE OF FRAMING OR CENTERLINE OF FIXTURE UNLESS OTHERWISE INDICATED. TOILET PARTITION DIMENSIONS ARE TO FACE OF GYPSUM BOARD AND CENTERLINE OF PANEL. PANEL 1" (NOMINAL) THICKNESS DIMENSIONS NOT SHOWN
- $\langle \mathtt{C} \rangle$ REFER TO PLUMBING PLANS FOR PLUMBING FIXTURE TYPES.
- $\langle D \rangle$ REFER TO INTERIOR FINISH PLANS FOR MATERIALS AND FINISHES.
- \langle E \rangle REFER TO FLOOR PLAN FOR WALL TYPES AND ASSEMBLIES.

KEY NOTES

- \langle 1 \rangle VENDING MACHINE (BY OTHERS).
- \langle 2 \rangle DEDICATED RECYCLING CONTAINER (BY OTHERS).
- (3) HIGH / LOW DRINKING FOUNTAIN WITH CAIN GUARD, REFER TO PLUMBING DRAWINGS.
- \langle 4 \rangle JANITOR'S SINK, REFER TO PLUMBING DRAWINGS.
- (5) FLOOR DRAIN, REFER TO DETAIL 2/A-501 AND PLUMBING DRAWINGS.
- 5 SHOWER TRENCH DRAIN, REFER TO STRUCTURAL AND PLUMBING DRAWINGS. SLOPE CONCRETE FLOOR 1/4":12" MAXIMUM TO DRAIN.

 \langle 6 \rangle WALL CONSTRUCTION, REFER TO FLOOR PLAN FOR TYPES.

- \langle 8 \rangle 8" DIAMETER COUNTER OPENING FOR BELOW COUNTER TRASH
- (9) SOLID SURFACE COUNTER TOP, SINK, FRONT, BACKSPLASH &
- $\langle 10 \rangle$ FAUCET, REFER TO PLUMBING DRAWINGS.
- $\langle 11 \rangle$ (NOT USED).

SIDESPLASH.

BARRACKS (3)

107

- 12 FUTURE ICE MACHINE (BY OTHERS).
- (13) STAINLESS STEEL (24 GA. WITH US32D FINISH) WALL COVERING WITH EXPOSED EDGES BEVELED.
- (14) SHOWER UNIT, REFER TO PLUMBING DRAWINGS
- (15) FIRE TREATED 2X WOOD BLOCKING.
- (16) GLAZED WALL TILE, REFER TO FINISH SCHEDULE ON SHEET I-101.
- $\langle 17 \rangle$ GLAZED TILE BASE REFER TO FINISH SCHEDULE ON SHEET I-101.

ΛK	DESCRIPTION	MANUFACTURER	SERIES / MODEL	MOUNTING LOCATION	ACCESSORY NOTES
(A)	TISSUE PAPER DISPENSER	(REFER TO PROJECT MANUAL)	DOUBLE ROLL, STACKED	REFER PLANS, ELEVATIONS, LEGEND	
\widehat{B}	GRAB BAR	(REFER TO PROJECT MANUAL)	48" LENGTH	REFER PLANS, ELEVATIONS, LEGEND	
<u>©</u>	GRAB BAR	(REFER TO PROJECT MANUAL)	18" LENGTH	REFER PLANS, ELEVATIONS, LEGEND	
(D)	GRAB BAR	(REFER TO PROJECT MANUAL)	42" LENGTH	REFER PLANS, ELEVATIONS, LEGEND	
(E)	GRAB BAR	(REFER TO PROJECT MANUAL)	24"x36" L-SHAPED	REFER PLANS, ELEVATIONS, LEGEND	
F	SOAP DISPENSER	(REFER TO PROJECT MANUAL)	(REFER TO PROJECT MANUAL)	REFER PLANS, ELEVATIONS, LEGEND	
(G)	SANITARY NAPKIN RECEPTACLE	(REFER TO PROJECT MANUAL)	(REFER TO PROJECT MANUAL)	REFER PLANS, ELEVATIONS, LEGEND	SHOWER 106A ONLY
(H)	ACCESSIBLE R.R. SIGN (MEN)	(REFER TO PROJECT MANUAL)	(REFER TO PROJECT MANUAL)	REFER PLANS, ELEVATIONS, LEGEND	NOTE 6
\bigcirc	ACCESSIBLE R.R. SIGN (WOMEN)	(REFER TO PROJECT MANUAL)	(REFER TO PROJECT MANUAL)	REFER PLANS, ELEVATIONS, LEGEND	NOTE 6
<u>(j)</u>	PAPER TOWEL DISPENSER	(REFER TO PROJECT MANUAL)	(REFER TO PROJECT MANUAL)	REFER PLANS, ELEVATIONS, LEGEND	NOTE 7
⟨K⟩	PAPER TOWEL DISPENSER / WASTE RECEPTACLE	(REFER TO PROJECT MANUAL)	(REFER TO PROJECT MANUAL)	REFER PLANS, ELEVATIONS, LEGEND	NOTE 7
Û	MIRROR	(REFER TO PROJECT MANUAL)	24" W. x 36" H.	REFER PLANS, ELEVATIONS, LEGEND	
<u>(M)</u>	TOILET PARTITIONS	(REFER TO PROJECT MANUAL)	(REFER TO PROJECT MANUAL)	REFER PLANS, ELEVATIONS, LEGEND	NOTE 1
$\langle N \rangle$	ACCESSIBLE UNIT DOUBLE ROBE HOOK	(REFER TO PROJECT MANUAL)	(REFER TO PROJECT MANUAL)	48" MAX. A.F.F. TO CENTER	
<u></u>	DOUBLE ROBE HOOK	(REFER TO PROJECT MANUAL)	(REFER TO PROJECT MANUAL)	68" A.F.F. TO CENTER	
P	SOAP DISH	(REFER TO PROJECT MANUAL)	(REFER TO PROJECT MANUAL)	48" MAX. A.F.F. TOP OF DISH	
<u>Q</u>	SHOWER CURTAIN ROD	(REFER TO PROJECT MANUAL)	(REFER TO PROJECT MANUAL)	74 1/2" A.F.F. TO CENTER LINE	NOTES 2 & 3
$\langle \hat{R} \rangle$	FOLD-UP SHOWER SEAT	(REFER TO PROJECT MANUAL)	(REFER TO PROJECT MANUAL)	REFER PLANS, ELEVATIONS, LEGEND	
<u>\$</u>	MOP HANGER	(REFER TO PROJECT MANUAL)	(REFER TO PROJECT MANUAL)	TOP OF SHELF 60" A.F.F.	NOTE 4
$\langle \hat{T} \rangle$	TRASH CAN (UNDER COUNTER)	(REFER TO PROJECT MANUAL)			NOTE 5

STALL DOORS TO BE 32" MINIMUM CLEAR WIDTH PER ADA/ANSI STANDARDS AND NON-ACCESSIBLE STALL

DOORS TO BE 24" MINIMUM CLEAR WIDTH.

OWNER FURNISHED AND CONTRACTOR INSTALLED.

PROVIDE LENGTH REQUIRED FOR UNIT.

REFER TO PLUMBING DRAWINGS.

"C" FOLD PAPER TOWEL DISPENSER.

SHOWER CURTAIN TO BE FURNISHED AND INSTALLED BY OWNER

REFER TO INTERIOR FINISH PLAN SIGN SCHEDULE FOR ADDITIONAL REQUIREMENTS.

BARRACKS (4)

106

BARRACKS 107 AND SHOWER 107

PROJECT MANUAL - SECTION 01 2

CORRIDOR

101

00 FOR DESCRIPTION OF WORK.

SHOWERS

(5) →

JANTOR'

ALTERNATE NO. 1: BARRACKS 107 AND SHOWER 107A


PROJECT MANUAL - SECTION 01 2 00 FOR DESCRIPTION OF WORK.

INTERIOR INFILL. REFER TO


102

INTERIOR INFILL. REFER TO

CORRIDOR

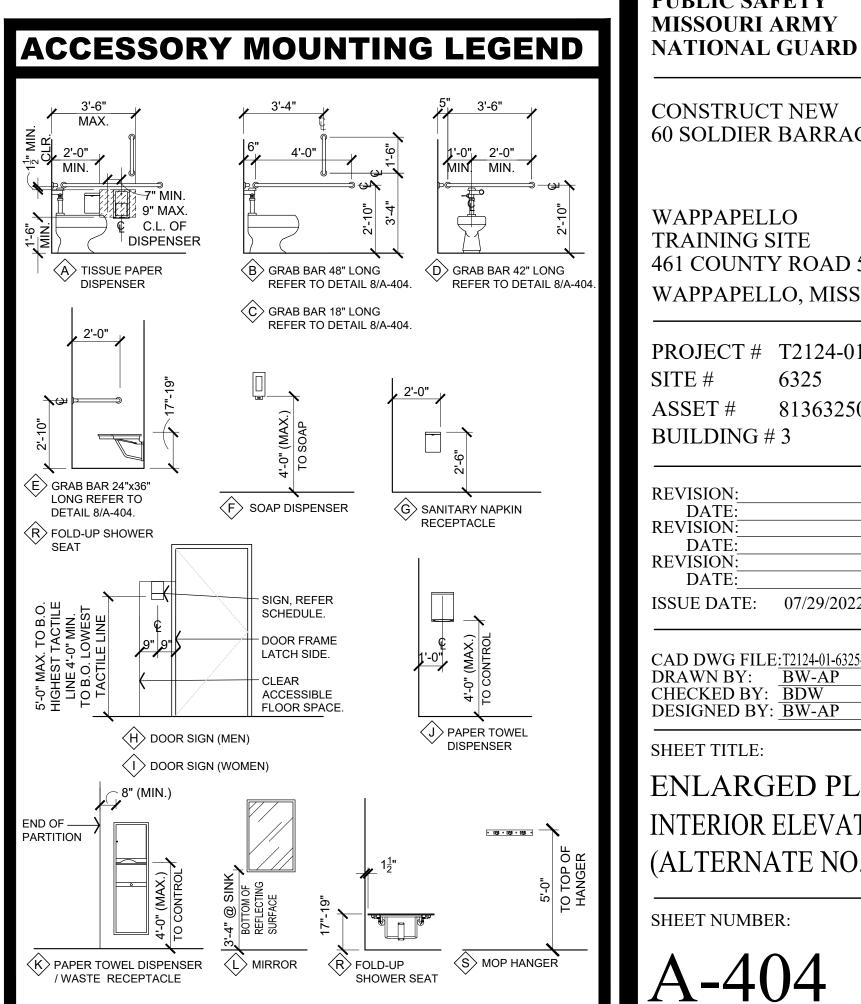

STATE OF MISSOURI MICHAEL L. PARSON, **GOVERNOR**

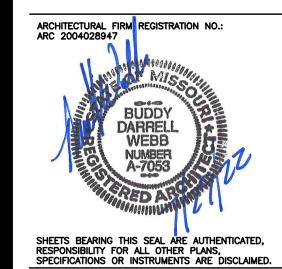

OFFICE OF ADMINISTRATION **DIVISION OF FACILITIES** MANAGEMENT, **DESIGN AND CONSTRUCTION**

DEPARTMENT OF PUBLIC SAFETY MISSOURI ARMY

CONSTRUCT NEW 60 SOLDIER BARRACKS

WAPPAPELLO TRAINING SITE 461 COUNTY ROAD 517 WAPPAPELLO, MISSOURI

PROJECT # T2124-01 6325 ASSET # 8136325016

BUILDING # 3

REVISION: REVISION: DATE: **REVISION:**

ISSUE DATE: 07/29/2022

DESIGNED BY: BW-AP

CAD DWG FILE: T2124-01-6325-8136325016-A DRAWN BY: BW-AP CHECKED BY: BDW


SHEET TITLE:

DATE:

ENLARGED PLAN, INTERIOR ELEVATIONS (ALTERNATE NO. 1)

SHEET NUMBER:


07/29/2022

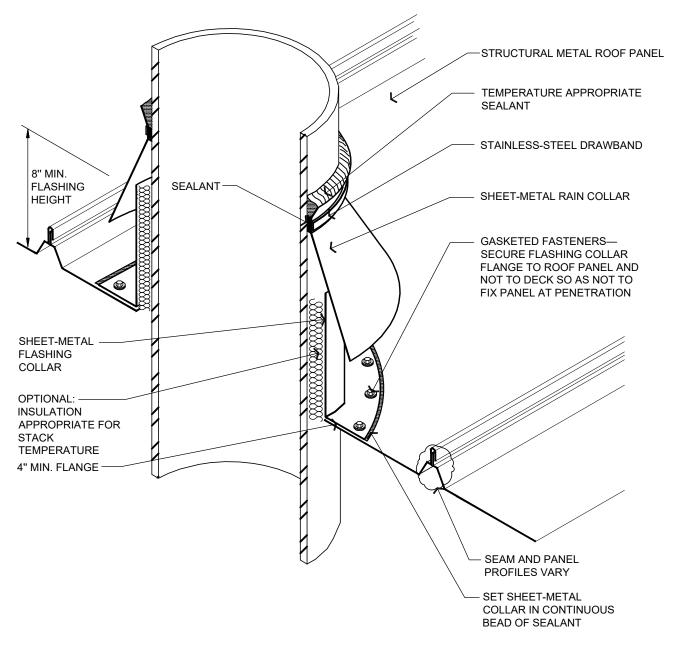


- 1. NRCA STRONGLY RECOMMENDS PENETRATIONS SHOULD NOT INTERFERE WITH PANEL SEAMS OR OCCUR AT TRANSVERSE SEAMS. 2. VENT STACKS AND OTHER PIPES SHOULD HAVE ADEQUATE CLEARANCE ON ALL SIDES FROM WALLS AND OTHER PROJECTIONS TO FACILITATE PROPER FLASHING AND PANEL DRAINAGE.
- 3. INSULATION, VAPOR RETARDER AND THERMAL BLOCKS FOR ROOF SYSTEM ARE NOT SHOWN FOR 4. REFER TO THE INTRODUCTION IN CHAPTER 10—CONSTRUCTION DETAILS FOR ADDITIONAL


SHEET-METAL STACK VENT [HOT OR COLD]

 $\underbrace{\frac{1}{\text{A-501}}}_{\text{NOT TO SCALE}}$

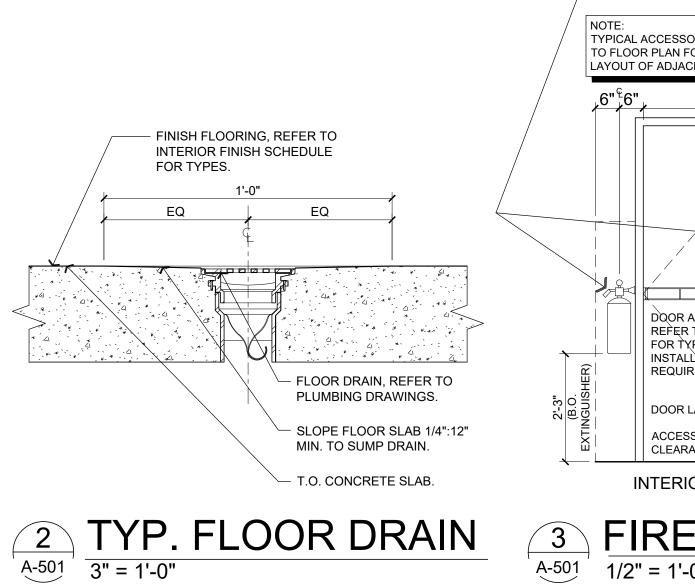

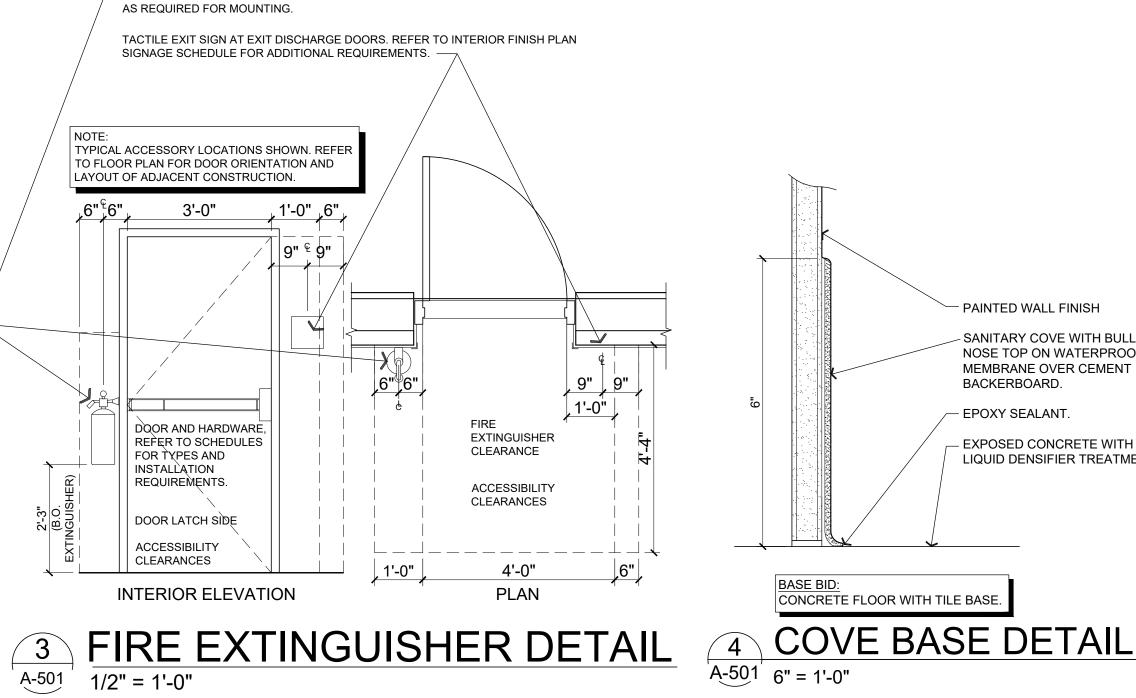

SURFACE MOUNTED PORTABLE FIRE EXTINGUISHER. FIRE EXTINGUISHERS SHALL BE UL LISTED ABC TYPE WITH 10 LBS. CAPACITY. SURFACE MOUNTING BRACKET QUICK RELEASE TYPE. REFER TO FLOOR PLAN FOR LOCATIONS. PROVIDE BLOCKING

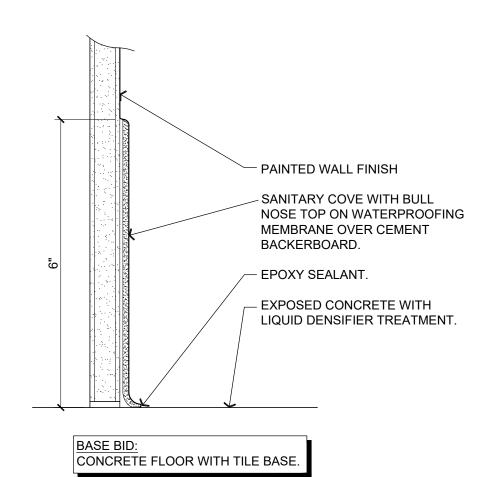

OFFICE OF ADMINISTRATION DIVISION OF FACILITIES MANAGEMENT, DESIGN AND CONSTRUCTION

STATE OF MISSOURI MICHAEL L. PARSON,

GOVERNOR

SHEETS BEARING THIS SEAL ARE AUTHENTICATED, RESPONSIBILITY FOR ALL OTHER PLANS, SPECIFICATIONS OR INSTRUMENTS ARE DISCLAIMED.

ARCHITECTURAL FIRM REGISTRATION NO.: ARC 2004028947

PUBLIC SAFETY MISSOURI ARMY NATIONAL GUARD

DEPARTMENT OF

CONSTRUCT NEW 60 SOLDIER BARRACKS

WAPPAPELLO TRAINING SITE 461 COUNTY ROAD 517 WAPPAPELLO, MISSOURI

PROJECT # T2124-01 6325 ASSET # 8136325016 BUILDING # 3

REVISION: DATE: **REVISION:** DATE: **REVISION:** DATE: ISSUE DATE: 07/29/2022


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DRAWN BY: BW-AP
CHECKED BY: BDW

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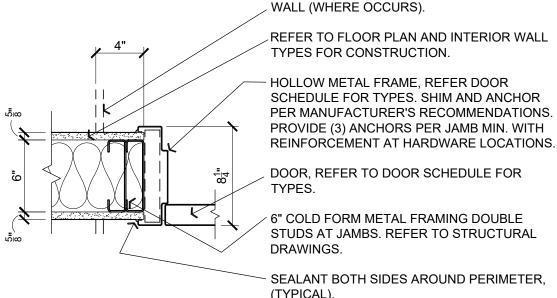
DESIGNED BY: BW-AP

MISCELLANEOUS DETAILS


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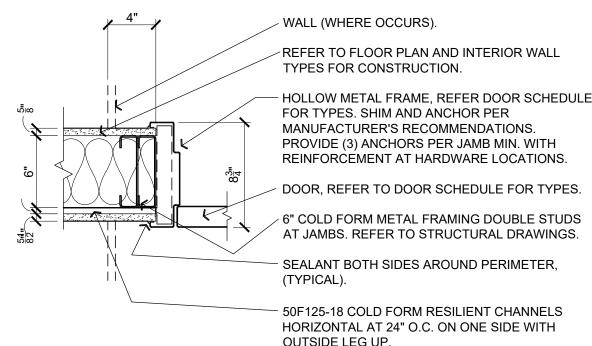
HEAD DETAIL 1 1/2" = 1'-0"

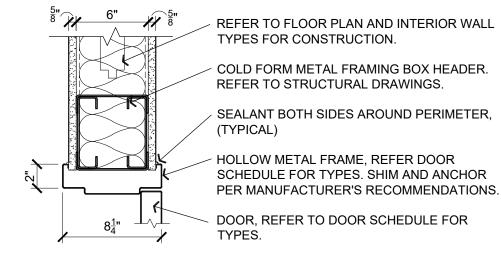

JAMB DETAIL A-601



HEAD DETAIL 1 1/2" = 1'-0"

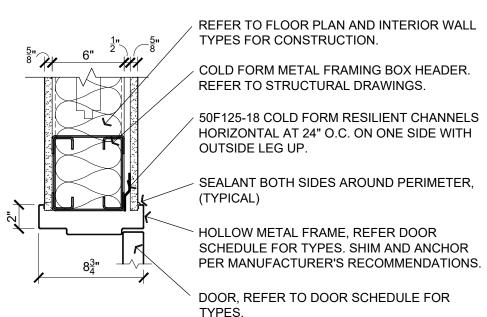


JAMB DETAIL 1 1/2" = 1'-0"

DOOR SCHEDULE DOOR **HARDWARE FRAME** REMARKS **DETAILS FIRE** MARK (REFER RATING HEAD JAMB SILL SIZE (W x H x D) TYPE SWING KEYED TYPE MATERIAL NOTES (PAIR) 3'-0" X 7'-0" X 1 3/4" CC RHR/LHR 1 | 1 | LEVEL 1 1, 2 102 1, 2 3'-0" X 7'-0" X 1 3/4" RH 4 LEVEL 3 HOL. METAL 1/A-601 2/A-601 20 MIN. 1, 2 103A 3'-0" X 7'-0" X 1 3/4" LHR HOL. METAL 20 MIN. -- | 5 | ----3/A-601 4/A-601 103B 1, 2 3'-0" X 7'-0" X 1 3/4" LHR HOL. METAL -- | 2 | LEVEL 1 HOL. METAL 6/A-401 | 7/A-401 | 8/A-401 | 1, 2 3'-0" X 7'-0" X 1 3/4" RHR HOL. METAL 20 MIN. ----6/A-401 7/A-401 104 3'-0" X 7'-0" X 1 3/4" LHR HOL. METAL --- 3 | LEVEL 3 HOL. METAL 8/A-401 1, 2 SIMILAR SIMILAR 1, 2 3'-0" X 7'-0" X 1 3/4" LHR HOL. METAL - 5 ----HOL. METAL 3/A-601 4/A-601 20 MIN. 105B 1, 2 3'-0" X 7'-0" X 1 3/4" RHR HOL. METAL -- | 2 | LEVEL 1 HOL. METAL 6/A-401 | 7/A-401 | 8/A-401 1, 2 3'-0" X 7'-0" X 1 3/4" RHR HOL. METAL HOL. METAL 3/A-601 4/A-601 20 MIN. ----106A 1, 2 3'-0" X 7'-0" X 1 3/4" LHR HOL. METAL HOL. METAL 3/A-601 4/A-601 20 MIN. ----106B 3'-0" X 7'-0" X 1 3/4" LHR HOL. METAL 3/A-601 4/A-601 20 MIN. 1, 2 HOL. METAL ----107A 1, 2, 3 3'-0" X 7'-0" X 1 3/4" RHR HOL. METAL ----HOL. METAL 3/A-601 4/A-601 20 MIN. 1, 2 3'-0" X 7'-0" X 1 3/4" RHR -- | 2 | LEVEL 1 HOL. METAL 6/A-401 7/A-401 8/A-401 1, 2 107C 3'-0" X 7'-0" X 1 3/4" LHR HOL. METAL 3/A-601 4/A-601 20 MIN. ----

 ALL DOORS SHALL BE SHOP PREPARED FOR HARDWARE. 2. REFER TO HARDWARE NOTES FOR ADDITIONAL REQUIREMENTS. . ALTERNATE NO. 1: BARRACKS 107 AND SHOWER 107A INTERIOR INFILL. REFER TO PROJECT MANUAL - SECTION 01 23 00 FOR DESCRIPTION OF WORK.

DOOR TYPES

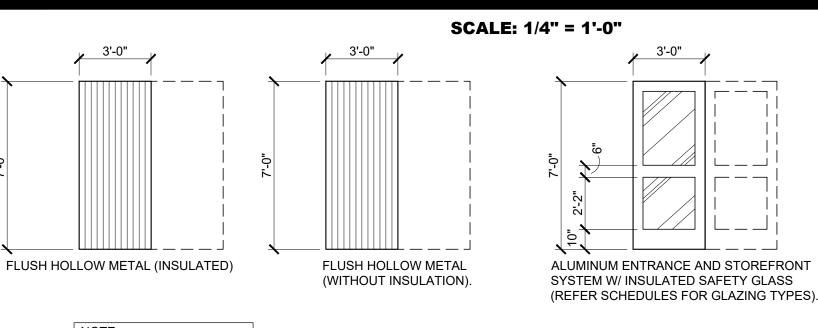


DASHED IN DOOR AND DOUBLE LETTER INDICATE PAIRED DOOR LOCATIONS


CG


WINDOW SCHEDULE

FRAME TYPES

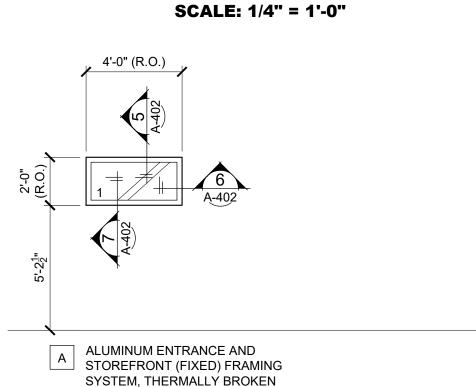



(2" X 4 1/2") SYSTEM (FRAME TYPE 4).

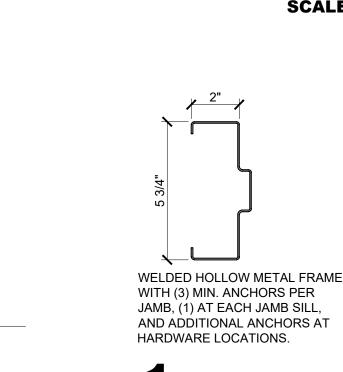

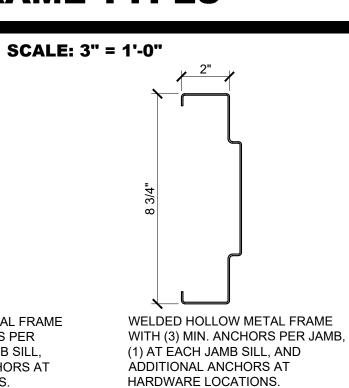

HARDWARE LOCATIONS.

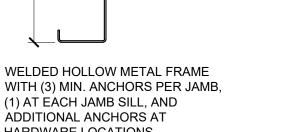

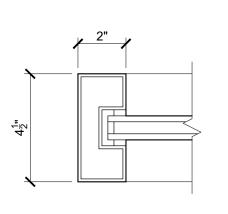

ALUMINUM STOREFRONT FRAMING SYSTEM (THERMALLY BROKEN) WITH 1" INSULATED GLAZING. REFER TO GLAZING SCHEDULE FOR GLAZING TYPES.

HARDWARE SCHEDULE

SET NO. 1 (DOOR: 101)

CONTINUOUS GEARED HINGES EXTERIOR CYLINDERS WITH REMOVABLE CORES

- (ANSI FUNCTION NO. 08) ENTRY LOCK AND EXIT PANIC WITH TWO POINT LOCKING SURFACE VERTICAL RODS, COVER GUARDS, DUST PROOF BOTTOM STRIKES, EXTERIOR LEVER HANDLES WITH ESCUTCHEON TRIM, THRU-BOLT MOUNTED
- CLOSERS WITH COVER, PARALLEL ARM, HOLD OPEN WITH SPRING CUSH, ACCESSORY PLATES AND SPACERS (AS REQUIRED), THRU-BOLT
- SET WEATHER SEAL PERIMETER GASKETS
- SET WEATHER SEAL MEETING STILE GASKETS
- WEATHER SEAL DOOR BOTTOM SWEEPS
- THRESHOLD (ADA / ANSI COMPLIANT)

ET NO. 2 (DOORS: 103B, 105B, 107B) CONTINUOUS GEARED HINGE

- EXTERIOR CYLINDER REMOVABLE CORE (ANSI FUNCTION NO. 03) MORTIS ENTRY LOCK AND EXIT PANIC, EXTERIOR LEVER HANDLE WITH ESCUTCHEON TRIM, THRU-BOLT
- CLOSER WITH COVER, PARALLEL ARM, HOLD OPEN WITH SPRING CUSH,
- THRU-BOLT MOUNTED KICK PLATE (0.062T X 12"H X 2" L.D.W.)
- SET WEATHER SEAL PERIMETER GASKETS WEATHER SEAL DOOR BOTTOM SWEEP
- THRESHOLD (ADA / ANSI COMPLIANT)

- CONTINUOUS GEARED HINGE EXTERIOR CYLINDER REMOVABLE CORE
- (ANSI FUNCTION NO. F04) MORTIS ENTRY LOCK WITH LEVER HANDLES AND ESCUTCHEON TRIM
- CLOSER WITH COVER, PARALLEL ARM, SPRING CUSH, THRU-BOLT MOUNTED
- SET WEATHER SEAL PERIMETER GASKETS
- WEATHER SEAL DOOR BOTTOM SWEEP
- THRESHOLD (ADA / ANSI COMPLIANT) RAIN DRIP

BALL BEARING HINGES

- (ANSI FUNCTION NO. F86) STOREROOM LOCK WITH LEVER HANDLES CLOSER WITH COVER, PARALLEL ARM, SPRING CUSH STOP, THRU-BOLT
- MOUNTED SET SMOKE SEAL PERIMETER GASKETS
- SMOKE SEAL DOOR BOTTOM SWEEP

SET NO. 5 (DOORS: 103A, 103C, 105A, 105C, 106B, 107A (ALTERNATE NO. 1

- 3 BALL BEARING HINGES
- 1 (ANSI FUNCTION NO. F75) PASSAGE LATCH WITH LEVER HANDLES 1 CLOSER WITH COVER, PARALLEL ARM, SPRING CUSH STOP, THRU-BOLT
- MOUNTED 1 KICK PLATE (0.062T X 12"H X 2" L.D.W.)
- SET SMOKE SEAL PERIMETER GASKETS 1 SMOKE SEAL DOOR BOTTOM SWEEP

- SET NO. 6 (DOOR: 106A) 3 BALL BEARING HINGES
- 1 (ANSI FUNCTION NO. F76) PRIVACY LOCK WITH LEVER HANDLES 1 CLOSER WITH COVER, PARALLEL ARM, SPRING CUSH STOP, THRU-BOLT
- 1 KICK PLATE (0.062T X 12"H X 2" L.D.W.) 1 SET SMOKE SEAL PERIMETER GASKETS
- SMOKE SEAL DOOR BOTTOM SWEE

GENERAL NOTES

- \langle A angle REFER TO PROJECT MANUAL FOR ADDITIONAL REQUIREMENTS.
- \langle B angle REFER TO BUILDING CODE SUMMARY AND STRUCTURAL DRAWINGS FOR PROJECT STRUCTURAL DESIGN CRITERIA. SUBMITTALS SHALL

INCLUDE MANUFACTURER'S REQUIREMENTS FOR ANCHOR TYPES,

SPACING, AND LOCATIONS REQUIRED FOR PROJECT CONDITIONS.

- DIMENSIONS TO ROUGH FACE OF OPENING UNLESS OTHERWISE INDICATED. FIELD VERIFY FINAL ROUGH OPENING DIMENSIONS PRIOR TO OPENING ASSEMBLY FABRICATION.
- \langle D angle WINDOW TYPE ELEVATIONS SHOWN VIEWED FROM EXTERIOR SIDE.
- \langle E angle REFER TO EXTERIOR FINISH SCHEDULE AND INTERIOR FINISH PLAN FOR ADDITIONAL REQUIREMENTS.

HARDWARE NOTES

I. ALL HARDWARE TO BE ADA AND ANSI A117.1 COMPLIANT. CLOSURE SPEEDS SHALL BE ADJUSTED SO THAT FROM AN OPEN POSITION OF 90 DEGREES, THE TIME REQUIRED TO MOVE THE DOOR TO AN OPEN POSITION OF 12 DEGREES SHALL BE 5 SECONDS MINIMUM. DOOR OPENING FORCE FOR PUSHING OR PULLING OPEN DOORS, OTHER THAN FIRE DOORS, SHALL BE AS FOLLOWS: - INTERIOR HINGED DOORS: 5.0 POUNDS MAXIMUM.

2. VERIFY COMPATIBILITY OF HARDWARE SPECIFIED. NOTIFY ARCHITECT OF INCOMPATIBILITY ISSUES PRIOR TO ORDERING AND INSTALLATION.

3. ALL HARDWARE TO BE GRADE 1 (HEAVY DUTY COMMERCIAL).

4. ALL KEYED HARDWARE TO BE COMPATIBLE WITH OWNER'S KEYING (BEST 7 PIN) SYSTEM. ALL EXTERIOR DOORS TO BE KEYED ALIKE. ALL HARDWARE CONTRACTOR FURNISHED AND INSTALLED. COORDINATE ORDERING AND DELIVERY REQUIREMENTS WITH OWNER. SUBMIT CORE SCHEDULE AS SPECIFIED TO:

MISSOURI NATIONAL GUARD ATTN: JOSEPH SCHAEFER, DESIGN PROJECT MANAGER 6819 N. BOUNDARY ROAD JEFFERSON CITY, MO 65101 OFFICE (573) 638-9500 EXT. 39692 CELL: (573) 690-4945 EMAIL: joseph.e.schaefer10.nfgAmail.mil.

KEYING LEGEND

UPGRADED SECURITY: PERIMETER ENTRANCE

BASIC SECURITY: OFFICE, GENERAL STORAGE

BASIC SECURITY: MAINTENANCE, MECHANICAL / ELECTRICAL, JANITOR

GLAZING SCHEDULE

T" INSULATED SAFETY (FULLY TEMPERED) GLAZING: (REFER TO PROJECT MANUAL SECTION 08 80 00 GLAZING FOR ADDITIONAL REQUIREMENTS).

EXTERIOR PANE: 1/4" TINTED (SOLARGRAY) (2) SURFACE (LOW-E). HEAT-TREATED (FT)

AIR CAVITY: 1/2"

INTERIOR PANE: 1/4" CLEAR, HEAT-TREATED (FT) PERFORMANCE REQUIREMENTS:

VISIBLE LIGHT TRANSMITTANCE (VLT): 35 VISIBLE LIGHT REFLECTANCE (EXTERIOR %): 6 VISIBLE LIGHT REFLECTANCE (INTERIOR %): 10 (NFRC) U-VALUE (WINTER NIGHTTIME): 0.29 SOLAR HEAT GAIN COEFFICIENT (SHGC): 0.25 LIGHT TO SOLAR GAIN (LSG): 1.40

RESPONSIBILITY FOR ALL OTHER PLANS, SPECIFICATIONS OR INSTRUMENTS ARE DISCLAIMED.

STATE OF MISSOURI MICHAEL L. PARSON,

GOVERNOR

ARCHITECTURAL FIRM REGISTRATION NO.:

OFFICE OF ADMINISTRATION DIVISION OF FACILITIES MANAGEMENT, **DESIGN AND CONSTRUCTION**

DEPARTMENT OF PUBLIC SAFETY MISSOURI ARMY NATIONAL GUARD

CONSTRUCT NEW 60 SOLDIER BARRACKS

WAPPAPELLO TRAINING SITE 461 COUNTY ROAD 517

WAPPAPELLO, MISSOURI

PROJECT # T2124-01 6325

ASSET # 8136325016 BUILDING # 3

REVISION: DATE **REVISION:** DATE: **REVISION:**

DATE: ISSUE DATE: 07/29/2022

CAD DWG FILE:T2124-01-6325-8136325016-A-601 DRAWN BY: BW-AP CHECKED BY: BDW DESIGNED BY: BW-AP


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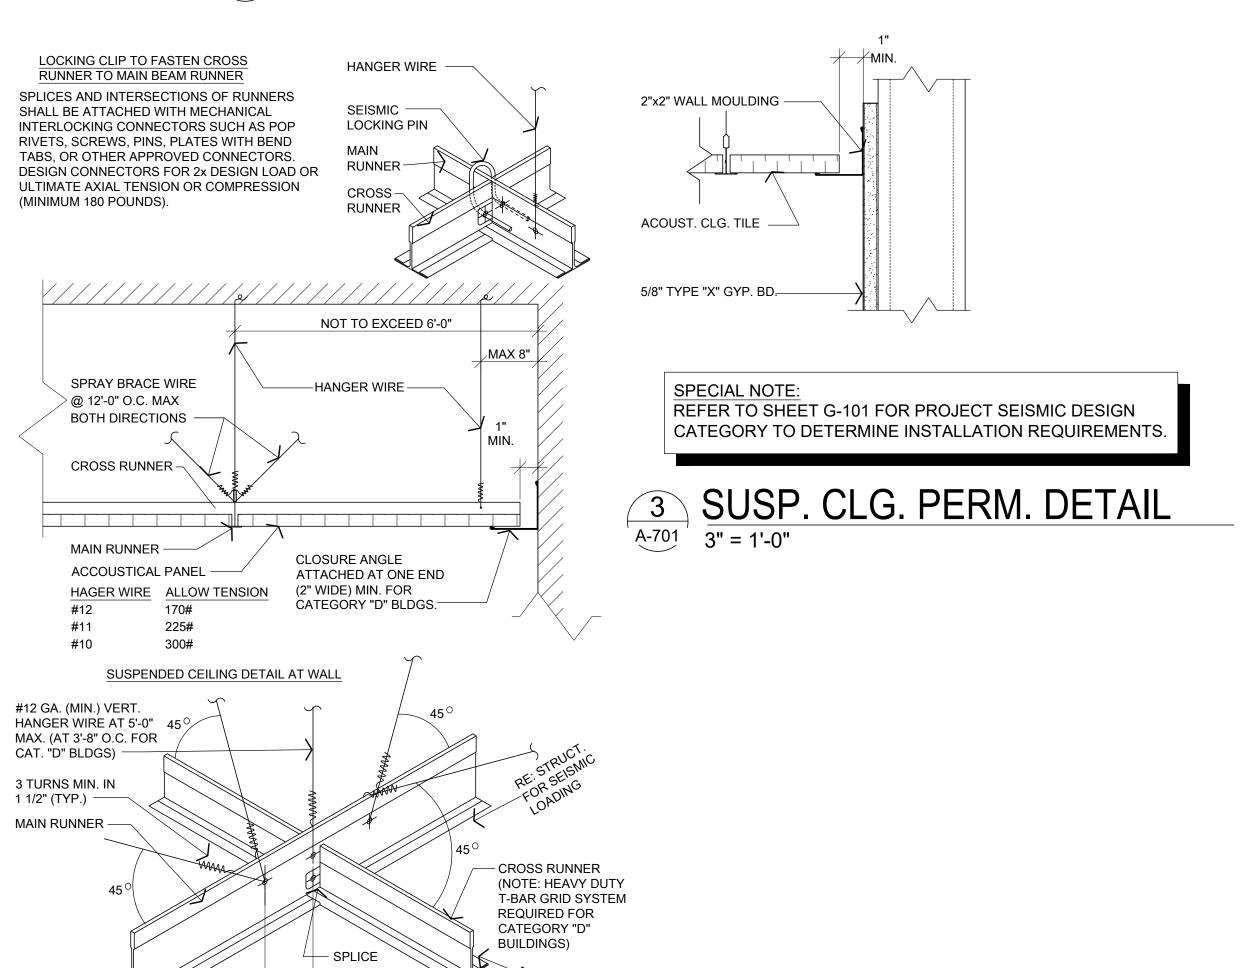
DOOR AND WINDOW **SCHEDULES** (ALTERNATE NO. 1)

SHEET NUMBER:

25 OF 36 SHEETS 07/29/2022

ALTERNATE NO. 1 BARRACKS 107 AND SHOWER 107A INTERIOR INFILL. REFER TO PROJECT MANUAL - SECTION 01 23 00 FOR DESCRIPTION OF WORK.



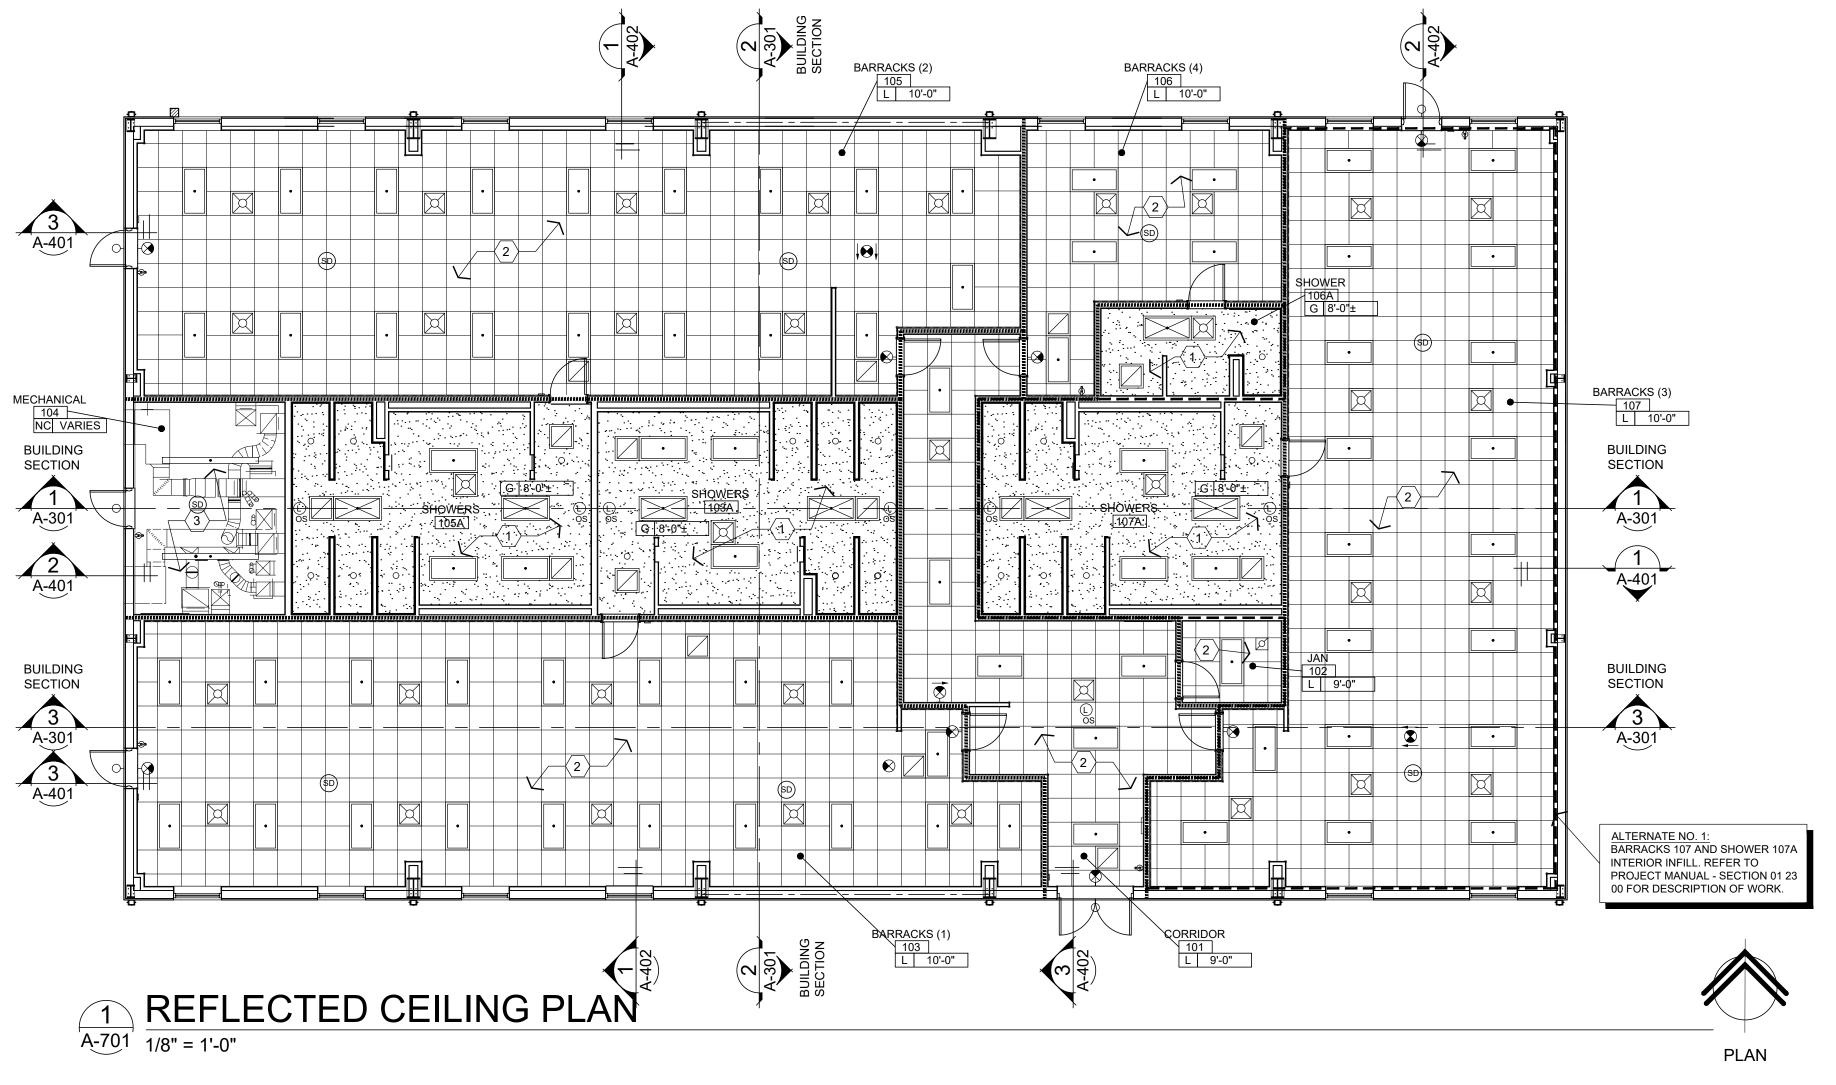

2 SUSP. CLG. SEISMIC DETĂĬL

NOT TO SCALE


GENERAL NOTES

- $\overline{\langle \mathsf{A} \rangle}$ REFER TO PROJECT MANUAL FOR ADDITIONAL REQUIREMENTS.
- B REFER TO INTERIOR WALL AND CEILING GENERAL NOTES FOR ADDITIONAL REQUIREMENTS.
- C MECHANICAL REGISTERS ARE SHOWN ON THIS DRAWING FOR THE ARCHITECTURAL LOCATIONS ONLY. REFER TO THE MECHANICAL DRAWINGS FOR TYPES, SIZES, DISTRIBUTION, CONNECTIONS, AND ALL OTHER REQUIREMENTS.
- D LIGHTING FIXTURES ARE SHOWN ON THIS DRAWING FOR THE ARCHITECTURAL LOCATIONS, QUANTITIES, AND GENERAL FIXTURE TYPE ONLY. SEE THE ELECTRICAL DRAWINGS FOR EXACT FIXTURE TYPE AND CIRCUITING.
- CONTRACTOR SHALL COORDINATE THE INSTALLATION OF THE VARIOUS TRADE ITEMS WITHIN THE SPACE ABOVE ALL CEILINGS (INCLUDING, BUT NOT LIMITED TO: STRUCTURAL MEMBERS, MECHANICAL DUCTS AND INSULATION, CONDUITS, RACEWAYS, SPRINKLER SYSTEM, LIGHT FIXTURES, CEILING SYSTEMS, AND ANY SPECIAL STRUCTURAL SUPPORTS REQUIRED) AND SHALL BE RESPONSIBLE FOR MAINTAINING THE FINISH CEILING HEIGHT ABOVE THE FINISH FLOOR INDICATED ON THE DRAWING.
- F CONTRACTOR TO SUBMIT FIRE SUPPRESSION HEAD LOCATIONS SHOWING COORDINATION WITH REFLECTED CEILING MECHANICAL AND ELECTRICAL SYSTEMS. CENTER HEADS IN TILES.
- $\langle \mathsf{G} \rangle$ REFER TO INTERIOR FINISH PLAN FOR CEILING FINISHES.
- H PROVIDE SUSPENDED ACOUSTICAL CEILING TILE HOLD DOWN CLIPS AT AREAS SUBJECT TO UPLIFT. EXTEND 8'-0" MINIMUM INTO INTERIOR AT EXTERIOR DOOR LOCATIONS
- INDICATED CEILING ELEVATIONS TO BOTTOM OF FRAMING AT GYPSUM BOARD CONSTRUCTION AND BOTTOM OF SUSPENDED ACOUSTICAL CEILING GRID CONSTRUCTION, UNLESS OTHERWISE NOTED.
- PROVIDE SUSPENDED CEILING SEISMIC BRACING, REFER TO DETAILS 2/A-701 AND 3/A-701.
- K COORDINATE ATTACHMENT REQUIREMENTS TO PRE-ENGINEERED METAL BUILDING STRUCTURE WITH MANUFACTURER.
- L EXPOSED MECHANICAL, ELECTRICAL AND FIRE SUPPRESSION SYSTEMS TO BE INSTALLED IN NEAT AND ORDERLY LAYOUT. PROVIDE FRAMING, SUPPORTS AND ATTACHMENTS AS REQUIRED FOR COMPLETE INSTALLATION.

KEY NOTES

- 1 5/8" GYPSUM BOARD ON COLD-FORM METAL JOIST FRAMING. REFER TO STRUCTURAL DRAWINGS AND INTERIOR FINISH PLAN FOR ADDITIONAL REQUIREMENTS.
- $\fbox{2}$ SUSPENDED ACOUSTICAL CEILING SYSTEM, REFER TO INTERIOR FINISH PLANS FOR FINISHES.
- 3 EXPOSED UNFINISHED STRUCTURE, MECHANICAL AND ELECTRICAL

SYMBOLS LEGEND

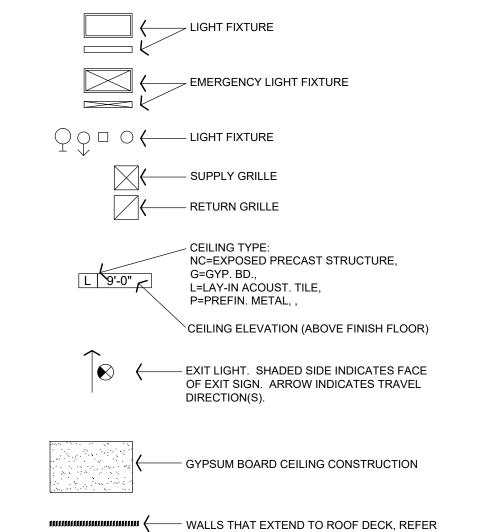


©os CEILING MOUNTED OCCUPANCY SENSOR

TO CODE ANALYSIS PLAN FOR ADDITIONAL

SD CEILING MOUNTED SMOKE DETECTOR SENSOR

REQUIREMENTS.

STATE OF MISSOURI MICHAEL L. PARSON, GOVERNOR

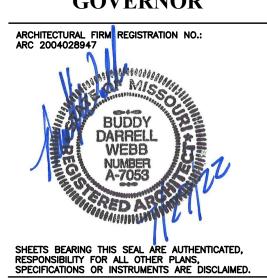

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OFFICE OF ADMINISTRATION DIVISION OF FACILITIES MANAGEMENT, DESIGN AND CONSTRUCTION

DEPARTMENT OF PUBLIC SAFETY MISSOURI ARMY NATIONAL GUARD

CONSTRUCT NEW 60 SOLDIER BARRACKS

WAPPAPELLO TRAINING SITE 461 COUNTY ROAD 517 WAPPAPELLO, MISSOURI

PROJECT # T2124-01 SITE # 6325 ASSET # 8136325016

BUILDING # 3

REVISION:	
DATE:	
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DATE:	
REVISION:	
DATE:	
ISSUE DATE:	07/29/2022


CAD DWG FILE:T2124-01-6325-8136325016-A
DRAWN BY: BW-AP
CHECKED BY: BDW
DESIGNED BY: BW-AP

SHEET TITLE:

REFLECTED
CEILING PLAN
(ALTERNATE NO. 1)

SHEET NUMBER:

A-701

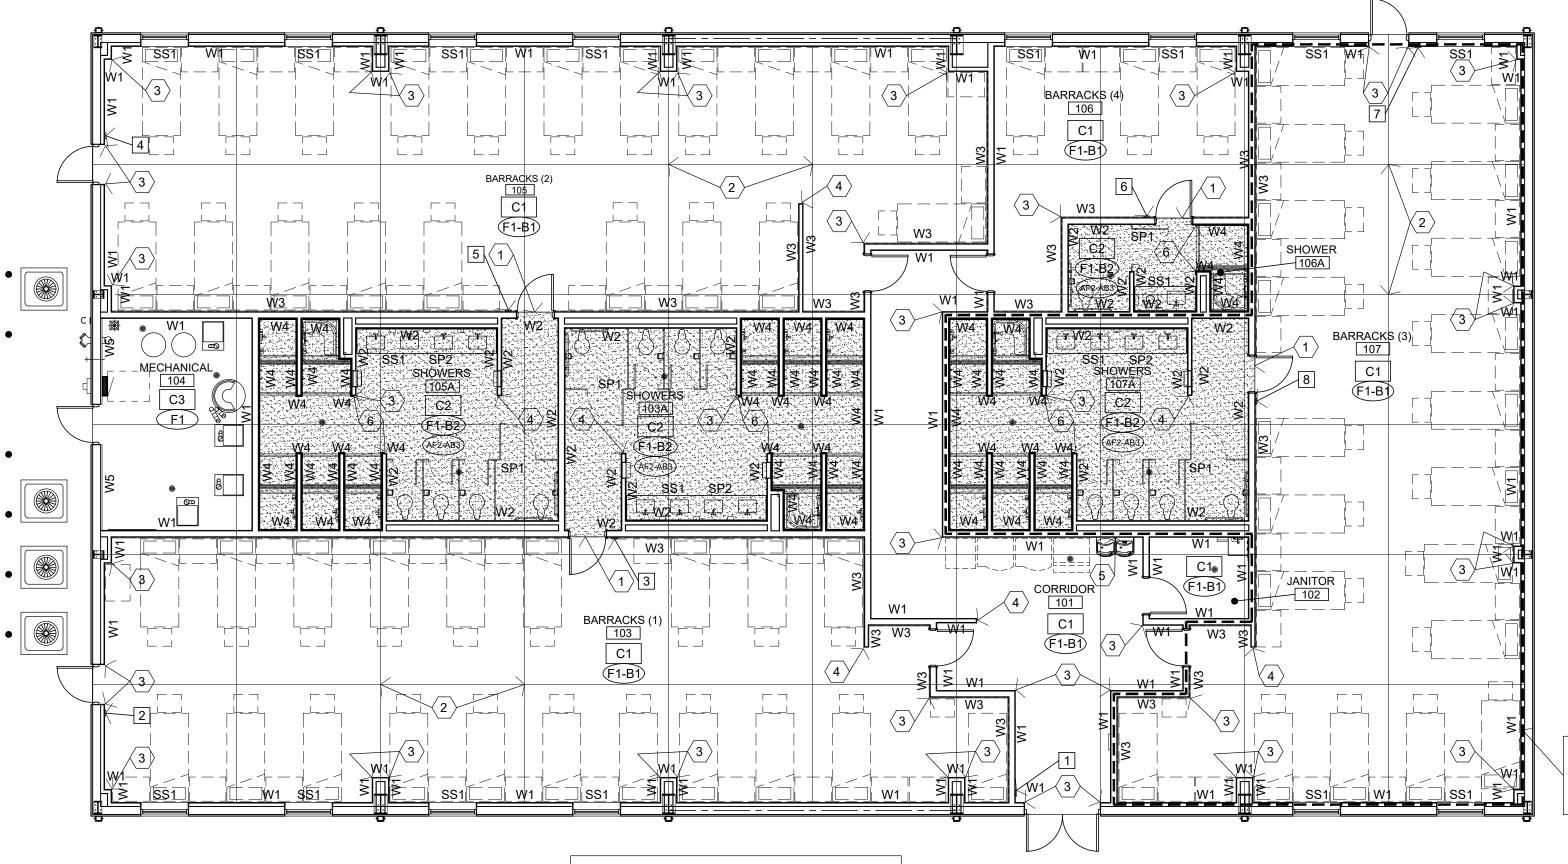


ALTERNATE NO. 1: BARRACKS 107 AND SHOWER 107A INTERIOR INFILL. REFER TO PROJECT MANUAL - SECTION 01 23 00 FOR DESCRIPTION OF WORK.

ALTERNATE NO. 1 BARRACKS 107 AND SHOWER 107A INTERIOR INFILL. REFER TO PROJECT MANUAL - SECTION 01 23 00 FOR DESCRIPTION OF WORK.

ALTERNATE NO. 3: RESINOUS FLOORING AND BASE.






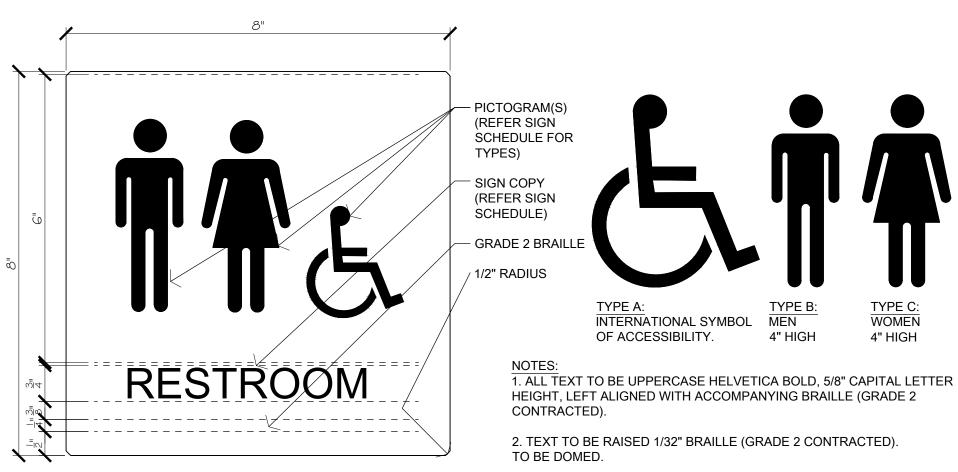


2 PICTOGRAM SIGNS

1-101 6" = 1'-0"

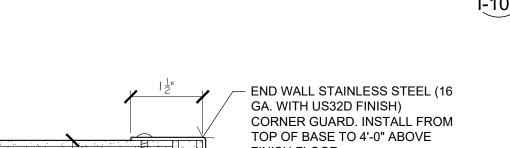


3. PICTOGRAMS ILLUSTRATED FOR GRAPHIC PROPORTIONS ONLY. REFER

TO SIGN TYPE FOR PICTOGRAM HEIGHTS REQUIRED.

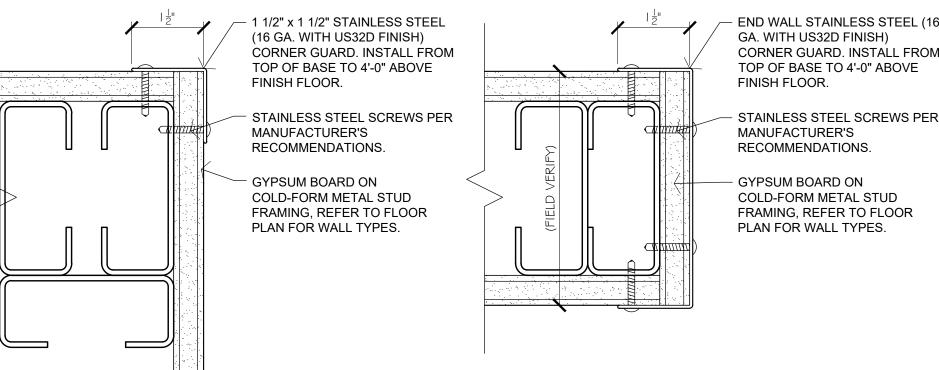


5 CORNER GUARD 6 CORNER GUARD

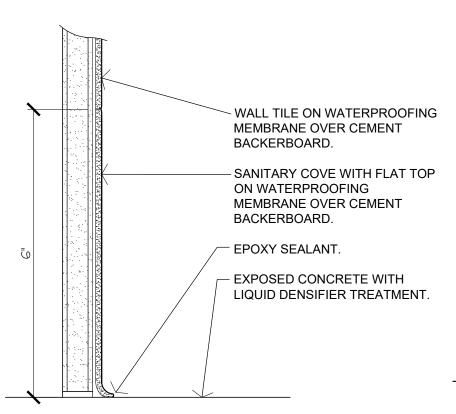

CONCRETE FLOOR WITH TILE BASE


COVE BASE DETAIL I-101 6" = 1'-0"

TILE ON WATERPROOFING MEMBRANE OVER CEMENT BACKERBOARD.

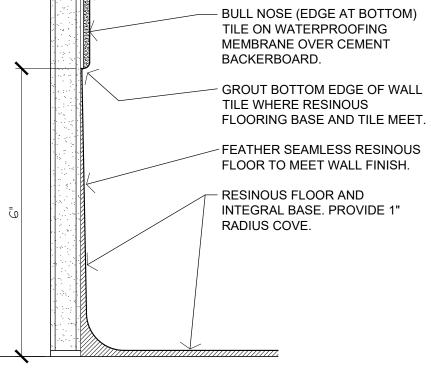

RESINOUS FLOORING AND BASE.

COVE BASE DETAIL I-101 6" = 1'-0"

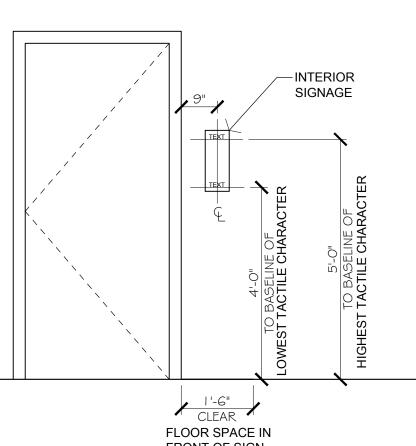

NORTH

FRONT OF SIGN 1. INSTALL INTERIOR SIGNS THAT IDENTIFY ROOMS ON THE WALL ADJACENT TO THE LATCH SIDE OF THE DOOR. IF THERE IS NOT ADEQUATE SPACE ADJACENT TO THE LATCH SIDE OF THE DOOR ON THE WALL, MOUNT THE SIGN ON THE DOOR. CENTER THE SIGN ALONG THE WIDTH OF THE DOOR AND MOUNT AS THE SAME HEIGHTS AS INDICATED ABOVE.

2. MOUNT WITH CONCEALED ANCHORS, PER MANUFACTURER'S STANDARD METHOD FOR SUBSTRATE. SIGN PANEL SHALL REMAIN FLAT UNDER INSTALLED CONDITIONS AS INDICATED AND WITHIN A TOLERANCE OF +/-1/16" MEASURED DIAGONALLY FROM CORNER TO CORNER.

TYP. SIGN MOUNTING I-101 1/2" = 1'-0"

RESINOUS FLOORING FEATHER SEAMLESS RESINOUS FLOORING TO MEET SEALED CONCRETE, SLOPE SHALL NOT BE STEEPER THAN 1:2 PER ADA - CONCRETE FLOOR

RESINOUS FLOORING AND BASE.

8 FLOOR TRANSITION

INTERIOR FINISH TYPES

_	<u>FLOORS</u>	
F1)	TYPE:	EXPOSED CONCRETE WITH LIQUID DENSIFIER
		TREATMENT
	MFG:	(REFER PROJECT MANUAL)
	COLOR:	CLEAR

(AF2) BASE BID: PROVIDE FLOOR FINISH TYPE "F1". ALTERNATE NO. 3: RESINOUS FLOORING (SEAMLESS) "DUR-A-FLEX" - DUR-A-CHIP (BASIS FOR DESIGN) COBBLESTONE (GRAY WITH BLACK, GRAY, BEIGE AND WHITE FLAKES) MACRO / COURSE (NON-SLIP)

TYPE: RESILIENT BASE JOHNSONITE OR EQUAL (BASIS FOR DESIGN) MFG: MATERIAL: RUBBER COLOR: 40 BLACK SIZE: 6" (TYPE TS

(B2) DAL-TILE OR EQUAL (BASIS FOR DESIGN) COLOR WHEEL COLLECTION - CLASSIC MATTE DESERT GRAY X714 (OR EQUAL) 6" X 6" SANITARY COVE WITH BULLNOSE TOP OR FLAT TOP, REFER TO DETAILS 4/A-501 & 3/I-101. PROVIDE SPECIAL SHAPES FOR INSIDE CORNER, OUTSIDE CORNER, AND FINISH TYPE TRANSITIONS. (OMIT AT ALTERNATE NO. 3 LOCATIONS)

BASE BID: PROVIDE BASE FINISH TYPE "B2". RESINOUS FLOORING (SEAMLESS) "DUR-A-FLEX" - DUR-A-CHIP (BASIS FOR DESIGN) COLOR: COBBLESTONE (GRAY WITH BLACK, GRAY, BEIGE AND WHITE FLAKES) MACRO / COURSE (NON-SLIP) SIZE: EXTEND UP WALL INTEGRAL WITH FLOORING 6", REFER TO DETAIL 7/I-101.

TYPE: GYPSUM BOARD W1 FINISH: PAINT (FIELD) SHERWIN WILLIAMS OR EQUAL (BASIS FOR DESIGN) COLOR: SW 7029 (AGREEABLE GRAY) SHEEN: SEMI-GLOSS

TYPE: **GYPSUM BOARD** FINISH: PAINT (FIELD) SHERWIN WILLIAMS OR EQUAL (BASIS FOR DESIGN) SW 7029 (AGREEABLE GRAY) (MOLD AND MILDEW RESISTANT) SEMI-GLOSS SHEEN:

TYPE: **GYPSUM BOARD** W3 PAINT (ACCENT) SHERWIN WILLIAMS OR EQUAL (BASIS FOR DESIGN) MFG: SW 6425 (RELENTLESS OLIVE) COLOR: SHEEN: SEMI-GLOSS

GLAZED CERAMIC TILE DAL-TILE OR EQUAL (BASIS FOR DESIGN) COLOR WHEEL COLLECTION - CLASSIC SERIES: SIZE: MATTE ARCTIC WHITE 0790 (1) (OR EQUAL) PATTERN: STACKED MAPEI (BASIS FOR DESIGN) KERAPOXY CQ (BASIS FOR DESIGN) 38 AVALANCHE (OR EQUAL)

PROVIDE SPECIAL SHAPES FOR INSIDE CORNERS, OUTSIDE CORNERS, AND EDGE FINISH TRANSITIONS. PRE-ENGINEERED METAL BUILDING LINER PANEL CHIEF BUILDINGS OR EQUAL (BASIS FOR DESIGN) CHIEF CS/AP PANEL WALL SYSTEM

FROST WHITE (FW) COLOR: **CEILINGS** SUSPENDED ACOUSTICAL CEILING TYPE: C1 ARMSTRONG OR EQUAL (BASIS FOR DESIGN) MFG: STYLE: DUNE ITEM NO.: 1774 SIZE: 24"X24"X5/8" ANGLED TEGULAR EDGE: COLOR: WHITE ALUMINUM 15/16" EXPOSED TEE GRID: COLOR: WHITE GYPSUM BOARD

TEXTURE: LEVEL 5 SMOOTH DRYWALL SURFACE FINISH: SHERWIN WILLIAMS OR EQUAL (BASIS FOR DESIGN SW 7029 (AGREEABLE GRAY) (MOLD AND MILDEW RESISTANT) SEMI-GLOSS

TYPE: **EXPOSED STRUCTURE** FINISH: UNFINISHED

COLOR:

DOORS AND FRAMES INTERIOR SURFACES HOLLOW METAL DOORS & **FRAMES** FINISH: SHERWIN WILLIAMS OR EQUAL (BASIS FOR DESIGN)

SW 6991 (BLACK MAGIC)

SEMI-GLOSS SHEEN: EXTERIOR SURFACES DOORS & FRAMES MFG: SHERWIN WILLIAMS OR EQUAL (BASIS FOR DESIGN) COLOR: (MATCH EXTERIOR SHEET METAL COLOR) SHEEN:

SOLID SURFACE FABRICATIONS SOLID SURFACE MILLWORK AND WINDOW SILLS WILSONART OR EQUAL (BASIS FOR DESIGN) COLOR: MIDNIGHT FROST 9244SS LAVATORY: WILSONART "AV1812" OR EQUAL (BASIS FOR DESIGN)

TOILET COMPARTMENTS MFG: ASI - ACCURATE PARTITIONS OR EQUAL (BASIS FOR GRAPHITE GRAFIX 3020 (BLACK CORE)

METAL SUPPORT BRACKETS AT LAVATORY LOCATIONS FINISH: PAINT MFG: SHERWIN WILLIAMS OR EQUAL (BASIS FOR DESIGN) COLOR: SW 6991 (BLACK MAGIC) (MATCH "D1") SEMI-GLOSS SHEEN:

GENERAL NOTES

 \langle A angle REFER TO PROJECT MANUAL FOR ADDITIONAL REQUIREMENTS.

 \langle B \rangle FINAL COLORS AND TEXTURES TO BE SELECTED BY OWNER FROM MANUFACTURER'S SPECIFIED SAMPLES.

 \langle C \rangle PROVIDE FLOORING TRANSITIONS, REDUCERS AND EDGING AS REQUIRED FOR SPECIFIC CONDITIONS.

 \langle D angle REFER TO EXTERIOR FINISH SCHEDULE FOR ADDITIONAL REQUIREMENTS.

 \langle E \rangle REFER TO ELEVATIONS, SECTIONS, AND DETAILS FOR ADDITIONAL

 \langle F angle REFER TO REFLECTED CEILING PLAN FOR ADDITIONAL REQUIREMENTS.

 \langle G angle GYPSUM BOARD FINISH TEXTURE TO BE SMOOTH FINISH ON "LEVEL" 5" SURFACE. FINAL TEXTURES TO BE SELECTED BY OWNER FROM SPECIFIED SAMPLES.

 $\langle \mathsf{H} \,
angle$ ALL GYPSUM BOARD EXPOSED WALLS TO BE FINISH TYPE "W1" UNLESS OTHERWISE INDICATED.

ALL GYPSUM BOARD EXPOSED WALLS TO BE PROVIDED WITH BASE $^{\prime}$ FINISH TYPE "B1" UNLESS OTHERWISE INDICATED.

 \langle J angle ALL SHOWER ENCLOSURE WALLS TO BE FINISH TYPE "W4" UNLESS OTHERWISE INDICATED.

 \langle K \rangle ALL INTERIOR STEEL DOORS AND FRAMES TO BE FINISH TYPE "D1". UNLESS OTHERWISE INDICATED. ALL EXTERIOR STEEL DOORS AND FRAMES TO BE FINISH TYPE "D1" ON INTERIOR SIDE AND FINISH TYPE "D2" ON EXTERIOR SIDE OF DOOR.

 \langle $_{\sf L}$ angle ALL TOILET COMPARTMENTS TO BE FINISH TYPE "SP1".

 $\langle \mathsf{M} \rangle$ ALL MILLWORK AND WINDOW SILL SOLID SURFACE FABRICATIONS TO BE FINISH TYPE "SS1", UNLESS OTHERWISE INDICATED.

 \langle N angle PROVIDE SEALANT AT ALL EXPOSED CONCRETE FLOOR JOINTS. COLOR TO MATCH NATURAL CONCRETE GRAY.

 \langle O \rangle ALL ELECTRICAL DEVICES TO BE BLACK FINISH AND COVER PLATES TO BE STAINLESS STEEL FINISH, UNLESS OTHERWISE INDICATED.

 \langle P angle ALL WINDOW OPENINGS TO BE PROVIDED WITH WINDOW BLINDS. COLOR TO MATCH WINDOW FRAME.

 $\langle { t Q}
angle$ ALL METAL SUPPORT BRACKETS FOR MILLWORK TO BE PAINTED "SP2", UNLESS OTHERWISE INDICATED.

KEY NOTES

 \langle 1 \rangle RESIN FLOORING TO CONCRETE FLOOR FINISH TRANSITION, REFER TO DETAIL 8/I-101 (ALTERNATE NO. 3).

 \langle 2 \rangle CONCRETE FLOOR JOINTS, REFER TO STRUCTURAL. PROVIDE SEALANT AT ALL EXPOSED LOCATIONS.

 \langle 3 \rangle CORNER GUARD, REFER TO DETAIL 5/I-101.

 \langle $_4$ \rangle WALL END CORNER GUARD, REFER TO DETAIL 6/I-101.

 \langle 5 angle DRINKING FOUNTAIN STAINLESS STEEL (24 GA. WITH US32D FINISH) WALL COVERING WITH EXPOSED EDGES BEVELED, REFER TO INTERIOR ELEVATIONS.

 \langle 6 angle TILE TO PAINT WALL FINISH TRANSITION.

SIGNAGE GENERAL NOTES

A. CONFIRM ALL ROOM SIGNAGE COPY WITH OWNER.

B. FOR TYPICAL SIGN MOUNTING HEIGHT REFER TO DETAIL 4/I-101.

C. SIGN DIMENSIONS SHOWN REFLECT FACE PLATE ONLY.

D. THE MOUNTING LOCATION OF INTERIOR SIGNS SHOULD BE ARRANGED SO THAT A PERSON CAN APPROACH WITHIN 3" OF SIGN WITHOUT ENCOUNTERING PROTRUDING OBJECTS OR A DOOR SWING.

E. SIGNAGE COLORS TO BE WHITE TEXT AND SYMBOLS ON BLUE (NO. 15090 IN FEDERAL STANDARD 595B) BACKGROUND. COPY AND GRAPHICS TO BE A CONTRASTING COLOR. ARCHITECT TO SELECT FINAL COLORS FROM MANUFACTURER'S FULL RANGE OF COLORS.

F. SIGN MATERIAL TO LAMINATED-SHEET; SANDBLASTED POLYMER FACE SHEET WITH RAISED GRAPHICS LAMINATED TO ACRYLIC OR PHENOLIC BACKING TO PRODUCE COMPOSITE SHEET. COMPOSITE SHEET THICKNESS TO BE 1/4". SURFACE FINISH AND APPLIED GRAPHICS TO BE MANUFACTURER'S STANDARD FACTORY APPLIED EXTERIOR GRADE SIGN

SIGNAGE SCHEDULE

SIGN NO.	ROOM NO.	SIGN TYPE	SIGN COPY	PICTOGRAMS TYPE(S)
1	101	2/I-101	EXIT	Α
2	103	2/I-101	EXIT	Α
3	103	2/I-101	MEN	A & B
4	105	2/I-101	EXIT	Α
5	105	2/I-101	MEN	A & B
6	106	2/I-101	WOMEN	A & C
7	107	2/I-101	EXIT	Α
8	107	2/I-101	MEN	A & B

SYMBOLS LEGEND


FX-BX FLOOR OR BASE FINISH TYPE

CX CEILING FINISH TYPE

WX WALL FINISH TYPE(S) AND TRIM TYPE(S) FLOOR FINISH PATTERN

SIGN TYPE NUMBER, REFER SIGN SCHEDULE

STATE OF MISSOURI MICHAEL L. PARSON, **GOVERNOR**

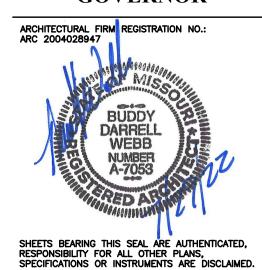

OFFICE OF ADMINISTRATION **DIVISION OF FACILITIES** MANAGEMENT, **DESIGN AND CONSTRUCTION**

DEPARTMENT OF PUBLIC SAFETY **MISSOURI ARMY** NATIONAL GUARD

CONSTRUCT NEW 60 SOLDIER BARRACKS

WAPPAPELLO TRAINING SITE 461 COUNTY ROAD 517

WAPPAPELLO, MISSOURI

PROJECT # T2124-01 6325 ASSET # 8136325016

REVISION: DATE REVISION: DATE

BUILDING # 3

REVISION: DATE: ISSUE DATE: 07/29/2022

CAD DWG FILE:T2124-01-6325-8136325016-I-101 DRAWN BY: BW-AP CHECKED BY: BDW DESIGNED BY: BW-AP

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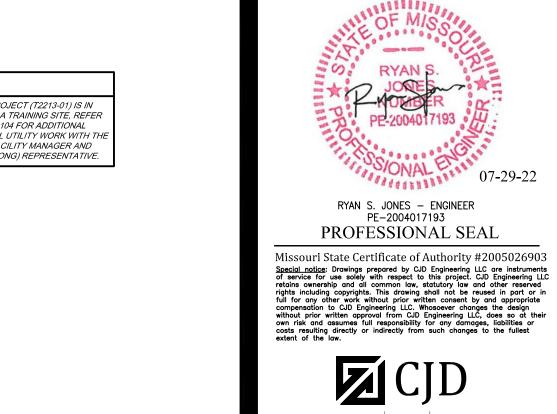
INTERIOR FINISH PLAN (ALTERNATES NO. 1 & NO. 3)

SHEET NUMBER

WALL PACKS SHALL BE MOUNTED AT APPROXIMATELY 9'-0". REFER TO LIGHTING PLAN FOR CIRCUITRY.

SPECIAL NOTE:

A UTILITY INFRASTRUCTURE PROJECT (T2213-01) IS IN PROGRESS AT THE WAPPAPELLA TRAINING SITE, REFER TO SITE UTILITY PLAN SHEET C-104 FOR ADDITIONAL INFORMATION. COORDINATE ALL UTILITY WORK WITH THE WAPPAPELLA TRAINING SITE FACILITY MANAGER AND MISSOURI NATIONAL GUARD (MONG) REPRESENTATIVE.



OFFICE OF ADMINISTRATION DIVISION OF FACILITIES MANAGEMENT, DESIGN AND CONSTRUCTION

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STATE OF MISSOURI

MICHAEL L. PARSON, GOVERNOR

DEPARTMENT OF PUBLIC SAFETY MISSOURI ARMY NATIONAL GUARD

CONSTRUCT NEW 60 SOLDIER BARRACKS

WAPPAPELLO TRAINING SITE 461 COUNTY ROAD 517 WAPPAPELLO, MISSOURI

PROJECT # T2124-01 SITE # 6325 ASSET # 8136325016 BUILDING #3

REVISION:
DATE:
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ISSUE DATE: 07/29/2022

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DRAWN BY: TJG
CHECKED BY: RSJ
DESIGNED BY: TJG

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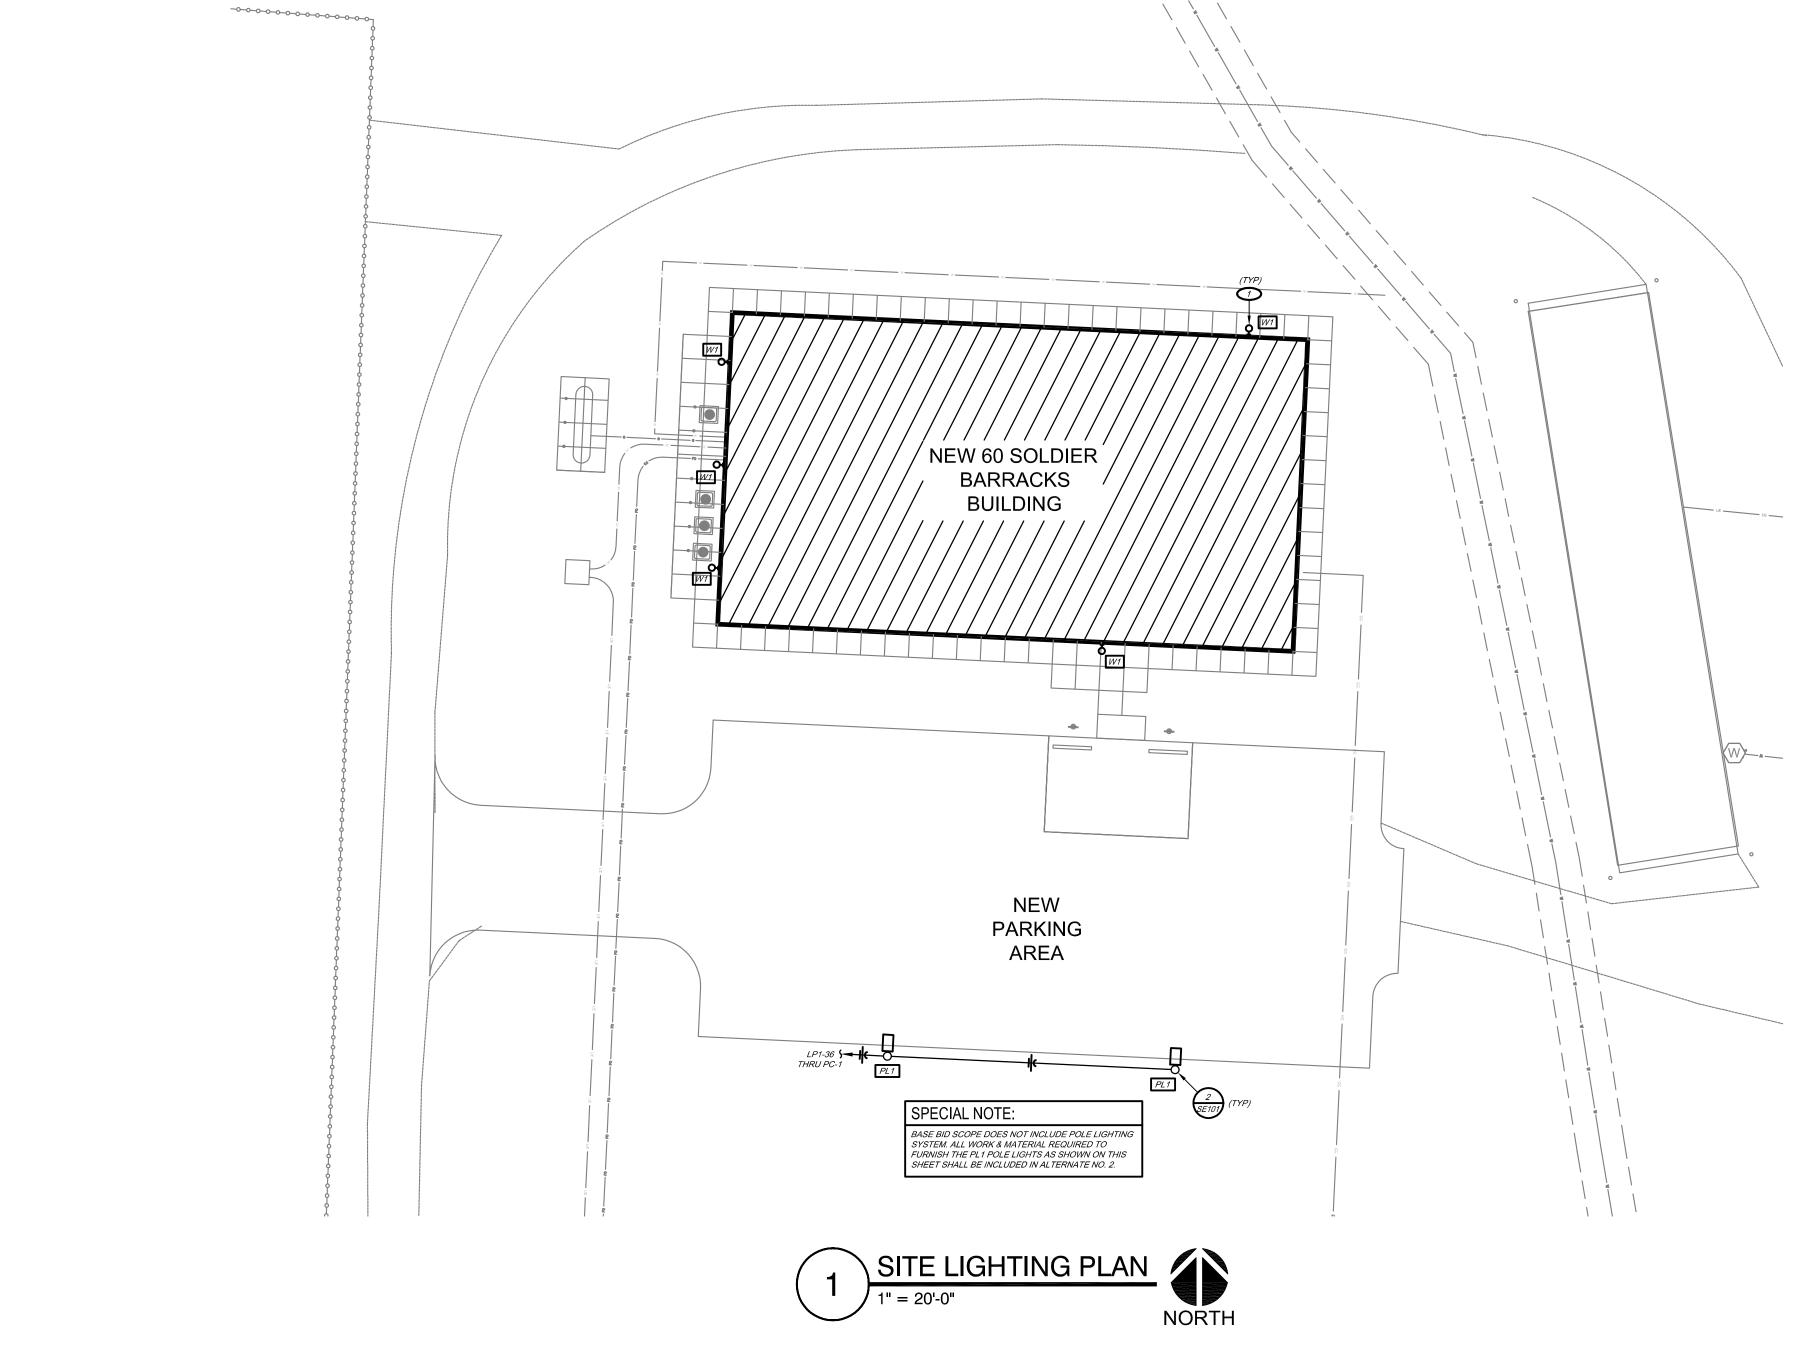
SITE LIGHTING PLAN


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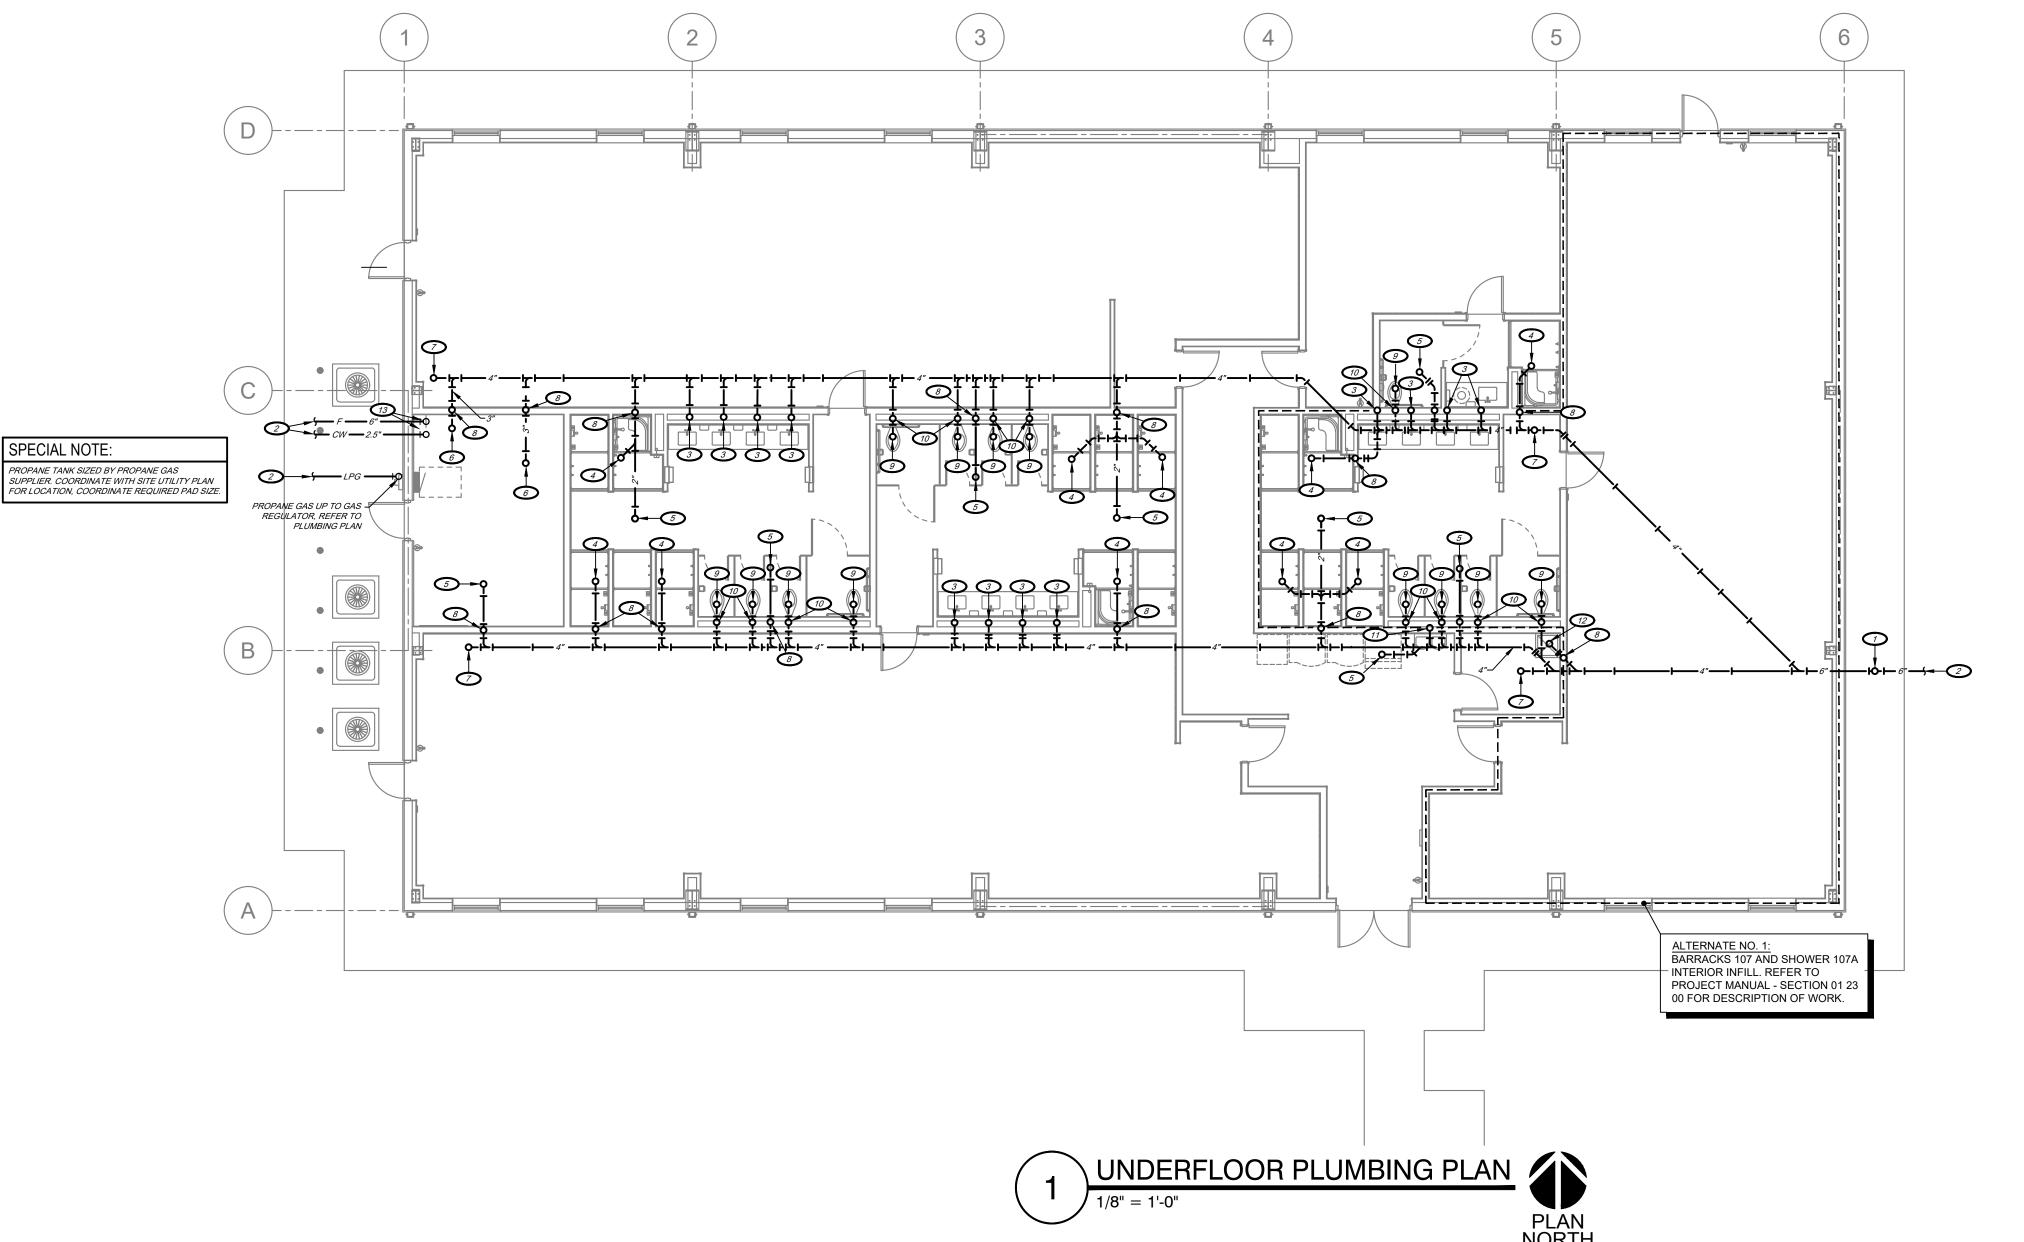
SE-101

28 OF 36 SHEET 07/29/2022





2 LIGHT POLE CONCRETE BASE

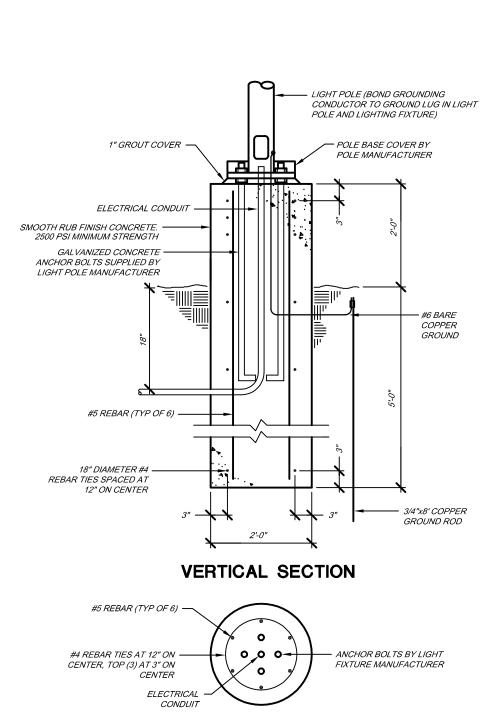

4" WASTE UP TO FINISH GRADE CLEANOUT.

SERVICES SHALL BE INSTALLED 5'-0" OUTSIDE BUILDING, REFER TO CIVIL DRAWINGS FOR CONTINUATION.

3 2" WASTE UP TO LAVATORY. 2" TRAPPED WASTE UP TO SHOWER DRAIN.

5 2" TRAPPED WASTE UP TO FLOOR DRAIN.

6 3" TRAPPED WASTE UP TO FLOOR DRAIN. 4" WASTE UP TO FINISHED FLOOR CLEANOUT.

8 1.5" VENT UP.

4" WASTE UP TO WATER CLOSET.

10 2" VENT UP. 11) 2" WASTE UP TO DRINKING FOUNTAIN.

12) 3" TRAPPED WASTE UP TO MOP SINK. 6" FIRE SERVICE AND 2.5" DOMESTIC WATER SERVICE PIPING UP.

STATE OF MISSOURI MICHAEL L. PARSON, **GOVERNOR**



RYAN S. JONES - ENGINEER PE-2004017193 PROFESSIONAL SEAL

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PLUMBING GENERAL NOTES:

- REFER TO SPECIFICATIONS FOR ADDITIONAL REQUIREMENTS.
- PLANS ARE DIAGRAMMATIC AND SHALL NOT BE SCALED. REFER TO ARCHITECTURAL DRAWINGS
- FOR DIMENSIONS. PIPING LAYOUTS ARE DIAGRAMMATIC. FIELD COORDINATE EXACT LOCATIONS AND ROUTINGS WITH STRUCTURE, DUCTWORK, LIGHT FIXTURES, CONDUITS, ETC.
- COOPERATE CLOSELY WITH ALL OTHER TRADES TO EXPEDITE CONSTRUCTION AND AVOID INTERFERENCES AND CONFLICTS. BEFORE ANY PIPING, DUCTWORK, CONDUIT, ETC. IS INSTALLED,
- COORDINATE WITH ALL CONTRACTORS TO MAINTAIN ALL CLEARANCES REQUIRED FOR EQUIPMENT. DO NOT ROUTE PIPING, DUCTWORK, ETC. ABOVE ELECTRICAL PANELS.
- CONTRACTOR SHALL MAKE ALL FINAL CONNECTIONS TO EQUIPMENT. PROVIDE ADAPTER AND FITTINGS FOR ALL EQUIPMENT AS REQUIRED. COORDINATE SPECIFIC REQUIREMENTS WITH
- ALL MATERIALS IN PLENUMS SHALL BE NON COMBUSTIBLE PLENUM RATED.
- ROOF CONTRACTOR SHALL BE RESPONSIBLE FOR ALL ROOF PENETRATIONS AND FLASHING REQUIREMENTS TO MAINTAIN ROOF WARRANTY. COORDINATE CLOSELY WITH ROOF CONTRACTOR ALL ROOF REQUIREMENTS.
- DRAWINGS ARE NOT SET UP SPECIFICALLY ACCORDING TO TRADE AND EACH CONTRACTOR AND SUB-CONTRACTOR OR TRADE IS REQUIRED TO REVIEW THE CONSTRUCTION DOCUMENTS AS A WHOLE AND PROVIDE ANY MISC. ITEMS, MATERIALS, WORK, ETC. REQUIRED TO COMPLETE THE WORK AS SHOWN ON ALL DOCUMENTS. THIS REQUIREMENT APPLIES TO ALL TRADES. STRUCTURAL, MECHANICAL, ELECTRICAL, AND PLUMBING REQUIREMENTS AND RELATED WORK ARE INDICATED THROUGHOUT THE DOCUMENTS AND SHOULD BE REVIEWED WITH THE SPECIFIC
- SEAL AROUND ALL FIRE RATED WALLS WITH FIRE STOPPING/CAULKING TO MAINTAIN FIRE RATING. REFER TO ARCHITECTURAL DRAWINGS FOR FIRE RATINGS.
- PROVIDE UNISTRUTS AND ACCESSORIES AS REQUIRED FOR SUPPORT OF PIPING, EQUIPMENT,
- ALL EXPOSED PIPING, SUPPORTS, ETC. SHALL BE PRIMED AND PAINTED PER THE SPECIFICATIONS.

MEP AND STRUCTURAL DRAWINGS FOR OVERALL SCOPE OF WORK.

PLUMBING SYMBOLS:

SANITARY WASTE PIPING BELOW SLAB SANITARY WASTE PIPING ABOVE SLAB ---- SANITARY COMBINATION WASTE AND VENT PIPING PRIMARY ROOF DRAIN PIPING BELOW SLAB PRIMARY ROOF DRAIN PIPING ABOVE SLAB SECONDARY ROOF DRAIN PIPING ABOVE SLAB DOMESTIC COLD WATER PIPING DOMESTIC HOT WATER PIPING DOMESTIC HOT WATER RETURN PIPING FIRE SPRINKLER PIPING —————— PLUMBING VENT PIPING CONDENSATE DRAIN PIPING PRESSURE GAUGE TEE / ELBOW DOWN WITH VALVE IN VERTICAL PIPE FPWH HB1 FREEZEPROOF WALL HYDRANT / HOSE BIBB BFP BACKFLOW PREVENTER

PRESSURE REGULATOR

FINISH GRADE CLEANOUT FINISH FLOOR CLEANOUT

FINISH WALL CLEANOUT

• FGCO

FWCO

OFFICE OF ADMINISTRATION DIVISION OF FACILITIES MANAGEMENT,

DESIGN AND CONSTRUCTION

DEPARTMENT OF PUBLIC SAFETY MISSOURI ARMY NATIONAL GUARD

CONSTRUCT NEW 60 SOLDIER BARRACKS

WAPPAPELLO TRAINING SITE 461 COUNTY ROAD 517 WAPPAPELLO, MISSOURI

PROJECT # T2124-01

6325

8136325016 ASSET# BUILDING #3

REVISION: DATE: **REVISION: REVISION:** DATE:

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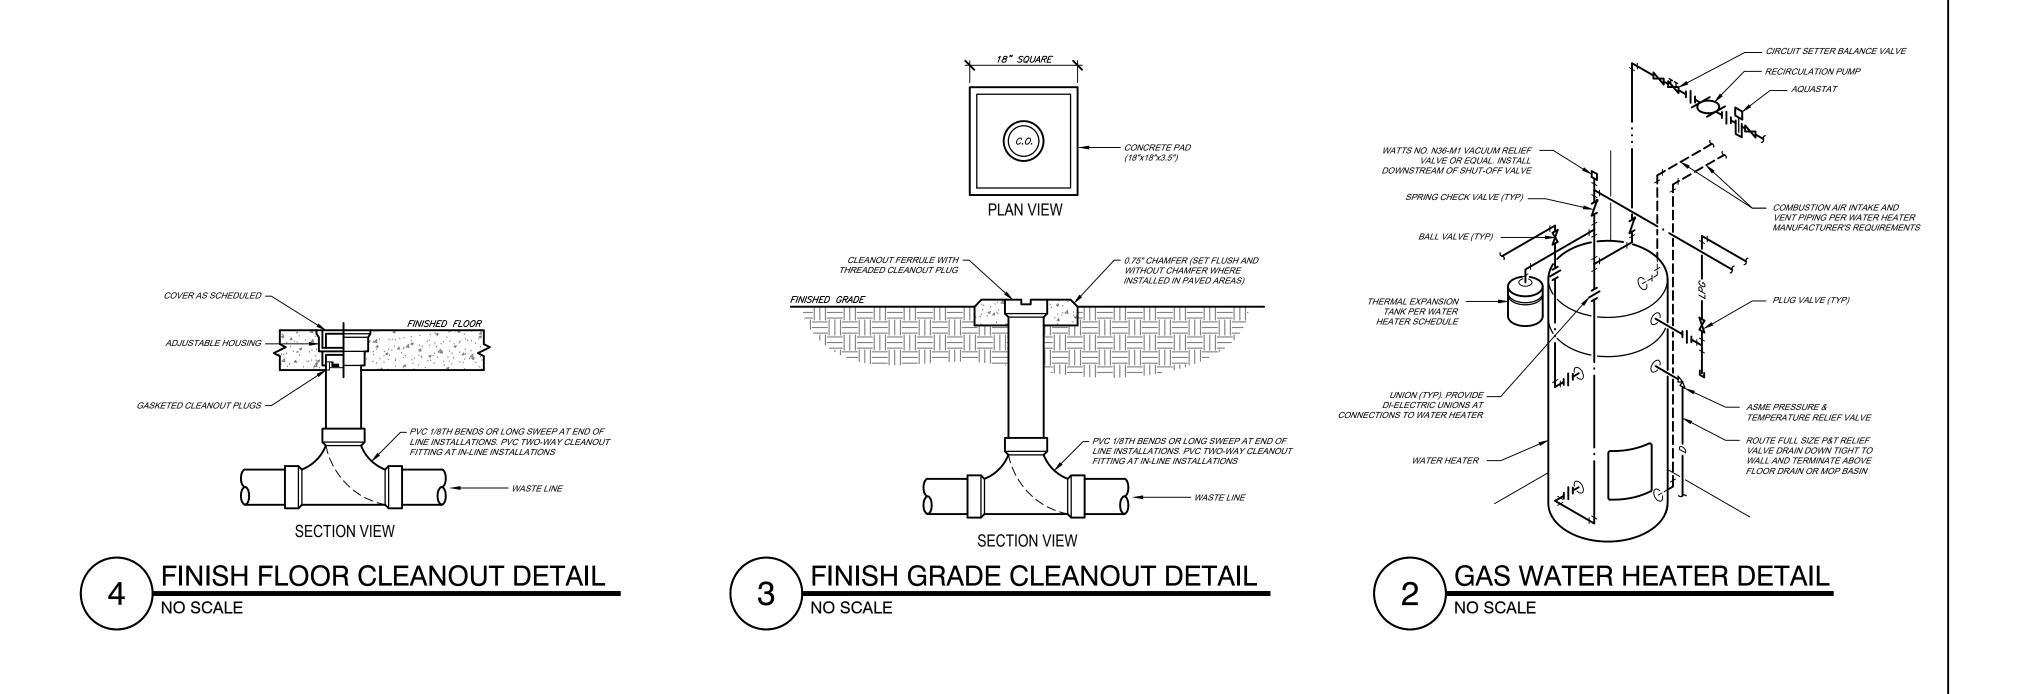
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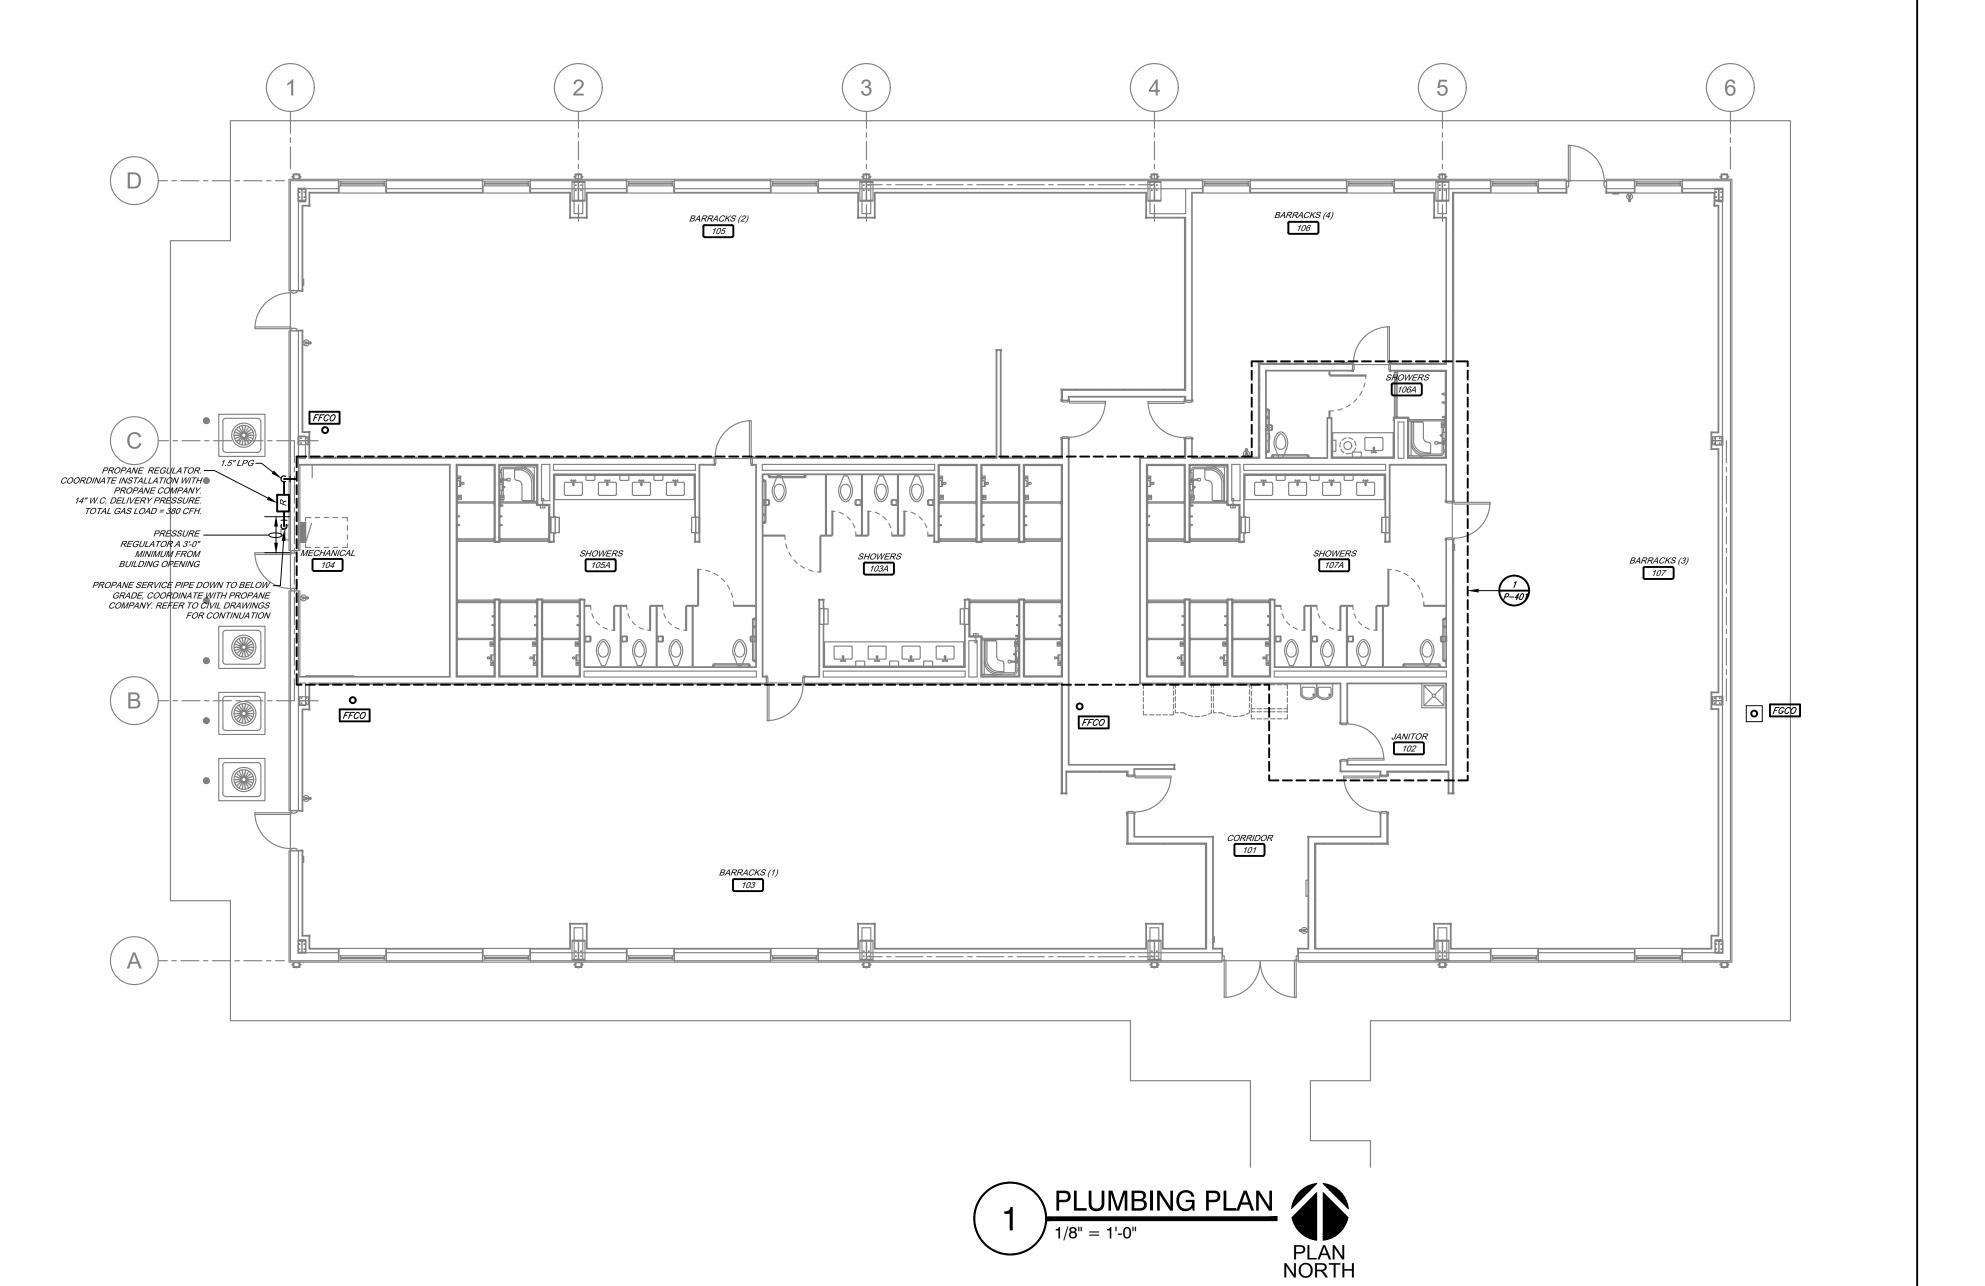
DRAWN BY: CHECKED BY: RS DESIGNED BY: TKB

SHEET TITLE:

UNDERFLOOR PLUMBING PLAN (ALTERNATE NO.1)

SHEET NUMBER:





STATE OF MISSOURI MICHAEL L. PARSON, GOVERNOR



RYAN S. JONES – ENGINEER PE-2004017193 PROFESSIONAL SEAL

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OFFICE OF ADMINISTRATION DIVISION OF FACILITIES MANAGEMENT, DESIGN AND CONSTRUCTION

DEPARTMENT OF PUBLIC SAFETY MISSOURI ARMY NATIONAL GUARD

CONSTRUCT NEW 60 SOLDIER BARRACKS

WAPPAPELLO TRAINING SITE 461 COUNTY ROAD 517 WAPPAPELLO, MISSOURI

PROJECT # T2124-01 SITE # 6325 ASSET # 8136325016 BUILDING #3

REVISION:

DATE:

REVISION:

DATE:

REVISION:

DATE: ISSUE DATE: 07/29/2022

CAD DWG FILE: T2124-01-6325-8136325016-P-102
DRAWN BY: TKB
CHECKED BY: RSJ
DESIGNED BY: TKB

SHEET TITLE:

PLUMBING PLAN

SHEET NUMBER:

P-10

		PIPI	NG MA	TER	IAL SC	HEDL	JLE						
			PIPINO	3			FITTII	NGS	MAXIMUM	WORKING	FIELD	TEST	
SYSTEM	SIZE	TYPE	SCHEDULE	GRADE	ASTM	MATERIAL	MATERIAL	TYPE	PRESSURE (PSI)	TEMP (DEG	PRESSURE (PSI)	TIME (HOURS)	NOTES
CONDENSATE DRAIN ABOVE GRADE	ALL	М	-	-	B88	COPPER	COPPER	DR\SJ	10 FT	40-70	10 FT	1	-
DOMESTIC WATER ABOVE GRADE	0.5"-3"	L	-	-	B88	COPPER	COPPER	SJ	120	40-180	150	1	7
DOMESTIC WATER BELOW GRADE	ALL	К	-	-	B88	COPPER	COPPER	SJ	120	40-180	150	1	-
DOMESTIC WATER SERVICE BELOW GRADE	ALL	PVC	-	-	AWWA C900	PVC	DI	MJ	200	50-90	200	2	6
FIRE PROTECTION	ALL		PER NFPA 13 AND FIRE SPRINKLER DRAWINGS 200 2 2							2			
FIRE SPRINKLER SERVICE BELOW GRADE	ALL			PER	NFPA 13 AND	FIRE SPRINK	LER DRAWING	s			200	2	-
PROPANE GAS ABOVE GRADE	0.5" - 2.5"	CW	40	Α	A53	CS/BLK	MI	THRD	5		150	2	-
REFRIGERANT PIPING	ALL	ACR			B280	CP	CP	SJ	150	40-180	200	4	-
SANITARY WASTE BELOW GRADE	ALL	DWV	40	-	2665	PVC	PVC	DR\SW	10 FT	50-180	10 FT	1	1
SANITARY WASTE AND VENT - RETURN AIR PLENUMS	ALL	NH	SS	-	A74	CI	CI	DR \ NH	10 FT	50-180	10 FT	1	3
SANITARY WASTE AND VENT ABOVE GRADE	ALL	DWV	40	-	2665	PVC	PVC	DR\SW	10 FT	50-180	10 FT	1	1,3
TEMPERATURE & PRESSURE RELIEF DRAIN	ALL	М	-	-	B88	COPPER	COPPER	DR \ SJ	10 FT	40-70	10 FT	1	-

THE USE OF CELLULAR CORE PVC WASTE AND VENT PIPING IS STRICTLY PROHIBITED.

THE USE OF CPVC AND POLYBUTYLENE PIPING IS STRICTLY PROHIBITED.

SANITARY WASTE/VENT AND ROOF DRAIN PIPING LOCATED WITHIN RETURN AIR PLENUMS SHALL BE CAST IRON OR SHALL BE ENCLOSED IN A GYPSUM BOARD SOFFIT. . NATURAL GAS PIPING INSTALLED IN RETURN AIR PLENUMS AND CONCEALED SPACES SHALL HAVE APPROVED FITTINGS ONLY. VALVES, UNIONS, THREADED FITTINGS, ETC. ARE NOT PERMITTED.

. NATURAL GAS INSTALLED OUTSIDE SHALL BE PAINTED WITH TWO COATS OF UV RESISTANT ENAMEL PAINT. COLOR TO MATCH WALL COLOR ON EXTERIOR WALL AND YELLOW ON THE ROOF.

VERIFY PAINT COLOR WITH ARCHITECT BEFORE INSTALLATION. :. PROVIDE PIPING MATERIAL PER LOCAL WATER COMPANY REQUIREMENTS IF DIFFERENT THAN SCHEDULED.

AT CONTRACTORS OPTION, PEX CROSSLINKED POLYEHTYLENE TUBING MAY BE USED FOR DOMESTIC WATER ABOVE GROUND PIPING. REFER TO SPECIFICATIONS.

APPROVED PIPE & FITTING MANUFACTURERS: CAST IRON - CHARLOTTE, TYLER, CENTRAL FOUNDRY OR PRE-BID APPROVED EQUAL.

COPPER - CERRO, CHASE, MUELLER, REVERE COPPER OR PRE-BID APPROVED FOUAL

PEX-B - WATTS, VIEGA, OR PRE-BID APPROVED EQUAL.

PVC (SOLID) - CHARLOTTE, TYLER, CHEMTROL OR PRE-BID APPROVED EQUAL. ARBON STEEL - ARMCO, YOUNGSTOWN, UNITED STATES STEEL OR PRE-BID APPROVED EQUAL. GROOVED FITTINGS - VICTAULIC, GRUVLOK OR PRE-BID APPROVED EQUAL.

ABBREVIATIONS: BS - BELL AND SPIGOT

CI - CAST IRON CS - CARBON STEEL CW - CONTINUOUS WELD

DI - DUCTILE IRON

FRP - FIBERGLASS REINFORCED

DR - DRAINAGE FITTING

HDPE - HIGH DENSITY POLYETHYLENE - MECHANICAL JOINT - NEOPRENE GASKET PI-FRP - PRE-INSULATED FIBERGLASS REINFORCED PLASTIC RPF-HDPE - RIGID POLYURETHANE INSULATION WITH HDPE JACKET

- DRAINAGE WASTE AND VENT

- 95-5 TIN-ANTIMONY SOLDER JOINT - STANDARD STRENGTH / SERVICE WEIGHT - SOLVENT WELD TEAH - THERMOSETING EPOXY ADHESIVE WITH HEAT

- NO-HUB

- PEX CROSSLINKED POLYETHYLENE TUBING

)	HEDU	LE						
	WORKING CLASS	H.P. (W)	RPM	VOLTAGE/ PHASE	CONST.	FLUID TYPE	FLUID TEMP.	NOTES/ ACCESSORIES
	150	921//	2940	120/1	AR	W/ATER	100-140	12

<u>GENERAL NOTES:</u> 1. PROVIDE TIME CLOCK AND AQUASTAT KIT. INSTALL REMOTE TEMPERATURE SENSOR WHERE HOT WATER RETURN PIPING CONNECTS TO HOT WATER PIPNG. PROVIDE BALANCE, CHECK AND SERVICE VALVES AT ALL BRANCH PIPING FROM MAIN HOT WATER RECIRCULATION PIPE.

BBREVIATIONS:

- NET POSITIVE SUCTION HEAD - DOMESTIC HOT WATER

BASIS OF DESIGN

MANUFACTURER

BASIS OF DESIGN

MANUFACTURER

CULLIGAN

MODEL NO.

CTM-300-DF

AB - ALL BF AI - ALL IF

PLUMBING PUMP SC

BRONZE	AS	- AQUASTAT KIT
RON	IL	- IN-LINE

V	VATER S	OFTEN	NER S	CHEDUL	E			
NORMAL FLOW RATE (GPM) @ 15PSI LOSS	MAX. FLOW RATE (GPM) @ 25 PSI LOSS	BACKWASH FLOW RATE (GPM)	RESIN VOLUME (CU. FT.)	BACKWASH VOLUME (NOM. GALLONS)	DAILY WATER USAGE (GALLONS)	BRINE TANK SALT CAPACITY (LBS.)	VOLTAGE/ PHASE	ACCES
70	95	15	10	541	2,500	1,800	120/1	1,

BASIS OF DESIGN CULLIGAN CONTACT INFORMATION: MARCUS MONTEZ (417) 434-4091 mmontez@hallswater.com 2. INCLUDE PROGRAMMABLE SYSTEM CONTROLLER WITH DIGITAL KEYPAD WITH BATTERY BACKUP.

EQUIVALENT MANUFACTURER'S 1. EASY WATER 2. FLECK

3. ROBERT B HILL

EQUIVALENT MANUFACTURER'S

1. GRUNDFOSS 2. TACO

3. WATTS

ACCESSORIES:

3. ASME PRESSURE & TEMPERATURE RELIEF VALVE 4. INCLUDE CONDENSATE NEUTRALIZATION KIT. 5. INCLUDE CONCENTRIC VENT TERMINATION KIT.

BASIS OF DESIGN

MANUFACTURER

ZURN

ZURN

ZURN

ZURN

ZURN

GUY GRAY

ZURN

ZURN

ZURN

SYMMONS

SYMMONS

ACCESSORIES SHALL BE SAME MANUFACTURER AS FIXTURE / EQUIPMENT UNLESS NOTED OTHERWISE.

PROVIDE RECTANGULAR STEEL TUBE CARRIER AT FRAMED WALLS, WALL HANGER AT CMU WALLS.

INSTALL ACCESSORIES AS RECOMMENDED BY MANUFACTURER FOR ADA COMPLIANCE.

MODEL NUMBER

EMABFTL8WSSK

FD2210

ZN1400

ZN1400-HD

Z1446

Z1320

Z1341XL-PC

MIB1HAAB

MSB-2424

Z1700

S-9601-P

9605-PLR

Z5655-BWL

Z5665-BWL1

ARCHITECTURAL PLANS. REFER TO UNDERFLOOR PLUMBING PLAN FOR APPROXIMATE LOCATIONS OF DRAIN OUTLET IN FRAME.

DESCRIPTION

BACKFLOW PREVENTER

BI-LEVEL ELECTRIC WATER

OOLER WITH BOTTLE FILLE

FINISH FLOOR CLEANOUT

FINISH GRADE CLEANOUT

FINISH WALL CLEANOUT

HOSE BIBB

ICE MAKER BOX

LAVATORY, INTERGRAL BOWL

MOP BASIN

SHOCK ABSORBER

SHOWER DRAIN

SHOWER DRAIN

SHOWER DRAIN

SHOWER VALVE

ADA SHOWER VALVE

FLOOR MOUNT FLUSH VALVE

WATER CLOSET

ADA FLOOR MOUNT FLUSH

VALVE WATER CLOSET

REFER TO ARCHITECTURAL DRAWINGS FOR MOUNTING HEIGHT.

TRUEBRO ADA LAV SHIELD ON SUPPLIES, WASTE, AND MIXING VALVES.

ALL COLORS AND FINISHES SELECTED BY ARCHITECT.

REFER TO ARCHITECTURAL

VH FREEZEPROOF WALL HYDRAI

FD1 LIGHT DUTY FLOOR DRAIN

3. STATE

PLUMBING FIXTURE & EQUIPMENT SCHEDULE

ACCESSORIES

TAINLESS STEEL HOUSING, TWO IN LINE INDEPENDENT CHECK VALVES, EPLACEABLE CHECK SEATS WITH AN INTERMEDIATE RELIEF VALVE. AN

BALL VALVE TEST COCKS, NON-RISING RESILIENT SEATED GATE VALVES, AIR GAP DRAIN FITTING

ZURN Z1225-BL CARRIER, 1.25" TRAP, SUPPLY AND STOP VALVE,

MATCHING ACCESSORY CANE APRON FOR ADA PROTECTION.

NICKEL BRONZE GRATE, PROSET TRAPGUARD

NICKEL BRONZE TOP

HEAVY DUTY TOP

STAINLESS STEEL COVER

1/4 TURN, NON-FREEZE WALL HYDRANT W/INTEGRAL VACUUM BREAKEI

PLOISHED CHROME WALL HOSE BIBB W/VACUUM BREAKER

QUARTER TURN VALVE, WATTS 7C DUAL CHECK BACKFLOW PREVENTE

HAMMER ARRESTER, FLEXIBLE SUPPLY

AMERICAN STANDARD #7385.004 SINGLE CONTROL FAUCET WITH 0.5 GPM

VADAL-RESISTANT AERATOR, WATTS USG-B MIXING VALVE (SET AT 120F),

830-AA FAUCET WITH INTEGRAL MIXER, WATTS USG-B MIXING VALVE (SET

AT 120F), 838-AA HOSE AND BRACKET, 889-CC MOP HANGER, MSG2424

36" LONG FRAME WITH #WG WAVE GRATE, 2" NO-HUB BOTTOM OUTLET

90" LONG FRAME WITH (1)-36" L. #WG WAVE GRATE AND (1)-48" L. #WG

120" LONG FRAME WITH (2)-36" L. #WG WAVE GRATES. (2)-2" NO-HUB

SHOWER TRIM WITH TEMPTROL PRESSURE BALANCE SHOWER VALVE

ADA SHOWER TRIM WITH TEMPTROL PRESSURE BALANCE SHOWER

955SS-EL ELONGATED, STANDARD WHITE OPEN FRONT SEAT, SUPPL

955SS-EL ELONGATED, STANDARD WHITE OPEN FRONT SEAT, SUPPLY

& STOP VALVE, ZURN ZER6000-HET AQUA VANTAGE FLUSH VALVE

& STOP VALVE, ZURN ZER6000-HET AQUA VANTAGE FLUSH VALVE

VALVE WITH ADA 36" GRAB BAR AND HAND SHOWER. DIVERTOR VALVE

WAVE GRATE. (1)-2" NO-HUB BOTTOM OUTLETS.

GRID STRAINER, 1.25" TAILPIECE AND TRAP, SUPPLIES AND STOP VALVE

PIPING CONNECTION SIZES

VASTE

SEE PLAN SEE PLAN

1.5"


1.5"

SEE PLAN

SEE PLAN


SEE PLAN

SEE PLAN | SEE PLAN

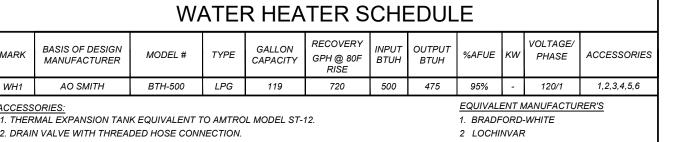

PROVIDE SHOCK ABSORBER FOR ALL INDIVIDUAL FIXTURES OR BATTERIES. SIZE UNITS SERVING FIXTURE BATTERIES PER MANUFACTURERS RECOMMENDATIONS.

FRAME TO EXTEND CONTINUOUS UNDER SHOWER SEPARATING WALLS WITH GRATES SEPARATED BETWEEN SHOWER WALLS. REFER TO PLUMBING PLAN. COORDINATE EXACT DIMENSIONS WITH

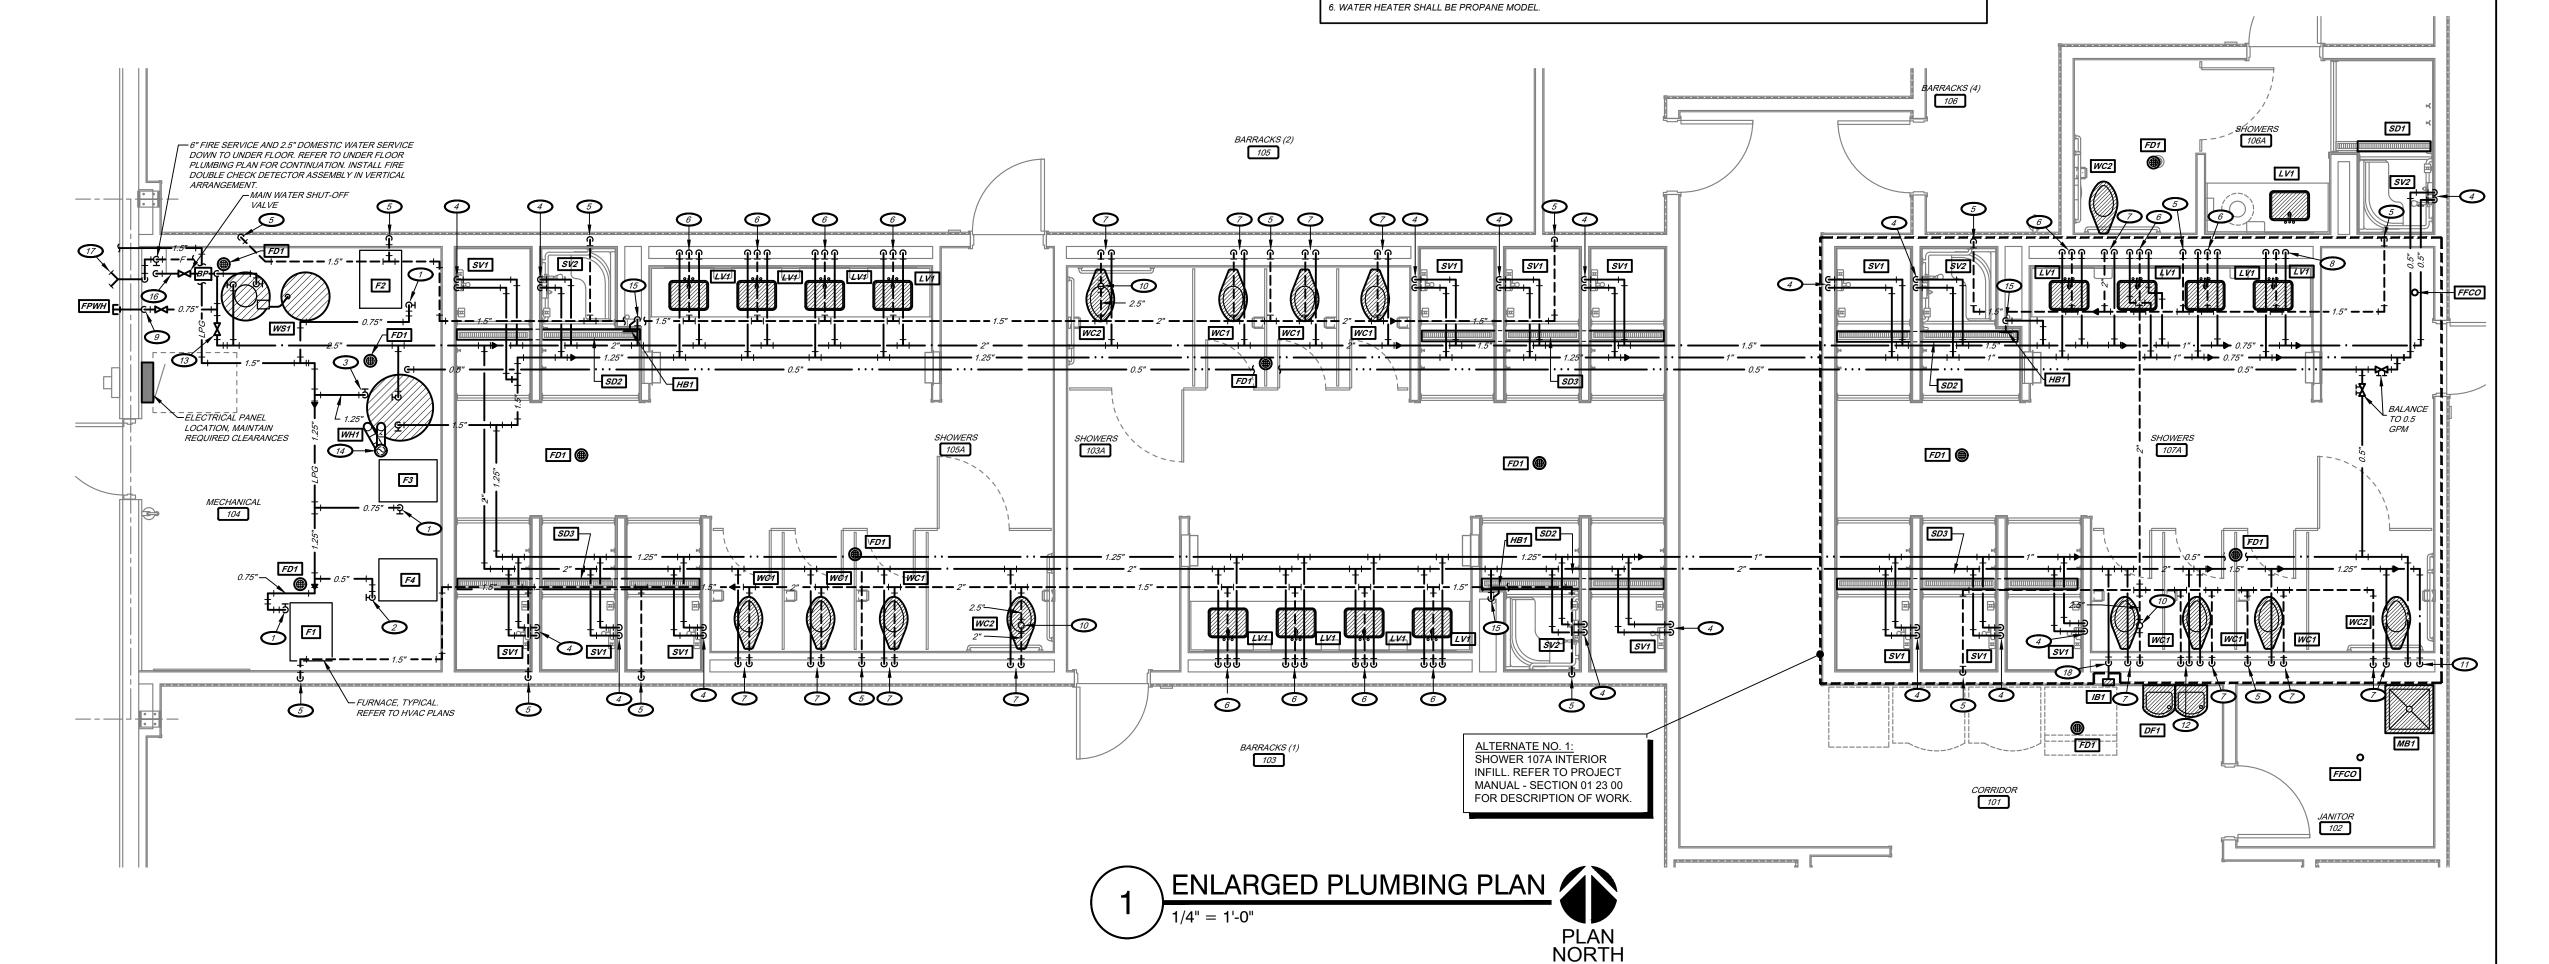

KEYNOTES:

EQUIVALENT

MANUFACTURERS

FEBCO, ZURN

HAWS, OASIS

IOSAM, SIOUX CHIEF, SMIT

IOSAM, SIOUX CHIEF, SMI

IOSAM, SIOUX CHIEF, SMIT

WATTS

SMITH. WATTS, WOODFOR

WATTS, WOODFORD, PRIER

LSP, OATEY

ZURN, DELTA

STERN WILLIAMS, ZURN

SIOUX CHIEF, SMITH, WATT

PROFLO

INFINITY, LUXE

INFINITY, LUXE

INFINITY, LUXE

MERICAN STANDARD, DELT

MERICAN STANDARD, DELT.

TOTO, AMERICAN STANDAR

TOTO, AMERICAN STANDARD

1,2,3,4,7

1,2,3,4,5

3,6

- 0.75" PROPANE DOWN TO FURNACE, PROVIDE SHUTOFF VALVE, DIRT LEG AND UNION.
- 2 0.5" PROPANE DOWN TO FURNACE, PROVIDE SHUTOFF VALVE, DIRT LEG AND UNION.
- 3 1.25" PROPANE DOWN TO WATER HEATER, PROVIDE SHUTOFF VALVE, DIRT LEG AND UNION. 0.5" COLD AND HOT WATER DOWN IN SHOWER VALVE ENCLOSURE TO MIXING VALVE.
- 5 1.5" VENT DOWN TO UNDER FLOOR.
- 6 1.5" VENT, 0.5" COLD AND HOT WATER DOWN TO LAVATORY. 2" WASTE DOWN TO UNDER FLOOR, COORDINATE ROUTING OF WASTE PIPE THROUGH THICKENED SLAB UNDER WALL
- 7 2" VENT AND 1.25" COLD WATER DOWN TO WATER CLOSET.
- 8 1.5" VENT, 0.75" COLD AND HOT WATER DOWN IN WALL. 2" WASTE DOWN TO UNDER FLOOR. PROVIDE TEE IN WALL ON WATER PIPING WITH 0.5" COLD AND HOT WATER TO BACK TO BACK

LAVATORIES. PROVIDE DOUBLE WYE FITTING IN WASTE PIPING FOR BACK TO BACK

- 9 0.75" COLD WATER DOWN SECURED TO WALL, AT APPROXIMATELY 18" ABOVE FLOOR ROUTE THRU EXTERIOR WALL TO WALL HYDRANT.
- 10 2.5" VENT UP, 3" VENT THRU ROOF.
- 11 0.5" COLD AND HOT WATER DOWN TO MOP BASIN.
- 12 1.5" VENT AND 0.5" COLD WATER DOWN TO DRINKING FOUNTAIN.
- 13 2.5" NORMALLY CLOSED BALL VALVE FOR WATER SOFTENER BYPASS. 4" PVC VENT AND 4" COMBUSTION AIR VENT FROM WATER HEATER, ROUTE UP TO 6"
- CONCENTRIC VENT TERMINATION KIT. REFER TO WATER HEATER MANUFACTURER'S INSTALLATION INSTRUCTIONS. 15 0.75" COLD WATER DOWN AND HORIZONTALLY THRU WALL TO HOSE BIBB. LOCATE HOSE BIBB
- AT APPROXIMATELY 18" ABOVE FINISHED FLOOR 16 CONFIGURE WATER SERVICE PIPING TO MAINTAIN SPACE FOR INSTALLATION OF A POSSIBLE
- FUTURE WATER METER.
- 17 PROPOSED LOCATION FOR FIRE DEPARTMENT CONNECTION, VERIFY LOCATION WITH LOCAL FIRE DEPARTMENT AUTHORITIES. COORDINATE ROUTING OF PIPING WITH ALL OTHER TRADES. 18 0.5" COLD WATER DOWN IN WALL TO ICE MAKER SUPPLY BOX.


FIRE SPRINKLER GENERAL NOTES:

CONTRACTOR/ENGINEER. ANY PIPING SHOWN AT BUILDINGS OR ON SITE IS FOR REFERENCE

- REFER TO SPECIFICATIONS DIVISION 21 FOR ADDITIONAL REQUIREMENTS. PROVIDE DESIGN, MATERIALS, EQUIPMENT, FABRICATION, INSTALLATION, ETC. FOR A WET PIPE FIRE SPRINKLER SYSTEM THROUGHOUT THE ENTIRE BUILDING, ALL PORTIONS OF THE FIRE SPRINKLER SYSTEM SHALL BE THE RESPONSIBILITY OF THE FIRE SPRINKLER
- THE FIRE SPRINKLER SYSTEM DESIGN AND INSTALLATION SHALL COMPLY WITH THE LATEST EDITION OF NFPA 13, STATE AND LOCAL CODES AS ADOPTED BY THE COUNTY OF NEWTON, MISSOURI, ALL FIRE SPRINKLER SYSTEM MATERIALS SHALL BE U.L. LISTED, FIRE SPRINKLER SYSTEM CONTRACTOR SHALL ENGINEER AND INSTALL THE FIRE SPRINKLER SYSTEM AS REQUIRED TO PROVIDE PROPER COVERAGE FOR THE AREA OF WORK.
- SECURE ALL FEES, PERMITS, ETC. NECESSARY IN CONJUNCTION WITH THIS WORK. CONTRACTOR SHALL PAY ALL TAP AND EQUIPMENT FEES.
- THE FIRE SPRINKLER CONTRACTOR SHALL BE RESPONSIBLE FOR OBTAINING HIS OWN FLOW READINGS FOR PURPOSES OF DESIGN. SPRINKI FR HFADS LOCATED IN GYPSLIM AND LAY-IN CEILING AREAS SHALL BE CONCEALED.
- RECESSED HEADS WITH COVERPLATES IN COLOR AS SELECTED BY ARCHITECT. HEADS IN AREAS WITH EXPOSED STRUCTURE SHALL BE BRASS, UPRIGHT HEADS. CONTRACTOR SHALL SUBMIT AN ELECTRONIC SET OF SCALED LAYOUT DRAWINGS. CALCULATIONS, AND CUT SHEETS TO ARCHITECT/ENGINEER FOR COORDINATION AND
- APPROVAL. LAYOUT DRAWINGS SHALL INCLUDE SPRINKLER HEAD AND PIPING LOCATIONS. SERVICE DETAILS, ETC. SUBMIT REQUIRED MATERIALS TO AGENCY HAVING JURISDICTION FIRE SPRINKLER WORK SHALL BE PERFORMED BY A QUALIFIED CONTRACTOR WITH AT LEAST 3 YEARS OF INSTALLATION EXPERIENCE ON PROJECTS WITH FIRE PROTECTION WORK SIMILAR TO THAT REQUIRED FOR THE PROJECT. THE FIRE SPRINKLER SYSTEM SHALL BE
- MISSOURI, AND THE DESIGN DRAWINGS AND CALCULATIONS SHALL BEAR HIS/HER MISSOURI SEAL AND SIGNATURE. PROVIDE FIRE DEPARTMENT CONNECTIONS IN ACCORDANCE WITH LOCAL FIRE DEPARTMENT
- CENTER SPRINKLER HEADS IN CEILING TILES AND BETWEEN LIGHTING FIXTURES AS APPLICABLE. HEAD PLACEMENT SHALL BE SUBJECT TO ARCHITECTURAL APPROVAL BASED

ENGINEERED BY A REGISTERED PROFESSIONAL ENGINEER LICENSED IN THE STATE OF

STATE OF MISSOURI MICHAEL L. PARSON, **GOVERNOR**

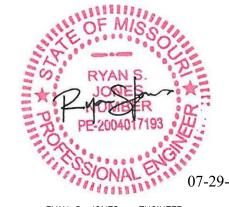

RYAN S. JONES - ENGINEER PE-2004017193 PROFESSIONAL SEAL

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CONSTRUCT NEW 60 SOLDIER BARRACKS

WAPPAPELLO TRAINING SITE 461 COUNTY ROAD 517 WAPPAPELLO, MISSOURI

PROJECT # T2124-01 6325 8136325016 ASSET#

REVISION: DATE **REVISION: REVISION:** DATE:

ISSUE DATE: 07/29/2022

BUILDING #3

CAD DWG FILE:T2124-01-6325-8136325016-P-401 DRAWN BY:


SHEET TITLE:

CHECKED BY: \overline{R}

DESIGNED BY: TKB

ENLARGED PLUMBING PLAN AND SCHEDULES (ATERNATE NO.1)

SHEET NUMBER:

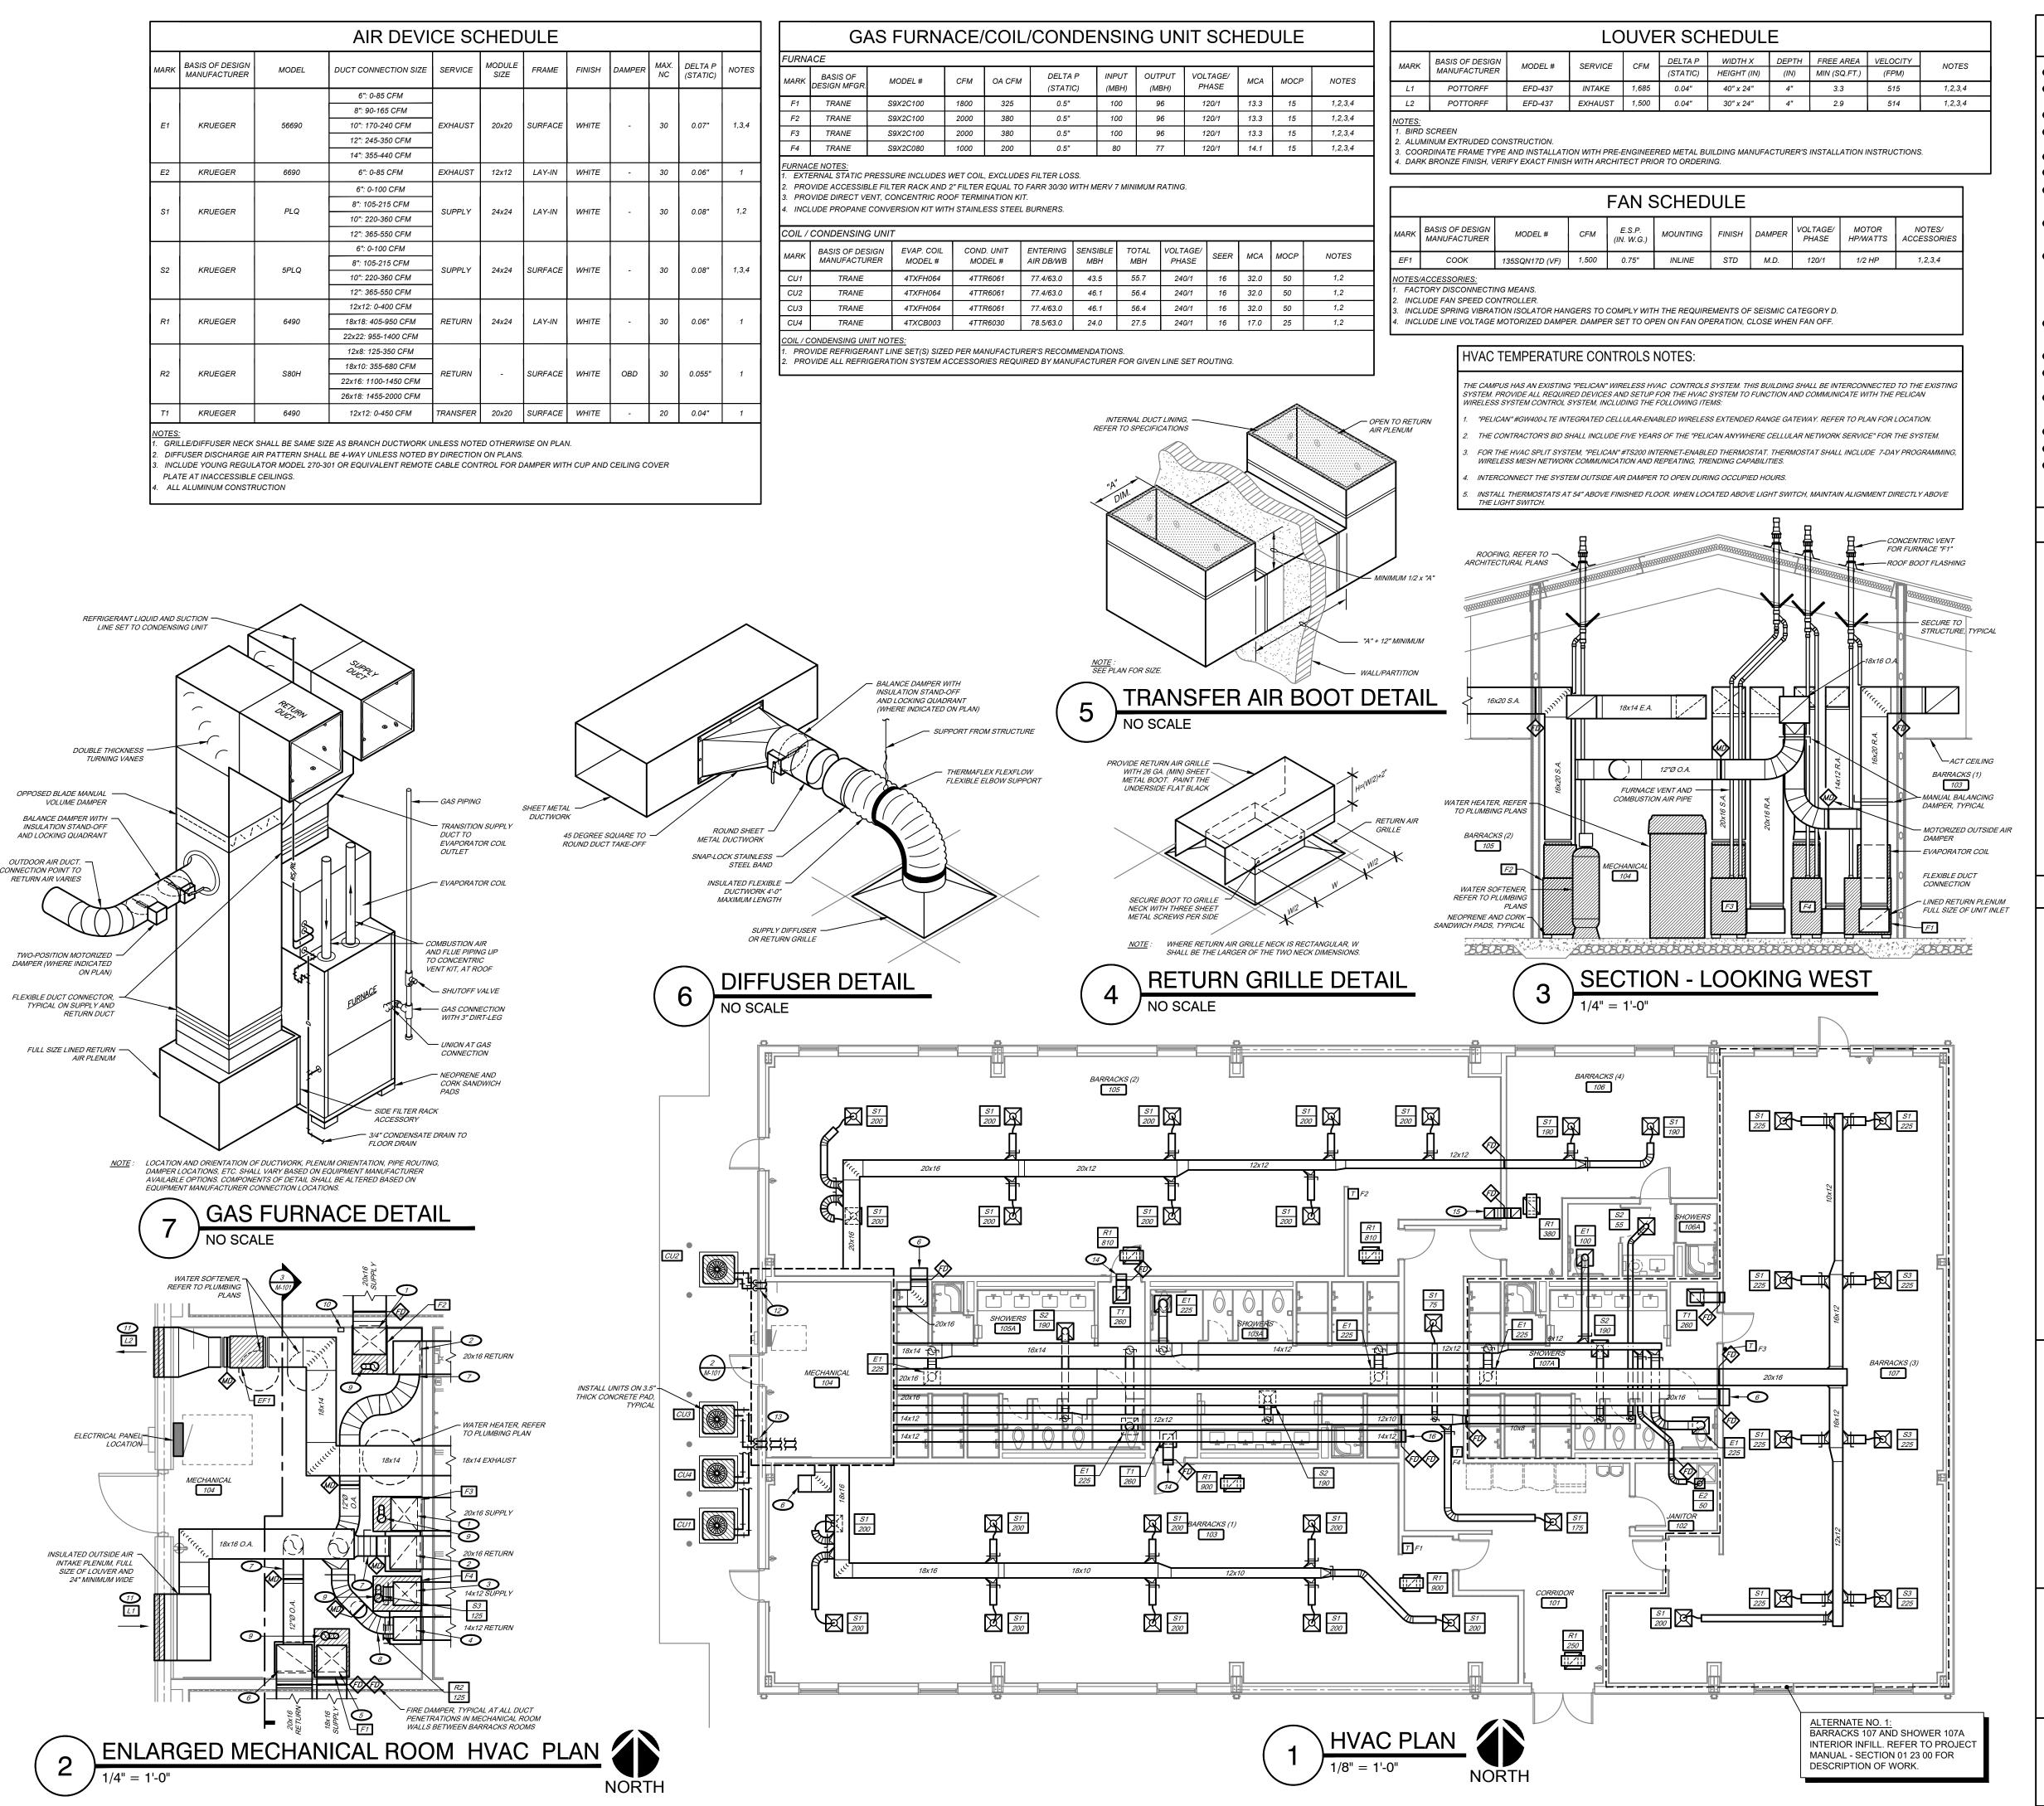

NOTED IN FURNACE SCHEDULE

20x16 SUPPLY DUCT DOWN AND TRANSITION TO FURNACE SUPPLY AIR CONNECTION. 20x16 RETURN DUCT DOWN TO RETURN PLENUM OF FURNACE, REFER TO GAS FURNACE

3 12x12 SUPPLY DUCT DOWN AND FURNACE SUPPLY AIR CONNECTION.

12x12 RETURN DUCT DOWN TO RETURN PLENUM OF FURNACE, REFER TO GAS FURNACE

5 16x16 SUPPLY DUCT DOWN AND FURNACE SUPPLY AIR CONNECTION.

6 20x16 RETURN DUCT OPEN ENDED TO CEILING SPACE. 7 12"Ø OUTSIDE AIR DUCT WITH 2-POSITION MOTORIZED DAMPER AND MANUAL BALANCING

DAMPER, ROUTE TO RETURN DUCT ON FURNACE. BALANCE TO OUTSIDE AIR CFM AS NOTED IN FURNACE SCHEDULE. 8 10"Ø OUTSIDE AIR DUCT WITH 2-POSITION MOTORIZED DAMPER AND MANUAL BALANCING DAMPER, ROUTE TO RETURN DUCT ON FURNACE. BALANCE TO OUTSIDE AIR CFM AS

9 2" PVC COMBUSTION AIR AND VENT FROM FURNACE, ROUTE UP TO CONCENTRIC VENT THRU ROOF. AT ROOF PENETRATION PROVIDE A FEMA P-361/ICC-500 TESTED STEEL PIPE VENT THRU ROOF ASSEMBLY AND ROUTE CONCENTRIC VENT THRU THE ASSEMBLY. FEMA PIPE ASSEMBLY SHALL BE "ROOF PENETRATION HOUSINGS" MODEL CVTR-2006-PC", 6" INSIDE DIAMETER FOR PRE-CAST INSTALLATION. COORDINATE HEIGHT OF FEMA PIPE ASSEMBLY TO ACCOMMODATE THE CONCENTRIC VENT KIT. ASSEMBLY SHALL BE SECURELY INSTALLED

INTO PRECAST ROOF STRUCTURE, COORDINATE WITH PRECAST CONTRACTOR

10 HVAC CONTROL SYSTEM WIRELESS EXTENDED RANGE GATEWAY, SECURE TO WALL APPROXIMATELY 48" ABOVE FLOOR. REFER TO ELECTRICAL DRAWINGS FOR RECEPTACLE

11) REFER TO ARCHITECTURAL DRAWINGS FOR ELEVATION OF LOUVER IN WALL.

12 ROUTE REFRIGERANT LINES TO ASSOCIATED EVAPORATOR COIL. SEAL WALL PENETRATION 13 ROUTE REFRIGERANT LINES TO ASSOCIATED EVAPORATOR COIL. SEAL WALL PENETRATION NEATHERTIGHT. COORDINATE ROUTING OF REFRIGERANT LINES WITH PHONE BOARD ON

INSIDE SURFACE OF EXTERIOR WALL, REFER TO ELECTRICAL PLANS. 12x10 INTERNALLY LINED TRANSFER DUCT OPEN ENDED TO CEILING SPACE.

15) 12x12 INTERNALLY LINED DOUBLE ELBOW TRANSFER DUCT ABOVE CEILING. 16) 14x12 RETURN DUCT OPEN ENDED TO CEILING SPACE.

GENERAL HVAC NOTES:

THE PLANS ARE DIAGRAMMATIC AND SHALL NOT BE SCALED. REFER TO ARCHITECTURAL DRAWINGS FOR DIMENSIONS.

EQUIPMENT AND DUCTWORK LAYOUTS ARE DIAGRAMMATIC. FIELD COORDINATE EXACT LOCATIONS AND ROUTINGS WITH STRUCTURE. PIPING. CONDUITS. LIGHT FIXTURES. ETC. FINAL RESULT SHALL BE EQUIVALENT TO THAT INDICATED ON DRAWINGS.

COOPERATE CLOSELY WITH ALL OTHER TRADES TO EXPEDITE CONSTRUCTION AND AVOID INTERFERENCES AND CONFLICTS. BEFORE ANY PIPING, DUCTWORK, CONDUIT, ETC. IS INSTALLED. IT SHALL BE COORDINATED CAREFULLY BETWEEN ALL TRADES.

CONTRACTOR SHALL FIELD VERIFY EXTENT OF EXISTING CONSTRUCTION.

CONTRACTOR SHALL COORDINATE WITH ARCHITECT AND STRUCTURAL ENGINEER FOR SIZE

MAINTAIN ALL CLEARANCES REQUIRED FOR EQUIPMENT. DO NOT ROUTE PIPING, DUCTWORK, ETC. ABOVE ELECTRICAL PANELS.

PROVIDE UNISTRUTS AND ACCESSORIES AS REQUIRED FOR SUPPORT OF DUCTWORK,

SEAL AROUND ALL RATED WALL PENETRATIONS WITH FIRE STOPPING/CAULKING PER

ALL EXPOSED DUCTWORK, PIPING, SUPPORTS, ETC. SHALL BE PRIMED AND PAINTED PER THE SPECIFICATIONS.

BRANCH DUCTS SHALL BE THE SAME SIZE AS DIFFUSER NECK UNLESS NOTED OTHERWISE. COORDINATE CEILING DIFFUSER AND GRILLE LOCATIONS WITH ARCHITECTURAL REFLECTED

REFER TO EQUIPMENT SCHEDULES FOR OUTSIDE AIR QUANTITIES TO INDIVIDUAL HVAC

REFER TO SPECIFICATIONS FOR ADDITIONAL REQUIREMENTS.

HVAC DUCTWORK:

	FLEXIBLE DUCT
12x12	RECTANGULAR DUCT DIMENSIONS (WIDTH x HEIGHT)
	VOLUME DAMPER WITH LOCKING QUADRANT
	BRANCH DUCT WITH 45° BOOT FITTING
	BRANCH DUCT WITH BELLMOUTH SPIN-IN FITTING WITH MANUAL VOLUME DAMPER
	BRANCH DUCT WITH HIGH EFFICIENCY RECTANGULAR TO ROUND TAKE-OFF WITH MANUAL VOLUME DAMPER
\ \rightarrow \rightarrow \ \rightarrow \ \rightarrow \ \rightarrow \rightarrow \ \rightarrow \rightarrow \ \rightarrow \rightarrow \ \rightarrow \r	ELBOW WITH DOUBLE WALL TURNING VANES

RETURN, EXHAUST OR FRESH AIR DUCT UP

RETURN, EXHAUST OR FRESH AIR DUCT DOWN

SUPPLY AIR DUCT UP SUPPLY AIR DUCT DOWN

EQUIPMENT WITH FLEXIBLE DUCT CONNECTION **HVAC EQUIPMENT:**

SUPPLY DIFFUSER RETURN, EXHAUST GRILLE

LINEAR DIFFUSER DIFFUSER/GRILLE TYPE, AIRFLOW

SMOKE DAMPER FIRE/SMOKE DAMPER MOTORIZED DAMPER

HVAC CONTROLS:

THERMOSTAT AND EQUIPMENT SERVED SPACE CO2 SENSOR

HUMIDITY SENSOR


NOTE: INSTALL THERMOSTATS AND SENSORS AT 48" ABOVE

NOTATION:

OUTSIDE AIR RETURN AIR

SUPPLY AIR

07/29/2022

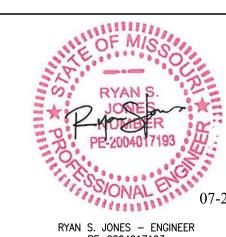

STATE OF MISSOURI

MICHAEL L. PARSON,

GOVERNOR

PE-2004017193 PROFESSIONAL SEAL

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MANAGEMENT, DESIGN AND CONSTRUCTION **DEPARTMENT OF PUBLIC SAFETY**

MISSOURI ARMY

NATIONAL GUARD

DIVISION OF FACILITIES

OFFICE OF ADMINISTRATION

CONSTRUCT NEW 60 SOLDIER BARRACKS

WAPPAPELLO TRAINING SITE 461 COUNTY ROAD 517

WAPPAPELLO, MISSOURI PROJECT # T2124-01

6325

8136325016 ASSET# BUILDING #3

REVISION: REVISION: REVISION: DATE:

ISSUE DATE: 07/29/2022

CAD DWG FILE:T2124-01-6325-8136325016-M-101 DRAWN BY: CHECKED BY: \overline{R} DESIGNED BY: TKB

SHEET TITLE: **HVAC PLAN**

(ATLERNATE NO.1)

SHEET NUMBER:

32 OF 36 SHEETS





WALL PACK SHALL BE INSTALLED AT APPROXIMATELY 9'-0".

FIELD COORDINATE EXACT LOCATION AND MOUNTING OF LIGHTING FIXTURE TO AVOID CONFLICT WITH DUCTWORK IN MECHANICAL ROOM.

LIGHTING SYMBOLS:

EXIT/EMERGENCY LIGHT

LIGHT SWITCH
3-WAY LIGHT SWITCH

____ CONDUIT BELOW GRADE

GROUND WIRE

———— FEEDER PER SCHEDULE

EXIT LIGHT; WALL MOUNTED / CEILING MOUNTED

FLUORESCENT OR LED LIGHT FIXTURE

RECESSED CAN LIGHT FIXTURE

EMERGENCY LIGHT FIXTURE

CEILING MOUNTED OCCUPANCY SENSOR

HOME RUN: TICK MARKS INDICATE NUMBER OF WIRES, ARROWS INDICATE NUMBER
OF CIRCUITS

LIGHTING & POWER PANELBOARD

CONDUIT CONCEALED IN CEILING OR WALL

STATE OF MISSOURI MICHAEL L. PARSON, GOVERNOR



RYAN S. JONES - ENGINEER
PE-2004017193
PROFESSIONAL SEAL

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Z CJ

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DEPARTMENT OF PUBLIC SAFETY MISSOURI ARMY NATIONAL GUARD

CONSTRUCT NEW 60 SOLDIER BARRACKS

WAPPAPELLO TRAINING SITE 461 COUNTY ROAD 517 WAPPAPELLO, MISSOURI

PROJECT # T2124-01 SITE # 6325 ASSET # 8136325016

BUILDING #3

REVISION:
DATE:
REVISION:
DATE:
REVISION:
DATE:
ISSUE DATE: 07/29/2022

CAD DWG FILE: T2124-01-6325-8136325016-E-101 DRAWN BY: TJG


CHECKED BY: RSJ DESIGNED BY: TJG


SHEET TITLE:

LIGHTING PLAN
(ALTERNATE NO. 1)

SHEET NUMBER:

E-101

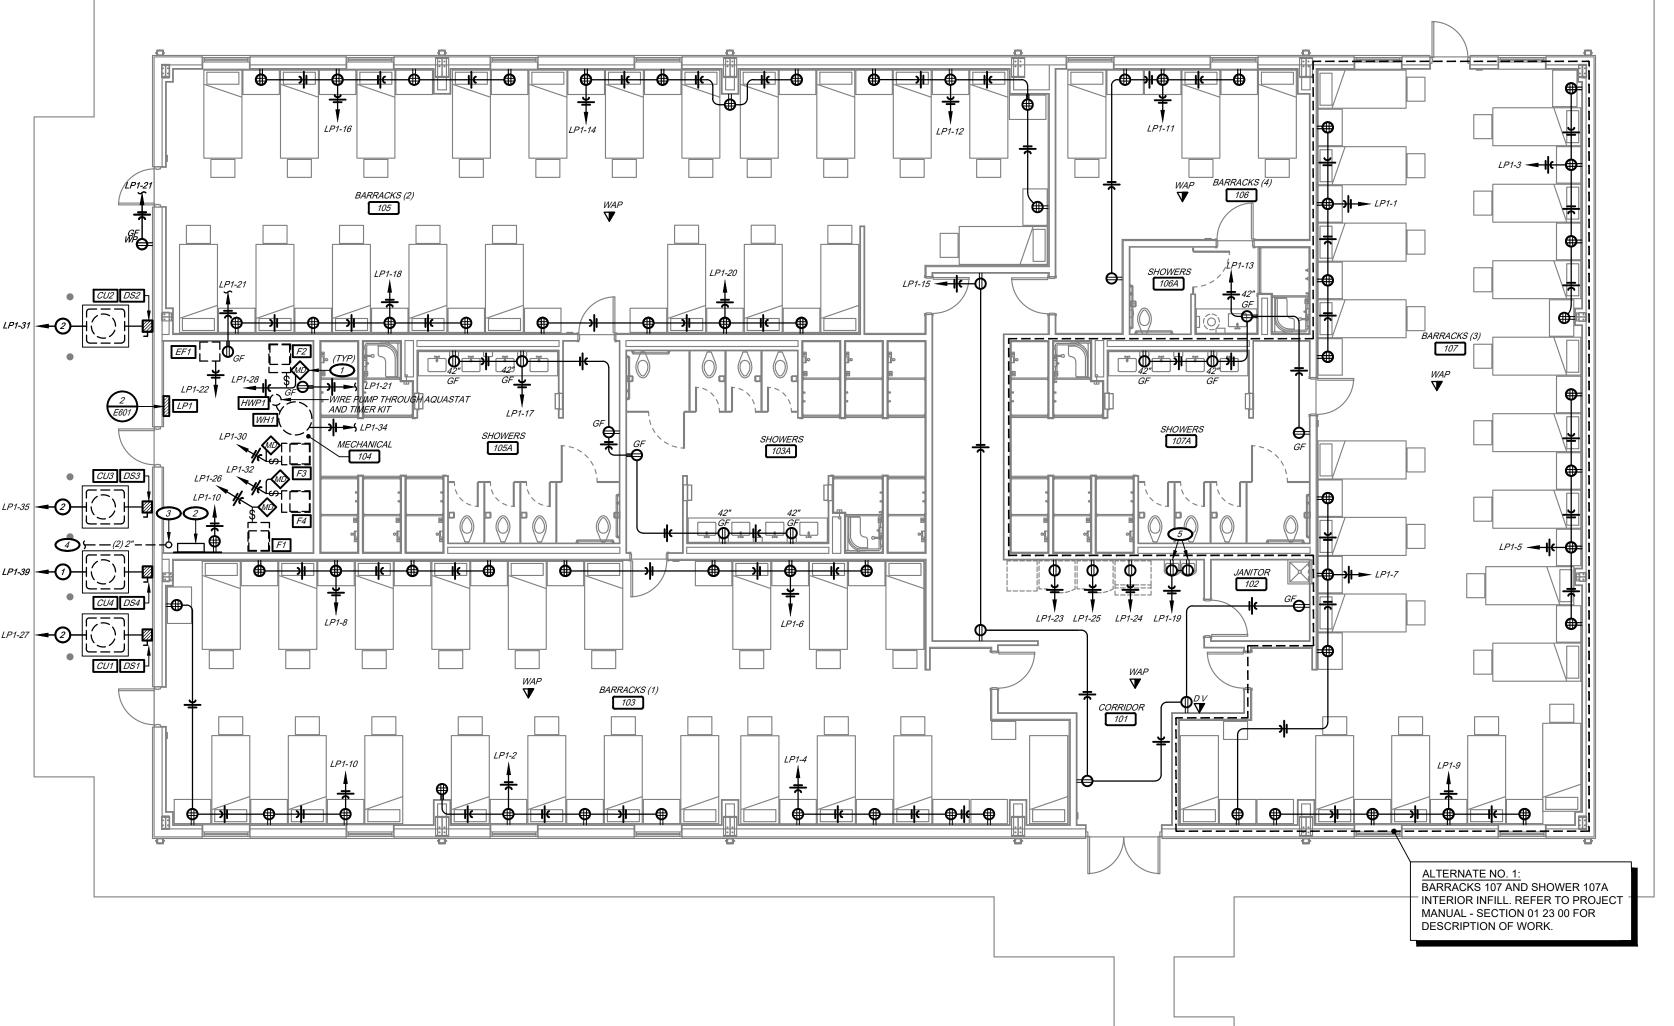

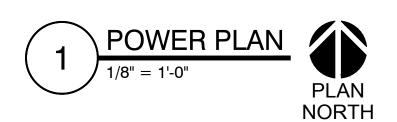

PROVIDE POWER TO MOTORIZED DAMPERS. FIELD COORDINATE EXACT LOCATIONS WITH MECHANICAL CONTRACTOR.

2 LOW-VOLTAGE PATCH PANEL AND ENCLOSURE INSTALLED ON PHONE BOARD.

(2) 2" COMMUNICATIONS CONDUIT STUBBED UP TO PHONE BOARD. 4 REFER TO CIVIL PLANS FOR CONTINUATION.

(5) INSTALL RECEPTACLES CONCEALED BEHIND DRINKING FOUNTAIN ENCLOSURE PER MANUFACTURER'S INSTRUCTIONS.

STATE OF MISSOURI MICHAEL L. PARSON, **GOVERNOR**



RYAN S. JONES – ENGINEER PE-2004017193 PROFESSIONAL SEAL

Missouri State Certificate of Authority #2005026903 Missouri State Certificate of Authority #2003020905

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DEPARTMENT OF PUBLIC SAFETY MISSOURI ARMY NATIONAL GUARD

CONSTRUCT NEW 60 SOLDIER BARRACKS

WAPPAPELLO TRAINING SITE 461 COUNTY ROAD 517 WAPPAPELLO, MISSOURI

PROJECT # T2124-01 6325

ASSET # 8136325016 BUILDING #3

CONDUIT & CONDUCTOR SCHEDULE: **REVISION:** DATE:

REVISION: DATE: **REVISION:** DATE:

ISSUE DATE: 07/29/2022


CAD DWG FILE: T2124-01-6325-8136325016-E-102 DRAWN BY: CHECKED BY: RSJ DESIGNED BY: TJG

SHEET TITLE:

POWER PLAN (ALTERNATE NO. 1)

SHEET NUMBER:

34 OF 36 SHEETS 07/29/2022

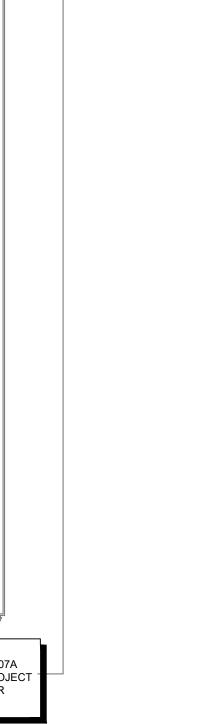

(2) #10 AND (1) #10 GROUND IN 0.5" CONDUIT.

(2) #8 AND (1) #10 GROUND IN 0.75" CONDUIT.

J

JUNCTION BOX

---- CONDUIT BELOW GRADE

FEEDER PER SCHEDULE

GROUND WIRE

LIGHTING & POWER PANELBOARD

CONDUIT CONCEALED IN CEILING OR WALL

DISCONNECT SWITCH

ELECTRICAL SYMBOLS:

SIMPLEX RECEPTACLE; 2P, 3W, 15A OR 20A, 125V

DUPLEX RECEPTACLE; 2P, 3W, 15A OR 20A, 125V

DUPLEX RECPTACLE; WEATHERPROOF

SIMPLEX RECEPTACLE; NEMA CONFIGURATION AS INDICATED

DUPLEX RECEPTACLE; MOUNTED @ 42" ABOVE FINISHED FLOOR

DUPLEX RECEPTACLE; INSTALLED FLUSH WITH CEILING

DUPLEX RECEPTACLE W/ GROUND FAULT INTERRUPTER

DOUBLE DUPLEX RECEPTACLE WITH COMMON FACEPLATE

DUPLEX RECEPTACLE; MOUNTED 6" ABOVE COUNTERTOP BACKSPLASH


RECEPTACLE MOUNTED IN FLUSH FLOOR BOX. REFER TO SPECIFICATIONS


COMBINATION VOICE & DATA TELECOMMUNICATIONS OUTLET: ROUGH-IN JUNCTION BOX OR PLASTER RING, (1) CAT6 VOICE CABLE & (1) CAT6 DATA CABLE ROUTED TO PATCH PANEL, COVER PLATE & JACK

DATA TELECOMMUNICATIONS OUTLET INSTALLED FLUSH WITH CEILING: ROUGH-IN JUNCTION BOX OR PLASTER RING, (1) CAT6 DATA CABLE ROUTED TO PATCH PANEL, COVER PLATE & JACK

CABLE TV OUTLET: ROUGH-IN JUNCTION BOX OR PLASTER RING ONLY. CABLE, COVER PLATE & JACKS PROVIDED BY OTHERS.

HOME RUN: TICK MARKS INDICATE NUMBER OF WIRES, ARROWS INDICATE NUMBER OF CIRCUITS

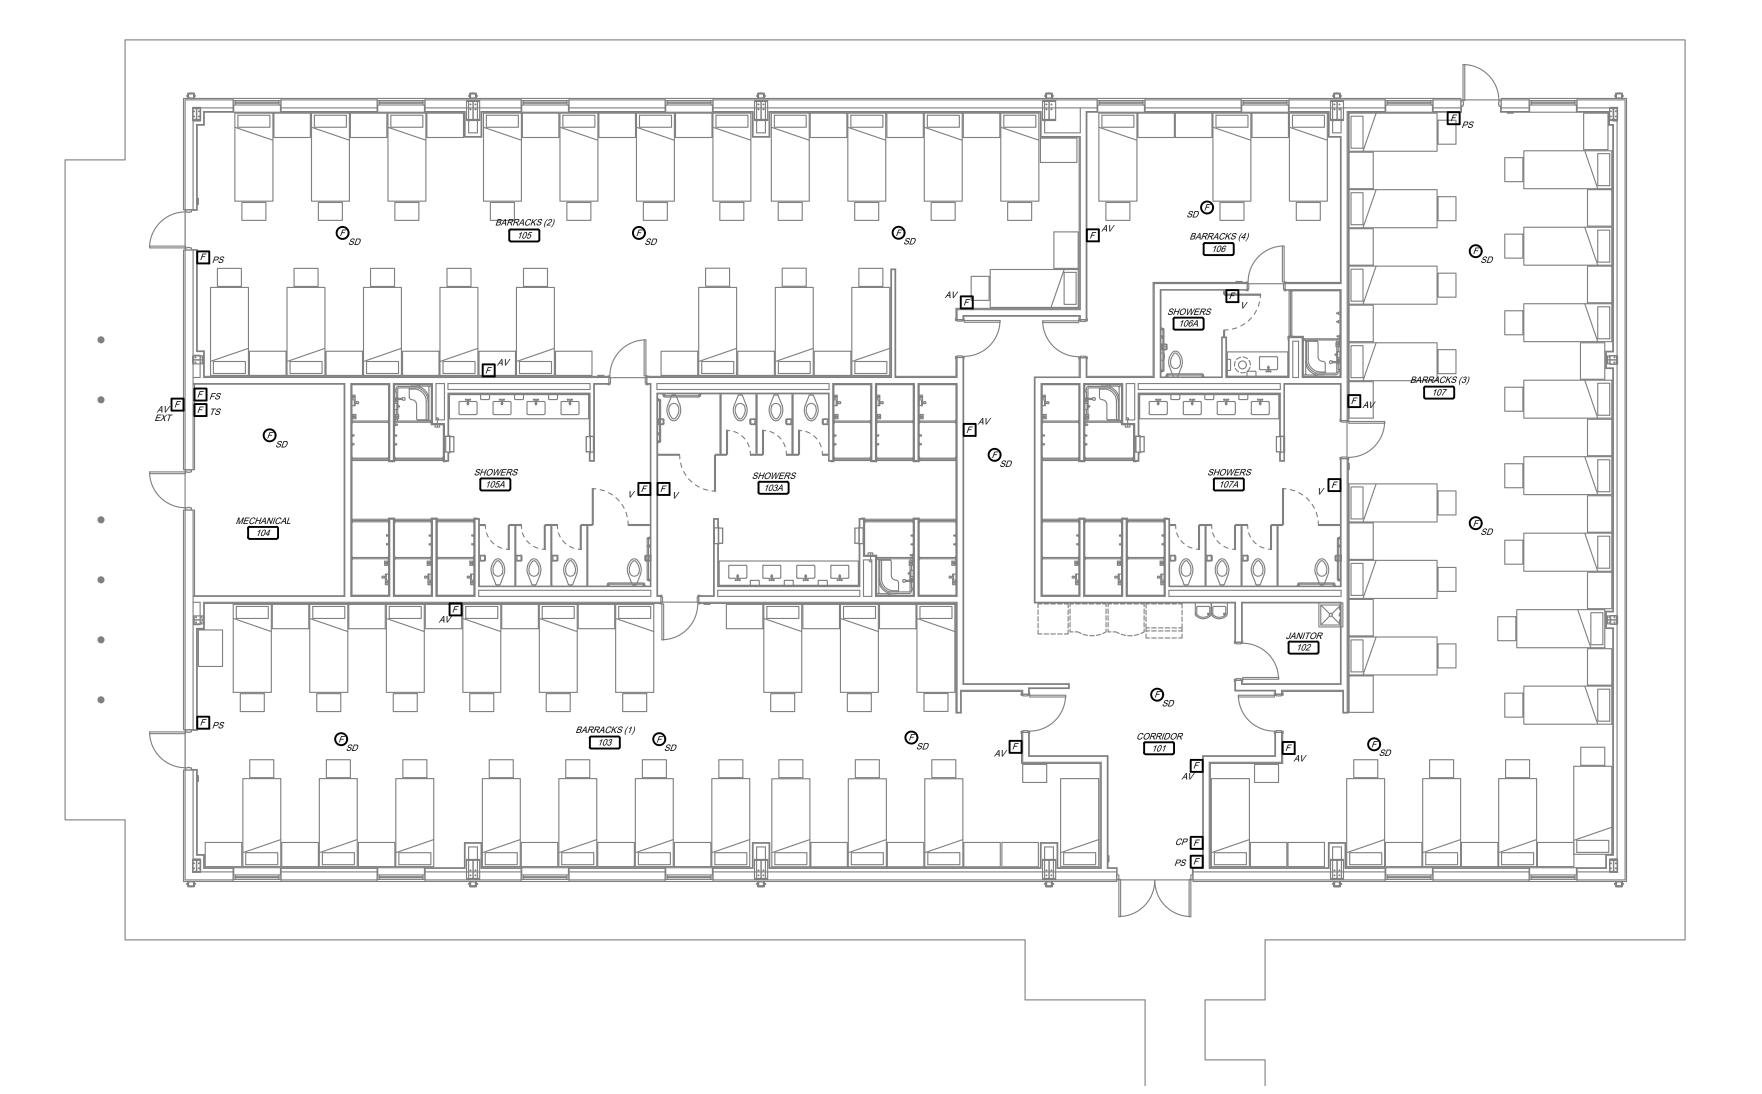

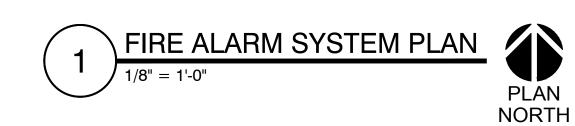

FIRE ALARM GENERAL NOTES:

- PROVIDE FIRE ALARM SYSTEM INITIATION DEVICES AND NOTIFICATION APPLIANCES, MONITORING AND CONTROL DEVICES AS INDICATED ON THE DRAWINGS AND/OR AS REQUIRED PER SPECIFICATIONS, LATEST EDITION OF NFPA 72 OR AUTHORITY HAVING JURISDICTION(AHJ).
- ALL FIRE ALARM WORK SHALL BE IN ACCORDANCE WITH THE LATEST EDITION OF NFPA 72 AND THE NATIONAL ELECTRICAL CODE.
- FIRE ALARM SYSTEM WIRING SHALL BE PER MANUFACTURER'S INSTALLATION INSTRUCTIONS
- AND SHALL COMPLY WITH N.E.C. ARTICLE 760. ALL EXPOSED FIRE ALARM SYSTEM WIRING SHALL BE IN CONDUIT. PAINT FIRE ALARM CONDUIT, JUNCTION BOXES AND FITTINGS RED.
- ALL FIRE ALARM SYSTEM WIRING SHALL BE INSTALLED IN CONDUIT.
- FIRE ALARM SYSTEM EQUIPMENT SUBMITTALS SHALL INCLUDE PRODUCT DATA SHEETS, FIRE ALARM SYSTEM PLAN, EQUIPMENT WIRING DIAGRAMS, SEQUENCE OF OPERATIONS, VOLTAGE DROP AND BATTERY CALCULATIONS. IN ADDITION TO SUBMITTALS BEING SUBMITTED TO A/E, SUBMITTALS SHALL BE SUBMITTED TO AUTHORITY HAVING JURISDICTION(AHJ) FOR REVIEW AND APPROVAL. AN APPROVED COPY AS SUBMITTED TO AHJ SHALL ALSO BE SUBMITTED TO
- WHERE A POWER EXTENDER IS REQUIRED, PROVIDE POWER EXTENDER, ASSOCIATED 120-VOLT POWER SUPPLY AND A SMOKE DETECTOR IN SAME ROOM AS POWER EXTENDER.
- IF SHOWN ON THE PLANS, CONTRACTOR SHALL PROVIDE ALL MAGNETIC DOOR HOLDERS, AND ALL CONTROL WIRING, TO CLOSE DOORS UPON DETECTION BY ASSOCIATED SMOKE DETECTOR. DOOR HOLDER FINISH SHALL MATCH ALL DOOR HARDWARE FINISH OF DOOR HARDWARE PROVIDED BY OTHERS.
- FIRE ALARM SYSTEM SHALL BE INSTALLED IN ACCORDANCE WITH NFPA STANDARDS AND MANUFACTURER'S RECOMMENDATIONS, AND SHALL BE INSTALLED BY PERSONS WHO ARE QUALIFIED AND EXPERIENCED IN THE INSTALLATION, INSPECTION AND TESTING OF FIRE ALARM SYSTEMS. INSTALLER SHALL HAVE A MINIMUM OF 3 YEARS OF EXPERIENCE.
 PERFORM OPERATIONAL SYSTEM TESTS UPON COMPLETION OF INSTALLATION. CORRECT
 DEFICIENCIES AND RETEST PRIOR TO OWNER OCCUPATION OF BUILDING. PROVIDE A
 COMPLETED NFPA 72 RECORD OF COMPLETION FORM TO THE OWNER AND AUTHORITY HAVING JURISDICTION.
- FIRE ALARM SYSTEM CONTROL PANEL SHALL ALLOW FOR DETECTOR SENSITIVITY ADJUSTMENT AND TESTING, AND SHALL INCLUDE INDIVIDUAL CONTROLS [AT CONTROL PANEL] FOR TESTING AUDIBLE APPLIANCES AND VISUAL STROBES.

FIRE ALARM SYMBOLS:

CEILING MOUNTED SMOKE DETECTOR

FIRE ALARM SYSTEM CONTROL PANEL

REMOTE ANNUCIATOR PANEL

MANUAL PULL STATION

TAMPER SWITCH

CEILING MOUNTED AUDIO/VISUAL FIRE ALARM ANNUNCIATING DEVICE

WALL MOUNTED AUDIO/VISUAL FIRE ALARM ANNUNCIATING DEVICE

WALL MOUNTED VISUAL FIRE ALARM ANNUNCIATING DEVICE

 ${\cal F}^{AV}_{EXT}$ WALL MOUNTED EXTERIOR AUDIO/VISUAL FIRE ALARM ANNUNCIATING DEVICE

DUCT MOUNTED SMOKE DETECTOR WITH SAMPLING TUBE. INSTALL AT RETURN DUCT UNLESS OTHERWISE NOTED

STATE OF MISSOURI MICHAEL L. PARSON,

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CONSTRUCT NEW 60 SOLDIER BARRACKS

WAPPAPELLO TRAINING SITE 461 COUNTY ROAD 517 WAPPAPELLO, MISSOURI

PROJECT # T2124-01 6325 ASSET # 8136325016

BUILDING #3

REVISION: REVISION: REVISION: DATE: ISSUE DATE: 07/29/2022

CAD DWG FILE:T2124-01-6325-8136325016-E-103

DRAWN BY: CHECKED BY: RSJ DESIGNED BY: TJG

SHEET TITLE:

FIRE ALARM SYSTEM PLAN

SHEET NUMBER:

	PHOTOCELL SCHEDULE									
	LOA	D					SWI	TCH		
MARK	EQUIPMENT SERVED	WATTS	VOLTAGE	BASIS OF DESIGN		AMD	DOLE.	ENCLOSURE	APPROVED MANUFACTURERS	ACCESS.
	EQUIPMENT SERVED	WATTS	VOLTAGE	MFR	MODEL#	AMP POLE				
PC1	LIGHTING	-	-	INTERMATIC	K4121C	15	1	NEMA 3R	TORK, KICHLER	1,2
	<u>RIES:</u> L MOUNTING LEVEL SLIDE ADJUSTMENT									

		DI	SCON	INEC	T SV	/ITCI	1 SCH	EDULE				
MARK	LOAD			SWITCH			OVERCUR	RENT PROTEC	TION		NEMA	NOTES &
WAKK	EQUIPMENT SERVED	VOLTAGE	DUTY	AMP	POLE	TYPE	MFR	MODEL	AMP	KAIC	ENCLOSURE	ACCESS.
DS1	CONDENSING UNIT - CU1	240	GD	60	1	NF					3R	1
DS2	CONDENSING UNIT - CU2	240	GD	60	1	NF					3R	1
DS3	CONDENSING UNIT - CU3	240	GD	60	1	NF					3R	1
DS4	CONDENSING UNIT - CU4	240	GD	30	1	NF					3R	1
2. SOLI 3. SER	SORIES: DIND LUG KIT IUD NEUTRAL VICE ENTRANCE RATING CONNECT SHALL BE LOCKABLE IN THE OPEN	POSITION					ABBREVIATIONS CB - ENCLOSED GD - GENERAL HD - HEAVY DU NF - NON-FUSIE	CIRCUIT BREAKER DUTY TY	?		D MANUFACTURERS: E, SIEMENS, SQUARE	

		00	CCUPAN	CY SENS	SOR S	CHE	DULE			
	LOAD					SE	NSOR			
MARK	LOAD		BASIS OF	DESIGN						
	EQUIPMENT SERVED	VOLTAGE	MANUFACTURER	MODEL #	VOLTAGE	TYPE	TIME DELAY	MOUNTING	INTERLOCK	ACCESS.
OS1	RESTROOM LIGHTING	120	HUBBELL	OMNIDT500	24V	IR/US	AUTO	CEILING	-	1,2,4
OS2	CORRIDOR LIGHTING	120	HUBBELL	OMNIDT2000	24V	IR/US	AUTO	CEILING	-	1,2,4
 WHERI WALL 	ESSORIES: DE CONTROL UNIT(S) AS REQUIRED. E SWITCHING IS SHOWN, WIRE OCCUPANC SWITCH SHALL BE CAPABLE OF MANUAL C N SERIES WITH MULTIPLE SENSORS WHEI	N-OFF CONTRO		OCAL LIGHT SWITCHIN	G.		ABBREVIATIONS: PIR - PASSIVE INFR US - ULTRASONIC IR/US -DUAL TECHI			
1. EACH 2. EQUIP. SUBMI	TES (APPLIES TO ALL SENSORS): SENSOR TYPE MAY BE SHOWN IN MULTIP! MENT SUBMITTAL: PRIOR TO APPROVAL, Y T PLAN (PROVIDED BY MANUFACTURER'S DR TYPE, MOUNTING HEIGHT AND SENSOI	WITH OCCUPAN REPRESENTAT	ICY SENSOR SPECIFICAT				APPROVED MANUF GREENGATE/NOVIT WATTSTOPPER LEVITON			

MADV	BAS	BASIS OF DESIGN		COVER	SERVICE TYPE	MAX. KNOCKOUT	APPROVED	NOTES
MARK —	MANUFACTURER	SERIES / MODEL #	MATERIAL	COVER	SERVICE TIPE	OR HUB SIZE	MANUFACTURERS	NOTES
FB1	HUBBELL	B2436	CAST IRON	SA3825	CONCRETE FLOOR	1"	LEVITON, WIREMOLD	1,2

PANEL	BOARD SCHEDU	LE											LP1	
VOLTAGE:	120/240	POLES:		54			MOUNTING:		SUR	RFACE	ENCLOSURE:	NEMA 1		
PHASE / WIRE:	1/3	KAIC AMPS (RMS): MAIN BREAKER / MLO:			22 225A MB		LOCATION: FED FROM:			MEC	Н. 104	BASIS OF DESIGN: So	SQUARE D	
AMPS:	225								ME		IETER	MODEL:	NQ	
CIRC. NO.	EQUIPMENT SERVED	C/ AM		/B LES C/B AC	C. LOAD (VA,	PHASE L	OADS (VA)	LOAD (VA)	C/B ACC.	C/B POLES	C/B AMPS	EQUIPMENT SERVED	CIRC. NO.	
1	BARRACKS RECEPTACLES	20	0 1	1 -	1440	2880		1440	-	1	20	BARRACKS RECEPTACLES	2	
3	BARRACKS RECEPTACLES	20	0 1	1 -	1440		2880	1440	-	1	20	BARRACKS RECEPTACLES	4	
5	BARRACKS RECEPTACLES	20	0 1	1 -	1440	2880		1440	-	1	20	BARRACKS RECEPTACLES	6	
7	BARRACKS RECEPTACLES	20	0 1	1 -	1440		2880	1440	-	1	20	BARRACKS RECEPTACLES	8	
9	BARRACKS RECEPTACLES	20	0 1	1 -	1440	3240		1800	-	1	20	BARRACKS RECEPTACLES	10	
11	BARRACKS RECEPTACLES	20	0 1	1 -	1260		2700	1440	-	1	20	BARRACKS RECEPTACLES	12	
13	BATHROOM RECEPTACLES	20	0 1	1 -	900	2340		1440	-	1	20	BARRACKS RECEPTACLES	14	
15	CORRIDOR/JANITOR RECEPTACLES	20	0 1	1 -	720		2160	1440	-	1	20	BARRACKS RECEPTACLES	16	
17	BATHROOM RECEPTACLES	20	0 1	1 -	1080	2520		1440	-	1	20	BARRACKS RECEPTACLES	18	
19	DRINKING FOUNTAIN RECEPTACLE	20	0 1	1 GFC	500		1940	1440	-	1	20	BARRACKS RECEPTACLES	20	
21	MECHANICAL RECEPTACLES	20	0 1	1 -	360	1540		1180	-	1	20	FAN EF1	22	
23	VENDING MACHINE RECEPTACLE	20	0 1	1 -	500		1500	1000	-	1	20	ICE MACHINE	24	
25	VENDING MACHINE RECEPTACLE	20	0 1	1 -	500	1832		1332	-	1	20	FURNACE F1	26	
27	CONDENSING UNIT (CU1)	50	0 2	2 HAC	R 2574		3906	1332	-	1	20	FURNACE F2	28	
29	п				2574	3906		1332	_	1	20	FURNACE F3	30	
31	CONDENSING UNIT (CU2)	50	0 2	2 HAC	R 2574		3906	1332	-	1	20	FURNACE F4	32	
33	п				2574	2674		100	-	1	20	WATER HEATER / PUMP	34	
35	CONDENSING UNIT (CU3)	50	0 2	2 HAC	R 2574		3164	590	-	1	20	EXTERIOR LIGHTING	36	
37	п				2574	3184		610	-	1	20	INTERIOR LIGHTING	38	
39	CONDENSING UNIT (CU4)	2:	5 2	2 HAC	R 1398		2178	780	-	1	20	INTERIOR LIGHTING	40	
41	"				1398	2088		690	-	1	20	INTERIOR LIGHTING	42	
43	SPARE	20	0 -	1 -			580	580	_	1	20	INTERIOR LIGHTING	44	
45	SPARE	20	0 1	1 -		0			_	1	20	SPARE	46	
47	SPARE	20	0 1	1 -			0		_	1	20	SPARE	48	
49	SPARE	20	0 1	1 -		0			_	1	20	SPARE	50	
51	SPARE	20		1 -		Ū	0		_	1	20	SPARE	52	
53	SPARE	20		1 -		0			_	1	20	SPARE	54	
	ACCESSORIES: CH, FL			,		ů		PANEI	BOARD	•				
HACR - HACR RATING EGT - EXTENDED GUI HLF - HANDLE LOCK-OFF EGB - EXTENDED GUI HLN - HANDLE LOCK-ON EGSL - EXTENDED GUI				VIDTH PANEL DOOR WITHII GUTTER TO GUTTER BO GUTTER LE GUTTER RIO	PANELBOARD ACCESSORIE INGE			SORIES ESSION LUGS HRU LUGS HENT GROUND BAR KIT TED GROUND BAR KIT AL BONDING KIT RED CIRCUIT BREAKER SPACE			SFB - SUB-FEED CIRCUIT BREAKER SFL - SUB-FEED LUGS CBB - TIN PLATED COPPER BUS BARS ABB - TIN PLATED ALUMINUM BUS BARS TRN - 200% RATED NEUTRAL BUS BAR TVSS - TRANSIENT VOLTAGE SURGE SUPPRESSION APPOVED MANUFACTURERS: EATON, GE, SIEMENS			

	HLF - HANDLE LOCK-OFF EGB HLN - HANDLE LOCK-ON EGSL SR - SWITCH RATING EGSR		- EXTENDED GUTTER BOTTOM - EXTENDED GUTTER LEFT HAND SIDE - EXTENDED GUTTER RIGHT HAND SIDE		NBK - PS - SB -	INSULATED GROUND BAR KIT NEUTRAL BONDING KIT PREPARED CIRCUIT BREAKER SPACE SPLIT BUS SERVICE ENTRANCE RATING		ABB - TIN PLATED ALUMINUM BUS BARS TRN - 200% RATED NEUTRAL BUS BAR TVSS - TRANSIENT VOLTAGE SURGE SUPPRESSION APPOVED MANUFACTURERS: EATON, GE, SIEMENS				
_		,	LIGHTING	FIXTUR	E SC	HEDULE						
1ARK	BASIS OF DESIGN	MODEL#	FINISH	MOUNTING	LAMPS			FIXTURE	VOLTAGE	APPROVED	NOTES	
IAKK	MANUFACTURER	WIODEL#	FIINISH		TYPE	CODE	QTY.	WATTS	VULTAGE	MANUFACTURERS	NOTES	
C1	WILLIAMS	6DR-TL-L10/840-DIM-UNV-SM-OF-CS-WET/CC	WHITE	RECESSED	LED	WITH FIXTURE	-	9	120	LITHONIA, COOPER IND.	1,2,3,7	
PL1	LUMARK	PRV-C40-D-UNV-T4-BZ	ARCH	POLE	LED	WITH FIXTURE	-	145	120	LITHONIA, HUBBELL	1,2,4,9	
<i>S</i> 1	WILLIAMS	75R-8-L60/840-DRV-120	WHITE	SUSPENDED	LED	WITH FIXTURE	-	36	120	LITHONIA, COOPER IND.	7	
T1	WILLIAMS	LT24-L40/840-AF-DRV-120	WHITE	RECESSED	LED	WITH FIXTURE	-	32	120	LITHONIA, COOPER IND.	7,8	
T1E	WILLIAMS	LT24-L40/840-AF-EM/12W-DRV-120	WHITE	RECESSED	LED	WITH FIXTURE	-	32	120	LITHONIA, COOPER IND.	5,7,8	
W1	WILLIAMS	WPCS-L44/840-BZ-EM/6W-DIM-UNV	ARCH	WALL	LED	WITH FIXTURE	IRE -		120	LITHONIA, COOPER IND.	1,2,9	
X1	WILLIAMS	EXIT-R-EM-WHT-D	WHITE	UNIVERSAL	LED	WITH FIXTURE	-	5	120	LITHONIA, COOPER IND.	6,7	

C1	WILLIAMS	6DR-TL-L10/840-DIM-UNV-SM-OF-CS-WET/CC	WHITE	RECESSED	LED	WITH FIXTURE	-	9	120	LITHONIA, COOPER IND.	1,2,3,7
PL1	LUMARK	PRV-C40-D-UNV-T4-BZ	ARCH	POLE	LED	WITH FIXTURE	-	145	120	LITHONIA, HUBBELL	1,2,4,9
S1	WILLIAMS	75R-8-L60/840-DRV-120	WHITE	SUSPENDED	LED	WITH FIXTURE	-	36	120	LITHONIA, COOPER IND.	7
T1	WILLIAMS	LT24-L40/840-AF-DRV-120	WHITE	RECESSED	LED	WITH FIXTURE	-	32	120	LITHONIA, COOPER IND.	7,8
T1E	WILLIAMS	LT24-L40/840-AF-EM/12W-DRV-120	WHITE	RECESSED	LED	WITH FIXTURE	-	32	120	LITHONIA, COOPER IND.	5,7,8
W1	WILLIAMS	WPCS-L44/840-BZ-EM/6W-DIM-UNV	ARCH	WALL	LED	WITH FIXTURE	-	42	120	LITHONIA, COOPER IND.	1,2,9
X1	WILLIAMS	EXIT-R-EM-WHT-D	WHITE	UNIVERSAL	LED	WITH FIXTURE	-	5	120	LITHONIA, COOPER IND.	6,7
NOTES:	IXTURE SHALL BE LISTED FOR	OUTDOOR USE AND SHALL BE UL LISTED FOR DAMP AND WET LOCATION	ONS AS REQUIRED.								

FIXTURE LAMP AND BALLAST SHALL BE CAPABLE OF OPERATING DOWN TO 0 DEGREES F AND UP TO 110 DEGREES F.

COLOR SELECTION SHALL BE VERIFIED WITH ARCHITECT/OWNER PRIOR TO ORDERING.

PROVIDE 25' STRAIGHT STEEL POLE AND ACCESSORIES AS REQUIRED FOR COMPLETE INSTALLATION.

PROVIDE FIXTURE WITH EMERGENCY BATTERY BACK-UP FOR MINIMUM 120-MINUTES OPERATION.
REFER TO PLANS AND COORDINATE WITH OWNER/ARCHITECT FOR MOUNTING TYPE, FACE ORIENTATION, AND CHEVRON DIRECTION AS APPLICABLE. PROVIDE CLIPS OR MEANS OF SUPPORT AS REQUIRED TO COMPLY WITH THE REQUIREMENTS OF SEISMIC CATEGORY D.

GENERAL NOTES (APPLY TO ALL LIGHT FIXTURES):

1. SUBMIT ALL REQUESTS FOR EQUIVALENCY TO ARCHITECT/ENGINEER A MINIMUM OF (10) WORKING DAYS PRIOR TO BID DATE. REQUESTS ARE SUBJECT TO APPROVAL BY ARCHITECT/ENGINEER BASED ON PERFORMANCE AND AESTHETICS.

2. PROVIDE INSULATION BARRIER, WHERE NON IC-RATED LIGHT FIXTURES ARE INSTALLED WHERE THEY MAY BE IN DIRECT CONTACT WITH INSULATION. INSULATION BARRIER SHALL BE EQUAL TO PRODUCTS BY 'E.Z. BARRIER' PROVIDE SURFACE MOUNT KIT LT-24-SMK-W WHERE INSTALLED AT HARD LID CEILING. VERIFY FINISH WITH ARCHITECT.

GENERAL ELECTRICAL NOTES:

SPECIFICATIONS FOR ADDITIONAL REQUIREMENTS.

THE PLANS ARE DIAGRAMMATIC AND SHALL NOT BE SCALED. REFER TO ARCHITECTURAL DRAWINGS AND FXISTING CONDITIONS FOR DIMENSIONS FIFI D VERIFY DIMENSIONS

GENERAL NOTES AND DETAILS ON THIS SHEET APPLY TO ALL ELECTRICAL SHEETS. REFER TO

- THE CONTRACTOR SHALL SCHEDULE AND EXECUTE THE WORK WITH REGARD TO THE OWNER'S
- COOPERATE CLOSELY WITH ALL OTHER TRADES TO EXPEDITE CONSTRUCTION AND AVOID INTERFERENCES AND CONFLICTS. COORDINATE LOCATIONS OF CONDUITS, RACEWAYS, SUPPORTS, ETC. WITH ALL TRADES PRIOR TO ROUGH-IN. YIELD RIGHT OF WAY TO SYSTEMS REQUIRED TO BE INSTALLED AT A SLOPE.
- COORDINATE REQUIRED CLEARANCES ABOUT AND ABOVE ELECTRICAL EQUIPMENT WITH PLUMBING, HVAC AND OTHER TRADES TO KEEP DUCTWORK, PIPING, ETC. FROM BEING INSTALLED ABOVE ELECTRICAL EQUIPMENT.
- COORDINATE LIGHT FIXTURE LOCATIONS WITH ARCHITECTURAL REFLECTED CEILING PLANS. COORDINATE LOCATIONS OF WALL MOUNTED LIGHT FIXTURES WITH ARCHITECTURAL INTERIOR ELEVATIONS PRIOR TO ROUGH-IN.
- COORDINATE WALL MOUNTED SWITCH, RECEPTACLE, TELEPHONE, DATA, AND OTHER ELECTRICAL SYSTEM DEVICE LOCATIONS WITH ARCHITECTURAL INTERIOR AND MILLWORK ELEVATION DRAWINGS PRIOR TO ROUGH-IN.
- THERMOSTATS, SENSORS, DAMPERS AND HVAC EQUIPMENT CONTROL WIRING SHALL BE FURNISHED BY HVAC CONTRACTOR. THE ELECTRICAL CONTRACTOR SHALL FURNISH AND INSTALL THE NECESSARY CONDUIT AND BOXES FOR THE INSTALLATION OF DEVICES AND CABLING.
- WHERE SHOWN ADJACENT TO LIGHT SWITCHES, JUNCTION BOXES FOR SENSORS, ETC. SHALL BE INSTALLED TO ALLOW 3"-6" BETWEEN EDGE OF SENSOR AND SWITCH COVERPLATE. WHERE SHOWN NOT ADJACENT TO LIGHT SWITCHES, JUNCTION BOXES FOR SENSORS, ETC. SHALL BE LOCATED WITHIN 12" OF NEAREST INSIDE OR OUTSIDE CORNER, NOT IN CENTER SECTION OF WALLS. ALL LOCATIONS SHALL BE SUBJECT TO APPROVAL BY ARCHITECT, ENGINEER, AND/OR
- INSTALL RECEPTACLES ADJACENT TO PHONE, DATA, TV, ETC. OUTLETS WHERE SHOWN IN SAME
- ALL BRANCH CIRCUITS OR FEEDERS SHALL BE INSTALLED WITH AN EQUIPMENT GROUNDING
- ROUTE ALL EXPOSED CONDUIT TIGHT TO STRUCTURE IN A NEAT AND ORDERLY FASHION.

STATE OF MISSOURI MICHAEL L. PARSON, **GOVERNOR**



RYAN S. JONES - ENGINEER PE-2004017193 PROFESSIONAL SEAL

Missouri State Certificate of Authority #2005026903 MISSOUTT State CELLIFICATE OF ALLIFICATE OF

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OFFICE OF ADMINISTRATION DIVISION OF FACILITIES MANAGEMENT, DESIGN AND CONSTRUCTION

DEPARTMENT OF PUBLIC SAFETY MISSOURI ARMY NATIONAL GUARD

CONSTRUCT NEW 60 SOLDIER BARRACKS

WAPPAPELLO TRAINING SITE 461 COUNTY ROAD 517 WAPPAPELLO, MISSOURI

PROJECT # T2124-01 6325

8136325016 ASSET# BUILDING #3

REVISION: DATE REVISION: DATE: **REVISION:** DATE: ISSUE DATE: 07/29/2022

CAD DWG FILE: T2124-01-6325-8136325016-E-601


DRAWN BY: CHECKED BY: RS. DESIGNED BY: TJG

SHEET TITLE:


ELECTRICAL DETAILS AND SCHEDULES

SHEET NUMBER:

36 OF 36 SHEETS

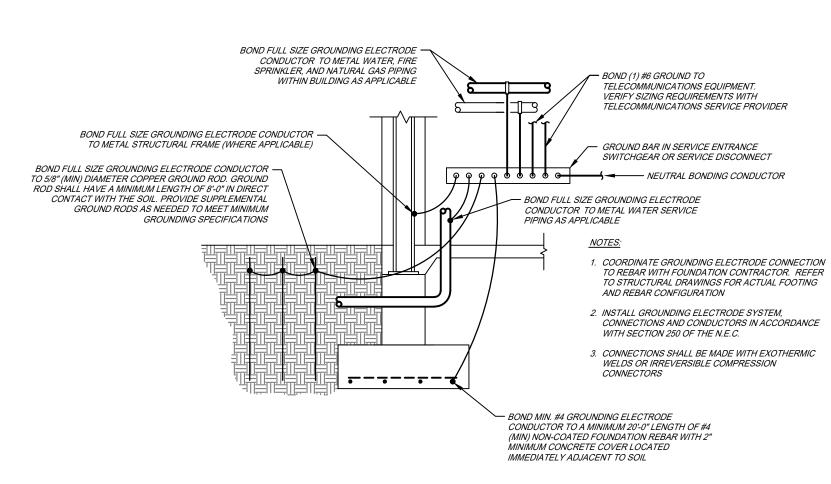

GROUNDING ELECTRODE DETAIL

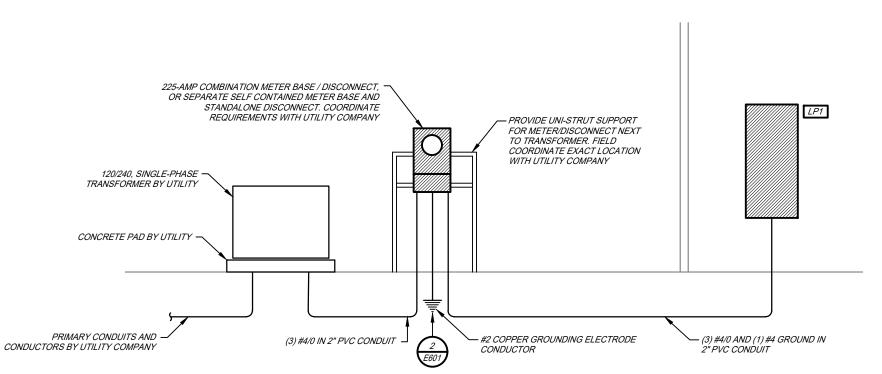

ELECTRICAL RISER DIAGRAM