
LATRINE RENOVATION

FULTON READINESS CENTER Fulton, Missouri

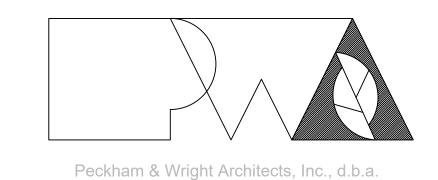

PWArchitects, Inc.

2120 Forum Blvd., Ste 101 Columbia, Missouri 65203 Ph:(573) 449-2683 Fax:(573) 442-6213

OWNER: STATE OF MISSOURI

MICHAEL L. PARSON,

GOVERNOR

MISSOURI NATIONAL GUARD

OFFICE OF THE ADJUTANT GENERAL FACILITIES MANAGEMENT OFFICE

PROJECT OFFICE OF ADMINISTRATION

MANAGEMENT: DIVISION OF FACILITIES MANAGEMENT,

DESIGN AND CONSTRUCTION


DESIGNER: PWArchitects, Inc.

2120 Forum Blvd., Ste. 101 Columbia, Missouri 65203


PROJECT NUMBER: T2137-01

SITE NUMBER: 6290

ASSET NUMBER: **8136290001**

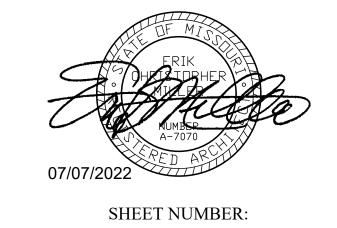



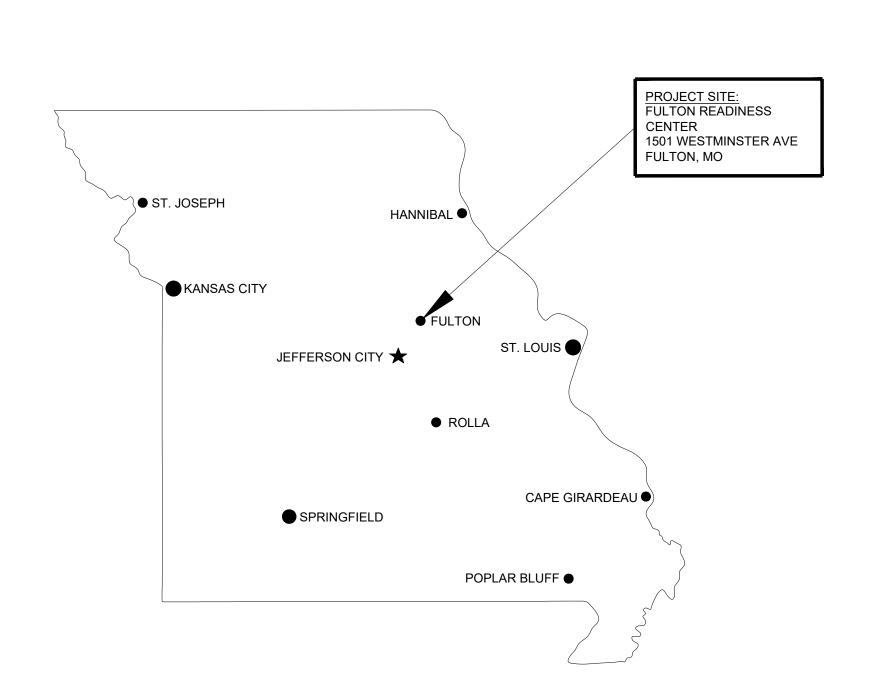


ALTERNATE #1: APPROX. LOCATION OF TEMPORARY RESTROOM FACILITIES -FIELD COORDINATE FINAL LOCATION WITH OWNER'S REPRESENTATIVE PROJECT LOCATION WITHIN BUILDING

LIST OF DRAWINGS

COVER SHEET G-101 INDEX SHEET GENERAL NOTES & LEGENDS PARTIAL FLOOR PLAN & DETAILS DEMO FLOOR PLAN & REFLECTED CEILING PLAN SLAB PLAN A-100 FLOOR PLAN & REFLECTED CEILING PLAN A-101 ACCESSORY PLAN & ADA DETAILS A-201 **ELEVATIONS & DETAILS** A-301 PARTITION TYPES & DETAILS SCHEDULES & DETAILS A-601 **HVAC PLAN** HVAC DETAILS & SCHEDULES ED-101 ELECTRICAL DEMOLITION PLAN E-101 ELECTRICAL PLANS ELECTRICAL DETAILS & SCHEDULES E-501 SANITARY SEWER PLAN

WATER PLAN PLUMBING DETAILS & SCHEDULES

PROJECT SITE: FULTON READINESS 1501 WESTMINSTER AVE FULTON, MO

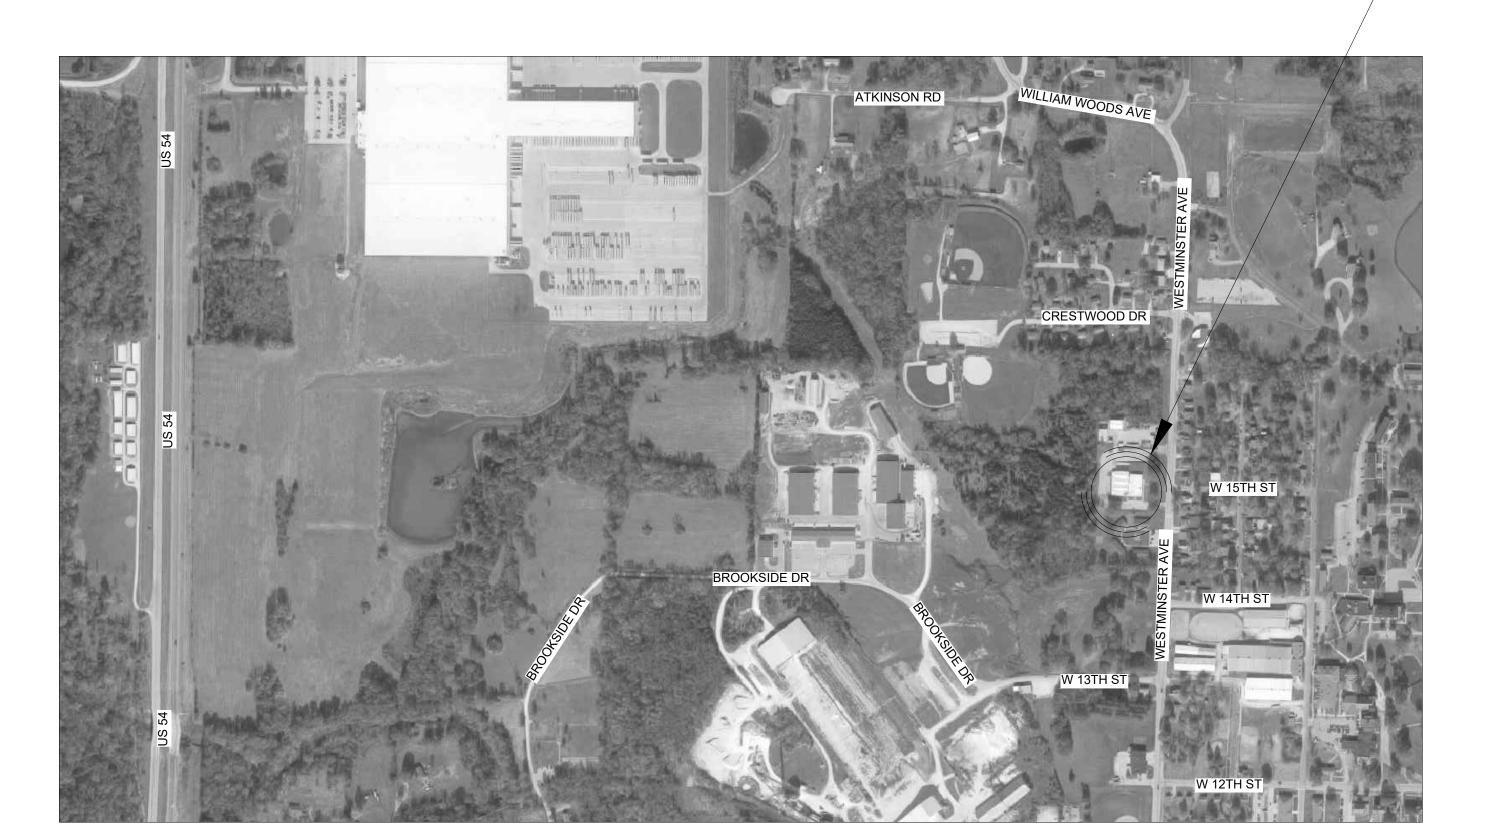

DIVISION OF FACILITIES MANAGEMENT, **DESIGN AND** CONSTRUCTION

ADMINISTRATION

OFFICE OF

STATE OF MISSOURI MICHAEL L. PARSON, **GOVERNOR**

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Missouri State Certificate of Authority No. 000244

LATRINE RENOVATION

FULTON READINESS CENTER 1501 WESTMINSTER AVE. FULTON, MO

PROJECT # T2137-01 6290 ASSET # 8136290001

REVISION: DATE: REVISION: DATE: REVISION: DATE:

ISSUE DATE: 07/07/2022

CAD DWG FILE:G-101
DRAWN BY: MM
CHECKED BY: EM DESIGNED BY: MM / EM

SHEET TITLE:

INDEX SHEET


SHEET NUMBER:

2 OF 19 SHEETS

07/07/2022

LOCATION MAP SCALE: N.T.S.

STATE OF MISSOURI MAP SCALE: N.T.S.

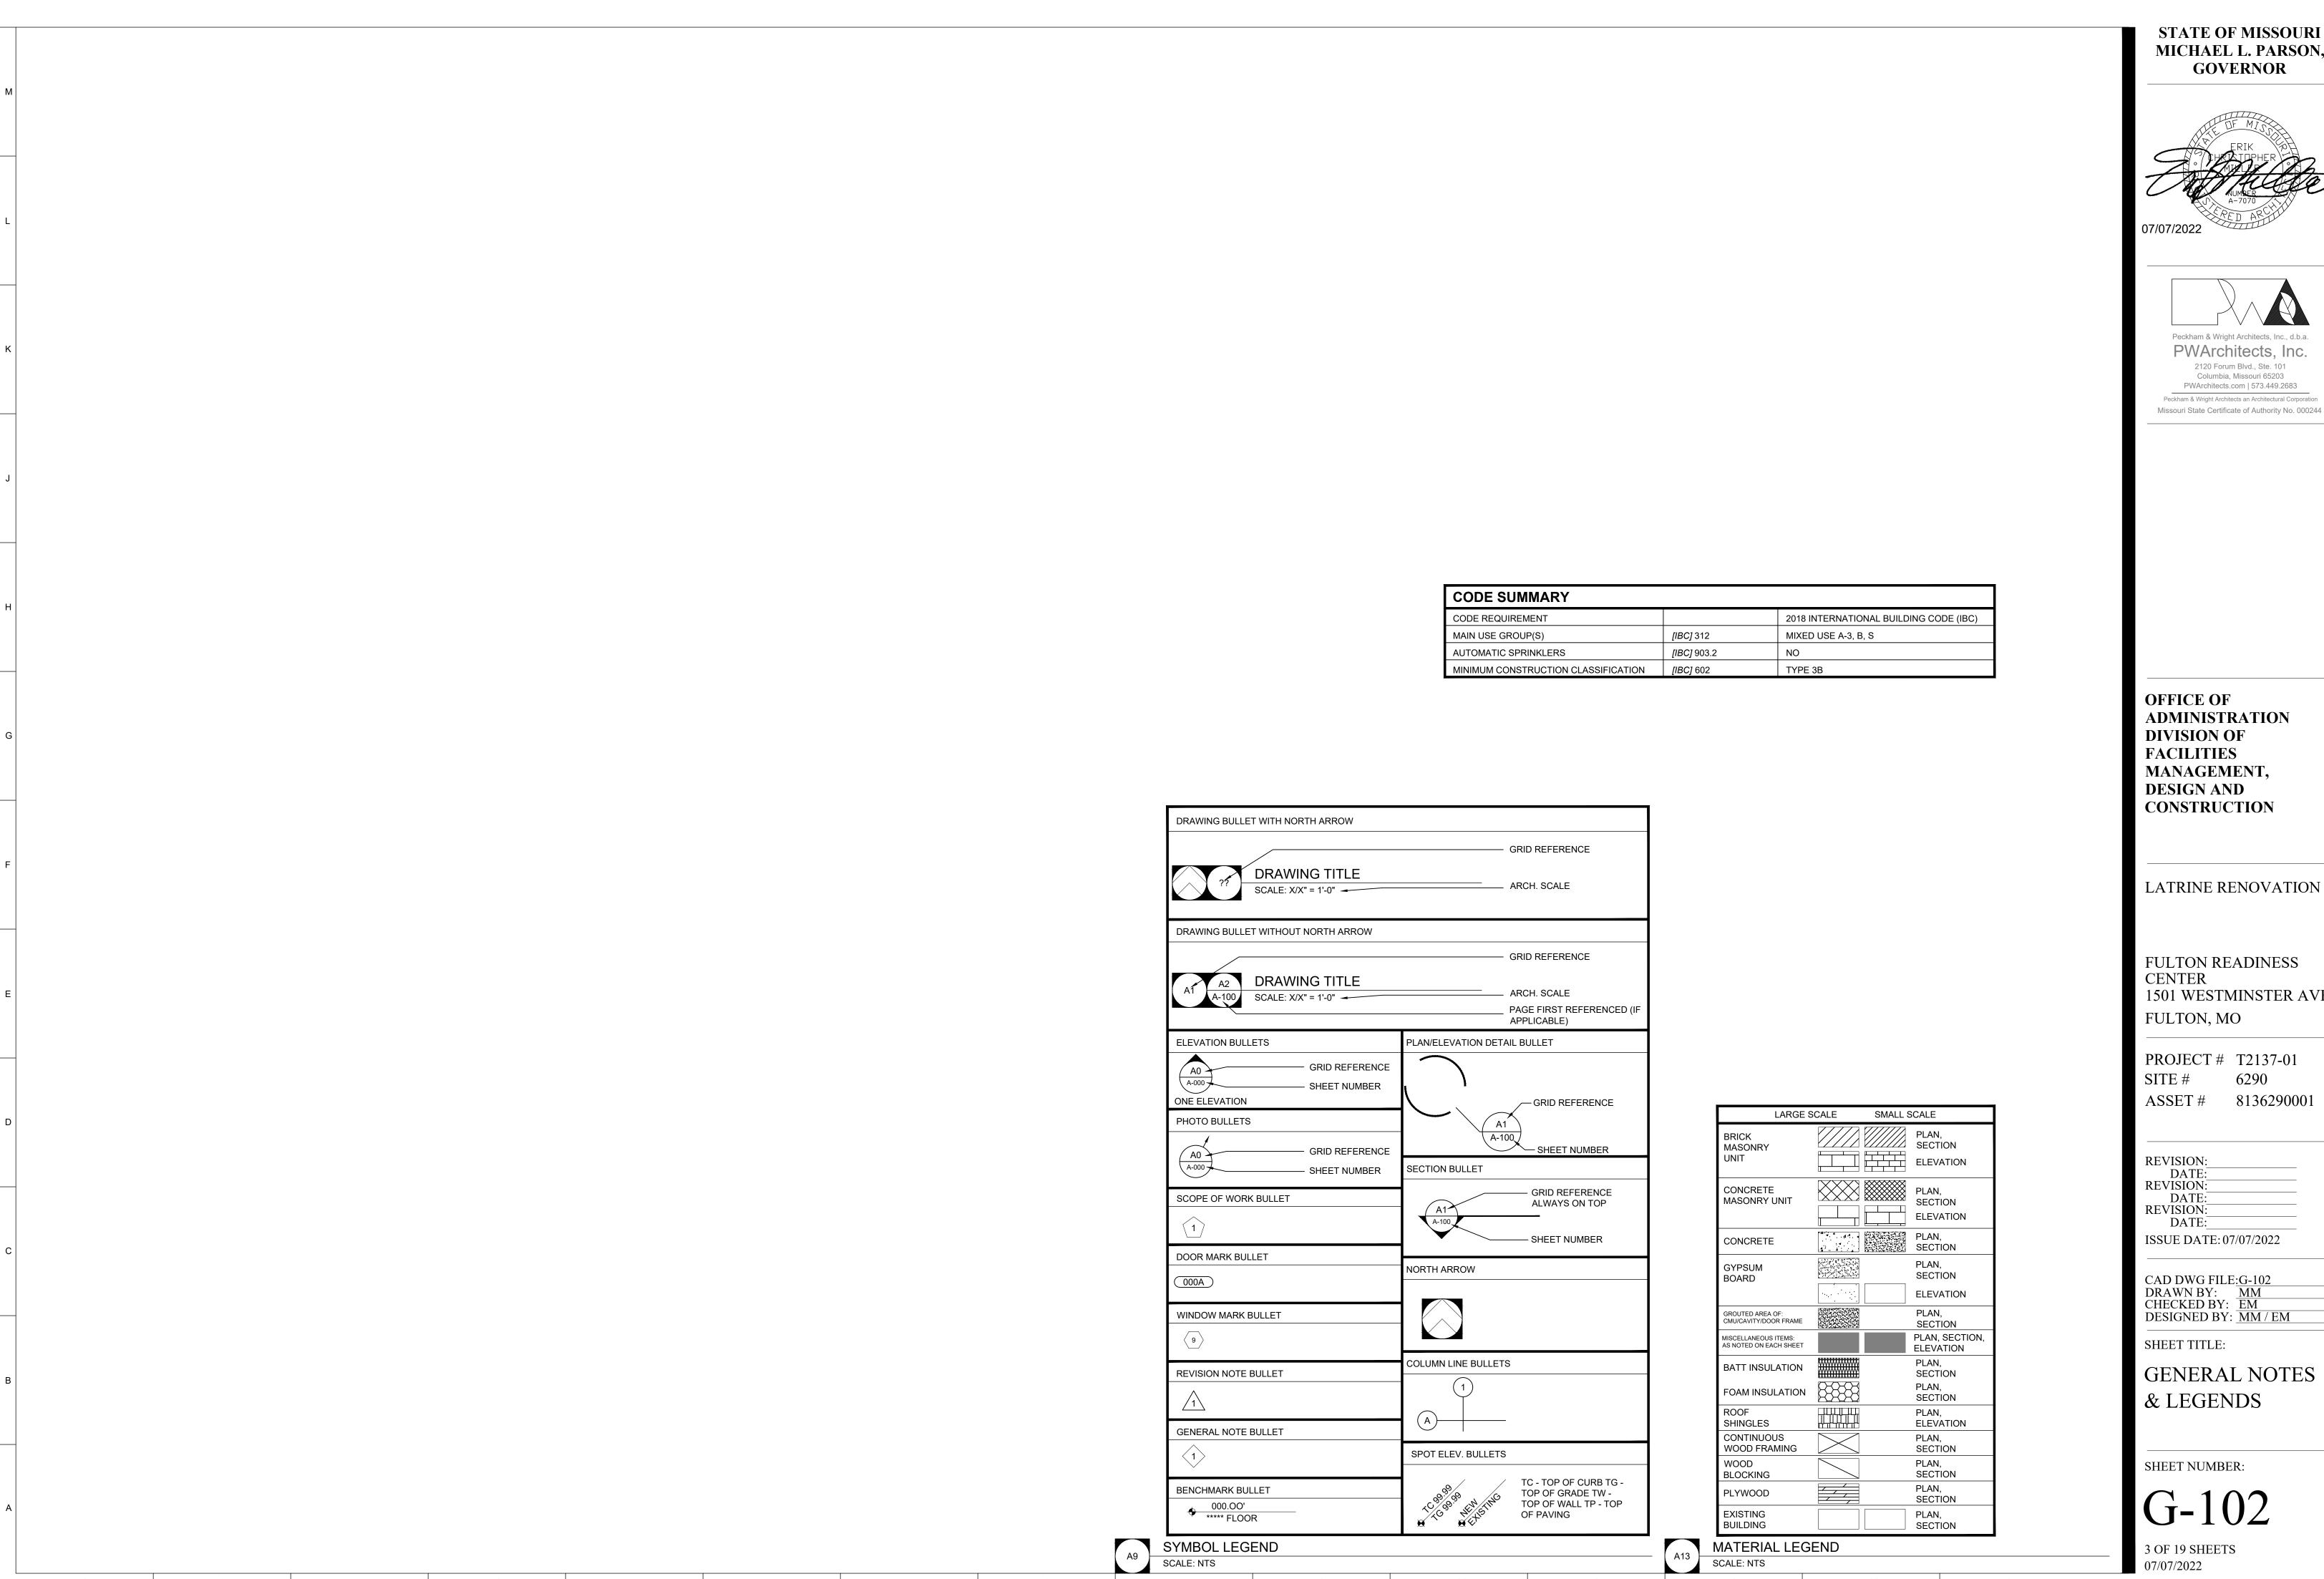

MICHAEL L. PARSON,





1501 WESTMINSTER AVE.

REVISION:	
DATE:	
REVISION:	
DATE:	
REVISION:	
DATE:	
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STRUCTURAL STEEL

- 1. FABRICATION AND ERECTION OF STRUCTURAL STEEL SHALL BE IN ACCORDANCE WITH THE CURRENT EDITION OF THE AISC SPECIFICATIONS FOR STRUCTURAL STEEL BUILDINGS, THE AISC CODE OF STANDARD PRACTICE FOR STEEL BUILDINGS AND BRIDGES AND CURRENT OSHA STANDARDS.
- 2. WIDE FLANGE SHAPES SHALL CONFORM TO ASTM A992. STRUCTURAL TUBES SHALL CONFORM TO ASTM
- A500 GRADE B. ALL OTHER STRUCTURAL STEEL SHALL CONFORM TO ASTM A36.

 3. BOLTS, UNLESS OTHERWISE SHOWN, SHALL CONFORM TO ASTM A325—N,
- SIZE AS PER PLAN.
- 4. ANCHOR BOLTS, UNLESS OTHERWISE SHOWN, SHALL CONFORM TO
- ASTM F1554 GRADE 36.
 5. SPLICING OF STRUCTURAL STEEL IS PROHIBITED EXCEPT AS DETAILED.
- 6. ALL STRUCTURAL AND MISCELLANEOUS STEEL ITEMS SHALL RECEIVE ONE COAT OF "IRONCLAD RETARDO RUST INHIBITIVE PAINT 163" (BENJAMIN MOORE) OR APPROVED EQUAL UNLESS OTHERWISE INDICATED IN THE SPECIFICATIONS. ALL STEEL SURFACES EMBEDDED IN CONCRETE SHALL NOT BE PAINTED. PREPARATION OF STEEL SURFACES SHALL MEET THE REQUIREMENTS OF THE STEEL STRUCTURES PAINTING COUNCIL (SSPC—SP1) AND THE REMOVAL OF GREASE AND OIL BY SOLVENT CLEANING
- (SSPC-SP1) AND THE REMOVAL OF MILL SCALE, RUST, WELD FLUX AND SLAG BY HAND TOOL CLEANING (SSPC-SP2). PRIMER SHALL BE APPLIED AT THE MANUFACTURER'S RECOMMENDED RATE BUT NOT LESS THAN ONE GALLON PER 400 SQ.FT. THEREBY DEPOSITING A DRY FILM THICKNESS OF NOT LESS THAN 1.5 MILS. ANY SCARRED AREAS SHALL BE TOUCHED UP WITH THE SAME PAINT AFTER ERECTION.
- 7. ALL WELDING SHALL BE DONE BY QUALIFIED WELDERS IN ACCORDANCE WITH THE CURRENT EDITION OF THE AWS STRUCTURAL WELDING CODE. WELDING ELECTRODES SHALL BE E70XX.

POST-INSTALLED ANCHORS


- 1. ALL POST-INSTALLED ANCHORS SHALL MEET THE REQUIREMENTS OF THE CODE-CITED EDITION OF ACI 318, APPENDIX "D", AND SHALL BE ACCEPTABLE FOR BOTH CRACKED AND UNCRACKED CONCRETE.
- 2. EXPANSION ANCHORS HAVE BEEN DESIGNED AS HILTI KWIK BOLT TZ ANCHORS, UNLESS NOTED
- 3. ADHESIVE ANCHORS HAVE BEEN DESIGNED TO USE HILTI HIT HY 200 ADHESIVE IN CONCRETE OR SOLID MASONRY, UNLESS NOTED OTHERWISE.
- 4. EQUIVALENT ANCHORS MAY BE SUBMITTED FOR THE ENGINEER'S APPROVAL. SUBMITTALS ARE THE CONTRACTOR'S RESPONSIBILITY AND MUST INCLUDE EVALUATION REPORTS FROM THE INTERNATIONAL CONFERENCE OF BUILDING OFFICIALS (ICBO).
- 5. EMBEDMENT DEPTH IS DEFINED AS THE DISTANCE FROM THE SURFACE OF THE LOAD-BEARING BASE MATERIAL TO THE DEEPEST PART OF THE ANCHOR AFTER THE ANCHOR HAS BEEN DRIVEN INTO THE HOLE BUT NOT YET EXPANDED.
- 6. ADHESIVE ANCHORS SHALL BE ACCEPTABLE FOR LONG-TERM LOADING. WHEN BASE MATERIAL TEMPERATURES ARE BELOW 40 DEG F, ONLY NON-EPOXY-BASED ADHESIVES SHALL BE USED.
- 7. POST-INSTALLED ANCHORS SHALL ONLY BE USED WHERE SPECIFIED ON THE DRAWINGS. THE CONTRACTOR SHALL OBTAIN APPROVAL FROM THE ENGINEER PRIOR TO USING POST-INSTALLED ANCHORS FOR MISSING OR MISPLACED CAST-IN-PLANE ANCHORS. CARE SHALL BE TAKEN TO AVOID CONFLICTS WITH EXISTING REINFORCING BARS. HOLES SHALL BE DRILLED AND CLEANED PER ANCHOR MANUFACTURER'S SPECIFICATIONS.
- 8. STAINLESS STEEL ANCHORS ARE REQUIRED AT ALL PERMANENTLY EXPOSED WEATHER CONDITIONS.


SPECIAL INSPECTIONS

THE FOLLOWING ITEMS REQUIRE SPECIAL INSPECTION IN ACCORDANCE WITH CHAPTER 17 OF THE INTERNATIONAL BUILDING CODE.

- a. BOLTS & ANCHORS EMBEDDED IN CONCRETE (PERIODIC)
- b. STRUCTURAL STEEL FABRICATIONS (UNLESS AISC APPROVED) (PERIODIC)
- c. STRUCTURAL STEEL BOLTING & WELDING (PERIODIC)
- d. POST INSTALLED ANCHORS IN CONCRETE (CONTINUOUS)
- e. MASONRY AND REINFORCING STEEL (CONTINUOUS ON CELL GROUTING / PERIODIC ON REINFORCING)


THE CONTRACTOR SHALL REQUEST SPECIAL INSPECTION OF THE ITEMS LISTED ABOVE PRIOR TO THOSE ITEMS BECOMING INACCESSIBLE AND UNOBSERVABLE DUE TO PROGRESSION OF THE WORK.

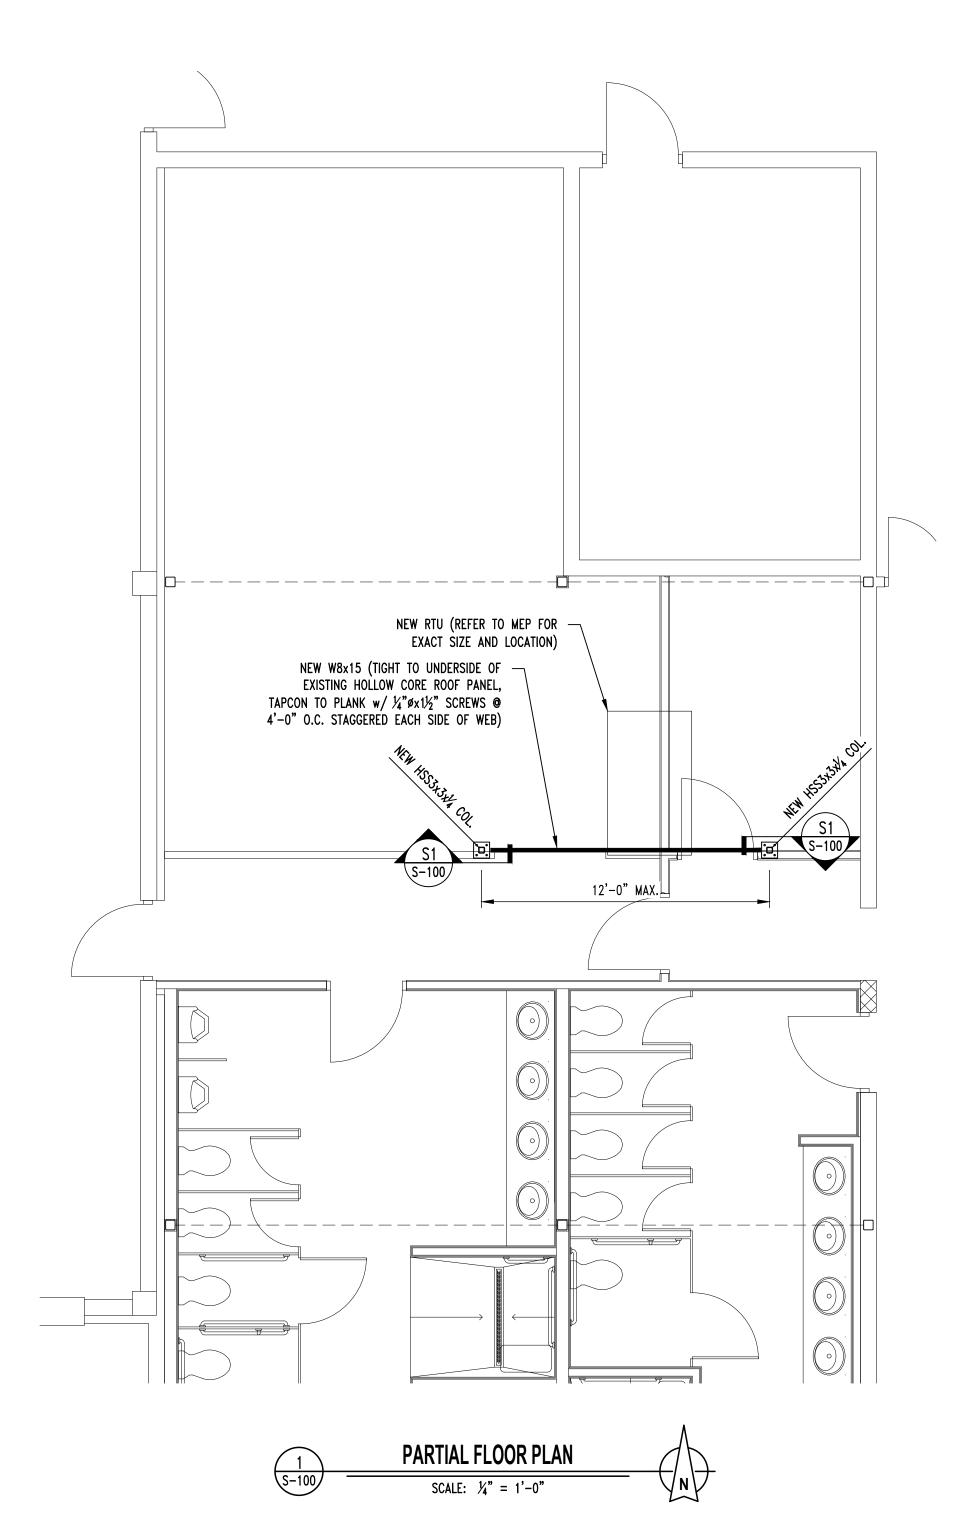


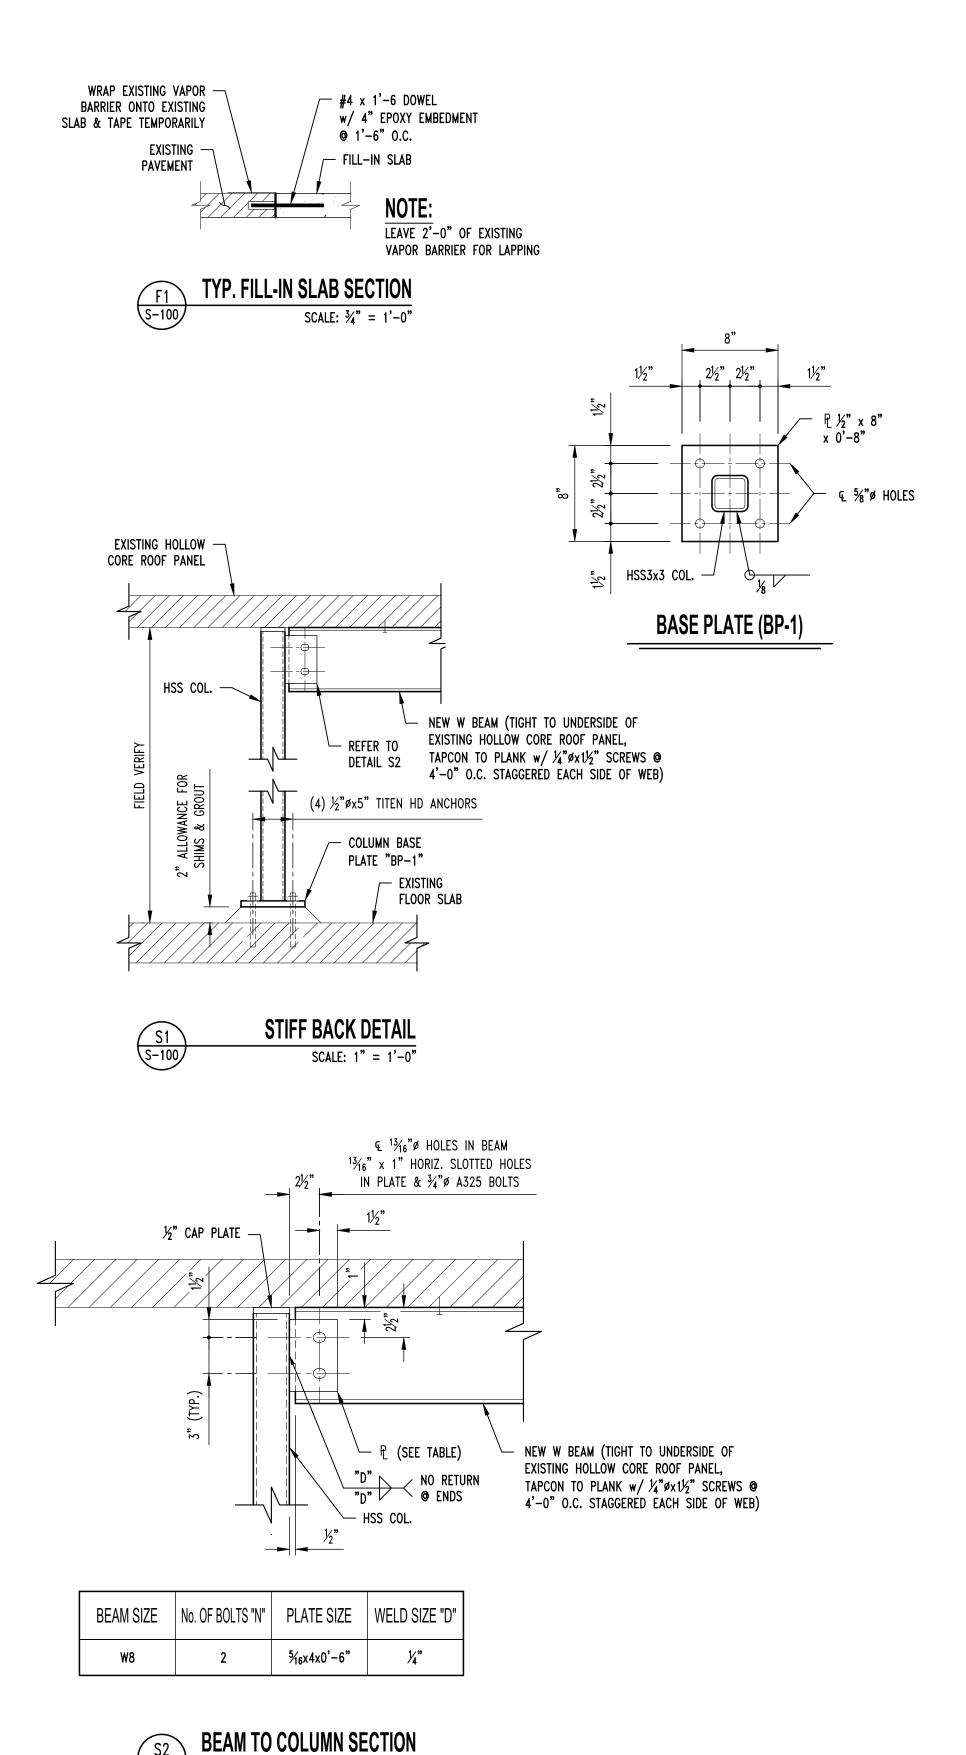

SCALE: $1\frac{1}{2}$ " = 1'-0"

STATE OF MISSOURI MICHAEL L. PARSON, GOVERNOR

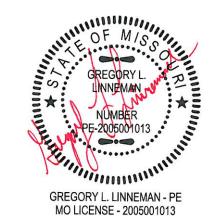

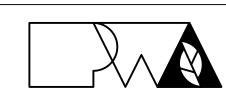

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STRUCTURAL ENGINEER:

ENGINEERING CONSULTANTS
1000 W. Nifong Blvd., Bldg. 1
Columbia, Missouri 65203
(573) 447-0292

www.crockettengineering.com

Crockett Engineering Consultants, LLC Missouri Certificate of Authority #2000151301

OFFICE OF ADMINISTRATION DIVISION OF FACILITIES MANAGEMENT, DESIGN AND CONSTRUCTION

LATRINE RENOVATION

FULTON READINESS CENTER 1501 WESTMINSTER AVE. FULTON, MO

PROJECT # T2137-01 SITE # 6290 ASSET # 8136290001

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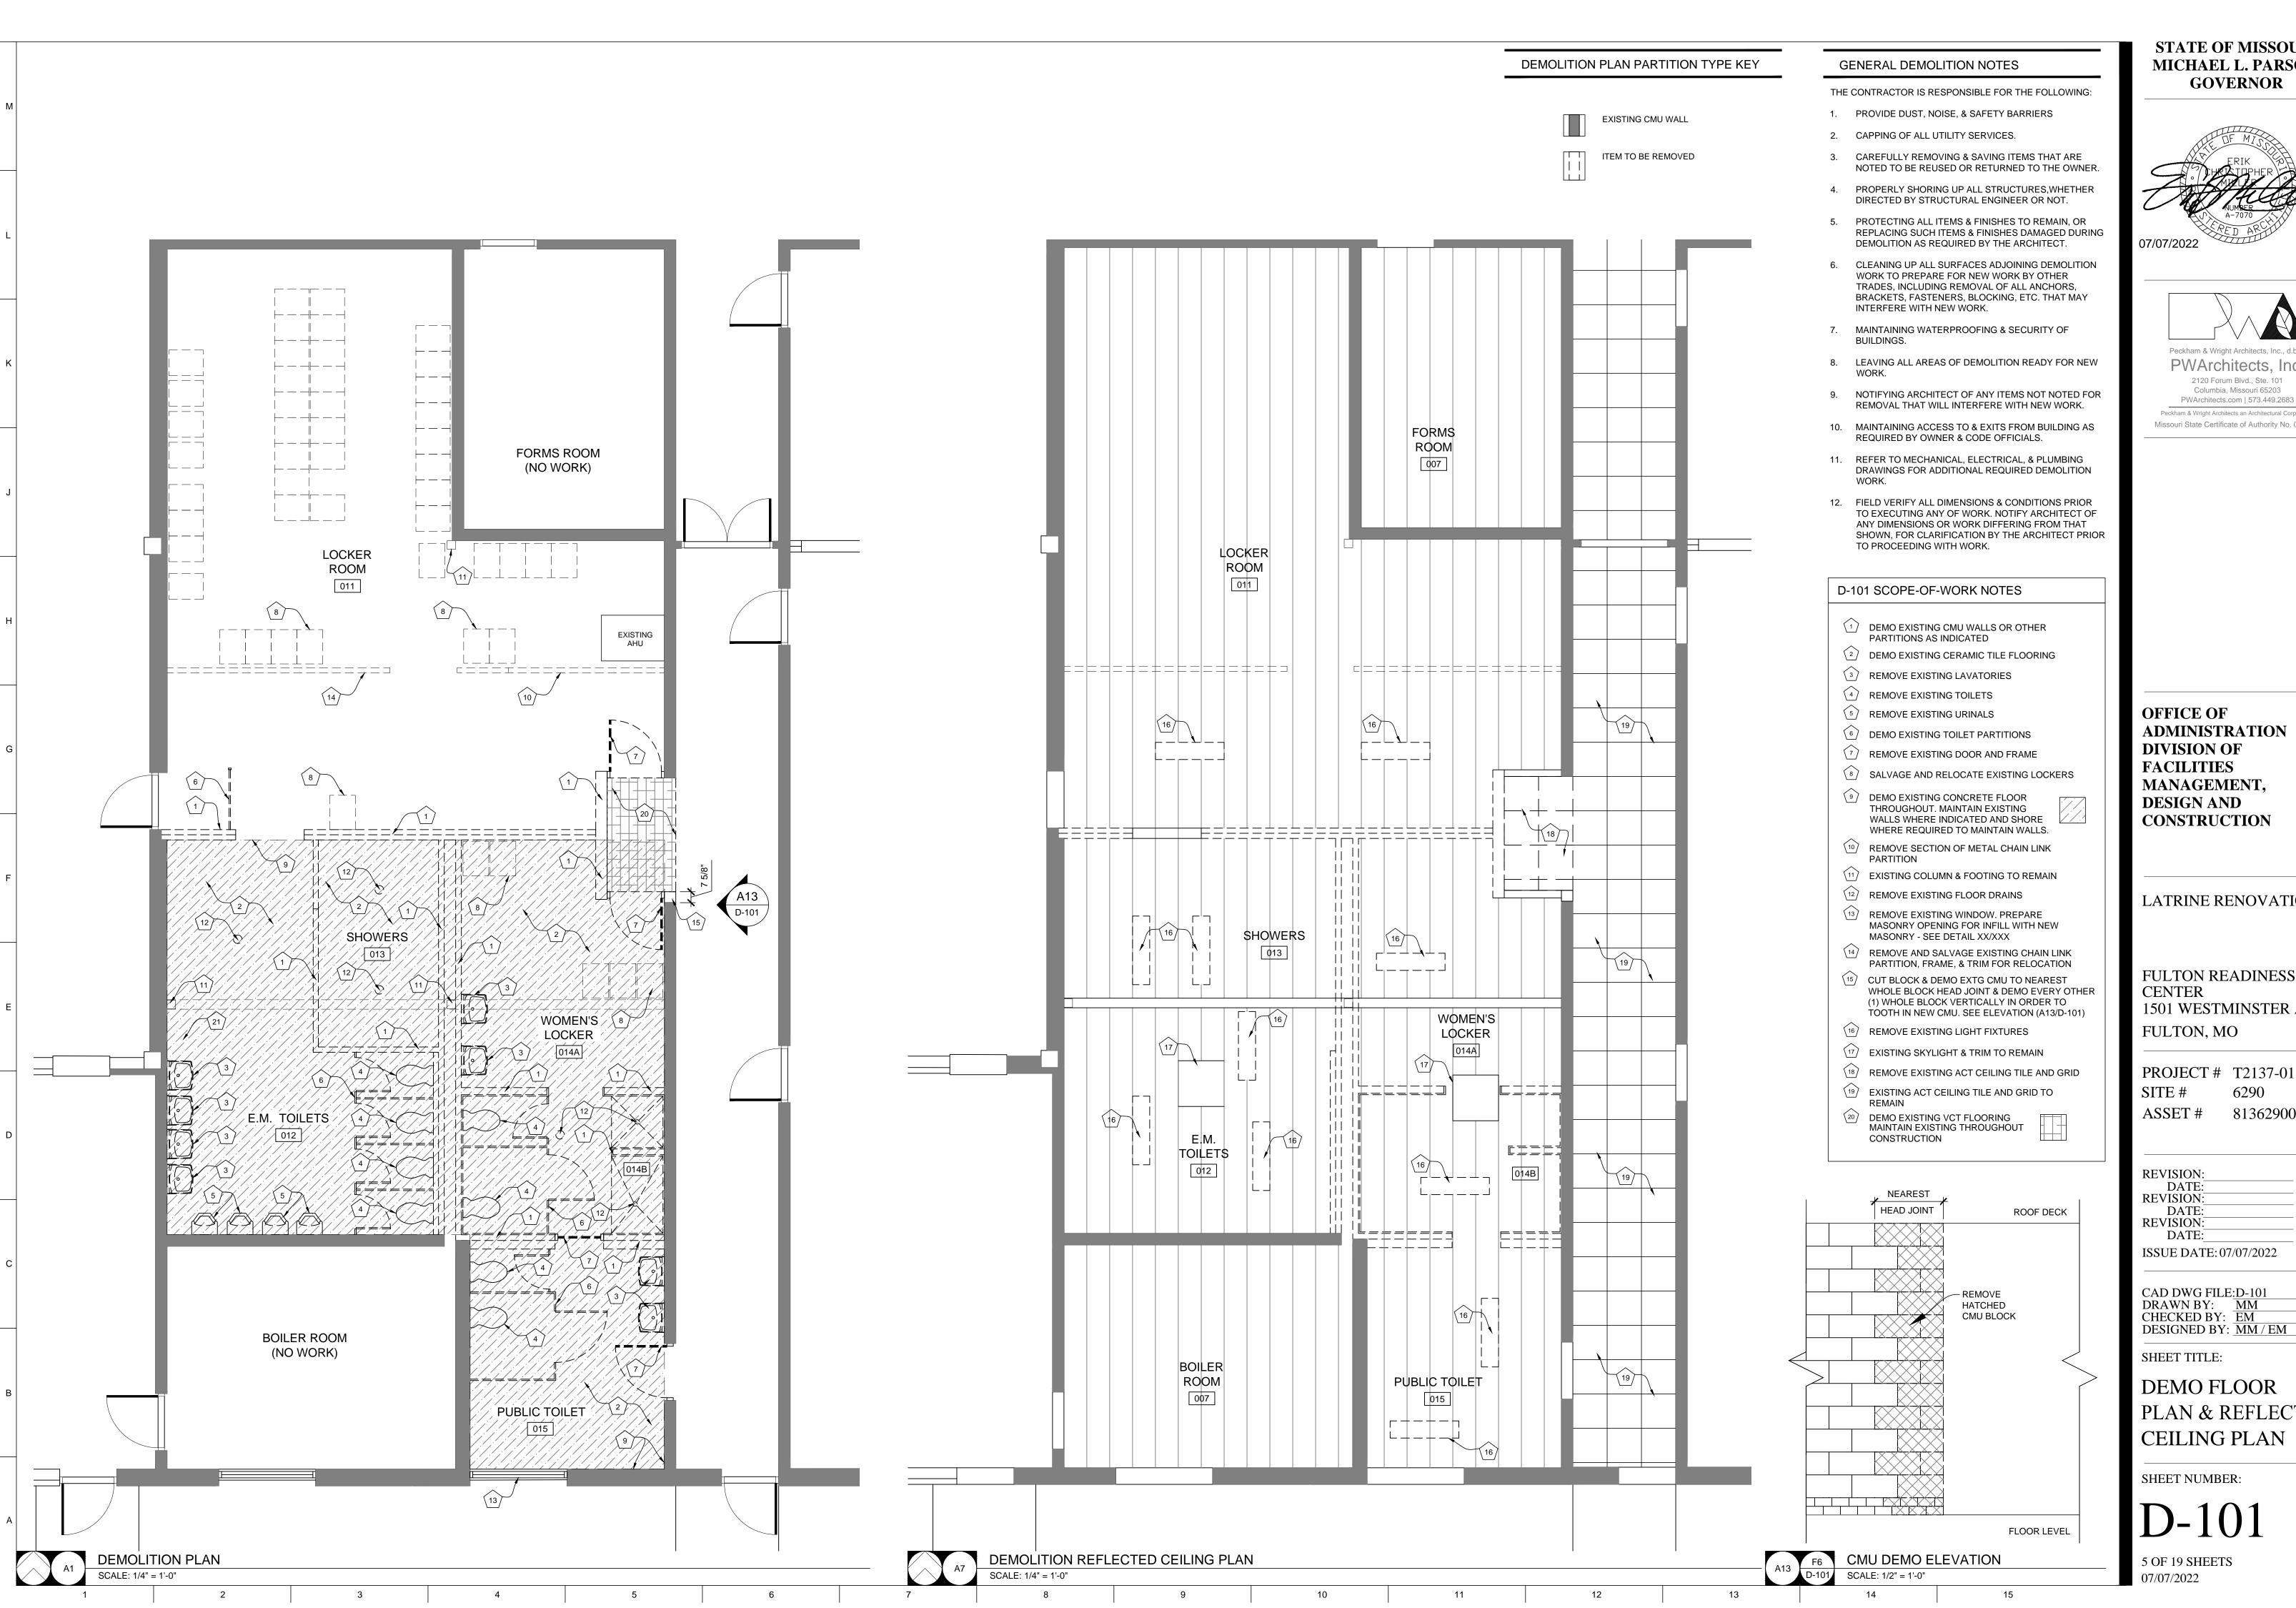
CAD DWG FILE:S-100
DRAWN BY: RCA
CHECKED BY: GLL
DESIGNED BY: GLL

SHEET TITLE:

PARTIAL FLOOR PLAN & DETAILS

SHEET NUMBER:

S-100



STATE OF MISSOURI MICHAEL L. PARSON,



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ADMINISTRATION DIVISION OF MANAGEMENT, **DESIGN AND CONSTRUCTION**

LATRINE RENOVATION


FULTON READINESS 1501 WESTMINSTER AVE.


6290

8136290001


CAD DWG FILE:D-101 DRAWN BY: MM

PLAN & REFLECTED **CEILING PLAN**

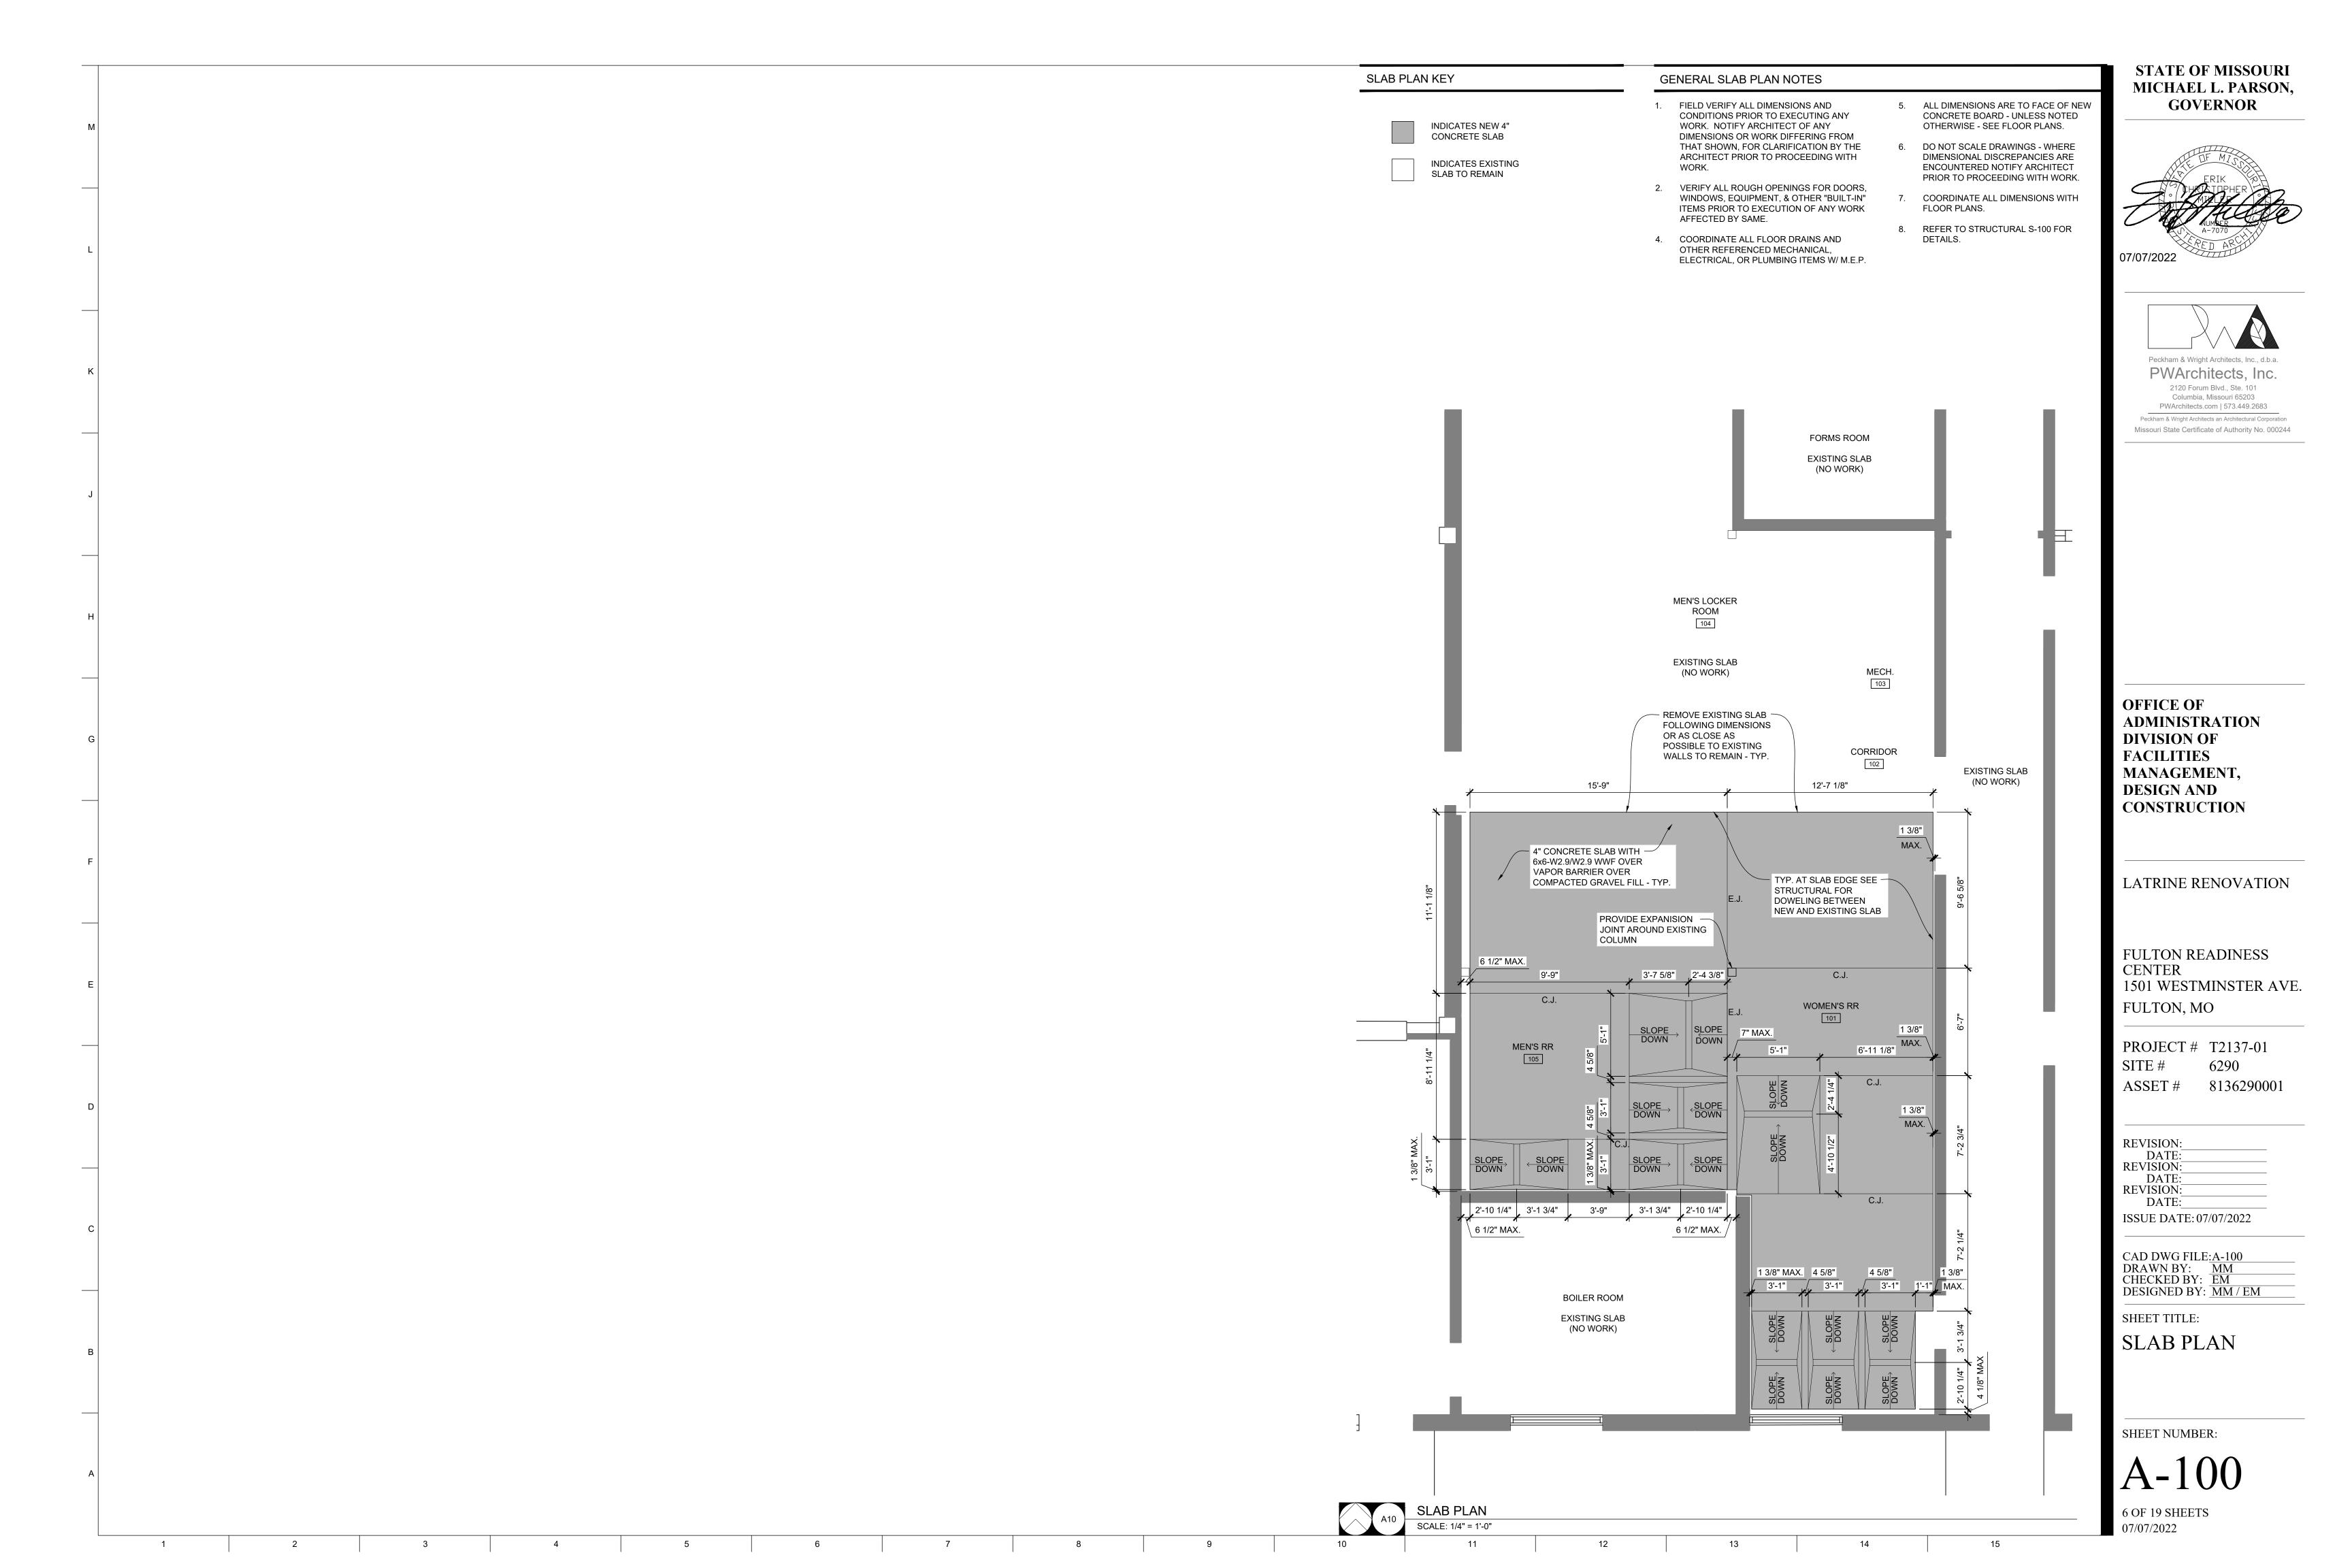

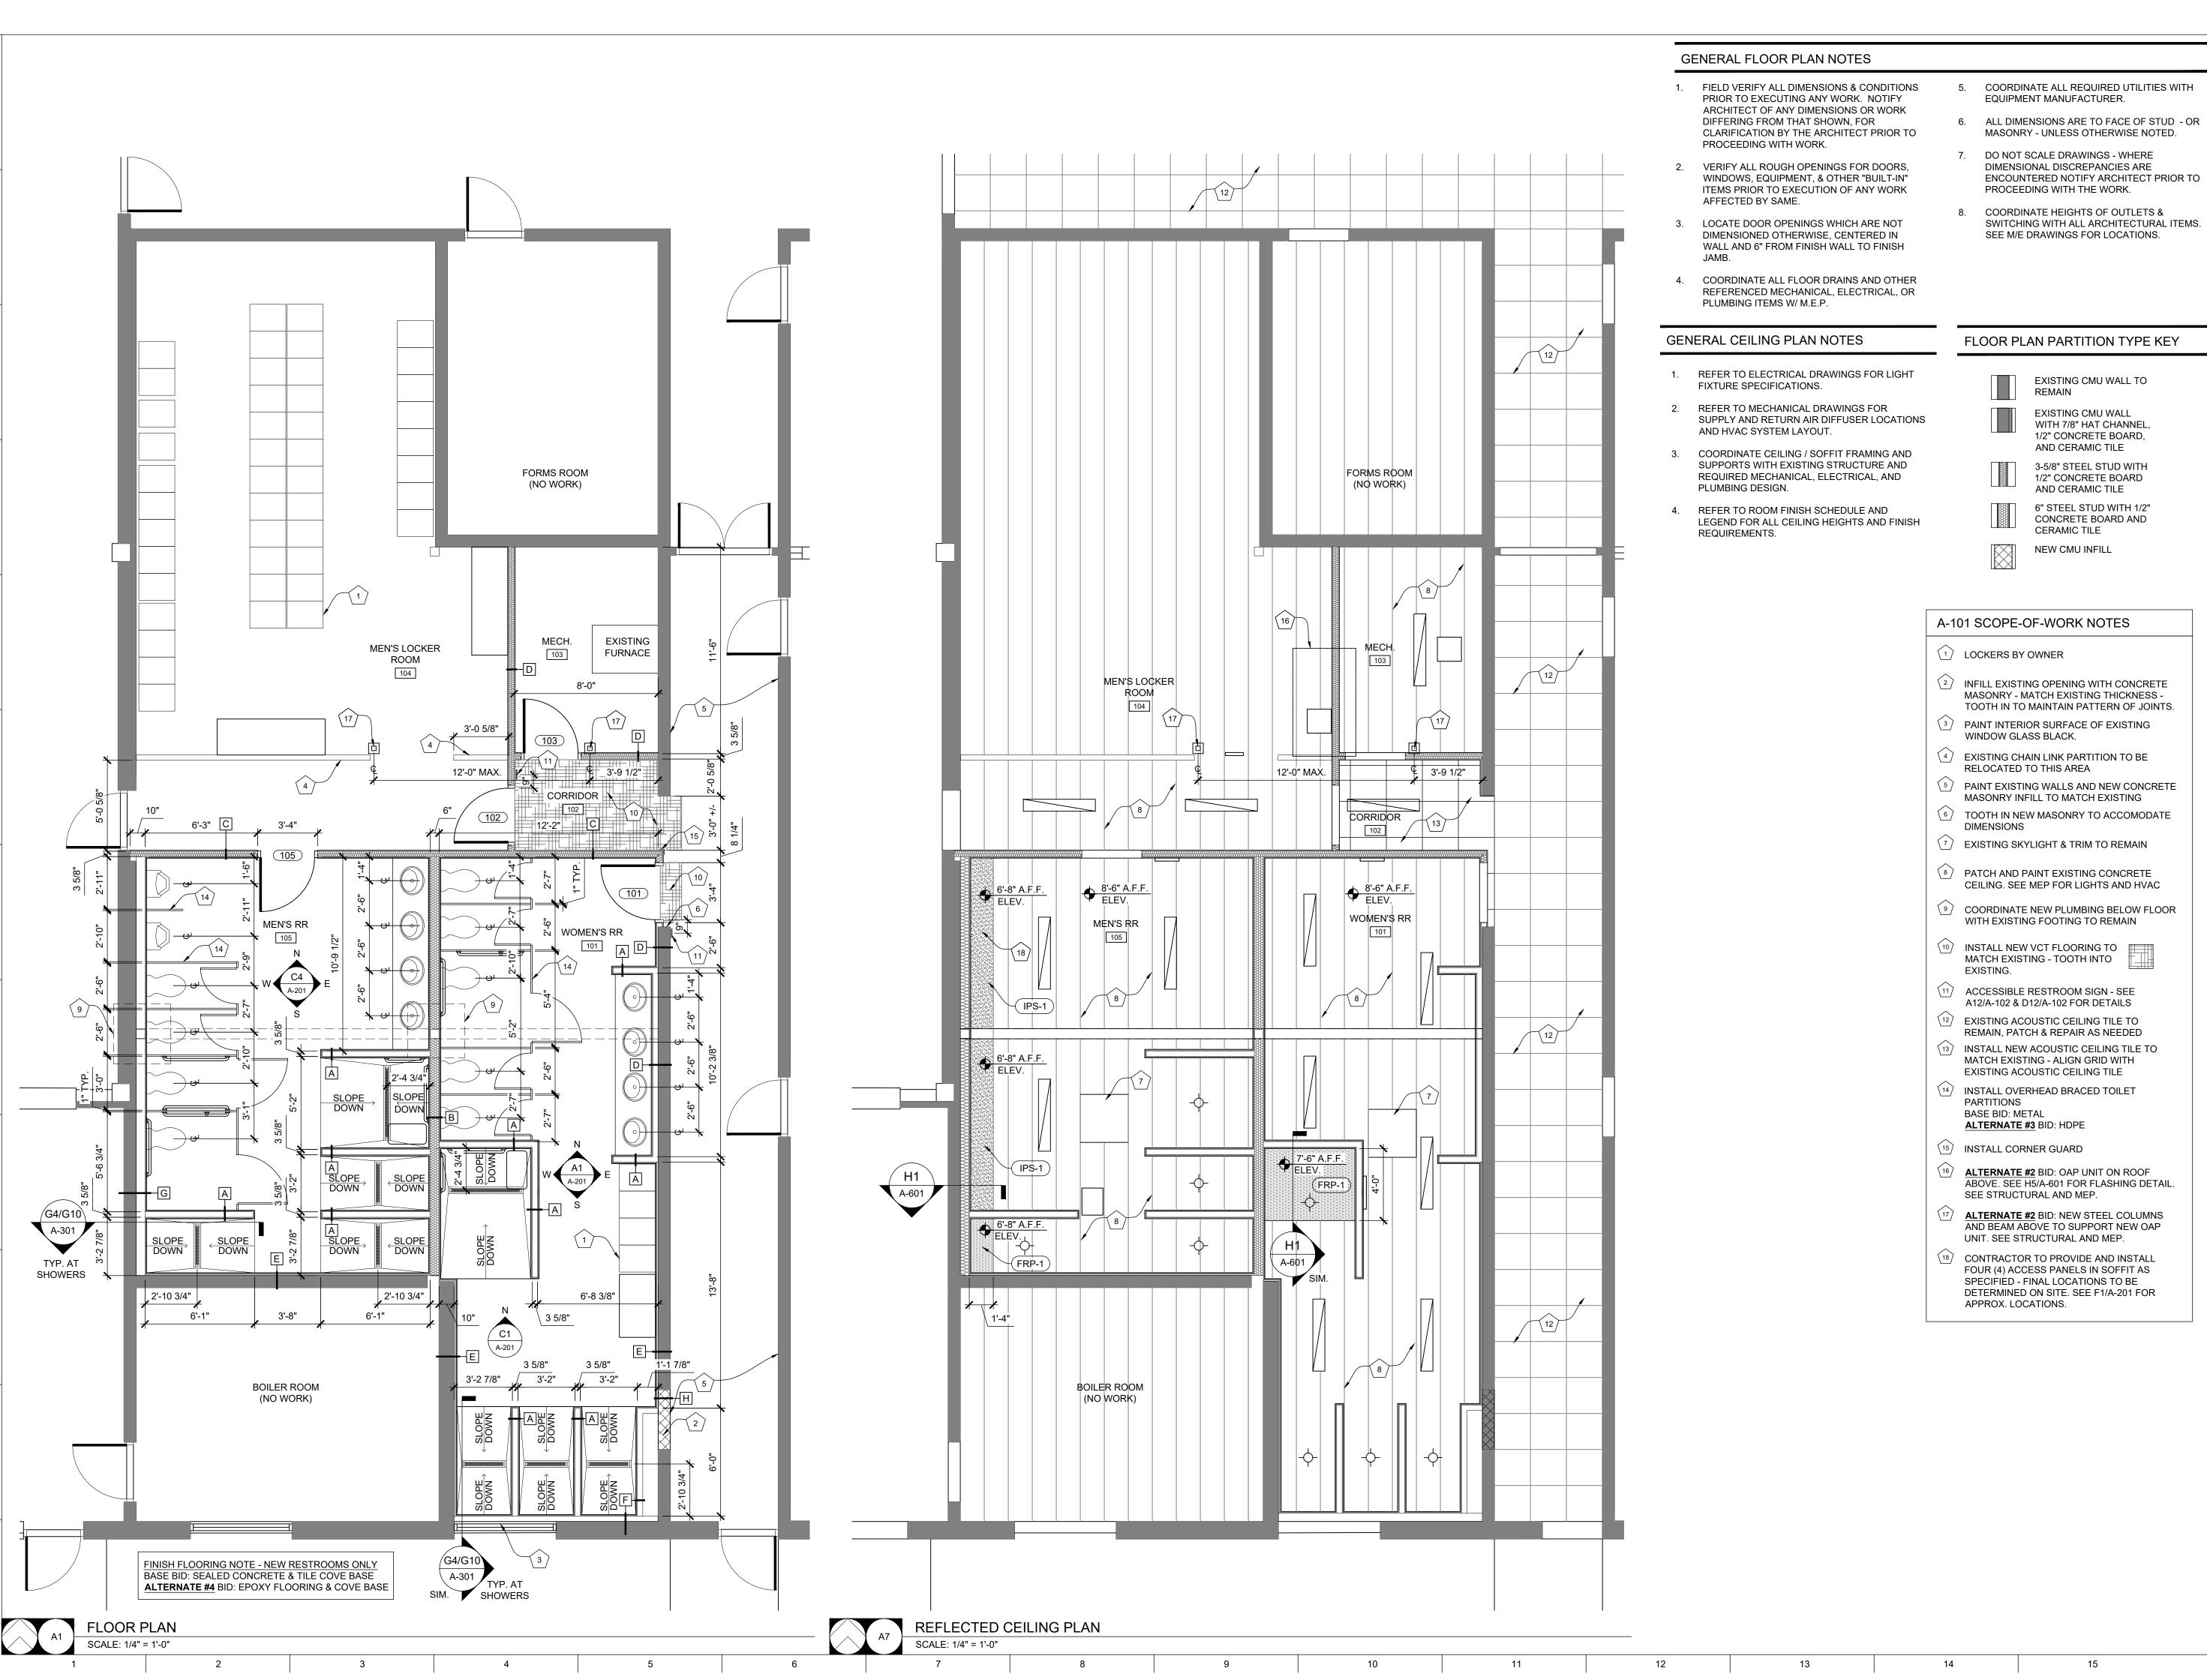

STATE OF MISSOURI MICHAEL L. PARSON, **GOVERNOR**

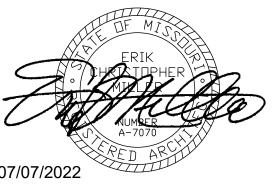

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1/2" CONCRETE BOARD AND CERAMIC TILE

6" STEEL STUD WITH 1/2" CONCRETE BOARD AND CERAMIC TILE

EXISTING CMU WALL TO

EXISTING CMU WALL

AND CERAMIC TILE

WITH 7/8" HAT CHANNEL,

1/2" CONCRETE BOARD,

3-5/8" STEEL STUD WITH

NEW CMU INFILL

A-101 SCOPE-OF-WORK NOTES

1 LOCKERS BY OWNER

2 INFILL EXISTING OPENING WITH CONCRETE MASONRY - MATCH EXISTING THICKNESS -TOOTH IN TO MAINTAIN PATTERN OF JOINTS.

³ PAINT INTERIOR SURFACE OF EXISTING WINDOW GLASS BLACK.

4 EXISTING CHAIN LINK PARTITION TO BE RELOCATED TO THIS AREA

5 PAINT EXISTING WALLS AND NEW CONCRETE MASONRY INFILL TO MATCH EXISTING

6 TOOTH IN NEW MASONRY TO ACCOMODATE DIMENSIONS

EXISTING SKYLIGHT & TRIM TO REMAIN

8 PATCH AND PAINT EXISTING CONCRETE CEILING. SEE MEP FOR LIGHTS AND HVAC

(9) COORDINATE NEW PLUMBING BELOW FLOOR WITH EXISTING FOOTING TO REMAIN

10 INSTALL NEW VCT FLOORING TO MATCH EXISTING - TOOTH INTO

ACCESSIBLE RESTROOM SIGN - SEE

A12/A-102 & D12/A-102 FOR DETAILS

(12) EXISTING ACOUSTIC CEILING TILE TO REMAIN, PATCH & REPAIR AS NEEDED

install new acoustic ceiling tile to match existing - align grid with EXISTING ACOUSTIC CEILING TILE

14 INSTALL OVERHEAD BRACED TOILET **PARTITIONS** BASE BID: METAL

15 INSTALL CORNER GUARD

ALTERNATE #2 BID: OAP UNIT ON ROOF ABOVE. SEE H5/A-601 FOR FLASHING DETAIL.

ALTERNATE #2 BID: NEW STEEL COLUMNS AND BEAM ABOVE TO SUPPORT NEW OAP UNIT. SEE STRUCTURAL AND MEP.

(18) CONTRACTOR TO PROVIDE AND INSTALL FOUR (4) ACCESS PANELS IN SOFFIT AS SPECIFIED - FINAL LOCATIONS TO BE DETERMINED ON SITE. SEE F1/A-201 FOR APPROX. LOCATIONS.

OFFICE OF ADMINISTRATION DIVISION OF FACILITIES MANAGEMENT, **DESIGN AND** CONSTRUCTION

LATRINE RENOVATION

FULTON READINESS CENTER 1501 WESTMINSTER AVE. FULTON, MO

PROJECT # T2137-01 6290 8136290001

REVISION: DATE: **REVISION:** DATE: **REVISION:**

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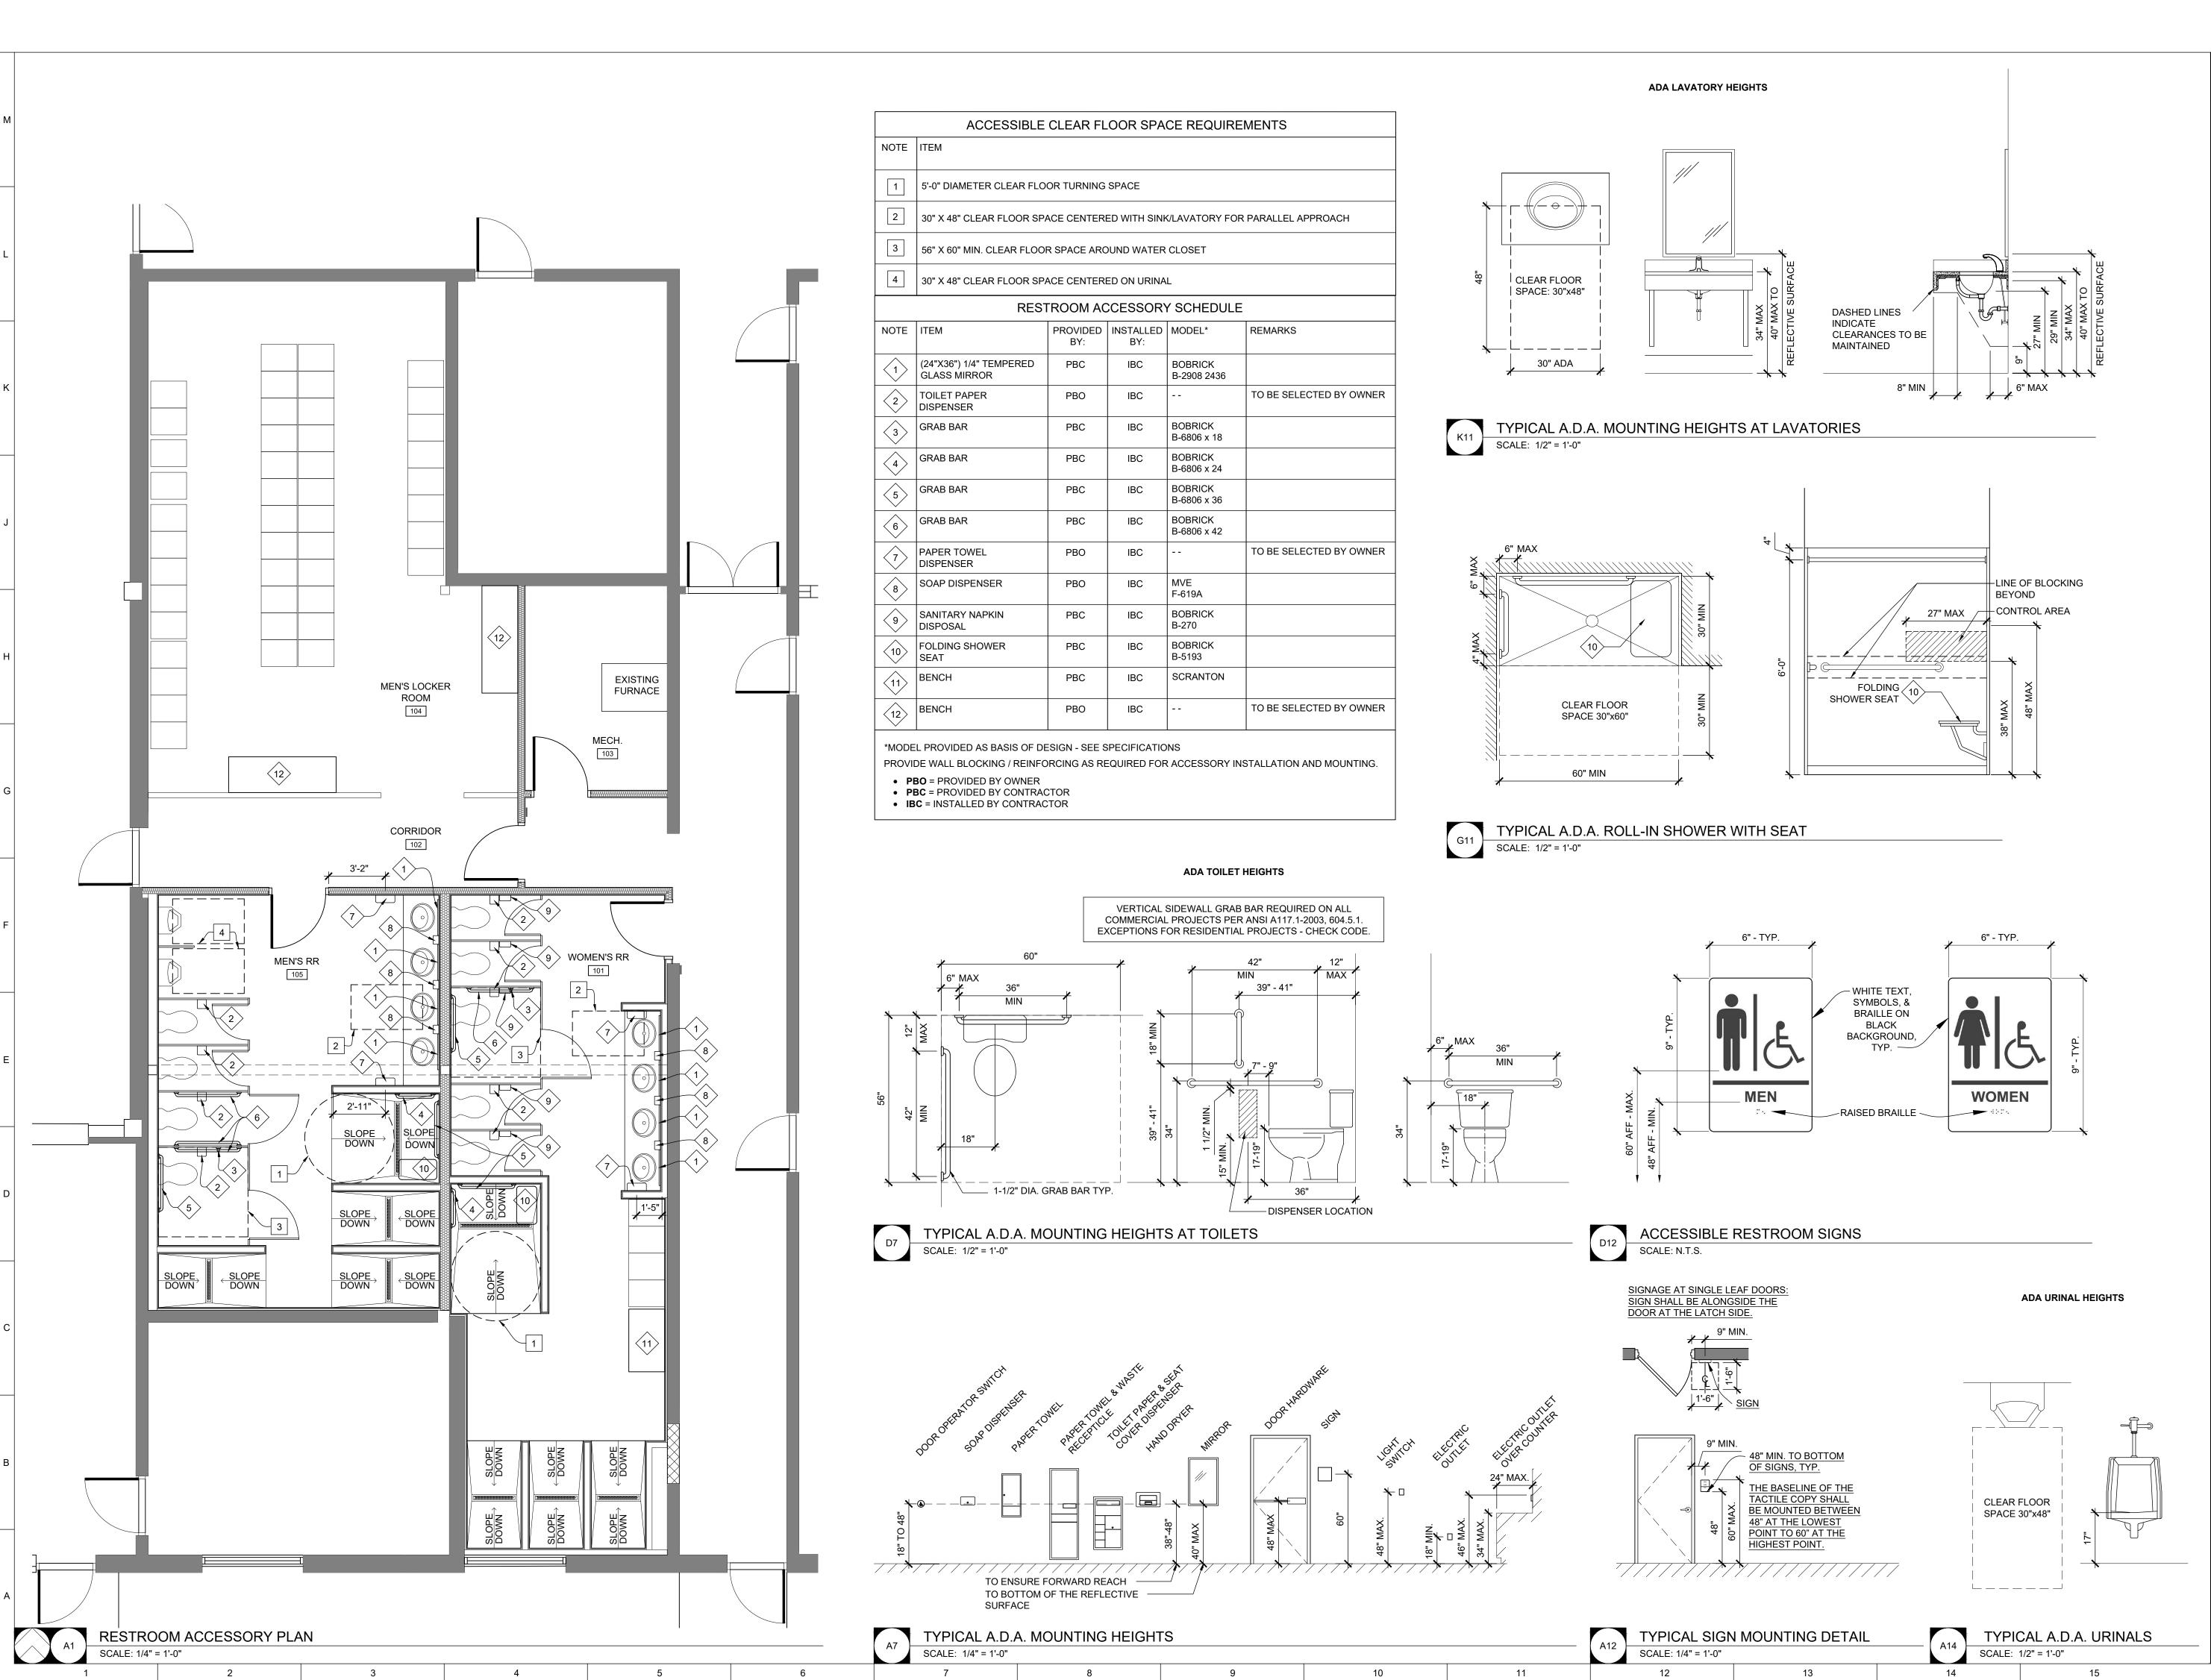
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SHEET TITLE:

DATE:

FLOOR PLAN & REFLECTED CEILING PLAN

SHEET NUMBER:



STATE OF MISSOURI MICHAEL L. PARSON, GOVERNOR





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OFFICE OF
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LATRINE RENOVATION

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PROJECT # T2137-01 SITE # 6290 ASSET # 8136290001

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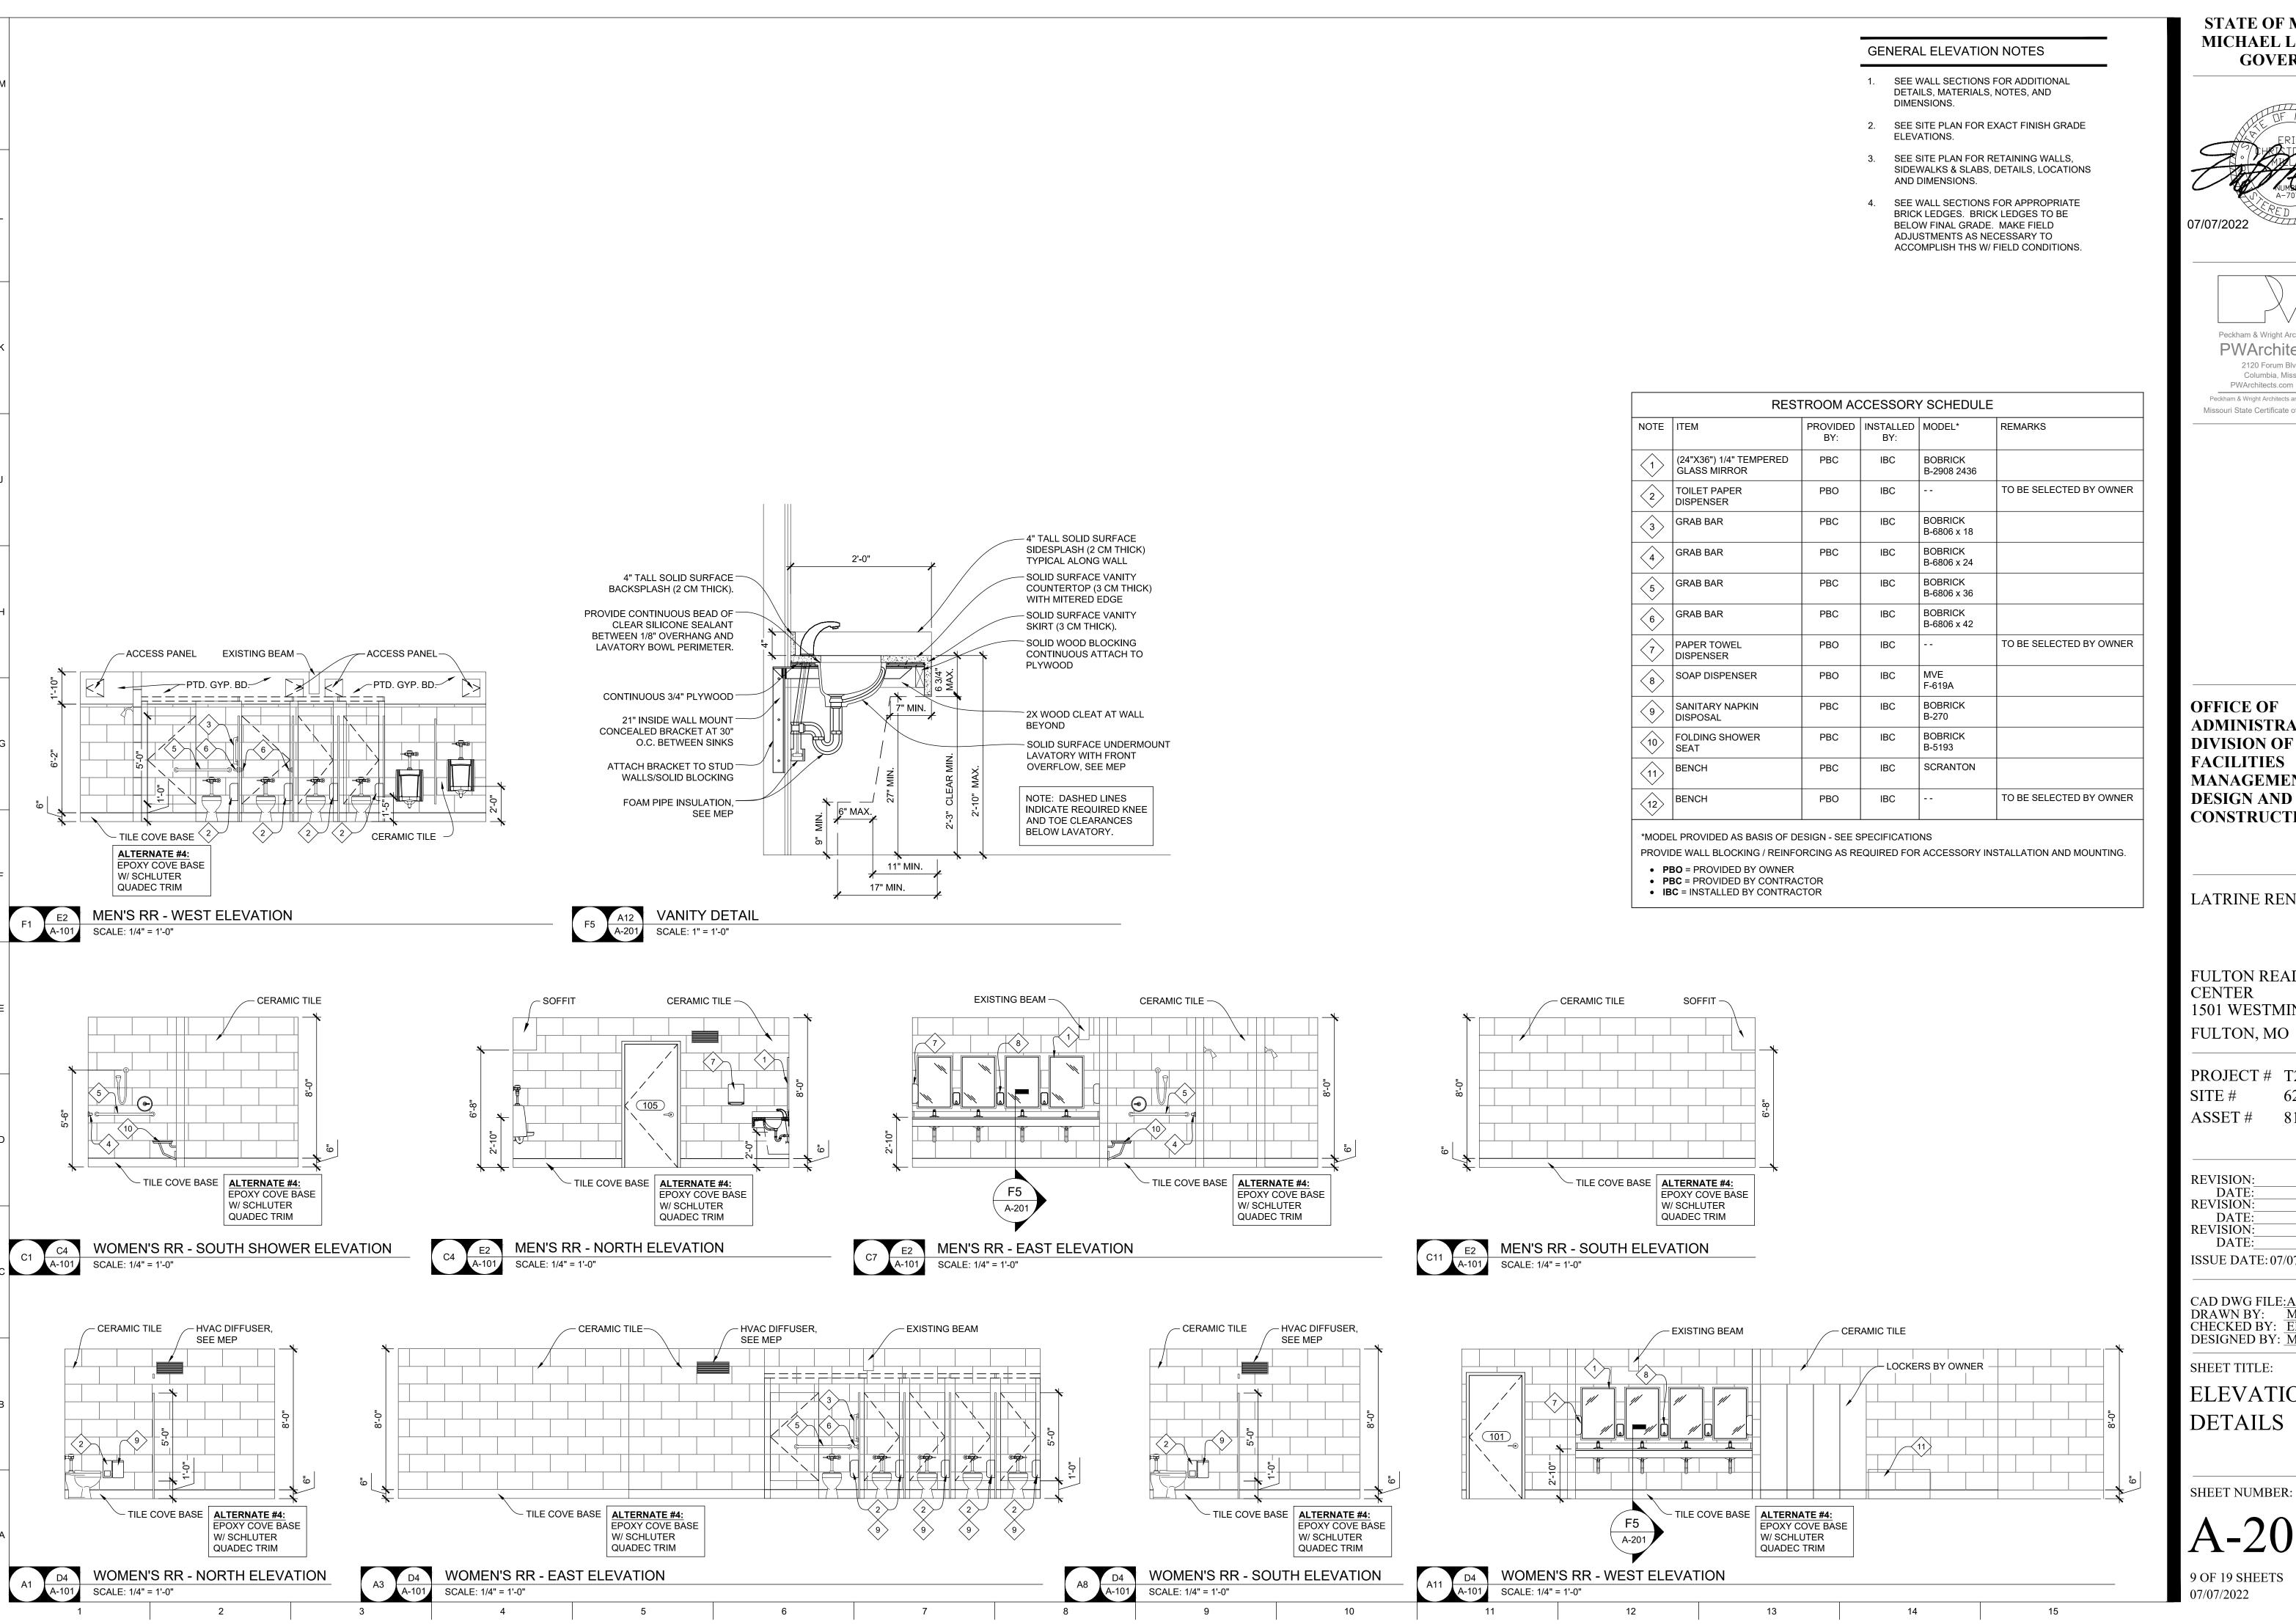
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CHECKED BY: EM
DESIGNED BY: MM / EM

SHEET TITLE:

ACCESSORY PLAN & ADA DETAILS


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A-102



STATE OF MISSOURI MICHAEL L. PARSON, **GOVERNOR**



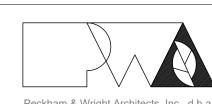

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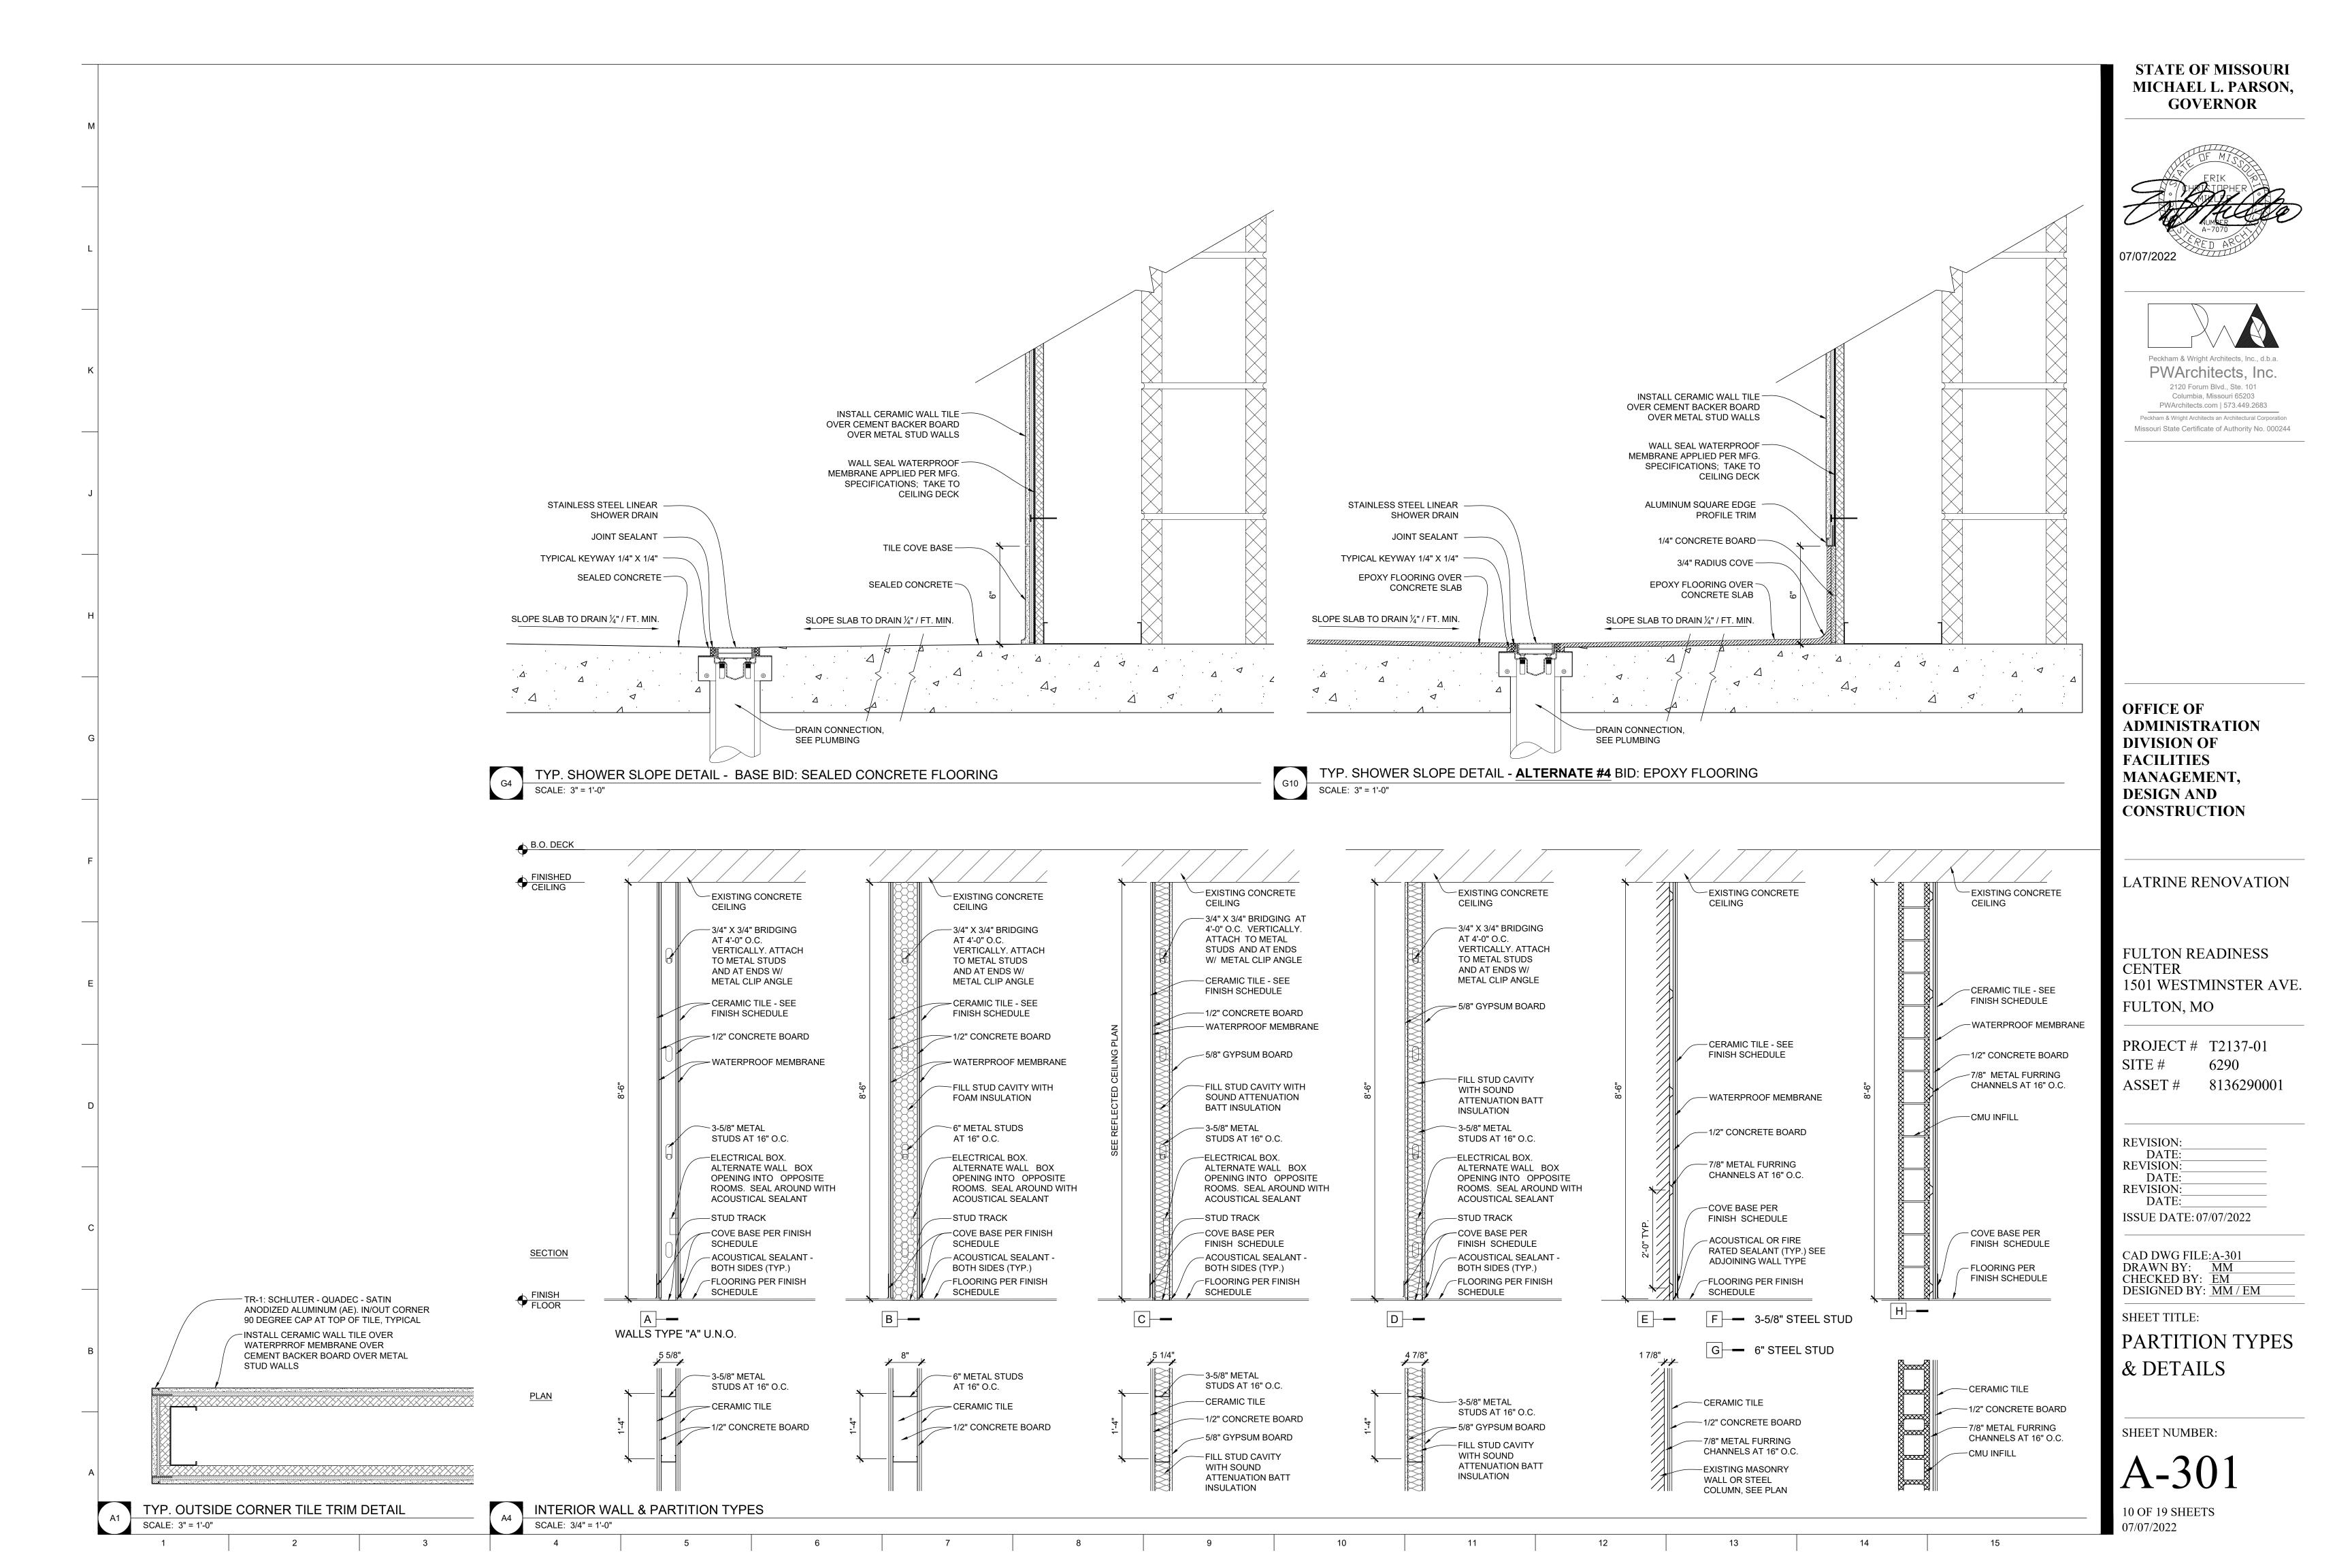
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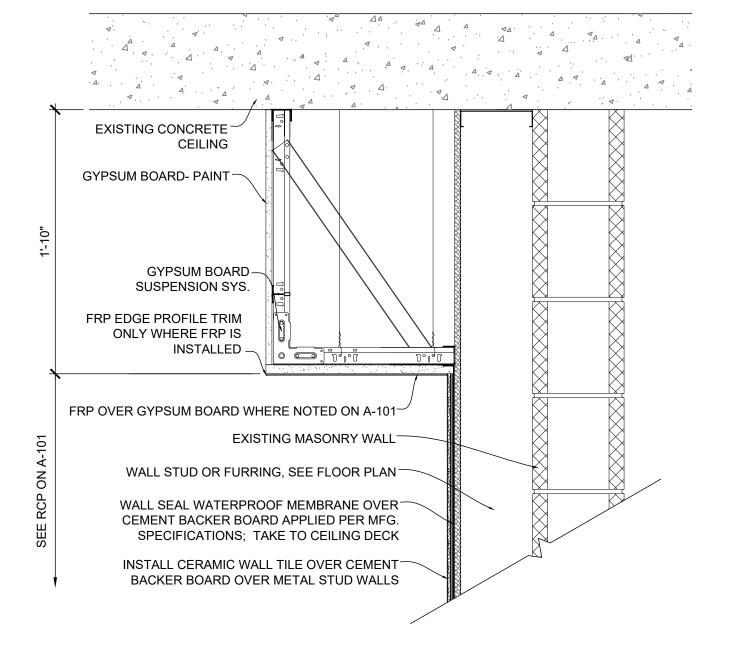
CAD DWG FILE:A-201
DRAWN BY: MM
CHECKED BY: EM DESIGNED BY: MM / EM

SHEET TITLE:

ELEVATIONS & DETAILS

SHEET NUMBER:





NEOPRENE SEAL, TYPICAL -PRE-FABRICATED, AROUND CURB PERIMETER INSULATED, GALVANIZED STEEL TREATED WOOD NAILER -ROOF CURB, SEE MEP PRE-FINISHED METAL FLASHING AND COUNTERFLASHING WITH GASKETED FASTENERS EXTEND EPDM ROOFING -MEMBRANE UP CURB AND TERMINATE BEHIND COUNTERFLASHING WITH FASTENERS AND SEAM FASTENING PLATES SPACED 12" ON CENTER MAX. EXISTING ROOFING AND -INSULATION TO REMAIN

TYP. SOFFIT DETAIL SCALE: 1 1/2" = 1'-0"

TYP. ROOF CURB DETAIL SCALE: 1 1/2"" = 1'-0"

SS: SOLID SURFACE (COUNTERTOPS)

CORIAN - COLOR SELECTED FROM STANDARDS

DOOR SO	CHEDULE					F	RA	ME	SCHE	DULE			HDWR	FIRE RATING	REMARKS
DOOR NO.	DOOR LEAF SIZE W X I	1	MA	TERI	AL		MA	TER	IIAL		DETAILS		HARDWARE GROUP		
		DOOR ELEVATION	WOOD	HOLLOW METAL		FRAME ELEVATION	WOOD	HOLLOW METAL		НЕАD	JAMB	SILL			
101	3'-0" X 7'-0"	D1		X		F1		X		A10 / A-601	A10 / A-601		2		
102	3'-0" X 7'-0"	D1		X		F1		\times		A13 / A-601	A13 / A-601		2		
103	3'-0" X 7'-0"	D1		X		F1		X		A13 / A-601	A13 / A-601		1		
105	3'-0" X 7'-0"	D1		X		F1		X		A10 / A-601	A10 / A-601		2		

ALL DOORS <u>3'-0" x 7'-0"</u> UNLESS NOTED OTHERWISE. ALL DOORS TYPE <u>D1</u> UNLESS NOTED OTHERWISE. . ALL DOORS <u>WOOD</u> UNLESS NOTED OTHERWISE. 4. ALL FRAMES TYPE F1 HOLLOW METAL UNLESS NOTED OTHERWISE. ALL HEAD, SILL AND THRESHOLD DETAILS A10/A-601 UNLESS NOTED OTHERWISE. INTERIOR DOORS UNDERCUT 5/8" TYPICAL UNLESS NOTED OTHERWISE. SEE PLAN FOR DOOR HAND.

DOOR SCHEDULE NOTES

DOOR SCHEDULE AND LEGEND

SCALE: NTS

50011"	5001111115	FLOOR	BASE		W	/ALL		CE	ILING				
ROOM#	ROOM NAME	MAT'L	MAT'L	NORTH	EAST	SOUTH	WEST	FINISH	HEIGHT	REMARKS			
BASE BID:													
101	WOMEN'S RESTROOM	sc	ТВ	СТ	СТ	СТ	СТ	P-1	EXTG. 8'-6"	PAINT ENTIRE CEILING			
102	CORRIDOR	VCT	VB	P-1	P-1	P-1	P-1	ACT	7'-6"	PAINT NEW WALLS, TOUCH UP OTHER WALLS			
103	MECHANICAL		VB	P-1	P-1	P-1	P-1	EXTG.	EXTG. 8'-6"	PAINT NEW WALLS, TOUCH UP OTHER WALLS & CLNC			
104	MEN'S LOCKER ROOM		VB*		P-1	P-1		EXTG.	EXTG. 8'-6"	PAINT NEW WALLS, TOUCH UP OTHER WALLS & CLNG			
105	MEN'S RESTROOM	sc	ТВ	СТ	СТ	СТ	СТ	P-1	EXTG. 8'-6"	PAINT ENTIRE CEILING			
ALTERNATE	BID:												
101	WOMEN'S RESTROOM	EFP	EB	СТ	СТ	СТ	СТ	P-1	EXTG. 8'-6"	PAINT ENTIRE CEILING			
102	CORRIDOR	VCT	VB	P-1	P-1	P-1	P-1	ACT	7'-6"	PAINT NEW WALLS, TOUCH UP OTHER WALLS			
103	MECHANICAL		VB	P-1	P-1	P-1	P-1	EXTG.	EXTG. 8'-6"	PAINT NEW WALLS, TOUCH UP OTHER WALLS & CLNC			
104	MEN'S LOCKER ROOM		VB*		P-1	P-1		EXTG.	EXTG. 8'-6"	PAINT NEW WALLS, TOUCH UP OTHER WALLS & CLNG			
105	MEN'S RESTROOM	EFP	EB	СТ	СТ	СТ	СТ	P-1	EXTG. 8'-6"	PAINT ENTIRE CEILING			
			* WHERE D	DESIGNATED	ON PARTIT	ION TYPES							
FINISH	SCHEDULE MATER	IAL LEG	SEND										
FLOORS:				WALL 1	ΓILE:				CEILI	NGS:			
	LED CONCRETE					LOR BLOX 2.0 -	12 X 24		P-3 C	ON EXISTING CONCRETE CEILINGS			
SC: SEALED C	ONCRETE OMPOSITE TILE				COLOR: SLINK` :: MAPEI	Y CBX03				FIBERGLASS REINFORCED PLASTIC			
	ATCH EXISTING				COLOR: IRON	107				NE - GLASBORD - COLOR SELECTED FROM IDARDS			
	LOORING							STANDANDS					

P-2: MATCH EXISTING TRIM

P-3: MATCH EXISTING CEILING



GENERAL DOOR DETAIL NOTES

- FIELD VERIFY ALL DIMENSIONS AND CONDITIONS PRIOR TO EXECUTING ANY WORK. NOTIFY ARCHITECT OF ANY DIMENSIONS OR WORK DIFFERING FROM THAT SHOWN, FOR CLARIFICATION BY THE ARCHITECT PRIOR TO PROCEEDING WITH
- VERIFY ALL ROUGH OPENINGS FOR DOORS, WINDOWS, EQUIPMENT, & OTHER "BUILT-IN" ITEMS PRIOR TO EXECUTION OF ANY WORK AFFECTED BY SAME.
- 3. LOCATE DOOR OPENINGS IN METAL STUD WALLS WHICH ARE NOT DIMENSIONED OTHERWISE, CENTERED IN WALL AND 6" FROM FINISH WALL TO FINISH JAMB.
- 4. SEE DOOR SCHEDULE FOR DOOR DIMENSIONS AND DETAILS.

CONTINUOUS TOOLED

PERIMETER (BOTH SIDES)

SEALANT, TYPICAL

SEE SCHEDULE FOR

DOOR TYPES & SIZES

PROVIDE (3) FRAME ANCHORS MINIMUM

- REFER TO FLOOR PLANS

FOR PARTITION TYPES

CONTINUOUS TOOLED

PERIMETER (BOTH SIDES)

- 2" x 4" WOOD BLOCKING

SEE SCHEDULE FOR

DOOR TYPES & SIZES

METAL STUD HEADER

SEALANT, TYPICAL

AROUND FRAME

2" x 4" WOOD BLOCKING CONTRACTOR OPTION


PER JAMB

AROUND FRAME

5. LOCATE DOOR OPENINGS IN CMU WALLS WHICH ARE NOT DIMENSIONED OTHERWISE, CENTERED IN WALL AND 8" FROM FINISH WALL TO FINISH JAMB.

STATE OF MISSOURI MICHAEL L. PARSON, **GOVERNOR**



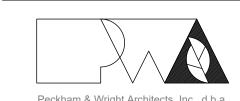

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CAD DWG FILE:A-601 DRAWN BY: MM CHECKED BY: EM DESIGNED BY: MM / EM

SHEET TITLE:

SCHEDULES & DETAILS

SHEET NUMBER:


INTERIOR HOLLOW METAL DOOR FRAMES


SEE SCHEDULE FLOOR LEVEL FLOOR LEVEL $\langle F1 \rangle$ WOOD DOOR HOLLOW METAL FRAME





FRAME ELEVATIONS
SCALE: 3/4" = 1'-0"

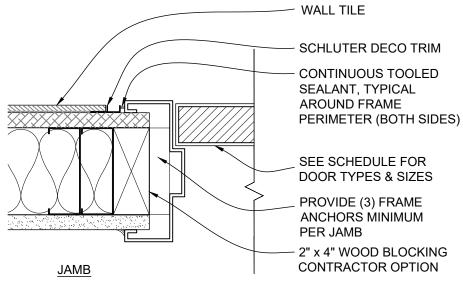

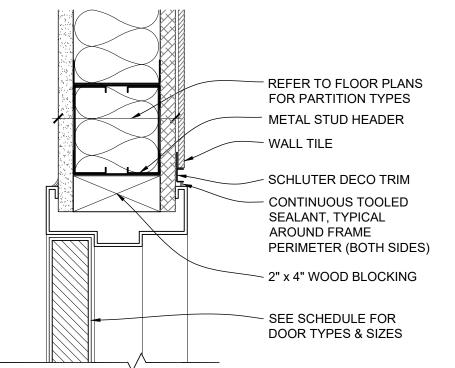

H.M. FRAME DETAIL WITH WALL TILE @ JAMB

SCALE: 3" = 1'-0"

SCALE: 3" = 1'-0"

<u>HEAD</u>

SCALE: NTS

FINISH SCHEDULE AND LEGEND

TB: TILE COVE BASE TO MATCH WALL TILE (CT)

EB: EPOXY COVE BASE TO MATCH EPOXY FLOORING (EFP)

VB: VINYL COVE BASE

HVAC PLAN SYMBOL LEGEND EQUIPMENT TYPE (REFER TO EQUIPMENT SCHEDULE) EQUIPMENT REFERENCE NUMBER DIFFUSER/GRILLE TYPE (REFER TO SCHEDULE) CUBIC FEET PER MINUTE (CFM) / FACE SIZE SUPPLY DUCTWORK RETURN DUCTWORK EXHAUST DUCTWORK OUTSIDE AIR DUCTWORK VENT / COMBUSTION AIR TIE INTO EXISTING SUPPLY DIFFUSER (HATCH INDICATES "NO FLOW ZONE") RETURN DIFFUSER BALANCE DAMPER

BALANCE DAMPER

MOTORIZED DAMPER

CEILING RADIATION DAMPER

FIRE RATED DAMPER

SMOKE DAMPER

THERMOSTAT

CO2

CO2 DETECTOR

RETURN DUCT SMOKE DETECTOR

TO FIRE ALARM SYSTEM (IF PRESENT) OR TO REMOTE SOUNDER LOCATED IN AN OCCUPIED SPACE (EQUAL TO SYSTEM SENSOR #D4120)

PEMOTE SOUNDER WIDED TO RETURN DUCT SMOKE DETECTOR

WIRED TO FAN STARTER TO SHUT UNIT(S) DOWN AND SEND ALARM SIGNAL

REMOTE SOUNDER WIRED TO RETURN DUCT SMOKE DETECTOR (EQUAL TO SYSTEM SENSOR #MHW)

HVAC PLAN GENERAL NOTES:


- . SEE SHEET M-501 FOR ADDITIONAL HVAC NOTES, DETAIL, AND SCHEDULES.
- 2. SET DISCHARGE AIR TEMPERATURE OF OAP-1 TO 72°F; ADJUSTABLE BY THERMOSTAT IN
- MECHANICAL ROOM.
 3. INSTALL NEW DUCTWORK TIGHT TO CEILING.


HVAC PLAN KEY NOTES:

- 1) DEMOLISH EXISTING EXHAUST FAN ON ROOF.
- 2 DEMOLISH EXISTING WALL-MOUNTED EXHAUST FAN. REFER TO ARCHITECTURAL FOR PATCHING OF WALL PENETRATION.
- 3 DEMOLISH EXISTING TRANSFER GRILLE (APPROXIMATELY 6x10) ABOVE DOOR. PATCH OPENING.
- (4) DEMOLISH EXISTING 6x6 SUPPLY DUCT & CAP AT MAIN DUCT.
- (5) INSTALL NEW SURFACE-MOUNTED GRILLE OVER EXISTING 12x16 EXHAUST DUCT.

(8) USE EXISTING GRAVITY VENT OPENING FOR NEW FRESH AIR SUPPLY DUCT.

- (6) INSTALL NEW EXHAUST FAN (EF-1) ON EXISTING CURB. PROVIDE CURB ADAPTER AS NEEDED.
- (7) INSTALL NEW EXHAUST FAN (EF-2) ON EXISTING CURB. PROVIDE CURB ADAPTER AS NEEDED.

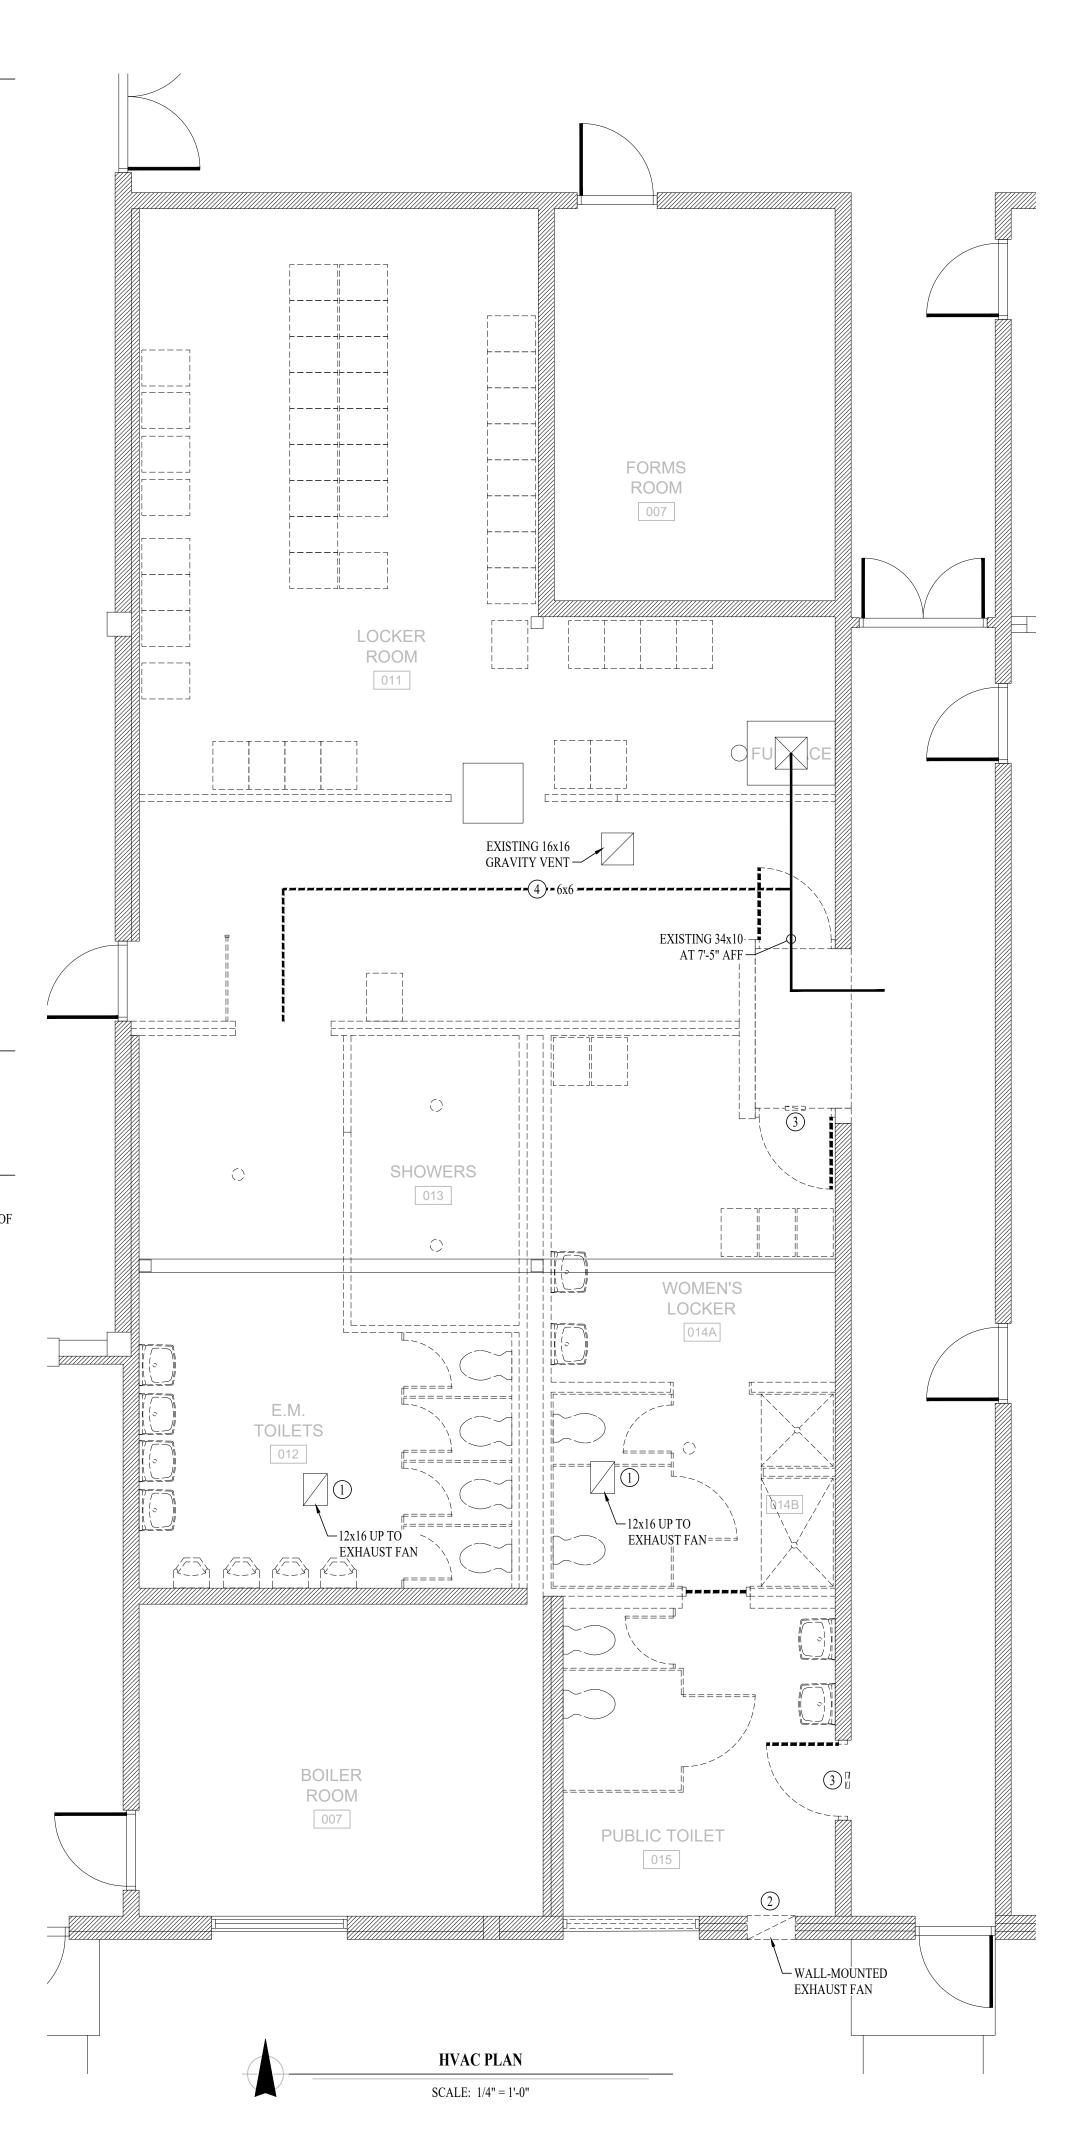

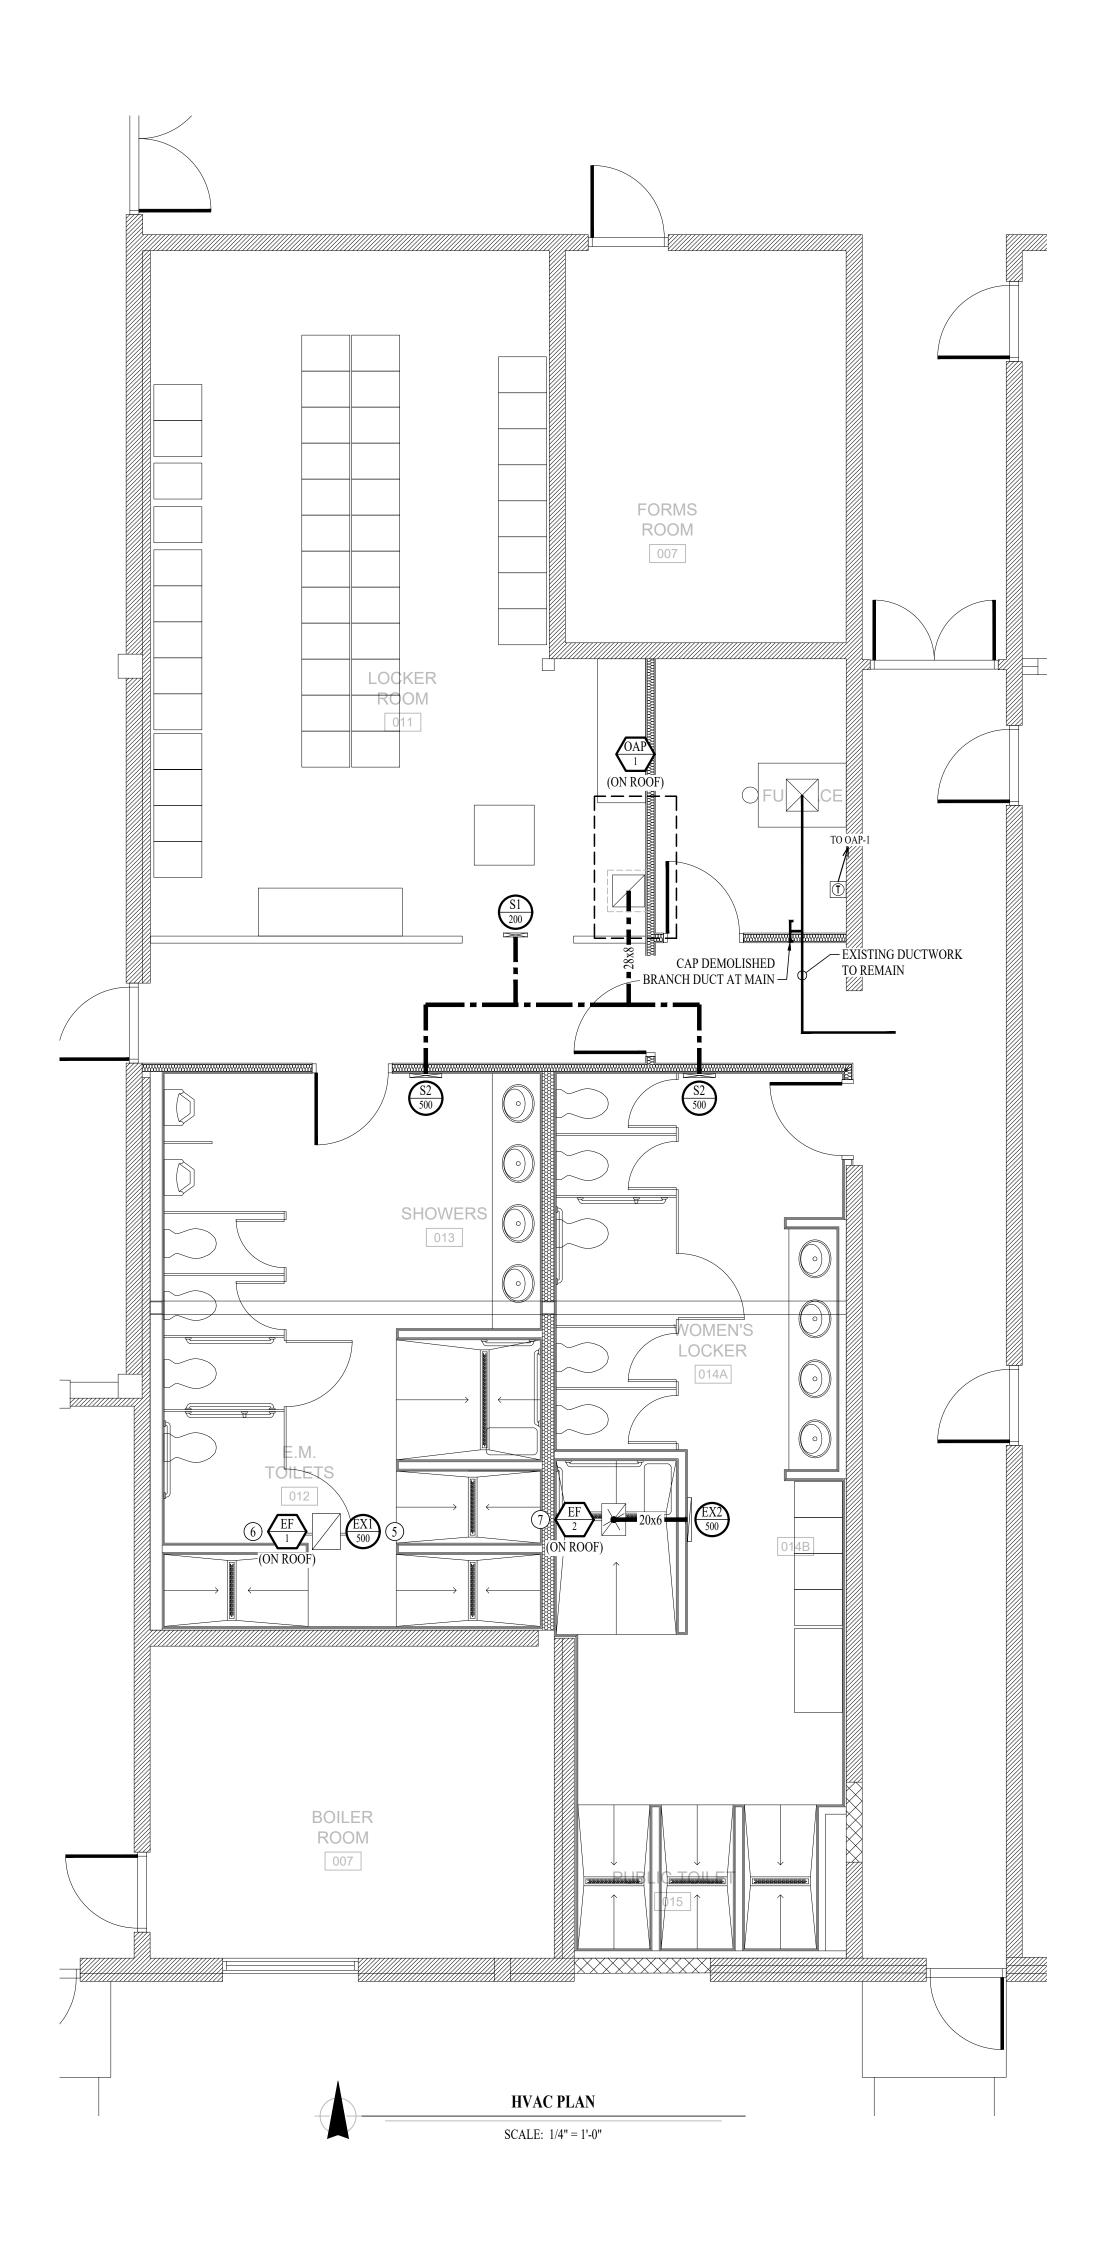






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LATRINE RENOVATION

FULTON READINESS CENTER 1501 WESTMINSTER AVE. FULTON, MO

PROJECT # T2137-01 SITE # 6290 ASSET # 8136290001

REVISION:
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ISSUE DATE: 07/07/2022

CAD DWG FILE: J20662
DRAWN BY: DET
CHECKED BY: JPW
DESIGNED BY: JAP

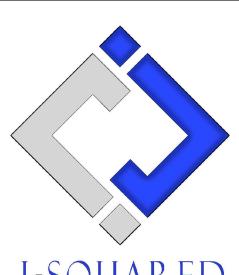SHEET TITLE:

HVAC PLAN

SHEET NUMBER:

M-10

HVAC SPECIFICATIONS

- 1. EQUIPMENT
- 1.1. ALL EQUIPMENT MUST PROVIDE THE PERFORMANCE SPECIFIED ON PLANS. WHERE SPECIFIC MAKES AND MODELS ARE INDICATED ON PLAN, CONTRACTOR TO PROVIDE MODEL
- INDICATED OR APPROVED EQUAL.

 2. CONTRACTOR TO SUPPLY SUBMITTALS FOR ALL EQUIPMENT FOR REVIEW BY ARCHITECT
- AND ENGINEER PRIOR TO PURCHASE,

 3. ALL HORIZONTAL FURNACES WITH AC COILS TO BE EQUIPPED WITH CORROSION RESISTANT DRAIN PAIN. DRAIN PAN TO DISCHARGE TO SANITARY WASTE VIA INDIRECT CONNECTION WITH AIR GAP. DRAIN PAN TO PROVIDE SECONDARY OVERFLOW OR FLOAT SWITCH
- INTERLOCKED WITH UNIT TO SHUT DOWN UNIT ON HIGH WATER SIGNAL.

 1.4. ALL EXTERIOR REFRIGERANT COILS TO BE PROTECTED BY FACTORY EQUIPPED HAIL
- 1.5. REFRIGERANT PIPING TO BE ACR COPPER OR TYPE L COPPER.
- DUCTWORK
 DUCTWORK TO BE GALVANIZED STEEL, SEAL CLASS B, CONSTRUCTED PER SMACNA
- STANDARDS.
 2.2. 26 GA. MINIMUM UP TO 16" DUCT, 24 GA. UP TO 20", 22 GA. UP TO 24", 20 GA. UP TO 28", AND 18
- GA. UP TO 36".

 2.3. TURNING VANES TO BE PROVIDED AND INSTALLED AT ALL 90° BENDS AND TEES.
- 2.4. DUCT DIMENSIONS LISTED ARE TO INTERIOR OF DUCT LINER.
- 2.5. BALANCE DAMPERS MUST BE PROVIDED TO ALLOW ADJUSTMENT AT EACH AIR TERMINAL.2.5.1. WHERE BRANCH TAKEOFF IS ACCESSIBLE (ABOVE LAY-IN CEILING OR EXPOSED DUCT),
- THE BALANCE DAMPER IS TO BE INSTALLED AT TAKEOFF.
 2.5.2. WHERE TAKEOFF IS INACCESSIBLE (IN ATTIC OR SOFFIT), THE BALANCE DAMPER IS TO
- BE LOCATED SO IT IS ACCESSIBLE FROM FACE OF AIR DEVICE.

 2.6. HVAC CONTRACTOR RESPONSIBLE FOR ALL DUCTWORK TRANSITIONS AND FITTINGS AS
- 3. INSULATION
- 3.1. DUCTWORK
- 3.1.1. SEE "TYPICAL DUCT INSULATION DIAGRAM" FOR INSTALLATION SPECIFIC
- REQUIREMENTS.
 3.1.2. INTERNAL DUCT LINER TO BE EQUAL TO 'JOHNS MANVILLE LINACOUSTIC R-300'.

REQUIRED FOR FINAL CONNECTIONS TO HVAC EQUIPMENT.

- 3.1.2. INTERNAL DUCT LINER TO BE EQUAL TO JOHNS MARVILLE ENVACOUSTIC RESULT.

 3.1.3. EXTERNAL DUCT WRAP TO INCLUDE VAPOR BARRIER. EQUAL TO JOHNS MANVILLE
- MICROLITE' WITH FSK JACKET.

 3.2. REFRIGERANT PIPING
- 3.2.1. REFRIGERANT PIPING
 3.2.1. REFRIGERANT PIPING SHALL BE TYPE ACR OR TYPE L COPPER.
- 3.2.2. SPLIT SYSTEM (SUCTION LINE ONLY) 1" CLOSED CELL ELASTOMERIC FOAM (EQUAL TO 'ARMAFLEX AP').
- 3.3. CONDENSATE PIPING
- 3.3.1. OAP INSULATE WITH ½" ELASTOMERIC.
- 4. WORKMANSHIP
 4.1. COORDINATE WITH OTHER TRADES SO THAT HVAC EQUIPMENT AND DUCT WORK DOES NOT
- BLOCK REQUIRED ACCESS OR CLEARANCE TO EQUIPMENT.
 4.2. ALL HVAC EQUIPMENT IS TO BE INSTALLED PER MANUFACTURER'S PUBLISHED
- RECOMMENDATIONS.
- 4.3. ALL EQUIPMENT TO BE INSTALLED LEVEL AND PLUMB.
- 4.4. ROOFTOP MOUNTED RTUS TO BE INSTALLED ON CURBS PER MANUFACTURES INSTRUCTIONS.
 4.5. GRADE MOUNTED RTUS, CONDENSING UNITS, AND HEAT PUMPS TO BE INSTALLED ON 4"
- REINFORCED CONCRETE PAD EXTENDING 4" BEYOND EACH EDGE OF THE EQUIPMENT, OR A MANUFACTURER APPROVED PRE-MANUFACTURED BASE.
- 5. TESTING AND BALANCING
 5.1 THIRD DARTY CERTIFIED TEST AND RALANCE NOT REQUIRE
- 5.1. THIRD PARTY CERTIFIED TEST AND BALANCE NOT REQUIRED.

											OA	P SC	HED	ULE													
					No. Alexandra de la compansión de la compa	OA	GAS HI	EATING					COC	DLING IN	NFORMA	TION					REHEAT INF	ORMATIO	N		EL ECEDICA I		
TAC	EQUIPMENT	MODEL NUMBER	SIZE	ODIENTATION	TOTAL	AIRFLOW	INFORM	MATION	OUTSII	DEAIR	MIXE	D AIR	LE	AVING A	AIR	CAPA	ACITY	мэтиги	DISCH	IARGE	CAPAC	TTY	MOISTURE	,	ELECTRICAL		NOTES
TAG	DESCRIPTION	MODEL NUMBER	(TONS)	ORIENTATION	AIRFLOW (CFM)	MAX/MIN	INPUT	OUTPUT	DB	WB	DB	WB	DB	WB	DP	TOTAL	SENSIBLE	MINIMUM EFFICIENCY	DB	WB	DESIRED	MAX	REMOVAL RATE	VOLTS /	MCA	OCD	NOTES
					(CIM)	(CFM)	(kBTU)	(kBTU)	(°F)	(°F)	(°F)	(°F)	(°F)	(°F)	(°F)	(kBTU)	(kBTU)	EFFICIENCI	(°F)	(°F)	(kBTU)	(kBTU)	(LBS / HR)	PHASE	MCA	ОСР	
OAP-1	OUTSIDE AIR	CA SRTULI 150-18-7 5T-DOA S	7.5	DOWN FLOW	1300	1300	150	120	98	76	98	76	51.1	50.5	50.1	102	61.6	18 6 IFFR	70	58.1	26.9	60	36.7	208/1	62	70	1 THRU 15

NOTES:

- 1. INVERTER SCROLL COMPRESSOR WITH INTEGRATED OIL SENSOR
- 2. DIRECT DRIVE PLENUM BLOWER


PROCESSING UNIT

- 3. INTEGRATED MONITORING VIA CELLULAR CONNECTION BY MANUFACTURER
- 4. REFRIGERATION PRESSURE MONITORING ON HIGH & LOW PRESSURE SIDE OF SYSTEM INCLUDED THROUGH DIGITAL INTERFACE
- 5. EC MOTOR CONDENSING FANS
- 6. ELECTRONIC EXPANSION VALVE
- 7. SUCTION LINE ACCUMULATOR
- 8. FACTORY COMMISSIONING WITH 5 YEAR PARTS WARRANTY, 25 YEAR WARRANTY ON STAINLESS STEEL HEAT EXCHANGER
- 9. A VERAGING INTAKE, EVAP & DISCHARGE TEMPERATURE SENSORS (DISCHARGE SENSOR TO BE FACTORY MOUNTED WITHIN UNIT
- 10. 80% EFFICIENT FURNACE, WITH MODULATING INDUCER TO MAINTAIN CONSTANT COMBUSTION EFFICIENCY ACROSS FIRING RANGE; 6:1 TURNDOWN WITH NATURAL GAS
- 11. SUPPLY CFM MONITORING INTEGRAL TO UNIT WITH CFM MEASUREMENT INCLUDED THROUGH DIGITAL INTERFACE
- 12. FULLY MODULATING HOT GAS REHEAT
- 13. HAIL GUARD FOR CONDENSING COIL
- 14. 1" EXTERIOR DUAL-WALL CONSTRUCTION w/ R4.3 INSULATION MINIMUM 24GA EXTERIOR w/ 18GA BASE
- 15. DOWN DISCHARGE


]	EXHAUS	ST FAN	SCHED	ULE				
TAG	EQUIDMENT TVDE	EQUIPMENT TYPE MANUFACTURER		FLO	OW	ELECTRICAL			PHYS	SICAL	NOTES
IAG	AG EQUIPMENT TIPE	(OR EQUAL)	(OR EQUAL)	CFM	S.P.	VOLT/PH	MCA	ОСР	DIM.	WEIGHT	NOTES
EF-1	ROOF EXHAUSTER	S&P	SDBD8	500	0.375	120/1		20			1,2,3
EF-2	ROOF EXHAUSTER	S&P	SDBD8	500	0.375	120/1		20			1,2,3
NOTES:											

- WITH BACKDRAFT DAMPER
 WITH SPEED CONTROLLED
- 2. WITH SPEED CONTROLLER
- 3. 1450 RPM, 1/10 HP, 0.5 BHP


TAG	SERVICE	MANUFACTURER (OR EQUAL / SEE SPECS)	MODEL (OR EQUAL / SEE SPECS)	SIZE	COLOR / FINISH	NOTES
EX1	EXHA UST	PRICE	80	14x18	WHITE	
EX2	EXHAUST	PROCE	530	22x8	WHITE	
S1	SUPPLY	PRICE	520	12x4	WHITE	
S2	SUPPLY	PRICE	520	18x8	WHITE	

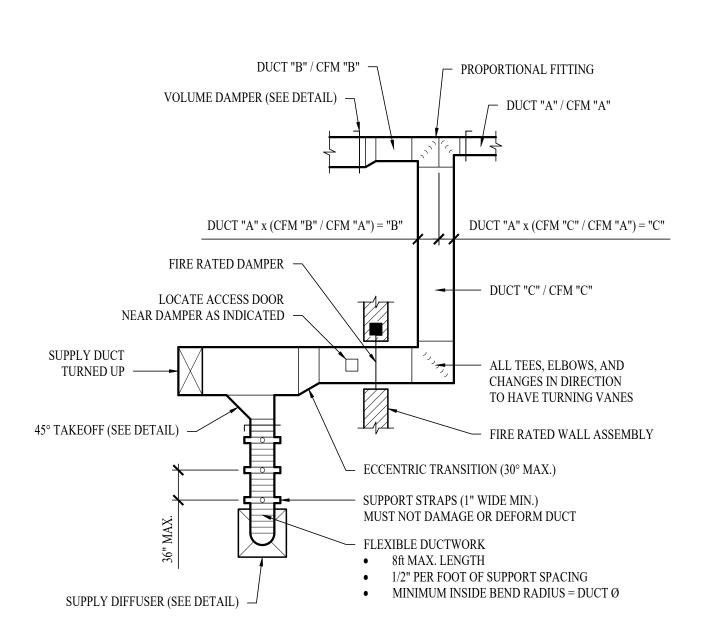

TYPICAL DUCTWORK DETAIL

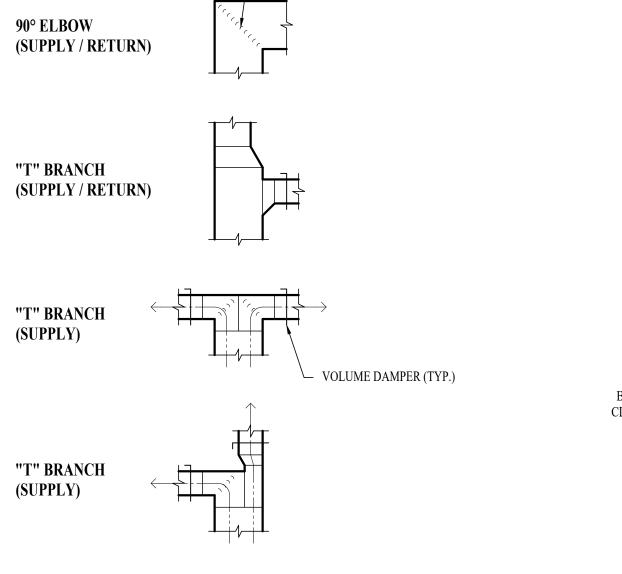


TURNING VANES (TYP.)

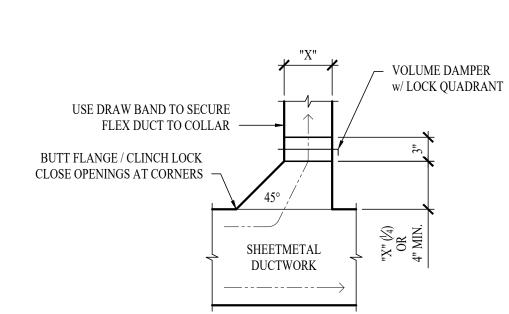

TYPICAL DUCTWORK FITTINGS DETAIL

TYPICAL 45° TAKEOFF DETAIL

STATE OF MISSOURI MICHAEL L. PARSON, GOVERNOR

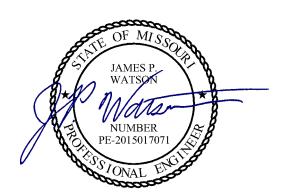

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CHECKED BY: JPW
DESIGNED BY: JAP

SHEET TITLE:

HVAC DETAILS & SCHEDULES

SHEET NUMBER:


M-50

ELECTRICAL DEMOLITION PLAN GENERAL NOTES:

1. SEE SHEET M501 FOR ADDITIONAL HVAC NOTES, DETAIL, AND SCHEDULES.

ELECTRICAL DEMOLITION PLAN KEY NOTES:

1) DEMOLISH EXISTING LIGHTING IN THIS AREA. REMOVE CIRCUIT BACK TO NEAREST J-BOX.

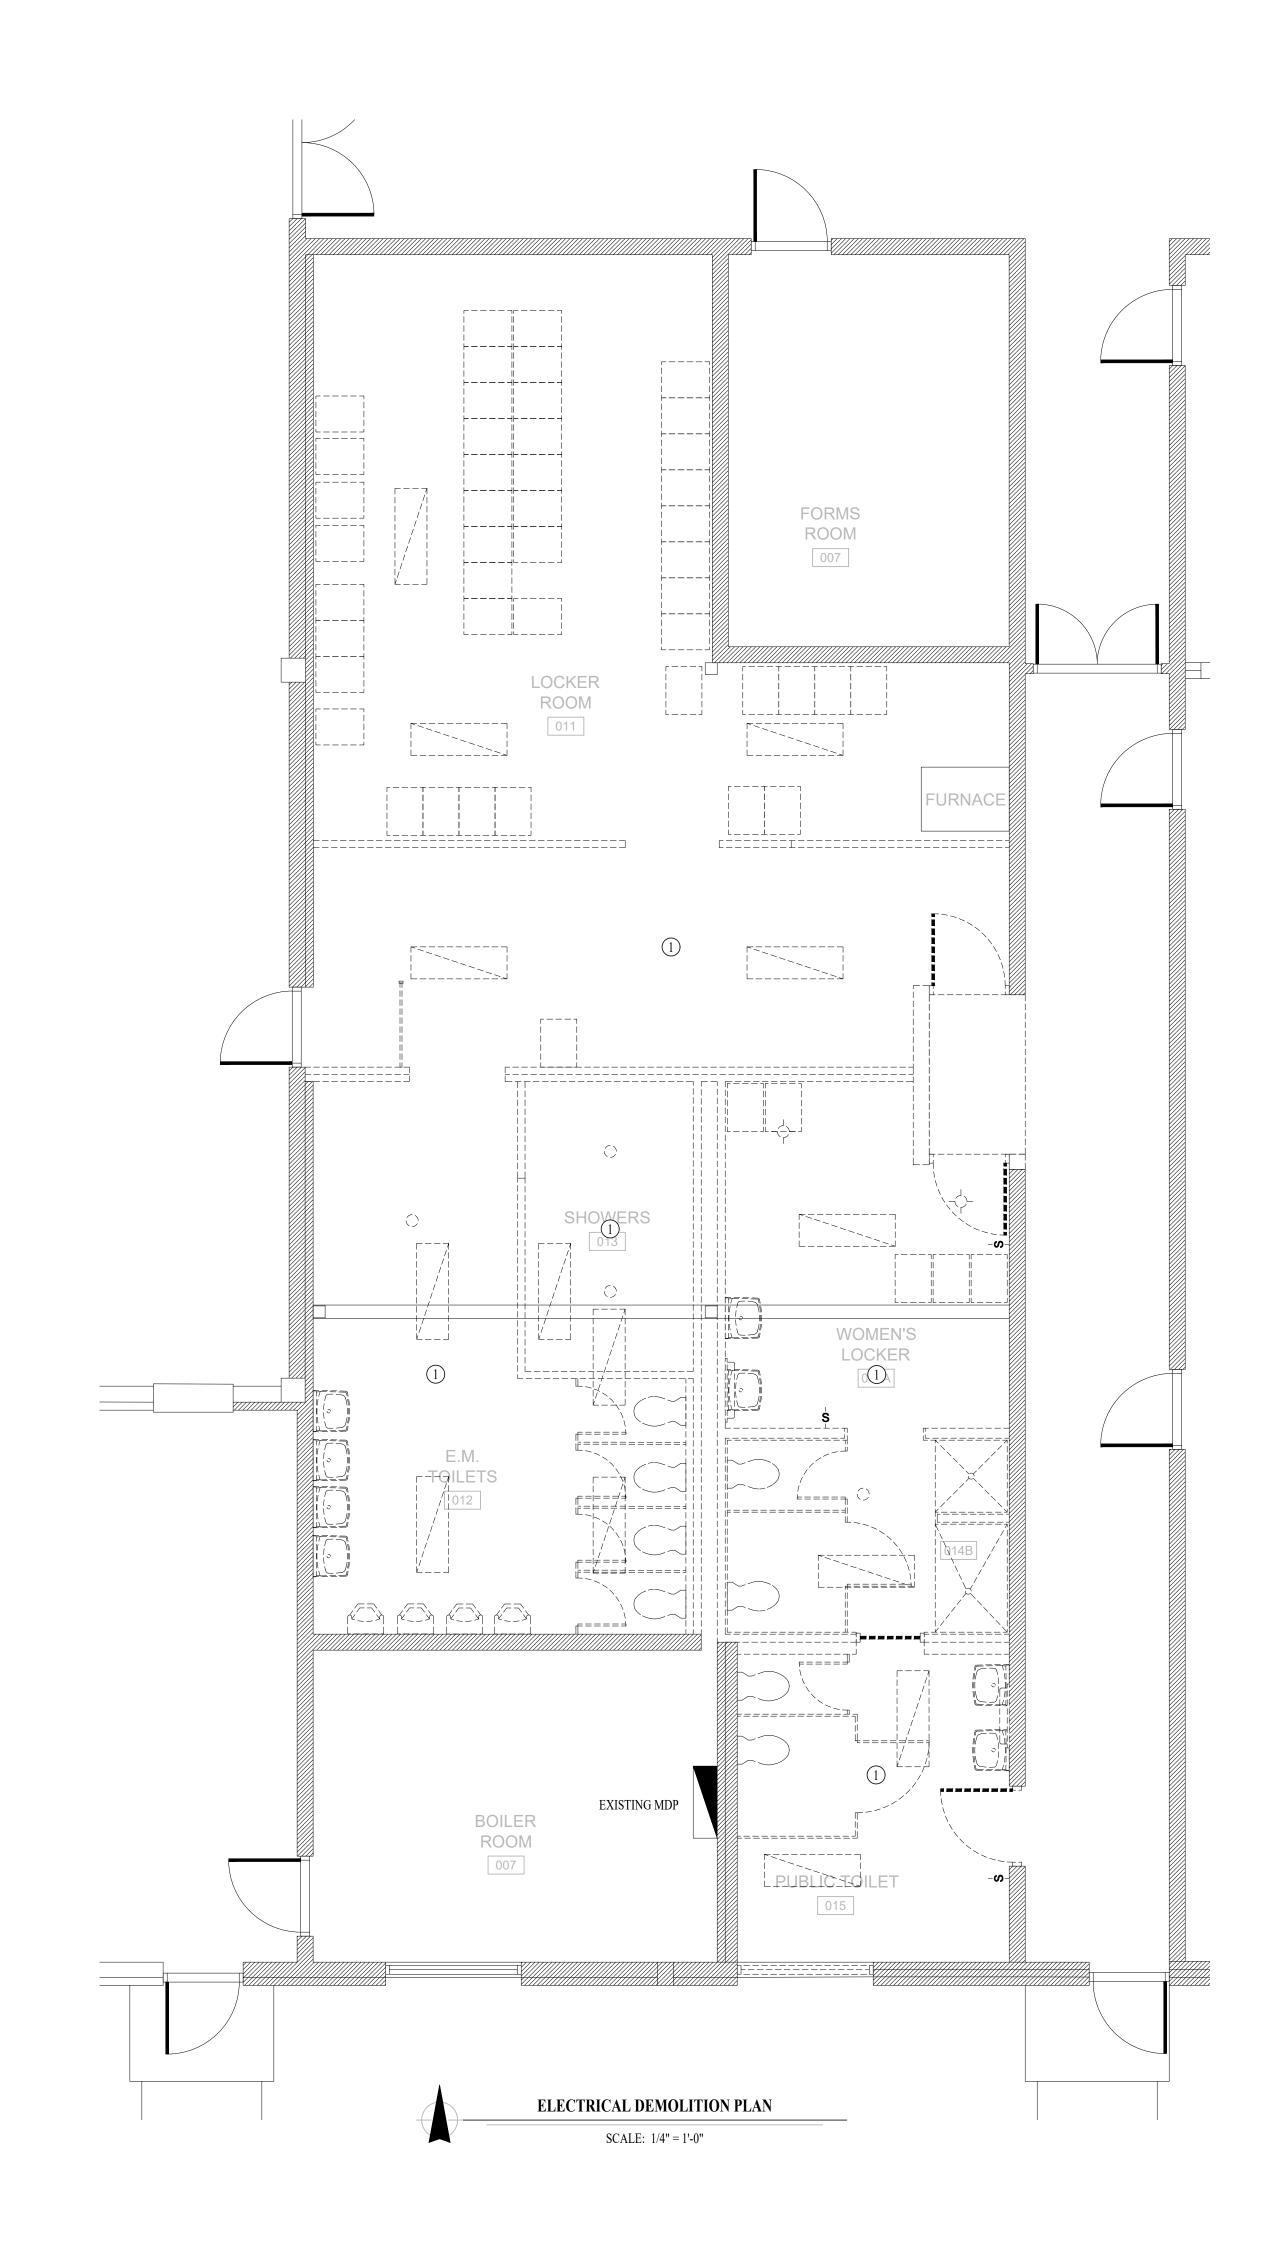

STATE OF MISSOURI MICHAEL L. PARSON, GOVERNOR




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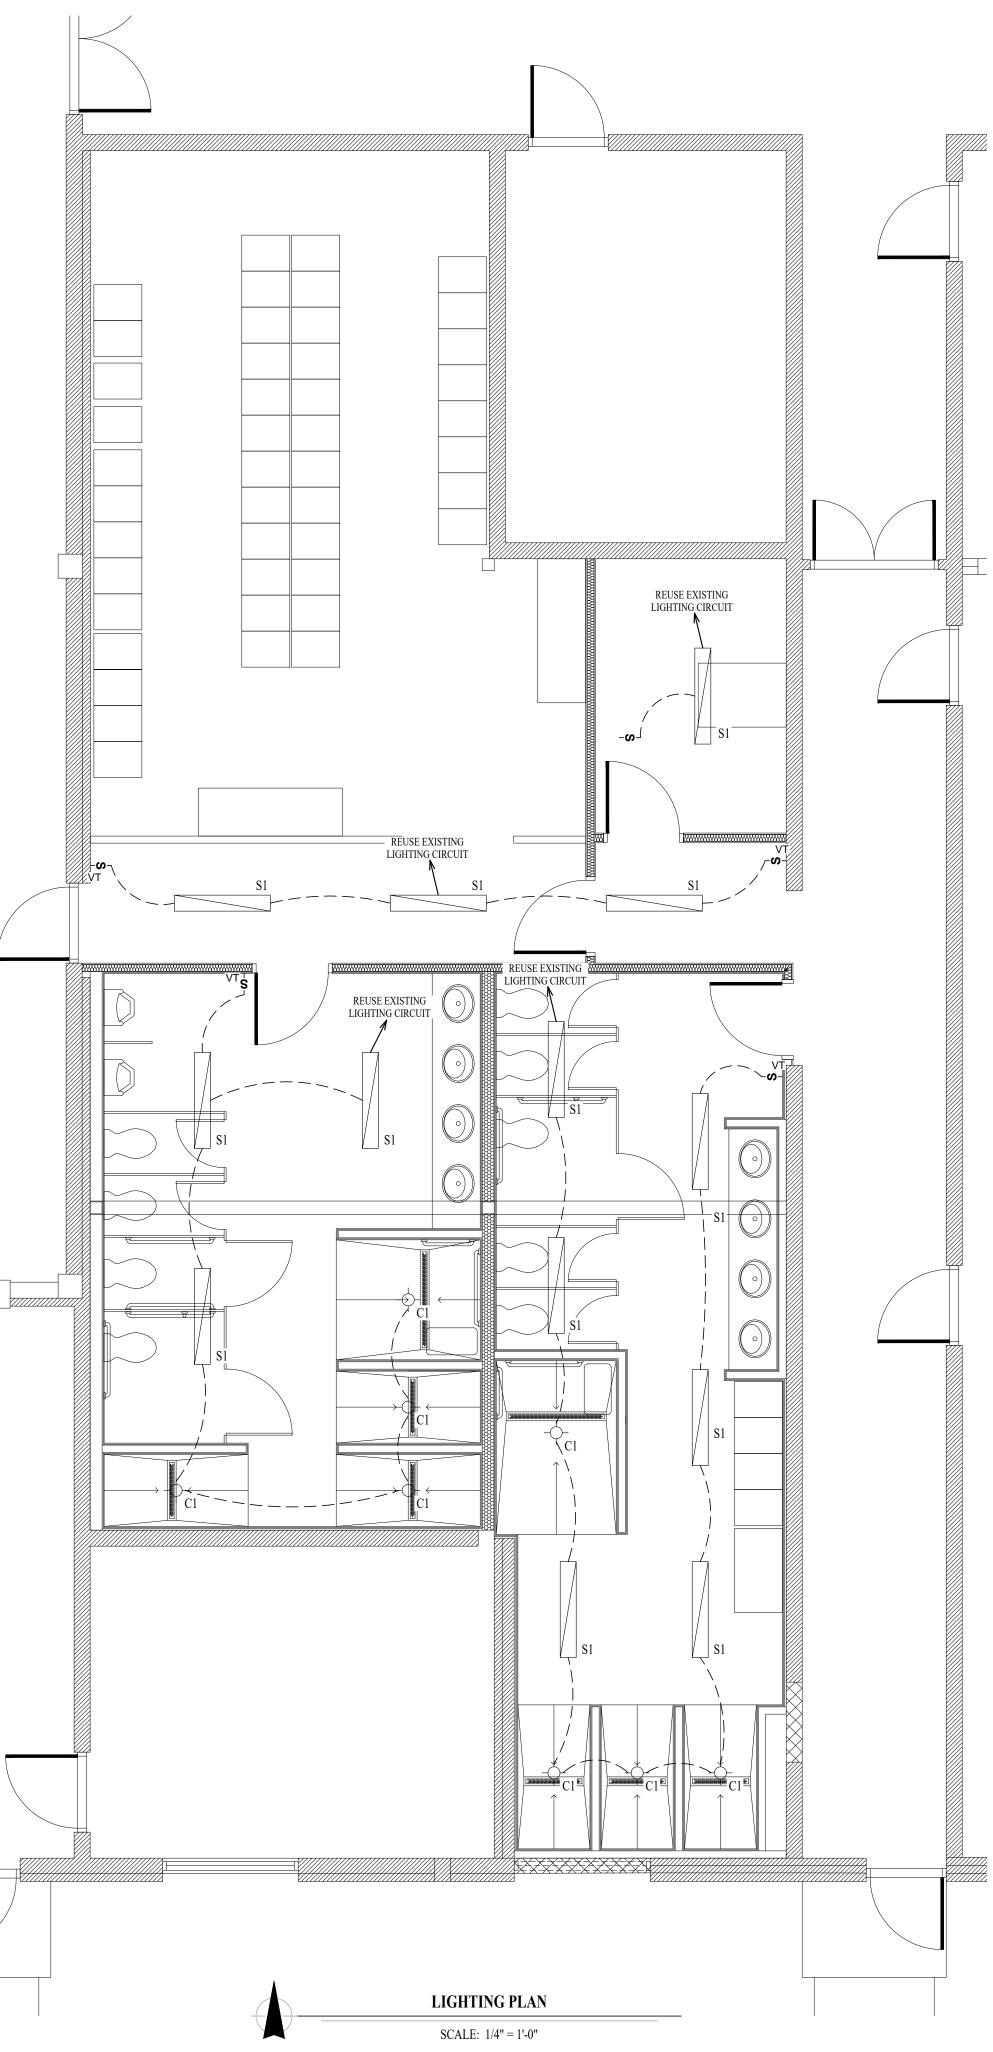
ELECTRICAL DEMOLITION PLAN

SHEET NUMBER:

ED-101

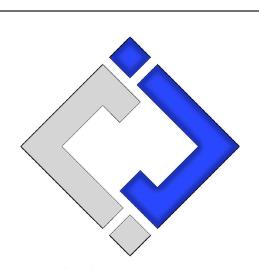

SCALE: 1/4" = 1'-0"



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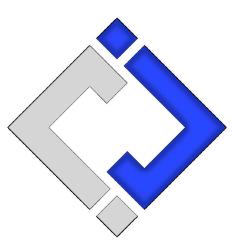
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SHEET TITLE:

ELECTRICAL PLANS

SHEET NUMBER:

E-10

ELECTRICAL SPECIFICATIONS


- GENERAL
- 1.1. THE ENTIRE ELECTRICAL SYSTEM SHALL BE CONTINUOUSLY GROUNDED. EVERY BRANCH CONDUIT SHALL INCLUDE A GREEN GROUND CONDUCTOR SIZED PER NEC.
- 1.2. PROVIDE PERMANENT ARC-FLASH LABEL AFFIXED TO EVERY DISCONNECT AND PANEL.
- 1.3. PROVIDE TYPE WRITTEN PANEL SCHEDULE FOR EACH PANEL. 2. MATERIALS
- 2.1. CONDUIT & CONDUCTORS
- ALL CONDUCTORS SIZES INDICATED ON PLANS ARE COPPER UNLESS NOTED
- ABOVE GRADE CONDUCTORS SHALL BE THHN COPPER. BELOW GRADE CONDUCTORS
- SHALL BE XHHW-2. MINIMUM CONDUCTOR SIZE SHALL BE #12 UNLESS NOTED OTHERWISE. 120V, 20 AMP CIRCUITS WITH CONDUCTOR LENGTH GREATER THAN 100' SHALL BE MINIMUM #10. ELECTRICAL CONTRACTOR IS RESPONSIBLE FOR MEASURING ACTUAL CONDUCTOR LENGTH AND INCREASING CONDUCTOR SIZE TO COMPENSATE FOR VOLTAGE DROP AS
- RIGID GALVANIZED OR SCHEDULE 40 PVC CONDUIT SHALL BE USED FOR SERVICE
- WIRING, BELOW GRADE INSTALLATIONS, OR WHERE EXPOSED TO WEATHER.
- CONTRACTOR TO PROVIDE J-BOXES, COVER PLATES, AND ANY ACCESSORIES REQUIRED TO PROVIDE A COMPLETE SYSTEM. SEE ARCHITECTURAL PLANS FOR DEVICE COLORS. DUPLEX RECEPTACLES SHALL BE TAMPER RESISTANT, 20 AMP, EQUAL TO LEVITON

LIGHT FIXTURE SCHEDULE MANUFACTURER MODEL NUMBER LUMEN **TAG** DESCRIPTION MOUNTING CCT (°K) CRI VOLTS WATTS NOTES **OUTPUT** (OR EQUAL) (OR EQUAL) HALO SLD612-8-35-WH-UNV 6" ROUND LED CAN 1,200 **SURFACE** 3500 120 **METALUX** 4SLSTP4035DD-UNV 4' LED STRIP LIGHT WALL / CEILING 4,766 3500 80 120 NOTES:

1. VERIFY LIGHT FIXTURE FINISHES WITH OWNER / ARCHITECT PRIOR TO INSTALLATION

TIE INTO EXISTING CIRCUIT
AT EXISTING OUTLET DRILL FLOOR POWER PLAN - NEW EXTERIOR OUTLET SCALE: 1/4" = 1'-0"

STATE OF MISSOURI MICHAEL L. PARSON, **GOVERNOR**

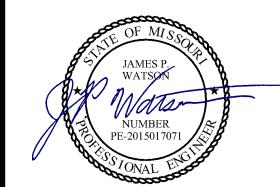


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ELECTRICAL DETAILS & SCHEDULES

SHEET NUMBER:

16 OF 19 SHEETS

SANITARY SEWER PLAN SYMBOL LEGEND

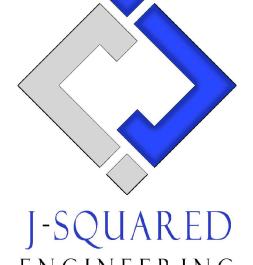---- SANITARY SEWER PIPING
----- VENT PIPING

PIPING TURNED DOWN / TURNED UP


TIE INTO EXISTING


SANITARY SEWER PLAN GENERAL NOTES:

1. SEE SHEET P-501 FOR ADDITIONAL PLUMBING NOTES, DETAIL, AND SCHEDULES.

SANITARY SEWER PLAN KEY NOTES:

- 1) DEMOLISH WATER CLOSET & CAP AT SEWER MAIN.
- (2) DEMOLISH LAVATORY & SANITARY BACK TO SEWER MAIN.
- 3 DEMOLISH SHOWER & SANITARY BACK TO SEWER MAIN.
- (4) DEMOLISH FLOOR DRAIN & CAP AT SEWER MAIN.
- (5) DEMOLISH URINAL & SANITARY BACK TO SEWER MAIN.

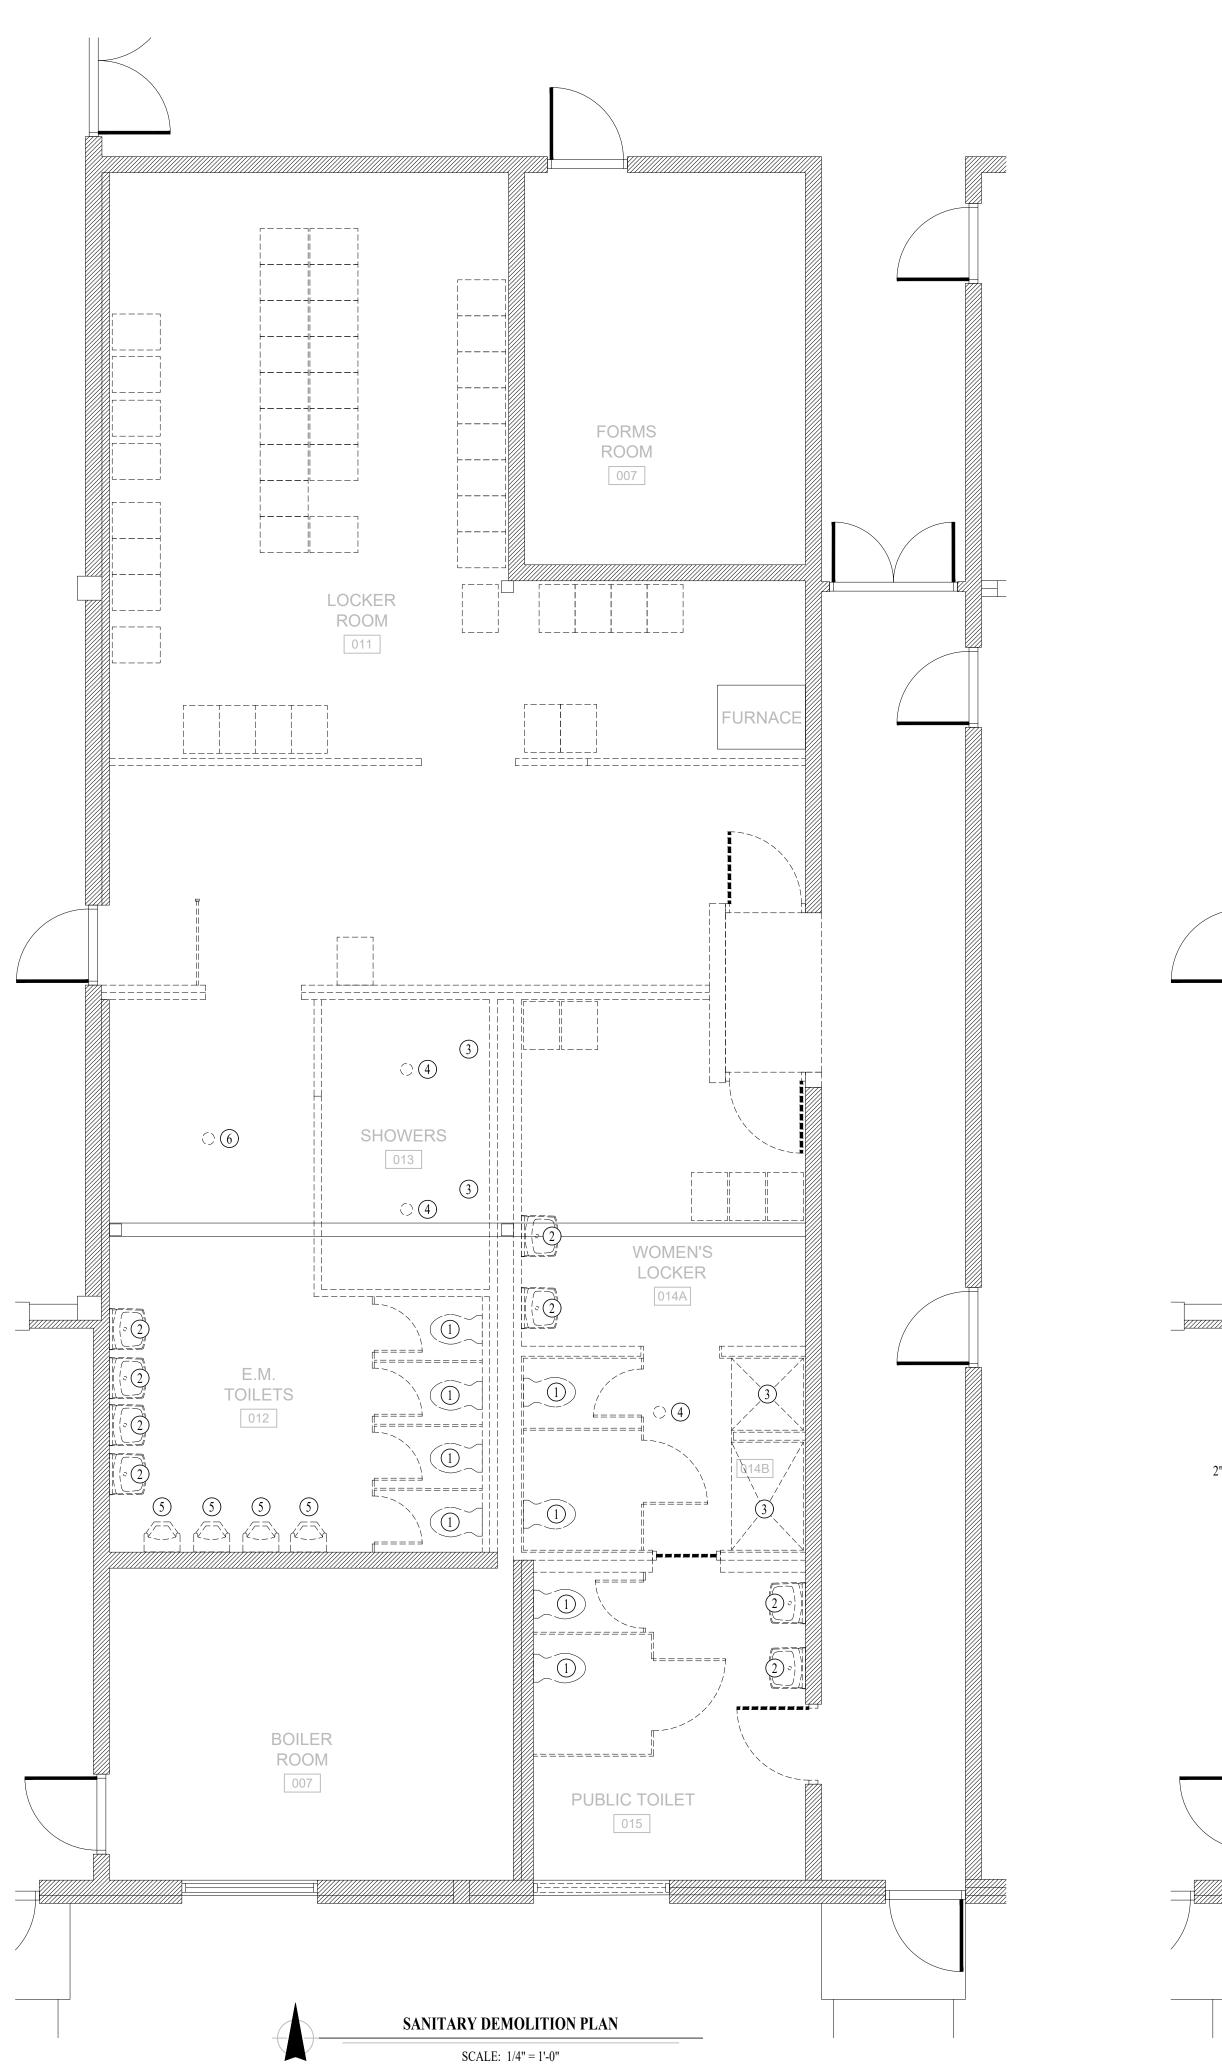

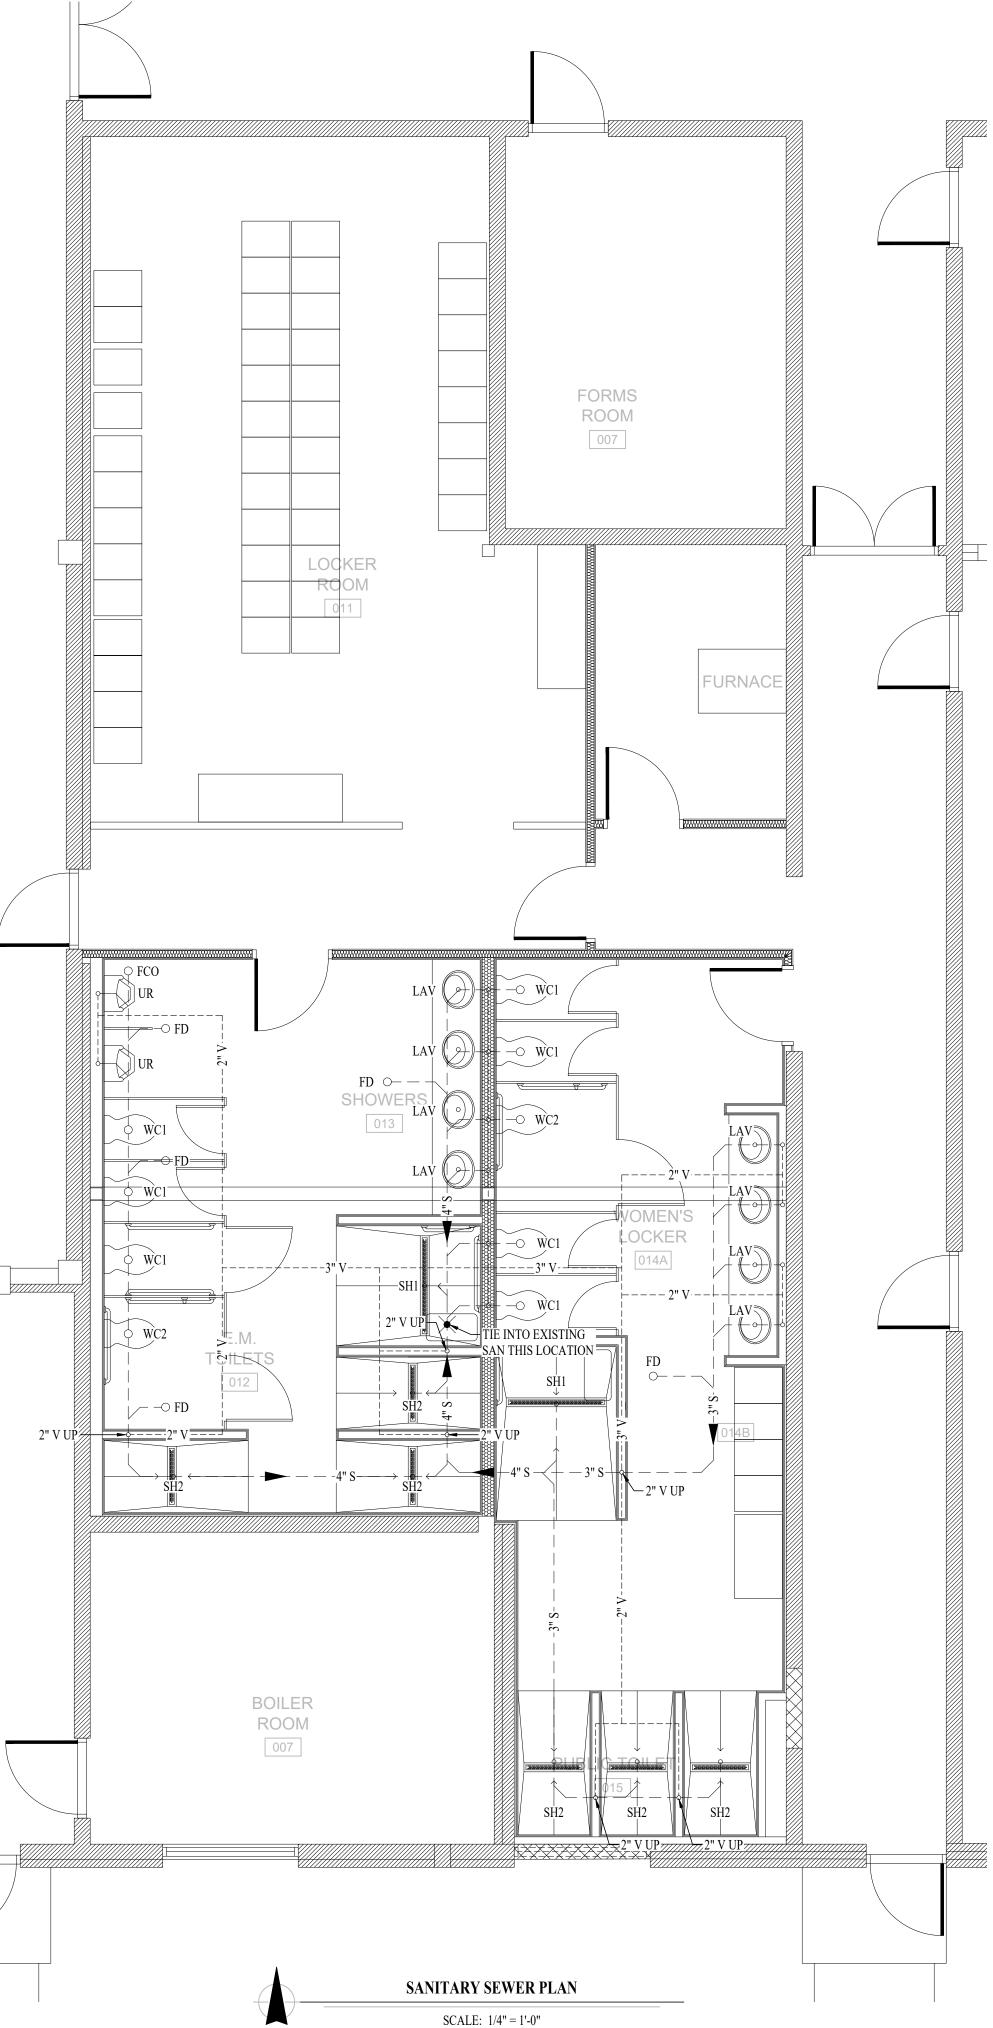

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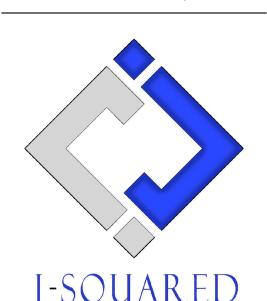
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SANITARY SEWER PLAN

SHEET NUMBER:

P-10

WATER PLAN SYMBOL LEGEND COLD WATER LINE HOT WATER LINE HOT WATER RECIRCULATION LINE WATER METER VALVE PUMP PIPING TURNED DOWN / TURNED UP TIE INTO EXISTING

WATER PLAN GENERAL NOTES:

1. SEE SHEET P-501 FOR ADDITIONAL PLUMBING NOTES, DETAILS, & SCHEDULES.

WATER PLAN KEY NOTES:

- (1) DEMOLISH WATER CLOSET & WATER LINE BACK TO MAIN.
- (2) DEMOLISH LAVATORY & WATER LINE BACK TO MAIN.
- 3 DEMOLISH SHOWER & WATER LINES BACK TO MAIN.
- 4 DEMOLISH URINAL & WATER LINE BACK TO MAIN.



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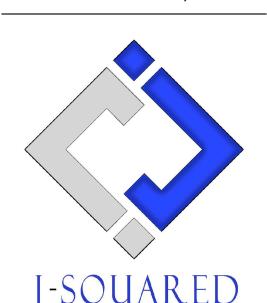
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WATER PLAN

SHEET NUMBER:

P-102

PLUMBING SPECIFICATIONS

1. GENERAL

- 1.1. CONTRACTOR IS RESPONSIBLE TO PROVIDE ALL ESCUTCHEONS, ¼ TURN STOPS, P-TRAPS, AND SUPPLY LINES TO PROVIDE A COMPLETE SYSTEM AT EACH FIXTURE INDICATED ON PLANS UNLESS NOTED OTHERWISE.
- SANITARY
 BELOW AND ABOVE GRADE WASTE AND VENT PIPING IN BUILDING TO BE SOLID CORE SCH.
- 40 PVC DWV. 2.2. NO PIPE SMALLER THAN 2" BELOW GRADE.
- 2.3. WASTE AND VENT PIPING IN PLENUMS TO BE CAST IRON, OR PVC WITH AN INSULATION
- WRAP LISTED FOR USE AS SUCH AN ASSEMBLY.
 2.4. ALL VENT PIPE TERMINATIONS ARE TO BE LOCATED EITHER 10' HORIZONTALLY OR 3' ABOVE MECHANICAL AIR INTAKE LOCATIONS.


3. DOMESTIC WATER3.1. DOMESTIC WATER PIPING TO BE EITHER COPPER.

- 2. COPPER WATER PIPING BELOW GRADE SHALL BE TYPE "K". BELOW GRADE JOINTS SHALL BE SILVER SOLDERED. THERE SHALL BE NO JOINTS IN WATER PIPING LOCATED BENEATH BUILDING SLAB.
- 3.3. COPPER WATER PIPING ABOVE GRADE SHALL BE TYPE "L".
- PROVIDE WATER HAMMER ARRESTORS AT ALL QUICK-CLOSE VALVES. FIXTURES REQUIRING WATER HAMMER ARRESTORS INCLUDE BUT ARE NOT LIMITED TO FLUSH VALVES, SENSOR FAUCETS, AND WASHING MACHINE BOXES. AIR CHAMBERS ARE NOT ACCEPTABLE.
- 3.5. DOMESTIC WATER PIPING INSULATION
- .5.1. ALL HW PIPING SHALL BE INSULATED WITH PLENUM-RATED CLOSED CELL
- ELASTOMERIC INSULATION. FOR PIPING LESS THAN 1½", INSULATION THICKNESS TO BE 1". FOR PIPING 1½" OR GREATER, INSULATION THICKNESS SHALL BE 1½".
- 3.5.2. CW COPPER PIPING TO INSULATED WITH ½" PLENUM-RATED CLOSED CELL
- 4. GAS PIPING
- 4.1. ABOVE GRADE NATURAL GAS AND LP PIPING TO BE SCH. 40 BLACK STEEL WITH CLASS 150
- 4.2. WHERE PIPING IS EXPOSED ON EXTERIOR FACE OF BUILDING, PAINT TO MATCH BUILDING.
- PAINT YELLOW IN ALL OTHER LOCATIONS.


 4.3. ON ROOFTOPS, INSTALL GAS PIPE WITH "ROOFTOP BLOX" PER MANUFACTURE'S
- INSTRUCTION.

FIXTURE		SANITAR	RYPIPING	SUPPLY	PIPING
ТҰРЕ	TYPICAL ABBREVIATION	WASTE CONNECTION	VENT CONNECTION	COLD WATER CONNECTION	HOT WATER CONNECTION
DRINKING FOUNTAIN	DF	1-1/2"	1-1/4"	1/2"	-
FLOOR DRAIN	FD	3"	2"	-	-
HAND / HAIR SINK	HS / SK	2"	1-1/4"	1/2"	1/2"
HOSEBIBB	HB	ı	-	3/4"	-
LAVATORY	LAV	1-1/2"	1-1/4"	1/2"	1/2"
MOP SINK	MS	3"	1-1/2"	1/2"	1/2"
ICE MAKER OUTLET BOX	REF	ı	-	1/2"	-
SHOWER	SH	3"	1-1/2"	1/2"	1/2"
URINAL	UR	2"	1-1/4"	3/4"	-
WATER CLOSET (FLUSH TANK)	WC	3"	2"	1/2"	-
WATER CLOSET (FLUSH VALVE)	WC	3"	2"	1"	-

TAG	DESCRIPTION	MANUFACTURER (OR EQUAL / SEE SPECS)	MODEL (OR EQUAL / SEE SPECS)	NOTES
FCO	FLOOR CLEANOUT	ZURN	Z1400	
FD	FLOOR DRAIN	ZURN	Z415-BZ	WITH Z1072 TRAP SEAL
LAV	LA VA TORY FA UCET	ZURN	Z81104-XL	WITH 1/4 TURN STOPS, BRAIDED STAINLESS STEEL SUPPLIES, & TRAP INSULATION
SH1	SHOWER - 48" LINEAR DRAIN	ZURN	ZS880	WITH MOEN #T9342EP15, 3360, & 8371HD SHOWER TRIM
SH2	SHOWER - 28" LINEAR DRAIN	ZURN	ZS880	WITH MOEN #T9375EP15 & 8371HD SHOWER TRIM
UR	URINAL - MANUAL FLUSH	AMERICAN STANDARD	6550.001	WITH ZURN Z6003AV-WS1 MANUAL FLUSH VALVE (1.0 GPM/FLUSH)
WC1	WATER CLOSET - STANDARD HEIGHT - MANUAL FLUSH VALVE	AMERICAN STANDARD	2234.001	WITH ZURN Z6000A V-WS1 MANUAL FLUSH VALVE (1.6 GPM/FLUSH) AND CHURCH 9500SSCT SELF SUSTAINING SEAT
WC2	WATER CLOSET - ADA HEIGHT - MANUAL FLUSH VALVE	AMERICAN STANDARD	3043.001	WITH ZURN Z6000A V-WS1 MANUAL FLUSH VALVE (1.6 GPM/FLUSH) AND CHURCH 9500SSCT SELF SUSTAINING SEAT

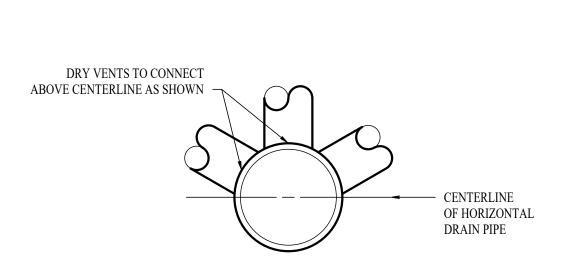

DRY VENT DETAIL

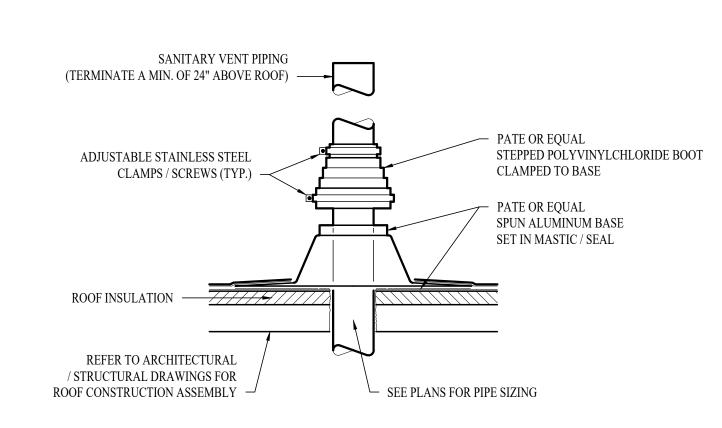

SANITARY VENT THRU ROOF DETAIL

STATE OF MISSOURI MICHAEL L. PARSON, GOVERNOR




James Watson, P.E. July 7, 20
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OFFICE OF
ADMINISTRATION
DIVISION OF
FACILITIES
MANAGEMENT,
DESIGN AND
CONSTRUCTION

LATRINE RENOVATION

FULTON READINESS CENTER 1501 WESTMINSTER AVE. FULTON, MO

PROJECT # T2137-01 SITE # 6290 ASSET # 8136290001

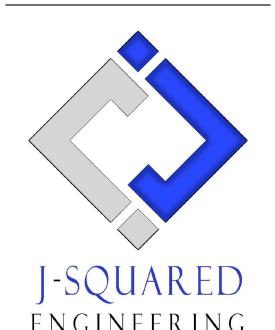REVISION:
DATE:
REVISION:
DATE:
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DATE:
REVISION:
DATE:
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PLUMBING DETAILS & SCHEDULES

SHEET NUMBER:

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