RE-BID RENOVATE INTERIOR AND EXTERIOR KENNETT READINESS CENTER Kennett, Missouri



OWNER: STATE OF MISSOURI

MICHAEL L. PARSON,

GOVERNOR

MISSOURI NATIONAL GUARD

OFFICE OF THE ADJUTANT GENERAL FACILITIES MANAGEMENT OFFICE

PROJECT OFFICE OF ADMINISTRATION

DIVISION OF FACILITIES MANAGEMENT, MANAGEMENT:

DESIGN AND CONSTRUCTION

DESIGNER:

Architect

Dille Pollard, LLC


Engineer

Smith & Boucher, Inc.

PROJECT NUMBER:

T2209-01

FACILITY NUMBER: 8136313002

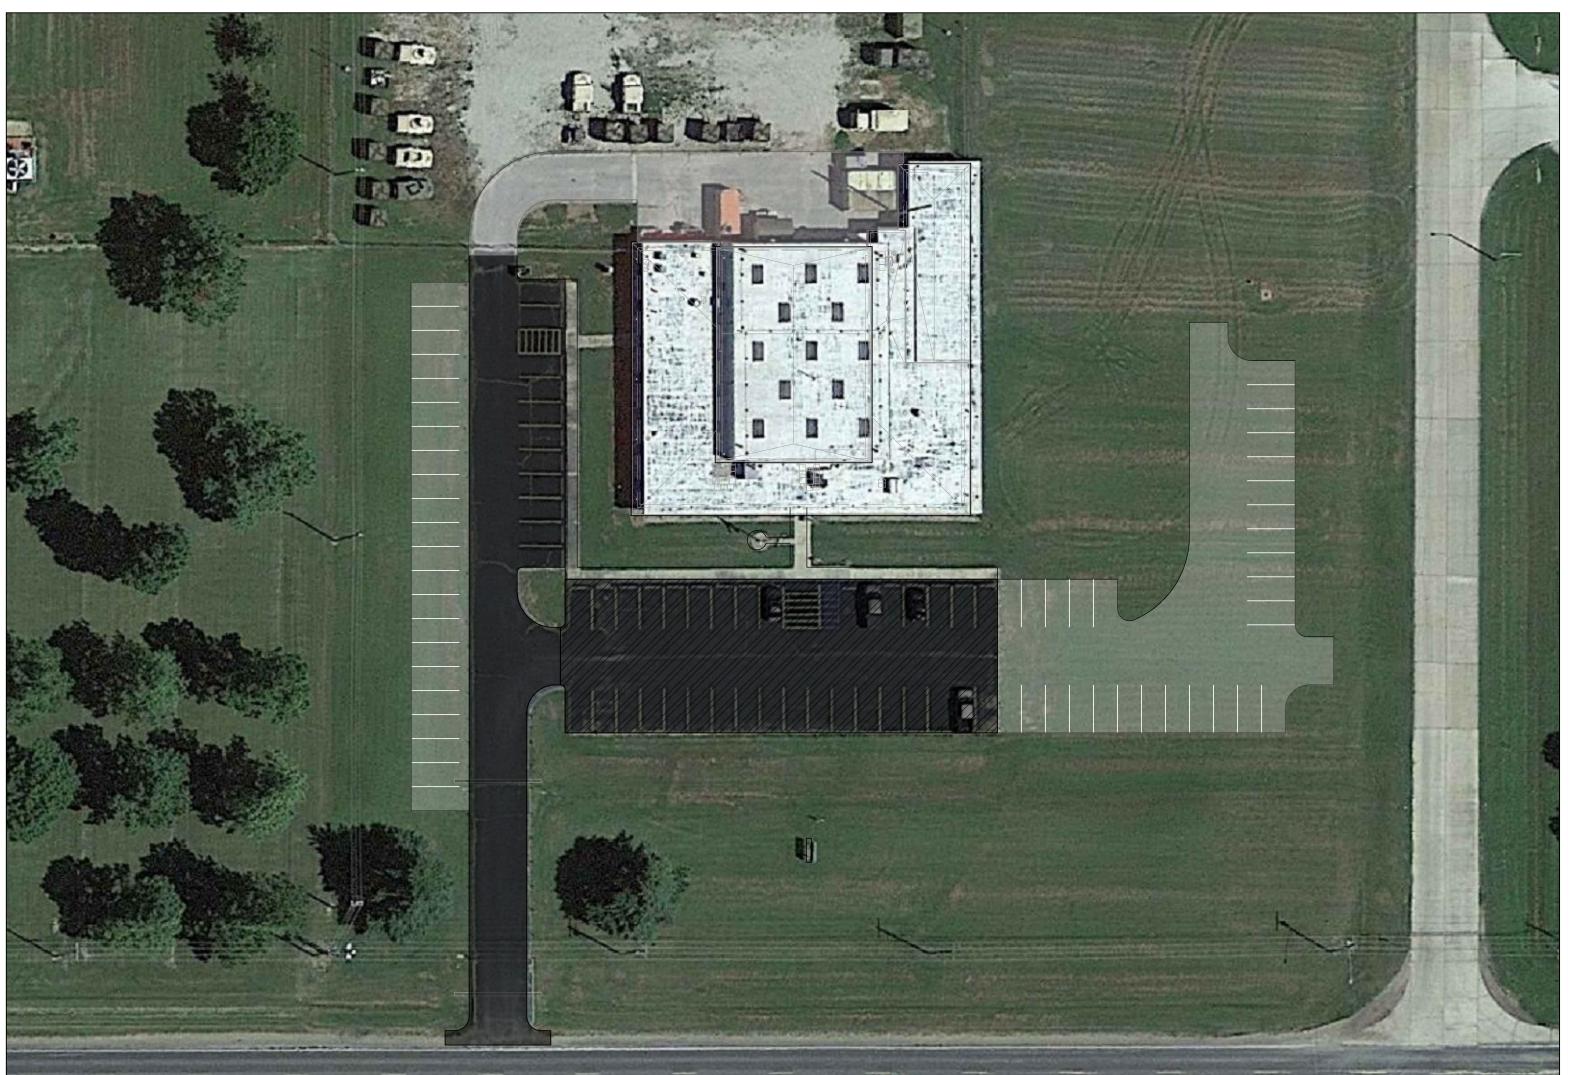

GENERAL NOTES - SITE PLAN:

- EXISTING CONDITIONS HAVE BEEN NOTED USING OWNER'S FACILITY DRAWINGS AND FIELD VISUAL SURVEYS. THE CONTRACTORS ARE REQUIRED TO VISIT THE SITE AND VERIFY CONDITIONS FOR THE WORK PRIOR TO BIDDING.
- COORDINATE ALL SITE WORK WITH OWNER PRIOR TO START OF CONSTRUCTION AND OWNER'S PREPARATION FOR THE WORK AREAS. PREPARE A RENOVATION PLAN / SCHEDULE FOR THE OWNER'S APPROVAL PRIOR TO THE WORK.
- C. MATERIAL STAGING AREA(S) ON SITE WILL BE DETERMINED BY THE OWNER AT PRE-BID OR PRE- CONSTRUCTION CONFERENCE.
- D. CONTRACTOR'S MOBILE OFFICE, STORAGE TRAILERS AND VEHICLE PARKING ON SITE WILL BE DETERMINED BY THE OWNER AT PRE-BID OR PRE-CONSTRUCTION CONFERENCE.
- ALL AGGREGATE AND CONCRETE SURFACES DISTURBED OR DAMAGED DURING CONSTRUCTION SHALL BE RESTORED TO ORIGINAL CONDITION.
- CONTRACTOR TO COORDINATE ACCESS AND PARKING WITH OWNER PRIOR TO START OF WORK. REFER TO SHEET A-001 FOR EXTENT OF WORK.

SYMBOL LEGEND (THIS SHEET ONLY)




ALTERNATE BID NO. 3: AREA OF EXISTING ASPHALT PAVING TO BE REMOVED AND REPLACED WITH CONCRETE **EXISTING PAVING - POTENTIAL UNIT COST**

EXISTING PAVING - NO WORK


SITE PLAN REFERENCE

2 LOCATION MAPS

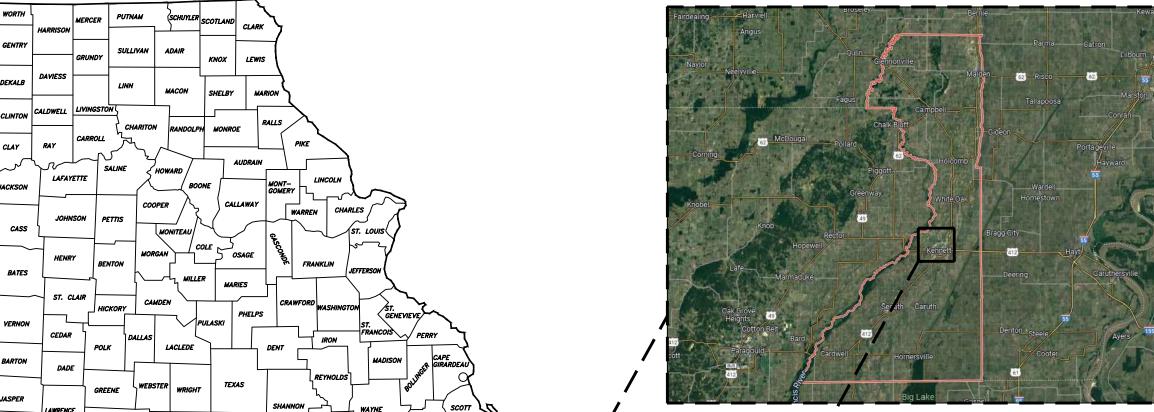



SYMBOL LEGEND

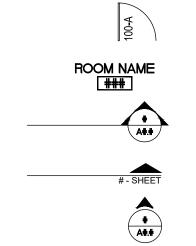

DOOR TAG - DOOR# **ROOM TAG**

WALL SECTION - DETAIL#-SHEET#

BUILDING SECTION - DETAIL# / SHEET#

INTERIOR ELEVATION - DETAIL# / SHEET#

ENLARGED DETAIL - DETAIL# / SHEET#

ELEVATION LOCATION

ELEVATION TARGET

PARTITION TYPE

PARTITION TO BE DEMOLISHED

ABBREVIATIONS

A.D.A. AMERICAN DISABILITIES ASSOCIATION BLDG. BUILDING C.J. CONTROL JOINT

CLG. CEILING CONCRETE MASONRY UNIT CONC. CONCRETE CONT. CONTINUOUS

DR. DOOR E.W.C. ELECTRIC WATER COOLER E.I.F.S. EXTERIOR INSULATION AND FINISH SYSTEM E.J. EXPANSION JOINT

EA. EACH EXT. EXTERIOR FIN. FLR. FLOOR G.B. GRAB BAR

GYP. GYPSUM H.M. HOLLOW METAL HT. HEIGHT INT. INTERIOR INSULATION INSUL. LEVEL

MANUFACTURER MANF. METAL BUILDING CONTRACTOR MINIMUM OR MINUTE MTL. METAL

O.C. ON CENTER PART. PRE-FINISHED REQ'D REQUIRED SCH. SCHEDULE

S.S. STAINLESS STEEL STL. STEEL SPEC. SPECIFICATIONS STRUCTURAL STRUCT. TLT. TOILET

WIDTH

W.

WITH U.L. UNDERWRITERS LABORATORIES WNDW. WINDOW V.C.T. VINYL COMPOSITION TILE

DRAWING INDEX

SHEET INDEX, SITE LOCATION PLANS, LEGEND, AND ABBREVIATIONS

SITE PLANS AND SITE DETAILS **DEMOLITION PLAN - FLOOR PLAN**

DEMOLITION PLAN - REFLECTED CEILING DEMOLITION PLAN - ROOF PLAN ALTERATIONS PLAN - FLOOR PLAN

ALTERATIONS PLAN - REFLECTED CEILING ALTERATIONS PLAN - ROOF PLAN

ALTERATIONS - ELEVATIONS A-300 DETAIL PLANS, ELEVATIONS AND DETAILS

SCHEDULES AND DETAILS SCHEDULES AND DETAILS

SYMBOLS, ABBREVIATIONS - MECHANICAL AND ELECTRICAL

SITE PLAN - MECHANICAL AND ELECTRICAL ROOF PLAN - MECHANICAL AND ELECTRICAL SCHEDULES - MECHANICAL AND ELECTRICAL

SCHEDULES - MECHANICAL AND ELECTRICAL DETAILS - MECHANICAL AND ELECTRICAL

DEMOLITION HVAC - FLOOR PLAN DEMOLITION PLUMBING - FLOOR PLAN

HVAC - FLOOR PLAN **HVAC CONTROL SCHEMATICS**

PLUMBING - FLOOR PLAN **RISER DIAGRAMS - PLUMBING**

DE-100 DEMOLITION ELECTRICAL - FLOOR PLAN

LIGHTING - FLOOR PLAN POWER - FLOOR PLAN


ELECTRICAL - SCHEDULES AND DETAILS

GENERAL NOTES

ARCHITECTURAL DWGS

- A. INFORMATION SHOWN ON THE DOCUMENTS FOR THE EXISTING BUILDING HAS BEEN REPRODUCED FROM THE ORIGINAL DRAWINGS AND FIELD VISUAL SURVEYS. REFER TO MEP DRAWINGS FOR ADDITIONAL INFORMATION. NO FORENSIC INVESTIGATIONS HAVE BEEN MADE FOR CONSTRUCTION ABOVE CEILINGS, UNDER FLOORS OR WITHIN WALLS. THE CONTRACTORS ARE REQUIRED TO VISIT THE SITE AND VERIFY CONDITIONS FOR THE WORK PRIOR
- B. EXISTING FURNISHINGS, LOCKERS, BENCHES, ETC. ARE NOT SHOWN; BUT WILL BE MOVED BY THE OWNER PRIOR TO CONSTRUCTION. CONTRACTOR TO COORDINATE WITH OWNER.
- C. THE SITE WILL BE FULLY OCCUPIED DURING THE HOURS OF 8:00 A.M. AND 5:00 P.M. COORDINATE ALL SITE WORK WITH THE OWNER PRIOR TO START OF CONSTRUCTION FOR AREAS THAT WILL BE OCCUPIED AND OWNER'S PREPARATION FOR THE WORK AREAS. PREPARE A RENOVATION PLAN/SCHEDULE FOR THE OWNER'S APPROVAL PRIOR TO THE WORK.
- D. THE CONTRACTOR WILL REPORT EXISTING DAMAGE TO MATERIALS THAT ARE TO REMAIN PRIOR TO THE WORK AND REPAIR OR REPLACE MATERIALS THAT ARE DAMAGED BY THE RENOVATION WORK.
- E. PROTECT & KEEP CLEAR ALL BUILDING ACCESSES.
- F. ALL EXISTING SERVICES & UTILITIES SHALL BE MAINTAINED TO ADJACENT AREAS THAT ARE IN OPERATION & SERVED BY THESE UTILITIES & SERVICES. COORDINATE ALL DISRUPTIONS OR DISCONTINUATION OF UTILITIES & SERVICES WITH THE OWNER'S REPRESENTATIVE AT THE FACILITY.
- G. PROVIDE TEMPORARY DUST BARRIERS IN ALL AREAS OF WORK. COORDINATE EXACT LOCATIONS WITH OWNER.
- H. EXISTING ITEMS, STRUCTURE, EQUIPMENT, ETC. TO REMAIN IN PLACE SHALL BE PROTECTED FROM DIRT & DAMAGE DURING DEMOLITION & CONSTRUCTION.
- REMOVE ONLY WHAT IS NECESSARY TO COMPLETE DEMOLITION & ACCOMMODATE NEW CONSTRUCTION. PREPARE ALL DISTURBED AREAS FOR NEW CONSTRUCTION.
- J. ANY DAMAGE RESULTING FROM DEMOLITION TO BE REPAIRED TO ITS ORIGINAL STATE BY THE CONTRACTOR.
- K. GENERAL CONTRACTOR SHALL INSTALL SOLID WOOD BLOCKING AT WALLS AND PARTITIONS AS NECESSARY FOR INSTALLATION OF TOILET PARTITIONS, ACCESSORIES, LOCKERS, ETC. COORDINATE WITH OWNER.

STATE OF MISSOURI MICHAEL L. PARSON, **GOVERNOR**

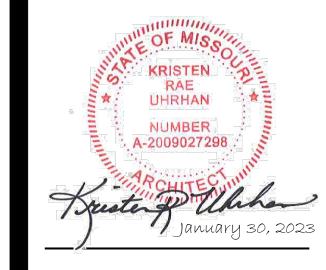

OFFICE OF ADMINISTRATION DIVISION OF FACILITIES MANAGEMENT, **DESIGN AND CONSTRUCTION**

MISSOURI ARMY NATIONAL GUARD FACILITIES DIVISION

RE-BID RENOVATE INTERIOR AND EXTERIOR

KENNETT READINESS CENTER 1450 NORTH BY-PASS

PROJECT # T2209-01

FACILITY # 8136313002

KENNETT, MO 63857

REVISION: DATE: **REVISION:** DATE **REVISION:** DATE: ISSUE DATE: January 30, 2023

CAD DWG FILE: G-002.DWG DRAWN BY: CHECKED BY: **DESIGNED BY:**


> SHEET TITLE: SHEET INDEX SITE LOCATION PLANS **LEGENDS AND ABBREVIATIONS**


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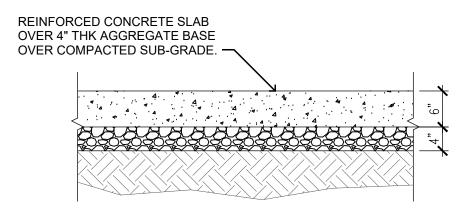
G-002

2 of 29 sheets





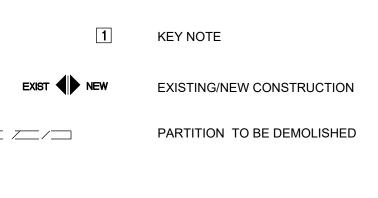

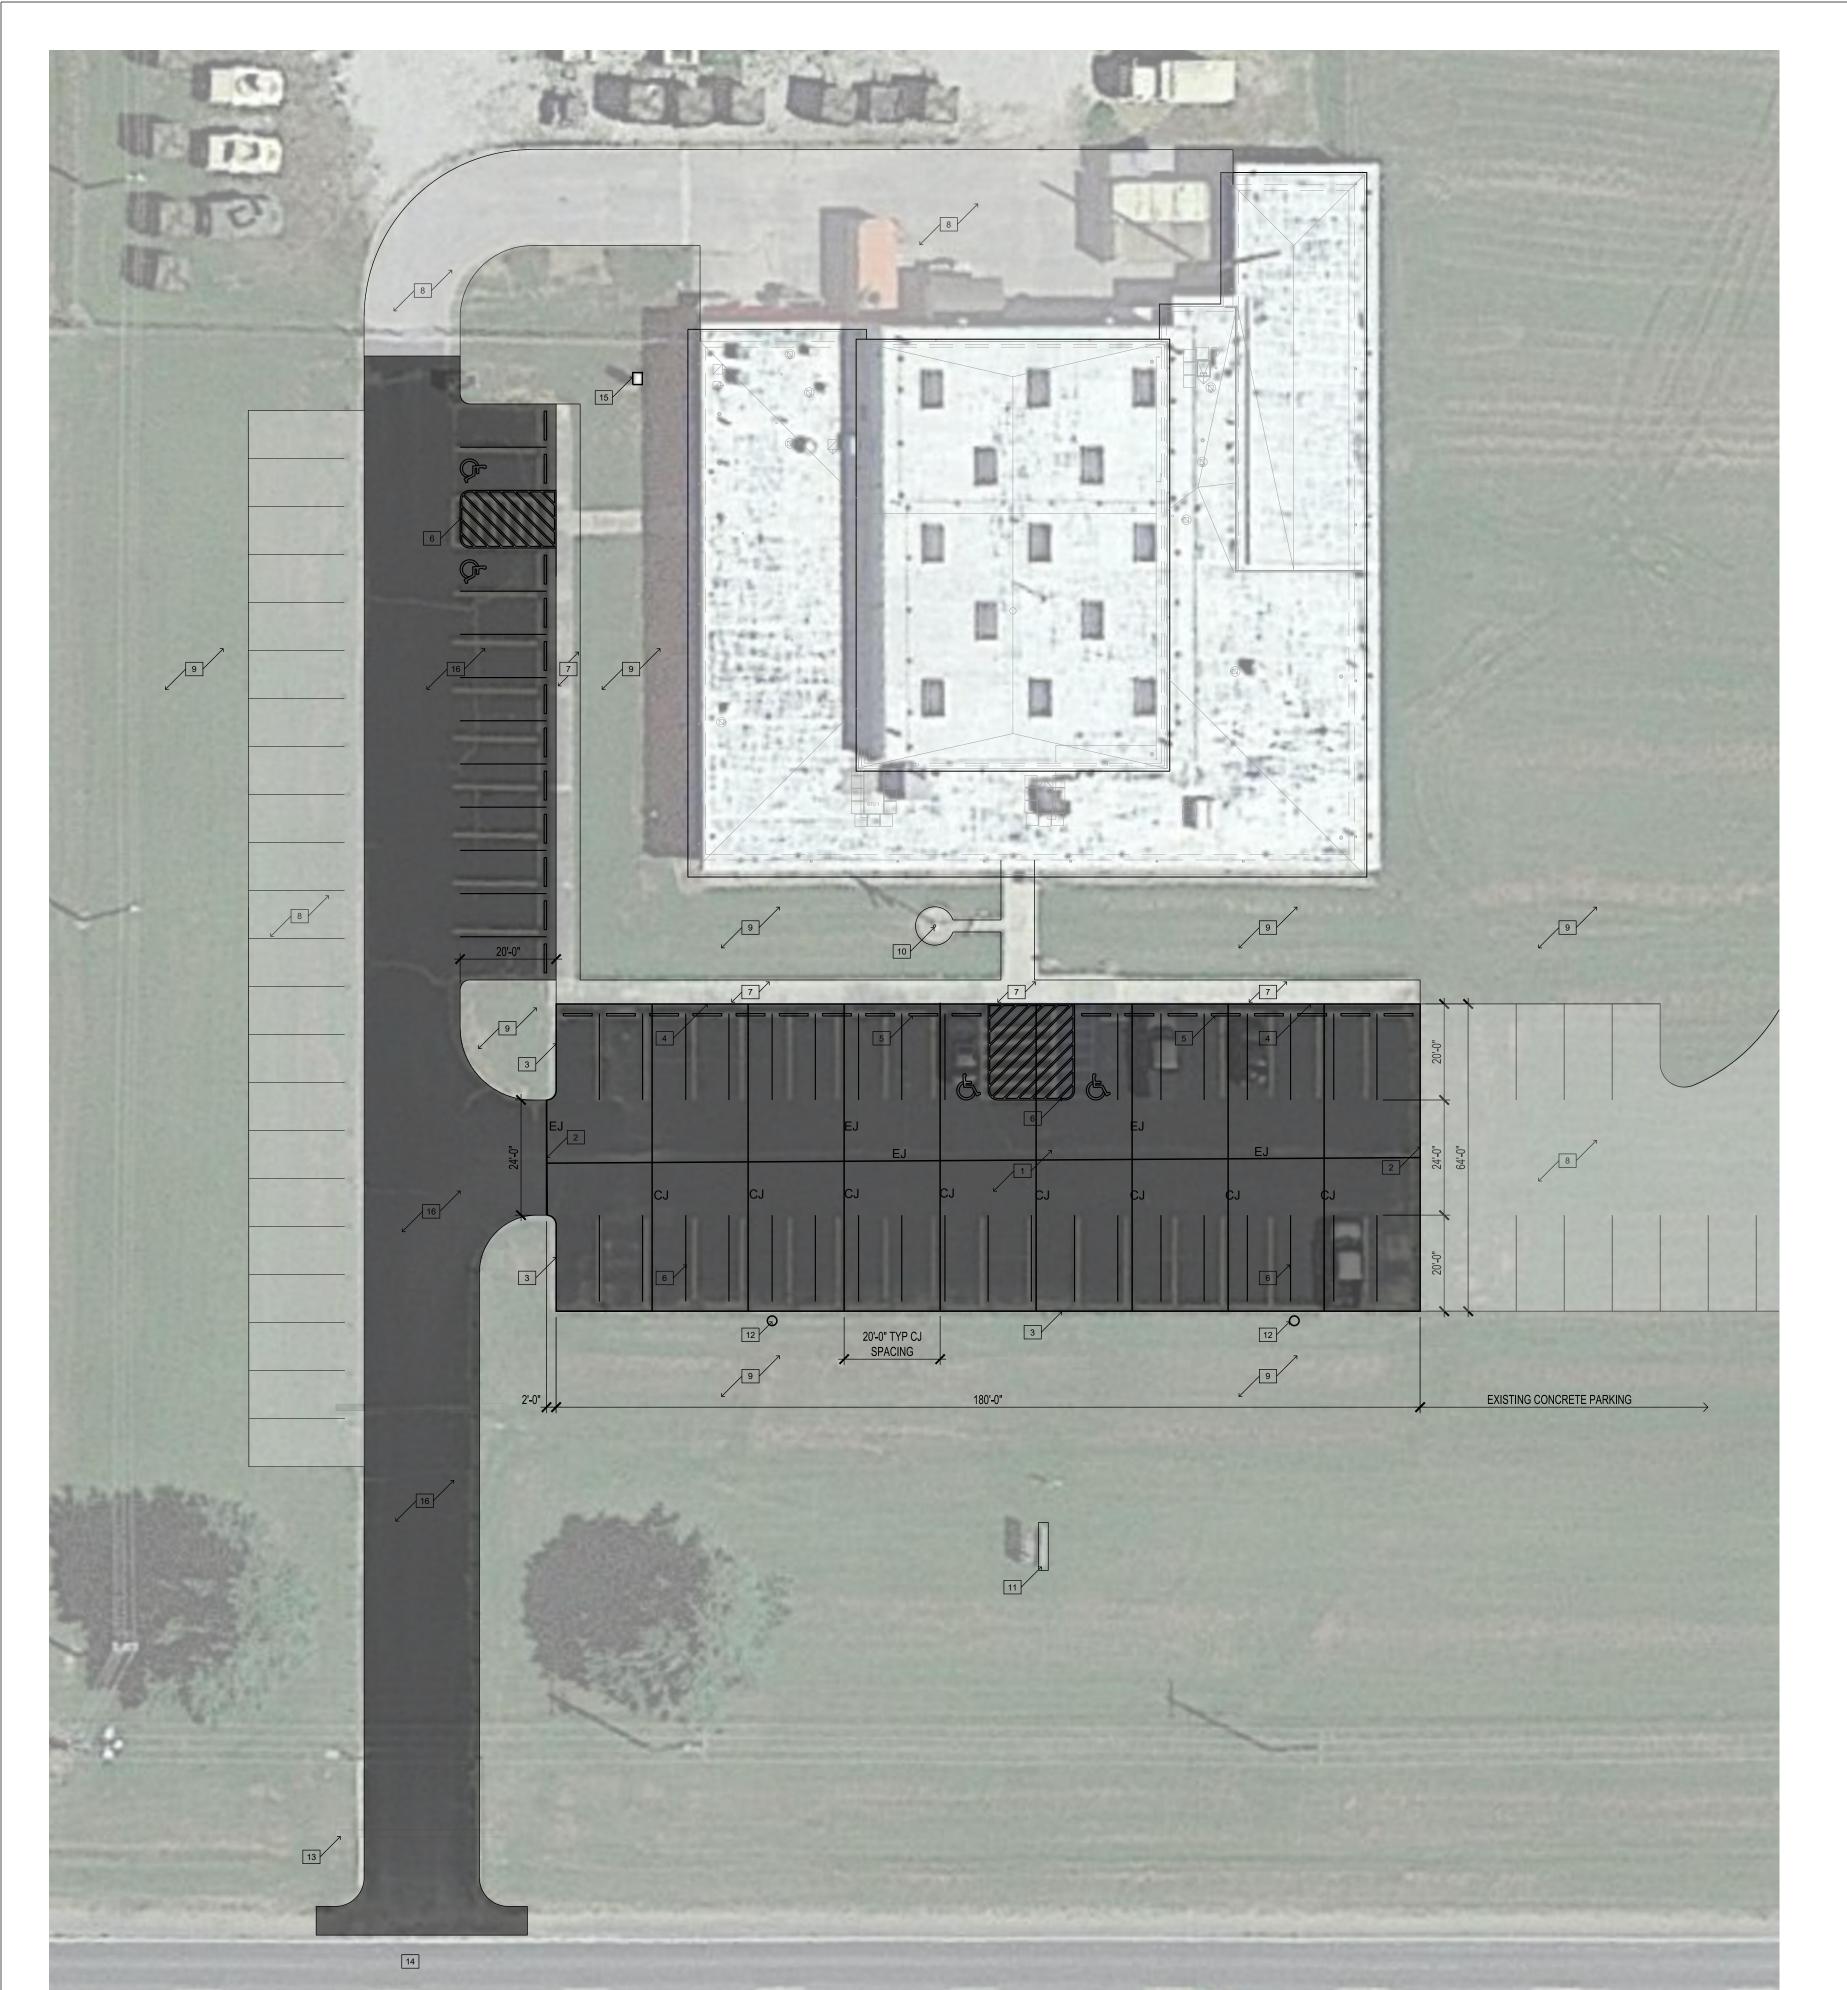


*PROVIDE SAWCUT JOINTS AT 12'-0" CENTERS EACH WAY -WHERE POSSIBLE, ALIGN WITH EXISTING CONCRETE JOINTS.

TYPICAL PAVING DETAIL

REINFORCED CONCRETE SLAB OVER 4" THK AGGREGATE BASE OVER COMPACTED SUB-GRADE. -TOOLED EDGE. — EXISTING GRADE.—

3 TYPICAL PAVING DETAIL @ XGRADE SCALE: 3/4" = 1'-0"

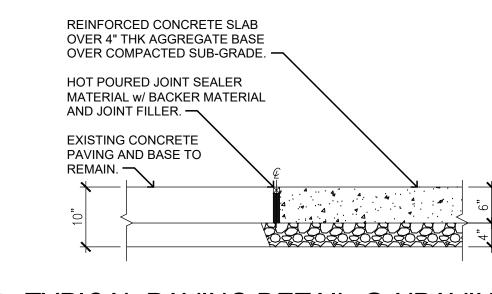

TYPICAL PAVING DETAIL @ XPAVING

SCALE: 3/4" = 1'-0"

EXISTING CONCRETE WALK TO REMAIN. — HOT POURED JOINT SEALER MATERIAL w/ BACKER MATERIAL AND JOINT FILLER. — REINFORCED CONCRETE SLAB OVER 4" THK AGGREGATE BASE OVER COMPACTED SUB-GRADE.

TYPICAL PAVING DETAIL @ XWALK

SCALE: 3/4" = 1'-0"

GENERAL SITE PLAN NOTES:

- A. ALL CIVIL WORK SHOWN ON THIS SHEET SHALL BE BY ALTERNATE BID NO. 3. ALSO REFERENCE UNIT PRICES FOR ADDITIONAL CONCRETE PAVING. ALSO REFERENCE ELECTRICAL DRAWINGS.
- B. ALL GRASSES, AGGREGATE AND CONCRETE SURFACES DISTURBED OR DAMAGED DURING CONSTRUCTION SHALL BE RESTORED TO THEIR ORIGINAL CONDITION.
- C. BURY ELEVATIONS OF UNDERGROUND PIPING AND CONDUITS ARE UNKNOWN. UTILITIES CUT OR DAMAGED DURING CONSTRUCTION ARE TO BE RESTORED TO THEIR ORIGINAL CONDITION.
- D. HATCHED AREA INDICATES EXTENTS OF EXISTING PAVING TO BE TOTALLY REMOVED BY CONTRACTOR UNLESS OTHERWISE NOTED. DEMO'D ITEMS TO BE REMOVED AND DISPOSED OF IN A SAFE AND LAWFUL MANNER AS SPECIFIED.
- ALSO REFERENCE SHEET G-002 FOR GENERAL NOTES APPLICABLE FOR THE FULL PROJECT.


KEYED NOTES - SITE PLAN:

- BY ALTERNATE BID NO. 3: REMOVE EXISTING ASPHALT PAVING AND REPLACE WITH NEW REINFORCED 4000 PSI CONCRETE PAVING. NEW RIGID CONCRETE PAVING CONSTRUCTION TO BE: 6"THK WITH 6X6XW2.0XW2.0 WWF AT MID-DEPTH OVER 4" COMPACTED AGGREGATE BASE ON COMPACTED SUB- GRADE. REFERENCE DETAIL 2, THIS SHEET. TAKE CARE NOT TO DAMAGE EXISTING PAVING TO REMAIN. IF DAMAGED REPAIR TO RESTORE TO ORIGINAL CONDITION.
- BY ALTERNATE BID NO. 3: PROVIDE NEW EXPANSION JOINT FILLER AND SEALANT BETWEEN NEW CONCRETE PAVING AND EXISTING CONCRETE PAVING. SAWCUT AS REQUIRED TO PROVIDE STRAIGHT EDGE JOINT BETWEEN EXISTING AND NEW. REFERENCE DETAIL 4, THIS SHEET.
- 3. BY ALTERNATE BID NO. 3: 12" THICKENED EDGE WHERE NEW CONCRETE MEETS EXISTING GRADE. REF: DETAIL 3, THIS SHEET.
- BY ALTERNATE BID NO. 3: PROVIDE NEW EXPANSION JOINT FILLER AND SEALANT BETWEEN NEW CONCRETE PAVING AND EXISTING CONCRETE WALK. REFERENCE DETAIL 5, THIS SHEET.
- TEMPORARILY REMOVED DURING PAVING AND RE-INSTALLED WHERE INDICATED.

5. <u>BY ALTERNATE BID NO. 3</u>: EXISTING WHEELSTOPS TO BE

- 6. BY ALTERNATE BID NO. 3: NEW 4" WIDE PARKING STRIPING AS SHOWN.
- 7. EXISTING CONCRETE SIDEWALKS AND ACCESSIBLE ACCESS TO REMAIN.
- 8. EXISTING (RECENT) CONCRETE PAVING AND STRIPING TO REMAIN.
- 9. EXISTING GRASS AREA TO REMAIN.
- 10. EXISTING FLAGPOLE TO REMAIN.
- 11. EXISTING BUILDING SIGN TO REMAIN.
- 12. NEW PARKING LIGHTING TO MATCH EXISTING. REFERENCE MECHANICAL / ELECTRICAL DRAWINGS.
- 13. EXISTING STORMWATER PIPING TO REMAIN.
- 14. EXISTING ROADWAY.
- 15. <u>BY ALTERNATE BID NO. 2</u>: EXISTING TRANSFER SWITCH. REFERENCE ELECTRICAL DRAWINGS FOR NEW TRANSFER SWITCH.
- 16. BY UNIT PRICE NO. 1: PER SQUARE FOOT REMOVE EXISTING ASPHALT PAVING AND REPLACE WITH NEW REINFORCED 4000 PSI CONCRETE PAVING. NEW RIGID CONCRETE PAVING CONSTRUCTION TO BE: 6"THK WITH 6X6XW2.0XW2.0 WWF AT MID-DEPTH OVER 4" COMPACTED AGGREGATE BASE ON COMPACTED SUB-GRADE. REFERENCE DETAIL 2, THIS SHEET. TAKE CARE NOT TO DAMAGE EXISTING PAVING TO REMAIN. IF DAMAGED REPAIR TO RESTORE TO ORIGINAL CONDITION.

SYMBOL LEGEND (THIS SHEET ONLY)

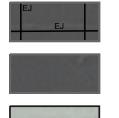

ALTERNATE BID NO. 3: AREA OF EXISTING ASPHALT PAVING TO BE REMOVED AND REPLACED WITH CONCRETE **EXISTING PAVING - POTENTIAL UNIT COST**



EXISTING PAVING - NO WORK



ELEVATION - EXISTING FINISH FLOOR ELEVATION **BOTTOM OF CURB**

BOC TOC TOP OF CURB CONTROL JOINT **EXPANSION JOINT** DOWNSPOUT LOCATION STATE OF MISSOURI MICHAEL L. PARSON, **GOVERNOR**



OFFICE OF ADMINISTRATION DIVISION OF FACILITIES

MISSOURI ARMY NATIONAL GUARD **FACILITIES DIVISION**

DESIGN AND CONSTRUCTION

MANAGEMENT,

RE-BID RENOVATE INTERIOR AND EXTERIOR

KENNETT READINESS CENTER 1450 NORTH BY-PASS KENNETT, MO 63857

PROJECT # T2209-01

FACILITY # 8136313002

REVISION: REVISION **REVISION:** DATE:

CAD DWG FILE: A-001.DWG

ISSUE DATE: January 30, 2023

DRAWN BY: CHECKED BY: DESIGNED BY:


SHEET TITLE:

SITE PLAN AND SITE DETAILS ALTERNATE NO. 3

SHEET NUMBER

3 _{OF} 29 _{SHEETS}

SITE PLAN

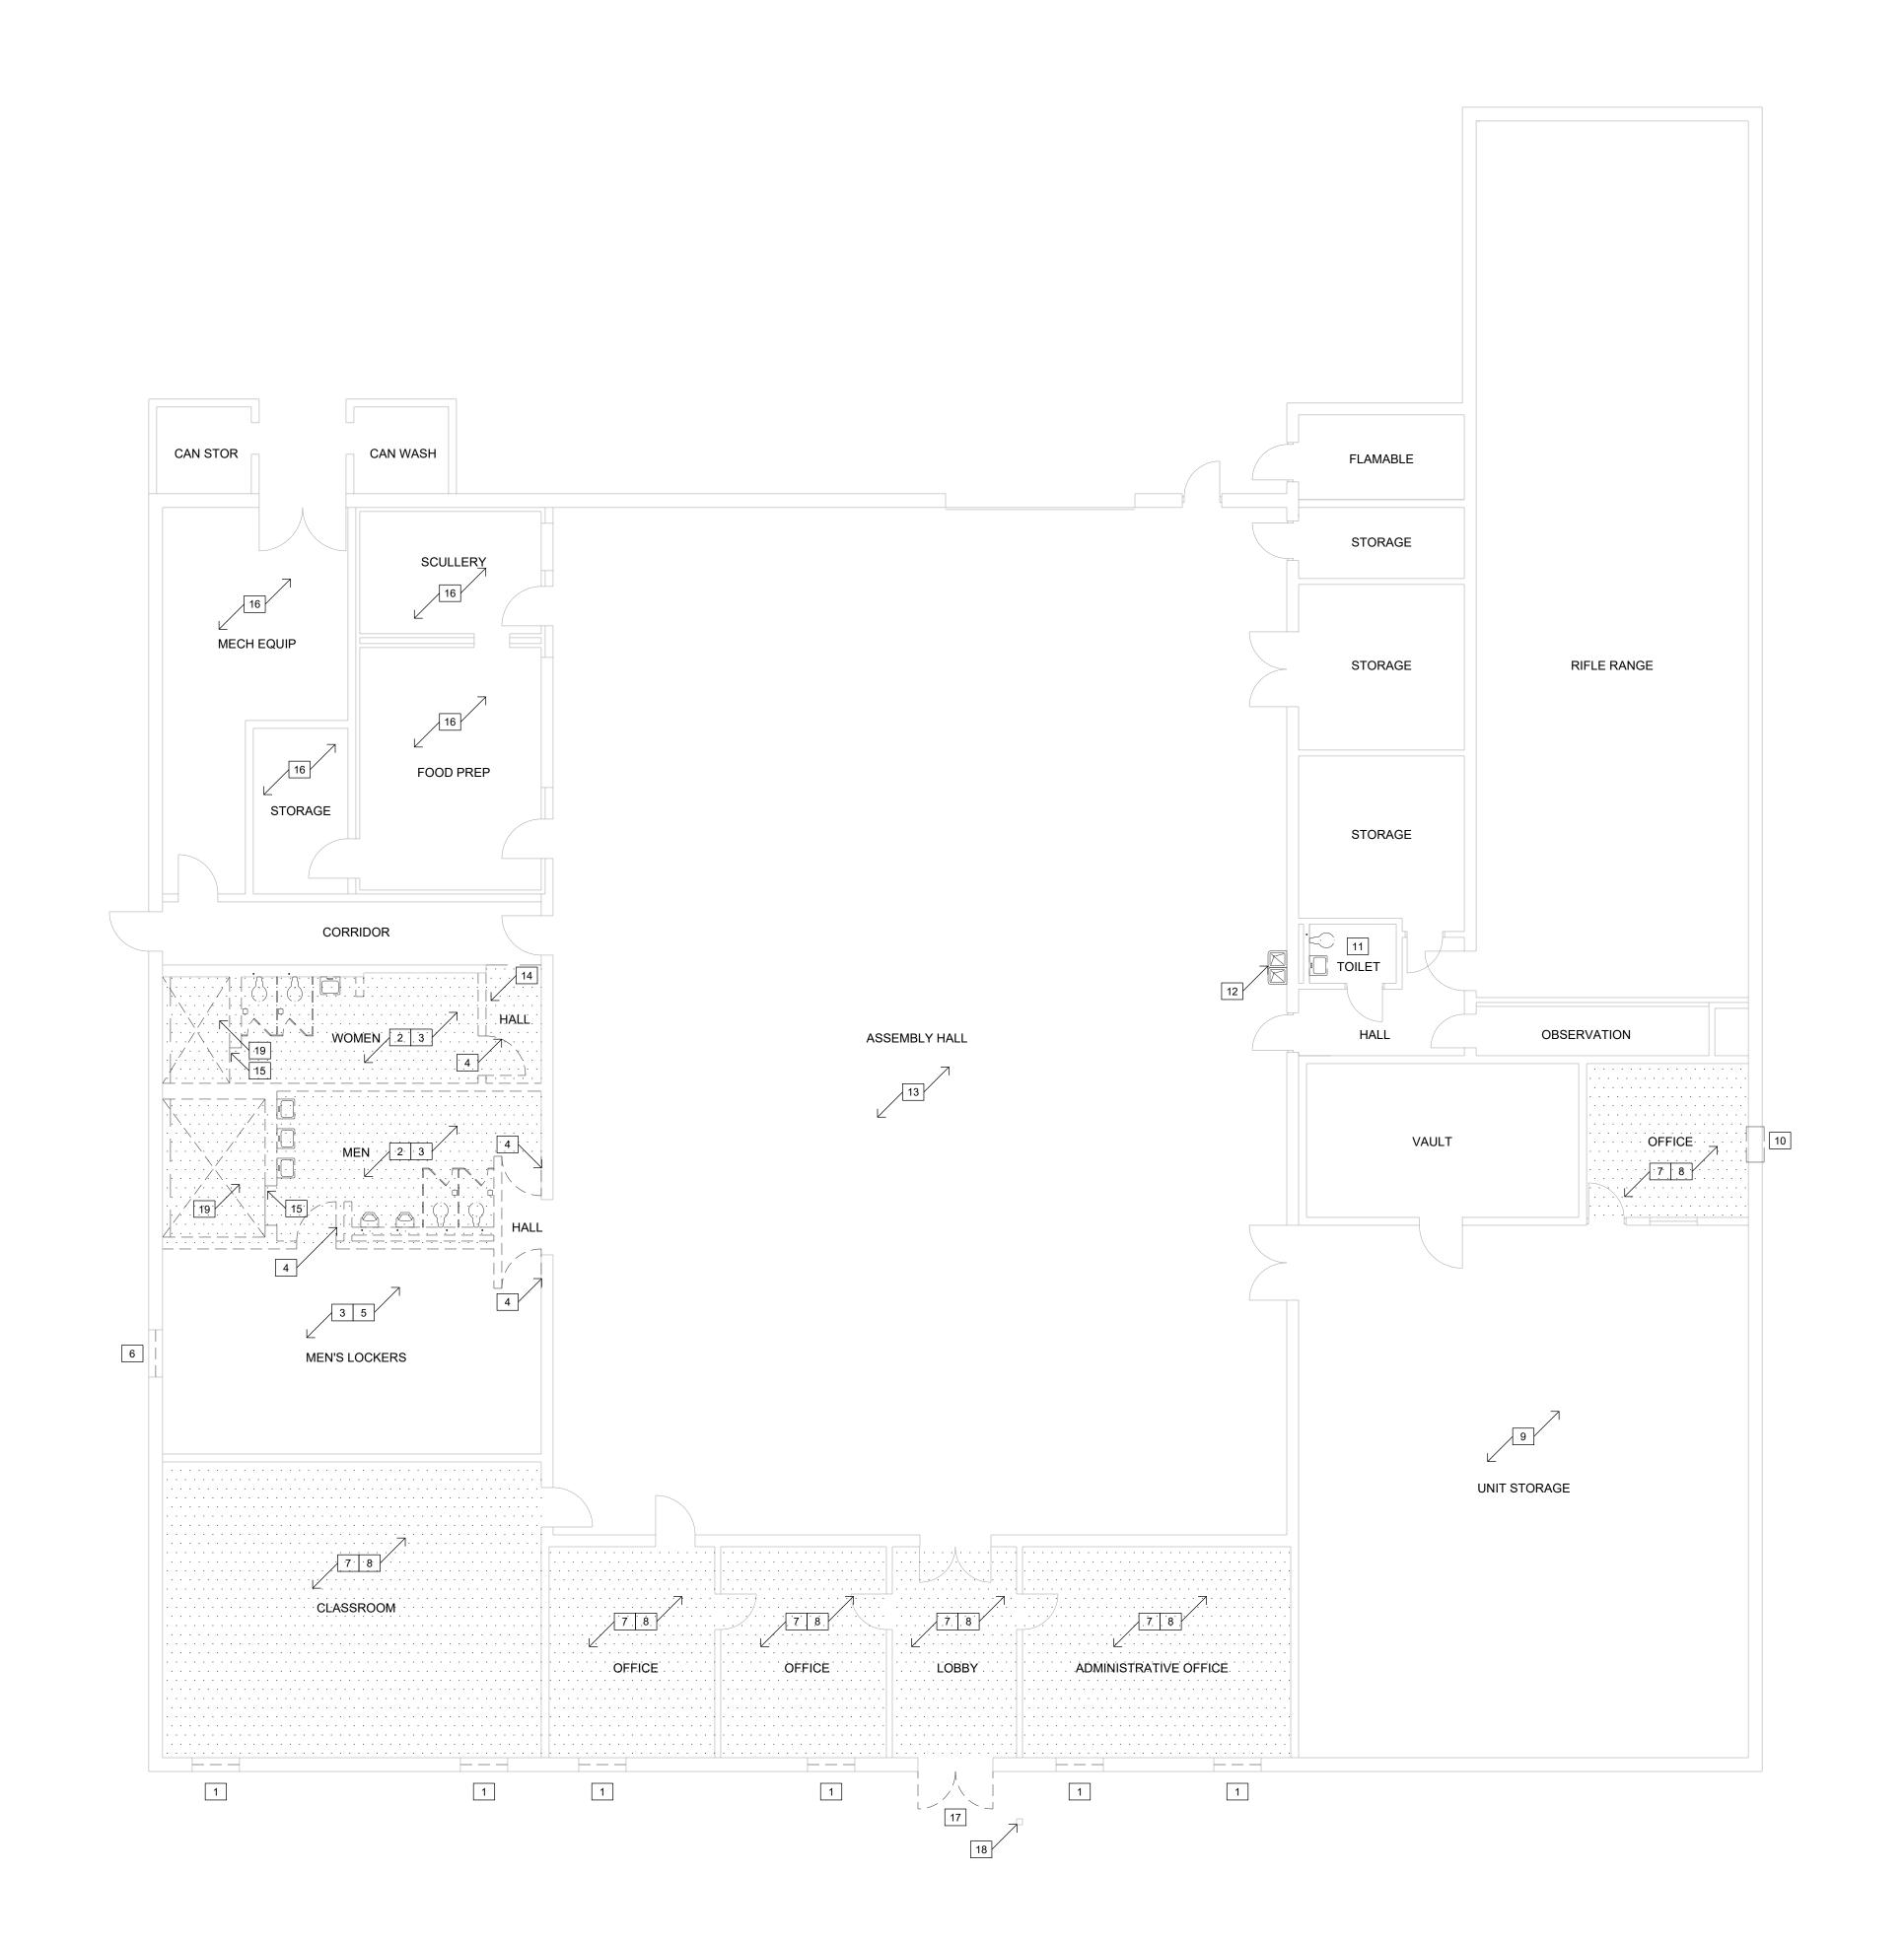

GENERAL DEMOLITION PLAN NOTES:


- A. DASHED LINES INDICATE EXISTING CONSTRUCTION TO BE TOTALLY REMOVED BY CONTRACTOR UNLESS OTHERWISE NOTED. DEMO'D ITEMS TO BE REMOVED AND DISPOSED OF IN A SAFE AND LAWFUL MANNER AS SPECIFIED.
- B. EXISTING SURFACES TO RECEIVE NEW FINISHES SHALL BE PATCHED AND PREPPED AS REQUIRED TO RECEIVE NEWLY SPECIFIED SURFACE TREATMENT / FINISHES PER MANUFACTURER'S RECOMMENDATIONS.
- C. LEVEL ALL FLOOR SLABS AS REQUIRED WHERE SLAB DEPRESSIONS HAVE BEEN LEFT BY DEMOLITION OR NECESSARY FOR NEW FLOORING.
- D. PROVIDE TEMPORARY BRACING AND SHORING AS REQUIRED TO SUPPORT EXISTING STRUCTURE PRIOR TO ANY DEMOLITION OF LOAD BEARING CONSTRUCTION.
- E. REFERENCE ALSO DEMOLITION REFLECTED CEILING PLAN AND ROOF PLAN.
- F. REFERENCE MEP DRAWINGS FOR EXTENTS OF ADDITIONAL DEMOLITION.

KEYED NOTES (DEMOLITION):

FOR WINDOW REMOVAL AND REPLACEMENT.

- EXISTING WINDOWS TO REMAIN IN BASE BID. TAKE CARE NOT TO DAMAGE. ALSO REFERENCE ALTERNATE NO. 2
- 2. EXISTING MOSAIC TILE FLOORING AND INTERIOR CMU WALLS WHERE INDICATED TO BE TOTALLY REMOVED FOR NEW WORK. CLEAN AND PREP CONCRETE FLOOR SLAB FOR NEW INFILL AND FLOORING. ALSO REFERENCE MEP FOR EXTENT OF REMOVAL OF PLUMBING FIXTURES AND DEVICES.
- 3. EXISTING CONCRETE SLAB DEMOLITION CONTRACTOR'S OPTIONS:
- 3.1. OPTION 1: TRENCHING SAWCUT AND DEMO AS REQUIRED FOR NEW WORK AND UNDERFLOOR/SLAB PIPING. REF: MEP DRAWINGS.
- 3.2. OPTION 2: FULL SLAB SAWCUT AT ROOM PERIMETER AND DEMO FOR NEW WORK AND
- UNDERGLOOR/SLAB PIPING. REF: MEP DRAWINGS.
 3.3. NOTE: IN EITHER OPTION, CONTRACTOR TO TAKE CARE NOT TO UNDERMINE BUILDING FOOTINGS.
- 4. EXISTING DOORS AND FRAMES TO BE TOTALLY REMOVED.
- EXISTING EXPOSED STRUCTURE TO REMAIN. ALSO REFERENCE MEP DWGS.
- 6. EXISTING WINDOW UNIT TO BE TOTALLY REMOVED. REFERENCE NEW WORK FOR EXISTING MASONRY OPENING TO BE INFILLED TO MATCH EXISTING.
- 7. EXISTING FINISH FLOORING TO BE TOTALLY REMOVED. EXISTING CONCRETE SLAB TO BE CLEANED AND PREPPED FOR NEW WORK.
- 8. EXISTING WALLS TO REMAIN. INSPECT AND REPAIR AS REQUIRED. PREP FOR NEW PAINT FINISH.
- 9. EXISTING UNIT STORAGE TO REMAIN. PREP AREA FOR INSTALLATION OF NEW FULL HEIGHT WIRE PARTITION PANELS. REF: NEW WORK.
- 10. REFERENCE MEP DRAWINGS FOR EXISTING THRU-WALL UNIT TO BE TOTALLY REMOVED. REFERENCE NEW WORK FOR EXISTING MASONRY OPENING TO BE INFILLED TO MATCH EXISTING.
- 11. EXISTING MOSAIC TILE AND WALL TILE TO REMAIN AND BE CLEANED. TOILET ACCESSORIES TO BE COMPLETELY REMOVED. REFERENCE MEP DRAWINGS FOR PLUMBING FIXTURES.
- 12. EXISTING ELECTRIC WATER COOLER TO BE REMOVED. REFERENCE MEP DRAWINGS.
- 13. REFERENCE ELECTRICAL DRAWINGS FOR EXTENT OF DEMOLITION WORK THIS AREA.
- 14. FINISH FLOORING TO BE REMOVED TO EXTENTS SHOWN. FLOORS AND WALLS TO BE PREPPED FOR NEW WORK. ALSO REFERENCE MEP DRAWINGS.
- 15. EXISTING CURB AT SHOWER AREA TO BE REMOVED.
- REFERENCE MEP DRAWINGS FOR EXTENT OF DEMOLITION OF EXISTING EQUIPMENT.
- 17. EXISTING STOREFRONT TO REMAIN IN BASE BID. TAKE CARE NOT TO DAMAGE. REFERENCE <u>ALTERNATE NO. 1</u> FOR REMOVAL OF EXISTING ALUMINUM STOREFRONT AND PREP FOR NEW OPENING AND HARDWARE.
- 18. REFERENCE MEP FOR EXISTING ADA ACCESS TO BE REPLACED. MOUNTING POLE TO REMAIN.
- 19. TOP OF EXISTING SLAB AT SHOWER AREA IS RECESSED TO A DEPTH OF $3\frac{1}{2}$ " BELOW FINISH FLOOR ELEVATION.

SYMBOL LEGEND (THIS SHEET ONLY)

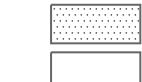


REMOVED AND REPLACED.

AREA OF EXISTING FLOOR FINISH TO BE

AREA RECESSED CONCRETE SLAB

STATE OF MISSOURI MICHAEL L. PARSON, GOVERNOR

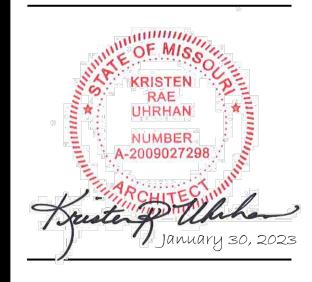



OFFICE OF ADMINISTRATION DIVISION OF FACILITIES MANAGEMENT, DESIGN AND CONSTRUCTION

MISSOURI ARMY NATIONAL GUARD FACILITIES DIVISION

RE-BID RENOVATE INTERIOR AND EXTERIOR

KENNETT READINESS CENTER 1450 NORTH BY-PASS KENNETT, MO 63857

PROJECT # T2209-01

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CAD DWG FILE: A-100.DWG

DRAWN BY: KU
CHECKED BY: BD
DESIGNED BY: KU

SHEET TITLE:


DEMOLITION PLAN
- FLOOR PLAN

SHEET NUMBER:

A-100

4 OF 29 SHEETS

1 100

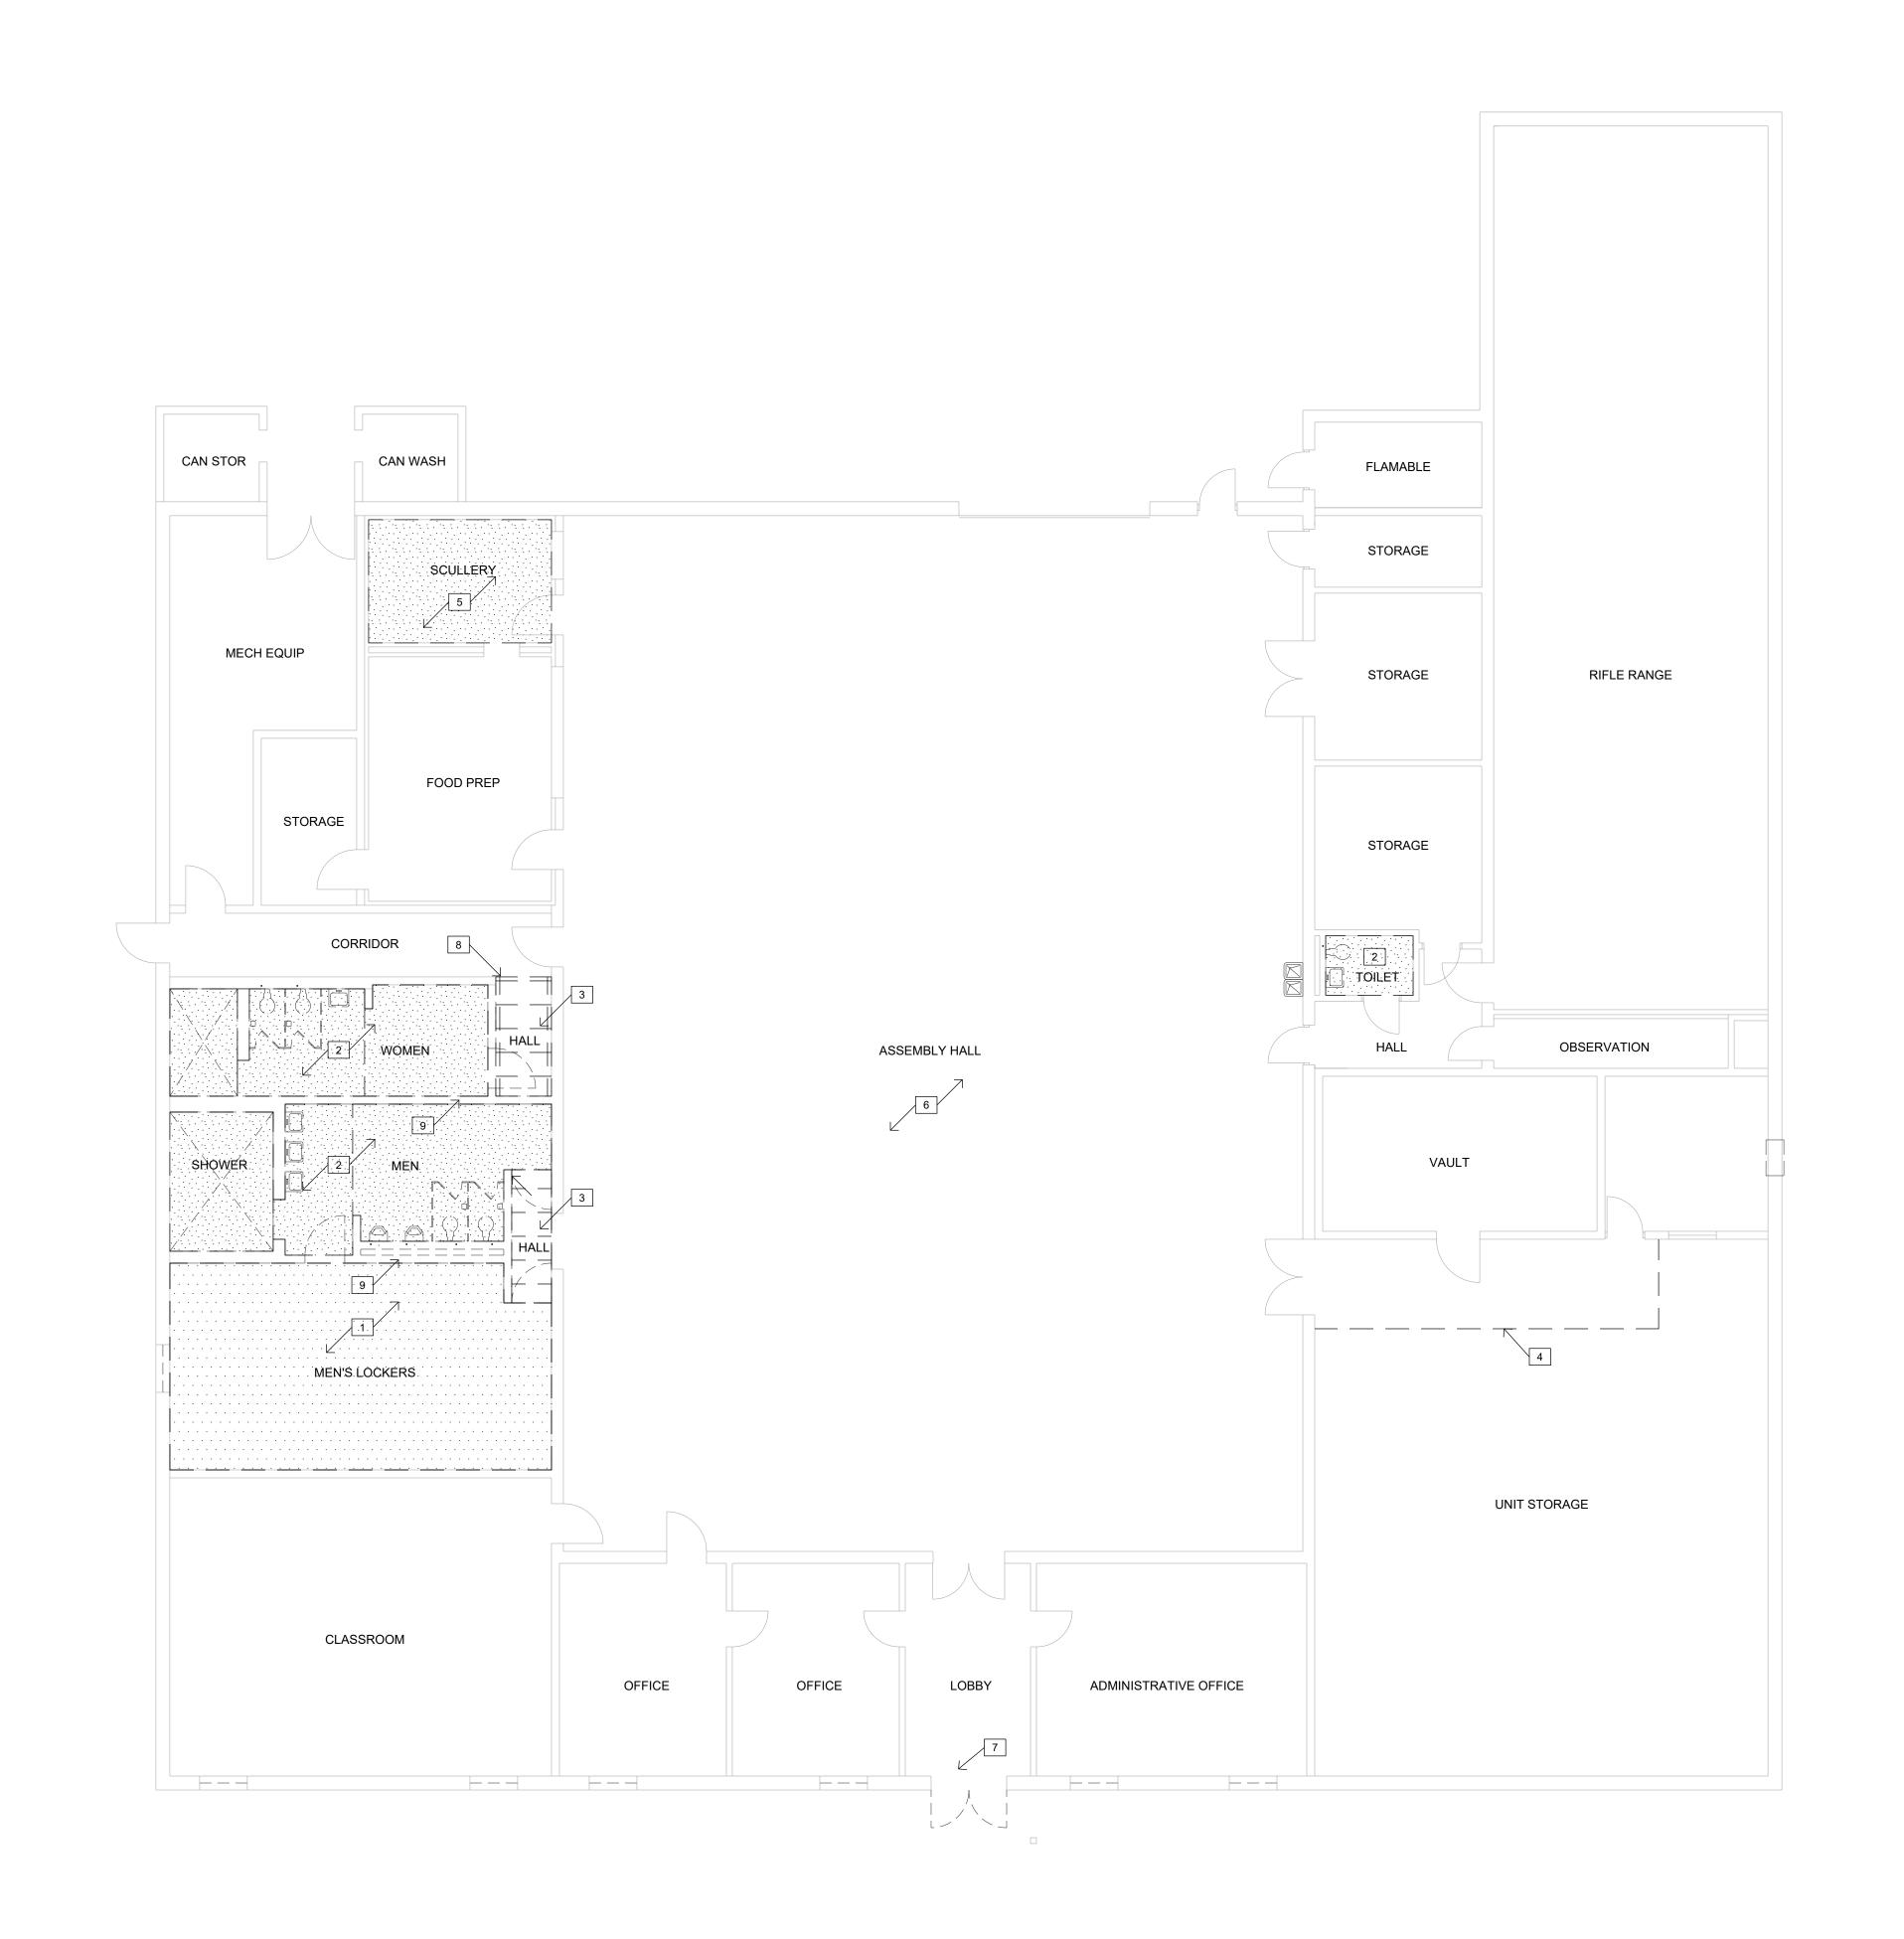

GENERAL DEMOLITION PLAN NOTES:

- A. DASHED LINES INDICATE EXISTING CONSTRUCTION TO BE TOTALLY REMOVED BY CONTRACTOR UNLESS OTHERWISE NOTED. DEMO'D ITEMS TO BE REMOVED AND DISPOSED OF IN A SAFE AND LAWFUL MANNER AS SPECIFIED.
- B. EXISTING SURFACES TO RECEIVE NEW FINISHES SHALL BE PATCHED AND PREPPED AS REQUIRED TO RECEIVE NEWLY SPECIFIED SURFACE TREATMENT / FINISHES PER MANUFACTURER'S RECOMMENDATIONS.
- C. PROVIDE TEMPORARY BRACING AND SHORING AS REQUIRED TO SUPPORT EXISTING STRUCTURE PRIOR TO ANY DEMOLITION OF LOAD BEARING CONSTRUCTION.

KEYED NOTES (DEMOLITION):

- EXISTING EXPOSED STRUCTURE TO REMAIN. LIGHTING AND DEVICES TO BE REMOVED. OWNER RESERVES THE FIRST RIGHT TO REFUSAL OF THE FIXTURES. ALSO REFERENCE MEP DWGS.
- 2. EXISTING GYPSUM PLASTER OVER METAL LATH CEILING ON STEEL C-CHANNEL SUSPENDED FRAME, LIGHTING FIXTURES AND DEVICES TO BE TOTALLY REMOVED. ALSO REFERENCE MEP DRAWINGS.
- 3. EXISTING SUSPENDED CEILING, GRID AND DEVICES TO BE TOTALLY REMOVED. REFERENCE MEP FOR TEMPORARY SUPPORT OF EXISTING LIGHT FIXTURES TO BE RE-USED.
- 4. EXISTING EXPOSED STRUCTURE TO REMAIN. MODIFY AS REQUIRED FOR INSTALLATION OF NEW PARTITION PANELS. REF: NEW WORK.
- 5. EXISTING GYPSUM PLASTER OVER METAL LATH CEILING TO REMAIN. REFERENCE MEP DRAWINGS FOR NEW CEILING DEVICES IN EXISTING CEILING. REPAIR AS
- 6. EXISTING LIGHT FIXTURES TO BE TOTALLY REMOVED, THIS AREA. REFERENCE ELECTRICAL DRAWINGS.

REQUIRED, PREP FOR NEW PAINT FINISH.

- 7. ALTERNATE BID NO. 1: REMOVE AND MODIFY EXISTING SUSPENDED CEILING GRID SYSTEM AS NECESSARY TO ACCESS STOREFRONT FOR REMOVAL AND REPLACEMENT.
- 8. MODIFY EXISTING SUSPENDED CEILING GRID SYSTEM AS NECESSARY DUE TO WALL INFILL.
- 9. ROOF DECK IS WELDED TO CONTINUOUS EMBED PLATES IN THE TOP OF THE CMU WALLS TO BE DEMO'D. CONTRACTOR TO TAKE SPECIAL CAUTION DURING DEMOLITION TO ENSURE THE WALL REMOVAL DOES NOT DAMAGE THE ROOF DECK AND ROOF JOISTS. ANY DAMAGE AND SUBSEQUENT REPAIR (MATERIAL & LABOR) WILL BE THE FULL RESPONSIBILITY OF THE CONTRACTOR.


SYMBOL LEGEND (THIS SHEET ONLY)

AREA OF EXISTING GYPSUM PLASTER OVER METAL LATH CEILING

AREA EXPOSED STRUCTURE ABOVE

AREA OF SUSPENDED CEILING GRID AND TILE TO BE REMOVED

STATE OF MISSOURI MICHAEL L. PARSON, **GOVERNOR**

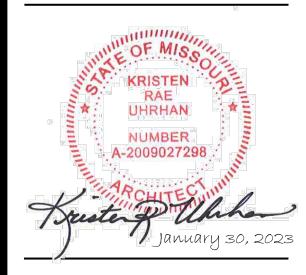



OFFICE OF ADMINISTRATION DIVISION OF FACILITIES MANAGEMENT,

DESIGN AND CONSTRUCTION

MISSOURI ARMY NATIONAL GUARD FACILITIES DIVISION

RE-BID RENOVATE INTERIOR AND EXTERIOR

KENNETT READINESS CENTER 1450 NORTH BY-PASS KENNETT, MO 63857

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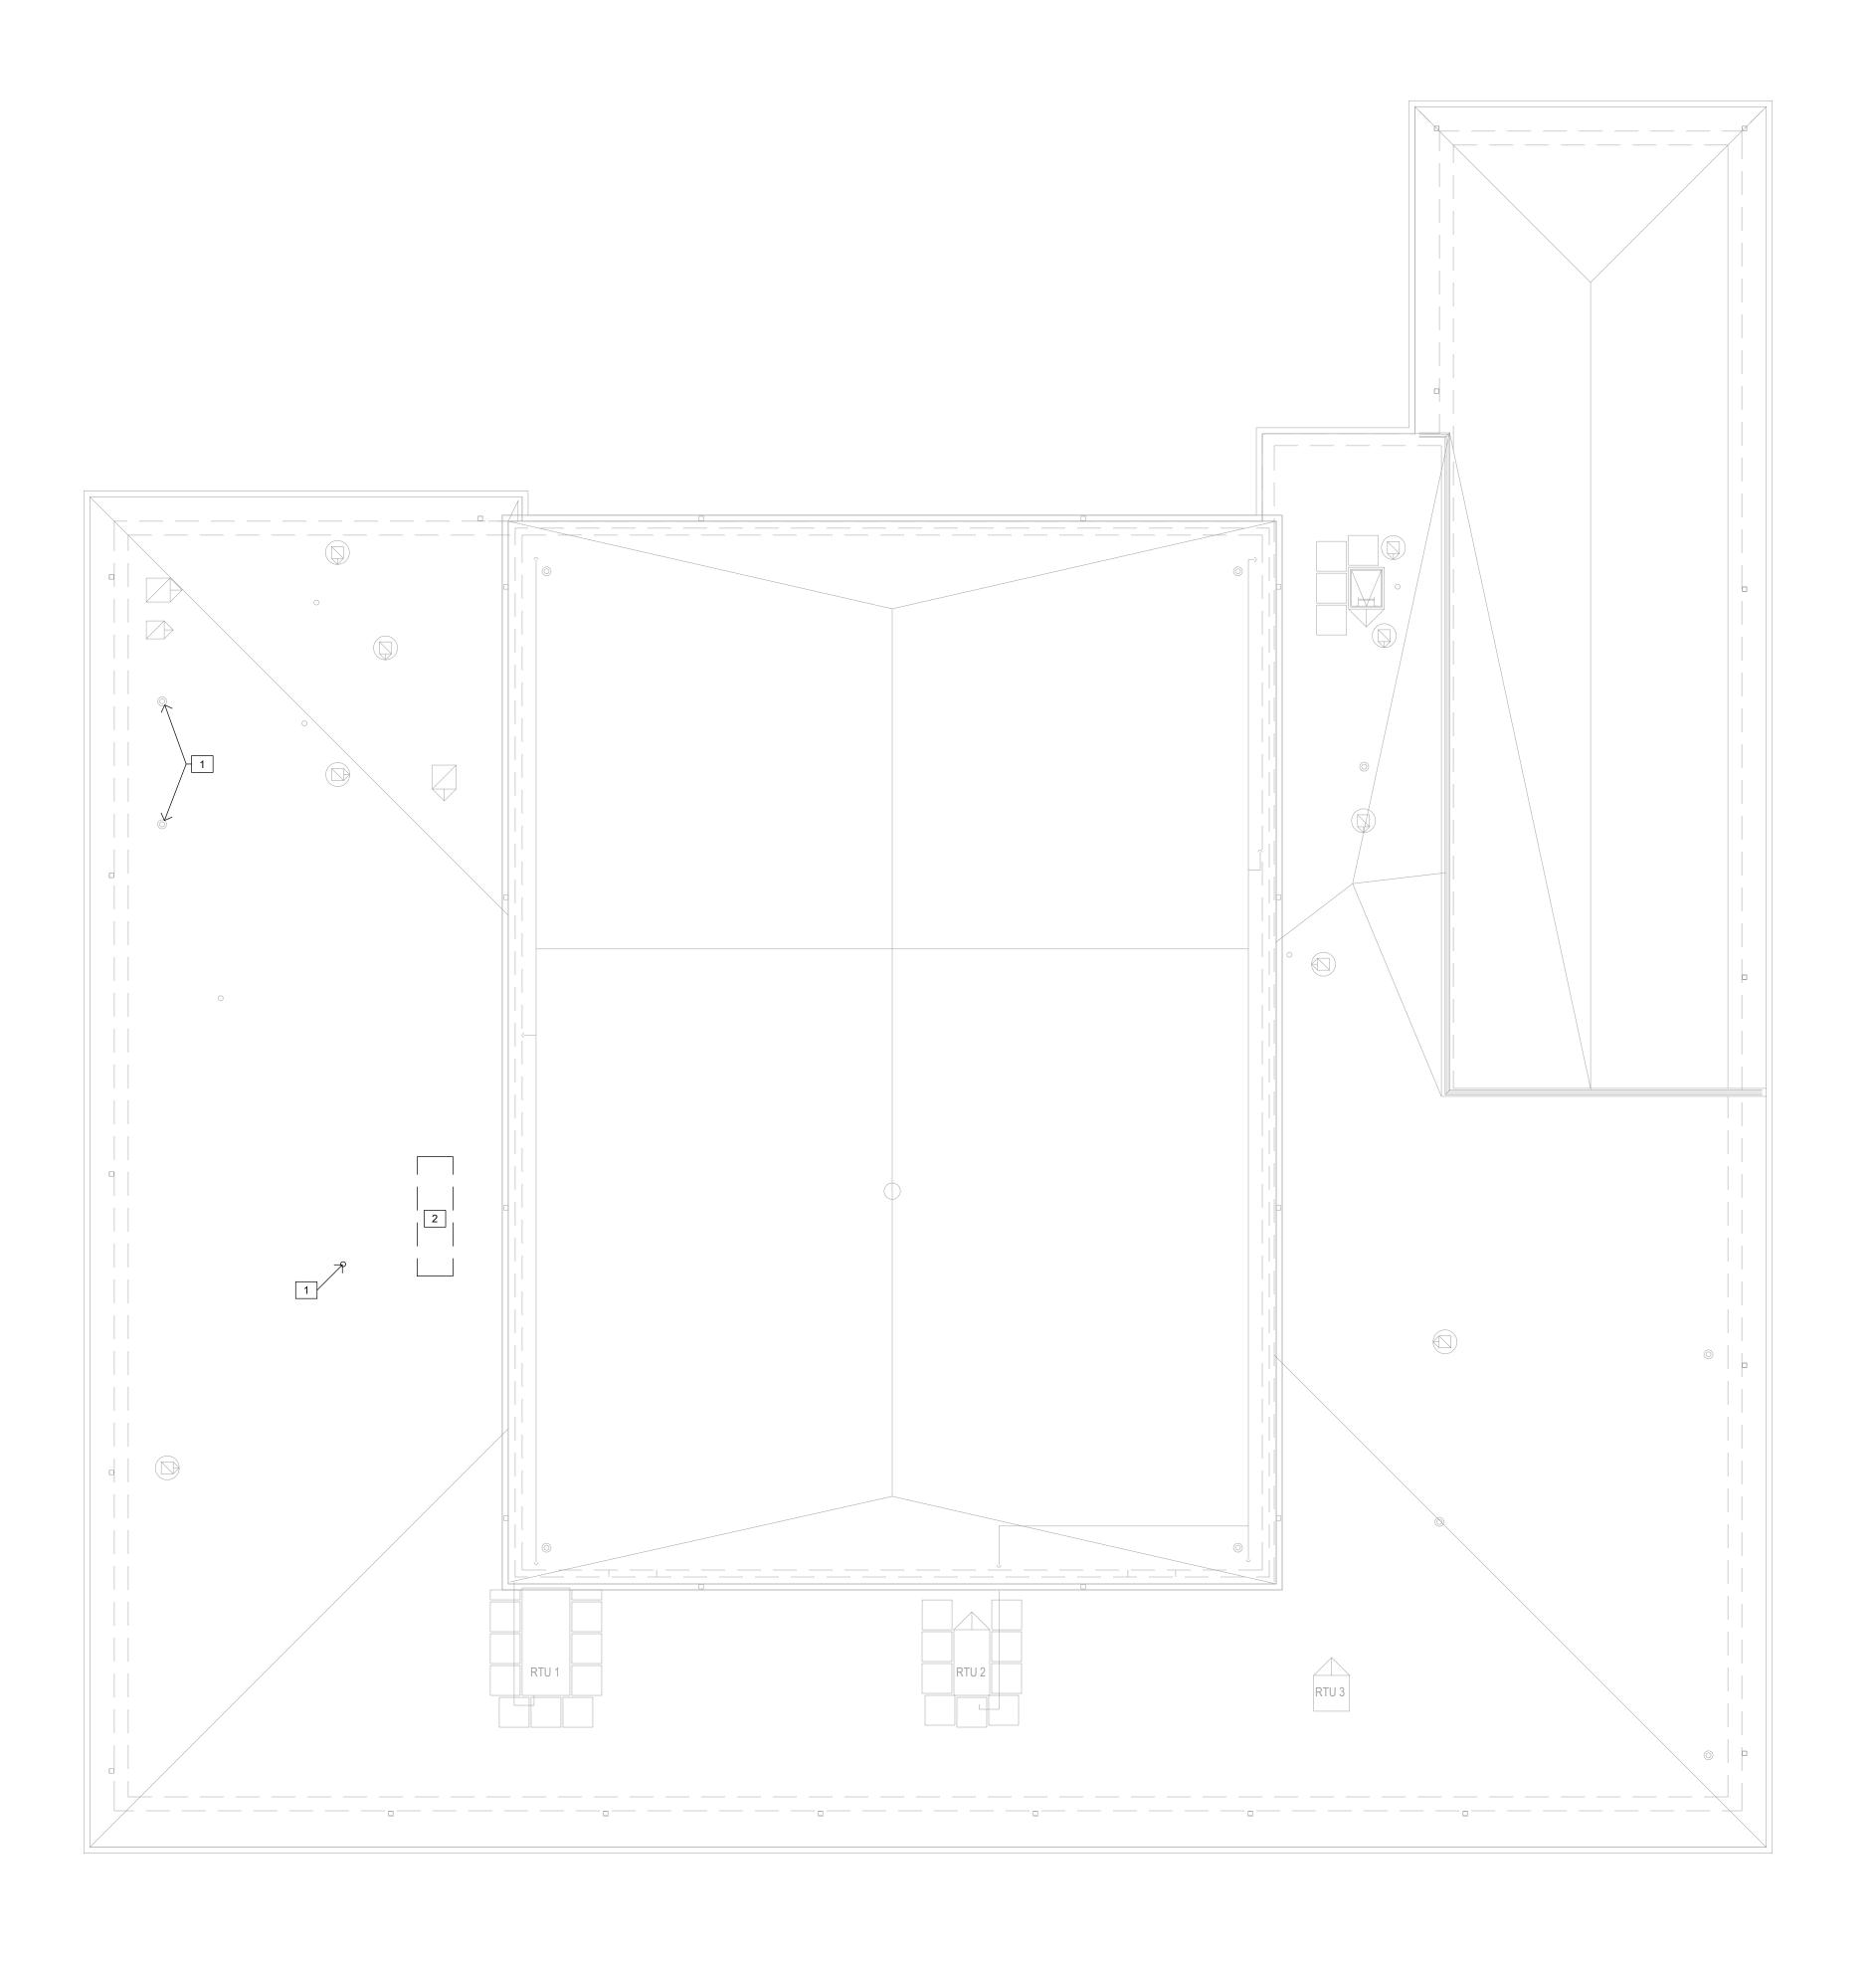
CAD DWG FILE: A-101.DWG DRAWN BY: CHECKED BY: DESIGNED BY:

SHEET TITLE:

DEMOLITION PLAN - REFLECTED CEILING

SHEET NUMBER:

A-101



GENERAL DEMOLITION NOTES - ROOF PLAN:


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- B. EXISTING SURFACES TO RECEIVE NEW FINISHES SHALL BE PATCHED AND PREPPED AS REQUIRED TO RECEIVE NEWLY SPECIFIED SURFACE TREATMENT / FINISHES PER MANUFACTURER'S RECOMMENDATIONS.
- C. PROVIDE TEMPORARY BRACING AND SHORING AS REQUIRED TO SUPPORT EXISTING STRUCTURE PRIOR TO ANY DEMOLITION OF LOAD BEARING CONSTRUCTION.
- D. ROOF CONSTRUCTION AT AREA WHERE WORK IS TO OCCUR IS .060 mil TPO SINGLE PLY MEMBRANE (FIRESTONE) FULLY ADHERED TO 1/2" THICK HD COVERBOARD ADHERED TO 1/4" PER FOOT TAPERED POLYISO INSULATION (1/2" MIN) OVER 5" THICK BASE LAYER POLYISO RIGID INSULATION BOARD (R-30 ci) ON EXISTING METAL DECKING. ROOF IS CURRENTLY UNDER WARRANTY. CONTRACTOR SHALL ENSURE NEW WORK SHALL NOT VOID EXISTING ROOF WARRANTY AND BEAR ANY COSTS ASSOCIATED THEREIN. ROOFING WARRANTY IS FIRESTONE RED SHIELD TPO 20-YEAR 72 MPH WITH START DATE 09/15/2022.

KEYED NOTES - DEMOLITION ROOF PLAN: X

- EXISTING VENT THRU ROOF TO REMAIN AND BE UTILIZED FOR NEW WORK. REFERENCE MEP DRAWINGS.
- PROVIDE NEW PENETRATION IN EXISTING ROOF FOR NEW ROOFTOP EQUIPMENT. OPENING TO BE COORDINATED WITH EXISTING STRUCTURE. REFERENCE STRUCTURAL AND MEP DRAWINGS.

STATE OF MISSOURI MICHAEL L. PARSON, GOVERNOR



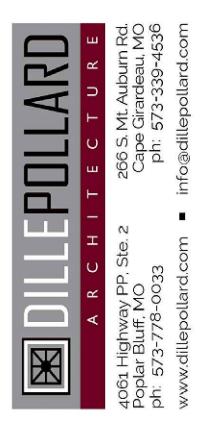

OFFICE OF ADMINISTRATION
DIVISION OF FACILITIES
MANAGEMENT,
DESIGN AND CONSTRUCTION

MISSOURI ARMY NATIONAL GUARD FACILITIES DIVISION

RE-BID RENOVATE INTERIOR AND EXTERIOR

KENNETT READINESS CENTER 1450 NORTH BY-PASS KENNETT, MO 63857

PROJECT # T2209-01

FACILITY # 8136313002

REVISION:
DATE:
REVISION:
DATE:
REVISION:
DATE:
REVISION:
DATE:
January 30, 2023

D DWG FILE: A-100.DWG


CAD DWG FILE: A-100.DWG
DRAWN BY: KU
CHECKED BY: BD
DESIGNED BY: KU

SHEET TITLE:

DEMOLITION PLAN
- ROOF PLAN

SHEET NUMBER:

A-102

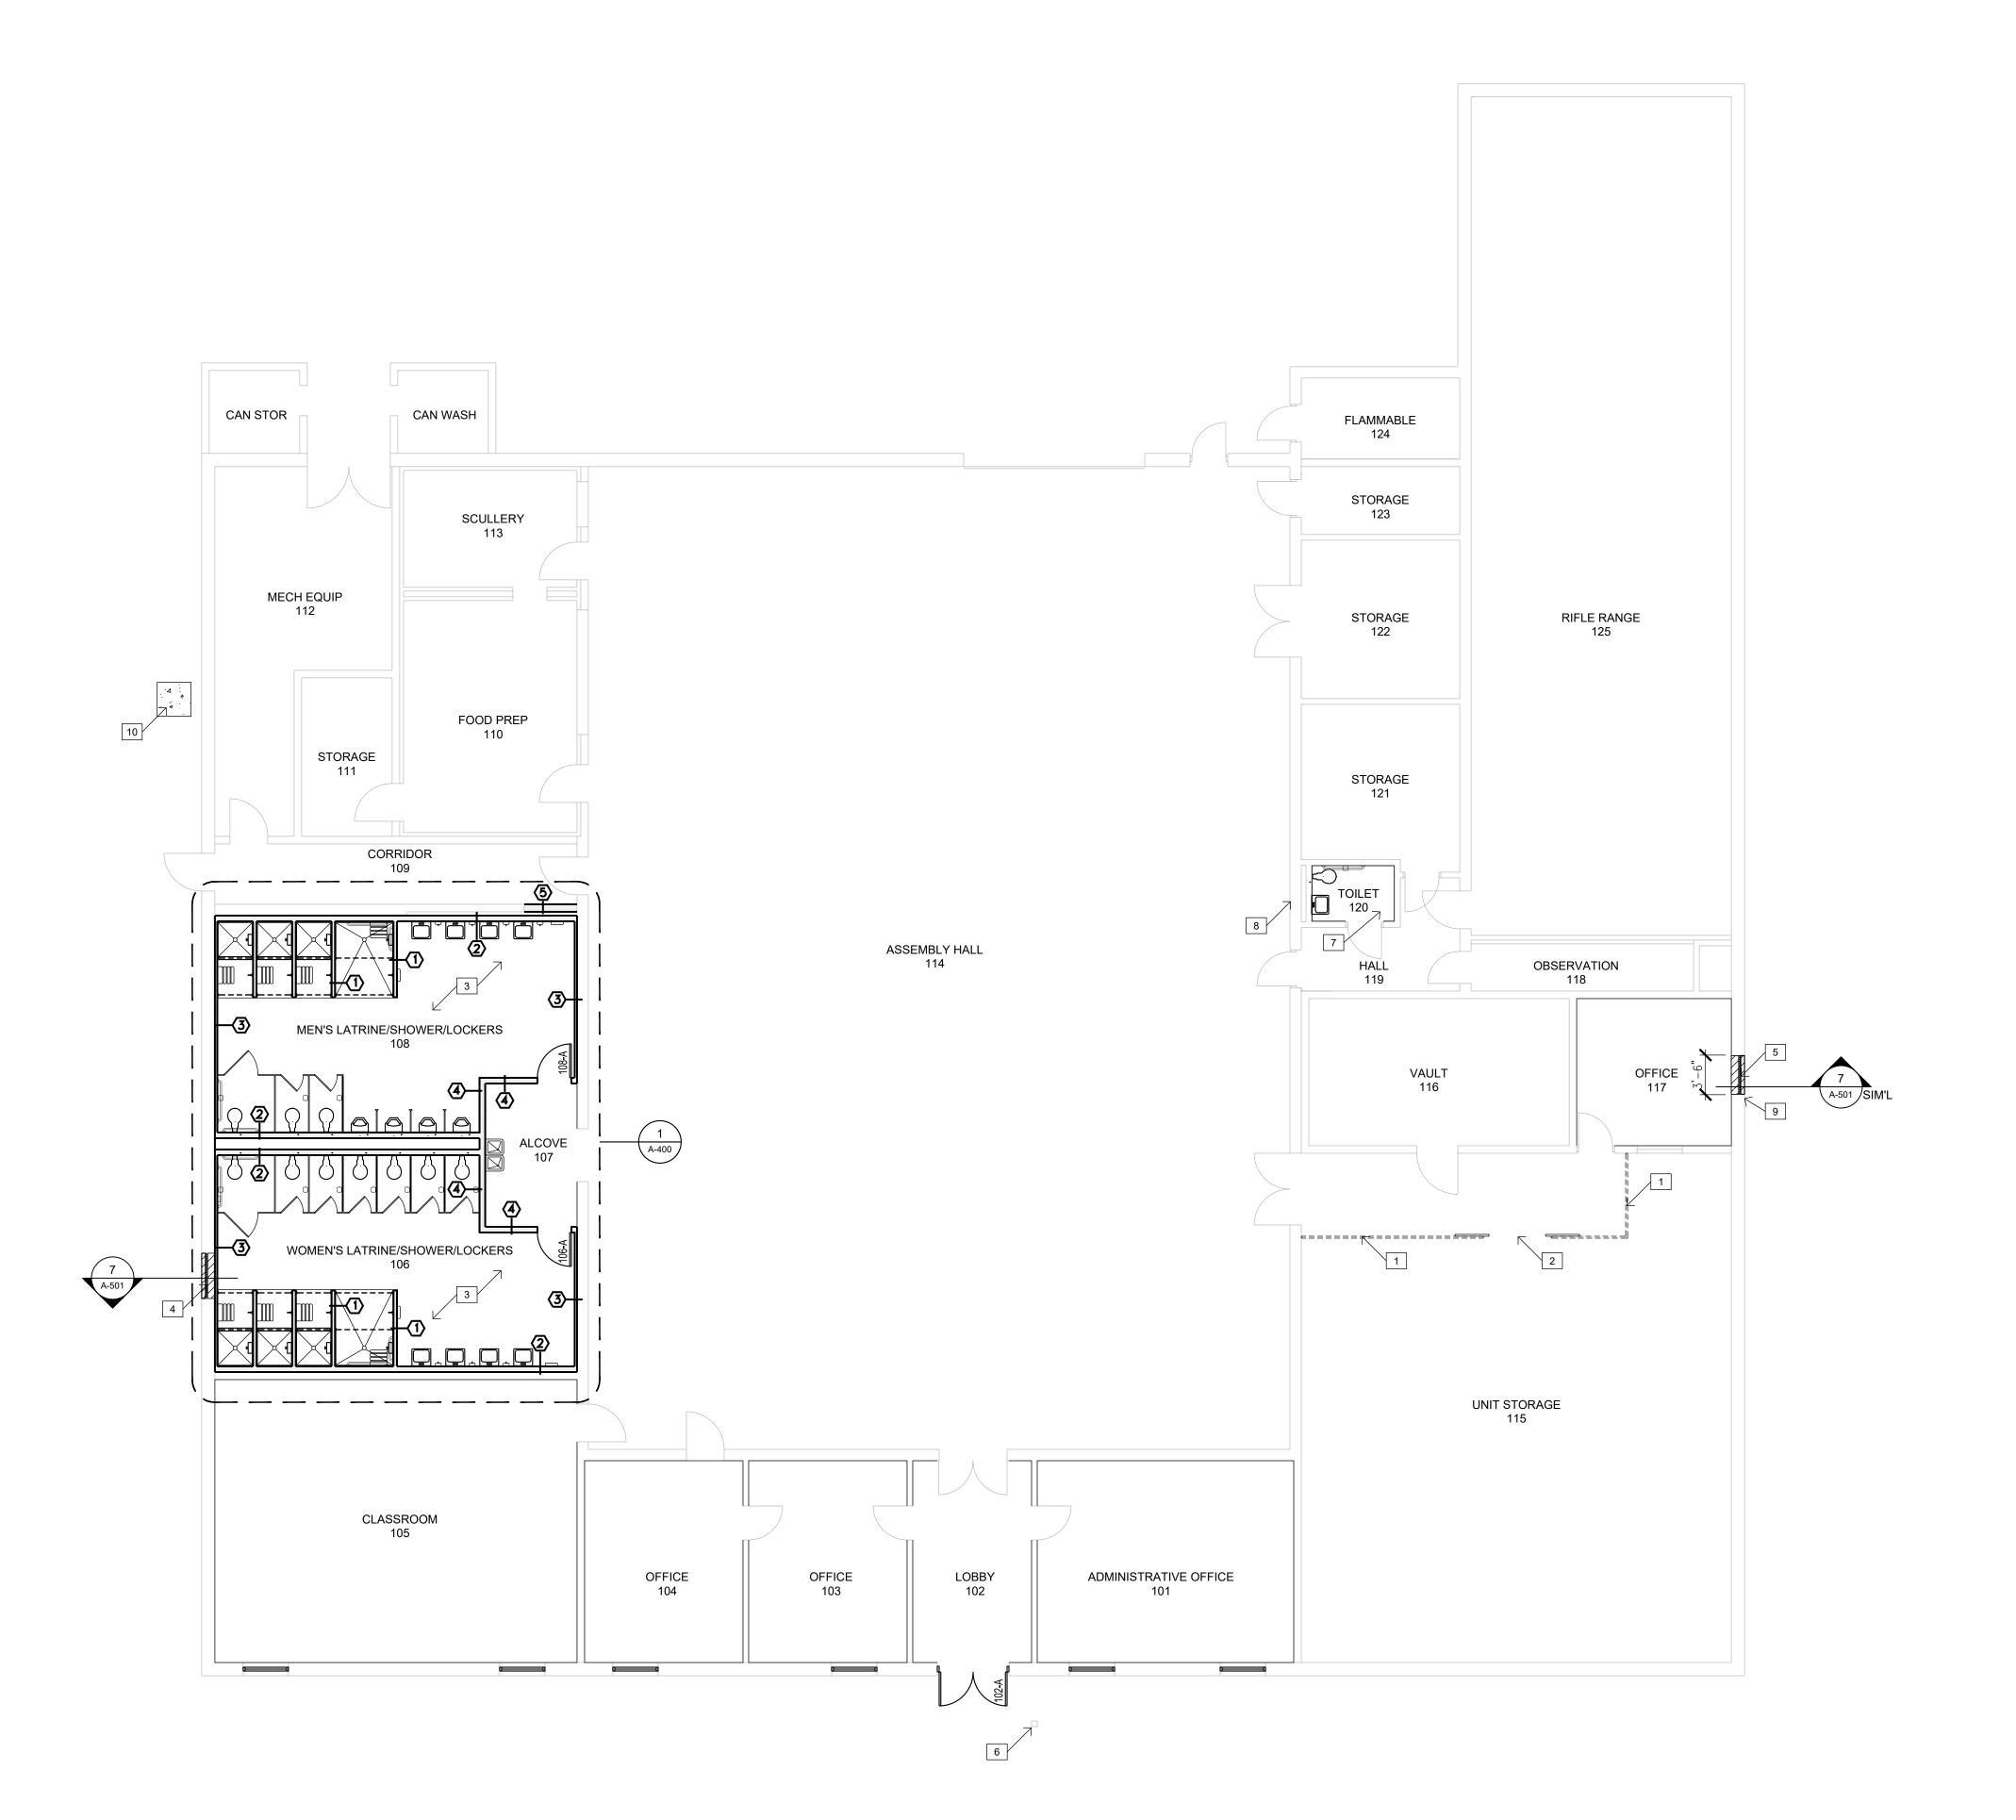

REFER TO SHEET G-002 FOR GENERAL NOTES

KEYED NOTES - FLOOR PLAN:

WIRE PARTITION PANELS, FLOOR TO WITHIN 2" OF BTM OF STRUCTURE ABOVE (APPROX. 12'-0" A.F.F.). SCRIBE PANELS AROUND EXISTING BAR JOISTS IN NORTH/SOUTH DIRECTION. ALIGN WITH EXISTING STEEL JOISTS ALONG

EAST/WEST DIRECTION. REFERENCE PROJECT MANUAL. 2. WIRE PARTITION SLIDING GATE, 3'X7' (DBL) & PARTITION

- 3. RENOVATED TOILET ROOMS. REFERENCE DETAIL PLAN, SHEET A-400 AND MEP DRAWINGS.
- 4. INFILL EXISTING WINDOW OPENING WITH MASONRY TO MATCH EXISTING CONSTRUCTION. REFERENCE DETAIL 7, SHEET A-501.
- 5. INFILL EXISTING PTAC UNIT OPENING WITH MASONRY TO MATCH EXISTING CONSTRUCTION. (APPROX. 3'-6" X 1'-4") REFERENCE SIMILAR DETAIL 7, SHEET A-501.
- 7. TOILET ROOM REMODEL: REFERENCE FINISH SCHEDULE,

6. EXISTING ADA ACCESS POLE TO REMAIN. REFERENCE ELECTRICAL DRAWINGS. PREP AND PROVIDE PAINT

SHEET A-500 AND MEP DRAWINGS. 8. REPAIR MASONRY WALL AS NECESSARY AFTER ELECTRIC WATER COOLER REMOVAL. CLEAN, PRIME,

AND PAINT AT DISTURBED AREAS TO NEAREST BLOCK

9. REPAIR MASONRY AS NECESSARY AT FASTENER LOCATIONS AFTER PROTECTIVE STEEL CAGE REMOVAL.

JOINT. REFERENCE MEP DRAWINGS.

10. 4-INCH THICK MIN, REINFORCED WITH W1.4xW1.4WWF AND #4 BARS CONTINUOUS AT 8" TURN DOWN AT PERIMETER. CONCRETE PAD FOR MECHANICAL EQUIPMENT BY GC. EXTEND EDGE OF PAD A MINIMUM OF 6-INCHES BEYOND THE EQUIPMENT FOOTPRINT. COORDINATE SIZE WITH MECH DWGS. PROVIDE 4-INCH MIN COMPACTED TYPE "B" BACKFILL BENEATH ENTIRE

STATE OF MISSOURI MICHAEL L. PARSON, **GOVERNOR**





OFFICE OF ADMINISTRATION DIVISION OF FACILITIES MANAGEMENT, DESIGN AND CONSTRUCTION

MISSOURI ARMY NATIONAL GUARD FACILITIES DIVISION

RE-BID RENOVATE INTERIOR AND **EXTERIOR**

KENNETT READINESS CENTER 1450 NORTH BY-PASS KENNETT, MO 63857

PROJECT # T2209-01

FACILITY # 8136313002

REVISION: REVISION: DATE: **REVISION:** ISSUE DATE: January 30, 2023


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SHEET TITLE:

ALTERATIONS PLAN - FLOOR PLAN

SHEET NUMBER:

A-200

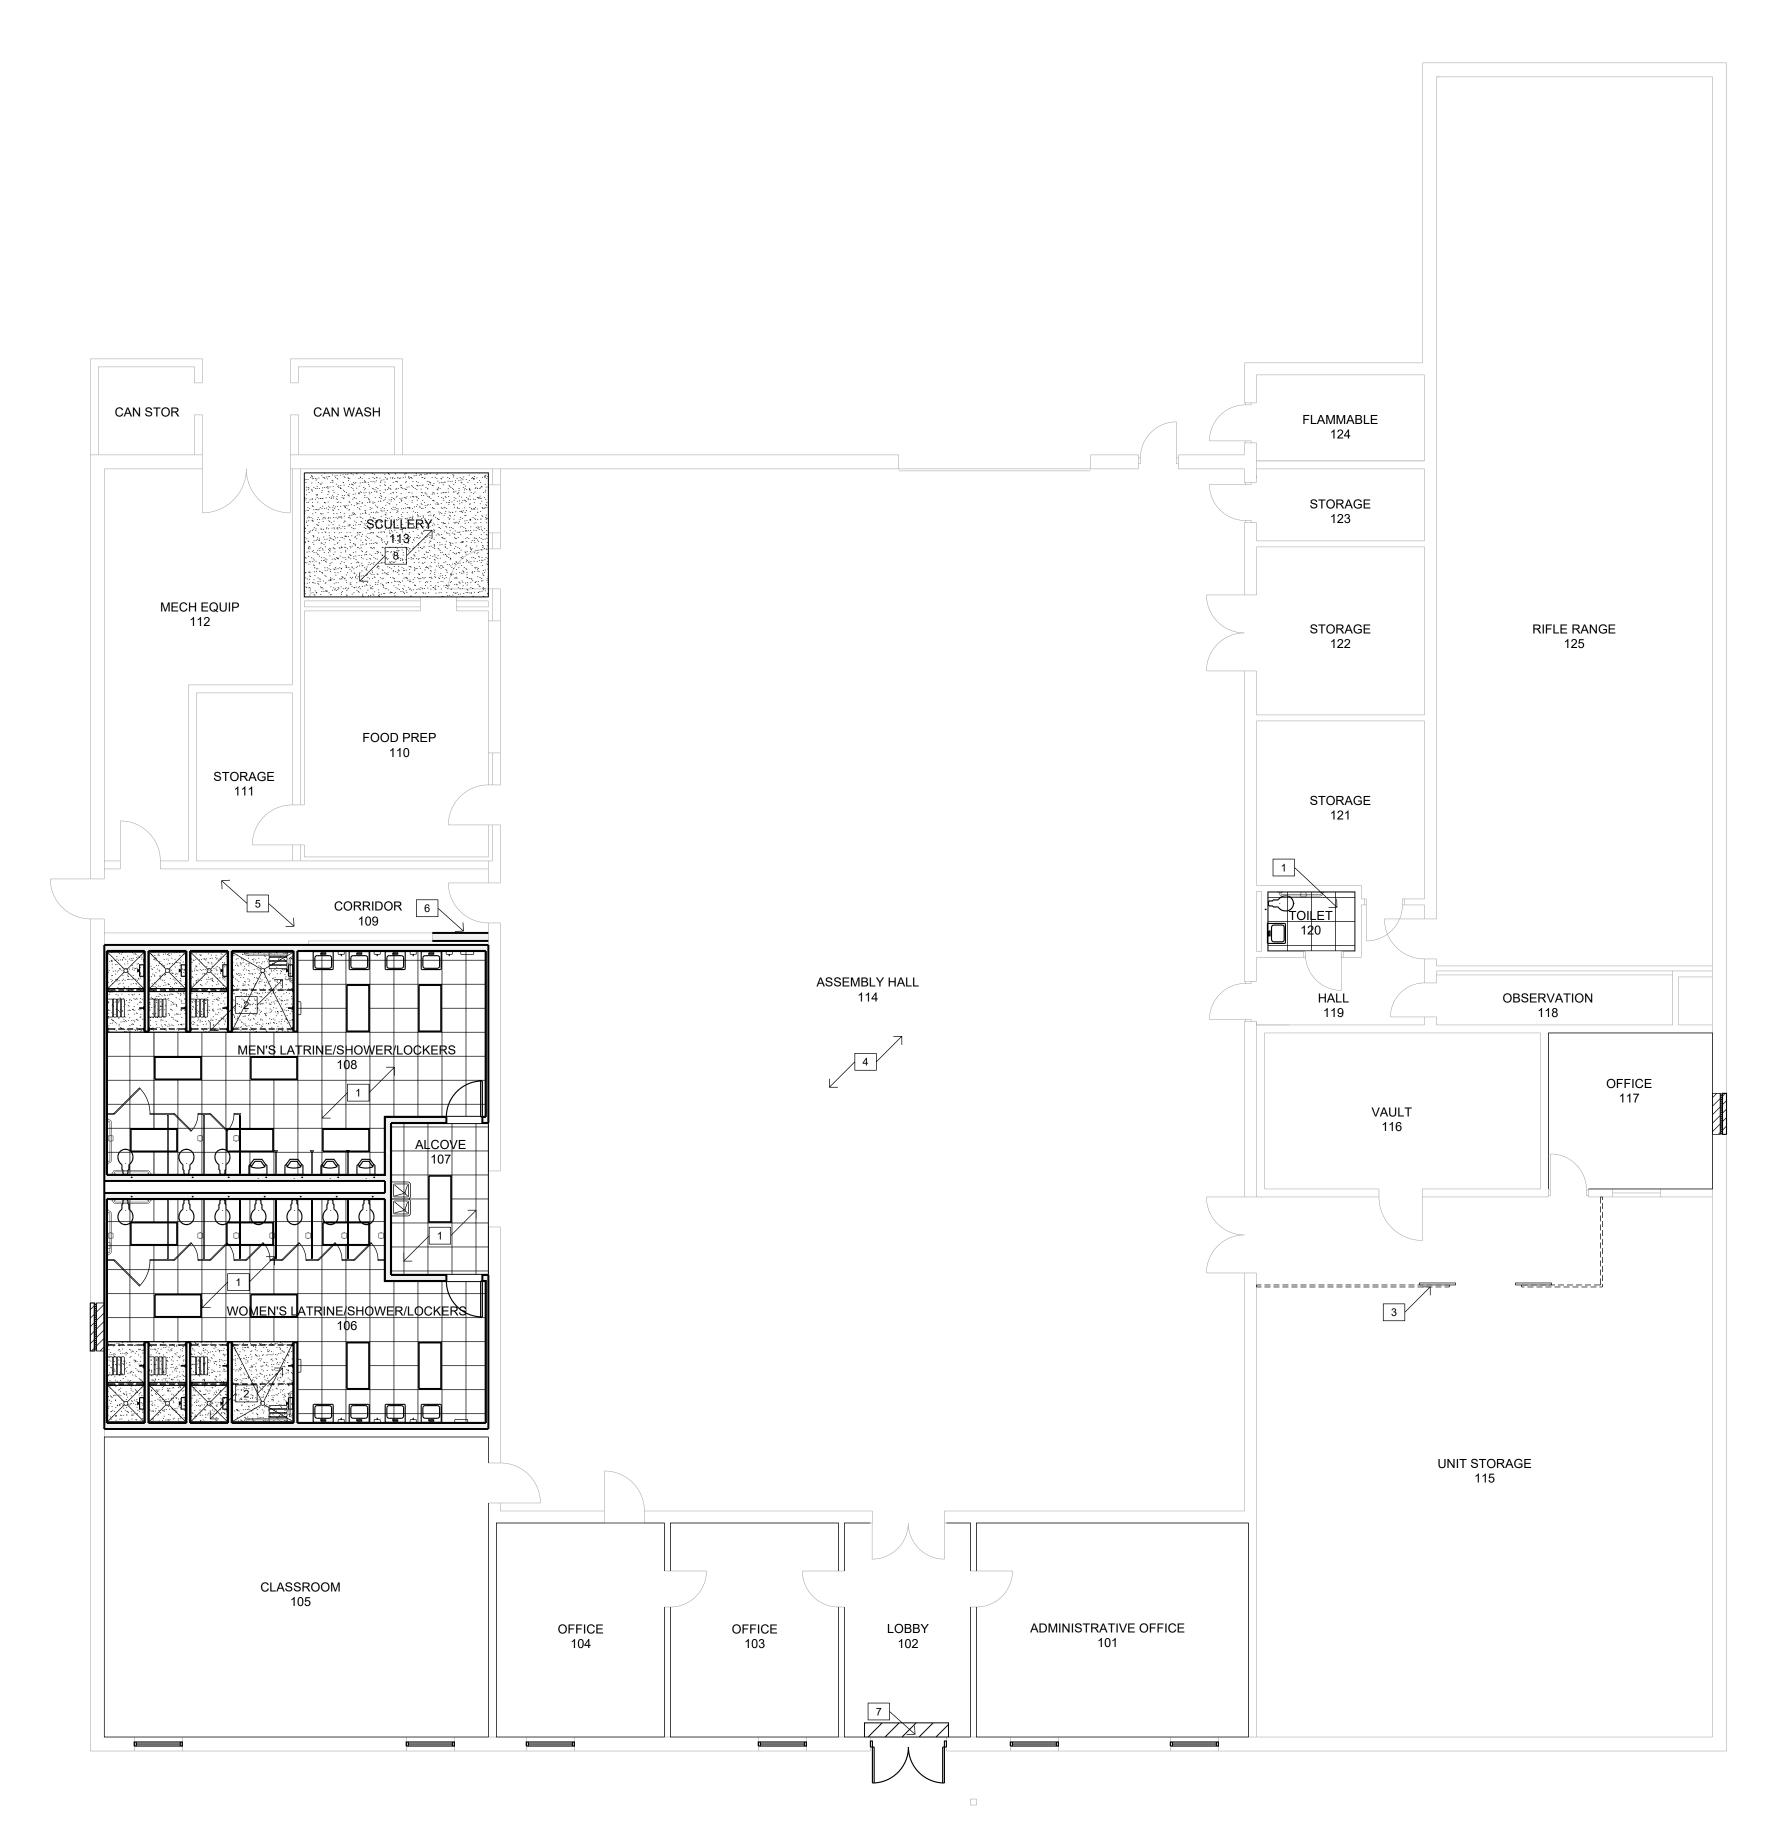

REFER TO SHEET G-002 FOR GENERAL NOTES

KEYED NOTES - REFLECTED CEILING PLAN: X

- 1. INSTALL NEW LAY-IN TILE AND GRID AS SPECIFIED. REFER TO FINISH SCHEDULE, SHEET A-500. REFERENCE MEP DRAWINGS FOR PLACEMENT OF REGISTERS, GRILLES, LIGHTING, ETC.
- 2. NEW GYPSUM BOARD OVER METAL FRAMED SOFFIT. REFERENCE DETAIL THIS SHEET.
- 3. EXISTING EXPOSED STRUCTURE TO REMAIN. NEW WIRE PARTITION TO EXTEND TO BTM OF EXISTING STRUCTURE. MODIFY TOP OF PARTITION TO WORK AROUND EXISTING STEEL JOISTS AND OTHER EXPOSED STRUCTURE.
- 4. EXISTING EXPOSED STRUCTURE TO REMAIN. REFERENCE ELECTRICAL DRAWINGS FOR NEW LIGHT FIXTURES.
- 5. EXISTING CEILING TILES AND GRID TO REMAIN. TILES TO BE REMOVED AND RE-INSTALLED AS REQUIRED FOR ACCESS TO ABOVE CEILING WORK. REFERENCE MEP DRAWINGS.
- 6. MODIFY EXISTING CEILING GRID AS NECESSARY AT NEW PARTITION LOCATION. INSTALL NEW WALL ANGLE ALONG NEW PARTITION AND MODIFY CROSS BEAMS. RE-SIZE AND INSTALL EXISTING TILE.
- 7. <u>ALTERNATE BID NO. 1:</u> TEMPORARILY REMOVE EXISTING LAY-IN TILE AND GRID AS NECESSARY TO ACCESS STOREFRONT SYSTEM FOR REPLACEMENT. RE-INSTALL EXISTING ONCE STOREFRONT IS IN PLACE.
- 8. EXISTING GYPSUM PLASTER LATHE CEILING TO REMAIN. REFERENCE MEP DRAWINGS FOR NEW OPENING AS REQUIRED. REPAIR AND PAINT.

CEILING SYMBOLS LEGEND:

GYP. BOARD CEILING OVER METAL FRAMING

24"x 24" LAY-IN CEILING TILE AND GRID AS SPECIFIED. REFER TO ROOM FINISH SCHEDULE, SHEET A-400 FOR INSTALLATION HEIGHT



SUPPLY AIR REGISTER - REFER TO MECHANICAL SHEETS



RETURN AIR GRILLE - REFER TO MECHANICAL SHEETS. LAY-IN TROFFER LIGHT FIXTURE -

REFER TO ELECTRICAL SHEETS

MANAGEMENT, **DESIGN AND CONSTRUCTION** RECESSED LIGHT FIXTURE - REFER TO ELECTRICAL SHEETS

> MISSOURI ARMY NATIONAL GUARD FACILITIES DIVISION

OFFICE OF ADMINISTRATION

DIVISION OF FACILITIES

STATE OF MISSOURI MICHAEL L. PARSON,

GOVERNOR

KRISTEN

UHRHAN

NUMBER

A-2009027298

RE-BID RENOVATE INTERIOR AND EXTERIOR

KENNETT READINESS CENTER 1450 NORTH BY-PASS KENNETT, MO 63857

PROJECT # T2209-01

FACILITY # 8136313002

REVISION: REVISION: DATE: **REVISION:** DATE: ISSUE DATE: January 30, 2023

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SHEET TITLE:

ALTERATIONS PLAN - REFLECTED CEILING

SHEET NUMBER:


8 OF 29 SHEETS

A-201

2 TYPICAL SECTION @ SHOWER UNIT SCALE: 3/4" = 1'-0"

5/8"thk MOISTURE-RESISTANT GYPSUM BOARD ON 6" DW STUDS @ 16"oc. TAPE, FINISH, PRIME, AND 2 COATS PAINT.

-RESINOUS FINISH

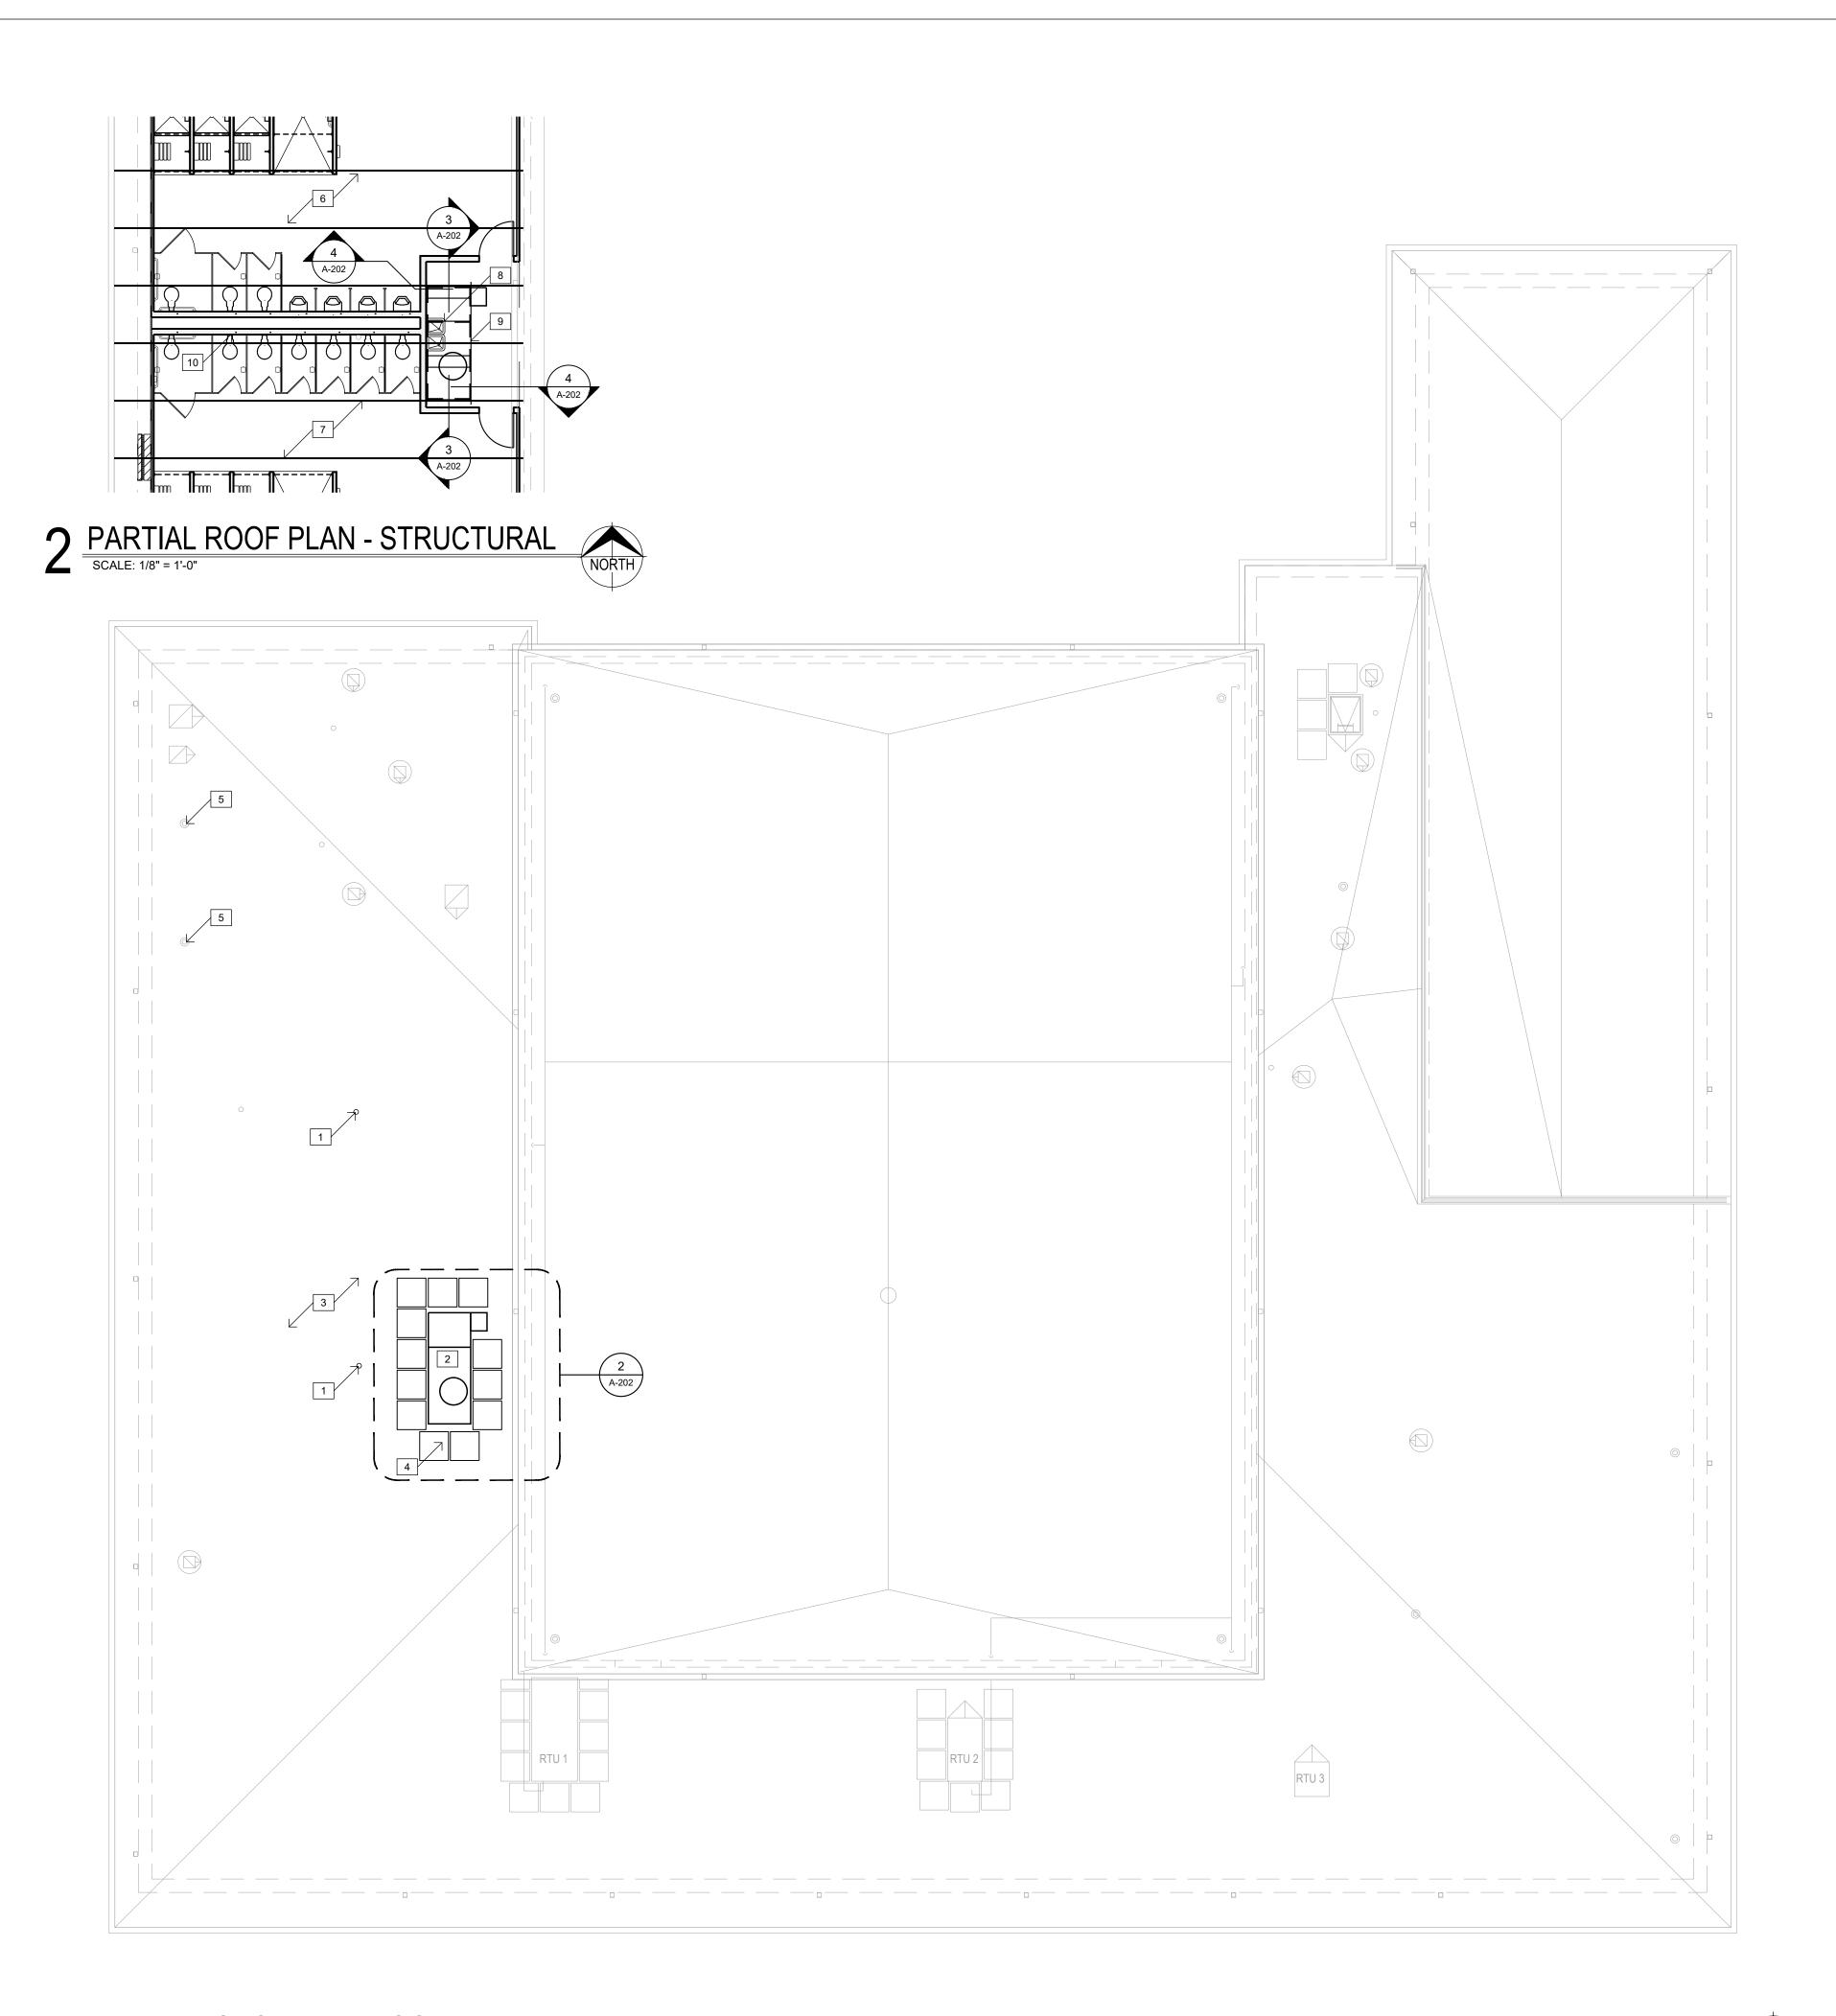


GENERAL ROOF PLAN NOTES:

- A. DASHED LINES INDICATE EXISTING CONSTRUCTION TO BE TOTALLY REMOVED BY CONTRACTOR UNLESS OTHERWISE NOTED. DEMO'D ITEMS TO BE REMOVED AND DISPOSED OF IN A SAFE AND LAWFUL MANNER PER AS SPECIFIED.
- B. EXISTING SURFACES TO RECEIVE NEW FINISHES SHALL BE PATCHED AND PREPPED AS REQUIRED TO RECEIVE NEWLY SPECIFIED SURFACE TREATMENT / FINISHES PER MANUFACTURER'S RECOMMENDATIONS.
- C. PROVIDE TEMPORARY BRACING AND SHORING AS REQUIRED TO SUPPORT EXISTING STRUCTURE PRIOR TO ANY DEMOLITION OF LOAD BEARING CONSTRUCTION.
- D. ROOF CONSTRUCTION AT AREA WHERE WORK IS TO OCCUR IS .060 mil TPO SINGLE PLY MEMBRANE (FIRESTONE) FULLY ADHERED TO 1/2" THICK HD COVERBOARD ADHERED TO 1/4" PER FOOT TAPERED POLYISO INSULATION (1/2" MIN) OVER 5" THICK BASE LAYER POLYISO RIGID INSULATION BOARD (R-30 ci) ON EXISTING METAL DECKING. ROOF IS CURRENTLY UNDER WARRANTY. CONTRACTOR SHALL ENSURE NEW WORK SHALL NOT VOID EXISTING ROOF WARRANTY AND BEAR ANY COSTS ASSOCIATED THEREIN. ROOFING WARRANTY IS FIRESTONE RED SHIELD TPO 20-YEAR 72 MPH WITH START DATE 09/15/2022.
- EXISTING STRUCTURE SHOWN PER OWNER'S EXISTING DOCUMENTS. CONTRACTOR TO FIELD VERIFY ALL CONDITIONS PRIOR TO DEMOLITION AND NEW WORK, SPECIFICALLY NEW ROOF PENETRATION. NOTIFY ARCHITECT OF ANYTHING THAT DIFFERS FROM THE DOCUMENTS.

KEYED NOTES - ROOF PLAN:

- EXISTING VENT THRU ROOF TO REMAIN. CONTRACTOR SHALL UTILIZE EXISTING ROOF VENT OPENINGS FOR NEW PLUMBING VENTS. IN THE EVENT A NEW OPENING IS NECESSARY, COORDINATE OPENING WITH ROOFING CONTRACTOR FOR VENT BOOST INSTALLATION. REFERENCE MEP DRAWINGS.
- 2. NEW ROOFTOP EQUIPMENT. PROVIDE NEW ROOF PENETRATION IN EXISTING ROOF. PROVIDE SHEET METAL CLOSURE CONTINUOUS AT OPENING. COORDINATE EXACT LOCATION, OPENING AND SIZE WITH EXISTING STRUCTURE, MECHANICAL SHEETS AND RTU MANUFACTURER'S REQUIREMENTS. ALSO REFERENCE MEP DRAWINGS.
- 3. EXISTING ROOF TO REMAIN. TAKE CARE NOT TO DAMAGE DURING CONSTRUCTION ACTIVITIES.
- 4. INSTALL NEW TPO WALKWAY PADS (30"x30" MIN.) AT NEW EQUIPMENT. COORDINATE WITH EXISTING ROOF MANUFACTURER (FIRESTONE) FOR ACCEPTABLE PRODUCTS. INSTALL PER MANUFACTURER'S INSTRUCTIONS.
- 5. EXISTING FLU ROOF OPENING TO REMAIN.
 CONTRACTOR SHALL UTILIZE EXISTING ROOF FLUE
 OPENINGS FOR NEW VENTS. IN THE EVENT A NEW
 OPENING IS NECESSARY, COORDINATE OPENING WITH
 ROOFING CONTRACTOR FOR VENT BOOST
 INSTALLATION. REFERENCE MEP DRAWINGS.
- 6. EXISTING ROOF DECK 1-1/2"x22 GA TYPE F PAINTED STEEL DECK.
- 7. EXISTING 20H8 JOISTS @ 5'-0" +/- ON CENTER.
- 8. $L3x3x_4^1$ EACH SIDE OF ROOF PENETRATION.
- 9. $L4x4x\frac{5}{16}$ (4) SIDES OF UNIT CURB.
- 10. TOP OF EXISTING CMU WALLS ARE WELDED TO ROOF DECK AT 6" oc. EXISTING EMBED PLATE IS CONTINUOUS. CONTRACTOR TO USE CAUTION DURING DEMOLITION. REFERENCE DEMOLITION PLANS.

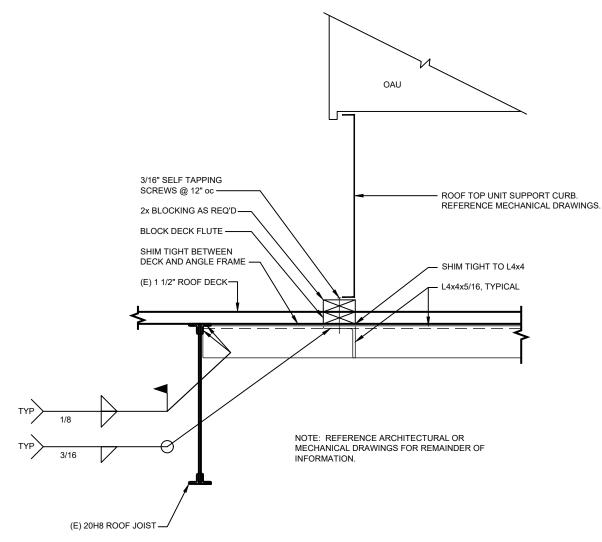

3 ROOF OPENING DETAIL - STRUCTURAL SCALE: 1" = 1'-0"

AND TOP UNIT SUPPORT CURB.
REFERENCE MECHANICAL DRAWINGS.

2x BLOCKING AS RECO'D
BLOCK DECK FLUTE

(E) 1 1/2" ROOF DECK

VARIES
(FIELD VERIFY)

L222X3/16 EACH SIDE OF
JOIST TO BOTTOM CHORD
PANEL POINT Is "X" DIMENSON IS GREATER THAN 2".

NOTE: REFERENCE ARCHITECTURAL OR MECHANICAL DRAWINGS FOR REMAINDER

4 ROOF OPENING DETAIL - STRUCTURAL

SCALE: 1" = 1'-0"

STATE OF MISSOURI MICHAEL L. PARSON, GOVERNOR





OFFICE OF ADMINISTRATION DIVISION OF FACILITIES MANAGEMENT, DESIGN AND CONSTRUCTION

MISSOURI ARMY NATIONAL GUARD FACILITIES DIVISION

RE-BID RENOVATE INTERIOR AND EXTERIOR

KENNETT READINESS CENTER 1450 NORTH BY-PASS KENNETT, MO 63857

PROJECT # T2209-01

FACILITY # 8136313002

REVISION:
DATE:
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JATE:
January 30, 2023

CAD DWG FILE: A-100.DWG
DRAWN BY: KU
CHECKED BY: BD
DESIGNED BY: KU


SHEET TITLE:

EET TITLE:

ALTERATIONS PLAN
- ROOF PLAN

SHEET NUMBER:

A-202

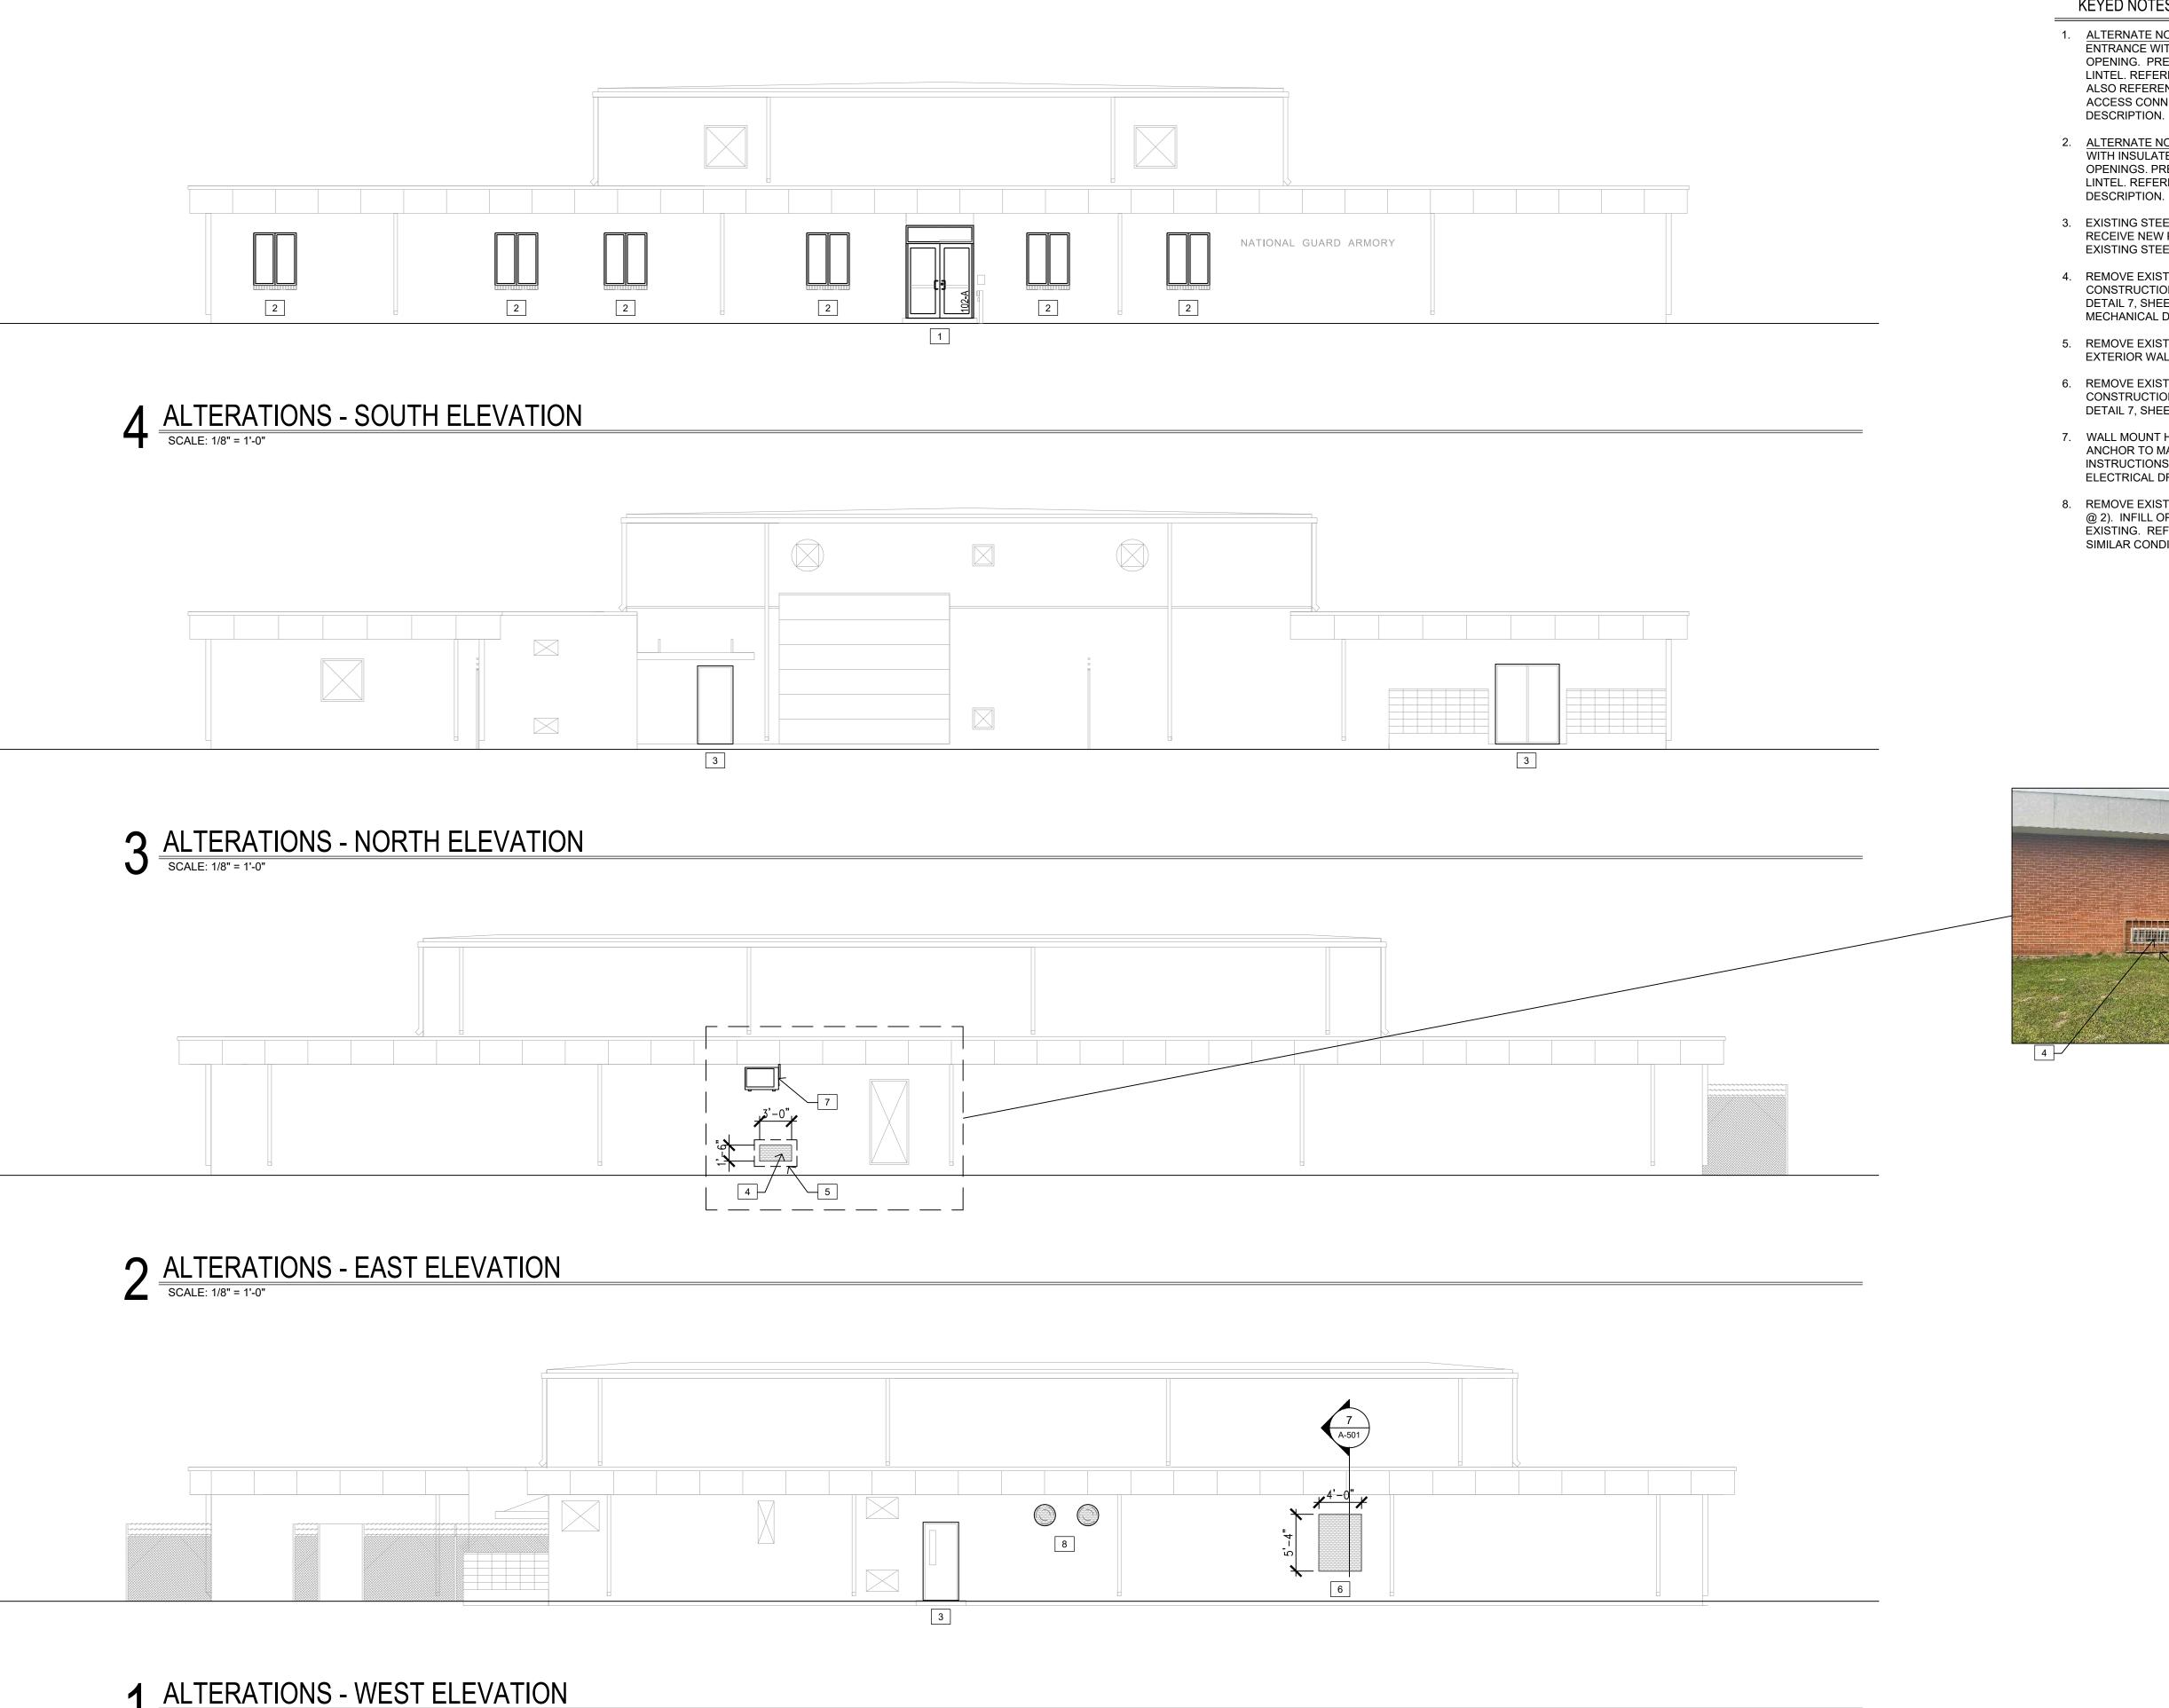

SCALE: 1/8" = 1'-0"

REFER TO SHEET G-002 FOR GENERAL NOTES

KEYED NOTES - ELEVATIONS:

- 1. ALTERNATE NO. 1: NEW ALUMINUM STOREFRONT ENTRANCE WITH TRANSOM IN EXISTING MASONRY OPENING. PREP, PRIME, AND PAINT EXISTING STEEL LINTEL. REFERENCE DETAILS AND PROJECT MANUAL. ALSO REFERENCE ELECTRICAL DRAWINGS FOR ADA ACCESS CONNECTION AND ALTERNATE FOR FULL
- 2. <u>ALTERNATE NO. 1:</u> NEW ALUMINUM SLIDING WINDOWS WITH INSULATED GLAZING IN EXISTING MASONRY OPENINGS. PREP, PRIME, AND PAINT EXISTING STEEL LINTEL. REFERENCE ALTERNATE FOR FULL DESCRIPTION.
- 3. EXISTING STEEL DOOR AND FRAME TO BE PREPPED AND RECEIVE NEW PAINT FINISH. PREP, PRIME, AND PAINT EXISTING STEEL LINTEL.
- 4. REMOVE EXISTING PTAC UNIT. INFILL OPENING WITH CONSTRUCTION TO MATCH EXISTING. REFERENCE DETAIL 7, SHEET A-501 FOR SIMILAR CONDITION AND MECHANICAL DRAWINGS.
- 5. REMOVE EXISTING STEEL CAGE AND FRAME FROM EXTERIOR WALL. REPAIR MASONRY AT ANCHOR POINTS.
- 6. REMOVE EXISTING WINDOW. INFILL OPENING WITH CONSTRUCTION TO MATCH EXISTING. REFERENCE DETAIL 7, SHEET A-501.
- 7. WALL MOUNT HEAT PUMP MOUNTED TO EXISTING WALL. ANCHOR TO MASONRY PER MANUFACTURER'S INSTRUCTIONS. REFERENCE MECHANICAL AND ELECTRICAL DRAWINGS.
- 8. REMOVE EXISTING SIDE WALL EXHAUST FANS (TYPICAL @ 2). INFILL OPENING WITH CONSTRUCTION TO MATCH EXISTING. REFERENCE DETAIL 7, SHEET A-501 FOR SIMILAR CONDITION AND MECHANICAL DRAWINGS.

OFFICE OF ADMINISTRATION DIVISION OF FACILITIES MANAGEMENT, **DESIGN AND CONSTRUCTION**

STATE OF MISSOURI MICHAEL L. PARSON,

GOVERNOR

KRISTEN

RAE

UHRHAN

NUMBER

A-2009027298

POLLARD

MISSOURI ARMY NATIONAL GUARD FACILITIES DIVISION

RE BID RENOVATE INTERIOR AND **EXTERIOR**

KENNETT READINESS CENTER 1450 NORTH BY-PASS KENNETT, MO 63857

PROJECT # T2209-01

FACILITY #8136313002

REVISION: DATE: **REVISION:** DATE: **REVISION:**

ISSUE DATE: January 30, 2023


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DESIGNED BY: KU

SHEET TITLE:

ALTERATIONS - ELEVATIONS **ALTERNATE #1**


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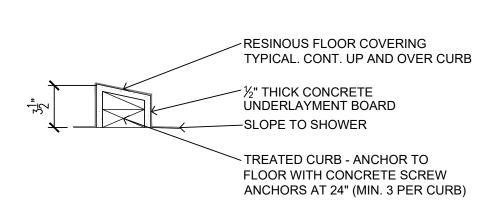
A-300

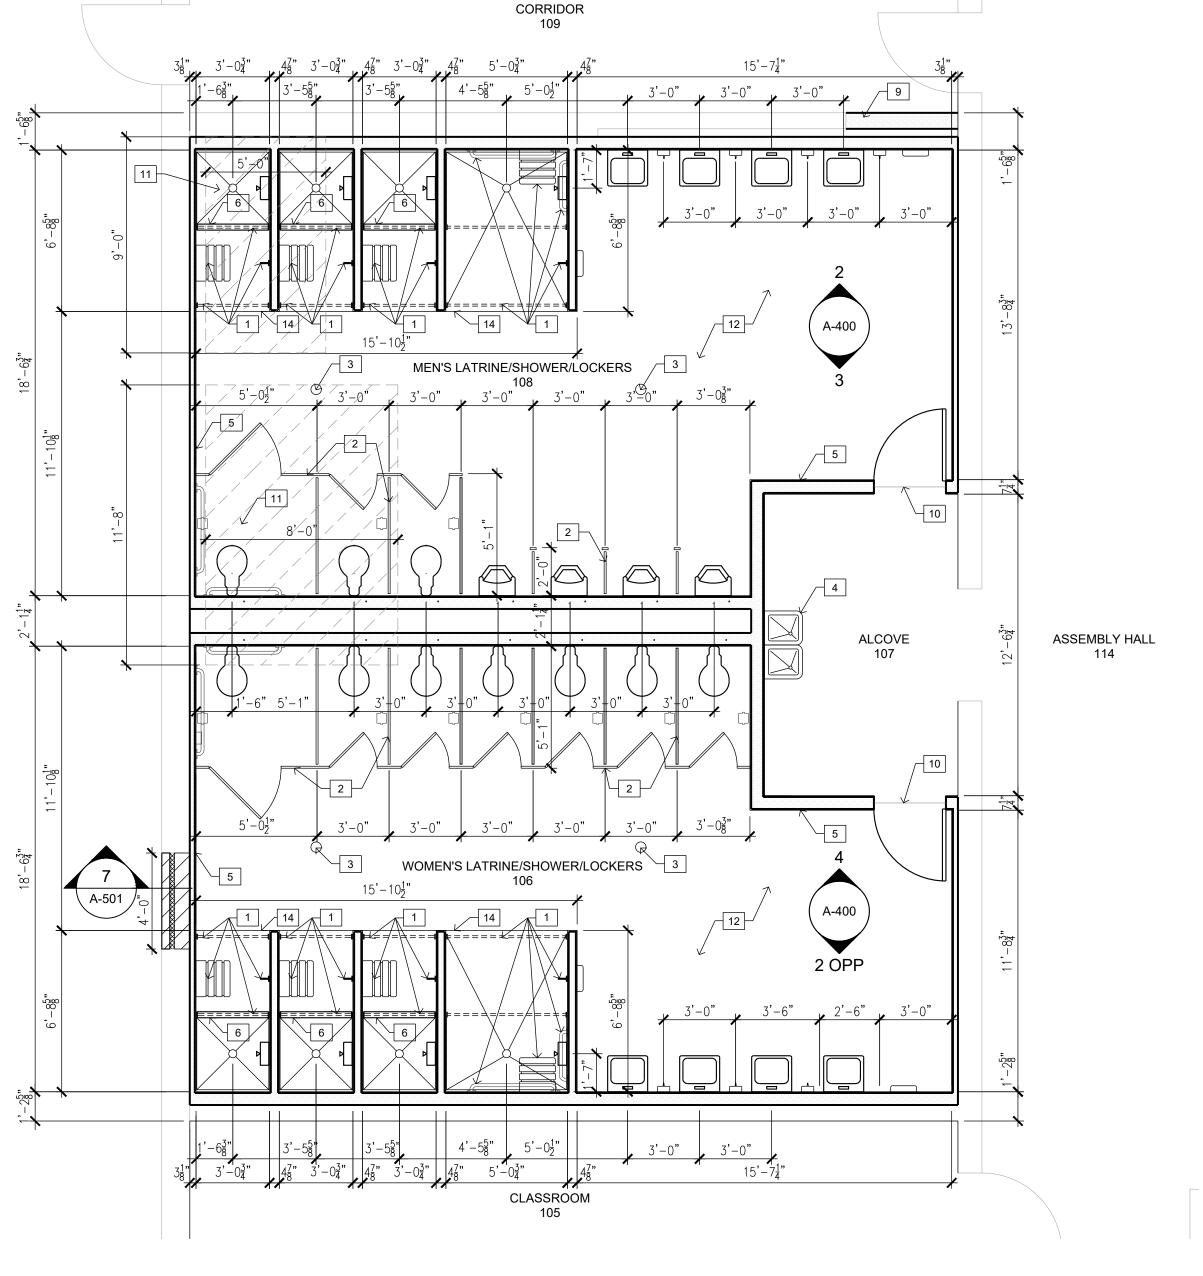

DETAIL PLAN - LATRINES / SHOWERS / LOCKERS


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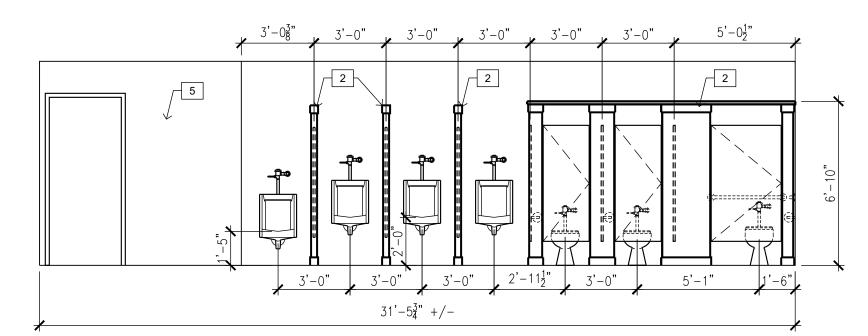


6 TYPICAL SHOWER CURB DETAIL

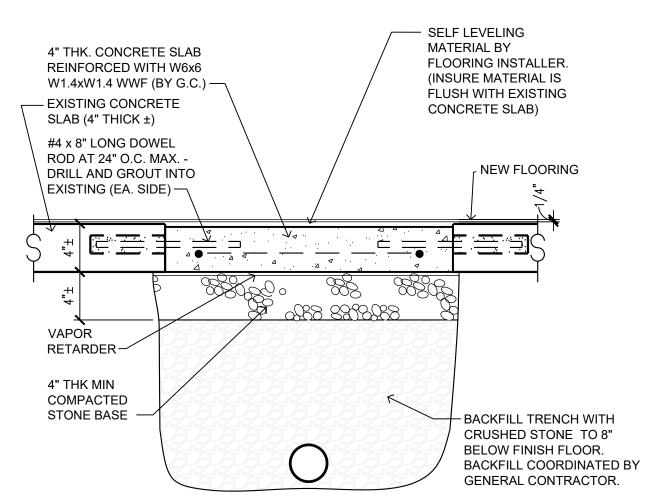SCALE: 1/4" = 1'-0"




2 DETAIL ELEVATION - SHOWERS & LAVATORIES (TYPICAL) 106 & 108

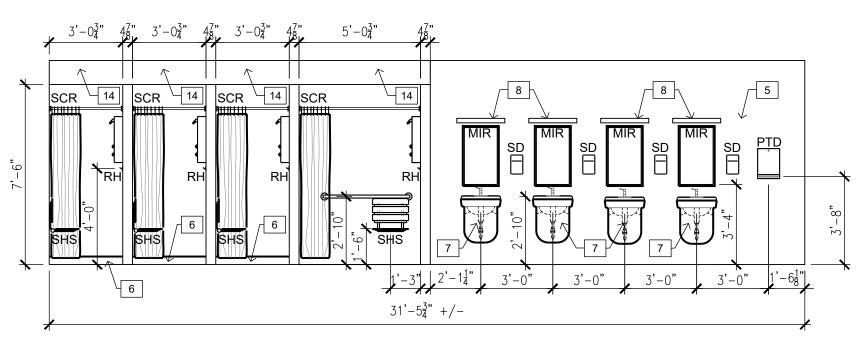



3 DETAIL ELEVATION - MEN'S LATRINES 108

SCALE: 1/4" = 1'-0"

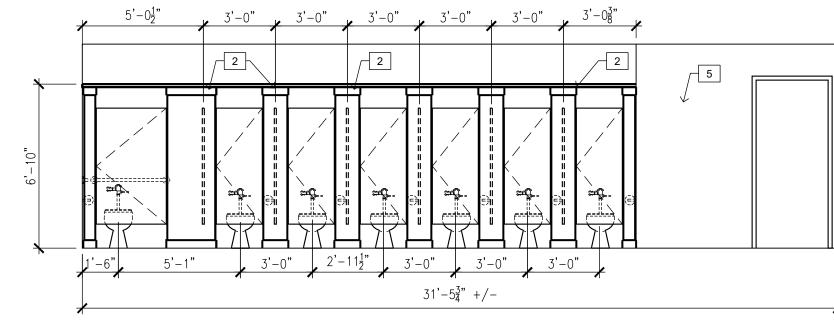

DETAIL ELEVATION - WOMEN'S LATRINES 106 SCALE: 1/4" = 1'-0"

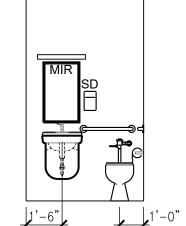

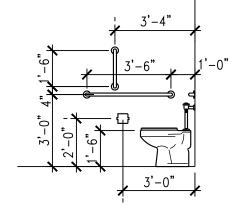

GENERAL FLOOR PLAN NOTES:

- A. GENERAL CONTRACTOR SHALL INSTALL SOLID WOOD BLOCKING AT WALLS AND PARTITIONS AS NECESSARY FOR INSTALLATION OF TOILET PARTITIONS, ACCESSORIES, LOCKERS, ETC. COORDINATE WITH
- B. REFER TO SHEET G-002 FOR TYPICAL GENERAL NOTES.

KEYED NOTES (ALTERATIONS):

- 1. SHOWER ACCESSORIES PER SPECIFICATIONS. PROVIDE BLOCKING AS REQUIRED.
- 2. FLOOR MOUNTED, OVER-HEAD BRACED TOILET PARTITIONS AS SPECIFIED. PROVIDE BLOCKING AS REQUIRED.
- 3. SLOPE CONCRETE 3/8" TO FLOOR DRAIN. COORDINATE WITH MEP SHEETS. SLOPE SHALL NOT EXCEED 2% SLOPE IN ANY DIRECTION.
- 4. HIGH-LOW ADA COMPLIANT ELECTRIC WATER COOLER, REFERENCE PLUMBING SHEET P-100.
- 5. RESINOUS WALL COVERING AS SPECIFIED. PREP WALLS AS RECOMMENDED BY PRODUCT MANUFACTURER. TYPICAL AT LATRINES/SHOWER AREAS.
- 6. INSTALL NEW SHOWER CURB AT SHOWER ENTRANCE. REF. DETAIL 6, THIS SHEET.
- 7. PROVIDE ADA COMPLIANT LAVATORY GUARD AT EACH
- 8. WALL MOUNTED LIGHT FIXTURE. REF. ELECTRICAL

LAVATORY SUPPLY AND WASTE LINES.

EXISTING. REF: FINISH SCHEDULE.

- 9. CONTINUE EXISTING CORRIDOR PARTITION TO ASSEMBLY HALL PARTITION. INFILL OPENING WITH CMU TO MATCH EXISTING CONSTRUCTION. FINISH TO MATCH
- 10. CUT 1/4" WIDE X 1/4" DEEP KEYWAY, FULL LENGTH OF OPENING FOR RESINOUS FLOOR EDGE. COORDINATE WITH RESINOUS FLOORING MANUFACTURER FOR FINISH REQUIREMENTS AT EXISTING SLAB.
- 11. INSTALL LIGHTWEIGHT CONCRETE INFILL AT EXISTING MORTAR BED (DESIGNATED WITH DASHED HATCH PATTERN). COORDINATE WITH RESINOUS FLOORING MANUFACTURER FOR FINISH REQUIREMENTS AND EDGE TREATMENTS AT EXISTING SLAB.
- 12. PREP EXISTING CONCRETE SLAB FOR RESINOUS FLOORING, COORDINATE WITH RESINOUS FLOORING MANUFACTURER FOR REQUIREMENTS.
- 13. INSTALL 4" THICK CONCRETE OVER VAPOR BARRIER OVER 4" OF COMPACTED BASE AT FLOOR INFILL AREAS DEMOLISHED FOR PLUMBING LINE INSTALLATION. DRILL-IN AND EPOXY #4X12" DOWELS AT 24" O.C. AT PERIMETER OF OPENING. COORDINATE WITH RESINOUS FLOORING MANUFACTURER FOR FINISH REQUIREMENTS AND EDGE TREATMENTS AT EXISTING SLAB. SEE DETAIL 5, SHEET A-400.
- 14. INSTALL GYP BOARD SOFFIT/CEILING AT SHOWER AREAS. SEE DETAIL 2, SHEET A-201.

SYMBOL LEGEND (THIS SHEET ONLY)



AREA OF EXISTING GYPSUM PLASTER OVER METAL LATH CEILING

ABBREVIATIONS (THIS SHEET ONLY)

GRAB BAR (LENGTH NOTED) (BY G.C.) 18"x30" MIRROR (BY G.C.)

WITH 5" x 18" S.S. SHELF BELOW (BY G.C.)

PAPER TOWEL DISPENSER (BY OWNER)

ROBE HOOK (BY G.C.) SHOWER CURTAIN ROD (BY G.C.)

SHOWER SEAT (BY G.C.)

SOAP DISPENSER (BY OWNER)

SANITARY NAPKIN DISPENSER (BY G.C.)

TOILET PAPER DISPENSER (BY G.C.)

SHEET TITLE:

DRAWN BY:

CHECKED BY:

DESIGNED BY:

DETAIL PLANS, ELEVATIONS AND **DETAILS**

STATE OF MISSOURI MICHAEL L. PARSON, **GOVERNOR**

UHRHAN

NUMBER.

A-2009027298

OFFICE OF ADMINISTRATION

DESIGN AND CONSTRUCTION

DIVISION OF FACILITIES

MANAGEMENT,

MISSOURI ARMY

RE-BID RENOVATE

KENNETT READINESS

CENTER 1450 NORTH

PROJECT # T2209-01

FACILITY # 8136313002

ISSUE DATE: January 30, 2023

CAD DWG FILE: A-100.DWG

BY-PASS KENNETT,

INTERIOR AND

EXTERIOR

MO 63857

REVISION:

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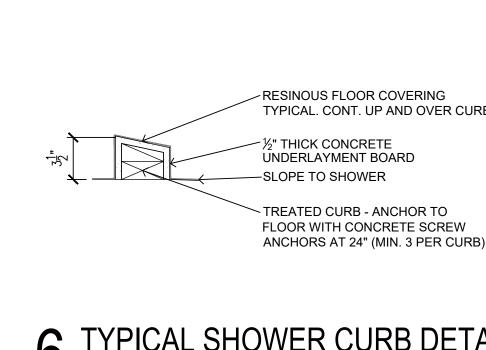
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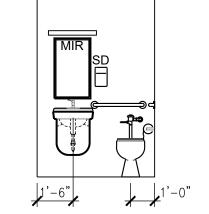
FACILITIES DIVISION

SHEET NUMBER:


A-400

11 OF **29** SHEETS





7 DETAIL ELEVATION - TOILET 120

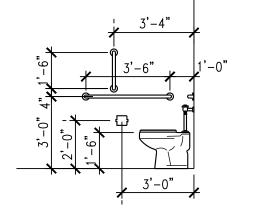


8 TYPICAL DETAIL ELEVATIONS

SCALE: 1/4" = 1'-0"

5 TYPICAL CONCRETE INFILL @ PLBG TRENCH

SCALE: 1/4" = 1'-0"


		,					
ROOM	ROOM NAME	FLOOR FINISH	BASE FINISH	WALL FINISH	CEILING FINISH	CEILING	REMARKS
101	ADMINISTRATIVE OFFICE	CARPET TILE (CT)	VINYL WALL BASE (VWB)	PAINT	EXISTING / NO WORK	-	
102	LOBBY	LUXURY VINYL TILE (LVT)	VINYL WALL BASE (VWB)	PAINT	EXISTING / NO WORK		[5]
103	OFFICE	CARPET TILE (CT)	VINYL WALL BASE (VWB)	PAINT	EXISTING / NO WORK		
104	OFFICE	CARPET TILE (CT)	VINYL WALL BASE (VWB)	PAINT	EXISTING / NO WORK	-	[5]
105	CLASSROOM	LUXURY VINYL TILE (LVT)	VINYL WALL BASE (VWB)	PAINT	EXISTING / NO WORK	-	[5]
106	WOMEN'S LATRINE/SHOWERS/LOCKERS		INTEGRAL RESINOUS BASE	GYPSUM BOARD w/ RESINOUS WALL FINISH	SUSPENDED CEILING 2x2	8'-6"	[1], [3], [4]
107	ALCOVE	LUXURY VINYL TILE (LVT)	VINYL WALL BASE (VWB)	PAINT	SUSPENDED CEILING 2x2	9'-0"	7 () 40 Andrew (40 Challes (40 Challes
108	MEN'S LATRINE/SHOWERS/LOCKERS	RESINOUS FLOORING	INTEGRAL RESINOUS BASE	GYPSUM BOARD w/ RESINOUS WALL FINISH	SUSPENDED CEILING 2x2	8'-6"	[1], [3], [4]
109	CORRIDOR	EXISTING / NO WORK	VINYL WALL BASE (VWB)	PAINT	EXISTING / NO WORK	-	[5], [8]
110	FOOD PREP	EXISTING / NO WORK	EXISTING / NO WORK	EXISTING / NO WORK	EXISTING / NO WORK	-	[2], [5]
111	STORAGE	EXISTING / NO WORK	EXISTING / NO WORK	EXISTING / NO WORK	EXISTING / NO WORK	-	[2]
112	MECHANICAL EQUIPMENT	EXISTING / NO WORK	EXISTING / NO WORK	EXISTING / NO WORK	EXISTING / NO WORK	72	[2]
113	SCULLERY	EXISTING / NO WORK	EXISTING / NO WORK	EXISTING / NO WORK	EXISTING / NO WORK	-	[2], [5]
114	ASSEMBLY HALL	EXISTING / NO WORK	EXISTING / NO WORK	EXISTING / NO WORK	OPEN TO STRUCTURE	20'-0" +/-	[5]
115	UNIT STORAGE	EXISTING / NO WORK	EXISTING / NO WORK	EXISTING / NO WORK	OPEN TO STRUCTURE	-	[2], [5]
116	VAULT	EXISTING / NO WORK	EXISTING / NO WORK	EXISTING / NO WORK	EXISTING / NO WORK	-	[2]
117	OFFICE	CARPET TILE (CT)	VINYL WALL BASE (VWB)	PAINT	SUSPENDED CEILING 2x2	9'-0"	[7]
118	OBSERVATION	EXISTING / NO WORK	EXISTING / NO WORK	EXISTING / NO WORK	EXISTING / NO WORK	-	[2]
119	HALL	EXISTING / NO WORK	EXISTING / NO WORK	EXISTING / NO WORK	EXISTING / NO WORK	-	[2], [5]
120	TOILET	EXISTING / NO WORK	EXISTING / NO WORK	PAINT	EXISTING / PAINT	-	[6]
121	STORAGE	EXISTING / NO WORK	EXISTING / NO WORK	EXISTING / NO WORK	EXISTING / NO WORK	= 0	[2]
122	STORAGE	EXISTING / NO WORK	EXISTING / NO WORK	EXISTING / NO WORK	EXISTING / NO WORK	-	[2], [5]
123	STORAGE	EXISTING / NO WORK	EXISTING / NO WORK	EXISTING / NO WORK	EXISTING / NO WORK	-	[2], [5]
124	FLAMMABLE	EXISTING / NO WORK	EXISTING / NO WORK	EXISTING / NO WORK	EXISTING / NO WORK	-	[2]
125	RIFLE RANGE	EXISTING / NO WORK	EXISTING / NO WORK	EXISTING / NO WORK	EXISTING / NO WORK	-	[2]
FINISH REI	MARKS:						
[1]	EXISTING FINISHES AND WALLS TO BE DEFLOOR LEVELER FOR NEW RESINOUS F			E SLABS TO BE SAWCUT AS REQUIRED FOR NEW	V PLUMBING AND REPAIRED A	CCORDINGLY TO	RECEIVE
[2]				QUIRED TO RESTORE TO ORIGINAL CONDITIONS.			
[3]				. HEIGHT OF WALL). REFERENCE SPECIFICATION I	FOR RESINOUS TYPE		
	5/8" MOISTURE-RESISTANT GYPSUM BO			THEIGHT OF WALE). HE EITENOL OF LOW 10 KITOK	TOTAL CONTROL OF THE		
[4] [5]	PREP AND PAINT EXISTING WALK DOOR	THE RESERVE OF THE PARTY OF THE	50 0210 mm20 0				
[5] [6]	EXISTING FLOOR AND WALL TILE TO REF		ET HALL ANLA				
[7]	RE-INSTALL EXISTING LIGHT FIXTURES IN		RENCE ELECTRICAL DRAWINGS				
[8]	INSTALL NEW VINYL BASE TO MATCH EX		E.I.O. ELECTROPIC DIVINION	7			
.0]	INGIAE NEW VINTE BAGE TO MIXTON E	NOTING AT WALLINTILL					
GENERAL	FINISH NOTES:						
A	REFER TO THE REFLECTED CEILING PLA	ANS FOR LOCATION AND TRE	ATMENT OF HEADWALLS, FUR	RED CEILINGS, EXPANSION JOINTS NOT NOTED I	N SCHEDULE.		
В	PROVIDE TRANSITION STRIPS BETWEEN						
C	REFER TO THE DOOR, OPENING & FRAM						
D	HEADWALLS, FURRED CEILINGS, ETC. T						1

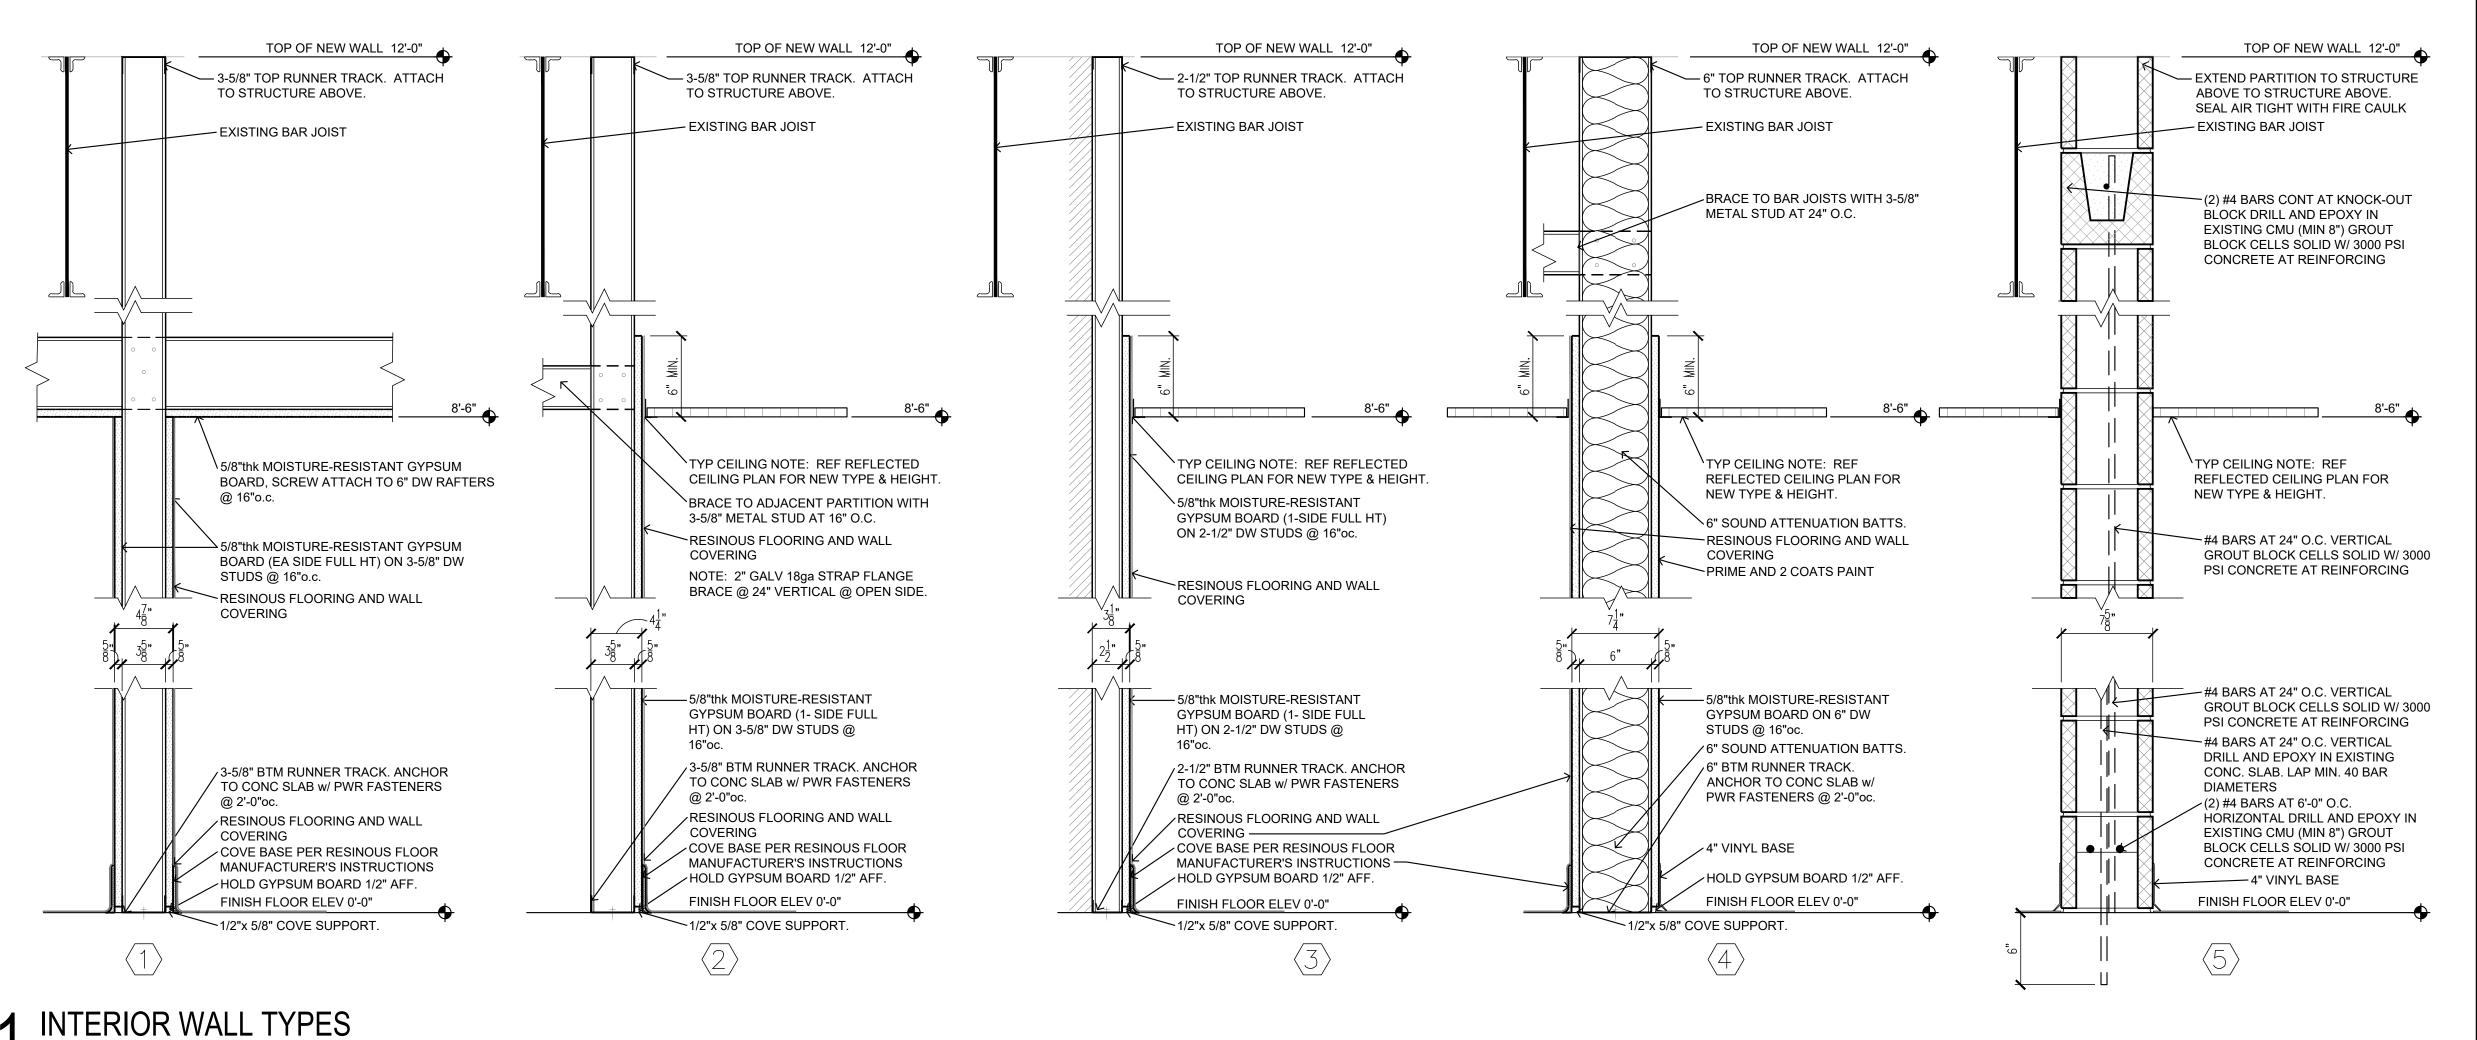

SCALE: 1 1/2" = 1'-0"

STATE OF MISSOURI MICHAEL L. PARSON, GOVERNOR



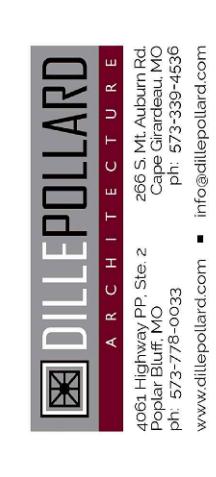

OFFICE OF ADMINISTRATION DIVISION OF FACILITIES MANAGEMENT, DESIGN AND CONSTRUCTION


MISSOURI ARMY NATIONAL GUARD FACILITIES DIVISION

RE-BID RENOVATE INTERIOR AND EXTERIOR

KENNETT READINESS CENTER 1450 NORTH BY-PASS KENNETT, MO 63857

PROJECT # T2209-01

FACILITY # 8136313002

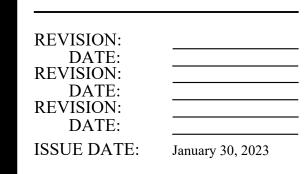


CAD DWG FILE: A-100.DWG
DRAWN BY: KU
CHECKED BY: BD
DESIGNED BY: KU

SHEET TITLE:

SCHEDULES AND DETAILS


SHEET NUMBER:

A-50

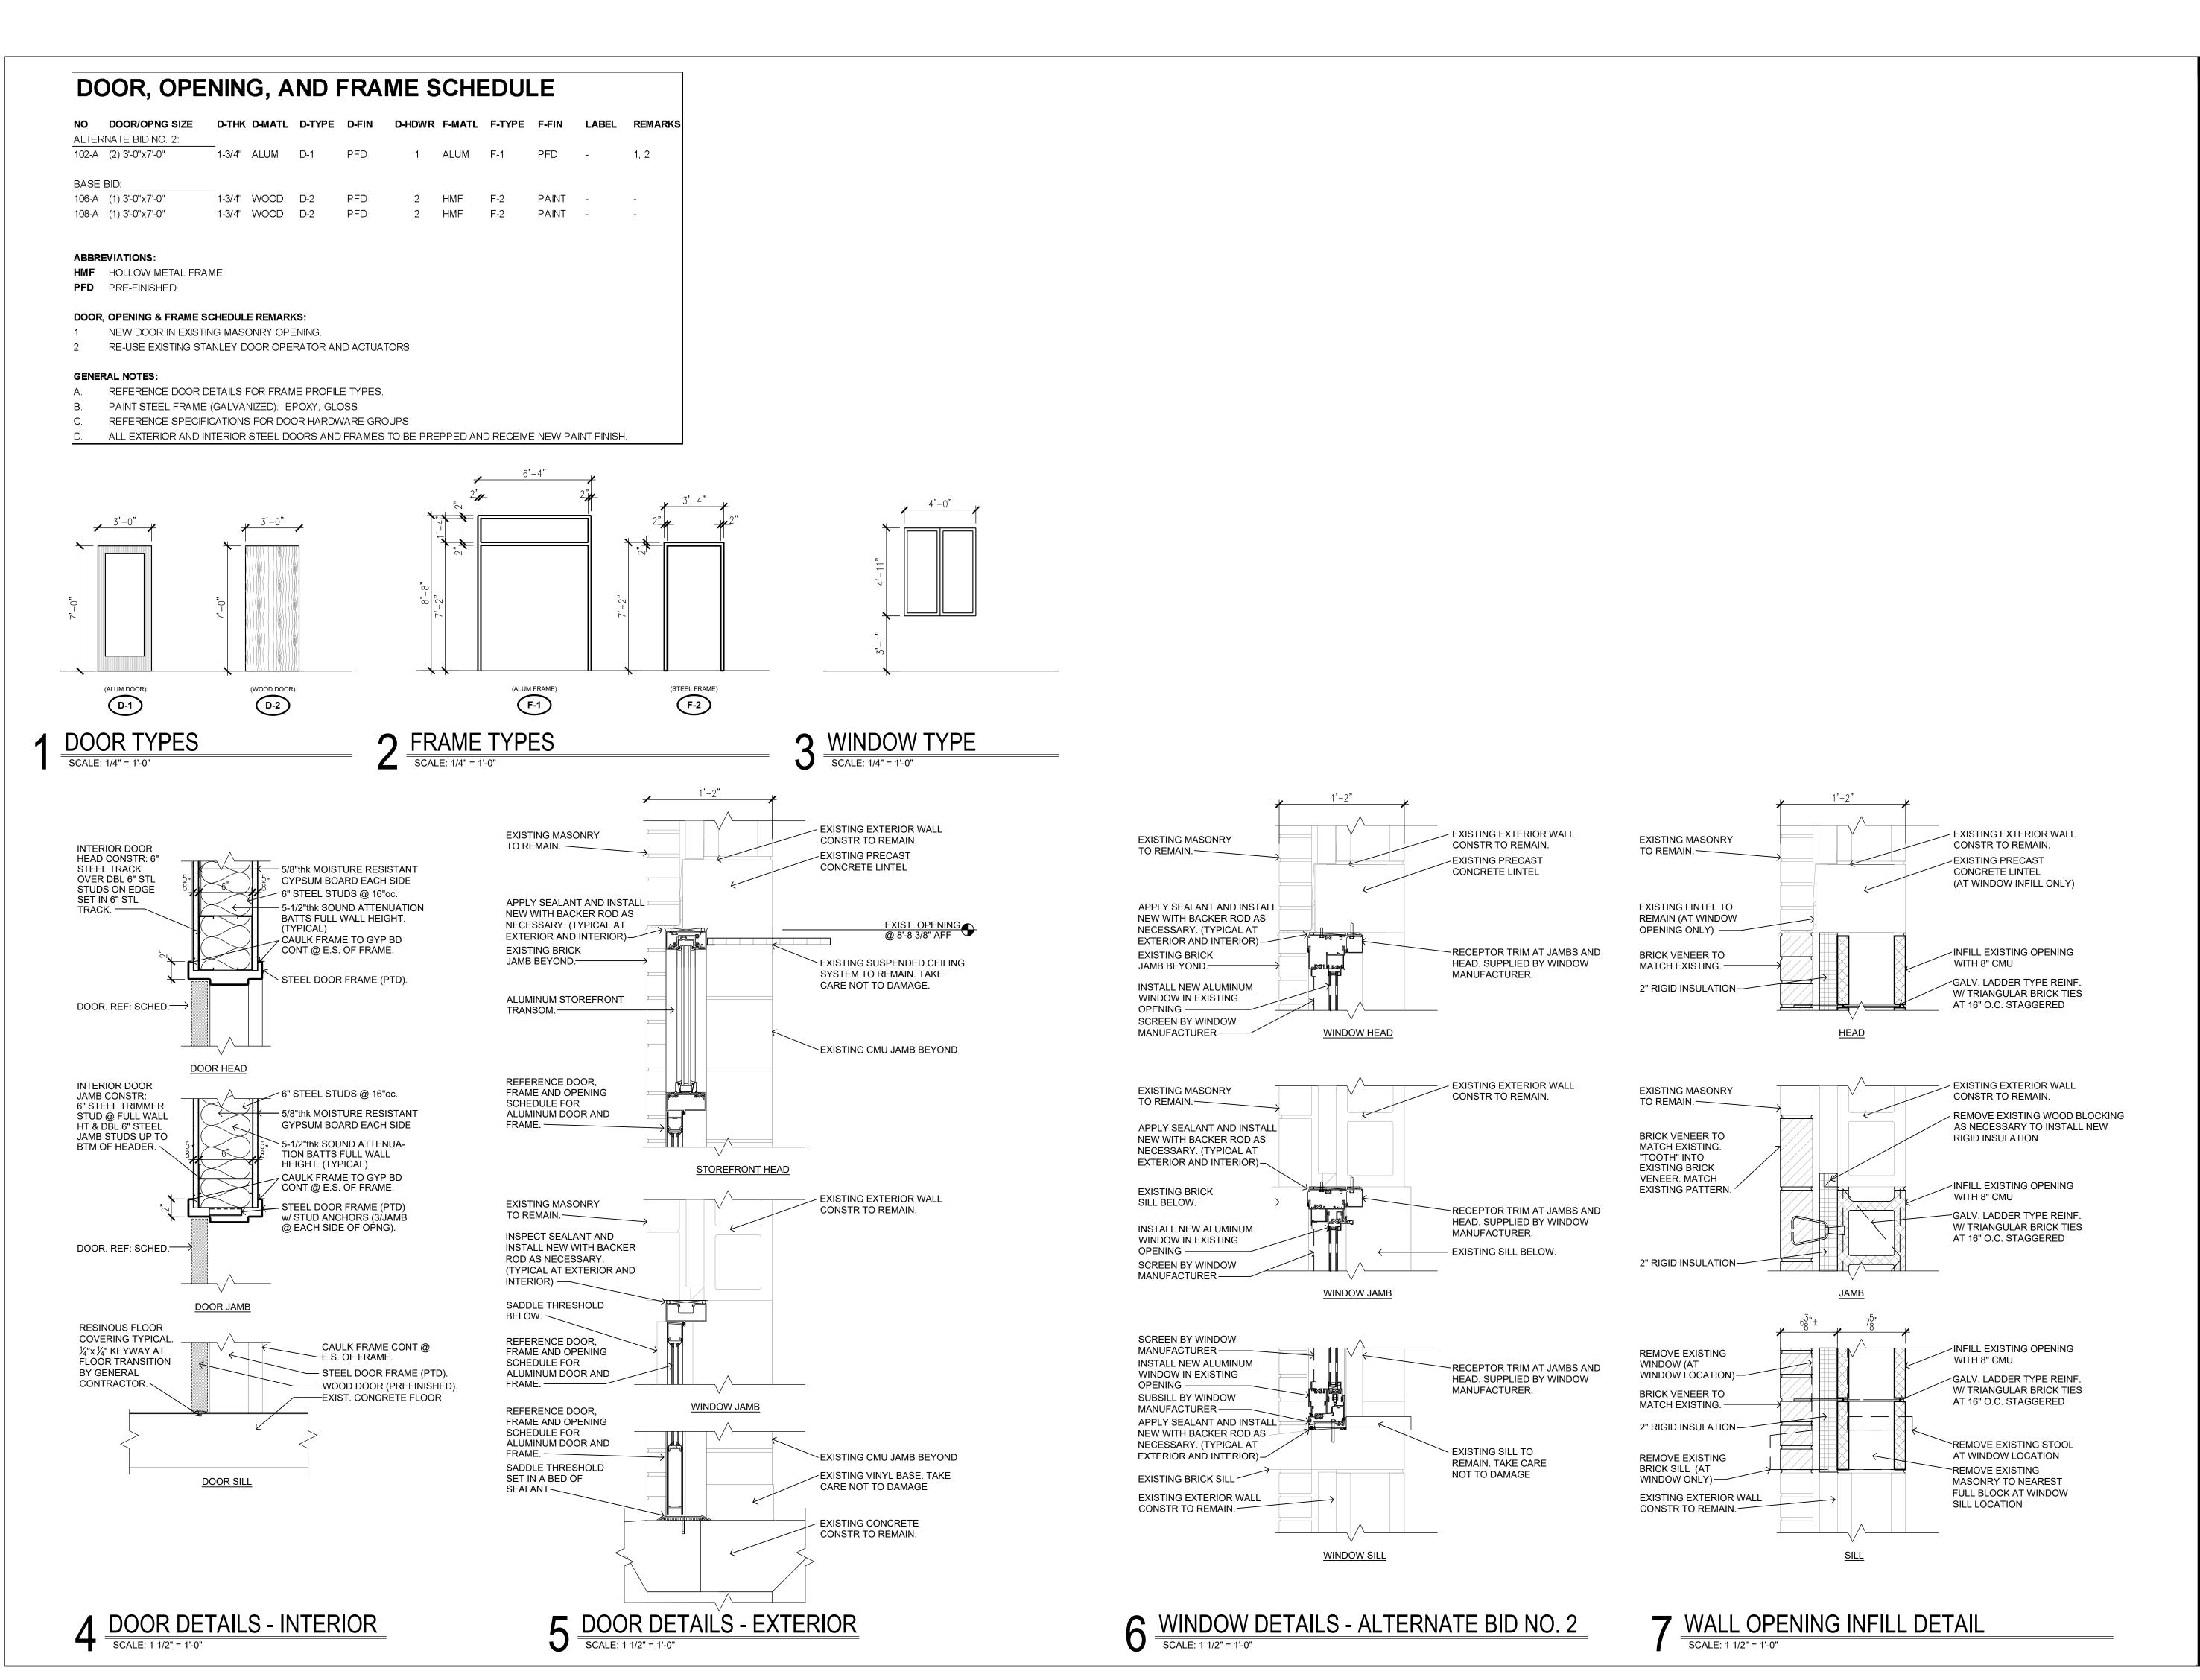

STATE OF MISSOURI MICHAEL L. PARSON, GOVERNOR



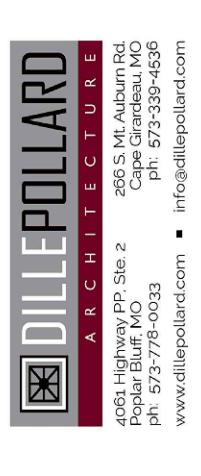

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MISSOURI ARMY NATIONAL GUARD FACILITIES DIVISION

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KENNETT READINESS CENTER 1450 NORTH BY-PASS KENNETT, MO 63857

PROJECT # T2209-01

FACILITY # 8136313002

REVISION:
DATE:
REVISION:
DATE:
REVISION:
DATE:
REVISION:
JATE:
January 30, 2023

CAD DWG FILE: A-100.DWG
DRAWN BY: KU
CHECKED BY: BD
DESIGNED BY: KU

SHEET TITLE:

SCHEDULES AND DETAILS

SHEET NUMBER

A-50

AMPS

AFG

BKR

BOP

BOS

BTU

CB

CFM

CKT

CO

CU

CW

DDC

DN

AIR CONDITIONING

ABOVE FINISH CEILING

ABOVE FINISH GRADE

BACKDRAFT DAMPER

BOTTOM OF DUCT

CIRCUIT BREAKER

BOTTOM OF STRUCTURE

BRITISH THERMAL UNIT

CUBIC FEET PER MINUTE

DOMESTIC COLD WATER

DIRECT DIGITAL CONTROL

ENTERING AIR TEMPERATURE

INDICATES EMERGENCY CIRCUIT

ELECTRICAL CONTRACTOR

BOTTOM OF PIPE

CONDUIT

CLEANOUT

EXHAUST AIR

EXHAUST FAN

ABOVE FINISHED FLOOR

ANNUNCIATOR CONTROL PANEL

EXHAUST REGISTER

ELECTRIC WATER HEATER

GAS (NATURAL), GROUND

GFI/GFCI GROUND FAULT CIRCUIT INTERRUPTER

FACP FIRE ALARM CONTROL PANEL

ETR EXISTING TO REMAIN

EWB ENTERING WET BULB

FCO FLOOR CLEANOUT

FLA FULL LOAD AMPS

GCO GRADE CLEANOUT

HOSE BIBE

GPM GALLONS PER MINUTE

DOMESTIC HOT WATER

HOT WATER RETURN

HWS HOT WATER SUPPLY

KCMIL 1000 CIRCULAR MILS

KVA KILOVOLT AMPS

FD FLOOR DRAIN

FS FLOOR SINK

EXH EXHAUST

FLR FLOOR

GND GROUND

HTG HEATING

HTR HEATER

KV KILOVOLT

KW KILOWATT

HB

KWH KILOWATT HOUR

LV LOW VOLTAGE

MFR MANUFACTURER

MAKE UP

MUAF MAKE UP AIR FAN

NIGHT LIGHT

OUTSIDE AIR

ОА

PH PHASE

PNL PANEL

QTY QUANTITY

RA RETURN AIR

MIXING VALVE

NOT APPLICABLE

NOT IN CONTRACT

MTD MOUNTED

MAIN LUGS ONLY

LEAVING AIR TEMPERATURE

LEAVING WATER TEMPERATURE

LEAVING DRY BULB

LOCKED ROTOR AMPS

LEAVING WET BULB

MAKE UP AIR UNIT

1000 BTU PER HOUR

MECHANICAL CONTRACTOR

MINIMUM CIRCUIT AMPACITY


INDICATES NON-FUSED DEVICE



<u>HVAC</u> POWER DEVICE AND CONTROLS **PIPING** CONDUIT AND WIRE ARROWS INDICATE CONDUIT AND WIRE HOME RUN(S) \bigcirc THERMOSTAT TO PANEL WITH 2-#12 AWG CONDUCTORS UNLESS -----O ELBOW UP TEMPERATURE/HUMIDITY SENOR DISCONNECT SWITCH. 30A-3P, NON-FUSED NOTED OR OTHERWISE REQUIRED. EXCEPT AS NOTED SUPPLY AIR FLOW INDICATOR ———— TEE UP CONDUIT RUN CONCEALED IN WALL OR ABOVE RETURN AND EXHAUST AIR FLOW INDICATOR TEE DOWN SUPPLY DIFFUSER CAP CONDUIT RUN UNDERGROUND OR CONCEALED IN PANELBOARD (SEE ONE-LINE) FLOOR SLAB. SUPPLY STRIP DIFFUSER TELEPHONE CONDUIT $\left(\mathsf{J}\right)$ RETURN GRILLE OR EXHAUST REGISTER JUNCTION BOX ----LV---- LOW VOLTAGE CONDUIT AND WIRING PUSHBUTTON REFRIGERANT LIQUID/REFRIGERANT SUCTION PRESSURE GAUGE WITH GAUGE COCK —— D —— DRAIN (CONDENSATE) TEMPERATURE GAUGE <u>LIGHTING</u> **SECURITY** BATTERY OPERATED EMERGENCY LIGHT (WALL MOUNTED) THERMOMETER. **PLUMBING** CARD READER SURFACE/RECESSED LIGHT FIXTURE ——— — DOMESTIC COLD WATER -+♥+---- Shutoff valve DOOR CONTACT ---- DOMESTIC HOT WATER SHUTOFF VALVE IN RISER • LIGHT FIXTURE VIDEO INTERCOM DOOR STATION ----- RECIRCULATING DOMESTIC HOT WATER ____ BALANCING VALVE • STRIP FIXTURE RELIEF VALVE -- SAN -- SOIL OR WASTE BELOW GRADE OR FLOOR SHADING DENOTES EMERGENCY FIXTURE ---v--- PLUMBING VENT CHECK VALVE. POLE MOUNTED LIGHT FIXTURE FIRE ALARM — G — GAS (NATURAL) PRESSURE REDUCING VALVE EXIT LIGHT - DOUBLE FACE - ARROWS AS SHOWN MANUAL PULL STATION + HB HOSE BIBB WALL CLEAN OUT EXIT LIGHT - SINGLE FACE - ARROWS AS SHOWN PHOTOELECTRIC DETECTOR ('D' DENOTES IN DUCT) ('B' DENOTES BEÀM-TYPE) ——⇒СО CLEAN OUT ('R' DENOTES IN RETURN AIR PLENUM) LIGHTING SWITCHES-SINGLE POLE, 3-WAY, 4-WAY FLOOR CLEAN OUT □ FCO IONIZATION DETECTOR ('D' DENOTES WALL MOUNTED MOTION SENSOR $\oslash \equiv$ FLOOR DRAIN, AREA DRAIN, FLOOR SINK IN DUCT) ('P' DENOTES PLENUM-TYPE) SHOWER HEAD. CEILING MOUNTED MOTION SENSOR INF D INFRARED DETECTOR ('D' DENOTES IN DUCT) (LETTER DENOTES TYPE) THERMODETECTOR ('D' DENOTES IN DUCT) DENOTES A WALL MOUNTED FIXTURE FIXED TEMPERATURE AS NOTED **GENERAL** DOOR HOLDER MECHANICAL NOTE REFERENCE CHIME WIRING DEVICES FC BELL ELECTRICAL NOTE REFERENCE DUPLEX RECEPTACLE. FIRE ALARM STROBE LIGHT LINE THRU DEVICE INDICATES ABOVE COUNTER DEMOLITION NOTE REFERENCE FIRE ALARM SPEAKER - ARROWS DENOTE SINGLE RECEPTACLE PROJECTORS IF ANY. ('L' DENOTES REVISION NOTE REFERENCE COMBINATION SPEAKER AND VISUAL FIRE LIGHT) FIRE HORN. ('L' DENOTES COMBINATION CONNECT TO EXISTING WORK HORN AND VISUAL FIRE LIGHT) FIREMAN'S PHONE JACK DETAIL REFERENCE - NO./SHEET NO.

DUCTWORK

SECTION CUT - SECTION/SHEET NO.

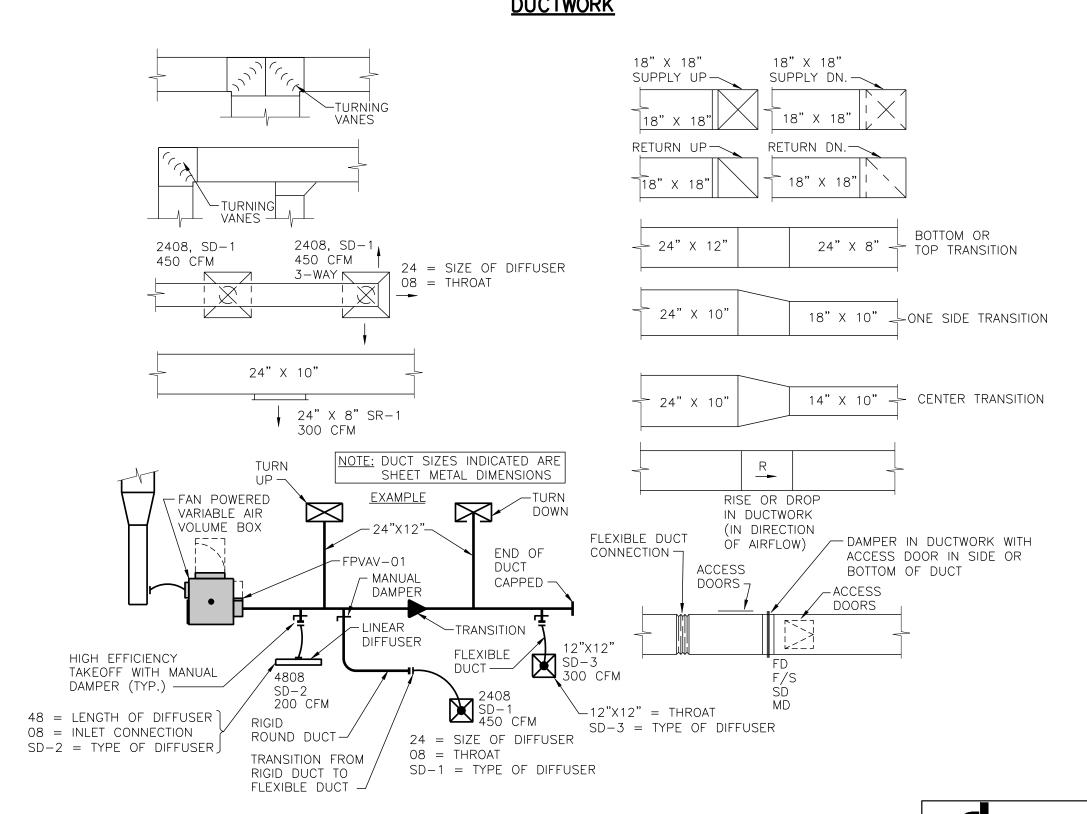



"SOME SYMBOLS AND ABBREVIATIONS ON THIS LEGEND MAY NOT BE USED. REFER TO FLOOR PLANS FOR ALL SYMBOLS AND ABBREVIATIONS."

REV REVISION

RG RETURN GRILLE

RELATIVE HUMIDITY

REFRIGERANT LIQUID

RUNNING LOAD AMPS

REFRIGERANT SUCTION

RPM REVOLUTIONS PER MINUTE

SUPPLY AIR

SQUARE FEET

VENT PIPE

VD VOLUME DAMPER

WET BULB

WITH

W/O WITHOUT

WIRE, WATT(S)

WALL CLEANOUT

WEATHERPROOF

STATIC PRESSURE

SUPPLY REGISTER

SAN SANITARY

TSTAT THERMOSTAT

W/

DOMESTIC RECIRCULATION HOT WATER

SUPPLY DIFFUSER, SMOKE DAMPER

UNDERWRITERS LABORATORIES INC.


UNLESS NOTED OTHERWISE

VENT THROUGH ROOF

STATE OF MISSOURI MICHAEL L. PARSON, **GOVERNOR**



PROFESSIONAL SEAL

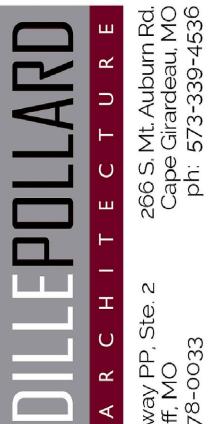

OFFICE OF ADMINISTRATION DIVISION OF FACILITIES MANAGEMENT, **DESIGN AND CONSTRUCTION**


MISSOURI ARMY NATIONAL GUARD **FACILITIES DIVISION**

RE-BID RENOVATE INTERIOR AND **EXTERIOR**

KENNETT READINESS CENTER 1450 NORTH BY-PASS KENNETT, MO 63857

PROJECT # T2209-01

FACILITY # 8136313002

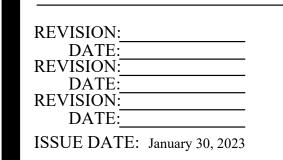

CAD DWG FILE: ME-100.DWG JEB DRAWN BY: CHECKED BY: RJD DESIGNED BY: JEB

SHEET TITLE:

SYMBOLS AND **ABBREVIATIONS -**MECHANICAL AND **ELECTRICAL**

SHEET NUMBER:

smith & boucher

25618 west 103rd St olathe, ks 66061 phone 913.345.2127 fax 913.345.0617

__ engineers

project number 2219000

ME-100



wings\01-2219000_ME-200.dw January 27, 2023 1:54:40 PM January 27, 2023 2:50:09 PM

PACE — Kennett Readiness Center X:\22\22190\2219000\Drawi Jblackburn Booty Charles Friday, J

ELECTRICAL PLAN NOTES:

- 1 ALTERNATE NO.2 COMBINATION MANUAL TRANSFER SWITCH WITH GENERATOR QUICK CONNECTS, RE: DE-100 AND E-200.
- 2 ALTERNATE NO.3 PROVIDE POLE LIGHTS AND ALL REQUIRED CIRCUITING AND CONDUITS. (2)#8,#10G., 1"C ENTIRE CIRCUIT. REFER TO POLE BASE DETAIL THIS SHEET
- 3 ALTERNATE NO.3 PROVIDE 1" CONDUIT WITH PULL ROPE AND CAPPED AT EACH END BELOW PARKING LOT FOR FUTURE POLE LIGHTS AT SOUTH SIDE OF PARKING LOT.
- 4 GROUND MOUNT FLOOD LIGHTS, INSTALL AT 120 DEG APART AND 6'-0" FROM FLAG POLE. PROVIDE FINAL AIMING OF FLOOD LIGHTS FOR FLAG ILLUMINATION. (2)#8,#10G., 1"C. ENTIRE CIRCUIT. REFER TO FLOOD LIGHT BASE DETAIL.

STATE OF MISSOURI MICHAEL L. PARSON, **GOVERNOR**



PROFESSIONAL SEAL



OFFICE OF ADMINISTRATION DIVISION OF FACILITIES MANAGEMENT, **DESIGN AND CONSTRUCTION**


MISSOURI ARMY NATIONAL GUARD FACILITIES DIVISION

RE-BID RENOVATE INTERIOR AND EXTERIOR

KENNETT READINESS CENTER 1450 NORTH BY-PASS KENNETT, MO 63857

PROJECT # T2209-01

FACILITY # 8136313002

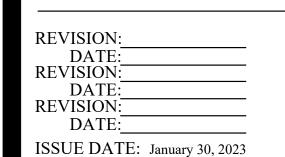

CAD DWG FILE: ME-200.DWG DRAWN BY: JEB DRAWN BY: JEB CHECKED BY: RJD

DESIGNED BY: JEB

SHEET TITLE:

SITE PLAN -MECHANICAL AND **ELECTRICAL**

SHEET NUMBER:

ME-200


15 OF 29 SHEETS

smith & boucher engineers


25618 west 103rd St olathe, ks 66061

project number 2219000

phone 913.345.2127 fax 913.345.0617

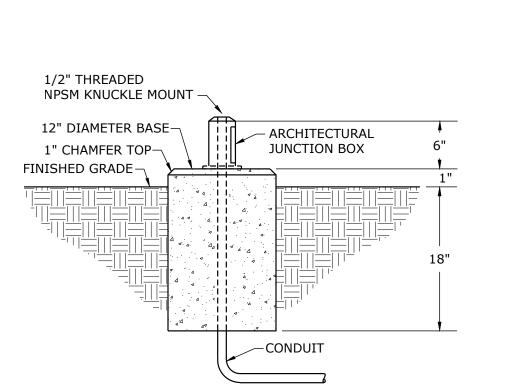

3 FLOOD LIGHT BASE DETAIL

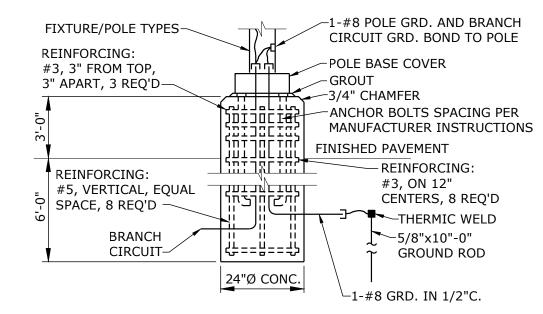


NOTES:

- 1. CONCRETE BASES SHALL BE 4000 PSI COMPRESSIVE STRENGTH AIR ENTRAINED CONCRETE MINIMUM, CAST IN PLACE OR PRE-CAST. REINFORCING # TIES SHALL EXTEND FULL LENGTH OF BASES ST 12" O.C., WITH ADDITIONAL TIES AT TOP.
- 2. ANCHOR BOLTS AND BASE PLATE TEMPLATE SHALL BE PROVIDED BY LIGHTING POLE MANUFACTURER TO VENDOR FOR BASES PRIOR TO CONSTRUCTION.
- 3. INSTALL A CURVED LID JUNCTION BOX IN THE FACE OF ALL POLE BASES. SERVES AS A TERMINATION POINT FOR SECURITY CONDUIT AND A LOCATION TO MOUNT LOW VOLTAGE EQUIPMENT. J-BOX MANUFACTURED BY CARLON.

POLE BASE DETAIL

NOT TO SCALE

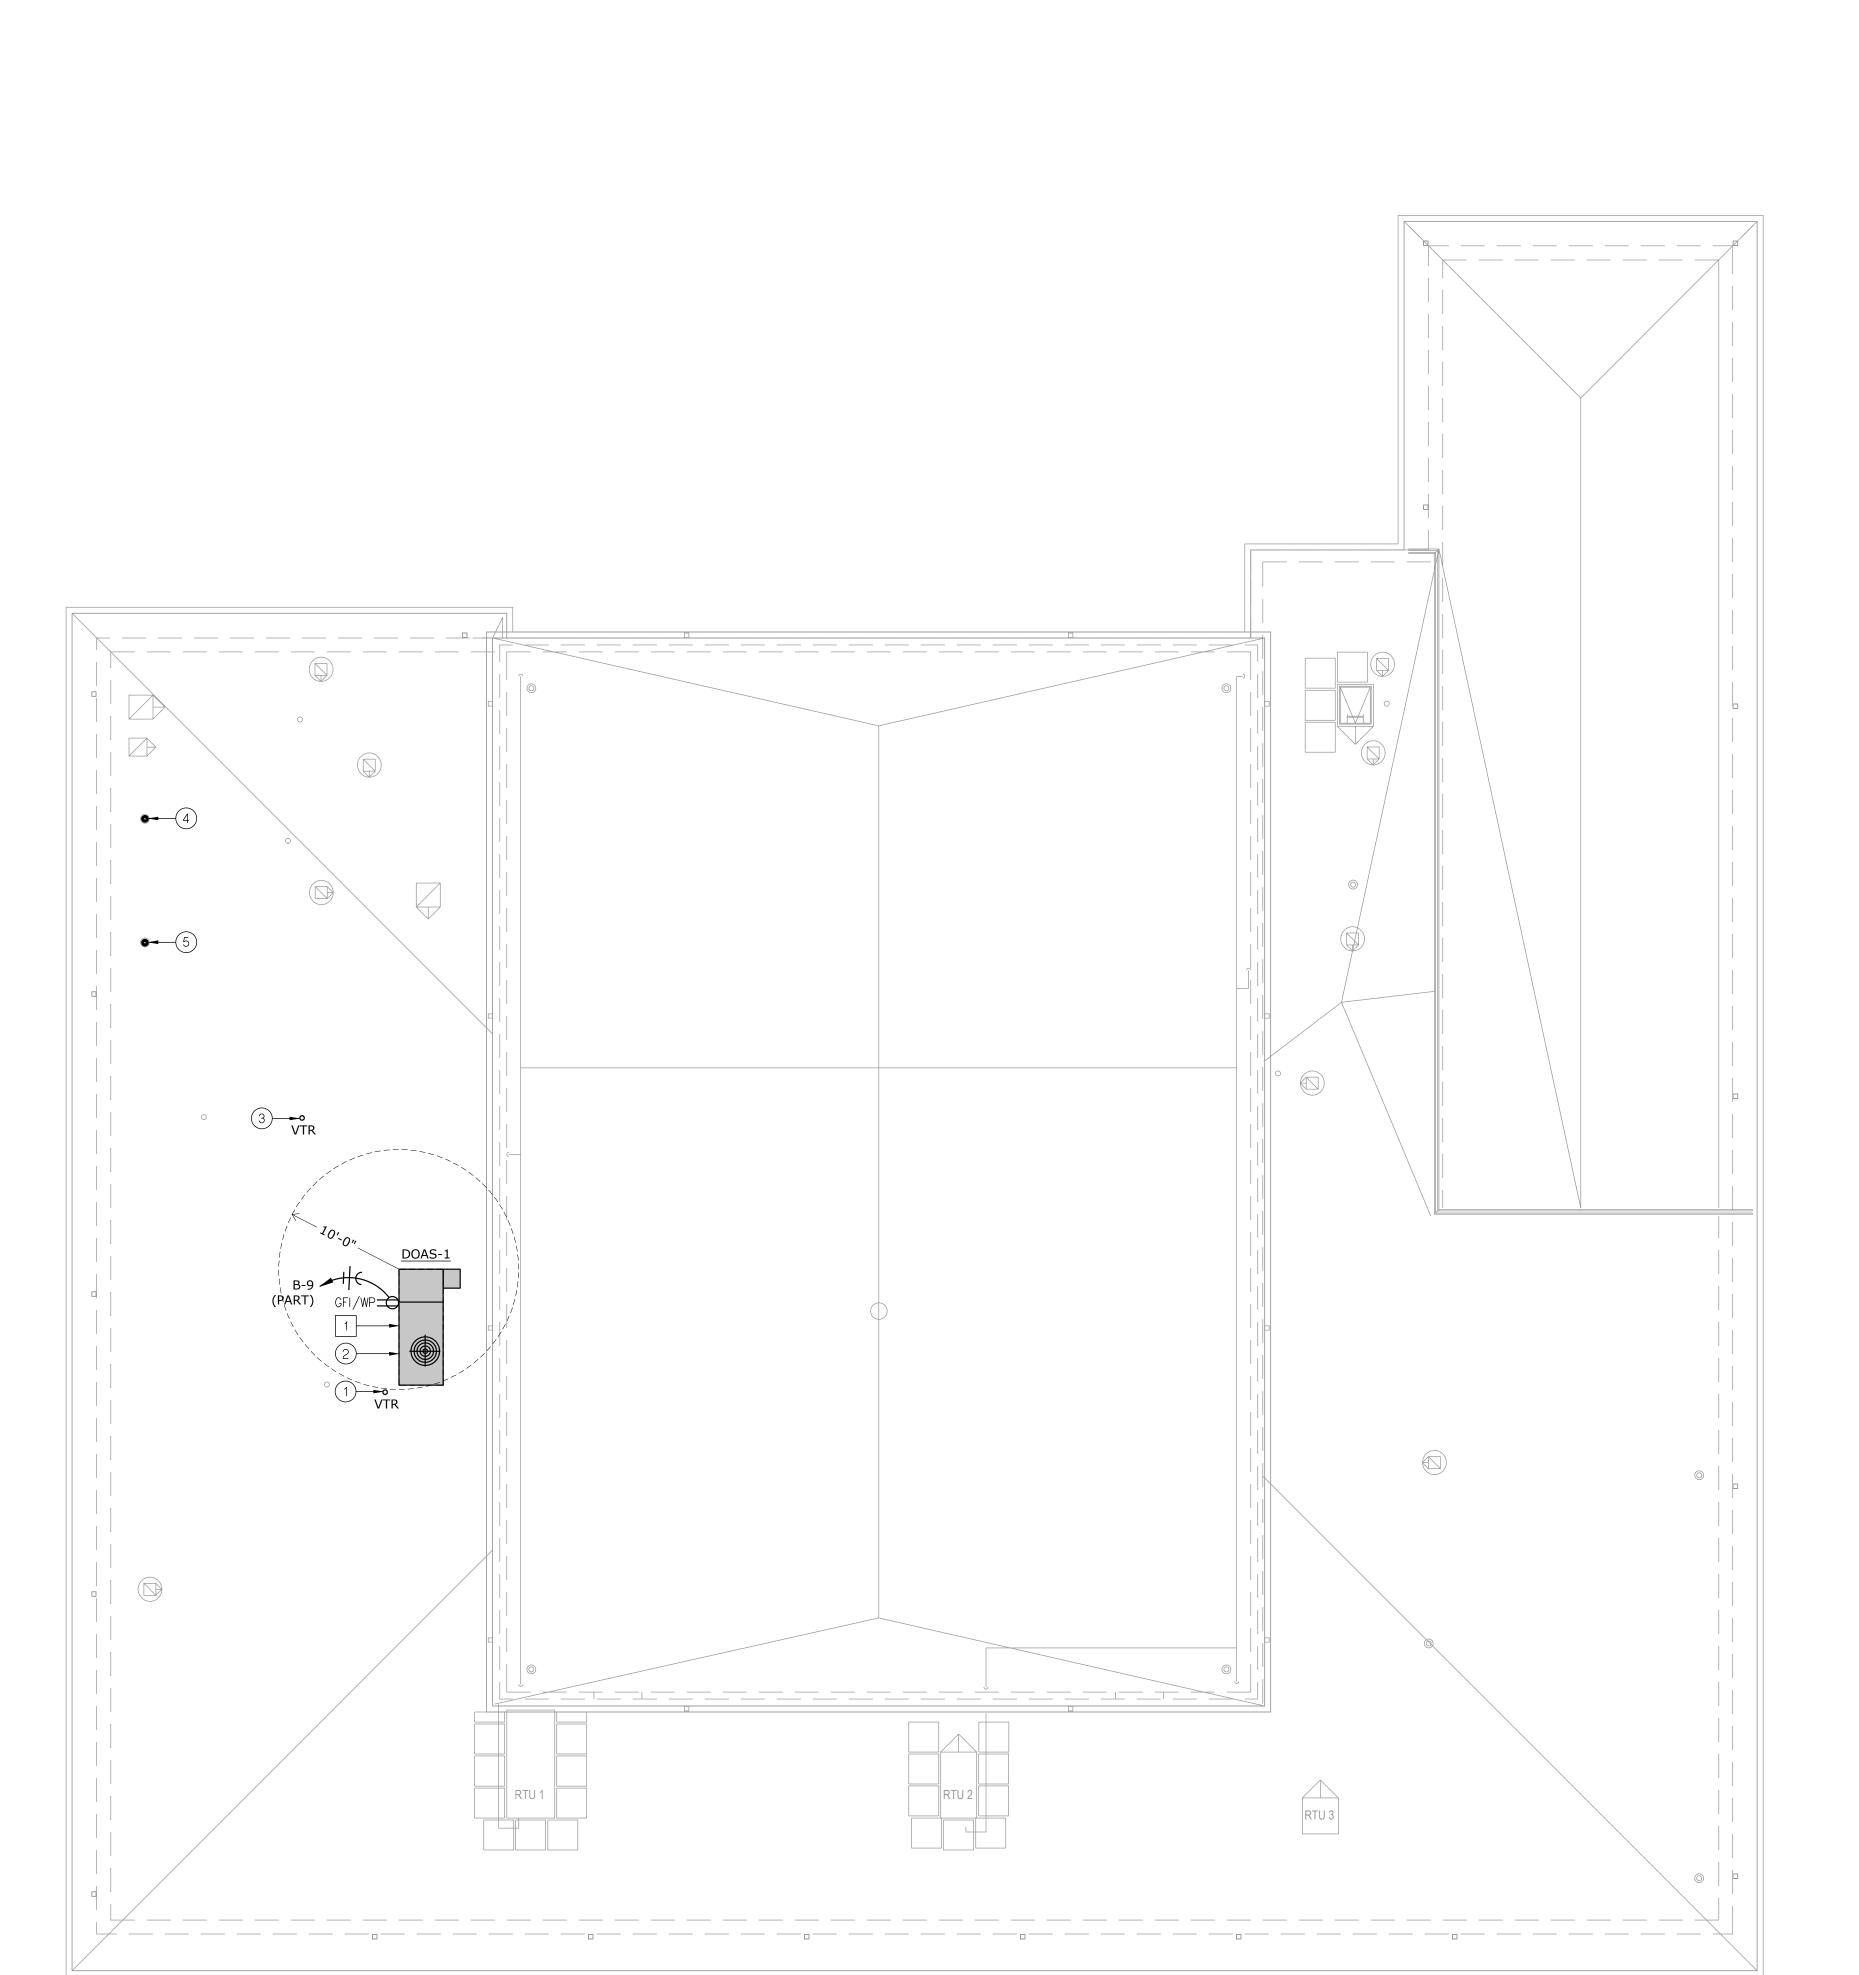

GENERAL NOTES:

1. REFER TO GENERAL NOTES, SHEET M-100, P-100, E-100.

MECHANICAL PLAN NOTES:

- (1) UTILIZE EXISTING VENT THRU ROOF WHERE POSSIBLE. REFER TO PLUMBING PLANS FOR ADDITIONAL INFORMATION AND DIRECTION. FIELD VERIFY LOCATION.
- (2) COORDINATE LOCATION OF DEDICATED OUTSIDE AIR UNIT WITH STRUCTURE. MAINTAIN 10 FEET SEPARATION BETWEEN ANY INTAKE OPENING AND ALL EXISTING EXHAUST OR VENTS. FIELD VERIFY EXACT LOCATION AND CONDITIONS.
- 3 UTILIZE EXISTING VENT THRU ROOF OPENING WHERE POSSIBLE FOR NEW LARGER VENT THRU ROOF. REFER TO PLUMBING PLANS FOR ADDITIONAL INFORMATION AND DIRECTION. FIELD VERIFY LOCATION.
- 4 UTILIZE EXISTING FLUE ROOF OPENING FOR NEW ON FURNACE CONCENTRIC VENT. REFER TO HVAC PLANS FOR ADDITIONAL INFORMATION AND DIRECTION. FIELD VERIFY LOCATION.
- (5) UTILIZE EXISTING FLUE ROOF OPENING FOR NEW ON WATER HEATER CONCENTRIC VENT. REFER TO PLUMBING PLANS FOR ADDITIONAL INFORMATION AND DIRECTION. FIELD VERIFY LOCATION.

ELECTRICAL PLAN NOTES:

1 REFER TO SCHEDULE FOR ELECTRICAL CONNECTION.

STATE OF MISSOURI MICHAEL L. PARSON, **GOVERNOR**



PROFESSIONAL SEAL



OFFICE OF ADMINISTRATION DIVISION OF FACILITIES MANAGEMENT, DESIGN AND CONSTRUCTION

MISSOURI ARMY NATIONAL GUARD FACILITIES DIVISION

RE-BID RENOVATE INTERIOR AND EXTERIOR

KENNETT READINESS CENTER 1450 NORTH BY-PASS KENNETT, MO 63857

PROJECT # T2209-01

FACILITY # 8136313002

REVISION:
DATE:
REVISION: DATE:
REVISION:
DATE:
ISSUE DATE: January 30, 2023

CAD DWG FILE: ME-200.DWG
DRAWN BY: JEB
CHECKED BY: RJD
DESIGNED BY: JEB

SHEET TITLE:

ROOF PLAN -MECHANICAL AND ELECTRICAL

SHEET NUMBER:

ME-201

16 OF 29 SHEETS



smith & boucher
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25618 west 103rd St olathe, ks 66061
phone 913.345.2127 fax 913.345.0617
project number 2219000

×	Jblc Boo	
AUTOCAD FILE LOCATION \ NAME:	LAST CORRECTION BY ♦ DATE ♦ TIME: PLOTTED BY ♦ DATE ♦ TIME:	

SI	GNA	TION	DOAS-1
		MANUFACTURER	AAON
j.	_	MODEL NO.	RQ-005
1	5	NOMINAL SIZE (TONS)	5
		UNIT WEIGHT	1250
	4	SYSTEM TYPE	CV 0.05
	DATA	MOTOR HP TOTAL EFFECTIVENESS (%) WINTER / SLIMMER	49.4 / 50.8
	I LINO	TOTAL EFFECTIVENESS (%) WINTER / SUMMER CFM THROUGH WHEEL (OSA / EXHAUST)	49.4 / 50.8
ENERGY WHEEL	<u> </u>	OUTSIDE AIR (DB)	16
	ER	RETURN AIR (DB/WB)	70 / 60
	MINTER	SUPPLY AIR (DB/WB)	45.60 / 42.51
		EXHAUST AIR (DB/WB)	41.62 / 41.18
i	~	OUTSIDE AIR (DB/WB)	91.70 / 81.50
	IMER	RETURN AIR (DB/WB)	75 / 62
	SUMME	SUPPLY AIR (DB/WB)	81.81 / 72.01
		EXHAUST AIR (DB/WB)	83.92 / 75.52
	 	CFM	1000
	SUPPLY	E.S.P. (IN. WG.)	0.45
:	SU	MOTOR HORSEPOWER (HP) VFD	1 YES
		CFM	1120
	UST	E.S.P. (IN. WC)	0.45
	EXHAUST	MOTOR HORSEPOWER (HP)	1
	Ш̀	VFD	YES
		SUPPLY CFM	1000
-		OA CFM	RE: ENERGY WHEEL
	3	TOTAL COOLING CAPACITY (MBH)	60.89
UNIT I	2	SENSIBLE COOLING CAPACITY (MBH)	31.28
	3	COOLING ENT. AIR (DB/WB)	81.53 / 71.67
•		COOLING COIL LVG. AIR (DB/WB)	51.51 / 51.37
		COOLING UNIT LVG. AIR (DB/WB)	53.70 / 52.30 105
DX COOLING		AMBIENT AIR (DB) REFRIGERANT	410A
		NO. OF COMPRESSORS	1
>	<u>კ</u>	STAGES OF COOLING	1-VARIABLE CAPACITY SCROLL
_	د	MINIMUM E.E.R @ AHRI	12.4
		TYPE OF HOT GAS REHEAT	MODULATING
		HOT GAS REHEAT CAPACITY (MBH)	22
ב ני	E	HOT GAS REHEAT TEMPERATURE RISE (DB)	17.00
		DISCHARGE TEMPERATURE (DB)	72
٥	2	CFM	1000
CMIT	= {	GAS HEATING (MBH) INPUT/OUTPUT	60 / 48
j	Ē	TEMPERATURE RISE (DB)	45.00 91.60
(5	DISCHARGE TEMPERATURE (DB) STAGES OF HEATING / TOTAL TURNDOWN RATIO	91.60 MODULATING / 10:1
_	<u>A</u>		
TER	(A & OSA)	THICKNESS	2"
∄	(RA 8	EFFICIENCY	MERV 13
		DISCHARGE	00 04 04 70 70 70 70
MO Mo Mo Mo Mo Mo Mo Mo Mo Mo Mo Mo Mo Mo	S. H	OCTAVE BANDS 63, 125, 250, 500, 1000, 2000, 4000, 8000	83, 81, 84, 78, 72, 70, 66, 61
	LEVELS (HZ)	RETURN	00 70 75 00 00 04 00 54
SOL	<u>"</u>	OCTAVE BANDS 63, 125, 250, 500, 1000, 2000, 4000, 8000	80, 78, 75, 68, 66, 64, 60, 54
		DISCONNECT	INTEGRAL
ACCERGODIER	Ĭ	SMOKE DETECTOR SHUTDOWN	NOT REQUIRED
Ü	7661	POWERED RECEPTACLE	YES
	<u>.</u>	DEMAND CONTROL VENTILATION	NO
_	_	ECONOMIZER OPERATION	DIFF. ENTHALPY
		MINIMUM CIRCUIT AMPACITY	36
2		PANEL & CIRCUIT	MDP (NOTE 5)
) U	WIRE & CONDUIT	(3)#6,#10G.,3/4"C.
	200	VOLTAGE/PHASE	208/3
ELECTEDION CONNECTION	, Ar	OVERCURRENT DEVICE	50A-3P CB
TOIL	<u> </u>	DISCONNECT	INTEGRAL TO UNIT
) 	STARTER VFD	VFDs VFDs
L	-	CONTROL SEQUENCE	NOTE 2
FE	REN	CE DRAWING/DETAIL	ME-200, M-100, M-200
			1 , ,

NOTES:
1: PROVIDE SPRING ISOLATION CURB WITH A MINIMUM OF 2 INCH STATIC DEFLECTION. PROVIDE BASE CURB HEIG
AS REQUIRED FOR BASE CURB TO EXTEND MINIMUM 12" ABOVE FINAL ROOFING MEMBRANE. COORDINATE
REQUIRED HEIGHT OF BASE CURB WITH ROOFING INSULATION; REFER TO ARCHITECTURAL DRAWINGS.

^{2:} PROVIDE UNIT WITH FACTORY CONTROLLER. REFER TO SPECIFICATIONS.

FU	RNACESCHEDULE	
DESI	GNATION	F-1
	MANUFACTURER	BOSCH
	MODEL	BGH96M120D5A
		BMAC4860DNTF
AHU	CFM	1875
•	OUTSIDE AIR CFM	200
	EXTERNAL STATIC PRES. (IN. W.G.)	0.56
	MOTOR HORSEPOWER	1 HP
(P	ENT. AIR (DB/WB)	80/67
COOLING	TOTAL COOLING CAP (MBH)	55.5
	SENSIBLE COOLING CAP (MBH)	43.3
	STAGE OF COOLING	2
	HEATING INPUT (MBH)	110
HEATING	HEATING OUTPUT (MBH)	106
	HEATING TEMPERATURE RISE (DB)	57
	STAGES OF HEATING	2
	MINIMUM AFUE (%)	96
LTER	FILTER TYPE	MERV 13
<u>H</u>	SIZE	
	VOLTAGE/PHASE	120/1
≰	MCA	12
DATA	PANEL AND CIRCUIT	MDP (NOTE 5)
LEC.	WIRE AND CONDUIT	(2)#12,#12G.,1/2"C.
岀	OVERCURRENT DEVICE	20A-1P CB
	DISCONNECT	NOTE 2
REFE	RENCE DRAWING/DETAIL	M100
REM	ARKS	NOTE 1,3,4
HE	AT PUMP SCHEDULE	
DESI	GNATION	HP-2
	MANUFACTURER	BOSCH
⋖	MODEL NO.	BOVA-60HDN1-M18M
ATA	NOMINAL TONNAGE	5

REFERENCE DRAWING/DETAIL	M-100					
REMARKS	NOTE 4					
NOTES:						
PROVIDE CONDENSATE NEUTRALIZATION KIT. PROVIDE POLYPROPELENE INTAKE AND						
ELLIE PIPING WITH CONCENTRIC THRU THE ROOF TERMINATION. SIZE ROUTE AND SLOPE						

AS REQUIRED BY MANUFACTURER. INSULATE ALL INTAKE AND FLUE PIPING AS REQUIRED

2: PROVIDE MOTOR RATED TOGGLE SWITCH.

MINIMUM S.E.E.R. @ AHRI

NO COMPRESSORS / STAGES

AMBIENT AIR TEMP (°F)

VOLTAGE/PHASE

FANEL AND CIRCUIT

DISCONNECT

BY MANUFACTURER.

WIRE AND CONDUIT

OVERCURRENT DEVICE

3: PROVIDE WITH 7-DAY PROGRAMMABLE, TOUCH SCREEN THERMOSTAT.

4: PROVIDE AND INSTALL REFRIGERANT LINE SETS PER MANUFACTURER'S INSTRUCTIONS. 5: CIRCUIT TO EXISTING PANELS 'MDP', LOCATED IN BOLIER ROOM. RELOCATE THREE 20A-1P RECEPTACLE CIRCUITS TO NEW PANEL 'B' AS DETERMINED TO SERVE HP-2 AND F-1 OUT OF ONE OF THE THREE 'MDP' PANELS.

SERVICE	DUCT		OTHER REQUIREMENTS		
	SHAPE	CLASSIFICATION	SEAL CLASS	LEAKAGE CLASS	
SUPPLY AIR DUCTS CONNECTED TO DEDICATED OUTDOOR	RECTANGULAR	2" WG POSITIVE	В	12	
AIR HANDLING UNITS	ROUND	4" WG POSITIVE	В	3	
SUPPLY AIR DUCTS CONNECT TO FURANCES	(EXPOSED)	SPIRAL SEAM			
RETURN AIR AND TRANSFER AIR BOOT	RECTANGULAR	2" WG POSITIVE	В	12 - RECTANGULAR	1/2" , 3LB DENSITY LINER
TRANSER AIR DUCTWORK	OR ROUND			3 - ROUND	
RETURN AIR DUCTS CONNECTED TO FURANCES	RECTANGULAR	2" WG NEGATIVE	B - RECTANGULAR	12 - RECTANGULAR	
	OR ROUND		A - ROUND	3 - ROUND	
EXHAUST DUCTS CONNECTED TO DEDICATED OUTDOOR	RECTANGULAR	2" WG NEGATIVE	B - RECTANGULAR	12 - RECTANGULAR	
AIR HANDLING UNITS	OR ROUND		A - ROUND	3 - ROUND	
EXHAUST DUCTS TO THE INLET OF THE FAN	RECTANGULAR	2" WG NEGATIVE	B - RECTANGULAR	12 - RECTANGULAR	
	OR ROUND		A - ROUND	3 - ROUND	

1: SEE DUCTWORK INSULATION SCHEDULE FOR REQUIREMENTS ON DUCT INSULATION

DUCTWORK INSULATION SCHEDULE				
SERVICE	INSULATION			
CONCEALED DUCTWORK AS FOLLOWS:				
SUPPLY AIR (ROUND AND SQUARE)	1-1/2", 1 LB. RIGID FIBERGLASS BLANKET, BAPPOR BARRIER FACED,			
EXHAUST AIR (ROUND AND SQUARE)	WITH HEAVY DUTY FOIL-SCRIM-KRAFT FACING.			
SUPPLY AIR AND EXHAUST AIR TO DEDICATED OUTDOOR AIR				
HANDLING UNITS (NOTE 2)				

1: SEE DUCTWORK SCHEDULE FOR ITEMS THAT ARE TO BE LINED.

2: THE RECTANGULAR SUPPLY AND EXHAUST AIR DUCT EXPOSED IN THE LOCKER ROOM FROM THE DEDICATED OUTDOOR AIR UNIT TO ABOVE THE WOMEN'S LATRENE

PLAN MARK	MANUFACTURER MODEL NUMBER	SERVICE	MOUNT TYPE	VOLUME DAMPER	MATERIAL	COLOR	REMARKS
SD-1	TITUS OMNI-AA-24x24	SUPPLY	LAY-IN	NO	ALUMINUM	WHITE	-
SD-2	TITUS OMNI-24x24	SUPPLY	LAY-IN	NO	STEEL	WHITE	-
SD-3	TITUS OMNI-12x12	SUPPLY	LAY-IN	NO	STEEL	WHITE	-
SD-4	TITUS TDCA-AA-24x24	SUPPLY	SURFACE	NO	ALUMINUM	WHITE	-
RG-1	TITUS 355RL-24x24	RETURN	LAY-IN	NO	STEEL	WHITE	-
RG-2	TITUS 355RL-12x12	RETURN	LAY-IN	NO	STEEL	WHITE	-
EG-1	TITUS 355FL-24x24	EXHAUST	LAY-IN	NO	ALUMINUM	WHITE	-
EG-2	TITUS 355RL-12x12	EXHAUST	LAY-IN	NO	STEEL	WHITE	-
TG-1	TITUS 355FL-24x12	TRANSFER	LAY-IN	NO	ALUMINUM	WHITE	-

NOTES:

95

1 / VARIABLE

208/1

MDP (NOTE 5)

(2)#6,#10G.,3/4"C.

50A-2P CB

60A/2P/240V/NF/3R

1: PROVIDE FULL SIZE STEEL RETURN PLENUM ON TOP OF GRILLE FOR DIRECT DUCT CONNECTION TO SIDE.

CHEDULE MITSUBISHI AHU-1 PKA-A12LA		
AHU-1		
PKA-A12LA		
WALL MOUNT		
455		
R410A		
12,000		
21		
13,000		
208/1		
NOTE 1		
(3)#12,#12G.,1/2"C.		
NOTE 1		
NOTE 1		
HP-1		
PUY-A12NKA7		
95		
14		
208/1		
NOTE 4		
(2)#12,#12G.,1/2"C.		
20A-2P CB		
30A/2P/240V/NF/3R		
M-100		
NOTE 2, 3		


1: INDOOR UNIT CIRCUITED THROUGH OUTDOOR UNIT.

2: FOR OUTDOOR UNIT, PROVIDE WALL MOUNT SUPPORT KIT. MOUNT UNIT TO WALL MOUNT WITH NEOPRENE ISOLATION PADS WITH A MINIMUM OF 0.25 INCH STATIC DEFLECTION. PROVIDE LOW AMBIENT WIND BAFFLE.


3: PROVIDE AND INSTALL REFRIGERANT LINE SETS PER MANUFACTURER'S INSTRUCTIONS.

4: UTILIZE EXISTING DEMO'ED PTAC UNIT CIRCUIT TO SERVE NEW OUTDOOR UNT. FIELD VERIFY EXISTING CONDITIONS AND WIRE SIZE. PROVIDE WITH OCPD AS INDICATED IN SCHEDULE IF EXISTING DIFFERENT.


THE MANUFACTURERS LISTED SHALL BE THE BASIS OF DESIGN. REFER TO THE PROJECT SPECIFICATION FOR ACCEPTABLE ALTERNATIVE MANUFACTURERS.

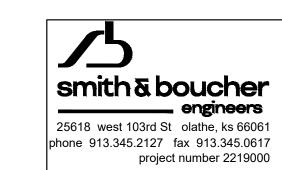

STATE OF MISSOURI MICHAEL L. PARSON, **GOVERNOR**

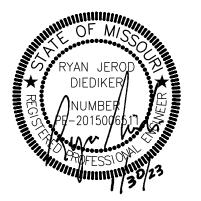

PROFESSIONAL SEAL

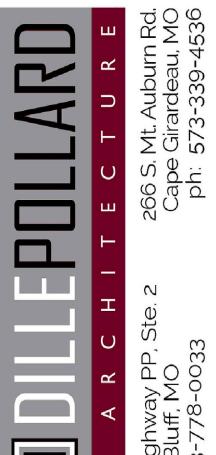

OFFICE OF ADMINISTRATION DIVISION OF FACILITIES MANAGEMENT, **DESIGN AND CONSTRUCTION**

MISSOURI ARMY NATIONAL GUARD FACILITIES DIVISION

RE-BID RENOVATE INTERIOR AND EXTERIOR

KENNETT READINESS CENTER 1450 NORTH BY-PASS KENNETT, MO 63857

PROJECT # T2209-01

FACILITY # 8136313002

REVISION:	
DATE:	_
REVISION:	_
DATE:	_
REVISION:	_
DATE:	
ICCLIE DATE. I 20 202	_

ISSUE DATE: January 30, 2023

CAD DWG FILE: ME-300.DWG
DRAWN BY: JEB
CHECKED BY: RJD DESIGNED BY: JEB

SHEET TITLE:

SCHEDULES -MECHANICAL AND ELECTRICAL

SHEET NUMBER:

ME-300

^{3:} PROVIDE THROUGH THE BASE CONNECTIONS FOR ELECTRICAL AND GAS. 4: PROVIDE ALL OTHER ACCESSORIES AS SCHEDULED AND SPECIFIED.

^{5:} CIRCUIT TO EXISTING PANELS 'MDP', LOCATED IN BOLIER ROOM. RELOCATE THREE 20A-1P RECEPTACLE CIRCUITS TO NEW PANEL 'B' AS DETERMINED TO SERVE DOAS-1 OUT OF ONE OF THE THREE 'MDP' PANELS.

PROJECI NAME: AUTOCAD FILE LOCATION \ NAME:	
LASI CORRECTION BI + DAIE + TIME:	

PLUM	PLUMBING FIXTURE SCHEDULE									
			FITTINGS			PIP	ING CO	NNECTIC	CTIONS	
MARK	MFGR./MODEL	DESCRIPTION	MANUFACTURER/MODEL	DESCRIPTION	NOTE	cw	HW	SAN	VENT	
WC1	AMERICAN STANDARD	WATER CLOSET: WHITE VITREOUS CHINA, ELONGATED BOWL, WALL MOUNTED	SLOAN	SENSOR ACTIVATED, EXPOSED WATER CLOSET SINGLE FLUSH VALVE,	5	1-1/4"		4"	2"	
	AFWALL	FLUSH VALVE BOWL WITH TOP SPUD AND FLAT BOLT COVERS, 1.28 GALLON	ECOS	1.28 GPF, CHROME PLATED, FLUSH OVERRIDE BUTTON, BATTERY POWERED, VACUUM						
	2257.101	SIPHON JET FLUSHING ACTION.	8111-1.28	BREAKER FLUSH CONNECTION AND SPUD COUPLING FOR 1 1/2" TOP SPUD.						
	WADE	PROVIDE CARRIER AS REQUIRED TO SUIT APPLICATION FOR MOUNTING IN CHASE.		PROVIDE WALL AND SPUD FLANGES.						
	CHURCH	SEAT: SOLID PLASTIC, OPEN FRONT, WHITE, ELONGATED BOWL, INTEGRATED								
	9500C	BUMPERS, EXTERNAL CHECK HINGES WITH STAINLESS STEEL POSTS.								
WC2	AMERICAN STANDARD	ADA COMPLIANT WATER CLOSET: WHITE VITREOUS CHINA, ELONGATED BOWL,	SLOAN	SENSOR ACTIVATED, EXPOSED WATER CLOSET SINGLE FLUSH VALVE,	5	1-1/4"		4"	2"	
	AFWALL	WALL MOUNTED FLUSH VALVE BOWL WITH TOP SPUD AND FLAT BOLT COVERS,	ECOS	1.28 GPF, CHROME PLATED, FLUSH OVERRIDE BUTTON, BATTERY POWERED, VACUUM						
	2257.101	1.28 GALLON SIPHON JET FLUSHING ACTION.	8111-1.28	BREAKER FLUSH CONNECTION AND SPUD COUPLING FOR 1 1/2" TOP SPUD.						
	WADE	PROVIDE CARRIER AS REQUIRED TO SUIT APPLICATION FOR MOUNTING IN CHASE.		PROVIDE WALL AND SPUD FLANGES.						
	CHURCH	SEAT: SOLID PLASTIC, OPEN FRONT, WHITE, ELONGATED BOWL, INTEGRATED								
	9500C	BUMPERS, EXTERNAL CHECK HINGES WITH STAINLESS STEEL POSTS.								
WC3	AMERICAN STANDARD	ADA COMPLIANT WATER CLOSET: WHITE VITREOUS CHINA, ELONGATED BOWL,	SLOAN	SENSOR ACTIVATED, EXPOSED WATER CLOSET SINGLE FLUSH VALVE,	5	1-1/4"		4"	2"	
	MADERA	FLOOR MOUNTED FLUSH VALVE BOWL WITH TOP SPUD AND FLAT BOLT COVERS,	ECOS	1.28 GPF, CHROME PLATED, FLUSH OVERRIDE BUTTON, BATTERY POWERED, VACUUM						
	3461.001	1.28 GALLON SIPHON JET FLUSHING ACTION.	8111-1.28	BREAKER FLUSH CONNECTION AND SPUD COUPLING FOR 1 1/2" TOP SPUD.						
	CHURCH	SEAT: SOLID PLASTIC, OPEN FRONT, WHITE, ELONGATED BOWL, INTEGRATED		PROVIDE WALL AND SPUD FLANGES.						
	9500C	BUMPERS, EXTERNAL CHECK HINGES WITH STAINLESS STEEL POSTS.								
U1	AMERICAN STANDARD	ADA COMPLIANT WHITE VIRTEOUS CHINA WALL HUNG URINAL, 3/4" TOP SPUD.	SLOAN	SENSOR ACTIVATED, EXPOSED URINAL FLUSH VALVE, 0.125 GPF, CHROME PLATED,	5	3/4"		2"	1-1/2"	
	TRIMBROOK	0.5 GALLON SIPHON JET FLUSHING ACTION. MOUNT TOP OF RIM PER	ECOS	FLUSH OVERRIDE BUTTON, BATTERY POWERED, VACUUM BREAKER FLUSH						
	6561.017	ARCHITECTURAL PLANS.	8186-0.125	CONNECTION AND SPUD COUPLING FOR 3/4" TOP SPUD.						
	WADE	PROVIDE CARRIER AS REQUIRED TO SUIT APPLICATION FOR MOUNTING IN CHASE.		PROVIDE SPUD FLANGES.						
L1	AMERICAN STANDARD	ADA COMPLIANT LAVATORY: WALL-HUNG, WHITE VITREOUS CHINA, FRONT	AMERICAN STANDARD	ADA COMPLIANT FAUCET: VANDAL RESISTANT LEVER HANDLES, 2-HOLE, 4" CENTERS,	2,3,4	1/2"	1/2"	2"	1-1/2"	
	LUCERNE	OVERFLOW, 4 CENTER HOLES, GRID STAINER, TAILPIECE.	MONTERREY	0.5 GPM, CHROME FINISH.						
	0355.012		5502.145							
	WADE	PROVIDE CARRIER AS REQUIRED TO SUIT APPLICATION FOR MOUNTING.	LEONARD	THERMOSTATIC MIXING VALVE						
DF1	ELKAY	ADA COMPLIANT WATER FOUNTAIN: BI-LEVEL, LEFT HAND HIGH, LEFT SIDE BOTTLE			3	1/2"		1-1/2"	1-1/4"	
	LZSTL8WS	FILLING STATION, FILTERED, 8 GPH, STAINLESS STEEL, CANE APRON.								
HB1	WOODFORD	ANTI-SIPHON WALL FAUCET WITH FLUSH MOUNT ANODIZED ALUMINUM BOX		-		1/2"				
	B24-AL	WITH DOOR ASSEMBLY, VACUUM BREAKER, LOOSE TEE KEY.								
NH1	WOODFORD	FREEZE-PROOF WALL HYDRANT, AUTOMATIC DRAINING, HOSE-CONNECTION		-		3/4"				
	65P-12	ANTI SIPHON VACUUM BREAKER, LOOSE KEY HANDLE.								
SH1	SYMMONS	SURFACE MOUNTED SHOWER SYSTEM, THROUGH WALL PIPING CONFIGURATION,			1	1/2"	1/2"			
	H901S-15	SOAP DISH, PRESSURE BALANCING MIXING VALVE WITH SERVICE STOPS, MANUAL								
		SHUT-OFF AND LEVER HANDLE, SHOWER HEAD, 1.5 GPM FLOW RESTICTOR,								
		STAINLESS STEEL COVERING WITH SLOPED TOP.								
SH2	SYMMONS	ADA COMPLIANT SURFACE MOUNTED SHOWER SYSTEM, THROUGH WALL PIPING			1	1/2"	1/2"			
	H902S-15	CONFIGURATION, SOAP DISH, PRESSURE BALANCING MIXING VALVE WITH SERVICE								
		STOPS, MANUAL SHUT-OFF AND LEVER HANDLE, DIVERTER, SHOWER HEAD, 1.5								
		GPM FLOW RESTRICTOR, SLIDE BAR/CRADEL WITH HAND SHOWER AND 60" HOSE,								
		STAINLESS STEEL COVERING WITH SLOPED TOP.								

1: REFER TO ARCHITECTURAL PLANS FOR MOUNTING HEIGHT.

2: PROVIDE CHROME PLATED BRASS TAILPIECE AND GRID DRAIN. 3: PROVIDE LOOSE KEY STOPS AND FLEXIBLE RISERS.

4: INSULATE EXPOSED TAILPIECE, P-TRAP, AND WATER RISERS.

5: PROVIDE CAULK AROUND FIXTURE CONNECTION TO FLOOR/WALL. COLOR BY ARCHITECT.

PIPE INSULATION SCHEDULE - PLUMBING				
SERVICE PIPE SIZE INSULATION				
DOMESTIC COLD WATER	1/2" - 2"	1/2" FIBERGLASS, ASJ		
EXPOSED FIXTURE WASTETRAPS AND DOMESTIC HOT WATER		TRUBRO LAV AGUARD MOLDED PROTECTIVE PIPE COVER OVI		
AT HANDICAPPED ACCESSIBLE SINKS AND LAVATORIES ALL 1/2		1/2" FIBERGLASS INSULATION		
DOMESTIC HOT WATER	A1.1	4" FIREBOLASS AS I		
RECIRCULATING HOT WATER	ALL	1" FIBERGLASS, ASJ		

1: FOR ALL EXPOSED PIPING, PROVIDE PAINTABLE PVC JACKET ON PIPING AND FITTINGS (INCLUDES MECHANICAL SPACES).

DRAIN SCHEDULE			
MARK	MANUFACTURER/ MODEL	DESCRIPTION	
FD1	WADE W-1100-5	CAST IRON DRAIN WITH ADJUSTABLE TOP AND 5" NICKEL BRASS STRAINER WITH VANDAL RESISTANT SCREWS. SEE PLAN FOR OUTLET SIZE.	
FD2	WADE W-1100-6-TSD	CAST IRON DRAIN WITH ADJUSTABLE TOP AND 6" NICKEL BRASS STRAINER WITH VANDAL RESISTANT SCREWS. SEE PLAN FOR OUTLET SIZE. PROVIDE WITH PROSET TRAP GUARD BY PROVENT SYSTEMS INC.	

THERMOSTATIC MIXING VALVE				
DESIGNATION	TMV-1			
MANUFACTURER	LEONARD			
MODEL	TM-520B-LF-DT			
SERVICE	MEN/WOMEN LATRINE			
MIN GPM	1			
PEAK DEMAND GPM	24.6			
SYSTEM MAX PRESSURE DROP	10			
OUTLET TEMP. (°F)	105			
REFERENCE DRAWING/DETAIL	ME-302, P-100			
REMARKS	-			

DOMESTIC HOT WATER PUMP SCHEDULE			
DESI	GNATION	HWP-1	
ASSC	CIATED WATER HEATER	DWH-1	
LOCA	TION	MECH EQUIP 112	
	MANUFACTURER	BELL & GOSSETT	
∢	MODEL NO.	NBF-25	
UNIT DATA	PUMP TYPE	INLINE	
Ę	GРM	2	
D	PUMP HEAD (FT.)	12	
	MOTOR HORSEPOWER	125 WATTS	
ΤA	PANEL & CIRCUIT	B-11 (PART)	
PA .	WIRE & CONDUIT	(2)#12,#12G.,1/2"C.	
ROL	VOLTAGE/PHASE	120/1	
ON	OVERCURRENT DEVICE	20A-1P CB	
AL/C	DISCONNECT	NOTE 2	
ELECTRICAL/CONTROL DATA	STARTER	NO	
ECT	COMBINATION STARTER	NO	
ᆸ	CONTROL	AQUASTAT, NOTE 2	
REFERENCE DRAWING/DETAIL		ME-302,P-100	
REMARKS			

1: CIRCUIT WITH DOMESTIC WATER HEATER 'DWH-1'.

2: PROVIDE MOTOR RATED TOGGLE SWITCH AT 60" AFF ON WALL ADJACENT TO PUMP FOR DISCONNECT MEANS AND OWNER MANUAL ON/OFF USE DURING PERIODS OF DEPLOYMENT. LABEL SWITCH PLATE WITH "HWP-1".


DES	SIGNATION	DWH-1
	MANUFACTURER	A.O. SMITH
	LOCATION	MECH EQUIP 11
⋖	MODEL	BTH-250
DATA	CAPACITY (GALLONS)	250
TINO	RECOVERY @ 100°F RISE (GPH)	175
n	OUTLET TEMP. (°F)	140
	INPUT (BTUH)	150,000
	VOLTAGE/MCA	120V / 5AMPS
ROL	PANEL & CIRCUIT	B-2 (PART)
ELEC./CONTROL	WIRE & CONDUIT	(2)#12,#12G.,1/2"(
EC./C	OVERCURRENT DEVICE	20A-1P CB
ᆸ	DISCONNECT	NOTE 2
REF	ERENCE DRAWING/DETAIL	ME-302, P-100
REN	IARKS	NOTE 3,4

2: PROVIDE MOTOR RATED TOGGLE SWITCH ADJACENT TO WATER HEATER FOR DISCONNECT MEANS.

3: FURNISH WITH CONDENSATE NEUTRALIZARION KIT.

4: PROVIDE VENT EXHAUST PIPING PER MANUFACTURER'S REQUIREMENTS.

THE MANUFACTURERS LISTED SHALL BE THE BASIS OF DESIGN. REFER TO THE PROJECT SPECIFICATION FOR ACCEPTABLE ALTERNATIVE MANUFACTURERS.

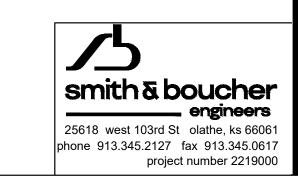

STATE OF MISSOURI MICHAEL L. PARSON, **GOVERNOR**





OFFICE OF ADMINISTRATION DIVISION OF FACILITIES MANAGEMENT, DESIGN AND CONSTRUCTION

MISSOURI ARMY NATIONAL GUARD FACILITIES DIVISION

RE-BID RENOVATE INTERIOR AND EXTERIOR

KENNETT READINESS CENTER 1450 NORTH BY-PASS KENNETT, MO 63857

PROJECT # T2209-01

FACILITY # 8136313002

PELMATON
REVISION:
DATE:
REVISION:
DATE:
REVISION:
DATE:
ISSUE DATE: January 30, 2023


CAD DWG FILE: ME-301.DWG
DRAWN BY: JEB
CHECKED BY: RJD
DESIGNED BY: JEB

SHEET TITLE:

SCHEDULES -MECHANICAL AND **ELECTRICAL**

SHEET NUMBER:

ME-301

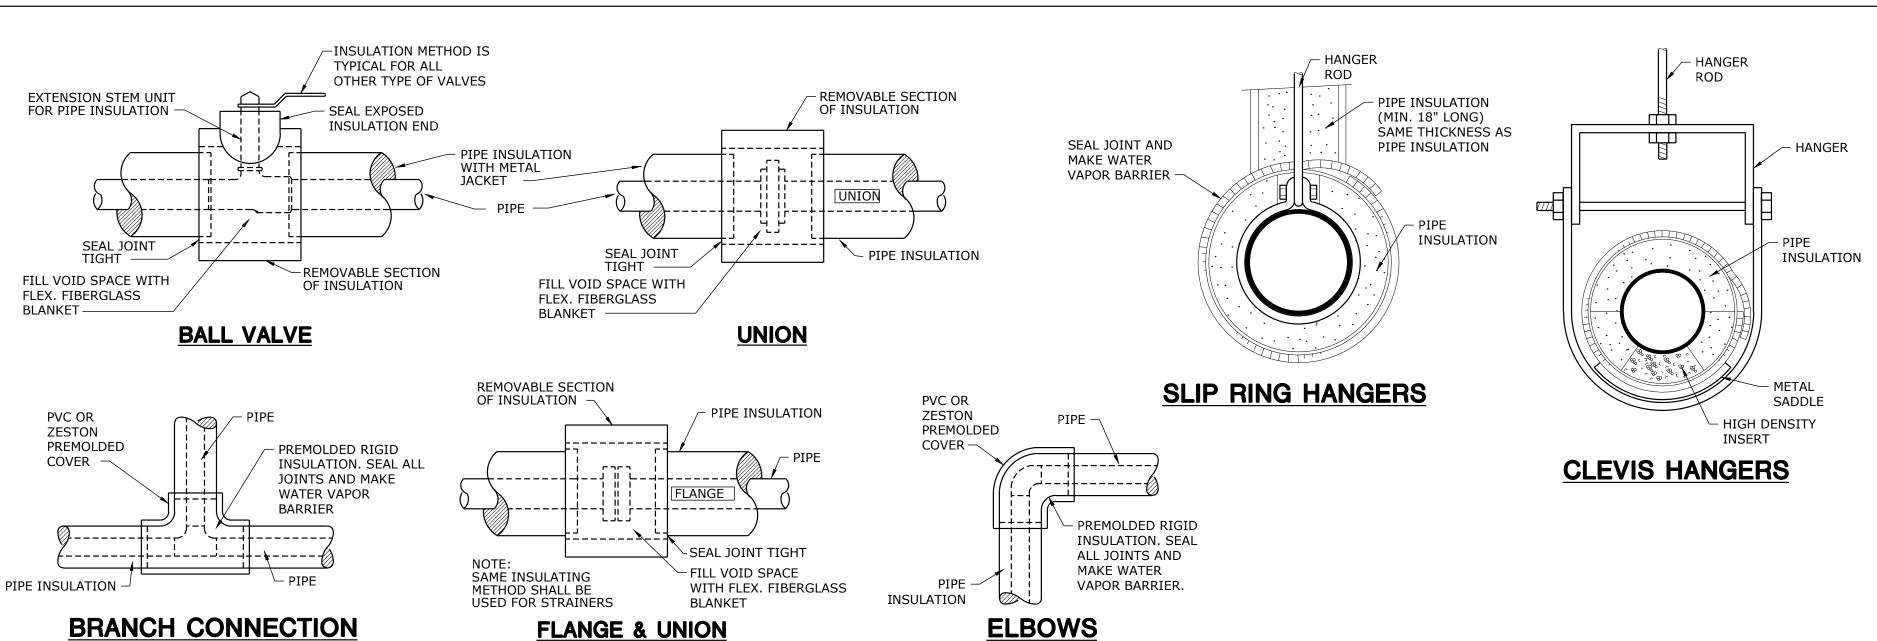

ROOF PENETRATION DETAIL NOT TO SCALE

PIPE INSULATION DETAILS NOT TO SCALE


SLOPE TO

HVAC DRAIN PAN

⊢2" MIN. SIZE,

EQUIP. DRAIN

SLOPE TO

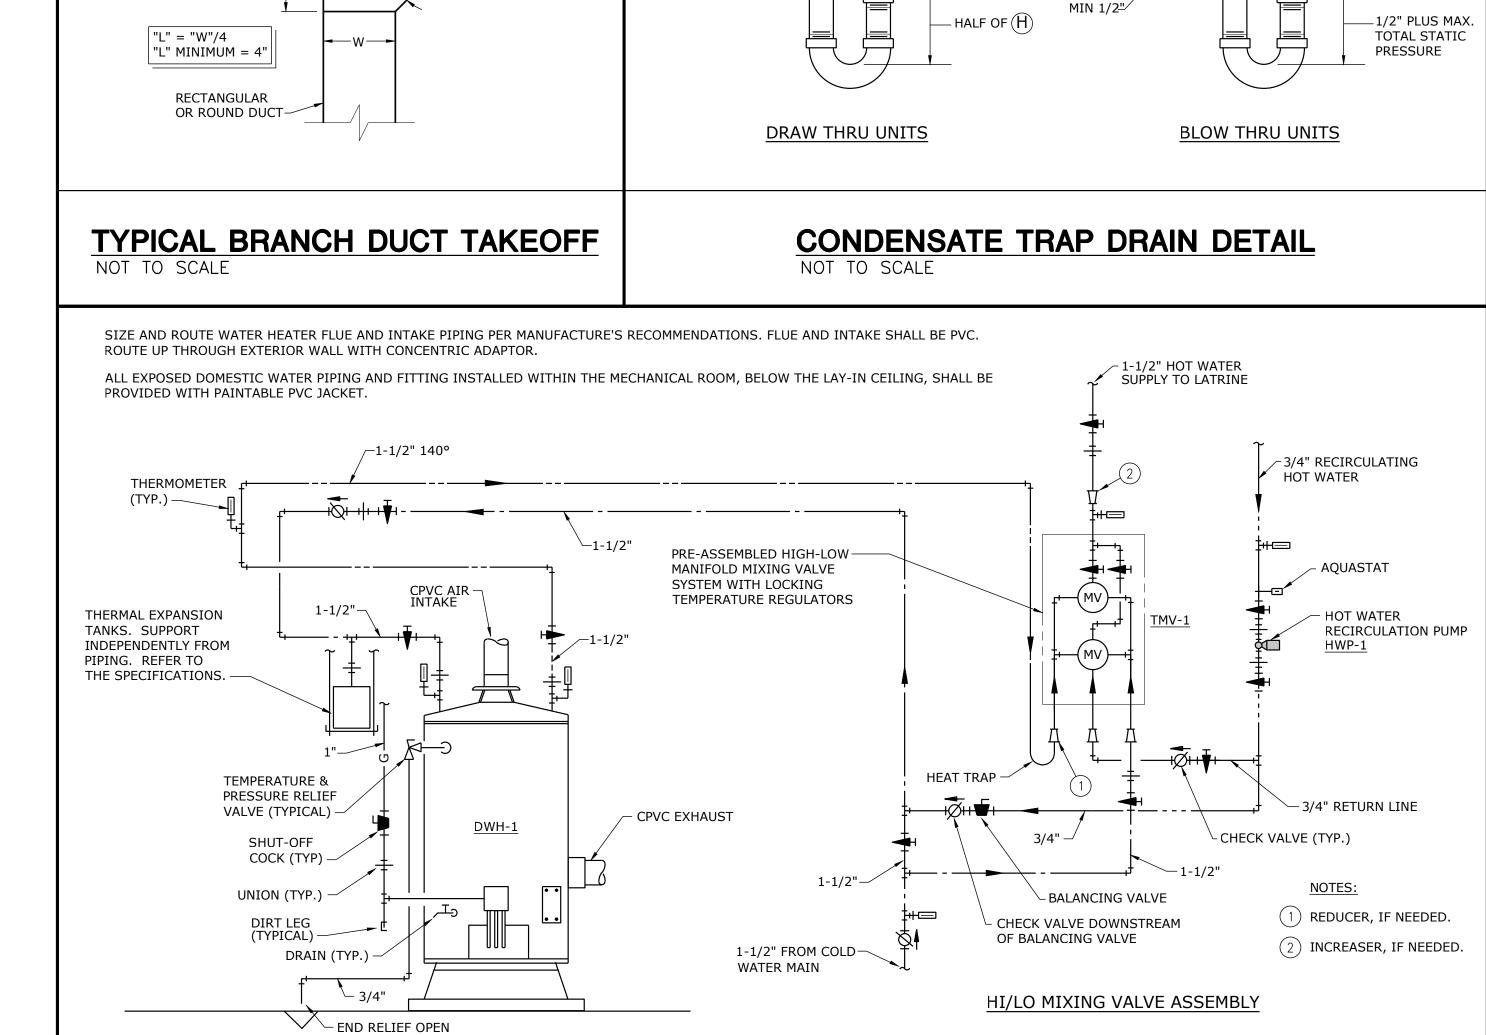

HVAC DRAIN PAN

1" FOR EACH 1"

OF MAXIMUM

PRESSURE -


NEGATIVE

STATIC


MAIN AIR DUCT

OVER FLOOR DRAIN



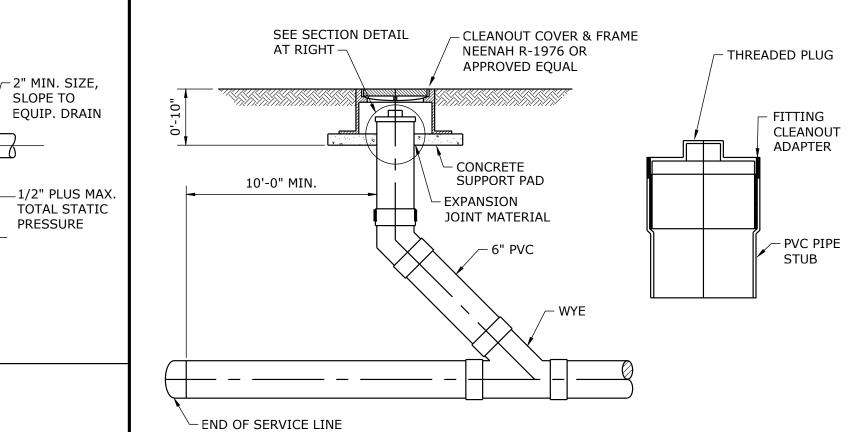


FLOOR CLEANOUT DETAIL (FCO)

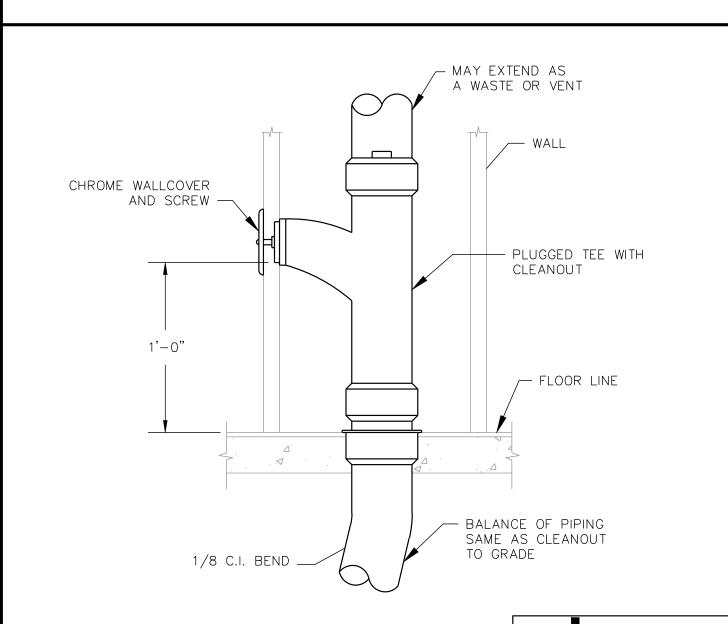


WALL CLEANOUT DETAIL (WCO) NOT TO SCALE

smith & boucher 25618 west 103rd St olathe, ks 66061 phone 913.345.2127 fax 913.345.0617 project number 2219000

STATE OF MISSOURI MICHAEL L. PARSON, **GOVERNOR**

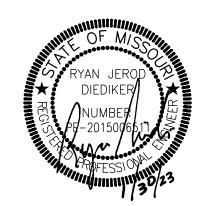

PROFESSIONAL SEAL

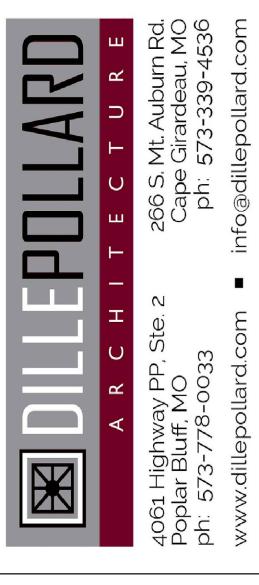

OFFICE OF ADMINISTRATION DIVISION OF FACILITIES MANAGEMENT, **DESIGN AND CONSTRUCTION**


MISSOURI ARMY NATIONAL GUARD **FACILITIES DIVISION**

RE-BID RENOVATE INTERIOR AND EXTERIOR

KENNETT READINESS CENTER 1450 NORTH BY-PASS KENNETT, MO 63857

PROJECT # T2209-01

FACILITY # 8136313002

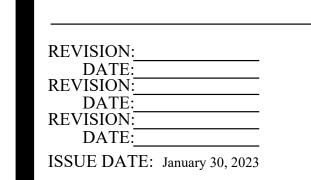

CAD DWG FILE: ME-302.DWG DRAWN BY: CHECKED BY: RJD DESIGNED BY: JEB

SHEET TITLE:

DETAILS -MECHANICAL AND **ELECTRICAL**

SHEET NUMBER:

ME-302


PROJECT NAME: AUTOCAD FILE LOCATION \ NAME: LAST CORRECTION BY ♦ DATE ♦ TIME: PLOTTED BY ♦ DATE ♦ TIME:

smith & boucher

25618 west 103rd St olathe, ks 66061

project number 2219000

phone 913.345.2127 fax 913.345.0617

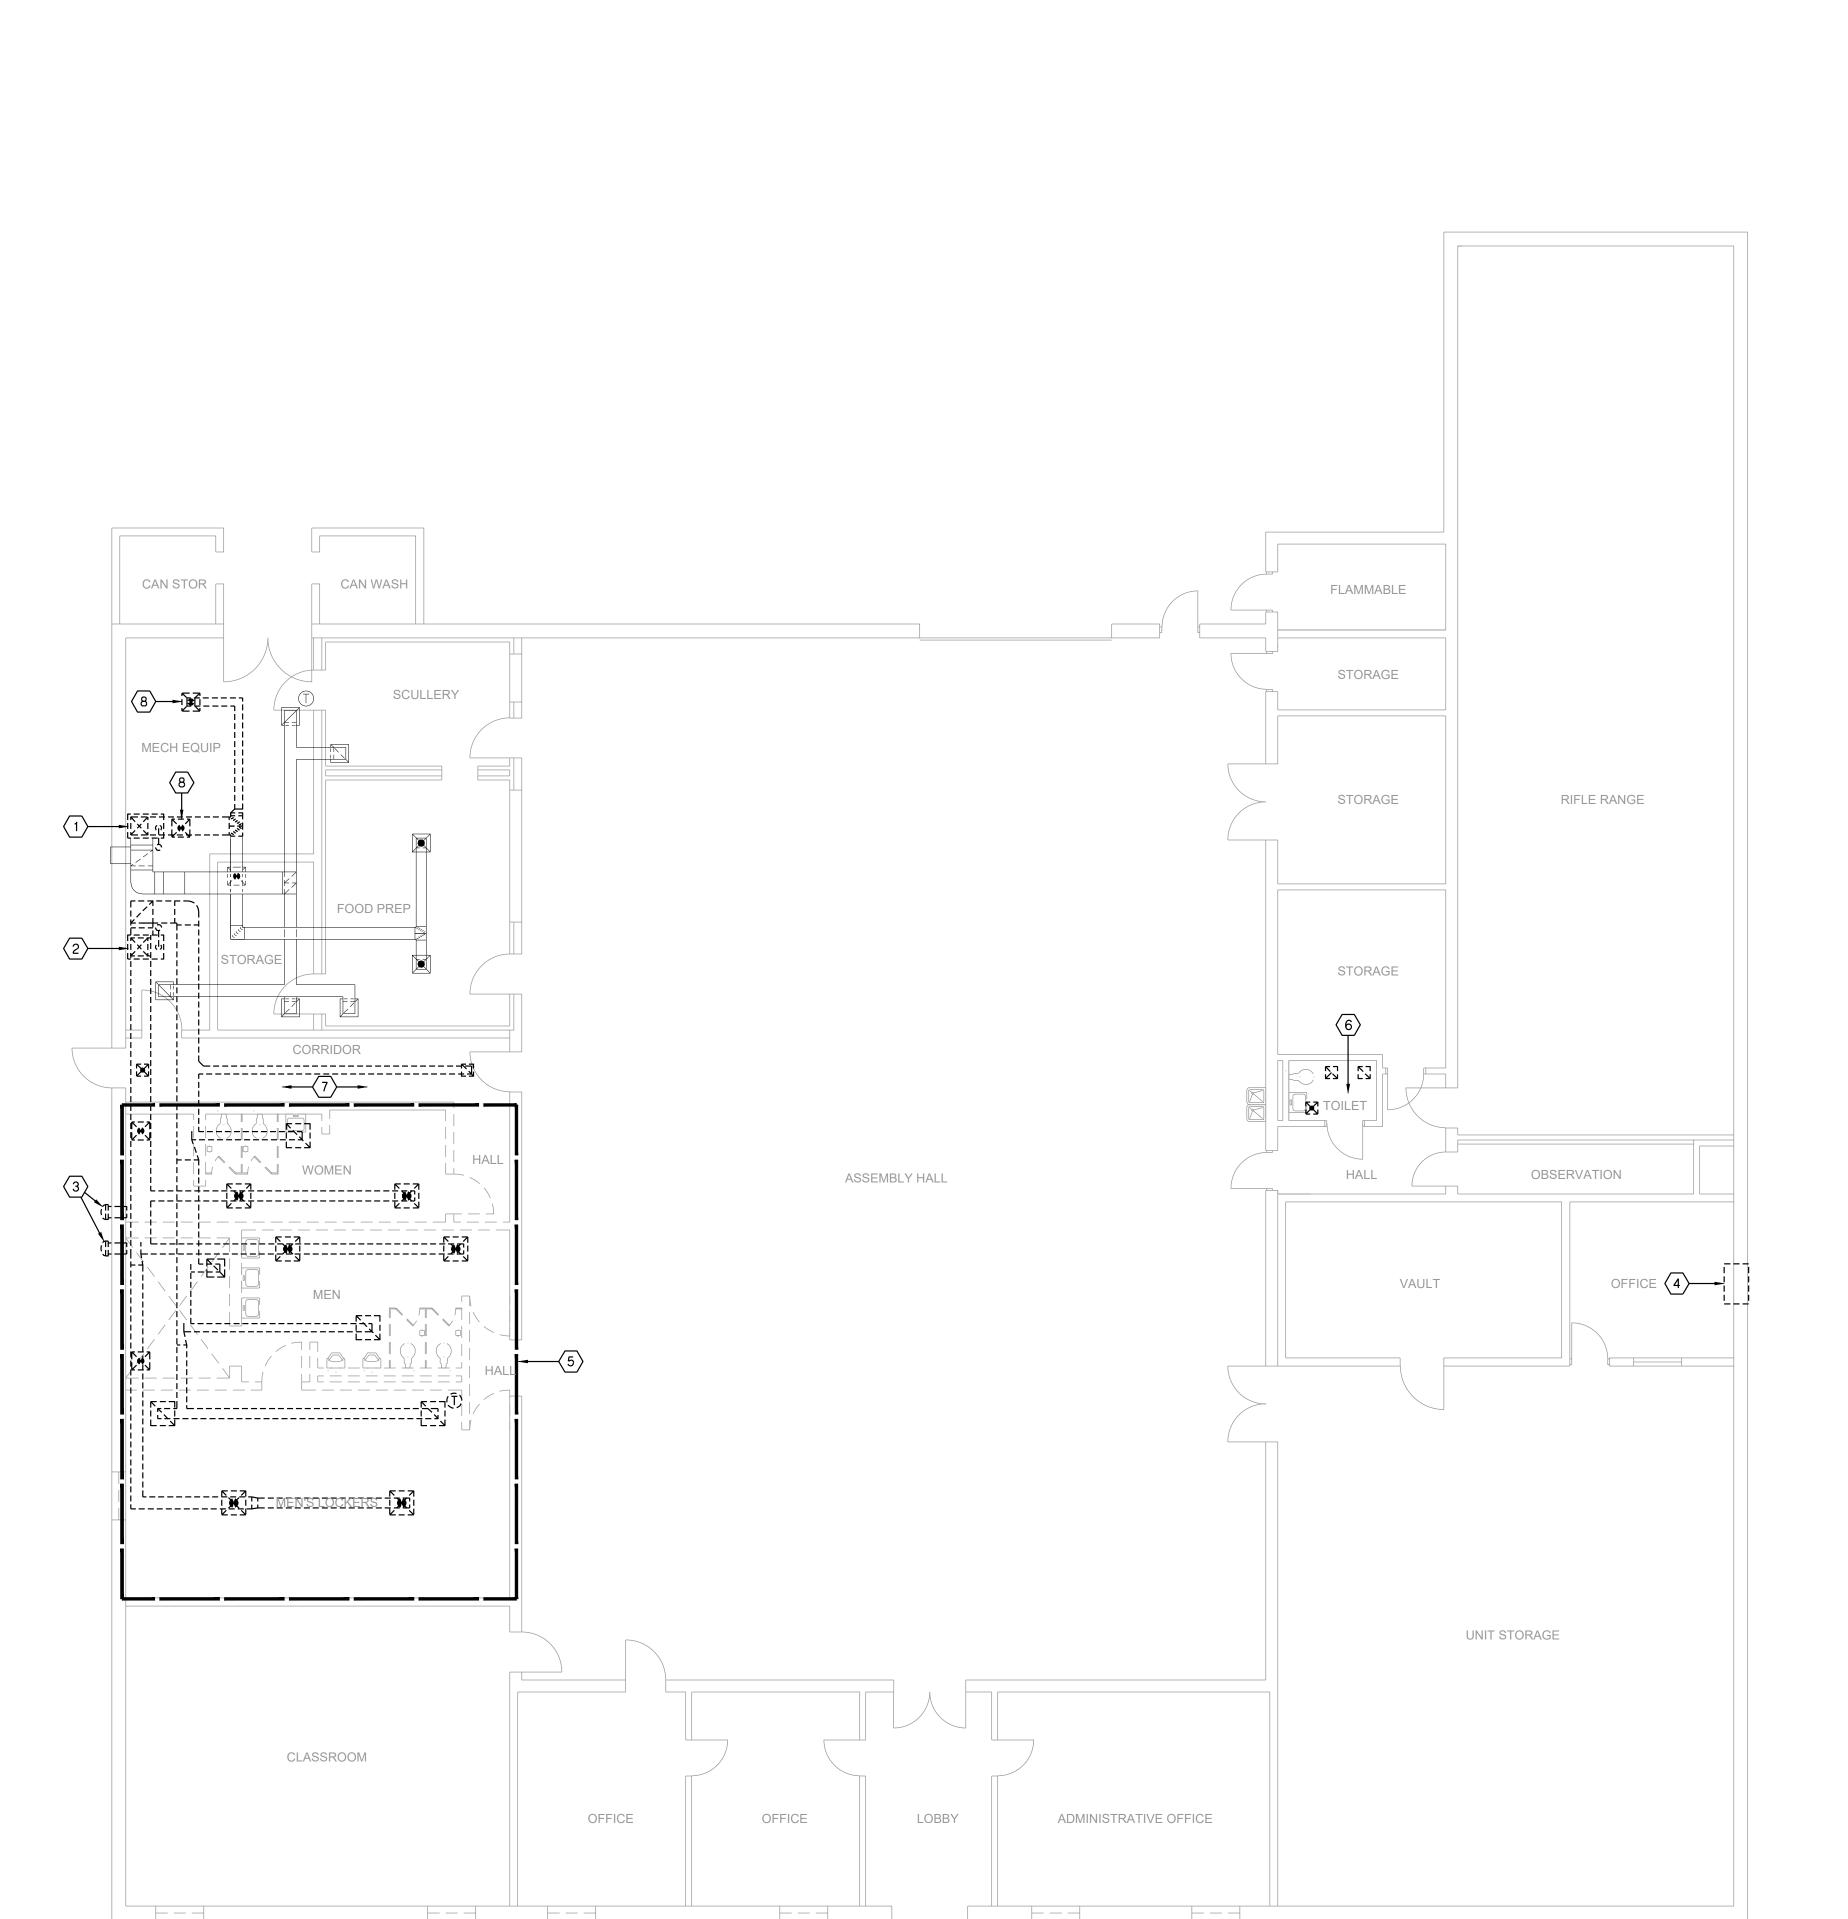

GENERAL DEMOLITION NOTES:

- UNLESS OTHERWISE NOTED, SERVICES AND EQUIPMENT SHOWN WITH BOLD DASHED LINES ARE TO BE DEMOLISHED. SERVICES AND EQUIPMENT SHOWN WITH SOLID HALF TONE LINE WEIGHT ARE TO REMAIN IN PLACE.
- 2. THE EXISTING CONDITIONS INDICATED ON THE DRAWINGS ARE TAKEN FROM THE BEST INFORMATION AVAILABLE AND FROM VISUAL SITE INSPECTION AND ARE NOT TO BE CONSIDERED "AS BUILT" CONDITIONS. THE INFORMATION SHOWN IS TO ESTABLISH THE EXTENT OF THE SCOPE OF WORK. VERIFY ALL ACTUAL EXISTING CONDITIONS AT THE PROJECT SITE AND PERFORM WORK AS REQUIRED TO MEET THE EXISTING CONDITIONS AND THE EXTENT OF THE WORK INDICATED.
- 3. PATCH AND REPAIR ANY INFRASTRUCTURE THAT IS TO REMAIN WHERE ANY SERVICES ARE REMOVED UNLESS NOTED OTHERWISE. DISCONNECT AND REMOVE ALL WIRING, CABLING, RACEWAY AND CONDUIT THAT BECOMES UNNECESSARY AS A RESULT OF THE REMOVAL OF EQUIPMENT INDICATED TO BE REMOVED.
- 4. WHERE MECHANICAL AND ELECTRICAL FIXTURES OR EQUIPMENT ARE REMOVED, CAP ALL UNUSED CONDUIT, WIRING AND PIPING BEHIND THE FLOOR LINE OR WALL LINE TO FACILITATE THE RESTORATION OF FINISH.
- 5. PROVIDE FOR THE CONTINUITY OF ALL REMAINING SERVICES, SYSTEMS, AND CIRCUITS. RELOCATE AND RECONNECT ANY MECHANICAL AND ELECTRICAL FACILITIES THAT MUST BE RELOCATED IN ORDER TO ACCOMPLISH THE REMODELING SHOWN IN THE DRAWINGS OR INDICATED IN THE SPECIFICATIONS.

DEMOLITION PLAN NOTES:

- DEMO FURNACE, INDICATED DUCT, GAS CONNECTION TO UNIT, AND FLUE AS SHOWN. SALVAGE FLUE PENETRATION FOR REUSE FOR NEW FURNACE VENT. SALAVAGE GAS FOR NEW GAS CONNECTION.
- DEMO FURNACE, ASSOCIATED DUCT DIFFUSERS, GAS PIPING CONNECTION, FLUE, AND THERMOSTAT AS SHOWN.

 SALAVAGE FLUE PENETRATION FOR REUSE FOR NEW WATER HEATER VENT.
- DEMO SIDE WALL EXHAUST FAN, ASSOCIATED DUCT AND EXHAUST GRILLE. COORDINATE EXTERIOR WALL PATCHING WITH GENERAL CONTRACTOR.
 DEMO THRU THE WALL HEATING/COOLING UNIT.

COORDINATE EXTERIOR WALL PATCHING WITH GENERAL

- CONTRACTOR.

 5 PROVIDE COMPLETE DEMOLITION OF ALL HVAC DUCT, SUPPLY AIR DIFFUSERS, AND RETURN AIR GRILLES IN
- LOCKER ROOM AND SHOWER/RESTROOM.

 6 DEMO SUPPLY AIR DIFFUSERS, RETURN AIR AND EXHAUST AIR GRILLES WITHIN ROOM, TO ACCOMMODATE NEW LAY-IN CEILING, SALVAGING EXISTING BRANCH DUCTS FOR RECONNECTION TO. REFER TO NEW WORK PLANS.
- DEMO SUPPLY AIR DIFFUSER AND RETURN AIR GRILLES, ASSOCIATED DUCT WITHIN CORRIDOR TO ACCOMMODATE NEW WORK IN LATRINES. REFER TO NEW WORK PLANS.
- DEMO AND SALVAGE SUPPLY AIR DIFFUSER ASSOCIATED WITH SUPPLY AIR DUCT SHOWN FOR DEMOLITION.
 REINSTALL DIFFUSER IN APPROXIMATE SAME LOCATION WITH NEW DUCT PER NEW WORK PLANS.

STATE OF MISSOURI MICHAEL L. PARSON, GOVERNOR



PROFESSIONAL SEAL



OFFICE OF ADMINISTRATION DIVISION OF FACILITIES MANAGEMENT, DESIGN AND CONSTRUCTION

MISSOURI ARMY NATIONAL GUARD FACILITIES DIVISION

RE-BID RENOVATE INTERIOR AND EXTERIOR

KENNETT READINESS CENTER 1450 NORTH BY-PASS KENNETT, MO 63857

PROJECT # T2209-01

FACILITY # 8136313002

REVISION:
DATE:
REVISION:
DATE:
REVISION:
DATE:
ISSUE DATE: January 30, 2023

CAD DWG FILE: DM-100.DWG
DRAWN BY: JEB
CHECKED BY: RJD
DESIGNED BY: JEB

SHEET TITLE:

DEMOLITION HVAC -FLOOR PLAN

SHEET NUMBER:

DM-100

20 OF 29 SHEETS

DEMOLITION FLOOR PLAN - HVAC

SCALE: 1/8" = 1'-0"

MEN'S LATRINE/SHOWER/LOCKERS

20x12

12x12

PACE - Kennett Readiness Center
X:\22\22\22190\2219000\Drawings\04-2219000_M-100.dwg
Jblackburn
Friday, January 27, 2023 10:33:12 AM
Booty Charles Friday, January 27, 2023 2:51:34 PM

PROJECT NAME: AUTOCAD FILE LOCATION \ NAME: LAST CORRECTION BY ◆ DATE ◆ TIME: PLOTTED BY ◆ DATE ◆ TIME:

(2) WALL MOUNT HEAT PUMP JUST BELOW EXTERIOR SOFFIT. MAINTAIN REQUIRED CLEARANCE FROM TOP OF UNIT TO BELOW SOFFIT.

(3) WALL MOUNT EVAPORATOR UNIT. PROVIDE REFRIGERANT LINE SET TO OUTDOOR UNIT. PROVIDE 3/4" CONDENSATE DRAIN TO EXTERIOR, DISCHARGE 12" ABOVE GRADE.

(4) 3/4" CONDENSATE DRAIN DOWN TO 12" ABOVE GRADE. SECURE TO EXTERIOR. PROVIDE WITH BUG SCREEN.

(5) DOAS TOUCHSCREEN CONTROLLER, RE: M-200.

(6) TRANSITION DUCT TO FULL SIZE SUPPLY AIR AND RETURN AIR DUCTS THRU ROOF TO ROOFTOP UNIT AS REQUIRED. ROOF PENETRATIONS WITH ROOFING CONTRACTOR.

PLAN NOTES:

(7) DOAS AVERAGING TEMP SENSOR, RE: M-200.

(8) TRANSITION SUPPLY AIR DUCT DOWN TO UNIT INLET AS

REQUIRED. PROVIDE WITH FLEXIBLE DUCT CONNECTION. (9) CONNECT EXISTING RETURN AIR DUCT TO NEW FURNACE. PROVIDE WITH 1" FILTER RACK. TRANSITION AS

REQUIRED. PROVIDE WIT FLEXIBLE DUCT CONNECTION.

(10) CONNECT EXISTING SUPPLY AIR DUCT TO NEW SUPPLY AIR MAIN DUCT.

(11) CONNECT NEW RETURN AIR BRANCH DUCT TO EXISTING RETURN AIR MAIN.

(12) PROVIDE 4" CONCRETE PAD FOR HEAT PUMP. PROVIDE REFRIGERANT LINE SET TO FURNACE. SIZE LINE SET PER MANUFACTURER'S REQUIREMENTS.

PROVIDE WITH FLEXIBLE DUCT CONNECTIONS. COORDINATE (13) REUSE AND CONNECT TO SALVAGED SUPPLY AIR DIFFUSE. MATCH EXISTING DUCT SIZE. BALANCE DIFFUSER TO AIRFLOW AS SHOWN.

PLAN NOTES:

(14) PROVIDE FURNACE CONCENTRIC VENT, THRU DEMO'ED FLUE ROOF PENETRATIN. SIZE AND INSTALL PER MANUFACTURER'S REQUIREMENTS. COORDINATE WITH ROOFING CONTRACTOR.

(15) PROVIDE NEW SUPPLY AIR DIFFUSER AND DUCT ABOVE EXISTING CEILING. FIELD DETERMINE EXACT CONDITIONS. INTENT IS TO NOT DEMO AND REPAIR

(16) EXISTING SUPPLY AIR DIFFUSER, BALANCE TO AIRFLOW AS

GENERAL NOTES:

1. ALL DUCTWORK AND PIPING IS SHOWN DIAGRAMMATICALLY AND DOES NOT INCLUDE ALL OFFSETS, DROPS, AND RISES. CAREFULLY COORDINATE DUCT AND PIPE ROUTING WITH STRUCTURE AS WELL AS ALL OTHER TRADES TO MAINTAIN EQUIPMENT CLEARANCES, EQUIPMENT ACCESSIBILITY, DESIRED CEILING HEIGHTS, AND AESTHETICS. THE CONTRACTOR SHALL INCLUDE ANY NEEDED OFFSETS AND CHANGES OF DIRECTION IN THE BID PRICING.

2. COORDINATE ALL DUCT PENETRATIONS WITH STRUCTURAL PRIOR TO ROOF PENETRATIONS.

3. FURNISH ALL EXPOSED DUCTWORK IN FINISHED SPACES WITH PAINTABLE FINISH.

4. DUCT SIZES SHOWN ARE SHEET METAL DIMENSIONS. WHERE DUCT LINER IS REQUIRED, DUCT SIZES ARE NOT REQUIRED TO BE INCREASED TO ACCOUNT FOR LINER.

STATE OF MISSOURI

MICHAEL L. PARSON,

GOVERNOR

PROFESSIONAL SEAL

OFFICE OF ADMINISTRATION DIVISION OF FACILITIES MANAGEMENT, **DESIGN AND CONSTRUCTION**

MISSOURI ARMY NATIONAL GUARD FACILITIES DIVISION

RE-BID RENOVATE INTERIOR AND **EXTERIOR**

KENNETT READINESS CENTER 1450 NORTH BY-PASS KENNETT, MO 63857

PROJECT # T2209-01

FACILITY # 8136313002

REVISION: REVISION: **REVISION:** DATE:

ISSUE DATE: January 30, 2023

CAD DWG FILE: M-100.DWG
DRAWN BY: JEB
CHECKED BY: RJD
DESIGNED BY: JEB

SHEET TITLE:

HVAC -**FLOOR PLAN**

SHEET NUMBER:

M-100


21 OF 29 SHEETS


smith & boucher

25618 west 103rd St olathe, ks 66061

phone 913.345.2127 fax 913.345.0617

project number 2219000

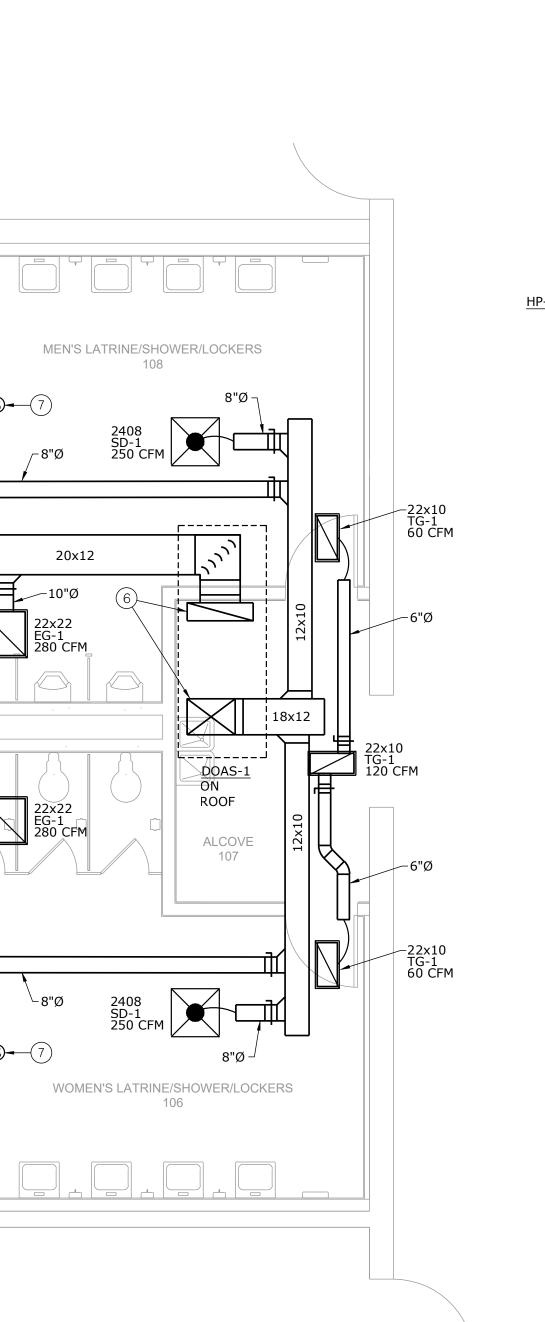

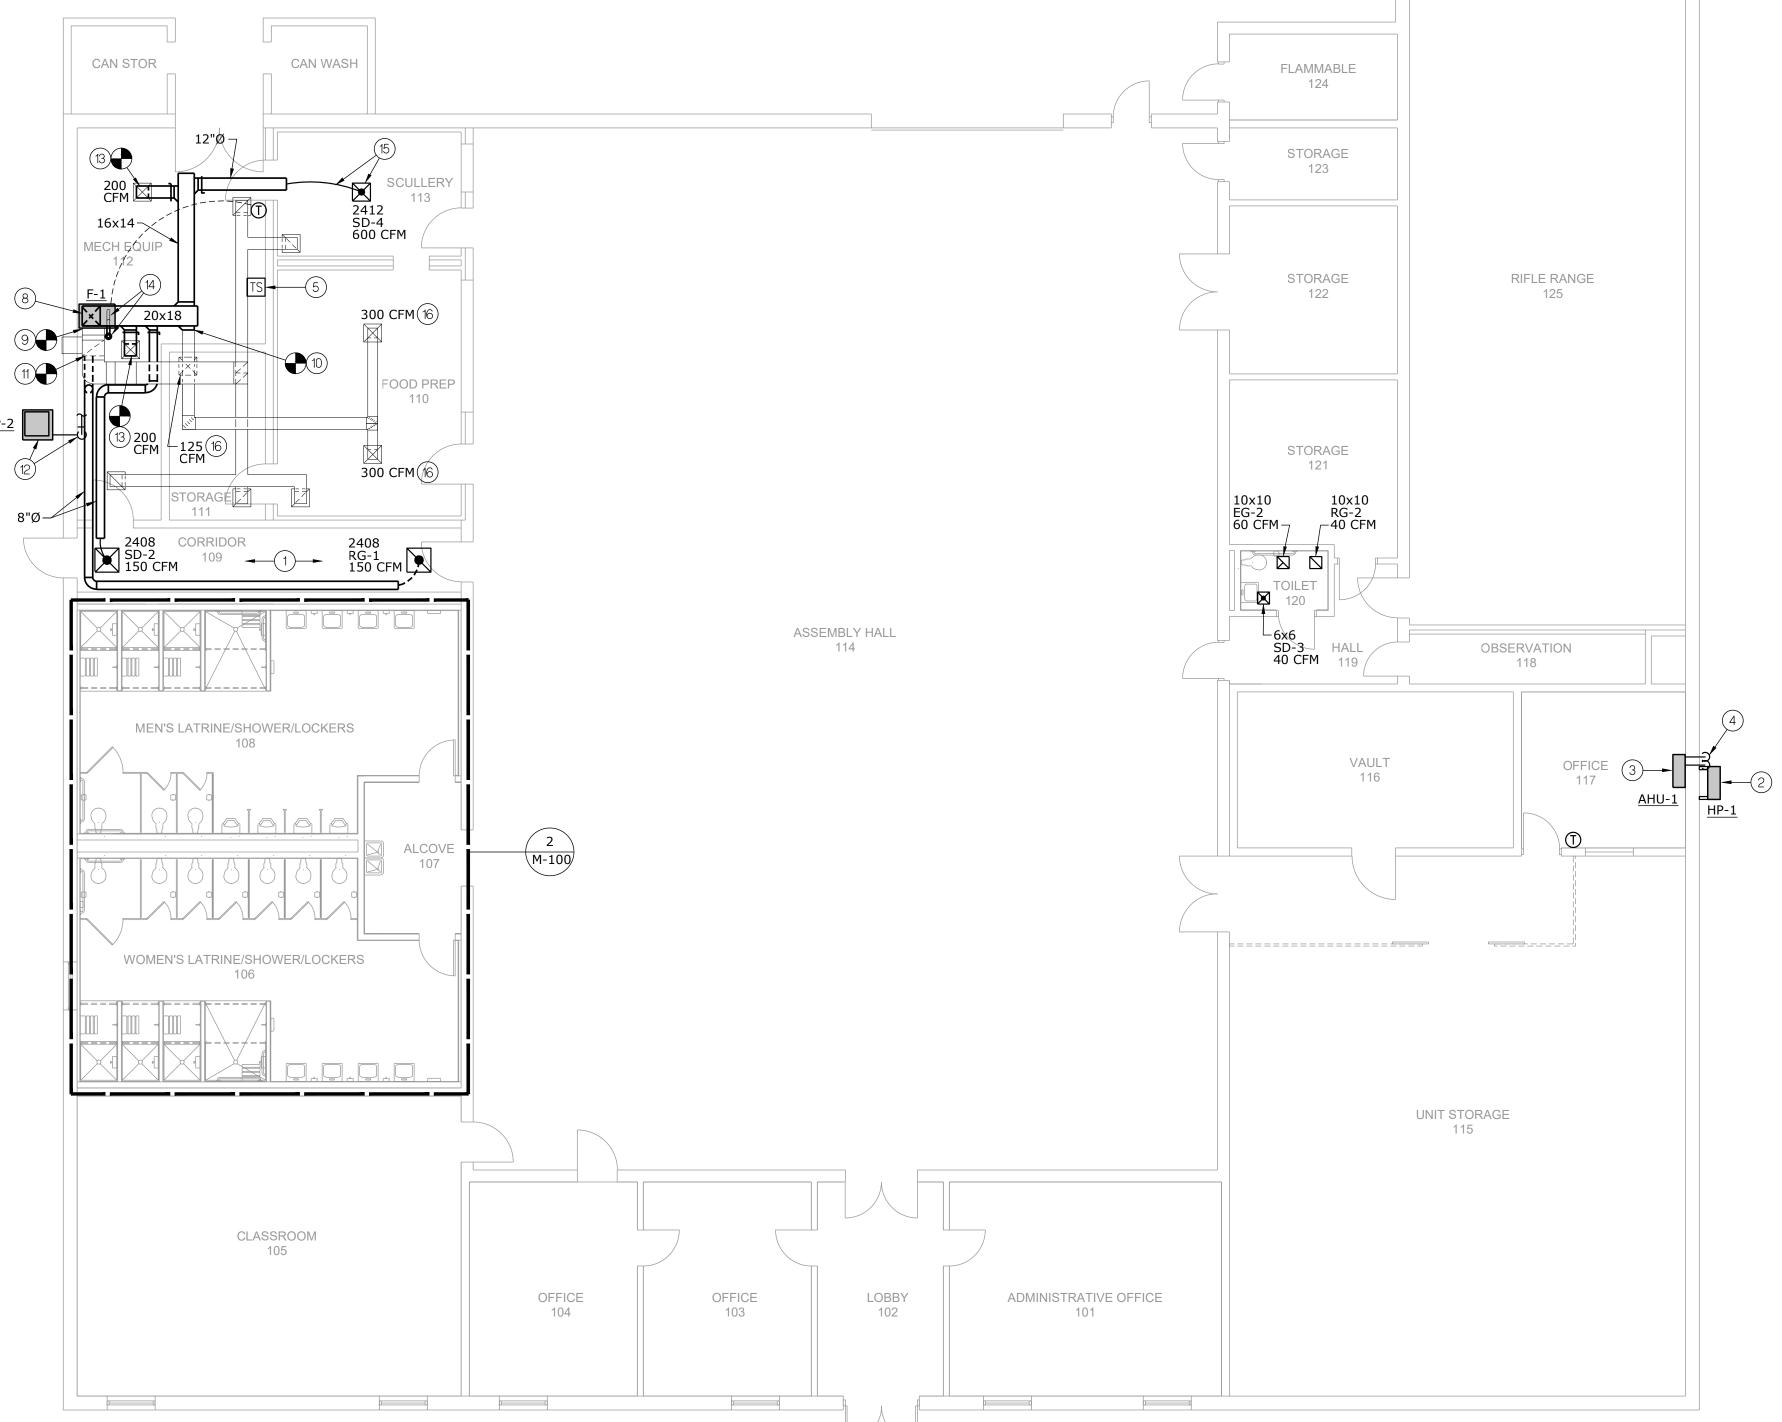

2 ENLARGED FLOOR PLAN - HVAC

SCALE: 1/4" = 1'-0"



DOAS-1 ON ROOF

ALCOVE 107

FLOOR PLAN - HVAC SCALE: 1/8" = 1'-0"



REVISION: DATE: **REVISION:** REVISION: DATE:

ISSUE DATE: January 30, 2023

STATE OF MISSOURI MICHAEL L. PARSON, **GOVERNOR**

PROFESSIONAL SEAL

OFFICE OF ADMINISTRATION

DESIGN AND CONSTRUCTION

DIVISION OF FACILITIES

MANAGEMENT,

MISSOURI ARMY

NATIONAL GUARD FACILITIES DIVISION

RE-BID RENOVATE

KENNETT READINESS CENTER 1450 NORTH BY-PASS KENNETT,

PROJECT # T2209-01

FACILITY # 8136313002

INTERIOR AND

EXTERIOR

MO 63857


CAD DWG FILE: M-200.DWG DRAWN BY: CHECKED BY: RJD DESIGNED BY: JEB

SHEET TITLE:

HVAC CONTROL SCHEMATIC

SHEET NUMBER:

22 OF 29 SHEETS project number 2219000

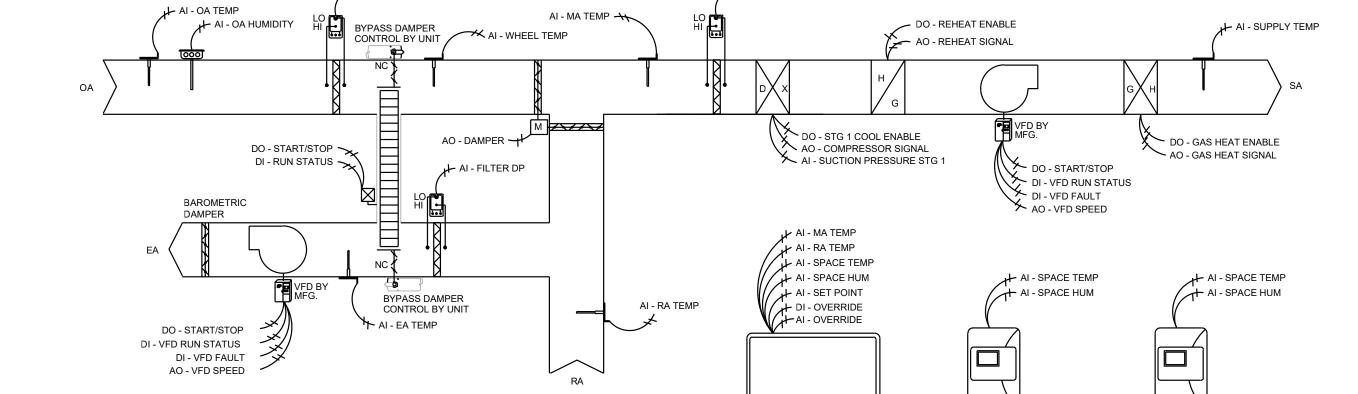

AI - FILTER DP

REMOTE TOUCHSCREEN CONTROLLER

TEMP/HUM SENSORS, REMOTE TOUCHSCREEN CONTROLLER FURNISHED BY UNIT MANUFACTURER, INSTALLED BY MECHANICAL CONTRACTOR ACTUATORS/VFDS PROVIDED/INSTALLED BY UNIT MANUFACTURER

AI - FILTER DP

SEQUENCE OF OPERATION: Dedicated Outside Air System (Standalone control)

The remote touch screen controller shall enable the DOAS unit to be occupied via its time-of-day schedule and provide full control of the unit, via terminal strip, for the sequence as

When the unit is in occupied mode (weekend), the outside air damper shall open and the supply fan, exhaust fan and energy recovery wheel shall run continuously. The unit shall supply 100%

If the outside air wheel temperature falls more than 1°F below the heating setpoint for more

Supply Air Temperature Setpoint: The supply air temperature setpoint shall be reset based on a space temperature sensor. In cooling mode, the supply air temperature setpoint shall be reset from 74°F (adj.) down to 55°F (adj.), as the space temperature increases above 74°F (adj.). In heating mode, the supply air

When the unit is in cooling mode, the DX Cooling shall be enabled and modulate DX capacity to maintain the supply air setpoint. Suction pressure shall be monitored and the variable capacity compressor signal shall be limited to maintain a minimum suction pressure setpoint of 110psi

Dehumidification Mode: If the outside air dewpoint rises above 55°F (adj.) or the space humidity rises above 55%, the unit shall enter into a dehumidification mode. During the dehumidification mode, DX cooling shall be enabled and all variable capacity compressors shall modulate to maintain current suction pressure setpoint of 120psi (adj.). The modulating hot gas reheat shall be enabled and modulate to maintain the current cooling mode supply air temperature setpoint. Once the outside air dewpoint drops below 52°F (adj.) or the space humidity below 45%, the

When the unit is in heat mode, the gas heating is enabled and shall modulate to maintain the supply air setpoint.

Energy Recovery Wheel Defrost Stop/jog defrost sequence shall be utilized for the prevention of frost buildup on energy

recovery wheel when necessary. Zone Occupied (Weekday):

When the zone is scheduled to be occupied on a weekday via its time-of-day schedule, the outside air damper shall allow only 30% outside air (adj.).

Zone Unoccupied: When the zone is scheduled to be unoccupied, the outside air damper shall close, and the supply fan and heating and cooling shall be energized to maintain set back back temperatures of 55°F (heating) and 80°F (cooling).

The touchscreen interface shall allow the user to dynamically change the occupancy schedule and force weekday or weekend occupancy for an adjustable amount of time.

Filter Differential Pressure Monitor: The controller shall monitor the differential pressure across all unit filters.

The controller shall provide the following alarms at the touchscreen interface for any of the following conditions: supply air fan failure, exhaust air fan failure, energy recovery wheel failure, high and low supply air temperature, and high filter pressure drop.

outside air.

Heating/Cooling Switchover:

dehumidification mode shall be disabled.

than 10 minutes (adj.), and the outside air dewpoint is below 55°F (adj.), then the unit shall enter the heating mode. If the outside air wheel temperature rises more than 1°F above the cooling setpoint for more than 10 minutes (adj.) or the outside air dewpoint is above 55°F (adj.), the unit shall enter the cooling mode.

temperature setpoint shall be reset from 70°F (adj.) up to 95°F (adj.), as the space temperature decreases below 70°F (adj.).

(adj.) to avoid freezing the cooling coil.

smith & boucher 25618 west 103rd St olathe, ks 66061 phone 913.345.2127 fax 913.345.0617

AVERAGING SPACE TEMP &

HUMIDITY SENSOR W/ DISPLAY

AVERAGING SPACE TEMP & HUMIDITY SENSOR W/ DISPLAY



GENERAL DEMOLITION NOTES:

- 1. UNLESS OTHERWISE NOTED, SERVICES AND EQUIPMENT SHOWN WITH BOLD DASHED LINES ARE TO BE DEMOLISHED. SERVICES AND EQUIPMENT SHOWN WITH SOLID HALF TONE LINE WEIGHT ARE TO REMAIN IN PLACE.
- 2. THE EXISTING CONDITIONS INDICATED ON THE DRAWINGS ARE TAKEN FROM THE BEST INFORMATION AVAILABLE AND FROM VISUAL SITE INSPECTION AND ARE NOT TO BE CONSIDERED "AS BUILT" CONDITIONS. THE INFORMATION SHOWN IS TO ESTABLISH THE EXTENT OF THE SCOPE OF WORK. VERIFY ALL ACTUAL EXISTING CONDITIONS AT THE PROJECT SITE AND PERFORM WORK AS REQUIRED TO MEET THE EXISTING CONDITIONS AND THE EXTENT OF THE WORK INDICATED.
- 3. PATCH AND REPAIR ANY INFRASTRUCTURE THAT IS TO REMAIN WHERE ANY SERVICES ARE REMOVED UNLESS NOTED OTHERWISE. DISCONNECT AND REMOVE ALL WIRING, CABLING, RACEWAY AND CONDUIT THAT BECOMES UNNECESSARY AS A RESULT OF THE REMOVAL OF EQUIPMENT INDICATED TO BE REMOVED.
- 4. WHERE MECHANICAL AND ELECTRICAL FIXTURES OR EQUIPMENT ARE REMOVED, CAP ALL UNUSED CONDUIT, WIRING AND PIPING BEHIND THE FLOOR LINE OR WALL LINE TO FACILITATE THE RESTORATION OF FINISH.
- 5. PROVIDE FOR THE CONTINUITY OF ALL REMAINING SERVICES, SYSTEMS, AND CIRCUITS. RELOCATE AND RECONNECT ANY MECHANICAL AND ELECTRICAL FACILITIES THAT MUST BE RELOCATED IN ORDER TO ACCOMPLISH THE REMODELING SHOWN IN THE DRAWINGS OR INDICATED IN THE SPECIFICATIONS.


DEMOLITION PLAN NOTES:

- 1 PROVIDE COMPLETE DEMOLITION OF ALL PLUMBING FIXTURES, FLOOR DRAINS, AND CLEANOUTS IN SHOWER/RESTROOM. PROVIDE DEMOLITION OF ALL ASSOCIATED SANITARY, VENT, AND WATER PIPING.
- $\langle 2 \rangle$ PROVIDE DEMOLITION OF DRINKING FOUNTAIN. CAP SANITARY AND CW PIPING BACK IN WALL. COORDINATE WALL PATCHING WITH GENERAL CONTRACTOR.
- (3) PROVIDE DEMOLITION OF LAVATORY AND WATER CLOSET. SALVAGE SANITARY, CW, AND HW POINT OF USE HEATER FOR NEW FIXTURES PER NEW WORK PLANS.
- $\langle 4 \rangle$ PROVIDE DEMOLITION OF WALL HYDRANT. COORDINATE EXTERIOR WALL PATCHING WITH GENERAL CONTRACTOR.

STATE OF MISSOURI MICHAEL L. PARSON, **GOVERNOR**



PROFESSIONAL SEAL

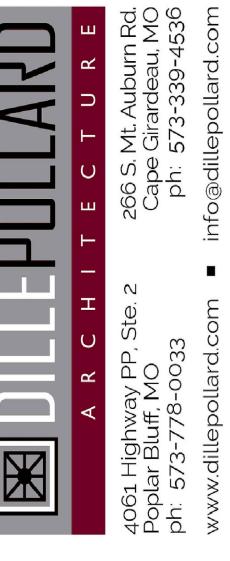

OFFICE OF ADMINISTRATION DIVISION OF FACILITIES MANAGEMENT, **DESIGN AND CONSTRUCTION**

MISSOURI ARMY NATIONAL GUARD FACILITIES DIVISION

RE_BID RENOVATE INTERIOR AND EXTERIOR

KENNETT READINESS CENTER 1450 NORTH BY-PASS KENNETT, MO 63857

PROJECT # T2209-01

FACILITY # 8136313002

REVISION:
DATE:
REVISION:
DATE:
REVISION:
DATE:
ISSUE DATE: January 30, 2023

CAD DWG FILE: DP-100.DWG
DRAWN BY: JEB
CHECKED BY: RJD
DESIGNED BY: JEB

SHEET TITLE:

DEMOLITION PLUMBING -**FLOOR PLAN**

smith & boucher 25618 west 103rd St olathe, ks 66061 phone 913.345.2127 fax 913.345.0617 project number 2219000

SHEET NUMBER:

DP-100

(3) 2" SAN UP IN WALL TO LAVATORIES. REFER TO RISER

(4) 4" SAN, 2" VENT TO BACK TO BACK WATER CLOSET CARRIER. 1-1/4" CW TO EACH WATER CLOSET.

(5) 4" SAN TO WATER CLOSET CARRIER, 2" WET VENT TO URINAL, TO 2" VENT. 1-1/4" CW WATER CLOSET, 1" CW TO

(6) 2" SAN, 1-1/2" VENT, 1/2" CW AND HW TO LAVATORY.

(7) 3" TRAPPED SAN UP TO 2" FLOOR DRAIN.

(8) 2" VENT UP THRU ROOF TO VTR. EXISTING 4" VTR SERVING DEMOLISHED RESTROOMS SHALL BE PERMITTED TO BE REUSED. FIELD DETERMINE EXACT LOCATION. COORDINATE WITH ROOFING CONTRACTOR.

PLAN NOTES:

(9) 4" VENT UP THRU ROOF TO 4" VTR. UTILIZE EXISTING ROOF PENETRATION FROM DEMOLISHED RESTROOMS VTR. MODIFY/ENLARGE EXISTING ROOF PENETRATION AS REQUIRED FOR NEW LARGER VTR. FIELD DETERMINE EXACT LOCATION. COORDINATE WITH ROOFING CONTRACTOR.

(10) 3" VENT DOWN IN CHASE.

(11) 3" TRAPPED SAN UP TO 2" SHOWER DRAIN.

(12) CONNECT NEW 2-1/2" CW TO EXISTING 2-1/2" CW SERVING DEMOLISHED RESTROOMS. FIELD DETERMINE EXACT LOCATION.

(13) 2-1/2" CW DOWN IN CHASE TO FIXTURES. REFER TO RISER

(14) 3/4" CW AND HW DOWN IN CHASE TO FIXTURES. REFER TO RISER DIAGRAM.

(15) 1/2" CW AND HW DOWN TO SHOWER.

(16) 2" SAN, 1-1/2" VENT, 1/2" CW TO DRINKING FOUNTAIN.

(17) 4" SAN UP TO FINISH FLOOR CLEANOUT.

PLAN NOTES:

(18) 2" VENT DOWN IN WALL, THRU FLOOR TO COMBINATION WASTE AND VENT.

(19) 3/4" CW WITH SHUTOFF VALVE DOWN IN CHASE TO WALL

(20) 1/2" CW AND HW TO HOSE BIBB IN FLUSH MOUNT WALL BOX, INSTALLED BELOW LAVATORY. REFER TO RISER

(21) CONNECT NEW 1-1/2" CW TO EXISTING 2-1/2" CW IN GENERAL AREA. FIELD DETERMINE EXACT LOCATION.

(22) PROVIDE WATER HEATER CONCENTRIC VENT, THRU EXISTING ROOF DEMO'ED FLUE PENETRATION. SIZE AND INSTALL PER MANUFACTURER'S REQUIREMENTS. COORDINATE WITH ROOFING CONTRACTOR.

NEW FIXTURES IN PLACE OF EXISTING. PROVIDE NEW FIXTURE TRIM AND ACCESSORIES PER PLUMBING FIXTURE SCHEDULE.

(24) PROVIDE NEW SAN PIPING MAIN IN PLACE OF EXISTING BETWEEN THE POINTS OF CONNECTION TO THE EXISTING (SEE PLAN NOTE 1).

PLAN NOTES:

(25) CONNECT NEW 1" GAS TO EXISTING GAS SERVICE INSIDE BUILDING. FIELD DETERMINE EXACT LOCATION.

(26) CONNECT EXISTING GAS TO NEW FURNACE. PROVIDE UNION AND FLEXIBLE CONNECTION AFTER EXISTING SHUT

(27) CONNECT NEW 1-1/4" GAS TO EXISTING GAS MAIN ABOVE CEILING. FIELD DETERMINE EXACT LOCATION.

(28) 1-1/4" GAS UP THRU ROOF CURB TO DOAS UNIT ON ROOF. (EXISTING GAS LOAD ON 3" MAIN IS 1485 MBH. 315 MBH CAPACITY AVAILABLE @ 300 LF.)

GENERAL NOTES:

1. ALL DUCTWORK AND PIPING IS SHOWN DIAGRAMMATICALLY AND DOES NOT INCLUDE ALL OFFSETS, DROPS, AND RISES. CAREFULLY COORDINATE DUCT AND PIPE ROUTING WITH STRUCTURE AS WELL AS ALL OTHER TRADES TO MAINTAIN EQUIPMENT CLEARANCES, EQUIPMENT ACCESSIBILITY, DESIRED CEILING HEIGHTS, AND AESTHETICS. THE CONTRACTOR SHALL INCLUDE ANY NEEDED OFFSETS AND CHANGES OF DIRECTION IN THE BID PRICING.

2. COORDINATE ALL PIPING PENETRATIONS WITH STRUCTURAL PRIOR TO CORE DRILLING.

3. COORDINATE ALL SLAB CUTTING, REMOVAL, AND PATCHING WITH GENERAL CONTRACTOR AS REQUIRED FOR NEW BELOW GRADE PLUMBING WORK.

4. PROVIDE SHUT OFF VALVES ABOVE ACCESSIBLE CEILING OR OTHER ACCESSIBLE LOCATION FOR ALL BRANCH PIPING AND INDIVIDUAL CONNECTIONS TO PLUMBING FIXTURES. WHERE STOPS ARE PROVIDED FOR INDIVIDUAL FIXTURES SHUT OFF VALVES ARE ALSO REQUIRED AT THE BRANCH CONNECTION. PLUMBING STOPS ARE NOT CONSIDERED A SUBSTITUTE FOR SHUT OFF VALVES.

5. PROVIDE WATER HAMMER ARRESTERS IN WATER PIPING ACCORDING TO STANDARD PDI-WH 201.

CAN STOR CAN WASH FLAMMABLE 124 SCULLERY STORAGE MECH EQUIP REFER TO EQUIPMENT 112 DETAIL FOR PIPING CONNECTIONS STORAGE

EXISTING WATER HEATERS FOOD PREP 110

__ 2-1/2"(EXISTING) _3"(EXISTING) ←

CORRIDOR

MEN'S LATRINE/SHOWER/LOCKERS

9999 ALCOVE 107

WOMEN'S LATRINE/SHOWER/LOCKERS

CLASSROOM 105

OFFICE

104

P-100


OFFICE LOBBY 103

ASSEMBLY HALL

ADMINISTRATIVE OFFICE

101

smith & boucher 25618 west 103rd St olathe, ks 66061 phone 913.345.2127 fax 913.345.0617 project number 2219000 STATE OF MISSOURI MICHAEL L. PARSON, **GOVERNOR**

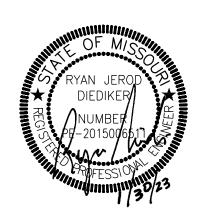

PROFESSIONAL SEAL



OFFICE OF ADMINISTRATION DIVISION OF FACILITIES MANAGEMENT,

MISSOURI ARMY NATIONAL GUARD FACILITIES DIVISION

DESIGN AND CONSTRUCTION

RE-BID RENOVATE INTERIOR AND EXTERIOR

KENNETT READINESS CENTER 1450 NORTH BY-PASS KENNETT, MO 63857

PROJECT # T2209-01

FACILITY # 8136313002

REVISION: REVISION: REVISION: DATE: ISSUE DATE: January 30, 2023

CAD DWG FILE: P-100.DWG
DRAWN BY: JEB
CHECKED BY: RJD

DESIGNED BY: JEB


SHEET TITLE:

PLUMBING -**FLOOR PLAN**

SHEET NUMBER:

P-100

24 OF 29 SHEETS

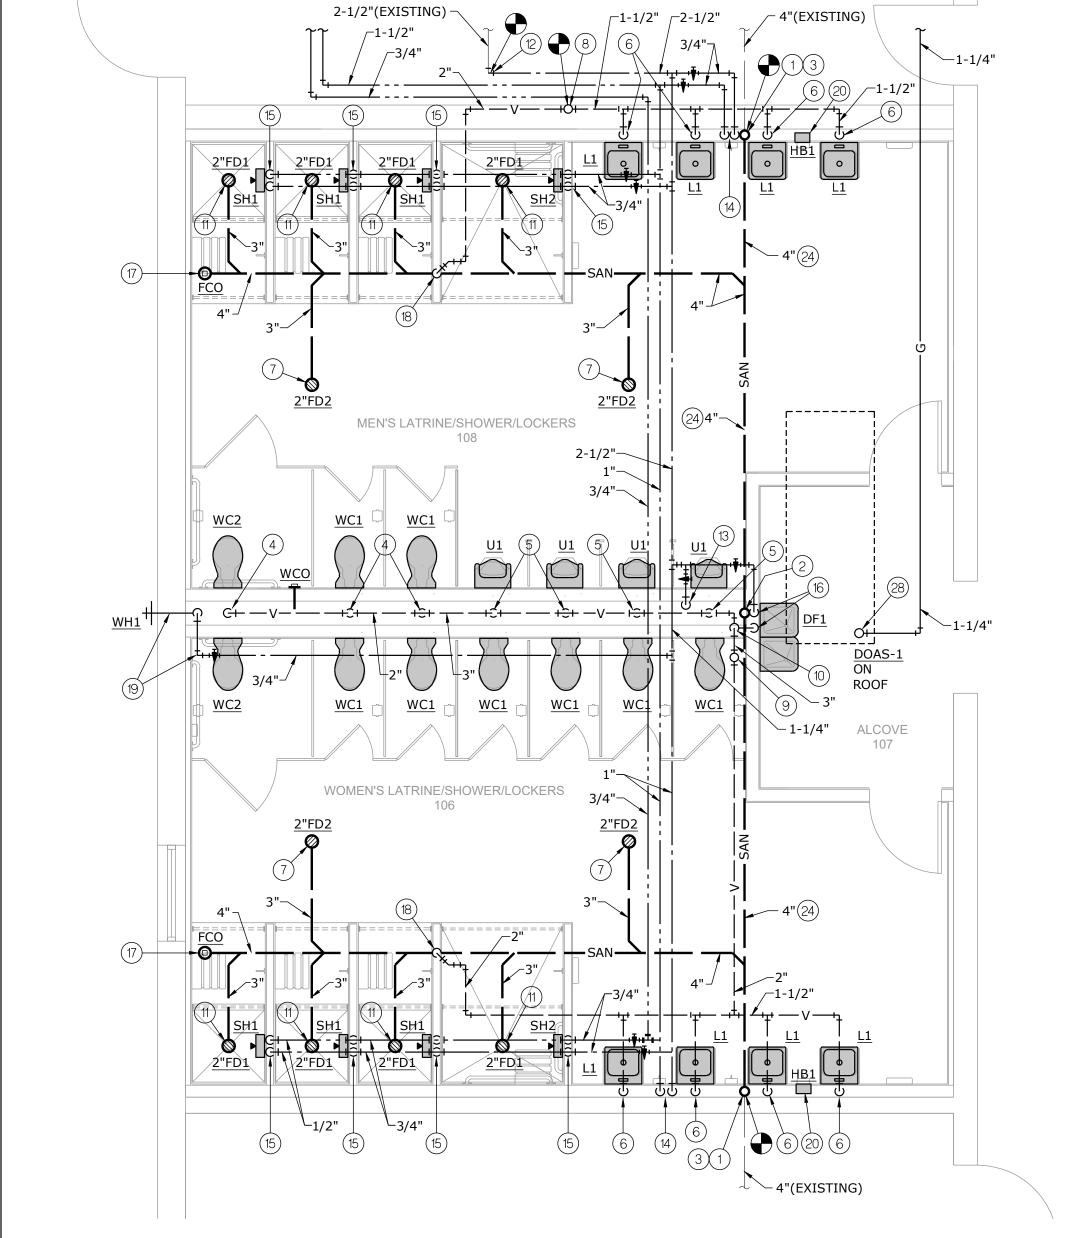

wings\04-2219000_P-100. January 27, 2023 1:26:43 January 27, 2023 2:51:56

RIFLE RANGE 125

OBSERVATION

118

UNIT STORAGE

115

OFFICE

117

STORAGE 121


VAULT

116

HALL

119

RISER DIAGRAM - WASTE & VENT - MEN'S LATRINE/SHOWERS/LOCKERS & WOMEN'S LATRINE/SHOWERS/LOCKERS

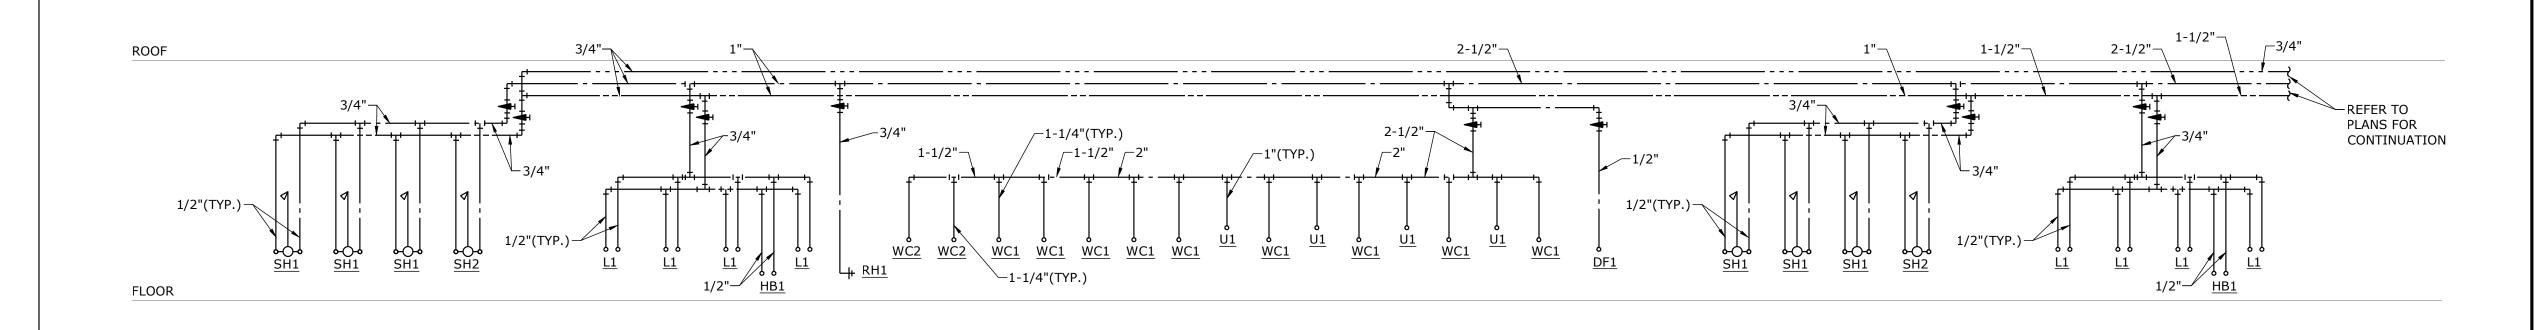


RISER DIAGRAM - WATER - MEN'S LATRINE/SHOWERS/LOCKERS & WOMEN'S LATRINE/SHOWERS/LOCKERS NO SCALE

GENERAL NOTES:

- BELOW GRADE PLUMBING WORK.
- CONNECTION. PLUMBING STOPS ARE NOT CONSIDERED A
- PROVIDE WATER HAMMER ARRESTERS IN WATER PIPING ACCORDING TO STANDARD PDI-WH 201.

STATE OF MISSOURI MICHAEL L. PARSON, **GOVERNOR**

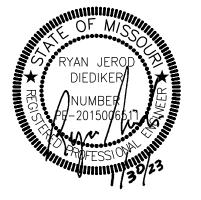

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KENNETT READINESS CENTER 1450 NORTH BY-PASS KENNETT, MO 63857

PROJECT # T2209-01

FACILITY # 8136313002

REVISION:
DATE:
REVISION:
DATE:
REVISION:
DATE:
ISSUE DATE: January 30, 2023

CAD DWG FILE: P-200.DWG
DRAWN BY: JEB
CHECKED BY: RJD
DESIGNED BY: JEB

SHEET TITLE:

RISER DIAGRAM -**PLUMBING**

smith & boucher engineers 25618 west 103rd St olathe, ks 66061 phone 913.345.2127 fax 913.345.0617 project number 2219000

SHEET NUMBER:

P-200

25 OF 29 SHEETS

PACE - Kennett Readiness Center
X:\22\22190\2219000\Drawings\04-2219000_P-200.dwg
Jblackburn
Friday, January 27, 2023 1:21:42 PM
Booty Charles Friday, January 27, 2023 2:52:06 PM

PROJECT NAME: AUTOCAD FILE LOCATION \ NAME: LAST CORRECTION BY ♦ DATE ♦ TIME: PLOTTED BY ♦ DATE ♦ TIME:

PACE - Kennett Readiness Center
X:\22\22\22190\2219000\Drawings\05-2219000_DE-100.dwg
Jblackburn
Friday, January 27, 2023 10:38:38 AM
Booty Charles Friday, January 27, 2023 2:52:17 PM

PROJECT NAME: AUTOCAD FILE LOCATION \ NAME: LAST CORRECTION BY ♦ DATE ♦ TIME: PLOTTED BY ♦ DATE ♦ TIME: **GENERAL DEMOLITION NOTES:**

- UNLESS OTHERWISE NOTED, SERVICES AND EQUIPMENT SHOWN WITH BOLD DASHED LINES ARE TO BE DEMOLISHED. SERVICES AND EQUIPMENT SHOWN WITH SOLID HALF TONE LINE WEIGHT ARE TO REMAIN IN PLACE.
- 2. THE EXISTING CONDITIONS INDICATED ON THE DRAWINGS ARE TAKEN FROM THE BEST INFORMATION AVAILABLE AND FROM VISUAL SITE INSPECTION AND ARE NOT TO BE CONSIDERED "AS BUILT" CONDITIONS. THE INFORMATION SHOWN IS TO ESTABLISH THE EXTENT OF THE SCOPE OF WORK. VERIFY ALL ACTUAL EXISTING CONDITIONS AT THE PROJECT SITE AND PERFORM WORK AS REQUIRED TO MEET THE EXISTING CONDITIONS AND THE EXTENT OF THE WORK INDICATED.
- 3. PATCH AND REPAIR ANY INFRASTRUCTURE THAT IS TO REMAIN WHERE ANY SERVICES ARE REMOVED UNLESS NOTED OTHERWISE. DISCONNECT AND REMOVE ALL WIRING, CABLING, RACEWAY AND CONDUIT THAT BECOMES UNNECESSARY AS A RESULT OF THE REMOVAL OF EQUIPMENT INDICATED TO BE REMOVED.
- 4. WHERE MECHANICAL AND ELECTRICAL FIXTURES OR EQUIPMENT ARE REMOVED, CAP ALL UNUSED CONDUIT, WIRING AND PIPING BEHIND THE FLOOR LINE OR WALL LINE TO FACILITATE THE RESTORATION OF FINISH.
- 5. PROVIDE FOR THE CONTINUITY OF ALL REMAINING SERVICES, SYSTEMS, AND CIRCUITS. RELOCATE AND RECONNECT ANY MECHANICAL AND ELECTRICAL FACILITIES THAT MUST BE RELOCATED IN ORDER TO ACCOMPLISH THE REMODELING SHOWN IN THE DRAWINGS OR INDICATED IN THE SPECIFICATIONS.

DEMOLITION PLAN NOTES:


- PROVIDE COMPLETE DEMOLITION OF ALL LIGHT FIXTURES, ASSOCIATED CONDUIT AND CONDUCTORS, AND SWITCHES IN LOCKER ROOM AND SHOWER/RESTROOM. OWNER SHALL HAVE FIRST RIGHT OF REFUSAL OF DEMOLISHED LIGHT FIXTURES.
- PROVIDE DEMOLITION OF HI-BAY LIGHT FIXTURE. SALVAGE CIRCUIT AND SWITCHING FOR REUSE FOR REPLACEMENT FIXTURES PER NEW WORK PLANS.OWNER SHALL HAVE FIRST RIGHT OF REFUSAL OF DEMOLISHED LIGHT FIXTURES.
- ALTERNATE NO.2 PROVIDE DEMOLITION OF EXTERIOR TRANSFER SWITCH. SALVAGE CONDUIT AND CONDUCTORS FOR CONNECTION TO NEW TRANSFER SWITCH PER NEW WORK PLANS.
- TEMPORARILY SUPPORT AND REINSTALL EXISTING LIGHT FIXTURES WITHIN HALL AS REQUIRED TO ACCOMMODATE ABOVE CEILING WORK RELATED TO NEW HVAC AND PLUMBING.
- (5) EXISTING LIGHT FIXTURES SHOWN FOR REFERENCE. NO WORK.
- 6 PROVIDE DEMOLITION OF LIGHT FIXTURE. SALVAGE CIRCUIT AND SWITCHING FOR REUSE FOR REPLACEMENT FIXTURE PER NEW WORK PLANS.
- PROVIDE DEMOLITION OF 3-WAY LIGHT SWITCH, ASSOCIATED CONDUIT AND CONDUCTORS. REFER TO NEW WORK PLANS FOR RELOCATION.

 MISSOURI ARMY
 NATIONAL GUAR
- B DEMO RECEPTACLE. SALVAGE CIRCUIT AND ASSOCIATED CONDUCTORS TO SERVE NEW MINI-SPLIT SYSTEM PER NEW WORK PLANS. PROVIDE BLANK WALL PLATE.
- 9 RELOCATE/SHIFT AS REQUIRED EXISTING EXHAUST FAN STARTERS ON OTHER SIDE OF EXISTING GAS PIPE TO ACCOMMODATE SPACE FOR NEW ELECTRICAL PANEL PER NEW WORK PLANS.

STATE OF MISSOURI MICHAEL L. PARSON, GOVERNOR



PROFESSIONAL SEAL

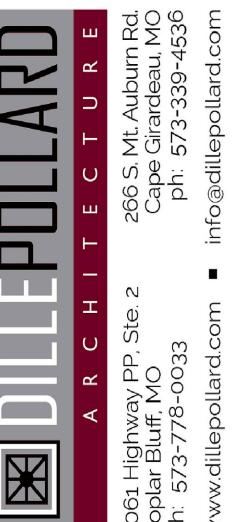

OFFICE OF ADMINISTRATION DIVISION OF FACILITIES MANAGEMENT, DESIGN AND CONSTRUCTION

MISSOURI ARMY NATIONAL GUARD FACILITIES DIVISION

RE-BID RENOVATE INTERIOR AND EXTERIOR

KENNETT READINESS CENTER 1450 NORTH BY-PASS KENNETT, MO 63857

PROJECT # T2209-01

FACILITY # 8136313002

REVISION:
DATE:
REVISION:
DATE:
REVISION:
DATE:
ISSUE DATE: January 30, 2023

CAD DWG FILE: DE-100.DWG
DRAWN BY: JEB
CHECKED BY: RJD
DESIGNED BY: JEB

SHEET TITLE:

DEMOLITION ELECTRICAL -FLOOR PLAN

SHEET NUMBER:

DE-100

26 OF 29 SHEETS

smith & boucher

25618 west 103rd St olathe, ks 66061

phone 913.345.2127 fax 913.345.0617


____ engineers

project number 2219000

DEMOLITION FLOOR PLAN - ELECTRICAL


SCALE: 1/8" = 1'-0"

NORT

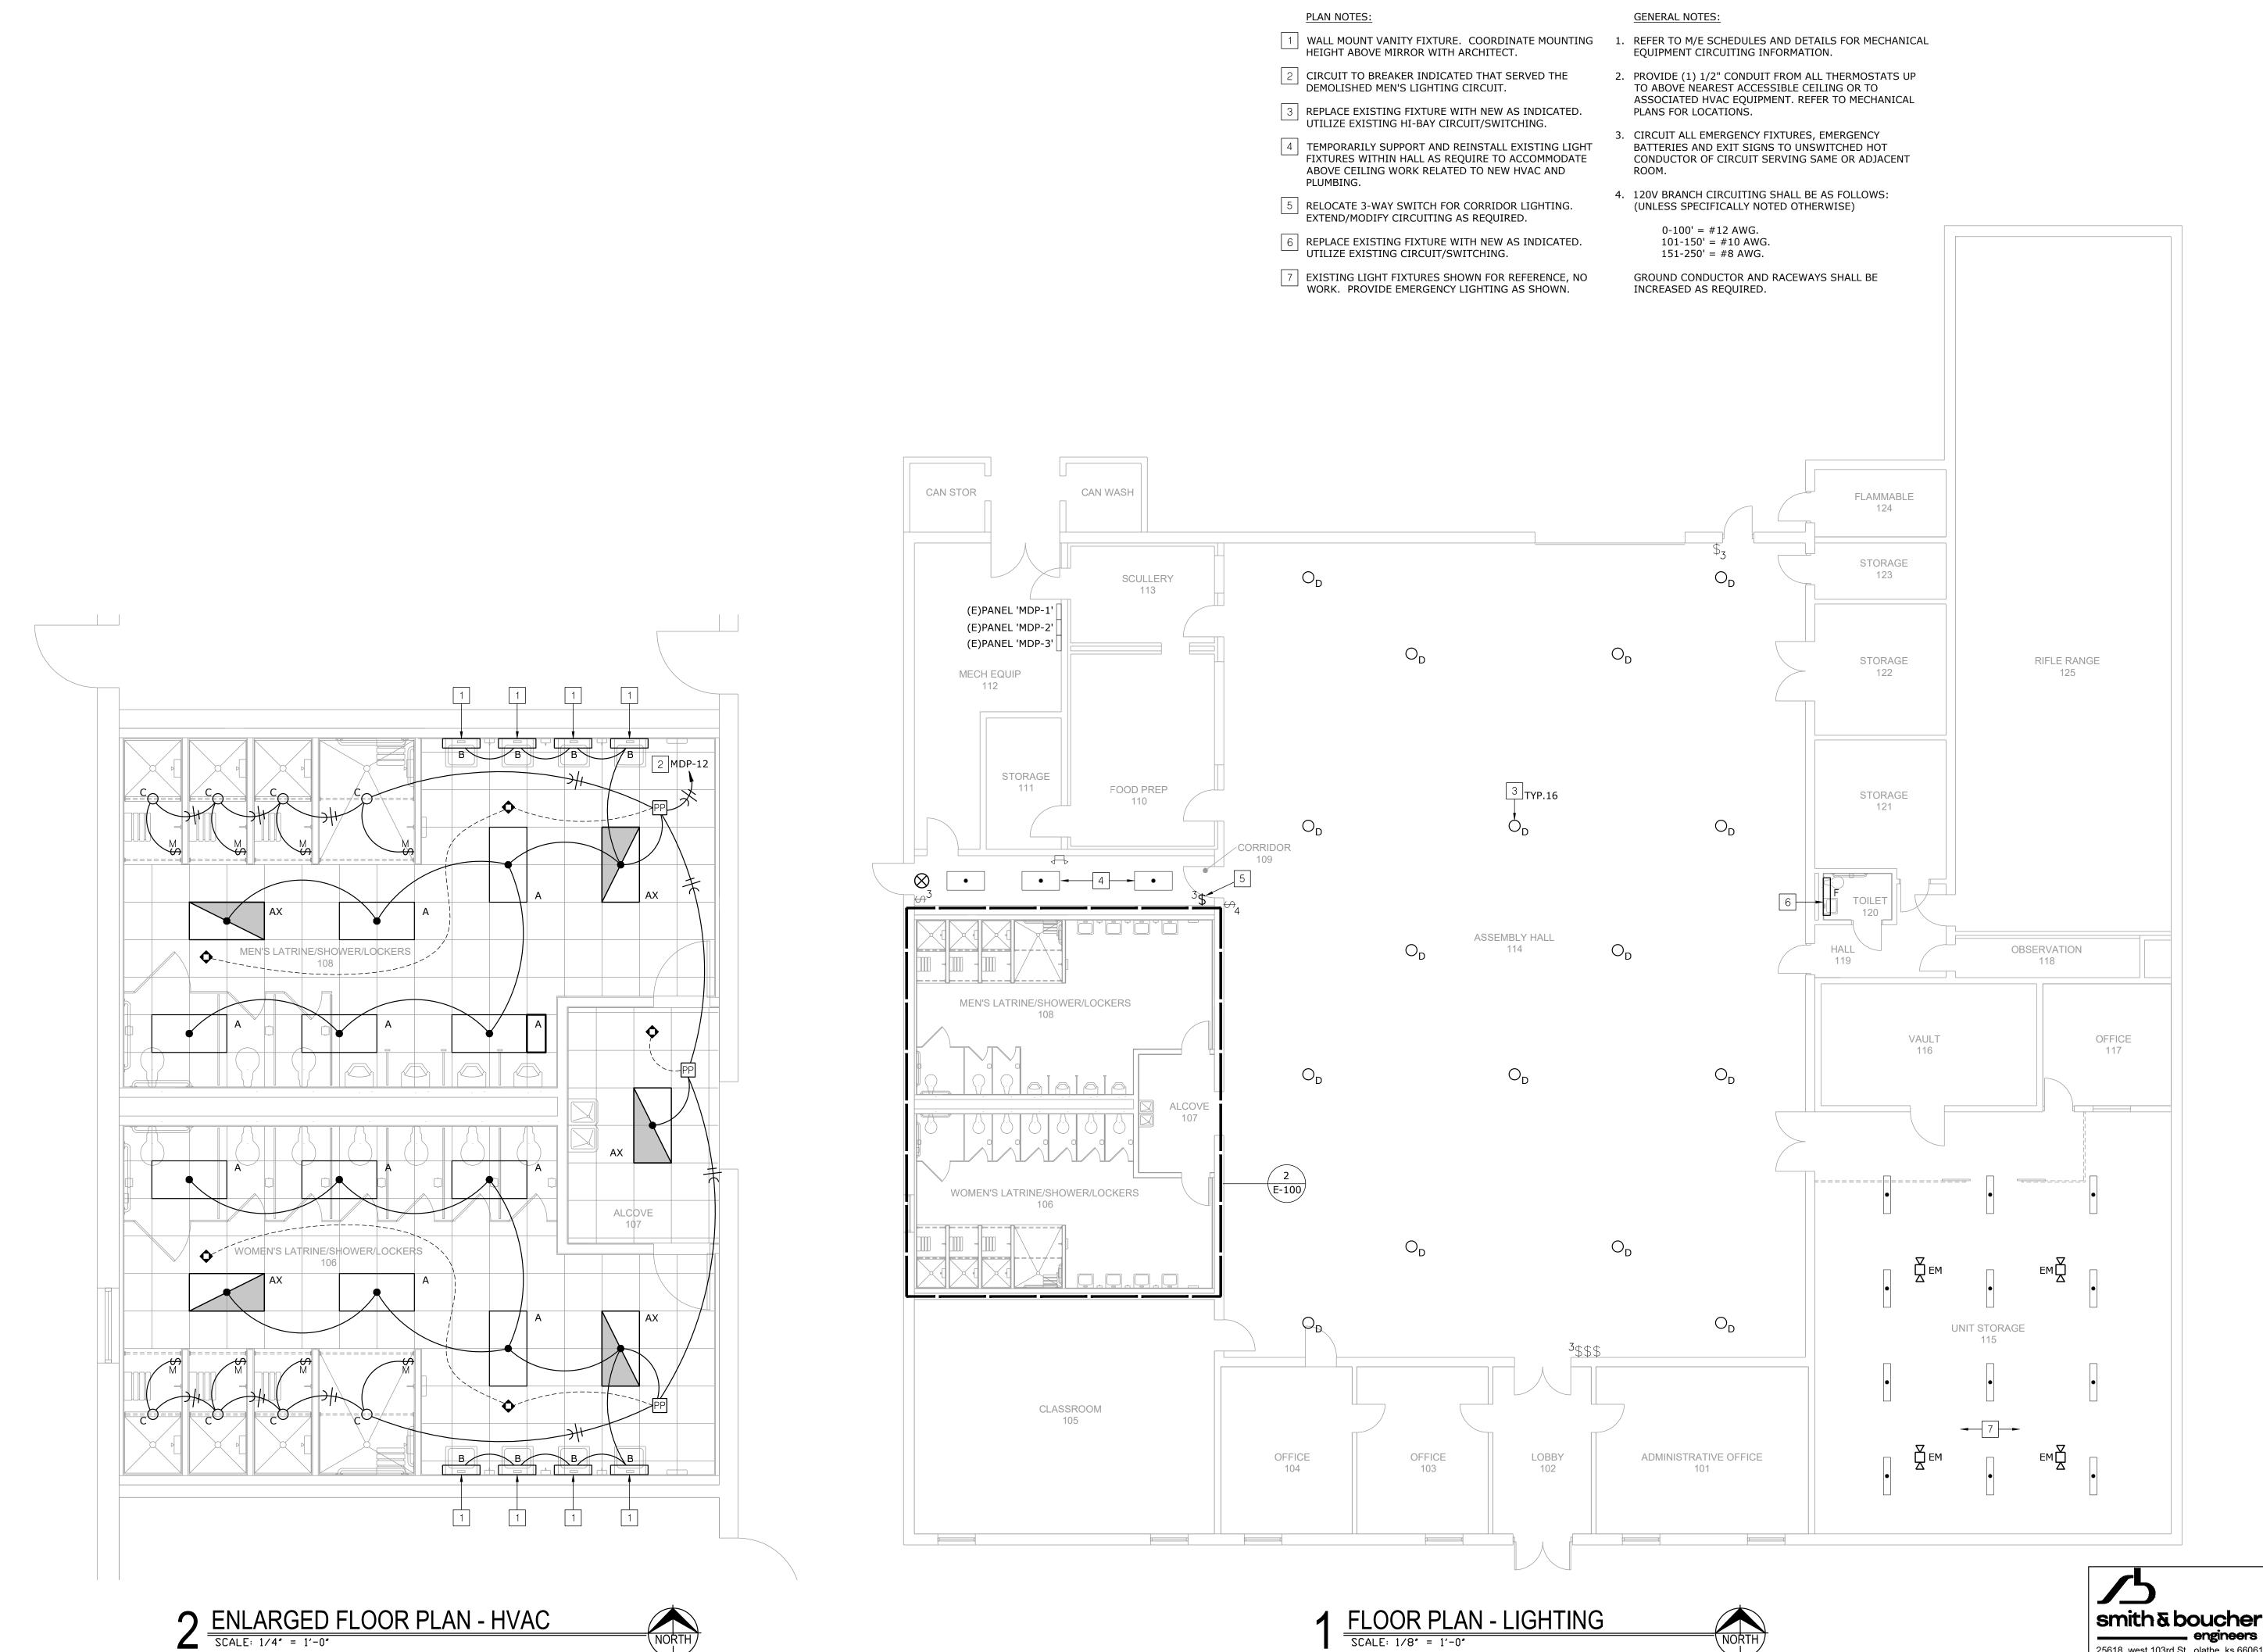

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STATE OF MISSOURI MICHAEL L. PARSON, **GOVERNOR**

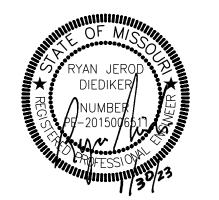

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KENNETT READINESS CENTER 1450 NORTH BY-PASS KENNETT, MO 63857

PROJECT # T2209-01

FACILITY # 8136313002

REVISION: **REVISION: REVISION:** DATE: ISSUE DATE: January 30, 2023

CAD DWG FILE: E-100.DWG
DRAWN BY: JEB
CHECKED BY: RJD
DESIGNED BY: JEB

SHEET TITLE:

LIGHITNG -FLOOR PLAN

SHEET NUMBER:

E-100

27 OF 29 SHEETS

25618 west 103rd St olathe, ks 66061

phone 913.345.2127 fax 913.345.0617

project number 2219000

FLOOR PLAN - LIGHTING SCALE: 1/8" = 1'-0"

CAN STOR

<u>DWH-1</u>-

<u>HWP-1</u>¬

MECH EQUIP

<u>HP-2</u>

(E)PANEL 'MDP-1'

(E)PANEL 'MDP-2'-

(E)PANEL 'MDP-3'-

STORAGE

PE L CORRIDOR

MEN'S LATRINE/SHOWER/LOCKERS

WOMEN'S LATRINE/SHOWER/LOCKERS

CLASSROOM 105

PE 🔼

CAN WASH

SCULLERY

– NEW PANEL 'B/1'

PE 🛕

FOOD PREP

PE 🔼

PE 🔼

PE 🔼

OFFICE

103

PE 🔼

OFFICE

104

PE 🔼

LOBBY

PE 🔼 L

ASSEMBLY HALL

114


GENERAL NOTES:

1. REFER TO GENERAL NOTES, SHEET E-100.

PLAN NOTES:

- 1 CIRCUIT NEW PANEL 'B' VIA EXISTING PANEL 'MDP-1', 'MDP-2', OR 'MDP-3'. CONDUIT/WIRE SHALL BE (4)#4,#10G.,1-1/4"C. FIELD DETERMINE THE MOST FEASIBLE PANEL WHICH TO USE TO SERVE THE NEW PANEL 'B'. IN THE EXISTING PANEL UTILIZED, THREE (3) 20A, 120V RECEPTACLE LOADS WILL BE REQUIRED TO BE RELOCATED AND PROTECTED VIA THE NEW PANEL 'B' IN ORDER TO ACCOMMODATE THE NEW PANEL 'B' OCPD (60A-3P CB).
- PROVIDE MONITORING OF EXISTING KITCHEN HOOD WITH NEW FIRE ALARM PANEL. FIELD DETERMINE REQUIREMENTS WITH EXISTING HOOD SYSTEM.
- 3 COORDINATE REPLACEMENT OF EXISTING ADA DOOR OPENER MOTOR, ASSOCIATED ADA DOOR PUSH BUTTON, AND CABLING WITH DOOR HARDWARE PROVIDER. REUSE EXISTING POWER SUPPLY, LOW VOLTAGE CONDUIT AND BOXES WHERE POSSIBLE. FIELD DETERMINE EXACT REQUIREMENTS.
- 4 | ALTERNATE NO.1 PROVIDE CONDUIT AND CABLING AS REQUIRED FOR DOOR HARDWARE REQUIRED FOR REMOTE LOCK/UNLOCKING WITHIN MAIN OFFICE. COORDINATE WITH DOOR HARDWARE PROVIDER AND OWNER'S SECURITY CONTRACTOR. FIELD DETERMINE EXACT REQUIREMENTS.
- 5 LOCATION OF NEW FIRE ALARM PANEL.
- 6 LOCATION OF NEW FIRE ALARM PANEL REMOTE ANNUNCIATOR PANEL.
- 7 EXISTING AI PHONE.
- 8 ALTERNATE NO.2 600A, 120/208V, 3 PHASE MANUAL TRANSFER SWITCH CABINET WITH GENERATOR CAM-LOK CONNECTIONS, THREE POSITION MANUAL OPERATING HANDLE, 3R ENCLOSURE, PAD MOUNT. BASES OF DESIGN ASCO MODEL #J-03MTQ-B-3-0600-C-00-M. EQUALS BY EATON, KOHLER POWER SYSTEMS, SIEMENS, CUMMINS POWER GENERATION, RUSS ELECTRIC.
- WITHIN THE EXISTING 'MDP' PANEL(S), SIX (6) 20A, 120V RECEPTACLE LOADS WILL BE REQUIRED TO BE RELOCATED AND PROTECTED VIA THE NEW PANEL 'B' IN ORDER TO ACCOMMODATE THE OCPD FOR CU-1, F-1, AND DOAS-1. REFER TO M/E SCHEDULES FOR EQUIPMENT CIRCUITING INFORMATION. FIELD DETERMINE MOST FEASIBLE EXISTING LOADS TO RELOCATE.
- 10 RELOCATE EXHAUST FAN STARTERS.
- 11 UTILIZE EXISTING CIRCUIT AND CONDUCTORS SERVING DEMOLISHED PTAC UNIT TO SERVE NEW MINI-SPLIT SYSTEM. REFER TO EQUIPMENT SCHEDULE. FIELD VERIFY EXACT REQUIREMENTS.

STATE OF MISSOURI MICHAEL L. PARSON, **GOVERNOR**

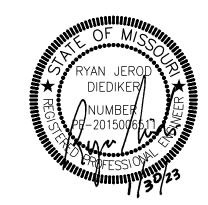

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PROJECT # T2209-01

FACILITY # 8136313002

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CAD DWG FILE: E-200.DWG
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CHECKED BY: RJD DESIGNED BY: JEB

SHEET TITLE:

POWER -FLOOR PLAN

SHEET NUMBER:

E-200

28 OF 29 SHEETS


smith & boucher

25618 west 103rd St olathe, ks 66061

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____ engineers

project number 2219000

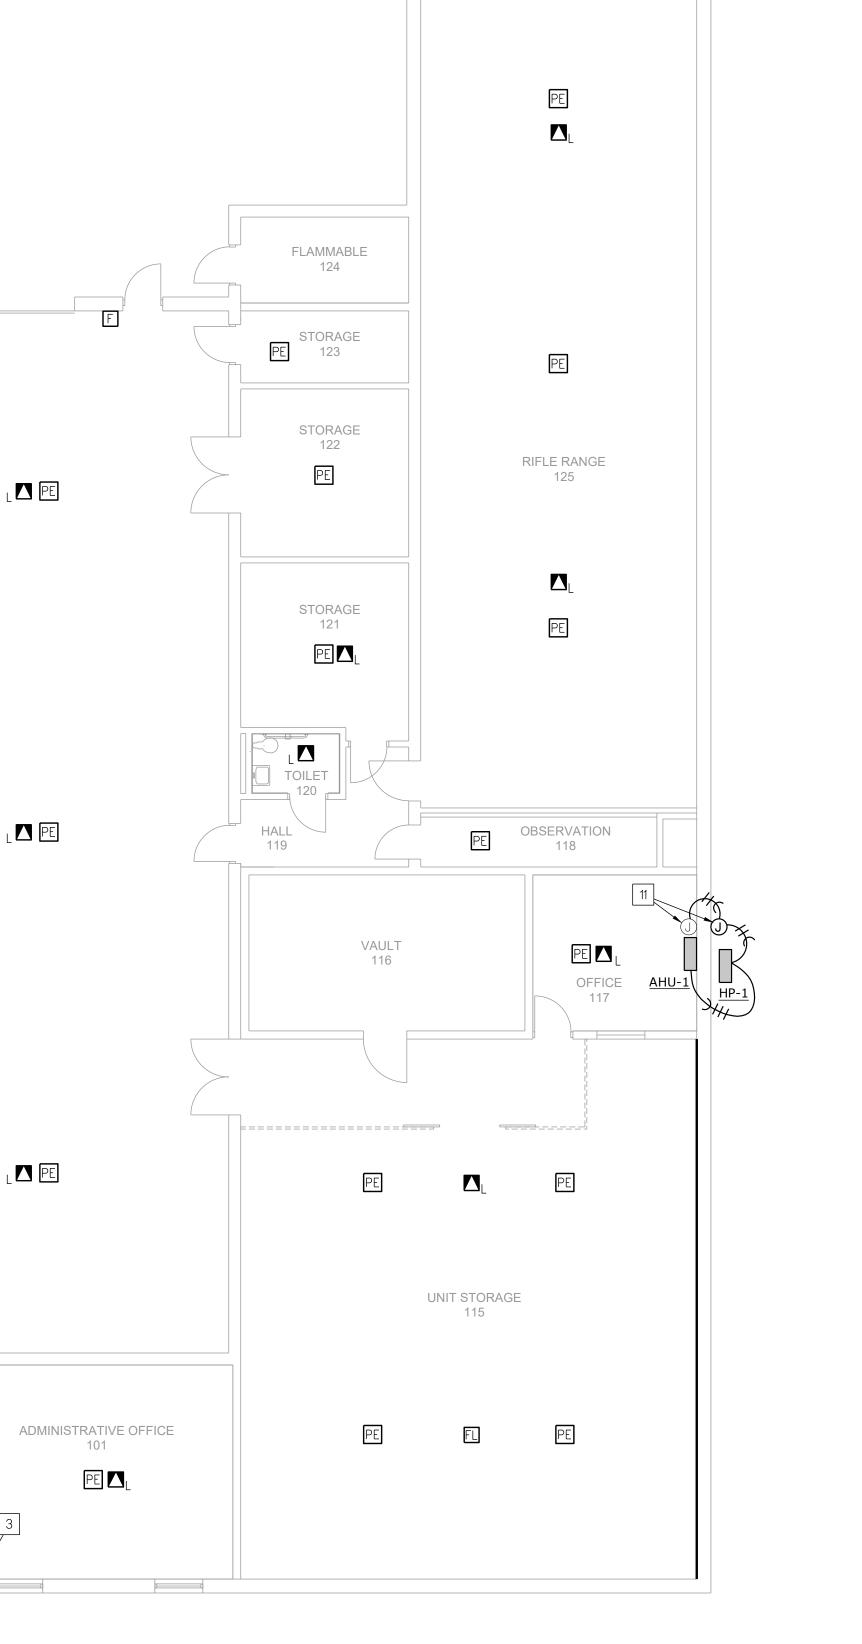

PANEL MAIN BUS AMPS: MAIN BREAKER: VOLTAGE: PHASES/WIRES:	B (Note 2 100 A N/A 208Y/120 V 3 PH / 4 W	AI SE MO	C: ECTIONS: DUNTING: ICLOSURE	TYPE:	10,000 A 1-24 SPAC SURFACE NEMA 1	E		MAIN LUGS ONLY EQUIPMENT GROUND BUS
CIRCUIT DESCRIPTION			AMPS	CKT NO	CKT NO	AMPS	POLES	CIRCUIT DESCRIPTION
FIRE ALARM PANEL		1	20 -LCK	1	2	20	1	CIRCUIT (NOTE 1)
RCPT-W	OMEN'S LATRENE	1	20	3	4	20	1	CIRCUIT (NOTE 1)
RCP	T-MEN'S LATRENE	1	20	5	6	20	1	CIRCUIT (NOTE 1)
RCPT-DF	rinking fountain	1	20	7	8	20	1	CIRCUIT (NOTE 1)
RCPT-GENERAL	PURPOSE, ROOF	1	20	9	10	20	1	CIRCUIT (NOTE 1)
PUMP HWP-1, WATE	R HEATER DHW-1	1	20	11	12	20	1	CIRCUIT (NOTE 1)
SOUTH PA	RKING LOT LIGHTS	2	20	13	14	20	1	CIRCUIT (NOTE 1)
FLAG POLE LIGHTS				15	16	20	1	CIRCUIT (NOTE 1)
	SPARE	1	20	17	18	20	1	CIRCUIT (NOTE 1)
	SPARE	1	20	19	20	20	1	SPARE
	SPARE	1	20	21	22	20	1	SPARE
SPARE			20	23	24	20	1	SPARE

1. RELOCATED GENERAL RECEPTACLE CIRCUIT FROM EXISTING PANEL. IDENTIFY

2: PANEL SERVED VIA 60A-3P CB IN EXISTING MDP-1, MDP-2, OR MDP-3 PANEL.

THE E.C. SHALL FIELD DETERMINE EXISTING PANEL TO UTILIZE.

AND PROVIDE PROPER CIRCUIT DESCRIPTION.


GFI - GROUND FAULT BREAKER LCK - LOCKABLE TAB

NEUTRAL CEILING CEILING MOUNTED MOUNTED OCCUPANCY OCCUPANCY SENSORS AS SENSOR +24VDC REQUIRED **PRIMARY** LOAD LINE MOUNTED PRIMARY LOAD DEVICE POWER _ PACK GROUND NEUTRAL LINE VOLTAGE OCCUPANCY LOW VOLTAGE OCCUPANCY SENSOR WIRING DIAGRAM **SENSOR WIRING DIAGRAM** WITH AUTOMATIC ON OPERATION (SYMBOL PP /♠)

NTERIOR LIGHTING CONTROL EQUIPMENT LEGEND								
SYMBOL	FUNCTION	SYSTEM WIRING	MOUNTING	SETTING(TYPICAL)	MANUFACTURER	NOTES		
\$ _M	SWITCH	LINE VOLTAGE	WALL SWITCH	ON: MANUAL OFF: 30 MINUTE DELAY	WATTSTOPPER PW-100	NOTE 1		
\$	MOTION SENSOR	LOW VOLTAGE	CEILING	ON: AUTOMATIC OFF: 30 MINUTE DELAY	WATTSTOPPER DT-300	NOTE 1,2,4		
PP	POWER PACK	DIGITAL	CEILING		WATTSTOPPER BZ-50	NOTE 1,3		

- DRAWINGS FOR QUANTITIES.
- NOTE 2: PROVIDE 8'-0" OF EXCESS CONTROL WIRING, COILED AND TIED, BETWEEN CEILING MOUNTED OCCUPANCY SENSORS AND CORRESPONDING POWER PACKS.
- NOTE 3: LOCATE DEVICE ABOVE ACCESSIBLE CEILING, LOCATIONS SHOWN ON DRAWINGS ARE SCHEMATIC.
- NOTE 4: MODIFY LOCATIONS OF CEILING MOUNTED OCCUPANCY SENSORS AS REQUIRED SO THAT NO OCCUPANCY SENSOR IS WITHIN 4'-0" OF AN HVAC SUPPLY DIFFUSER.

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ISSUE DATE: January 30, 2023

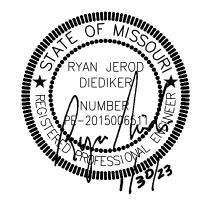CAD DWG FILE: E-300.DWG DRAWN BY: JEB CHECKED BY: RJD DESIGNED BY: JEB

SHEET TITLE:

ELECTRICAL -SCHEDULES & **DETAILS**

SHEET NUMBER:

E-300

29 OF 29 SHEETS

PACE - Kennett Readiness Center X:\22\22190\2219000\Drawings\06-2219000_E-300.dwg Jblackburn Booty Charles Friday, January 27, 2023 2:52:53 PM

PROJECT NAME: AUTOCAD FILE LOCATION \ NAME: LAST CORRECTION BY ♦ DATE ♦ TIME: PLOTTED BY ♦ DATE ♦ TIME:

smith & boucher 25618 west 103rd St olathe, ks 66061 phone 913.345.2127 fax 913.345.0617 project number 2219000