RENOVATE INTERIOR AND EXTERIOR KENNETT READINESS CENTER Kennett, Missouri

OWNER: STATE OF MISSOURI MICHAEL L. PARSON, GOVERNOR

> MISSOURI NATIONAL GUARD OFFICE OF THE ADJUTANT GENERAL FACILITIES MANAGEMENT OFFICE


PROJECTOFFICE OF ADMINISTRATIONMANAGEMENT:DIVISION OF FACILITIES MANAGEMENT,DESIGN AND CONSTRUCTION




DESIGNER: Architect Dille Pollard, LLC Engineer Smith & Boucher, Inc.

PROJECT NUMBER: T2209-01

FACILITY NUMBER: 8136313002

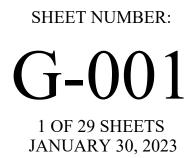

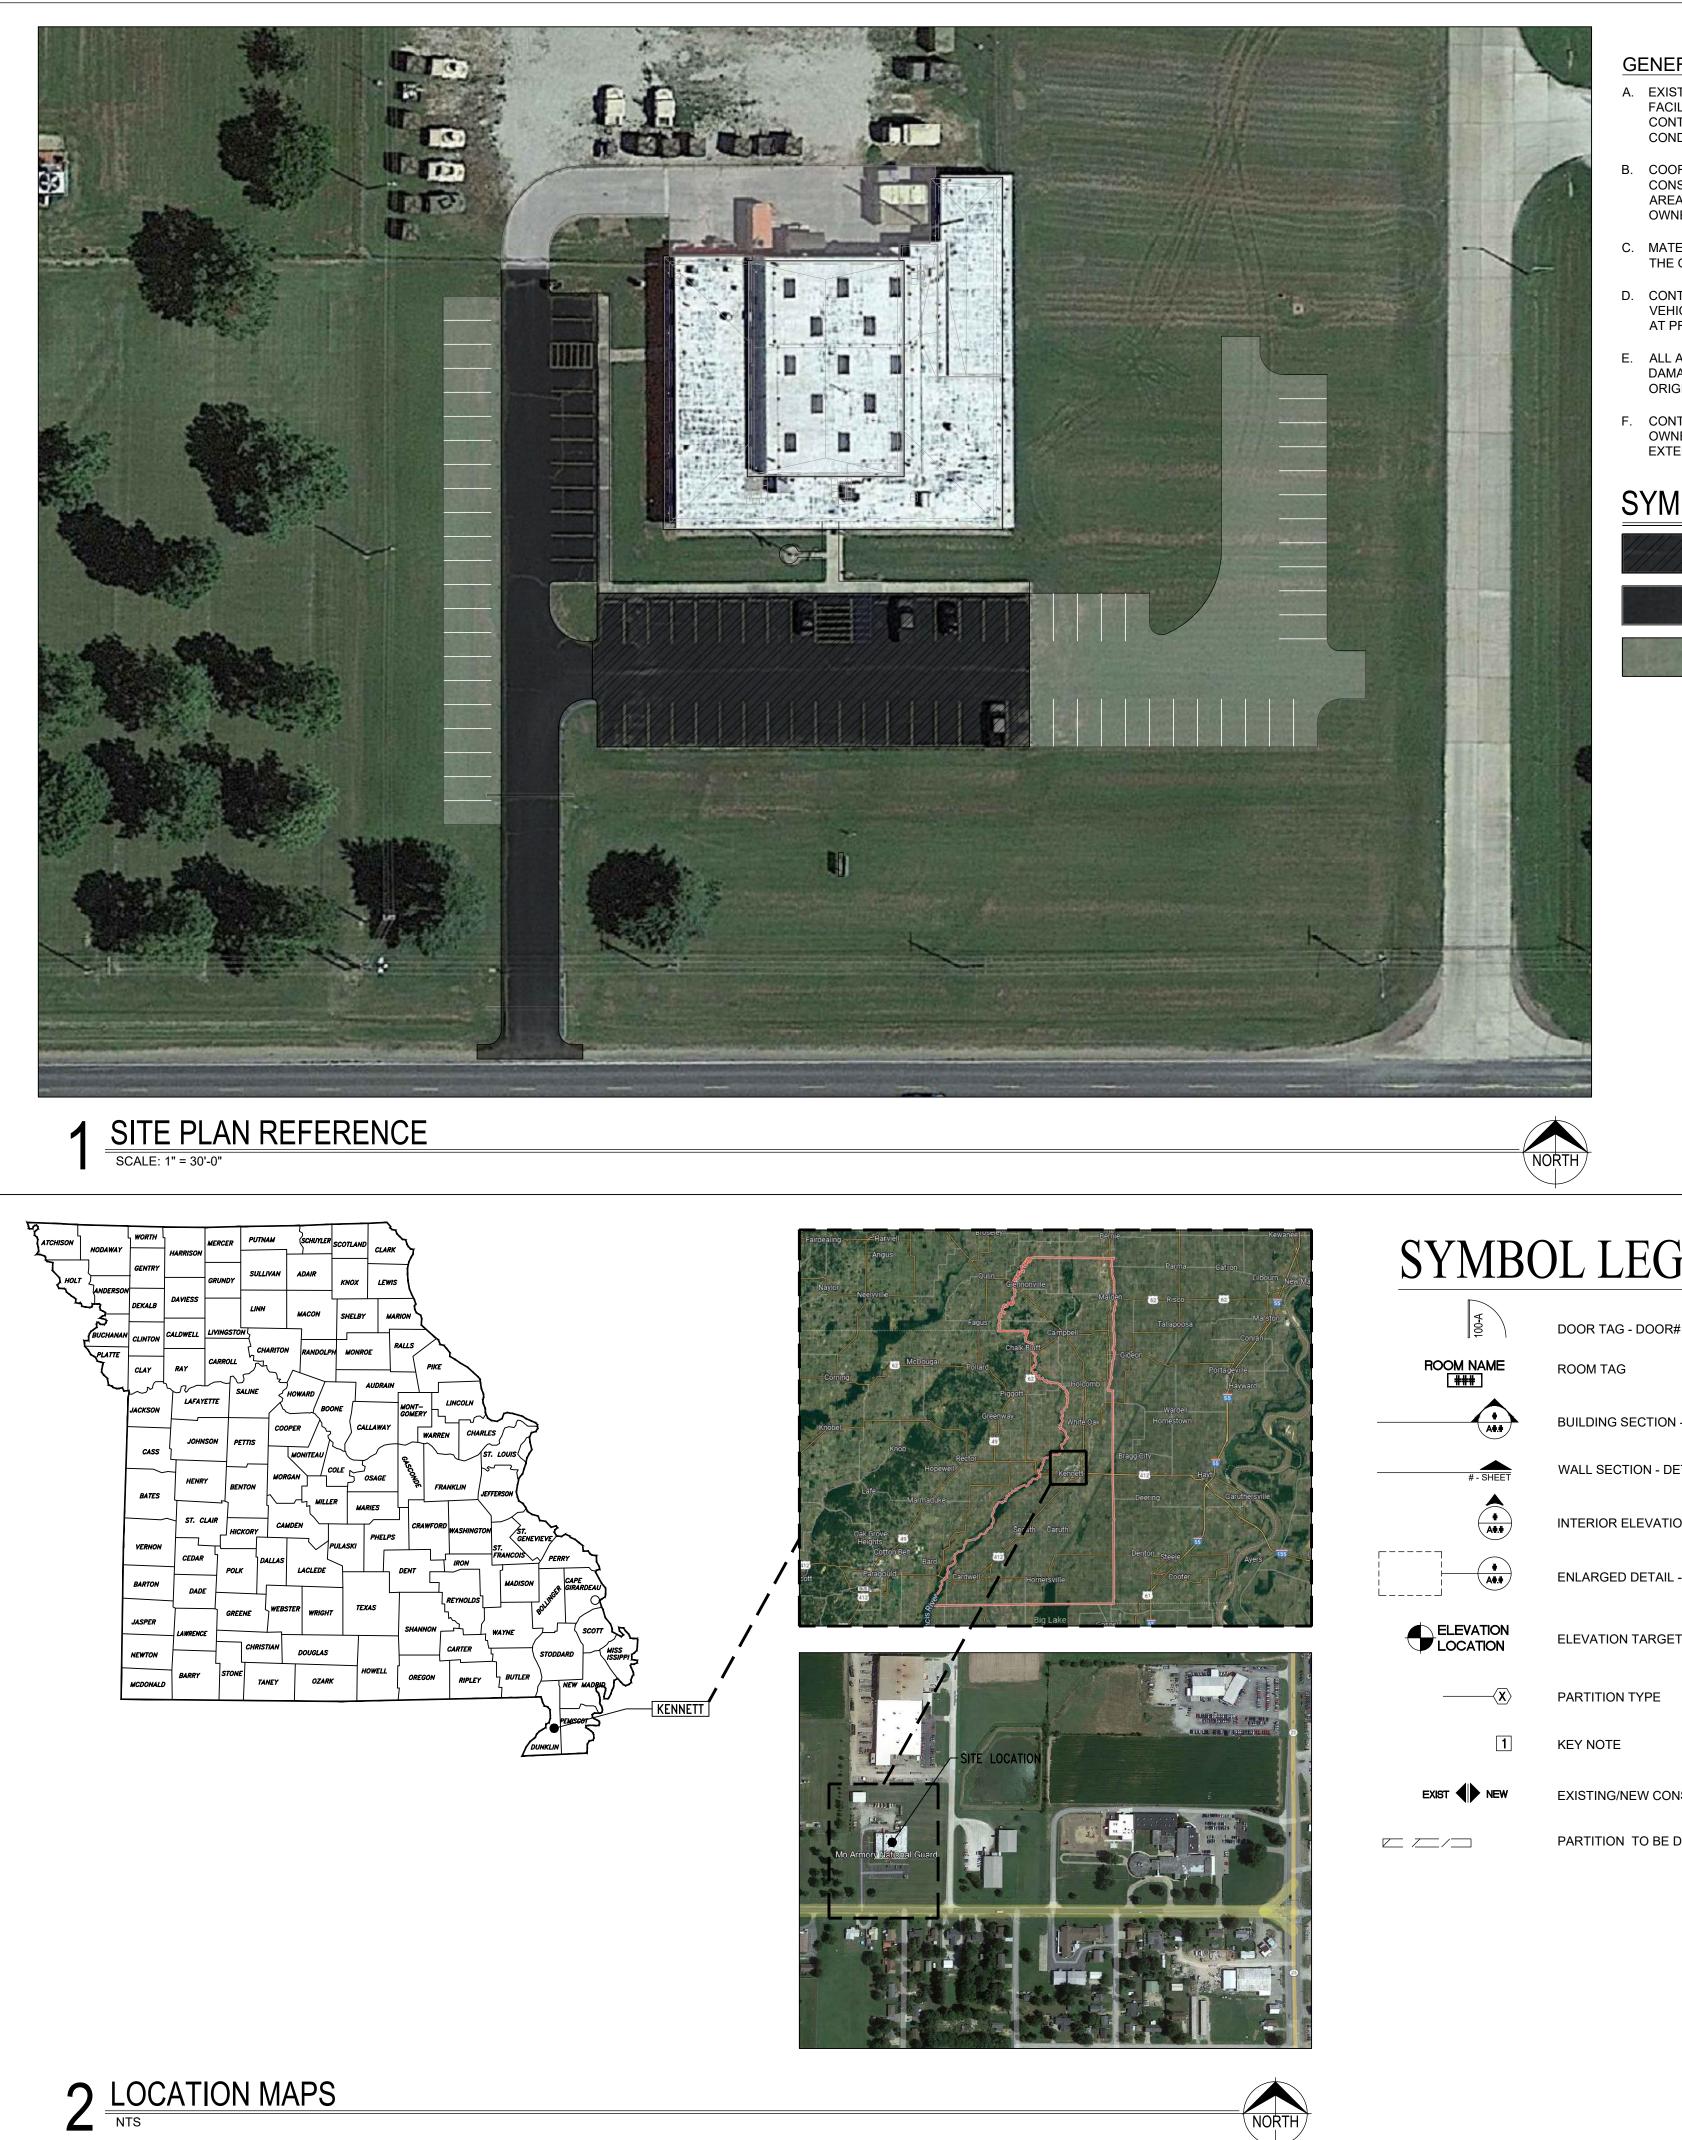

GENERAL NOTES - SITE PLAN:

- EXISTING CONDITIONS HAVE BEEN NOTED USING OWNER'S FACILITY DRAWINGS AND FIELD VISUAL SURVEYS. THE CONTRACTORS ARE REQUIRED TO VISIT THE SITE AND VERIFY CONDITIONS FOR THE WORK PRIOR TO BIDDING.
- COORDINATE ALL SITE WORK WITH OWNER PRIOR TO START OF CONSTRUCTION AND OWNER'S PREPARATION FOR THE WORK AREAS. PREPARE A RENOVATION PLAN / SCHEDULE FOR THE OWNER'S APPROVAL PRIOR TO THE WORK.
- C. MATERIAL STAGING AREA(S) ON SITE WILL BE DETERMINED BY THE OWNER AT PRE-BID OR PRE- CONSTRUCTION CONFERENCE.
- D. CONTRACTOR'S MOBILE OFFICE, STORAGE TRAILERS AND VEHICLE PARKING ON SITE WILL BE DETERMINED BY THE OWNER AT PRE-BID OR PRE-CONSTRUCTION CONFERENCE.
- ALL AGGREGATE AND CONCRETE SURFACES DISTURBED OR DAMAGED DURING CONSTRUCTION SHALL BE RESTORED TO ORIGINAL CONDITION.
- CONTRACTOR TO COORDINATE ACCESS AND PARKING WITH OWNER PRIOR TO START OF WORK. REFER TO SHEET A-001 FOR EXTENT OF WORK.

SYMBOL LEGEND (THIS SHEET ONLY)

ALTERNATE BID NO. 3: AREA OF EXISTING ASPHALT PAVING TO BE REMOVED AND REPLACED WITH CONCRETE EXISTING PAVING - POTENTIAL UNIT COST WORK

EXISTING PAVING - NO WORK

ROOM NAME [###]	ROOM TAG
	BUILDING SEC
# - SHEET	WALL SECTIC
* 	INTERIOR ELE
	ENLARGED D
ELEVATION	ELEVATION T
{X>	PARTITION TY
1	KEY NOTE
XIST NEW	EXISTING/NE

ECTION - DETAIL# / SHEET# ION - DETAIL#-SHEET# LEVATION - DETAIL# / SHEET# DETAIL - DETAIL# / SHEET# TARGET TYPE EW CONSTRUCTION PARTITION TO BE DEMOLISHED

ABBREVIATIONS

A.D.A. BLDG.	AMERICAN DISABILITIES ASSOCIATION BUILDING
C.J.	CONTROL JOINT
CLG.	CEILING
C.M.U. CONC.	CONCRETE MASONRY UNIT CONCRETE
CONC. CONT.	CONTINUOUS
DR.	DOOR
E.W.C.	
E.I.F.S. E.J.	EXTERIOR INSULATION AND FINISH SYSTEM EXPANSION JOINT
	EACH
	EXTERIOR
FIN.	FINISH FLOOR
	GRAB BAR
	GYPSUM
H.M.	HOLLOW METAL
HT. INT.	HEIGHT INTERIOR
INSUL.	INSULATION
LVL.	LEVEL
MANF.	
M.B.C. MIN.	METAL BUILDING CONTRACTOR MINIMUM OR MINUTE
MTL.	
0.C.	ON CENTER
PART. PR	PARTITION PAIR
PRE-FIN	PRE-FINISHED
REQ'D	REQUIRED
SCH. S.S.	SCHEDULE STAINLESS STEEL
3.3. STL.	STEEL
SPEC.	SPECIFICATIONS
STRUCT.	STRUCTURAL
TLT. W.	TOILET WIDTH
Ŵ/	WITH
U.L.	UNDERWRITERS LABORATORIES
	WINDOW VINYL COMPOSITION TILE
v.c.1.	VINTE COMPOSITION TILE

DRAWING INDEX

G-001	TITLE SHEET
G-002	SHEET INDEX, SITE LOCATION PLANS, LEGEND, AND ABBREVIATIONS
A-001	SITE PLANS AND SITE DETAILS
A-100	DEMOLITION PLAN - FLOOR PLAN
A-101	DEMOLITION PLAN - REFLECTED CEILING
A-102	DEMOLITION PLAN - ROOF PLAN
A-200	ALTERATIONS PLAN - FLOOR PLAN
A-201	ALTERATIONS PLAN - REFLECTED CEILING
A-202	ALTERATIONS PLAN - ROOF PLAN
A-300	ALTERATIONS - ELEVATIONS
A-400	DETAIL PLANS, ELEVATIONS AND DETAILS
A-500	SCHEDULES AND DETAILS
A-501	SCHEDULES AND DETAILS
ME-100	SYMBOLS, ABBREVIATIONS - MECHANICAL AND ELECTRICAL
ME-200	SITE PLAN - MECHANICAL AND ELECTRICAL
ME-201	ROOF PLAN - MECHANICAL AND ELECTRICAL
ME-300	SCHEDULES - MECHANICAL AND ELECTRICAL
ME-301	SCHEDULES - MECHANICAL AND ELECTRICAL
ME-302	DETAILS - MECHANICAL AND ELECTRICAL
DM-100	DEMOLITION HVAC - FLOOR PLAN
DP-100	DEMOLITION PLUMBING - FLOOR PLAN
M-100	HVAC - FLOOR PLAN
M-200	HVAC CONTROL SCHEMATICS
P-100	PLUMBING - FLOOR PLAN
P-200	RISER DIAGRAMS - PLUMBING
DE-100	DEMOLITION ELECTRICAL - FLOOR PLAN
E-100	LIGHTING - FLOOR PLAN
E-200	POWER - FLOOR PLAN
E-300	ELECTRICAL - SCHEDULES AND DETAILS


GENERAL NOTES

ARCHITECTURAL DWGS

- A. INFORMATION SHOWN ON THE DOCUMENTS FOR THE EXISTING BUILDING HAS BEEN REPRODUCED FROM THE ORIGINAL DRAWINGS AND FIELD VISUAL SURVEYS. REFER TO MEP DRAWINGS FOR ADDITIONAL INFORMATION. NO FORENSIC INVESTIGATIONS HAVE BEEN MADE FOR CONSTRUCTION ABOVE CEILINGS, UNDER FLOORS OR WITHIN WALLS. THE CONTRACTORS ARE REQUIRED TO VISIT THE SITE AND VERIFY CONDITIONS FOR THE WORK PRIOR TO BIDDING.
- B. EXISTING FURNISHINGS, LOCKERS, BENCHES, ETC. ARE NOT SHOWN; BUT WILL BE MOVED BY THE OWNER PRIOR TO CONSTRUCTION. CONTRACTOR TO COORDINATE WITH OWNER.
- C. THE SITE WILL BE FULLY OCCUPIED DURING THE HOURS OF 8:00 A.M. AND 5:00 P.M. COORDINATE ALL SITE WORK WITH THE OWNER PRIOR TO START OF CONSTRUCTION FOR AREAS THAT WILL BE OCCUPIED AND OWNER'S PREPARATION FOR THE WORK AREAS. PREPARE A RENOVATION PLAN/SCHEDULE FOR THE OWNER'S APPROVAL PRIOR TO THE WORK.
- D. THE CONTRACTOR WILL REPORT EXISTING DAMAGE TO MATERIALS THAT ARE TO REMAIN PRIOR TO THE WORK AND REPAIR OR REPLACE MATERIALS THAT ARE DAMAGED BY THE RENOVATION WORK.
- E. PROTECT & KEEP CLEAR ALL BUILDING ACCESSES.
- F. ALL EXISTING SERVICES & UTILITIES SHALL BE MAINTAINED TO ADJACENT AREAS THAT ARE IN OPERATION & SERVED BY THESE UTILITIES & SERVICES. COORDINATE ALL DISRUPTIONS OR DISCONTINUATION OF UTILITIES & SERVICES WITH THE OWNER'S REPRESENTATIVE AT THE FACILITY.
- G. PROVIDE TEMPORARY DUST BARRIERS IN ALL AREAS OF WORK. COORDINATE EXACT LOCATIONS WITH OWNER.
- H. EXISTING ITEMS, STRUCTURE, EQUIPMENT, ETC. TO REMAIN IN PLACE SHALL BE PROTECTED FROM DIRT & DAMAGE DURING DEMOLITION & CONSTRUCTION.
- REMOVE ONLY WHAT IS NECESSARY TO COMPLETE DEMOLITION & ACCOMMODATE NEW CONSTRUCTION. PREPARE ALL DISTURBED AREAS FOR NEW CONSTRUCTION.
- J. ANY DAMAGE RESULTING FROM DEMOLITION TO BE REPAIRED TO ITS ORIGINAL STATE BY THE CONTRACTOR.
- K. GENERAL CONTRACTOR SHALL INSTALL SOLID WOOD BLOCKING AT WALLS AND PARTITIONS AS NECESSARY FOR INSTALLATION OF TOILET PARTITIONS, ACCESSORIES, LOCKERS, ETC. COORDINATE WITH OWNER.





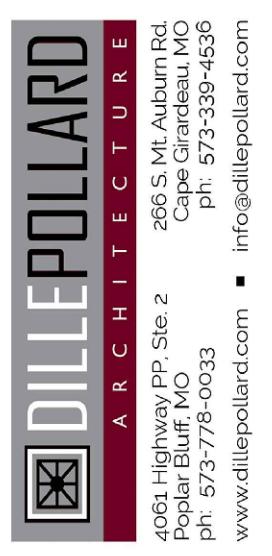

OFFICE OF ADMINISTRATION DIVISION OF FACILITIES MANAGEMENT, **DESIGN AND CONSTRUCTION**


MISSOURI ARMY NATIONAL GUARD FACILITIES DIVISION

RENOVATE INTERIOR AND EXTERIOR

KENNETT **READINESS CENTER** 1450 NORTH BY-PASS KENNETT, MO 63857

PROJECT # T2209-01

FACILITY # 8136313002

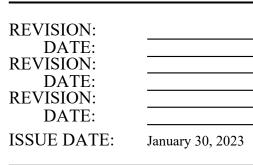


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SHEET TITLE:


SHEET INDEX SITE LOCATION PLANS LEGENDS AND ABBREVIATIONS

SHEET NUMBER:

G-002



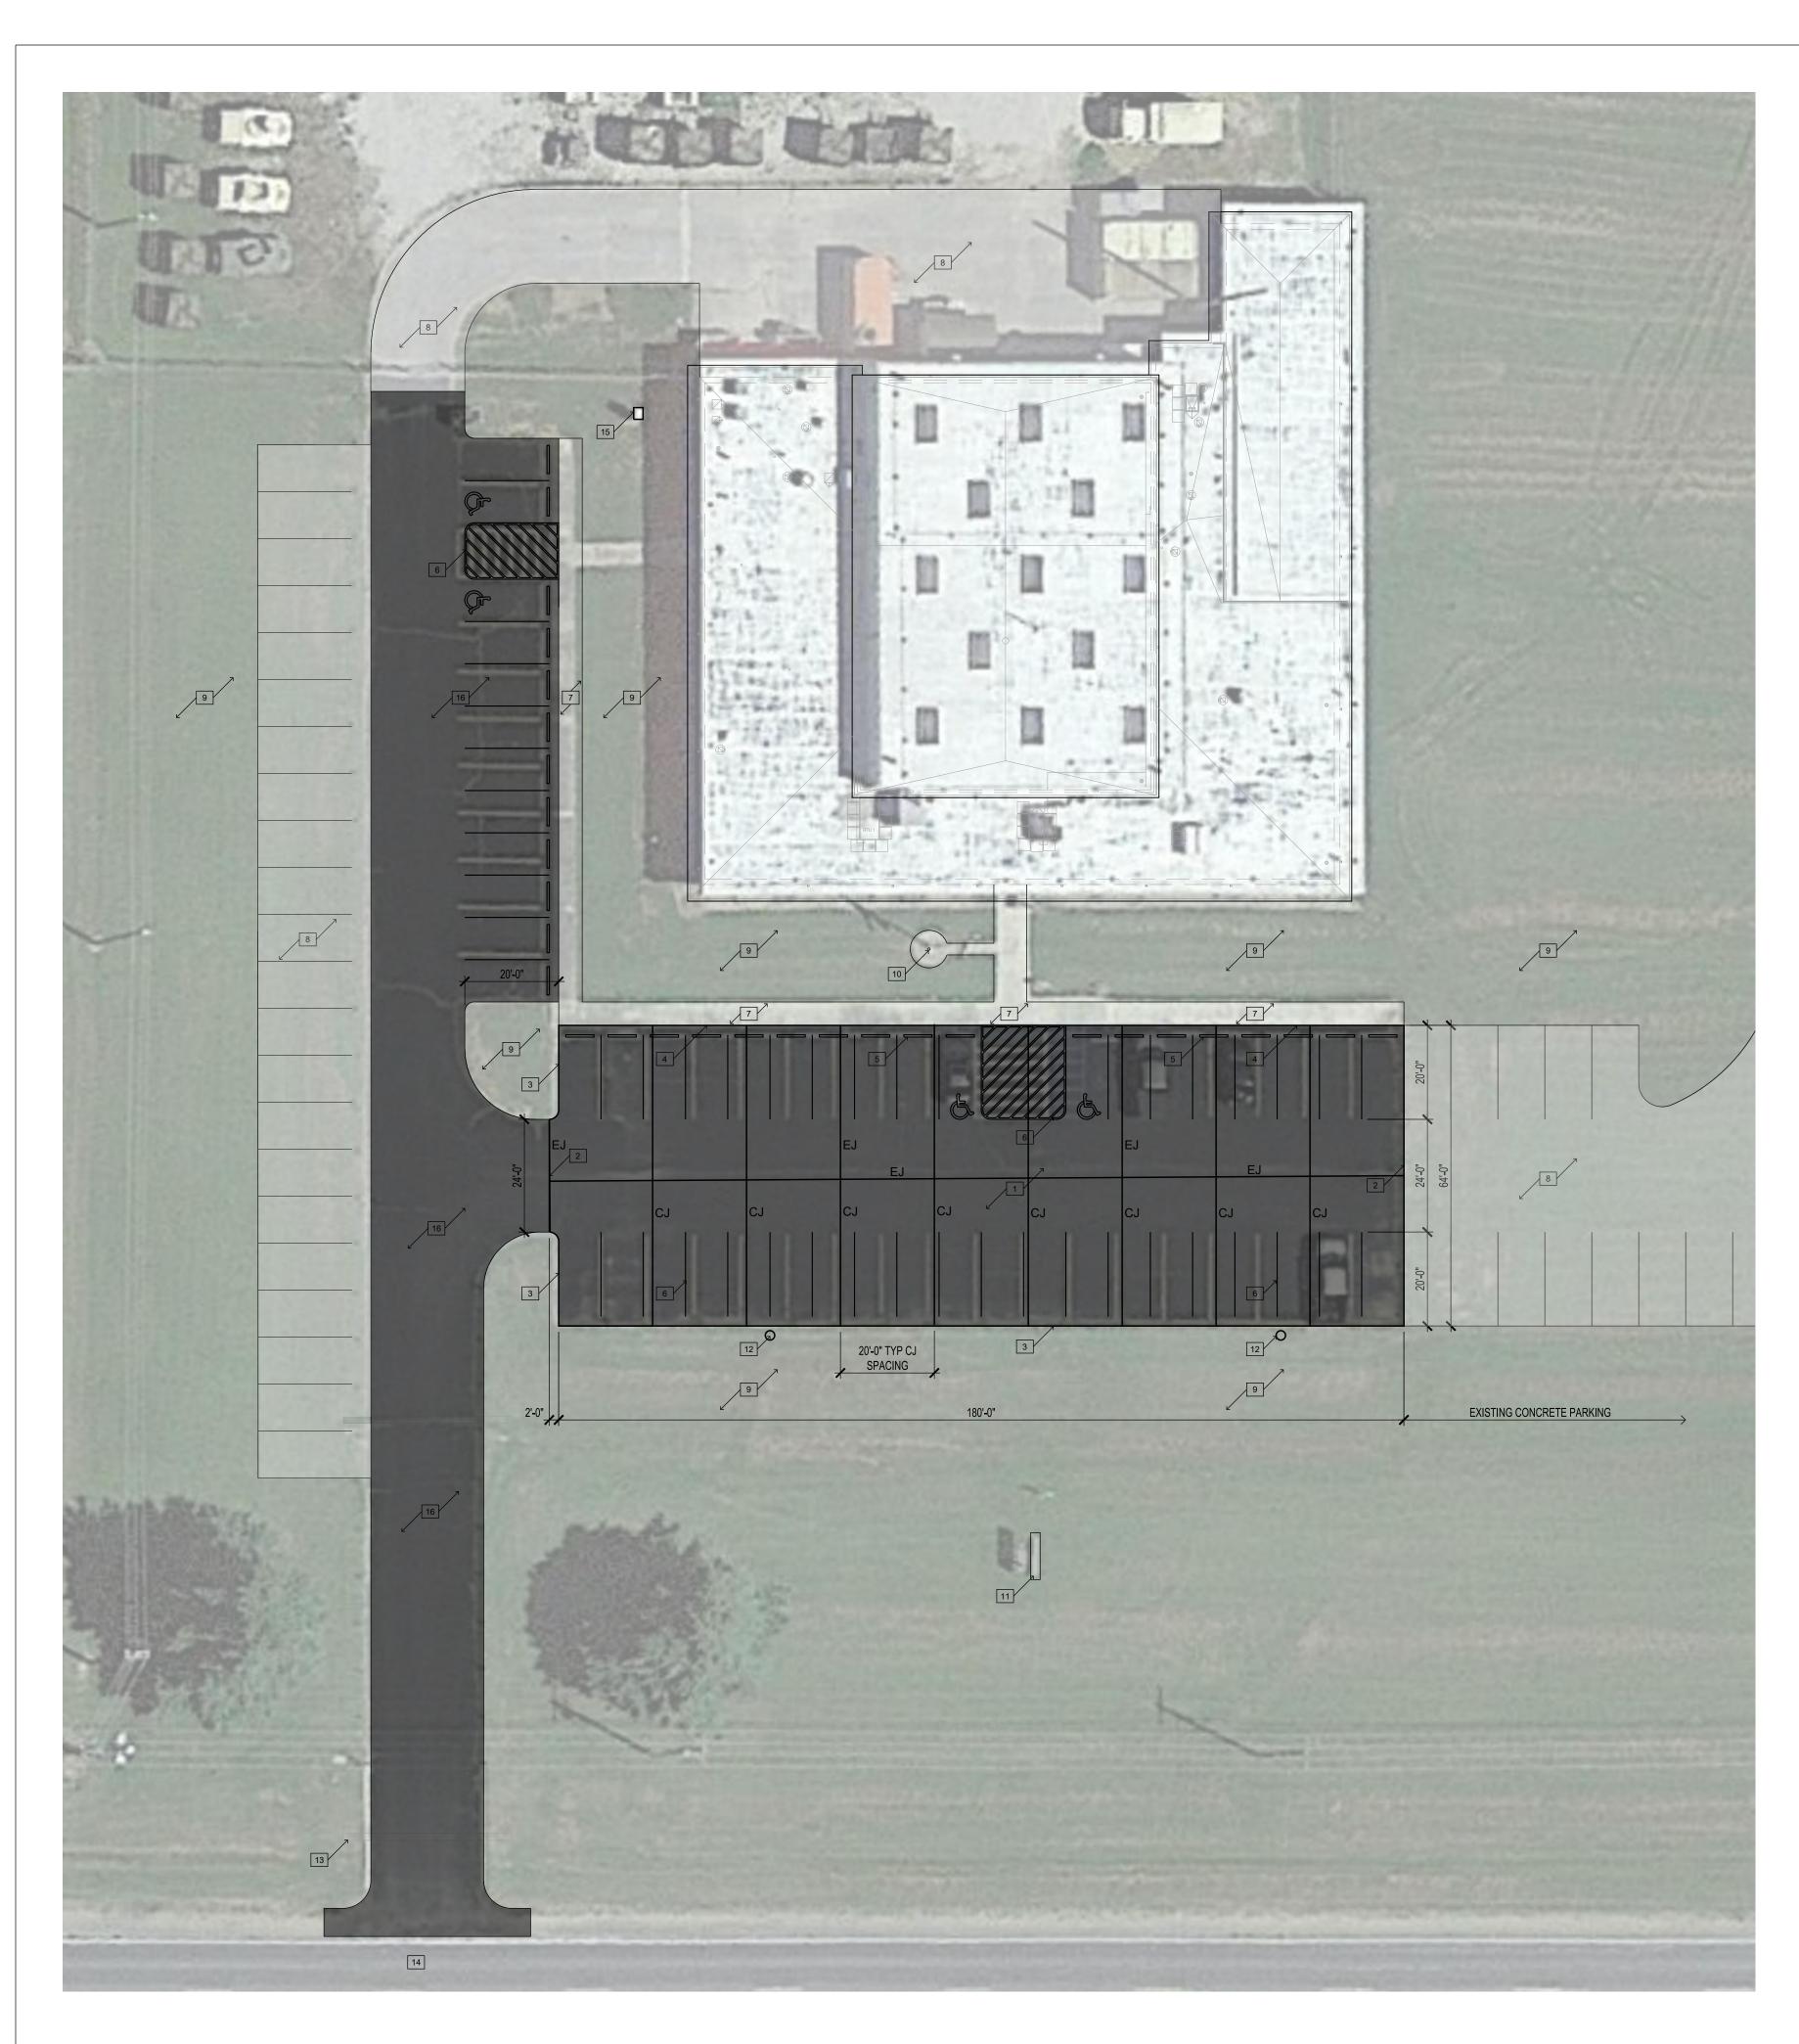

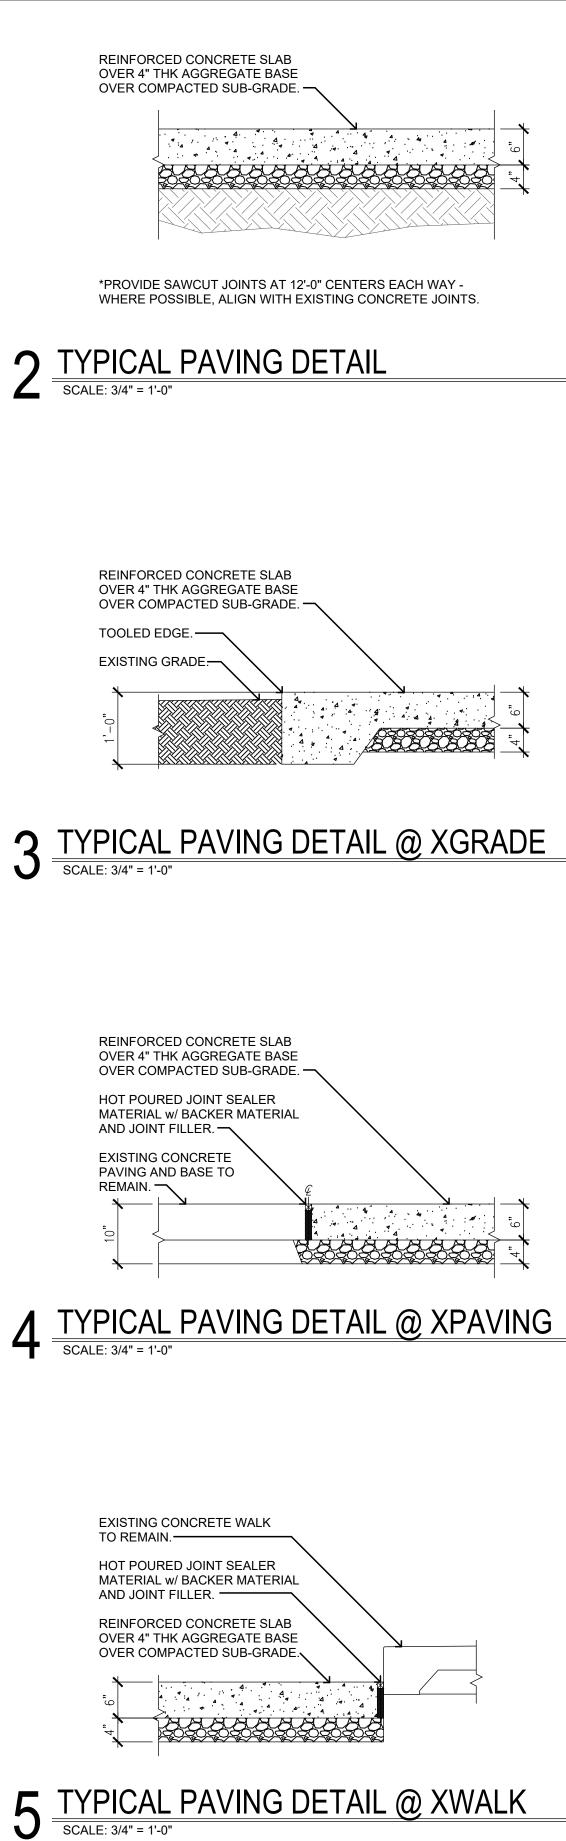



GENERAL SITE PLAN NOTES:

- A. ALL CIVIL WORK SHOWN ON THIS SHEET SHALL BE BY ALTERNATE BID NO. 3. ALSO REFERENCE UNIT PRICES FOR ADDITIONAL CONCRETE PAVING. ALSO REFERENCE ELECTRICAL DRAWINGS.
- B. ALL GRASSES, AGGREGATE AND CONCRETE SURFACES DISTURBED OR DAMAGED DURING CONSTRUCTION SHALL BE RESTORED TO THEIR ORIGINAL CONDITION.
- C. BURY ELEVATIONS OF UNDERGROUND PIPING AND CONDUITS ARE UNKNOWN. UTILITIES CUT OR DAMAGED DURING CONSTRUCTION ARE TO BE RESTORED TO THEIR ORIGINAL CONDITION.
- D. HATCHED AREA INDICATES EXTENTS OF EXISTING PAVING TO BE TOTALLY REMOVED BY CONTRACTOR UNLESS OTHERWISE NOTED. DEMO'D ITEMS TO BE REMOVED AND DISPOSED OF IN A SAFE AND LAWFUL MANNER AS SPECIFIED.
- ALSO REFERENCE SHEET G-002 FOR GENERAL NOTES APPLICABLE FOR THE FULL PROJECT.


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KEYED NOTES - SITE PLAN:

F

- BY ALTERNATE BID NO. 3: REMOVE EXISTING ASPHALT PAVING AND REPLACE WITH NEW REINFORCED 4000 PSI CONCRETE PAVING. NEW RIGID CONCRETE PAVING CONSTRUCTION TO BE: 6"THK WITH 6X6XW2.0XW2.0 WWF AT MID-DEPTH OVER 4" COMPACTED AGGREGATE BASE ON COMPACTED SUB- GRADE. REFERENCE DETAIL 2, THIS SHEET. TAKE CARE NOT TO DAMAGE EXISTING PAVING TO REMAIN. IF DAMAGED REPAIR TO RESTORE TO ORIGINAL CONDITION.
- BY ALTERNATE BID NO. 3: PROVIDE NEW EXPANSION JOINT FILLER AND SEALANT BETWEEN NEW CONCRETE PAVING AND EXISTING CONCRETE PAVING. SAWCUT AS REQUIRED TO PROVIDE STRAIGHT EDGE JOINT BETWEEN EXISTING AND NEW. REFERENCE DETAIL 4, THIS SHEET.
- 3. BY ALTERNATE BID NO. 3: 12" THICKENED EDGE WHERE NEW CONCRETE MEETS EXISTING GRADE. REF: DETAIL 3, THIS SHEET.
- <u>BY ALTERNATE BID NO. 3</u>: PROVIDE NEW EXPANSION JOINT FILLER AND SEALANT BETWEEN NEW CONCRETE PAVING AND EXISTING CONCRETE WALK. REFERENCE DETAIL 5, THIS SHEET.
- 5. <u>BY ALTERNATE BID NO. 3</u>: EXISTING WHEELSTOPS TO BE TEMPORARILY REMOVED DURING PAVING AND RE-INSTALLED WHERE INDICATED.
- <u>BY</u> <u>ALTERNATE</u> <u>BID</u> <u>NO.</u> <u>3</u>: NEW 4" WIDE PARKING 6. STRIPING AS SHOWN.
- 7. EXISTING CONCRETE SIDEWALKS AND ACCESSIBLE ACCESS TO REMAIN.
- 8. EXISTING (RECENT) CONCRETE PAVING AND STRIPING TO REMAIN.
- 9. EXISTING GRASS AREA TO REMAIN.
- 10. EXISTING FLAGPOLE TO REMAIN.
- 11. EXISTING BUILDING SIGN TO REMAIN.
- 12. NEW PARKING LIGHTING TO MATCH EXISTING. REFERENCE MECHANICAL / ELECTRICAL DRAWINGS.
- 13. EXISTING STORMWATER PIPING TO REMAIN.
- 14. EXISTING ROADWAY.
- 15. <u>BY ALTERNATE BID NO. 2</u>: EXISTING TRANSFER SWITCH. REFERENCE ELECTRICAL DRAWINGS FOR NEW TRANSFER SWITCH.
- 16. BY UNIT PRICE NO. 1: PER SQUARE FOOT REMOVE EXISTING ASPHALT PAVING AND REPLACE WITH NEW REINFORCED 4000 PSI CONCRETE PAVING. NEW RIGID CONCRETE PAVING CONSTRUCTION TO BE: 6"THK WITH 6X6XW2.0XW2.0 WWF AT MID-DEPTH OVER 4" COMPACTED AGGREGATE BASE ON COMPACTED SUB-GRADE. REFERENCE DETAIL 2, THIS SHEET. TAKE CARE NOT TO DAMAGE EXISTING PAVING TO REMAIN. IF DAMAGED REPAIR TO RESTORE TO ORIGINAL CONDITION.

SYMBOL LEGEND (THIS SHEET ONLY)

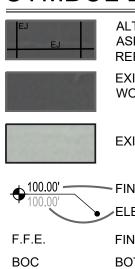

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ALTERNATE BID NO. 3: AREA OF EXISTING ASPHALT PAVING TO BE REMOVED AND REPLACED WITH CONCRETE **EXISTING PAVING - POTENTIAL UNIT COST** WORK


EXISTING PAVING - NO WORK

100.00'	FINISH ELEVATION - NEW
=.E.	FINISH FLOOR ELEVATION

- BOTTOM OF CURB
- TOP OF CURB
- CONTROL JOINT EXPANSION JOINT
 - DOWNSPOUT LOCATION

STATE OF MISSOURI MICHAEL L. PARSON, GOVERNOR



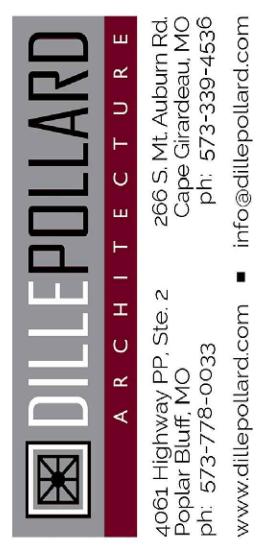

OFFICE OF ADMINISTRATION DIVISION OF FACILITIES MANAGEMENT, **DESIGN AND CONSTRUCTION**

MISSOURI ARMY NATIONAL GUARD FACILITIES DIVISION

RENOVATE INTERIOR AND EXTERIOR

KENNETT

READINESS CENTER 1450 NORTH BY-PASS KENNETT, MO 63857

PROJECT # T2209-01

FACILITY # 8136313002

REVISION:	
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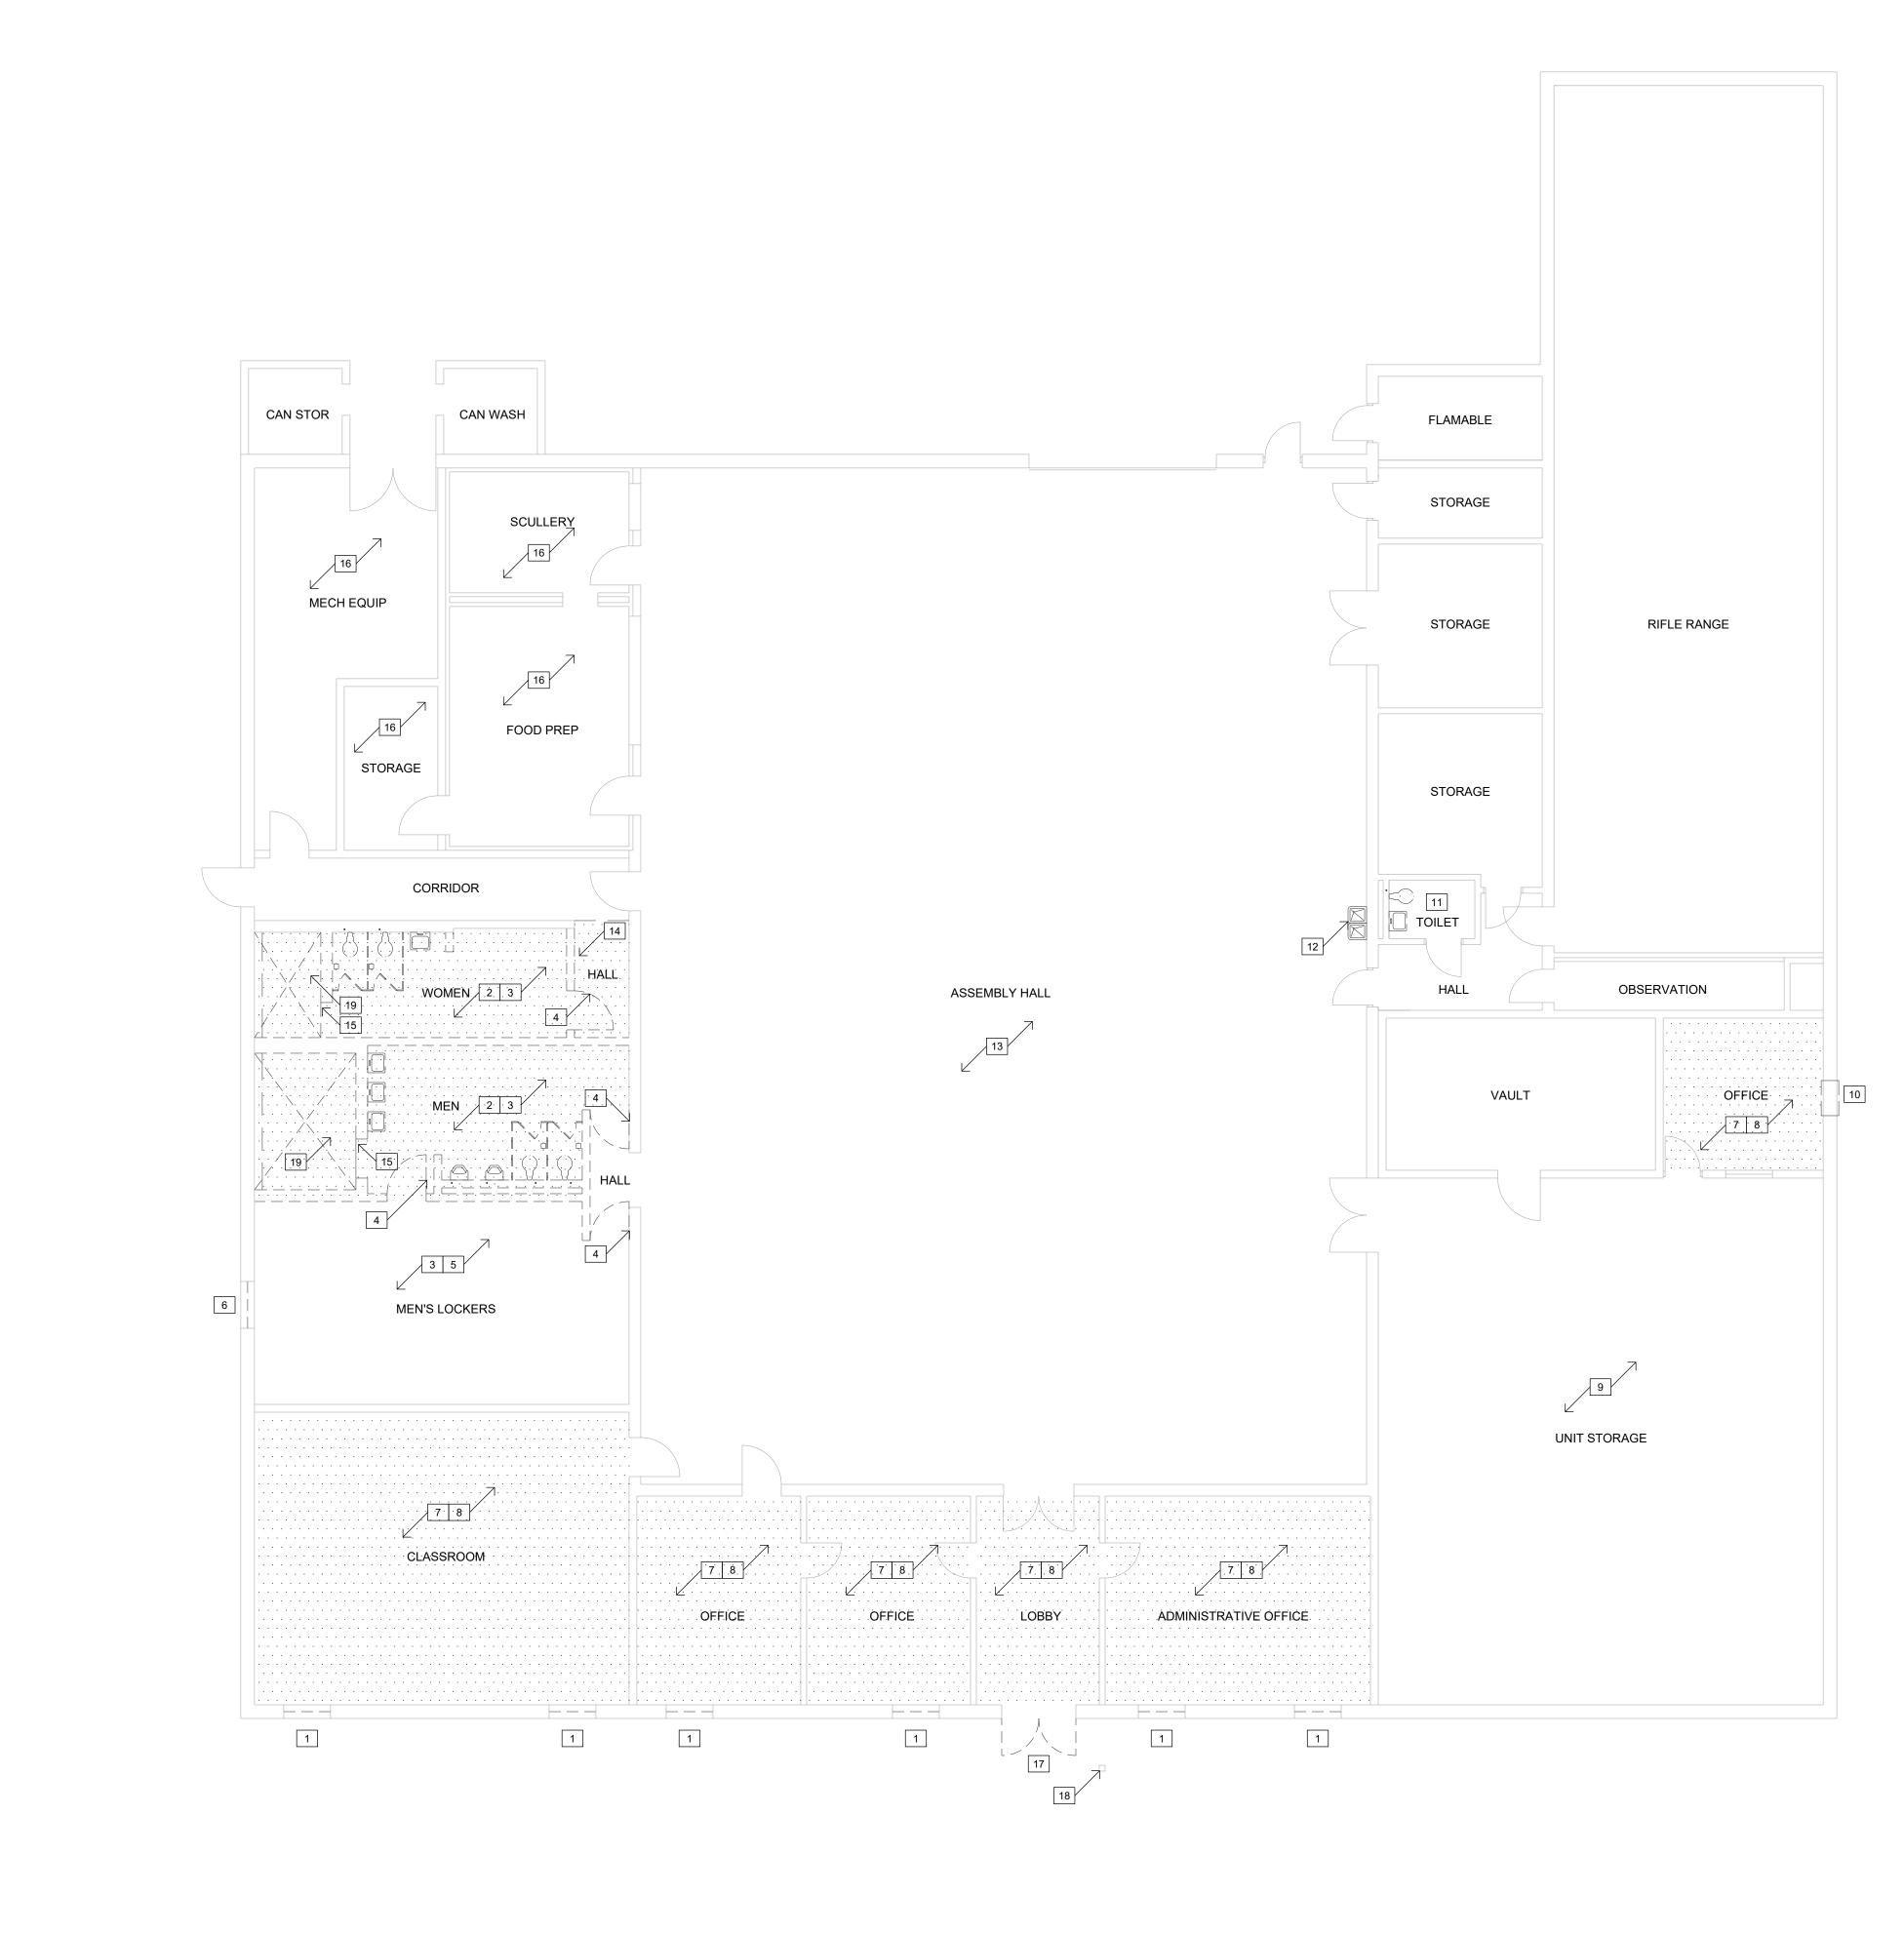
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DRAWN BY:	KU
CHECKED BY:	BD
DESIGNED BY:	KU

SHEET TITLE:

SITE PLAN AND SITE DETAILS ALTERNATE NO. 3

SHEET NUMBER:

A-001



DEMOLITION FLOOR PLAN SCALE: 1/8" = 1'-0"

GENERAL DEMOLITION PLAN NOTES:

- A. DASHED LINES INDICATE EXISTING CONSTRUCTION TO BE TOTALLY REMOVED BY CONTRACTOR UNLESS OTHERWISE NOTED. DEMO'D ITEMS TO BE REMOVED AND DISPOSED OF IN A SAFE AND LAWFUL MANNER AS SPECIFIED.
- B. EXISTING SURFACES TO RECEIVE NEW FINISHES SHALL BE PATCHED AND PREPPED AS REQUIRED TO RECEIVE NEWLY SPECIFIED SURFACE TREATMENT / FINISHES PER MANUFACTURER'S RECOMMENDATIONS.
- C. LEVEL ALL FLOOR SLABS AS REQUIRED WHERE SLAB DEPRESSIONS HAVE BEEN LEFT BY DEMOLITION OR NECESSARY FOR NEW FLOORING.
- D. PROVIDE TEMPORARY BRACING AND SHORING AS REQUIRED TO SUPPORT EXISTING STRUCTURE PRIOR TO ANY DEMOLITION OF LOAD BEARING CONSTRUCTION.
- E. REFERENCE ALSO DEMOLITION REFLECTED CEILING PLAN AND ROOF PLAN.
- F. REFERENCE MEP DRAWINGS FOR EXTENTS OF ADDITIONAL DEMOLITION.

KEYED NOTES (DEMOLITION):

1. EXISTING WINDOWS TO REMAIN IN BASE BID. TAKE CARE NOT TO DAMAGE. ALSO REFERENCE <u>ALTERNATE NO. 2</u> FOR WINDOW REMOVAL AND REPLACEMENT.

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- 2. EXISTING MOSAIC TILE FLOORING AND INTERIOR CMU WALLS WHERE INDICATED TO BE TOTALLY REMOVED FOR NEW WORK. CLEAN AND PREP CONCRETE FLOOR SLAB FOR NEW INFILL AND FLOORING. ALSO REFERENCE MEP FOR EXTENT OF REMOVAL OF PLUMBING FIXTURES AND DEVICES.
- 3. EXISTING CONCRETE SLAB DEMOLITION -
- CONTRACTOR'S OPTIONS: 3.1. OPTION 1: TRENCHING - SAWCUT AND DEMO AS REQUIRED FOR NEW WORK AND UNDERFLOOR/SLAB PIPING. REF: MEP DRAWINGS.
- 3.2. OPTION 2: FULL SLAB SAWCUT AT ROOM PERIMETER AND DEMO FOR NEW WORK AND UNDERGLOOR/SLAB PIPING. REF: MEP DRAWINGS.
- 3.3. NOTE: IN EITHER OPTION, CONTRACTOR TO TAKE CARE NOT TO UNDERMINE BUILDING FOOTINGS.
- 4. EXISTING DOORS AND FRAMES TO BE TOTALLY REMOVED.
- 5. EXISTING EXPOSED STRUCTURE TO REMAIN. ALSO REFERENCE MEP DWGS.
- 6. EXISTING WINDOW UNIT TO BE TOTALLY REMOVED. REFERENCE NEW WORK FOR EXISTING MASONRY OPENING TO BE INFILLED TO MATCH EXISTING.
- 7. EXISTING FINISH FLOORING TO BE TOTALLY REMOVED. EXISTING CONCRETE SLAB TO BE CLEANED AND PREPPED FOR NEW WORK.
- 8. EXISTING WALLS TO REMAIN. INSPECT AND REPAIR AS REQUIRED. PREP FOR NEW PAINT FINISH.
- 9. EXISTING UNIT STORAGE TO REMAIN. PREP AREA FOR INSTALLATION OF NEW FULL HEIGHT WIRE PARTITION PANELS. REF: NEW WORK.
- 10. REFERENCE MEP DRAWINGS FOR EXISTING THRU-WALL UNIT TO BE TOTALLY REMOVED. REFERENCE NEW WORK FOR EXISTING MASONRY OPENING TO BE INFILLED TO MATCH EXISTING.
- 11. EXISTING MOSAIC TILE AND WALL TILE TO REMAIN AND BE CLEANED. TOILET ACCESSORIES TO BE COMPLETELY REMOVED. REFERENCE MEP DRAWINGS FOR PLUMBING FIXTURES.
- 12. EXISTING ELECTRIC WATER COOLER TO BE REMOVED. REFERENCE MEP DRAWINGS.
- 13. REFERENCE ELECTRICAL DRAWINGS FOR EXTENT OF DEMOLITION WORK THIS AREA.
- 14. FINISH FLOORING TO BE REMOVED TO EXTENTS SHOWN. FLOORS AND WALLS TO BE PREPPED FOR NEW WORK. ALSO REFERENCE MEP DRAWINGS.
- 15. EXISTING CURB AT SHOWER AREA TO BE REMOVED.
- 16. REFERENCE MEP DRAWINGS FOR EXTENT OF DEMOLITION OF EXISTING EQUIPMENT.
- 17. EXISTING STOREFRONT TO REMAIN IN BASE BID. TAKE CARE NOT TO DAMAGE. REFERENCE <u>ALTERNATE NO. 1</u> FOR REMOVAL OF EXISTING ALUMINUM STOREFRONT AND PREP FOR NEW OPENING AND HARDWARE.
- 18. REFERENCE MEP FOR EXISTING ADA ACCESS TO BE REPLACED. MOUNTING POLE TO REMAIN.
- 19. TOP OF EXISTING SLAB AT SHOWER AREA IS RECESSED TO A DEPTH OF 3 $\frac{1}{2}"$ BELOW FINISH FLOOR ELEVATION.


SYMBOL LEGEND (THIS SHEET ONLY)

AREA OF EXISTING FLOOR FINISH TO BE REMOVED AND REPLACED.

AREA RECESSED CONCRETE SLAB

STATE OF MISSOURI MICHAEL L. PARSON, GOVERNOR



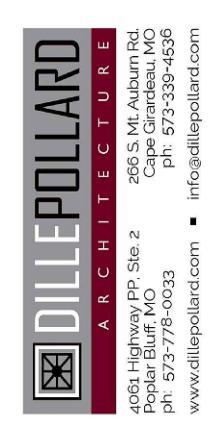

OFFICE OF ADMINISTRATION DIVISION OF FACILITIES MANAGEMENT, DESIGN AND CONSTRUCTION

MISSOURI ARMY NATIONAL GUARD FACILITIES DIVISION

RENOVATE INTERIOR AND EXTERIOR

KENNETT READINESS CENTER 1450 NORTH BY-PASS KENNETT, MO 63857

PROJECT # T2209-01

FACILITY # 8136313002

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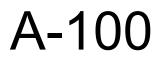
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CAD DWG FILE:	A-100.DWG
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CHECKED BY:	BD
DESIGNED BY:	KU


SHEET TITLE:

DEMOLITION PLAN - FLOOR PLAN

SHEET NUMBER:





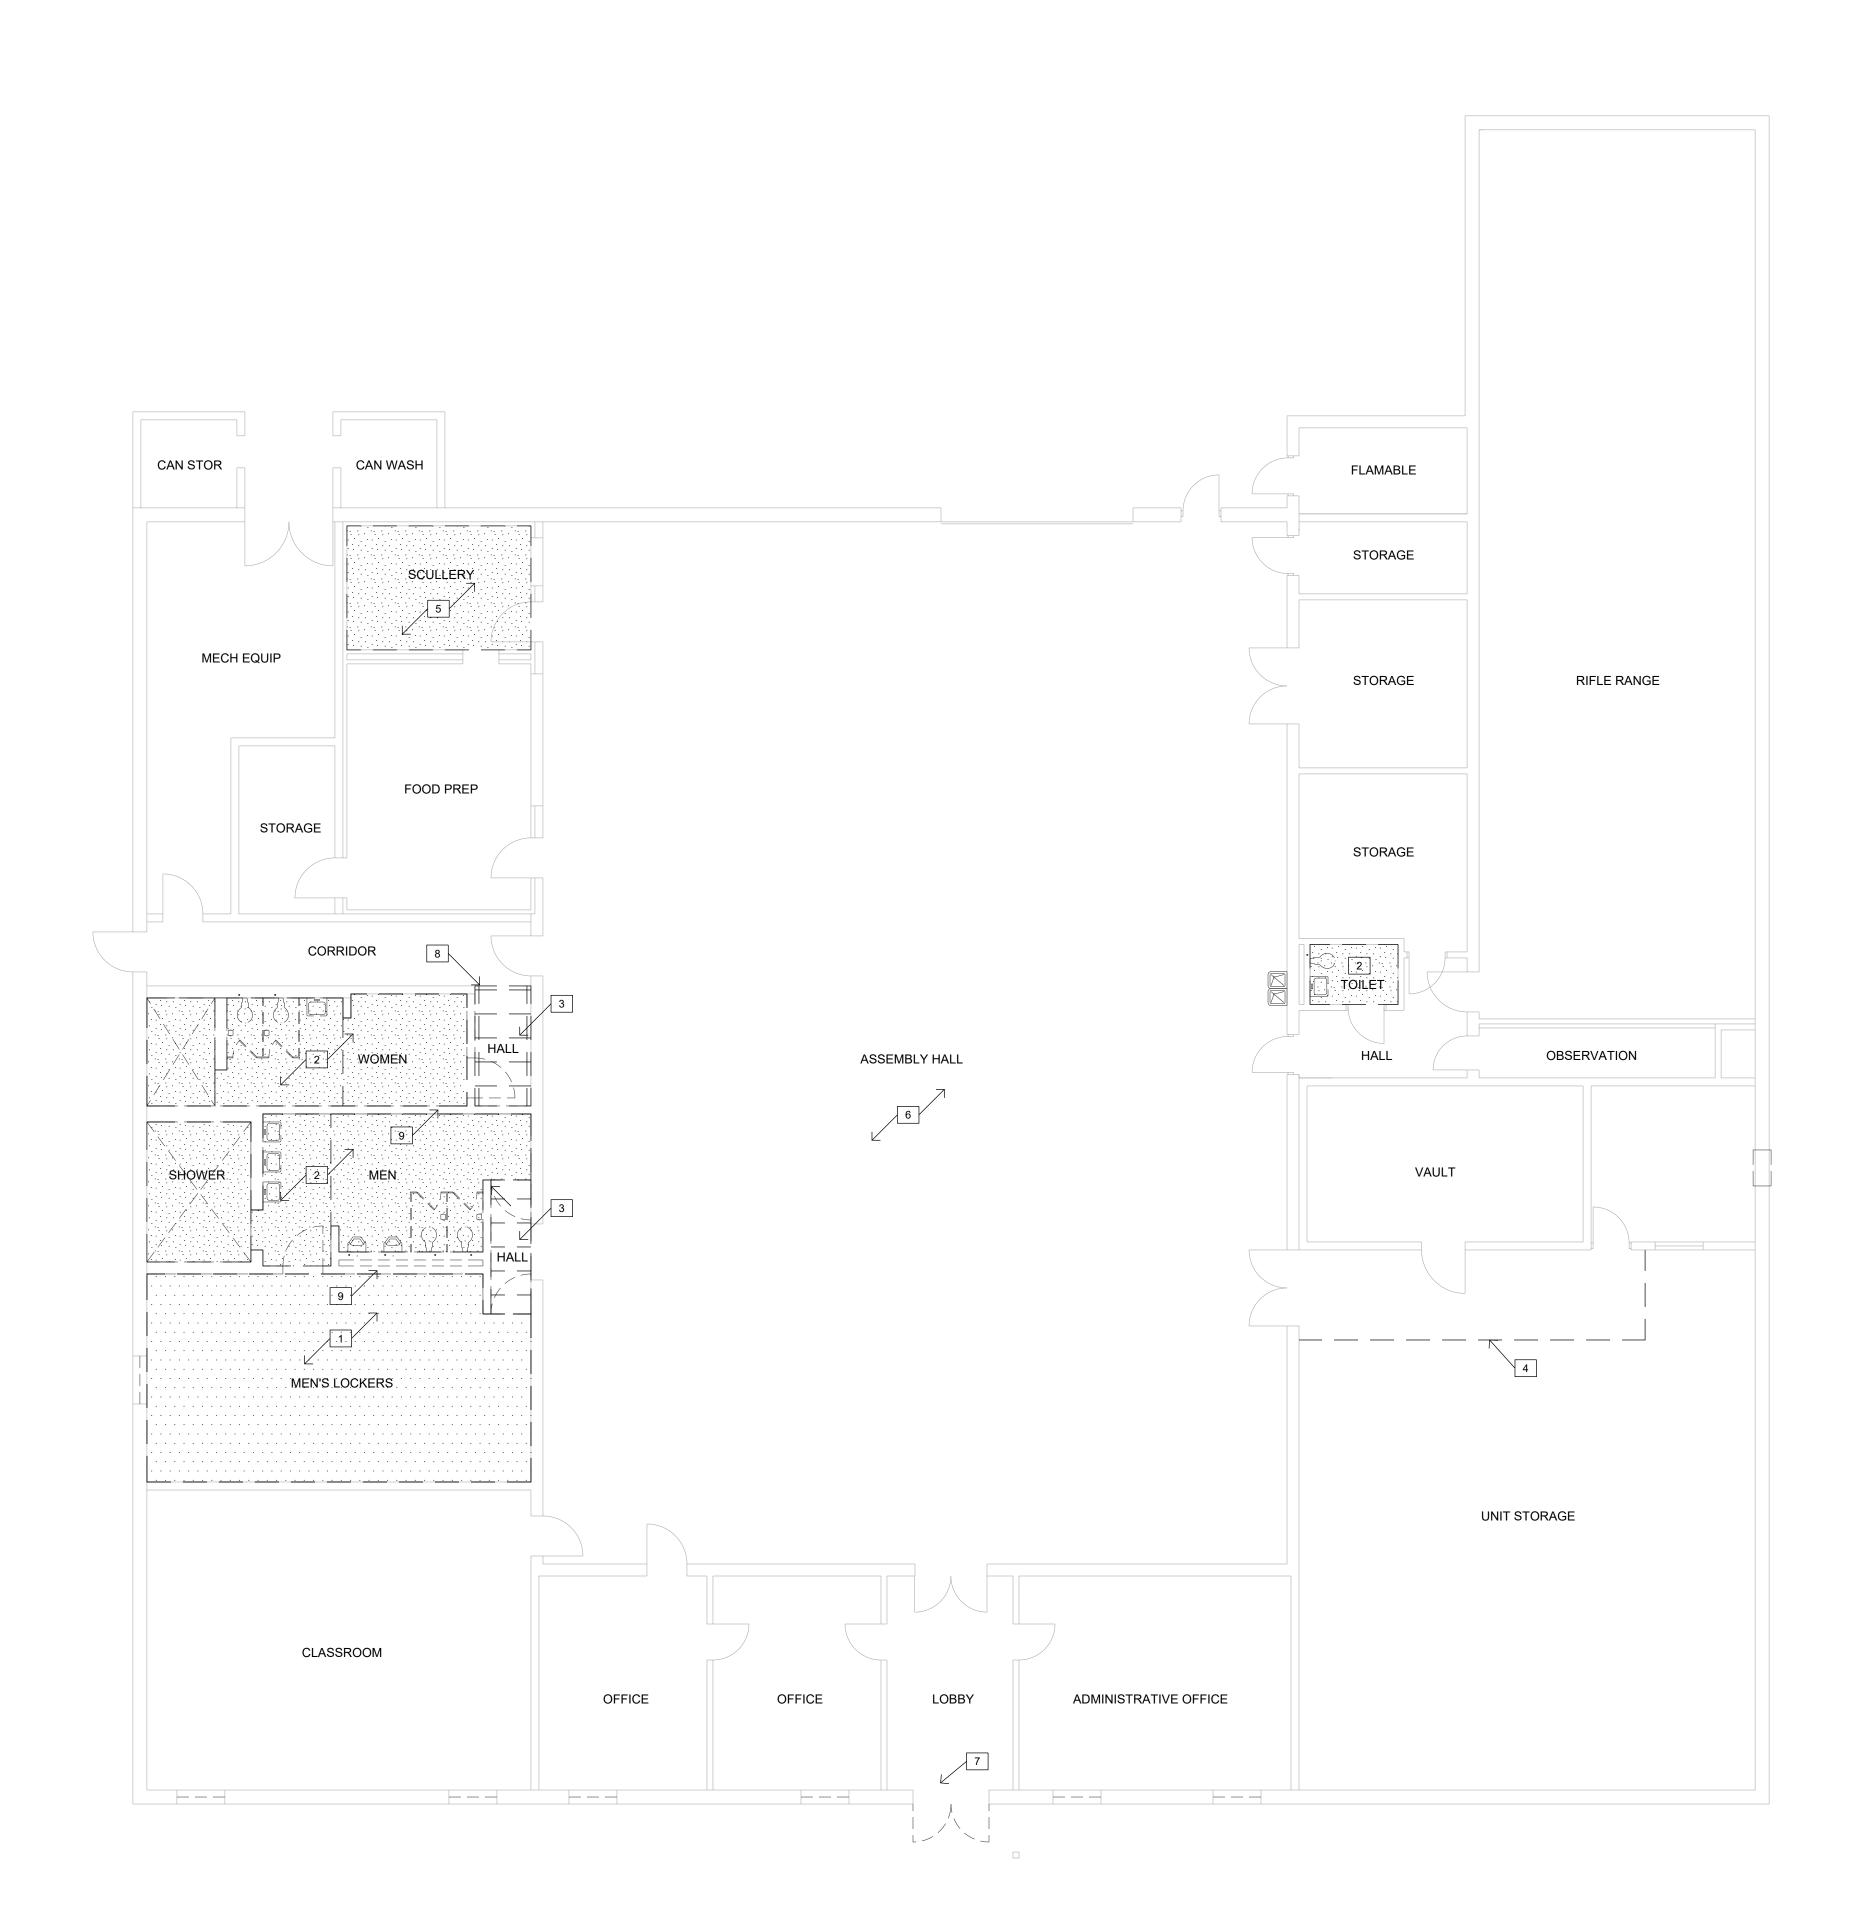

DEMOLITION - REFLECTED CEILING PLAN

SCALE: 1/8" = 1'-0"

GENERAL DEMOLITION PLAN NOTES:


- A. DASHED LINES INDICATE EXISTING CONSTRUCTION TO BE TOTALLY REMOVED BY CONTRACTOR UNLESS OTHERWISE NOTED. DEMO'D ITEMS TO BE REMOVED AND DISPOSED OF IN A SAFE AND LAWFUL MANNER AS SPECIFIED.
- B. EXISTING SURFACES TO RECEIVE NEW FINISHES SHALL BE PATCHED AND PREPPED AS REQUIRED TO RECEIVE NEWLY SPECIFIED SURFACE TREATMENT / FINISHES PER MANUFACTURER'S RECOMMENDATIONS.
- C. PROVIDE TEMPORARY BRACING AND SHORING AS REQUIRED TO SUPPORT EXISTING STRUCTURE PRIOR TO ANY DEMOLITION OF LOAD BEARING CONSTRUCTION.

KEYED NOTES (DEMOLITION):

1. EXISTING EXPOSED STRUCTURE TO REMAIN. LIGHTING AND DEVICES TO BE REMOVED. OWNER RESERVES THE FIRST RIGHT TO REFUSAL OF THE FIXTURES. ALSO REFERENCE MEP DWGS.

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- 2. EXISTING GYPSUM PLASTER OVER METAL LATH CEILING ON STEEL C-CHANNEL SUSPENDED FRAME, LIGHTING FIXTURES AND DEVICES TO BE TOTALLY REMOVED. ALSO REFERENCE MEP DRAWINGS.
- 3. EXISTING SUSPENDED CEILING, GRID AND DEVICES TO BE TOTALLY REMOVED. REFERENCE MEP FOR TEMPORARY SUPPORT OF EXISTING LIGHT FIXTURES TO BE RE-USED.
- 4. EXISTING EXPOSED STRUCTURE TO REMAIN. MODIFY AS REQUIRED FOR INSTALLATION OF NEW PARTITION PANELS. REF: NEW WORK.
- 5. EXISTING GYPSUM PLASTER OVER METAL LATH CEILING TO REMAIN. REFERENCE MEP DRAWINGS FOR NEW CEILING DEVICES IN EXISTING CEILING. REPAIR AS REQUIRED, PREP FOR NEW PAINT FINISH.
- 6. EXISTING LIGHT FIXTURES TO BE TOTALLY REMOVED, THIS AREA. REFERENCE ELECTRICAL DRAWINGS.
- 7. ALTERNATE BID NO. 1: REMOVE AND MODIFY EXISTING SUSPENDED CEILING GRID SYSTEM AS NECESSARY TO ACCESS STOREFRONT FOR REMOVAL AND REPLACEMENT.
- 8. MODIFY EXISTING SUSPENDED CEILING GRID SYSTEM AS NECESSARY DUE TO WALL INFILL.
- 9. ROOF DECK IS WELDED TO CONTINUOUS EMBED PLATES IN THE TOP OF THE CMU WALLS TO BE DEMO'D. CONTRACTOR TO TAKE SPECIAL CAUTION DURING DEMOLITION TO ENSURE THE WALL REMOVAL DOES NOT DAMAGE THE ROOF DECK AND ROOF JOISTS. ANY DAMAGE AND SUBSEQUENT REPAIR (MATERIAL & LABOR) WILL BE THE FULL RESPONSIBILITY OF THE CONTRACTOR.

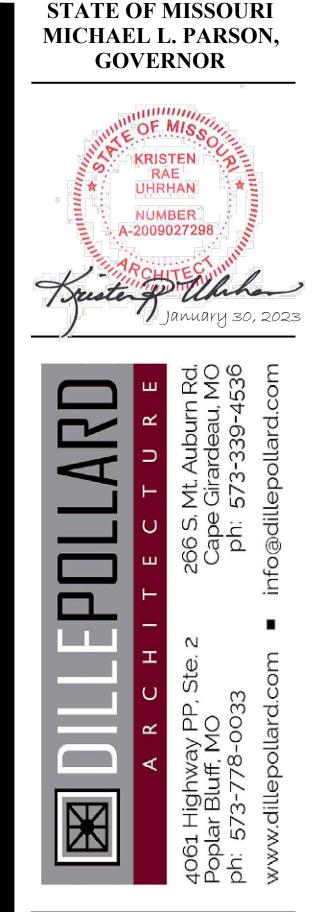

OFFICE OF ADMINISTRATION **DIVISION OF FACILITIES** MANAGEMENT, **DESIGN AND CONSTRUCTION**

MISSOURI ARMY NATIONAL GUARD FACILITIES DIVISION

RENOVATE INTERIOR AND EXTERIOR

KENNETT **READINESS CENTER** 1450 NORTH BY-PASS KENNETT, MO 63857

PROJECT # T2209-01

FACILITY # 8136313002

REVISION: DATE: REVISION DATE: **REVISION:** DATE: ISSUE DATE: January 30, 2023

KU

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CAD DWG FILE: A-101.DWG DRAWN BY: CHECKED BY: DESIGNED BY: KU

SHEET TITLE:

DEMOLITION PLAN - REFLECTED CEILING

SHEET NUMBER:




SYMBOL LEGEND (THIS SHEET ONLY)

AREA OF EXISTING GYPSUM PLASTER OVER METAL LATH CEILING

AREA EXPOSED STRUCTURE ABOVE

AREA OF SUSPENDED CEILING GRID AND TILE TO BE REMOVED



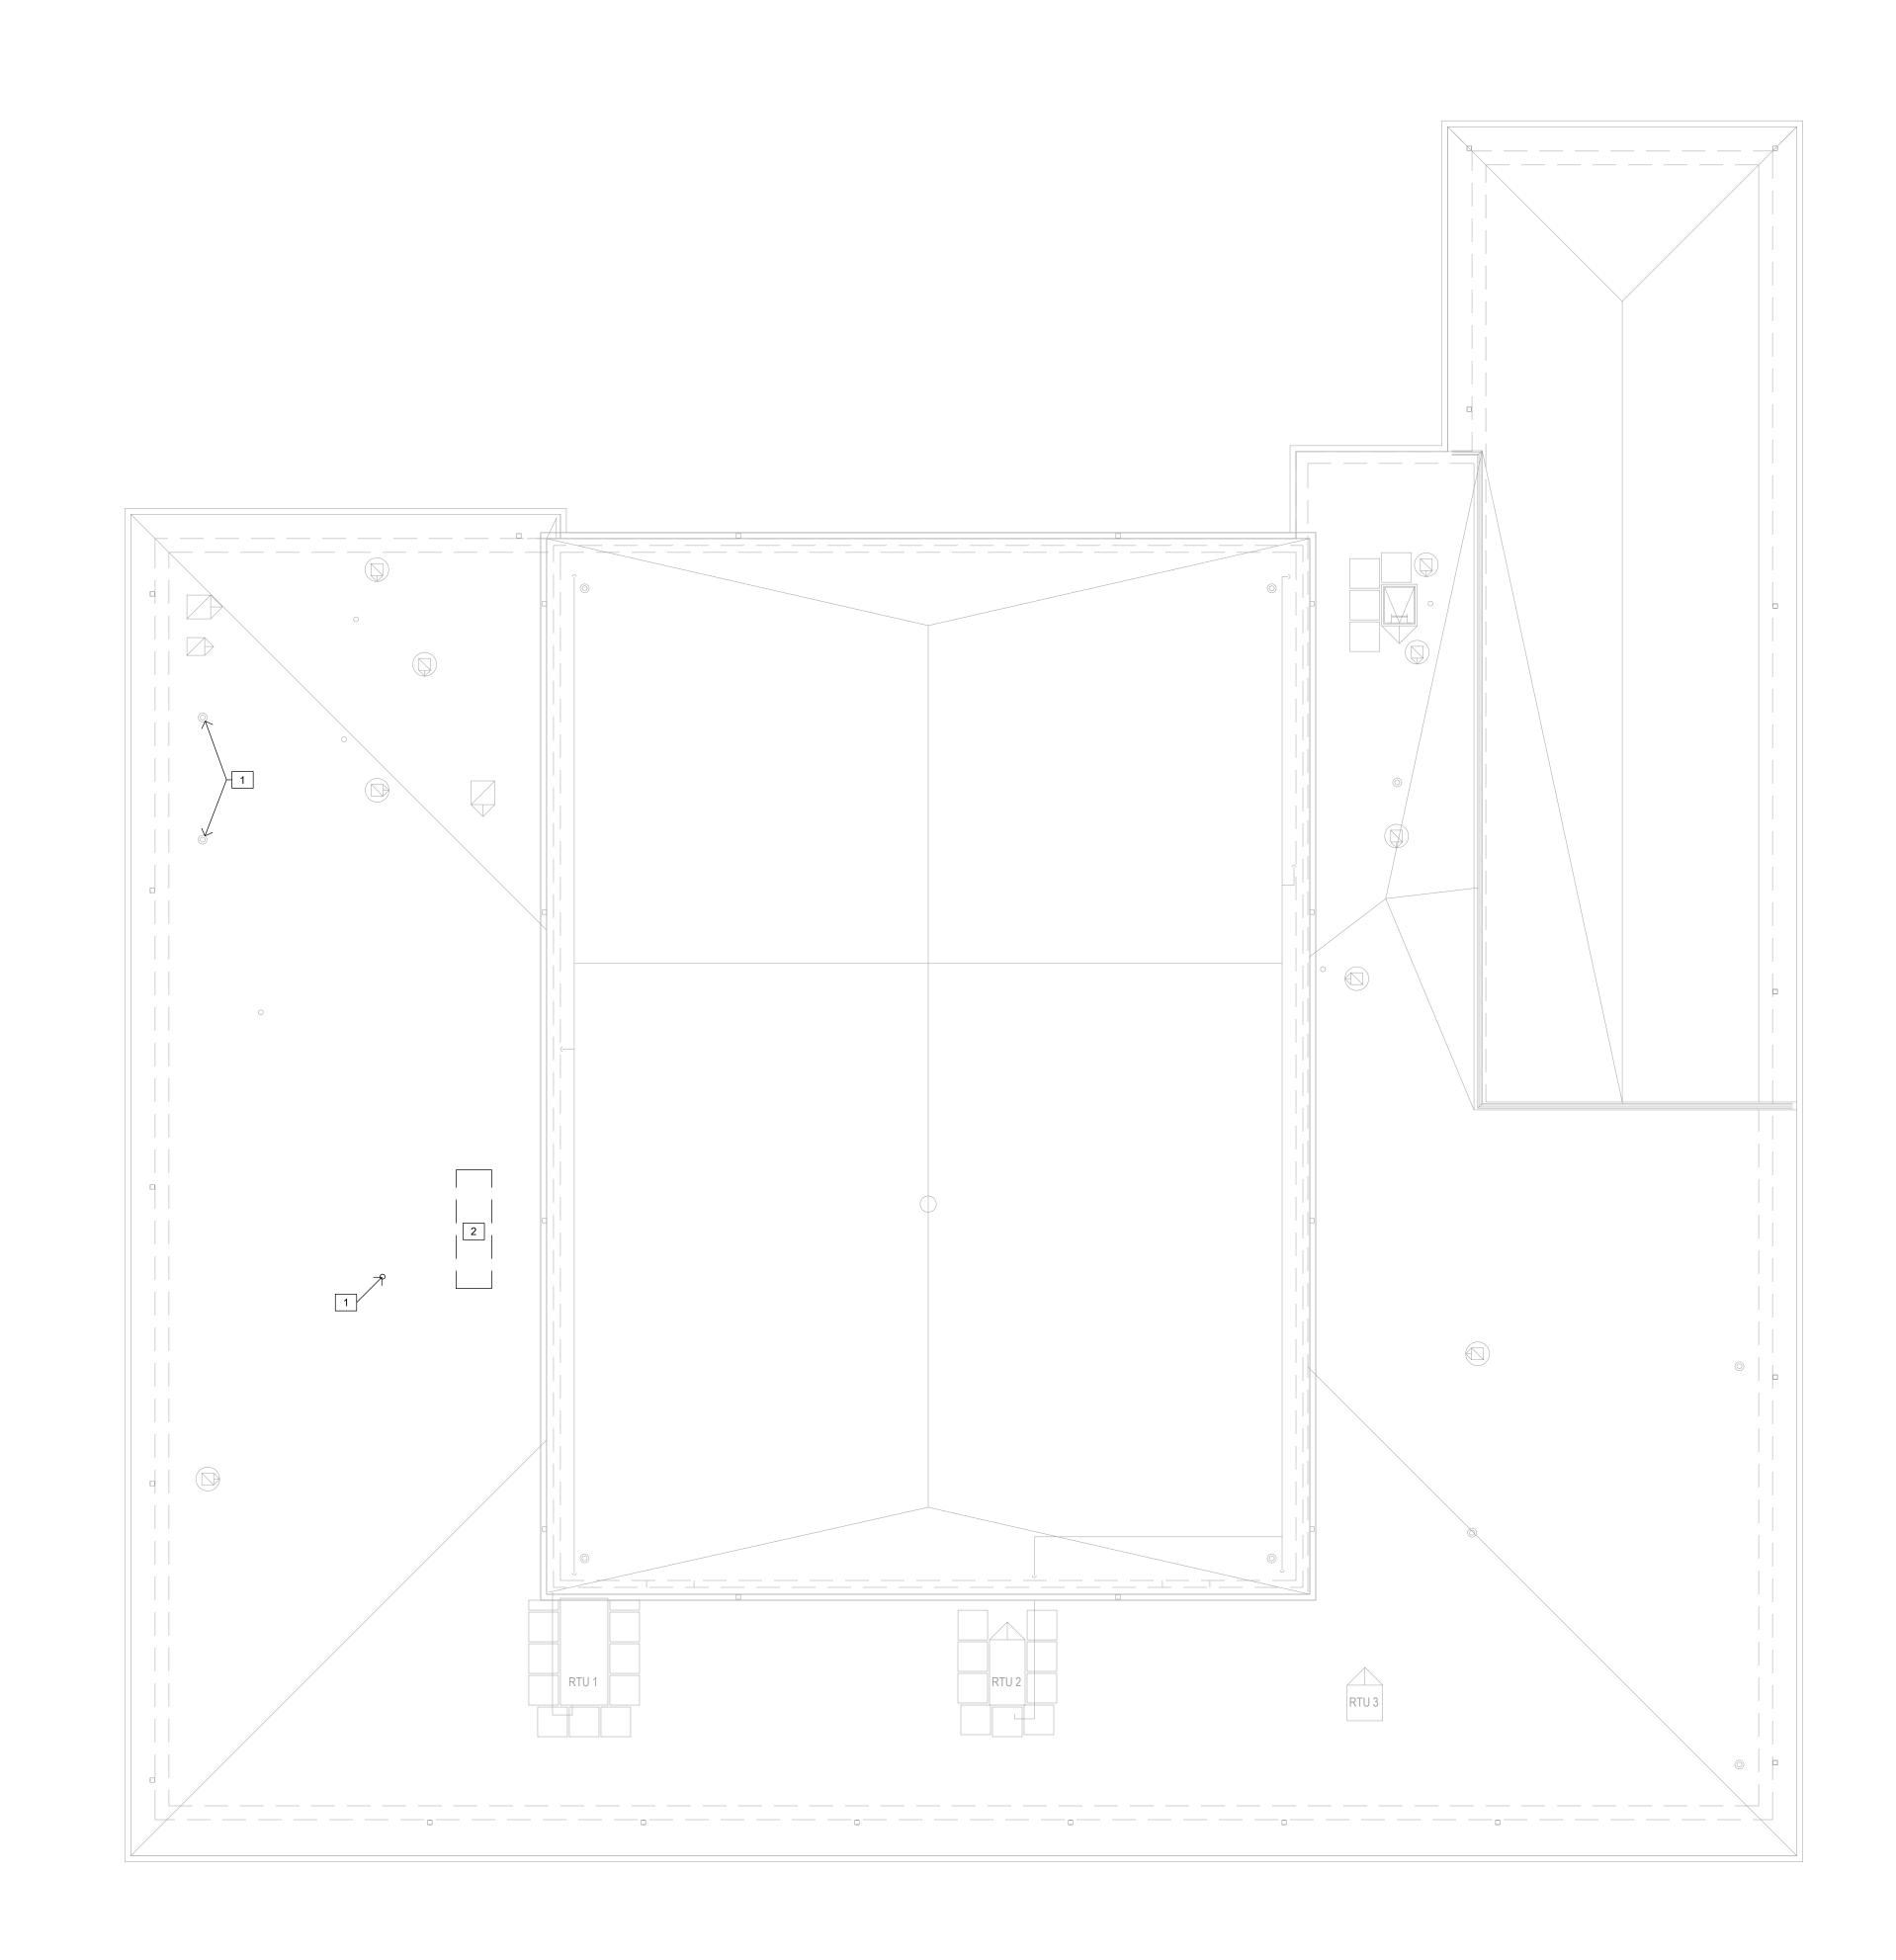

DEMOLITION ROOF PLAN SCALE: 1/8" = 1'-0"

GENERAL DEMOLITION NOTES - ROOF PLAN:


- A. DASHED LINES INDICATE EXISTING CONSTRUCTION TO BE TOTALLY REMOVED BY CONTRACTOR UNLESS OTHERWISE NOTED. DEMO'D ITEMS TO BE REMOVED AND DISPOSED OF IN A SAFE AND LAWFUL MANNER AS SPECIFIED.
- B. EXISTING SURFACES TO RECEIVE NEW FINISHES SHALL BE PATCHED AND PREPPED AS REQUIRED TO RECEIVE NEWLY SPECIFIED SURFACE TREATMENT / FINISHES PER MANUFACTURER'S RECOMMENDATIONS.
- C. PROVIDE TEMPORARY BRACING AND SHORING AS REQUIRED TO SUPPORT EXISTING STRUCTURE PRIOR TO ANY DEMOLITION OF LOAD BEARING CONSTRUCTION.
- D. ROOF CONSTRUCTION AT AREA WHERE WORK IS TO OCCUR IS .060 mil TPO SINGLE PLY MEMBRANE (FIRESTONE) FULLY ADHERED TO 1/2" THICK HD COVERBOARD ADHERED TO 1/4" PER FOOT TAPERED POLYISO INSULATION (1/2" MIN) OVER 5" THICK BASE LAYER POLYISO RIGID INSULATION BOARD (R-30 ci) ON EXISTING METAL DECKING. ROOF IS CURRENTLY UNDER WARRANTY. CONTRACTOR SHALL ENSURE NEW WORK SHALL NOT VOID EXISTING ROOF WARRANTY AND BEAR ANY COSTS ASSOCIATED THEREIN. ROOFING WARRANTY IS FIRESTONE RED SHIELD - TPO - 20-YEAR -72 MPH WITH START DATE 09/15/2022.

KEYED NOTES - DEMOLITION ROOF PLAN:

- 1. EXISTING VENT THRU ROOF TO REMAIN AND BE UTILIZED FOR NEW WORK. REFERENCE MEP DRAWINGS.
- 2. PROVIDE NEW PENETRATION IN EXISTING ROOF FOR NEW ROOFTOP EQUIPMENT. OPENING TO BE COORDINATED WITH EXISTING STRUCTURE. REFERENCE STRUCTURAL AND MEP DRAWINGS.

STATE OF MISSOURI MICHAEL L. PARSON, GOVERNOR



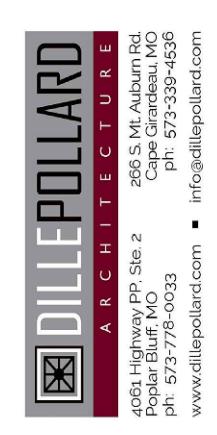

OFFICE OF ADMINISTRATION DIVISION OF FACILITIES MANAGEMENT, **DESIGN AND CONSTRUCTION**

MISSOURI ARMY NATIONAL GUARD FACILITIES DIVISION

RENOVATE INTERIOR AND EXTERIOR

KENNETT **READINESS CENTER** 1450 NORTH BY-PASS KENNETT, MO 63857

PROJECT # T2209-01

FACILITY # 8136313002

REVISION:
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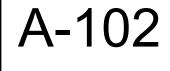
January 30, 2023

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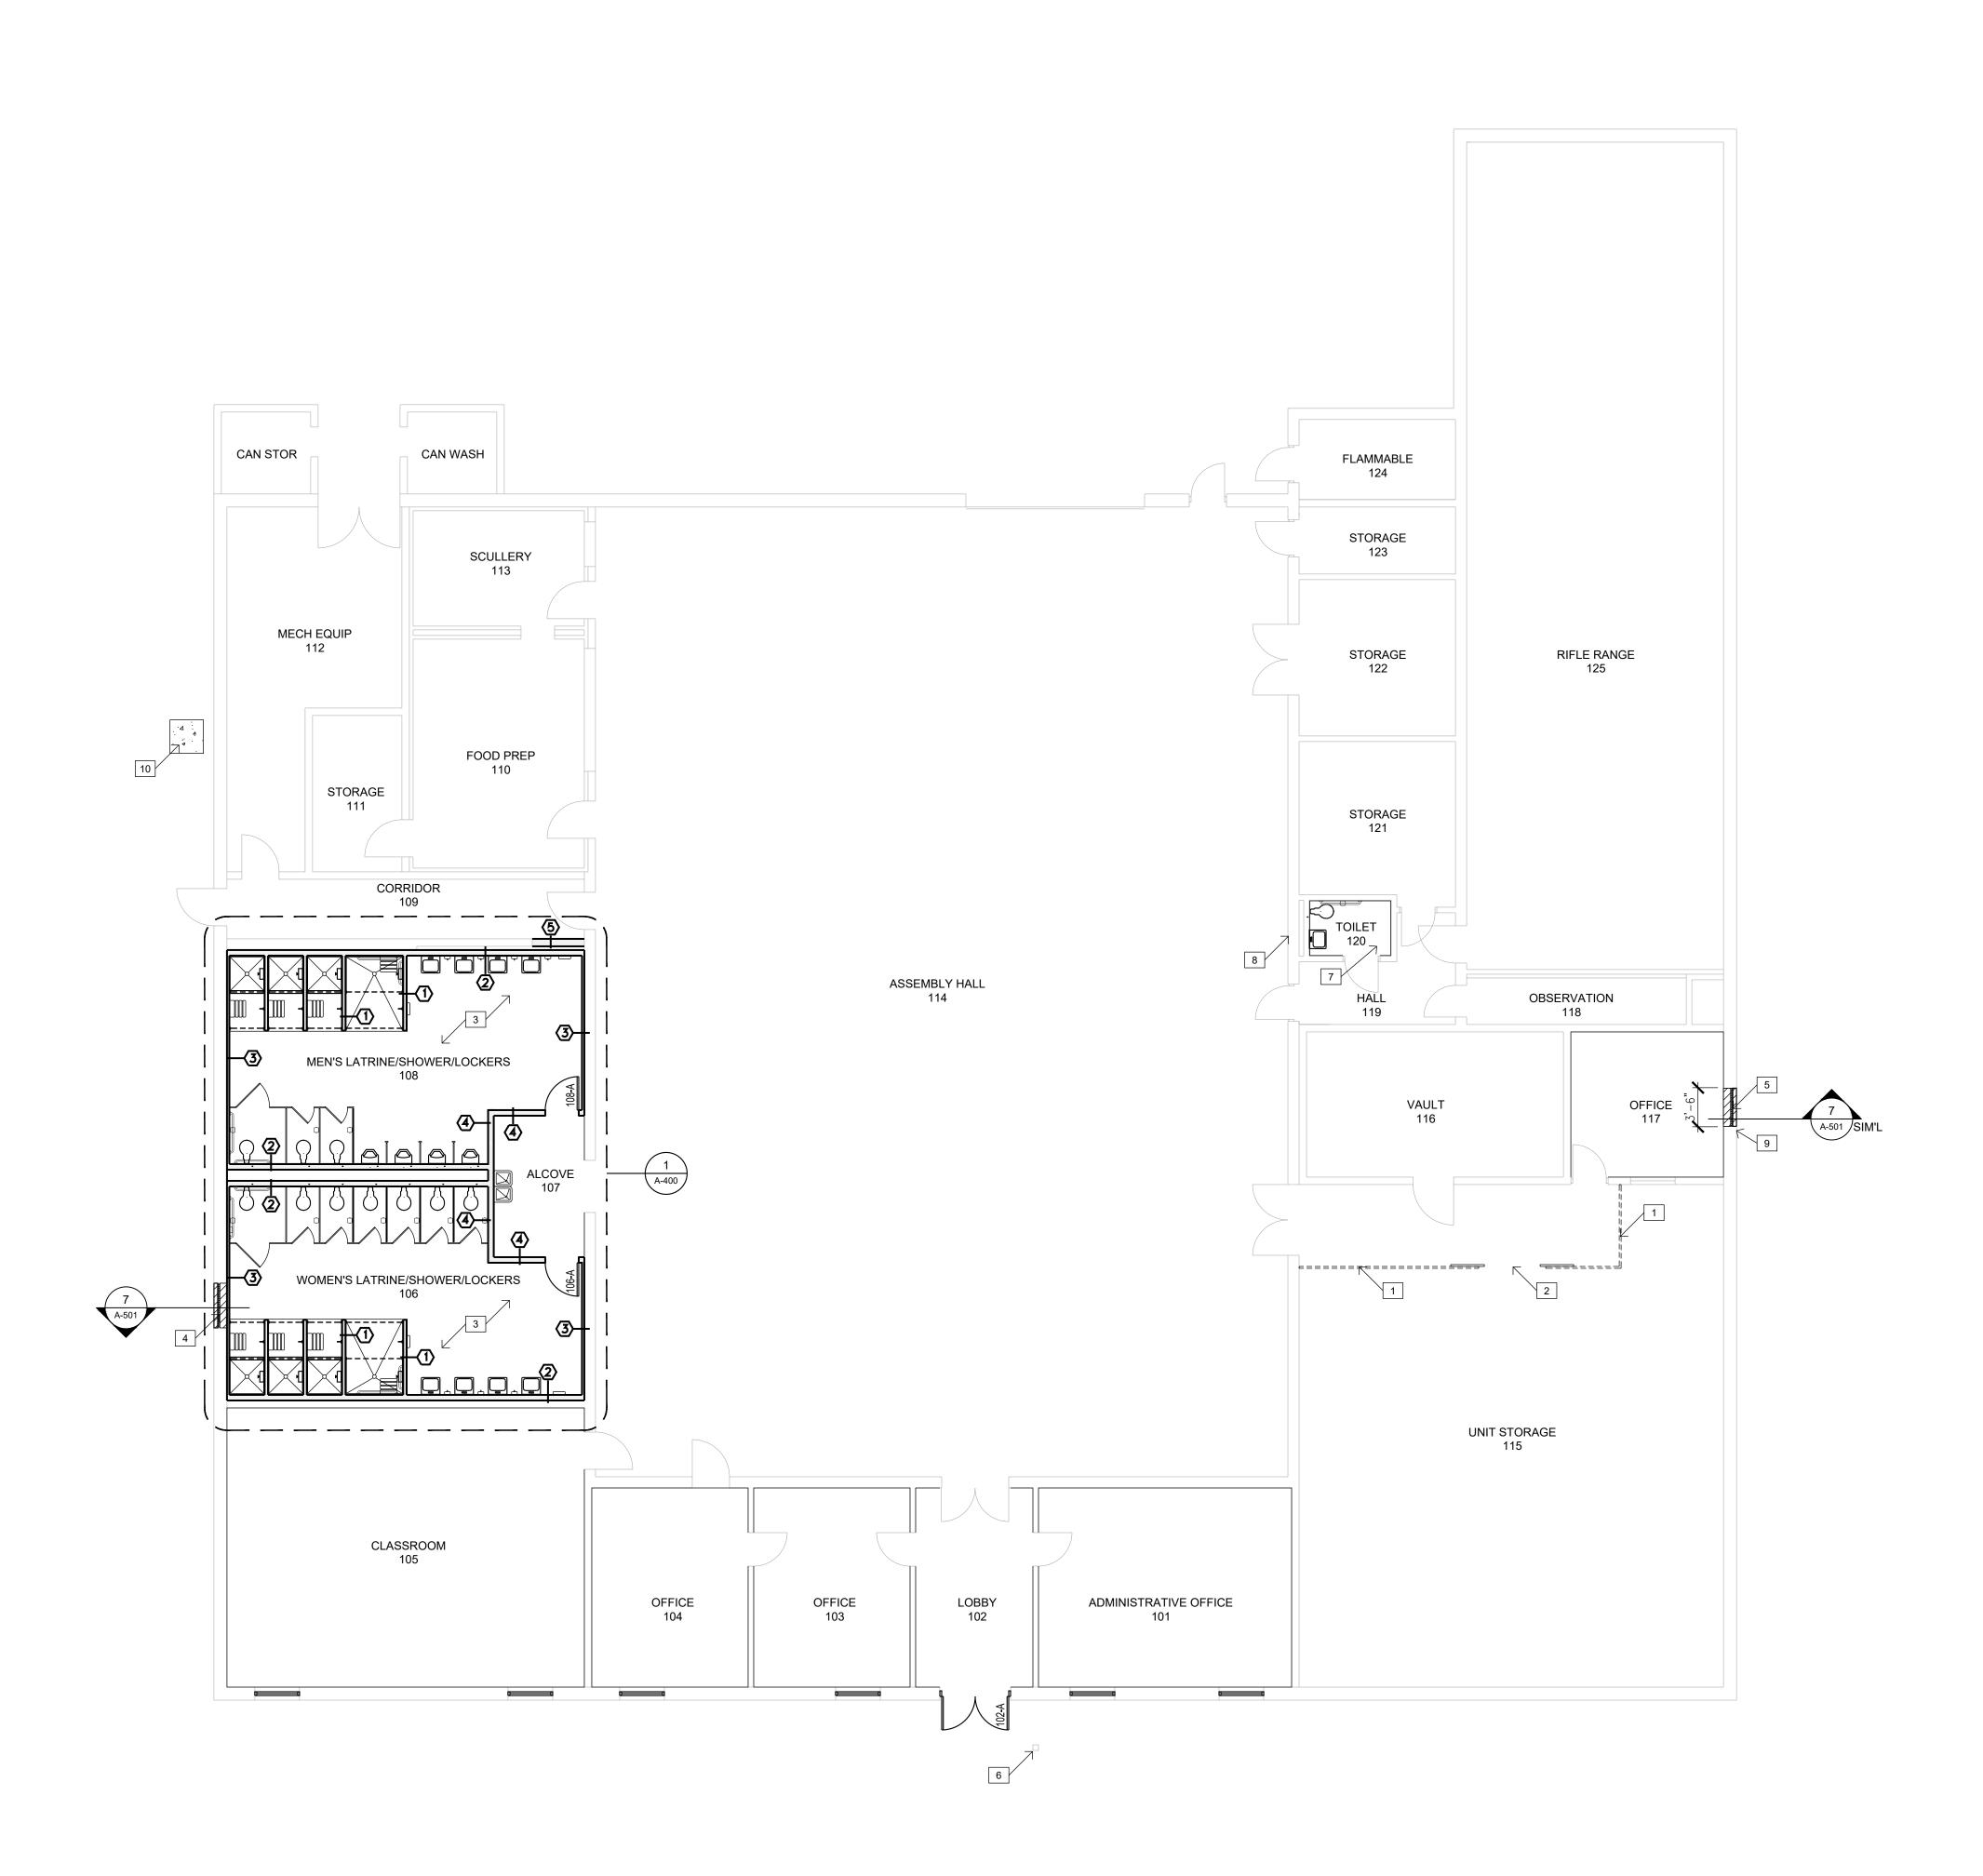
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DEMOLITION PLAN - ROOF PLAN

SHEET NUMBER:








ALTERATIONS FLOOR PLAN SCALE: 1/8" = 1'-0"

REFER TO SHEET G-002 FOR GENERAL NOTES


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KEYED NOTES - FLOOR PLAN:

- 1. WIRE PARTITION PANELS, FLOOR TO WITHIN 2" OF BTM OF STRUCTURE ABOVE (APPROX. 12'-0" A.F.F.). SCRIBE PANELS AROUND EXISTING BAR JOISTS IN NORTH/SOUTH DIRECTION. ALIGN WITH EXISTING STEEL JOISTS ALONG EAST/WEST DIRECTION. REFERENCE PROJECT MANUAL.
- 2. WIRE PARTITION SLIDING GATE, 3'X7' (DBL) & PARTITION FRAME.
- 3. RENOVATED TOILET ROOMS. REFERENCE DETAIL PLAN, SHEET A-400 AND MEP DRAWINGS.
- 4. INFILL EXISTING WINDOW OPENING WITH MASONRY TO MATCH EXISTING CONSTRUCTION. REFERENCE DETAIL 7, SHEET A-501.
- 5. INFILL EXISTING PTAC UNIT OPENING WITH MASONRY TO MATCH EXISTING CONSTRUCTION. (APPROX. 3'-6" X 1'-4") REFERENCE SIMILAR DETAIL 7, SHEET A-501.
- 6. EXISTING ADA ACCESS POLE TO REMAIN. REFERENCE ELECTRICAL DRAWINGS. PREP AND PROVIDE PAINT FINISH.
- 7. TOILET ROOM REMODEL: REFERENCE FINISH SCHEDULE, SHEET A-500 AND MEP DRAWINGS.
- 8. REPAIR MASONRY WALL AS NECESSARY AFTER ELECTRIC WATER COOLER REMOVAL. CLEAN, PRIME, AND PAINT AT DISTURBED AREAS TO NEAREST BLOCK JOINT. REFERENCE MEP DRAWINGS.
- 9. REPAIR MASONRY AS NECESSARY AT FASTENER LOCATIONS AFTER PROTECTIVE STEEL CAGE REMOVAL.
- 10. 4-INCH THICK MIN, REINFORCED WITH W1.4xW1.4WWF AND #4 BARS CONTINUOUS AT 8" TURN DOWN AT PERIMETER. CONCRETE PAD FOR MECHANICAL EQUIPMENT BY GC. EXTEND EDGE OF PAD A MINIMUM OF 6-INCHES BEYOND THE EQUIPMENT FOOTPRINT. COORDINATE SIZE WITH MECH DWGS. PROVIDE 4-INCH MIN COMPACTED TYPE "B" BACKFILL BENEATH ENTIRE SLAB.

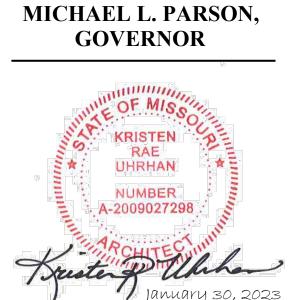

STATE OF MISSOURI

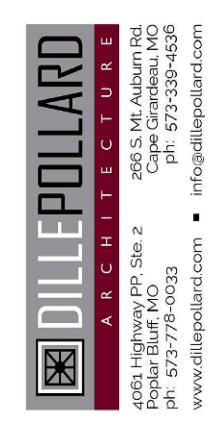

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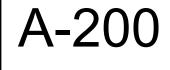
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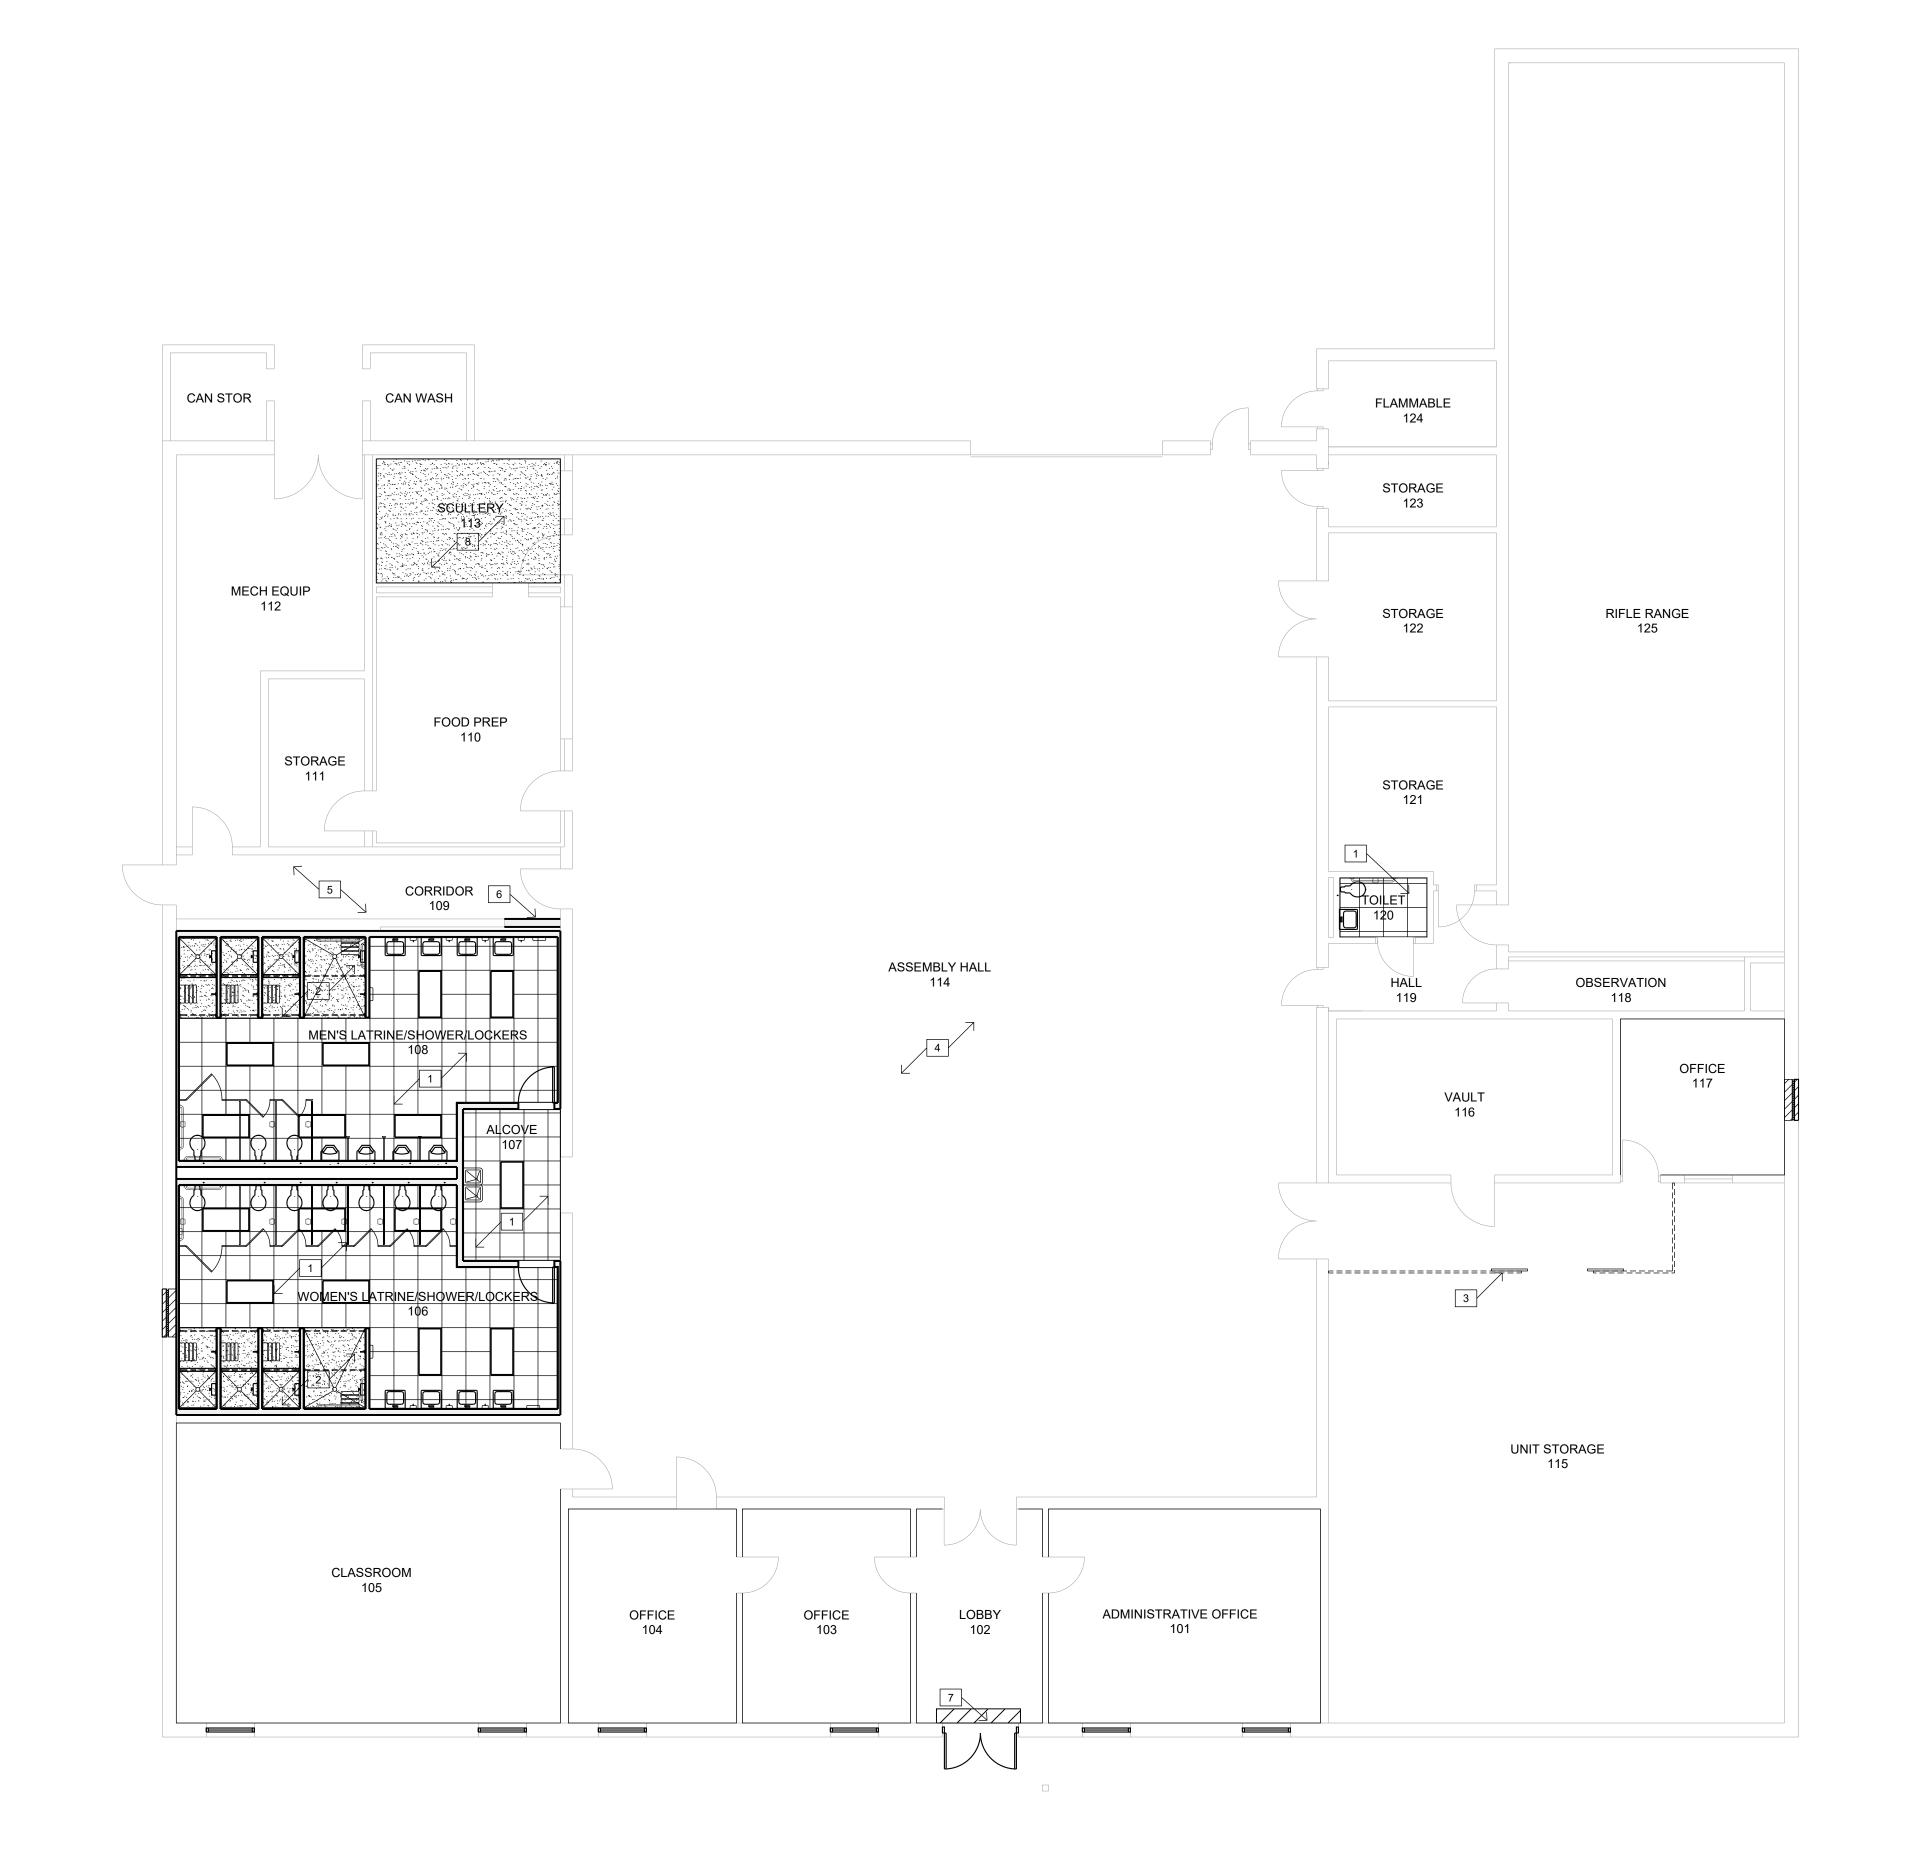
ALTERATIONS PLAN - FLOOR PLAN

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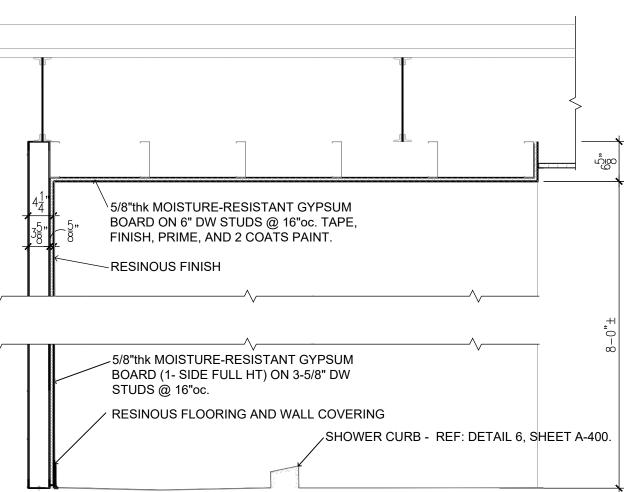













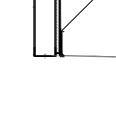


REFER TO SHEET G-002 FOR GENERAL NOTES


KEYED NOTES - REFLECTED CEILING PLAN:


- 1. INSTALL NEW LAY-IN TILE AND GRID AS SPECIFIED. REFER TO FINISH SCHEDULE, SHEET A-500. REFERENCE MEP DRAWINGS FOR PLACEMENT OF REGISTERS, GRILLES, LIGHTING, ETC.
- 2. NEW GYPSUM BOARD OVER METAL FRAMED SOFFIT. REFERENCE DETAIL THIS SHEET.
- 3. EXISTING EXPOSED STRUCTURE TO REMAIN. NEW WIRE PARTITION TO EXTEND TO BTM OF EXISTING STRUCTURE. MODIFY TOP OF PARTITION TO WORK AROUND EXISTING STEEL JOISTS AND OTHER EXPOSED STRUCTURE.
- 4. EXISTING EXPOSED STRUCTURE TO REMAIN. REFERENCE ELECTRICAL DRAWINGS FOR NEW LIGHT FIXTURES.
- 5. EXISTING CEILING TILES AND GRID TO REMAIN. TILES TO BE REMOVED AND RE-INSTALLED AS REQUIRED FOR ACCESS TO ABOVE CEILING WORK. REFERENCE MEP DRAWINGS.
- 6. MODIFY EXISTING CEILING GRID AS NECESSARY AT NEW PARTITION LOCATION. INSTALL NEW WALL ANGLE ALONG NEW PARTITION AND MODIFY CROSS BEAMS. RE-SIZE AND INSTALL EXISTING TILE.
- 7. ALTERNATE BID NO. 1: TEMPORARILY REMOVE EXISTING LAY-IN TILE AND GRID AS NECESSARY TO ACCESS STOREFRONT SYSTEM FOR REPLACEMENT. RE-INSTALL EXISTING ONCE STOREFRONT IS IN PLACE.
- 8. EXISTING GYPSUM PLASTER LATHE CEILING TO REMAIN. REFERENCE MEP DRAWINGS FOR NEW OPENING AS REQUIRED. REPAIR AND PAINT.

CEILING SYMBOLS LEGEND:

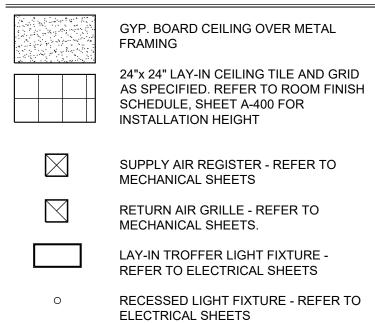



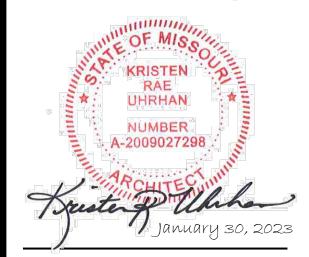

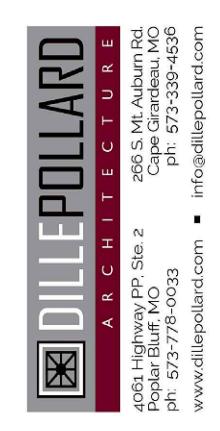

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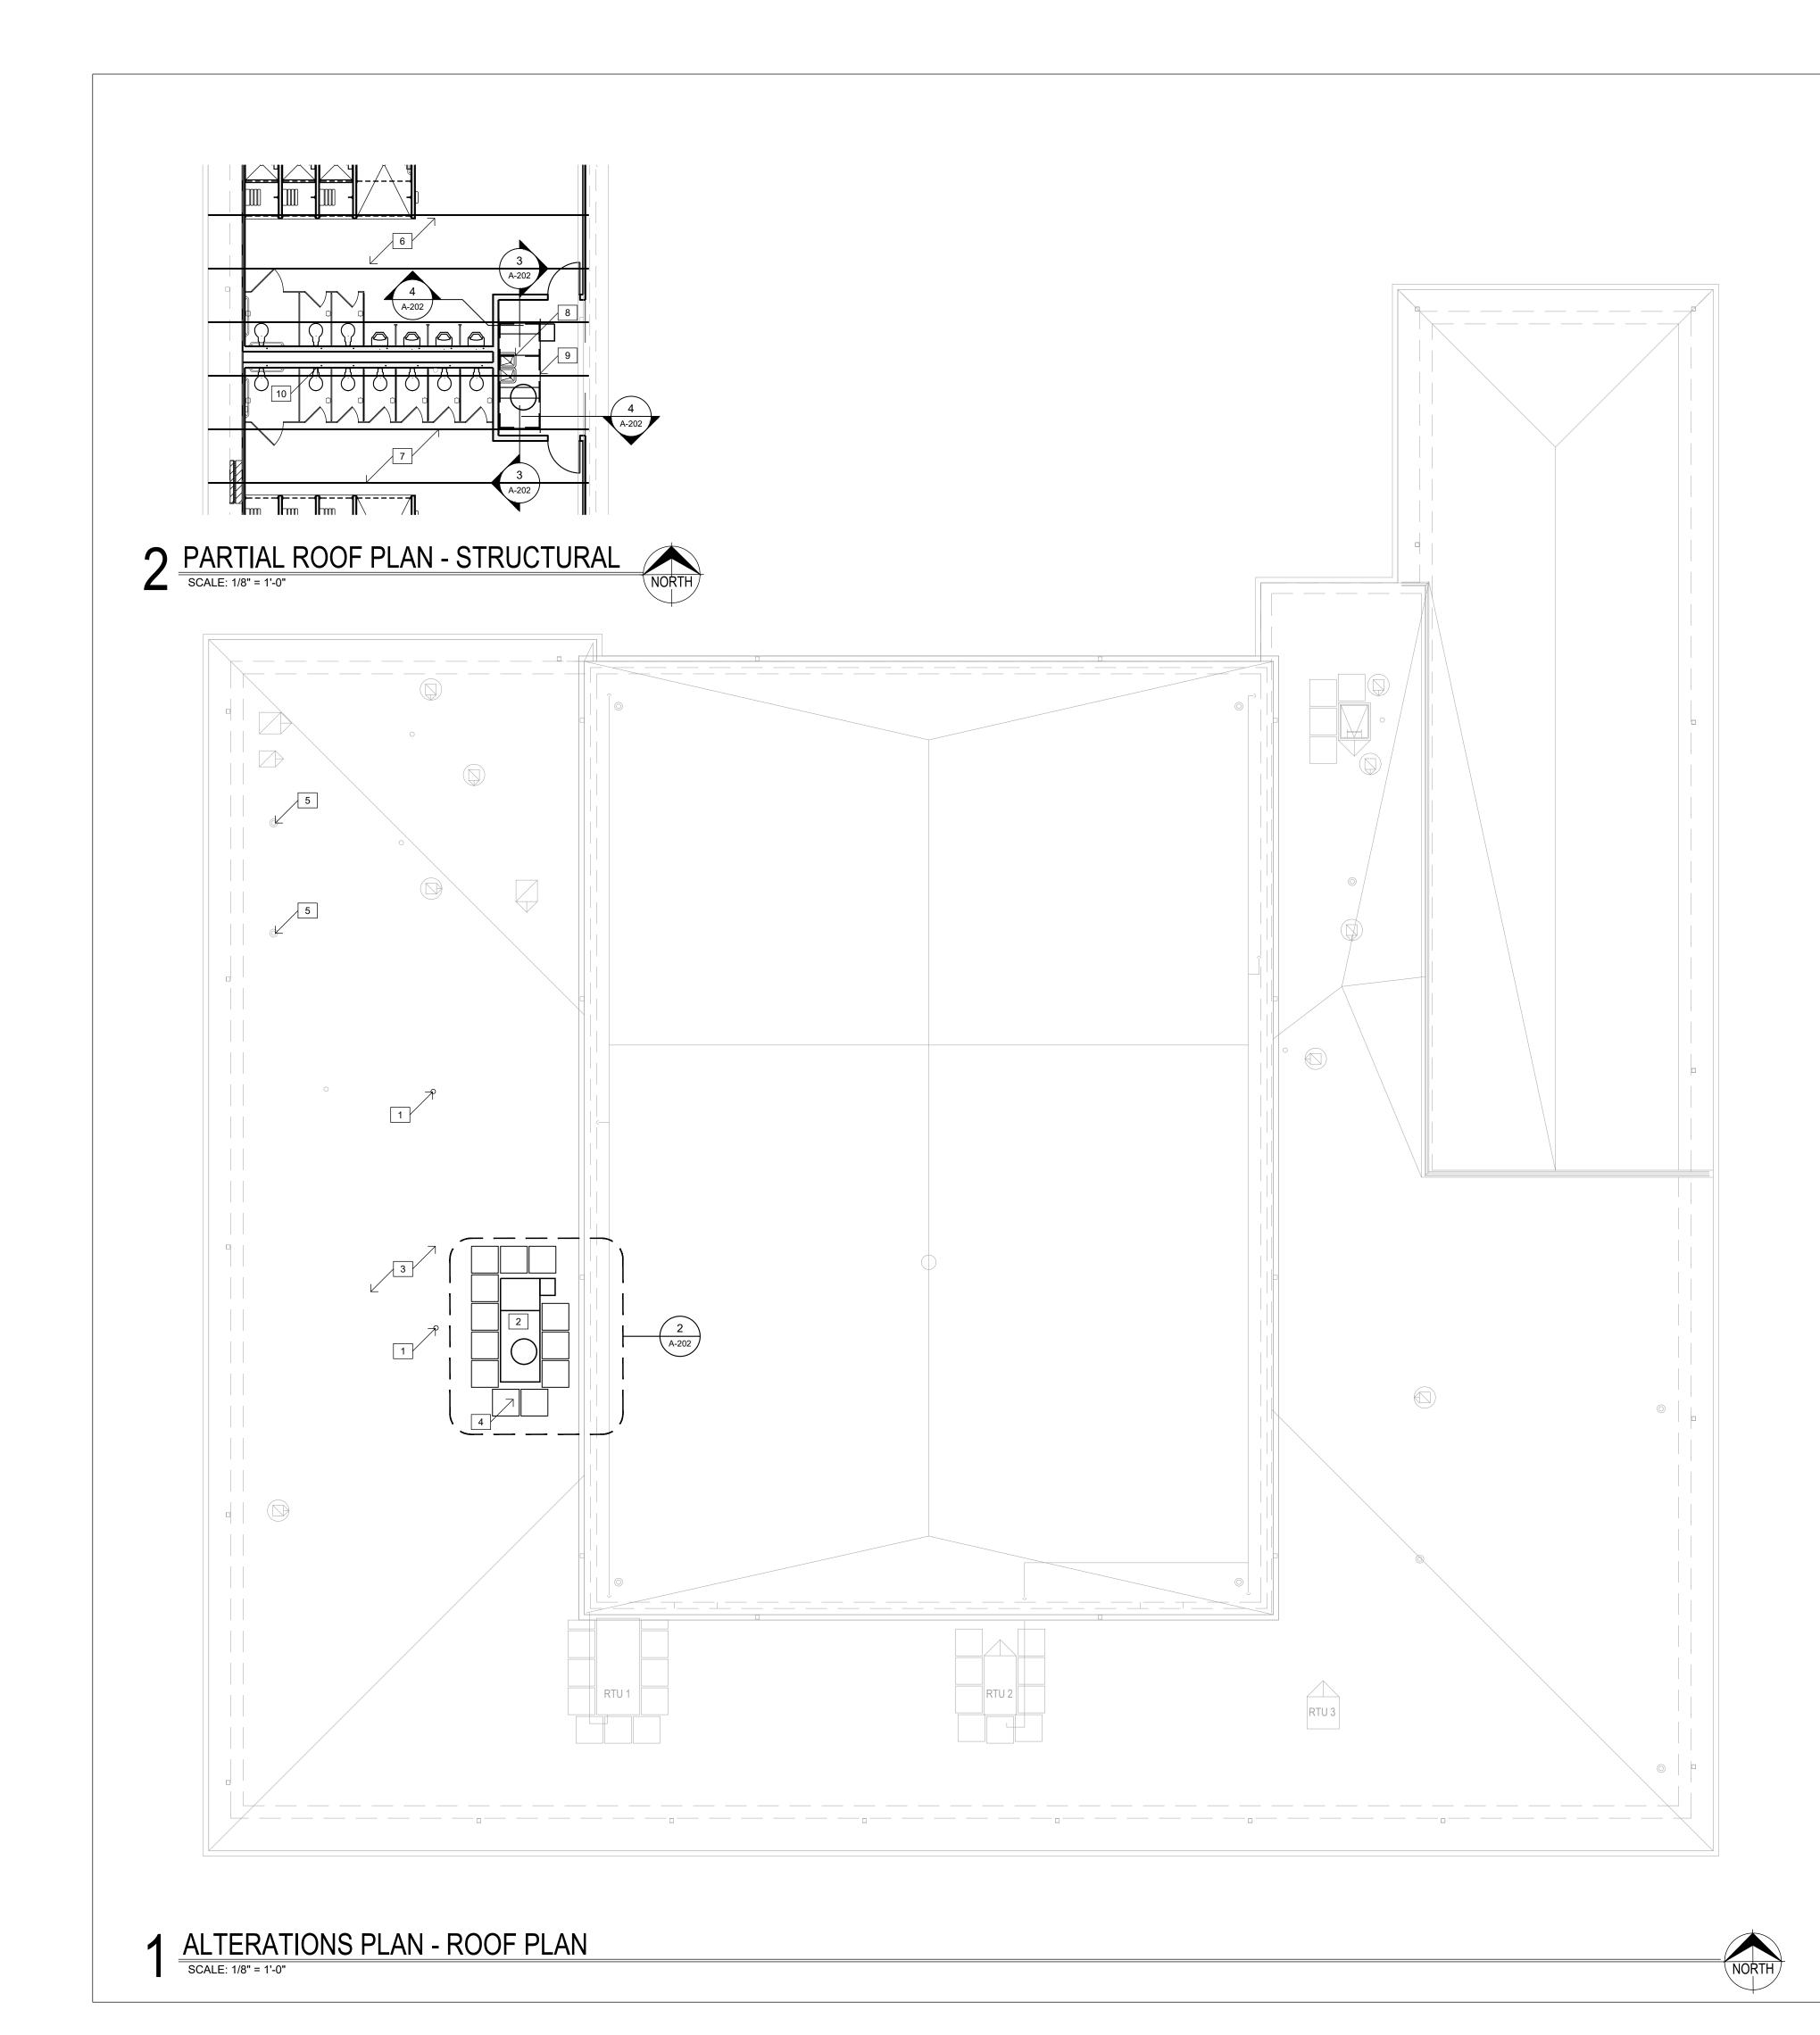
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ALTERATIONS PLAN - REFLECTED CEILING


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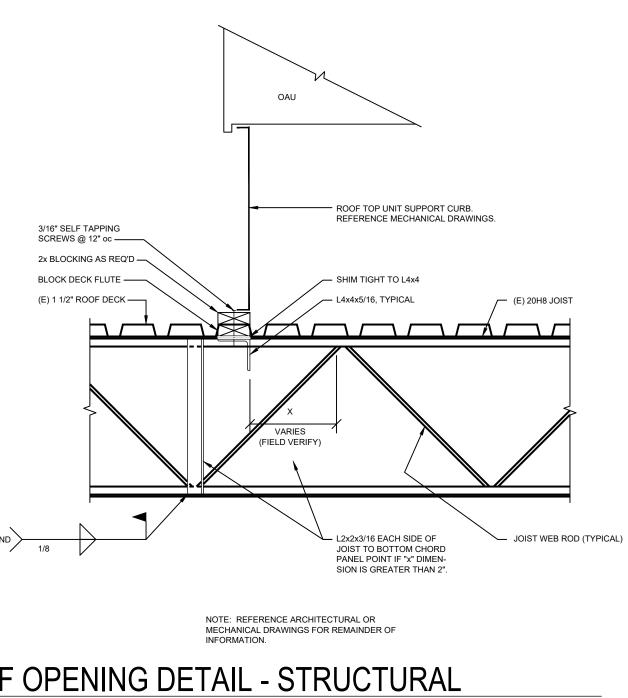
GENERAL ROOF PLAN NOTES:


- AS SPECIFIED.
- MANUFACTURER'S RECOMMENDATIONS.
- C.
- D. ROOF CONSTRUCTION AT AREA WHERE WORK IS TO OCCUR IS .060 mil TPO SINGLE PLY MEMBRANE (FIRESTONE) FULLY ADHERED TO 1/2" THICK HD COVERBOARD ADHERED TO 1/4" PER FOOT TAPERED POLYISO INSULATION (1/2" MIN) OVER 5" THICK BASE LAYER POLYISO RIGID INSULATION BOARD (R-30 ci) ON EXISTING METAL DECKING. ROOF IS CURRENTLY UNDER WARRANTY. CONTRACTOR SHALL ENSURE NEW WORK SHALL NOT VOID EXISTING ROOF WARRANTY AND BEAR ANY COSTS ASSOCIATED THEREIN. ROOFING WARRANTY IS FIRESTONE RED SHIELD - TPO - 20-YEAR -72 MPH WITH START DATE 09/15/2022.
- DOCUMENTS.



(E) 20H8 ROOF JOIST -



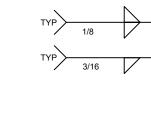

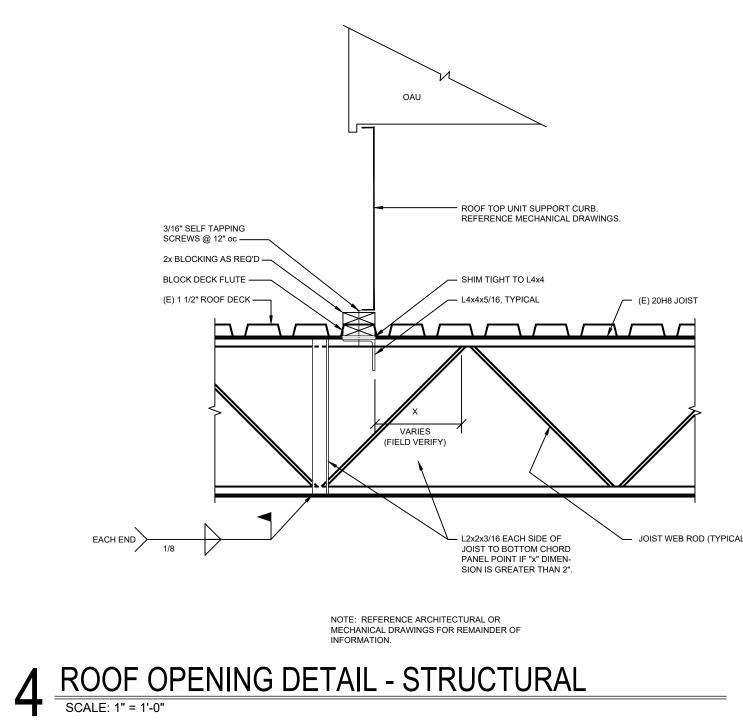

A. DASHED LINES INDICATE EXISTING CONSTRUCTION TO BE TOTALLY REMOVED BY CONTRACTOR UNLESS OTHERWISE NOTED. DEMO'D ITEMS TO BE REMOVED AND DISPOSED OF IN A SAFE AND LAWFUL MANNER PER

B. EXISTING SURFACES TO RECEIVE NEW FINISHES SHALL BE PATCHED AND PREPPED AS REQUIRED TO RECEIVE NEWLY SPECIFIED SURFACE TREATMENT / FINISHES PER

PROVIDE TEMPORARY BRACING AND SHORING AS REQUIRED TO SUPPORT EXISTING STRUCTURE PRIOR TO ANY DEMOLITION OF LOAD BEARING CONSTRUCTION.


EXISTING STRUCTURE SHOWN PER OWNER'S EXISTING DOCUMENTS. CONTRACTOR TO FIELD VERIFY ALL CONDITIONS PRIOR TO DEMOLITION AND NEW WORK, SPECIFICALLY NEW ROOF PENETRATION. NOTIFY ARCHITECT OF ANYTHING THAT DIFFERS FROM THE

KEYED NOTES - ROOF PLAN:

1. EXISTING VENT THRU ROOF TO REMAIN. CONTRACTOR SHALL UTILIZE EXISTING ROOF VENT OPENINGS FOR NEW PLUMBING VENTS. IN THE EVENT A NEW OPENING IS NECESSARY, COORDINATE OPENING WITH ROOFING CONTRACTOR FOR VENT BOOST INSTALLATION. REFERENCE MEP DRAWINGS.

X


- 2. NEW ROOFTOP EQUIPMENT. PROVIDE NEW ROOF PENETRATION IN EXISTING ROOF. PROVIDE SHEET METAL CLOSURE CONTINUOUS AT OPENING. COORDI-NATE EXACT LOCATION, OPENING AND SIZE WITH EXISTING STRUCTURE, MECHANICAL SHEETS AND RTU MANUFACTURER'S REQUIREMENTS. ALSO REFERENCE MEP DRAWINGS.
- EXISTING ROOF TO REMAIN. TAKE CARE NOT TO DAMAGE 3. DURING CONSTRUCTION ACTIVITIES.
- 4. INSTALL NEW TPO WALKWAY PADS (30"x30" MIN.) AT NEW EQUIPMENT. COORDINATE WITH EXISTING ROOF MANUFACTURER (FIRESTONE) FOR ACCEPTABLE PRODUCTS. INSTALL PER MANUFACTURER'S INSTRUCTIONS.
- EXISTING FLU ROOF OPENING TO REMAIN. CONTRACTOR SHALL UTILIZE EXISTING ROOF FLUE OPENINGS FOR NEW VENTS. IN THE EVENT A NEW OPENING IS NECESSARY, COORDINATE OPENING WITH ROOFING CONTRACTOR FOR VENT BOOST INSTALLATION. REFERENCE MEP DRAWINGS.
- 6. EXISTING ROOF DECK 1-1/2"x22 GA TYPE F PAINTED STEEL DECK.
- 7. EXISTING 20H8 JOISTS @ 5'-0" +/- ON CENTER.
- 8. $L3x3x_4^1$ EACH SIDE OF ROOF PENETRATION.
- 9. $L4x4x_{16}^{5}$ (4) SIDES OF UNIT CURB.
- 10. TOP OF EXISTING CMU WALLS ARE WELDED TO ROOF DECK AT 6" oc. EXISTING EMBED PLATE IS CONTINUOUS. CONTRACTOR TO USE CAUTION DURING DEMOLITION. REFERENCE DEMOLITION PLANS.

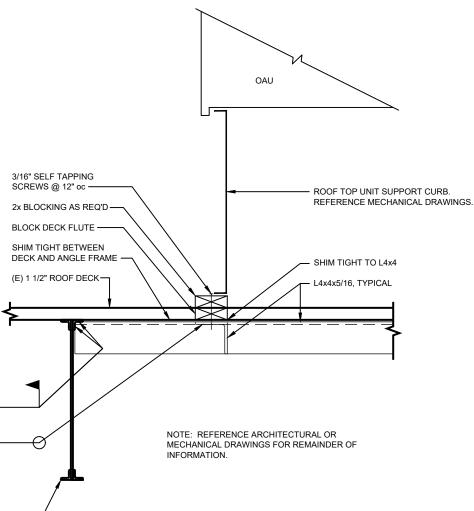

3 ROOF OPENING DETAIL - STRUCTURAL SCALE: 1" = 1'-0"

STATE OF MISSOURI MICHAEL L. PARSON, GOVERNOR



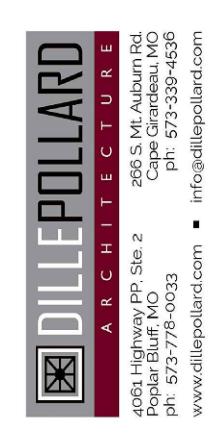

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MISSOURI ARMY NATIONAL GUARD FACILITIES DIVISION

RENOVATE INTERIOR AND EXTERIOR

KENNETT **READINESS CENTER** 1450 NORTH BY-PASS KENNETT, MO 63857

PROJECT # T2209-01

FACILITY # 8136313002

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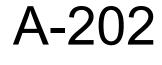
January 30, 2023


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DESIGNED BY:	KU

SHEET TITLE:

ALTERATIONS PLAN - ROOF PLAN

SHEET NUMBER:



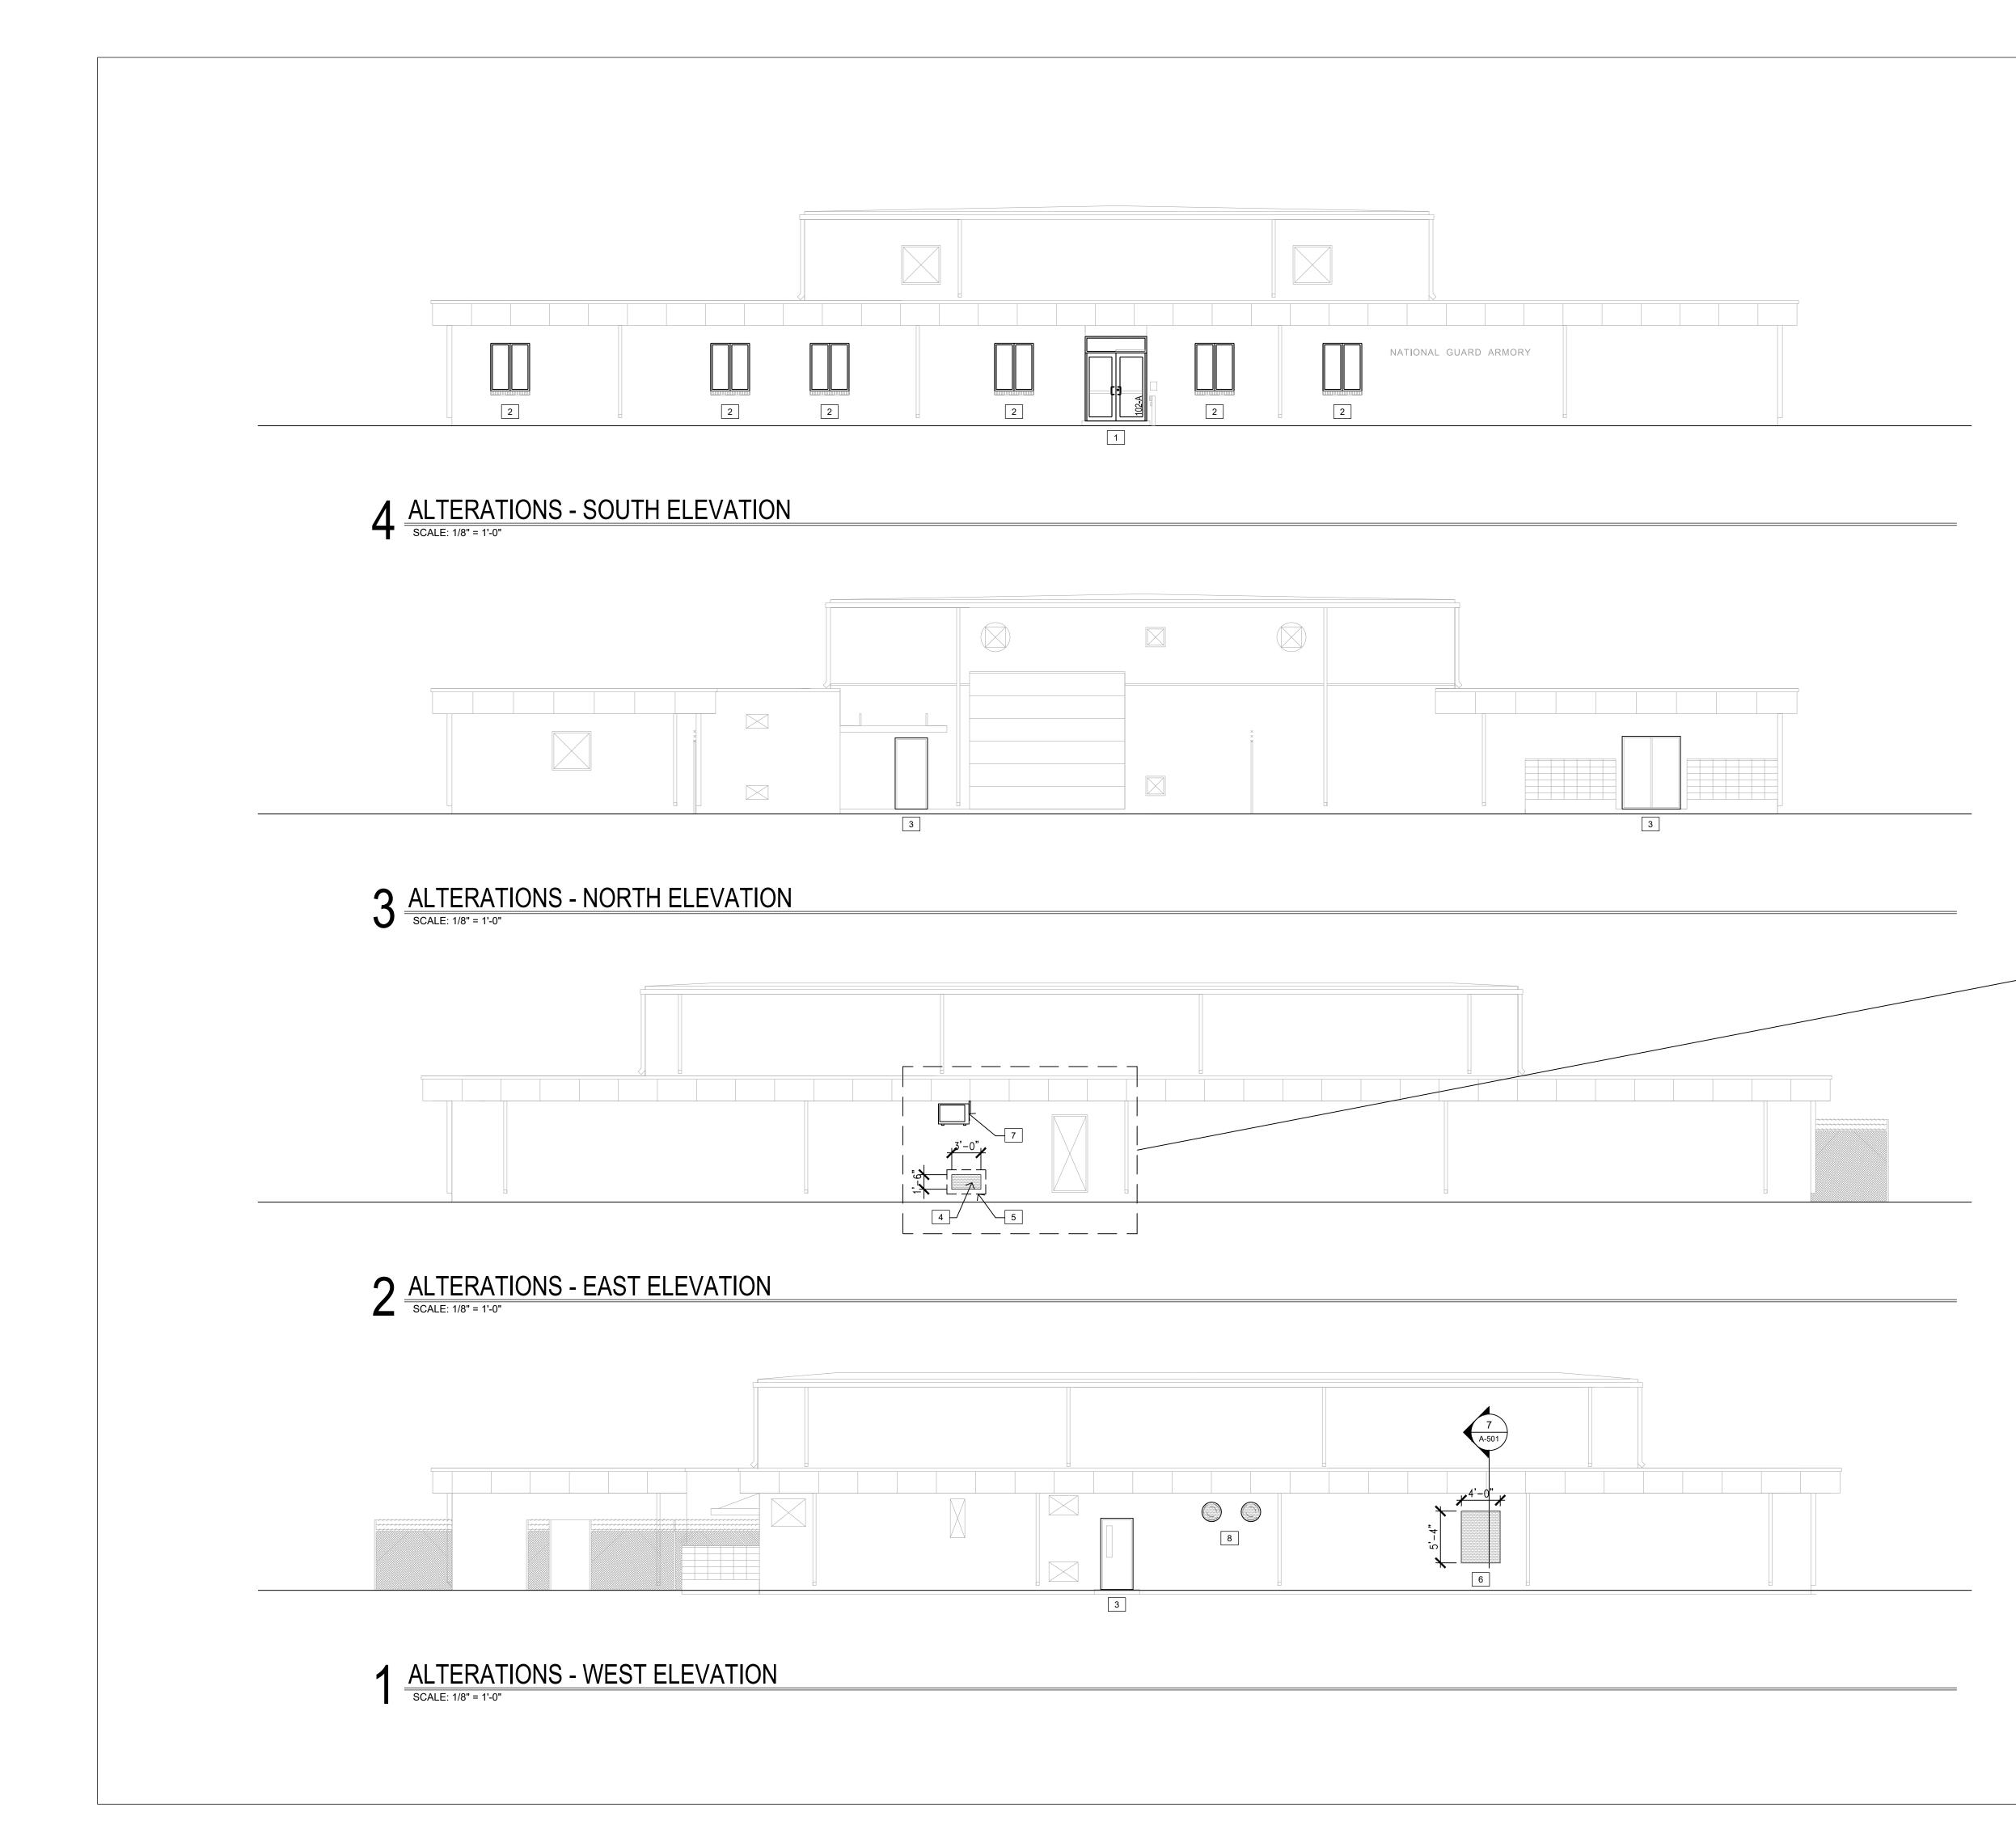

REFER TO SHEET G-002 FOR GENERAL NOTES

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KEYED NOTES - ELEVATIONS:


- 1. <u>ALTERNATE NO. 1:</u> NEW ALUMINUM STOREFRONT ENTRANCE WITH TRANSOM IN EXISTING MASONRY OPENING. PREP, PRIME, AND PAINT EXISTING STEEL LINTEL. REFERENCE DETAILS AND PROJECT MANUAL. ALSO REFERENCE ELECTRICAL DRAWINGS FOR ADA ACCESS CONNECTION AND ALTERNATE FOR FULL DESCRIPTION.
- 2. <u>ALTERNATE NO. 1:</u> NEW ALUMINUM SLIDING WINDOWS WITH INSULATED GLAZING IN EXISTING MASONRY OPENINGS. PREP, PRIME, AND PAINT EXISTING STEEL LINTEL. REFERENCE ALTERNATE FOR FULL DESCRIPTION.
- 3. EXISTING STEEL DOOR AND FRAME TO BE PREPPED AND RECEIVE NEW PAINT FINISH. PREP, PRIME, AND PAINT EXISTING STEEL LINTEL.
- 4. REMOVE EXISTING PTAC UNIT. INFILL OPENING WITH CONSTRUCTION TO MATCH EXISTING. REFERENCE DETAIL 7, SHEET A-501 FOR SIMILAR CONDITION AND MECHANICAL DRAWINGS.
- 5. REMOVE EXISTING STEEL CAGE AND FRAME FROM EXTERIOR WALL. REPAIR MASONRY AT ANCHOR POINTS.
- 6. REMOVE EXISTING WINDOW. INFILL OPENING WITH CONSTRUCTION TO MATCH EXISTING. REFERENCE DETAIL 7, SHEET A-501.
- WALL MOUNT HEAT PUMP MOUNTED TO EXISTING WALL. ANCHOR TO MASONRY PER MANUFACTURER'S INSTRUCTIONS. REFERENCE MECHANICAL AND ELECTRICAL DRAWINGS.
- REMOVE EXISTING SIDE WALL EXHAUST FANS (TYPICAL @ 2). INFILL OPENING WITH CONSTRUCTION TO MATCH EXISTING. REFERENCE DETAIL 7, SHEET A-501 FOR SIMILAR CONDITION AND MECHANICAL DRAWINGS.



MICHAEL L. PARSON, GOVERNOR

STATE OF MISSOURI



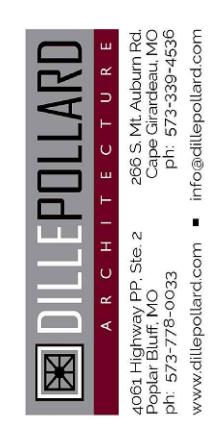

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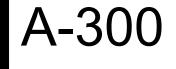
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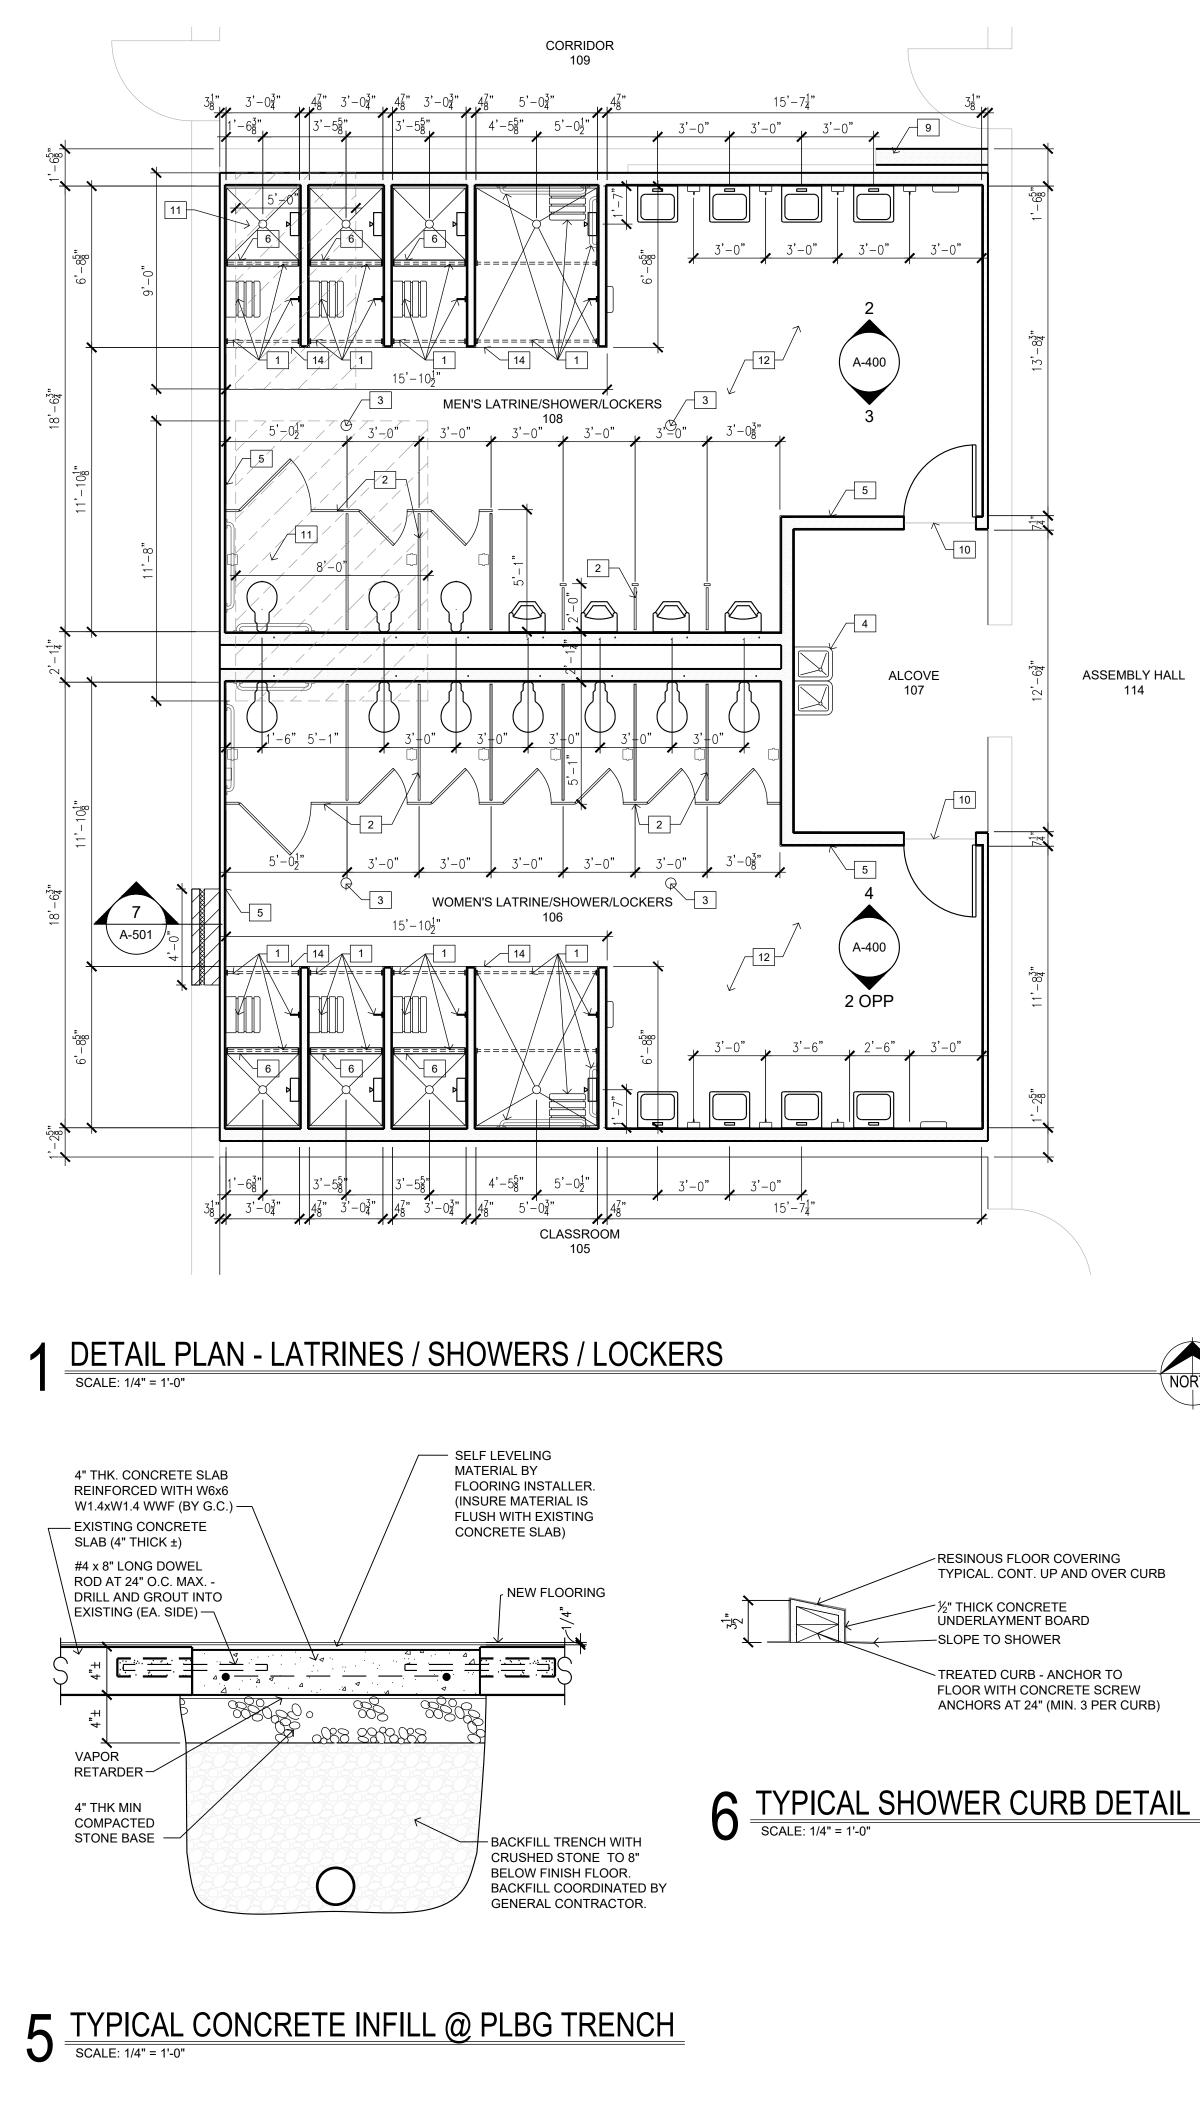
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ALTERATIONS - ELEVATIONS ALTERNATE #1


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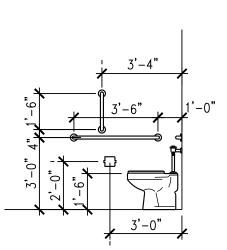
TREATED CURB - ANCHOR TO FLOOR WITH CONCRETE SCREW ANCHORS AT 24" (MIN. 3 PER CURB)

- RESINOUS FLOOR COVERING TYPICAL. CONT. UP AND OVER CURB



7 DETAIL ELEVATION - TOILET 120



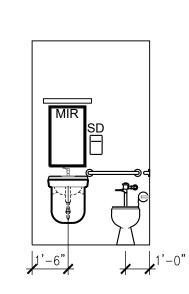




SCALE: 1/4" = 1'-0"


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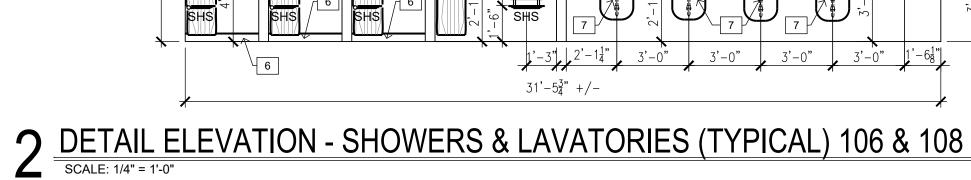
ASSEMBLY HALL


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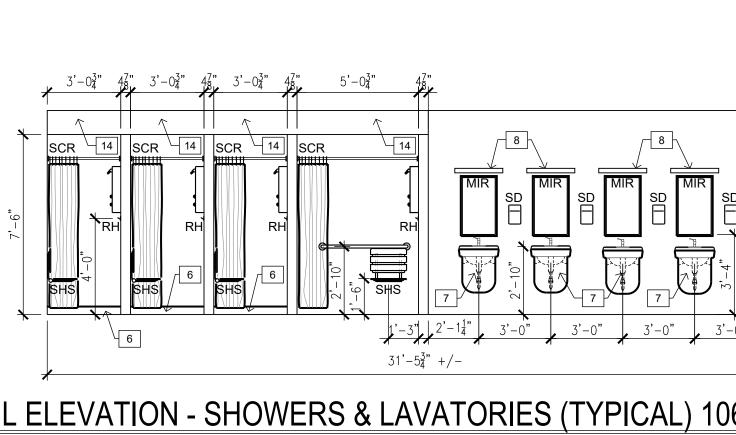




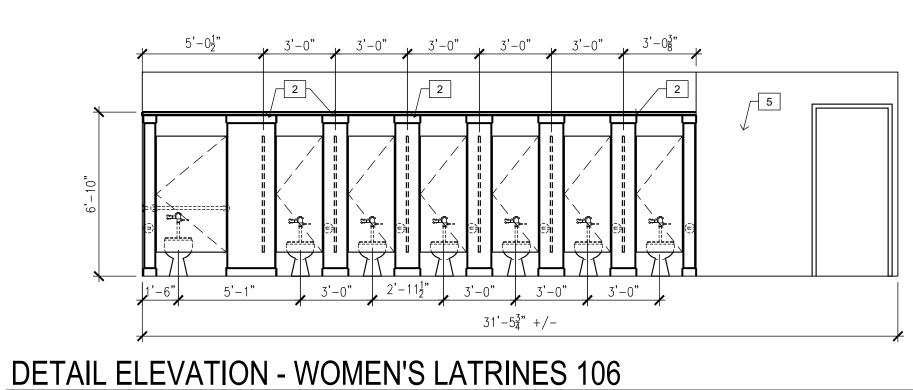



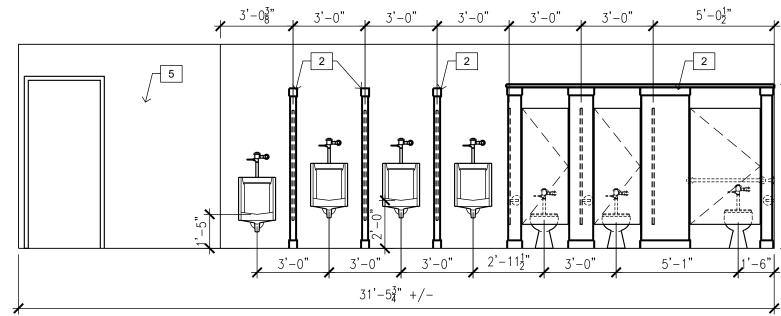

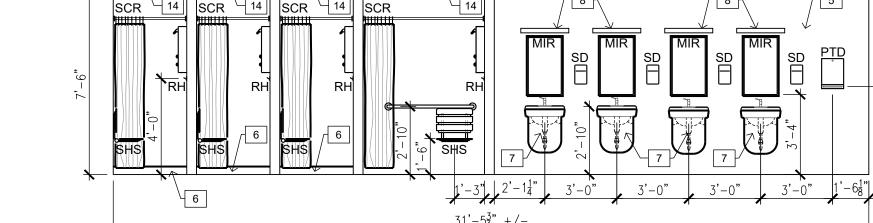

GENERAL FLOOR PLAN NOTES:

- A. GENERAL CONTRACTOR SHALL INSTALL SOLID WOOD BLOCKING AT WALLS AND PARTITIONS AS NECESSARY FOR INSTALLATION OF TOILET PARTITIONS, ACCESSORIES, LOCKERS, ETC. COORDINATE WITH OWNER.
- B. REFER TO SHEET G-002 FOR TYPICAL GENERAL NOTES.

X

- **KEYED NOTES (ALTERATIONS):**
- 1. SHOWER ACCESSORIES PER SPECIFICATIONS. PROVIDE BLOCKING AS REQUIRED.
- 2. FLOOR MOUNTED, OVER-HEAD BRACED TOILET PARTITIONS AS SPECIFIED. PROVIDE BLOCKING AS REQUIRED.
- 3. SLOPE CONCRETE ³/₈" TO FLOOR DRAIN. COORDINATE WITH MEP SHEETS. SLOPE SHALL NOT EXCEED 2% SLOPE IN ANY DIRECTION.
- 4. HIGH-LOW ADA COMPLIANT ELECTRIC WATER COOLER, REFERENCE PLUMBING SHEET P-100.
- 5. RESINOUS WALL COVERING AS SPECIFIED. PREP WALLS AS RECOMMENDED BY PRODUCT MANUFACTURER. TYPICAL AT LATRINES/SHOWER AREAS.
- 6. INSTALL NEW SHOWER CURB AT SHOWER ENTRANCE. REF. DETAIL 6, THIS SHEET.
- 7. PROVIDE ADA COMPLIANT LAVATORY GUARD AT EACH LAVATORY SUPPLY AND WASTE LINES.
- 8. WALL MOUNTED LIGHT FIXTURE. REF. ELECTRICAL SHEETS.
- 9. CONTINUE EXISTING CORRIDOR PARTITION TO ASSEMBLY HALL PARTITION. INFILL OPENING WITH CMU TO MATCH EXISTING CONSTRUCTION. FINISH TO MATCH EXISTING. REF: FINISH SCHEDULE.
- 10. CUT 1/4" WIDE X 1/4" DEEP KEYWAY, FULL LENGTH OF OPENING FOR RESINOUS FLOOR EDGE. COORDINATE WITH RESINOUS FLOORING MANUFACTURER FOR FINISH REQUIREMENTS AT EXISTING SLAB.
- 11. INSTALL LIGHTWEIGHT CONCRETE INFILL AT EXISTING MORTAR BED (DESIGNATED WITH DASHED HATCH PATTERN). COORDINATE WITH RESINOUS FLOORING MANUFACTURER FOR FINISH REQUIREMENTS AND EDGE TREATMENTS AT EXISTING SLAB.
- 12. PREP EXISTING CONCRETE SLAB FOR RESINOUS FLOORING. COORDINATE WITH RESINOUS FLOORING MANUFACTURER FOR REQUIREMENTS.
- 13. INSTALL 4" THICK CONCRETE OVER VAPOR BARRIER OVER 4" OF COMPACTED BASE AT FLOOR INFILL AREAS DEMOLISHED FOR PLUMBING LINE INSTALLATION. DRILL-IN AND EPOXY #4X12" DOWELS AT 24" O.C. AT PERIMETER OF OPENING. COORDINATE WITH RESINOUS FLOORING MANUFACTURER FOR FINISH REQUIREMENTS AND EDGE TREATMENTS AT EXISTING SLAB. SEE DETAIL 5, SHEET A-400.
- 14. INSTALL GYP BOARD SOFFIT/CEILING AT SHOWER AREAS. SEE DETAIL 2, SHEET A-201.

SYMBOL LEGEND (THIS SHEET ONLY)



MIR

RH


AREA OF EXISTING GYPSUM PLASTER OVER METAL LATH CEILING

ABBREVIATIONS (THIS SHEET ONLY)

- GRAB BAR (LENGTH NOTED) (BY G.C.) GBXX
- 18"x30" MIRROR (BY G.C.) WITH 5" x 18" S.S. SHELF BELOW (BY G.C.)
- PAPER TOWEL DISPENSER (BY OWNER) PTD ROBE HOOK (BY G.C.)
- SHOWER CURTAIN ROD (BY G.C.) SCR
- SHOWER SEAT (BY G.C.) SHS
- SOAP DISPENSER (BY OWNER) SD
- SANITARY NAPKIN DISPENSER (BY G.C.) SND
- TOILET PAPER DISPENSER (BY G.C.) TPD





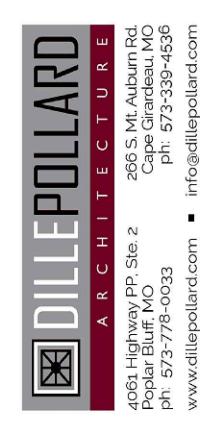

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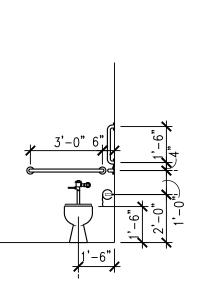
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DESIGNED BY:	KU

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DETAIL PLANS, ELEVATIONS AND DETAILS


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A-400







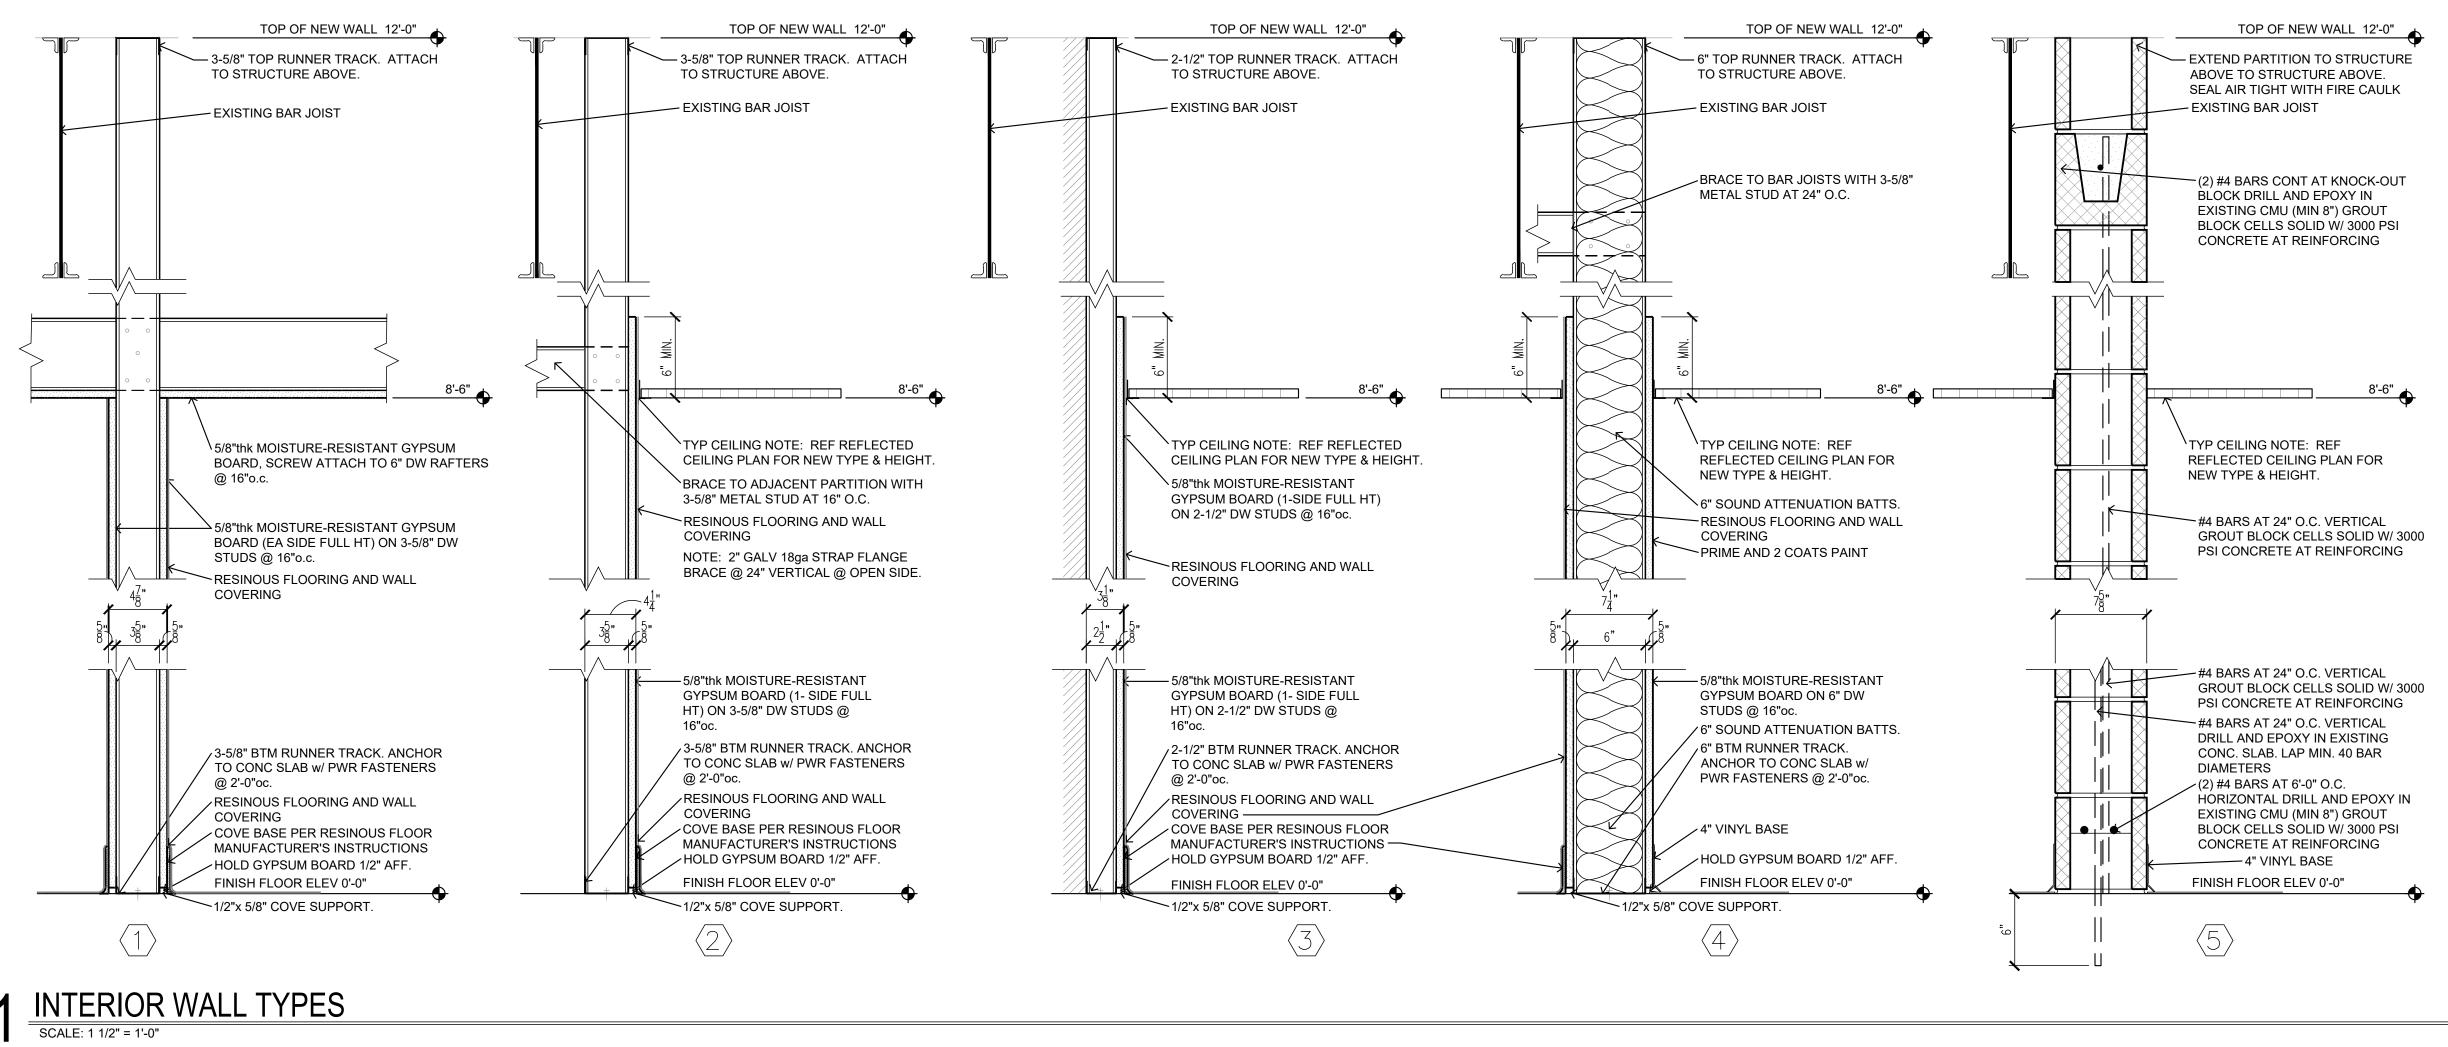

ROOM	ROOM NAME	FLOOR FINISH	BASE FINISH	WALL FINISH	CEILING FINISH	CEILING	REMARKS
01	ADMINISTRATIVE OFFICE	CARPET TILE (CT)	VINYL WALL BASE (VWB)	PAINT	EXISTING / NO WORK	-	INE MAINING
2		LUXURY VINYL TILE (LVT)	VINYL WALL BASE (VWB)	PAINT	EXISTING / NO WORK	2	[5]
)3	OFFICE	CARPET TILE (CT)	VINYL WALL BASE (VWB)	PAINT	EXISTING / NO WORK	-	
)4		CARPET TILE (CT)	VINYL WALL BASE (VWB)	PAINT	EXISTING / NO WORK	-	[5]
)5		LUXURY VINYL TILE (LVT)	VINYL WALL BASE (VWB)	PAINT	EXISTING / NO WORK	-	[5]
)6	WOMEN'S LATRINE/SHOWERS/LOCKERS		INTEGRAL RESINOUS BASE	GYPSUM BOARD w/ RESINOUS WALL FINISH	SUSPENDED CEILING 2x2	8'-6"	[1], [3], [4]
)7	ALCOVE	LUXURY VINYL TILE (LVT)	VINYL WALL BASE (VWB)	PAINT	SUSPENDED CEILING 2x2	9'-0"	
8	MEN'S LATRINE/SHOWERS/LOCKERS	RESINOUS FLOORING	INTEGRAL RESINOUS BASE	GYPSUM BOARD w/ RESINOUS WALL FINISH	SUSPENDED CEILING 2x2	8'-6"	[1], [3], [4]
9	CORRIDOR	EXISTING / NO WORK	VINYL WALL BASE (VWB)	PAINT	EXISTING / NO WORK	-	[5], [8]
0	FOOD PREP	EXISTING / NO WORK	EXISTING / NO WORK	EXISTING / NO WORK	EXISTING / NO WORK	-	[2], [5]
1	STORAGE	EXISTING / NO WORK	EXISTING / NO WORK	EXISTING / NO WORK	EXISTING / NO WORK		[2]
12	MECHANICAL EQUIPMENT	EXISTING / NO WORK	EXISTING / NO WORK	EXISTING / NO WORK	EXISTING / NO WORK	17.1	[2]
13	SCULLERY	EXISTING / NO WORK	EXISTING / NO WORK	EXISTING / NO WORK	EXISTING / NO WORK	-	[2], [5]
14	ASSEMBLY HALL	EXISTING / NO WORK	EXISTING / NO WORK	EXISTING / NO WORK	OPEN TO STRUCTURE	20'-0" +/-	[5]
15	UNIT STORAGE	EXISTING / NO WORK	EXISTING / NO WORK	EXISTING / NO WORK	OPEN TO STRUCTURE	New York	[2], [5]
16	VAULT	EXISTING / NO WORK	EXISTING / NO WORK	EXISTING / NO WORK	EXISTING / NO WORK		[2]
17	OFFICE	CARPET TILE (CT)	VINYL WALL BASE (VWB)	PAINT	SUSPENDED CEILING 2x2	9'-0"	[7]
8	OBSERVATION	EXISTING / NO WORK	EXISTING / NO WORK	EXISTING / NO WORK	EXISTING / NO WORK	-	[2]
19	HALL	EXISTING / NO WORK	EXISTING / NO WORK	EXISTING / NO WORK	EXISTING / NO WORK	-	[2], <mark>[</mark> 5]
20	TOILET	EXISTING / NO WORK	EXISTING / NO WORK	PAINT	EXISTING / PAINT	<u></u>	[6]
21	STORAGE	EXISTING / NO WORK	EXISTING / NO WORK	EXISTING / NO WORK	EXISTING / NO WORK	1 	[2]
22	STORAGE	EXISTING / NO WORK	EXISTING / NO WORK	EXISTING / NO WORK	EXISTING / NO WORK	-	[2], [5]
23	STORAGE	EXISTING / NO WORK	EXISTING / NO WORK	EXISTING / NO WORK	EXISTING / NO WORK	-	[2], [5]
24	FLAMMABLE	EXISTING / NO WORK	EXISTING / NO WORK	EXISTING / NO WORK	EXISTING / NO WORK	-	[2]
25	RIFLE RANGE	EXISTING / NO WORK	EXISTING / NO WORK	EXISTING / NO WORK	EXISTING / NO WORK	7/	[2]
NISH REI	MARKS:						
]	EXISTING FINISHES AND WALLS TO BE DE	EMO'D TO EXTENTS INDICAT	ED ON THE PLANS. CONCRETE	SLABS TO BE SAWCUT AS REQUIRED FOR NEV	V PLUMBING AND REPAIRED A	CORDINGLY TO	RECEIVE
4	EXISTING FINISHES AND WALLS TO BE DEMOD TO EXTENTS INDICATED ON THE PLANS. CONCRETE SLABS TO BE SAWCUT AS REQUIRED FOR NEW PLUMBING AND REPAIRED ACCORDINGLY TO RECEIVE FLOOR LEVELER FOR NEW RESINOUS FINISH. REFERENCE SPECIFICATION FOR RESINOUS TYPE.						
]	EXISTING SPACE - NO WORK REQUIRED.	IF AREA IS DISTURBED BY	DEMO WORK, REPAIR AS REQ	UIRED TO RESTORE TO ORIGINAL CONDITIONS.			
]				HEIGHT OF WALL). REFERENCE SPECIFICATION	FOR RESINOUS TYPE.		
]	5/8" MOISTURE-RESISTANT GYPSUM BOA						
]	PREP AND PAINT EXISTING WALK DOORS	AND FRAMES AT ASSEMB	LY HALL AREA				
]	EXISTING FLOOR AND WALL TILE TO REM	IAIN AND CLEANED.					5
]	RE-INSTALL EXISTING LIGHT FIXTURES IN	NEW CEILING GRID. REFER	RENCE ELECTRICAL DRAWINGS				
]	INSTALL NEW VINYL BASE TO MATCH EX	ISTING AT WALL INFILL					
	FINISH NOTES:						
		NS FOR LOCATION AND TRE	ATMENT OF HEADWALLS FUR	RED CEILINGS, EXPANSION JOINTS NOT NOTED I	N SCHEDULE		
	PROVIDE TRANSITION STRIPS BETWEEN				an oracial and a second and a so		
	REFER TO THE DOOR, OPENING & FRAM						
	HEADWALLS, FURRED CEILINGS, ETC. TO						

ROOM	ROOM NAME	FLOOR FINISH	BASE FINISH	WALL FINISH	CEILING FINISH	CEILING	REMARK
01	ADMINISTRATIVE OFFICE	CARPET TILE (CT)	VINYL WALL BASE (VWB)	PAINT	EXISTING / NO WORK	-	
2	LOBBY	LUXURY VINYL TILE (LVT)	VINYL WALL BASE (VWB)	PAINT	EXISTING / NO WORK		[5]
3	OFFICE	CARPET TILE (CT)	VINYL WALL BASE (VWB)	PAINT	EXISTING / NO WORK	_	1-1
4	OFFICE	CARPET TILE (CT)	VINYL WALL BASE (VWB)	PAINT	EXISTING / NO WORK	-	[5]
)5	CLASSROOM	LUXURY VINYL TILE (LVT)	VINYL WALL BASE (VWB)	PAINT	EXISTING / NO WORK	-	[5]
6	WOMEN'S LATRINE/SHOWERS/LOCKERS		INTEGRAL RESINOUS BASE	GYPSUM BOARD w/ RESINOUS WALL FINISH	SUSPENDED CEILING 2x2	8'-6"	[1], [3], [4]
7	ALCOVE	LUXURY VINYL TILE (LVT)	VINYL WALL BASE (VWB)	PAINT	SUSPENDED CEILING 2x2	9'-0"	
8	MEN'S LATRINE/SHOWERS/LOCKERS	RESINOUS FLOORING	INTEGRAL RESINOUS BASE	GYPSUM BOARD w/ RESINOUS WALL FINISH	SUSPENDED CEILING 2x2	8'-6"	[1], [3], [4]
9	CORRIDOR	EXISTING / NO WORK	VINYL WALL BASE (VWB)	PAINT	EXISTING / NO WORK	-	[5], [8]
0	FOOD PREP	EXISTING / NO WORK	EXISTING / NO WORK	EXISTING / NO WORK	EXISTING / NO WORK	-	[2], [5]
1	STORAGE	EXISTING / NO WORK	EXISTING / NO WORK	EXISTING / NO WORK	EXISTING / NO WORK	-	[2]
2	MECHANICAL EQUIPMENT	EXISTING / NO WORK	EXISTING / NO WORK	EXISTING / NO WORK	EXISTING / NO WORK		[2]
3	SCULLERY	EXISTING / NO WORK	EXISTING / NO WORK	EXISTING / NO WORK	EXISTING / NO WORK	-	[2], [5]
4	ASSEMBLY HALL	EXISTING / NO WORK	EXISTING / NO WORK	EXISTING / NO WORK	OPEN TO STRUCTURE	20'-0" +/-	[5]
5	UNIT STORAGE	EXISTING / NO WORK	EXISTING / NO WORK	EXISTING / NO WORK	OPEN TO STRUCTURE	<u></u>	[2], [5]
6	VAULT	EXISTING / NO WORK	EXISTING / NO WORK	EXISTING / NO WORK	EXISTING / NO WORK	. 	[2]
7	OFFICE	CARPET TILE (CT)	VINYL WALL BASE (VWB)	PAINT	SUSPENDED CEILING 2x2	9'-0"	[7]
8	OBSERVATION	EXISTING / NO WORK	EXISTING / NO WORK	EXISTING / NO WORK	EXISTING / NO WORK	-	[2]
9	HALL	EXISTING / NO WORK	EXISTING / NO WORK	EXISTING / NO WORK	EXISTING / NO WORK	-	[<mark>2], [</mark> 5]
0	TOILET	EXISTING / NO WORK	EXISTING / NO WORK	PAINT	EXISTING / PAINT	<u></u>	[6]
21	STORAGE	EXISTING / NO WORK	EXISTING / NO WORK	EXISTING / NO WORK	EXISTING / NO WORK	1 	[2]
22	STORAGE	EXISTING / NO WORK	EXISTING / NO WORK	EXISTING / NO WORK	EXISTING / NO WORK	-	[2], [5]
23	STORAGE	EXISTING / NO WORK	EXISTING / NO WORK	EXISTING / NO WORK	EXISTING / NO WORK	-	[2], [5]
24	FLAMMABLE	EXISTING / NO WORK	EXISTING / NO WORK	EXISTING / NO WORK	EXISTING / NO WORK	-	[2]
25	RIFLE RANGE	EXISTING / NO WORK	EXISTING / NO WORK	EXISTING / NO WORK	EXISTING / NO WORK	<u>72</u>	[2]
NISH REI	MARKS:						
	EXISTING FINISHES AND WALLS TO BE D	EMO'D TO EXTENTS INDICAT	ED ON THE PLANS. CONCRET	E SLABS TO BE SAWCUT AS REQUIRED FOR NEV	V PLUMBING AND REPAIRED A	CCORDINGLY TO	RECEIVE
	FLOOR LEVELER FOR NEW RESINOUS F	INISH. REFERENCE SPECIFI	CATION FOR RESINOUS TYPE.				
	EXISTING SPACE - NO WORK REQUIRED.	IF AREA IS DISTURBED BY	DEMO WORK, REPAIR AS REG	UIRED TO RESTORE TO ORIGINAL CONDITIONS.			
]	5/8" MOISTURE-RESISTANT GYPSUM BOA	ARD (ALL TOILET ROOM WAL	LS) w/ RESINOUS FINISH (FULL	HEIGHT OF WALL). REFERENCE SPECIFICATION	FOR RESINOUS TYPE.		
	5/8" MOISTURE-RESISTANT GYPSUM BOA	ARD AT ALL SHOWER CEILIN	IGS.				
]	PREP AND PAINT EXISTING WALK DOORS	S AND FRAMES AT ASSEMB	LY HALL AREA				
]	EXISTING FLOOR AND WALL TILE TO REM	IAIN AND CLEANED.					
]	RE-INSTALL EXISTING LIGHT FIXTURES IN	NEW CEILING GRID. REFER	RENCE ELECTRICAL DRAWINGS				
]	INSTALL NEW VINYL BASE TO MATCH EX	ISTING AT WALL INFILL					
	FINISH NOTES:						
		NS FOR LOCATION AND TRE	ATMENT OF HEADWALLS. FUR	RED CEILINGS, EXPANSION JOINTS NOT NOTED	N SCHEDULE.		
	PROVIDE TRANSITION STRIPS BETWEEN				seereess door an		
	REFER TO THE DOOR, OPENING & FRAM						
	HEADWALLS, FURRED CEILINGS, ETC. TO						
	The second of the second se						

BOOM							DEMADIA
ROOM		FLOOR FINISH	BASE FINISH	WALL FINISH	CEILING FINISH	CEILING	REMARK
01	ADMINISTRATIVE OFFICE LOBBY		VINYL WALL BASE (VWB)	PAINT	EXISTING / NO WORK	-	[6]
102 102		LUXURY VINYL TILE (LVT)	VINYL WALL BASE (VWB)	PAINT	EXISTING / NO WORK		[5]
103 104		CARPET TILE (CT) CARPET TILE (CT)	VINYL WALL BASE (VWB)	PAINT	EXISTING / NO WORK EXISTING / NO WORK	1000 (Contraction of the contraction of the contrac	[5]
104	CLASSROOM	LUXURY VINYL TILE (LVT)	VINYL WALL BASE (VWB)	PAINT	EXISTING / NO WORK		[5]
105	WOMEN'S LATRINE/SHOWERS/LOCKERS		VINYL WALL BASE (VWB) INTEGRAL RESINOUS BASE	GYPSUM BOARD w/ RESINOUS WALL FINISH	SUSPENDED CEILING 2x2	- 8'-6"	[5]
106	ALCOVE	LUXURY VINYL TILE (LVT)	VINYL WALL BASE (VWB)	PAINT	SUSPENDED CEILING 2x2	9'-0"	[1], [3], [4]
107	MEN'S LATRINE/SHOWERS/LOCKERS	RESINOUS FLOORING	INTEGRAL RESINOUS BASE	GYPSUM BOARD w/ RESINOUS WALL FINISH	SUSPENDED CEILING 2x2	8'-6"	-
109	CORRIDOR	EXISTING / NO WORK	VINYL WALL BASE (VWB)	PAINT	EXISTING / NO WORK	Real South -	[1], [3], [4]
110	FOOD PREP	EXISTING / NO WORK	EXISTING / NO WORK	EXISTING / NO WORK	EXISTING / NO WORK	-	[5], [8]
110	STORAGE	EXISTING / NO WORK	EXISTING / NO WORK	EXISTING / NO WORK	EXISTING / NO WORK	-	[2], [5] [2]
112	MECHANICAL EQUIPMENT	EXISTING / NO WORK	EXISTING / NO WORK	EXISTING / NO WORK	EXISTING / NO WORK		[2]
113	SCULLERY	EXISTING / NO WORK	EXISTING / NO WORK	EXISTING / NO WORK	EXISTING / NO WORK	-	[2], [5]
114	ASSEMBLY HALL	EXISTING / NO WORK	EXISTING / NO WORK	EXISTING / NO WORK	OPEN TO STRUCTURE	20'-0" +/-	[2], [0] [5]
115	UNIT STORAGE	EXISTING / NO WORK	EXISTING / NO WORK	EXISTING / NO WORK	OPEN TO STRUCTURE	-	[2], [5]
116	VAULT	EXISTING / NO WORK	EXISTING / NO WORK	EXISTING / NO WORK	EXISTING / NO WORK	_	[2]
117		CARPET TILE (CT)	VINYL WALL BASE (VWB)	PAINT	SUSPENDED CEILING 2x2	9'-0"	[7]
118	OBSERVATION	EXISTING / NO WORK	EXISTING / NO WORK	EXISTING / NO WORK	EXISTING / NO WORK	-	[2]
119	HALL	EXISTING / NO WORK	EXISTING / NO WORK	EXISTING / NO WORK	EXISTING / NO WORK	-	[2], [5]
120	TOILET	EXISTING / NO WORK	EXISTING / NO WORK	PAINT	EXISTING / PAINT	2	[6]
121	STORAGE	EXISTING / NO WORK	EXISTING / NO WORK	EXISTING / NO WORK	EXISTING / NO WORK	-	[2]
122	STORAGE	EXISTING / NO WORK	EXISTING / NO WORK	EXISTING / NO WORK	EXISTING / NO WORK	-	[2], [5]
123	STORAGE	EXISTING / NO WORK	EXISTING / NO WORK	EXISTING / NO WORK	EXISTING / NO WORK	-	[2], [5]
124	FLAMMABLE	EXISTING / NO WORK	EXISTING / NO WORK	EXISTING / NO WORK	EXISTING / NO WORK		[2]
125	RIFLE RANGE	EXISTING / NO WORK	EXISTING / NO WORK	EXISTING / NO WORK	EXISTING / NO WORK		[2]
INISH RE	MARKS:						
[1]	EXISTING FINISHES AND WALLS TO BE DEMO'D TO EXTENTS INDICATED ON THE PLANS. CONCRETE SLABS TO BE SAWCUT AS REQUIRED FOR NEW PLUMBING AND REPAIRED ACCORDINGLY TO RECEIVE				RECEIVE		
	FLOOR LEVELER FOR NEW RESINOUS FI	NISH. REFERENCE SPECIF	CATION FOR RESINOUS TYPE.				
2]	EXISTING SPACE - NO WORK REQUIRED.	IF AREA IS DISTURBED BY	DEMO WORK, REPAIR AS REG	UIRED TO RESTORE TO ORIGINAL CONDITIONS.			
3]	5/8" MOISTURE-RESISTANT GYPSUM BOA	ARD (ALL TOILET ROOM WAI	LS) w/ RESINOUS FINISH (FULL	HEIGHT OF WALL). REFERENCE SPECIFICATION	FOR RESINOUS TYPE.		
4]	5/8" MOISTURE-RESISTANT GYPSUM BOA	ARD AT ALL SHOWER CEILIN	IGS.				
5]	PREP AND PAINT EXISTING WALK DOORS	SAND FRAMES AT ASSEMB	LY HALL AREA				
6]	EXISTING FLOOR AND WALL TILE TO REM	AIN AND CLEANED.					
[7]	RE-INSTALL EXISTING LIGHT FIXTURES IN NEW CEILING GRID. REFERENCE ELECTRICAL DRAWINGS.						
8]	INSTALL NEW VINYL BASE TO MATCH EX	ISTING AT WALL INFILL					
GENERAL	FINISH NOTES:						
١		NS FOR LOCATION AND TRE	ATMENT OF HEADWALLS, FUR	RED CEILINGS, EXPANSION JOINTS NOT NOTED	N SCHEDULE.		
3	PROVIDE TRANSITION STRIPS BETWEEN				nene - service de la		
2	REFER TO THE DOOR, OPENING & FRAM	E SCHEDULE FOR FINISH O	F DOORS, FRAME AND TRIM.				
D	HEADWALLS, FURRED CEILINGS, ETC. TO						

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	Poplar Bluff, MO ph: 573-778-0033 www.dillepollard.

STATE OF MISSOURI MICHAEL L. PARSON, GOVERNOR

MISSOURI ARMY

DESIGN AND CONSTRUCTION

NATIONAL GUARD FACILITIES DIVISION

RENOVATE INTERIOR AND EXTERIOR

KENNETT **READINESS CENTER** 1450 NORTH BY-PASS KENNETT, MO 63857

PROJECT # T2209-01

FACILITY # 8136313002

REVISION: DATE: **REVISION:**

DATE: **REVISION:** DATE: ISSUE DATE: January 30, 2023

KU

BD

CAD DWG FILE: <u>A-100.DWG</u> DRAWN BY: CHECKED BY: **DESIGNED BY:**


_____KU

SHEET TITLE:

SCHEDULES AND DETAILS

SHEET NUMBER:

A-500

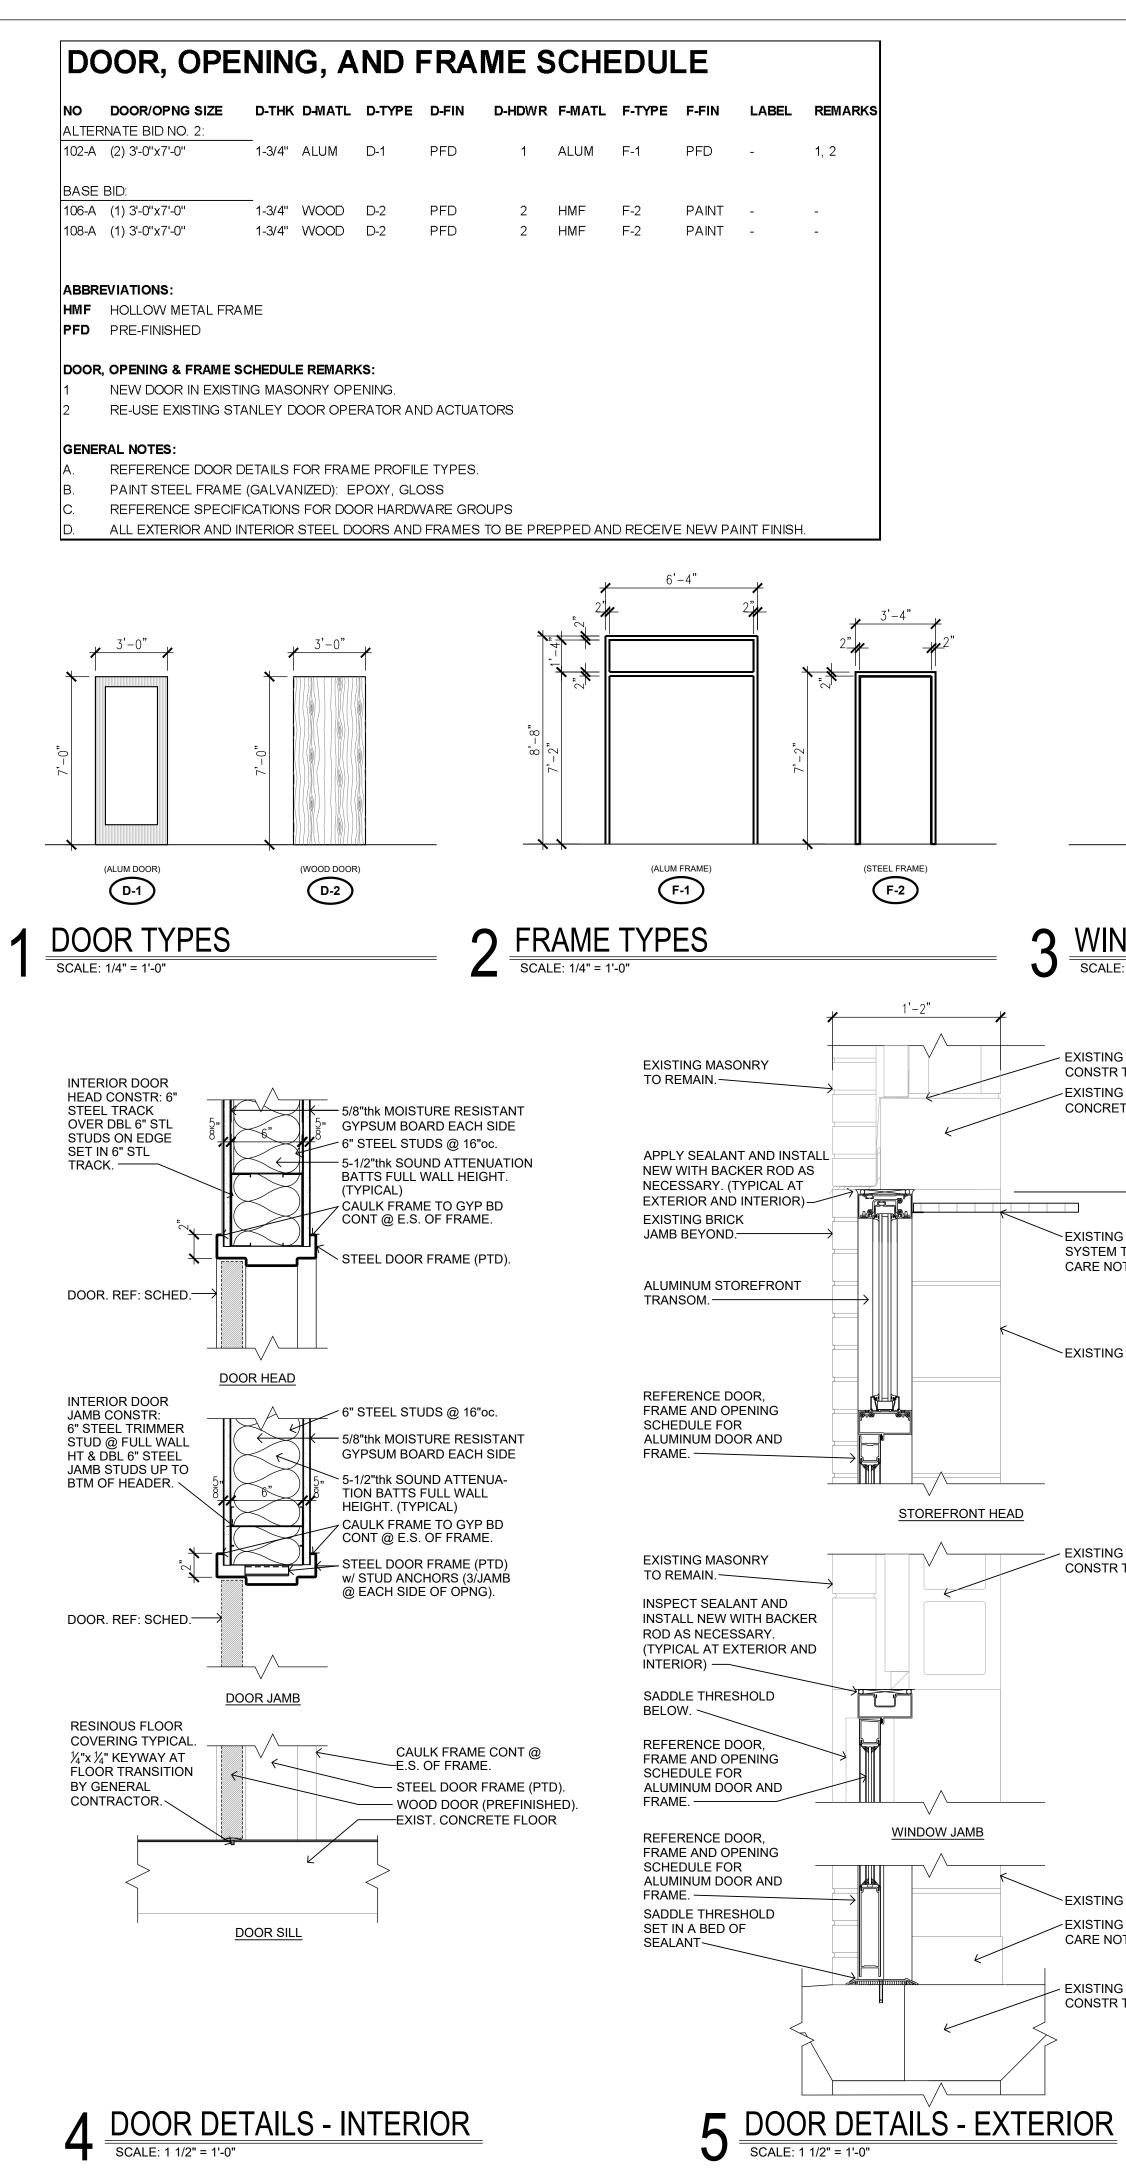

WINDOW DETAILS - ALTERNATE BID NO. 2 SCALE: 1 1/2" = 1'-0"

EXISTING MASONRY

APPLY SEALANT AND INSTALL

WINDOW HEAD

WINDOW JAMB

WINDOW SILL

NEW WITH BACKER ROD AS

NECESSARY. (TYPICAL AT

EXTERIOR AND INTERIOR)-

INSTALL NEW ALUMINUM

WINDOW IN EXISTING

SCREEN BY WINDOW MANUFACTURER —

EXISTING MASONRY

APPLY SEALANT AND INSTALL

NEW WITH BACKER ROD AS

NECESSARY. (TYPICAL AT

EXTERIOR AND INTERIOR)-

INSTALL NEW ALUMINUM

WINDOW IN EXISTING

SCREEN BY WINDOW

SCREEN BY WINDOW

WINDOW IN EXISTING

SUBSILL BY WINDOW

MANUFACTURER —

INSTALL NEW ALUMINUM

APPLY SEALANT AND INSTALL

NEW WITH BACKER ROD AS

EXTERIOR AND INTERIOR)-

NECESSARY. (TYPICAL AT

EXISTING EXTERIOR WALL

EXISTING BRICK SILL

CONSTR TO REMAIN.

MANUFACTURER —

OPENING -

MANUFACTURER-

TO REMAIN.

EXISTING BRICK

SILL BELOW. -


OPENING -

EXISTING BRICK

JAMB BEYOND.

OPENING -

TO REMAIN.-

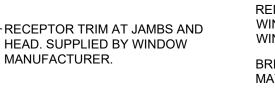

EXISTING EXTERIOR WALL

RECEPTOR TRIM AT JAMBS AND

HEAD. SUPPLIED BY WINDOW

- EXISTING EXTERIOR WALL

RECEPTOR TRIM AT JAMBS AND

HEAD. SUPPLIED BY WINDOW

MANUFACTURER.

MANUFACTURER.

• EXISTING SILL TO

NOT TO DAMAGE

REMAIN. TAKE CARE

— EXISTING SILL BELOW.

CONSTR TO REMAIN.

CONSTR TO REMAIN

-EXISTING PRECAST

CONCRETE LINTEL

MANUFACTURER.

EXISTING MASONRY

EXISTING LINTEL TO

REMAIN (AT WINDOW

OPENING ONLY) -

BRICK VENEER TO

MATCH EXISTING. -

2" RIGID INSULATION-

EXISTING MASONRY

TO REMAIN.-

TO REMAIN.

REMOVE EXISTING BRICK SILL (AT WINDOW ONLY)-

EXISTING CMU JAMB BEYOND

- EXISTING VINYL BASE. TAKE

CARE NOT TO DAMAGE

EXISTING CONCRETE CONSTR TO REMAIN.

- EXISTING EXTERIOR WALL CONSTR TO REMAIN.


> EXISTING CMU JAMB BEYOND

EXISTING SUSPENDED CEILING SYSTEM TO REMAIN. TAKE CARE NOT TO DAMAGE.

EXIST. OPENING @ 8'-8 3/8" AFF


EXISTING EXTERIOR WALL CONSTR TO REMAIN. - EXISTING PRECAST CONCRETE LINTEL

2 WINDOW TYPE SCALE: 1/4" = 1'-0"

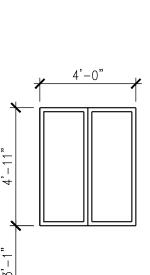



SCALE: 1 1/2" = 1'-0"

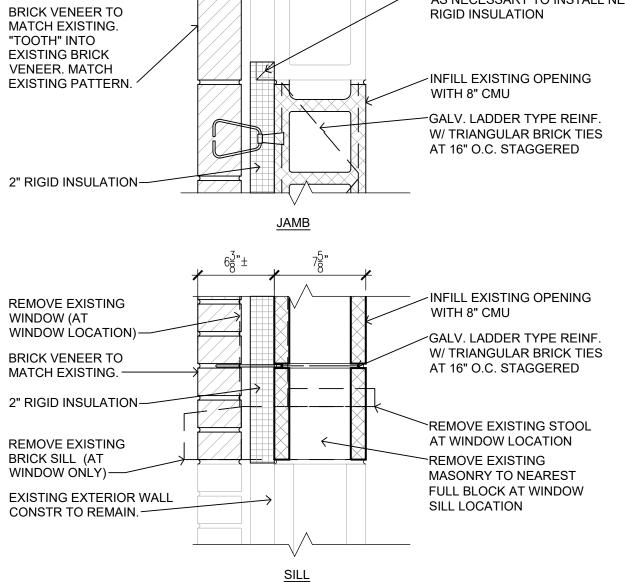

1'-2"

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<u>HEAD</u>


- EXISTING EXTERIOR WALL CONSTR TO REMAIN. REMOVE EXISTING WOOD BLOCKING AS NECESSARY TO INSTALL NEW
- GALV. LADDER TYPE REINF. W/ TRIANGULAR BRICK TIES AT 16" O.C. STAGGERED

INFILL EXISTING OPENING

WITH 8" CMU

- EXISTING EXTERIOR WALL CONSTR TO REMAIN. - EXISTING PRECAST CONCRETE LINTEL (AT WINDOW INFILL ONLY)



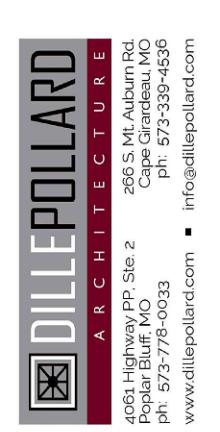

OFFICE OF ADMINISTRATION DIVISION OF FACILITIES MANAGEMENT, **DESIGN AND CONSTRUCTION**

MISSOURI ARMY NATIONAL GUARD FACILITIES DIVISION

RENOVATE INTERIOR AND EXTERIOR

KENNETT **READINESS CENTER** 1450 NORTH BY-PASS KENNETT, MO 63857

PROJECT # T2209-01

FACILITY # 8136313002

REVISION: DATE **REVISION:** DATE **REVISION:** DATE:

ISSUE DATE: January 30, 2023

CAD DWG FILE: A-100.DWG DRAWN BY: KU BD

KU

DETAILS

SHEET NUMBER

A-501

13 OF 29 SHEETS

SHEET TITLE:

SCHEDULES AND

CHECKED BY:

DESIGNED BY:



MA

M	EC
	"Some

A/C	AIR CONDITIONING	E
AD	ACCESS DOOR	E
AFC	ABOVE FINISH CEILING	E
AFG	ABOVE FINISH GRADE	E
AFF	ABOVE FINISHED FLOOR	F /
ANN	ANNUNCIATOR CONTROL PANEL	F
BD	BACKDRAFT DAMPER	F
BKR	BREAKER	F
BOD	BOTTOM OF DUCT	F
BOP	BOTTOM OF PIPE	F
BOS	BOTTOM OF STRUCTURE	
BTU	BRITISH THERMAL UNIT	G
С	CONDUIT	GFI,
СВ	CIRCUIT BREAKER	G
CFM	CUBIC FEET PER MINUTE	G
СКТ	CIRCUIT	ŀ
СО	CLEANOUT	Н
CU	COPPER	н
CW	DOMESTIC COLD WATER	F
DDC	DIRECT DIGITAL CONTROL	Н
DN	DOWN	Н
EA	EXHAUST AIR	KC
EAT	ENTERING AIR TEMPERATURE	٢
EC	ELECTRICAL CONTRACTOR	K
EF	EXHAUST FAN	k
EM	INDICATES EMERGENCY CIRCUIT	

AMPS

А

ER	EXHAUST REGISTER	КWН	KILOWATT HOUR	REV	REVISION
ETR	EXISTING TO REMAIN	LAT	LEAVING AIR TEMPERATURE	RG	RETURN GRILLE
EWB	ENTERING WET BULB	LDB	LEAVING DRY BULB	RH	RELATIVE HUMIDITY
EWH	ELECTRIC WATER HEATER	LRA	LOCKED ROTOR AMPS	RHW	DOMESTIC RECIRCULATION HOT WATER
EXH	EXHAUST	LV	LOW VOLTAGE	RL	REFRIGERANT LIQUID
FACP	FIRE ALARM CONTROL PANEL	LWB	LEAVING WET BULB	RLA	RUNNING LOAD AMPS
FCO	FLOOR CLEANOUT	LWT	LEAVING WATER TEMPERATURE	RPM	REVOLUTIONS PER MINUTE
FD	FLOOR DRAIN	MAU	MAKE UP AIR UNIT	RS	REFRIGERANT SUCTION
FLA	FULL LOAD AMPS	MBH	1000 BTU PER HOUR	SA	SUPPLY AIR
FLR	FLOOR	MC	MECHANICAL CONTRACTOR	SAN	SANITARY
FS	FLOOR SINK	MCA	MINIMUM CIRCUIT AMPACITY	SD	SUPPLY DIFFUSER, SMOKE DAMPER
G	GAS (NATURAL), GROUND	MFR	MANUFACTURER	SF	SQUARE FEET
GCO	GRADE CLEANOUT	MLO	MAIN LUGS ONLY	SP	STATIC PRESSURE
GFI/GFCI	GROUND FAULT CIRCUIT INTERRUPTER	MTD	MOUNTED	SR	SUPPLY REGISTER
GND	GROUND	MU	MAKE UP	TSTAT	THERMOSTAT
GPM	GALLONS PER MINUTE	MUAF	MAKE UP AIR FAN	UL	UNDERWRITERS LABORATORIES INC.
HB	HOSE BIBB	ΜV	MIXING VALVE	UNO	UNLESS NOTED OTHERWISE
HTG	HEATING	N/A	NOT APPLICABLE	V	VENT PIPE
HTR	HEATER	NF	INDICATES NON-FUSED DEVICE	VD	VOLUME DAMPER
ΗW	DOMESTIC HOT WATER	NIC	NOT IN CONTRACT	VTR	VENT THROUGH ROOF
HWR	HOT WATER RETURN	NL	NIGHT LIGHT	W	WIRE, WATT(S)
HWS	HOT WATER SUPPLY	OA	OUTSIDE AIR	W/	WITH
KCMIL	1000 CIRCULAR MILS	PH	PHASE	W/O	WITHOUT
ΚV	KILOVOLT	PNL	PANEL	WB	WET BULB
KVA	KILOVOLT AMPS	QTY	QUANTITY	WCO	WALL CLEANOUT
КW	KILOWATT	RA	RETURN AIR	WP	WEATHERPROOF

 \bigcirc •

<u>C(</u>	ONDUIT AND WIRE
	ARROWS INDICATE CONDUIT AND WIRE HOME RUN(S) TO PANEL WITH 2-#12 AWG CONDUCTORS UNLESS NOTED OR OTHERWISE REQUIRED.
	CONDUIT RUN CONCEALED IN WALL OR ABOVE CEILING.
~ - ~	CONDUIT RUN UNDERGROUND OR CONCEALED IN FLOOR SLAB.
T	TELEPHONE CONDUIT
LV	LOW VOLTAGE CONDUIT AND WIRING

<u>LIGH TING</u>

	BATTERY OPERATED EMERGENCY LIGHT (WALL MOUNTED)	CR
\bigcirc	SURFACE/RECESSED LIGHT FIXTURE	
•	LIGHT FIXTURE	AI
	STRIP FIXTURE	
	SHADING DENOTES EMERGENCY FIXTURE	
	POLE MOUNTED LIGHT FIXTURE	
	EXIT LIGHT – DOUBLE FACE – ARROWS AS SHOWN	F
	EXIT LIGHT – SINGLE FACE – ARROWS AS SHOWN	PED
\$ \$ ³ \$ ⁴	LIGHTING SWITCHES-SINGLE POLE, 3-WAY, 4-WAY	
\$ ^M	WALL MOUNTED MOTION SENSOR	ION D
Φ (A)	CEILING MOUNTED MOTION SENSOR (LETTER DENOTES TYPE)	INFD
K)	DENOTES A WALL MOUNTED FIXTURE	日 ¹⁹⁰ D
W	IRING DEVICES	DH
C	DUPLEX RECEPTACLE.	FO
¢ =	LINE THRU DEVICE INDICATES ABOVE COUNTER	FL
θ-	SINGLE RECEPTACLE	

POWER DEVICE AND CONTROLS THERMOSTAT

DISCONNECT SWITCH. 30A-3P, NON-FUSED \Box EXCEPT AS NOTED 0 MOTOR PANELBOARD (SEE ONE-LINE) J JUNCTION BOX PUSHBUTTON

<u>SECURITY</u>

 (\mathbb{T})

CARD	READER		
DOOR	CONTACT		
VIDEO	INTERCOM	DOOR	STATION

FIRE ALARM

F	MANUAL PULL STATION
PED	PHOTOELECTRIC DETECTOR ('D' DENOTES IN DUCT) ('B' DENOTES BEAM–TYPE) ('R' DENOTES IN RETURN AIR PLENUM)
IOND	IONIZATION DETECTOR ('D' DENOTES IN DUCT) ('P' DENOTES PLENUM-TYPE)
INFD	INFRARED DETECTOR ('D' DENOTES IN DUCT)
田 _D 190	THERMODETECTOR ('D' DENOTES IN DUCT) FIXED TEMPERATURE AS NOTED
DH	DOOR HOLDER
С	CHIME
FO	BELL
FL	FIRE ALARM STROBE LIGHT
	FIRE ALARM SPEAKER – ARROWS DENOTE PROJECTORS IF ANY. ('L' DENOTES COMBINATION SPEAKER AND VISUAL FIRE LIGHT)
	FIRE HORN. ('L' DENOTES COMBINATION HORN AND VISUAL FIRE LIGHT)
⊲ _F	FIREMAN'S PHONE JACK

<u>HVAC</u> ΗŢ THERMOSTAT НS TEMPERATURE/HUMIDITY SENOR SUPPLY AIR FLOW INDICATOR -RETURN AND EXHAUST AIR FLOW -1- $\mathbf{\mathbf{x}}$ SUPPLY DIFFUSER \square —— RL/RS—

(1)

2

 $\langle 3 \rangle$

4

 $\mathbf{\mathbf{O}}$ $\overline{1}$

(M1)


A M1

SUPPLY STRIP DIFFUSER RETURN GRILLE OR EXHAUST REC REFRIGERANT LIQUID/REFRIGERANT LINE SET — D — DRAIN (CONDENSATE) **PLUMBING**

	DOMESTIC COLD WATER
	DOMESTIC HOT WATER
	RECIRCULATING DOMESTIC HOT W
—— SAN ——	SOIL OR WASTE ABOVE GRADE (
— —SAN — —	SOIL OR WASTE BELOW GRADE (
v	PLUMBING VENT
G	GAS (NATURAL)
——————————————————————————————————————	HOSE BIBB
——∏ wco	WALL CLEAN OUT
—————————————————————————————————————	CLEAN OUT
<pre> FCO </pre>	FLOOR CLEAN OUT
$\oslash \blacksquare$	FLOOR DRAIN, AREA DRAIN, FI
\triangleleft	SHOWER HEAD.

<u>GENERAL</u> MECHANICAL NOTE REFERENCE

MECHANICAE NOTE REFERENCE
ELECTRICAL NOTE REFERENCE
DEMOLITION NOTE REFERENCE
REVISION NOTE REFERENCE
CONNECT TO EXISTING WORK
DETAIL REFERENCE – NO./SHE
SECTION CUT - SECTION/SHEE

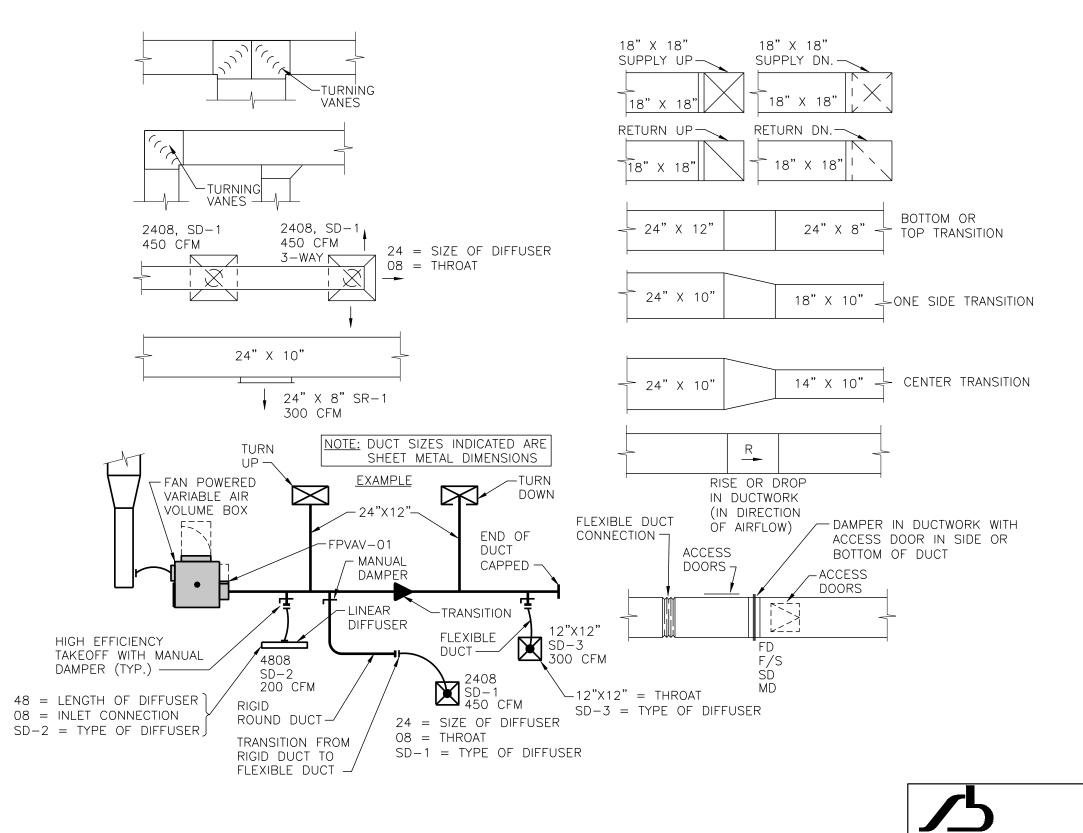

CHANICAL AND ELECTRICAL SYMBOLS AND ABBREVIATIONS

E SYMBOLS AND ABBREVIATIONS ON THIS LEGEND MAY NOT BE USED. REFER TO FLOOR PLANS FOR ALL SYMBOLS AND ABBREVIATIONS."

<u>PIPING</u>


	<u> </u>	
	C+	ELBOW DOWN
	+O	ELBOW UP
	+0+	TEE UP
V INDICATOR		TEE DOWN
]	САР
		UNION
EGISTER	——————————————————————————————————————	ANCHOR
NT SUCTION		PRESSURE GAUGE WITH GAUGE COCK
	T	TEMPERATURE GAUGE
	∏ +	THERMOMETER.
	+₹+	SHUTOFF VALVE
		SHUTOFF VALVE IN RISER
VATER		BALANCING VALVE
OR FLOOR OR FLOOR		RELIEF VALVE
		CHECK VALVE.
	₽ +⊖+	PRESSURE REDUCING VALVE

FLOOR SINK

HEET NO.

EET NO.

DUCTWORK

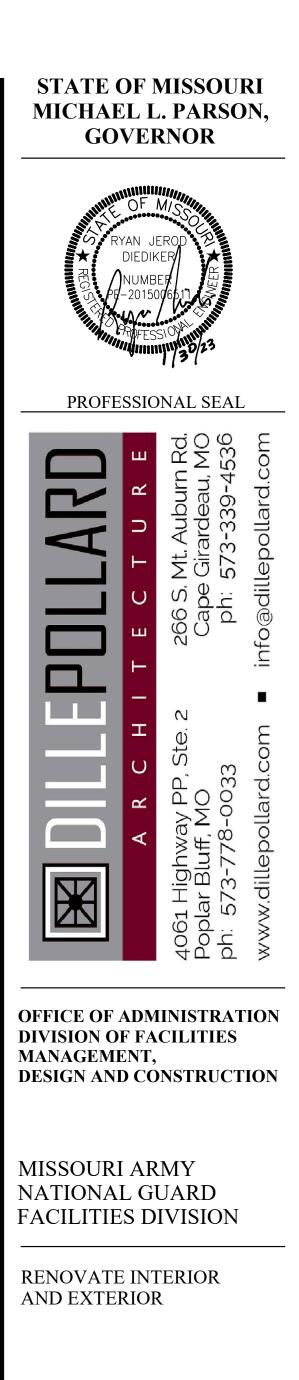

KENNETT **READINESS CENTER** 1450 NORTH BY-PASS KENNETT, MO 63857

PROJECT # T2209-01

FACILITY # 8136313002

REVISION: DATE: **REVISION:** DATE: **REVISION:** DATE: ISSUE DATE: January 30, 2023

CAD DWG FILE: ME-100.DWG DRAWN BY: JEB CHECKED BY: RJD DESIGNED BY: JEB

SHEET TITLE:

SYMBOLS AND **ABBREVIATIONS -**MECHANICAL AND ELECTRICAL

SHEET NUMBER: ME-100

14 OF 29 SHEETS

smith & boucher

25618 west 103rd St olathe, ks 66061

phone 913.345.2127 fax 913.345.0617


____ engineers


project number 2219000



PACE – Kennett Readiness Center X:\22\22190\2219000\Drawings\01-2219000_ME-200.dw Jblackburn Friday, January 27, 2023 1:54:40 PM Booty Charles Friday, January 27, 2023 2:50:09 PM



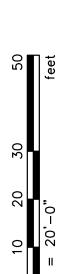

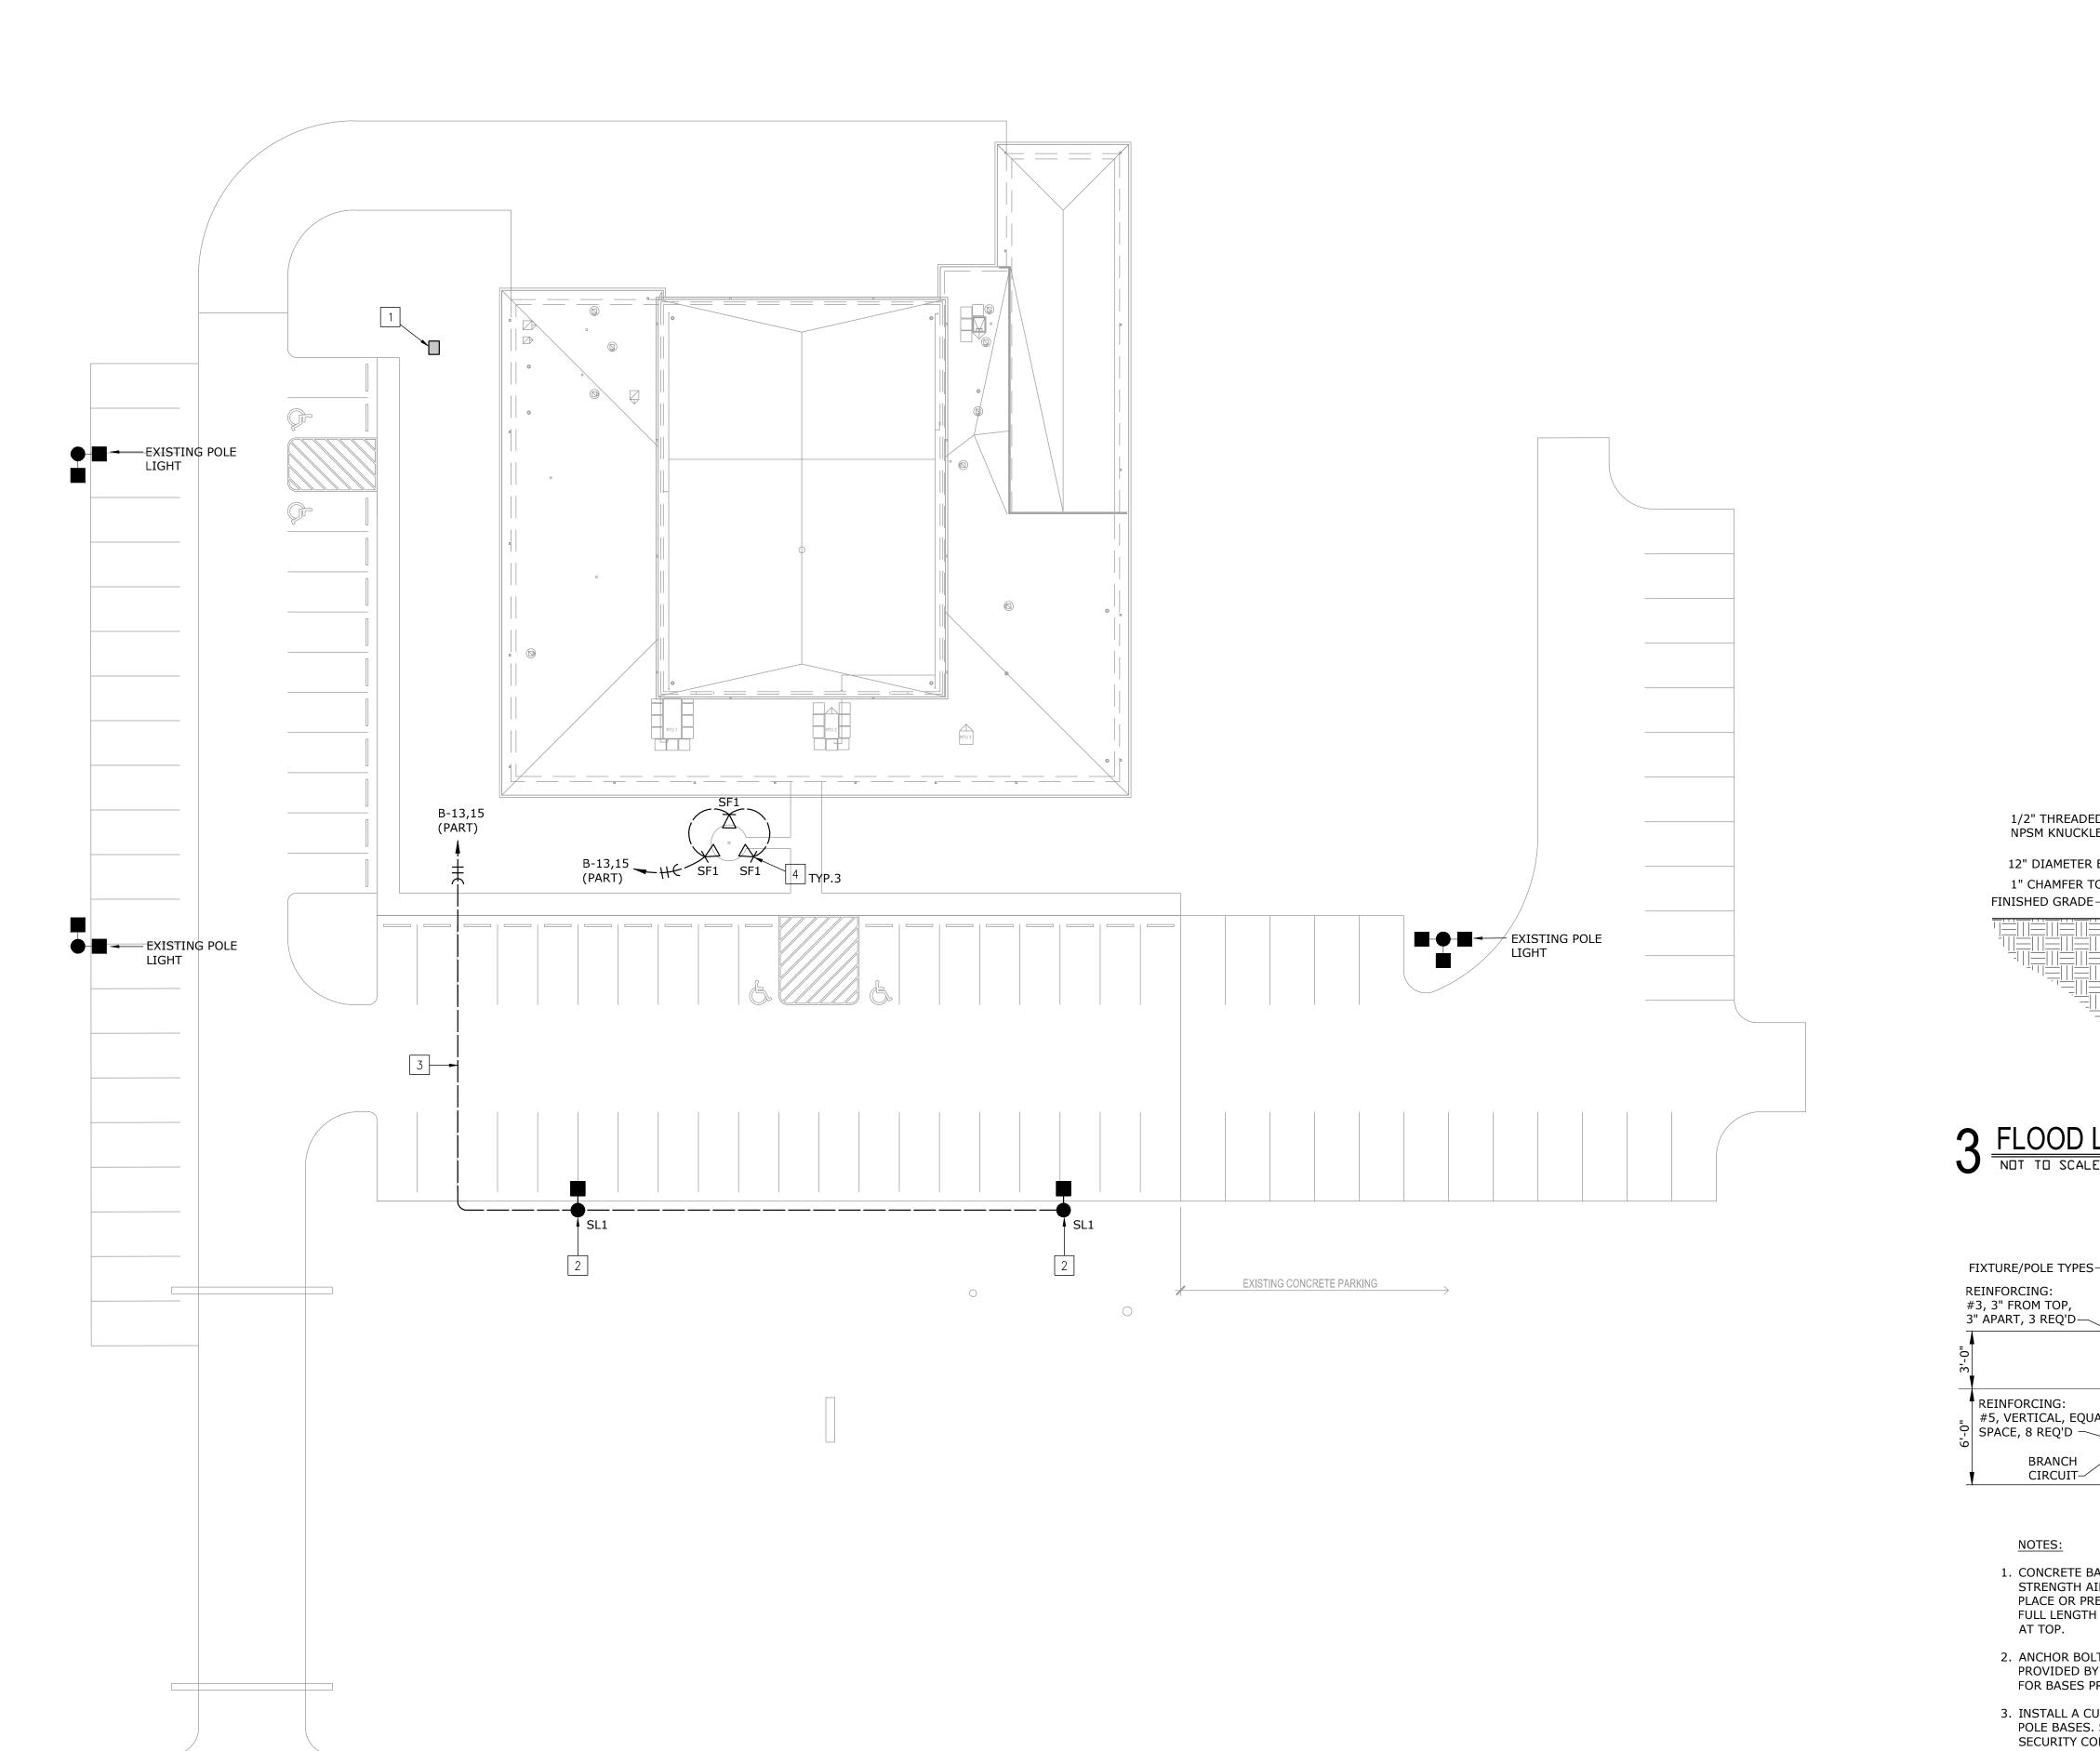


SITE PLAN - MECHANICAL AND ELECTRICAL





ELECTRICAL PLAN NOTES:

- 1 ALTERNATE NO.2 COMBINATION MANUAL TRANSFER SWITCH WITH GENERATOR QUICK CONNECTS, RE: DE-100 AND E-200.
- 2 ALTERNATE NO.3 PROVIDE POLE LIGHTS AND ALL REQUIRED CIRCUITING AND CONDUITS. (2)#8,#10G., 1"C ENTIRE CIRCUIT. REFER TO POLE BASE DETAIL THIS SHEET
- 3 ALTERNATE NO.3 PROVIDE 1" CONDUIT WITH PULL ROPE AND CAPPED AT EACH END BELOW PARKING LOT FOR FUTURE POLE LIGHTS AT SOUTH SIDE OF PARKING LOT.
- 4 GROUND MOUNT FLOOD LIGHTS, INSTALL AT 120 DEG APART AND 6'-0" FROM FLAG POLE. PROVIDE FINAL AIMING OF FLOOD LIGHTS FOR FLAG ILLUMINATION. (2)#8,#10G., 1"C. ENTIRE CIRCUIT. REFER TO FLOOD LIGHT BASE DETAIL.

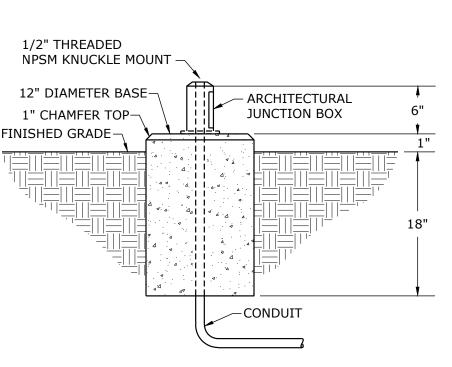

3 FLOOD LIGHT BASE DETAIL


-1-#8 POLE GRD. AND BRANCH CIRCUIT GRD. BOND TO POLE -POLE BASE COVER GROUT ANCHOR BOLTS SPACING PER ANCHOR BOLTS SPACING PER MANUFACTURER INSTRUCTIONS INTITITITI INTITITI INTIT - REINFORCING: #3, ON 12" #5, VERTICAL, EQUAL CENTERS, 8 REQ'D THERMIC WELD 5/8"x10"-0" BRANCH |&===₩===₩| CIRCUIT-GROUND ROD 24"Ø CONC. └─1-#8 GRD. IN 1/2"C.

1. CONCRETE BASES SHALL BE 4000 PSI COMPRESSIVE STRENGTH AIR ENTRAINED CONCRETE MINIMUM, CAST IN PLACE OR PRE-CAST. REINFORCING # TIES SHALL EXTEND FULL LENGTH OF BASES ST 12" O.C., WITH ADDITIONAL TIES

2. ANCHOR BOLTS AND BASE PLATE TEMPLATE SHALL BE PROVIDED BY LIGHTING POLE MANUFACTURER TO VENDOR FOR BASES PRIOR TO CONSTRUCTION.


3. INSTALL A CURVED LID JUNCTION BOX IN THE FACE OF ALL POLE BASES. SERVES AS A TERMINATION POINT FOR SECURITY CONDUIT AND A LOCATION TO MOUNT LOW VOLTAGE EQUIPMENT. J-BOX MANUFACTURED BY CARLON.

2 POLE BASE DETAIL

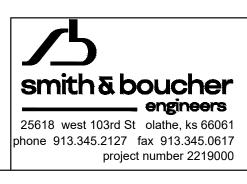





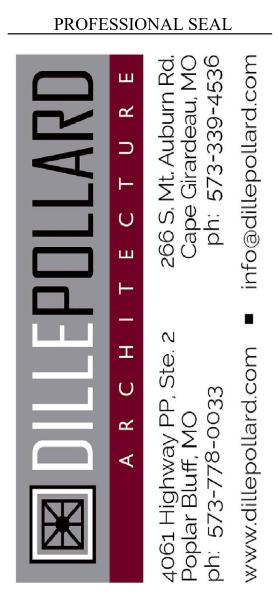

OFFICE OF ADMINISTRATION DIVISION OF FACILITIES MANAGEMENT, **DESIGN AND CONSTRUCTION**

MISSOURI ARMY NATIONAL GUARD FACILITIES DIVISION

RENOVATE INTERIOR AND EXTERIOR

KENNETT **READINESS CENTER** 1450 NORTH BY-PASS KENNETT, MO 63857

PROJECT # T2209-01

FACILITY # 8136313002

REVISION:

DATE:
REVISION:
DATE:
REVISION:
DATE:
ISSUE DATE: January 30, 2023

CAD DWG FILE: ME-200.DWG DRAWN BY: JEB DRAWN BY: JEB CHECKED BY: RJD DESIGNED BY: JEB


SHEET TITLE:

SITE PLAN -MECHANICAL AND ELECTRICAL



PROJECT NAME: AUTOCAD FILE LOCATION \ NAME: LAST CORRECTION BY ← DATE ← TIME: PLOTTED BY ← DATE ← TIME:

PACE — Kennett Readiness Center X:\22\22190\2219000\Drawings\01—2219000_ME—201.dwg Jblackburn Friday, January 27, 2023 1:09:49 PM Booty Charles Friday, January 27, 2023 2:50:19 PM

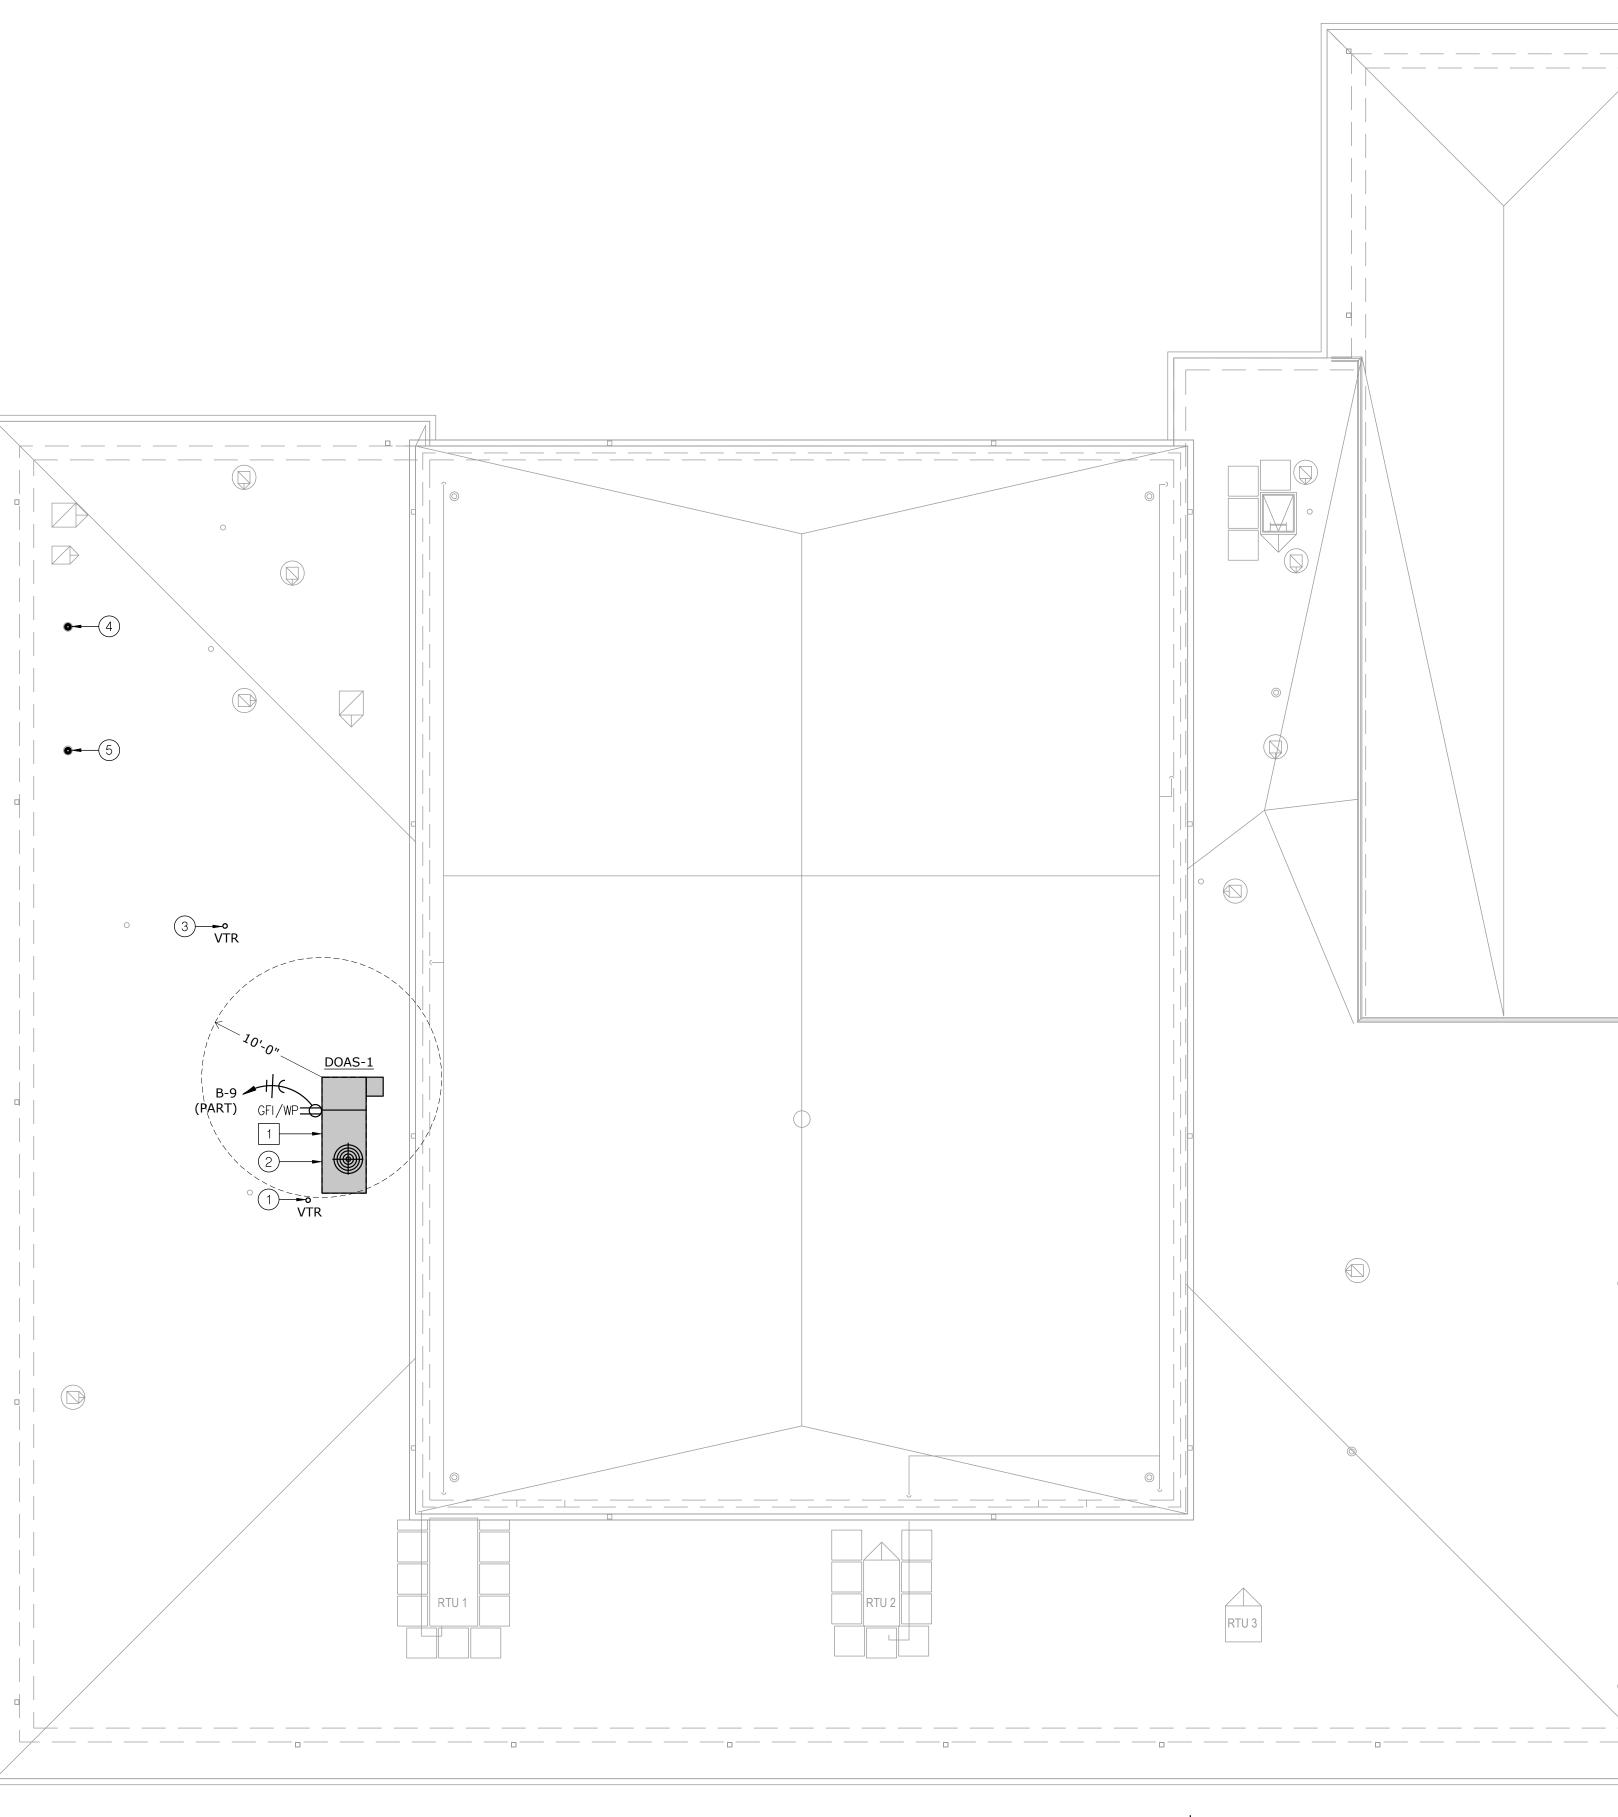

1 ROOF PLAN - MECHANICAL AND ELECTRICAL SCALE: 1/8" = 1'-0"



GENERAL NOTES:


1. REFER TO GENERAL NOTES, SHEET M-100, P-100, E-100.

MECHANICAL PLAN NOTES:

- 1 UTILIZE EXISTING VENT THRU ROOF WHERE POSSIBLE. REFER TO PLUMBING PLANS FOR ADDITIONAL INFORMATION AND DIRECTION. FIELD VERIFY LOCATION.
- (2) COORDINATE LOCATION OF DEDICATED OUTSIDE AIR UNIT WITH STRUCTURE. MAINTAIN 10 FEET SEPARATION BETWEEN ANY INTAKE OPENING AND ALL EXISTING EXHAUST OR VENTS. FIELD VERIFY EXACT LOCATION AND CONDITIONS.
- 3 UTILIZE EXISTING VENT THRU ROOF OPENING WHERE POSSIBLE FOR NEW LARGER VENT THRU ROOF. REFER TO PLUMBING PLANS FOR ADDITIONAL INFORMATION AND DIRECTION. FIELD VERIFY LOCATION.
- 4 UTILIZE EXISTING FLUE ROOF OPENING FOR NEW ON FURNACE CONCENTRIC VENT. REFER TO HVAC PLANS FOR ADDITIONAL INFORMATION AND DIRECTION. FIELD VERIFY LOCATION.
- 5 UTILIZE EXISTING FLUE ROOF OPENING FOR NEW ON WATER HEATER CONCENTRIC VENT. REFER TO PLUMBING PLANS FOR ADDITIONAL INFORMATION AND DIRECTION. FIELD VERIFY LOCATION.

ELECTRICAL PLAN NOTES:


1 REFER TO SCHEDULE FOR ELECTRICAL CONNECTION.

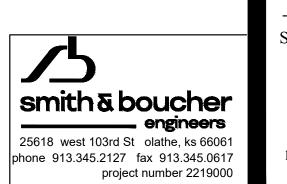

STATE OF MISSOURI MICHAEL L. PARSON, GOVERNOR



PROFESSIONAL SEAL

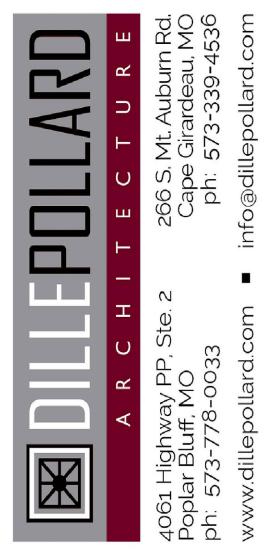

OFFICE OF ADMINISTRATION DIVISION OF FACILITIES MANAGEMENT, DESIGN AND CONSTRUCTION

MISSOURI ARMY NATIONAL GUARD FACILITIES DIVISION

RENOVATE INTERIOR AND EXTERIOR

KENNETT READINESS CENTER 1450 NORTH BY-PASS KENNETT, MO 63857

PROJECT # T2209-01

FACILITY # 8136313002

REVISION:

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ISSUE DATE: January 30, 2023

CAD DWG FILE: ME-200.DWG DRAWN BY: JEB CHECKED BY: RJD DESIGNED BY: JEB

SHEET TITLE:

ROOF PLAN -MECHANICAL AND ELECTRICAL

sheet number:

-	GNA	ΓΙΟΝ	DOAS-1
		MANUFACTURER	AAON
		MODEL NO.	RQ-005
ŀ		NOMINAL SIZE (TONS)	5
-	-	UNIT WEIGHT	1250
		SYSTEM TYPE	CV
_	ATA	MOTOR HP	0.05
	UNIT DATA	TOTAL EFFECTIVENESS (%) WINTER / SUMMER	49.4 / 50.8
	N N	CFM THROUGH WHEEL (OSA / EXHAUST)	1000/1050
	~	OUTSIDE AIR (DB)	16
IHM	WINTER	RETURN AIR (DB/WB)	70 / 60
ENERGY WHEEL	N N		45.60 / 42.51
ENE	 		41.62 / 41.18
	۲. ۲.		91.70 / 81.50
	SUMMER	RETURN AIR (DB/WB) SUPPLY AIR (DB/WB)	75 / 62 81.81 / 72.01
	ns 	EXHAUST AIR (DB/WB)	83.92 / 75.52
		CFM	1000
	<u>۲</u>	E.S.P. (IN. WG.)	0.45
	SUPPLY	MOTOR HORSEPOWER (HP)	1
ATA	°	VFD	YES
FAN D	 .	СГМ	1120
Ľ	EXHAUST	E.S.P. (IN. WC)	0.45
	HX:	MOTOR HORSEPOWER (HP)	1
		VFD	YES
		SUPPLY CFM	1000
=	Ę	OA CFM	RE: ENERGY WHEEL
		TOTAL COOLING CAPACITY (MBH)	60.89
	Ż		31.28
	ž		81.53 / 71.67
			51.51 / 51.37 53.70 / 52.30
		COOLING UNIT LVG. AIR (DB/WB) AMBIENT AIR (DB)	105
Ç	פצ	REFRIGERANT	410A
Ģ		NO. OF COMPRESSORS	1
	ך א	STAGES OF COOLING	1-VARIABLE CAPACITY SCROLL
ć	Ľ	MINIMUM E.E.R @ AHRI	12.4
		TYPE OF HOT GAS REHEAT	MODULATING
2	Ē	HOT GAS REHEAT CAPACITY (MBH)	22
	н И И И И И	HOT GAS REHEAT TEMPERATURE RISE (DB)	17.00
		DISCHARGE TEMPERATURE (DB)	72
(СГМ	1000
	DNIIRA	GAS HEATING (MBH) INPUT/OUTPUT	60 / 48
		TEMPERATURE RISE (DB)	45.00
	GAD	DISCHARGE TEMPERATURE (DB)	91.60
		STAGES OF HEATING / TOTAL TURNDOWN RATIO	MODULATING / 10:1
ER	(RA & OSA)	THICKNESS	2"
FILTER	A &	EFFICIENCY	MERV 13
WEF	(HZ)	DISCHARGE	83, 81, 84, 78, 72, 70, 66, 61
D PC	LEVELS (HZ)	OCTAVE BANDS 63, 125, 250, 500, 1000, 2000, 4000, 8000	
SOUND POWER	LEVI		80, 78, 75, 68, 66, 64, 60, 54
ŏ		OCTAVE BANDS 63, 125, 250, 500, 1000, 2000, 4000, 8000	
Ċ	о П		
	ACCESSORIES		
C L	Ň		YES
	ACL		NO
			DIFF. ENTHALPY
_	-		36
Ċ			MDP (NOTE 5)
			(3)#6,#10G.,3/4"C.
			208/3
	CAL		
		DISCONNECT	INTEGRAL TO UNIT VFDs
C L -		VFD	VFDs
L	ч		NOTE 2
		CE DRAWING/DETAIL	ME-200, M-100, M-200
?FF	-862		WIE 200, WITTOU, WITZOU

NOTES: 1: PROVIDE SPRING ISOLATION CURB WITH A MINIMUM OF 2 INCH STATIC DEFLECTION. PROVIDE BASE CURB HEIGHT AS REQUIRED FOR BASE CURB TO EXTEND MINIMUM 12" ABOVE FINAL ROOFING MEMBRANE. COORDINATE REQUIRED HEIGHT OF BASE CURB WITH ROOFING INSULATION; REFER TO ARCHITECTURAL DRAWINGS.

2: PROVIDE UNIT WITH FACTORY CONTROLLER. REFER TO SPECIFICATIONS.

3: PROVIDE THROUGH THE BASE CONNECTIONS FOR ELECTRICAL AND GAS.

4: PROVIDE ALL OTHER ACCESSORIES AS SCHEDULED AND SPECIFIED.

5: CIRCUIT TO EXISTING PANELS 'MDP', LOCATED IN BOLIER ROOM. RELOCATE THREE 20A-1P RECEPTACLE CIRCUITS TO NEW PANEL 'B' AS DETERMINED TO SERVE DOAS-1 OUT OF ONE OF THE THREE 'MDP' PANELS.

PACE - Kennett Readiness Center X:\22\22190\2219000\Drawings\01-2219000_ME-300.dw Jblackburn Tuesday, December 13, 2022 9:09:20 Booty Charles Friday, January 27, 2023 2:50:32 PM

PROJECT NAME: AUTOCAD FILE LOCATION \ NAME: LAST CORRECTION BY ♦ DATE ♦ TIME PLOTTED BY ♦ DATE ♦ TIME:

JRNACE SCHEDULE	
BIGNATION	F-1
MANUFACTURER	BOSCH
MODEL	BGH96M120D5A
	BMAC4860DNTF
СҒМ	1875
OUTSIDE AIR CFM	200
EXTERNAL STATIC PRES. (IN. W.G.)	0.56
MOTOR HORSEPOWER	1 HP
ENT. AIR (DB/WB)	80/67
TOTAL COOLING CAP (MBH)	55.5
SENSIBLE COOLING CAP (MBH)	43.3
STAGE OF COOLING	2
HEATING INPUT (MBH)	110
HEATING OUTPUT (MBH)	106
HEATING TEMPERATURE RISE (DB)	57
STAGES OF HEATING	2
MINIMUM AFUE (%)	96
FILTER TYPE	MERV 13
SIZE	
VOLTAGE/PHASE	120/1
МСА	12
PANEL AND CIRCUIT	MDP (NOTE 5)
WIRE AND CONDUIT	(2)#12,#12G.,1/2"C.
OVERCURRENT DEVICE	20A-1P CB
DISCONNECT	NOTE 2
ERENCE DRAWING/DETAIL	M100
IARKS	NOTE 1,3,4
EAT PUMP SCHEDULE	
IGNATION	HP-2
MANUFACTURER	BOSCH
MODEL NO.	BOVA-60HDN1-M18M
NOMINAL TONNAGE	5
MINIMUM S.E.E.R. @ AHRI	16
AMBIENT AIR TEMP (°F)	95
NO COMPRESSORS / STAGES	1 / VARIABLE
VOLTAGE/PHASE	208/1
МСА	36
PANEL AND CIRCUIT	MDP (NOTE 5)
WIRE AND CONDUIT	(2)#6,#10G.,3/4"C.
OVERCURRENT DEVICE	50A-2P CB
DISCONNECT	60A/2P/240V/NF/3R
ERENCE DRAWING/DETAIL	M-100
IARKS	NOTE 4

NOTES:

REF

DES

1: PROVIDE CONDENSATE NEUTRALIZATION KIT. PROVIDE POLYPROPELENE INTAKE AND FLUE PIPING WITH CONCENTRIC THRU THE ROOF TERMINATION. SIZE, ROUTE, AND SLOPE AS REQUIRED BY MANUFACTURER. INSULATE ALL INTAKE AND FLUE PIPING AS REQUIRED BY MANUFACTURER.

2: PROVIDE MOTOR RATED TOGGLE SWITCH.

3: PROVIDE WITH 7-DAY PROGRAMMABLE, TOUCH SCREEN THERMOSTAT.

4: PROVIDE AND INSTALL REFRIGERANT LINE SETS PER MANUFACTURER'S INSTRUCTIONS. 5: CIRCUIT TO EXISTING PANELS 'MDP', LOCATED IN BOLIER ROOM. RELOCATE THREE 20A-1P RECEPTACLE CIRCUITS TO NEW PANEL 'B' AS DETERMINED TO SERVE HP-2 AND F-1 OUT OF ONE OF THE THREE 'MDP' PANELS.

SERVICE	DUCT		OTHER REQUIREMENTS		
	SHAPE	CLASSIFICATION	SEAL CLASS	LEAKAGE CLASS	
SUPPLY AIR DUCTS CONNECTED TO DEDICATED OUTDOOR	RECTANGULAR	2" WG POSITIVE	В	12	
AIR HANDLING UNITS	ROUND	4" WG POSITIVE	В	3	
SUPPLY AIR DUCTS CONNECT TO FURANCES	(EXPOSED)	SPIRAL SEAM			
RETURN AIR AND TRANSFER AIR BOOT	RECTANGULAR	2" WG POSITIVE	В	12 - RECTANGULAR	1/2", 3LB DENSITY LINER
TRANSER AIR DUCTWORK	OR ROUND			3 - ROUND	
RETURN AIR DUCTS CONNECTED TO FURANCES	RECTANGULAR	2" WG NEGATIVE	B - RECTANGULAR	12 - RECTANGULAR	
	OR ROUND		A - ROUND	3 - ROUND	
EXHAUST DUCTS CONNECTED TO DEDICATED OUTDOOR	RECTANGULAR	2" WG NEGATIVE	B - RECTANGULAR	12 - RECTANGULAR	
AIR HANDLING UNITS	OR ROUND		A - ROUND	3 - ROUND	
EXHAUST DUCTS TO THE INLET OF THE FAN	RECTANGULAR	2" WG NEGATIVE	B - RECTANGULAR	12 - RECTANGULAR	
	OR ROUND		A - ROUND	3 - ROUND	

1: SEE DUCTWORK INSULATION SCHEDULE FOR REQUIREMENTS ON DUCT INSULATION

DUCTWORK INSULATION SCHEDULE					
SERVICE	INSULATION				
CONCEALED DUCTWORK AS FOLLOWS:					
SUPPLY AIR (ROUND AND SQUARE)	1-1/2", 1 LB. RIGID FIBERGLASS BLANKET, BAPPC				
EXHAUST AIR (ROUND AND SQUARE)	WITH HEAVY DUTY FOIL-SCRIM-KRAFT FACING.				
SUPPLY AIR AND EXHAUST AIR TO DEDICATED OUTDOOR AIR					
HANDLING UNITS (NOTE 2)					

NOTES: 1: SEE DUCTWORK SCHEDULE FOR ITEMS THAT ARE TO BE LINED.

2: THE RECTANGULAR SUPPLY AND EXHAUST AIR DUCT EXPOSED IN THE LOCKER ROOM FROM THE DEDICATED OUTDOOR AIR UNIT TO ABOVE THE WOMEN'S LATRENE

GRILLE, REGISTER & DIFFUSER SCHEDULE							
PLAN MARK	MANUFACTURER MODEL NUMBER	SERVICE		VOLUME DAMPER	MATERIAL	COLOR	REMARKS
SD-1	TITUS OMNI-AA-24x24	SUPPLY	LAY-IN	NO	ALUMINUM	WHITE	-
SD-2	TITUS OMNI-24x24	SUPPLY	LAY-IN	NO	STEEL	WHITE	-
SD-3	TITUS OMNI-12x12	SUPPLY	LAY-IN	NO	STEEL	WHITE	-
SD-4	TITUS TDCA-AA-24x24	SUPPLY	SURFACE	NO	ALUMINUM	WHITE	-
RG-1	TITUS 355RL-24x24	RETURN	LAY-IN	NO	STEEL	WHITE	-
RG-2	TITUS 355RL-12x12	RETURN	LAY-IN	NO	STEEL	WHITE	-
EG-1	TITUS 355FL-24x24	EXHAUST	LAY-IN	NO	ALUMINUM	WHITE	-
EG-2	TITUS 355RL-12x12	EXHAUST	LAY-IN	NO	STEEL	WHITE	-
TG-1	TITUS 355FL-24x12	TRANSFER	LAY-IN	NO	ALUMINUM	WHITE	-

NOTES:

1: PROVIDE FULL SIZE STEEL RETURN PLENUM ON TOP OF GRILLE FOR DIRECT DUCT CONNECTION TO SIDE.

ΑΙ	AIR CONDITIONING UNIT SCHEDULE				
MAN	IUFACTURER	MITSUBISHI			
INDO	DOR UNIT				
DES	IGNATION	AHU-1			
	MODEL	PKA-A12LA			
		WALL MOUNT			
	СҒМ	455			
	EXTERNAL S.P. (IN. W.C.)				
UNIT	REFRIGERANT	R410A			
	RATED COOLING CAP (BTUH)	12,000			
	SEER AT AHRI	21			
	RATED HEATING CAP (BTUH)	13,000			
	HSPF				
	МСА				
A	VOLTAGE/PHASE	208/1			
ELEC. DATA	PANEL AND CIRCUIT	NOTE 1			
Щ. С	WIRE AND CONDUIT	(3)#12,#12G.,1/2"C.			
	OVERCURRENT DEVICE	NOTE 1			
	DISCONNECT	NOTE 1			
ουτ	DOOR UNIT	•			
DES	IGNATION	HP-1			
NIT	MODEL NO.	PUY-A12NKA7			
N	AMBIENT AIR TEMP (DEG F.)	95			
	МСА	14			
A	VOLTAGE/PHASE	208/1			
DATA	PANEL AND CIRCUIT	NOTE 4			
ELEC	WIRE AND CONDUIT	(2)#12,#12G.,1/2"C.			
	OVERCURRENT DEVICE	20A-2P CB			
	DISCONNECT	30A/2P/240V/NF/3R			
REF	ERENCE DRAWING/DETAIL	M-100			
REM	ARKS	NOTE 2, 3			
NOT	EQ:	•			

NOTES:

1: INDOOR UNIT CIRCUITED THROUGH OUTDOOR UNIT.

2: FOR OUTDOOR UNIT, PROVIDE WALL MOUNT SUPPORT KIT. MOUNT UNIT TO WALL MOUNT WITH NEOPRENE ISOLATION PADS WITH A MINIMUM OF 0.25 INCH STATIC DEFLECTION. PROVIDE LOW AMBIENT WIND BAFFLE.

3: PROVIDE AND INSTALL REFRIGERANT LINE SETS PER MANUFACTURER'S INSTRUCTIONS.

4: UTILIZE EXISTING DEMO'ED PTAC UNIT CIRCUIT TO SERVE NEW OUTDOOR UNT. FIELD VERIFY EXISTING CONDITIONS AND WIRE SIZE. PROVIDE WITH OCPD AS INDICATED IN SCHEDULE IF EXISTING DIFFERENT.

GLASS BLANKET, BAPPOR BARRIER FACED,

THE MANUFACTURERS LISTED SHALL BE THE BASIS OF DESIGN. REFER TO THE PROJECT SPECIFICATION FOR ACCEPTABLE ALTERNATIVE MANUFACTURERS.



STATE OF MISSOURI MICHAEL L. PARSON, GOVERNOR							
PROFESSIONAL SEAL							
Image: Non-State independence Image: Non-State independence Image: Non-State independence Image: Non-State independence Image: Non-State independence Image: Non-State independence Image: Non-State independence Image: Non-State independence Image: Non-State independence Image: Non-State independence Image: Non-State independence Image: Non-State independence Image: Non-State independence Image: Non-State independence Image: Non-State independence							
DIVISION OI MANAGEME DESIGN ANI MISSOURI NATIONAI FACILITIE	OFFICE OF ADMINISTRATION DIVISION OF FACILITIES MANAGEMENT, DESIGN AND CONSTRUCTION MISSOURI ARMY NATIONAL GUARD FACILITIES DIVISION						
RENOVATE INTERIOR AND EXTERIOR KENNETT READINESS CENTER 1450 NORTH BY-PASS KENNETT, MO 63857 PROJECT # T2209-01							
FACILITY # 8136313002 REVISION: DATE: REVISION: DATE: REVISION: DATE: REVISION: DATE: ISSUE DATE: January 30, 2023							
CAD DWG FILE: ME-300.DWG DRAWN BY: JEB CHECKED BY: RJD DESIGNED BY: JEB							

SHEET TITLE: SCHEDULES -MECHANICAL AND ELECTRICAL

SHEET NUMBER: **ME-300**

PROJECT NAME: AUTOCAD FILE LOCATION \ NAME: LAST CORRECTION BY ♦ DATE ♦ TIME: PLOTTED BY ♦ DATE ♦ TIME:

PACE – Kennett Readiness Center X:\22\22190\2219000\Drawings\01-2219000_ME-301.dw Jblackburn Friday, January 27, 2023 1:57:40 PM Booty Charles Friday, January 27, 2023 2:50:45 PM

SERVICE DOMESTIC COLD WATER EXPOSED FIXTURE WASTETRAPS A AT HANDICAPPED ACCESSIBLE SIN DOMESTIC HOT WATER RECIRCULATING HOT WATER

NOTES:

1: FOR ALL EXPOSED PIPING, PROVIDE PAINTABLE PVC JACKET ON PIPING AND FITTINGS (INCLUDES MECHANICAL SPACES).

DRAIN SCHEDULE					
MARK	MANUFACTURER/ MODEL	DESCRIPTION			
FD1		CAST IRON DRAIN WITH ADJUSTABLE TOP AND 5" NICKEL BRASS STRAINER WITH VANDAL RESISTANT SCREWS. SEE PLAN FOR OUTLET SIZE.			
FD2		CAST IRON DRAIN WITH ADJUSTABLE TOP AND 6" NICKEL BRASS STRAINER WITH VANDAL RESISTANT SCREWS. SEE PLAN FOR OUTLET SIZE. PROVIDE WITH PROSET TRAP GUARD BY PROVENT SYSTEMS INC.			

				FITTINGS			PIPING CONNECT		
MARK	MFGR./MODEL	DESCRIPTION		DESCRIPTION	NOTE		1.5.47		
WC1	AMERICAN STANDARD	WATER CLOSET: WHITE VITREOUS CHINA, ELONGATED BOWL, WALL MOUNTED	MANUFACTURER/MODEL SLOAN	DESCRIPTION SENSOR ACTIVATED. EXPOSED WATER CLOSET SINGLE FLUSH VALVE.	NOTE 5	CW	HW	SAN	2"
VVC1	AMERICAN STANDARD	FLUSH VALVE BOWL WITH TOP SPUD AND FLAT BOLT COVERS, 1.28 GALLON	ECOS	1.28 GPF, CHROME PLATED, FLUSH OVERRIDE BUTTON, BATTERY POWERED, VACUUM	5	1-1/4		4	2
	2257.101	SIPHON JET FLUSHING ACTION.	8111-1.28	BREAKER FLUSH CONNECTION AND SPUD COUPLING FOR 1 1/2" TOP SPUD.					
	2237.101	SIFTION JETT LUSTING ACTION.	0111-1.20	BREAKER I LUSIT CONNECTION AND SPOD COOPEING TOR T 1/2 TOP SPOD.					
	WADE	PROVIDE CARRIER AS REQUIRED TO SUIT APPLICATION FOR MOUNTING IN CHASE.		PROVIDE WALL AND SPUD FLANGES.					
	CHURCH	SEAT: SOLID PLASTIC, OPEN FRONT, WHITE, ELONGATED BOWL, INTEGRATED							
	9500C	BUMPERS, EXTERNAL CHECK HINGES WITH STAINLESS STEEL POSTS.							
WC2	AMERICAN STANDARD	ADA COMPLIANT WATER CLOSET: WHITE VITREOUS CHINA, ELONGATED BOWL,	SLOAN	SENSOR ACTIVATED, EXPOSED WATER CLOSET SINGLE FLUSH VALVE,	5	1-1/4"		4"	2"
	AFWALL	WALL MOUNTED FLUSH VALVE BOWL WITH TOP SPUD AND FLAT BOLT COVERS,	ECOS	1.28 GPF, CHROME PLATED, FLUSH OVERRIDE BUTTON, BATTERY POWERED, VACUUM					
	2257.101	1.28 GALLON SIPHON JET FLUSHING ACTION.	8111-1.28	BREAKER FLUSH CONNECTION AND SPUD COUPLING FOR 1 1/2" TOP SPUD.					
	WADE	PROVIDE CARRIER AS REQUIRED TO SUIT APPLICATION FOR MOUNTING IN CHASE.		PROVIDE WALL AND SPUD FLANGES.					
	CHURCH	SEAT: SOLID PLASTIC, OPEN FRONT, WHITE, ELONGATED BOWL, INTEGRATED							
	9500C	BUMPERS, EXTERNAL CHECK HINGES WITH STAINLESS STEEL POSTS.							
WC3	AMERICAN STANDARD	ADA COMPLIANT WATER CLOSET: WHITE VITREOUS CHINA, ELONGATED BOWL,	SLOAN	SENSOR ACTIVATED, EXPOSED WATER CLOSET SINGLE FLUSH VALVE,	5	1-1/4"		4"	2"
	MADERA	FLOOR MOUNTED FLUSH VALVE BOWL WITH TOP SPUD AND FLAT BOLT COVERS,	ECOS	1.28 GPF, CHROME PLATED, FLUSH OVERRIDE BUTTON, BATTERY POWERED, VACUUM					
	3461.001	1.28 GALLON SIPHON JET FLUSHING ACTION.	8111-1.28	BREAKER FLUSH CONNECTION AND SPUD COUPLING FOR 1 1/2" TOP SPUD.					
	CHURCH	SEAT: SOLID PLASTIC, OPEN FRONT, WHITE, ELONGATED BOWL, INTEGRATED		PROVIDE WALL AND SPUD FLANGES.					
	9500C	BUMPERS, EXTERNAL CHECK HINGES WITH STAINLESS STEEL POSTS.							
U1	AMERICAN STANDARD	ADA COMPLIANT WHITE VIRTEOUS CHINA WALL HUNG URINAL, 3/4" TOP SPUD.	SLOAN	SENSOR ACTIVATED, EXPOSED URINAL FLUSH VALVE, 0.125 GPF, CHROME PLATED,	5	3/4"		2"	1-1/2
	TRIMBROOK	0.5 GALLON SIPHON JET FLUSHING ACTION. MOUNT TOP OF RIM PER	ECOS	FLUSH OVERRIDE BUTTON, BATTERY POWERED, VACUUM BREAKER FLUSH					
	6561.017	ARCHITECTURAL PLANS.	8186-0.125	CONNECTION AND SPUD COUPLING FOR 3/4" TOP SPUD.					
	WADE	PROVIDE CARRIER AS REQUIRED TO SUIT APPLICATION FOR MOUNTING IN CHASE.		PROVIDE SPUD FLANGES.					
L1	AMERICAN STANDARD	ADA COMPLIANT LAVATORY: WALL-HUNG, WHITE VITREOUS CHINA, FRONT	AMERICAN STANDARD	ADA COMPLIANT FAUCET: VANDAL RESISTANT LEVER HANDLES, 2-HOLE, 4" CENTERS,	2,3,4	1/2"	1/2"	2"	1-1/2
	LUCERNE	OVERFLOW, 4 CENTER HOLES, GRID STAINER, TAILPIECE.	MONTERREY	0.5 GPM, CHROME FINISH.					
	0355.012		5502.145						
	WADE	PROVIDE CARRIER AS REQUIRED TO SUIT APPLICATION FOR MOUNTING.	LEONARD	THERMOSTATIC MIXING VALVE					
DF1	ELKAY	ADA COMPLIANT WATER FOUNTAIN: BI-LEVEL, LEFT HAND HIGH, LEFT SIDE BOTTLE			3	1/2"		1-1/2"	1-1/4
	LZSTL8WS	FILLING STATION, FILTERED, 8 GPH, STAINLESS STEEL, CANE APRON.							
HB1	WOODFORD	ANTI-SIPHON WALL FAUCET WITH FLUSH MOUNT ANODIZED ALUMINUM BOX				1/2"			
	B24-AL	WITH DOOR ASSEMBLY, VACUUM BREAKER, LOOSE TEE KEY.							
WH1	WOODFORD	FREEZE-PROOF WALL HYDRANT, AUTOMATIC DRAINING, HOSE-CONNECTION				3/4"			
	65P-12	ANTI SIPHON VACUUM BREAKER, LOOSE KEY HANDLE.							
SH1	SYMMONS	SURFACE MOUNTED SHOWER SYSTEM, THROUGH WALL PIPING CONFIGURATION,			1	1/2"	1/2"		
	H901S-15	SOAP DISH, PRESSURE BALANCING MIXING VALVE WITH SERVICE STOPS, MANUAL							
		SHUT-OFF AND LEVER HANDLE, SHOWER HEAD, 1.5 GPM FLOW RESTICTOR,							
		STAINLESS STEEL COVERING WITH SLOPED TOP.							
SH2	SYMMONS	ADA COMPLIANT SURFACE MOUNTED SHOWER SYSTEM, THROUGH WALL PIPING			1	1/2"	1/2"		
	H902S-15	CONFIGURATION, SOAP DISH, PRESSURE BALANCING MIXING VALVE WITH SERVICE							
		STOPS, MANUAL SHUT-OFF AND LEVER HANDLE, DIVERTER, SHOWER HEAD, 1.5							
		GPM FLOW RESTRICTOR, SLIDE BAR/CRADEL WITH HAND SHOWER AND 60" HOSE,							
		STAINLESS STEEL COVERING WITH SLOPED TOP.							

1: REFER TO ARCHITECTURAL PLANS FOR MOUNTING HEIGHT.

2: PROVIDE CHROME PLATED BRASS TAILPIECE AND GRID DRAIN.

3: PROVIDE LOOSE KEY STOPS AND FLEXIBLE RISERS.

4: INSULATE EXPOSED TAILPIECE, P-TRAP, AND WATER RISERS.

5: PROVIDE CAULK AROUND FIXTURE CONNECTION TO FLOOR/WALL. COLOR BY ARCHITECT.

PIPE INSULATION SCHEDULE - PLUMBING

	PIPE SIZE	INSULATION
	1/2" - 2"	1/2" FIBERGLASS, ASJ
AND DOMESTIC HOT WATER	ALL	TRUBRO LAV AGUARD MOLDED PROTECTIVE PIPE COVER OVER
INKS AND LAVATORIES	ALL	1/2" FIBERGLASS INSULATION
	ALL	1" FIBERGLASS, ASJ

THERMOSTATIC MIXING VALVE			
DESIGNATION	TMV-1		
MANUFACTURER	LEONARD		
MODEL	TM-520B-LF-DT		
SERVICE	MEN/WOMEN LATRINE		
MIN GPM	1		
PEAK DEMAND GPM	24.6		
SYSTEM MAX PRESSURE DROP	10		
OUTLET TEMP. (°F)	105		
REFERENCE DRAWING/DETAIL	ME-302, P-100		
REMARKS			

	DMESTIC HOT WATER	PUMP SCHEDULE
DESI	IGNATION	HWP-1
ASS	OCIATED WATER HEATER	DWH-1
	ATION	MECH EQUIP 112
	MANUFACTURER	BELL & GOSSETT
∢	MODEL NO.	NBF-25
UNIT DATA	PUMP TYPE	INLINE
ЫŢ	GPM	2
D PUMP HEAD (FT.)	12	
	MOTOR HORSEPOWER	125 WATTS
Ā	PANEL & CIRCUIT	B-11 (PART)
. DATA	WIRE & CONDUIT	(2)#12,#12G.,1/2"C.
ROL	VOLTAGE/PHASE	120/1
ONT	OVERCURRENT DEVICE	20A-1P CB
AL/C	DISCONNECT	NOTE 2
RIC/	STARTER	NO
ELECTRICAL/CONTROL	COMBINATION STARTER	NO
Ц	CONTROL	AQUASTAT, NOTE 2
REFE	ERENCE DRAWING/DETAIL	ME-302,P-100
	ARKS	

1: CIRCUIT WITH DOMESTIC WATER HEATER 'DWH-1'.

2: PROVIDE MOTOR RATED TOGGLE SWITCH AT 60" AFF ON WALL ADJACENT TO PUMP FOR DISCONNECT MEANS AND OWNER MANUAL ON/OFF USE DURING PERIODS OF DEPLOYMENT. LABEL SWITCH PLATE WITH "HWP-1".

A.O. SMITH MANUFACTURER LOCATION MECH EQUIP 112 MODEL BTH-250 CAPACITY (GALLONS) 250 RECOVERY @ 100°F RISE (GPH) 175 OUTLET TEMP. (°F) 140 INPUT (BTUH) 150,000 120V / 5AMPS VOLTAGE/MCA 러 PANEL & CIRCUIT B-2 (PART) Z WIRE & CONDUIT (2)#12,#12G.,1/2"C. 20A-1P CB NOTE 2 REFERENCE DRAWING/DETAIL ME-302, P-100 NOTE 3,4 REMARKS NOTES:

DOMESTIC WATER HEATER - GAS

DESIGNATION

1: CIRCUIT WITHOT WATER RECIRCULATION PUMP 'HWP-1' .

2: PROVIDE MOTOR RATED TOGGLE SWITCH ADJACENT TO WATER HEATER FOR DISCONNECT MEANS.

3: FURNISH WITH CONDENSATE NEUTRALIZARION KIT.

4: PROVIDE VENT EXHAUST PIPING PER MANUFACTURER'S REQUIREMENTS.

THE MANUFACTURERS LISTED SHALL BE THE BASIS OF DESIGN. REFER TO THE PROJECT SPECIFICATION FOR ACCEPTABLE ALTERNATIVE MANUFACTURERS.



DWH-1

* REGISTING	DIEDIK NUMB 20150 RØFES	EROD KER EF SIONAL SEAL
DLLARD	r e c t u r e	266 S. Mt. Auburn Rd. Cape Girardeau, MO ph: 573-339-4536 info@dillepollard.com
	ARCHIT	4061 Highway PP, Ste. 2 Poplar Bluff, MO ph: 573-778-0033 www.dillepollard.com ■ i

STATE OF MISSOURI MICHAEL L. PARSON, GOVERNOR

OFFICE OF ADMINISTRATION DIVISION OF FACILITIES MANAGEMENT, **DESIGN AND CONSTRUCTION**

MISSOURI ARMY NATIONAL GUARD FACILITIES DIVISION

RENOVATE INTERIOR AND EXTERIOR

KENNETT **READINESS CENTER** 1450 NORTH BY-PASS KENNETT, MO 63857

PROJECT # T2209-01

FACILITY # 8136313002

REVISION:


DATE:
REVISION:
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DATE:
ISSUE DATE: January 30, 2023

CAD DWG FILE: ME-301.DWG DRAWN BY: JEB CHECKED BY: RJD DESIGNED BY: JEB


SHEET TITLE:

SCHEDULES -MECHANICAL AND ELECTRICAL

SHEET NUMBER: ME-301

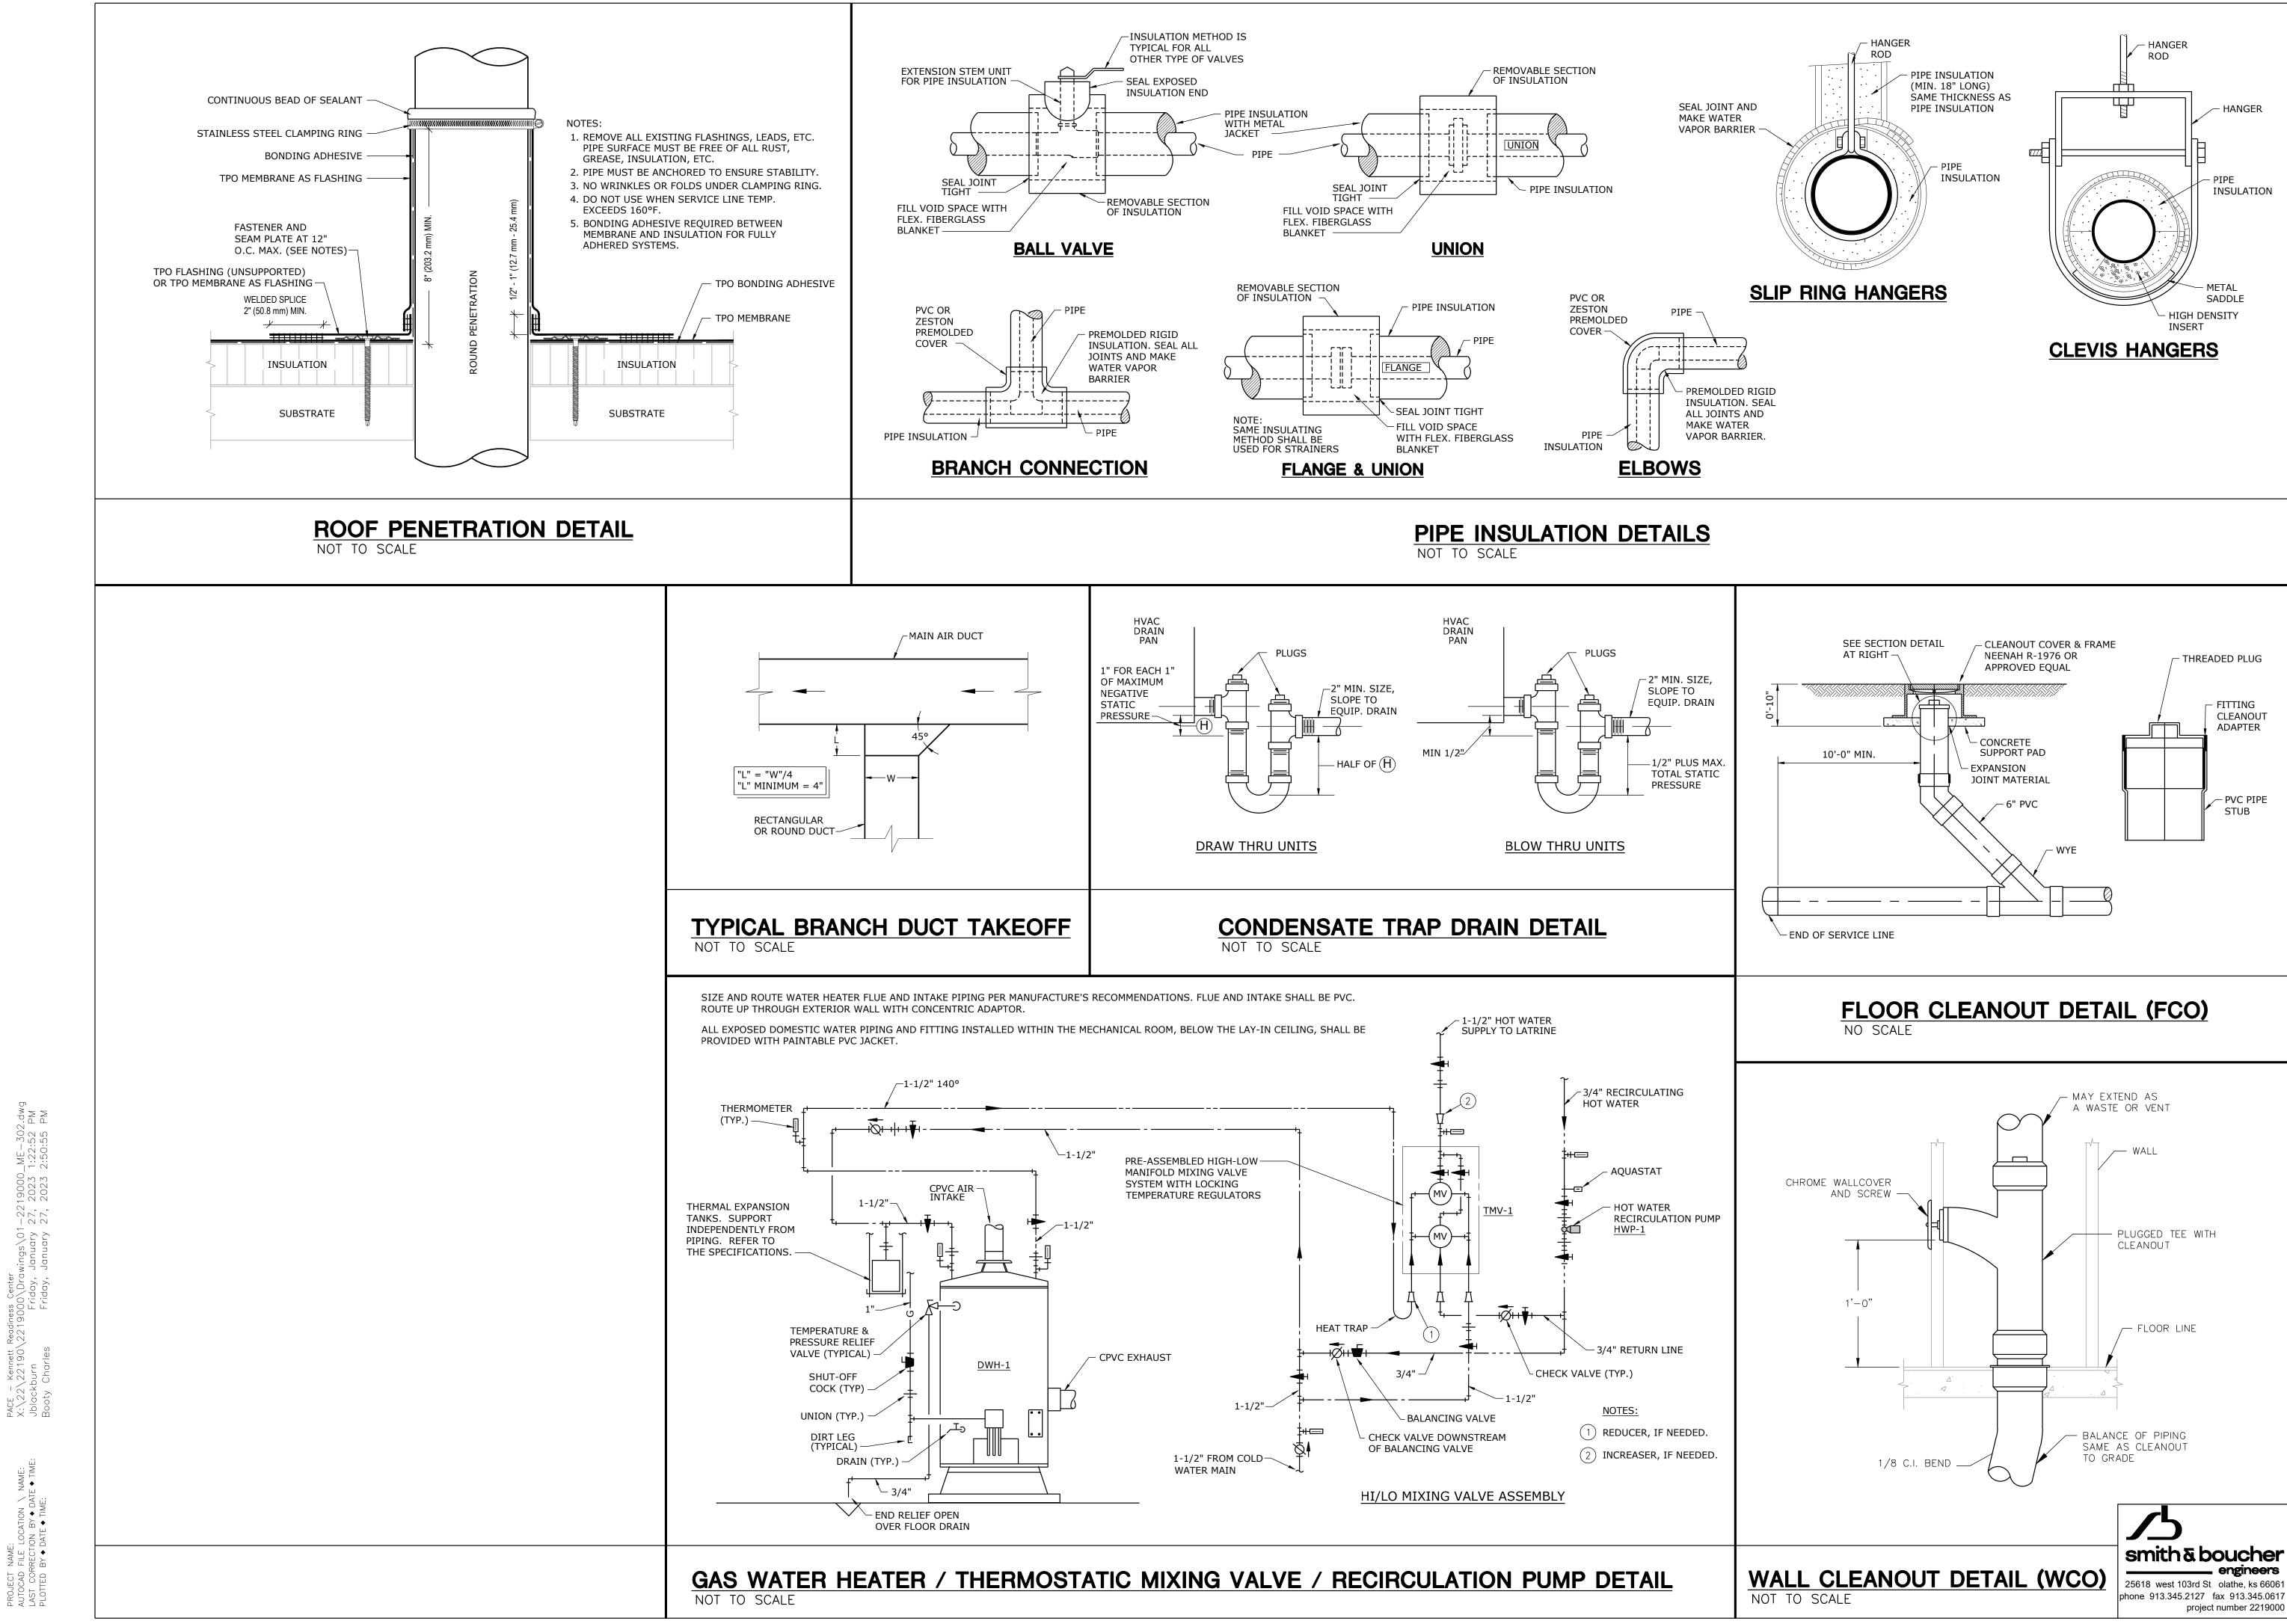


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ME-302

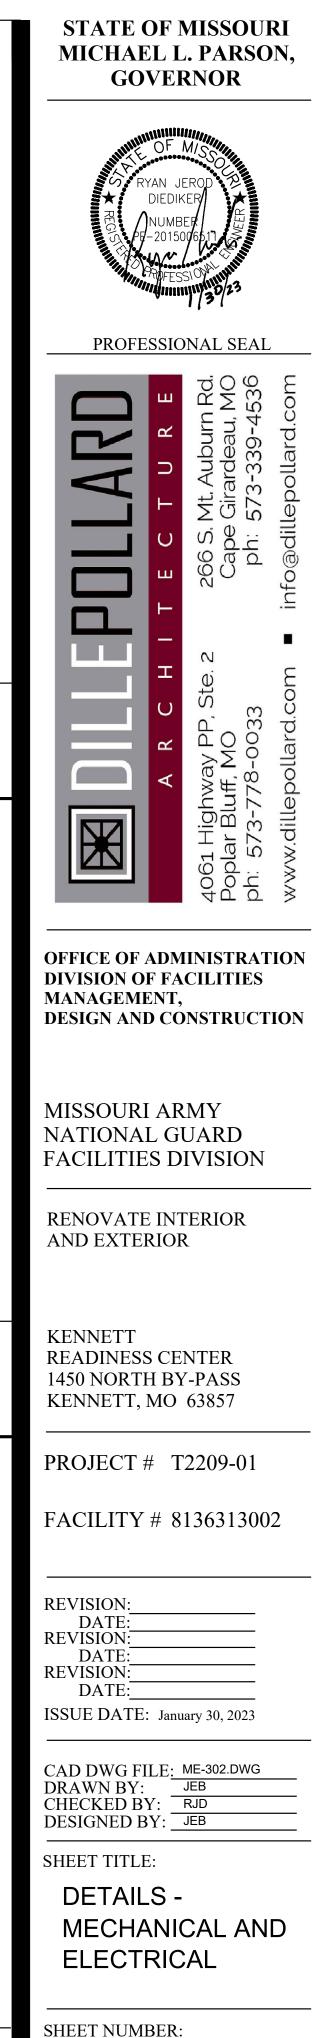PROJECT NAME: AUTOCAD FILE LOCATION \ NAME: LAST CORRECTION BY ♦ DATE ♦ TIME: PLOTTED BY ♦ DATE ♦ TIME:

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GENERAL DEMOLITION NOTES:

- UNLESS OTHERWISE NOTED, SERVICES AND EQUIPMENT SHOWN WITH BOLD DASHED LINES ARE TO BE DEMOLISHED. SERVICES AND EQUIPMENT SHOWN WITH SOLID HALF TONE LINE WEIGHT ARE TO REMAIN IN PLACE.
- 2. THE EXISTING CONDITIONS INDICATED ON THE DRAWINGS ARE TAKEN FROM THE BEST INFORMATION AVAILABLE AND FROM VISUAL SITE INSPECTION AND ARE NOT TO BE CONSIDERED "AS BUILT" CONDITIONS. THE INFORMATION SHOWN IS TO ESTABLISH THE EXTENT OF THE SCOPE OF WORK. VERIFY ALL ACTUAL EXISTING CONDITIONS AT THE PROJECT SITE AND PERFORM WORK AS REQUIRED TO MEET THE EXISTING CONDITIONS AND THE EXTENT OF THE WORK INDICATED.
- 3. PATCH AND REPAIR ANY INFRASTRUCTURE THAT IS TO REMAIN WHERE ANY SERVICES ARE REMOVED UNLESS NOTED OTHERWISE. DISCONNECT AND REMOVE ALL WIRING, CABLING, RACEWAY AND CONDUIT THAT BECOMES UNNECESSARY AS A RESULT OF THE REMOVAL OF EQUIPMENT INDICATED TO BE REMOVED.
- 4. WHERE MECHANICAL AND ELECTRICAL FIXTURES OR EQUIPMENT ARE REMOVED, CAP ALL UNUSED CONDUIT, WIRING AND PIPING BEHIND THE FLOOR LINE OR WALL LINE TO FACILITATE THE RESTORATION OF FINISH.
- 5. PROVIDE FOR THE CONTINUITY OF ALL REMAINING SERVICES, SYSTEMS, AND CIRCUITS. RELOCATE AND RECONNECT ANY MECHANICAL AND ELECTRICAL FACILITIES THAT MUST BE RELOCATED IN ORDER TO ACCOMPLISH THE REMODELING SHOWN IN THE DRAWINGS OR INDICATED IN THE SPECIFICATIONS.

DEMOLITION PLAN NOTES:

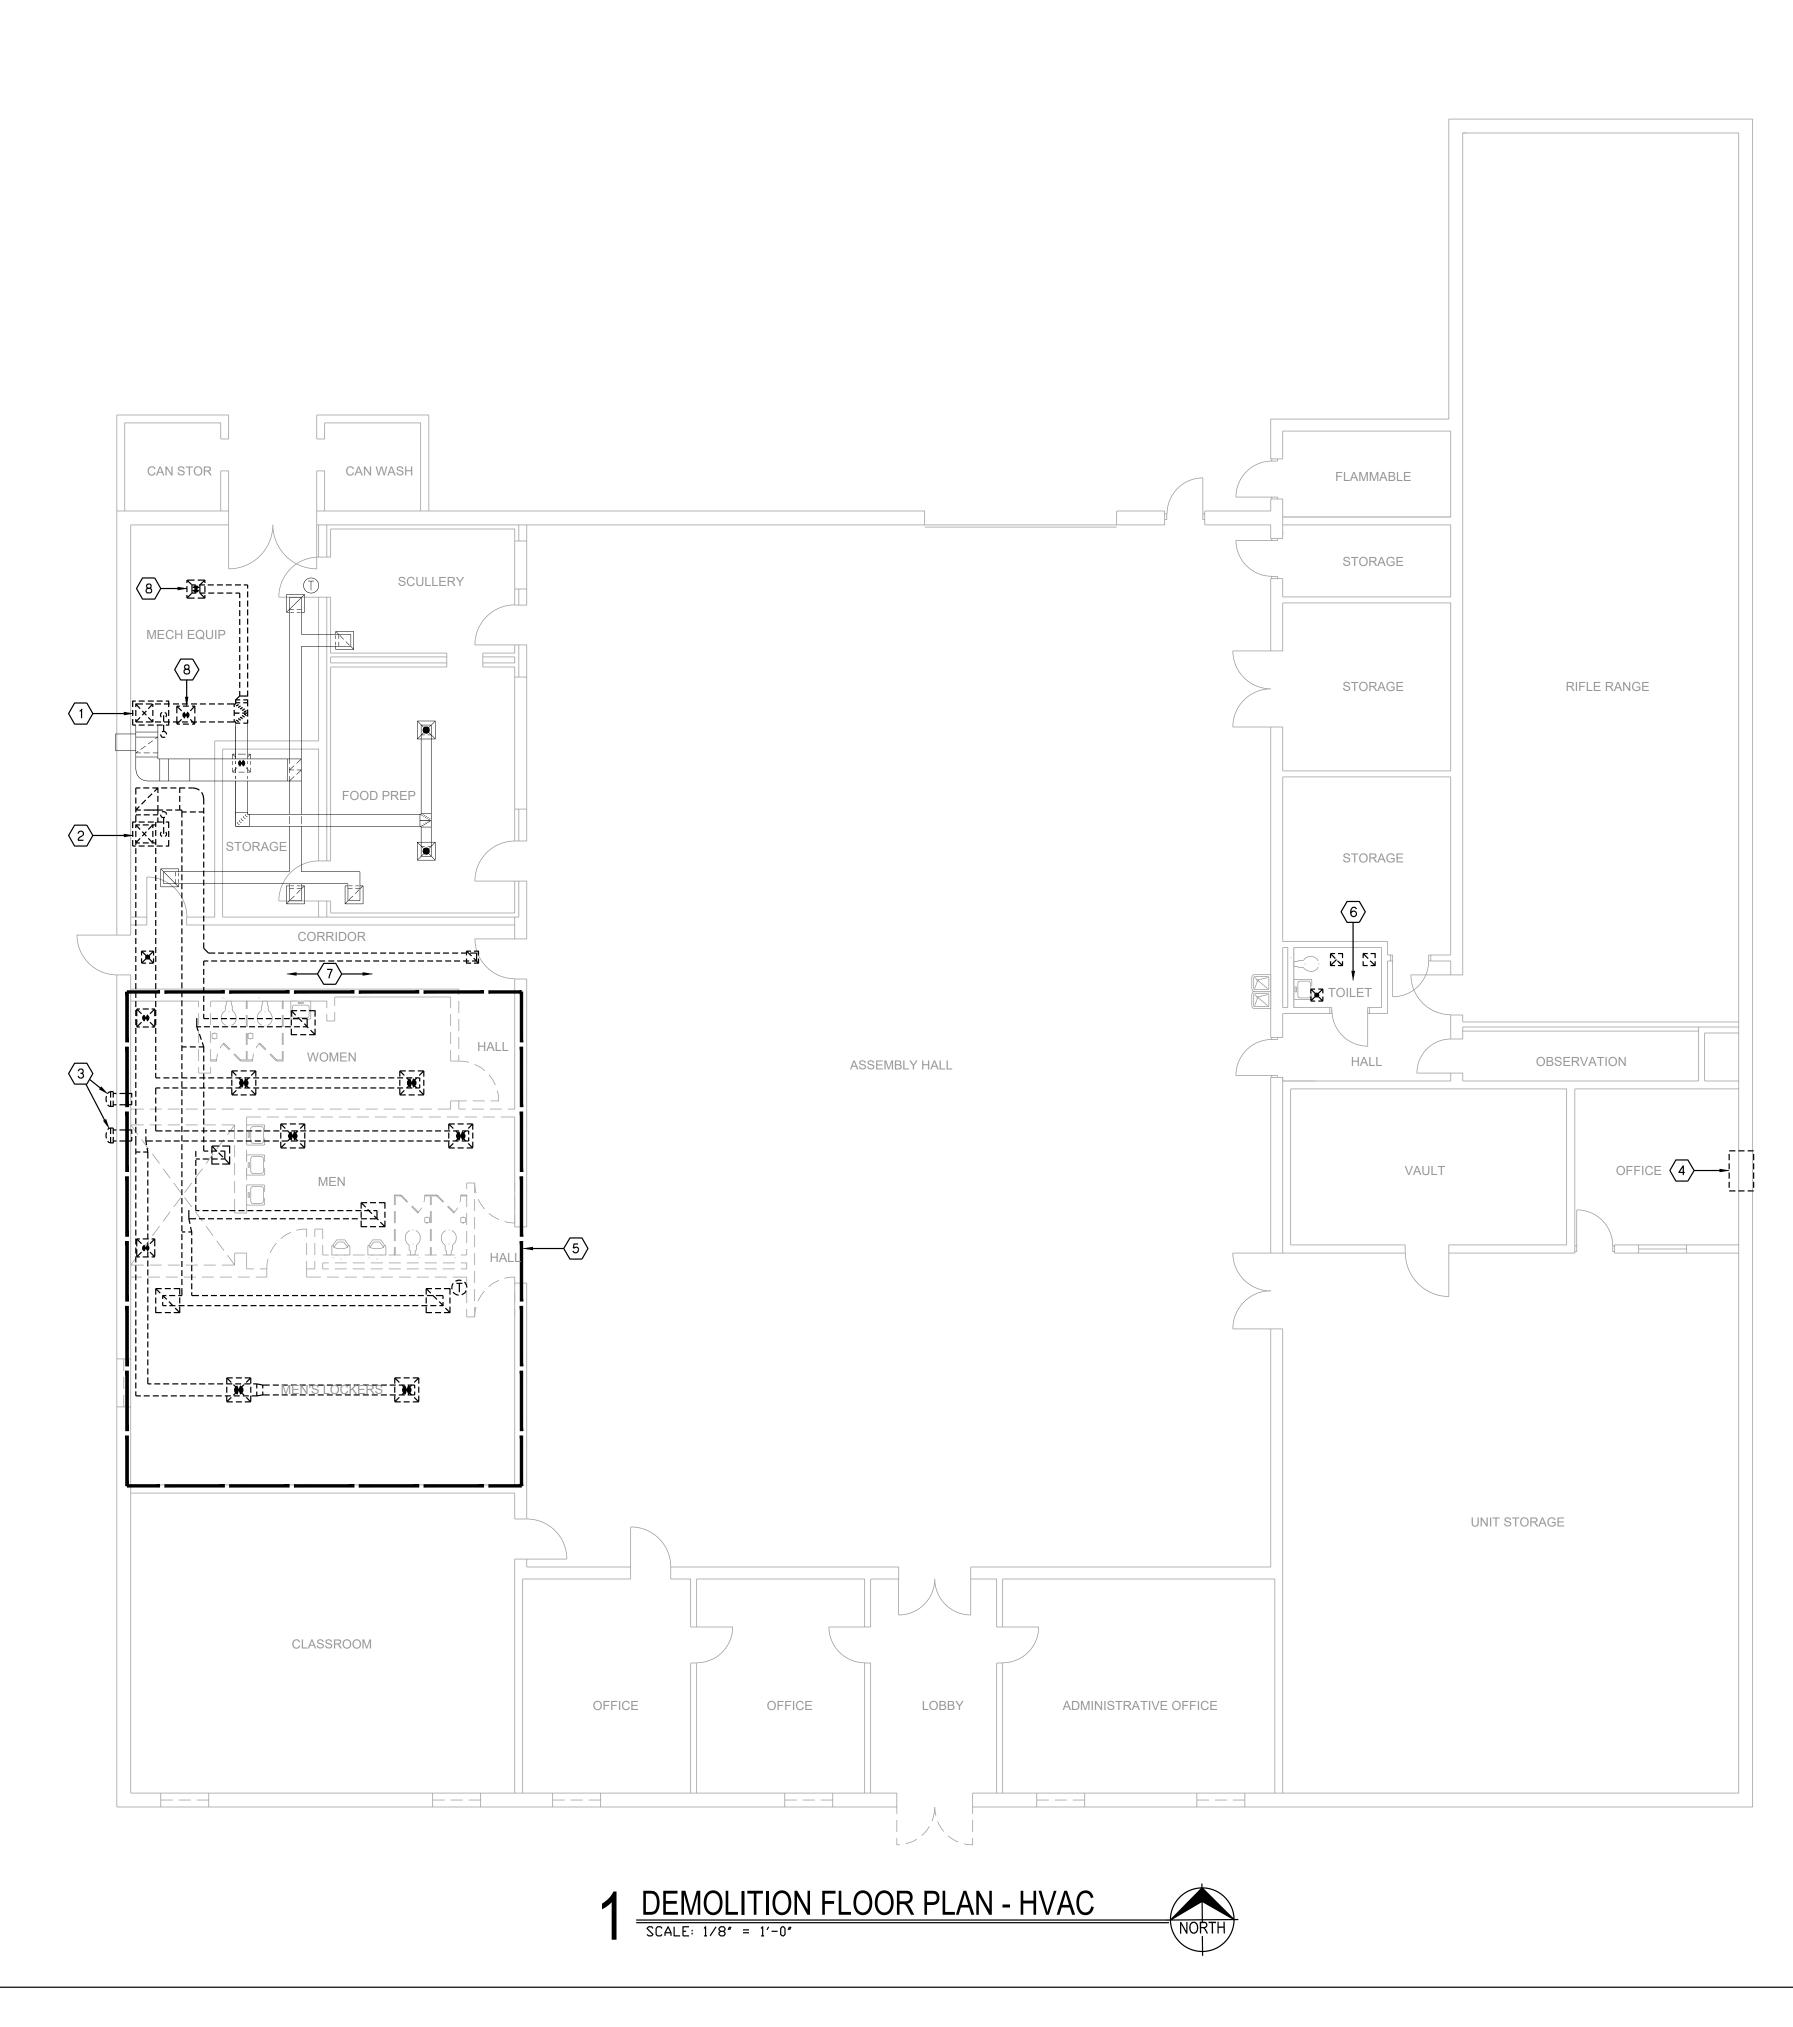
- 1 DEMO FURNACE, INDICATED DUCT, GAS CONNECTION TO UNIT, AND FLUE AS SHOWN. SALVAGE FLUE PENETRATION FOR REUSE FOR NEW FURNACE VENT. SALAVAGE GAS FOR NEW GAS CONNECTION.
- DEMO FURNACE, ASSOCIATED DUCT DIFFUSERS, GAS PIPING CONNECTION, FLUE, AND THERMOSTAT AS SHOWN. SALAVAGE FLUE PENETRATION FOR REUSE FOR NEW WATER HEATER VENT.
- 3 DEMO SIDE WALL EXHAUST FAN, ASSOCIATED DUCT AND EXHAUST GRILLE. COORDINATE EXTERIOR WALL PATCHING WITH GENERAL CONTRACTOR.
- 4 DEMO THRU THE WALL HEATING/COOLING UNIT. COORDINATE EXTERIOR WALL PATCHING WITH GENERAL CONTRACTOR.
- 5 PROVIDE COMPLETE DEMOLITION OF ALL HVAC DUCT, SUPPLY AIR DIFFUSERS, AND RETURN AIR GRILLES IN LOCKER ROOM AND SHOWER/RESTROOM.
- 6 DEMO SUPPLY AIR DIFFUSERS, RETURN AIR AND EXHAUST AIR GRILLES WITHIN ROOM, TO ACCOMMODATE NEW LAY-IN CEILING, SALVAGING EXISTING BRANCH DUCTS FOR RECONNECTION TO. REFER TO NEW WORK PLANS.
- DEMO SUPPLY AIR DIFFUSER AND RETURN AIR GRILLES, ASSOCIATED DUCT WITHIN CORRIDOR TO ACCOMMODATE NEW WORK IN LATRINES. REFER TO NEW WORK PLANS.
- 8 DEMO AND SALVAGE SUPPLY AIR DIFFUSER ASSOCIATED WITH SUPPLY AIR DUCT SHOWN FOR DEMOLITION. REINSTALL DIFFUSER IN APPROXIMATE SAME LOCATION WITH NEW DUCT PER NEW WORK PLANS.







PROFESSIONAL SEAL

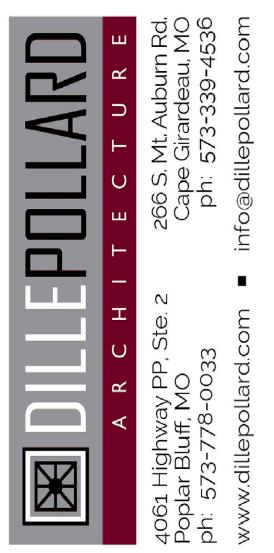

OFFICE OF ADMINISTRATION DIVISION OF FACILITIES MANAGEMENT, DESIGN AND CONSTRUCTION

MISSOURI ARMY NATIONAL GUARD FACILITIES DIVISION

RENOVATE INTERIOR AND EXTERIOR

KENNETT READINESS CENTER 1450 NORTH BY-PASS KENNETT, MO 63857

PROJECT # T2209-01

FACILITY # 8136313002

REVISION:


DATE:
REVISION:
DATE:
REVISION:
DATE:
ISSUE DATE: January 30, 2023

CAD DWG FILE: DM-100.DWG DRAWN BY: JEB CHECKED BY: RJD DESIGNED BY: JEB

SHEET TITLE:

DEMOLITION HVAC -FLOOR PLAN



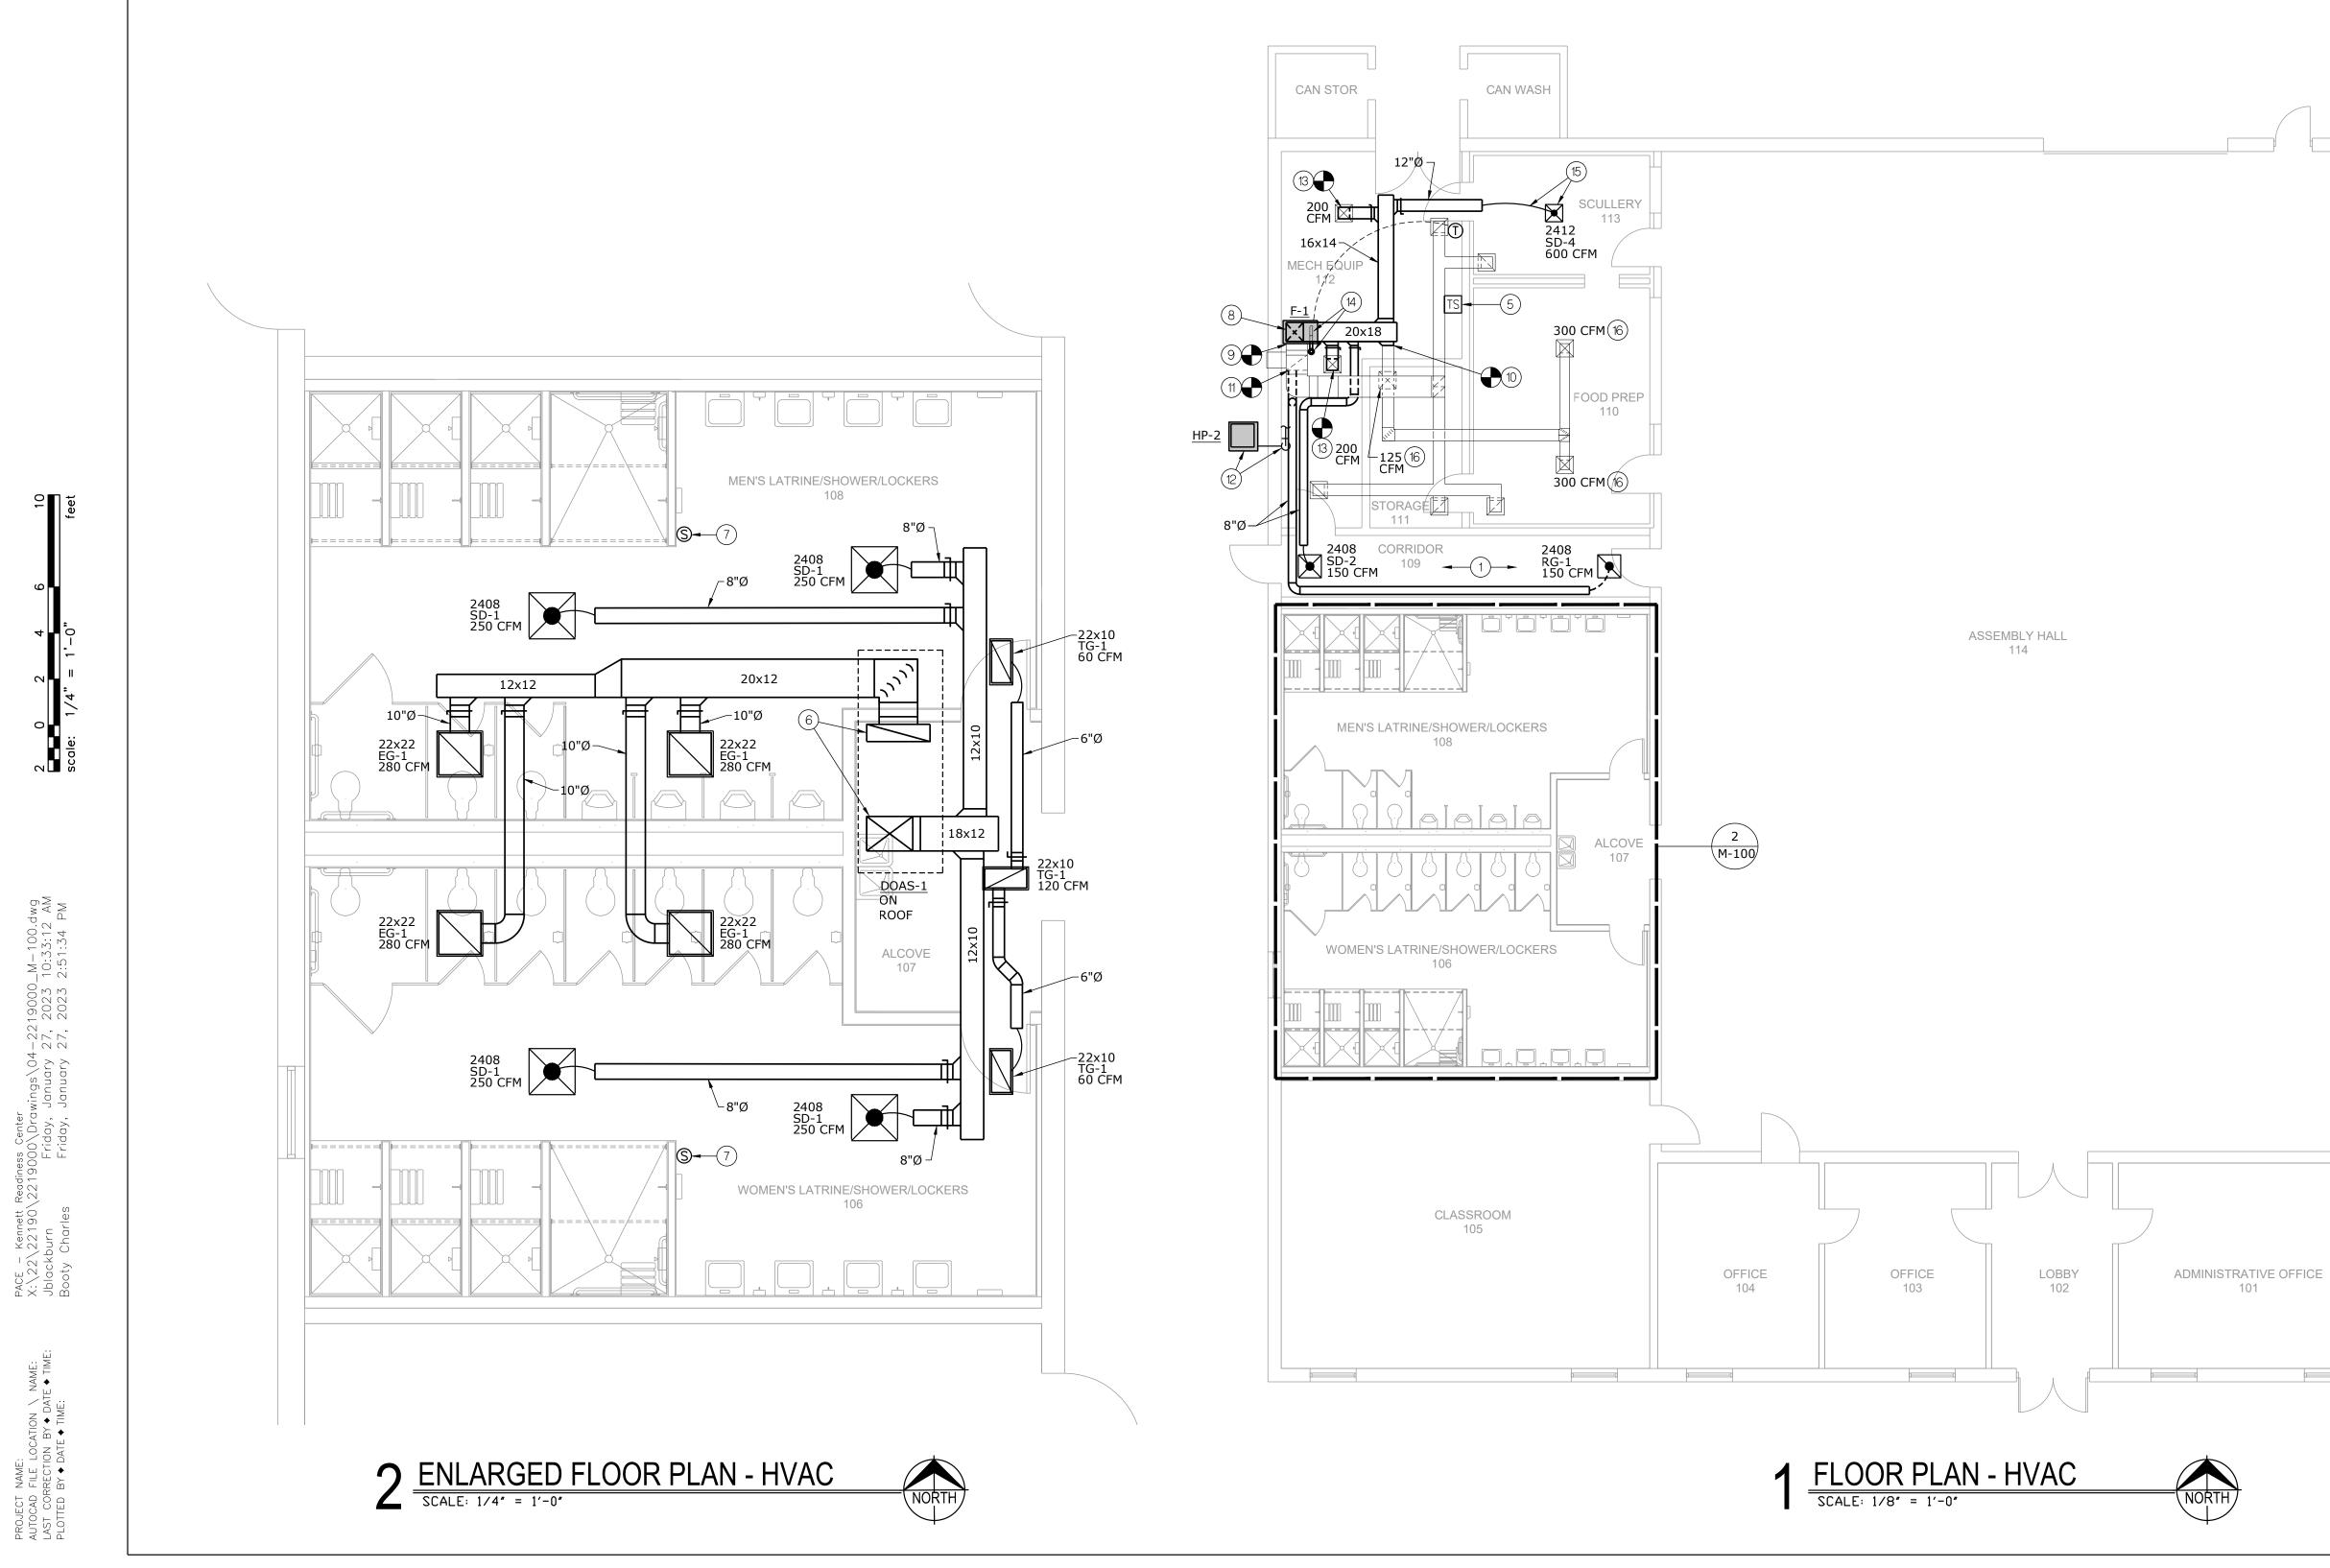

- PLAN NOTES:
- (1) PROVIDE NEW SUPPLY AIR DIFFUSER AND RETURN AIR GRILLE, ASSOCIATED DUCT ABOVE EXISTING LAY-IN CEILING.
- (2) WALL MOUNT HEAT PUMP JUST BELOW EXTERIOR SOFFIT. MAINTAIN REQUIRED CLEARANCE FROM TOP OF UNIT TO BELOW SOFFIT.
- (3) WALL MOUNT EVAPORATOR UNIT. PROVIDE REFRIGERANT LINE SET TO OUTDOOR UNIT. PROVIDE 3/4" CONDENSATE DRAIN TO EXTERIOR, DISCHARGE 12" ABOVE GRADE.
- (4) 3/4" CONDENSATE DRAIN DOWN TO 12" ABOVE GRADE. SECURE TO EXTERIOR. PROVIDE WITH BUG SCREEN.
- (5) DOAS TOUCHSCREEN CONTROLLER, RE: M-200.
- (6) TRANSITION DUCT TO FULL SIZE SUPPLY AIR AND RETURN AIR DUCTS THRU ROOF TO ROOFTOP UNIT AS REQUIRED. ROOF PENETRATIONS WITH ROOFING CONTRACTOR.

- PLAN NOTES:
- (7) DOAS AVERAGING TEMP SENSOR, RE: M-200.
- (8) TRANSITION SUPPLY AIR DUCT DOWN TO UNIT INLET AS REQUIRED. PROVIDE WITH FLEXIBLE DUCT CONNECTION.
- (9) CONNECT EXISTING RETURN AIR DUCT TO NEW FURNACE. PROVIDE WITH 1" FILTER RACK. TRANSITION AS REQUIRED. PROVIDE WIT FLEXIBLE DUCT CONNECTION.
- (10) CONNECT EXISTING SUPPLY AIR DUCT TO NEW SUPPLY AIR MAIN DUCT.
- (11) CONNECT NEW RETURN AIR BRANCH DUCT TO EXISTING RETURN AIR MAIN.
- (12) PROVIDE 4" CONCRETE PAD FOR HEAT PUMP. PROVIDE REFRIGERANT LINE SET TO FURNACE. SIZE LINE SET PER MANUFACTURER'S REQUIREMENTS.
- PROVIDE WITH FLEXIBLE DUCT CONNECTIONS. COORDINATE (13) REUSE AND CONNECT TO SALVAGED SUPPLY AIR DIFFUSE. MATCH EXISTING DUCT SIZE. BALANCE DIFFUSER TO AIRFLOW AS SHOWN.

PLAN NOTES:

- (14) PROVIDE FURNACE CONCENTRIC VENT, THRU DEMO'ED FLUE ROOF PENETRATIN. SIZE AND INSTALL PER MANUFACTURER'S REQUIREMENTS. COORDINATE WITH ROOFING CONTRACTOR.
- (15) PROVIDE NEW SUPPLY AIR DIFFUSER AND DUCT ABOVE EXISTING CEILING. FIELD DETERMINE EXACT CONDITIONS. INTENT IS TO NOT DEMO AND REPAIR CEILING.
- (16) EXISTING SUPPLY AIR DIFFUSER, BALANCE TO AIRFLOW AS SHOWN.

1. ALL DUCTWORK AND PIPING IS SHOWN DIAGRAMMATICALLY AND DOES NOT INCLUDE ALL OFFSETS, DROPS, AND RISES. CAREFULLY COORDINATE DUCT AND PIPE ROUTING WITH STRUCTURE AS WELL AS ALL OTHER TRADES TO MAINTAIN EQUIPMENT CLEARANCES, EQUIPMENT ACCESSIBILITY, DESIRED CEILING HEIGHTS, AND AESTHETICS. THE CONTRACTOR SHALL INCLUDE ANY NEEDED OFFSETS AND CHANGES OF DIRECTION IN THE BID PRICING.


GENERAL NOTES:

- - 4. DUCT SIZES SHOWN ARE SHEET METAL DIMENSIONS.

2. COORDINATE ALL DUCT PENETRATIONS WITH STRUCTURAL PRIOR TO ROOF PENETRATIONS.

3. FURNISH ALL EXPOSED DUCTWORK IN FINISHED SPACES WITH PAINTABLE FINISH.

WHERE DUCT LINER IS REQUIRED, DUCT SIZES ARE NOT REQUIRED TO BE INCREASED TO ACCOUNT FOR LINER. FLAMMABLE 124 STORAGE 123 STORAGE **RIFLE RANGE** 122 125 STORAGE 121 10x10 10x10 EG-2 60 CFM-7 RG-2 ┌─40 CFM TOILET **-**Ø 6x6 SD-3 40 CFM OBSERVATION HALL 119 118 OFFICE 3 VAULT 116 <u>AHU-1</u> <u>HP-1</u> \bigcirc _____ UNIT STORAGE 115 乙 smith & boucher

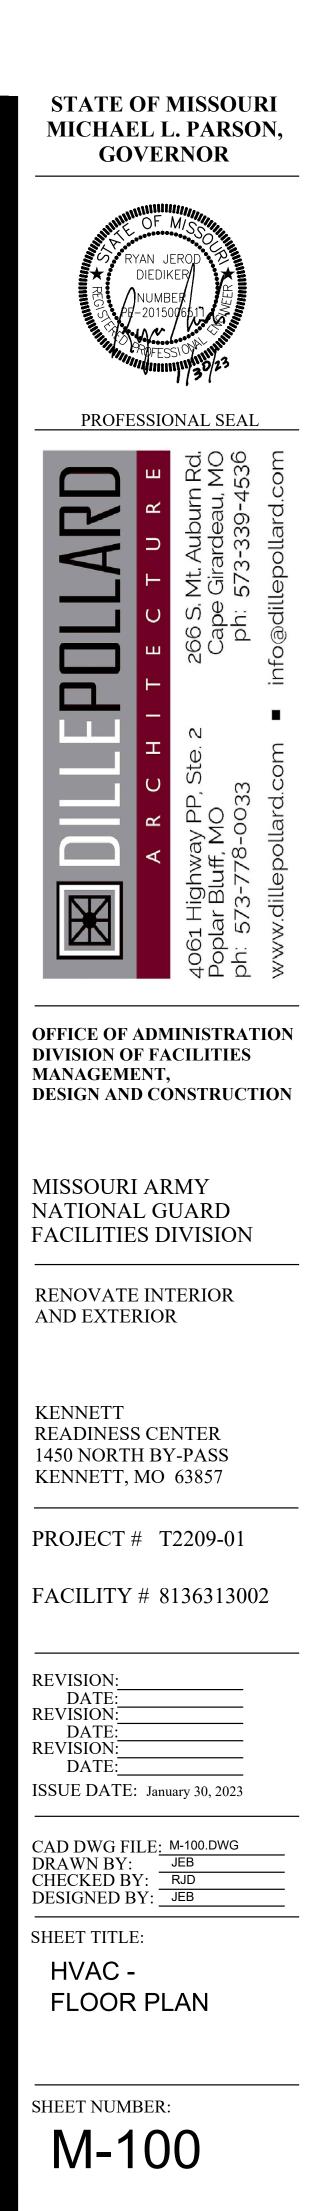

21 OF 29 SHEETS

project number 2219000


25618 west 103rd St olathe, ks 66061

phone 913.345.2127 fax 913.345.0617



wings\04-2219000_M-200.dwg January 27, 2023 10:33:34 AM January 27, 2023 2:51:44 PM PACE – Kennett Readiness Center X:\22\22190\221900\Draw Jblackburn Friday, J Bootv Charles Friday, .

PROJECT NAME: AUTOCAD FILE LOCATION \ NAME LAST CORRECTION BY ♦ DATE ♦ TII PLOTTED BY ♦ DATE ♦ TIME:

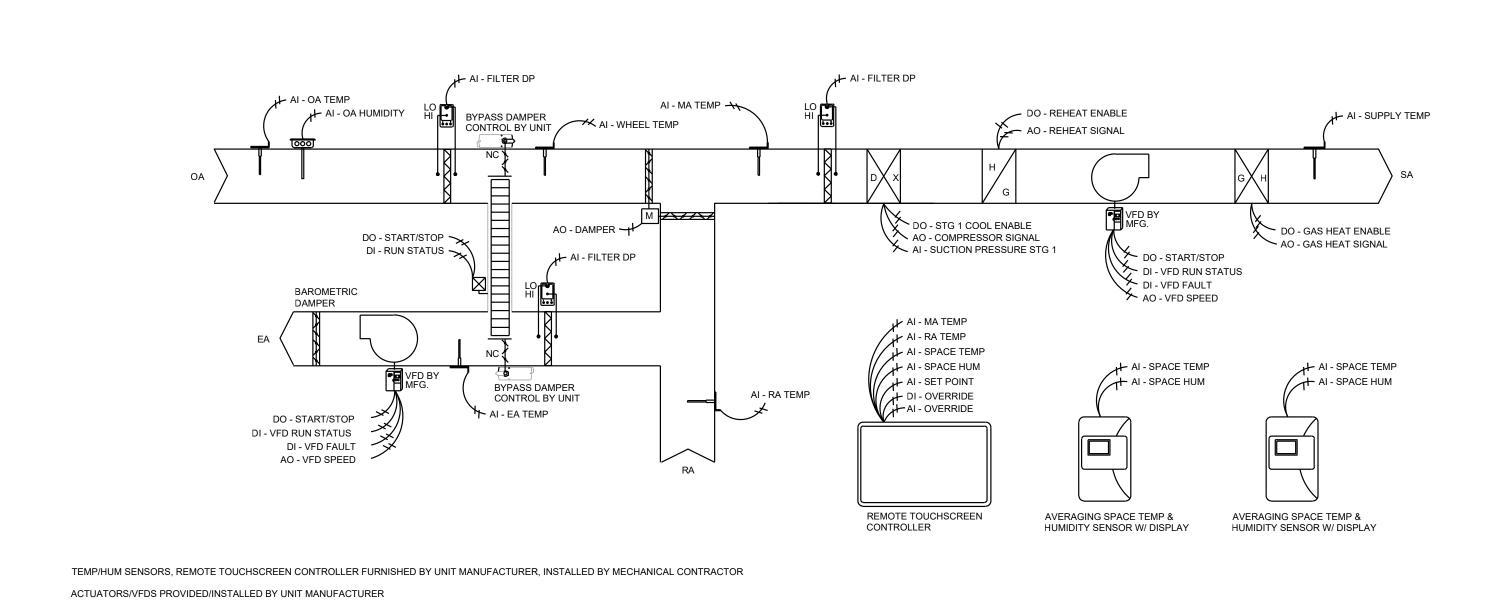

DEDICATED OUTSIDE AIR UNIT DOAS-1 NOT TO SCALE

SEQUENCE OF OPERATION: Dedicated Outside Air System (Standalone control)

Zone Occupancy: The remote touch screen controller shall enable the DOAS unit to be occupied via its time-of-day schedule and provide full control of the unit, via terminal strip, for the sequence as follows:

When the unit is in occupied mode (weekend), the outside air damper shall open and the supply fan, exhaust fan and energy recovery wheel shall run continuously. The unit shall supply 100% outside air.

Heating/Cooling Switchover:

If the outside air wheel temperature falls more than 1°F below the heating setpoint for more than 10 minutes (adj.), and the outside air dewpoint is below 55°F (adj.), then the unit shall enter the heating mode. If the outside air wheel temperature rises more than 1°F above the cooling setpoint for more than 10 minutes (adj.) or the outside air dewpoint is above 55°F (adj.),

the unit shall enter the cooling mode.

Supply Air Temperature Setpoint:

The supply air temperature setpoint shall be reset based on a space temperature sensor. In cooling mode, the supply air temperature setpoint shall be reset from 74°F (adj.) down to 55°F temperature setpoint shall be reset from 70°F (adj.) up to 95°F (adj.), as the space temperature

(adj.), as the space temperature increases above 74°F (adj.). In heating mode, the supply air decreases below 70°F (adj.).

Cooling Mode: When the unit is in cooling mode, the DX Cooling shall be enabled and modulate DX capacity to

maintain the supply air setpoint. Suction pressure shall be monitored and the variable capacity compressor signal shall be limited to maintain a minimum suction pressure setpoint of 110psi (adj.) to avoid freezing the cooling coil.

Dehumidification Mode: If the outside air dewpoint rises above 55°F (adj.) or the space humidity rises above 55%, the unit shall enter into a dehumidification mode. During the dehumidification mode, DX cooling shall be enabled and all variable capacity compressors shall modulate to maintain current suction pressure setpoint of 120psi (adj.). The modulating hot gas reheat shall be enabled and modulate to maintain the current cooling mode supply air temperature setpoint. Once the outside air dewpoint drops below 52°F (adj.) or the space humidity below 45%, the

dehumidification mode shall be disabled.

Heating Mode: When the unit is in heat mode, the gas heating is enabled and shall modulate to maintain the supply air setpoint.

Zone Unoccupied: When the zone is scheduled to be unoccupied, the outside air damper shall close, and the supply fan and heating and cooling shall be energized to maintain set back back temperatures

of 55°F (heating) and 80°F (cooling).

Occupancy Override: The touchscreen interface shall allow the user to dynamically change the occupancy schedule and force weekday or weekend occupancy for an adjustable amount of time. Filter Differential Pressure Monitor:

Alarms:

乃 smith & boucher 25618 west 103rd St olathe, ks 66061 phone 913.345.2127 fax 913.345.0617 project number 2219000

KENNETT **READINESS CENTER** 1450 NORTH BY-PASS KENNETT, MO 63857 DATE: DATE: DATE:

RENOVATE INTERIOR

MISSOURI ARMY

PROFESSIONAL SEAL

STATE OF MISSOURI MICHAEL L. PARSON, GOVERNOR



OFFICE OF ADMINISTRATION DIVISION OF FACILITIES MANAGEMENT, **DESIGN AND CONSTRUCTION**

NATIONAL GUARD FACILITIES DIVISION

AND EXTERIOR

PROJECT # T2209-01

FACILITY # 8136313002

REVISION: REVISION: ISSUE DATE: January 30, 2023

CAD DWG FILE: M-200.DWG JEB DRAWN BY: CHECKED BY: RJD DESIGNED BY: JEB

SHEET TITLE: HVAC CONTROL SCHEMATIC

SHEET NUMBER: M-200

REVISION:

22 OF 29 SHEETS

The controller shall monitor the differential pressure across all unit filters.

The controller shall provide the following alarms at the touchscreen interface for any of the following conditions: supply air fan failure, exhaust air fan failure, energy recovery wheel failure, high and low supply air temperature, and high filter pressure drop.


Energy Recovery Wheel Defrost Stop/jog defrost sequence shall be utilized for the prevention of frost buildup on energy

recovery wheel when necessary.

Zone Occupied (Weekday): When the zone is scheduled to be occupied on a weekday via its time-of-day schedule, the outside air damper shall allow only 30% outside air (adj.).

PROJECT NAME: AUTOCAD FILE LOCATION \ NAME: LAST CORRECTION BY ♦ DATE ♦ TIME: PLOTTED BY ♦ DATE ♦ TIME:

PACE – Kennett Readiness Center X:\22\22190\2219000\Drawings\03-2219000_DP-100.dwg Jblackburn Wednesday, January 18, 2023 2:48:45 Booty Charles Friday, January 27, 2023 2:51:22 PM

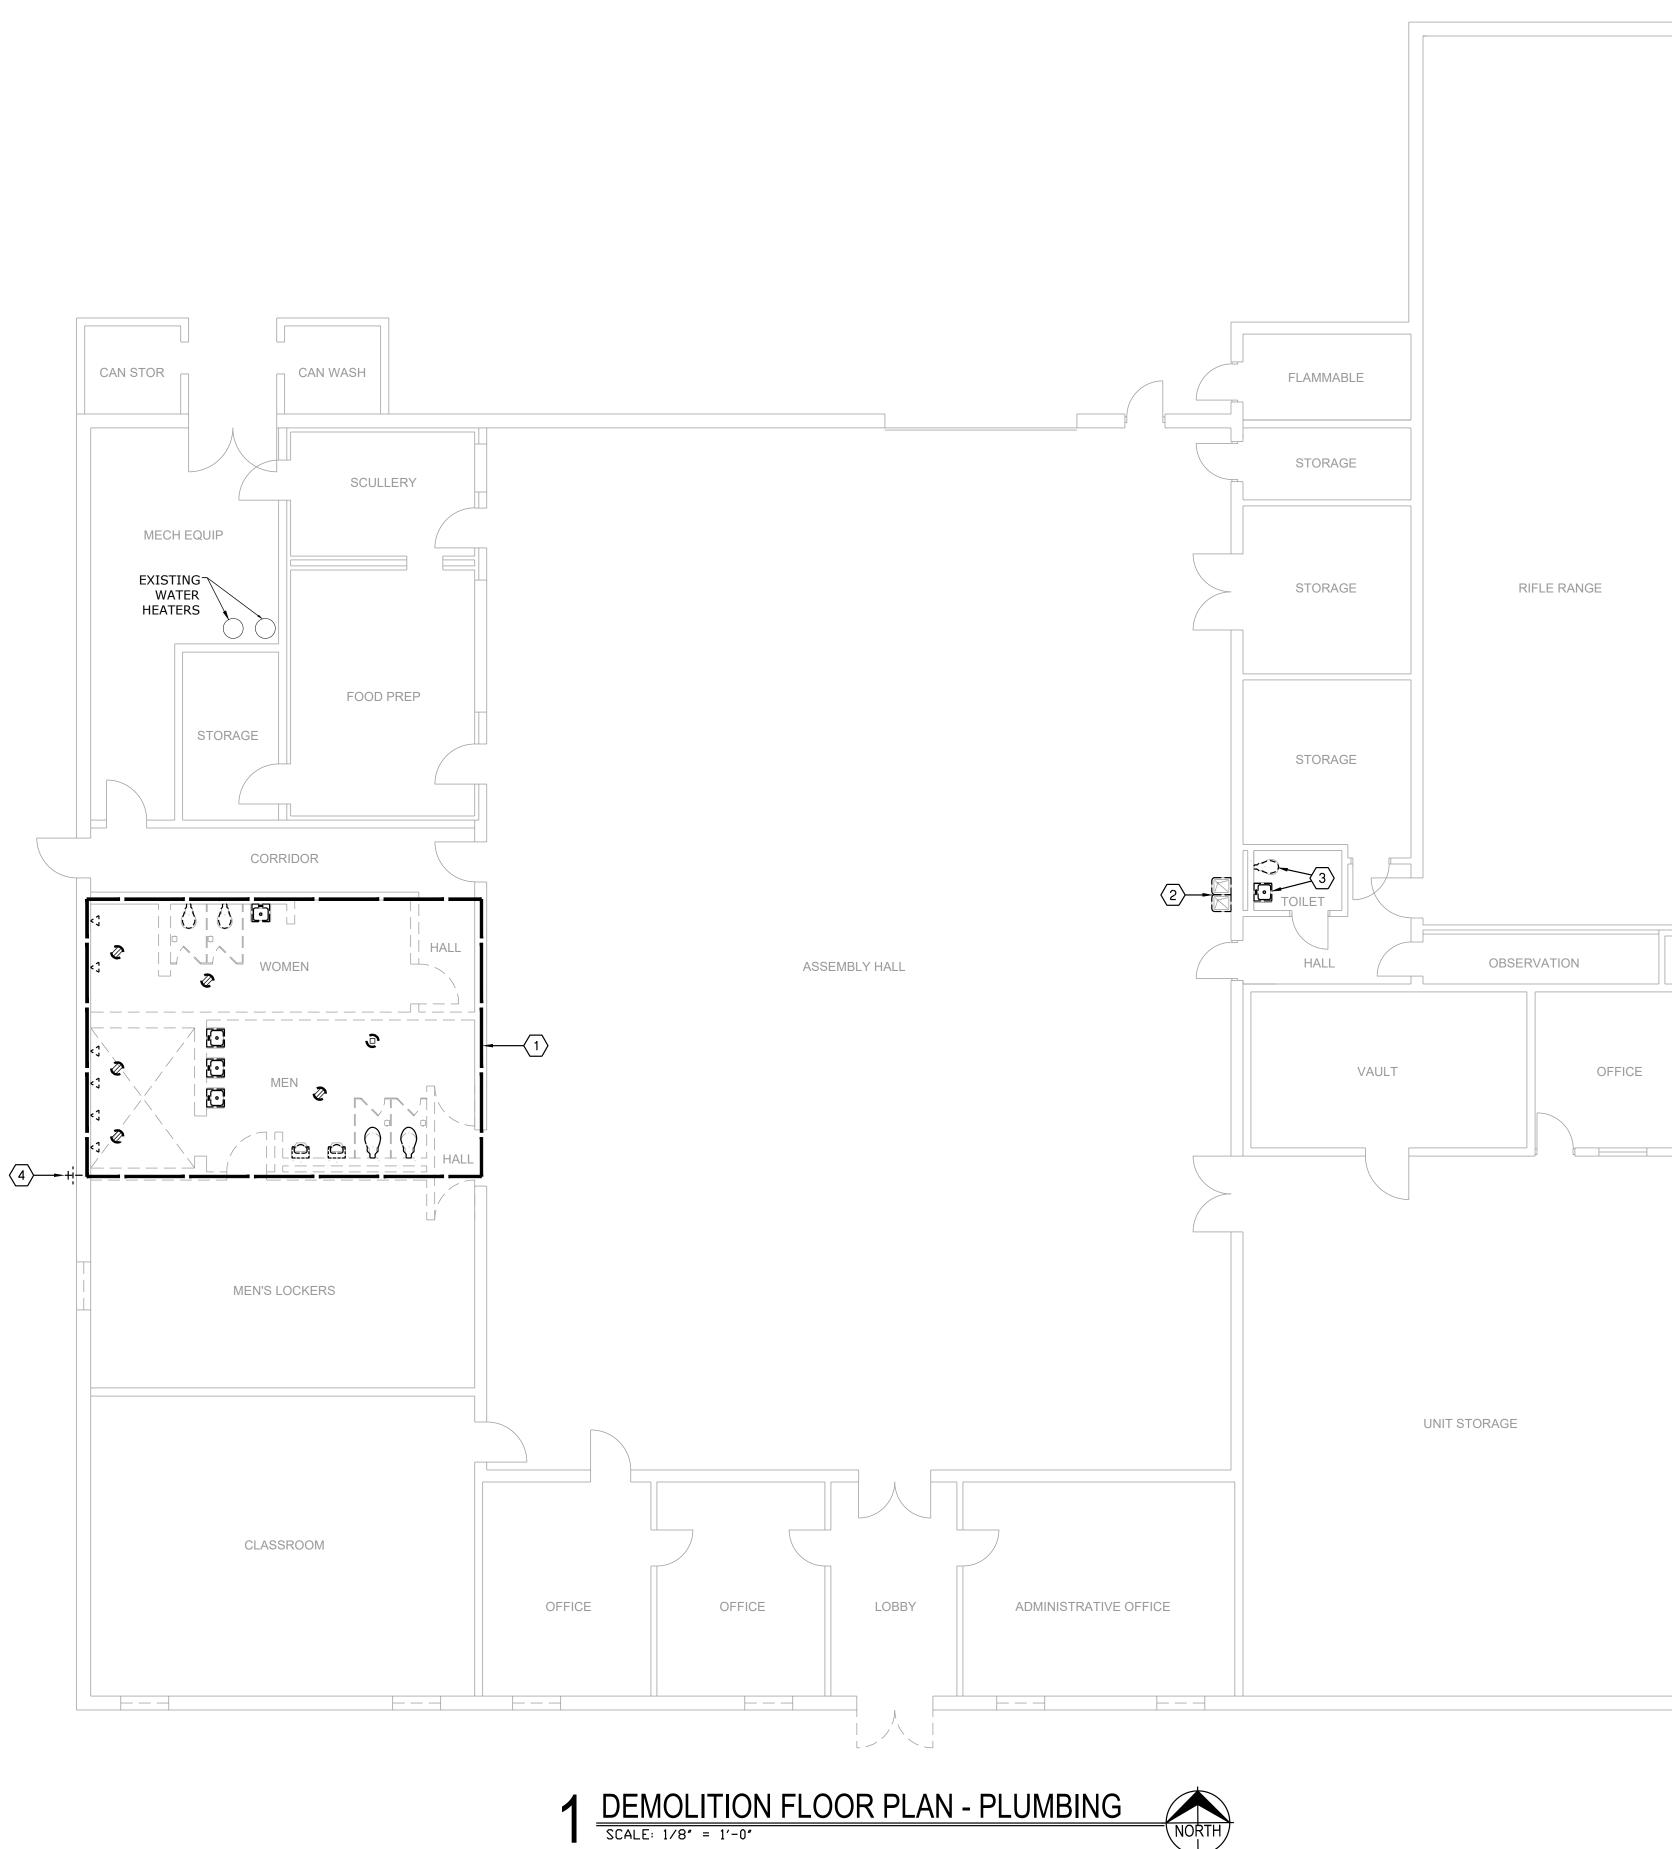

NORTH

GENERAL DEMOLITION NOTES:

- 1. UNLESS OTHERWISE NOTED, SERVICES AND EQUIPMENT SHOWN WITH BOLD DASHED LINES ARE TO BE DEMOLISHED. SERVICES AND EQUIPMENT SHOWN WITH SOLID HALF TONE LINE WEIGHT ARE TO REMAIN IN PLACE.
- 2. THE EXISTING CONDITIONS INDICATED ON THE DRAWINGS ARE TAKEN FROM THE BEST INFORMATION AVAILABLE AND FROM VISUAL SITE INSPECTION AND ARE NOT TO BE CONSIDERED "AS BUILT" CONDITIONS. THE INFORMATION SHOWN IS TO ESTABLISH THE EXTENT OF THE SCOPE OF WORK. VERIFY ALL ACTUAL EXISTING CONDITIONS AT THE PROJECT SITE AND PERFORM WORK AS REQUIRED TO MEET THE EXISTING CONDITIONS AND THE EXTENT OF THE WORK INDICATED.
- 3. PATCH AND REPAIR ANY INFRASTRUCTURE THAT IS TO REMAIN WHERE ANY SERVICES ARE REMOVED UNLESS NOTED OTHERWISE. DISCONNECT AND REMOVE ALL WIRING, CABLING, RACEWAY AND CONDUIT THAT BECOMES UNNECESSARY AS A RESULT OF THE REMOVAL OF EQUIPMENT INDICATED TO BE REMOVED.
- 4. WHERE MECHANICAL AND ELECTRICAL FIXTURES OR EQUIPMENT ARE REMOVED, CAP ALL UNUSED CONDUIT, WIRING AND PIPING BEHIND THE FLOOR LINE OR WALL LINE TO FACILITATE THE RESTORATION OF FINISH.
- 5. PROVIDE FOR THE CONTINUITY OF ALL REMAINING SERVICES, SYSTEMS, AND CIRCUITS. RELOCATE AND RECONNECT ANY MECHANICAL AND ELECTRICAL FACILITIES THAT MUST BE RELOCATED IN ORDER TO ACCOMPLISH THE REMODELING SHOWN IN THE DRAWINGS OR INDICATED IN THE SPECIFICATIONS.

DEMOLITION PLAN NOTES:

- (1) PROVIDE COMPLETE DEMOLITION OF ALL PLUMBING FIXTURES, FLOOR DRAINS, AND CLEANOUTS IN SHOWER/RESTROOM. PROVIDE DEMOLITION OF ALL ASSOCIATED SANITARY, VENT, AND WATER PIPING.
- $\langle 2 \rangle$ PROVIDE DEMOLITION OF DRINKING FOUNTAIN. CAP SANITARY AND CW PIPING BACK IN WALL. COORDINATE WALL PATCHING WITH GENERAL CONTRACTOR.
- $\langle 3 \rangle$ PROVIDE DEMOLITION OF LAVATORY AND WATER CLOSET. SALVAGE SANITARY, CW, AND HW POINT OF USE HEATER FOR NEW FIXTURES PER NEW WORK PLANS.
- $\langle 4 \rangle$ PROVIDE DEMOLITION OF WALL HYDRANT. COORDINATE EXTERIOR WALL PATCHING WITH GENERAL CONTRACTOR.

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smith & boucher

25618 west 103rd St olathe, ks 66061


phone 913.345.2127 fax 913.345.0617

project number 2219000





PROFESSIONAL SEAL

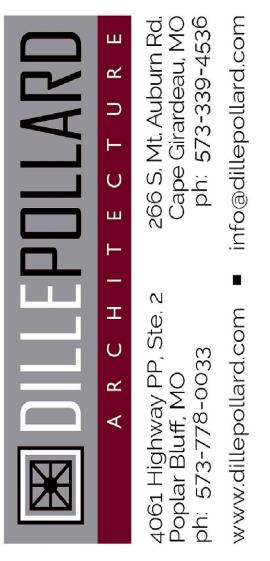

OFFICE OF ADMINISTRATION DIVISION OF FACILITIES MANAGEMENT, **DESIGN AND CONSTRUCTION**

MISSOURI ARMY NATIONAL GUARD FACILITIES DIVISION

RENOVATE INTERIOR AND EXTERIOR

KENNETT **READINESS CENTER** 1450 NORTH BY-PASS KENNETT, MO 63857

PROJECT # T2209-01

FACILITY # 8136313002

REVISION:


DATE:
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DATE:
ISSUE DATE: January 30, 2023

CAD DWG FILE: DP-100.DWG DRAWN BY: JEB CHECKED BY: RJD DESIGNED BY: JEB

SHEET TITLE:


DEMOLITION PLUMBING -FLOOR PLAN



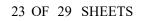

PLAN NOTES:


- (1) CONNECT NEW 4" SAN TO EXISTING 4" SAN. FIELD VERIFY LOCATION.
- (2) 4" SAN UP IN CHASE TO FIXTURES. REFER TO RISER DIAGRAM.
- (3) 2" SAN UP IN WALL TO LAVATORIES. REFER TO RISER DIAGRAM.
- (4) 4" SAN, 2" VENT TO BACK TO BACK WATER CLOSET CARRIER. 1-1/4" CW TO EACH WATER CLOSET.
- (5) 4" SAN TO WATER CLOSET CARRIER, 2" WET VENT TO URINAL, TO 2" VENT. 1-1/4" CW WATER CLOSET, 1" CW TO URINAL.
- (6) 2" SAN, 1-1/2" VENT, 1/2" CW AND HW TO LAVATORY.
- (7) 3" TRAPPED SAN UP TO 2" FLOOR DRAIN.
- (8) 2" VENT UP THRU ROOF TO VTR. EXISTING 4" VTR SERVING DEMOLISHED RESTROOMS SHALL BE PERMITTED TO BE REUSED. FIELD DETERMINE EXACT LOCATION. COORDINATE WITH ROOFING CONTRACTOR.

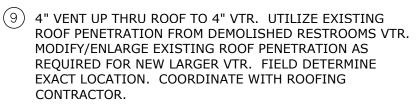

(10) 3" VENT DOWN IN CHASE.

PLAN NOTES:

- (11) 3" TRAPPED SAN UP TO 2" SHOWER DRAIN.
- (12) CONNECT NEW 2-1/2" CW TO EXISTING 2-1/2" CW SERVING DEMOLISHED RESTROOMS. FIELD DETERMINE
- (22) PROVIDE WATER HEATER CONCENTRIC VENT, THRU EXACT LOCATION. EXISTING ROOF DEMO'ED FLUE PENETRATION. SIZE AND (13) 2-1/2" CW DOWN IN CHASE TO FIXTURES. REFER TO RISER INSTALL PER MANUFACTURER'S REQUIREMENTS. COORDINATE WITH ROOFING CONTRACTOR. DIAGRAM.
- (14) 3/4" CW AND HW DOWN IN CHASE TO FIXTURES. REFER TO
- RISER DIAGRAM.
- (15) 1/2" CW AND HW DOWN TO SHOWER. (16) 2" SAN, 1-1/2" VENT, 1/2" CW TO DRINKING FOUNTAIN.
- (17) 4" SAN UP TO FINISH FLOOR CLEANOUT.

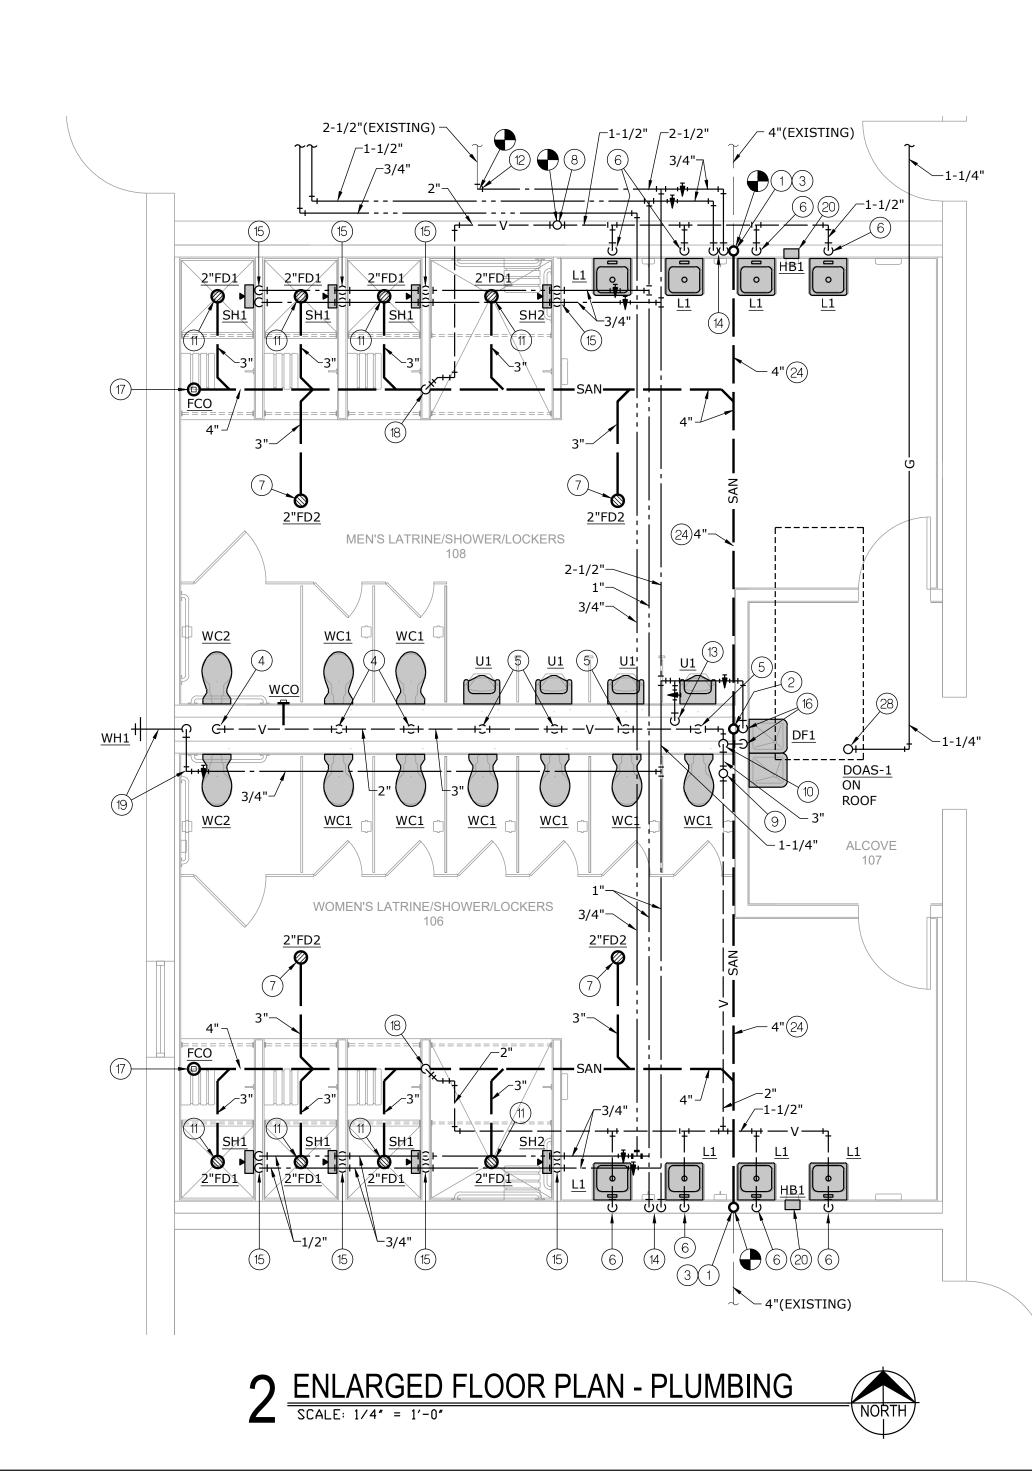

py A Dy A Dy A A wings\04-2219000_P-100. January 27, 2023 1:26:43 January 27, 2023 2:51:56 PACE — Kennett Readiness Center X:\22\22190\2219000\Draw Jblackburn Friday, J Booty Charles Friday, J

PROJECT NAME: AUTOCAD FILE LOCATION \ NAME: LAST CORRECTION BY ♦ DATE ♦ TIME PLOTTED BY ♦ DATE ♦ TIME:

PLAN NOTES:


- (18) 2" VENT DOWN IN WALL, THRU FLOOR TO COMBINATION WASTE AND VENT.
- (19) 3/4" CW WITH SHUTOFF VALVE DOWN IN CHASE TO WALL HYDRANT.
- (20) 1/2" CW AND HW TO HOSE BIBB IN FLUSH MOUNT WALL BOX, INSTALLED BELOW LAVATORY. REFER TO RISER DIAGRAM.
- (21) CONNECT NEW 1-1/2" CW TO EXISTING 2-1/2" CW IN GENERAL AREA. FIELD DETERMINE EXACT LOCATION.
- NEW FIXTURES IN PLACE OF EXISTING. PROVIDE NEW SCHEDULE.
- (24) PROVIDE NEW SAN PIPING MAIN IN PLACE OF EXISTING BETWEEN THE POINTS OF CONNECTION TO THE EXISTING (SEE PLAN NOTE 1).

PLAN NOTES:

- (25) CONNECT NEW 1" GAS TO EXISTING GAS SERVICE INSIDE BUILDING. FIELD DETERMINE EXACT LOCATION.
- (26) CONNECT EXISTING GAS TO NEW FURNACE. PROVIDE UNION AND FLEXIBLE CONNECTION AFTER EXISTING SHUT OFF.
- (27) CONNECT NEW 1-1/4" GAS TO EXISTING GAS MAIN ABOVE CEILING. FIELD DETERMINE EXACT LOCATION.
- (28) 1-1/4" GAS UP THRU ROOF CURB TO DOAS UNIT ON ROOF. (EXISTING GAS LOAD ON 3" MAIN IS 1485 MBH. 315 MBH CAPACITY AVAILABLE @ 300 LF.)


GENERAL NOTES:

- PRIOR TO CORE DRILLING.
- BELOW GRADE PLUMBING WORK.

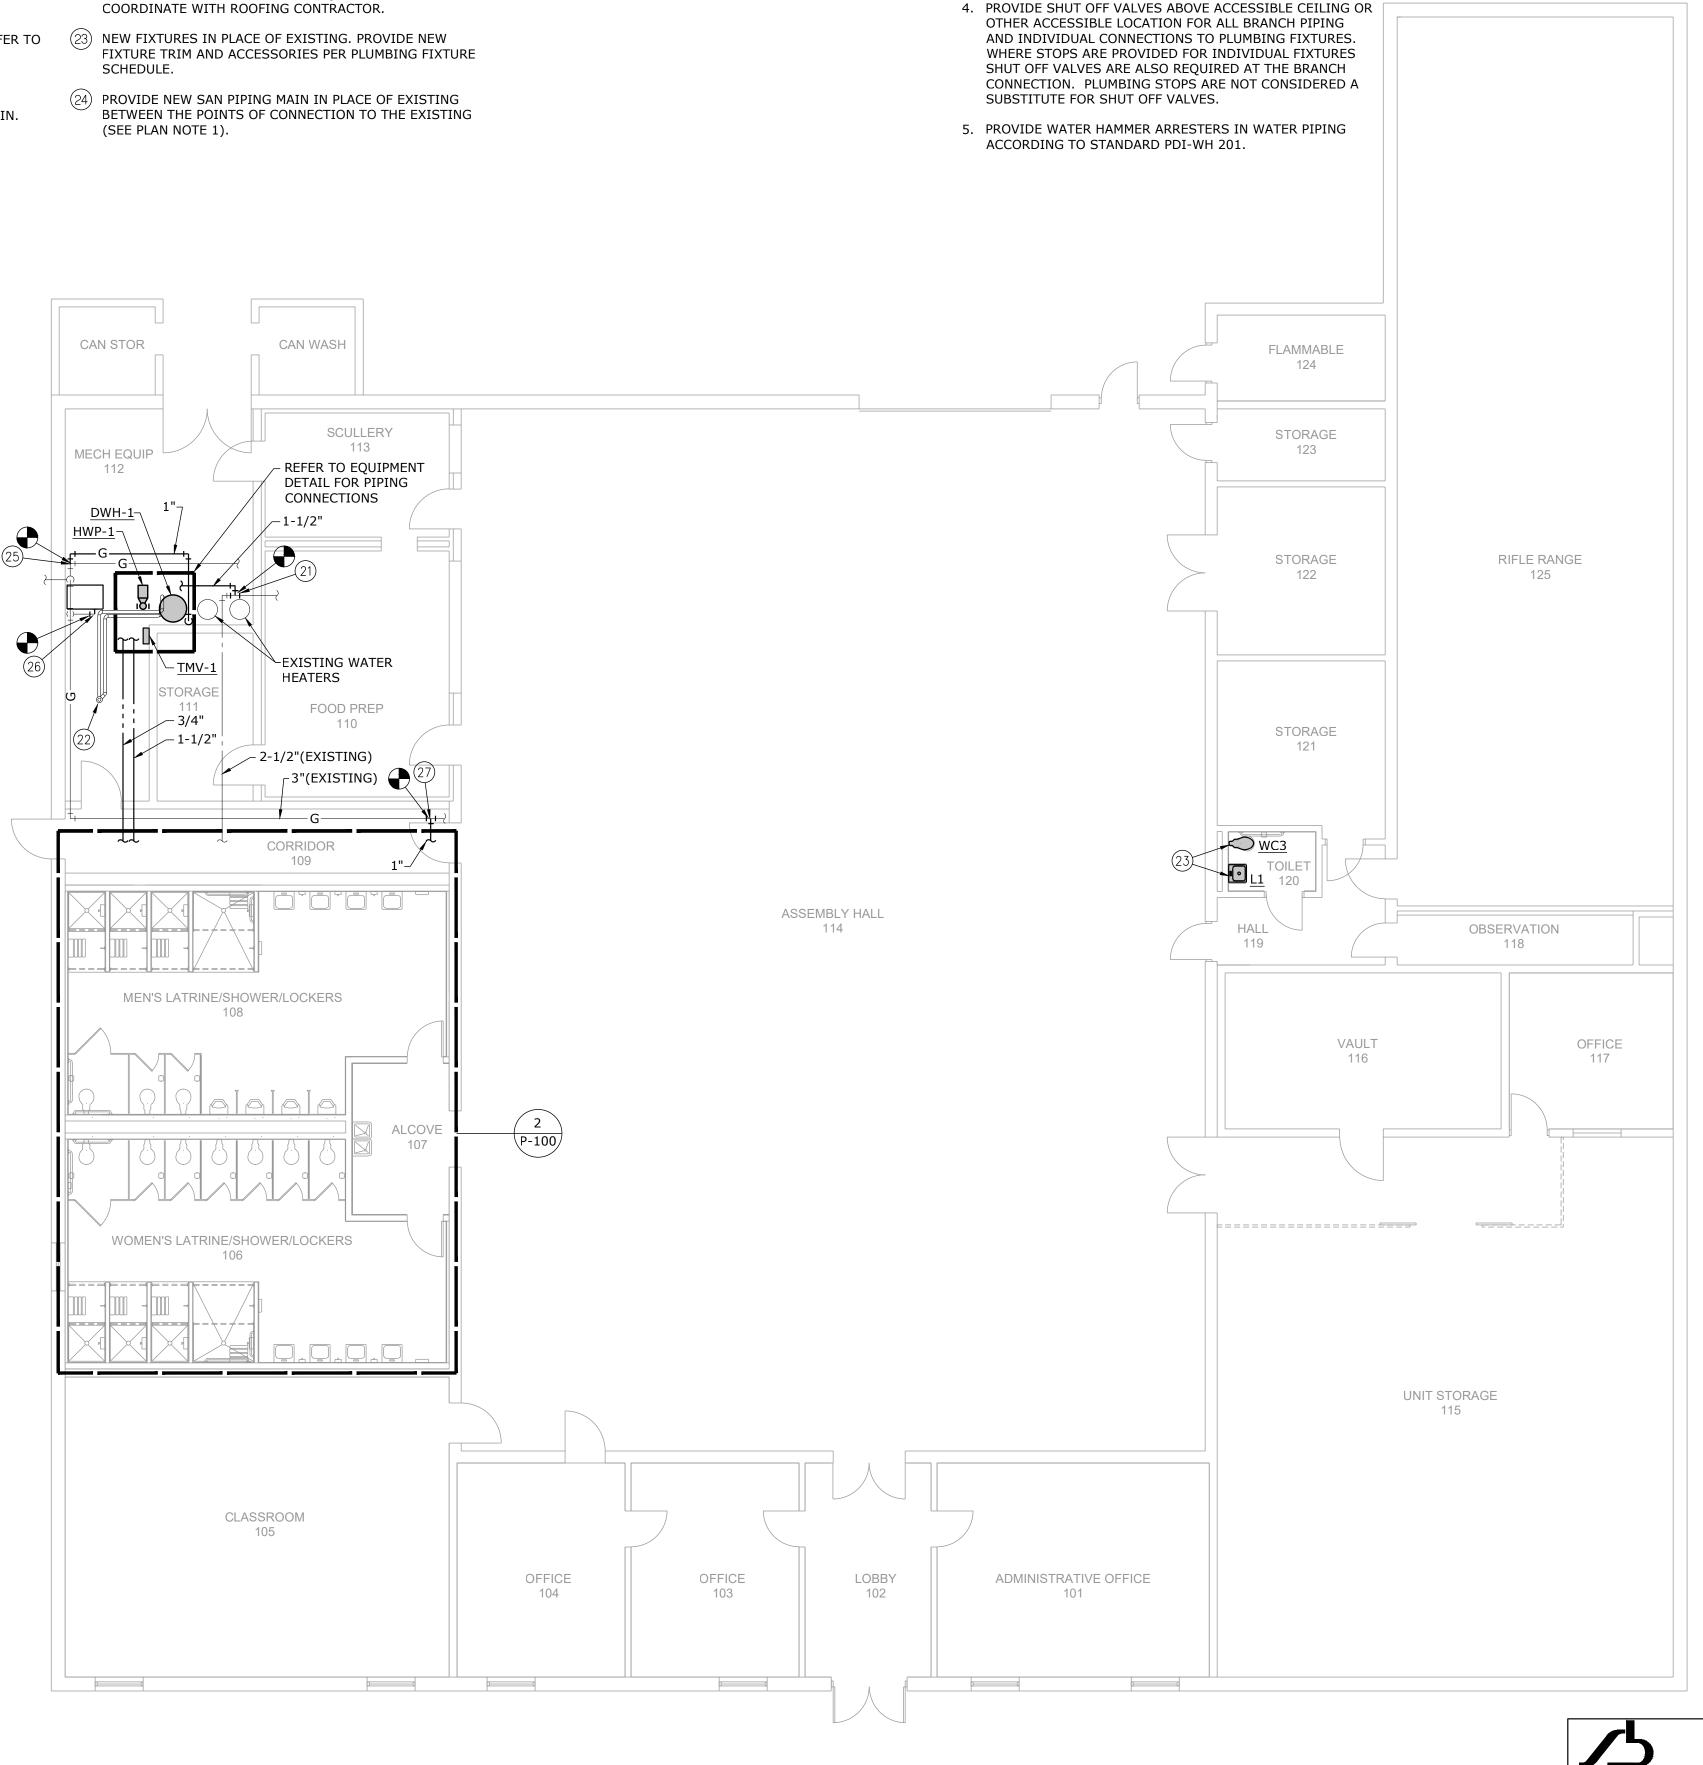


FLOOR PLAN - PLUMBING

SCALE: 1/8" = 1'-0"

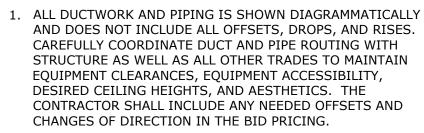



2. COORDINATE ALL PIPING PENETRATIONS WITH STRUCTURAL

3. COORDINATE ALL SLAB CUTTING, REMOVAL, AND PATCHING WITH GENERAL CONTRACTOR AS REQUIRED FOR NEW

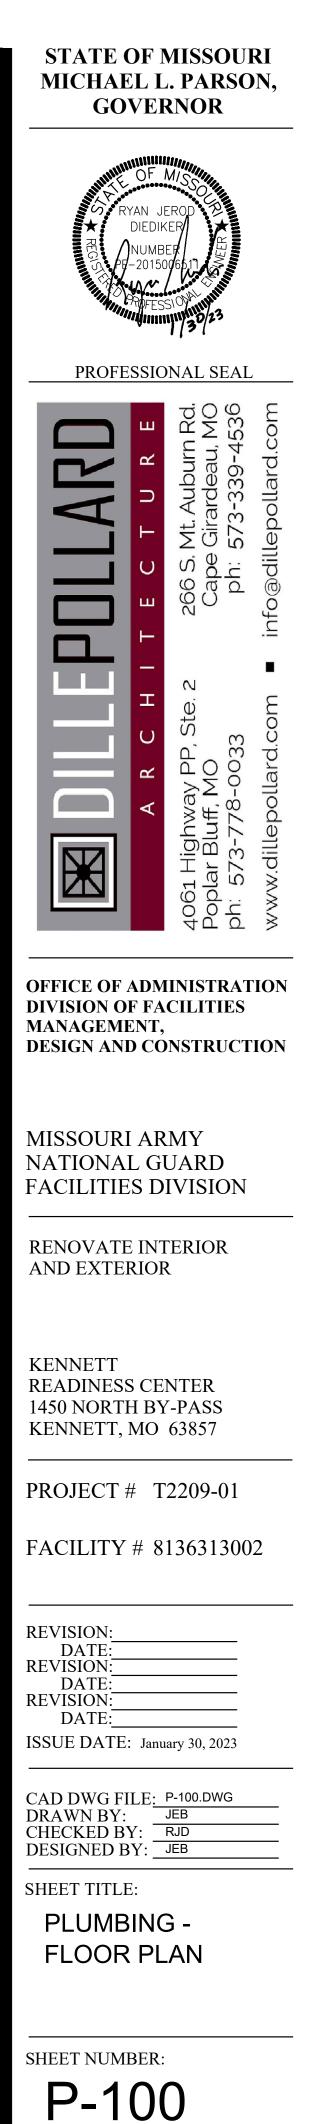

NORTH

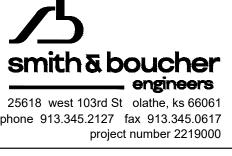

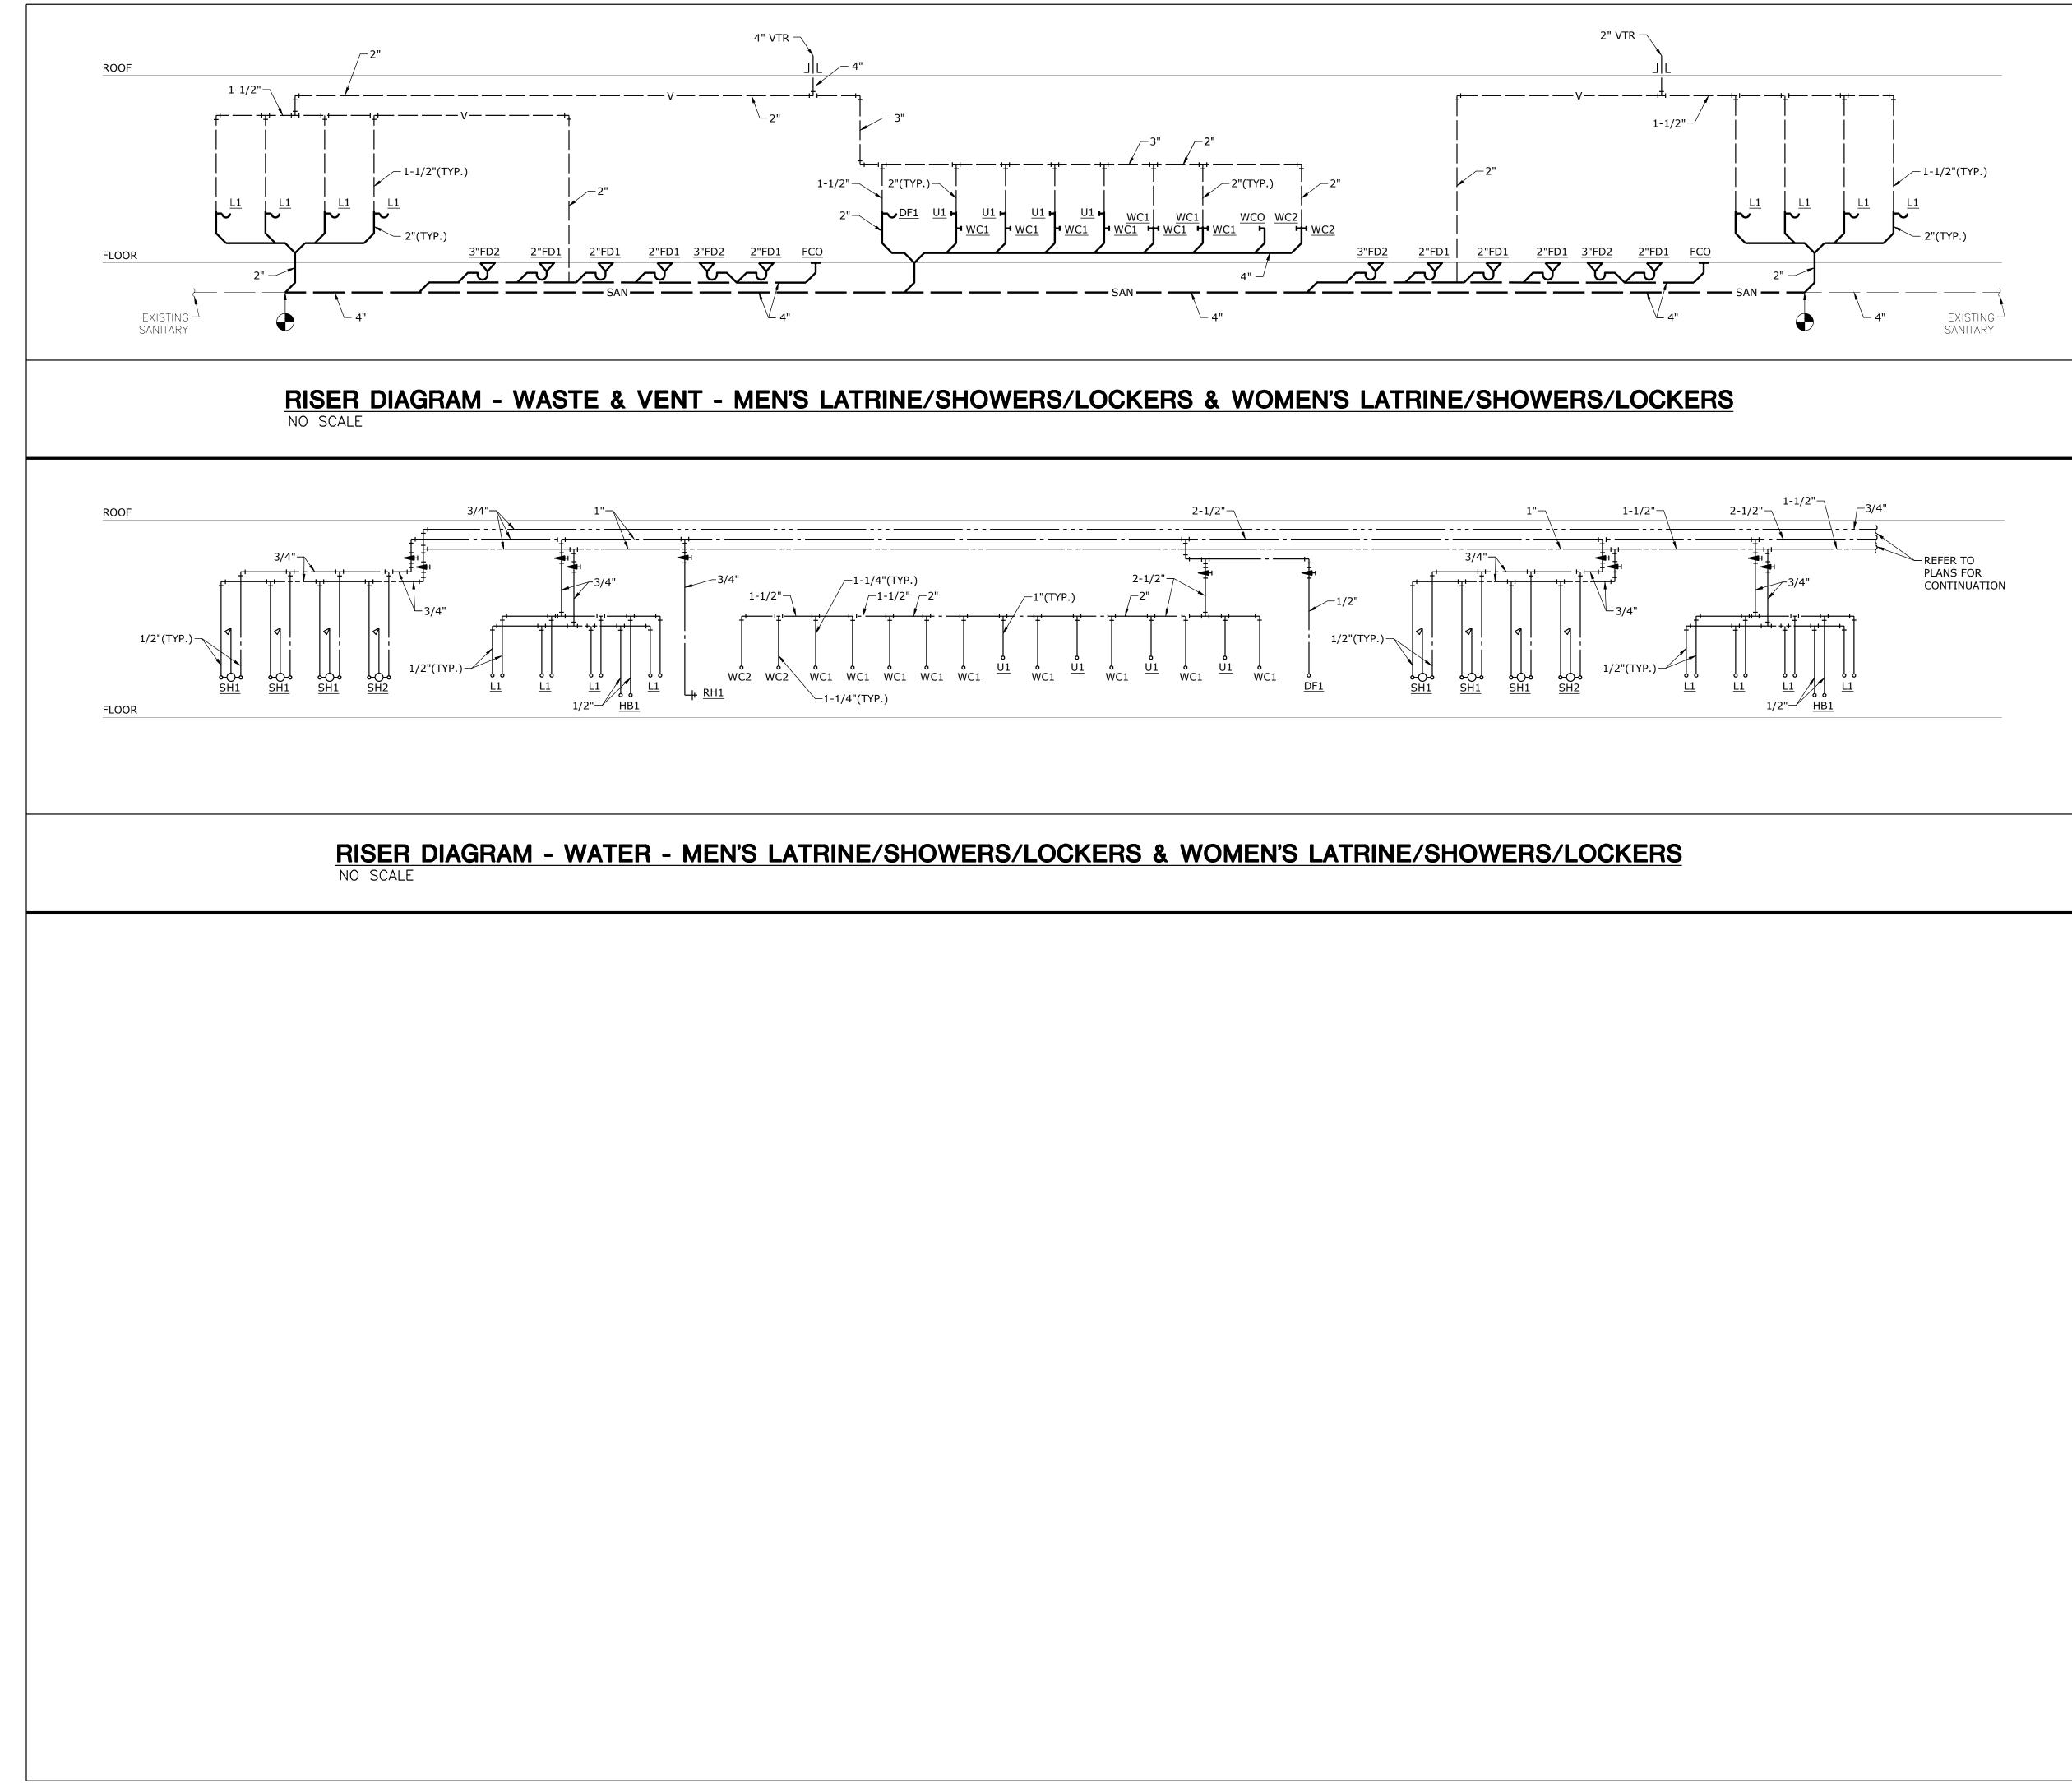

PACE – Kennett Readiness Center X:\22\22190\2219000\Drawings\04-2219000_P-200.dwg Jblackburn Friday, January 27, 2023 1:21:42 PM Booty Charles Friday, January 27, 2023 2:52:06 PM

PROJECT NAME: AUTOCAD FILE LOCATION \ NAME: LAST CORRECTION BY ← DATE ← TIME: PLOTTED BY ← DATE ← TIME:


GENERAL NOTES:

- ALL DUCTWORK AND PIPING IS SHOWN DIAGRAMMATICALLY AND DOES NOT INCLUDE ALL OFFSETS, DROPS, AND RISES. CAREFULLY COORDINATE DUCT AND PIPE ROUTING WITH STRUCTURE AS WELL AS ALL OTHER TRADES TO MAINTAIN EQUIPMENT CLEARANCES, EQUIPMENT ACCESSIBILITY, DESIRED CEILING HEIGHTS, AND AESTHETICS. THE CONTRACTOR SHALL INCLUDE ANY NEEDED OFFSETS AND CHANGES OF DIRECTION IN THE BID PRICING
- COORDINATE ALL PIPING PENETRATIONS WITH STRUCTURA PRIOR TO CORE DRILLING.
- COORDINATE ALL SLAB CUTTING, REMOVAL, AND PATCHING WITH GENERAL CONTRACTOR AS REQUIRED FOR NEW BELOW GRADE PLUMBING WORK.
- PROVIDE SHUT OFF VALVES ABOVE ACCESSIBLE CEILING O OTHER ACCESSIBLE LOCATION FOR ALL BRANCH PIPING AND INDIVIDUAL CONNECTIONS TO PLUMBING FIXTURES. WHERE STOPS ARE PROVIDED FOR INDIVIDUAL FIXTURES SHUT OFF VALVES ARE ALSO REQUIRED AT THE BRANCH CONNECTION. PLUMBING STOPS ARE NOT CONSIDERED A SUBSTITUTE FOR SHUT OFF VALVES.
- PROVIDE WATER HAMMER ARRESTERS IN WATER PIPING ACCORDING TO STANDARD PDI-WH 201.


乙 smith & boucher engineers

25618 west 103rd St olathe, ks 66061 phone 913.345.2127 fax 913.345.0617 project number 2219000

STATE OF MISSOURI MICHAEL L. PARSON, GOVERNOR

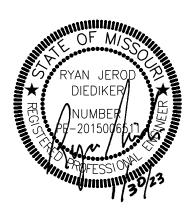

PROFESSIONAL SEAL

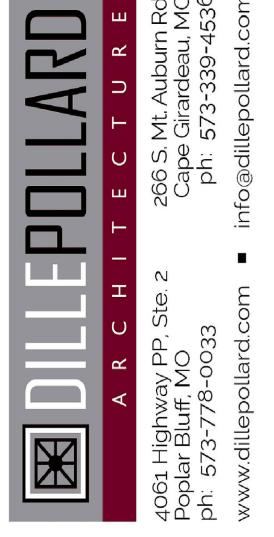

OFFICE OF ADMINISTRATION DIVISION OF FACILITIES MANAGEMENT, **DESIGN AND CONSTRUCTION**

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RENOVATE INTERIOR AND EXTERIOR

KENNETT **READINESS CENTER** 1450 NORTH BY-PASS KENNETT, MO 63857

PROJECT # T2209-01

FACILITY # 8136313002

REVISION:


DATE:
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ISSUE DATE: January 30, 2023

CAD DWG FILE: P-200.DWG DRAWN BY: JEB CHECKED BY: RJD DESIGNED BY: JEB

SHEET TITLE:

RISER DIAGRAM -PLUMBING



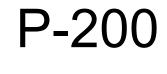


PROJECT NAME: AUTOCAD FILE LOCATION \ NAME: LAST CORRECTION BY ♦ DATE ♦ TIME: PLOTTED BY ♦ DATE ♦ TIME:

PACE – Kennett Readiness Center X:\22\22190\2219000\Drawings\05-2219000_DE-100.dwg Jblackburn Friday, January 27, 2023 10:38:38 AM Booty Charles Friday, January 27, 2023 2:52:17 PM



CAN STOR CAN WASH SCULLERY (E)PANEL 'MDP-1' (E)PANEL 'MDP-2' (E)PANEL 'MDP-3' _____ MECH EQUIP FOOD PREP STORAGE [----] ר----ז נא∟י • t____ WOMEN _ __ _≯_ ר *א*ר אפר c--------• i Ľ L___J MEN LVILVI. 段 7 T - 47 ÷ 5**3-**533 :::•:::\$ 55**-**553 MEN'S LOCKERS CI¥II3 CLASSROOM

3

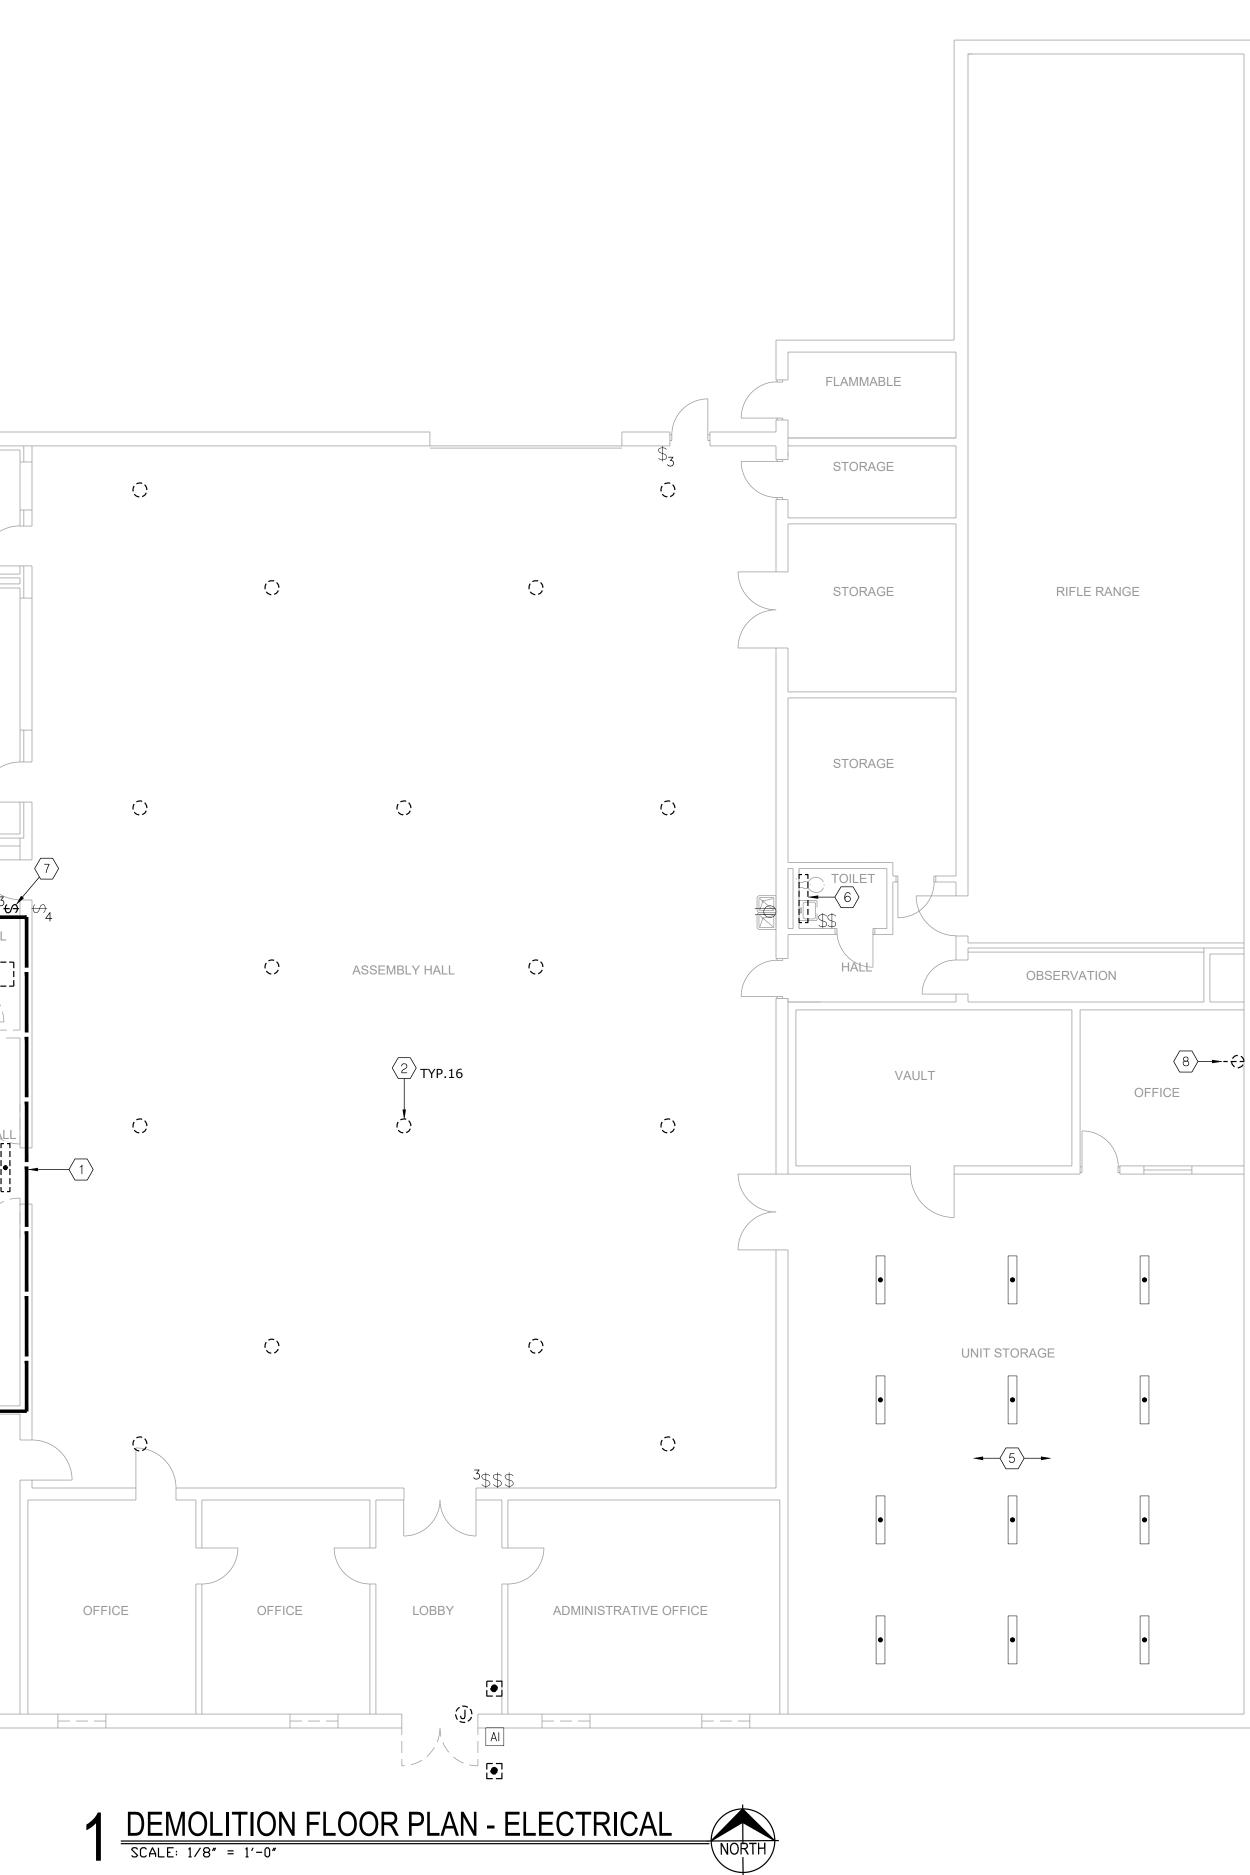

GENERAL DEMOLITION NOTES:

- UNLESS OTHERWISE NOTED, SERVICES AND EQUIPMENT SHOWN WITH BOLD DASHED LINES ARE TO BE DEMOLISHED. SERVICES AND EQUIPMENT SHOWN WITH SOLID HALF TONE LINE WEIGHT ARE TO REMAIN IN PLACE.
- 2. THE EXISTING CONDITIONS INDICATED ON THE DRAWINGS ARE TAKEN FROM THE BEST INFORMATION AVAILABLE AND FROM VISUAL SITE INSPECTION AND ARE NOT TO BE CONSIDERED "AS BUILT" CONDITIONS. THE INFORMATION SHOWN IS TO ESTABLISH THE EXTENT OF THE SCOPE OF WORK. VERIFY ALL ACTUAL EXISTING CONDITIONS AT THE PROJECT SITE AND PERFORM WORK AS REQUIRED TO MEET THE EXISTING CONDITIONS AND THE EXTENT OF THE WORK INDICATED.
- 3. PATCH AND REPAIR ANY INFRASTRUCTURE THAT IS TO REMAIN WHERE ANY SERVICES ARE REMOVED UNLESS NOTED OTHERWISE. DISCONNECT AND REMOVE ALL WIRING, CABLING, RACEWAY AND CONDUIT THAT BECOMES UNNECESSARY AS A RESULT OF THE REMOVAL OF EQUIPMENT INDICATED TO BE REMOVED.
- 4. WHERE MECHANICAL AND ELECTRICAL FIXTURES OR EQUIPMENT ARE REMOVED, CAP ALL UNUSED CONDUIT, WIRING AND PIPING BEHIND THE FLOOR LINE OR WALL LINE TO FACILITATE THE RESTORATION OF FINISH.
- 5. PROVIDE FOR THE CONTINUITY OF ALL REMAINING SERVICES, SYSTEMS, AND CIRCUITS. RELOCATE AND RECONNECT ANY MECHANICAL AND ELECTRICAL FACILITIES THAT MUST BE RELOCATED IN ORDER TO ACCOMPLISH THE REMODELING SHOWN IN THE DRAWINGS OR INDICATED IN THE SPECIFICATIONS.

DEMOLITION PLAN NOTES:

- 1 PROVIDE COMPLETE DEMOLITION OF ALL LIGHT FIXTURES, ASSOCIATED CONDUIT AND CONDUCTORS, AND SWITCHES IN LOCKER ROOM AND SHOWER/RESTROOM. OWNER SHALL HAVE FIRST RIGHT OF REFUSAL OF DEMOLISHED LIGHT FIXTURES.
- 2 PROVIDE DEMOLITION OF HI-BAY LIGHT FIXTURE. SALVAGE CIRCUIT AND SWITCHING FOR REUSE FOR REPLACEMENT FIXTURES PER NEW WORK PLANS.OWNER SHALL HAVE FIRST RIGHT OF REFUSAL OF DEMOLISHED LIGHT FIXTURES.
- 3 ALTERNATE NO.2 PROVIDE DEMOLITION OF EXTERIOR TRANSFER SWITCH. SALVAGE CONDUIT AND CONDUCTORS FOR CONNECTION TO NEW TRANSFER SWITCH PER NEW WORK PLANS.
- 4 TEMPORARILY SUPPORT AND REINSTALL EXISTING LIGHT FIXTURES WITHIN HALL AS REQUIRED TO ACCOMMODATE ABOVE CEILING WORK RELATED TO NEW HVAC AND PLUMBING.
- $\langle 5 \rangle$ EXISTING LIGHT FIXTURES SHOWN FOR REFERENCE. NO WORK.
- 6 PROVIDE DEMOLITION OF LIGHT FIXTURE. SALVAGE CIRCUIT AND SWITCHING FOR REUSE FOR REPLACEMENT FIXTURE PER NEW WORK PLANS.
- (7) PROVIDE DEMOLITION OF 3-WAY LIGHT SWITCH, ASSOCIATED CONDUIT AND CONDUCTORS. REFER TO NEW WORK PLANS FOR RELOCATION.
 MISSOURI ARMY NATIONAL GUAR
- 8 DEMO RECEPTACLE. SALVAGE CIRCUIT AND ASSOCIATED CONDUCTORS TO SERVE NEW MINI-SPLIT SYSTEM PER NEW WORK PLANS. PROVIDE BLANK WALL PLATE.
- 9 RELOCATE/SHIFT AS REQUIRED EXISTING EXHAUST FAN STARTERS ON OTHER SIDE OF EXISTING GAS PIPE TO ACCOMMODATE SPACE FOR NEW ELECTRICAL PANEL PER NEW WORK PLANS.



STATE OF MISSOURI MICHAEL L. PARSON,

GOVERNOR

A R C H I 4061 Highway PP, Ste. 2 Poplar Bluff, MO ph: 573-778-0033 www.dillepollard.com

OFFICE OF ADMINISTRATION DIVISION OF FACILITIES MANAGEMENT, DESIGN AND CONSTRUCTION

MISSOURI ARMY NATIONAL GUARD FACILITIES DIVISION

RENOVATE INTERIOR AND EXTERIOR

KENNETT READINESS CENTER 1450 NORTH BY-PASS KENNETT, MO 63857

PROJECT # T2209-01

FACILITY # 8136313002

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CAD DWG FILE: DE-100.DWG DRAWN BY: JEB CHECKED BY: RJD DESIGNED BY: JEB

SHEET TITLE:

DEMOLITION ELECTRICAL -FLOOR PLAN



26 OF 29 SHEETS

smith & boucher

25618 west 103rd St olathe, ks 66061


phone 913.345.2127 fax 913.345.0617


engineers

project number 2219000



PACE – Kennett Readiness Center X:\22\22190\2219000\Drawings\06-2219000_E-100.dwg Jblackburn Friday, January 27, 2023 10:38:50 AM Booty Charles Friday, January 27, 2023 2:52:31 PM

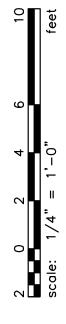

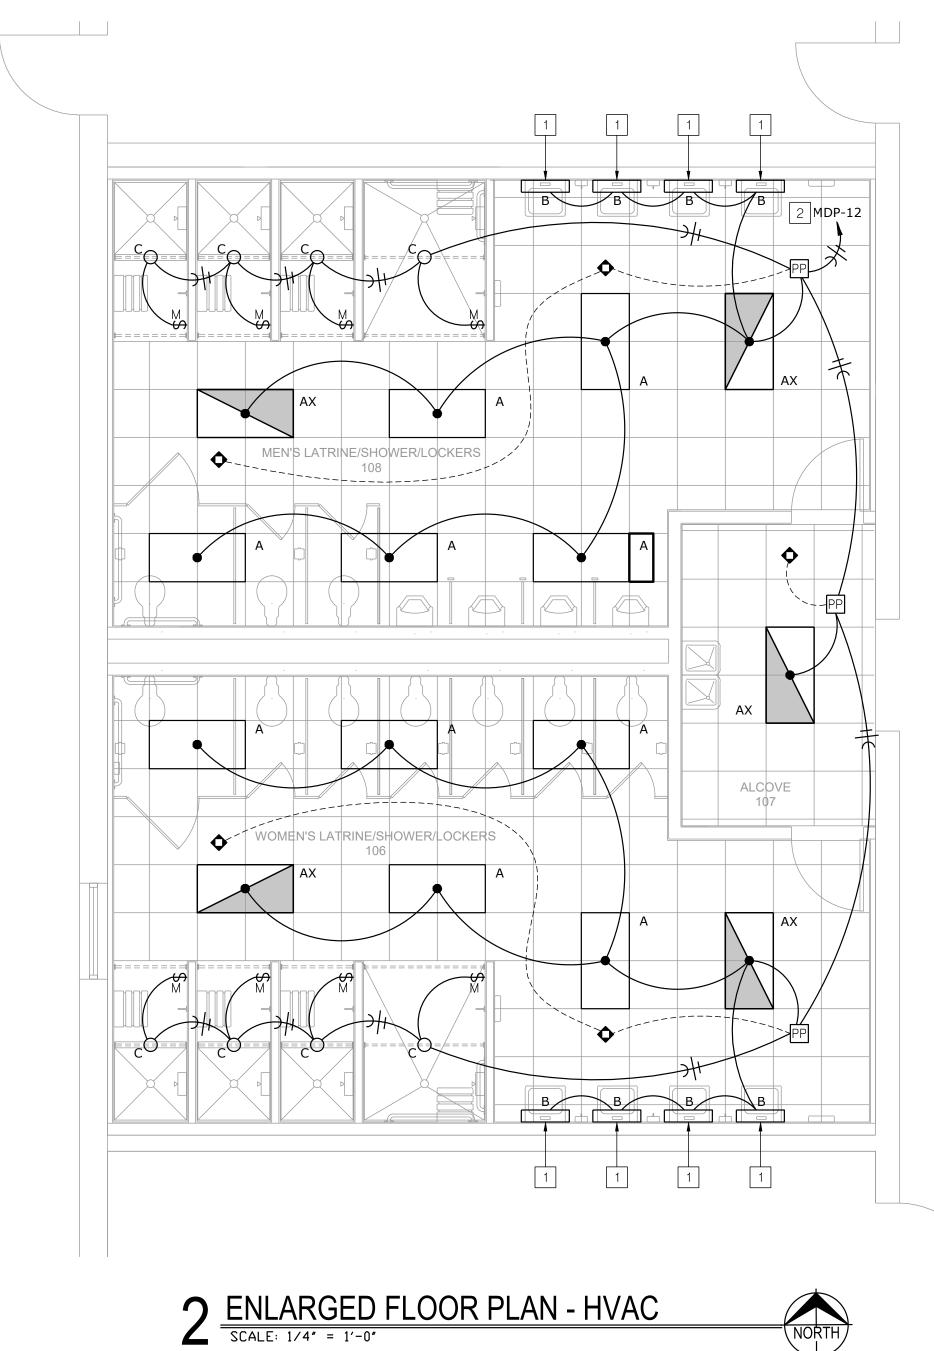


PLAN NOTES:

- 1 WALL MOUNT VANITY FIXTURE. COORDINATE MOUNTING 1. REFER TO M/E SCHEDULES AND DETAILS FOR MECHANICAL HEIGHT ABOVE MIRROR WITH ARCHITECT.
- 2 CIRCUIT TO BREAKER INDICATED THAT SERVED THE DEMOLISHED MEN'S LIGHTING CIRCUIT.
- 3 REPLACE EXISTING FIXTURE WITH NEW AS INDICATED. UTILIZE EXISTING HI-BAY CIRCUIT/SWITCHING.
- 4 TEMPORARILY SUPPORT AND REINSTALL EXISTING LIGHT FIXTURES WITHIN HALL AS REQUIRE TO ACCOMMODATE ABOVE CEILING WORK RELATED TO NEW HVAC AND PLUMBING.
- 5 RELOCATE 3-WAY SWITCH FOR CORRIDOR LIGHTING. EXTEND/MODIFY CIRCUITING AS REQUIRED.

GENERAL NOTES:

- PLANS FOR LOCATIONS.
- ROOM.
- (UNLESS SPECIFICALLY NOTED OTHERWISE)

NORTH

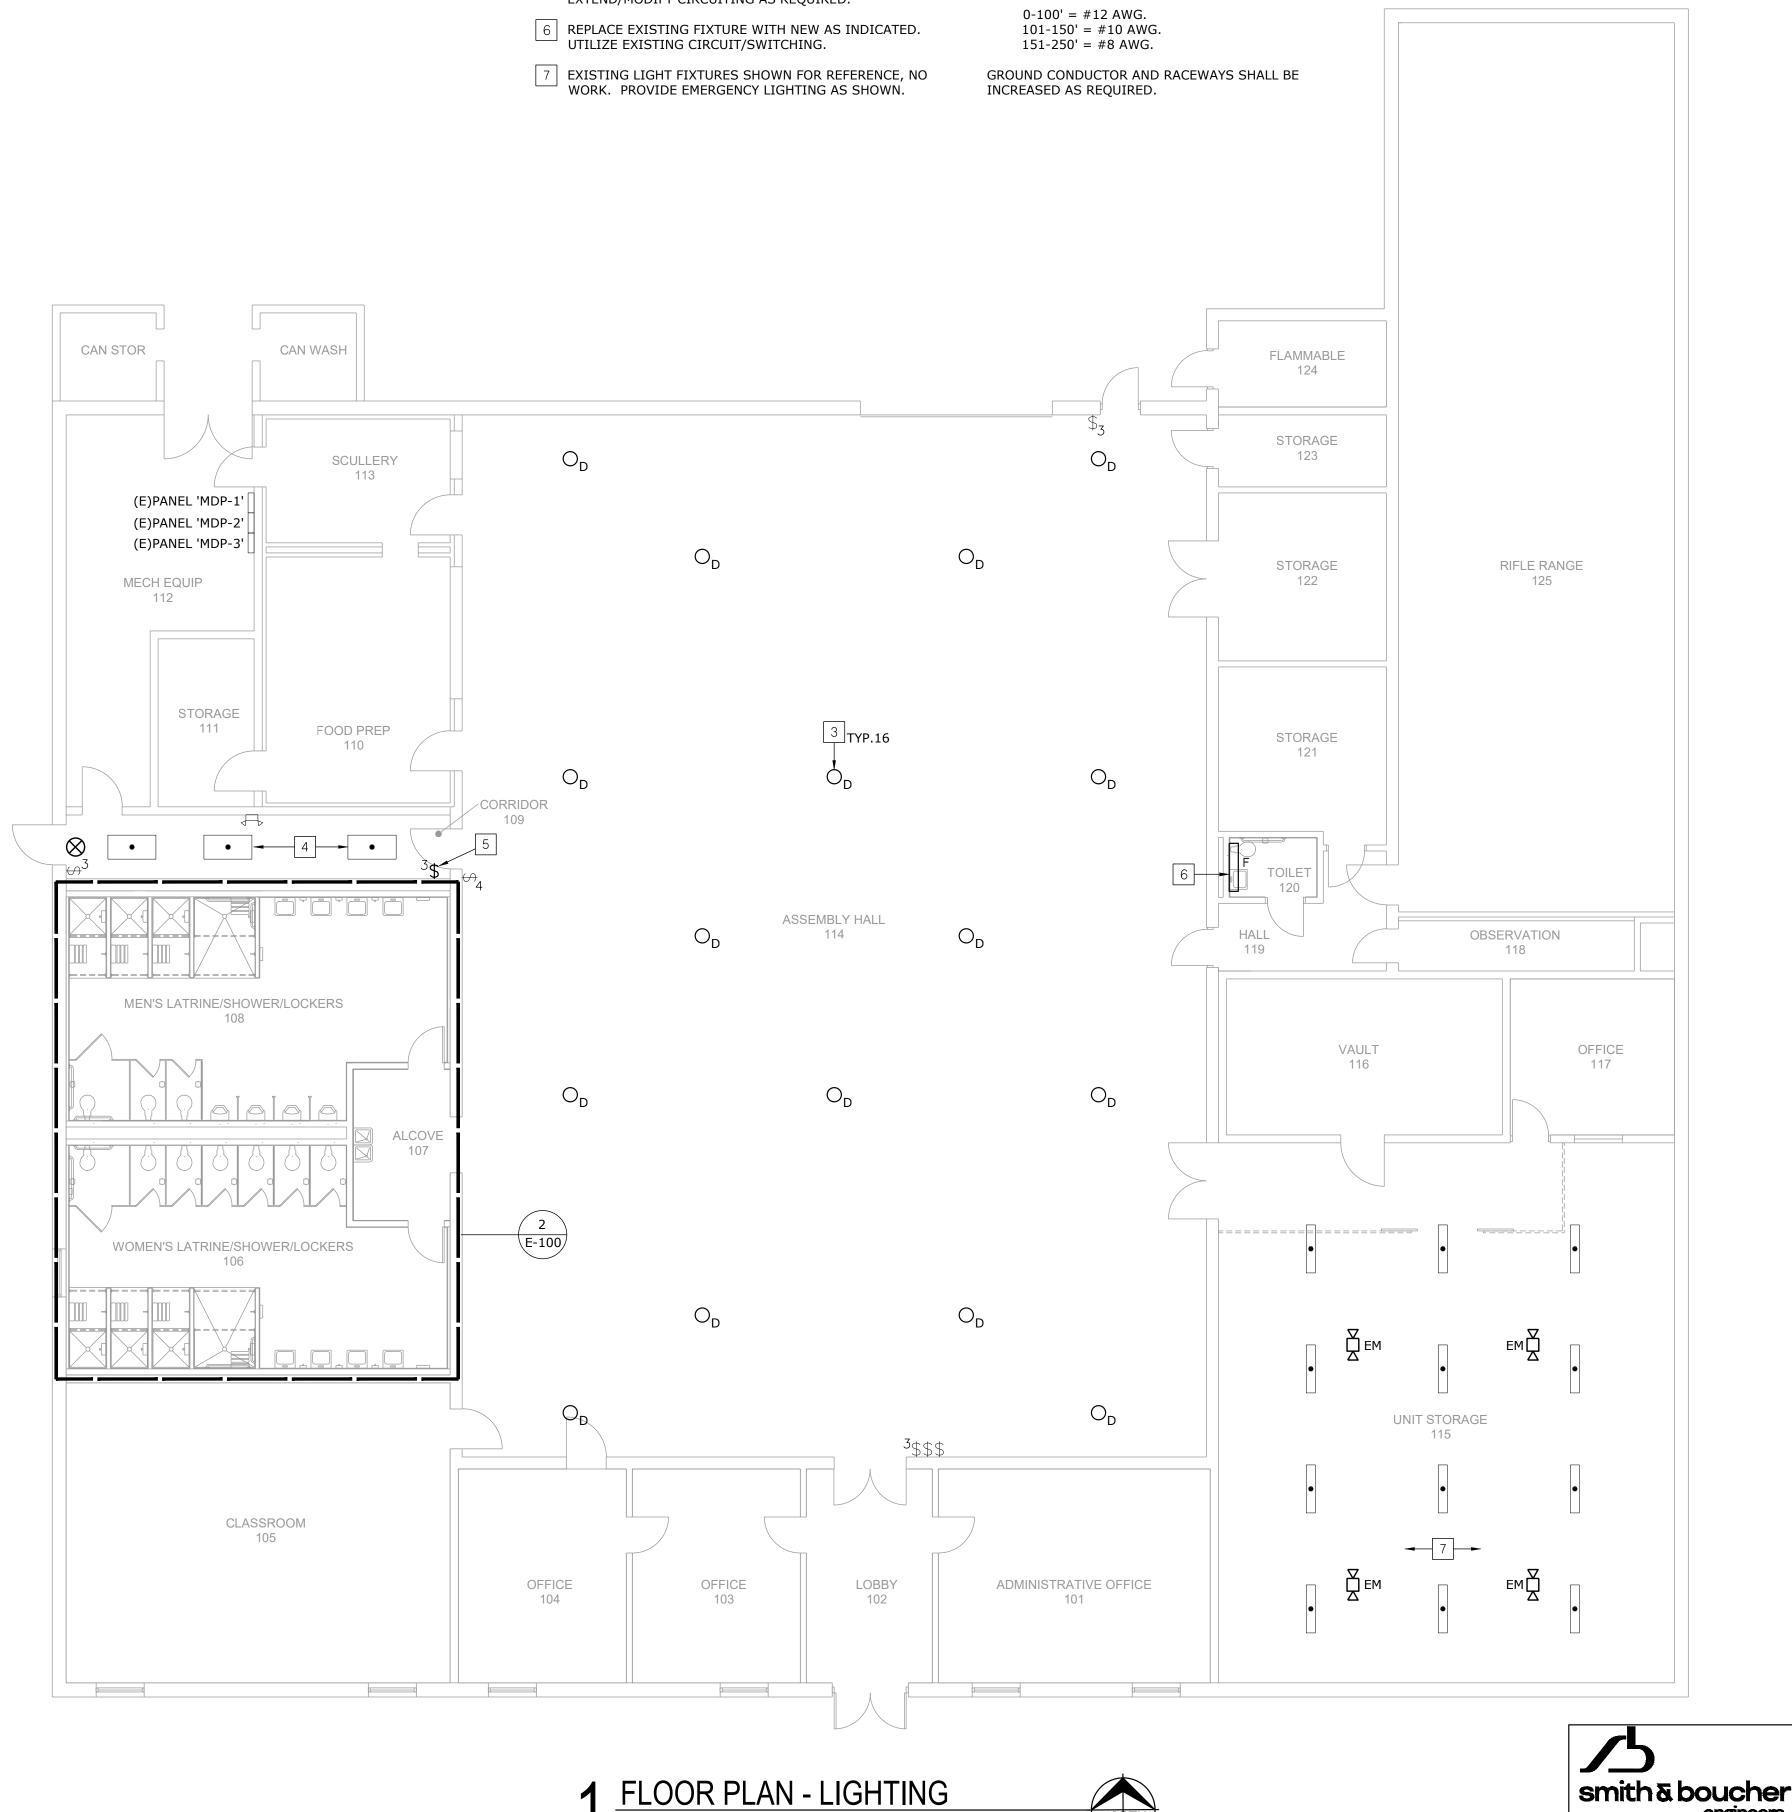


SCALE: 1/8" = 1'-0"

EQUIPMENT CIRCUITING INFORMATION.


2. PROVIDE (1) 1/2" CONDUIT FROM ALL THERMOSTATS UP TO ABOVE NEAREST ACCESSIBLE CEILING OR TO ASSOCIATED HVAC EQUIPMENT. REFER TO MECHANICAL

3. CIRCUIT ALL EMERGENCY FIXTURES, EMERGENCY BATTERIES AND EXIT SIGNS TO UNSWITCHED HOT CONDUCTOR OF CIRCUIT SERVING SAME OR ADJACENT

4. 120V BRANCH CIRCUITING SHALL BE AS FOLLOWS:

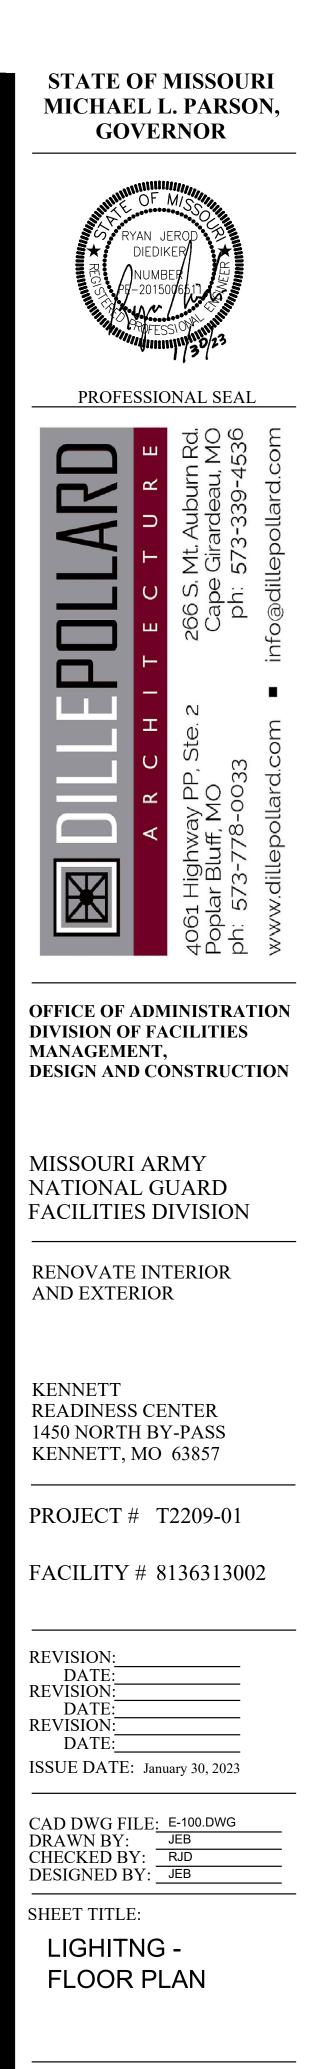

SHEET NUMBER: E-100

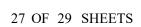

project number 2219000

25618 west 103rd St olathe, ks 66061

phone 913.345.2127 fax 913.345.0617

PROJECT NAME: AUTOCAD FILE LOCATION \ NAME: LAST CORRECTION BY ♦ DATE ♦ TIME: PLOTTED BY ♦ DATE ♦ TIME:

PACE – Kennett Readiness Center X:\22\22190\2219000\Drawings\06-2219000_E-200.dwg Jblackburn Friday, January 27, 2023 2:01:17 PM Booty Charles Friday, January 27, 2023 2:52:42 PM

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PE <u>HWP-1</u>¬ 10 <u>F-1</u> \bigcirc MECH EQUIP STORAGE 112 111 PE 🔼 <u>HP-2</u> PE FOOD PREP 110 5 B-9 (PART) `×⊂₽ 109 F RAR 42" 42" GFI GFI ┢╴╴╴╺┫┢╸╴╴╺┫┢╴╴╴╴→ B-5 PE MEN'S LATRINE/SHOWER/LOCKERS 108 ALCOVE E E GF. PE WOMEN'S LATRINE/SHOWER/LOCKERS 106 B-3 GFI GFI GFI 42" 42" 42" CLASSROOM 105 PE 🔼

CAN STOR

<u>DWH-1</u>-

L

(E)PANEL 'MDP-1'

(E)PANEL 'MDP-2'-

(E)PANEL 'MDP-3'-

CAN WASH

SCULLERY

113

PE FL



GENERAL NOTES:

1. REFER TO GENERAL NOTES, SHEET E-100.

PLAN NOTES:

- 1 CIRCUIT NEW PANEL 'B' VIA EXISTING PANEL 'MDP-1', 'MDP-2', OR 'MDP-3'. CONDUIT/WIRE SHALL BE (4)#4,#10G.,1-1/4"C. FIELD DETERMINE THE MOST FEASIBLE PANEL WHICH TO USE TO SERVE THE NEW PANEL 'B'. IN THE EXISTING PANEL UTILIZED, THREE (3) 20A, 120V RECEPTACLE LOADS WILL BE REQUIRED TO BE RELOCATED AND PROTECTED VIA THE NEW PANEL 'B' IN ORDER TO ACCOMMODATE THE NEW PANEL 'B' OCPD (60A-3P CB).
- PROVIDE MONITORING OF EXISTING KITCHEN HOOD WITH NEW FIRE ALARM PANEL. FIELD DETERMINE REQUIREMENTS WITH EXISTING HOOD SYSTEM.
- 3 COORDINATE REPLACEMENT OF EXISTING ADA DOOR OPENER MOTOR, ASSOCIATED ADA DOOR PUSH BUTTON, AND CABLING WITH DOOR HARDWARE PROVIDER. REUSE EXISTING POWER SUPPLY, LOW VOLTAGE CONDUIT AND BOXES WHERE POSSIBLE. FIELD DETERMINE EXACT REQUIREMENTS.
- 4 ALTERNATE NO.1 PROVIDE CONDUIT AND CABLING AS REQUIRED FOR DOOR HARDWARE REQUIRED FOR REMOTE LOCK/UNLOCKING WITHIN MAIN OFFICE. COORDINATE WITH DOOR HARDWARE PROVIDER AND OWNER'S SECURITY CONTRACTOR. FIELD DETERMINE EXACT REQUIREMENTS.
- 5 LOCATION OF NEW FIRE ALARM PANEL.
- 6 LOCATION OF NEW FIRE ALARM PANEL REMOTE ANNUNCIATOR PANEL.
- 7 EXISTING AI PHONE.
- 8 ALTERNATE NO.2 600A, 120/208V, 3 PHASE MANUAL TRANSFER SWITCH CABINET WITH GENERATOR CAM-LOK CONNECTIONS, THREE POSITION MANUAL OPERATING HANDLE, 3R ENCLOSURE, PAD MOUNT. BASES OF DESIGN ASCO MODEL #J-03MTQ-B-3-0600-C-00-M. EQUALS BY EATON, KOHLER POWER SYSTEMS, SIEMENS, CUMMINS POWER GENERATION, RUSS ELECTRIC.
- WITHIN THE EXISTING 'MDP' PANEL(S), SIX (6) 20A, 120V RECEPTACLE LOADS WILL BE REQUIRED TO BE RELOCATED AND PROTECTED VIA THE NEW PANEL 'B' IN ORDER TO ACCOMMODATE THE OCPD FOR CU-1, F-1, AND DOAS-1. REFER TO M/E SCHEDULES FOR EQUIPMENT CIRCUITING INFORMATION. FIELD DETERMINE MOST FEASIBLE EXISTING LOADS TO RELOCATE.
- 10 RELOCATE EXHAUST FAN STARTERS.

HP-1

11 UTILIZE EXISTING CIRCUIT AND CONDUCTORS SERVING DEMOLISHED PTAC UNIT TO SERVE NEW MINI-SPLIT SYSTEM. REFER TO EQUIPMENT SCHEDULE. FIELD VERIFY EXACT REQUIREMENTS.



STATE OF MISSOURI MICHAEL L. PARSON,

GOVERNOR

PROFESSIONAL SEAL S

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RENOVATE INTERIOR AND EXTERIOR

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CAD DWG FILE: E-200.DWG DRAWN BY: JEB CHECKED BY: RJD DESIGNED BY: JEB

SHEET TITLE: POWER -FLOOR PLAN



28 OF 29 SHEETS

SHEET NUMBER:


E-200

TYPE	DESCRIPTION	MOUNTING	LAMP	VOLTS	MANUFACTURER	V-A
А	2'-0" X 4'-0" LED PANEL, MATTE WHITE PAINT, OPAQUE WHITE ACRYLIC LENS,	RECESSED	3,400 LUMEN	UNV	METALUX 24FP	29
AX	INTEGRAL DRIVER THAT IS COMPATIBLE WITH SUBMITED LIGHTING CONTROLS.	GRID	3500K		CREE C-TR-C	
			80 CRI		LITHONIA CPX	
	(X) = PROVIDE WITH 10W EMERGENCY BATTERY PACK FOR 90 MIN. BACKUP				COLUMBIA CFP	
					OR PRE-BID APPROVED EQUAL	
В	2'-0" LED VANITY LIGHT, MATTE WHITE PAINT, EXTRUDED ALUMINUM HOUSING,	SURFACE	1,600 LUMEN	UNV	WILLIAMS AX2WD	15
	FROSTED ACRYLIC LENS, INTEGRAL DRIVER THAT IS COMPATIBLE WITH	WALL	3500K		EXTANT HUNTINGTON 1	
	SUBMITTED LIGHTING CONTROLS.		80 CRI		ALW LIGHTPLANE 2	
					OR PRE-BID APPROVED EQUAL	
С	4.5" ROUND APERTURE LED DOWNLIGHT, WHITE TEXTURE POWDER COAT,	RECESSED	1,500 LUMEN	UNV	WILLIAMS 4DR SERIES	14
	WIDE DISTRIBUTION, FLUSH SHOWER TRIM WITH ACRYLIC LENS, INTEGRAL DRIVER	GYP	3500K		PORTFOLIO LD4A SERIES	
	THAT IS COMPATIBLE WITH SUBMITTED LIGHTING CONTROLS.		80 CRI		CREE SERIES KR4	
					LITONIA LDN4 SERIES	
					OR PRE-BID APPROVED EQUAL	
D	11"(TO 14") ROUND COMPACT LED HIGH BAY FIXTURE, DIE CAST ALUMINUM	CABLE VIA	18,000 LUMEN	UNV	METALUX UHB	153
	HOUSING, WHITE POWDER-COATED FINISH, INTEGRAL DRIVER, WIRE GUARD.	RING BOLT	4000K		KEYSTONE KT-RHLED	
			80 CRI		SUNCO HB-UFO	
					PRE-BID APPROVED EQUAL	
F	4'-0" LED VANITY LIGHT, MATTE WHITE PAINT, EXTRUDED ALUMINUM HOUSING,	SURFACE	3,300 LUMEN	UNV	WILLIAMS AX2WD	41
	FROSTED ACRYLIC LENS, INTEGRAL DRIVER.	WALL	3500K		EXTANT HUNTINGTON 1	
			80 CRI		ALW LIGHTPLANE 2	
					OR PRE-BID APPROVED EQUAL	
SF1	LED EXTERIOR FLOOD LIGHT, DIE CAST ALUMINUM HOUSING, HEAVY DUTY	CONCRETE	3,000 LUMEN	UNV	INVUE SERIES VFS	35
	DIE-CAST ALUMINUM KNUCKLE, MOUNT KNUCKLE ON CONCRETE BASE PER	BASE /	3000K		LITHONIA SERIES DSXF1	
	MANUFACTURER'S RECOMMENDATION, TIGHT SPOT DISTRIBUTION, SOFTENING	ARCH J-BOX	80 CRI		GARDCO SERIES DFL7	
	GLASS, BUTTON PHOTOCELL. COORDINATE DESIRED FINISH WITH ARCHITECT.				OR PRE-BID APPROVED EQUAL	
SL1	LED SINGLE HEAD PARKING LOT EXTERIOR POLE MOUNTED FIXTURE. TYPE	25'-0" POLE +	56,200 LUMEN	UNV	LITHONIA	369
	T4W DIST, FULL CUTOFF, TWIST LOCK PHOTOCELL. POLE TO MATCH FIXTURE	2'-6" CONCRETE	5000K		RSX4 LED P3 50K MVOLT SPA DDBXD	
	FINISH - DARK BRONZE. 25'-0" X 5" SQUARE STEEL POLE.	BASE	80 CRI		(FIXTURE TO MATCH EXISTING)	
	FIXTURE AND FIXTURE POLE SHALL MATCH EXISTING - NO EQUALS.					

PANEL	B (Note 2	2)				
MAIN BUS AMPS: MAIN BREAKER: VOLTAGE: PHASES/WIRES:	100 A N/A 208Y/120 V 3 PH / 4 W	M	CTIONS:	TYPE:	10,000 A 1-24 SPACE SURFACE NEMA 1	
	SCRIPTION	POLES	AMPS	CKT NO	CKT NO	
F	IRE ALARM PANEL	1	20 -LCK	1	2	
RCPT-W	OMEN'S LATRENE	1	20	3	4	
RCF	'T-MEN'S LATRENE	1	20	5	6	
RCPT-D	RINKING FOUNTAIN	1	20	7	8	
RCPT-GENERAL	PURPOSE, ROOF	1	20	9	10	0000000
PUMP HWP-1, WATE	ER HEATER DHW-1	1	20	11	12	
SOUTH PA	RKING LOT LIGHTS	2	20	13	14	
F	LAG POLE LIGHTS			15	16	
	SPARE	1	20	17	18	
	SPARE	1	20	19	20	
	SPARE	1	20	21	22	
	SPARE	1	20	23	24	

MAIN LUGS ONLY EQUIPMENT GROUND BUS CIRCUIT DESCRIPTION 1 CIRCUIT (NOTE 1) 20 CIRCUIT (NOTE 1) 20 20 CIRCUIT (NOTE 1) 20 CIRCUIT (NOTE 1) 20 20 20 20 CIRCUIT (NOTE 1) CIRCUIT (NOTE 1) CIRCUIT (NOTE 1) 1 CIRCUIT (NOTE 1) 1 CIRCUIT (NOTE 1) 20 1 SPARE 1 SPARE 20 20 20 1 SPARE GFI - GROUND FAULT BREAKER 1. RELOCATED GENERAL RECEPTACLE CIRCUIT FROM EXISTING PANEL. IDENTIFY LCK - LOCKABLE TAB AND PROVIDE PROPER CIRCUIT DESCRIPTION. 2: PANEL SERVED VIA 60A-3P CB IN EXISTING MDP-1, MDP-2, OR MDP-3 PANEL. THE E.C. SHALL FIELD DETERMINE EXISTING PANEL TO UTILIZE.

PROJECT NAME: AUTOCAD FILE LOCATION \ NAME: LAST CORRECTION BY ← DATE ← TIME: PLOTTED BY ← DATE ← TIME:

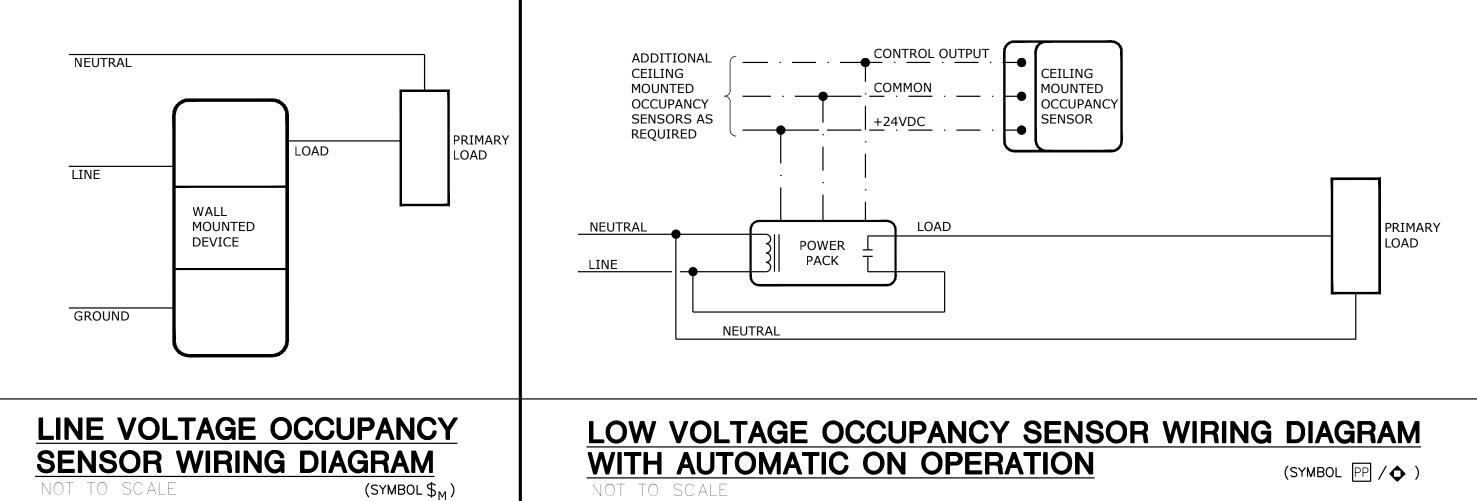


INTERIOR LIGHTING CONTROL EQUIPMENT LEGEND						
SYMBOL	FUNCTION	SYSTEM WIRING	MOUNTING	SETTING(TYPICAL)	MANUFACTURER	NOTES
\$ _M	SWITCH	LINE VOLTAGE	WALL SWITCH	ON: MANUAL OFF: 30 MINUTE DELAY	WATTSTOPPER PW-100	NOTE 1
\$	MOTION SENSOR	LOW VOLTAGE	CEILING	ON: AUTOMATIC OFF: 30 MINUTE DELAY	WATTSTOPPER DT-300	NOTE 1,2,4
PP	POWER PACK	DIGITAL	CEILING		WATTSTOPPER BZ-50	NOTE 1,3

NOTE 1: THE MANUFACTURERS AND MODELS LISTED ARE THE BASIS OF DESIGN, ALL PRODUCT SUBSTITUTIONS SUBMITTED MUST BE APPROVED AS EQUAL. REFER TO DRAWINGS FOR QUANTITIES.

NOTE 2: PROVIDE 8'-0" OF EXCESS CONTROL WIRING, COILED AND TIED, BETWEEN CEILING MOUNTED OCCUPANCY SENSORS AND CORRESPONDING POWER PACKS. NOTE 3: LOCATE DEVICE ABOVE ACCESSIBLE CEILING, LOCATIONS SHOWN ON DRAWINGS ARE SCHEMATIC.

NOTE 4: MODIFY LOCATIONS OF CEILING MOUNTED OCCUPANCY SENSORS AS REQUIRED SO THAT NO OCCUPANCY SENSOR IS WITHIN 4'-0" OF AN HVAC SUPPLY DIFFUSER.

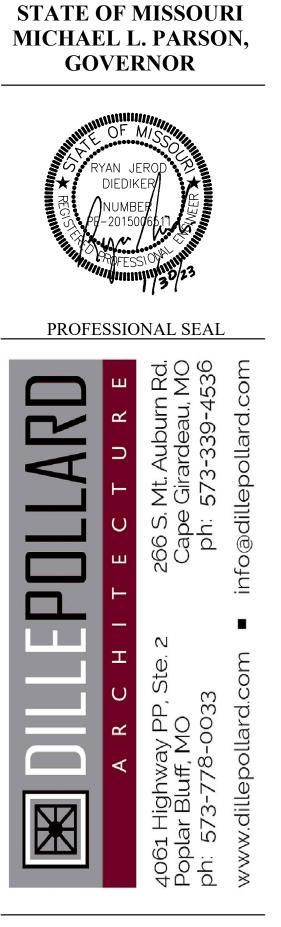

OFFICE OF ADMINISTRATION DIVISION OF FACILITIES MANAGEMENT, **DESIGN AND CONSTRUCTION**

MISSOURI ARMY NATIONAL GUARD FACILITIES DIVISION

RENOVATE INTERIOR AND EXTERIOR

KENNETT **READINESS CENTER** 1450 NORTH BY-PASS KENNETT, MO 63857

PROJECT # T2209-01

FACILITY # 8136313002

REVISION:

DATE:
REVISION:
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REVISION:
DATE:
ISSUE DATE: January 30, 2023

CAD DWG FILE: E-300.DWG DRAWN BY: JEB CHECKED BY: RJD DESIGNED BY: JEB

SHEET TITLE:

ELECTRICAL -SCHEDULES & DETAILS



