# REPLACE COURTYARD STEPS & ADD ADA RAMP - USPFO BUILDING

IKE SKELTON TRAINING SITE JEFFERSON CITY, MISSOURI



STATE OF MISSOURI MICHAEL L. PARSON,

GOVERNOR

OWNER:

DEPARTMENT OF NATIONAL GUARD

**PROJECT** OFFICE OF ADMINISTRATION

DIVISION OF FACILITIES MANAGEMENT, MANAGEMENT:

**DESIGN AND CONSTRUCTION** 

CONNELL ARCHITECTURE, P.C.

2311 East Walnut Sreet Suite B Columbia, Missouri 65201

573-875-2455

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DESIGNER: CONNELL ARCHITECTURE, P.C.

2311 EAST WALNUT STREET SUITE B


COLUMBIA, MISSOURI 65201

T2223-01 PROJECT NUMBER:

SITE NUMBER: ASSET NUMBER:

6300 8136300005




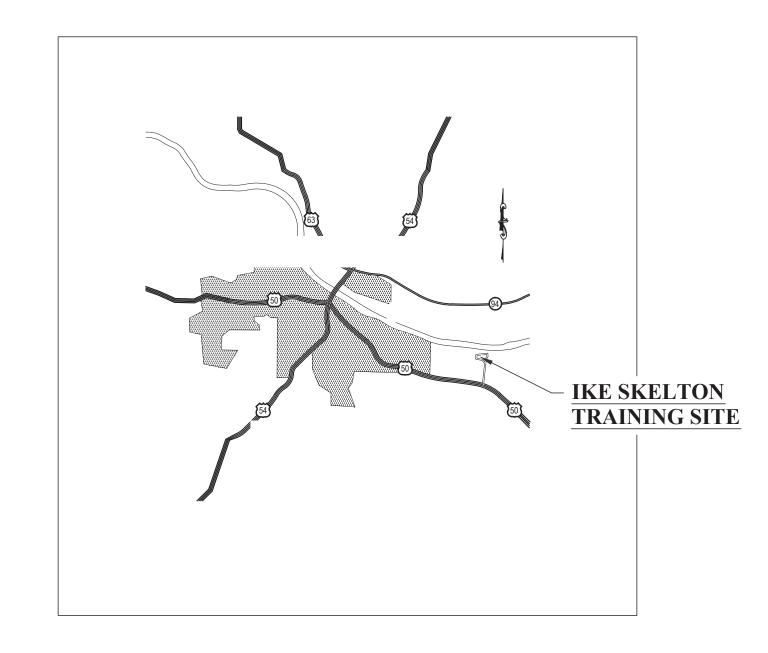







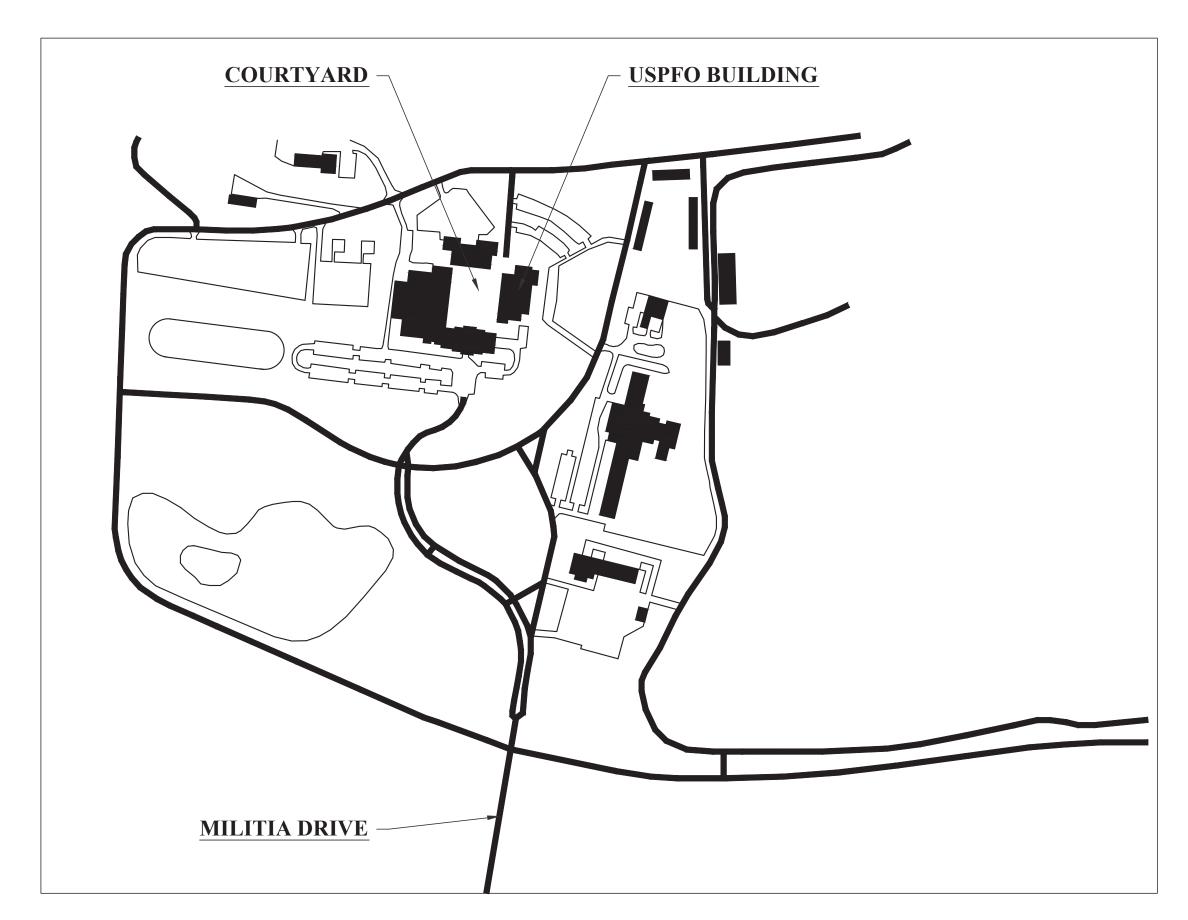

# VICINITY MAP - IKE SKELTON TRAINING SITE

#### **SITE UTILITIES NOTE:**

THE CONTRACTOR SHALL CONTACT MISSOURI ONE CALL AT 1-800-344-7483 OR ONLINE AT mo1call.com AND REQUEST A LOCATE OF ALL PUBLIC AND PRIVATE UTILITIES PRIOR TO THE COMMENCEMENT OF ANY LAND DISTURBANCE ACTIVITIES.

THE CONTRACTOR IS RESPONSIBLE FOR ANY DAMAGE TO SITE UTILITIES OR DISRUPTION OF UTILITY SERVICE TO THE OWNER RESULTING FROM THE WORK OF THIS

#### **GENERAL NOTES:**

IT IS THE RESPONSIBILITY OF THE GENERAL CONTRACTOR AND EACH SUBCONTRACTOR TO REVIEW THE DRAWINGS TO ASSURE COORDINATION OF ALL WORL AFFECTING EACH TRADE. FAILURE TO REVIEW ALL CONTRACT DOCUMENTS FOR APPLICABLE ITEMS OF WORL SHALL NOT RELIEVE THE RESPONSIBLE PARTY FROM PERFORMING ALL WOR REDUIRED BY THE CONTRACT DOCUMENTS.

- 1. DRAWINGS THESE DRAWINGS SHALL NOT BE SCALED. REFER TO DIMENSIONS INDICATED, ACTUAL SIZES OF CONSTRUCTION ITEMS, OR OTHER RELIABLE METHODS OF LOCATING CONSTRUCTION. WHERE NO DIMENSION OR METHOD OF DETERMINING A LOCATION IS GIVEN, VERIFY CORRECT LOCATION WITH CONNELL ARCHITECTURE P.C. PRIOR TO INSTALLATION.
- 2. DIMENSIONS DIMENSIONS ON PLANS ARE FROM FACE OF CONCRETE, MASONRY, OR FRAMING UNLESS OTHERWISE NOTED. DIMENSIONS INDICATED AS "CLEAR" ARE CRITICAL FOR MINIMUM REI UIRED CLEARANCES AND SHALL BE A MINIMUM DIMENSION MEASURED FROM FACE OF FINISH MATERIALS.
- 3. COORDINATION GENERAL CONTRACTOR SHALL COORDINATE RED UIREMENTS OF ALL TRADES TO ALLOW FOR TIMELY INCLUSION IN THE WOR! SO AS NOT TO DELAY THE WOR! OR THE WOR! OF ANY SUBCONTRACTOR.
- 4. EXISTING CONDITIONS THE EXISTING CONDITIONS SHOWN ON THESE DRAWINGS ARE DERIVED FROM OBSERVATIONS AND MEASUREMENTS TAIL EN DURING SITE VISITS AND FROM ARCHIVE INFORMATION PROVIDED BY THE OWNER. THE CONTRACTOR SHALL VERIFY ALL EXISTING CONDITIONS ON THE 11 OB SITE AND NOTIFY THE CONSTRUCTION ADMINISTRATOR OF DEVIATIONS FROM THESE DRAWINGS PRIOR TO FABRICATION AND INSTALLATION OF THE WOR ...
- 5. PRECAUTIONS CONTRACTOR SHALL IMMEDIATELY REPORT ANY UNFORESEEN CONDITIONS DISCOVERED IN THE WORD WHICH COULD RESULT IN DAMAGE TO THE STRUCTURE OR INDURY TO THE OCCUPANTS TO THE OWNER'S REPRESENTATIVE AND THE CONSTRUCTION ADMINISTRATOR. IMPLEMENT NECESSARY PRECAUTIONS TO PROPERLY SUPPORT THE STRUCTURE AND PROTECT THE OCCUPANTS.
- 6. HAZARDOUS MATERIALS CONTRACTOR SHALL IMMEDIATELY REPORT THE DISCOVERY OF ANY HAZARDOUS MATERIALS TO THE OWNERIS REPRESENTATIVE AND CONSTRUCTION ADMINISTRATOR.
- 7. SITE UTILIZATION USE OF THE SITE FOR ANY CONSTRUCTION STAGING OR OTHER OPERATIONS SHALL BE COORDINATED WITH THE OWNER'S REPRESENTATIVE AND CONSTRUCTION ADMINISTRATOR. THE CONTRACTORIS OPERATIONS SHALL NOT OBSTRUCT OR ADVERSELY AFFECT ANY PUBLIC RIGHT-OF-WAY OR AD ACENT PROPERTIES.
- 8. EXIT ACCESS MAINTAIN FREE, SAFE, AND APPROVED MEANS OF EGRESS IN AND OUT OF PROJECT LOCATION AND EXISTING OCCUPIED BUILDINGS IN ACCORDANCE WITH REIL UIREMENTS OF APPLICABLE REGULATORY AGENCIES.
- 9. CONTRACTOR SHALL FURNISH & INSTALL ALL SYSTEMS, MATERIALS, COMPONENTS AND ACCESSORIES REI UIRED FOR A COMPLETE INSTALLATION, WHETHER OR NOT ALL SUCH MATERIALS & DETAILS OF INSTALLATION HAVE BEEN SPECIFICALLY MENTIONED OR SHOWN ON THE CONSTRUCTION DRAWINGS. ALL INSTALLATION AND DETAILS TO CONFORM TO MANUFACTURERIS WRITTEN SPECIFICATIONS AND RECOMMENDATIONS.
- 10. ANY AND ALL MATERIALS NOTED "TO REMAIN" ARE EXISTING MATERIALS TO REMAIN A PART OF THE WORL UNLESS OTHERWISE NOTED. ANY MATERIAL NOT DESIGNATED "TO REMAIN" SHALL BE REMOVED AND DISPOSED OF IN A LEGAL MANNER. AND REPLACED WITH NEW MATERIALS UNLESS OTHERWISE NOTED.
- 11. SITE UTILITIES THE CONTRACTOR SHALL BE RESPONSIBLE FOR VERIFYING THE LOCATION OF ANY EXISTING PUBLIC AND PRIVATE UTILITIES LOCATED WITHIN PROXIMITY OF THE LIMITS OF WOR

#### ACCESSIBILITY NOTES (COURTYARD STEPS & RAMP)

- 1. COMPLIANCE WITH 2021 IBC CHAPTER 11 ACCESSIBILITY.
- 2. COMPLIANCE WITH ICC ANSI A117-1-2017 FOR ACCESSIBLE ROUTES.

#### DRAWING SHEET INDEX: (CD SUBMITTAL)

#### **ARCHITECTURAL DRAWINGS**

COVER PAGE (1 OF 11)

LOCATION MAPS & DRAWING INDEX (2 OF 11)

COURTYARD PLAN - BASE BID & ALTERNATES No. 1 & 2 (3 OF 11) USPFO BUILDING FLOOR PLAN - ENTRANCE DOORS (4 OF 11)

#### **CIVIL/SITE DRAWINGS**

**DEMOLITION PLAN (5 OF 11)** SITE PLAN & RAMP DETAILS (6 OF 11)

#### STRUCTURAL DRAWINGS

GENERAL DATA - PARTIAL SITE PLAN (7 OF 11) **RETAINING WALL DETAILS (8 OF 11)** 

#### **ELECTRICAL DRAWINGS**

LIGHTING PLAN - COURTYARD (9 OF 11) POWER PLAN - USPFO BUILDING (10 OF 11) **ELECTRICAL DETAILS & SCHEDULES (11 OF 11)** 

#### STATE OF MISSOURI MICHAEL L. PARSON, **GOVERNOR**



BRIAN DOUGLAS CONNELL ARCHITECT MO A-5036



**OFFICE OF ADMINISTRATION DIVISION OF FACILITIES** MANAGEMENT, DESIGN AND CONSTRUCTION

**MISSOURI ARMY** NATIONAL GUARD

REPLACE COURTYARD STEPS & ADD ADA RAMP -**USPFO BUILDING** 

IKE SKELTON TRAINING SITE 7101 MILITARY CIRCLE **JEFFERSON CITY, MO 65101** 

PROJECT No. T2223-01 6300 8136300005

**REVISION: REVISION**: DATE:

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ASSET No.

**ISSUE DATE: 7/28/2023 CAD DWG FILE:** 

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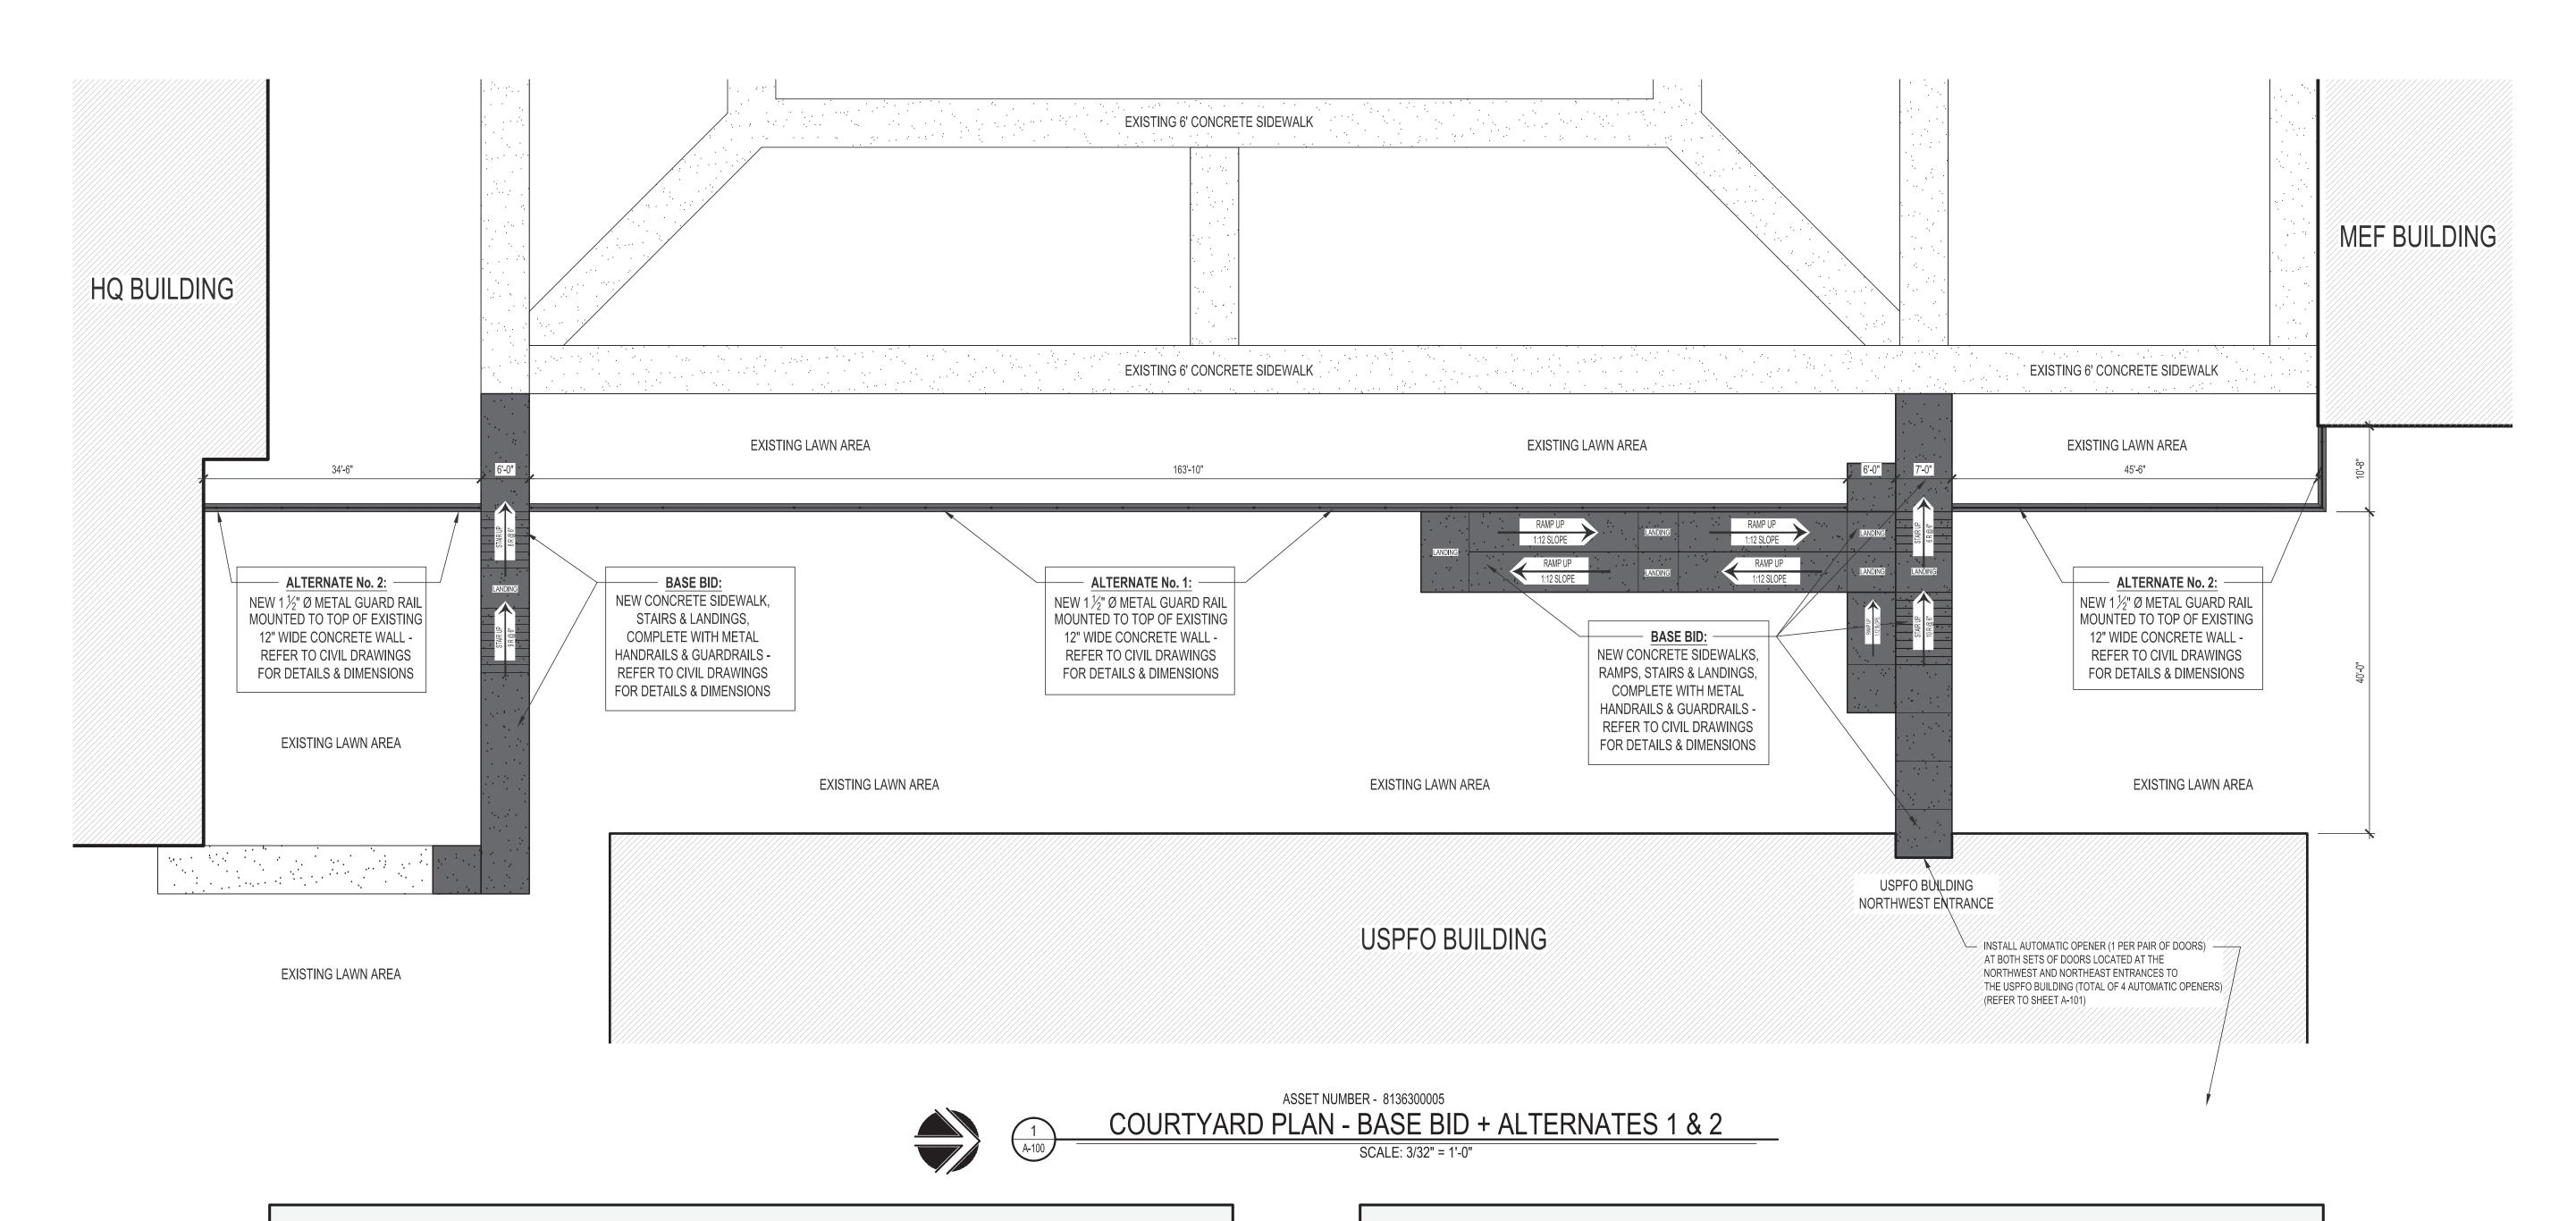
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**LOCATION MAPS & DRAWING INDEX** 

**SHEET NUMBER:** 

G-001SHEET 2 OF 1

**ISSUE DATE: 7/28/2023** 



## BASE BID:

THE SCOPE OF THE BASE BID INCLUDES BUT IS NOT LIMITED TO:

- SELECTIVE DEMOLITION OF EXISTING DAMAGED OR DETERIORATED CONCRETE SIDEWALKS, STEPS, LANDINGS AND PORTIONS OF THE EXISTING CONCRETE RETAINING WALL, INCLUDING METAL HANDRAILS AS SHOWN ON THE CIVIL DRAWINGS.
- RELOCATE EXISTING TREES, SHRUBS, OUTDOOR FURNITURE AS SHOWN ON THE CIVIL DRAWINGS.
- EXCAVATION, BACKFILLING, COMPACTION AND GRADING REQUIRED TO ACCOMMODATE NEW CONSTRUCTION AS SHOWN ON THE CIVIL DRAWINGS.
- CONSTRUCTION OF NEW CONCRETE SIDEWALKS, FOOTINGS, FOUNDATION WALLS, RAMPS, STAIRS, AND LANDINGS AS SHOWN ON THE CIVIL DRAWINGS.
- INSTALLATION OF NEW METAL HANDRAILS AND GUARDRAILS AS SHOWN ON THE CIVIL DRAWINGS.
- INSTALLATION OF NEW SITE LIGHTING AS SHOWN ON THE MEP DRAWINGS.
- INSTALLATION OF NEW DIRECTIONAL AND INFORMATIONAL SIGNAGE.
- INSTALLATION OF AUTOMATIC OPERATORS ON USPFO ENTRANCE DOORS.

# **ALTERNATE No. 1:**

THE SCOPE OF ALTERNATE No. 1 INCLUDES BUT IS NOT LIMITED TO:

INSTALLATION OF NEW METAL GUARDRAIL ON TOP OF THE EXISTING 12"
WIDE CONCRETE RETAINING WALLS IN LOCATIONS AS SHOWN ON DETAIL
1/A-100 AND AS SHOWN ON THE CIVIL DRAWINGS.

(APPROXIMATELY 164 LINEAR FEET OF 42" HIGH GUARD RAIL)

## **ALTERNATE No. 2:**

THE SCOPE OF ALTERNATE No. 2 INCLUDES BUT IS NOT LIMITED TO:

INSTALLATION OF NEW METAL GUARDRAIL ON TOP OF THE EXISTING 12"
WIDE CONCRETE RETAINING WALLS IN LOCATIONS AS SHOWN ON DETAIL
1/A-100 AND AS SHOWN ON THE CIVIL DRAWINGS.
(APPROXIMATELY 90 LINEAR FEET OF 42" HIGH GUARD RAIL)

STATE OF MISSOURI MICHAEL L. PARSON, GOVERNOR



7/28/2023
BRIAN DOUGLAS CONNELL ARCHITECT MO A-5036

CONNELL ARCHITECTURE, P.C. 2311 East Walnut Street Suite B Columbia, Missouri 65201 573-875-2455 Cell: 573-268-6166

OFFICE OF
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MISSOURI ARMY NATIONAL GUARD

REPLACE COURTYARD STEPS & ADD ADA RAMP -USPFO BUILDING

IKE SKELTON TRAINING SITE 7101 MILITARY CIRCLE JEFFERSON CITY, MO 65101

PROJECT No. T2223-01
SITE No. 6300
ASSET No. 8136300005

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CAD DWG FILE:

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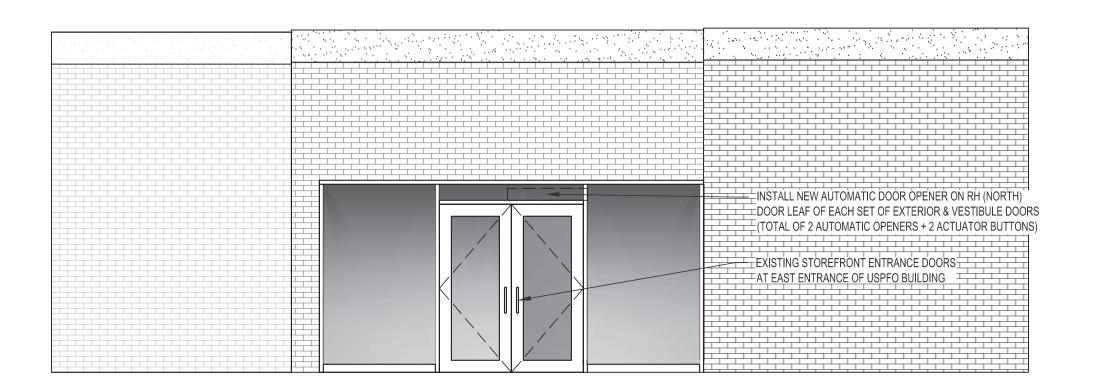
COURTYARD PLAN -BASE BID +


ALTERNATES No. 1 & 2

SHEET NUMBER:

A-100


SHEET 3 OF 11 ISSUE DATE: 7/28/2023



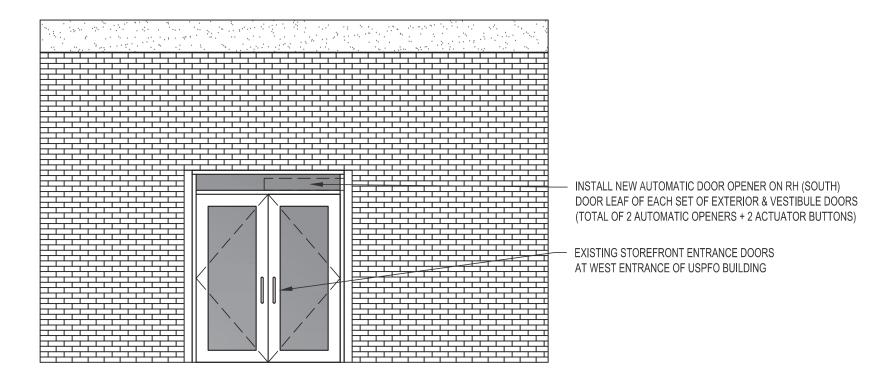

EXTERIOR ELEVATION - USPFO BLDG WEST ENTRANCE DOORS SCALE: 1/4" = 1'-0"


EXTERIOR ELEVATION - USPFO BLDG EAST ENTRANCE DOORS

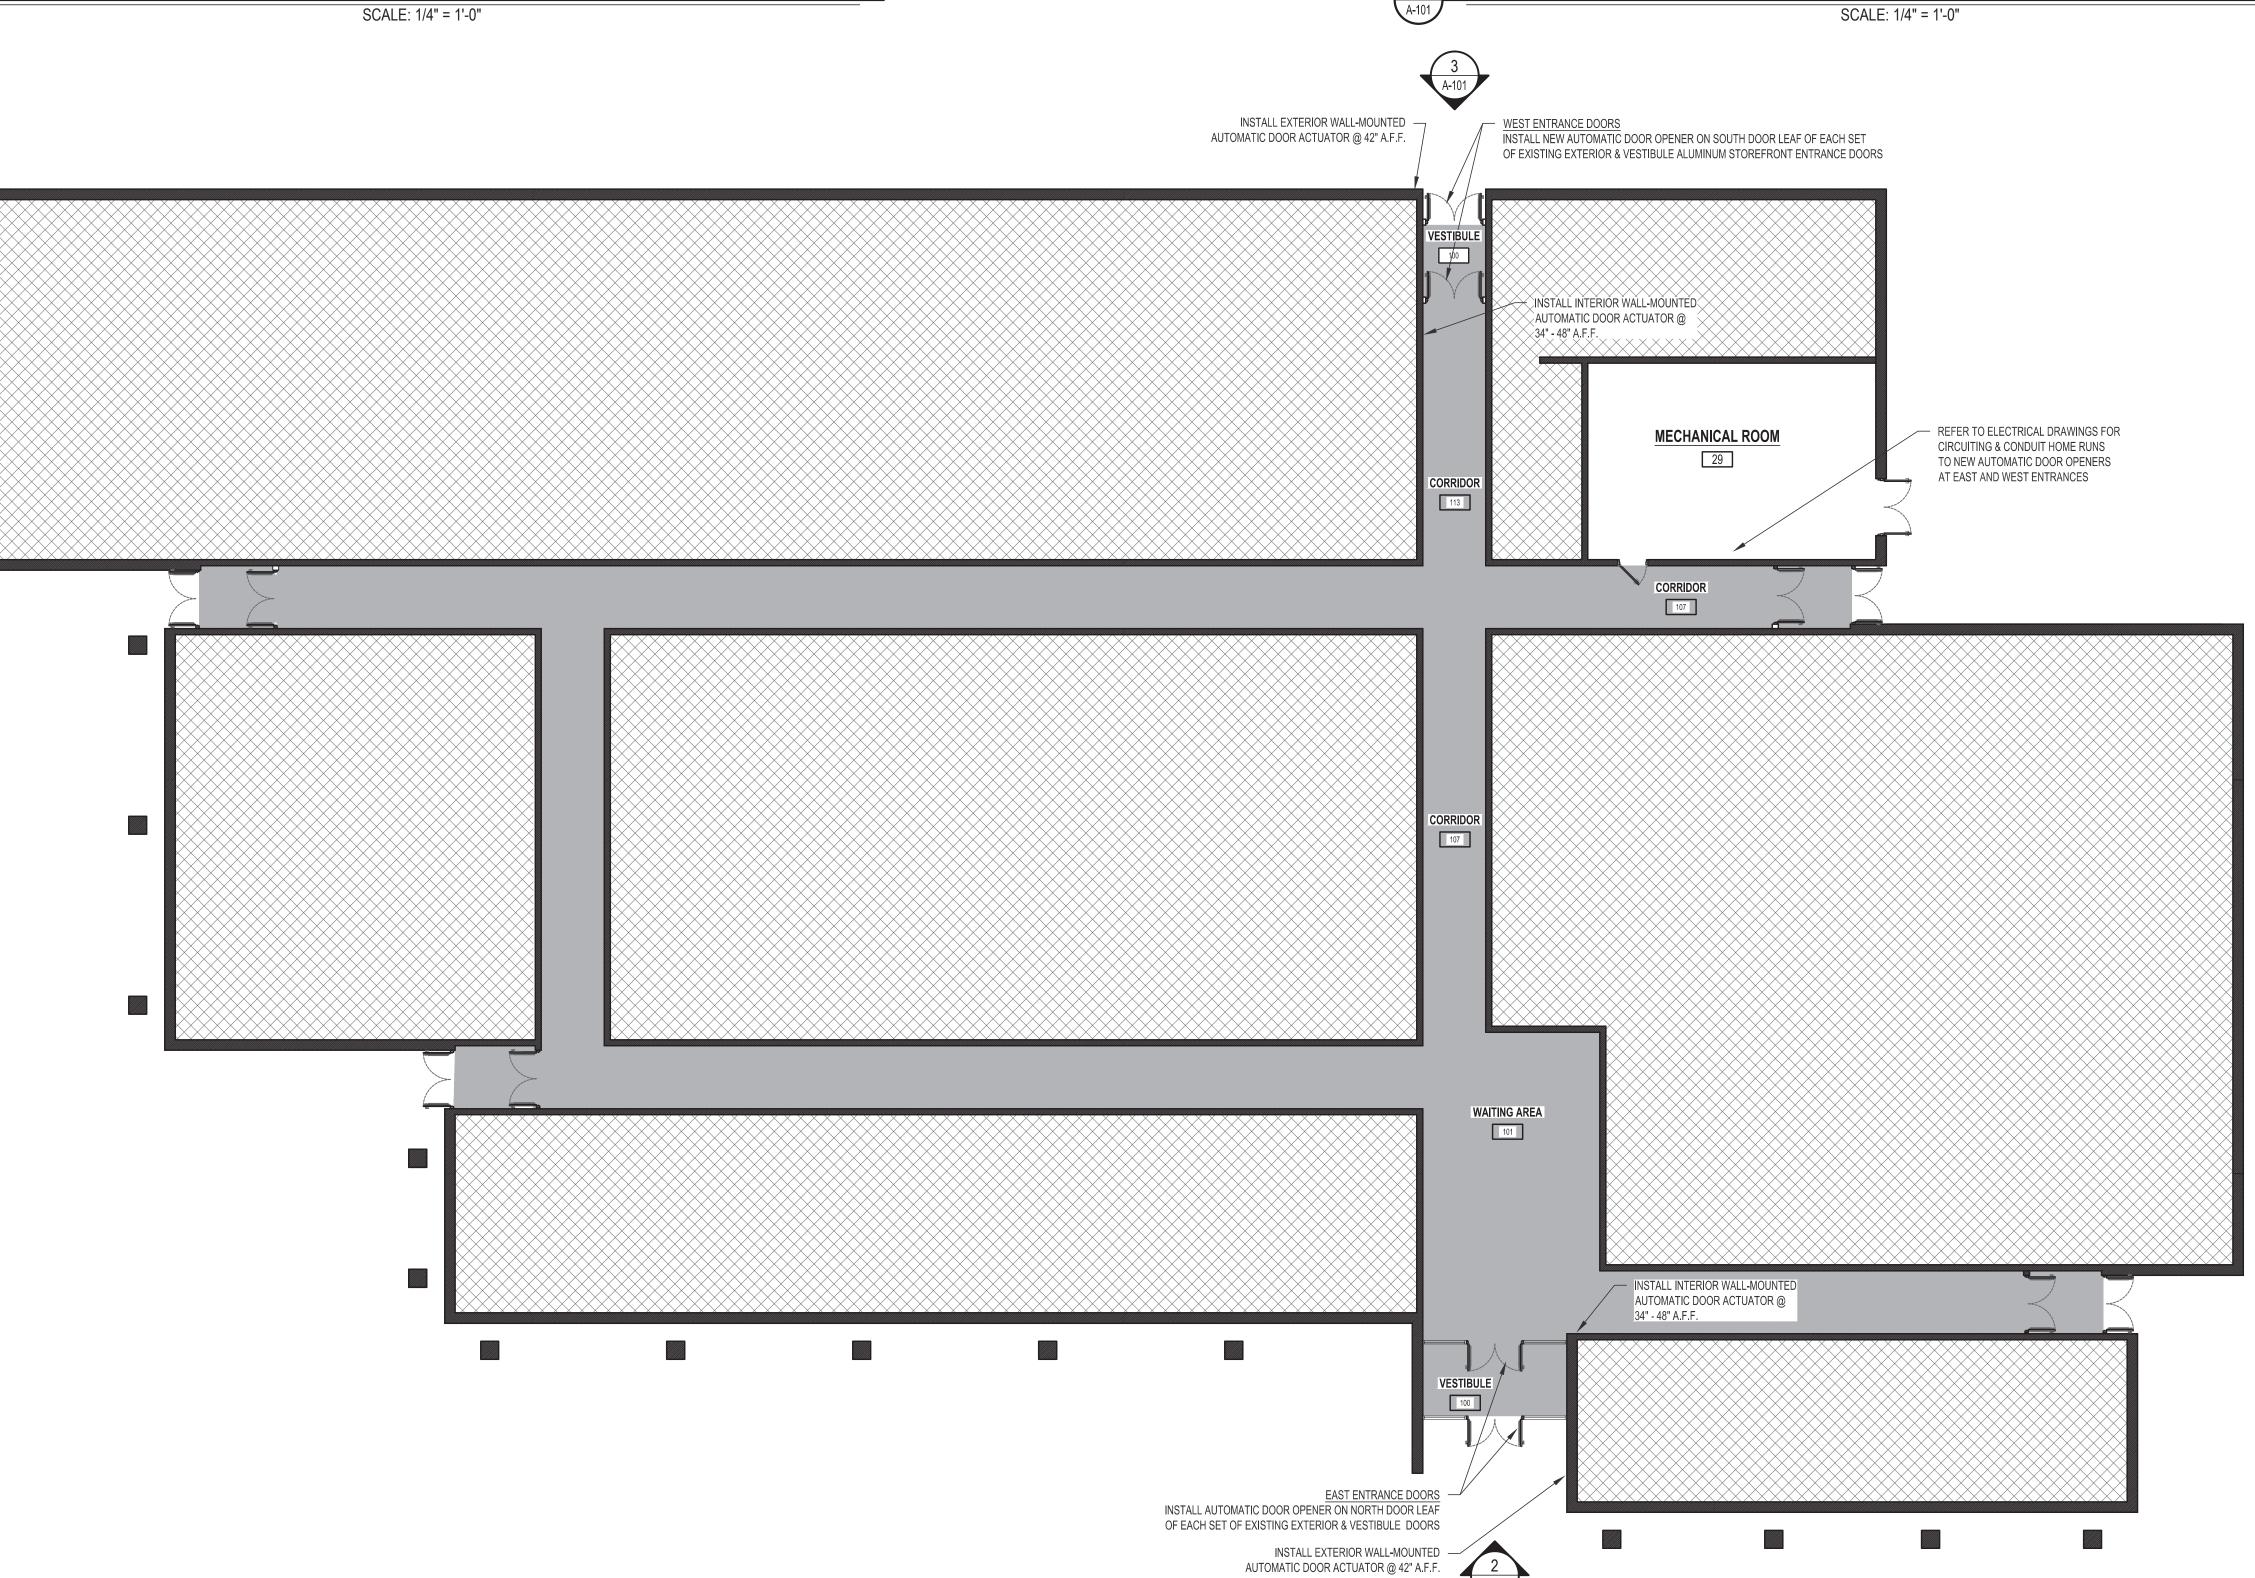



ASSET NUMBER - 8136300005 USPFO BUILDING FLOOR PLAN - ENTRANCE DOORS SCALE: 3/32" = 1'-0"

STATE OF MISSOURI MICHAEL L. PARSON, **GOVERNOR** 

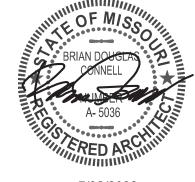

BRIAN DOUGLAS CONNELL ARCHITECT MO A-5036



**OFFICE OF ADMINISTRATION DIVISION OF FACILITIES** MANAGEMENT, DESIGN AND CONSTRUCTION

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PROJECT No. T2223-01 6300 SITE No. 8136300005

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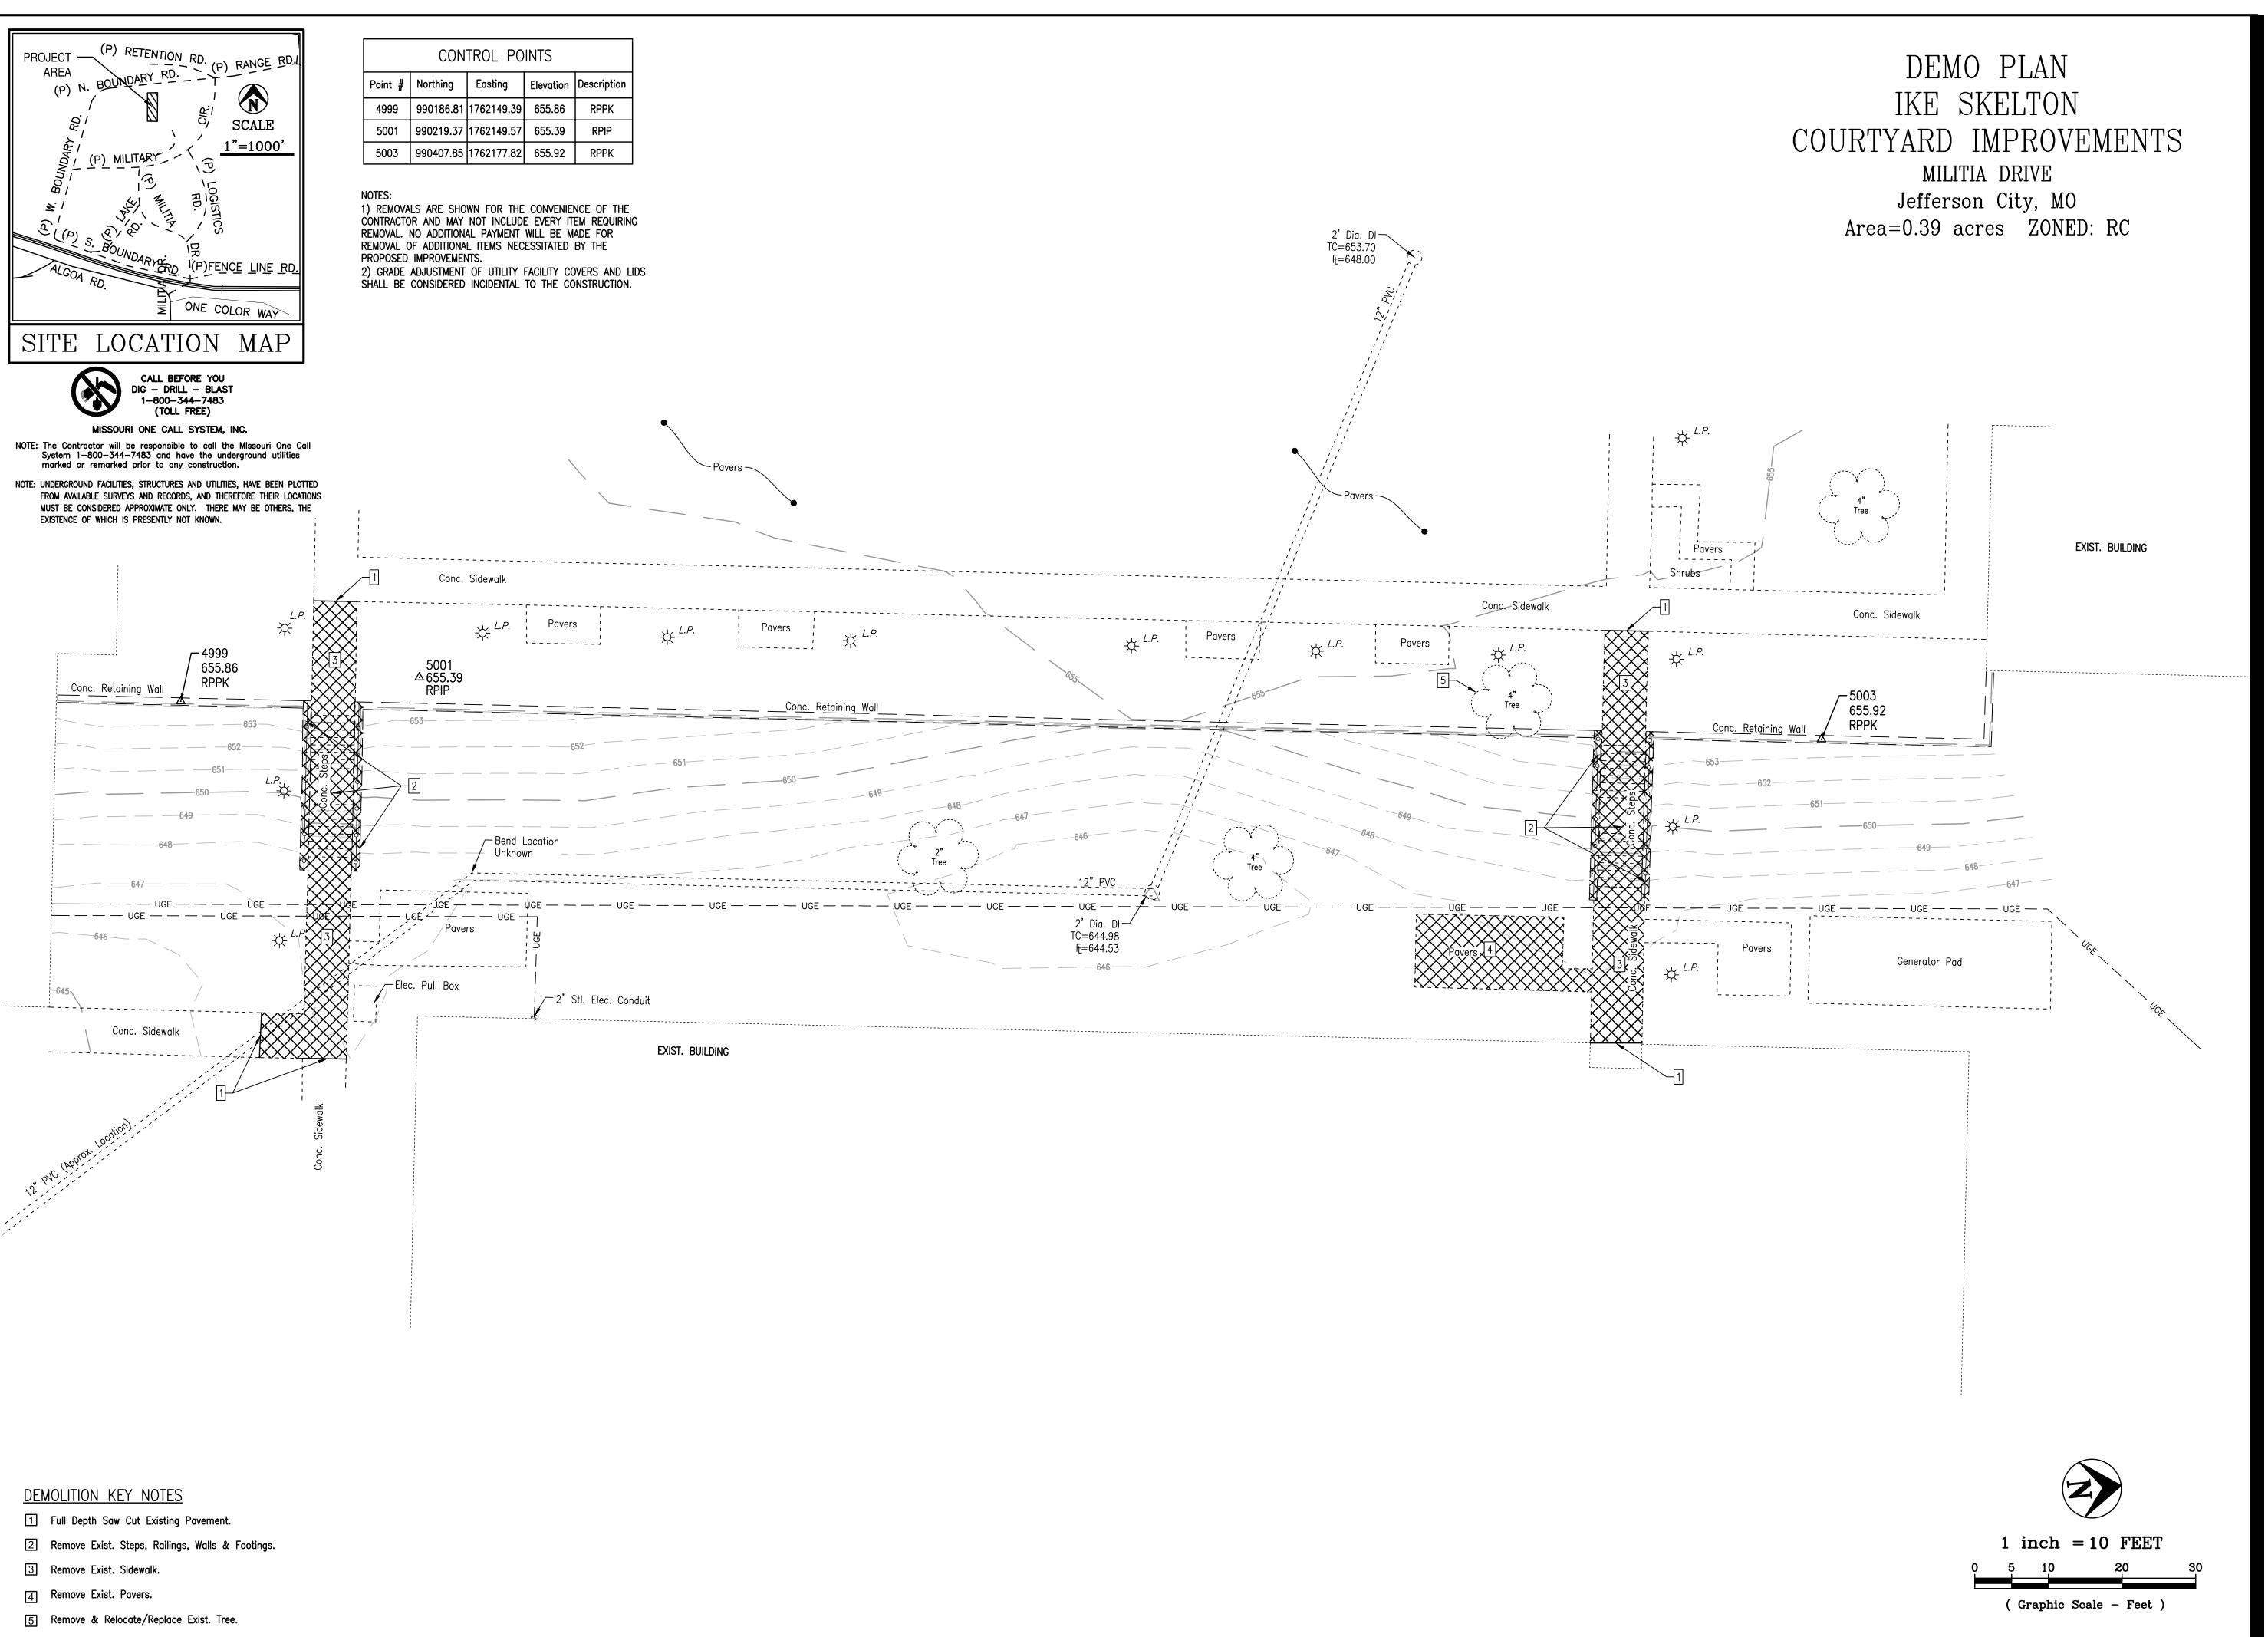
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USPFO BUILDING FLOOR PLAN -ENTRANCE DOORS

**SHEET NUMBER:** 

SHEET 4 OF 11 ISSUE DATE: 7/28/2023




STATE OF MISSOURI MICHAEL L. PARSON, GOVERNOR



1/28/23

GLENN STRUEMPH PROFESSIONAL ENGINEER NO. PE-2004017251

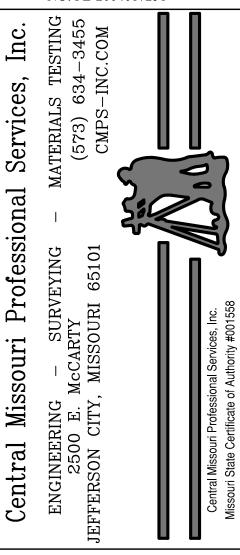

OFFICE OF ADMINISTRATION DIVISION OF FACILITIES MANAGEMENT, DESIGN AND CONSTRUCTION

MISSOURI ARMY NATIONAL GUARD

REPLACE COURTYARD STEPS & ADD ADA RAMP -USPFO BUILDING

IKE SKELTON TRAINING SITE 7101 MILITARY CIRCLE JEFFERSON CITY, MO 65101

PROJECT # T2223-01 SITE # 6300 FACILITY # 8136300006

REVISION:
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ISSUE DATE: 7/28/2023

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DRAWN BY: P.L.S. & G.J.S.
CHECKED BY: P.L.S.
DESIGNED BY: P.L.S.


SHEET TITLE:

TOPOGRAPHIC SURVEY & DEMOLITION PLAN

SHEET NUMBER:

C-001

SHEET 5 OF 11 ISSUE DATE: 7/28/2023

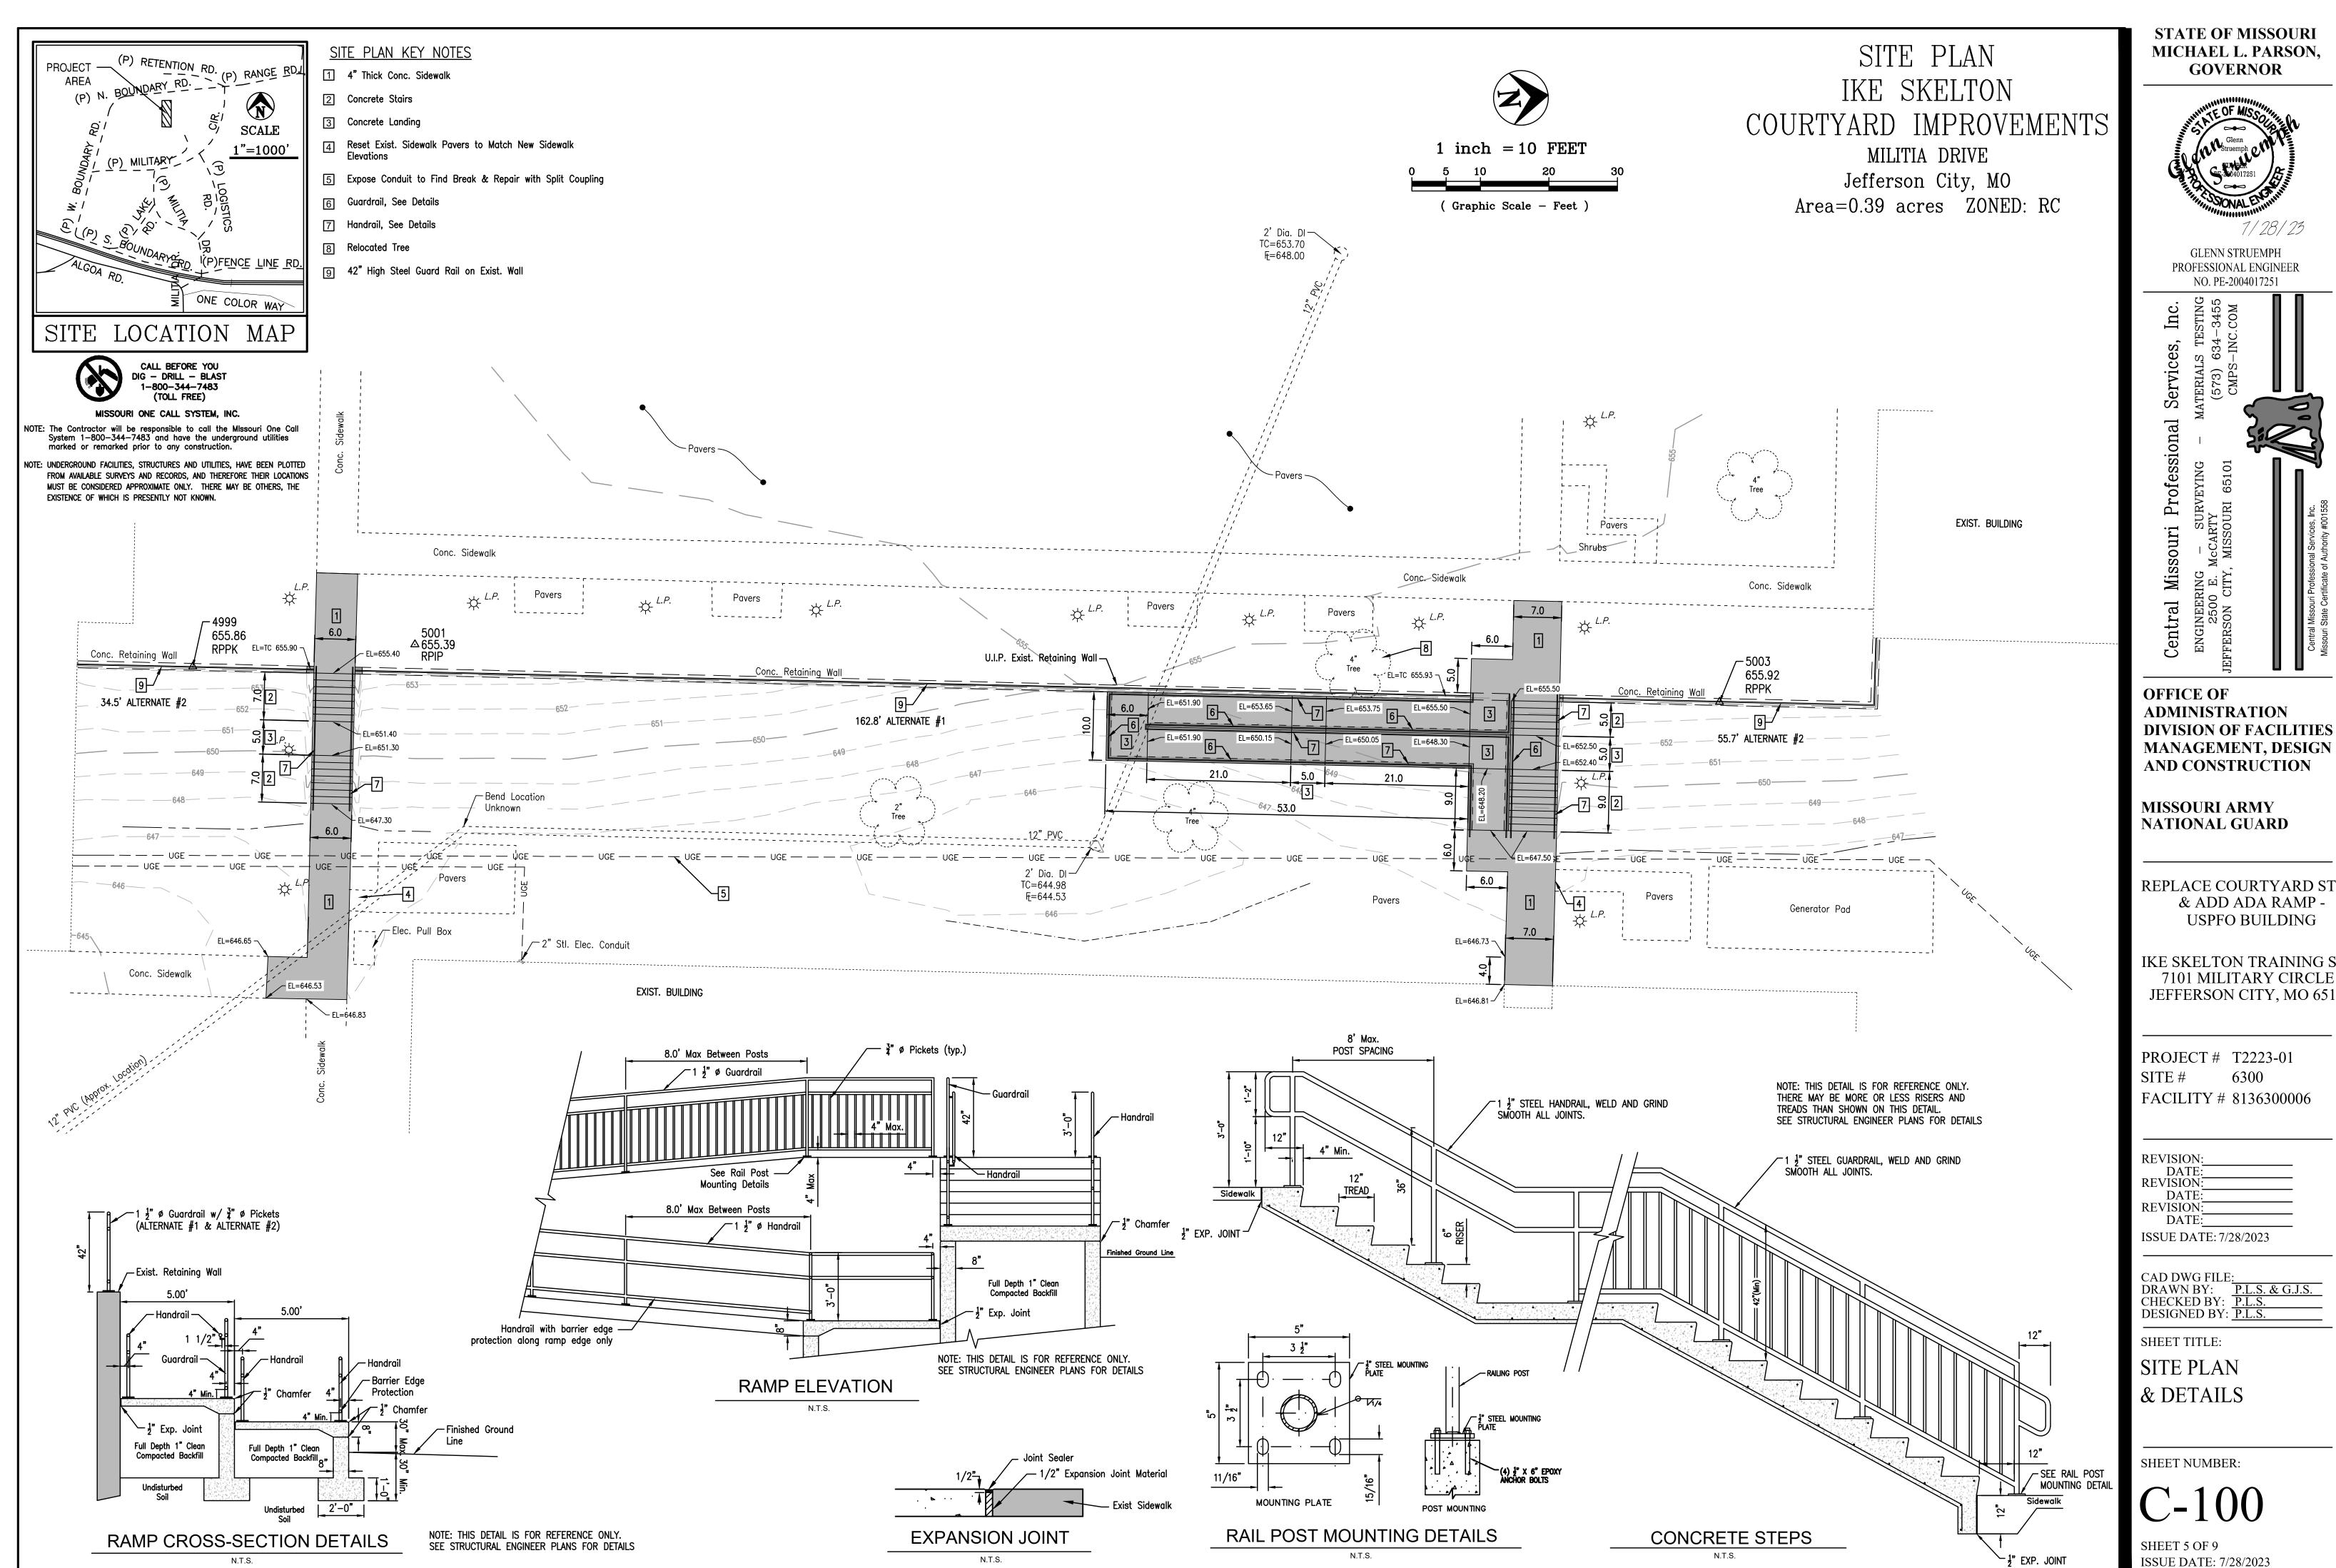

REPLACE COURTYARD STEPS

IKE SKELTON TRAINING SITE 7101 MILITARY CIRCLE JEFFERSON CITY, MO 65101

#### **GENERAL NOTES**

ELEVATION DATUM
SEE PLANS PROVIDED.

#### **DESIGN SPECIFICATIONS**

2015 INTERNATIONAL BUILDING CODE.

#### EARTHWORK

EARTHWORK OPERATIONS SHALL BE PERFORMED UNDER THE DIRECTION OF A PROFESSIONAL TESTING AGENCY TO ASSURE COMPLIANCE WITH THE RECOMMENDATIONS OF THE SOILS REPORT.

#### **FOOTINGS**

ALL FOOTINGS SHALL BEAR ON UNDISTURBED SOIL OR ENGINEERED FILL.
 HORIZONTAL REINFORCING IN FOOTINGS SHALL BE CONTINUOUS AT CORNERS AND INTERSECTIONS.
 CORNER BARS SHALL BE PROVIDED TO MATCH HORIZONTAL STEEL. REINFORCING STEEL SHALL BE
 LAPPED AS FOLLOWS WHERE SPLICES ARE REQUIRED:

BAR SIZE	LAP DIMENSION
# 4	1'-6"
# 5	1'-9"
 # 6	2'-0"

3. ANCHOR BOLTS, UNLESS OTHERWISE SHOWN, SHALL CONFORM TO ASTM F1554 GRADE 36.

#### CONCRETE

CONCRETE WORK SHALL CONFORM TO ALL REQUIREMENTS OF THE CURRENT ACI 301, SPECIFICATIONS FOR STRUCTURAL CONCRETE FOR BUILDINGS, ACI 318 BUILDING CODE REQUIREMENTS FOR STRUCTURAL CONCRETE, ACI 305 SPECIFICATIONS FOR HOT WEATHER CONCRETE, AND ACI 306 SPECIFICATIONS FOR COLD WEATHER CONCRETE, WITH THE FOLLOWING ADDITIONAL REQUIREMENTS:

- 1. CONCRETE SHALL DEVELOP THE FOLLOWING 28-DAY MINIMUM COMPRESSIVE STRENGTH:
- FOUNDATIONS/WALLS 4,000 PSI (w/c < 0.50)

  2. CONCRETE EXPOSED TO WEATHER, VEHICLES, AND/OR DEICING CHEMICALS SHALL BE AIR ENTRAINED WITH 6% (+/-) 1.5% ENTRAINED AIR BY VOLUME AT POINT OF DISCHARGE. DO NOT ALLOW AIR CONTENT OF TROWELED FINISHED FLOORS TO EXCEED 3%.
- 3. CONCRETE SLUMP SHALL BE A MAXIMUM OF 4" +/- 1" (ASTM C-143) AS DELIVERED IN THE FIELD. CONTRACTOR MAY USE CHEMICAL ADMIXTURES TO ATTAIN A MAXIMUM SLUMP OF 8" FOR WORKABILITY.
- 4. NO WATER MAY BE ADDED TO THE CONCRETE MIX ON SITE UNLESS WATER IS WITHHELD AT THE BATCHING FACILITY. IF WATER IS WITHHELD AT THE BATCHING FACILITY IT SHOULD BE REFLECTED ON THE LOAD TICKET. THE TOTAL AMOUNT OF WATER IN THE MIX SHALL NOT EXCEED WHAT IS NOTED ON THE APPROVED MIX. THIS SHALL BE NOTED IN THE SPECIAL INSPECTOR'S RECORDS.
- 5. CHLORIDE—BASED ADMIXTURES ARE PROHIBITED IN ALL REINFORCED CONCRETE.
- 6. REINFORCING STEEL SHALL CONFORM TO ASTM A615, A616, OR A617, GRADE 60.

#### SPECIAL INSPECTIONS

- A. THE FOLLOWING ITEMS REQUIRE SPECIAL INSPECTION IN ACCORDANCE WITH CHAPTER 17 OF THE INTERNATIONAL BUILDING CODE.
- a. PLACING OF CONCRETE AND REINFORCING STEEL (CONTINUOUS OF CONCRETE SAMPLING /
- PERIODIC REINFORCING)
  b. BOLTS & ANCHORS EMBEDDED IN CONCRETE (PERIODIC)
- b. BOLIS & ANCHORS EMBEDDED IN CONCRETE (PERIODIC)
   c. POST INSTALLED ANCHORS IN CONCRETE (CONTINUOUS)
- d. IN-SITU SOILS, EXCAVATIONS, FILLING & COMPACTION (PERIODIC)
- B. THE CONTRACTOR SHALL REQUEST SPECIAL INSPECTION OF THE ITEMS LISTED ABOVE PRIOR TO THOSE ITEMS BECOMING INACCESSIBLE AND UNOBSERVABLE DUE TO PROGRESSION OF THE WORK.

#### TECHNICAL REQUIREMENTS

- 1. PRIOR TO CONSTRUCTION OF THE WALLS, THE GRADING CONTRACTOR SHALL CLEAR AND GRUB THE REINFORCED BACKFILL ZONE AREA, REMOVING TOP SOILS, BRUSH, SOD OR OTHER ORGANIC OR DELETERIOUS MATERIALS. ANY UNSUITABLE SOILS SHALL BE OVER—EXCAVATED, REPLACED AND COMPACTED WITH REINFORCED BACKFILL MATERIAL TO PROJECT SPECIFICATIONS OR OTHERWISE DIRECTED BY THE OWNER'S GEOTECHNICAL ENGINEER.
- 2. THE GEOTECHNICAL ENGINEER SHALL CONFIRM THAT THE SITE HAS BEEN PROPERLY PREPARED AND THE DESIGN PARAMETERS IN DESIGN PARAMETERS SECTION ARE APPROPRIATE PRIOR TO FILL PLACEMENT. A WRITTEN CONFIRMATION SHALL BE PROVIDED TO CROCKETT ENGINEERING PRIOR TO FILL PLACEMENT.
- FILL SHALL BE PLACED IN HORIZONTAL LAYERS NOT EXCEEDING 10 INCHES IN UNCOMPACTED THICKNESS FOR HEAVY COMPACTION EQUIPMENT. FOR ZONES WHERE COMPACTION IS ACCOMPLISHED WITH HAND OPERATED EQUIPMENT, FILL SHALL BE PLACED IN HORIZONTAL LAYERS NOT EXCEEDING 6 INCHES IN UNCOMPACTED THICKNESS. ONLY HAND-OPERATED EQUIPMENT SHALL BE ALLOWED WITHIN THREE FEET OF THE BACK FACE OF WALL.
- 4. FILL SHALL BE COMPACTED AS SPECIFIED BY PROJECT SPECIFICATIONS OR TO A MINIMUM 95 PERCENT OF THE MAXIMUM DRY DENSITY AS DETERMINED IN ACCORDANCE WITH ASTM D-698.
- 5. TESTING METHODS AND FREQUENCY, AND VERIFICATION OF MATERIAL SPECIFICATIONS AND COMPACTION SHALL BE THE RESPONSIBILITY OF THE OWNER'S GEOTECHNICAL ENGINEER. A COPY OF THE REPORT SHALL BE
- PROVIDED TO CROCKETT ENGINEERING.
  6. FILL WALL EVENLY EACH SIDE PRIOR TO BACKFILLING.

#### DRAINAGE

- 1. AT THE END OF EACH WORK DAY, BACKFILL SURFACE SHALL BE COMPACTED WITH A SMOOTH PLATE COMPACTOR TO MINIMIZE PONDING OF WATER AND SATURATION OF THE BACKFILL.
- 2. PERMANENT SURFACE WATER DIVERSION SHALL BE AS REQUIRED AND PROVIDED BY THE OWNER OR OWNER'S REPRESENTATIVE.

#### DESIGN PARAMETERS

1. DESIGN OF THE REINFORCED SOIL STRUCTURE IS BASED ON THE FOLLOWING PARAMETERS:

BEARING CAPACITY = 1,700 PSF
LATERAL PRESSURES

ACTIVE = 40 PCF (CLEAN GRAVEL)

PASSIVE = 270 PCF

SLIDING RESISTANCE

COEFFICIENT OF FRICTION = 0.32

2. EXTERNAL STABILITY:

MINIMUM FACTOR OF SAFETY FOR OVERTURNING = 2.0

MINIMUM FACTOR OF SAFETY FOR SLIDING = 1.5

3. SURCHARGE LOADING
LIVE LOAD TRAFFIC AREAS = 250 PSF


4. GLOBAL STABILITY DESIGN WAS CONSIDERED AS PART OF THE WALL DESIGN.

#### SPECIAL PROVISIONS


- 1. THE DESIGN PRESENTED HEREIN IS BASED ON SOIL PARAMETERS, FOUNDATION CONDITIONS, GROUNDWATER CONDITIONS AND LOADINGS.
- 2. WALL ELEVATION VIEWS AND LOCATIONS AND GEOMETRY OF EXISTING STRUCTURES AND GRADE ABOVE AND BELOW THE WALLS MUST BE VERIFIED BY THE CONTRACTOR, TO MATCH ELEVATIONS SHOWN IN THE CONTRACT DOCUMENTS, PRIOR TO CONSTRUCTION.

#### GUARDRAIL

- 1. SHALL BE 42" TALL ABOVE THE ADJACENT WALKING SURFACE.
- 2. SHALL NOT HAVE OPENINGS LARGE ENOUGH TO PASS A 4" SPHERE.
- 3. MAIN RAILS SHALL RESIST 50 POUND PER LINEAL FOOT LATERALLY AT THE TOP RAIL OR 200 POUNDS CONCENTRATED LOAD LATERALLY.
- 4. INTERMEDIATE RAILS SHALL RESIST A CONCENTRATED LOAD OF 50 POUNDS LATERALLY.

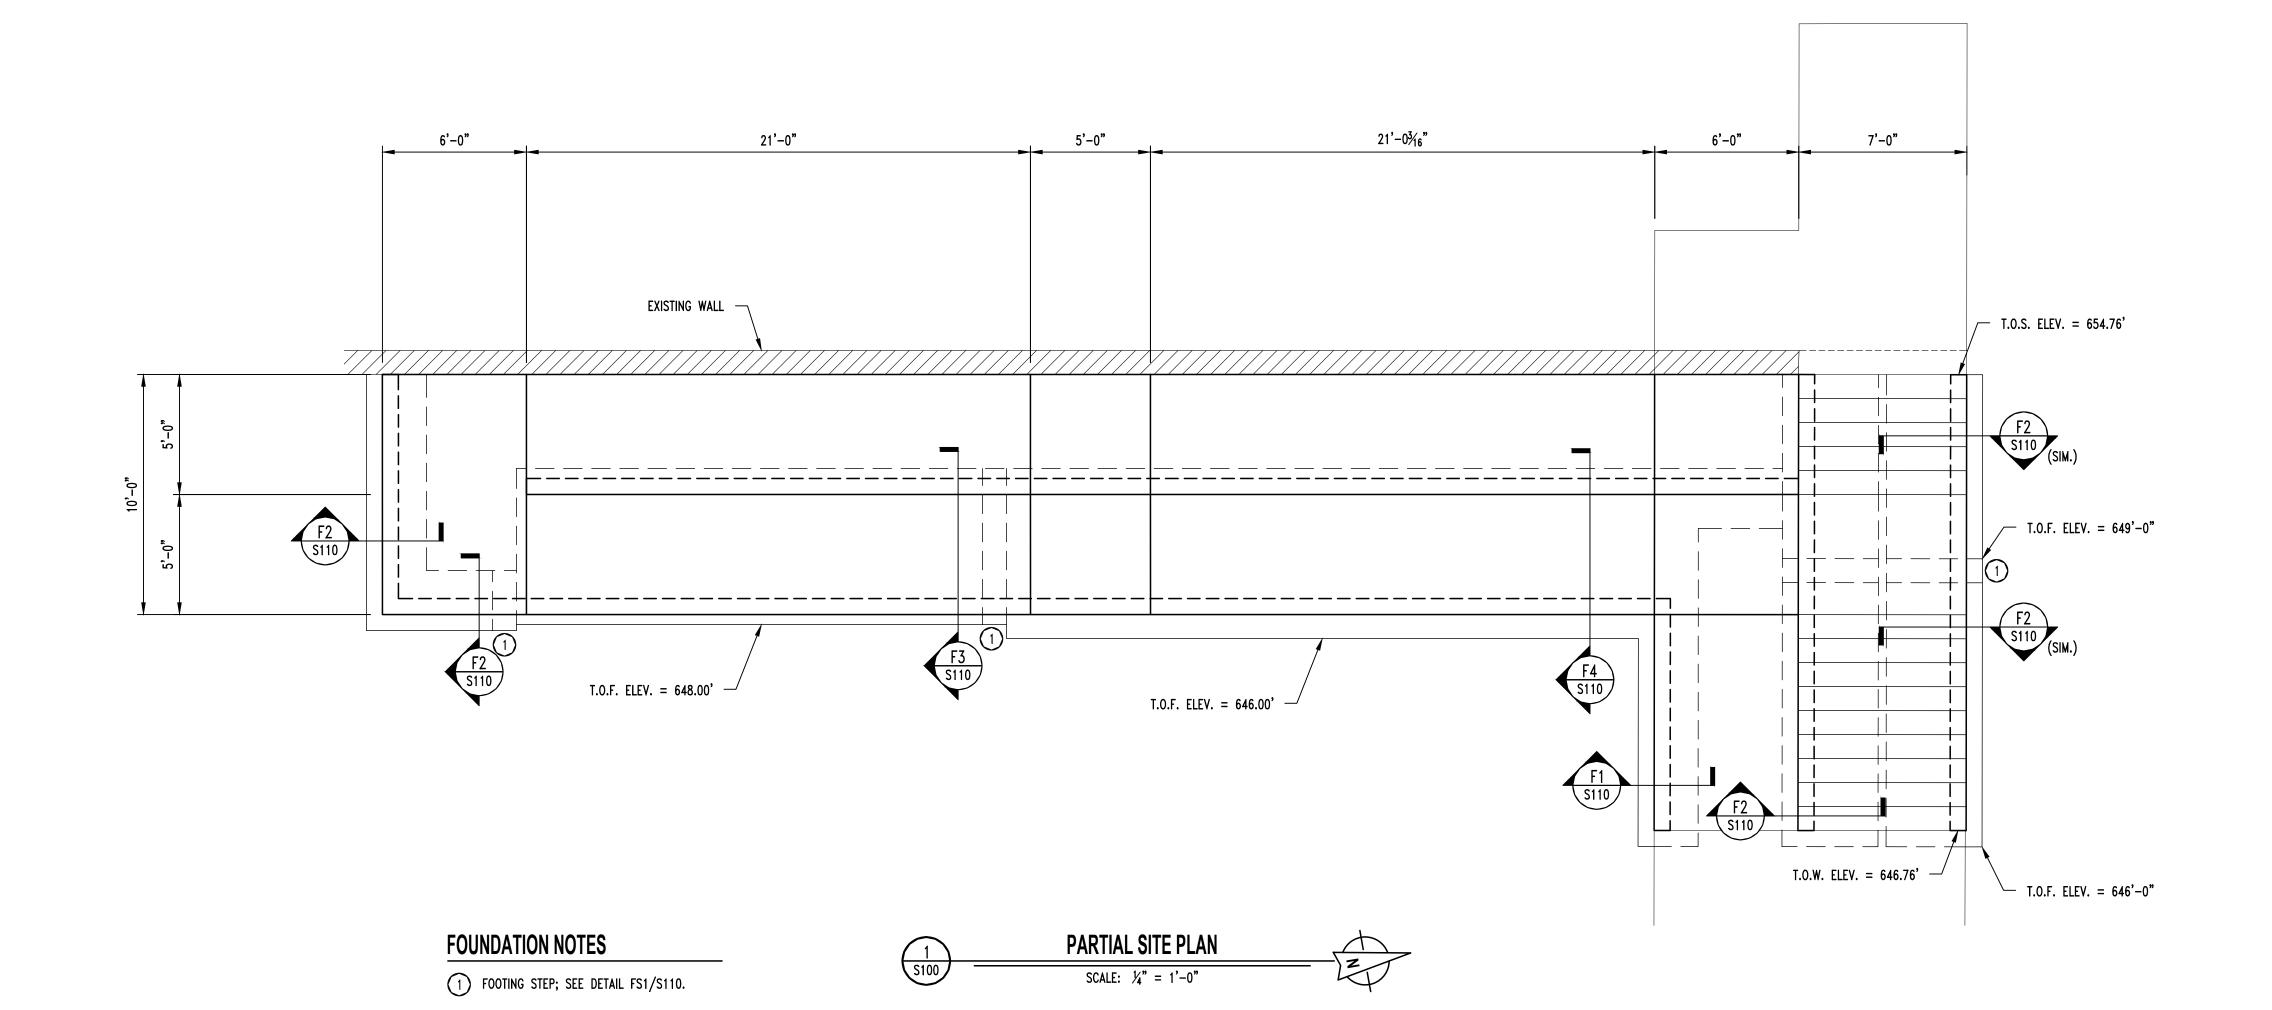

#### STATE OF MISSOURI MICHAEL L. PARSON, GOVERNOR

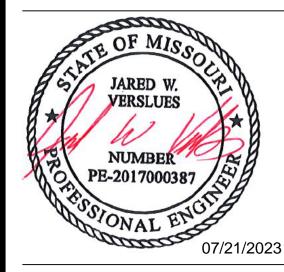

CONNELL ARCHITECTURAL CORPORATION
CERTIFICATE OF AUTHORITY: 000827

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OFFICE OF ADMINISTRATION DIVISION OF FACILITIES MANAGEMENT, DESIGN AND CONSTRUCTION

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IKE SKELTON TRAINING SITE 7101 MILITARY CIRCLE JEFFERSON CITY, MO 65101

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PROJECT No. T2223-01 SITE No. 6300

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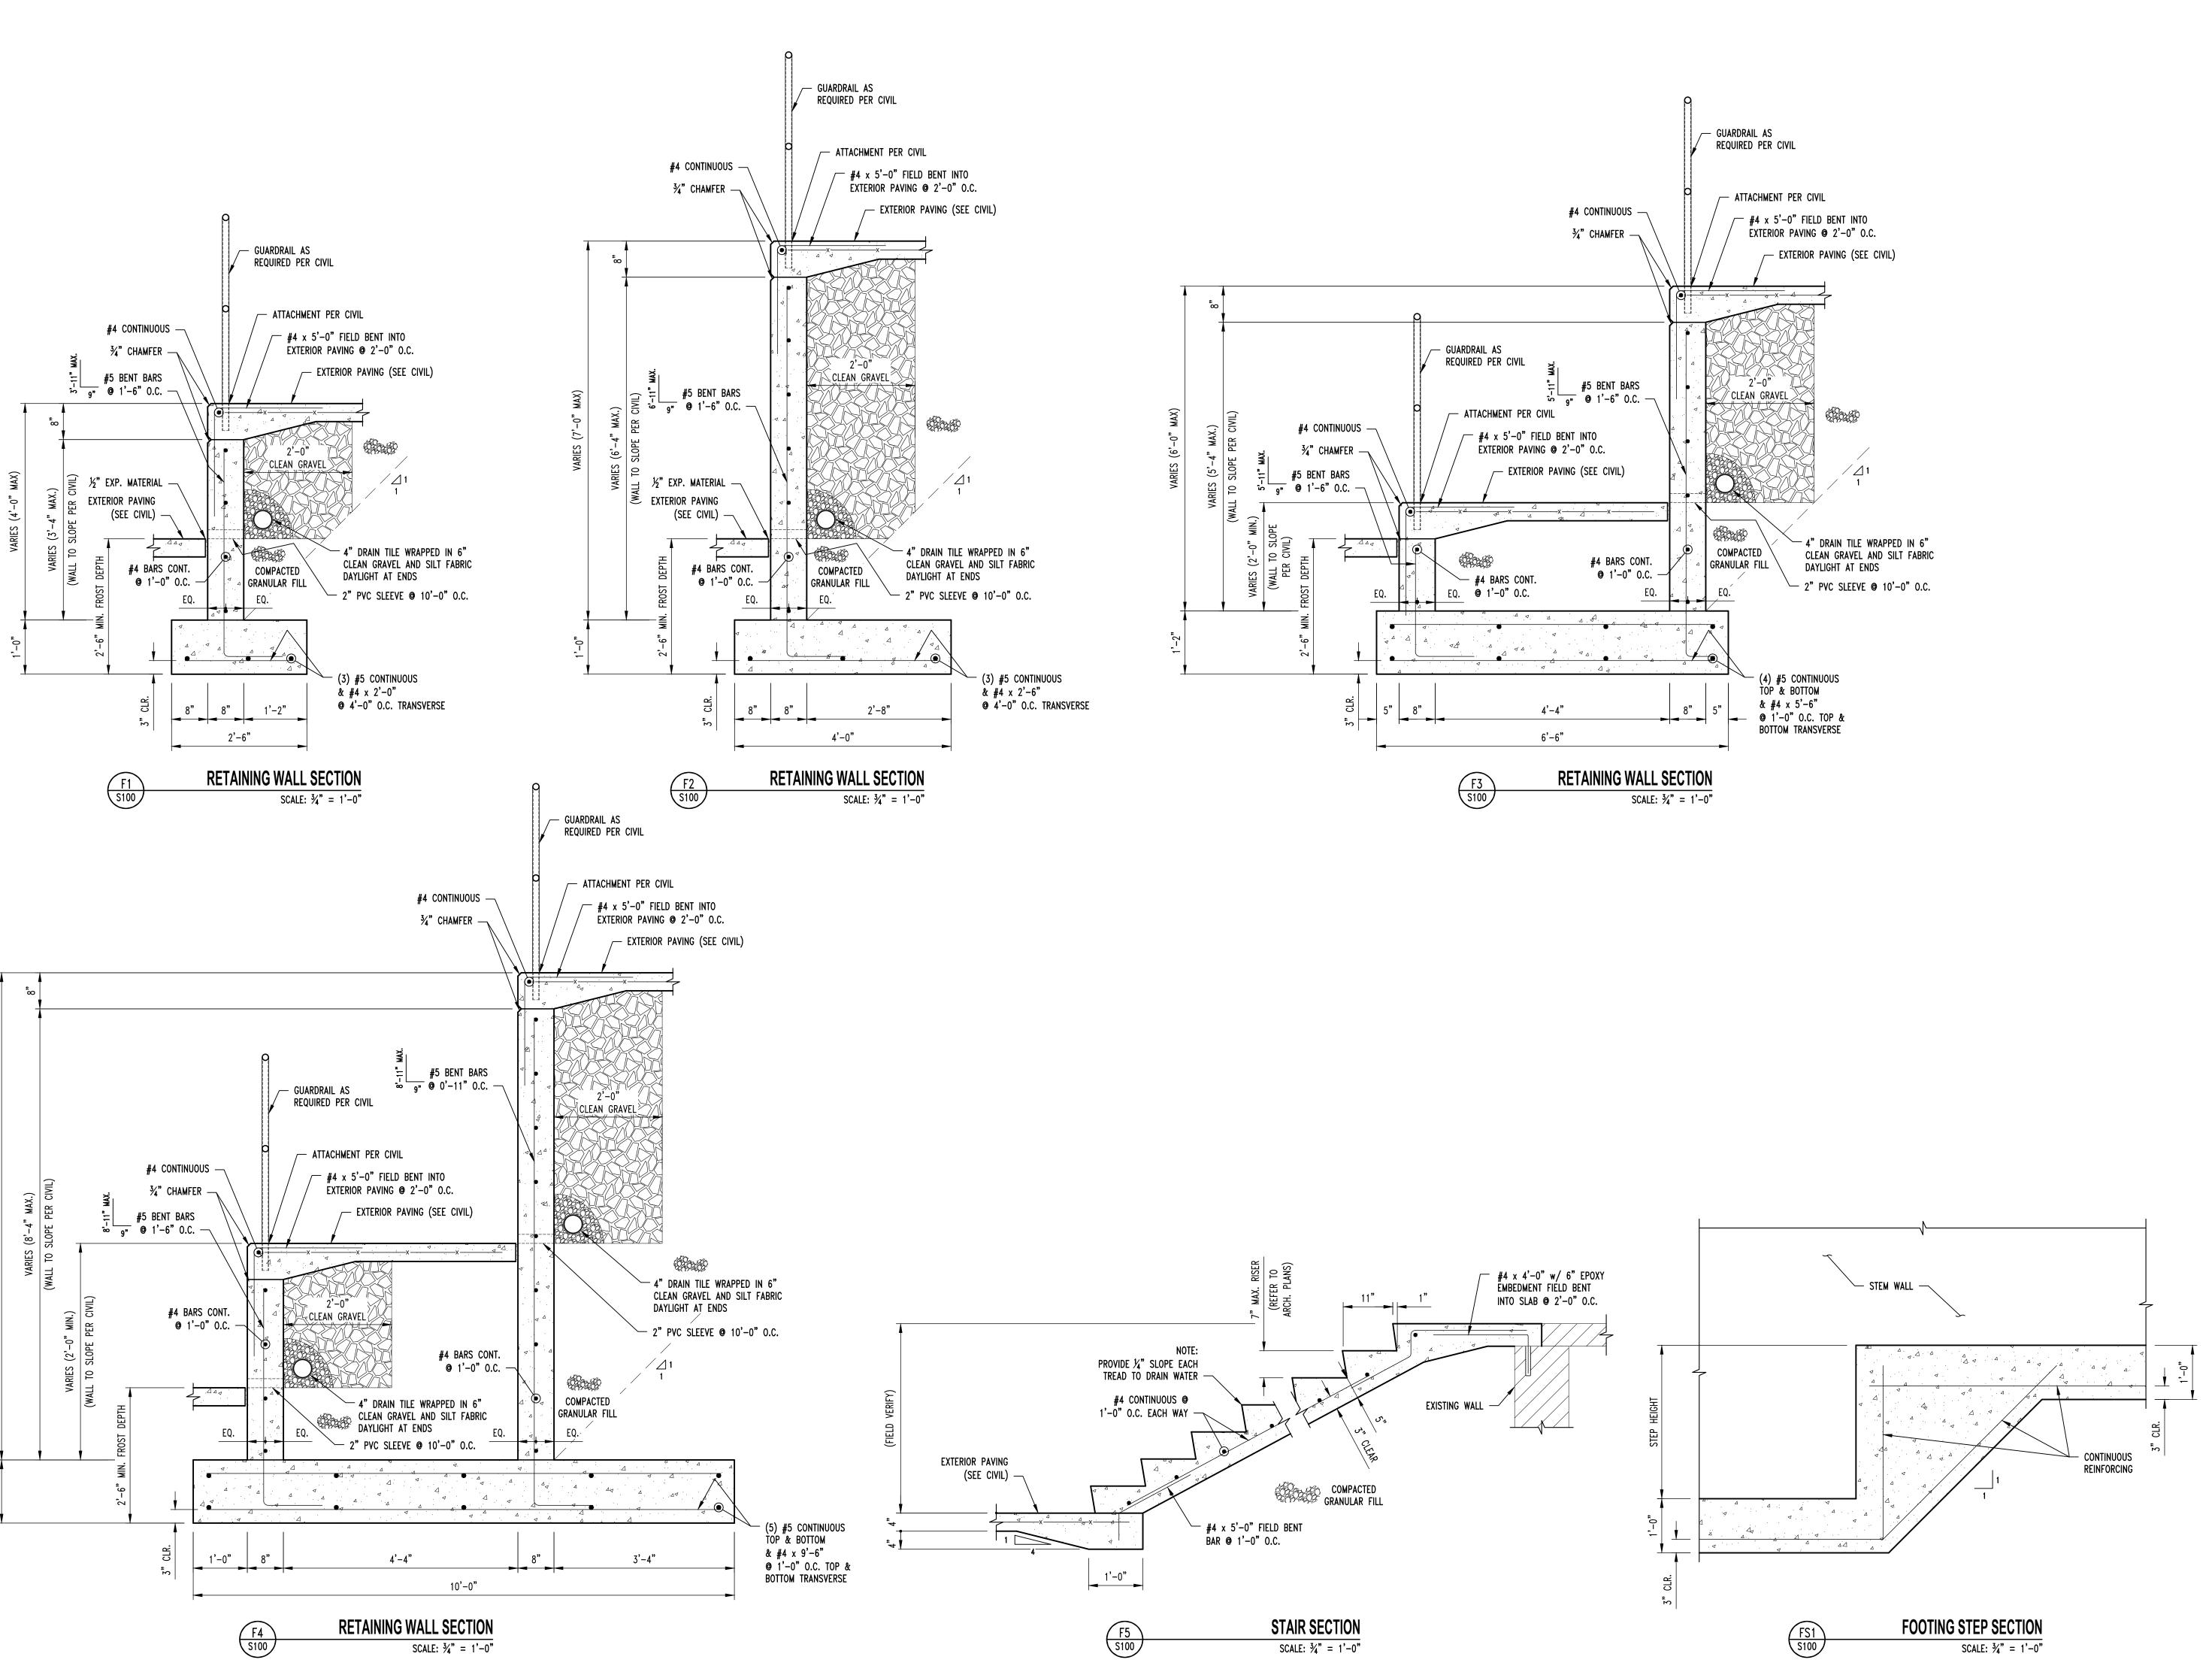
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SHEET TITLE:

GENERAL DATA
PARTIAL SITE PLAN

**SHEET NUMBER:** 

S100 7 OF 11 SHEETS ISSUE DATE: 7/28/2023



**STATE OF MISSOURI** MICHAEL L. PARSON, **GOVERNOR** 



**OFFICE OF ADMINISTRATION DIVISION OF FACILITIES** MANAGEMENT, DESIGN AND CONSTRUCTION

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IKE SKELTON TRAINING SITE 7101 MILITARY CIRCLE **JEFFERSON CITY, MO 65101** 

PROJECT No. T2223-01 6300 SITE No. 8136300005 ASSET No.

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**SHEET TITLE:** 

**RETAINING WALL DETAILS** 

**SHEET NUMBER:** 

8 OF 11 SHEETS ISSUE DATE: 7/28/2023

#### LIGHTING PLAN GENERAL NOTES:

1. SEE SHEET E501 FOR ADDITIONAL ELECTRICAL DETAILS, & SCHEDULES.

#### LIGHTING PLAN KEY NOTES:

(1) EXISTING BOLLARD LIGHT TO REMAIN.

2) TIE INTO EXISTING POLE LIGHT CIRCUIT AT EXISTING BOLLARD LIGHT & EXTEND NEW 1" UNDERGROUND PVC CONDUIT & CONDUCTORS ((2) #10, (1)#10 EQ. GRD.) TO NEW BOLLARD LIGHT AS

COURTYARD PLAN

SCALE: 1'' = 10 ft


#### REFERENCED CODES IN EFFECT

2018 INTERNATIONAL MECHANICAL CODE 2018 INTERNATIONAL PLUMBING CODE 2018 INTERNATIONAL FUEL GAS CODE 2018 INTERNATIONAL FIRE CODE


2017 NATIONAL ELECTRIC CODE

2018 INTERNATIONAL ENERGY CONSERVATION CODE

STATE OF MISSOURI MICHAEL L. PARSON, **GOVERNOR** 

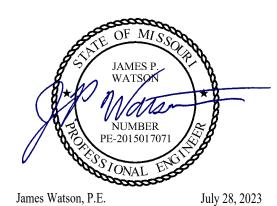

James Watson, P.E. PE-2015017071 MO Certificate of Authority # 2018029680

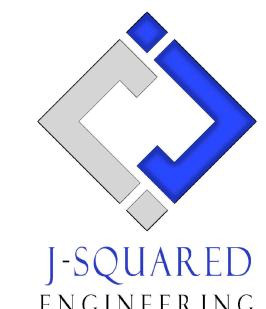

2400 Bluff Creek Drive, Suite 101 Columbia, Missouri 65201 573 - 234 - 4492 phone www.j-squaredeng.com

OFFICE OF ADMINISTRATION DIVISION OF FACILITIES MANAGEMENT, **DESIGN AND** CONSTRUCTION

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SHEET TITLE:

LIGHTING PLAN -COURTYARD

SHEET NUMBER:


9 OF 11 SHEETS ISSUE DATE: 07/28/2023

#### POWER PLAN GENERAL NOTES:

1. SEE SHEET E501 FOR ADDITIONAL ELECTRICAL DETAILS, & SCHEDULES.


#### POWER PLAN KEY NOTES:


- (1) J-BOX FOR WALL-MOUNTED AUTOMATIC DOOR ACTUATOR.
- 2) J-BOX ABOVE CEILING FOR AUTOMATIC DOOR OPENER. RUN CONDUIT DOWN VERTICAL MULLION
- (3) INSTALL NEW 20-1 BREAKER IN EXISTING PANEL BREAKER SLOTS 42 & 44.
- 4) ½" SURFACE-MOUNT CONDUIT DOWN TO ADA PUSH BUTTON BACK BOX. PAINT TO MATCH WALL.
- (5) J-BOX ABOVE CEILING FOR AUTOMATIC DOOR OPENER. RUN CONDUIT FROM J-BOX SURFACE-MOUNTED TO INTERIOR WALL THEN TO ADA OPERATOR.

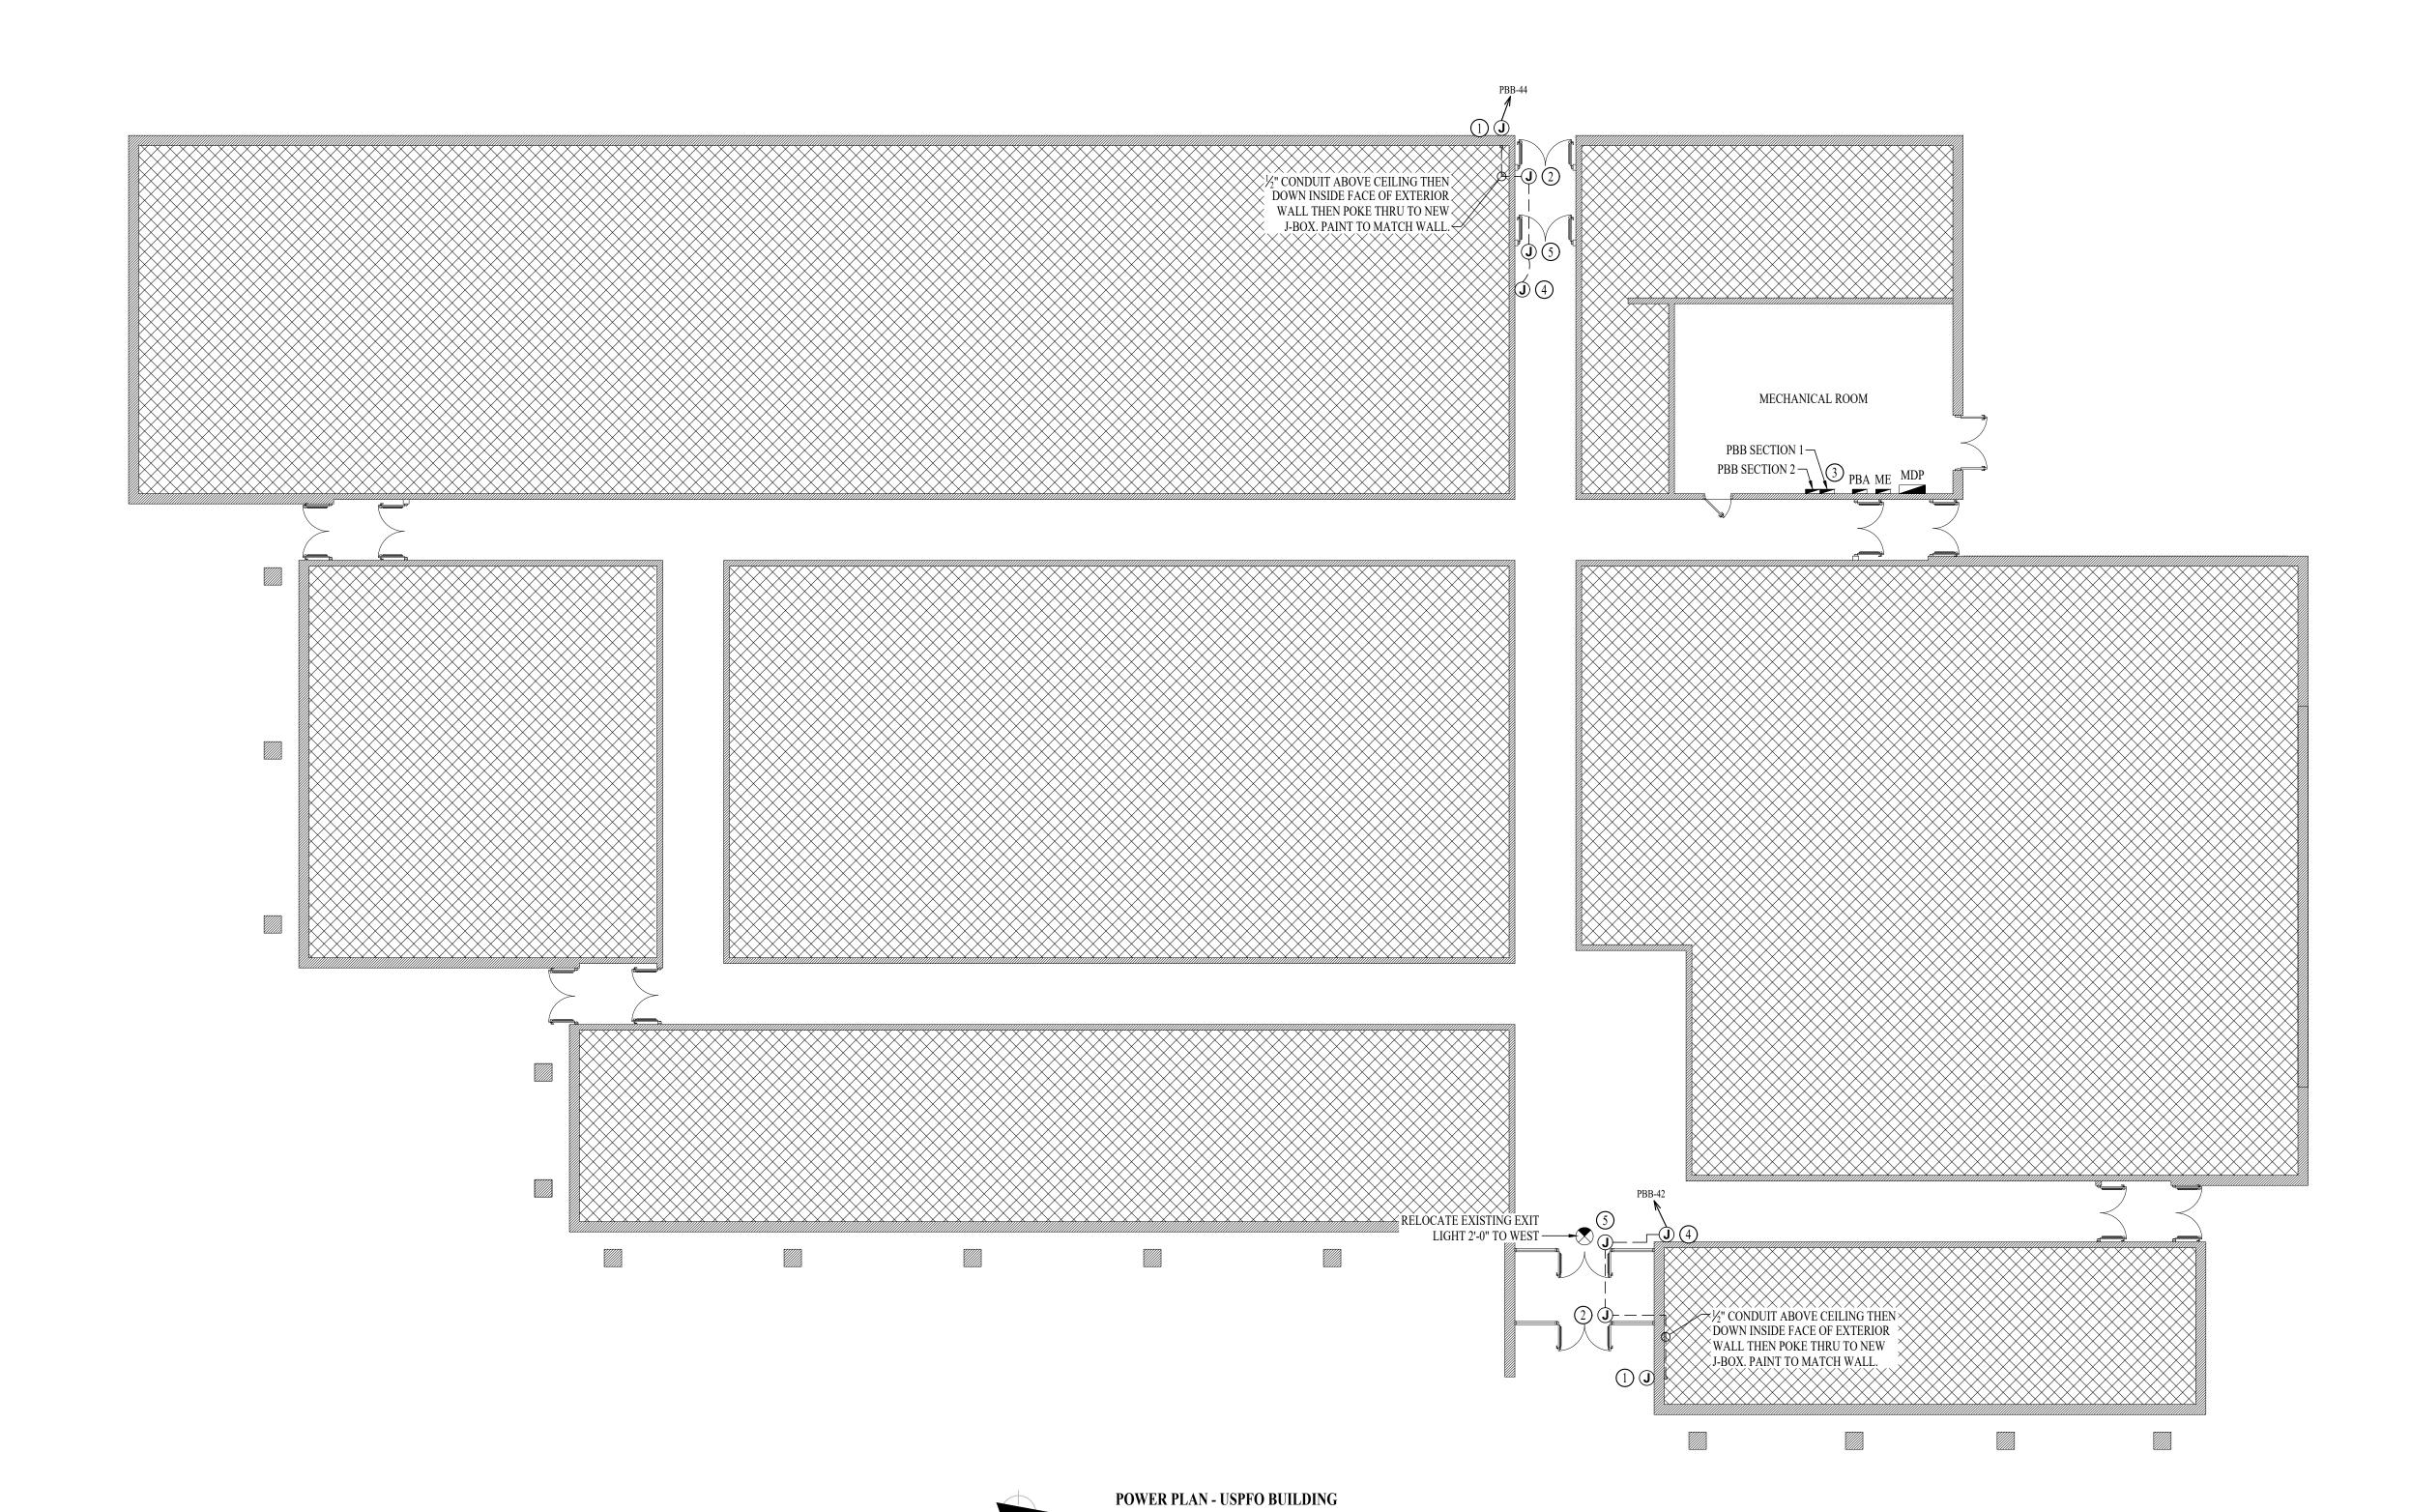

SCALE: 3/32" = 1'-0"

STATE OF MISSOURI MICHAEL L. PARSON, **GOVERNOR** 

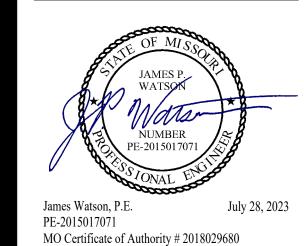

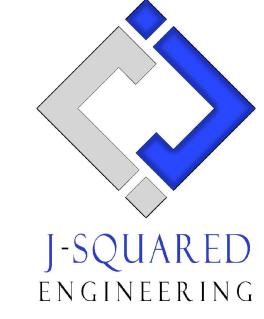

Columbia, Missouri 65201 573 - 234 - 4492 phone www.j-squaredeng.com

OFFICE OF **ADMINISTRATION** DIVISION OF FACILITIES MANAGEMENT, **DESIGN AND** CONSTRUCTION

MISSOURI ARMY NATIONAL GUARD

REPLACE COURTYARD STEPS & ADD ADA RAMP -USPFO BUILDING

IKE SKELTON TRAINING SITE 7101 MILITARY CIRCLE JEFFERSON CITY, MO 65101

PROJECT # T2223-01 6300 ASSET # 8136300005

REVISION: **REVISION:** DATE: ISSUE DATE: 07/28/2023

DRAWN BY: CHECKED BY: **DESIGNED BY:** 

SHEET TITLE:

POWER PLAN -USPFO BUILDING

SHEET NUMBER:

10 OF 11 SHEETS ISSUE DATE: 07/28/2023

#### GENERAL MEP SPECIFICATIONS

- 1. IT IS THE RESPONSIBILITY OF THE CONTRACTOR TO REVIEW AND UNDERSTAND ALL DRAWINGS AND SPECIFICATIONS IN THE CONTRACT DOCUMENTS. EACH CONTRACTOR IS RESPONSIBLE FOR ALL WORK ASSOCIATED WITH HIS TRADE REGARDLESS OF WHERE THE WORK IS DEPICTED IN THE DRAWINGS OR SPECIFICATIONS.
- DRAWINGS OR SPECIFICATIONS.

  2. THE LAYOUT OF SYSTEMS SHOWN ON PLANS ARE APPROXIMATE AND WILL NEED TO BE COORDINATED IN FIELD. THE CONTRACTOR SHALL INCLUDE THIS COORDINATION IN HIS SCOPE AND INCLUDE ALL COSTS OF MODIFYING THE LAYOUT AS REQUIRED IN HIS BID.
- 3. THE CONTRACTOR IS RESPONSIBLE FOR PROVIDING ALL NECESSARY PARTS AND LABOR TO PRODUCE A COMPLETE AND FULLY OPERATIONAL SYSTEM UNLESS STATED OTHERWISE ON
- PLANS.
  4. ALL MATERIALS TO BE NEW, FIRST CLASS, AND INSTALLED PER MANUFACTURE'S PUBLISHED
- INSTRUCTIONS.
  5. ALL WORK SHALL BE PERFORMED IN COMPLIANCE WITH LOCALLY ADOPTED CODES AND
- ORDINANCES.
  6. CONTRACTOR IS RESPONSIBLE FOR COORDINATING EQUIPMENT LOCATIONS AND SYSTEM
- ROUTING WITH OTHER TRADES PRIOR TO INSTALLATION.
  7. CONTRACTOR TO GUARANTEE ALL MATERIALS AND WORKMANSHIP FOR A PERIOD OF ONE YEAR
- FROM THE DATE THE PROJECT IS TURN OVER TO THE OWNER, UNLESS NOTED OTHERWISE.

  8. CONTRACTOR IS TO INCLUDE IN THEIR SCOPE THE COST OF ALL PERMITS, INSPECTIONS,
- METERING, AND TAPS ASSOCIATED WITH THEIR WORK.
  9. CONTRACTOR IS RESPONSIBLE FOR ALL EXCAVATION, CUTTING, CORING, PATCHING, AND
- BACKFILL REQUIRED TO COMPLETE THEIR WORK, UNLESS NOTED OTHERWISE.

  10. THESE PLANS ARE NOT TO BE SCALED. SEE ARCHITECTURAL PLANS FOR DIMENSIONS. WHERE THERE IS A CONFLICT BETWEEN ARCHITECTURAL DIMENSIONS AND MEP DIMENSION,
- ARCHITECTURAL SHALL GOVERN.

  11. SEE DISCIPLINE SHEETS FOR ADDITIONAL DISCIPLINE SPECIFIC SPECIFICATIONS.


#### **ELECTRICAL SPECIFICATIONS**

- 1. GENERAL
- 1.1. GENERAL


  1.1. THE ENTIRE ELECTRICAL SYSTEM SHALL BE CONTINUOUSLY GROUNDED. EVERY BRANCH
  CONDUIT SHALL INCLUDE A GREEN GROUND CONDUCTOR SIZED PER NEC.
- 2. MATERIALS
- 2.1. CONDUIT & CONDUCTORS
- 2.1.1. ALL CONDUCTORS SIZES INDICATED ON PLANS ARE COPPER UNLESS NOTED
- OTHERWISE.
  2.1.2. BELOW GRADE CONDUCTORS SHALL BE XHHW-2.
- 2.1.3. MINIMUM CONDUCTOR SIZE SHALL BE #12 UNLESS NOTED OTHERWISE. 120V, 20 AMP CIRCUITS WITH CONDUCTOR LENGTH GREATER THAN 100' SHALL BE MINIMUM #10. ELECTRICAL CONTRACTOR IS RESPONSIBLE FOR MEASURING ACTUAL CONDUCTOR LENGTH AND INCREASING CONDUCTOR SIZE TO COMPENSATE FOR VOLTAGE DROP AS REQUIRED BY NEC.
- 2.1.4. SCHEDULE 40 PVC CONDUIT SHALL BE USED FOR BELOW GRADE INSTALLATIONS


LIGHT FIXTURE SCHEDULE										
TAG	MANUFACTURER (OR EQUAL)	MODEL NUMBER (OR EQUAL)	DESCRIPTION	MOUNTING	LUMEN OUTPUT	CCT (°K)	CRI	VOLTS	WATTS	NOTES
P1	WILLIAMS	OSA8R-L22-8-40-AC-DT-PAB-DIM-UNV	8" ROUND BOLLARD	GRADE	2204	4000	80	120	27	CONTRACTOR TO MATCH EXISITNG BOLLARDS ON SITE.
NOTES:										

1. VERIFY LIGHT FIXTURE FINISHES WITH OWNER / A RCHITECT PRIOR TO INSTALLATION

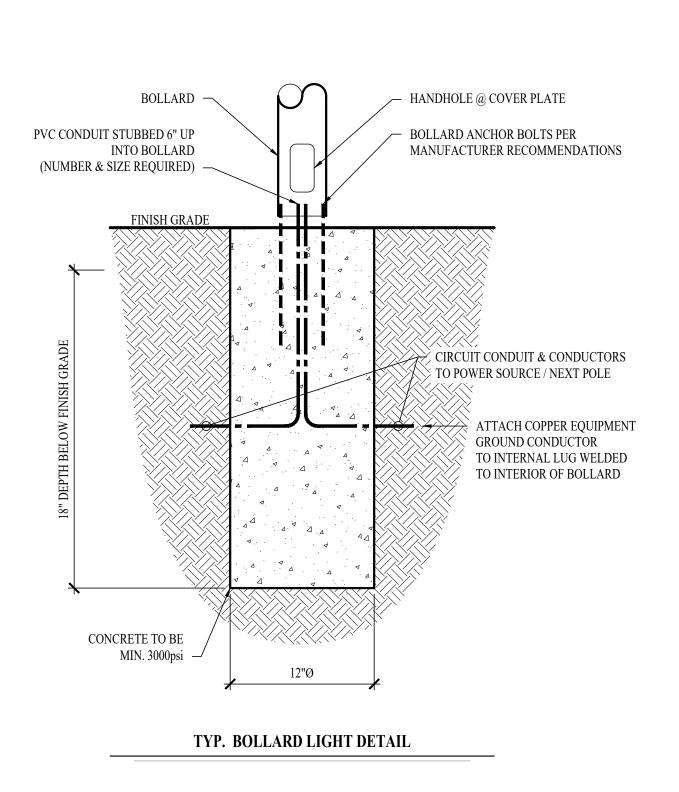

#### STATE OF MISSOURI MICHAEL L. PARSON, GOVERNOR

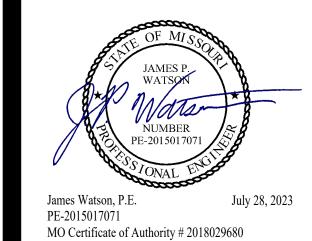

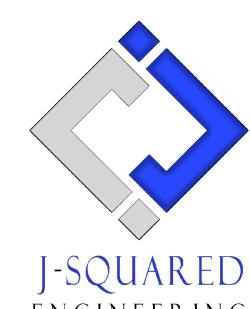

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ISSUE DATE: 07/28/2023

CAD DWG FILE: J20972
DRAWN BY: DET
CHECKED BY: JPW
DESIGNED BY: JAP

SHEET TITLE:

ELECTRICAL DETAILS & SCHEDULES

SHEET NUMBER:

E50

11 OF 11 SHEETS ISSUE DATE: 07/28/2023