# COMBINED SUPPORT MAINTENANCE SHOP (CSMS) INTERIOR RENOVATION & REROOF

# IKE SKELTON TRAINING SITE JEFFERSON CITY, MISSOURI

OWNER:

STATE OF MISSOURI MIKE PARSON, GOVERNOR

DEPARTMENT OF PUBLIC SAFETY OFFICE OF THE ADJUTANT GENERAL MISSOURI NATIONAL GUARD FACILITIES DIVISION

APPLICABLE CODES: 2018 INTERNATIONAL BUILDING CODE

2018 INTERNATIONAL EXISTING BUILDING CODE

2017 NATIONAL ELECTRICAL CODE 2018 INTERNATIONAL MECHANICAL CODE 2018 INTERNATIONAL PLUMBING CODE 2018 INTERNATIONAL FUEL GAS CODE

**DESIGNER:** 

CASCO DIVERSIFIED

CORPORATION

PROJECT NUMBER: T2225-01

SITE NUMBER: 6300

ASSET NUMBER: 8136300007 CASCO

12 SUNNEN DR. SUITE 100 ST. LOUIS, MO 63143 ARCHITECTS / ENGINEERS 314-821-1100

CASCO DIVERSIFIED CORPORATION MISSOURI STATE CERTIFICATE OF AUTHORITY #000613 (ENG) MISSOURI STATE CERTIFICATE OF AUTHORITY #000329 (ARCH)



VICINITY MAP

NORTH

ADDRESS:

65101

2302 MILITIA DRIVE

JEFFERSON CITY, MO

## SHEET INDEX

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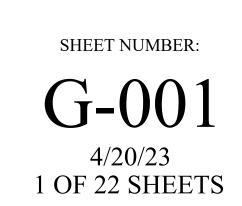
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### **GENERAL NOTES:**

EXISTING ROOF DEAD LOAD

BUILDING CODE - 2018 INTERNATIONAL BUILDING CODE

٠.	MINIMUM ROOF LIVE LOAD	10 1 01
	TRIBUTARY AREA 0 TO 200 SQ. FT.	= 20 PSF
	TRIBUTARY AREA 201 TO 600 SQ. FT.	= 20(1.2-0.001At) PSF
	TRIBUTARY AREA OVER 600 SQ. FT.	= 12 PSF
2.	SNOW LOADS:	
	- GROUND SNOW LOAD, Pg	= 20 PSF
3.	WIND LOADS:	
	- ULTIMATE WIND SPEED (3 SEC. GUST), Vult	= 107 MPH
	- BASIC WIND SPEED, Vasd	= 83 MPH
	- RISK CATEGORY	=
	- BUILDING CATEGORY	= ENCLOSED SIMPLI DIAPHRAGN
	- OVERALL EXPOSURE CATEGORY	= C
	- OVERALE EXI OGGIVE GATEGORY	-0
4.	SEISMIC:	_
	- RISK CATEGORY	=
	- SEISMIC IMPORTANCE FACTOR, le - MAPPED SPECTRAL RESPONSE COEFFICIENTS	= 1.0
	- MAPPED SPECTRAL RESPONSE COEFFICIENTS Ss	= 0.201
	S1	= 0.109
	- SITE CLASS	= E
	- SPECTRAL RESPONSE COEFFICIENTS	
	SDS	= 0.322
	SD1	= 0.305
	- SEISMIC DESIGN CATEGORY	= D

### CONCRETE

ALL CONCRETE SHALL BE NORMAL-WEIGHT (DENSITY=145 PCF) AND SHALL HAVE A 28-DAY COMPRESSIVE STRENGTH IN ACCORDANCE WITH THE FOLLOWING:

> ALL FOUNDATIONS, INTERIOR SLAB EXTERIOR SLABS, CURBS, SIDEWALKS 4000psi ALL OTHER CONCRETE (U.N.O.)

3000psi 3000psi

= 15 PSF

THE SLUMP OF ALL CONCRETE SHALL NOT EXCEED 4" UNLESS A HIGH RANGE WATER-REDUCING ADMIXTURE IS USED. THE SLUMP OF CONCRETE PRIOR TO ADDITION OF A HIGH-RANGE WATER-REDUCING ADMIXTURE SHALL NOT EXCEED 4". THE SLUMP OF CONCRETE CONTAINING A HIGH RANGE WATER-REDUCING ADMIXTURE SHALL NOT EXCEED 10".

- ALL EXTERIOR CONCRETE SHALL BE AIR-ENTRAINED WITH BETWEEN 4% AND 8%, AIR CONTENT.
- THE COARSE AGGREGATE SIZE SHALL BE #57 OR LARGER.
- THE MINIMUM PORTLAND CEMENT CONTENT (ASTM C150 TYPE I OR II) OF ALL CONCRETE SHALL CONFORM TO THE FOLLOWING TABLE (FLY ASH NOT PERMITTED):

SPECIFIED COMPRESSIVE SRENGTH (psi)	NON AIR-ENTRAINED CONCRETE (lbs.)	AIR-ENTRAINED CONCRETE (lbs.)
3000	470	517
4000	564	611

- THE CONTRACTOR SHALL SUBMIT CONCRETE MIX DESIGNS FOR REVIEW A MINIMUM OF ONE WEEK PRIOR TO THE PLACEMENT OF ANY CONCRETE. THE CONCRETE MIX DESIGNS SHALL INCLUDE ALL STRENGTH DATA NECESSARY TO SHOW COMPLIANCE WITH THE PROJECT SPECIFICATIONS FOR EITHER THE TRIAL BATCH OR FIELD EXPERIENCE METHOD.
- CONCRETE REINFORCING STEEL SHALL CONFORM TO ASTM A615, GRADE 60, UNLESS NOTED OTHERWISE.
- CONCRETE REINFORCING STEEL TO BE WELDED SHALL CONFORM TO ASTM A706.
- WELDED WIRE FABRIC SHALL CONFORM TO ASTM A185.
- 10. ALL REINFORCING SHALL BE DETAILED, FABRICATED, AND PLACED IN ACCORDANCE WITH THE LATEST EDITION OF THE AMERICAN CONCRETE INSTITUTE DETAILING MANUAL
- ALL REINFORCING SHALL BE SUPPORTED IN FORMS, SPACED WITH NECESSARY ACCESSORIES AND SHALL BE SECURELY WIRED TOGETHER, IN ACCORDANCE WITH THE LATEST EDITION OF THE CRSI "MANUAL OF STANDARD PRACTICE".
- 12. THE MINIMUM CONCRETE CLEAR COVER OVER REINFORCING STEEL, UNLESS NOTED OTHERWISE,

SHALL BE: UNFORMED SURFACE IN CONTACT WITH THE GROUND FORMED SURFACES EXPOSED TO EARTH OR WEATHER: #5 BARS AND SMALLER 1 1/2 IN. SLABS, WALLS, AND JOISTS: #11 BARS AND SMALLER 3/4 IN.

13. ALL BASE PLATES, ANCHOR BOLTS, SUPPORT ANGLES, ETC., WHICH ARE BELOW GRADE SHALL BE COVERED WITH A MINIMUM OF 3" OF CONCRETE.

### STRUCTURAL STEEL:

1. STEEL SHALL CONFORM TO THE FOLLOWING GRADES:

WIDE FLANGE SHAPES A992 OR A572 GR. 50 (Fy = 50) CHANNELS, ANGLES, PLATES, ETC. (UNO) A36 (Fy = 36)STRUCTURAL TUBE A500 (Fy=46) STEEL PIPE A53 (Fy=35) THREADED RODS F1554, A36 OR A307 BOLTS A325 WELDING ELECTRODES E70XX

- ALL STRUCTURAL STEEL SHALL BE DETAILED, FABRICATED AND ERECTED IN ACCORDANCE WITH THE AISC CODE OF STANDARD PRACTICE (360-05), EXCEPT AS MODIFIED IN THESE NOTES AND THE
- ALL STRUCTURAL STEEL TO HAVE A SHOP GRADE PRIMER UNLESS NOTED OTHERWISE.

### MISCELLANEOUS:

- NO CHANGE IN SIZE OR DIMENSION OF STRUCTURAL MEMBERS SHALL BE MADE WITHOUT THE WRITTEN APPROVAL OF THE PROFESSIONAL OF RECORD.
- 2. STRUCTURAL DRAWINGS ARE INTENDED TO BE USED WITH ARCHITECTURAL AND MECHANICAL DRAWINGS. CONTRACTOR IS RESPONSIBLE FOR COORDINATING SUCH REQUIREMENTS INTO THEIR SHOP DRAWINGS AND WORK.
- 3. NO OPENINGS SHALL BE MADE IN ANY STRUCTURAL MEMBER WITHOUT THE WRITTEN APPROVAL OF THE PROFESSIONAL OF RECORD.
- 4. DO NOT SCALE THESE DRAWINGS, USE DIMENSIONS.
- 5. THE CONTRACTOR SHALL INFORM THE PROFESSIONAL OF RECORD IN WRITING OF ANY DEVIATION FROM THE CONTRACT DOCUMENTS. THE CONTRACTOR SHALL NOT BE RELIEVED OF THE RESPONSIBILITY OF SUCH DEVIATION BY THE PROFESSIONAL OF RECORD REVIEW OF SHOP DRAWINGS, PRODUCT DATA, ETC., UNLESS THE CONTRACTOR HAS SPECIFICALLY INFORMED THE PROFESSIONAL OF RECORD OF SUCH DEVIATION AT THE TIME OF SUBMISSION, AND THE PROFESSIONAL OF RECORD HAS GIVEN WRITTEN APPROVAL TO THE SPECIFIC
- 6. ANY DETAIL TITLED AS A TYPICAL DETAIL IS APPLICABLE THROUGHOUT THE DESIGN DRAWINGS. THESE DETAILS ARE DEFINED AS GENERAL STANDARDS THAT ARE USUALLY NOT IDENTIFIED BY SPECIFIC REFERENCE WITHIN THE DRAWINGS. THESE DETAILS MAY BE MODIFIED OR SUPERSEDED BY SPECIFIC DETAILS THAT ARE REFERENCED WITHIN THE DRAWINGS.
- THE CONTRACTOR IS RESPONSIBLE FOR LIMITING THE AMOUNT OF CONSTRUCTION LOAD IMPOSED UPON THE STRUCTURAL FRAMING. CONSTRUCTION LOADS SHALL NOT EXCEED THE DESIGN CAPACITY OF THE FRAMING AT THE TIME THE LOADS ARE IMPOSED

### **EXISTING CONSTRUCTION:**

- 1. WORK SHOWN IS NEW UNLESS INDICATED AS EXISTING.
- 2. EXISTING CONSTRUCTION SHOWN IS BASED UPON ASSUMED EXISTING CONDITIONS AND CAN BE USED FOR BIDDING PURPOSES. THE CONTRACTOR SHALL FIELD VERIFY ALL EXISTING JOB CONDITIONS, REVIEW ALL DRAWINGS AND VERIFY DIMENSIONS, ELEVATIONS, AND MEMBER SIZES PRIOR TO CONSTRUCTION OR MATERIAL PURCHASE. THE CONTRACTOR SHALL NOTIFY THE PROFESSIONAL OF RECORD IN WRITING OF ALL DISCREPANCIES AND EXCEPTIONS BEFORE PROCEEDING WITH THE WORK.
- THE REMOVAL, CUTTING, DRILLING, ETC. OF EXISTING CONSTRUCTION SHALL BE PERFORMED WITH GREAT CARE IN ORDER NOT TO JEOPARDIZE THE STRUCTURAL INTEGRITY OF THE BUILDING. IF STRUCTURAL MEMBERS OR MECHANICAL, ELECTRICAL, OR ARCHITECTURAL FEATURES NOT INDICATED FOR REMOVAL INTERFERE WITH THE NEW WORK, THE PROFESSIONAL OF RECORD SHALL BE IMMEDIATELY NOTIFIED AND PRIOR WRITTEN APPROVAL SHALL BE OBTAINED BEFORE REMOVAL OR MODIFICATION OF MEMBERS.
- THE CONTRACTOR SHALL RESTORE ALL EXISTING INCIDENTAL CONSTRUCTION REQUIRED TO BE REMOVED TO ACCOMMODATE THE ERECTION OF THE NEW JOIST CONSTRUCTION TO ITS ORIGINAL WORKING CONDITION.
- THE CONTRACTOR IS SOLELY RESPONSIBLE FOR THE MEANS & METHOD OF ALL DEMOLITION WORK & FOR PROVIDING ALL NECESSARY TEMPORARY SHORING, BRACING & PROTECTION AS NECESSARY FOR SAFETY, STABILITY & PROTECTION OF ALL BUILDING ELEMENTS & STRUCTURE DURING CONSTRUCTION & DEMOLITION.

### **FOUNDATIONS**


- THE FOUNDATIONS HAVE BEEN DESIGNED TO BEAR ON SOIL CAPABLE OF SUPPORTING A PRESUMED NET ALLOWABLE BEARING PRESSURE OF 1500PSF
- 2. ALL EXPOSED AND/OR DISTURBED GRANULAR BASE AREAS SHALL BE COMPACTED TO A MINIMUM OF 95% OF OPTIMUM DENSITY IN ACCORDANCE W/ASTM D 1557 AT OPTIMUM MOISTURE CONTENT AND TO A MINIMUM DEPTH OF 8" - ALL SUBGRADE SOIL AREAS EXPOSED BY EXCAVATIONS AND GRADING SHALL BE COMPACTED TO A MINIMUM OF 95% OF OPTIMUM DENSITY IN ACCORDANCE W/ASTM D 1557 AT OPTIMUM MOISTURE CONTENT AND TO A MINIMUM DEPTH OF 12" - FILL WHERE REQUIRED SHALL BE PLACED IN LIFTS NOT TO EXCEED 8" LOOSE MEASURE AND SHALL BE COMPACTED AS OUTLINED ABOVE - THE ON SITE TESTING COMPANY SHALL PROVIDE TESTING AND INSPECTION OF THE SOIL WORK PRIOR TO PLACING CONCRETE
- ALL BEARING MATERIAL SHALL BE INSPECTED BY THE INDEPENDENT TESTING AGENCY PRIOR TO CONCRETE PLACEMENT. THE INDEPENDENT TESTING AGENCY SHALL BE THE SOLE JUDGE AS TO THE SUITABILITY OF THE BEARING MATERIAL. FOOTING ELEVATIONS SHALL BE
- 4. FOOTINGS MAY BE POURED INTO AN EARTH-FORMED TRENCH IF SOIL CONDITIONS PERMIT.


### COLD FORMED STEEL:

- ALL SIZING BASED ON STEEL STUD MANUFACTURERS ASSOCIATION (ICBO ER-4943P) PRODUCT
- ALL GALVANIZED STUDS AND JOISTS 12, 14 AND 16 GAUGE SHALL BE FORMED FROM STEEL THAT CORRESPONDS TO THE MINIMUM REQUIREMENTS OF ASTM A653 SS, GRADE 50, CLASS 1 OR 3 WITH A MINIMUM YIELD OF 50,000 PSI.
- 3. ALL GALVANIZED STUDS, JOISTS, TRACK, BRIDGING AND ACCESSORIES SHALL BE FORMED FROM STEEL HAVING A GALVANIZED COATING MEETING THE REQUIREMENTS OF ASTM A525.
- THE PHYSICAL AND STRUCTURAL PROPERTIES LISTED BY THE STEEL STUD MANUFACTURER ASSOCIATION AND AISI DESIGN MANUAL SHALL BE CONSIDERED THE MINIMUM PERMITTED FOR ALL FRAMING MEMBERS. SPECIFICALLY, THE FOLLOWING MINIMUM PROPERTIES, CALCULATED IN ACCORDANCE WITH THE LATEST AISI SPECIFICATION SHALL BE PROVIDED: IX (IN.4), SX (IN.3), AREA (IN.2), RX (IN.), FY (KSI), RESISTING MOMENT (IN.-LB.).
- ANY SUBSTITUTIONS MUST BE APPROVED IN WRITING PRIOR TO DELIVERY, BY THE ARCHITECT AND/OR ENGINEER OF RECORD.
- INSTALLATION OF STUDS SHALL BE AS PER ASTM C1007-00 "INSTALLATION OF LOAD BEARING (TRANSVERSE AND AXIAL) STEEL STUDS AND ACCESSORIES", ASTM C955-00a "SPECIFICATION FOR LOAD BEARING (TRANSVERSE AND AXIAL) STEEL STUDS, RUNNERS (TRACK), AND BRACING OR BRIDGING FOR SCREW APPLICATION OF GYPSUM BOARD AND METAL PLASTER BASES", AND ASTM C754-00 "SPECIFICATION FOR INSTALLATION OF STEEL FRAMING MEMBERS TO RECEIVE SCREW ATTACHED GYPSUM BOARD"
- 7. ALL FRAMING COMPONENTS SHALL BE CUT SQUARELY FOR ATTACHMENT TO PERPENDICULAR MEMBERS, OR AS REQUIRED FOR AN ANGULAR FIT AGAINST ABUTTING MEMBERS. MEMBERS SHALL BE HELD POSITIVELY IN PLACE UNTIL PROPERLY FASTENED.
- A MINIMUM OF 10" OF UNPUNCHED STEEL AT EACH END.

JOISTS MUST HAVE A MINIMUM OF 10" UNPUNCHED STEEL AT BEARING POINTS. STUDS MUST HAVE

9. COLD-FORMED STEEL IDENTIFICATION LEGEND:

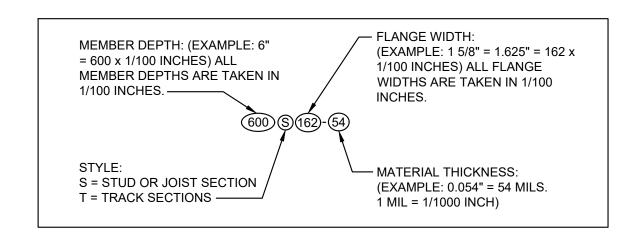

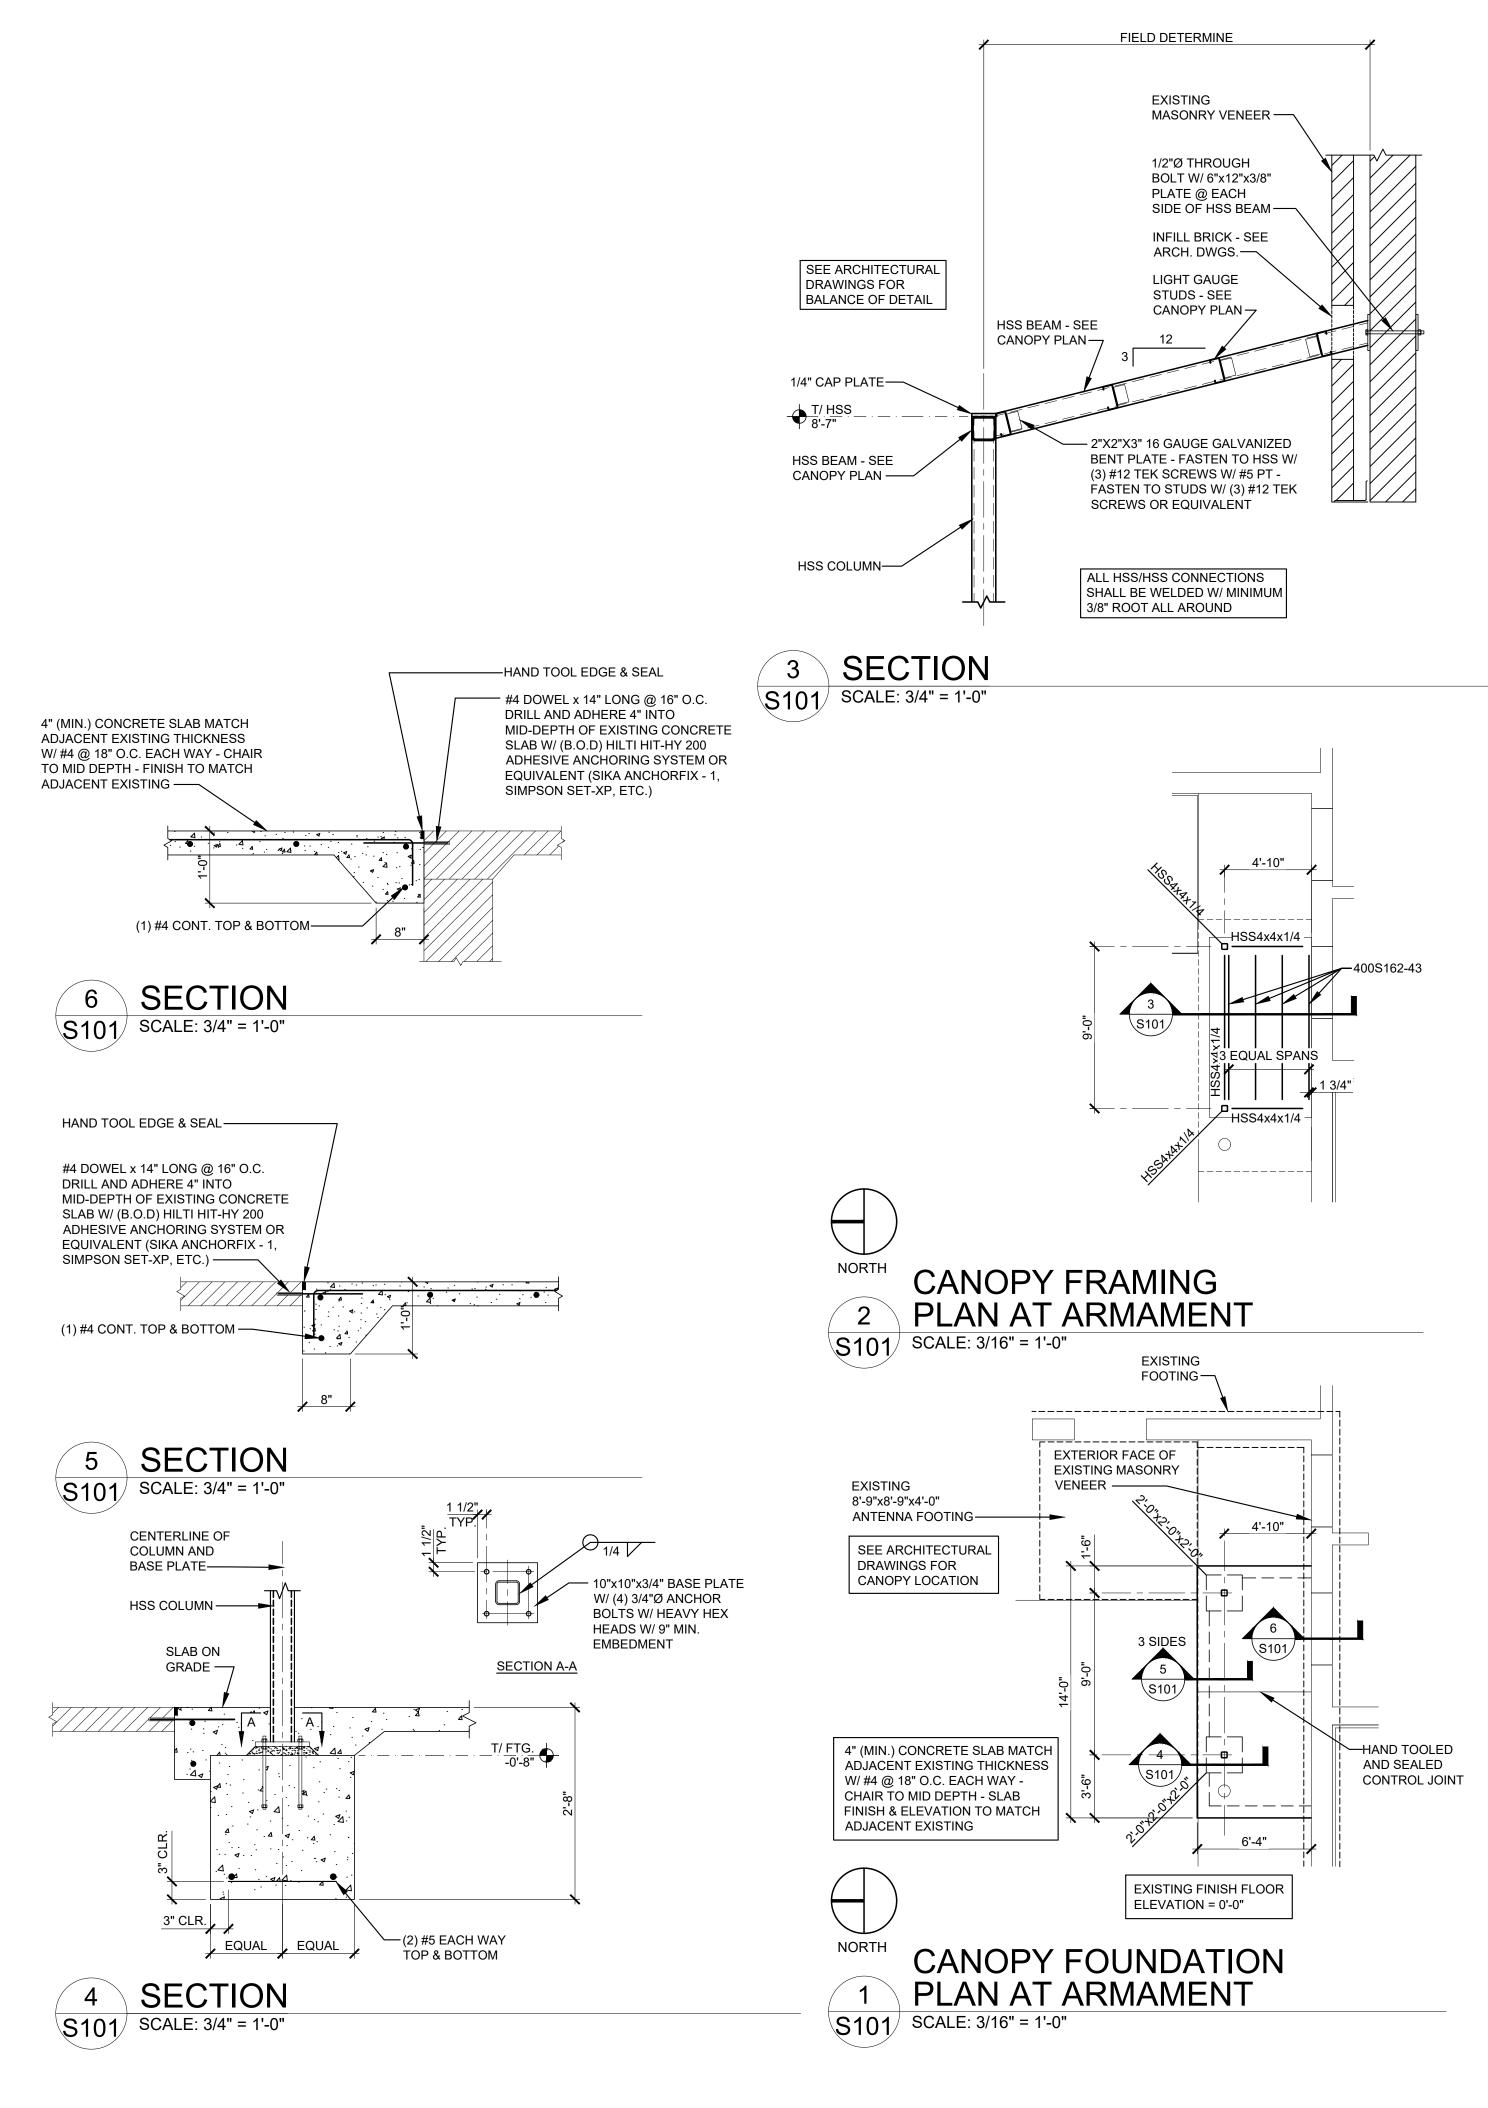

### STATE OF MISSOURI MICHAEL L. PARSON, **GOVERNOR**



**CASCO** Diversified Corporation MO Certificate of Authority #000329 Arch. MO Certificate of Authority #000613 Eng.

**OFFICE OF ADMINISTRATION DIVISION OF FACILITIES** MANAGEMENT, **DESIGN AND CONSTRUCTION** 

MISSOURI NATIONAL **GUARD** 

INTERIOR RENOVATIONS & ROOF REPLACEMENT AT COMBINED SUPPORT MAINTENANCE SHOP (CSMS)

COMBINED SUPPORT MAINTENANCE SHOP (CSMS) 2302 MILITIA DRIVE JEFFERSON CITY, MISSOURI 65101

PROJECT # T2225-01 6300 SITE# ASSET# 8136300007


**REVISION:** DATE: **REVISION:** DATE: **REVISION:** DATE: ISSUE DATE: 04/20/2023

CAD DWG FILE: DRAWN BY: BW' CHECKED BY: MAS DESIGNED BY: ND

SHEET TITLE:

STRUCTURAL GENERAL NOTES, PLANS AND DETAILS

SHEET NUMBER

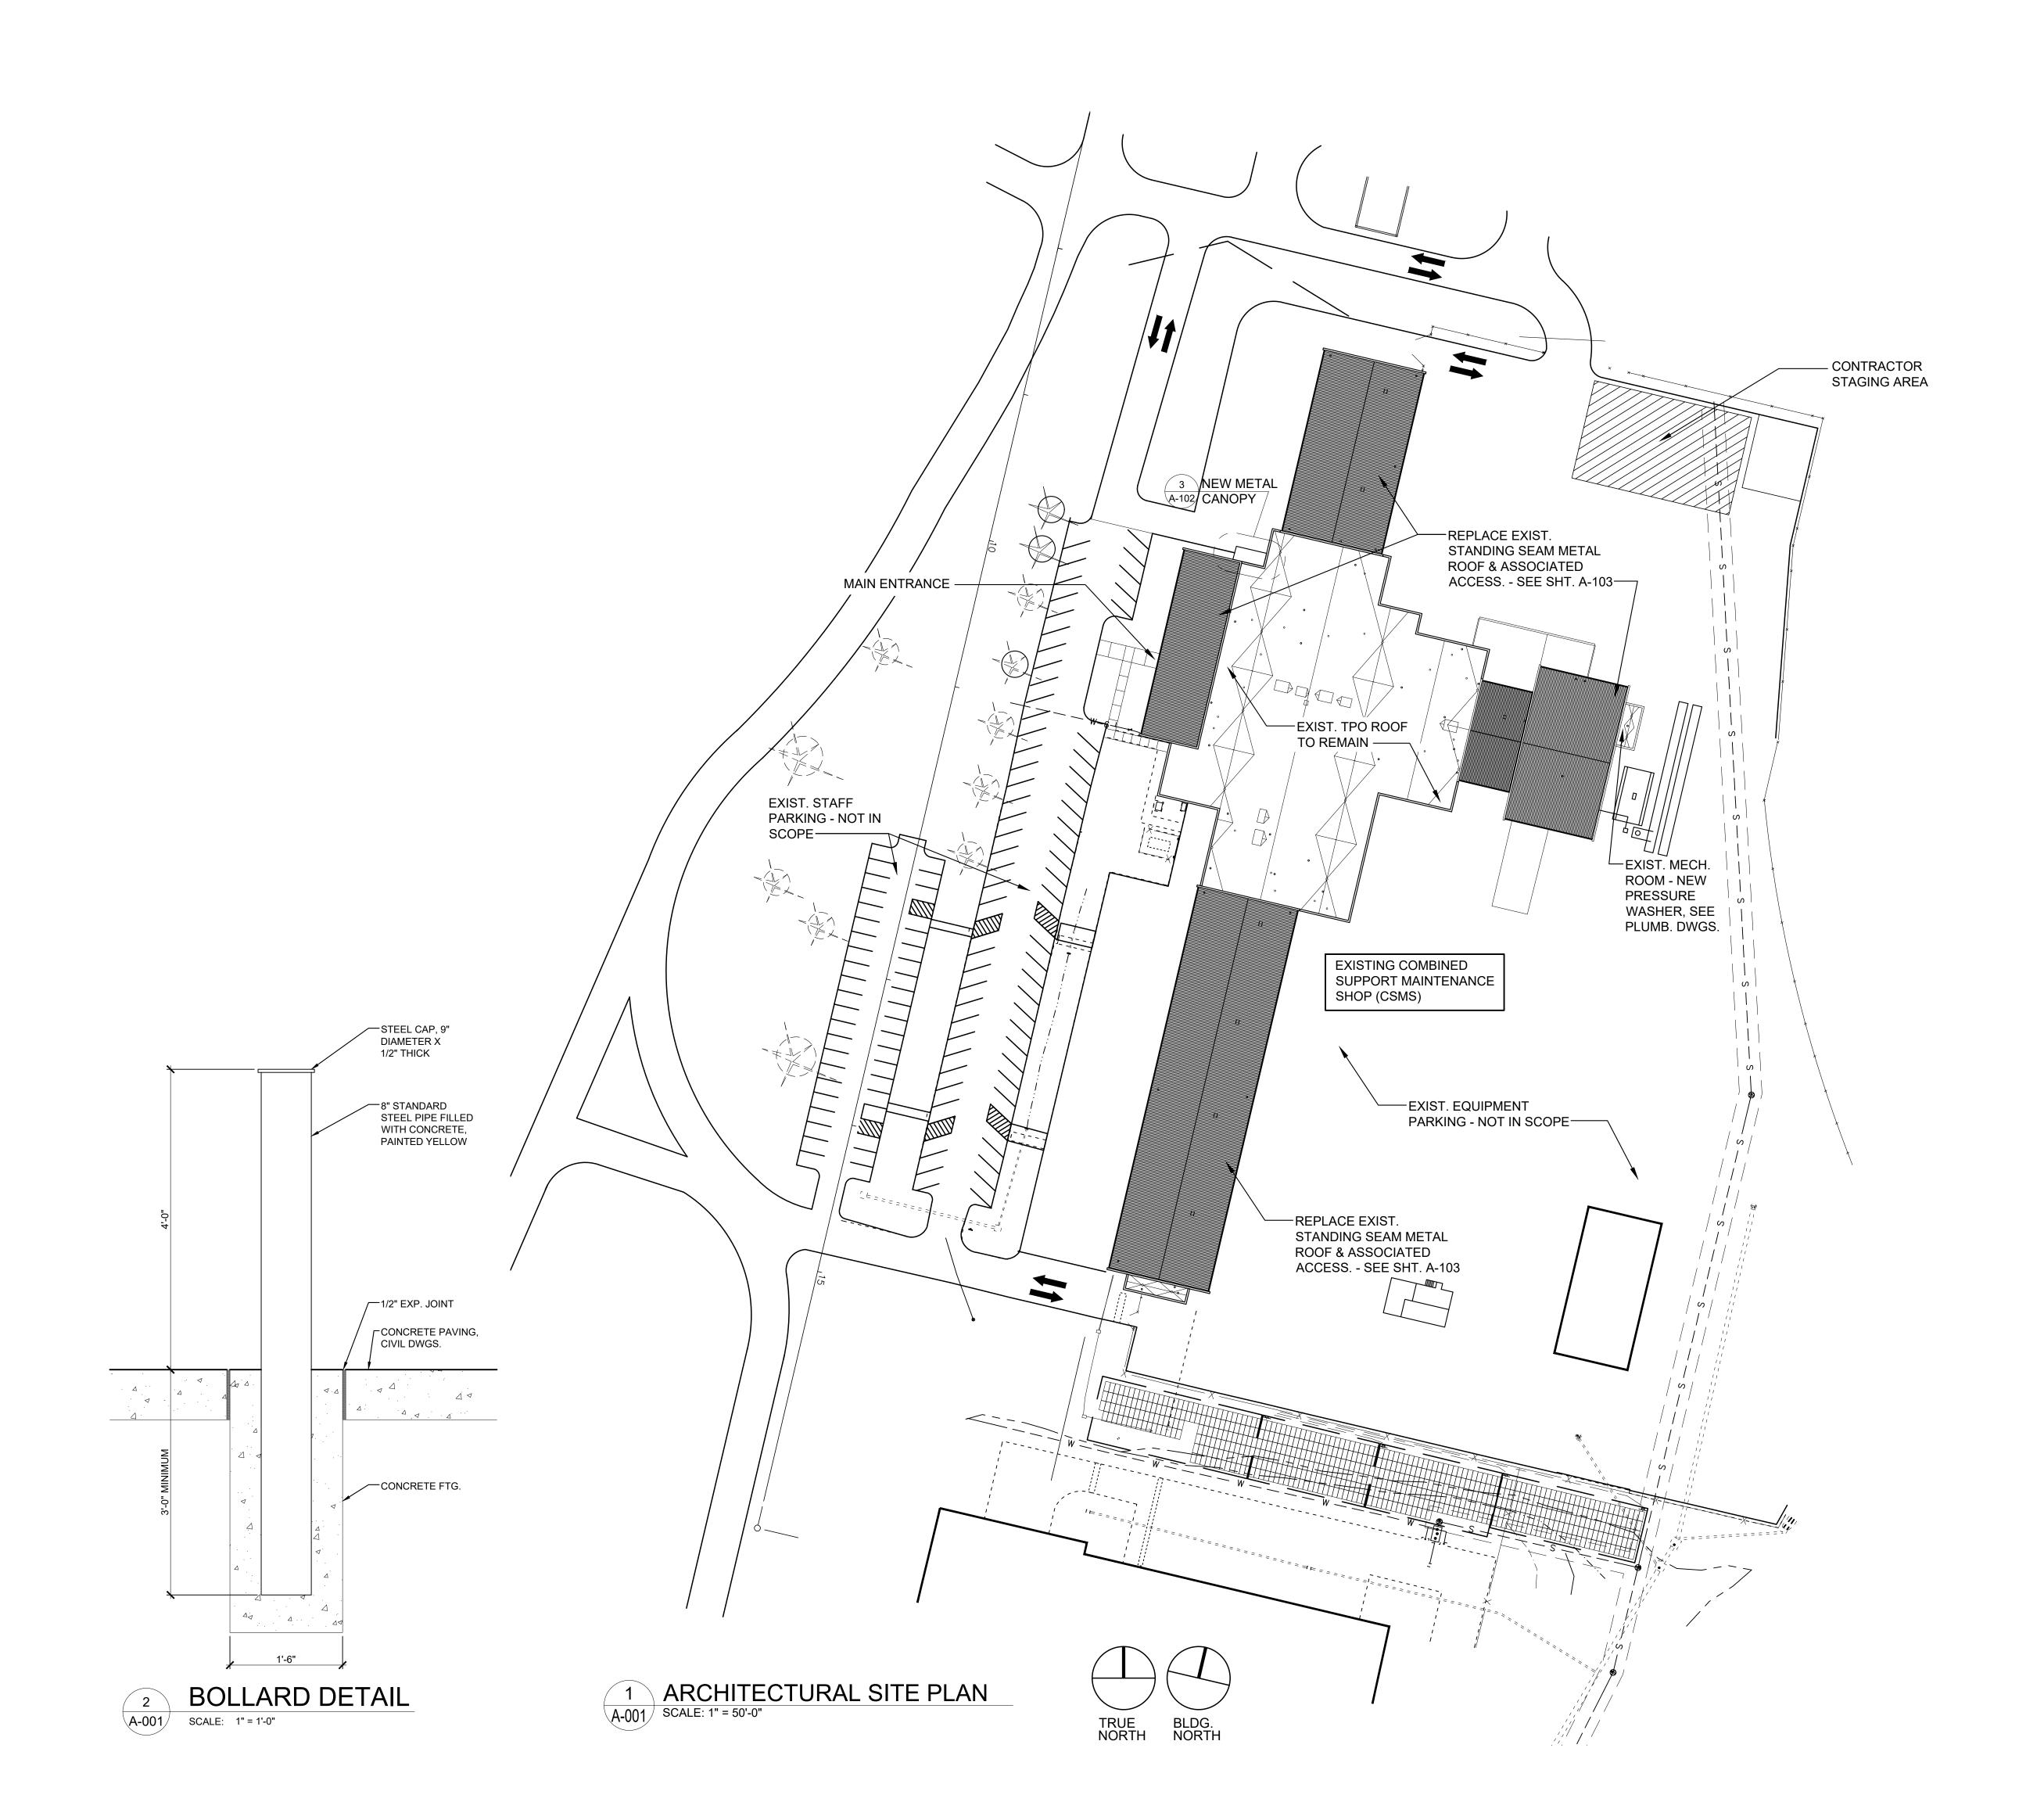

STATE OF MISSOURI MICHAEL L. PARSON, GOVERNOR



CASCO Diversified Corporation MO Certificate of Authority #000329 Arch. MO Certificate of Authority #000613 Eng.

12 Sunnen Drive, Suite 100, St. Louis, MO 63143 T

OFFICE OF
ADMINISTRATION
DIVISION OF FACILITIES
MANAGEMENT,
DESIGN AND
CONSTRUCTION

MISSOURI NATIONAL GUARD

INTERIOR RENOVATIONS & ROOF REPLACEMENT AT COMBINED SUPPORT MAINTENANCE SHOP (CSMS)

COMBINED SUPPORT MAINTENANCE SHOP (CSMS) 2302 MILITIA DRIVE JEFFERSON CITY, MISSOURI 65101

PROJECT # T2225-01 SITE # 6300

ASSET# 8136300007

REVISION:

DATE: REVISION: DATE: REVISION:

DATE: ISSUE DATE: 04/20/2023

ISSUE DATE: 04/20/202

CAD DWG FILE:
DRAWN BY: KMS
CHECKED BY: RAR
DESIGNED BY: RAR

SHEET TITLE:

ARCHITECTURAL SITE PLAN

SHEET NUMBER:

SHEET NUMBER:

4/20/23 3 OF 22 SHEETS



- AT THE TIME OF SUBMITTING FINAL BID. THE G.C. SHALL VERIFY ALL RELEVANT DIMENSIONS AND EXISTING CONDITIONS BEFORE PROCEEDING WITH THE AFFECTED WORK AND NOTIFY THE ARCHITECT OF ANY DISCREPANCIES IMMEDIATELY. ALL DISCREPANCIES SHALL BE RESOLVED PRIOR TO PROCEEDING WITH AFFECTED WORK.
- THE CONTRACTOR SHALL CONTAIN ALL CONSTRUCTION ACTIVITY (WHICH SHALL INCLUDE STORAGE OF MATERIALS AND EQUIPMENT) WITHIN THE LIMITS OF CONSTRUCTION.
- SEE ALTERNATES BELOW FOR ITEMS OUTSIDE OF BASE SCOPE OF WORK.
- 4. ALL NEW BUILDING MATERIALS TO BE OF NON-COMBUSTIBLE OR WOOD FIRE RETARDANT TREATED
- THE CONTRACTOR SHALL COMPLY WITH FEDERAL ENVIRONMENTAL AND OCCUPATIONAL HEALTH AND SAFETY ADMINISTRATION REGULATIONS AND ALL LOCAL AND STATE HEALTH DEPARTMENT REQUIREMENTS AND RECOMMENDATIONS REGARDING MOLD AND MILDEW.
- 3. IN THE EVENT THE CONTRACTOR DISCOVERS, AT ANY TIME THE PRESENCE OF MOLD AND / OR MILDEW, THE CONTRACTOR SHALL IMMEDIATELY NOTIFY THE OWNER'S REPRESENTATIVE AND THE ARCHITECT / ENGINEER OF RECORD, IN WRITING, OF THE CONCERNS AND/OR SUSPICIONS.
- THE CONTRACTOR SHALL CONTAIN ALL CONSTRUCTION ACTIVITY (WHICH SHALL INCLUDE STORAGE OF MATERIALS AND EQUIPMENT) WITHIN THE LIMITS OF CONSTRUCTION OR WITHIN THE DESIGNATED STAGING AREA AS DETERMINED BY THE PRE-BID MEETING.
- 3. THE CONTRACTOR SHALL BE RESPONSIBLE FOR REPAIRING ANY SURFACES DAMAGED BY CONSTRUCTION ACTIVITY THAT IS UNDER THE CONTROL OF THE CONTRACTOR (THIS INCLUDES ALL SUBCONTRACTOR WORK). REPAIRS SHALL MATCH EXISTING MATERIALS AND BE APPROVED BY THE OWNER.
- 9. THE CONTRACTOR SHALL FIELD VERIFY ALL EXISTING CONDITIONS PRIOR TO FABRICATION.
- 10. THE CONTRACTOR SHALL ENSURE THAT ALL MOISTURE AND DEBRIS HAVE BEEN ELIMINATED PRIOR TO INSTALLING NEW MATERIALS AND PREPARE SURFACE IN ACCORDANCE WITH MANUFACTURER'S REQUIREMENTS. REFERENCE SPECIFICATIONS FOR FURTHER DIRECTION.
- 1. SHOULD THE CONTRACTOR OBSERVE ANY DETERIORATED MATERIALS OR DAMAGED STRUCTURAL CONDITIONS, THE ARCHITECT AND OWNER SHALL BE NOTIFIED.
- 12. CONTRACTOR SHALL INSPECT ALL INTERNAL /EXTERNAL ROOF DRAINS AND INCLUDE ALL COMPONENTS NECESSARY TO CONSTRUCT A COMPLETE DRAINAGE SYSTEM.
- 13. ANY EQUIPMENT NOT IDENTIFIED TO BE REMOVED IS TO REMAIN UNLESS NOTED OTHERWISE.
- 14. THE CONTRACT WORK SHALL INCLUDE FURNISHING ALL MATERIALS, EQUIPMENT, TOOLS, LABOR & SERVICES NECESSARY FOR COMPLETION OF THE PROJECT.
- 15. THE CONTRACTOR SHALL BE RESPONSIBLE FOR THE QUALITY OF WORKMANSHIP & FOR COMPLIANCE WITH THE DESIGN. THE CONTRACTOR SHALL CORRECT ALL ERRORS & DEVIATIONS AS REQUESTED BY THE
- 16. THE CONTRACTOR SHALL BE RESPONSIBLE FOR QUALITY OF ALL REFURBISHED MATERIALS. ALL REFURBISHED MATERIALS TO APPEAR NEW.
- 17. THE CONTRACTOR SHALL VERIFY ALL RELEVANT DIMENSIONS AND EXISTING CONDITIONS BEFORE PROCEEDING WITH THE AFFECTED WORK AND NOTIFY THE ARCHITECT OF ANY DISCREPANCIES IMMEDIATELY. ALL DISCREPANCIES SHALL BE RESOLVED PRIOR TO PROCEEDING WITH AFFECTED WORK.
- 18. SHOULD ANY OF THE DETAILED INSTRUCTIONS ON THE DRAWINGS CONFLICT WITH THE NOTES OR SPECIFICATIONS OR WITH EACH OTHER, THE STRICTEST PROVISION SHALL APPLY.
- 19.  $\,$  JOB SITE CLEANING: DURING DEMOLITION & CONSTRUCTION, THE JOB SITE SHALL BE CLEANED ON A DAILY BASIS, INCLUDING REMOVAL OF TRASH, RUBBLE, DEBRIS & ORGANIZATION OF MATERIALS & EQUIPMENT. UPON COMPLETION OF THE WORK, THE JOB SITE SHALL BE THOROUGHLY CLEANED, INCLUDING AREAS OF THE BUILDING MADE DIRTY BY CONSTRUCTION WORK. THE G.C. SHALL REMOVE TRASH, RUBBLE, TOOLS, EQUIPMENT & EXCESS MATERIALS FROM THE PREMISES. THE BUILDING IS TO BE LEFT IN A CLEAN CONDITION.
- 20. THE CONTRACTOR IS TO PROVIDE SUPERVISION OF ALL TRADES / SUBS, AS WELL AS ON-SITE SUPERVISION DURING ALL CONSTRUCTION.
- 21. THE CONTRACTOR IS RESPONSIBLE TO PROVIDE ALL DUMPSTERS REQUIRED FOR EXECUTION OF THE PROJECT SCOPE INCLUDING DISPOSAL OF ALL NON-REUSED FIXTURES.
- 22. IF ROOF PENETRATIONS ARE REQUIRED ON EXISTING ROOF, THEN THE CONTRACTOR SHALL EMPLOY A
- 23. CONTRACTOR SHALL PROVIDE 10 WORKING DAY NOTICE PRIOR TO START OF DEMOLITION IN ARMAMENT /
- INSTRUMENT ROOMS FOR COORDINATION WITH GUARD STAFF ON WORKBENCH / EQUIPMENT REMOVAL.

# H TRAVEL DISTANCE = 65'-0" G TRAVEL DISTANCE = 128'-6" J TRAVEL DISTANCE = 55'-8" TRAVEL DISTANCE = 83'-3' \_------DISTANCE = 167'-11" <u>OFFICES</u> NSTRUMEN<sup>T</sup> VEHICLE WORK VEHICLE WORK C TRAVEL DISTANCE = 193'-1' TRAVEL DISTANCE = 235'-7" STORAGE RESTROOMS <u>OFFICES</u> MAIN ENTRANCE 34"W — **EGRESS PLAN** NOT TO SCALE NORTH

COLUMN BUBBLE

ENLARGED PLAN /

XXX DETAIL BUBBLE

INTERIOR ELEV

PARTITION TYPE

EQUIP. TAG

#) → DOOR TAG

(#)

### SCOPE OF WORK:

**BID ALTERNATES:** 

### MAIN BUILDING:

- REPLACE THE EXISTING STANDING SEAM METAL ROOF AND ALL ASSOCIATED ACCESSORIES AT ALL LOCATIONS WITH THE EXCEPTION OF THE ROOF OVER THE SHOP BAY IN THE PAINT / BLAST AREA. ACCESSORIES INCLUDE FASCIA, SOFFITS, GUTTERS, DOWNSPOUTS, METAL COPING AND ALL DAMAGED WOOD BLOCKING AT PARAPETS. ALL NEW METAL IS TO BE PREFINISHED, COLOR TO BE SELECTED BY ARCHITECT AND OWNER.
- ADD ADDITIONAL LED LIGHTS IN THE ARMAMENT AND INSTRUMENT ROOMS. REPLACE EXISTING ESD FLOOR TILES IN ARMAMENT, INSTRUMENT REPAIR, STORAGE ROOM, AND
- CALIBRATE ROOM. REPLACE EXISTING VCT IN RAD ROOM.
- ADD NEW METAL CANOPY OVER DELIVERIES DOOR, INCLUDE CONCRETE FILLED PIPE BOLLARD PROTECTION
- NORTH AND SOUTH WORK BAYS: • REPLACE ALL EXISTING LIGHTING WITH NEW LED FIXTURES
- REMOVE ALL EXISTING CEILING FANS AND REPLACE FEWER, LARGER FANS
- REPLACE EXISTING GAS-FIRED, INFRARED UNITS IN THEIR ENTIRETY

ROOFING CONTRACTOR TO MAINTAIN EXISTING WARRANTIES.

MATERIAL KEY

ZZZZZZ NEW BRICK

NEW CMU

+---- NEW CONSTRUCTION

\_\_\_\_ DEMO CONSTRUCTION

**EXISTING DOOR** 

EXIST. CONSTRUCTION

### CODE DATA

ALTERNATE 1 - REPLACE GAS-FIRED, INFRARED HEATING SYSTEM IN NORTH AND SOUTH WORK BAYS.

ALTERNATE 2 - REPLACE ALL OVERHEAD DOORS AND MOTORS THROUGH BUILDING AND NORTH & SOUTH WORK BAYS, WITH EXCEPTION OF TWO OVERHEAD DOORS AT PAINT AND BLAST BAYS ADDITION.

ALTERNATE 3 - ADD NEW HEATED, WET PRESSURE WASHER SYSTEM TO EXISTING MECHANICAL ROOM ON EAST SIDE OF PAINT AND BLAST BAYS. RELOCATE EXISTING WATER BLASTER FROM WASH BAY TO MECHANICAL ROOM.

ALTERNATE 4 - REFINISH FRONT OFFICES - NEW PAINT, LIGHTING UPGRADES FROM FLUORESCENT TO LED FIXTURES, FLOORING, AND VINYL WALL BASE.

### SCOPE OF WORK DOES NOT CHANGE EXISTING BUILDING SIZE OR OCCUPANCY.

THESE PLANS WERE PREPARED AND SHALL COMPLY WITH THE FOLLOWING CODES:

STEEL

**■**4" U.N.O

CONCRETE

DEMO DOOR

**NEW DOOR** 

- 2018 INTERNATIONAL BUILDING CODE
- 2012 INTERNATIONAL ENERGY CONSERVATION CODE 2018 INTERNATIONAL PLUMBING CODE
- 2018 INTERNATIONAL MECHANICAL CODE 2017 NATIONAL ELECTRICAL CODE

### OCCUPANCY CLASSIFICATION (MIXED OCCUPANCY)

### **USE GROUP TYPES:**

- B: BUSINESS (IBC 304) F-1: FACTORY INDUSTRIAL, MODERATE-HAZARD (IBC 306.2)
- F-2: FACTORY INDUSTRIAL, LOW-HAZARD (IBC 306.3) H-2: HIGH HAZARD, GROUP H-2 (IBC 307.4)
- S-1: STORAGE, MODERATE-HAZARD (IBC 306.3) S-2: STORAGE, LOW-HAZARD (IBC 311.3)
- BUILDING AREA PRIMARY COMBINED SUPPORT MAINTENANCE SHOP (CSMS):

### AREA RESTRICTIONS: PER IBC 506.2 THIS FACILITY IS ALLOWED UNLIMITED AREA **BUILDING SQUARE FOOTAGE:** 76,529 S.F.

# MAXIMUM FLOOR AREA ALLOWANCES PER OCCUPANT: (IBC TABLE 1004.5):

-GARAGE WORK BAYS 200 GROSS -OFFICES 150 GROSS -LOCKER ROOMS 50 GROSS -ACCESSORY STORAGE AREAS 300 GROSS

SYMBOL LEGEND

# \ EXTERIOR ELEV.

X# TAG

ROOM TAG

#> ► KEYED NOTE

FINISH FLOOR FLOOR / STRUCT.
EL: 100'-0" FLOOR / STRUCT.

SECTION CUTS

-STORAGE ROOMS 300 GROSS MINIMUM OCCUPANT LOAD (TABLE 1004.1.2) 40,697 S.F. AT 200 S.F. / PERSON =

1,357 PERSONS (WORK BAYS) 119 PERSONS (OFFICE) 17,779 S.F. AT 150 S.F. / PERSON = 2,835 S.F. AT 50 S.F. / PERSON = 57 PERSONS (LOCKER ROOMS) 13 PERSONS (STORAGE/UTILITY AREA) 3,913 S.F. AT 300 S.F. / PERSON = TOTAL = 1,546 PERSONS

MEANS OF EGRESS (SECTION 1005): EXIT DOORS - .2" PER PERSON x 1,546 = 309.2" < 7148" (17 EXIST EXIT DOORS (13 @ 34", 4 @ 68" = 714")

### FIRE TREATED PLAM PLASTIC LAMINATE BM BENCH MARK PI ATF FLG FLR FLASHING BI OCK FLOOR PLYWOOD BLKG BLOCKING FD FLOOR DRAIN POLYVINYL CHLORIDE BD BOARD POUNDS PER SQUARE FT. FTG FOOTING B.O. BOTTOM OF FOUNDATION POUNDS PER SQUARE IN. FDN BRK BRICK FUR PRESSURE TREATED FURRED(ING) BLDG BUILDING GAGE, GAUGE PROPERTY LINE CAB CABINET GALV REMOVE GALVANIZED CLG CEILING RETURN GENERAL CONTRACT(OR) CL CENTER LINE RIGHT HAND GLASS, GLAZING C/O CENTER OF GYP ROOF DRAIN CENTER TO CENTER GWB **GYPSUM WALL BOARD** ROOFING CLR CLEAR HEATING ROOM COL COLUMN HEATING/VENTILATION RO **ROUGH OPENING** CONC CONCRETE /AIR CONDITIONING SLNT SEALANT CONCRETE MASONRY UNIT SECT SECTION HEIGHT CONSTRUCTION CONST SHTHG **HOLLOW CORE** CONTR CONTRACTOR SHT SHEET НМ HOLLOW METAL CONT CONTINUOUS SIMII AR HOR HORIZONTAL CNTR COUNTER HOSE BIBB CFL COUNTER FLASHING INSULATE(D), (ION) CISK CRS COUNTERSUNK INTERIOR COURSE(S) CF **CUBIC FOOT** TAIOI. STD CY CUBIC YARD LEFT HAND STO DEAD LOAD LINEAL FOOT SUSP DEMC DEMOLISH, DEMOLITION LINTEL SYM DTL DIAG DETAIL LIVE LOAD TEL DIAGONAL MACHINE THK DIAM DIAMETER **MANHOLE** DIM **DIMENSION** MFR **MANUFACTURER** TOM DR DOOR MAS **MASONRY** TPO DS DOWN SPOUT MO MASONRY OPENING MAX MAXIMUM DWG DRAWING MECH MECHANIC(AL) DRINKING FOUNTAIN

MTL

MIN

MISC

NIC

NTS

OC

MINIMUM

**MISCELLANEOUS** 

MOUNT(ED), (ING)

NOT IN CONTRACT

NOT TO SCALE

ON CENTER(S)

FRP

FFE

FEC

FACE OF MASONRY

PLASTIC

FINISH(ED)

FIBERGLASS REINFORCED

FIRE EXTINGUISHER CABINET

FINISHED FLOOR ELEV.

FINISHED FLOOR LINE

FIRE EXTINGUISHER

**ABBREVIATIONS** 

ACOUSTICAL

ALTERNATE

ANCHOR BOLT

ELECTRIC(AL)

ELEVATION

EQUAL

FXISTING

EXPOSED

EXTERIOR

**EMERGENCY** 

**ELECTROSTATIC DISSIPATIVE** 

ELEC

ELEV

ESD

EXIS

EXP

EXT

EQ

ARCHITECT(URAL)

ALUMINUM

BEARING

ALUM

ARCH

AIR CONDITIONING

ABOVE FINISHED FLOOR

**MEDIUM** TOW **METAL** METER(S) **MILLWORK** 

SHEATHING SOLID CORE SQUARE FOOT SQUARE INCH SQUARE YARD STANDARD STORAGE SUSPENDED SYMMETRY, (ICAL) TELEPHONE THICK(NESS) **TONGUE & GROOVE** TOP OF MASONRY THERMOPLASTIC POLYOLEFIN TOP OF STEEL TOP OF STEEL TOP OF WALL TOP OF WALL TYPICAL UNLESS NOTED OTHERWISE VERTICAL WATER CLOSET WELDED WIRE FABRIC

WIDTH, WIDE

WINDOW

WITHOUT

WOOD

W/O

WD

OPENING

OUT TO OUT

OVERALL

OVERHEAD

PAINT(ED)

PARKING

OPPOSITE HAND

**OUTSIDE DIAMETER** 

OPH

00

PKG

STATE OF MISSOURI MICHAEL L. PARSON, **GOVERNOR** 



**CASCO** Diversified Corporation MO Certificate of Authority #000329 Arch.

MO Certificate of Authority #000613 Eng.

**OFFICE OF ADMINISTRATION DIVISION OF FACILITIES** MANAGEMENT, **DESIGN AND** CONSTRUCTION

**MISSOURI NATIONAL GUARD** 

INTERIOR RENOVATIONS & ROOF REPLACEMENT AT COMBINED SUPPORT MAINTENANCE SHOP (CSMS)

COMBINED SUPPORT MAINTENANCE SHOP (CSMS) 2302 MILITIA DRIVE JEFFERSON CITY, MISSOURI 65101

PROJECT # T2225-01 6300 SITE# ASSET# 8136300007


**REVISION:** DATE: **REVISION:** DATE: **REVISION:** DATE: ISSUE DATE: 04/20/2023

CAD DWG FILE: DRAWN BY: CHECKED BY: RAR DESIGNED BY: RAR

SHEET TITLE:

CODE DATA, EGRESS FLOOR PLAN, NOTES & SYMBOLS

SHEET NUMBER:

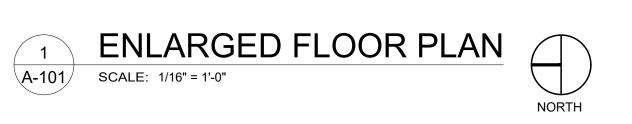



STATE OF MISSOURI MICHAEL L. PARSON, **GOVERNOR** 



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8136300007

PROJECT # T2225-01 6300

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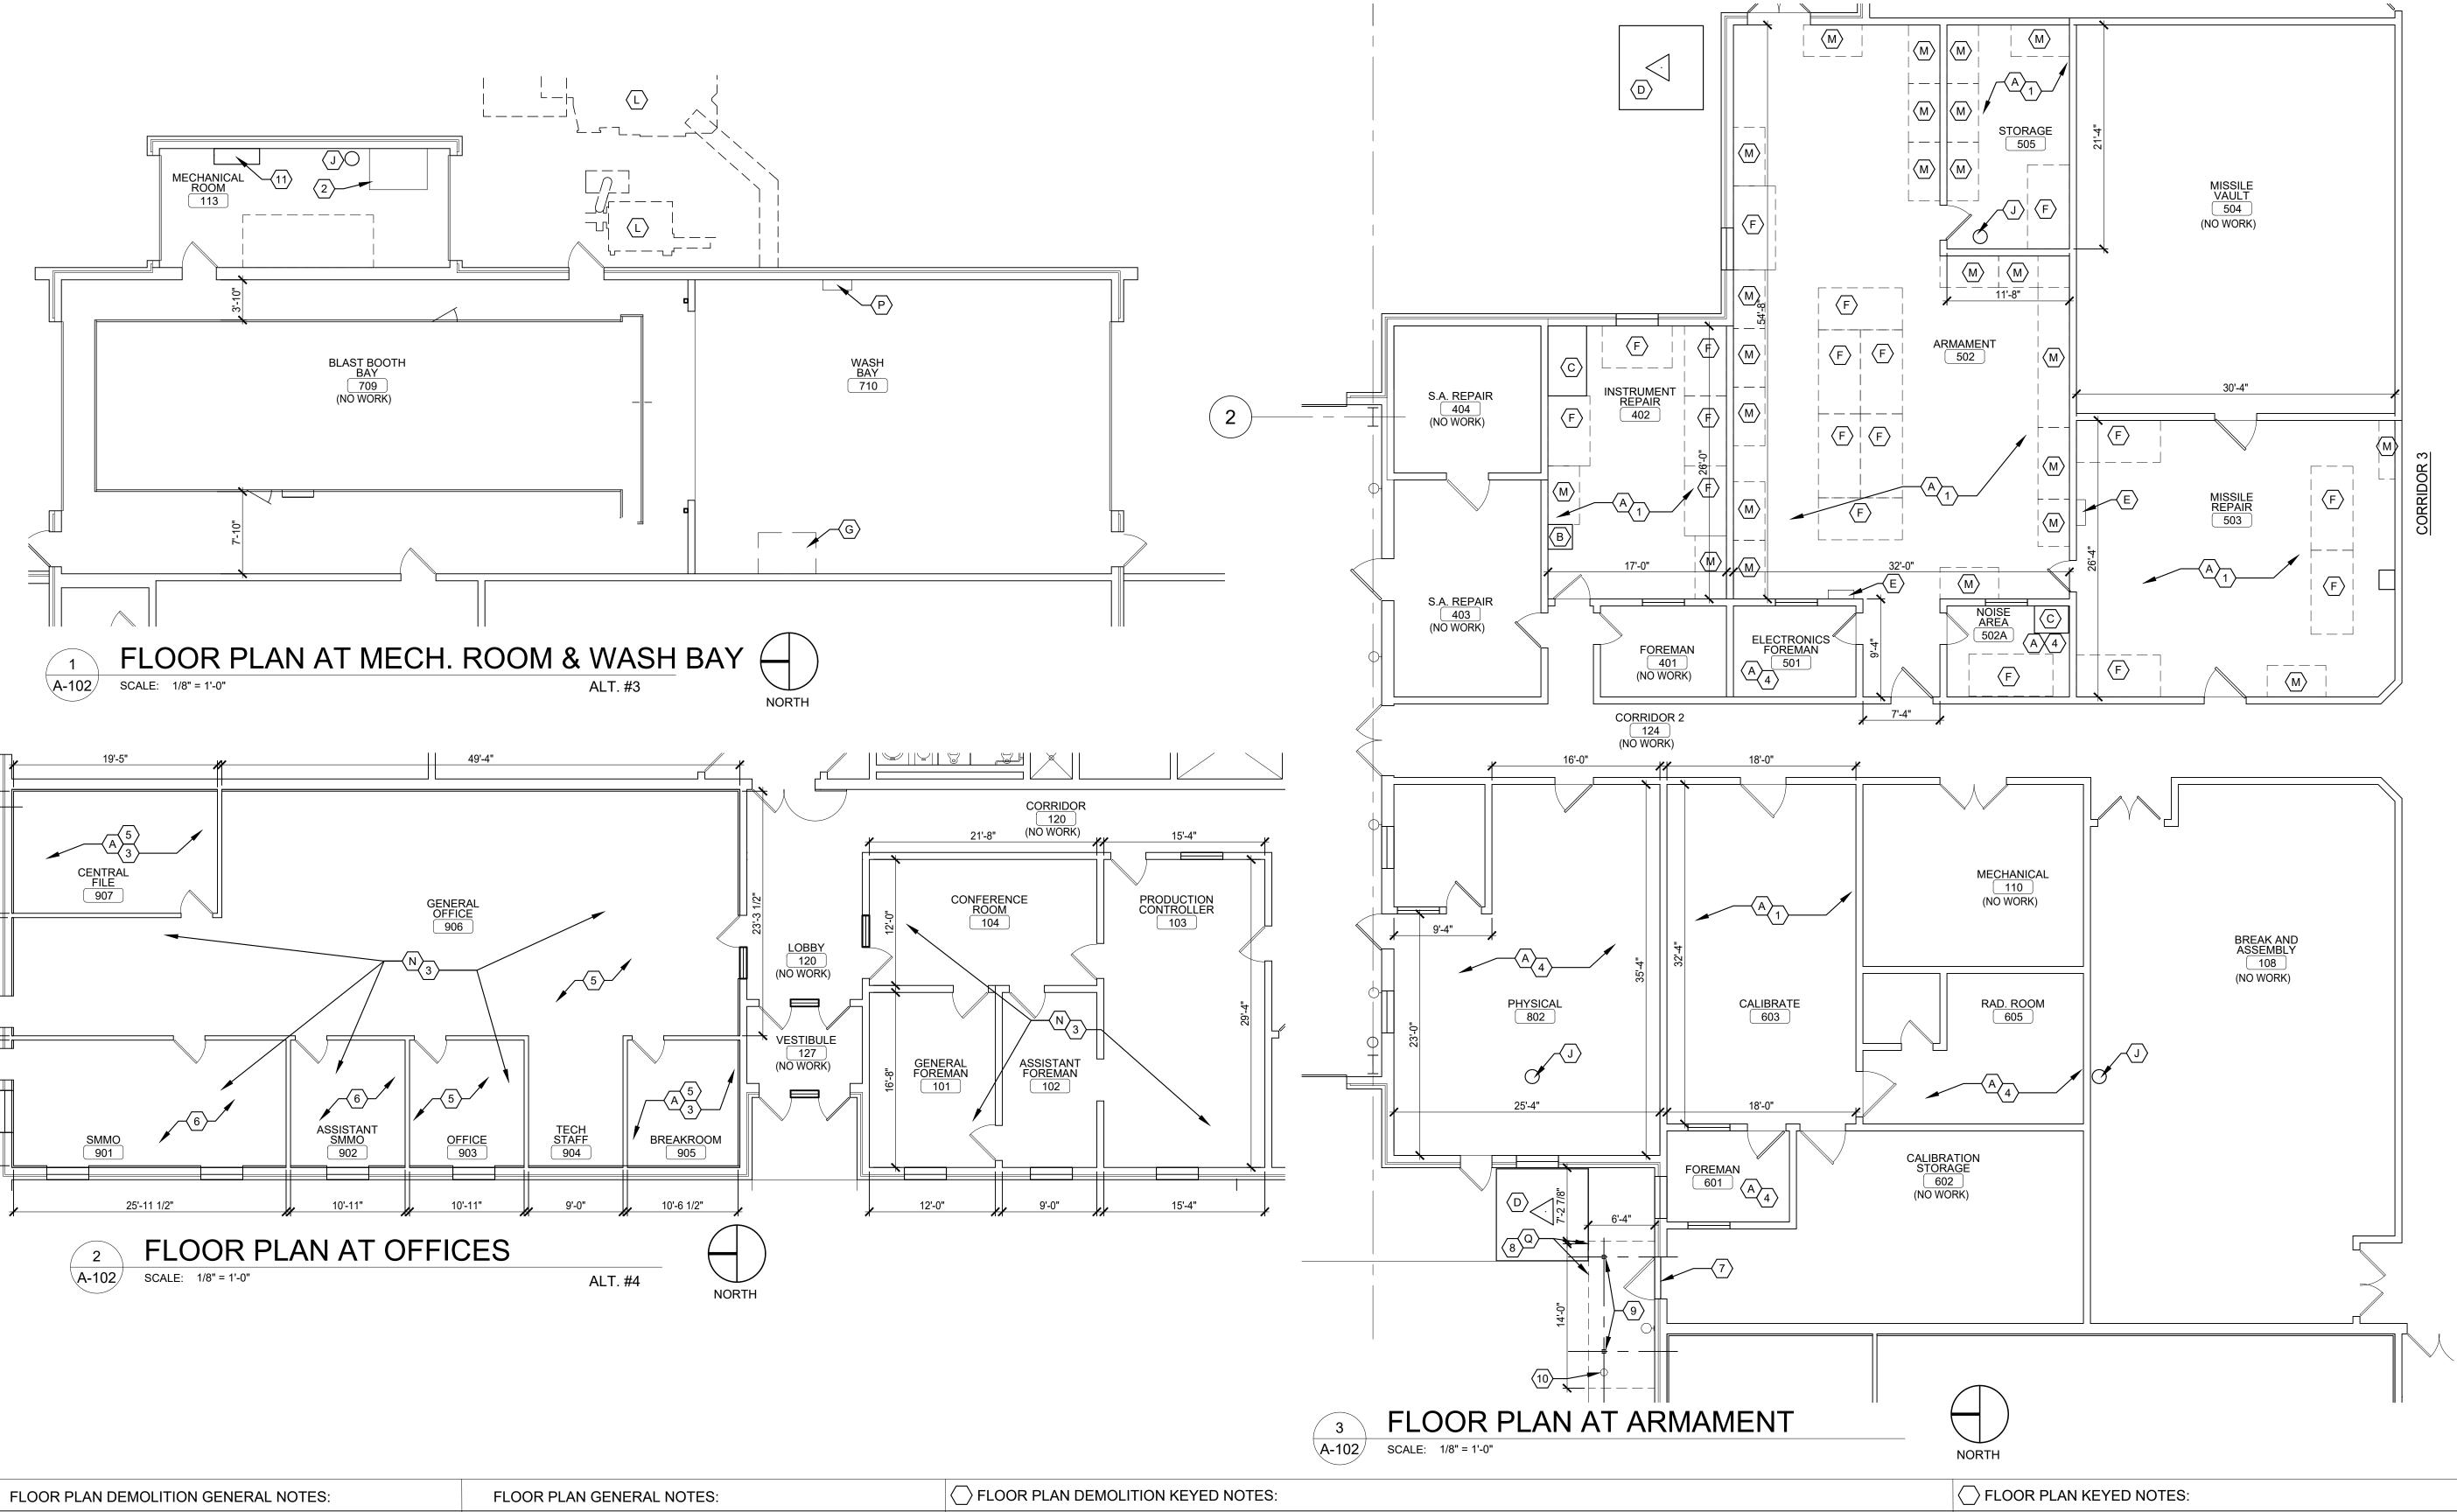
CAD DWG FILE:
DRAWN BY: KMS
CHECKED BY: RAR
DESIGNED BY: RAR

SHEET TITLE:

CENTER CORE FLOOR **PLAN** 

SHEET NUMBER:

4/20/23 5 OF 22 SHEETS



### REFER TO GENERAL SPECIFICATIONS FOR ADDITIONAL REQUIREMENTS. OWNER TO REMOVE AND STORE EXISTING WORK-BENCHES. CONTRACTOR TO PROVIDE TO GUARD STAFF 10 WORKING DAY NOTICE PRIOR TO DEMO FOR COORDINATION OF EQUIPMENT REMOVAL. CONTRACTOR TO COORDINATE WITH OWNER FOR REINSTALLATION OF EXISTING WORK-BENCHES PRIOR TO COMPLETION OF CONSTRUCTION OF THE ARMAMENT AND INSTRUMENT ROOMS. OWNER IS RESPONSIBLE FOR THE INSTALLATION OF THE EXISTING WORK-BENCHES. . ALL NEW BUILDING MATERIALS TO BE OF NON-COMBUSTIBLE OR FIRE RETARDANT TREATED MATERIAL. REFER TO DEMOLITION PLANS FOR LOCATIONS OF ALL ITEMS TO BE REPAIR TO LIKE NEW CONDITION. COORDINATE WITH PROJECT REMOVED UNLESS NOTED OTHERWISE. 6. ALL INTERIOR WALL DIMENSIONS ARE FROM FACE OF EXISTING OR NEW CMU AND GYPSUM WALLBOARD UNLESS NOTED OTHERWISE. ALL EXISTING CONSTRUCTION TO REMAIN SHALL BE PROTECTED DURING

DEMO AND CONSTRUCTION.

REFER TO GENERAL SPECIFICATIONS FOR ADDITIONAL REQUIREMENTS. ALL NEW BUILDING MATERIALS TO BE OF NON-COMBUSTIBLE OR WOOD FIRE RETARDANT TREATED MATERIAL REFER TO DEMOLITION PLANS FOR LOCATIONS OF ALL ITEMS TO BE

REMOVED UNLESS NOTED OTHERWISE. REFER TO INTERIOR FINISH SCHEDULE FOR NEW WALL FINISHES, FLOOR

FINISH AND CEILING HEIGHTS.

ALL INTERIOR WALL DIMENSIONS ARE FROM FACE OF EXISTING OR NEW CMU AND GYPSUM WALLBOARD UNLESS NOTED OTHERWISE. 6. ALL EXISTING CONSTRUCTION TO REMAIN SHALL BE CLEANED. PATCH AND

ADMINISTRATOR FOR REPAINTING IF REQUIRED. PORTABLE FIRE EXTINGUISHERS (F.E.): PROVIDE PORTABLE FIRE EXTINGUISHERS (MIN. 10-LB, QUANTITY OF 1) AS REQUIRED PER LOCAL FIRE A REMOVE EXISTING VINYL TILE FLOORING AND BASE.

B EXIST. SINK TO REMAIN.

C EXIST. HOOD TO REMAIN.

D COMM. TOWER, EXISTING TO REMAIN.

 $\langle \mathsf{E} \rangle$  EXISTING ELECT. PANEL TO REMAIN.

EXISTING WORK-BENCHES TO BE MOVED TO STORAGE BY GUARD STAFF. CONTRACTOR TO COORDINATE DEMO WORK WITH STAFF PRIOR TO START.

G DISCONNECT AND RELOCATE EXISTING WATER BLASTER. CAP EXISTING PLUMBING. REFER TO ELECT. AND PLUMBING DWGS.

H NOT USED.

 $\left| \left\langle \mathsf{J} \right\rangle \right|$  EXISTING ROOF DRAIN TO REMAIN IN SAME LOCATION. PROTECT DURING CONSTRUCTION.

K NOT USED.

## $\langle L \rangle$ EXISTING PARTICULATE AND DUST HOPPERS TO REMAIN.

- EXISTING SHELVING AND STORAGE TO BE MOVED TO STORAGE BY GUARD STAFF. CONTRACTOR TO COORDINATE DEMO WORK WITH STAFF PRIOR TO START.
- $\langle N \rangle$  EXISTING CARPET AND VINYL BASE TO BE REMOVED.
- O NOT USED
- EXISTING AIR/WATER LINES TO BE RELOCATED TO WITH EXISTING WATER BLASTER. REFER TO PLUMBING DWGS.
- Q DEMO EXIST. CONC. SLAB FOR NEW CANOPY CONSTRUCTION. SEE SHEET A-301 AND STRUCT. DWGS. FOR MORE INFORMATION.
- 1 NEW ELECTROSTATIC DISSIPATIVE (ESD) FLOORING.
- $\langle 2 \rangle$  RELOCATED WATER BLASTER SYSTEM, SEE PLUMBING DWGS.
- $\left| \left\langle 3 \right\rangle \right|$  NEW FINISHES CARPET, VWB. SEE RM FINISH SCHEDULE
- 4 NEW VCT FLOORING AND VINYL BASE.
- (5) NEW SEMI-GLOSS ENAMEL ON DRYWALL.
- $\langle 6 \rangle$  NEW SEMI-GLOSS PAINT ON CMU.
- 7 NEW DOOR THRESHOLD TO MATCH EXISTING.
- 8 NEW CONCRETE FOOTINGS AND SLAB, SEE STRUCTURAL DWGS. FOR MORE INFORMATION, AND SHEET A-A301
- ${\Large \bigcirc}$  NEW 4" TUBE STEEL COLS., PAINT TO MATCH NEW STANDING SEAM METAL ROOF. SEE STRUCT. DWGS. FOR MORE INFORMATION
- (10) NEW 8" X 48" CONCRETE FILLED PIPE BOLLARD
- (11) NEW HOT WATER, POWER WASHER, ALLOW FOR 30" CLEARANCE AROUND ALL SIDES. SEE

STATE OF MISSOURI MICHAEL L. PARSON, **GOVERNOR** 



MICHAEL S. SUNDERMEYER License Number:2014026855 Expiration Date: 12/31/24

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8136300007

PROJECT # T2225-01 6300 SITE#

**REVISION:** DATE: **REVISION:** 

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ASSET#

ISSUE DATE: 04/20/2023


CAD DWG FILE: DRAWN BY:

CHECKED BY: RAR DESIGNED BY: RAR

SHEET TITLE:

DEMO AND **NEW FLOOR PLANS** 

SHEET NUMBER:

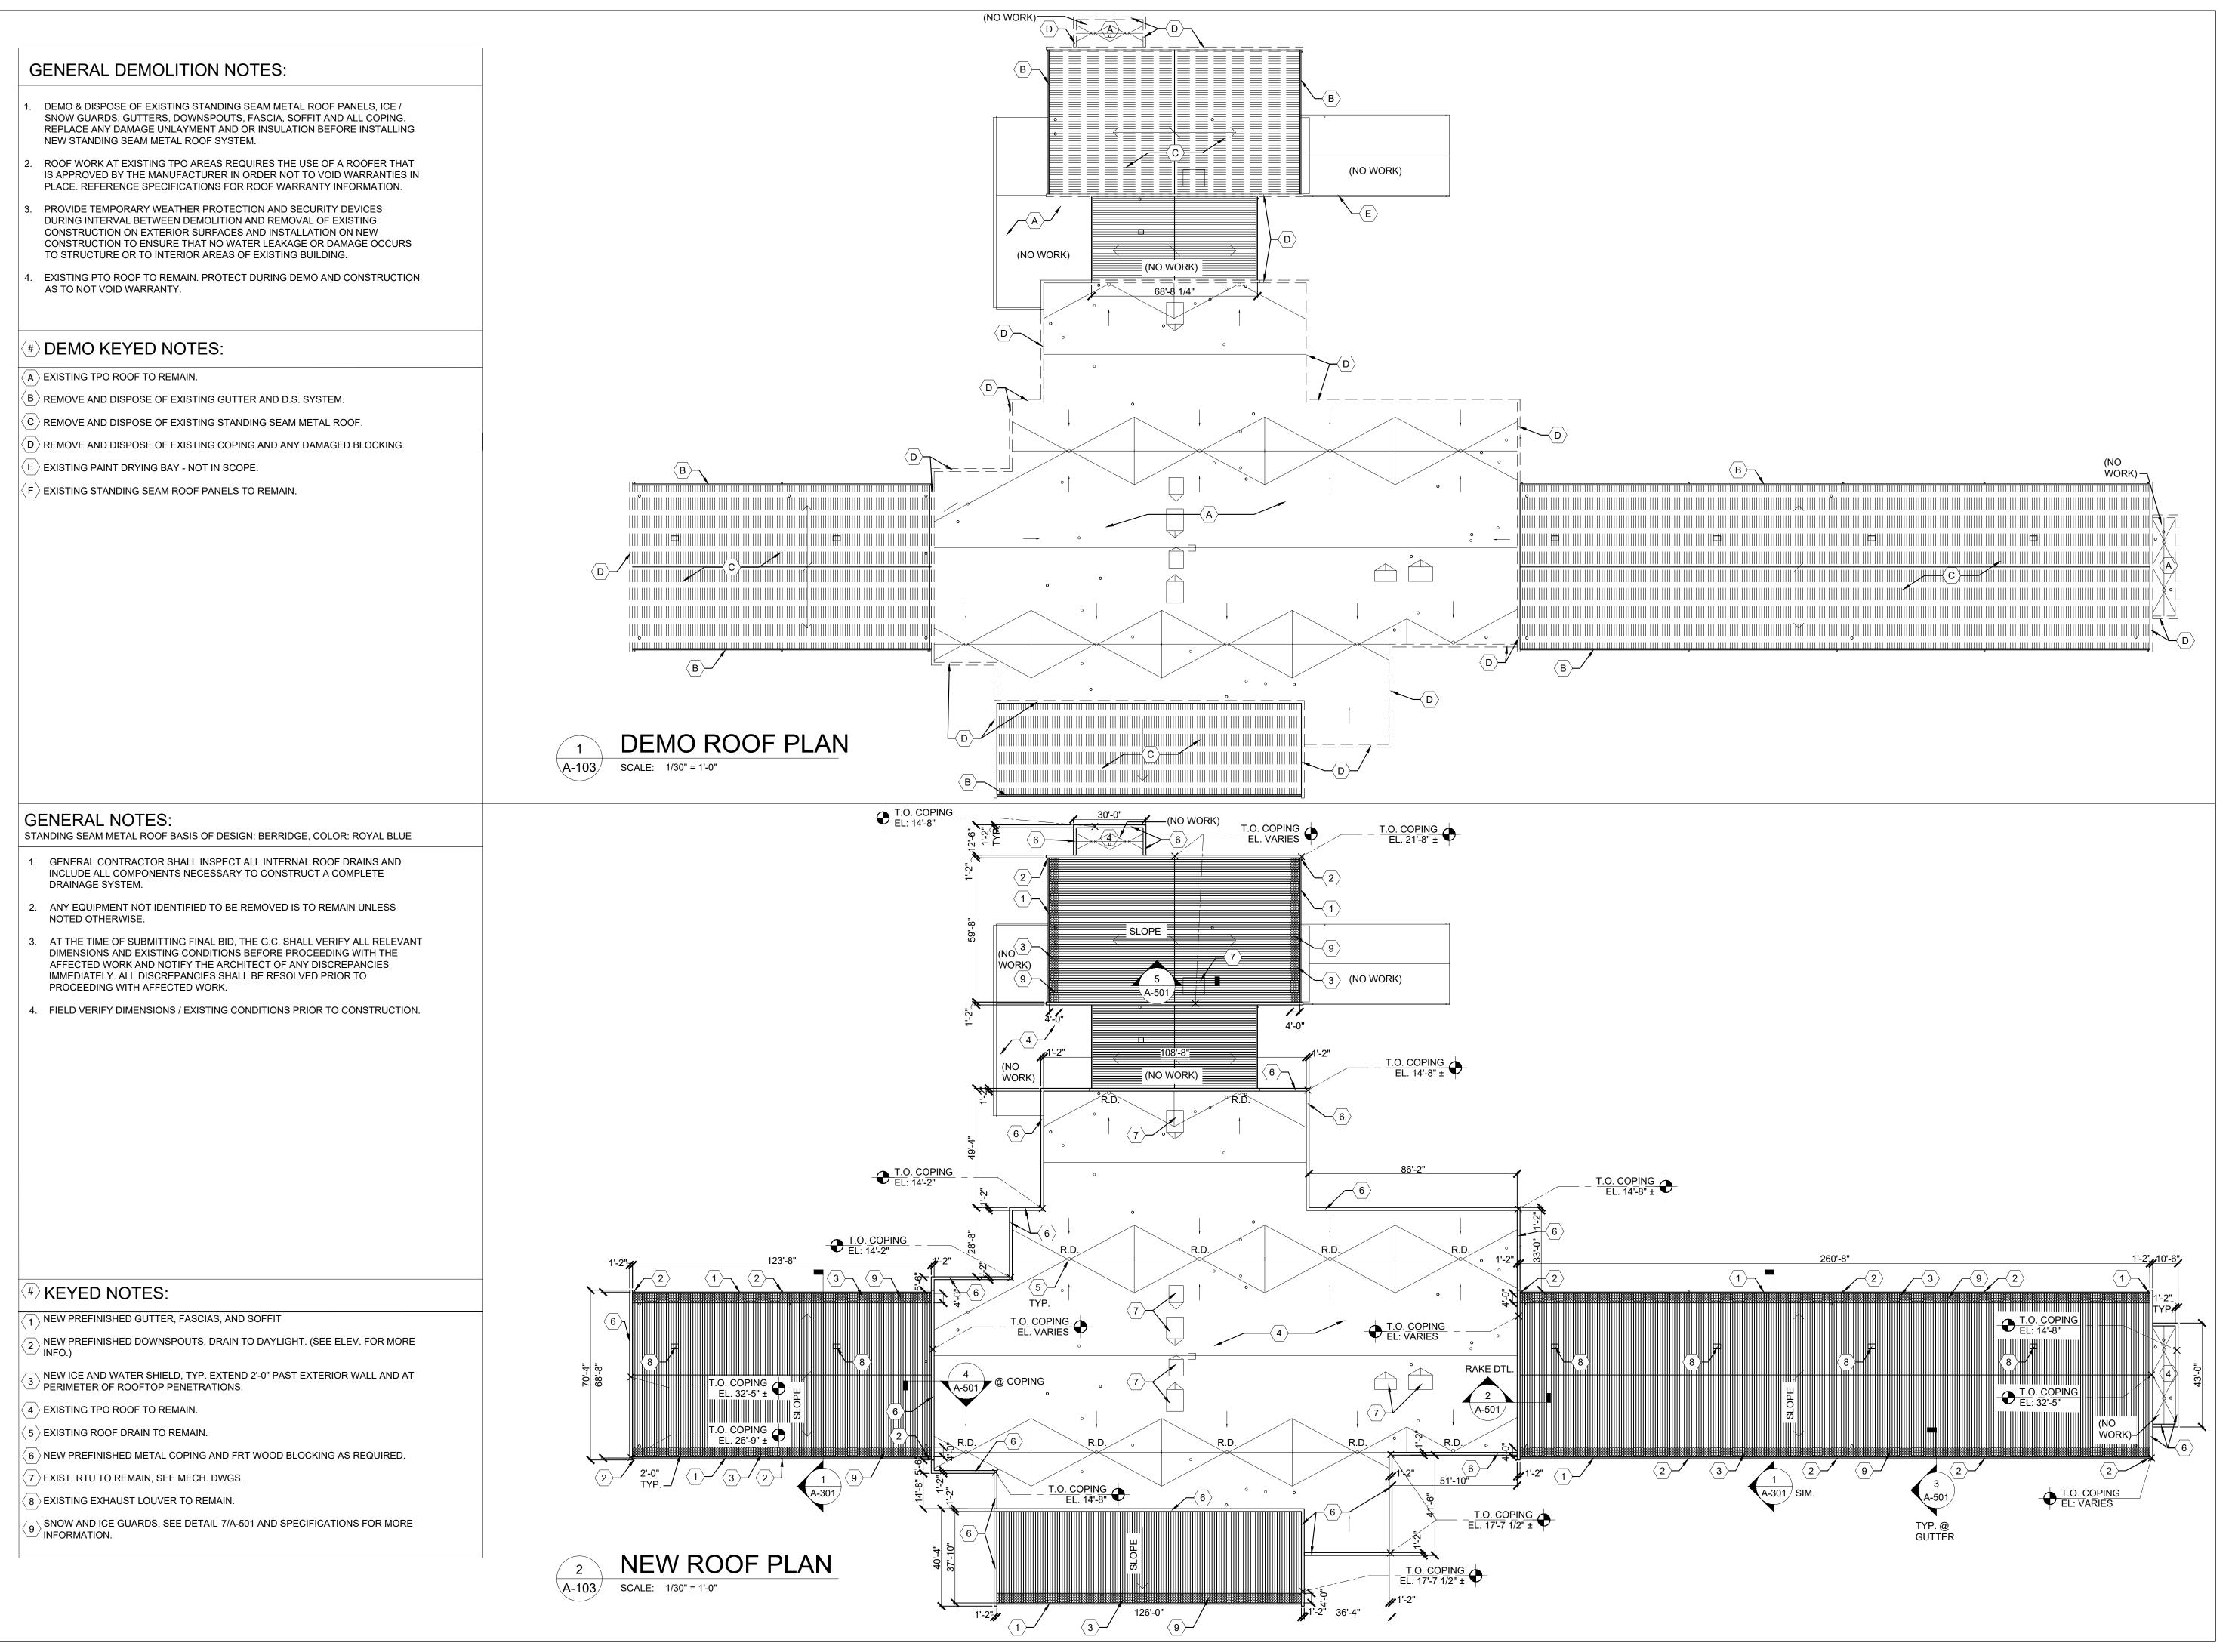

STATE OF MISSOURI MICHAEL L. PARSON, GOVERNOR



License Number:2014026855
Expiration Date: 12/31/24

CASCO Diversified Corporation MO Certificate of Authority #000329 Arch. MO Certificate of Authority #000613 Eng.

12 Sunnen Drive, Suite 100, St. Louis, MO 63143 T:

OFFICE OF ADMINISTRATION DIVISION OF FACILITIES MANAGEMENT, DESIGN AND CONSTRUCTION

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INTERIOR RENOVATIONS &
ROOF REPLACEMENT AT
COMBINED SUPPORT
MAINTENANCE SHOP (CSMS)

COMBINED SUPPORT MAINTENANCE SHOP (CSMS) 2302 MILITIA DRIVE JEFFERSON CITY, MISSOURI 65101

PROJECT # T2225-01 SITE # 6300

ASSET# 8136300007

REVISION:

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DRAWN BY: KMS
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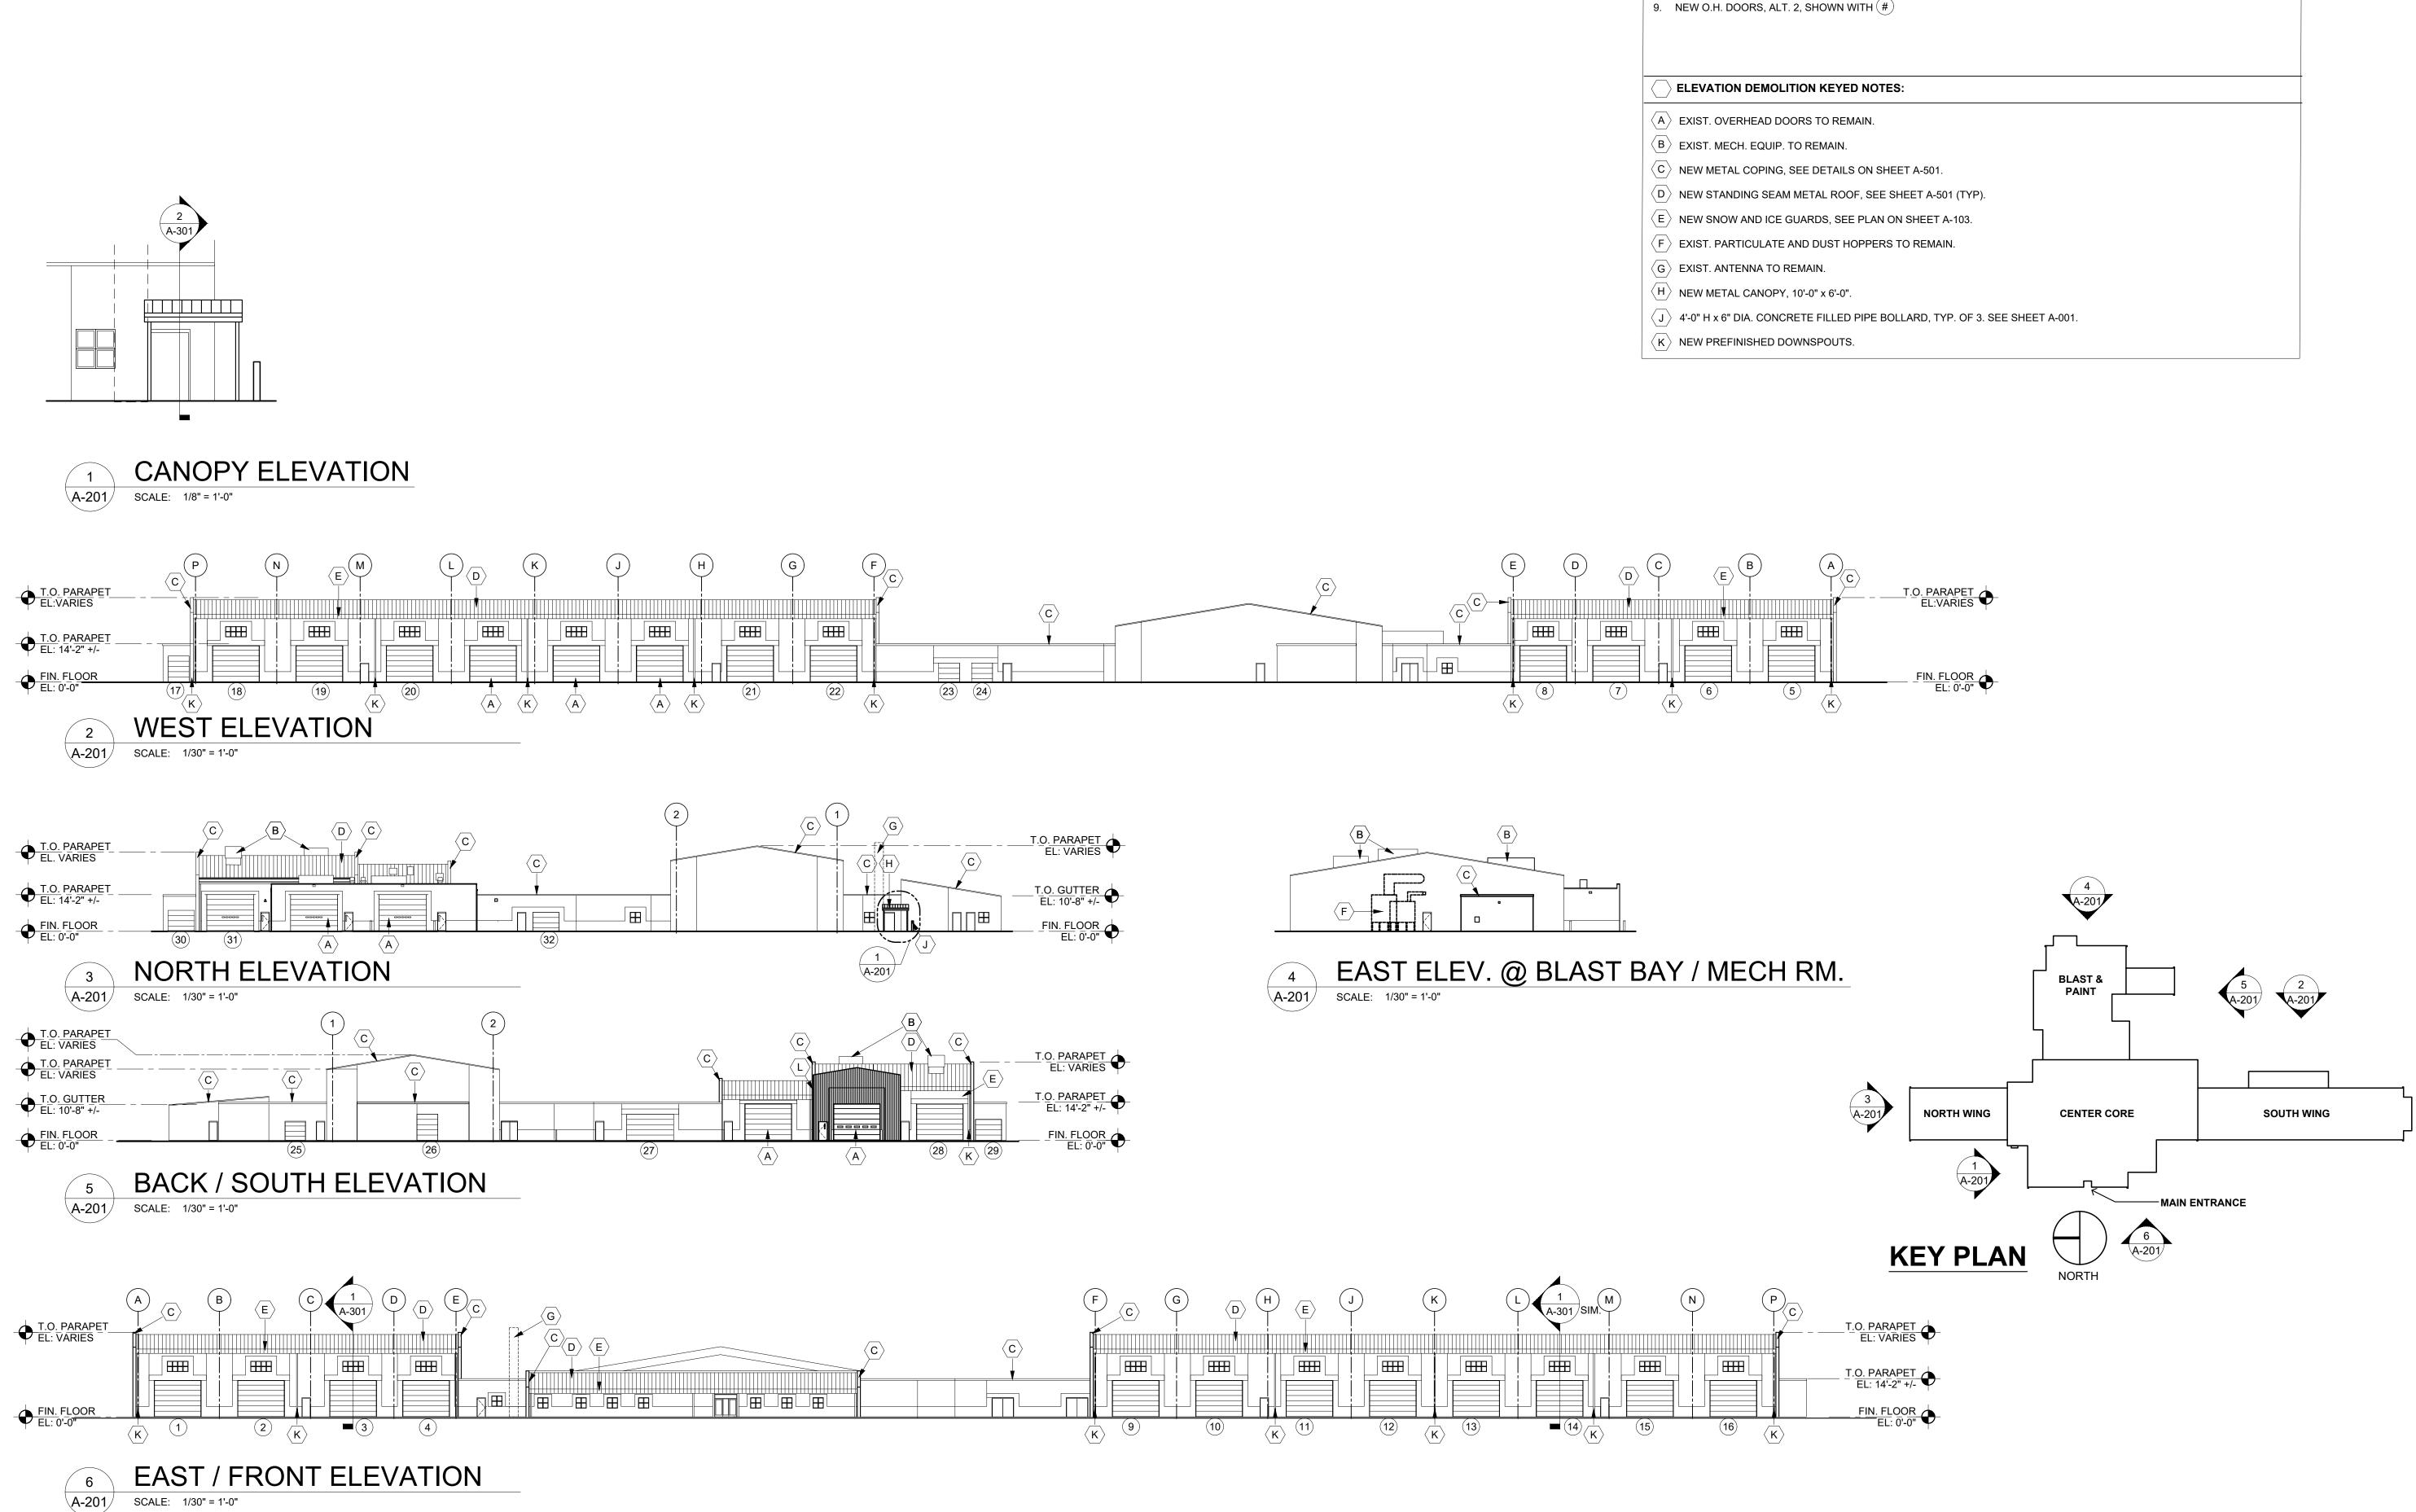
SHEET TITLE:

DEMO & NEW ROOF PLANS

SHEET NUMBER:

A-103

4/20/23 7 OF 22 SHEETS



**ELEVATION GENERAL NOTES:** 

8. ALL NEW ROOF DETAILS SEE SHT. A-501.

REFER TO SPECIFICATIONS FOR ADDITIONAL REQUIREMENTS.

5. EXISTING BOLLARDS TO REMAIN UNLESS NOTED OTHERWISE.

6. EXIST. LIGHTS, LOUD SPEAKERS, ETC. TO REMAIN UNLESS NOTED OTHERWISE.

7. EXIST. HOLLOW METAL DOORS TO REMAIN UNLESS NOTES OTHERWISE.

ALL NEW BUILDING MATERIALS TO BE OF NON-COMBUSTIBLE OR WOOD FIRE RETARDANT TREATED MATERIAL.
 REFER TO DEMOLITION PLANS FOR LOCATIONS OF ALL ITEMS TO BE REMOVED UNLESS NOTED OTHERWISE.
 ALTERNATE #2 - ALL OVERHEAD DOOR TO BE DEMOLISHED AND REPLACED TO MATCH EXISTING UNLESS NOTED

STATE OF MISSOURI MICHAEL L. PARSON, GOVERNOR



MICHAEL S. SUNDERMEYER License Number:2014026855 Expiration Date: 12/31/24

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2 Sunnen Drive, Suite 100, St. Louis, MO 63143

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DIVISION OF FACILITIES
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MISSOURI NATIONAL GUARD

INTERIOR RENOVATIONS &
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COMBINED SUPPORT
MAINTENANCE SHOP (CSMS)

COMBINED SUPPORT MAINTENANCE SHOP (CSMS) 2302 MILITIA DRIVE JEFFERSON CITY, MISSOURI 65101

PROJECT # T2225-01 SITE # 6300 ASSET# 8136300007

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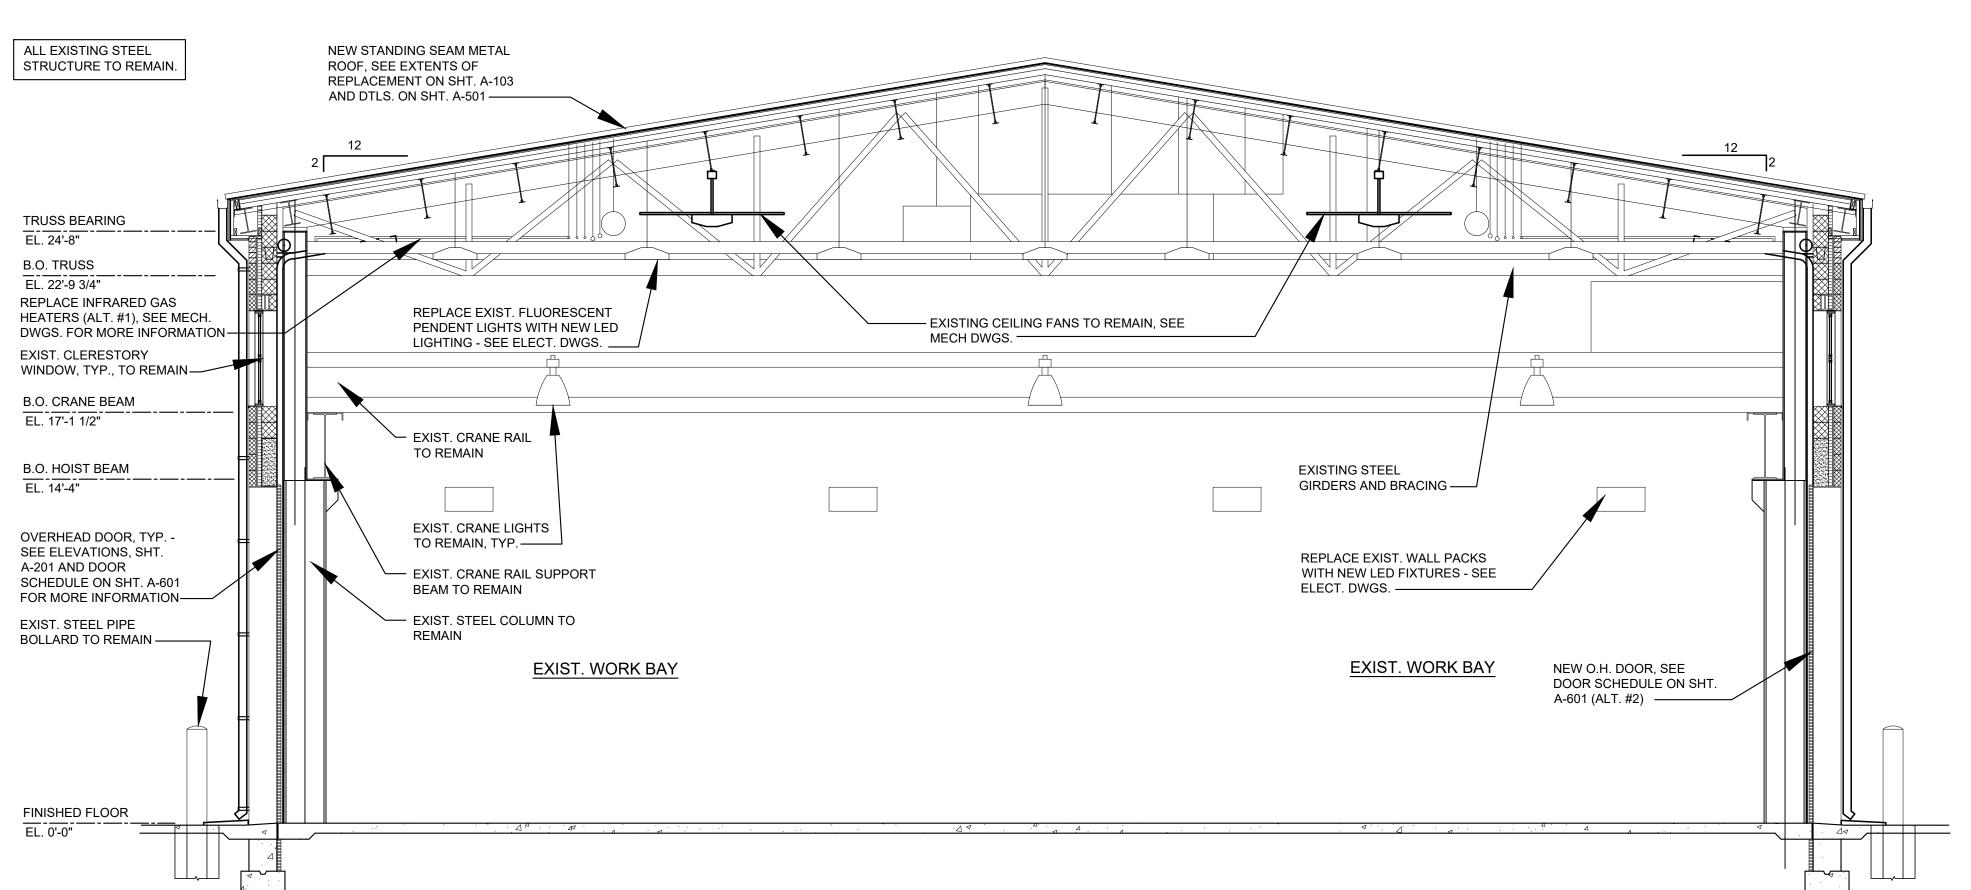
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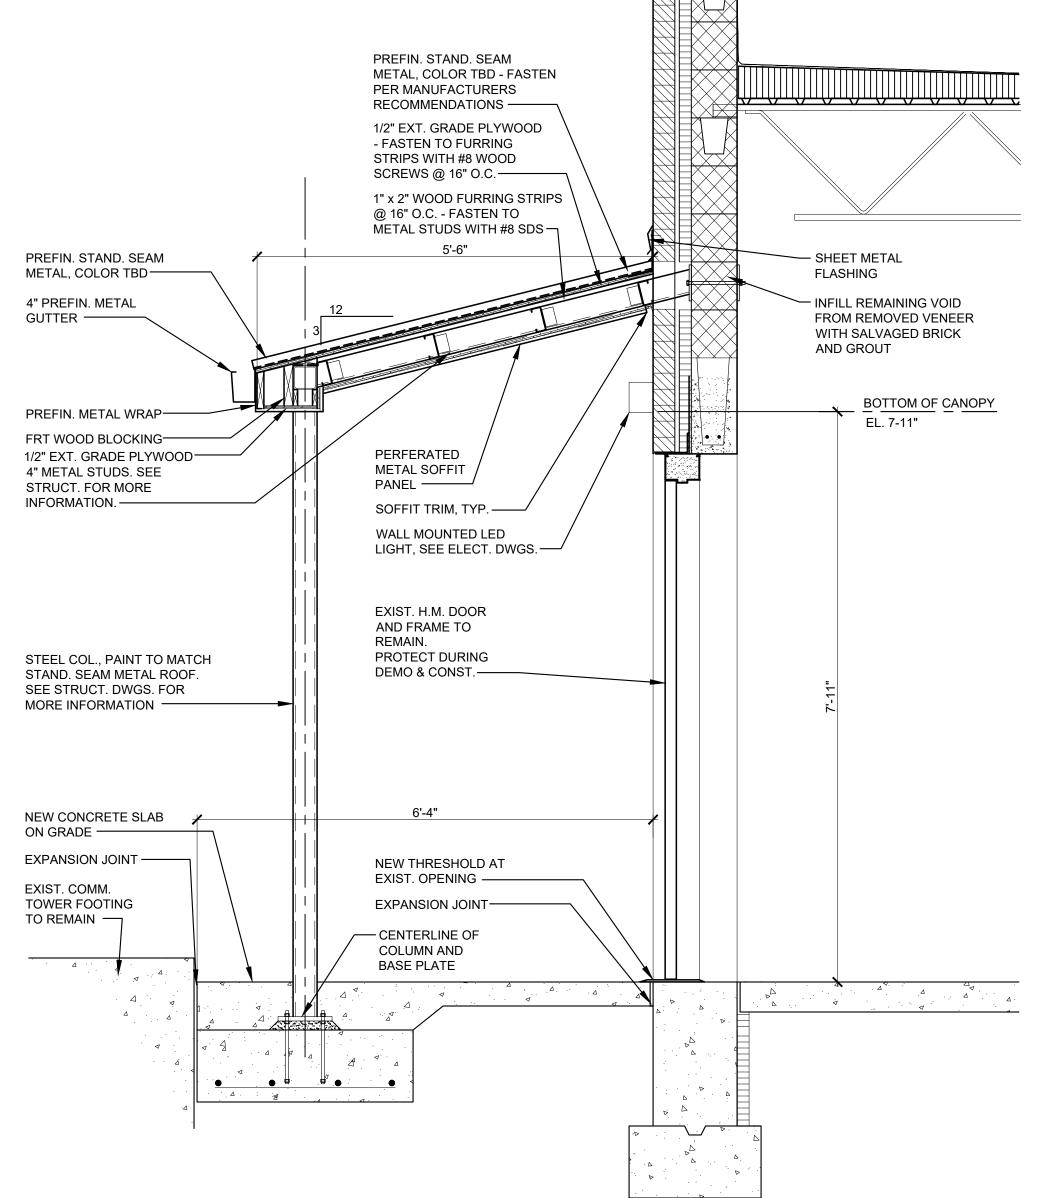
ELEVATIONS

SHEET NUMBER:

A-20

4/20/23 8 OF 22 SHEETS





SECTION THROUGH WORK BAYS

SCALE: 1/4" = 1'-0"

WALL SECTION AT NEW CANOPY
SCALE: 3/4" = 1'-0"

STATE OF MISSOURI MICHAEL L. PARSON, GOVERNOR



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PROJECT # T2225-01 SITE # 6300

ASSET# 8136300007

DATE: REVISION: DATE: REVISION:

**REVISION:** 

DATE:
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CAD DWG FILE:
DRAWN BY: KMS
CHECKED BY: RAR
DESIGNED BY: RAR

SHEET TITLE:

WALL SECTIONS

SHEET NUMBER:

A-30

4/20/23 9 OF 22 SHEETS ROOF WARRANTY INFORMATION.

INSTALL NEW TERMINATION BARS AS REQUIRED.

FLASH ALL ROOF PENETRATIONS AS REQUIRED.

METAL COUNTERFLASHING SHALL BE 24 GAUGE PRE-FINISHED STEEL OR 0.032" MIN. ALUMINUM FORMED WITH HEMMED LOWER EDGE.


INSTALL TERMINATION BAR WITH 1/4" GAP BETWEEN ADJOING SECTIONS.

TERM BAR MUST BE CUT AT INSIDE CORNERS. DO NOT BEND AROUND CORNERS.

TERM BAR MUST BE FASTENED WITHIN 1" MAX. OF ALL SECTION ENDS INSTALL METAL WORK IN ACCORDANCE WITH CURRENT SMACNA RECOMMENDATIONS.

ALL ROOF WORK AND CURB CONNECTIONS SHALL BE COORDINATED WITH AN EXPERIENCED ROOFING CONTRACTOR. SEE SPECIFICATIONS.

ALL NEW MATERIALS SHOULD MATCH EXISTING COLOR AND FINISH AS CLOSELY AS POSSIBLE.

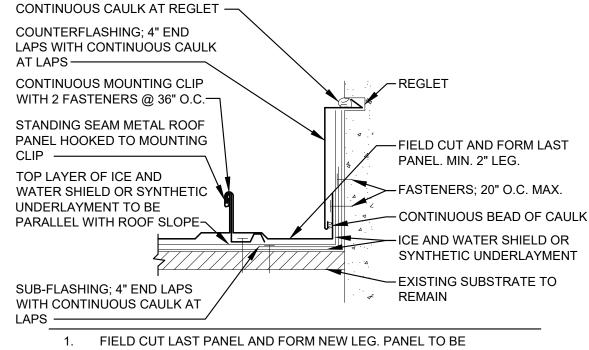


CONTINUOUS FROM RIDGE TO EAVE


2. SOLID SHEATHING TO BE MINIMUM 1/2" PLYWOOD OR EQUIVALENT IN STRENGTH FOR HOLDING POWER OF FASTENERS.




A-501

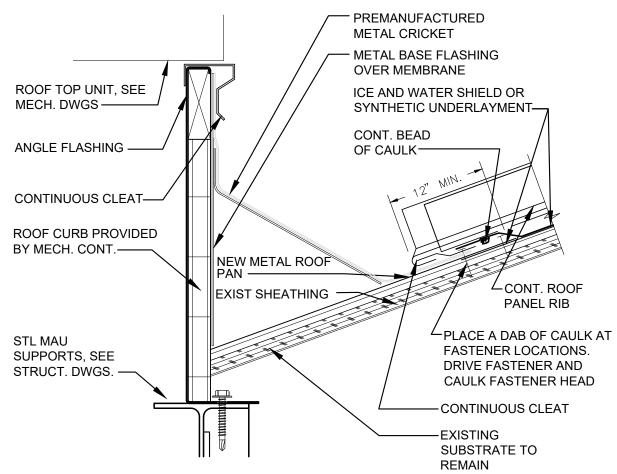



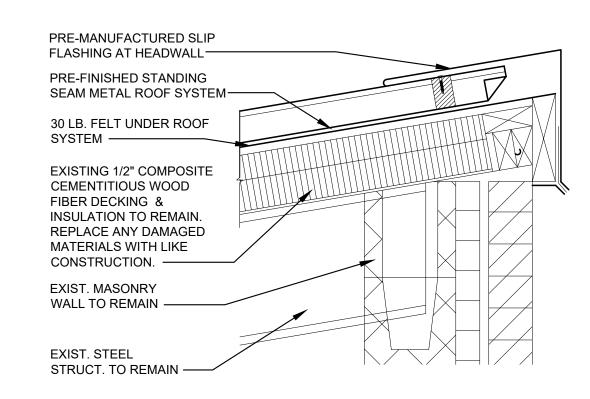


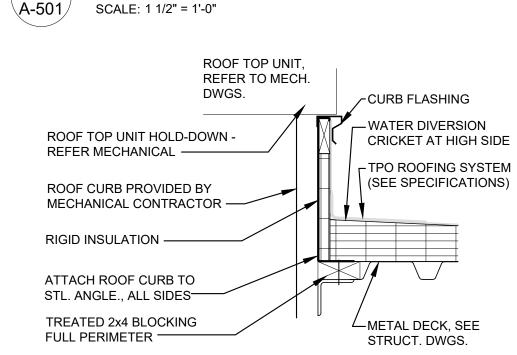

\A-501/


SCALE: 1 1/2" = 1'-0"


ROOF EDGE DETAIL

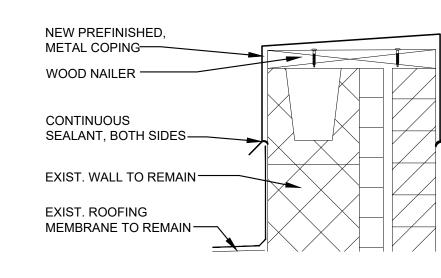




METAL COPING DETAIL A-501 SCALE: 1 1/2" = 1'-0"

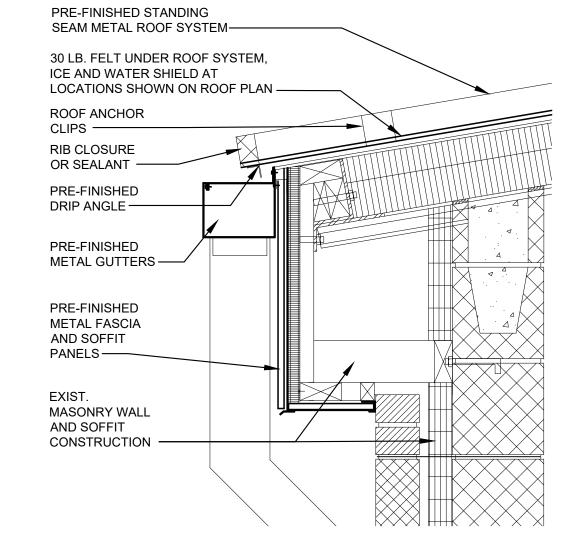

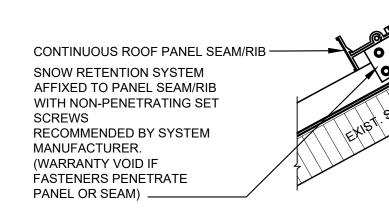

NOTES: 1. ONLY SEAM/RIB MOUNTED SNOW RETENTION DEVICES WHICH INCORPORATE SET SCREWS ALLOWED. 2. REFER TO ROOFING MANUFACTURER FOR PANEL SPACING, SEAM/RIB THICKNESS AND HEIGHT. 3. REFER TO ROOFING MANUFACTURER FOR FASTENER COMPATIBILITY WITH METAL. 4. SPECIFIC TYPE, NUMBER AND SPACING OF SNOW RETENTION CLIPS TO BE DETERMINED BY SNOW RETENTION SYSTEM MANUFACTURE OR A QUALIFIED DESIGN PROFESSIONAL. 5. CAUTION: ADHERED SNOWGUARDS ARE NOT ACCEPTABLE.



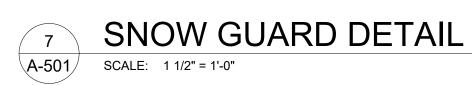

### STATE OF MISSOURI MICHAEL L. PARSON, **GOVERNOR**



MICHAEL S. SUNDERMEYER License Number:2014026855 Expiration Date: 12/31/24

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PROJECT #	T2225-0
SITE#	6300
ASSET#	8136300

**REVISION:** DATE: **REVISION:** DATE: **REVISION:** DATE:

ISSUE DATE: 04/20/2023 CAD DWG FILE:

DRAWN BY: KMS CHECKED BY: RAR DESIGNED BY: RAR

SHEET TITLE:

ROOF DETAILS

SHEET NUMBER:

4/20/23 10 OF 22 SHEETS

				W	WALLS			FLOOR CEILING		ING	
	TAG	ROOM	NORTH	WEST	SOUTH	EAST	FLOOR BASE	FLOOR	MATERIAL	FINISH	COMMENTS
	402	INSTRUMENT REPAIR	PT-1	PT-1	PT-1	PT-1	VB-1	NC-1	ACT-1	EXIST.	
	502	ARMAMENT	PT-1 / AWP-1	PT-1	PT-1 / AWP-1	PT-1	VB-1	NC-1	ACT-1	EXIST.	
	503	MISSILE REPAIR	PT-1	PT-1	PT-1	PT-1	VB-1	NC-1	ACT-1	EXIST.	
	505	STORAGE	PT-1	PT-1	PT-1	PT-1	VB-1	NC-1	ACT-1	EXIST.	
	603	CALIBRATE	PT-1	PT-1	PT-1	PT-1	VB-1	NC-1	ACT-1	EXIST.	
	605	RAD. ROOM	PT-1	PT-1	PT-1	PT-1	VB-1	VCT-1	ACT-1	EXIST.	
	802	PHYSICAL	PT-1	PT-1	PT-1	PT-1	VB-1	VCT-1	ACT-1	EXIST.	
	901	SMMO	PT-2	PT-2	PT-2	PT-2	VB-1	CPT-1	ACT-1	EXIST.	
	902	ASSISTANT SMMO	PT-2	PT-2	PT-2	PT-2	VB-1	CPT-1	ACT-1	EXIST.	
	903	OFFICE	PT-1	PT-1	PT-1	PT-1	VB-1	CPT-1	ACT-1	EXIST.	
	904	TECH. STAFF	PT-1	PT-1	PT-1	PT-1	VB-1	CPT-1	ACT-1	EXIST.	
	905	BREAKROOM	PT-1	PT-1	PT-1	PT-1	VB-1	VCT-1	ACT-1	EXIST.	
	906	GENERAL OFFICE	PT-1	PT-1	PT-1	PT-1	VB-1	CPT-1	ACT-1	EXIST.	
	907	CENTRAL FILE	PT-1	PT-1	PT-1	PT-1	VB-1	VCT-1	ACT-1	EXIST.	
	101	GENERAL FOREMAN	PT-1	PT-1	PT-1	PT-1	VB-1	CPT-1	ACT-1	EXIST.	
	102	ASSISTANT FOREMAN	PT-1	PT-1	PT-1	PT-1	VB-1	CPT-1	ACT-1	EXIST.	
	103	PRODUCTION CONTROLLER	PT-1	PT-1	PT-1	PT-1	VB-1	CPT-1	ACT-1	EXIST.	
	104	CONFERENCE ROOM	PT-1	PT-1	PT-1	PT-1	VB-1	CPT-1	ACT-1	EXIST.	

			# R00	M FINISH S	CHEDULE	(COLORS TO BE DETERMINED)
TAG	MATERIAL	COLOR	MANUFACTURER (B.O.D.)	APPROVED E	EQUIVALENTS	NOTES
PT-1	DRY-FALL PAINT		BM, LATEX DRY FALL	SW - PRO INDUSTRIAL	PPG, AQUAPON	SEMI-GLOSS SHEEN
PT-2	ENAMEL PAINT		BM, COROTECH, ALKYD ENAMEL			SEMI-GLOSS SHEEN
PT-3	H.M. DOORS / FRAMES		BM, COROTECH, ALKYD ENAMEL			SATIN SHEEN
NC-1	ESD					
VCT-1	VINYL COMPOSITE TILES					
CPT-1	CARPET					
VB-1	VINYL BASE					
ACT-1	ACOUSTIC CEILING TILES					EXISTING TO REMAIN, REPLACE UP TO 20 TILES
AWP-1	ACOUSTIC WALL PANELS					EXISTING TO REMAIN

			SIZE		DOOR		FRAME				
	SYM.	ROOM							HEAD DETAIL	JAMB DETAIL	COMMENTS
			WIDTH	HEIGHT	MATERIAL	TYPE	MATERIAL	TYPE			
	1-16, 18-22	WORK BAY	18'-0"	14'-0"	METAL	B-2					HARDWARE PER MANUFACTURER STANDARD, REUSE EXIST. TRACKS.
	17	CONTROLLED WASTE HANDLING	8'-0"	8'-0"	METAL	B1					HARDWARE PER MANUFACTURER STANDARD, REUSE EXIST. TRACKS.
	23	FLAMMABLE STORAGE	8'-0"	8'-0"	METAL	B1					HARDWARE PER MANUFACTURER STANDARD, REUSE EXIST. TRACKS.
	24	SUPPLY ROOM	8'-0"	8'-0"	METAL	B1					HARDWARE PER MANUFACTURER STANDARD, REUSE EXIST. TRACKS.
	25	UNHEATED CLASS IX STORAGE	8'-0"	10'-0"	METAL	B2					HARDWARE PER MANUFACTURER STANDARD, REUSE EXIST. TRACKS.
	26	CONTROLLED WASTE HANDLING	10'-0"	8'-0"	METAL	B2					HARDWARE PER MANUFACTURER STANDARD, REUSE EXIST. TRACKS.
	27	CARPENTRY SHOP	18'-0"	8'-0"	METAL	B2					HARDWARE PER MANUFACTURER STANDARD, REUSE EXIST. TRACKS.
	28	WASH BAY	18'-0"	14'-0"	METAL	B1					HARDWARE PER MANUFACTURER STANDARD, REUSE EXIST. TRACKS.
	29-30	MECHANICAL	8'-0"	8'-0"	METAL	B1					HARDWARE PER MANUFACTURER STANDARD, REUSE EXIST. TRACKS.
	31	PAINT STRIP BAY	18'-0"	14'-0"	METAL	B1					HARDWARE PER MANUFACTURER STANDARD, REUSE EXIST. TRACKS.
	32	CANVAS SHOP	10'-0"	8'-0"	METAL	B2					HARDWARE PER MANUFACTURER STANDARD, REUSE EXIST. TRACKS.

SEE SCHEDULE	L	SEE SCHEDULE	<b>v</b>	
	SEE SCHEDULE		SEE SCHEDULE	FINISH FLOOR EL: 0'-0"
B1 COILING OVERHEAD DOOR WITH GASKETS AND WEATHERSTRIPPING  DOOR TYPES - ALTERNATE #2		B2 SECTIONAL OVERHEAD DOOR WITH GASKETS AND WEATHERSTRIPPING		EL: 0'-0" <b>\</b>

STATE OF MISSOURI MICHAEL L. PARSON, **GOVERNOR** 



CASCO Diversified Corporation MO Certificate of Authority #000329 Arch. MO Certificate of Authority #000613 Eng.

**OFFICE OF ADMINISTRATION** DIVISION OF FACILITIES MANAGEMENT, DESIGN AND **CONSTRUCTION** 

MISSOURI NATIONAL **GUARD** 

INTERIOR RENOVATIONS & ROOF REPLACEMENT AT COMBINED SUPPORT MAINTENANCE SHOP (CSMS)

COMBINED SUPPORT MAINTENANCE SHOP (CSMS) 2302 MILITIA DRIVE JEFFERSON CITY, MISSOURI 65101

PROJECT # T2225-01 SITE# 6300

ASSET# 8136300007

REVISION: DATE: REVISION: DATE: REVISION: DATE:

ISSUE DATE: 04/20/2023


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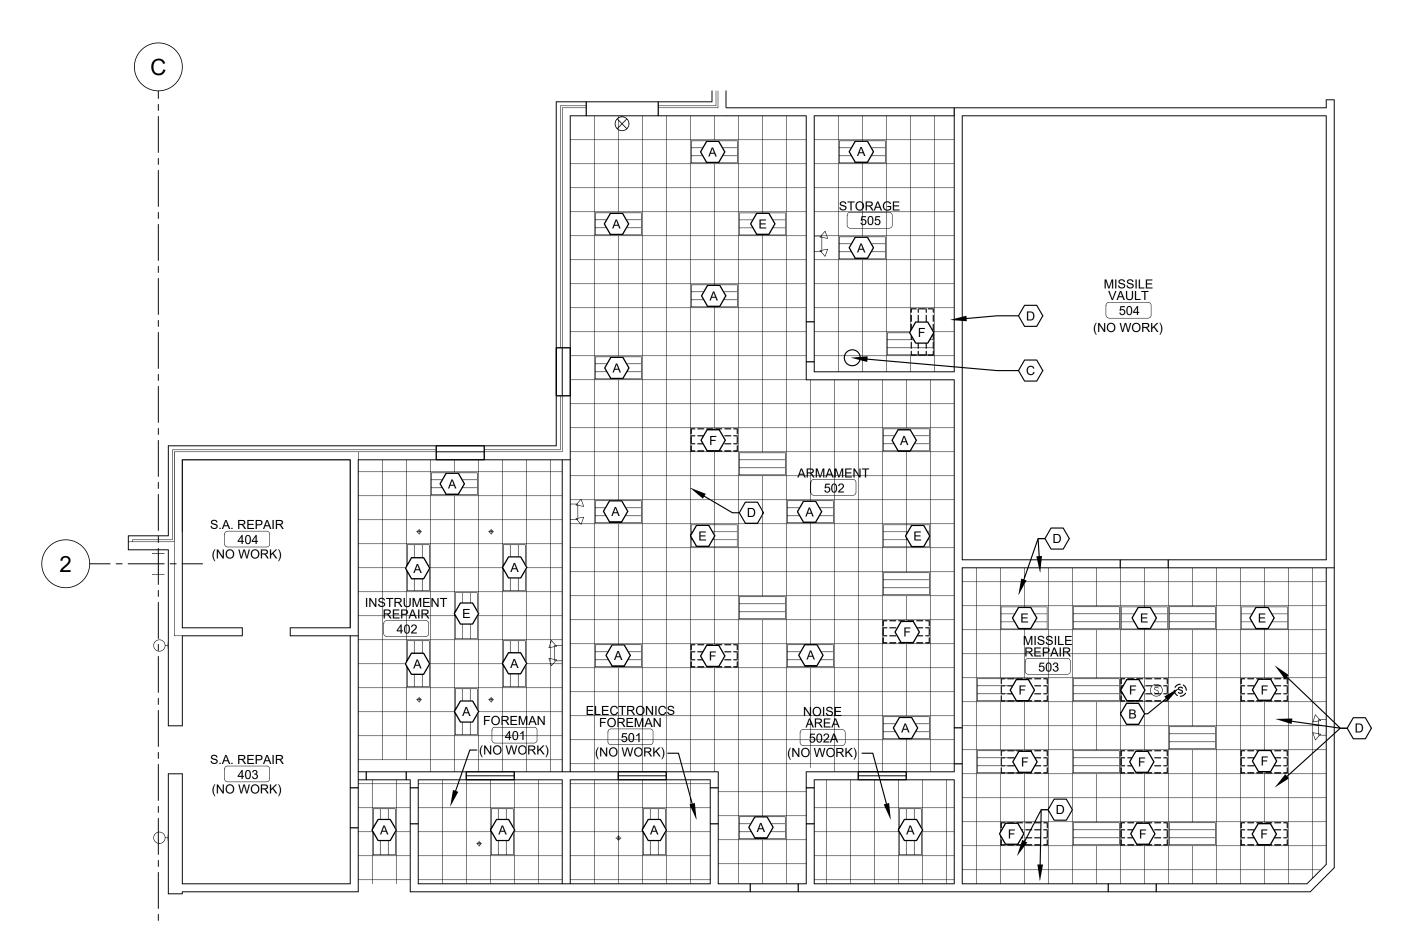
DOOR & FINISH SCHEDULES, AND DOOR TYPES

SHEET NUMBER:

4/20/23 11 OF 22 SHEETS



1 DEMO R A-701 SCALE: 1/8" = 1'-0"

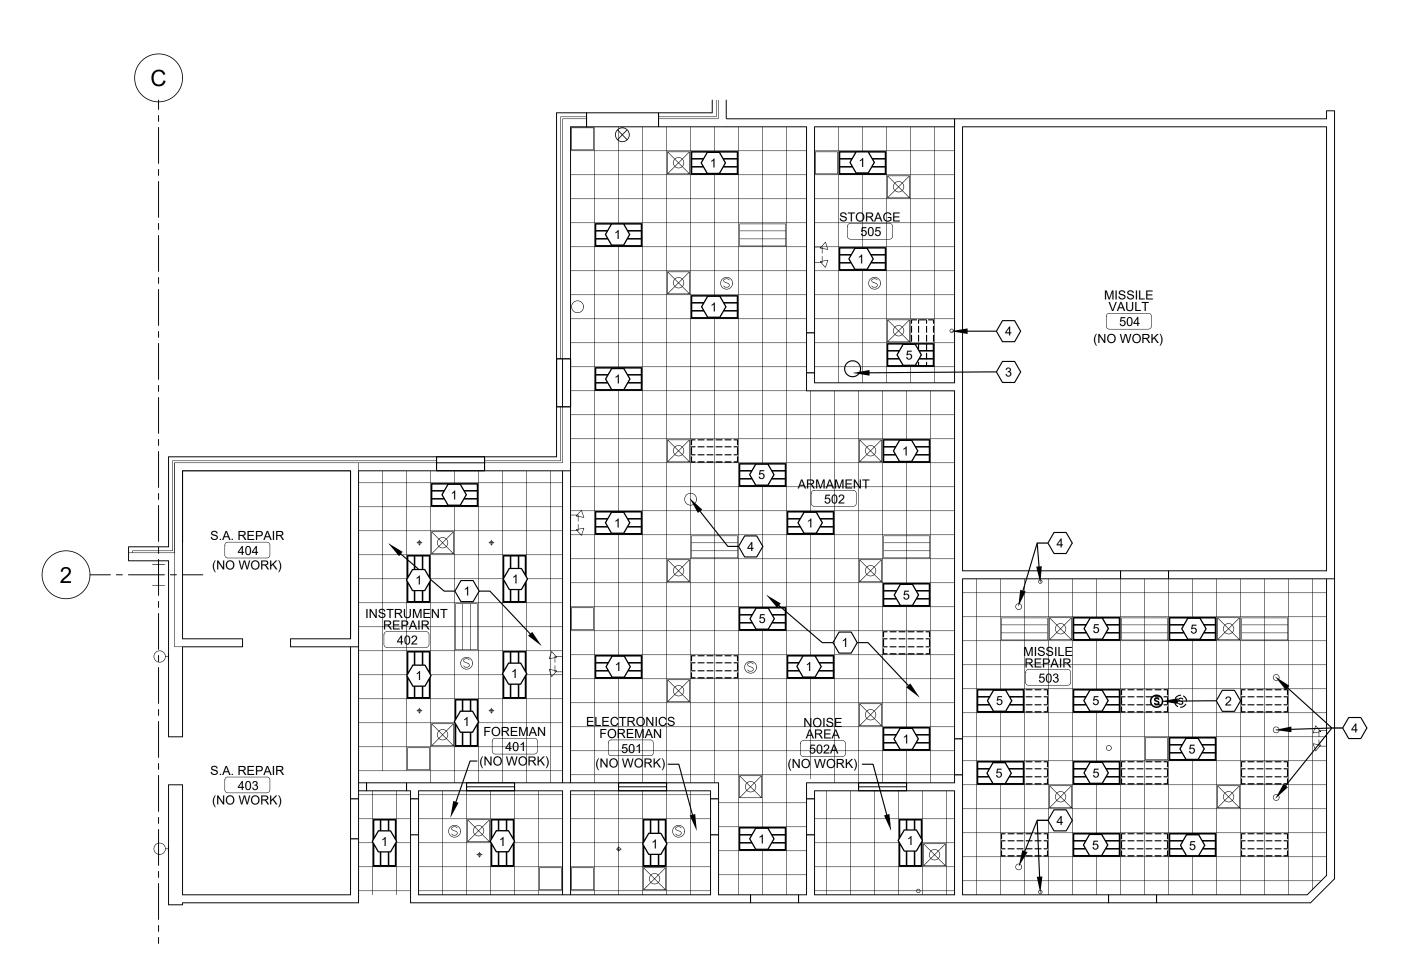

DEMO REFLECTED CEILING PLAN - ARMAMENT

REFLECTED CEILING PLAN - ARMAMENT SCALE: 1/8" = 1'-0"

NORTH

REFLECTED CEILING PLAN GENERAL NOTES:	REFLECTED CEILING PLAN KEYED NOTES:	REFLECTED CEILING PLAN KEYED NOTES:	CEILING DEVICE LEGEND
MECHANICAL DEVICES SHOWN ON THE REFLECTED CEILING PLAN ARE FOR COORDINATION.	1 EXIST. 2'-0" x 4'-0" LED LIGHTING TO REMAIN IN PLACE.	(A) EXIST. 2'-0" x 4'-0" LED LIGHTING TO REMAIN.	NEW 2x4 LED LIGHT, SEE ELECT. DWGS.
LIGHTING FIXTURES SHOWN ON THE REFLECTED CEILING PLAN ARE FOR ARCHITECTURAL	2 EXIST. SPEAKER TO BE REMOVED AND RELOCATED.	B EXIST. SPEAKER TO BE RELOCATED FOR NEW LIGHTING LAYOUT.	EXIST. 2x4 LED LIGHT TO REMAIN, SEE ELECT. DWGS.
LOCATIONS, QUANTITIES, AND GENERAL FIXTURE TYPE ONLY. REFER TO ELECTRICAL DRAWINGS FOR EXACT FIXTURE TYPE AND CIRCUITING.	(3) EXIST. ROOF DRAIN, PROTECT DURING DEMO AND CONSTRUCTION.	© EXIST. ROOF DRAIN, PROTECT DURING DEMO AND CONTRUCTION.	EXIST. LED LIGHT TO BE RELOCATED, SEE ELECT. DWGS.
ALL LIGHTS MUST BE PROPERLY INSTALLED AND SUPPORTED TO STRUCTURAL SUPPORT MEMBERS ABOVE CEILING SYSTEM AND ATTACHED DIAGONALLY ON LIGHT FIXTURE OR	4 EXIST. POWER POLE TO REMAIN.	D EXIST. POWER POLE TO REMAIN.	S EXIST. SPEAKER
WHERE SURFACE MOUNT LIGHT FIXTURES OCCURS AT SUSPENDED CEILING SYSTEM, DO NOT SUPPORT FROM FINISH CEILING MATERIAL.	EXIST. 2'-0" x 4'-0" LED LIGHTING TO BE REMOVED FOR RELOCATION. SEE ELECT. DWG.	E NEW 2'-0" x 4'-0" LED LIGHTING. SEE ELECTRICAL DWG.	© EXIST. POWER POLE
		F EXIST. 2'-0" x 4'-0" LED LIGHTING TO BE REMOVED AND RELOCATED. SEE ELECT. DWG.	* EXIST. SPRINKLER HEAD
			EXIST. BUG EYE LIGHT, SEE ELECT. DWGS.

STATE OF MISSOURI MICHAEL L. PARSON, **GOVERNOR** 



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COMBINED SUPPORT MAINTENANCE SHOP (CSMS) 2302 MILITIA DRIVE JEFFERSON CITY, MISSOURI 65101

8136300007

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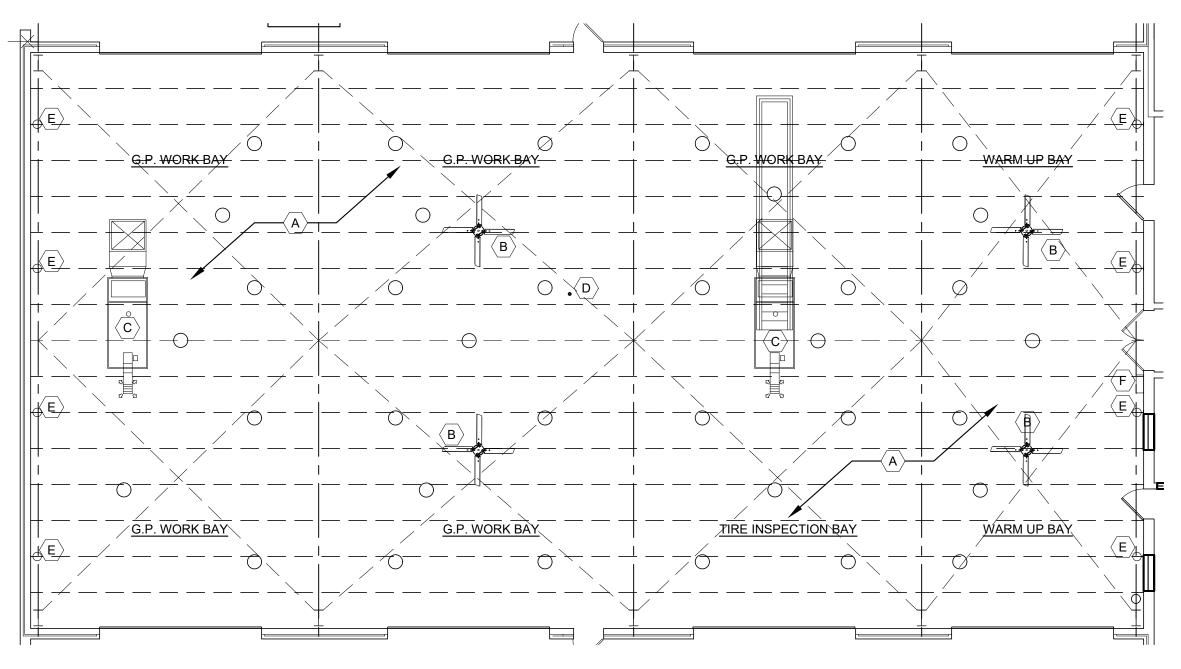
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CHECKED BY: RAR
DESIGNED BY: RAR

SHEET TITLE:

DEMO & NEW REFLECTED **CEILING PLANS** 


SHEET NUMBER:

4/20/23



REFLECTED CLG. PLAN - NORTH BAY

A-703 SCALE: 3/32" = 1'-0"

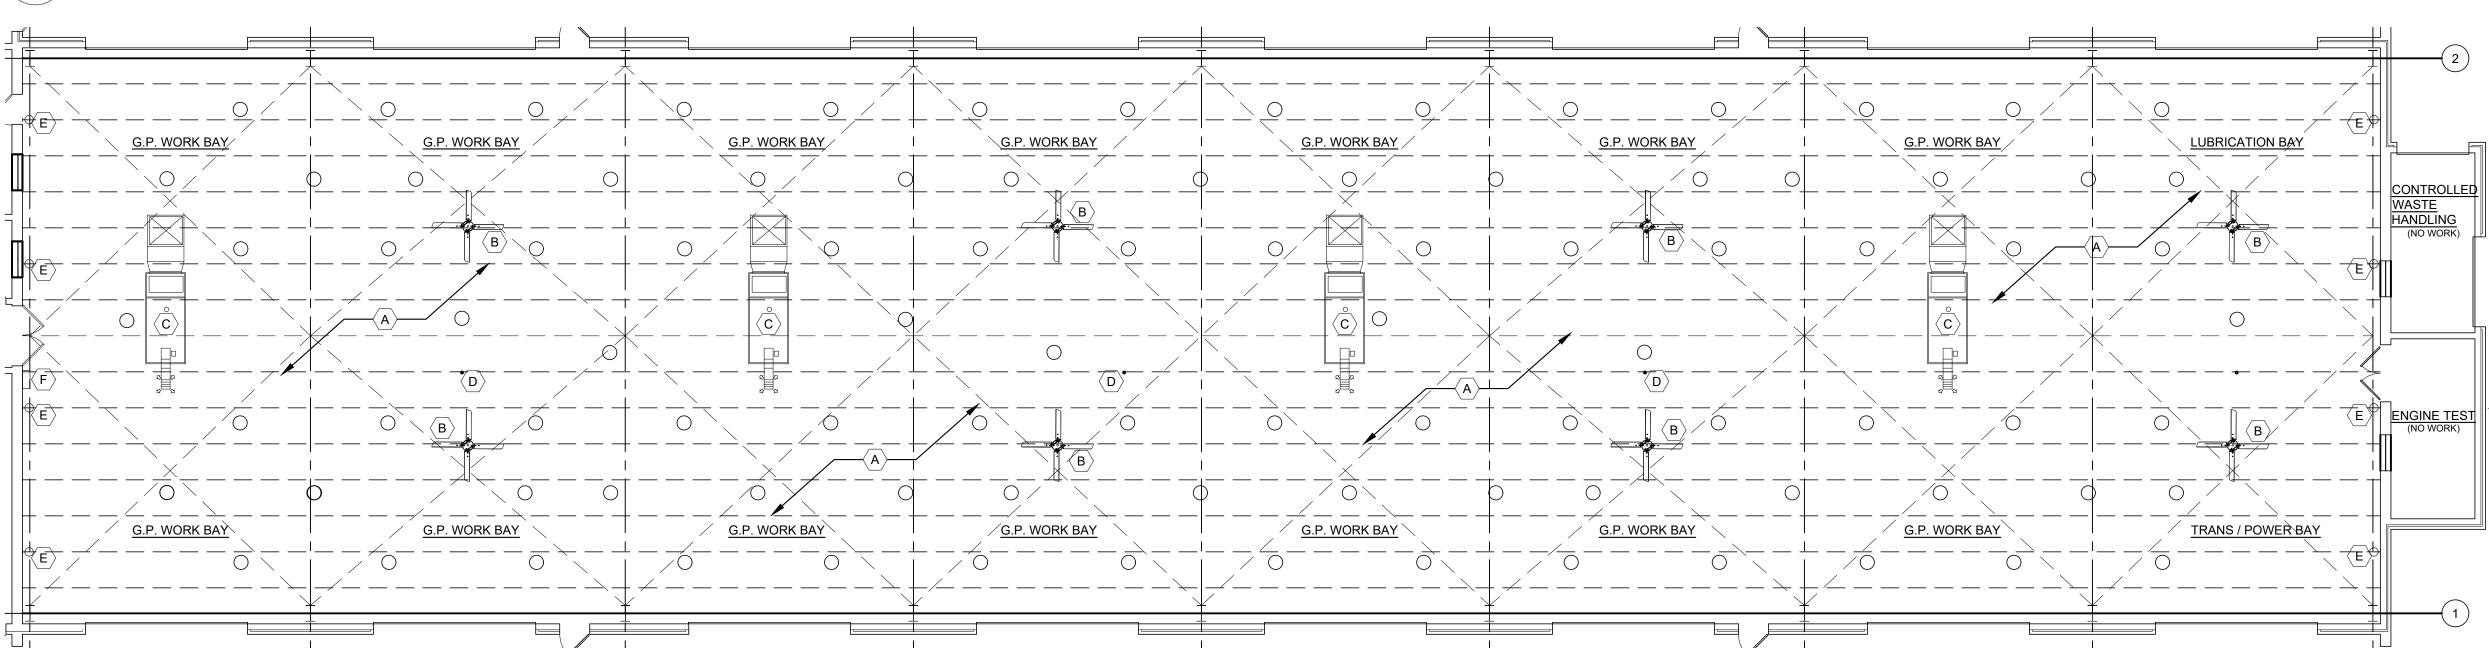

REFLECTED CLG. PLAN - SOUTH BAY SCALE: 3/32" = 1'-0"

REFLECTED CEILING PLAN GENERAL NOTES:	REFLECTED CEILING PLAN KEYED NOTES:	CEILING DEVICE LEGEND
<ol> <li>MECHANICAL DEVICES SHOWN ON THE REFLECTED CEILING PLAN ARE FOR COORDINATION.</li> <li>LIGHTING FIXTURES SHOWN ON THE REFLECTED CEILING PLAN ARE FOR ARCHITECTURAL LOCATIONS, QUANTITIES, AND GENERAL FIXTURE TYPE ONLY. REFER TO ELECTRICAL DRAWINGS FOR EXACT FIXTURE TYPE AND CIRCUITING.</li> <li>ALL LIGHTS MUST BE PROPERLY INSTALLED AND SUPPORTED TO STRUCTURAL SUPPORT MEMBERS ABOVE CEILING SYSTEM AND ATTACHED DIAGONALLY ON LIGHT FIXTURE OR WHERE SURFACE MOUNT LIGHT FIXTURES OCCURS AT SUSPENDED CEILING SYSTEM, DO NOT SUPPORT FROM FINISH CEILING MATERIAL.</li> </ol>	EXIST. 2'-0" x 4'-0" LIGHTING TO BE REMOVED. UPGRADE TO LED LIGHTING, ONE FOR ONE REPLACEMENT U.N.O. SEE ELECT. DWGS.  B EXIST. INDUSTRIAL CEILING FAN TO REMAIN. SEE MECH. DWGS.  C EXIST. MAU TO REMAIN, SEE MECH. DWGS.  D EXIST. CO DETECTOR TO REMAIN.  E EXIST. WALL LIGHT FIXTURES TO REMOVED, SAVE FOR REUSE. SEE ELECT. DWGS.  WALL MOUNTED. FAN CONTROLLER, SEE ELECTRICAL DWGS.	NEW LED PENDANT LIGHT, SEE ELECT. DWGS.  EXIST. INDUSTRIAL FAN TO REMAIN, SEE MECH. DWGS.  EXIST. CO DETECTOR

STATE OF MISSOURI MICHAEL L. PARSON, **GOVERNOR** 



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COMBINED SUPPORT MAINTENANCE SHOP (CSMS) 2302 MILITIA DRIVE JEFFERSON CITY, MISSOURI 65101

8136300007

PROJECT # T2225-01 6300 SITE#

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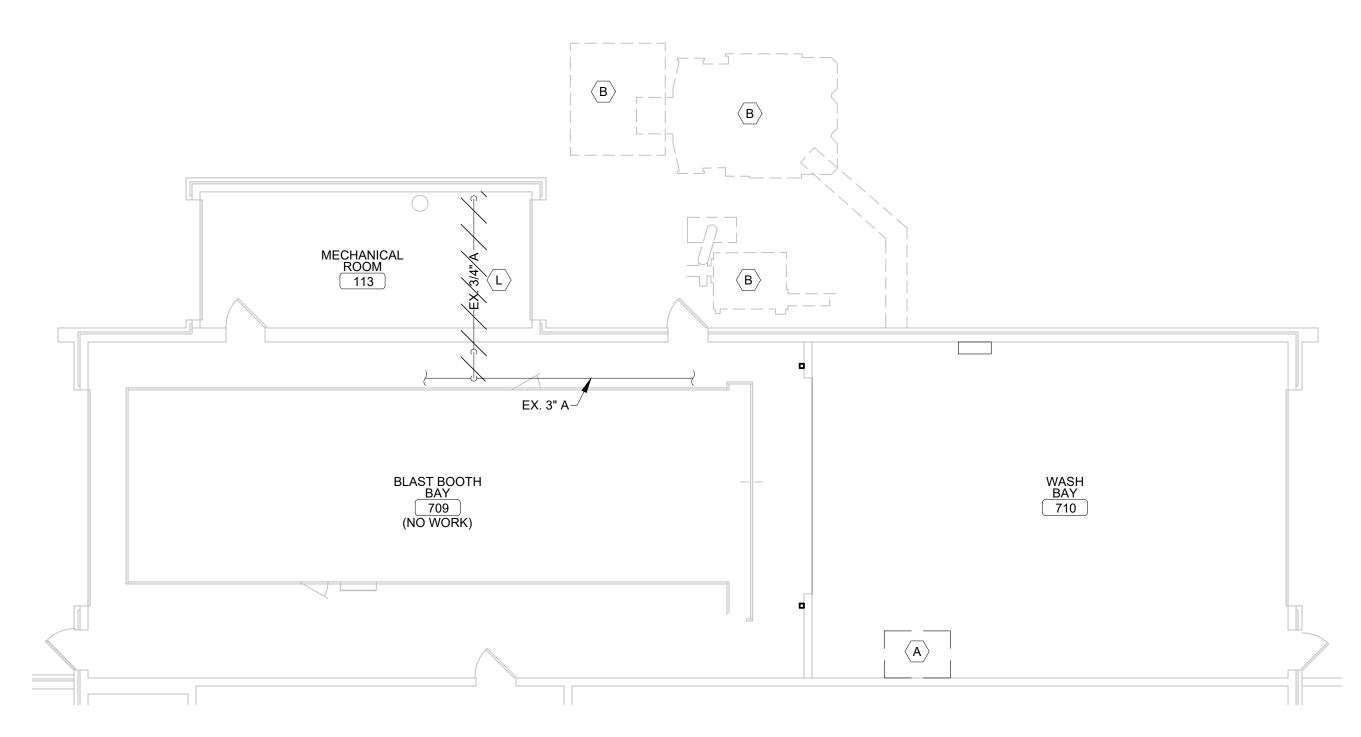
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CHECKED BY: RAR
DESIGNED BY: RAR

SHEET TITLE:

**WORK BAYS** REFLECTED CEILING PLANS

SHEET NUMBER:


4/20/23



DEMO MECHANICAL FLOOR PLAN AT MECH. ROOM & WASH BAY

M-101 SCALE: 1/8" = 1'-0"



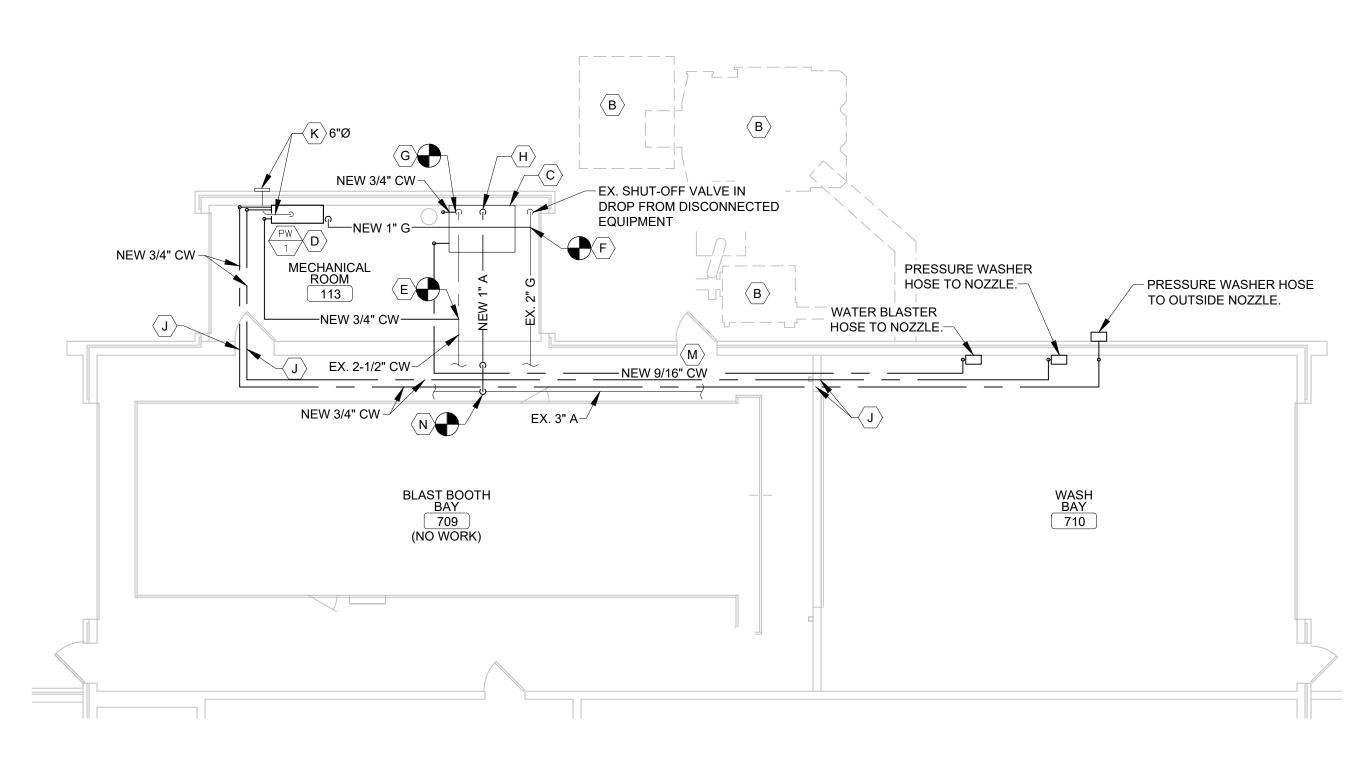

MECHANICAL FLOOR PLAN AT MECH. ROOM & WASH BAY

SCALE: 1/8" = 1'-0"



### **GENERAL NOTES:**


1. DEMOLITION PLAN SHOWS APPROXIMATE LAYOUT OF EXISTING MECHANICAL & PIPING SYSTEMS AND IS NOT INTENDED TO PRESENT "AS-BUILT" CONDITIONS. GC TO VISIT SITE AND OTHERWISE BECOME FAMILIAR WITH ACTUAL CONDITIONS WHEN BIDDING THE WORK.

- 2. PROVIDE ALL NECESSARY SHORING, BRACING, AND SUPPORT TO PREVENT MOVEMENT, SETTLEMENT, OR COLLAPSE OF STRUCTURE OF ELEMENT TO BE DEMOLISHED, AND ADJACENT STRUCTURE OR ELEMENT SHOWN TO REMAIN. SHORING AND BRACING SHALL BE DESIGNED BY CONTRACTOR'S PROFESSIONAL ENGINEER LICENSED IN THE APPLICABLE JURISDICTION.
- 3. G.C. TO PROVIDE DUMPSTER & CONTINUOUS CLEAN-UP DURING DEMOLITION TO PROVIDE SAFE AND CLEAN WORK SITE.
- 4. ALL DIMENSIONS TO BE FIELD VERIFIED AFTER DEMOLITION HAS BEEN COMPLETED. NOTIFY ARCHITECT OF RECORD IMMEDIATELY IF ANY DISCREPANCIES ARE FOUND.
- 5. EXISTING PARTITIONS, FINISHES, EQUIPMENT AND FIXTURES THAT ARE TO REMAIN ARE TO BE PROTECTED BY THE G.C. THROUGHOUT THE DEMOLITION PROCESS UNLESS NOTED OTHERWISE (U.N.O.)
- 6. REMOVE ALL EXISTING ELECTRICAL EQUIPMENT ASSOCIATED TO RELOCATED EQUIPMENT & PIPING, INCLUDING ELECTRICAL CONDUIT, JUNCTION BOXES, WIRING, ETC. AND ALL RELATED EQUIPMENT THAT WILL NOT BE RE-USED. TYPICAL THROUGHOUT AREA OF WORK. COORDINATE ALL ELECTRICAL WORK WITH ENGINEERING DRAWINGS AND NEW PLANS.
- 7. VERIFY WITH THE OWNER, PRIOR TO DEMOLITION, ALL REMOVED ITEMS TO BE SALVAGED, STORED, OR THROWN AWAY. REMOVE DEBRIS, RUBBISH AND OTHER MATERIALS RESULTING FROM DEMOLITION OPERATIONS FROM BUILDING SITE. COORDINATE WITH THE OWNER ANY AND ALL NECESSARY SHUTOFF, CAPPING AND CONTINUATION OF UTILITY SERVICES PRIOR TO COMMENCEMENT. THE OWNER ASSUMES NO RESPONSIBILITY FOR ACTUAL CONDITION OF ITEMS OR STRUCTURES TO BE DEMOLISHED.
- 8. PROMPTLY REPAIR DAMAGES CAUSED BY DEMOLITION TO ANY ADJACENT FACILITIES AT NO COST TO OWNER.
- 9. DO NOT INTERRUPT EXISTING UTILITIES SERVING ADJACENT FACILITIES. COORDINATE ANY SHUT OFF OR TEMPORARY DISRUPTION WITH CSMS PROJECT MANAGER.
- 10. DO NOT CLOSE, BLOCK OR OTHERWISE OBSTRUCT STREETS, WALKS OR OTHER FACILITIES OCCUPIED OR USED BY THE GENERAL PUBLIC.
- 11. COMPLY WITH LOCAL, SATE AND FEDERAL APPLICABLE REGULATIONS.
- 12. REFER TO ARCHITECTURAL INSTRUCTION FOR ROOF PATCH & REPAIR RELATED TO REMOVAL OF MECHANICAL & PIPING SYSTEMS.
- B. ATUM SYMBOL INDICATES POINT OF NEW TO EXISTING CONNECTION.

### **KEYED NOTES:**

- $\overline{oldsymbol{A}}$  DISCONNECT AND RELOCATE EXISTING WATER BLASTER IN WASH BAY. CAP EXISTING PLUMBING.
- B EXISTING PARTICULATE AND DUST HOPPERS TO REMAIN.
- igcap Cigcap EXISTING WATER BLASTER RELOCATED TO MECHANICAL ROOM. INSTALL PER MANUFACTURER'S INSTRUCTIONS.
- D ALTERNATE #3: CONNECT NEW GAS AND NEW WATER SUPPLY TO NEW PRESSURE WASHER IN MECHANICAL ROOM.
- ALTERNATE #3: CONNECT NEW 3/4" COLD WATER LINE TO EXISTING 2-1/2" COLD WATER LINE. CONTRACTOR SHALL INSTALL SHUTOFF VALVE IN AN EASILY ACCESSIBLE LOCATION ON LINE.
- F ALTERNATE #3: CONNECT NEW 1" GAS LINE TO PRESSURE WASHER FROM EXISTING GAS LINE.
- $\overline{ igg( G igg) }$  NEW 3/4" COLD WATER LINE FROM EXISTING 2-1/2" CW LINE TO CONNECT TO RELOCATED WATER BLASTER.
- H EXTEND AND CONNECT NEW COMPRESSED AIR TO RELOCATED WATER BLASTER IN MECHANICAL ROOM.
- J ALTERNATE #3: PROVIDE MINIMUM PENETRATION EQUAL TO PIPE DIAMETER. CLEAN AND REPAIR BLOCK, FINISH SMOOTH.
- ALTERNATE #3: INSTALL PRESSURE WASHER FLUE EXHAUST, 6" DIAMETER, AGA/CSA TYPE B GAS FLUE PIPE WITH ACCESSORIES AND WALL CAP. W. CAP ELEVATION TO BE 8 FEET ABOVE PAVEMENT.
- L DEMO EXISTING 3/4" COMPRESSED AIR LINE IN MECHANICAL ROOM. SEE MECHANICAL FLOOR PLAN FOR NEW COMPRESSED AIR LIN
- NEW 9/16" UHP PIPING FROM WATER BLASTER TO HOSE. INSTALL AND MOUNT PER MANUFACTURER'S INSTRUCTIONS.
- CONNECT NEW 1" COMPRESSED AIR LINE TO EXISTING 3" COMPRESSED AIR LINE. CONTRACTOR SHALL INSTALL SHUTOFF VALVE IN AN EASILY

### STATE OF MISSOURI MICHAEL L. PARSON, GOVERNOR

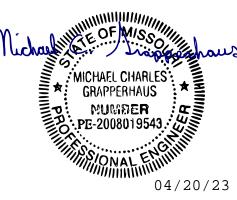

MICHAEL C. GRAPPERHAUS License Number: 2008019543 Expiration Date: 12/31/24

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Sunnen Drive, Suite 100, St. Louis, MO 6314:

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INTERIOR RENOVATIONS & ROOF REPLACEMENT AT COMBINED SUPPORT MAINTENANCE SHOP (CSMS)

COMBINED SUPPORT MAINTENANCE SHOP (CSMS) 2302 MILITIA DRIVE JEFFERSON CITY, MISSOURI 65101

PROJECT # T2225-01 SITE # 6300

ASSET# 8136300007

REVISION:

DATE: REVISION: DATE: REVISION:

DATE: ISSUE DATE: 03/09/2023

CAD DWG FILE:
DRAWN BY: MEA
CHECKED BY: MCG


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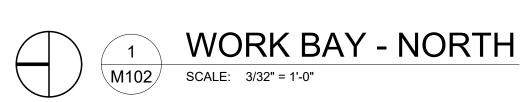
SHEET TITLE:

DEMOLITION AND NEW FLOOR PLANS


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4/20/23 14 OF 22 SHEETS



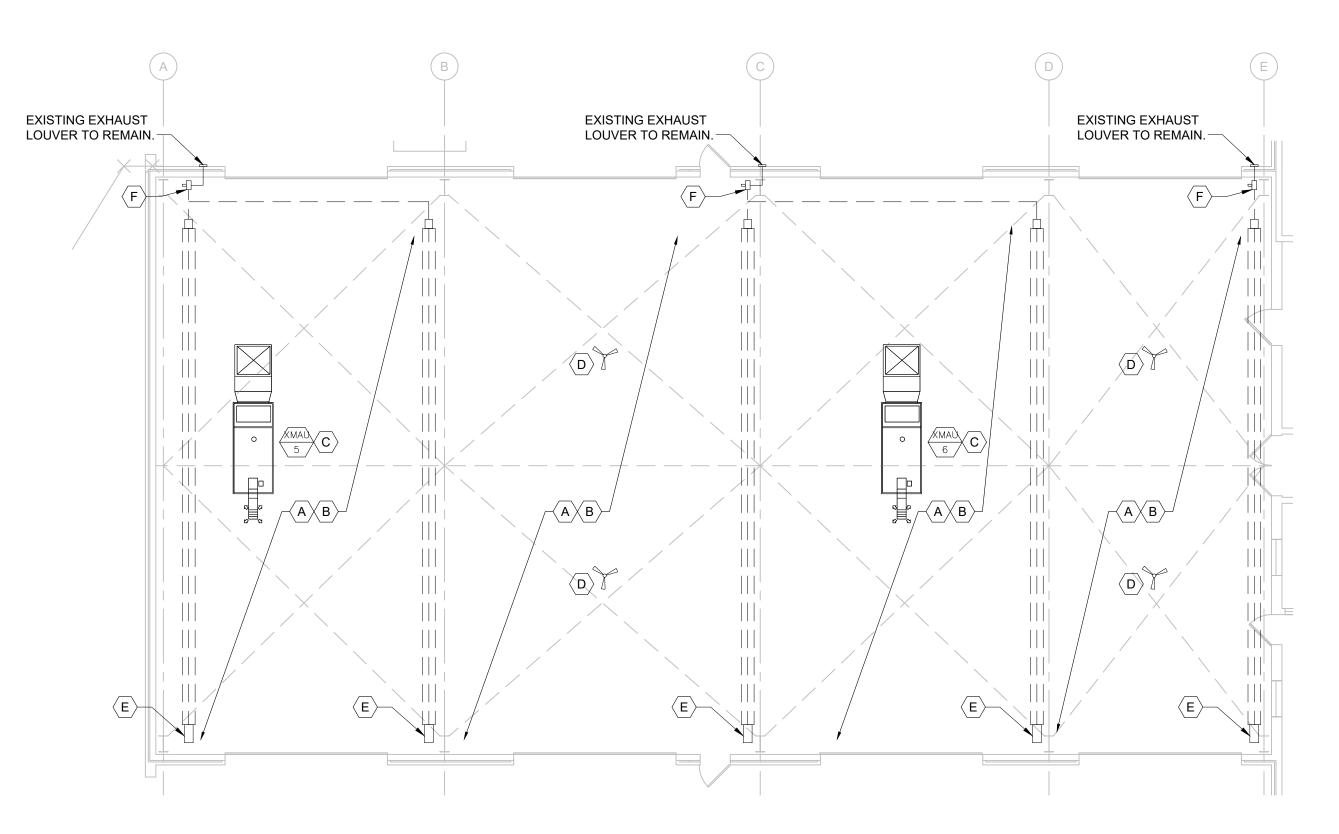

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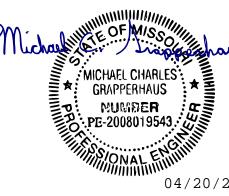
### **GENERAL NOTES:**

- 1. REFER TO SPECIFICATIONS FOR ADDITIONAL REQUIREMENTS.
- 2. THE CONTRACTOR SHALL BE RESPONSIBLE FOR FIELD VERIFICATION OF THE CONTRACT DOCUMENTS. THE ENGINEER AND OWNER SHALL BE NOTIFIED OF ANY UNFORESEEN CONDITIONS WHICH MAY AFFECT PROGRESS OR COST OF WORK PERFORMED.
- 3. THE CONTRACT WORK SHALL INCLUDE FURNISHING ALL MATERIAL, EQUIPMENT, TOOLS, LABOR, AND SERVICES NECESSARY FOR COMPLETION OF THE PROJECT.
- 4. THE CONTRACTOR SHALL BE RESPONSIBLE FOR THE QUALITY OF WORKMANSHIP AND FOR COMPLIANCE WITH THE DESIGN.
- 5. THE CONTRACTOR SHALL CORRECT ALL ERRORS AND DEVIATIONS AS REQUESTED BY THE OWNER.
- 6. THE CONTRACTOR SHALL CONTACT THE OWNER/ENGINEER IMMEDIATELY IF ANY WORKER ENCOUNTERS HAZARDOUS MATERIALS.
- THE CONTRACTOR SHALL COORDINATE MECHANICAL DRAWINGS WITH THE ELECTRICAL DRAWINGS AND SPECIFICATIONS BEFORE PROCEEDING WITH THE WORK AND SHALL NOTIFY THE ARCHITECT OF ANY DISCREPANCIES OR CONFLICTS IMMEDIATELY. ALL DISCREPANCIES SHALL BE RESOLVED PRIOR TO THE CONTRACTOR PROCEEDING WITH WORK.
- 8. ALL PRECAUTIONS SHALL BE TAKEN NOT TO DISTURB EXISTING SERVICES AND UTILITIES.
- 9. ALTERNATE #1: THERMOSTATS, & REMOTE TEMPERATURE SENSORS SHALL BE MOUNTED AT 60" A.F.F.
- 10. ALL COMPONENTS OF INDUSTRIAL CEILING FAN SHALL BE INSTALLED BY CONTRACTOR.
- 11. ALTERNATE #1: ALL COMPONENTS OF THE NEW GAS FIRED INFRARED HEATING SYSTEMS (14) SHALL BE INSTALLED BY A FACTORY-TRAINED CONTRACTOR IN ACCORDANCE WITH MANUFACTURERS INSTALLATION INSTRUCTIONS.
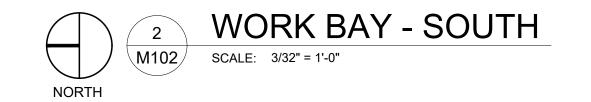
### KEYED NOTES:

- ALTERNATE #1: REMOVE GAS FIRED INFRARED HEATING SYSTEMS AND ALL ASSOCIATED COMPONENTS TUBING, BURNER HEADS, HANGERS, SUPPORTS. DISCONNECT ELECTRIC SERVICE AND PRESERVE CONDUCTORS FOR RECONNECTION TO NEW EQUIPMENT. DISCONNECT GAS PIPING & PRESERVE FOR RECONNECTION TO NEW EQUIPMENT.
- B ALTERNATE #1: REMOVE THERMOSTATS AND ASSOCIATED CONTROLS FOR INFRARED HEATING SYSTEMS.
- C EXISTING MAKE-UP AIR UNITS SERVING THE SERVICE BAYS TO REMAIN IN PLACE FOR CONTINUED USE.
- $\langle \mathsf{D} \rangle$  CEILING FAN IN WORK BAYS EXISTING TO REMAIN. CLEAN AND REPAIR TO LIKE NEW CONDITION.
- (E) ALTERNATE #1: GAS PIPING CONNECTION TO INFRARED HEATING UNIT TO REMAIN FOR RECONNECTION TO NEW EQUIPMENT.
- ALTERNATE #1: REMOVE RADIANT HEATING SYSTEM VACUUM BLOWERS. DISCONNECT ELECTRIC SERVICE AND PRESERVE CONDUCTORS FOR RECONNECTION.

STATE OF MISSOURI MICHAEL L. PARSON, GOVERNOR



MICHAEL C. GRAPPERHAUS License Number: PE-2008019543 Expiration Date: 12/31/24

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12 Sunnen Drive, Suite 100, St. Louis, MO 63143

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MAINTENANCE SHOP (CSMS)

COMBINED SUPPORT MAINTENANCE SHOP (CSMS) 2302 MILITIA DRIVE JEFFERSON CITY, MISSOURI 65101

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PROJECT # T2225-01 SITE # 6300

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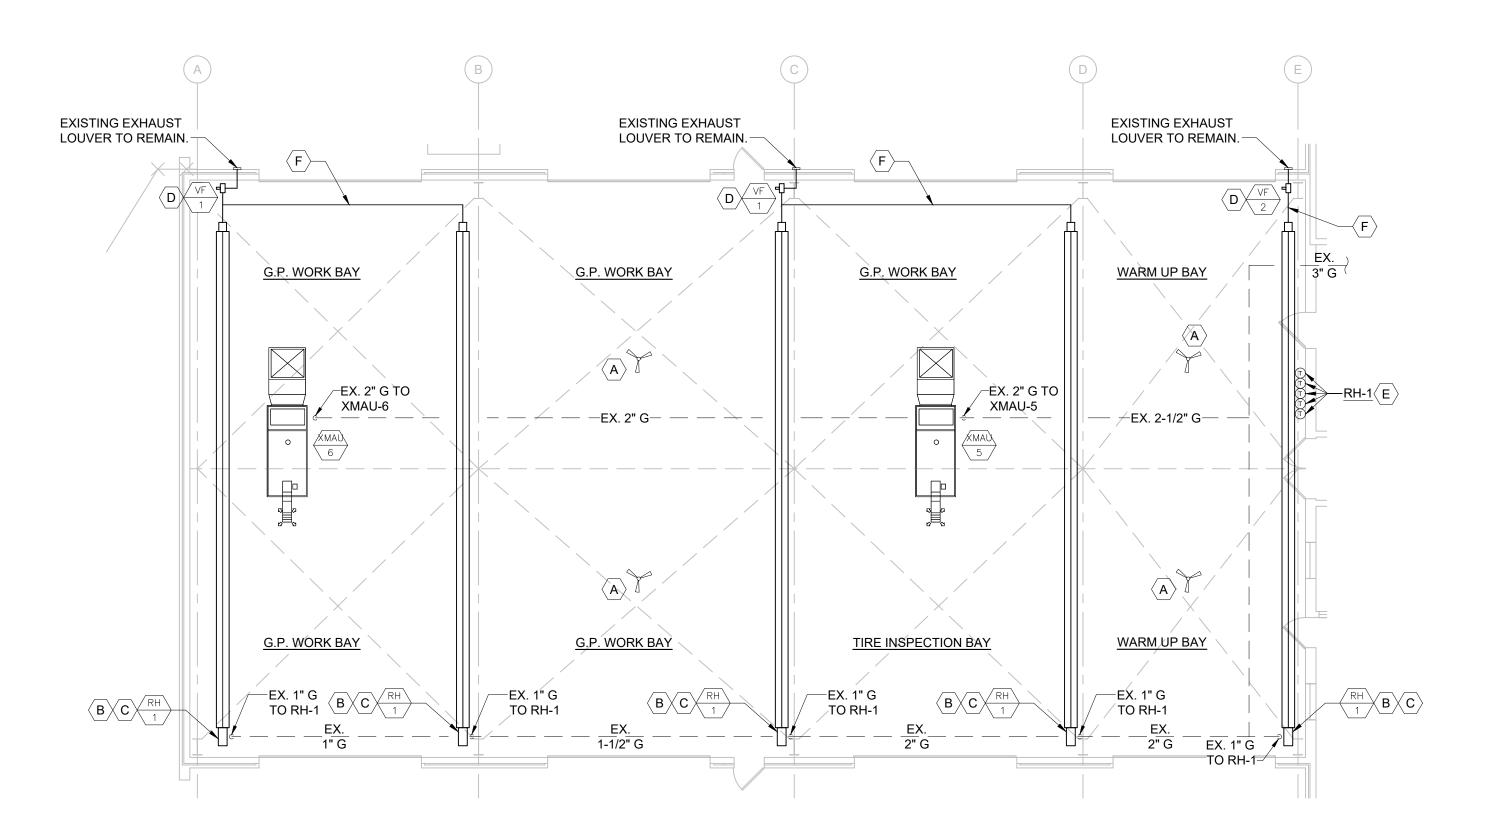
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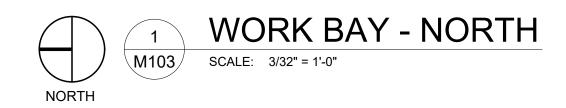
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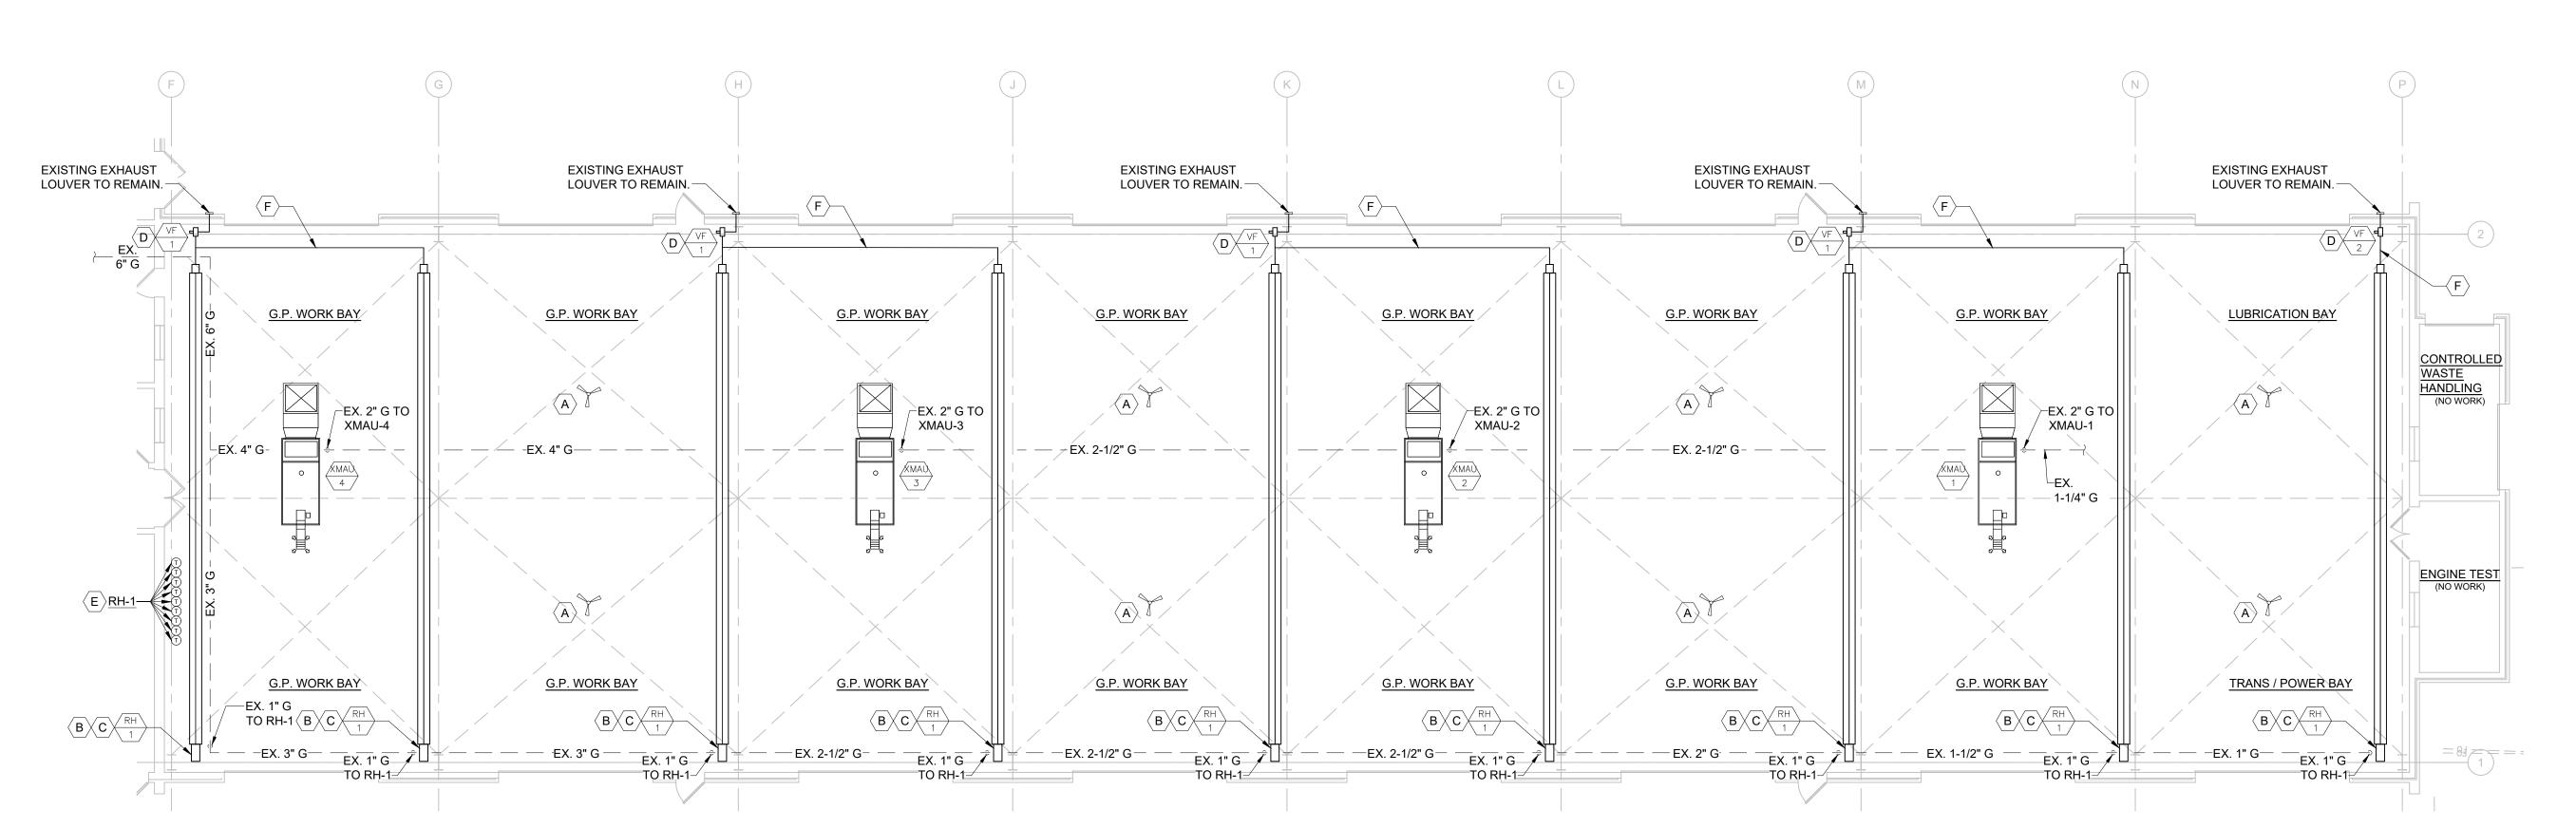
WORK BAYS MECHANICAL DEMOLITION PLAN


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M-102
4/20/23
15 OF 22 SHEETS







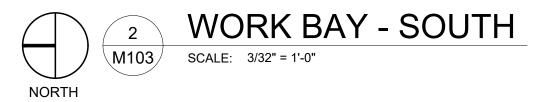


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- REFER TO SPECIFICATIONS FOR ADDITIONAL REQUIREMENTS.
- 2. THE CONTRACTOR SHALL BE RESPONSIBLE FOR FIELD VERIFICATION OF THE CONTRACT DOCUMENTS. THE ENGINEER AND OWNER SHALL BE NOTIFIED OF ANY UNFORESEEN CONDITIONS WHICH MAY AFFECT PROGRESS OR COST OF WORK PERFORMED.
- 3. THE CONTRACT WORK SHALL INCLUDE FURNISHING ALL MATERIAL, EQUIPMENT, TOOLS, LABOR, AND SERVICES NECESSARY FOR COMPLETION OF THE PROJECT.
- 4. THE CONTRACTOR SHALL BE RESPONSIBLE FOR THE QUALITY OF WORKMANSHIP AND FOR COMPLIANCE WITH THE DESIGN.
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- 8. ALL PRECAUTIONS SHALL BE TAKEN NOT TO DISTURB EXISTING SERVICES AND UTILITIES.
- 9. ALTERNATE #1: THERMOSTATS, & REMOTE TEMPERATURE SENSORS SHALL BE MOUNTED AT 60" A.F.F.
- 10. ALL COMPONENTS OF INDUSTRIAL CEILING FAN SHALL BE INSTALLED BY CONTRACTOR.
- 11. ALTERNATE #1: ALL COMPONENTS OF THE NEW GAS FIRED INFRARED HEATING SYSTEMS (14) SHALL BE INSTALLED BY A FACTORY-TRAINED CONTRACTOR IN ACCORDANCE WITH MANUFACTURERS INSTALLATION INSTRUCTIONS.

### KEYED NOTES:

- (A) CEILING FAN IN WORK BAYS EXISTING TO REMAIN. CLEAN AND REPAIR TO LIKE NEW CONDITION.
- ALTERNATE #1: PROVIDE AND INSTALL NEW GAS FIRED INFRARED HEATING SYSTEM TIN EXISTING LOCATIONS, CONSISTING OF: BURNER HEAD, INFRARED TUBULAR ASSEMBLY, VACUUM PRODUCER, WALL EXHAUST TERMINATION. SEE SCHEDULE ON SHEET M-601.
- C ALTERNATE #1: RECONNECT NEW BURNER HEADS TO EXISTING GAS PIPING.
- (D) ALTERNATE #1: REPLACE RADIANT HEATING SYSTEM VACUUM FANS WITH NEW VACUUM FANS AT ELEVATION OF THE EXISTING FANS.
- $\langle \mathsf{E} \rangle$  ALTERNATE #1: INSTALL THERMOSTATS AT 5 FT, AFF. ATTACH TO WALL.
- ALTERNATE #1: INSTALL NEW GAS FLUE FOR INFRARED HEATING SYSTEMS. SEE VACUUM BLOWER SCHEDULE ON SHEET M-601 FOR FURTHER INFORMATION.

STATE OF MISSOURI MICHAEL L. PARSON, GOVERNOR

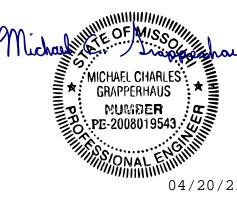

MICHAEL C. GRAPPERHAUS License Number: PE-2008019543 Expiration Date: 12/31/24

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MAINTENANCE SHOP (CSMS)
2302 MILITIA DRIVE
JEFFERSON CITY, MISSOURI
65101

PROJECT # T2225-01 SITE # 6300

ASSET# 8136300007

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SHEET TITLE:

WORK BAYS MECHANICAL FLOOR PLAN

SHEET NUMBER:

M-103
4/20/23
16 OF 22 SHEETS

## VACUUM BLOWER SCHEDULE (FOR RADIANT HEATERS) (BASIS OF DESIGN) (BASIS OF DESIGN) **ALTERNATE #1**

MARK	MANUFACTURER & MODEL	SYSTEM MBH	INLET/OUTLET CONNECTION SIZE	RPM	VOLTS	HP	RLA	UNIT DIMENSIONS	MOUNTING HEIGHT
VF-1	DETROIT RADIANT PRODUCTS, MODEL: PB9B-1PH	280 - 545	4" RND.	3450	208 / 1	3/4	5.0	LENGTH = 19.8" WIDTH = 14.5" HEIGHT = 16.5"	MATCH EXISTING
VF-2	DETROIT RADIANT PRODUCTS, MODEL: PB8B-1PH	50 - 275	4" RND.	3450	208 / 1	1/2	3.9	LENGTH = 19.8" WIDTH = 11.0" HEIGHT = 16.5"	MATCH EXISTING

ACCEPTABLE MANUFACTURERS FOR EQUIVALENT OF SCHEDULE PRODUCT \* REFLECT O-RAY (COMBUSTION RESEARCH CORP), SPACE-RAY (GAS-FIRED PRODUCTS, INC), ROBERTS / GORDON, INC.

### NOTES:

- 1. VACUUM BLOWERS SHALL BE INSTALLED PER MANUFACTURER'S INSTALLATION INSTRUCTIONS.
- 2. ELECTRICAL CONTRACTOR TO PROVIDE LINE VOLTAGE WIRING TO THE CONTROL RELAY OF THE VACUUM BLOWERS.
- 3. SEE PLAN VIEW FOR VACUUM BLOWER LOCATIONS.
- 4. VACUUM BLOWERS SHALL MAINTAIN A CONTINUOUS NEGATIVE PRESSURE DURING OPERATION, THROUGH CONNECTED BURNERS, BURNER TUBES, EMITTERS, BALANCING DAMPERS, AND TAIL PIPE.
- 5. FLUE PIPE MATERIAL SHALL BE WELDED SEAM ALUMINIZED STEEL TUBING WITH LONG RADIUS SINGLE PIECE WELDED FITTINGS (ELBOWS & TEES).
- 6. TUBING JOINTS SHALL BE SECURED & SEALED WITH SCREWS AND HIGH TEMPERATURE MASTIC SEALANT.
- 7. TEFC MOTOR WITH HEAT SLINGER.
- 8. PRIMARY AIR DAMPER AT INLET TO VACUUM BLOWER
- WARRANTY: 1 YEAR VACUUM BLOWER.

# GAS FIRED RADIANT HEATER SCHEDULE (NEGATIVE PR) (BASIS OF DESIGN)

MARK	MANUFACTURER & MODEL	MBH INPUT	THERM EFF	GAS CONN	TUBE SIZE	BURNER TUBE LENGTH	COMBUST CHAMBER LENGTH	RADIANT EMITTER LENGTH	POWER REQUIREMENTS	VACUUM BLOWER DATA	UNIT DIMENSIONS	MOUNTING HEIGHT
RH-1	DETROIT RADIANT PRODUCTS, MODEL: HLV-150	150 / 120	92%	7/8"	4" RND.	60 FT	10 FT.	60 FT.	120 / 1PH / 2 AMP	REFER TO VACUUM BLOWER SCHEDULE	WIDTH = 18" HEIGHT = 18"	MATCH EXISTING

ACCEPTABLE MANUFACTURERS FOR EQUIVALENT OF SCHEDULE PRODUCT:

\* REFLECT O-RAY (COMBUSTION RESEARCH CORP), SPACE-RAY (GAS-FIRED PRODUCTS, INC), ROBERTS / GORDON, INC.

### NOTES:


- 1. HEATERS SHALL BE INSTALLED PER MANUFACTURER'S INSTALLATION INSTRUCTIONS.
- 2. HEATERS SHALL BE CONTROLLED BY A SINGLE TWO-STAGE 24-7 PROGRAMMABLE DIGITAL THERMOSTAT, MOUNTED 4'-0" ABOVE THE FINISHED FLOOR. SEE MECHANICAL PLAN FOR LOCATIONS.
- 3. VACUUM BLOWERS SHALL MAINTAIN A CONTINUOUS NEGATIVE PRESSURE DURING OPERATION, THROUGH CONNECTED BURNERS, BURNER TUBES, EMITTERS, BALANCING DAMPERS, AND TAIL PIPE.
- 4. COMBUSTION TUBES: 4" DIA 16 GAUGE TITANIUM ALLOY STEEL TUBES.
- 5. EMITTER TUBES: 4" DIA 16 GAUGE ALUMINIZED STEEL TUBES WITH EMISSIVE BLACK COATING (EMISSIVITY = 0.95)
- 6. LINEAR PARABOLIC REFLECTORS ALONG ENTIRE LENGTH OF COMBUSTION CHAMBER & EMITTERS: HIGHLY POLISHED REFLECTIVE SURFACE TO DIVERT RADIANT ENERGY TO THE SPACE & FLOOR
- 7. HOT ROLLED TUBING NOT ALLOWED.
- 8. TWO-STAGE GAS VALVE, HOT SURFACE IGNITION, DIGITAL BURNER CONTROLS
- 9. FLUE PIPE MATERIAL SHALL BE WELDED SEAM ALUMINIZED STEEL TUBING WITH LONG RADIUS SINGLE PIECE WELDED FITTINGS (ELBOWS & TEES.
- 10. TUBING JOINTS SHALL BE SECURED & SEALED WITH SCREWS AND HIGH TEMPERATURE MASTIC SEALANT.
- 11. WARRANTY: 3-YEAR BURNER CONTROL BOX, 1 YEAR VACUUM PUMP, 5 YEARS COMBUSTION & RADIANT TUBES, 10 YEARS BURNER.

			PW #	RESS	SURE (				SYSTE DESIG		SCF	HEDU	JLE					ALTERNA	TE #3
K	MANUFACTURER	MODEL#	TYPE		WATER				STEAM			ELECT					JT WEIGHT		EQUIVALENT
				НОТ	COLD	GPM I	PSI	TEMP	LBS/HR	PSI	HP	VOLTS	PHASE	HZ	CFH	IN. W.C	(LBS)	MANUF/ MODEL #	MANUF/ MODEL #
																		EASY-KLEEN	DELCO
-1	DAIMER INDUSTRIES	SM-15900 -236DH	FIXED MOUNTED FREE STANDING	180-210 F	AMBIENT	5 3	000	330 F	AMBIENT	3000	10	208	3	60	446	7-14	1025	MODEL: EZN3004-3	MODEL: 65044
			PRESSURE WASHER SYSTEM																
CC	CESSORIES:																		

- DIRECT DRIVE, CAPACITOR START CONTINUOUS DUTY MOTOR -- NEMA DESIGN B. 2. NEMA 1 DISCONNECT
- 3. CHEMICAL INFUSION PORT -- HIGH DISCHARGE PRESSURE
- 4. 3 FOOT TRIGGER WAND WITH 0, 15, 25, 40 DEGREE STEAM NOZZLES (2 TOTAL) 100 FEET OF HIGH PRESSURE STEAM HOSE -- DISCHARGE (2 TOTAL)
- 6. DIMENSIONS (W x D x H): 52" x 23" x 50"
- 7. AUTOMATIC SHUTOFF TECHNOLOGY: TRIGGER CONTROL TO MOTOR TO REDUCE EQUIPMENT WEAR
- . ELECTRONIC SPARK IGNITION NATURAL GAS HEAT EXCHANGER

STATE OF MISSOURI MICHAEL L. PARSON, **GOVERNOR** 

ALTERNATE #1

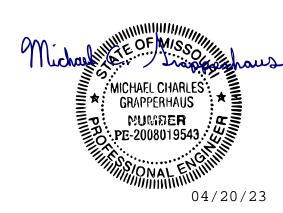

MICHAEL C. GRAPPERHAUS License Number: PE-2008019543

**CASCO** Diversified Corporation MO Certificate of Authority #000329 Arch MO Certificate of Authority #000613 Eng.

**OFFICE OF ADMINISTRATION DIVISION OF FACILITIES** MANAGEMENT, **DESIGN AND** CONSTRUCTION

MISSOURI NATIONAL **GUARD** 

INTERIOR RENOVATIONS & ROOF REPLACEMENT AT COMBINED SUPPORT MAINTENANCE SHOP (CSMS)

COMBINED SUPPORT MAINTENANCE SHOP (CSMS) 2302 MILITIA DRIVE JEFFERSON CITY, MISSOURI 65101

8136300007

PROJECT # T2225-01 6300 SITE#

**REVISION:** DATE: REVISION: DATE: **REVISION:** 

ASSET#

DATE: ISSUE DATE: 03/09/2023

CAD DWG FILE: DRAWN BY: MEA

CHECKED BY: MCG

DESIGNED BY: MCG SHEET TITLE:

> **MECHANICAL** SCHEDULES

SHEET NUMBER:

4/20/23 17 OF 22 SHEETS

	M	MOUNT: SURFACE 120/208 3-PHASE, 4V				3-PHASE, 4W	EX	PANE	L	Р	7	7 CAPACITY: 200A			INT CAP: 10KA					
Г	LOCATION: BAY ADDITION					LUGS:			MLO		DEMAND LOAD:	143A		AV. F	AULT:	6A		1		
Γ	CKT	LTG	REC	HVAC	MISC	NP	DESCRIPTION	AMP	POLE	ф	AMP	POLE	DESCRIPTION	LTG	REC	HVAC	MISC	NP	CKT	1
T	1				10.8					Α						1.2			2	1
T	3				10.8		SPECIAL EQUIP OUTLET	100	3	В	15	3	MAU-6			1.2			4	
Τ	5				10.8					С						1.2			6	
Ī	7		1.1				REC-SHOP	20	1	Α	20	1	RH1&2			0.5			8	
T	9				1.2		OH DOOR	20	1	В	20	1	PENDANT LIGHTS	1.3					10	
Γ	11		0.2				RTU RECEPT	20	1	С	20	1	WALL LIGHTS	0.5					12	
Ī	13						SPARE	20	1	Α			PW-1				3.7		14	
15		SPARE		1	В	40	3	PRESSURE				3.7		16	•					
T	17						SPARE	20	1	С			WASHER				3.7		18	
Ť	19						SPARE	20	1	Α	20	1	SPARE						20	
Ī	21						SPARE	20	1	В	20	1	SPARE						22	
T	23						PROMSION			C			PROVISION						24	
T	25						PROMSION			Α			PROVISION						26	
Ī	27						PROMSION			В			PROVISION						28	
I	29						PROMSION			С			PROVISION						30	
Γ	Б	IAOE E		0.	LOAD	TYPE	CONNECTED	DEMAND		IAND		DEMA	AND FORMULA			TOTAL		L LOAD DEMAND		
۱	PH	IASE E	SALAN	CE	LIGH	TING	1.8 KVA		2.3 KVA			LOAD	X 125% NEC 210.19 CONTINUOUS		CONNECTED	•				
t	ф	LO	AD	%	RECEF	PTACLE	1.3 KVA	1.3 K		1.3 KVA		10KVA + 50% REMAINDER NEC 220.44			4	51.7 KVA		51.4KVA		•
r	A 16.9 KVA 33% HVAC		/AC	3.9 KVA		3.2 KVA		LOAD X 80% (USED MCA IN CALCULATION			TION)	143.6A		142.7A						
r	B 18.3 KVA 36% MISC		SC	44.7 KVA	44.7 KVA				LOAD	OAD X 100% NEC 210.19 NON-CONT.				FILEN	NAME:		•			
r	С	16.2	KVA	32%	N	P	0.0 KVA		0.0 K	VA		10N 0	NCOINCIDENTAL LOADS I	NEC 22	0.60	22025	27 LOA	D.xlsm		
Ī	OTES	S:																		1

	EQUIPME	NT SCH	HEDUL	Е			FILE:	2202527 LOAD.xls m	
PLAN MARK	EQUIPMENT SERVED	LOAD	VOLT/ PHASE	FED BY	DISC BY	MCA	MOCPD	FEEDER	REMARKS
PW-1	PRESSURE WASHER	11.10KVA	208/3	<b>P</b> 7	EC	30.80	40A	(3)#8,#10G 3/4"C	ALT #3

C. PROVIDE CIRCUIT BREAKER WITH SAME INTERRUPTING RATING AND MANUFUFACTURER.


### **GENERAL NOTES:**

- A. COORDINATE DEMOLITION AND NEW WORK WITH ALL DISCIPLINES AND EXISTING CONDITIONS PRIOR TO CONSTRUCTION.
- B. PERFORM ALL WORK IN ACCORDANCE WITH THE ELECTRICAL CODE, O.S.H.A., PERTINENT NFPA CODES, THE RULES AND REGULATIONS OF ALL LOCAL, STATE AND FEDERAL AUTHORITIES HAVING JURISDICTIONS, AND ALL STANDARDS APPLIED BY THE BUILDING MANAGEMENT. PROVIDE OWNER WITH CERTIFICATES OF INSPECTION.
- C. REFER TO ARCHITECTURAL DRAWINGS FOR AREAS OF DEMOLITION. EXISTING LIGHTING FIXTURES AND OTHER NOTED CEILING MOUNTED DEVICES TO BE REMOVED IN THESE AREAS SHALL BE DISCONNECTED FROM THEIR EXISTING SOURCES TO ALLOW FOR REMOVAL UNLESS OTHERWISE NOTED ON ARCHITECTURAL DRAWINGS.
- D. MAINTAIN CONTINUITY OF ALL ACTIVE LIGHTING & POWER CIRCUITS. INTERRUPT WIRING AND REROUTE WHERE REQUIRED TO POWER EXISTING DEVICES TO REMAIN. UPDATE PANELBOARD CIRCUIT DIRECTORIES FOR ALL PANELBOARDS AFFECTED BY THE WORK.
- E. OWNER RETAINS RIGHTS OF SALVAGE FOR ELECTRICAL EQUIPMENT AND LIGHT FIXTURES TO BE REMOVED. COORDINATE WITH OWNER THE EQUIPMENT AND LIGHT FIXTURES TO BE SALVAGED AND THE LOCATION FOR STORAGE. AVOID DAMAGE TO SALVAGED EQUIPMENT, FIXTURES AND DEVICES DURING DEMOLITION WORK AND DURING TRANSPORT TO OWNER'S DESIGNATED STORAGE LOCATION.
- F. ALL PREVIOUSLY ABANDONED OR OBSOLETE CONDUIT AND WIRING SHALL BE REMOVED IN ITS ENTIRETY.G. REVIEW EXISTING CONDITIONS PRIOR TO START OF DEMOLITION AND COORDINATE ANY POWER
- INTERRUPTIONS WITH OWNER'S REPRESENTATIVE.
- H. SEAL ALL PENETRATIONS THROUGH FLOORS, WALLS, CEILINGS, AND ROOF WHERE ELECTRICAL COMPONENTS ARE REMOVED AND WHERE THE EXISTING PENETRATION IS NOT USED FOR THE NEW INSTALLATION. REPAIR DAMAGED SURFACES TO MATCH ADJACENT AREAS.
- I. REMOVE ALL EXISTING ELECTRICAL EQUIPMENT, FIXTURES, SYSTEMS, CONDUIT AND WIRING NO LONGER REQUIRED AFTER PROJECT COMPLETION.


### # KEYED NOTES:

- 1. EXISTING LIGHTING TO REMAIN IN-PLACE AND CONNECTED.
- 2. EXISTING EMERGENCY & EXIT LIGHT FIXTURE TO REMAIN IN-PLACE AND CONNECTED, UNO.
- 3. RELOCATE LIGHT FIXTURE: DISCONNECT, REMOVE EXISTING CEILING LIGHT FIXTURE AND SALVAGE FOR REUSE. FOR NEW LOCATION, SEE SHEET E103.
- 4. EXISTING TABLE & DESK POWER/COMMUNICATION FEEDS TO REMAIN IN-PLACE.
- EXISTING WATER BLASTER: PRIOR TO REMOVAL AND RELOCATION OF WATER BLASTER, DISCONNECT POWER FEEDERS

  AND TIE-LIP FOR RELISE
- RELOCATED WATER BLASTER: AFTER WATER BLASTER IS IN-PLACE, EXTEND FEEDER TO NEW LOCATION AND RECONNECT AS REQUIRED.

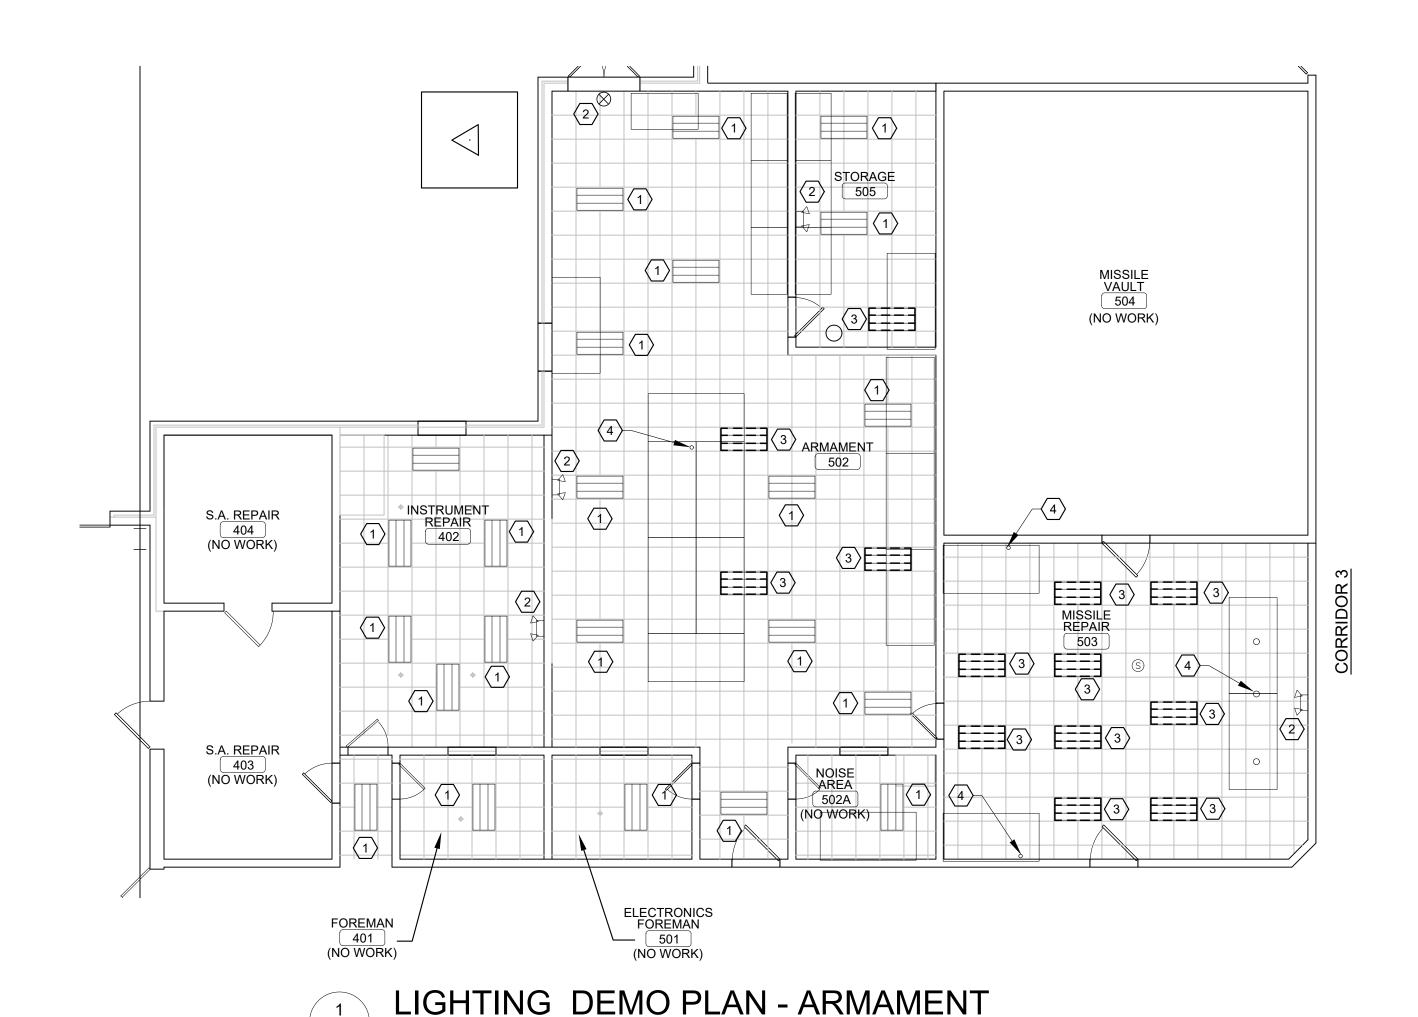

SCALE: 1/8" = 1'-0"

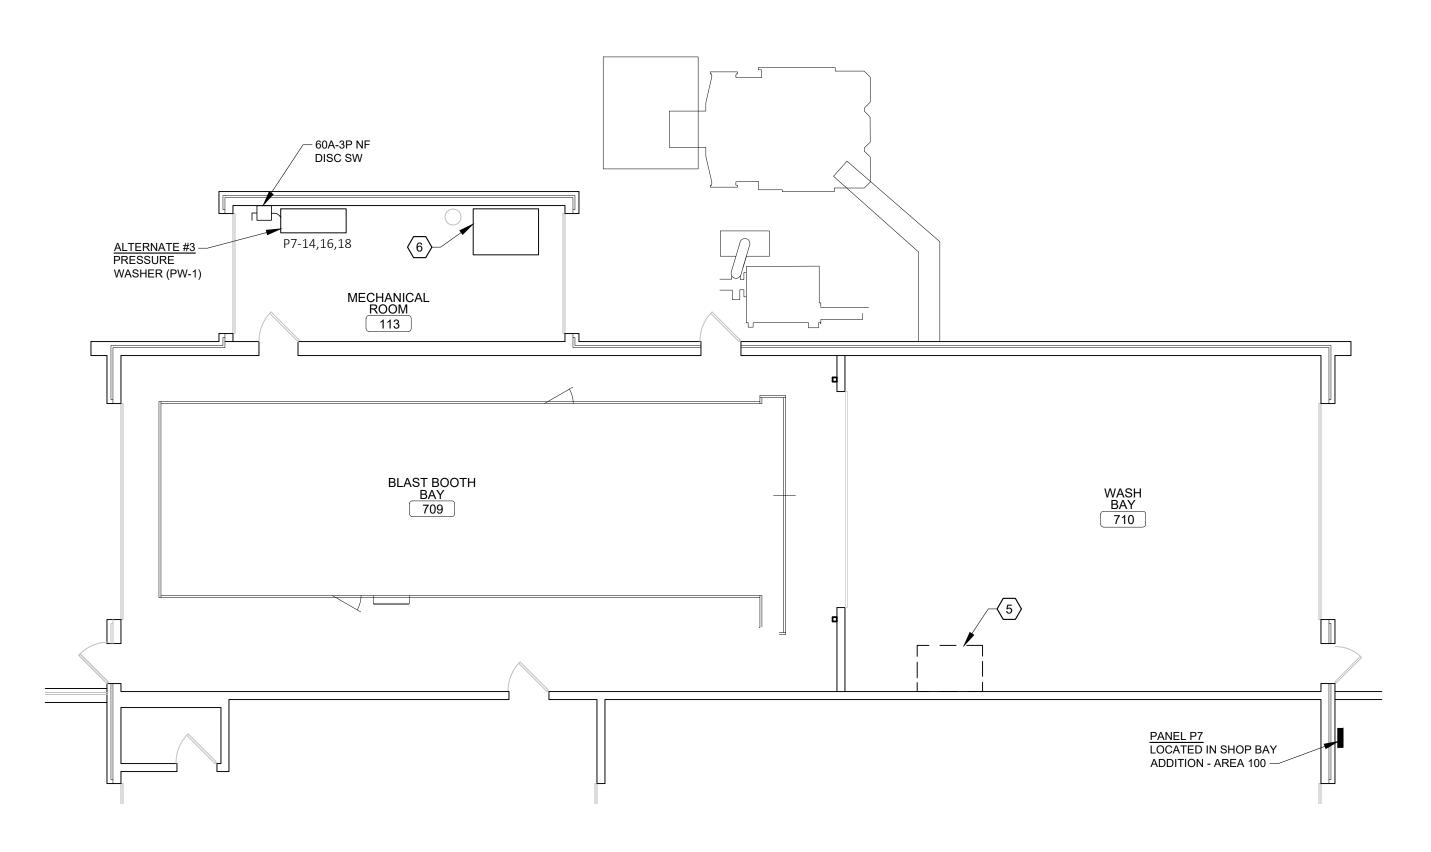


ELECTRICAL FLOOR PLAN AT MECH. ROOM

SCALE: 1/8" = 1'-0"



STATE OF MISSOURI MICHAEL L. PARSON, GOVERNOR

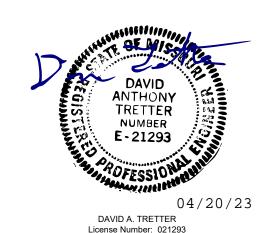

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MO Certificate of Authority #000613 Eng.

Expiration Date: 12/31/23

12 Sunnen Drive, Suite 100, St. Louis, MO 63143

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COMBINED SUPPORT MAINTENANCE SHOP (CSMS) 2302 MILITIA DRIVE JEFFERSON CITY, MISSOURI 65101

8136300007

PROJECT # T2225-01 SITE # 6300

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ASSET#

DATE:\_ REVISION:\_ DATE:

ISSUE DATE: 04/20/2023


CAD DWG FILE:
DRAWN BY: RA
CHECKED BY: WJK
DESIGNED BY:

SHEET TITLE:

ELECTRICAL FLOOR PLANS

SHEET NUMBER:

E-101

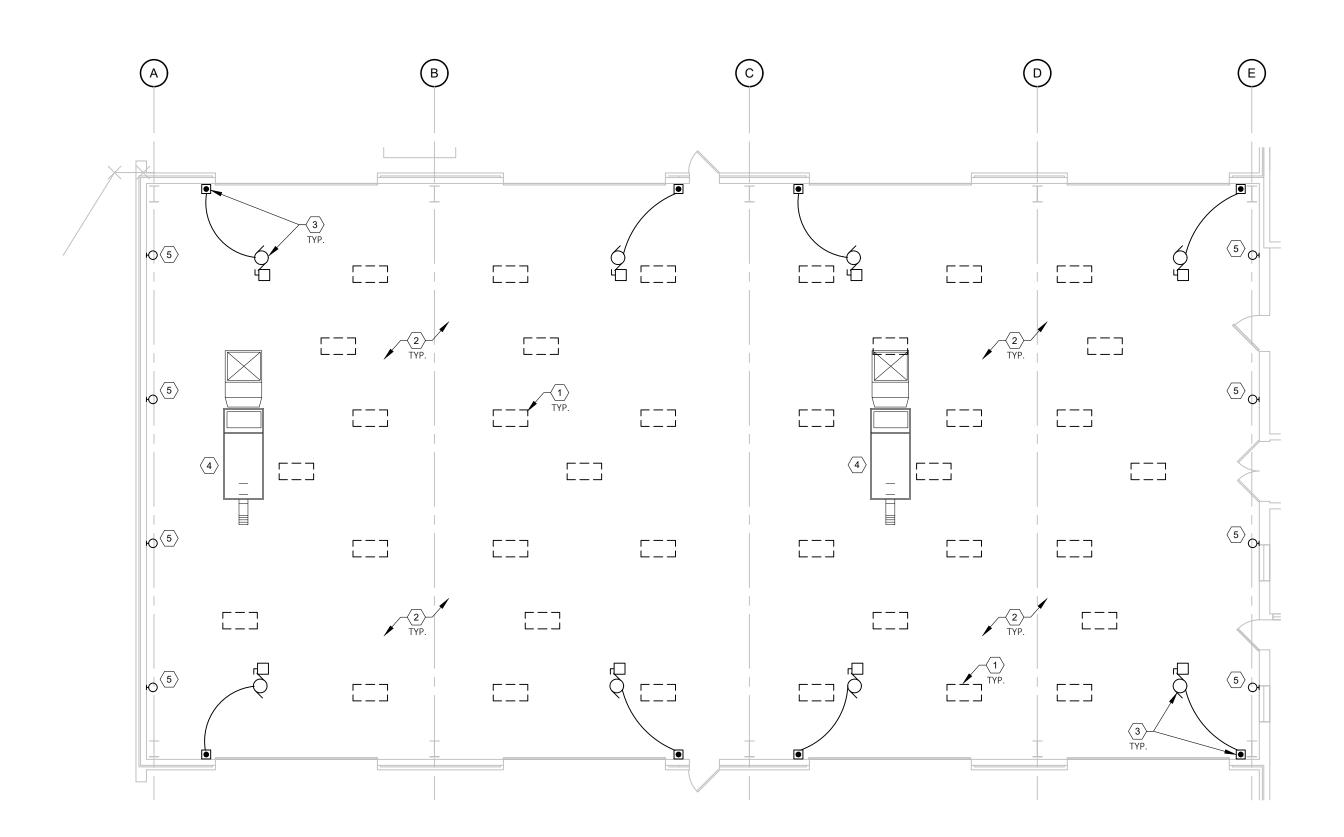

1 ELECTRICAL DEMO WORK BAY - NORTH
E102 SCALE: 3/32" = 1'-0"

DEMOLITION GENERAL NOTES:

A. COORDINATE DEMOLITION AND NEW WORK WITH ALL DISCIPLINES AND EXISTING CONDITIONS PRIOR TO CONSTRUCTION.

B. PERFORM ALL WORK IN ACCORDANCE WITH THE ELECTRICAL CODE, O.S.H.A., PERTINENT NFPA CODES, THE RULES AND REGULATIONS OF ALL LOCAL, STATE AND FEDERAL AUTHORITIES HAVING JURISDICTIONS, AND ALL STANDARDS APPLIED BY THE BUILDING MANAGEMENT. PROVIDE OWNER WITH CERTIFICATES OF INSPECTION.

C. REFER TO ARCHITECTURAL DRAWINGS FOR AREAS OF DEMOLITION. EXISTING LIGHTING FIXTURES AND OTHER NOTED CEILING MOUNTED DEVICES TO BE REMOVED IN THESE AREAS SHALL BE DISCONNECTED FROM

THEIR EXISTING SOURCES TO ALLOW FOR REMOVAL UNLESS OTHERWISE NOTED ON ARCHITECTURAL DRAWINGS.

D. MAINTAIN CONTINUITY OF ALL ACTIVE LIGHTING & POWER CIRCUITS. INTERRUPT WIRING AND REROUTE

ALL PANELBOARDS AFFECTED BY THE WORK.

E. OWNER RETAINS RIGHTS OF SALVAGE FOR ELECTRICAL EQUIPMENT AND LIGHT FIXTURES TO BE REMOVED. COORDINATE WITH OWNER THE EQUIPMENT AND LIGHT FIXTURES TO BE SALVAGED AND THE LOCATION FOR

WHERE REQUIRED TO POWER EXISTING DEVICES TO REMAIN. UPDATE PANELBOARD CIRCUIT DIRECTORIES FOR

COORDINATE WITH OWNER THE EQUIPMENT AND LIGHT FIXTURES TO BE SALVAGED AND THE LOCATION FOR STORAGE. AVOID DAMAGE TO SALVAGED EQUIPMENT, FIXTURES AND DEVICES DURING DEMOLITION WORK AND DURING TRANSPORT TO OWNER'S DESIGNATED STORAGE LOCATION.

F. ALL PREVIOUSLY ABANDONED OR OBSOLETE CONDUIT AND WIRING SHALL BE REMOVED IN ITS ENTIRETY.

H. SEAL ALL PENETRATIONS THROUGH FLOORS, WALLS, CEILINGS, AND ROOF WHERE ELECTRICAL


G. REVIEW EXISTING CONDITIONS PRIOR TO START OF DEMOLITION AND COORDINATE ANY POWER INTERRUPTIONS WITH OWNER'S REPRESENTATIVE.

COMPONENTS ARE REMOVED AND WHERE THE EXISTING PENETRATION IS NOT USED FOR THE NEW INSTALLATION. REPAIR DAMAGED SURFACES TO MATCH ADJACENT AREAS.


I. REMOVE ALL EXISTING ELECTRICAL EQUIPMENT, FIXTURES, SYSTEMS, CONDUIT AND WIRING NO LONGER REQUIRED AFTER PROJECT COMPLETION.

### $| \overline{t} \rangle$ DEMOLITION KEYED NOTES:


- 1. EXISTING HIGHBAY LIGHT FIXTURES: DISCONNECT AND REMOVE HIGHBAY LIGHT FIXTURES. TIE-UP WIRING AND MAKE SAFE FOR REUSE. SEE DEMO GENERAL NOTE E.
- 2. CEILING PADDLE FANS TO REMAIN IN-PLACE AND CONNECTED.
- 3. EXISTING OVERHEAD DOOR (ALTERNATE #2): PRIOR TO REMOVAL OF OH DOOR MOTOR AND WALL CONTROLLER,
  DISCONNECT FEEDER, TIE-UP AND MAKE SAFE FOR REUSE. SALVAGE DISCONNECT AND REUSE IF COMPATIBLE WITH NEW
  DOOR MOTOR. SEE SHEET E104 FOR NEW WORK.
- 4. EXISTING ROOF TOP UNIT TO REMAIN IN-PLACE AND CONNECTED.
- 5. EXISTING WALL LIGHT FIXTURES: DISCONNECT AND REMOVE WALL MOUNT LIGHT FIXTURES. TIE-UP WIRING AND MAKE SAFE FOR REUSE. SEE DEMO GENERAL NOTE E.

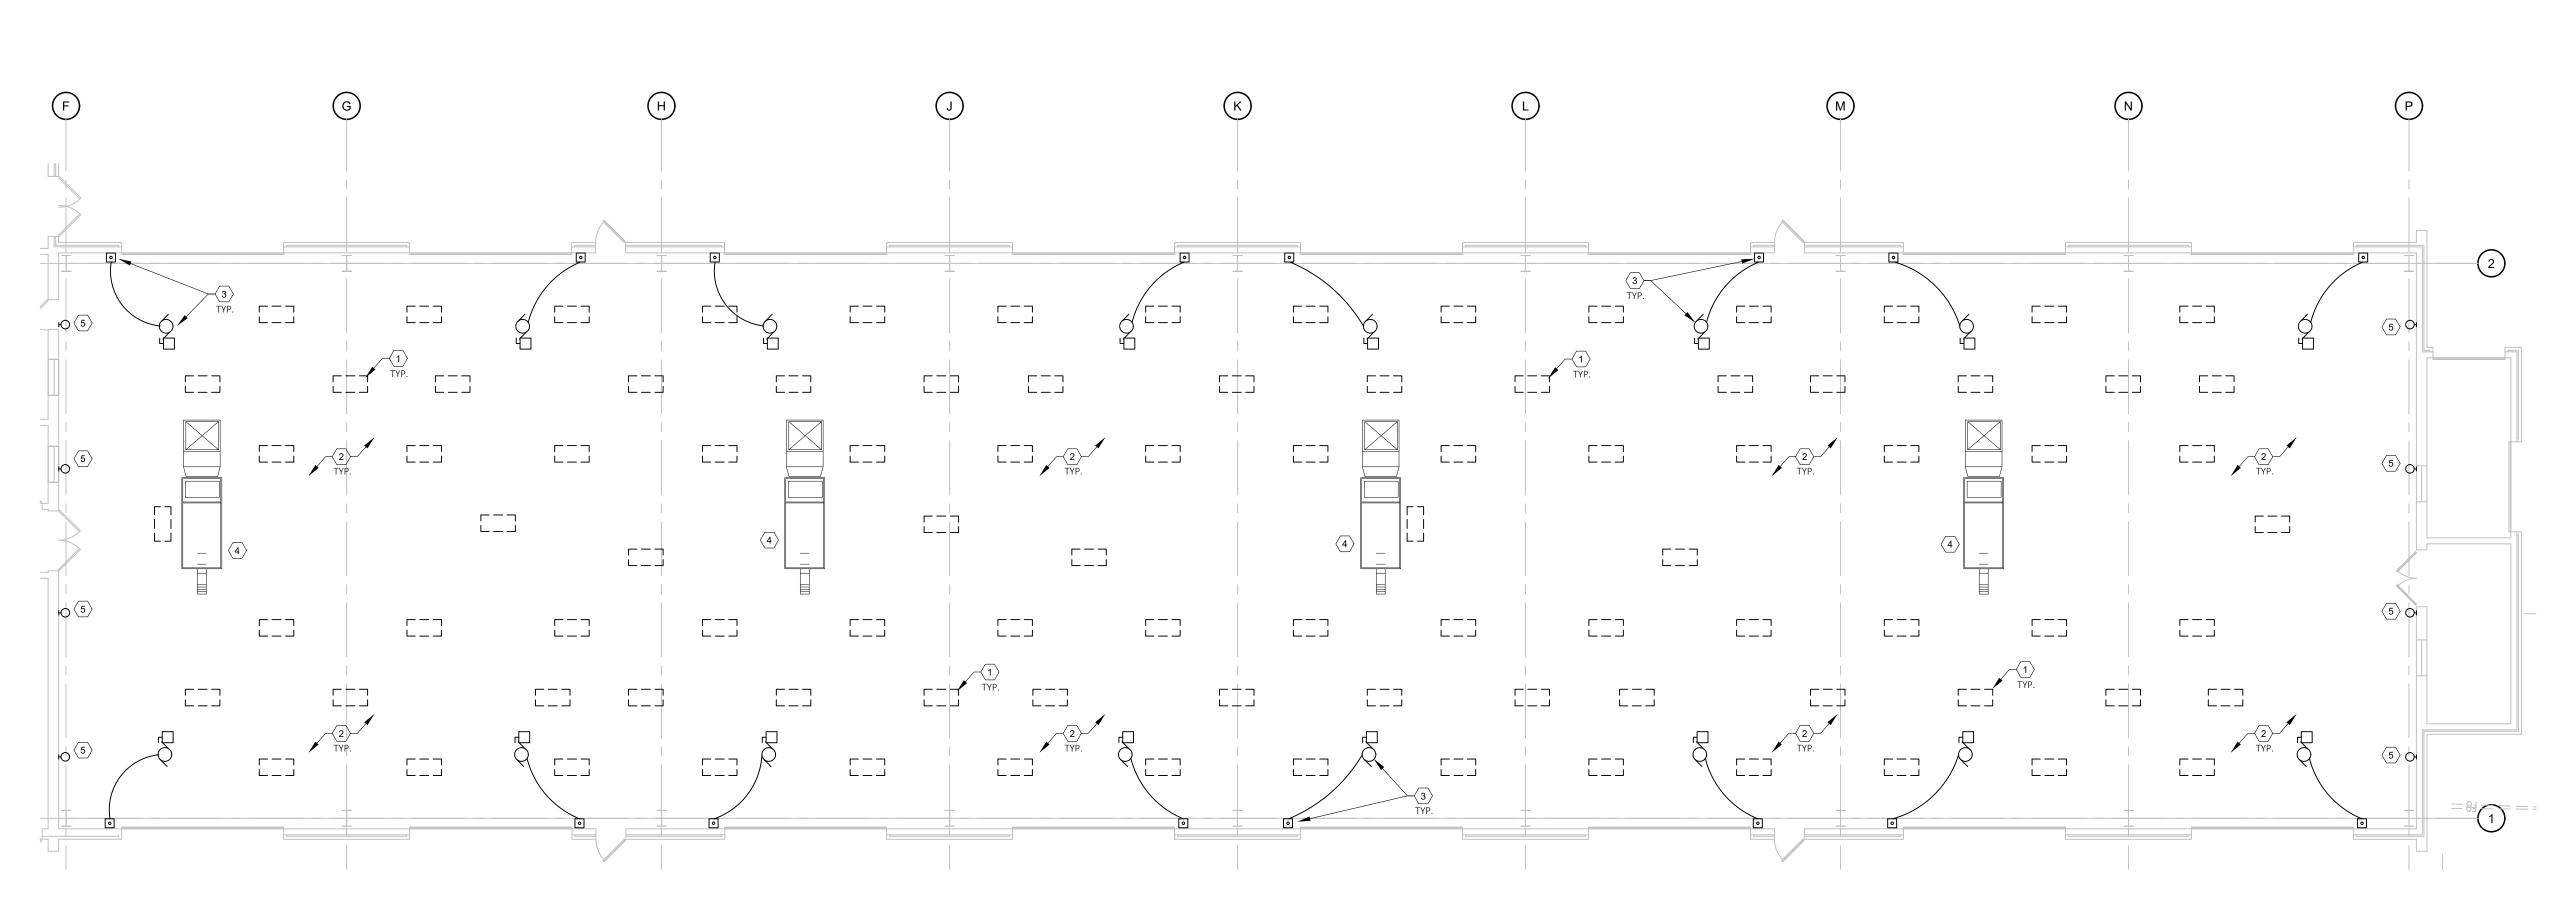

2 ELECTRICAL DEMO WORK BAY - SOUTH
E102 SCALE: 3/32" = 1'-0"

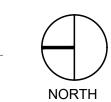

STATE OF MISSOURI MICHAEL L. PARSON, GOVERNOR

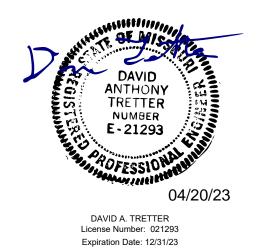

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Sunnen Drive, Suite 100, St. Louis, MO 63143 T

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MISSOURI NATIONAL GUARD

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COMBINED SUPPORT MAINTENANCE SHOP (CSMS) 2302 MILITIA DRIVE JEFFERSON CITY, MISSOURI 65101

8136300007

PROJECT # T2225-01 SITE # 6300

REVISION: DATE:

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ISSUE DATE: 04/20/2023

CAD DWG FILE:
DRAWN BY:
CHECKED BY: RA
DESIGNED BY: WJK


SHEET TITLE:

ELECTRICAL DEMO WORK BAYS FLOOR PLANS

SHEET NUMBER:

E-102

4/20/23 19 OF 22 SHEETS

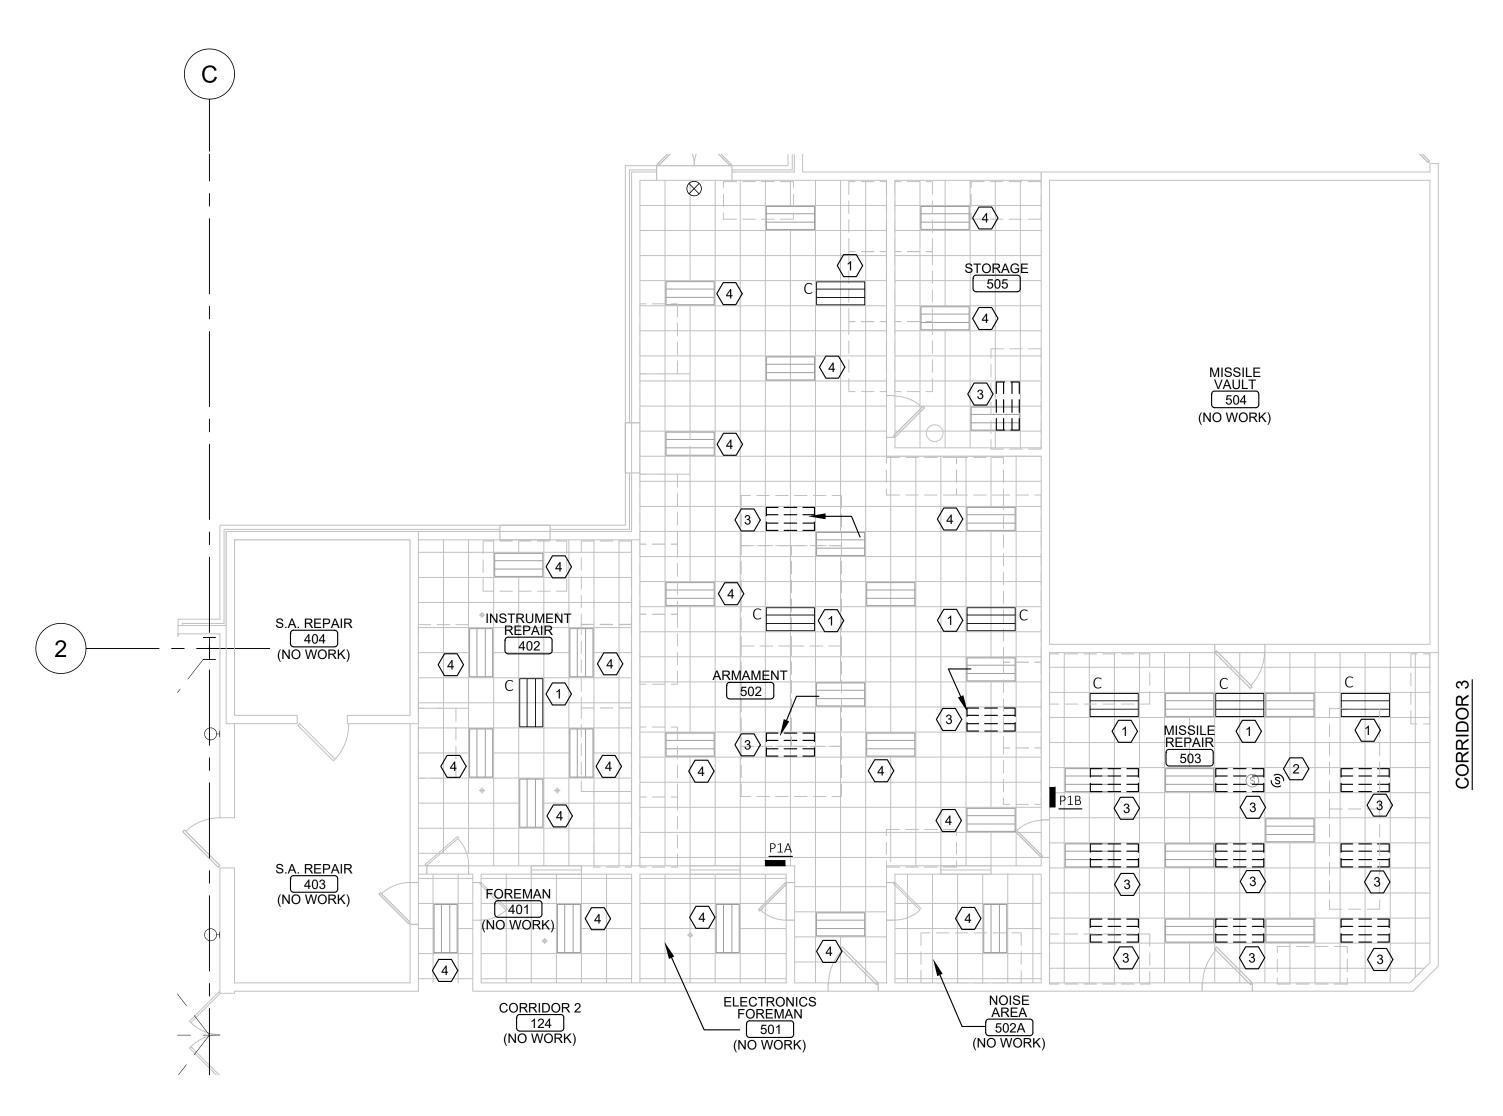

ELECTRICAL LIGHTING PLAN - ARMAMENT

SCALE: 1/8" = 1'-0"




### **ELECTRICAL LIGHTING GENERAL NOTES:**

- A. FOR LIGHT FIXTURE SCHEDULE, SEE SHEET E601.
- B. CONDUIT RUNS SHALL BE INSTALLED PER STATE AND LOCAL CODES.
- C. ALL MATERIALS SHALL BE NEW, WITH "UL" APPROVED LABELS.
- D. ALL FIXTURES, WIRE SHALL BE U.L. APPROVED TYPE.
- E. ALL BRANCH LIGHTING AND POWER CIRCUITS IN EXCESS OF 100 FT FROM PANEL SHALL BE #10 AWG.
- F. NEW LIGHTING SHALL BE RECONNECTED TO CURRENT LIGHTING CIRCUITS AND CONTROLS, UNO.
- G. ALL LED LIGHTS SHALL HAVE DEDICATED NEUTRAL.
- H. CONTRACTOR SHALL FURNISH ALL LABOR MATERIALS AND EQUIPMENT FOR THE COMPLETE INSTALLATION .

### # ELECTRICAL LIGHTING KEYED NOTES:

- 1. PROVIDE NEW LIGHT FIXTURE AS NOTED AND CONNECT TO EXISTING LIGHTING CIRCUIT AND CONTROLS IN THIS SPACE.
- DISCONNECT, REMOVE, RELOCATE CEILING SPEAKER TO THIS LOCATION AND RECONNECT AS REQUIRED.
- 3. REINSTALL EXISTING LIGHT FIXTURE AT LOCATION SHOWN, SALVAGED DURING DEMOLITION WORK. RECONNECT TO EXISTING LIGHTING CIRCUIT & CONTROLS TIED-UP DURING DEMOLITION WORK.
- 4. EXISTING LIGHT FIXTURE TO REMAIN IN-PLACE AND CONNECTED.

STATE OF MISSOURI MICHAEL L. PARSON, GOVERNOR

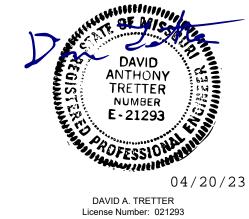

Expiration Date: 12/31/23

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PROJECT # T2225-01 SITE # 6300

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ASSET#

REVISION: DATE: REVISION: DATE: REVISION:

DATE: ISSUE DATE: 04/20/2023

CAD DWG FILE:
DRAWN BY: RA
CHECKED BY: WJK
DESIGNED BY:


SHEET TITLE:

ELECTRICAL LIGHTING PLANS

SHEET NUMBER:

E-103

4/20/23 20 OF 22 SHEETS

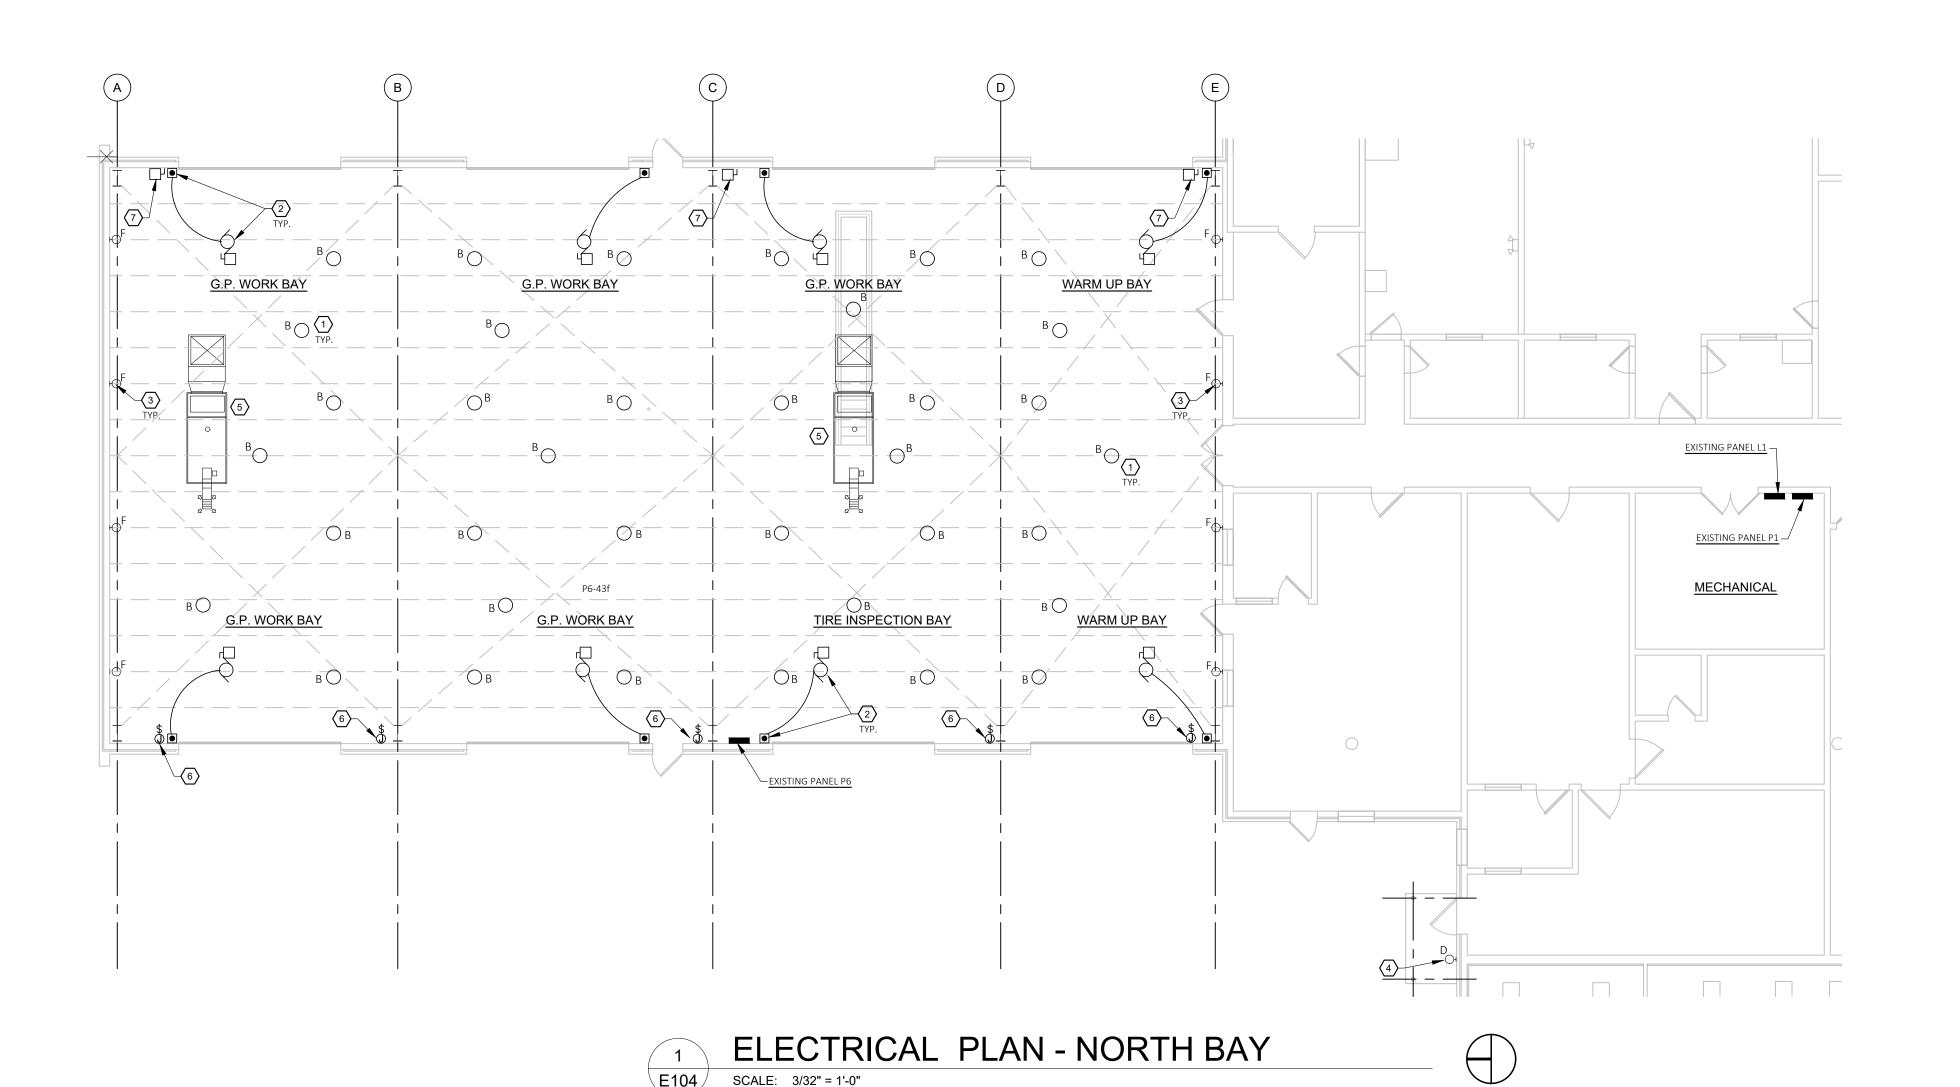

E104


SCALE: 3/32" = 1'-0"

### ELECTRICAL GENERAL NOTES:

- A. FOR LIGHT FIXTURE SCHEDULE, SEE SHEET E601.
- B. LIGHT FIXTURE LOCATIONS SHOWN ARE ONE FOR ONE REPLACEMENT. CONTRACTOR SHALL COORDINATE ACTUAL LOCATIONS WITH OTHER TRADES AND THE OWNER'S AUTHORIZED REPRESENTATIVE.
- C. CONDUIT RUNS SHALL BE INSTALLED PER STATE AND LOCAL CODES.
- D. ALL MATERIALS SHALL BE NEW, WITH "UL" APPROVED LABELS.
- E. DEVICE LOCATIONS SHOWN ON THE PLAN SHALL BE PLACED EXACTLY AS SHOWN. REFER ANY QUESTIONS TO THE OWNER'S REPRESENTATIVE.
- F. ALL FIXTURES, WIRE, AND ELECTRIC DEVICES SHALL BE U.L. APPROVED TYPE
- G. ALL BRANCH LIGHTING AND POWER CIRCUITS IN EXCESS OF 100 FT FROM PANEL SHALL BE #10 AWG.
- H. NEW LIGHTING SHALL BE RECONNECTED TO CURRENT LIGHTING CIRCUITS AND CONTROLS, UNO.
- I. ALL LED LIGHTS SHALL HAVE DEDICATED NEUTRAL.
- J. CONTRACTOR SHALL FURNISH ALL LABOR MATERIALS AND EQUIPMENT FOR THE COMPLETE INSTALLATION .

### $\langle$ # angle ELECTRICAL KEYED NOTES:

- NEW HIGHBAY LIGHT FIXTURES: MOUNT NEW HIGHBAY LIGHT FIXTURES AT 26-FT AFF, UNO. CONNECT TO EXISTING LIGHTING CIRCUIT TIED-UP DURING DEMOLITION WORK AND CONNECT TO EXISTING LIGHTING CONTROLS.
- NEW OVERHEAD DOOR (ALTERNATE #2): AFTER NEW OVERHEAD DOOR MOTORIZED OPERATOR AND WALL CONTROLLER IS IN-PLACE, EXTEND EXISTING CIRCUIT TIED-UP DURING DEMO WORK AND CONNECT SALVAGED DISCONNECT TO NEW MOTORIZED OPERATOR AND CONNECT AS REQUIRED. VERIFY EXISTING DISCONNECT SWITCH IS COMPATIBLE WITH NEW
- NEW WALL LIGHT FIXTURES: MOUNT NEW WALL LIGHT FIXTURES IN SAME LOCATION AND MOUNTING HEIGHT AS PREVIOUS LIGHT FIXTURES. CONNECT TO EXISTING LIGHTING CIRCUIT TIED-UP DURING DEMOLITION WORK AND CONNECT TO EXISTING LIGHTING CONTROLS.
- EXTERIOR WALL FIXTURE: INSTALL WALL LIGHT FIXTURE WITH INTEGRAL PHOTOCELL AND CONNECT TO LOCAL EXISTING 20A-1P UNSWITCHED RECEPTACLE CIRCUIT FROM EXISTING PANEL P1.
- 5. EXISTING HVAC EQUIPMENT TO REMAIN.
- RADIANT HEATER (ALTERNATE #1): PROVIDE HP RATED 20A-120V TOGGLE TYPE DISCONNECT SWITCH FOR RADIANT
- VACUUM BLOWER (ALTERNATE #1): PROVIDE 30A-2P NON-FUSED DISCONNECT SWITCH FOR RADIANT HEATER VACUUM BLOWER AND CONNECT TO EXISTING CIRCUIT.

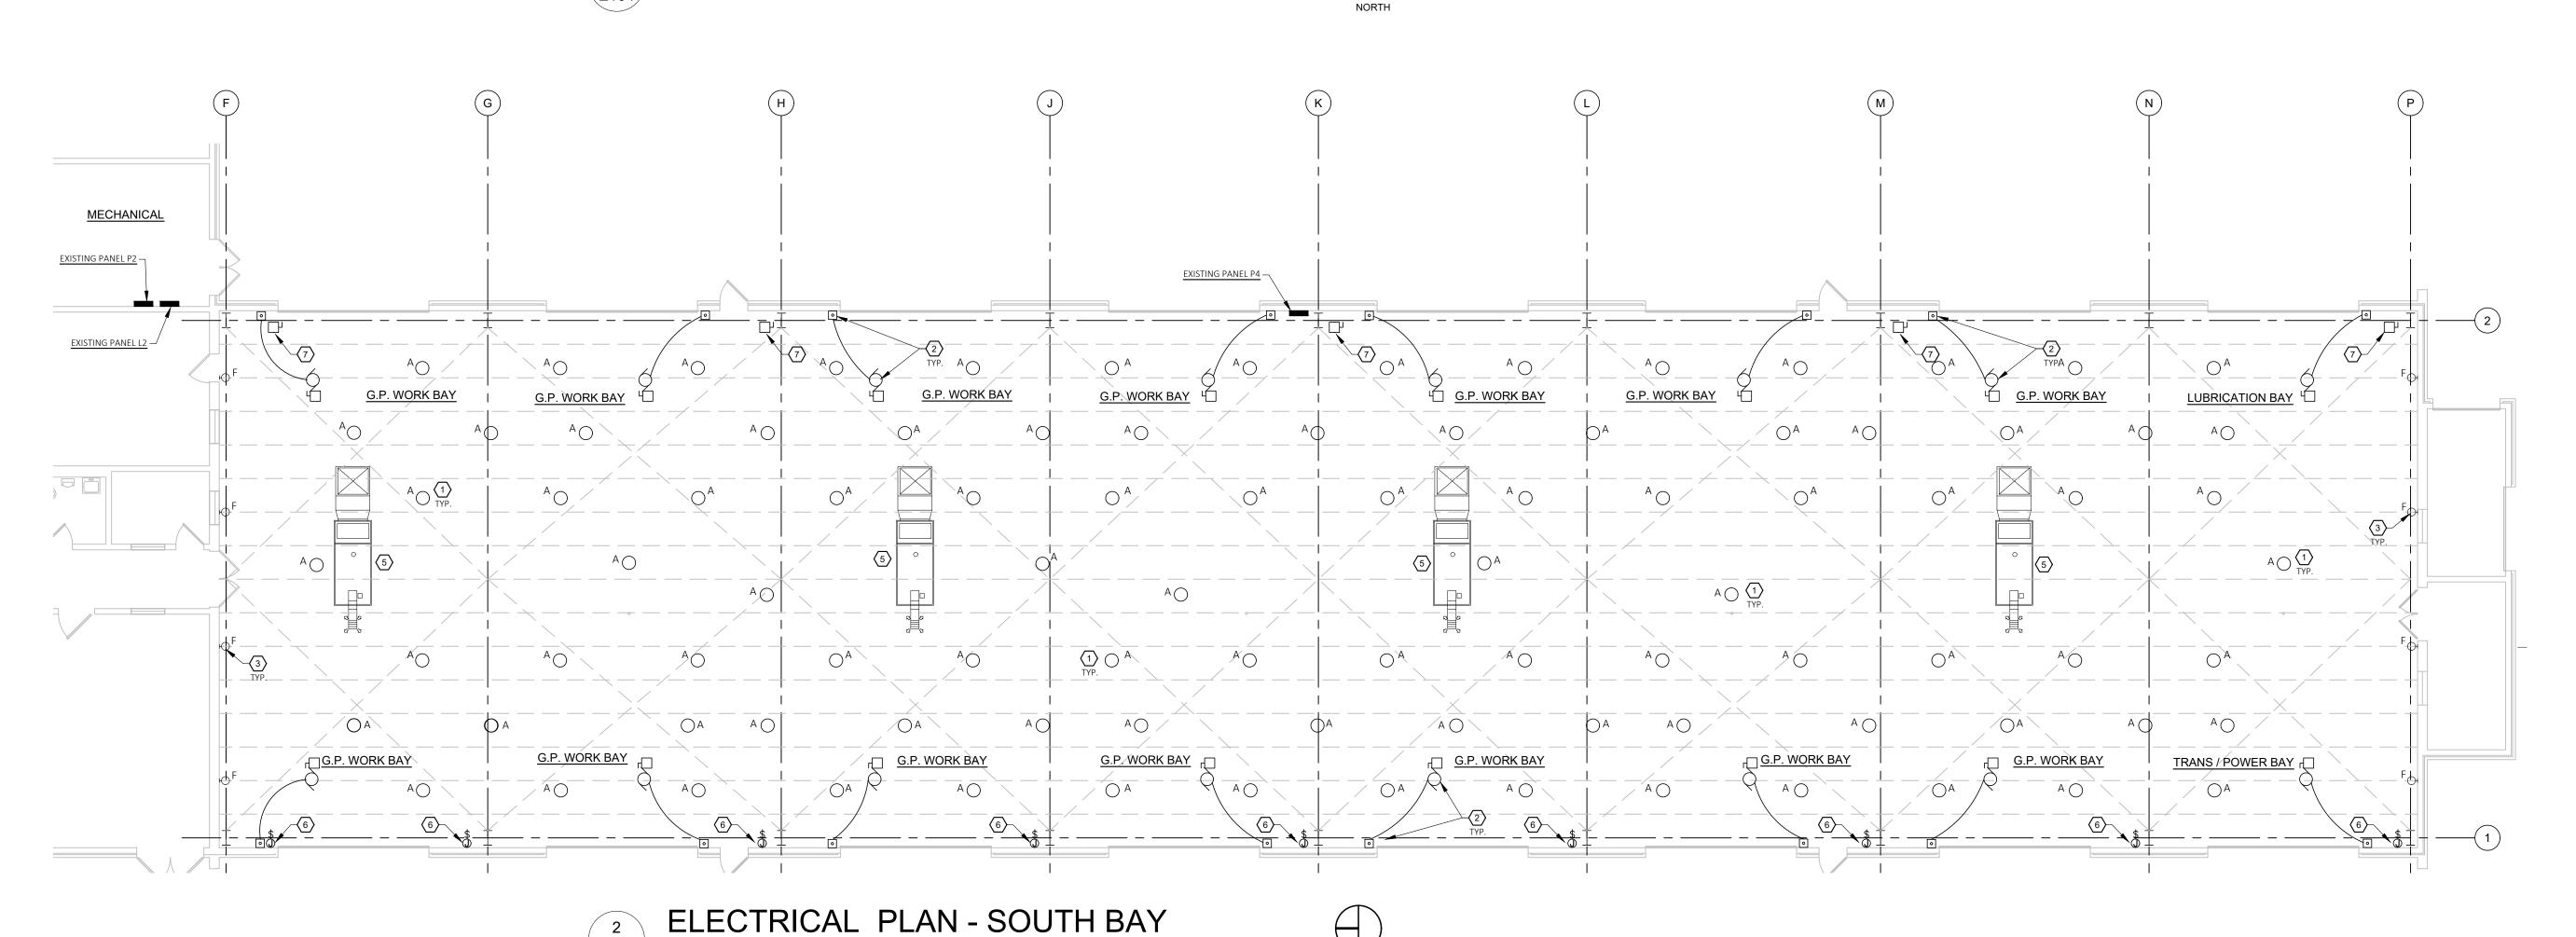

STATE OF MISSOURI MICHAEL L. PARSON, **GOVERNOR** 



DAVID A. TRETTER License Number: 021293 Expiration Date: 12/31/23

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MISSOURI NATIONAL **GUARD** 

INTERIOR RENOVATIONS & ROOF REPLACEMENT AT COMBINED SUPPORT MAINTENANCE SHOP (CSMS)

COMBINED SUPPORT MAINTENANCE SHOP (CSMS) 2302 MILITIA DRIVE JEFFERSON CITY, MISSOURI 65101

8136300007

PROJECT # T2225-01 SITE# 6300

**REVISION:** DATE: **REVISION:** 

ASSET#

DATE: REVISION: DATE:

ISSUE DATE: 04/20/2023

CAD DWG FILE:
DRAWN BY: RA
CHECKED BY: WJK
DESIGNED BY:

SHEET TITLE:

ELECTRICAL NORTH - SOUTH WORK BAYS

SHEET NUMBER:

4/20/23

	ABBREVIATIONS (NOTE: NOT ALL ABBREVIATIONS ARE USED)									
AFF	ABOVE FINISHED FLOOR	EM	EMERGENCY							
AL	ALUMINUM	EWC	ELECTRIC WATER COOLER							
AMP	AMPERE	EXISTG	EXISTING							
ATS	AUTO-TRANSFER-SWITCH	GFCI	GROUND FAULT CURRENT INTERUPTER							
BFG	BELOW FINSHED GRADE	FL	FLOOR							
BLDG	BUILDING	FLUOR	FLUORESCENT							
СВ	CIRCUIT BREAKER	GND OR (G)	GROUND							
скт	CIRCUIT	IG	ISOLATED GROUND							
CLG	CEILING	JB	JUNCTION BOX							
COND OR "C"	CONDUIT	мсв	MAIN CIRCUIT BREAKER							
CONN	CONNECT	MDP	MAIN DISTRIBUTION PANEL							
CONT	CONTRACTOR	MLO	MAIN LUG ONLY							
CU	COPPER	MTD HT	MOUNTING HEIGHT							
С/Т	CURRENT TRANSFORMER	NF	NON FUSED							
DIM	DIMMER	NIC	NOT IN CONTRACT							
DMC	DESTINATION MATERNITY	OFOI	OWNER FURNISH, OWNER INSTALL							
DISC SW	DISCONNEC SWITCH	RT	RAIN TIGHT, NEMA 3R							
DP	DOUBLE POLE	RTU	ROOF TOP UNIT							
DT	DOUBLE THROW	sw	SWITCH							
DPP	DISTRIBUTION POWER PANEL	UG	UNDER GROUND							
EC	EMPTY CONDUIT	UNO	UNLESS NOTED OTHERWISE							
EF	EXHAUST FAN	WP	WEATHER-PROOF							
V.I.F.	VERIFY IN FIELD	XFMR	TRANSFORMER							

		LIGHTING					I
TYPE	MANF	CATALOG NO.	**	NO.	AMP DATA LAMPS	REMARKS	WATTS
А	METALUX	BMK-15-WFL-UNV-L840-CD-C6-U	L	1	15423 LUMENS 4000K LED	18" DIAMETER X 16"HT LED PENDANT FIXTURE, CABLE MOUNT, WIDE FROSTED LENS, 0-10V DIMMABLE FIXTURE, WHITE FINISH, MOUNT 26-FT AFF TO BOTTOM OF FIXTURE	95W
Α	HUBBELL (ALTERNATE)	CRN2-40K-LX-ED-U-FP WITH CR2WA18 REFLECTOR	L	1	14444 LUMENS 4000K LED	14-1/2" DIAMETER X 8"HT LED PENDANT FIXTURE, CABLE MOUNT, WIDE FROSTED LENS, 0-10V DIMMABLE FIXTURE, WHITE FINISH, MOUNT 26-FT AFF TO BOTTOM OF FIXTURE	
Α	LITHONIA (ALTERNATE)	JHBL-12000L-ACL-MD-MVOLT-40K-80CRI	L	1	12158 LUMENS 4000K LED	22-3/8" DIAMETER X 17"HT LED PENDANT FIXTURE, CABLE MOUNT, WIDE FROSTED LENS, 0-10V DIMMABLE FIXTURE, WHITE FINISH, MOUNT 26-FT AFF TO BOTTOM OF FIXTURE	83W
В	METALUX	BMK-18-WFL-UNV-L840-CD-C6-U	L	1	18450 LUMENS 4000K LED	18" DIAMETER X 16"HT LED PENDANT FIXTURE, CABLE MOUNT, WIDE FROSTED LENS, 0-10V DIMMABLE FIXTURE, WHITE FINISH, MOUNT 26-FT AFF TO BOTTOM OF FIXTURE	114W
В	HUBBELL (ALTERNATE)	CRN2-40K-MM-ED-U-FP WITH CR2WA18 REFLECTOR	L	1	19860 LUMENS 4000K LED	14-1/2" DIAMETER X 8"HT LED PENDANT FIXTURE, CABLE MOUNT, WIDE FROSTED LENS, 0-10V DIMMABLE FIXTURE, WHITE FINISH, MOUNT 26-FT AFF TO BOTTOM OF FIXTURE	
В	LITHONIA (ALTERNATE)	JHBL-18000L-ACL-MD-MVOLT-40K-80CRI	L	1	18544 LUMENS 4000K LED	22-3/8" DIAMETER X 17"HT LED PENDANT FIXTURE, CABLE MOUNT, WIDE FROSTED LENS, 0-10V DIMMABLE FIXTURE, WHITE FINISH, MOUNT 26-FT AFF TO BOTTOM OF FIXTURE	131W
С	METALUX	24CZ2-40-S-UNV-L840-CD1-U	L	1	4000 LUMENS 4000K LED	2' X 4' LED TROFFER, RECESSED MTD, 0-10V DIMMABLE FIXTURE, SMOOTH ACRYLIC FROSTED LENS, WHITE FINISH	33W
С	HUBBELL (ALTERNATE)	LCAT24-40-LW-G-ED-U	L	1	4465 LUMENS 4000K LED	2' X 4' LED TROFFER, RECESSED MTD, 0-10V DIMMABLE FIXTURE, SMOOTH ACRYLIC FROSTED LENS, WHITE FINISH	36W
С	LITHONIA (ALTERNATE)	2BLT4-40L-ADSM-MVOLT-GZ1-LP840	L	1	4000 LUMENS 4000K LED	2' X 4' LED TROFFER, RECESSED MTD, 0-10V DIMMABLE FIXTURE, SMOOTH ACRYLIC FROSTED LENS, WHITE FINISH	32W
D	HUBBELL	SG1-20-4K7-FT-UNV-DBT-PCU-EH	L	1	2310 LUMENS 4000K LED	9"WD X 6"DP X 11"HT EXTERIOR WALL LED FIXTURE AT 8'-0"AFF, INTEGRAL EMERGENCY BATTERY, INTEGRAL PHOTOCELL CONTROL, BRONZE FINISH	21W
D	LUMARK (ALTERNATE)	XTOR6B-W-BZ-PC1-CBP	L	1	5611 LUMENS 4000K LED	9"WD X 7"DP X 11"HT EXTERIOR WALL LED FIXTURE AT 8'-0"AFF, INTEGRAL EMERGENCY BATTERY, INTEGRAL PHOTOCELL CONTROL, BRONZE FINISH	58W
D	WAC LIGHTING (ALTERNATE)	WP-LED-127-30-BZ with PC120-BZ	L	1	2100 LUMENS 3000K LED	7"WD X 4"DP X 8"HT EXTERIOR WALL LED FIXTURE AT 8'-0"AFF, INTEGRAL EMERGENCY BATTERY, INTEGRAL PHOTOCELL CONTROL, BRONZE FINISH	27W
F	LITHONIA	TWPX2-LED-ALO-40K-MVOLT-DDBXD	L	1	6600 LUMENS 4000K LED	WALL MOUNT LED FIXTURE, FIELD ADJUSTABLE LIGHT OUTPUT, POLYCARBONATE LENS, 0-10V DIMMABLE FIXTURE, BRONZE FINISH	54W
F	SYLVANIA (ALTERNATE)	WALPAK-1N-050-UNV-7-40-NC-BZ	L	1	5300 LUMENS 4000K LED	WALL MOUNT LED FIXTURE, NON-CUTOFF DISTRIBUTION, BOROSILICATE GLASS LENS, BRONZE FINISH	50W
F	RAB LIGHTING (ALTERNATE)	WP2-LED-49L-740-U	L	1	4900 LUMENS 4000K LED	WALL MOUNT LED FIXTURE, GLASS LENS, 0-10V DIMMABLE FIXTURE, BRONZE FINISH	33W

A. CONTRACTOR SHALL BE RESPONSIBLE FOR COORDINATION AND QUANTITY OF FIXTURES.

\*\* LAMPS L - LED; F - FLUORESCENT; CF - COMPACT FLUORESCENT; MH - METAL HALIDE;

B. PROVIDE ALL NECESSARY ACCESSORIES, CONNECTORS, HANGERS, END CAPS, ETC FOR A COMPLETE OPERABLE INSTALLATION.

C. ALL LUMINAIRES ARE 277V, UNLESS NOTED OTHERWISE.

# ELECTRICAL SYMBOLS

(NOT ALL SYMBOLS ARE USED)

CIRCUIT NUMBER FIXTURE TYPE, SWITCH LEG OR "NL" IF NON-SWITCHED SEE LIGHT FIXTURE SCHEDULE LIGHTING CIRCUITING KEY

2' X 4' LED LIGHT FIXTURE, RECESSED

RECESSED DOWNLIGHT

SINGLE POLE SW-20A-120/277V-LEVITON CSB1-20 IVORY OR EQ, MOUNT 48" AFF

SINGLE POLE SW-20A-120V/277V-3-WAY LEVITON CSB3-20 IVORY OR EQ, MOUNT 48" AFF SINGLE POLE SWITCH, MOTOR RATED, MOUNT 48" AFF

SINGLE POLE WALL MOUNTED OCCUPANCY SENSOR, LEVITON OSSMT-GD WITH

CEILING MOUNTED OCCUPANCY SENSOR, 1,000 SF COVERAGE, LEVITON ODC10-MDW

CEILING MOUNTED OCCUPANCY SENSOR, 1,000 SF COVERAGE, LOW VOLTAGE, LEVITON OSC10-RMW

POWER PACK FOR LOW VOLTAGE OCCUPANCY SENSOR, LEVITON OSP20-NDO

DUPLEX RECEPTACLE, LEVITON 5320 IVORY, 18" AFF UNO

OVER-RIDE OR APPROVED EQUAL, MOUNT 48" AFF

GROUND FAULT RECEPTACLE, LEVITON T-7599 IVORY, 18" AFF UNO

EQUIP OUTLET, WITH FLEX TO EQUIP, MOUNT 18" AFF UNO, PROVIDE APPROPRIATE RECEPTACLE, GROUNDED

TELEPHONE OUTLET, 18" AFF UNO

COMPUTER OUTLET, 18" AFF UNO

WALL MOUNTED TWIN HEAD BATTERY OPERATED EMERGENCY LIGHT FIXTURE, MOUNT 84" AFF

BATTERY POWERED EMERGENCY EXIT LIGHT W/EMERGENCY LIGHT HEADS

ELECTRIC MOTOR

JUNCTION BOX, SIZE AS REQUIRED

DISTRIBUTION PANELBOARD BRANCH PANELBOARD

DISCONNECT SWITCH, SIZE AS NOTED

**F** FA MANUAL PULL STATION, MOUNT 48" AFF


**SD** FA SMOKE DETECTOR

TM TV MONITOR

INT INTERCOM STATION, MOUNT 48" AFF

BRANCH CIRCUIT HOMERUN TO PANELBOARD; ALPHA-NUMERIC NOTATION INDICATES PANEL DESIGNATION AND CIRCUIT NUMBER

STATE OF MISSOURI MICHAEL L. PARSON, **GOVERNOR** 

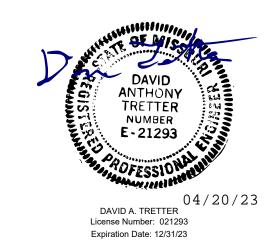

CASCO Diversified Corporation MO Certificate of Authority #000329 Arch. MO Certificate of Authority #000613 Eng.

**OFFICE OF ADMINISTRATION DIVISION OF FACILITIES** MANAGEMENT, **DESIGN AND CONSTRUCTION** 

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ELECTRICAL LEGEND AND SCHEDULES

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4/20/23 22 OF 22 SHEETS