

## ADDENDUM NO. 1

**TO: PLANS AND SPECIFICATIONS FOR STATE OF MISSOURI**

**Connect Camp Clark Sewer System to City of Nevada Sewer System  
Camp Clark Training Site  
Nevada, Missouri  
Project No.: T2301-02**

**Bid Opening Date: 1:30 PM, Thursday, August 29, 2024 (Not Changed)**

**Bidders are hereby informed that the construction Plans and/or Specifications are modified as follows:**

### **SPECIFICATION CHANGES:**

1. None

### **DRAWING CHANGES:**

1. Issue full size (24x36) drawings. See attachment.

### **GENERAL COMMENTS:**

1. The Pre-Bid Meeting is scheduled for August 8, 2024 at 10:00 AM.
2. Please contact April Howser, Contract Specialist, at 573-751-0053 or [April.Howser@oa.mo.gov](mailto:April.Howser@oa.mo.gov) for questions about bidding procedures, MBE\WBE\SDVE Goals, and other submittal requirements.
3. The deadline for technical questions is August 21, 2024.
4. Changes to, or clarification of, the bid documents are only made as issued in the addenda.
5. All correspondence with respect to this project must include the State of Missouri project number as indicated above.
6. Current Plan holders list is available online at: [T2301-02 Connect Camp Clark Sewer System to City of Nevada Sewer System :: Plan Holders :: State of Missouri Office of Administration \(oafmdcplanroom.com\)](https://oafmdcplanroom.com).
7. Prospective Bidders contact American Document Solutions, 1400 Forum Blvd Suite 1C, Columbia MO 65201, 573-446-7768 to order official plans and specifications.
8. **All bids shall be submitted on the bid form without additional terms and conditions, modifications, or stipulations. Each space on the bid form shall be properly filled. Failure to do so will result in rejection of the bid.**
9. **MBE/WBE/SDVE participation requirements can be found in DIVISION 00. The MBE/WBE/SDVE participation goals are 10%/10%/3%, respectively. Only certified firms as of the bid opening date can be used to satisfy the MBE/WBE/SDVE participation goals for this project. If a bidder is unable to meet a participation goal, a Good Faith Effort Determination Form must be completed. Failure to complete this process will result in rejection of the bid.**

### **ATTACHMENTS:**

1. Full Size (24x36) Drawings

**July 31, 2024**

**END OF ADDENDUM NO. 1**


# CONNECT CAMP CLARK SEWER SYSTEM TO CITY OF NEVADA SEWER SYSTEM CAMP CLARK TRAINING SITE NEVADA, MISSOURI



ALLGEIER, MARTIN and ASSOCIATES, INC.

OWNER: STATE OF MISSOURI  
MICHAEL L. PARSON,  
GOVERNOR  
DEPARTMENT OF  
MISSOURI NATIONAL GUARD

PROJECT  
MANAGEMENT: OFFICE OF ADMINISTRATION  
DIVISION OF FACILITIES MANAGEMENT,  
DESIGN AND CONSTRUCTION

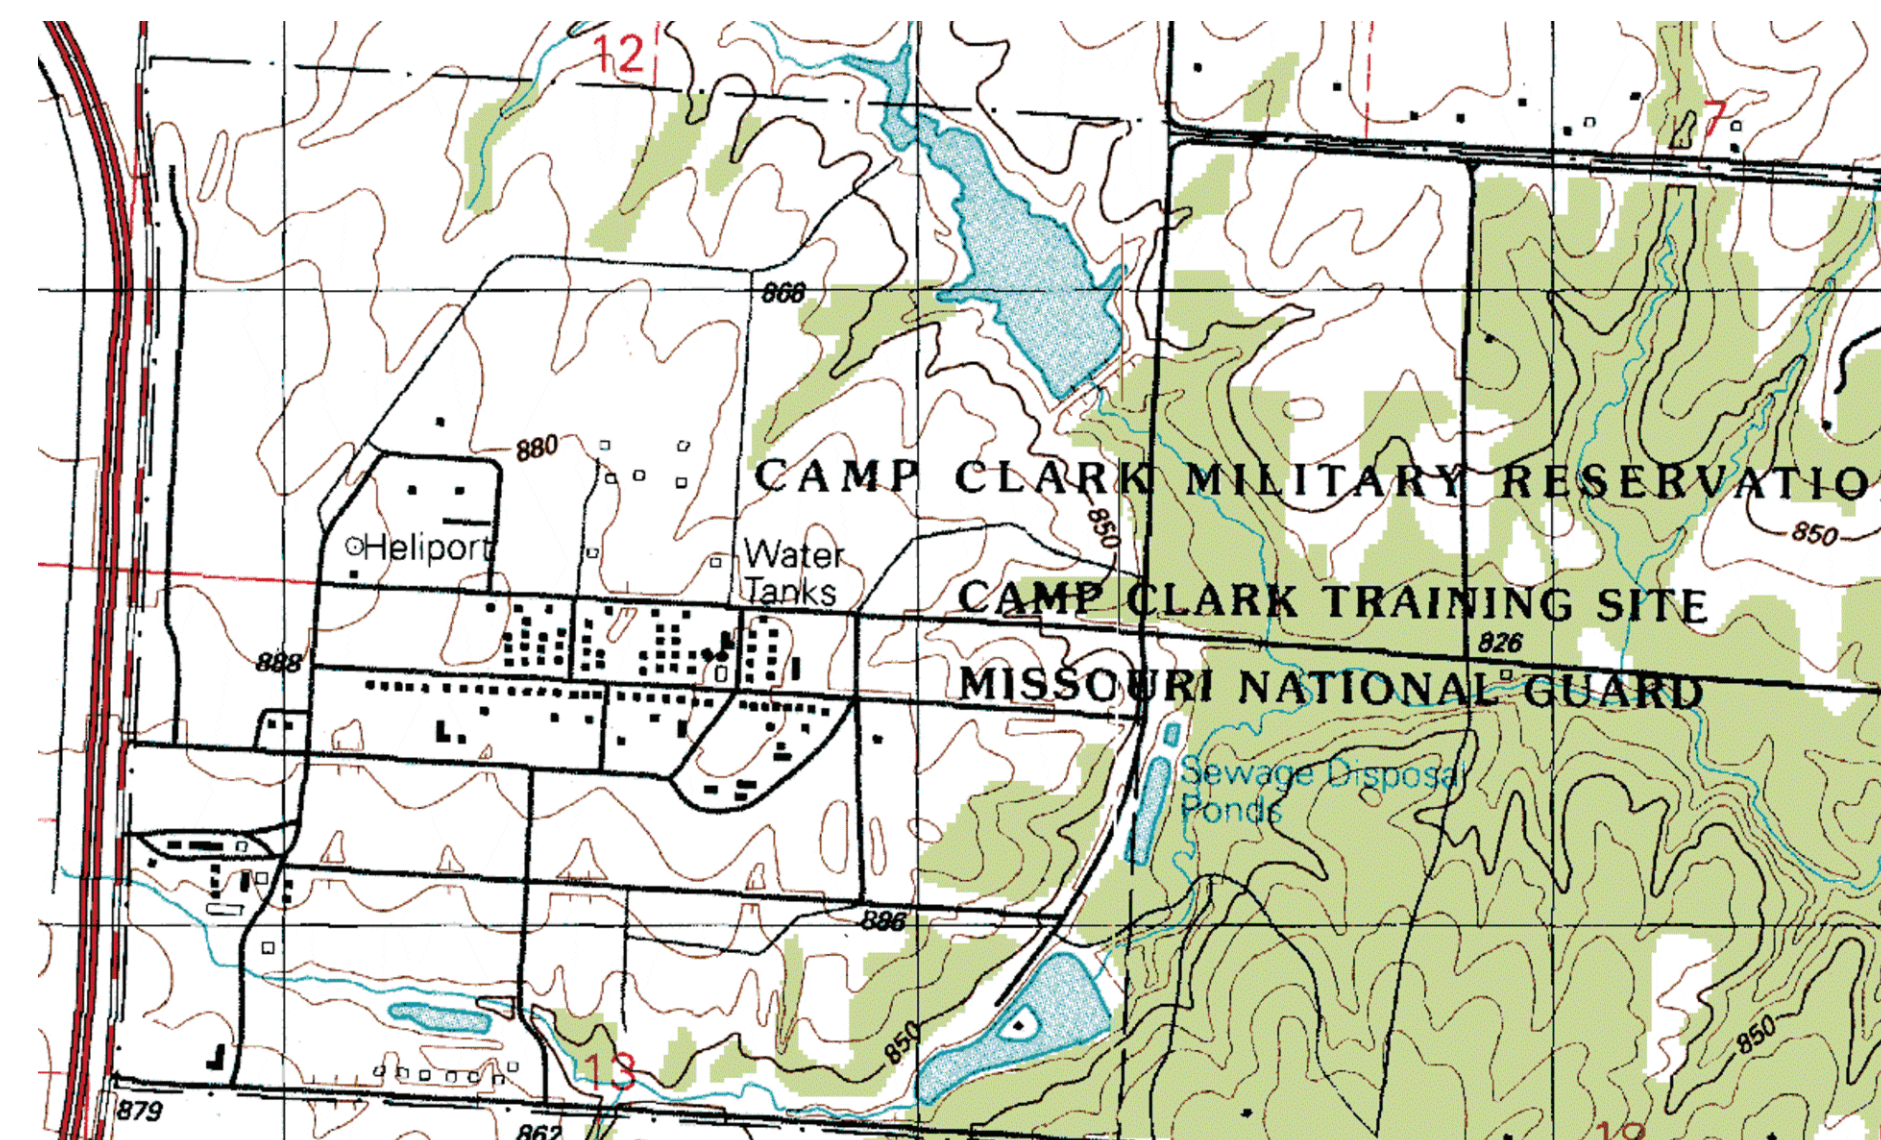

LOCATION MAP  
NTS


PROJECT ADDRESS:  
18159 EE HIGHWAY  
NEVADA, MO 64772

DESIGNER: Allgeier Martin & Associates  
7231 East 24th Street Joplin, Missouri 64804  
(417) 680-7200  
PROJECT NUMBER: T2301-02  
SITE NUMBER: 6274  
ASSET NUMBER: 8136274075

SHEET NUMBER:

## G-001

1 OF 23 SHEETS  
JUNE 14, 2024

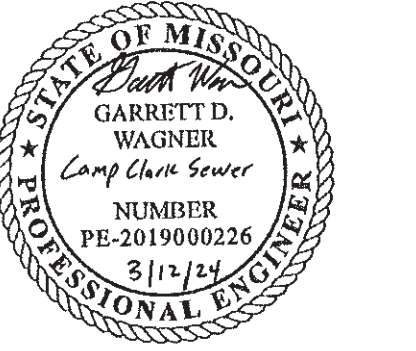

OFFICE OF ADMINISTRATION  
DIVISION OF FACILITIES  
MANAGEMENT,  
DESIGN AND CONSTRUCTION

MISSOURI  
NATIONAL GUARD

CONNECT CAMP CLARK  
TO CITY OF NEVADA  
SEWER SYSTEM

CAMP CLARK

NEVADA, MISSOURI

PROJECT # T2301-02  
SITE # 6274  
ASSET # 8136274075

REVISION: REMOVE LOCATION MAP

DATE: 03-12-2024

REVISION:

DATE:

REVISION:

DATE:

ISSUE DATE: 06/14/2024

CAD DWG FILE:

DRAWN BY: AWW

CHECKED BY: SCW

DESIGNED BY: GDW


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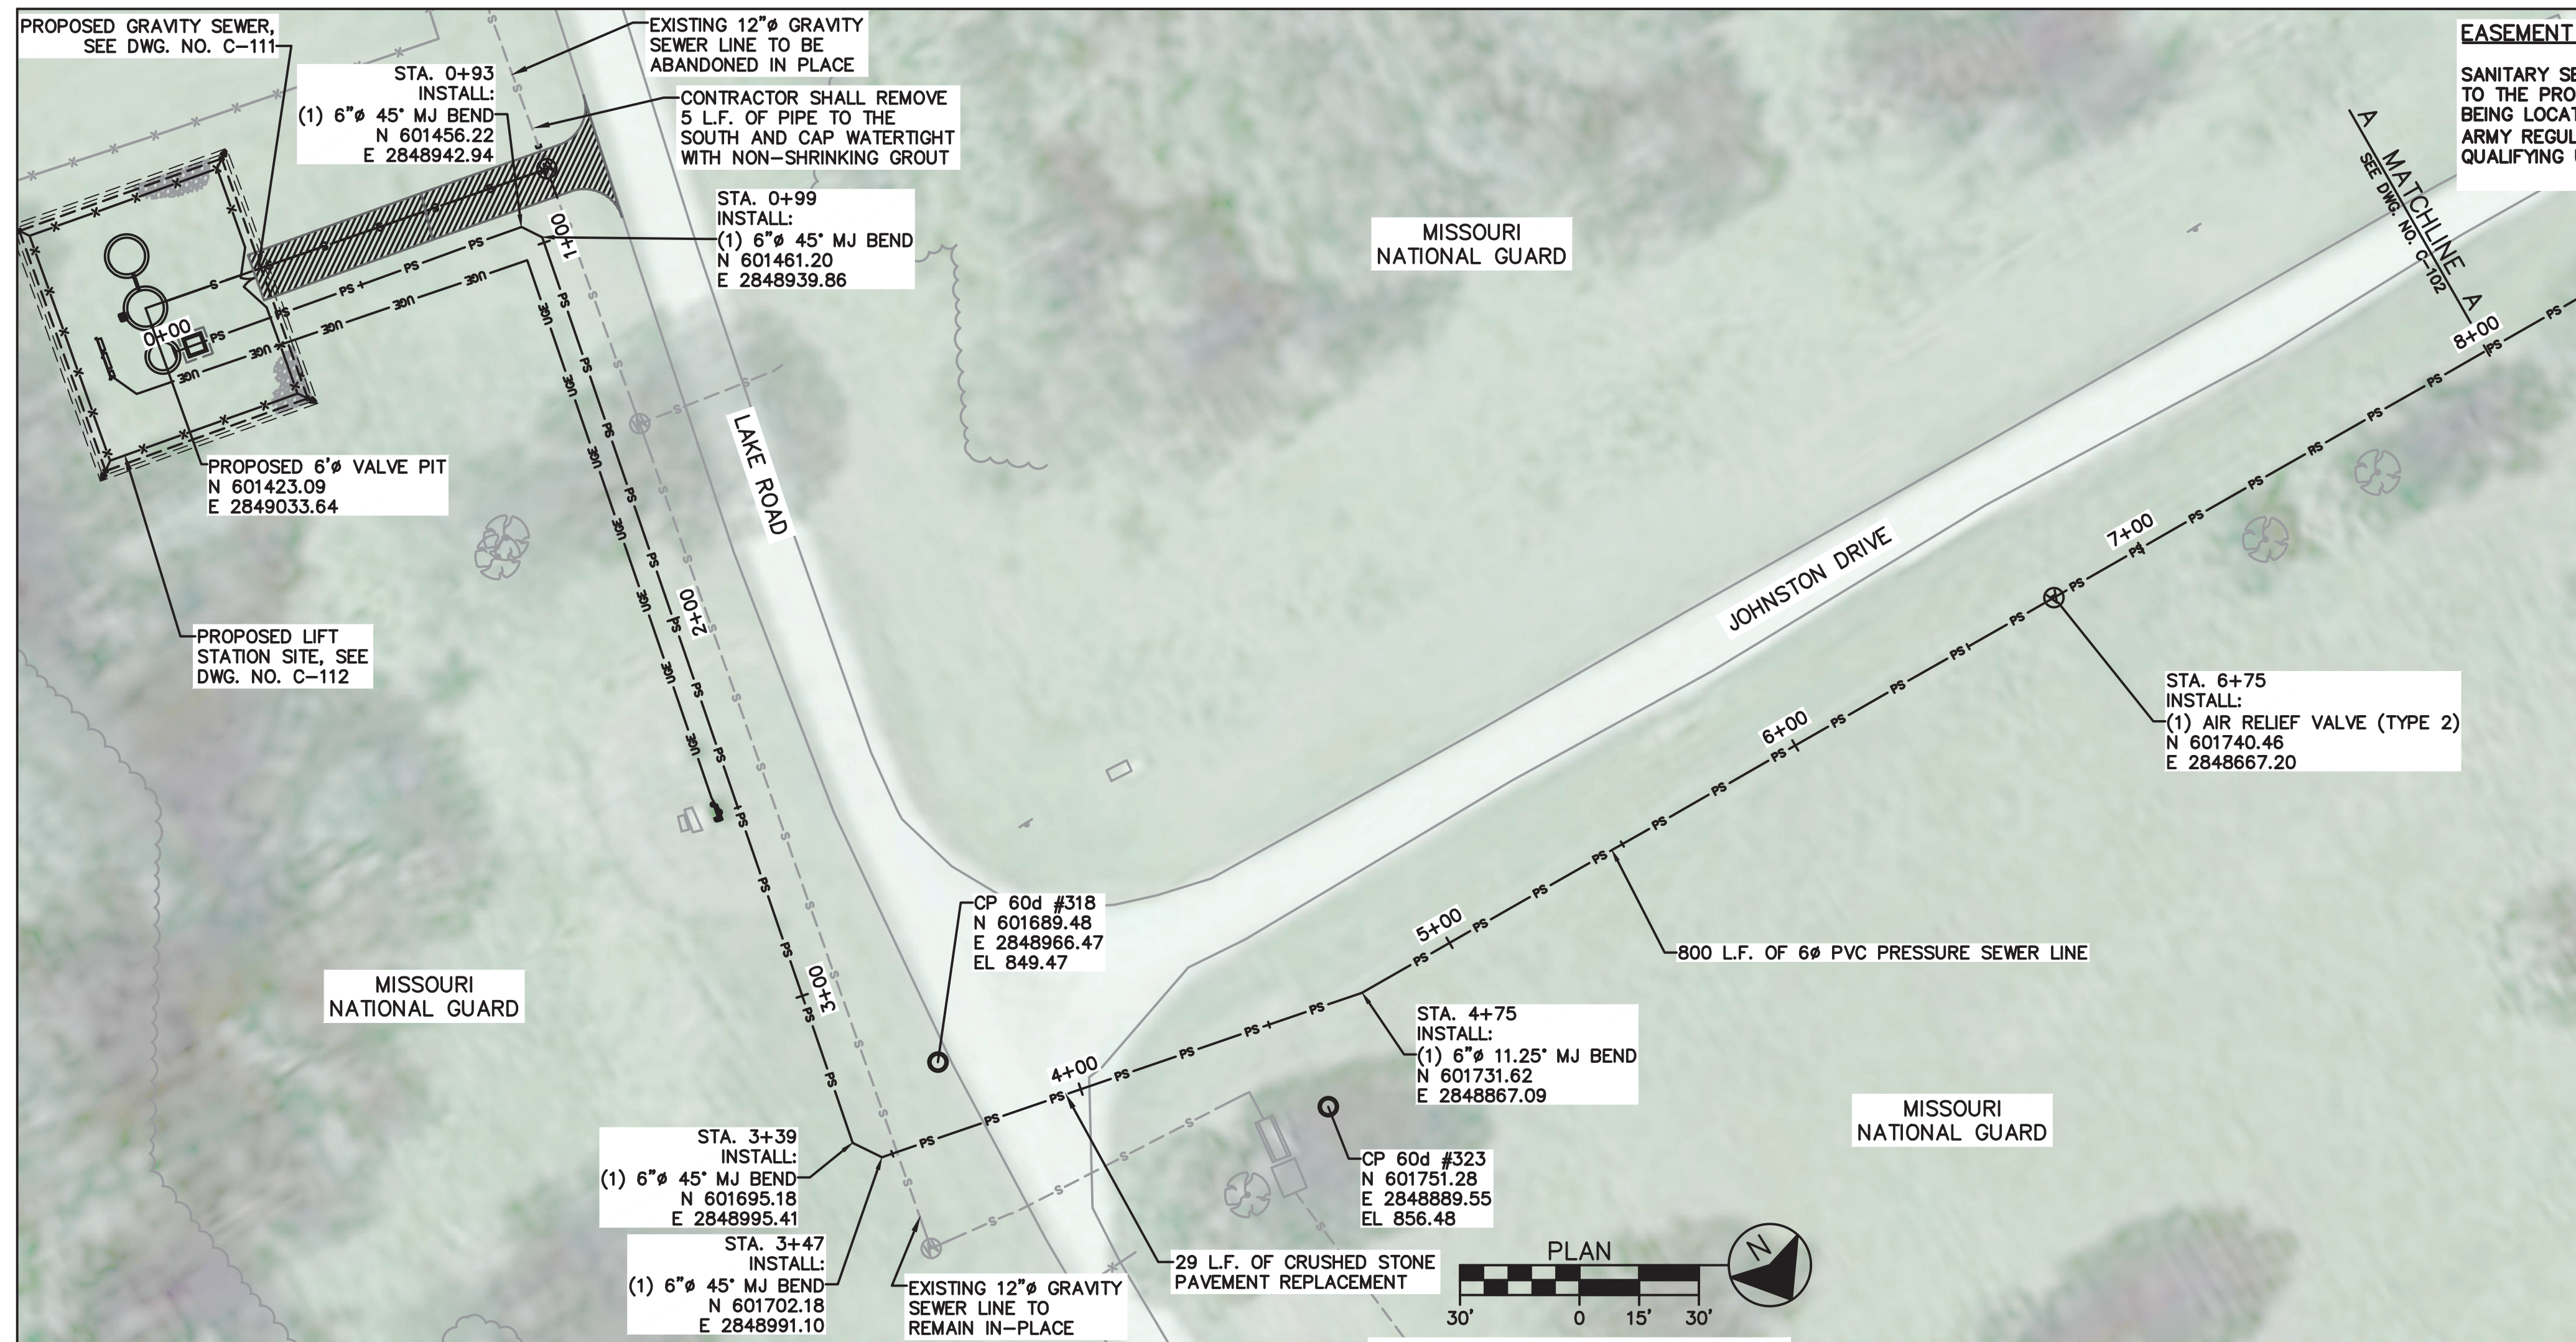
OVERALL SITE PLAN

SHEET NUMBER:

G-002

2 OF 23 SHEETS



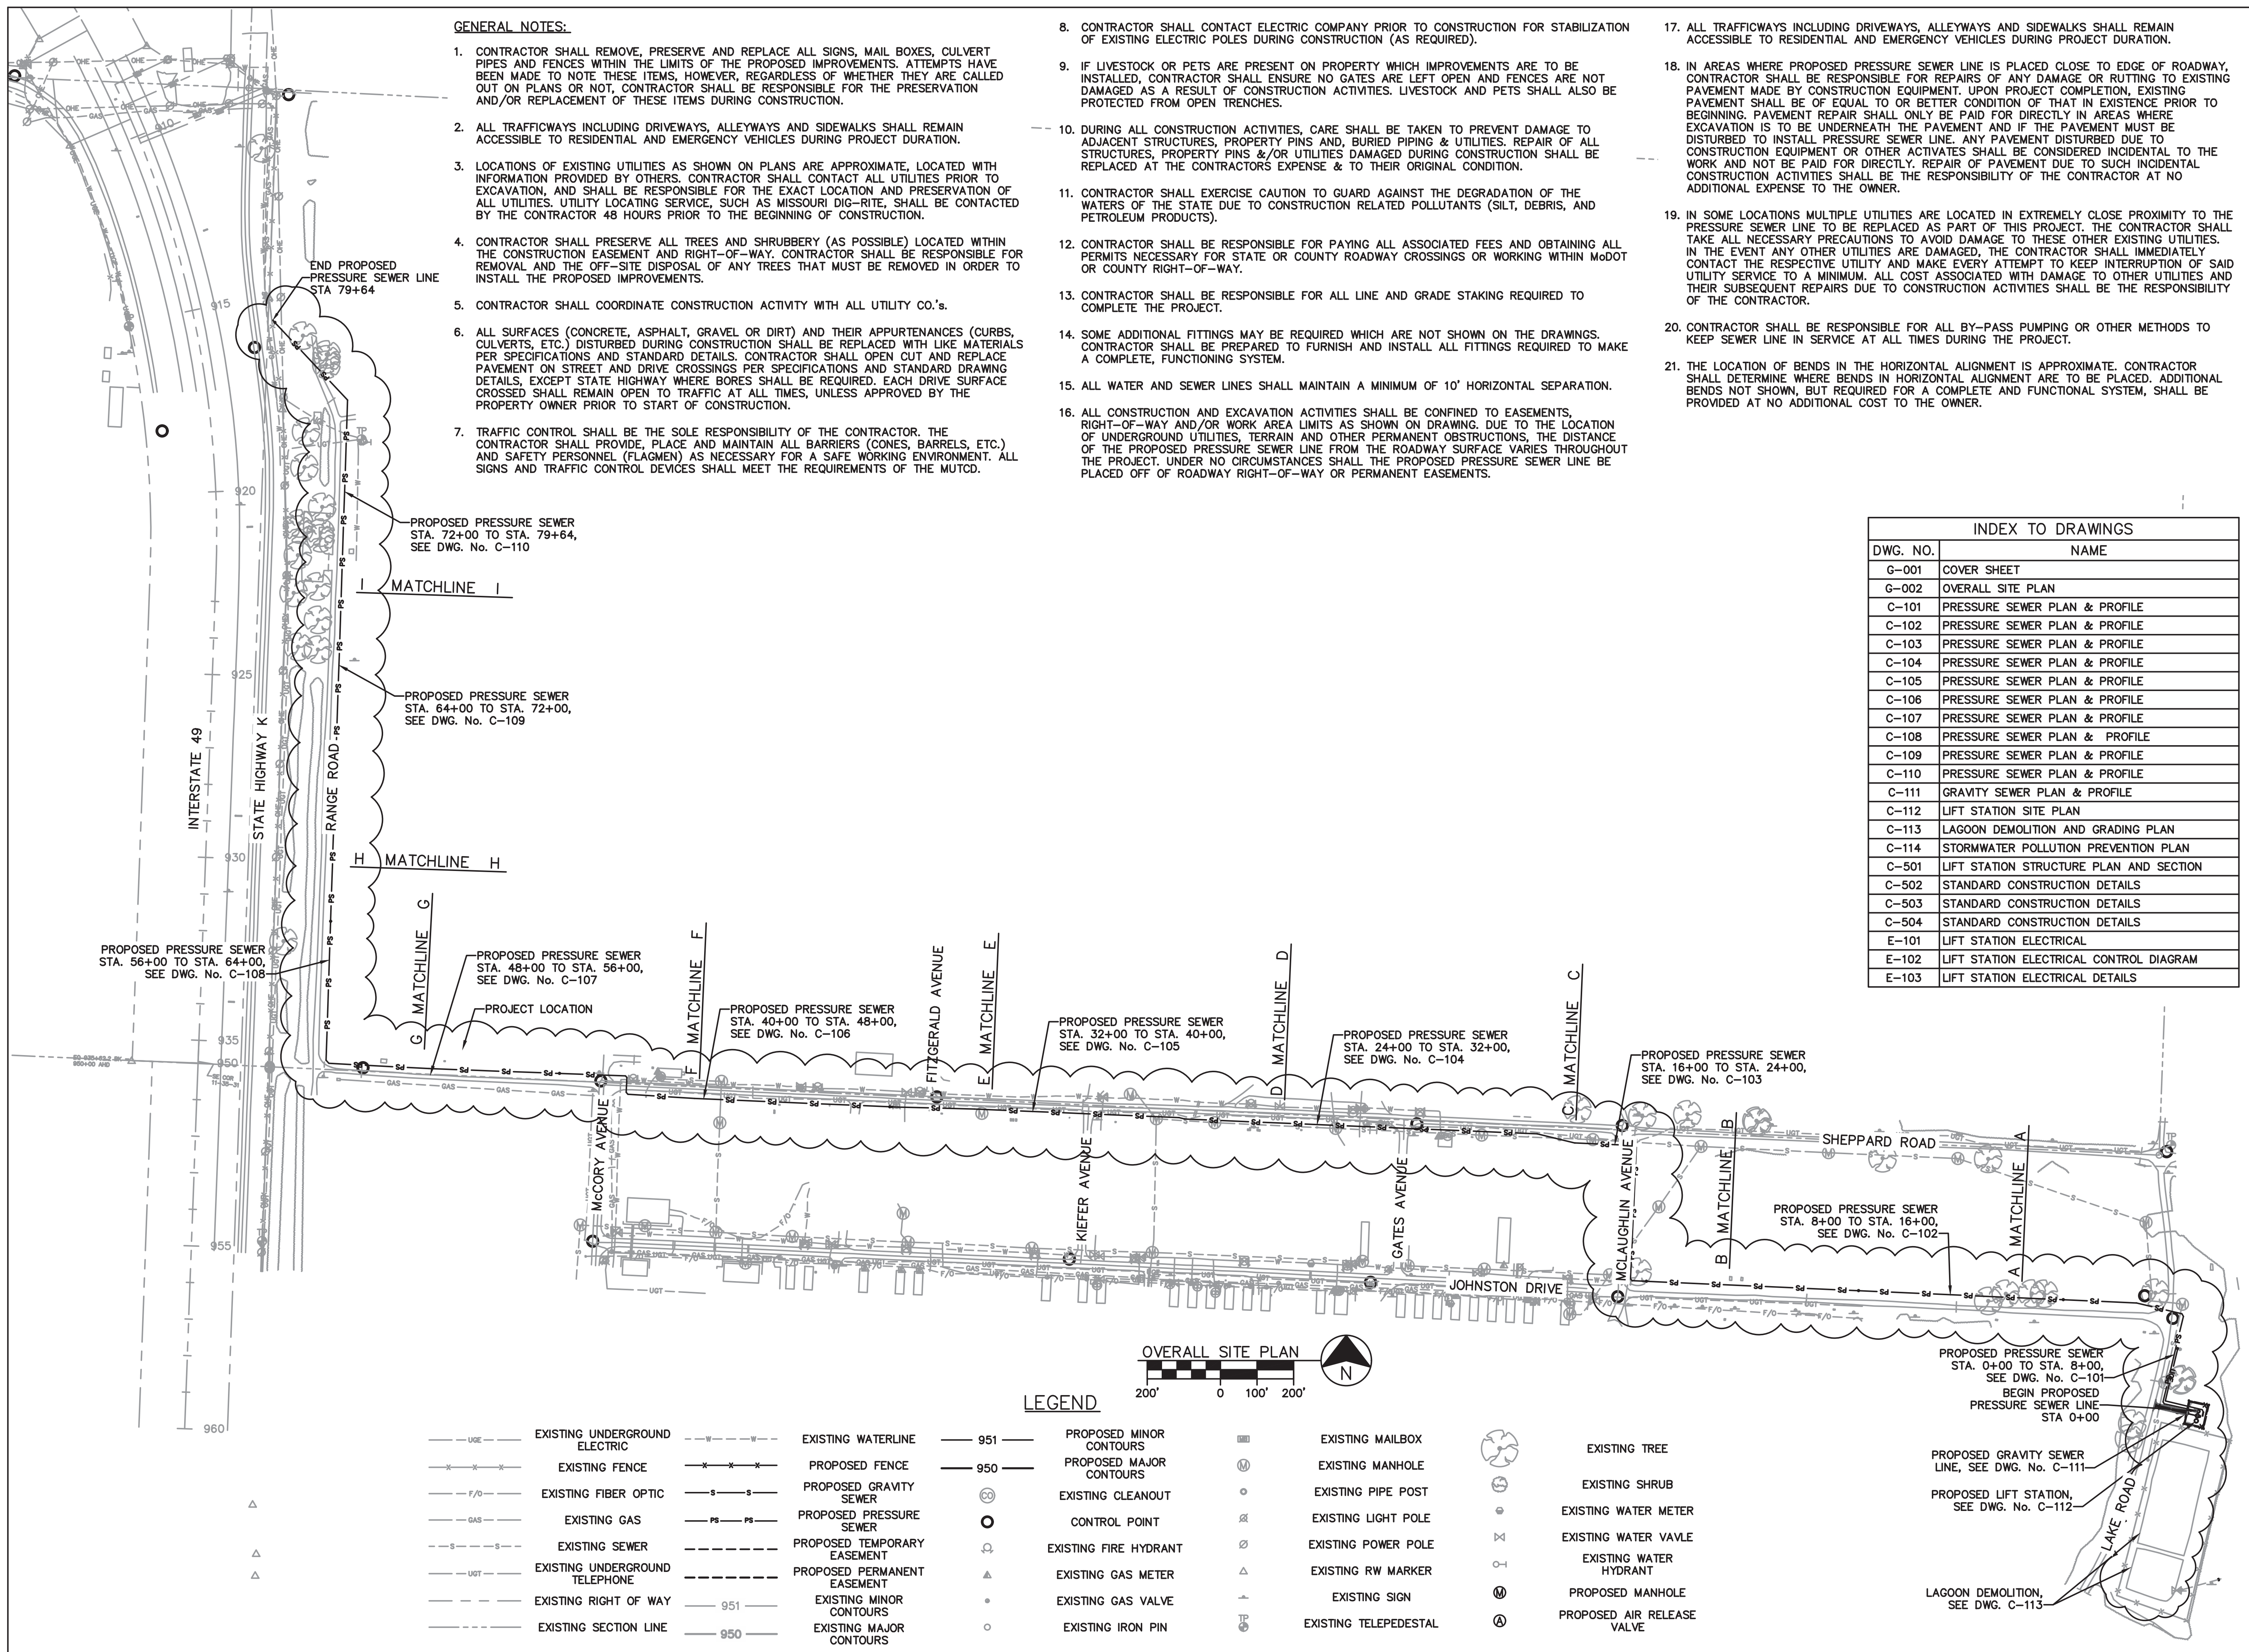

**EASEMENT NOTE:**

SANITARY SEWER EASEMENTS HAVE NOT BEEN OBTAINED DUE TO THE PROPOSED PRESSURE SEWER PIPE AND LIFT STATION BEING LOCATED ON FEDERAL PROPERTY THAT IS COVERED IN ARMY REGULATION (AR 405-80) GRANTING ACCESS FOR ALL QUALIFYING UTILITIES.

**PRESSURE SEWER NOTES:**


- NO. 12 COATED COPPER DETECTION WIRE SHALL BE RUN IN TRENCH FOR ENTIRE LENGTH OF INSTALLED PRESSURE SEWER MAIN, PER DETAILS AND SPECIFICATIONS.
- PRESSURE SEWER LINE SHALL BE INSTALLED WITH A MINIMUM OF 42" OF COVER OVER TOP OF PIPE.

**LEGEND**

---	EXISTING UNDERGROUND ELECTRIC	⊗	EXISTING FIRE HYDRANT
---	EXISTING FENCE	▲	EXISTING GAS METER
-F/O-	EXISTING FIBER OPTIC	•	EXISTING GAS VALVE
---	EXISTING GAS	○	EXISTING IRON PIN
-S-S-	EXISTING SEWER	■	EXISTING MAILBOX
---	EXISTING UNDERGROUND TELEPHONE	⊙	EXISTING MANHOLE
---	EXISTING RIGHT OF WAY	○	EXISTING PIPE POST
---	EXISTING SECTION LINE	⊗	EXISTING LIGHT POLE
-W-W-	EXISTING WATERLINE	⊗	EXISTING POWER POLE
x-x-x	PROPOSED FENCE	▲	EXISTING RW MARKER
-S-S-	PROPOSED GRAVITY SEWER	+	EXISTING SIGN
-PS-PS-	PROPOSED PRESSURE SEWER	⊕	EXISTING TELEPEDESTAL
---	PROPOSED TEMPORARY EASEMENT	⊗	EXISTING TREE
---	PROPOSED PERMANENT EASEMENT	⊗	EXISTING SHRUB
951	EXISTING MINOR CONTOURS	⊗	EXISTING WATER METER
950	EXISTING MAJOR CONTOURS	⊗	EXISTING WATER VALVE
951	PROPOSED MINOR CONTOURS	⊗	EXISTING WATER HYDRANT
950	PROPOSED MAJOR CONTOURS	⊗	PROPOSED MANHOLE
⊗	EXISTING CLEANOUT	⊗	PROPOSED AIR RELEASE VALVE
○	CONTROL POINT		

STATE OF MISSOURI  
MICHAEL L. PARSON,  
GOVERNOR

CHIEF ENGINEER: GARRETT D. WAGNER  
LICENSE NO. PE-2019000226

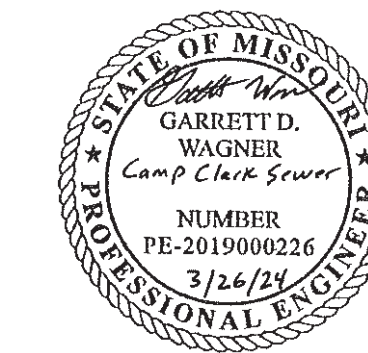

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CONNECT CAMP CLARK  
TO CITY OF NEVADA  
SEWER SYSTEM

CAMP CLARK

NEVADA, MISSOURI

PROJECT # T2301-02  
SITE # 6274  
ASSET # 8136274075

REVISION: EASEMENTS  
DATE: 03-26-2024  
REVISION:  
DATE:  
REVISION:  
DATE:  
ISSUE DATE: 06/14/2024


CAD DWG FILE:  
DRAWN BY: AWW  
CHECKED BY: SCW  
DESIGNED BY: GDW

SHEET TITLE:  
**PRESSURE SEWER  
PLAN & PROFILE**

SHEET NUMBER:

**C-101**

3 OF 23 SHEETS

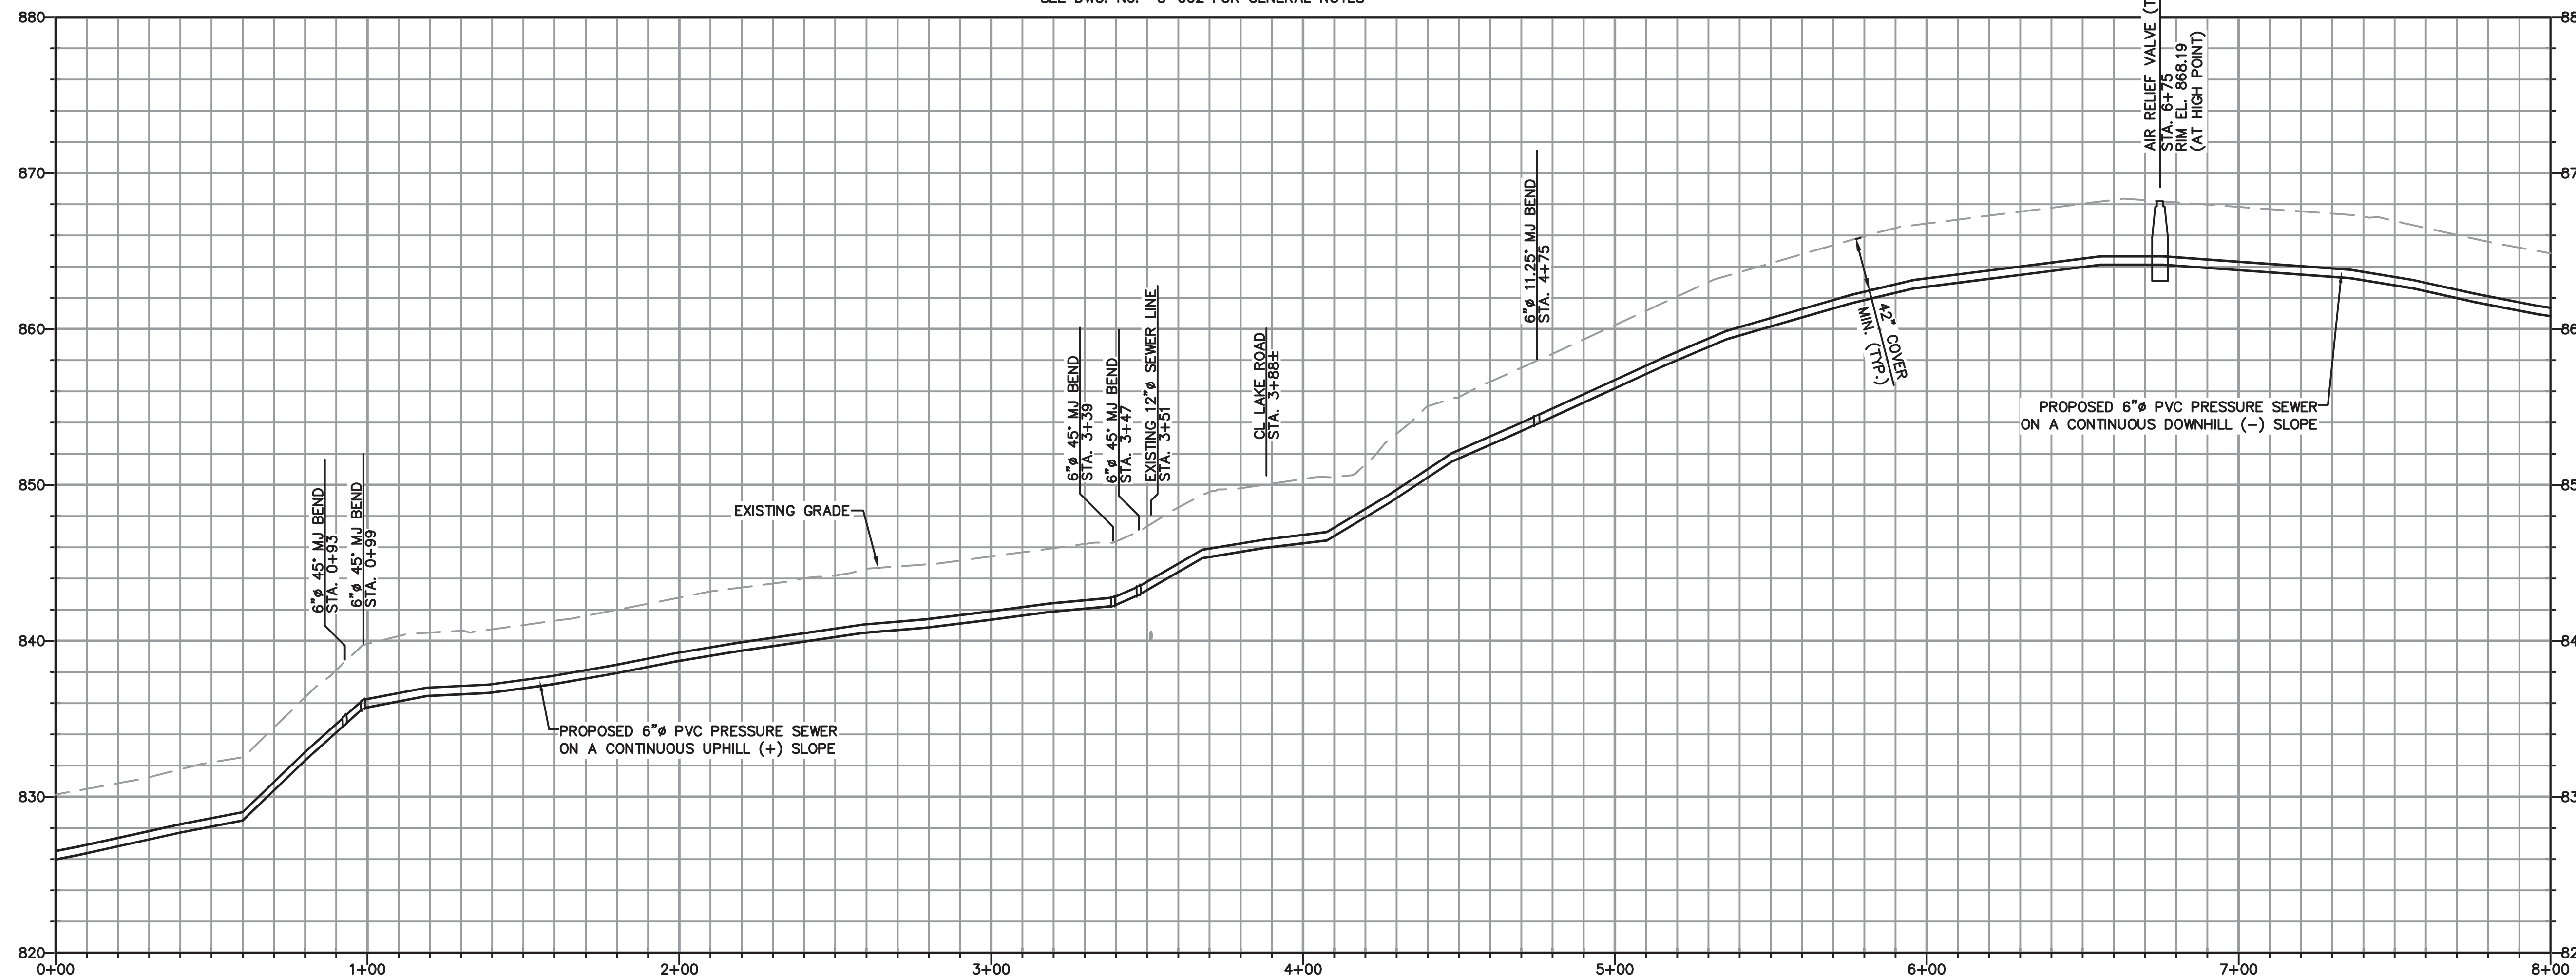

SCALE  
VERT. = 1:6  
HORIZ. = 1:30




LEGEND			
---E---	EXISTING UNDERGROUND ELECTRIC	---S---	PROPOSED GRAVITY SEWER
---F/O---	EXISTING FIBER OPTIC	---PS---	PROPOSED PRESSURE SEWER
---GAS---	EXISTING GAS	---	PROPOSED TEMPORARY EASEMENT
---	EXISTING SEWER	---	PROPOSED PERMANENT EASEMENT
---	EXISTING UNDERGROUND TELEPHONE	951	EXISTING MINOR CONTOURS
---	EXISTING RIGHT OF WAY	950	EXISTING MAJOR CONTOURS
---	EXISTING SECTION LINE	951	PROPOSED MINOR CONTOURS
---	EXISTING WATERLINE		
---	PROPOSED FENCE	○	PROPOSED MAJOR CONTOURS
---	PROPOSED GRAVITY SEWER	⊙	EXISTING CLEANOUT
---	PROPOSED PRESSURE SEWER	⊙	CONTROL POINT
---	PROPOSED TEMPORARY EASEMENT	⊙	EXISTING FIRE HYDRANT
---	PROPOSED PERMANENT EASEMENT	⊙	EXISTING GAS METER
---	EXISTING MINOR CONTOURS	○	EXISTING GAS VALVE
---	EXISTING MAJOR CONTOURS	○	EXISTING IRON PIN
---	PROPOSED MINOR CONTOURS	⊙	EXISTING MAILBOX
		⊙	EXISTING MANHOLE
		⊙	EXISTING PIPE POST
		⊙	EXISTING LIGHT POLE
		⊙	EXISTING POWER POLE
		⊙	EXISTING RW MARKER
		⊙	EXISTING SIGN
		⊙	EXISTING TELEPEDESTAL
		⊙	EXISTING TREE
		⊙	EXISTING SHRUB
		⊙	EXISTING WATER METER
		⊙	EXISTING WATER VALVE
		⊙	EXISTING WATER HYDRANT
		⊙	PROPOSED MANHOLE
		⊙	PROPOSED AIR RELEASE VALVE

**EASEMENT NOTE:**  
 SANITARY SEWER EASEMENTS HAVE NOT BEEN OBTAINED DUE TO THE PROPOSED PRESSURE SEWER PIPE AND LIFT STATION BEING LOCATED ON FEDERAL PROPERTY THAT IS COVERED IN ARMY REGULATION (AR 405-80) GRANTING ACCESS FOR ALL QUALIFYING UTILITIES.

- PRESSURE SEWER NOTES:**
- NO. 12 COATED COPPER DETECTION WIRE SHALL BE RUN IN TRENCH FOR ENTIRE LENGTH OF INSTALLED PRESSURE SEWER MAIN, PER DETAILS AND SPECIFICATIONS.
  - PRESSURE SEWER LINE SHALL BE INSTALLED WITH A MINIMUM OF 42" OF COVER OVER TOP OF PIPE.

STATE OF MISSOURI  
 MICHAEL L. PARSON,  
 GOVERNOR

CIVIL ENGINEER: GARRETT D. WAGNER  
 LICENSE NO. PE-2019000226

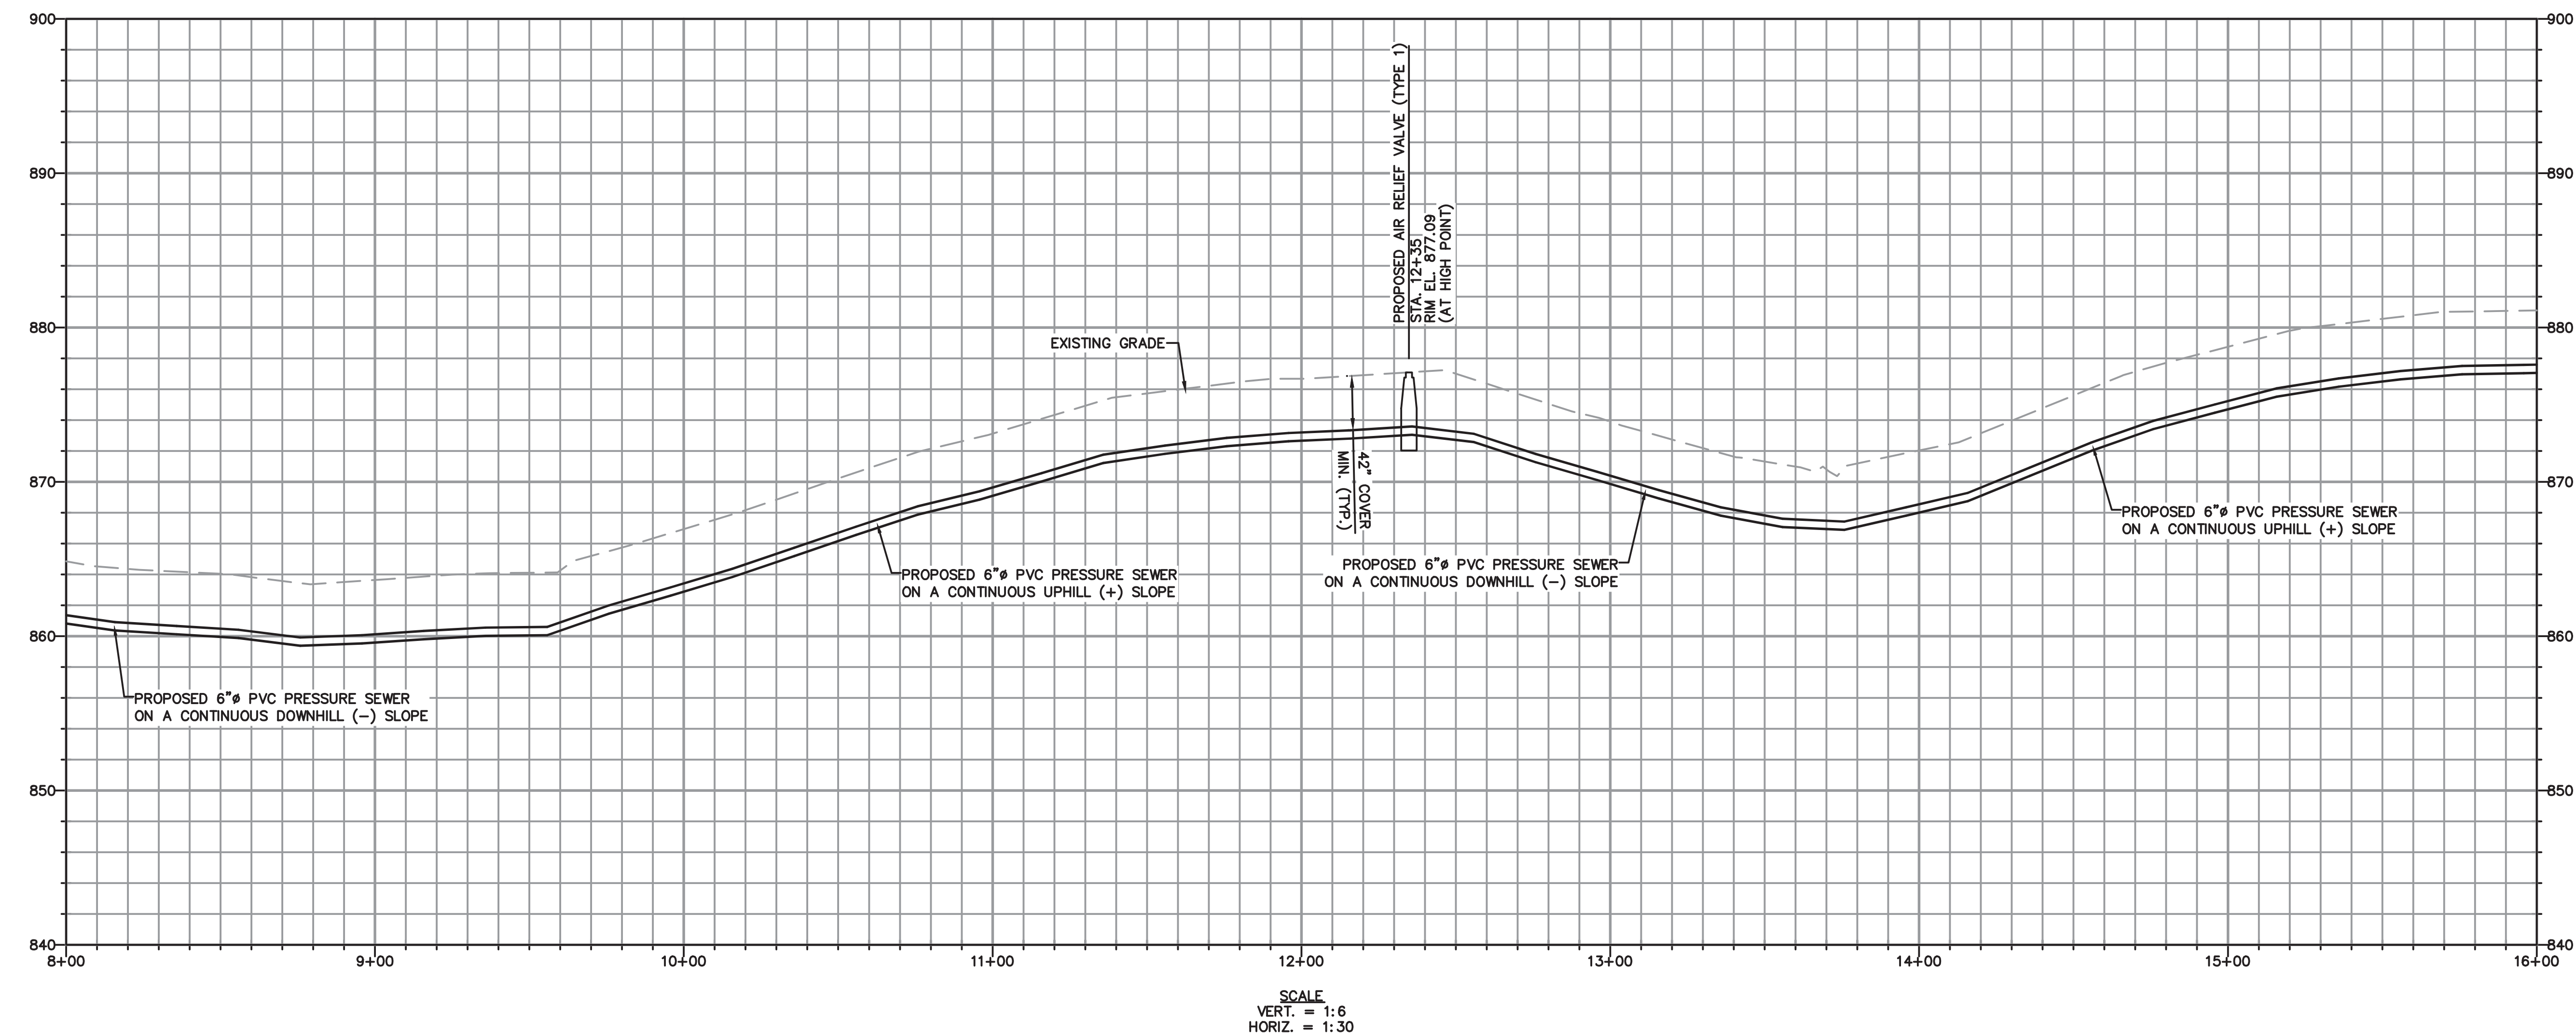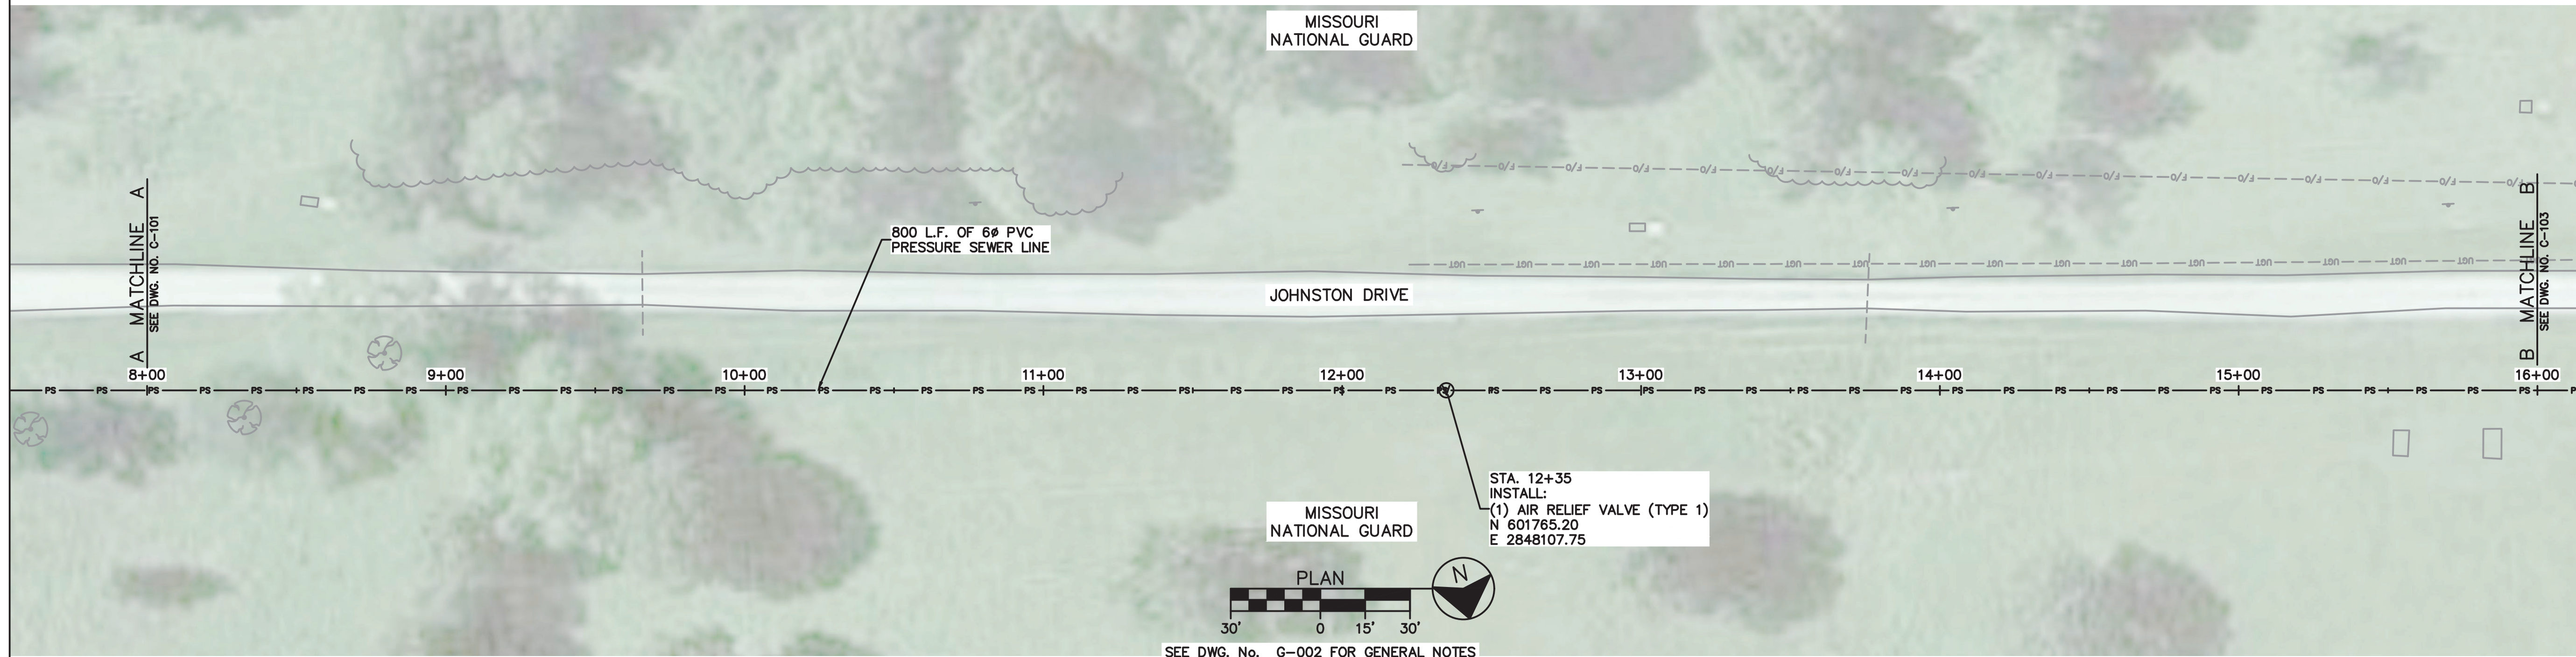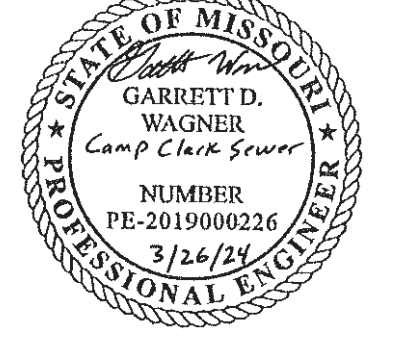

OFFICE OF ADMINISTRATION  
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MISSOURI  
 NATIONAL GUARD

CONNECT CAMP CLARK  
 TO CITY OF NEVADA  
 SEWER SYSTEM

CAMP CLARK  
 NEVADA, MISSOURI

PROJECT # T2301-02  
 SITE # 6274  
 ASSET # 8136274075


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 DATE: 03-26-2024  
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 DATE:  
 REVISION:  
 DATE:  
 ISSUE DATE: 06/14/2024

CAD DWG FILE:  
 DRAWN BY: AWW  
 CHECKED BY: SCW  
 DESIGNED BY: GDW

SHEET TITLE:  
 PRESSURE SEWER  
 PLAN & PROFILE

SHEET NUMBER:

C-102  
 4 OF 23 SHEETS

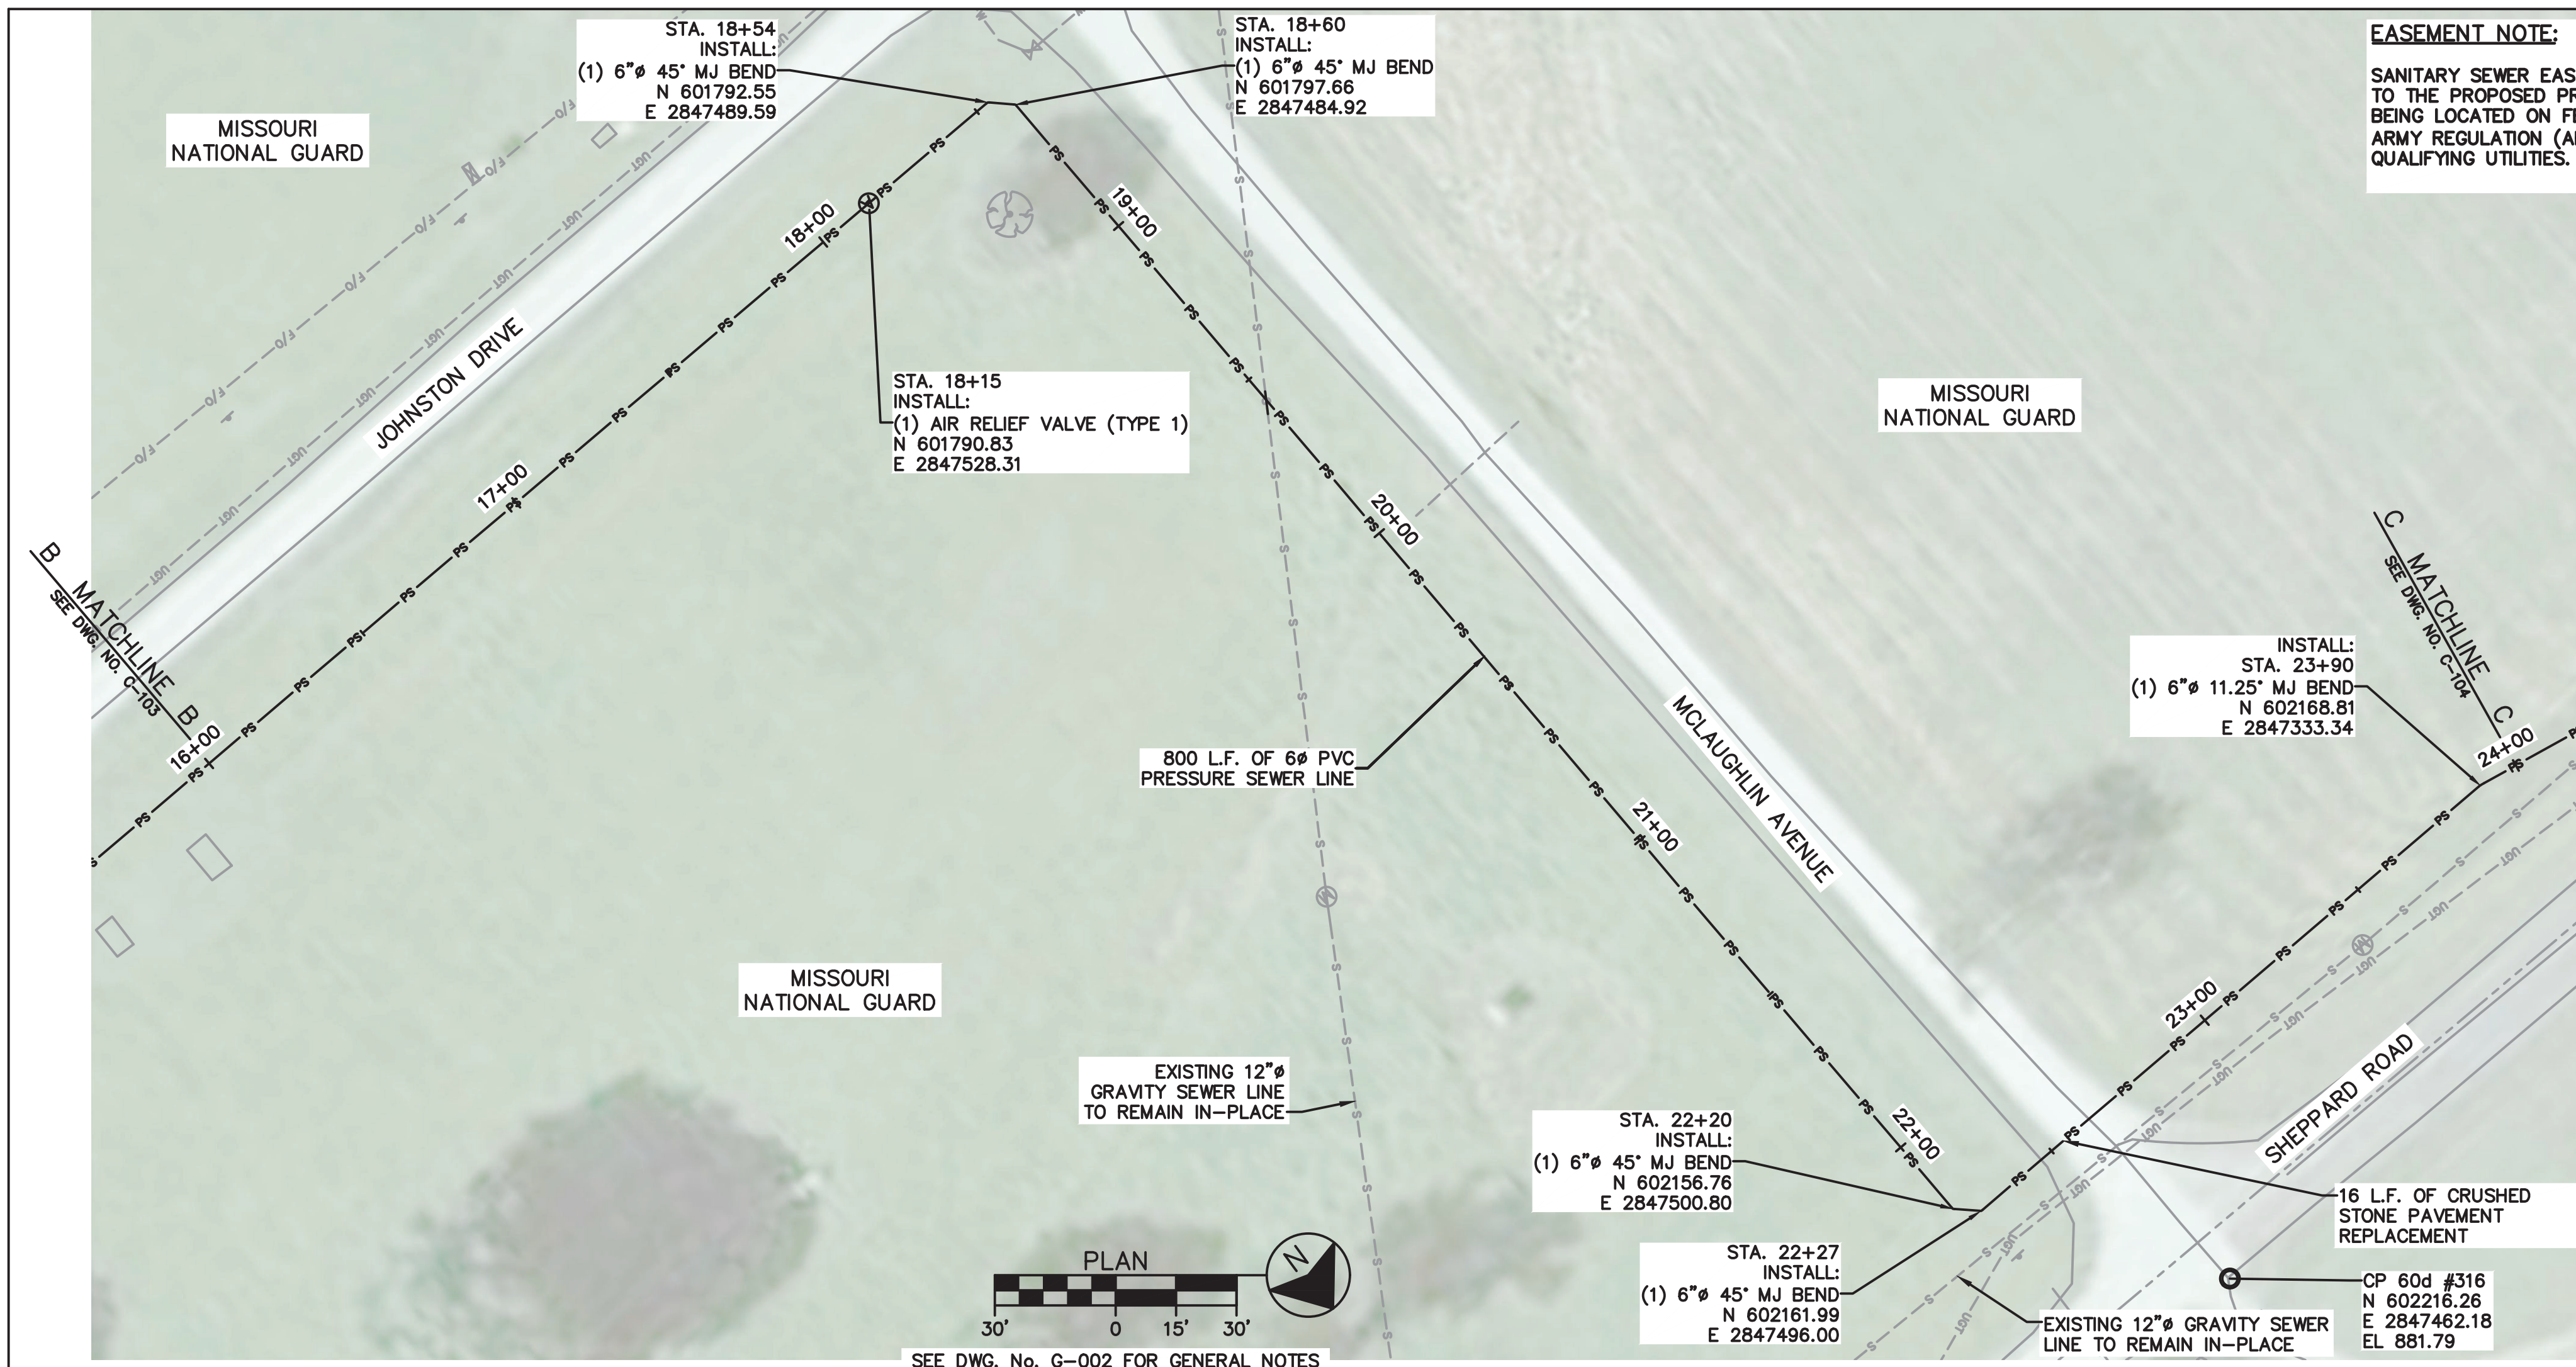

**EASEMENT NOTE:**  
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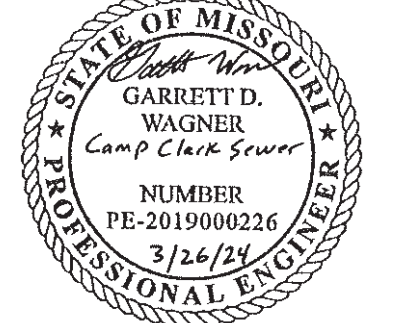
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**LEGEND**

---	EXISTING UNDERGROUND ELECTRIC	⊙	EXISTING FIRE HYDRANT
-x-x-	EXISTING FENCE	▲	EXISTING GAS METER
-F/O-	EXISTING FIBER OPTIC	•	EXISTING GAS VALVE
-GAS-	EXISTING GAS	○	EXISTING IRON PIN
-S-S-	EXISTING SEWER	⊠	EXISTING MAILBOX
-UOT-	EXISTING UNDERGROUND TELEPHONE	⊕	EXISTING MANHOLE
- - -	EXISTING RIGHT OF WAY	○	EXISTING PIPE POST
- - - -	EXISTING SECTION LINE	⊗	EXISTING LIGHT POLE
-W-W-	EXISTING WATERLINE	⊗	EXISTING POWER POLE
-x-x-x-	PROPOSED FENCE	▲	EXISTING RW MARKER
-S-S-	PROPOSED GRAVITY SEWER	+	EXISTING SIGN
-PS-PS-	PROPOSED PRESSURE SEWER	⊕	EXISTING TELEPEDESTAL
- - - -	PROPOSED TEMPORARY EASEMENT	⊕	EXISTING TREE
- - - -	PROPOSED PERMANENT EASEMENT	⊕	EXISTING SHRUB
951	EXISTING MINOR CONTOURS	⊕	EXISTING WATER METER
950	EXISTING MAJOR CONTOURS	⊕	EXISTING WATER VALVE
951	PROPOSED MINOR CONTOURS	⊕	EXISTING WATER HYDRANT
950	PROPOSED MAJOR CONTOURS	⊕	PROPOSED MANHOLE
⊕	EXISTING CLEANOUT	⊕	PROPOSED AIR RELEASE VALVE
○	CONTROL POINT		

STATE OF MISSOURI  
MICHAEL L. PARSON,  
GOVERNOR

CIVIL ENGINEER: GARRETT D. WAGNER  
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CONNECT CAMP CLARK  
TO CITY OF NEVADA  
SEWER SYSTEM

CAMP CLARK

NEVADA, MISSOURI

PROJECT # T2301-02  
SITE # 6274  
ASSET # 8136274075

REVISION: EASEMENTS  
DATE: 03-26-2024  
REVISION:  
DATE:  
REVISION:  
DATE:  
ISSUE DATE: 06/14/2024


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DRAWN BY: AWW  
CHECKED BY: SCW  
DESIGNED BY: GDW


SHEET TITLE:  
**PRESSURE SEWER  
PLAN & PROFILE**

SHEET NUMBER:

**C-103**

5 OF 23 SHEETS

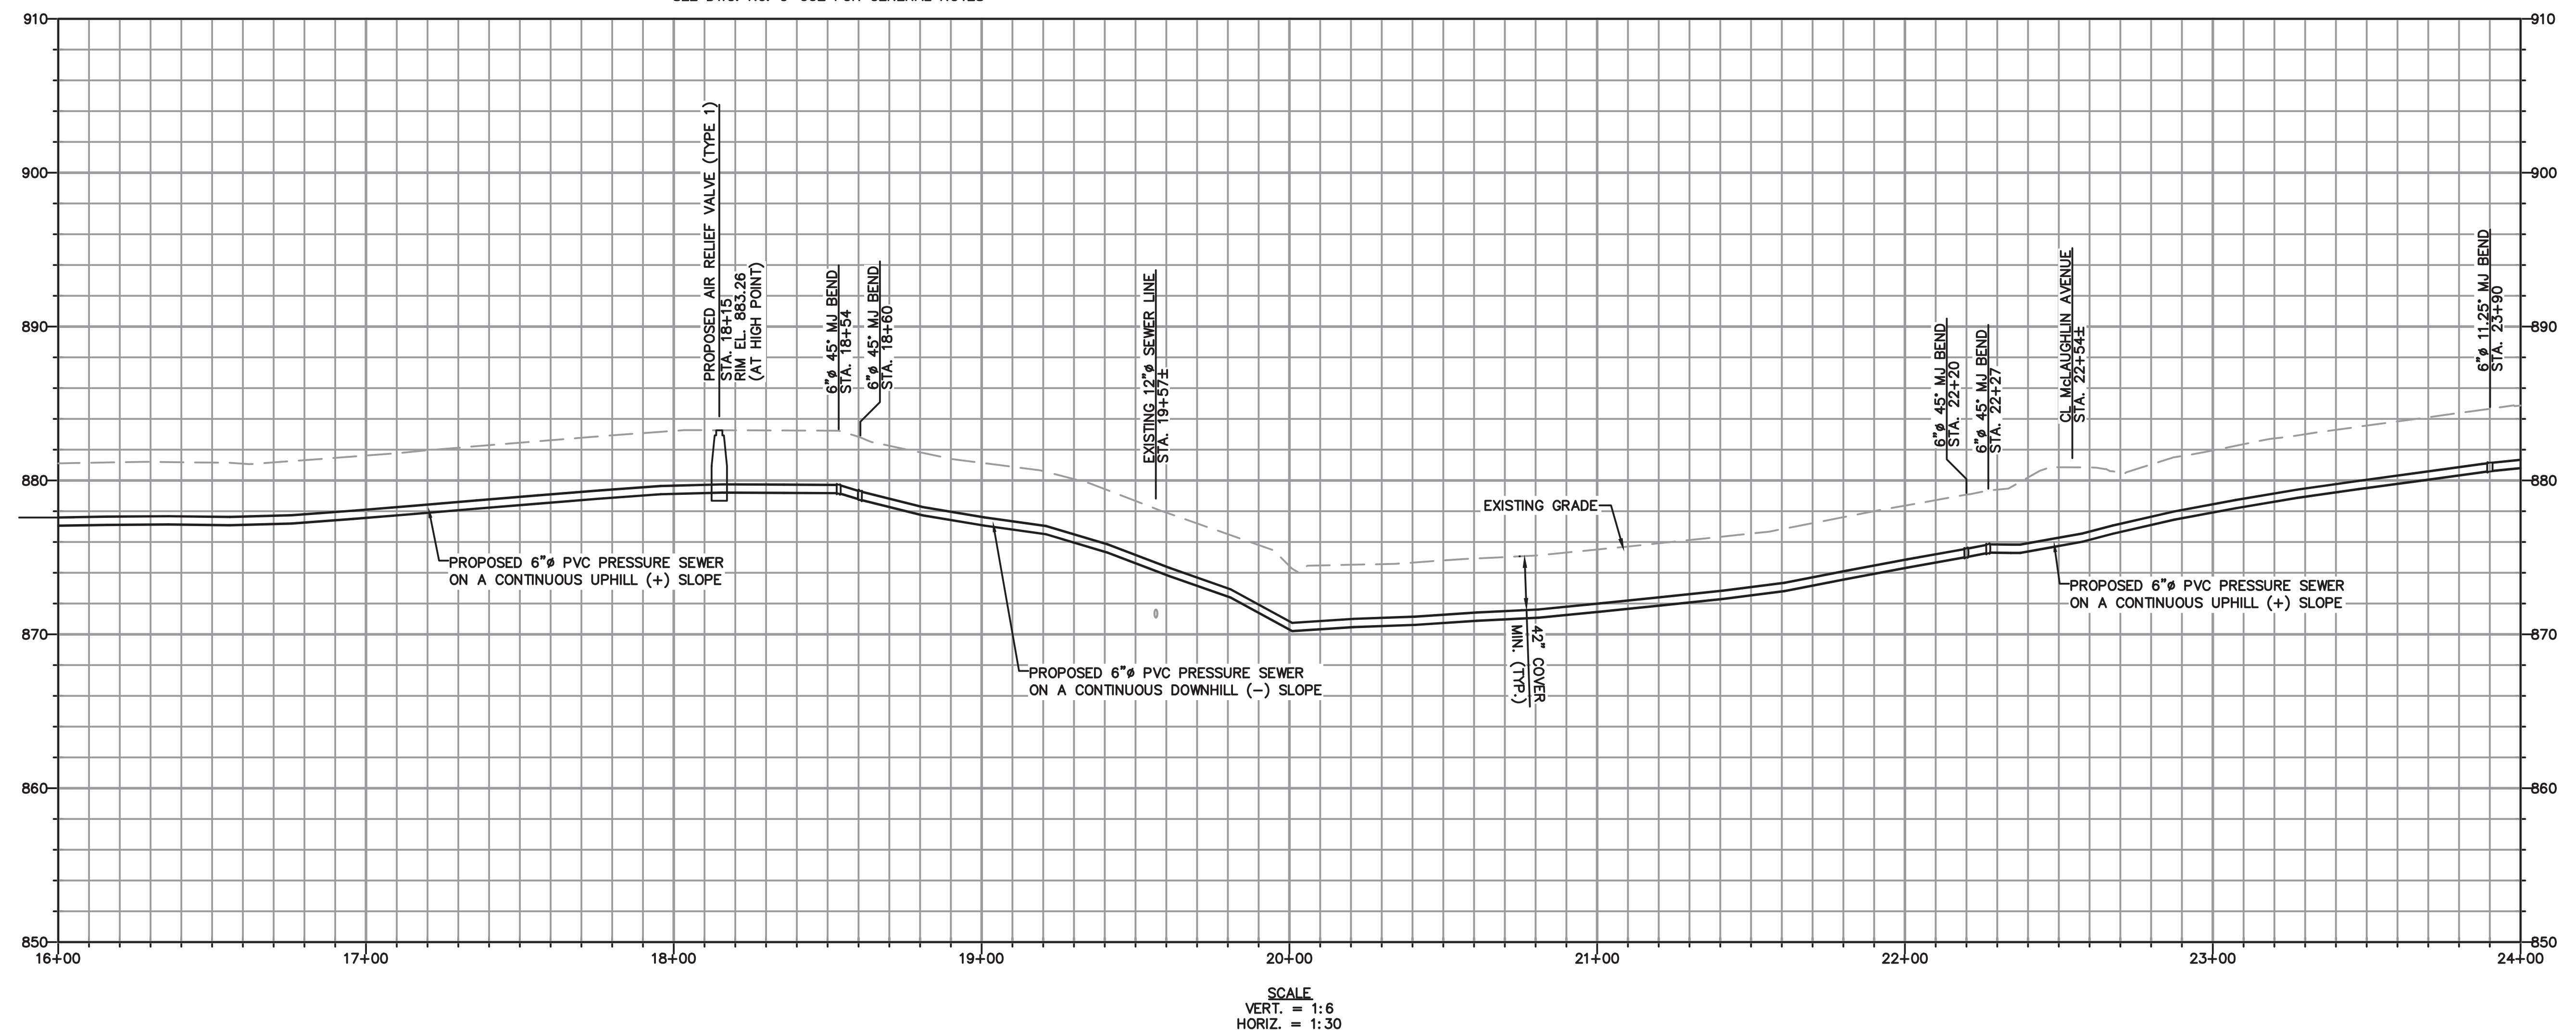

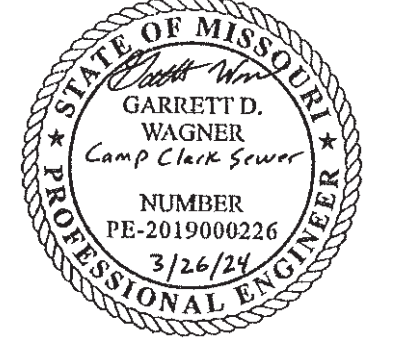

OFFICE OF ADMINISTRATION  
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CONNECT CAMP CLARK  
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REVISION: EASEMENTS  
DATE: 03-26-2024  
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CAD DWG FILE:  
DRAWN BY: AWW  
CHECKED BY: SCW  
DESIGNED BY: GDW

SHEET TITLE:  
**PRESSURE SEWER  
PLAN & PROFILE**

SHEET NUMBER:

**C-104**

6 OF 23 SHEETS

**LEGEND**



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— x — x —	EXISTING FENCE	— s — s —	PROPOSED GRAVITY SEWER	⊙	EXISTING CLEANOUT	⊗	EXISTING LIGHT POLE	⊗	EXISTING WATER VALVE
— F/O —	EXISTING FIBER OPTIC	— ps — ps —	PROPOSED PRESSURE SEWER	⊙	CONTROL POINT	⊗	EXISTING POWER POLE	⊗	EXISTING WATER HYDRANT
— GAS —	EXISTING GAS	- - - - -	PROPOSED TEMPORARY EASEMENT	⊙	EXISTING FIRE HYDRANT	△	EXISTING RW MARKER	⊙	PROPOSED MANHOLE
— S — S —	EXISTING SEWER	- - - - -	PROPOSED PERMANENT EASEMENT	△	EXISTING GAS METER	+	EXISTING SIGN	⊙	PROPOSED AIR RELEASE VALVE
— UGT —	EXISTING UNDERGROUND TELEPHONE	— 951 —	EXISTING MINOR CONTOURS	○	EXISTING GAS VALVE	⊙	EXISTING TELEPEDESTAL	⊙	EXISTING TREE
— — — —	EXISTING RIGHT OF WAY	— 950 —	EXISTING MAJOR CONTOURS	⊙	EXISTING IRON PIN	⊙	EXISTING SHRUB		
— — — —	EXISTING SECTION LINE	— 951 —	PROPOSED MINOR CONTOURS	⊙	EXISTING MAILBOX	⊙			
— W — W —	EXISTING WATERLINE			⊙	EXISTING MANHOLE				

**EASEMENT NOTE:**


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SEE DWG. No. G-002 FOR GENERAL NOTES



SCALE  
VERT. = 1:6  
HORIZ. = 1:30

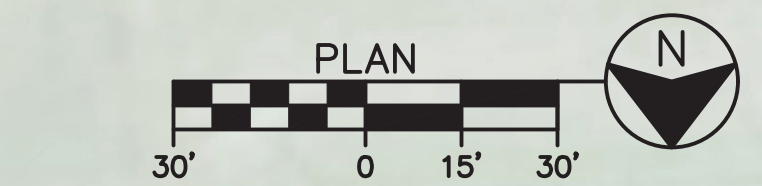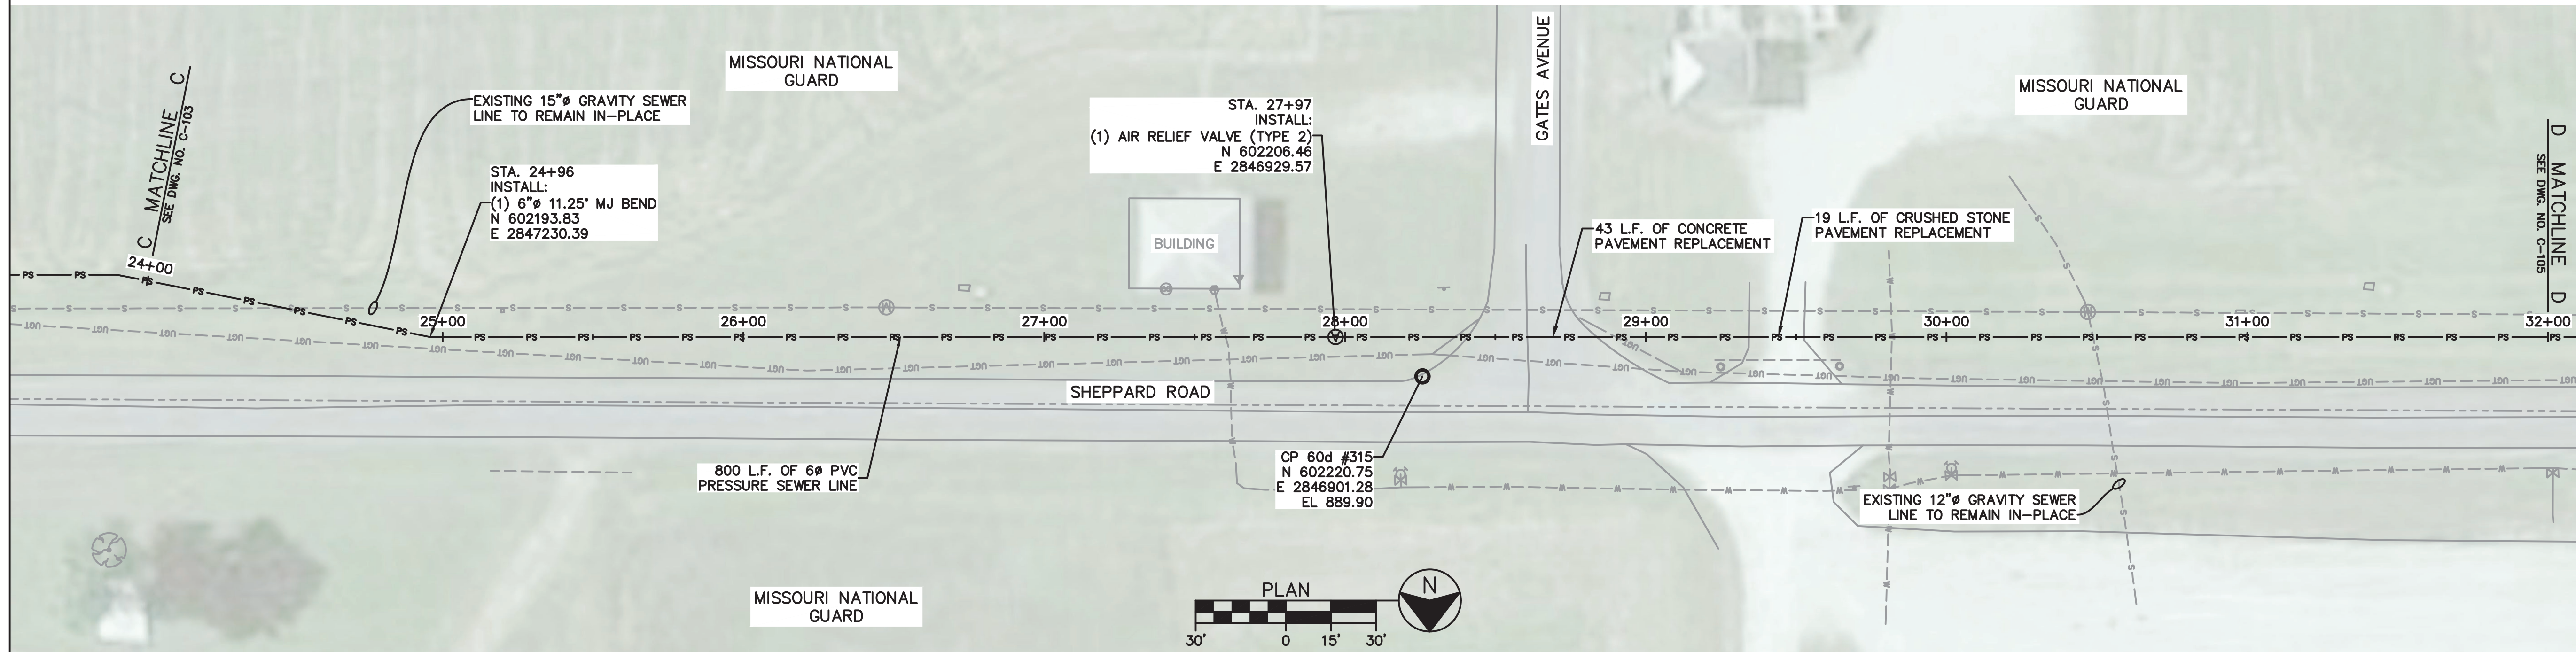---	EXISTING UNDERGROUND ELECTRIC	---	EXISTING UNDERGROUND TELEPHONE
-x-x-	EXISTING FENCE	-s-s-	EXISTING RIGHT OF WAY
-f/o-	EXISTING FIBER OPTIC	-ps-ps-	EXISTING SECTION LINE
-g-g-	EXISTING GAS	-w-w-	EXISTING WATERLINE
-s-s-	EXISTING SEWER	951	EXISTING MINOR CONTOURS
-s-s-	EXISTING PERMANENT EASEMENT	950	EXISTING MAJOR CONTOURS
-s-s-	EXISTING TEMPORARY EASEMENT	951	PROPOSED MINOR CONTOURS

**LEGEND**

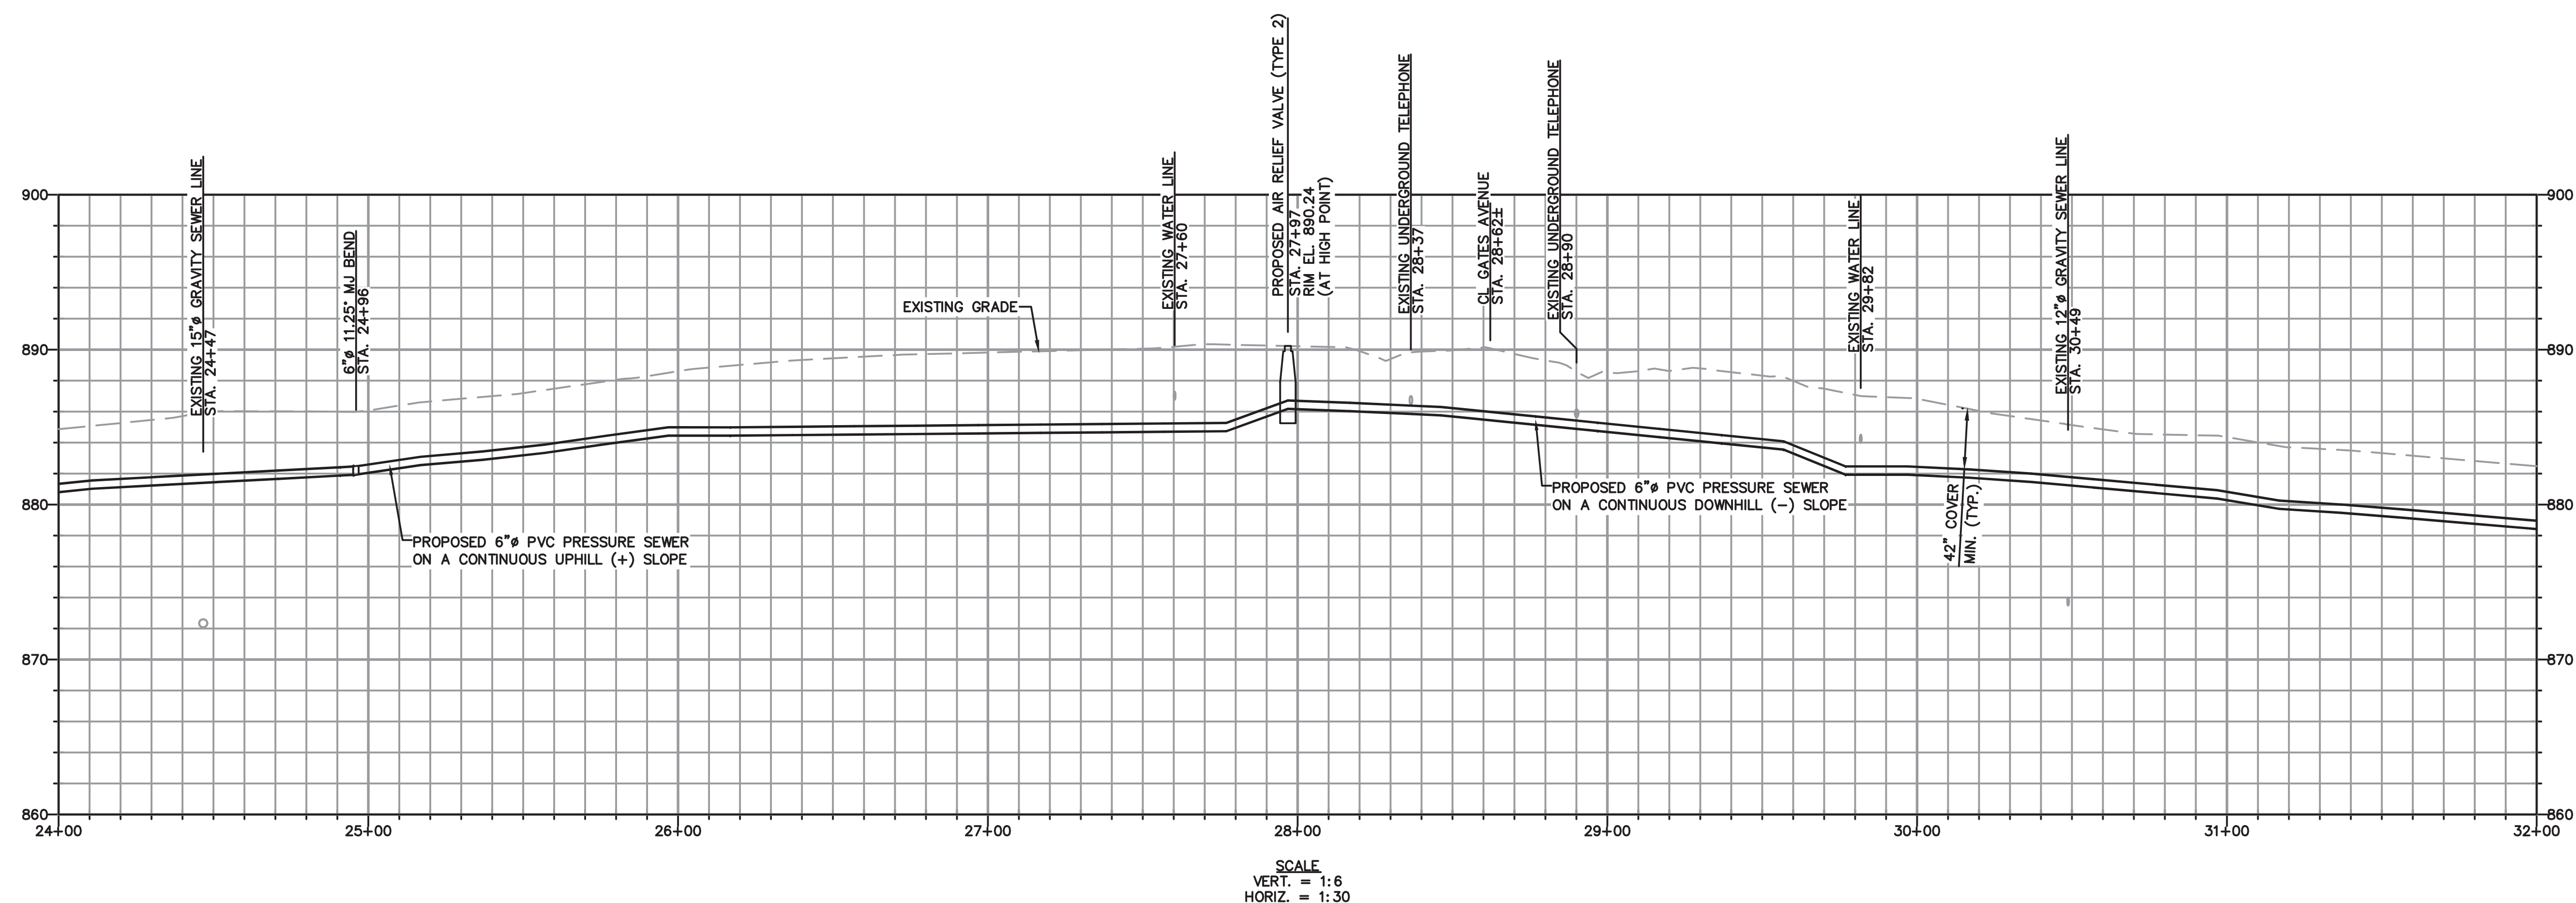---950---	PROPOSED MAJOR CONTOURS	○	EXISTING PIPE POST	⊗	EXISTING WATER METER
⊙	EXISTING CLEANOUT	⊗	EXISTING LIGHT POLE	⊗	EXISTING WATER VALVE
○	CONTROL POINT	⊗	EXISTING POWER POLE	⊗	EXISTING WATER HYDRANT
⊙	EXISTING FIRE HYDRANT	⊗	EXISTING RW MARKER	⊗	PROPOSED MANHOLE
△	EXISTING GAS METER	⊗	EXISTING SIGN	⊗	PROPOSED AIR RELEASE VALVE
•	EXISTING GAS VALVE	⊗	EXISTING TELEPEDESTAL	⊗	
○	EXISTING IRON PIN	⊗	EXISTING TREE		
⊙	EXISTING MAILBOX	⊗	EXISTING SHRUB		
⊙	EXISTING MANHOLE				

**EASEMENT NOTE:**



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STATE OF MISSOURI  
MICHAEL L. PARSON,  
GOVERNOR

CIVIL ENGINEER: GARRETT D. WAGNER  
LICENSE NO. PE-201900226



SCALE  
VERT. = 1:6  
HORIZ. = 1:30

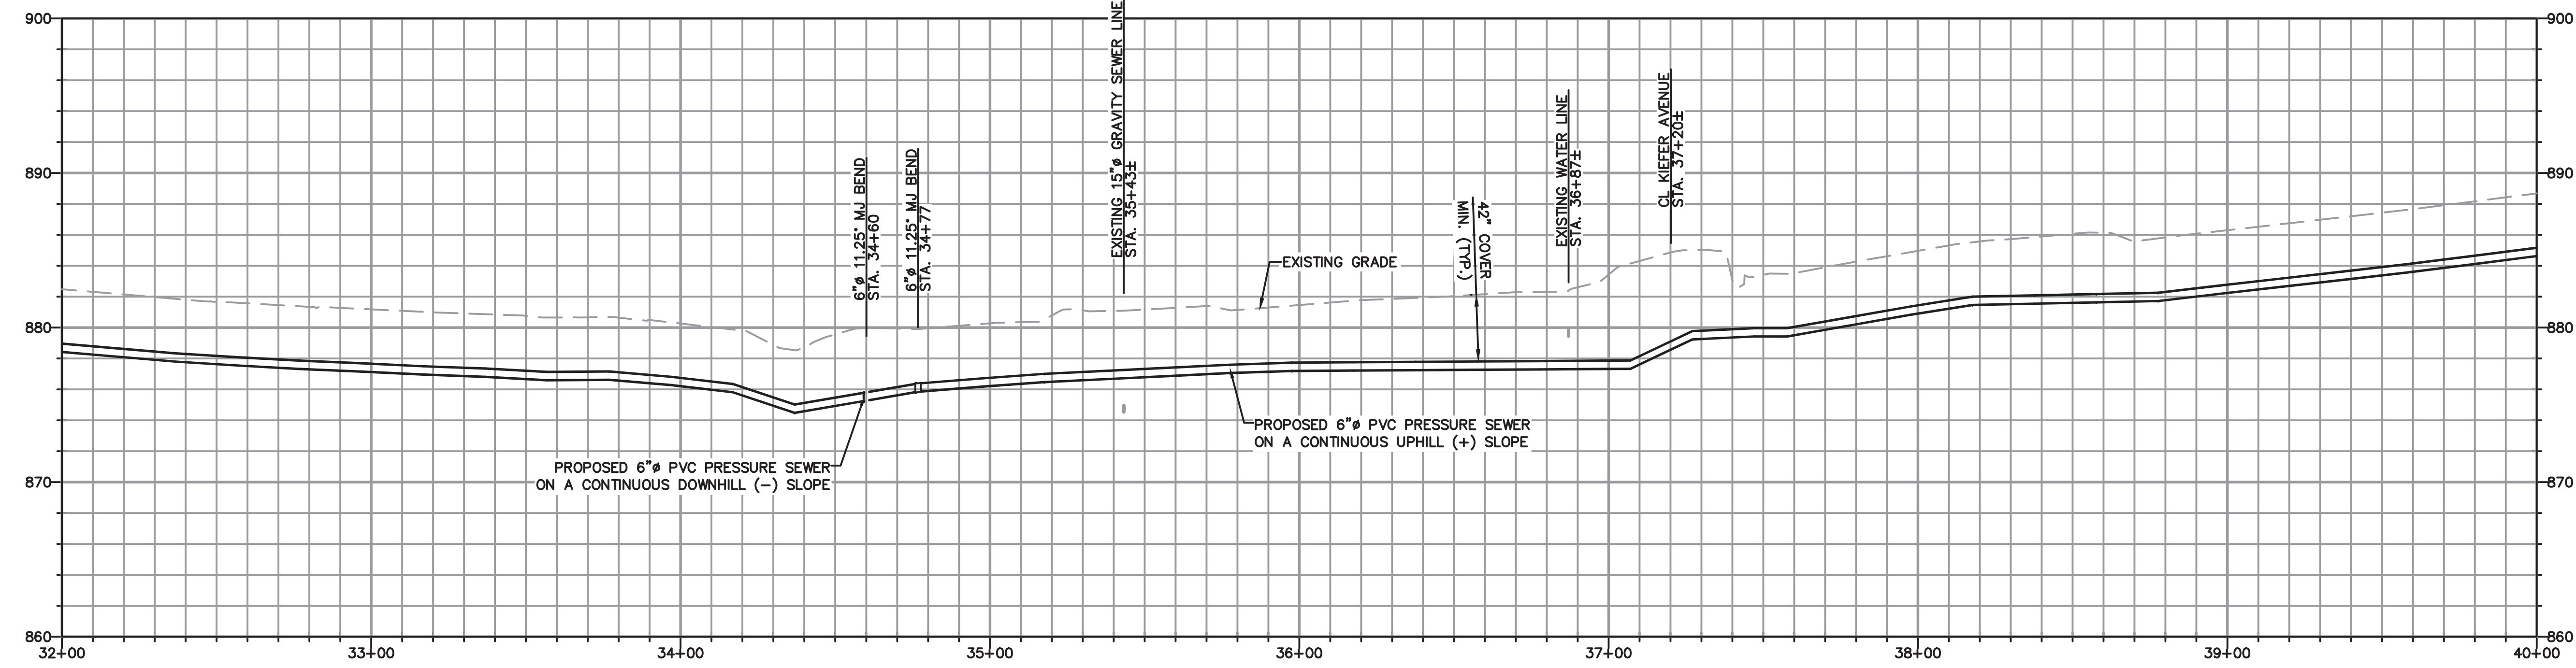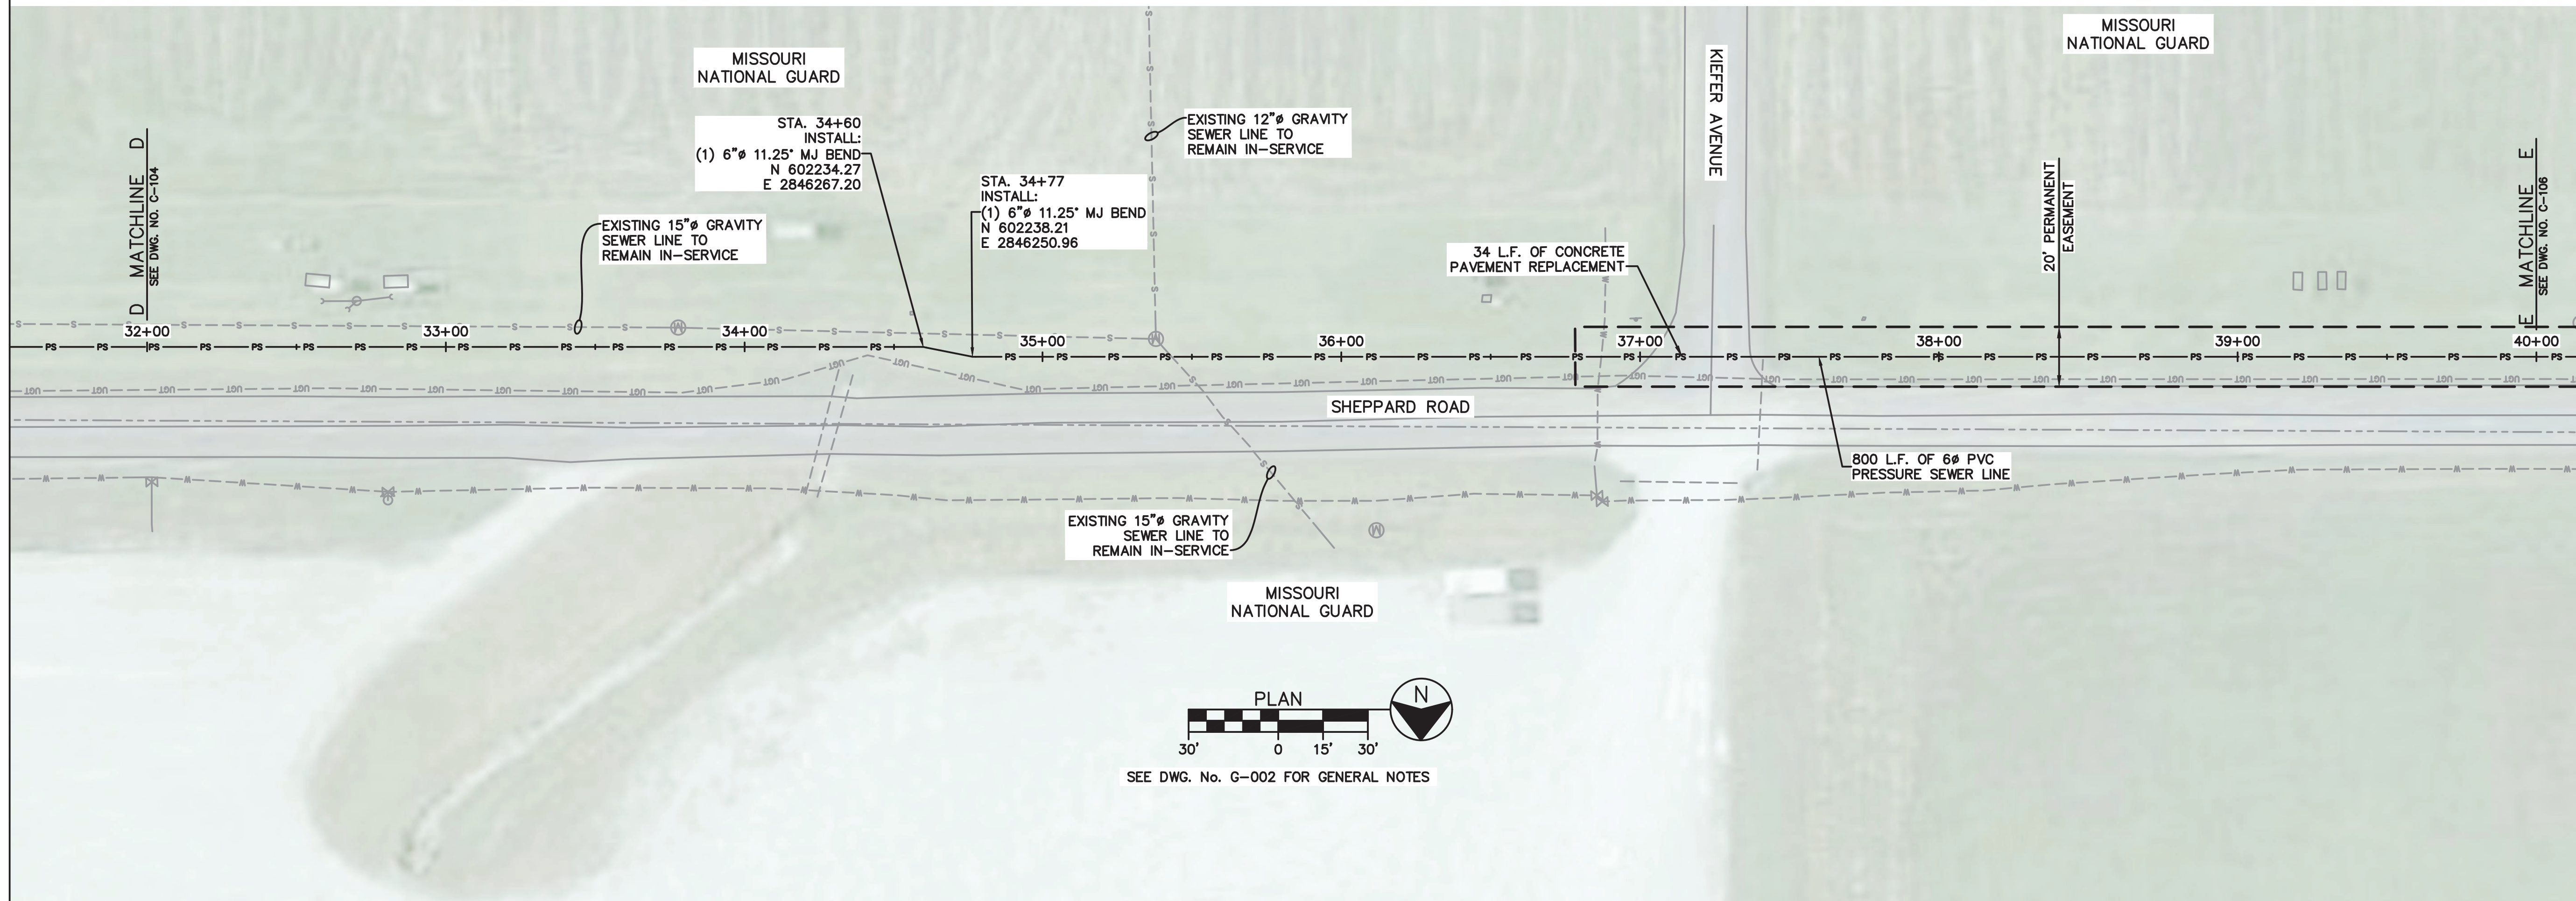

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PROJECT # T2301-02  
SITE # 6274  
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REVISION: EASEMENTS  
DATE: 03-26-2024  
REVISION: REMOVE TEMP EASEMENT  
DATE: 05-03-2024  
REVISION:  
DATE:  
ISSUE DATE: 06/14/2024

CAD DWG FILE:  
DRAWN BY: AWW  
CHECKED BY: SCW  
DESIGNED BY: GDW

SHEET TITLE:  
PRESSURE SEWER  
PLAN & PROFILE

SHEET NUMBER:

C-105

7 OF 23 SHEETS





LEGEND			
---E---	EXISTING UNDERGROUND ELECTRIC	---S---	PROPOSED FENCE
---F/O---	EXISTING FIBER OPTIC	---PS---	PROPOSED GRAVITY SEWER
---GAS---	EXISTING GAS	---PS---	PROPOSED PRESSURE SEWER
---S---	EXISTING SEWER	---	PROPOSED TEMPORARY EASEMENT
---UST---	EXISTING UNDERGROUND TELEPHONE	---	PROPOSED PERMANENT EASEMENT
---	EXISTING RIGHT OF WAY	951	EXISTING MINOR CONTOURS
---	EXISTING SECTION LINE	950	EXISTING MAJOR CONTOURS
---	EXISTING WATERLINE	951	PROPOSED MINOR CONTOURS
---		950	PROPOSED MAJOR CONTOURS
---		○	EXISTING CLEANOUT
---		○	CONTROL POINT
---		○	EXISTING FIRE HYDRANT
---		△	EXISTING GAS METER
---		○	EXISTING GAS VALVE
---		○	EXISTING IRON PIN
---		□	EXISTING MAILBOX
---		○	EXISTING MANHOLE
---		○	EXISTING PIPE POST
---		○	EXISTING LIGHT POLE
---		○	EXISTING POWER POLE
---		○	EXISTING RW MARKER
---		○	EXISTING SIGN
---		○	EXISTING TELEPEDESTAL
---		○	EXISTING TREE
---		○	EXISTING SHRUB
---		○	EXISTING WATER METER
---		○	EXISTING WATER VALVE
---		○	EXISTING WATER HYDRANT
---		○	PROPOSED MANHOLE
---		○	PROPOSED AIR RELEASE VALVE
---		○	PROPOSED VALVE

**PRESSURE SEWER NOTES:**


- NO. 12 COATED COPPER DETECTION WIRE SHALL BE RUN IN TRENCH FOR ENTIRE LENGTH OF INSTALLED PRESSURE SEWER MAIN, PER DETAILS AND SPECIFICATIONS.
- PRESSURE SEWER LINE SHALL BE INSTALLED WITH A MINIMUM OF 42" OF COVER OVER TOP OF PIPE.

STATE OF MISSOURI  
MICHAEL L. PARSON,  
GOVERNOR

CIVIL ENGINEER: GARRETT D. WAGNER  
LICENSE NO. PE-2019000226

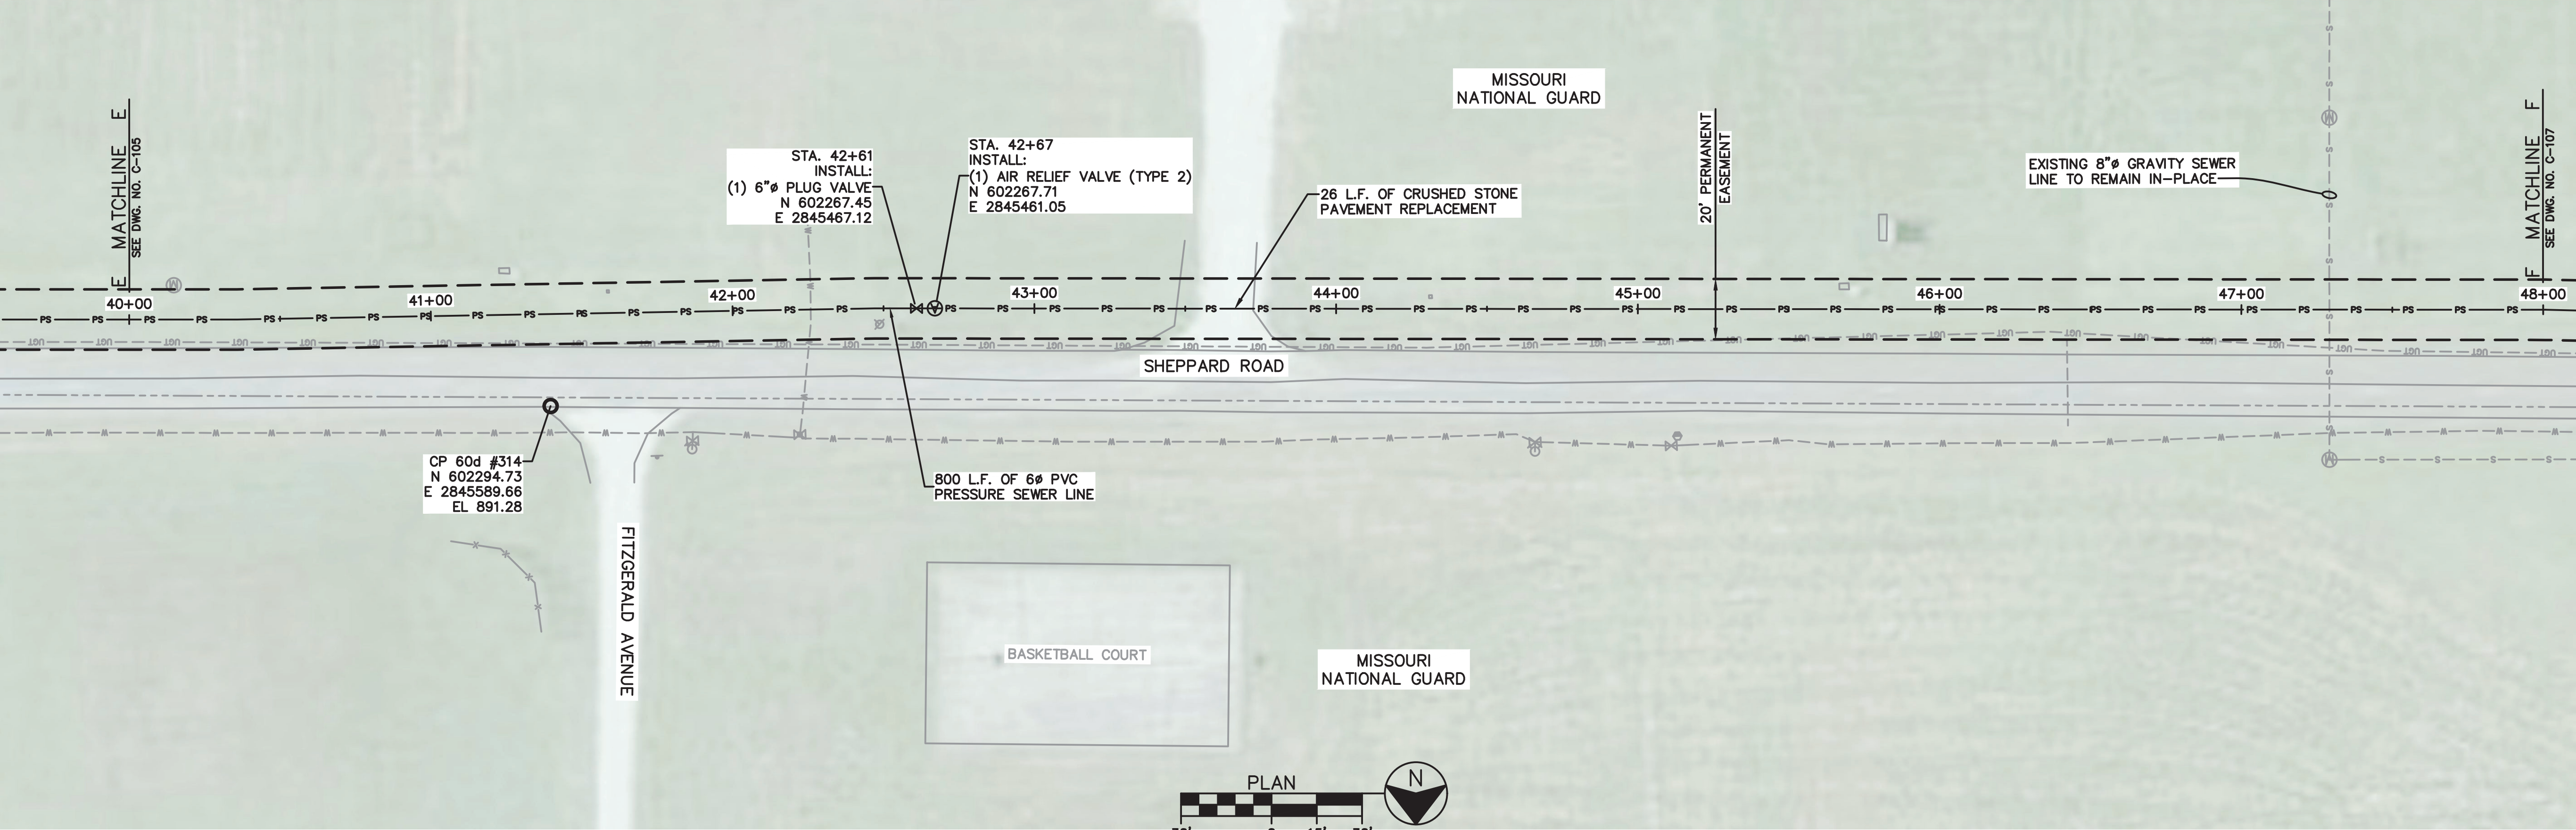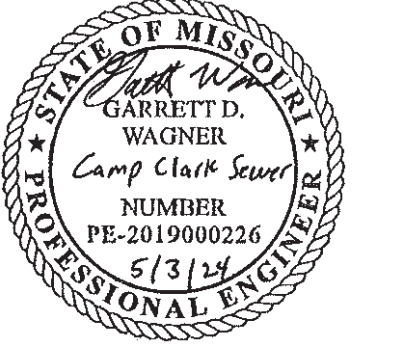

SEE DWG. No. G-002 FOR GENERAL NOTES

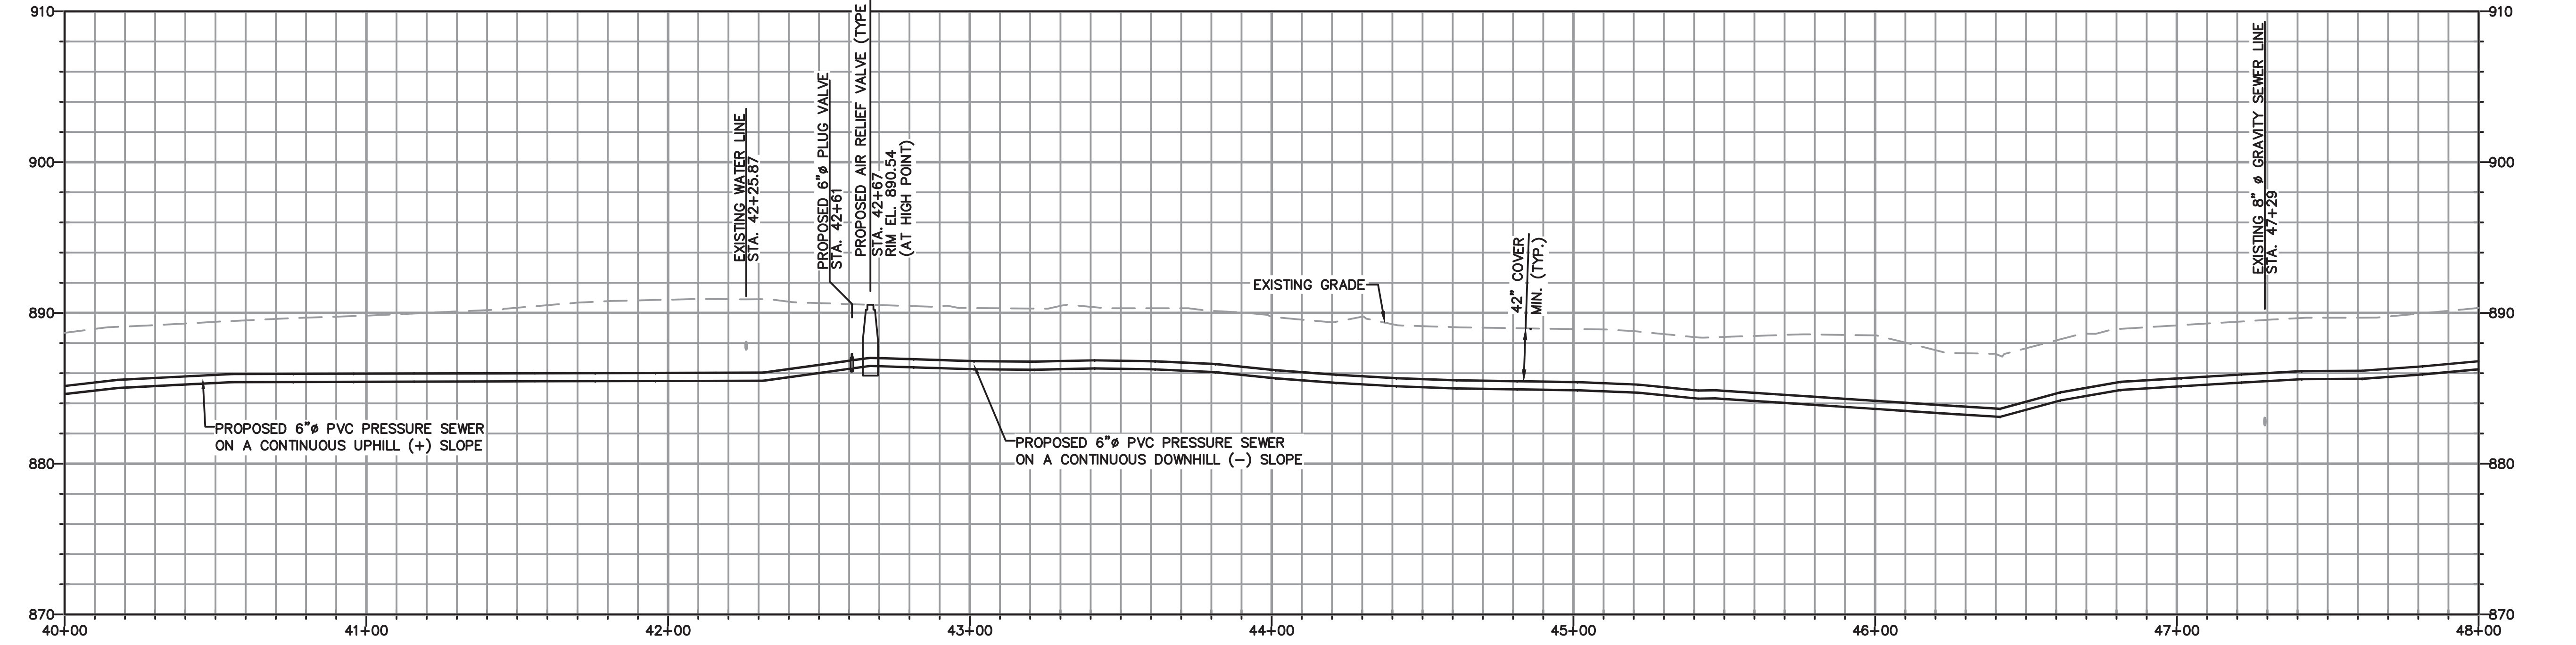

SCALE  
VERT. = 1:6  
HORIZ. = 1:30

OFFICE OF ADMINISTRATION  
DIVISION OF FACILITIES  
MANAGEMENT,  
DESIGN AND CONSTRUCTION

MISSOURI  
NATIONAL GUARD

CONNECT CAMP CLARK  
TO CITY OF NEVADA  
SEWER SYSTEM

CAMP CLARK

NEVADA, MISSOURI

PROJECT # T2301-02  
SITE # 6274  
ASSET # 8136274075

REVISION: REMOVE TEMP EASEMENT  
DATE: 05-03-2024  
REVISION: \_\_\_\_\_  
DATE: \_\_\_\_\_  
REVISION: \_\_\_\_\_  
DATE: \_\_\_\_\_  
ISSUE DATE: 06/14/2024

CAD DWG FILE: \_\_\_\_\_  
DRAWN BY: AWW  
CHECKED BY: SCW  
DESIGNED BY: GDW

SHEET TITLE:  
**PRESSURE SEWER  
PLAN & PROFILE**

SHEET NUMBER:

**C-106**

8 OF 23 SHEETS


LEGEND			
---	EXISTING UNDERGROUND ELECTRIC	---x---x---	PROPOSED FENCE
---x---x---	EXISTING FENCE	---s---s---	PROPOSED GRAVITY SEWER
---F/O---	EXISTING FIBER OPTIC	---ps---ps---	PROPOSED PRESSURE SEWER
---GAS---	EXISTING GAS	---	PROPOSED TEMPORARY EASEMENT
---	EXISTING SEWER	---	PROPOSED PERMANENT EASEMENT
---UT---	EXISTING UNDERGROUND TELEPHONE	---	EXISTING MINOR CONTOURS
---	EXISTING RIGHT OF WAY	951	EXISTING MAJOR CONTOURS
---	EXISTING SECTION LINE	951	PROPOSED MINOR CONTOURS
---	EXISTING WATERLINE		
---		950	PROPOSED MAJOR CONTOURS
---		⊙	EXISTING CLEANOUT
---		⊙	CONTROL POINT
---		⊙	EXISTING FIRE HYDRANT
---		⊙	EXISTING GAS METER
---		⊙	EXISTING GAS VALVE
---		⊙	EXISTING IRON PIN
---		⊙	EXISTING MAILBOX
---		⊙	EXISTING MANHOLE
---		⊙	EXISTING PIPE POST
---		⊙	EXISTING LIGHT POLE
---		⊙	EXISTING POWER POLE
---		⊙	EXISTING RW MARKER
---		⊙	EXISTING SIGN
---		⊙	EXISTING TELEPEDESTAL
---		⊙	EXISTING TREE
---		⊙	EXISTING SHRUB
---		⊙	EXISTING WATER METER
---		⊙	EXISTING WATER VALVE
---		⊙	EXISTING WATER HYDRANT
---		⊙	PROPOSED MANHOLE
---		⊙	PROPOSED AIR RELEASE VALVE

**PRESSURE SEWER NOTES:**

- NO. 12 COATED COPPER DETECTION WIRE SHALL BE RUN IN TRENCH FOR ENTIRE LENGTH OF INSTALLED PRESSURE SEWER MAIN, PER DETAILS AND SPECIFICATIONS.
- PRESSURE SEWER LINE SHALL BE INSTALLED WITH A MINIMUM OF 42" OF COVER OVER TOP OF PIPE.

STATE OF MISSOURI  
MICHAEL L. PARSON,  
GOVERNOR

CIVIL ENGINEER: GARRETT D. WAGNER  
LICENSE NO. PE-2019000226

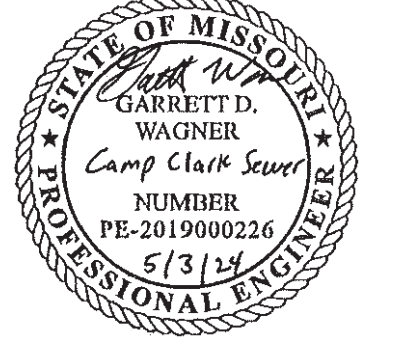

OFFICE OF ADMINISTRATION  
DIVISION OF FACILITIES  
MANAGEMENT,  
DESIGN AND CONSTRUCTION

MISSOURI  
NATIONAL GUARD

CONNECT CAMP CLARK  
TO CITY OF NEVADA  
SEWER SYSTEM

CAMP CLARK

NEVADA, MISSOURI

PROJECT # T2301-02  
SITE # 6274  
ASSET # 8136274075

REVISION: REMOVE TEMP EASEMENT  
DATE: 05-03-2024  
REVISION: \_\_\_\_\_  
DATE: \_\_\_\_\_  
REVISION: \_\_\_\_\_  
DATE: \_\_\_\_\_  
ISSUE DATE: 06/14/2024


CAD DWG FILE: \_\_\_\_\_  
DRAWN BY: AWW  
CHECKED BY: SCW  
DESIGNED BY: GDW

SHEET TITLE:  
**PRESSURE SEWER  
PLAN & PROFILE**


SHEET NUMBER:

**C-107**


9 OF 23 SHEETS

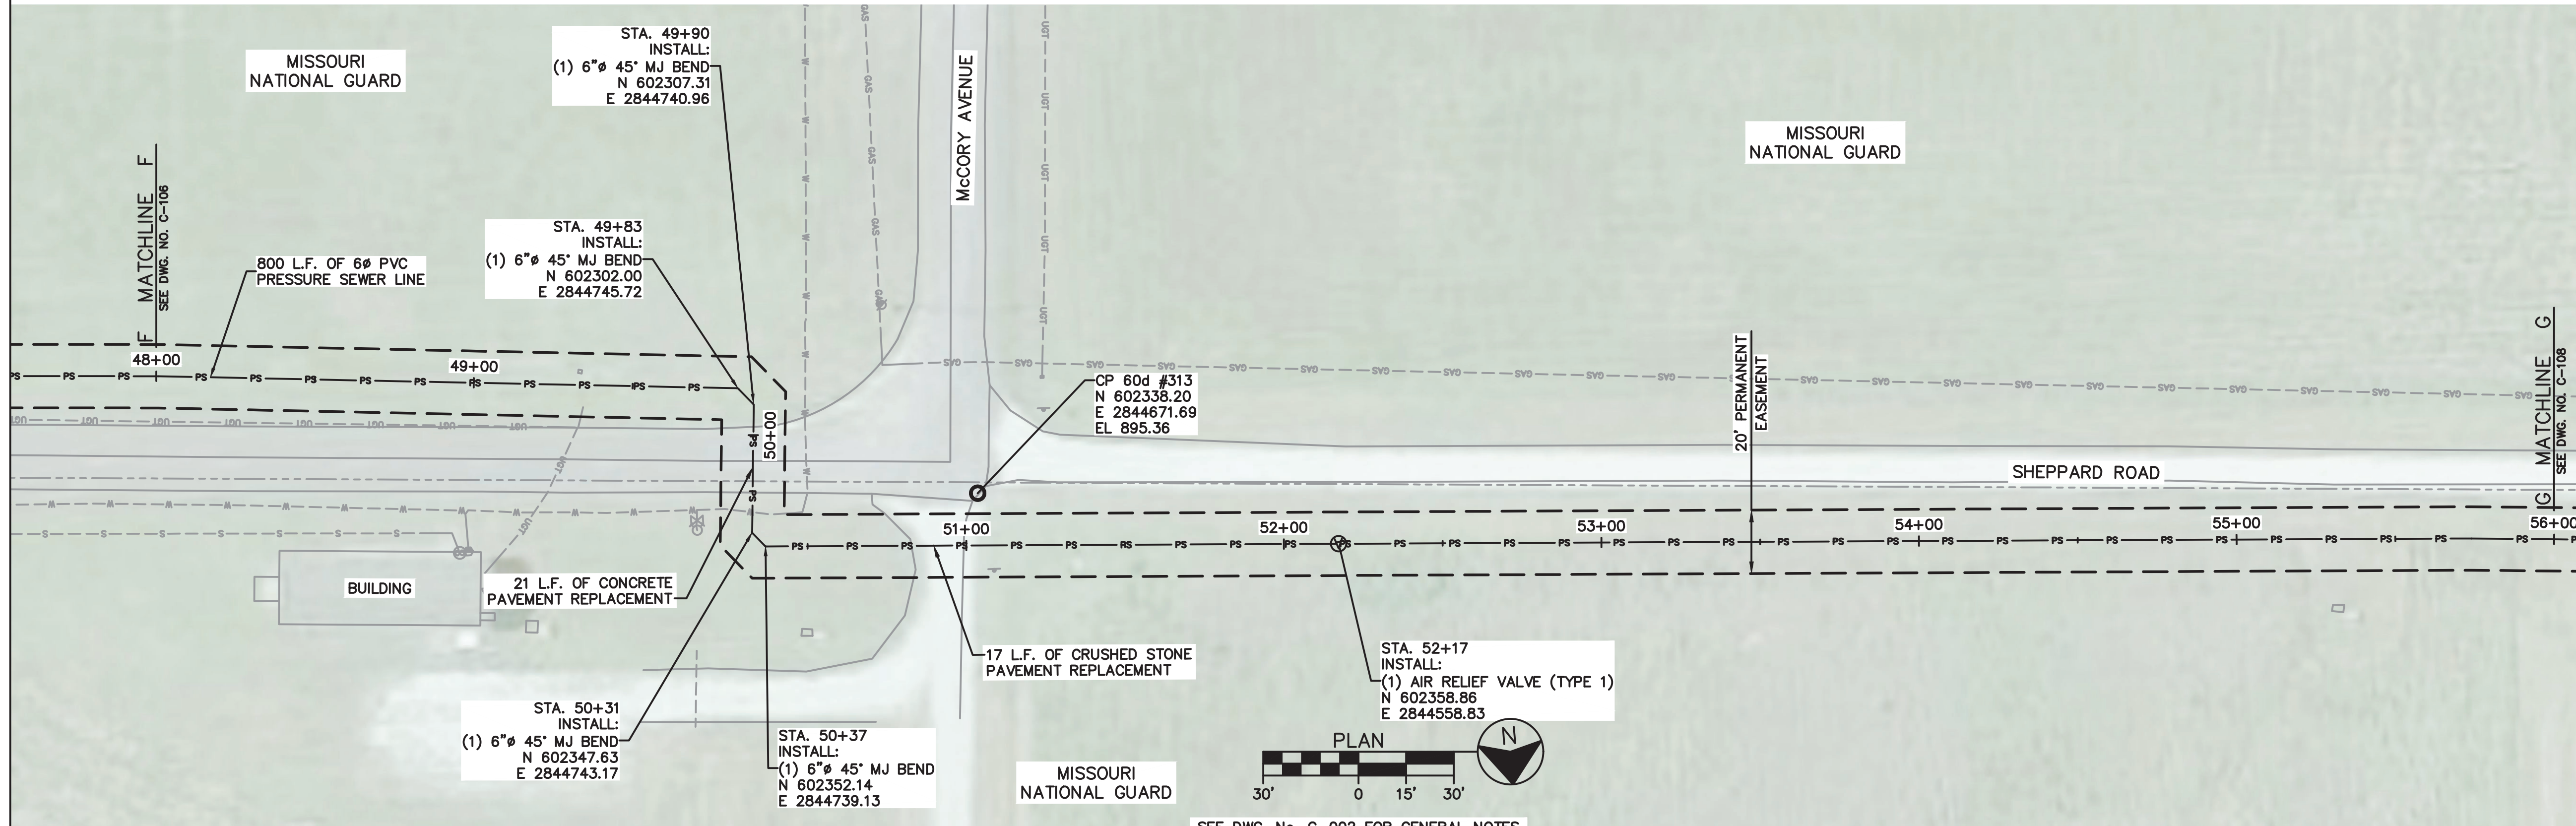

SEE DWG. No. G-002 FOR GENERAL NOTES

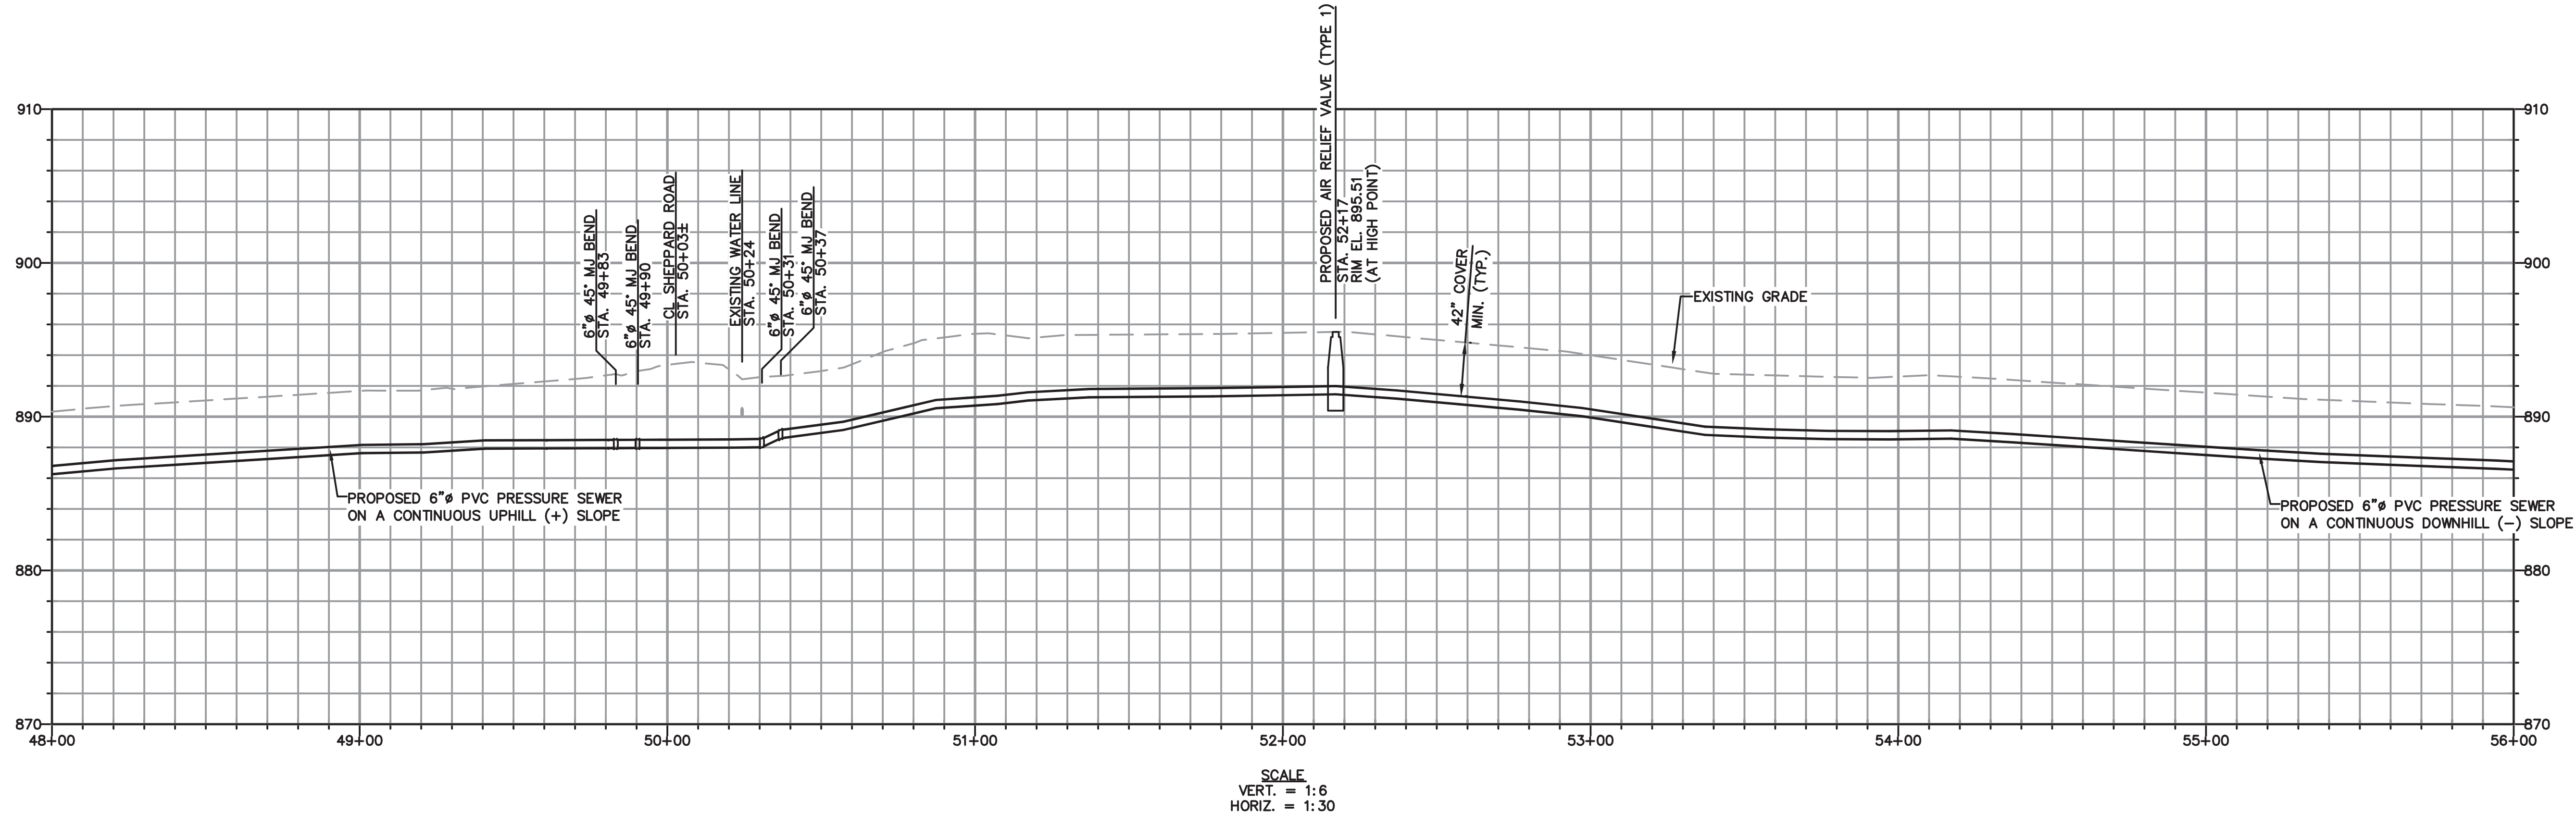

SCALE  
VERT. = 1:6  
HORIZ. = 1:30

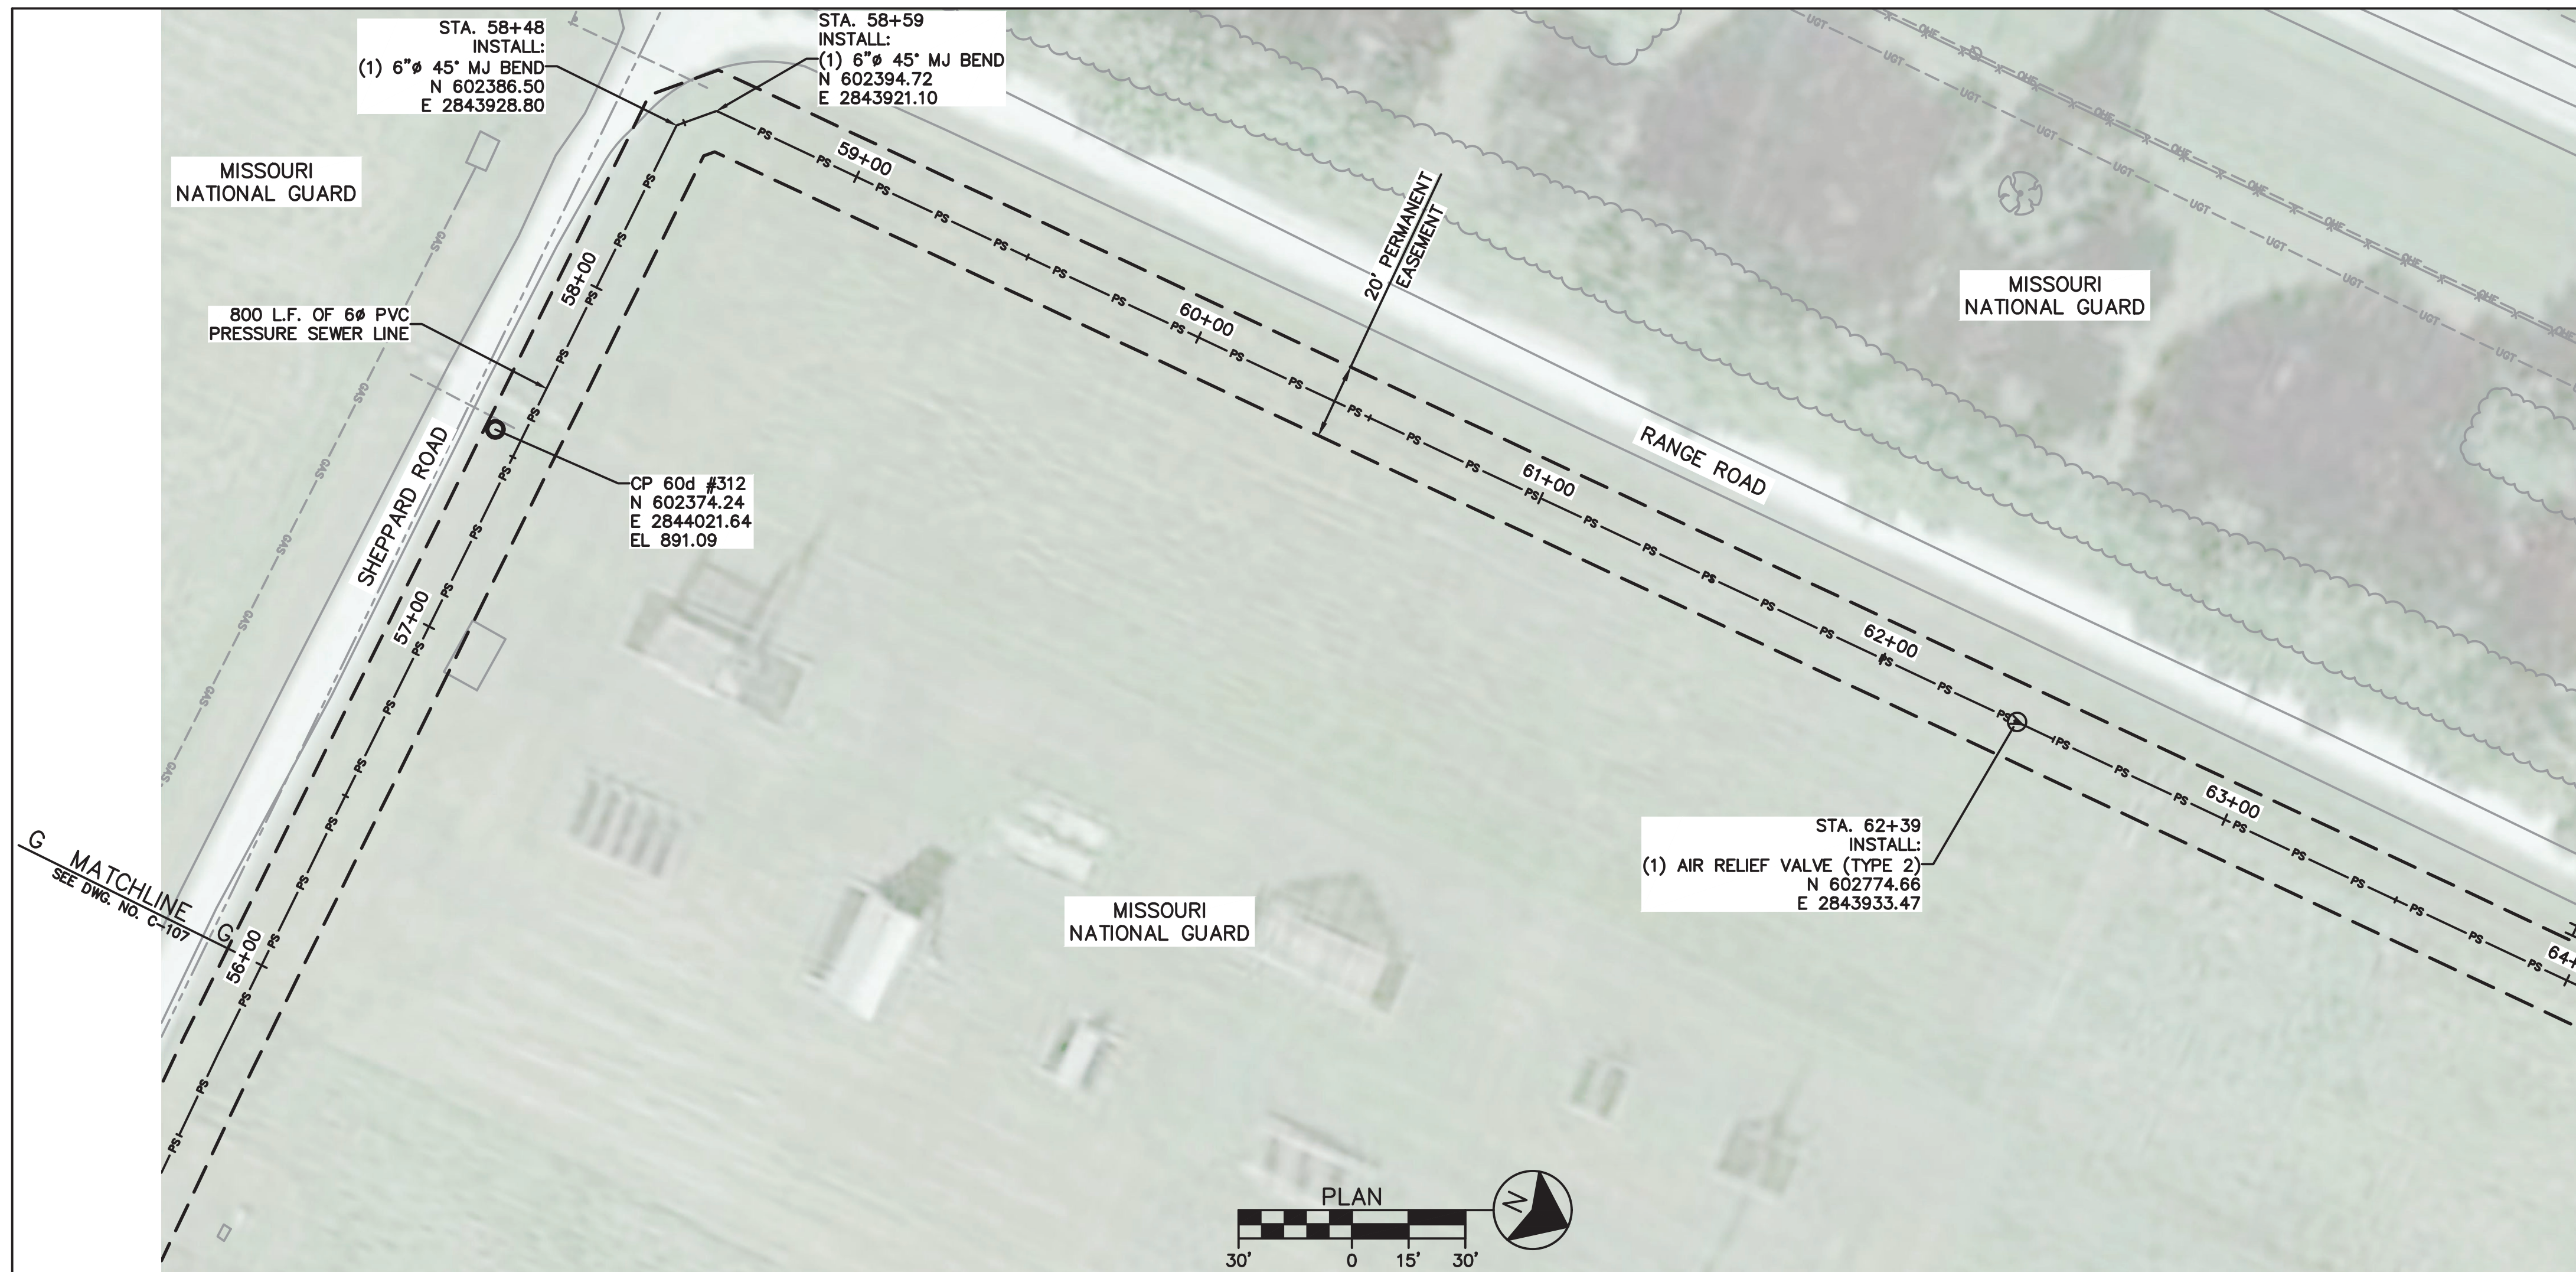

SEE DWG. No. G-002 FOR GENERAL NOTES

**PRESSURE SEWER NOTES:**


- NO. 12 COATED COPPER DETECTION WIRE SHALL BE RUN IN TRENCH FOR ENTIRE LENGTH OF INSTALLED PRESSURE SEWER MAIN, PER DETAILS AND SPECIFICATIONS.
- PRESSURE SEWER LINE SHALL BE INSTALLED WITH A MINIMUM OF 42" OF COVER OVER TOP OF PIPE.

**LEGEND**

---	EXISTING UNDERGROUND ELECTRIC	⊙	EXISTING FIRE HYDRANT
-x-x-	EXISTING FENCE	▲	EXISTING GAS METER
-F/O-	EXISTING FIBER OPTIC	•	EXISTING GAS VALVE
-GAS-	EXISTING GAS	○	EXISTING IRON PIN
-S-S-	EXISTING SEWER	⊞	EXISTING MAILBOX
-UOT-	EXISTING UNDERGROUND TELEPHONE	Ⓜ	EXISTING MANHOLE
- - -	EXISTING RIGHT OF WAY	○	EXISTING PIPE POST
- - - -	EXISTING SECTION LINE	⊗	EXISTING LIGHT POLE
-W-W-	EXISTING WATERLINE	⊗	EXISTING POWER POLE
-x-x-	PROPOSED FENCE	△	EXISTING RW MARKER
-S-S-	PROPOSED GRAVITY SEWER	+	EXISTING SIGN
-PS-PS-	PROPOSED PRESSURE SEWER	Ⓜ	EXISTING TELEPEDESTAL
- - - -	PROPOSED TEMPORARY EASEMENT	⊗	EXISTING TREE
- - - -	PROPOSED PERMANENT EASEMENT	⊗	EXISTING SHRUB
951	EXISTING MINOR CONTOURS	⊗	EXISTING WATER METER
950	EXISTING MAJOR CONTOURS	⊗	EXISTING WATER VALVE
951	PROPOSED MINOR CONTOURS	⊗	EXISTING WATER HYDRANT
950	PROPOSED MAJOR CONTOURS	Ⓜ	PROPOSED MANHOLE
⊗	EXISTING CLEANOUT	⊗	PROPOSED AIR RELEASE VALVE
○	CONTROL POINT		

STATE OF MISSOURI  
MICHAEL L. PARSON,  
GOVERNOR

CIVIL ENGINEER: GARRETT D. WAGNER  
LICENSE NO. PE-2019000226

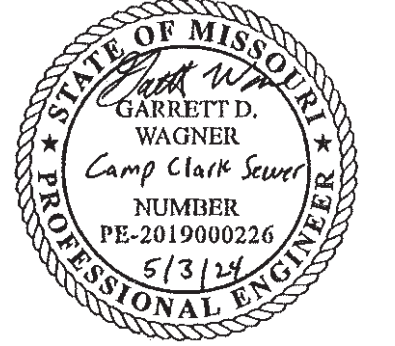

OFFICE OF ADMINISTRATION  
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MANAGEMENT,  
DESIGN AND CONSTRUCTION

MISSOURI  
NATIONAL GUARD

CONNECT CAMP CLARK  
TO CITY OF NEVADA  
SEWER SYSTEM

CAMP CLARK

NEVADA, MISSOURI

PROJECT # T2301-02  
SITE # 6274  
ASSET # 8136274075

REVISION: REMOVE TEMP EASEMENT  
DATE: 05-03-2024  
REVISION: \_\_\_\_\_  
DATE: \_\_\_\_\_  
REVISION: \_\_\_\_\_  
DATE: \_\_\_\_\_  
ISSUE DATE: 06/14/2024


CAD DWG FILE: \_\_\_\_\_  
DRAWN BY: AWW  
CHECKED BY: SCW  
DESIGNED BY: GDW

SHEET TITLE:  
**PRESSURE SEWER  
PLAN & PROFILE**


SHEET NUMBER:

**C-108**

10 OF 23 SHEETS

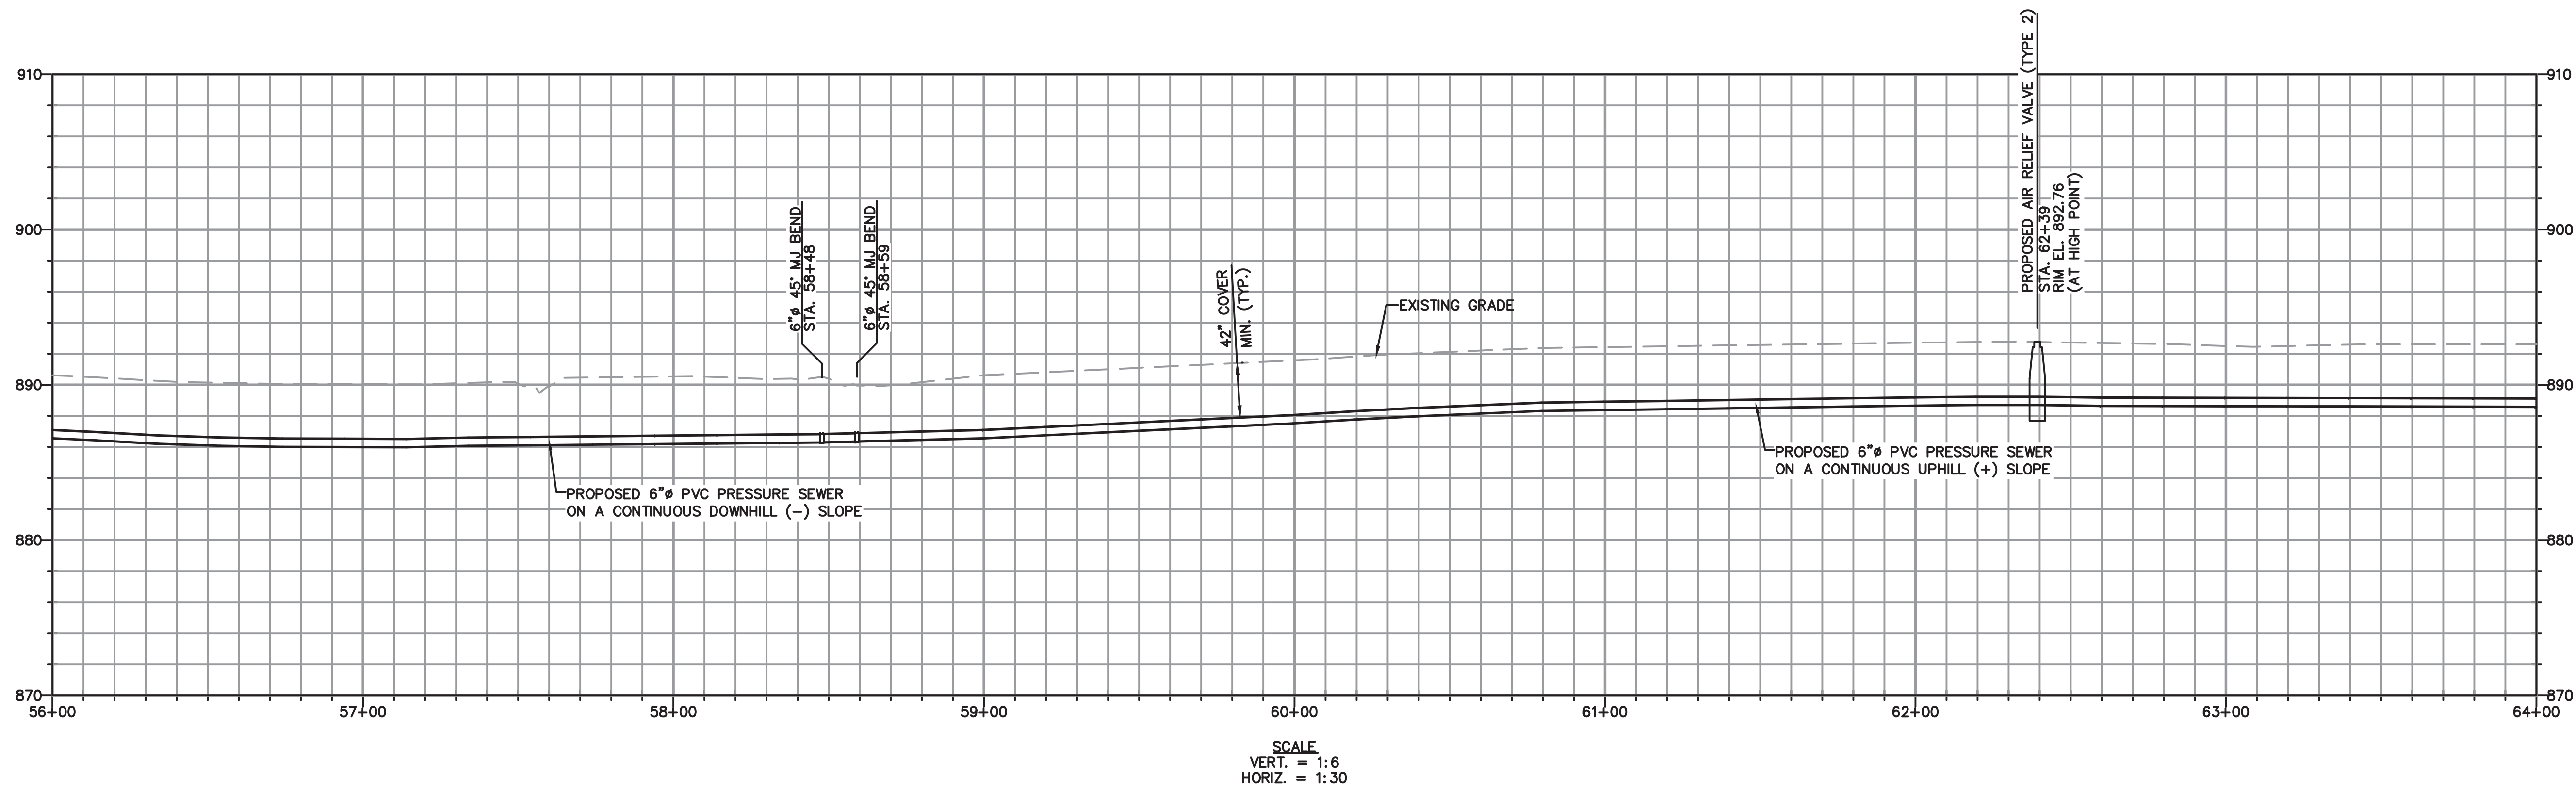

SCALE  
VERT. = 1:6  
HORIZ. = 1:30

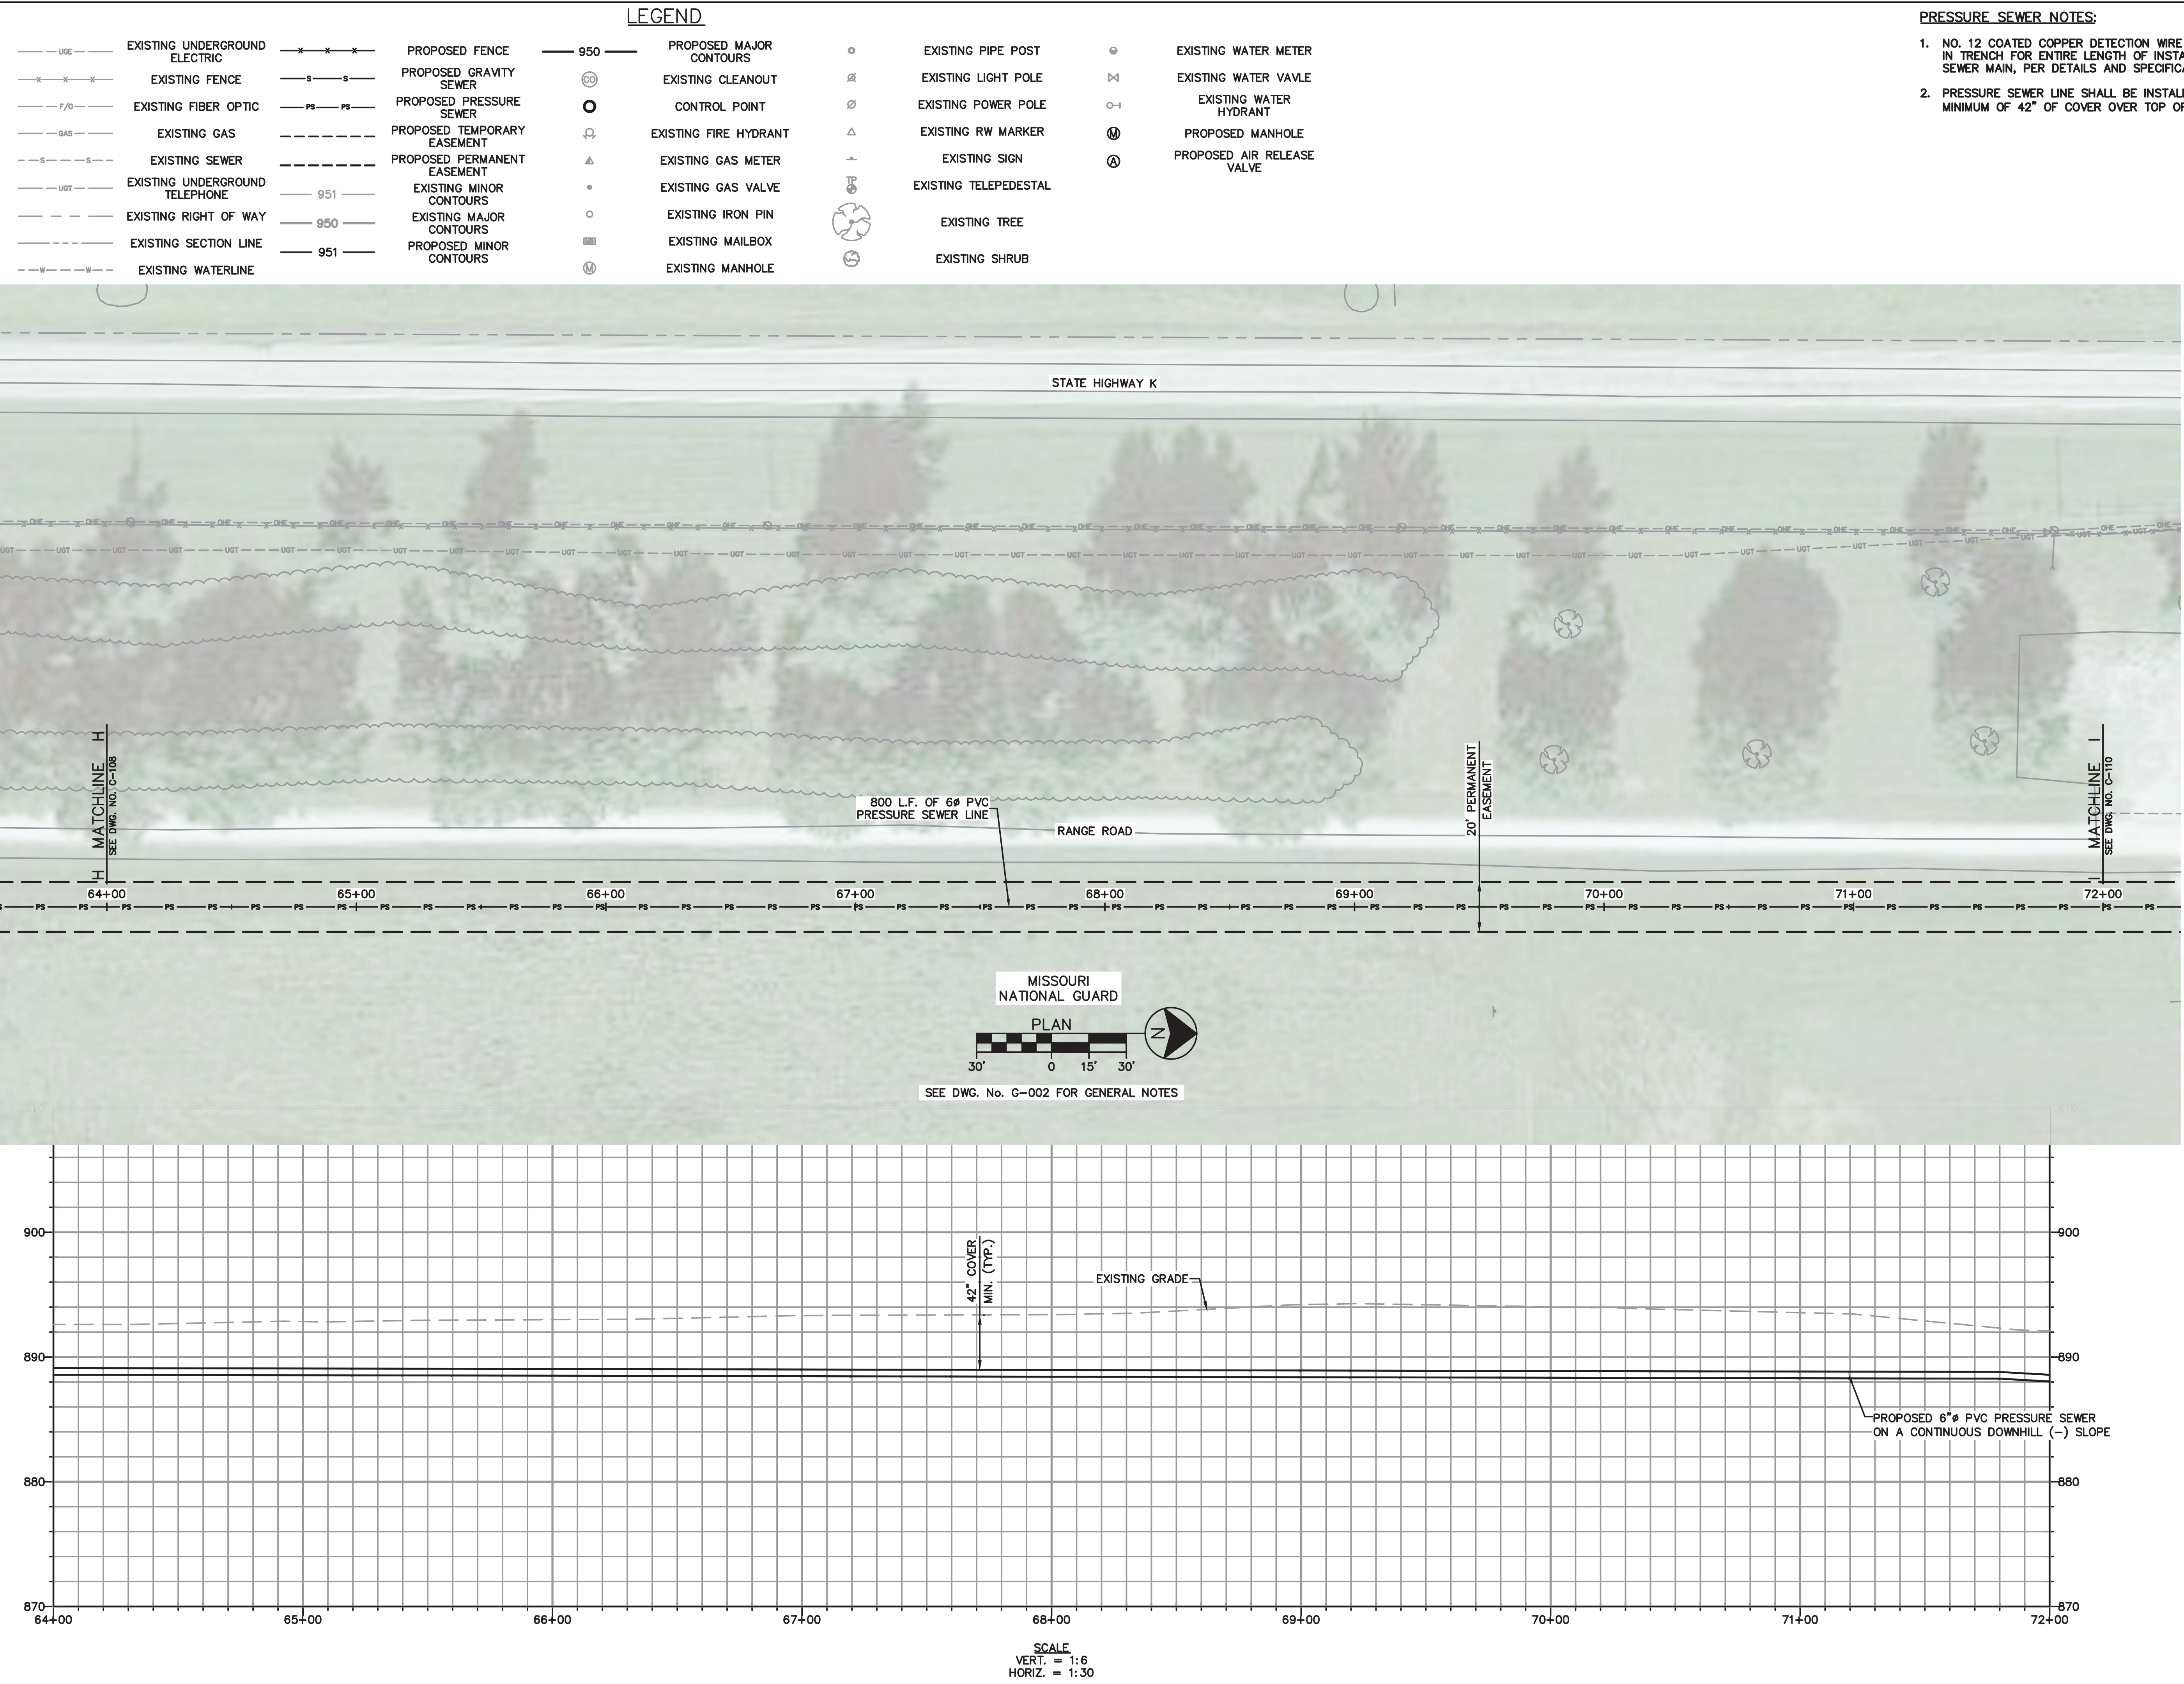

**LEGEND**


--- UGE ---	EXISTING UNDERGROUND ELECTRIC	--- x-x-x ---	PROPOSED FENCE	--- 950 ---	PROPOSED MAJOR CONTOURS	○	EXISTING PIPE POST	⊙	EXISTING WATER METER
--- x-x-x ---	EXISTING FENCE	--- s-s ---	PROPOSED GRAVITY SEWER	⊙	EXISTING CLEANOUT	⊗	EXISTING LIGHT POLE	⊗	EXISTING WATER VALVE
--- F/O ---	EXISTING FIBER OPTIC	--- ps-ps ---	PROPOSED PRESSURE SEWER	○	CONTROL POINT	⊗	EXISTING POWER POLE	⊗	EXISTING WATER HYDRANT
--- GAS ---	EXISTING GAS	---	PROPOSED TEMPORARY EASEMENT	⊗	EXISTING FIRE HYDRANT	△	EXISTING RW MARKER	⊗	PROPOSED MANHOLE
--- S ---	EXISTING SEWER	---	PROPOSED PERMANENT EASEMENT	△	EXISTING GAS METER	+	EXISTING SIGN	⊗	PROPOSED AIR RELEASE VALVE
--- UGT ---	EXISTING UNDERGROUND TELEPHONE	--- 951 ---	EXISTING MINOR CONTOURS	•	EXISTING GAS VALVE	⊗	EXISTING TELEPEDESTAL	⊗	
---	EXISTING RIGHT OF WAY	--- 950 ---	EXISTING MAJOR CONTOURS	○	EXISTING IRON PIN	♻️	EXISTING TREE		
---	EXISTING SECTION LINE	--- 951 ---	PROPOSED MINOR CONTOURS	⊗	EXISTING MAILBOX	♻️	EXISTING SHRUB		
--- W ---	EXISTING WATERLINE			⊗	EXISTING MANHOLE				

**PRESSURE SEWER NOTES:**

- NO. 12 COATED COPPER DETECTION WIRE SHALL BE RUN IN TRENCH FOR ENTIRE LENGTH OF INSTALLED PRESSURE SEWER MAIN, PER DETAILS AND SPECIFICATIONS.
- PRESSURE SEWER LINE SHALL BE INSTALLED WITH A MINIMUM OF 42" OF COVER OVER TOP OF PIPE.

STATE OF MISSOURI  
MICHAEL L. PARSON,  
GOVERNOR

CIVIL ENGINEER: GARRETT D. WAGNER  
LICENSE NO. PE-2019000226

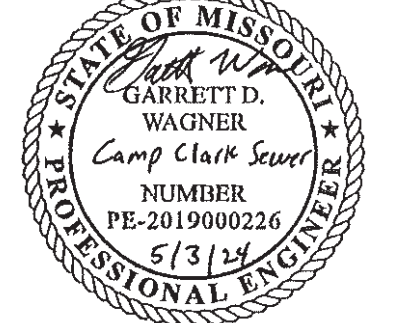

OFFICE OF ADMINISTRATION  
DIVISION OF FACILITIES  
MANAGEMENT,  
DESIGN AND CONSTRUCTION

MISSOURI  
NATIONAL GUARD

CONNECT CAMP CLARK  
TO CITY OF NEVADA  
SEWER SYSTEM

CAMP CLARK

NEVADA, MISSOURI

PROJECT # T2301-02  
SITE # 6274  
ASSET # 8136274075

REVISION: REMOVE TEMP EASEMENT  
DATE: 05-03-2024  
REVISION: \_\_\_\_\_  
DATE: \_\_\_\_\_  
REVISION: \_\_\_\_\_  
DATE: \_\_\_\_\_  
ISSUE DATE: 06/14/2024


CAD DWG FILE: \_\_\_\_\_  
DRAWN BY: AWW  
CHECKED BY: SCW  
DESIGNED BY: GDW

SHEET TITLE:  
**PRESSURE SEWER  
PLAN & PROFILE**

SHEET NUMBER:

**C-109**

11 OF 23 SHEETS

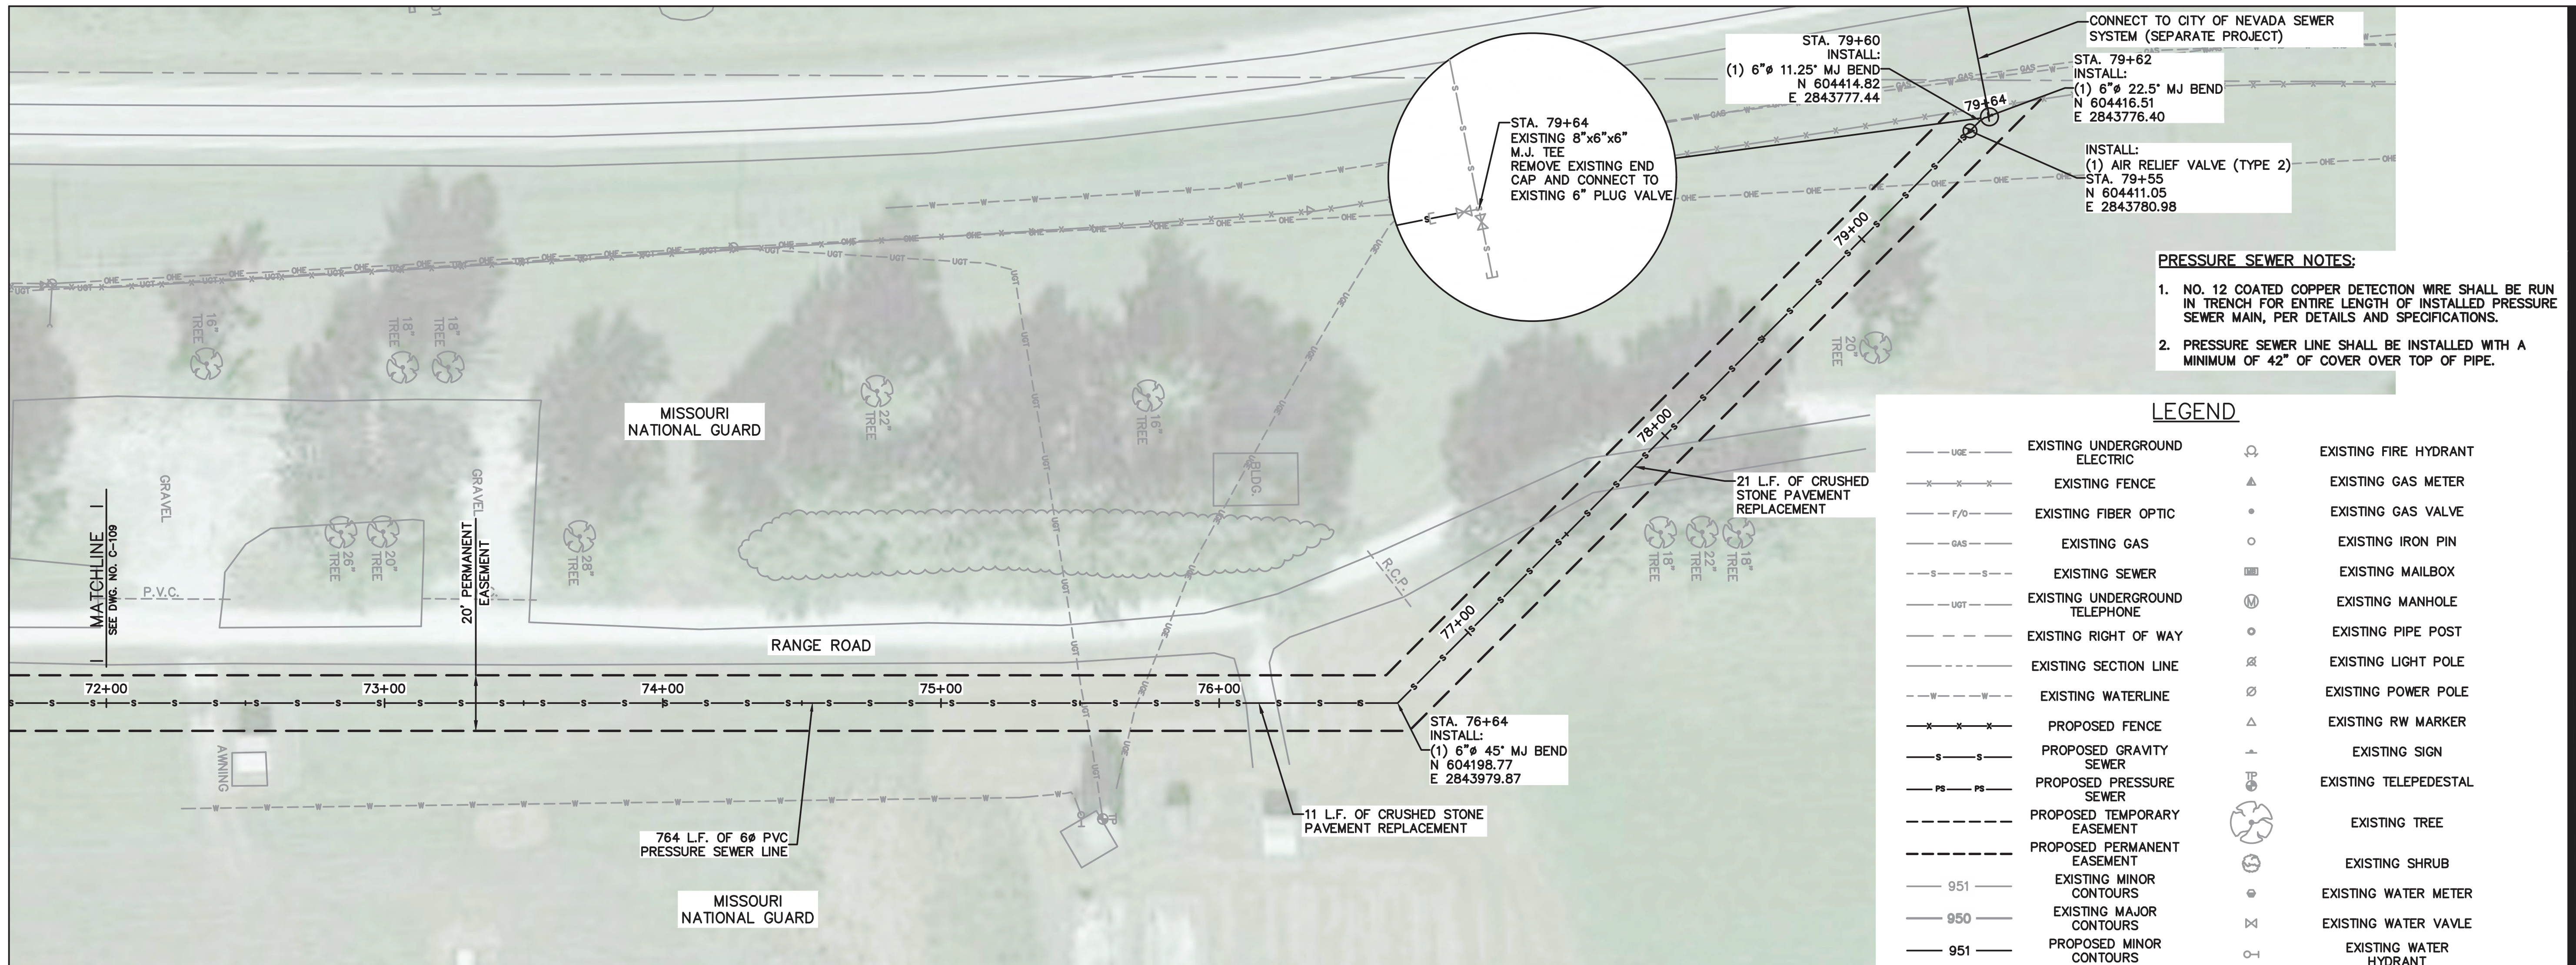


**PRESSURE SEWER NOTES:**


- NO. 12 COATED COPPER DETECTION WIRE SHALL BE RUN IN TRENCH FOR ENTIRE LENGTH OF INSTALLED PRESSURE SEWER MAIN, PER DETAILS AND SPECIFICATIONS.
- PRESSURE SEWER LINE SHALL BE INSTALLED WITH A MINIMUM OF 42" OF COVER OVER TOP OF PIPE.

**LEGEND**

---	EXISTING UNDERGROUND ELECTRIC	⊙	EXISTING FIRE HYDRANT
-x-x-	EXISTING FENCE	▲	EXISTING GAS METER
-F/O-	EXISTING FIBER OPTIC	•	EXISTING GAS VALVE
-GAS-	EXISTING GAS	○	EXISTING IRON PIN
-S-S-	EXISTING SEWER	⊞	EXISTING MAILBOX
-UOT-	EXISTING UNDERGROUND TELEPHONE	⊕	EXISTING MANHOLE
- - -	EXISTING RIGHT OF WAY	○	EXISTING PIPE POST
- - -	EXISTING SECTION LINE	⊞	EXISTING LIGHT POLE
-W-W-	EXISTING WATERLINE	⊞	EXISTING POWER POLE
-x-x-	PROPOSED FENCE	▲	EXISTING RW MARKER
-S-S-	PROPOSED GRAVITY SEWER	+	EXISTING SIGN
-PS-PS-	PROPOSED PRESSURE SEWER	⊞	EXISTING TELEPEDESTAL
- - -	PROPOSED TEMPORARY EASEMENT	⊞	EXISTING TREE
- - -	PROPOSED PERMANENT EASEMENT	⊞	EXISTING SHRUB
951	EXISTING MINOR CONTOURS	⊞	EXISTING WATER METER
950	EXISTING MAJOR CONTOURS	⊞	EXISTING WATER VALVE
951	PROPOSED MINOR CONTOURS	⊞	EXISTING WATER HYDRANT
950	PROPOSED MAJOR CONTOURS	⊞	PROPOSED MANHOLE
⊞	EXISTING CLEANOUT	⊞	PROPOSED AIR RELEASE VALVE
○	CONTROL POINT		

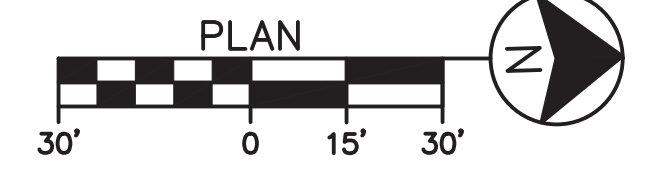


SEE DWG. No. G-002 FOR GENERAL NOTES

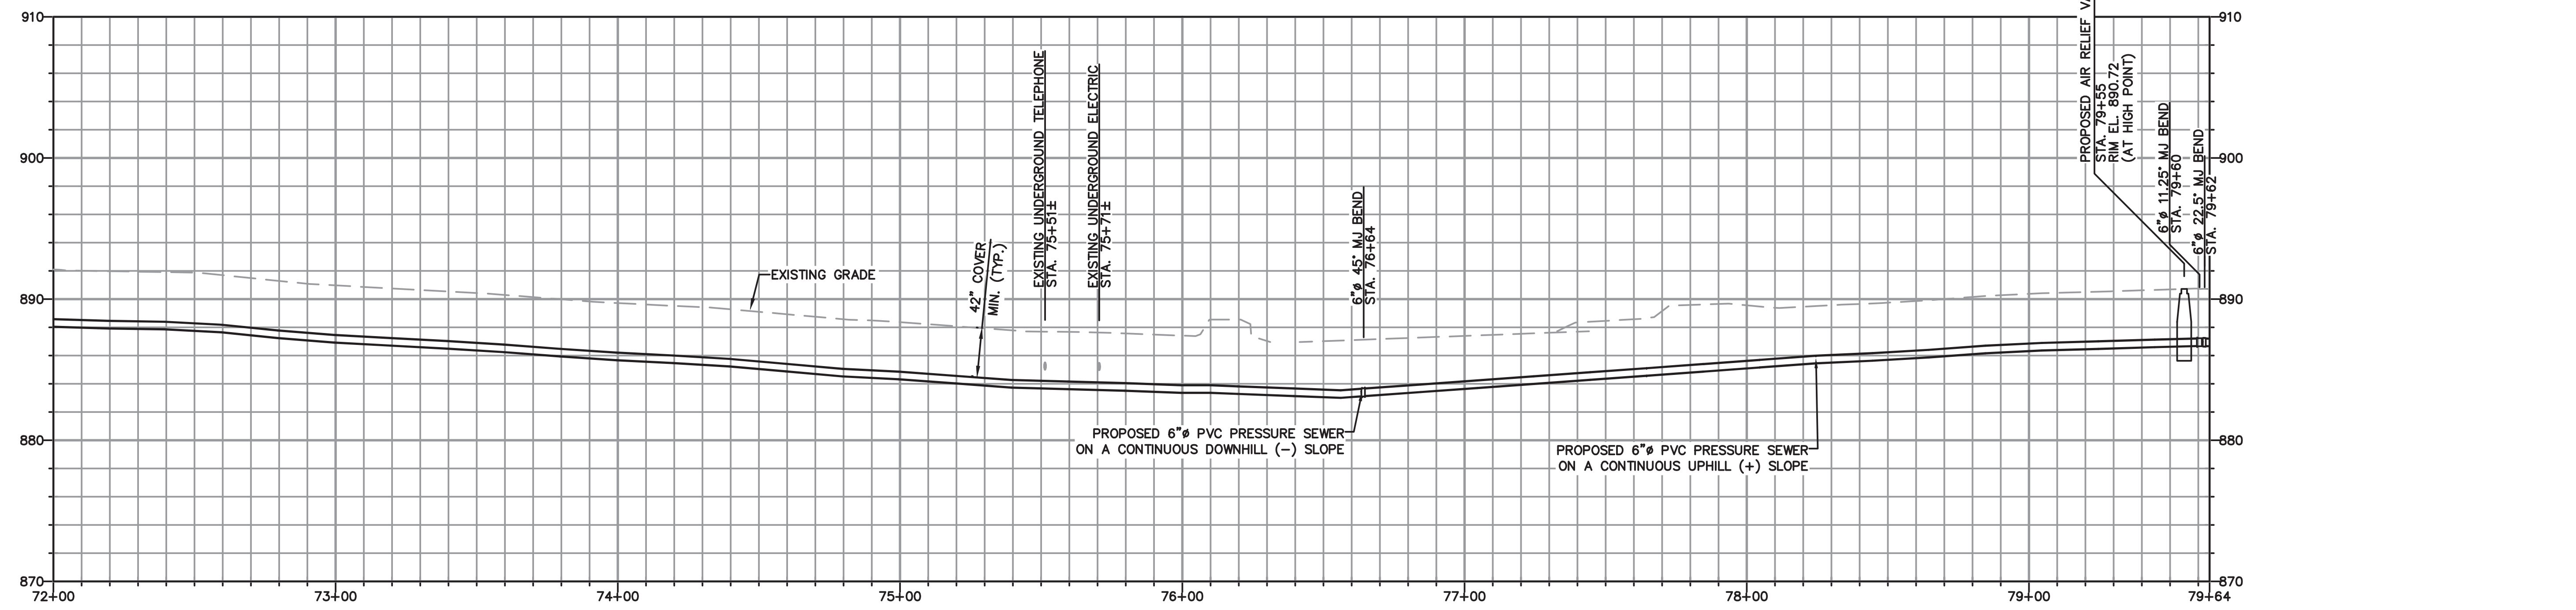

SCALE  
VERT. = 1:6  
HORIZ. = 1:30

STATE OF MISSOURI  
MICHAEL L. PARSON,  
GOVERNOR

CIVIL ENGINEER: GARRETT D. WAGNER  
LICENSE NO. PE-2019000226

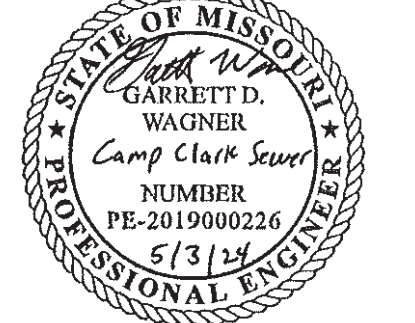

OFFICE OF ADMINISTRATION  
DIVISION OF FACILITIES  
MANAGEMENT,  
DESIGN AND CONSTRUCTION

MISSOURI  
NATIONAL GUARD

CONNECT CAMP CLARK  
TO CITY OF NEVADA  
SEWER SYSTEM

CAMP CLARK

NEVADA, MISSOURI

PROJECT # T2301-02  
SITE # 6274  
ASSET # 8136274075

REVISION: REMOVE TEMP EASEMENT  
DATE: 05-03-2024  
REVISION: \_\_\_\_\_  
DATE: \_\_\_\_\_  
REVISION: \_\_\_\_\_  
DATE: \_\_\_\_\_  
ISSUE DATE: 06/14/2024



CAD DWG FILE: \_\_\_\_\_  
DRAWN BY: AWW  
CHECKED BY: SCW  
DESIGNED BY: GDW

SHEET TITLE:  
**PRESSURE SEWER  
PLAN & PROFILE**


SHEET NUMBER:

**C-110**

12 OF 23 SHEETS

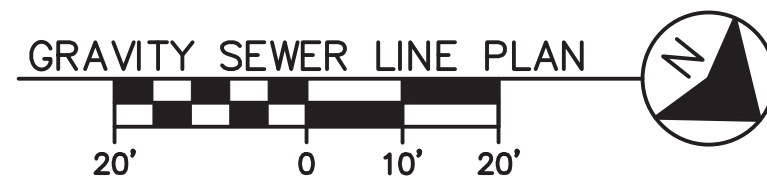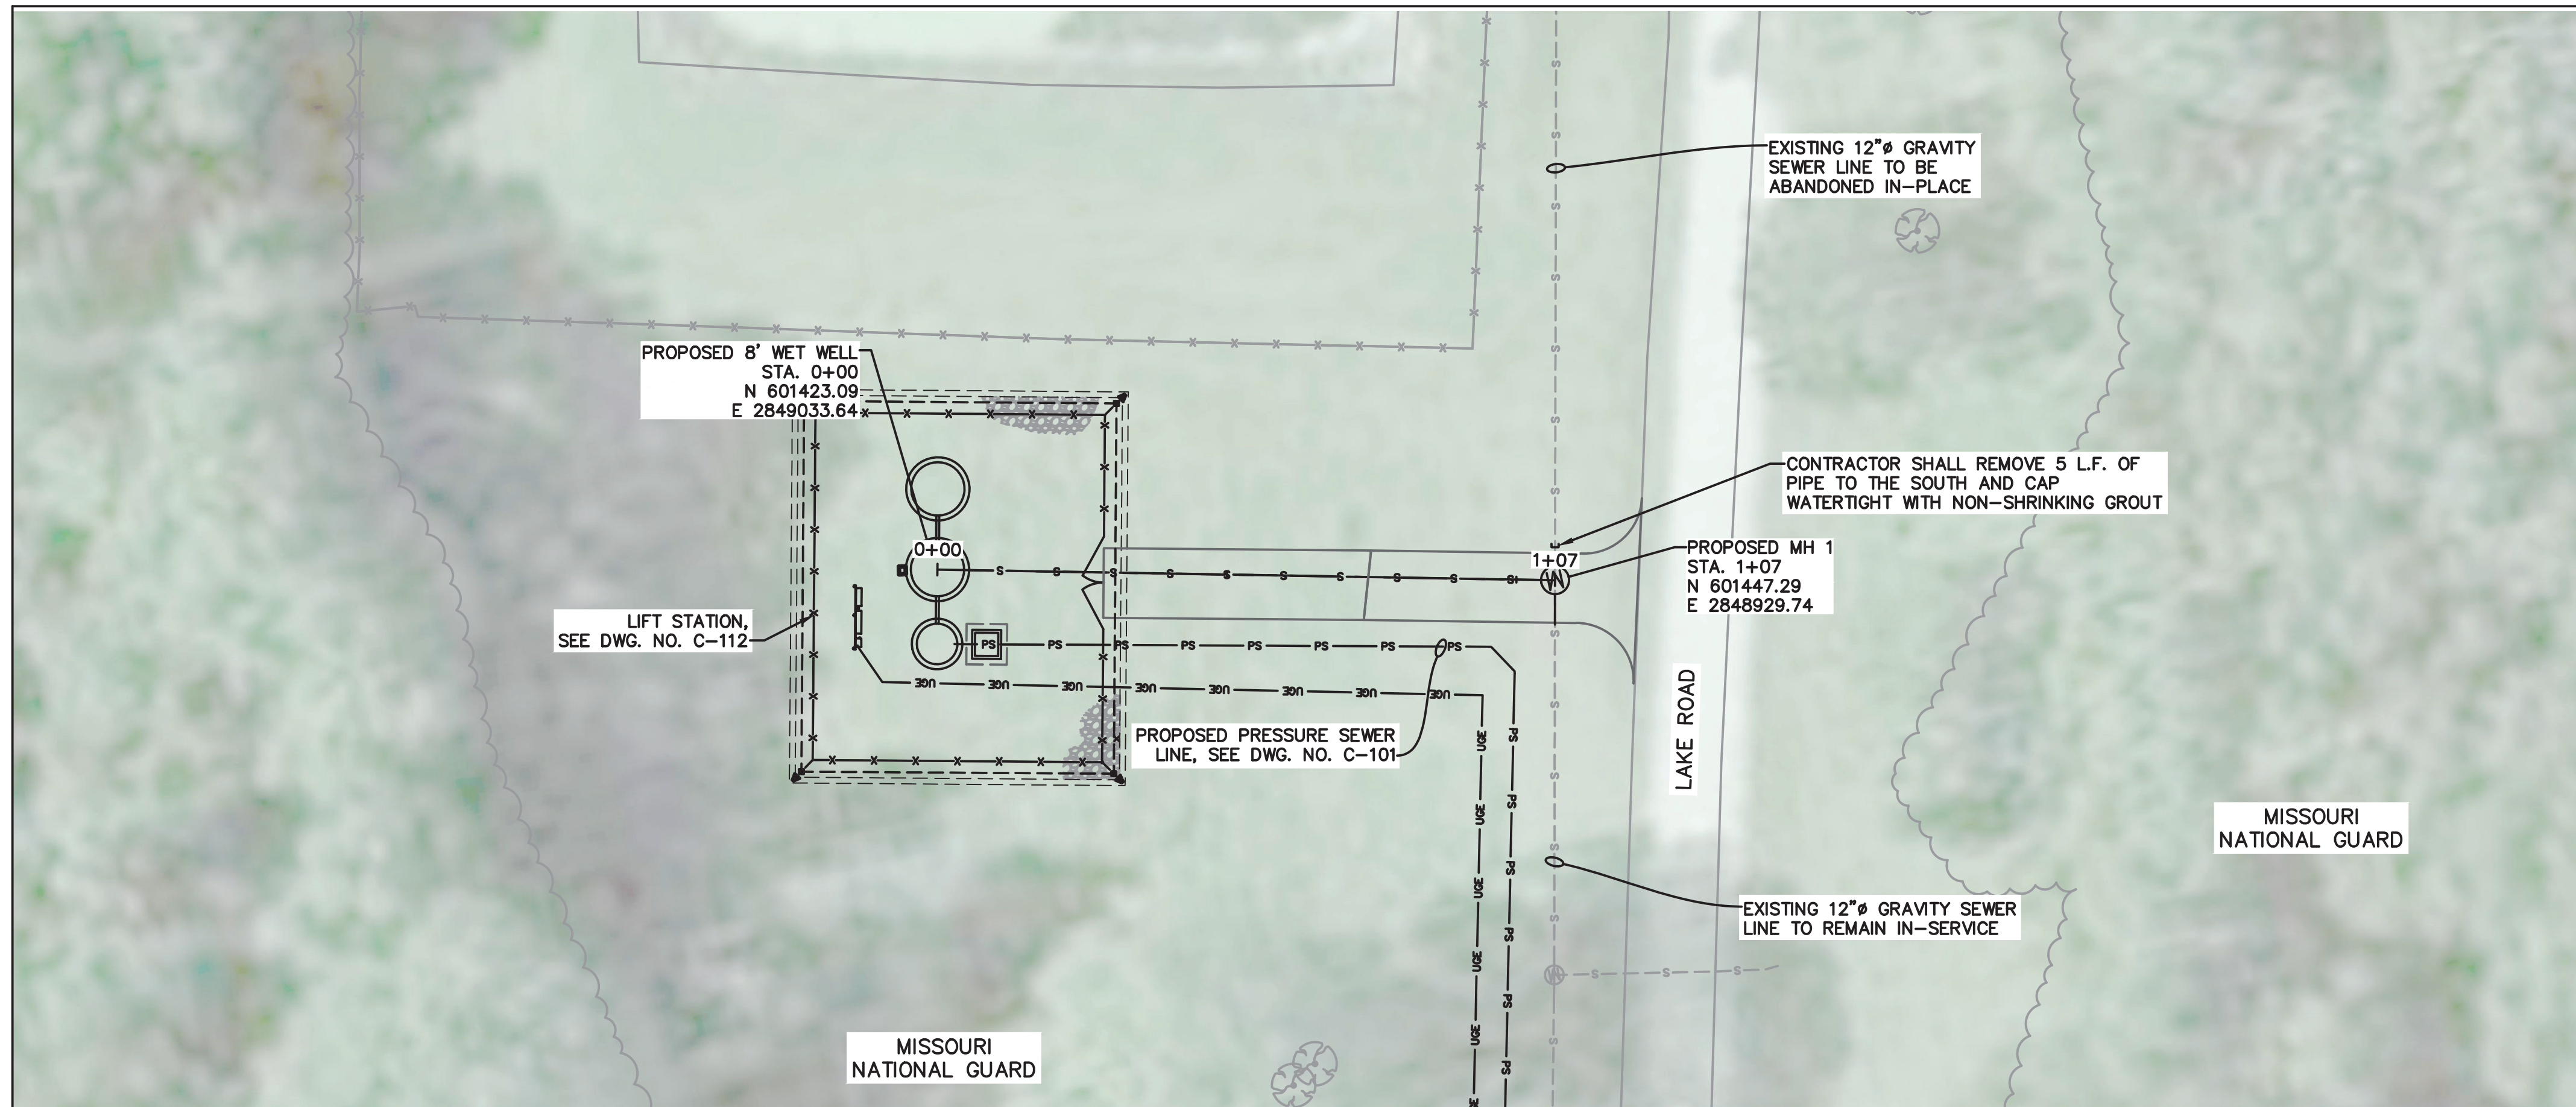

SEE DWG. No. G-002 FOR GENERAL NOTES

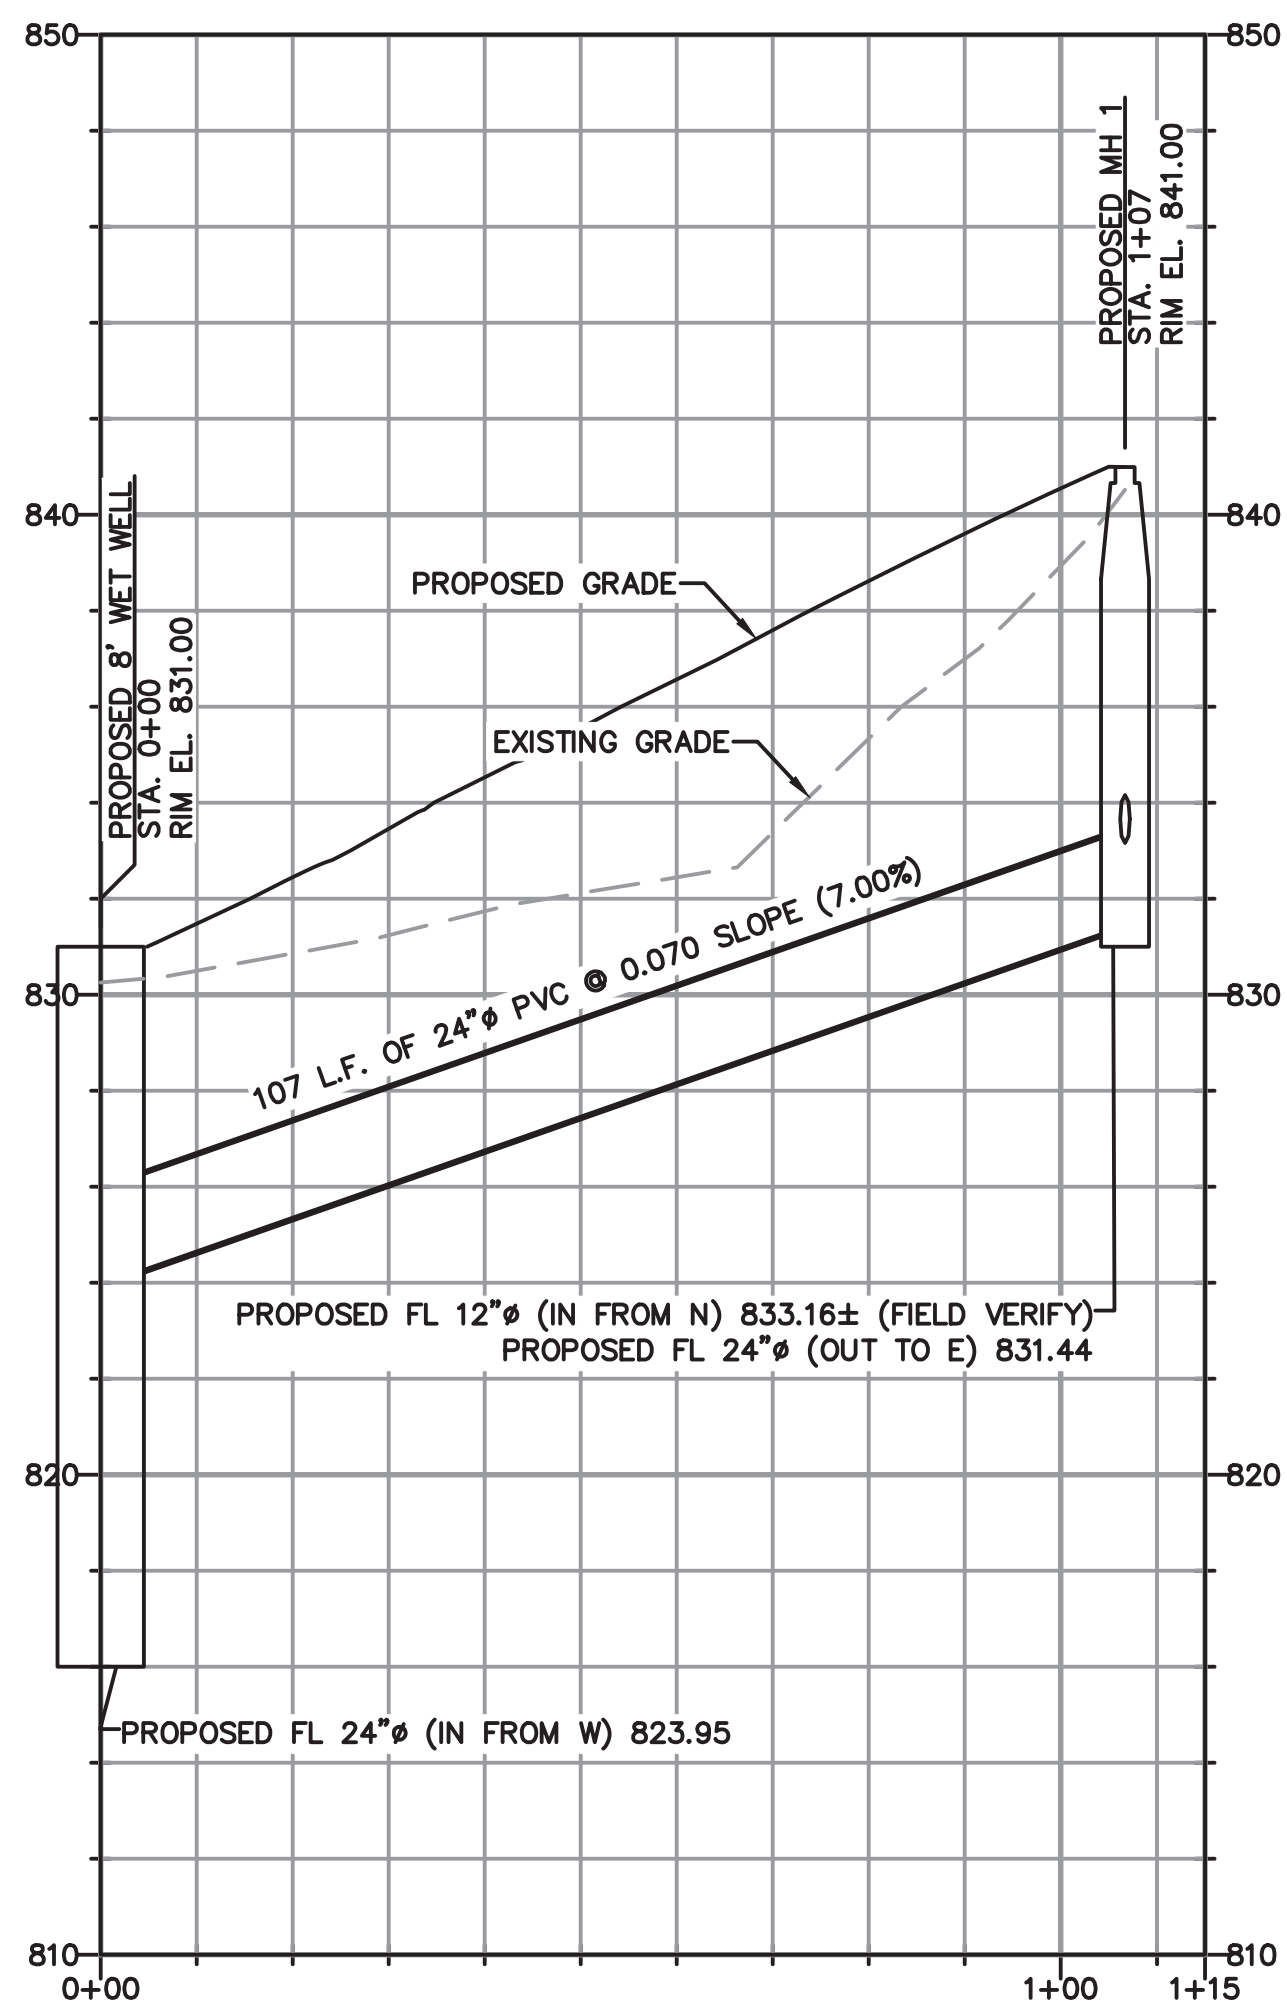

SCALE  
VERT. = 1:6  
HORIZ. = 1:30

**EASEMENT NOTE:**


SANITARY SEWER EASEMENTS HAVE NOT BEEN OBTAINED DUE TO THE PROPOSED PRESSURE SEWER PIPE AND LIFT STATION BEING LOCATED ON FEDERAL PROPERTY THAT IS COVERED IN ARMY REGULATION (AR 405-80) GRANTING ACCESS FOR ALL QUALIFYING UTILITIES.

**LEGEND**

---	EXISTING UNDERGROUND ELECTRIC	⊕	EXISTING FIRE HYDRANT
-x-x-	EXISTING FENCE	▲	EXISTING GAS METER
-F/O-	EXISTING FIBER OPTIC	•	EXISTING GAS VALVE
-GAS-	EXISTING GAS	○	EXISTING IRON PIN
-S-S-	EXISTING GRAVITY SEWER	■	EXISTING MAILBOX
-UGT-	EXISTING UNDERGROUND TELEPHONE	⊙	EXISTING MANHOLE
- - -	EXISTING RIGHT OF WAY	○	EXISTING PIPE POST
- - - -	EXISTING SECTION LINE	⊗	EXISTING LIGHT POLE
-W-W-	EXISTING WATERLINE	∅	EXISTING POWER POLE
-x-x-	PROPOSED FENCE	▲	EXISTING RW MARKER
-S-S-	PROPOSED SEWER	▲	EXISTING SIGN
-PS-PS-	PROPOSED PRESSURE SEWER	TP	EXISTING TELEPEDESTAL
- - - -	PROPOSED TEMPORARY EASEMENT	⊕	EXISTING TREE
- - - -	PROPOSED PERMANENT EASEMENT	⊕	EXISTING SHRUB
951	EXISTING MINOR CONTOURS	•	EXISTING WATER METER
950	EXISTING MAJOR CONTOURS	⊗	EXISTING WATER VALVE
951	PROPOSED MINOR CONTOURS	○	EXISTING WATER HYDRANT
950	PROPOSED MAJOR CONTOURS	⊕	PROPOSED MANHOLE
⊕	EXISTING CLEANOUT	⊕	PROPOSED AIR RELEASE VALVE
○	CONTROL POINT		

STATE OF MISSOURI  
MICHAEL L. PARSON,  
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CIVIL ENGINEER: GARRETT D. WAGNER  
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OFFICE OF ADMINISTRATION  
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MISSOURI  
NATIONAL GUARD

CONNECT CAMP CLARK  
TO CITY OF NEVADA  
SEWER SYSTEM

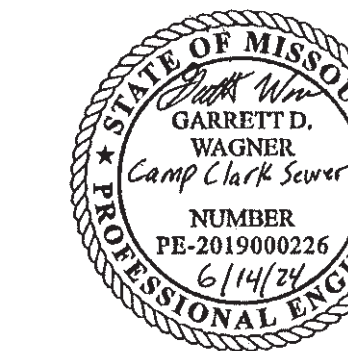CAMP CLARK

NEVADA, MISSOURI

PROJECT # T2301-02  
SITE # 6274  
ASSET # 8136274075

REVISION: EASEMENTS  
DATE: 03-26-2024  
REVISION: WET WELL SIZE  
DATE: 06-05-2024  
REVISION: ADD WET WELL/PIPE SIZE  
DATE: 06-14-2024  
ISSUE DATE: 06/14/2024


CAD DWG FILE: \_\_\_\_\_  
DRAWN BY: AWW  
CHECKED BY: SCW  
DESIGNED BY: GDW

SHEET TITLE:  
**GRAVITY SEWER  
PLAN & PROFILE**

SHEET NUMBER:

**C-111**


13 OF 23 SHEETS

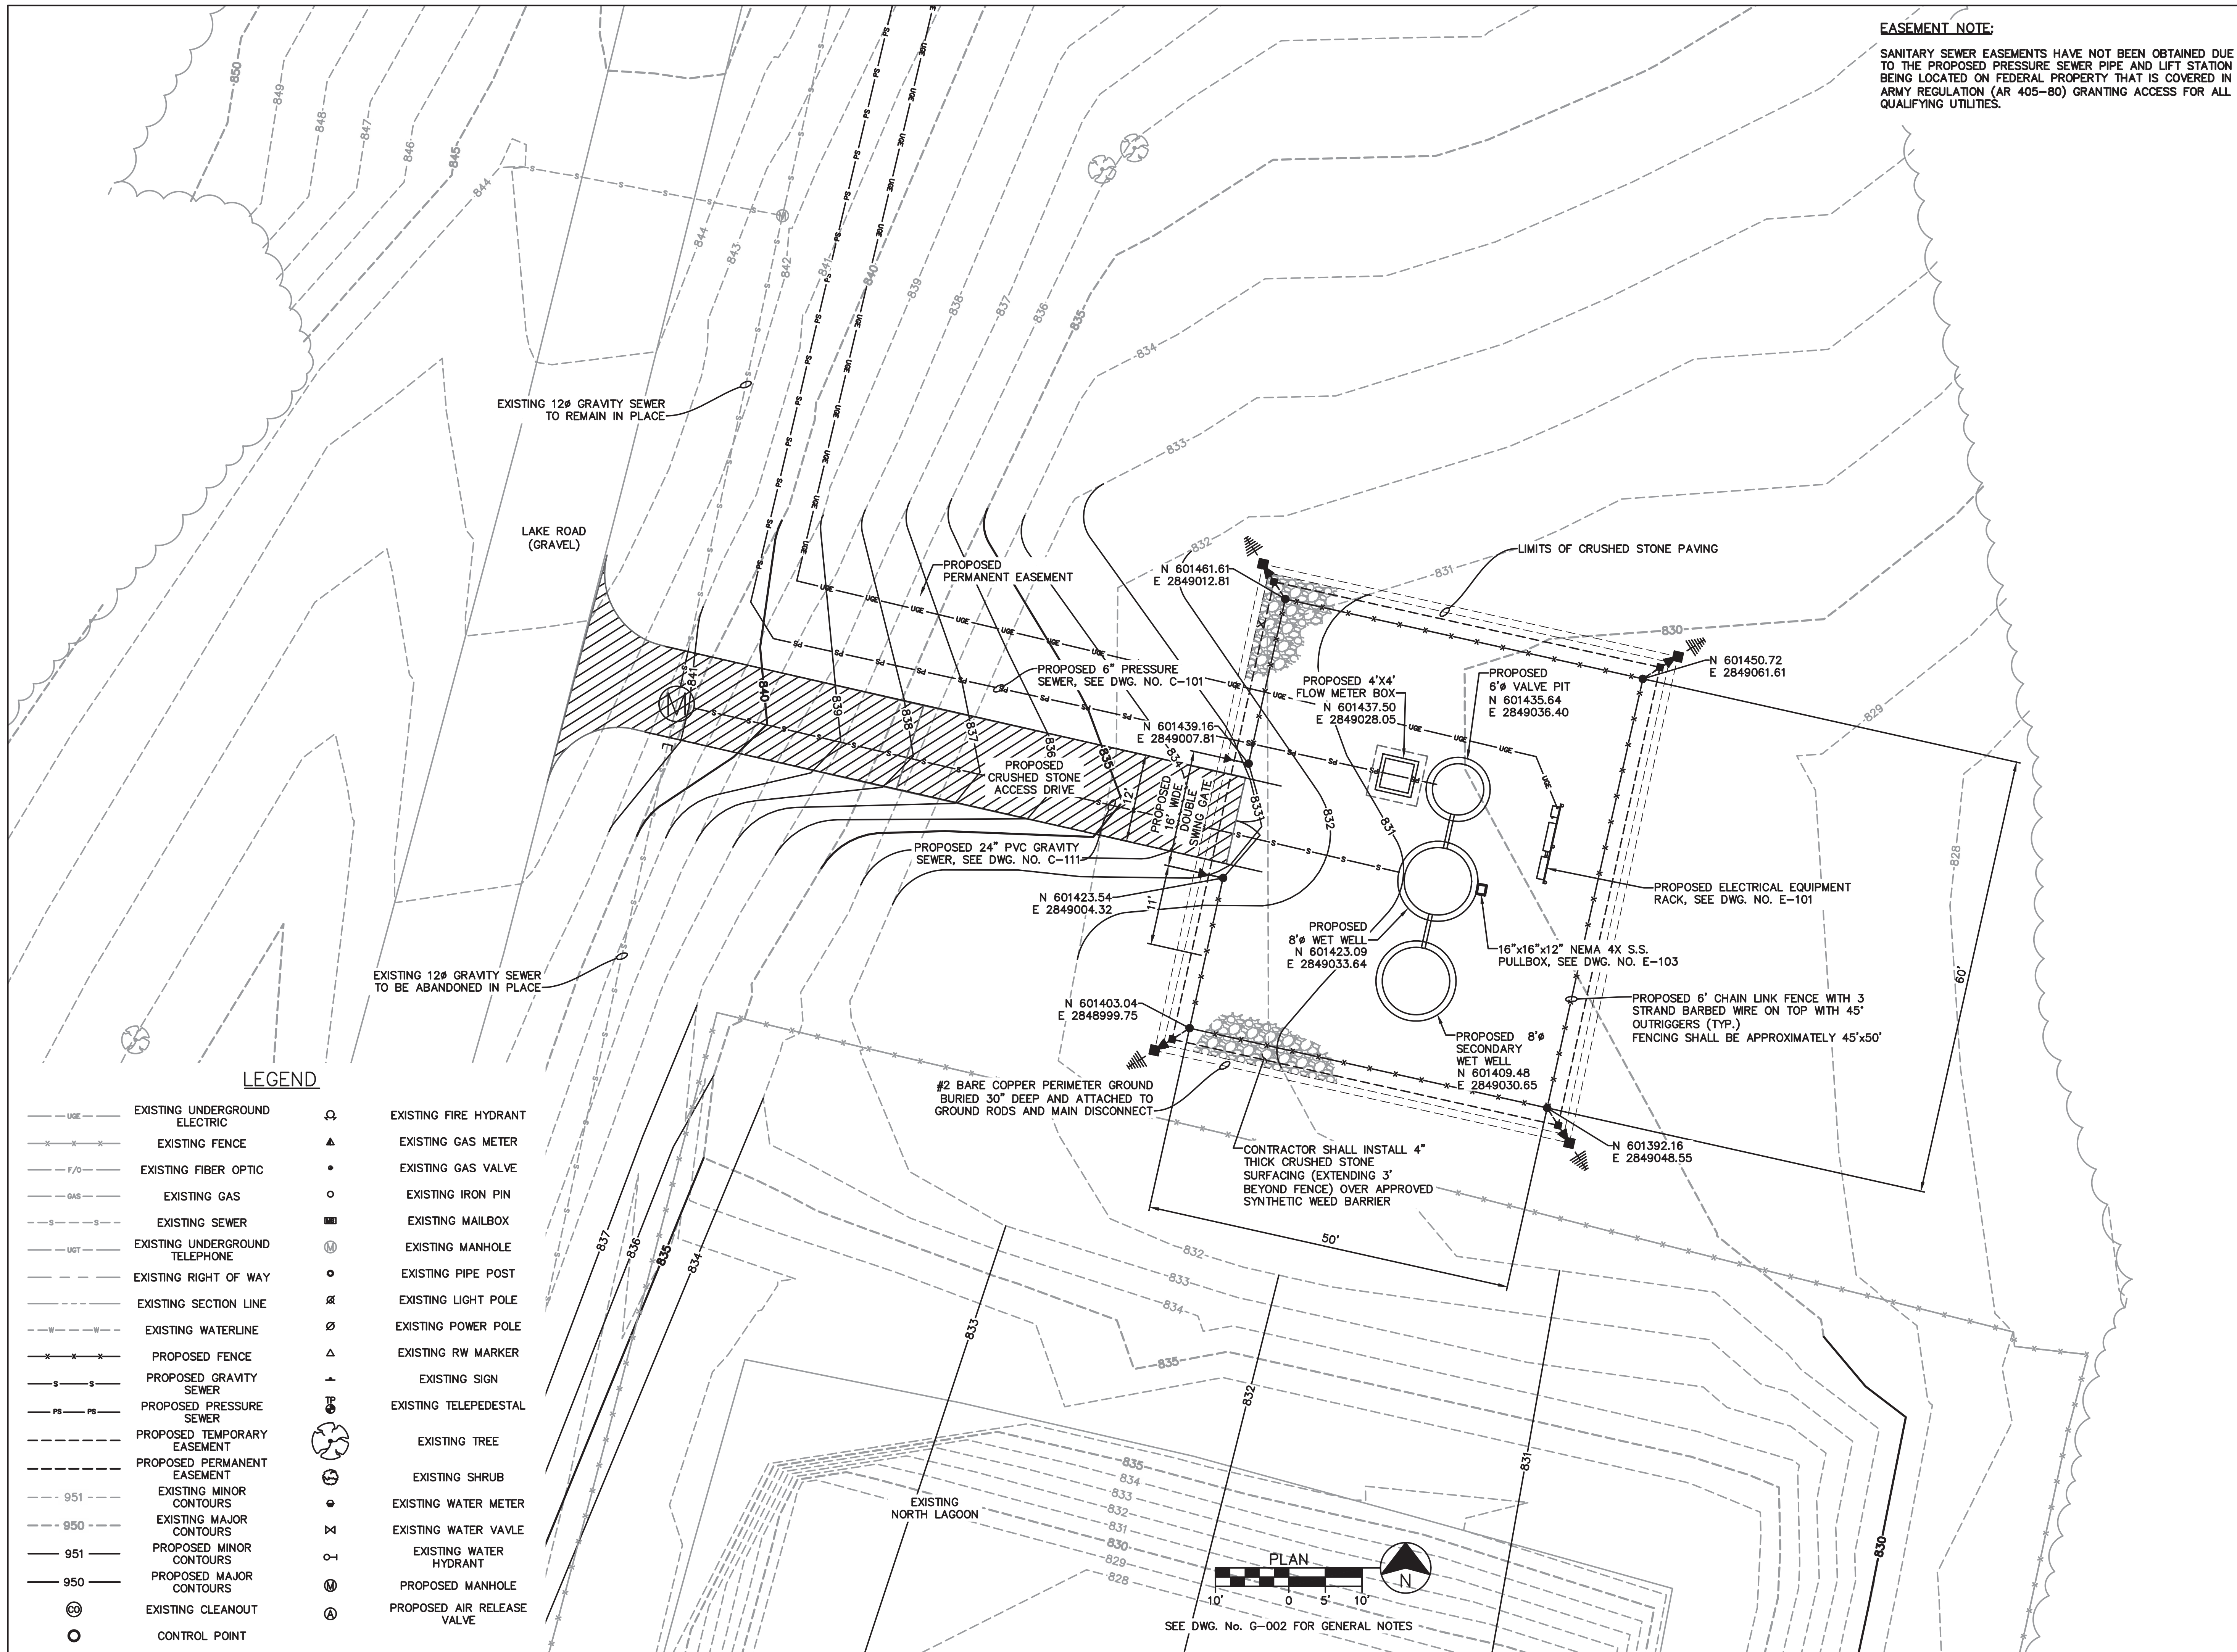

**EASEMENT NOTE:**  
 SANITARY SEWER EASEMENTS HAVE NOT BEEN OBTAINED DUE TO THE PROPOSED PRESSURE SEWER PIPE AND LIFT STATION BEING LOCATED ON FEDERAL PROPERTY THAT IS COVERED IN ARMY REGULATION (AR 405-80) GRANTING ACCESS FOR ALL QUALIFYING UTILITIES.

STATE OF MISSOURI  
 MICHAEL L. PARSON,  
 GOVERNOR

CIVIL ENGINEER: GARRETT D. WAGNER  
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NEVADA, MISSOURI

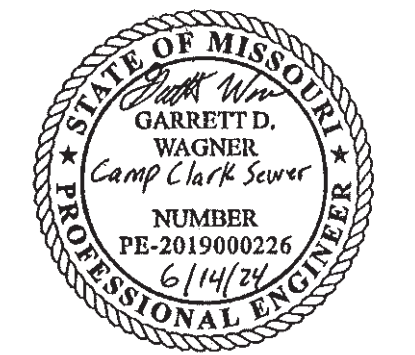PROJECT # T2301-02  
 SITE # 6274  
 ASSET # 8136274075

REVISION: EASEMENTS  
 DATE: 03-26-2024  
 REVISION: WET WELL SIZE  
 DATE: 06-05-2024  
 REVISION: ADD WET WELL  
 DATE: 06-14-2024  
 ISSUE DATE: 06/14/2024

CAD DWG FILE:  
 DRAWN BY: AWW  
 CHECKED BY: SCW  
 DESIGNED BY: GDW

SHEET TITLE:  
 LIFT STATION  
 SITE PLAN


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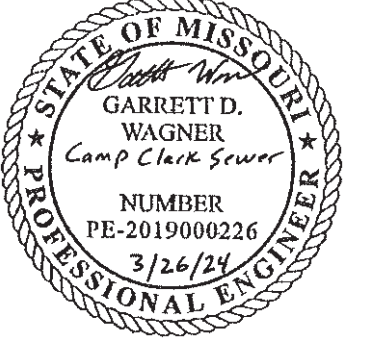
**C-112**

14 OF 23 SHEETS

**LEGEND**

- |     |                                |   |                            |
|-----|--------------------------------|---|----------------------------|
| --- | EXISTING UNDERGROUND ELECTRIC  | ⊙ | EXISTING FIRE HYDRANT      |
| --- | EXISTING FENCE                 | ▲ | EXISTING GAS METER         |
| --- | EXISTING FIBER OPTIC           | • | EXISTING GAS VALVE         |
| --- | EXISTING GAS                   | ○ | EXISTING IRON PIN          |
| --- | EXISTING SEWER                 | ⊠ | EXISTING MAILBOX           |
| --- | EXISTING UNDERGROUND TELEPHONE | ⊕ | EXISTING MANHOLE           |
| --- | EXISTING RIGHT OF WAY          | ○ | EXISTING PIPE POST         |
| --- | EXISTING SECTION LINE          | ⊗ | EXISTING LIGHT POLE        |
| --- | EXISTING WATERLINE             | ⊘ | EXISTING POWER POLE        |
| --- | PROPOSED FENCE                 | △ | EXISTING RW MARKER         |
| --- | PROPOSED GRAVITY SEWER         | ▲ | EXISTING SIGN              |
| --- | PROPOSED PRESSURE SEWER        | ⊕ | EXISTING TELEPEDESTAL      |
| --- | PROPOSED TEMPORARY EASEMENT    | ⊗ | EXISTING TREE              |
| --- | PROPOSED PERMANENT EASEMENT    | ⊕ | EXISTING SHRUB             |
| --- | EXISTING MINOR CONTOURS        | ○ | EXISTING WATER METER       |
| --- | EXISTING MAJOR CONTOURS        | ⊗ | EXISTING WATER VALVE       |
| --- | PROPOSED MINOR CONTOURS        | ○ | EXISTING WATER HYDRANT     |
| --- | PROPOSED MAJOR CONTOURS        | ⊕ | PROPOSED MANHOLE           |
| --- | EXISTING CLEANOUT              | ⊕ | PROPOSED AIR RELEASE VALVE |
| --- | CONTROL POINT                  | ○ |                            |



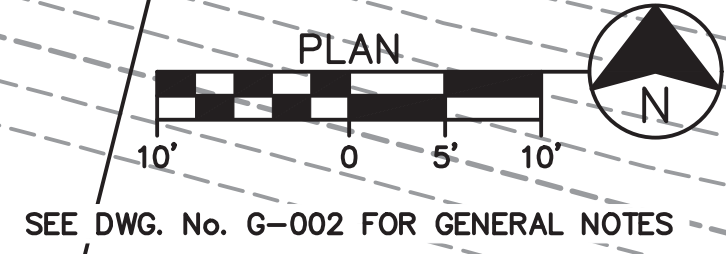

--- 951 ---	EXISTING MINOR CONTOURS
--- 950 ---	EXISTING MAJOR CONTOURS
— 951 —	PROPOSED MINOR CONTOURS
— 950 —	PROPOSED MAJOR CONTOURS

**EASEMENT NOTE:**

SANITARY SEWER EASEMENTS HAVE NOT BEEN OBTAINED DUE TO THE PROPOSED PRESSURE SEWER PIPE AND LIFT STATION BEING LOCATED ON FEDERAL PROPERTY THAT IS COVERED IN ARMY REGULATION (AR 405-80) GRANTING ACCESS FOR ALL QUALIFYING UTILITIES.

**LAGOON CLOSURE NOTES:**

- LAGOON SHALL BE CLOSED PER SPECIFICATION 312305.
- CONTRACTOR SHALL REMOVE AND DISPOSE OF LAGOON LINERS, PIPING, BAFFLES, AERATORS, ELECTRICAL EQUIPMENT AND OTHER ABOVE GROUND STRUCTURES.
- CONTRACTOR SHALL DEMOLISH BERMS AND GRADE SITE TO THE ELEVATIONS SHOWN HEREON. SITE SHALL BE SEEDED AND MULCHED AFTER FINAL GRADING.
- CONTRACTOR SHALL BE RESPONSIBLE FOR THE FINAL ESTIMATION OF ALL EARTHWORK QUANTITIES AND ASSOCIATED COSTS PRIOR TO BID SUBMISSION.
- IT IS INTENDED THAT CUTS AND FILLS WILL BE BALANCED WITH ON-SITE MATERIALS WHERE POSSIBLE. ADJUSTMENTS TO THE FINISH CONTOURS OF THE SITE ARE ANTICIPATED. CHANGES TO CONTOURS SHOWN SHALL BE APPROVED BY THE ENGINEER. THE FOLLOWING CUT AND FILL QUANTITIES ARE APPROXIMATE:  
LAGOON CUT: 5,291 CY  
LAGOON FILL: 7,966 CY  
SEWER LINE CUT: 988 CY

PROPOSED LIFT STATION,  
SEE DWG. NO. C-112


APPROXIMATELY 1,394 L.F. OF BARBED WIRE FENCE TO BE REMOVED BY CONTRACTOR. CONTRACTOR SHALL COORDINATE WITH OWNER ON RE-USE, OTHERWISE DISPOSE OF FENCE AT HIS EXPENSE

CONTRACTOR SHALL REMOVE APPROXIMATELY 5 L.F. OF OUTFALL PIPE AND CAP PIPE WATERTIGHT WITH CONCRETE

CONTRACTOR SHALL REMOVE AND DISPOSE OF OUTFALL SIGNS

EXISTING OUTFALL PIPE

LAGOON DEMOLITION PLAN

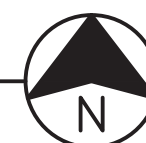

OFFICE OF ADMINISTRATION  
DIVISION OF FACILITIES  
MANAGEMENT,  
DESIGN AND CONSTRUCTION

MISSOURI  
NATIONAL GUARD

CONNECT CAMP CLARK  
TO CITY OF NEVADA  
SEWER SYSTEM

CAMP CLARK

NEVADA, MISSOURI

PROJECT # T2301-02  
SITE # 6274  
ASSET # 8136274075

REVISION: EASEMENTS  
DATE: 03-26-2024  
REVISION: \_\_\_\_\_  
DATE: \_\_\_\_\_  
REVISION: \_\_\_\_\_  
DATE: \_\_\_\_\_  
ISSUE DATE: 06/14/2024

CAD DWG FILE: \_\_\_\_\_  
DRAWN BY: AWW  
CHECKED BY: SCW  
DESIGNED BY: GDW


SHEET TITLE:  
LAGOON  
DEMOLITION &  
GRADING PLAN

SHEET NUMBER:

C-113

15 OF 23 SHEETS




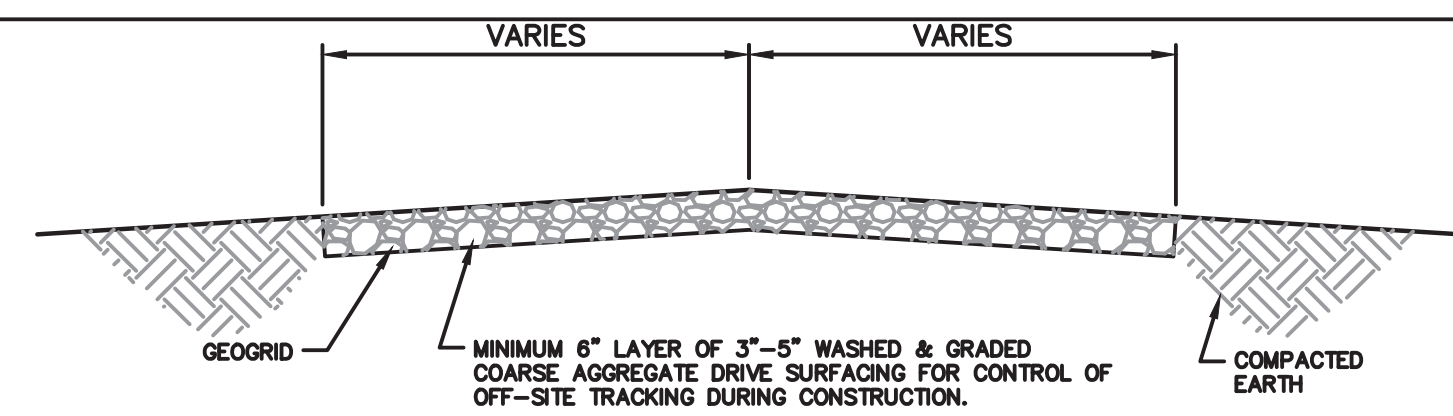

TYPICAL SECTION THRU CONSTRUCTION ENTRANCE  
N.T.S.

**NOTES:**


1. WHEN NECESSARY, EQUIPMENT/VEHICLES SHALL BE CLEANED TO REMOVE SEDIMENT PRIOR TO ENTRANCE ONTO A PUBLIC ROADWAY. WHEN WASHING IS REQUIRED, IT SHALL BE DONE ON AN AREA STABILIZED WITH CRUSHED STONE WITH DRAINAGE FLOWING AWAY FROM BOTH THE PUBLIC STREET OR ROAD AND THE STABILIZED ENTRANCE. ALL SEDIMENT SHALL BE PREVENTED FROM ENTERING ANY STORM DRAIN, DITCH OR WATERCOURSE USING APPROVED METHODS.
2. THE SITE ENTRANCE SHALL BE MAINTAINED IN A CONDITION WHICH WILL PREVENT TRACKING OR FLOWING OF SEDIMENT ONTO PAVED SURFACES. THIS MAY REQUIRE PERIODIC TOP DRESSING WITH ADDITIONAL STONE AS CONDITIONS MAY REQUIRE. ALL SEDIMENT SPILLED, DROPPED, WASHED AWAY OR TRACKED ONTO PAVED SURFACES MUST BE REMOVED AS SOON AS POSSIBLE.

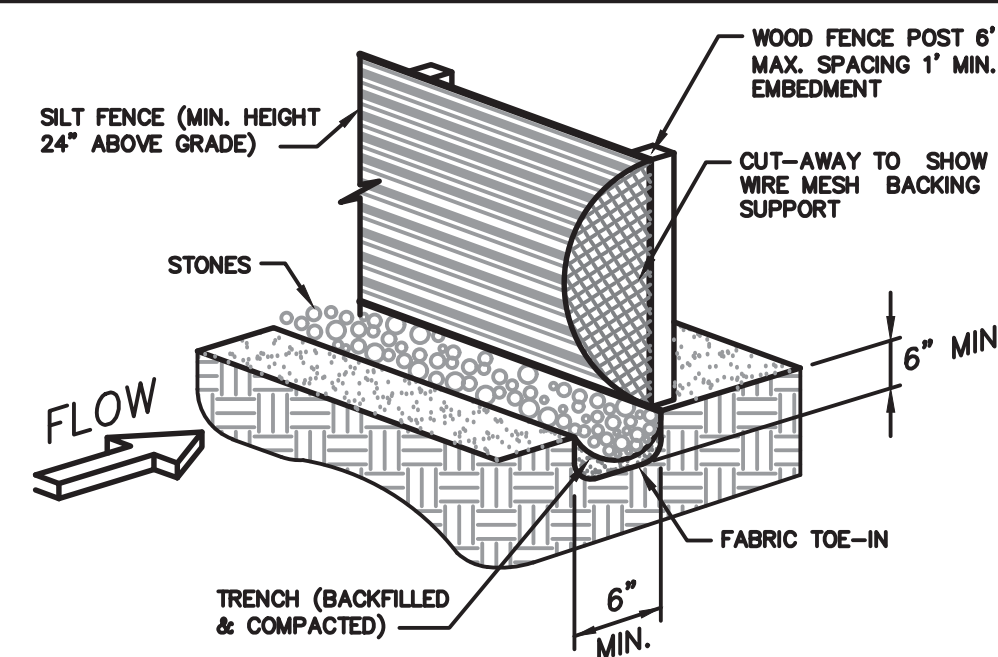

FILTER FABRIC SILT FENCE  
N.T.S.

**NOTES:**

1. SILT FENCE SHALL BE SECURELY FASTENED TO EACH WOOD SUPPORT POST OR TO WOVEN WIRE. THERE SHALL BE A 6 INCH DOUBLE OVERLAP, SECURELY FASTENED WHERE ENDS OF FABRIC MEET.
2. INSPECTION SHALL BE MADE AT LEAST WEEKLY, BEFORE A KNOWN MAJOR STORM EVENT, AND AFTER EACH 0.5" RAINFALL EVENT. REPAIR OR REPLACEMENT SHALL BE MADE PROMPTLY AS NEEDED.
3. ACCUMULATED SILT SHALL BE REMOVED FROM THE UPPER SIDE OF SILT FENCE WHEN IT REACHES A DEPTH OF 8 INCHES. THE SILT SHALL BE DISPOSED ON SITE (OR AT AN APPROVED SITE) AND IN SUCH A MANNER AS TO NOT CONTRIBUTE TO ADDITIONAL SILTATION.
4. FILTER FABRIC SILT FENCE SHALL BE ENHANCED WITH STRAW BALES IF SITE CONDITIONS INDICATE THE NEED FOR ADDITIONAL FILTRATION OF RUNOFF.

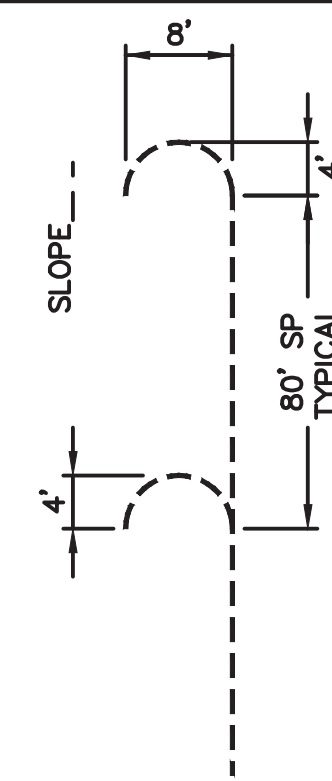

FILTER FABRIC SILT FENCE HOOK  
DETAIL  
N.T.S.


**NOTE:**  
HOOKS SHOWN LARGER FOR CLARITY  
INSTALL AS NEEDED ON SLOPES WHERE SILT FENCE IS INSTALLED PARALLEL TO SLOPE.

**NOTE:**  
FILTER FABRIC SILT FENCE/HOOKS AND STRAW BALE BARRIER LOCATIONS ARE APPROXIMATE. PLACEMENT MAY NEED ADJUSTED ACCORDING TO SITE SPECIFIC TERRAIN CONDITIONS.


**CONSTRUCTION NOTE:**  
THE CONTRACTOR SHALL PROVIDE ANY ADDITIONAL EROSION OR POLLUTION CONTROL DEVICES AS REQUIRED DURING THE CONSTRUCTION PHASE IN ORDER TO COMPLY WITH STORM WATER DISCHARGE REGULATIONS OF THE UNITED STATES ENVIRONMENTAL PROTECTION AGENCY AND ALL OTHER AGENCIES HAVING JURISDICTION.

**NOTE:**


1. POINT "A" MUST BE A MINIMUM OF 6 INCHES HIGHER THAN POINT "B" TO ENSURE THAT WATER FLOWS OVER THE DIKE AND NOT AROUND THE ENDS.

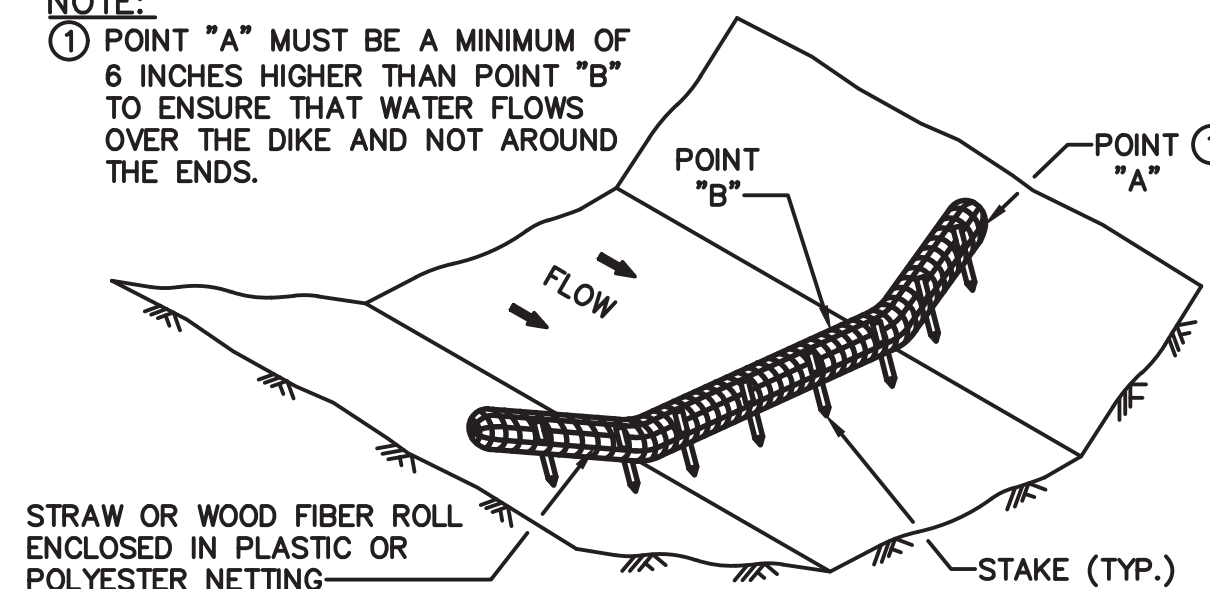

COMPOST FILTER SOCK DITCH CHECK  
N.T.S.

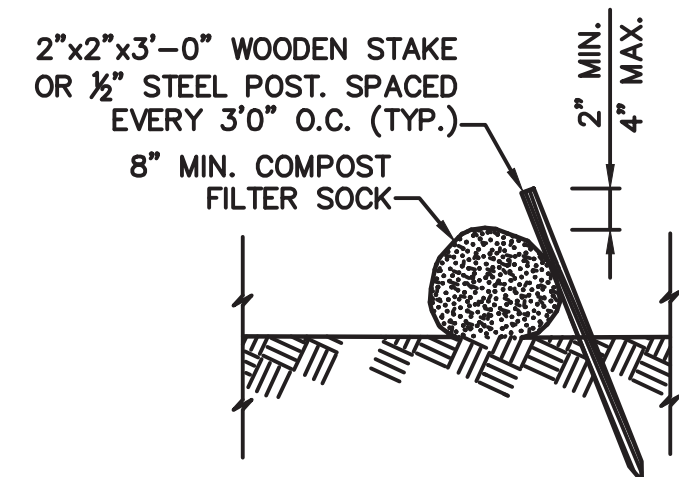


ALTERNATIVE 1 (Staking)  
N.T.S.

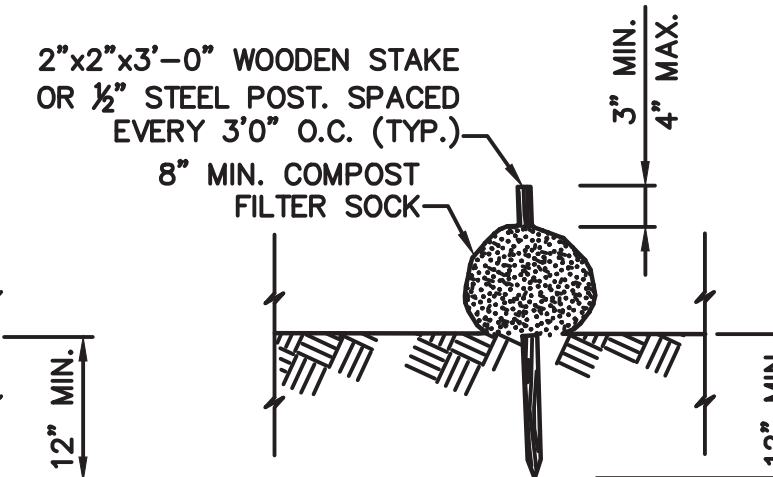

ALTERNATIVE 2 (Staking)  
N.T.S.

COMPOST FILTER SOCK

COMPOST FILTER SOCK: SLOPE, SOCK SPACING, AND SOCK DIAMETER		
SLOPE	SPACING (ft)	SOCK DIAMETER (inches)
<50:1	250	8
50:1 - 10:1	125	12
10:1 - 5:1	100	12
3:1 - 2:1	50	18
> 2:1	25	18

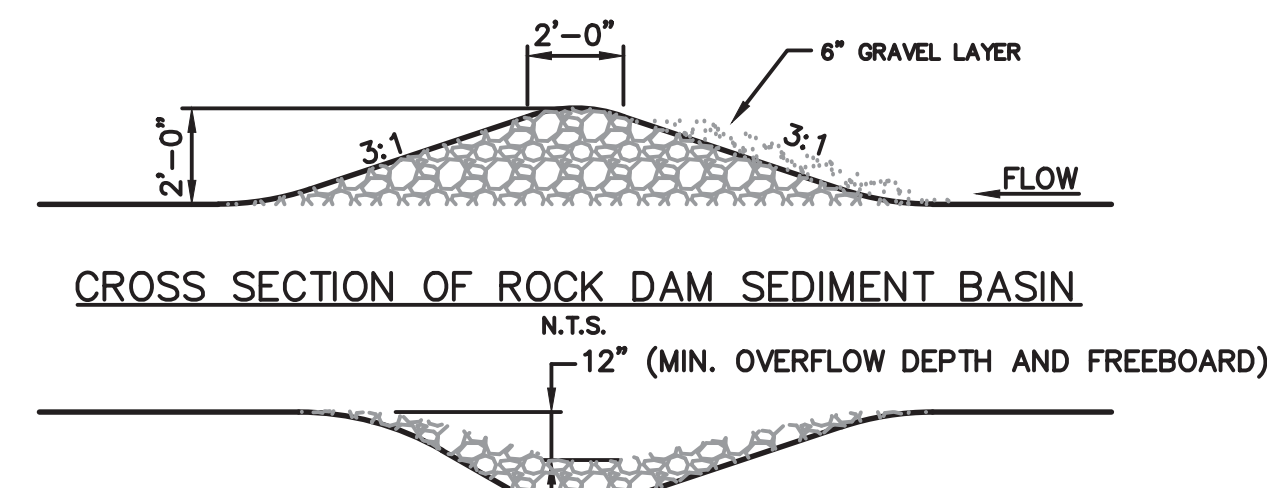

CROSS SECTION OF ROCK DAM SEDIMENT BASIN  
N.T.S.



CROSS SECTION OF DITCH AT ROCK DAM  
N.T.S.

THE CONTRACTOR SHALL MAINTAIN A COPY OF THE MDNR ISSUED NATIONAL POLLUTANT DISCHARGE ELIMINATION SYSTEM (NPDES) STORM WATER DISCHARGE PERMIT, A CURRENT SIGNED AND CERTIFIED COPY OF THE SWPPP, AND COPIES OF ALL COMPLETED INSPECTION AND MAINTENANCE FORMS AT THE CONSTRUCTION SITE AT ALL TIMES, AS REQUIRED. THE ISSUED STORM WATER DISCHARGE PERMIT AND THE SWPPP MUST BE AVAILABLE FOR REVIEW BY ANY AND ALL LOCAL, STATE, OR FEDERAL AUTHORIZED REGULATORY AGENCY REPRESENTATIVE UPON REQUEST.

**NOTE:**  
SEE SWPPP APPENDICES FOR ADDITIONAL INFORMATION AND EXAMPLES OF BMP'S AND REQUIRED INSPECTION AND REPORTING FORMS.

THE CONTRACTOR SHALL NAME AN INDIVIDUAL AS THE SITE ENVIRONMENTAL MANAGER RESPONSIBLE FOR ALL STORM WATER AND ENVIRONMENTAL ISSUES AT THE SITE DURING THE CONSTRUCTION OF THE PROJECT.



THE DESIGNATED ENVIRONMENTAL MANAGER FOR THE SITE IS:

THE CONTRACTOR SHALL PHYSICALLY MARK IN THE FIELD THE LOCATION OF THE OUTFALL AND INDICATE THE OUTFALL NUMBER, AS SHOWN ON THIS DRAWING.

THE CONTRACTOR SHALL PENCIL IN AND KEEP CURRENT, ANY UPDATE AS NEEDED, ANY AND ALL ADDITIONS OR CHANGES TO THE STORM WATER POLLUTION PREVENTION PLAN ON THE SWPPP DRAWING, INCLUDING, BUT NOT LIMITED TO, THE LOCATION OF THE FOLLOWING ITEMS, IF APPLICABLE:

- CONSTRUCTION OFFICE
- PORTABLE TOILET(S)
- SOLID WASTE CONTAINER(S)
- FUEL STORAGE AREA
- MATERIAL STORAGE AREA(S)
- CHEMICAL STORAGE AREA(S)
- EQUIPMENT STORAGE AREA(S)
- TOP SOIL STOCKPILE AREA(S)
- ANY AND ALL ADDITIONAL INSTALLED BMP'S

THIS DRAWING IS FOR A STORM WATER POLLUTION PREVENTION PLAN ONLY, AND IS NOT INTENDED TO BE USED FOR CONSTRUCTION PURPOSES.

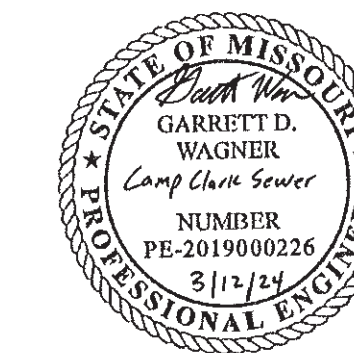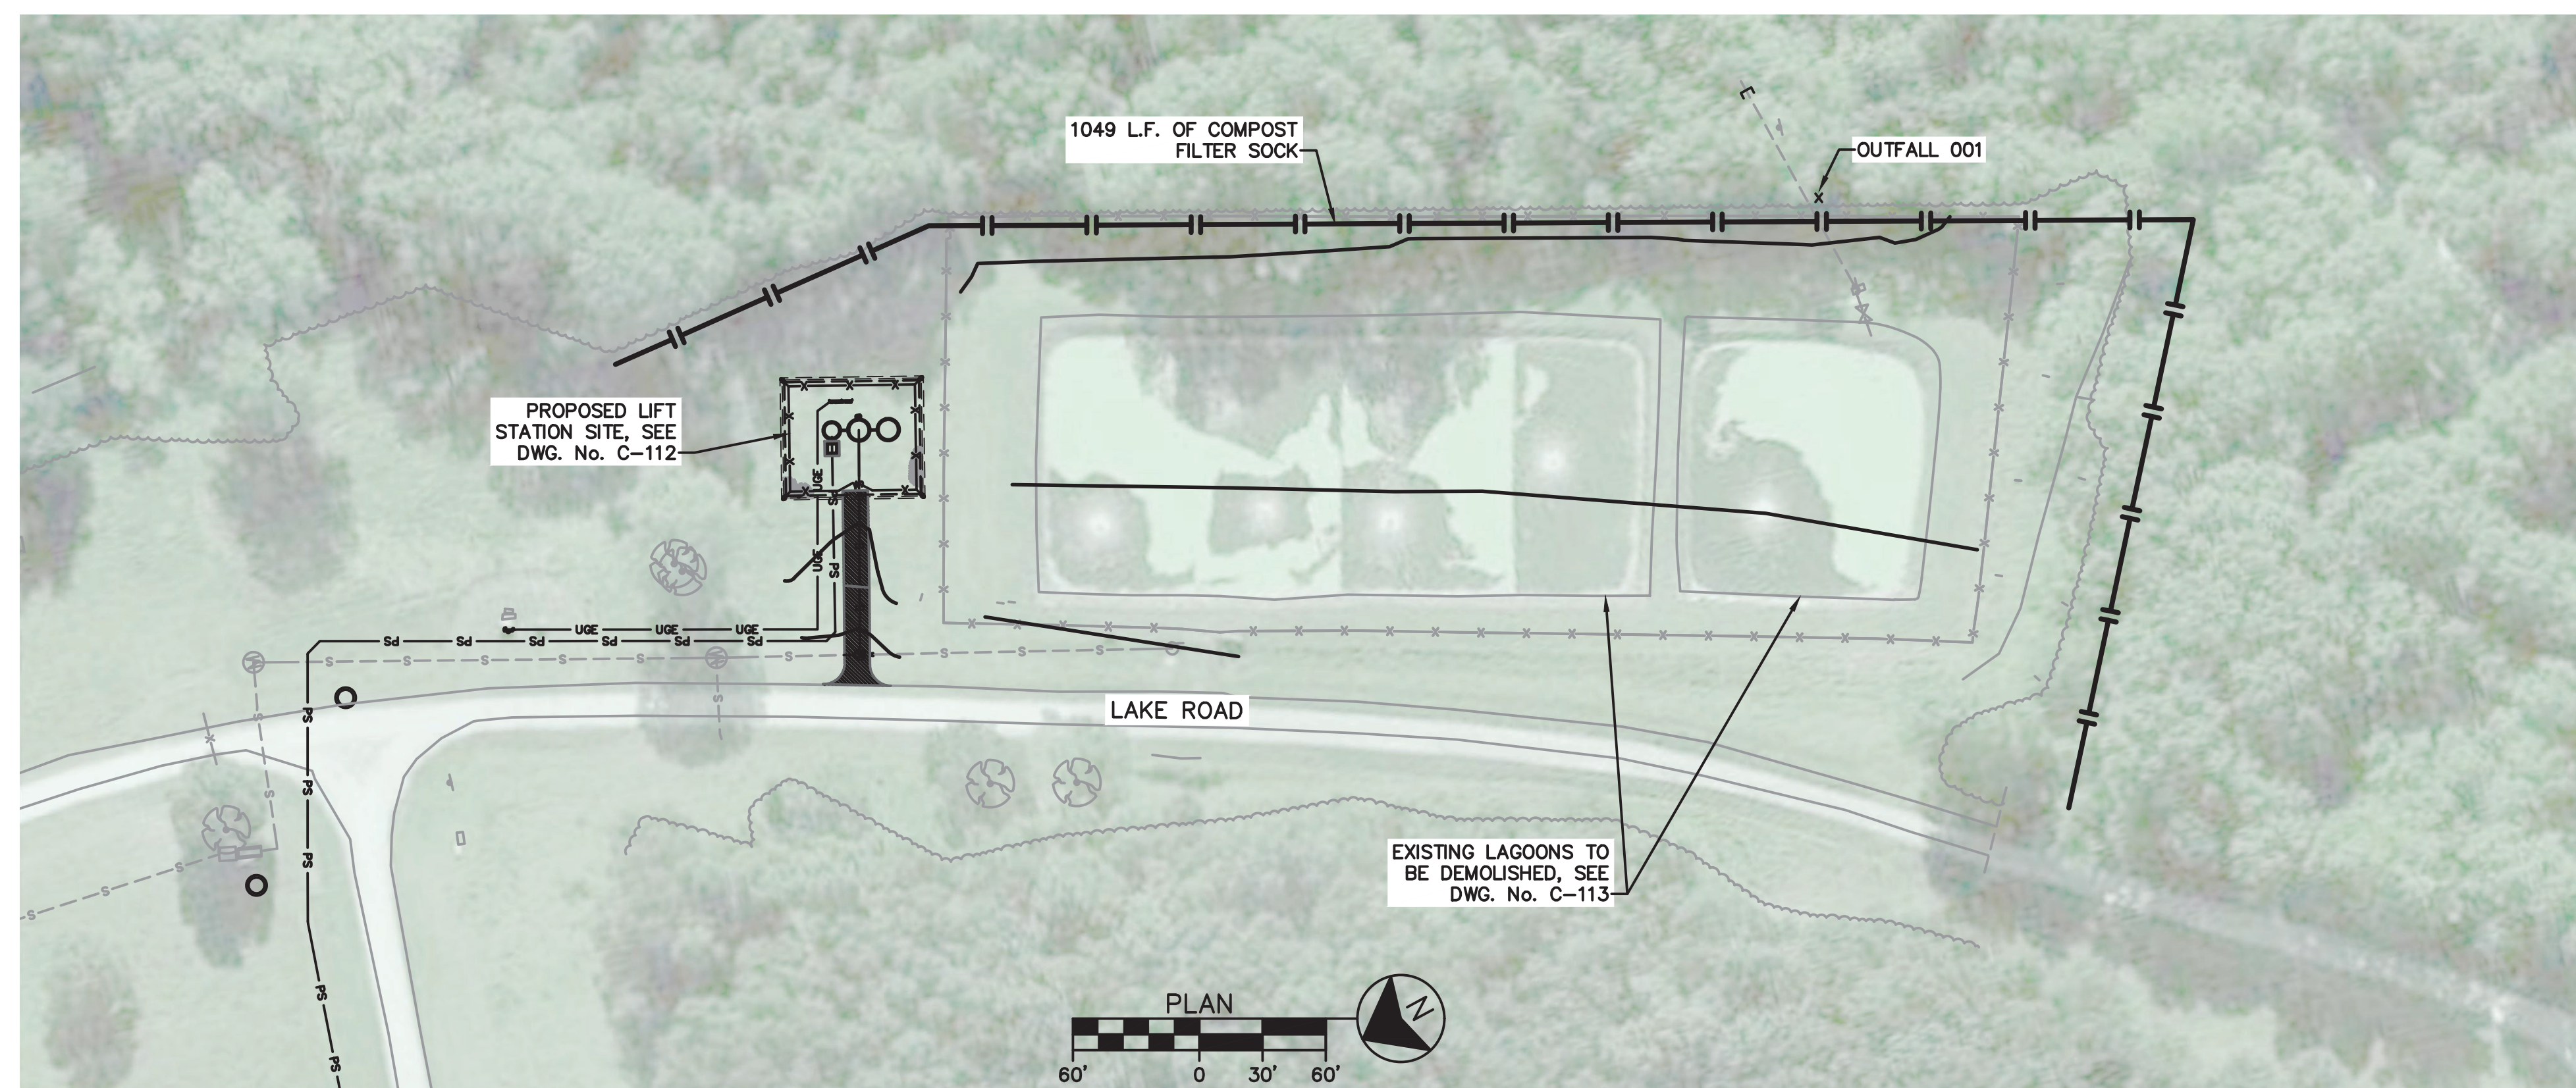



**NOTES:**

- (2) EA. ALUMINUM ACCESS DOOR SHALL BE U.S.F. FABRICATION, INC., MODEL No. APS300 FOR A 30" x 48" CONCRETE OPENING OR AN APPROVED EQUAL LOCATION OF ACCESS DOOR SHALL BE AS DIMENSIONED WITH DOOR HINGE LOCATION AS NOTED. DOOR MAY BE EITHER CAST-IN-PLACE OR GROUTED-IN-PLACE PER MFGR'S REQMT'S. THAT PORTION OF THE ACCESS DOOR FRAME IN CONTACT WITH CONCRETE OR GROUT SHALL HAVE A HEAVY SHOP COAT OF BITUMINOUS PAINT. ACCESS DOOR SHALL HAVE A NON-CORROSIVE FLUSH DROP HANDLE FOR LIFTING AND A NON-CORROSIVE STAPLE FOR PADLOCKING.
- (1) EA. ALUMINUM ACCESS DOOR SHALL BE U.S.F. FABRICATION, INC., MODEL No. APS300 FOR A 36" x 48" CONCRETE OPENING OR AN APPROVED EQUAL LOCATION OF ACCESS DOOR SHALL BE CENTERED ON FLATTOP LID WITH DOOR HINGE LOCATION AS NOTED. DOOR MAY BE EITHER CAST-IN-PLACE OR GROUTED-IN-PLACE PER MFGR'S REQMT'S. THAT PORTION OF THE ACCESS DOOR FRAME IN CONTACT WITH CONCRETE OR GROUT SHALL HAVE A HEAVY SHOP COAT OF BITUMINOUS PAINT. ACCESS DOOR SHALL HAVE A NON-CORROSIVE FLUSH DROP HANDLE FOR LIFTING AND A NON-CORROSIVE STAPLE FOR PADLOCKING.
- PROVIDE MIN. (2) EA. TYPE 304 S.S. SUPPORTS FOR VERTICAL DISCHARGE PIPE ON EACH PUMP. ANCHOR TO WALL W/ TYPE 304 S.S. EPOXY TYPE ANCHOR BOLTS, SIZE PER MFGR'S REQMT'S W/ MIN 4" EMBEDMENT.
- PUMP BASE ELBOW. PROVIDE PLAIN CONCRETE LEVELING BASE FOR PUMP DISCHARGE BASE ELBOW PER PUMP MFGR'S REQMT'S. ANCHOR BASE ELBOW W TYPE 304 S.S. EPOXY TYPE ANCHOR BOLTS, SIZED PER MFGR'S REQMT'S W/ MIN. 6" EMBEDMENT INTO BASE SLAB.
- PUMP SIZE & TYPE AS NOTED & SHOWN ON DRAWINGS. PIPE LENGTHS VARIABLE, AS REQUIRED FOR INSTALLATION PER DRAWINGS. FOR COMPLETE DESCRIPTION OF PIPE, CLASS & MATERIAL, SEE SPECIFICATIONS.
- ALL PIPING, VALVES & FITTINGS SHALL BE ADEQUATELY SUPPORTED. LOCATION FOR SUPPORTS & HANGERS ARE SHOWN ON DRAWINGS WHERE VIEWS ALLOW. FOR TYPICAL PIPE SUPPORTS & HANGERS; FLOOR, WALL & CEILING, SEE SPECIFICATIONS.
- SUBMERSIBLE RAW SEWAGE PUMPS & DISCHARGE PIPING CONFIGURATIONS HAVE BEEN ESTABLISHED USING THE TYPICAL PUMP DIMENSIONS FOR A SUBMERSIBLE SEWAGE PUMP. ANY DEVIATION IN PUMP ASSEMBLY CONFIGURATION, SIZE, MANUFACTURER, ETC. THAT ALTERS THE INSTALLATION AS SHOWN AND/OR DIMENSIONED, SHALL BE COORDINATED WITH THE ENGINEER PRIOR TO THEIR INSTALLATION.

FITTING SCHEDULE		
NO.	DESCRIPTION	QTY
1	6" FLANGE x PLAIN END DUCTILE IRON PIPE x LENGTH AS REQUIRED	
2	6" CAST IRON FLANGED COUPLING ADAPTER WITH (2) ANCHOR STUDS	4
3	6" FLANGED 90° ELBOW	3
4	6" FLANGED, HORIZONTAL SWING CHECK VALVE	2
5	6" FLANGED PLUG VALVE W/ EXTENDED NUT & STEM GUIDE	2
6	6" FLANGED DUCTILE IRON TEE	1
7	4" FLANGED PLUG VALVE W/ LEVER ACTUATOR	1
8	4" FLANGED QUICK CONNECT COUPLING W/ DUST CAP. SECURE DUST CAP W/ STAINLESS STEEL CHAIN.	1
9	4" FLG. x FLG. x D.I.P. x 24" LONG	1
10	ANNULAR DIAPHRAGM SEAL EQUAL TO ASHCROFT TYPE 81 WITH INSTRUMENT REMOVAL DEVICE AND 4" PRESSURE GAUGE EQUAL TO ASHCROFT 1279 DURAGAUGE, SILICONE.	2
11	6" x 4" FLANGED ECCENTRIC REDUCER	1
12	6" x 6" x 4" FLANGED DUCTILE IRON TEE	1

**CONSTRUCTION NOTES:**


- BASE SOCKET SHALL BE POSITIONED SO THAT PUMPS ARE WITHIN ACCESSIBLE RANGE OF DAVIT CRANE.
- PROVIDE MIN. (1) EA. TYPE 304 S.S. SUPPORTS FOR VERTICAL DISCHARGE PIPE ON EACH PUMP. ANCHOR TO WALL W/ TYPE 304 S.S. EPOXY TYPE ANCHOR BOLTS, SIZE PER MFGR'S REQMT'S W/ MIN. 4" EMBEDMENT.
- PROPOSED LIFT STATION IMPROVEMENTS TO BE INSTALLED WITHOUT INTERRUPTING THE FLOW OF WASTEWATER. CONTRACTOR SHALL UTILIZE ALL METHODS, TECHNIQUES AND EQUIPMENT NECESSARY TO MAINTAIN UNRESTRICTED FLOW OF WASTEWATER DURING CONSTRUCTION. THE CONTRACTOR SHALL NOT ALLOW WASTEWATER TO OVERFLOW FROM MANHOLES, TRENCHES, WET WELL, OR PITS ONTO GROUND SURFACE OR IN WATERWAYS. ALL WASTEWATER SHALL BE PUMPED INTO A VACUUM TRUCK, THE EXISTING FORCE MAIN, THE PROPOSED VALVE PIT / FORCE MAIN (ONCE CONNECTED TO EXISTING FORCE MAIN), OR THE DOWNSTREAM MANHOLE. CONTRACTOR SHALL SUBMIT TO THE ENGINEER THEIR TEMPORARY PUMPING PLAN PRIOR TO BEGINNING CONSTRUCTION.
- CONTRACTOR SHALL PENETRATE PROPOSED WET WELL WITH PROPOSED 24" SEWER LINE BY NEATLY CUTTING A HOLE 2" TO 4" LARGER THAN O.D. OF PRESSURE LINE. THE ANNULAR SPACE SHALL BE FILLED WITH NON-SHRINK GROUT AND MADE WATER TIGHT. PIPE PENETRATIONS IN VALVE BOX CAN BE SEALED IN THE SAME MANNER OR BY A-LOK OR APPROVED EQUAL.
- FLOAT CABLES SHALL BE BROUGHT THROUGH (1) ONE 2" RIGID GALVANIZED CONDUIT WITH DUCT SEAL IN THE END.
- PUMP CABLES & FLOAT CABLES SHALL BE OF SUFFICIENT LENGTH TO EXTEND FROM PIT TO CONTROL PANEL WITHOUT SPLICING OR JUNCTION BOXES.
- FLOAT CABLES SHALL BE OF SUCH LENGTH AS TO ALLOW REMOVAL OF THE FLOAT SWITCH SUPPORT PIPE FROM THE HOOK.
- CONSTRUCTION TO PROPOSED WET WELL SHALL BE ACCOMPLISHED BY NEATLY CORE DRILLING IN WET WELL 2" TO 4" LARGER MIN. O.D. OF PROPOSED PENETRATING PIPE. SEAL PENETRATING PIPE W/A-LOK AND FILL ANNULAR SPACE WITH NON-SHRINK GROUT FOR A WATER TIGHT SEAL.

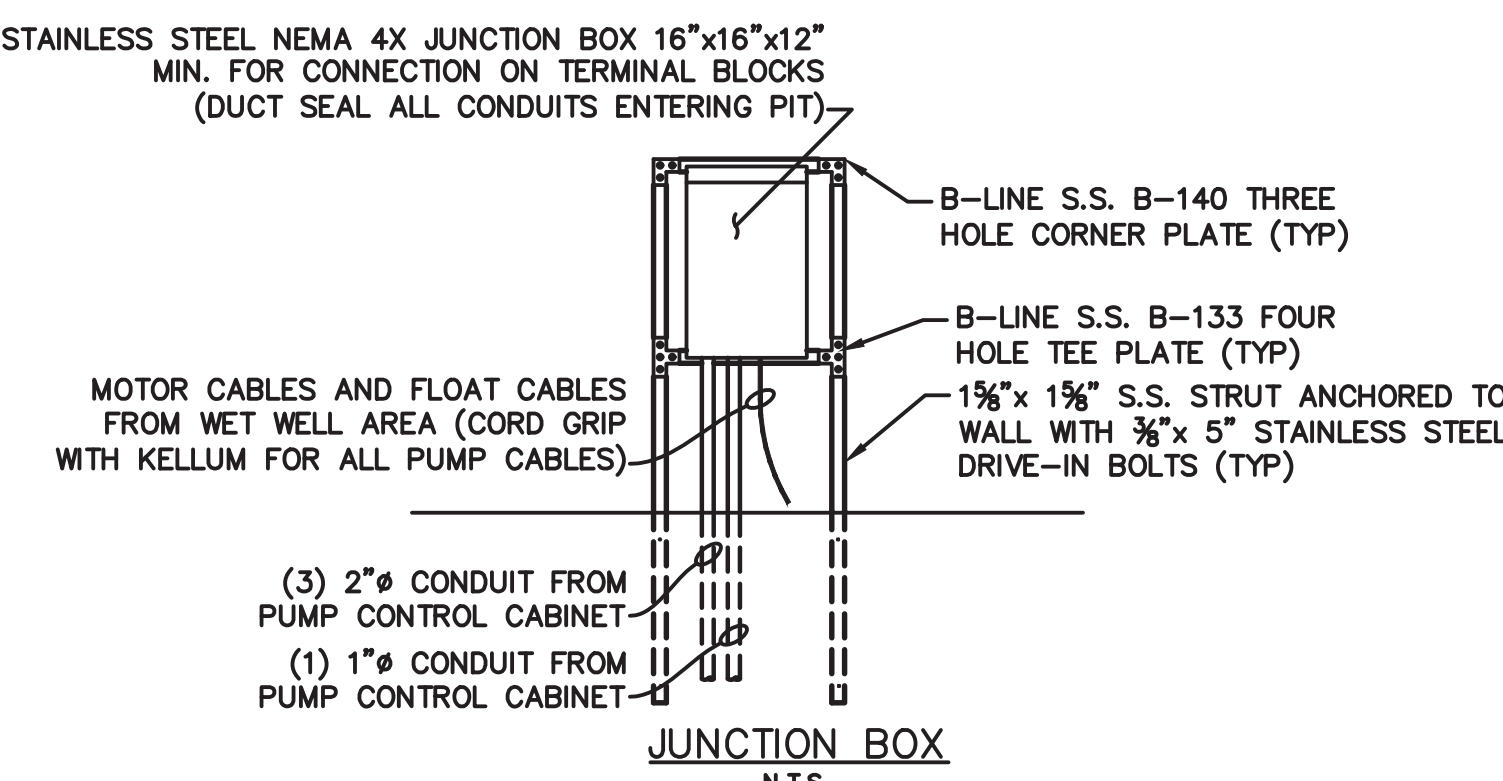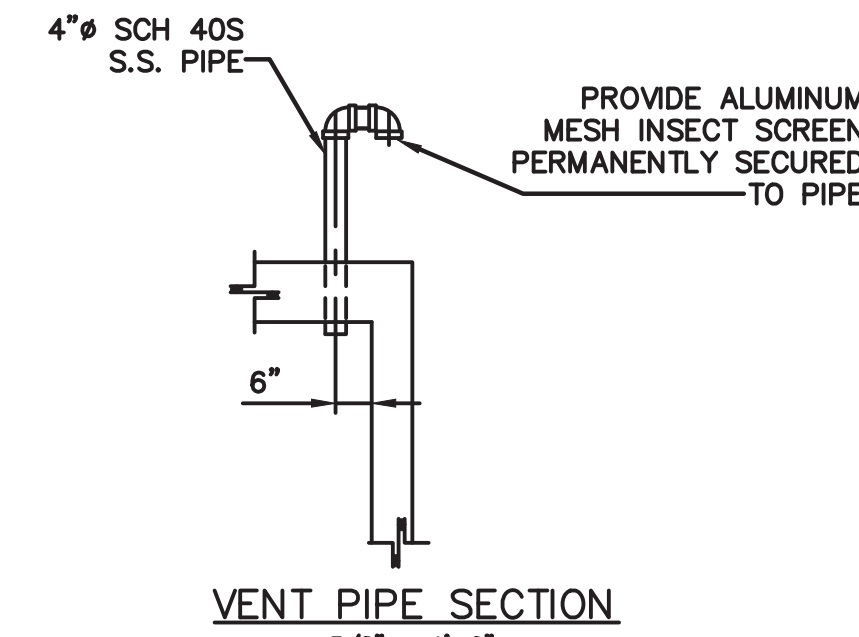


- NOTES:**
- ALL HARDWARE TO BE STAINLESS STEEL BOLTS, NUTS, WASHERS AND THIRL NUTS.
  - FOR PUMP FEEDS: SQUARE-D #8080BA362101 OR A APPROVED EQUAL.
  - TERMINAL BLOCKS FOR FLOAT CONTROL WIRES BUSSMAN TB-345-12L3 OR APPROVED EQUAL.

**NOTE:**

- FLOAT CABLES SHALL BE BROUGHT THROUGH (1) ONE 2" RIGID GALVANIZED CONDUIT WITH DUCT SEAL IN THE END.
- SMART POINT CABLE SHALL HAVE ENOUGH SLACK TO OPEN VAULT LID.

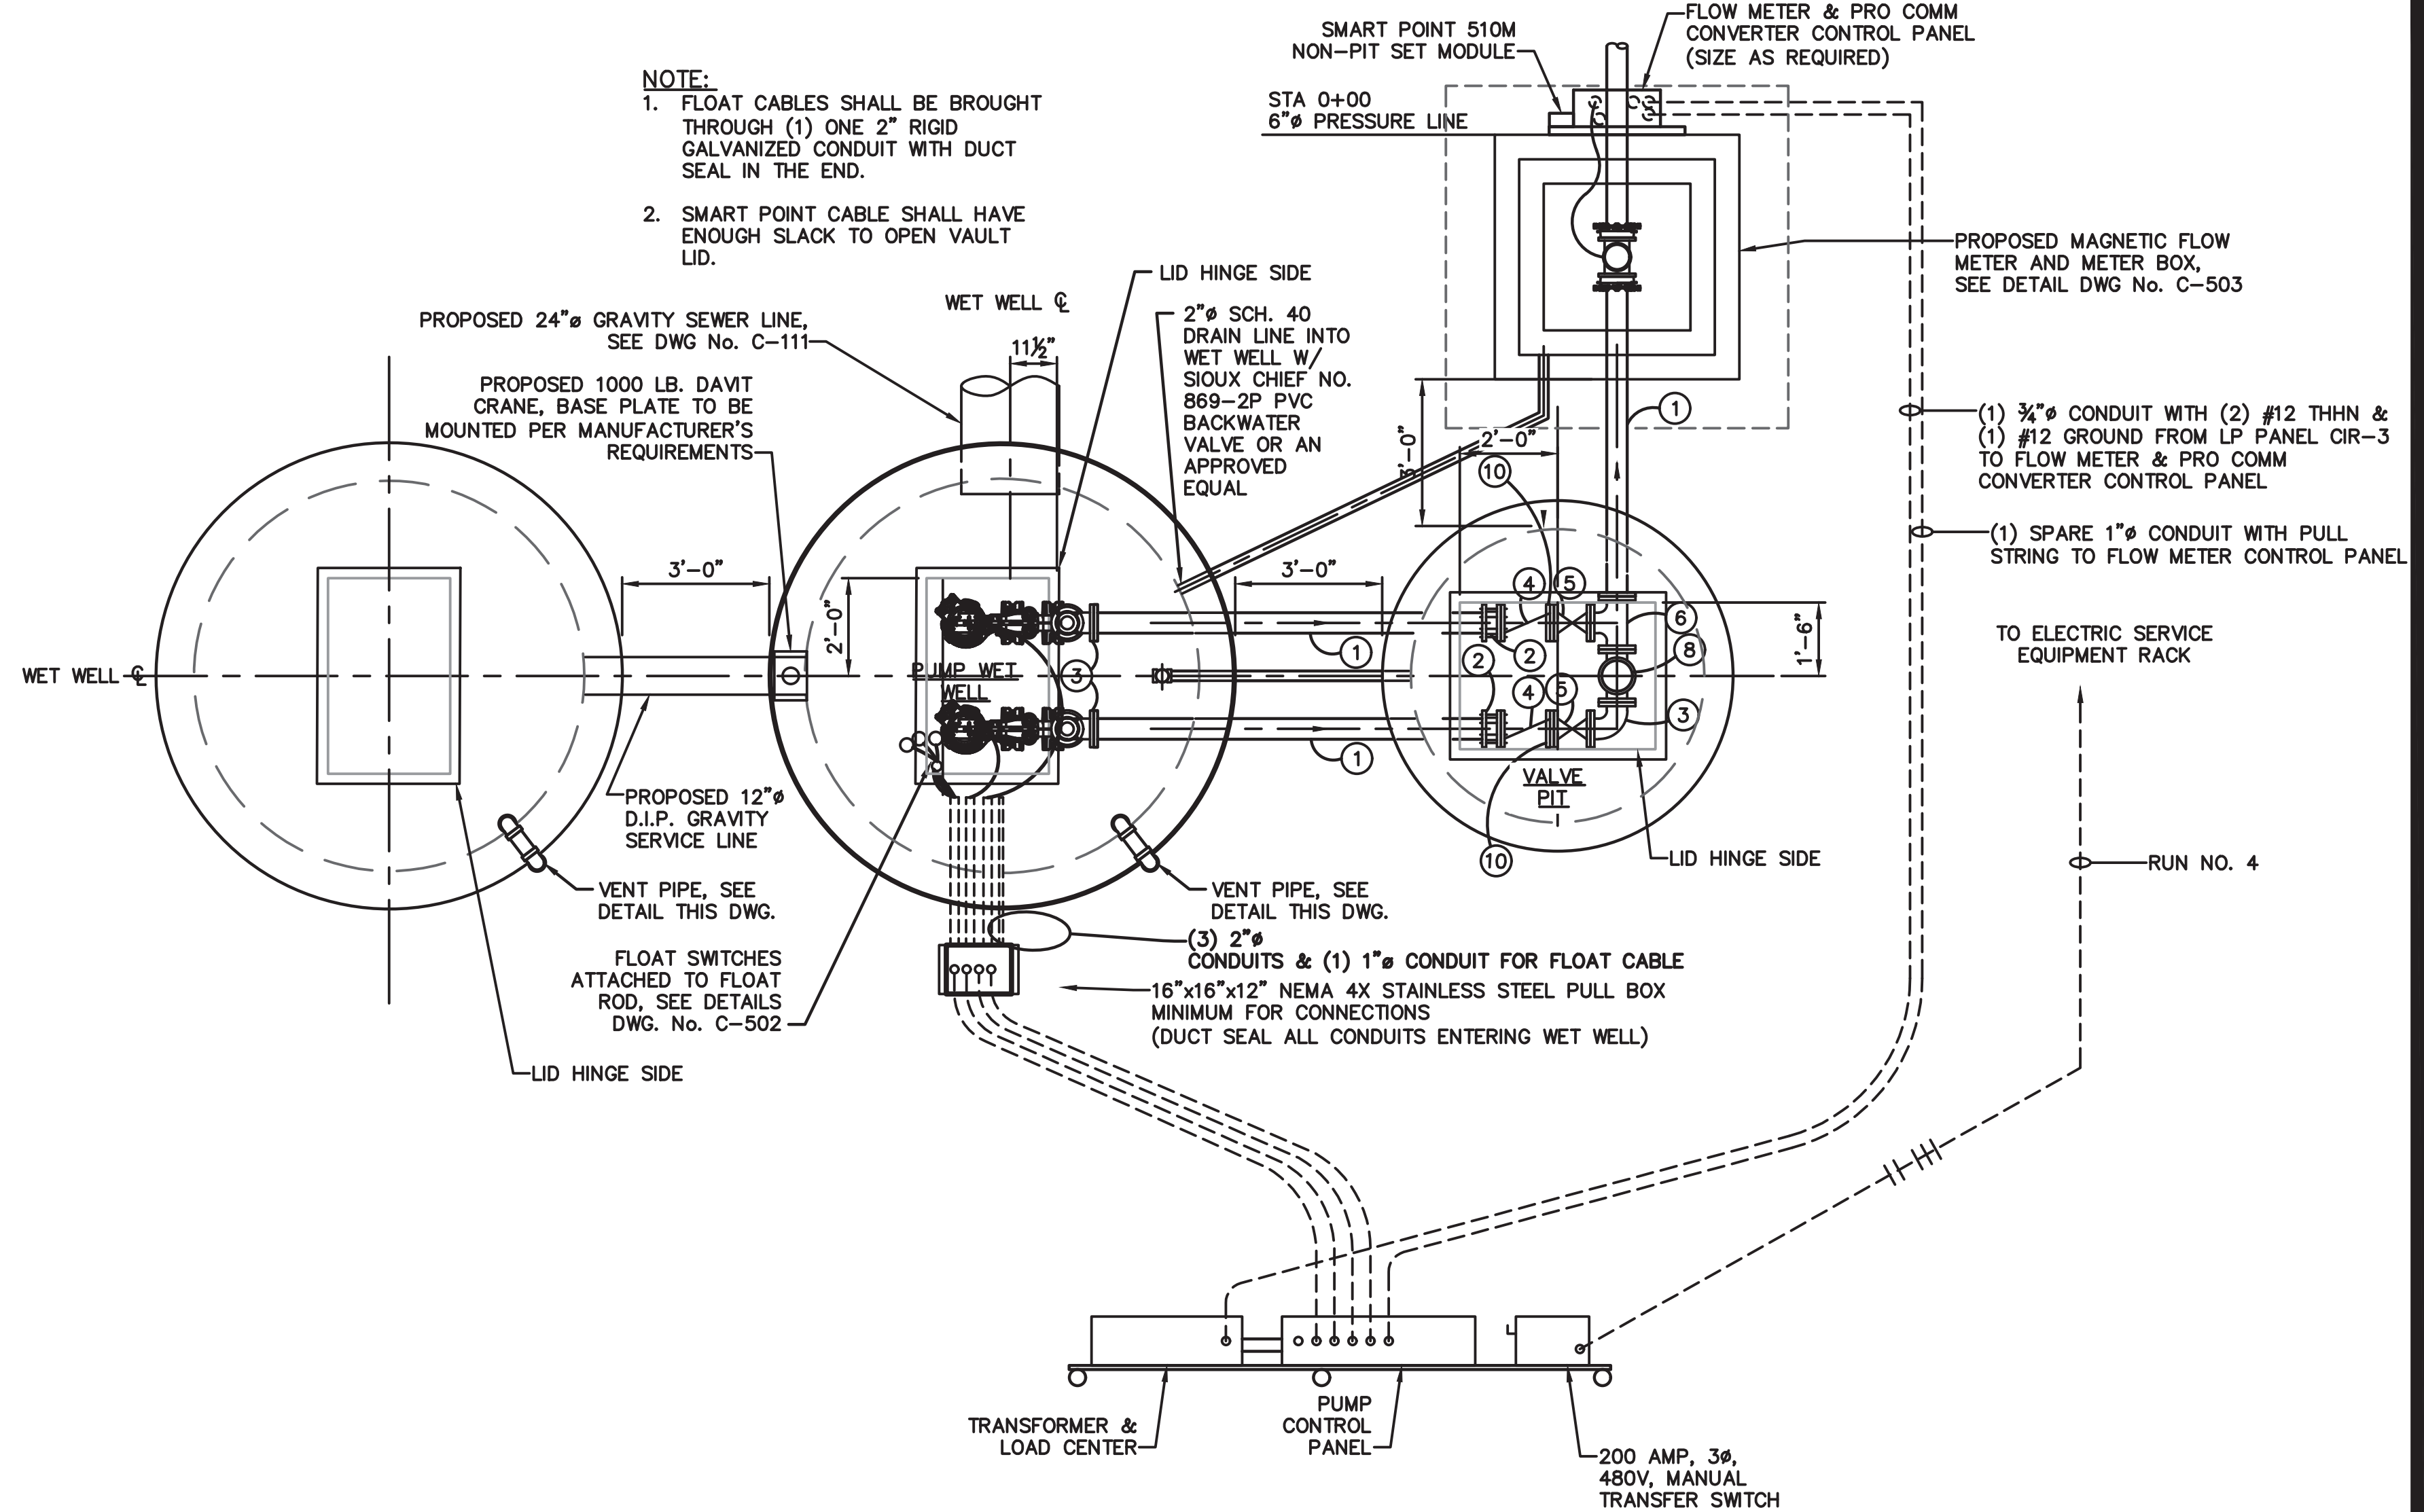


**LIFT STATION PIPING PLAN**  
3/8" = 1'-0"


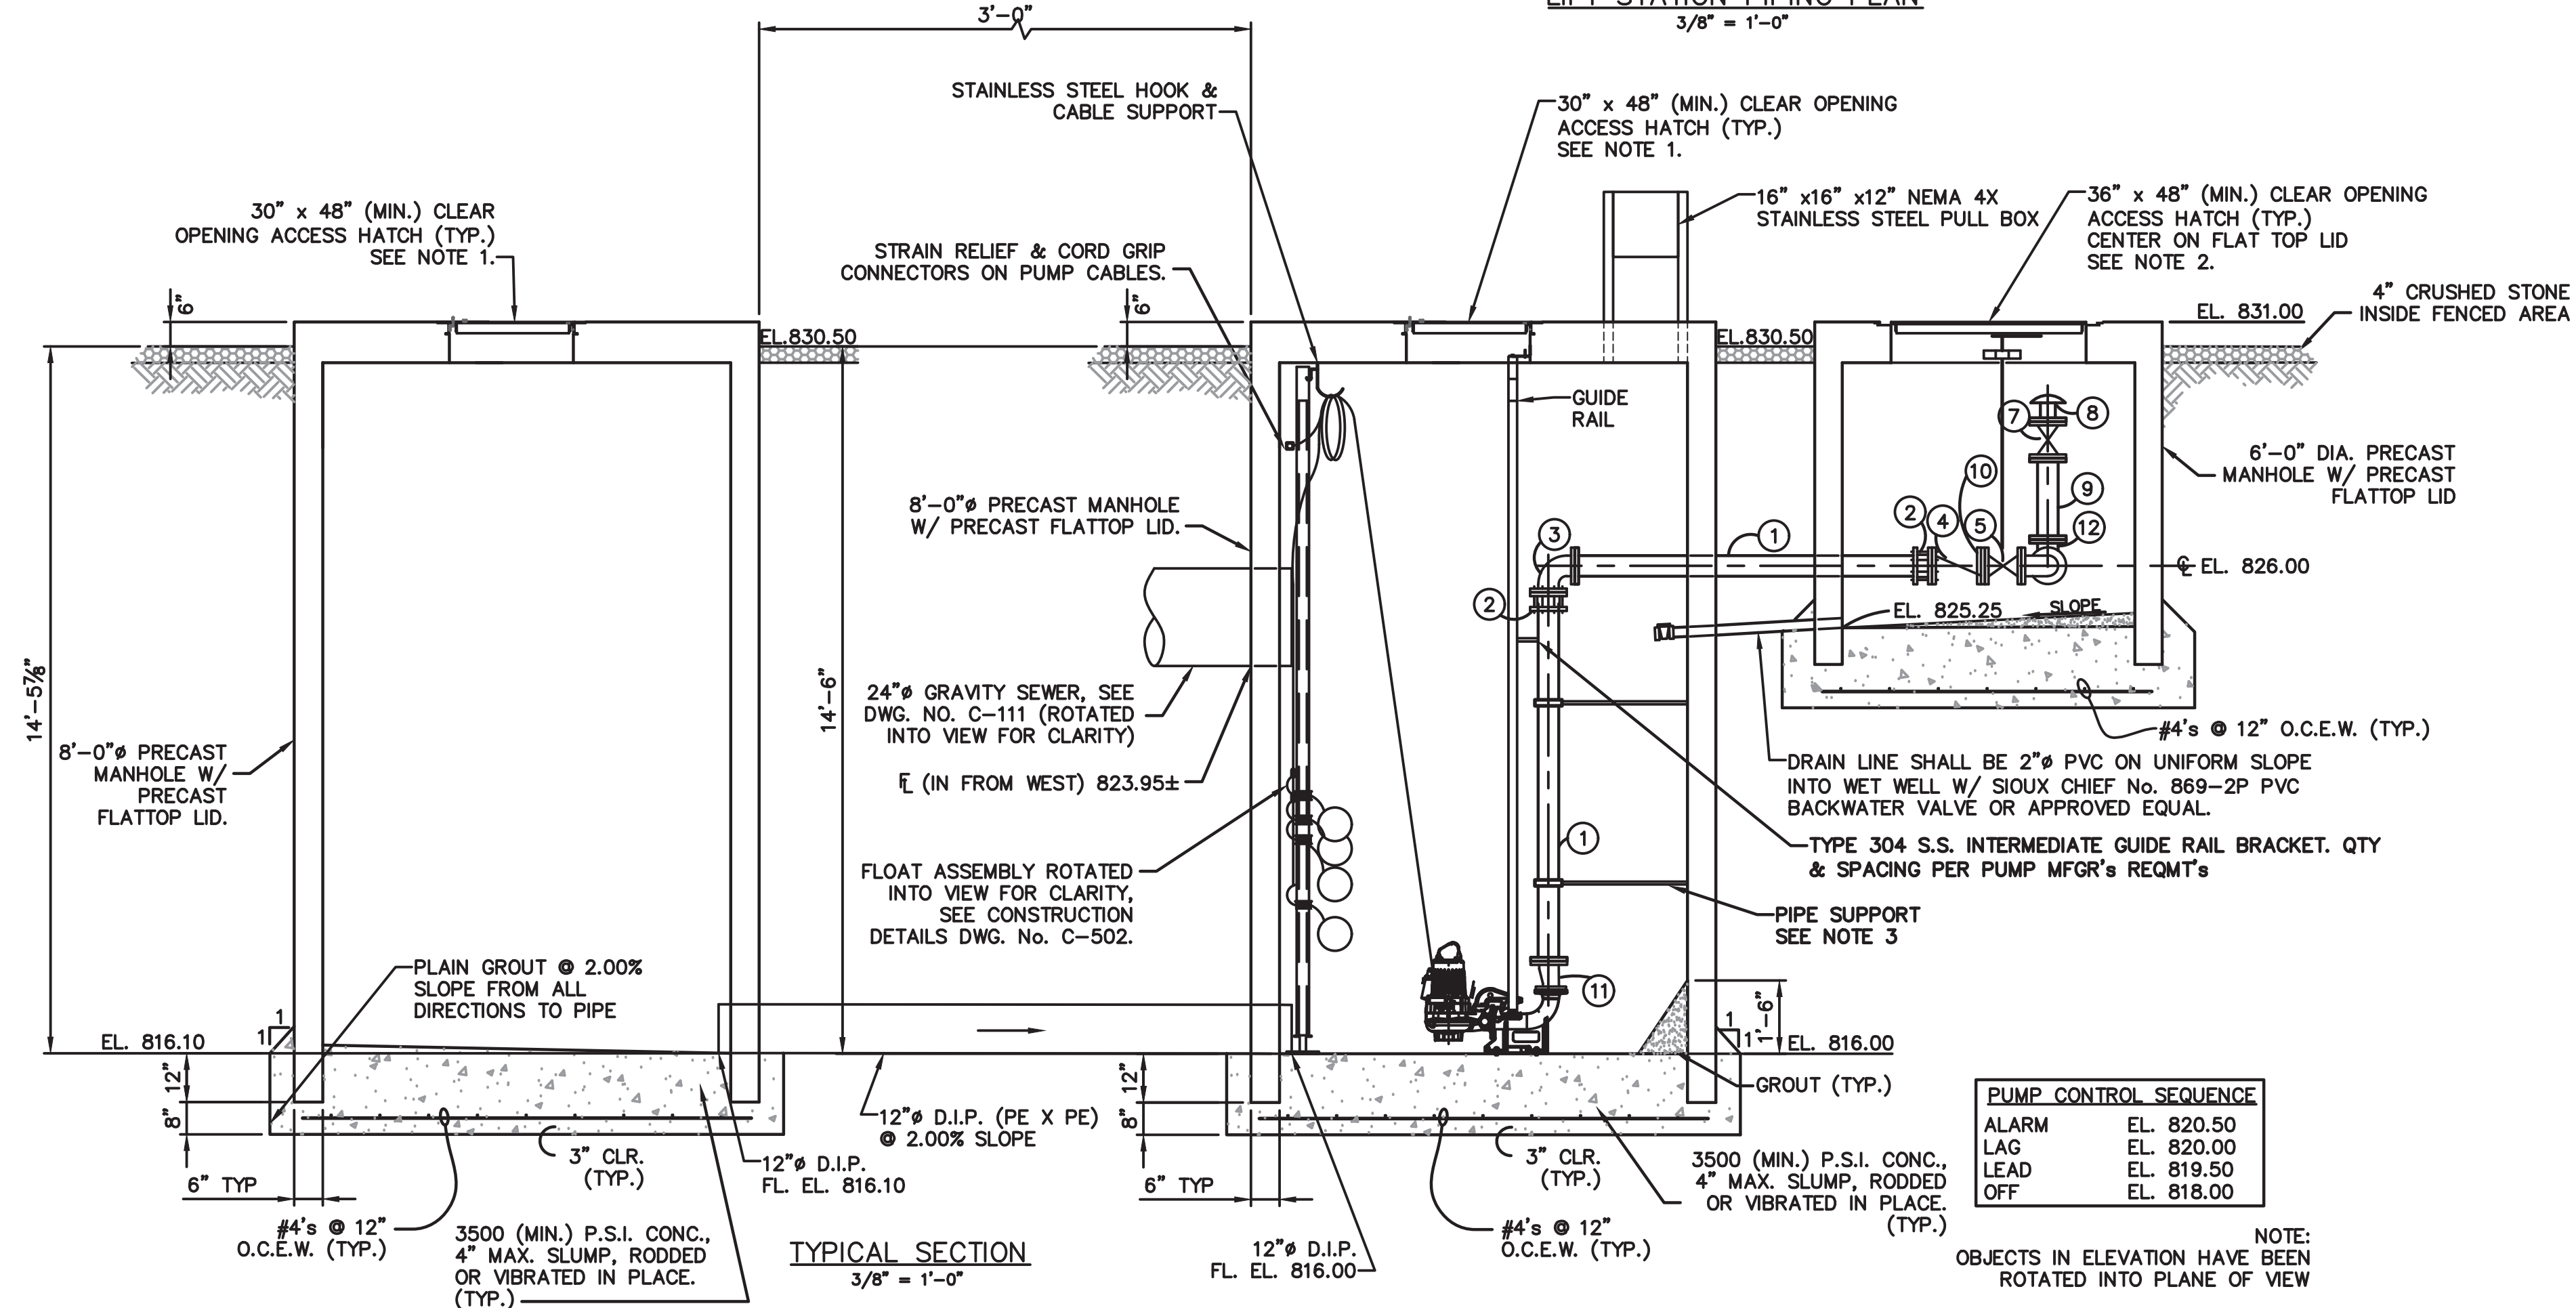


**TYPICAL SECTION**  
3/8" = 1'-0"


PUMP CONTROL SEQUENCE	
ALARM	EL. 820.50
LAG	EL. 820.00
LEAD	EL. 819.50
OFF	EL. 818.00

OBJECTS IN ELEVATION HAVE BEEN ROTATED INTO PLANE OF VIEW






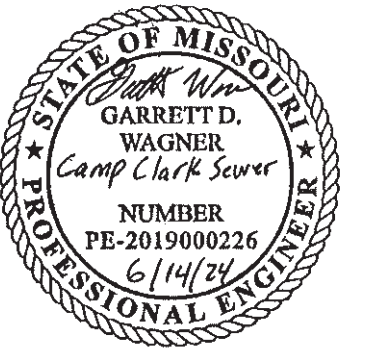


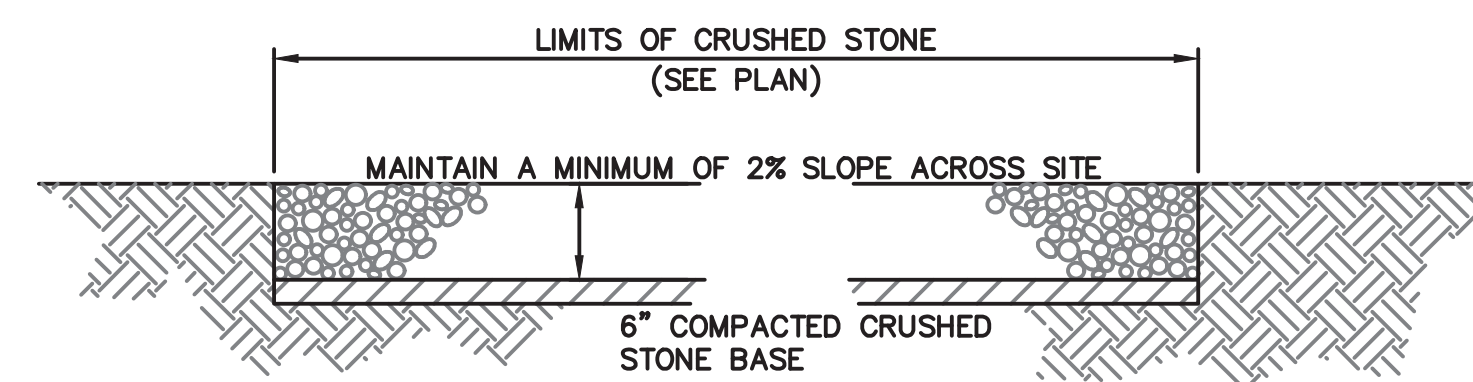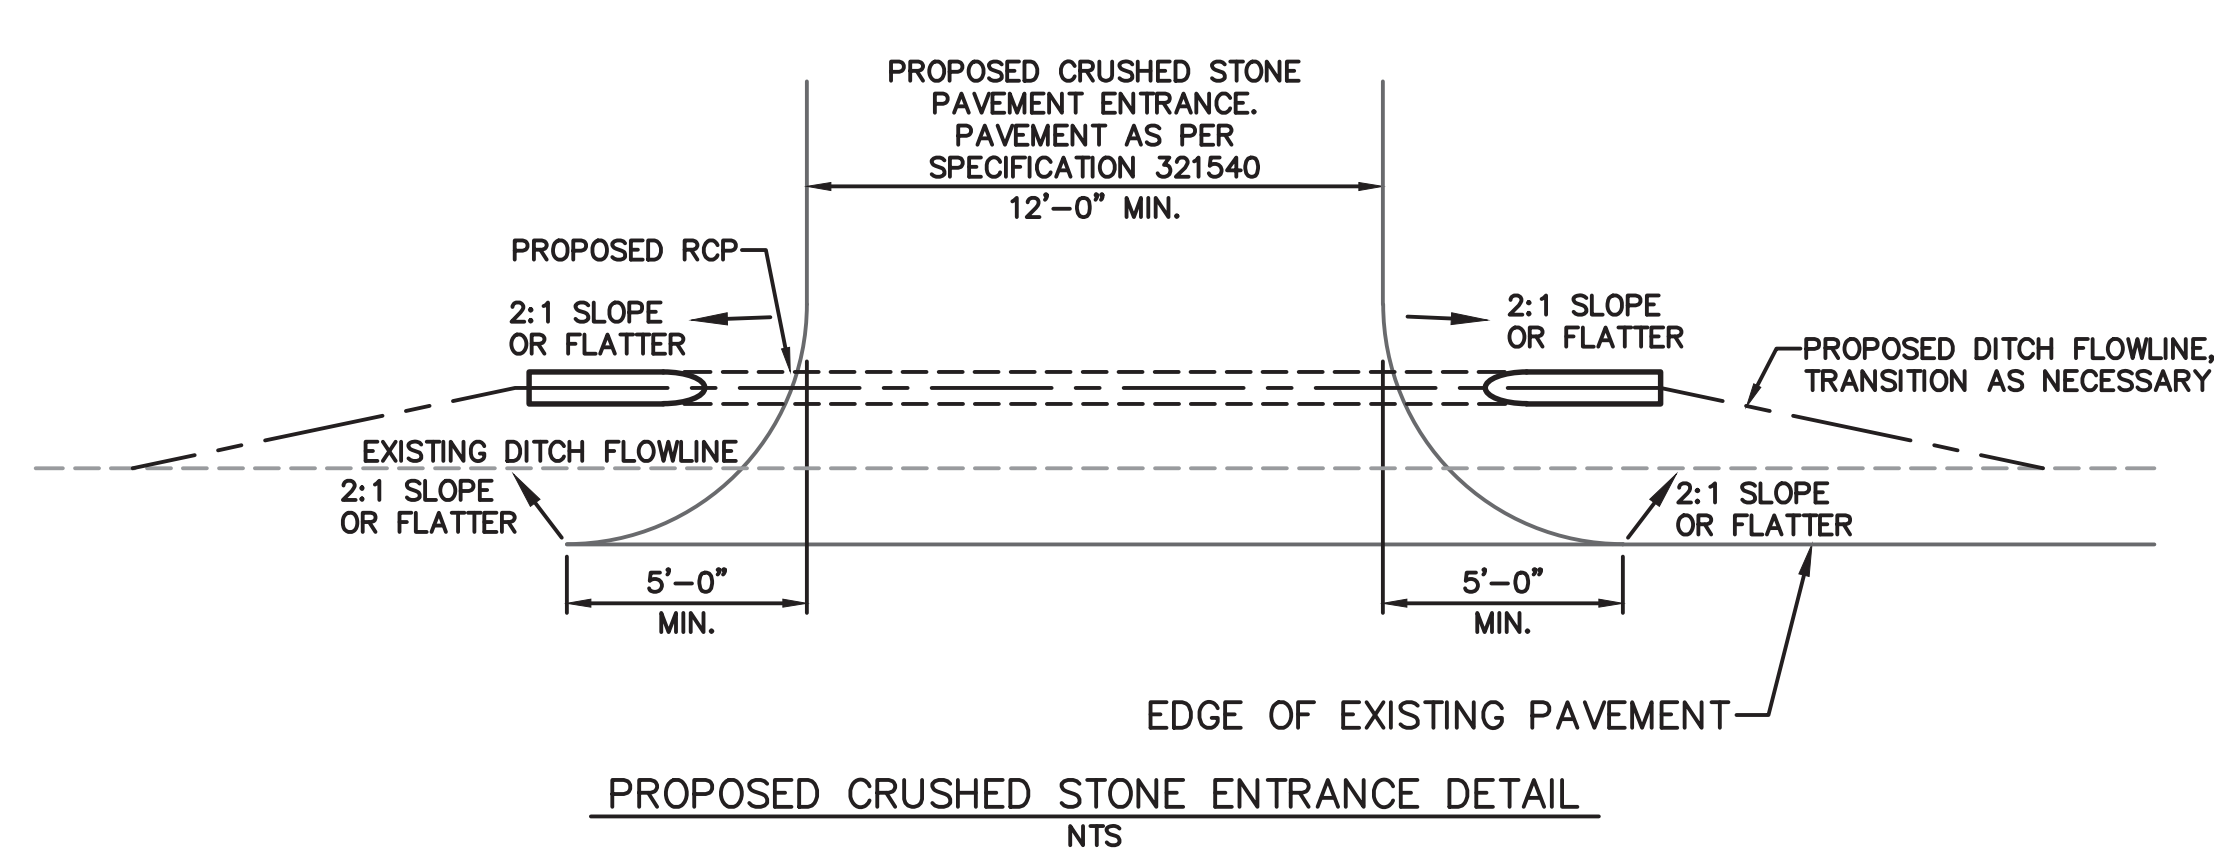





AIR RELIEF VALVE SCHEDULE		
NO.	STATION	TYPE
1	6+75	TYPE 2
2	12+35	TYPE 1
3	18+15	TYPE 1
4	27+97	TYPE 2
5	42+67	TYPE 2
6	52+17	TYPE 1
7	62+39	TYPE 2
8	79+55	TYPE 2

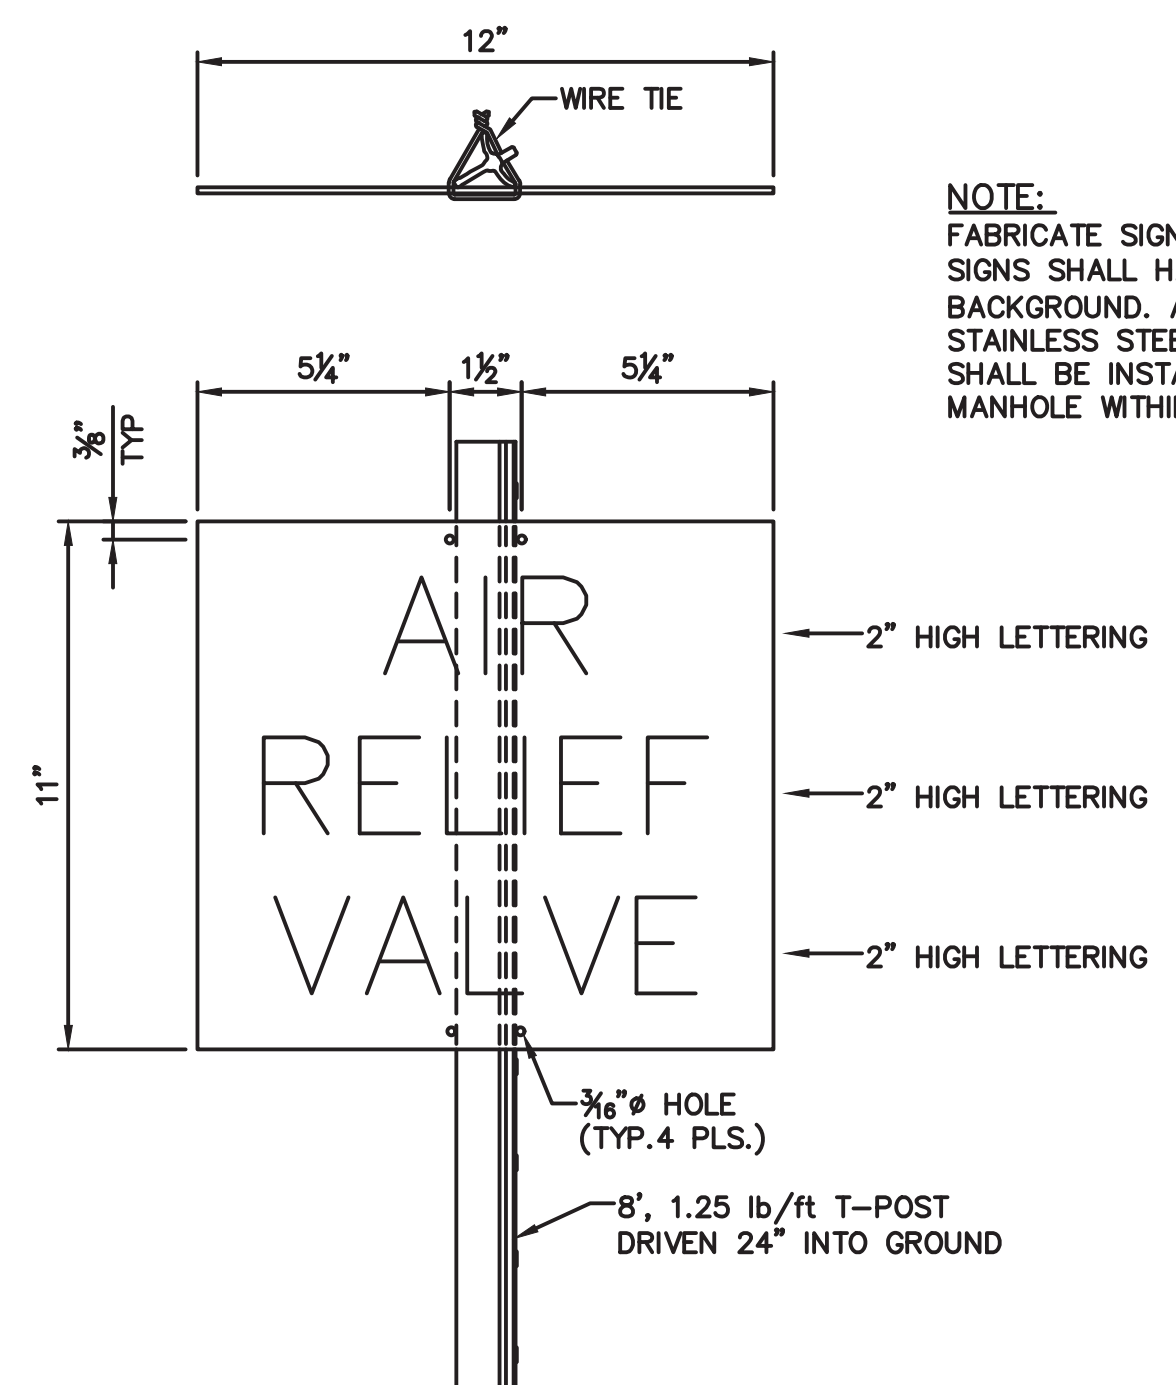

NOTE:  
FABRICATE SIGNS FROM 0.08" 3003 ALUMINUM SHEET. SIGNS SHALL HAVE BLACK LETTERING ON WHITE BACKGROUND. ATTACH SIGNS TO T-POST W/ 1/8" STAINLESS STEEL WIRE AT ANY LOCATION AS SHOWN. SIGN SHALL BE INSTALLED THREE FEET AWAY FROM CENTER OF MANHOLE WITHIN EASEMENT.

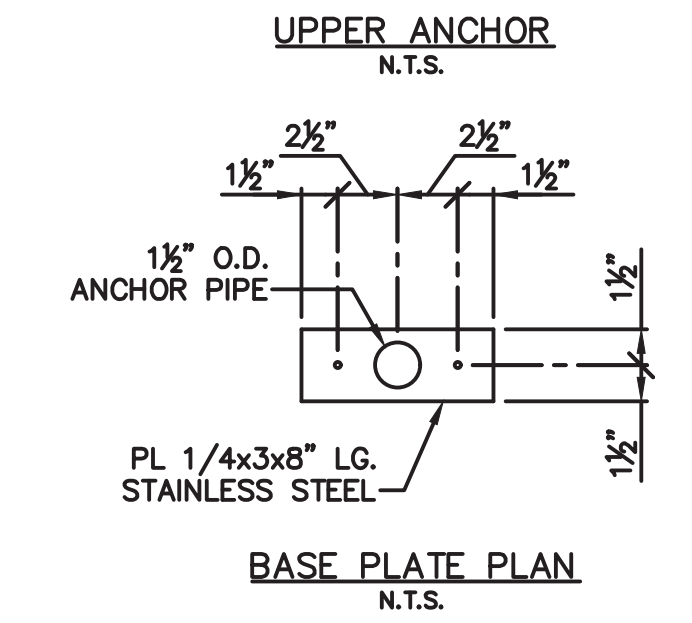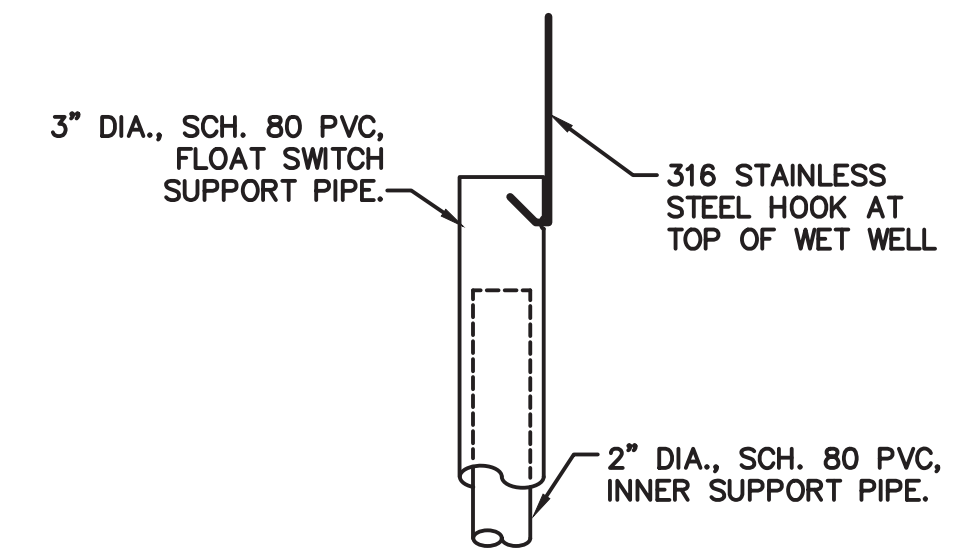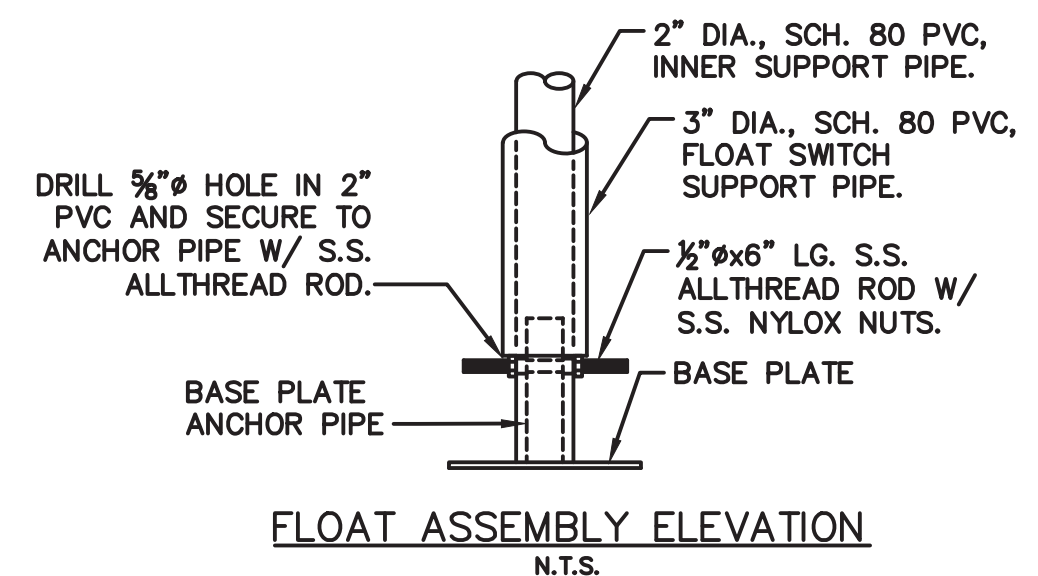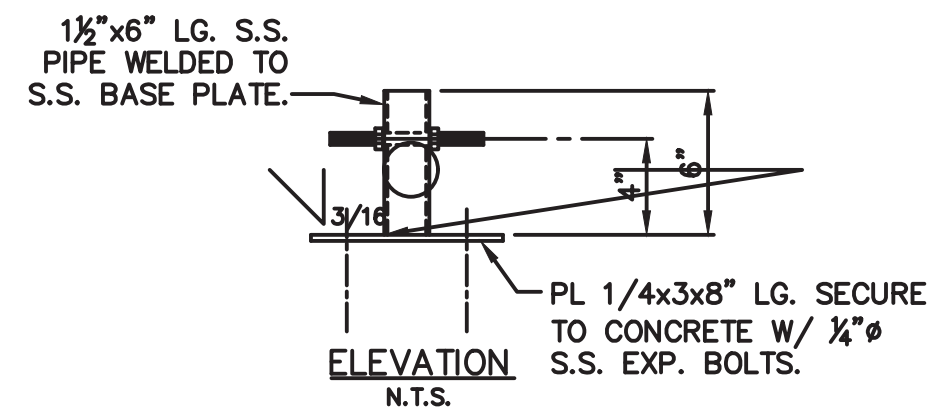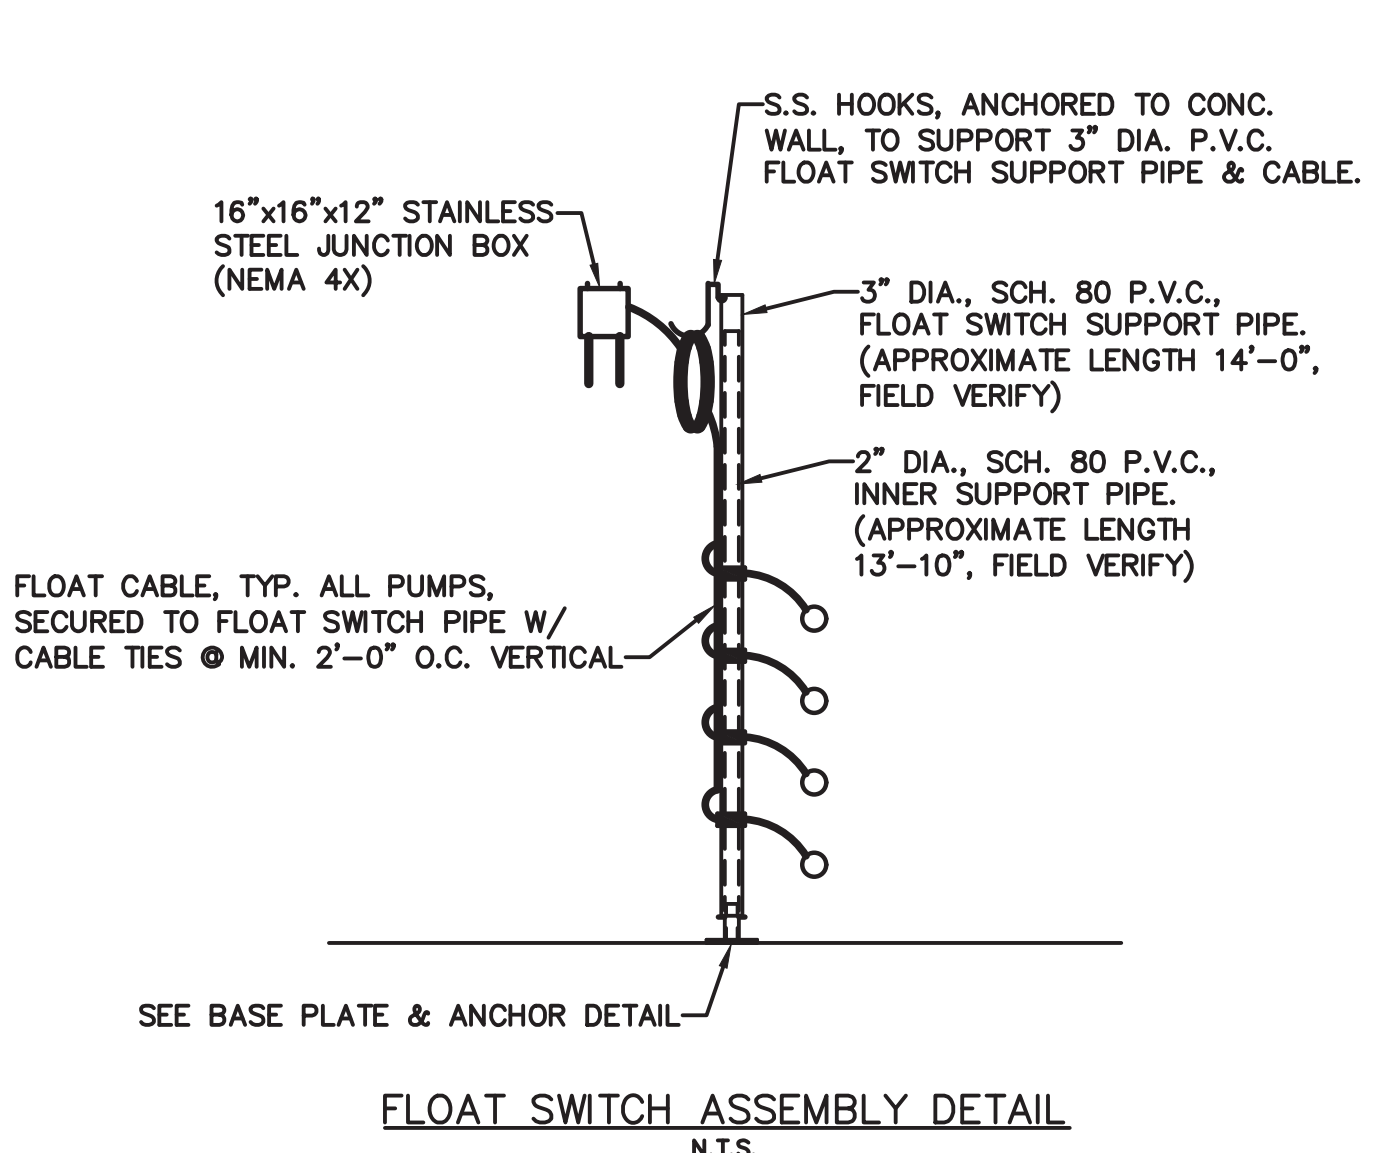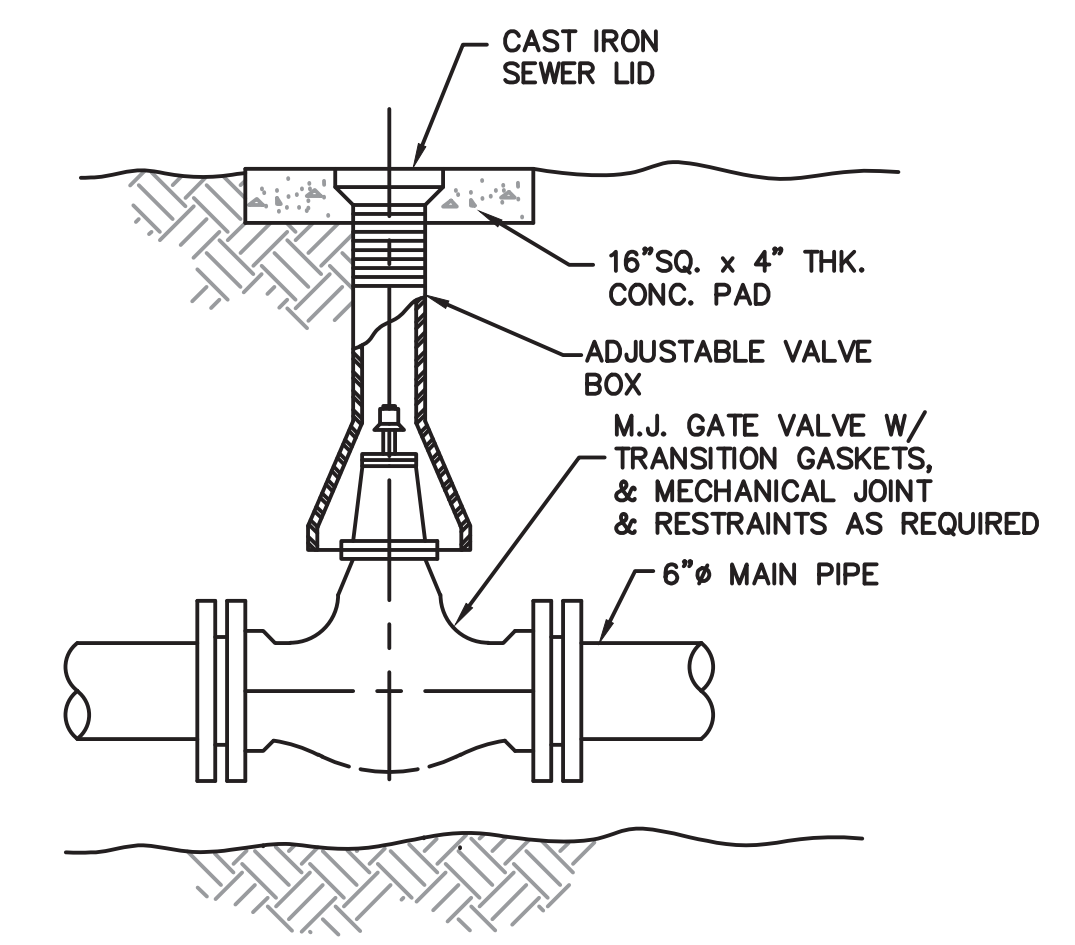

GROUNDING LEGEND

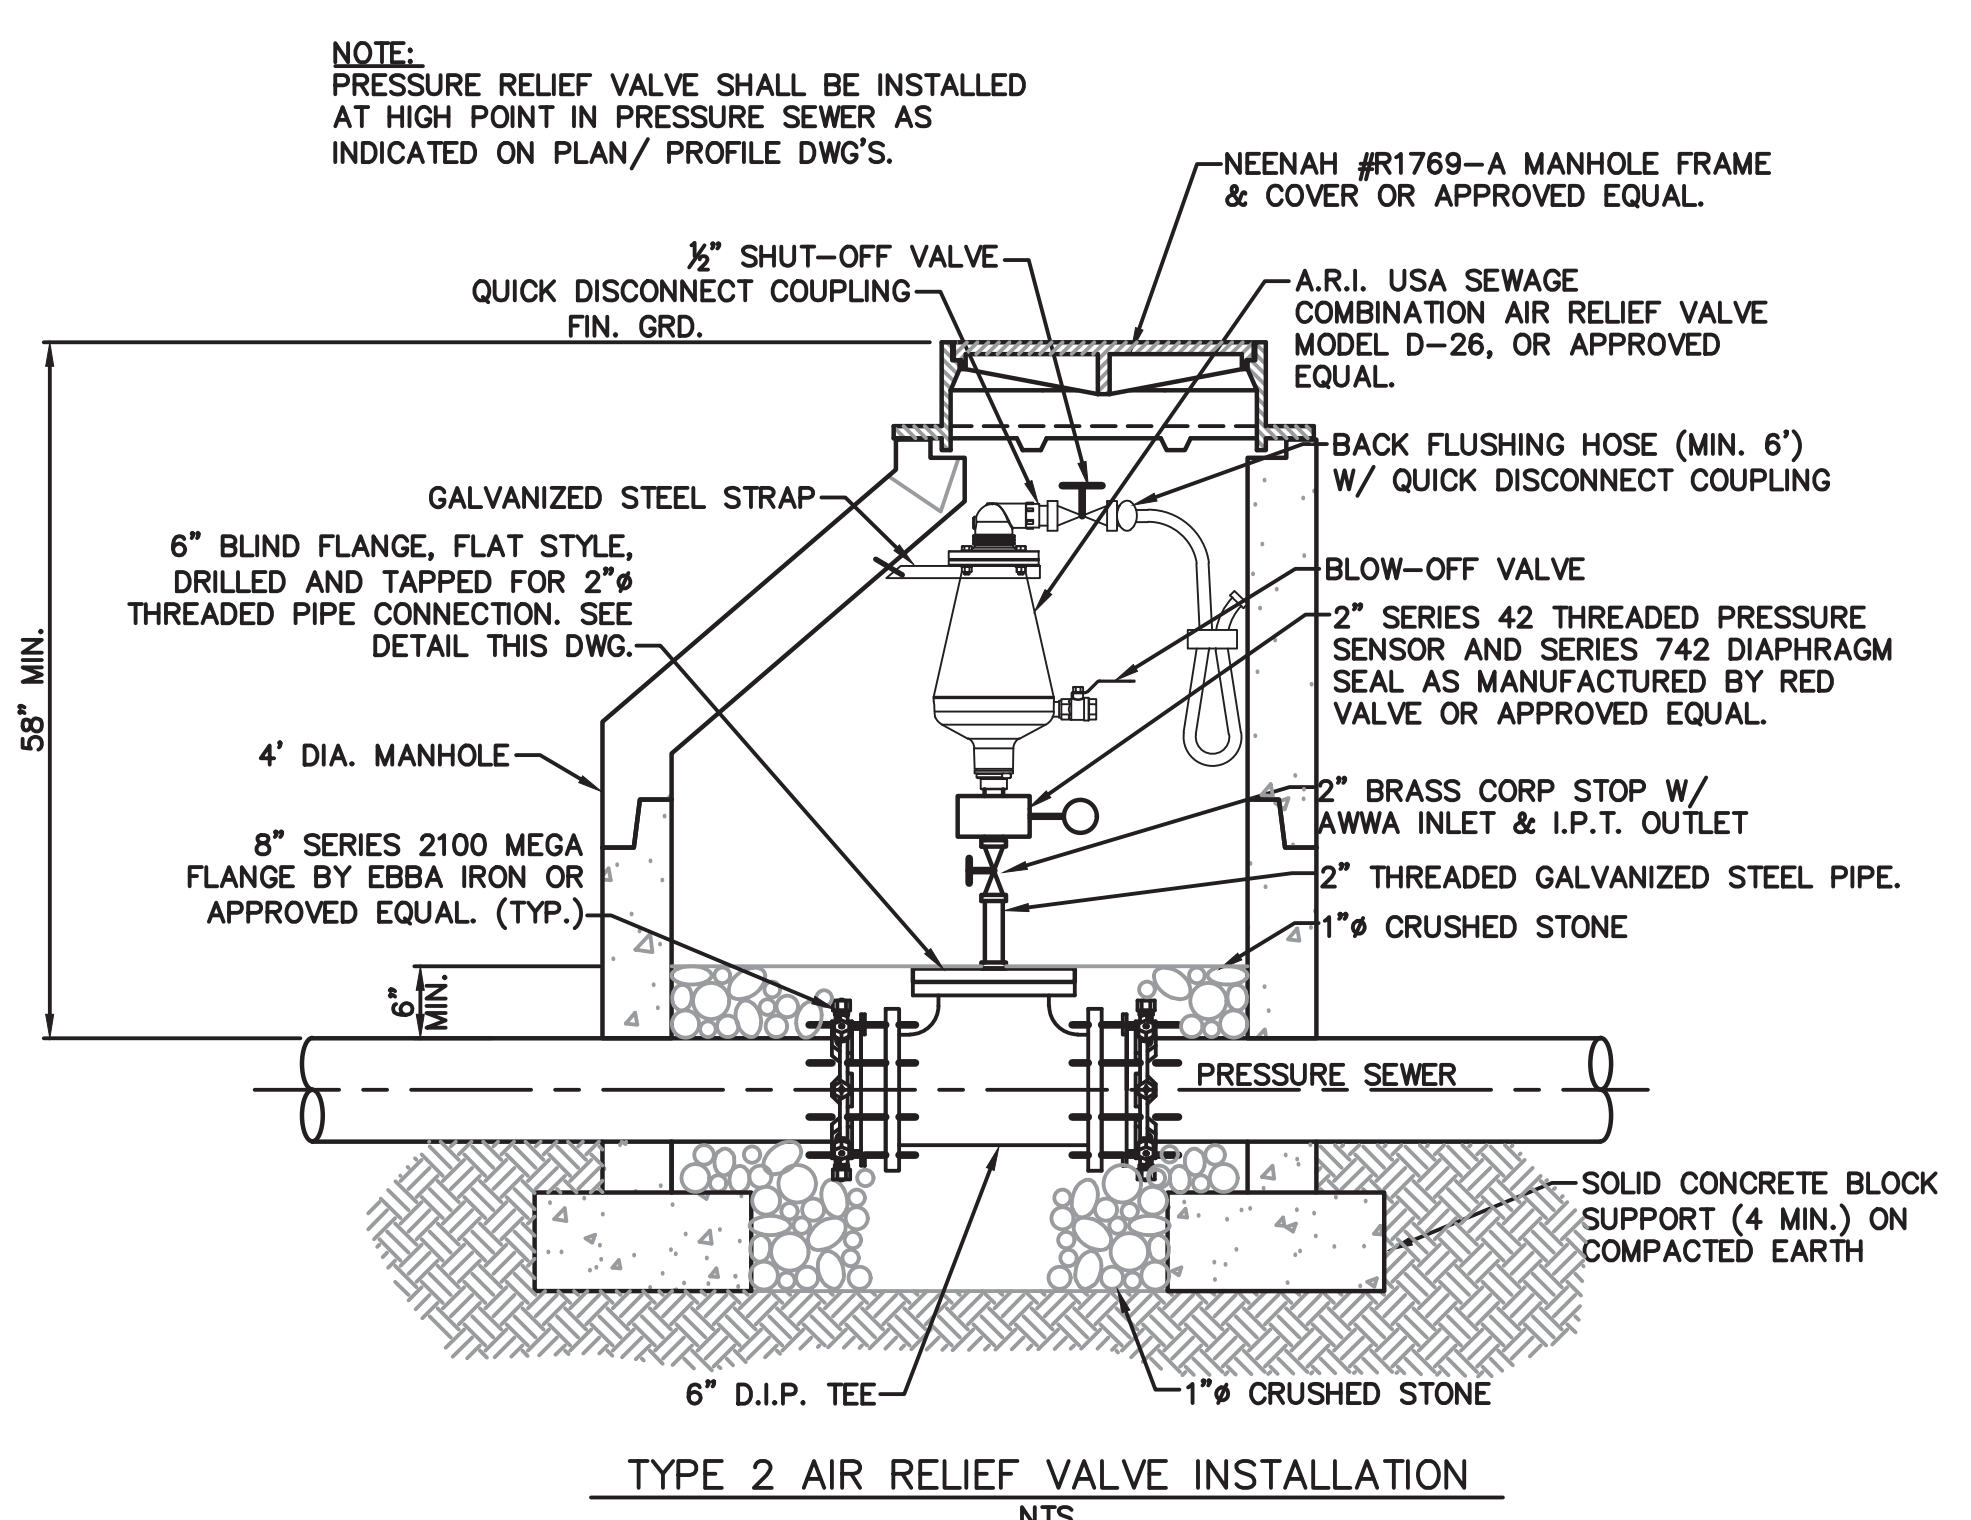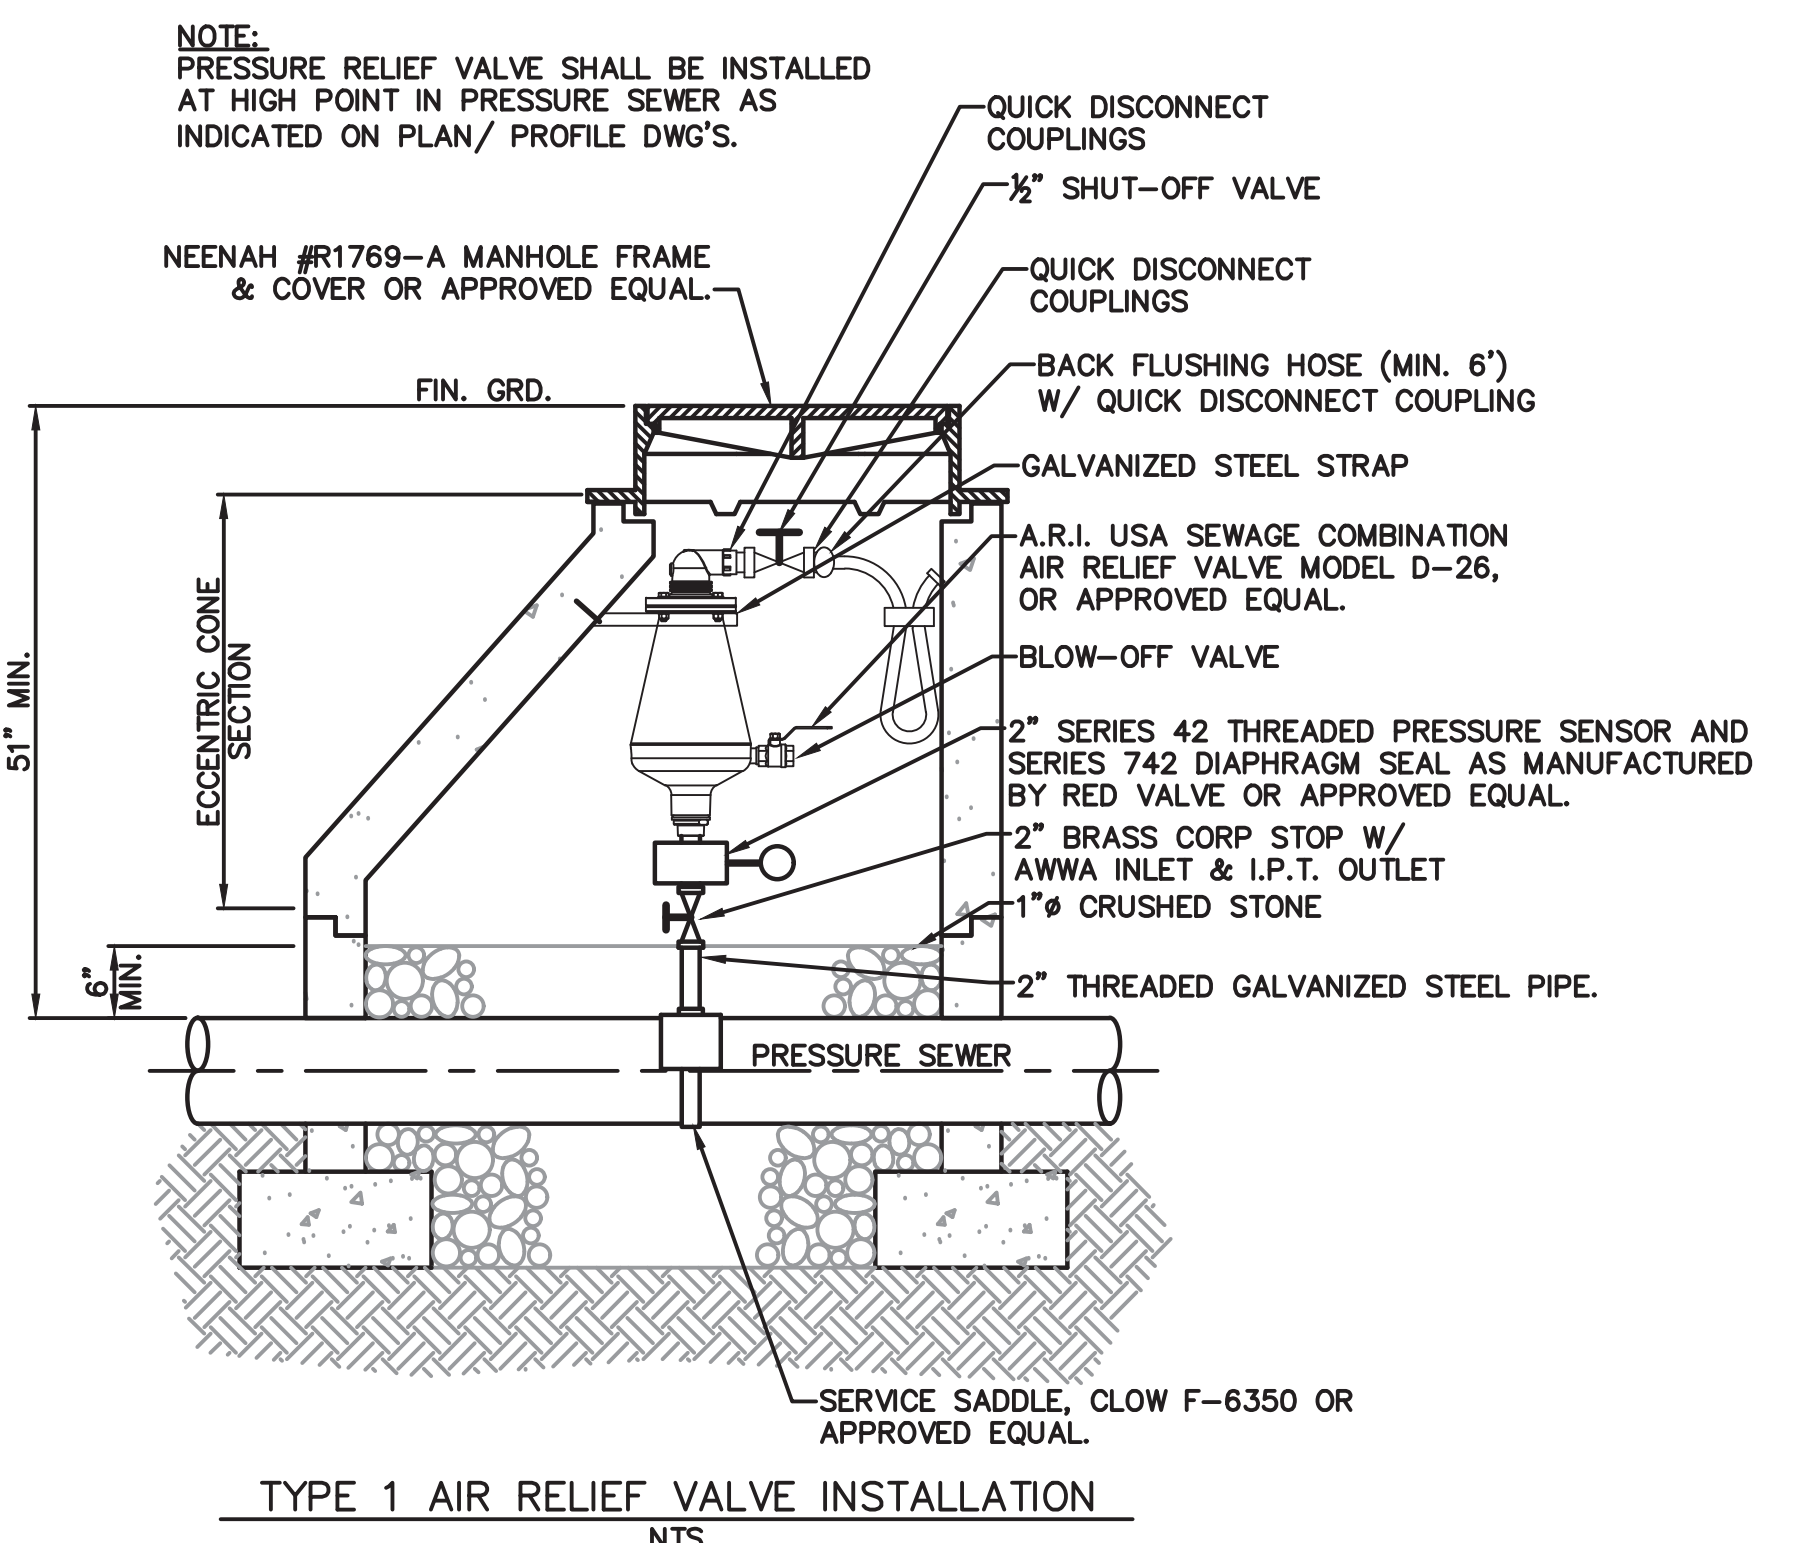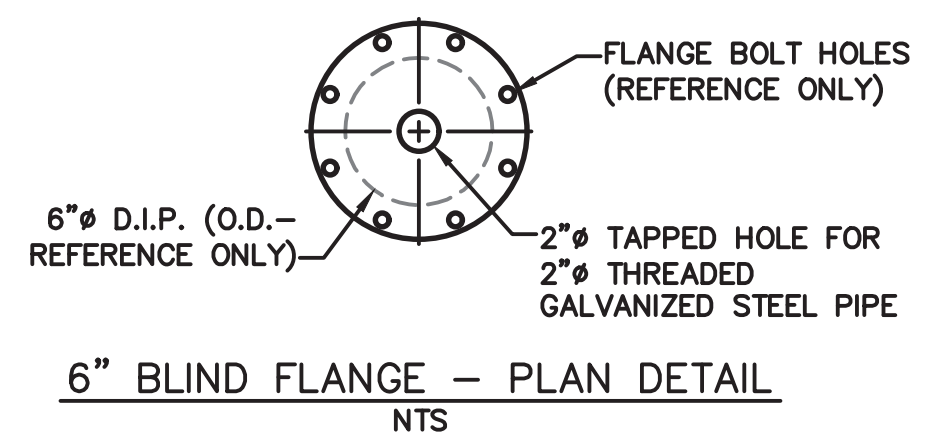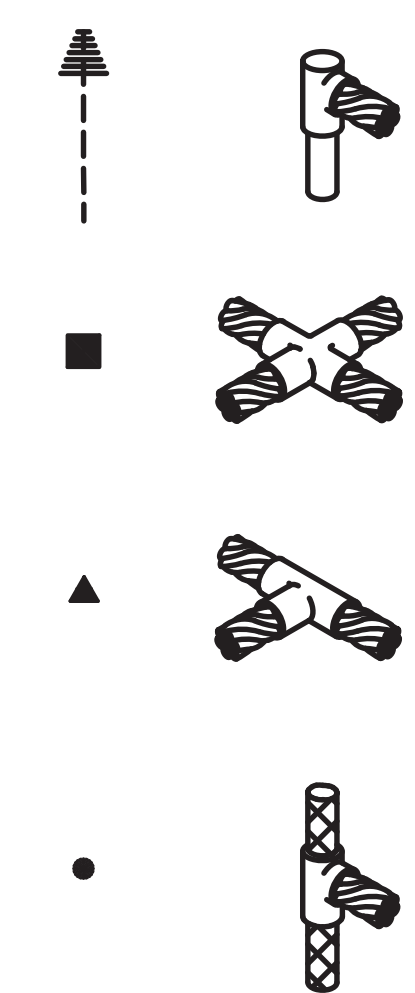

NOTE:  
PRESSURE RELIEF VALVE SHALL BE INSTALLED AT HIGH POINT IN PRESSURE SEWER AS INDICATED ON PLAN/ PROFILE DWG'S.

NOTE:  
PRESSURE RELIEF VALVE SHALL BE INSTALLED AT HIGH POINT IN PRESSURE SEWER AS INDICATED ON PLAN/ PROFILE DWG'S.

TYPE 1 AIR RELIEF VALVE INSTALLATION  
NTS

TYPE 2 AIR RELIEF VALVE INSTALLATION  
NTS

**NOTES:**

- (1) EA. ALUMINUM ACCESS DOOR SHALL BE HALLIDAY PRODUCTS MODEL No. S1S3636 SINGLE LEAF CONSTRUCTION FOR A 36" x 36" CONCRETE OPENING OR AN APPROVED EQUAL. DOOR SHALL HAVE A LOAD RATING OF 300 LBS. PER SQ. FT. LOCATION OF ACCESS DOOR SHALL BE AS DIMENSIONED W/ HINGE SIDE AS NOTED. INSTALLATION OF ACCESS DOOR MAY BE EITHER CAST-IN-PLACE OR GROUTED-IN-PLACE PER MFR'S. REQMT'S. THAT PORTION OF THE ACCESS DOOR FRAME IN CONTACT WITH CONCRETE OR GROUT SHALL HAVE A HEAVY SHOP COAT OF BITUMINOUS PAINT.
- FLOW METER BOX - (1) EA. WITH THE FOLLOWING REQUIREMENTS: THE METER BOX SHALL BE PRECAST REINFORCED CONCRETE WALLS, TOP & BOTTOM W/ FOLLOWING DIMENSIONS: 4'-0" x 4'-0" INSIDE, 6 3/4" THICK WALLS, 8" THICK TOP & 8" THICK BOTTOM. DEPTH PER PLANS. SMOOTH CAST HOLES IN WALLS FOR 6"Ø D.I. PIPES W/ HOLES LOCATED PER PIPING PLAN & SECTION. SMOOTH CAST HOLE IN BOTTOM SLAB FOR 2"Ø SCH. 40 P.V.C. PIPE W/ HOLE LOCATED PER PIPING PLAN & SECTION. INSTALLATION OF ALL PIPES SHALL BE PER REQUIREMENTS OF NOTE 3. ACCESS DOOR PER NOTE 1 IN TOP WITH LOCATION PER PIPING PLAN & SECTION
- PIPES SHALL BE INSTALLED IN CAST HOLES OF VALVE BOX & WET WELL WITH A BENTONITE/BUTYL-RUBBER BASED COMPOUND STRIP WATERSTOP ON THE PIPE WITH ONE (1) 360° WRAP AROUND PIPE WITH ENDS BUTTED TOGETHER TO FORM A CONTINUOUS WATERSTOP PER MFR'S. REQMT'S. LOCATION ON THE PIPE SHALL COINCIDE WITH THE CENTER OF THE WALL OR SLAB. WATERSTOP SHALL BE VOLCLAY WATERSTOP RX-102 (3/8" x 3/4") OR AN APPROVED EQUAL. AFTER PLACEMENT OF THE PIPE & WATERSTOP, FILL ANNULAR SPACE WITH NON-SHRINK, NON-METALLIC GROUT, FLUSH WITH BOTH SURFACES.


**GENERAL NOTES:**

CONTRACTOR SHALL BE RESPONSIBLE FOR SUPPLYING & INSTALLING FLOW METER, PIPING, VALVES, FITTINGS & APPURTENANCES FOR A COMPLETE & FUNCTIONING SYSTEM.

PIPE SIZE & TYPE AS NOTED & SHOWN ON DRAWINGS. PIPE LENGTHS VARIABLE, AS REQUIRED FOR INSTALLATION PER DRAWINGS. FOR COMPLETE DESCRIPTION OF PIPE, CLASS & MATERIAL, SEE SPECIFICATIONS.



ALL PIPING, VALVES & FITTINGS SHALL BE ADEQUATELY SUPPORTED. FOR TYPICAL PIPE SUPPORTS & HANGERS; FLOOR, WALL & CEILING, SEE SPECIFICATIONS.

ALL BURIED PIPE FITTINGS (BENDS, TEES, PLUGS, CAPS, ETC.) SHALL BE PLAIN CONCRETE THRUST BLOCKED AGAINST UNDISTURBED EARTH.

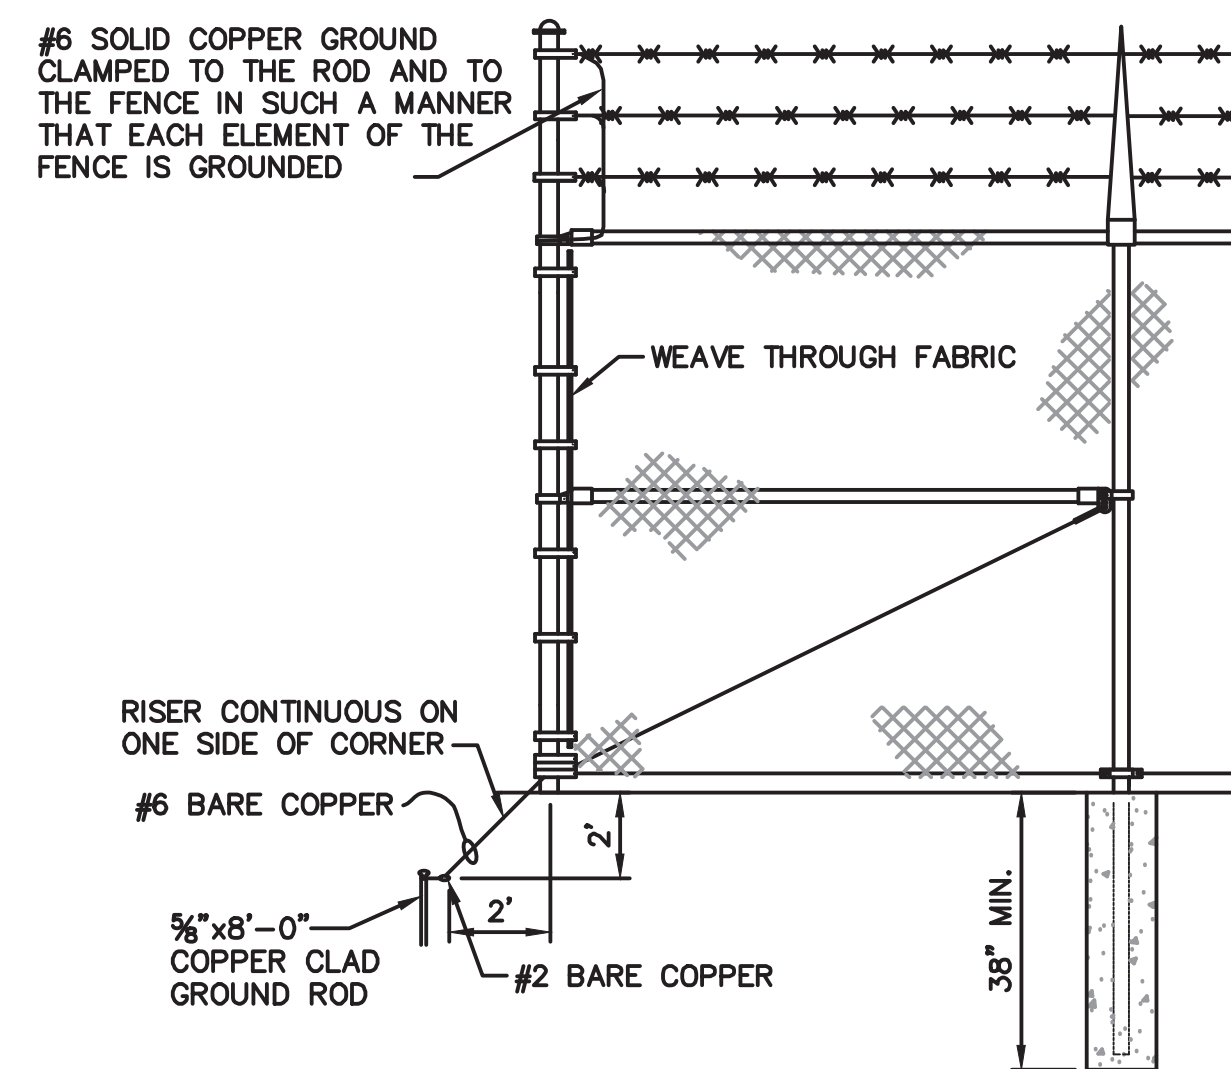


CHAINLINK FENCE GROUNDING  
NTS


**GROUNDING LEGEND**

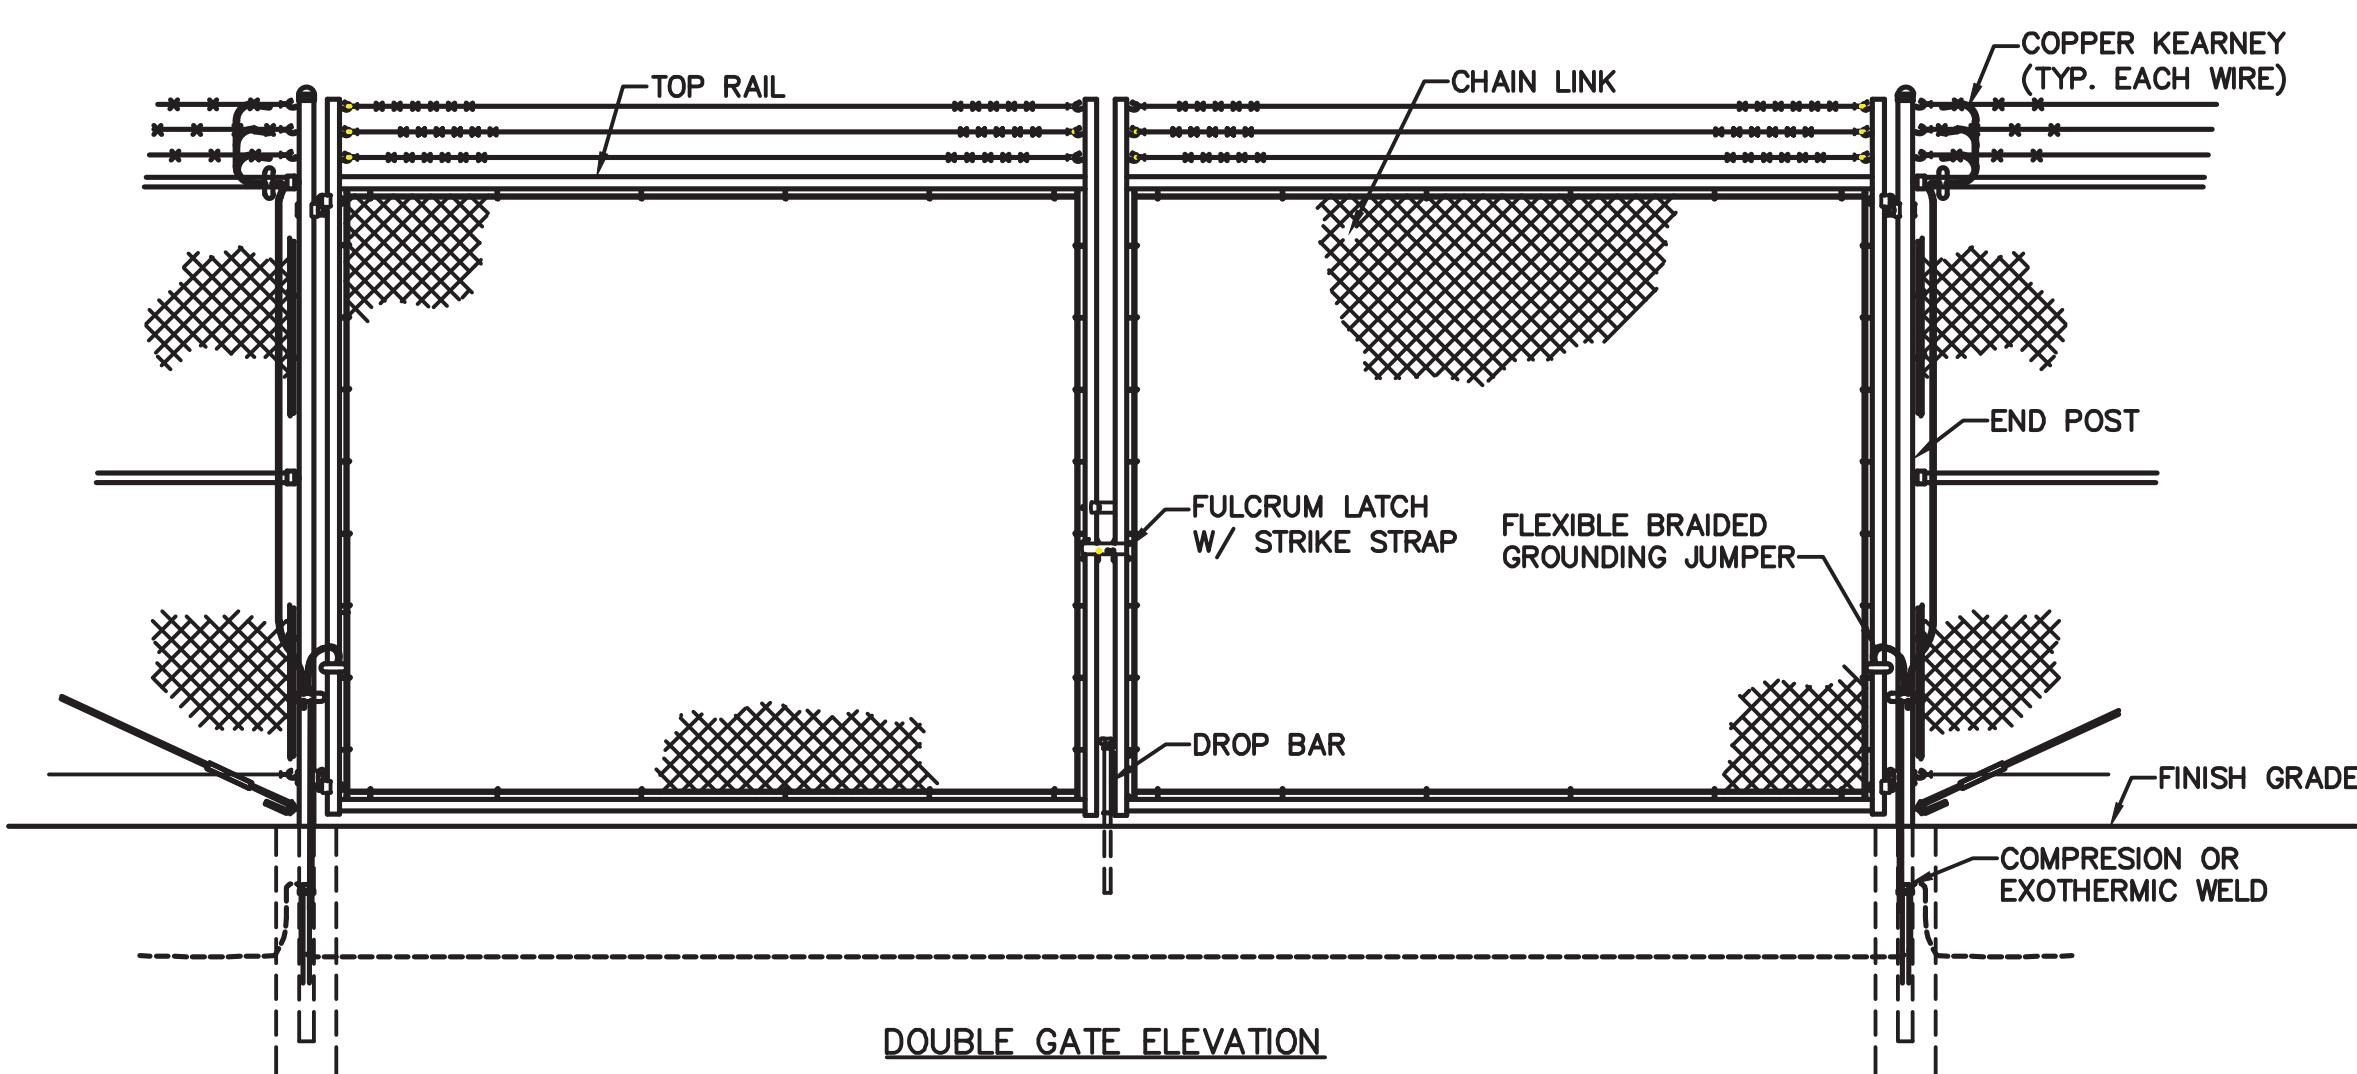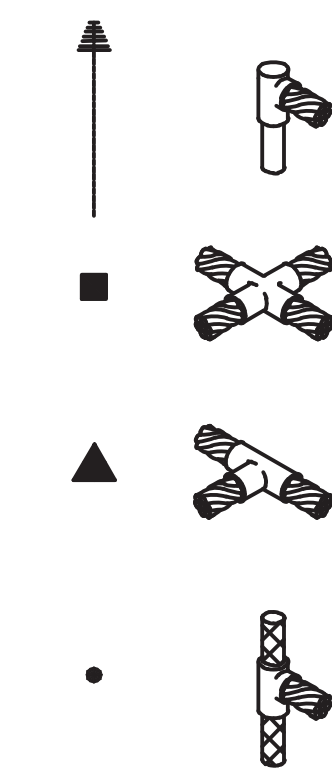


DOUBLE GATE ELEVATION

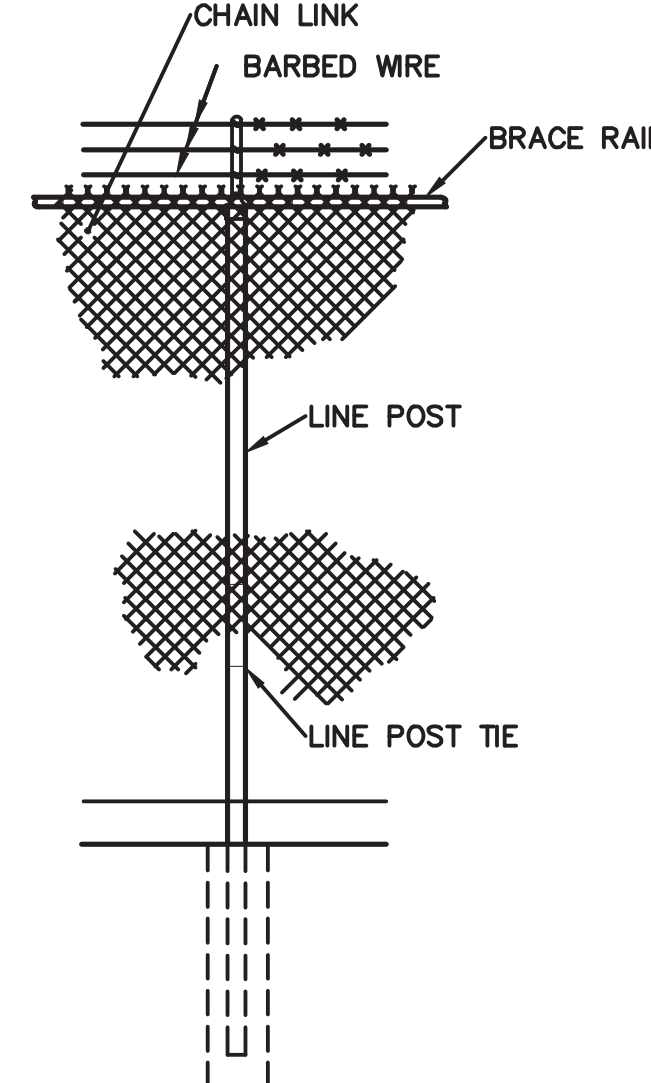


FENCE SECTION ELEVATION

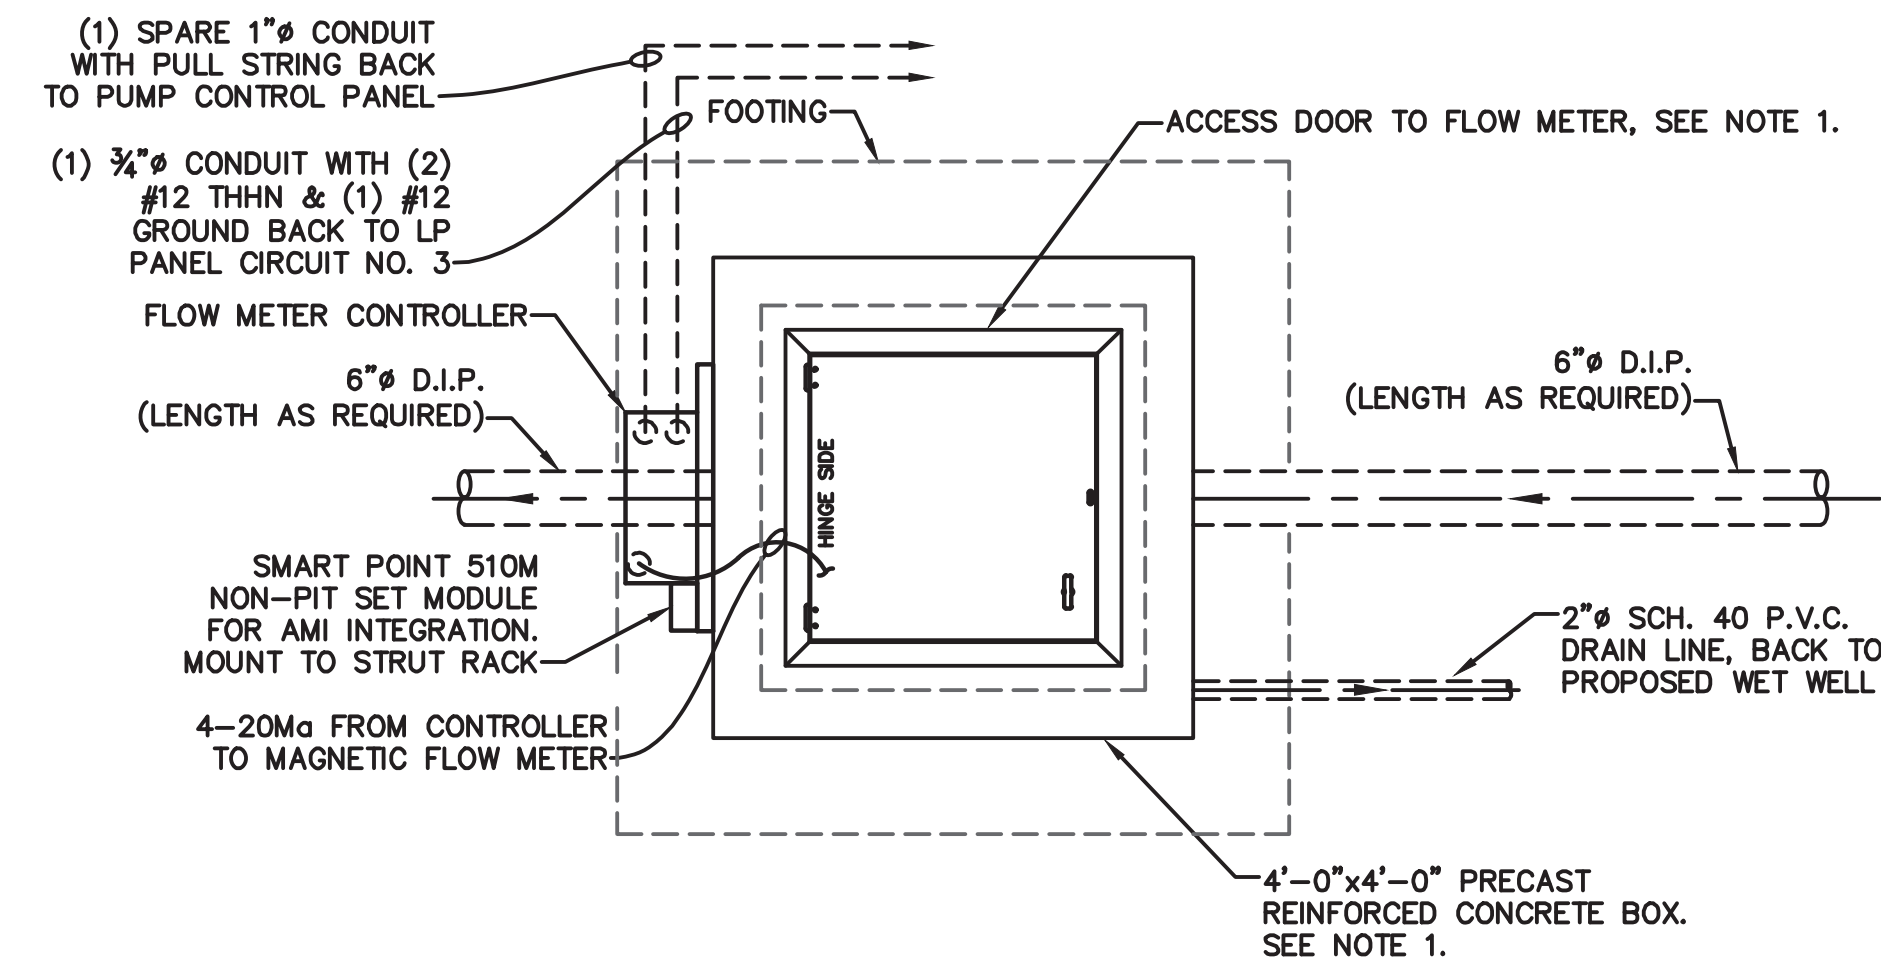

FLOW METER GENERAL PLAN  
1/2" = 1'-0"

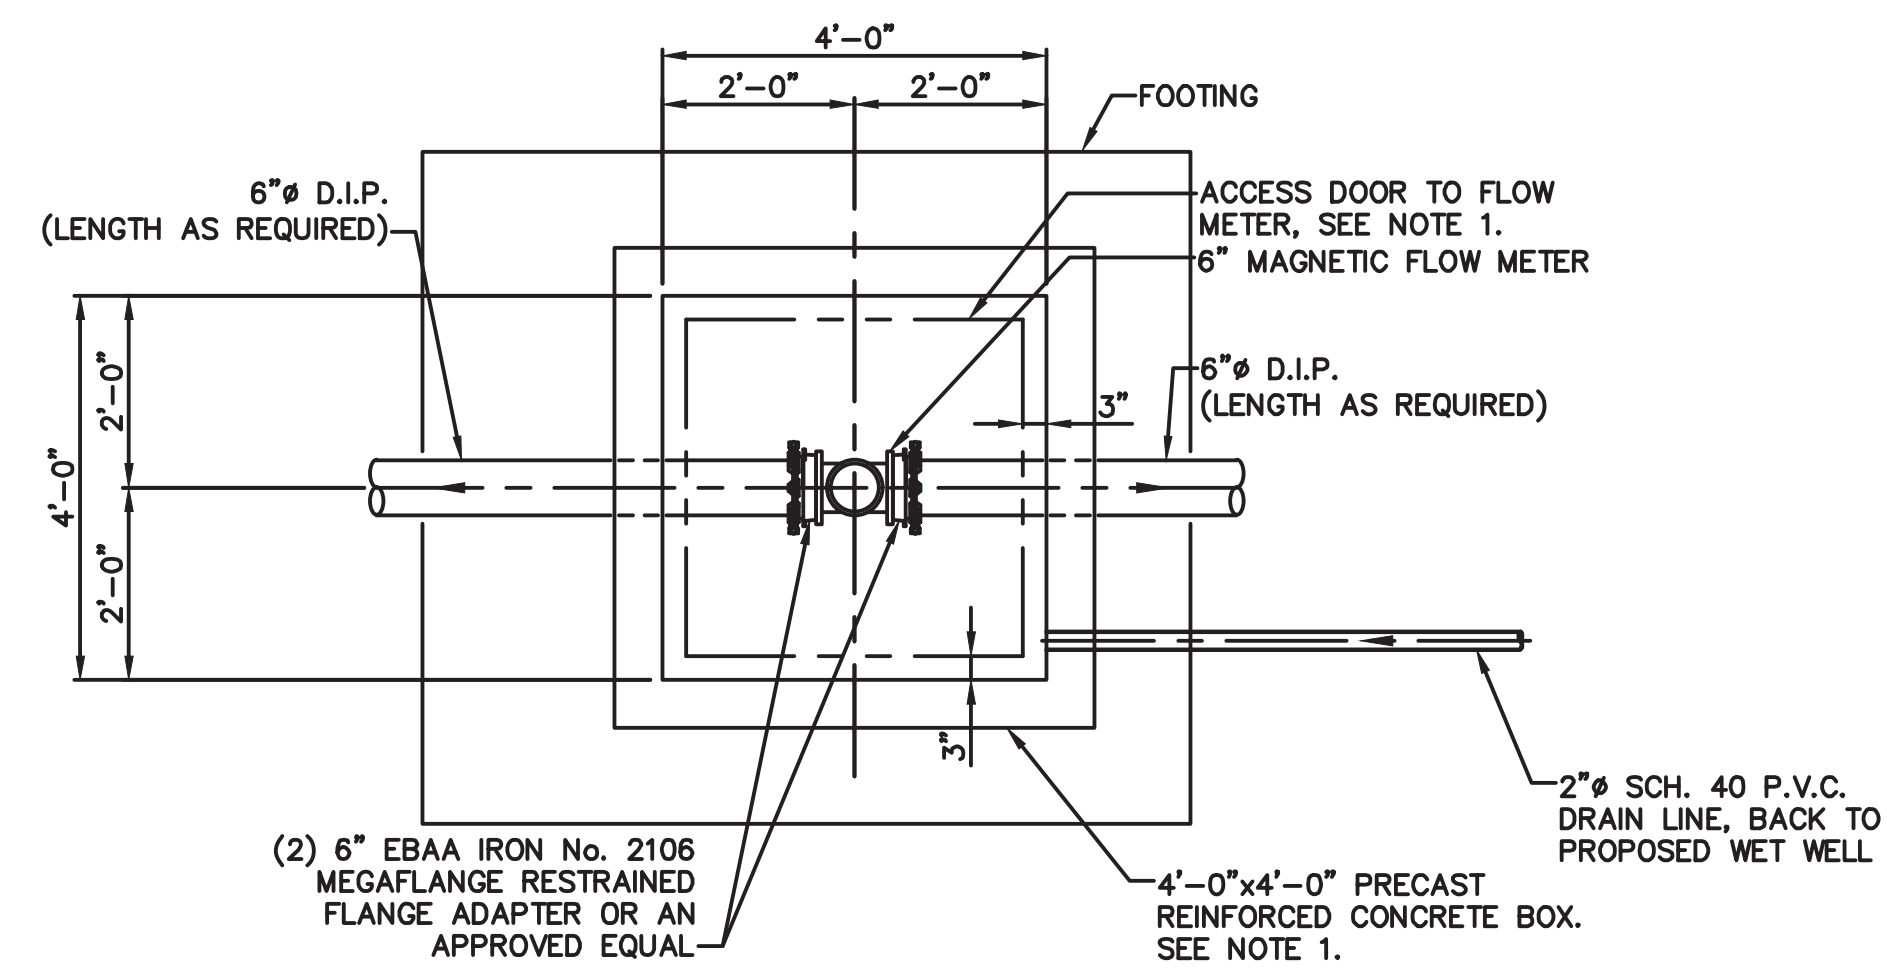

FLOW METER PIPING PLAN  
1/2" = 1'-0"

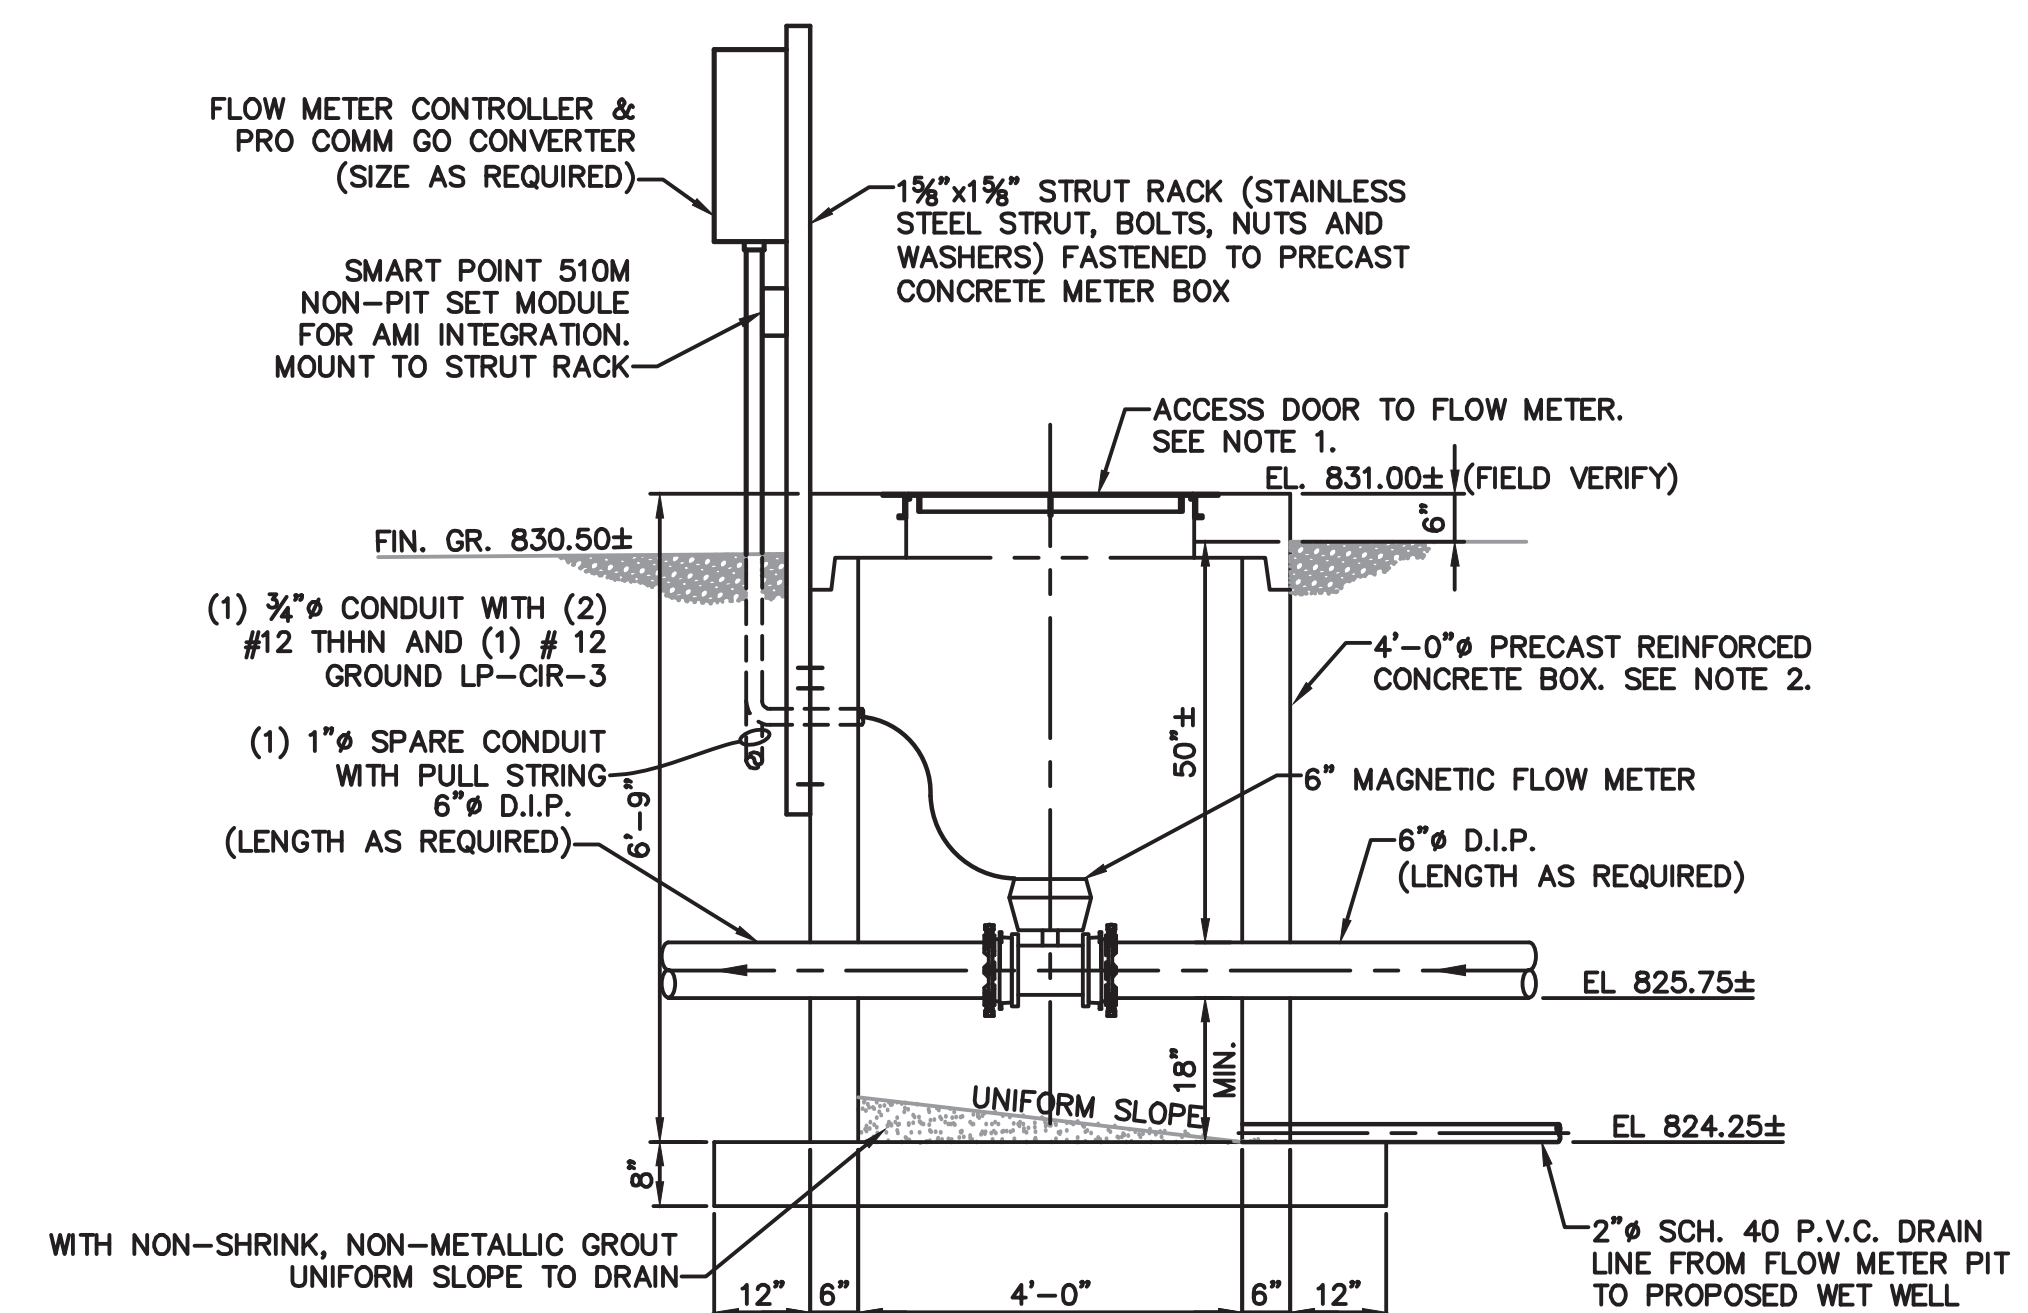

FLOW METER SECTION  
1/2" = 1'-0"



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ISSUE DATE:	06/14/2024


CAD DWG FILE:	
DRAWN BY:	AWW
CHECKED BY:	SCW
DESIGNED BY:	GDW

SHEET TITLE:  
**STANDARD  
CONSTRUCTION  
DETAILS**

SHEET NUMBER:

**C-503**


NOTE:  
ALL BURIED FITTINGS SHALL  
HAVE PLAIN CONCRETE (3000  
PSI MIN.) THRUST BLOCKING

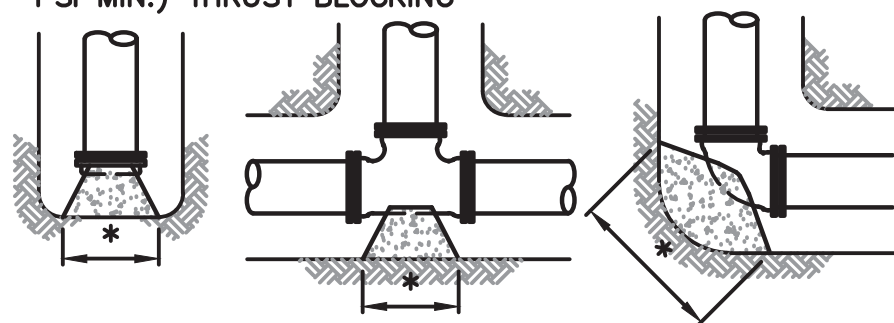

\* CONCRETE THRUST BLOCK SHALL HAVE A  
MINIMUM BEARING AREA ON UNDISTURBED SOIL  
OF 5 SQ. FT. ON 6" & 8" FITTINGS, 7 SQ. FT.  
ON 10" FITTINGS, 10 SQ. FT. ON 12" FITTINGS,  
13 SQ. FT. ON 14" FITTINGS AND 16" SQ. FT.  
ON 16" FITTINGS.

THRUST BLOCK DETAIL  
N.T.S.


NOTE: TRENCH SHALL BE EXCAVATED TO PROVIDE  
VERTICAL WALLS. SHORING SHALL BE PROVIDED  
AS NECESSARY TO MEET OSHA REQMT'S.

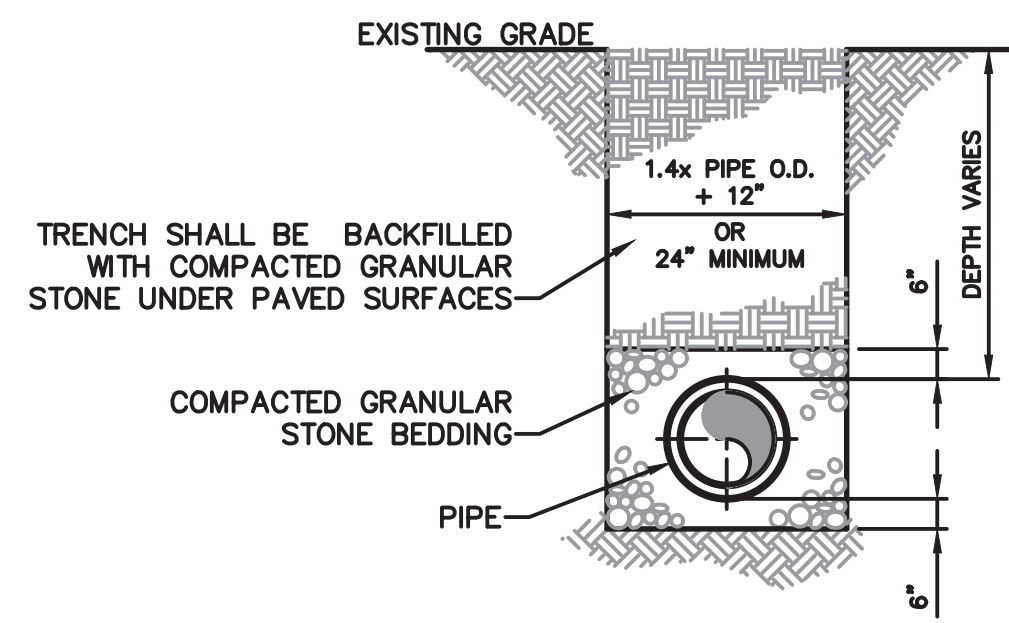


GRAVITY SANITARY AND STORM SEWER  
STANDARD TRENCH & BEDDING DETAIL  
N.T.S.

NOTE:  
TRENCH SHALL BE EXCAVATED TO A DEPTH OF  
6" BELOW BOTTOM OF PIPE AND BACKFILLED TO  
6" ABOVE PIPE WITH GRAVEL OR CRUSHED  
STONE CONFORMING TO THE FOLLOWING  
GRADATION TO PROVIDE UNIFORM BEDDING FOR  
THE ENTIRE LENGTH OF THE PIPE.

SIEVE SIZE	PERCENT PASSING
1	100
3/4	90-100
3/8	20-55
No. 4	0-10
No. 8	0-5

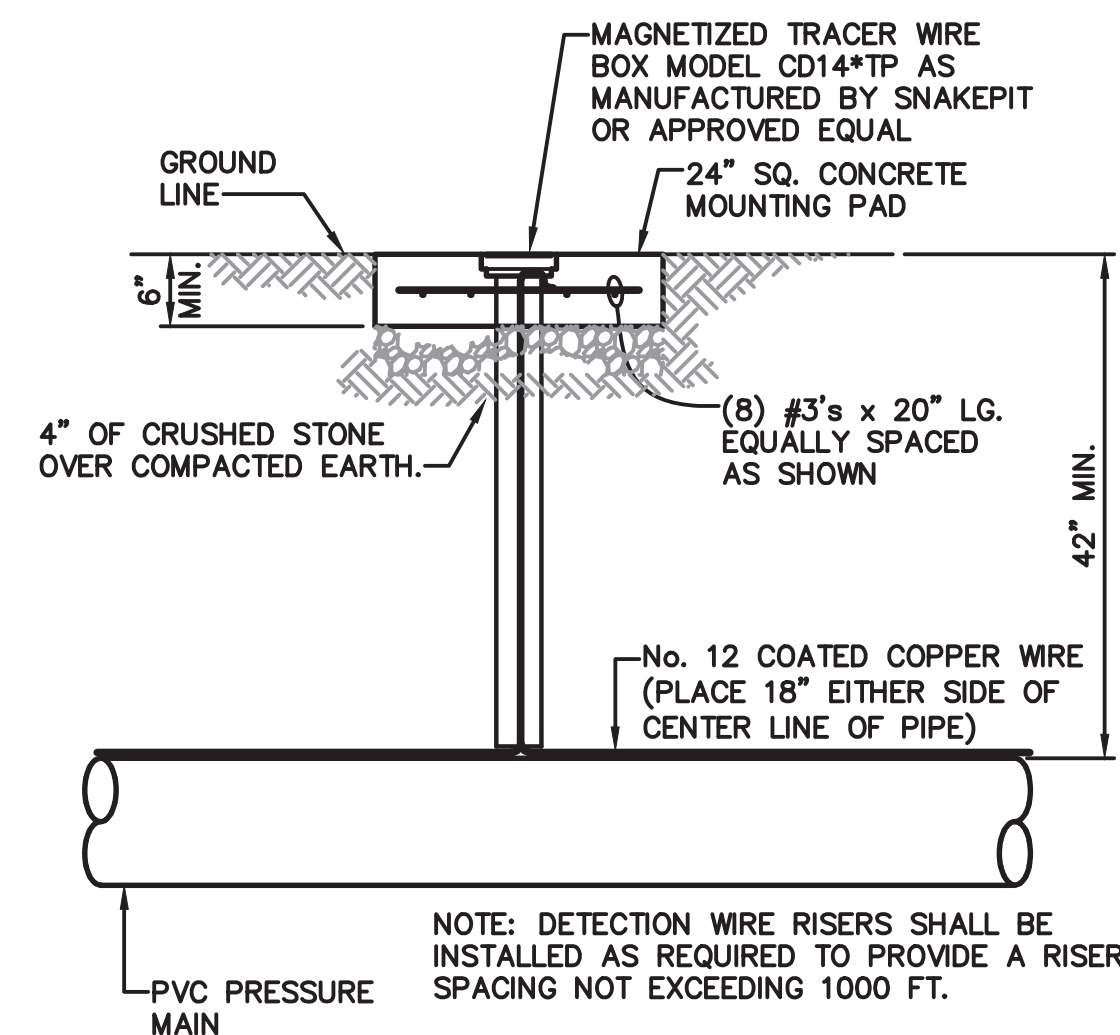

DETECTION WIRE RISER DETAIL  
N.T.S.

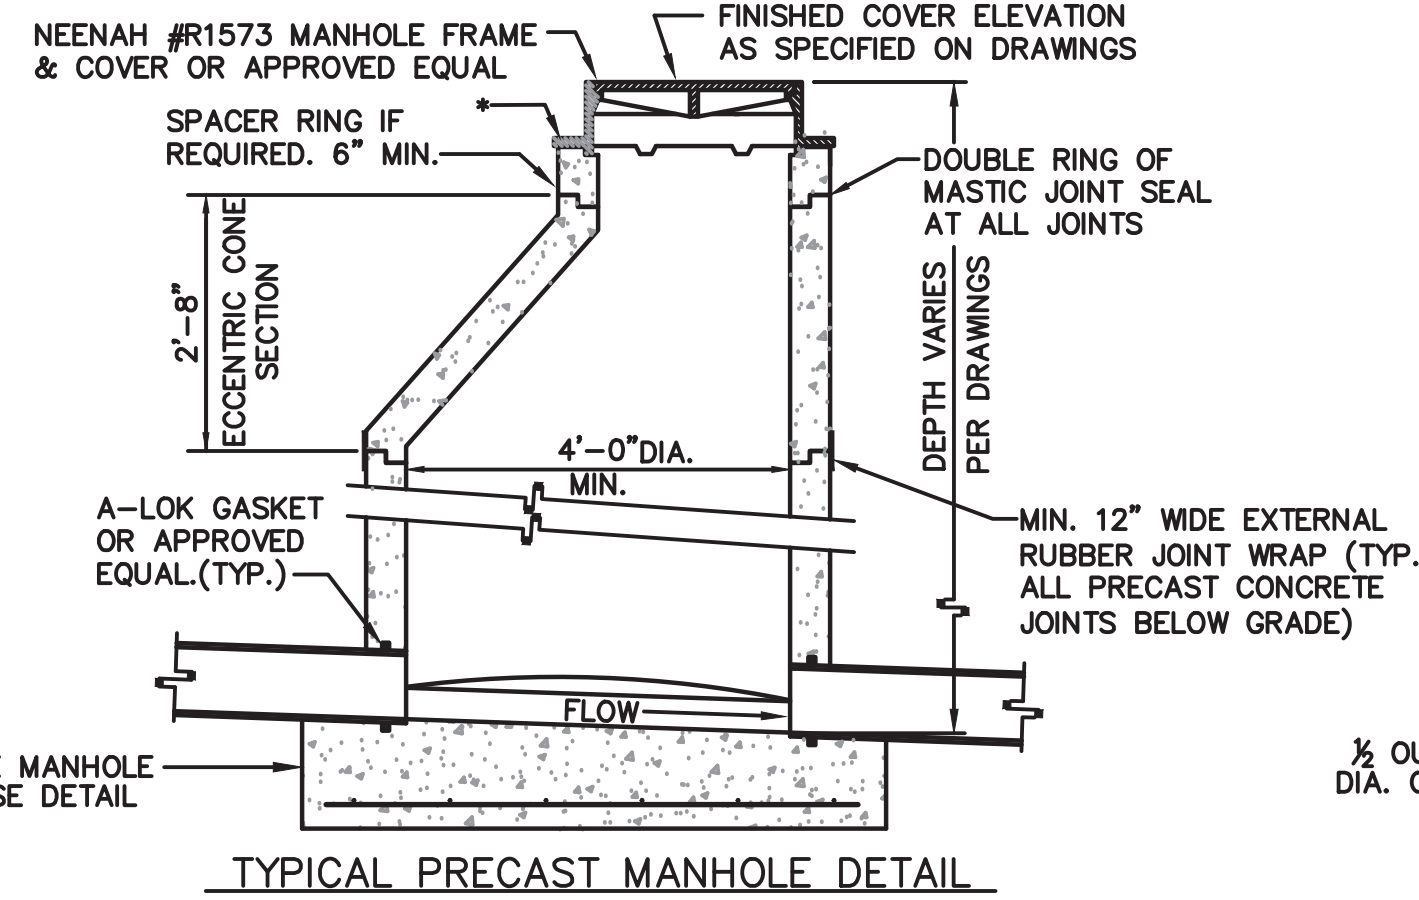


TYPICAL PRECAST MANHOLE DETAIL  
N.T.S.

\* IN LOW LYING AREAS WHERE GROUND WATER IS  
AN ISSUE & TO PREVENT INFILTRATION A UNI-BAND  
OR APPROVED EQUAL SHALL BE USED


GENERAL NOTES:

- JOINT BETWEEN MANHOLE FRAME AND ADJUSTMENT RING AREA SHALL BE WATERTIGHT. JOINT GASKET SHALL BE OF PREFORMED MASTIC (RAM-NEK, HAMILTON-KENT, OR APPROVED EQUAL). A ONE-PIECE EXTERNAL, MOLDED RUBBER SEAL SHALL BE INSTALLED AROUND MANHOLE FRAME AND ADJUSTMENT RING AREA ON ALL BELOW-GRADE MANHOLES.
- MANHOLE JOINTS SHALL BE WATERTIGHT. JOINT GASKET SHALL BE PREFORMED MASTIC (RAM-NEK, HAMILTON-KENT, OR APPROVED EQUAL). A MIN. 12" WIDE, EXTERNAL RUBBER JOINT WRAP SHALL BE INSTALLED ON ALL BELOW-GRADE PRECAST CONCRETE MANHOLE JOINTS.
- OPENINGS FOR SEWER PIPE IN MANHOLE SECTIONS SHALL BE FORMED AT THE FACTORY, EITHER CAST IN PLACE GASKET OR CUTOUT OPENING.
  - MINIMUM OPENING FOR CUTOUTS SHALL BE EQUAL TO OUTSIDE DIAMETER OF PIPE PLUS (4) FOUR INCHES AND MAXIMUM OPENING SHALL BE EQUAL TO OUTSIDE DIAMETER OF PIPE PLUS (6) INCHES
  - ANNULAR SPACE BETWEEN SEWER PIPE AND CUTOUT OPENING IN MANHOLE SECTIONS SHALL BE FILLED WITH NON-SHRINKING TYPE GROUT PER SPECIFICATIONS.
  - CAST-IN-PLACE GASKET SHALL BE A-LOK OR APPROVED EQUAL.
- ALL MANHOLE DETAILS ARE FOR PRECAST REINFORCED CONCRETE MANHOLE SECTIONS AND SHALL CONFORM TO ASTM SPEC. C478 - (CURRENT REVISION) WITH THE FOLLOWING MODIFICATIONS:
  - CEMENT USED SHALL CONFORM TO SPECIFICATIONS FOR PORTLAND CEMENT ASTM DESIGNATION C150. CONCRETE SHALL HAVE MINIMUM COMPRESSIVE STRENGTH OF 4000 PSI.
  - MINIMUM SHELL THICKNESS SHALL BE: FOR (0) TO 16 FEET DEPTH, (1/12) ONE-TWELFTH INTERNAL SHELL DIAMETER OR (4) FOUR INCHES, WHICHEVER IS GREATER. FOR 16 FEET AND OVER IN DEPTH, (1/12) ONE-TWELFTH INTERNAL SHELL DIAMETER PLUS (1) ONE INCH OR (5) INCHES, WHICHEVER IS GREATER.
  - EXTERIOR DAMP PROOFING SHALL CONFORM TO KOPPERS SPECIFICATIONS FOR COAL TAR BITUMASTIC SUPER SERVICE BLACK, TNEC HEAVY DUTY BLACK, CARBOLINE, OR APPROVED EQUAL. DAMP PROOFING SHALL BE FACTORY APPLIED.
  - JOINTS BETWEEN MANHOLE SECTIONS SHALL BE WATERTIGHT. JOINT GASKETS SHALL BE RUBBER O-RING TYPE (NATURAL OR SYNTHETIC) OR PREFORMED MASTIC (RAM-NEK, HAMILTON-KENT OR APPROVED EQUAL). A MIN. 12" WIDE, EXTERNAL RUBBER JOINT WRAP SHALL BE INSTALLED ON ALL BELOW-GRADE PRECAST CONCRETE MANHOLE JOINTS.


NOTE: COMPACTED BACKFILL, SLOPED  
FROM MANHOLE FRAME TO EXISTING  
GRADE SHALL BE PROVIDED AROUND  
ALL MANHOLES EXCEPT THOSE  
WITHIN STREET PAVEMENT.

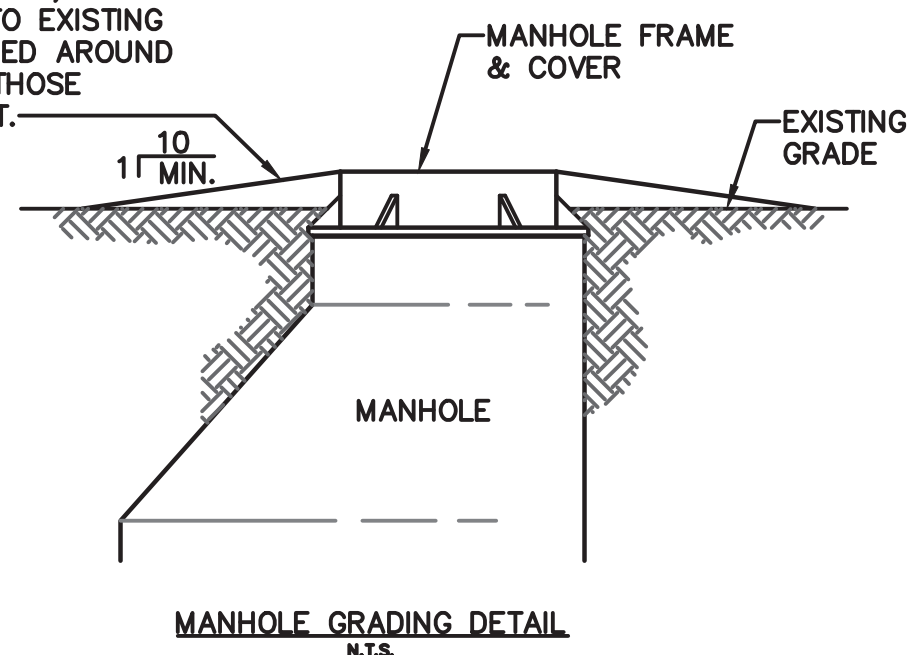

MANHOLE GRADING DETAIL  
N.T.S.

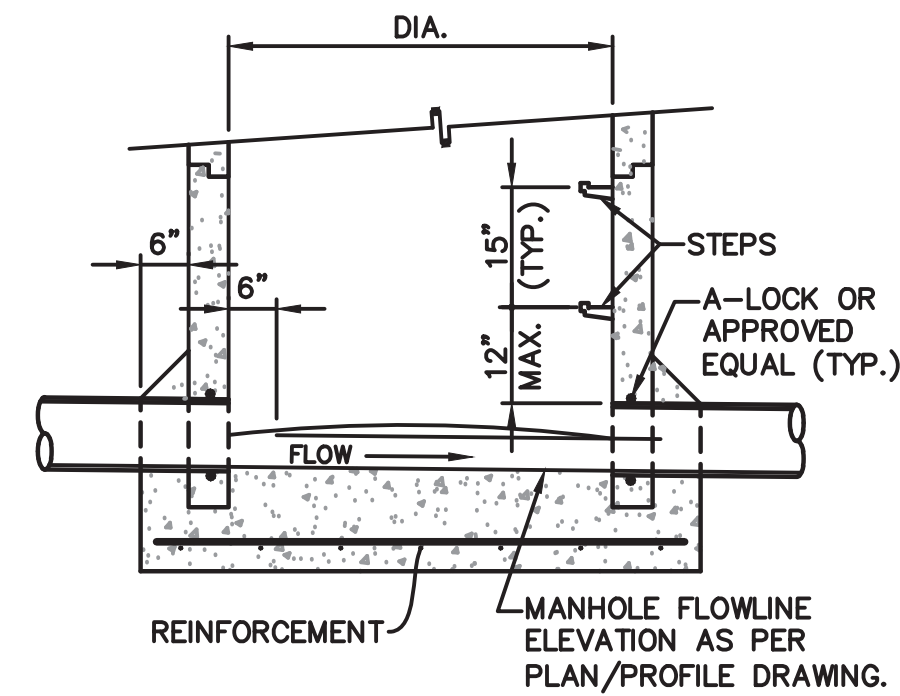


SECTION

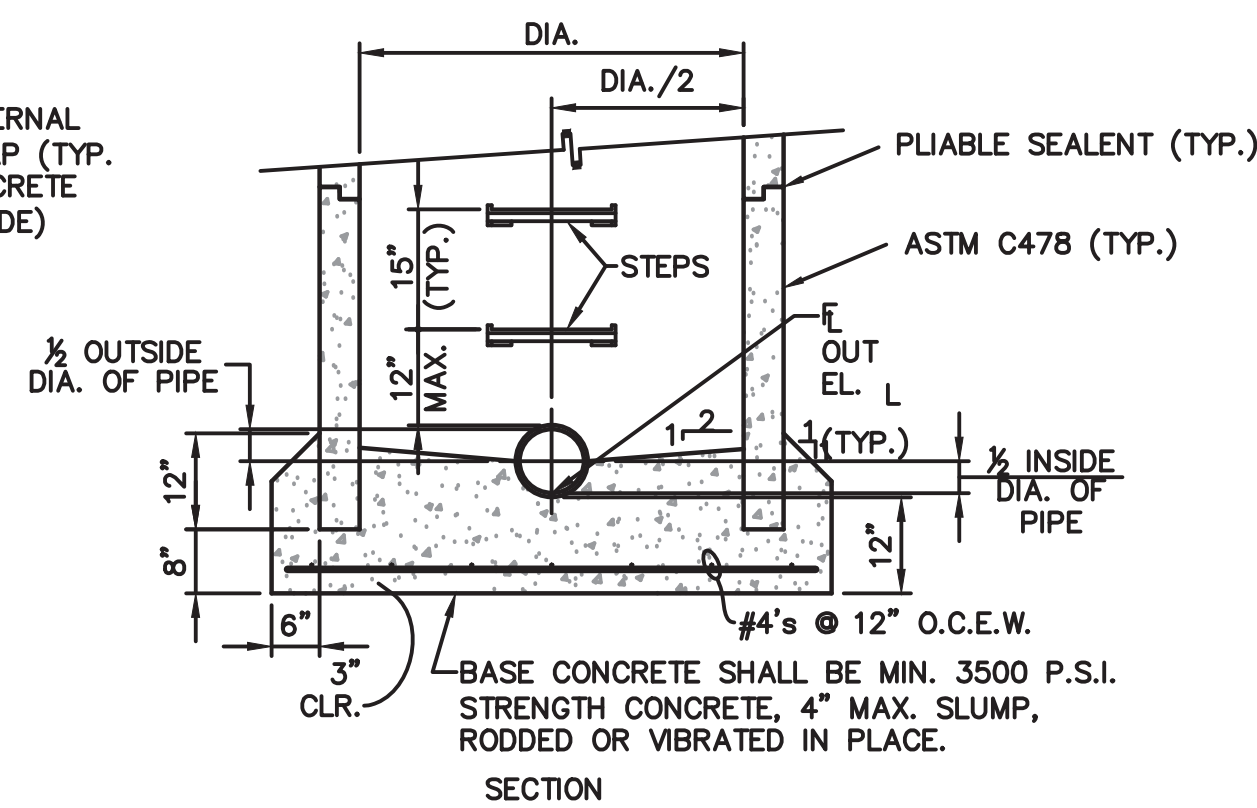


SECTION

CAST-IN-PLACE MANHOLE BASE DETAILS N.T.S.

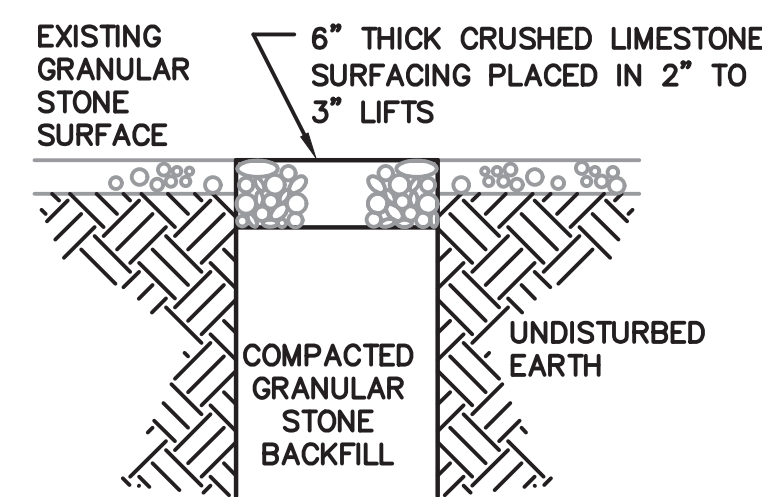

TYPE I  
CRUSHED STONE SURFACING

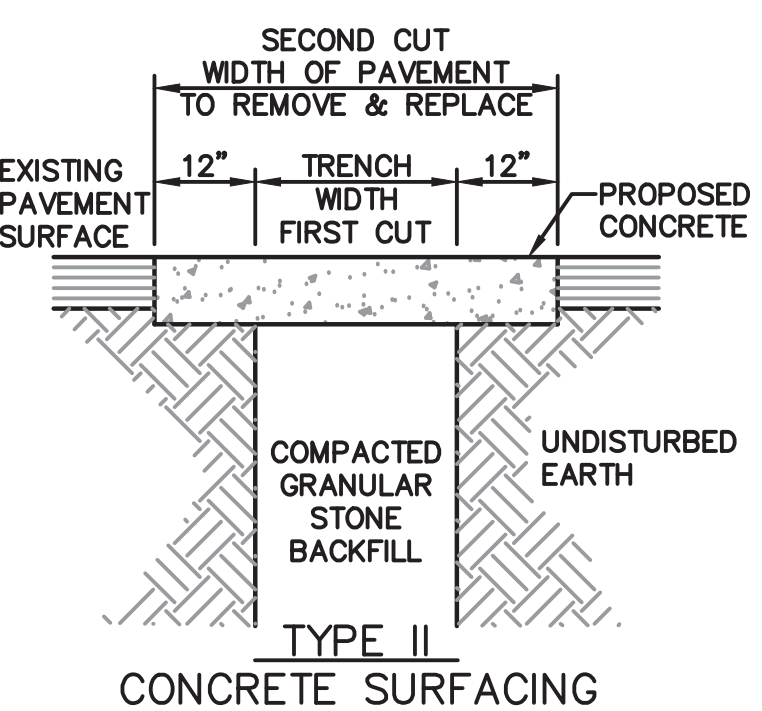


TYPE II  
CONCRETE SURFACING

PAVEMENT REPAIR DETAIL  
N.T.S.

NOTES:

PAVEMENT SHALL BE REMOVED AT THE  
TRENCH WIDTH AFTER THE FIRST CUT  
WITHOUT DAMAGE TO ADJACENT PAVEMENT.  
AFTER TRENCH IS PROPERLY BACKFILLED,  
PAVEMENT SHALL BE CUT AND REMOVED AN  
ADDITIONAL 12" ON EACH SIDE OF THE  
FIRST SAW CUT, AS SHOWN. THE SECOND  
CUT SHALL BE SAWN TO FULL DEPTH OF  
THE EXISTING SURFACE.


ALL EXISTING PAVEMENT SHALL BE  
REPLACED WITH A MINIMUM OF 6" OF  
CONCRETE OR A CONCRETE THICKNESS  
EQUAL TO THE EXISTING PAVEMENT  
THICKNESS PLUS TWO INCHES, WHICHEVER IS  
GREATER. SPECIAL REQUEST FOR USE OF  
ASPHALT SHALL BE SUBMITTED IN WRITING  
TO THE CITY. IF APPROVED, THE CITY SHALL  
ISSUE A WRITTEN APPROVAL.

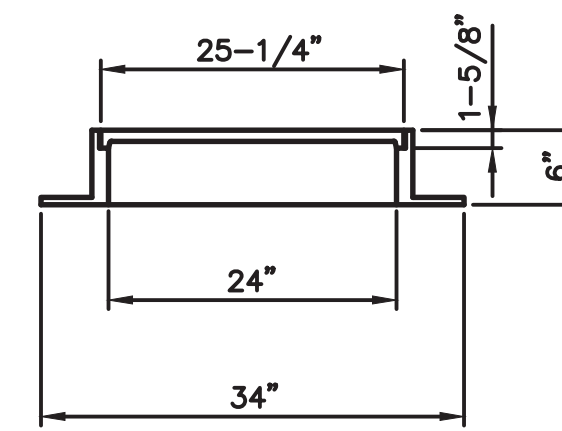


MANHOLE FRAME & COVER DETAIL  
N.T.S.

NOTES:

INVERTS COMING IN AT  
ELEVATION HIGHER THAN THE  
OUTLET INVERT SHALL BE  
FILLETED TO A UNIFORM  
SLOPE BETWEEN INLET AND  
OUTLET INVERTS. INVERTS  
COMING INTO THE MANHOLE  
AT AN ANGLE WITH THE  
OUTLET PIPE SHALL BE  
CURVED INTO THE OUTLET  
CHANNEL. FLOW CHANNEL  
THRU ALL MANHOLES SHALL  
CONFORM TO 1/2 THE INSIDE  
DIAMETER OF THE SEWER  
PIPE CROSS SECTION. 1/2  
SECTION OF SEWER PIPE MAY  
BE USED ON STRAIGHT  
RUNS THROUGH MANHOLES  
FOR FLOW CHANNEL.

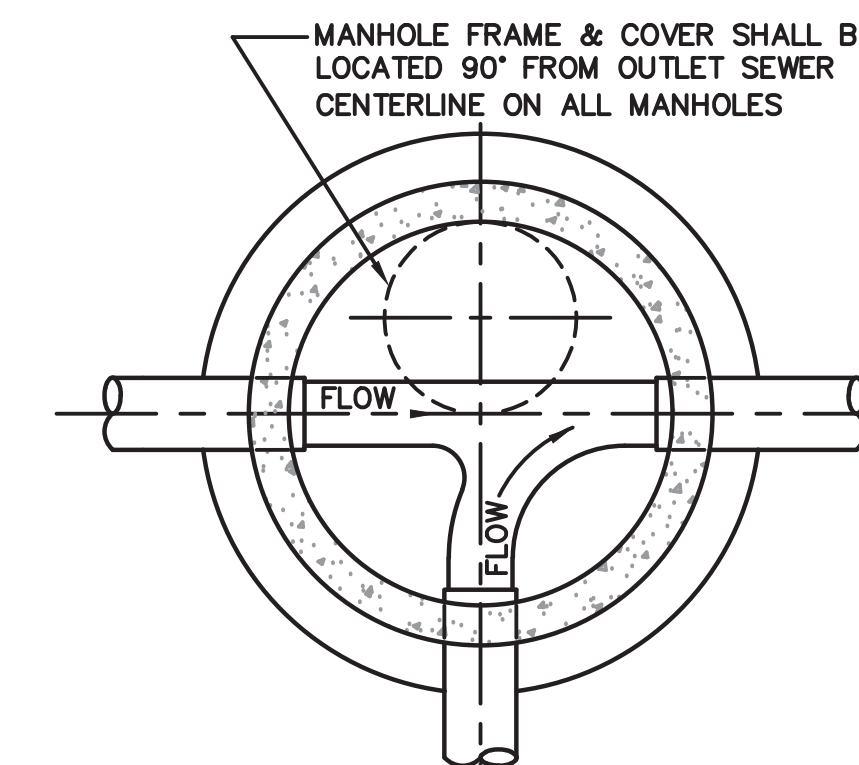

PLAN - TYPICAL ALL MANHOLES  
N.T.S.

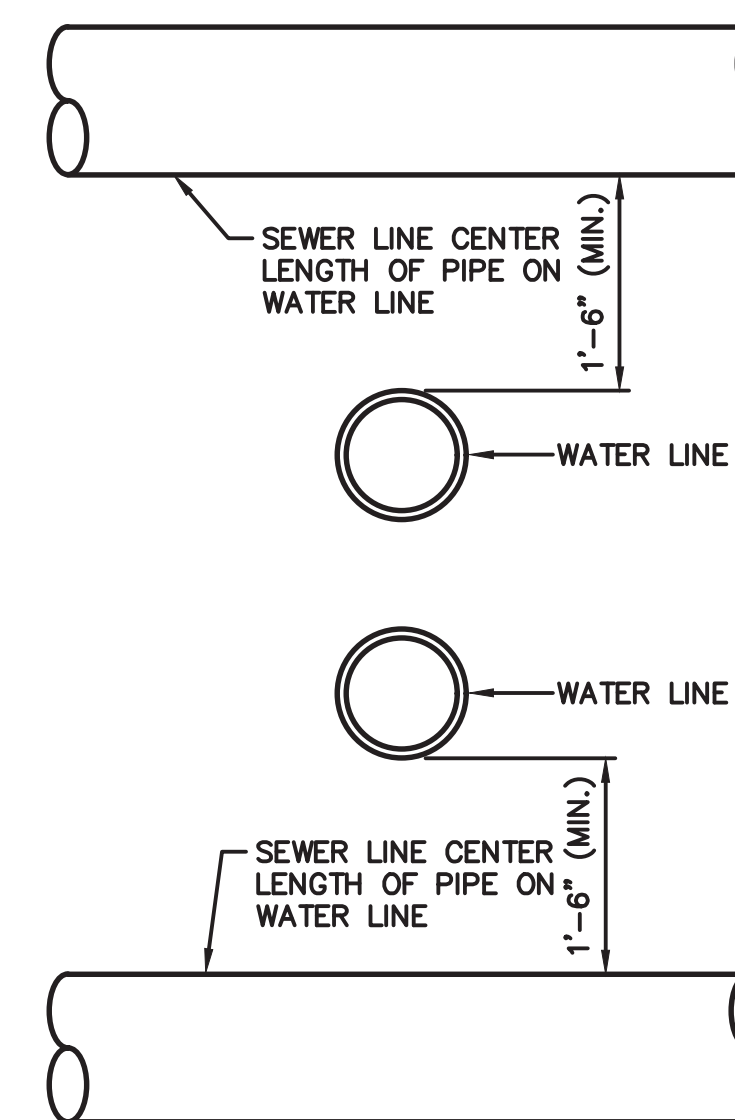

NOTE:  
IF 18" SEPARATION CANNOT BE ACHIEVED, THE  
ENGINEER SHALL BE NOTIFIED TO DETERMINE  
AN APPROPRIATE REMEDY.

WATER CROSSING DETAIL  
N.T.S.



REVISION:	_____
DATE:	_____
REVISION:	_____
DATE:	_____
REVISION:	_____
DATE:	_____
ISSUE DATE:	06/14/2024

CAD DWG FILE:	_____
DRAWN BY:	AWW
CHECKED BY:	SCW
DESIGNED BY:	GDW

**EASEMENT NOTE:**

SANITARY SEWER EASEMENTS HAVE NOT BEEN OBTAINED DUE TO THE PROPOSED PRESSURE SEWER PIPE AND LIFT STATION BEING LOCATED ON FEDERAL PROPERTY THAT IS COVERED IN ARMY REGULATION (AR 405-80) GRANTING ACCESS FOR ALL QUALIFYING UTILITIES.



EXISTING 120/208 3 $\phi$  PAD MOUNT TRANSFORMER TO BE REPLACED WITH A 277/480 VOLT 3 $\phi$  TRANSFORMER. CONTRACTOR SHALL COORDINATE WITH EVERGY.

PROPOSED ELECTRICAL SERVICE EQUIPMENT RACK, SEE DETAIL ON DWG. NO. E-103

**LEGEND**


---	EXISTING UNDERGROUND ELECTRIC	⊗	EXISTING FIRE HYDRANT
---	EXISTING FENCE	▲	EXISTING GAS METER
---	EXISTING FIBER OPTIC	•	EXISTING GAS VALVE
---	EXISTING GAS	○	EXISTING IRON PIN
---	EXISTING SEWER	⊞	EXISTING MAILBOX
---	EXISTING UNDERGROUND TELEPHONE	Ⓜ	EXISTING MANHOLE
---	EXISTING RIGHT OF WAY	○	EXISTING PIPE POST
---	EXISTING SECTION LINE	⊗	EXISTING LIGHT POLE
---	EXISTING WATERLINE	⊗	EXISTING POWER POLE
---	PROPOSED FENCE	▲	EXISTING RW MARKER
---	PROPOSED GRAVITY SEWER	+	EXISTING SIGN
---	PROPOSED PRESSURE SEWER	Ⓜ	EXISTING TELEPEDESTAL
---	PROPOSED TEMPORARY EASEMENT	⊗	EXISTING TREE
---	PROPOSED PERMANENT EASEMENT	⊗	EXISTING SHRUB
---	EXISTING MINOR CONTOURS	•	EXISTING WATER METER
---	EXISTING MAJOR CONTOURS	⊗	EXISTING WATER VALVE
---	PROPOSED MINOR CONTOURS	○	EXISTING WATER HYDRANT
---	PROPOSED MAJOR CONTOURS	Ⓜ	PROPOSED MANHOLE
⊗	EXISTING CLEANOUT	⊗	PROPOSED AIR RELEASE VALVE
○	CONTROL POINT		

**GROUNDING LEGEND**

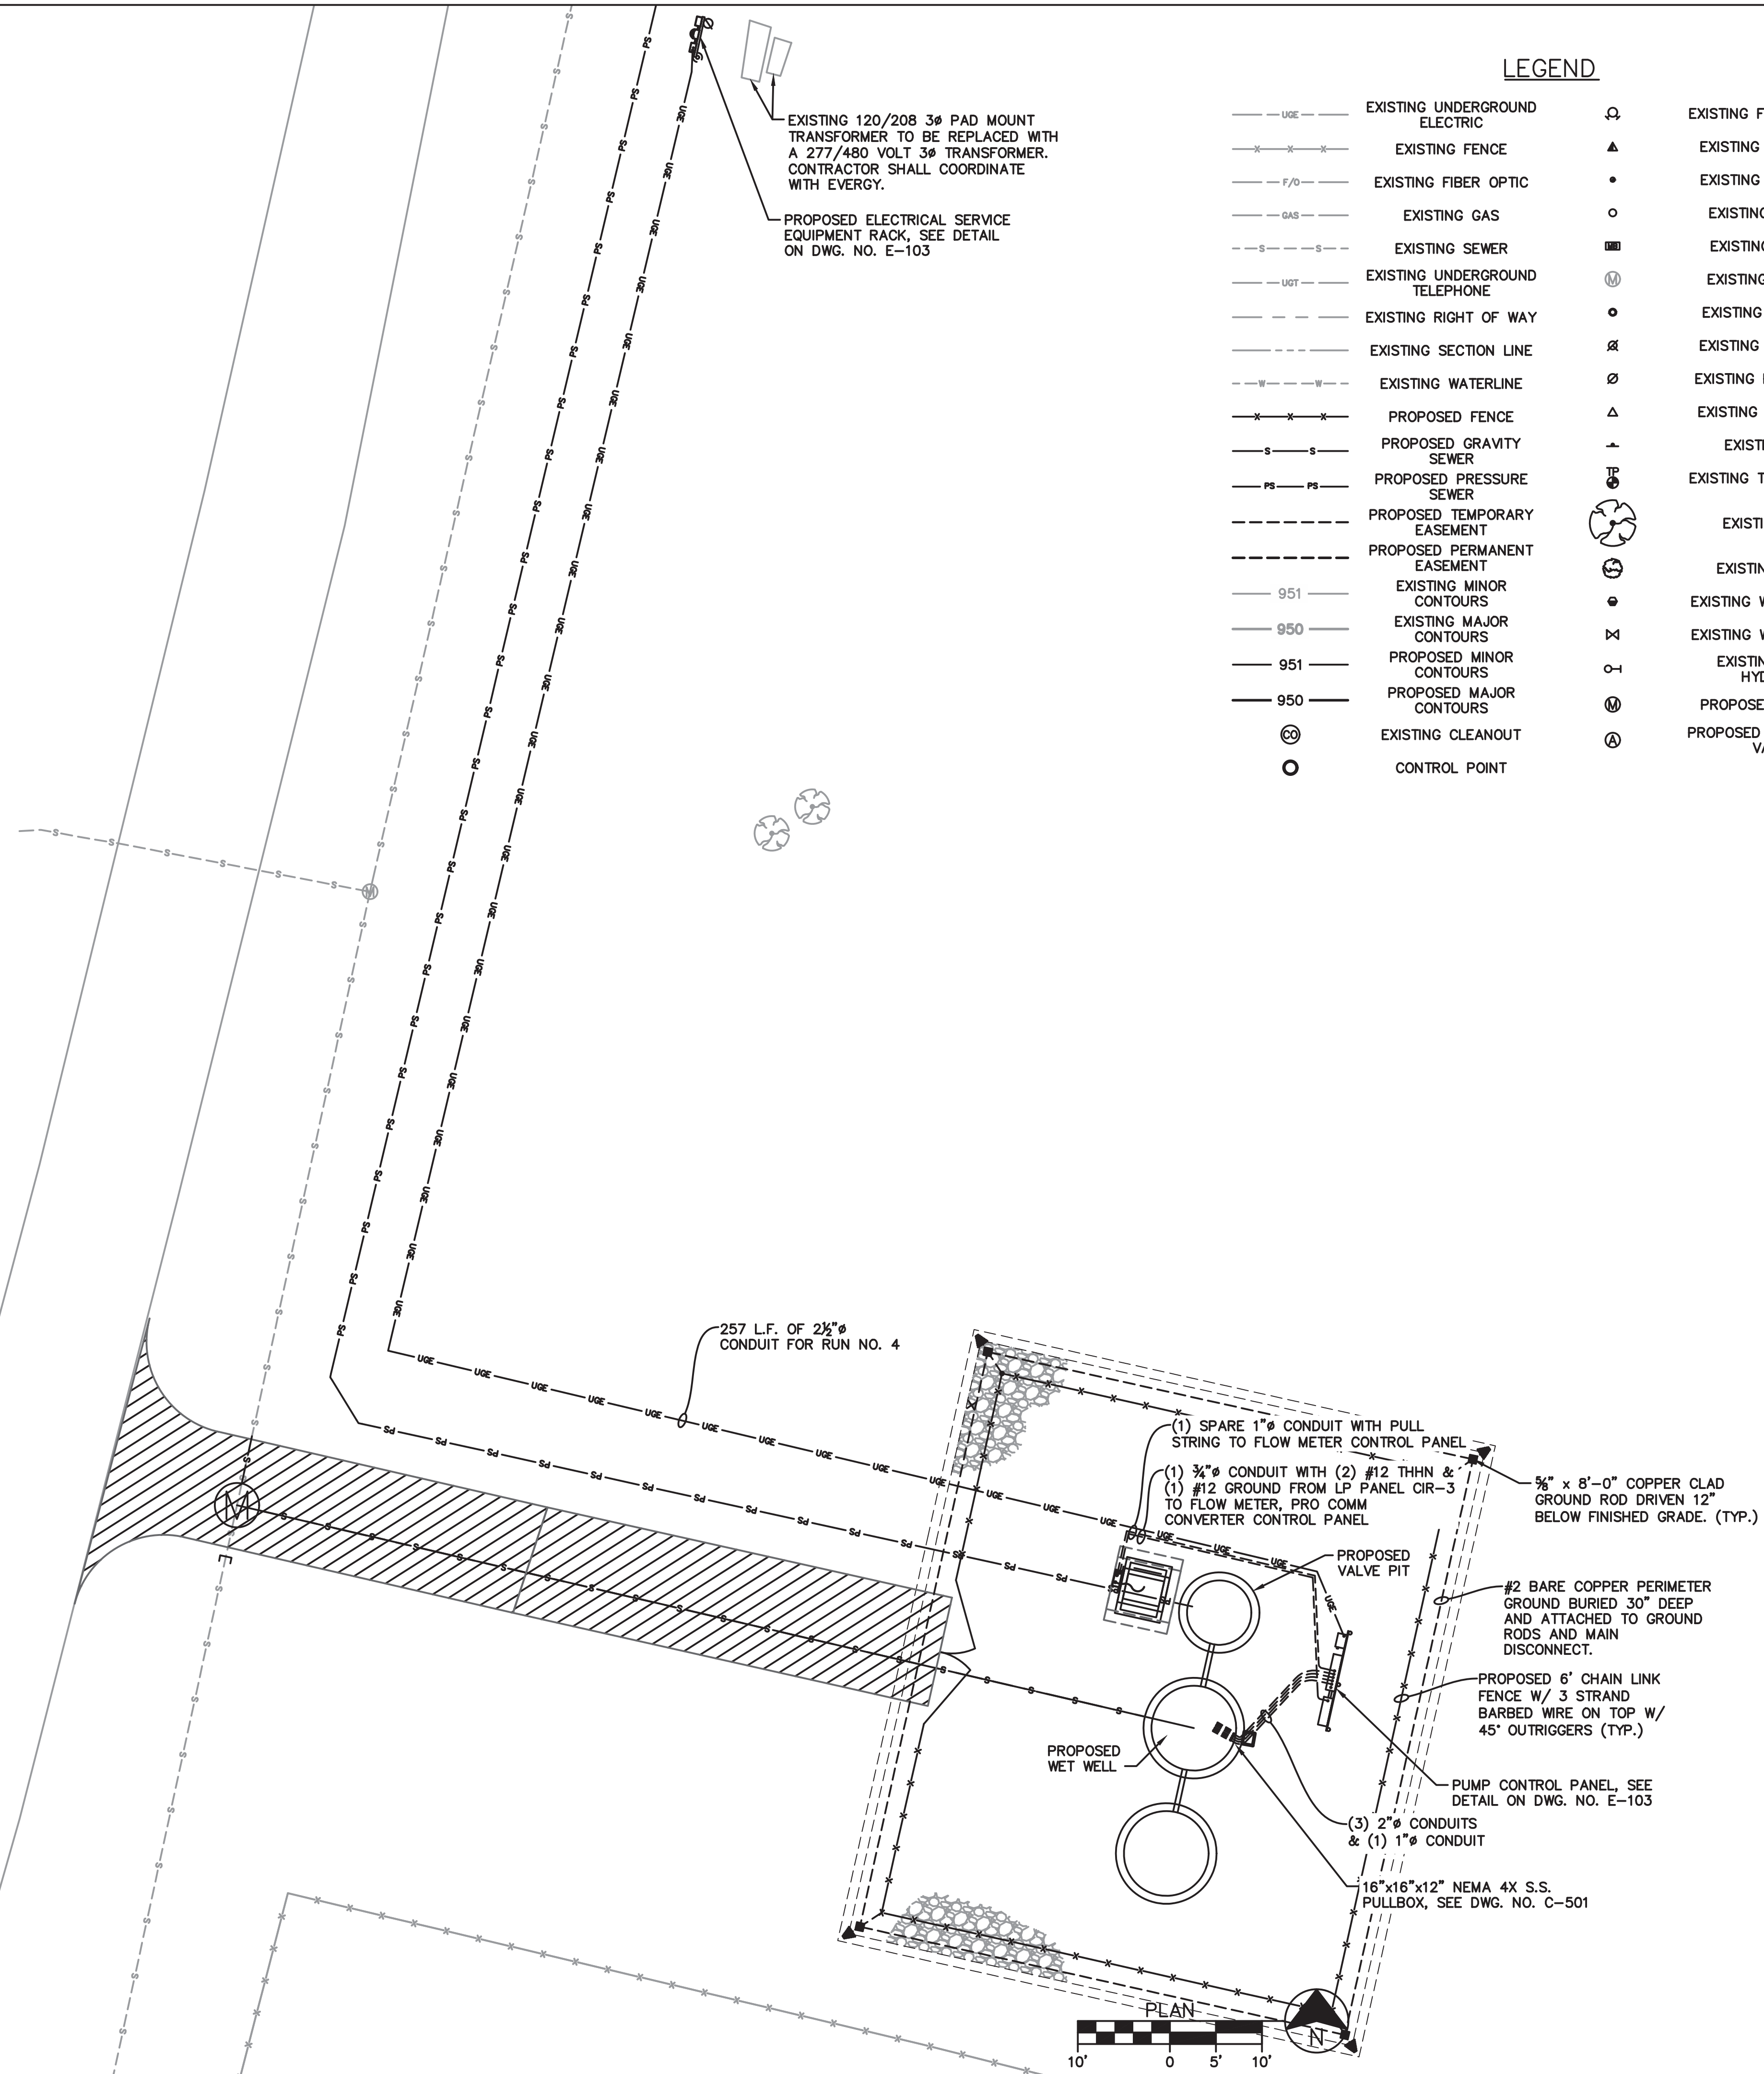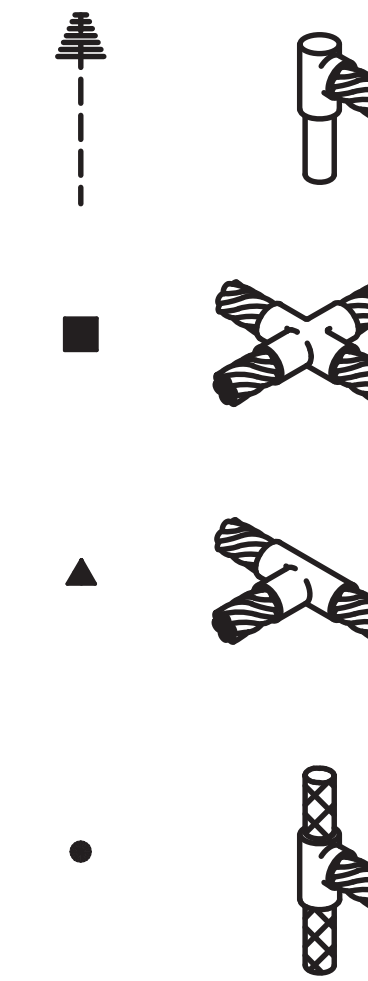

STATE OF MISSOURI  
MICHAEL L. PARSON,  
GOVERNOR

CIVIL ENGINEER: GARRETT D. WAGNER  
LICENSE NO. PE-2019000226

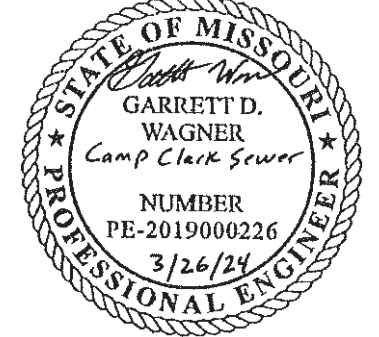

OFFICE OF ADMINISTRATION  
DIVISION OF FACILITIES  
MANAGEMENT,  
DESIGN AND CONSTRUCTION

MISSOURI  
NATIONAL GUARD

CONNECT CAMP CLARK  
TO CITY OF NEVADA  
SEWER SYSTEM

CAMP CLARK

NEVADA, MISSOURI

PROJECT # T2301-02  
SITE # 6274  
ASSET # 8136274075

REVISION: EASEMENTS  
DATE: 03-26-2024  
REVISION: \_\_\_\_\_  
DATE: \_\_\_\_\_  
REVISION: \_\_\_\_\_  
DATE: \_\_\_\_\_  
ISSUE DATE: 06/14/2024



CAD DWG FILE: \_\_\_\_\_  
DRAWN BY: AWW  
CHECKED BY: SCW  
DESIGNED BY: GDW

SHEET TITLE:  
**LIFT STATION  
ELECTRICAL**

SHEET NUMBER:

**E-101**

21 OF 23 SHEETS

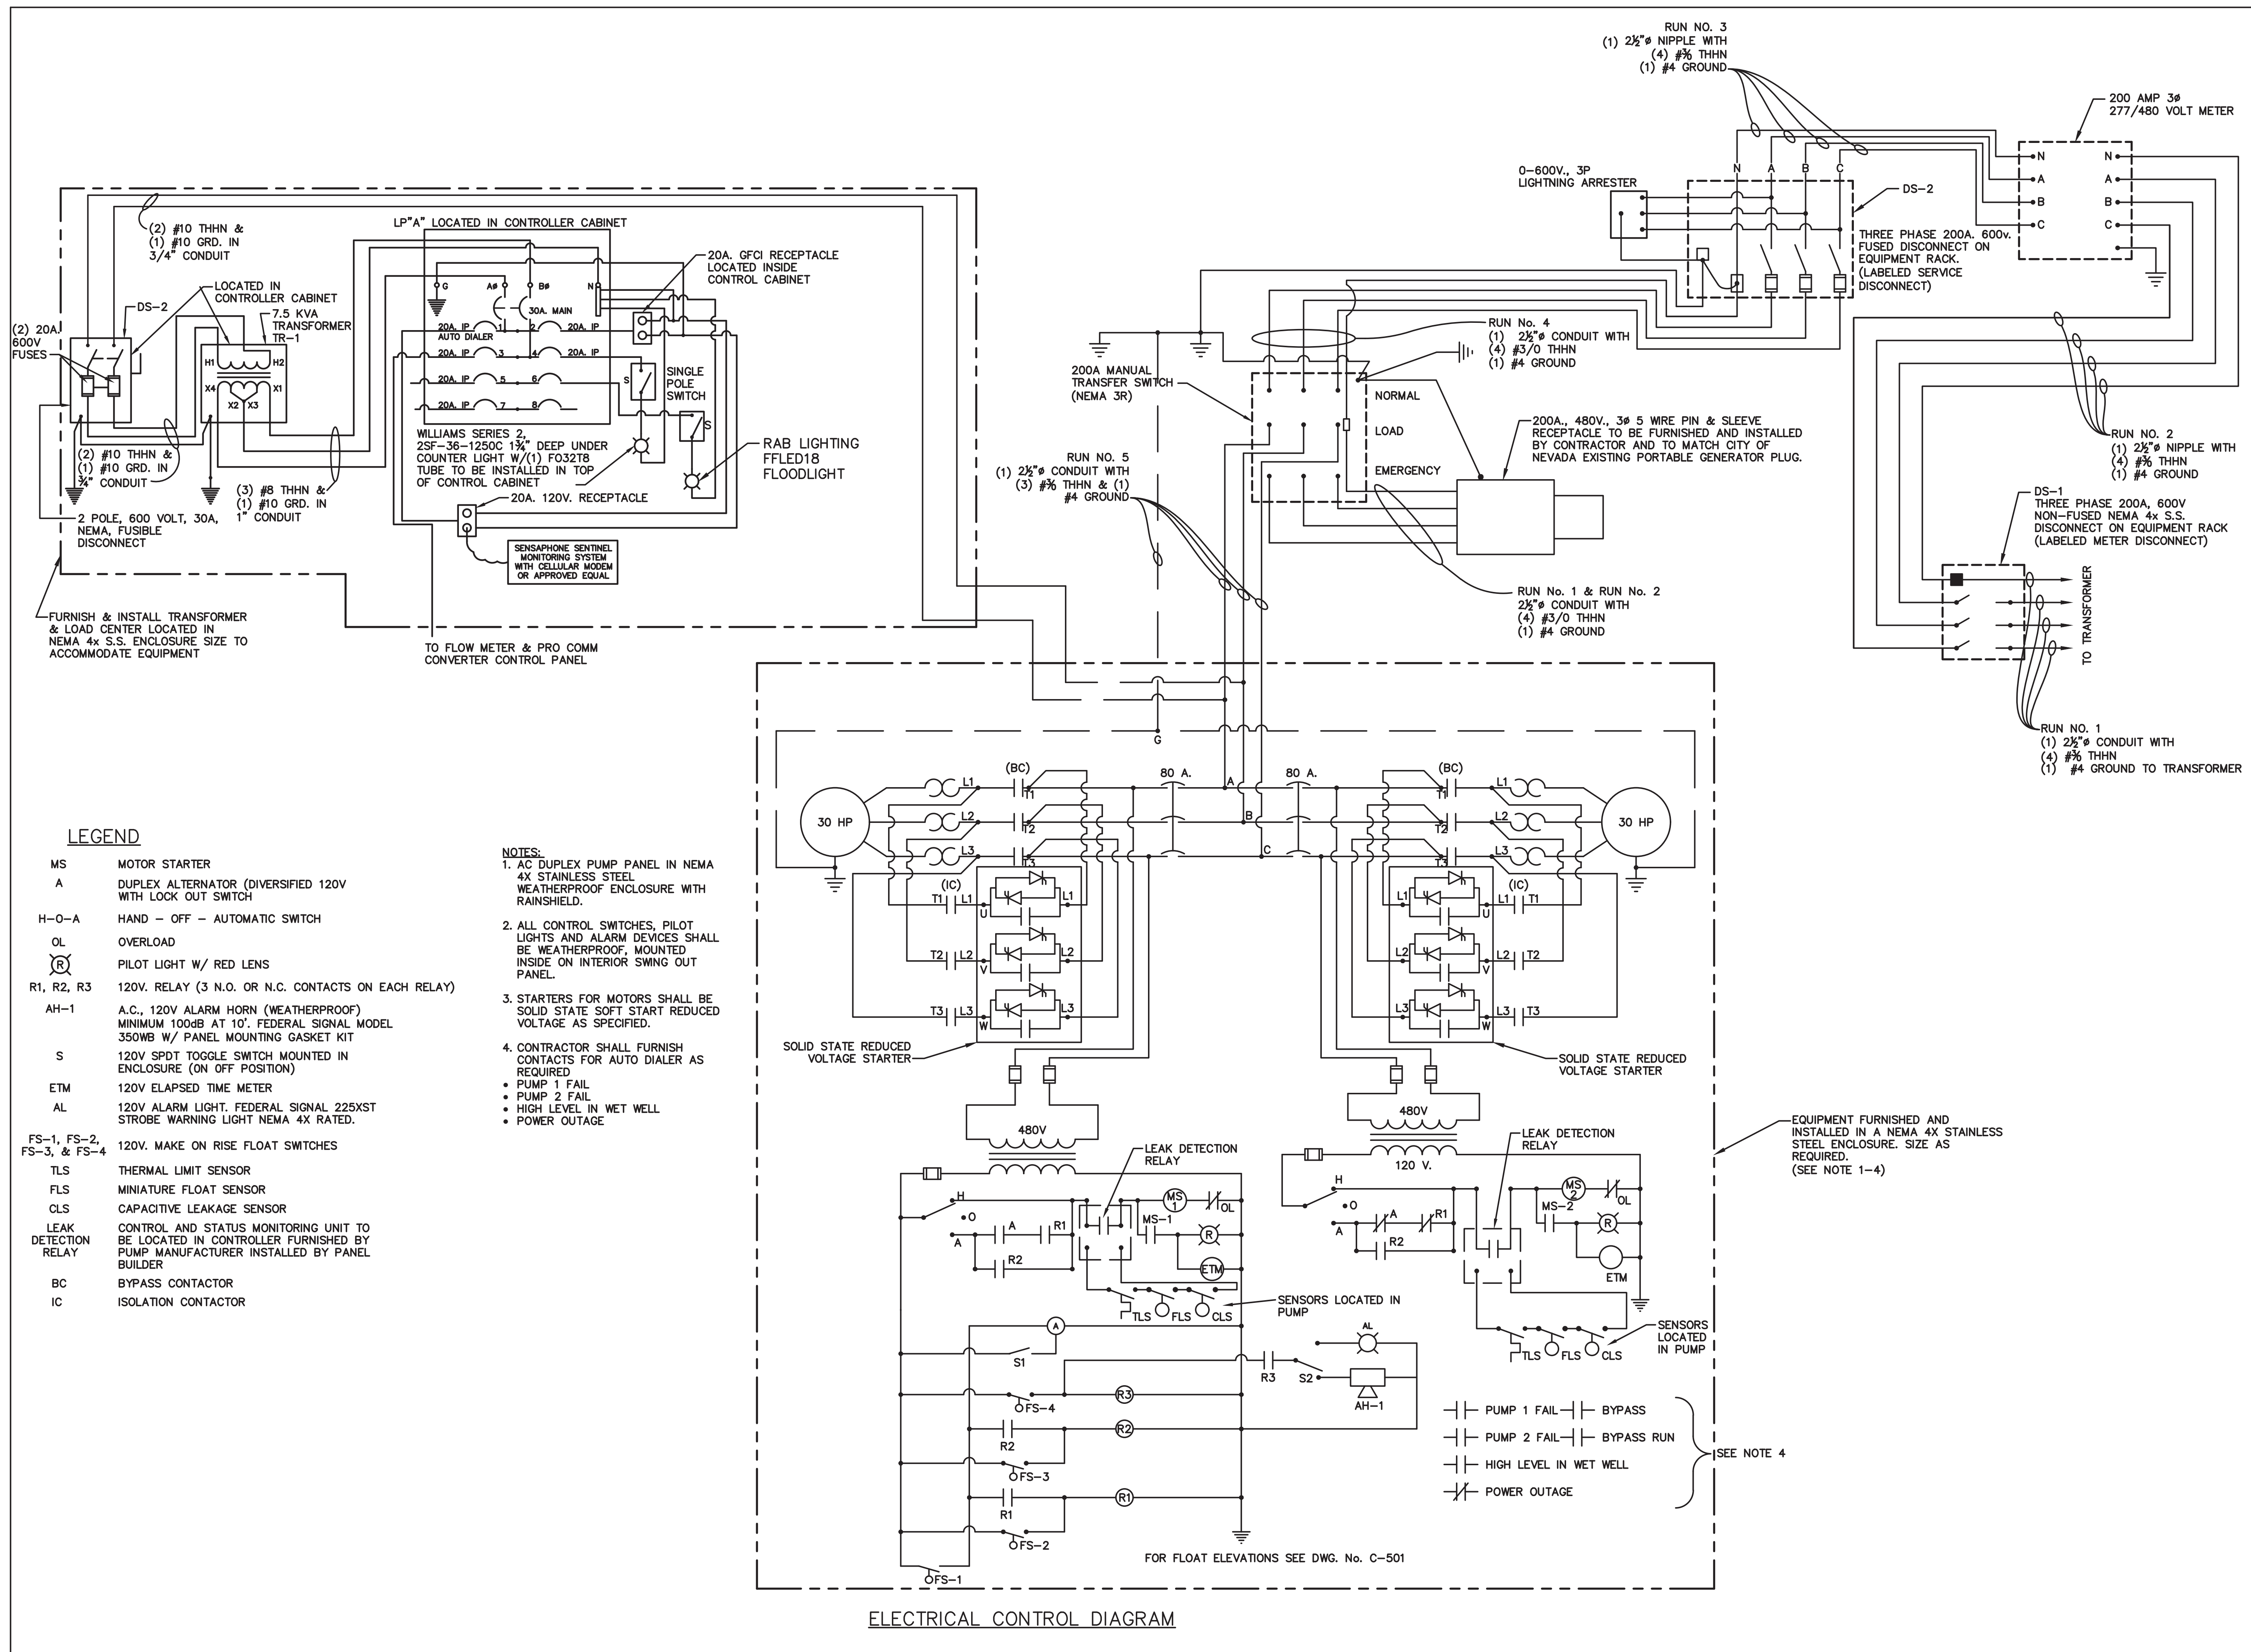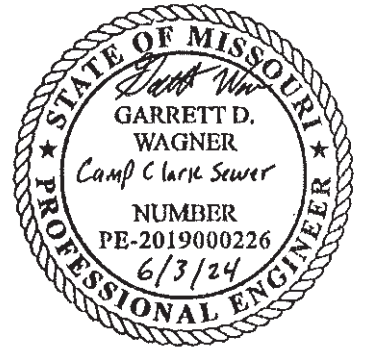

- LEGEND**
- MS MOTOR STARTER
  - A DUPLEX ALTERNATOR (DIVERSIFIED 120V WITH LOCK OUT SWITCH)
  - H-O-A HAND - OFF - AUTOMATIC SWITCH
  - OL OVERLOAD
  - (R) PILOT LIGHT W/ RED LENS
  - R1, R2, R3 120V. RELAY (3 N.O. OR N.C. CONTACTS ON EACH RELAY)
  - AH-1 A.C., 120V ALARM HORN (WEATHERPROOF) MINIMUM 100dB AT 10'. FEDERAL SIGNAL MODEL 350WB W/ PANEL MOUNTING GASKET KIT
  - S 120V SPDT TOGGLE SWITCH MOUNTED IN ENCLOSURE (ON OFF POSITION)
  - ETM 120V ELAPSED TIME METER
  - AL 120V ALARM LIGHT. FEDERAL SIGNAL 225XST STROBE WARNING LIGHT NEMA 4X RATED.
  - FS-1, FS-2, FS-3, & FS-4 120V. MAKE OR RISE FLOAT SWITCHES
  - TLS THERMAL LIMIT SENSOR
  - FLS MINIATURE FLOAT SENSOR
  - CLS CAPACITIVE LEAKAGE SENSOR
  - LEAK DETECTION RELAY CONTROL AND STATUS MONITORING UNIT TO BE LOCATED IN CONTROLLER FURNISHED BY PUMP MANUFACTURER INSTALLED BY PANEL BUILDER
  - BC BYPASS CONTACTOR
  - IC ISOLATION CONTACTOR

- NOTES:**
1. AC DUPLEX PUMP PANEL IN NEMA 4X STAINLESS STEEL WEATHERPROOF ENCLOSURE WITH RAINSHIELD.
  2. ALL CONTROL SWITCHES, PILOT LIGHTS AND ALARM DEVICES SHALL BE WEATHERPROOF, MOUNTED INSIDE ON INTERIOR SWING OUT PANEL.
  3. STARTERS FOR MOTORS SHALL BE SOLID STATE SOFT START REDUCED VOLTAGE AS SPECIFIED.
  4. CONTRACTOR SHALL FURNISH CONTACTS FOR AUTO DIALER AS REQUIRED
    - PUMP 1 FAIL
    - PUMP 2 FAIL
    - HIGH LEVEL IN WET WELL
    - POWER OUTAGE

- || PUMP 1 FAIL || BYPASS
  - || PUMP 2 FAIL || BYPASS RUN
  - || HIGH LEVEL IN WET WELL
  - || POWER OUTAGE
- { SEE NOTE 4

ELECTRICAL CONTROL DIAGRAM

