CONSTRUCT UNHEATED STORAGE BUILDING JEFFERSON BARRACKS ST. LOUIS, ST. LOUIS COUNTY, MO

OWNER:

MICHAEL L. PARSON, GOVERNOR

DEPARTMENT OF PUBLIC SAFETY MISSOURI NATIONAL GUARD

PROJECT MANAGEMENT:

OFFICE OF ADMINISTRATION DIVISION OF FACILITIES MANAGEMENT DESIGN AND CONSTRUCTION

ADDRESS:

24 DAVIS ST. ST. LOUIS, MO. 65125



CONSTRUCTION & FACILITIES MANAGEMENT OFFICE 6819 N BOUNDARY RD Jefferson City, Mo. 65101 573-638-9534

DESIGNER:

6303 SITE NUMBER: 8136303053 ASSET NUMBER:



SHEET INDEX


G001 :	COVER SHEET
C101:	SITE PLAN & DETAILS
S-101:	FOUNDATION PLAN
S-501:	FOUNDATION, JOINT &
	BOLLARD DETAILS
A100 :	FLOOR PLAN
	ENLARGED FLOOR PLAN
A300 :	CROSS SECTION
	NORTH ELEVATION
	WEST ELEVATION
E1 :	POWER AND LIGHTING PLAN

MISSOURI ARMY NATIONAL GUARD

PROJECT NUMBER: T2312-01

SHEET NUMBER:




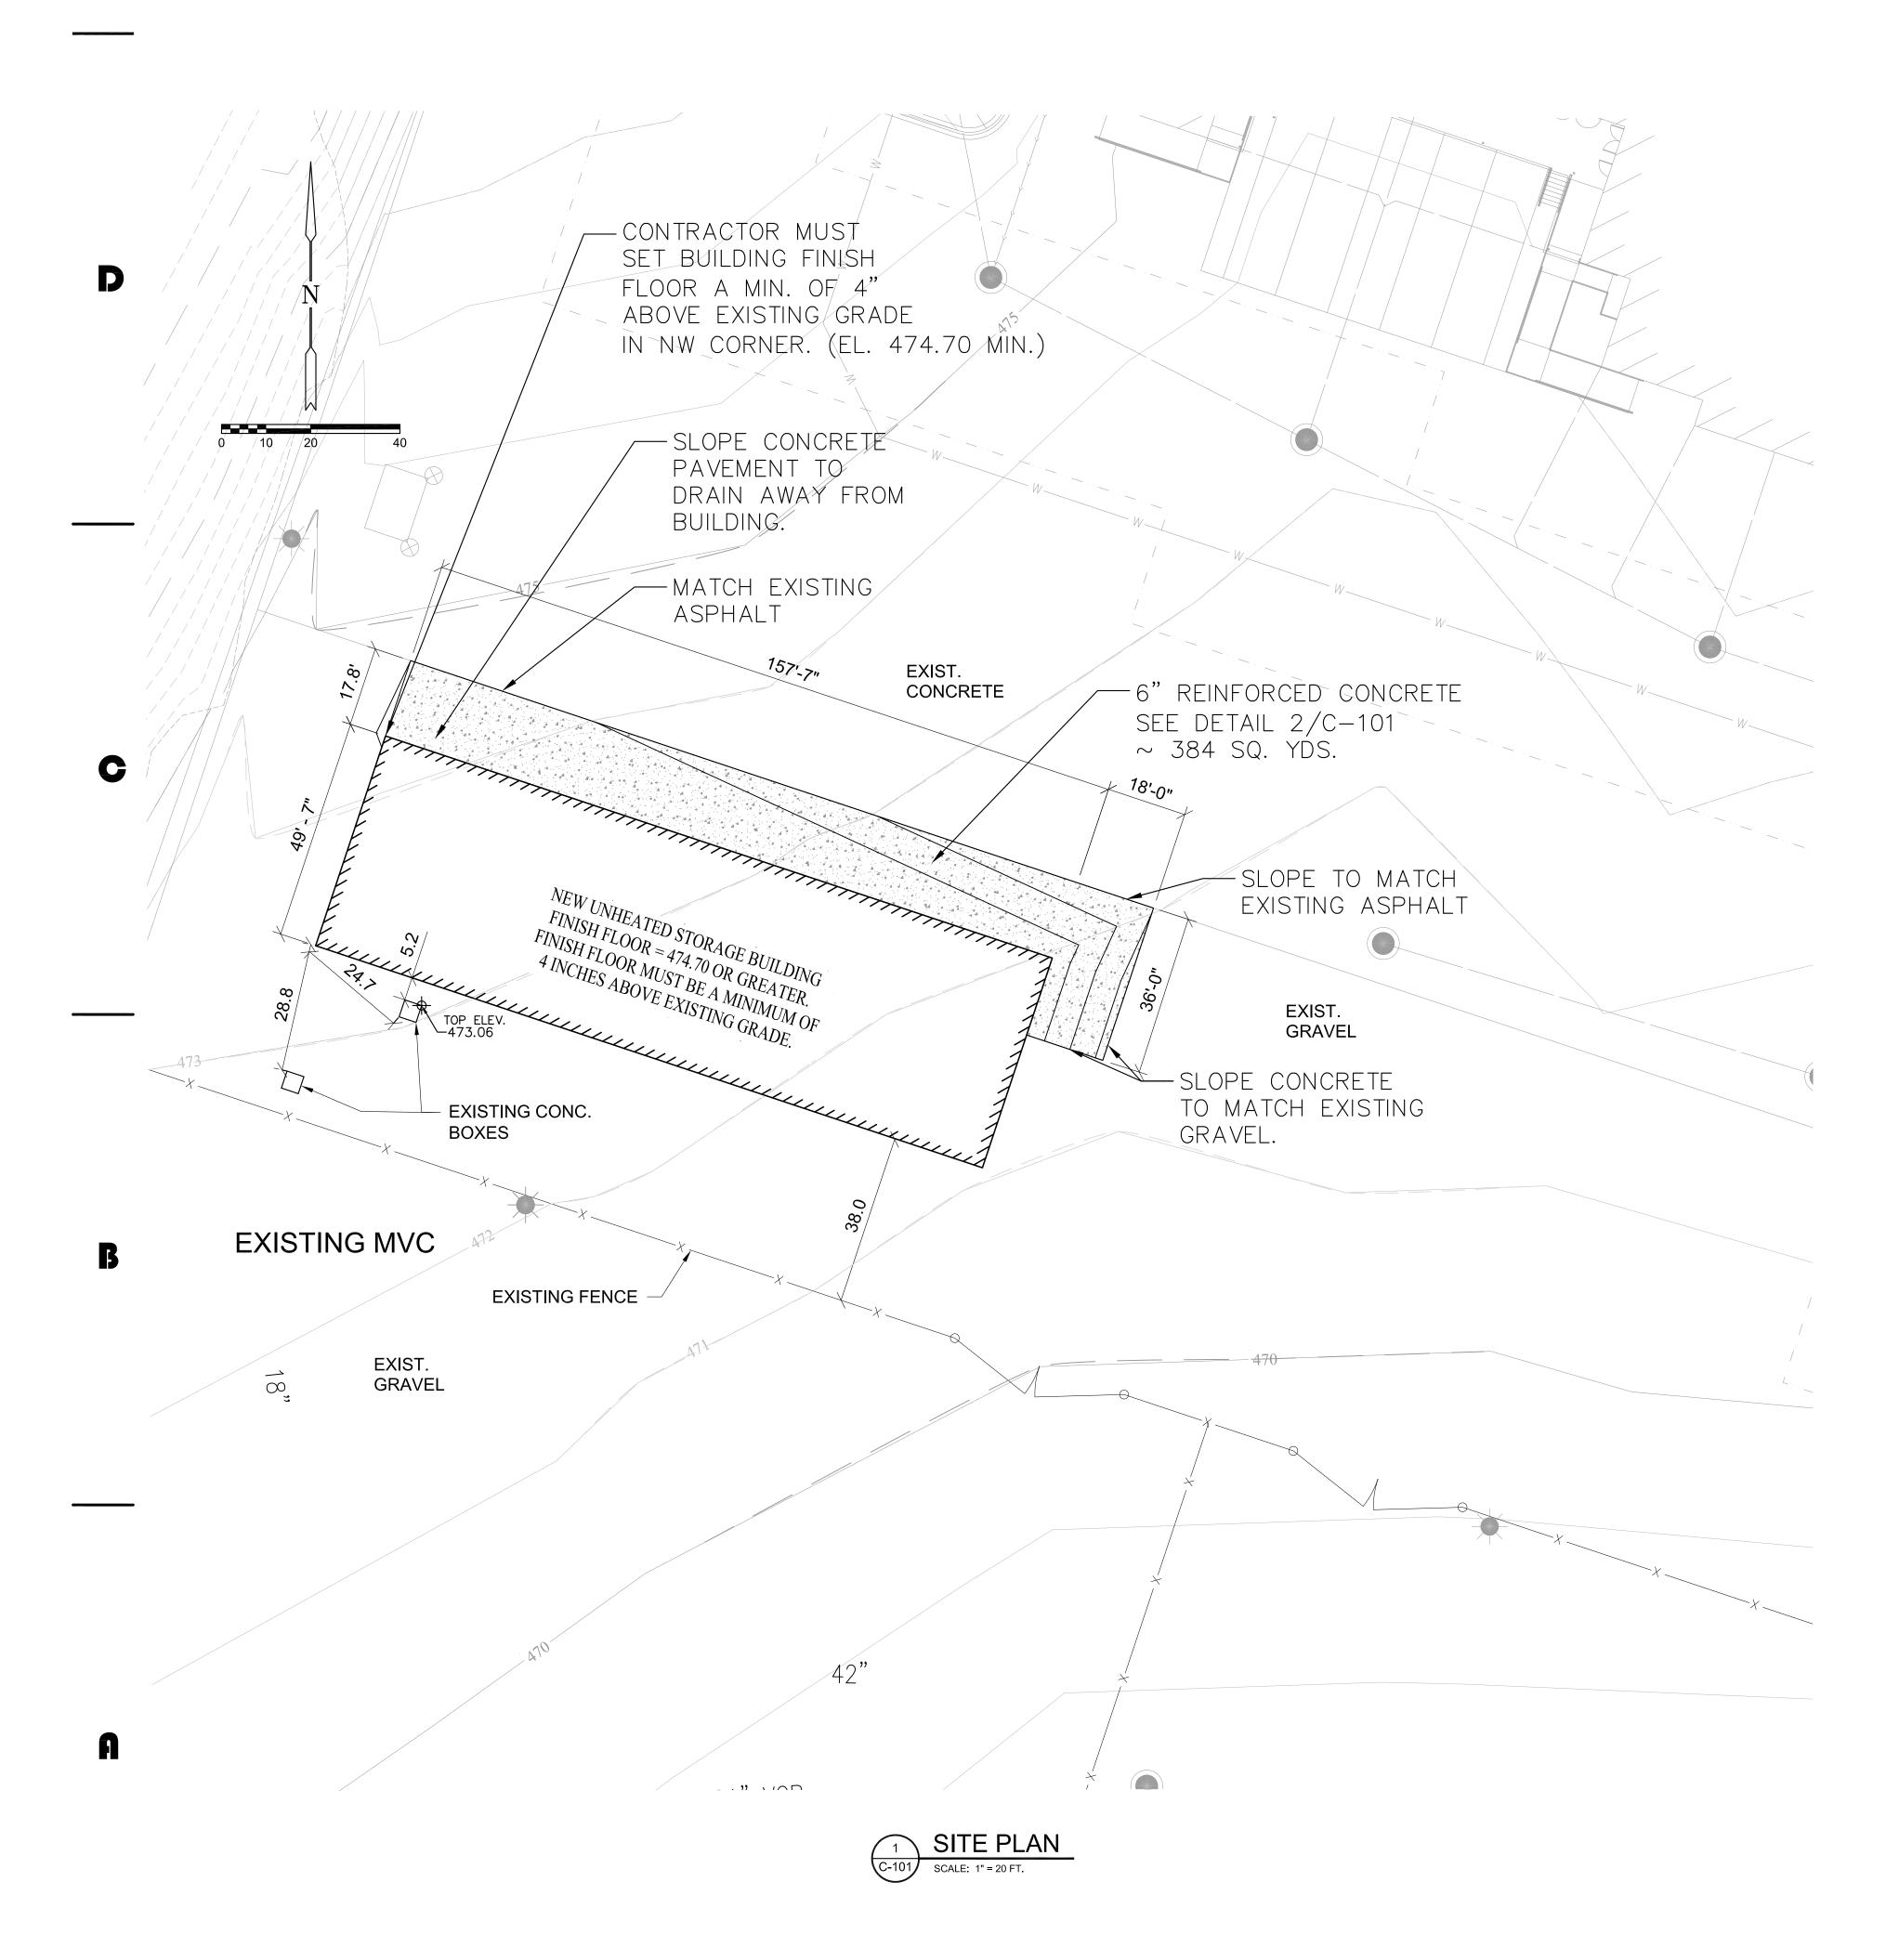



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GENERAL NOTES:

- 1-800-DIG-RITE (1-800-344-7483) PRIOR TO EXCAVATION OR DEMOLITION.
- OWNERS SITE.



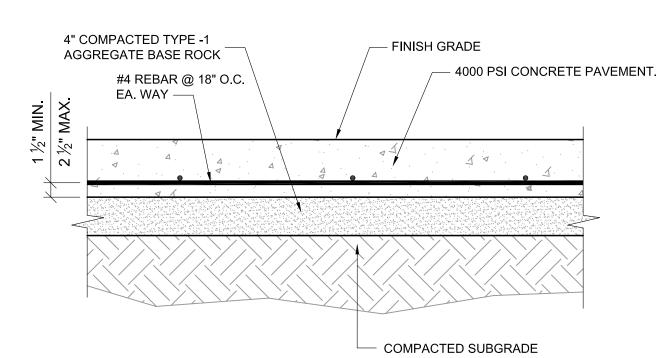

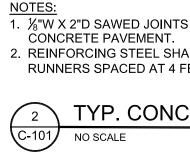

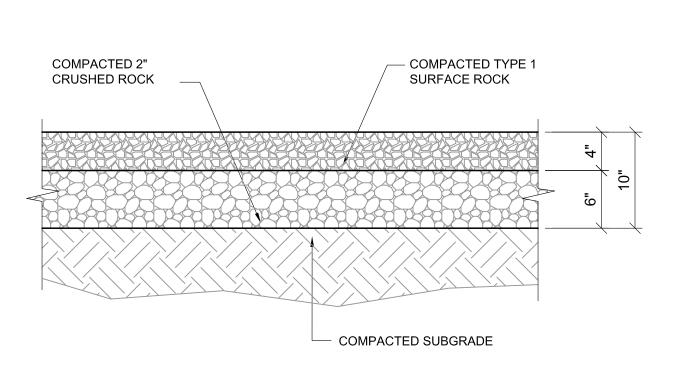

1. UNDERGROUND FACILITIES, STRUCTURES AND UTILITIES HAVE BEEN PLOTTED FROM AVAILABLE SURVEYS AND RECORDS AND , THEREFORE, LOCATIONS MUST BE CONSIDERED APPROXIMATE ONLY. THERE MAY BE OTHERS, THE EXISTENCE OF WHICH, AT PRESENT, IS NOT KNOWN. VERIFICATION OF THE LOCATIONS OF UNDERGROUND UTILITIES, SHOWN OR NOT SHOWN, WILL BE THE RESPONSIBILITY OF THE CONSTRUCTION CONTRACTOR. THE CONTRACTOR SHALL CONTACT THE MISSOURI ONE CALL SYSTEM AT

2. NO GUARANTEE IS GIVEN FOR THE ACCURACY OF QUANTITIES AND DIMENSIONS SHOWN. THE CONTRACTOR SHALL BE RESPONSIBLE FOR VERIFYING ALL INFORMATION AND REPORTING ANY DISCREPANCIES TO THE ENGINEER.

3. THE CONTRACTOR SHALL REMOVE ALL EXCESS OR UNSUITABLE EXCAVATED MATERIALS AND LEGALLY DISPOSE OF OFF


4. CONTRACTOR SHALL RECONSTRUCT DISTURBED AREAS WITHIN THE GRAVEL LOT AS SHOWN IN DETAIL 3/C-101.

1. 1/8"W X 2"D SAWED JOINTS AT 12' CENTERS (MAXIMUM) EACH WAY REQUIRED FOR ALL REINFORCING STEEL SHALL BE SUPPORTED WITH BAR CHAIRS W/ CONTINUOUS RUNNERS SPACED AT 4 FEET C/C MAXIMUM.

TYP. CONCRETE PAVEMENT

TYP. AGGREGATE ROAD/LOT

STATE OF MISSOURI MICHAEL L. PARSON, GOVERNOR

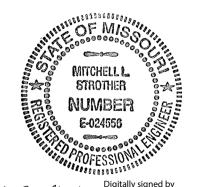

STROTHER.MITCHELL.LEE.151427 9698 Mod Stothe Date: 2023.06.21 10:36:06 -05'00

DATE: 06/21/2023 MITCHELL L STROTHER PROFESSIONAL ENGINEER E-024556

OFFICE OF THE ADJUTANT GENERAL

MISSOURI NATIONAL GUARD FACILITIES DIVISION

OFFICE OF ADMINISTRATION DIVISION OF FACILITIES MANAGEMENT, **DESIGN AND CONSTRUCTION**

OFFICE OF THE ADJUTANT GENERAL

MISSOURI NATIONAL GUARD **FACILITIES DIVISION**

CONSTRUCT UNHEATED STORAGE BUILDING

JEFFERSON BARRACKS 24 DAVIS ST. ST. LOUIS, ST. LOUIS COUNTY, MISSOURI

PROJECT # T2312-01 ASSET # 8136303053 SITE # 6303

REVISION: DATE: **REVISION**: DATE: **REVISION**: DATE: ISSUE DATE: 06/21/2023

CAD DWG FILE: DRAWN BY: MLS CHECKED BY: KAL/MLS

DESIGNED BY: MLS

SHEET TITLE:

SITE PLAN & DETAILS

SHEET NUMBER:

C101 SHEET 2 OF 7 DATE 06/21/2023

GENERAL NOTES:

D

GOVERNING CODE: INTERNATIONAL BUILDING CODE 2006 DESIGN LOADS: ROOF LIVE LOAD = 20 PSF ROOF SNOW LOAD = 25 PSF COLLATERAL LOAD = 5 PSF BASIC WIND SPEED (EXPOSURE B) = 90 MPH IMPORTANCE FACTOR, I = 1.0SEISMIC: SEISMIC IMPORTANCE FACTOR = 1.0 SEISMIC DESIGN CATEGORY = D SITE CLASS = D

FOOTING EXCAVATIONS SHALL BE FLAT, LEVEL AND WELL CLEANED OF ALL LOOSE SOIL PRIOR TO CONCRETING. THE FOOTING SUBGRADE SHALL BE THOROUGHLY COMPACTED USING MECHANICAL TAMPERS PRIOR TO INSTALLING REINFORCING STEEL. FOOTINGS ARE DESIGNED TO BEAR ON UNDISTURBED SOIL WITH A MAXIMUM NET BEARING PRESSURE OF 2000 PSF.

THE STRENGTH PROPERTIES OF THE SOIL WILL VARY WITH CHANGES IN MOISTURE CONTENT. THEREFORE, EVERY EFFORT SHOULD BE MADE TO PLACE CONCRETE THE SAME DAY AS THE FOOTING EXCAVATION IS COMPLETED.

COORDINATE WITH OTHER DISCIPLINES FOR ADDITIONAL EMBEDDED ITEMS.


THE CONTRACTOR SHALL VERIFY AND COORDINATE ALL FOUNDATION DIMENSIONS WITH THE FINAL "CERTIFIED" METAL BUILDING SYSTEM DRAWINGS FOR, BUT NOT LIMITED TO, COLUMN LOCATIONS, BUILDING LINE TO CENTER LINE COLUMNS, BASEPLATE AND ANCHOR BOLTS AND ALL OTHER BUILDING TO FOUNDATION INTERFACE ITEMS REQUIRED. ANY CHANGES TO THE FOUNDATION SHALL BE THE RESPONSIBILITY OF THE CONTRACTOR.

INSIDE FOUNDATION SHALL BE BACKFILLED WITH COMPACTED ENGINEERED FILL PER SPECIFICATIONS. SPOIL MATERIAL FROM FOOTING EXCAVATION SHALL BE USED TO BACKFILL OUTSIDE FOUNDATION WALL PROVIDING POSITIVE DRAINAGE AWAY FROM BUILDING.

EXTEND VERTICAL BARS IN GRADE BEAM AND COLUMN PIERS 6" INTO SLAB ABOVE. PROVIDE CORNER BARS TO MATCH SIZE AND SPACING OF HORIZONTAL BARS WITH 2'-6" EACH DIRECTION.

ISOLATION JOINTS SHALL HAVE 1/4" NON-EXTRUDING BITUMINOUS JOINT FILLER COMPLYING WITH ASTM D1751

CONTRACTOR SHALL CERTIFY THE DESIGN STRENGTH, PERFORM COMPRESSIVE STRENGTH TESTS PER ACI 318 AND AIR CONTENT PER ASTM C231. SLUMP TESTS PERFORMED FOR EACH LOAD AND ADDITIONAL TESTS WHEN CONCRETE CONSISTENCY CHANGES

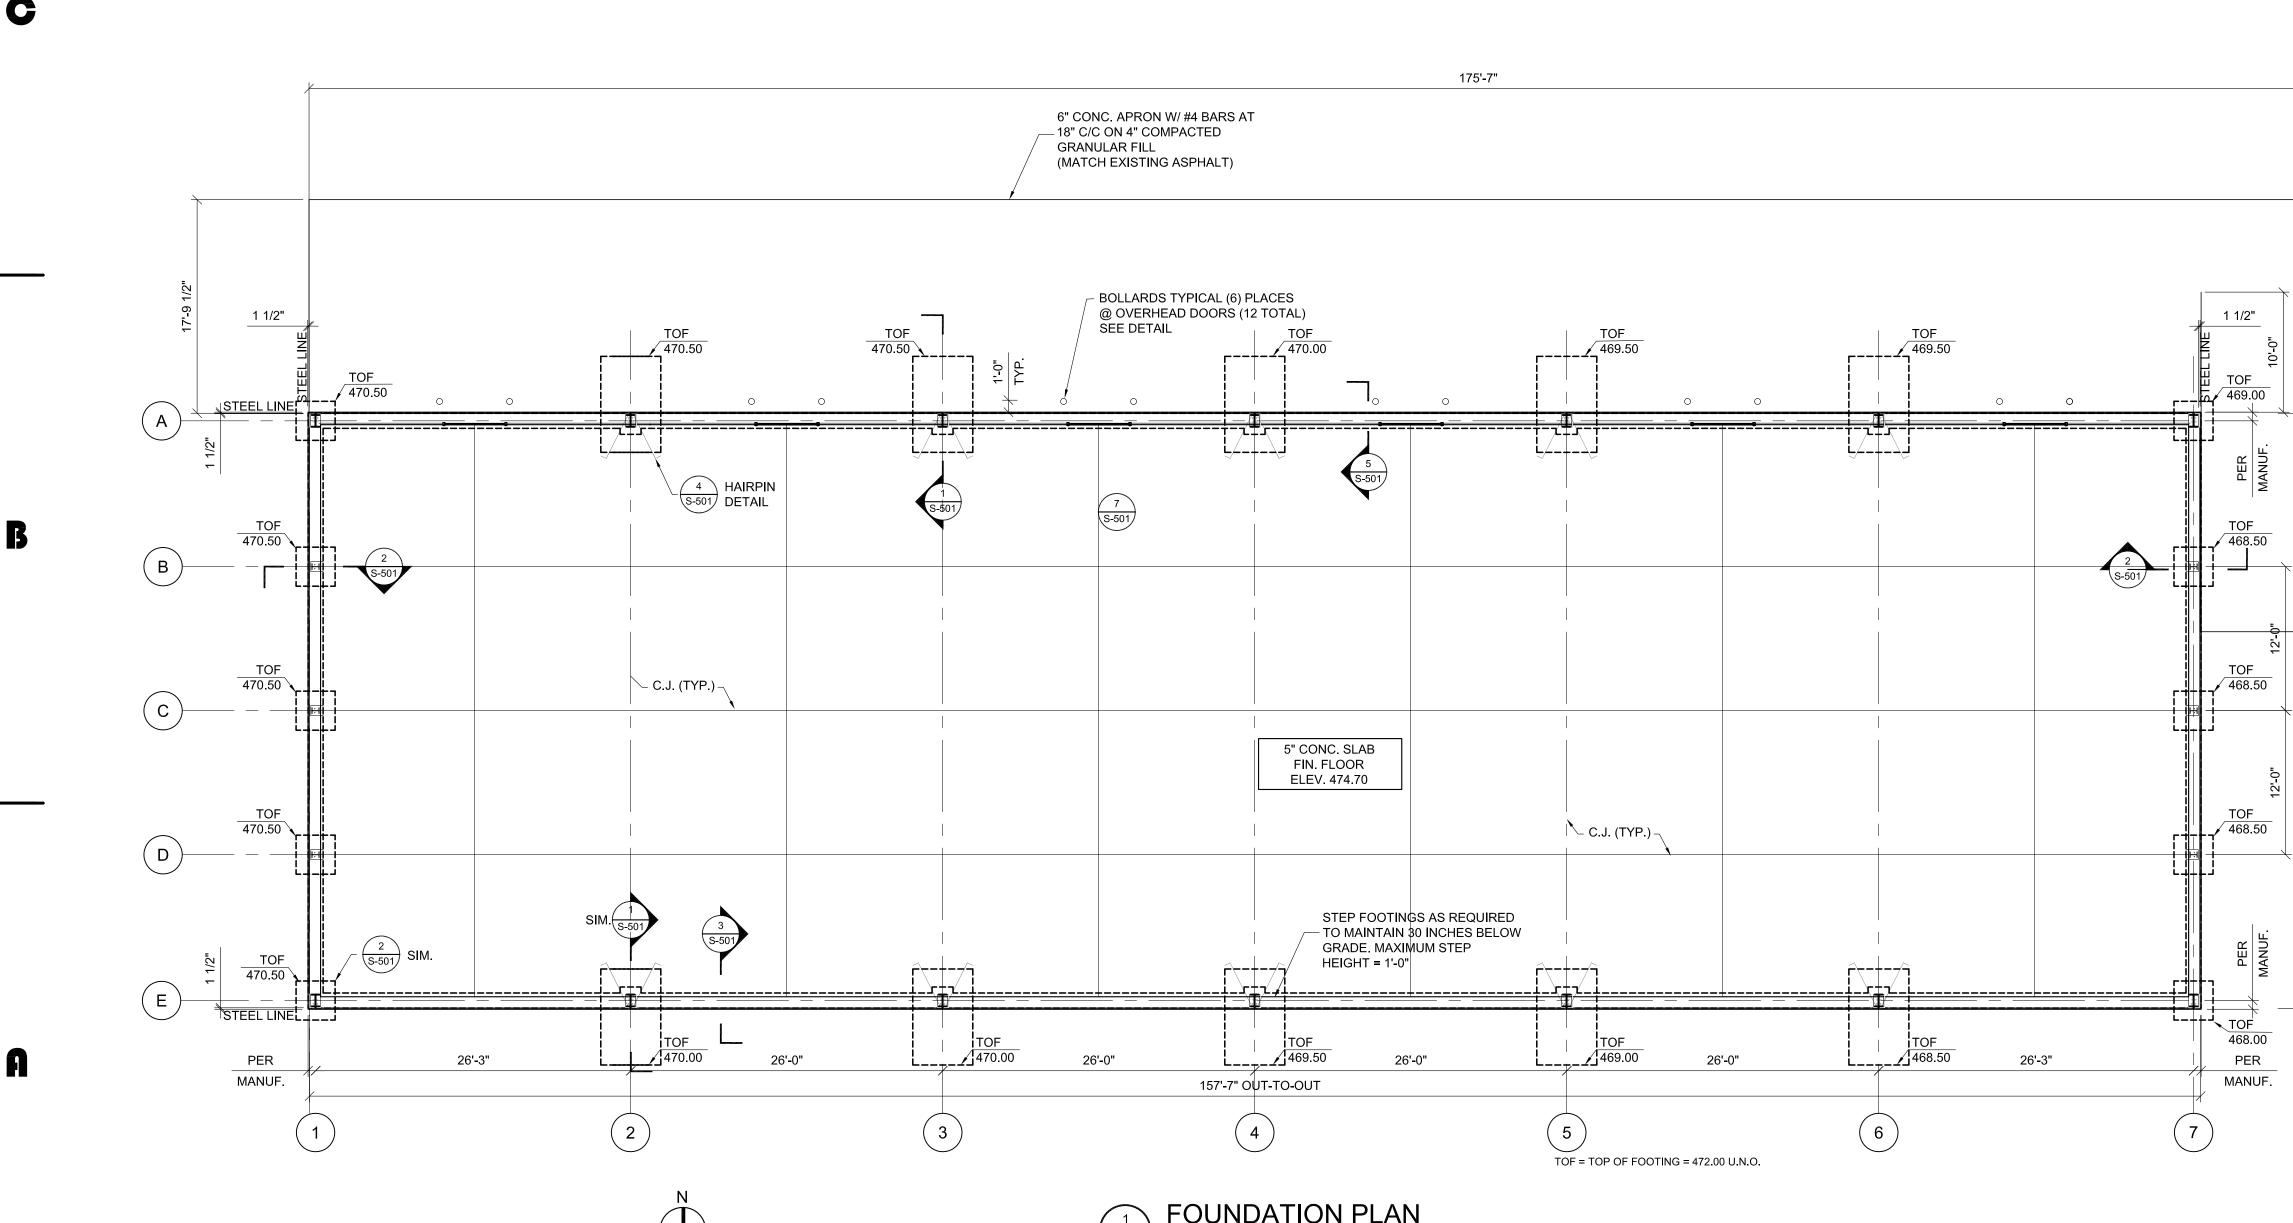

 \bigcirc PLAN NORTH

TOP AND BOTTOM BARS IN CONTINUOUS GRADE BEAMS SHALL RUN CONTINUOUS THROUGH MULTIPLE SPANS, WHERE POSSIBLE. OTHERWISE, TOP BARS SHALL SPLICE WITHIN THE MIDDLE 1/3 OF THE SPAN AND THE BOTTOM BARS SHALL SPLICE BY LAPPING 3'-0" OVER SUPPORTS

POUR GRADE BEAMS MONOLITHIC WITH COLUMN PILASTERS

PIPE BOLLARDS: ASTM A53 STD. WT. STEEL PIPE, 6.625 O.D., CONCRETE FILLED PAINTED SAFETY YELLOW. SET EDGE OF PIPE EVEN WITH FINISHED JAMB OF DOOR OPENING.

ANCHOR BOLTS - ASTM-A307 TO BE LOCATED BY TEMPLATE, DO NOT HAND SET ANCHOR BOLTS.

TOP OF FOUNDATION - GRADE BEAMS AND COLUMN PILASTERS - TO RECEIVE A TROWEL FINISH.


SEE ARCHITECTURAL AND ELECTRICAL REQUIREMENTS FOR IMBEDDED ITEMS NOT SHOWN HEREIN AND TO VERIFY SIZE AND LOCATION OF ALL OPENINGS.

INSTALL 8" X 3' X 3' THICKENED SLAB AT PORTAL COLUMNS (LOCATIONS DETERMINED BY PRE ENGINEERED BUILDING MANUFACTURER)

T FOUNDATION PLAN S-101 SCALE: 1/8" = 1'-0"

U Z
FOOT
OUT
T-TO-(
" OUT-
49'-7"

STATE OF MISSOURI MICHAEL L. PARSON, GOVERNOR

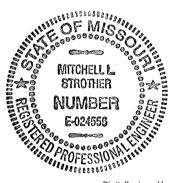

Digitally signed by STROTHER.MITCHELL.LEE.15142 79698 Date: 2023.06.21 10:37:35 -05'00'

DATE: 06/21/2023 MITCHELL L STROTHER PROFESSIONAL ENGINEER E-024556

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MISSOURI NATIONAL GUARD **FACILITIES DIVISION**

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PROJECT # T2312-01 ASSET # 8136303053 SITE # 6303

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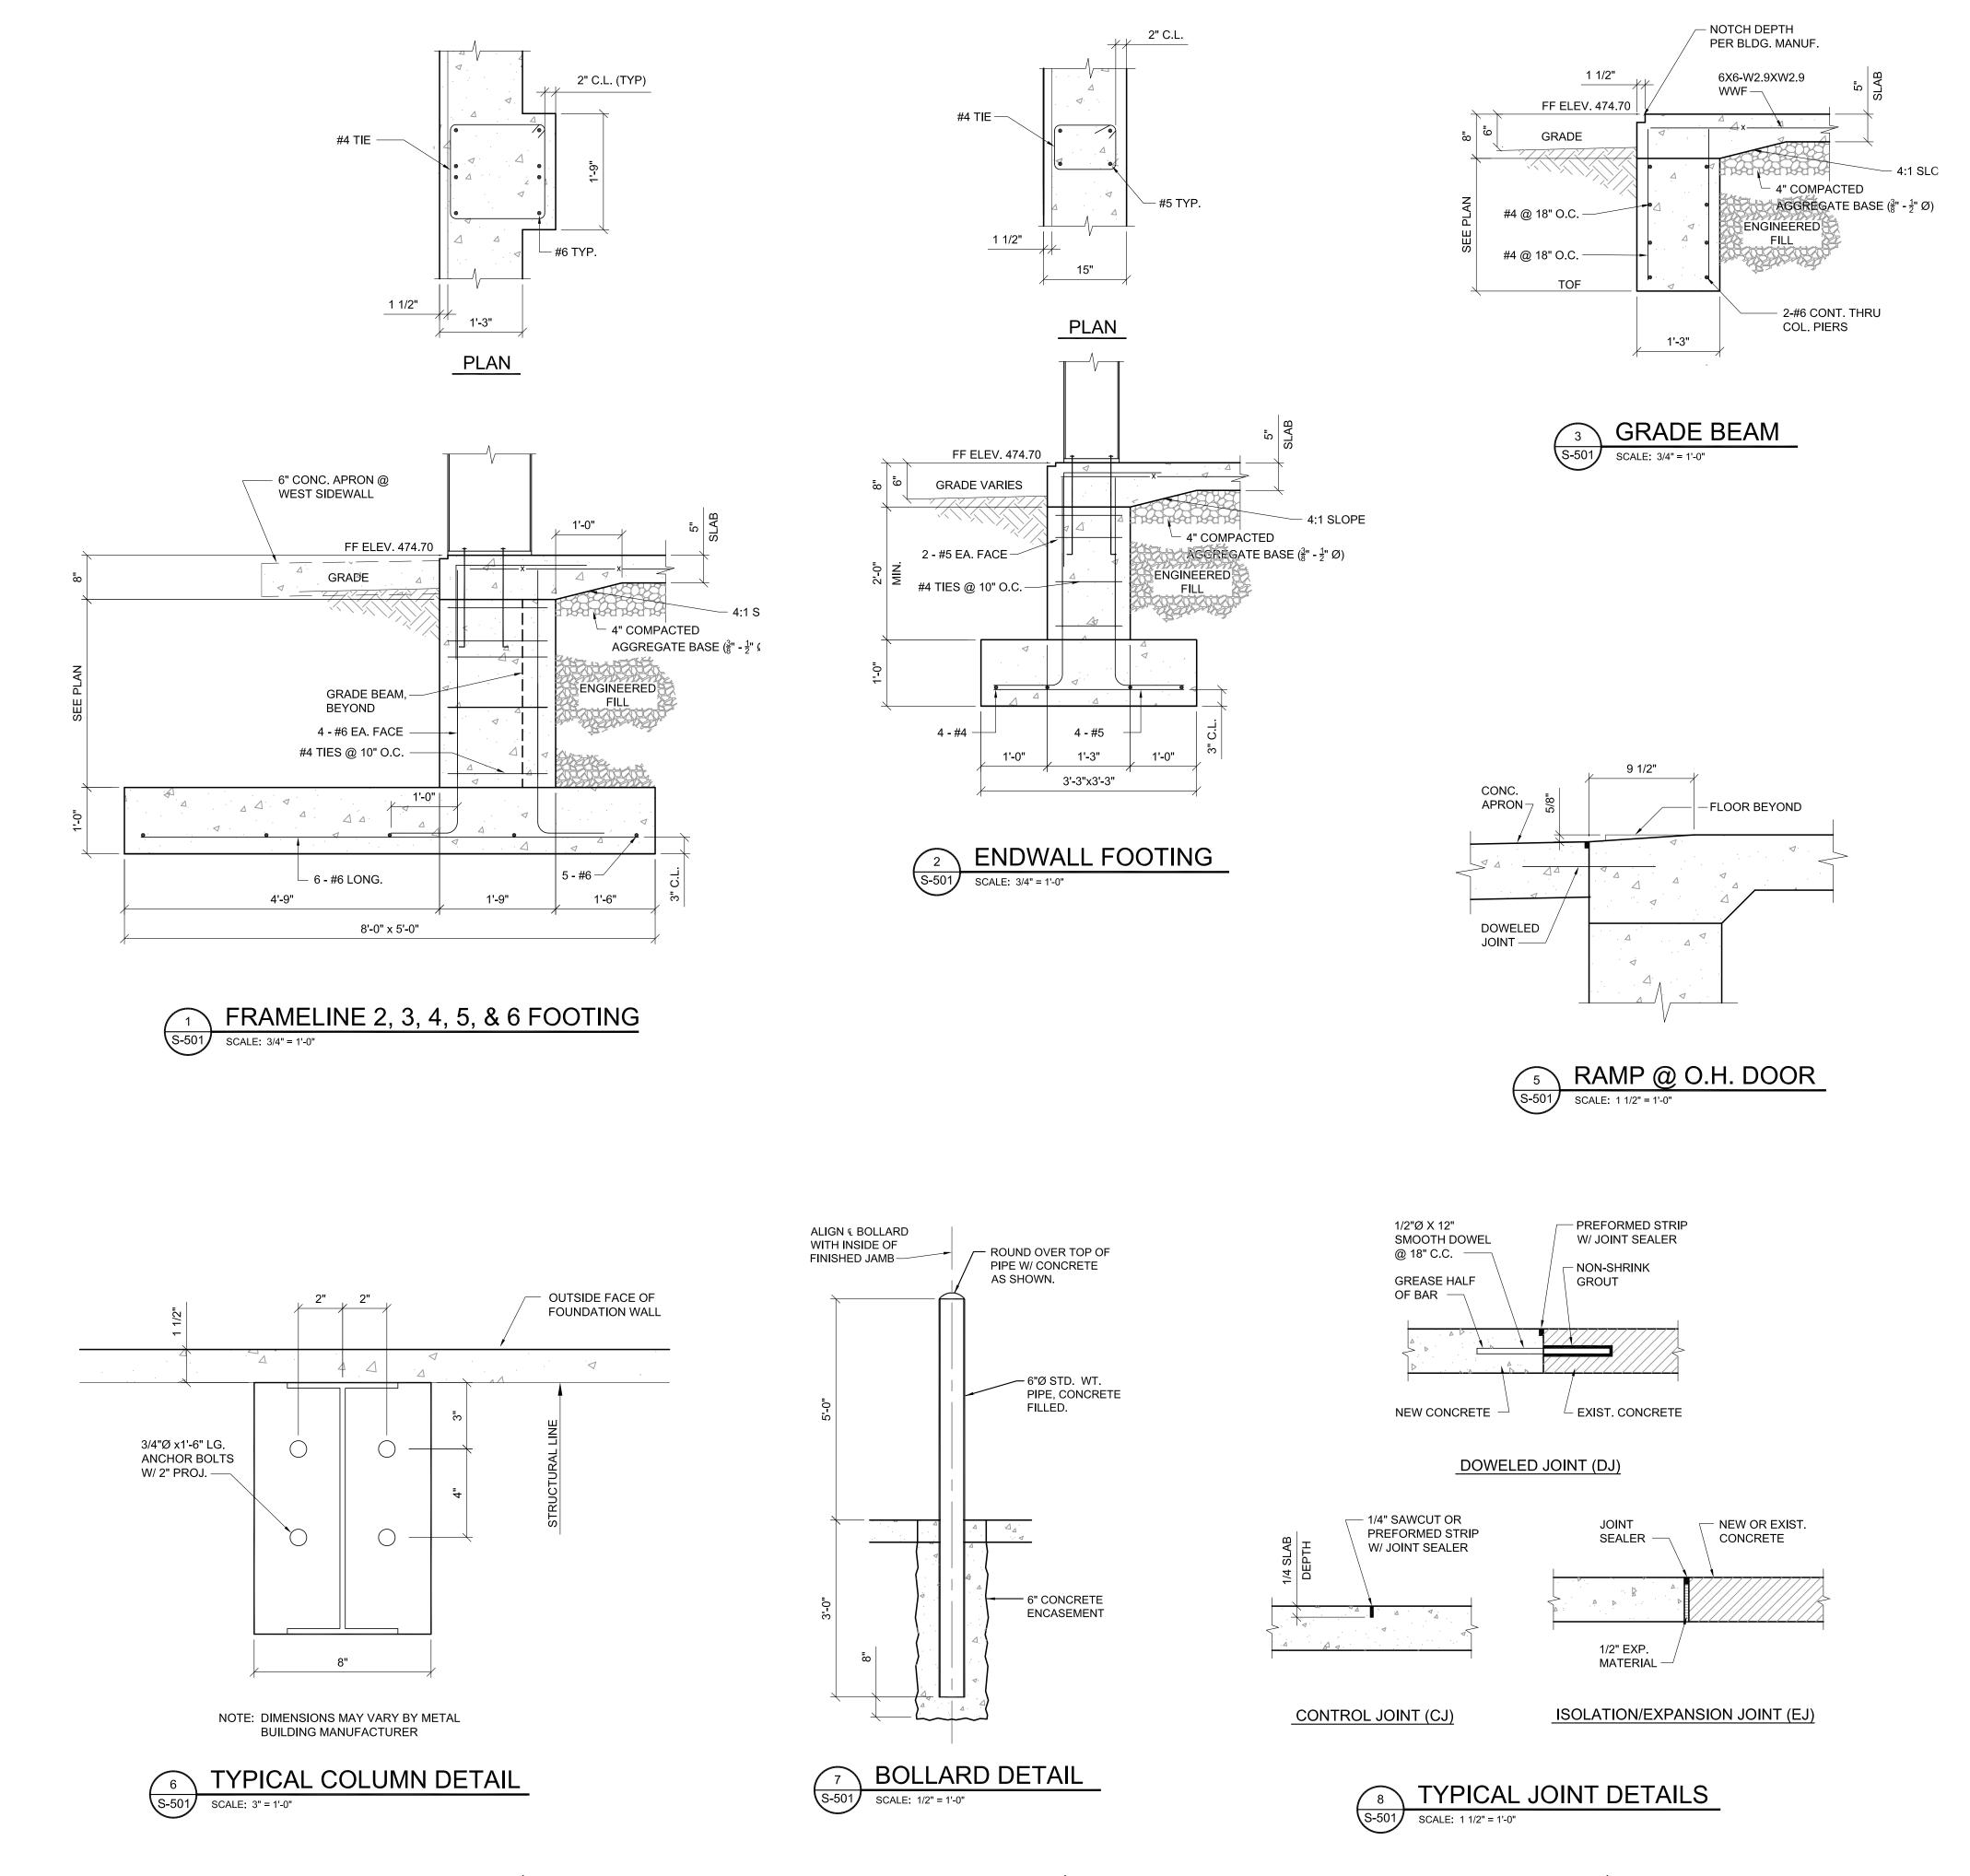
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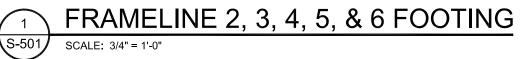
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SHEET TITLE: FOUNDATION PLAN

SHEET NUMBER:

S-101 SHEET 3 OF 7 DATE 06/21/2023







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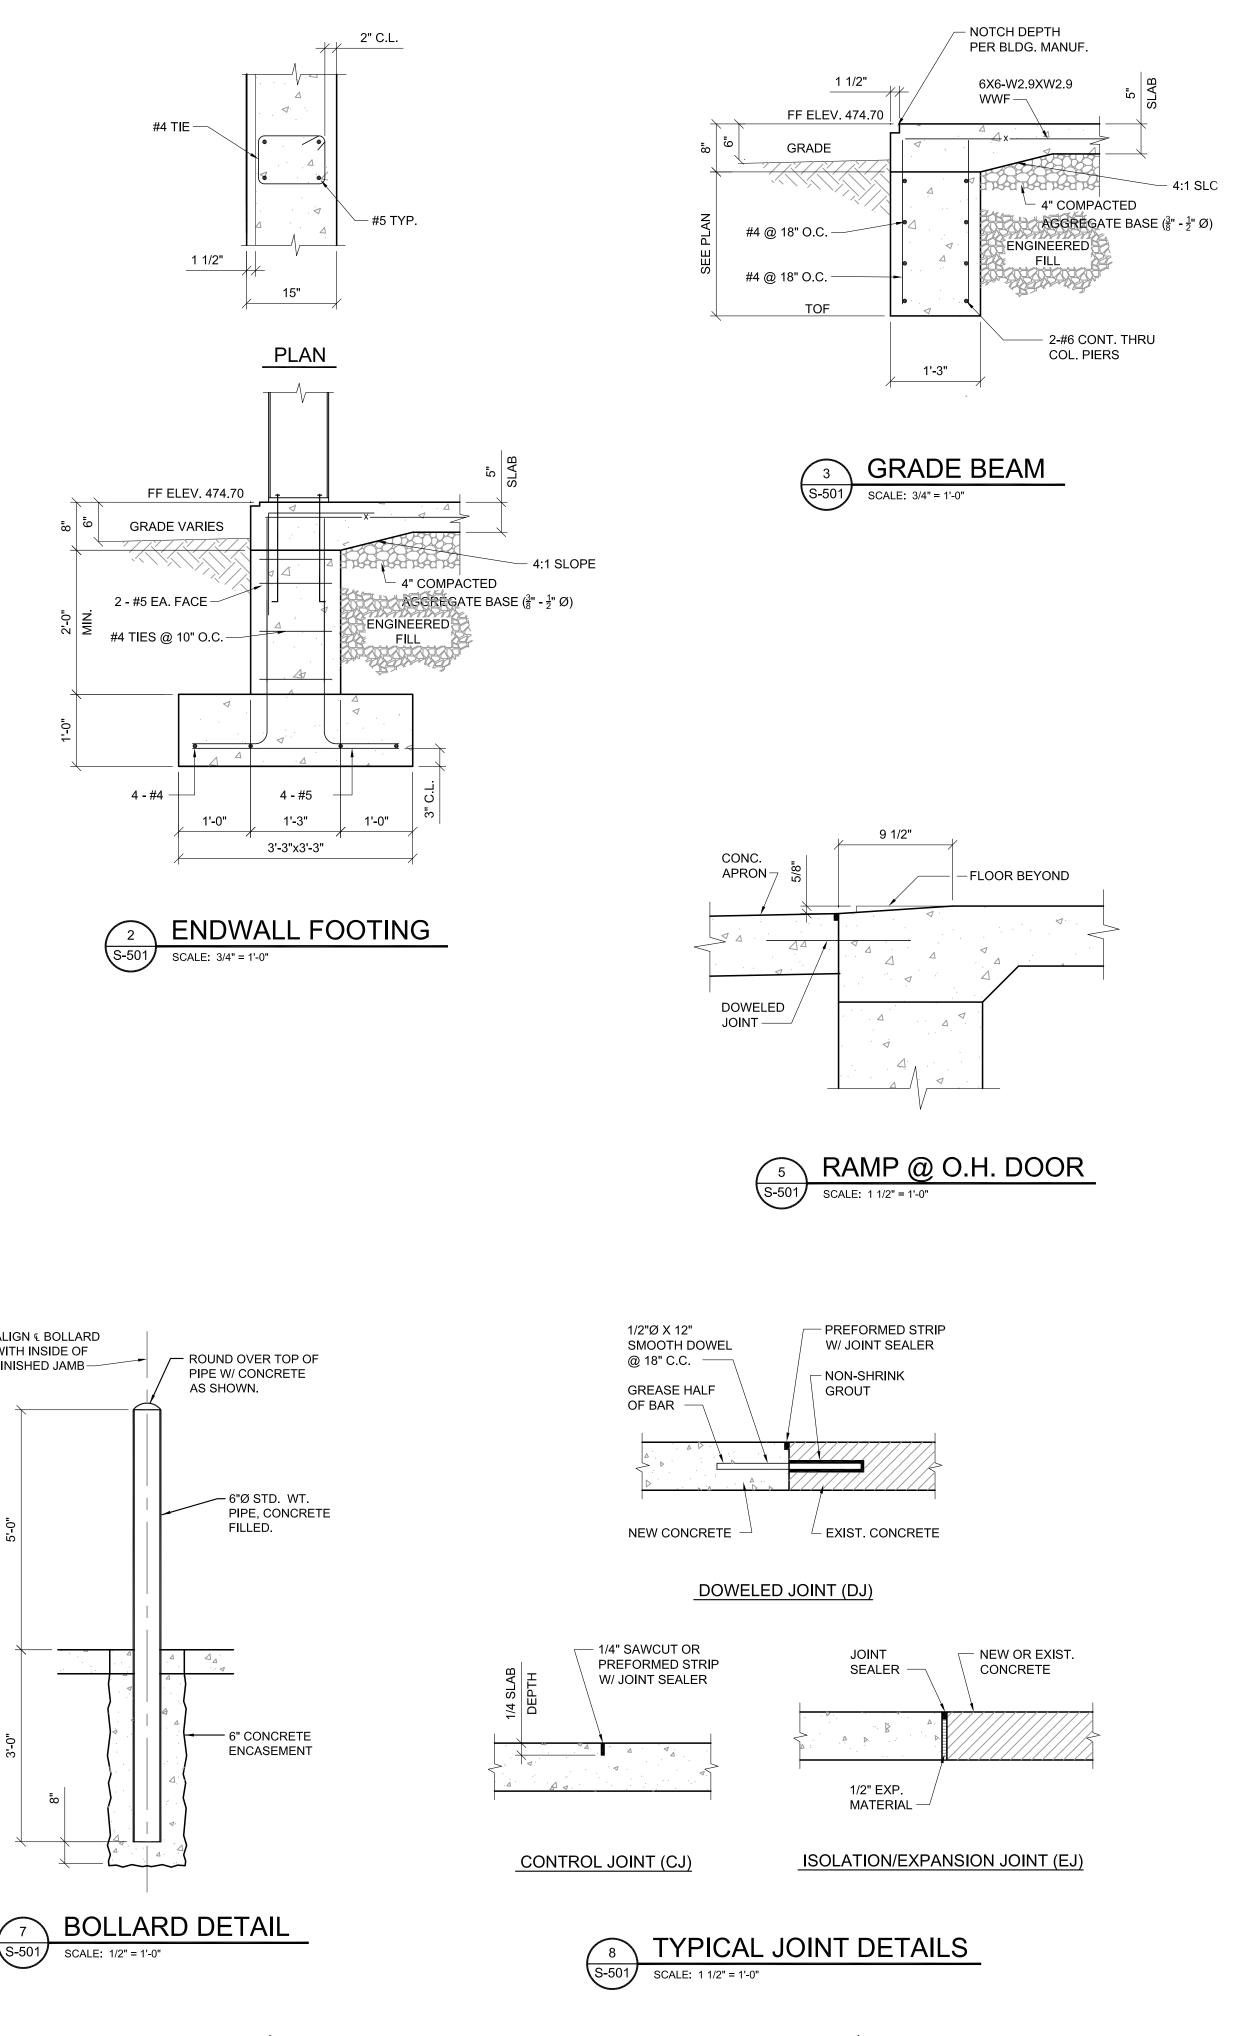
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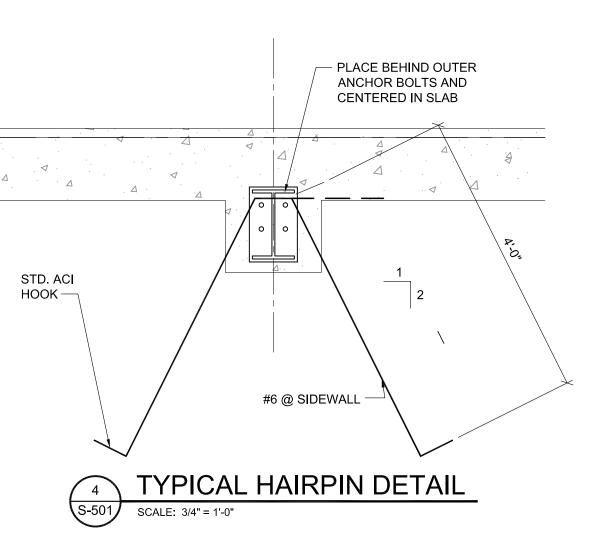
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STATE OF MISSOURI MICHAEL L. PARSON, GOVERNOR	
MITCHELL L STROTHER BE CONTROLLER	

Digitally signed by STROTHER.MITCHELL.LEE.15142 79698 Date: 2023.06.21 10:39:35 -05'00'

DATE: 06/21/2023 MITCHELL L STROTHER PROFESSIONAL ENGINEER E-024556
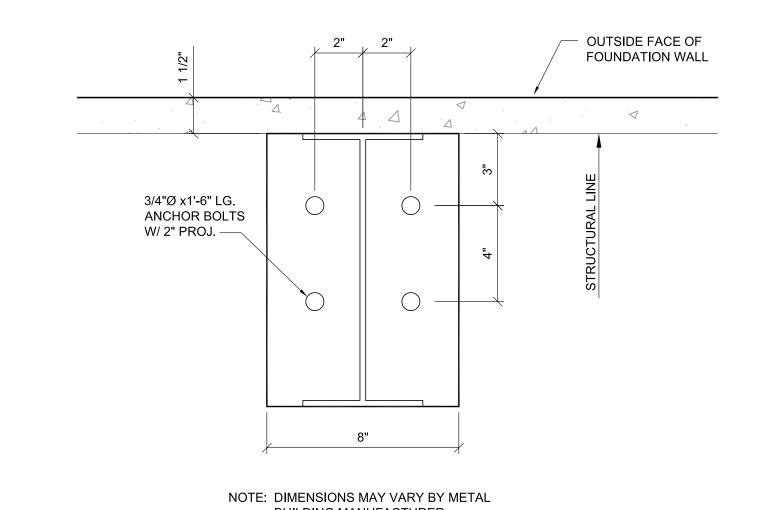
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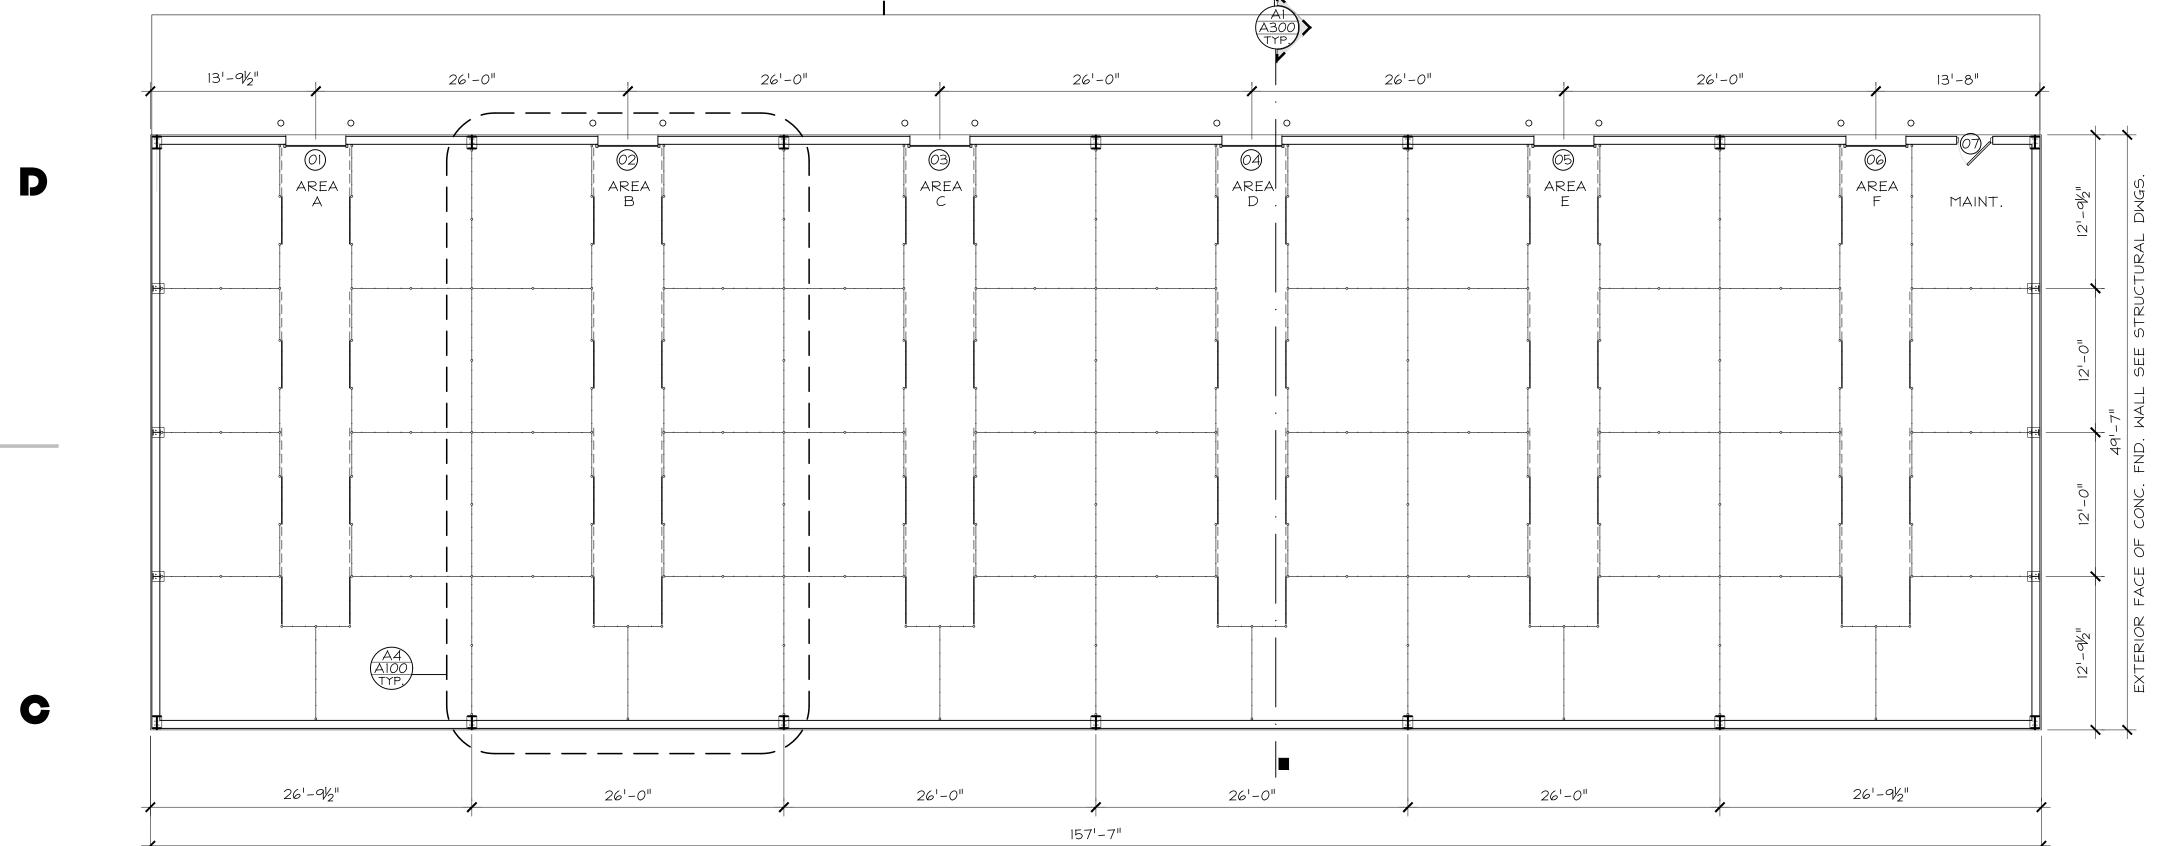
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SHEET TITLE: FOUNDATION, JOINT & BOLLARD DETAILS


SHEET NUMBER:

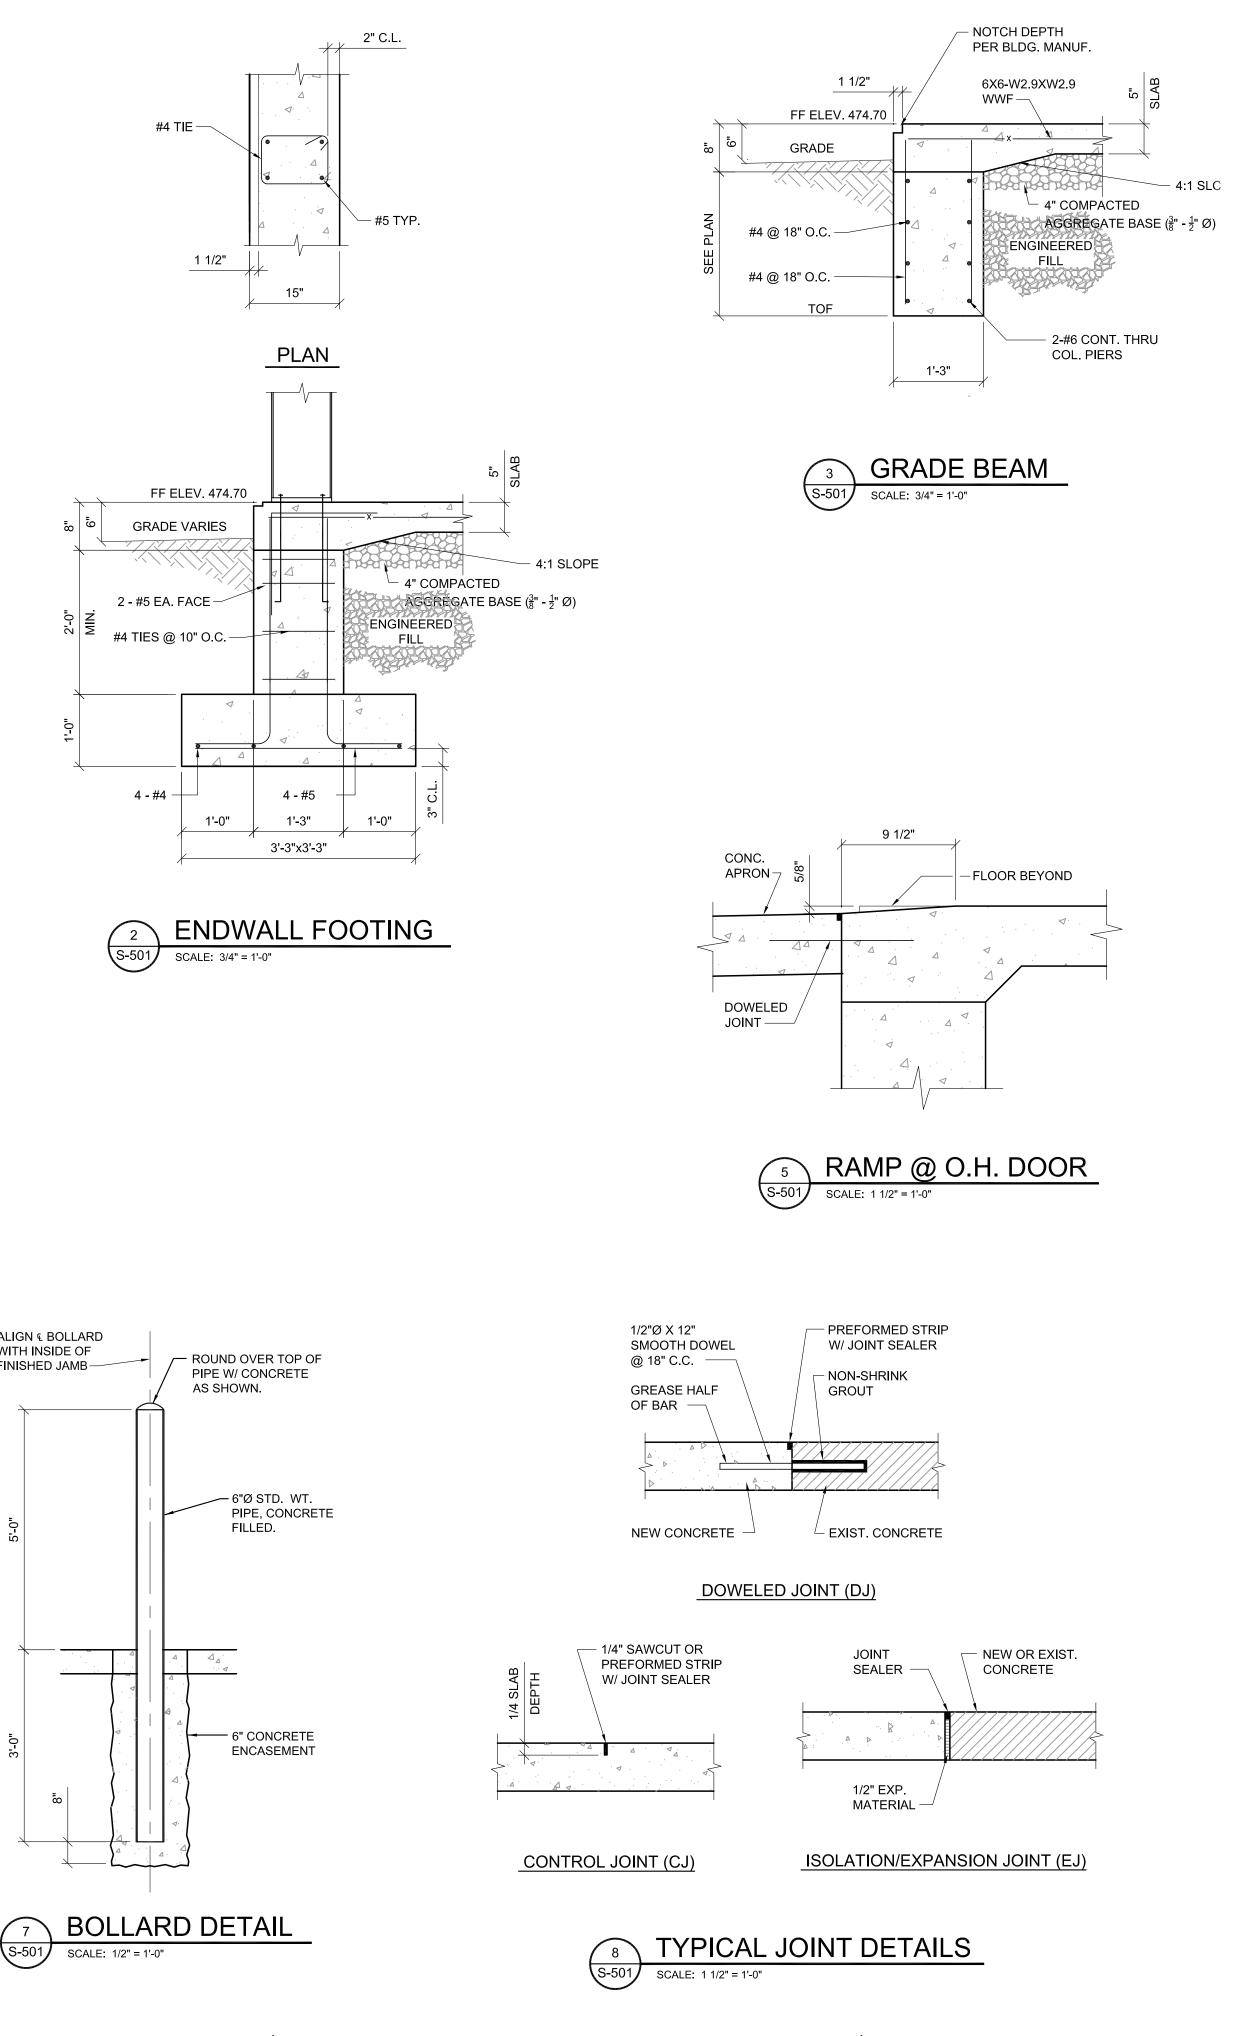S-501 SHEET 4 OF 7 DATE 06/21/2023

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EXTERIOR FACE OF CONC. FND. WALL SEE STRUCTURAL DWGS.



	DOOR SCHEDULE																			
DOOR NO.	SIZE	DESCRIPTION	FIRE RATING FRAME		HARDWARE											REMARKS				
				MORTISE LOCK	BOLT NATION LOCK	PANIC	KEYED CYLINDER		PUSH/PULL TO PUSH/PULL TO PRIVACY	LEAF	1 1/2 PR(@ LEAF) 2 PR (@ LEAF) II 5PRING	BEARING	FLUSH BOLT	DOOR STOP (@ DOOR)	THRESHOLD WFATHFR STRIP		CLOSER (ADA 5#)	CONTR	5TRAC	
1	5'-0" X 7'-0"	OVERHEAD COILING DOOR			•											•				MUST EXCEPT BEST CORE
2	5'-0" X 7'-0"	OVERHEAD COILING DOOR			•										•	1				MUST EXCEPT BEST CORE
3	5'-0" X 7'-0"	OVERHEAD COILING DOOR			•															MUST EXCEPT BEST CORE
4	5'-0" × 7'-0"	OVERHEAD COILING DOOR			•															MUST EXCEPT BEST CORE
5	5'-0" × 7'-0"	OVERHEAD COILING DOOR			•															MUST EXCEPT BEST CORE
6	5'-0" X 7'-0"	OVERHEAD COILING DOOR			•															MUST EXCEPT BEST CORE
7	3'-0" X 6'-8"	H.M. INSULATED	H.M.		•				•		•				• •		•			MUST EXCEPT BEST CORE

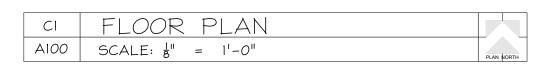
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STATE OF MISSOURI MICHAEL L. PARSON, GOVERNOR
KEITH AUGUST LESKO NUMBER A-6176 Digitally signed by
LESKO.KEITH.AUGUST.14560715 42 Date: 2023.06.21 10:16:25 -05'00' DATE: 06/21/2023
KEITH A. LESKO ARCHITECT A-6176 OFFICE OF THE
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FACILITIES DIVISION
OFFICE OF ADMINISTRATION DIVISION OF FACILITIES MANAGEMENT,
DESIGN AND CONSTRUCTION OFFICE OF THE
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MISSOURI NATIONAL GUARD FACILITIES DIVISION
CONSTRUCT UNHEATED STORAGE BUILDING
JEFFERSON BARRACKS 24 DAVIS ST.
ST. LOUIS, ST. LOUIS COUNTY, MISSOURI
PROJECT # T2312-01 ASSET # 8136303053 SITE # 6303
DEVISION.

REVISION:_____ DATE:____ REVISION:____ DATE: REVISION: DATE: ISSUE DATE: 06/21/2023


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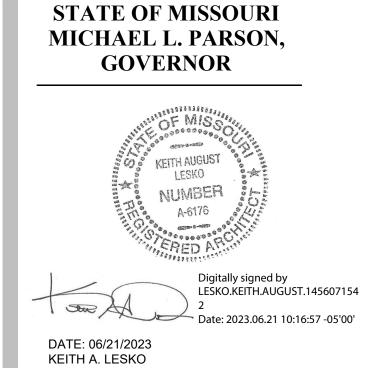
____ SHEET TITLE:

FLOOR PLAN ENLARGED FLOOR PLAN

SHEET NUMBER:

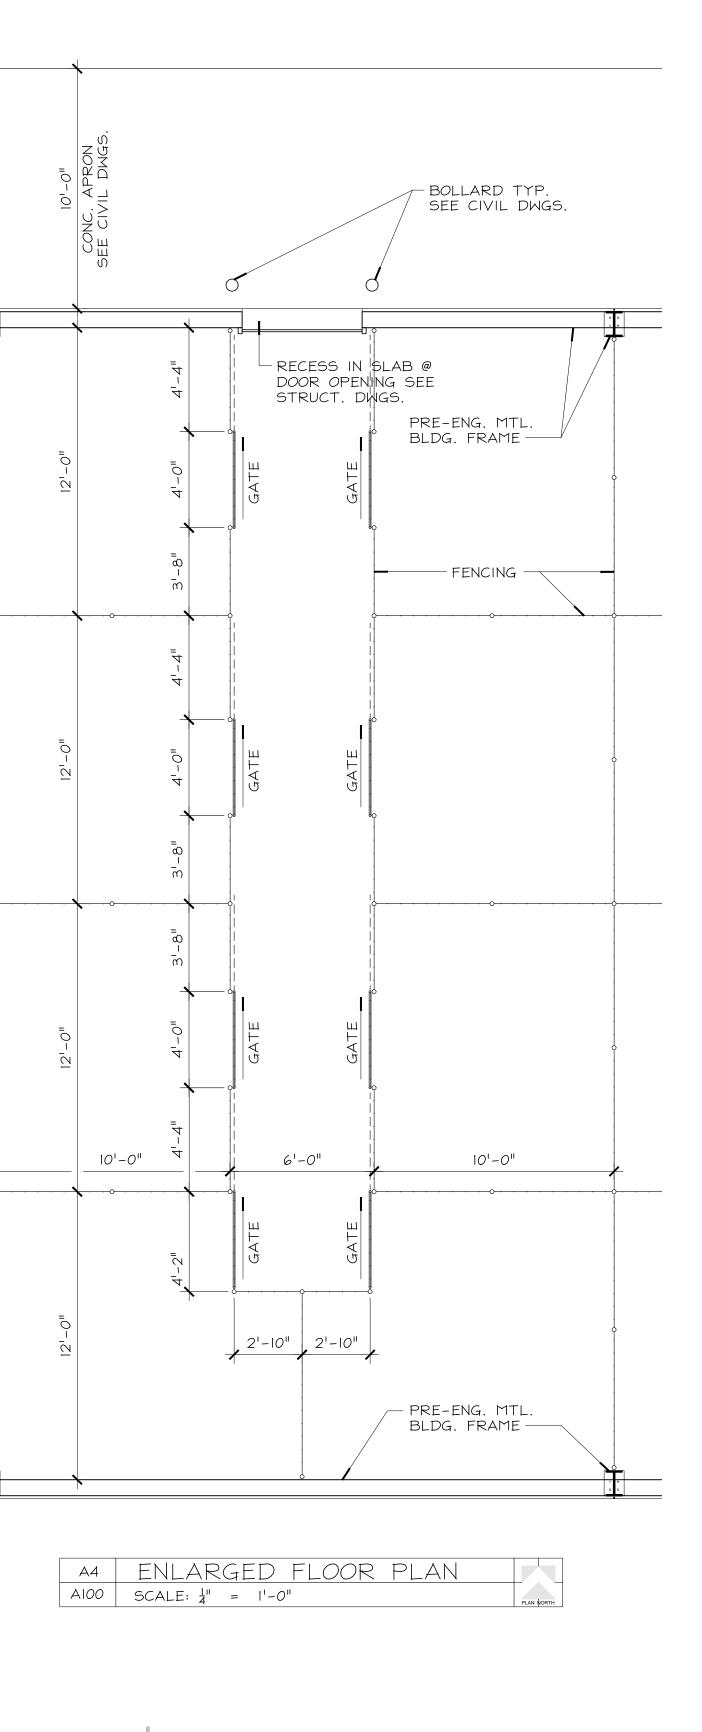A100 SHEET 5 OF 7 DATE 06/21/2023



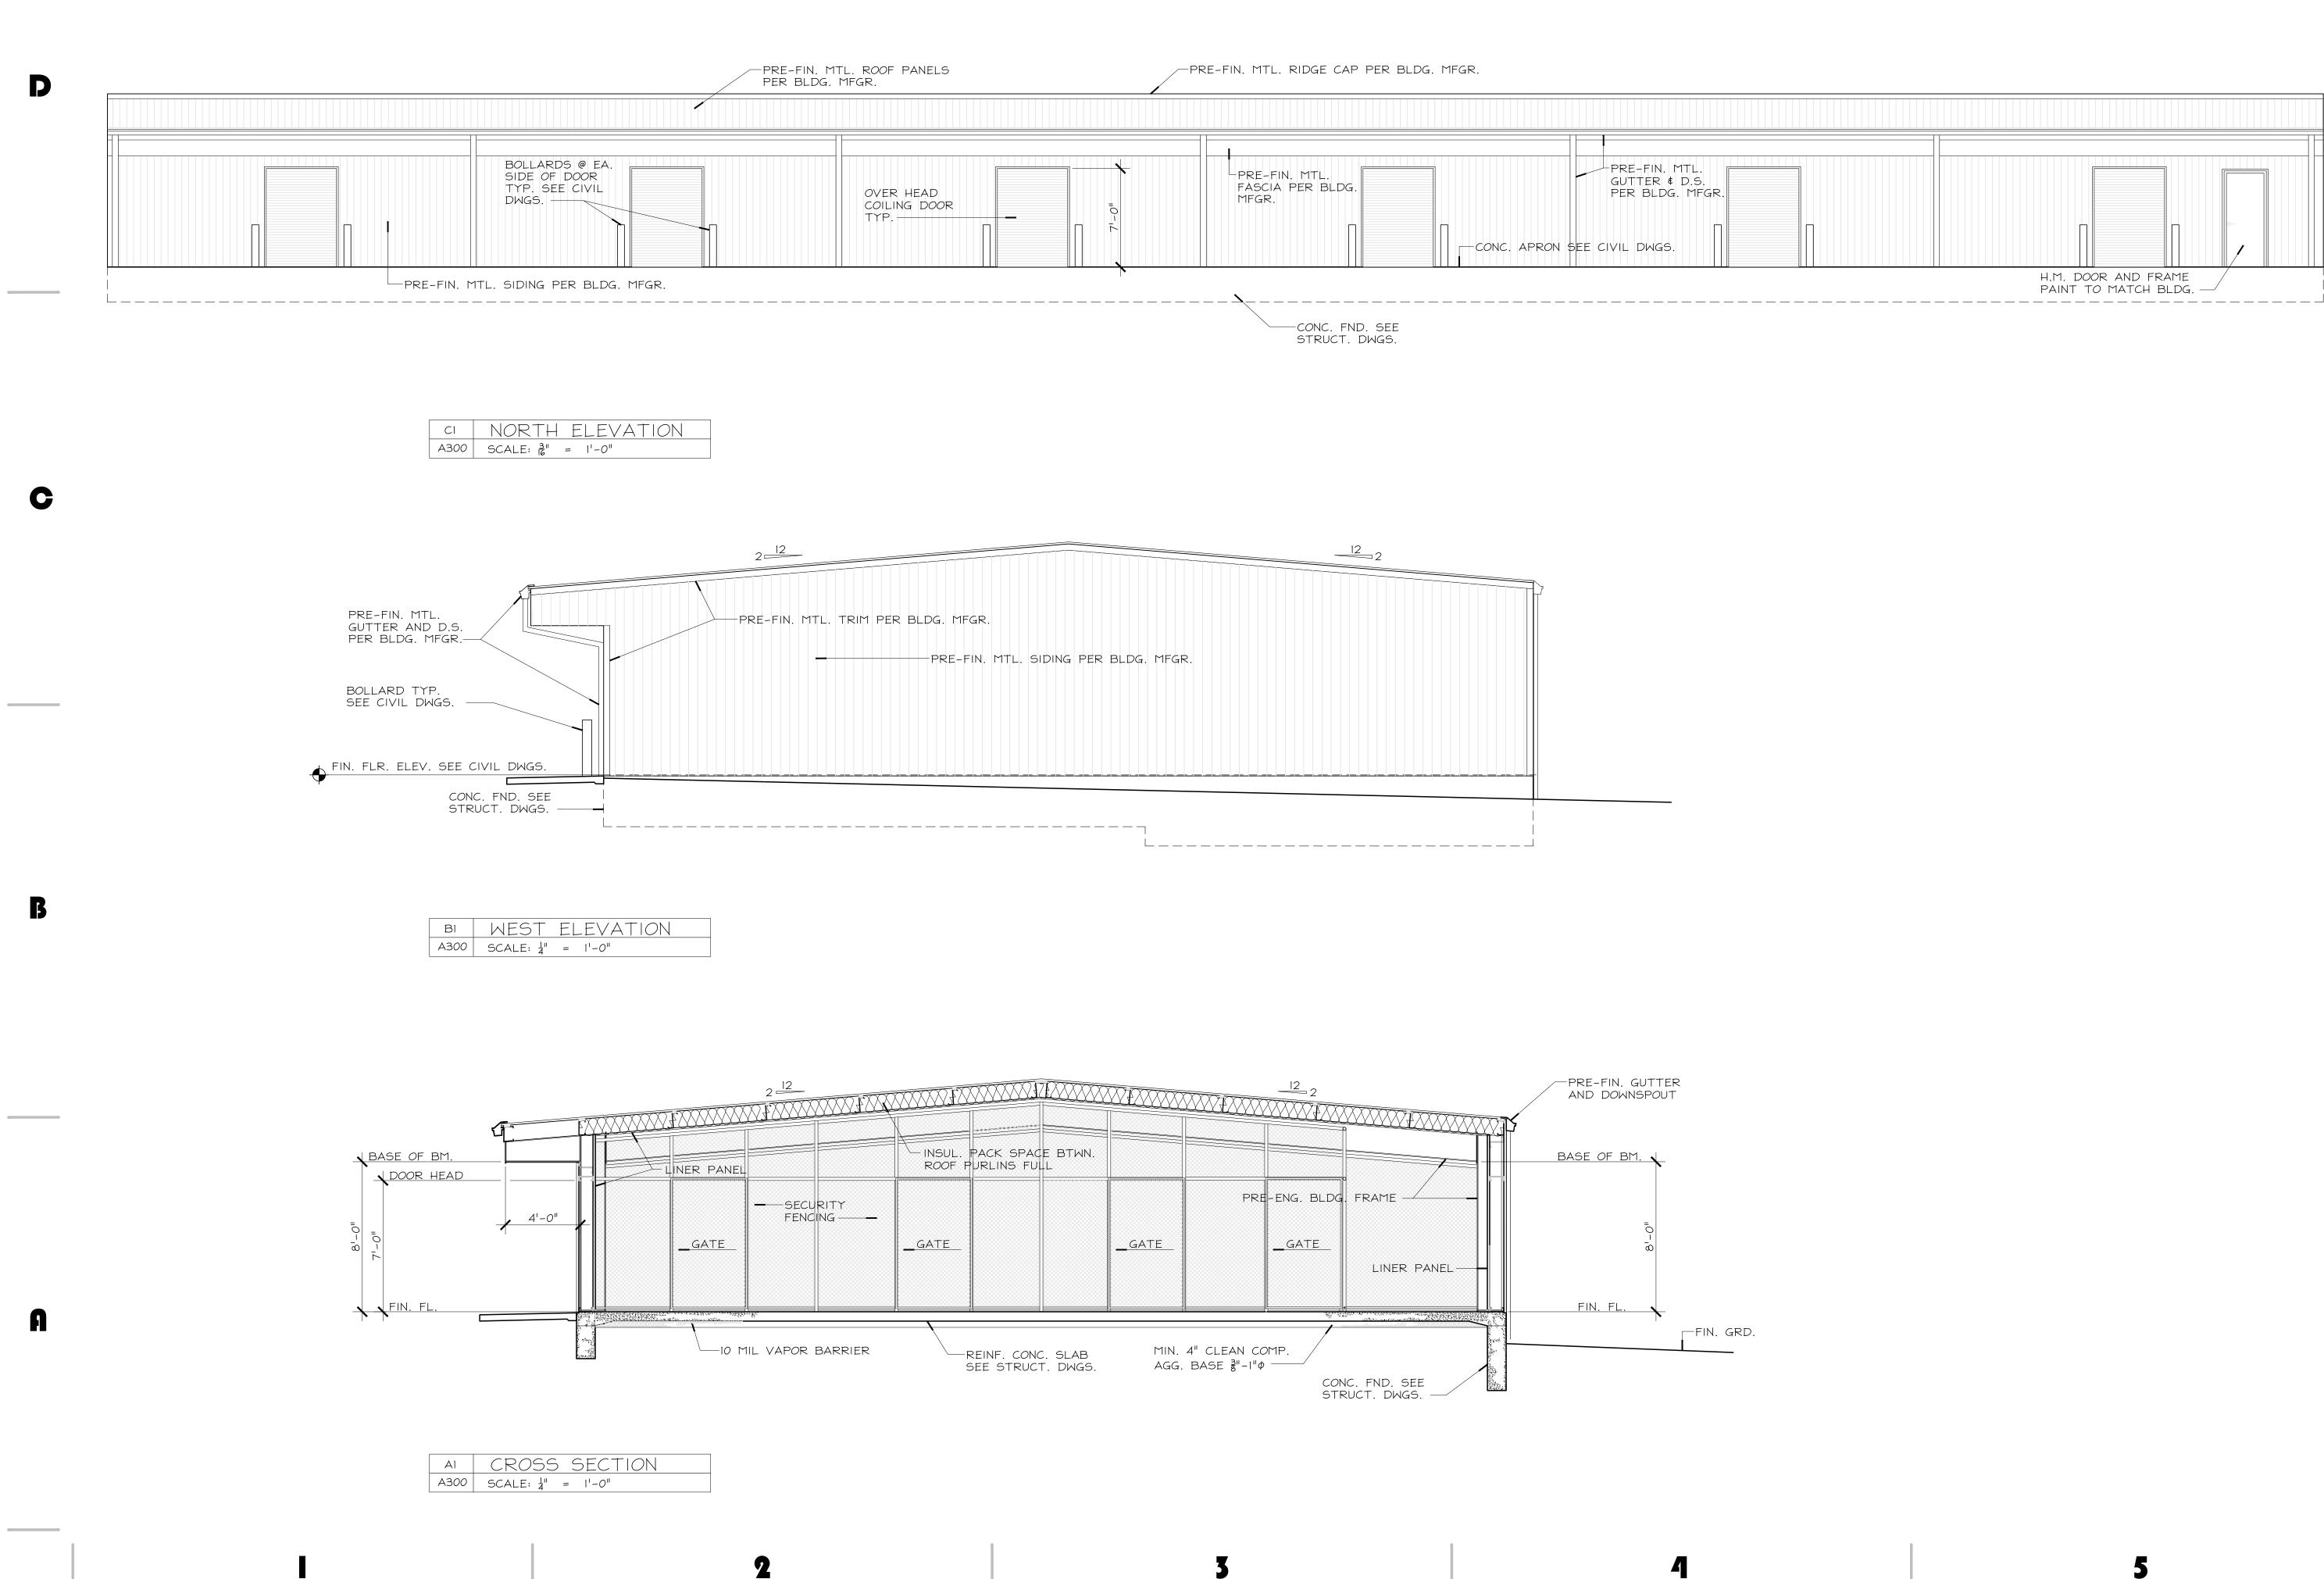

ADJUTANT GENERAL **MISSOURI NATIONAL GUARD**

FACILITIES DIVISION

ARCHITECT A-6176

OFFICE OF THE

OFFICE OF ADMINISTRATION DIVISION OF FACILITIES MANAGEMENT, **DESIGN AND CONSTRUCTION**

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MISSOURI NATIONAL GUARD FACILITIES DIVISION

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CAD DWG FILE: DRAWN BY: KAL CHECKED BY: KAL/MLS DESIGNED BY: KAL/MLS

SHEET TITLE:

CROSS SECTION NORTH ELEVATION WEST ELEVATION

SHEET NUMBER:


A300 SHEET 6 OF 7 DATE 06/21/2023

ELEC	TRICAL SYMBOL SCHEDULE
P2-22,24	HOME RUN CIRCUIT TO PANEL P2, CIRCUITS 22,24
, MK	EACH ARROW INDICATES ONE CIRCUIT
	SHORT HATCH MARKS INDICATE # OF PHASE CONDUCTORS
	LONG HATCH MARKS INDICATE # OF NEUTRAL CONDUCTORS
1	NO HATCH MARK INDICATES TWO CONDUCTORS
Е	ELECTRICAL SERVICE OR FEEDER WIRING
	WIRING IN WALL OR CEILING - WIRING IN FLOOR
\$ \$ ●	RECEPTACLE OUTLET (DUPLEX – QUADRUPLEX – SPECIAL POWER)
▼ ° ▼	COMMUNICATIONS OUTLET (TELEPHONE – CATV – DATA/PHONE)
-+ 3 D 4 P S K T OS	WALL SWITCH (3-WAY - DIMMER - 4-WAY - PILOT - SPEED - KEYED - TIMER - OCCUPANCY)
<u>-</u> ф-	LED STYLE LIGHT FIXTURE (CEILING MOUNTED – WALL MOUNTED)
	LED STYLE LIGHT FIXTURE (ENCLOSED – STRIP) (S INDICATES SPLIT WIRED)
+ A A+A	EXIT LIGHT - EMERGENCY LIGHT - EMERGENCY/EXIT LIGHT
¢ _c ⊚ φ	OTHER RECEPTACLE OUTLET (CLOCK – FLOOR – SPLIT WIRED)
	ELECTRIC PANEL
S 🗉	SPEAKER – PUSH TO TALK
J P	JUNCTION BOX - PULL BOX
F D	DISCONNECT (FUSED - NONFUSED)
S C	STARTER – CONTACTOR
5-208-3	ELECTRIC MOTOR (5 HP - 208V - 3 PHASE)
\bigcirc_1 \textcircled{H}_1	THERMOSTAT – HUMIDISTAT (ZONE SUBSCRIPT)
∯ 42 G W U	OUTLET MODIFIERS (MOUNT HEIGHT INCHES – GFI PROTECTED – WEATHER PROOF GFI – USB)
(S) (H) (D) (F)	SMOKE DETECTOR – HEAT DETECTOR – DUCT DETECTOR – MANUAL PULL STATION
	AUDIO VISUAL – VISUAL
$\langle M \rangle \langle R \rangle$	MAGNETIC DOOR HOLDER - INTERLOCK RELAY
	END OF LINE RESISTOR
FACP	FIRE ALARM CONTROL PANEL
DIAL	DIALER

	LIGHTING FIXT	JR	ES	SC	HED	ULE	Ξ
MARK	MANUFACTURER AND MODEL NUMBER	TYPE	LAN	IPS	MOUNTING	REMARKS	
			Ш	CIZE			

I	MARK	MANUFACIURER AND MUDEL NUMBER	TIPE	LAN	122	MOUNTING	REMARKS
				#	SIZE		
I	Α	MERCURY LSA-6-11400-40K-HTA-UNI	LED	1	99	CABLE	1,2
I	AE	MERCURY LSA-6-11400-40K-HTA-UNI-EM7	LED	1	99	CABLE	1,2
I	AO	MERCURY LSA-6-11400-40K-HTA-UNI-01	LED	1	99	CABLE	1,2
I	В	MOBERN DS150-36W-50K	LED	1	36	WALL	1
	1. OR /	COLOR AND MOUNTING HEIGHT WITH ARCHITECTURAL PLANS. APPROVED EQUAL. © GUARD #WG-LSA-4. 2 REQUIRED PER LIGHT FIXTURE.					

F	PH	HASE	120/208 1 3		Main Caf Buss Ma Mounting	TERIA) a mlo	A WATTS B WATTS TOTAL WATTS	4356 2430 6786
CIRC	LOCATION / DESCRIPTIO	N		BRKR	WATTS	ø	WATTS	BRKR	LOCATION / DESCRIPTION	CIRC
1	AREA F LIGHTS			20-1	1089	Α	1089	20-1	AREA E LIGHTS	2
3	AREA D LIGHTS			20-1	1089	В	1089	20-1	AREA C LIGHTS	4
5	AREA B LIGHTS			20-1	1089	Α	1089	20-1	AREA A LIGHTS	6
7	WALL PACKS			20-1	252	В	0	20-1	SPARE	8
9	SPARE			20-1	0	Α	0	20-1	SPARE	10
11	SPARE			20-1	0	В	0	20-1	SPARE	12
13	SPARE			20-1	0	Α	0	20-1	SPARE	14
15	SPARE			20-1	0	В	0	20-1	SPARE	16
17	SPARE			20-1	0	Α	0	20-1	SPARE	18
19	SPARE			20-1	0	В	0	20-1	SPARE	20

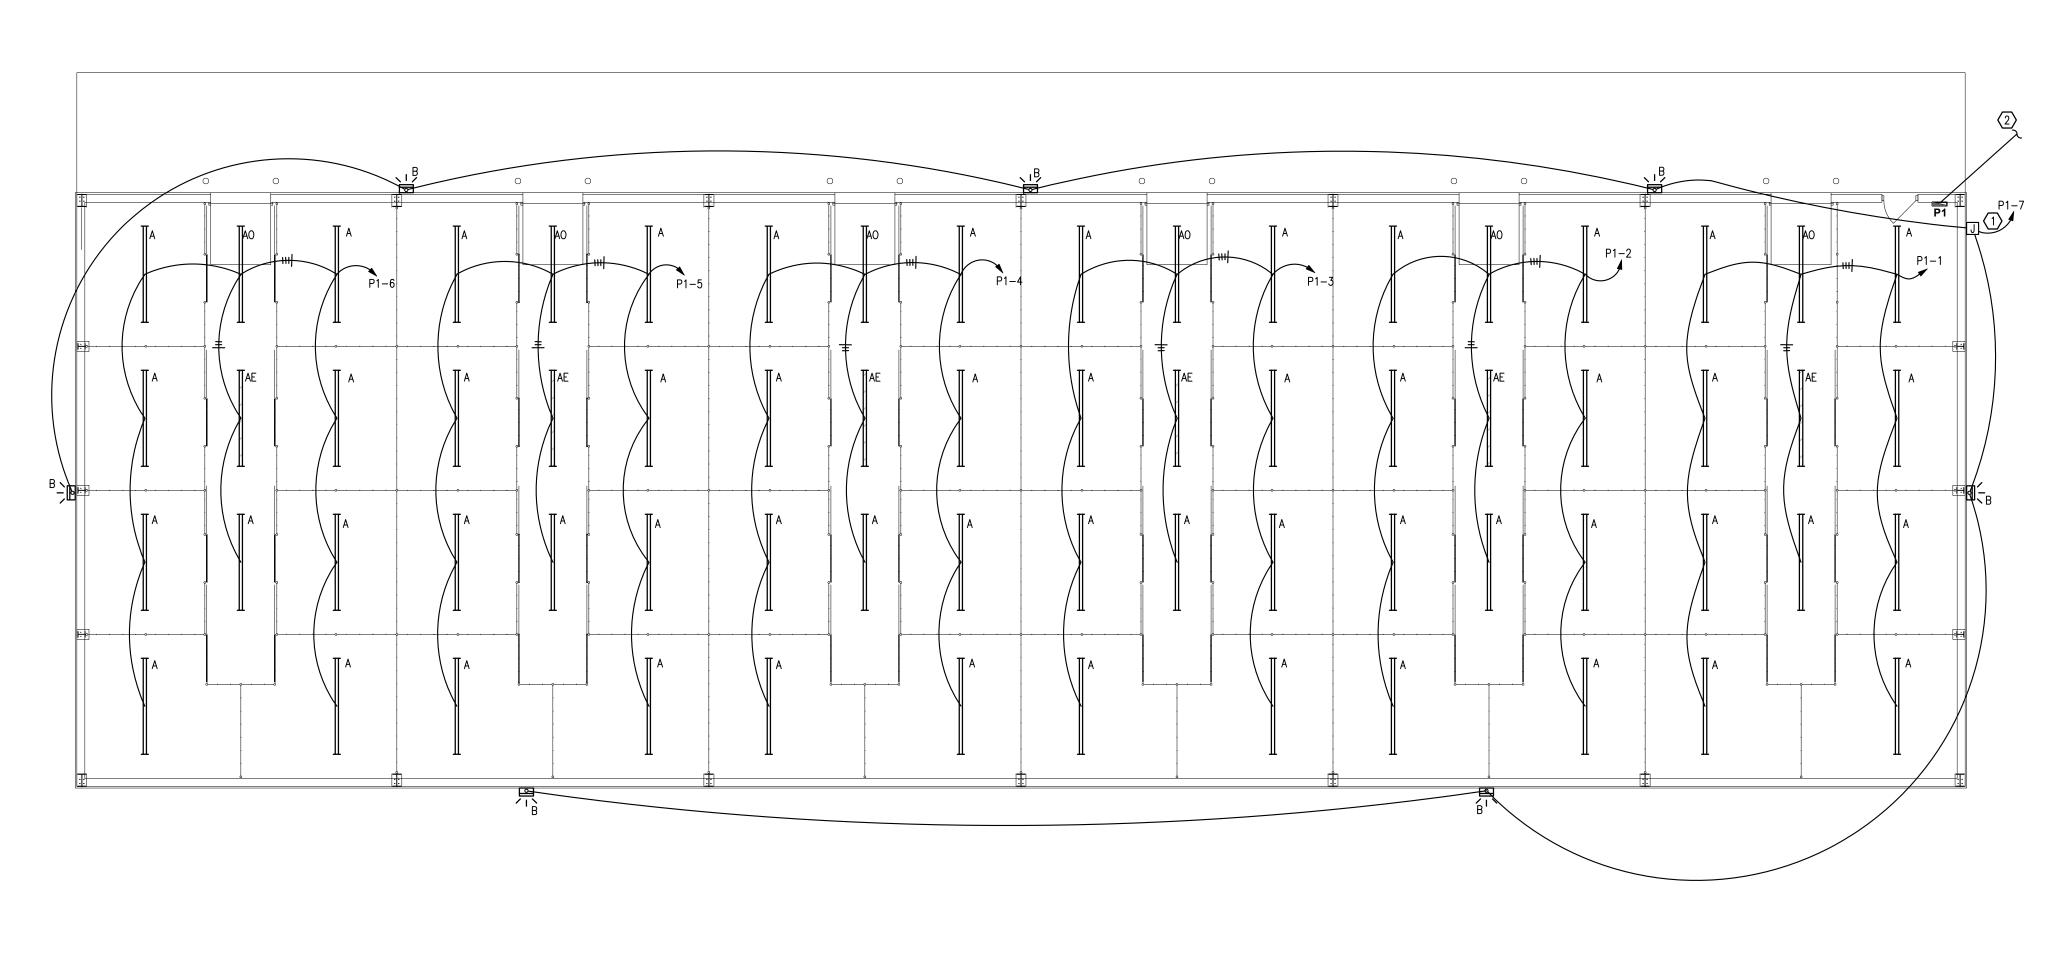

D

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TO ROUGH-IN.

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GENERAL MECHANICAL-ELECTRICAL SPECIFICATIONS

- 1) ALL WORK SHALL BE DONE IN STRICT CONFORMANCE TO THE BUILDING CODES OF THE CITY OF ST. LOUIS, MO.
- 2) ALL MATERIALS SHALL BE NEW, FIRST CLASS, AND INSTALLED TO MANUFACTURER'S WRITTEN SPECIFICATIONS.
- 3) ALL SYSTEMS SHALL BE COMPLETE AND OPERABLE IN EVERY WAY.
- 4) DO ALL EXCAVATION, BACKFILLING, CUTTING, PATCHING, OFFSETTING, ADJUSTING AND BALANCING AS REQUIRED TO COMPLETE THE JOB.
- 5) SPECIFIC MODELS ARE SPECIFIED TO ESTABLISH QUALITY ONLY. ENGINEER'S DECISION SHALL BE FINAL ON ALL MATERIAL SELECTIONS OR SUBSTITUTIONS.
- 6) MAINTAIN SAFETY SIGNS AND BARRIERS AS REQUIRED TO ASSURE SAFE WORKING CONDITIONS. 7) GUARANTEE ALL WORKMANSHIP AND MATERIALS FOR ONE YEAR FROM FINAL ACCEPTANCE. PROVIDE
- FIVE YEAR AIR CONDITIONING COMPRESSOR WARRANTY. 8) EACH CONTRACTOR SHALL BE RESPONSIBLE FOR CLEANING UP HIS OWN DEBRIS.
- 9) CONTRACTOR SHALL NOT BE RESPONSIBLE FOR PROPER OPERATION OF OWNER-FURNISHED
- 10) INSPECT JOB SITE PRIOR TO BIDDING TO DETERMINE EXACT JOB REQUIREMENTS. SEE ARCHITECTURAL DRAWINGS FOR DEMOLITION AND CONSTRUCTION DETAILS.
- 11) REMOVE ALL UNUSED PLUMBING, HVAC, AND ELECTRICAL WHETHER OR NOT SPECIFICALLY NOTED AND PROPERLY TERMINATE REMAINING SERVICES. ALL EXISTING PLUMBING, HVAC, AND ELECTRICAL SHALL BE REWORKED TO COMPLY WITH CODE WHETHER OR NOT SPECIFICALLY INDICATED.
- 12) ALL REMOVED MATERIALS SHALL BE REMOVED FROM SITE OR GIVEN TO OWNER AT OWNER'S DIRECTION.

ELECTRICAL SPECIFICATIONS

MATERIALS.

- 1) SEE GENERAL MECHANICAL-ELECTRICAL SPECIFICATIONS.
- 2) ALL CONDUCTORS SHALL BE COPPER MINIMUM #12 OR LARGER AS REQUIRED OR SHOWN.
- 3) ALL EQUIPMENT SHALL BE RATED FOR 75° C. CONDUCTORS.
- 4) ALL SERVICE WIRING, WIRING EXPOSED TO WEATHER, OR WIRING BELOW GRADE, SHALL BE IN RIGID GALVANIZED CONDUIT OR SCH 40 PVC.
- 5) ALL WIRING IN NONFIRE-RATED CONSTRUCTION MAY BE NON-METALLIC SHEATHED CABLE (ROMEX).
- 6) ALL OTHER WIRING SHALL BE IN EMT OR MC CABLE.
- 7) WALL SWITCHES SHALL BE LEVITON #1120 SERIES, OR APPROVED EQUAL, 20A.
- 8) DUPLEX CONVENIENCE RECEPTACLES SHALL BE LEVITON #5362 SERIES, OR APPROVED EQUAL, 20A., GROUNDING TYPE. GROUND FAULT RECEPTACLES SHALL BE LEVITON #7899-LW SERIES. USE SIDEWIRING ONLY, NOT BACKWIRING. COLOR AS SELECTED BY ARCHITECT.
- 9) SPECIAL OUTLETS SHALL BE AS REQUIRED OR SHOWN ON DRAWINGS, COMPLETE WITH COVER PLATE.
- 10) THE ENTIRE SYSTEM SHALL BE ELECTRICALLY CONTINUOUS AND PROPERLY GROUNDED. EVERY FEEDER AND BRANCH CONDUIT SHALL HAVE CODE SIZED GREEN INSULATED GROUND CONDUCTOR.
- 11) FURNISH AND INSTALL ALL LIGHTING FIXTURES, LAMPS, FUSES, BREAKERS, ETC. TO COMPLETE THE
- 12) ALL 120V., 20A LIGHTING AND RECEPTACLE CIRCUITS REQUIRING MORE THAN 100' OF CONDUCTORS (ONE WAY) SHALL BE #10 CONDUCTORS.

GENERAL NOTES:

BRANCH CIRCUITS INDICATED.

1. VERIFY POWER AND LIGHTING REQUIREMENTS FOR OWNER'S SPECIFIC EQUIPMENT PRIOR


2. COORDINATE INSTALLATION OF EQUIPMENT WITH MANUFACTURERS' INSTALLATION INSTRUCTIONS PRIOR TO ROUGH-IN.

KEYED NOTES:

(1) to timer and photocell.

TO 100A, 2P BREAKER IN MAINTENANCE BUILDING (APPROXIMATELY 425'). 3-#3, 1-#8 GROUND IN 2" CONDUIT. BURY MINIMUM 18" WITH MARKER TAPE.

STATE OF MISSOURI MICHAEL L. PARSON, GOVERNOR

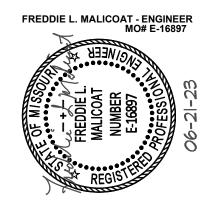

DATE: XX/XX/2023 NAME: FREDDIE MALICOAT PROFESSION: PE

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OFFICE OF ADMINISTRATION DIVISION OF FACILITIES MANAGEMENT, **DESIGN AND CONSTRUCTION**

OFFICE OF THE ADJUTANT GENERAL

MISSOURI NATIONAL GUARD **FACILITIES DIVISION**

CONSTRUCT UNHEATED STORAGE BUILDING

JEFFERSON BARRACKS 24 DAVIS ST. ST. LOUIS, ST. LOUIS COUNTY, MISSOURI

PROJECT # T2312-01 ASSET # 8136303053 SITE # 6303

REVISION: DATE: **REVISION:** DATE: **REVISION**: DATE:

ISSUE DATE: 06/21/2023

CAD DWG FILE: 23162.DWG DRAWN BY: FM CHECKED BY: FM DESIGNED BY: FM

SHEET TITLE:

POWER AND LIGHTING PLAN

SHEET NUMBER:

E1 SHEET 7 OF 7 DATE 06/21/2023