DESIGN & CONSTRUCT LAGOON EXPANSION WAPPAPELLO TRAINING SITE

WAPPAPELLO, MISSOURI

OWNER: STATE OF MISSOURI

MICHAEL L. PARSON,

GOVERNOR

MISSOURI NATIONAL GUARD

OFFICE OF THE ADJUTANT GENERAL FACILITIES MANAGEMENT OFFICE

PROJECT OFFICE OF ADMINISTRATION

MANAGEMENT: DIVISION OF FACILITIES MANAGEMENT,


DESIGN AND CONSTRUCTION


DESIGNER: Klingner & Associates, PC


PROJECT NUMBER: T2317-01

SITE NUMBER: 6325

ASSET NUMBER: 7016325013

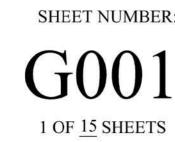

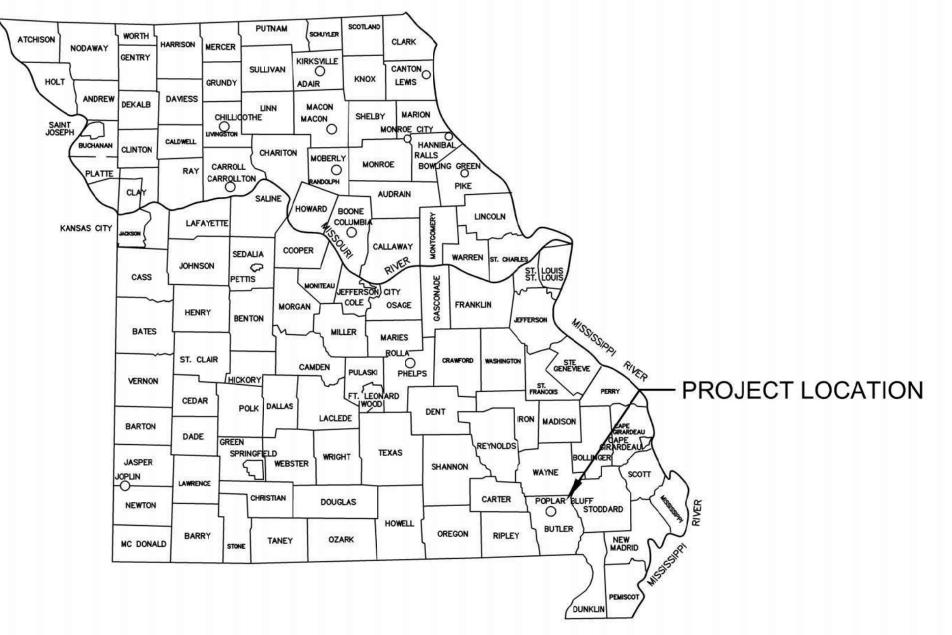

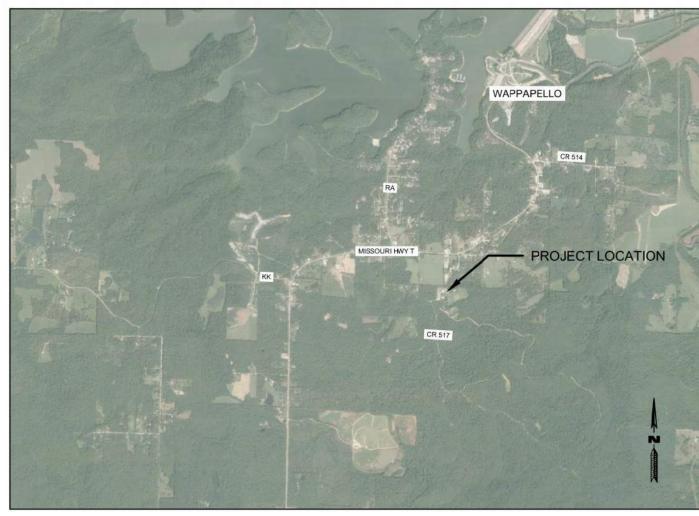

PROJECT LOCATION MAP

SHEET NUMBER	ISHELINAME		
G001	COVER SHEET	11/9/2023	
G002	GENERAL NOTES AND LEGENDS	11/9/2023	
C100	EXISTING SITE LAYOUT	11/9/2023	
C101	PROPOSED SITE SEWER MODIFICATIONS	11/9/2023	
C102	SEWER PLAN AND PROFILES RUNS 1 & 2	11/9/2023	
C103	SEWER PLAN AND PROFILES RUNS 3 & 4	11/9/2023	
C104	SEWER PLAN AND PROFILES RUNS 5-7	11/9/2023	
C200	PROPOSED LAGOON MODIFICATIONS	11-09-2023	
C201	PROPOSED LAGOON MODIFICATION COORDINATE TABLES	11/9/2023	
C202	CELL 1 MODIFICATION DETAILS & COORDINATE TABLE	11/9/2023	
C203	CELLS 2 & 3 MODIFICATION DETAILS AND COORDINATE TABLES	11/9/2023	
C204	PROPOSED FENCE DETAILS	11/9/2023	
C205	STORM WATER POLLUTION PREVENTION PLAN	11/9/2023	
C206	LAGOON INLET DETAILS	11/9/2023	
C501	MISCELLANEOUS DETAILS	11/9/2023	

THE CONTRACTOR(S) SHALL COMPLY WITH THE LATEST EDITION OF APPLICABLE CODES AND STANDARDS INCLUDING BUT NOT LIMITED TO:

- THE AMERICANS WITH DISABILITIES ACT (ADAAG)
- INTERNATIONAL BUILDING CODE (IBC)
- NATIONAL ELECTRIC CODE (NEC)
- INTERNATIONAL PLUMBING CODE (IPC)
- LIFE SAFETY CODE (NFPA 101)
- AMERICAN SOCIETY OF MECHANICAL ENGINEERS (ASME)
- AMERICAN NATIONAL STANDARDS INSTITUTE (ANSI)
- AMERICAN CONCRETE INSTITUTE (ACI) - MISSOURI DEPARTMENT OF TRANSPORTATION (MODOT)

- MISSOURI DEPARTMENT OF NATURAL RESOURCES (MODNR)

GENERAL NOTES

- 1. ALL DIMENSIONS SHALL BE FIELD VERIFIED BY THE CONTRACTOR.
- 2. ANY DISCREPANCIES BETWEEN SPECIFICATIONS, DRAWINGS, AND/OR SITE CONDITIONS SHALL BE REPORTED TO THE ENGINEER IMMEDIATELY.
- 3. ALL AREAS DESIGNATED TO REMAIN UNDISTURBED SHALL BE PROTECTED BY THE CONTRACTOR THROUGHOUT CONSTRUCTION.
- 4. THE CONTRACTOR SHALL BE RESPONSIBLE FOR STAKING THE LOCATION OF ALL PROPOSED IMPROVEMENTS, INCLUDING ROUGH AND FINISHED ELEVATIONS AND ALL OTHER PROPOSED IMPROVEMENTS INDICATED ON THE DRAWINGS.
- 5. THE CONTRACTOR SHALL VERIFY THAT ALL APPLICABLE LOCAL, STATE, & FEDERAL CODES ARE FOLLOWED. ALL APPLICABLE LOCAL AND STATE NOTIFICATIONS AND PERMITS SHALL BE ACQUIRED PRIOR TO CONSTRUCTION, INCLUDING ALL NECESSARY UTILITY CONNECTION PERMITS FROM THE RESPECTIVE UTILITIES.
- 6. THE CONTRACTOR SHALL BE RESPONSIBLE FOR ALL TEMPORARY UTILITIES AND SERVICES REQUIRED DURING CONSTRUCTION.
- 7. THE CONTRACTOR SHALL BE RESPONSIBLE FOR MAINTAINING ALL REFERENCE POINTS, BENCHMARKS, MONUMENTS, STAKES, AND PROPERTY CORNERS DURING CONSTRUCTION. REPLACEMENT OF LOST REFERENCE POINTS SHALL BE AT THE CONTRACTORS EXPENSE.
- 8. REMOVE ALL STRUCTURES, FOUNDATIONS, WALLS, PAVEMENTS, AND ALL OTHER ITEMS IN CONFLICT WITH PROPOSED IMPROVEMENTS IN ACCORDANCE WITH THE SPECIFICATIONS.
- 9. THE MEANS OF THE WORK AND THE SAFETY OF THE CONTRACTOR'S EMPLOYEES SHALL BE THE RESPONSIBILITY OF THE CONTRACTOR.
- 10. NO WORK SHALL BE PERFORMED BEYOND THE LIMITS OF CONSTRUCTION WITHOUT OWNER APPROVAL
- 11. SITE CLEAN-UP SHALL BE PERFORMED ON A DAILY BASIS. SIDEWALKS, PARKING LOTS. ROADWAYS, AND THE PROJECT SITE SHALL BE KEPT CLEAN AT ALL TIMES. CONTROL DUST IN AND AROUND ALL WORK AND STAGING AREAS.
- 12. ALL OPEN EXCAVATIONS SHALL BE PROTECTED.
- 13. MAINTAIN POSITIVE DRAINAGE ON THE SITE THROUGHOUT THE PROJECT DURATION.
- 14. IF A DISCREPANCY IN THE SPOT ELEVATIONS IS NOTED, THE CONTRACTOR SHALL NOTIFY THE ENGINEER PRIOR TO CONSTRUCTING. IF THERE IS A DISCREPANCY BETWEEN THE SPOT ELEVATIONS AND CONTOURS, THE CONTOURS SHALL GOVERN.
- 15. IF SOIL OR GROUNDWATER IS ENCOUNTERED WHICH EMITS A PETROLEUM ODOR OR IS DISCOLORED THE CONTRACTOR SHALL STOP EXCAVATION AND NOTIFY THE OWNER IMMEDIATELY. THE OWNER WILL COORDINATE ENVIRONMENTAL EFFORTS TO HANDLE THE IMPACTED SOIL OR GROUNDWATER IN ACCORDANCE WITH FEDERAL, STATE, AND LOCAL REQUIREMENTS. THE CONTRACTOR SHALL TAKE APPROPRIATE ACTION TO ENSURE PUBLIC AND EMPLOYEE SAFETY.
- 16. ALL QUANTITIES ARE FOR INFORMATIONAL PURPOSES ONLY. CONTRACTOR TO DO THEIR OWN TAKE-OFFS.

UTILITY NOTES

- 1. THE LOCATION OF EXISTING PUBLIC AND PRIVATE UTILITIES IN CONSTRUCTION AREAS SHALL BE FIELD VERIFIED BY THE CONTRACTOR BY CONTACTING THE MISSOURI ONE CALL SYSTEM, INC. OR THE INDIVIDUAL UTILITIES NOT PARTICIPATING IN THIS SYSTEM. EXISTING PUBLIC AND PRIVATE UTILITIES TO REMAIN SHALL BE PROTECTED. ANY REPAIR OR RELOCATION REQUIRED, AS A RESULT OF DAMAGE BY CONSTRUCTION ACTIVITIES SHALL BE AT THE CONTRACTOR'S EXPENSE. THE CONTRACTOR SHALL PAY UTILITY PERMIT AND/OR INSPECTION FEES.
- 2. UTILITY TRENCHES WITHIN PAVEMENT AREAS SHALL BE BACKFILLED WITH APPROVED COMPACTED GRANULAR BACKFILL.
- 3. ADJUST ALL VALVES, MANHOLES, CASTINGS, GAS VENTS, ETC., TO MATCH THE NEW SURFACE. MANHOLES TO EXTEND 6" ABOVE GRADE. ADJUSTMENT SHALL BE COORDINATED WITH THE UTILITY COMPANIES AND THE COST FOR ALL ADJUSTMENTS SHALL BE INCIDENTAL TO THE CONSTRUCTION AT NO ADDITIONAL COST TO THE OWNER. REPAIR ANY DAMAGE TO SAID STRUCTURES AND APPURTENANCES THAT OCCUR DURING CONSTRUCTION.
- 4. THE DRAWINGS INDICATE THE BEST KNOWLEDGE OF THE OWNER AND ENGINEER/ARCHITECT ON THE GENERAL LOCATION AND NATURE OF THE EXISTING AND OR PROPOSED UNDERGROUND UTILITIES IN THE AREA OF CONSTRUCTION. EXPLORATORY EXCAVATIONS AT THE SITE TO DETERMINE INSITU LOCATIONS WERE NOT CONDUCTED. QUALITY LEVEL D IN ACCORDANCE WITH CI/ASCE 38-02, STANDARD GUIDELINE FOR THE COLLECTION AND DEPICTION OF EXISTING SUBSURFACE UTILITY DATA, WAS UTILIZED. REGARDLESS OF THE LEVEL OF INVESTIGATION, THE UTILITIES SHOWN SHOULD NOT BE CONSIDERED A WARRANTY OR GUARANTEE OF ACTUAL PRESENCE OR LOCATION AND THE CONTRACTOR REMAINS RESPONSIBLE FOR THE LOCATION, VERIFICATION, AND PROPER NOTIFICATION OF POTENTIAL UTILITIES.

QUALITY LEVELS:(B)

QUALITY LEVEL A - PROVIDES THE HIGHEST LEVEL OF ACCURACY. BY LOCATING OR POTHOLING UTILITIES IN ADDITION TO QUALITY LEVELS B, C, AND D TASKS. THE LOCATED UTILITY INFRASTRUCTURE IS SURVEYED AND MAPPED TO DEVELOP PLAN AND PROFILE INFORMATION.

QUALITY LEVEL B - INVOLVES DESIGNATING THE HORIZONTAL POSITION OF SUBSURFACE UTILITIES THROUGH SURFACE DETECTION METHODS AND RECORDING THE INFORMATION THROUGH A SURVEY METHOD. IN ADDITION TO QUALITY LEVEL C AND D TASKS.

QUALITY LEVEL C - INVOLVES SURVEYING VISIBLE SUBSURFACE UTILITY STRUCTURES SUCH AS MANHOLES, HAND-HOLES, UTILITY VALVES AND METERS, FIRE HYDRANTS, PEDESTALS AND UTILITY MARKERS, AND THEN CORRELATING THE INFORMATION WITH EXISTING UTILITY RECORDS TO CREATE COMPOSITE DRAWINGS. IN ADDITION TO QUALITY LEVEL D TASKS

QUALITY LEVEL D - INVOLVES COLLECTING DATA FROM EXISTING UTILITY RECORDS, THAT MAY INCLUDE AS-BUILT DRAWINGS, DISTRIBUTION AND SERVICE MAPS, EXISTING GEOGRAPHIC INFORMATION SYSTEM DATABASE, CONSTRUCTION PLANS, ETC. DATABASES, CONSTRUCTION PLANS,

EROSION CONTROL NOTES

- 1. EROSION CONTROL SHALL BE INSTALLED IN ACCORDANCE WITH MANUFACTURER'S RECOMMENDATIONS, THE DETAILS IN THESE PLANS, AND THE MISSOURI DEPARTMENT OF NATURAL RESOURCES STANDARDS AND REQUIREMENTS FOR EROSION AND SEDIMENT
- 2. THE EROSION CONTROL SHOWN ON THIS SET OF PLANS SHALL BE CONSIDERED THE MINIMUM ACCEPTABLE FOR THIS PROJECT. THERE MAY BE ADDITIONAL EROSION CONTROL REQUIRED DUE TO THE VARIOUS CONSTRUCTION TECHNIQUES, WHICH MAY BE USED. THE CONTRACTOR IS RESPONSIBLE FOR CONTROLLING AND MAINTAINING ALL THE RUNOFF FROM THE SITE, IN A MANNER WHICH KEEPS ALL SILT ON SITE.
- 3. A LAND DISTURBANCE PERMIT WILL BE HANDLED WITH A LAND BLANKET DISTURBANCE PERMIT. CONTRACTOR STILL RESPONSIBLE FOR SWPPP.
- 4. ALL INLET PROTECTION AND TEMPORARY EROSION CONTROL MEASURES SHALL BE REMOVED UPON COMPLETION OF PAVING OPERATIONS AND FINAL STABILIZATION OF LANDSCAPED AND SEED AREAS.

ABBREVIATIONS

- FL FLOWLINE ELEVATION TOP OF CURB ELEVATION **GUTTER LINE ELEVATION** TOP OF GRATE ELEVATION STA STATION FES FLARED END SECTION STORM WATER INLET FINISH FLOOR ELEVATION HIGH POINT LOW POINT TOP OF WALL ELEVATION
 - BOTTOM OF WALL ELEVATION DOWNSPOUT **EDGE OF PAVEMENT**
- NOT IN CONTRACT (M) MATCH EXISTING

Know what's below.

Call before you dig.

— NOTE —

UTILITY INFORMATION IS FOR THE CONVENIENCE

OF THE CONTRACTOR. BEFORE CONSTRUCTION

BEGINS THE CONTRACTOR SHALL CONTACT

MISSOURI ONE CALL SYSTEM, INC. AT 811 OR 1-800-344-7483 AND THE INDIVIDUAL UTILITIES

NOT INCLUDED IN THIS SYSTEM FOR THE

LOCATION OF ALL EXISTING UTILITIES.

LECEND

	LEGE	ND
EXISTING	PROPOSED	
		PROPERTY LINE
		LOT LINE
		RIGHT OF WAY LINE
		CENTERLINE
		EASEMENT
		BUILDING SETBACK
		CONSTRUCTION LIMITS
X	x	FENCE LINE
o	o	CHAIN LINK FENCE
		FENCE W/ SQUARE POSTS
4 6500 -		STREAM
1111111111111111		STRUCTURE
. -		PAVEMENT MARKINGS
		EDGE OF PAVEMENT
		CURB AND GUTTER
<u>-</u> 1 × × 141 × -		RAILROAD TRACKS
——— w ———	—— w ——— w ——	WATER LINE
——— FP ———— FP ———	——FP——FP——	FIRE PROTECTION
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——— UE ————	———UE———UE———	UNDERGROUND ELECTRIC
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) ST)) sr)	STORM SEWER
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A A	4 4	MAST ARM SIGNALS (2 SIGNALS
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<u> </u>		CULVERT
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	181	WATER VALVE
X	Ÿ	FIRE HYDRANT
PIV	PIV	POST INDICATOR VALVE
W	W	WATER METER
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		ONO WILLE
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E Ø	☐ ☐ ☐ ☐ ☐ ☐ ☐ ☐ ☐ ☐ ☐ ☐ ☐ ☐ ☐ ☐ ☐ ☐ ☐	TELEPHONE PEDESTAL CABLE TV PEDESTAL ELECTRIC METER UTILITY POLE LIGHT STANDARD LIGHT POLE GUY WIRE SUMMIT / HIGH POINT CONTOURS INDEX CONTOURS DIRECTION OF DRAINAGE SPOT ELEVATION
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E Ø	E	TELEPHONE PEDESTAL CABLE TV PEDESTAL ELECTRIC METER UTILITY POLE LIGHT STANDARD LIGHT POLE GUY WIRE SUMMIT / HIGH POINT CONTOURS INDEX CONTOURS DIRECTION OF DRAINAGE SPOT ELEVATION DECIDUOUS SHRUB
E Ø	E	TELEPHONE PEDESTAL CABLE TV PEDESTAL ELECTRIC METER UTILITY POLE LIGHT STANDARD LIGHT POLE GUY WIRE SUMMIT / HIGH POINT CONTOURS INDEX CONTOURS DIRECTION OF DRAINAGE SPOT ELEVATION DECIDUOUS SHRUB
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STATE OF MISSOURI MICHAEL L. PARSON, **GOVERNOR**



JOSHUA D. HARTSOCK-ENGINEER MO # PE 2020000048

OFFICE OF ADMINISTRATION DIVISION OF FACILITIES MANAGEMENT, **DESIGN AND CONSTRUCTION**

DESIGN AND CONSTRUCT LAGOON EXPANSION


461 COUNTY ROAD 517 WAPPAPELLO, MO 63966

PROJECT # T2317-01 6325 SITE# 7016325013 ASSET #

REVISION: DATE REVISION: DATE REVISION: DATE: ISSUE DATE: 11-09-2023

CAD DWG FILE: DRAWING BY: JDH/MCB CHECKED BY: MCB/JJN DESIGNED BY: JDH/MCB/JJN

SHEET TITLE: **GENERAL NOTES AND LEGENDS**

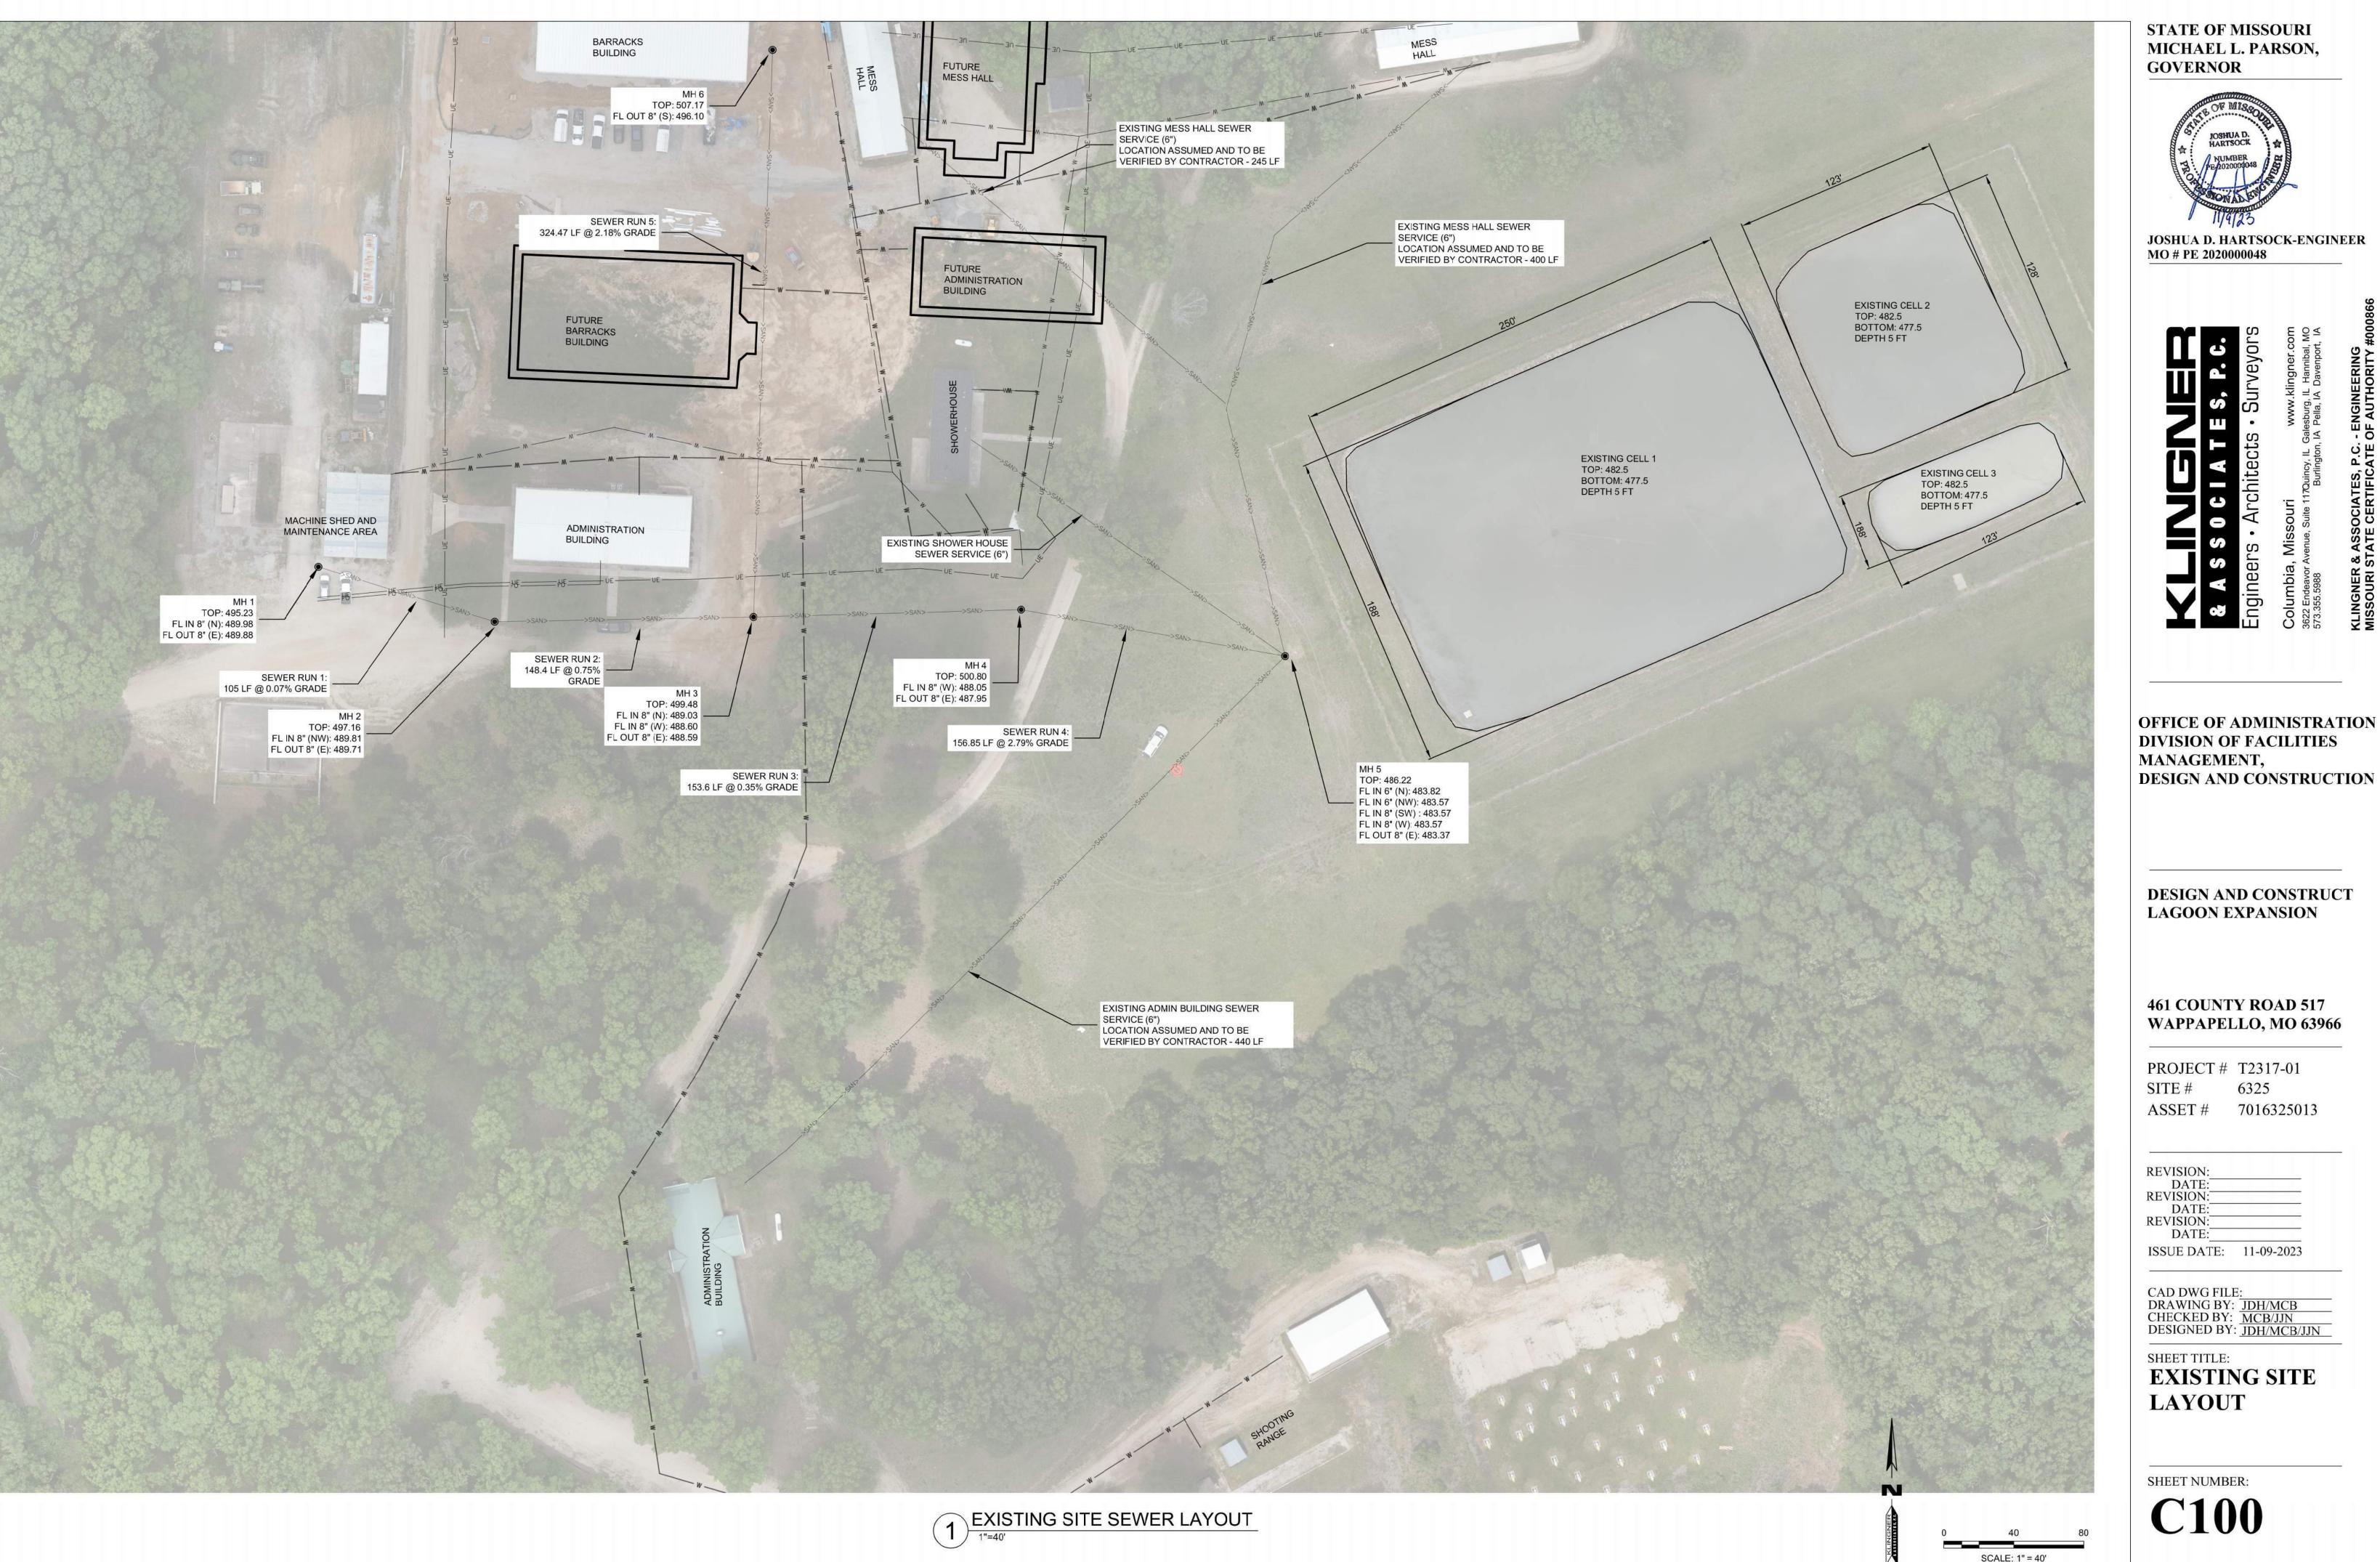



DESIGN AND CONSTRUCT

461 COUNTY ROAD 517 WAPPAPELLO, MO 63966


PROJECT # T2317-01 6325

ASSET # 7016325013 REVISION:

REVISION: REVISION: DATE: ISSUE DATE: 11-09-2023

CAD DWG FILE:
DRAWING BY: JDH/MCB
CHECKED BY: MCB/JJN
DESIGNED BY: JDH/MCB/JJN

SHEET TITLE:
EXISTING SITE **LAYOUT**

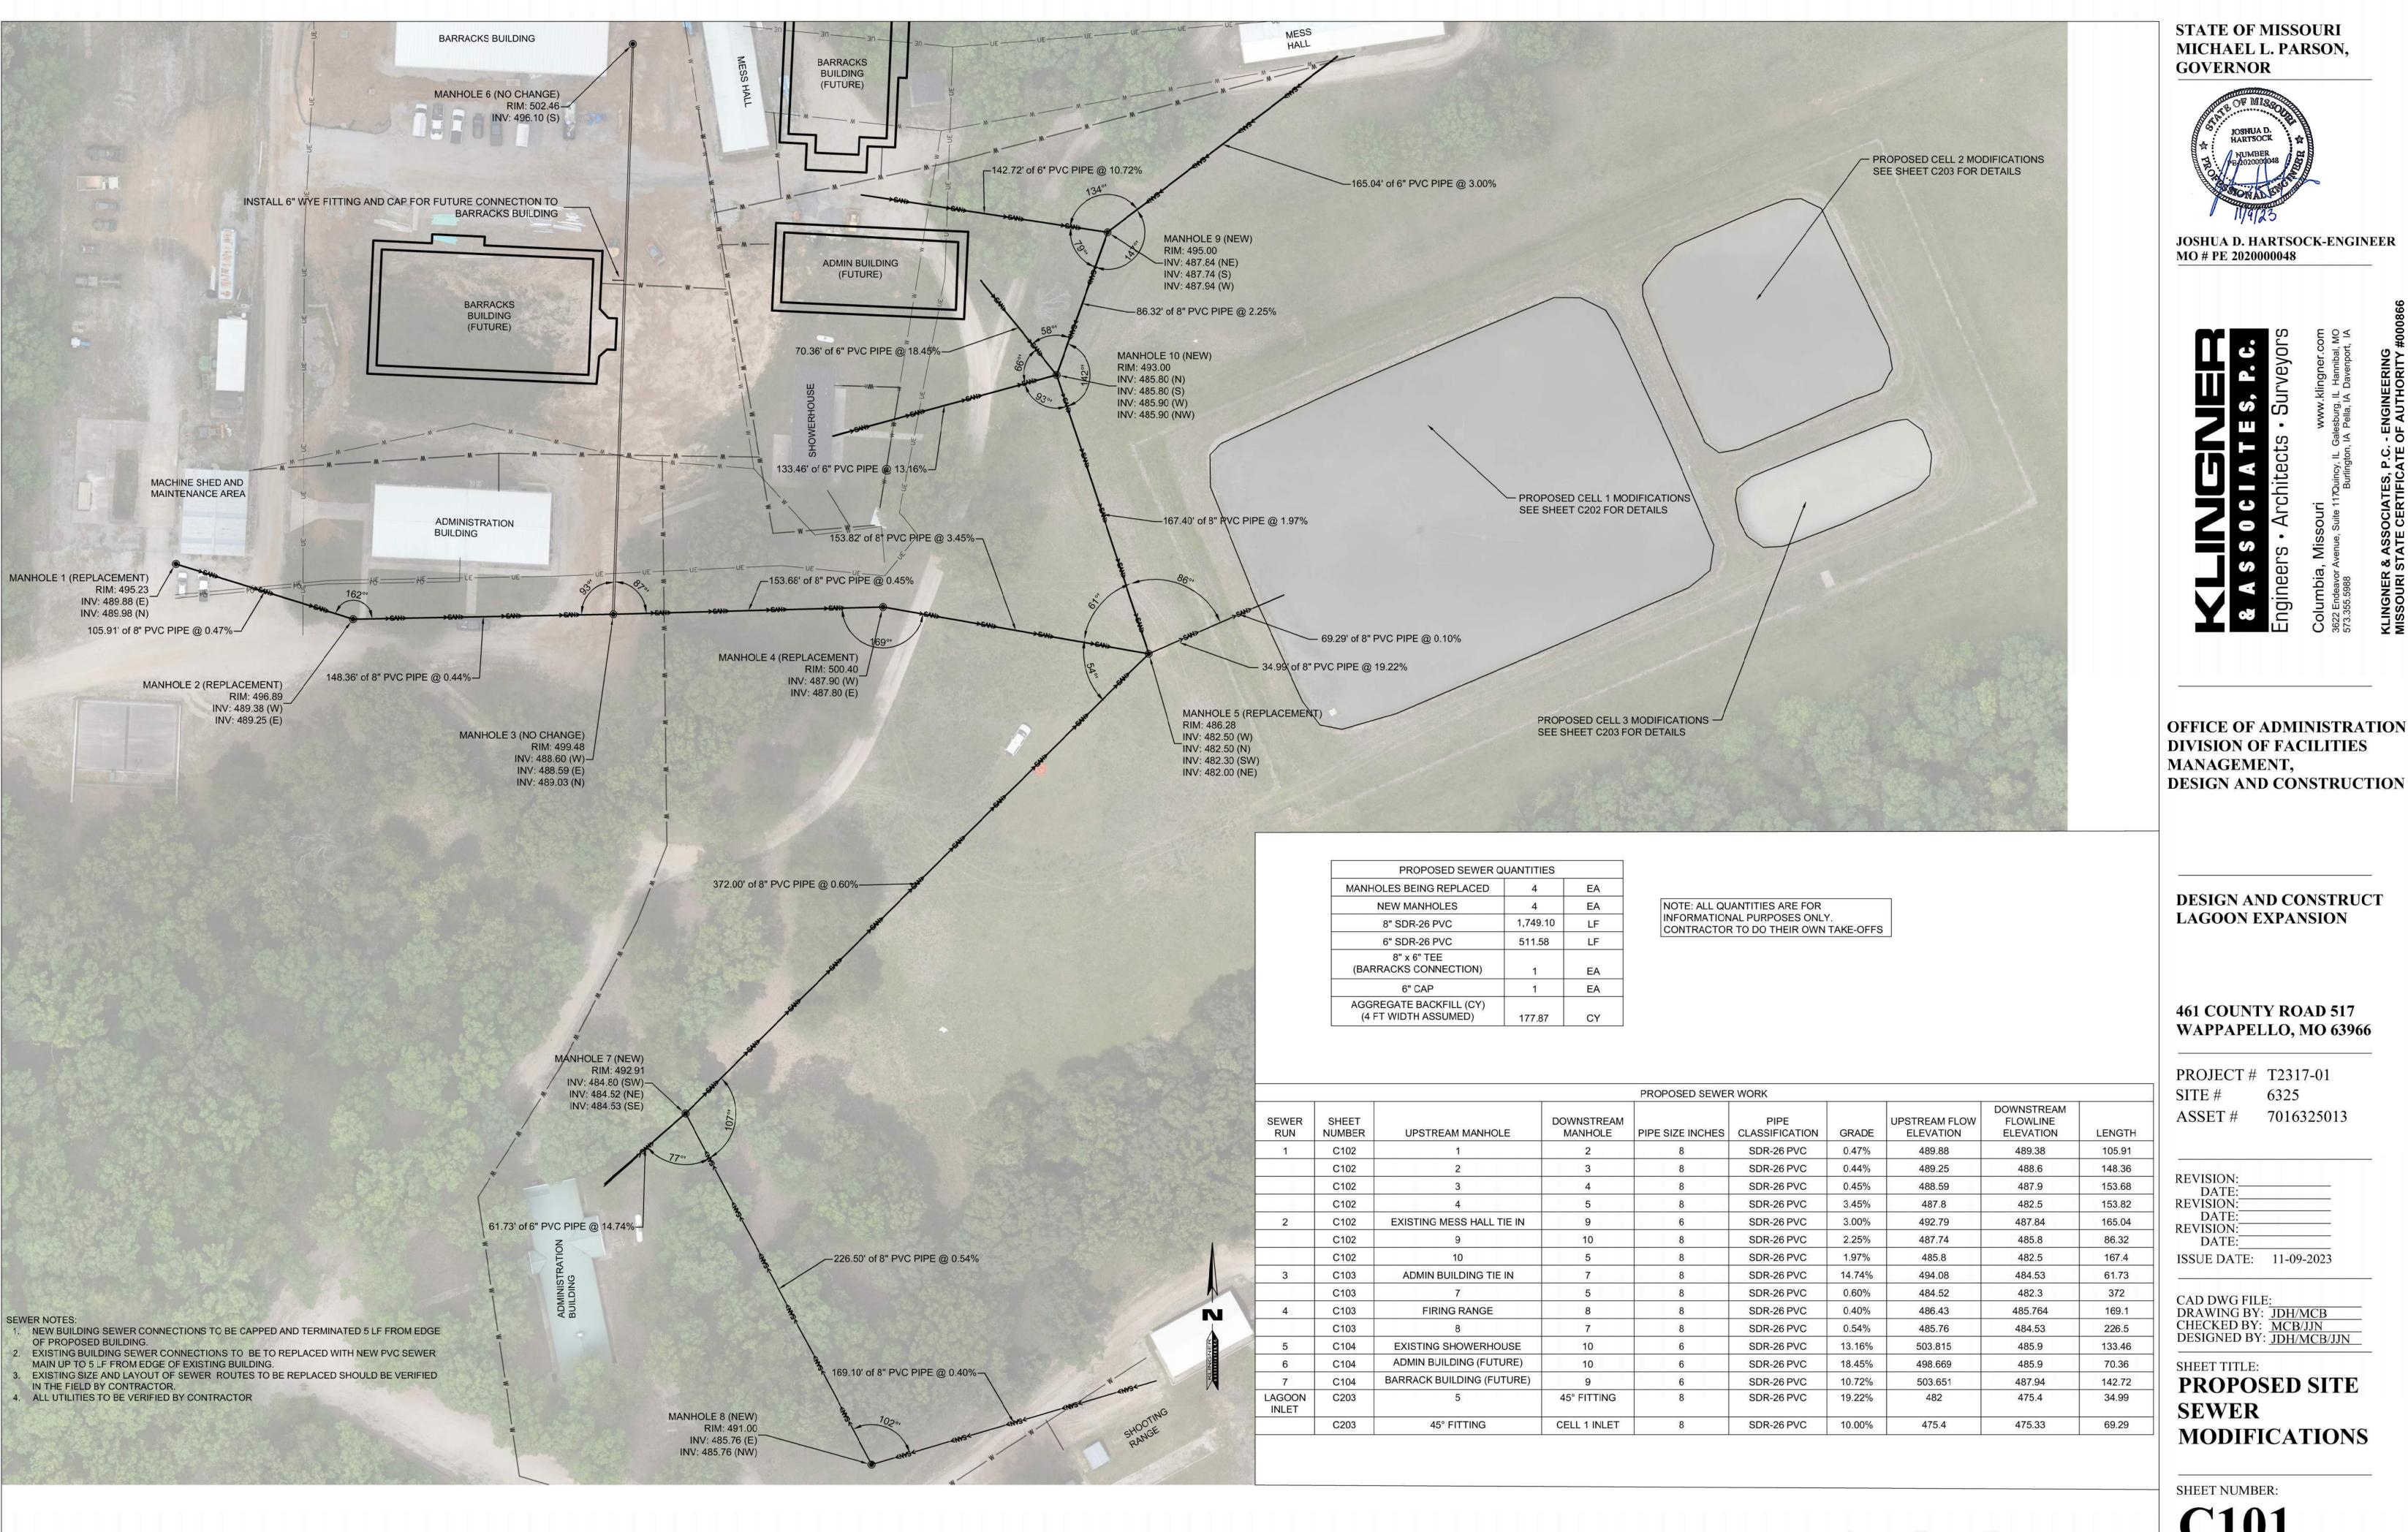



JOSHUA D. HARTSOCK-ENGINEER MO # PE 2020000048

461 COUNTY ROAD 517 WAPPAPELLO, MO 63966

PROJECT # T2317-01 7016325013

REVISION: DATE: REVISION: DATE: REVISION: DATE:


CAD DWG FILE: DRAWING BY: JDH/MCB CHECKED BY: MCB/JJN DESIGNED BY: JDH/MCB/JJN

SHEET TITLE:

PROPOSED SITE SEWER MODIFICATIONS

SHEET NUMBER:

SCALE: 1" = 40'

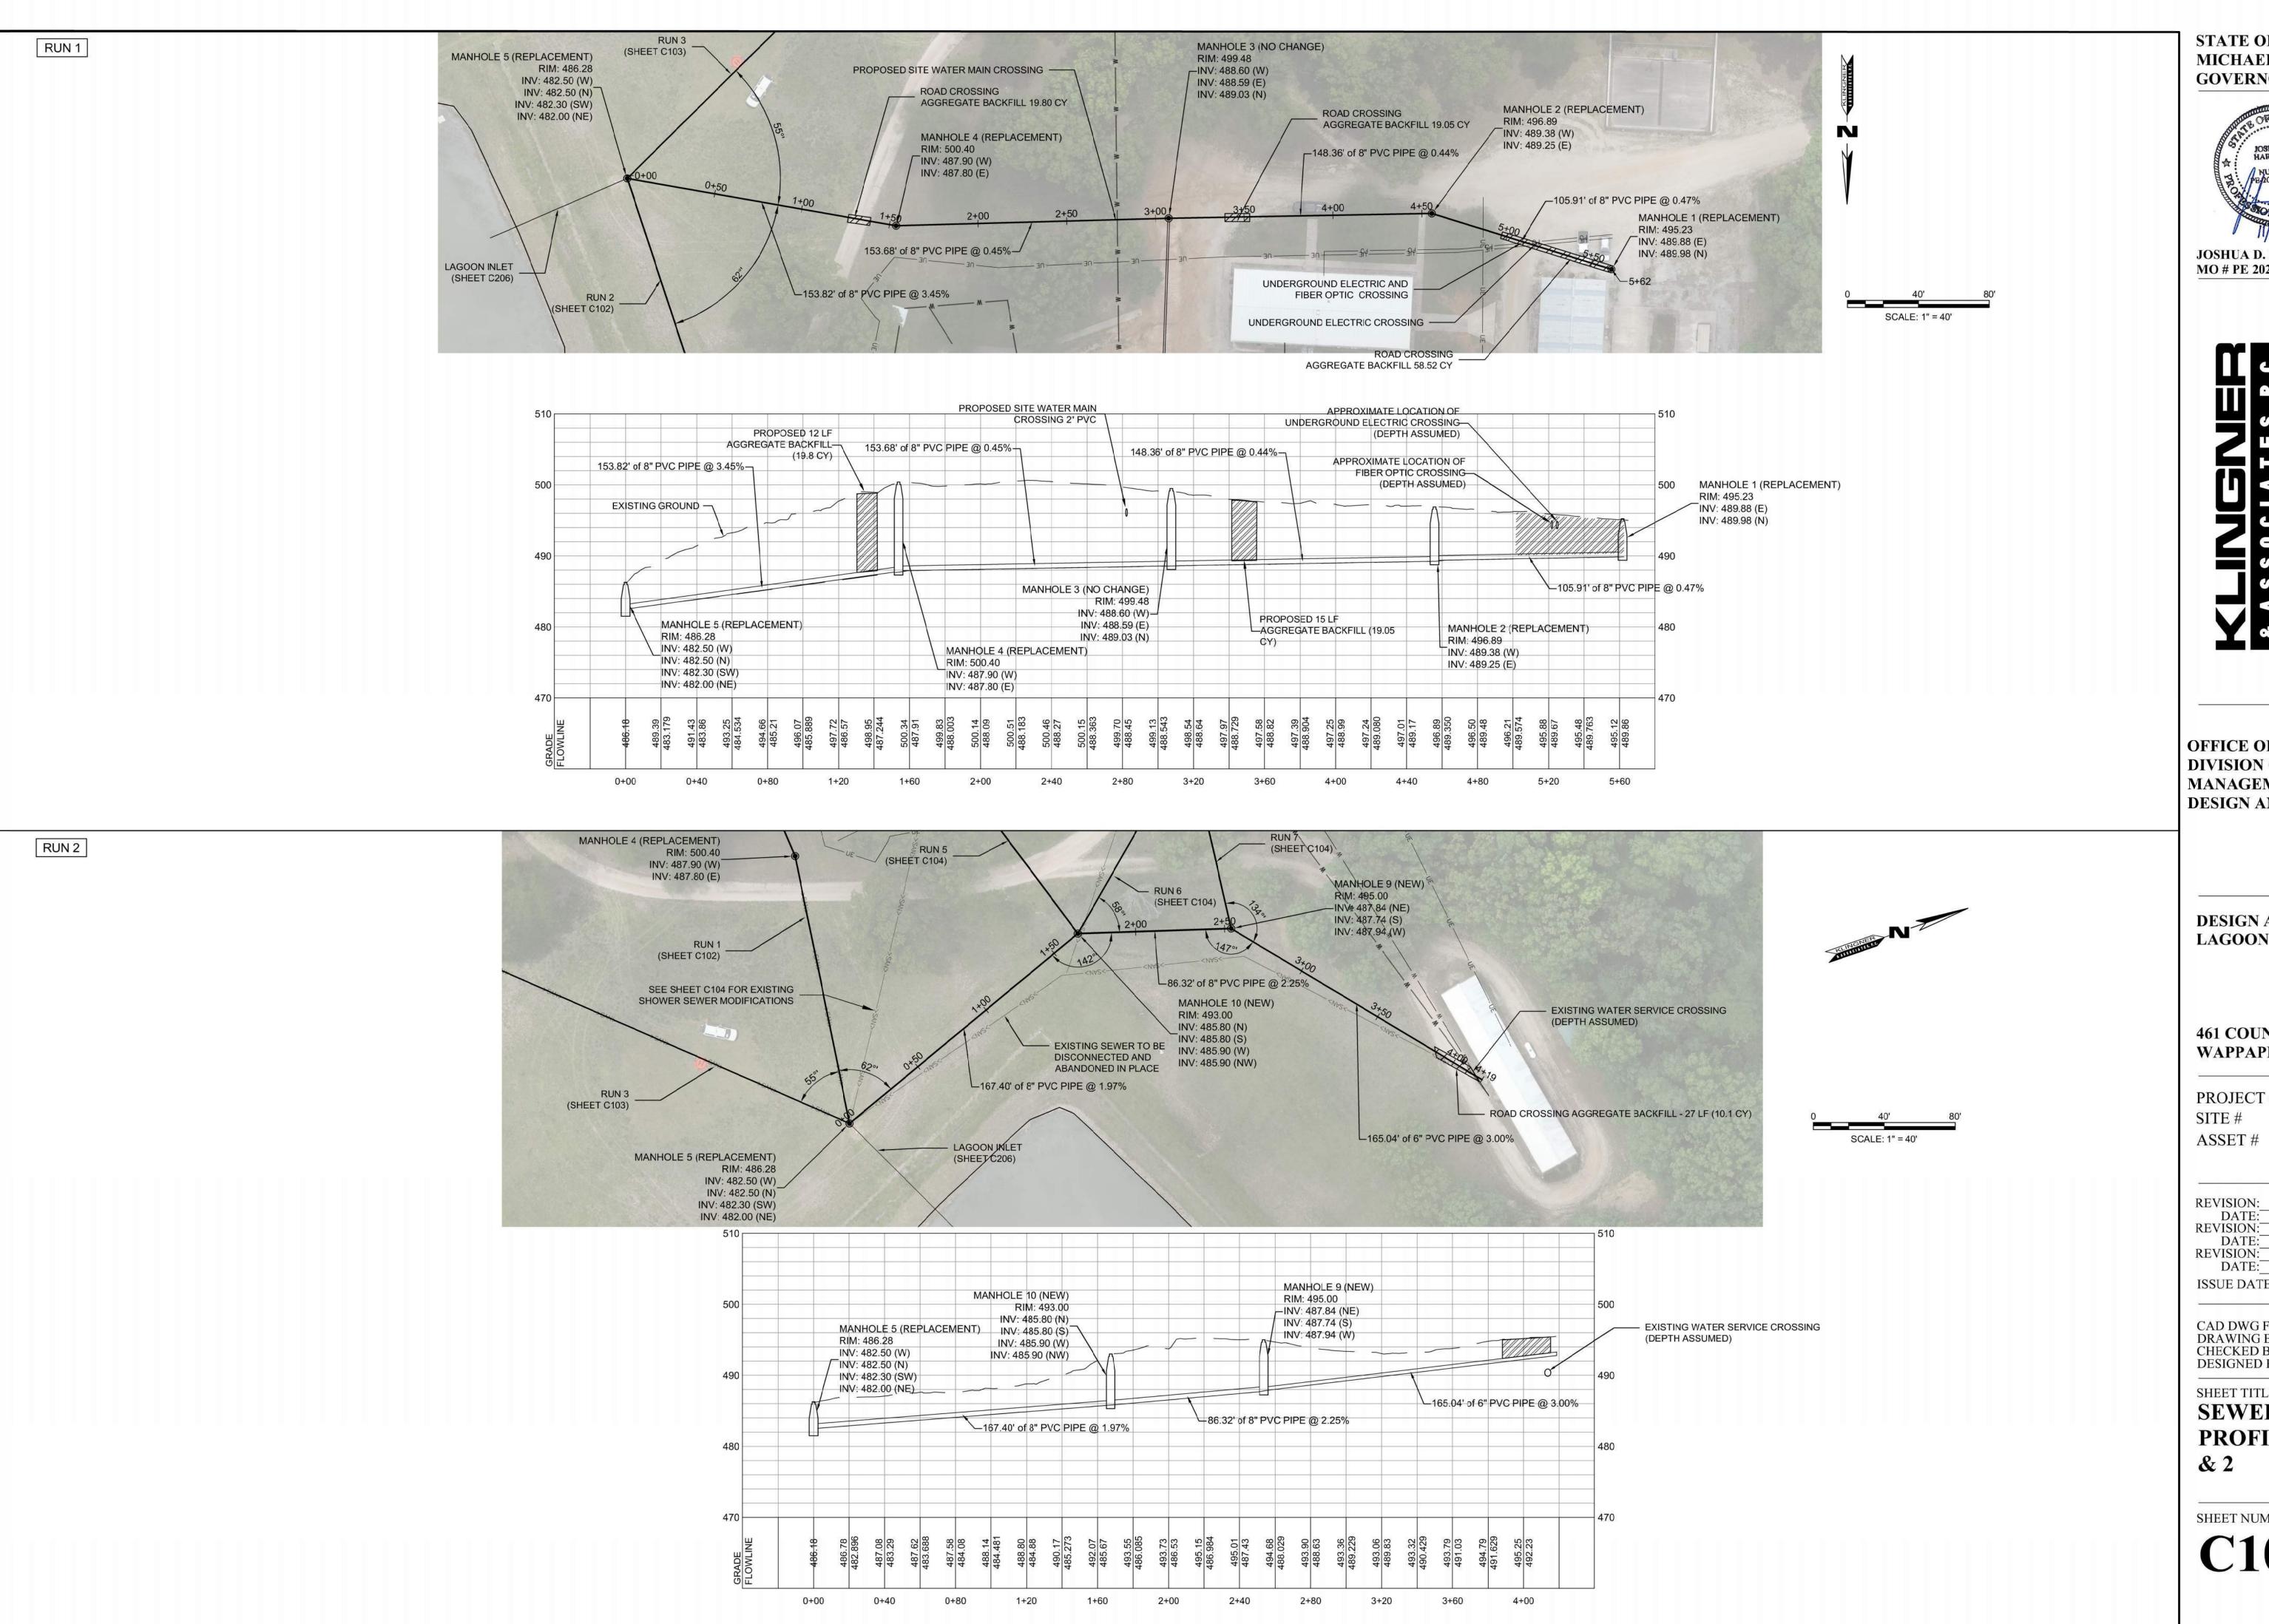



4

& ASSOCIATES, P.C. - ENGINEERING STATE CERTIFICATE OF AUTHORITY

OFFICE OF ADMINISTRATION DIVISION OF FACILITIES MANAGEMENT, DESIGN AND CONSTRUCTION

DESIGN AND CONSTRUCT LAGOON EXPANSION

461 COUNTY ROAD 517 WAPPAPELLO, MO 63966


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CAD DWG FILE:
DRAWING BY: JDH/MCB
CHECKED BY: MCB/JJN DESIGNED BY: JDH/MCB/JJN

SHEET TITLE:

SEWER PLAN & **PROFILES RUNS 1**



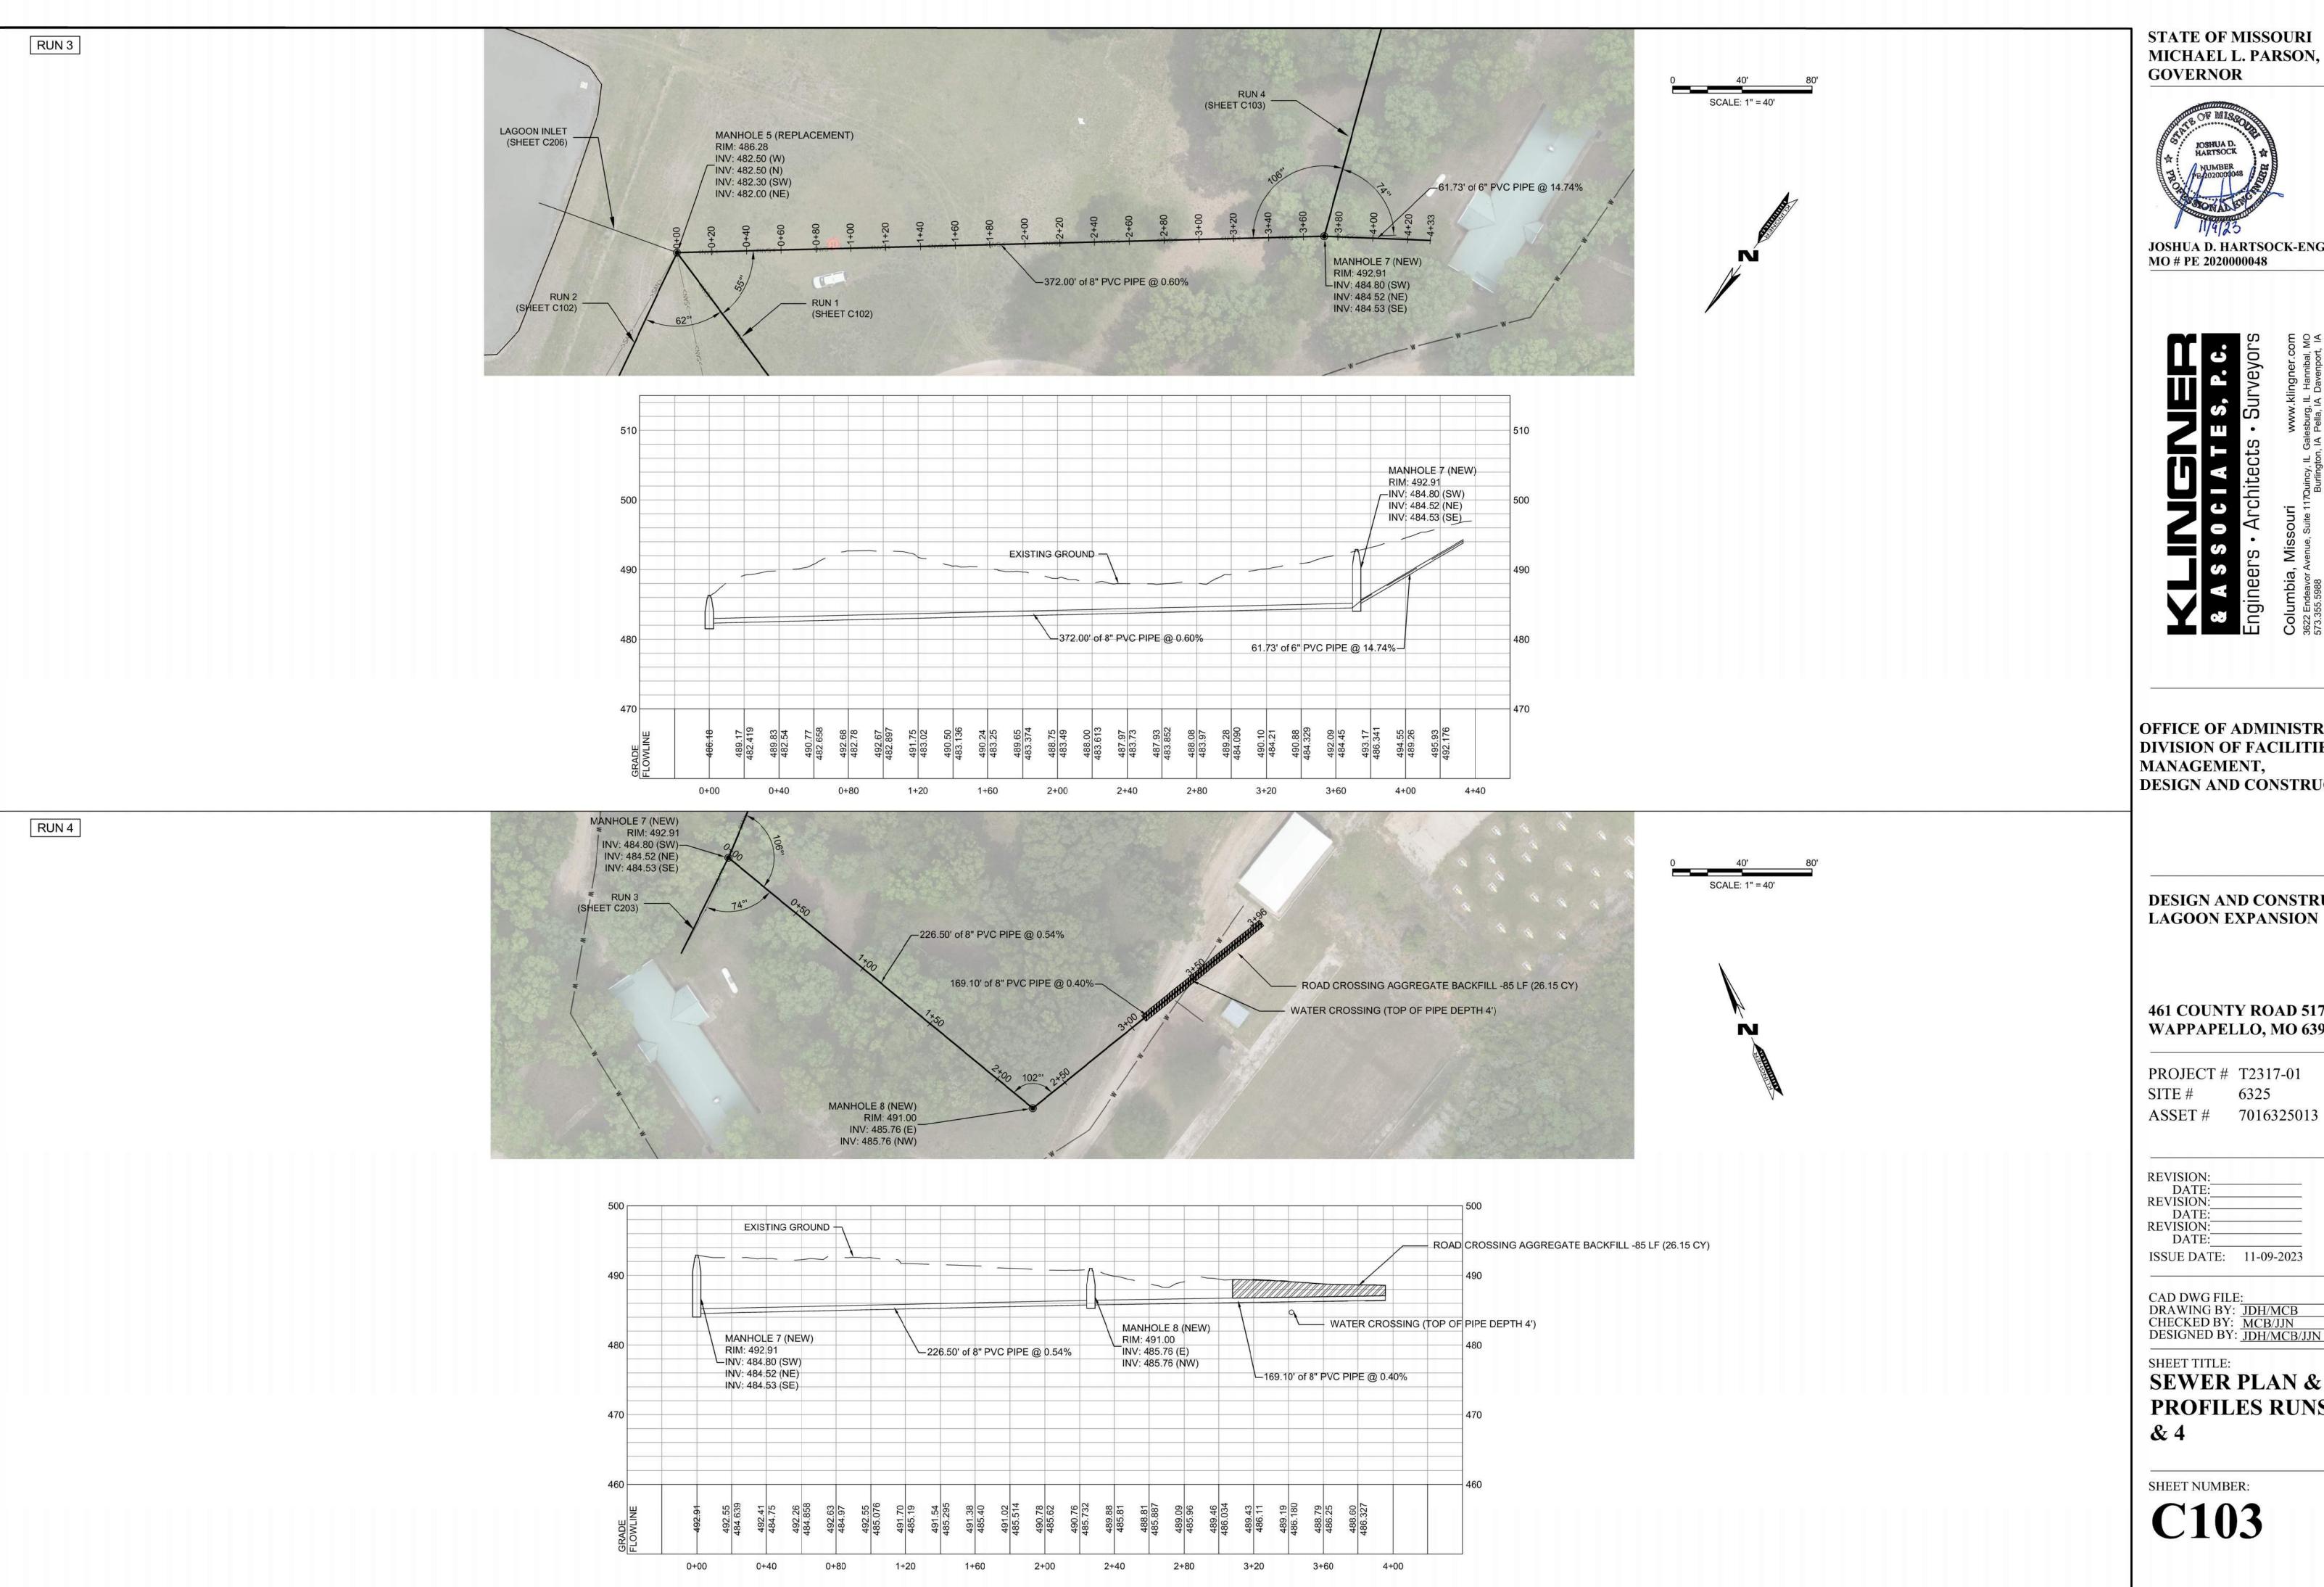

JOSHUA D. HARTSOCK-ENGINEER MO # PE 2020000048

KLINGNER & ASSOCIATES, P.C. - ENGINEERING MISSOURI STATE CERTIFICATE OF AUTHORITY

OFFICE OF ADMINISTRATION DIVISION OF FACILITIES MANAGEMENT, DESIGN AND CONSTRUCTION

DESIGN AND CONSTRUCT LAGOON EXPANSION


461 COUNTY ROAD 517 WAPPAPELLO, MO 63966

PROJECT # T2317-01 6325

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CAD DWG FILE:
DRAWING BY: JDH/MCB
CHECKED BY: MCB/JJN
DESIGNED BY: JDH/MCB/JJN

SEWER PLAN & PROFILES RUNS 3



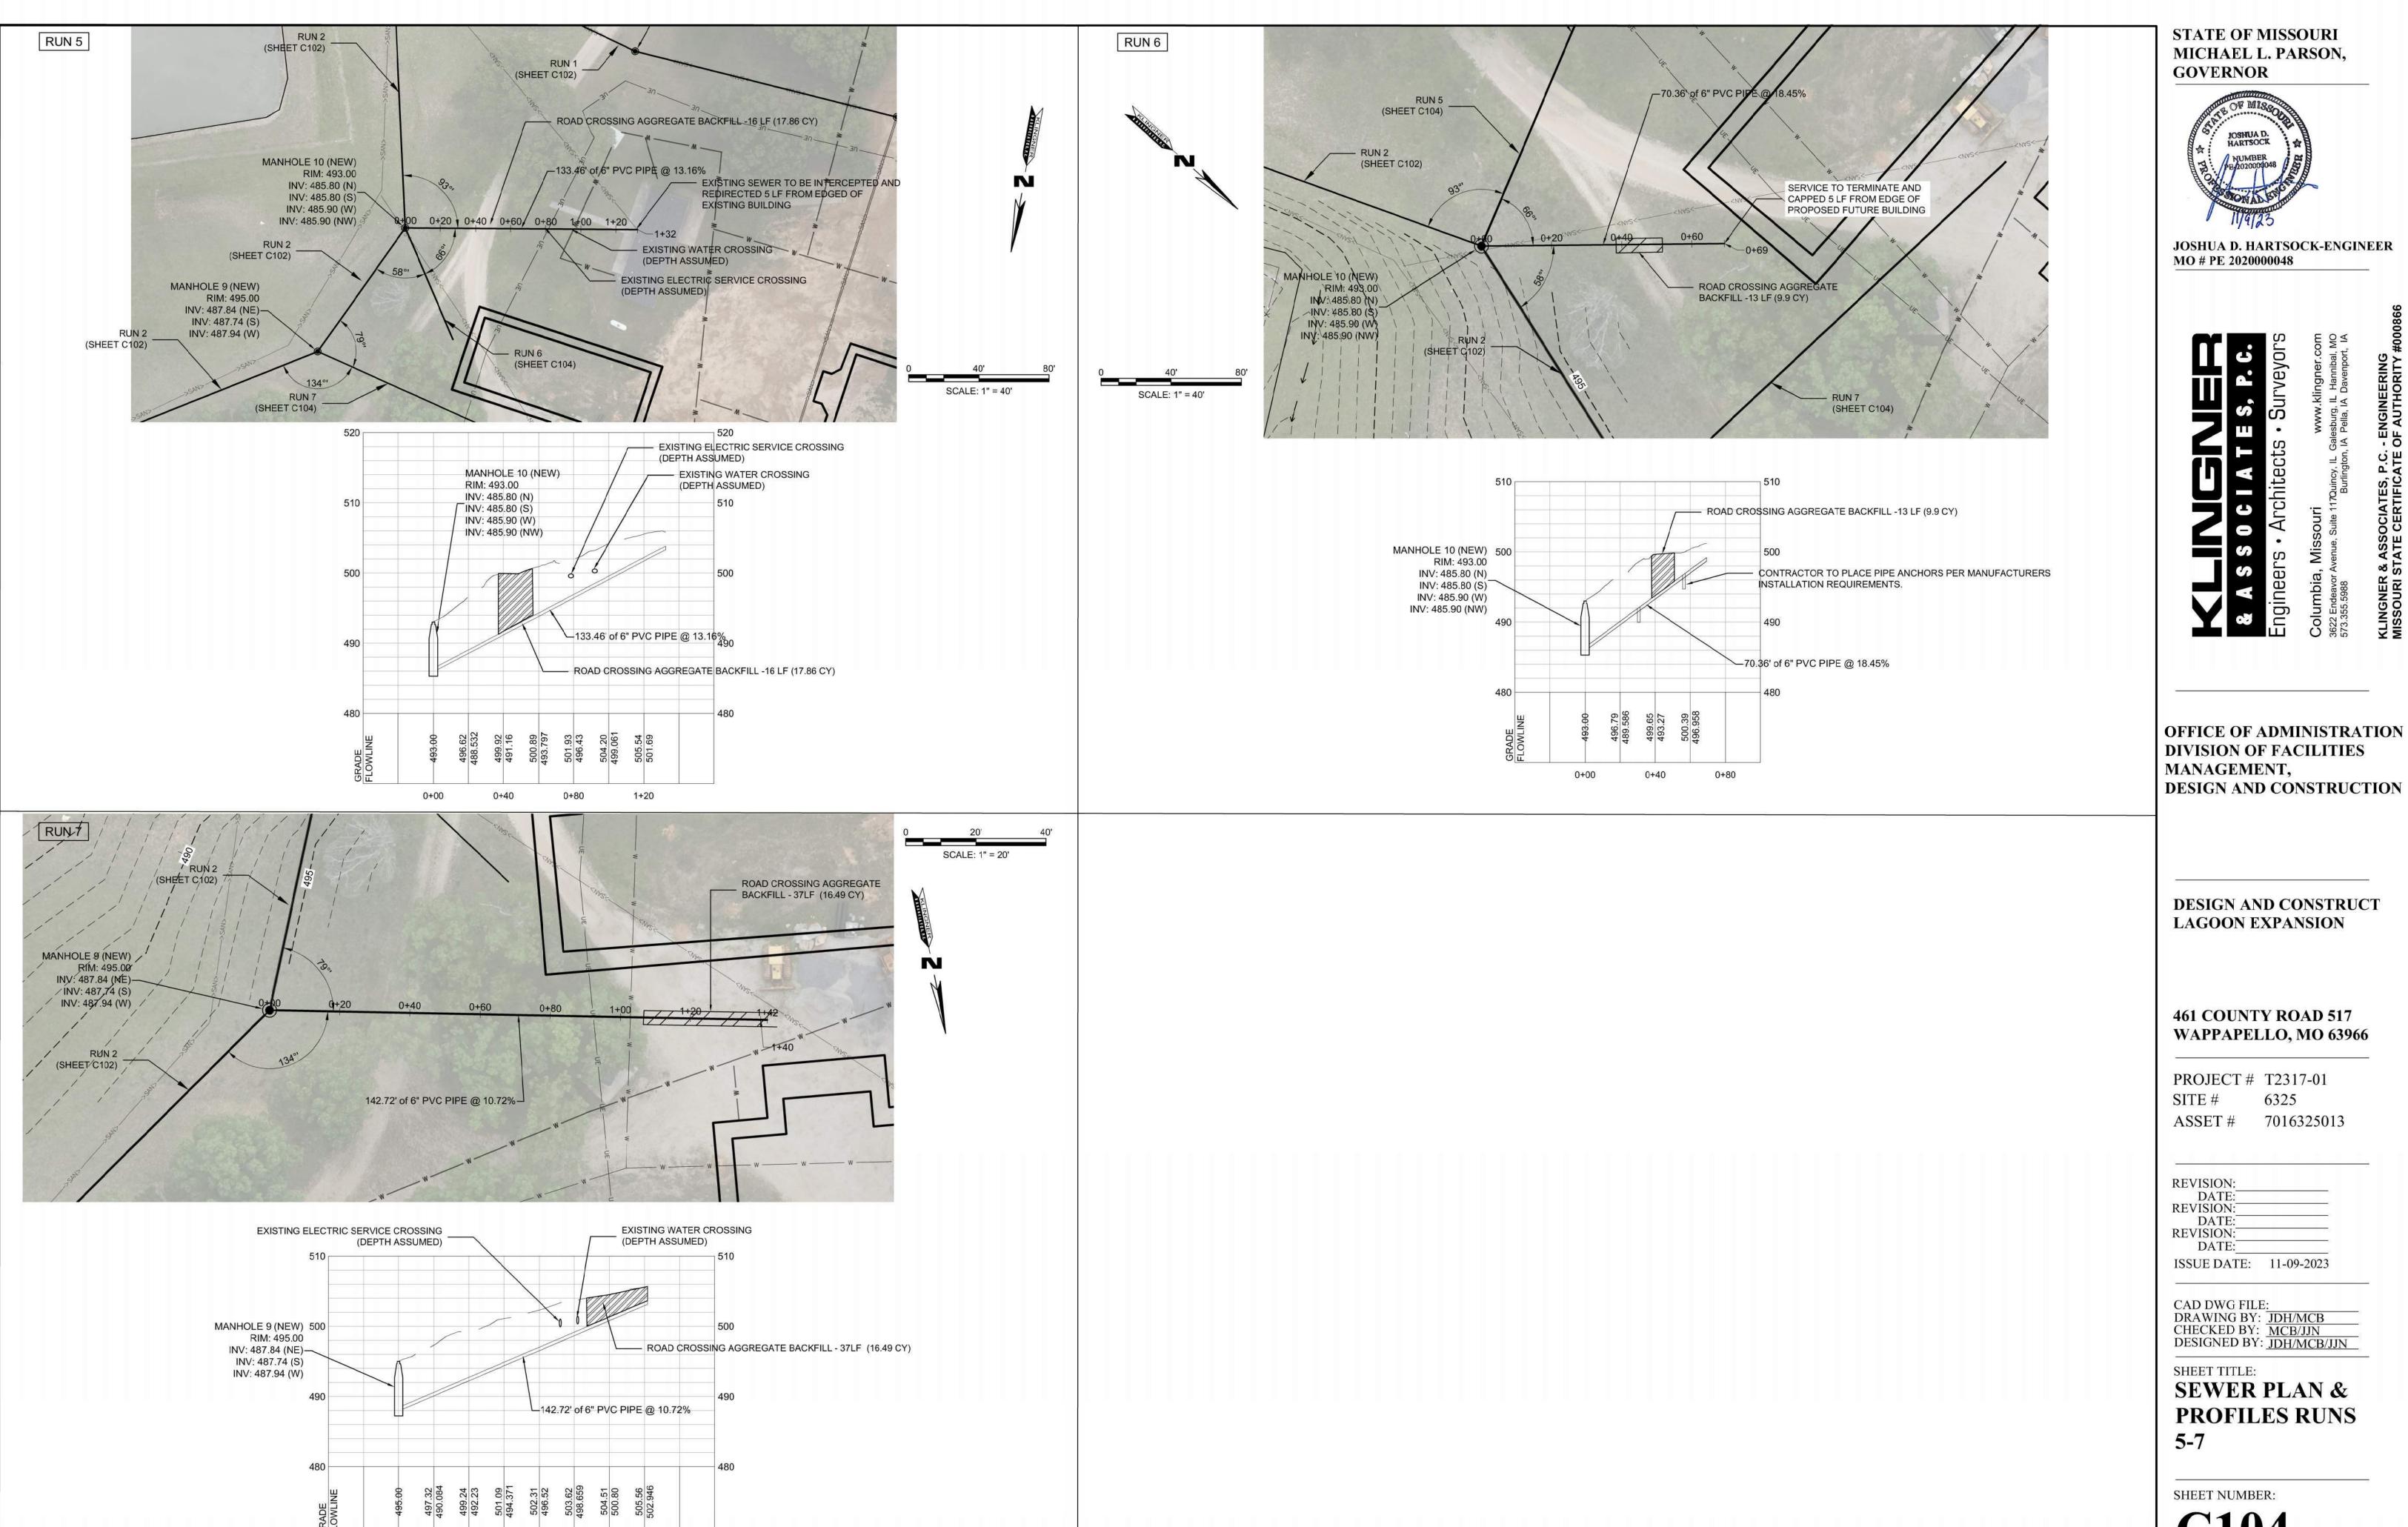

JOSHUA D. HARTSOCK-ENGINEER MO # PE 2020000048

OFFICE OF ADMINISTRATION DIVISION OF FACILITIES

DESIGN AND CONSTRUCT LAGOON EXPANSION

461 COUNTY ROAD 517 WAPPAPELLO, MO 63966


PROJECT # T2317-01 6325 ASSET # 7016325013

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CAD DWG FILE:
DRAWING BY: JDH/MCB
CHECKED BY: MCB/JJN DESIGNED BY: JDH/MCB/JJN

SHEET TITLE:

SEWER PLAN & PROFILES RUNS 5-7



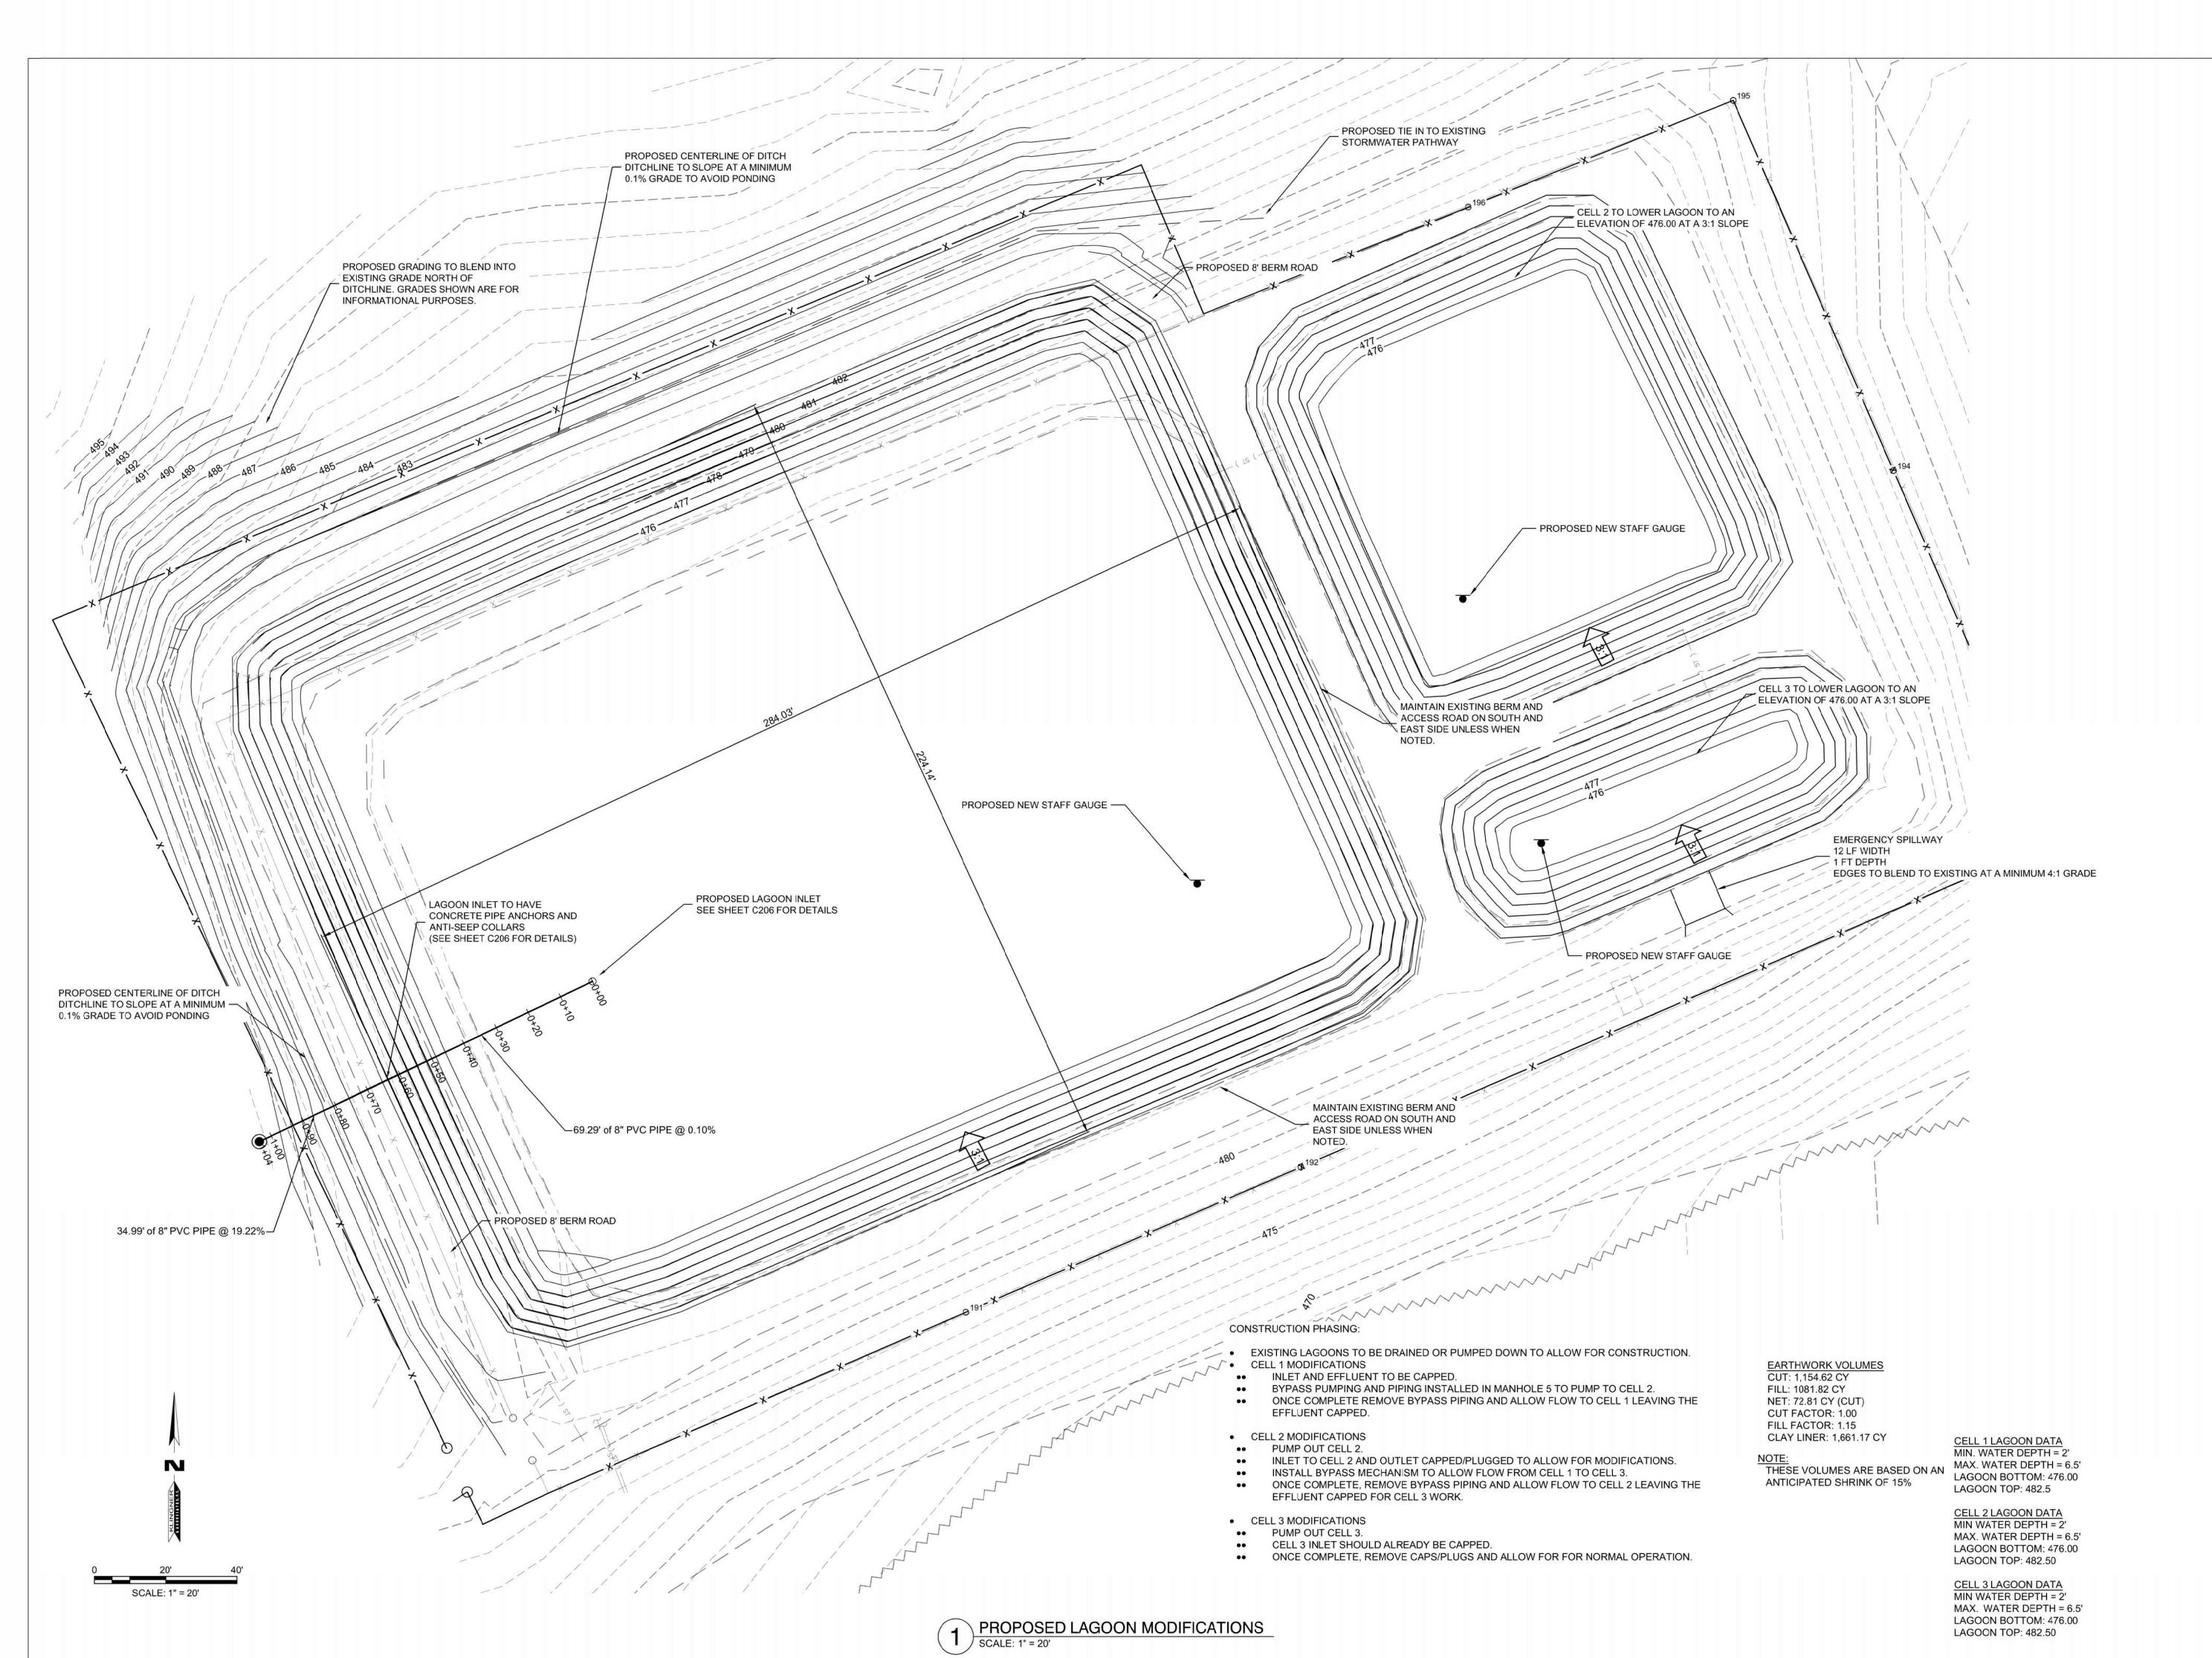

JOSHUA D. HARTSOCK-ENGINEER MO # PE 2020000048

ASSOCIATES, P.C.
gineers · Architects · Surveyor
mbia. Missouri

OFFICE OF ADMINISTRATION DIVISION OF FACILITIES MANAGEMENT, DESIGN AND CONSTRUCTION

DESIGN AND CONSTRUCT LAGOON EXPANSION

461 COUNTY ROAD 517 WAPPAPELLO, MO 63966

PROJECT # T2317-01 SITE # 6325 ASSET # 7016325013

REVISION:	
DATE:	
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DATE:	
ISSUE DATE:	11-09-2023

CAD DWG FILE:
DRAWING BY: JDH/MCB
CHECKED BY: MCB/JJN
DESIGNED BY: JDH/MCB/JJN

SHEET TITLE:

PROPOSED LAGOON MODIFICATIONS

SHEET NUMBER:

	P P P P P P P P P P P P P P P P P P P
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183 183 184 184 185 186 187 187 187 187 187 187 187 187 187 187	Z MINISHED

POINT#	ELEV	DESC.	NORTHING	EASTING
1	476.0	CELL 1	388698.8364	881389.8199
2	476.0	CELL 1	388695.8594	881389.3687
3	476.0	CELL 1	388690.5554	881383.0372
4	476.0	CELL 1	388681.4851	881363.2962
5	476.0	CELL 1	388659.1211	881310.2624
6	476.0	CELL 1	388652.3144	881293.6723
7	476.0	CELL 1	388629.1684	881240.2290
8	476.0	CELL 1	388601.4215	881169.5943
9	476.0	CELL 1	388602.4664	881165.5308
10	476.0	CELL 1	388608.0776	881161.8145
11	476.0	CELL 1	388663.1070	881136.2661
12	476.0	CELL 1	388707.0102	881117.0734
13	476.0	CELL 1	388757.8133	881095.9826
14	476.0	CELL 1	388766.6782	881095.8357
15	476.0	CELL 1	388773.5073	881109.2252
16	476.0	CELL 1	388798.5256	881164.8846
17	476.0	CELL 1	388822.3588	881221.0262
18	476.0	CELL 1	388833.4349	881248.1440
19	476.0	CELL 1	388845.7601	881277.2327
20	476.0	CELL 1	388857.3612	881304.6116
21	476.0	CELL 1	388859.4833	881313.9326
22	476.0	CELL 1	388855.5489	881319.7386
23	476.0	CELL 1	388853.2082	881320.8767
24	476.0	CELL 1	388846.4244	881324.1750
25	476.0	CELL 1	388812.3410	881339.5741
26	476.0	CELL 1	388797.2575	881345.5339
27	476.0	CELL 1	388716.5530	881382.3243
		SPEROCHEROLOGICAL CH	1.40.00026.04.000000000000000000000000000	
28	482.5	CELL 1	388701.3609	881409.9253
29	482.5	CELL 1	388685.6919	881407.5503
30	482.5	CELL 1	388673.8484	881393.5302
31	482.5	CELL 1	388663.6275	881371.1344
32	482.5	CELL 1	388641.1165	881317.7520
33	482.5	CELL 1	388634.2539	881301.0257
34	482.5	CELL 1	388611.3058	881248.0504
35	482.5	CELL 1	388591.0403	881201.9328
36	482.5	CELL 1	388584.2372	881180.0121
37	482.5	CELL 1	388581.1589	881170.0933
38	482.5	CELL 1	388585.4479	881153.4133
39	482.5	CELL 1	388598.5339	881144.7463
40	482.5	CELL 1	388654.9624	881118.5447
41	482.5	CELL 1	388699.3657	881099.1333
42	482.5	CELL 1	388753.8054	881076.5329
43	482.5	CELL 1	388774.4979	881076.2649
44	482.5	CELL 1	388782.5509	881084.1239
45	482.5	CELL 1	388791.0879	881100.7738
46	482.5	CELL 1	388816.3953	881157.0765
47	482.5	CELL 1	388840.3606	881213.5294
48	482.5	CELL 1	388851.4388	881240.6534
49	482.5	CELL 1	388863.7148	881269.6249
50	482.5	CELL 1	388875.9907	881298.5963
51	482.5	CELL 1	388880.3767	881317.8613
52	482.5	CELL 1	388868.7658	881334.9952
53	482.5	CELL 1	388854.7038	881341.8322
54	482.5	CELL 1	388819.9369	881357.5402
55	482.5	CELL 1	388804.8808	881363.4777
56	482.5	CELL 1	388724.3989	881400.1783
57	476.0	CELL 1	388609.3368	881195.0986
58	476.0	CELL 2	388844.8787	881380.6198
59	476.0	CELL 2	388851.0018	881384.9367
60	476.0	CELL 2	388858.3579	881392.3616
61	476.0	CELL 2	388869.8530	881418.4568
62	476.0	CELL 2	388881.0142	881445.2771
63	476.0	CELL 2	388882.7730	881449.7189
00				
64	476.0	CELL 2	388882.9569	881452.3717

POINT #	ELEV	DESC.	NORTHING	EASTING
66	476.0	CELL 2	388877.4488	881457.64
67	476.0	CELL 2	388865.9268	881463.19
68	476.0	CELL 2	388848.9694	881471.46
69 70	476.0 476.0	CELL 2	388813.7008	881488.84
71	476.0	CELL 2	388806.8395 388804.1708	881491.52
72	476.0	CELL 2	388801.1531	881491.95 881490.36
73	476.0	CELL 2	388798.0168	881481.47
74	476.0	CELL 2	388794.3876	881473.06
75	476.0	CELL 2	388782.7915	881446.96
76	476.0	CELL 2	388770.9349	881418.7
77	476.0	CELL 2	388769.7926	881415.96
78	476.0	CELL 2	388769.5628	881414.70
79	476.0	CELL 2	388769.2023	881412.73
80	476.0		388783.4601	881406.16
81	476.0	CELL 2	The second of the second of the second of	881393.66
270000	20,000,000		388811.3226	
82	476.0	CELL 2	388843.0645	881381.10
83	477.0	CELL 2	388845.5074	881377.39
84	477.0	CELL 2	388852.9467	881382.63
85	477.0	CELL 2	388860.8796	881390.64
86	477.0	CELL 2	388872.6108	881417.27
87	477.0	CELL 2	388883.8035	881444.07
88	477.0	CELL 2	388885.7337	881449.04
89	477.0	CELL 2	388886.0046	881452.95
90	477.0	CELL 2	388883.5658	881458.0
91	477.0	CELL 2	388878.7494	881460.3
92	477.0	CELL 2	388867.2198	881465.89
93	477.0	CELL 2	388850.2954	881474.15
94	477.0	CELL 2	388814.9111	881491.59
95	477.0	CELL 2	388807.6336	881494.43
96	477.0	CELL 2	388803.5838	881495.08
97	477.0	CELL 2	388801.7384	881494.00
98	477.0	CELL 2	388798.7295	881492.51
99	477.0	CELL 2	388795.2244	881482.56
100	477.0	CELL 2	388791.6397	881474.26
101	477.0	CELL 2	388780.0374	881448.15
102	477.0	CELL 2	388768.1644	881419.86
103	477.0	CELL 2	388766.8989	881416.82
104	477.0	CELL 2	388766.6115	881415.24
105	477.0	CELL 2	388765.9789	881411.77
106	477.0	CELL 2	388766.9783	881410.4
107	477.0	CELL 2	388782.2184	881403.43
108	477.0	CELL 2	388810.1219	881390.91
109	476.0	CELL 3	388725.2943	881433.47
110	476.0	CELL 3	388726.5982	881435.06
111	476.0	CELL 3	388743.2988	881476.14
112	476.0	CELL 3	388745.6416	881481.95
113	476.0	CELL 3	388754.1359	881503.37
114	476.0	CELL 3	388756.0812	881508.30
115	476.0	CELL 3	388756.7315	881511.97
***************************************	5777 - De Stesso		0-4	
116	476.0	CELL 3	388756.5299	881512.24
117	476.0	CELL 3	388749.9819	881514.77
118	476.0	CELL 3	388747.2567	881514.47
119	476.0	CELL 3	388745.3783	881512.79
120	476.0	CELL 3	388742.2297	881506.76
121	476.0	CELL 3	388736.0350	881493.60
122	476.0	CELL 3	388726.8358	881473.7
123	476.0	CELL 3	388722.1244	881461.5
124	476.0	CELL 3	388717.4395	881449.50
125	476.0	CELL 3	388714.8733	881442.16
126	476.0	CELL 3	388714.6277	881438.31
127	476.0	CELL 3	388716.0247	881436.35
128	476.0	CELL 3	388719.4440	881434.53
		ACRESCALUIAN BUD	200726 4002	0044000
129	477.0	CELL 3	388726.4983	881430.20

_				COORDINATE I	POINTS		
i		POINT#	ELEV	DESC.	NORTHING	EASTING	
77		131	477.0	CELL 3	388746.0793	881475.0228	
)5		132	477.0	CELL 3	388748.4269	881480.8383	
35		133	477.0	CELL 3	388756.9013	881502.2785	
36		134	477.0	CELL 3	388758.9824	881507.4894	
00		135	477.0	CELL 3	388759.9090	881512.7055	
30		136	477.0	CELL 3	388758.4339	881514.7274	
96		137	477.0	CELL 3	388750.3782	881517.8413	
33	2 9	138	477.0	CELL 3	388745.9706	881517.3475	,
08		139	477.0	CELL 3	388742.9714	881514.6646	
97	8	140	477.0	CELL 3	388739.5417	881508.0948	
37	ē. 9	141	477.0	CELL 3	388733.3164	881494.8699	
32	0 3	142	477.0	CELL 3	388724.0733	881474.8846	
33	ě	143	477.0	CELL 3	388719.3276	881462.6582	
15	3	144	477.0	CELL 3	388714.6317	881450.5383	
15	0 (145	477.0	CELL 3	388711.9056	881442.7673	
26	\$ 3	146	477.0	CELL 3	388711.5658	881437.4368	
26		147	477.0	CELL 3	388713.9932	881434.0416	
25	6	148	477.0	CELL 3	388718.4467	881431.6680	
73	ä s	149	482.5	EDGE OF ROAD	388868.0640	881344.2319	
13	8) 73	150	482.5	EDGE OF ROAD	388872.2638	881342.1899	
+3 57		151	482.5	EDGE OF ROAD	388875.3884	881339.4831	
98			33537633				
71	ā. S	152 153	482.5	EDGE OF ROAD	388886.9993	881322.3491	
54	6 7	153	482.5 482.5	EDGE OF ROAD	388888.1771 388883.7911	881316.0854 881296.8204	
41	3	155	482.5	EDGE OF ROAD	388883.3568	881295.4751	
11	8	156	482.5	EDGE OF ROAD	388871.0808	881266.5037	
76	6 8	157	482.5	EDGE OF ROAD		881237.5803	
76	9 8	158	482.5	EDGE OF ROAD	388858.8252 388847.1705	881210.4378	
17		159	482.5	EDGE OF ROAD	388823.6920	881153.7966	
)4	8	160	482.5	EDGE OF ROAD	388810.9962	881125.5516	
74	9	161	482.5	EDGE OF ROAD	388798.3004	881097.3066	0
36		162	482.5	EDGE OF ROAD	388793.6870	881088.3089	D
92	9 8	163	482.5	EDGE OF ROAD	388788.1384	881078.3985	M
16							,
		164					D
64 47	ĝ :	164 165	482.5 482.5	EDGE OF ROAD	388783.3924 388777.7113	881073.7668 881068.2226	ע
64		Secretaria.	482.5	EDGE OF ROAD	388783.3924	881073.7668	ע
64 47		165	482.5 482.5	EDGE OF ROAD	388783.3924 388777.7113	881073.7668 881068.2226	ע
64 47 95 94		165 166	482.5 482.5 482.7	EDGE OF ROAD EDGE OF ROAD	388783.3924 388777.7113 388768.1586	881073.7668 881068.2226 881068.3414	ע
64 47 95		165 166 167	482.5 482.5 482.7 482.6	EDGE OF ROAD EDGE OF ROAD EDGE OF ROAD	388783.3924 388777.7113 388768.1586 388759.8107	881073.7668 881068.2226 881068.3414 881068.4544	י ע
64 47 95 94		165 166 167 168	482.5 482.5 482.7 482.6 482.5	EDGE OF ROAD EDGE OF ROAD EDGE OF ROAD EDGE OF ROAD	388783.3924 388777.7113 388768.1586 388759.8107 388753.7189	881073.7668 881068.2226 881068.3414 881068.4544 881069.8563)]
64 47 95 94 24		165 166 167 168 169	482.5 482.7 482.6 482.5 482.5	EDGE OF ROAD	388783.3924 388777.7113 388768.1586 388759.8107 388753.7189 388743.0741	881073.7668 881068.2226 881068.3414 881068.4544 881069.8563 881073.4737)]
64 47 95 94 24 66 30		165 166 167 168 169 170	482.5 482.7 482.6 482.5 482.5 482.5	EDGE OF ROAD	388783.3924 388777.7113 388768.1586 388759.8107 388753.7189 388743.0741 388709.0854	881073.7668 881068.2226 881068.3414 881068.4544 881069.8563 881073.4737 881086.4362)
64 47 95 94 24 66 30		165 166 167 168 169 170	482.5 482.7 482.6 482.5 482.5 482.5 482.5	EDGE OF ROAD	388783.3924 388777.7113 388768.1586 388759.8107 388753.7189 388743.0741 388709.0854 388696.2984	881073.7668 881068.2226 881068.3414 881068.4544 881069.8563 881073.4737 881086.4362 881091.7447)]
64 47 95 94 24 66 30 31		165 166 167 168 169 170 171	482.5 482.7 482.6 482.5 482.5 482.5 482.5 482.5	EDGE OF ROAD	388783.3924 388777.7113 388768.1586 388759.8107 388753.7189 388743.0741 388709.0854 388696.2984 388652.2242	881073.7668 881068.2226 881068.3414 881068.4544 881069.8563 881073.4737 881086.4362 881091.7447 881111.0122]
64 47 95 94 24 66 30 31 05 32		165 166 167 168 169 170 171 172	482.5 482.7 482.6 482.5 482.5 482.5 482.5 482.5 482.5	EDGE OF ROAD	388783.3924 388777.7113 388768.1586 388759.8107 388753.7189 388743.0741 388709.0854 388696.2984 388652.2242 388652.2242	881073.7668 881068.2226 881068.3414 881068.4544 881069.8563 881073.4737 881086.4362 881091.7447 881111.0122 881124.4421	ט ! !
64 47 95 94 24 66 30 31 05 32		165 166 167 168 169 170 171 172 173	482.5 482.7 482.6 482.5 482.5 482.5 482.5 482.5 482.5	EDGE OF ROAD	388783.3924 388777.7113 388768.1586 388759.8107 388753.7189 388743.0741 388709.0854 388696.2984 388652.2242 388623.2658 388595.1647	881073.7668 881068.2226 881068.3414 881068.4544 881069.8563 881073.4737 881086.4362 881091.7447 881111.0122 881124.4421 881137.4904	ט ! !
64 47 95 94 24 66 30 31 95 32 37		165 166 167 168 169 170 171 172 173 174	482.5 482.7 482.6 482.5 482.5 482.5 482.5 482.5 482.5 482.5	EDGE OF ROAD	388783.3924 388777.7113 388768.1586 388759.8107 388753.7189 388743.0741 388709.0854 388696.2984 388652.2242 388623.2658 388595.1647 388594.1164	881073.7668 881068.2226 881068.3414 881068.4544 881069.8563 881073.4737 881086.4362 881091.7447 881111.0122 881124.4421 881137.4904 881138.0765)
64 47 95 94 24 66 30 31 05 32 37 93		165 166 167 168 169 170 171 172 173 174 175	482.5 482.7 482.6 482.5 482.5 482.5 482.5 482.5 482.5 482.5 482.5	EDGE OF ROAD	388783.3924 388777.7113 388768.1586 388759.8107 388753.7189 388743.0741 388709.0854 388696.2984 388652.2242 388623.2658 388595.1647 388594.1164 388581.0304	881073.7668 881068.2226 881068.3414 881068.4544 881069.8563 881073.4737 881086.4362 881091.7447 881111.0122 881124.4421 881137.4904 881138.0765 881146.7435	
64 47 95 94 24 66 33 95 33		165 166 167 168 169 170 171 172 173 174 175 176	482.5 482.7 482.6 482.5 482.5 482.5 482.5 482.5 482.5 482.5 482.5 482.5	EDGE OF ROAD	388783.3924 388777.7113 388768.1586 388759.8107 388753.7189 388743.0741 388709.0854 388696.2984 388652.2242 388623.2658 388595.1647 388594.1164 388581.0304 388577.6999	881073.7668 881068.2226 881068.3414 881068.4544 881069.8563 881073.4737 881086.4362 881091.7447 881111.0122 881124.4421 881137.4904 881138.0765 881146.7435 881151.4210	
64 47 95 94 24 66 30 31 05 32 37 93 93		165 166 167 168 169 170 171 172 173 174 175 176 177	482.5 482.7 482.6 482.5 482.5 482.5 482.5 482.5 482.5 482.5 482.5 482.5 482.5	EDGE OF ROAD	388783.3924 388777.7113 388768.1586 388759.8107 388753.7189 388743.0741 388709.0854 388696.2984 388652.2242 388652.2242 388595.1647 388594.1164 388581.0304 388577.6999 388573.4109	881073.7668 881068.2226 881068.3414 881068.4544 881069.8563 881073.4737 881086.4362 881091.7447 881111.0122 881124.4421 881137.4904 881138.0765 881146.7435 881151.4210 881168.1010	
64 47 95 94 24 66 30 31 05 32 33 93 93 93		165 166 167 168 169 170 171 172 173 174 175 176 177 178	482.5 482.7 482.6 482.5 482.5 482.5 482.5 482.5 482.5 482.5 482.5 482.5 482.5 482.5	EDGE OF ROAD	388783.3924 388777.7113 388768.1586 388759.8107 388753.7189 388743.0741 388709.0854 388696.2984 388652.2242 388652.2242 388652.2242 388595.1647 388594.1164 388581.0304 388577.6999 388573.4109 388573.5184	881073.7668 881068.2226 881068.3414 881068.4544 881069.8563 881073.4737 881086.4362 881091.7447 881111.0122 881124.4421 881137.4904 881138.0765 881146.7435 881151.4210 881168.1010 881172.4645	
64 47 95 94 24 66 33 33 93 93 93 93 93 93		165 166 167 168 169 170 171 172 173 174 175 176 177 178 179	482.5 482.7 482.6 482.5 482.5 482.5 482.5 482.5 482.5 482.5 482.5 482.5 482.5 482.5 482.5	EDGE OF ROAD	388783.3924 388777.7113 388768.1586 388759.8107 388753.7189 388743.0741 388709.0854 388696.2984 388652.2242 388623.2658 388595.1647 388594.1164 388581.0304 388577.6999 388573.4109 388573.5184 388576.5967	881073.7668 881068.2226 881068.3414 881068.4544 881069.8563 881073.4737 881086.4362 881091.7447 881111.0122 881124.4421 881137.4904 881138.0765 881146.7435 881151.4210 881168.1010 881172.4645 881182.3833	
64 47 95 94 24 66 30 31 93 93 93 93 93 95 97		165 166 167 168 169 170 171 172 173 174 175 176 177 178 179 180 181	482.5 482.7 482.6 482.5 482.5 482.5 482.5 482.5 482.5 482.5 482.5 482.5 482.5 482.5 482.5 482.5	EDGE OF ROAD	388783.3924 388777.7113 388768.1586 388759.8107 388753.7189 388743.0741 388709.0854 388696.2984 388652.2242 388623.2658 388595.1647 388594.1164 388581.0304 388577.6999 388573.4109 388573.5184 388576.5967 388540.2499	881073.7668 881068.2226 881068.3414 881068.4544 881069.8563 881073.4737 881086.4362 881091.7447 881111.0122 881124.4421 881137.4904 881138.0765 881146.7435 881151.4210 881168.1010 881172.4645 881182.3833 881164.7957	
64 47 95 94 24 66 33 37 93 93 93 15 97 98		165 166 167 168 169 170 171 172 173 174 175 176 177 178 179 180 181 182	482.5 482.7 482.6 482.5 482.5 482.5 482.5 482.5 482.5 482.5 482.5 482.5 482.5 482.5 482.5 482.5 482.5 482.5	EDGE OF ROAD	388783.3924 388777.7113 388768.1586 388759.8107 388753.7189 388743.0741 388709.0854 388696.2984 388652.2242 388652.2242 388652.2242 388595.1647 388594.1164 388581.0304 388577.6999 388573.4109 388573.5184 388576.5967 388540.2499 388531.5137	881073.7668 881068.2226 881068.3414 881068.4544 881069.8563 881073.4737 881086.4362 881091.7447 881111.0122 881124.4421 881137.4904 881138.0765 881146.7435 881151.4210 881168.1010 881172.4645 881182.3833 881164.7957 881146.4435	
64 47 95 94 24 66 33 33 93 93 93 93 93 93 93 93 93		165 166 167 168 169 170 171 172 173 174 175 176 177 178 179 180 181 182 183	482.5 482.7 482.6 482.5 482.5 482.5 482.5 482.5 482.5 482.5 482.5 482.5 482.5 482.5 482.5 482.5 482.5 482.5 482.5 482.5	EDGE OF ROAD FENCE FENCE	388783.3924 388777.7113 388768.1586 388759.8107 388753.7189 388743.0741 388709.0854 388696.2984 388652.2242 388652.2242 388652.2242 388595.1647 388594.1164 388597.6999 388573.4109 388573.5184 388576.5967 388540.2499 388531.5137 388540.5887	881073.7668 881068.2226 881068.3414 881068.4544 881069.8563 881073.4737 881086.4362 881091.7447 881111.0122 881124.4421 881137.4904 881138.0765 881146.7435 881151.4210 881168.1010 881172.4645 881182.3833 881164.7957 881146.4435 881142.1235	
64 47 95 94 24 66 30 31 93 93 93 93 93 93 93 93 93 93 93 93 94 95 95		165 166 167 168 169 170 171 172 173 174 175 176 177 178 179 180 181 182 183 184	482.5 482.7 482.6 482.5 482.5 482.5 482.5 482.5 482.5 482.5 482.5 482.5 482.5 482.5 482.5 482.5 482.5 482.5 482.5 482.5 482.5 482.5	EDGE OF ROAD FENCE FENCE FENCE	388783.3924 388777.7113 388768.1586 388759.8107 388753.7189 388743.0741 388709.0854 388696.2984 388652.2242 388652.2242 388652.2242 388595.1647 388594.1164 388577.6999 388573.4109 388573.5184 388576.5967 388540.2499 388531.5137 388540.5887 388552.8054	881073.7668 881068.3414 881068.4544 881069.8563 881073.4737 881086.4362 881091.7447 881111.0122 881124.4421 881137.4904 881138.0765 881146.7435 881151.4210 881168.1010 881172.4645 881182.3833 881164.7957 881146.4435 881146.4435	
64 47 95 94 24 66 30 31 93 93 93 93 93 93 93 93 93 93 93 93 94 95 96 97 97 98 97 97 98 97 97 97 97 97 97 97 97 97 97 97 97 97		165 166 167 168 169 170 171 172 173 174 175 176 177 178 179 180 181 182 183 184 185	482.5 482.7 482.6 482.5	EDGE OF ROAD FENCE FENCE FENCE FENCE	388783.3924 388777.7113 388768.1586 388759.8107 388753.7189 388743.0741 388709.0854 388696.2984 388652.2242 388652.2242 388652.2242 388595.1647 388594.1164 388577.6999 388573.4109 388573.5184 388576.5967 388540.2499 388531.5137 388540.5887 388552.8054 388594.2854	881073.7668 881068.2226 881068.3414 881068.4544 881069.8563 881073.4737 881086.4362 881091.7447 881111.0122 881124.4421 881137.4904 881138.0765 881146.7435 881151.4210 881168.1010 881172.4645 881182.3833 881164.7957 881146.4435 881146.4435 881136.3080 881116.4572	
64 47 95 94 24 66 30 31 93 93 93 93 93 93 93 93 93 93 93 93 94 95 96 97 98 97 98 97 98 97 98 97 98 97 98 97 98 97 98 97 98 97 98 97 97 97 97 97 97 97 97 97 97 97 97 97		165 166 167 168 169 170 171 172 173 174 175 176 177 178 179 180 181 182 183 184 185 186	482.5 482.7 482.6 482.5	EDGE OF ROAD	388783.3924 388777.7113 388768.1586 388759.8107 388753.7189 388743.0741 388709.0854 388696.2984 388652.2242 388652.2242 388595.1647 388594.1164 388594.1164 388577.6999 388573.4109 388573.5184 388576.5967 388540.2499 388531.5137 388540.5887 388552.8054 388594.2854 388635.5433	881073.7668 881068.3414 881068.4544 881069.8563 881073.4737 881086.4362 881091.7447 881111.0122 881124.4421 881137.4904 881138.0765 881146.7435 881151.4210 881168.1010 881172.4645 881182.3833 881164.7957 881146.4435 881146.4435 881136.3080 881116.4572 881097.0697	
64 47 95 94 24 66 30 31 93 93 93 93 93 93 93 93 93 93 93 94 94 95 96 97 97 98 97 97 97 97 97 97 97 97 97 97 97 97 97		165 166 167 168 169 170 171 172 173 174 175 176 177 178 179 180 181 182 183 184 185 186 187	482.5 482.7 482.6 482.5	EDGE OF ROAD FENCE FENCE FENCE FENCE FENCE FENCE FENCE	388783.3924 388777.7113 388768.1586 388759.8107 388753.7189 388743.0741 388709.0854 388696.2984 388652.2242 388652.2242 388652.2242 388595.1647 388594.1164 388577.6999 388573.4109 388573.5184 388576.5967 388540.2499 388531.5137 388540.2499 388531.5137 388540.5887 388552.8054 388635.5433 388669.2318	881073.7668 881068.3414 881068.4544 881069.8563 881073.4737 881086.4362 881091.7447 881111.0122 881124.4421 881137.4904 881138.0765 881146.7435 881151.4210 881168.1010 881172.4645 881182.3833 881164.7957 881146.4435 881146.4435 881136.3080 881116.4572 881097.0697 881081.5825	
64 47 95 94 24 66 30 31 93 93 93 93 93 93 93 93 93 93 94 94 95 95 96 97 97 97 98 97 97 97 97 97 97 97 97 97 97 97 97 97		165 166 167 168 169 170 171 172 173 174 175 176 177 178 179 180 181 182 183 184 185 186 187 188	482.5 482.7 482.6 482.5	EDGE OF ROAD	388783.3924 388777.7113 388768.1586 388759.8107 388753.7189 388743.0741 388709.0854 388696.2984 388652.2242 388652.2242 388652.2242 388595.1647 388594.1164 388577.6999 388573.4109 388573.5184 388576.5967 388540.2499 388531.5137 388540.2499 388531.5137 388540.2499 388531.5137 388540.5887 388594.2854 388635.5433 388669.2318	881073.7668 881068.3414 881068.4544 881069.8563 881073.4737 881086.4362 881091.7447 881111.0122 881124.4421 881137.4904 881138.0765 881146.7435 881151.4210 881168.1010 881172.4645 881182.3833 881164.7957 881146.4435 881146.4435 881136.3080 881116.4572 881097.0697 881081.5825 881025.8175	
64 47 95 94 24 66 30 31 93 93 93 93 93 93 93 93 93 94 95 95 97 97 98 97 97 98 97 98 98 98 98 98 98 98 98 98 98 98 98 98		165 166 167 168 169 170 171 172 173 174 175 176 177 178 179 180 181 182 183 184 185 186 187 188	482.5 482.7 482.6 482.5	EDGE OF ROAD	388783.3924 388777.7113 388768.1586 388759.8107 388753.7189 388743.0741 388709.0854 388696.2984 388652.2242 388652.2242 388595.1647 388594.1164 388577.6999 388573.4109 388573.5184 388576.5967 388540.2499 388531.5137 388540.2499 388531.5137 388540.2499 388531.5137 388540.2499 388531.5137	881073.7668 881068.3414 881068.4544 881069.8563 881073.4737 881086.4362 881091.7447 881111.0122 881124.4421 881137.4904 881138.0765 881146.7435 881151.4210 881172.4645 881182.3833 881164.7957 881186.3080 881146.4435 881136.3080 881116.4572 881097.0697 881081.5825 881025.8175 881330.9781	
64 47 95 94 24 66 30 31 93 93 93 93 93 93 93 93 93 93 93 94 94 95 96 97 97 98 97 98 97 98 98 98 98 98 98 98 98 98 98 98 98 98		165 166 167 168 169 170 171 172 173 174 175 176 177 178 179 180 181 182 183 184 185 186 187 188 189	482.5 482.7 482.6 482.5	EDGE OF ROAD	388783.3924 388777.7113 388768.1586 388759.8107 388753.7189 388743.0741 388709.0854 388696.2984 388652.2242 388623.2658 388595.1647 388594.1164 388577.6999 388573.4109 388573.4109 388573.5184 388576.5967 388540.2499 388531.5137 388540.5887 388540.5887 388594.2854 388635.5433 388669.2318 388784.9122 388912.4331 388870.6777	881073.7668 881068.3414 881068.4544 881069.8563 881073.4737 881086.4362 881091.7447 881111.0122 881124.4421 881137.4904 881138.0765 881146.7435 881151.4210 881172.4645 881182.3833 881164.7957 881186.3080 881146.4435 881146.4435 881136.3080 881116.4572 881097.0697 881081.5825 881025.8175 881330.9781 881348.4269	
64 47 95 94 94 96 93 93 93 93 93 93 93 93 93 93 93 93 93		165 166 167 168 169 170 171 172 173 174 175 176 177 178 179 180 181 182 183 184 185 186 187 188 189 190 191	482.5 482.7 482.6 482.5	EDGE OF ROAD FENCE	388783.3924 388777.7113 388768.1586 388759.8107 388753.7189 388743.0741 388709.0854 388696.2984 388652.2242 388623.2658 388595.1647 388594.1164 388577.6999 388573.4109 388573.4109 388573.5184 388576.5967 388540.2499 388531.5137 388540.5887 388540.5887 388552.8054 388594.2854 388635.5433 388669.2318 388784.9122 388912.4331 388870.6777 388590.9609	881073.7668 881068.3414 881068.4544 881069.8563 881073.4737 881086.4362 881091.7447 881111.0122 881124.4421 881137.4904 881138.0765 881146.7435 881151.4210 881151.4210 881168.1010 881172.4645 881182.3833 881164.7957 881182.3833 881164.7957 881186.3080 881146.4435 881146.4435 881146.4435 881146.4435 881146.4435 881146.4435 881182.3833 881164.7957 881186.3080 88116.4572 881097.0697 881081.5825 881025.8175 881330.9781 881348.4269 881348.4269	
64 47 95 94 24 66 30 31 93 93 93 93 93 93 93 93 93 93 93 94 95 15 97 97 98 10 10 10 10 10 10 10 10 10 10 10 10 10		165 166 167 168 169 170 171 172 173 174 175 176 177 178 179 180 181 182 183 184 185 186 187 188 189 190 191	482.5 482.5	EDGE OF ROAD FENCE	388783.3924 388777.7113 388768.1586 388759.8107 388753.7189 388743.0741 388709.0854 388696.2984 388652.2242 388652.2242 388595.1647 388594.1164 388577.6999 388573.4109 388573.5184 388576.5967 388540.2499 388573.5184 388540.2499 388531.5137 388540.2499 388531.5137 388540.2499 388573.8184 388576.5967 388540.2499 388573.5184 388576.5967 388540.2499 388573.5184 388576.5967	881073.7668 881068.3414 881068.4544 881069.8563 881073.4737 881086.4362 881091.7447 881111.0122 881124.4421 881137.4904 881138.0765 881146.7435 881151.4210 881151.4210 881168.1010 881172.4645 881182.3833 881164.7957 881182.3833 881164.7957 881186.3080 881146.4435 881146.4435 881146.4435 881146.4435 881182.3833 881164.7957 881182.3833 881164.7957 881182.3833 881164.7957 881182.3833	
64 47 95 94 24 66 30 31 93 93 93 93 93 93 93 93 93 93 93 94 95 95 112 114 110 27 29 114 110 110 110 110 110 110 110 110 110		165 166 167 168 169 170 171 172 173 174 175 176 177 178 179 180 181 182 183 184 185 186 187 188 189 190 191 192 193	482.5 482.5	EDGE OF ROAD EDGE	388783.3924 388777.7113 388768.1586 388759.8107 388753.7189 388743.0741 388709.0854 388696.2984 388652.2242 388652.2242 388652.2242 388595.1647 388594.1164 388577.6999 388573.4109 388573.5184 388576.5967 388540.2499 388573.5184 388552.8054 388594.2854 388635.5433 388669.2318 388784.9122 388912.4331 388870.6777 388590.9609 388631.6417 388723.0066	881073.7668 881068.3414 881068.4544 881069.8563 881073.4737 881086.4362 881091.7447 881111.0122 881124.4421 881137.4904 881138.0765 881146.7435 881151.4210 881151.4210 881168.1010 881172.4645 881182.3833 881164.7957 881146.4435 881182.3833 881164.7957 881146.4435 881182.3833 881164.7957 881146.4435 881182.3833 881164.7957 881182.3833 881164.7957 881182.3833 881164.7957 881182.3833	

COORDINATE POINTS

	STATE OF MISSOUR
	MICHAEL L. PARSON
_	GOVERNOR



JOSHUA D. HARTSOCK-ENGINEER MO # PE 2020000048

A S S O C I A T E S, P.C.
gineers · Architects · Surveyors
umbia. Missouri

OFFICE OF ADMINISTRATION DIVISION OF FACILITIES MANAGEMENT, DESIGN AND CONSTRUCTION

DESIGN AND CONSTRUCT LAGOON EXPANSION

461 COUNTY ROAD 517 WAPPAPELLO, MO 63966


PROJECT # T2317-01 SITE # 6325 ASSET # 7016325013

REVISION:
DATE:
REVISION:
DATE:
REVISION:
DATE:
REVISION:
TOTALE:
ISSUE DATE: 11-09-2023

CAD DWG FILE:
DRAWING BY: JDH/MCB
CHECKED BY: MCB/JJN
DESIGNED BY: JDH/MCB/JJN

PROPOSED LAGOON
MODIFICATION
COORDINATE TABLES

SHEET NUMBER:

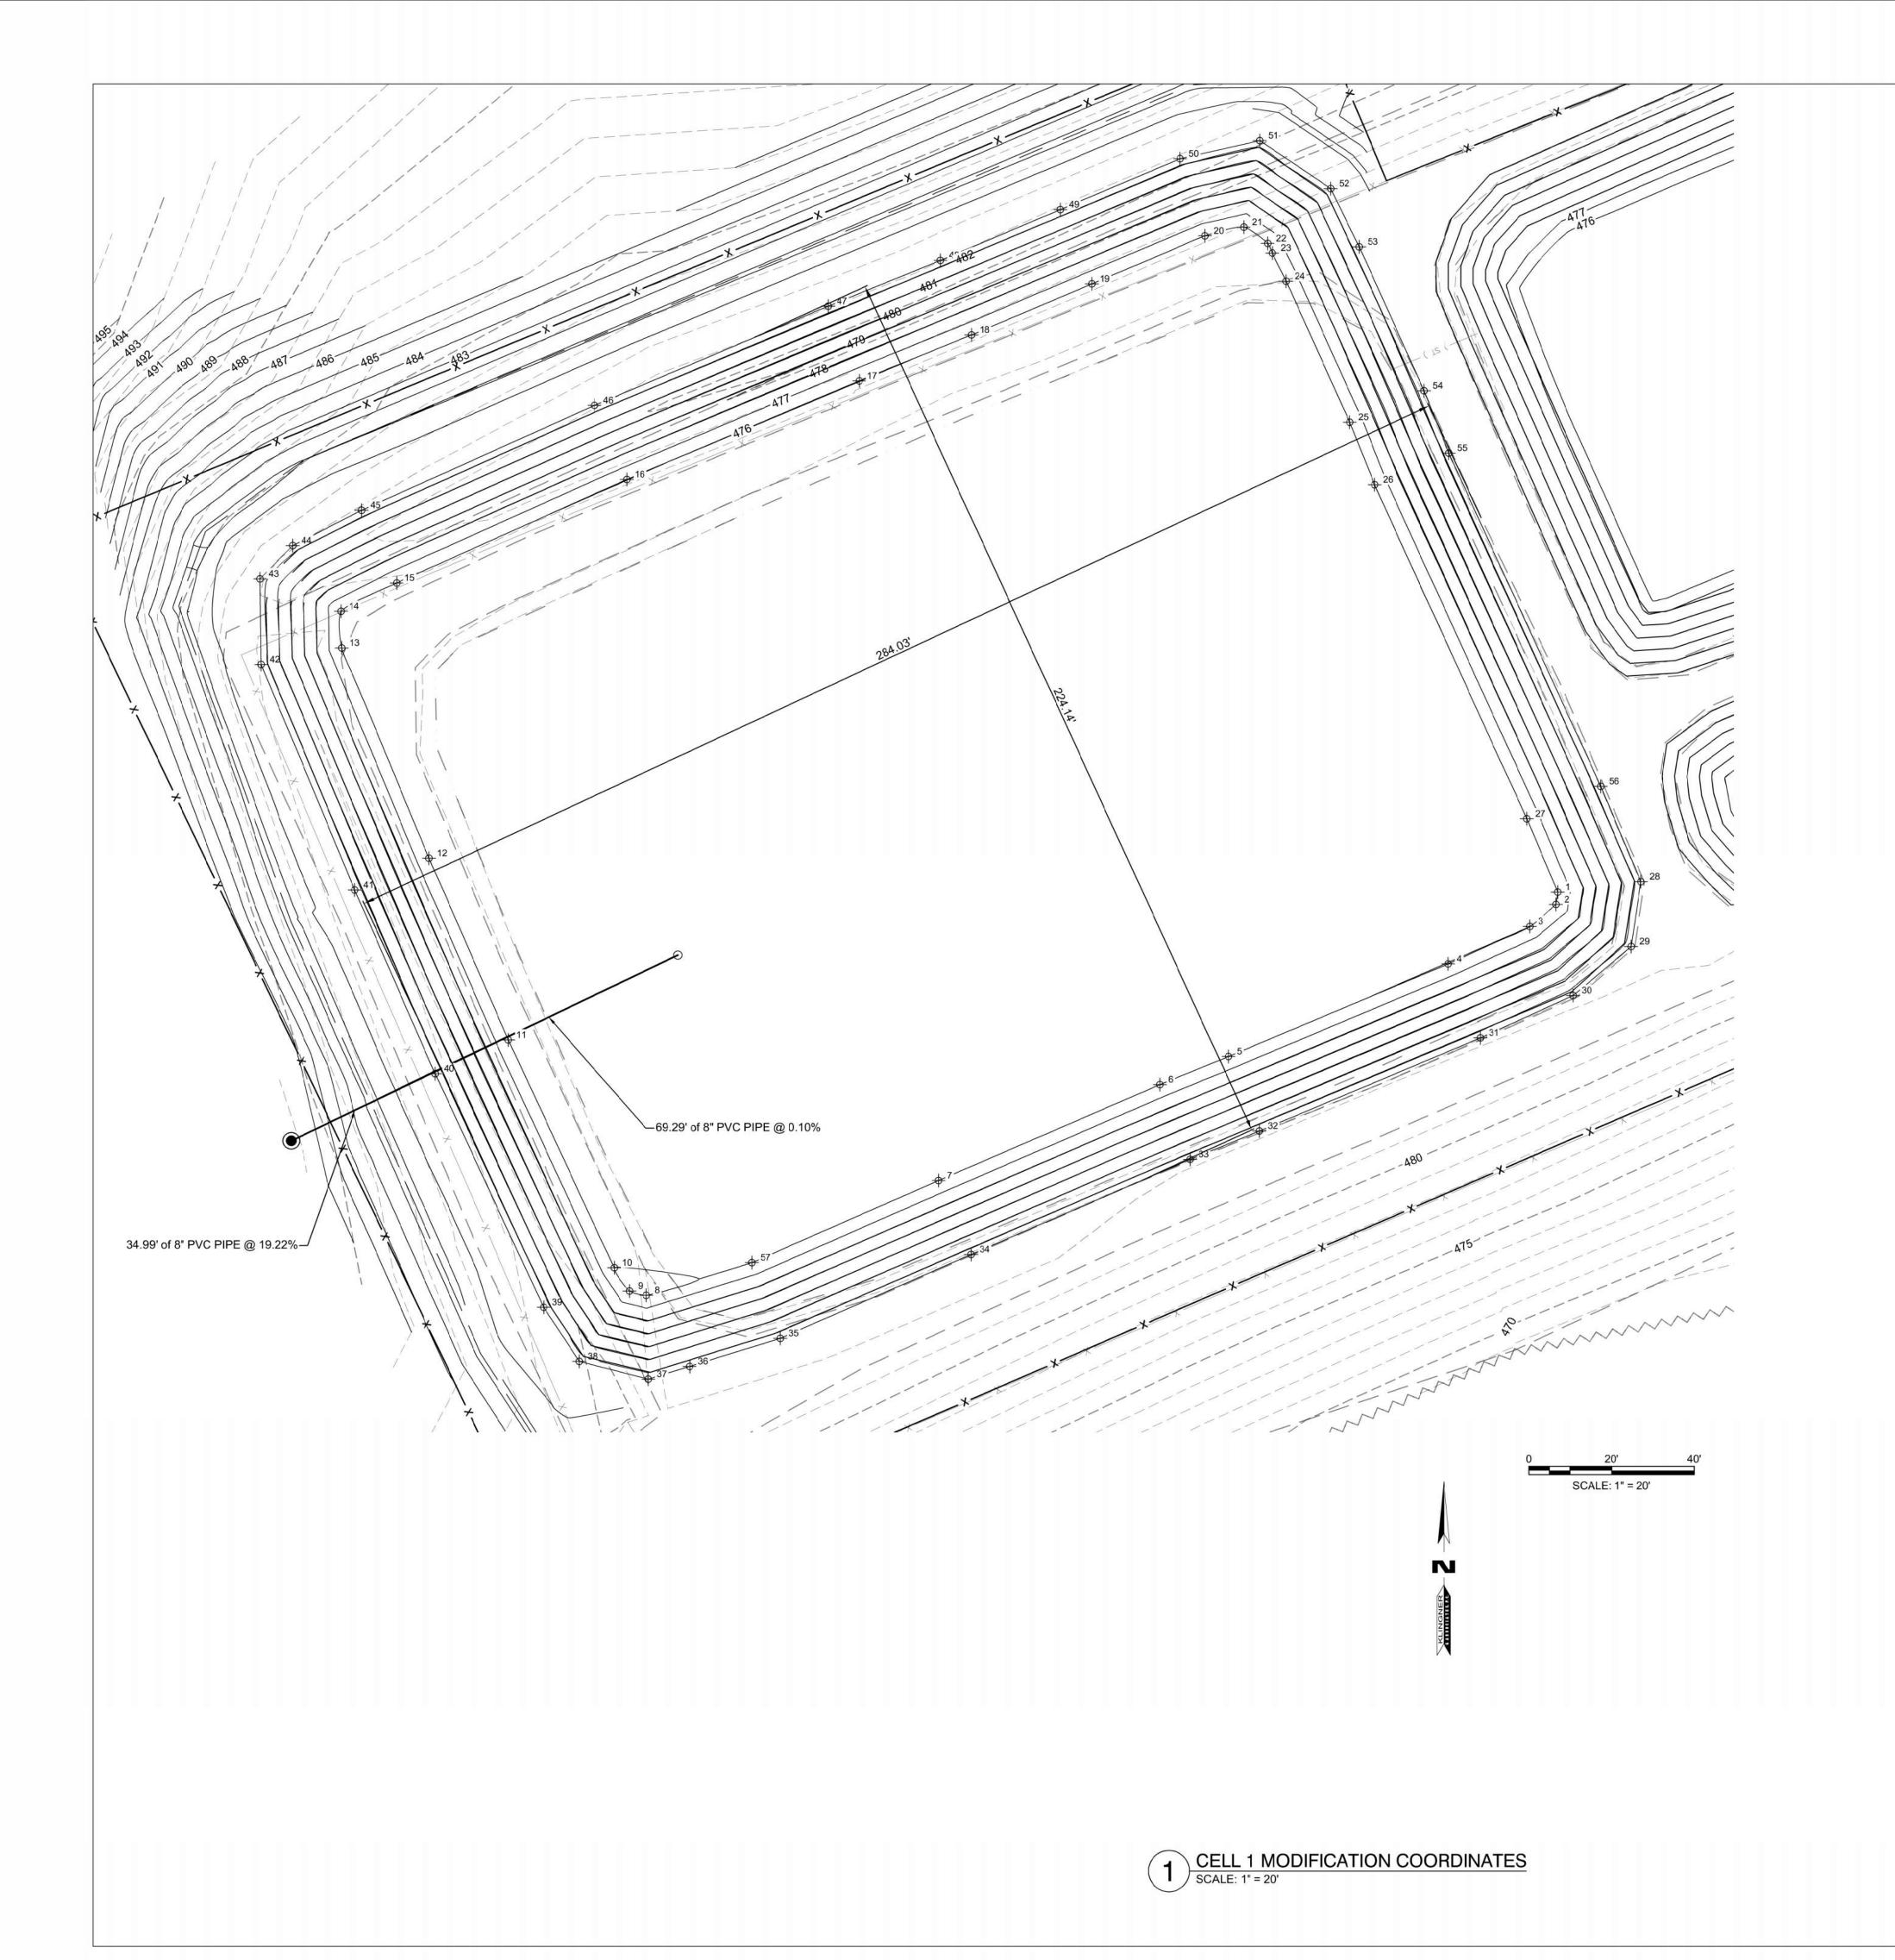

CELL 1 MODIFICATION COORDINATE POINTS

COORDINATE POINTS					
POINT #	ELEV	DESC.	NORTHING	EASTING	
1	476.0	CELL 1	388698.8364	881389.8199	
2	476.0	CELL 1	388695.8594	881389.3687	
3	476.0	CELL 1	388690.5554	881383.0372	
4	476.0	CELL 1	388681.4851	881363.2962	
5	476.0	CELL 1	388659.1211	881310.2624	
6	476.0	CELL 1	388652.3144	881293.6723	
7	476.0	CELL 1	388629.1684	881240.2290	
8	476.0	CELL 1	388601.4215	881169.5943	
9	476.0	CELL 1	388602.4664	881165.5308	
10	476.0	CELL 1	388608.0776	881161.8145	
11	476.0	CELL 1	388663.1070	881136.2661	
12	476.0	CELL 1	388707.0102	881117.0734	
13	476.0	CELL 1	388757.8133	881095.9826	
14	476.0	CELL 1	388766.6782	881095.8357	
15	476.0	CELL 1	388773.5073	881109.2252	
16	476.0	CELL 1	388798.5256	881164.8846	
	476.0	. 844 - 300 80			
17	2014-9-00-007	CELL 1	388822.3588	881221.0262 881248.1440	
18	476.0	CELL 1	388833.4349	881248.1440	
19	476.0	CELL 1	388845.7601		
20	476.0 476.0	CELL 1	388857.3612 388859.4833	881304.6116 881313.9326	
		0			
22	476.0	CELL 1	388855.5489	881319.7386	
23	476.0	CELL 1	388853.2082	881320.8767	
24	476.0	CELL 1	388846.4244	881324.1750	
25	476.0	CELL 1	388812.3410	881339.5741	
26	476.0	CELL 1	388797.2575	881345.5339	
27	476.0	CELL 1	388716.5530	881382.3243	
28	482.5	CELL 1	388701.3609	881409.9253	
29	482.5	CELL 1	388685.6919	881407.5503	
30	482.5		388673.8484	881393.5302	
31	482.5 482.5	CELL 1	388663.6275 388641.1165	881371.1344 881317.7520	
33	482.5	CELL 1	388634.2539	881301.0257	
34	482.5	CELL 1	388611.3058	881248.0504	
35	482.5	CELL 1	388591.0403	881201.9328	
36	482.5	CELL 1	388584.2372	881180.0121	
37	482.5	CELL 1	388581.1589	881170.0933	
38	482.5	CELL 1	388585.4479	881153.4133	
		MANAGE MARKAL SHAPE			
39 40	482.5 482.5	CELL 1	388598.5339 388654.9624	881144.7463 881118.5447	
41	482.5	CELL 1	388699.3657	881099.1333	
42	482.5	CELL 1	388753.8054	881076.5329	
43	482.5	CELL 1	388774.4979	881076.2649	
44	482.5	CELL 1	388782.5509	881084.1239	
45	482.5	CELL 1	388791.0879	881100.7738	
46	482.5	CELL 1	388816.3953	881157.0765	
47	482.5	CELL 1	388840.3606	881213.5294	
48	482.5	CELL 1	388851.4388	881240.6534	
1,000	(600-2000)	N-0-0-1			
49 50	482.5 482.5	CELL 1	388863.7148 388875.9907	881269.6249 881298.5963	
	482.5		250-000-00-000-00-00-00-00-00-00-00-00-00		
51	55000000000000	CELL 1	388880.3767	881317.8613	
52	482.5	CELL 1	388868.7658	881334.9952	
53	482.5	CELL 1	388854.7038	881341.8322	
54	482.5	CELL 1	388819.9369	881357.5402	
55	482.5	CELL 1	388804.8808	881363.4777	
56	482.5	CELL 1	388724.3989	881400.1783	
57	476.0	CELL 1	388609.3368	881195.0986	

STATE OF MISSOURI MICHAEL L. PARSON, GOVERNOR



JOSHUA D. HARTSOCK-ENGINEER MO # PE 2020000048



OFFICE OF ADMINISTRATION DIVISION OF FACILITIES MANAGEMENT, DESIGN AND CONSTRUCTION

DESIGN AND CONSTRUCT LAGOON EXPANSION

461 COUNTY ROAD 517 WAPPAPELLO, MO 63966

PROJECT # T2317-01 SITE # 6325 ASSET # 7016325013

REVISION:	
DATE:	
REVISION:	
DATE:	
REVISION:	
DATE:	
ISSUE DATE:	11-09-202

CAD DWG FILE:
DRAWING BY: JDH/MCB
CHECKED BY: MCB/JJN
DESIGNED BY: JDH/MCB/JJN

SHEET TITLE:
CELL 1 MODIFICATION
DETAILS &
COORDINATE TABLE

SHEET NUMBER:



CELL 2 MODIFICATION COORDINATE POINTS

58 476.0 CELL 2 388844.8787 881380.61 59 476.0 CELL 2 388851.0018 881384.93 60 476.0 CELL 2 388858.3579 881392.36 61 476.0 CELL 2 388869.8530 881418.45 62 476.0 CELL 2 388881.0142 881449.71 64 476.0 CELL 2 388882.9569 881452.37 65 476.0 CELL 2 388881.3169 881455.78 66 476.0 CELL 2 388865.9568 881457.64 67 476.0 CELL 2 388865.9268 881463.19 68 476.0 CELL 2 388806.8395 881491.52 71 476.0 CELL 2 388794.3876 881491.52 71 476.0 CELL 2 388794.3876 881491.52 71 476.0 CELL 2 388794.3876 881491.52 74 476.0 CELL 2 388794.3876 881414.70 75 476.0					
58 476.0 CELL 2 388844.8787 881380.61 59 476.0 CELL 2 388851.0018 881384.93 60 476.0 CELL 2 388858.3579 881392.36 61 476.0 CELL 2 388869.8530 881418.45 62 476.0 CELL 2 388881.0142 881445.27 63 476.0 CELL 2 388882.9569 881452.37 65 476.0 CELL 2 388881.3169 881455.78 66 476.0 CELL 2 388865.9568 881457.64 67 476.0 CELL 2 388865.9268 881463.19 68 476.0 CELL 2 388806.8395 881491.52 71 476.0 CELL 2 388804.1708 881491.52 71 476.0 CELL 2 388794.3876 881473.06 72 476.0 CELL 2 388794.3876 881473.06 73 476.0 CELL 2 388794.3876 881414.70 74 476.0		(COORDINA	ATE POINTS	
59 476.0 CELL 2 388851.0018 881382.36 60 476.0 CELL 2 388868.3579 881392.36 61 476.0 CELL 2 388869.8530 881418.45 62 476.0 CELL 2 388881.0142 881449.71 63 476.0 CELL 2 388882.9569 881452.37 65 476.0 CELL 2 388881.3169 881455.764 66 476.0 CELL 2 388881.3169 881457.64 67 476.0 CELL 2 388865.9268 881463.19 68 476.0 CELL 2 388806.8395 881491.52 70 476.0 CELL 2 388806.8395 881491.52 71 476.0 CELL 2 388798.0168 881491.95 72 476.0 CELL 2 388794.3876 881473.06 73 476.0 CELL 2 388794.3876 881413.70 75 476.0 CELL 2 388769.7926 881414.70 75 476.0	POINT #	ELEV	DESC.	NORTHING	EASTING
60	58	476.0	CELL 2	388844.8787	881380.61
61 476.0 CELL 2 388869.8530 881418.45 62 476.0 CELL 2 388881.0142 881445.27 63 476.0 CELL 2 388882.730 881449.71 64 476.0 CELL 2 388882.9569 881452.37 65 476.0 CELL 2 388881.3169 881455.78 66 476.0 CELL 2 388881.3169 881455.78 67 476.0 CELL 2 388865.9268 881452.63 68 476.0 CELL 2 388865.9268 881463.19 68 476.0 CELL 2 3888813.7008 881488.84 70 476.0 CELL 2 388806.8395 881491.52 71 476.0 CELL 2 388806.8395 881491.52 71 476.0 CELL 2 3888798.0168 881481.47 72 476.0 CELL 2 3888798.0168 881481.47 73 476.0 CELL 2 388798.0168 881481.47 74 476.0 CELL 2 388798.0168 881481.47 75 476.0 CELL 2 388782.7915 881446.96 76 476.0 CELL 2 388769.7926 881415.96 78 476.0 CELL 2 388769.9223 881412.73 80 476.0 CELL 2 388769.9226 881415.96 81 476.0 CELL 2 388769.8349 88141.73 80 476.0 CELL 2 388769.8349 88141.73 80 476.0 CELL 2 388769.838 81 477.0 CELL 2 388868.8395 881393.66 82 476.0 CELL 2 388878.4601 881406.16 81 476.0 CELL 2 388884.0645 881381.10 83 477.0 CELL 2 388860.8796 881393.66 84 477.0 CELL 2 388860.8796 881393.66 85 477.0 CELL 2 388885.2967 881382.63 85 477.0 CELL 2 388885.2967 881382.63 86 477.0 CELL 2 388885.918 88144.07 87 477.0 CELL 2 388885.918 88144.07 88 477.0 CELL 2 388885.918 88144.07 89 477.0 CELL 2 388885.918 88144.07 89 477.0 CELL 2 388885.935 88144.07 89 477.0 CELL 2 388886.036 88145.93 90 477.0 CELL 2 388878.7494 881460.35 91 477.0 CELL 2 388878.7494 881460.35 92 477.0 CELL 2 388879.795 881495.08 93 477.0 CELL 2 388879.795 881495.08 94 477.0 CELL 2 388879.795 881495.08 95 477.0 CELL 2 388879.795 881495.08 96 477.0 CELL 2 388879.798 881495.08 97 477.0 CELL 2 388860.8798 881495.08 98 477.0 CELL 2 388860.8798 881495.08 99 477.0 CELL 2 388860.8798 881495.08 91 477.0 CELL 2 388860.8798 881495.08 91 477.0 CELL 2 388860.8798 881495.08 91 477.0 CELL 2 388766.6115 881495.08 91 477.0 CELL 2 388766.6115 881495.08 91 477.0 CELL 2 388766.6115 881415.24 100 477.0 CELL 2 388766.6115 881415.24	59	476.0	CELL 2	388851.0018	881384.93
62 476.0 CELL 2 388881.0142 881445.27 63 476.0 CELL 2 388882.7730 881449.71 64 476.0 CELL 2 388882.9569 881452.37 65 476.0 CELL 2 388881.3169 881455.78 66 476.0 CELL 2 388877.4488 881457.64 67 476.0 CELL 2 388877.4488 881457.64 68 476.0 CELL 2 388865.9268 881463.19 68 476.0 CELL 2 388865.9268 881463.19 69 476.0 CELL 2 388806.8395 881491.52 71 476.0 CELL 2 388804.1708 881491.95 72 476.0 CELL 2 388798.0168 881481.47 74 476.0 CELL 2 388798.0168 881481.47 74 476.0 CELL 2 388798.0168 881481.47 75 476.0 CELL 2 388798.0168 881481.47 76 476.0 CELL 2 388798.0168 881481.47 77 476.0 CELL 2 388798.0168 881481.47 78 476.0 CELL 2 388798.0168 881481.47 79 476.0 CELL 2 388798.0168 881481.71 77 476.0 CELL 2 388798.0168 881481.71 78 476.0 CELL 2 388798.0168 881414.00 81 476.0 CELL 2 388769.5028 881411.72 80 476.0 CELL 2 388769.5028 881411.73 80 476.0 CELL 2 388783.4601 881406.16 81 476.0 CELL 2 388783.4601 881406.16 81 476.0 CELL 2 388885.9467 881393.66 82 476.0 CELL 2 388878.0645 881381.10 83 477.0 CELL 2 388865.8796 881393.66 84 477.0 CELL 2 388865.8796 881390.64 86 477.0 CELL 2 388865.7737 881444.07 87 477.0 CELL 2 388885.9467 881382.63 88 477.0 CELL 2 388885.9467 881382.63 89 477.0 CELL 2 388885.9467 881382.63 89 477.0 CELL 2 388885.9467 881382.63 90 477.0 CELL 2 388886.0046 881451.72 91 477.0 CELL 2 388885.9467 881382.63 92 477.0 CELL 2 388885.9467 881349.04 93 477.0 CELL 2 388885.935 881444.07 94 477.0 CELL 2 388886.036 88149.04 95 477.0 CELL 2 388887.7494 881460.35 96 477.0 CELL 2 388891.7384 88149.59 97 477.0 CELL 2 388801.7384 88149.59 98 477.0 CELL 2 388801.7384 88149.59 99 477.0 CELL 2 388860.0746 88145.52 90 477.0 CELL 2 388860.0746 88145.52 91 477.0 CELL 2 388860.0746 88145.52 91 477.0 CELL 2 388866.939 88144.91 96 477.0 CELL 2 388866.938 88149.90 98 477.0 CELL 2 388866.938 88149.90 98 477.0 CELL 2 388866.938 88149.90 98 477.0 CELL 2 388768.1644 881419.50 98 477.0 CELL 2 388768.6989 88149.50 99 477.0 CELL 2 388768.6989 88149.50 90 477.0 CELL 2 388766.9783 88149.50 91 477.0 CELL 2 388766.9783 88149.50 91 477.0 CELL 2	60	476.0	CELL 2	388858.3579	881392.36
63 476.0 CELL 2 388882.7730 881449.71 64 476.0 CELL 2 388882.9569 881452.37 65 476.0 CELL 2 388881.3169 881455.78 66 476.0 CELL 2 388877.4488 881457.64 67 476.0 CELL 2 388865.9268 881463.19 68 476.0 CELL 2 388865.9268 881463.19 68 476.0 CELL 2 388865.9268 881463.19 69 476.0 CELL 2 388866.8395 881491.52 71 476.0 CELL 2 388804.1708 881491.52 71 476.0 CELL 2 388804.1708 881491.93 72 476.0 CELL 2 388798.0168 881491.93 73 476.0 CELL 2 388798.0168 881473.06 75 476.0 CELL 2 388798.0168 881473.06 76 476.0 CELL 2 38879.7915 881446.96 76 476.0 CELL 2 38879.7926 881415.96 78 476.0 CELL 2 388769.7926 881415.96 78 476.0 CELL 2 388769.5628 881414.70 79 476.0 CELL 2 388769.2023 881412.73 80 476.0 CELL 2 388878.34601 881406.16 81 476.0 CELL 2 388881.3226 881393.66 82 476.0 CELL 2 388843.0645 881381.10 83 477.0 CELL 2 388852.9467 881382.63 84 477.0 CELL 2 388860.8796 881390.64 86 477.0 CELL 2 388872.6108 881417.27 87 477.0 CELL 2 388883.8035 881444.07 88 477.0 CELL 2 388883.8035 881444.07 88 477.0 CELL 2 388860.8796 881390.64 90 477.0 CELL 2 388883.8035 881444.07 88 477.0 CELL 2 388860.8796 881390.64 91 477.0 CELL 2 388863.034 881490.64 92 477.0 CELL 2 388863.035 881444.07 93 477.0 CELL 2 388883.8035 881444.07 94 477.0 CELL 2 388883.8035 881444.07 95 477.0 CELL 2 388883.8035 881444.07 96 477.0 CELL 2 388863.5638 881455.93 91 477.0 CELL 2 388863.5638 881455.93 93 477.0 CELL 2 388863.5638 881455.93 94 477.0 CELL 2 388863.5638 881455.93 95 477.0 CELL 2 388863.5638 881455.93 96 477.0 CELL 2 388863.5638 881455.93 97 477.0 CELL 2 388863.5638 881455.93 98 477.0 CELL 2 388863.5638 881455.93 99 477.0 CELL 2 388863.6344 881490.35 90 477.0 CELL 2 388863.6344 881490.35 91 477.0 CELL 2 388863.6348 881490.35 91 477.0 CELL 2 388863.6348 881490.35 91 477.0 CELL 2 388863.6348 881493.05 91 477.0 CELL 2 388863.6348 881493.05 91 477.0 CELL 2 388863.6348 881493.05 91 477.0 CELL 2 388663.6348 881493.05 91 477.0 CELL 2 388666.9783 881493.05 91 477.0 CELL 2 388766.9783 881410.32	61	476.0	CELL 2	388869.8530	881418.45
64 476.0 CELL 2 388882.9569 881452.37 65 476.0 CELL 2 38881.3169 881455.78 66 476.0 CELL 2 38887.4488 881457.64 67 476.0 CELL 2 388865.9268 881463.19 68 476.0 CELL 2 388865.9268 881463.19 68 476.0 CELL 2 388866.895 881491.52 70 476.0 CELL 2 388806.8395 881491.52 71 476.0 CELL 2 388804.1708 881491.95 72 476.0 CELL 2 388894.1708 881491.95 73 476.0 CELL 2 388798.0168 881481.47 74 476.0 CELL 2 388798.0168 881481.47 74 476.0 CELL 2 38879.3168 881481.47 75 476.0 CELL 2 38879.7915 881446.96 76 476.0 CELL 2 388799.7926 881415.96 78 476.0 CELL 2 388769.7926 881415.96 78 476.0 CELL 2 388769.7926 881415.96 81 476.0 CELL 2 388769.2023 881412.73 80 476.0 CELL 2 388769.2023 881412.73 80 476.0 CELL 2 388843.0645 881393.66 81 476.0 CELL 2 388843.0645 881393.66 82 476.0 CELL 2 388845.5074 881377.39 84 477.0 CELL 2 388860.8796 881390.64 85 477.0 CELL 2 388872.6108 881417.27 87 477.0 CELL 2 388883.8035 881444.07 88 477.0 CELL 2 388883.8035 881444.07 89 477.0 CELL 2 388886.0046 881452.95 90 477.0 CELL 2 388886.0046 881452.95 91 477.0 CELL 2 388886.0046 881452.95 91 477.0 CELL 2 388886.0046 881452.95 92 477.0 CELL 2 388886.0046 881452.95 93 477.0 CELL 2 388886.0046 881452.95 94 477.0 CELL 2 388886.0046 881452.95 95 477.0 CELL 2 388886.0046 881452.95 96 477.0 CELL 2 388886.0046 881452.95 97 477.0 CELL 2 388886.0046 881452.95 98 477.0 CELL 2 388886.0046 881452.95 99 477.0 CELL 2 388886.0046 881452.95 90 477.0 CELL 2 388886.0046 881452.95 91 477.0 CELL 2 388886.0046 881452.95 92 477.0 CELL 2 388886.0046 881452.95 93 477.0 CELL 2 388886.0046 881452.95 94 477.0 CELL 2 388860.0046 881452.95 95 477.0 CELL 2 388860.0046 881452.95 96 477.0 CELL 2 388860.0046 881452.95 97 477.0 CELL 2 388860.0046 881452.95 98 477.0 CELL 2 388860.0046 881452.95 99 477.0 CELL 2 388860.0046 881452.95 90 477.0 CELL 2 388860.0046 881452.95 91 477.0 CELL 2 388860.0046 881452.95 92 477.0 CELL 2 388860.0046 881452.95 93 477.0 CELL 2 388860.0046 881452.95 94 477.0 CELL 2 388860.0046 881490.004 95 477.0 CELL 2 388660.0046 881490.004 96 477.0 CELL 2 388660.0046 881490.	62	476.0	CELL 2	388881.0142	881445.27
65 476.0 CELL 2 38887.3169 881455.78 66 476.0 CELL 2 38887.4488 881457.64 67 476.0 CELL 2 388865.9268 881463.19 68 476.0 CELL 2 388865.9268 881463.19 69 476.0 CELL 2 388866.8395 881491.52 70 476.0 CELL 2 388806.8395 881491.52 71 476.0 CELL 2 388801.1708 881491.95 72 476.0 CELL 2 388801.1531 881490.36 73 476.0 CELL 2 388798.0168 881481.47 74 476.0 CELL 2 388798.0168 881481.47 74 476.0 CELL 2 388798.0168 881481.47 75 476.0 CELL 2 388762.7915 881446.96 76 476.0 CELL 2 388769.7926 881415.96 78 476.0 CELL 2 388769.7926 881415.96 78 476.0 CELL 2 388769.2023 881412.73 80 476.0 CELL 2 388769.2023 881412.73 80 476.0 CELL 2 388769.2023 881412.73 81 476.0 CELL 2 388863.4601 881406.16 81 476.0 CELL 2 388863.80645 881381.10 83 477.0 CELL 2 388863.80645 881381.10 83 477.0 CELL 2 388860.8796 881390.64 86 477.0 CELL 2 388876.6108 881417.27 87 477.0 CELL 2 388883.8035 881444.07 88 477.0 CELL 2 388860.8796 881390.64 89 477.0 CELL 2 388860.8796 881390.64 89 477.0 CELL 2 388885.7337 881449.04 89 477.0 CELL 2 388885.7337 881449.04 89 477.0 CELL 2 388885.958 88144.70 90 477.0 CELL 2 388885.958 88144.90 91 477.0 CELL 2 388885.958 88149.94 92 477.0 CELL 2 388885.958 88149.94 93 477.0 CELL 2 388885.958 88149.94 94 477.0 CELL 2 388885.9594 88149.94 95 477.0 CELL 2 388885.9594 88149.94 96 477.0 CELL 2 388887.2198 881465.89 91 477.0 CELL 2 388887.2198 881465.89 93 477.0 CELL 2 388887.2198 88149.95 94 477.0 CELL 2 388887.2198 88149.95 95 477.0 CELL 2 388887.2198 88149.95 96 477.0 CELL 2 388887.2198 88149.96 97 477.0 CELL 2 388878.7494 881490.35 98 477.0 CELL 2 388878.7494 881490.35 99 477.0 CELL 2 388860.046 881492.51 99 477.0 CELL 2 388860.046 881492.51 101 477.0 CELL 2 388860.036 881494.43 102 477.0 CELL 2 388866.046 881492.51 103 477.0 CELL 2 388866.046 881492.51 104 477.0 CELL 2 388866.046 881492.51 105 477.0 CELL 2 388766.998 881411.77 106 477.0 CELL 2 388766.998 881411.77 107 477.0 CELL 2 388766.998 881411.77 108 477.0 CELL 2 388766.998 881411.77 109 477.0 CELL 2 388766.998 881411.77	63	476.0	CELL 2	388882.7730	881449.71
66 476.0 CELL 2 388877.4488 881457.64 67 476.0 CELL 2 388865.9268 881463.19 68 476.0 CELL 2 388865.9268 881471.46 69 476.0 CELL 2 388813.7008 881488.84 70 476.0 CELL 2 388806.8395 881491.52 71 476.0 CELL 2 388804.1708 881491.95 72 476.0 CELL 2 388798.0168 881491.95 73 476.0 CELL 2 388798.0168 881481.47 74 476.0 CELL 2 388798.0168 881481.47 74 476.0 CELL 2 388798.9168 881481.47 75 476.0 CELL 2 388798.9168 881481.47 76 476.0 CELL 2 388799.9349 881418.71 77 476.0 CELL 2 388769.7926 881415.96 78 476.0 CELL 2 388769.7926 881415.96 78 476.0 CELL 2 388769.2023 881412.73 80 476.0 CELL 2 388769.2023 881412.73 80 476.0 CELL 2 388878.4601 881406.16 81 476.0 CELL 2 388878.4601 881406.16 81 476.0 CELL 2 388881.3226 881393.66 82 476.0 CELL 2 388843.0645 881381.10 83 477.0 CELL 2 388860.8796 881390.64 86 477.0 CELL 2 388883.8035 881444.07 87 477.0 CELL 2 388883.8035 881444.07 88 477.0 CELL 2 388883.8035 881444.07 89 477.0 CELL 2 388883.8035 881444.07 89 477.0 CELL 2 388883.6638 88149.94 90 477.0 CELL 2 388883.6638 88149.94 91 477.0 CELL 2 388883.6638 88149.94 92 477.0 CELL 2 388883.6638 88149.94 93 477.0 CELL 2 388883.8035 881444.07 94 477.0 CELL 2 388883.8035 881444.07 95 477.0 CELL 2 388883.8035 881444.07 96 477.0 CELL 2 388883.8035 881444.07 97 477.0 CELL 2 388883.8035 881449.94 98 477.0 CELL 2 388883.6638 88149.94 99 477.0 CELL 2 388883.6638 88149.94 90 477.0 CELL 2 388883.6638 88149.94 91 477.0 CELL 2 388883.6638 88149.95 91 477.0 CELL 2 388893.5838 88149.95 92 477.0 CELL 2 388893.5838 881495.08 93 477.0 CELL 2 388893.5838 881495.08 94 477.0 CELL 2 388893.6338 88149.95 95 477.0 CELL 2 388893.6338 88149.95 96 477.0 CELL 2 388866.046 881494.43	64	476.0	CELL 2	388882.9569	881452.37
67 476.0 CELL 2 388865.9268 881463.19 68 476.0 CELL 2 388848.9694 881471.46 69 476.0 CELL 2 388813.7008 881488.84 70 476.0 CELL 2 388806.8395 881491.52 71 476.0 CELL 2 388804.1708 881491.95 72 476.0 CELL 2 388798.0168 881481.47 73 476.0 CELL 2 388798.0168 881481.47 74 476.0 CELL 2 388794.3876 881473.06 75 476.0 CELL 2 388794.3876 881473.06 76 476.0 CELL 2 38879.9349 881418.71 77 476.0 CELL 2 388769.7926 881415.96 78 476.0 CELL 2 388769.7926 881415.96 78 476.0 CELL 2 388769.2023 881412.73 80 476.0 CELL 2 388769.2023 881412.73 80 476.0 CELL 2 388769.2023 881412.73 80 476.0 CELL 2 388869.8040 881383.666 81 476.0 CELL 2 388869.8046 881383.666 82 476.0 CELL 2 388843.0645 881381.10 83 477.0 CELL 2 388852.9467 881382.63 84 477.0 CELL 2 388860.8796 881390.64 86 477.0 CELL 2 388872.6108 881417.27 87 477.0 CELL 2 388872.6108 881417.27 88 477.0 CELL 2 388885.8936 881444.07 89 477.0 CELL 2 388885.8946 88149.04 89 477.0 CELL 2 388866.0046 881452.95 90 477.0 CELL 2 388867.2198 881465.89 91 477.0 CELL 2 388886.2954 881465.89 93 477.0 CELL 2 388887.2198 881465.89 94 477.0 CELL 2 388887.2198 881465.89 95 477.0 CELL 2 388879.325 881449.04 89 477.0 CELL 2 388887.2198 881465.89 91 477.0 CELL 2 388867.2198 881465.89 93 477.0 CELL 2 388879.7295 881490.03 94 477.0 CELL 2 388879.737 881449.04 95 477.0 CELL 2 388879.737 881449.04 96 477.0 CELL 2 388879.6336 881494.43 96 477.0 CELL 2 388879.6336 881494.43 96 477.0 CELL 2 388879.6336 881494.43 96 477.0 CELL 2 388879.6336 881490.03 97 477.0 CELL 2 388879.7394 881465.89 98 477.0 CELL 2 388879.6336 881490.03 98 477.0 CELL 2 388860.3738 881490.03 98 477.0 CELL 2 388860.3738 881490.03 98 477.0 CELL 2 388860.3998 881466.82 100 477.0 CELL 2 388798.7295 881492.51	65	476.0	CELL 2	388881.3169	881455.78
68	66	476.0	CELL 2	388877.4488	881457.64
69	67	476.0	CELL 2	388865.9268	881463.19
70	68	476.0	CELL 2	388848.9694	881471.46
71 476.0 CELL 2 388804.1708 881491.95 72 476.0 CELL 2 388801.1531 881490.36 73 476.0 CELL 2 388798.0168 881481.47 74 476.0 CELL 2 388794.3876 881473.06 75 476.0 CELL 2 388769.7926 881418.71 77 476.0 CELL 2 388769.7926 881415.96 78 476.0 CELL 2 388769.2023 881415.70 79 476.0 CELL 2 388769.2023 881412.73 80 476.0 CELL 2 388769.2023 881412.73 80 476.0 CELL 2 388783.4601 881406.16 81 476.0 CELL 2 388843.0645 881381.10 82 476.0 CELL 2 388845.5074 881377.39 84 477.0 CELL 2 388865.9467 881382.63 85 477.0 CELL 2 388886.876 881444.07 88 477.0	69	476.0	CELL 2	388813.7008	881488.84
72 476.0 CELL 2 388801.1531 881490.36 73 476.0 CELL 2 388798.0168 881481.47 74 476.0 CELL 2 388794.3876 881473.06 75 476.0 CELL 2 388782.7915 881446.96 76 476.0 CELL 2 388769.7926 881415.71 77 476.0 CELL 2 388769.5628 881414.70 79 476.0 CELL 2 388769.2023 881412.73 80 476.0 CELL 2 388783.4601 881406.16 81 476.0 CELL 2 388843.0645 881393.66 82 476.0 CELL 2 388845.5074 881377.39 84 477.0 CELL 2 388865.9467 881382.63 85 477.0 CELL 2 388865.9467 881390.64 86 477.0 CELL 2 388885.7337 881449.04 89 477.0 CELL 2 388886.0046 881452.96 90 477.0	70	476.0	CELL 2	388806.8395	881491.52
73 476.0 CELL 2 388798.0168 881481.47 74 476.0 CELL 2 388794.3876 881473.06 75 476.0 CELL 2 388770.9349 881418.71 76 476.0 CELL 2 388769.7926 881418.71 77 476.0 CELL 2 388769.7926 881415.96 78 476.0 CELL 2 388769.5628 881414.70 79 476.0 CELL 2 388769.2023 881412.73 80 476.0 CELL 2 388843.4601 881406.16 81 476.0 CELL 2 388843.0645 881381.10 82 476.0 CELL 2 388845.5074 881387.39 84 477.0 CELL 2 388865.9467 881382.63 85 477.0 CELL 2 388860.8796 881390.64 86 477.0 CELL 2 388885.7337 881444.07 89 477.0 CELL 2 388886.0046 881452.96 90 477.0	71	476.0	CELL 2	388804.1708	881491.95
74 476.0 CELL 2 388794.3876 881473.06 75 476.0 CELL 2 388782.7915 881446.96 76 476.0 CELL 2 388770.9349 881418.71 77 476.0 CELL 2 388769.7926 881415.96 78 476.0 CELL 2 388769.5628 881412.73 80 476.0 CELL 2 388769.2023 881412.73 80 476.0 CELL 2 38873.4601 881406.16 81 476.0 CELL 2 388843.0645 881391.66 82 476.0 CELL 2 388843.0645 881381.10 83 477.0 CELL 2 388852.9467 881392.63 84 477.0 CELL 2 388860.8796 881390.64 86 477.0 CELL 2 388883.8035 881441.07 87 477.0 CELL 2 388885.7337 881449.04 89 477.0 CELL 2 388860.046 881455.95 90 477.0	72	476.0	CELL 2	388801.1531	881490.36
75 476.0 CELL 2 388782.7915 881446.96 76 476.0 CELL 2 388770.9349 881418.71 77 476.0 CELL 2 388769.7926 881415.96 78 476.0 CELL 2 388769.5628 881412.73 80 476.0 CELL 2 388783.4601 881406.16 81 476.0 CELL 2 388843.0645 881381.00 82 476.0 CELL 2 388845.5074 881387.33 84 477.0 CELL 2 388860.8796 881382.63 85 477.0 CELL 2 388860.8796 881390.64 86 477.0 CELL 2 388860.8796 881390.64 87 477.0 CELL 2 388885.7337 881444.07 88 477.0 CELL 2 388886.0046 881452.95 90 477.0 CELL 2 388878.7494 881460.35 91 477.0 CELL 2 388867.2198 881474.15 92 477.0	73	476.0	CELL 2	388798.0168	881481.47
76 476.0 CELL 2 388770.9349 881418.71 77 476.0 CELL 2 388769.7926 881415.96 78 476.0 CELL 2 388769.5628 881414.70 79 476.0 CELL 2 388769.2023 881412.73 80 476.0 CELL 2 388783.4601 881406.16 81 476.0 CELL 2 388843.0645 881393.66 82 476.0 CELL 2 388845.5074 881377.39 84 477.0 CELL 2 388860.8796 881390.64 85 477.0 CELL 2 388860.8796 881390.64 86 477.0 CELL 2 388883.8035 881441.07.27 87 477.0 CELL 2 388885.7337 881449.04 89 477.0 CELL 2 388886.0046 881452.95 90 477.0 CELL 2 388878.7494 881460.35 91 477.0 CELL 2 388878.7494 881465.89 93 477.0	74	476.0	CELL 2	388794.3876	881473.06
77 476.0 CELL 2 388769.7926 881415.96 78 476.0 CELL 2 388769.5628 881414.70 79 476.0 CELL 2 388769.2023 881412.73 80 476.0 CELL 2 388783.4601 881406.16 81 476.0 CELL 2 388843.0645 881393.66 82 476.0 CELL 2 388845.5074 881387.39 84 477.0 CELL 2 388860.8796 881382.63 85 477.0 CELL 2 388860.8796 881390.64 86 477.0 CELL 2 388863.8035 881441.07 87 477.0 CELL 2 388883.8035 881444.07 88 477.0 CELL 2 388885.7337 881449.04 89 477.0 CELL 2 388865.0046 881452.95 90 477.0 CELL 2 38887.7494 881460.35 91 477.0 CELL 2 38887.2198 881465.89 93 477.0	75	476.0	CELL 2	388782.7915	881446.96
78 476.0 CELL 2 388769.5628 881414.70 79 476.0 CELL 2 388769.2023 881412.73 80 476.0 CELL 2 388769.2023 881412.73 81 476.0 CELL 2 388811.3226 881393.66 82 476.0 CELL 2 388843.0645 881381.10 83 477.0 CELL 2 388852.9467 881382.63 84 477.0 CELL 2 388860.8796 881390.64 86 477.0 CELL 2 388872.6108 881417.27 87 477.0 CELL 2 388883.8035 881444.07 88 477.0 CELL 2 388885.7337 881449.04 89 477.0 CELL 2 388886.0046 881452.95 90 477.0 CELL 2 388887.494 881460.35 91 477.0 CELL 2 388867.2198 881476.89 93 477.0 CELL 2 388876.2954 881477.15 94 477.0	76	476.0	CELL 2	388770.9349	881418.71
79 476.0 CELL 2 388769.2023 881412.73 80 476.0 CELL 2 388783.4601 881406.16 81 476.0 CELL 2 388841.3226 881393.66 82 476.0 CELL 2 388843.0645 881381.10 83 477.0 CELL 2 388852.9467 881382.63 85 477.0 CELL 2 388860.8796 881390.64 86 477.0 CELL 2 388872.6108 881417.27 87 477.0 CELL 2 388883.8035 881444.07 88 477.0 CELL 2 388885.7337 881449.04 89 477.0 CELL 2 388886.0046 881452.95 90 477.0 CELL 2 388878.7494 881460.35 91 477.0 CELL 2 388867.2198 881474.15 92 477.0 CELL 2 388878.2954 881474.15 94 477.0 CELL 2 388807.6336 881494.03 95 477.0	77	476.0	CELL 2	388769.7926	881415.96
80 476.0 CELL 2 388783.4601 881406.16 81 476.0 CELL 2 388811.3226 881393.66 82 476.0 CELL 2 388843.0645 881381.10 83 477.0 CELL 2 388845.5074 881377.39 84 477.0 CELL 2 388852.9467 881382.63 85 477.0 CELL 2 388860.8796 881390.64 86 477.0 CELL 2 388872.6108 881417.27 87 477.0 CELL 2 388883.8035 881444.07 88 477.0 CELL 2 388886.0046 881452.95 89 477.0 CELL 2 388886.0046 881452.95 90 477.0 CELL 2 388878.7494 881466.89 91 477.0 CELL 2 388867.2198 881465.89 93 477.0 CELL 2 388807.6336 881491.59 94 477.0 CELL 2 388807.6336 881494.03 95 477.0	78	476.0	CELL 2	388769.5628	881414.70
81 476.0 CELL 2 388811.3226 881393.66 82 476.0 CELL 2 388843.0645 881381.10 83 477.0 CELL 2 388845.5074 881377.39 84 477.0 CELL 2 388852.9467 881382.63 85 477.0 CELL 2 388860.8796 881390.64 86 477.0 CELL 2 388883.8035 8814417.27 87 477.0 CELL 2 388885.7337 881449.04 89 477.0 CELL 2 388886.0046 881452.95 90 477.0 CELL 2 388883.5658 881458.03 91 477.0 CELL 2 388887.7494 881460.36 92 477.0 CELL 2 388867.2198 881465.89 93 477.0 CELL 2 388867.2198 881491.59 94 477.0 CELL 2 388803.5838 881494.43 95 477.0 CELL 2 388803.5838 881494.43 96 477.0 CELL 2 388807.6336 881494.43 97 477.0 CELL 2 388801.7384 881492.51 98 477.0 CELL 2 388795.2244 881482.56 100 477.0 CELL 2 388795.2244 881482.56 101 477.0 CELL 2 388796.0374 881448.15 102 477.0 CELL 2 388766.8989 881416.82 104 477.0 CELL 2 388766.8989 881416.82 105 477.0 CELL 2 388766.9783 881411.77 106 477.0 CELL 2 388765.9789 881411.77 106 477.0 CELL 2 388765.9789 881411.77	79	476.0	CELL 2	388769.2023	881412.73
82 476.0 CELL 2 388843.0645 881381.10 83 477.0 CELL 2 388845.5074 881377.39 84 477.0 CELL 2 388852.9467 881382.63 85 477.0 CELL 2 388860.8796 881390.64 86 477.0 CELL 2 3888872.6108 881417.27 87 477.0 CELL 2 388883.8035 881444.07 88 477.0 CELL 2 388885.7337 881449.04 89 477.0 CELL 2 388886.0046 881452.95 90 477.0 CELL 2 388887.7494 881460.35 91 477.0 CELL 2 388867.2198 881465.89 92 477.0 CELL 2 388867.2198 881474.15 94 477.0 CELL 2 388887.6336 881494.43 95 477.0 CELL 2 388803.5838 881494.43 96 477.0 CELL 2 388803.5838 881494.43 97 477.0 CELL 2 388801.7384 881494.00 98 477.0 CELL 2 388795.2244 881492.51 99 477.0 CELL 2 388795.2244 881482.56 100 477.0 CELL 2 388795.2244 881482.56 101 477.0 CELL 2 388796.6915 881492.51 102 477.0 CELL 2 388766.8989 881416.82 104 477.0 CELL 2 388766.8989 881411.77 106 477.0 CELL 2 388766.9783 881411.77 106 477.0 CELL 2 388766.9783 881410.45 107 477.0 CELL 2 388766.9783 881410.45	80	476.0	CELL 2	388783.4601	881406.16
83 477.0 CELL 2 388845.5074 881377.39 84 477.0 CELL 2 388852.9467 881382.63 85 477.0 CELL 2 388860.8796 881390.64 86 477.0 CELL 2 388872.6108 881417.27 87 477.0 CELL 2 388883.8035 881444.07 88 477.0 CELL 2 388885.7337 881449.04 89 477.0 CELL 2 388886.0046 881452.95 90 477.0 CELL 2 388883.5658 881458.03 91 477.0 CELL 2 388867.2198 881465.89 92 477.0 CELL 2 388867.2198 881465.89 93 477.0 CELL 2 388867.2198 881491.59 94 477.0 CELL 2 388807.6336 881494.43 96 477.0 CELL 2 388807.6336 881494.43 96 477.0 CELL 2 388801.7384 881494.00 97 477.0 CELL 2 388891.7384 881492.51 99 477.0 CELL 2 388795.2244 881482.56 100 477.0 CELL 2 388795.2244 881482.56 100 477.0 CELL 2 388796.899 881416.82 101 477.0 CELL 2 388766.8989 881416.82 102 477.0 CELL 2 388766.8989 881416.82 103 477.0 CELL 2 388766.8989 881411.77 106 477.0 CELL 2 388766.9783 881410.45 107 477.0 CELL 2 388766.9783 881410.45 107 477.0 CELL 2 388766.9783 881410.45	81	476.0	CELL 2	388811.3226	881393.66
84 477.0 CELL 2 388852.9467 881382.63 85 477.0 CELL 2 388860.8796 881390.64 86 477.0 CELL 2 388872.6108 881417.27 87 477.0 CELL 2 388883.8035 881444.07 88 477.0 CELL 2 388885.7337 881449.04 89 477.0 CELL 2 388886.0046 881452.95 90 477.0 CELL 2 388883.5658 881458.03 91 477.0 CELL 2 388878.7494 881460.35 92 477.0 CELL 2 388867.2198 881465.89 93 477.0 CELL 2 388850.2954 881474.15 94 477.0 CELL 2 388807.6336 881494.43 95 477.0 CELL 2 388803.5838 881495.08 97 477.0 CELL 2 388803.5838 881494.00 98 477.0 CELL 2 388798.7295 881492.51 99 477.0 CELL 2 388795.2244 881492.56 100 477.0	82	476.0	CELL 2	388843.0645	881381.10
85 477.0 CELL 2 388860.8796 881390.64 86 477.0 CELL 2 388872.6108 881417.27 87 477.0 CELL 2 388883.8035 881444.07 88 477.0 CELL 2 388885.7337 881449.04 89 477.0 CELL 2 388886.0046 881452.95 90 477.0 CELL 2 388883.5658 881458.03 91 477.0 CELL 2 388878.7494 881460.35 92 477.0 CELL 2 388867.2198 881465.89 93 477.0 CELL 2 388850.2954 881474.15 94 477.0 CELL 2 388807.6336 881491.59 95 477.0 CELL 2 388807.6336 881494.43 96 477.0 CELL 2 388801.7384 881495.08 97 477.0 CELL 2 388798.7295 881492.51 98 477.0 CELL 2 388795.2244 881482.56 100 477.0 CELL 2 388768.1644 881419.86 101 477.0	83	477.0	CELL 2	388845.5074	881377.39
86 477.0 CELL 2 388872.6108 881417.27 87 477.0 CELL 2 388883.8035 881444.07 88 477.0 CELL 2 388885.7337 881449.04 89 477.0 CELL 2 388886.0046 881452.95 90 477.0 CELL 2 388878.7494 881460.35 91 477.0 CELL 2 388867.2198 881465.89 93 477.0 CELL 2 388850.2954 881474.15 94 477.0 CELL 2 388807.6336 881491.59 95 477.0 CELL 2 388807.6336 881494.43 96 477.0 CELL 2 388803.5838 881494.00 97 477.0 CELL 2 388798.7295 881492.51 99 477.0 CELL 2 388795.2244 881482.56 100 477.0 CELL 2 388780.0374 881474.26 101 477.0 CELL 2 388766.8989 881416.82 103 477.0 CELL 2 388766.6115 881415.24 105 477.0	84	477.0	CELL 2	388852.9467	881382.63
87 477.0 CELL 2 388883.8035 881444.07 88 477.0 CELL 2 388885.7337 881449.04 89 477.0 CELL 2 388886.0046 881452.95 90 477.0 CELL 2 388883.5658 881458.03 91 477.0 CELL 2 3888878.7494 881460.35 92 477.0 CELL 2 388867.2198 881465.89 93 477.0 CELL 2 388867.2198 881474.15 94 477.0 CELL 2 388807.6336 881494.43 95 477.0 CELL 2 388807.6336 881494.43 96 477.0 CELL 2 388803.5838 881495.08 97 477.0 CELL 2 388801.7384 881494.00 98 477.0 CELL 2 388798.7295 881492.51 99 477.0 CELL 2 388795.2244 881482.56 100 477.0 CELL 2 388791.6397 881474.26 101 477.0 CELL 2 388768.1644 881419.86 103 477.0 CELL 2 388766.8989 881416.82 104 477.0 CELL 2 388766.6115 881415.24 105 477.0 CELL 2 388766.9783 881411.77 106 477.0 CELL 2 388766.9783 881410.45 107 477.0 CELL 2 388766.9783 881410.45	85	477.0	CELL 2	388860.8796	881390.64
88	86	477.0	CELL 2	388872.6108	881417.27
89 477.0 CELL 2 388886.0046 881452.95 90 477.0 CELL 2 388883.5658 881458.03 91 477.0 CELL 2 388878.7494 881460.35 92 477.0 CELL 2 388867.2198 881465.89 93 477.0 CELL 2 388850.2954 881474.15 94 477.0 CELL 2 388807.6336 881491.59 95 477.0 CELL 2 388807.6336 881494.43 96 477.0 CELL 2 388803.5838 881495.08 97 477.0 CELL 2 388801.7384 881494.00 98 477.0 CELL 2 388798.7295 881492.51 99 477.0 CELL 2 388791.6397 881474.26 100 477.0 CELL 2 388780.0374 881474.26 101 477.0 CELL 2 388766.8989 881416.82 103 477.0 CELL 2 388766.815 881415.24 104 477.0 CELL 2 388766.9783 881411.77 106 477.0	87	477.0	CELL 2	388883.8035	881444.07
90 477.0 CELL 2 388883.5658 881458.03 91 477.0 CELL 2 388878.7494 881460.35 92 477.0 CELL 2 388867.2198 881465.89 93 477.0 CELL 2 388850.2954 881474.15 94 477.0 CELL 2 388814.9111 881491.59 95 477.0 CELL 2 388807.6336 881494.43 96 477.0 CELL 2 388803.5838 881495.08 97 477.0 CELL 2 388801.7384 881494.00 98 477.0 CELL 2 388798.7295 881492.51 99 477.0 CELL 2 388795.2244 881482.56 100 477.0 CELL 2 388791.6397 881474.26 101 477.0 CELL 2 388780.0374 881448.15 102 477.0 CELL 2 388766.8989 881416.82 104 477.0 CELL 2 388766.8989 881416.82 105 477.0 CELL 2 388765.9789 881411.77 106 477.0 CELL 2 388766.9783 881410.45 107 477.0 CELL 2 388766.9783 881410.45 107 477.0 CELL 2 388766.9783 881410.45	88	477.0	CELL 2	388885.7337	881449.04
91 477.0 CELL 2 388878.7494 881460.38 92 477.0 CELL 2 388867.2198 881465.89 93 477.0 CELL 2 388850.2954 881474.15 94 477.0 CELL 2 388814.9111 881491.59 95 477.0 CELL 2 388807.6336 881494.43 96 477.0 CELL 2 388803.5838 881495.08 97 477.0 CELL 2 388801.7384 881494.00 98 477.0 CELL 2 388798.7295 881492.51 99 477.0 CELL 2 388795.2244 881482.56 100 477.0 CELL 2 388791.6397 881474.26 101 477.0 CELL 2 388780.0374 881448.15 102 477.0 CELL 2 388766.8989 881416.82 104 477.0 CELL 2 388766.6115 881415.24 105 477.0 CELL 2 388766.9783 881411.77 106 477.0 CELL 2 388766.9783 881410.45 107 477.0 CELL 2 388782.2184 881403.43	89	477.0	CELL 2	388886.0046	881452.95
92 477.0 CELL 2 388867.2198 881465.89 93 477.0 CELL 2 388850.2954 881474.15 94 477.0 CELL 2 388814.9111 881491.59 95 477.0 CELL 2 388807.6336 881494.43 96 477.0 CELL 2 388803.5838 881495.08 97 477.0 CELL 2 388801.7384 881494.00 98 477.0 CELL 2 388798.7295 881492.51 99 477.0 CELL 2 388795.2244 881482.56 100 477.0 CELL 2 388791.6397 881474.26 101 477.0 CELL 2 388780.0374 881448.15 102 477.0 CELL 2 388766.8989 881416.82 104 477.0 CELL 2 388766.6115 881415.24 105 477.0 CELL 2 388765.9789 881411.77 106 477.0 CELL 2 388766.9783 881410.45 107 477.0 CELL 2 388782.2184 881403.43	90	477.0	CELL 2	388883.5658	881458.03
93 477.0 CELL 2 388850.2954 881474.15 94 477.0 CELL 2 388814.9111 881491.59 95 477.0 CELL 2 388807.6336 881494.43 96 477.0 CELL 2 388803.5838 881495.08 97 477.0 CELL 2 388801.7384 881494.00 98 477.0 CELL 2 388798.7295 881492.51 99 477.0 CELL 2 388795.2244 881482.56 100 477.0 CELL 2 388791.6397 881474.26 101 477.0 CELL 2 388780.0374 881448.15 102 477.0 CELL 2 388766.8989 881416.82 104 477.0 CELL 2 388766.6115 881415.24 105 477.0 CELL 2 388765.9789 881411.77 106 477.0 CELL 2 388766.9783 881410.45 107 477.0 CELL 2 388766.9783 881410.45	91	477.0	CELL 2	388878.7494	881460.35
94 477.0 CELL 2 388814.9111 881491.59 95 477.0 CELL 2 388807.6336 881494.43 96 477.0 CELL 2 388803.5838 881495.08 97 477.0 CELL 2 388801.7384 881494.00 98 477.0 CELL 2 388798.7295 881492.51 99 477.0 CELL 2 388795.2244 881482.56 100 477.0 CELL 2 388791.6397 881474.26 101 477.0 CELL 2 388780.0374 881448.15 102 477.0 CELL 2 388766.8949 881419.86 103 477.0 CELL 2 388766.6915 881415.24 105 477.0 CELL 2 388765.9789 881411.77 106 477.0 CELL 2 388766.9783 881410.45 107 477.0 CELL 2 388782.2184 881403.43	92	477.0	CELL 2	388867.2198	881465.89
95 477.0 CELL 2 388807.6336 881494.43 96 477.0 CELL 2 388803.5838 881495.08 97 477.0 CELL 2 388801.7384 881494.00 98 477.0 CELL 2 388798.7295 881492.51 99 477.0 CELL 2 388795.2244 881482.56 100 477.0 CELL 2 388791.6397 881474.26 101 477.0 CELL 2 388780.0374 881448.15 102 477.0 CELL 2 388768.1644 881419.86 103 477.0 CELL 2 388766.8989 881416.82 104 477.0 CELL 2 388766.6115 881415.24 105 477.0 CELL 2 388765.9789 881411.77 106 477.0 CELL 2 388766.9783 881410.45 107 477.0 CELL 2 388782.2184 881403.43	93	477.0	CELL 2	388850.2954	881474.15
96 477.0 CELL 2 388803.5838 881495.08 97 477.0 CELL 2 388801.7384 881494.00 98 477.0 CELL 2 388798.7295 881492.51 99 477.0 CELL 2 388795.2244 881482.56 100 477.0 CELL 2 388791.6397 881474.26 101 477.0 CELL 2 388780.0374 881448.15 102 477.0 CELL 2 388768.1644 881419.86 103 477.0 CELL 2 388766.8989 881416.82 104 477.0 CELL 2 388766.6115 881415.24 105 477.0 CELL 2 388765.9789 881411.77 106 477.0 CELL 2 388766.9783 881410.45 107 477.0 CELL 2 388782.2184 881403.43	94	477.0	CELL 2	388814.9111	881491.59
97 477.0 CELL 2 388801.7384 881494.00 98 477.0 CELL 2 388798.7295 881492.51 99 477.0 CELL 2 388795.2244 881482.56 100 477.0 CELL 2 388791.6397 881474.26 101 477.0 CELL 2 388780.0374 881448.15 102 477.0 CELL 2 388768.1644 881419.86 103 477.0 CELL 2 388766.8989 881416.82 104 477.0 CELL 2 388766.6115 881415.24 105 477.0 CELL 2 388766.9783 881410.45 106 477.0 CELL 2 388766.9783 881410.45 107 477.0 CELL 2 388782.2184 881403.43	95	477.0	CELL 2	388807.6336	881494.43
98 477.0 CELL 2 388798.7295 881492.51 99 477.0 CELL 2 388795.2244 881482.56 100 477.0 CELL 2 388791.6397 881474.26 101 477.0 CELL 2 388780.0374 881448.15 102 477.0 CELL 2 388768.1644 881419.86 103 477.0 CELL 2 388766.8989 881416.82 104 477.0 CELL 2 388766.6115 881415.24 105 477.0 CELL 2 388765.9789 881411.77 106 477.0 CELL 2 388766.9783 881410.45 107 477.0 CELL 2 388782.2184 881403.43	96	477.0	CELL 2	388803.5838	881495.08
99 477.0 CELL 2 388795.2244 881482.56 100 477.0 CELL 2 388791.6397 881474.26 101 477.0 CELL 2 388780.0374 881448.15 102 477.0 CELL 2 388768.1644 881419.86 103 477.0 CELL 2 388766.8989 881416.82 104 477.0 CELL 2 388766.6115 881415.24 105 477.0 CELL 2 388765.9789 881411.77 106 477.0 CELL 2 388766.9783 881410.45 107 477.0 CELL 2 388782.2184 881403.43	97	477.0	CELL 2	388801.7384	881494.00
100 477.0 CELL 2 388791.6397 881474.26 101 477.0 CELL 2 388780.0374 881448.15 102 477.0 CELL 2 388768.1644 881419.86 103 477.0 CELL 2 388766.8989 881416.82 104 477.0 CELL 2 388766.6115 881415.24 105 477.0 CELL 2 388765.9789 881411.77 106 477.0 CELL 2 388766.9783 881410.45 107 477.0 CELL 2 388782.2184 881403.43	98	477.0	CELL 2	388798.7295	881492.51
101 477.0 CELL 2 388780.0374 881448.15 102 477.0 CELL 2 388768.1644 881419.86 103 477.0 CELL 2 388766.8989 881416.82 104 477.0 CELL 2 388766.6115 881415.24 105 477.0 CELL 2 388765.9789 881411.77 106 477.0 CELL 2 388766.9783 881410.45 107 477.0 CELL 2 388782.2184 881403.43	99	477.0	CELL 2	388795.2244	881482.56
102 477.0 CELL 2 388768.1644 881419.86 103 477.0 CELL 2 388766.8989 881416.82 104 477.0 CELL 2 388766.6115 881415.24 105 477.0 CELL 2 388765.9789 881411.77 106 477.0 CELL 2 388766.9783 881410.45 107 477.0 CELL 2 388782.2184 881403.43	100	477.0	CELL 2	388791.6397	881474.26
103 477.0 CELL 2 388766.8989 881416.82 104 477.0 CELL 2 388766.6115 881415.24 105 477.0 CELL 2 388765.9789 881411.77 106 477.0 CELL 2 388766.9783 881410.45 107 477.0 CELL 2 388782.2184 881403.43	101	477.0	CELL 2	388780.0374	881448.15
104 477.0 CELL 2 388766.6115 881415.24 105 477.0 CELL 2 388765.9789 881411.77 106 477.0 CELL 2 388766.9783 881410.45 107 477.0 CELL 2 388782.2184 881403.43	102	477.0	CELL 2	388768.1644	881419.86
105 477.0 CELL 2 388765.9789 881411.77 106 477.0 CELL 2 388766.9783 881410.45 107 477.0 CELL 2 388782.2184 881403.43	103	477.0	CELL 2	388766.8989	881416.82
106 477.0 CELL 2 388766.9783 881410.45 107 477.0 CELL 2 388782.2184 881403.43	104	477.0	CELL 2	388766.6115	881415.24
106 477.0 CELL 2 388766.9783 881410.45 107 477.0 CELL 2 388782.2184 881403.43	105	477.0	CELL 2	388765.9789	881411.77
107 477.0 CELL 2 388782.2184 881403.43					881410.45
	x			GHESWOODSSATPROVIDENCE WEST WESTERN	881403.43
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	.00	1	J Z	555510.1210	33,1000.01

CELL 3 MODIFICATION COORDINATE POINTS

COORDINATE POINTS					
POINT#	ELEV	DESC.	NORTHING	EASTING	
109	476.0	CELL 3	388725.2943	881433.4737	
110	476.0	CELL 3	388726.5982	881435.0693	
111	476.0	CELL 3	388743.2988	881476.1493	
112	476.0	CELL 3	388745.6416	881481.9528	
113	476.0	CELL 3	388754.1359	881503.3715	
114	476.0	CELL 3	388756.0812	881508.3097	
115	476.0	CELL 3	388756.7315	881511.9708	
116	476.0	CELL 3	388756.5299	881512.2470	
117	476.0	CELL 3	388749.9819	881514.7782	
118	476.0	CELL 3	388747.2567	881514.4729	
119	476.0	CELL 3	388745.3783	881512.7925	
120	476.0	CELL 3	388742.2297	881506.7612	
121	476.0	CELL 3	388736.0350	881493.6014	
122	476.0	CELL 3	388726.8358	881473.7110	
123	476.0	CELL 3	388722.1244	881461.5727	
124	476.0	CELL 3	388717.4395	881449.5029	
125	476.0	CELL 3	388714.8733	881442.1655	
126	476.0	CELL 3	388714.6277	881438.3124	
127	476.0	CELL 3	388716.0247	881436.3584	
128	476.0	CELL 3	388719.4440	881434.5359	
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130	477.0	CELL 3	388729.2071	881433.5209	
131	477.0	CELL 3	388746.0793	881475.0228	
132	477.0	CELL 3	388748.4269	881480.8383	
133	477.0	CELL 3	388756.9013	881502.2785	
134	477.0	CELL 3	388758.9824	881507.4894	
135	477.0	CELL 3	388759.9090	881512.7055	
136	477.0	CELL 3	388758.4339	881514.7274	
137	477.0	CELL 3	388750.3782	881517.8413	
138	477.0	CELL 3	388745.9706	881517.3475	
139	477.0	CELL 3	388742.9714	881514.6646	
140	477.0	CELL 3	388739.5417	881508.0948	
141	477.0	CELL 3	388733.3164	881494.8699	
142	477.0	CELL 3	388724.0733	881474.8846	
143	477.0	CELL 3	388719.3276	881462.6582	
144	477.0	CELL 3	388714.6317	881450.5383	
145	477.0	CELL 3	388711.9056	881442.7673	
146	477.0	CELL 3	388711.5658	881437.4368	
147	477.0	CELL 3	388713.9932	881434.0416	
148	477.0	CELL 3	388718.4467	881431.6680	

STATE OF MISSOURI MICHAEL L. PARSON, GOVERNOR



JOSHUA D. HARTSOCK-ENGINEER MO # PE 2020000048

SSOCIATES, P.C.
ers · Architects · Surveyors

OFFICE OF ADMINISTRATION DIVISION OF FACILITIES MANAGEMENT, DESIGN AND CONSTRUCTION

DESIGN AND CONSTRUCT LAGOON EXPANSION

461 COUNTY ROAD 517 WAPPAPELLO, MO 63966


PROJECT # T2317-01 SITE # 6325 ASSET # 7016325013

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ISSUE DATE: 11-09-2023

CAD DWG FILE:
DRAWING BY: JDH/MCB
CHECKED BY: MCB/JJN
DESIGNED BY: JDH/MCB/JJN

SHEET TITLE:
CELLS 2 & 3
MODIFICATION DETAILS
& COORDINATE TABLES

SHEET NUMBER:

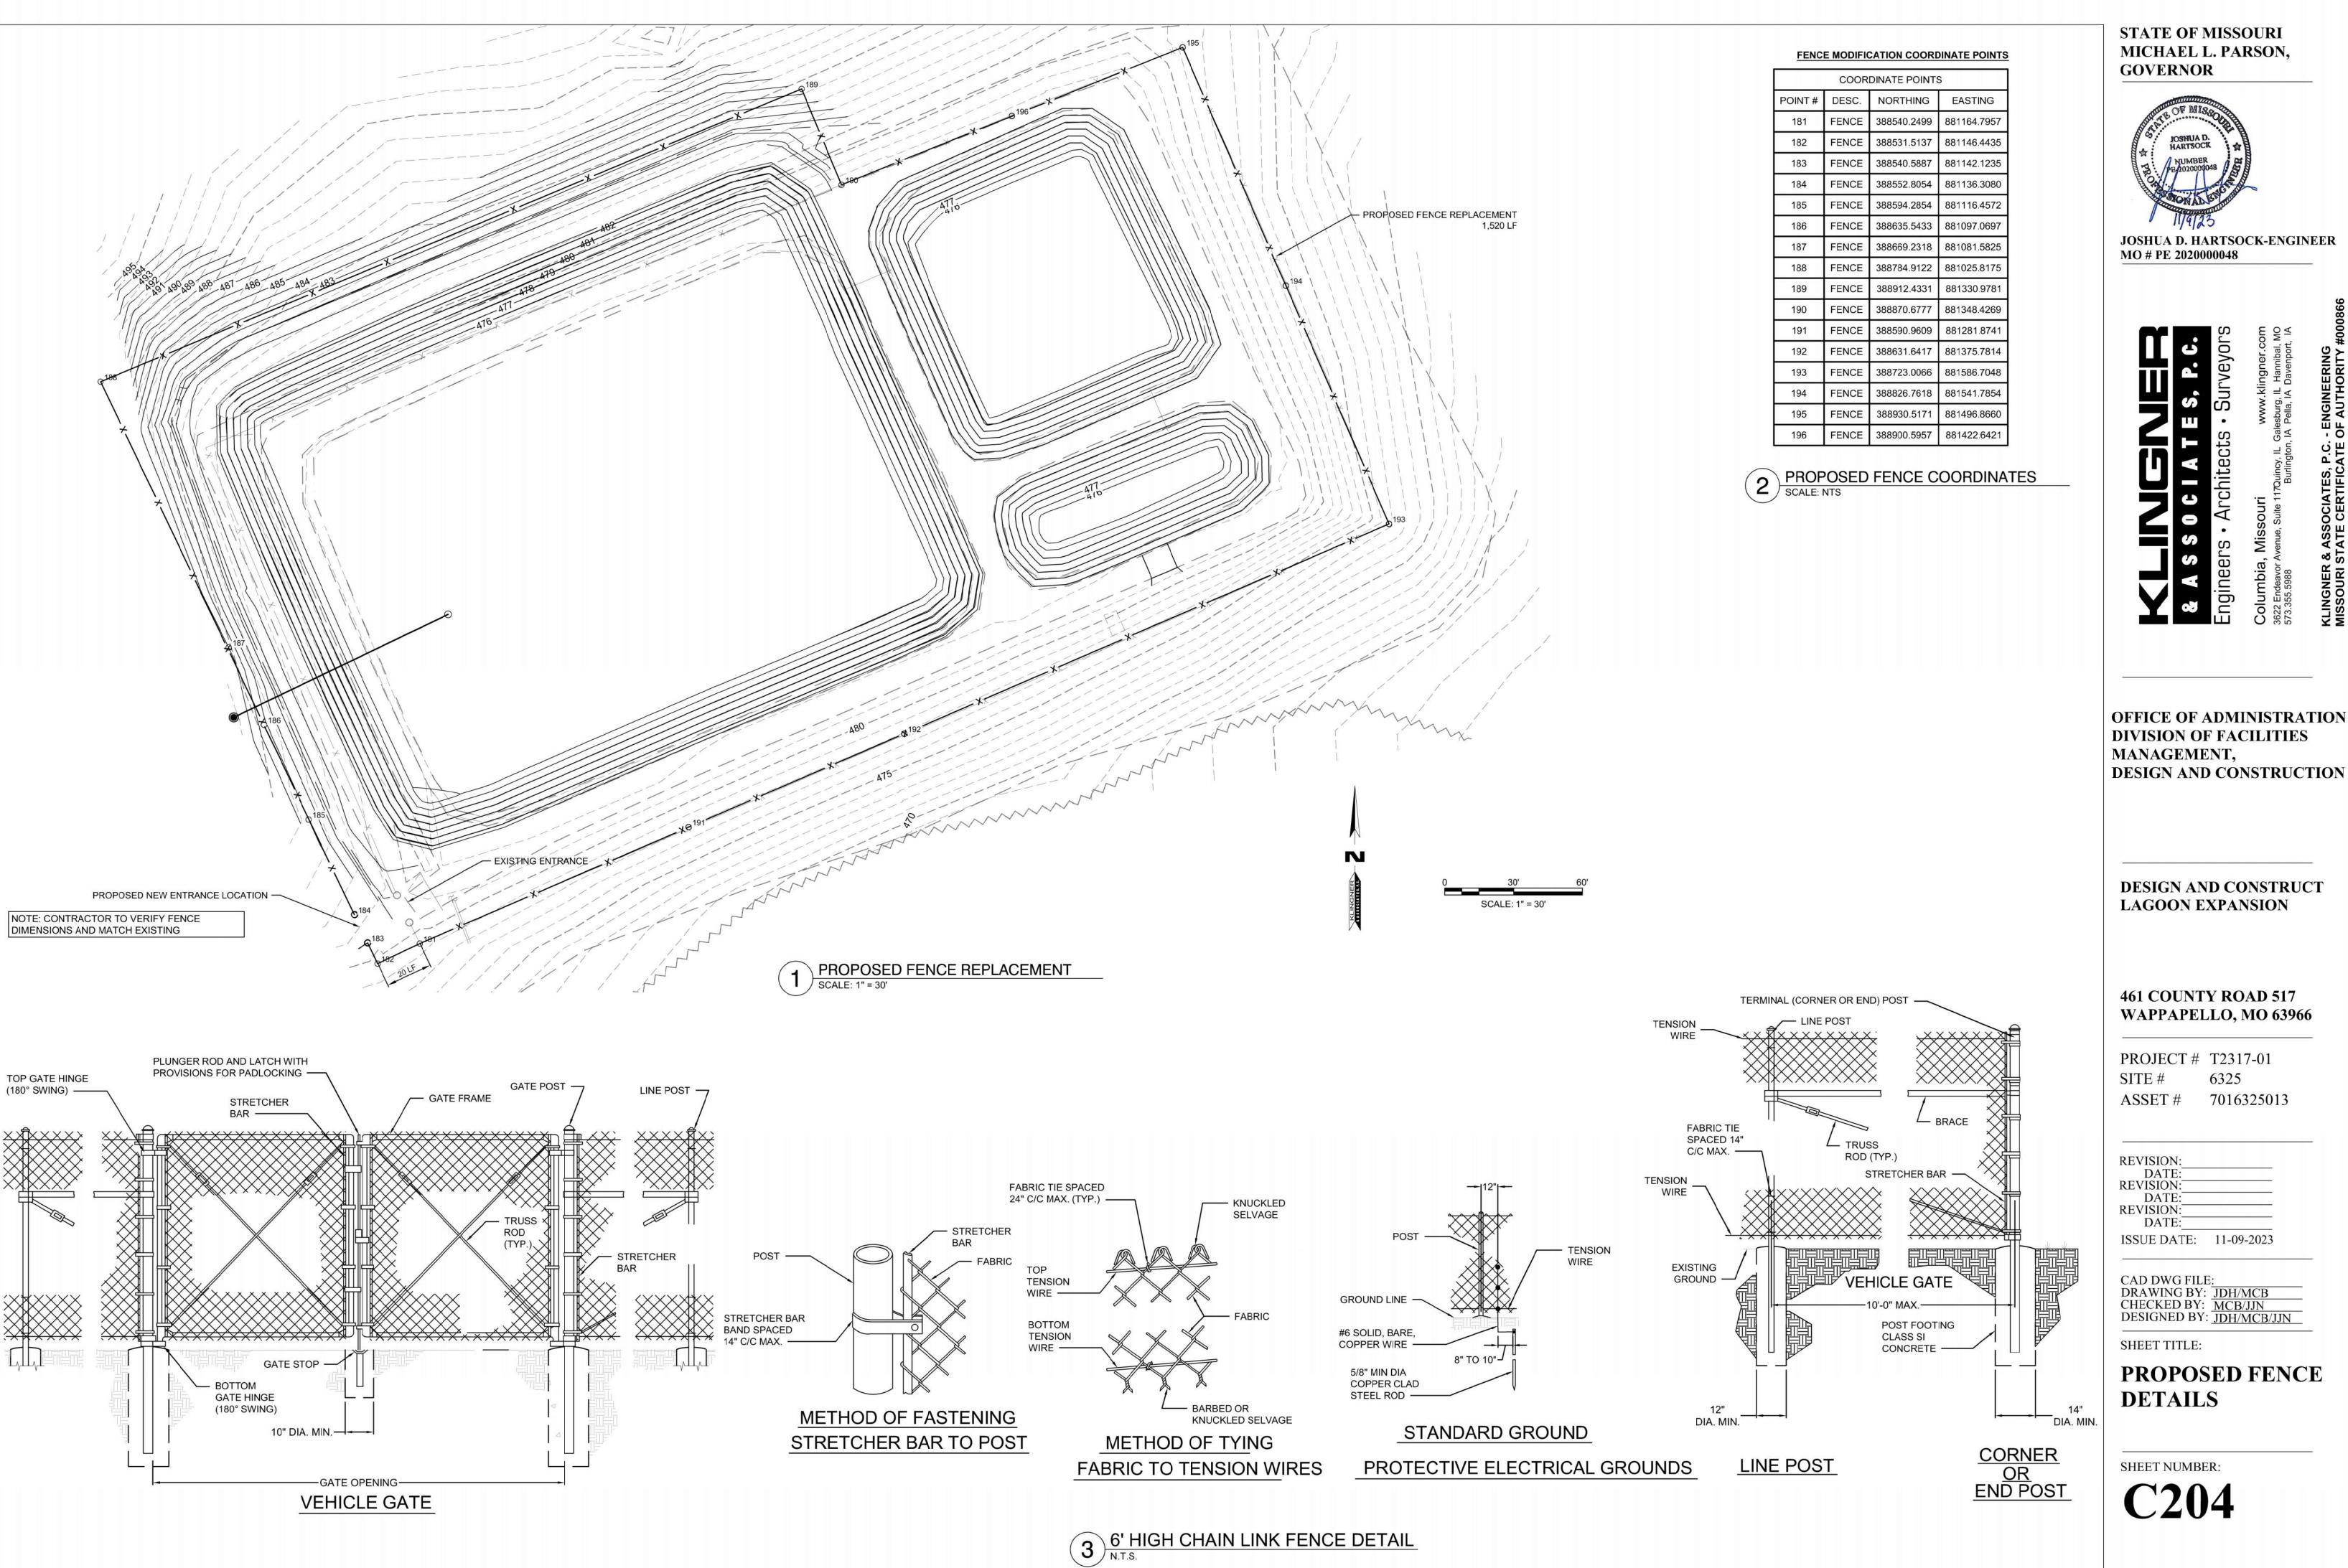



JOSHUA D. HARTSOCK-ENGINEER MO # PE 2020000048

DIVISION OF FACILITIES MANAGEMENT, **DESIGN AND CONSTRUCTION**

DESIGN AND CONSTRUCT LAGOON EXPANSION

461 COUNTY ROAD 517 WAPPAPELLO, MO 63966

PROJECT # T2317-01 6325 7016325013

REVISION: DATE: **REVISION:** DATE: **REVISION:**

CAD DWG FILE:
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CHECKED BY: MCB/JJN
DESIGNED BY: JDH/MCB/JJN

PROPOSED FENCE **DETAILS**

STORM WATER POLLUTION PREVENTION PLAN

CERTIFICATION STATEMENTS

This plan and certifications are a part of the Storm Water Pollution Prevention Plan for the project described below. PROJECT INFORMATION:

Site: Wappapello Army National Guard Training Site Location: 461 County Road 517, Wappapello, MO 63966 County: Wayne County City: Wappapello, Missouri

PERMITTEE (OWNER) CERTIFICATION:CONTRACTOR CERTIFICATION STATEMENT certify under penalty of law that this document and all attachments were prepared under my direct supervision in accordance with a system designed to assure that qualified personnel properly gather and evaluated the information submitted. Based on my inquiry of the person or persons who manage the system, or those persons directly responsible for gathering the information, the information submitted is, to the best of my knowledge and belief, true, accurate and complete. I am aware that there are significant penalties for submitting false information, including the possibility of fine and imprisonment for knowing violations. I certify under penalty of law that I understand the terms.

OWNER (PERMITTEE):			CONTRACTOR:			
SIGNATURE:	viii i LL)		_ SIGNATURE:			
PRINT NAME:			PRINT NAME:			
STREET ADDRESS:			STREET ADDRESS:			
City	State	Zip	City	State	Zip	
TELEPHONE NUMBER:			TELEPHONE N	IUMBER:		
FAX NUMBER:			FAX NUMBER:	-		
DATE:			DATE:			

STORM WATER POLLUTION PLAN

The following plan is established and incorporated in the project to aid the contractor in the placement of temporary erosion control systems and to provide a storm sewer water pollution prevention plan for compliance under MODNR.

The purpose of this plan is to minimize erosion within the construction site and to limit sediments from leaving the construction site by utilizing proper temporary erosion control systems and providing ground cover within a reasonable amount of time.

Certain erosion control facilities shall be installed by the contractor at the beginning of construction. Other items shall be installed by the contractor as deemed necessary, on a case-by-case situation, depending on the contractor's sequence of activities, time of year and expected weather conditions.

The contractor shall install permanent erosion control systems and seeding within a time frame specified herein. Therefore minimizing the amount of area susceptible to erosion and reducing the amount of temporary seeding. Contractor shall further determine if any temporary erosion control systems shown in the plan can be deleted and if any additional temporary erosion control systems which are not included in this plan shall be added.

SITE DESCRIPTION.

- 1. The project consists of site work to expand the existing wastewater lagoons and replacement of the sewer collection system.
- Construction includes earth excavation, embankment, and other miscellaneous items of construction.

DESCRIPTION OF INTENDED SEQUENCE FOR MAJOR CONSTRUCTION ACTIVITIES, WHICH WILL DISTURB SOILS FOR MAJOR PORTIONS OF THE CONSTRUCTION SITE.

- 1. Placement, maintenance, removal and proper clean-up of temporary erosion control, such as perimeter erosion control barriers;
- temporary ditch checks; siltation basins, temporary seeding, etc.
- Topsoil removal and stockpiling. Excavation and embankment at the job site to achieve the proposed site contours.
- Final grading, seeding, and other miscellaneous items.

Placement of permanent erosion control such as riprapped ditches, erosion control blanket, seeding, etc.

AREA OF CONSTRUCTION SITE:

1. The total area of the construction is estimated to be 9 acres of which 2.25 acres will be disturbed by excavation, grading, and other activities.

OTHER REPORTS, STUDIES AND PLANS WHICH AID IN THE DEVELOPMENT OF THE STORM WATER POLLUTION PREVENTION PLAN AS REFERENCED DOCUMENTS:

1. Project plan documents, specifications, hydraulic reports, and plan drawings indicate drainage patterns and approximate slopes anticipated after grading activities were utilized for the proposed placement of the temporary erosion control systems.

DRAINAGE TRIBUTARIES AND SENSITIVE AREAS RECEIVING RUNOFF FROM THIS CONSTRUCTION SITE:

- 1. The names of receiving water(s) is a tributary to the Saint Francis River.
- 2. Location of any sensitive areas (i.e. wetlands, habitats)

CONTROLS-EROSION CONTROLS AND SEDIMENT CONTROL:

- 1. DESCRIPTION OF STABILIZATION PRACTICES AT THE BEGINNING OF CONSTRUCTION
- The drawings and specifications should ensure that existing vegetation is preserved where attainable and disturbed portions of the site will be stabilized. Stabilization practices include temporary seeding, permanent seeding, mulching, protection of trees, preservation of mature vegetation, and other appropriate measures. Stabilization measures shall be initiated immediately in portions of the site where construction activities have temporarily or permanently ceased, and completed in no more than 7 days after the construction activity in that portion of the site has temporarily or permanently ceased. Allowances to the seven (7) day completion period for temporary and permanent stabilization may be made due to weather and equipment malfunctions. The allowances shall be documented in the SWPPP.
- a. Areas of existing vegetation; wood and grasslands; outside the proposed construction limits shall be identified for
- preserving and shall be protected from construction activities. b. Dead, diseased, or unsuitable vegetation within the site shall be removed, along with required tree removal.

As soon as reasonable access is available to all locations where water drains away from the project, temporary ditch checks, inlet and pipe protection, and perimeter erosion barrier shall be installed as called out in this plan.

- d. Bare and sparsely vegetated ground in high erodable areas shall be temporarily seeded at the beginning of construction where not construction activities are expected within seven days.
- e. Immediately after tree removal or stripping is completed, areas which are highly erodable shall be temporarily seeded when no construction activities are expected within seven days.
- f. At locations where a significant amount of water drains into the construction zone from outside areas (adjacent
- landowners), temporary ditch checks or silt fencing will be utilized to locally divert water, reduce flow rates, and collect outside siltation inside the site.

Establishment of these temporary erosion control measures will have additional benefits to the project. Desirable grass seed will become established in these areas and will spread seeds onto the construction site until permanent seeding/mowing and overseeding can be completed.

2. DESCRIPTION OF STABILIZATION PRACTICES DURING CONSTRUCTION

During construction, areas outside the construction limits as outlined previously herein shall be protected. The contractor shall not use this area for staging (except as described on the plans) and parking of vehicles or construction equipment, storage of materials, or other construction related activities.

- a. Within the construction limits, areas which may be susceptible to erosion, shall remain undisturbed until full scale construction is underway to prevent unnecessary soil erosion.
- b. Earth stockpiles shall be temporarily seeded immediately if they are to remain unused for more than fourteen (14) days.

- d. As construction proceeds, the contractor shall institute the following:
- Place temporary erosion control facilities at locations shown on the plans.
- ii. Temporarily seed erodable bare earth on a weekly basis to minimize the amount of erodable surface area within the contract
- iii. Construct ditches and provide temporary erosion control systems including ditch lining and ditch stops.
- iv. Temporarily divert water around culvert locations.
- v. Build necessary embankments at culvert locations and then excavate and place culvert.
- vi. Continue building up the embankment to the proposed grade while at the same time, placing permanent erosion control such as riprap ditch lining and conducting final shaping to the slopes.
- d. Excavated areas and embankment shall be permanently seeded immediately after final grading. If not, they shall be temporarily seeded immediately if no construction activity in the area is planned for 7 days.

e. Construction equipment shall be stored and fueled only at designated locations. All necessary measures shall be taken to contain any fuel or other pollutant in accordance with EPA water quality regulations. Leaking equipment or supplies shall be immediately repaired or removed from the site.

f. The contractor shall inspect the project daily during construction activities. Inspection shall also be done weekly and after heavy

- g. Sediment collected during construction of the various temporary erosion control systems shall be disposed of on the site on a
- h. The temporary erosion control systems shall be removed after use is no longer or no longer functioning.
- DESCRIPTION OF STRUCTURAL PRACTICES AFTER FINAL GRADING
 - Temporary erosion control systems shall be left in place with proper maintenance until permanent erosion control is in place and working properly and all proposed turf areas seeded and established.
- Once permanent erosion control systems as proposed in the plans are functional and established, temporary items shall be removed, cleaned up, and disturbed turf reseeded.

MAINTENANCE AFTER CONSTRUCTION

1. Construction is complete after acceptance by the Owner. Maintenance up to this date will be by the Contractor.

MISCELLANEOUS

- 1. Temporary ditch checks shall be located at every 1.5 ft. fall/rise in ditch grade.
- 2. Temporary erosion control seeding shall be applied at a rate of 100 lbs/acres.
- 3. Straw bales, hay bales, perimeter erosion barrier and silt fences will not be permitted for permanent ditch checks. Ditch checks shall be composed of aggregate, silt panels, rolled excelsior, geotextile web grids and/or other equal materials.
- 4. Sediment collected during construction by the various temporary erosion control systems shall be disposed on the site on a regular

INSPECTIONS.

1. The Permittee (or a representative of the permittee) shall conduct regularly scheduled inspections at least once every seven calendar days. these inspections shall be conducted by a qualified personnel, one who is responsible for environmental matters at the site, or a person directly supervised by the person responsible for environmental matters. For disturbed areas that have not been finally stabilized, all installed BMP's and other polution control measures shall be inspected for proper installation, operation and maintenance. All stormwater outfalls shall be inspected 50 feet downstream of the outfall. Any structural or maintenance problems shall be noted in an inspection report and corrected within seven calendar days of the inspection. If a rainfall causes stormwater runoff to occur on-site, the BMP's must be inspected within reasonible time period after the rainfall event has ceased. These inspections must occur within 48 hours after the rain event has ceased during a normal work day and within 72 hours if the rain event ceases during a non-work day, such as a weekend or a holiday.

ON SITE INSF	PECTOR NAME:	
COMPANY NA	AME:	
STREET ADD	RESS:	
City	State	Zip_
TELEPHONE	NUMBER:	** ## &
FAX NUMBER	:	

- a. Disturbed areas and areas used for storage of materials that are exposed to precipitation shall be inspected for evidence of, or the potential for, pollutants entering the drainage system. Erosion and sediment control measures identified in the plan shall be observed to ensure that they are operating correctly. Where discharge locations or points are accessible, they shall be inspected to ascertain whether erosion control measures are effective in preventing significant impacts to receiving waters. Locations where vehicles enter or exit the site shall be inspected for evidence of off site sediment tracking.
- b. Based on the results of the inspection, the description of potential pollutant sources identified herein and pollution prevention measures identified herein shall be revised as appropriate as soon as practicable after such inspection. Any changes to this plan resulting from the required inspections shall be implemented within 7 calendar days following the inspection.
- c. A report summarizing the scope of the inspection, names(s) and qualifications of personnel making the inspection, the date(s) of the inspection, major observations relating to the implementation of this storm water pollution prevention plan, and actions taken shall be made and retained as part of the plan for at least three (3) years after the date of the Letter of Termination. The report shall be signed in accordance with Requirements and Guidelines of the general permit.
- d. If, for any reason, the permittee does not comply with or will be unable to comply with any daily maximum effluent limitation specified in this permit, the permittee shall provide the Department with the following information, in writing within five (5) days of becoming aware of such conditions:
- (i) a description of discharge and cause of noncompliance, and
- (ii) the period of noncompliance, including exact dates and times or, if not corrected, the anticipated the noncompliance is expected to continue m and steps being taken to reduce, eliminate and prevent recurrence of the noncomplying discharge.
- e. Twenty-four hour reporting. The permittee shall report any noncompliance which may endanger health or environment. Any information shall be provided orally with in 24 hours from the time the permittee becomes aware of the circumstances. A written submission shall also be provided within five (5) days of the time the permittee becomes aware of the circumstances. The Department may waive the written report on a case-by-case basis if the oral report has been received within 24 hours.

The report of noncompliance shall be mailed to the following address: Missouri Department of Natural Resources St. Louis Regional Office 7545 S. Lindbergh, Suite 210 St. Louis, Missouri 63125 (314) 416-2960

(314) 416-2960 fax

Special Provision

This project will result in a disturbance of one (1) or more acres of total land area and will require compliance with the National Pollutant Discharge Elimination System (NPDES) Storm Water Permit.

National Pollutant Discharge Elimination System


The Owner is the PERMITTEE and the Contractors and Subcontractors will be required to certify that they understand and will comply with all requirements of the permit.

A storm water pollution plan shall be cooperatively developed by the PERMITTEE and contractor for this project using good engineering practices. The plan shall identify potential sources of pollution which may reasonably be expected to affect the quality of storm water discharges. In addition, the plan shall describe and ensure the implementation of practices which will be used to reduce the pollutants in storm water discharges associated with this project and assure compliance with the terms and conditions of the Storm Water Permit.

The EPERMITTING process on the Missouri Department of Natural Resource (MoDNR) website shall be completed in order to receive the Land Disturbance Permit. At the completion of the project stabilization the following form shall be completed and submitted to the MoDNR:


FORM H - REQUEST FOR TERMINATION OF A GENERAL PERMIT

The Contractor shall prepare a stormwater management plan which is certified by both the Owner and Contractor. The Contractor shall be responsible for obtaining the NPDES permit including but not limited to the epermitting application for Land Disturbance Permit, Posting a copy of the public notification sign on the site and Request for Termination as well as maintaining the Stormwater Management Plan and maintenance records on-site.

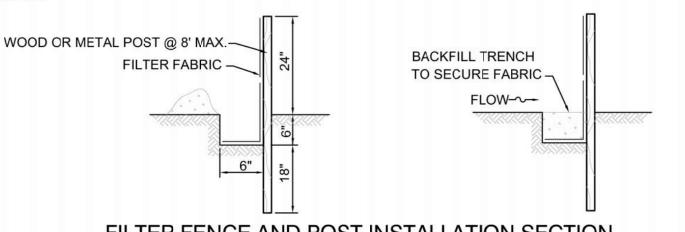

FILTER FENCE AND POST INSTALLATION SECTION


FOR EACH STRAW BALE, DRIVE 2 NO. 5 REBARS, STEEL PICKETS. OR 2"x 2" WOODEN STAKES INTO THE GROUND. ANGLE FIRST STAKE

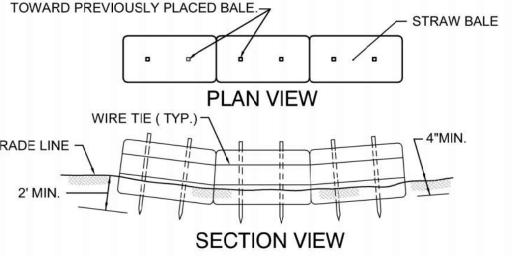

STRAW BALE INSTALLATION

- 1. STRAW BALES TO BE STACKED IN A SINGLE ROW & EMBEDDED IN THE
- SOIL TO A DEPTH OF 4 INCHES MINIMUM 2. ALL BALES ARE TO BE SECURELY BOUND WITH WIRE OR STRING.
- 3. LENGTH OF SEDIMENT BARRIER AS INDICATED ON THE PLANS
- 4. SCATTER LOOSE STRAW OVER THE AREA IMMEDIATELY UPSLOPE FROM SEDIMENT BARRIERS. FILL GAPS BETWEEN BALES WITH LOOSE STRAW. 5. CONTRACTOR SHALL BE RESPONSIBLE FOR MAINTAINING SEDIMENT BARRIERS IN A CONDITION THAT IS SATISFACTORY TO THE CONTRACTING

OFFICER UNTIL FINAL ACCEPTANCE OF WORK. TEMPORARY EROSION CONTROL BARRIER DETAILS

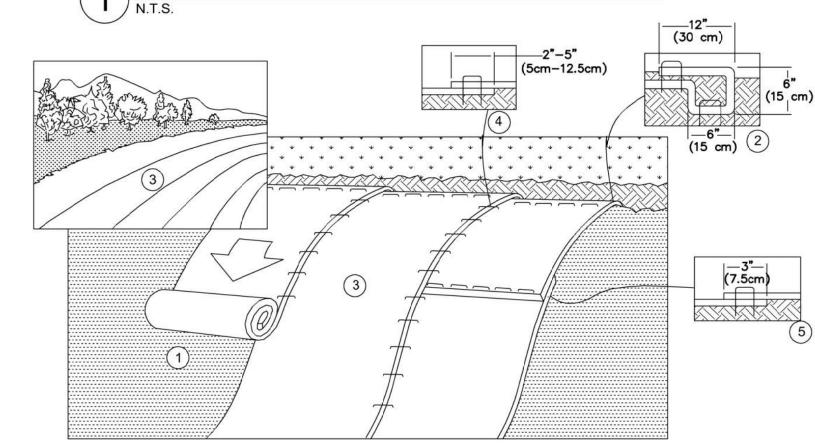

- 1. PREPARE SOIL BEFORE INSTALLING ROLLED EROSION CONTROL PRODUCTS (RECP'S), INCLUDING ANY NECESSARY APPLICATION OF LIME, FERTILIZER, AND SEED. SEEDING WILL BE COMPLETED BY THE OWNER, CONTRACTOR TO COORDINATE WITH OWNER TO ALLOW PROPER TIMING AND COORDINATION FOR THE SEEDING AND EROSION BLANKET INSTALLATION.
- 2. BEGIN AT THE TOP OF THE SLOPE BY ANCHORING THE RECP'S IN A 6" (15 CM) DEEP X 6" (15 CM) WIDE TRENCH WITH APPROXIMATELY 12" (30CM) OF RECP'S EXTENDED BEYOND THE UP-SLOPE PORTION OF THE TRENCH. ANCHOR THE RECP's WITH A ROW OF STAPLES/STAKES APPROXIMATELY 12" (30 CM) APART IN THE BOTTOM OF THE TRENCH. BACKFILL AND COMPACT THE TRENACH AFTER STAPLING. APPLY SEED TO COMPACTED SOIL AND FOLD REMAINING 12" (30 CM) PORTION OF RECP's BACK OVER SEED AND COMPACTED SOIL. SECURE RECP'S OVER COMPACTED SOIL WITH A ROW OF STAPLES/STAKES SPACED APPROXIMATELY 12" (30 CM) APART ACROSS THE WIDTH OF THE RECP's.
- 3. ROLL THE RECP's (A) DOWN OR (B) HORIZONTALLY ACROSS THE SLOPE. RECP's WILL UNROLL WITH APPROXIMATE SIDE AGAINST THE SOIL SURFACE. ALL RECP'S MUST BE SECURELY FASTENED TO SOIL SURFACE BY PLACING STAPLES/STAKES IN APPROXIMATE LOCATIONS AS SHOWN IN THE STAPLE PATTERN GUIDE. WHEN USING THE DOT SYSTEM, STAPLES/STAKES SHOULD BE PLACED THROUGH EACH OF THE COLORED DOTS CORRESPONDING TO THE APPROPRIATE STAPLE PATTERN.

4. THE EDGES OF PARALLEL RECP's MUST BE STAPLED WITH APPROXIMATELY 2" - 54" (5 CM - 12.5 CM) OVERLAP DEPENDING

- ON RECP,s TYPE. 5. CONSECUTIVE RECP's SPLICED DOWN THE SLOPE MUST BE PLACED END OVER END (SHINGLE STYLE) WITH AN APPROXIMATE 3" (7.5 CM) OVERLAP. STAPLE THROUGH OVERLAPPED AREA, APPROXIMATELY 12" (30 CM) APART ACROSS ENTIRE RECP's WIDTH.
- NOTE: IN LOOSE SOIL CONDITIONS, THE USE OF STAPLE OR STAKE LENGTHS GREATER THAN 6" (15 CM) MAY BE NECESSARY TO PROPERLY SECURE THE RECP's.
- 6. EROSION CONTROL BLANKET SHALL BE USED ON ALL SLOPES 4:1 AND STEEPER.



STATE OF MISSOURI MICHAEL L. PARSON, **GOVERNOR**



JOSHUA D. HARTSOCK-ENGINEER MO # PE 2020000048

OFFICE OF ADMINISTRATION DIVISION OF FACILITIES MANAGEMENT, DESIGN AND CONSTRUCTION

DESIGN AND CONSTRUCT LAGOON EXPANSION

461 COUNTY ROAD 517 WAPPAPELLO, MO 63966

PROJECT # T2317-01 7016325013 ASSET #

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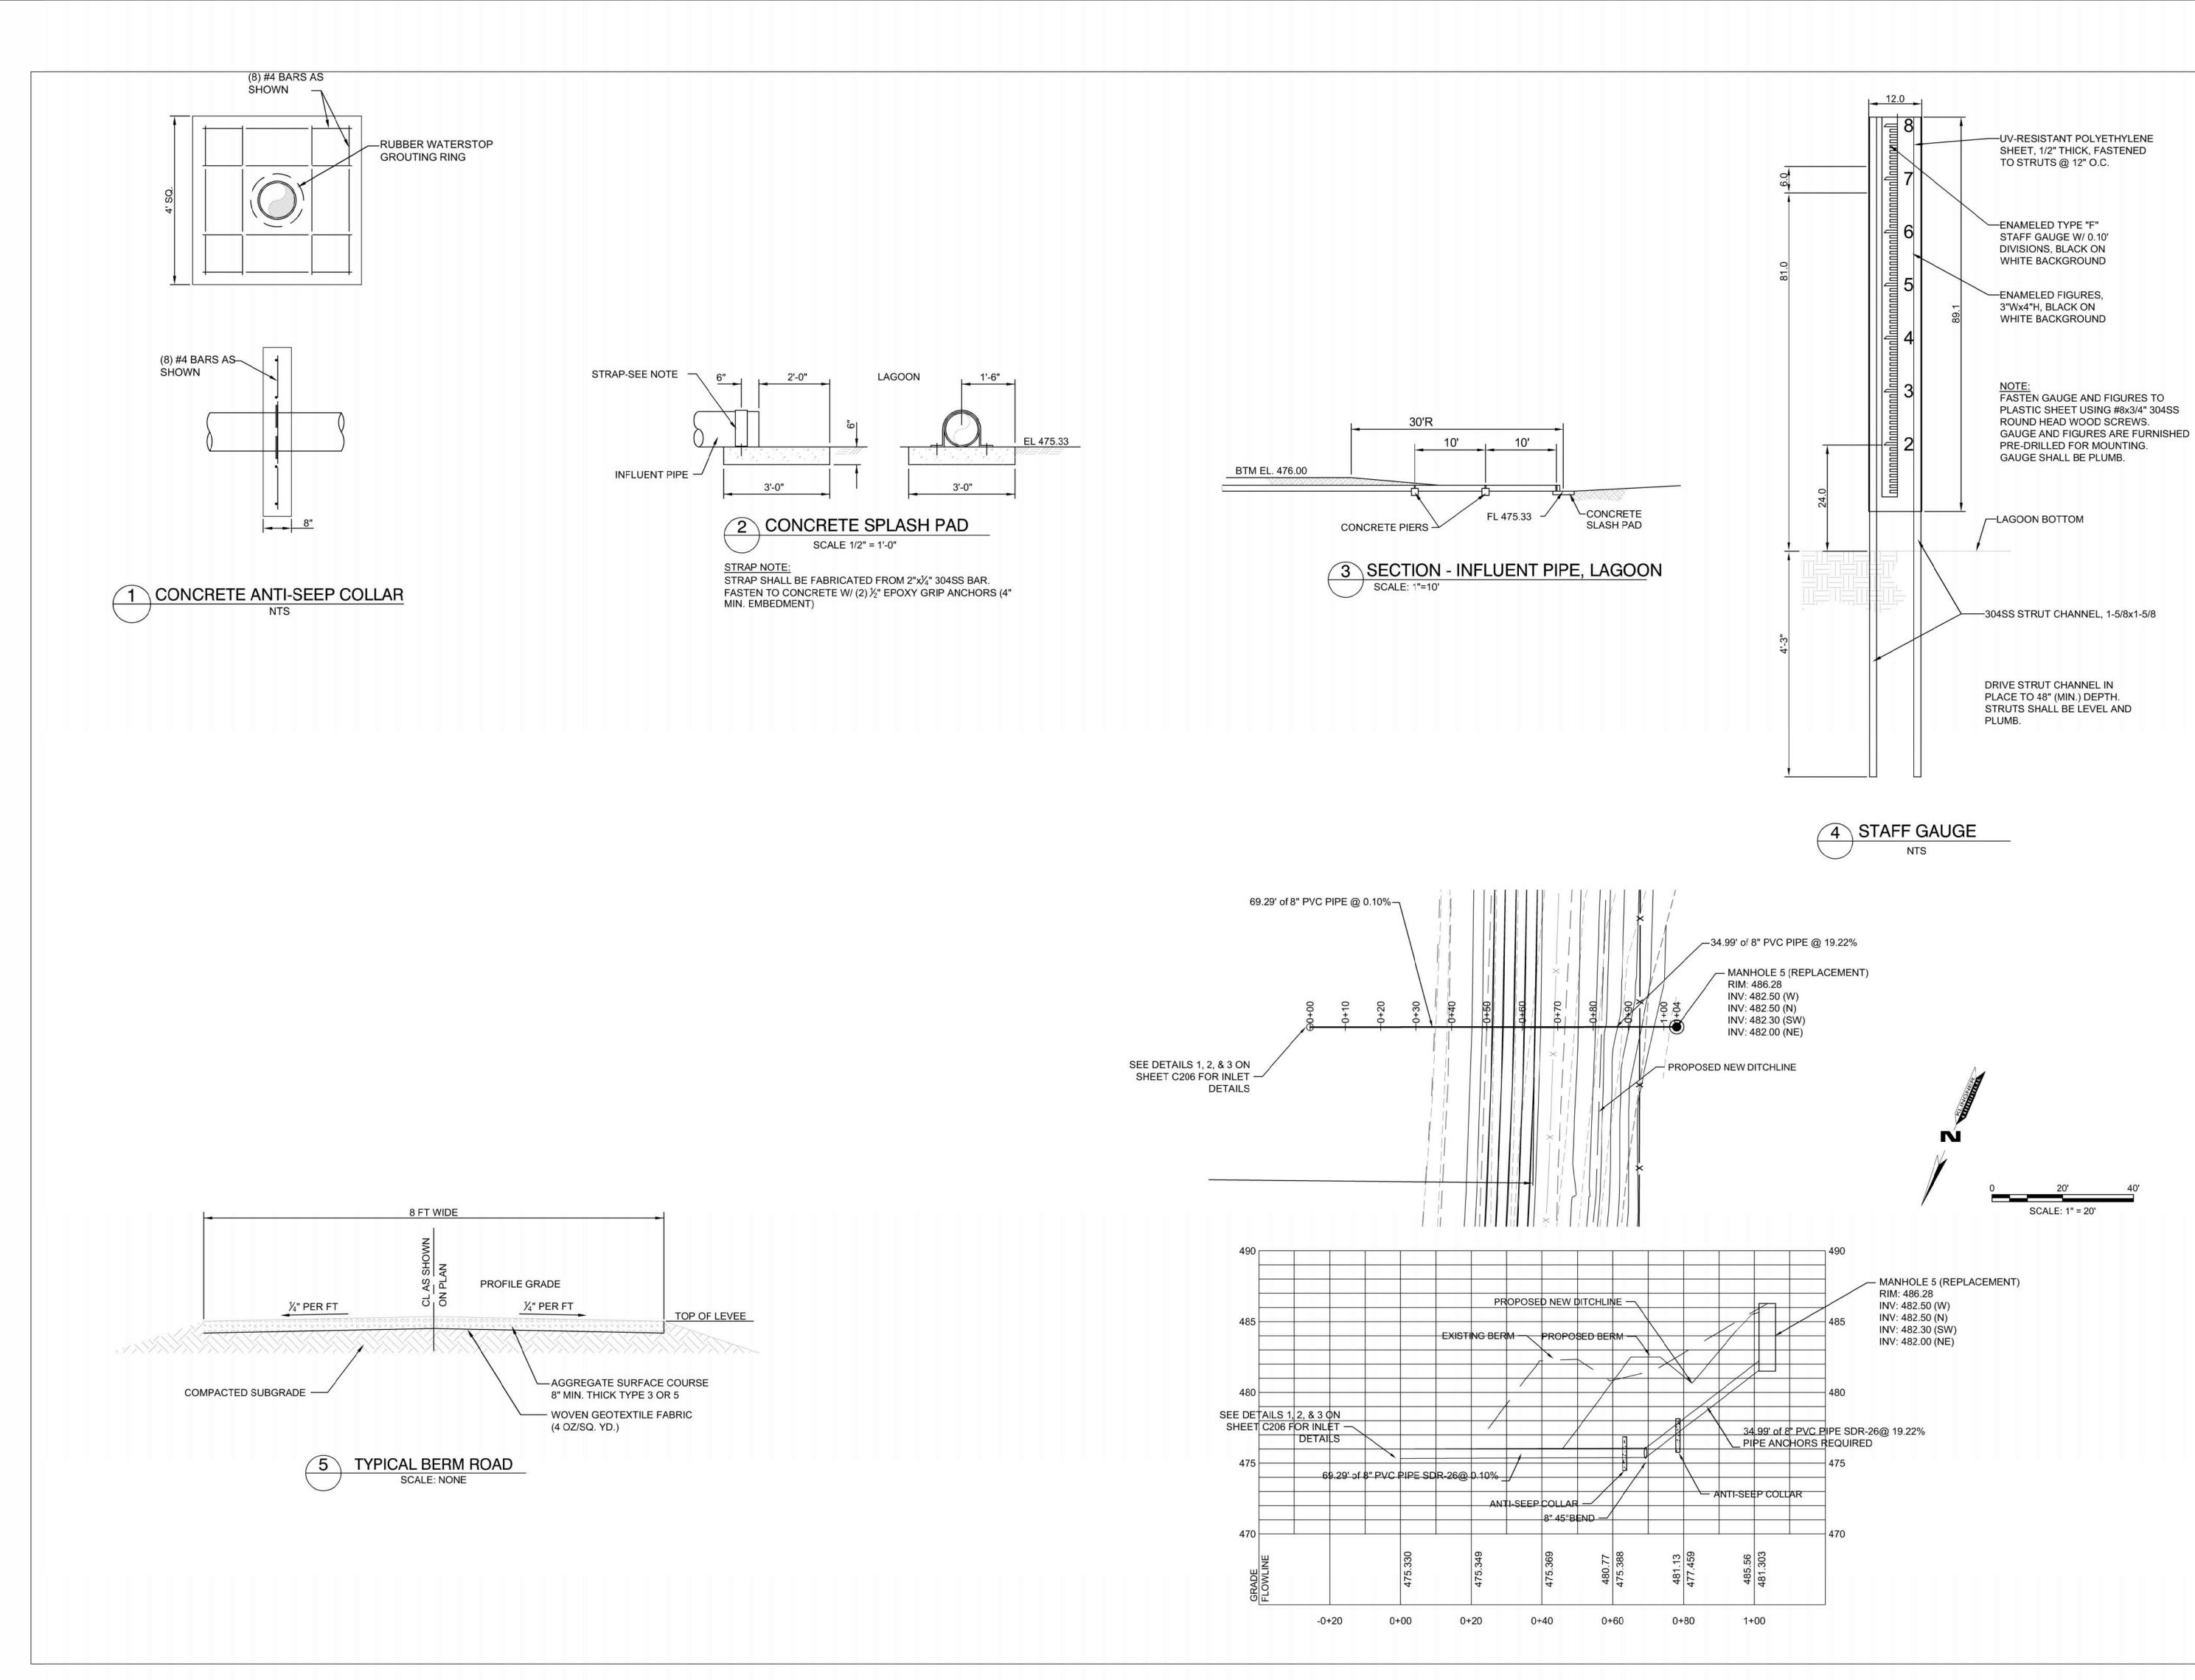
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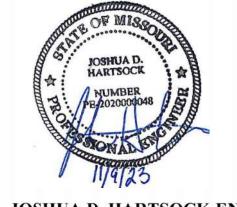
SHEET TITLE:

STORM WATER **POLLUTION** PREVENTION PLAN

SHEET NUMBER:

SHEET 13 OUT OF 15





JOSHUA D. HARTSOCK-ENGINEER MO # PE 2020000048

Engineers • Architects • Surveyors

Columbia, Missouri

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573.355.5988

Burlington, IA Pella, IA Davenport, IA

KLINGNER & ASSOCIATES, P.C. - ENGINEERING MISSOURI STATE CERTIFICATE OF AUTHORITY

OFFICE OF ADMINISTRATION DIVISION OF FACILITIES MANAGEMENT, DESIGN AND CONSTRUCTION

DESIGN AND CONSTRUCT LAGOON EXPANSION

461 COUNTY ROAD 517 WAPPAPELLO, MO 63966

PROJECT # T2317-01 SITE # 6325 ASSET # 7016325013


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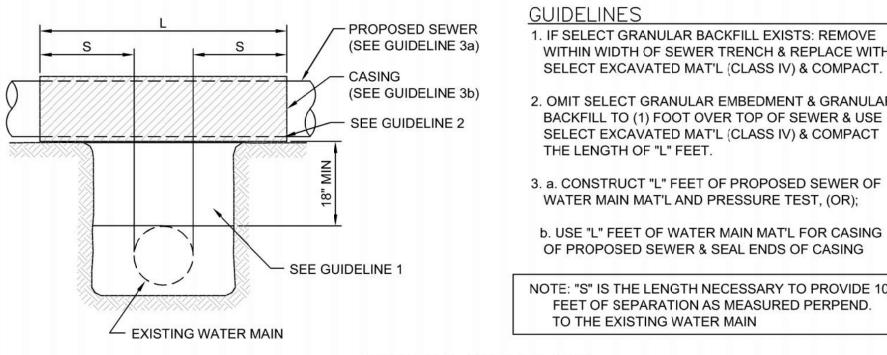
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LAGOON INLET DETAILS

SHEET NUMBER:



A - WATER AND SEWER SEPARATION REQUIREMENTS

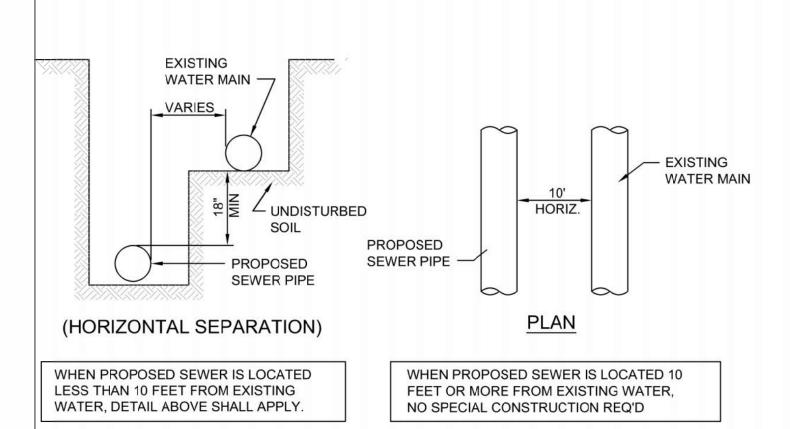

GUIDELINES 1. IF SELECT GRANULAR BACKFILL EXISTS: REMOVE WITHIN WIDTH OF SEWER TRENCH & REPLACE WITH SELECT EXCAVATED MAT'L (CLASS IV) & COMPACT.

2. OMIT SELECT GRANULAR EMBEDMENT & GRANULAR BACKFILL TO (1) FOOT OVER TOP OF SEWER & USE SELECT EXCAVATED MAT'L (CLASS IV) & COMPACT THE LENGTH OF "L" FEET.

WATER MAIN MAT'L AND PRESSURE TEST, (OR); b. USE "L" FEET OF WATER MAIN MAT'L FOR CASING


OF PROPOSED SEWER & SEAL ENDS OF CASING

NOTE: "S" IS THE LENGTH NECESSARY TO PROVIDE 10 FEET OF SEPARATION AS MEASURED PERPEND. TO THE EXISTING WATER MAIN

(VERTICAL SEPARATION)

B - WATER AND SEWER SEPARATION REQUIREMENTS

WATER & SEWER SEPARATION REQUIREMENTS

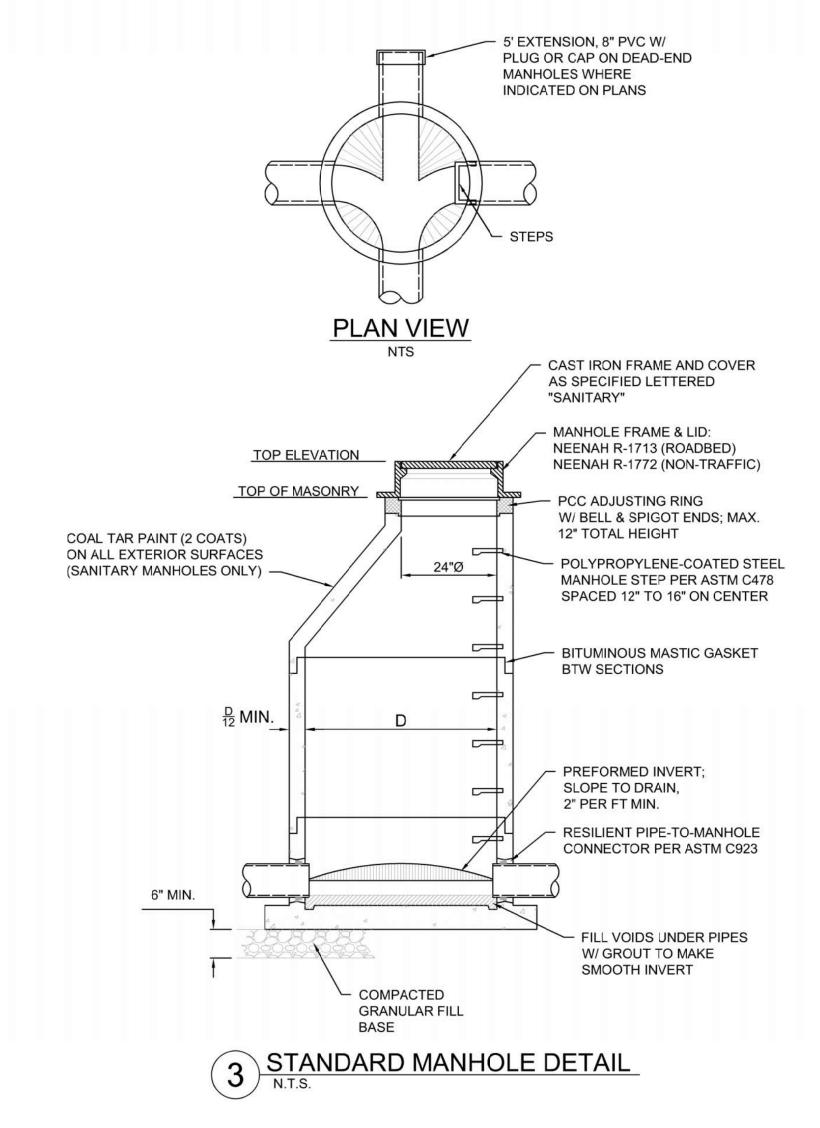

EXISTING WATER MAIN - EXISTING BACKFILL PROPOSED SEWER

GUIDELINES 1. PROVIDE ADEQUATE SUPPORT FOR EXISTING WATER MAIN TO PREVENT DAMAGE

DUE TO SETTLEMENT OF SEWER TRENCH.

(VERTICAL SEPARATION) C - WATER AND SEWER SEPARATION REQUIREMENTS



& USE SELECT EXCAVATED MAT'L (CLASS IV) & COMPACT FOR "S" FT. ON EA. SIDE OF WATER MAIN 2. a. CONSTRUCT "L" FEET OF PROPOSED SEWER OF

WATER MAIN MAT'L & PRESSURE TEST, (OR);


b. USE "L" FEET OF WATER MAIN MAT'L FOR CASING OF PROPOSED SEWER & SEAL ENDS OF CASING

3. PROVIDE ADEQUATE SUPPORT FOR EXISTING WATER MAIN TO PREVENT DAMAGE DUE TO SETTLEMENT OF SEWER TRENCH

NOTE: "S" IS THE LENGTH NECESSARY TO PROVIDE 10 FEET OF SEPARATION AS MEASURED PERPEND. TO THE EXISTING WATER MAIN

(VERTICAL SEPARATION)

D - WATER AND SEWER SEPARATION REQUIREMENTS

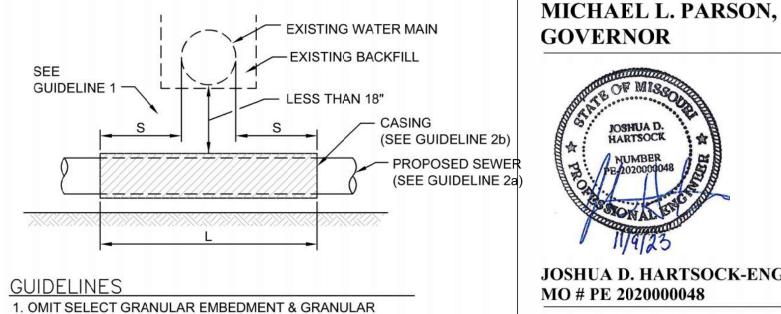

JOSHUA D. HARTSOCK-ENGINEER MO # PE 2020000048

STATE OF MISSOURI



OFFICE OF ADMINISTRATION DIVISION OF FACILITIES MANAGEMENT, **DESIGN AND CONSTRUCTION**

DESIGN AND CONSTRUCT LAGOON EXPANSION

461 COUNTY ROAD 517 WAPPAPELLO, MO 63966

PROJECT # T2317-01 6325 ASSET# 7016325013

REVISION: DATE: **REVISION:** DATE REVISION: DATE: ISSUE DATE: 11-09-2023

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MISCELLANEOUS DETAILS

