# FESTUS READINESS CENTER

Repairs to Interior/Exterior Readiness Center and Unheated Storage Buildings (Festus, Missouri)

OWNER:

STATE OF MISSOURI

MIKE KEHOE, GOVERNOR

DEPARTMENT OF

MISSOURI NATIONAL GUARD

**PROJECT** 

OFFICE OF ADMINISTRATION

MANAGEMENT: DIVISION OF FACILITIES MANAGEMENT,

DESIGN AND CONSTRUCTION

DESIGNER:

JEMA ARCHITECTS

PROJECT NUMBER:

T2330-01

SITE NUMBER:

6302

FACILITY NUMBER: 56377


# FESTUS READINESS CENTER


# **2740 STATE RD. P**

# INTERIOR RENOVATION

## PROJECT DATA

## **DRAWING INDEX**

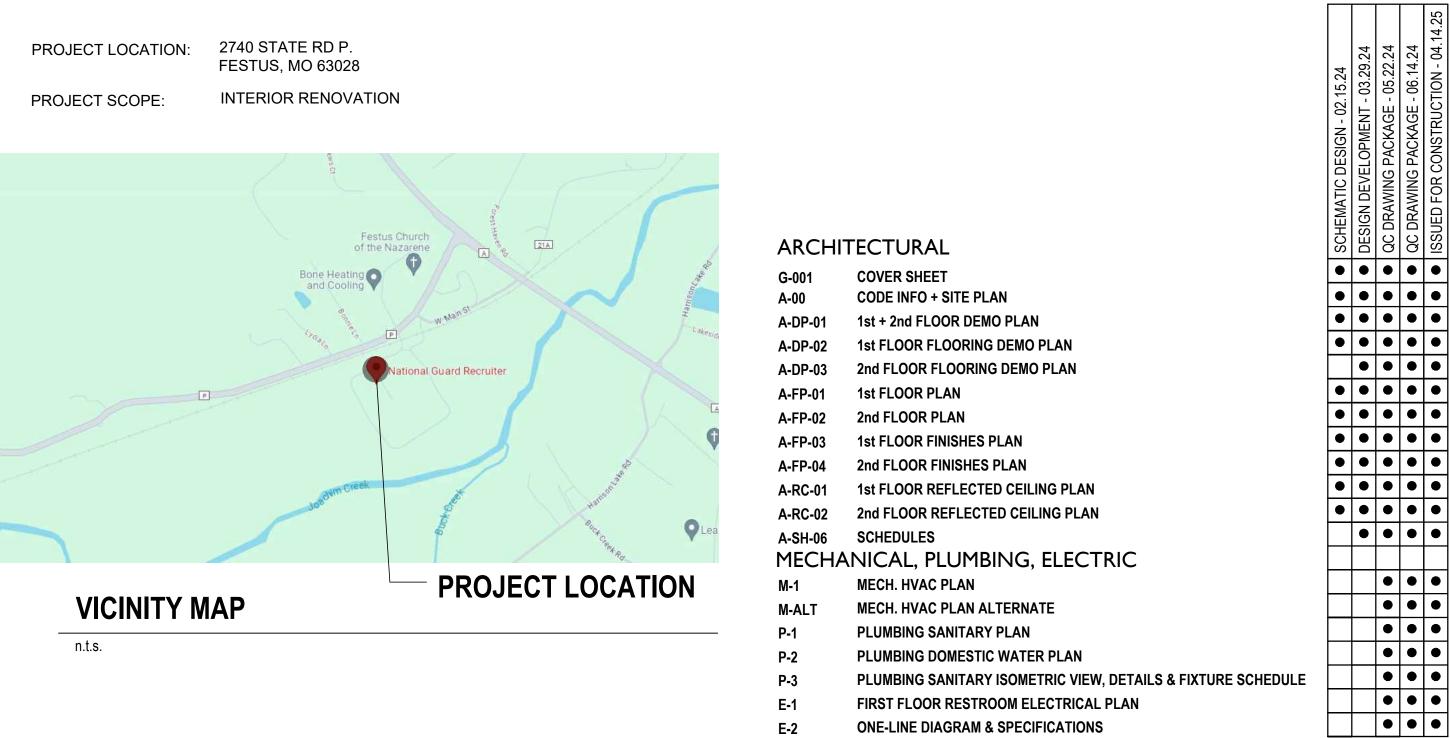

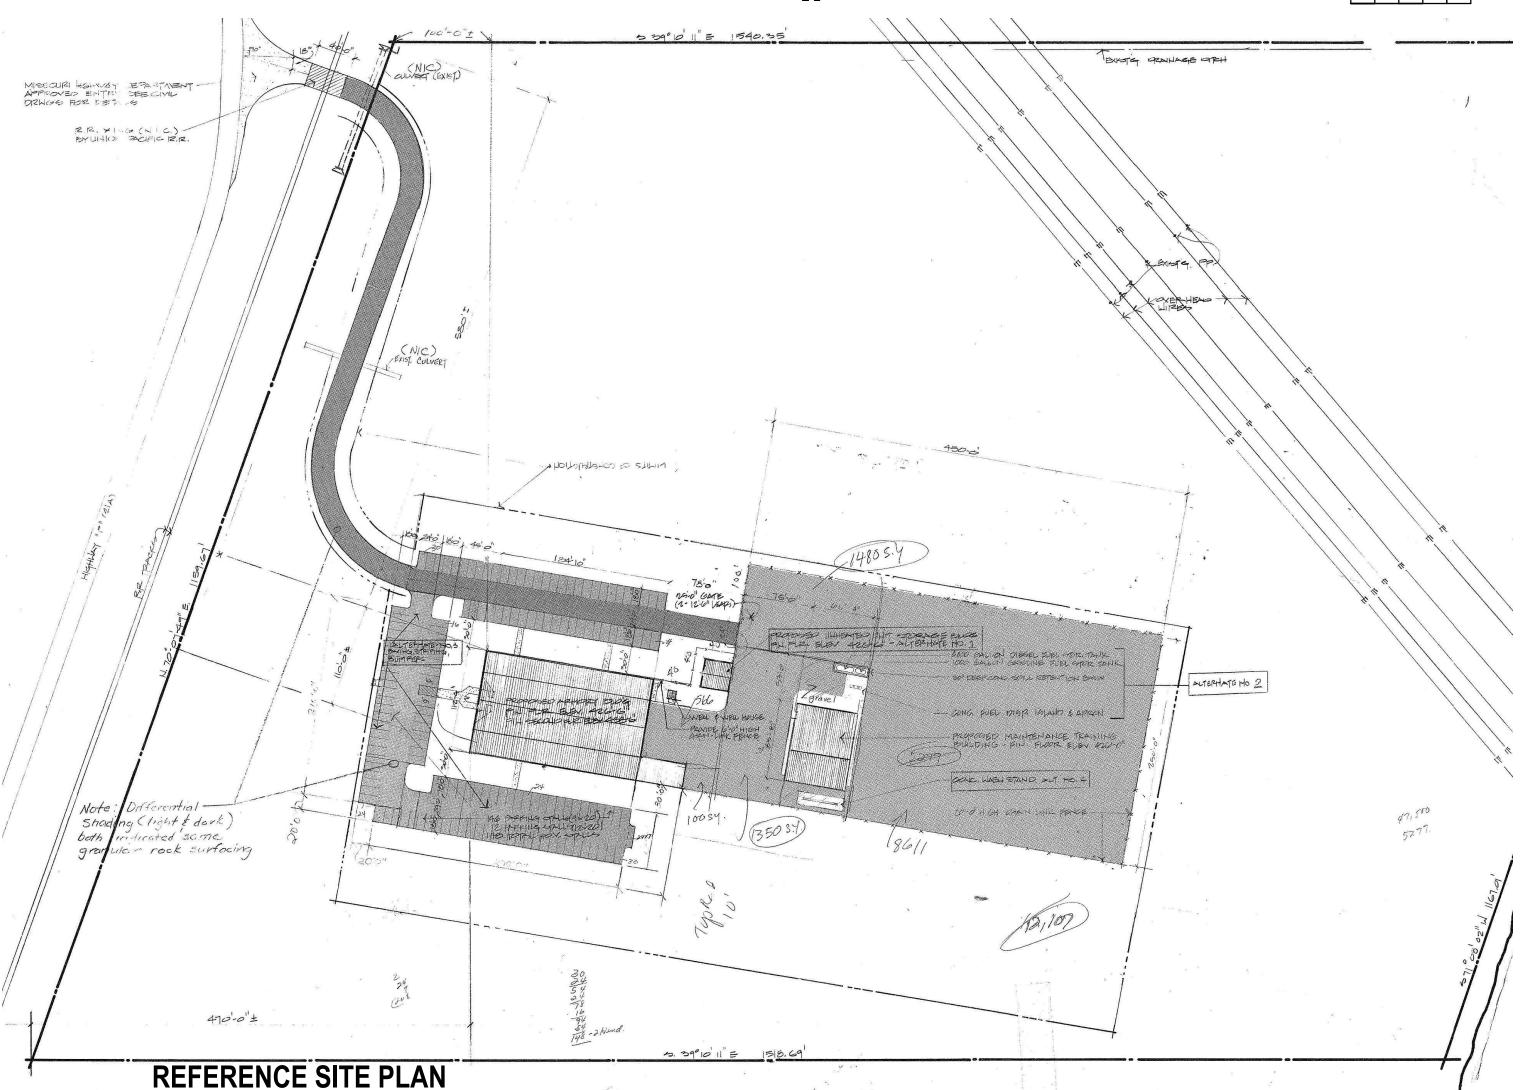

#### **FESTUS READINESS CENTER**

#### Code Analysis

#### APPLICABLE BUILDING CODES (Jefferson County, MO as amended): INTERNATIONAL BUILDING CODE 2015

- INTERNATIONAL RESIDENTIAL BUILDING CODE 2015 INTERNATIONAL FIRE CODE 2015
- INTERNATIONAL FUEL GAS CODE 2015
- INTERNATIONAL MECHANICAL CODE 201 INTERNATIONAL ENERGY CONSERVATION CODE 2015
- INTERNATIONAL PLUMBING CODE 2015 NATIONAL ELECTRIC CODE 2014/JEFFERSON COUNTY ELECTRICAL CODE 2017
- INTERNATIONAL SWIMMING POOL AND SPA CODE 2015

#### 021 INTERNATIONAL BUILDING CODE 2021 INTERNATIONAL EXISTING BUILDING CODE

#### 1-6.1 -- BUILDING CODES Use 2021 IBC and 2021 IEBC as follows:

- -- USE IBC, INCLUDING ALL PUBLISHED ERRATA, AS THE BUILDING CODE FOR DOD ,EXCEPT AS MODIFIED BY THIS UFC, OTHER UFC, AND FC. WHERE A PARAGRAPH IN ANY CHAPTER OF IBC REFERENCES A PARAGRAPH IN A DIFFERENT CHAPTER,
- MODIFYTHE REFERENCED CHAPTER AS DESCRIBED IN CHAPTER 2 OF UFC. -- USE IEBC, INCLUDING PUBLISHED ERRATA, EXCEPT AS MODIFIED BY THIS UFC, OTHER UFC, AND FC. WHERE A PARAGRAPH IN ANY CHAPTER OF IEBC REFERENCES A PARAGRAPH IN A DIFFERENT CHAPTER 3 OF UFC.

#### 1-6.2 REFERENCED CODES AND SUBSTITUTIONS.

#### TREAT REFERENCES IN THE DOD BUILDING CODE (SEE PARAGRAPH 2-1.1) AND THE DOD EXISTING BUILDING CODE (SEE PARAGRAPH 3-1.1) TO OTHER CODES AS FOLLOWS:

- -- DISMISS REFERENCES TO THE INTERNATIONAL FUEL GAS CODE® (IFGC), AS IFGC IS NOT ADOPTED. UFC 3-430-05 IS USED FOR GASEOUS FUEL DISTRIBUTION, UFC 3-460-01 IS USED FOR LIQUID FUEL STORAGE AND DISTRIBUTION AND SPECIFIC NFPA CODES ARE DIRECTLY REFERENCED BY APPROPRIATE APPLICATION IN UFCS.
- REFERENCES TO THE INTERNATIONAL MECHANICAL CODE® (IMC) ARE REFERENCES TO UFC 3-410-01, WHICH CITES IMC.
- REFERENCES TO THE INTERNATIONAL PLUMBING CODE® (IPC) ARE REFERENCES TO UFC 3-420-01, WHICH CITES IPC. DISMISS REFERENCES TO THE INTERNATIONAL PROPERTY MAINTENANCE CODE (IPMC) AS IPMC IS NOT ADOPTED. REFERENCES TO THE INTERNATIONAL FIRE CODE® (IFC) ARE REFERENCES TO UFC 3-600-01, WHICH CITES NFPA 1.
- REFERENCES TO THE INTERNATIONAL ENERGY CONSERVATION CODE® (IECC) ARE REFERENCES TO UFC 1-200-02, WHICH
- -- REFERENCES TO THE INTERNATIONAL GREEN CONSTRUCTION CODE® (IGCC) ARE REFERENCES TO UFC 1-200-02, WHICH
- -- REFERENCES TO NFPA 70, NATIONAL ELECTRICAL CODE® (NEC) ARE REFERENCES TO UFC 3-501-01, WHICH CITES NFPA 70.

# CONSTRUCTION TYPE: --NON-COMBUSTIBLE FXISTING FACILITY: TYPE II-B (NON COMBUSTIBLE, PRE-ENGINEERED BUILDINGS)

#### EXISTING BUILDING - Office/Storage Bldg: 7,223 SF+/-

B BUSINESS

#### S-1 STORAGE NOT SPRINKLERED

#### EXISTING BUILDING CODE (IEBC) ALTERATIONS - LEVEL 2 (sec. 603)

#### **BUILDING CODE ANALYSIS -- EXISTING BUILDING**

#### 506.3 eq 5-4:

23,000 SF (t506.2 occ. S-1 TYPE II-B) + (23,000 SF x .75 AREA FACTOR INCREASE) = 40,250 SF ALLOWED

#### sec. 508 for Mixed Use Occupancy - sec. 508.4 Separated Occupancies

# [506.2 eq 5-2 AREA FACTOR INCREASE = 697' BLDG PERIMETER/697" OPEN BLDG PERIMETER = 1.00 - .25 = .75] SEPARATED OCCUPANCIES (sec. 508.4) sec. 508.4.2 ALLOWABLE BUILDING AREA: t. 508.4 REQUIRED SEPARATE OF OCCUPANCIES: B / S-1 = N = NO SEPARATION REQUIREMENT OK

#### **PRICE ALTERNATES:**

THE FOLLOWING LIST PRICE ALTERNATES ARE TO BE PROVIDED AS SEPARATE LINE ITEMS COSTS FOR REVIEW AND ACCEPTANCE OR REJECTION BY THE OWNER. EACH PRICE ALTERNATE IS TO INCLUDE THE COMPLETE COST OR CREDIT TO THE OWNER FOR THE DIFFERENCE BETWEEN THE SCOPE DESCRIBED IN THE BASE BID AND THE SCOPE DESCRIBED IN THE ALTERNATE FOR THE AREAS AFFECTED

#### 1. ALTERNATE #1:

RETAIN THE EXISTING (4) MECHANICAL UNITS. ALTERNATE: REPLACE PER THE MECHANICAL EQUIPMENT SCHEDULE ON M-ALT.

#### 2. ALTERNATE #2:


SINGLE TWO COMPONENT URETHANE SEALER TOP COAT. ADDITIONAL TWO COMPONENT URETHANE SEALER TOP COAT.


3. ALTERNATE #3: RETAIN DOORS AND HARDWARE #107, 108, 201, 202. REPLACEMENT OF DOORS AND HARDWARE #107, 108, 201, 202. SEE DOOR. SCHEDULE SHEET A-SH-06.


#### ALTERNATE


4. ALTERNATE #4: BASE BID: ALL VCT FLOORING TO REMAIN.

ALTERNATE: VCT FLOORING REMOVAL AND REPLACEMENT AS INDICATED ON DRAWINGS A-FP-03 AND A-FP-04.

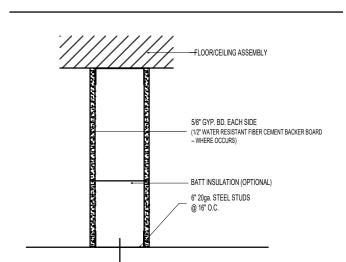

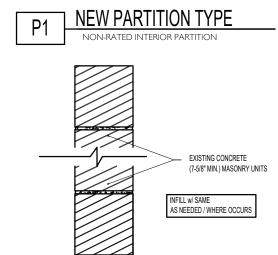

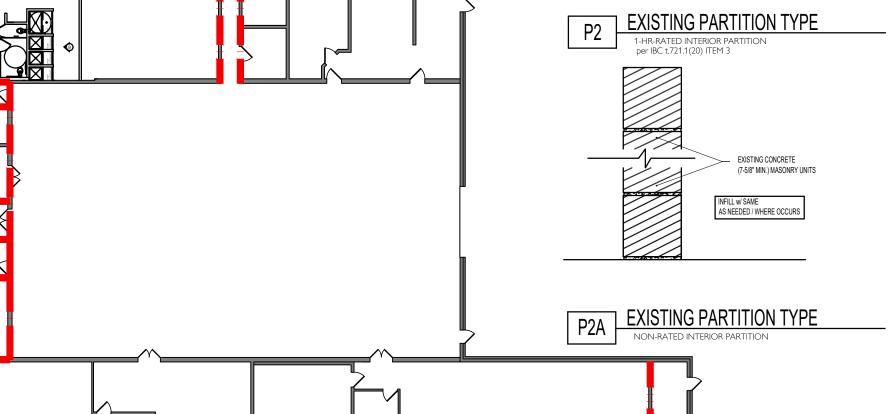


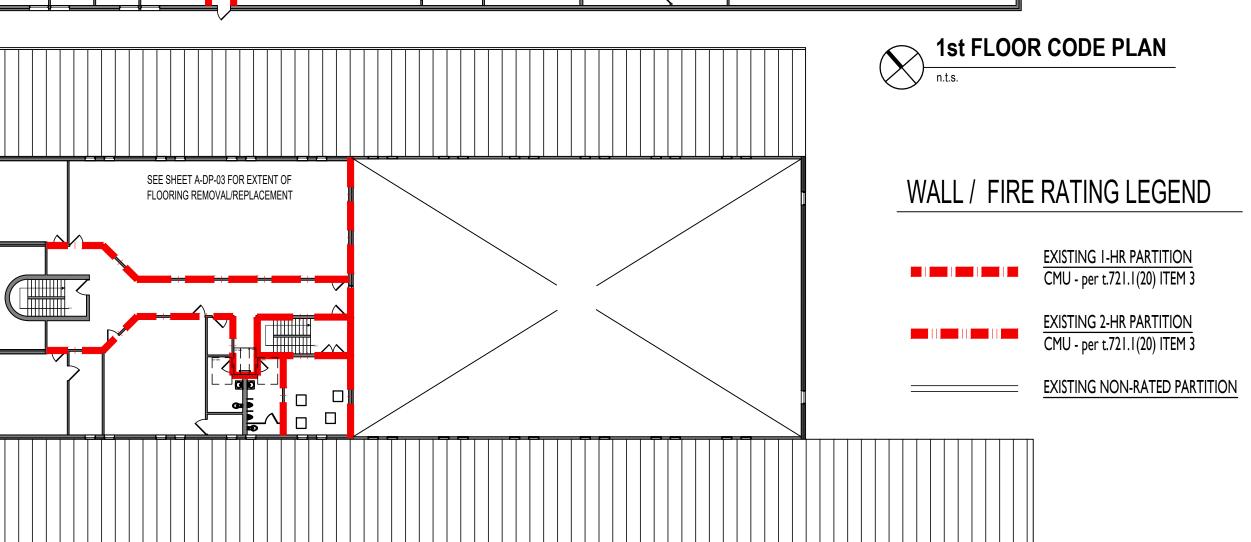

2nd FLOOR CODE PLAN

n.t.s.

STATE OF MISSOURI MIKE KEHOE, **GOVERNOR** 

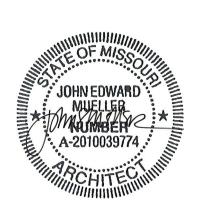

OFFICE OF ADMINISTRATION **DIVISION OF FACILITIES** MANAGEMENT, **DESIGN AND CONSTRUCTION** 

**DEPARTMENT OF** 

#### **Festus Readiness Center**

Repars to Int./Ext. Readiness Center, and Unheated Storage Buildings

ARMY NATIONAL GUARD 2740 State Rd P, Festus, MO 63028

PROJECT # T-2330-01 FACILITY # 56377

**REVISION: REVISION:** 

ISSUE DATE: 06/23/2025 DRAWN BY:


**DESIGNED BY** SHEET TITLE:

CODE INFORMATION SITE PLAN

SHEET NUMBER:

2 OF 19 SHEETS

n.t.s.

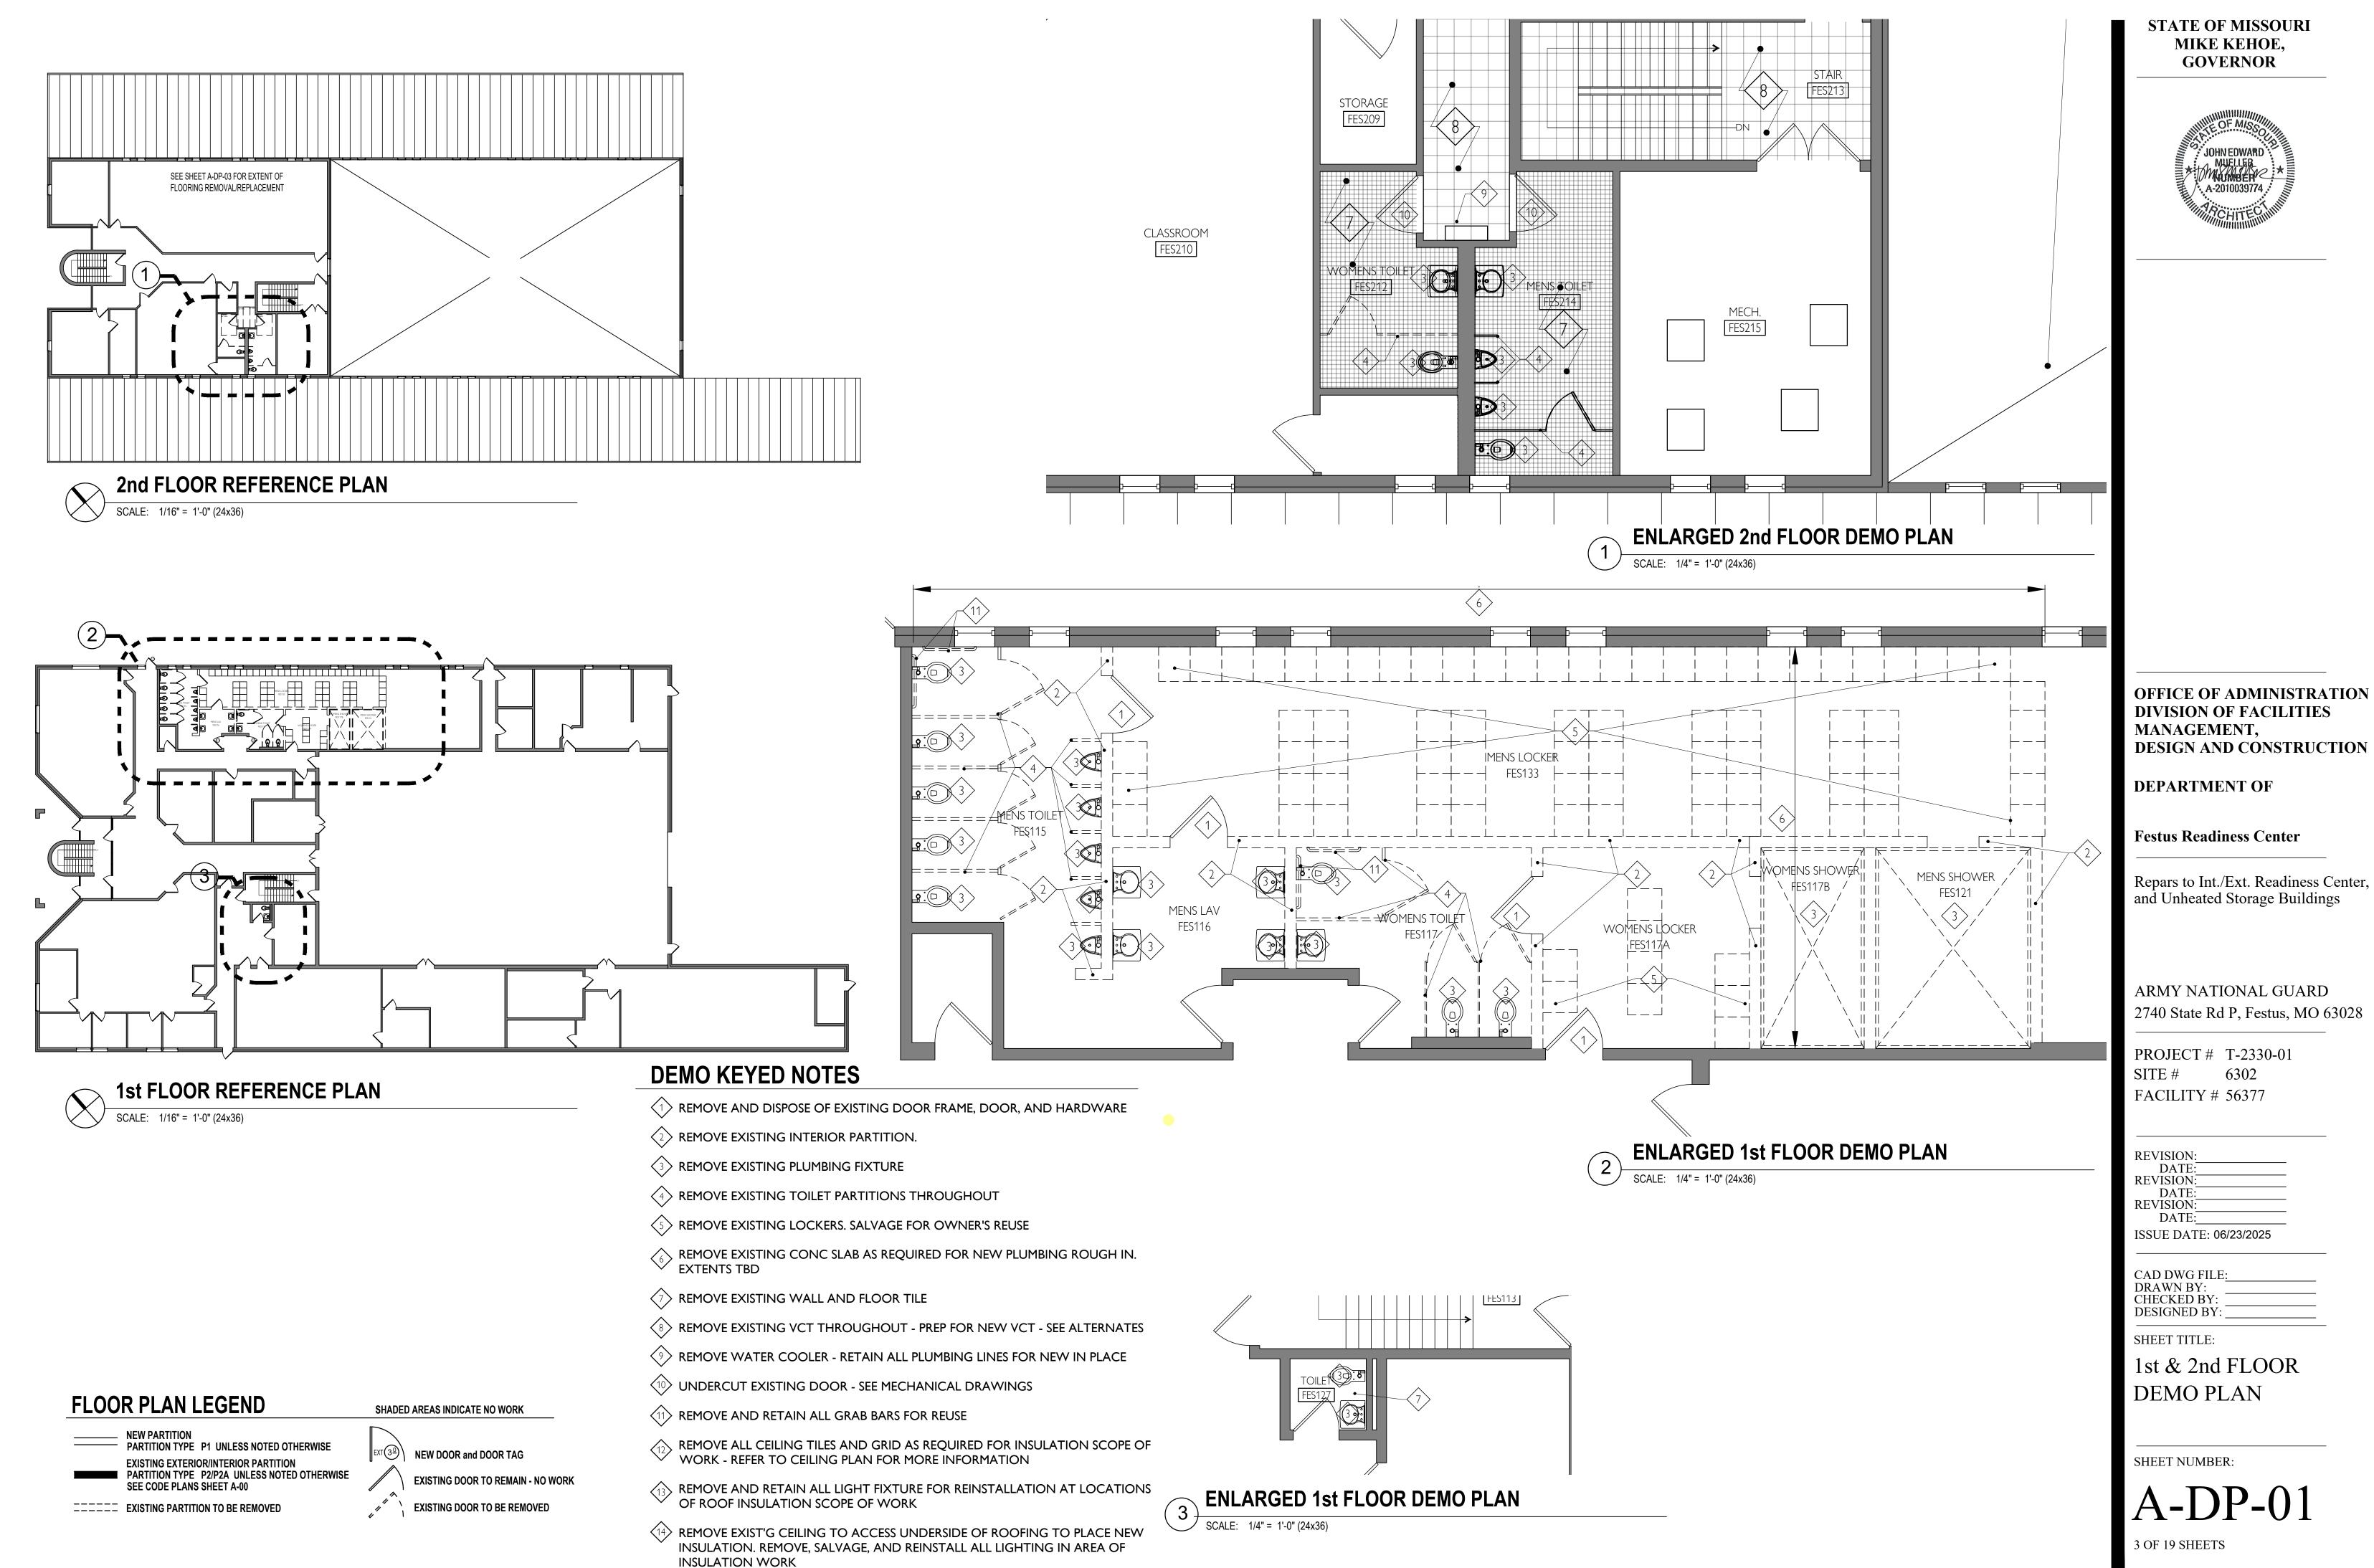

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INSULATION WORK

STATE OF MISSOURI MIKE KEHOE, GOVERNOR



OFFICE OF ADMINISTRATION DIVISION OF FACILITIES MANAGEMENT, DESIGN AND CONSTRUCTION

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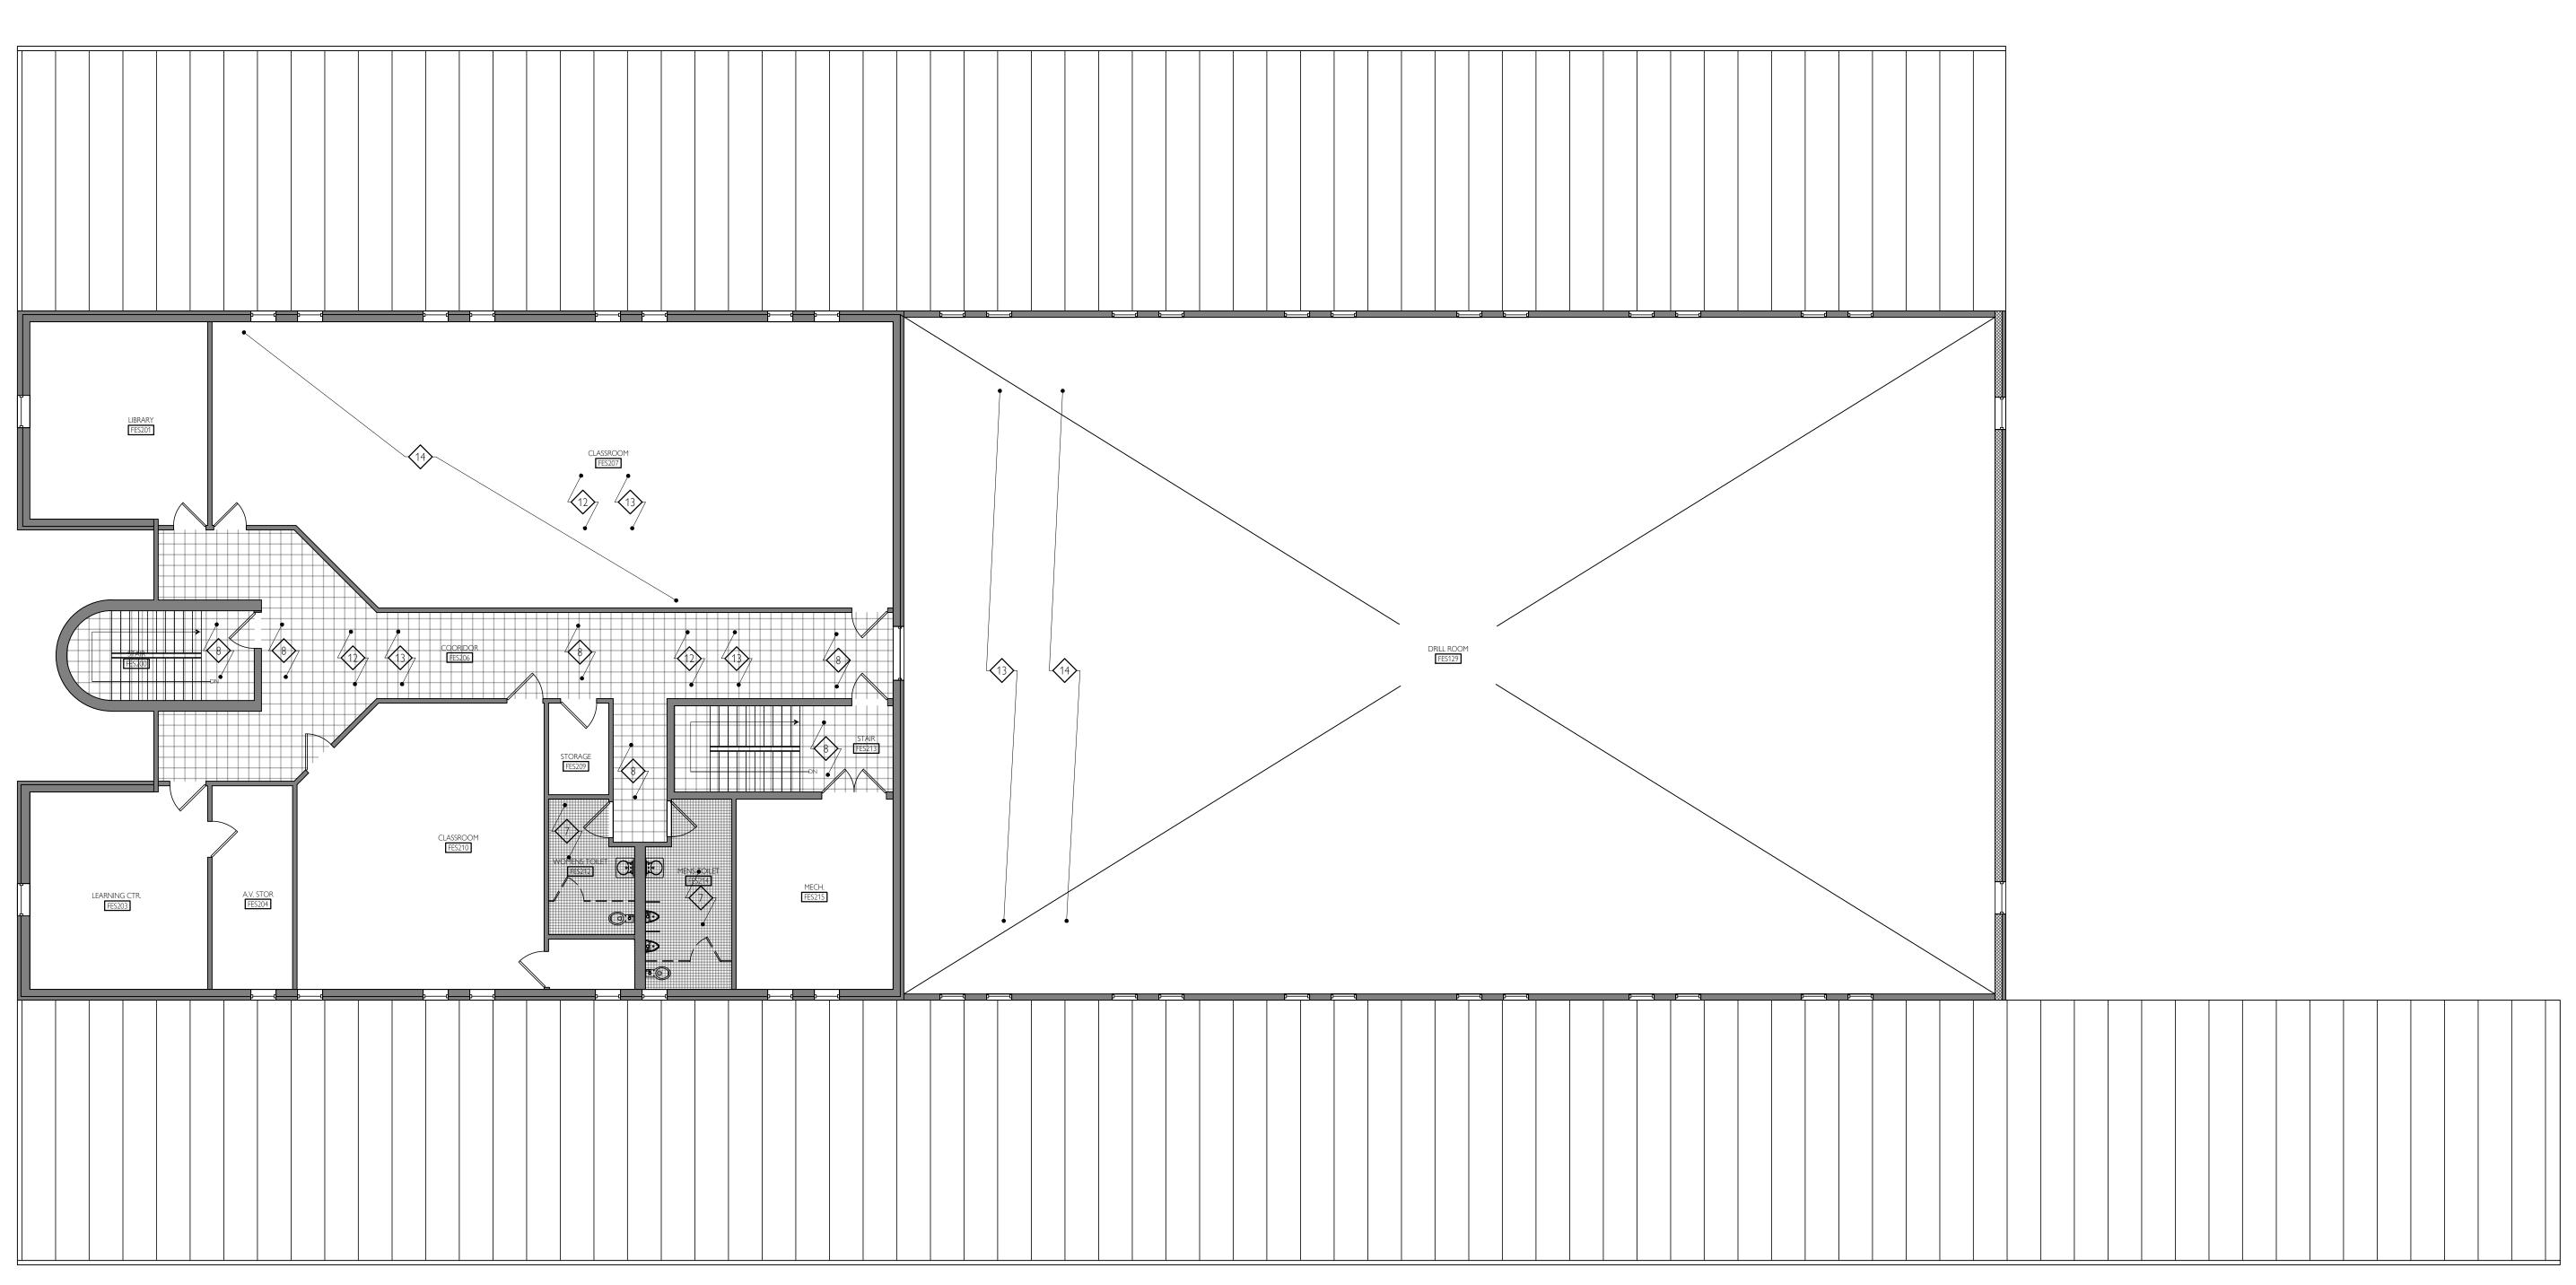
CAD DWG FILE:
DRAWN BY:
CHECKED BY:
DESIGNED BY:

SHEET TITLE:

1st FLOOR FLOORING DEMO PLAN

SHEET NUMBER:

A-DP-02



## **DEMO KEYED NOTES**

- REMOVE AND DISPOSE OF EXISTING DOOR FRAME, DOOR, AND HARDWARE
- 2 REMOVE EXISTING INTERIOR PARTITION.
- REMOVE EXISTING PLUMBING FIXTURE
- REMOVE EXISTING TOILET PARTITIONS THROUGHOUT
- 5 REMOVE EXISTING LOCKERS. SALVAGE FOR OWNER'S REUSE
- REMOVE EXISTING WALL AND FLOOR TILE
- REMOVE EXISTING VCT THROUGHOUT PREP FOR NEW VCT SEE ALTERNATES
- PREMOVE WATER COOLER RETAIN ALL PLUMBING LINES FOR NEW IN PLACE
- UNDERCUT EXISTING DOOR SEE MECHANICAL DRAWINGS

- REMOVE EXIST'G CEILING TO ACCESS UNDERSIDE OF ROOFING TO PLACE NEW INSULATION. REMOVE, SALVAGE, AND REINSTALL ALL LIGHTING IN AREA OF **INSULATION WORK**

MIKE KEHOE, **GOVERNOR** 

STATE OF MISSOURI



OFFICE OF ADMINISTRATION DIVISION OF FACILITIES MANAGEMENT, **DESIGN AND CONSTRUCTION** 

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PROJECT # T-2330-01 SITE# 6302 FACILITY # 56377

2nd FLOOR FLOORING DEMO PLAN

<b>REVISION:</b>	
DATE:	
REVISION:	
DATE:	
REVISION:	
DATE:	

ISSUE DATE: 06/23/2025

CAD DWG FILE DRAWN BY: CHECKED BY: **DESIGNED BY:** 

SHEET TITLE:

2nd FLOOR FLOORING DEMO PLAN

SHEET NUMBER:

A-DP-03

5 OF 19 SHEETS



SHADED AREAS INDICATE NO WORK

NEW DOOR and DOOR TAG

EXISTING DOOR TO BE REMOVED

EXISTING DOOR TO REMAIN - NO WORK

FLOOR PLAN LEGEND

PARTITION TYPE P1 UNLESS NOTED OTHERWISE


SEE CODE PLANS SHEET A-00

===== EXISTING PARTITION TO BE REMOVED

EXISTING EXTERIOR/INTERIOR PARTITION
PARTITION TYPE P2/P2A UNLESS NOTED OTHERWISE

**NEW PARTITION** 

- REMOVE EXISTING CONC SLAB AS REQUIRED FOR NEW PLUMBING ROUGH IN. EXTENTS TBD
- REMOVE AND RETAIN ALL GRAB BARS FOR REUSE
- REMOVE ALL CEILING TILES AND GRID AS REQUIRED FOR INSULATION SCOPE OF WORK REFER TO CEILING PLAN FOR MORE INFORMATION
- REMOVE AND RETAIN ALL LIGHT FIXTURE FOR REINSTALLATION AT LOCATIONS OF ROOF INSULATION SCOPE OF WORK

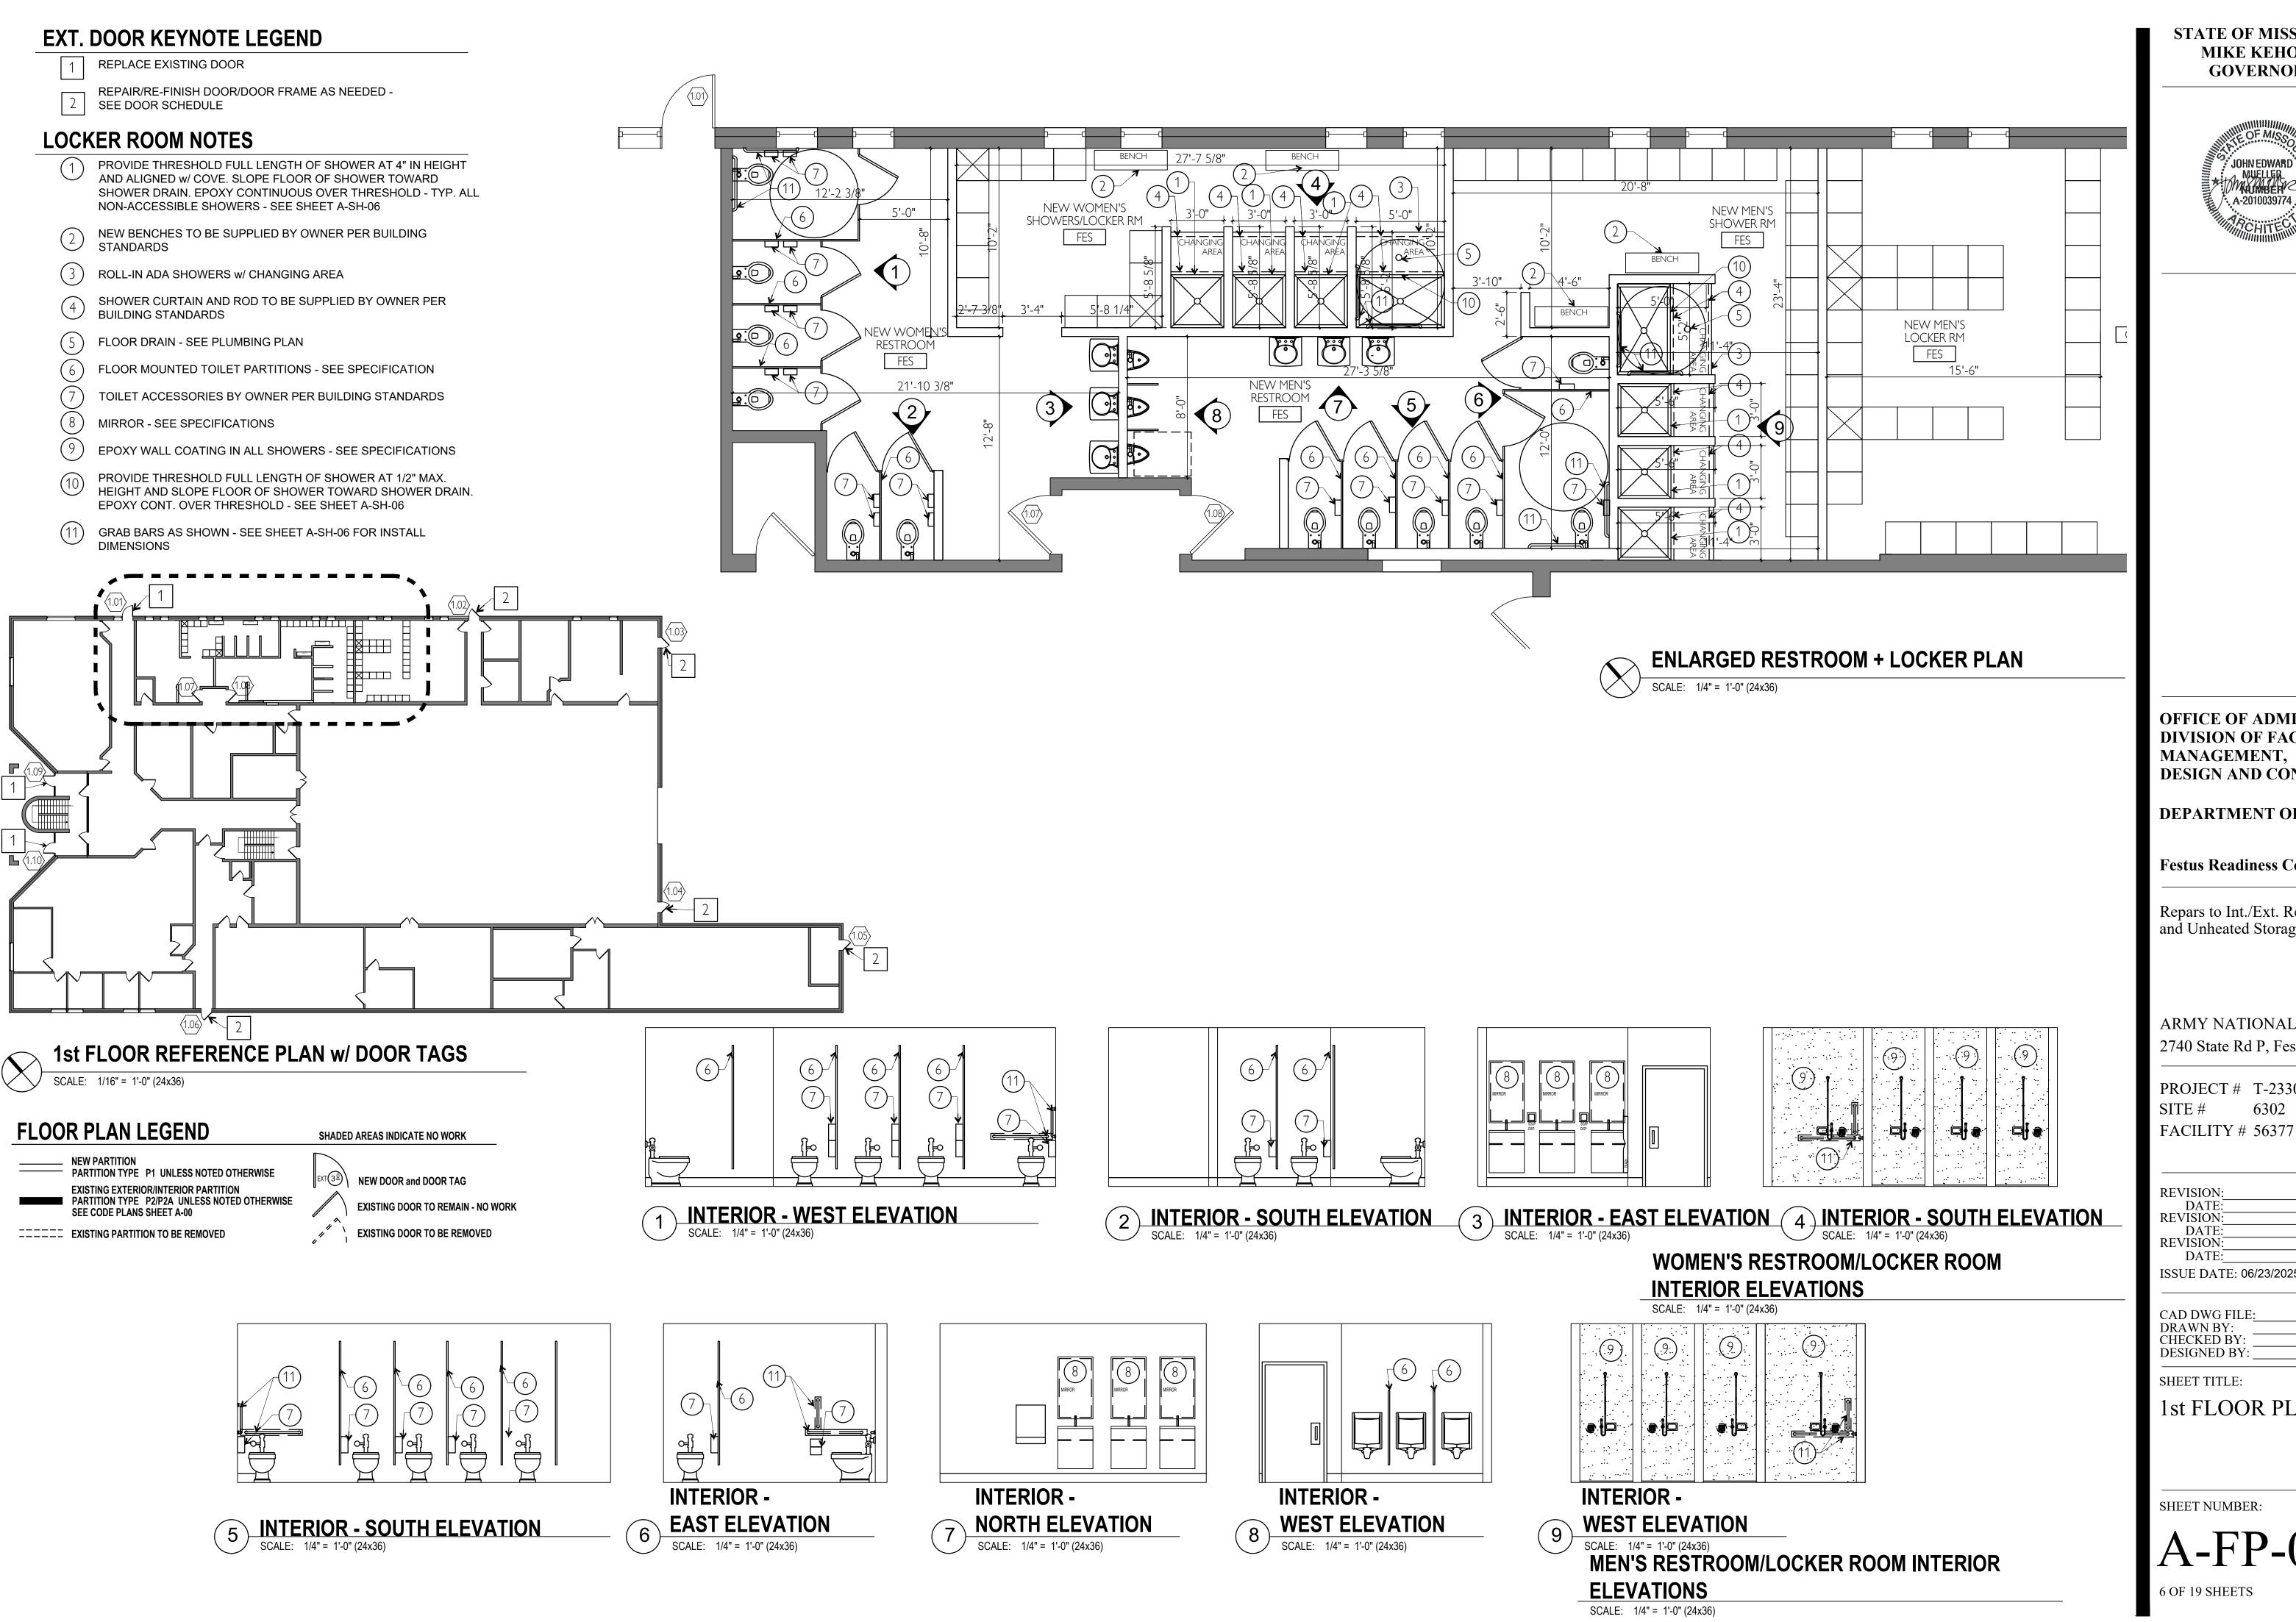



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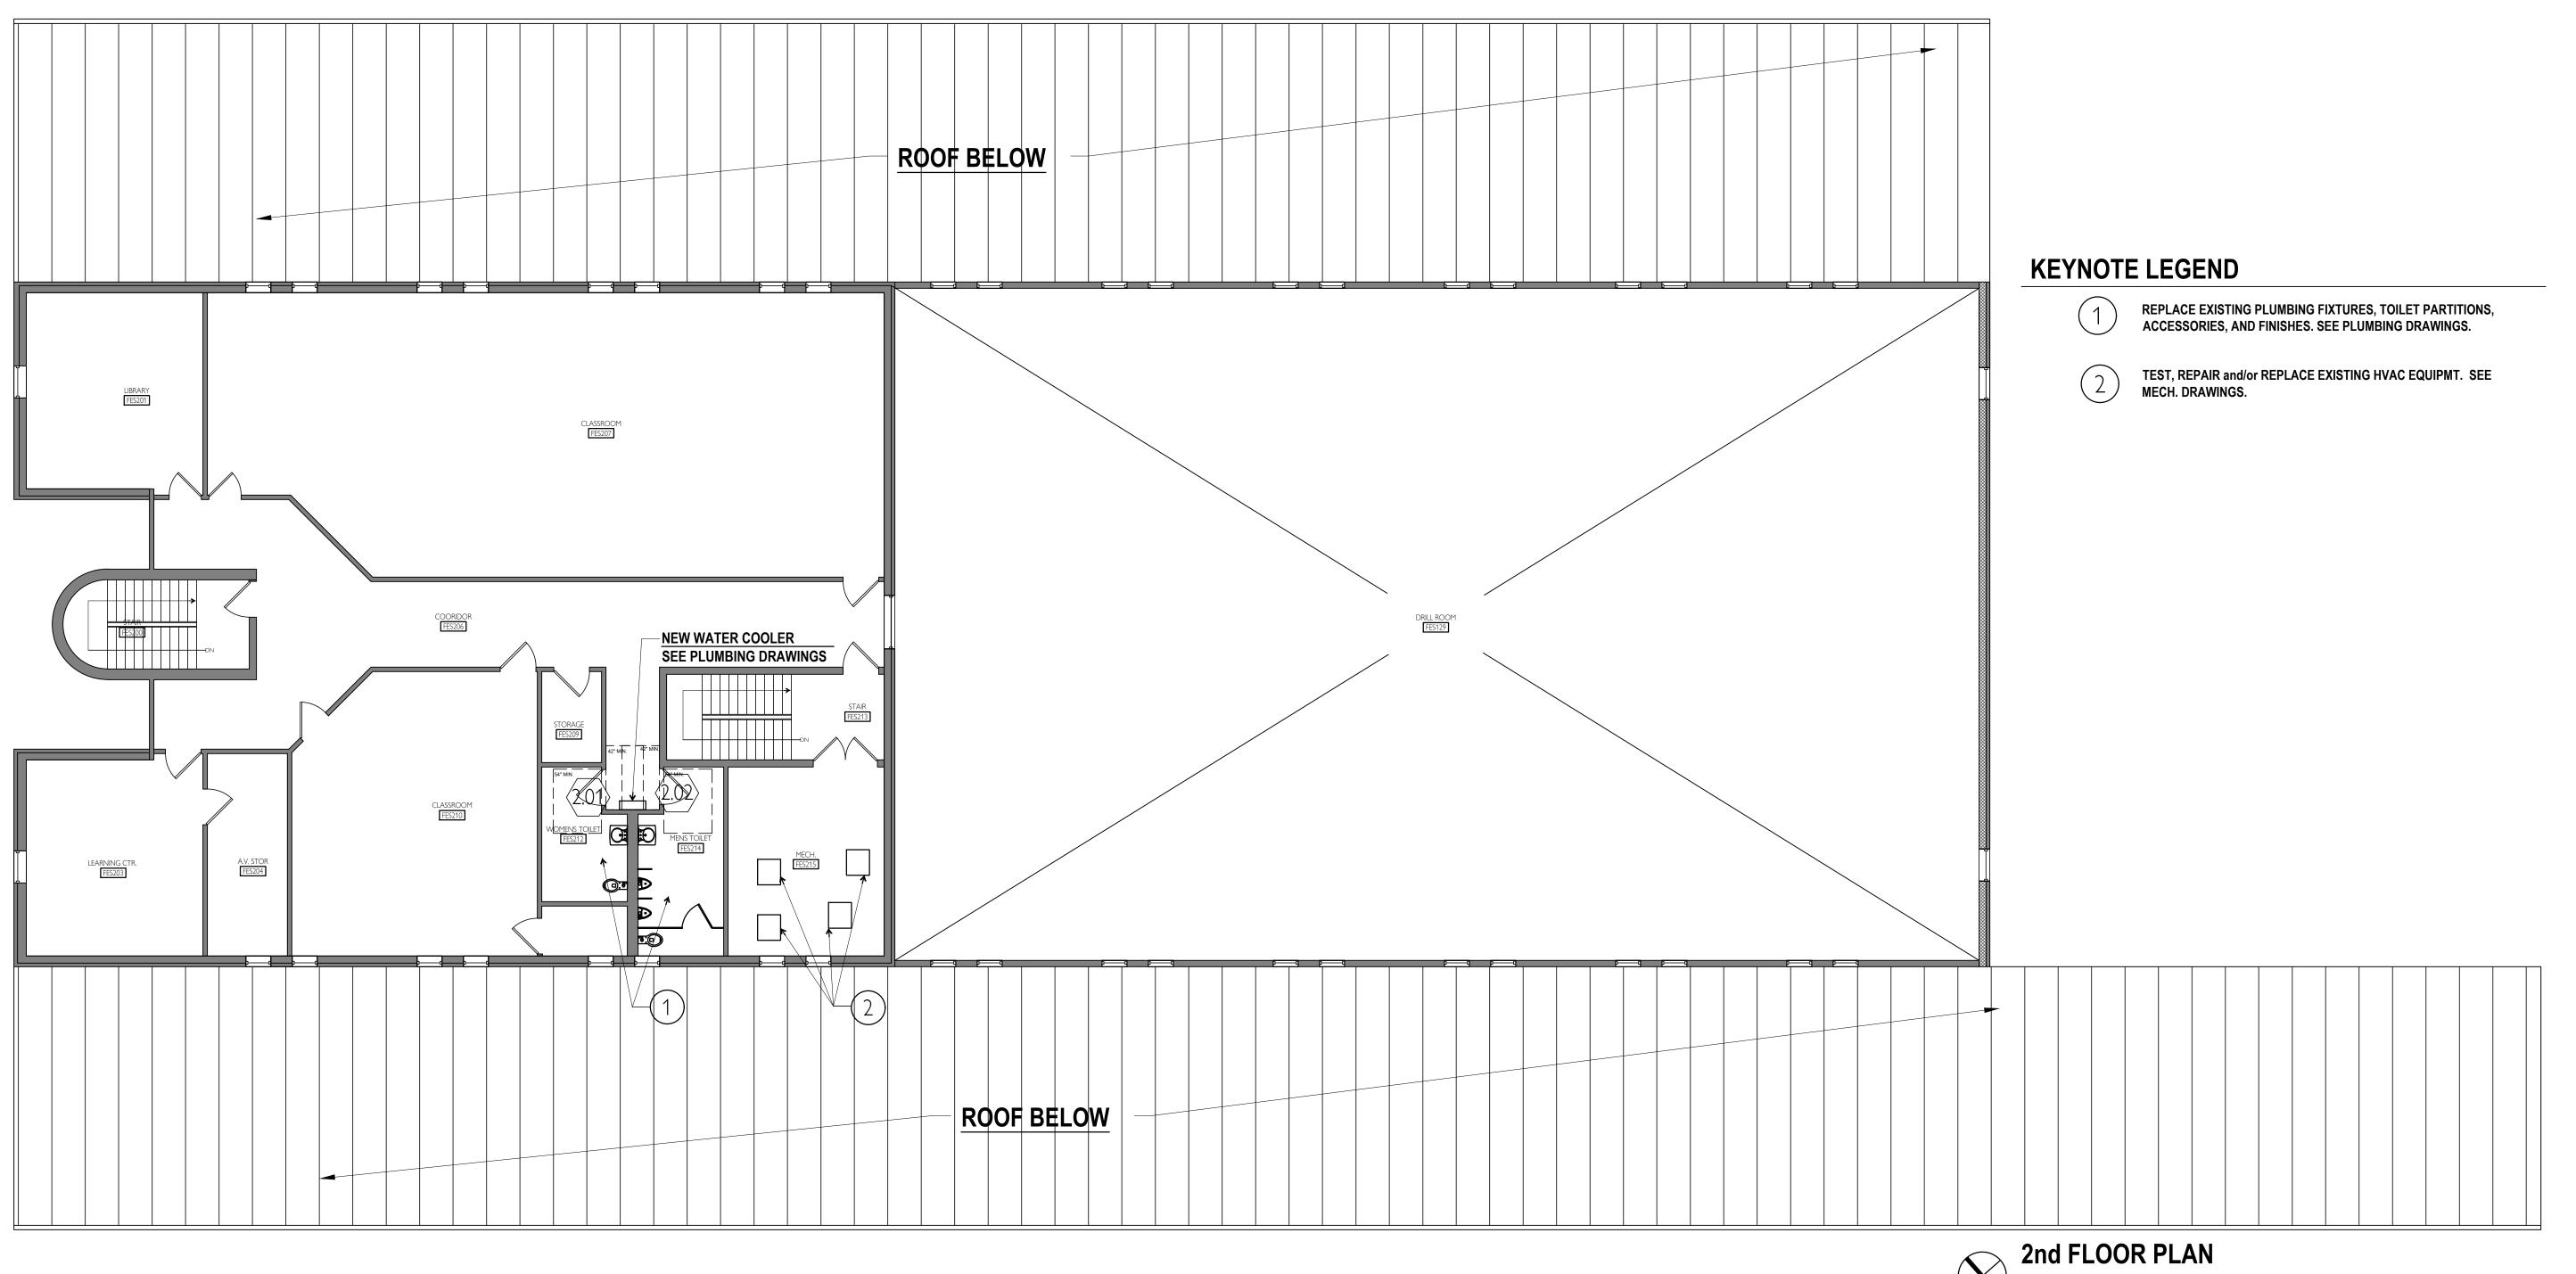
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SHEET TITLE:

1st FLOOR PLAN

SHEET NUMBER:

A-FP-01





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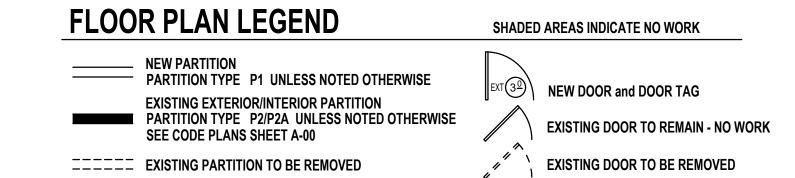
ISSUE DATE: 06/23/2025


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SHEET TITLE:

2nd FLOOR PLAN

SHEET NUMBER:





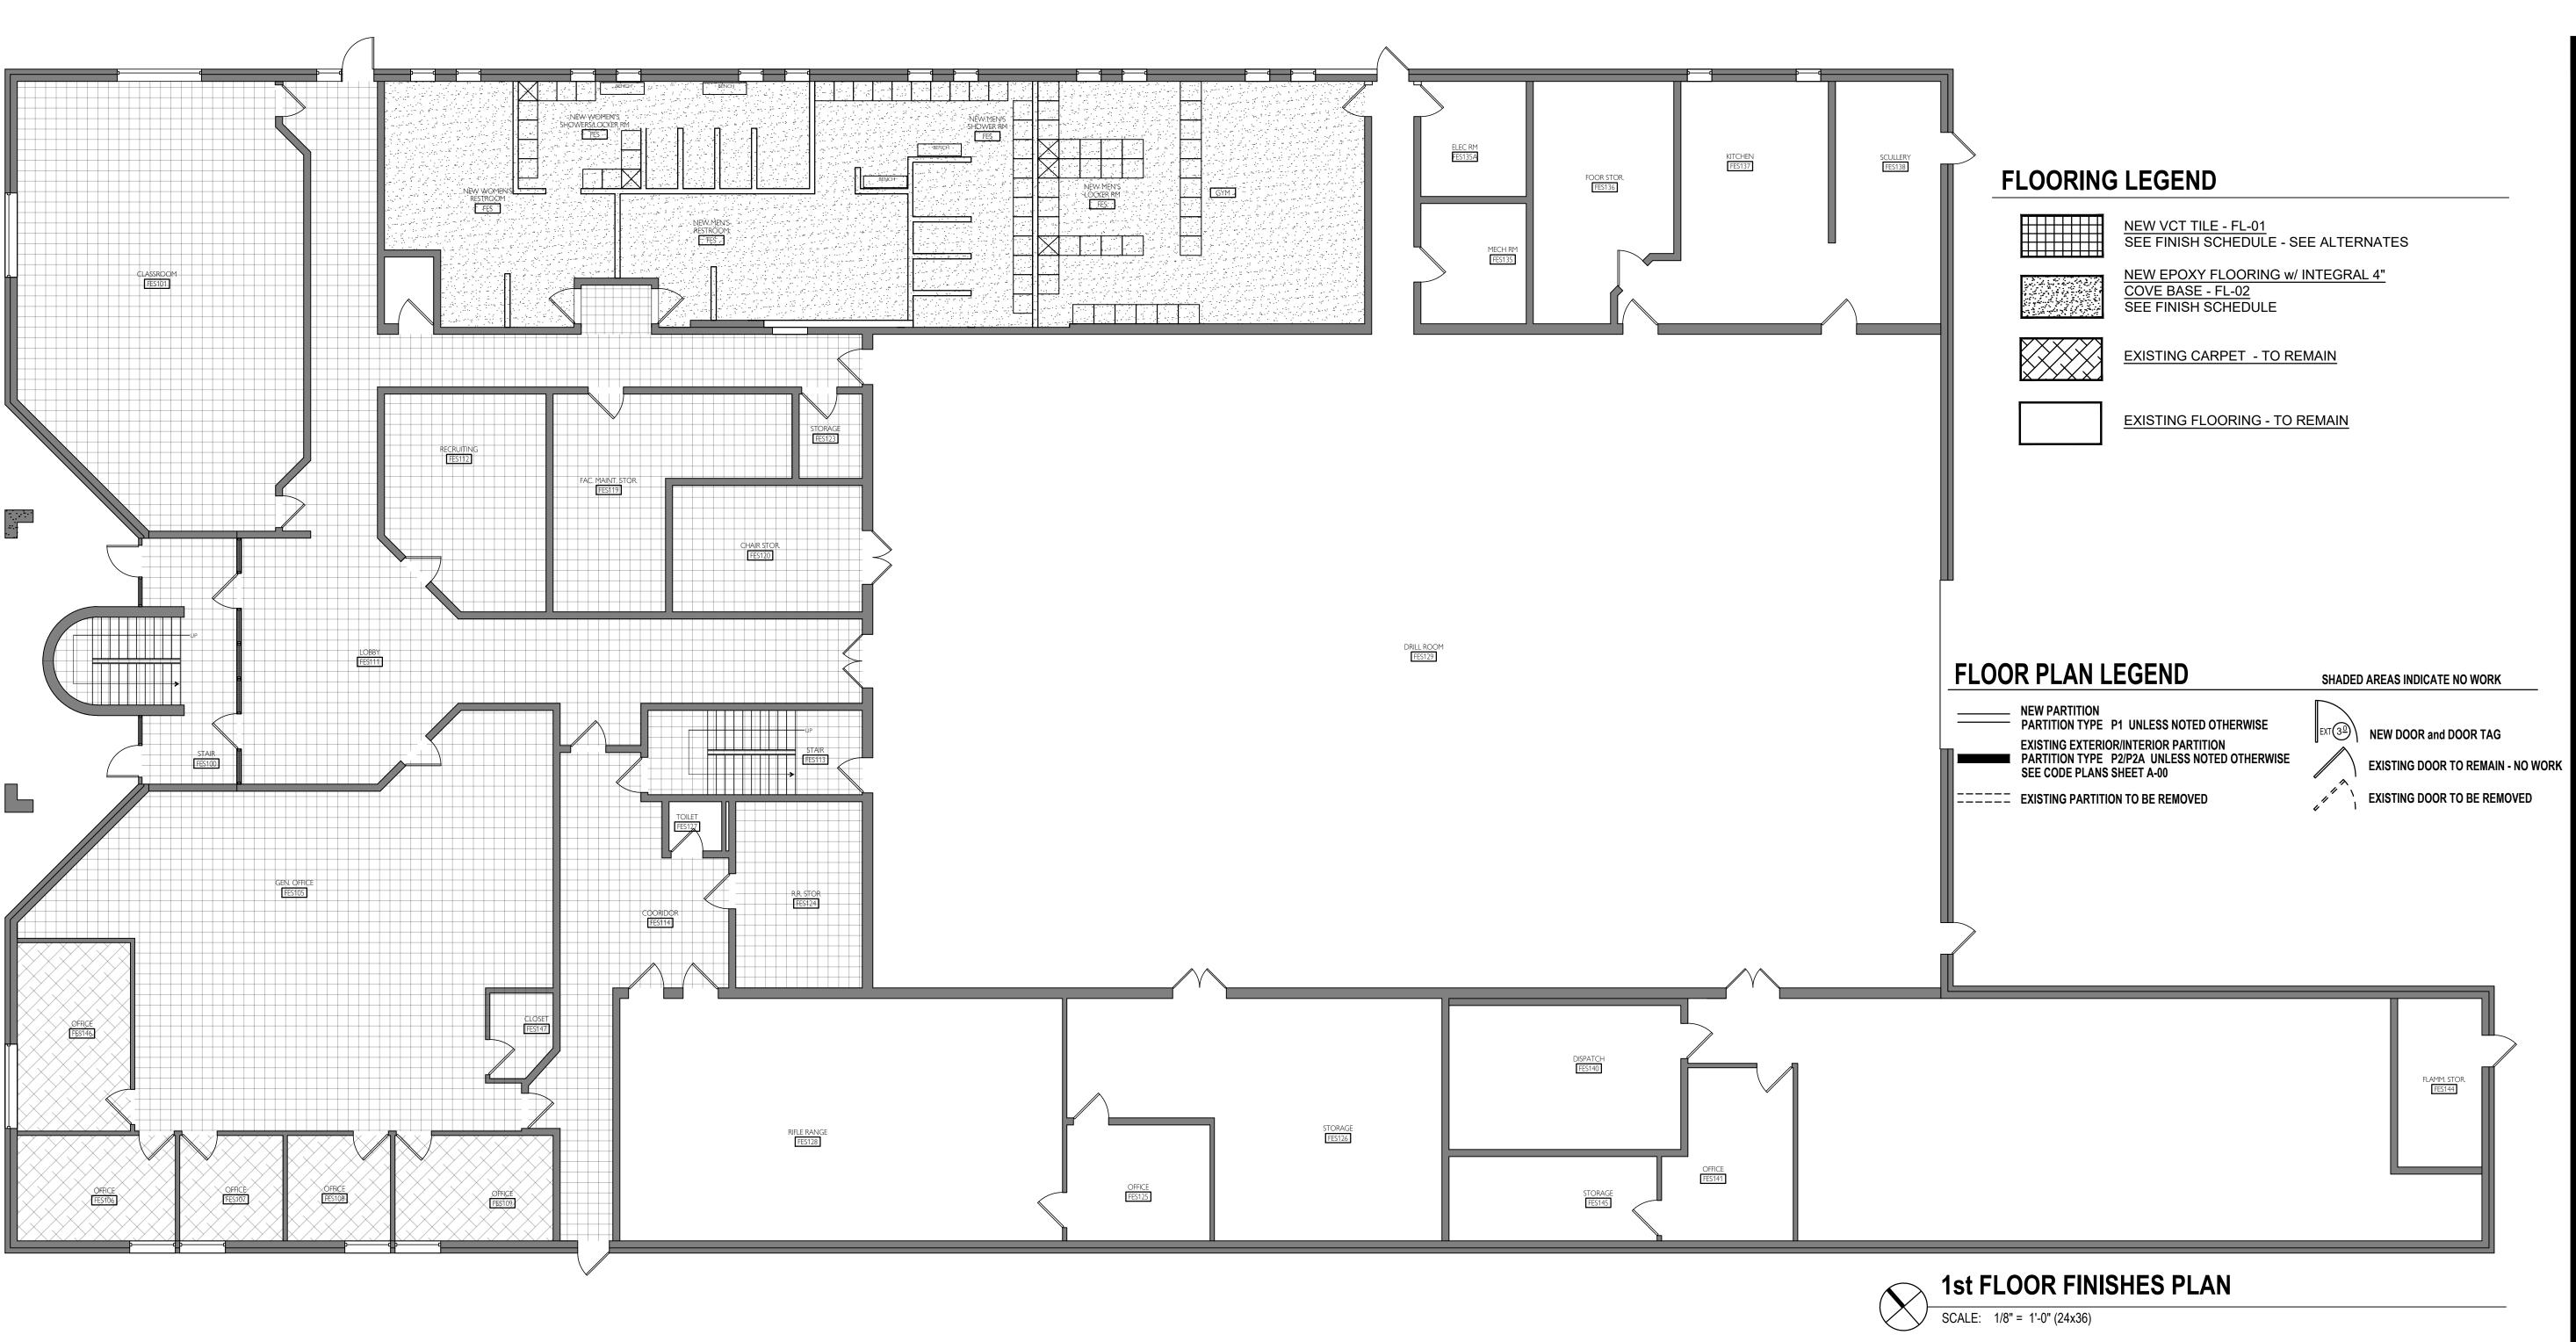

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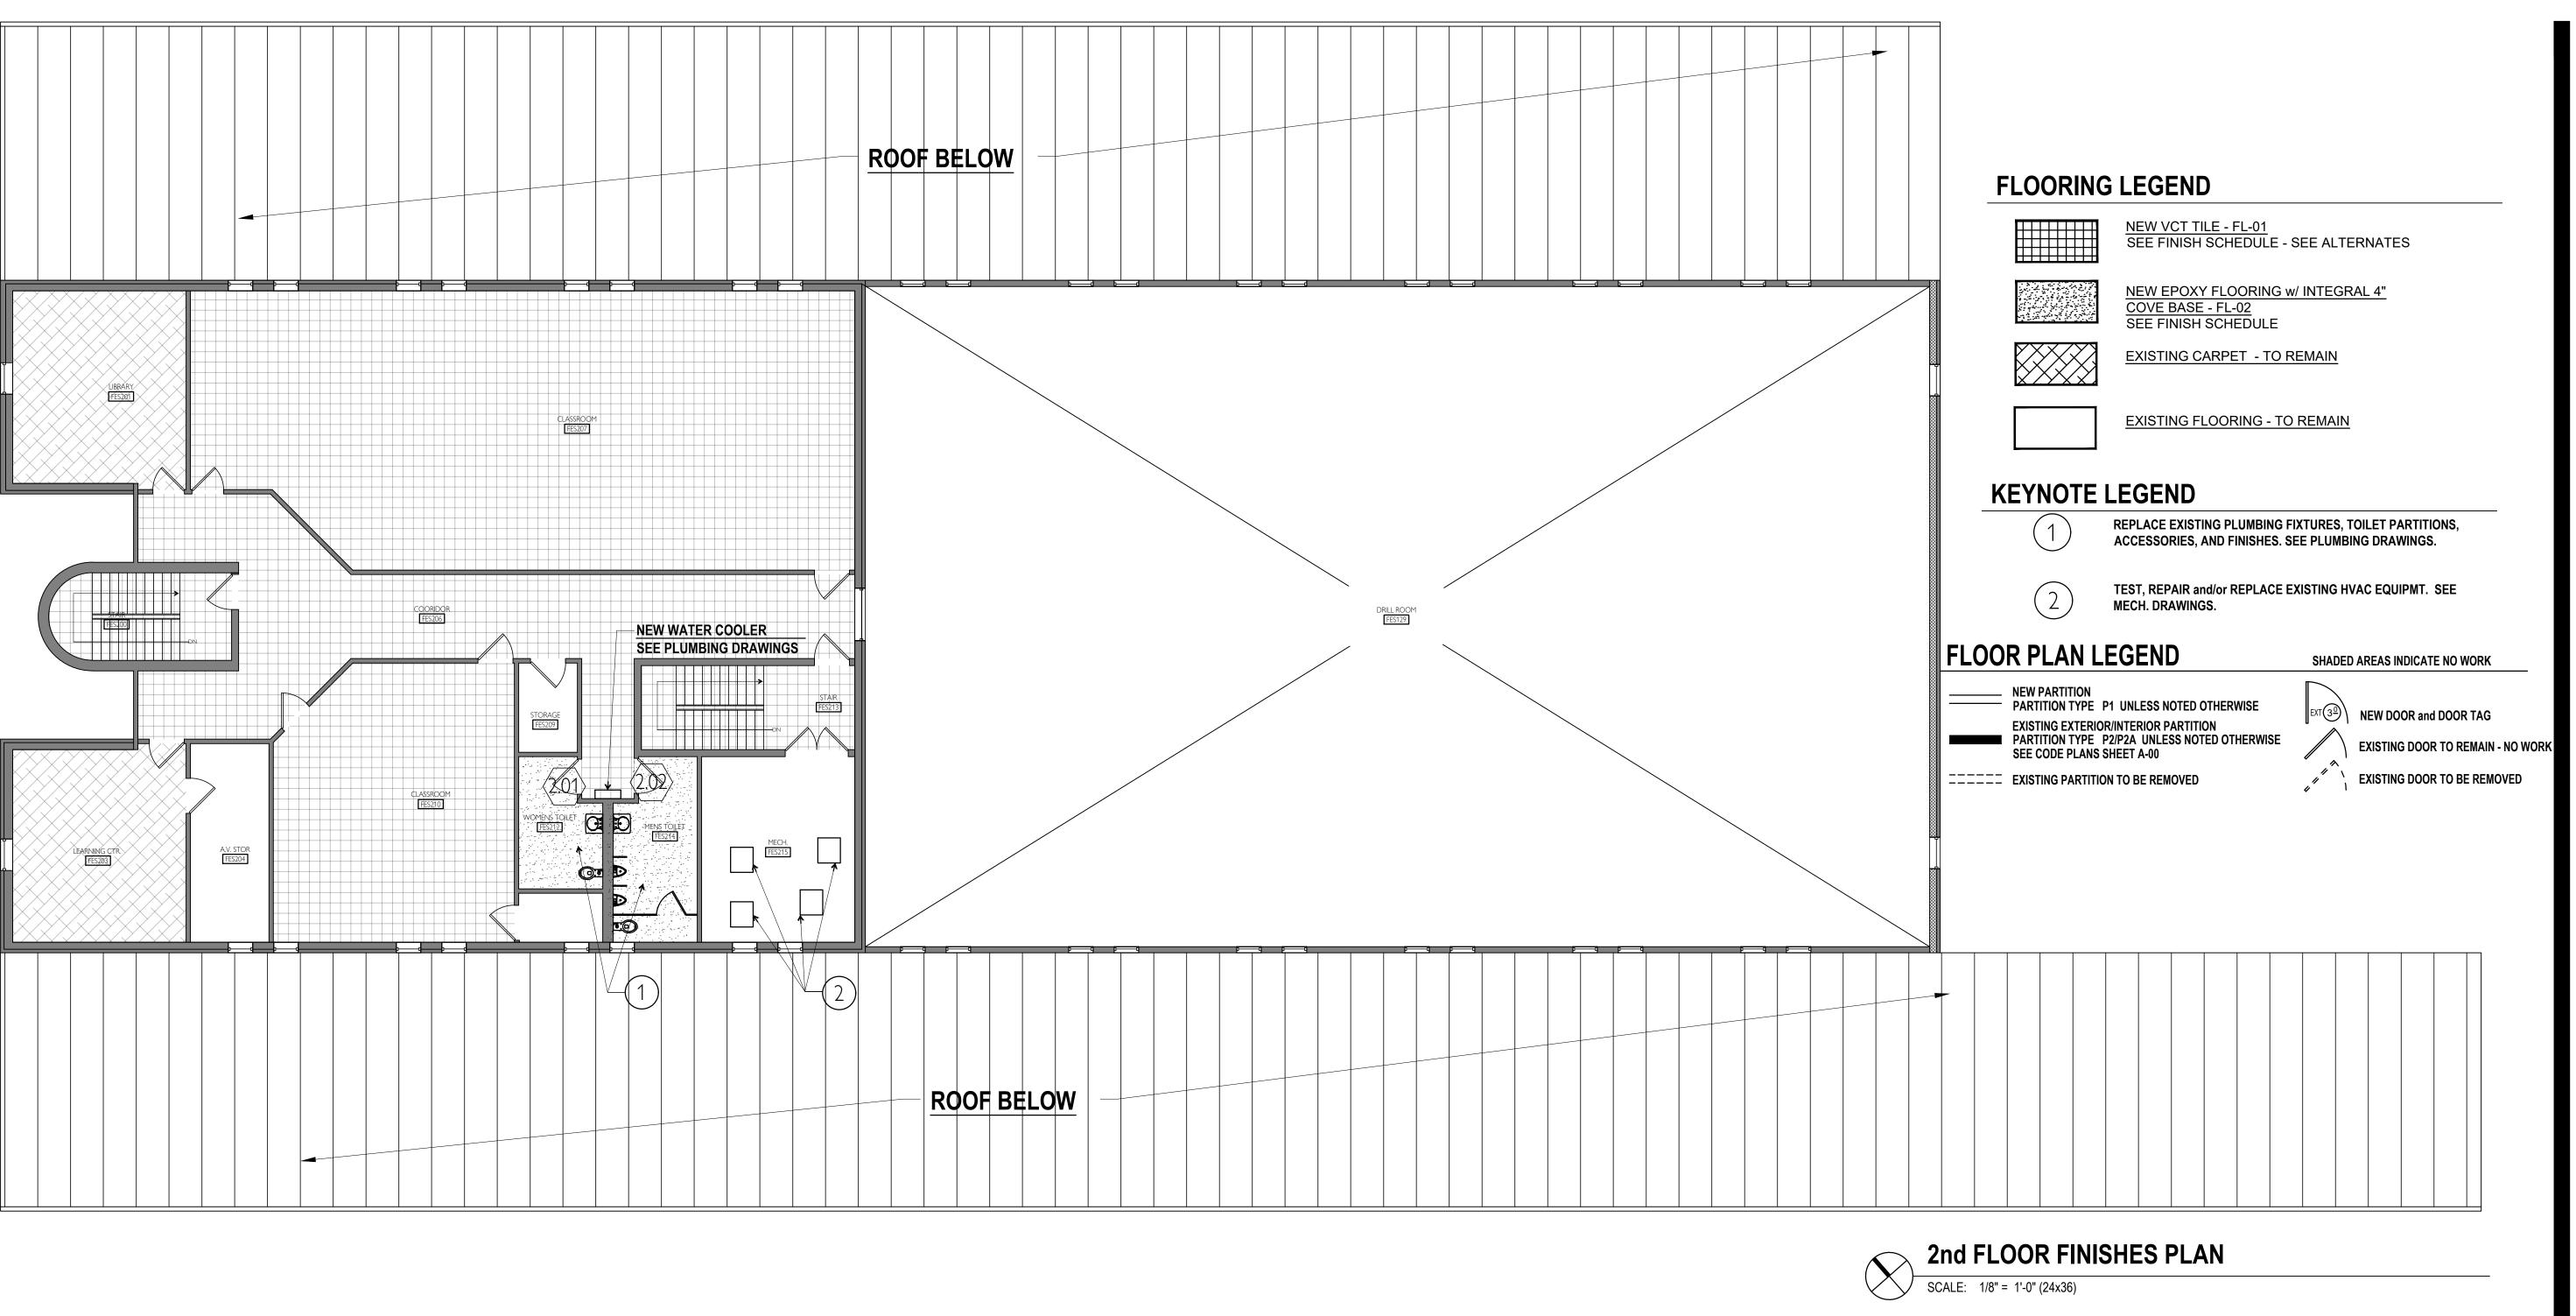
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CHECKED BY:
DESIGNED BY:

SHEET TITLE:

1st FLOOR FINISHES PLAN

SHEET NUMBER:

A-FP-03



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REVISION:

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DRAWN BY:
CHECKED BY:
DESIGNED BY:

SHEET TITLE:

2nd FLOOR FINISHES PLAN

SHEET NUMBER:

A-FP-04





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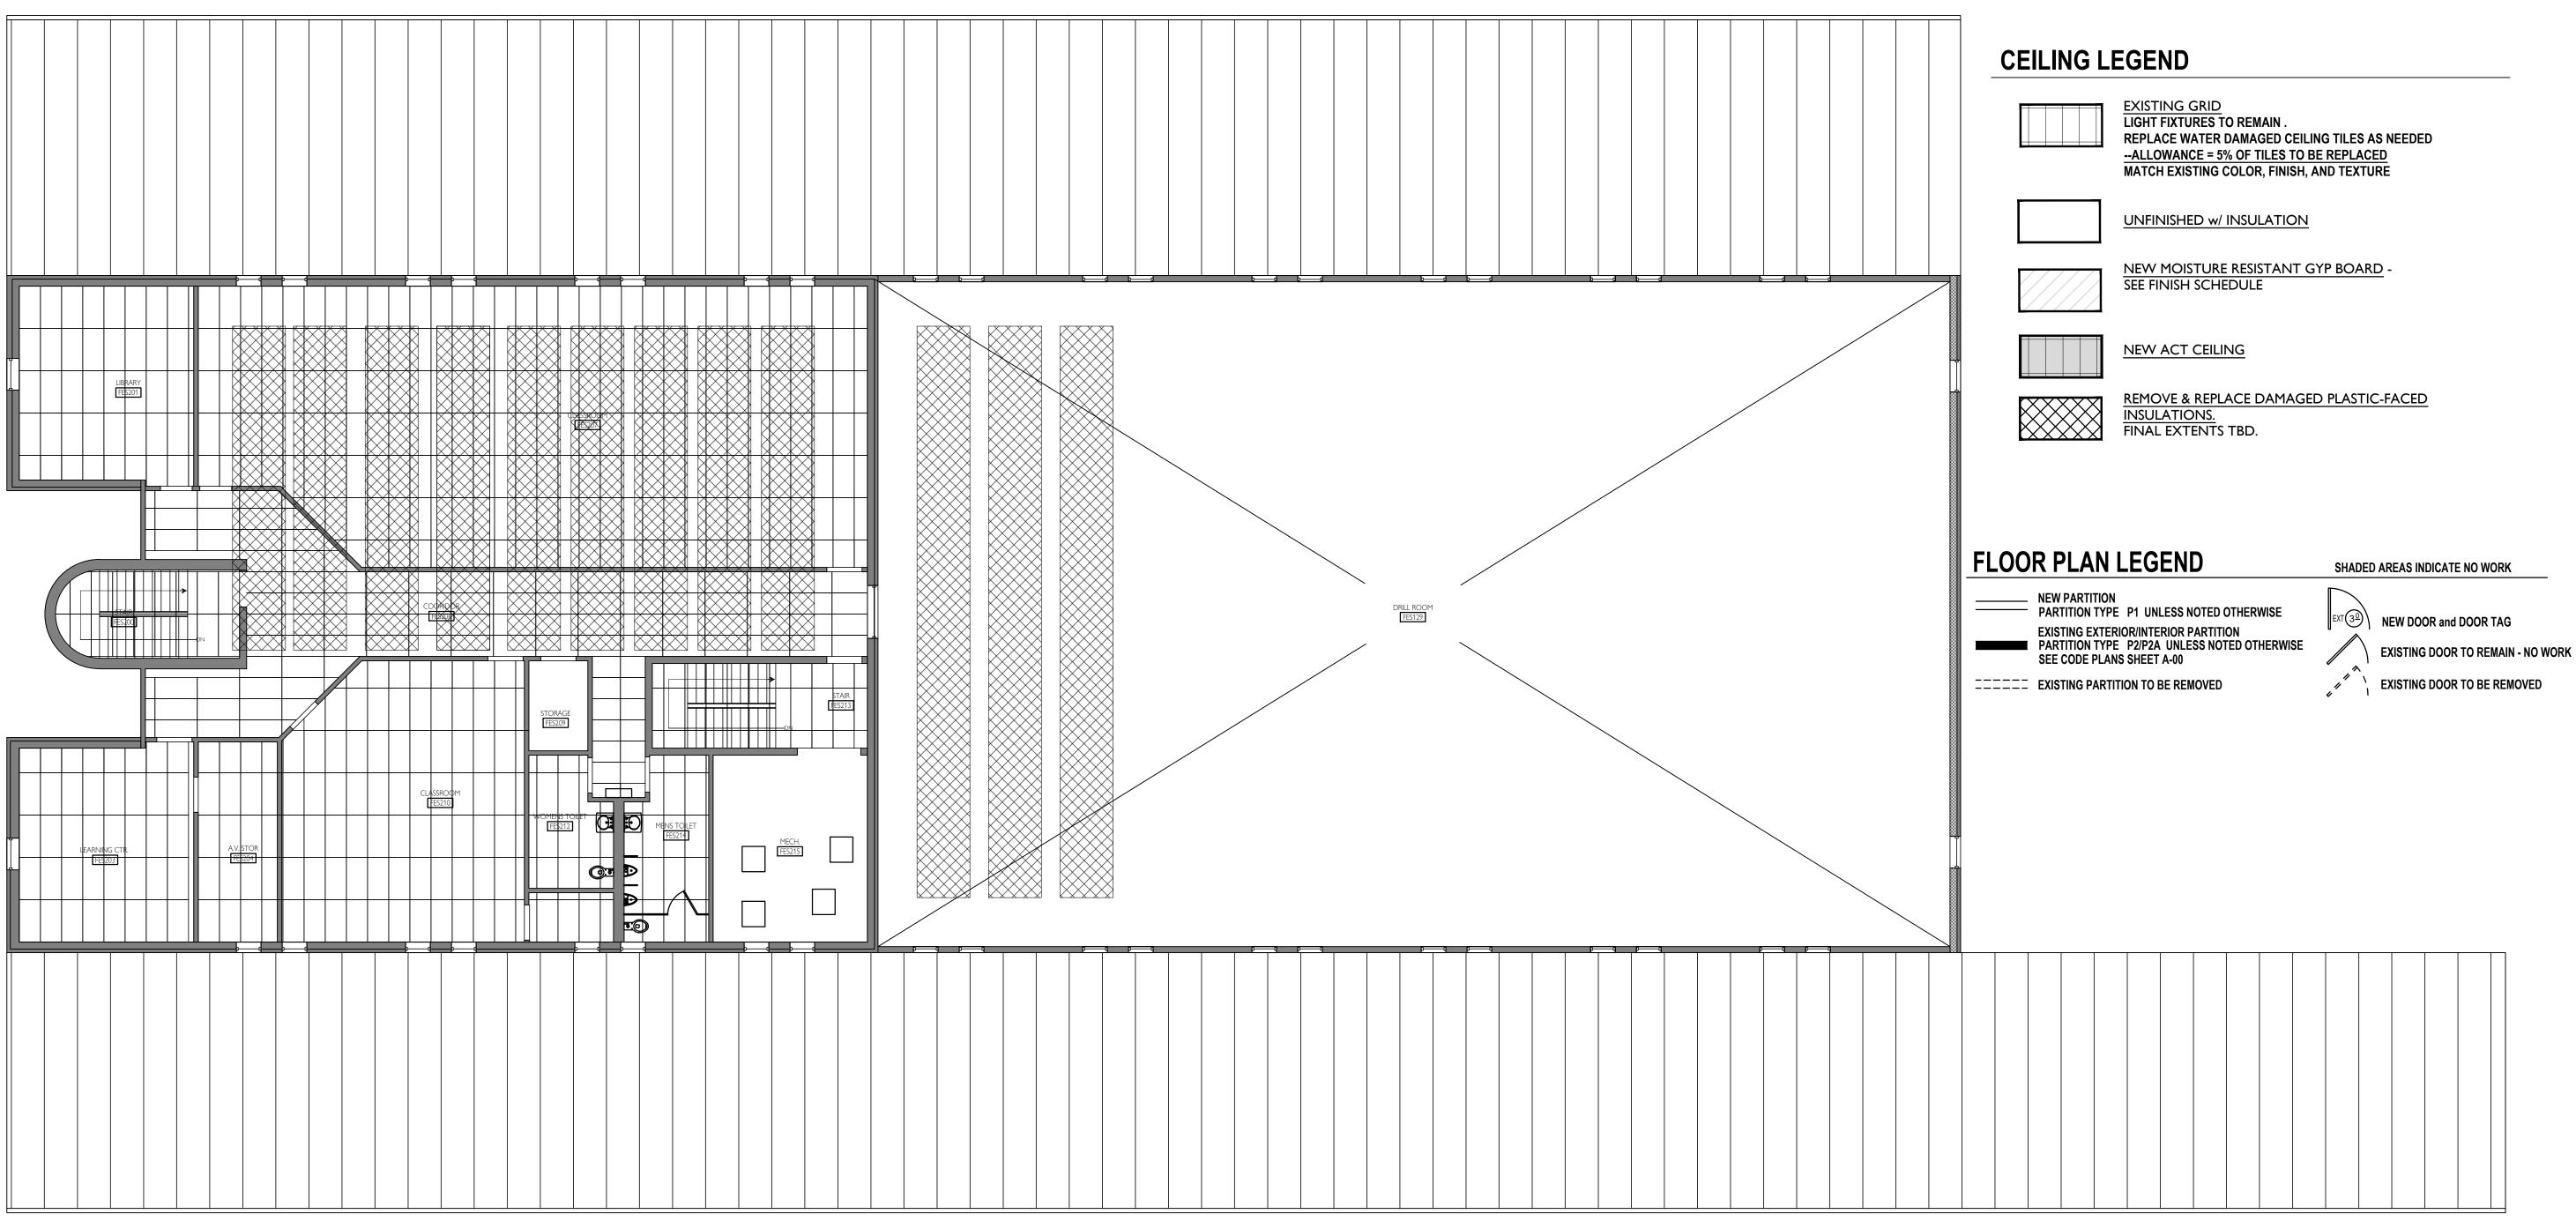
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DRAWN BY:
CHECKED BY:
DESIGNED BY:

SHEET TITLE:

1st FLOOR REFLECTED CEILING PLAN

SHEET NUMBER:

A-RC-01



2nd FLOOR REFLECTED CEILING PLAN

SCALE: 1/8" = 1'-0" (24x36)

STATE OF MISSOURI MIKE KEHOE, GOVERNOR



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ISSUE DATE: 06/23/2025

CAD DWG FILE:
DRAWN BY:
CHECKED BY:
DESIGNED BY:

SHEET TITLE:

2nd FLOOR REFLECTED CEILING PLAN

SHEET NUMBER:

A-RC-02

ROOM FIN	ISH SCHEDULE									
ROOM#	ROOM NAME	FLOOR	BASE	NORTH WALL	SOUTH WALL	EAST WALL	WEST WALL	CLG. FIN.	CLG. HGT.	NOTES
1st FLOOR										<b>-</b>
FES N-01	WOMEN'S RESTROOM	FL-02	INTGRL	PT-1 / PT-2	PT-1 / PT-2	PT-1 / PT-2	PT-1 / PT-2	PT-3	8'-0" ±	BRADLEY CORP BRADMAR PARTITIONS - DESERT STONE 5406
FES N-02	WOMEN'S SHOWER/LOCKER	FL-02	INTGRL	PT-1 / PT-2	PT-1 / PT-2	PT-1 / PT-2	PT-1 / PT-2	PT-3	8'-0" ±	BRADLEY CORP BRADMAR PARTITIONS - DESERT STONE 5406
FES N-03	MEN'S RESTROOM	FL-02	INTGRL	PT-1A / PT-2A	PT-1A / PT-2A	PT-1A / PT-2A	PT-1A / PT-2A	PT-3	8'-0" ±	BRADLEY CORP BRADMAR PARTITIONS - DESERT STONE 5406
FES N-04	MEN'S SHOWER/LOCKER 1	FL-02	INTGRL	PT-1A / PT-2A	PT-1A / PT-2A	PT-1A / PT-2A	PT-1A / PT-2A	PT-3	8'-0" ±	BRADLEY CORP BRADMAR PARTITIONS - DESERT STONE 5406
FES N-05	MEN'S SHOWER/LOCKER 2	FL-02	INTGRL	PT-1A / PT-2A	PT-1A / PT-2A	PT-1A / PT-2A	PT-1A / PT-2A	PT-3	8'-0" ±	BRADLEY CORP BRADMAR PARTITIONS -DESERT STONE 5406
FES N-06	NEW MEN'S LOCKER ROOM	FL-02	INTGRL	PT-1A / PT-2A	PT-1A / PT-2A	PT-1A / PT-2A	PT-1A / PT-2A	PT-3	8'-0" ±	BRADLEY CORP BRADMAR PARTITIONS - DESERT STONE 5406
	– ALL REMAINING 1st FLOOR	FL-01	BS-01							SEE ALTERNATES
	– ALL STAIRS – ANGLE FIT RUBBER STA	AIR TREADS w/ RAIS	SED ROUND P	ROFILE						SEE ALTERNATES
2nd FLOOF	<u> </u>									
008	EXST'G WOMENS RESTROOM	FL-02	INTGRL	PT-1 / PT-2	PT-1 / PT-2	PT-1 / PT-2	PT-1 / PT-2	PT-3	8'-0" ±	BRADLEY CORP BRADMAR PARTITIONS - DESERT STONE 5406
009	EXST'G MENS RESTROOM	FL-02	INTGRL	PT-1A / PT-2A	PT-1A / PT-2A	PT-1A / PT-2A	PT-1A / PT-2A	PT-3	8'-0" ±	BRADLEY CORP BRADMAR PARTITIONS - DESERT STONE 5406
	– ALL REMAINING 2nd FLOOR –	FL-01	BS-01	_	<b> </b>					SEE ALTERNATES
	– ALL STAIRS – ANGLE FIT RUBBER STA	AIR TREADS w/ RAIS	SED ROUND P	ROFILE						SEE ALTERNATES

NOTES

PREP, PRIME, PAINT WITH EXTEIOR RATED LOUVERS. MATCH EXISTING

PREP, PRIME, PAINT | FULLY ITEMPERED INSULATED CLEAR GLASS UNIT

PREP, PRIME, PAINT FULLY ITEMPERED INSULATED CLEAR GLASS UNIT

PREP, PRIME, PAINT FULLY ITEMPERED INSULATED CLEAR GLASS UNIT

\*\*\* FIELD VERIFY SIZES OF ALL REPLACEMENT DOORS \*\*\*

FULLY ITEMPERED INSULATED CLEAR GLASS UNIT

**EPOXY ADA SHOWER THRESHOLD** 

**FRAMES** 

REMARKS

PREP, PRIME, PAINT

MTL.

DOOR SCHEDULE

DOORS \*\*\* FIELD VERIFY SIZES OF ALL REPLACEMENT DOORS \*\*\*

NONE ANONDZD REPLACEMENT, SIDELITE TO REMAIN.

MATCH EXISTING, MEDIUM STYLE. FIELD VERIFY

ANONDZD MEDIUM STYLE. FIELD VERIFY.

REPLACEMENT, MATCH EXISTING

REPLACEMENT, MATCH EXISTING

MEDIUM STYLE. FIELD VERIFY. ALTERNATE / OWNER'S OPTION

ALTERNATE / OWNER'S OPTION

NONE ANONDZD REPLACEMENT, SIDELITE TO REMAIN.
MATCH EXISTING, MEDIUM STYLE. FIELD VERIFY

NONE ANONDZD MATCH EXISTING, MEDIUM STYLE. FIELD VERIFY

REPLACEMENT MATCH EXIST'G. FIELD VERIFY.

REPLACEMENT MATCH EXIST'G. FIELD VERIFY.

REPLACEMENT MATCH EXIST'G. FIELD VERIFY.

ALTERNATE / OWNER'S OPTION REPLACEMENT MATCH EXIST'G. FIELD VERIFY.

EPOXY FLOORING SYSTEM W/ SLIP RESIST. AGGREGATE

FLOOR FILLER SUITABLE FOR

UNDER USE EPOXY FLOORING

SECURED TO FLOOR SLAB

FLOOR SLAB

PRE-FORMED SHOWER THRESHOLD

REPLACEMENT, SIDELITE TO REMAIN.

ALTERNATE / OWNER'S OPTION

\*\*\* NOTE — UNMARKED DOORS INDICATE EXISTING, WITH HARDWARE, OPERATION, AND FIRE RATING TO REMAIN AS EXISTING — NO

RATING

NONE

NONE

20 min

20 min

20 min

20 min

84

84

84

36

A1 103 HLW 36 84

A 110 HLW 36 84

C 202 MTL 36 84

SLOPE TO DRAIN

**EPOXY SHOWER THRESHOLD** 

#### INTERIOR FINISHES


#### L FLOORING - VINYL COMPOSITE TILE (VCT) - ARMSTRONG 'STANDARD FL-01 EXCELON IMPERIAL TEXTURE' 12"x12" COLOR: SILK 59234. FINAL SELECTION BY OWNER - SEE ALTERNATES

FL-02 FLOORING - POURED EPOXY FLOOR w/ 6" INTEGRAL BASE -DUR-A-QUARTZ Q28-21 (2) GROUT COATS ARMOR TOP GLOSS PREP FLOOR w/ 2 COATS CLEAR EPOXY COATING ALTERNATE: 1 COAT CLEAR EPOXY FINISH

BS-01 BASE - JOHNSONITE TRADITIONAL 6" RUBBER BASE w/ TOE PROFILE, FULL SPREAD ADHESIVE INSTALLATION BASEBOARDS THROUGHOUT. COLOR 71 'STORM CLOUD' - SEE ALTERNATES

#### PAINT SYSTEMS - SHERWIN-WILLIAMS PAINTS

- CMU WALLS (2) COATS LOXON BLOCK FILLER (2) COATS PRO-MAR 400 SEMI-GLOSS COLOR SW7065 ARGOS
- NEW GYP. BD. WALLS (1) COAT PRO-MAR 200 INTERIOR LATEX PRIMER (2) COATS PRO-MAR 200 SATIN COLOR SW7065 ARGOS
- CMU WALLS (2) COATS LOXON BLOCK SURFACER (2) COATS PRO-MAR 400 SEMI-GLOSS COLOR SW7065 ARGOS
- PT-2A NEW GYP. BD. WALLS (1) COAT PRO-MAR 200 INTERIOR LATEX PRIMER (2) COATS PRO-MAR 200 SATIN COLOR SW7065 ARGOS
  - NEW GYP. CEILINGS (1) COAT PRO-MAR 200 INTERIOR LATEX PRIMER (2) COATS PRO-MAR INTERIOR LATEX CEILING PAINT COLOR SW7005 PURE WHITE
- HOLLOW METAL DOOR and FRAMES, WOOD DOORS (1) COAT SW PRO INDUSTRIAL PRO-CRYL UNIVERSAL PRIMER (2) COATS SW PRO INDUSTRIAL ACRYLIC SEMI-GLOSS COLOR - MATCH EXISTING ADJACENT

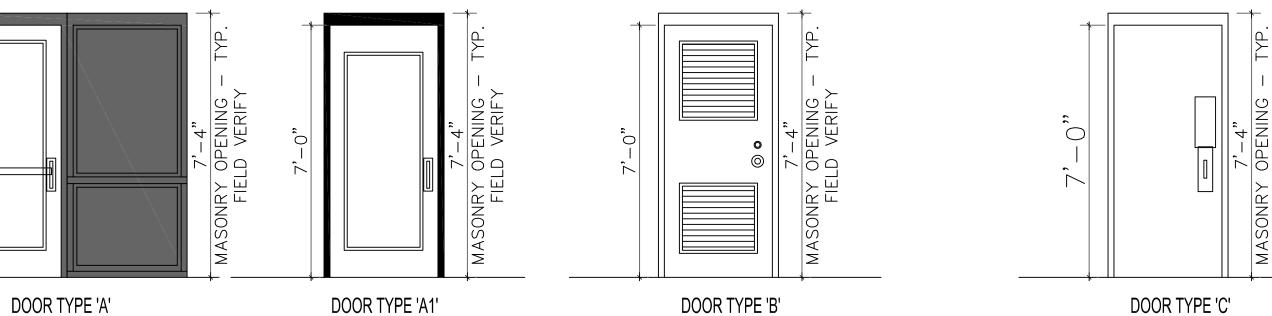

#### HARDWARE GROUP A: REPLACEMENT ENTRY/EXIT DOORS (EXTERIOR)

EPOXY FLOORING SYSTEM W/

FLOOR FILLER SUITABLE FOR

UNDER USE EPOXY FLOORING

FORMED EDGE THRESHOLD

FLOOR SLAB

PER ACCESSIBILITY STANDARD

For use on mark/door sets #(s): 101 102 103 104 106 109 110 Each Set of Doors To Have: (note these are double door configurations)

У	Description	Catalog Number	Finish	Mfr
	CONT. HINGE	780-111 HD	ALM	HAGER
		(780-110 ONLY FOR D	OORS 1" TO 1.375")	
	CLOSERS	5200 HDCS	ALM	HAGER
	MORTISE CYLNDR	3902 x LAR	US32D	HAGER
	CYLNDR ESTCHN	45CE	US32D	HAGER
	EXIT DEVICE	4501SVR LBR F	US32D	HAGER
	EXIT DEVICE TRIMS	4501SVR AUG	US32D	HAGER
	SET SEALS	726 x LAR	CHA	HAGER
	(OR BY DOOR MANUFR.)			
	DOOR SWEEP	200NA	CLR	NATIONAL GUARD PRODUCTS

#### HARDWARE GROUP B: NON-EXIT DOORS (EXTERIOR)

For use on mark/door sets #(s): 105

Each Door To Have:

D	escription	Catalog Number	Finish	Mfr
H	IINGES	BB1168 4.5x4.5 NRP	US26D	HAGER
M	ORTISE CYLNDR	3902 x LAR	US32D	HAGER
С	YLNDR ESTCHN	45CE	US32D	HAGER
D	EADLOCK	3215	US32D	HAGER
S	ET SEALS	726 x LAR	CHA	HAGER
	(OR BY DOOR MANUFR.)			
D	OOR SWEEP	200NA	CLR	NATIONAL GUARD PRODUCTS
	IEAD WTHR STRP	810S	MIL	HAGER

FLOOR STOP

and HOLDER

REPLACEMENT INTERIOR DOORS (RESTROOMS) - ALTERNATE / OWNER OPTION

For use on mark/door #(s): 107 108 201 202

Each Door To Have:

Description	Catalog Number	Finish	Mfr	
HINGES	BB1168 4.5x4.5 NRP	US26D	HAGER	Danage to Lat /East Dandings Contain
CLOSERS	5200 HDCS	ALM	HAGER	Repars to Int./Ext. Readiness Center,
PUSH PLATE	30S 3 X12	US32D	HAGER	and Unheated Storage Buildings
SOLID PULL	3G	US32D	HAGER	
KICK PLATES	190S 8"x1" LDW CKS	US32D	HAGER	
DOOR SWEEP	200NA	CLR	NATIONAL	
			GUARD	
			PRODUCTS	

ARMY NATIONAL GUARD 2740 State Rd P, Festus, MO 63028

OFFICE OF ADMINISTRATION

**DESIGN AND CONSTRUCTION** 

**DIVISION OF FACILITIES** 

MANAGEMENT,

**DEPARTMENT OF** 

**Festus Readiness Center** 

STATE OF MISSOURI

MICHAEL L. PARSON, **GOVERNOR** 

· A-2010039774

PROJECT # T-2330-01 6302 FACILITY # 56377

**REVISION:** REVISION: REVISION: DATE:

CAD DWG FILE DRAWN BY: CHECKED BY


ISSUE DATE: 06/23/2025

**DESIGNED BY** SHEET TITLE:


**SCHEDULES** 


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A-SH-06

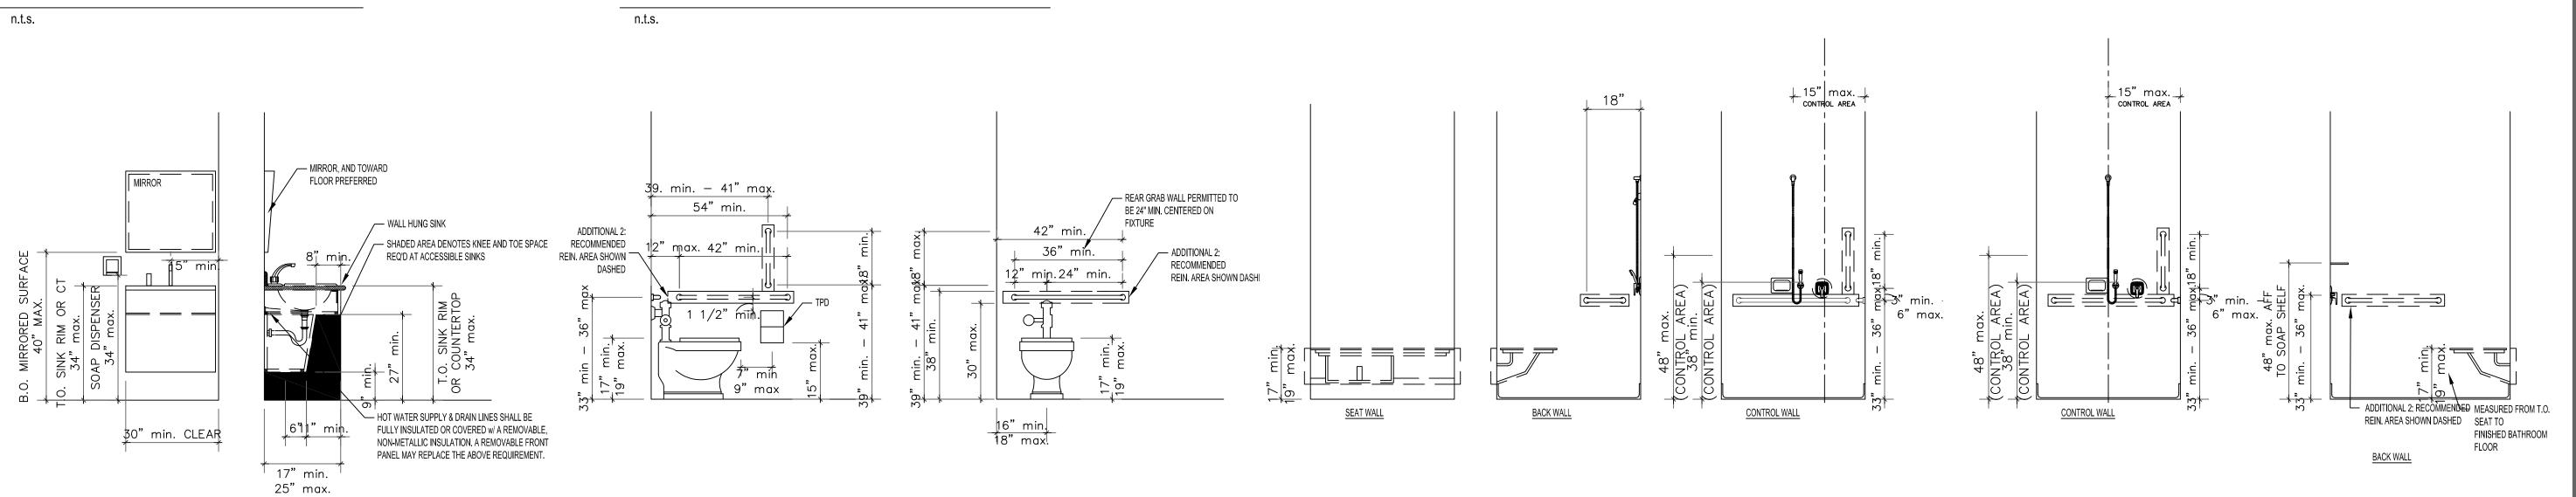


**SINK CLEARANCES & HEIGHT TOILET STANDARDS** TRANSFER SHOWERS **ROLL-IN SHOWERS w/ SEAT** 



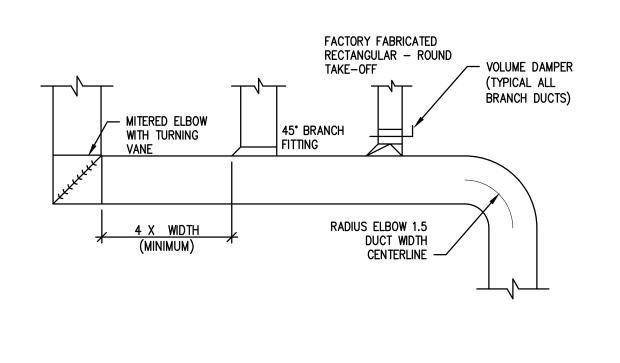

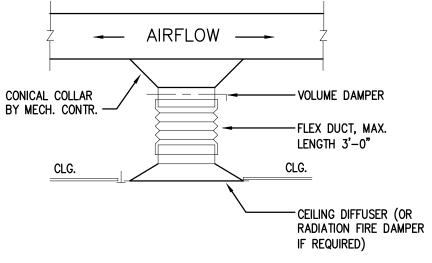NOTES: PROVIDE ADAPTERS FOR DIFFUSERS WITH SQUARE AND RECTANGULAR NECKS AS REQUIRED.

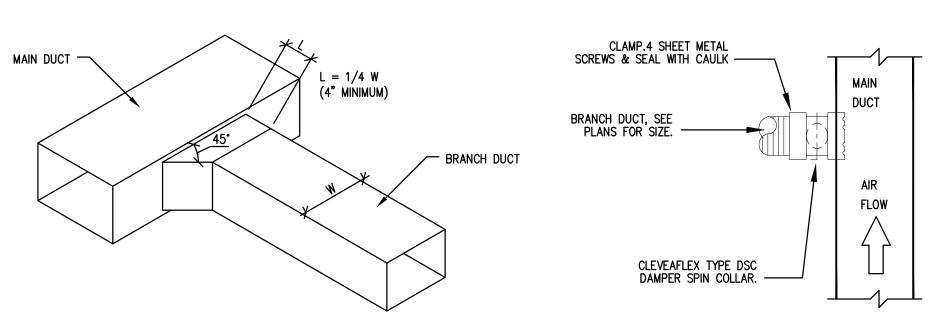

#### **DUCT TAKE OFF DETAILS**

SCALE: NTS


# CONCENTRIC VENT KIT (OPTIONAL). MAINTAIN 10'-0" FROM ANY BUILDING FRESH AIR INTAKES PVC PIPE SIZE PER MANUFACTURER'S RECOMMENDATIONS

# **CONCENTRIC VENT TERMINATION**

SCALE: NTS

2. TWO STAGE COMPRESSOR WITH VARIABLE SPEED FAN MOTOR.


3. RUN CONDENSATE LINE TO NEARBY FLOOR DRAIN.

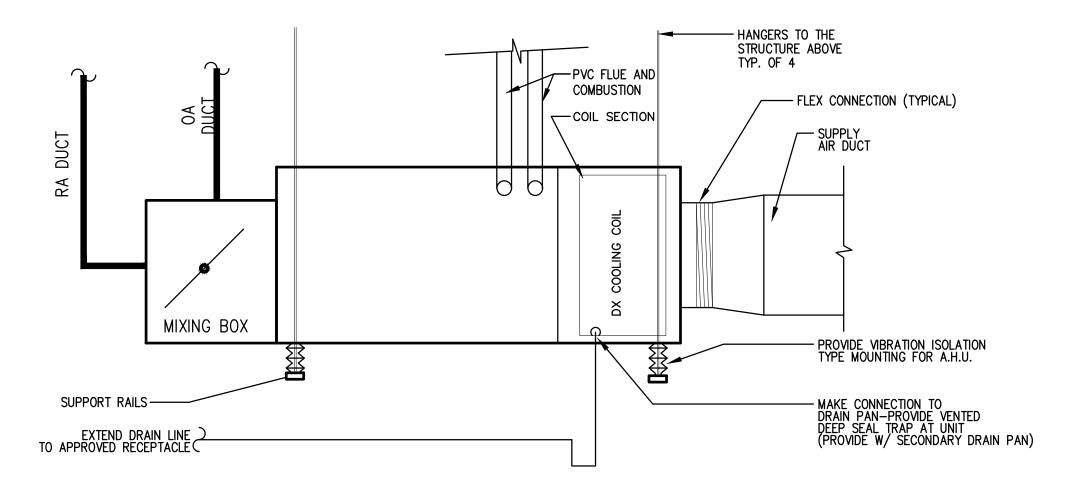

\* REFER TO AIRFLOW SCHEDULE ON THIS SHEET FOR OUTDOOR AIR MINIMUM SET POINT.

## HORIZONTAL MOUNT FURNACE DETAIL

SCALE: NTS

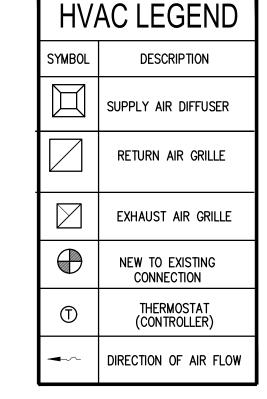

EXHAUST	REQU	IREME	NTS
SPACE NAME	SQFT	EXH CFM	OA CFM
WMNS RR	364	300	250
WMNS SHO/ LR	263	145	120
TOTAL	627	445	370
SPACE NAME	SQFT	EXH CFM	OA CFM
GYM	352	_	100
MENS LR	377	100	-
MENS RR	306	450	400
MENS SHO	330	80	60
TOTAL	1365	630	560

	EXHAUST FAN SCHEDULE (FIRST FLOOR ONLY)									
PLAN MARK	MANUFACTURER	MODEL	TYPE	SP	CFM	FRPM	ELECTRICAL	OPTIONS	NOTES	
EF-1	GREENHECK	SQ-100-VG	INLINE	0.5	630	1253	120/1/60 1/4 HP	BACK DRAFT DAMPER ROOF CURB	1,2,3	
EF-2	GREENHECK	SQ-90-VG	INLINE	0.375	445	1545	120/1/60 1/10 HP	BACK DRAFT DAMPER ROOF CURB	1,2,3	
NOTES:	NOTES: 1. PROVIDE BACKDRAFT DAMPER. 2. RUN CONTINUOUSLY DURING OCCUPIED CYCLE. 3. PROVIDE W/ SPEED CONTROLLER.									

# **GENERAL MECHANICAL DEMOLITION NOTES:**


ALL INFORMATION AND WORK SHOWN AS EXISTING WAS TAKEN FROM NOTES OF CURSORY FIELD VISITS WITH OWNER REPRESENTATION AND/OR FROM PAST CONSTRUCTION DOCUMENTS. EQUIPMENT AND DUCTWORK HAVE BEEN SHOWN IN AN APPROXIMATE WAY. NOT ALL ASPECTS SHOWN ON THESE DOCUMENTS MAY NOT BEEN ABLE TO BE VERIFIED DUE TO SITE CONDITIONS DURING VISIT(S). CONSEQUENTLY, THE CONTRACTOR SHALL BE RESPONSIBLE FOR DETERMINING ALL WORK NECESSARY TO RENOVATE, ALTER, CHANGE, AND REPAIR EXISTING SYSTEM(S) BASED UPON THE ACTUAL FIELD CONDITIONS.

THE CONTRACTOR SHALL VISIT THE SITE AND THOROUGHLY UNDERSTAND THE EXISTING EQUIPMENT/ SYSTEMS TO BE REMOVED VS THE EXISTING TO REMAIN AND NEW PROPOSED TO BE INSTALLED. NO UNUSED EQUIPMENT, DUCTWORK AND/OR ACCESSORIES ETC... SHALL BE ABANDONED IN PLACE. THIS INCLUDES ALL RELATIVE EQUIPMENT THAT WAS LOCATED ON BOTH THE LOWER AND UPPER FLOORS, THE PARKING GARAGE BELOW, THE LOADING DOCK AND ASSOCIATED MEZZANINE AREAS. THE CONTRACTOR SHALL VERIFY ANY DEMOLITION OF THE ABOVE IN QUESTION WITH THE LANDLORDS REPRESENTATIVE FOR DIRECTION.

	MECHANICAL EQUIPMENT SCHEDULE (FIRST FLOOR ONLY)																								
	OUTDOOR UNIT																								
PLAN MARK	MANUFACTURER	INDOOR UNIT MODEL NUMBERS	TEDB (* F)	TEWB	SUPPLY AIR (CFM)	EXTERNAL S.P. (IN WC)	MOTOR	VOLTAGE	MCA/MOCP	HEATING CAPACITY IN (MBH)	HEATING CAPACITY OUT (MBH)	AFUE	OUTSIDE AIR (CFM) MIN.	FILTER TYPE	AMBIENT AIR (DEG F)	HEATING STAGE(S)	OPERATING WEIGHT (LBS)	PLAN MARK	CU MODEL NUMBER	TOTAL CLG CAPACITY (MBH)/TON/SEER	CONDENSING UNIT ELEC.	COOLING STAGE(S)	T-STAT TYPE	SHIPPING WEIGHT LBS	NOTES
F-1	TRANE	4TXCC009DS3 / S9V2C080U5PSB	80	67	1600	0.5"	STANDARD	120/1/60	13.9/15	52/80	50.4/77.8	96%	560	THROWAWAY	95	TWO	150	CU-1	4TTR6048N1	47.5/4/16.0	208/1/60//24/40	TWO	ONE PIECE PROGRAM	256	1 – 7
F-2	TRANE	4TXCB006DS3 / S9V2C060U4PSB	80	67	800	0.5"	STANDARD	120/1/60	10.8/15	39/60	37.8/58.2	96%	370	THROWAWAY	95	TWO	122	CU-2	4TTR6024N1	25.2/2/16.0	208/1/60//13.4/20	TWO	ONE PIECE PROGRAM	244	1 – 7
NOTES:	1. PROVIΓ	DE WITH SUPPORT.							4. PROV	IDE WITH LOW	AMBIENT CO	NTROL.					7. PROVIDE	WITH XL824 (	CONTROLLER WITH	BUILT-IN DEHUMID	IFICATION.				

# **KEYED NOTES**

- PROVIDE AND INSTALL FURNACE PART OF SPLIT SYSTEM PER MANUFACTURER'S RECOMMENDATION SUSPENDED FROM STRUCTURE WITH VIBRATION ISOLATORS. REFER TO SCHEDULE ON THIS SHEET. SUSPEND FROM STRUCTURE ABOVE. PROVIDE WITH PRIMARY DRAIN AND DRAIN PAN WITH FLOAT SWITCH PER SECTION 307.2.3 OF THE 2105 IMC. EXTEND CONDENSATE, REFER TO PLUMBING THIS SET FOR LOCATION. ROUTE FURNACE VENT AND COMBUSTION RELIEF THRU ROOF WITH CONCENTRIC VENT KIT. COORDINATE ROUTING AND FINAL LOCATION IN FIELD. MAINTAIN 10' MINIMUM FROM FRESH AIR INTAKES.
- PROVIDE AND INSTALL ONE PIECE PROGRAMMABLE THERMOSTAT,
  MOUNTED. AT 54"A.F.F PER ADA. COORDINATE LOCATION WITH OTHER
  ELEMENTS OF WALL. VERIFY EXACT PLACEMENT WITH OWNER.
- CONDENSING UNITS TO BE LOCATED ON CONCRETE PAD AT GRADE.
  VERIFY EXACT LOCATION WITH CLIENT AND EXTEND REFRIGERANT LINES
  BASED ON FINAL LENGTH AND ROUTING PER MANUFACTURER'S
  RECOMMENDATIONS.
- OUTDOOR AIR INTAKE FROM ROOF. PROVIDE RAIN GUARD, INSECT SCREEN AND BACKDRAFT. COORDINATE ROUTING AND LOCATION WITH STRUCTURE. MAINTAIN 10' FROM AND EXHAUST, VENT OR FLUE.
- PROVIDE NEW INLINE FAN AND ASSOCIATED EXHAUST DUCT AND GRILLES.
  ROUTE DUCT FROM EACH GRILLE TO FANS INLET AND FROM FAN'S OUT
  TRANSITION TO EXISTING DUCT PRIOR TO WALL PENETRATION. FAN TO BE
  SUSPENDED FROM CEILING WITH VIBRATION ISOLATORS.

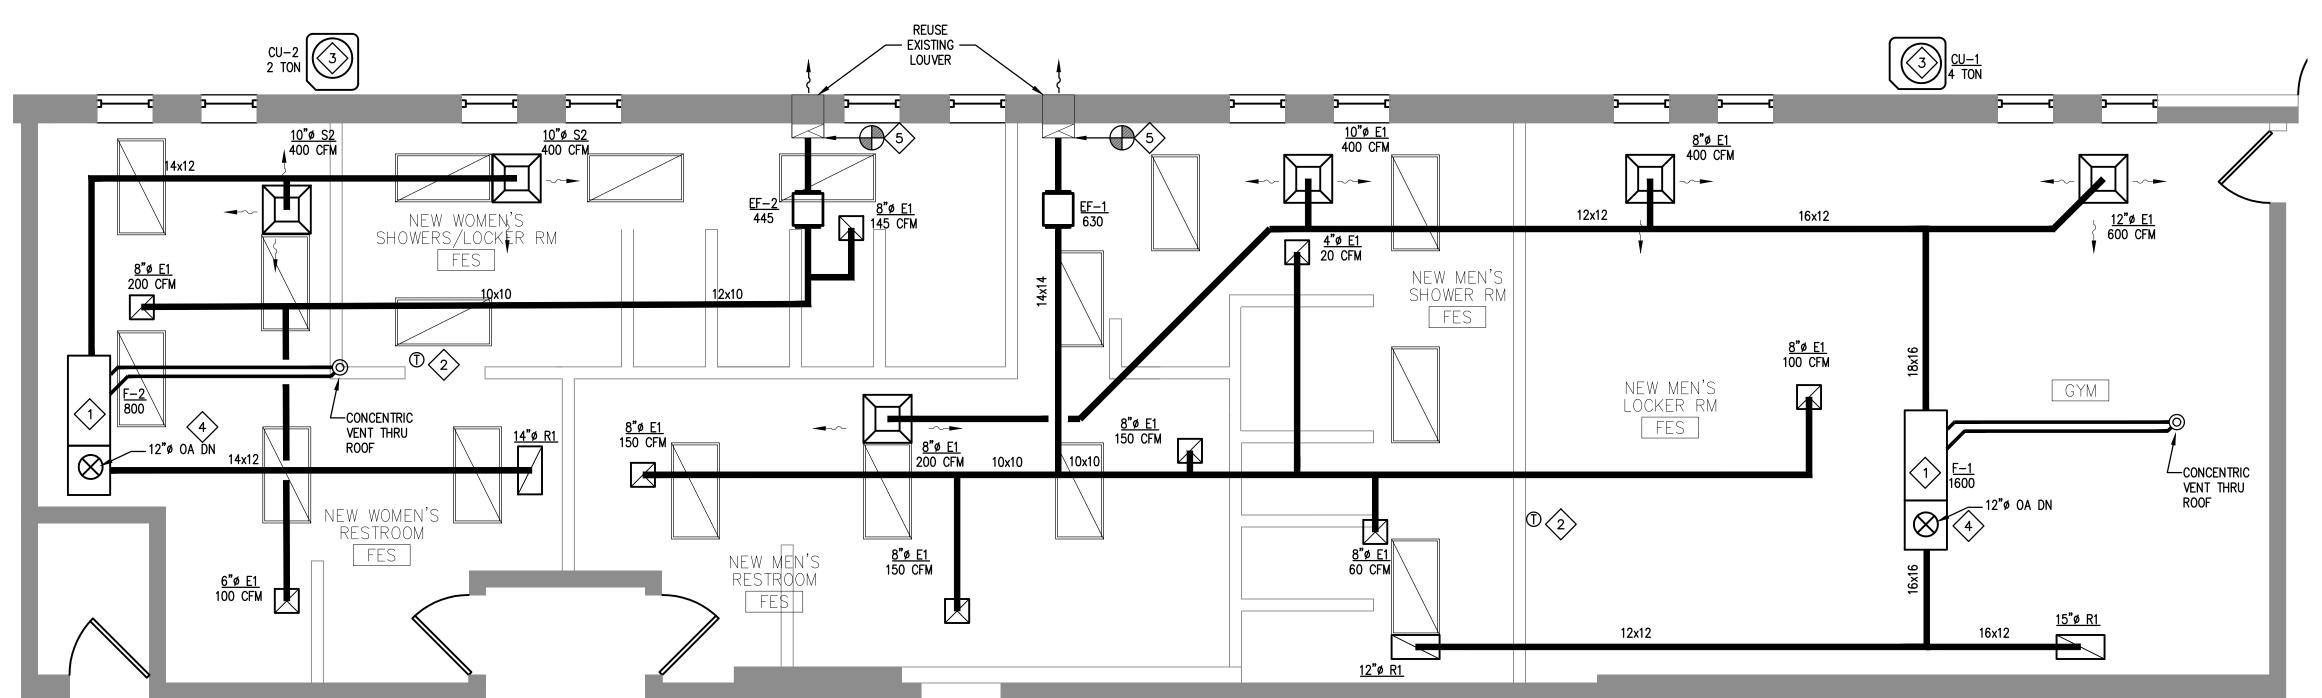


5. SUCTION AND LIQUID LINE SIZES AS REQUIRED PER MANUFACTURER RECOMMENDATION.


6. PROVIDE MANUAL VOLUME DAMPERS FOR RETURN AND O.A. DUCTS.

ENLARGED RESTROOM + LOCKER PLAN

SCALE: 1/4" = 1'-0" (24x36)

STATE OF MISSOURI MIKE KEHOE, GOVERNOR

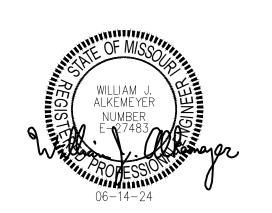

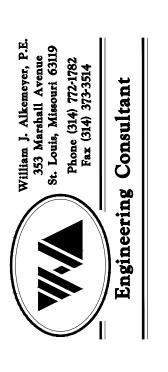

OFFICE OF ADMINISTRATION DIVISION OF FACILITIES MANAGEMENT, DESIGN AND CONSTRUCTION

**DEPARTMENT OF** 

**Festus Readiness Center** 

Repars to Int./Ext. Readiness Center, and Unheated Storage Buildings

ARMY NATIONAL GUARD 2740 State Rd P, Festus, MO 63028

PROJECT # T-2330-01

SITE # 6302 FACILITY # 56377

REVISION:
DATE:
REVISION:
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DATE:
REVISION:
DATE:
ISSUE DATE 06/23/2025

CAD DWG FILE: M-HVC-01
DRAWN BY: MHT
CHECKED BY: WJA
DESIGNED BY: MHT

SHEET TITLE:

MECHANICAL


MECHANICAL HVAC PLAN


SHEET NUMBER:

M-1

	EXHAUST FAN SCHEDULE (ALTERNATE)										
PLAN MARK	MANUFACTURER	MODEL	TYPE	SP	CFM	FRPM	ELECTRICAL	OPTIONS	NOTES		
EF-1ALT	GREENHECK	SP-A90	CEILING	0.25	70	857	120/1/60 13 W	BACK DRAFT DAMPER ROOF CURB	1,2,3		
F-2ALT	GREENHECK	SP-A200	INLINE	0.25	210	900	120/1/60 48 W	BACK DRAFT DAMPER ROOF CURB	1,2,3		
NOTES:	OTES: 1. PROVIDE BACKDRAFT DAMPER. 2. VIA OCCUPANCY WSWITCH. 3. PROVIDE W / SPEED CONTROLLER										

	MECHANICAL EQUIPMENT SCHEDULE (ALTERNATE)																								
	OUTDOOR UNIT																								
PLAN MARK	MANUFACTURER	INDOOR UNIT MODEL NUMBERS	TEDB (* F)	TEWB	I AIR	EXTERNAL S.P. (IN WC)	MOTOR	VOLTAGE	MCA/MOCP	HEATING CAPACITY IN (MBH)	HEATING CAPACITY OUT (MBH)	AFUE	OUTSIDE AIR (CFM) MIN.	FILTER TYPE	AMBIENT AIR (DEG F)	HEATING STAGE(S)	OPERATING WEIGHT (LBS)	PLAN MARK	CU MODEL NUMBER	TOTAL CLG CAPACITY (MBH)/TON/SEER	CONDENSING UNIT ELEC.	COOLING STAGE(S)	T-STAT TYPE	SHIPPING WEIGHT LBS	NOTES
F-1, -3	TRANE	4TXCC009DS3 / S9X2C100U5PSB	80	67	VERIFY	VERIFY	STANDARD	120/1/60	14.5/15	65/100	63/97	95%	VERIFY	THROWAWAY	95	TWO	155	CU-1, -3	4TTR4048N1	48/4/14	208/1/60//24/40	TWO	ONE PIECE PROGRAM	256	1, 2
F-2	TRANE	4TXCD010DS3 / S9X2D120U5PSBA	80	67	VERIFY	VERIFY	STANDARD	120/1/60	14.4/15	78/120	75.6/116.4	95%	VERIFY	THROWAWAY	95	TWO	156	CU-2	4TTR4060N1	60/5/14	208/1/60//34/60	TWO	ONE PIECE PROGRAM	277	1, 2
F-4	TRANE	4TXCC007DS3 / S9X2C080U5PSBA	80	67	VERIFY	VERIFY	STANDARD	120/1/60	14.4/15	52/80	50.4/77.6	95%	VERIFY	THROWAWAY	95	TWO	139	CU-4	4TTR4036N1	36/3/14	208/1/60//18/30	TWO	ONE PIECE PROGRAM	156	1, 2
NOTES:	NOTES: 1 BASIS FOR BIDDING. EXISTING UNIT UNITS TO BE VERIFIED PRIOR TO REPLACEMENT IF ALTERNATE IS ACCEPTED. 2 IF ALTERNATE IS ACCEPTED, COORDINATE WITH ELECTRICAL AND GAS REQUIREMENTS AFTER FINAL SELECTIONS ARE MADE.																								

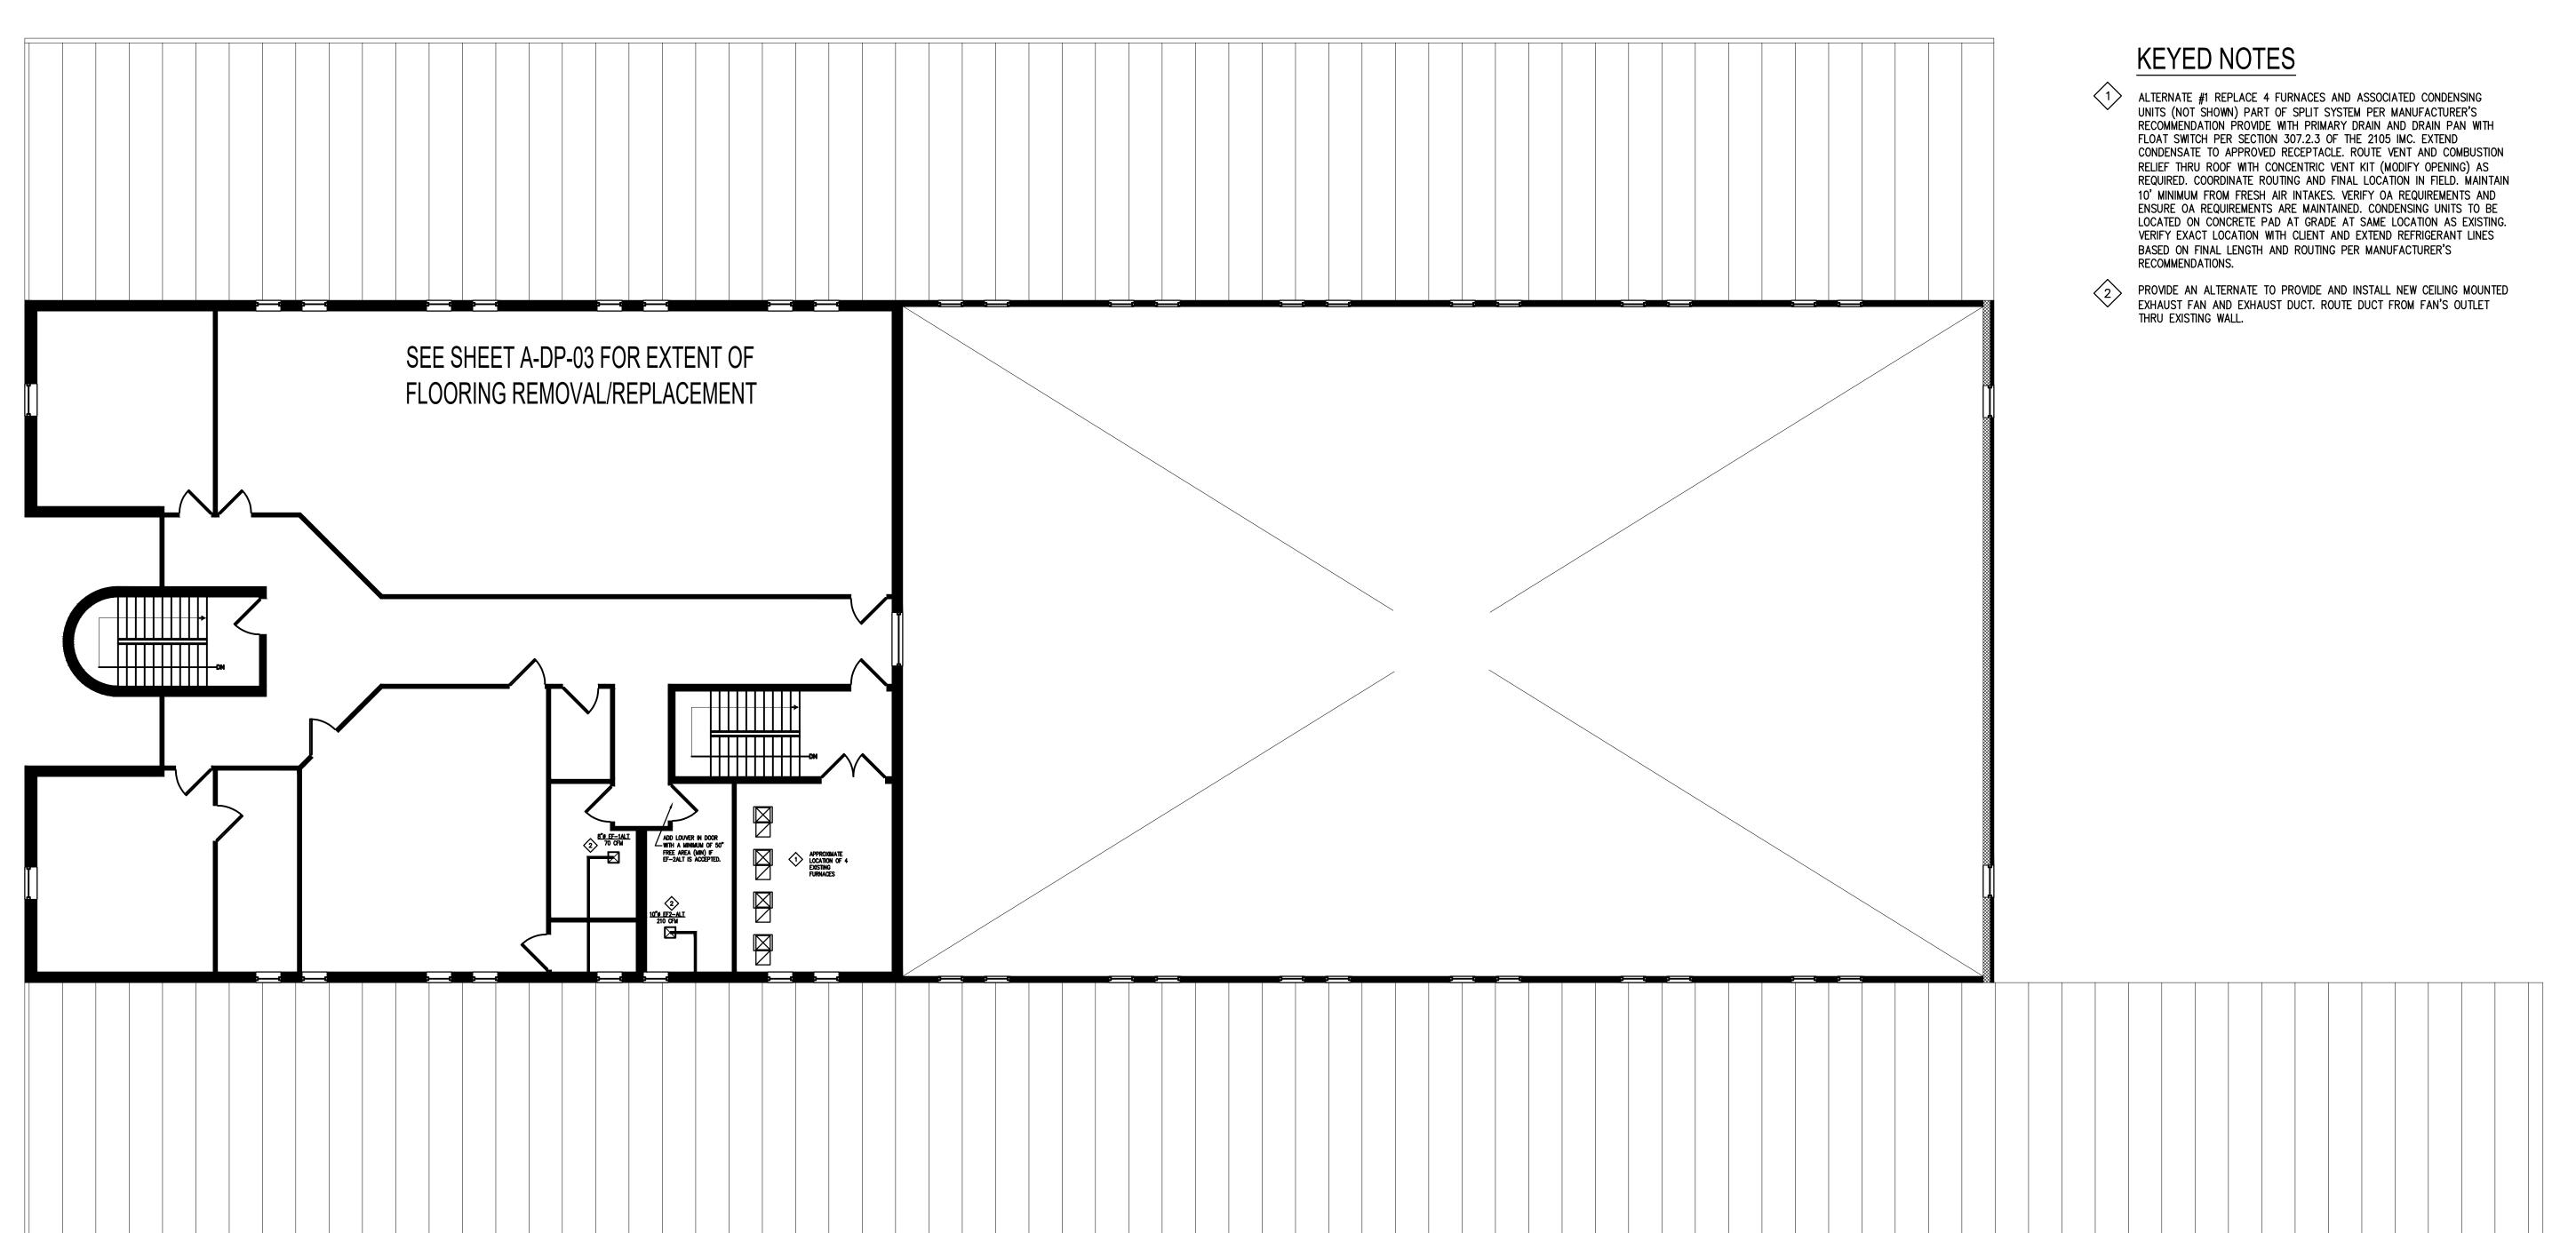

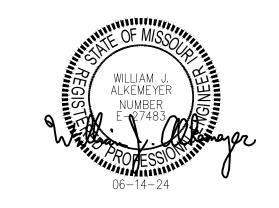



OFFICE OF ADMINISTRATION DIVISION OF FACILITIES MANAGEMENT, DESIGN AND CONSTRUCTION

**DEPARTMENT OF** 

Festus Readiness Center

Repars to Int./Ext. Readiness Center, and Unheated Storage Buildings

ARMY NATIONAL GUARD 2740 State Rd P, Festus, MO 63028

PROJECT # T-2330-01 SITE # 6302 FACILITY # 56377

REVISION:
DATE:
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DATE:
ISSUE DATE 06/23/2025

CAD DWG FILE: M-HVC-02
DRAWN BY: MHT
CHECKED BY: WJA
DESIGNED BY: MHT


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MECHANICAL
HVAC
ALTERNATE

SHEET NUMBER:

M-ALT


2nd FLOOR PLAN

SCALE: 1/8" = 1'-0" (24x36)

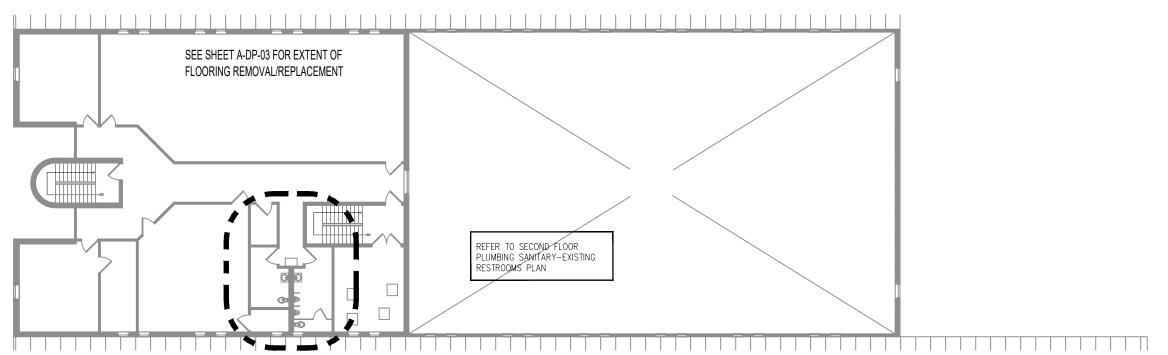


# 2nd FLOOR REFERENCE PLAN


SCALE: 1/16" = 1'-0" (24x36)

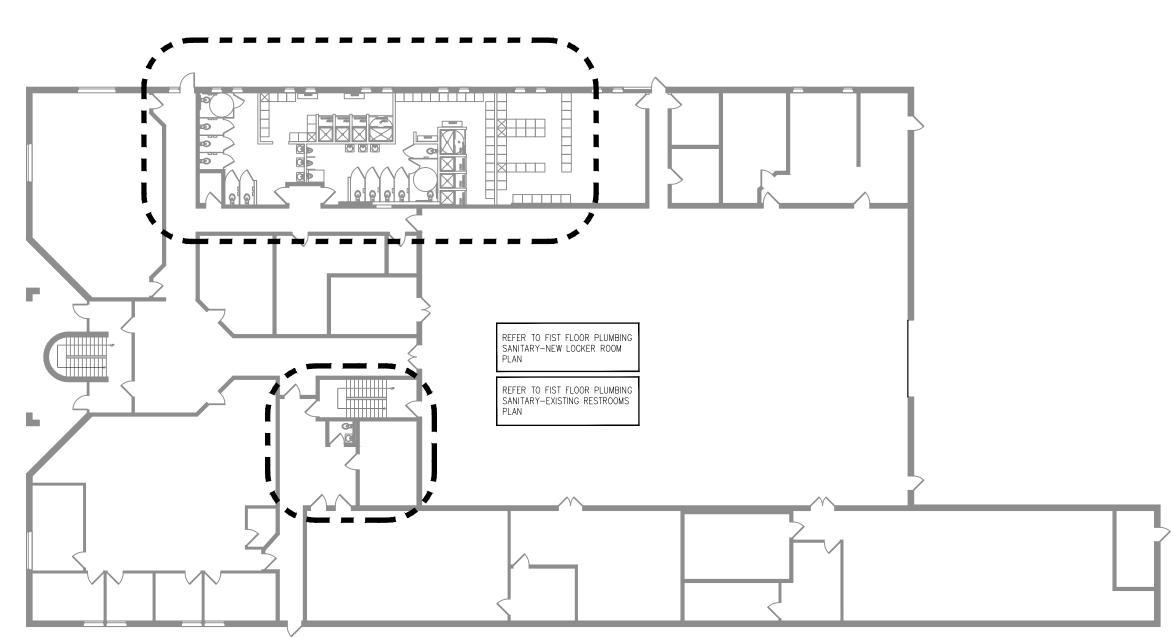

# 1st FLOOR REFERENCE PLAN SCALE: 1/16" = 1'-0" (24x36)

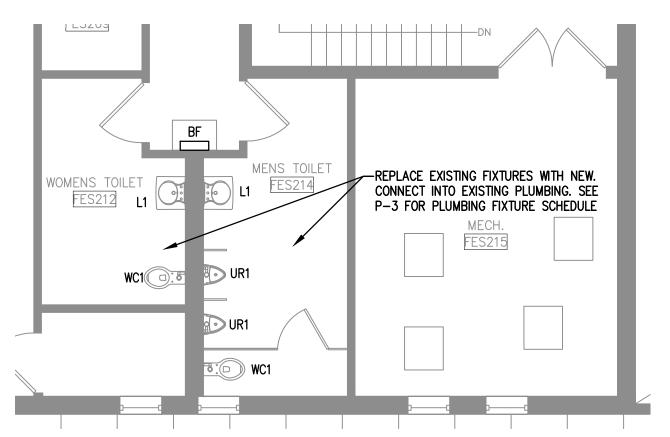

SECOND FLOOR PLUMBING SANITARY - EXISTING RESTROOMS

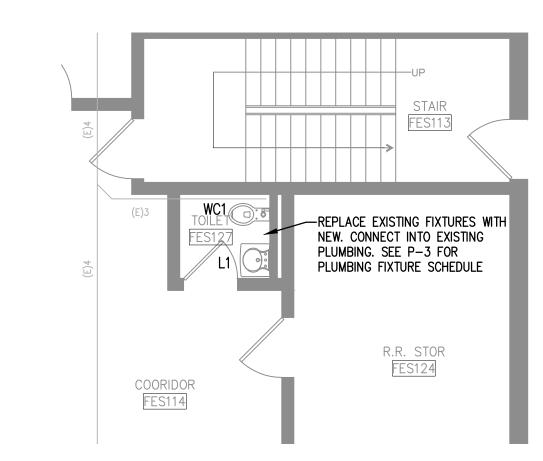

SCALE: 3/16" = 1'-0" (24x36)

# FIRST FLOOR PLUMBING SANITARY - EXISTING RESTROOM SCALE: 3/16" = 1'-0" (24x36)

#### LINE TYPES:

#### GENERAL NOTES:

- 1. ALL PLUMBING WORK SHALL BE PERFORMED IN FULL COMPLIANCE WITH THE LOCAL PLUMBING CODE, HEALTH REGULATIONS, AND LOCAL ORDINANCES.
- 2. THE PLUMBING CONTRACTOR IS RESPONSIBLE FOR ALL PERMIT FEES, UTILITY TAP FEES, AND INSPECTION FEES AS REQUIRED.
- 3. THE CONTRACTOR SHALL COORDINATE THE LOCATION OF FLOOR DRAINS, HUB DRAINS AND CONNECTION POINTS WITH THE GENERAL CONTRACTOR. THE PLUMBING CONTRACTOR SHALL FIELD VERIFY EXISTING CONDITIONS PRIOR TO SUBMITTING HIS BID.
- 4. PROVIDE INSULATION ON ALL EQUIPMENT CONDENSATE DRAIN LINES.
- 5. REFER TO THE ARCHITECTURAL PLANS FOR FIRE STOPPING REQUIREMENTS.


#### KEYED NOTES:

- MAKE CONNECTION TO EXISTING BUILDING VENT SYSTEM.
- 2 3" FLOOR DRAIN (FD) W/ TRAP PRIMER.
- (3) CAP EXISTING SANITARY AND DEMO EXISTING SANITARY BEYOND THIS POINT.
- 4" WALL CLEANOUT TEE WITH CLEANOUT COVER AND RETAINING SCREW.
- MAKE CONNECTION TO EXISTING 4" SEWER INSIDE THE PREMISES.

#### PLUMBING DEMOLITION NOTES

- 1. REMOVE ALL UNUSED, ABOVE FLOOR PIPING AND ACCESSORIES AND HANGERS COMPLETELY TO A POINT JUST BEYOND THE DEMISING PARTITIONS CAP OFF AS INSTRUCTED BY LANDLORD.
- 2. REMOVE UNUSED FLOOR DRAINS FROM SLAB AND PLUG WASTE ROUGH—IN AT A POINT BELOW THE SLAB WITH GAS—TIGHT PLUG. BELOW SLAB WASTE PIPING SHALL BE ABANDONED IN PLACE. TAG ALL ABANDONED PIPING PER LANDLORD'S REQUIREMENTS
- FLOOR PENETRATION SHALL BE PATCHED PER LANDLORD'S REQUIREMENTS AND FINISHED TO RECEIVE NEW FLOOR FINISH
- 3. REMOVE WASTE ROUGH-IN TO A POINT BELOW THE SLAB AND PLUG WASTE LINE WITH A GAS-TIGHT PLUG.
  BELOW SLAB WASTE PIPING SHALL BE ABANDONED IN PLACE. TAG ALL ABANDONED PIPING PER LANDLORD'S
  REQUIREMENTS.
- FLOOR PENETRATION SHALL BE PATCHED PER LANDLORD'S REQUIREMENTS AND FINISHED TO RECEIVE NEW
- 4. REMOVE ALL UNUSED VENT(S)-THRU-ROOF COMPLETELY AND PATCH PER LANDLORD'S REQUIREMENTS

STATE OF MISSOURI MIKE KEHOE, GOVERNOR

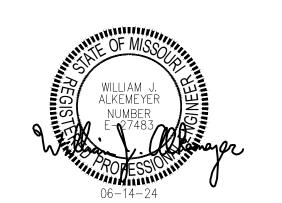



OFFICE OF ADMINISTRATION DIVISION OF FACILITIES MANAGEMENT, DESIGN AND CONSTRUCTION

#### DEPARTMENT OF

#### **Festus Readiness Center**

Repars to Int./Ext. Readiness Center, and Unheated Storage Buildings

ARMY NATIONAL GUARD 2740 State Rd P, Festus, MO 63028

PROJECT # T-2330-01 SITE # 6302 FACILITY # 56377

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REVISION:
DATE:
REVISION:

CAD DWG FILE: P-PLB-01
DRAWN BY: MEW
CHECKED BY: AMK
DESIGNED BY: MEW


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PLUMBING


ISSUE DATE 06/23/2025

PLUMBING SANITARY PLAN

SHEET NUMBER:

P-1

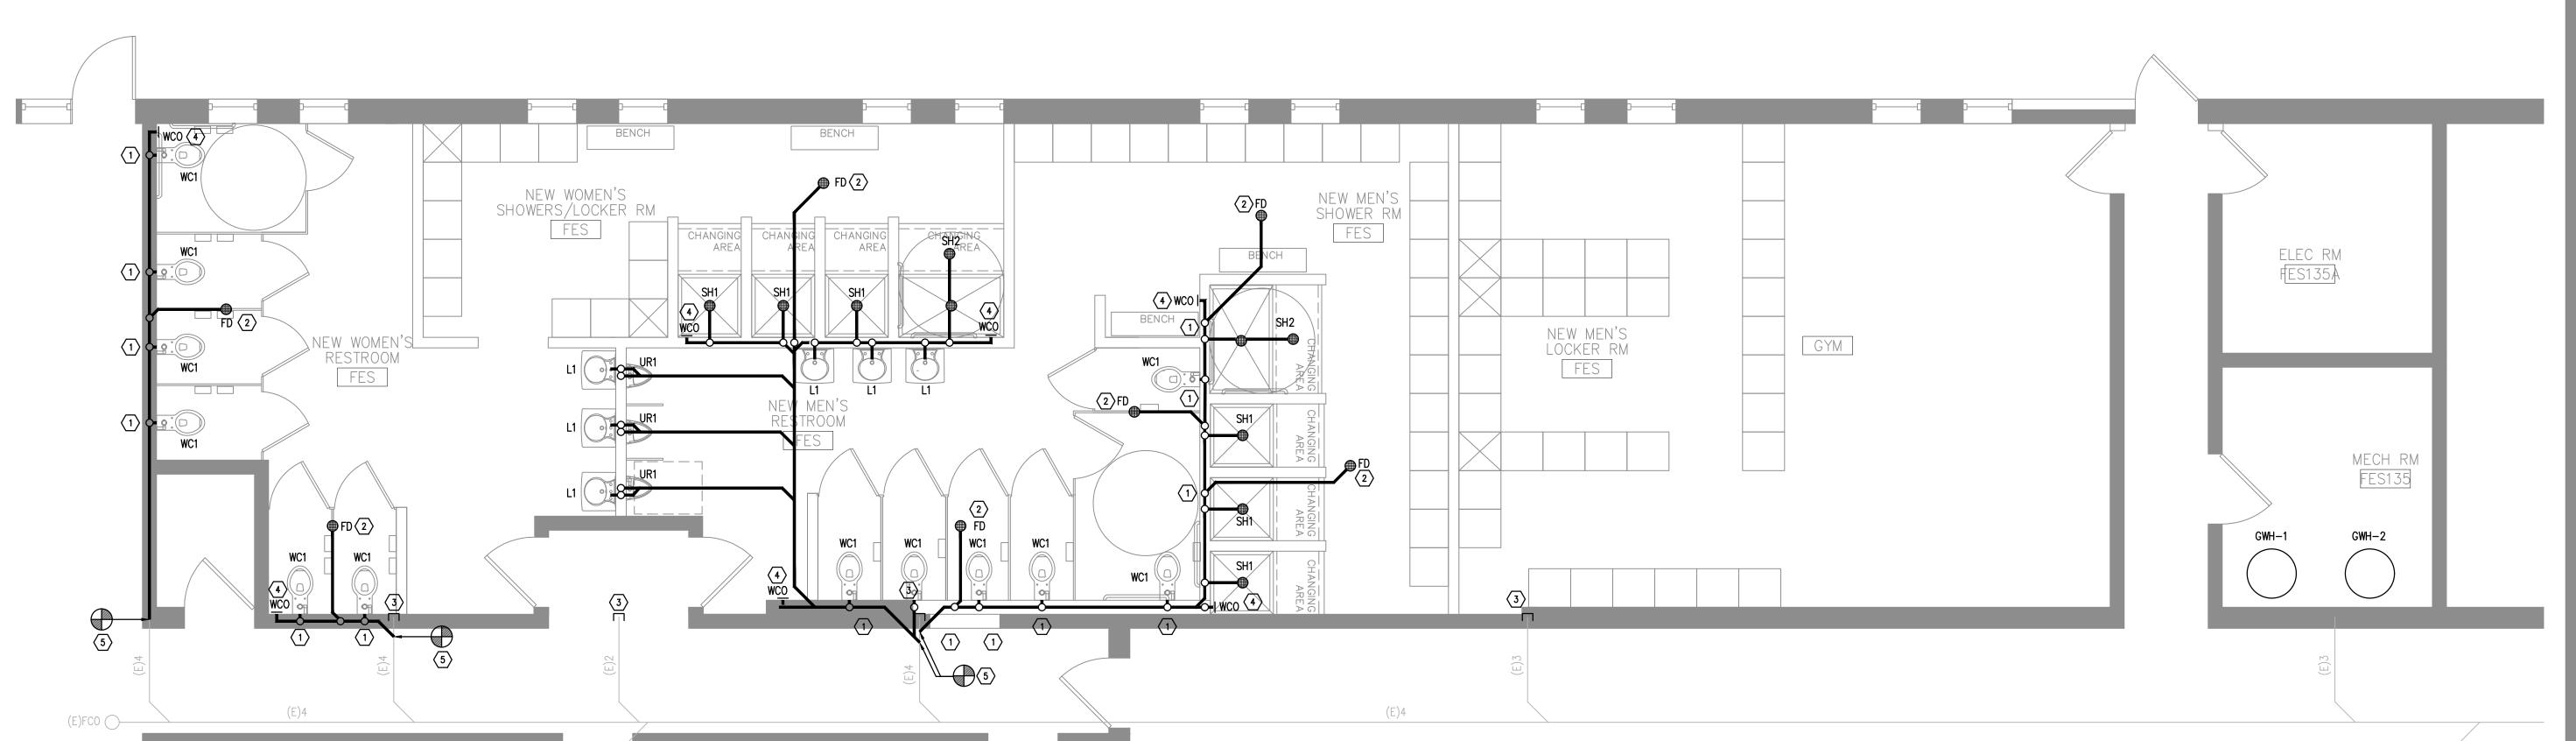


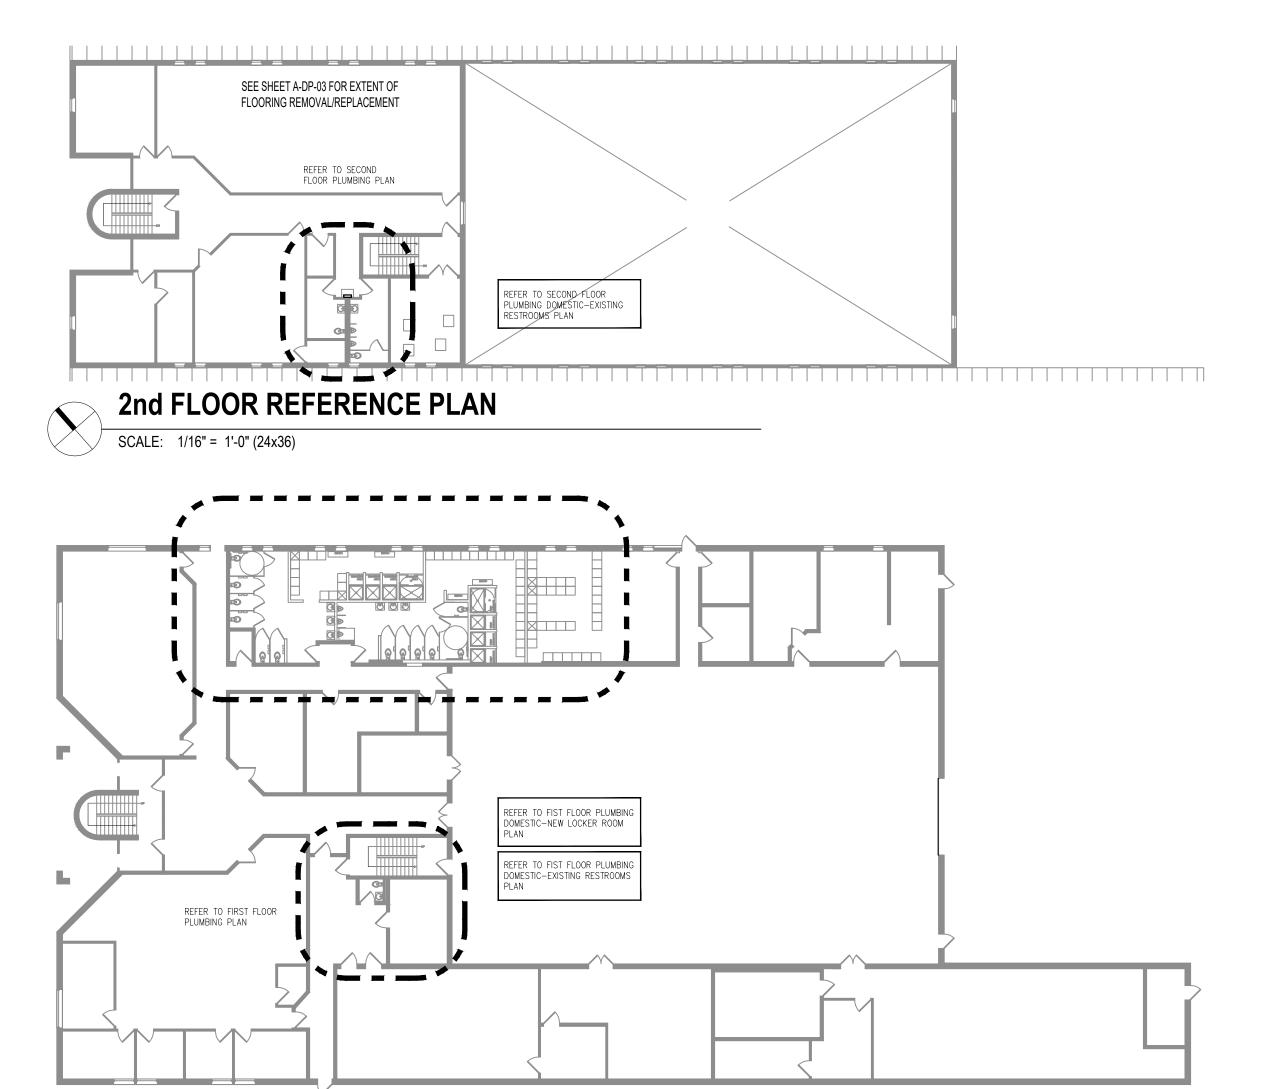


←-(E)2"CW

1st FLOOR REFERENCE PLAN

SCALE: 1/16" = 1'-0" (24x36)

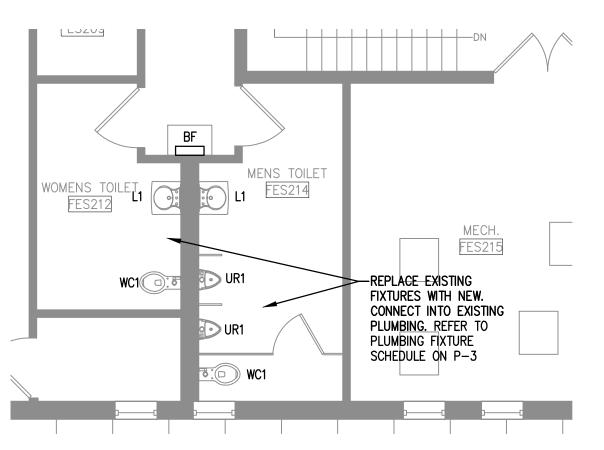

SECOND FLOOR PLUMBING DOMESTIC - EXISTING RESTROOMS

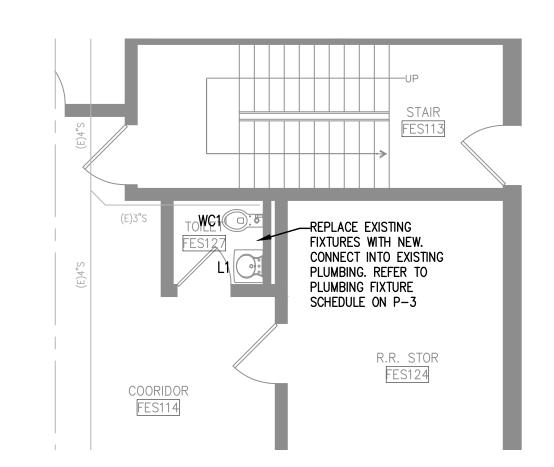

FIRST FLOOR PLUMBING DOMESTIC - EXISTING RESTROOM

SCALE: 3/16" = 1'-0" (24x36)

SCALE: 3/16" = 1'-0" (24x36)



COLD WATER PIPING HOT WATER PIPING SANITARY PIPING — GAS — GAS —

EXISTING PIPING SHOWN IN A LIGHTER SHADE.

#### **GENERAL NOTES**

- ALL PLUMBING WORK SHALL BE PERFORMED IN FULL COMPLIANCE WITH THE LOCAL PLUMBING CODE, HEALTH REGULATIONS, AND LOCAL ORDINANCES.
- 2. THE PLUMBING CONTRACTOR IS RESPONSIBLE FOR ALL PERMIT FEES, UTILITY TAP FEES, AND INSPECTION FEES AS REQUIRED.
- THE CONTRACTOR SHALL COORDINATE THE LOCATION OF FLOOR DRAINS, HUB DRAINS AND CONNECTION POINTS WITH THE GENERAL CONTRACTOR. THE PLUMBING CONTRACTOR SHALL FIELD VERIFY EXISTING
- 4. PROVIDE INSULATION ON ALL COLD WATER PIPING, HOT WATER PIPING AND HOT WATER RETURN PIPING.
- 5. REFER TO THE ARCHITECTURAL PLANS FOR FIRE STOPPING REQUIREMENTS.

#### **KEYED NOTES:**

1/2" CW FOR FLOOR DRAIN TRAP PRIMER.

CONDITIONS PRIOR TO SUBMITTING HIS BID.

- EXISTING GAS WATER HEATERS TO BE REPLACED WITH IDENTICAL NEW GAS WATER HEATERS. CONNECT INTO EXISTING GAS PIPING, COLD WATER, HOT WATER AND HOT WATER RECIRCULATION PIPING. INSTALL PER MANUFACTURERS INSTALLATION REQUIREMENTS AND CODE. VERIFY AND MATCH EXISTING WATER HEATER OUTPUT TEMPERATURE. PROVIDE ANY MIXING VALVES AND/OR APPURTENANCES AS NECESSARY TO SERVE EXISTING FIXTURES NOT SHOWN.
- 3 EXISTING GAS PIPING FROM EXISTING GAS METER.
- CAP EXISTING GAS PIPING.
- CONNECT NEW GAS PIPE INTO EXISTING GAS PIPE.
- CONNECT NEW COLD WATER AND NEW HOT WATER INTO EXISTING.
- PROVIDE THERMOSTATIC MIXING VALVE AT ALL SHOWERS AND LAVATORIES.
- CONNECT NEW 1" CW INTO EXISTING CW PIPE.
- NEW F-1 @ 60,000 BTUH TO REPLACE EXISTING UH-2 @ 60,000 BTUH AND EXISTING UH-3 @ 60,000 BTUH. NEW F-1 IS LOCATED 200' FROM EXISTING GAS METER.
- NEW F-2 @ 60,000 BTUH TO REPLACE EXISTING UH-1 @ 30,000 BTUH. NEW F-2 IS LOCATED 100' FROM EXISTING GAS METER.

#### PLUMBING DEMOLITION NOTES

- REMOVE ALL UNUSED, ABOVE FLOOR PIPING AND ACCESSORIES AND HANGERS COMPLETELY TO A POINT JUST BEYOND THE DEMISING PARTITIONS - CAP OFF AS INSTRUCTED BY LANDLORD.
- REMOVE UNUSED FLOOR DRAINS FROM SLAB AND PLUG WASTE ROUGH—IN AT A POINT BELOW THE SLAB WITH GAS-TIGHT PLUG. BELOW SLAB WASTE PIPING SHALL BE ABANDONED IN PLACE. TAG ALL ABANDONED PIPING PER LANDLORD'S REQUIREMENTS
- FLOOR PENETRATION SHALL BE PATCHED PER LANDLORD'S REQUIREMENTS AND FINISHED TO RECEIVE NEW
- REMOVE WASTE ROUGH-IN TO A POINT BELOW THE SLAB AND PLUG WASTE LINE WITH A GAS-TIGHT PLUG. BELOW SLAB WASTE PIPING SHALL BE ABANDONED IN PLACE. TAG ALL ABANDONED PIPING PER LANDLORD'S
  - FLOOR PENETRATION SHALL BE PATCHED PER LANDLORD'S REQUIREMENTS AND FINISHED TO RECEIVE NEW
- FLOOR FINISH 4. REMOVE ALL UNUSED VENT(S)—THRU—ROOF COMPLETELY AND PATCH PER LANDLORD'S REQUIREMENTS



STATE OF MISSOURI

**GOVERNOR** 

MIKE KEHOE,

**OFFICE OF ADMINISTRATION DIVISION OF FACILITIES** MANAGEMENT, **DESIGN AND CONSTRUCTION** 

**DEPARTMENT OF** 

**Festus Readiness Center** 

Repars to Int./Ext. Readiness Center, and Unheated Storage Buildings

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PROJECT # T-2330-01

6302 SITE# FACILITY # 56377

**REVISION** REVISION REVISION

ISSUE DATE 06/23/2025


CAD DWG FILE: P-PLB-02
DRAWN BY: MEW
CHECKED BY: AMK CHECKED BY: DESIGNED BY: MEW

SHEET TITLE:


**PLUMBING** DOMESTIC WATER **PLAN** 

SHEET NUMBER:


P-2

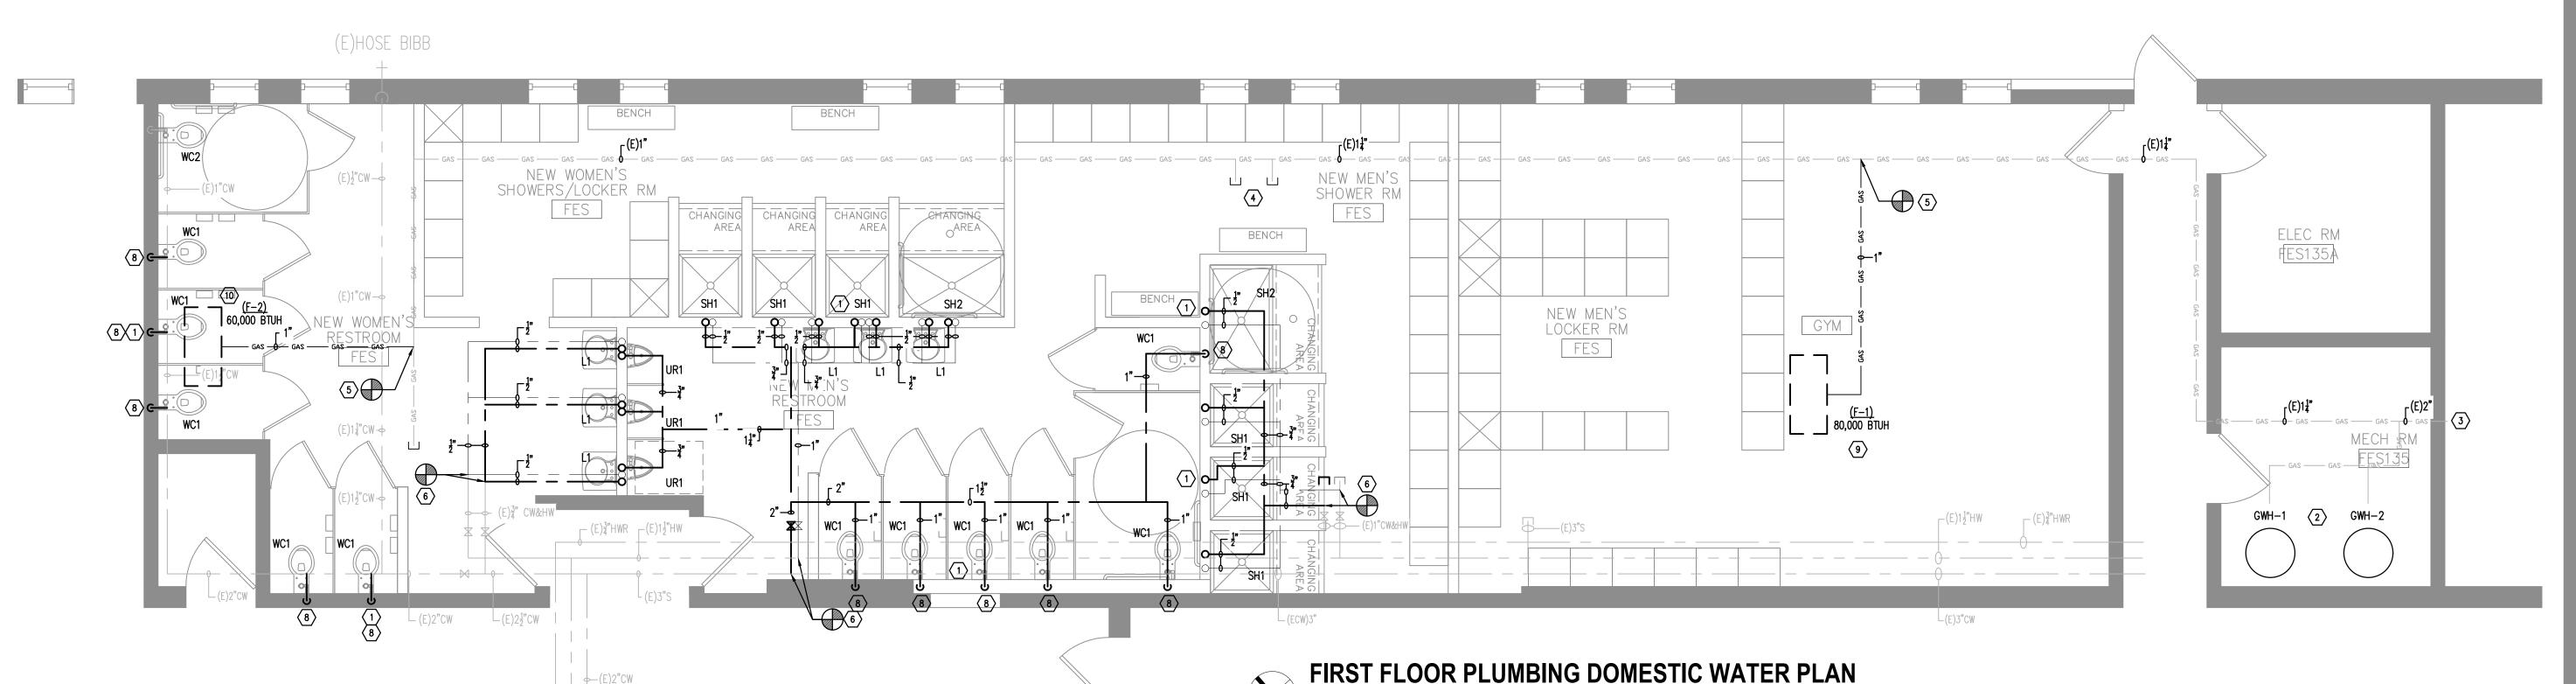

SCALE: 1/4" = 1'-0" (24x36)

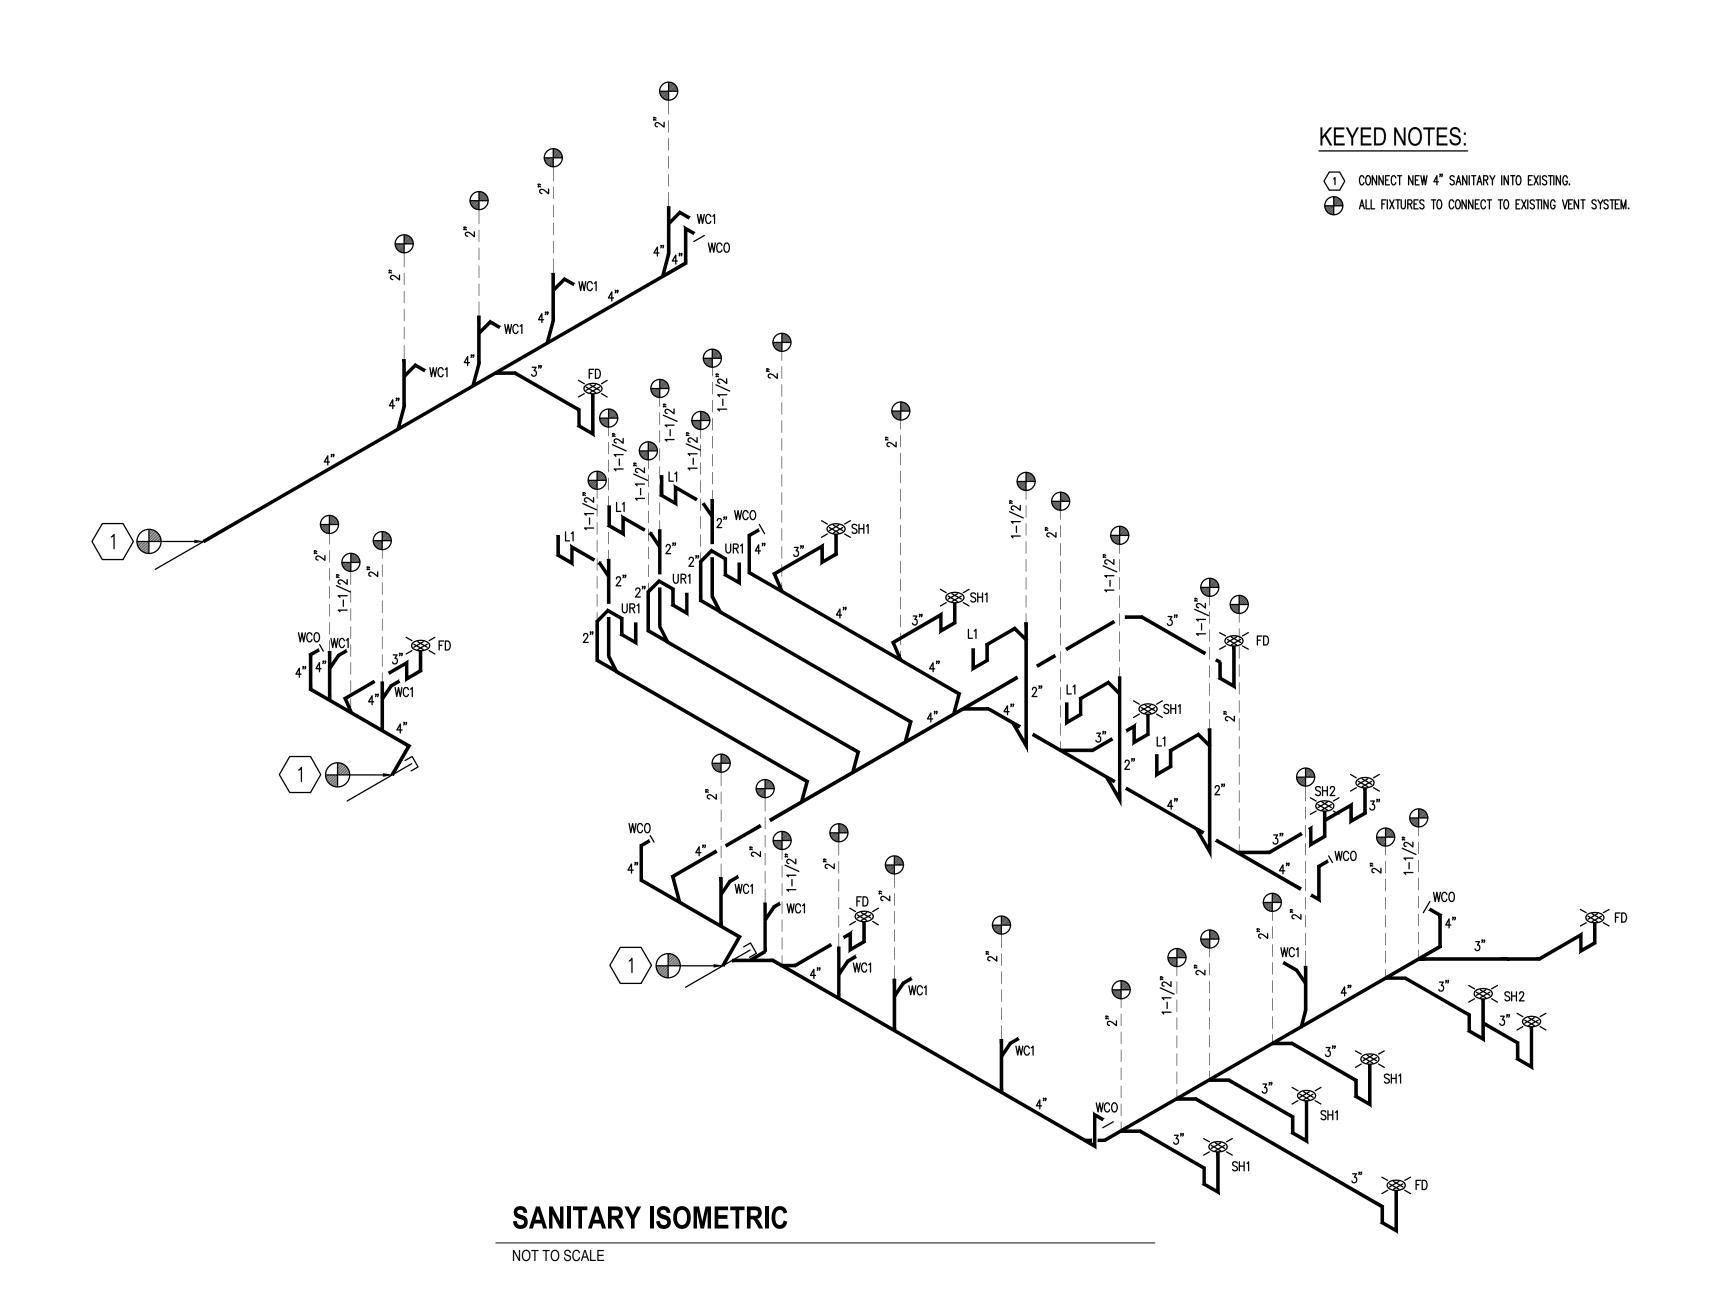



	PLUMBING FIXTURE/EQUIPMENT SCHEDULE
EQ. TAG	SPECIFICATION
WC1	KOHLER MODEL # K-4325-0 VITREOUS CHINA ELONGATED TOILET, ADA COMPLIANT, WHITE OPEN-FRON-T SEAT, SLOAN ROYAL 111 ESS-1.28-BN-OR-HW W/ OPTIMA EL-1500-L SENSOR.
UR1	TOTO MODEL # UT104EV WHITE VITREOUS CHINA LOW CONSUMPTION WASHOUT URINAL WITH TEU2UA12#SS, INTEGRAL VACUUM BREAKER, 3/4" CW CONNECTTION, 0.125 GPF.
L1	KOHLER MODEL # K-2602-SU SINGLE COMPARTMENT STAINLESS ADA OVAL. SUPPLY WITH FAUCET - KOHLER MODEL # EAF-100-ISM
BF	ELKAY MODEL # LZWSSM, ELECTRONIC BOTTLE FILLING STATION. 115/1/60, NON-REFRIGERATED, FILTER OPTION ADA COMPLIANT
SH1	SUPPLY WITH DELTA MODEL # T17230 MONITOR 17 SERIES SHOWER TRIM, 1.8 GPM MAX SHOWER HEAD. PRO' STAINLESS STEEL FLOOR DRAIN. PROVIDE TEMPERATURE MIXING VALVE TO PROVIDE 110 DEG. F. TEMP WATER. VERIFY EXACT SPECIFICATION AND REQUIREMENTS WITH OWNER.
SH2	ACCESSIBLE CUSTOM BUILT SHOWER. SUPPLY WITH DELTA MODEL #T13H153 UNIVERSAL SHOWER TRIM, AND 1.5 GPM MAX. HAND SHOWER. PROVIDE STAINLESS STEEL FLOOR DRAIN. PROVIDE TEMPERATURE MIXING VALVE TO PROVIDE 110 DEG. TEMPERED WATER. VERIFY EXACT REQUIREMENTS WITH ON
FD	SCHLUTER KERDI-DRAIN 4" SQUARE DESIGN (1) E, 3" WASTE OUTLET, WITH TRAP PRIMER
GWH1,2	NATURAL GAS HOT WATER HEATER, REPLACE WITH LIKE KIND, 100 GALLON, 255,000 BTU INPUT EACH, PLUMBING CONTRACTOR TO PROVIDE START-UP, AND COMPLETE INSTALLATION OF EACH UNIT IN TOTAL CONFORMANCE WITH THE MANUFACTURER'S INSTALLATION INSTRUCTIONS.

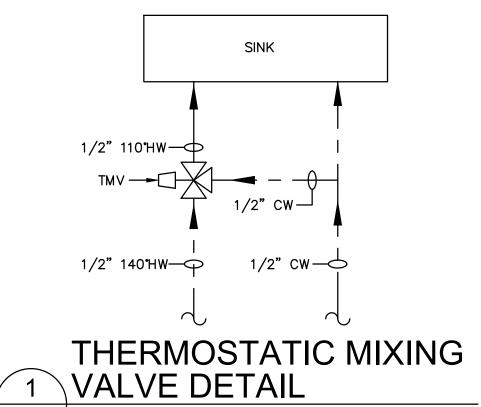

P4 N.T.S.

STATE OF MISSOURI MIKE KEHOE, GOVERNOR

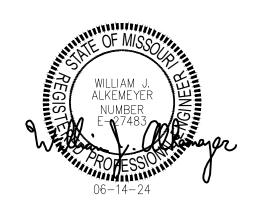

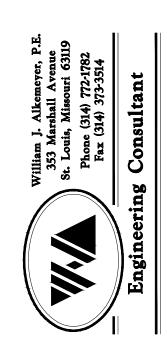

OFFICE OF ADMINISTRATION DIVISION OF FACILITIES MANAGEMENT, DESIGN AND CONSTRUCTION

**DEPARTMENT OF** 

**Festus Readiness Center** 

Repars to Int./Ext. Readiness Center, and Unheated Storage Buildings

ARMY NATIONAL GUARD 2740 State Rd P, Festus, MO 63028

PROJECT # T-2330-01 SITE # 6302

SITE # 6302 FACILITY # 56377

REVISION:
DATE:
REVISION:
DATE:
REVISION:
DATE:
ISSUE DATE 06/23/2025

CAD DWG FILE: P-PL


CAD DWG FILE: P-PLB-03
DRAWN BY: MEW
CHECKED BY: AMK
DESIGNED BY: MEW

SHEET TITLE:

PLUMBING SANITARY ISOMETRIC VIEW, DETAILS & FIXTURE SCHEDULE

SHEET NUMBER:

P-3

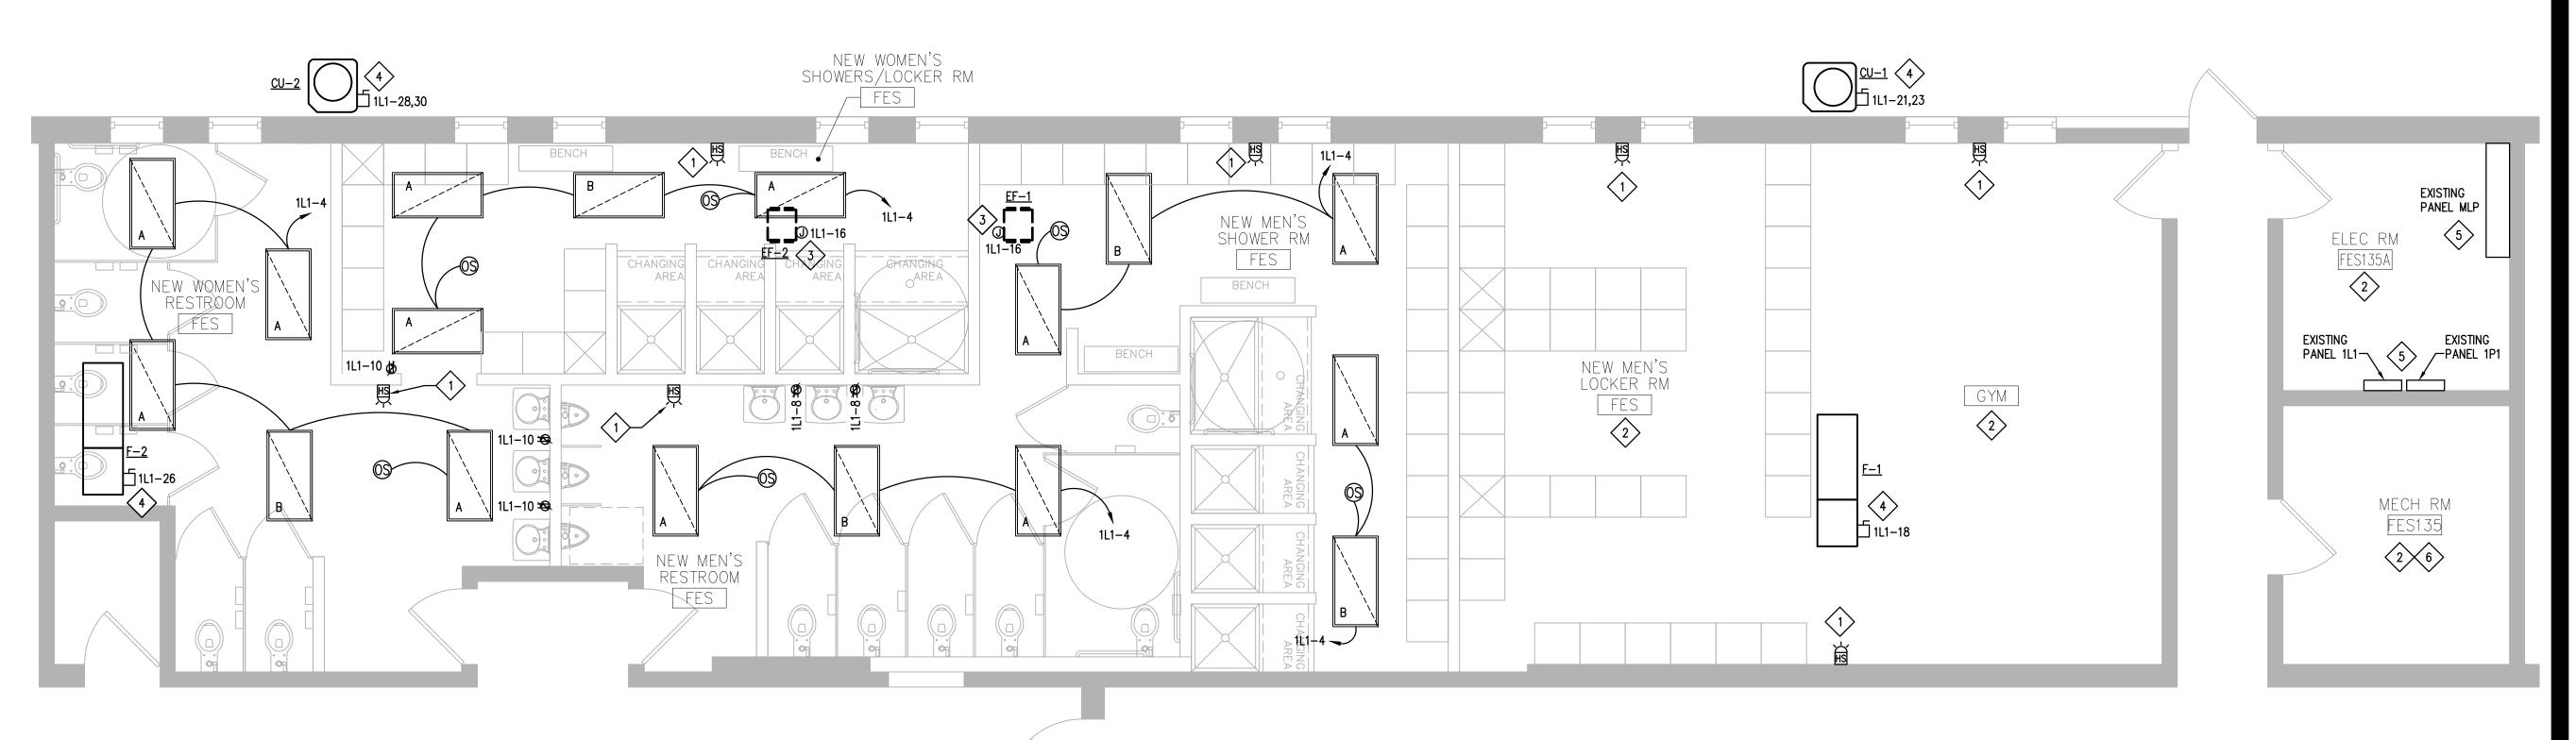

# **GENERAL NOTES**

COORDINATE FINAL LOCATIONS OF ALL RECEPTACLES WITH ARCHITECT AND OWNER'S REPRESENTATIVE PRIOR TO COMMENCING WORK.

FOLLOW ALL THE LOCAL AMENDMENTS TO THE NATIONAL ELECTRICAL CODE, INCLUDING A GROUNDING CONDUCTOR IN ALL RACEWAYS.

ALL 15 AND 20 AMP, 125 VOLT ELECTRICAL OUTLETS SHALL COMPLY WITH 2008 NEC 210.8 (B) WHICH REQUIRES RESTROOMS, ROOFS, KITCHENS, AND OUTDOORS TO BE GFI PROTECTED. PROVIDE EITHER INDIVIDUAL GFI DEVICES OR GFI CIRCUIT BREAKERS.

VERIFY ELECTRICAL REQUIREMENTS, CONNECTIONS, AND EXACT LOCATION OF CONNECTIONS. COORDINATE WITH EQUIPMENT SUPPLIER/CONTRACTOR

NO INTERIOR TIMECLOCK IS REQUIRED DUE TO ALL INTEREIOR LIGHTING BEING CONTROLLED BY OCCUPANCY SENSORS.

ALL EXIT & EMERGENCY LIGHTING FIXTURES SHALL BE PROVIDED WITH A 90 MINUTE (MINIMUM) EMERGENCY BATTERY AND CONNECTED TO THE NEAREST "LOCAL" LIGHTING CIRCUIT AHEAD OF ANY SWITCHING.

THE ELECTRICAL CONTRACTOR SHALL COORDINATE WITH ALL OTHER TRADES IN LOCATING DEVICES, WIRING, CONDUIT, AND EQUIPMENT TO AVOID ANY INTERFERENCE.

ALL WIRING INSTALLED IN RETURN PLENUM SHALL BE UL LISTED FOR PLENUM INSTALLATION OR RUN IN CONDUIT IN ACCORDANCE WITH THE N.E.C.

CONTRACTOR TO VERIFY ALL SWITCH LOCATIONS WITH OWNER.

CONTRACTOR TO INSTALL ALL WORK IN STRICT COMPLIANCE WITH LOCAL CODES AND ORDINANCES.

SEE ARCHITECTURAL SHEETS FOR DEMOLITION WORK AND NOTES.

#### **KEYED NOTES**

- RELOCATE EXISTING HORN/STROBE DEVICE OR PROVIDE NEW DEVICE COMPATIBLE WITH EXISTING FIRE ALARM SYSTEM AS REQUIRED. CONNECT TO EXISTING FIRE ALARM SYSTEM. ADDITIONAL DEVICE(S) MAY BE REQUIRED AS DIRECTED BY THE FIRE MARSHAL. FIELD VERIFY REQUIREMENTS.
- 2 EXISTING LIGHTING AND CONTROLS IN THIS ROOM TO REMAIN.
- PROVIDE ROUGH—IN AND FINAL CONNECTION TO EXHAUST FAN. FIELD VERIFY EXACT LOCATION AND REQUIREMENTS. COORDINATE WITH MECHANICAL CONTRACTOR.
- PROVIDE ROUGH—IN AND FINAL CONNECTION TO HVAC EQUIPMENT. FIELD VERIFY EXACT LOCATION AND REQUIREMENTS. COORDINATE WITH MECHANICAL CONTRACTOR
- SEE ONE-LINE DIAGRAM AND PANEL SCHEDULES ON SHEET E-2 FOR MORE INFORMATION.
- PROVIDE FINAL CONNECTION TO GAS WATER HEATER CONTROLS IN THIS ROOM.
  RE-USE EXISTING CIRCUITING FROM DEMOLISHED WATER HEATER. COORDINATE EXACT LOCATION AND REQUIREMENTS WITH PLUMBING CONTRACTOR.


# FIRST FLOOR ENLARGED RESTROOM ELECTRICAL PLAN SCALE: 1/4" = 1'-0" (24x36)

## LIGHT FIXTURES

A - <u>METALUX</u> 24RLN-LD5-45-UNV-L840-CD1-U 2' x 4' RECESSED TROFFER LED FIXTURE, 4K COLOR TEMP. 34 WATTS EACH.

B - <u>METALUX</u> 24RLN-LD5-45-UNV-L840-CD1-U-EL14W 2' X 4' RECESSED TROFFER LED FIXTURE WITH EMERGENCY BATTERY PACK, 4K COLOR TEMP. 48 WATTS EACH.

ELECTRICAL LEGEND								
SYMBOL	DESCRIPTION							
<b>⋬</b>	DUPLEX GROUND FAULT INTERRUPTING TYPE RECEPTACLE							
0	JUNCTION BOX							
	DISCONNECT SWITCH							
	SINGLE SECTION PANELBOARD							
	CIRCUIT HOME RUN							
©S)	CEILING MOUNTED OCCUPANCY SENSOR SWITCH							
EH.	WALL MOUNTED FIRE ALARM HORN/STROBE DEVICE							

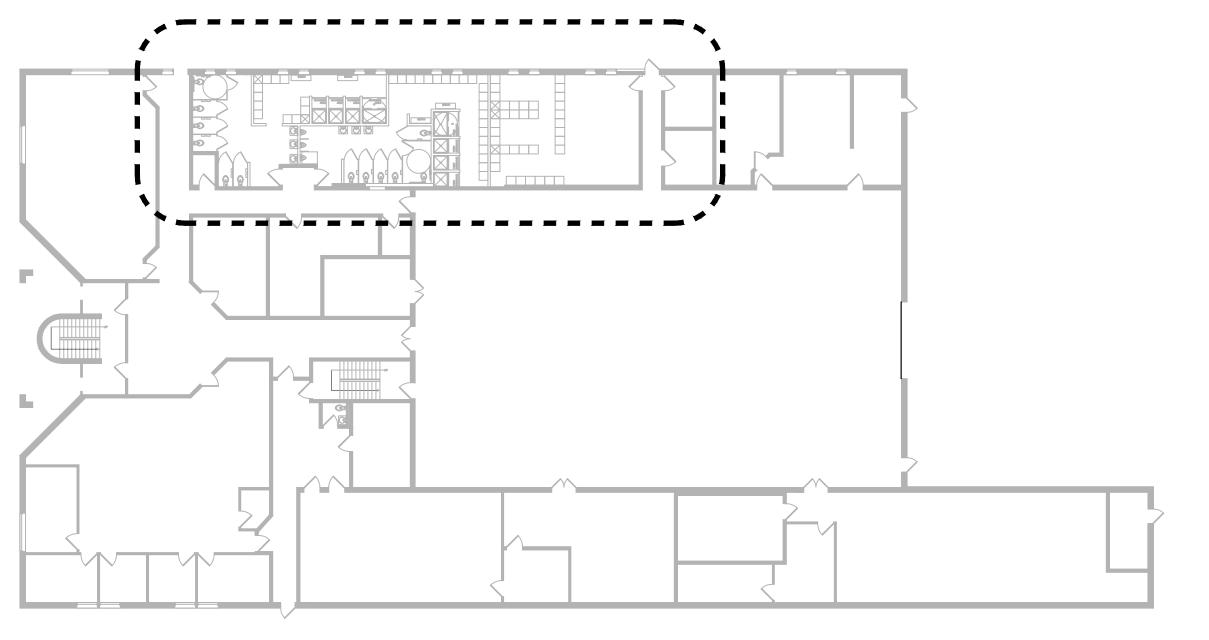



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CAD DWG FILE: E-CEL-01
DRAWN BY: PB
CHECKED BY: BS
DESIGNED BY: PB

ISSUE DATE 06/23/2025

SHEET TITLE:
FIRST FLOOR
RESTROOM
ELECTRICAL
PLAN


SHEET NUMBER:

E-1

PANEL 1L1 (EXISTING) 100A MLO										
120/20	20/208V - 3PH - 4W - S/N 30 POLE									
CKT. BRKR.		SERVICE	LOAD	PHASE	LOAD	SERVICE	BRKR.	CKT.		
NO.	SIZE		(VA)		(VA)		SIZE	NO.		
1	20/1	LIGHTS	1000	Α	1000	LIGHTS	20/1	2		
3 5	20/1	EXTERIOR LIGHTS	1000	В	730	NEW RESTROOM LIGHTS	20/1	4		
5	20/1	LIGHTS	1000	С	1000	LIGHTS	20/1	6		
7	20/1	LIGHTS	1000	Α	360	MEN'S RESTROOM RECEPTACLES	20/1	8		
9	20/1	RECEPTACLES	720	В	540	WOMEN'S RESTROOM RECEPTACLES	20/1	10		
11	20/1	RECEPTACLES	720	С	1000	EAST PARK LIGHTS	20/2	12		
13	20/1	WATER COOLER	500	A	1000			14		
15	20/1	EAST & SOUTH BLDG LIGHTS	1000	В	260	EF-1, 2	20/1	16		
17	20/1	UNIT HEATERS	1500	С	1670	F-1	20/1	18		
19	20/1	EXHAUST FAN #10	500	Α	-	SPARE	20/1	20		
21	40/2	CU-1	2500	В	-	SPARE	20/1	22		
23	70/2	00-1	2500	С	500	POT SINK EXHAUST FAN	20/1	24		
25	20/1	PUMP HOUSE HEATER	1500	A	1300	F-2	20/1	26		
27	20/1	PUMP HOUSE RECEPTACLES	540	В	1400	CU-2	20/2	28		
29	20/1	DISHWASER E.F.	500	С	1400	C0-2	2012	30		
CONNECTED LOAD A:			8160 VA		28640 VA :TOTAL LOAD		79.5	AMPS		
B:		8690 VA		28640 VA :DEMAND LOAD		79.5	AMPS			
C: 11790 VA										

PANEL SCHEDULE NOTES:

SHADED EQUIPMENT = EXISTING EQUIPMENT AND/OR CONNECTION TO REMAIN. SHOWN FOR REFERENCE ONLY.

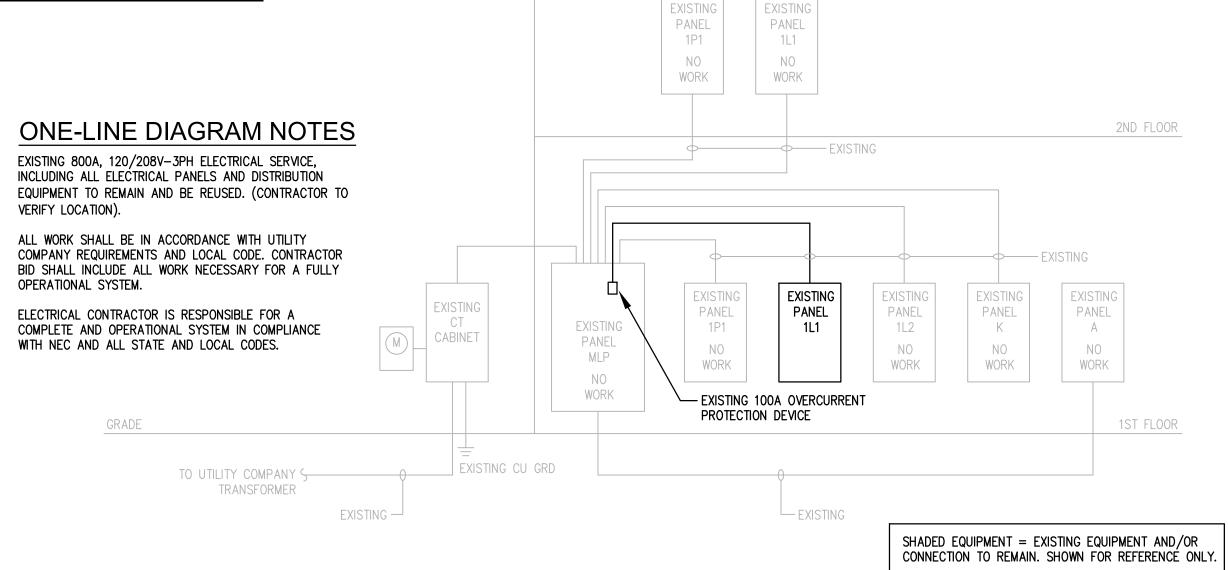


EXTERIOR INTERIOR

ONE-LINE DIAGRAM

SCALE: NONE

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CAD DWG FILE: E-CEL-02
DRAWN BY: PB
CHECKED BY: BS

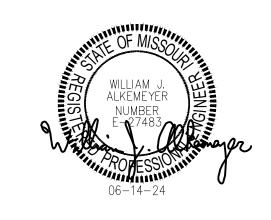DESIGNED BY: PB
SHEET TITLE:
ONE-LINE

ONE-LINE
DIAGRAM AND
SPECIFICATIONS

SHEET NUMBER:

E-2