HARRISONVILLE READNESS CENTER REPAIRS TO INTERIOR & EXTERIOR HARRISONVILLE, MISSOURI





OWNER: STATE OF MISSOURI

MIKE KEHOE, GOVERNOR

DEPARTMENT OF MISSOURI

NATIONAL GUARD

PROJECT: OFFICE OF ADMINISTRATION

MANAGEMENT: DIVISION OF FACILITIES MANAGEMENT,

DESIGN AND CONSTRUCTION

DESIGNER:

ARCHITECTURAL
Wellner Architects + Engineers
1627 Main Street #100

6271

1627 Main Street #100 Kansas City, MO 64108 816.221.0017 Olsson
1301 Burlington Street

MECHANICAL, ELECTRICAL, PLUMBING, FIRE ALARM

1301 Burlington Street North Kansas City, MO 64116 816.361.1177


PROJECT NUMBER: T2334-01

SITE NUMBER:

FACILITY NUMBER: 8136271003

SHEET NUMBER:



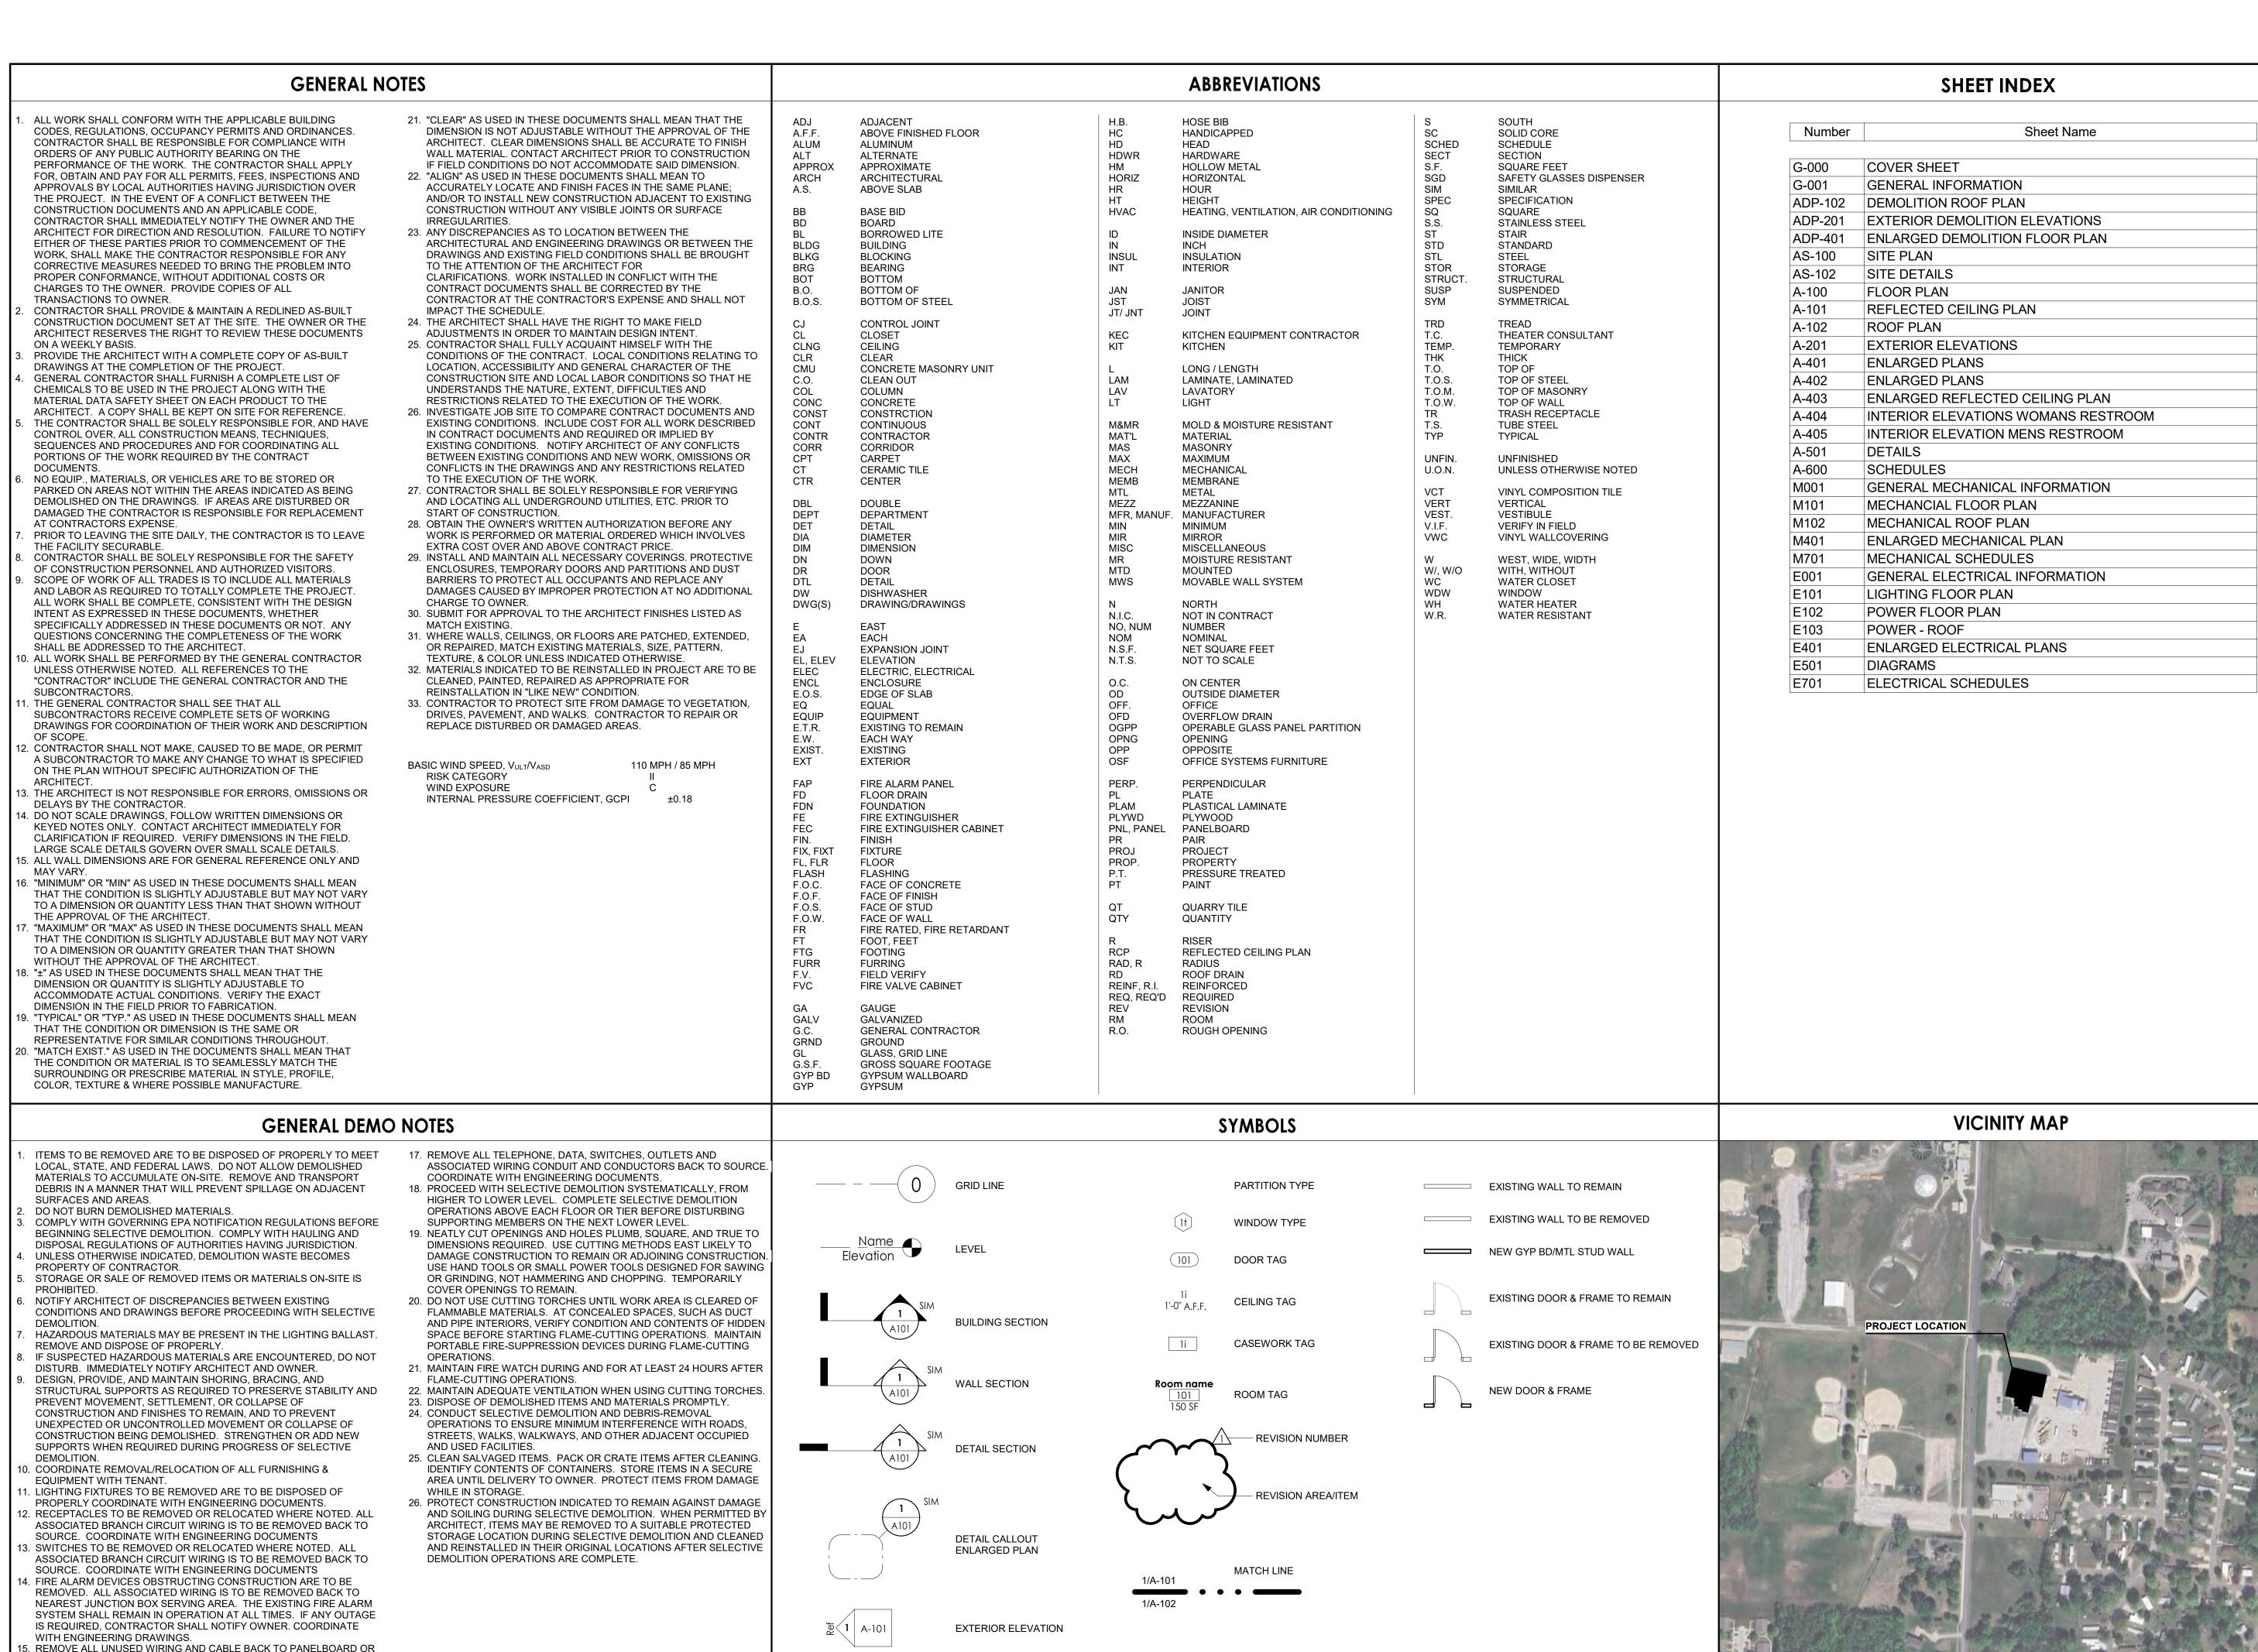

INTERIOR ELEVATION

STATE OF MISSOURI MIKE KEHOE, GOVERNOR



PROFESSIONAL SEAL



MRCHITECTURAL
Wellner Architects + Engineers
1627 Main Street #100
Kansas City, MO 64108
816.221.0017

MECHANICAL, ELECTRICAL, PLUMBING,
FIRE ALARM, FIRE SPRINKLER, &
INFORMATION TECHNOLOGY
Olsson

Oisson 1301 Burlington Street North Kansas City, MO 64116 816.361.1177

OFFICE OF ADMINISTRATION DIVISION OF FACILITIES MANAGEMENT, DESIGN AND CONSTRUCTION

DEPARTMENT OF MISSOURI NATIONAL GUARD

HARRISONVILLE
READNESS CENTER
REPAIRS TO INTERIOR &
EXTERIOR

HARRISONVILLE, MISSOURI

PROJECT # T2334-01 SITE # 6271 FACILITY #8136271003

No.	Date	Description

ISSUE DATE: 07.09.2025 CAD DWG FILE:

DRAWN BY: KP CHECKED BY: JB DESIGNED BY: KP

SHEET TITLE:

GENERAL INFORMATION

SHEET NUMBER:

G-001


2 OF 30 SHEETS7/30/2025 2:09:33 PM

NEAREST OUTLET TO REMAIN IN SERVICE. REMOVE ALL UNUSED CONDUIT BACK TO SOURCE OR PERIMETER WALL. PROVIDE CONDUIT CAP AT FLOOR OR PERIMETER WALL LOCATIONS. COORDINATE WITH

. DUCTWORK TO BE REMOVED BACK TO SOURCE. COORDINATE WITH

ENGINEERING DOCUMENTS.


ENGINEERING DOCUMENTS.

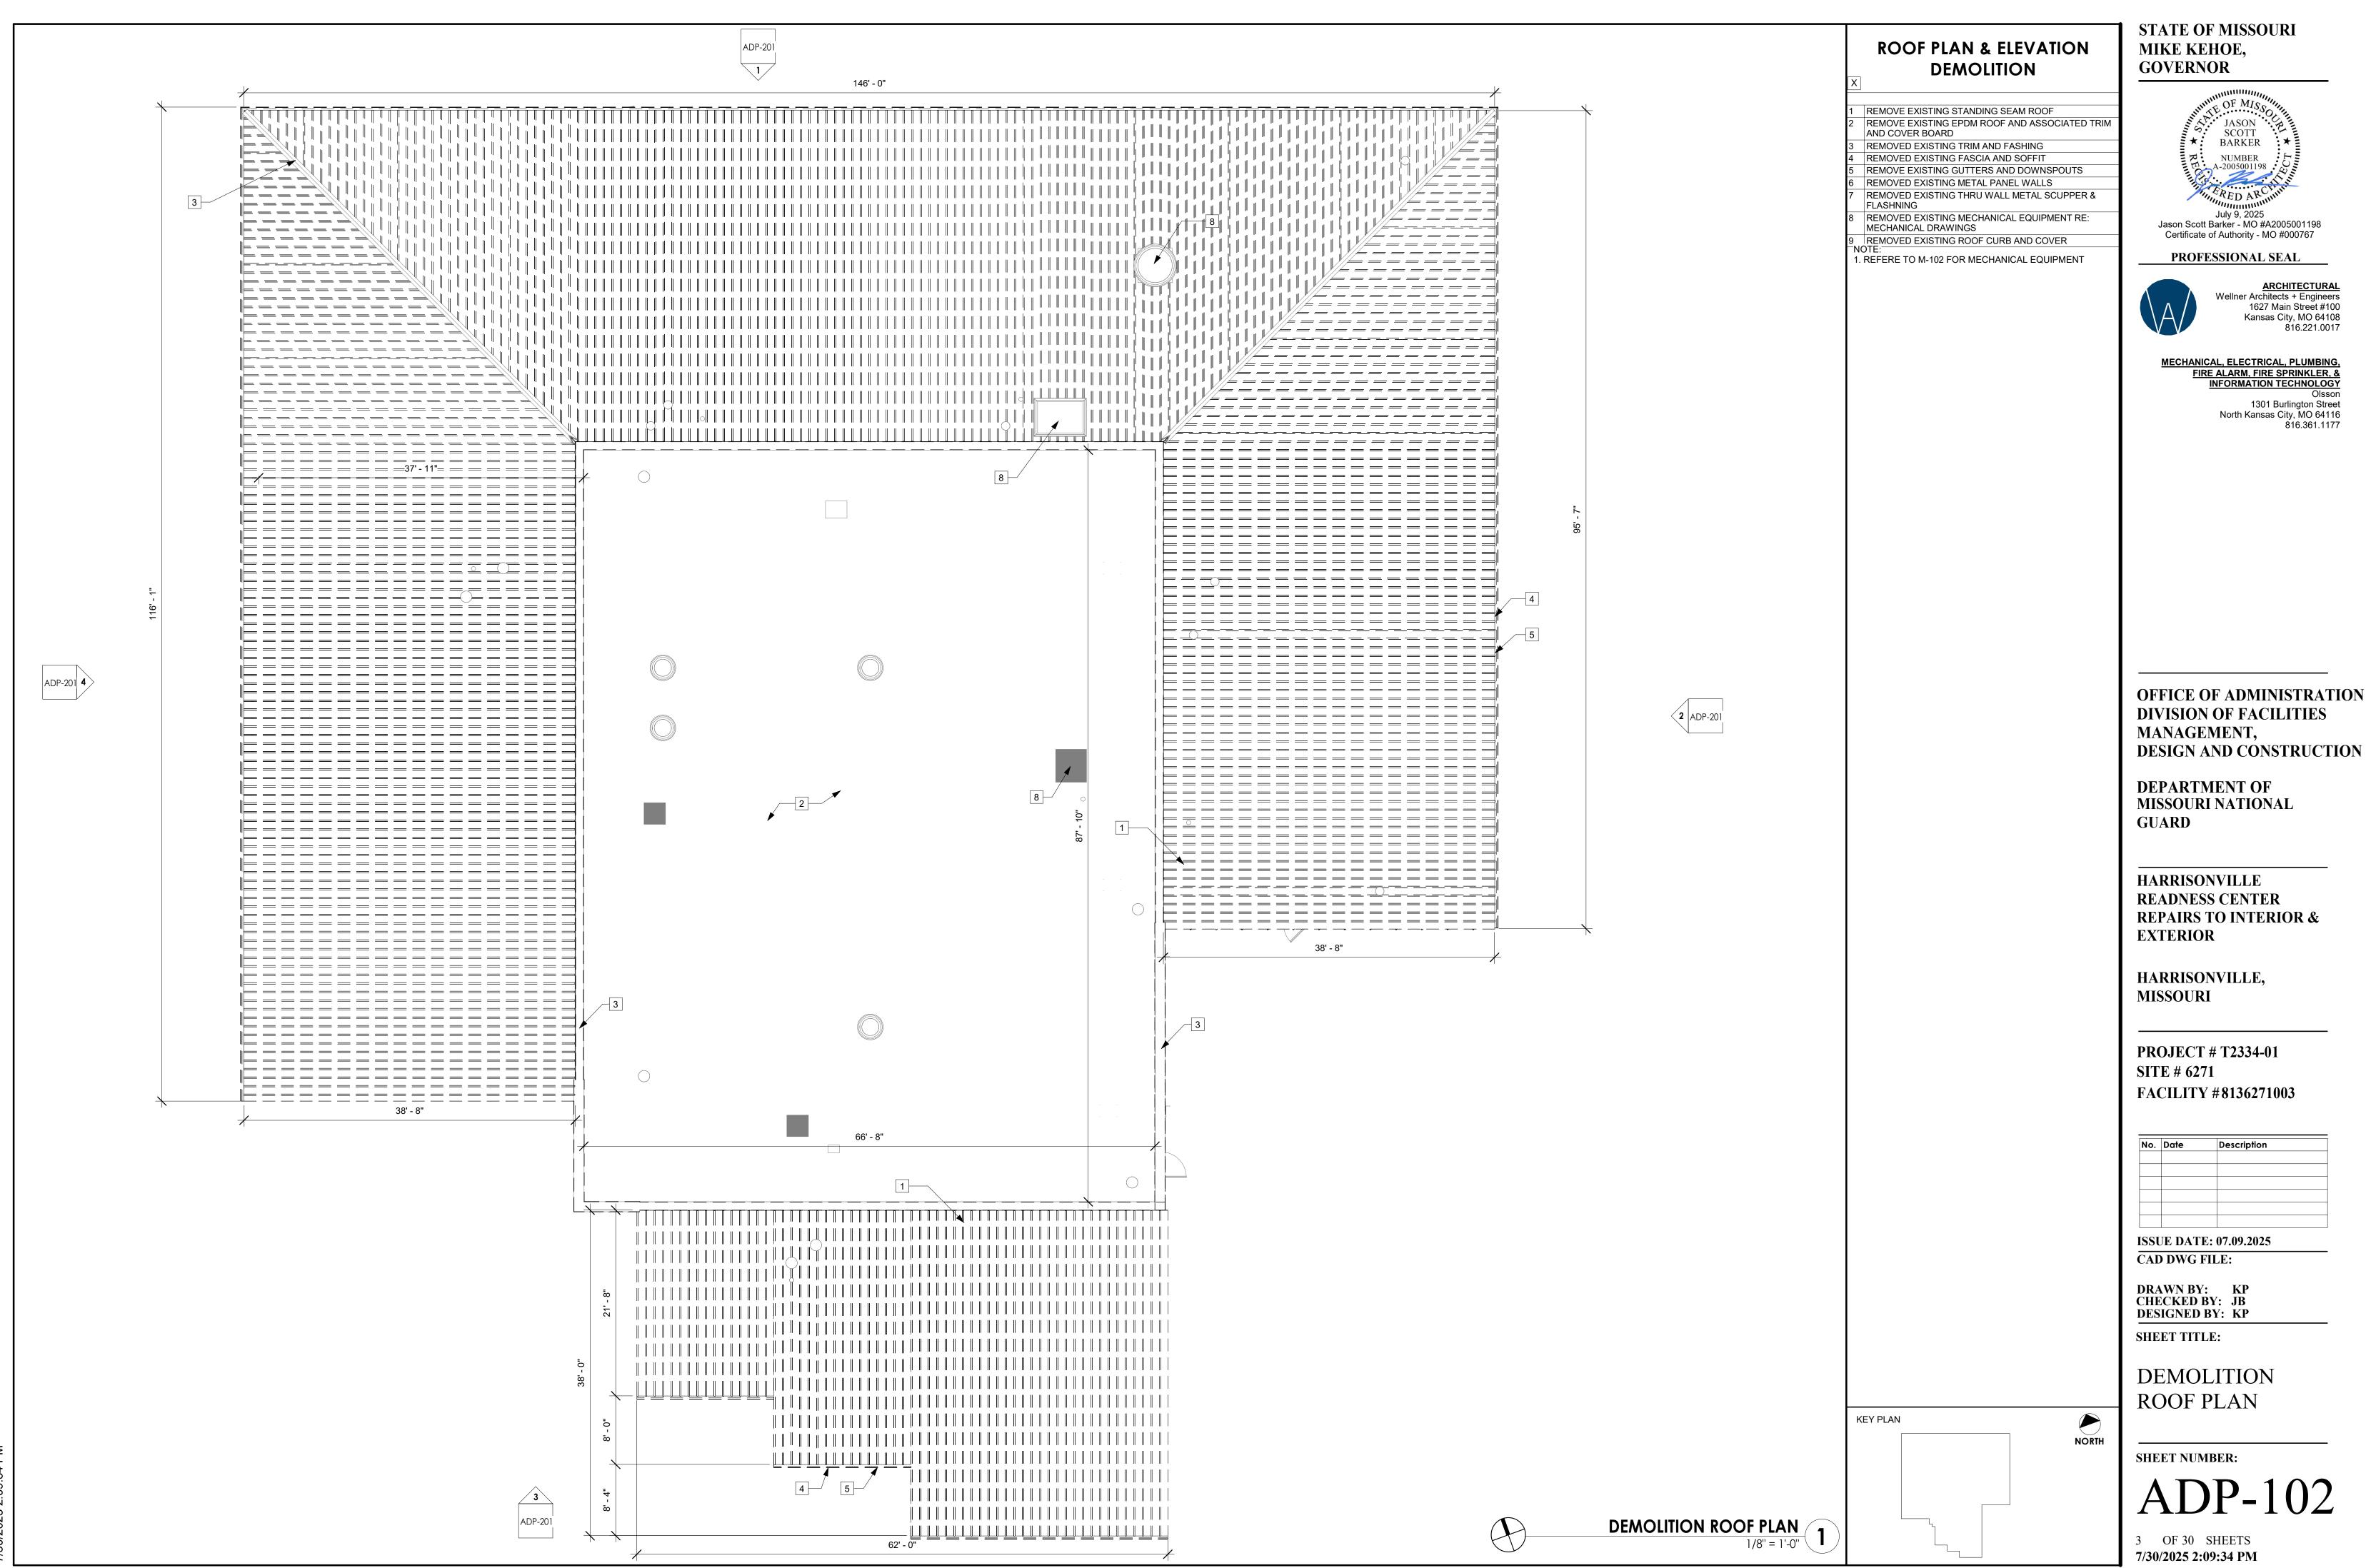

Kansas City, MO 64108

FIRE ALARM, FIRE SPRINKLER, 8 INFORMATION TECHNOLOGY

1301 Burlington Street

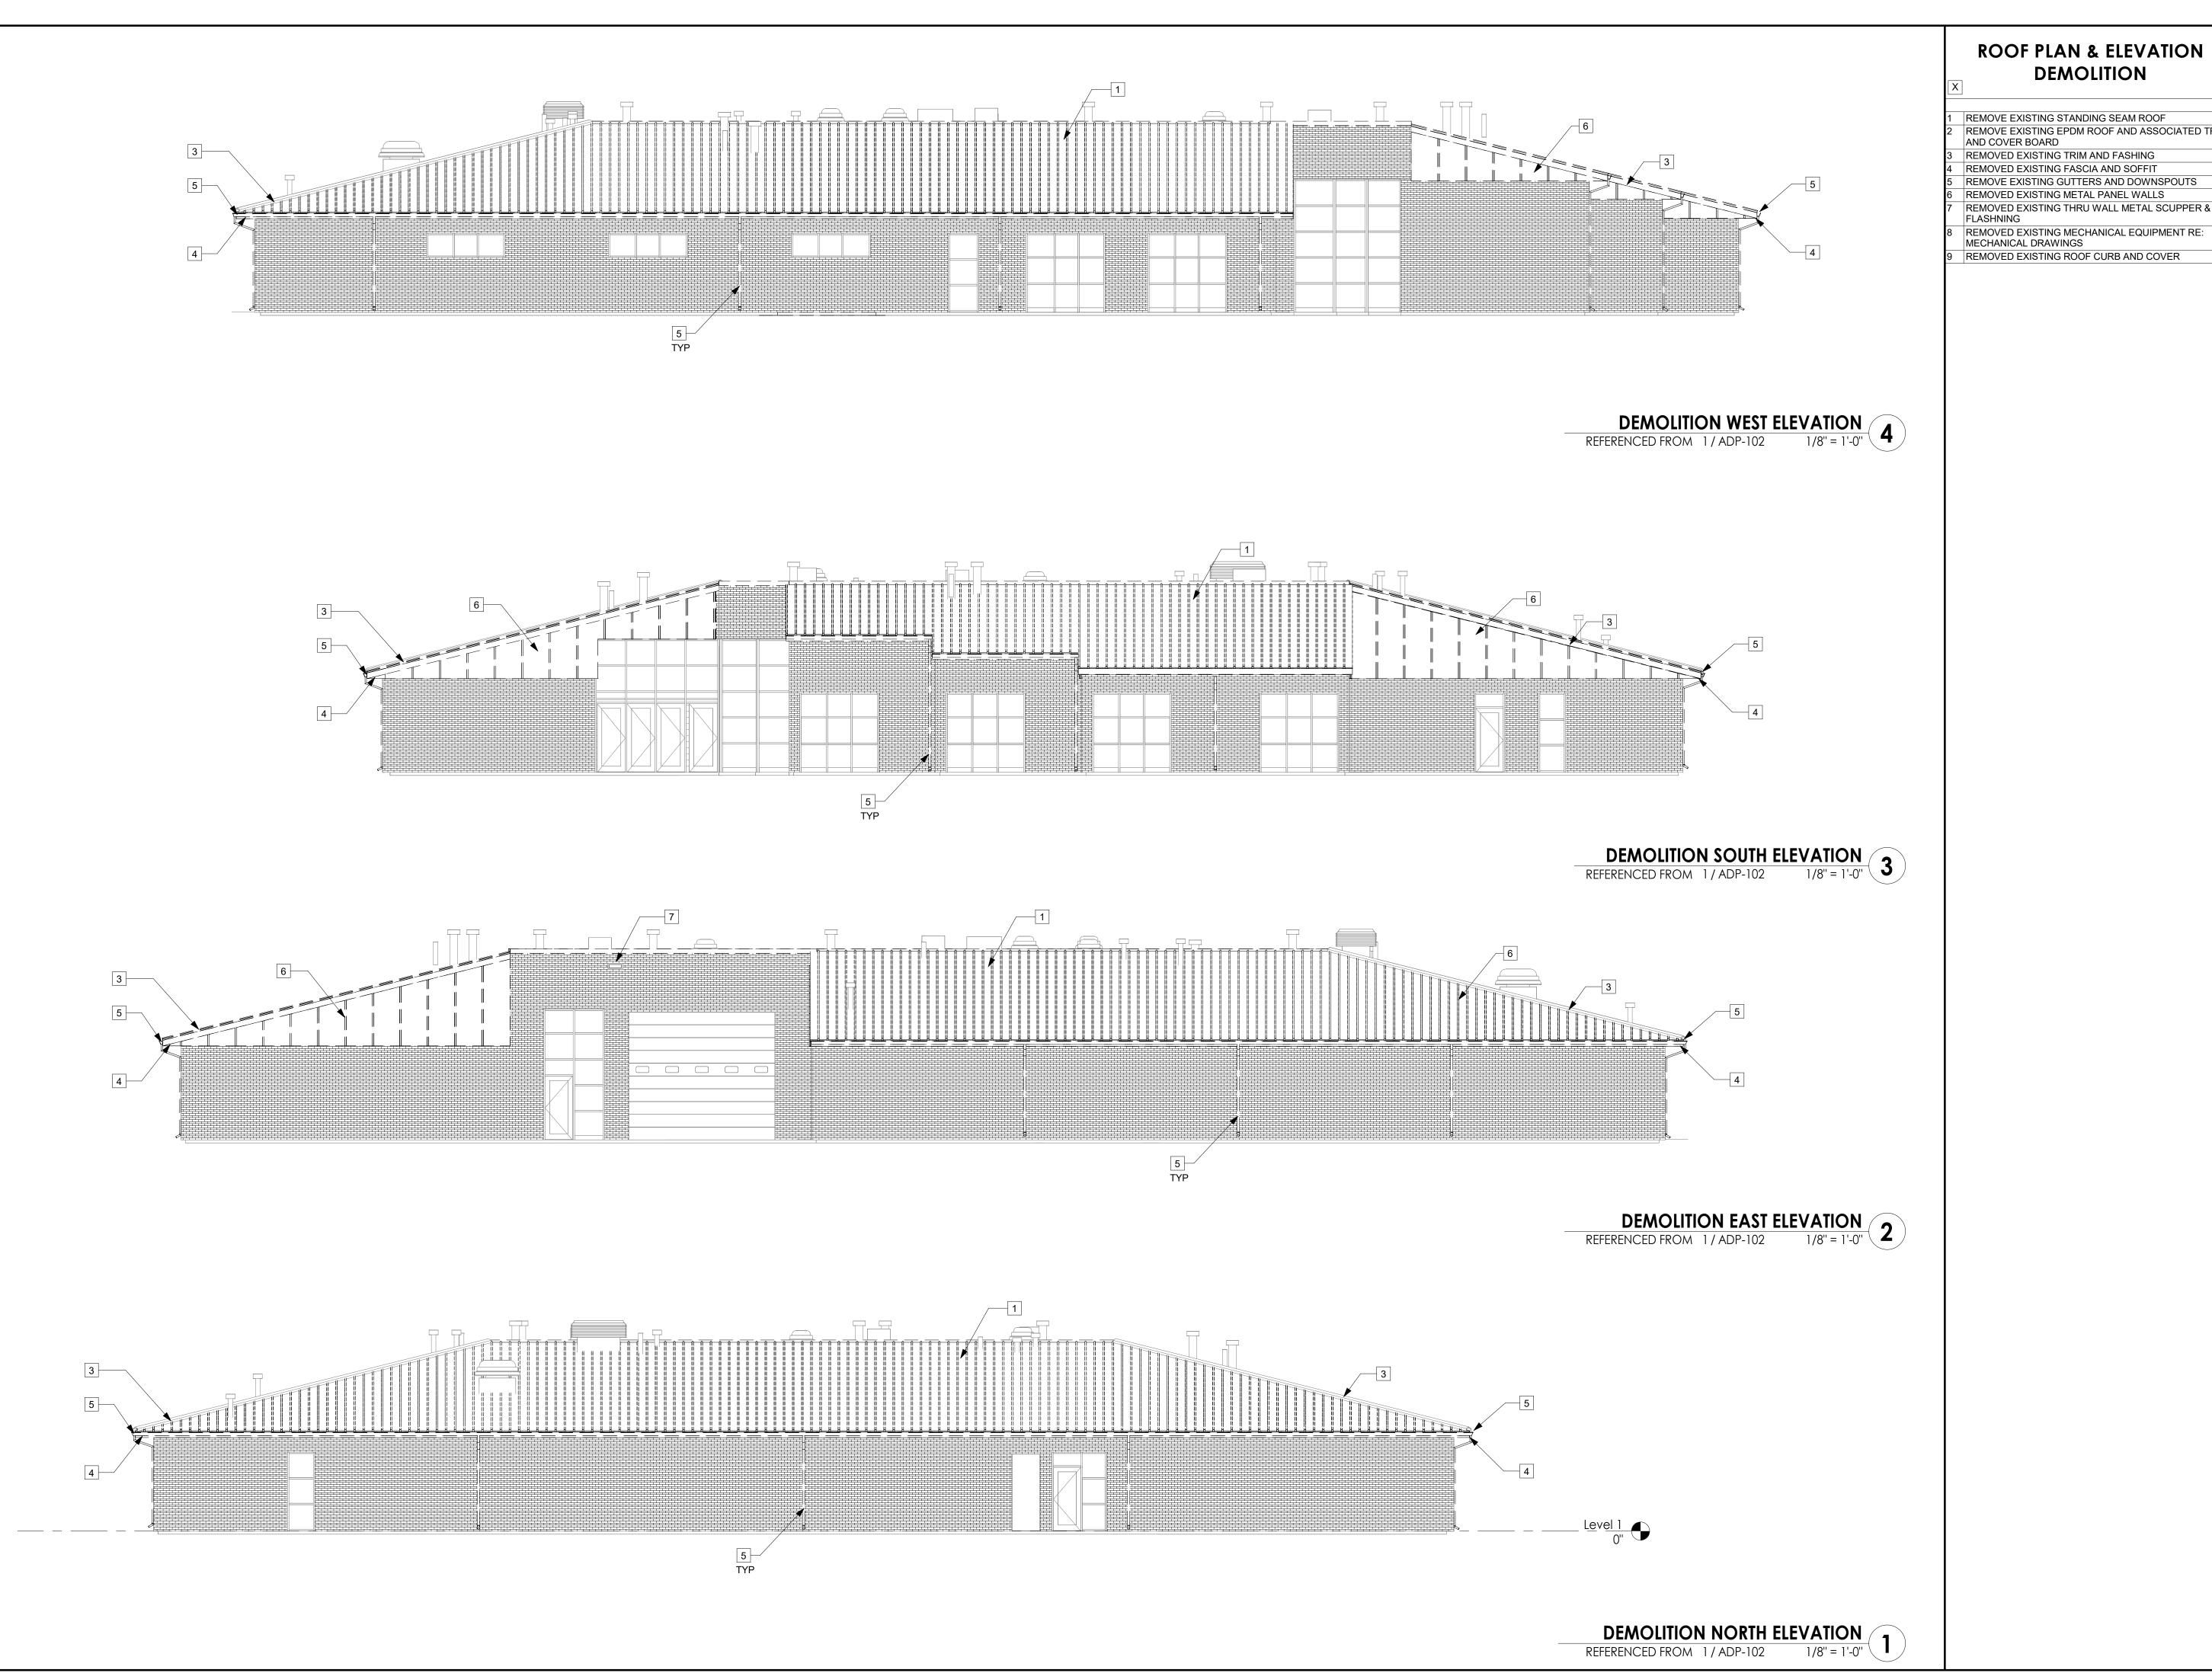

ROOF PLAN & ELEVATION DEMOLITION

REMOVE EXISTING STANDING SEAM ROOF

REMOVE EXISTING EPDM ROOF AND ASSOCIATED TRIM AND COVER BOARD REMOVED EXISTING TRIM AND FASHING

REMOVED EXISTING FASCIA AND SOFFIT REMOVE EXISTING GUTTERS AND DOWNSPOUTS REMOVED EXISTING METAL PANEL WALLS

REMOVED EXISTING MECHANICAL EQUIPMENT RE: MECHANICAL DRAWINGS


REMOVED EXISTING ROOF CURB AND COVER

MIKE KEHOE, **GOVERNOR**

STATE OF MISSOURI



PROFESSIONAL SEAL

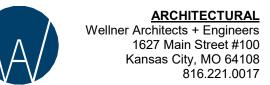

816.221.0017 MECHANICAL, ELECTRICAL, PLUMBING FIRE ALARM, FIRE SPRINKLER, & INFORMATION TECHNOLOGY

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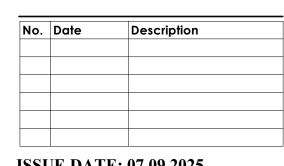
OFFICE OF ADMINISTRATION DIVISION OF FACILITIES MANAGEMENT, **DESIGN AND CONSTRUCTION**

DEPARTMENT OF MISSOURI NATIONAL **GUARD**

HARRISONVILLE READNESS CENTER REPAIRS TO INTERIOR & **EXTERIOR**

HARRISONVILLE, **MISSOURI**

PROJECT # T2334-01 **SITE # 6271** FACILITY #8136271003



ISSUE DATE: 07.09.2025 **CAD DWG FILE:**

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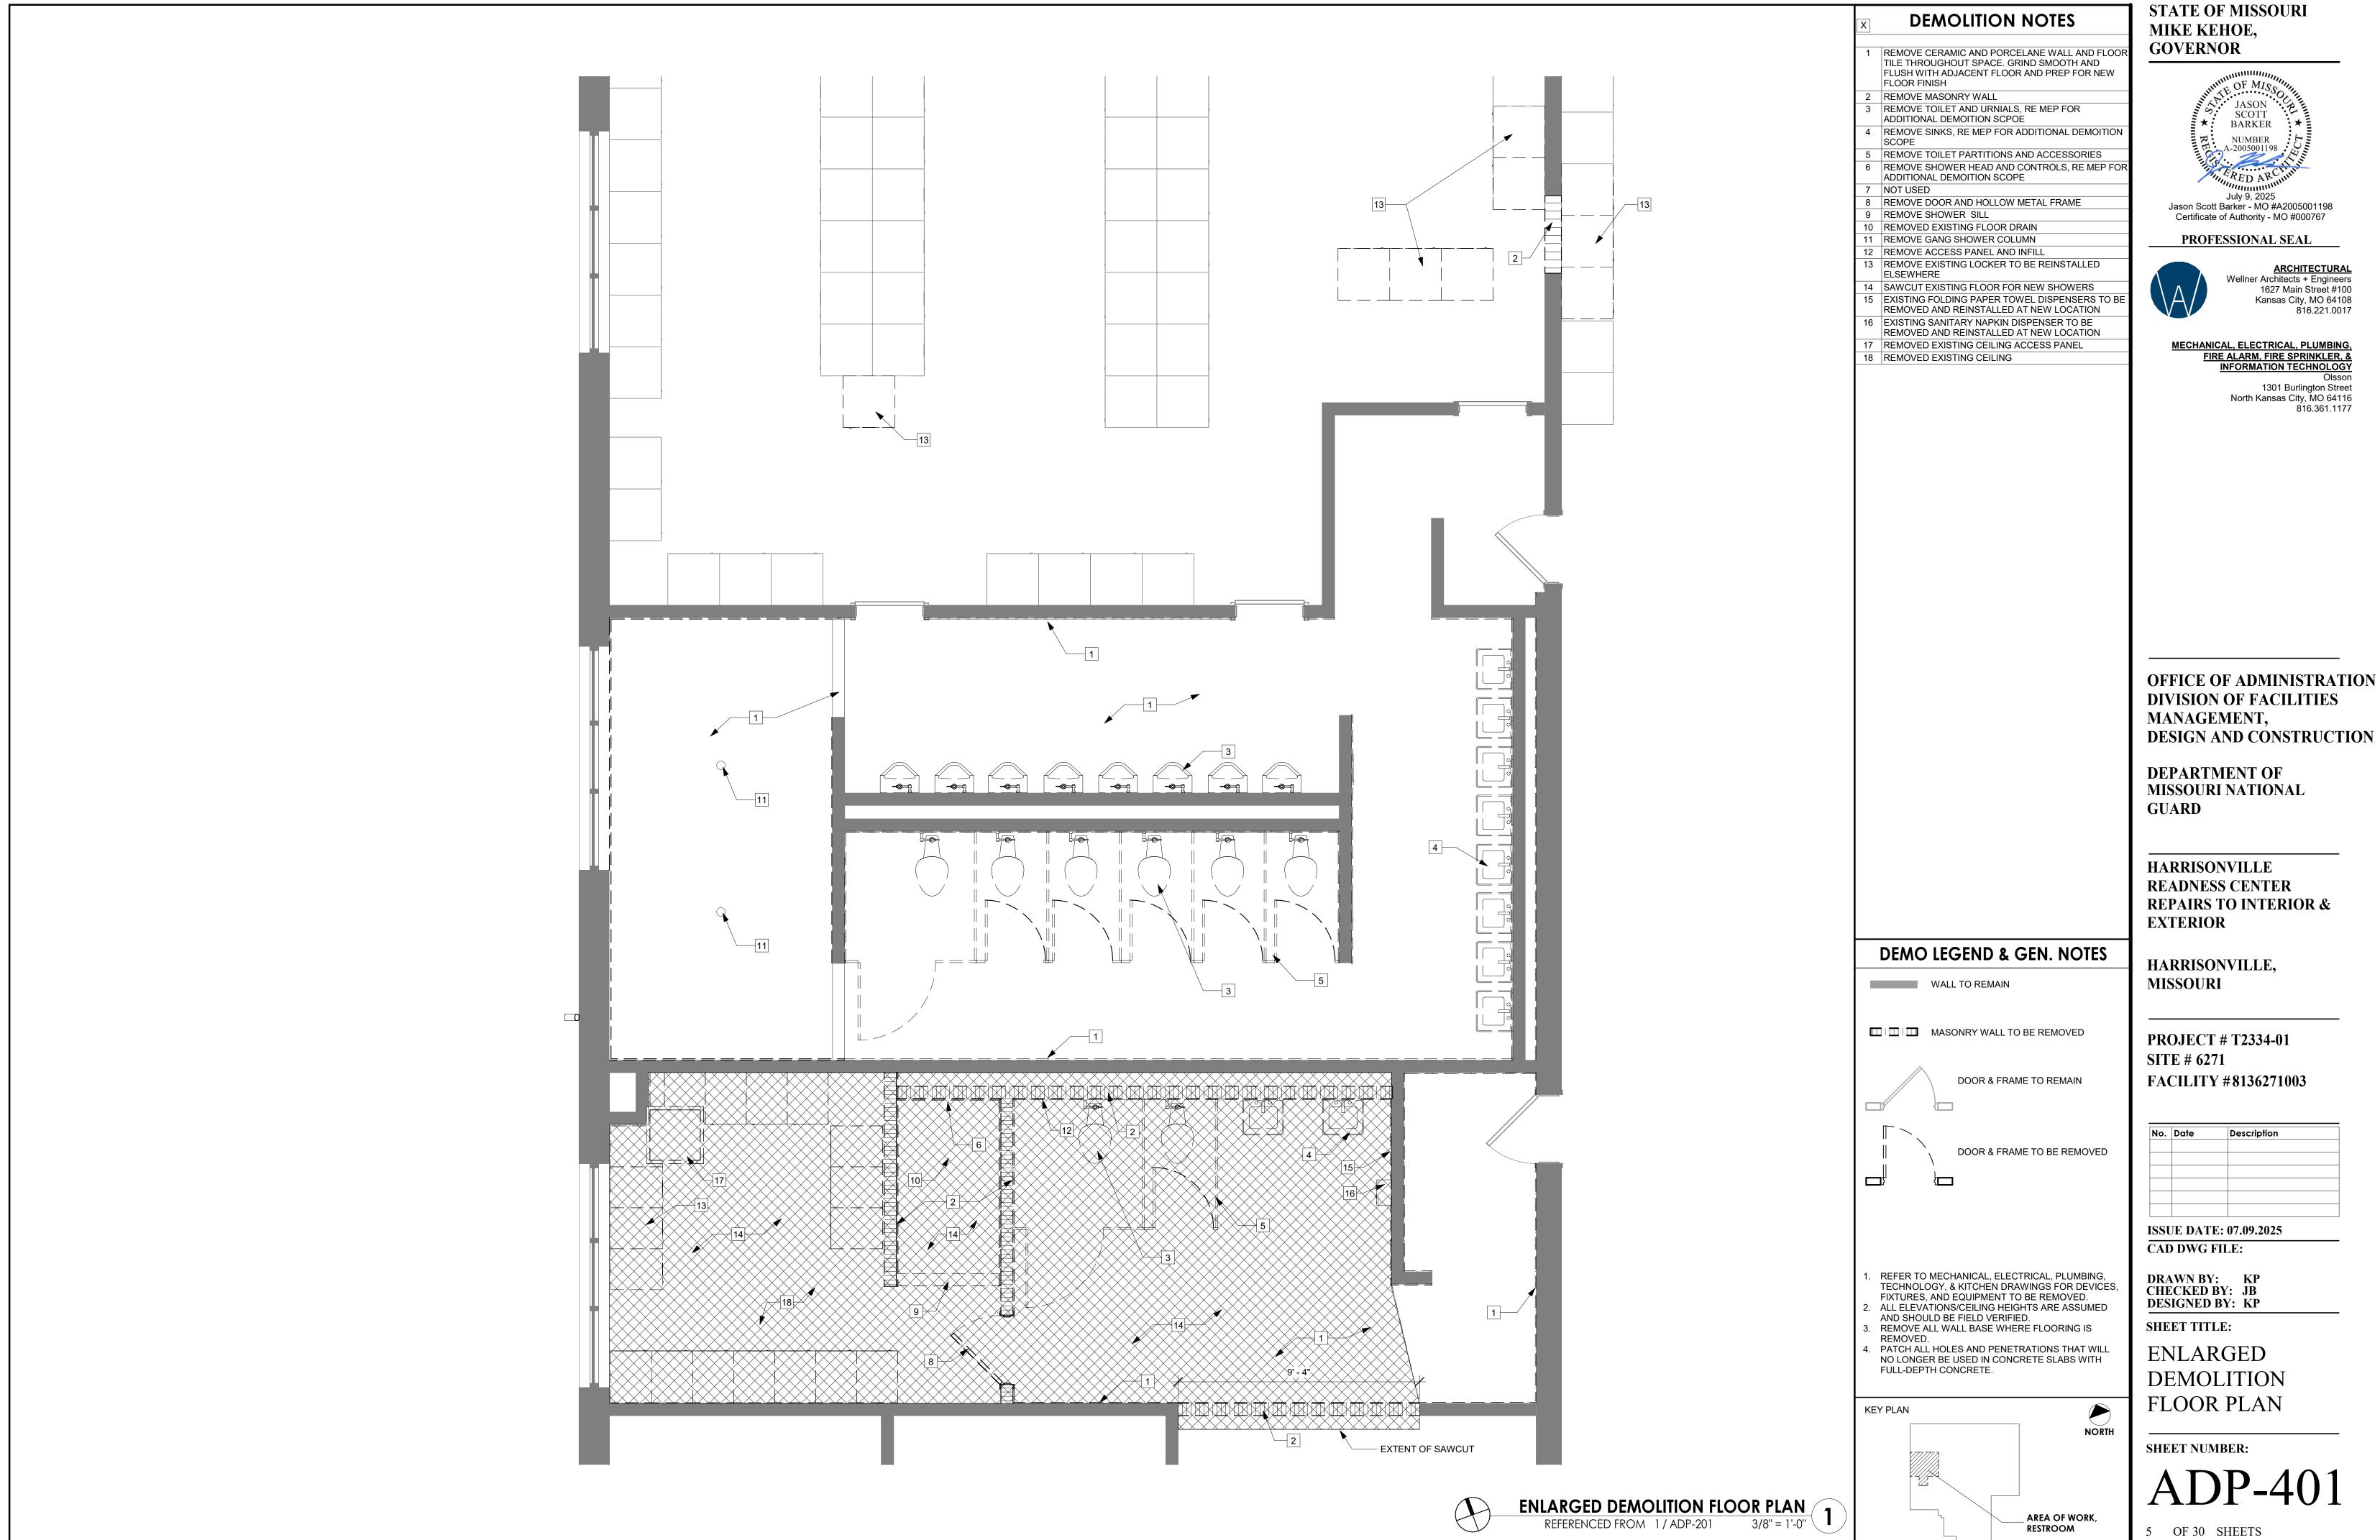
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EXTERIOR DEMOLITION ELEVATIONS

SHEET NUMBER:

ADP-201

4 OF 30 SHEETS **7/30/2025 2:09:35 PM**




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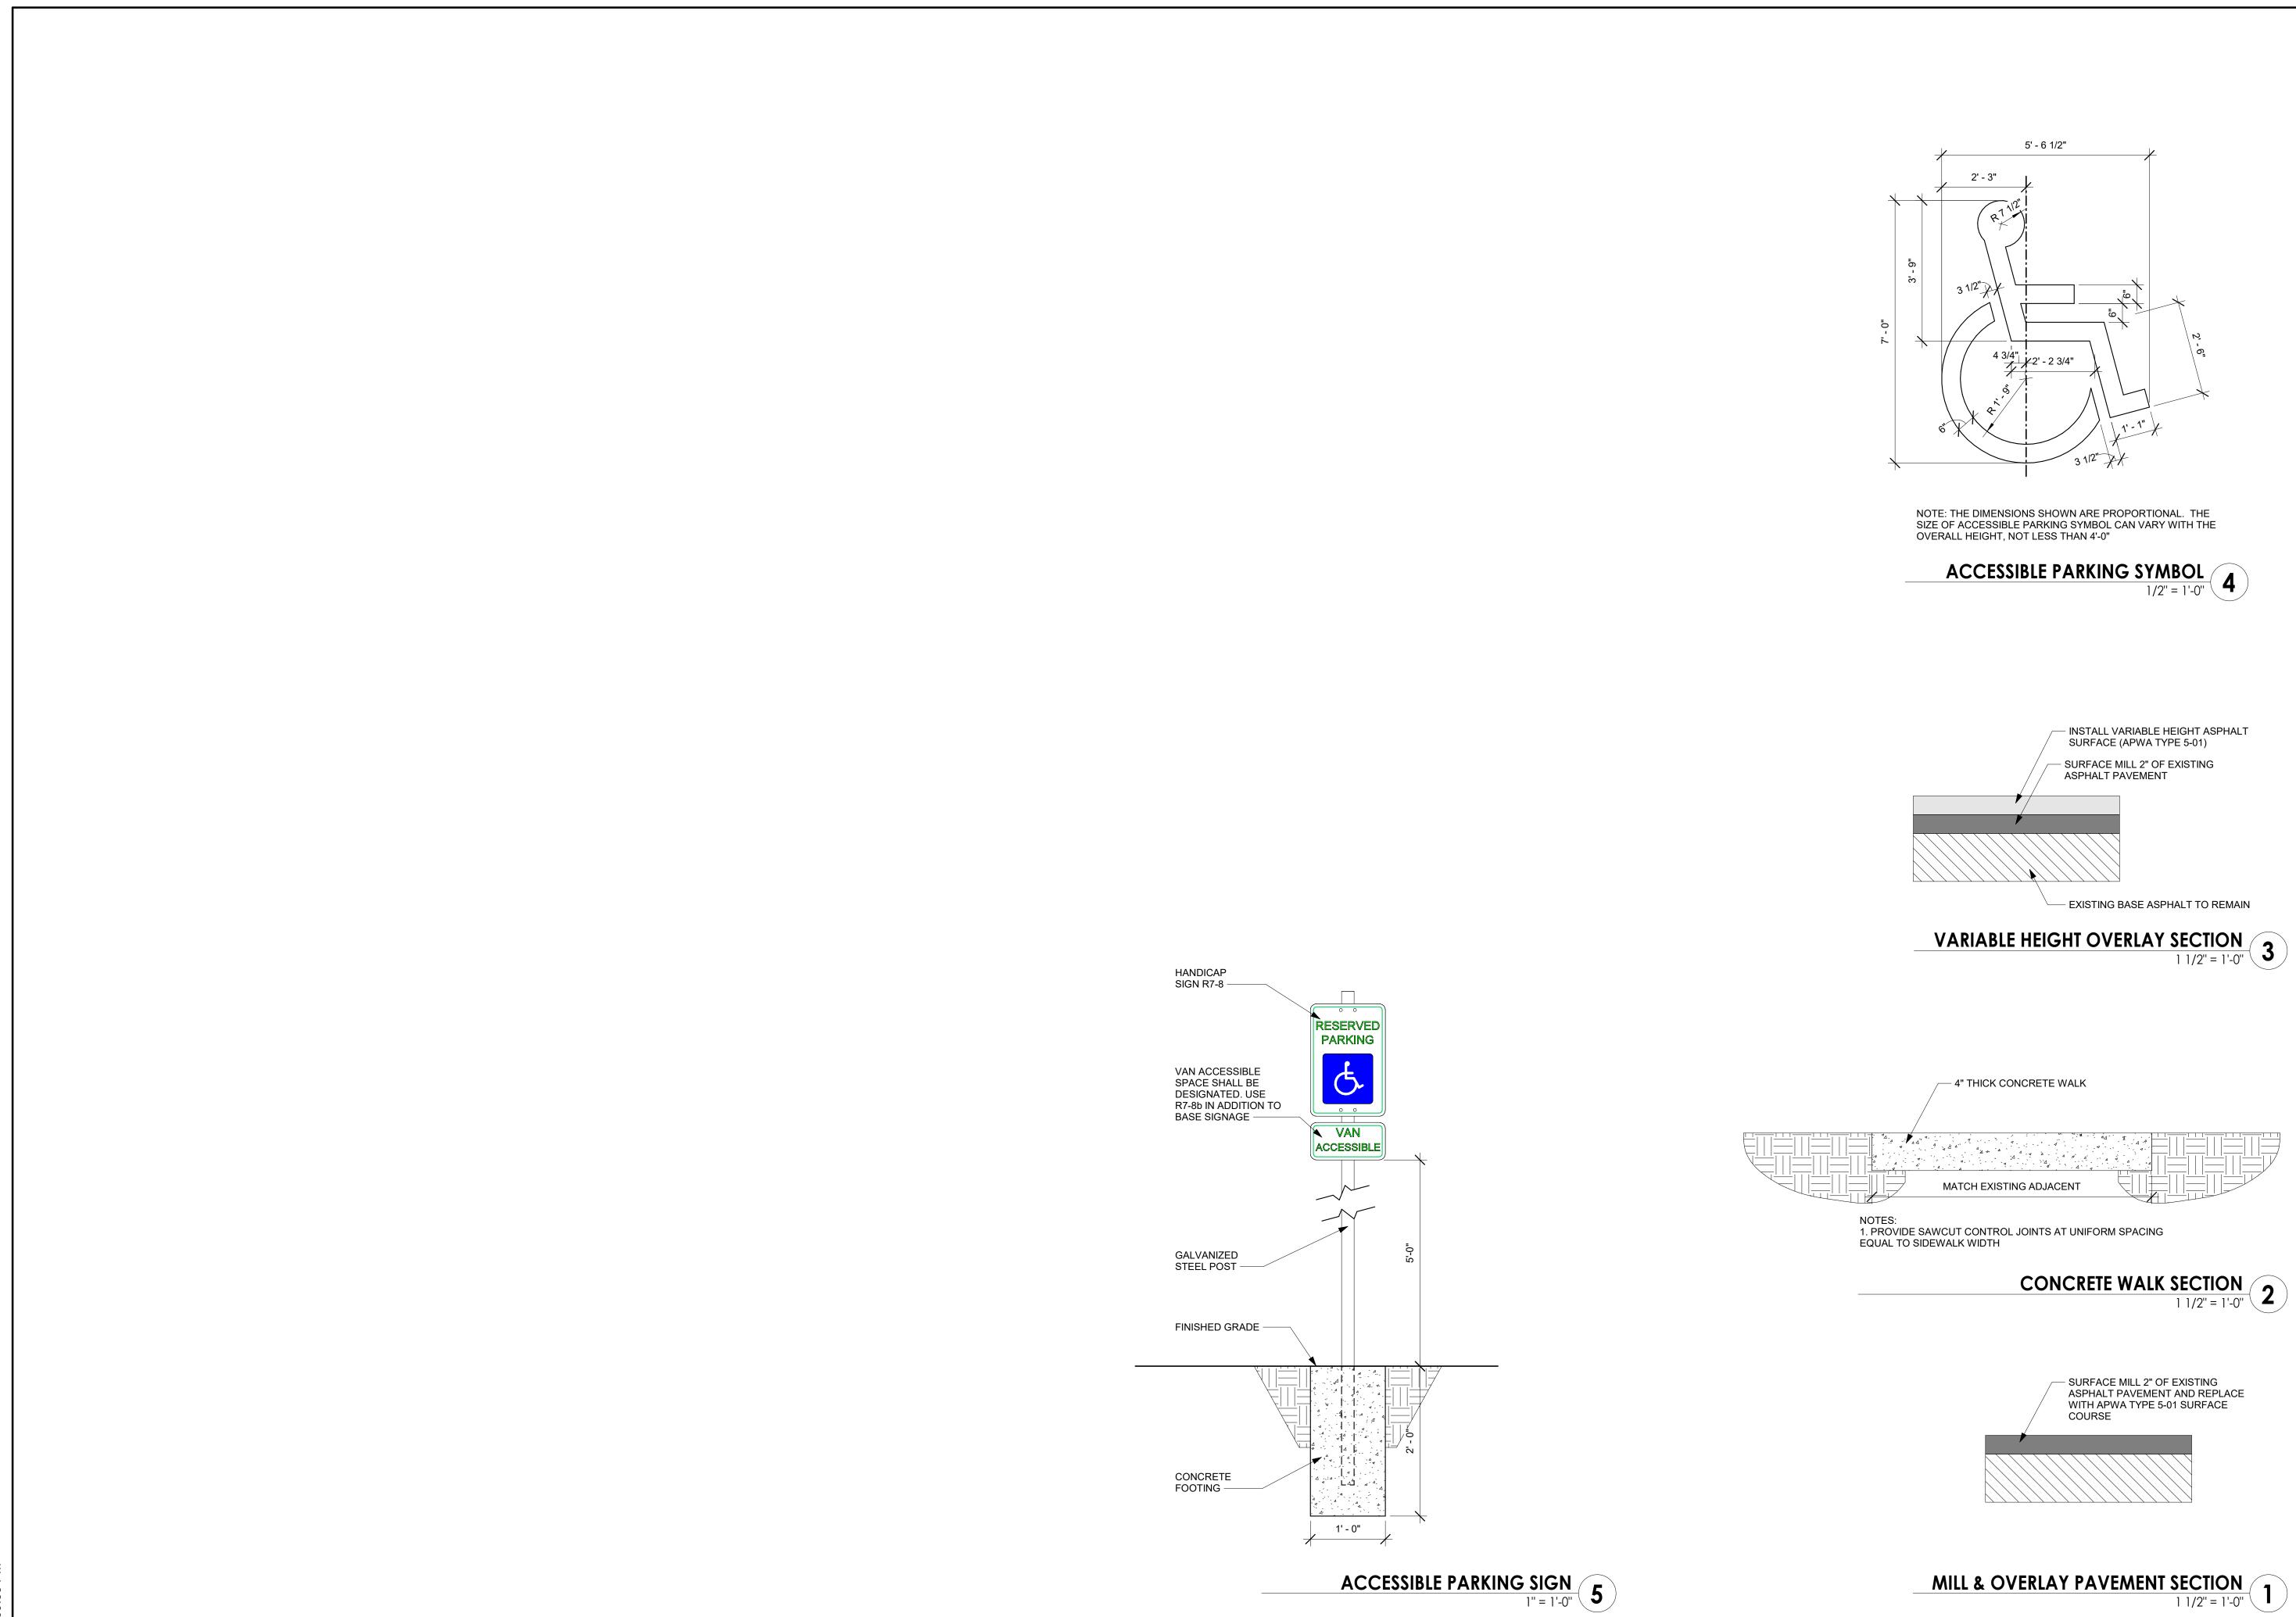
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OFFICE OF ADMINISTRATION




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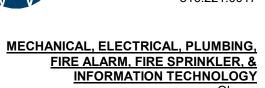


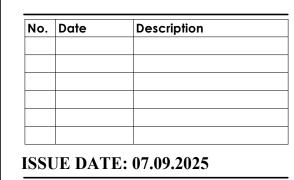

STATE OF MISSOURI MIKE KEHOE, **GOVERNOR**





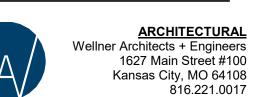

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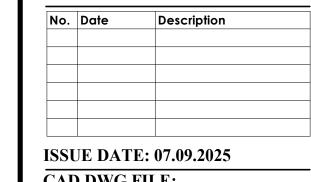
OFFICE OF ADMINISTRATION DIVISION OF FACILITIES MANAGEMENT, **DESIGN AND CONSTRUCTION**

DEPARTMENT OF MISSOURI NATIONAL **GUARD**

HARRISONVILLE READNESS CENTER REPAIRS TO INTERIOR & **EXTERIOR**

HARRISONVILLE, **MISSOURI**

PROJECT # T2334-01 **SITE # 6271** FACILITY #8136271003



CAD DWG FILE:


DRAWN BY: KP CHECKED BY: JB **DESIGNED BY: KP**

SHEET TITLE:

SITE DETAILS

SHEET NUMBER:

7 OF 30 SHEETS 7/30/2025 2:09:53 PM

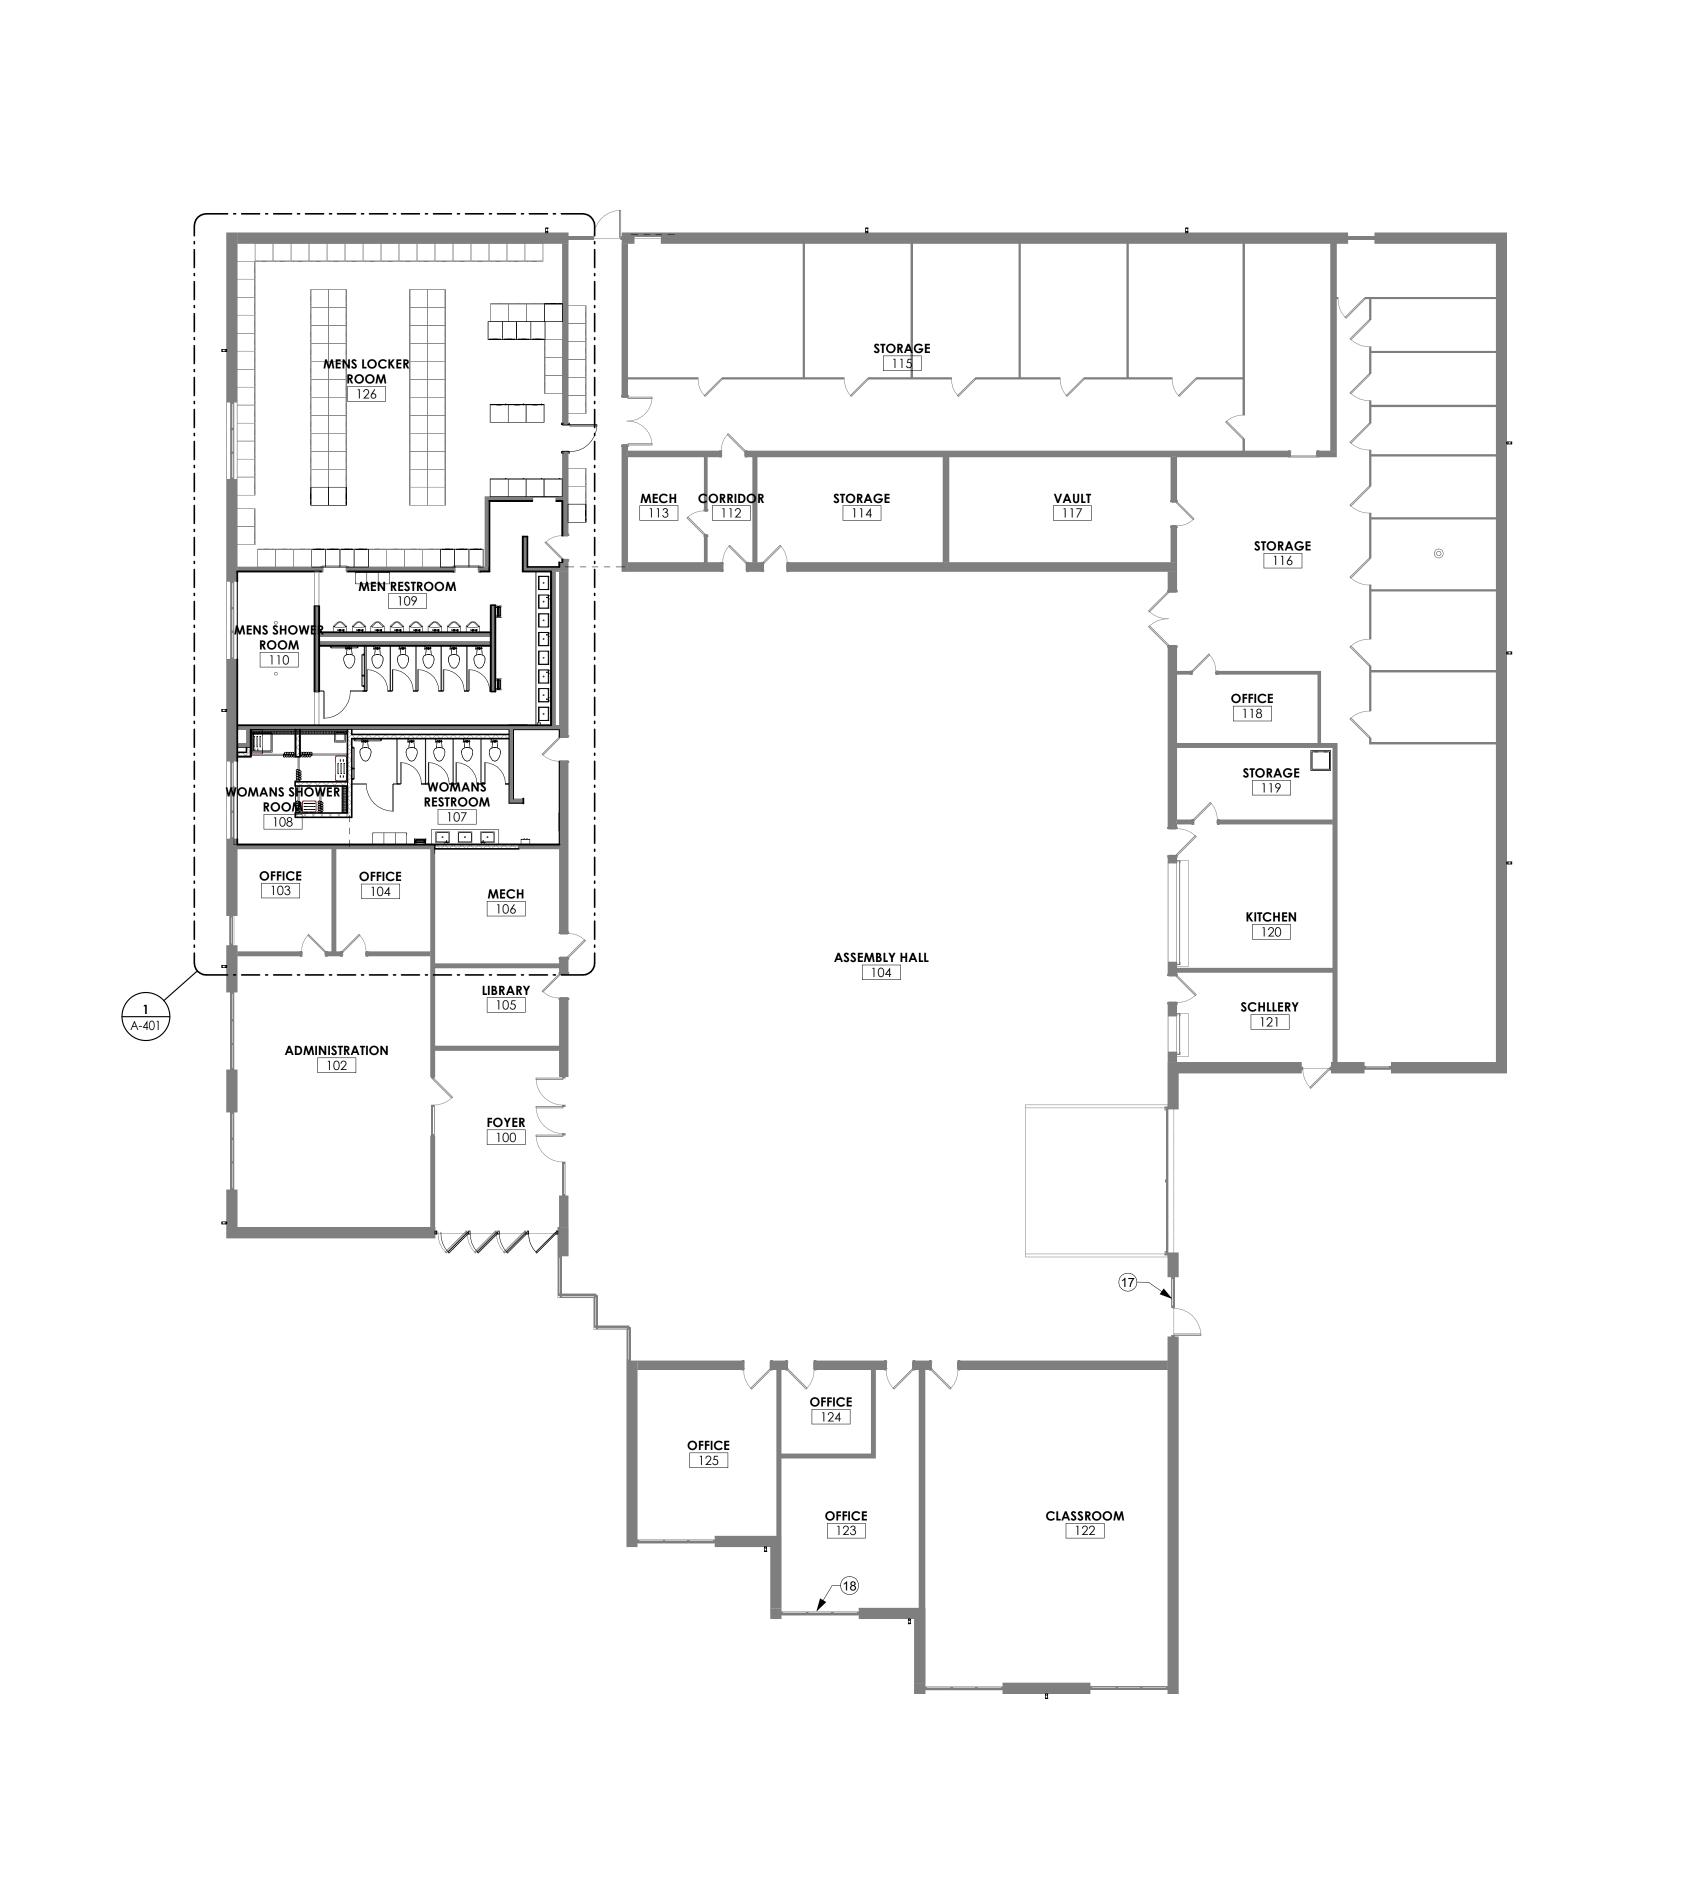

FLOOR PLAN NOTES

- FLOOR MOUNTED ADA TOILET
- WALL MOUNTED SINK
- URNIAL REMOVE AND REINSTALL URINAL, TYP
- REMOVE AND REINSTALL URNIAL AT ADA HEIGHT PLASTIC TOILET PARTITION FLOOR MOUNTED
- RESINOUS FLOORING AND BASE SHOWER FIXTURE
- CURVED SHOWER ROD AND CURTAIN
- ADA FOLDING SHOWER BENCH 33" x 16" ADA FOLDING SHOWER BENCH 18" x 16"
- GANG SHOWER ADA SINK
- 3 EXISTING FOLDING PAPER TOWEL DISPENSERS TO BE
- REMOVED AND REINSTALLED AT NEW LOCATION EXISTING SANITARY NAPKIN DISPENSER TO BE
- REMOVED AND REINSTALLED AT NEW LOCATION NEW 16" X 16" ACCESS PANEL IN EXISTING MASONRY
- REMOVE AND REPLACE EXISTING SEALNT AND
- BACKERROD AT STOREFRONT UNIT 8 REMOVE AND REPLACE EXISTING SEALNT AND
- BACKERROD AT WINDOW 9 EXISTING 24" X 24" LOCKERS TO BE RELOCATED
- 20 EXISTING 18" X 24" LOCKERS TO BE MOVED TO NEW WOMENS LOCKER ROOM
- NEW CONCRETE FLOOR SLAB
- NEW ADA GRAB BARS: 42", 36" AND VERTICAL 18"
- 3 PARTITION MOUNTED DUAL TOILET TISSUE DISPENSER 24 SURFACE MOUNTED TOILET TISSUE DISPENSER
- 25 PARTITION MOUNTED DUAL SANITARY NAPKIN DISPOSA 26 SURFACE MOUNTED SANITARY NAPKIN DISPOSAL
- NEW CONCRETE FLOOR SLAB SLOPE TO TRENCH DRAINS AT MAX 2% 28 NEW MASONRY WALL IN SAME LOCATION AS EXISTING
- 29 OMMIT FIRST MASONRY UNIT SO WALL SPANS OVER
- TRENCH DRAIN 30 OUTSIDE EDGE OF TRENCH DRAIN TO BE WITHIN 6" OF
- BACK WALL

STATE OF MISSOURI MIKE KEHOE,

GOVERNOR SCOTT BARKER

> July 9, 2025 Jason Scott Barker - MO #A2005001198 Certificate of Authority - MO #000767

PROFESSIONAL SEAL



MECHANICAL, ELECTRICAL, PLUMBING, FIRE ALARM, FIRE SPRINKLER, & INFORMATION TECHNOLOGY

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HARRISONVILLE READNESS CENTER REPAIRS TO INTERIOR & **EXTERIOR**

HARRISONVILLE, **MISSOURI**

PROJECT # T2334-01 **SITE # 6271** FACILITY #8136271003

No.	Date	Description	

CAD DWG FILE:

DRAWN BY: KP CHECKED BY: JB DESIGNED BY: KP

SHEET TITLE:

FLOOR PLAN

SHEET NUMBER:

NORTH

KEY PLAN

8 OF 30 SHEETS 7/30/2025 2:09:40 PM


FLOOR PLAN 1 3/32" = 1'-0"



FIRE ALARM, FIRE SPRINKLER, & INFORMATION TECHNOLOGY

OFFICE OF ADMINISTRATION


7/30/2025 2:09:41 PM

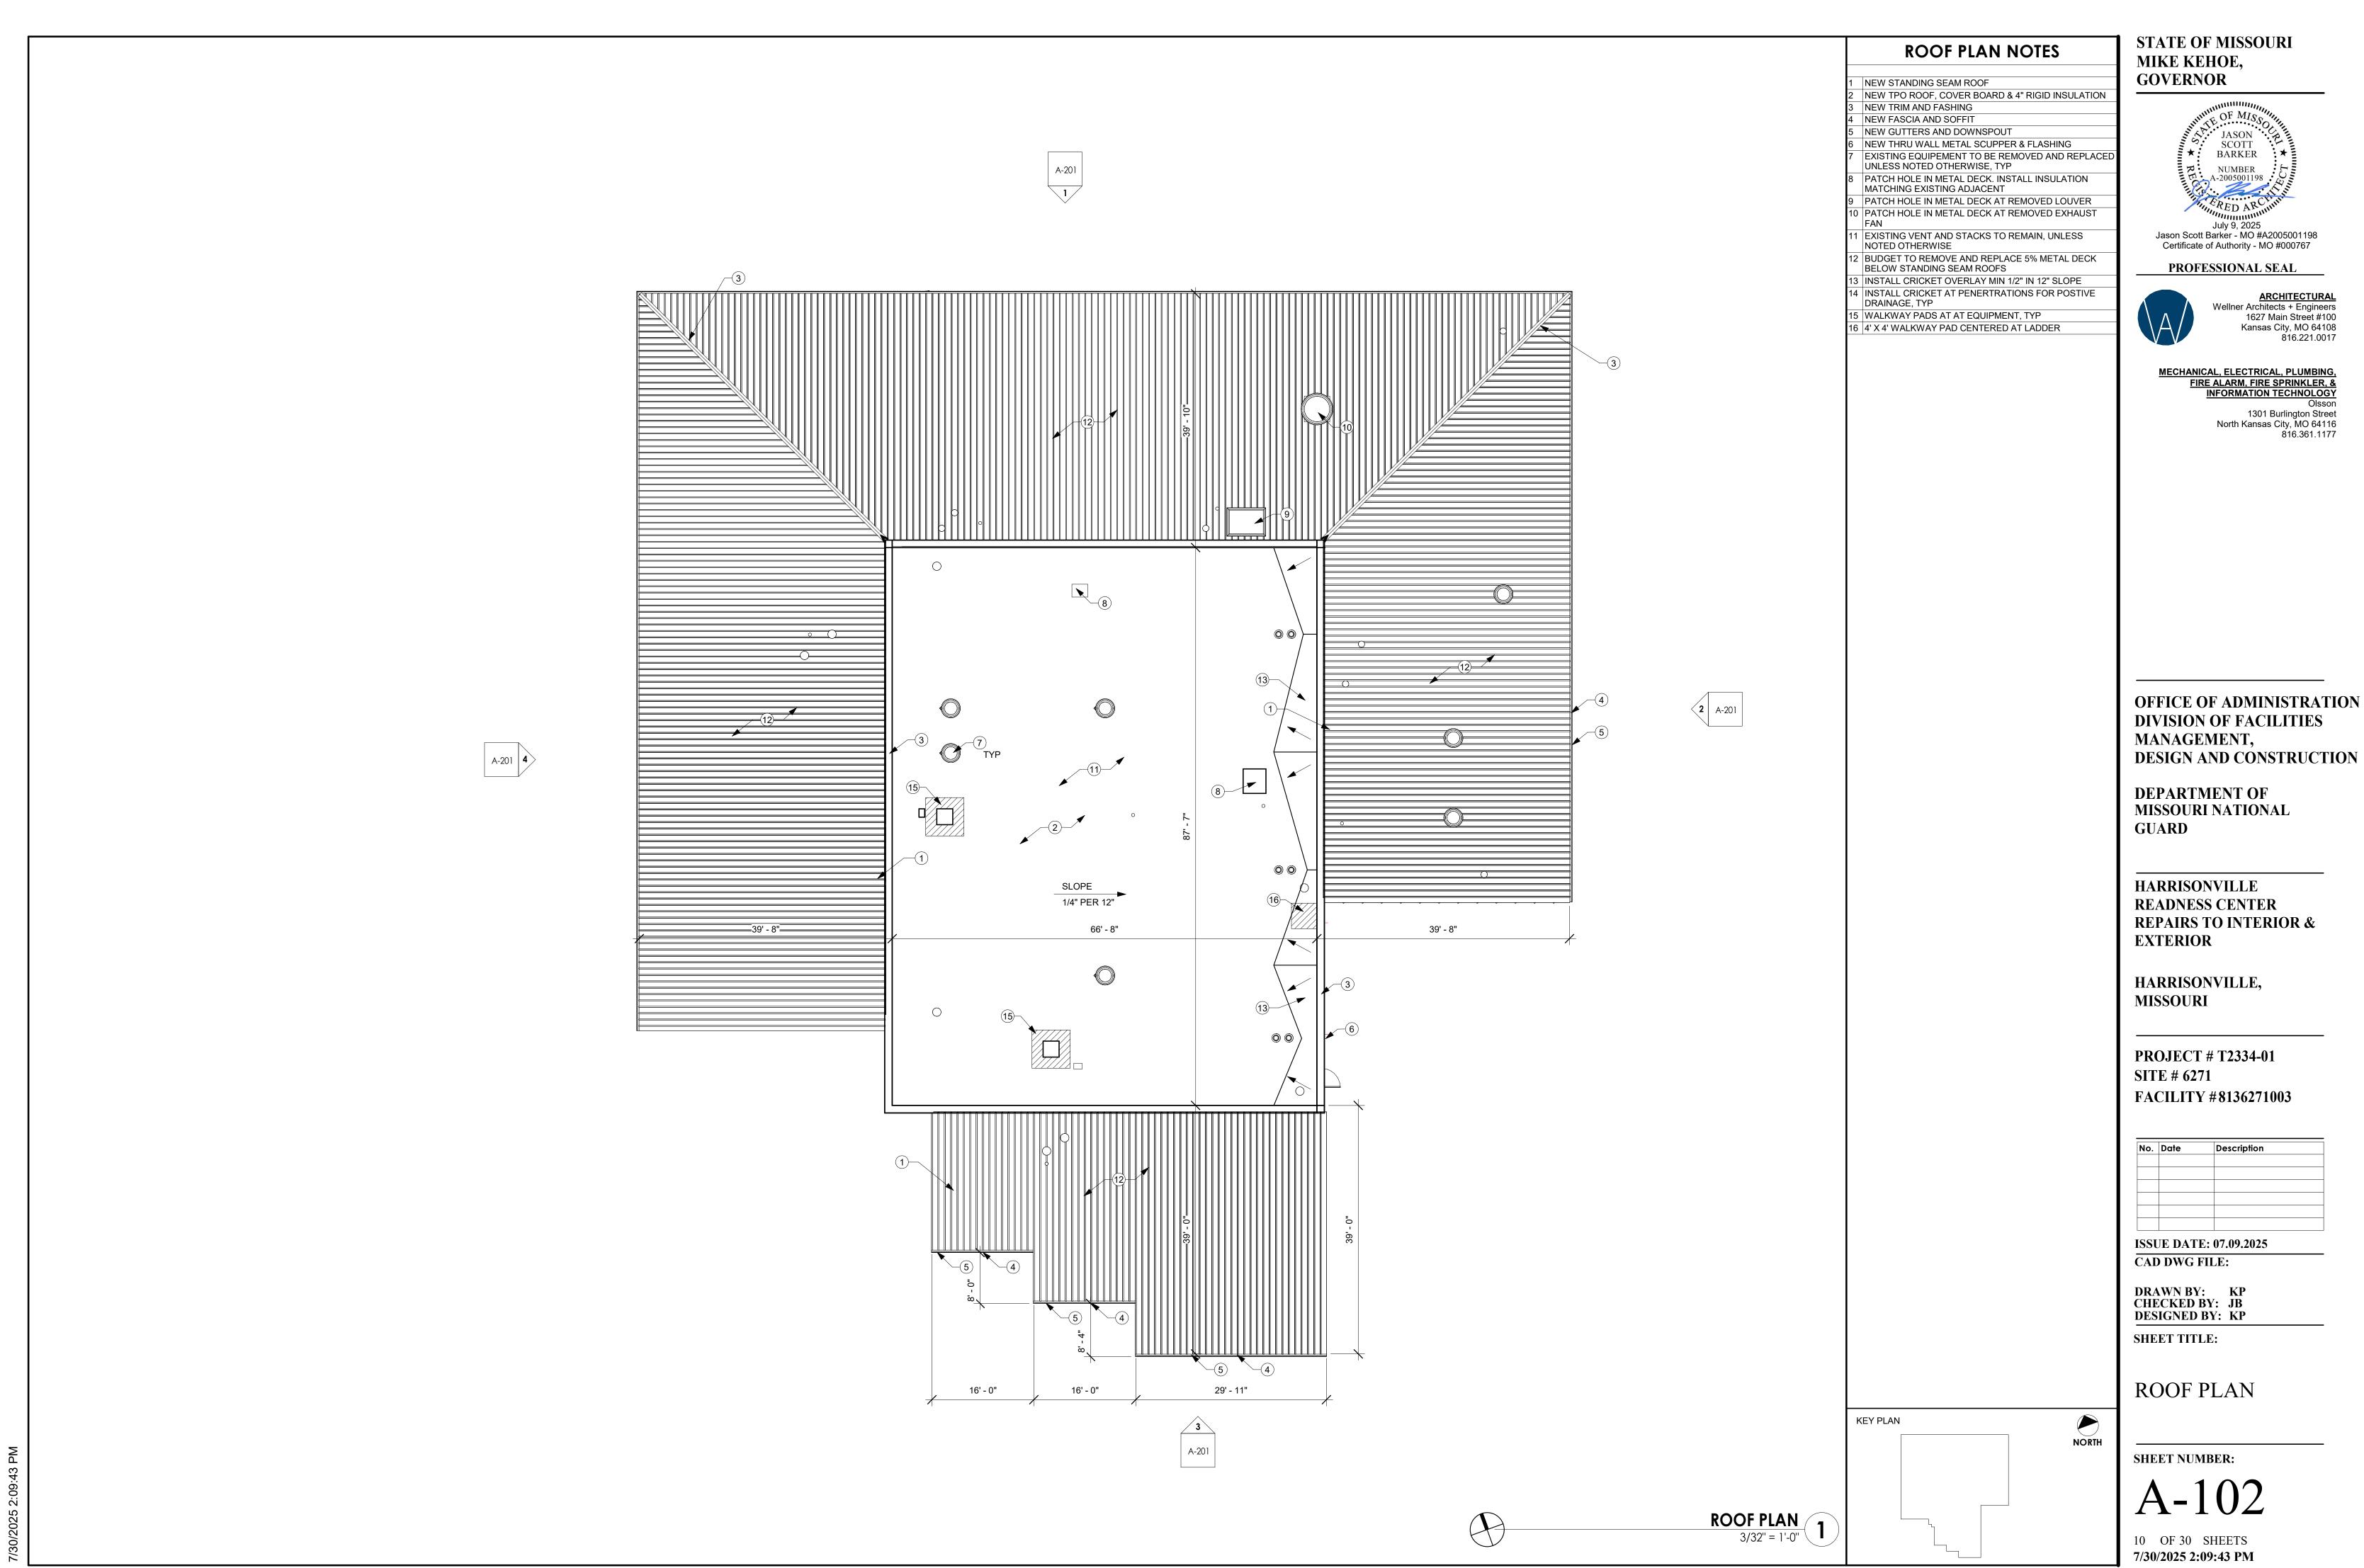

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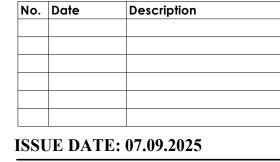
MECHANICAL, ELECTRICAL, PLUMBING, FIRE ALARM, FIRE SPRINKLER, & INFORMATION TECHNOLOGY


1301 Burlington Street North Kansas City, MO 64116

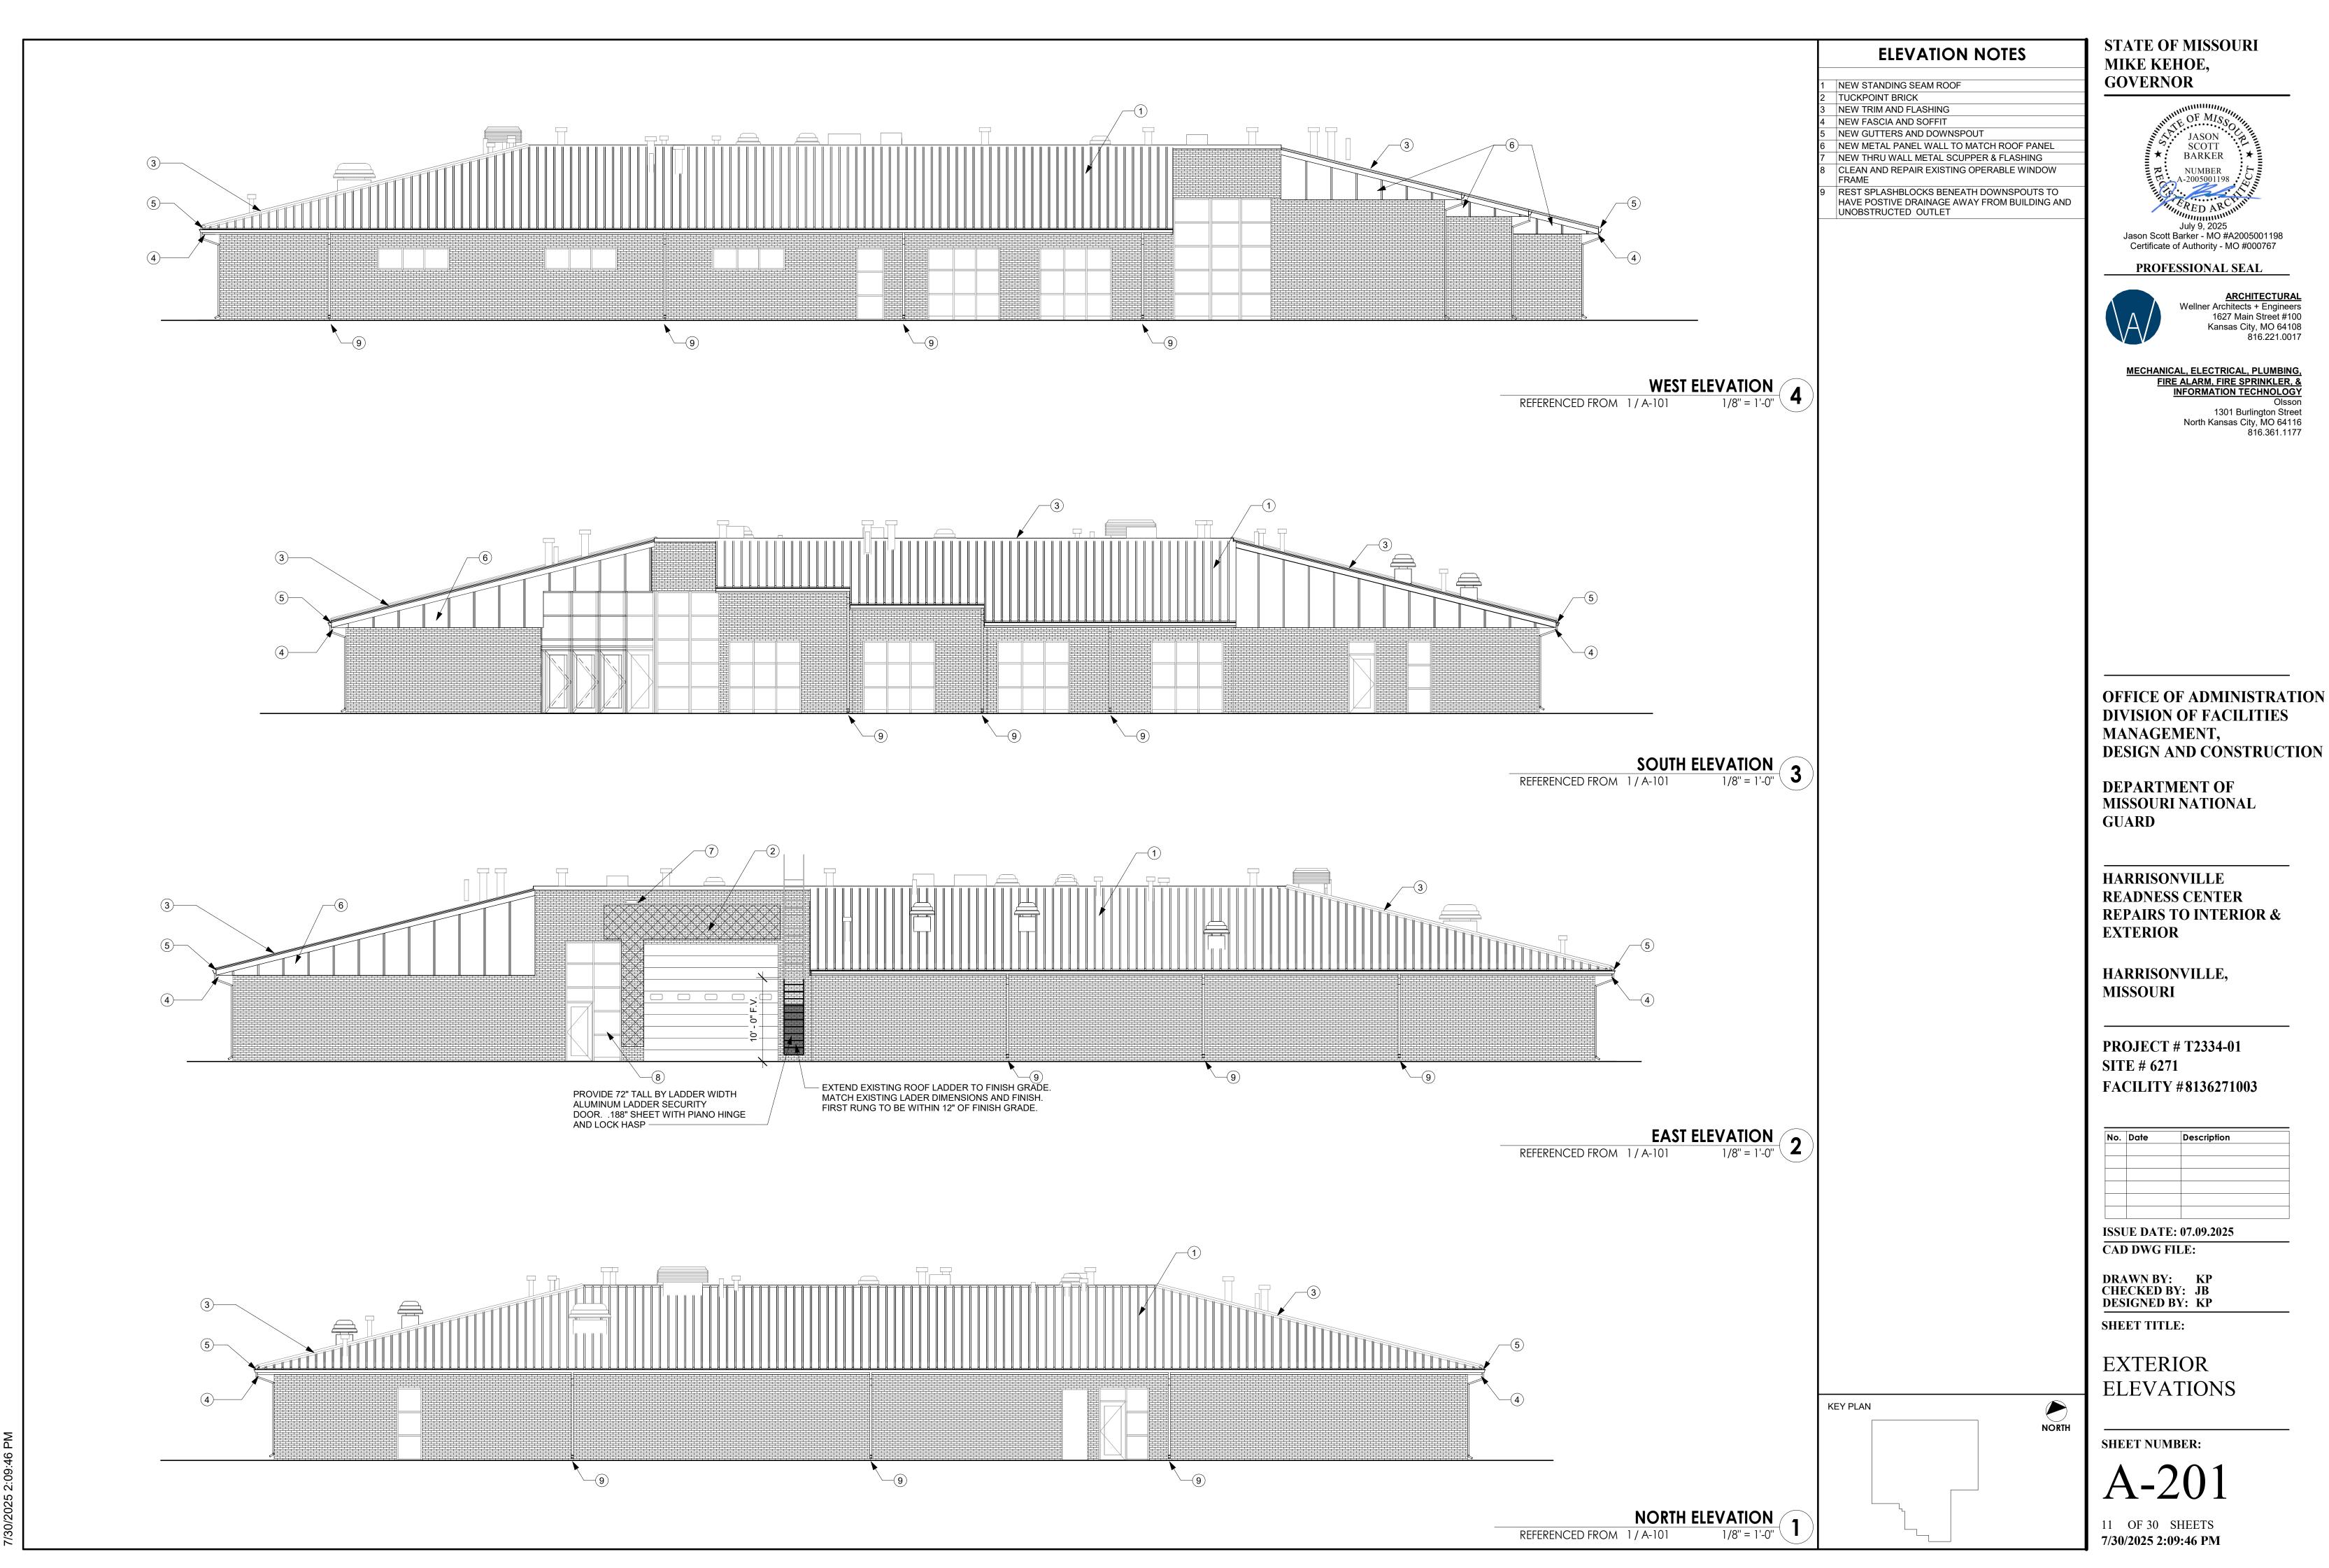

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FLOOR PLAN NOTES

- FLOOR MOUNTED ADA TOILET
- WALL MOUNTED SINK
- URNIAL REMOVE AND REINSTALL URINAL, TYP REMOVE AND REINSTALL URNIAL AT ADA HEIGHT
- PLASTIC TOILET PARTITION FLOOR MOUNTED RESINOUS FLOORING AND BASE
- SHOWER FIXTURE
- CURVED SHOWER ROD AND CURTAIN
- ADA FOLDING SHOWER BENCH 33" x 16" ADA FOLDING SHOWER BENCH 18" x 16" GANG SHOWER
- 2 ADA SINK
- 3 EXISTING FOLDING PAPER TOWEL DISPENSERS TO BE REMOVED AND REINSTALLED AT NEW LOCATION
- 4 EXISTING SANITARY NAPKIN DISPENSER TO BE REMOVED AND REINSTALLED AT NEW LOCATION
- NEW 16" X 16" ACCESS PANEL IN EXISTING MASONRY
- REMOVE AND REPLACE EXISTING SEALNT AND BACKERROD AT STOREFRONT UNIT
- REMOVE AND REPLACE EXISTING SEALNT AND BACKERROD AT WINDOW
- 9 EXISTING 24" X 24" LOCKERS TO BE RELOCATED 0 EXISTING 18" X 24" LOCKERS TO BE MOVED TO NEW
- WOMENS LOCKER ROOM NEW CONCRETE FLOOR SLAB
- NEW ADA GRAB BARS: 42", 36" AND VERTICAL 18"
- PARTITION MOUNTED DUAL TOILET TISSUE DISPENSER 24 SURFACE MOUNTED TOILET TISSUE DISPENSER
- 25 PARTITION MOUNTED DUAL SANITARY NAPKIN DISPOSAI 26 SURFACE MOUNTED SANITARY NAPKIN DISPOSAL
- NEW CONCRETE FLOOR SLAB SLOPE TO TRENCH DRAINS AT MAX 2%
- 8 NEW MASONRY WALL IN SAME LOCATION AS EXISTING
- OMMIT FIRST MASONRY UNIT SO WALL SPANS OVER TRENCH DRAIN
- OUTSIDE EDGE OF TRENCH DRAIN TO BE WITHIN 6" OF BACK WALL

STATE OF MISSOURI MIKE KEHOE,

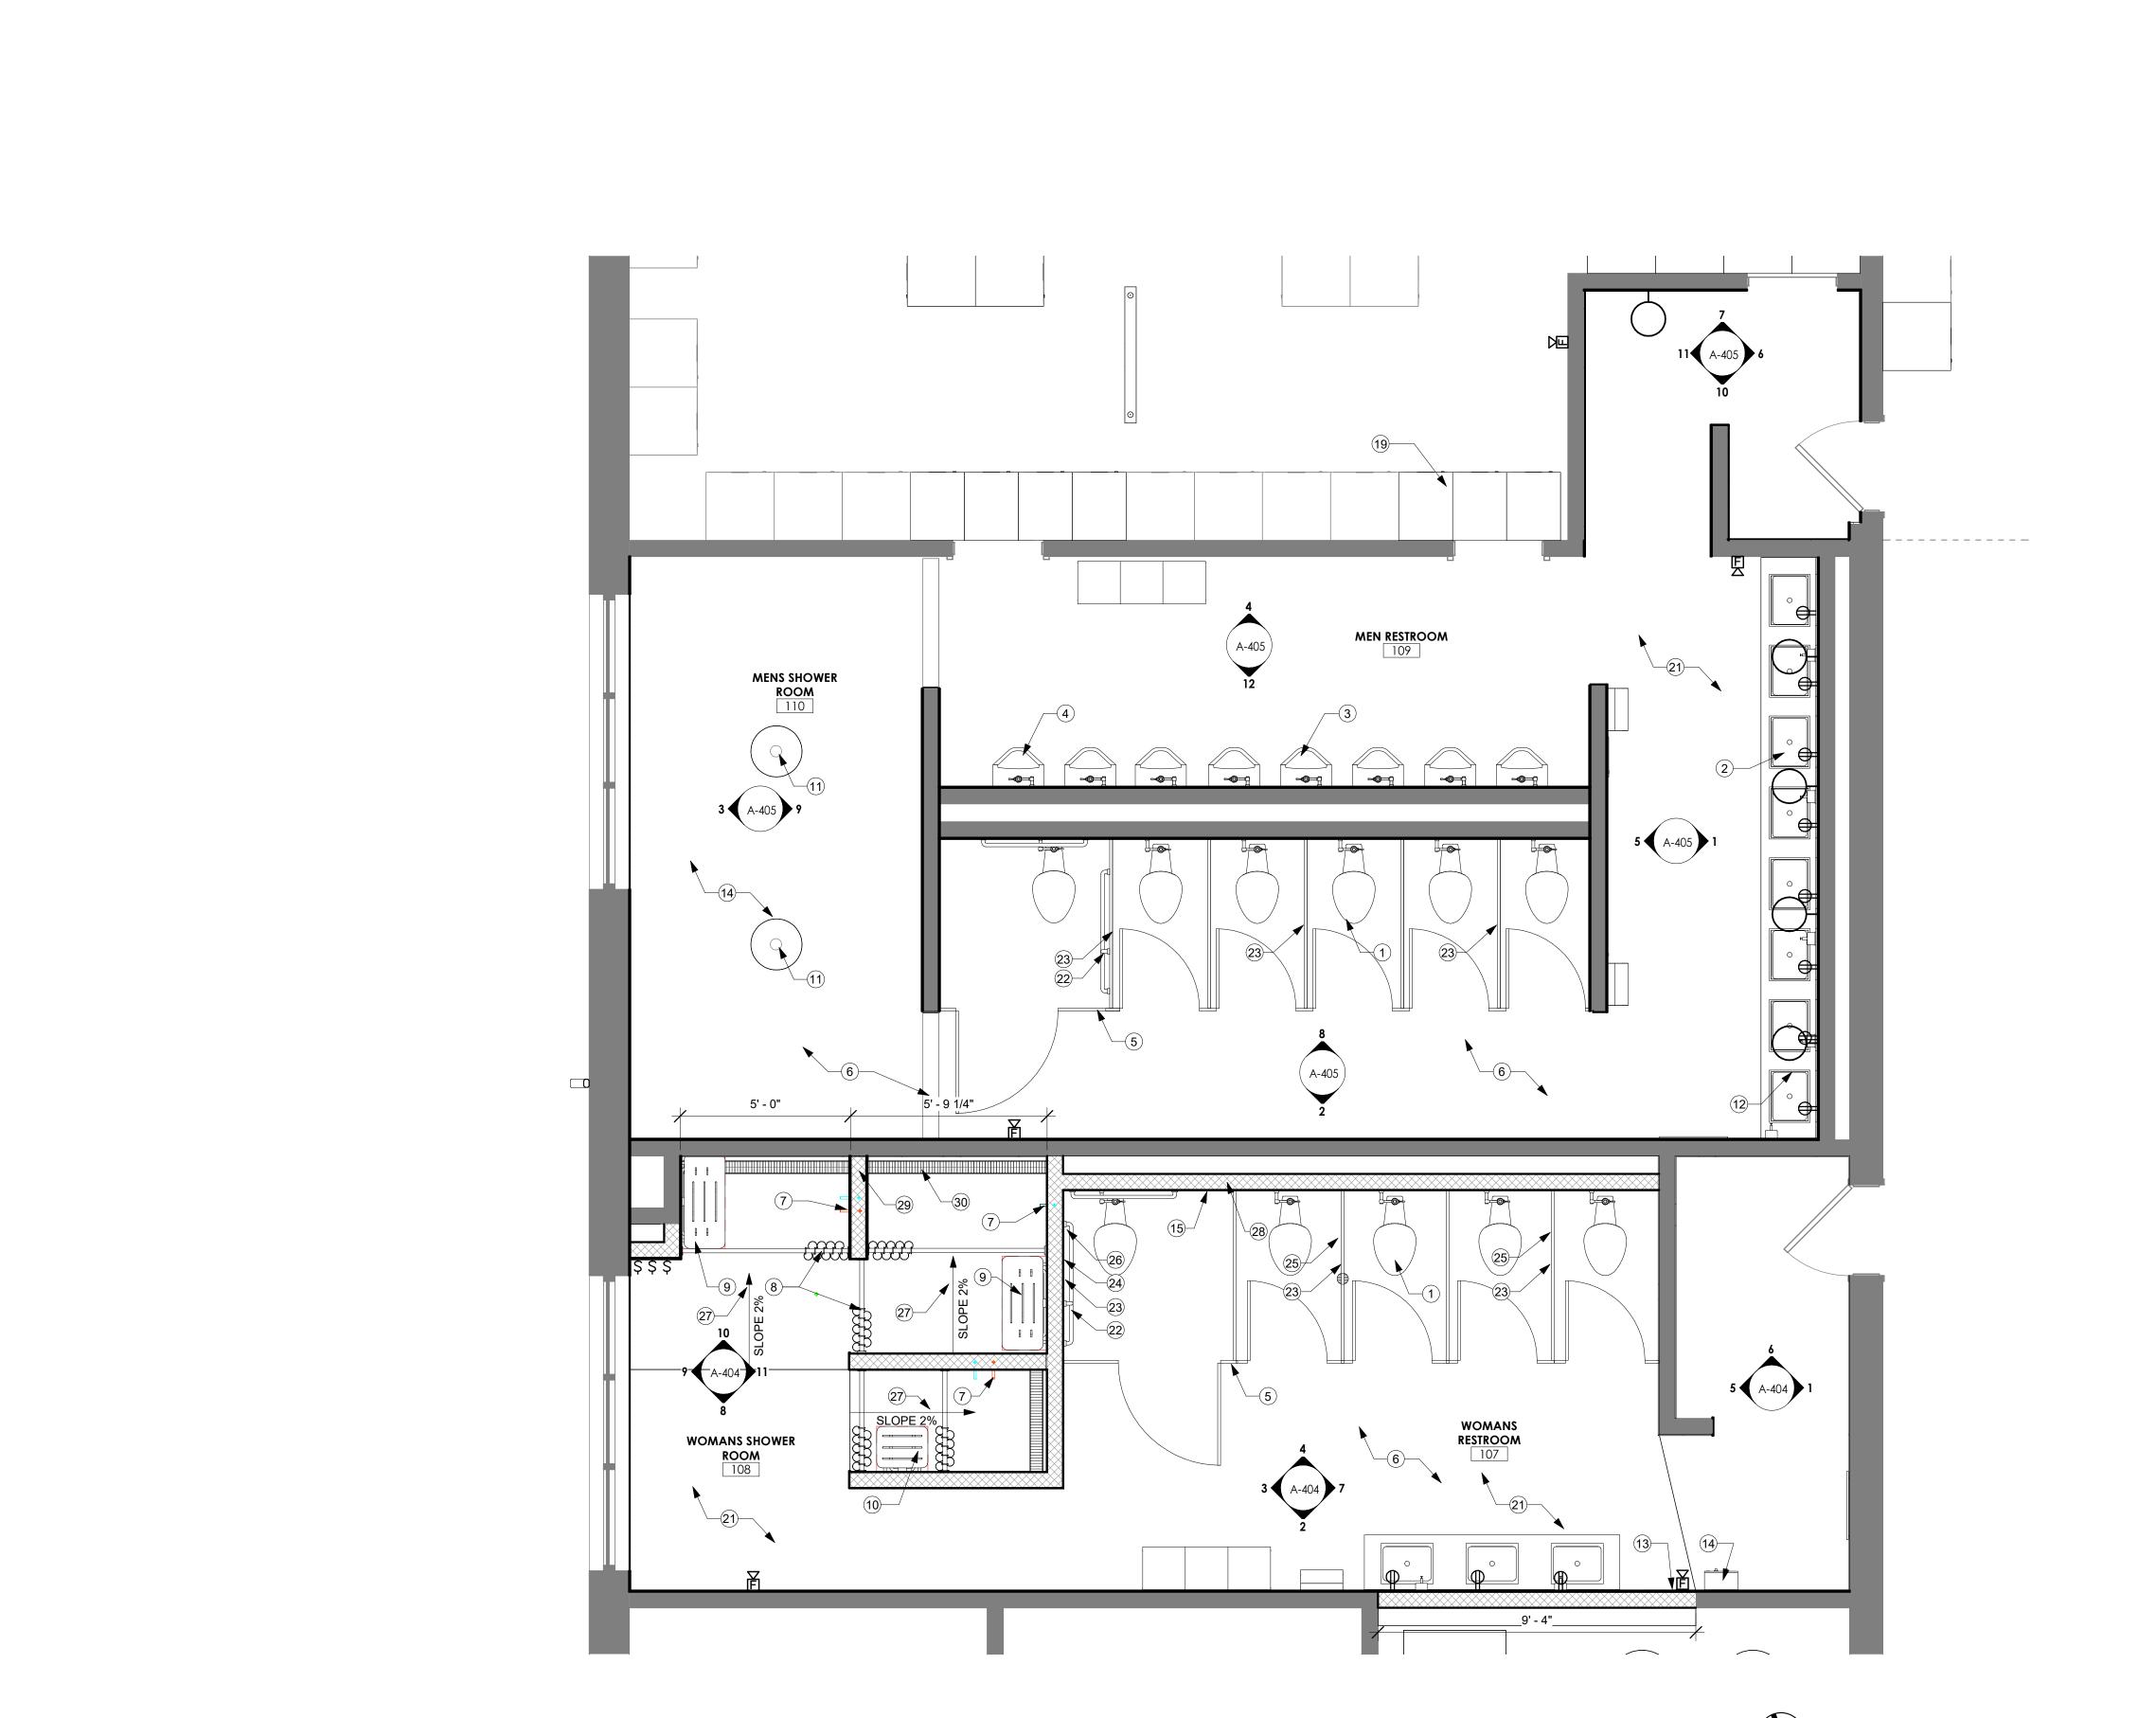GOVERNOR SCOTT BARKER

July 9, 2025 Jason Scott Barker - MO #A2005001198 Certificate of Authority - MO #000767

PROFESSIONAL SEAL



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OFFICE OF ADMINISTRATION DIVISION OF FACILITIES MANAGEMENT, **DESIGN AND CONSTRUCTION**

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HARRISONVILLE READNESS CENTER REPAIRS TO INTERIOR & **EXTERIOR**

HARRISONVILLE, **MISSOURI**

PROJECT # T2334-01 **SITE # 6271** FACILITY #8136271003

No.	Date	Description

ISSUE DATE: 07.09.2025 CAD DWG FILE:

DRAWN BY: KP CHECKED BY: JB DESIGNED BY: KP

SHEET TITLE:

ENLARGED PLANS

NORTH


AREA OF WORK, RESTROOM

KEY PLAN

SHEET NUMBER:

12 OF 30 SHEETS 7/30/2025 2:09:46 PM

ENLARGED FLOOR PLAN RESTROOM
REFERENCED FROM 1 / A-100 3/8" = 1'-0"

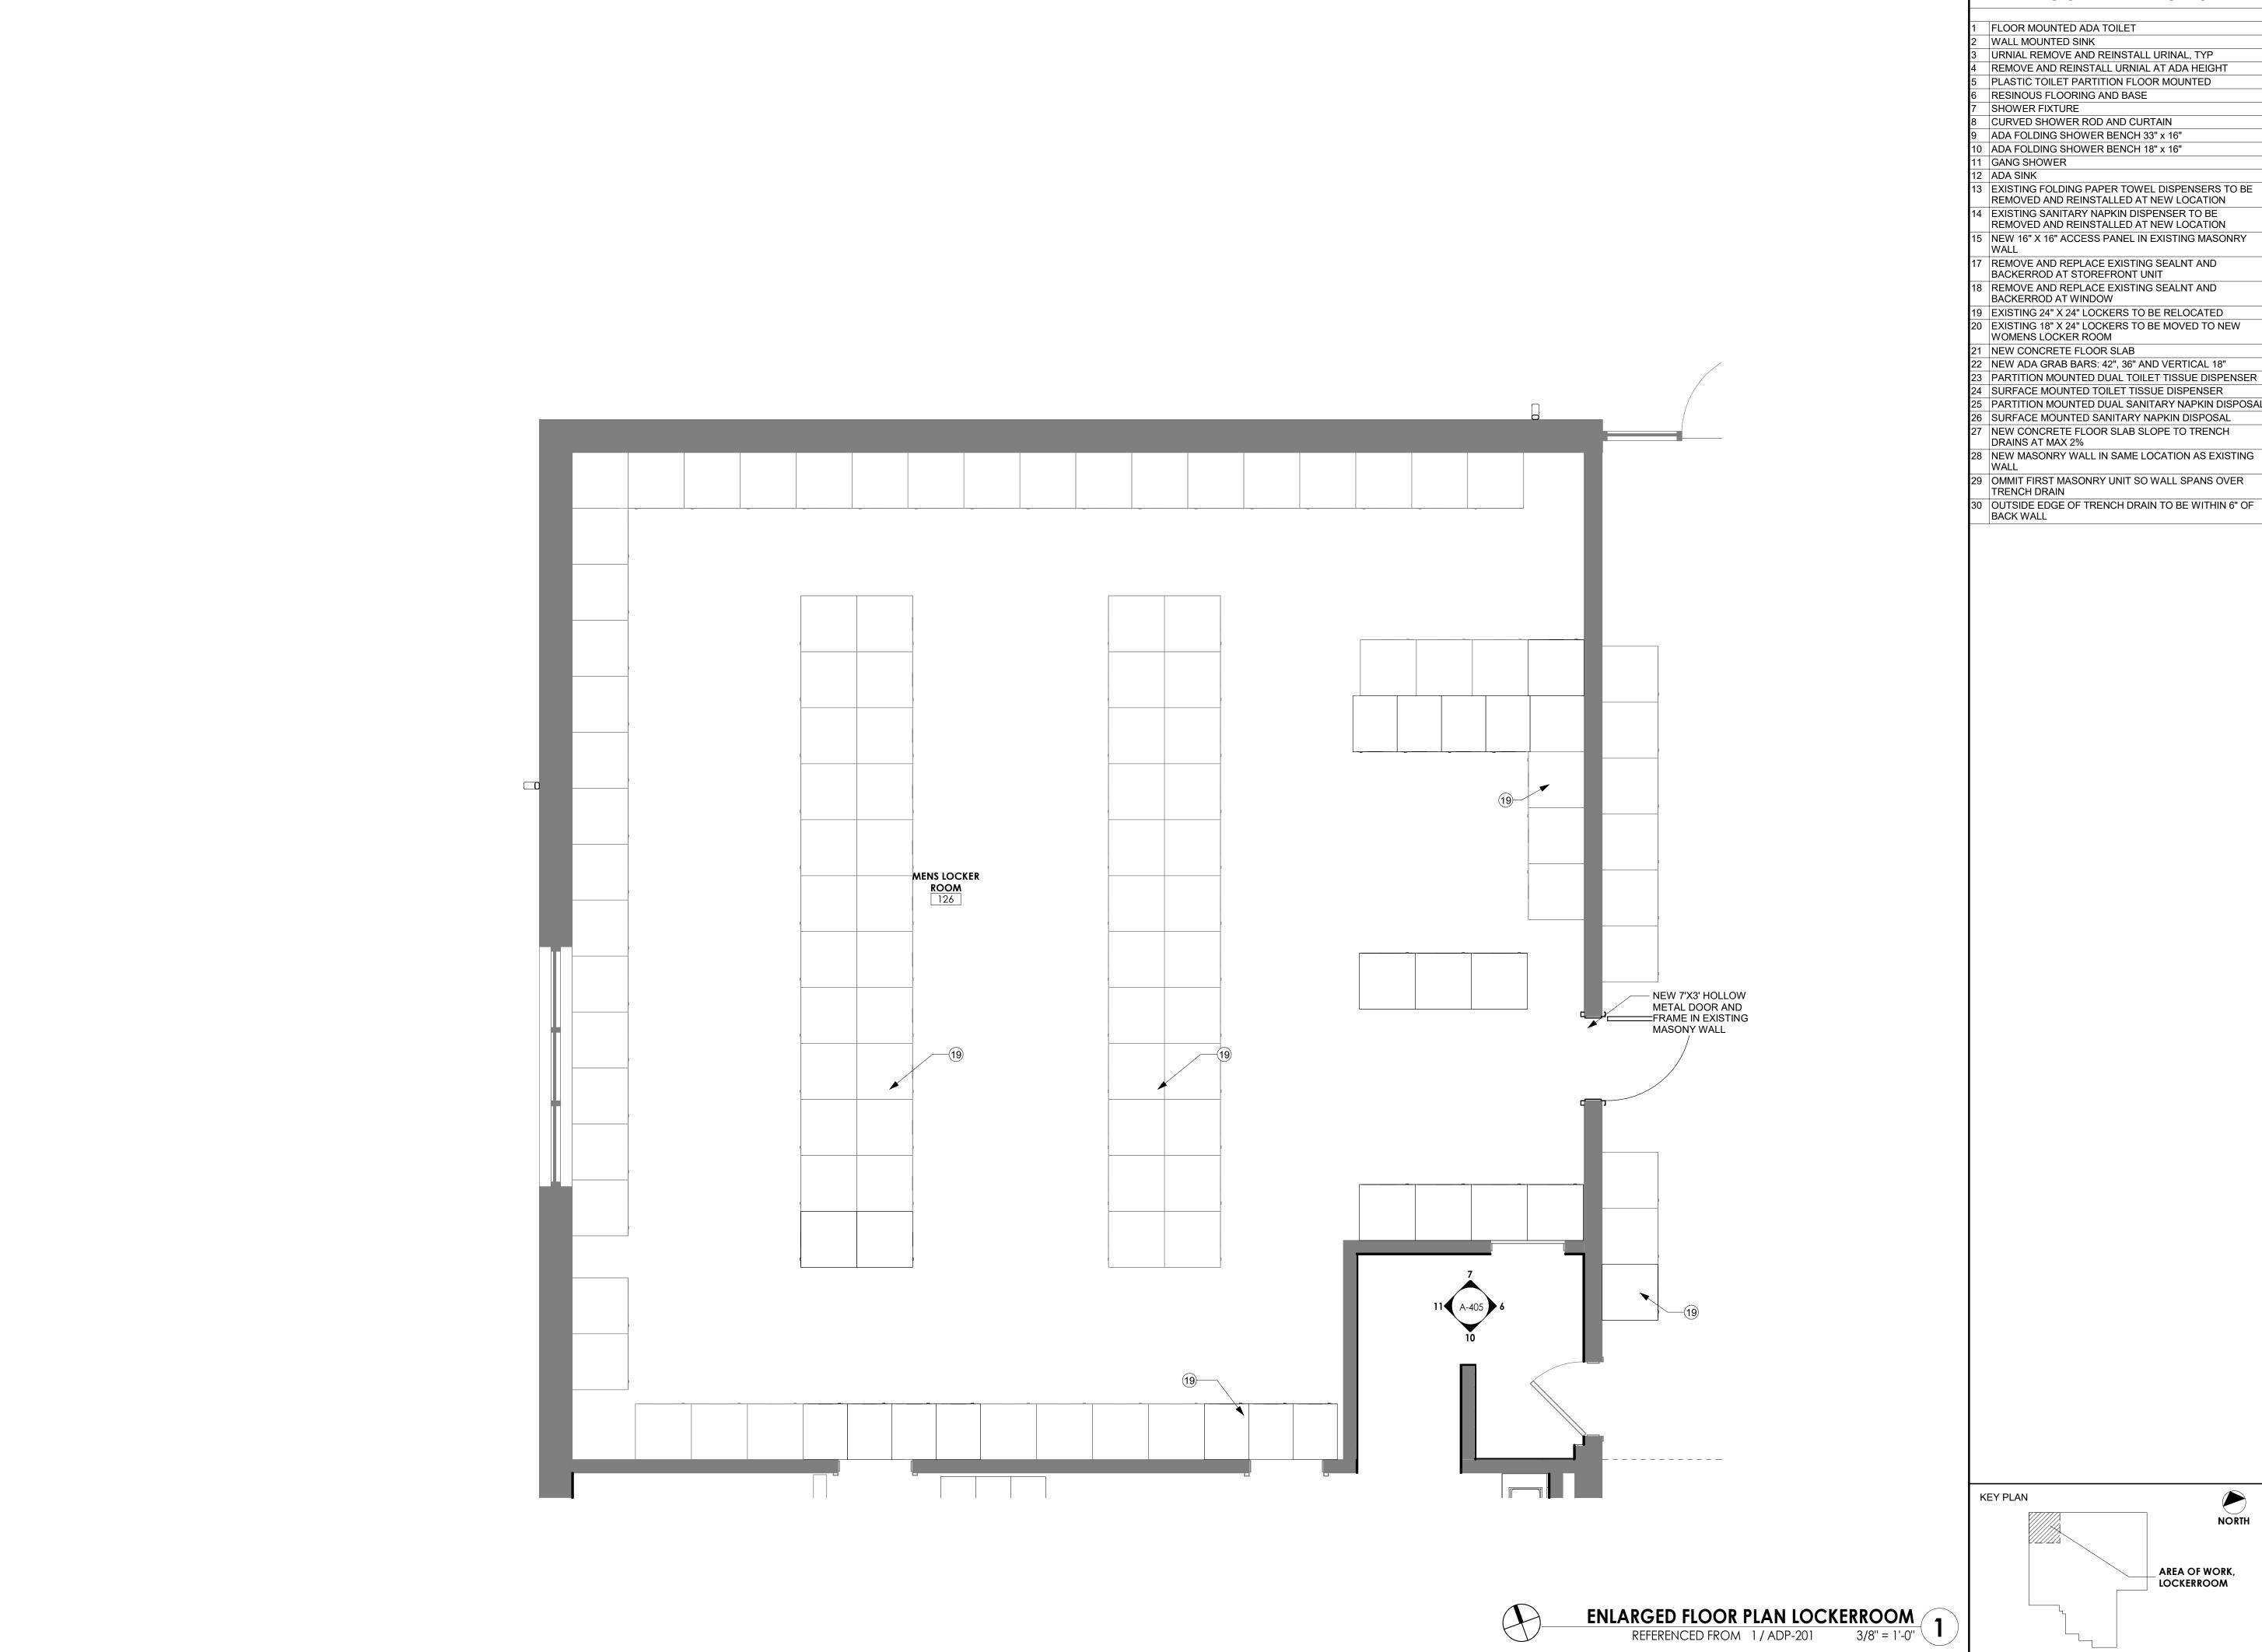

FLOOR PLAN NOTES

- FLOOR MOUNTED ADA TOILET
- WALL MOUNTED SINK
- URNIAL REMOVE AND REINSTALL URINAL, TYP REMOVE AND REINSTALL URNIAL AT ADA HEIGHT
- PLASTIC TOILET PARTITION FLOOR MOUNTED RESINOUS FLOORING AND BASE SHOWER FIXTURE
- CURVED SHOWER ROD AND CURTAIN
- ADA FOLDING SHOWER BENCH 33" x 16"
- 0 ADA FOLDING SHOWER BENCH 18" x 16" GANG SHOWER
- ADA SINK
- 3 EXISTING FOLDING PAPER TOWEL DISPENSERS TO BE REMOVED AND REINSTALLED AT NEW LOCATION
- 4 EXISTING SANITARY NAPKIN DISPENSER TO BE REMOVED AND REINSTALLED AT NEW LOCATION
- NEW 16" X 16" ACCESS PANEL IN EXISTING MASONRY REMOVE AND REPLACE EXISTING SEALNT AND
- BACKERROD AT STOREFRONT UNIT
- 8 REMOVE AND REPLACE EXISTING SEALNT AND BACKERROD AT WINDOW
- 19 EXISTING 24" X 24" LOCKERS TO BE RELOCATED 0 EXISTING 18" X 24" LOCKERS TO BE MOVED TO NEW
- WOMENS LOCKER ROOM
- NEW CONCRETE FLOOR SLAB NEW ADA GRAB BARS: 42", 36" AND VERTICAL 18"
- PARTITION MOUNTED DUAL TOILET TISSUE DISPENSER 24 SURFACE MOUNTED TOILET TISSUE DISPENSER
- 26 SURFACE MOUNTED SANITARY NAPKIN DISPOSAL 27 NEW CONCRETE FLOOR SLAB SLOPE TO TRENCH
- DRAINS AT MAX 2%
- 28 NEW MASONRY WALL IN SAME LOCATION AS EXISTING
- 29 OMMIT FIRST MASONRY UNIT SO WALL SPANS OVER TRENCH DRAIN
- OUTSIDE EDGE OF TRENCH DRAIN TO BE WITHIN 6" OF BACK WALL

STATE OF MISSOURI MIKE KEHOE, **GOVERNOR**



PROFESSIONAL SEAL



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DEPARTMENT OF MISSOURI NATIONAL **GUARD**

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HARRISONVILLE, **MISSOURI**

PROJECT # T2334-01 **SITE # 6271** FACILITY #8136271003

No.	Date	Description
SSI	J E DAT	E: 07.09.2025

CAD DWG FILE:

DRAWN BY: KP CHECKED BY: JB DESIGNED BY: KP

SHEET TITLE:


ENLARGED PLANS

SHEET NUMBER:

NORTH


_ AREA OF WORK, LOCKERROOM

13 OF 30 SHEETS 7/30/2025 2:09:47 PM

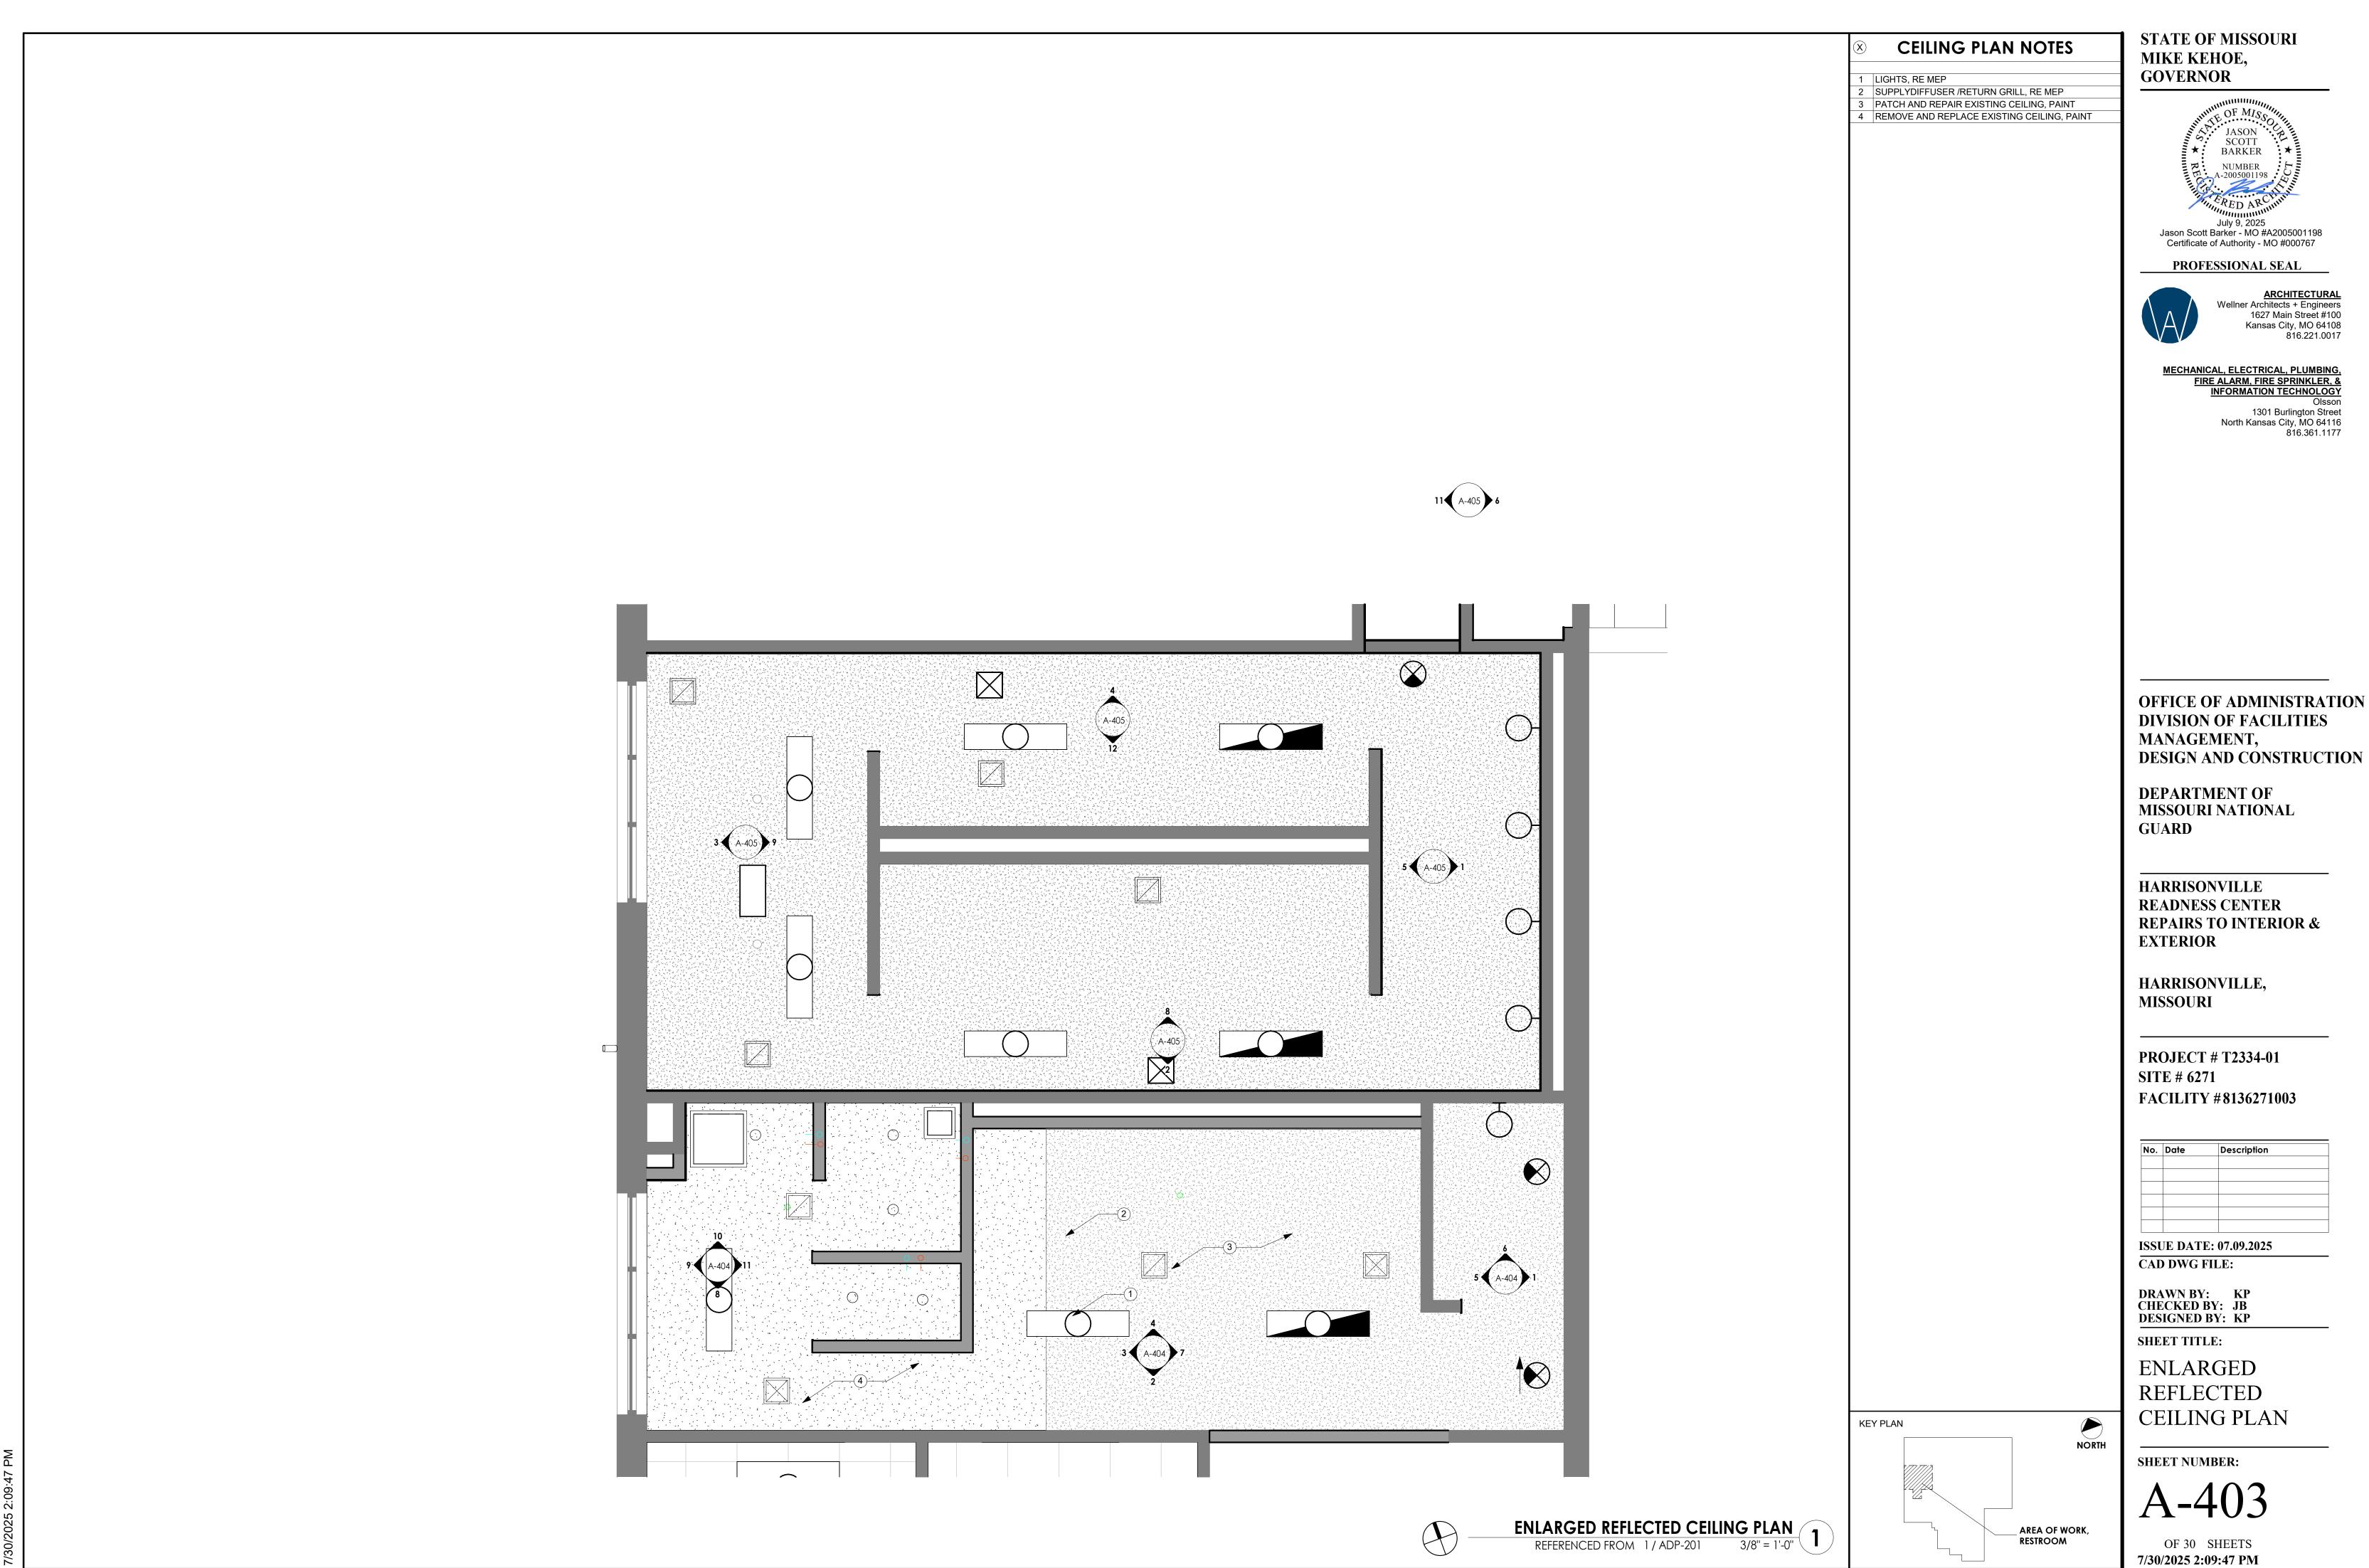

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STATE OF MISSOURI MIKE KEHOE, **GOVERNOR**

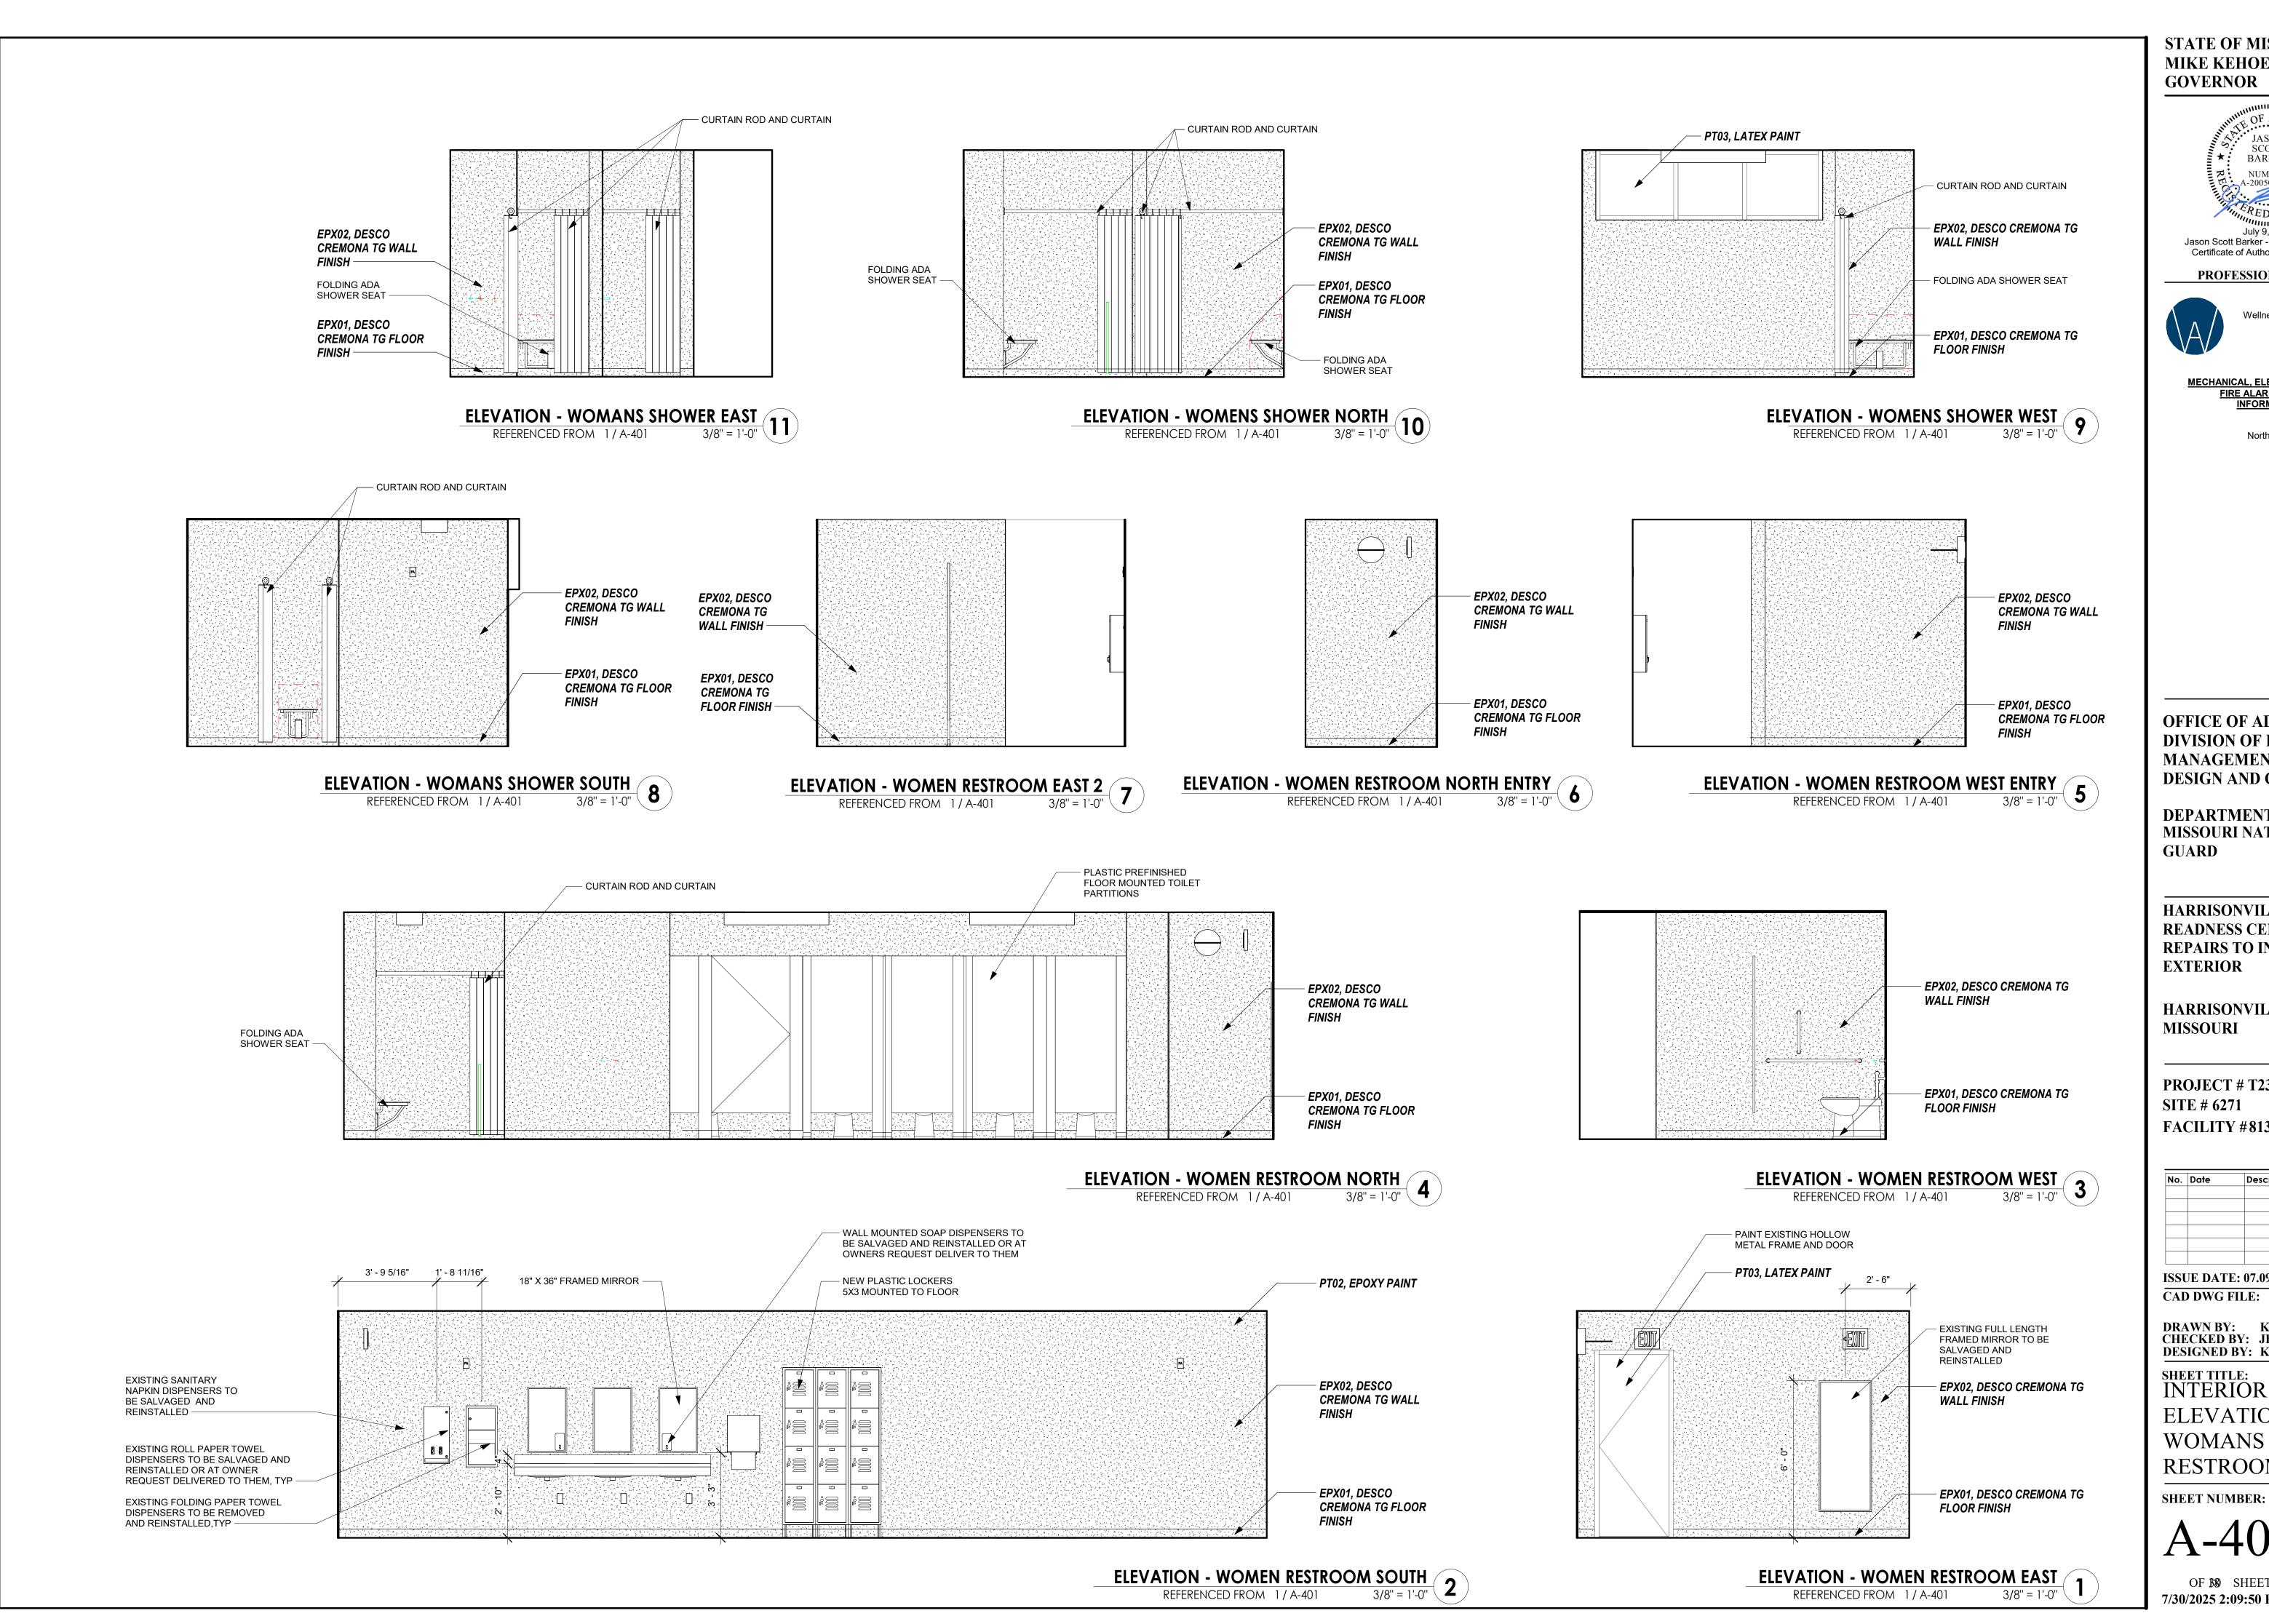

ARCHITECTURAL
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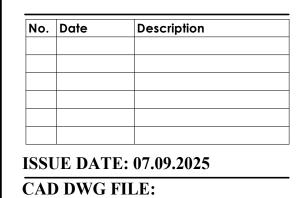
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HARRISONVILLE, **MISSOURI**

PROJECT # T2334-01 **SITE # 6271** FACILITY #8136271003




DRAWN BY: KP CHECKED BY: JB **DESIGNED BY: KP**

SHEET TITLE: INTERIOR **ELEVATIONS** WOMANS

RESTROOM

OF 30 SHEETS 7/30/2025 2:09:50 PM

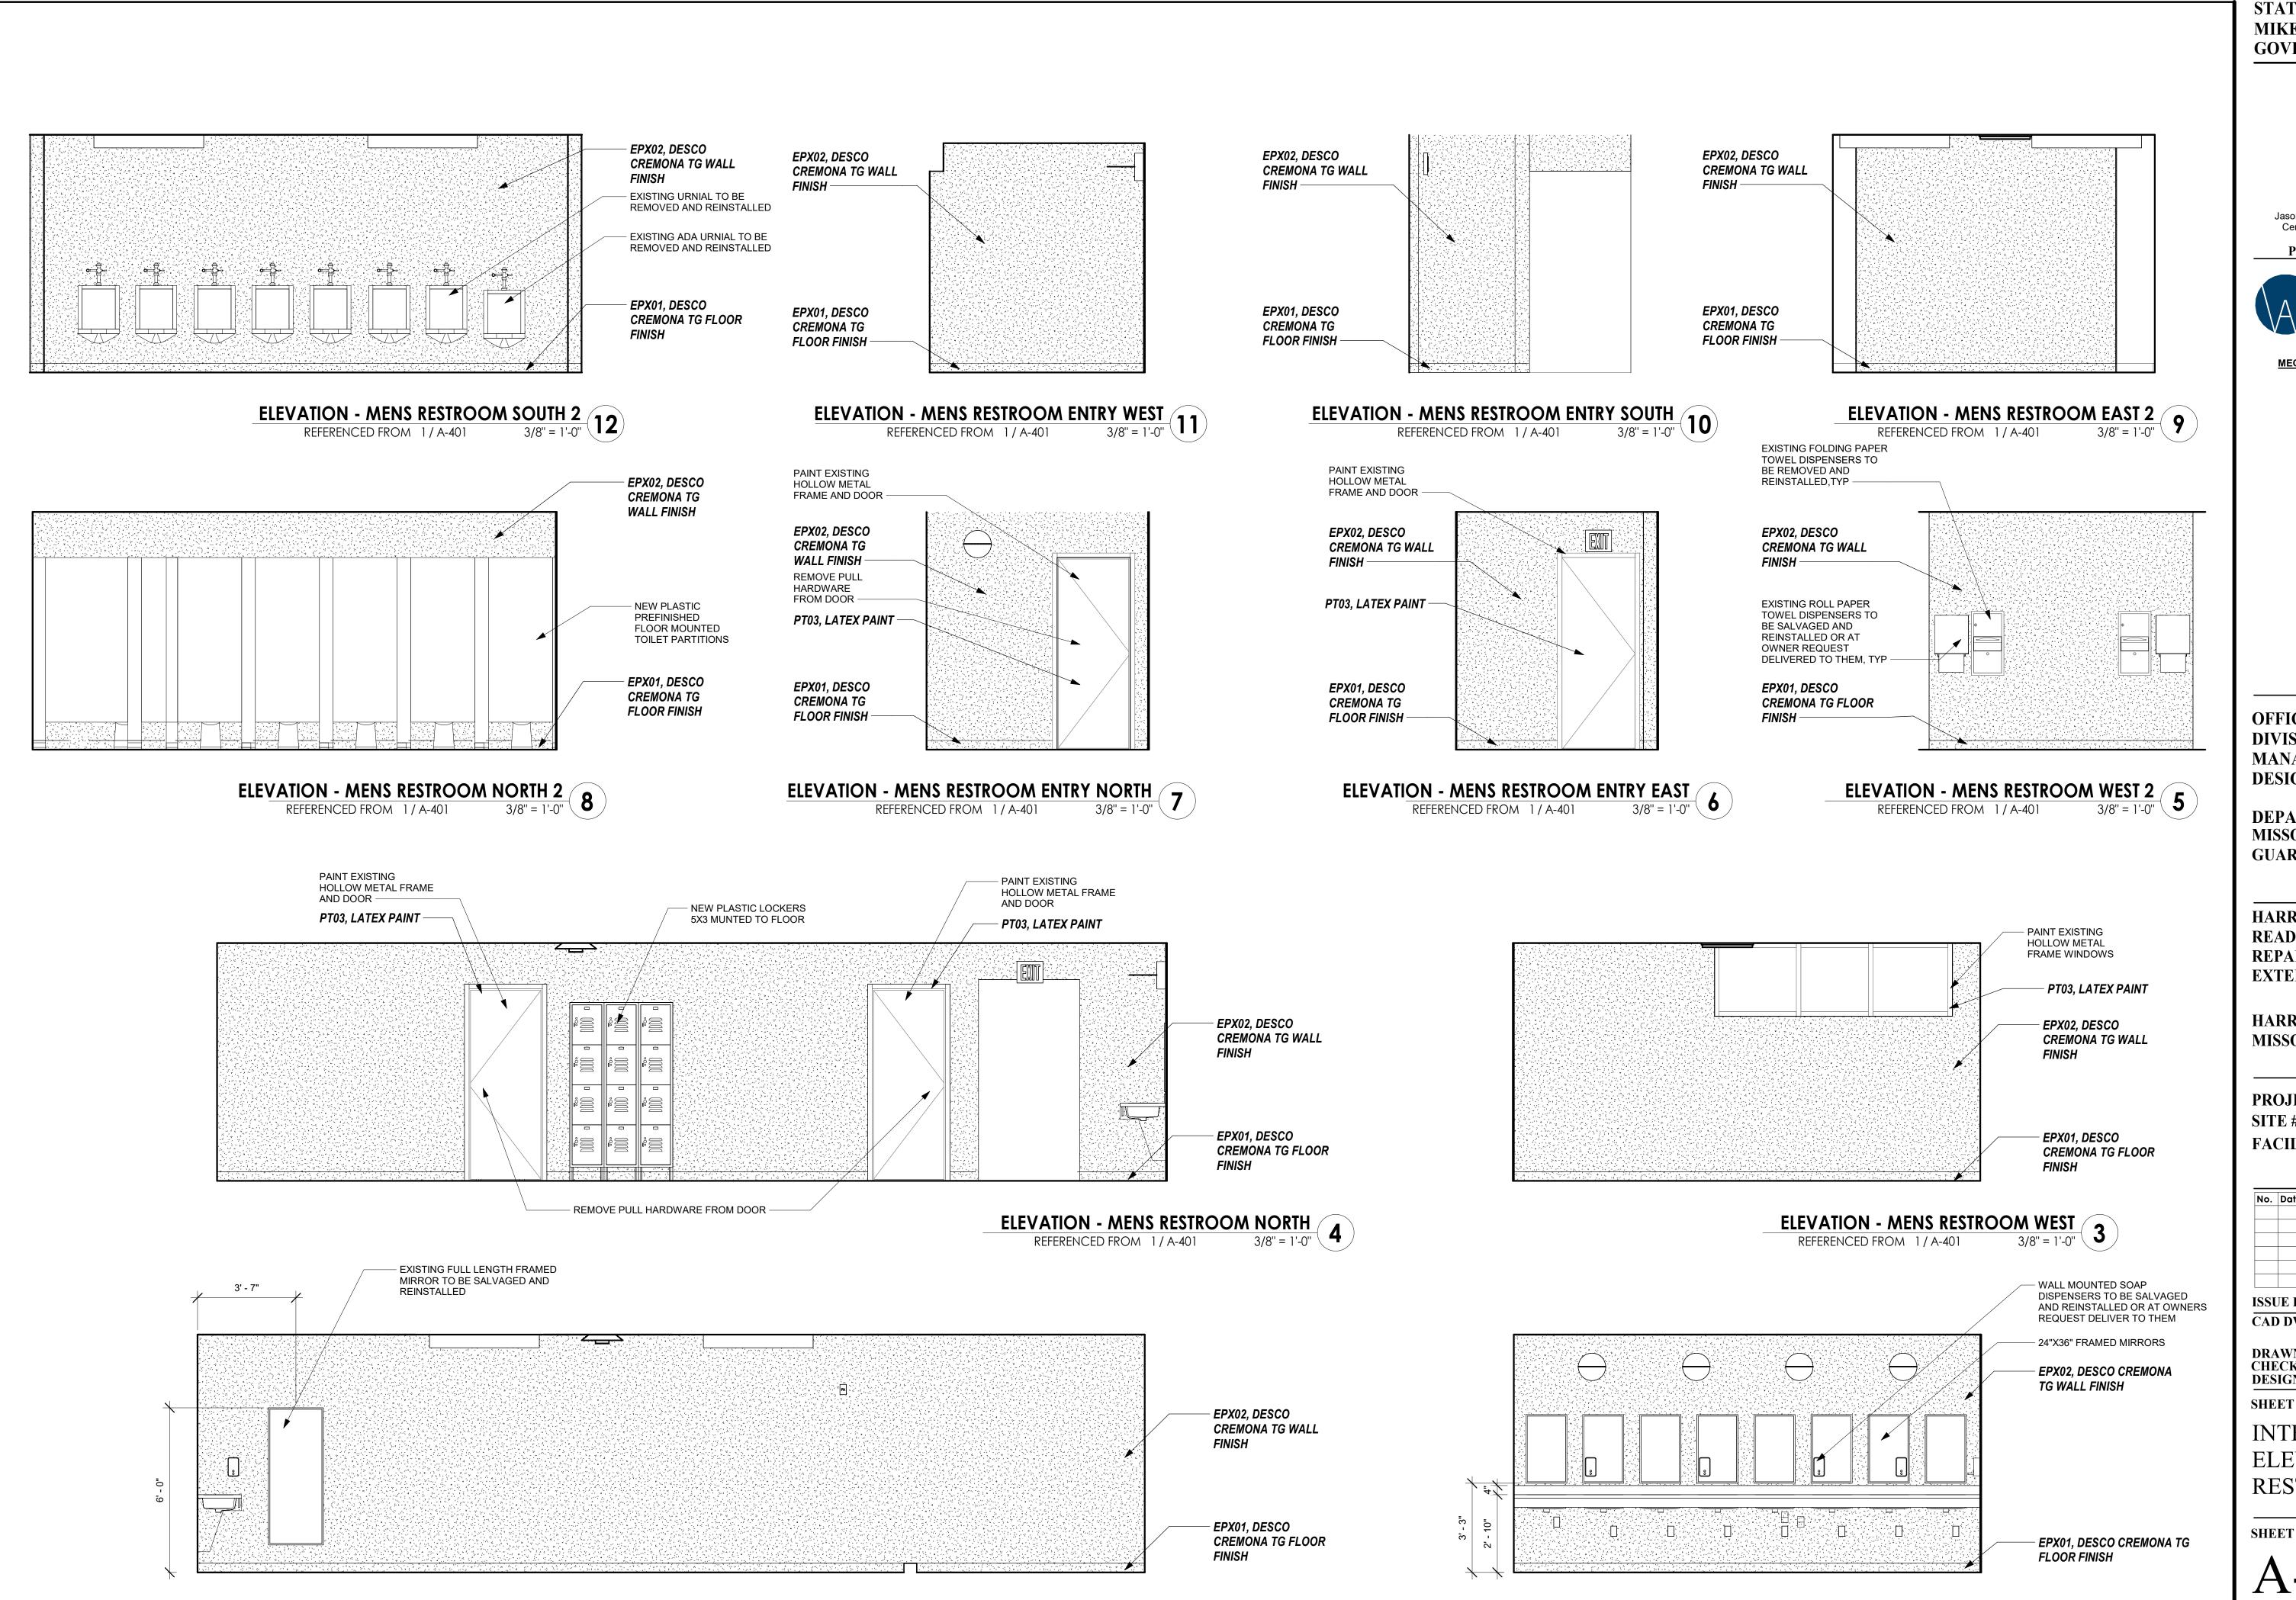

ELEVATION - MENS RESTROOM SOUTH

REFERENCED FROM 1 / A-401 3/8" = 1'-0"

2

STATE OF MISSOURI MIKE KEHOE, **GOVERNOR**

> SCOTT BARKER NUMBER Jason Scott Barker - MO #A2005001198 Certificate of Authority - MO #000767

PROFESSIONAL SEAL

<u>ARCHITECTURAL</u> Wellner Architects + Engineers 1627 Main Street #100 Kansas City, MO 64108 816.221.0017

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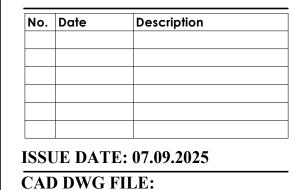
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DEPARTMENT OF MISSOURI NATIONAL **GUARD**

HARRISONVILLE READNESS CENTER REPAIRS TO INTERIOR & **EXTERIOR**

HARRISONVILLE, **MISSOURI**

PROJECT # T2334-01 **SITE # 6271** FACILITY #8136271003



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SHEET TITLE:


INTERIOR ELEVATION MENS RESTROOM

SHEET NUMBER:

ELEVATION - MENS RESTROOM EAST

REFERENCED FROM 1 / A-401

16 OF 30 SHEETS 7/30/2025 2:09:52 PM

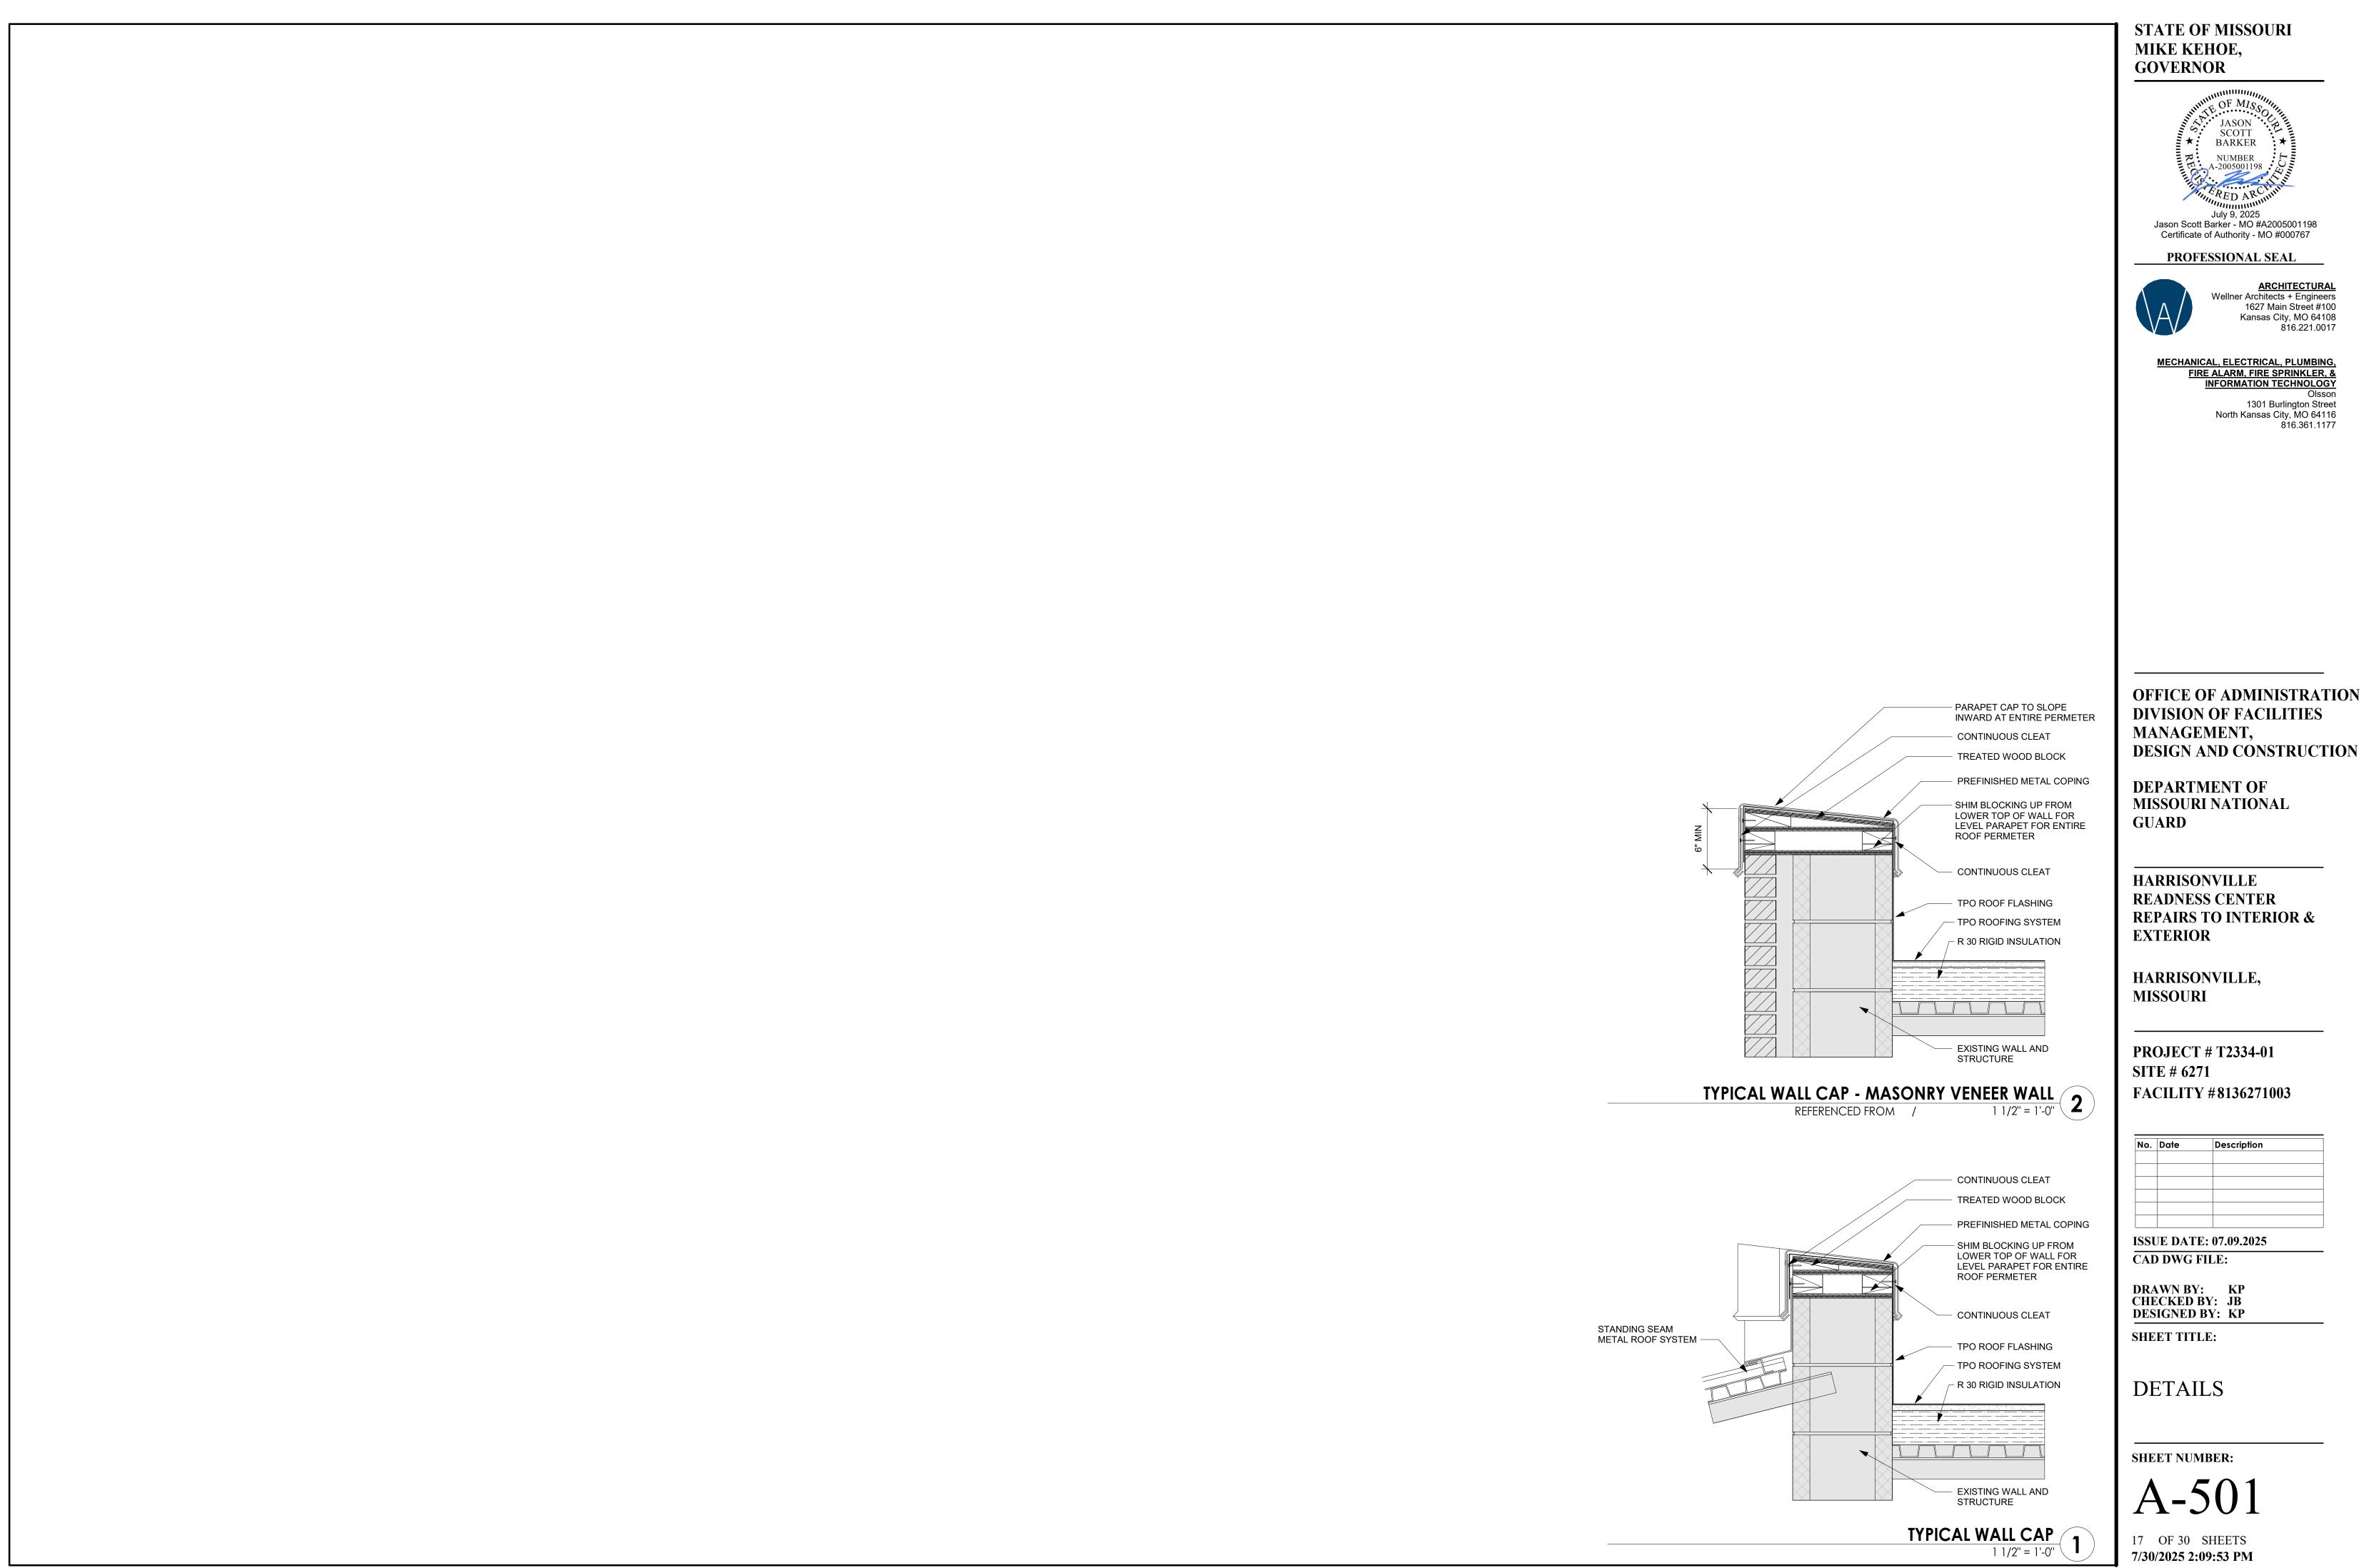

				Wall Finishes					
Number	ROOM NAME	Floor Finish	Base Finish	North	East	South	West	Ceiling Finish	Notes
110	MENS SHOWER ROOM	EPXY-1	EPXY-1	EPXY-2/PNT-1	EPXY-2/PNT-1	EPXY-2/PNT-1	EPXY-2/PNT-1	PNT-1	
113	MECH	ETR	ETR						
115	STORAGE	ETR	ETR						
114	STORAGE	ETR	ETR						
117	VAULT	ETR	ETR						
119	STORAGE	ETR	ETR						
120	KITCHEN	ETR	ETR						
121	SCHLLERY	ETR	ETR						
104	ASSEMBLY HALL	ETR	ETR						14
122	CLASSROOM	ETR	ETR						1
123	OFFICE	ETR	ETR						6 of 25
125	OFFICE	ETR	ETR						8 of 25
100	FOYER	ETR	ETR						
105	LIBRARY	ETR	ETR						4 of 25
106	MECH	ETR	ETR						
103	OFFICE	ETR	ETR						2 of 25
102	ADMINISTRATION	ETR	ETR						1 of 25
109	MEN RESTROOM	EPXY-1	EPXY-1	EPXY-2/PNT-1	EPXY-2/PNT-1	EPXY-2/PNT-1	EPXY-2/PNT-1	PNT-1	
107	WOMANS RESTROOM	EPXY-1	EPXY-1	EPXY-2/PNT-1	EPXY-2/PNT-1	EPXY-2/PNT-1	EPXY-2/PNT-1	PNT-1	
108	WOMANS SHOWER ROOM	EPXY-1	EPXY-1	EPXY-2/PNT-1	EPXY-2/PNT-1	EPXY-2/PNT-1	EPXY-2/PNT-1	PNT-1	
118	OFFICE	ETR	ETR						5 of 25
124	OFFICE	ETR	ETR						7 of 25
112	CORRIDOR	ETR	ETR						
111	CORRIDOR	ETR	ETR						
116	STORAGE	ETR	ETR						
104	OFFICE	ETR	ETR						3 of 25
126	MENS LOCKER ROOM	ETR	ETR						


			1 1111011	Legend	
Symbol	Manufacturer	Series/Pattern	Number	Color	Remarks
Ероху					
EPXY-1	Desco	Cremoa		60:20:20 White:Navy:Black	RR Floors
EPXY-2	Desco	Cremoa		80:10:10 White:Navy:Blackk	RR Walls
Paint PNT-1	Sherwin Williams	Epoxy Paint	SW 7063	Nebulous White	Above Epoxy
PNT-2	Sherwin Williams	Ероху г инт	SW 7063	Nebulous White	Non Wet Areas
				111111111111111111111111111111111111111	
Quartz				Weybourne	RR Sink Coutner

					DOOR	SCHEDULE			
MARK	PANEL SIZE	PANEL TYPE	PANEL FINISH	FRAME TYPE	FRAME SIZE	FRAME TYPE	FRAME FINISH	HARDWARE SET	NOTES
126A	3'-0" X 7'-0"	P00HM	PAINT	F00M	8 3/4" W/ 4" HEAD	HM GALV	PAINT	1	


HARD	WARE SET 1 -			
QTY	DESCRIPTION	CATALOG NUMBER	FINISH	MFR
3 EA	HINGE	5BB1HW	652	IVE
1 EA	PUSH PLATE	8200 4x16	US32D	SCH
1 EA	PULL PLATE	8302 4x16F	US32D	SCH
1 EA	SURFACE CLOSER	4040XP HCUSH	689	LCN
1 EA	KICK PLATE	8400 10" X 2" LDW B-CS	630	IVE

GENERAL NOTES:

1. ALL DIMENSIONS LISTED IN DOOR SCHEDULE ARE EXISTING AND ARE TO BE FIELD VERIFIED BY THE CONTRACTOR PRIOR TO ORDERING MATERIALS.

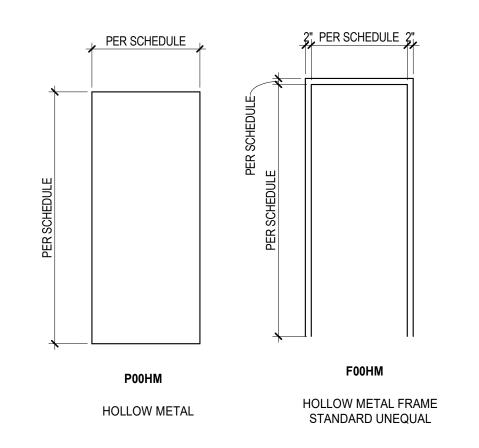




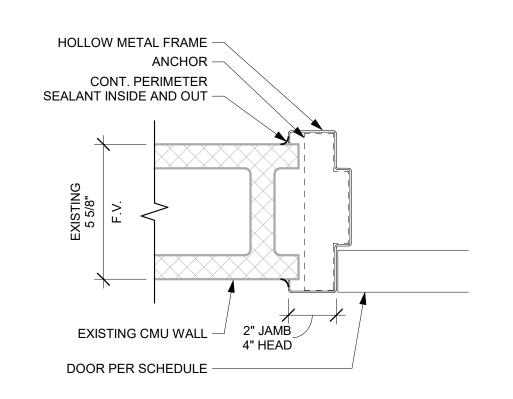

HOLLOW METAL FRAME @ EXISTING CMU

STATE OF MISSOURI MIKE KEHOE, GOVERNOR

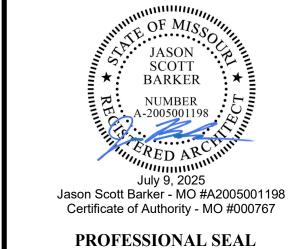



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HARRISONVILLE
READNESS CENTER
REPAIRS TO INTERIOR &
EXTERIOR

HARRISONVILLE, MISSOURI

PROJECT # T2334-01 SITE # 6271 FACILITY #8136271003

		-
root	TE DAT	E: 07.09.2025
1991	JE DAI	E: 07.09.2025
		FII F.

CAD DWG FILE:

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SHEET TITLE:


SCHEDULES

SHEET NUMBER:

A-600

18 OF 30 SHEETS **7/30/2025 2:09:52 PM**

7/30/2025 2:09:52 PM

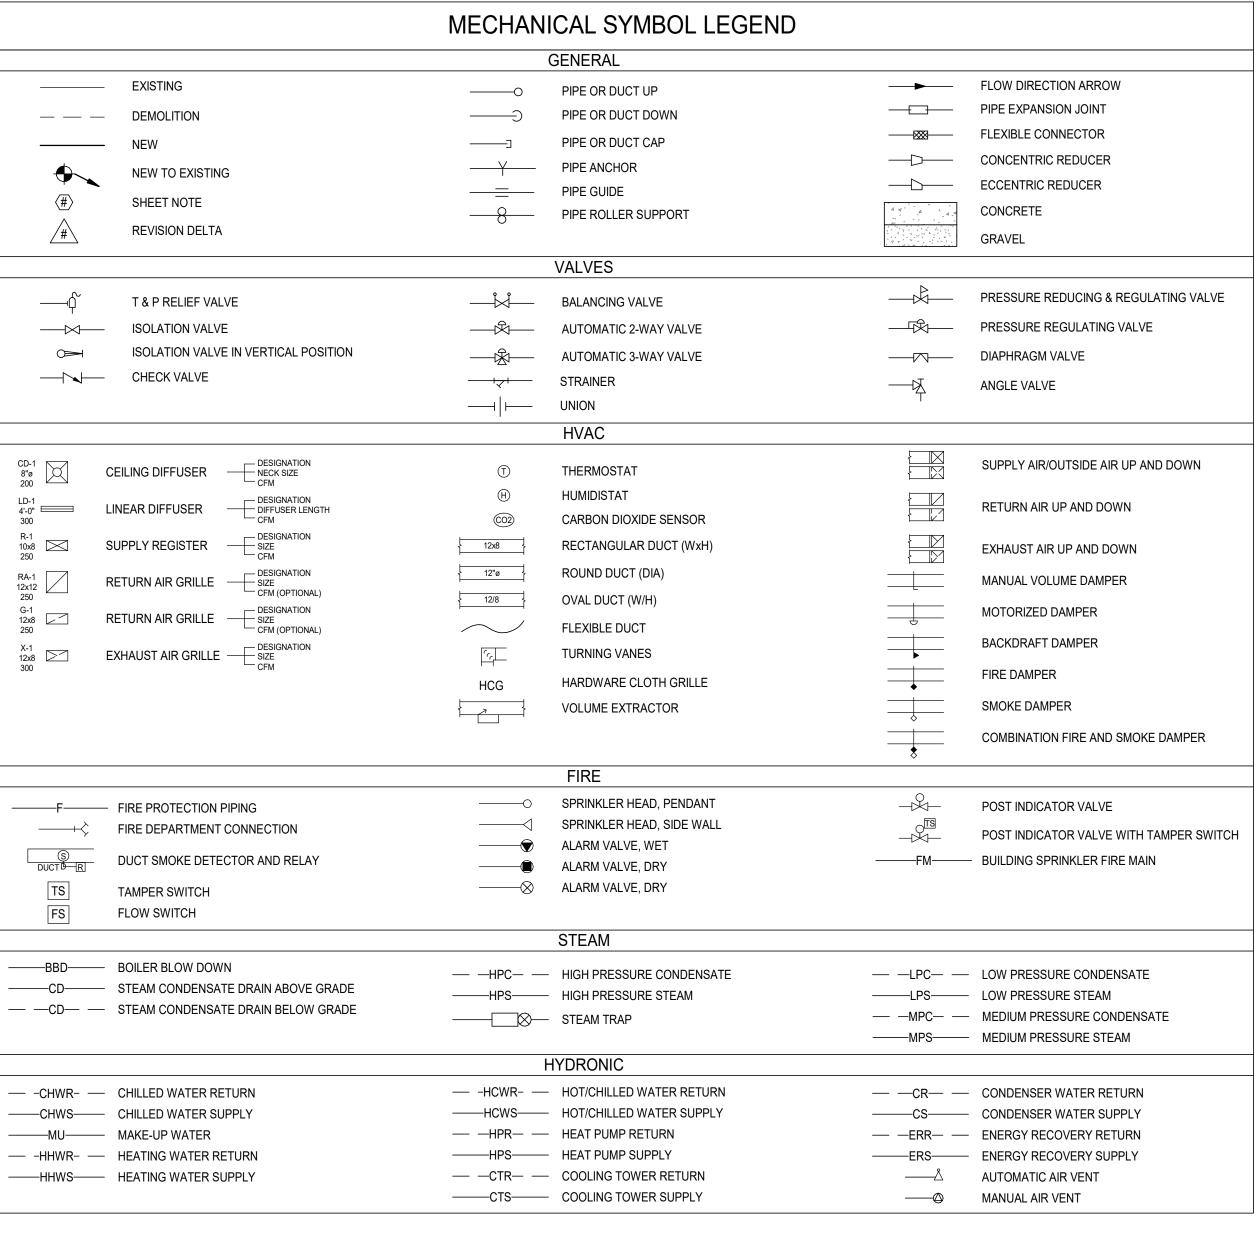

		FLUIVIDI	NG SYMBOL LEGEND		
			GENERAL		
	EXISTING		PIPE OR DUCT UP		FLOW DIRECTION ARROW
	DEMOLITION		PIPE OR DUCT DOWN		PIPE EXPANSION JOINT
	NEW	——]	PIPE OR DUCT CAP		FLEXIBLE CONNECTOR
•	NEW TO EXISTING		PIPE ANCHOR	\longrightarrow	CONCENTRIC REDUCER
#\ #\	SHEET NOTE	 _	PIPE GUIDE		ECCENTRIC REDUCER
\wedge	REVISION DELTA	8	PIPE ROLLER SUPPORT		
	REVISION DELTA				
		S	ANITARY & DOMESTIC		
	SANITARY DRAIN BELOW GRADE (PLAN)	——т—	TEMPERED WATER	RD	ROOF DRAIN (ABOVE GRADE)
	SANITARY DRAIN ABOVE GRADE (PLAN)	——TC——	TEMPERED WATER CIRCULATING	— —RD— —	,
	COLD WATER (CW)	V	VENT	——OD——	OVERFLOW DRAIN (ABOVE GRADE)
	HOT WATER (HW)	— —VBF— —	VENT BELOW FLOOR		OVERFLOW DRAIN (BELOW GRADE)
	HOT WATER CIRCULATING (HWC)	——CD——	CONDENSATE DRAIN PIPING		
-140 HW	140°F DOMESTIC HOT WATER				
			VALVES		
	T & P RELIEF VALVE	;	BALANCING VALVE	——————————————————————————————————————	PRESSURE REDUCING & REGULATING VAL
	ISOLATION VALVE	— \	AUTOMATIC 2-WAY VALVE	── \$ ─	PRESSURE REGULATING VALVE
	ISOLATION VALVE IN VERTICAL POSITION	— \$ —	AUTOMATIC 3-WAY VALVE	———	DIAPHRAGM VALVE
	CHECK VALVE		STRAINER	<u>—</u> ф	ANGLE VALVE
		<u>—— </u> ——	UNION	~	ANOLE VALVE
		<u>'</u>	FIXTURES		
O VTR	VENT THRU ROOF	—— GCO	GRADE CLEAN OUT	☐ FD-1/FS-1	FLOOR DRAIN OR SINK AND TYPE
(i) RD-1	ROOF DRAIN	— FCO	FLOOR CLEAN OUT	— [⊤] _ HB-1	HOSE BIBB
(i) OD-1	OVERFLOW DRAIN	—— wco	WALL CLEAN OUT	—— WH-1	WALL HYDRANT
		——— co	HORIZ. CLEAN OUT	──	YARD HYDRANT
			SITE		
W	WATER SERVICE	W	WELL	SD-	STORM DRAIN
	CURB STOP VALVE	- (YHT	YARD HYDRANT	4	THRUST BLOCK
—SAN— —	SANITARY SEWER (SITE)	□GAR	GAS RISER	I	
	STORM SEWER (SITE)	M	GAS METER	— —W— —	WATER MAIN

GENERAL DEMO NOTES

- A. REMOVE ALL DEMOLISHED MATERIALS FROM SITE AND DISPOSE IN ACCORDANCE WITH LOCAL, STATE, AND FEDERAL REGULATIONS. OWNER SHALL HAVE FIRST RIGHT OF REFUSAL OF ALL EQUIPMENT THAT IS REMOVED.
- B. PROTECT DURING THE COURSE OF THIS WORK. EXISTING UTILITIES, EXISTING BUILDING, AND/OR MATERIALS WHICH ARE DAMAGED BY NEGLIGENCE SHALL BE REPAIRED OR REPLACED AT THE CONTRACTOR'S EXPENSE, IN A TIMELY MANNER AND TO THE ENGINEER'S AND OWNER'S WRITTEN ACCEPTANCE.
- C. EXISTING INFORMATION SHOWN WAS TAKEN FROM SITE VISITS.
 CONTRACTOR SHALL FAMILIARIZE THEMSELVES WITH ALL WORK TO BE
 DONE BY OBSERVATION OF THE SITE. FIELD VERIFY SIZE, LOCATION,
 ELEVATION, AND QUANTITY OF ALL ARCHITECTURAL, MECHANICAL,
 ELECTRICAL, PIPING, AND EQUIPMENT/COMPONENTS THAT MAY IMPACT
 IMPLEMENTATION OF THIS WORK. FAILURE TO DO SO WILL NOT RELIEVE THE
 RESPONSIBILITY OF PERFORMING ALL WORK NECESSARY TO PROVIDE A
 FULLY FUNCTIONAL INSTALLATION.
- D. SCHEDULE AND EXECUTE ALL WORK WITH REGARD TO THE OWNER'S USE OF THE BUILDING. ALL WORK ASSOCIATED WITH EXISTING MECHANICAL SYSTEMS THAT WILL REQUIRE DISRUPTION OF SERVICE TO OTHER SPACES OCCUPIED DURING CONSTRUCTION SHALL BE COORDINATED WITH THE OWNER A MINIMUM OF TWO (2) DAYS PRIOR TO WORK.
- E. WHERE DUCTWORK IS SHOWN TO BE REMOVED, REMOVE ALL SUPPORTS, INSULATION WRAP, ETC. WHERE EQUIPMENT IS SHOWN TO BE REMOVED, COORDINATE WITH OTHER TRADES FOR DISCONNECTING UTILITIES, I.E. POWER, GAS, CONDENSATE, ETC.
- F. WHERE EQUIPMENT IS SCHEDULED FOR DEMOLITION ON THE ROOF, PATCH THE OPENING AND SEAL WEATHERTIGHT. ALL EXISTING ROOFING SYSTEMS SHALL BE PATCHED, INSULATED, AND COORDINATED WITH GENERAL CONTRACTOR TO MAINTAIN ANY WARRANTIES.
- G. IDENTIFY ALL ABANDONED PIPING, DUCTWORK, AND CONDUIT DISCOVERED IN THE EXECUTION OF THIS PROJECT, USING ORANGE PAINT MARKINGS EVERY 20 FEET.
- H. WHERE EXISTING BRANCH TAKEOFFS FROM EXISTING SUPPLY, RETURN, OR EXHAUST DUCTS ARE NOTED TO BE DISCONNECTED FROM MAIN AND REMOVED, PATCH, SEAL, AND INSULATE OPENING IN EXISTING MAIN DUCTWORK AIRTIGHT. PRIOR TO PATCH/SEAL, COORDINATE WITH NEW WORK PLANS TO RECONNECT TO EXISTING OPENINGS WHERE APPLICABLE.

GENERAL NOTES

- A. CAREFULLY REVIEW THE CONSTRUCTION DOCUMENTS. INFORMATION REGARDING THE COMPLETE WORK IS DISPERSED THROUGHOUT THE DOCUMENT SET AND CANNOT BE ACCURATELY DETERMINED WITHOUT REFERENCE TO THE COMPLETE DOCUMENT SET.
- B. ALL WORK SHALL COMPLY WITH STATE AND LOCAL CODE REQUIREMENTS AS APPROVED AND AMENDED BY THE GOVERNING CITY AND THE AUTHORITY HAVING JURISDICTION. PURCHASE ALL PERMITS ASSOCIATED WITH THE WORK. OBTAIN ALL INSPECTIONS REQUIRED BY CODE.
- C. COORDINATE WITH THE WORK OF OTHER SECTIONS, EQUIPMENT FURNISHED BY OTHERS, REQUIREMENTS OF THE OWNER, AND WITH THE CONSTRAINTS OF THE EXISTING CONDITIONS OF THE PROJECT SITE. PROVIDE RISES, DROPS, AND OFFSETS AS REQUIRED FOR FIELD INSTALLATION AND TRADE COORDINATION. NOTIFY ENGINEER OF ANY DISCREPANCIES BEFORE STARTING WORK.
- D. REFER TO EXISTING STRUCTURAL PLANS, OR VERIFY IN FIELD, THE LOCATION OF ALL STRUCTURAL MEMBERS.
- E. REFER TO STRUCTURAL DRAWINGS TO COORDINATE LOCATIONS OF ALL DUCTWORK AND PIPING PENETRATIONS.
- F. DRAWINGS ARE DIAGRAMMATIC, SHOWING THE GENERAL LOCATION, TYPE, LAYOUT, AND EQUIPMENT REQUIRED. THE DRAWINGS SHALL NOT BE SCALED FOR EXACT MEASUREMENT. REFER TO ARCHITECTURAL DRAWINGS FOR DIMENSIONS. REFER TO MANUFACTURER'S STANDARD INSTALLATION DRAWINGS FOR EQUIPMENT CONNECTIONS AND INSTALLATION REQUIREMENTS.
- G. USE OF COMBUSTIBLE MATERIALS IS NOT ALLOWED IN THE RETURN AIR PLENUM. MATERIALS USED IN THE PLENUM SHALL HAVE FLAME SPREAD RATING NOT TO EXCEED 25, AND SMOKE DEVELOPED RATING NOT TO EXCEED 50 WHEN TESTED IN ACCORDANCE WITH ASTM E 84. ALL EXPOSED WIRING IN THE PLENUM SHALL BE PLENUM RATED.
- H. DUCT DIMENSIONS: UNLESS OTHERWISE NOTED, DUCT DIMENSIONS ON THE DRAWINGS ARE INSIDE CLEAR DIMENSIONS.
- I. NEW ROOF PENETRATIONS AND ROOF CURBS FOR EQUIPMENT ON ROOF ARE SHOWN SCHEMATICALLY AND SHALL BE COORDINATED WITH EXISTING STRUCTURAL MEMBERS.
- J. PROVIDE DUCT TRANSITIONS AT CONNECTIONS TO ALL DUCTED MECHANICAL EQUIPMENT.
- K. COORDINATE ALL CEILING INSTALLED EQUIPMENT AND DIFFUSER, REGISTER, AND GRILLE LOCATIONS WITH ARCHITECTURAL REFLECTED CEILING PLANS AND ELECTRICAL LIGHTING PLANS.
- L. INSTALL BALANCING DAMPERS IN ALL DUCT BRANCHES TO INDIVIDUAL AIR DISTRIBUTION DEVICES. INSTALL AS CLOSE AS POSSIBLE TO BRANCH DUCT TAKEOFF FROM LARGER DUCT UNLESS SHOWN OTHERWISE ON THE FLOOR PLANS. DAMPERS IN AIR DISTRIBUTION DEVICES SHALL NOT BE USED TO BALANCE SYSTEMS.
- M. MAINTAIN 3'-0" CLEARANCE IN FRONT OF ELECTRICAL PANELS AND EQUIPMENT. DO NOT ROUTE ANY PIPING OR DUCTWORK OVER ELECTRICAL EQUIPMENT.
- N. BRANCH DUCTS TO DIFFUSERS SHALL BE THE SAME SIZE AS THE DIFFUSER NECK UNLESS NOTED OTHERWISE. MAXIMUM LENGTH OF FLEXIBLE DUCT ROUTING TO BE 5'-0" (NO EXCEPTIONS).
- O. TEMPERATURE SENSORS/THERMOSTATS/CO2 SENSORS SHALL BE LOCATED ON WALL NEAR LOCATIONS SHOWN. LOCATE ON WALL WITH CENTER AT 3'-8" A.F.F. TO CENTER OF T-STAT (MATCHING LIGHT SWITCH HEIGHT).
- P. REPAIR OR REPLACE LAY-IN OR GYPBOARD CEILINGS AS NECESSARY TO INSTALL NEW DUCTWORK, PIPING, AND ELECTRICAL CONDUITS.
- Q. ALL ROOF-MOUNTED EQUIPMENT SHALL BE LOCATED MINIMUM 10'-0" FROM ROOF EDGE UNLESS MINIMUM 42" GUARD OR PARAPET IS NOTED ON DRAWINGS
- R. CONTRACT OWNER'S APPROVED ROOFING CONTRACTOR TO FLASH AND SEAL ROOF CURB TO MAINTAIN ROOF WARRANTY.
- S. DEFINITIONS:
- 1. PROVIDE CONTRACTOR SHALL FURNISH AND INSTALL
- FURNISH CONTRACTOR SHALL OBTAIN FOR OTHERS TO INSTALL.
 INSTALL CONTRACTOR IS RESPONSIBLE FOR ALL LABOR AND
- CONSTRUCTION EQUIPMENT NECESSARY TO SET IN PLACE, CONNECT, CALIBRATE.

STATE OF MISSOURI MIKE KEHOE, GOVERNOR



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OFFICE OF ADMINISTRATION DIVISION OF FACILITIES MANAGEMENT, DESIGN AND CONSTRUCTION

DEPARTMENT OF Owner

HARRISONVILLE READINESS CENTER

1503 SOUTH JEFFERSON PARKWAY HARRISONVILLE, MO

PROJECT # 023-05260 SITE # FACILITY #

No.	Date	Description	

ISSUE DATE: 07/09/2025 CAD DWG FILE:

DRAWN BY: KP CHECKED BY: JB DESIGNED BY: KP

SHEET TITLE:


GENERAL MECHANICAL INFORMATION

SHEET NUMBER:

M00

19 OF 30 SHEETS **7/8/2025 10:36:07 AM**

7/8/2025 10:36:07 AM

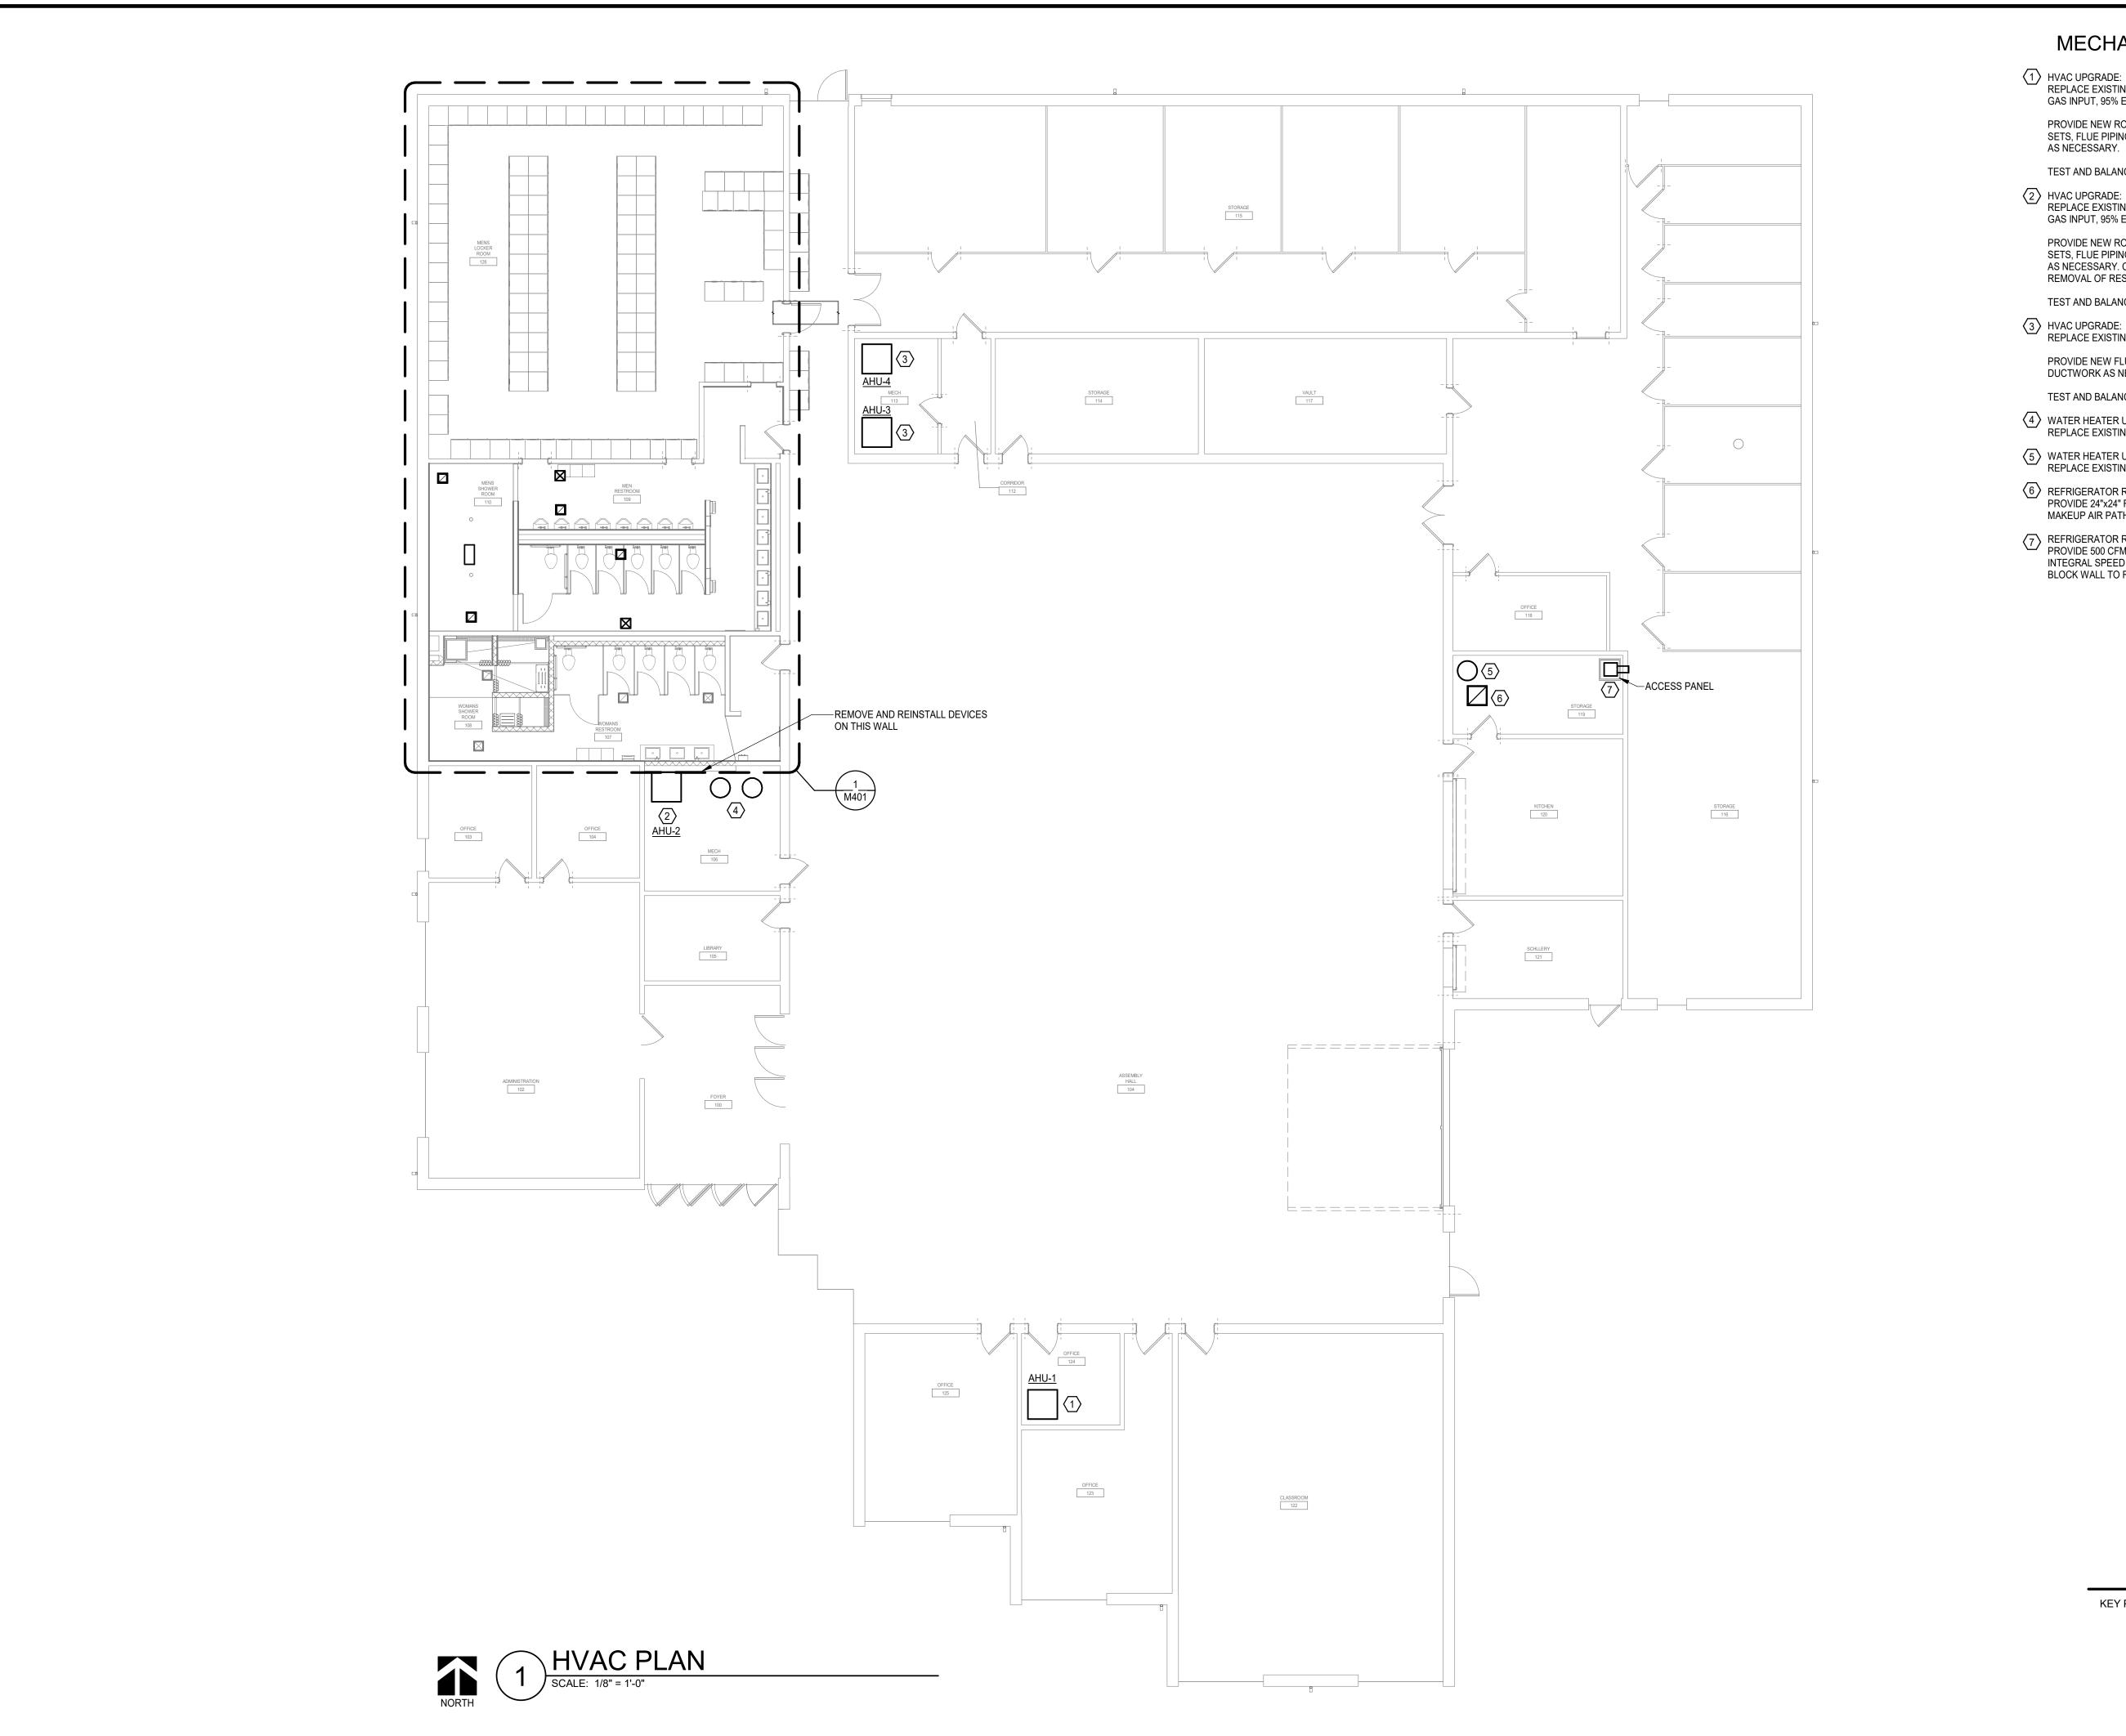

MECHANICAL KEYNOTES

HVAC UPGRADE:
REPLACE EXISTING FURNACE, DX COIL, AND CONDENSING UNIT. 110 MBH GAS INPUT, 95% EFFICIENCY. 5-TON CONDENSING UNIT.

PROVIDE NEW ROOF-MOUNTED EQUIPMENT STANDS, REFRIGERANT LINE SETS, FLUE PIPING, AND CONTROLS. CONNECT TO EXISTING DUCTWORK

TEST AND BALANCE SYSTEM.

HVAC UPGRADE:
REPLACE EXISTING FURNACE, DX COIL, AND CONDENSING UNIT. 80 MBH GAS INPUT, 95% EFFICIENCY. 4-TON CONDENSING UNIT.

PROVIDE NEW ROOF-MOUNTED EQUIPMENT STANDS, REFRIGERANT LINE SETS, FLUE PIPING, AND CONTROLS. CONNECT TO EXISTING DUCTWORK AS NECESSARY. COORDINATE DEMOLITION AND INSTALLATION WITH REMOVAL OF RESTROOM WALL.

TEST AND BALANCE SYSTEM.

REPLACE EXISTING FURNACE. 110 MBH GAS INPUT, 95% EFFICIENCY.

PROVIDE NEW FLUE PIPING, AND CONTROLS. CONNECT TO EXISTING DUCTWORK AS NECESSARY.

TEST AND BALANCE SYSTEM.

KEY PLAN

- WATER HEATER UPGRADE:
 REPLACE EXISTING WATER HEATER IN KIND. 75 GALLON, 75 MBH INPUT.
- WATER HEATER UPGRADE:
 REPLACE EXISTING WATER HEATER IN KIND. 75 GALLON, 75 MBH INPUT.
- 6 REFRIGERATOR ROOM COOLING:
 PROVIDE 24"x24" RETURN AIR GRILLE IN CEILING FOR EXHAUST FAN
 MAKEUP AIR PATH.
- REFRIGERATOR ROOM COOLING:
 PROVIDE 500 CFM ABOVE CEILING-MOUNTED EXHAUST FAN WITH INTEGRAL SPEED CONTROL AND THMERMOSTAT. DUCT FAN THROUGH BLOCK WALL TO REJECT HEAT INTO STORAGE-116.

STATE OF MISSOURI MIKE KEHOE, **GOVERNOR**



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HARRISONVILLE READINESS CENTER

1503 SOUTH JEFFERSON PARKWAY HARRISONVILLE, MO

PROJECT # 023-05260 SITE# FACILITY#

No.	Date	Description	

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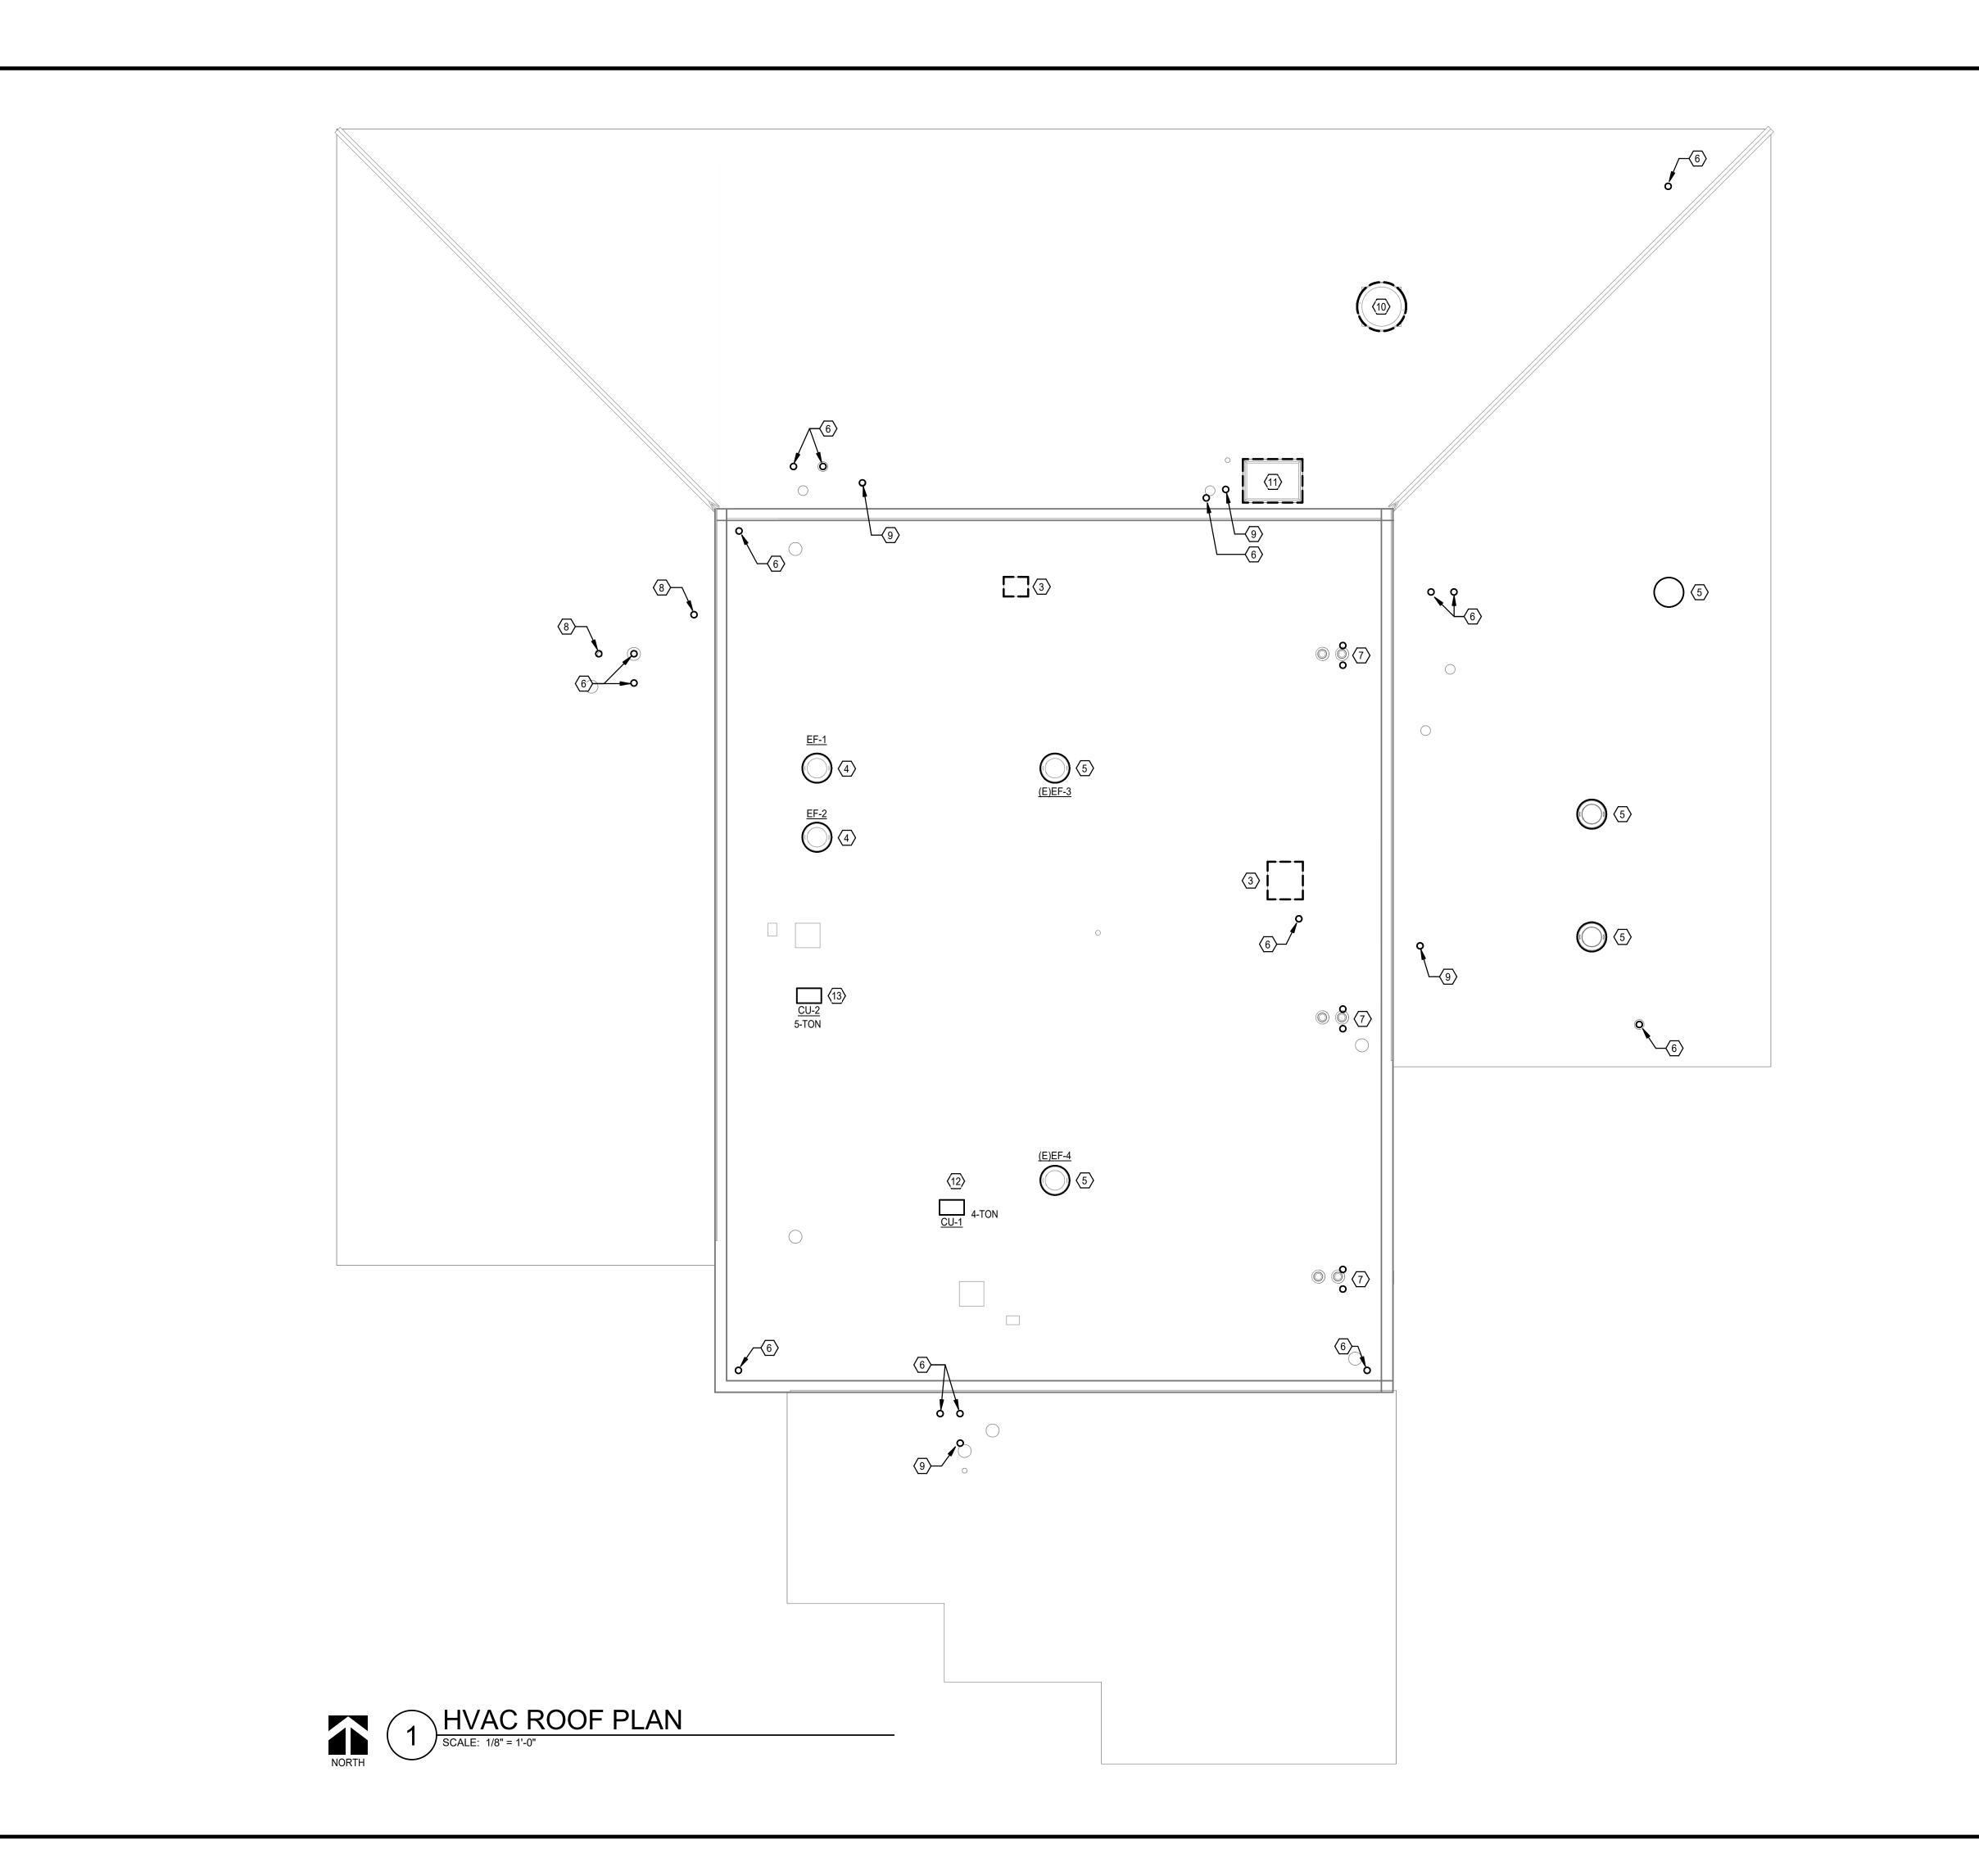
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SHEET TITLE:

MECHANCIAL FLOOR PLAN

SHEET NUMBER:

20 OF 30 SHEETS 7/8/2025 10:36:07 AM



MECHANICAL KEYNOTES

- ROOF REPLACEMENT:
 TEMPORARILY UNINSTALL AND THEN REINSTALL EXISTING CONDENSING
 UNIT. PROVIDE NEW PIPE CURB PENETRATION AND ROOF-EQUIPMENT
 SUPPORT RAILS. RECHARGE REFRIGERANT AS NECESSARY.
- ROOF REPLACEMENT:
 TEMPORARILY UNINSTALL AND THEN REINSTALL EXISTING CONDENSING
 UNIT. PROVIDE NEW PIPE CURB PENETRATION AND ROOF-EQUIPMENT
 SUPPORT RAILS. RECHARGE REFRIGERANT AS NECESSARY.
- ROOF REPLACEMENT: REMOVE ABANDONED CURB CAP.
- RESTROOM/LOCKER UPGRADES:
 REPLACE NON-FUNCTIONING EXHAUST FANS WHICH SERVE LOCKER
 ROOM AREAS. LOREN COOK "ACEB 180". PROVIDE WITH NEW ROOF CURB.
- (5) ROOF REPLACEMENT:
 TEMPORARILY UNINSTALL AND THEN REINSTALL EXISTING EXHAUST FAN.
 PROVIDE NEW ROOF CURB.
- 6 ROOF REPLACEMENT: TEMPORARILY UNINSTALL AND THEN REINSTALL GAS FLUE.
- 7 ROOF REPLACEMENT:
 TEMPORARILY UNINSTALL AND THEN REINSTALL ROOF DRAINS AND
 OVERFLOW DRAINS.
- 8 ROOF REPLACEMENT: TEMPORARILY UNINSTALL AND THEN REINSTALL PLUMBING VENT.
- PROOF REPLACEMENT:
 REMOVE ABANDONED ROOF PIPING PENETRATION.
- ROOF REPLACEMENT:
 REMOVE ABANDONED RANGE EXHAST FAN AND ALL ASSOCIATED DUCTWORK, SUPPORTS, ACCESSORIES.
- ROOF REPLACEMENT:
 REMOVE ABANDONED RANGE INTAKE HOOD AND ALL ASSOCIATED DUCTWORK, SUPPORTS, ACCESSORIES.
- (12) INSTALL NEW CONDENSING UNIT TO SERVE AHU-1.

KEY PLAN

(13) INSTALL NEW CONDENSING UNIT TO SERVE AHU-2.

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HARRISONVILLE READINESS CENTER

1503 SOUTH JEFFERSON PARKWAY HARRISONVILLE, MO 64701

PROJECT # 023-05260 SITE # FACILITY #

No.	Date	Description	

ISSUE DATE: 07/09/2025
CAD DWG FILE:

DRAWN BY: KP CHECKED BY: JB DESIGNED BY: KP

SHEET TITLE:

MECHANICAL ROOF PLAN

SHEET NUMBER:

NORTH

M102

21 OF 30 SHEETS **7/8/2025 10:36:08 AM**

(TYP. 8) 5 (TYP. 8) (o) (6) (a) (b) TRENCH DRAIN \boxtimes 2" FLOOR — DRAIN (TYP. 5) ENLARGED MECHANICAL PLAN SCALE: 1/4" = 1'-0"

MECHANICAL KEYNOTES

RESTROOM/LOCKER UPGRADES: PROVIDE NEW 3-STATION WASH BASINS. BRADLEY "LVAD3"

NATURAL QUARTZ WASH BASIN WITH 3 LAVATORY CONNECTIONS SPACED AT 30" ON CENTERS. INTERGRAL DRAIN TROUGH.

PROVIDE WITH TOUCHLESS FAUCETS (0.5 GPM) AND TOUCHLESS SOAP DISPENSERS, SUPPORT BRACKETS, COMPONENT ACCESS PANELS.

(2) RESTROOM/LOCKER UPGRADES: PROVIDE NEW SHOWER SYSTEMS.

ZURN Z415B FLOOR DRAIN WITH AMERICAN STANDARD TU662.211 SHOWER TRIM.

THERMOSTATIC MIXING VALVE WITH SHAPE MEMORY ALLOY, INTEGRATED SERVICE STOPS, 1/2" NPT CONNECTIONS, AND CORROSION RESISTANCE. UNIT SHALL BE COMPLIANT WITH ASME A112.18.1.

PROVIDE WITH SOLID BRASS TEMPERATURE CONTROL TRIM WITH ANTI-SCALD SAFETY STOP, LEVER HANDLE, AND POLISHED CHROME FINISH. TRIM SHALL BE ASME A112.18.1 AND ADA COMPLIANT. PROVIDE WITH SINGLE SPRAY SHOWERHEAD WITH HOSE AND 36" SLIDE BAR. PROVIDE ADA GRAB BARS FOR ADA SHOWERS. REFER TO ARCHITECTURAL PLANS FOR MOUNTING HEIGHTS OF ALL COMPONENTS.

RESTROOM/LOCKER UPGRADES:
PROVIDE NEW WATER CLOSETS - KOHLER "WELLWORTH" K-4406

ELONGATED, VITREOUS CHINA BOWL WITH SIPHON-JET DESIGN, FLOOR MOUNTED, 1-1/2" TOP SPUD, FLOOR OUTLET, 1.6 GPF.

INCLUDE BOLT CAPS MATCHING FIXTURE, KOHLER "LUSTRA" K-4670-C, ELONGATED SEAT, OPEN FRONT, NO LID (WHITE).

SLOAN G2 OPTIMA+ MODEL 8111 EXPOSED, BATTERY-POWERED, SENSOR-OPERATED FLUSHOMETER, 1.6 GPF, ADA COMPLIANT, WITH BUTTON OVER-RIDE, NON-HOLD-OPEN SOLENOID OPERATOR, SELF-ADAPTIVE INFRARED SENSOR & INDICATOR LIGHT, AND CHROME-PLATED EXPOSED PIECES.

4 RESTROOM/LOCKER UPGRADES: REPLACE LAVATORIES - KOHLER "KINGSTON" K-2005

WHITE, VITREOUS CHINA, FRONT OVERFLOW, D-SHAPED BOWL, FAUCET

LEDGE AND SELF-DRAINING DECK AREA WITH CONTOURED BACK AND SIDE SPLASH SHIELDS. FAUCET HOLES SHALL BE 4" ON CENTER. NOMINAL DIMENSION OF 21-1/4"x18-1/8" BOWL DIMENSION OF 16"x10".

PROVIDE WITH FLOOR-MOUNTED FIXTURE CARRIER (IF REQUIRED), CHROME-PLATED COPPER SUPPLIES WITH LOOSE TEE KEY STOPS.

PROVIDE 1-1/2" CHROME-PLATED CAST-BRASS TRAP WITH CLEANOUT AND WALL ESCUTCHEONS. KOHLER CORALAIS K-15593 FAUCET, ADA-COMPLIANT, CHROME-PLATED METAL CONSTRUCTION, ONE-PIECE LEVER HANDLE FAUCET, 0.5 GPM

VANDAL RESISTANT AERATOR, HIGH-TEMP LIMIT STOP, AND CHROME PLATED BRASS GRID STRAINER.

(5) EXISTING URINALS TO REMAIN. CONTRACTOR TO ENSURE NO DAMAGE IS DONE TO URINALS DURING CONSTRUCTION.

6 RESTROOM/LOCKER UPGRADES:

REPLACE GROUP SHOWERS - BRADLEY COL-6C

SIX STATION COLUMN SHOWER WITH 304 STAINLESS STEEL OR POLISHED CHROME-PLATED BRASS EXPOSED MATERIALS. INDIVIDUAL TEMPERATURE ADJUSTMENT AT EACH STATION WITH PRESSURE BALANCING VALVE. 1.5 GPM STANDARD SHOWER HEAD. SUPPLIES FROM

7 RESTROOM/LOCKER UPGRADE: REBALANCE LOCKERROOM EXHAUST AND HEATING SYSTEM.

(8) CONNECT 2 WASTE FROM FLOOR DRAIN TO THE NEAREST MAIN.

© CONNECT 3/4" HW AND CW TO THE NEAREST EXISTING MAIN AND PROVIDE ISOLATION VALVES. RECONNECT NEW EXHAUST FAN TO EXISTING DUCTWORK AND NEW GRILLES.

(11) 12" ACCESS PANEL FOR VALVE ACCESS.

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DEPARTMENT OF Owner

HARRISONVILLE READINESS CENTER

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PROJECT # 023-05260 SITE# **FACILITY #**

No.	Date	Description	

ISSUE DATE: 07/09/2025 CAD DWG FILE:

DRAWN BY: KP CHECKED BY: JB **DESIGNED BY: KP**

SHEET TITLE:

ENLARGED MECHANICAL PLAN


SHEET NUMBER:

22 OF 30 SHEETS

7/8/2025 10:36:09 AM

NORTH KEY PLAN _ AREA OF WORK, LOCKERROOM AREA OF WORK, RESTROOM

PLUMBI	NG FIXTURE S	CHEDULE							
MARK	TYPE	MANUFACTURER	MODEL	DESCRIPTION	ACCESSORIES		CONNE	CTIONS	
WAIN	1112	MANUI ACTURLIK	WODEL	BEGGINI HON	ACCESSORIES	WASTE	VENT	CW	HW
WC-1	WATER CLOSET FLOOR MOUNTED FLUSH VALVE	KOHLER	"HIGHCLIFF" K-96057	ELONGATED, VITREOUS CHINA BOWL, FLOOR MOUNTED, 1-1/2" TOP SPUD, FLOOR OUTLET, 1.28 GPF.	INCLUDE BOLT CAPS MATCHING FIXTURE, KOHLER "LUSTRA" K-4670-C, ELONGATED SEAT, OPEN FRONT, NO LID (WHITE). FLUSH VALVE: ZURN MODEL NO. Z6000AV-HET FLUSH VALVE, 1.28 GPF, CHROME PLATED, HIGH BACK PRESSURE VACUUM BREAKER FLUSH CONNECTION, ONE-PIECE BOTTOM HEX COUPLING NUT, CONTROL STOP WITH INTERNAL SIPHON GUARD PROTECTION, VANDAL RESISTANT STOP CAP, ADJUSTABLE TAILPIECE. LOCATE FLUSH LEVER ON OPEN SIDE OF FIXTURE, REFER TO PLANS PRIOR TO ORDERING.	4"	2"	1-1/4"	_
WC-2	WATER CLOSET FLOOR MOUNTED FLUSH VALVE ADA	KOHLER	"HIGHCLIFF" K-96057	ELONGATED, VITREOUS CHINA BOWL, FLOOR MOUNTED, 1-1/2" TOP SPUD, FLOOR OUTLET, 1.28 GPF, ADA-COMPLIANT.	INCLUDE BOLT CAPS MATCHING FIXTURE, KOHLER "LUSTRA" K-4670-C, ELONGATED SEAT, OPEN FRONT, NO LID (WHITE). FLUSH VALVE: ZURN MODEL NO. Z6000AV-HET FLUSH VALVE, 1.28 GPF, CHROME PLATED, HIGH BACK PRESSURE VACUUM BREAKER FLUSH CONNECTION, ONE-PIECE BOTTOM HEX COUPLING NUT, CONTROL STOP WITH INTERNAL SIPHON GUARD PROTECTION, VANDAL RESISTANT STOP CAP, ADJUSTABLE TAILPIECE, ADA COMPLIANT. LOCATE FLUSH LEVER ON OPEN SIDE OF FIXTURE, REFER TO PLANS PRIOR TO ORDERING.	4"	2"	1-1/4"	-
L-1	LAVATORY WALL HUNG	KOHLER	"KINGSTON" K-2005	WHITE, VITREOUS CHINA, UNDERMOUNT, FRONT OVERFLOW, D-SHAPED BOWL, FAUCET LEDGE AND SELF-DRAINING DECK AREA WITH CONTOURED BACK AND SIDE SPLASH SHIELDS. FAUCET HOLES SHALL BE 4" ON CENTER.	PROVIDE WITH FLOOR-MOUNTED FIXTURE CARRIER, CHROME-PLATED COPPER SUPPLIES WITH LOOSE TEE KEY STOPS. PROVIDE 1-1/2" CHROME-PLATED CAST-BRASS TRAP WITH CLEANOUT AND WALL ESCUTCHEONS. KOHLER "CORALAIS" K-15598 FAUCET, ADA-COMPLIANT, CHROME-PLATED METAL CONSTRUCTION, ONE-PIECE AUTOMATIC FAUCET, 1.5 GPM VANDAL RESISTANT AERATOR, HIGH-TEMP LIMIT STOP, AND CHROME PLATED BRASS GRID STRAINER.	2" UP TO 1-1/2" TRAP ARM	1-1/4"	1/2"	1/2"
EWC-1	ELECTRIC WATER COOLER	ELKAY	EZSTL8WS	WALL MOUNT WATER COOLER. 8 GPH AT 90°F AMBIENT, 370 WATTS 5.0 FLA, SELF-CLOSING EASY-TOUCH CONTROLS ON THE FRONT, LEFT AND RIGHT OF UNIT, AND FLEXI-GUARD SAFETY BUBBLER.	PROVIDE CHROME-PLATED COPPER SUPPLY STOPS, CHROME-PLATED CAST-BRASS TRAP WITH CLEANOUT (0.045" THICK TUBULAR BRASS WASTE TO WALL) AND WALL ESCUTCHEONS.	1-1/2"	1-1/4"	1/2"	-
MS-1	MOP SINK	FIAT	MSB 2424	24"x24"x10" MOLDED STONE BASIN WITH 3" DRAIN OUTLET WITH STRAINER.	PROVIDE CHROME-PLATED COPPER SUPPLY STOPS, CHROME-PLATED CAST-BRASS TRAP WITH CLEANOUT (0.045" THICK TUBULAR BRASS WASTE TO WALL) AND WALL ESCUTCHEONS.	3"	2"	1/2"	1/2"
HB-1	EXPOSED HOSE BIBB	WOODFORD	24	EXPOSED, ANTI-SIPHON WALL HOSE BIBB WITH CHROME FINISH, HOSE TREADED SPOUT, VACUUM BREAKER, AND REMOVABLE KEY OPERATOR.	PROVIDE CHROME-PLATED COPPER SUPPLY STOPS, CHROME-PLATED CAST-BRASS TRAP WITH CLEANOUT (0.045" THICK TUBULAR BRASS WASTE TO WALL) AND WALL ESCUTCHEONS.	-	-	3/4"	-
FD-1	SQUARE FLOOR DRAIN	ZURN	Z415S	CAST IRON TWO PIECE BODY WITH DOUBLE DRAINAGE FLANGE, WEEP HOLES, REVERSIBLE CLAMPING COLLAR, NICKEL BRONZE ADJUSTABLE STRAINER.	DIMENSIONS OF TOP STRAINER: 2" AND 3" OUTLETS WITH A 5"x5" STRAINER, 2", 3" AND 4" OUTLET WITH 6"x6 OR 7"x7" STRAINER, 3" AND 4" OUTLET WITH 8"x8" STRAINER, 6" OUTLET WITH A 10"x10" STRAINER. PROVIDE TY SEALS FOR FLOOR DRAINS MOUNTED IN FLOORS ABOVE GRADE. VERIFY PIPE SIZES ON PLANS.	_	1-1/2" (2" BELOW SLAB)	-	-
FS-1	SQUARE FLOOR SINK	ZURN	Z1901	12x12x8 DEEP CAST IRON BODY AND SQUARE SLOTTED MEDIUM DUTY GRATE, WITH WHITE ACID RESISTING PORCELAIN ENAMEL INTERIOR AND TOP, COMPLETE WITH WHITE ABS ANTI-SPLASH INTERIOR BOTTOM DOME STRAINER.	PROVIDE WITH 1/2 GRATE AND SECURITY SCREWS. VERIFY PIPE SIZES ON PLANS.	_	2"	-	-
FCO	FLOOR CLEANOUT	ZURN	Z1400	CAST IRON BODY, WITH GAS AND WATER-TIGHT ABS TAPERED THREAD PLUG AND ROUND POLISHED BRONZE SCORIATED SECURED TOP, ADJUSTABLE TO FINISH FLOOR.	CLEANOUT SHALL BE THE SAME SIZE AS PIPING UP TO 4". 4" AND LARGER PIPING SHALL BE A 4" CLEANOUT.	_	-	-	-
wco	WALL CLEANOUT	ZURN	Z1446	CLEANOUT TEE, DURA COATED CAST IRON BODY, GAS AND WATERTIGHT, ABS TAPERED THREAD PLUG AND ROUND, SMOOTH STAINLESS STEEL WALL ACCESS COVER WITH SECURING SCREW.	CLEANOUT SHALL BE THE SAME SIZE AS PIPING UP TO 4". 4" AND LARGER PIPING SHALL BE A 4" CLEANOUT.	-	-	-	-
BF-1	BOTTLE FILLER			1.1 GPM LAMINAR FLOW BOTTLE FILLER, ELECTRIC SENSOR FOR TOUCHLESS ACTIVATION, MOUNTED AT ADA HEIGHT		_	-	1/2"	_

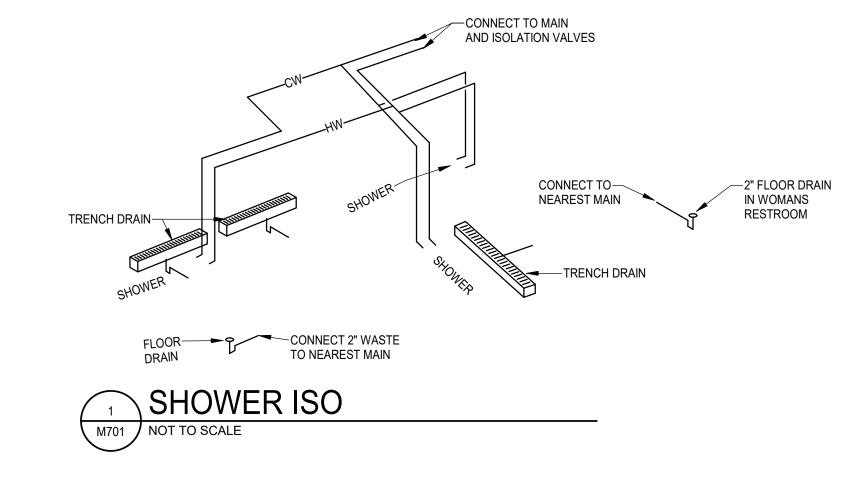

STATE OF MISSOURI MIKE KEHOE, GOVERNOR



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OFFICE OF ADMINISTRATION DIVISION OF FACILITIES MANAGEMENT, DESIGN AND CONSTRUCTION

DEPARTMENT OF Owner

HARRISONVILLE READINESS CENTER

1503 SOUTH JEFFERSON PARKWAY HARRISONVILLE, MO 64701

PROJECT # 023-05260 SITE # FACILITY #

No.	Date	Description

ISSUE DATE: 07/09/2025 CAD DWG FILE:

DRAWN BY: KP CHECKED BY: JB DESIGNED BY: KP


SHEET TITLE:

MECHANICAL SCHEDULES

SHEET NUMBER:

M701

23 OF 30 SHEETS **7/8/2025 10:36:09 AM**

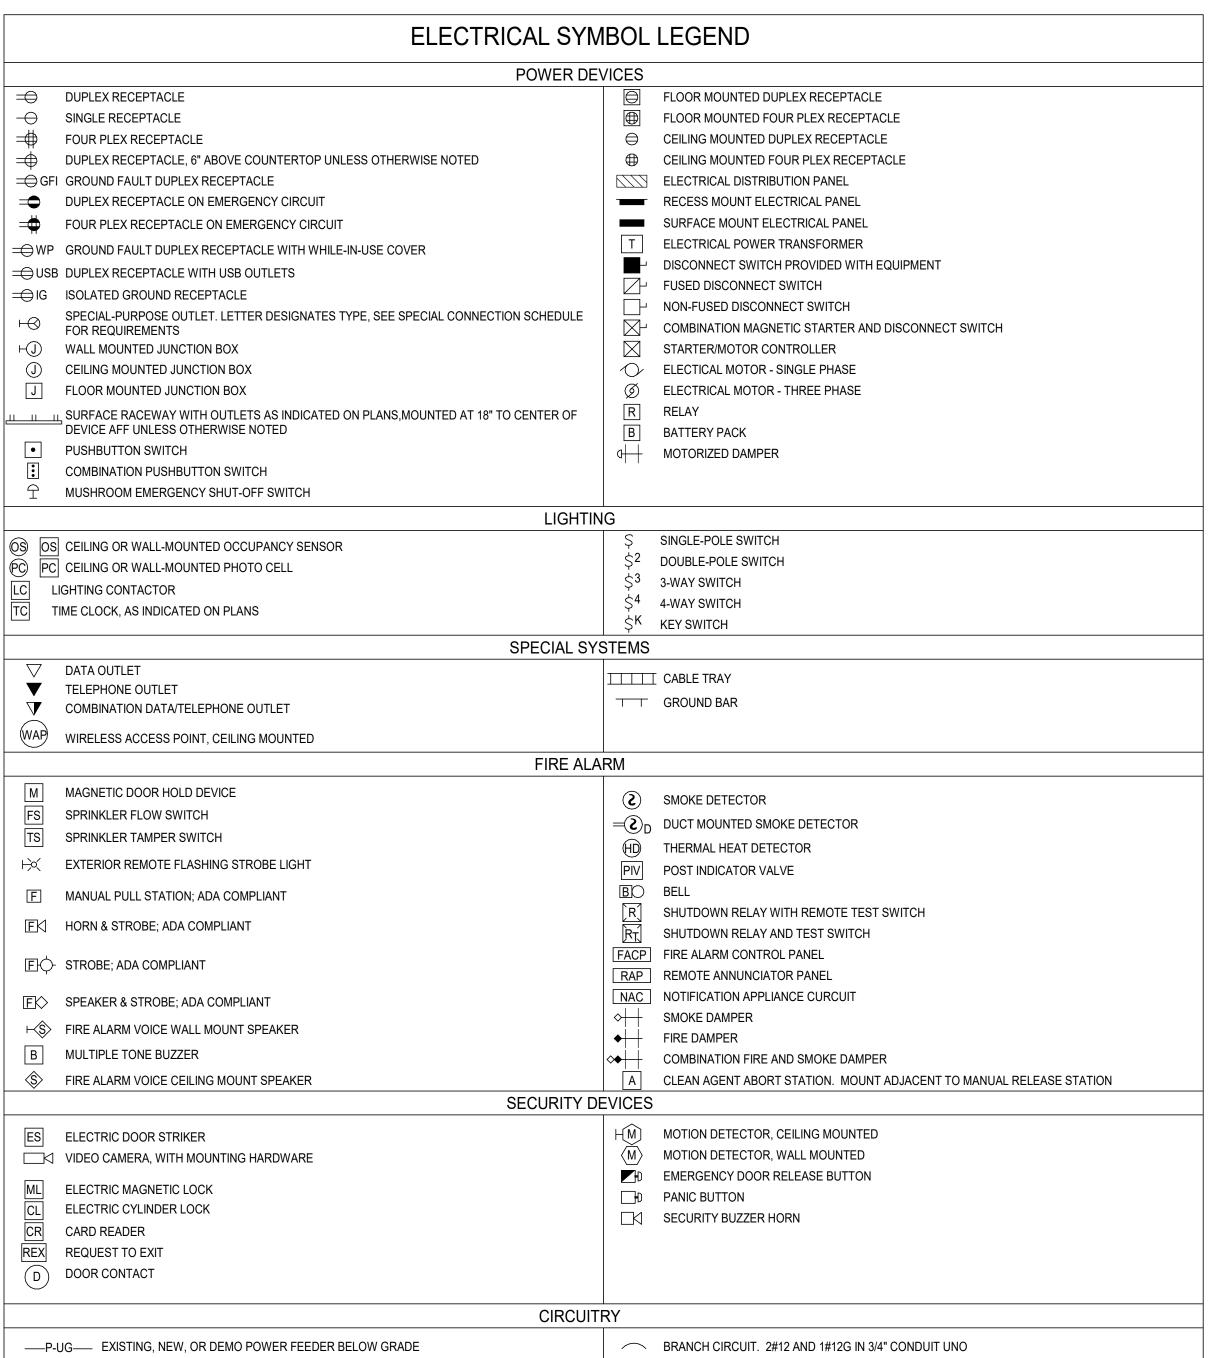

___ _ ITEM BELOW GRADE (NEW WORK) OR TO BE DEMOLISHED (DEMO)

ABBREVIATIONS/MODIFIERS

- SHEET NOTE TAG, LABEL INDICATES NOTE NUMBER
- XX > FEEDER TAG ABOVE COUNTER
- A AMPERE
- AD AUTOMATIC DAMPER
- AFF ABOVE FINISHED FLOOR
- AFG ABOVE FINISHED GRADE
- AHU AIR HANDLING UNIT
 - AFCI ARC FAULT CIRCUIT INTERUPTER ATS AUTOMATIC TRANSFER SWITCH
 - C CONDUIT

 - C/B CIRCUIT BREAKER CIR CIRCUIT
 - CUH CABINET UNIT HEATER
 - E EXISTING DEVICES TO REMAIN
 - EF EXHAUST FAN
 - EMT ELECTRIC METALLIC TUBING
 - ER NEW LOCATION OF EXISTING RELOCATED
 - EWC ELECTRIC WATER COOLER
 - EWH ELECTRIC WATER HEATER
 - FA FIRE ALARM
 - FB FLOOR BOX
 - FMC FLEXIBLE METALLIC TUBING GFI GROUND FAULT INTERRUPTER
 - HD HAND DRYER
 - IG ISOLATED GROUND
 - MAU MAKE-UP AIR UNIT
 - MD MOTORIZED DAMPER NF NON-FUSED
 - NL NIGHT LIGHT
 - NR NEW TO REPLACE EXISTING
 - P POLE PE PRIMARY ELECTRIC SERVICE
 - PTD ELECTRIC PAPER TOWEL DISPENSER
 - PVC POLYVINYL CHLORIDE CONDUIT
 - RE REMOVE EXISTING REF ROOF EXHAUST FAN
 - RL RELOCATE EXISTING
 - RMC RIGID METALLIC CONDUIT
 - RR REMOVE AND REPLACE ON NEW SURFACE
 - RTU ROOFTOP UNIT
 - SD SMOKE DAMPER
 - SE SECONDARY ELECTRIC SERVICE
 - S&P SPACE AND PROVISION
 - T TELEPHONE SERVICE
 - TCP TEMPERATURE CONTROL PANEL
 - TP TAMPER PROOF TV TELEVISION
 - UGE UNDERGROUND ELECTRICAL
 - VFC VARIABLE FREQUENCY CONTROLLER
 - VFD VARIABLE FREQUENCY DRIVE
 - WG WIRE GUARD
 - WP WEATHERPROOF
 - WR WEATHER RESISTANT XFMR TRANSFORMER

GENERAL DEMO NOTES

- AND ALL LOCAL, STATE AND STATUTORY REQUIREMENTS.
- EXISTING BUILDING DEVICES AND MATERIALS, AND PROTECT DURING THE COURSE OF THIS WORK. EXISTING UTILITIES, EXISTING BUILDING, AND/OR MATERIALS WHICH ARE DAMAGED BY NEGLIGENCE SHALL BE REPAIRED OR REPLACED AT THE CONTRACTOR'S EXPENSE. IN A TIMELY MANNER. AND TO THE ENGINEER'S AND OWNER'S WRITTEN ACCEPTANCE.
- PROVIDE TEMPORARY AND/OR MODIFY EXISTING POWER, EMERGENCY POWER, LIGHTING, FIRE ALARM, TELECOMMUNICATIONS, AND OTHER SERVICES AS REQUIRED FOR CONSTRUCTION-PERIOD INTERIM LIFE SAFETY
- ALL PANELBOARDS, SWITCHBOARDS, LIGHTING FIXTURES, ETC. WHICH ARE REMOVED, SHALL BE REMOVED FROM THE SITE, UNLESS OTHERWISE
- ANY EXISTING DEVICES OR CIRCUITS SHOWN ARE FOR INFORMATION PURPOSES ONLY. FIELD VERIFY ALL EXISTING CONDITIONS. REMOVE, RELOCATE AND REWORK ANY ELECTRICAL EQUIPMENT OR CIRCUITS NECESSARY FOR A COMPLETE AND OPERATIONAL ELECTRICAL SYSTEM.
- EXISTING DEVICES AND/OR CIRCUITS SHOWN ARE TAKEN FROM EXISTING DRAWINGS AND SITE VISITS. CONTRACTOR SHALL FAMILIARIZE THEMSELVES WITH ALL WORK TO BE DONE BY OBSERVATION OF THE SITE. FAILURE TO DO SO WILL NOT RELIEVE THE RESPONSIBILITY FOR PERFORMING ALL WORK NECESSARY TO PROVIDE A FULLY FUNCTIONAL AND WORKMANLIKE INSTALLATION
- . ALL ABANDONED CONDUIT AND WIRE SHALL BE REMOVED IN ITS ENTIRETY. ANY CONCEALABLE CONDUITS MADE OBSOLETE DUE TO DEMOLITION SHALL BE CUT FLUSH WITH THE FLOOR, WALL, OR CEILING WITH THE REMAINING ENDS PLUGGED TO ALLOW REFINISHING OF THE SURFACE. EXISTING CONDUITS CURRENTLY INSTALLED IN WALLS OR FLOORS THAT ARE TO REMAIN THAT ARE NOT TO BE USED IN NEW WORK AND WILL NOT INTERFERE WITH THE WORK OF ANY OTHER TRADE MAY REMAIN.
- CONDUIT RUN IN EXISTING CONCRETE SLAB SHALL BE SAW-CUT OFF AS IT ENTERS THE SLAB, THEN SEALED TO PREVENT MOISTURE ACCESS.
- MAINTAIN ACCURATE RECORDS OF ALL CHANGES TO THE EXISTING ELECTRICAL SYSTEMS WHICH ARE TO REMAIN AND DELIVER "RECORD" DRAWINGS TO THE OWNER AT THE COMPLETION OF THE PROJECT.
- MANAGER, PRIOR TO ANY INTERRUPTIONS TO THE ELECTRICAL UTILITY

PROVIDE A MINIMUM OF TEN (10) DAYS WRITTEN NOTICE TO CONSTRUCTION

- EXPOSED CONDUITS THAT ARE NOT BEING USED IN THE NEW CONSTRUCTION AND THAT ARE NOT SUITABLE TO USE IN THE FUTURE, SHALL BE REMOVED.
- SERVICES PASSING THROUGH AREAS OF DEMOLITION SHALL BE MAINTAINED THROUGHOUT THE CONSTRUCTION PERIOD, CIRCUITS SERVING AREAS ADJACENT TO THE CONSTRUCTION AREA THAT ARE MODIFIED AS PART OF THE REMOLDING PROJECT, SHALL BE RE-CIRCUITED AS PART OF THE PROJECT.
- M. ALL ROMEX, BX AND OTHER FLEXIBLE CABING SHALL BE REMOVED. WHERE EXISTING EQUIPMENT OR CIRCUITS ARE EXISTING TO REMAIN AND ARE CIRCUITED USING ROMEX OR BX CABLING, THE CABLING SHALL BE REPLACED WITH AN APPROVED WIRING METHOD.
- N. ALL ABANDONED AND UNUSED MC AND AC CABLING SHALL BE REMOVED.
- . WHERE FEEDERS ARE LEFT ABANDONED IN PLACE, THE CONDUCTORS SHALL BE DISCONNECTED ON BOTH ENDS AND LABELED.
- P. WHERE NEW WORK INTERFERS WITH EXISTING CIRCUITS THAT ARE OTHERWISE UNDISTURBED, EXISTING CIRCUITS SHALL BE REWORKED AS REQUIRED TO MAINTAIN SERVICE.
- . WHERE UNUSED BACKBOXES ARE LEFT ABANDONED IN PLACE, PROVIDE BLANK COVERPLATES MATCHING THE COVERPLATES FOR DEVICES IN THE T. DEFINITIONS: AREA. WHERE POSSIBLE THESE BOXES SHALL BE REMOVED.
- R. COORDINATE THE REMOVAL OF ALL MECHANICAL AND PLUMBING EQUIPMENT WITH THE RESPECTIVE CONTRACTOR. REMOVE ALL POWER CONNECTIONS AND CONTROL WIRING. IF CONDUIT CANNOT BE REUSED FOR FUTURE EQUIPMENT, REMOVE CONDUIT BACK TO PANELBOARD.
- S. CIRCUITS AND ROUTINGS IN REMODELED AREAS MAY BE MODIFIED FOR FIELD CONDITIONS. MAKE EVERY EFFORT TO KEEP THE CIRCUITING AS CLOSE AS INDICATED TO AVOID OVERLOADING CIRCUITS, MAINTAINING CONTROLLABILITY, ETC.
- T. REMOVE ALL EXISTING TELEPHONE/DATA/NETWORK/SECURITY CABLING UNLESS OTHERWISE NOTED.
- U. WHERE EQUIPMENT IS REMOVED FROM A LOCATION WHICH PENETRATES A FIRE RATED ELEMENT, PROVIDE THE APPROPRIATE FIRE STOPPING MATERIALS SUCH THAT THE RATING OF THE ELEMENT WILL BE MAINTAINED.

GENERAL NOTES

- ALL WORK SHALL CONFORM TO THE ADOPTED ELECTRICAL CODE, OSHA, UL A. ALL ELECTRICAL WORK SHALL BE IN ACCORDANCE WITH THE ADOPTED ELECTRICAL CODE.
- . FIELD VERIFY THE LOCATION OF ALL EXISTING UTILITIES, THE CONDITION OF B. ELECTRICAL DESIGN HAS BEEN BASED ON THE INSTALLATION OF 90-DEGREE CONDUCTORS CONNECTED TO TERMINAL LUGS AND EQUIPMENT UL LISTED FOR A MINIMUM OF 75-DEGREES. CONDUCTORS TERMINATED ON EQUIPMENT WITH A LOWER RATING OR NO RATING SHALL HAVE CONDUCTOR SIZE INCREASED TO CONFORM TO THE ADOPTED ELECTRICAL
 - C. CONTACT ELECTRIC UTILITY AND ARRANGE FOR ELECTRICAL SERVICE AS INDICATED ON DRAWINGS. INCLUDE ALL COSTS, CHARGES, FEES, ETC. INCURRED BY UTILITY COMPANY INTO BID. PROVIDE ALL MATERIALS AS REQUIRED BY LOCAL AUTHORITIES FOR ELECTRIC SERVICE INSTALLATION. ALL WORK SHALL BE IN ACCORDANCE WITH THE REQUIREMENTS OF THE LOCAL AUTHORITIES.
 - D. INFORMATION SHOWN ON THIS DRAWING CONCERNING TYPE AND LOCATION OF UNDERGROUND AND OTHER UTILITIES IS NOT GUARANTEED TO BE ACCURATE OR ALL INCLUSIVE. THE CONTRACTOR IS RESPONSIBLE FOR MAKING THEIR OWN DETERMINATION AS TO TYPE AND LOCATION OF SAME AS MAY BE NECESSARY TO AVOID DAMAGE THERE OF.
 - E. FIELD VERIFY LOCATION OF ALL UTILITIES PRIOR TO BEGINNING WORK. ANY INTERFERENCE SHALL BE BROUGHT TO ATTENTION OF THE ARCHITECT AND ENGINEER FOR DIRECTION.
 - F. PLANS ARE DIAGRAMMATIC AND SHALL NOT BE SCALED.
 - G. COOPERATE CLOSELY WITH ALL OTHER TRADES TO EXPEDITE CONSTRUCTION AND AVOID INTERFERENCES AND CONFLICTS. BEFORE ANY PIPING, DUCTWORK, CONDUIT, ETC. IS INSTALLED, IT SHALL BE COORDINATED CAREFULLY BETWEEN ALL TRADES.
 - H. GUARANTEE ALL EQUIPMENT, ACCESSORIES, AND MATERIAL FURNISHED BY THE CONTRACTOR FOR A PERIOD OF ONE YEAR FROM FINAL ACCEPTANCE AGAINST ALL DEFECTS.
 - I. ALL WIRING SHALL BE INSTALLED IN CONDUIT AND BE CONCEALED. REFER TO CONDUIT APPLICATION SCHEDULE.
 - J. COORDINATE EQUIPMENT LOCATIONS AND ELECTRICAL CONNECTIONS FOR MECHANICAL AND PLUMBING EQUIPMENT.
 - K. ALL BRANCH CIRCUITS SHALL CONSIST OF (2) #12 AND (1)#12 EQUIPMENT GROUND IN 1/2" EMT CONDUIT, UNLESS OTHERWISE NOTED.
 - L. ALL ELECTRICAL RACEWAYS SHALL HAVE AN EQUIPMENT GROUND CONDUCTOR SIZED PER THE ADOPTED ELECTRICAL CODE.
 - M. MINIMUM CONDUIT SIZE SHALL BE 1/2" ABOVE GRADE AND 3/4" BELOW
 - N. ALL EMPTY CONDUITS SHALL BE PROVIDED WITH A PULLSTRING.
 - O. ALL MATERIALS EXPOSED IN PLENUM SPACES SHALL BE NON-COMBUSTIBLE OR HAVE A FLAME SPREAD RATING OF NOT MORE THAN 25 AND A SMOKE DEVELOPED RATING NOT MORE THAN 50.
 - P. COORDINATE INSTALLATION OF ELECTRICAL WORK WITH OTHER TRADES. INSTALL AT THE GREATEST POSSIBLE CLEARANCE FOR INSTALLATION OF OTHER TRADES. TRADES WITH REQUIRED SLOPES SHALL HAVE PLACEMENT PRIORITY. WHERE POSSIBLE RACEWAYS SHALL BE ROUTED THROUGH
 - Q. ALL LOW VOLTAGE CABLING (FIBER, CATV, TELEPHONE, DATA/NETWORK, ETC.) SHALL BE PROVIDED BY OTHERS UNLESS OTHERWISE NOTED. ALL CABLING SHALL BE PLENUM RATED.
 - R. ALL CONDUITS THAT PENETRATE AN EXTERIOR WALL SHALL BE SEALED AIR TIGHT INSIDE THE CONDUIT, TO PREVENT COLD AIR AND WARM AIR FROM
 - S. ELECTRICAL SERVICE SHALL BE CLOCKWISE ROTATION.

CALIBRATE.

- PROVIDE CONTRACTOR SHALL FURNISH AND INSTALL 2. FURNISH - CONTRACTOR SHALL OBTAIN FOR OTHERS TO INSTALL. 3. INSTALL - CONTRACTOR IS RESPONSIBLE FOR ALL LABOR AND CONSTRUCTION EQUIPMENT NECESSARY TO SET IN PLACE, CONNECT,
- U. REFER TO ARCHITECTURAL PLANS AND INTERIOR ELEVATIONS FOR ALL WALL FIXTURE MOUNTING HEIGHTS AND INSTALLATION DETAILS.
- V. ALL CONDUITS THAT TERMINATE INSIDE MECHANICAL EQUIPMENT SHALL BE SEALED AIR TIGHT TO PREVENT AIR FROM TRANSFERRING THROUGH THE
- W. "CLEAN" POWER SHALL BE DEFINED AS ALL POWER DERIVED FROM THE UPS SYSTEM. "DIRTY" POWER SHALL BE DEFINED AS UTILITY POWER WITHOUT ANY POWER CONDITIONING.
- X. ELECTRICAL CONDUITS SHALL BE CONCEALED FROM PUBLIC VIEW. WHERE THE SPACE IS OPEN TO STRUCTURE THE CONDUITS SHALL BE ROUTED ABOVE THE BOTTOM FLANGE OF STRUCTURAL BEAMS. CONDUITS SHALL NOT BE ROUTED THROUGH THE VOID AREA CREATED BY THE CROWNS OF THE CORRUGATED ROOF DECKING PER THE ADOPTED ELECTRICAL CODE. CONDUITS SHALL NOT BE ROUTED THROUGH OPEN SPACES WHERE THEY CAN BE SEEN FROM THE FINISHED FLOOR. ALL CONDUITS NOT CONCEALED FROM PUBLIC VIEW WILL BE REMOVED AND RE-ROUTED AT THE CONTRACTOR'S EXPENSE.

STATE OF MISSOURI MIKE KEHOE, **GOVERNOR**



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DEPARTMENT OF Owner

HARRISONVILLE

READINESS CENTER

1503 SOUTH JEFFERSON **PARKWAY** HARRISONVILLE, MO

PROJECT # 023-05260 SITE # **FACILITY #**

No.	Date	Description						

ISSUE DATE: 07/09/2025 CAD DWG FILE:

DRAWN BY: KP CHECKED BY: JB **DESIGNED BY: KP**


SHEET TITLE:

GENERAL ELECTRICAL INFORMATION

SHEET NUMBER:

24 OF 30 SHEETS


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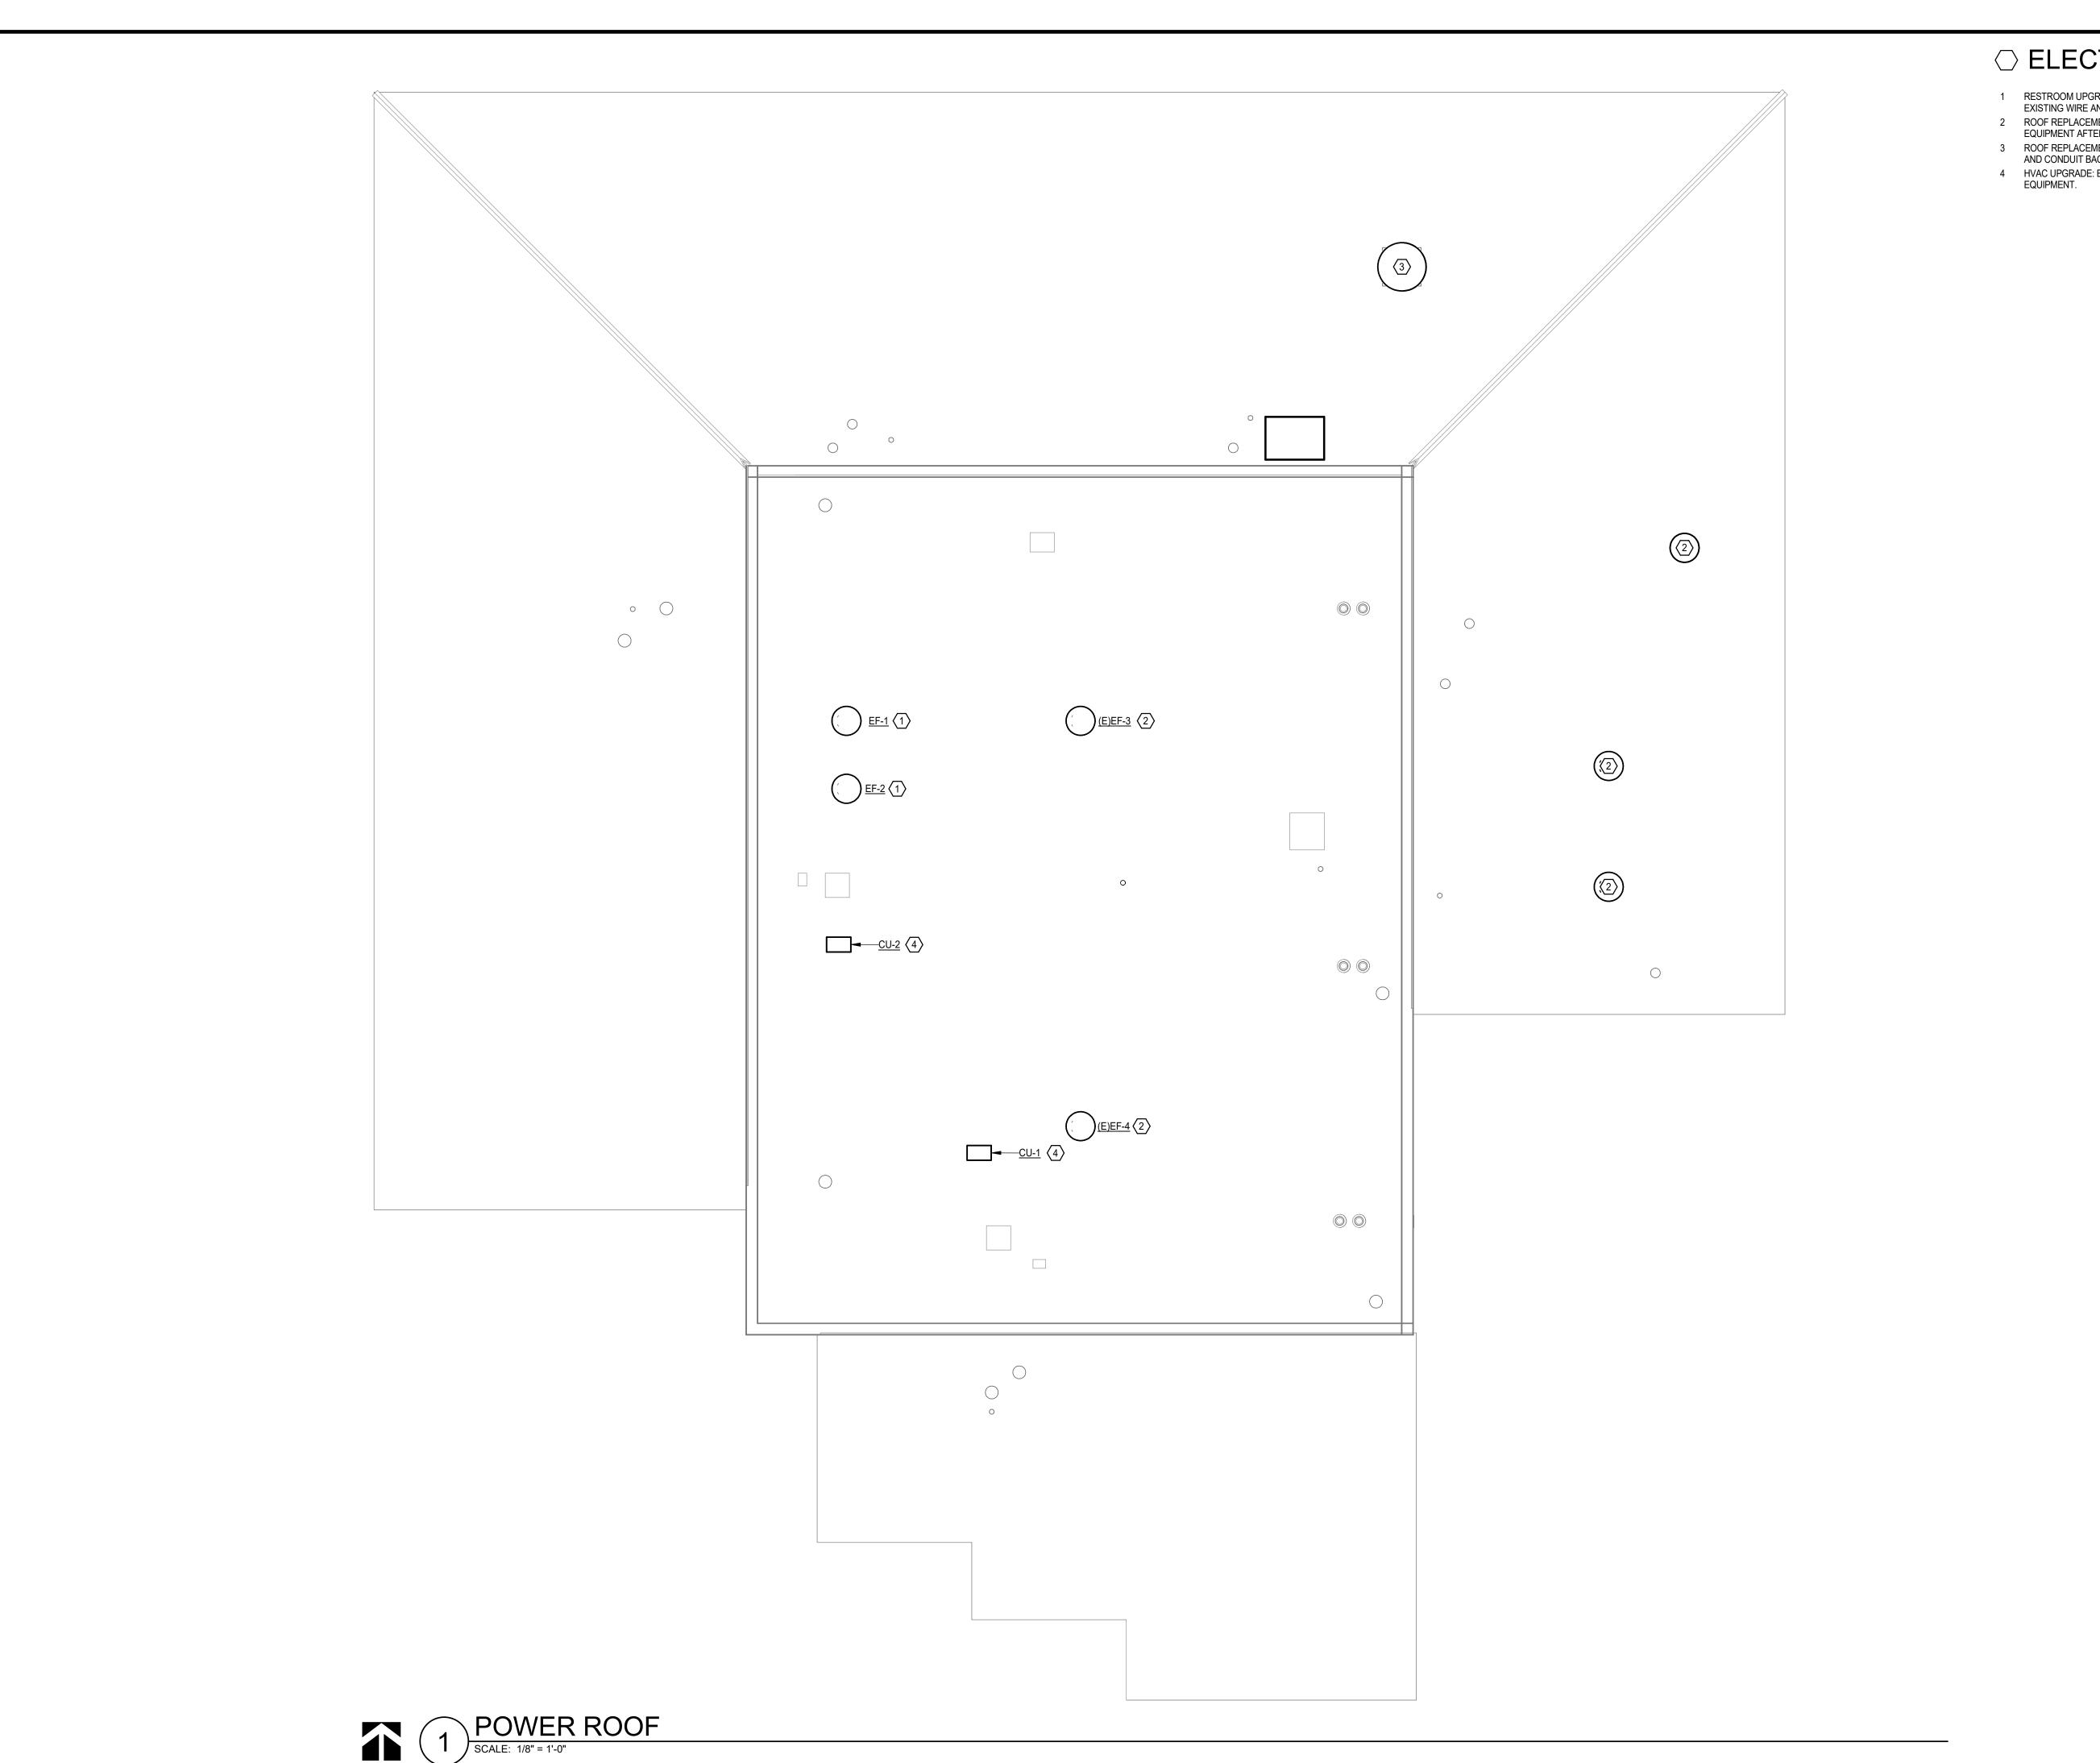
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HARRISONVILLE, MO

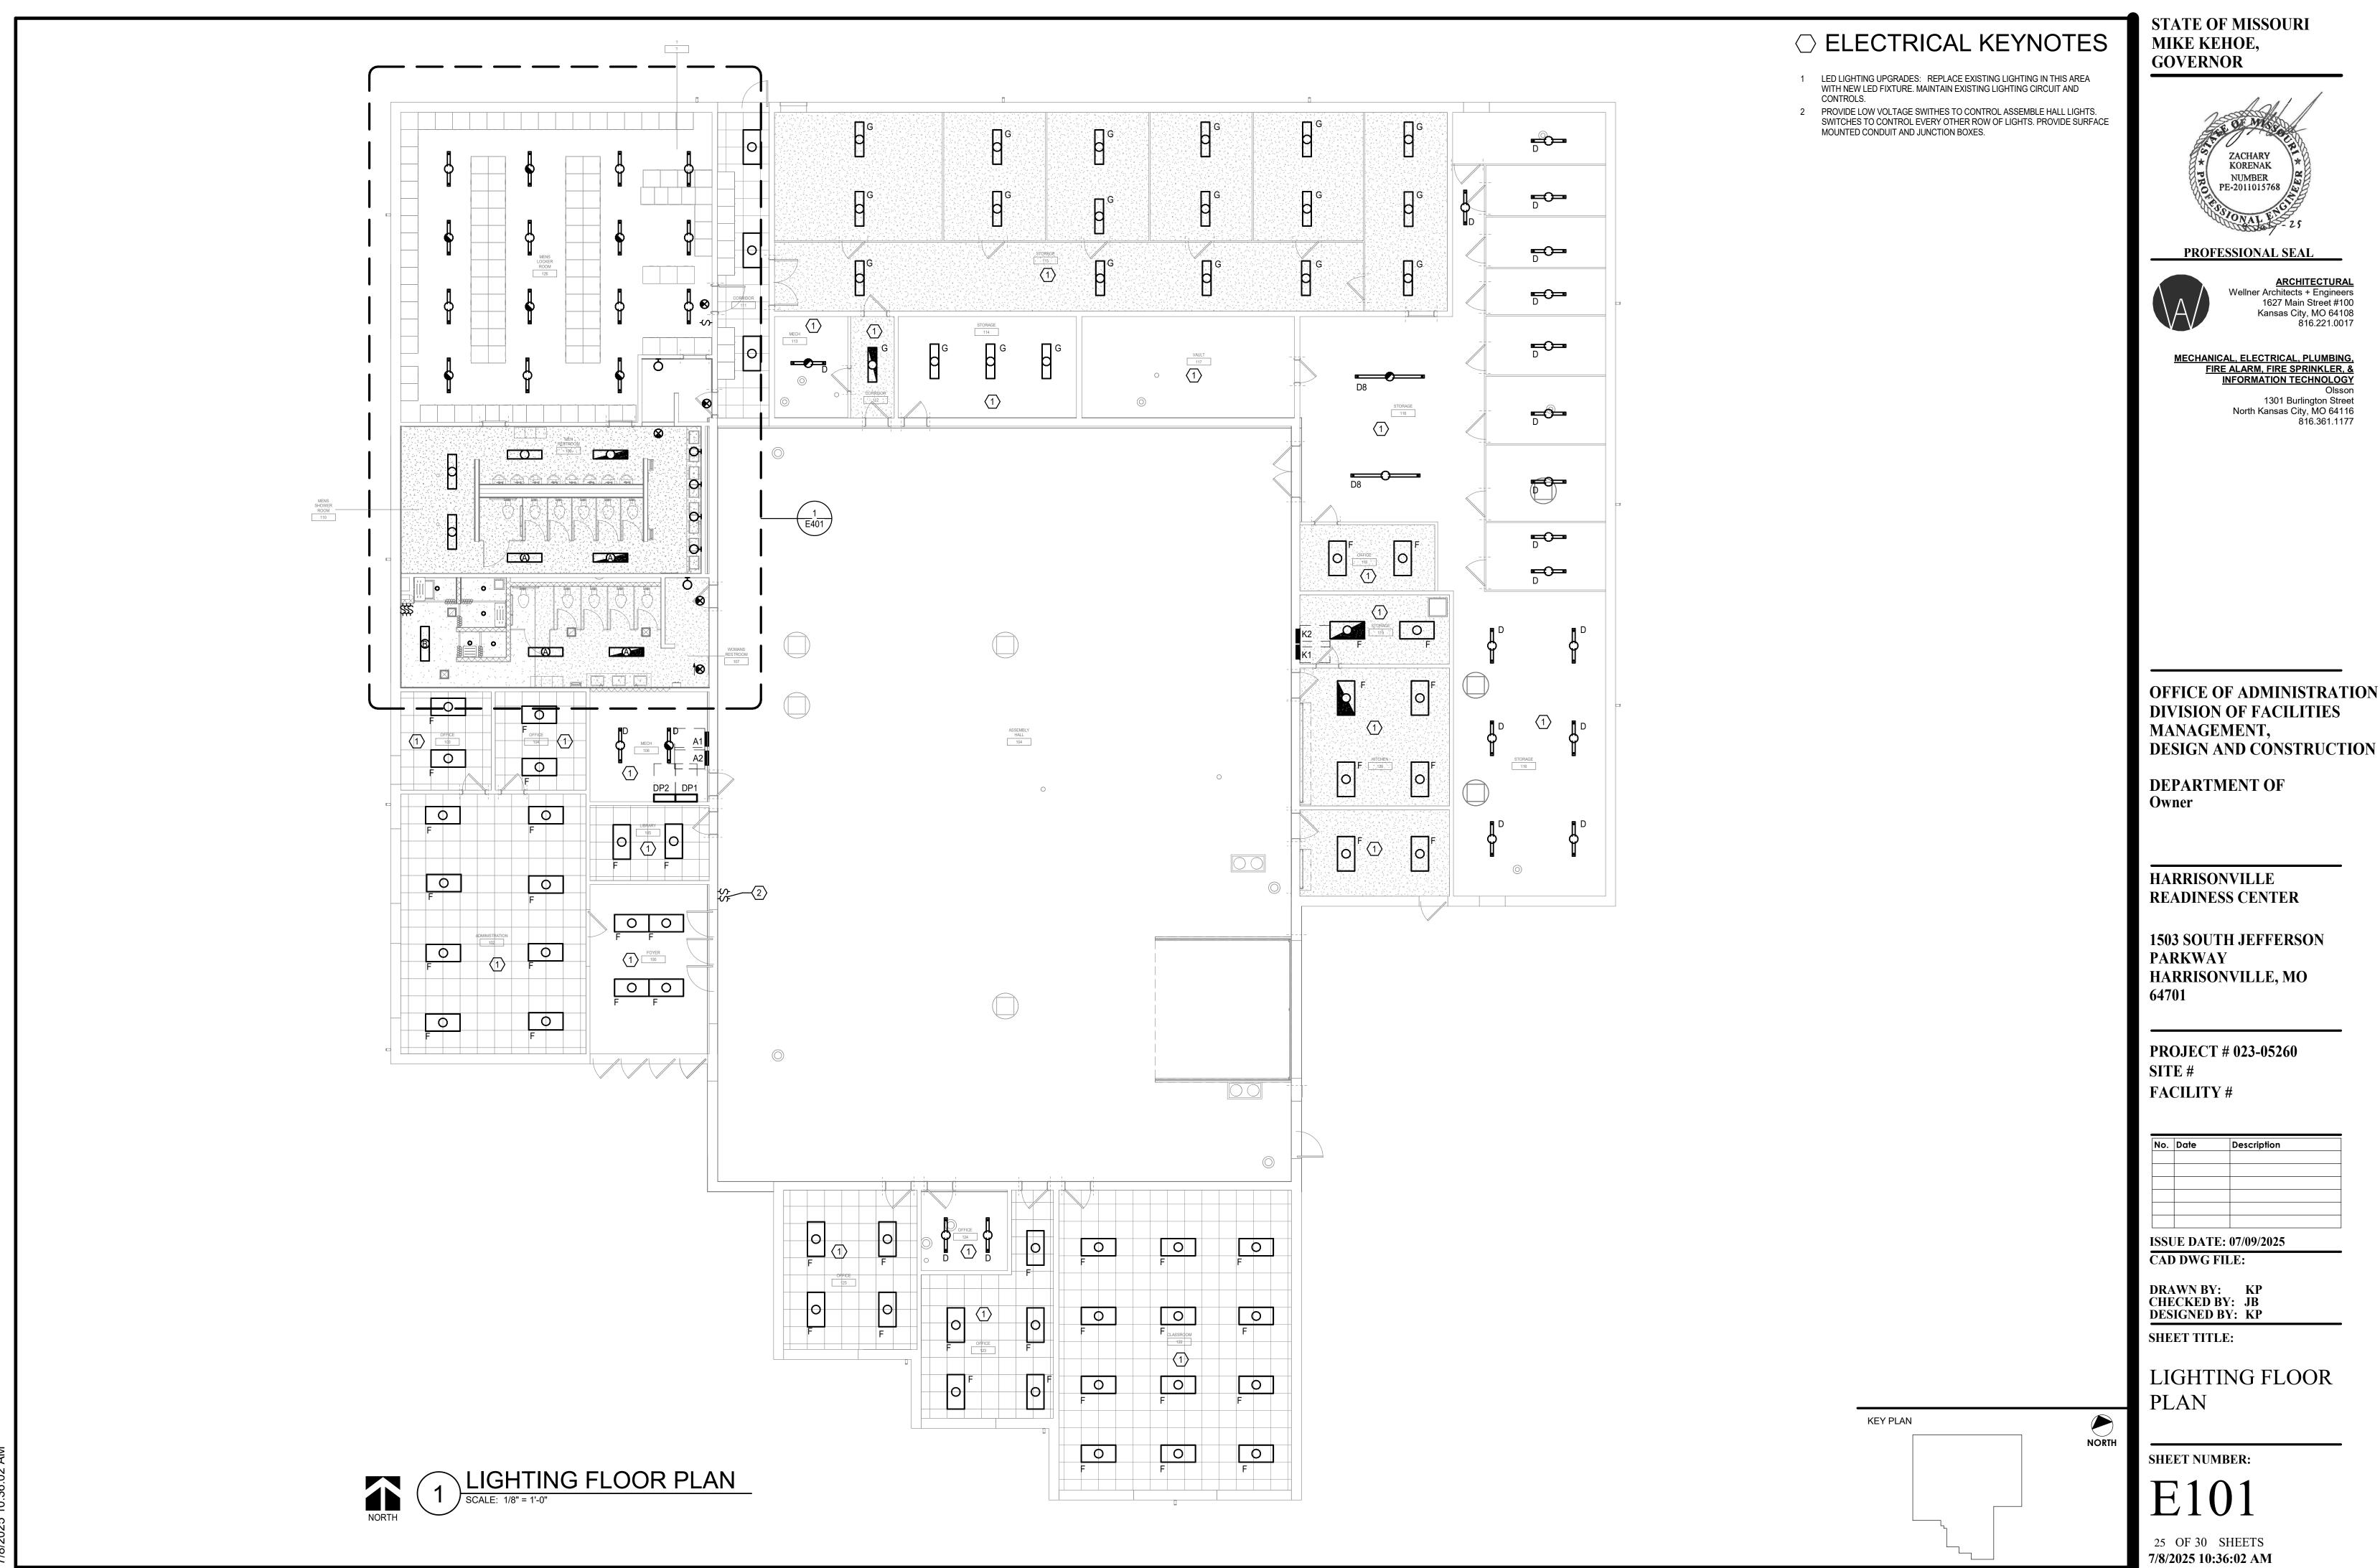No.	Date	Description	

26 OF 30 SHEETS 7/8/2025 10:36:03 AM



○ ELECTRICAL KEYNOTES

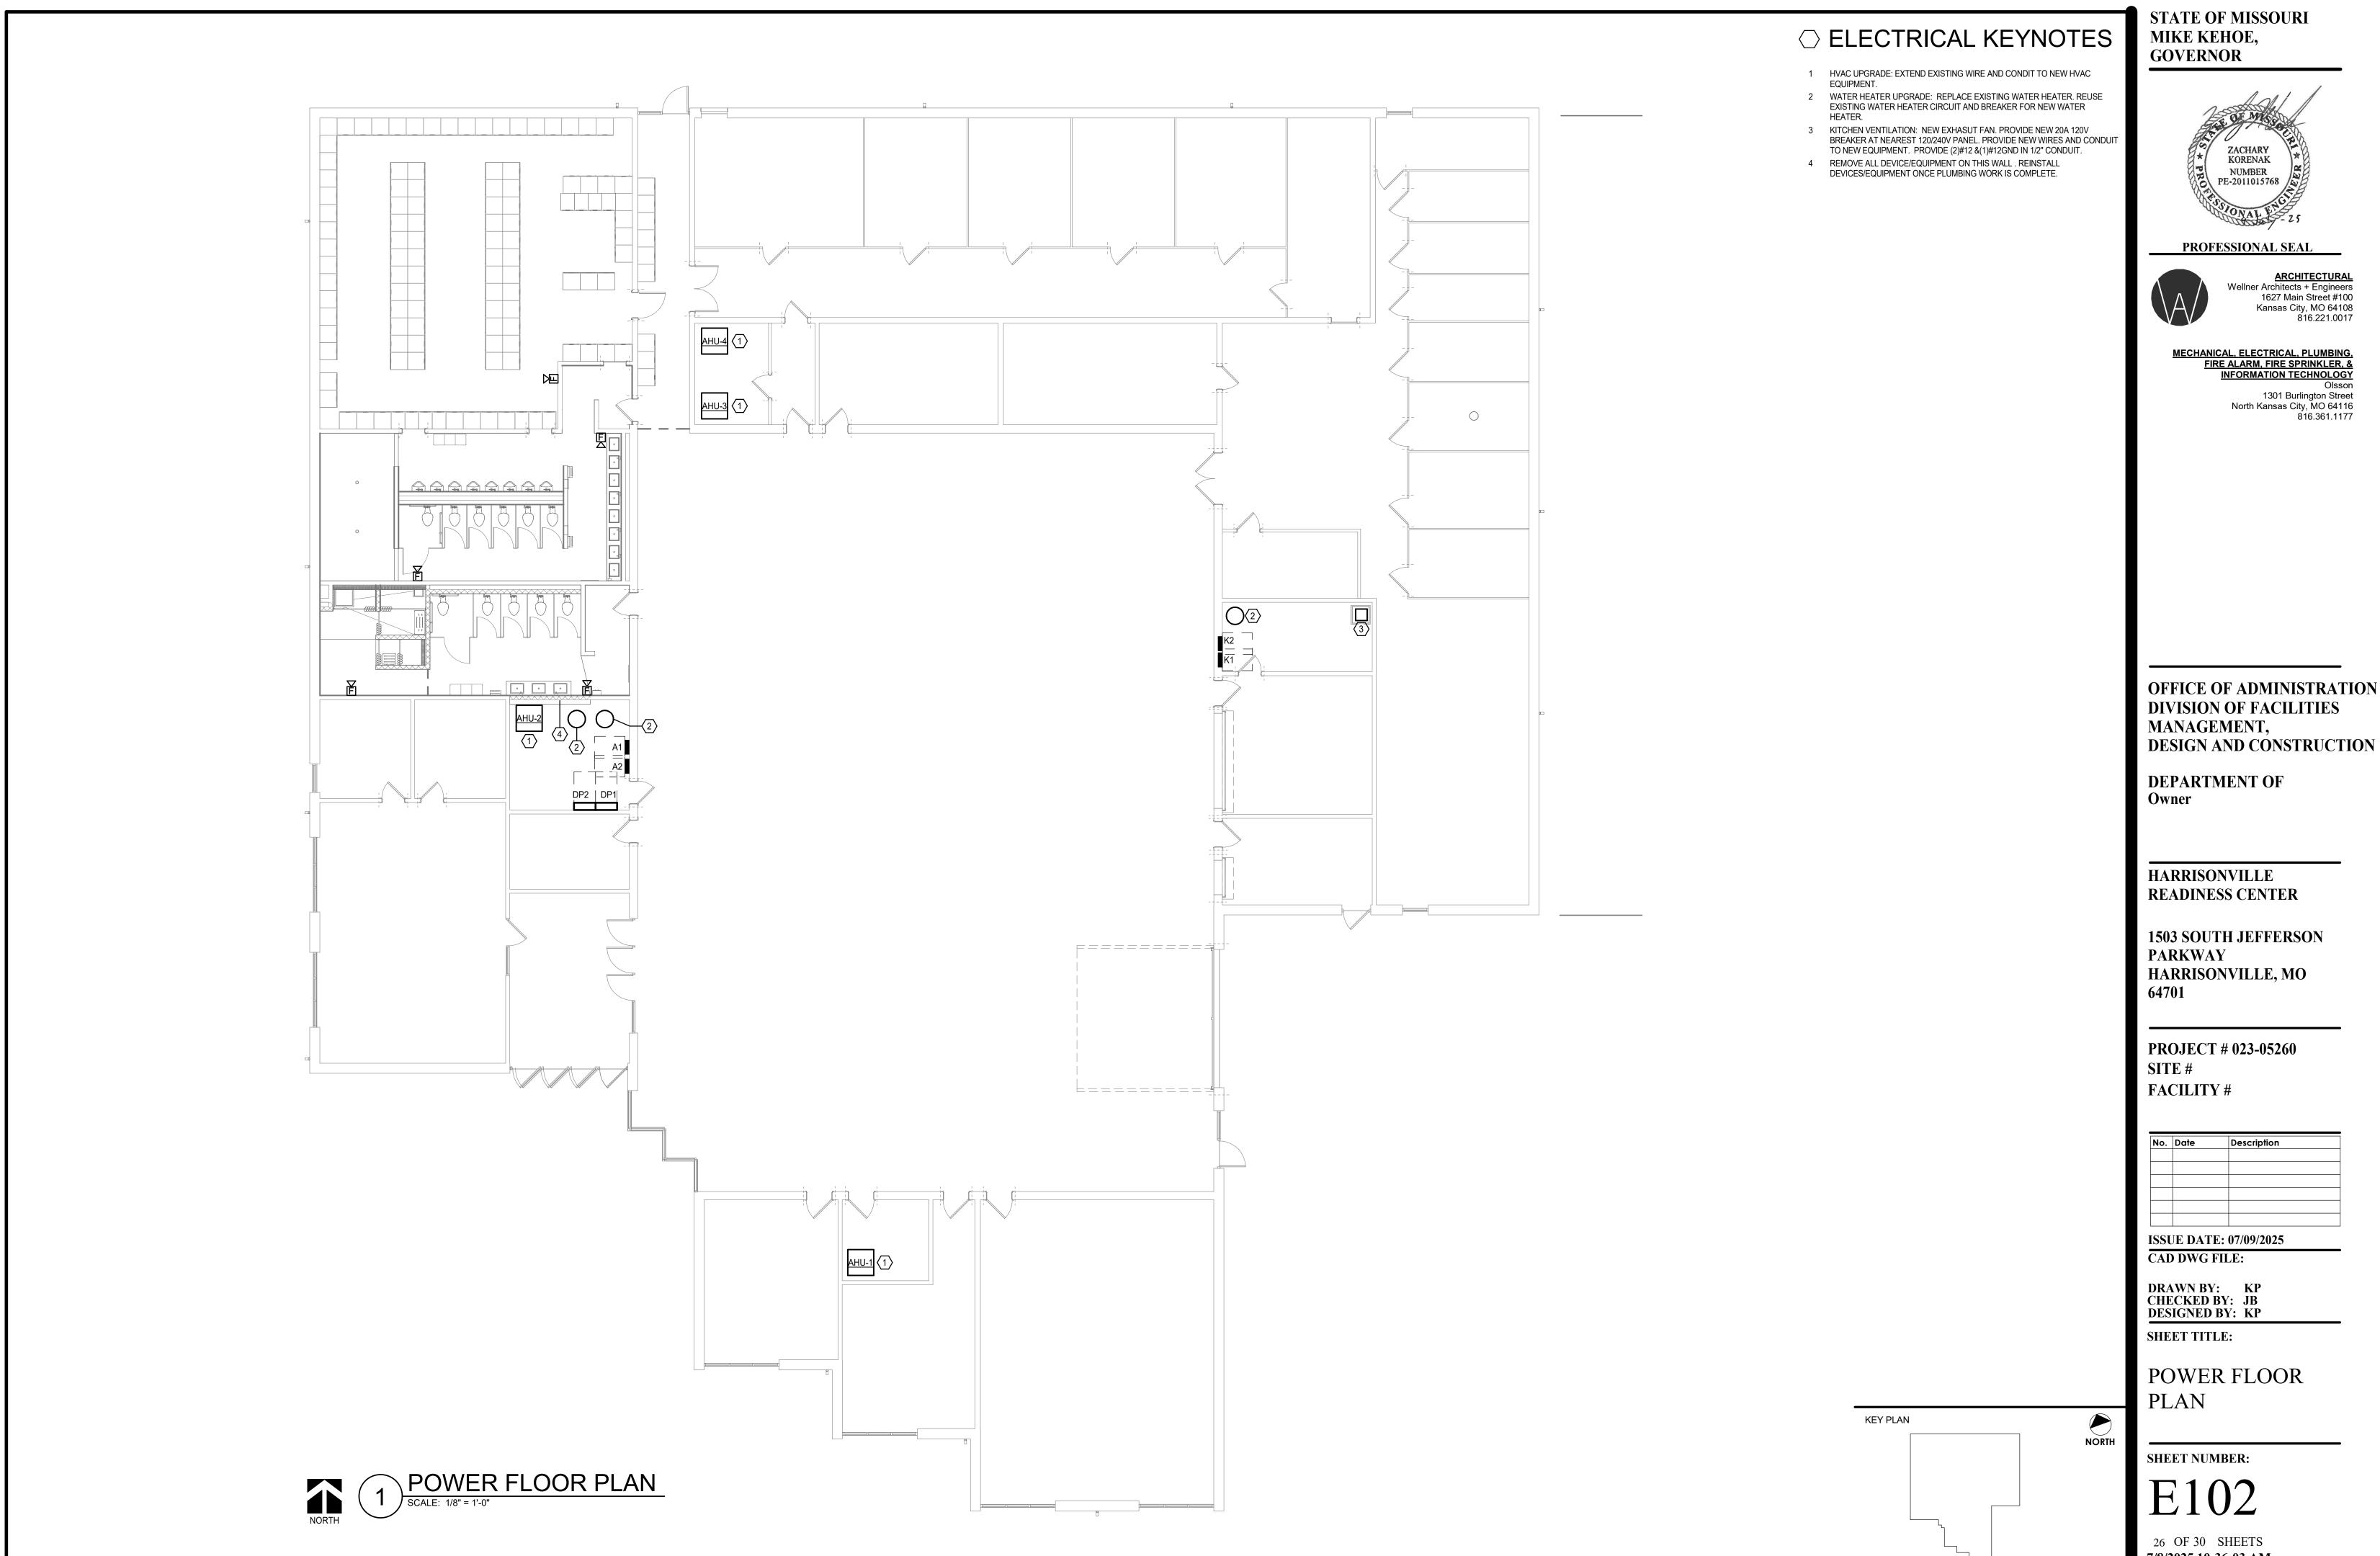- 1 RESTROOM UPGRADES: REPLACE EXISTING EXHAUST FAN. EXTEND EXISTING WIRE AND CONDUIT TO NEW EXHAUST FAN.
- 2 ROOF REPLACEMENT: REMOVE AND RECONNECT EXISTING HVAC EQUIPMENT AFTER ROOF REPLACEMENT.
- ROOF REPLACEMENT: REMOVE EXISTING HVAC EQUIPMENT. REMOVE WIRE AND CONDUIT BACK TO ELECTRICAL PANEL.
 HVAC UPGRADE: EXTEND EXISTING WIRE AND CONDIT TO NEW HVAC EQUIPMENT.

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> HARRISONVILLE READINESS CENTER

1503 SOUTH JEFFERSON PARKWAY HARRISONVILLE, MO

PROJECT # 023-05260 SITE# FACILITY #

Date	Description
	Date

ISSUE DATE: 07/09/2025

CAD DWG FILE:


DRAWN BY: KP CHECKED BY: JB DESIGNED BY: KP

SHEET TITLE:

POWER - ROOF

SHEET NUMBER:

27 OF 30 SHEETS 7/8/2025 10:36:04 AM

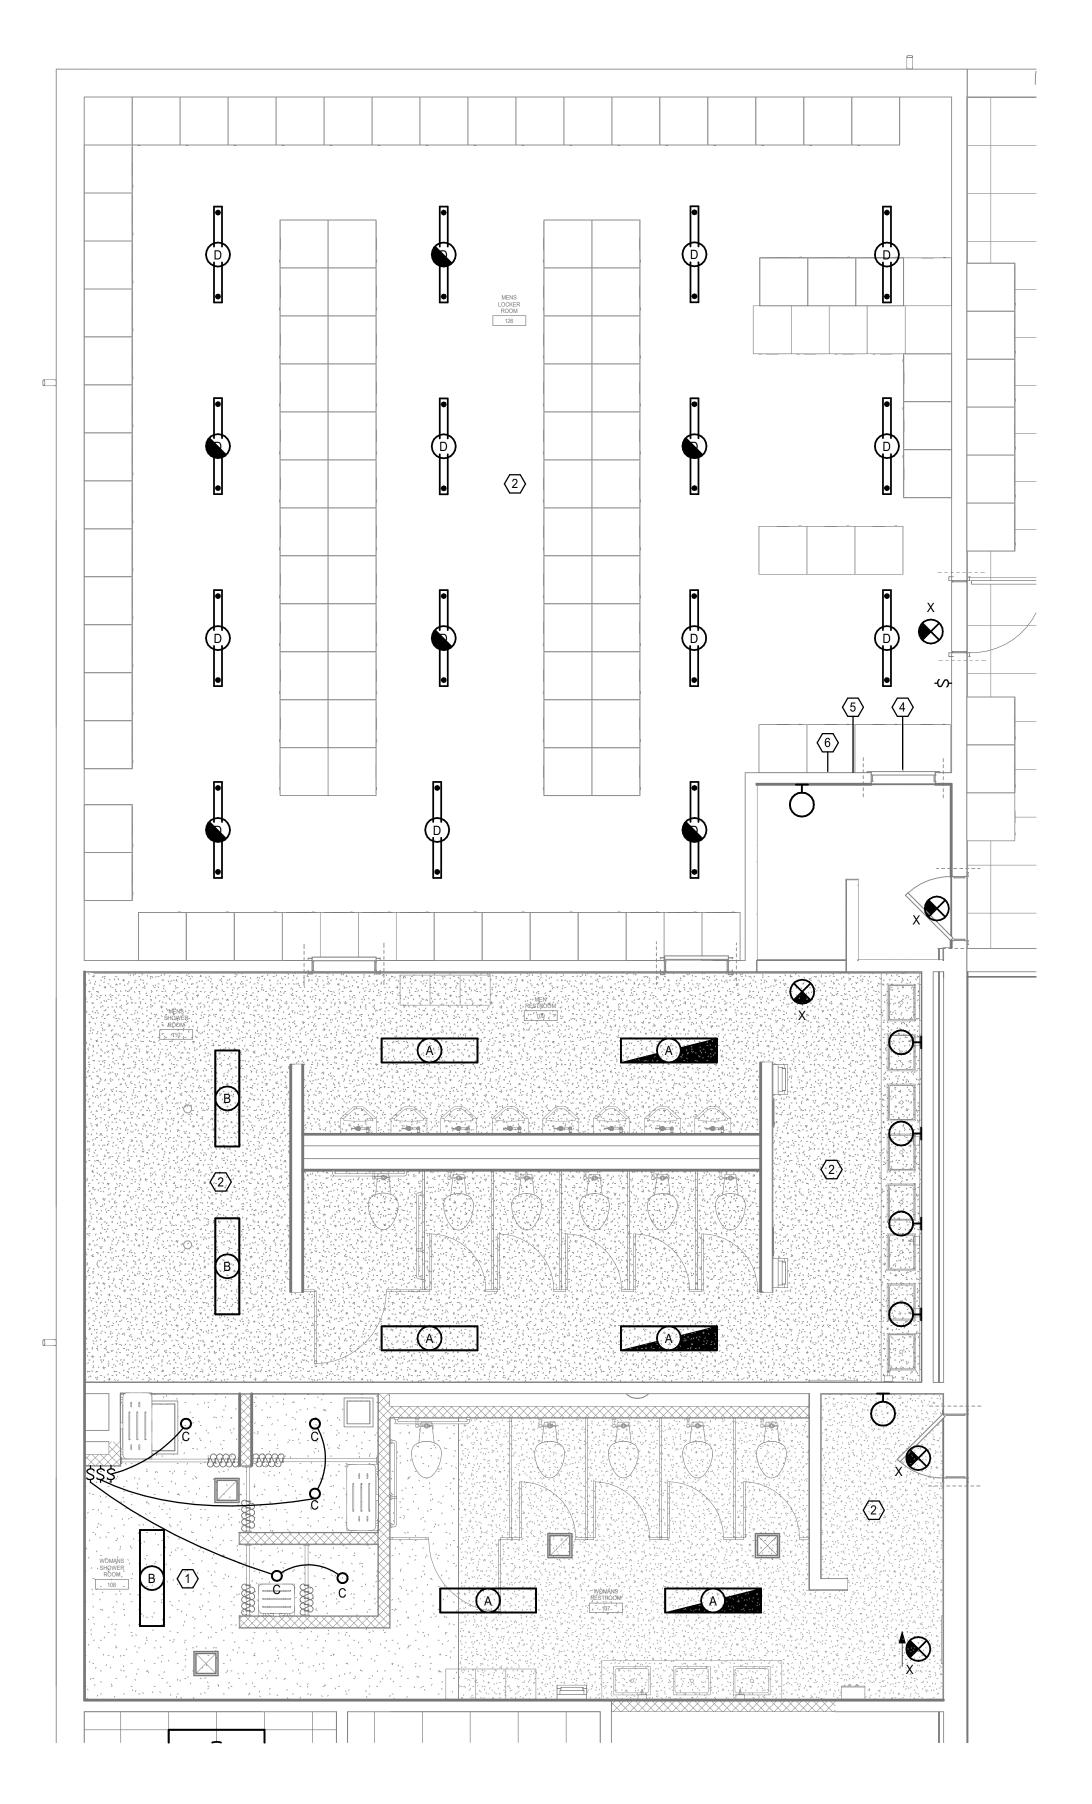

○ ELECTRICAL KEYNOTES

- 1 RESTROOM UPGRADES: PROVIDE NEW LIGHTING IN WOMEN'S SHOWER AREA. CONNECT LIGHTING TO EXISTING CIRCUIT SERVING WOMEN'S RESTROOM. VERIFY NEW LOAD WILL NOT OVERLOAD EXISTING CIRCUIT.
- RESTROOM UPGRADES: REPLACE EXSTING LIGHTING IN THIS AREA WITH NEW LED FIXTURE. MAINTAIN EXISTING CIRCUITS AND CONTROLS.
 CONNECT NEW OUTLETS TO SPARE 20A 120V BREAKER IN EXISTING 120/240V PANEL. PROVIDE NEW BREAKER AS NEEDED. SURFACE MOUNTES
- BOXES AND CONDUIT.

 4 EXISTING EXIT SIGN TO BE RELOCATED. EXTEND CONDUIT TO NEW
- LOCATION

 5 EXISTING LIGHT SWITCH TO BE ABANDONED. PROVIDE A BLANK PLATE.
- EXISTING EXHASUT FAN SWITCH, BOX AND CONDUIT TO BE DEMOLISHED.
 PROVIDE NEW FIRE ALARM DEVICES. CONNECTION NEW DEVICES TO FIRE ALARM CONTROL PANEL.

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MIKE KEHOE,

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1503 SOUTH JEFFERSON PARKWAY HARRISONVILLE, MO

PROJECT # 023-05260 SITE # FACILITY #

No.	Date	Description	

ISSUE DATE: 07/09/2025
CAD DWG FILE:

DRAWN BY: KP CHECKED BY: JB DESIGNED BY: KP

SHEET TITLE:

ENLARGED ELECTRICAL PLANS

SHEET NUMBER:

NORTH

_ AREA OF WORK, LOCKERROOM

AREA OF WORK, RESTROOM

KEY PLAN


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7/8/2025 10:36:05 AM

NORTH 1

ENLARGED RESTROOM LIGHTING PLAN

SCALE: 1/4" = 1'-0"

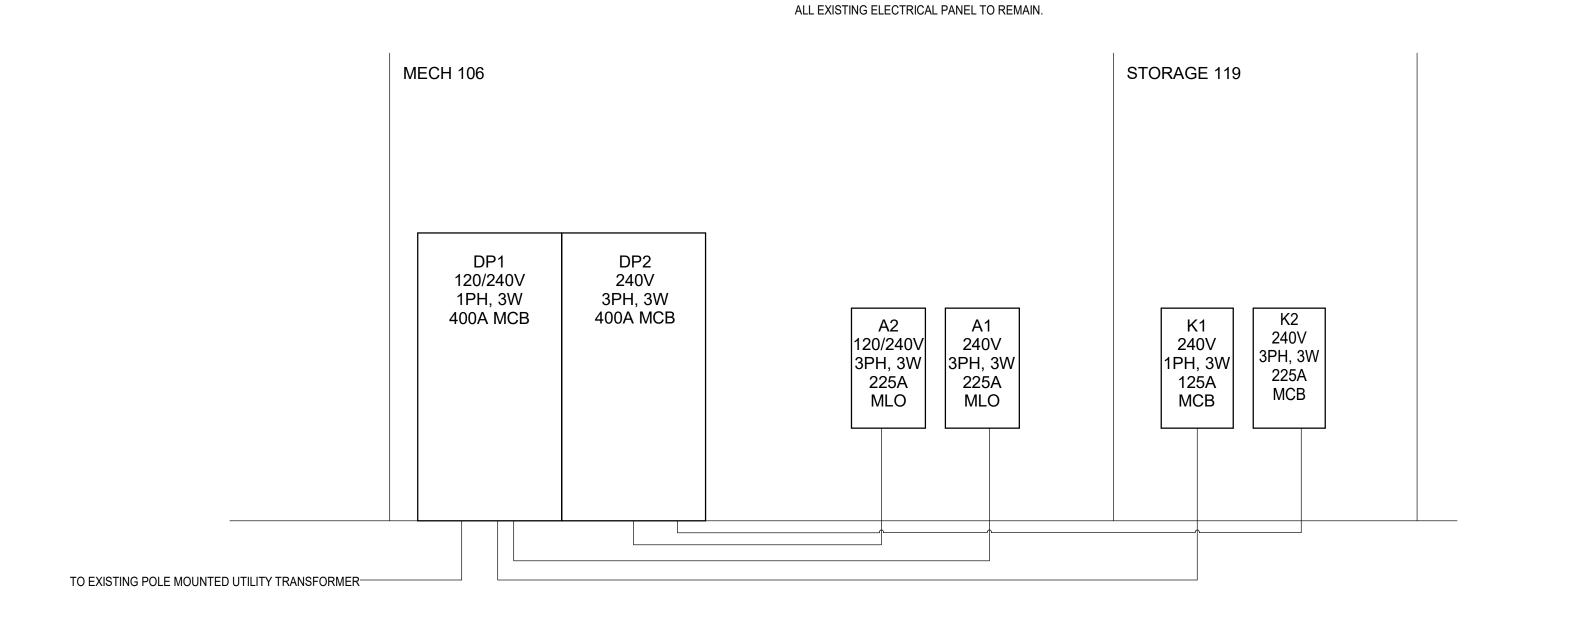

ONE-LINE DIAGARM NOT TO SCALE

MAINS TYPE:				LOCATION: MECH 106						
OCPD RATING:				MOUNTING: SURFACE						
BUS RATING:		DRAWING NO.:								
AIC RATING:	_ FEC	FROM ITE								
SERVICE VOLTAGE: 1	20/240V 3	3PH 3	B-Phase	4-Wire	_		ROM ID:			
<u> </u>		, •			_					
NOTES:										
LOAD DESCRIPTION	CKT NO.	Р	A (VA	B (VA)	C (VA)	FRAME SIZE	BREAKER TRIP		NOTES	
SPARE	1	3	0.0	0.0	0.0	60 A	60 A			
SPARE	2	3	0.0	0.0	0.0	60 A	60 A			
SPARE	3	3	0.0	0.0	0.0	100 A	100 A			
SPARE	4	3	0.0	0.0	0.0	100 A	100 A			
A2	5	3	0.0	0.0	0.0	225 A	200 A			
K2	6	3	0.0	0.0	0.0	225 A	200 A			
	Total L	.oad:	0.0 kV	A 0.0 kVA	0.0 kVA					
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Load Classification	,			,			Total Conn Total Conn. C Total Est. De Total Est. Der Future Load G	. Load: urrent: emand: mand	0.0 kVA 0.0 A 0.0 kVA	
Load Classification	,			,			Total Conn Total Conn. C Total Est. De Total Est. Der Future Load G	. Load: urrent: emand: mand	0.0 kVA 0.0 A 0.0 kVA	

Distribution: I			LOCATION: MECH 106							
OCPD RATING:					DUNTING: SU					
BUS RATING:		DRAWING NO.:								
AIC RATING:		FED FROM ITEM TYPE:								
SERVICE VOLTAGE: 1	20/240V, 1-F	hase, 3	3-Wire		_		FED	FROM ID:		
NOTES:										
LOAD DESCRIPTION	скт	P	A		В	FRAME S	2175	BREAKER		NOTES
LOAD DEGUNIF HON	NO.	r	~		.	I IVAIVIE S	,,,,,,,,,,,,,,,,,,,,,,,,,,,,,,,,,,,,,,,	TRIP		NOILS
SPARE	1	2	0.0	0	0.0	60 A		60 A		
SPARE	2	2	0.0	0	0.0	60 A		60 A		
SPARE	3	2	0.0	0	0.0	100 A		100 A		
SPARE	4	2	0.0		0.0	100 A		100 A		
K1	5	2	0.0		0.0	225 A		200 A		
A1	6	2	893.0		0.0	225 A		200 A		
		Load:	0.9 kVA		kVA	4				
	Total	Amps:	7.4 A	0.0	0 A					
Load Classification	Conne	cted	Demand F	actor	Esti	mated			Panel To	tals
Lighting	893		125.00%			16 VA				
								Total Cor	ın. Load:	0.9 kVA
								Total Conn.	Current:	3.7 A
								Total Est.	Demand:	1.1 kVA
								Total Est. D		4.7 A
								Future Load		
							Min.	Panel Rating	(Amps):	
						<u></u>				

ONLY NEW LOAD SHOWN IN PANEL SCHEDULE. ALL OTHER LOADS ARE EXISTING TO REMAIN.

LIGH	GHTING FIXTURE SCHEDULE											
FIXTURE					LAMP		APPARENT LOAD					
TYPE	DESCRIPTION	MANUFACTURER	MODEL	WATTS	TYPE	CCT	INPUT POWER	VOLTAGE	MOUNTING			
Α	1x4 SURFACE MOUNTED LED.	LITHONIA	CPX-1X4-AL07-80CRI-SWW7-SWL-MVOLT	24 W	LED	3500 K	24 VA	120 V	SURFACE			
В	SURFACE MOUNT 1X4 WET RATED	LITHONIA	FEM-L48-6000LM-LPAFL-WD-MVOLT-GZ10-35K-90CRI	38 W	LED	3500 K	38 VA	120 V	SURFACE			
С	6" DOWNLIGHT - WET RATED	LITHONIA	6VF-26-42TRT-6LRF1-MVOLT	13 W	LED	3500 K	13 VA	120 V	SURFACE	PROVIDE WITH AIRCRAFT CABLE FOR MOUNTING. FOR EMERGENCY FIXTURE PROVIDE WITH 'E10WLCP' OPTION.		
D	LED SUSPENDED LINEAR	LITHONIA	CLX-L48-4000LM-SEF-WDL-WD-MVOLT-GZ10-40K-80CRI	37 W	LED	3500 K	37 VA	120 V	SUSPENDED	PROVIDE WITH AIRCRAFT CABLE FOR MOUNTING. FOR EMERGENCY FIXTURE PROVIDE WITH 'E10WLCP' OPTION.		
D8	LED SUSPENDED LINEAR	LITHONIA	CLX-L96-8000LM-SEF-WDL-WD-MVOLT-GZ10-40K-80CRI	64 W	LED	3500 K	64 VA	120 V	SUSPENDED			
F	RECESSED 2X4 TROFFER	LITHONIA	CPX-2X4-4000LM-80CRI-SWL-MVOLT	37 W	LED	3500 K	37 VA	120 V	SURFACE	PROVIDE WITH BATTERY BACKUP FOR EMERGENCY FIXTURE REPLACEMENT.		
G	SURFACE MOUNT 1X4	LITHONIA	CPX-1X4-4000-80CRI-SWL-MVOLT	35 W	LED	3500 K	35 VA	120 V	SURFACE	PROVIDE WITH BATTERY BACKUP FOR EMERGENCY FIXTURE REPLACEMENT.		
Х	CEILING MOUNTED EXIT SIGN	LITHONIA	BE-W-R-SM-M6	5 W	LED	3200 K	5 VA	120 V	CEILING			

STATE OF MISSOURI MIKE KEHOE, GOVERNOR



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FIRE ALARM, FIRE SPRINKLER, &
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OFFICE OF ADMINISTRATION DIVISION OF FACILITIES MANAGEMENT, DESIGN AND CONSTRUCTION

DEPARTMENT OF Owner

HARRISONVILLE READINESS CENTER

1503 SOUTH JEFFERSON PARKWAY HARRISONVILLE, MO 64701

PROJECT # 023-05260 SITE # FACILITY #

No.	Date	Description

ISSUE DATE: 07/09/2025 CAD DWG FILE:

DRAWN BY: KP CHECKED BY: JB DESIGNED BY: KP

SHEET TITLE:

DIAGRAMS

SHEET NUMBER:

E50

29 OF 30 SHEETS **7/8/2025 10:36:05 AM**

	MC	PANEL A2 VOLTAGE No B OR MLO ML FED FROM DP	<u>ne</u> . <u>O</u>			AVA		PHASE BUS RATING 20 AIC RATING LABLE SHORT CKT		200 A			LOCATION MECH 106 MOUNTING SURFACE NO. OF POLES 42				
NOTE	LOAI	DESCRIPTION	N	AMP	Р	CKT. NO.	,	4	E	3		;	CKT. NO.	Р	АМР	LOAD DESCRIPTION	NOTE
	H-1 ARM LOCK	(ER RM		2 A	1	1	0	0					2	3	20 A	EXHAUST FAN	
	SPACE				1	3				0			4				
	SPACE				1	5						0	6				
	FLOOR LIGHT			50 A	3	7	0	0					8	2	40 A	FLOOR LIGHT	
						9			0	0			10				
						11					0		12	1		SPACE	
	FLOOR LIGHT			20 A	3	13	0	0					14	1	20 A	FLOOR LIGHT	
						15			0				16	1		SPACE	
						17					0		18	1		SPACE	
	FLOOR LIGHT			20 A	3	19	0	0					20	3	20 A	FLOOR LIGHT	
						21			0	0			22				
						23					0	0	24				
	EXHAUST FAN	I		20 A	3	25	0	0					26	3	20 A	CAB HEATER	
						27			0	0			28				
						29					0	0	30				
	CAB HEATER			35 A	3	31	0	0					32	3	20 A	SPARE	
						33			0	0			34				
						35					0	0	36				
	MAKE-UP AIR			40 A	3	37	0	0					38	3	40 A	EXHAUST FAN	
						39			0	0			40				
						41					0	0	42				
			<u>, </u>				KVA AMPS	<u>0</u>	KVA AMPS	<u>0</u>	KVA AMPS	<u>0</u>					!
	LOAD SIFICATIONS	CONNECTE D (VA)	DEMAND FACTOR		/ANE)						NOT	ES:				
								ECTED		<u>0</u>	<u>Not</u>						
							WAXIN	IUM DEI	WAND:	<u>0</u>	<u>Not</u>						
						_											
						_											
						\dashv											
						\dashv											
						_											

	MC	PANEL K2 VOLTAGE No B OR MLO MC FED FROM DP	o <u>ne</u> CB			AV	PHAS AILABLE	AIC	RATING RATING I CKT	<u>225 A</u>						LOCATION STORAGE 119 MOUNTING RECESSED NO. OF POLES 42	
NOTE	LOA	D DESCRIPTIO)N	AMP	Р	CKT. NO.		A		В		;	CKT. NO.	Р	АМР	LOAD DESCRIPTION	NOTE
	KITCHEN CAE	BINET HEATER	•	20 A	3	1	0	0					2	3	20 A	SCULLERY CABINET HEATER	
				-		3			0	0			4				
						5					0	0	6				
	GARBAGE DIS	SPOSAL		20 A	3	7	0	0					8	3	20 A	DISHWASHER	
						9			0	0			10				
						11					0	0	12				
	SH-1 SUPPLY	FAN		20 A	3	13	0	0					14	3	20 A	KITCHEN FOOD TABLE	
						15			0	0			16				
						17					0	0	18				
	E-11 EXHAUS	T FAN		20 A	3	19	0	0					20	3	20 A	E-7 EXHAUST FAN	
						21			0	0			22				
						23					0	0	24				
	BOOSTER HE	ATER		20 A	3	25	0	0					26	3	20 A	SPARE	
						27			0	0			28				
						29					0	0	30				
	SPARE			20 A	3	31	0	0					32	3	20 A	SPARE	
						33			0	0			34				
						35					0	0	36				
	SPARE			20 A	3	37	0						38	1		SPACE	
				1		39			0				40	1		SPACE	
						41					0	-	42	1		SPACE	
							KVA AMPS	<u>0</u>	KVA AMPS	<u>0</u>	KVA AMPS	<u>0</u>					
CLAS	LOAD SIFICATIONS	CONNECTE D (VA)	DEMAND FACTOR		MAND VA)			ECTED		<u>0</u> 0	<u>Not</u> Not	NOT	ES:				
										<u>v</u>							

	MC	VOLTAGE 120 B OR MLO MO FED FROM DP	CB			PH AVAILAB	AIC	RATING RATING T CKT	<u>225 A</u>					LOCATION MECH 106 MOUNTING SURFACE NO. OF POLES 42	
NOTE	LO	AD DESCRIPT	ION	AMP	Р	CKT. NO.	,	A	E	3	CKT. NO.	Р	AMP	LOAD DESCRIPTION	NOTE
	LTG - L.C 130), MECH 129		20 A	1	1	0	0			2	1	20 A	LTG - LIBRARY 128	
	LTG - CLASS			20 A	1	3			0	0	4	1		LTG - CLASSROOM 126	
	REC - CLASS			20 A	1	5	0	0			6	1		S HEATER - DRILL HL	
	N LTG - DRIL	L HALL		20 A	1	7			0	0	8	1		LTG - D.H, S TWO ROWS	
	LTG - D.H, S	TWO ROW		20 A	1	9	0	0			10	1	20 A	REC - 100, 102, E 101	
	REC - ADM V	V. 101		20 A	1	11			0	0	12	1	20 A	REC - L.C. 130, W.D.H	
	REC-L 128, N	IECH 129		20 A	1	13	0	0			14	1	20 A	LTS - 102, 100, 101 (1)	
	LTS - ADM. 1	01, W ROW		20 A	1	15			0	0	16	1	20 A	DRILL HALL - MIDDLE R	
	DRILL HALL -	· MIDDLE R		20 A	1	17	0	0			18	1	20 A	REC 103 / OFF 104/105	
	S-1 SUPPLY	UNIT FURNAC	ES	20 A	1	19			0	0	20	1	20 A	LTG - 103, OFF 104/105	
	LTS-103, OF	104/105		20 A	1	21	0	0			22	1	20 A	LTG - D.H, N TWO ROWS	
	LTG - D.H, N	TWO ROWS		20 A	1	23			0	0	24	1	20 A	REC - 106, 108 & W. FTN	
	REC - MEN 1	14, 110		20 A	1	25	0	0			26	1	20 A	LTG - EXIT & EMERGENCY	
	LTG -MEN L.I	R / B HALL		20 A	1	27			0	0	28	1	20 A	LTG - 118, 119, AV 120	
	HTRS - 119, I	VW DR HL		20 A	1	29	0	893			30	1	20 A	LTG - MEN 109 , 126, WM RR 107	
	LTS - MEN L.	R 114		20 A	1	31			0	0	32	1	20 A	S-2 SUPPLU UNIT FURNACE	
	OUTDOOR L	TG		20 A	2	33	0	0			34	1	20 A	PHONE PLUG	
						35			0	0	36	1	20 A	LTG - RIFLE RANGE	
	LIGHTS FOR	TARGET		20 A	1	37	0	0			38	1	20 A	LIGHTS FOR TARGET	
	LIGHTS FOR	TARGET		20 A	1	39			0	0	40	1	20 A	FIRING RANGE, PLUG SIGN LIGHTS	
	TARGET LINI	E LIGHTS		20 A	1	41	0	0			42	1	20 A	EMERGENCY CIRCUIT	
	I						KVA AMPS	0.893 <u>7</u>	KVA AMPS	<u>0</u> <u>0</u>					
LOAD CONNECTE DEMAND CLASSIFICATIONS D (VA) FACTOR			DEMAN (VA)		NOTES										
ighting		893 VA	125.00%	1116 V	'A			LOAD: EMAND: <u>1</u>		<u>4</u> <u>5</u>			ND FAUL	T CIRCUIT INTERRUPTING TYPE CIRCUI	T

	MCI	PANEL K1 VOLTAGE 120 B OR MLO MC ED FROM DP	<u>0/240V</u> C <u>B</u>				ASE BUS AIC LE SHORT	RATING						LOCATION STORAGE 119 MOUNTING RECESSED NO. OF POLES 30	
NOTE	LOA	AD DESCRIPTI	ION	AMP	Р	CKT. NO.	<i>A</i>	A		3	CKT. NO.	Р	AMP	LOAD DESCRIPTION	NOTE
	REC - 117,118	3,119,120,121		20 A	1	1	0	0			2	1	20 A	ARM VAULT - DED OUT	
	SPARE			20 A	1	3			0	0	4	1	20 A	SPARE	
	SPARE			20 A	1	5	0	0			6	1	20 A	SPARE	
	LTS - K 123 &	S124		20 A	1	7			0	0	8	1	20 A	LTS - FS 122, W 121	
	GAS HEATER			20 A	1	9	0	0			10	1	20 A	S LTSS - U.S 121	
	NE LTS - US 1	121		20 A	1	11			0	0	12	1	20 A	REC - N KITCHEN 123	
	REC - N FD S	TRG		20 A	1	13	0	0			14	1	20 A	REC - N FD FRDIGE STRG	
	REC - N FD S	TRG		20 A	1	15			0	0	16	1	20 A	REC - N FD. STRG	
	COLD FOOD	COUNTER		20 A	1	17	0	0			18	2	40 A	SPARE	
	E-6 EXHAUST	T FAN		20 A	1	19			0	0	20				
	REC - E 122 ,	123, 124, W-12	21	20 A	1	21	0	0			22	1	20 A	SCULLERY JBOX S-124	
	SPARE			20 A	1	23			0	0	24	1	20 A	AREC - DRILL HALL	
	REC - N & E D	R H U STORE	Ī	20 A	1	25	0	0			26	1	20 A	CAR VACCUM	
	SPARE			20 A	1	27			0	0	28	2	20 A	SUPPLY ROOM AC	
	KTN - HOOD I	FAN STRTS		20 A	1	29	0	0			30				
							KVA AMPS	<u>0</u> <u>0</u>	KVA AMPS	<u>0</u> <u>0</u>					
	LOAD IFICATIONS	CONNECTE D (VA)	DEMAND FACTOR	DEMAN (VA)							NOTES:				
							NNECTED (IMUM DE		<u>0</u> <u>0</u>	<u>0</u> <u>0</u>					

ONLY NEW LOAD SHOWN IN PANEL SCHEDULE. ALL OTHER LOADS ARE EXISTING TO REMAIN.

STATE OF MISSOURI MIKE KEHOE, GOVERNOR



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Olsson 1301 Burlington Street North Kansas City, MO 64116 816.361.1177

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DEPARTMENT OF Owner

HARRISONVILLE READINESS CENTER

1503 SOUTH JEFFERSON PARKWAY HARRISONVILLE, MO 64701

PROJECT # 023-05260 SITE # FACILITY #

No.	Date	Description	

ISSUE DATE: 07/09/2025
CAD DWG FILE:

DRAWN BY: KP CHECKED BY: JB DESIGNED BY: KP

SHEET TITLE:

ELECTRICAL SCHEDULES

SHEET NUMBER:

£'/01

30 OF 30 SHEETS **7/8/2025 10:36:06 AM**