Replace Roof and Construct Solar Array Bldg 1029 Fort Leonard Wood, Missouri



Engineering | Energy | Innovation

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OWNER: STATE OF MISSOURI

MICHAEL L. KEHOE, GOVERNOR

DEPARTMENT OF MISSOURI

NATIONAL GUARD

PROJECT DEPARTMENT OF MISSOURI

MANAGEMENT: NATIONAL GUARD

OFFICE OF THE ADJUTANT GENERAL

FACILITIES MANAGEMENT OFFICE

DESIGNER: CJD ENGINEERING LLC

CONSULTANT: BUDDY WEBB & COMPANY, INC.

LOCATION:



PROJECT NUMBER: T2412-01

SITE NUMBER: 6306

FACILITY NUMBER: 8136306003

SHEET INDEX:

G-000 COVER SHEET

G-001 ABBREVIATIONS, NOTES, AND SYMBOLS

D-101 ROOF DEMOLITION PLAN

A-101 ROOF PLAN

A-501 MISCELLANEOUS DETAILS A-502 MISCELLANEOUS DETAILS

A-503 MISCELLANEOUS DETAILS E-100 ROOF POWER PLAN


E-100 ROOF POWER PLAN
E-500 ELECTRICAL DETAILS

E-600 ELECTRICAL SCHEDULES

SHEET NUMBER:

G-000

1 OF 10 SHEETS
JULY 2, 2025

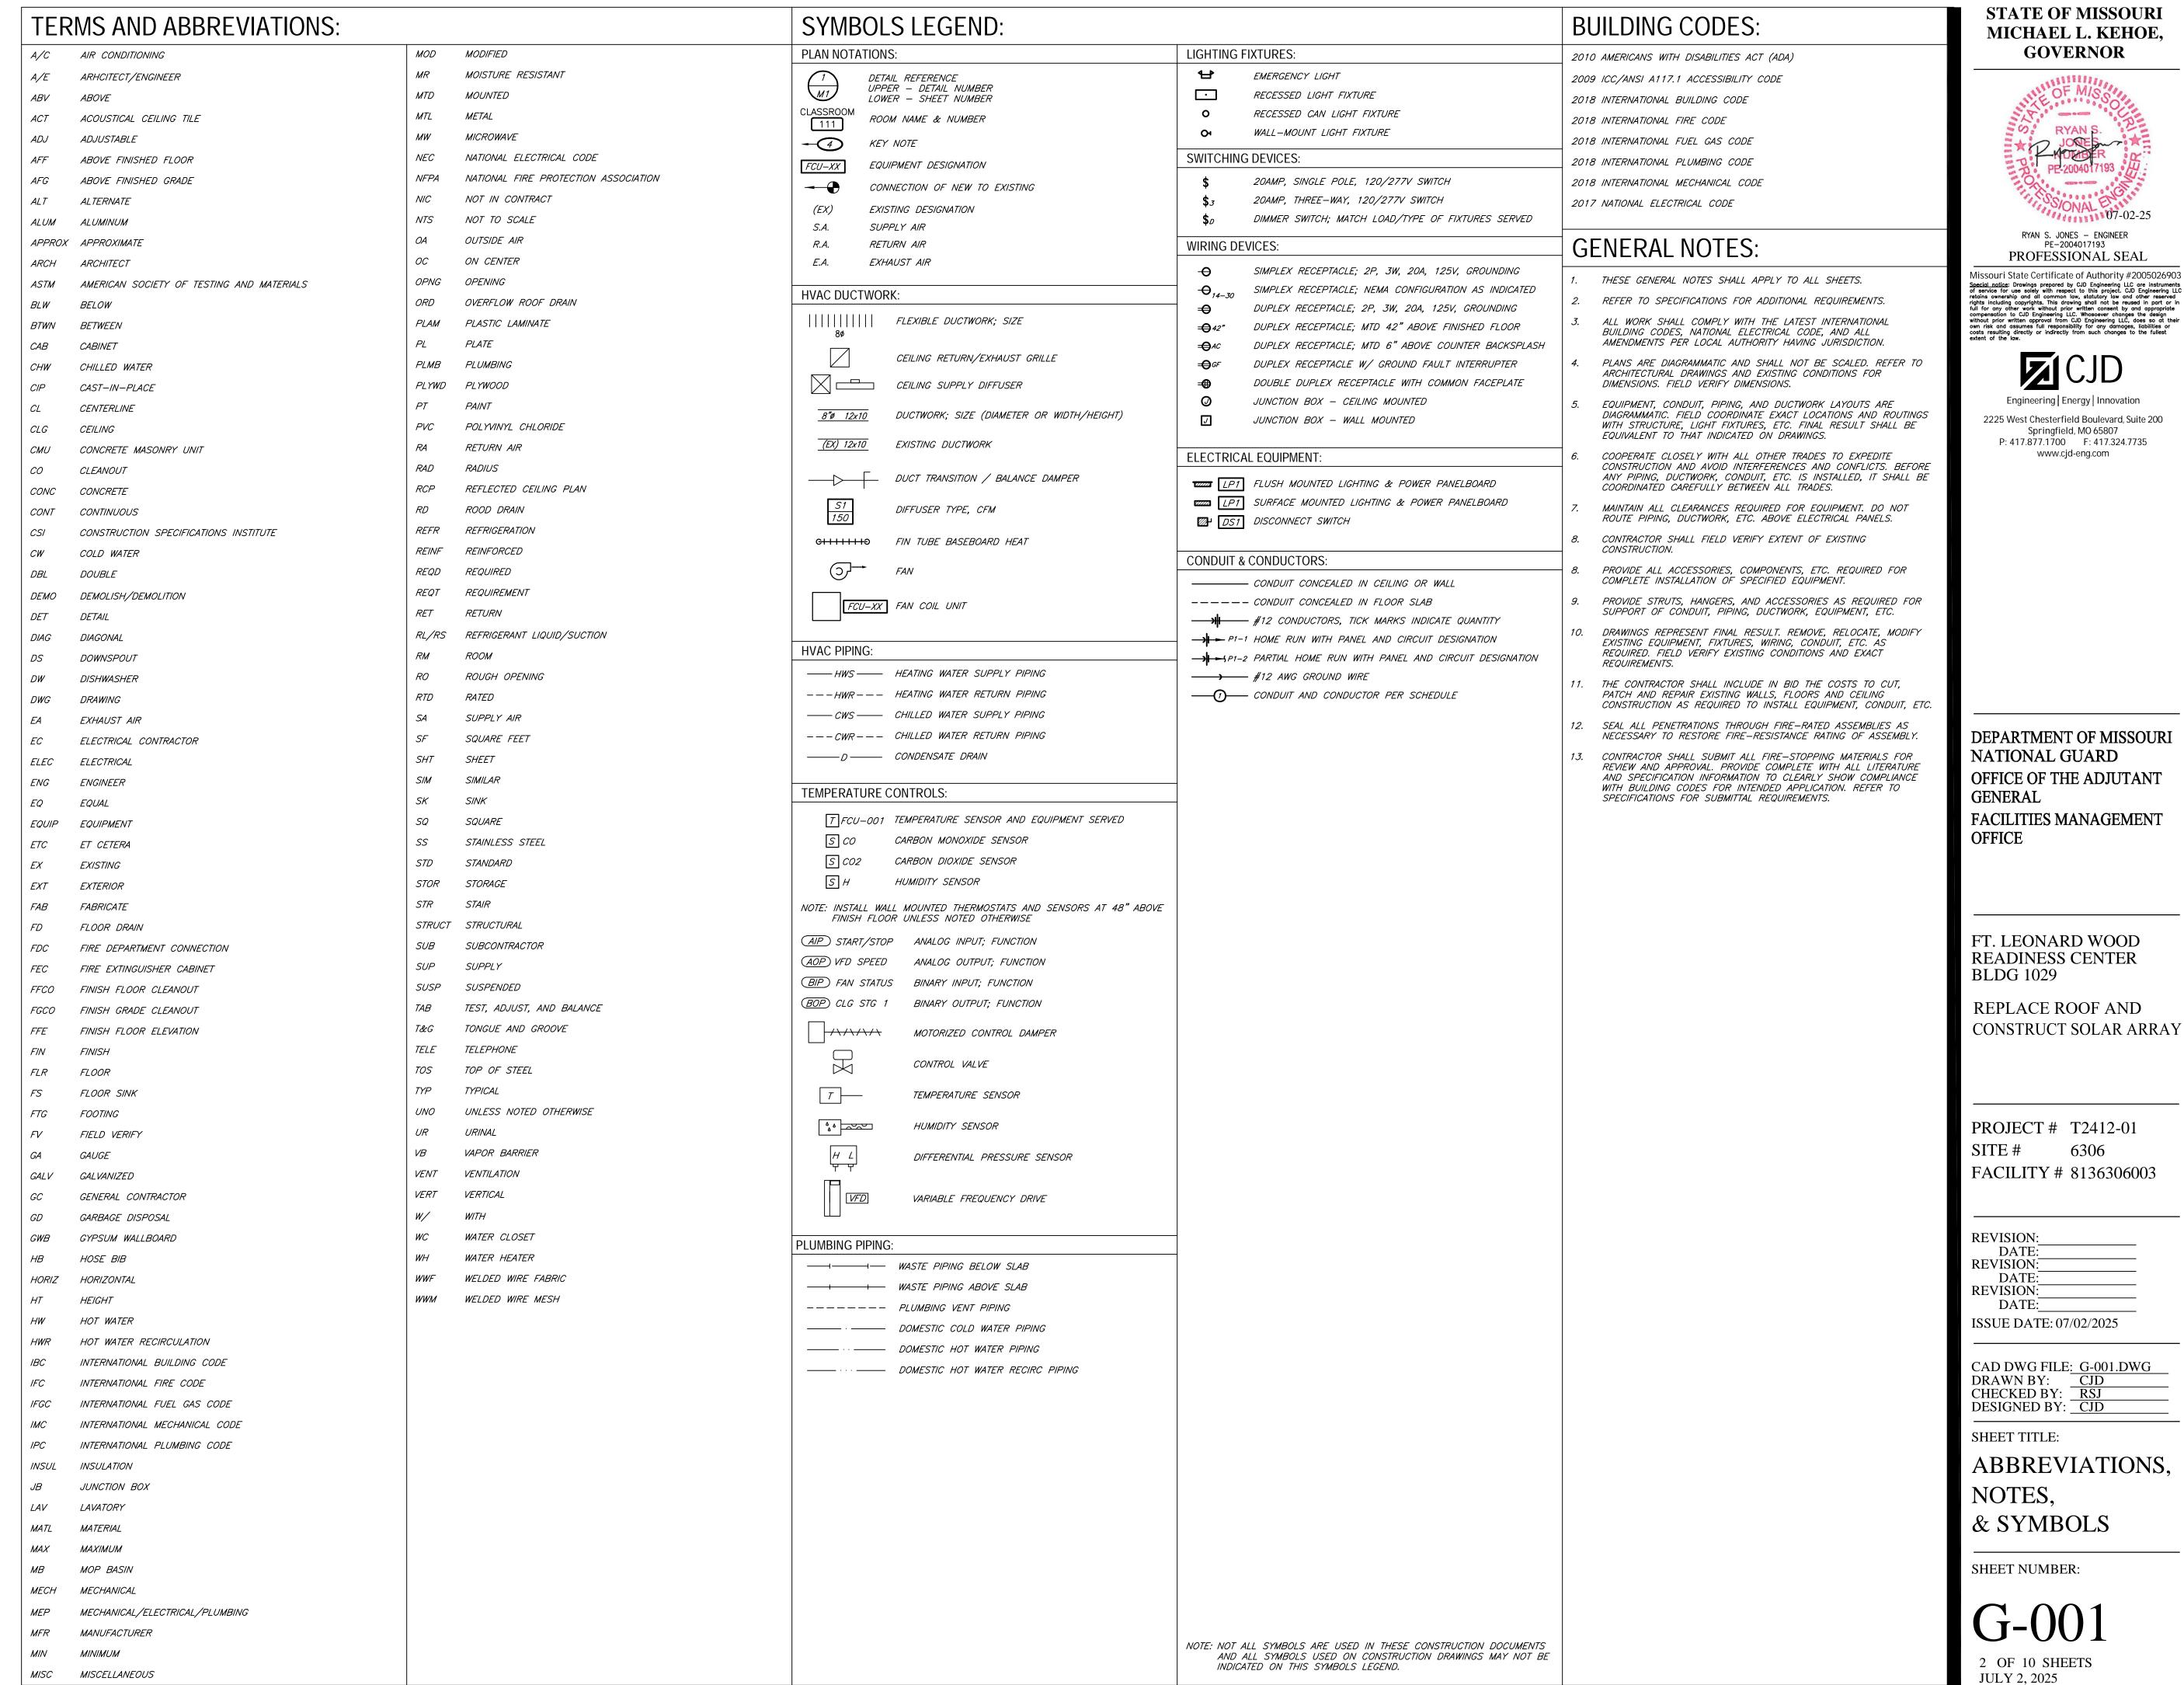

KEY NOTES

SYMBOLS LEGEND

GENERAL NOTES

- 1 REMOVE EXISTING STANDING METAL BUILDING STANDING SEAM ROOFING PANEL SYSTEM, PREPARE EXISTING ROOF TO ACCEPT NEW ROOFING SYSTEM.
- $\langle 2 \rangle$ REMOVE ALL EXISTING SHEET METAL GUTTER (TYPICAL).
- $\langle \overline{3} \rangle$ REMOVE ALL EXISTING SHEET METAL DOWNSPOUT (DS) SYSTEM TO EXISTING CAST IRON PIPING. PREPARE BUILDING FOR NEW DOWNSPOUT SYSTEM.
- (4) REMOVE EXISTING DAMAGE CAST IRON DOWNSPOUT PIPING (GROUND LEVEL) AND PREPARE PIPE FOR NEW DOWNSPOUT BOOT TO ACCEPT NEW
- 5 REMOVE ALL EXISTING PLUMBING VENT THRU ROOF (VTR) BOOT, PREPARE FOR NEW FLASHING.
- (6) REMOVE ALL EXISTING SHEET METAL RAKE EDGE FLASHING.
- $\langle 7 \rangle$ REMOVE ALL EXISTING SHEET METAL RIDGE CAP FLASHING.
- (8) REMOVE EXISTING MECHANICAL EXHAUST SYSTEM, CO2B AND FLASHING. REWORK EXISTING CONSTRUCTION AS REQUIRED FOR INSTALLATION OF NEW CONSTRUCTION. EXISTING MECHANICAL EXHAUST UNIT TO BE REVISED.
- (9) REMOVE EXISTING ROOF EXPANSION JOINT, PREPARE FOR INSTALLATION OF NEW EXPANSION JOINT SYSTEM.
- (10) REMOVE EXISTING ROOF HATCH AND CURB. REWORK EXISTING CONSTRUCTION AS REQUIRED FOR INSTALLATION OF NEW CONSTRUCTION.
- (11) REMOVE EXISTING ROOF HATCH AND ROOF CURB, PREPARE OPENING FOR NEW INFILL CONSTRUCTION.
- (12) REMOVE EXISTING GRAVITY OR RELIEF VENT AND FLASHING SYSTEM. REWORK EXISTING CONSTRUCTION AS REQUIRED FOR INSTALLATION OF NEW CONSTRUCTION.
- (13) REMOVE EXISTING ELECTRONIC COMMUNICATION DEVICE AND ASSOCIATED ELECTRICAL SYSTEM AND REWORK EXISTING CONSTRUCTION AS REQUIRED FOR INSTALLATION OF NEW CONSTRUCTION. COORDINATE WORK WITH

VTR VENT THROUGH ROOF

← MECHANICAL EXHAUST UNIT

 $\overset{\mathsf{G.V.}}{\circ}$ CRAVITY VENT THROUGH ROOF

RELIEF VENT THROUGH ROOF

D.S. LOCATION OF DOWNSPOUTS

ROOF HATCH

- ROOF HATCH (SEALED)


□← FALL PROTECTION ANCHOR SYSTEM

FALL PROTECTION SYSTEM

SNOW GUARD SYSTEM

× ← ELECTRONIC COMMUNICATION DEVICE

- $\langle \mathsf{A} \rangle$ REFER TO PROJECT MANUAL FOR ADDITIONAL REQUIREMENTS.
- (B) FIELD VERIFY EXISTING CONDITIONS BY DETAILED INSPECTION PRIOR TO SUBMITTING BID AND BEGINNING CONSTRUCTION. NOTIFY ARCHITECT IF EXISTING CONDITIONS DEVIATE SUBSTANTIALLY FROM THOSE INDICATED HEREIN.
- © EXISTING SHEET METAL ROOFING SYSTEM AND ASSOCIATED CONSTRUCTION, INCLUDING MECHANICAL ROOF CURBS, SHEET METAL FLASHING (UNLESS OTHERWISE INDICATED), GUTTERING, AND DOWNSPOUTS SYSTEMS, TO BE REMOVED DOWN TO TOP OF EXISTING STRUCTURAL SUPPORT OR SUBSTRATE SYSTEM CONDITIONS. EXISTING NAILERS IN GOOD CONDITION TO REMAIN.
- (D) VERIFY CONDITIONS OF EXISTING STRUCTURAL SUPPORT OR SUBSTRATE CONDITIONS TO REMAIN. REPAIR AND/OR REPLACE AS REQUIRED FOR PROPER INSTALLATION OF NEW ROOFING SYSTEM. FIELD VERIFY EXISTING CONDITIONS AND SCOPE OF WORK
- F UNLESS OTHERWISE INDICATED, ALL SALVAGE TO CONTRACTOR FOR PROPER DISPOSAL.
- $\langle \overline{\mathsf{G}} \rangle$ REFER TO ELECTRICAL DRAWINGS FOR ADDITIONAL REQUIREMENTS.

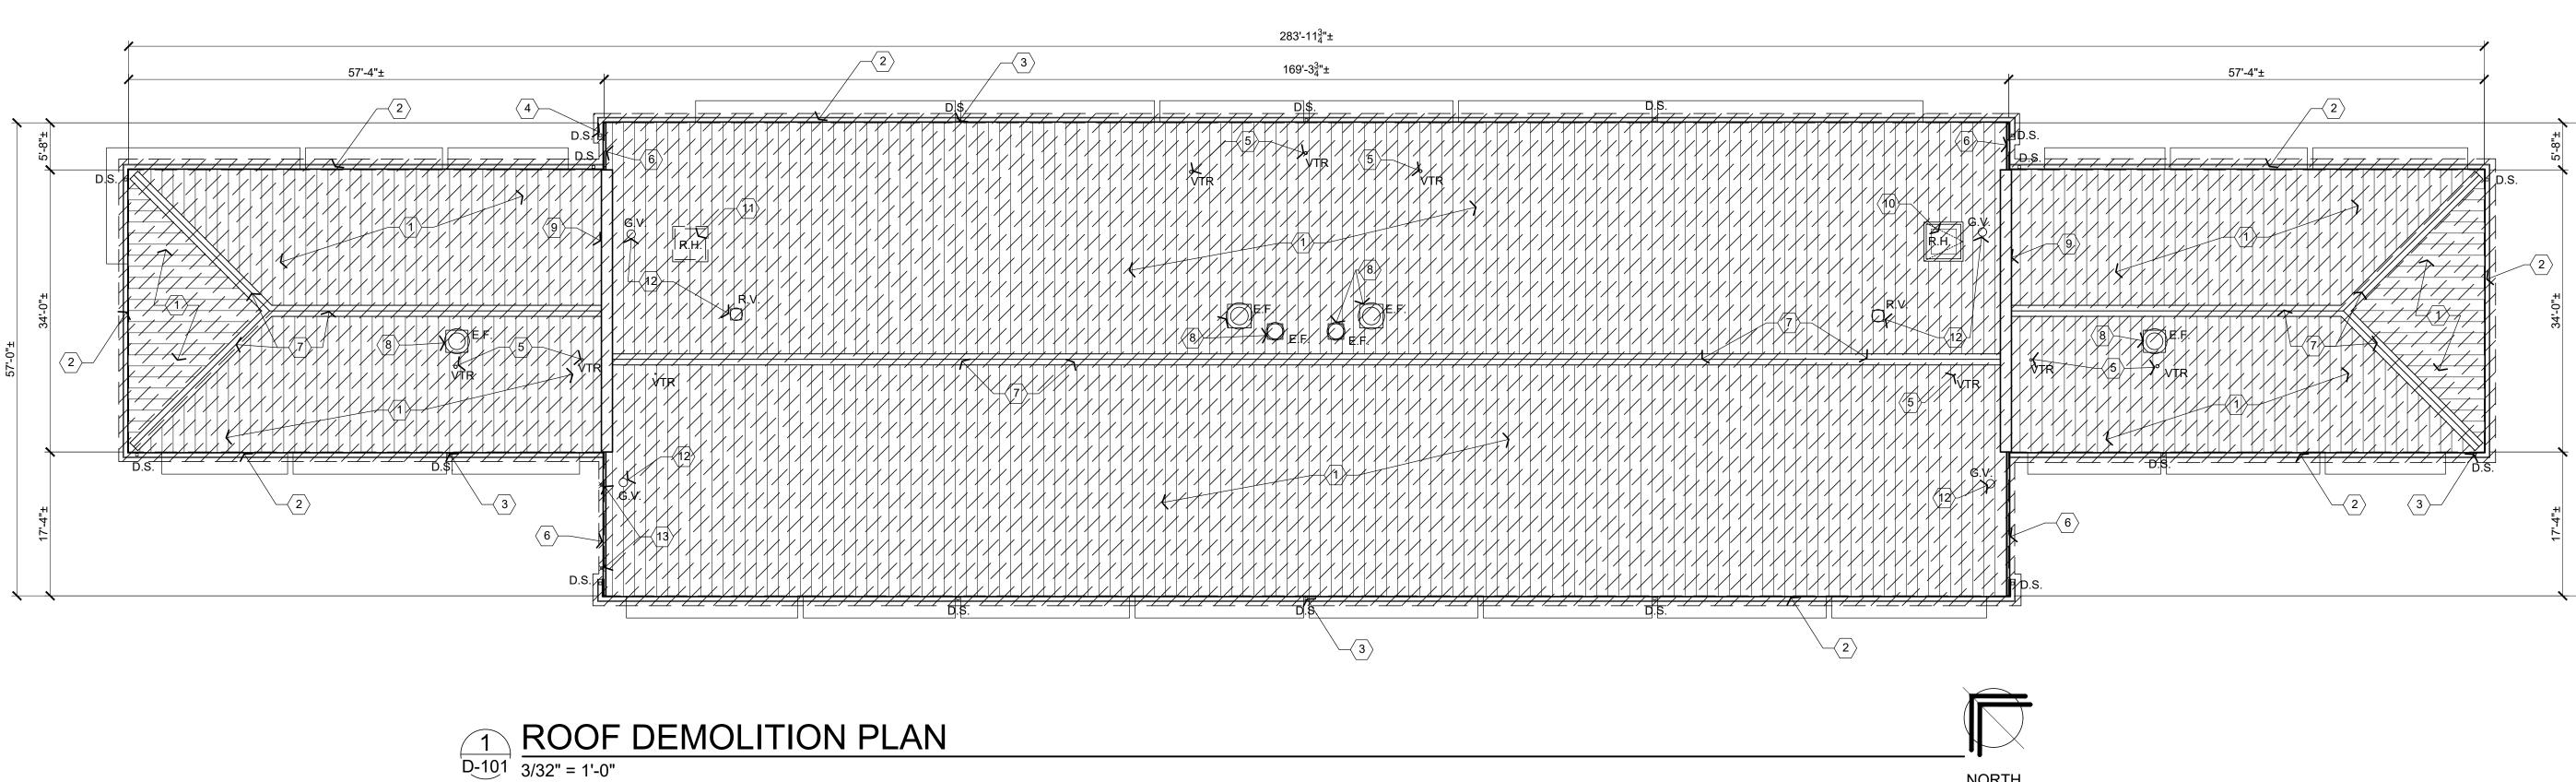

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STATE OF MISSOURI MICHAEL L. KEHOE,

GOVERNOR

ARCHITECTURAL FIRM REGISTRATION NO.: ARC 2004028947

DEPARTMENT OF MISSOURI NATIONAL GUARD OFFICE OF THE ADJUTANT GENERAL

FACILITIES MANAGEMENT **OFFICE**

FT. LEONARD WOOD READINESS CENTER BLDG 1029

REPLACE ROOF AND CONSTRUCT SOLAR ARRAY

PROJECT # T2412-01

FACILITY # 8136306003

REVISION: REVISION:

ISSUE DATE: 07/02/2025


CAD DWG FILE:6306-8136306003-A-102 DESIGNED BY: BV

SHEET TITLE:

ROOF DEMOLITION **PLAN**

SHEET NUMBER:

3 OF 10 SHEETS JULY 2, 2025

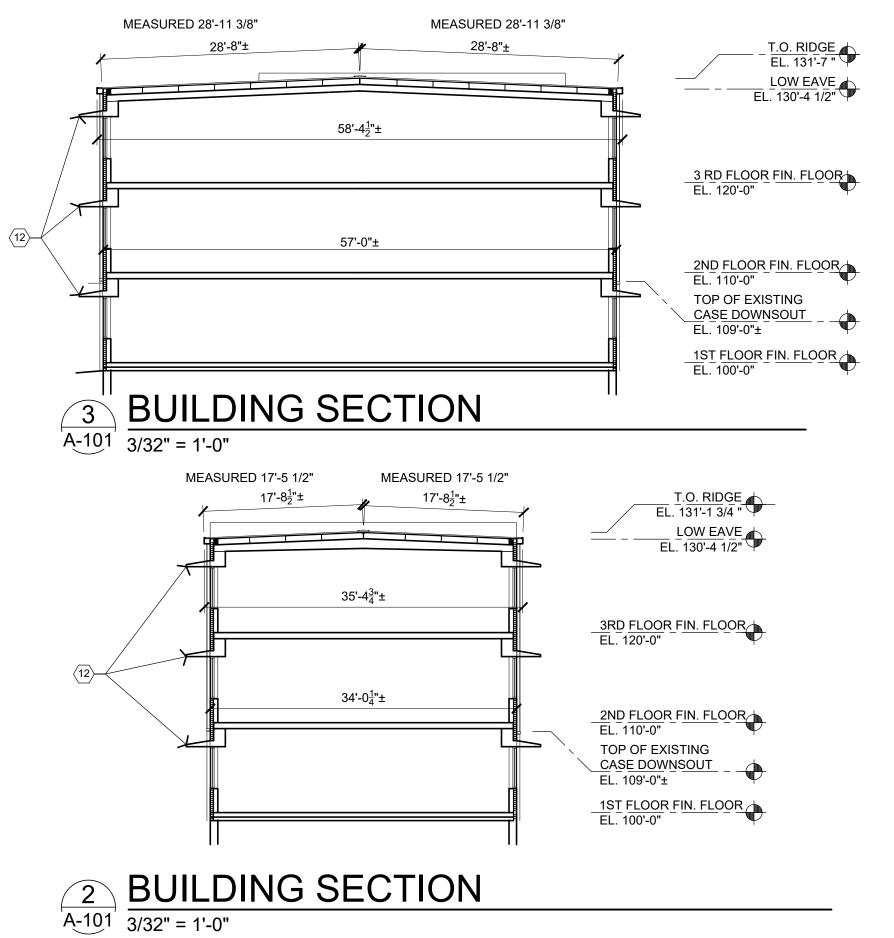

KEY NOTES

- SHEET METAL STANDING SEAM (MECHANICALLY SEAMED) ROOFING PANEL SYSTEM WITH R-5 THERMAL BLOCKS OVER EXISTING FRAMING.
- SNOW GUARD SYSTEM (EXTEND FULL LENGTH OF ROOF) ATTACHED WITH ALUMINUM S-5 CLAMPS. INSTALL 4'-0" FROM EDGE OF LOW EAVE.
- 3 SHEET METAL GUTTER (TYPICAL). REFER TO DETAIL 1/A-501. SIZES TO BE
- (4) SHEET METAL DOWNSPOUT (DS) SYSTEM. SIZES 4"x4" TYPICAL.
- (5) FALL PROTECTION ANCHOR SYSTEM ATTACHED WITH ALUMINUM "S-5" CLAMPS. INSTALL 2'-0" MIN FROM RIDGE OF ROOF. CENTER BETWEEN METAL ROOF PANEL SEAMS AND SPACE EQUALLY. COORDINATE WITH SHEET METAL ROOF SYSTEM MANUFACTURER FOR INSTALLATION.
- 6 PLUMBING VENT THRU ROOF (VTR). REFER TO 6/A-501 AND 7/A-501. CENTER BETWEEN ROOF PANEL SEAMS. MATCH EXISTING SIZES (FIELD VERIFY).
- \langle $^{7}
 angle$ Sheet metal rake / Head Wall Flashing. Refer to Detail 2/A-502 and
- (8) METAL RIDGE CAP FLASHING FIXED AT RIDGE. REFER TO DETAIL 4/A-501.
- 9 MECHANICAL SYSTEM HOT VENT FLUE. REFER TO DETAIL 8/A-501. MATCH EXISTING SIZES (FIELD VERIFY).
- (10) SOLAR ROOF PANEL SYSTEM AND RAIL MOUNTING SYSTEM ATTACHED TO ROOF PANELS WITH "S-5" CLAMPS. ATTACHMENT CLAMPS UTILIZES BASIS FOR DESIGN AS "S-5" METAL ROOF INNOVATIONS, LTD.". REFER TO ELECTRICAL DRAWINGS, PROJECT MANUAL AND ICC.ES.ORG PRODUCT #3869 FOR ADDITIONAL REQUIREMENTS.
- (11) SHEET METAL PARAPET FLASHING, REFER TO DETAIL 1/A-502.
- (12) EXISTING CONCRETE WINDOW SHADES BELOW TO REMAIN, PROTECT DURING CONSTRUCTION.
- (13) EXISTING MECHANICAL EXHAUST UNIT ON NEW RAISED ROOF CURB, REFER TO DETAIL 8/A-502. SIZE TO MATCH EXISTING MECHANICAL EQUIPMENT.
- (14) METAL HIP CAP FLASHING FIXED AT RIDGE. REFER TO DETAIL 5/A-501.
- (15) NEW ROOF HATCH WITH INSULATED CURB AND SAFETY POST. REFER TO DETAIL 4/A-503 AND 8/A-502. SIZE TO MATCH EXISTING CONCRETE OPENING.
- (16) EXISTING ROOF HATCH OPENING INFILL CONSTRUCTION, REFER TO DETAIL
- (17) PROVIDE SUPPLEMENTAL FRAMING AROUND EXISTING OPENING TO PROVIDE ADEQUATE SUPPORT FOR ROOFING.
- (18) SHEET METAL RAKE EDGE FLASHING, REFER TO DETAILS 2/A-501 AND
- (19) EXISTING GRAVITY VENT OR RELIEF VENT ON NEW RAISED ROOF CURB, REFER TO DETAIL 8/A-502. SIZE TO MATCH EXISTING VENT UNIT.
- (20) EXISTING ELECTRONIC COMMUNICATION DEVICE CONSTRUCTION TO BE REINSTALLED. COORDINATE WORK WITH OWNER.

SYMBOLS LEGEND

VTR ← VENT THROUGH ROOF - MECHANICAL EXHAUST UNIT

- GRAVITY VENT THROUGH ROOF

- RELIEF VENT THROUGH ROOF

LOCATION OF DOWNSPOUTS

- ROOF HATCH

ROOF HATCH (SEALED) - FALL PROTECTION ANCHOR SYSTEM

FALL PROTECTION SYSTEM

→ ← SNOW GUARD SYSTEM

× ← ELECTRONIC COMMUNICATION DEVICE


BUILDING CODES GENERAL NOTES

(A) REFER TO PROJECT MANUAL FOR ADDITIONAL REQUIREMENTS. (B) FIELD VERIFY EXISTING CONDITIONS BY DETAILED INSPECTION PRIOR TO SUBMITTING BID AND BEGINNING CONSTRUCTION. NOTIFY ARCHITECT IF

 $\langle \mathtt{C} \rangle$ ALL EXISTING ROOF MOUNTED MECHANICAL EQUIPMENT, GRAVITY VENTS, AND RELIEF VENTS TO BE REUSED ARE TO BE PROVIDED WITH NEW PREFABRICATED SHEET METAL INSULATED ROOF CURBS OR FIELD FABRICATED SHEET METAL CLADDING ON TREATED 2X6 (MIN.) WOOD ROOF CURBS IN SIZES AND TYPES TO MATCH EXISTING EQUIPMENT (FIELD VERIFY) ALL NEW CURBS TO BE PROVIDED WITH UP SLOPE CRICKETS FOR PROPER DRAINAGE. NEW ROOF CURB TYPES AND CONSTRUCTION TO BE APPROVED BY NEW SHEET METAL ROOFING SYSTEM MANUFACTURER. COORDINATE LOCATIONS WITH NEW SHEET METAL ROOFING SYSTEM JOINTS AND SEAMS.

EXISTING CONDITIONS DEVIATE SUBSTANTIALLY FROM THOSE INDICATED

- D PROVIDE NEW PREFABRICATED VENTS AND FLASHING BOOTS IN SIZES AND TYPES TO MATCH EXISTING TO BE REMOVED (FIELD VERIFY). TYPES AND CONSTRUCTION TO BE APPROVED BY NEW SHEET METAL ROOFING SYSTEM MANUFACTURER. COORDINATE LOCATIONS WITH NEW SHEET METAL ROOFING SYSTEM JOINTS AND SEAMS AND LOCATE IN CENTER OF ROOF PANELS.
- (F) ALL SUPPORTS FOR EXPOSED ROOF MOUNTED SOLAR PANEL SYSTEM FRAMING, PIPING, CONDUIT, FALL PROTECTION DEVICES, SNOW GUARDS, ETC. TO BE MOUNTED ON PREFABRICATED ALUMINUM S-5 CLAMPS ATTACHED TO TOP OF SHEET METAL ROOFING SYSTEM SEAMS. ALL EXPOSED FRAMING, SUPPORTS, AND FASTENERS SHALL BE NON-CORROSIVE MATERIAL TYPES. EXPOSED FINISHES TO MATCH NEW ROOFING SYSTEM.
- (G) WHERE REQUIRED, PROVIDE NEW STRUCTURAL FRAMING TO MATCH EXISTING OR TREATED 2X6 WOOD NAILERS TO PROPERLY SUPPORT PERIMETERS OF CURBS AND ROOF PENETRATIONS.
- (H) WHERE REQUIRED, PROVIDE CEMENTITIOUS LEVELING COMPOUND AT CONCRETE SUBSTRATE JOINTS, DEPRESSIONS AND SURFACE IRREGULARITIES AS REQUIRED FOR INSTALLATION OF ROOFING SYSTEM SUPPORT SYSTEMS.
- (I) WHERE REQUIRED, PROVIDE SEALANT WITH BACKER ROD AT EXISTING CONCRETE ROOF SLAB JOINTS.
- PROVIDE NEW TREATED 2X WOOD NAILERS TO REPLACE DAMAGED MATERIAL.
- (K) PROVIDE NEW SHEET METAL FLASHING, COUNTER FLASHING, DRIPS, AND FASCIA CLADDING AROUND PERIMETER OF ROOFING EDGES.
- (L) ROOF EDGE SECUREMENT TO COMPLY WITH ANSI/FM 4435/ES-1 WIND DESIGN STANDARD FOR EDGE SYSTEMS USED WITH LOW SLOPE ROOFING SYSTEMS.
- (M) SHEET METAL CONSTRUCTION SHALL COMPLY WITH SHEET METAL AND AIR CONDITIONING CONTRACTORS NATIONAL ASSOCIATION (SMACNA) DESIGN
- N ROOFING CONSTRUCTION SHALL COMPLY WITH NATIONAL ROOFING CONTRACTORS ASSOCIATION (NRCA) DESIGN STANDARDS AND RECOMMENDATIONS.
- (0) NEW ROOFING SYSTEM COLOR AND FINISH TO MATCH EXISTING AND TO BE SELECTED BY OWNER FROM FULL RANGE OF MANUFACTURER'S STANDARD AND/OR PREMIUM SAMPLES.

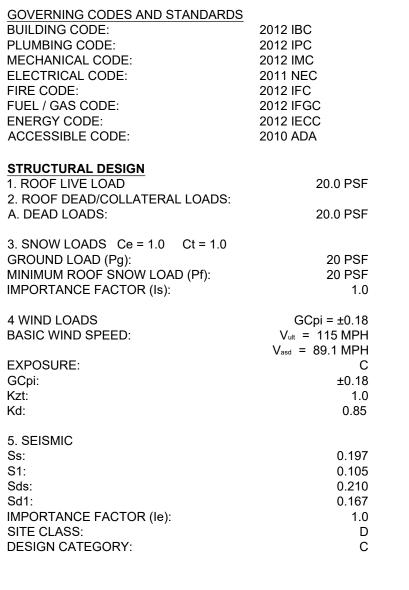

REFER TO PROJECT MANUAL SECTION 01 23 00 FOR

ALTERNATE NO. 1: (NEW ROOF INSULATION SYSTEM).

BELOW AREAS OF NEW ROOFING CONSTRUCTION.

PROVIDE NEW ROOF INSULATION BOARD (R-30 MINIMUM)

SYSTEM ON TOP OF EXISTING CONCRETE ROOF DECK


ADDITIONAL REQUIREMENTS.

POLASKI

COUNTY:

STANDARDS AND RECOMMENDATIONS.

STATE OF MISSOURI MICHAEL L. KEHOE, **GOVERNOR**

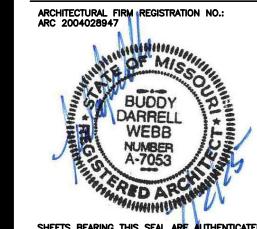

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DEPARTMENT OF MISSOURI NATIONAL GUARD OFFICE OF THE ADJUTANT GENERAL

FACILITIES MANAGEMENT OFFICE

FT. LEONARD WOOD READINESS CENTER BLDG 1029

REPLACE ROOF AND CONSTRUCT SOLAR ARRAY

PROJECT # T2412-01 6306 SITE# FACILITY # 8136306003

REVISION: REVISION: REVISION: ISSUE DATE: 07/02/2025


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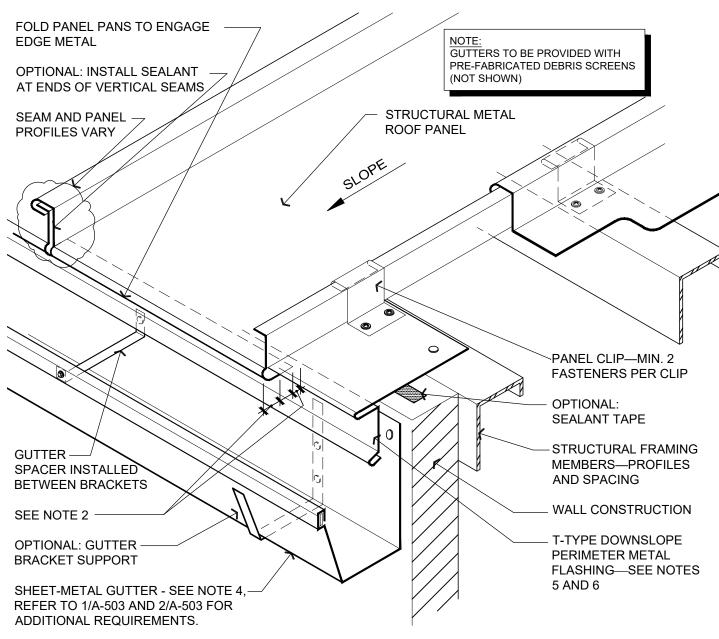
SHEET TITLE:

ROOF PLAN

SHEET NUMBER:

4 OF 10 SHEETS JULY 2, 2025



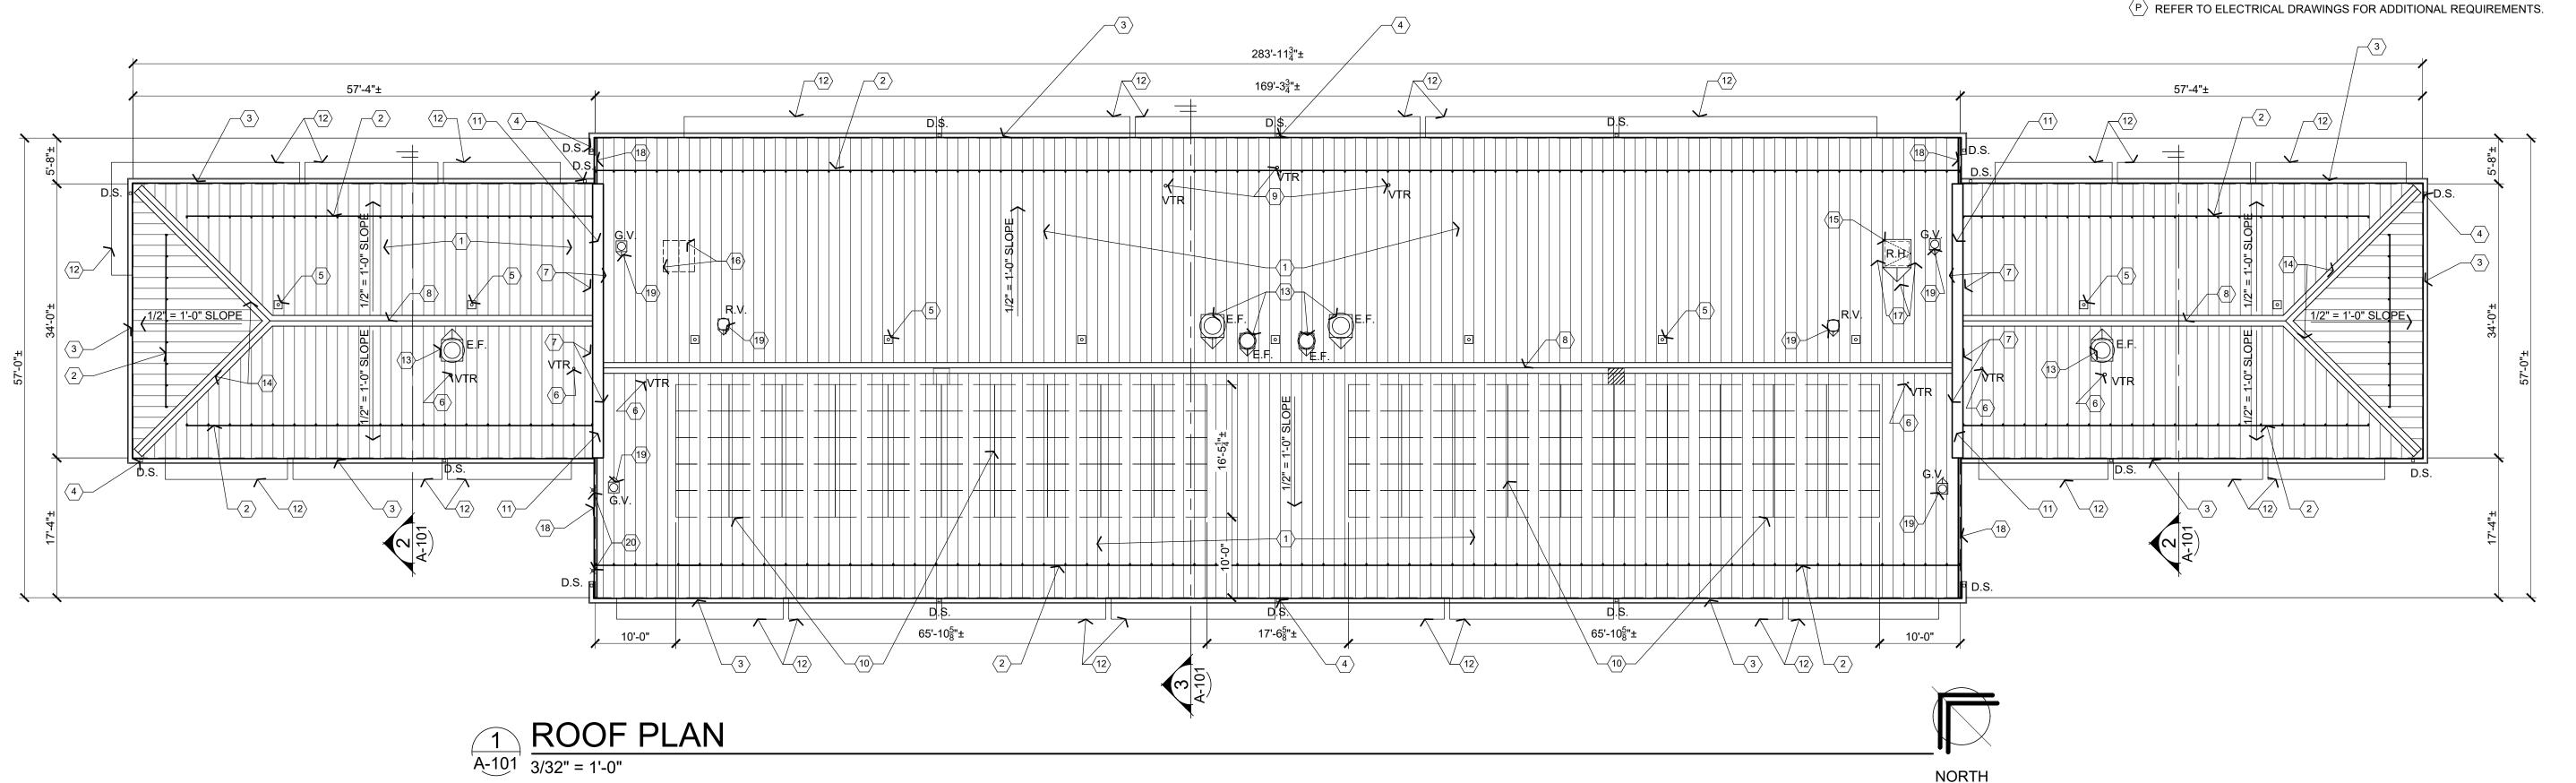

NOTES:

1. SPECIFIC FASTENING AND STRUCTURAL REQUIREMENTS ARE NOT INDICATED AS THEY VARY FROM SYSTEM TO SYSTEM DEPENDING ON PANEL MANUFACTURER'S REQUIREMENTS, WIND ZONE, BUILDING CODE AND WALL CONSTRUCTION.

3. INSULATION, VAPOR RETARDER AND THERMAL BLOCKS FOR ROOF SYSTEM ARE NOT SHOWN FOR CLARITY.

4. PEEER TO THE ARCHITECTURAL METAL ELASHING SECTION OF THE NRCA POOFING MANUAL.

DIMENSIONS SHOULD ACCOMMODATE EXPECTED MOVEMENT


4. REFER TO THE ARCHITECTURAL METAL FLASHING SECTION OF THE NRCA ROOFING MANUAL: ARCHITECTURAL METAL FLASHING, CONDENSATION CONTROL AND REROOFING FOR MORE INFORMATION ON GUTTERS.

5. REFER TO THE ARCHITECTURAL METAL FLASHING SECTION OF THE NRCA ROOFING MANUAL: ARCHITECTURAL METAL FLASHING, CONDENSATION CONTROL AND REROOFING FOR PERIMETER EDGE-METAL THICKNESS AND CLEAT RECOMMENDATIONS.

6. REFER TO THE INTRODUCTION IN CHAPTER 10—CONSTRUCTION DETAILS FOR ADDITIONAL INFORMATION.



EAVE FLASHING WITH GUTTER

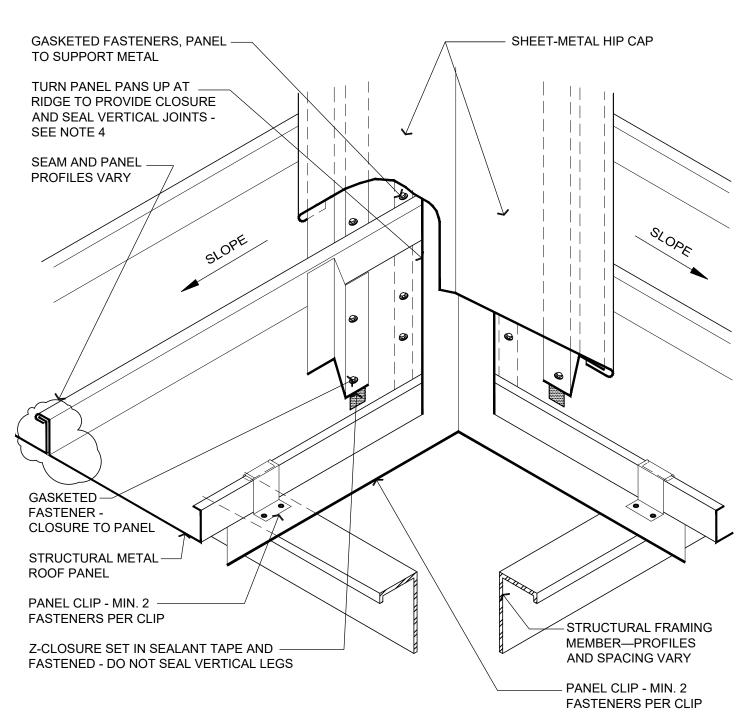

OTES:

 SPECIFIC FASTENING AND STRUCTURAL REQUIREMENTS ARE NOT INDICATED AS THEY VARY FROM SYSTEM TO SYSTEM DEPENDING ON PANEL MANUFACTURER'S REQUIREMENTS, WIND ZONE, BUILDING CODE AND WALL CONSTRUCTION.
 INSULATION, VAPOR RETARDER AND THERMAL BLOCKS FOR ROOF SYSTEM ARE NOT SHOWN FOR


CLARITY.

3. THIS DETAIL FIXES THE PANEL ALONG THE HIP.

4. REFER TO THE INTRODUCTION IN CHAPTER 10—CONSTRUCTION DETAILS FOR ADDITIONAL INFORMATION.

NOT TO SCALE

DETAIL HIP CAP FLASHING - FIXED AT HIP

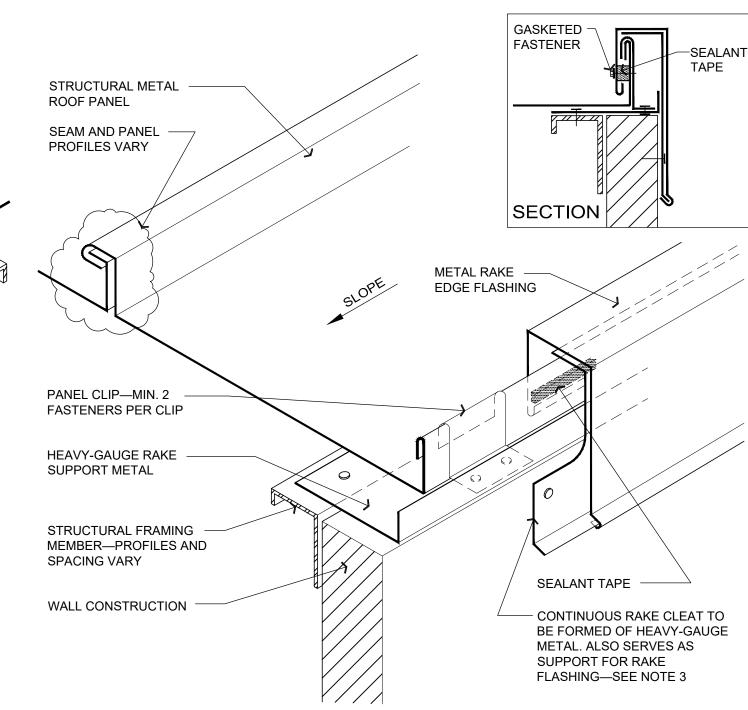


1. SPECIFIC FASTENING AND STRUCTURAL REQUIREMENTS ARE NOT INDICATED AS THEY VARY FROM SYSTEM TO SYSTEM DEPENDING ON PANEL MANUFACTURER'S REQUIREMENTS, WIND ZONE, BUILDING CODE AND WALL CONSTRUCTION.

2. INSULATION, VAPOR RETARDER AND THERMAL BLOCKS FOR ROOF SYSTEM ARE NOT SHOWN FOR CLARITY.

REFER TO THE ARCHITECTURAL METAL FLASHING SECTION OF THE NRCA ROOFING MANUAL:
 ARCHITECTURAL METAL FLASHING, CONDENSATION CONTROL AND REROOFING FOR PERIMETER EDGE-METAL
 THICKNESS AND CLEAT RECOMMENDATIONS.
 REFER TO THE INTRODUCTION IN CHAPTER 10—CONSTRUCTION DETAILS FOR ADDITIONAL INFORMATION.

2 DETAIL RAKE EDGE FLASHING - STARTER PANEL

NOT TO SCALE

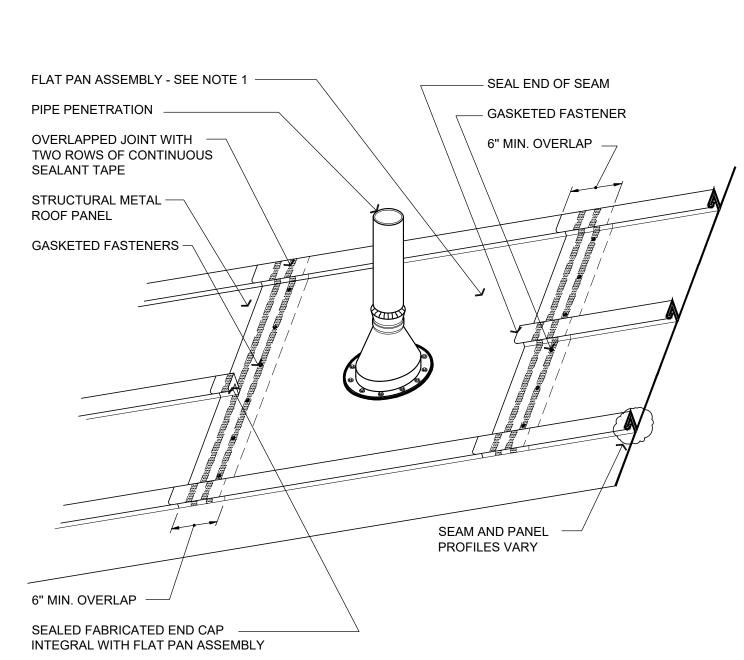

NOTES:


PROPER STRUCTURAL SUPPORT AND ATTACHMENT IS REQUIRED FOR FLAT PAN ASSEMBLY.
 WHERE PENETRATIONS INTERSECT SEAMS, THIS DETAIL IS PREFERRED RATHER THAN INSTALLING PREFORMED BOOT THROUGH SEAM.

IF FIELD PANELS OVERLAP AT THE PENETRATION, ATTACHMENT OF THE DOWNSLOPE PANEL ALONG ITS UPSLOPE END MAY BE NECESSARY.
 VENT STACKS AND OTHER PIPES SHOULD HAVE ADEQUATE CLEARANCE ON ALL SIDES FROM WALLS AND OTHER PROJECTIONS TO FACILITATE PROPER FLASHING AND PANEL DRAINAGE.

FOR HOT PIPES, SPECIFIC HIGH-TEMPERATURE BOOTS SHOULD BE USED.
 INSULATION, VAPOR RETARDER AND THERMAL BLOCKS FOR ROOF SYSTEM ARE NOT SHOWN FOR

7. REFER TO INTRODUCTION IN CHAPTER 10—CONSTRUCTION DETAILS FOR ADDITIONAL INFORMATION.

6 DETAIL PIPE PENETRATION FLASHING NOT TO SCALE

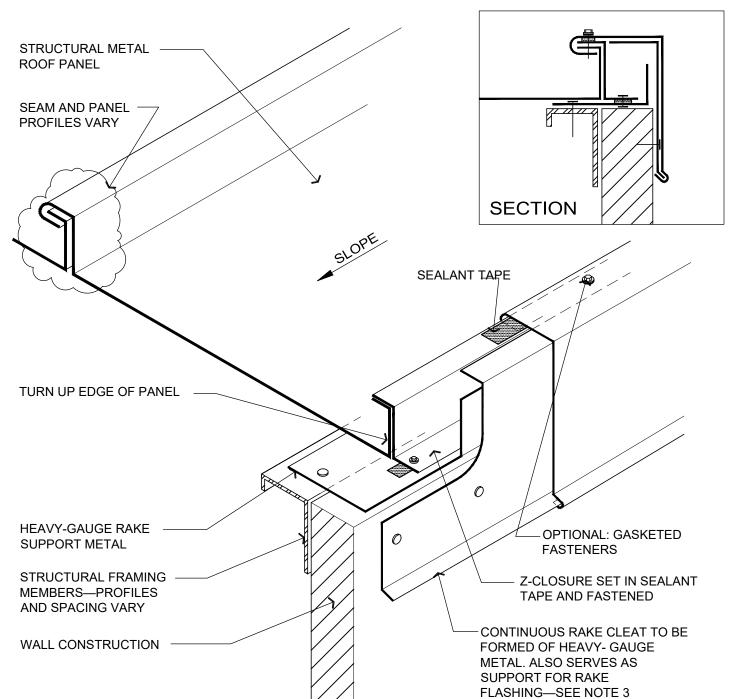

NOTES:


1. SPECIFIC FASTENING AND STRUCTURAL REQUIREMENTS ARE NOT INDICATED AS THEY VARY FROM SYSTEM TO SYSTEM DEPENDING ON PANEL MANUFACTURER'S REQUIREMENTS, WIND ZONE, BUILDING CODE AND WALL CONSTRUCTION.

INSULATION, VAPOR RETARDER AND THERMAL BLOCKS FOR ROOF SYSTEM ARE NOT SHOWN FOR CLARITY.
 REFER TO THE ARCHITECTURAL METAL FLASHING SECTION OF THE NRCA ROOFING MANUAL:

ARCHITECTURAL METAL FLASHING, CONDENSATION CONTROL AND REROOFING FOR PERIMETER EDGE-METAL THICKNESS AND CLEAT RECOMMENDATIONS.

4. REFER TO THE INTRODUCTION IN CHAPTER 10—CONSTRUCTION DETAILS FOR ADDITIONAL INFORMATION.

3 A-501 DETAIL RAKE EDGE FLASHING - END PANEL

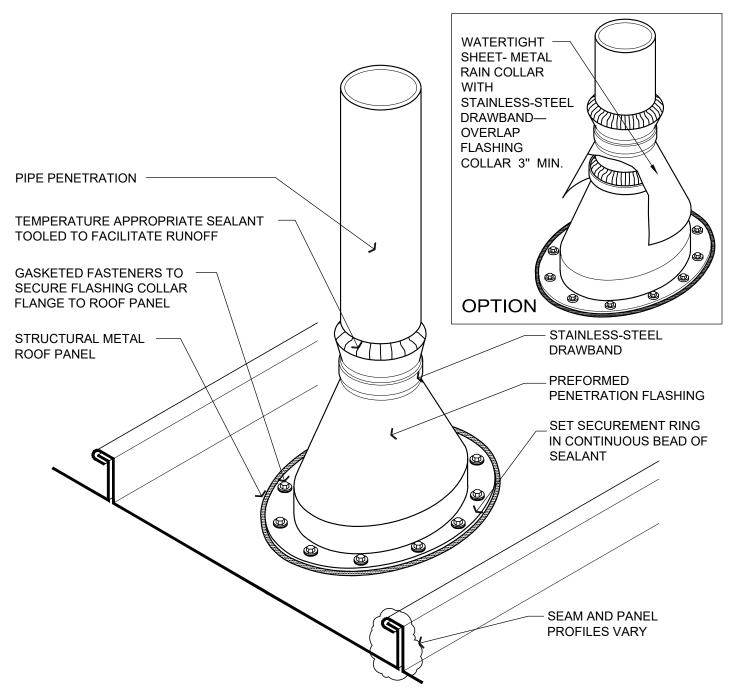

IOTES:

NRCA RECOMMENDS PENETRATIONS SHOULD NOT INTERFERE WITH PANEL SEAMS OR OCCUR AT


TRANSVERSE SEAMS. REFER TO DETAIL 6/A-501.
2. IF FIELD PANELS OVERLAP AT THE PENETRATION, ATTACHMENT OF THE DOWNSLOPE PANEL ALONG ITS UPSLOPE END MAY BE NECESSARY.

VENT STACKS AND OTHER PIPES SHOULD HAVE ADEQUATE CLEARANCE ON ALL SIDES FROM WALLS AND OTHER PROJECTIONS TO FACILITATE PROPER FLASHING AND PANEL DRAINAGE.
 FOR HOT PIPES, SPECIFIC HIGH-TEMPERATURE BOOTS SHOULD BE USED.
 INSULATION, VAPOR RETARDER AND THERMAL BLOCKS FOR ROOF SYSTEM ARE NOT SHOWN FOR

CLARITY.
6. REFER TO THE INTRODUCTION IN CHAPTER 10—CONSTRUCTION DETAILS FOR ADDITIONAL INFORMATION.

7 A-501 DETAIL NOT TO SCALE

PIPE PENETRATION FLASHING

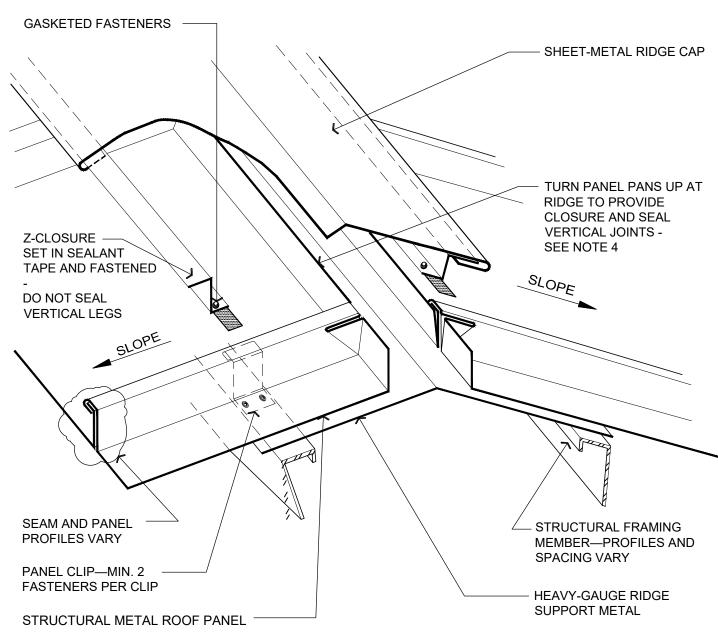

NOTES:


1. SPECIFIC FASTENING AND STRUCTURAL REQUIREMENTS ARE NOT INDICATED AS THEY VARY FROM SYSTEM TO SYSTEM DEPENDING ON PANEL MANUFACTURER'S REQUIREMENTS, WIND ZONE, BUILDING CODE AND WALL CONSTRUCTION.

THIS DETAIL FIXES THE PANEL ALONG THE RIDGE.
 INSULATION, VAPOR RETARDER AND THERMAL BLOCKS FOR ROOF SYSTEM ARE NOT SHOWN FOR

CLARITY.

4. REFER TO THE INTRODUCTION IN CHAPTER 10—CONSTRUCTION DETAILS FOR ADDITIONAL INFORMATION.

4 A-501 DETAIL RIDGE CAP FLASHING - FIXED AT RIDGE
NOT TO SCALE

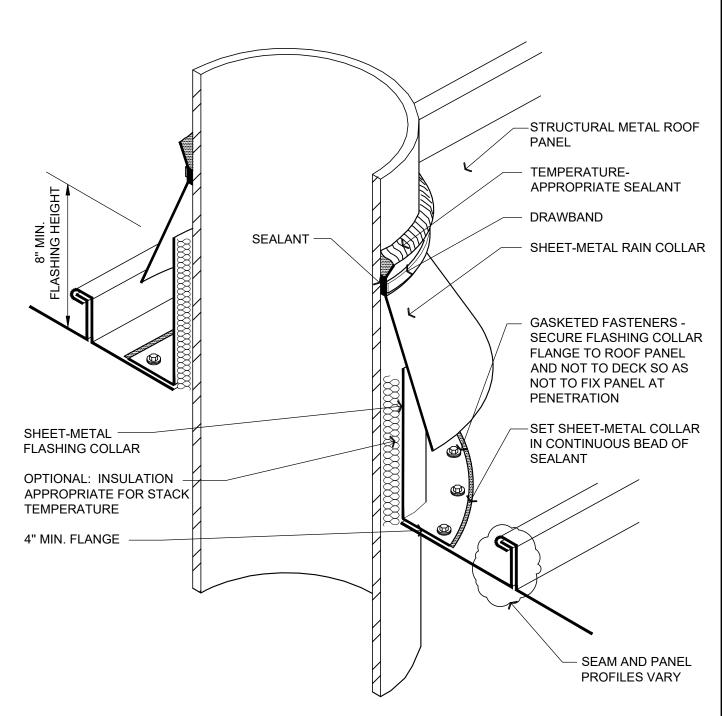


IOTES:

NRCA STRONGLY RECOMMENDS PENETRATIONS SHOULD NOT INTERFERE WITH PANEL SEAMS OR OCCUPAT TRANSVERSE SEAMS, REFER TO DETAIL 6/A-501
 VENT STACKS AND OTHER PIPES SHOULD HAVE ADEQUATE CLEARANCE ON ALL SIDES FROM WALLS AND

VENT STACKS AND OTHER PIPES SHOULD HAVE ADEQUATE CLEARANCE ON ALL SIDES FROM WALLS AND
OTHER PROJECTIONS TO FACILITATE PROPER FLASHING AND PANEL DRAINAGE.
 INSULATION, VAPOR RETARDER AND THERMAL BLOCKS FOR ROOF SYSTEM ARE NOT SHOWN FOR

8 A-501 DETAIL SHEET-METAL STACK VENT (HOT OR COLD)
NOT TO SCALE

STATE OF MISSOURI MICHAEL L. KEHOE, GOVERNOR

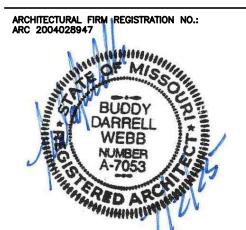

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DEPARTMENT OF MISSOURI NATIONAL GUARD

OFFICE OF THE ADJUTANT

GENERAL FACILITIES MANAGEMENT

FT. LEONARD WOOD READINESS CENTER BLDG 1029

REPLACE ROOF AND CONSTRUCT SOLAR ARRAY

PROJECT # T2412-01 SITE # 6306 FACILITY # 8136306003

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DRAWN BY:
CHECKED BY:
DESIGNED BY:

SHEET TITLE:


MISCELLANEOUS DETAILS

SHEET NUMBER:

CLARITY.

4. REFER TO THE INTRODUCTION IN CHAPTER 10—CONSTRUCTION DETAILS FOR ADDITIONAL INFORMATION. A = 50

5 OF 10 SHEETS JULY 2, 2025

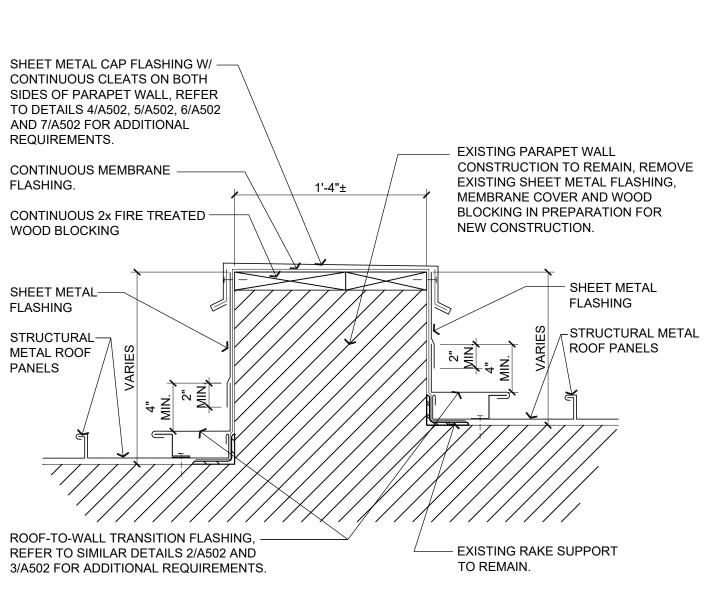

ROOF PARAPET TRANSITION

EACH SIDE

COPING CAP WITH COVER PLATE

COPING CAP WITH OVERLAP

SHEET METAL CONCEALED

PLATE SET IN SEALANT ON

SHEET METAL COPING CAP

SHEET METAL SET IN

COPING CAP OPTIONS

SEALANT ON EACH SIDE

- SHEET METAL COPING CAP

1 DETAIL
1 1/2" = 1'-0"

1. CONTINUOUS CLEAT NOT SHOWN FOR CLARITY.

COPING JOINERY IS SIMILAR ON BOTH SIDES.


DETAIL

NOT TO SCALE

REFER TO DETAIL 7/A-502 FOR COPING CAP SECUREMENT OPTIONS.

4. REMOVAL OF UNDERLYING METAL HEM MAY HELP FACILITATE PROPER NESTING.

[13 mm] GAP

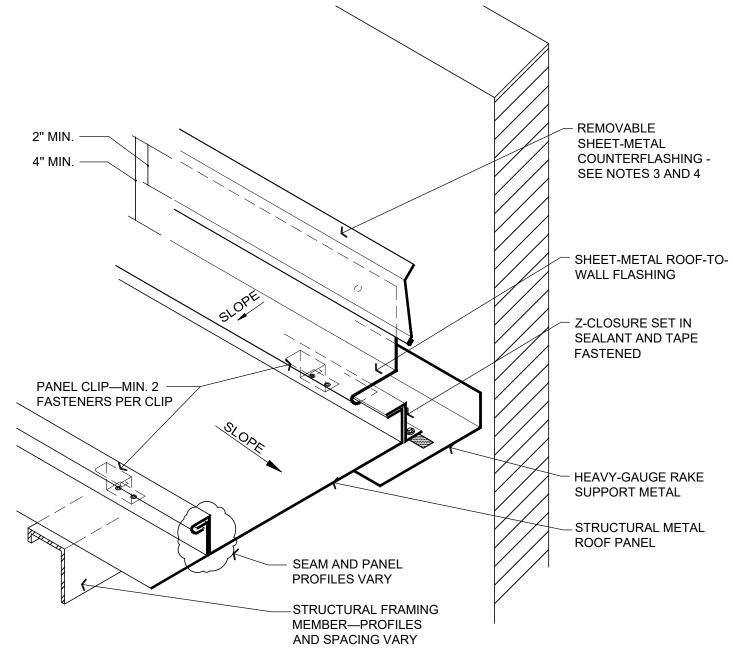


1. SPECIFIC FASTENING AND STRUCTURAL REQUIREMENTS ARE NOT INDICATED AS THEY VARY FROM SYSTEM TO SYSTEM DEPENDING ON PANEL MANUFACTURER'S REQUIREMENTS, WIND ZONE, BUILDING CODE AND WALL CONSTRUCTION.


2. INSULATION, VAPOR RETARDER AND THERMAL BLOCKS FOR ROOF SYSTEM ARE NOT SHOWN FOR 3. REFER TO THE ARCHITECTURAL METAL FLASHING SECTION OF THE NRCA ROOFING MANUAL:

ARCHITECTURAL METAL FLASHING, CONDENSATION CONTROL AND REROOFING FOR COUNTERFLASHING 4. REFER TO THE INTRODUCTION IN CHAPTER 10—CONSTRUCTION DETAILS FOR ADDITIONAL INFORMATION.

2 DETAIL ROOF-TO-WALL (SIDEWALL) TRANSITION

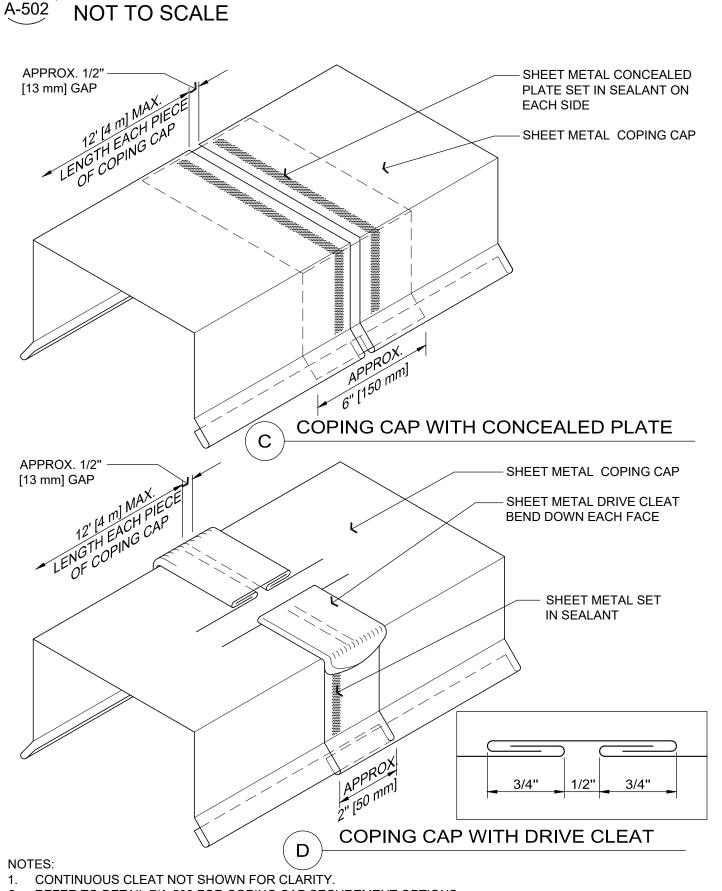

REFER TO DETAIL 7/A-502 FOR COPING CAP SECUREMENT OPTIONS. COPING JOINERY IS SIMILAR ON BOTH SIDES. REMOVAL OF UNDERLYING METAL HEM MAY HELP FACILITATE PROPER NESTING. DETAIL **COPING CAP OPTIONS** NOT TO SCALE

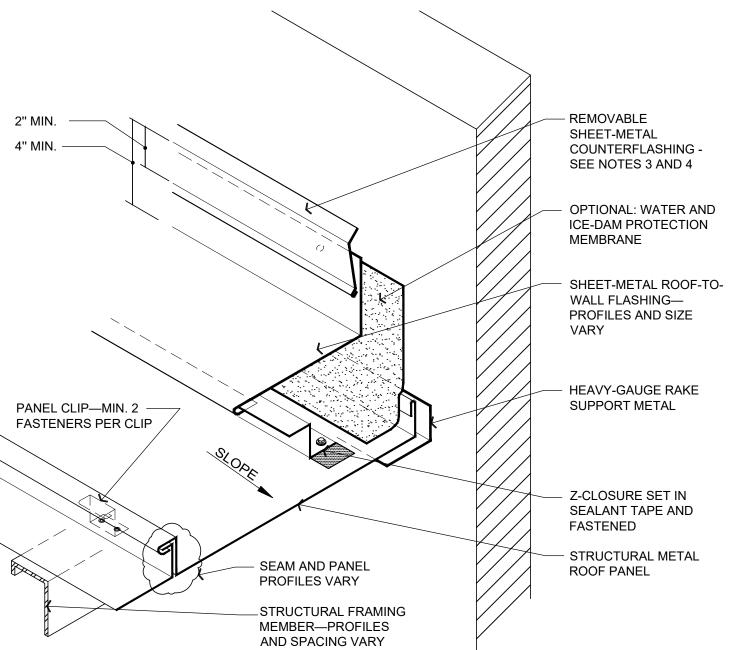



SPECIFIC FASTENING AND STRUCTURAL REQUIREMENTS ARE NOT INDICATED AS THEY VARY FROM SYSTEM TO SYSTEM DEPENDING ON PANEL MANUFACTURER'S REQUIREMENTS, WIND ZONE, BUILDING CODE AND WALL CONSTRUCTION. 2. INSULATION, VAPOR RETARDER AND THERMAL BLOCKS FOR ROOF SYSTEM ARE NOT SHOWN FOR

REFER TO THE ARCHITECTURAL METAL FLASHING SECTION OF THE NRCA ROOFING MANUAL ARCHITECTURAL METAL FLASHING, CONDENSATION CONTROL AND REROOFING FOR COUNTERFLASHING

4. REFER TO THE INTRODUCTION IN CHAPTER 10—CONSTRUCTION DETAILS FOR ADDITIONAL INFORMATION.

ROOF-TO-WALL (SIDEWALL) 3 DETAIL **TRANSITION - END PANEL** NOT TO SCALE

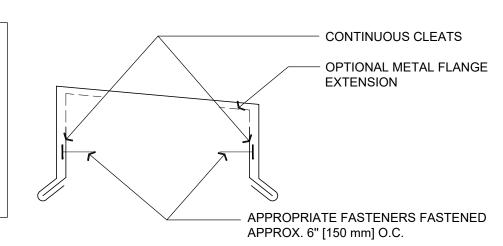


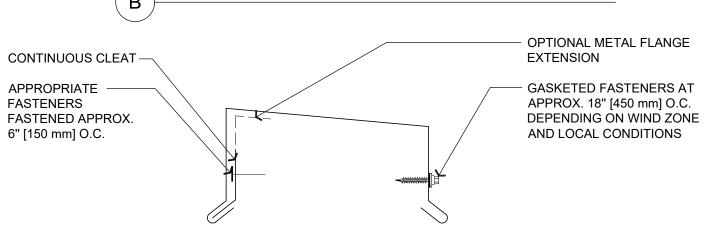

CONTINUOUS CLEAT AND GASKETED FASTENERS

DETAIL NOT TO SCALE


COPING CAP SECUREMENT OPTIONS

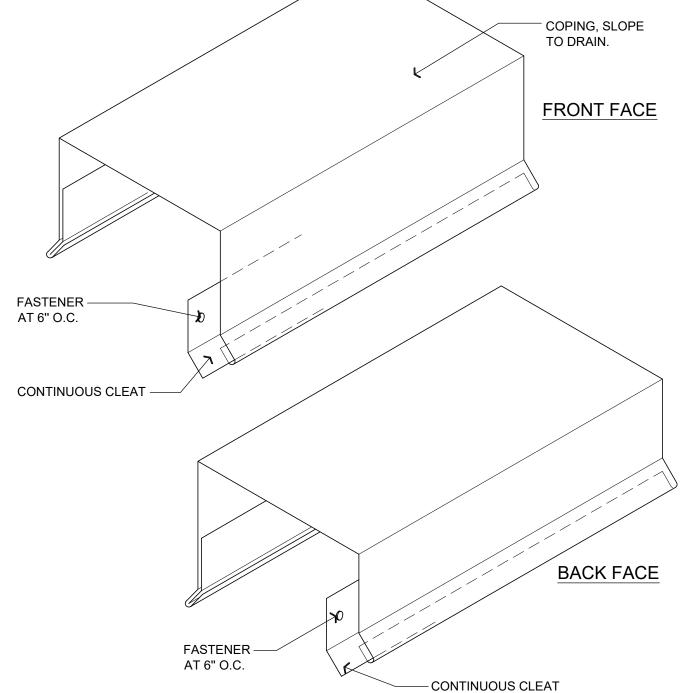

NRCA HAS OBTAINED AN ANSI/SPRI ES-1 APPROVAL LISTING FOR THIS SPECIFIC SHOP-FABRICATED FLASHING COMPONENT. REFER TO THE INTRODUCTION OF THE CONSTRUCTION DETAILS CHAPTER FOR ADDITIONAL INFORMATION. 3. REFER TO THE INTRODUCTION OF THE CONSTRUCTION DETAILS CHAPTER FOR ADDITIONAL INFORMATION.

1. ROOF MEMBRANE AND ASSOCIATED FLASHINGS NOT SHOWN FOR CLARITY

COPING WITH DRIP, FRONT AND 4 DETAIL BACK FACE CLEAT NOT TO SCALE

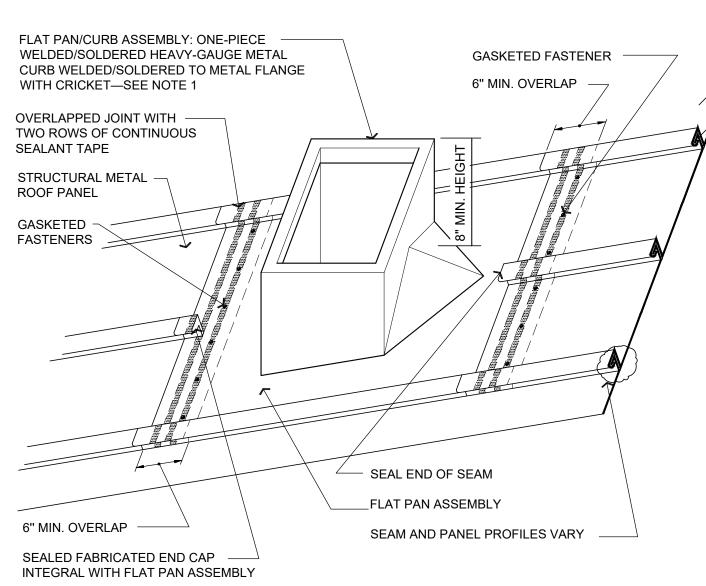

PROPER STRUCTURAL SUPPORT AND ATTACHMENT IS REQUIRED UNDER ALL SIDES OF THE RAISED CURB.

CURB-MOUNTED EQUIPMENT SHOULD BE WEATHERPROOF AND HAVE A WEATHERPROOF INTERLOCK OR

REFER TO THE INTRODUCTION IN CHAPTER 10—CONSTRUCTION DETAILS FOR ADDITIONAL INFORMATION.

THIS DETAIL FIXES THE RAISED CURB TO THE STRUCTURAL METAL PANELS. INSULATION, VAPOR RETARDER AND THERMAL BLOCKS NOT SHOWN FOR CLARITY.

SUFFICIENT OVERLAP WITH THE CURB.


PRE-MANUFACTURED CURBS ARE AVAILABLE.

NOT TO SCALE

DETAILS

SHEET NUMBER:

6 OF 10 SHEETS JULY 2, 2025

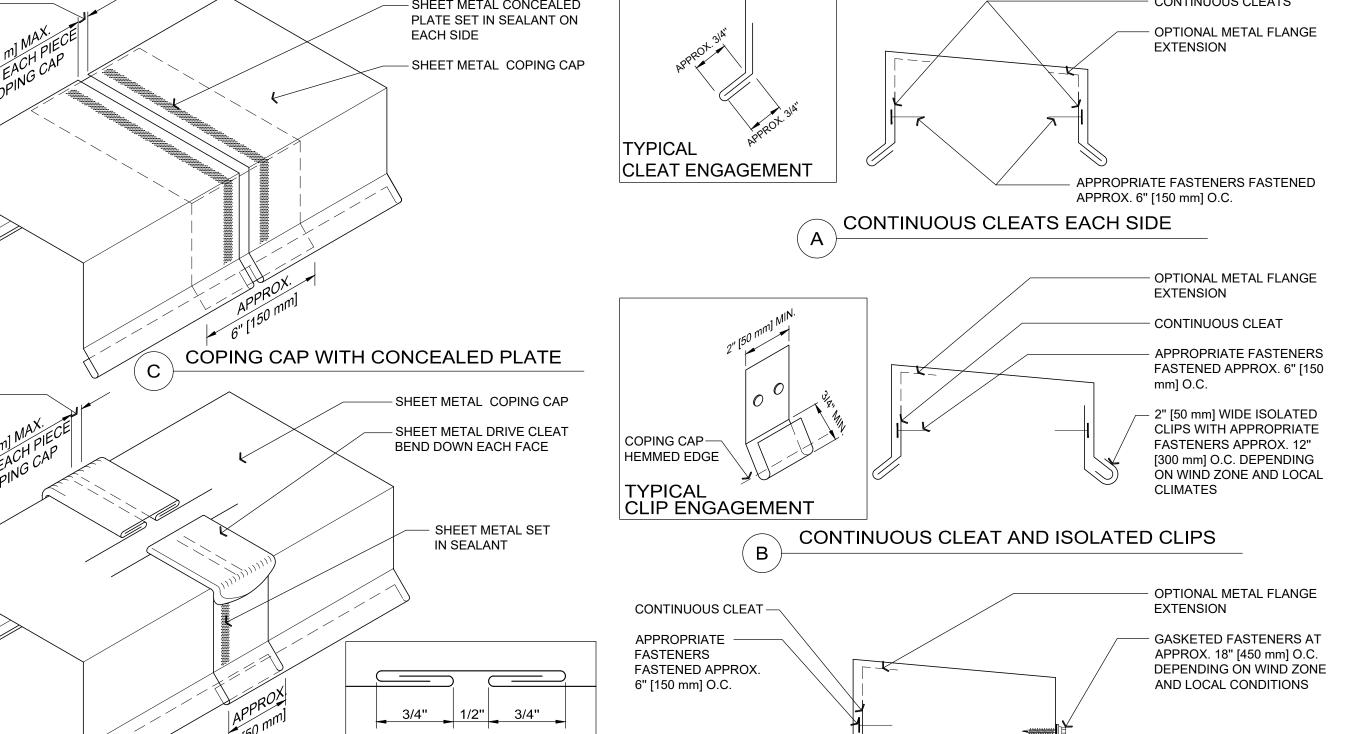



STATE OF MISSOURI MICHAEL L. KEHOE,

DEPARTMENT OF MISSOURI NATIONAL GUARD OFFICE OF THE ADJUTANT **GENERAL** FACILITIES MANAGEMENT **OFFICE**

FT. LEONARD WOOD READINESS CENTER BLDG 1029

REPLACE ROOF AND CONSTRUCT SOLAR ARRAY

PROJECT # T2412-01 FACILITY # 8136306003


REVISION:	
DATE:	
REVISION:	
DATE:	
REVISION:	
DATE:	
ISSUE DATE: 0'	7/02/2025

CAD DWG FILE:6306-8136306003-A-5 DRAWN BY: CHECKED BY **DESIGNED BY**

SHEET TITLE:

MISCELLANEOUS

DETAIL RAISED CURB FOR ROOFTOP EQUIPMENT

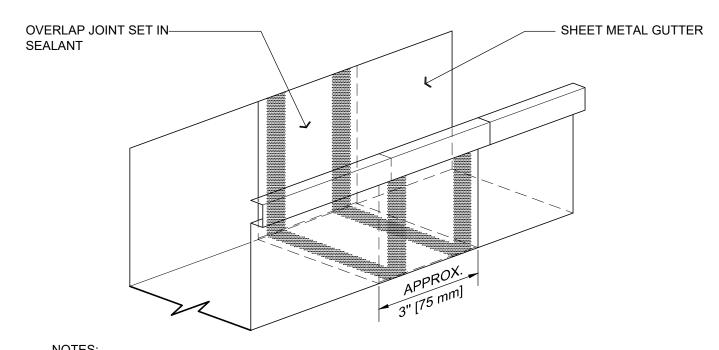


1. GUTTER PROFILES AND SIZE VARIES (8" SQUARE TYPICAL) 2. APPROPRIATE FASTENERS (E.G. POP-RIVETS) COVERED WITH SEALANT - NOT SHOWN FOR CLARITY. **GUTTER WITH OVERLAP JOINT AND SEALANT**


SHEET METAL GUTTER -SOLDERABLE METALS ONLY SOLDERED OVERLAP JOINT INTO SEAM

1. GUTTER PROFILES AND SIZE VARY (8" SQUARE TYPICAL) 2. APPROPRIATE FASTENERS (E.G. POP-RIVETS) COVERED WITH SEALANT - NOT SHOWN FOR CLARITY. GUTTER WITH OVERLAP JOINT AND SOLDER

1 DETAIL NOT TO SCALE


GUTTER JOINERY OPTIONS

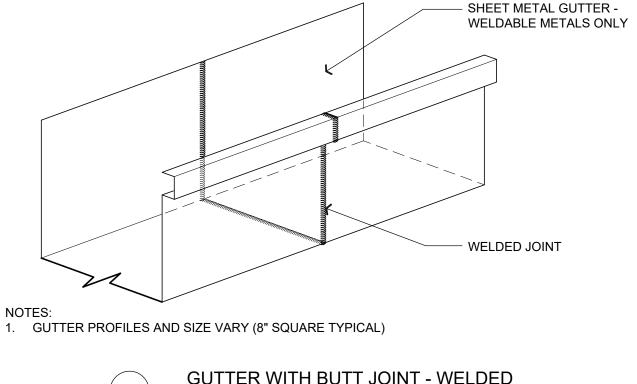


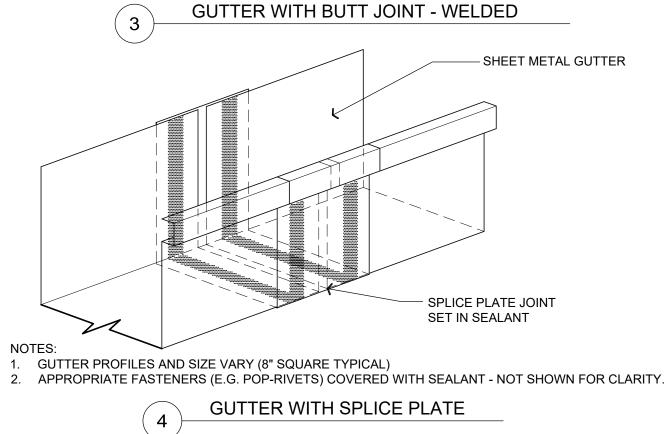

2 DETAIL **GUTTER JOINERY OPTIONS** A-503 NOT TO SCALE




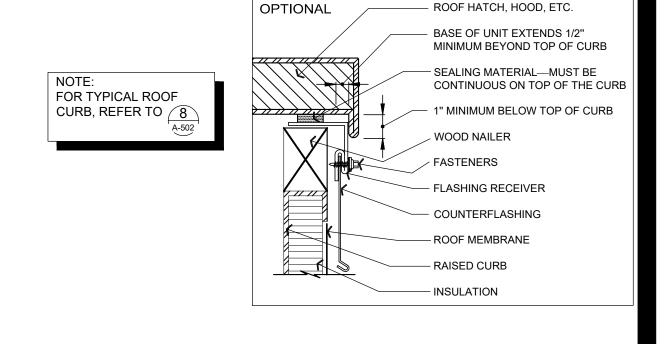

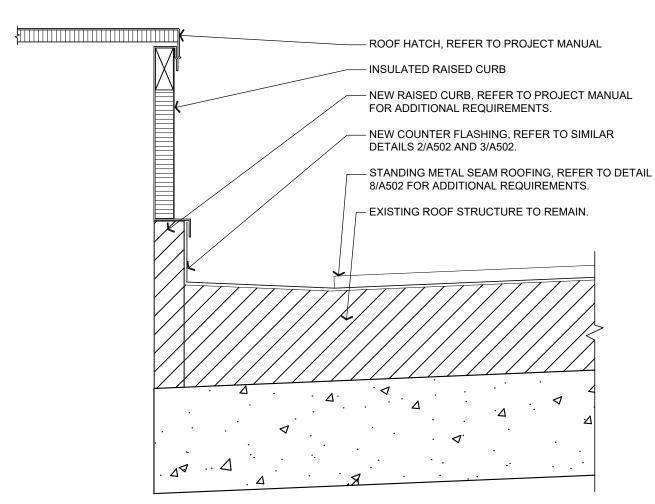


 $\underbrace{\frac{4}{\text{A-503}}}_{\text{NOT TO SCALE}}$ **ROOF CURB TRANSITION**

8 NOT USED
NOT TO SCALE

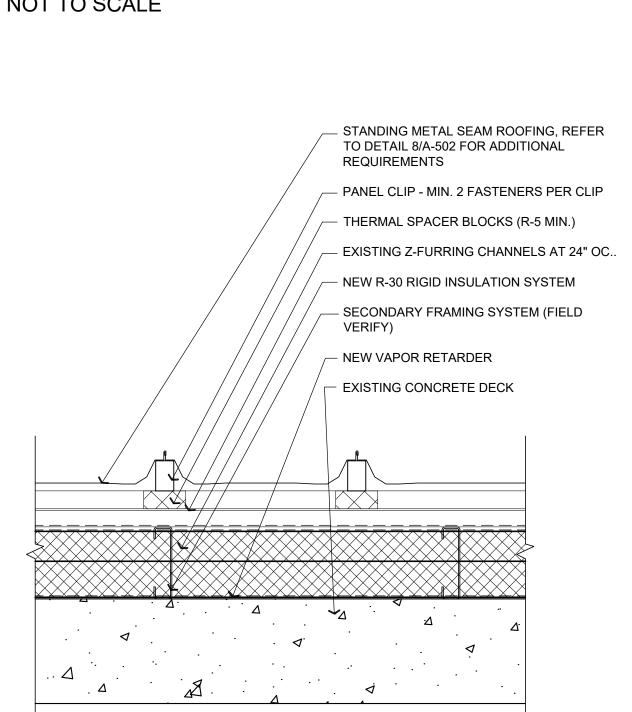

ALTERNATES:
REFER TO PROJECT MANUAL SECTION 01 23 00 FOR ADDITIONAL REQUIREMENTS. ALTERNATE NO. 1: (NEW ROOF INSULATION SYSTEM).

PROVIDE NEW ROOF INSULATION BOARD (R-30 MINIMUM) SYSTEM ON TOP OF EXISTING CONCRETE ROOF DECK BELOW AREAS OF NEW ROOFING CONSTRUCTION.

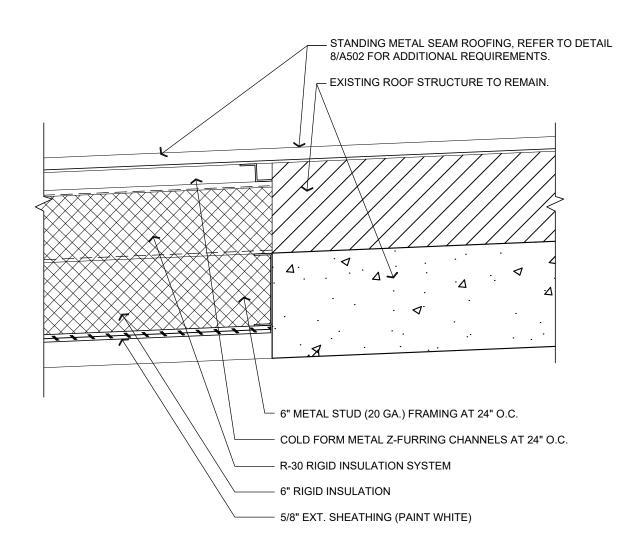

DETAIL A-503 NOT TO SCALE



FT. LEONARD WOOD READINESS CENTER BLDG 1029

REPLACE ROOF AND CONSTRUCT SOLAR ARRAY

DEPARTMENT OF MISSOURI

OFFICE OF THE ADJUTANT

FACILITIES MANAGEMENT

NATIONAL GUARD

GENERAL

STATE OF MISSOURI MICHAEL L. KEHOE, **GOVERNOR**

SHEETS BEARING THIS SEAL ARE AUTHENTICATED, RESPONSIBILITY FOR ALL OTHER PLANS, SPECIFICATIONS OR INSTRUMENTS ARE DISCLAIMED.

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PROJECT # T2412-01 6306 FACILITY # 8136306003

REVISION: REVISION: REVISION: ISSUE DATE: 07/02/2025

CAD DWG FILE:6306-8136306003-A-503 DRAWN BY: CHECKED BY:

SHEET TITLE:

DESIGNED BY

MISCELLANEOUS DETAILS

SHEET NUMBER:

A-503

7 OF 10 SHEETS JULY 2, 2025



CONDUIT AND CONDUCTORS DOWN IN CORNER TO ELECTRICAL ROOM. SECURELY ATTACH TO EXTERIOR MASONRY WALL AND PAINT TO MATCH ADJACENT SURFACE. REFER TO ELECTRICAL RISER

CONDUIT & CONDUCTOR SCHEDULE:

(2) #4s AND (1) #4 GROUND IN 1" CONDUIT.

KEYNOTES:

(2) (2) SETS: (2) #4s AND (1) #4 GROUND IN 1" CONDUITS.

STATE OF MISSOURI MICHAEL L. KEHOE, GOVERNOR



RYAN S. JONES – ENGINEER PE-2004017193 PROFESSIONAL SEAL

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FT. LEONARD WOOD READINESS CENTER BLDG 1029

REPLACE ROOF AND CONSTRUCT SOLAR ARRAY

PROJECT # T2412-01 SITE # 6306 FACILITY # 8136306003

REVISION:
DATE:
REVISION:
DATE:
REVISION:
DATE:

ISSUE DATE: 07/02/2025

CAD DWG FILE: E-100.DWG
DRAWN BY: QCJ
CHECKED BY: RSJ
DESIGNED BY: QCJ

SHEET TITLE:

ROOF POWER PLAN


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E-100


8 OF 10 SHEETS
JULY 2, 2025

SPECIAL NOTES:

- 1. <u>PLANS ARE DIAGRAMMATIC</u>. COORDINATE EXACT QUANTITIES AND SIZES OF MODULES, DC COMBINERS, INVERTERS, CONDUCTORS, AND CONDUITS WITH PV SYSTEM MANUFACTURER.
- 2. INSTALL ALL PHOTOVOLTAIC MODULES AND SUPPORTS PER MANUFACTURER'S RECOMMENDATIONS, WITH NO ROOF PENETRATIONS.
 REFER TO SHEET E-500 FOR CONNECTION DETAILS.
 PROVIDE ALL NECESSARY MOUNTING HARDWARE FOR COMPLETE INSTALLATION OF PV SYSTEM.
- 3. ELECTRICAL CONTRACTOR SHALL DISCONNECT AND RECONNECT POWER TO ALL EXISTING ROOF—MOUNTED MECHANICAL EQUIPMENT AS REQUIRED TO SUPPORT REPLACEMENT OF ROOFING SYSTEM. REFER TO SHEET A—101 FOR EQUIPMENT QUANTITIES AND LOCATIONS. FIELD VERIFY EXACT REQUIREMENTS.




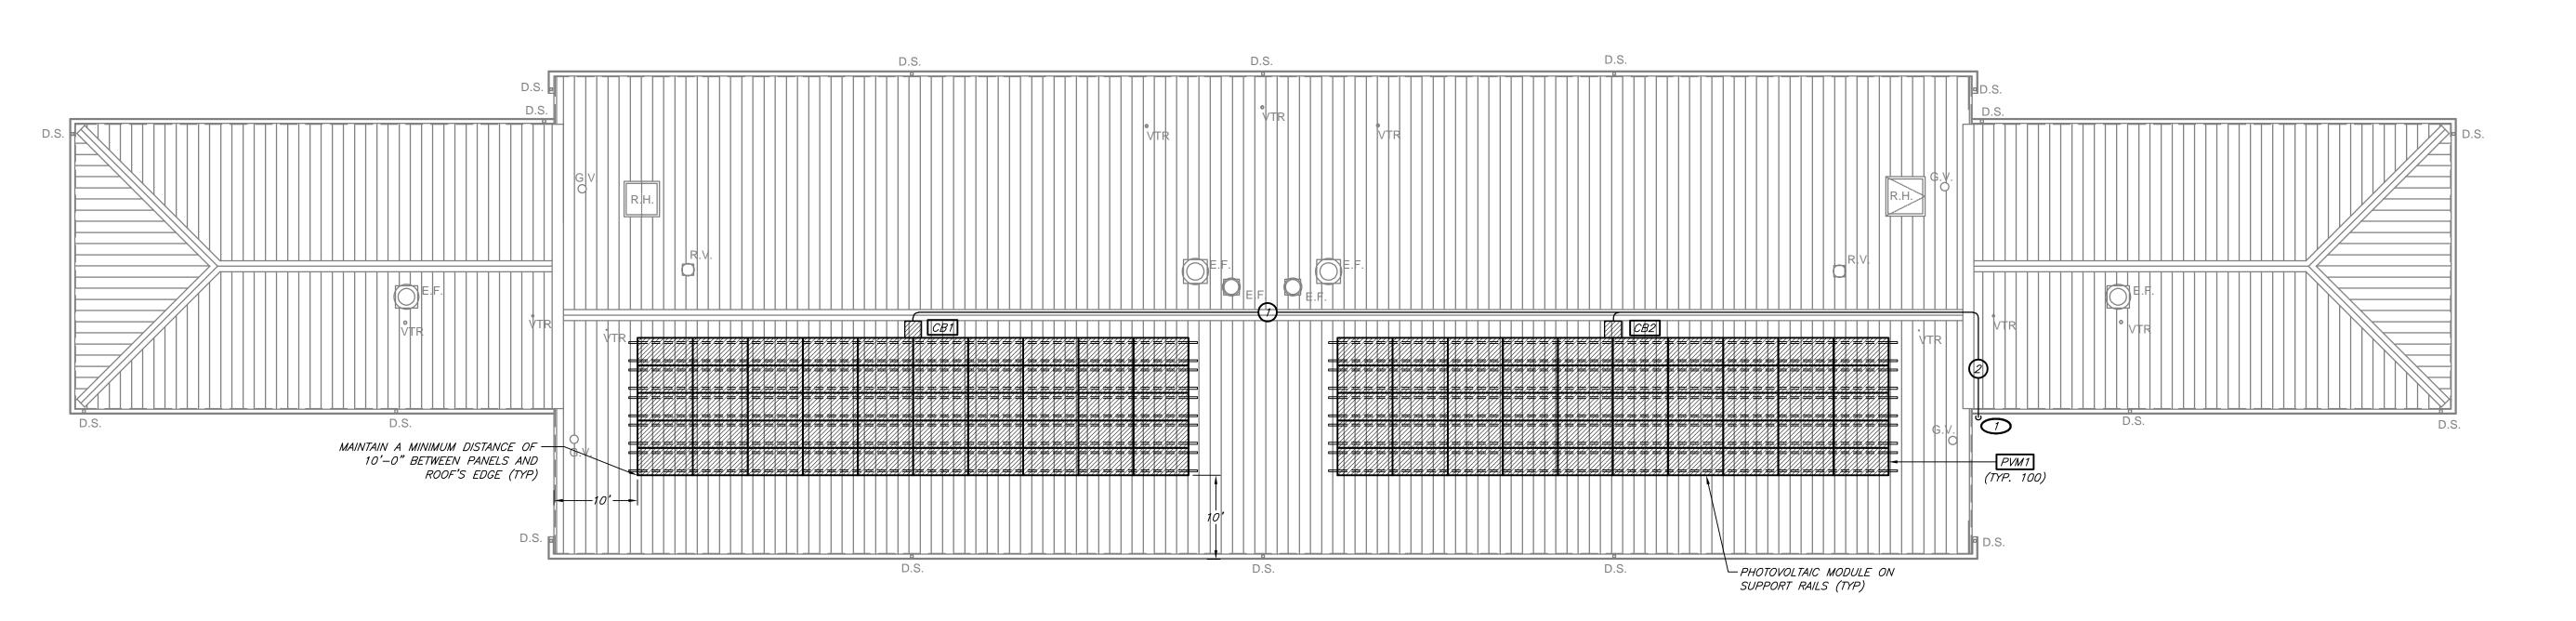

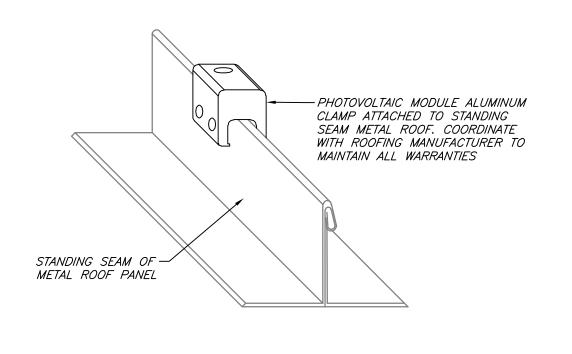


ROOF CLAMP DETAIL

NO SCALE

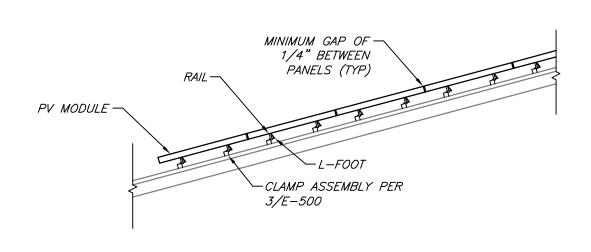

PV MODULE INSTALLATION DETAIL

NO SCALE

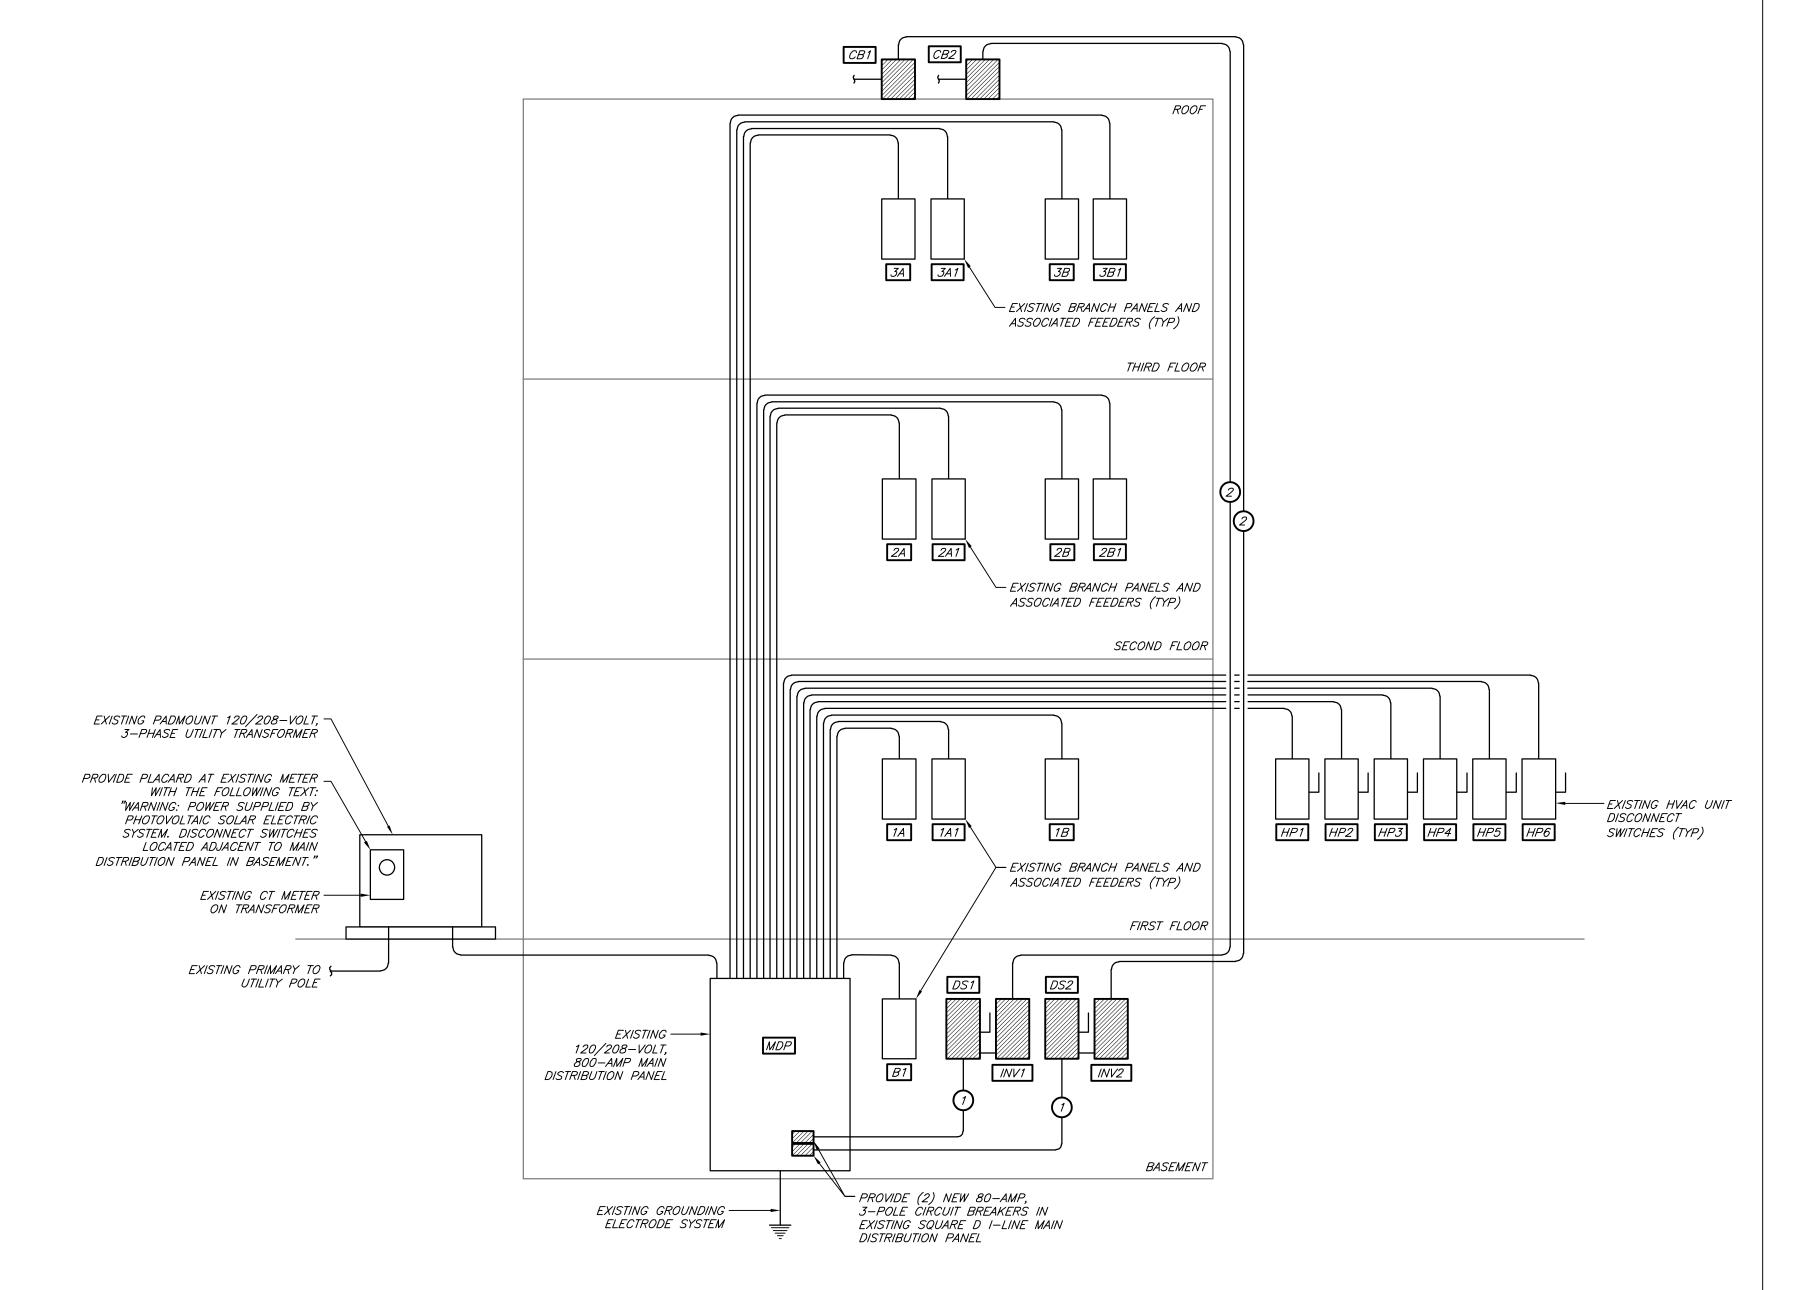


1 ELECTRICAL RISER DIAGRAM
NO SCALE

CONDUIT & CONDUCTOR SCHEDULE:

- (3) #4s AND (1) #8 GROUND IN 1" CONDUIT.
- (2) #4s AND (1) #4 GROUND IN 1" CONDUIT.

STATE OF MISSOURI MICHAEL L. KEHOE, GOVERNOR

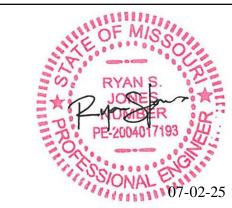

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DEPARTMENT OF MISSOURI NATIONAL GUARD OFFICE OF THE ADJUTANT GENERAL FACILITIES MANAGEMENT

OFFICE

FT. LEONARD WOOD READINESS CENTER BLDG 1029

REPLACE ROOF AND CONSTRUCT SOLAR ARRAY

PROJECT # T2412-01 SITE # 6306 FACILITY # 8136306003

REVISION:
DATE:
REVISION:
DATE:
REVISION:
DATE:
ISSUE DATE: 07/02/2025

CAD DWG FILE: E-500.DWG
DRAWN BY: QCJ
CHECKED BY: RSJ

DESIGNED BY: QCJ

SHEET TITLE:

ELECTRICAL DETAILS


SHEET NUMBER:

E-50C

9 OF 10 SHEETS
JULY 2, 2025



STATE OF MISSOURI MICHAEL L. KEHOE, **GOVERNOR**

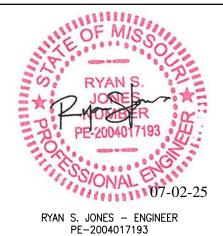

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FT. LEONARD WOOD READINESS CENTER BLDG 1029

REPLACE ROOF AND CONSTRUCT SOLAR ARRAY

PROJECT # T2412-01 FACILITY # 8136306003

> **REVISION:** DATE: **REVISION:** DATE: **REVISION:** DATE: ISSUE DATE: 07/02/2025

CAD DWG FILE: E-600.DWG DRAWN BY: CHECKED BY: RSJ DESIGNED BY: QCJ

SHEET TITLE:

ELECTRICAL **SCHEDULES**

SHEET NUMBER:

DISCONNECT SWITCH SCHEDULE OVERCURRENT PROTECTION LOAD SWITCH NOTES & NEMA MARK -| VOLTAGE | DUTY | AMP | POLE | TYPE | MFR | MODEL | AMP | KAIC | ENCLOSURE | ACCESS. **EQUIPMENT SERVED** DS1 1,5 INVERTER INV1 208 GD 100 3 NF INVERTER INV2 208 GD 100 3 NF - - - 3R 1,5 ABBREVIATIONS: CB - ENCLOSED CIRCUIT BREAKER GD - GENERAL DUTY

HD - HEAVY DUTY

NF - NON-FUSIBLE

ACCESSORIES:

1. GROUND LUG KIT
2. SOLID NEUTRAL

3. NEUTRAL BONDING JUMPER

4. SERVICE ENTRANCE RATING

5. DISCONNECT SHALL BE LOCKABLE IN THE OPEN POSITION

COMBINER BOX SCHEDULE MAX DC VOLTAGE | MAX INPUT (AMPS) | OUTPUT (AMPS) | INPUT STRINGS | NOTES MARK MANUFACTURER SERIES / MODEL # CB1 SUNWAY SW-PV10 1000 15 96 10 1 CB2 SUNWAY SW-PV10 1000 96 10 PRIOR TO ANY INSTALLATION, EXACT BOX LOCATIONS SHALL BE CONFIRMED WITH ARCHITECT/OWNER. LOCATIONS SHOWN ON POWER PLANS ARE APPROXIMATE.

	PHOTOVOLTAIC MODULE SCHEDULE									
MARK	MANUFACTURER	MODEL	MAXIMUM POWER RATING	VOLTAGE	CURRENT	MODULE EFFECIENCY (%)	NFPA FIRE TYPE	WEIGHT (LBS)	NOTES AND ACCESSORIES	
PVM1	JINKO SOLAR	JKM400M-72HL-V	400 W	41.7 V	9.6 A	19.88	1	49.6	1,2,3	

NOTES/ACCESSORIES:

- 1. REFER TO PHOTOVOLTAIC SYSTEM SPECIFICATIONS FOR APPROVED MANUFACTURERS AND ADDITIONAL REQUIREMENTS.
- 2. ALL RATINGS BASED ON STANDARD TESTING CONDITIONS.
- 3. PROVIDE ALL NECESSARY MOUNTING HARDWARE.

			IN	VERTER	SCHEDU	LE				
MARK	MANUFACTURER	MODEL	DC INPUT			AC OUTPUT			- NEMA	
			KW	MAX VOLTAGE	CURRENT (A)	V/PH/HZ	CURRENT (A)	MOCP	ENCLOSURE	NOTES
INV1	YASKAWA	PVI-25TL-208	25	1000	96	208/3/60	69.5	80	4X	1,2,3,4,5
INV2	YASKAWA	PVI-25TL-208	25	1000	96	208/3/60	69.5	80	4X	1,2,3,4,5

- 1. INTEGRAL DISCONNECT SWITCH
- 2. OUTPUT TRIP ALARM. 3. INTERNAL MAINTENANCE BYPASS SWITCH.