ADDENDUM NO. 02

TO: PLANS AND SPECIFICATIONS FOR STATE OF MISSOURI

BID St Louis Lambert Readiness Center-Upgrade Latrines & Showers, Building 233

St. Louis, Missouri

PROJECT NO.: T2417-01

Bid Opening Date: 1:30 PM, Thursday, September 4, 2025 (UNCHANGED)

Bidders are hereby informed that the construction Plans and/or Specifications are modified as follows:

SPECIFICATION CHANGES:

1. ADD Section 028213 Asbestos Abatement

DRAWINGS CHANGES:

- 1. <u>Sheet AD101</u>
 - a. Updated Keynote D10
- 2. Sheet A101
 - a. Updated Keynote N7
- 3. Sheet A402
 - a. Updated details 17 and 18 to match existing signage.
- 4. Sheet A701
 - a. Resinous Flooring symbol is now shown as RSF-1 and Corresponds with the Room Finish Schedule.
- 5. Sheet AB101
 - a. ADD in its entirety

GENERAL COMMENTS:

NONE

ATTACHMENTS:

- A. REVISED Sheet AD101
- B. REVISED Sheet A101
- C. REVISED Sheet A402
- D. REVISED Sheet A701
- E. Sheet AB101
- F. Spec Section 02821HAsbestos Abatement (3 Pages)

END ADDENDUM 02

GENERAL NOTES - OCCUPANCY BUILDING SHALL REMAIN OCCUPIED DURING THE DURATION OF THE CONSTRUCTION PERIOD AT NO TIME WILL THE OWNERS OPERATIONS BE IMPACTED DUE TO CONSTRUCTION EFFORT. D04 ∜D09∜ D04 #1×-61/8° X8\X10\X D01 C -D09 D09 D03 D09 D07

DEMOLITION FLOOR PLAN

Key Value	Keynote Legend Keynote Text
D01	THE CONTRACTOR WILL PERFORM GROSS INTERIOR DEMOLITION INCLUSIVE OF ALL WALLS, DOORS, CEILINGS, FLOOR FINISHES & ADHESIVE/MORTAR, EQUIPMENT & DEVICES, CASEWORK, EQUIPMENT, ETC. EXISTING BUILDING SHELL AND INTERIOR STRUCTURE WILL REMAIN.
D02	SAW CUT & REMOVE EXISTING FLOOR SLAB INCLUDING BUT NOT LIMITED TO TRENCHING FOR NEW MEPFP UTILITIES. FIELD VERIFY EXTENTS OF EXISTING FLOORING FOR REMOVAL. REMOVE EXISTING AND RELATED PIPING. BACKFILL WITH GRANULAR FILL FOR THE INSTALLATION OF A NEW CONCRETE SLAB. SEE MEPFP AND STRUCTURAL DRAWINGS FOR ADDITIONAL INFORMATION.
D03	REMOVE WALL MOUNTED DRINKING FOUNTAIN AND PLUMBING.
D04	NO WORK THIS AREA UNLESS REQUIRED FOR MEP ROUTING. COORDINATE W/ MEP DRAWINGS.
D06	REMOVE EXISTING PLUMBING FIXTURES COMPLETELY. CAP ALL SERVICES BELOW FLOOR AND/OR BEYOND FACE OF WALL CONSTRUCTION. REFER TO THE PLUMBING DRAWINGS FOR ADDITIONAL INFORMATION. PREPARE SURFACES TO REMAIN AS REQUIRED FOR NEW CONSTRUCTION.
D07	REMOVE EXISTING METAL STUD WALL CONSTRUCTION AS REQUIRED FOR NEW DOOR OPENING. REFER TO THE ARCHITECTURAL DRAWINGS AND OPENING SCHEDULE FOR ADDITIONAL INFORMATION.
D09	COORDINATE WITH ANY IN FLOOR TRENCHING (P102). SEE ENVIRONMENTAL ITEMS IN ROOM 125,
D10	ABATE AND REMOVE EXISTING HAZARDOUS MATERIAL FLOORING. SEE SHEET AB101 AND SPECIFICATION 02.82.13 ASBESTOS ABATEMENT.

GENERAL DEMOLITION NOTES

- A. EXISTING CONDITIONS ARE BASED ON INFORMATION OBTAINED FROM EXISTING DRAWINGS AND FIELD SURVEY, AND WILL NOT BE CONSTRUED AS "AS BUILT." THE CONTRACTOR WILL FIELD VERIFY
- EXISTING CONDITIONS PRIOR TO ONSET OF CONSTRUCTION.

 B. THE DEMOLITION DRAWING IS TO SHOW A GENERAL 'GUT' OF THE DEMOLITION AREA. ALL INTERIOR PARTITIONS, FLOORING, CEILING, CASEWORK, PLUMBING, MECHANICAL, AND ELECTRICAL FIXTURES ARE TO BE REMOVED (SHOWN DASHED) UNLESS SPECIFICALLY NOTED OTHERWISE. ALL EXISTING STRUCTURE TO REMAIN UNLESS SHOWN DEMOLISHED ON STRUCTURAL DRAWINGS. SEE MECHANICAL, PLUMBING, AND ELECTRICAL DRAWINGS FOR THE EXTENT OF THEIR WORK.
- C. ALL WALL PARTITIONS SHOWN DASHED ARE TO BE REMOVED. THE CONTRACTOR WILL PATCH ALL PARTITIONS, CEILINGS, AND FLOORS AFFECTED BY DEMOLITION TO MATCH ADJACENT CONSTRUCTION.
- D. THE OWNER WILL VERIFY WHICH REMOVAL ITEMS ARE TO BE RETAINED BY THE OWNER AT THE PRE-CONSTRUCTION MEETING.

 E. WHILE DEMOLITION IS OCCURRING, BUSINESS ACTIVITIES WILL BE
- PROCEEDING IN ADJACENT AREAS. MINIMIZE NOISE AND DUST LEVELS.

 F. ALL EXISTING HAZARDOUS MATERIALS IN THE BUILDING WILL BE REVIEWED AND DEMOLISHED BY AN ABATEMENT CONTRACTOR.
- REFER TO THE HAZARDOUS MATERIAL REPORT INCLUDED IN THE WORK PLAN.

 G. WHEN EXTERIOR WALLS, WINDOWS, AND DOORS ARE REMOVED, CONSTRUCT TEMPORARY PARTITIONS AS REQUIRED TO ASSURE EXISTING BUILDING REMAINS WATERTIGHT AND WITHOUT AIR
- INFILTRATION DURING WORK. MAINTAIN TEMPORARY PARTITIONS
 AS REQUIRED.
 H. TEMPORARY PARTITIONS AND TEMPORARY DOORS AS REQUIRED
 TO AVOID MIGRATION OF DUST AND DEBRIS INTO ADJOINING
 AREAS, TO MAINTAIN PROPER FIRE EXITS, AND TO CONFINE
 PEDESTRIAN ACTIVITY TO OCCUPIED SPACES WHILE MAINTAINING
- REQUIRED MEANS OF EGRESS.

 I. ALL DEMOLITION WILL BE COORDINATED WITH PHASING WORK REQUIRED TO COMPLETE WORK.
- J. COORDINATE DEMOLITION WORK IN OCCUPIED SPACES AND NOTIFY OWNER TWO WEEKS PRIOR TO COMMENCING WORK. MINIMIZE DISRUPTIONS TO SPACES THAT REMAIN IN OPERATION. PROTECT EXISTING FLOOR, WALL, AND CEILING FINISHES.
 K. THE CONTRACTOR WILL PROVIDE FALL AND SAFETY PROTECTION AT ANY HAZARDOUS CONDITION CAUSED BY THE DEMOLITION
- L. NOTES WHICH DO NOT HAVE ARROWS TO SPECIFIC ITEMS INDICATE MATERIAL TO BE REMOVED FOR ENTIRE ROOM IN WHICH NOTE OCCURS.
- I. MAKE ALL DEMOLITION CLEAN AND COMPLETE IN A MANNER
 SUITABLE FOR NEW FINISHES AND SURFACES.
- N. WHEN DEMOLITION CAUSES OR EXPOSES DAMAGE TO FLOOR SLAB, WALL, OR CEILING SURFACES WHICH WILL REMAIN IN THE FINISHED WORK, SUCH CONDITIONS WILL BE REPAIRED AND LEVELED AS REQUIRED TO RECEIVE NEW FINISHES. REPAIRS MUST BE ACCEPTABLE TO OWNER.
- O. THE CONTRACTOR WILL CLEAN, PATCH, AND REPAIR EXISTING SURFACES AFFECTED DURING DEMOLITION AND CONSTRUCTION TO MATCH EXISTING ADJACENT SURFACES. REPAIRS WILL BE MADE AS TO MATCH EXISTING CONSTRUCTION IN MATERIAL, METHOD, TECHNOLOGY, COLOR PATTERNS, ETC.
- P. REMOVE ALL EXISTING CEILING, SUSPENSION SYSTEM, FRAMEWORK, GRIDS, WALL MOULDING, ETC., WITHIN THE PROJECT LIMITS UNLESS OTHERWISE INDICATED ON PLANS.

 Q. PATCH OPENINGS IN EXTERIOR WALLS RESULTING FROM
- Q. PATCH OPENINGS IN EXTERIOR WALLS RESULTING FROM DEMOLITION ACTIVITIES.R. ALL DOORS SHOWN DASHED ARE TO BE REMOVED. ASSOCIATED
- DOOR FRAME TO BE REMOVED UNLESS NOTED OTHERWISE.

 S. VERIFY FLOOR ELEVATIONS ON EACH SIDE OF WALLS BEING REMOVED. GRIND AND PATCH FLOOR AND INSTALL EPOXY FILL
- MATERIAL, AS REQUIRED, FOR SMOOTH, LEVEL FLOOR CONDITION.

 T. THE CONTRACTOR WILL PROTECT THE EXISTING FLOOR FINISHES
 TO REMAIN FROM DAMAGE THROUGHOUT CONSTRUCTION.

 U. REMOVE EXISTING FLOOR FINISH AND BASE WHERE NEW FINISHES
- ARE REQUIRED. REMOVE FLOOR FINISH ADHESIVE. CLEAN AND PREPARE SUBSTRATES AS REQUIRED TO PRODUCE A FLAT, EVEN SURFACE IN A MANNER SUITABLE TO ACCEPT NEW FINISHES.

 V. PATCH FLOOR PENETRATIONS RESULTING FROM REMOVAL OF EXISTING DUCTWORK, PIPING, AND ELECTRICAL RACEWAYS. FILL PENETRATIONS WITH CONCRETE, FULL FLOOR THICKNESS AND
- MAINTAIN FIRE-RESISTIVE RATING OF FLOOR SYSTEM. FINISH SUBSTRATE IN A MANNER SUITABLE FOR NEW FLOOR FINISHES.

 W. THE CONTRACTOR WILL FILL ALL WALL PENETRATIONS RESULTING FROM THE REMOVAL OF EXISTING MEP DEVICES IN THE INTERIOR WALLS TO REMAIN. THE PENETRATIONS WILL BE FILLED FLUSH WITH, AND OF THE SAME MATERIALS AS, THE SURROUNDING WALLS, THIS INCLUDES WORK ABOVE ALL CEILINGS. THE CONTRACTOR WILL IN-FILL ALL OPENINGS IN EXTERIOR WALLS RESULTING FROM THE REMOVAL OF LOUVERS. EXHAUST FANS.
- SAME MATERIALS AS, THE SURROUNDING WALLS.

 X. THE CONTRACTOR WILL COORDINATE WITH THE OWNER FOR ALL EXISTING EQUIPMENT AND FURNITURE ITEMS THAT ARE TO BE SALVAGED OR RE-INSTALLED PRIOR TO THE COMMENCEMENT OF DEMOLITION. (THIS SHOULD BE DEFINED AT THE SITE

ETC. THE OPENINGS WILL BE FILLED FLUSH WITH, AND OF THE

- INVESTIGATION).

 Y. REMOVE ALL EXISTING WALL MOUNTED ITEMS WITHIN THE PROJECT LIMITS WHICH ARE NOT INDICATED TO REMAIN. IF ITEMS ARE REMOVED FROM WALLS OR COLUMNS THAT REMAIN, PATCH WALLS AND COLUMNS AS REQUIRED TO RECEIVE NEW FINISHES.

 Z. EXISTING SYSTEMS FURNITURE CURRENTLY LOCATED IN AREAS
- BY THE OWNER PRIOR TO CONSTRUCTION.

 AA. PORTIONS OF THE PLAN THAT HAVE BEEN CROSSED HATCHED ARE CONSIDERED OUTSIDE THE SCOPE OF WORK, UNLESS NOTED

THAT WILL BE AFFECTED BY CONSTRUCTION WILL BE REMOVED


- OTHERWISE BY THE MEPFP DOCUMENTS, TYPICAL.

 BB. *CONTRACTOR WILL VERIFY, MAINTAIN, AND PROTECT ALL

 EXISTING FIRE-RATED AND/OR SMOKE-RATED ASSEMBLIES WITHIN

 THE PROJECT AREA THAT ARE TO REMAIN DURING
- CONSTRUCTION.

 CC. *ALL FIRE-RATED FLOOR PENETRATIONS WILL BE REPAIRED AND/OR MAINTAINED TO A 2-HOUR MINIMUM RATING WITHIN FOUR (4) HOURS OF DEMOLITION.
- DD. *ALL PENETRATIONS WILL BE MAINTAINED AND/OR REPAIRED TO MEET THE MINIMUM RATING REQUIREMENTS WITHIN FOUR (4) HOURS OF DEMOLITION.
- EE. *ANY EXISTING FIRE-RATED AND/OR SMOKE-RATED ASSEMBLIES
 THAT ARE DISCOVERED TO BE COMPROMISED WILL BE REPAIRED
 WITHIN FOUR (4) HOURS OF THE DISCOVERY.

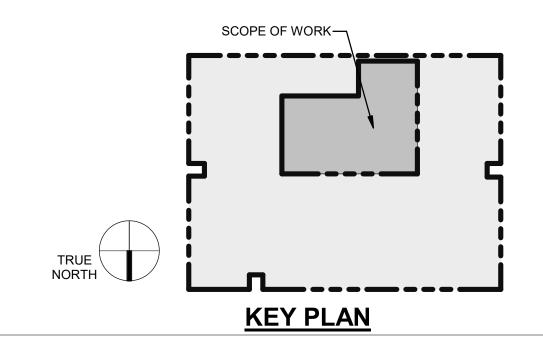

STATE OF MISSOURI MIKE KEHOE, GOVERNOR

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ADMINISTRATION
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CONSTRUCTION

MISSOURI ARMY NATIONAL GUARD

St. Louis Lambert Readiness Center - Latrines and Shower Renovations, Building 233, T2417-01

10800 Lambert International Rd.

Bridgeton, MO 63044

PROJECT # T2417-01 SITE # 6280

81362800001

REVISION:
DATE:
REVISION:
DATE:
REVISION: 2
DATE: 08/28/2025

ASSET#

ISSUE DATE: 08/28/2025

CAD DWG FILE:

DRAWN BY: CJM/DCR
CHECKED BY: BAP
DESIGNED BY: CJM/DCR

SHEET TITLE:


DEMOLITION FLOOR PLAN

SHEET NUMBER:

AD101

08/28/2025

SHEET 4 OF 32

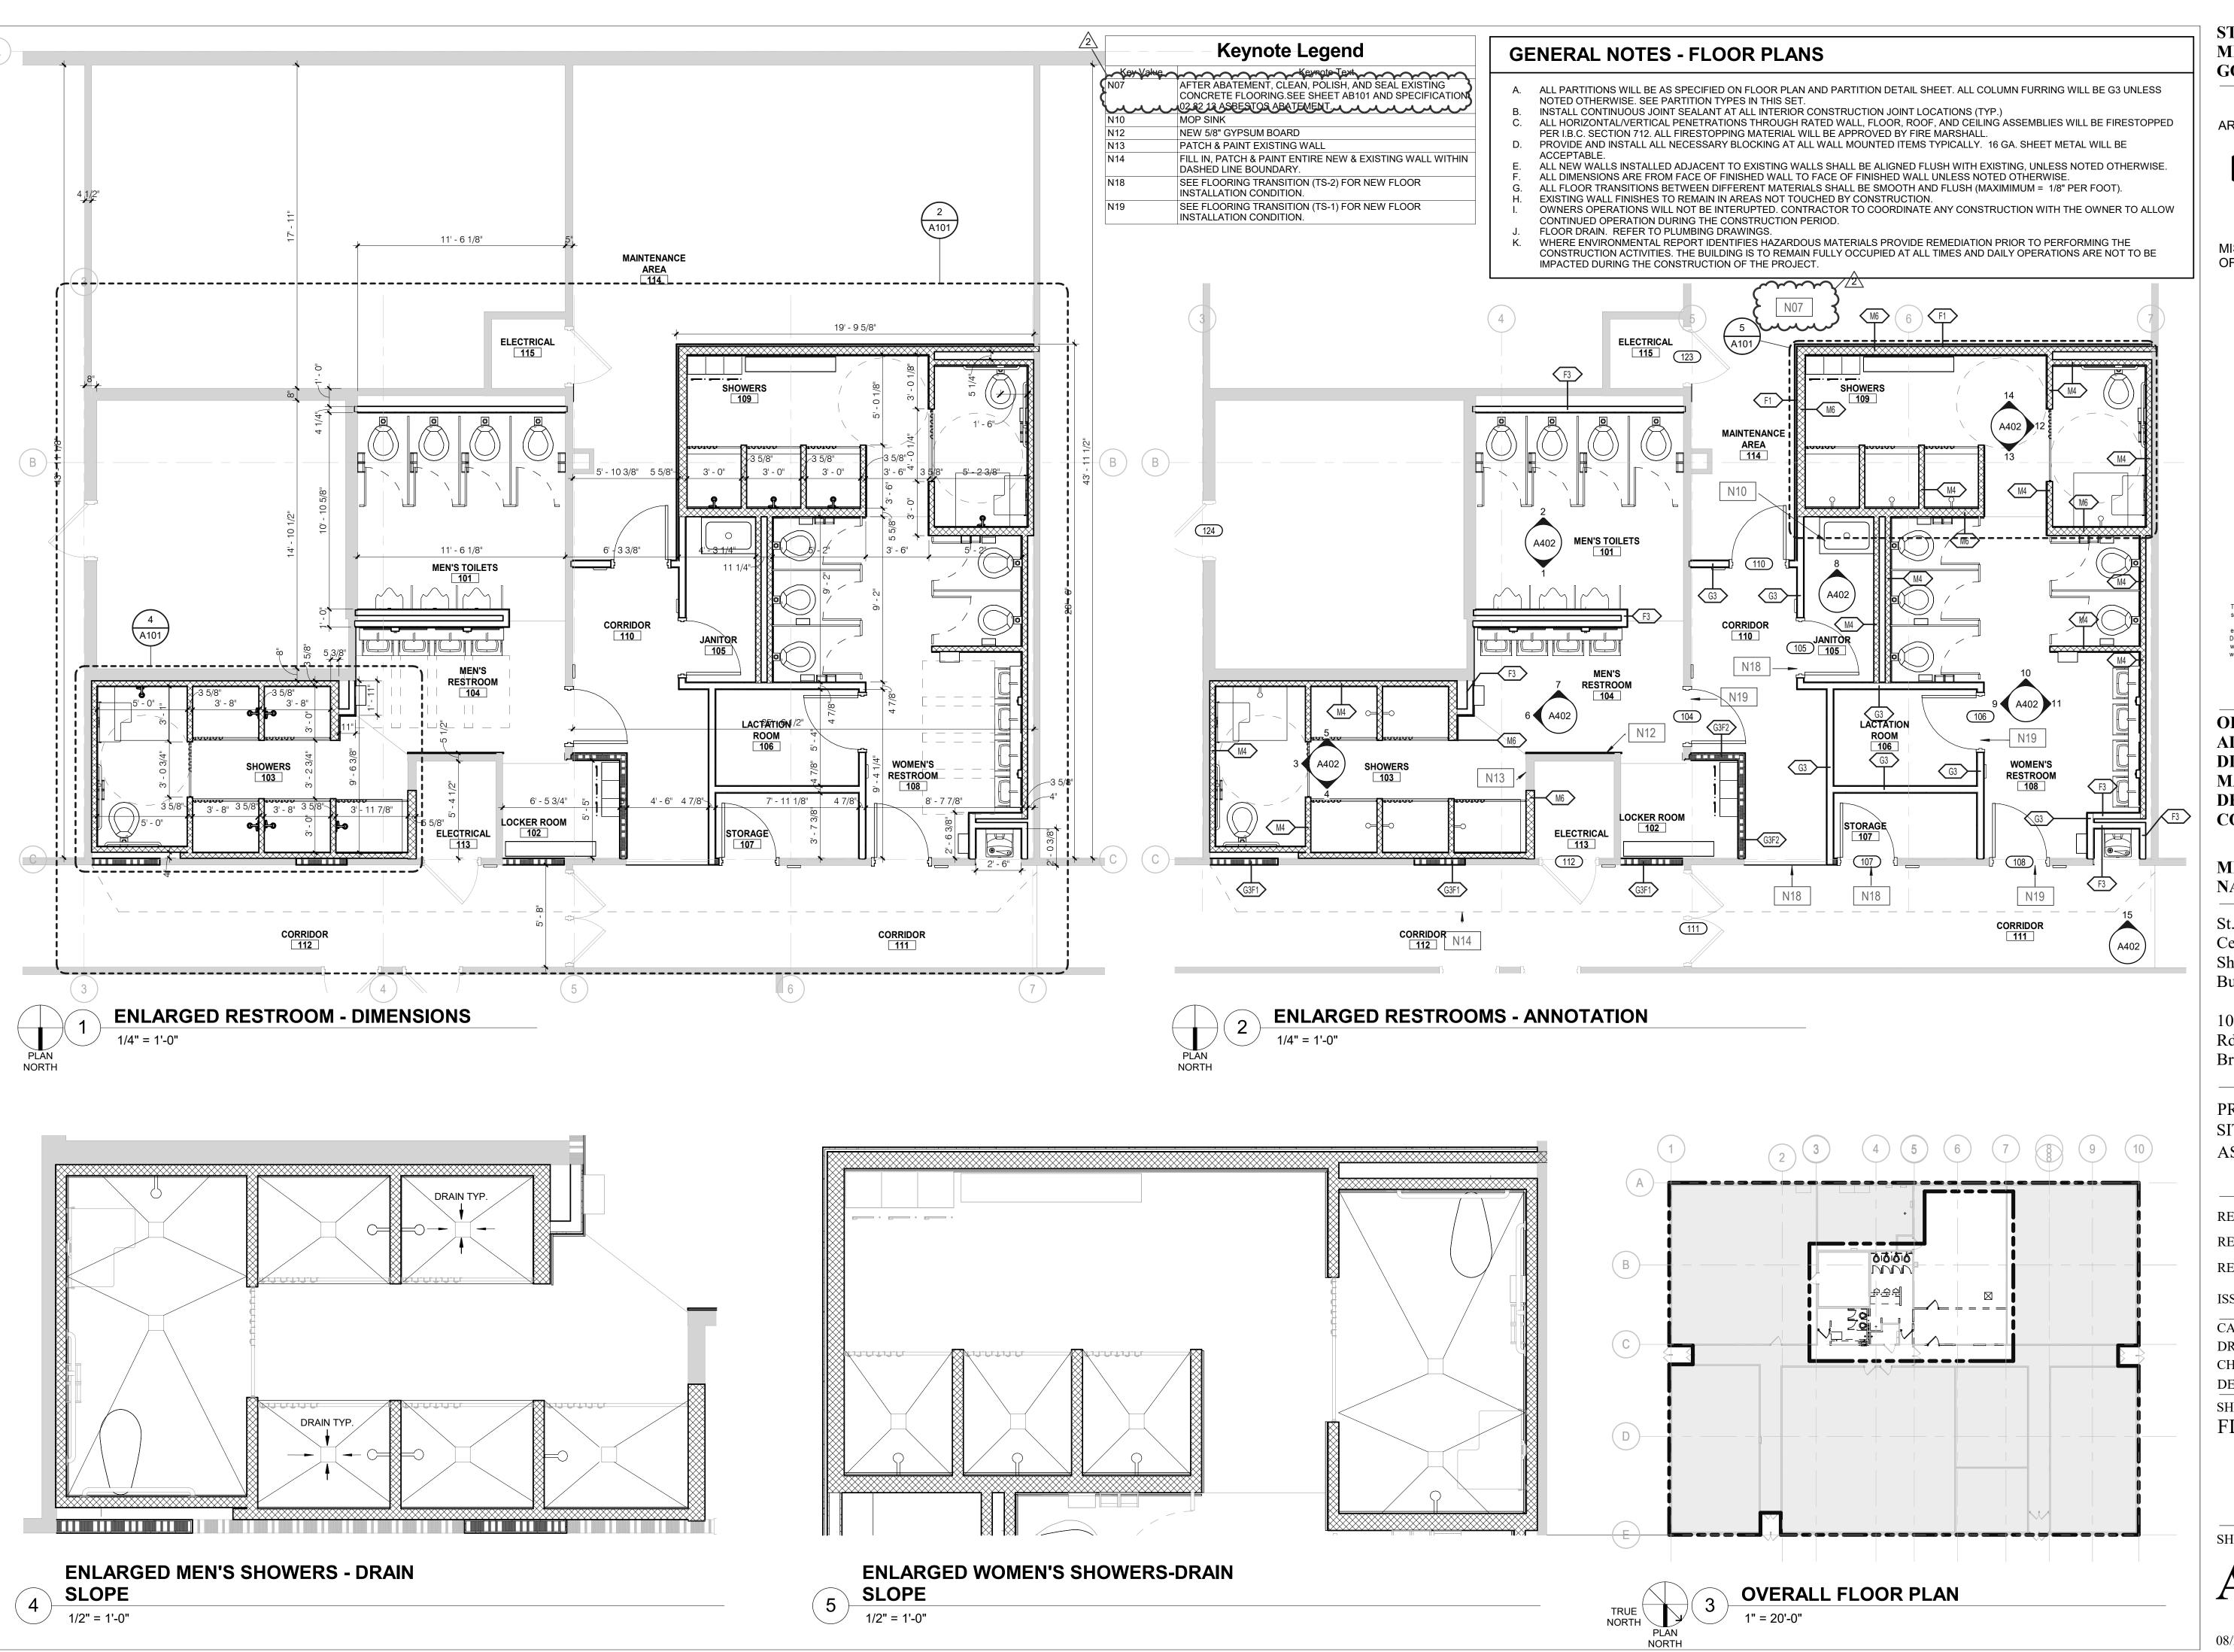

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PROJECT # T2417-01 6280 SITE# ASSET# 81362800001

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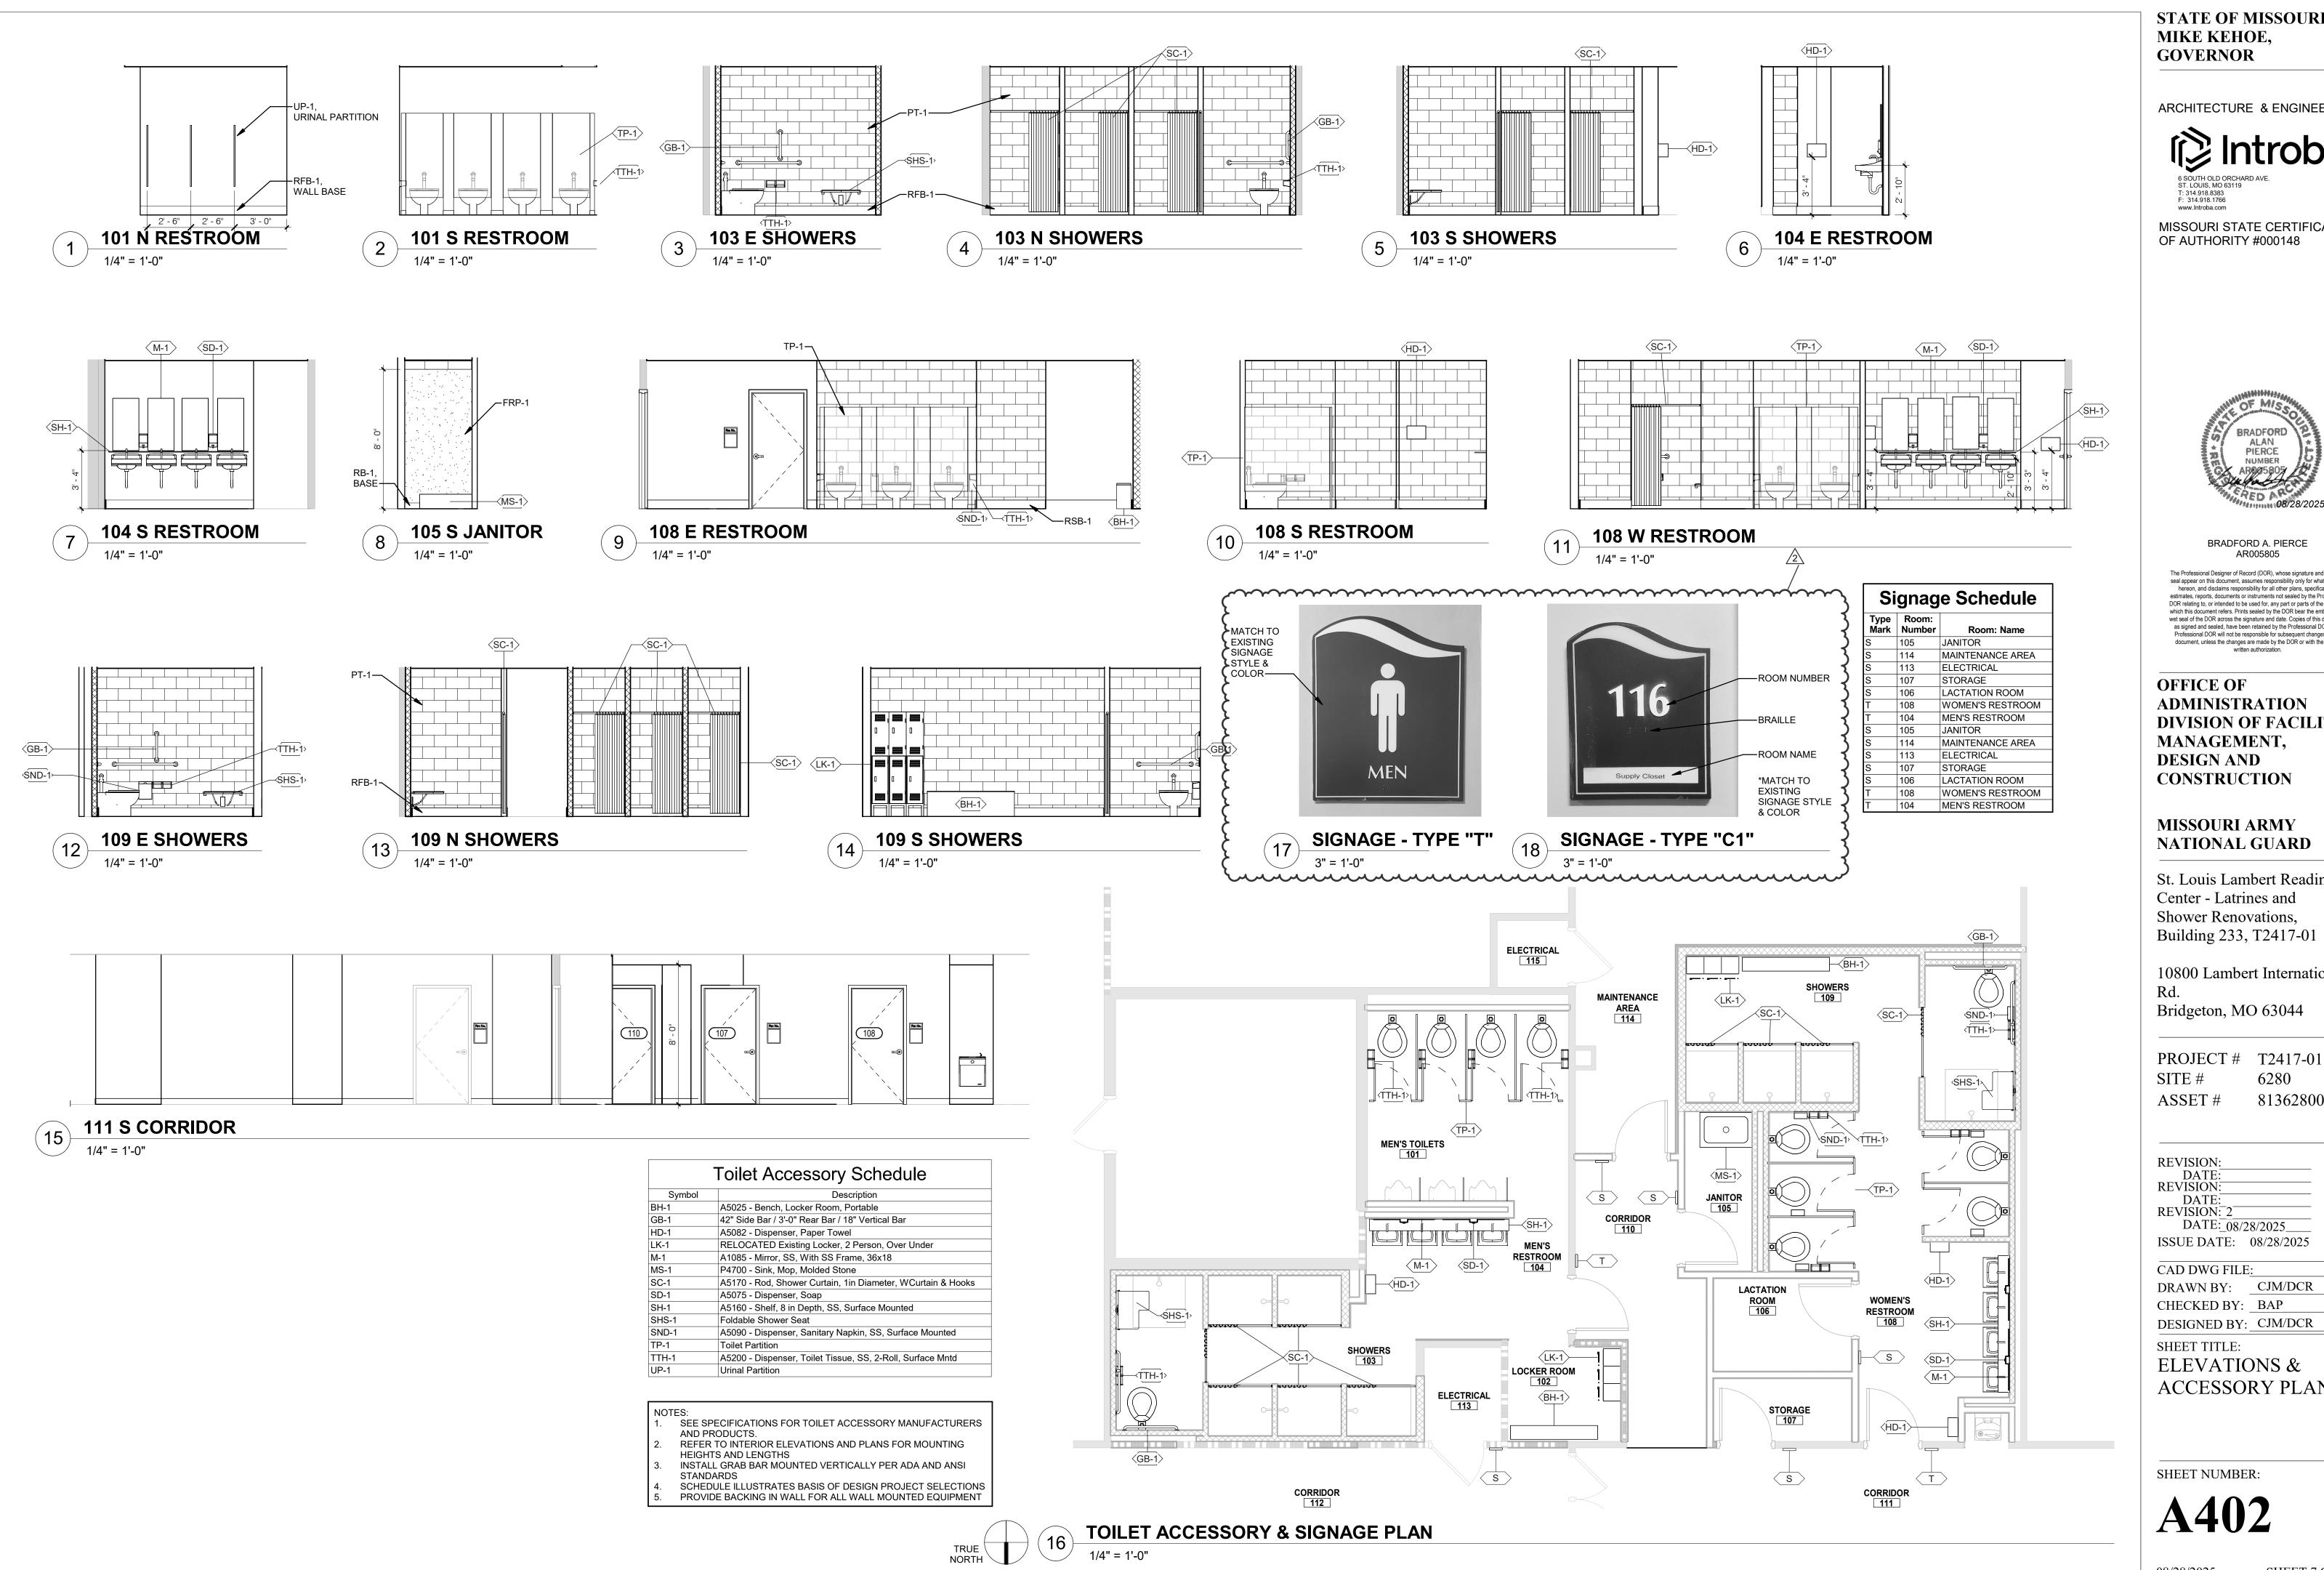
ISSUE DATE: 08/28/2025 CAD DWG FILE:

DRAWN BY: CJM/DCR CHECKED BY: BAP DESIGNED BY: CJM/DCR

SHEET TITLE: FLOOR PLANS

SHEET NUMBER:

08/28/2025 SHEET 5 OF 32



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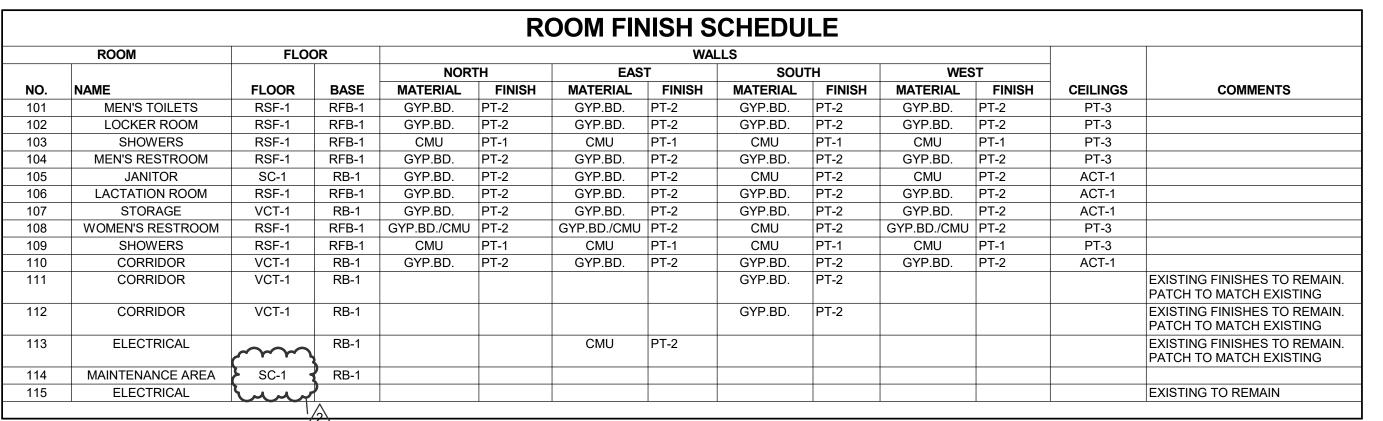
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ELEVATIONS & ACCESSORY PLAN

SHEET NUMBER:

08/28/2025

SHEET 7 OF 32



				MATERIAL FINISH LEGE	ND			
TYPE	SYMBOL	MATERIAL	MANUFACTURER	PATTERN	PATTERN NO.	COLOR	SIZE	COMMENTS
CEILING ACT-1		ACOUSTICAL CEILING TILE	ARMSTRONG	FINE FISSURED SQUARE LAY IN	607	WHITE	24"X24"X5/8"	GRID: 15/16" PRELUDE
FLOORING	RSF-1	RESINOUS FLOORING	STONEHARD	STONESHIELD URT		ASH		
FLOORING	SC-1	SEALED CONCRETE	010112131112	LIQUID SEALER OVER EXPOSED CONCRETE		CLEAR		
FLOORING	VCT-1	VINYL FLOORING	TARKETT	VCT II		527 MILITARY TAN	12"X12"X1/8"	
MISC.	TP-1	TOILET PARTITION	BOBRICK	DURALINE		CITADEL WARP 5882-58		BLACK CORE
MISC.	UP-1	URINAL PARTITION	BOBRICK	DURALINE		CITADEL WARP 5882-58		BLACK CORE
PAINT	PT-1	PAINT	STONEHARD	STONGLAZE VSE		ASH GRAY		SHOWER WALL PAINT
PAINT	PT-2	PAINT	SHERWIN WILLIAMS	EMERALD		EIDER WHITE SW7014		WALL PAINT
PAINT	PT-3	PAINT	SHERWIN WILLIAMS	PREMIUM CEILING PAINT		WHITE		CEILING PAINT
PAINT	PT-4	PAINT	SHERWIN WILLIAMS	PRO INDUSTRIAL WATER BASED PRE CATALYZED EPOXY	SEMI GLOSS	INKWELL SW6992		DOOR & FRAME PAINT
						I	1	
WALL TRIM	RB-1	RUBBER WALL BASE	JOHNSONITE	RUBBER WALL BASE		BLACK	4"	
WALL TRIM	RFB-1	RESINOUS BASE	STONEHARD	STONESHIELD URT		ASH	6"	@ SHOWERS

DOOR SCHEDULE												
	DOOR					FRAME		FRAME				
					DOOR			DETAILS			HARDWARE	
NUMBER	TYPE	WIDTH	HEIGHT	THICKNESS	MATERIAL	FRAME TYPE	FRAME FINISH	HEAD	JAMB	FIRE RATING	SET	COMMENTS
104	F	3' - 0"	6' - 8"	1 3/4"	НМ	1	PT-4	H1	J1		2	
105	F	3' - 0"	6' - 8"	1 3/4"	НМ	1	PT-4	H1	J1		1	
106	F	3' - 0"	6' - 8"	1 3/4"	HM	1	PT-4	H1	J1		3	
107	F	3' - 0"	6' - 8"	1 3/4"	НМ	1	PT-4	H1	J1		1	
108	F	3' - 0"	6' - 8"	1 3/4"	НМ	1	PT-4	H1	J1		2	
110	F	3' - 0"	6' - 8"	1 3/4"	НМ	1	PT-4	H1	J1		3	

GENERAL DOOR NOTES

- FIELD VERIFY ALL EXISTING DOOR OPENINGS. ALL METAL DOORS TO BE 1 3/4" HOLLOW METAL (STEEL)
- ALL WOOD DOORS TO BE 1 3/4" SOLID CORE WOOD. SEE SCHEDULE FOR DOOR MATERIALS AND SPECIAL CONDITIONS SUCH AS VISION PANELS, LOUVERS, REQUIRED U.L. LABELS, ETC.

FRAME)


SEE SPECS FOR DESCRIPTION OF HARDWARE GROUPS. COORDINATE ALL ELECTRIC LATCHES AND CARD READERS WITH CARD ACCESS VENDOR.

PUSH SIDE: 12" MIN. CLEAR OF OBSTRUCTIONS

SCHEDULED OP⊟NING WID#H


6" AT

- SEE DOOR HARDWARE SPECIFICATIONS. TYPICAL UNDERCUT AT DOORS TO BE 3/8" AT THRESHOLDS AND 3/4" AT ALL OTHER
- LOCATIONS. MAX UNDERCUT AT FIRE RATED DOORS IS 3/4" PER NFPA 80.

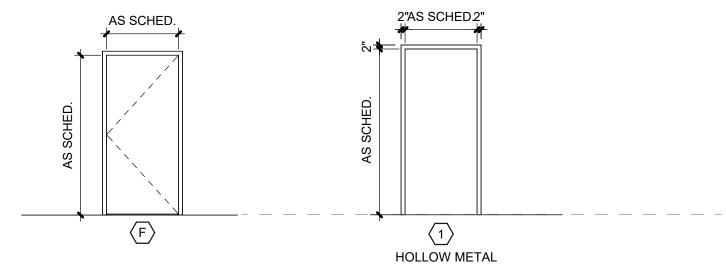

DOOR TYPES DOOR FRAME TYPES 1/4" = 1'-0"


SEE P-TYPE

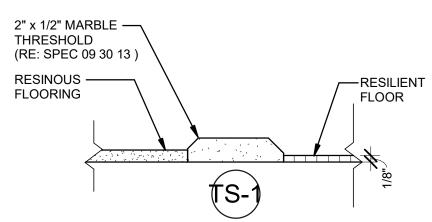

TYPICAL DOOR PLACEMENT

PULL SIDE: 18" MIN. CLEAR

OF OBSTRUCTIONS

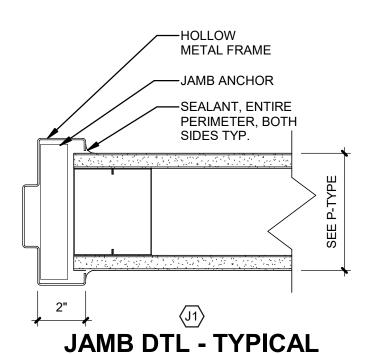

HEAD DTL - TYPICAL AT STANDARD PTN AT STANDARD PTN NOT TO SCALE

SEALANT,

PERIMETER,

BOTH SIDES

ENTIRE


HOLLOW

METAL


FRAME

TYP.


FINISH - MARBLE THRESHOLD (TS-1)

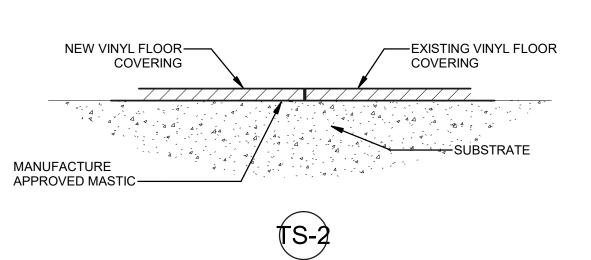

TRANSITION-TILE TO VCT TRAN (TS-2)

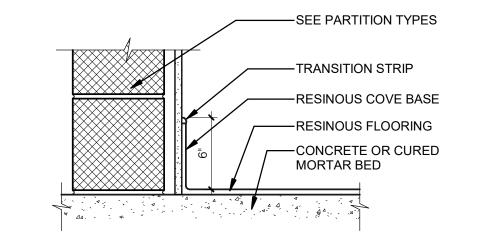


BASE-RESINOUS

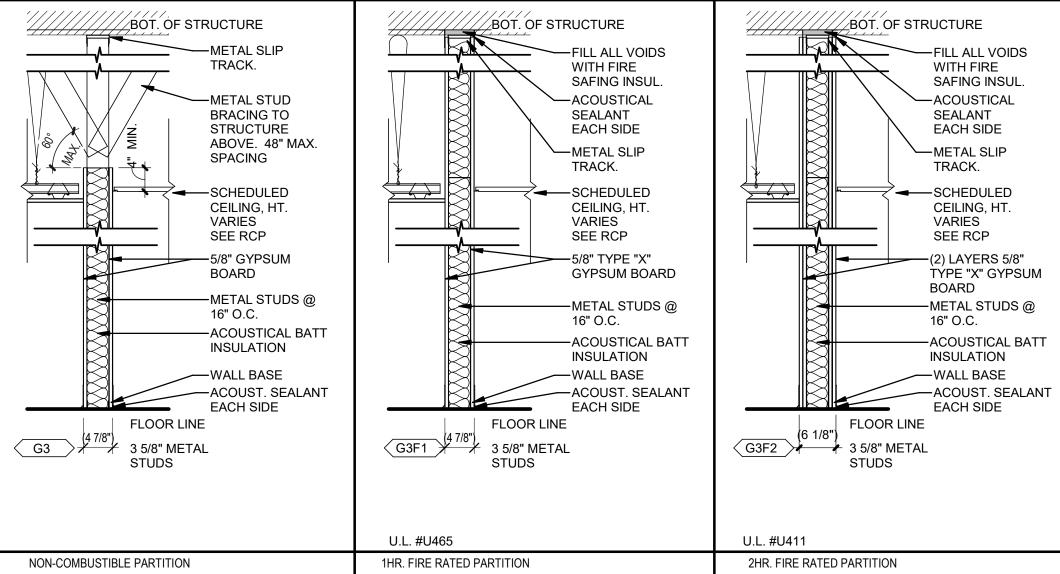



GENERAL NOTES - PARTITIONS


- USE TYPE 'X' GYP. BD. AT ALL FIRE RATED PARTITION ALL GYP. BD. IS TO BE MOLD AND MOISTURE RESISTANT TYPE (TYP.) IN ADDITION TO INDICATED REQUIRMENTS. CEMENTITIOUS BACKER BOARD TO BE USED IN ALL AREAS
- D. ALL RESTROOM PARTITIONS, RESTROOM CEILINGS, AND PLUMBING CHASE PARTITIONS TO RECEIVE 5/8" GREENBOARD GYPSUM TYPICALLY.
- ALL FIRE RATED PARTITIONS WILL BE PERMANENTLY IDENTIFIED WITH SIGNS OR STENCILING. IDENTIFICAITON WILL BE LOCATED IN ACCESSBILE FLOOR-CELING SPACES, LOCATED EVERY 30 FEET HORIZONTALLY ALONG THE PARTITION, AND LETTERING WILL BE MIN. OF 1/2" IN HEIGHT AND STATE "FIRE" AND/OR SMOKE BARRIER-PROTECT ALL OPENINGS
- REFER TO STC SCHEDULE THIS SHEET FOR ROOM STC RATINGS
- WHERE REQUIRED. WALLS WILL HAVE CONCEALED METAL STRAP BACKING SIZED TO ACCOMMODATE THE WEIGHT OF THE MOUNTED ITEM.

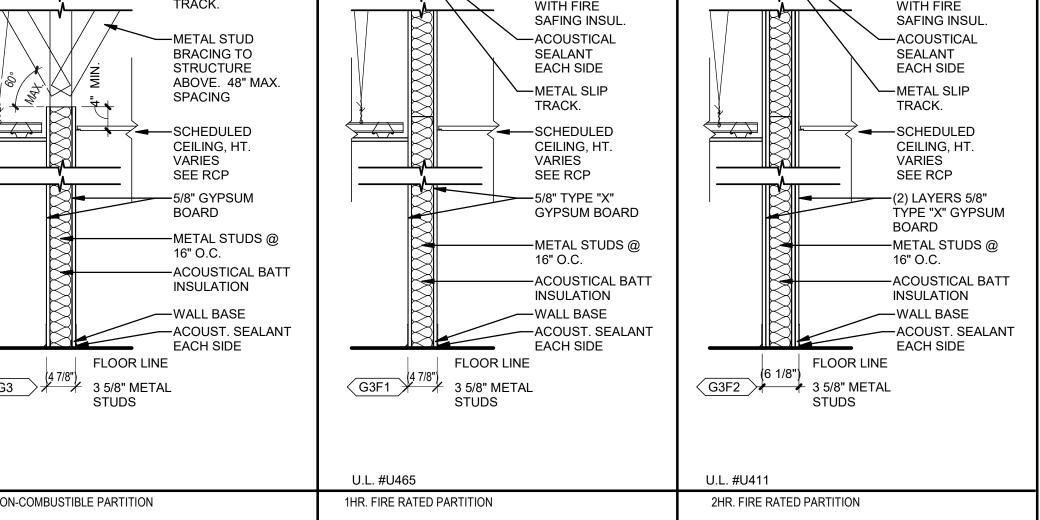


PARTITION TYPE LEGEND

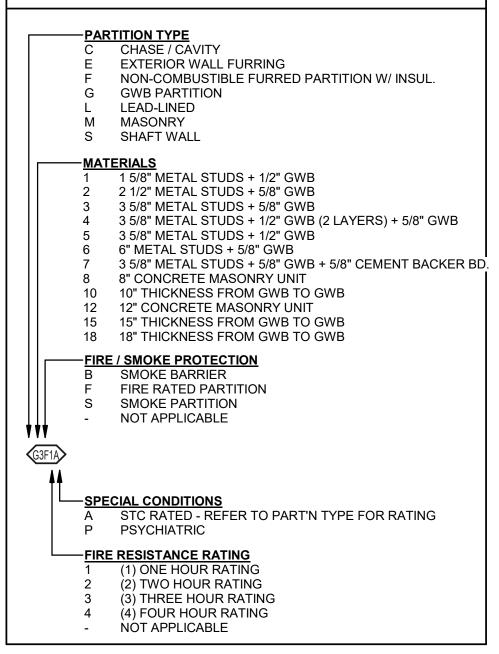

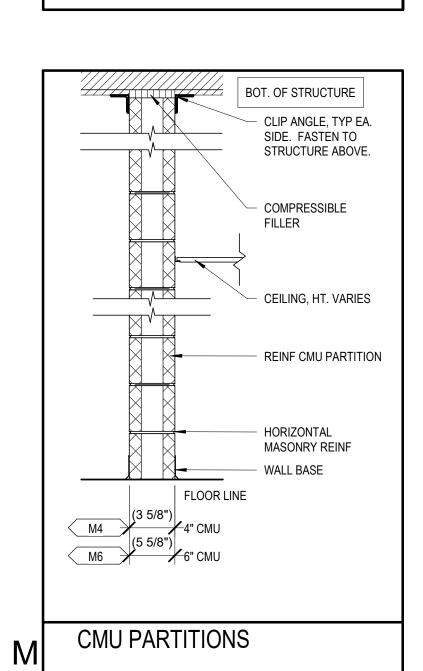

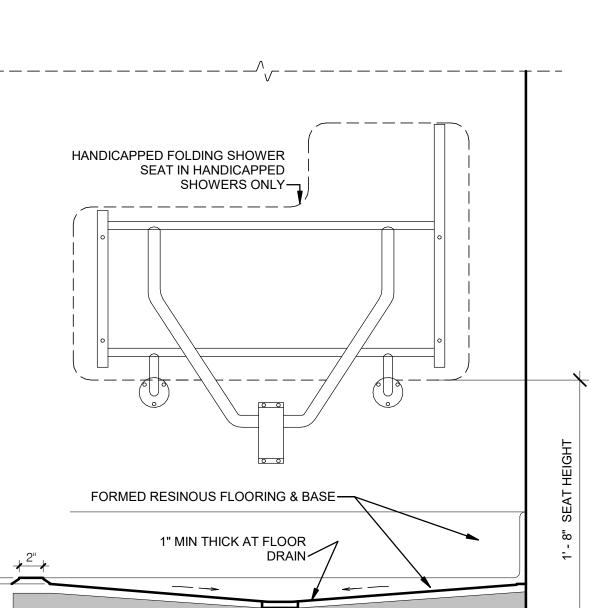

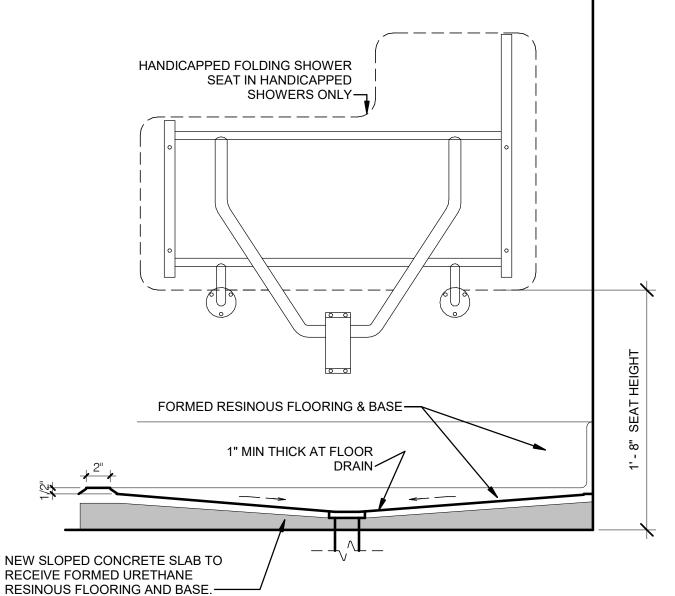

FOLDING ADA SHOWER SEAT

STATE OF MISSOURI MIKE KEHOE, **GOVERNOR**

BOT. OF STRUCTURE

—20ga. METAL SLIP

-METAL STUD

BRACING TO

STRUCTURE

SPACING

-CEILING, HT.

-5/8" GYPSUM

-METAL STUDS @

VARIES

BOARD

16" O.C.

-WALL BASE

FLOOR LINE

(1 1/2") F1 7/8" HAT CHANNEL

F3 4 1/4" 3 5/8" METAL STUDS

NON-COMBUSTIBLE FURRED PARTITION

ABOVE. 48" MAX.

TRACK.

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Bridgeton, MO 63044

PROJECT # T2417-01 6280 81362800001 ASSET#

REVISION:
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REVISION: 2
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CAD DWG FILE: DRAWN BY: CJM/DCR CHECKED BY: BAP DESIGNED BY: CJM/DCR


SHEET TITLE:

INTERIOR LEGENDS & **SCHEDULES**

SHEET NUMBER:

08/28/2025

SHEET 8 OF 32

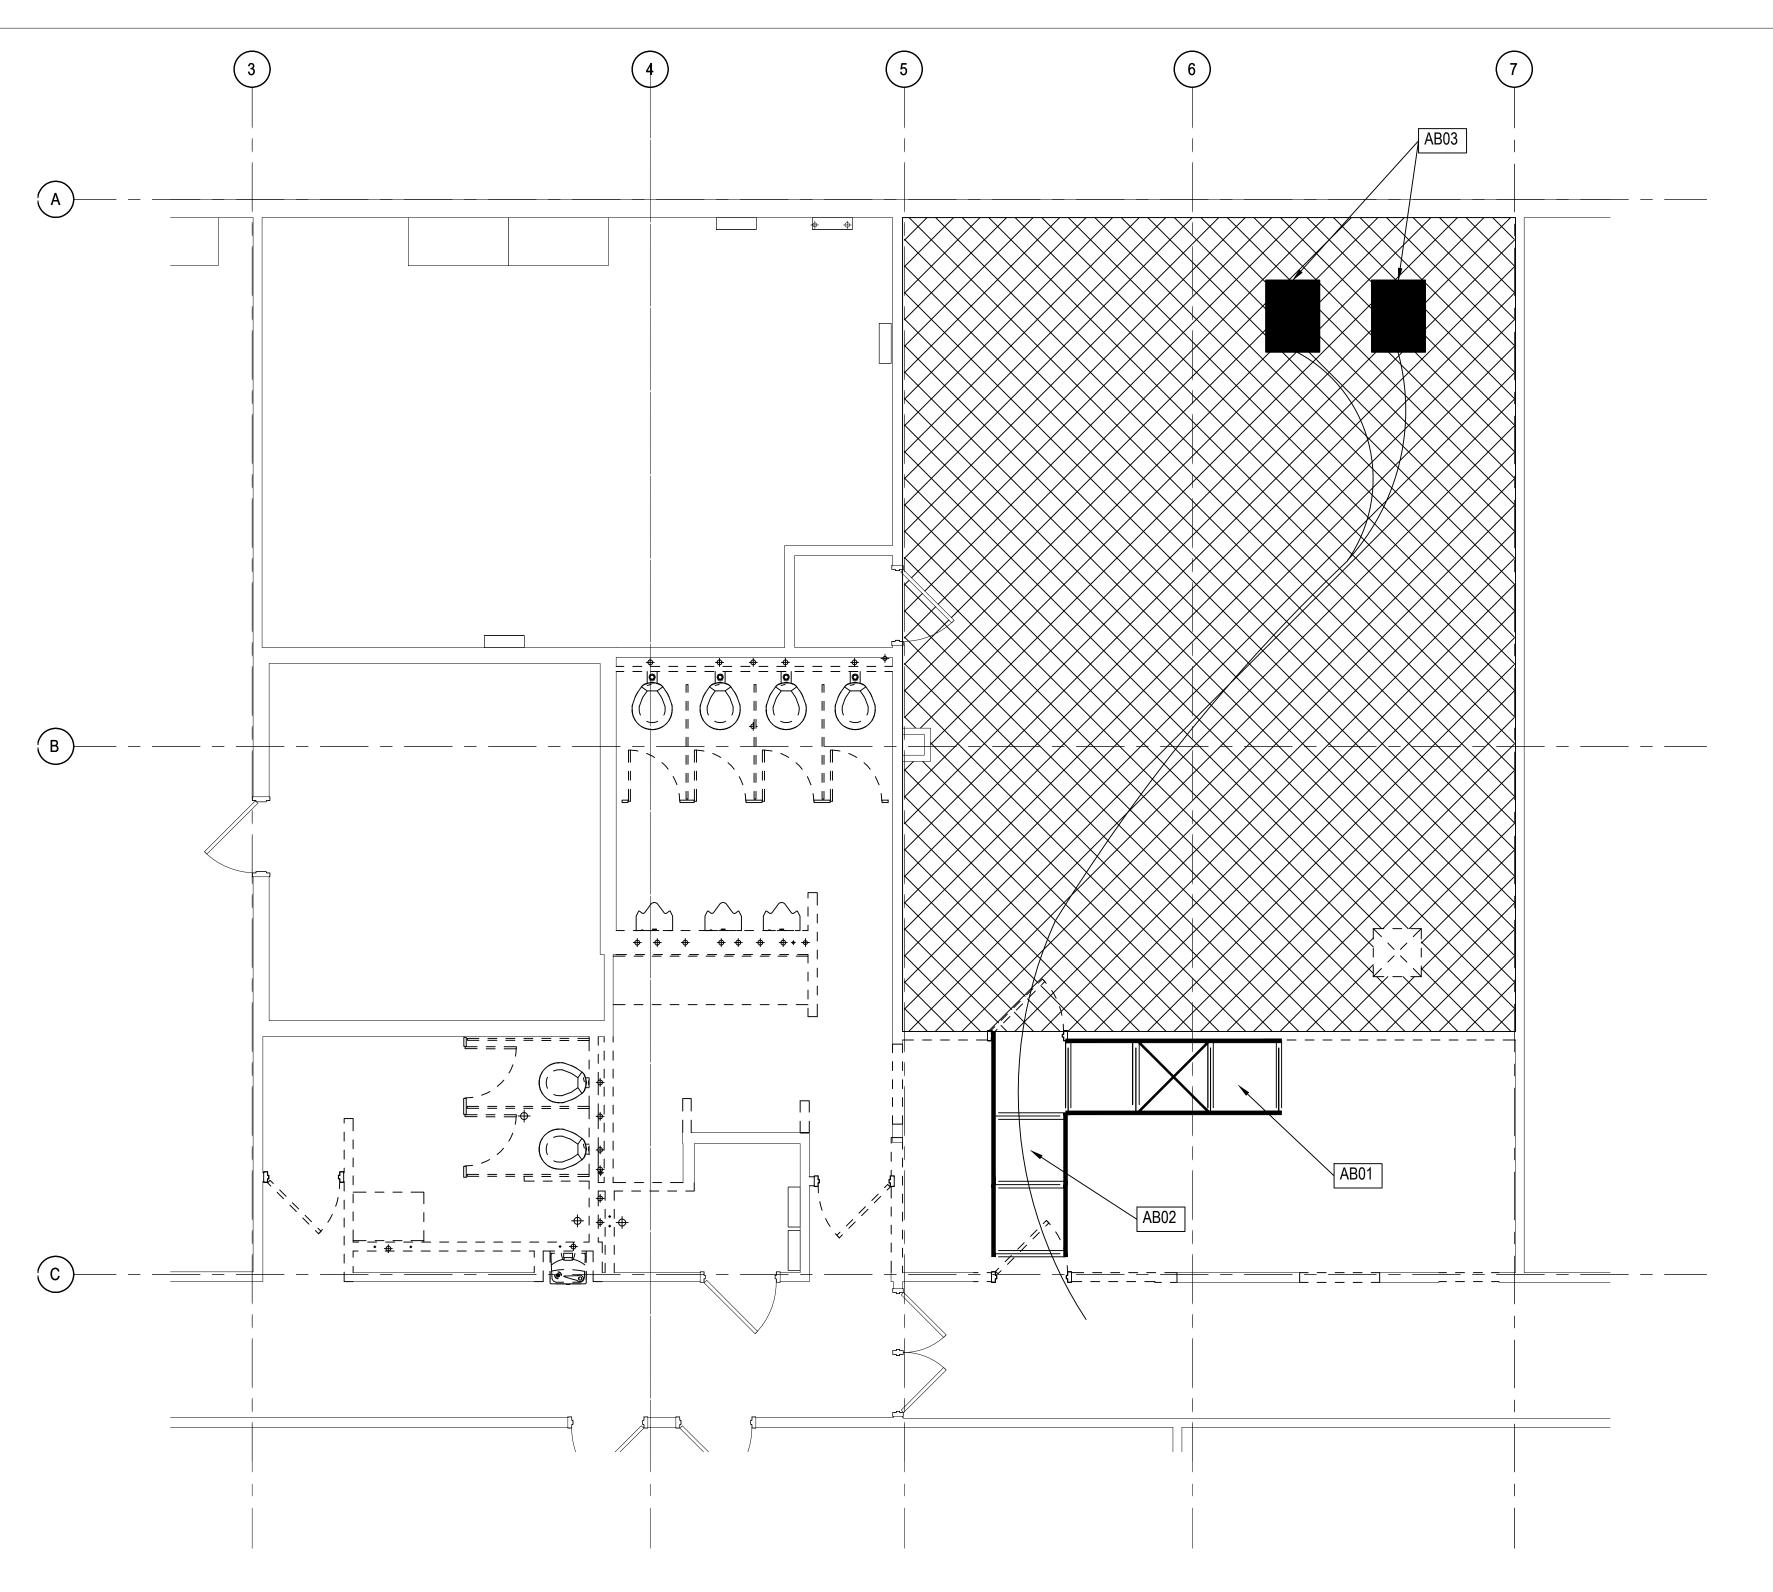

ABATEMENT FLOOR PLAN

GENERAL ABATEMENT NOTES

- A. ALL ABATEMENT WORK SHALL CONFORM TO ALL APPLICABLE ST. LOUIS COUNTY AND OSHA RULES AND REGULATIONS. B. THE ABATEMENT CONTRACTOR SHALL VERIFY JOB/FIELD CONDITIONS AND MEASUREMENTS, VERIFY ALL QUANTITIES, DIMENSIONS AND LOCATIONS AS INDICATED ON THIS DRAWING AND
- THE ABATEMENT CONTRACTOR SHALL USE ENOUGH NEGATIVE AIR MACHINES TO ENSURE A CHANGE OF AIR AT LEAST EVERY 15
- CONTAINING MATERIAL

ARCHITECTURE & ENGINEERING SPECIFICATIONS AND MAKE ANY FURTHER MEASUREMENTS AND COUNTS FOR THE ACCURATE PROSECUTION OF WORK.

MINUTES IN EACH NEGATIVE PRESSURE ENCLOSURE SYSTEM. THE NEGATIVE PRESSURE ENCLOSURE SYSTEM SHALL BE EXHAUSTED TO THE EXTERIOR OF THE BUILDING. THE NEGATIVE PRESSURE ENCLOSURE SYSTEM SHALL BE KEPT UNDER NEGATIVE PRESSURE THROUGHOUT THE PERIOD OF USE. THE NEGATIVE PRESSURE ENCLOSURE SYSTEM SHALL HAVE A MINIMUM OF -0.02 COLUMN INCHES OF WATER PRESSURE DIFFERENTIAL MAINTAINED AS EVIDENCED BY MANOMETRIC MEASUREMENTS.

D. THE ABATEMENT CONTRACTOR SHALL REMOVE ASBESTOS CONTAINING FLOOR TILE AND FLOOR TILE MASTIC IN A NEGATIVE PRESSURE ENCLOSURE IN ACCORDANCE WITH ST. LOUIS COUNTY RULES AND REGULATIONS AND DISPOSE OF ALL AS ASBESTOS

STATE OF MISSOURI

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GOVERNOR

Keynote Legend

Key Value

Keynote Text

LOCATION OF ASBESTOS CONTAINING FLOOR TILE AND FLOOR TILE MASTIC TO BE ABATED.

APPROXIMATELY 860 SQ. FT.

LOCATION OF THREE STAGE WORKER DECONTAMINATION UNIT

LOCATION OF TWO STAGE WASTE LOAD-OUT

LOCATION OF NEGATIVE AIR MACHINE(S) VENTED TO THE EXTERIOR OF THE BUILDING.

SCOPE OF WORK

KEY PLAN



The Professional Designer of Record (DOR), whose signature and personal seal appear on this document, assumes responsibility only for what appear hereon, and disclaims responsibility for all other plans, specifications, estimates, reports, documents or instruments not sealed by the Professional DOR relating to, or intended to be used for, any part or parts of the project to which this document refers. Prints sealed by the DOR bear the embossed or wet seal of the DOR across the signature and date. Copies of this document, as signed and sealed, have been retained by the Professional DOR. The Professional DOR will not be responsible for subsequent changes to this document, unless the changes are made by the DOR or with the DOR's

OFFICE OF ADMINISTRATION DIVISION OF FACILITIES MANAGEMENT, **DESIGN AND CONSTRUCTION**

MISSOURI ARMY NATIONAL GUARD

St. Louis Lambert Readiness Center - Latrines and Shower Renovations, Building 233, T2417-01

10800 Lambert International

Bridgeton, MO 63044

PROJECT # T2417-01

6280 SITE# 81362800001 ASSET#

REVISION:_ DATE:_ REVISION:_ DATE: REVISION: DATE:

ISSUE DATE: 08-28-2025

CAD DWG FILE: DRAWN BY: APK CHECKED BY: WCF DESIGNED BY: BAS

SHEET TITLE: ABATEMENT FLOOR PLAN

SHEET NUMBER:

AB101

08-28-2025

SHEET 32 OF 32

1. GENERAL

1.1 WORK INCLUDES

A. Base Bid Work –

The abatement contractor is responsible for providing labor, materials and disposal for the removal of asbestos containing materials in order to complete renovation as shown on the drawings:

1. Asbestos Containing Floor Tile and Mastic

Abatement contractor is responsible for the abatement of all asbestos containing flooring found under casework and walls to be demolished. Contractor will be responsible for performing select demolition to confirm where asbestos containing flooring is present.

Work is to be performed in a full negative pressure containment utilizing methods following all St. Louis County, MDNR, EPA and OSHA rules and regulations.

1.2 SCHEDULE

A. Coordinate abatement schedule with General Contractor.

1.3 OTHER WORK

A. By Others

- 1. Owner and General Contractor
 - a. Owner shall remove all moveable equipment, desks, chairs, window dressings, etc. prior to commencement of project.

1.4 REGULATORY REQUIREMENTS

- A. State Requirements:
 - 1. MDNR Missouri Department of Natural Resources
 - 2. St. Louis County, Missouri
- B. Federal Requirements:
 - NESHAP National Emissions Standards for Hazardous Air Pollutants.
 - 2. OSHA Occupational Safety and Health Administration, 200 Constitution Avenue, Washington, DC 20210.

1.5 FIELD QUALITY CONTROL

A. Environmental Consultant:

1. Abatement Contractor is to employ a Third-Party Air Monitoring for daily monitoring and final clearance monitoring as required by St. Louis County and MDNR rules and regulations.

B. Abatement Contractor:

- 1. Provide air monitoring of own personnel. Provide a copy of all results to the APM within 24 hours.
- 2. Responsible for amending Notification of Asbestos Abatement throughout project as needed and submitting amendments to MDNR.
- 3. Pay any additional costs which arise from failure of clearance testing and may include costs for services of ASP, laboratory, or A/E.
- EPA, OSHA, St. Louis County, MDNR or the Environmental Consultant may issue С. emergency stop work orders to the Contractor. Regulatory agencies may additionally assess fines and penalties in accord with relevant rules and regulations.

1.6 **SUBMITTALS**

- Make all submittals to Architect thirty (10) calendar days prior to commencing work. Α.
 - 1. Asbestos Abatement Notification submitted to St. Louis County
 - 2. Contractor's Asbestos Abatement Firm MDNR License
 - 3. Submit documented evidence that each person, including contractor's supervisor, performing asbestos work holds a valid MDNR License and accreditation certificate in accord with MDNR Rules and Regulations
- B. Closeout Submittal
 - 1. Contractor is to submit the following closeout documents to Architect within 45 days of project completion.
 - a. Supervisor Daily Logs
 - b. Waste Manifest
 - c. Daily Air Sample Results
 d. Final Clearance Results
- 1.7 PROTECTION Provide protection for personnel and building in accordance with all applicable EPA, MDNR and OSHA Rules and Regulations.
- 2. PRODUCTS / EQUIPMENT
- ASBESTOS ABATEMENT EQUIPMENT Use only materials and equipment complying with 2.1 the St. Louis County and MDNR Rules and Regulations.
- 3. EXECUTION

3.1 **PERFORMANCE**

- Perform all preparation work in accord with the EPA/NESHAPS, St. Louis County, A. MDNR and OSHA Rules and Regulations.
- B. The abatement contractor is to submit an original complete "Notification of of Asbestos Abatement" form to St. Louis County, Missouri for the abatement work.
- The asbestos abatement work is to be performed by an Missouri Department of C. Natural Resources licensed asbestos abatement contractor.
- D. All personnel performing abatement are to be licensed for asbestos abatement activities with the Missouri Department of Natural Resources with at least one

individual holding a Supervisor's license.

- E. Power and water are in service for the building.
- F. The material locations shown on drawings for the various Asbestos Containing Materials are not exhaustive. The abatement contractor will be responsible for contacting the Architect if a material is identified and not shown on drawings.
- G. Proper demarcation of the of the work areas is required.
- H. Disposal:
 - 1. The waste is to be placed in containers (six mil polyethylene or equivalent labeled bags or labeled drums) and sealed when full. The waste shall be double bagged when polyethylene bags are used for disposal. Bundles or components are to be wrapped in two layers of 6-mil thickness polyethylene sheeting. Sealed and labeled containers of asbestos-containing waste materials shall be removed and transported to an approved landfill for asbestos waste.
 - 2. Label all bags or containers containing asbestos debris as follows-

DEPARTMENT OF MILITARY AFFAIRS ST. LOUIS, MISSOURI

- 3. Whenever trucks or dumpsters are being loaded or unloaded with asbestos waste, post signs in accord with the NESHAP STANDARD- DANGER, ASBESTOS DUST HAZARD, CANCER AND LUNG DISEASE HAZARD, AUTHORIZED PERSONNEL ONLY.
- 4. Transport all waste to an MDNR approved landfill. Complete a waste shipment record for each load of waste in accord with the NESHAP STANDARD. Return the record, signed by waste disposal site owner/operator to APM within 10 days after completion of project.

3.2 CLEANUP

- A. Perform all cleanup operations daily in accord with the EPA/NESHAPS Rules and Regulations.
 - 1. Clearance Air Monitoring and Analysis:
 - 1) PCM in accordance with St. Louis County requirements

END 02 82 13.