LATRINES & SHOWER RENOVATIONS, BUILDING 233 ST. LOUIS LAMBERT READINESS CENTER BRIDGETON, MISSOURI

OWNER:

STATE OF MISSOURI MIKE KEHOE, **GOVERNOR**

PROJECT **MANAGEMENT:** OFFICE OF ADMINISTRATION **DIVISION OF FACILITIES** MANAGEMENT, **DESIGN AND CONSTRUCTION**




LOCATION PLAN NOT TO SCALE

ARCHITECTURE & ENGINEERING:

12 Introba ST. LOUIS, MO 63119

T 314.918.8383 F 314.918.1766 www.introba.com

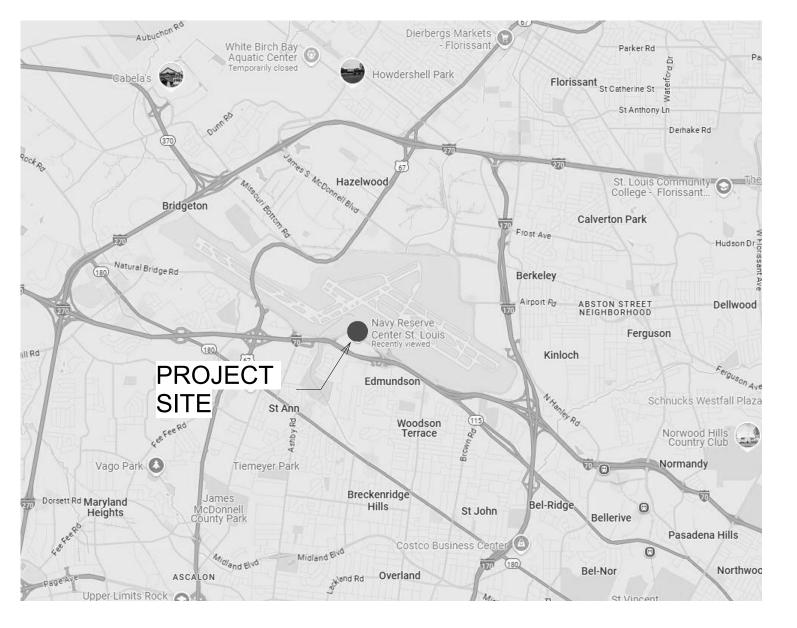


NORTH 2

	DRAWING INDEX
#	NAME
00-GENERA	L .
G000	COVER SHEET
G101	LIFE SAFETY PLAN
05-ARCHITE	ECTURE
A000	LEGEND, SYMBOLS, MOUNTING HEIGHTS, ABBREVIATIONS, AND SITE PLAN
AD101	DEMOLITION FLOOR PLAN
A101	FLOOR PLANS
A111	REFLECTED CEILING PLAN
A402	ELEVATIONS & ACCESSORY PLAN
A701	INTERIOR LEGENDS & SCHEDULES
09-PLUMBIN P000	PLUMBING SYMBOLS AND ABBREVIATIONS
P100	PLUMBING UNDERFLOOR PLANS - DEMO
P101	PLUMBING FLOOR PLANS - DEMO
P102	PLUMBING UNDERFLOOR PLANS - NEW WORK
P103	PLUMBING FLOOR PLANS - NEW WORK
P600	PLUMBING SANITARY & VENT ISOMETRICS
P601	PLUMBING DOMESTIC WATER ISOMETRICS
P602	PLUMBING DETAILS
P603	PLUMBING SCHEDULES
10-MECHAN	
M000 M101	MECHANICAL SYMBOLS & ABBREVIATIONS MECHANICAL FLOOR PLANS - DEMO
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M102 M103	MECHANICAL ROOF PLAN - DEMO MECHANICAL FLOOR PLANS - NEW WORK
M103	MECHANICAL ROOF PLANS - NEW WORK
M601	MECHANICAL SCHEDULES & CONTROL DIAGRAM
M602	MECHANICAL DETAILS
11- ELECTR	
E-000	ELECTRICAL LEGEND, ABBREVIATIONS, AND GENERAL NOTES
E-600	ELECTRICAL SCHEDULES
ED100	ELECTRICAL FLOOR PLAN - DEMO
ED101	ELECTRICAL ROOF PLAN - DEMO
EL100	ELECTRICAL RCP - MAIN LEVEL - NEW WORK
EP100	ELECTRICAL PLAN - MAIN LEVEL - NEW WORK ELECTRICAL ROOF PLAN - NEW WORK

DESIGNER: **PROJECT NUMBER:**

ASSET NUMBER:

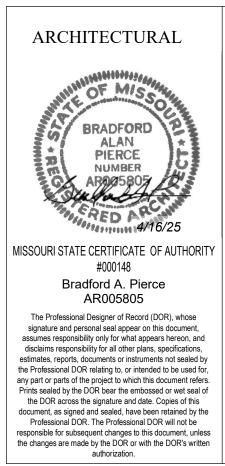

Introba, Inc.

6280

T2417-01

SITE NUMBER:

81362800001

PLUMBING

MICHAEL L WYLAND NUMBER PE-200402122

#000148

Michael Wyland PE-

The Professional Designer of Record (DOR), whose signature and personal seal appear on this document, assumes responsibility only for what appears hereon, and disclaims responsibility for all other plans, specifications estimates, reports, documents or instruments not sealed by he Professional DOR relating to, or intended to be used for, ny part or parts of the project to which this document refers. Prints sealed by the DOR bear the embossed or wet seal of the DOR across the signature and date. Copies of this ocument, as signed and sealed, have been retained by the Professional DOR. The Professional DOR will not be onsible for subsequent changes to this document, unles he changes are made by the DOR or with the DOR's written

authorization




MECHANICAL

MISSOURI STATE CERTIFICATE OF AUTHORITY | MISSOURI STATE CERTIFICATE OF AUTHORITY | MISSOURI STATE CERTIFICATE OF AUTHORITY #000148 Julie Ann Coulter

> E-029040 The Professional Designer of Record (DOR), whose signature and personal seal appear on this document, assumes responsibility only for what appears hereon, and isclaims responsibility for all other plans, specifications estimates, reports, documents or instruments not sealed b the Professional DOR relating to, or intended to be used for, any part or parts of the project to which this document refers. Prints sealed by the DOR bear the embossed or wet seal of the DOR across the signature and date. Copies of this document, as signed and sealed, have been retained by th Professional DOR. The Professional DOR will not be hanges to this document, unles the changes are made by the DOR or with the DOR's written authorizatior

ELECTRICAL

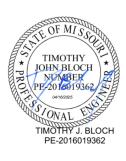


#000148 Timothy J. Bloch PE-2016019362


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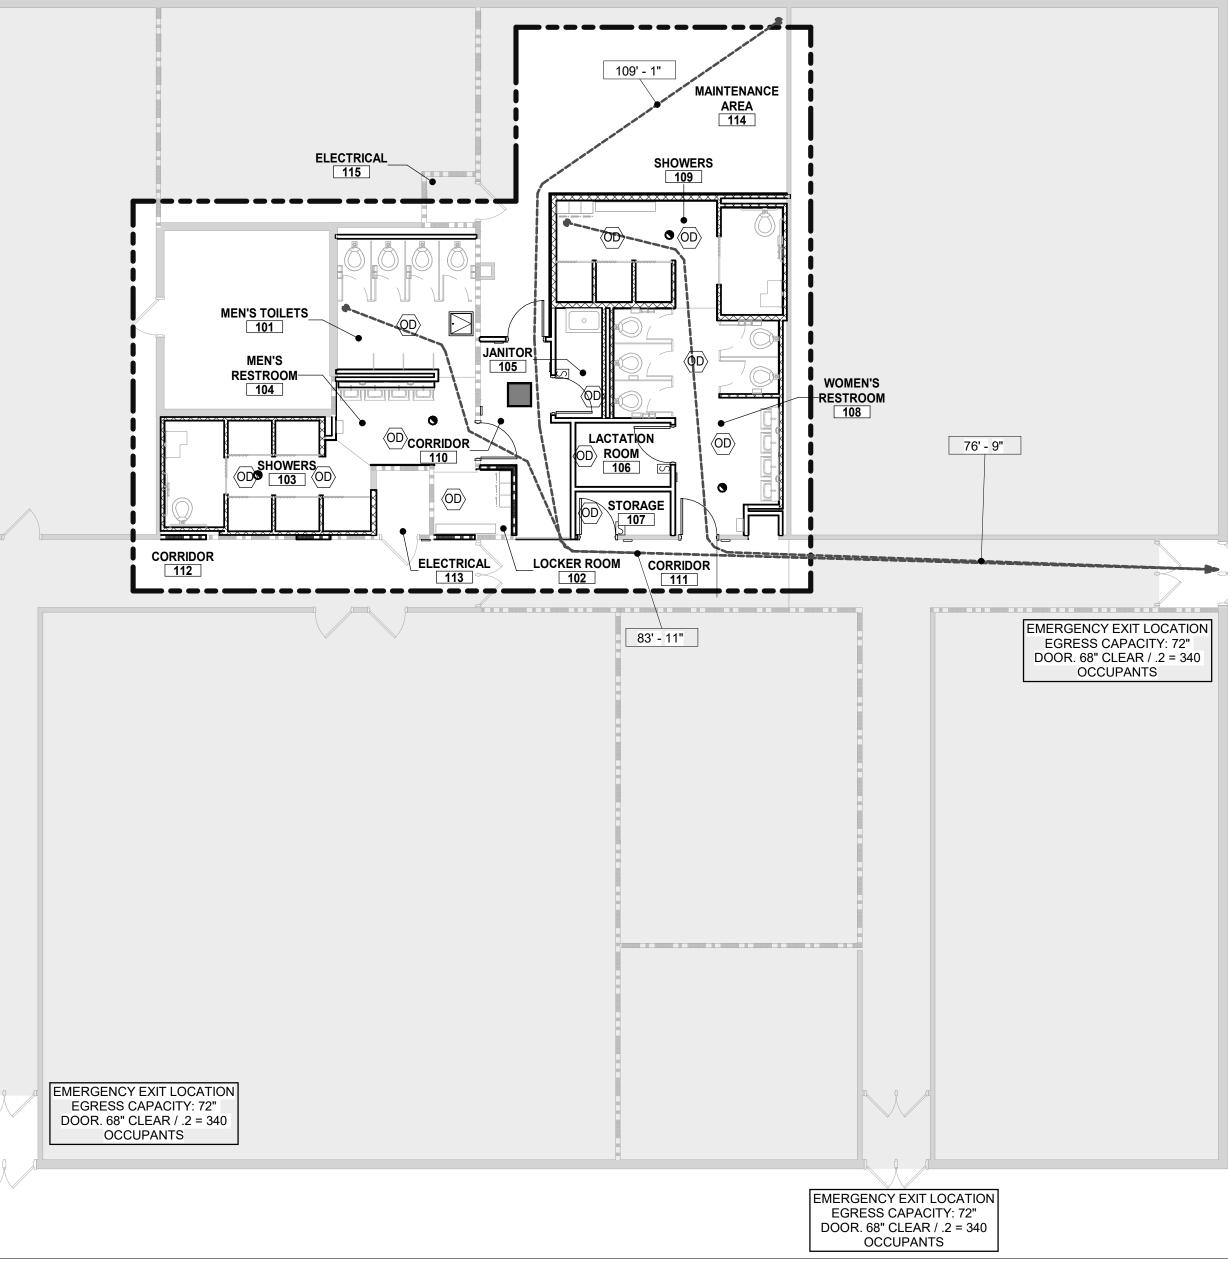
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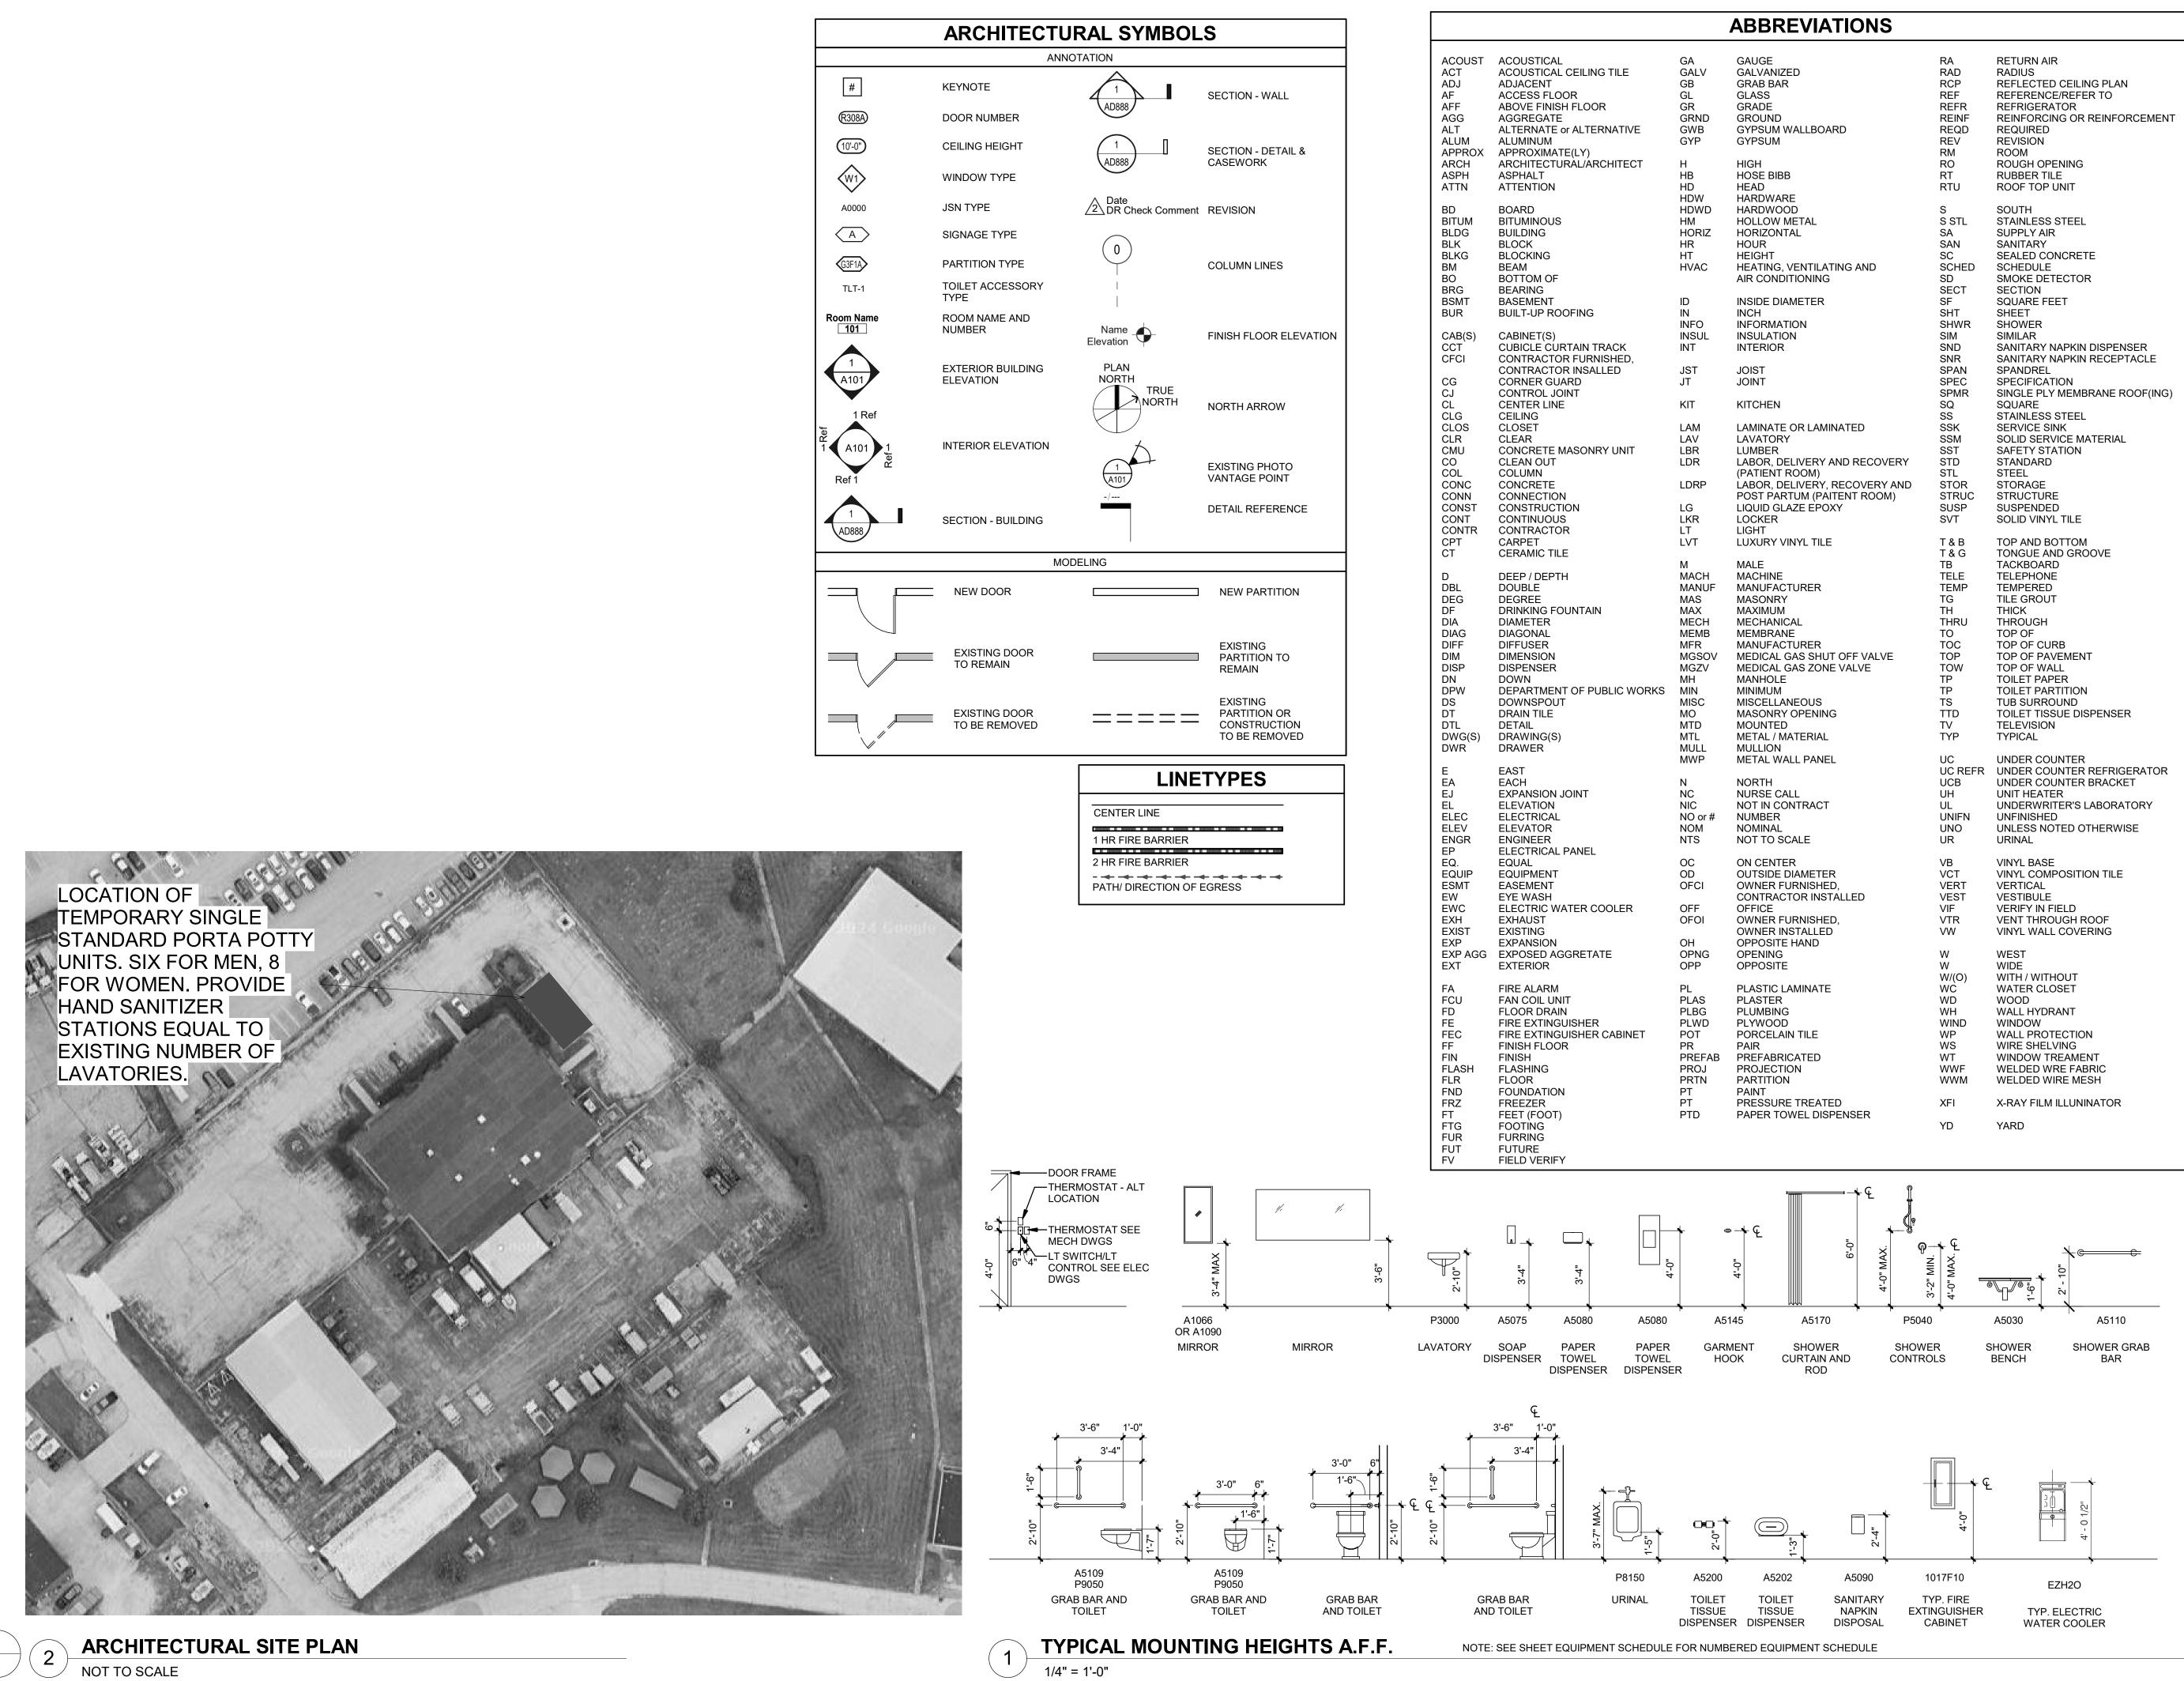


LIFE SAFETY PLAN
1/8" = 1'-0"




BASIC DESI	GN CRITERIA	MIKE KEHOE, GOVERNOR	
 2018 International Buildir 2018 International existir 2018 International Fire C 2018 International Mecha 2018 International Plumb 2018 International Energ 2017 National Electrical NFPA 72 National Fire A 	ng Building Code (IEBC) code (UFC) anical Code (IMC) bing Code (IPC) y Conservation Code	ARCHITECTURE & ENGINEERING	
		6 SOUTH OLD ORCHARD AVE.	
BUILDI	NG CODE DATA	ST. LOUIS, MO 63119 T: 314.918.8383 F: 314.918.1766 www.Introba.com	
USE: GROUP B - BUSINESS ACCESSORY OCCUPANCY C TYPE OF CONSTRUCTION: TYPE IIB (IBC) HAZARD OF CONTENTS CLA	HEIGHT: UL	MISSOURI STATE CERTIFICATE OF AUTHORITY #000148	
	ASSEMBLIES WILL BE FIRESTOPPED PER		
BUILDING ELEMENTS - FIRE	RESISTANT REQUIREMENTS		
FIRE WALLS	RATING ASSEMBLY N/A N/A		
STRUCTURAL FRAME BEARING WALLS EXTERIOR	N/A N/A	NUMBER OF MISSING	
INTERIOR NON-BEARING WALLS	N/A	BRADFORD	
EXTERIOR INTERIOR	N/A 1 HR		
FLOOR CONSTRUCTION	0 HR N/A	AROZSBOT	
PROJECT SQUARE FOOTAG		4/16/25	
OCCUPANT LOAD CALCULAT	FIONS (PER IBC TABLE 1004.1.2):	BRADFORD A. PIERCE AR005805	
BUSINESS OCCUPANC EXISTING TO REI ACCESSORY / MECHAN	YMAIN	The Professional Designer of Record (DOR), whose signature and personal seal appear on this document, assumes responsibility only for what appears hereon, and disclaims responsibility for all other plans, specifications, estimates, reports, documents or instruments not sealed by the Professional	
EXISTING TO REP	MAIN	DOR relating to, or intended to be used for, any part or parts of the project to which this document refers. Prints sealed by the DOR bear the embossed or wet seal of the DOR across the signature and date. Copies of this document,	
OCCUPANTS TOTAL = EXIST EXITING REQUIREMENTS		as signed and sealed, have been retained by the Professional DOR. The Professional DOR will not be responsible for subsequent changes to this document, unless the changes are made by the DOR or with the DOR's written authorization.	
EXITING REQUIREMEN	TS (1-500 OCCUPANTS): 1 THE MIN. NUMBER OF EXITS REQUIRED	OFFICE OF	
LOAD = 2 NUMBER OF EXITS PRO		ADMINISTRATION DIVISION OF FACILITIE	
	TANCE TO EXIT PER IBC TABLE 1017.2	MANAGEMENT, DESIGN AND	
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MAXIMUM TRAVEL DIS UNSPRINKLERED B-OC DEAD END CORRIDOR	CCUPANCY = 200 FT.	DESIGN AND CONSTRUCTION MISSOURI ARMY NATIONAL GUARD	
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SHEET 2 OF 31

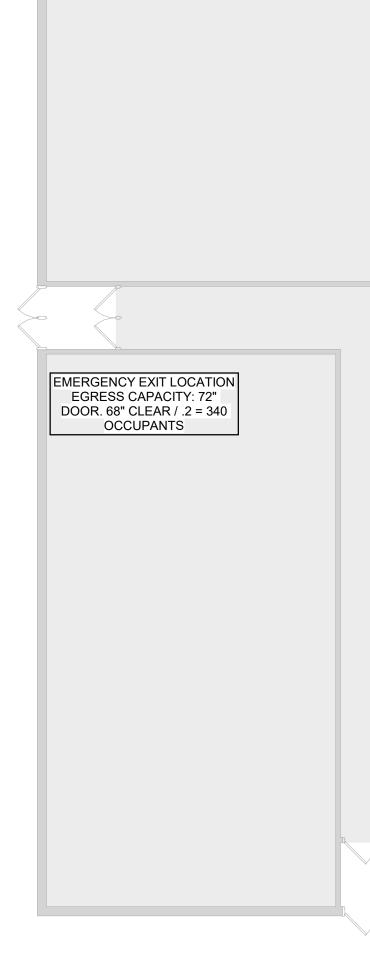

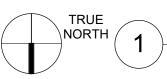
V ID 3	GAUGE GALVANIZED GRAB BAR GLASS GRADE GROUND GYPSUM WALLBOARD GYPSUM HIGH HOSE BIBB HEAD	RA RAD RCP REF REFR REINF REQD REV RM RO RT RTU	RETURN AIR RADIUS REFLECTED CEILING F REFERENCE/REFER T REFRIGERATOR REINFORCING OR REI REQUIRED REVISION ROOM ROUGH OPENING RUBBER TILE ROOF TOP UNIT
V VD RIZ .C	HARDWARE HARDWOOD HOLLOW METAL HORIZONTAL HOUR HEIGHT HEATING, VENTILATING AND AIR CONDITIONING	S S STL SA SAN SC SCHED SD SECT	SOUTH STAINLESS STEEL SUPPLY AIR SANITARY SEALED CONCRETE SCHEDULE SMOKE DETECTOR SECTION
) JL	INSIDE DIAMETER INCH INFORMATION INSULATION INTERIOR JOIST	SECT SF SHT SHWR SIM SND SNR SPAN	SQUARE FEET SHEET SHOWER SIMILAR SANITARY NAPKIN DIS SANITARY NAPKIN REG
	JOINT	SPEC SPMR SQ	SPECIFICATION SINGLE PLY MEMBRAN SQUARE
Р	LAMINATE OR LAMINATED LAVATORY LUMBER LABOR, DELIVERY AND RECOVERY (PATIENT ROOM) LABOR, DELIVERY, RECOVERY AND POST PARTUM (PAITENT ROOM) LIQUID GLAZE EPOXY LOCKER	SS SSK SSM SST STD STL STOR STRUC SUSP SVT	STAINLESS STEEL SERVICE SINK SOLID SERVICE MATE SAFETY STATION STANDARD STEEL STORAGE STRUCTURE SUSPENDED SOLID VINYL TILE
C L	LIGHT LUXURY VINYL TILE MALE MACHINE MANUFACTURER MASONRY MAXIMUM MECHANICAL MEMBRANE MANUFACTURER MEDICAL GAS SHUT OFF VALVE MEDICAL GAS SHUT OFF VALVE MEDICAL GAS ZONE VALVE MANHOLE MINIMUM MISCELLANEOUS MASONRY OPENING MOUNTED METAL / MATERIAL MULLION	T & B T & G TB TELE TEMP TG TH THRU TO TOC TOP TOC TOP TOW TP TP TS TTD TV TYP	TOP AND BOTTOM TONGUE AND GROOV TACKBOARD TELEPHONE TEMPERED TILE GROUT THICK THROUGH TOP OF TOP OF CURB TOP OF PAVEMENT TOP OF WALL TOILET PAPER TOILET PAPER TOILET PARTITION TUB SURROUND TOILET TISSUE DISPEN TELEVISION TYPICAL
p pr# 1	METAL WALL PANEL NORTH NURSE CALL NOT IN CONTRACT NUMBER NOMINAL NOT TO SCALE	UC UC REFR UCB UH UL UNIFN UNO UR	UNDER COUNTER UNDER COUNTER REF UNDER COUNTER BRA UNIT HEATER UNDERWRITER'S LABO UNFINISHED UNLESS NOTED OTHE URINAL
; I) I	ON CENTER OUTSIDE DIAMETER OWNER FURNISHED, CONTRACTOR INSTALLED OFFICE OWNER FURNISHED, OWNER INSTALLED	VB VCT VERT VEST VIF VTR VW	VINYL BASE VINYL COMPOSITION T VERTICAL VESTIBULE VERIFY IN FIELD VENT THROUGH ROOI VINYL WALL COVERING
IG S G /D FAB J N	OPPOSITE HAND OPENING OPPOSITE PLASTIC LAMINATE PLASTER PLUMBING PLYWOOD PORCELAIN TILE PAIR PREFABRICATED PROJECTION PARTITION PAINT	W W(O) WC WD WH WIND WP WS WT WWF WWF	WEST WIDE WITH / WITHOUT WATER CLOSET WOOD WALL HYDRANT WINDOW WALL PROTECTION WIRE SHELVING WINDOW TREAMENT WELDED WRE FABRIC WELDED WIRE MESH
	PRESSURE TREATED PAPER TOWEL DISPENSER	XFI YD	X-RAY FILM ILLUNINAT YARD

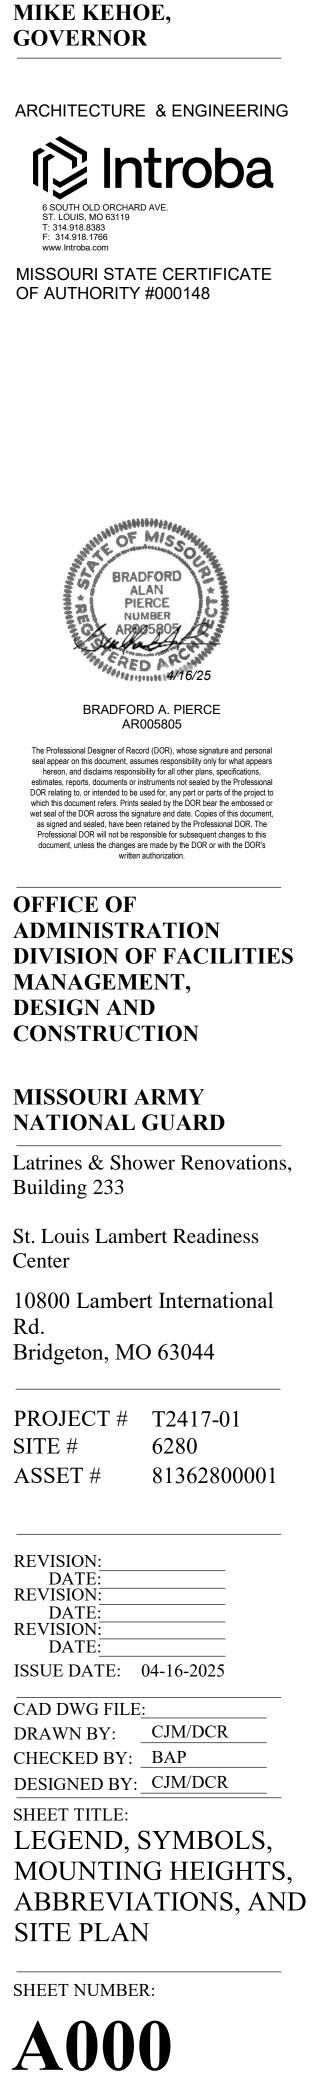

STATE OF MISSOURI

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	Keynote Legend			
Key Value	Keynote Text			
D01	THE CONTRACTOR WILL PERFORM GROSS INTERIOR DEMOLITION INCLUSIVE OF ALL WALLS, DOORS, CEILINGS, FLOOR FINISHES & ADHESIVE/MORTAR, EQUIPMENT & DEVICES, CASEWORK, EQUIPMENT, ETC. EXISTING BUILDING SHELL AND INTERIOR STRUCTURE WILL REMAIN.			
D02	SAW CUT & REMOVE EXISTING FLOOR SLAB INCLUDING BUT NOT LIMITED TO TRENCHING FOR NEW MEPFP UTILITIES. FIELD VERIFY EXTENTS OF EXISTING FLOORING FOR REMOVAL. REMOVE EXISTING AND RELATED PIPING. BACKFILL WITH GRANULAR FILL FOR THE INSTALLATION OF A NEW CONCRETE SLAB. SEE MEPFP AND STRUCTURAL DRAWINGS FOR ADDITIONAL INFORMATION.			
D03	REMOVE WALL MOUNTED DRINKING FOUNTAIN AND PLUMBING.			
D04	NO WORK THIS AREA UNLESS REQUIRED FOR MEP ROUTING. COORDINATE W/ MEP DRAWINGS.			
D05	LINE OF EXISTING BUILDING CONSTRUCTION TO REMAIN. PROTECT DURING DEMOLITION			
D06	REMOVE EXISTING PLUMBING FIXTURES COMPLETELY. CAP ALL SERVICES BELOW FLOOR AND/OR BEYOND FACE OF WALL CONSTRUCTION. REFER TO THE PLUMBING DRAWINGS FOR ADDITIONAL INFORMATION. PREPARE SURFACES TO REMAIN AS REQUIRED FOR NEW CONSTRUCTION.			
D07	REMOVE EXISTING METAL STUD WALL CONSTRUCTION AS REQUIRED FOR NEW DOOR OPENING. REFER TO THE ARCHITECTURAL DRAWINGS AND OPENING SCHEDULE FOR ADDITIONAL INFORMATION.			
D09	COORDINATE WITH ANY IN FLOOR TRENCHING (P102). SEE ENVIRONMENTAL ITEMS IN ROOM 125 NOTE AREAS OF ACM DISTERBANCE, STATE SEE ENVIRONMENTAL REPORT.			


NCY

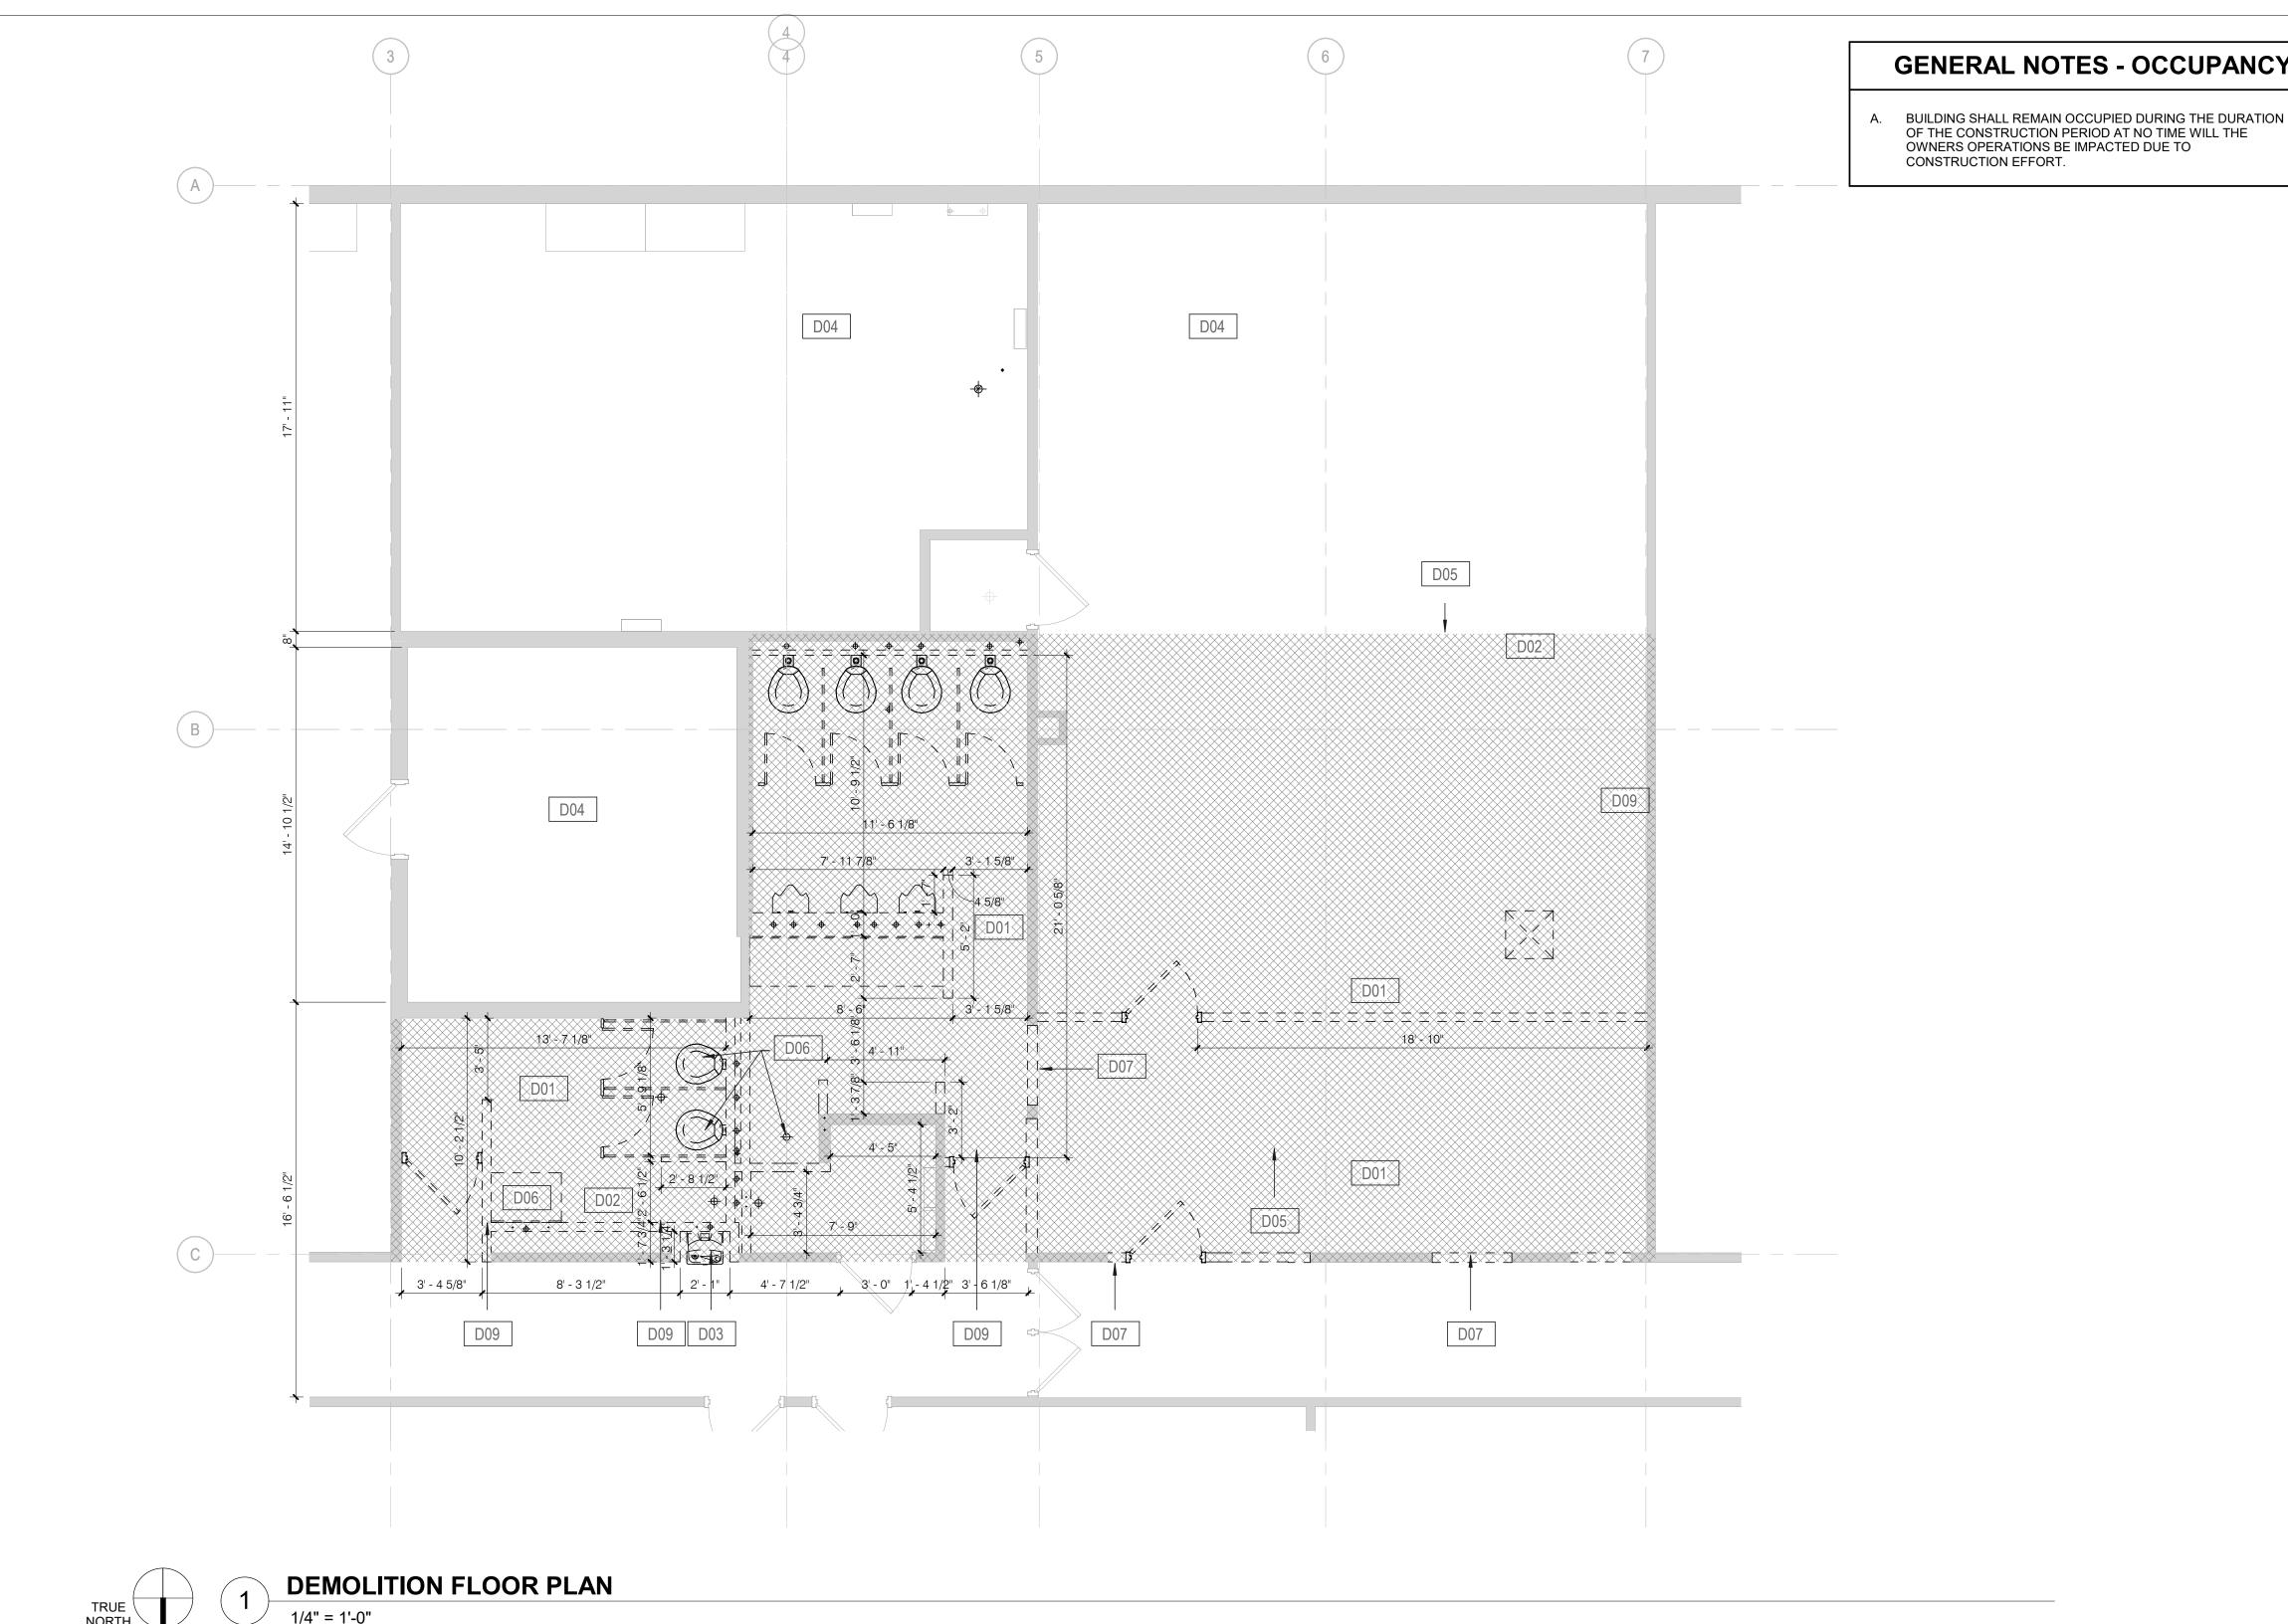
GENERAL DEMOLITION NOTES

EXISTING CONDITIONS ARE BASED ON INFORMATION OBTAINED FROM EXISTING DRAWINGS AND FIELD SURVEY, AND WILL NOT BE CONSTRUED AS "AS BUILT." THE CONTRACTOR WILL FIELD VERIFY EXISTING CONDITIONS PRIOR TO ONSET OF CONSTRUCTION. THE DEMOLITION DRAWING IS TO SHOW A GENERAL 'GUT' OF THE DEMOLITION AREA. ALL INTERIOR PARTITIONS, FLOORING, CEILING, CASEWORK, PLUMBING, MECHANICAL, AND ELECTRICAL FIXTURES ARE TO BE REMOVED (SHOWN DASHED) UNLESS SPECIFICALLY NOTED OTHERWISE. ALL EXISTING STRUCTURE TO REMAIN UNLESS SHOWN DEMOLISHED ON STRUCTURAL DRAWINGS. SEE MECHANICAL, PLUMBING, AND ELECTRICAL DRAWINGS FOR THE EXTENT OF THEIR WORK.

ALL WALL PARTITIONS SHOWN DASHED ARE TO BE REMOVED. THE CONTRACTOR WILL PATCH ALL PARTITIONS, CEILINGS, AND FLOORS AFFECTED BY DEMOLITION TO MATCH ADJACENT CONSTRUCTION.

- THE OWNER WILL VERIFY WHICH REMOVAL ITEMS ARE TO BE RETAINED BY THE OWNER AT THE PRE-CONSTRUCTION MEETING. WHILE DEMOLITION IS OCCURRING, BUSINESS ACTIVITIES WILL BE PROCEEDING IN ADJACENT AREAS. MINIMIZE NOISE AND DUST LEVELS.
- ALL EXISTING HAZARDOUS MATERIALS IN THE BUILDING WILL BE REVIEWED AND DEMOLISHED BY AN ABATEMENT CONTRACTOR. REFER TO THE HAZARDOUS MATERIAL REPORT INCLUDED IN THE WORK PLAN. WHEN EXTERIOR WALLS, WINDOWS, AND DOORS ARE REMOVED,
- CONSTRUCT TEMPORARY PARTITIONS AS REQUIRED TO ASSURE EXISTING BUILDING REMAINS WATERTIGHT AND WITHOUT AIR INFILTRATION DURING WORK. MAINTAIN TEMPORARY PARTITIONS AS REQUIRED.
- TEMPORARY PARTITIONS AND TEMPORARY DOORS AS REQUIRED TO AVOID MIGRATION OF DUST AND DEBRIS INTO ADJOINING AREAS, TO MAINTAIN PROPER FIRE EXITS, AND TO CONFINE PEDESTRIAN ACTIVITY TO OCCUPIED SPACES WHILE MAINTAINING REQUIRED MEANS OF EGRESS.
- ALL DEMOLITION WILL BE COORDINATED WITH PHASING WORK REQUIRED TO COMPLETE WORK. COORDINATE DEMOLITION WORK IN OCCUPIED SPACES AND
- NOTIFY OWNER TWO WEEKS PRIOR TO COMMENCING WORK. MINIMIZE DISRUPTIONS TO SPACES THAT REMAIN IN OPERATION. PROTECT EXISTING FLOOR, WALL, AND CEILING FINISHES. THE CONTRACTOR WILL PROVIDE FALL AND SAFETY PROTECTION AT ANY HAZARDOUS CONDITION CAUSED BY THE DEMOLITION PROCESS.
- NOTES WHICH DO NOT HAVE ARROWS TO SPECIFIC ITEMS INDICATE MATERIAL TO BE REMOVED FOR ENTIRE ROOM IN WHICH NOTE OCCURS.
- MAKE ALL DEMOLITION CLEAN AND COMPLETE IN A MANNER SUITABLE FOR NEW FINISHES AND SURFACES.
- WHEN DEMOLITION CAUSES OR EXPOSES DAMAGE TO FLOOR SLAB, WALL, OR CEILING SURFACES WHICH WILL REMAIN IN THE FINISHED WORK, SUCH CONDITIONS WILL BE REPAIRED AND LEVELED AS REQUIRED TO RECEIVE NEW FINISHES. REPAIRS MUST BE ACCEPTABLE TO OWNER.
- THE CONTRACTOR WILL CLEAN, PATCH, AND REPAIR EXISTING SURFACES AFFECTED DURING DEMOLITION AND CONSTRUCTION TO MATCH EXISTING ADJACENT SURFACES. REPAIRS WILL BE MADE AS TO MATCH EXISTING CONSTRUCTION IN MATERIAL, METHOD, TECHNOLOGY, COLOR PATTERNS, ETC. REMOVE ALL EXISTING CEILING, SUSPENSION SYSTEM,
- FRAMEWORK, GRIDS, WALL MOULDING, ETC., WITHIN THE PROJECT LIMITS UNLESS OTHERWISE INDICATED ON PLANS. PATCH OPENINGS IN EXTERIOR WALLS RESULTING FROM
- DEMOLITION ACTIVITIES. ALL DOORS SHOWN DASHED ARE TO BE REMOVED. ASSOCIATED DOOR FRAME TO BE REMOVED UNLESS NOTED OTHERWISE. VERIFY FLOOR ELEVATIONS ON EACH SIDE OF WALLS BEING REMOVED. GRIND AND PATCH FLOOR AND INSTALL EPOXY FILL
- MATERIAL, AS REQUIRED, FOR SMOOTH, LEVEL FLOOR CONDITION THE CONTRACTOR WILL PROTECT THE EXISTING FLOOR FINISHES TO REMAIN FROM DAMAGE THROUGHOUT CONSTRUCTION. REMOVE EXISTING FLOOR FINISH AND BASE WHERE NEW FINISHES ARE REQUIRED. REMOVE FLOOR FINISH ADHESIVE. CLEAN AND
- PREPARE SUBSTRATES AS REQUIRED TO PRODUCE A FLAT, EVEN SURFACE IN A MANNER SUITABLE TO ACCEPT NEW FINISHES. PATCH FLOOR PENETRATIONS RESULTING FROM REMOVAL OF EXISTING DUCTWORK, PIPING, AND ELECTRICAL RACEWAYS. FILL PENETRATIONS WITH CONCRETE, FULL FLOOR THICKNESS AND MAINTAIN FIRE-RESISTIVE RATING OF FLOOR SYSTEM. FINISH
- SUBSTRATE IN A MANNER SUITABLE FOR NEW FLOOR FINISHES. THE CONTRACTOR WILL FILL ALL WALL PENETRATIONS RESULTING FROM THE REMOVAL OF EXISTING MEP DEVICES IN THE INTERIOR WALLS TO REMAIN. THE PENETRATIONS WILL BE FILLED FLUSH WITH, AND OF THE SAME MATERIALS AS, THE SURROUNDING WALLS, THIS INCLUDES WORK ABOVE ALL CEILINGS. THE CONTRACTOR WILL IN-FILL ALL OPENINGS IN EXTERIOR WALLS RESULTING FROM THE REMOVAL OF LOUVERS, EXHAUST FANS, ETC. THE OPENINGS WILL BE FILLED FLUSH WITH, AND OF THE
- SAME MATERIALS AS, THE SURROUNDING WALLS. THE CONTRACTOR WILL COORDINATE WITH THE OWNER FOR ALL EXISTING EQUIPMENT AND FURNITURE ITEMS THAT ARE TO BE SALVAGED OR RE-INSTALLED PRIOR TO THE COMMENCEMENT OF DEMOLITION. (THIS SHOULD BE DEFINED AT THE SITE INVESTIGATION).
- REMOVE ALL EXISTING WALL MOUNTED ITEMS WITHIN THE PROJECT LIMITS WHICH ARE NOT INDICATED TO REMAIN. IF ITEMS ARE REMOVED FROM WALLS OR COLUMNS THAT REMAIN, PATCH WALLS AND COLUMNS AS REQUIRED TO RECEIVE NEW FINISHES. EXISTING SYSTEMS FURNITURE CURRENTLY LOCATED IN AREAS
- THAT WILL BE AFFECTED BY CONSTRUCTION WILL BE REMOVED BY THE OWNER PRIOR TO CONSTRUCTION. AA. PORTIONS OF THE PLAN THAT HAVE BEEN CROSSED HATCHED ARE CONSIDERED OUTSIDE THE SCOPE OF WORK, UNLESS NOTED
- OTHERWISE BY THE MEPFP DOCUMENTS, TYPICAL. BB. *CONTRACTOR WILL VERIFY, MAINTAIN, AND PROTECT ALL EXISTING FIRE-RATED AND/OR SMOKE-RATED ASSEMBLIES WITHIN THE PROJECT AREA THAT ARE TO REMAIN DURING CONSTRUCTION.
- CC. *ALL FIRE-RATED FLOOR PENETRATIONS WILL BE REPAIRED AND/OR MAINTAINED TO A 2-HOUR MINIMUM RATING WITHIN FOUR (4) HOURS OF DEMOLITION.
- DD. *ALL PENETRATIONS WILL BE MAINTAINED AND/OR REPAIRED TO MEET THE MINIMUM RATING REQUIREMENTS WITHIN FOUR (4) HOURS OF DEMOLITION.
- EE. *ANY EXISTING FIRE-RATED AND/OR SMOKE-RATED ASSEMBLIES THAT ARE DISCOVERED TO BE COMPROMISED WILL BE REPAIRED WITHIN FOUR (4) HOURS OF THE DISCOVERY.

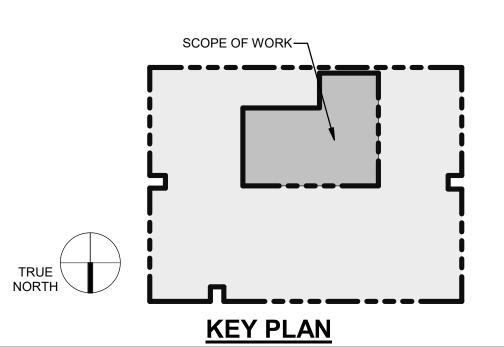

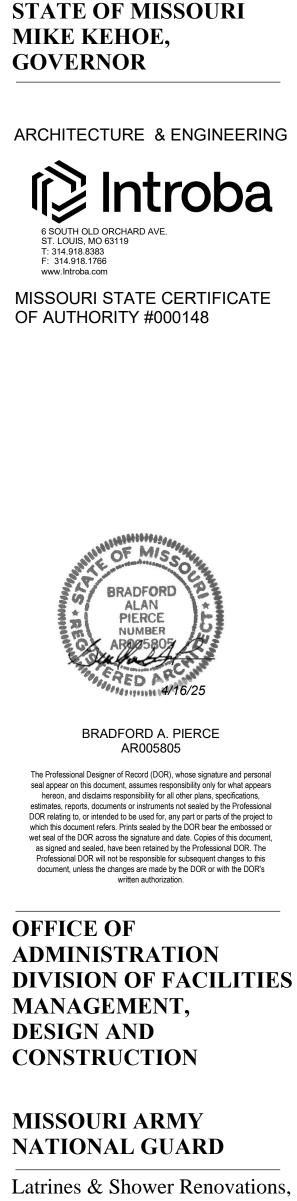

Building 233

St. Louis Lambert Readiness Center

10800 Lambert International Rd.

Bridgeton, MO 63044

PROJECT #	T2417-01
SITE #	6280
ASSET #	81362800001

REVISION:

DATE:	
REVISION:	
DATE:	
REVISION:	
DATE:	
ISSUE DATE:	04-16-2025

CAD DWG FILE: DRAWN BY: CJM/DCR CHECKED BY: BAP DESIGNED BY: CJM/DCR


SHEET TITLE: **DEMOLITION FLOOR** PLAN

SHEET NUMBER:



04-16-2025

SHEET 4 OF 31

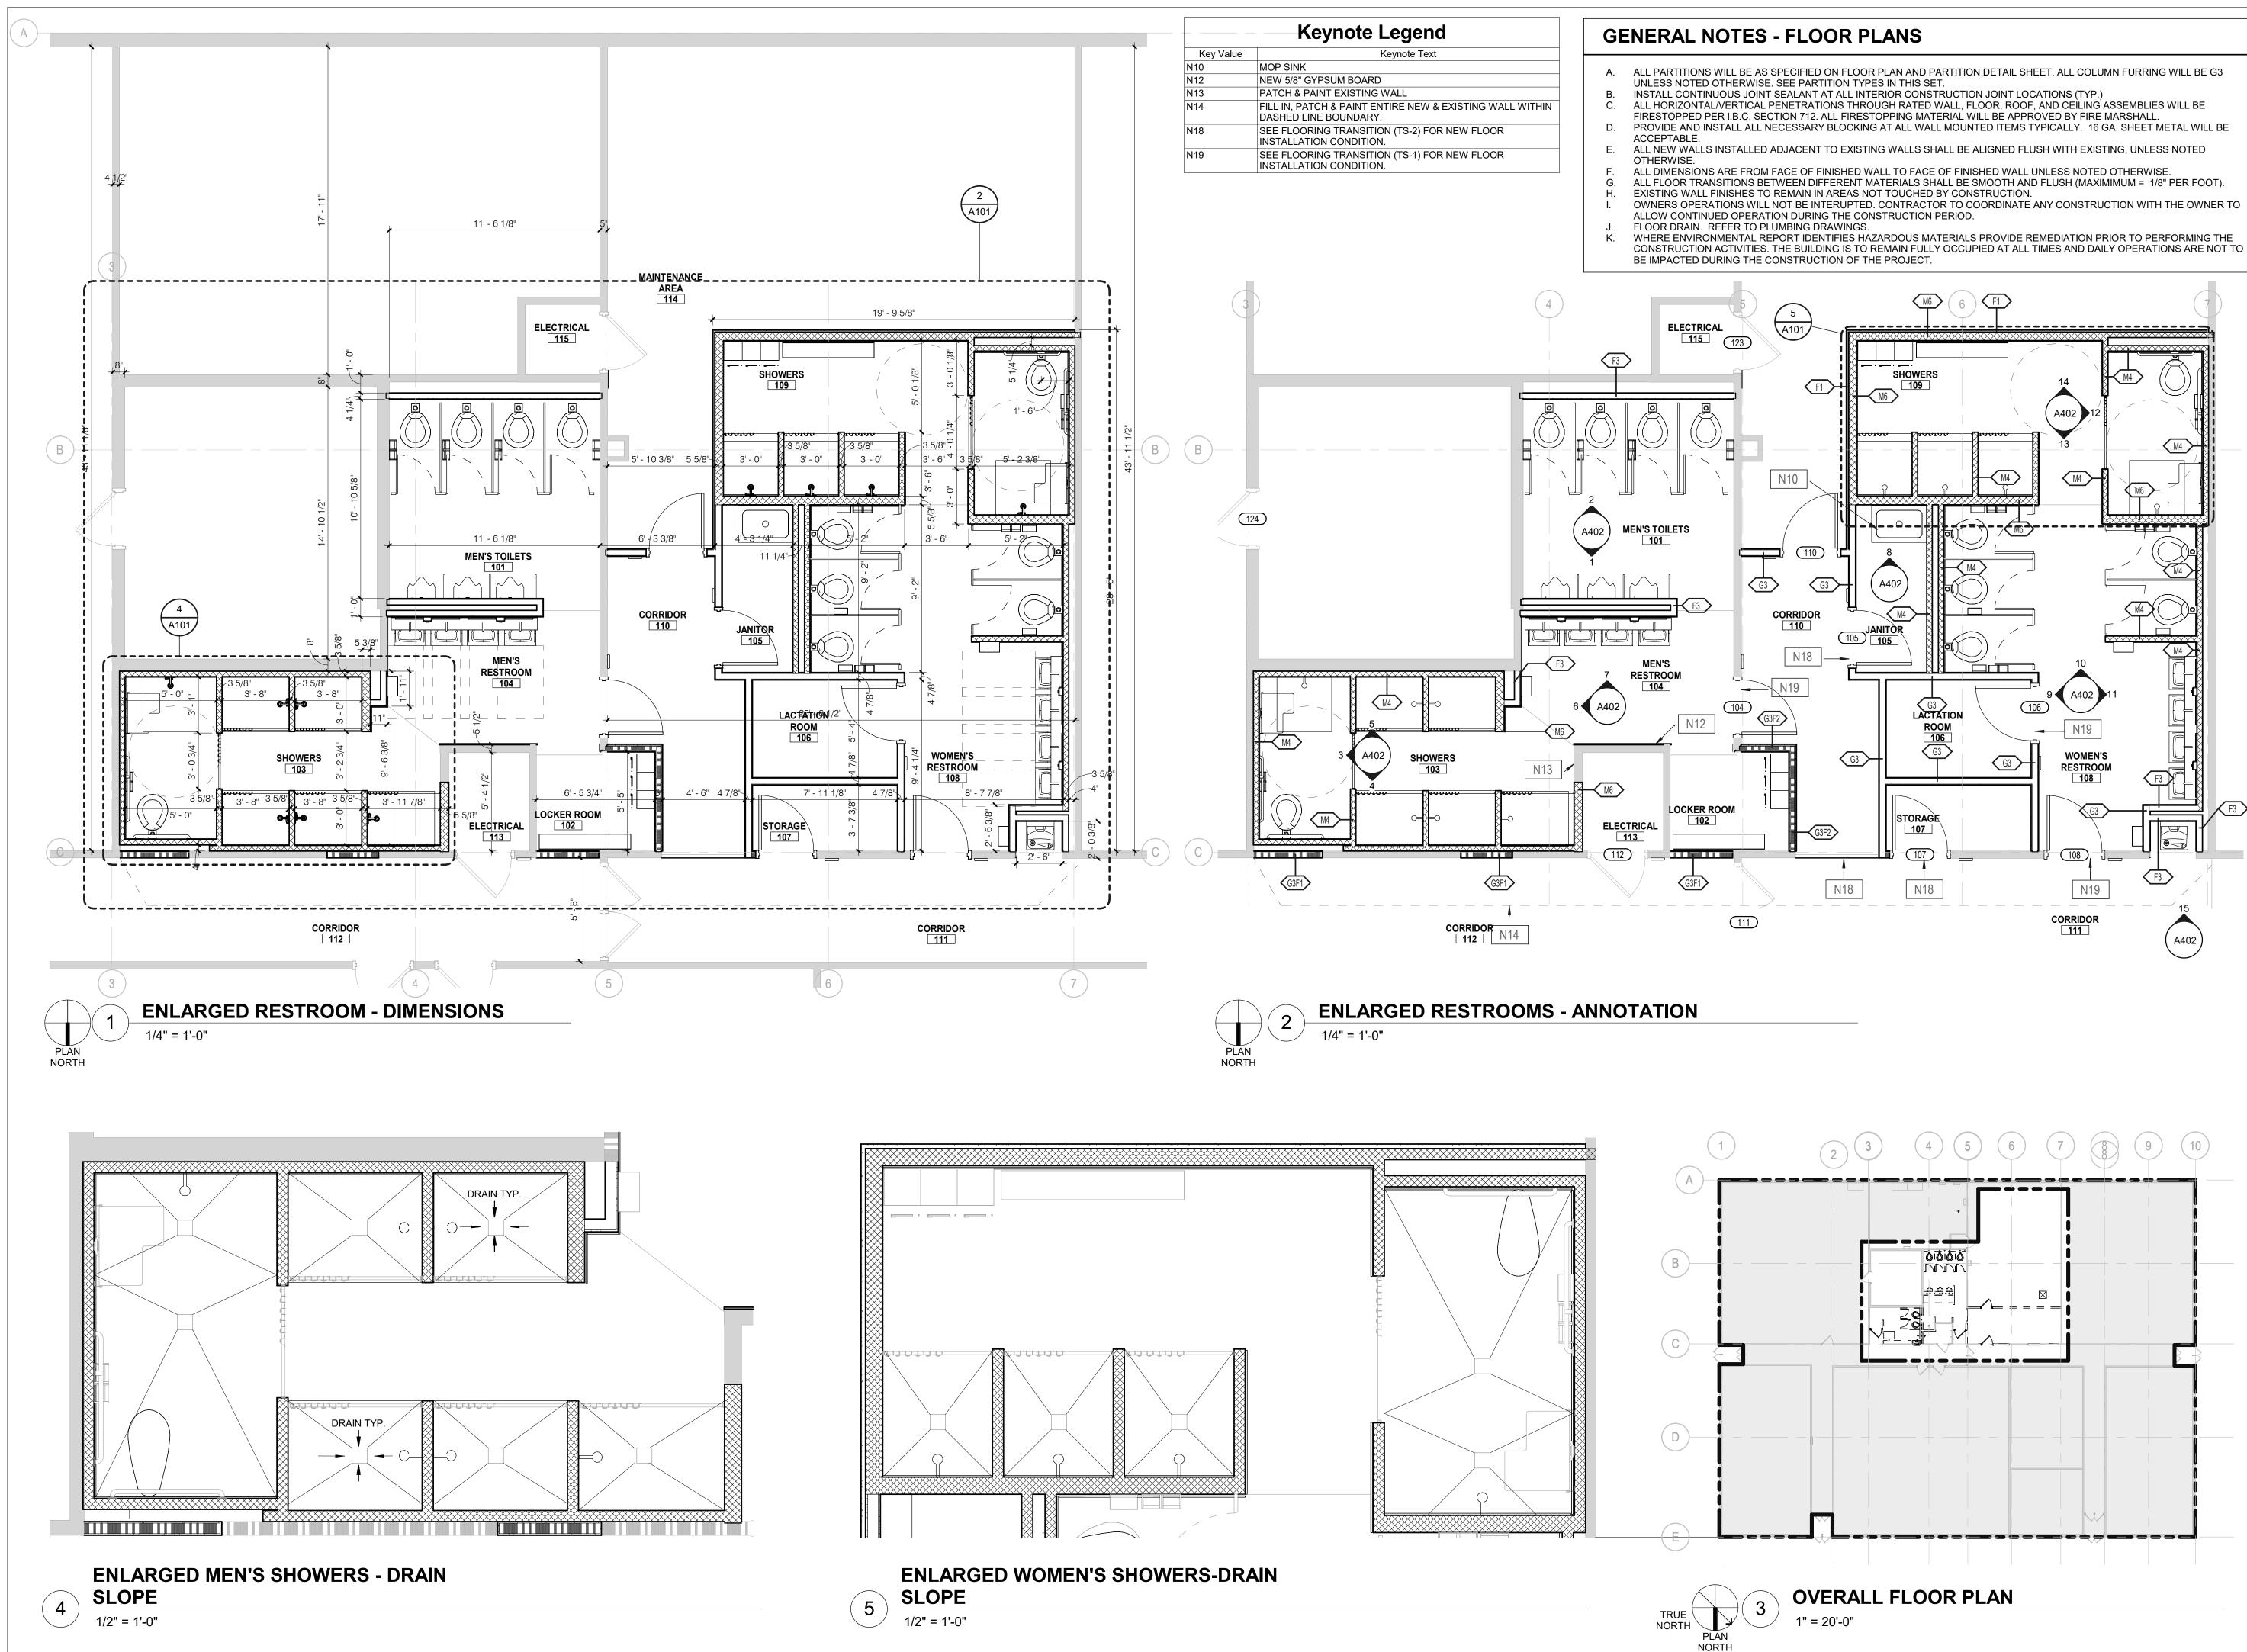

STATE OF MISSOURI MIKE KEHOE, GOVERNOR

ARCHITECTURE & ENGINEERING



MISSOURI STATE CERTIFICATE OF AUTHORITY #000148



BRADFORD A. PIERCE AR005805

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MISSOURI ARMY NATIONAL GUARD

Latrines & Shower Renovations, Building 233

St. Louis Lambert Readiness Center

10800 Lambert International Rd.

Bridgeton, MO 63044

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DATE: ISSUE DATE: 04-16-2025


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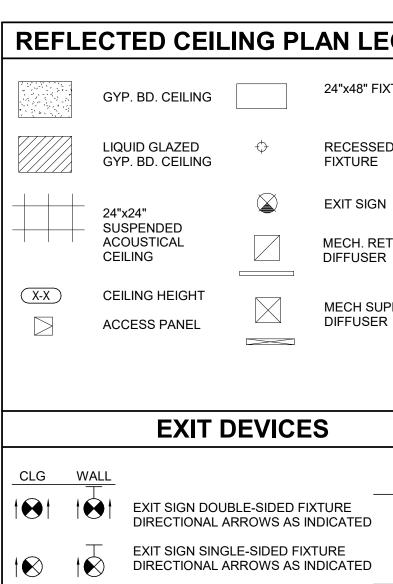
FLOOR PLANS

SHEET NUMBER:



04-16-2025



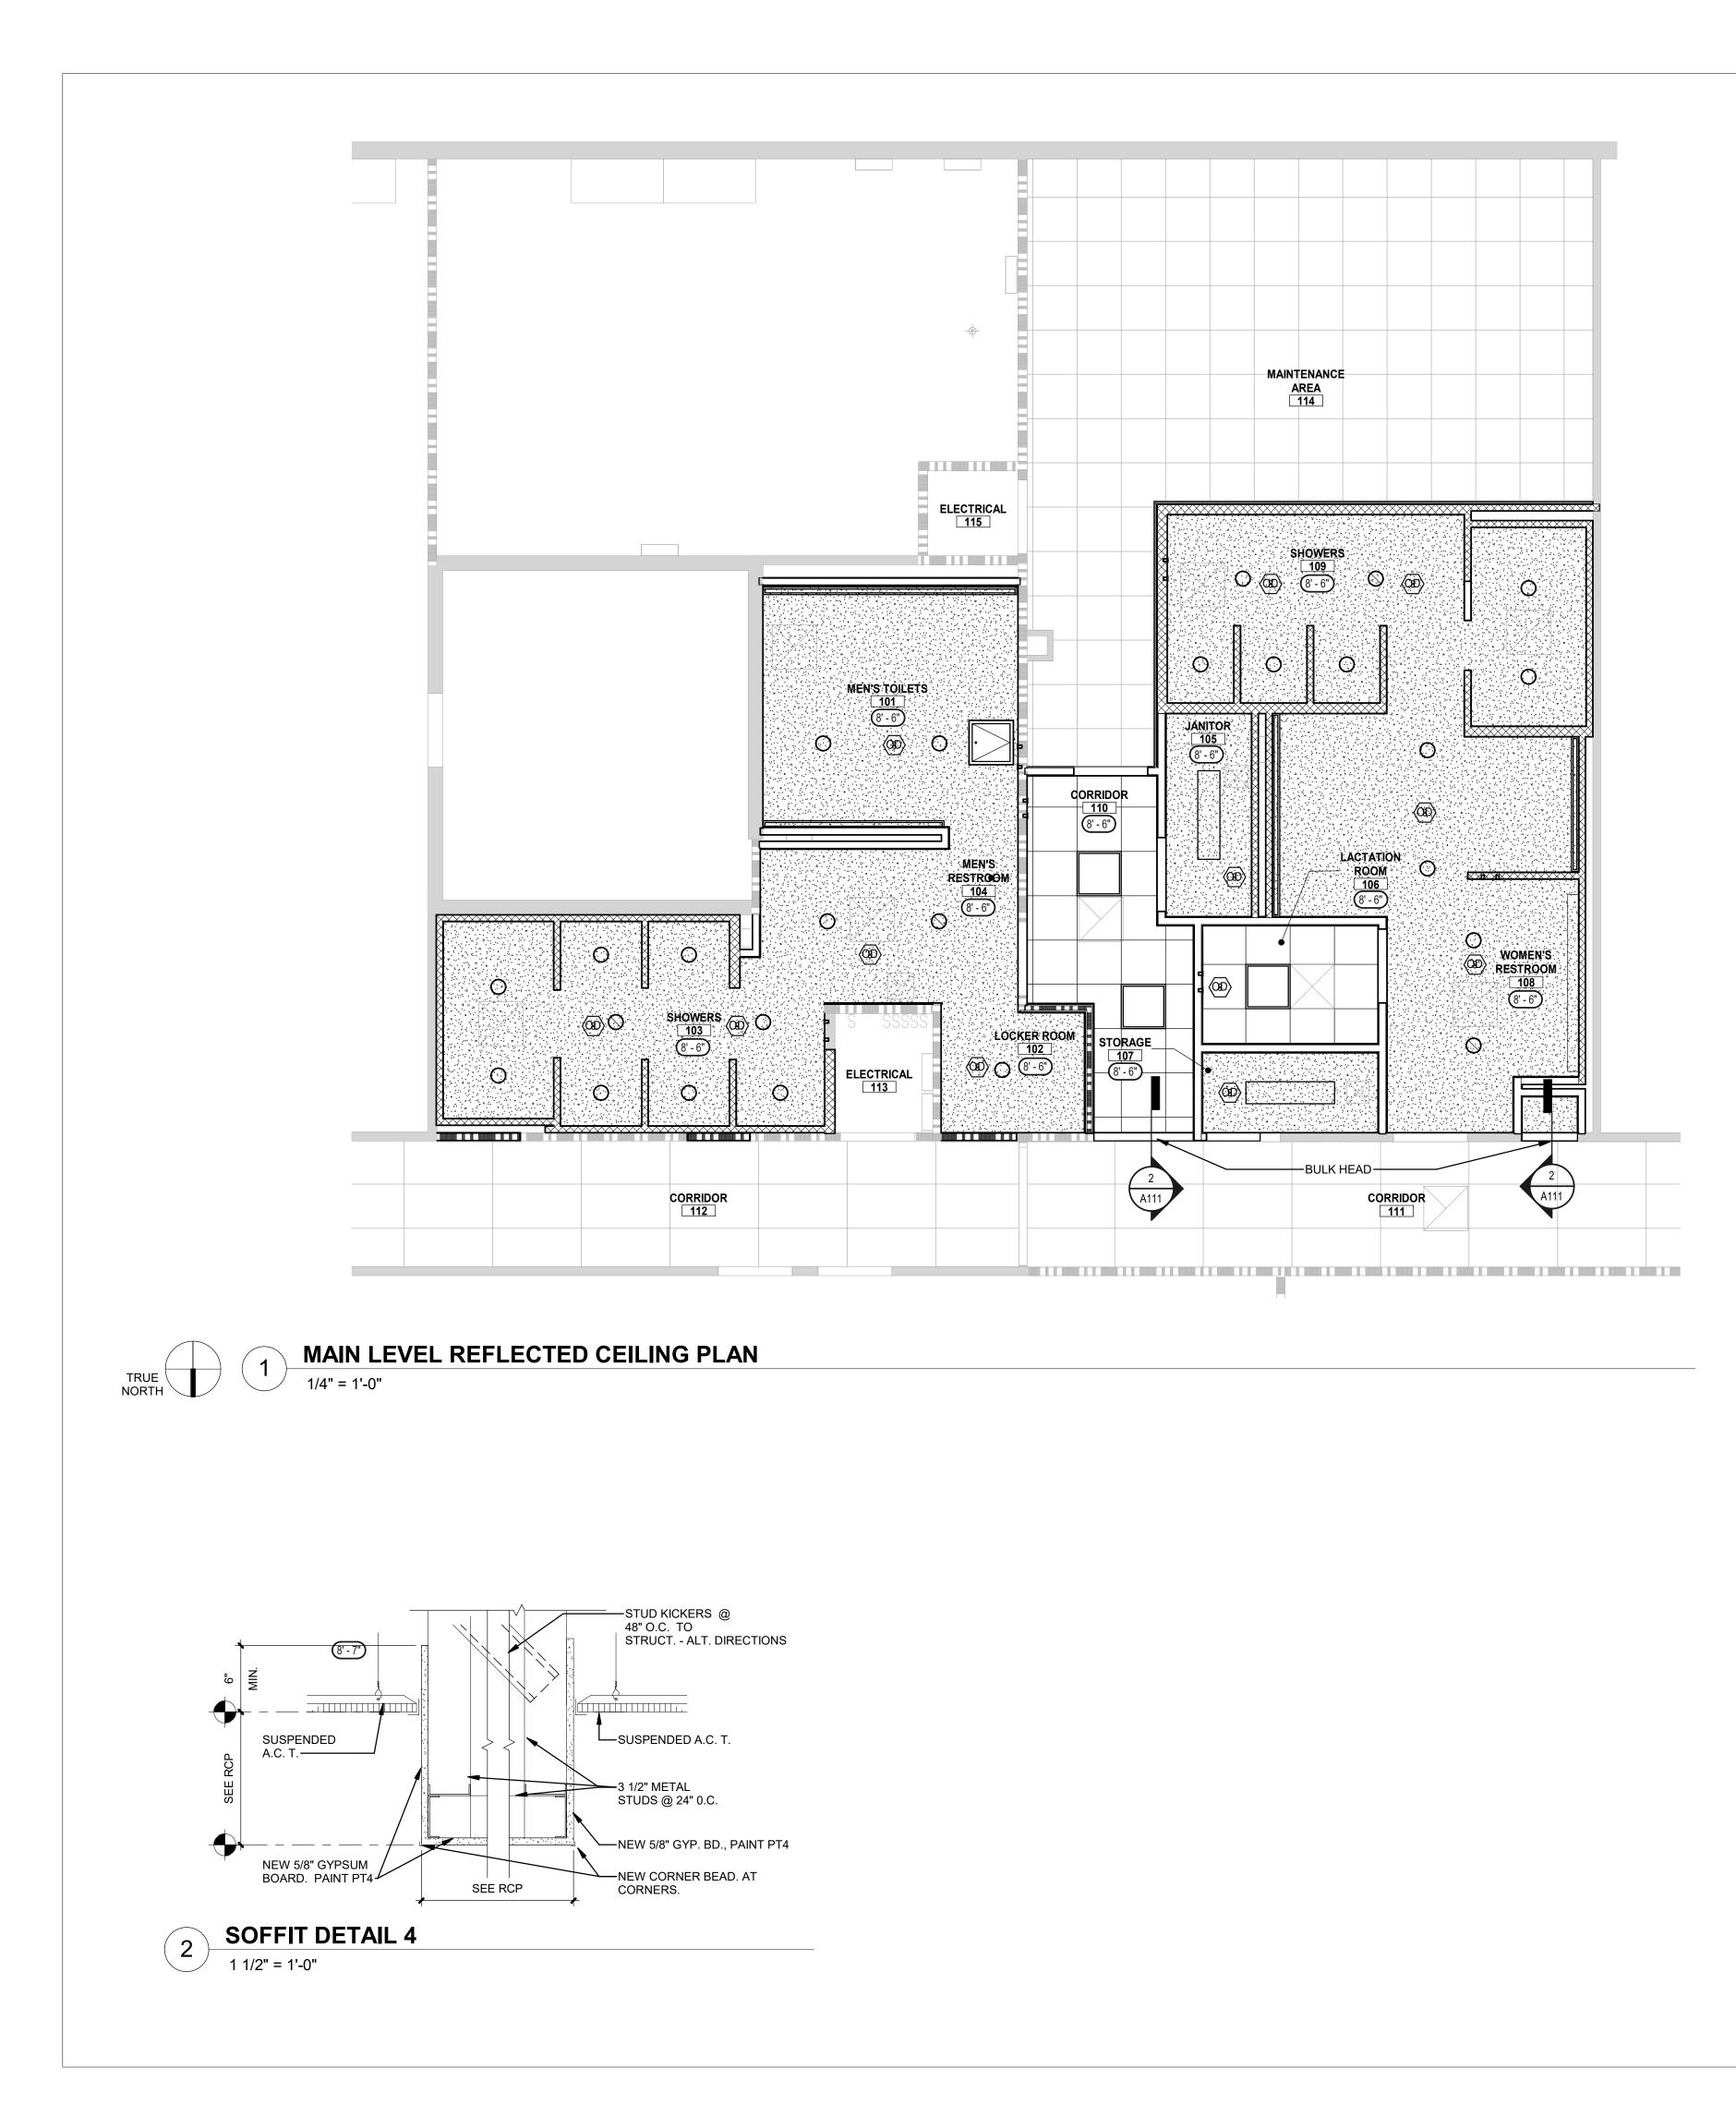

GEND	GENERAL NOTES - RCP	STATE OF MISSOURI MIKE KEHOE, GOVERNOR
XTURE	A. ALL TRADES WILL PARTICIPATE IN A COORDINATION MEETING PRIOR TO ANY INSTALLATION OF ABOVE CEILING SYSTEMS, SERVICES, EQUIPMENT, ETC. DURING THE SHOP DRAWING	ARCHITECTURE & ENGINEERING
D	PHASE. B. REFER TO THE PROJECT MANUAL AND THE FIRE PROTECTION PLANS FOR THE LOCATION OF THE SPRINKLER HEADS UNLESS DIMENSIONED OTHERWISE ON THE PLANS. DO NOT LOCATE ANY SPRINKLER HEADS IN A BULKHEAD OR SOFFIT WITHOUT FIRST	() Introba
TURN AIR	 COORDINATING THE LOCATION WITH THE ARCHITECT. C. REFER TO THE MECHANICAL, PLUMBING AND ELECTRICAL DRAWINGS FOR ADDITIONAL CEILING MOUNTED SERVICES. D. ALL CEILING MOUNTED SPRINKLER HEADS, DETECTORS, LIGHT FIXTURES, EXIT LIGHTS ETC WILL BE INSTALLED IN THE CENTER OF THE CEILING PANEL. REFER TO THE MECHANICAL AND 	6 SOUTH OLD ORCHARD AVE. ST. LOUIS, MO 63119 T: 314.918.8383 F: 314.918.1766 www.Introba.com
PPLY AIR R	 ELECTRICAL DRAWINGS FOR ADDITIONAL INFORMATION. E. COORDINATE ALL SYSTEMS TO BE LOCATED IN AND ABOVE THE CEILING, INCLUDING, BUT NOT LIMITED TO FIRE PROTECTION/SAFETY, HVAC, ELECTRICAL SYSTEMS, ETC. F. SEE ELECTRICAL PLANS FOR LIFE SAFETY/FIRE ALARM DEVICES. THESE DEVICES SHALL TAKE FIRST PRECEDENCE. CONTRACTOR TO ADJUST/COORDINATE LIGHT FIXTURES AND SUPPLY/RETURN 	OF AUTHORITY #000148
	 AIR GRILLES ACCORDINGLY. G. REFER TO THE DEMOLITION PLANS FOR LOCATION OF EXISTING CEILINGS TO BE REMOVED. H. GC SHALL COORDINATE ALL SYSTEMS TO BE LOCATED IN AND ABOVE THE CEILING, INCLUDING BUT NOT LIMITED TO: FIRE PROTECTION / LIFE SAFETY, HVAC, PLUMBING, ELECTRICAL 	
SHADING INDICATES FACE(S)	 SYSTEMS, ETC. REFER TO CEILING COORDINATION DETAILS IN THIS SET. [DESIGNER NOTE: ADD CLD DETAILS TO SET] I. REFER TO CASEWORK DETAILS FOR BULKHEADS OVER UPPOER WALL CABINETS. THE BULKHEAD MUST EXTEND BEYOND THE FACE OF THE CABINET DOOR A MINIMUM OF 1/2". J. PORTIONS OF THE PLAN SHOWN HATCHED INDICATES APPOXIMATE AREA WHERE MECHANICAL/PLUMBING WORK OCCURS. EXISTING CEILINGS TO BE REMOVED AS REQUIRED FOR MECHANCAL/PLUMBING WORK. REINSTALL CEILINGS AFTER WORK IS COMPLETED. AT GYP.BD. CEILING LOCATIONS, PATCH AFFECTED AREAS TO MATCH EXISTING CONSTRUCTION AND ENDING ASE MECHANICAL AND PLANMENCE FOR 	BRADFORD ALAN PIERCE NUMBER AR0/25805
	FINISH. SEE MECHANICAL AND PLUMBING DRAWINGS FOR ADDITIONAL INFORMATION. LUMINAIRES	BRADFORD A. PIERCE AR005805
	NO SHADING: NORMAL POWER	The Professional Designer of Record (DOR), whose signature and personal seal appear on this document, assumes responsibility only for what appears

HALF-SHADING: LIFE SAFETY OR BATTERY BACKUP

FULL-SHADING: CRITICAL POWER

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MISSOURI ARMY NATIONAL GUARD

Latrines & Shower Renovations, Building 233

St. Louis Lambert Readiness Center

10800 Lambert International Rd.

Bridgeton, MO 63044

PROJECT # T2417-01 6280 SITE # 81362800001 ASSET #

REVISION: DATE: REVISION: DATE: REVISION: DATE:

ISSUE DATE: 04-16-2025 CAD DWG FILE:

DRAWN BY: CJM/DCR CHECKED BY: BAP DESIGNED BY: CJM/DCR


SHEET TITLE: **REFLECTED CEILING** PLAN

SHEET NUMBER:



04-16-2025

SHEET 6 OF 31

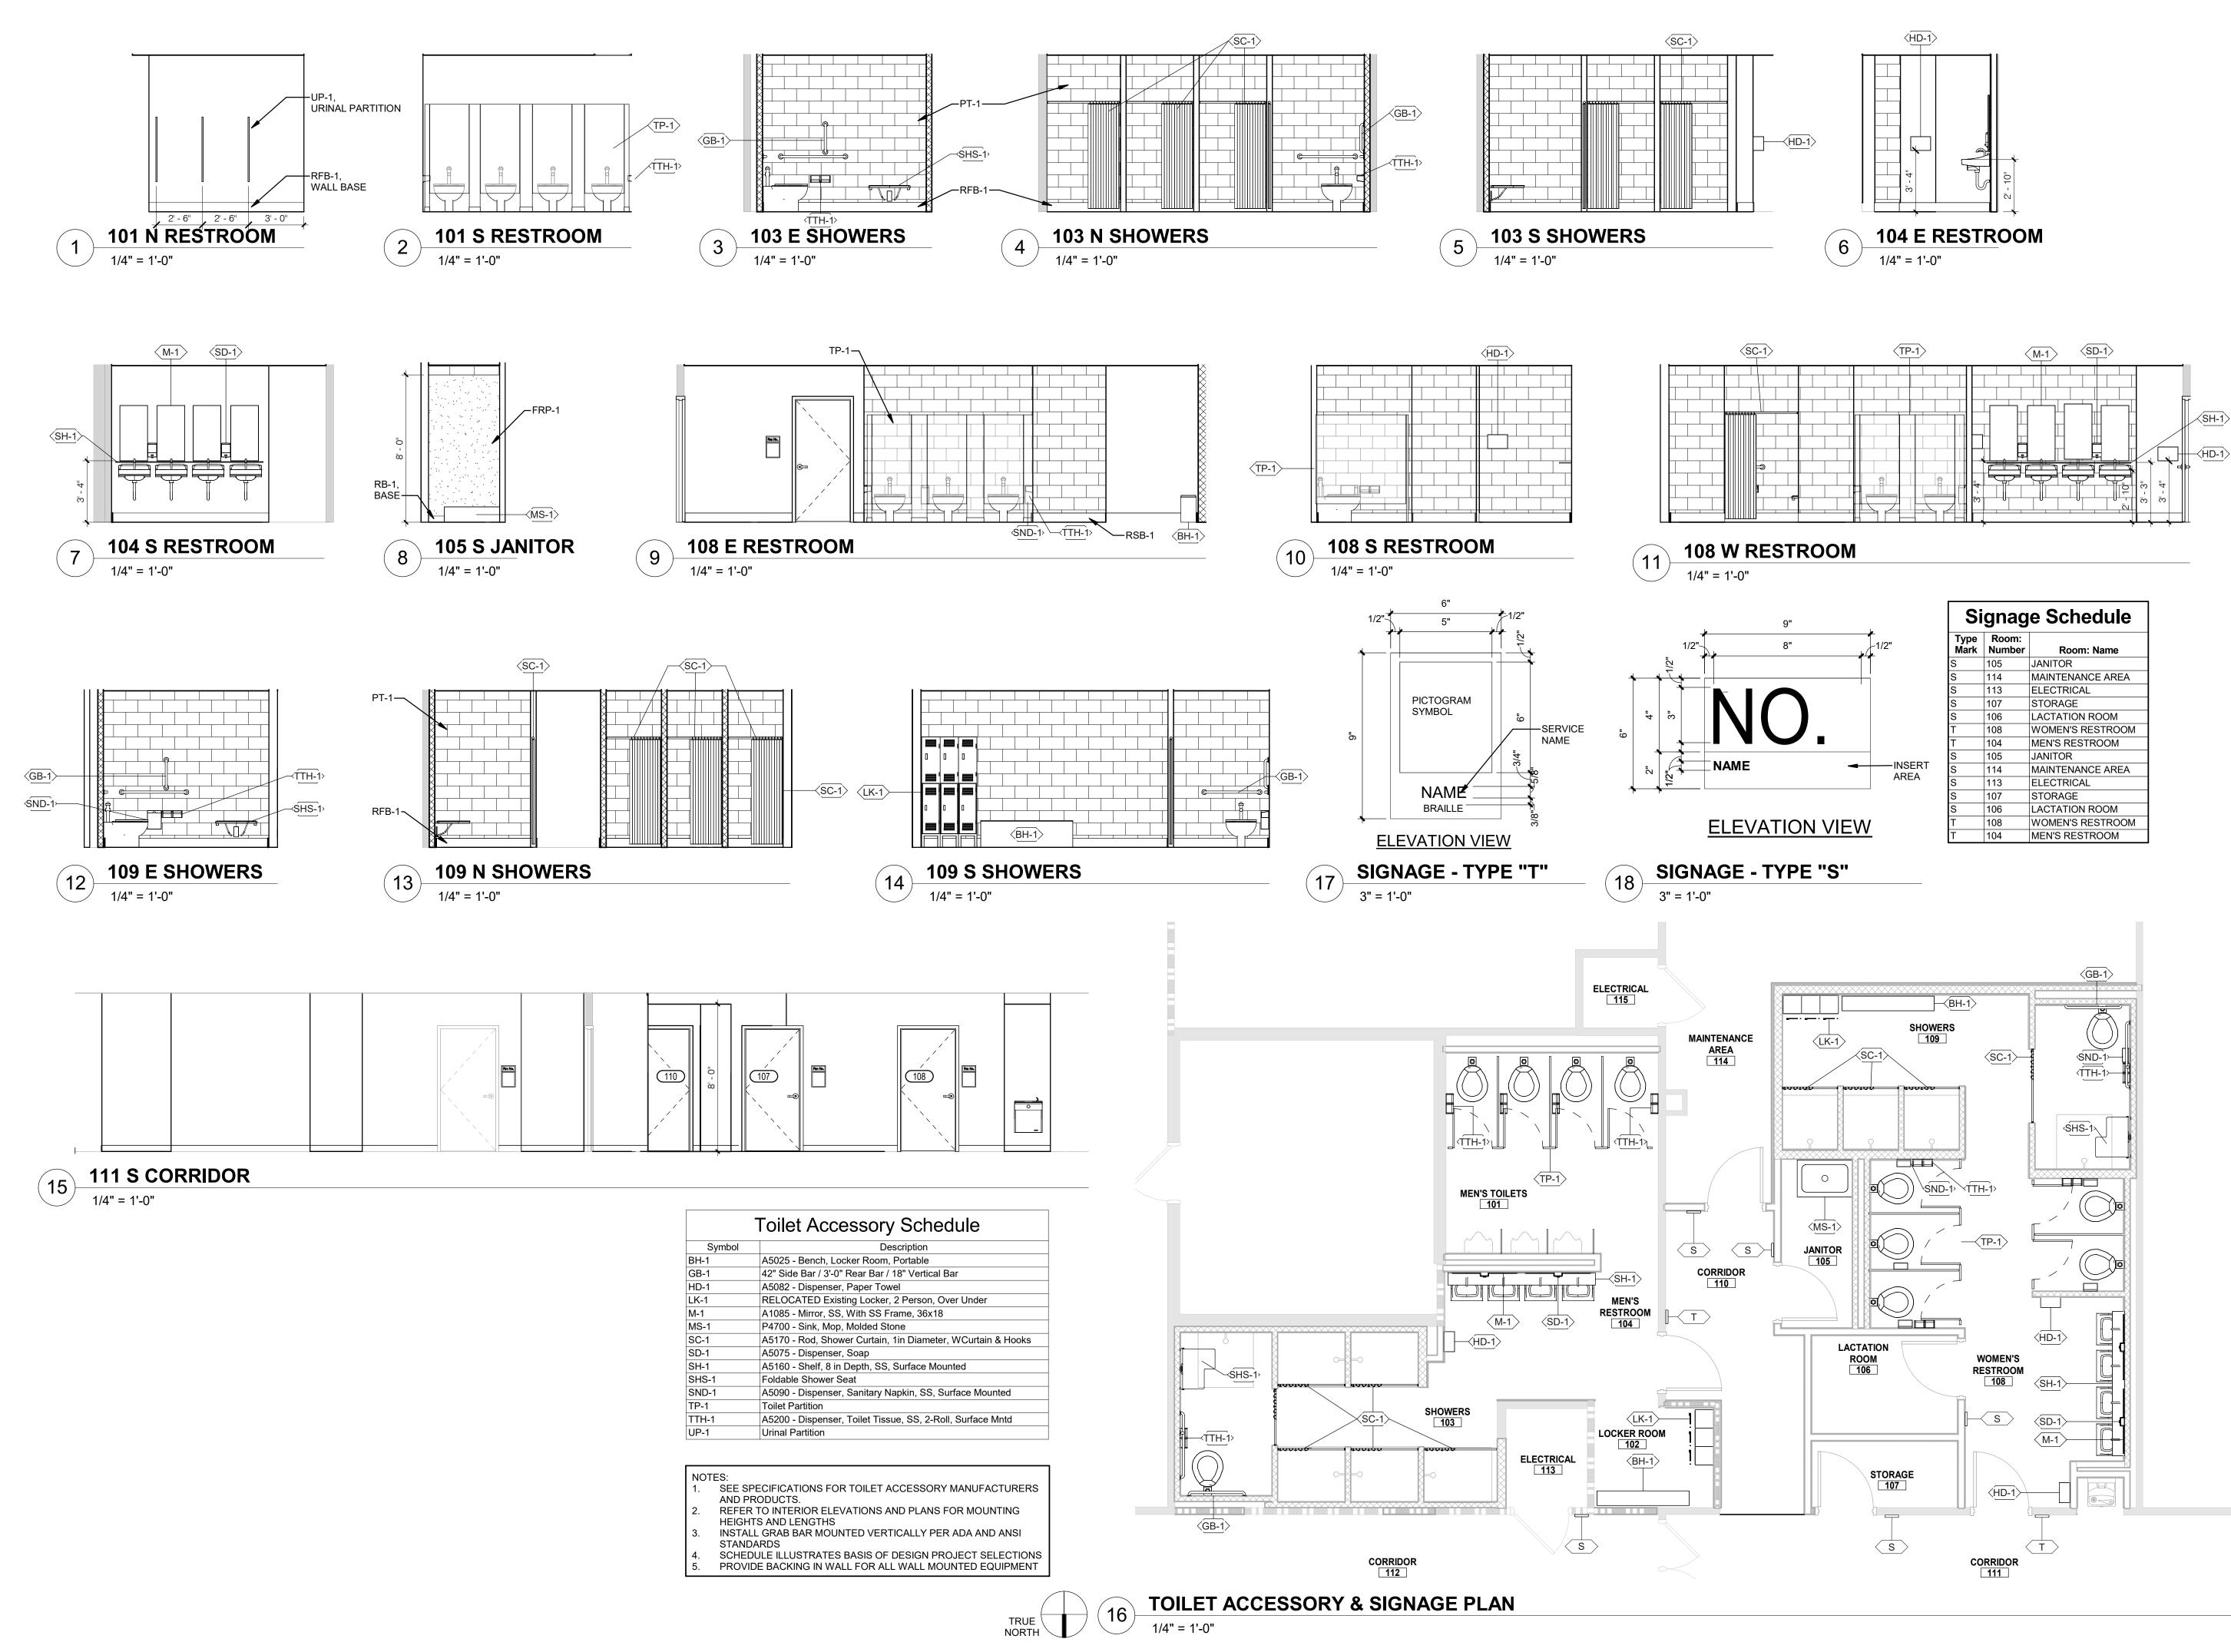

Signage Schedule			
Type Mark	Room: Number	Room: Name	
S	105	JANITOR	
S	114	MAINTENANCE AREA	
S	113	ELECTRICAL	
S	107	STORAGE	
S	106	LACTATION ROOM	
Т	108	WOMEN'S RESTROOM	
Т	104	MEN'S RESTROOM	
S	105	JANITOR	
S	114	MAINTENANCE AREA	
S	113	ELECTRICAL	
S	107	STORAGE	
S	106	LACTATION ROOM	
Т	108	WOMEN'S RESTROOM	
Т	104	MEN'S RESTROOM	
	•		

STATE OF MISSOURI MIKE KEHOE, GOVERNOR

ARCHITECTURE & ENGINEERING



MISSOURI STATE CERTIFICATE OF AUTHORITY #000148



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SHEET TITLE: **ELEVATIONS &** ACCESSORY PLAN


SHEET NUMBER:



04-16-2025

SHEET 7 OF 31

	ROOM		FLO	OR		K	OOM FI	NISH S WAI		LC			
NO.	NAME		FLOOR	BASE	NO MATERIAL	RTH FINISH	EAS MATERIAL		SOU" MATERIAL	TH FINISH	WE: MATERIAL	ST FINISH	
101 102	MEN'S	TOILETS R ROOM	RSF-1 RSF-1	RFB-1 RFB-1	GYP.BD. GYP.BD.	PT-2 PT-2	GYP.BD. GYP.BD.	PT-2 PT-2	GYP.BD. GYP.BD.	PT-2 PT-2	GYP.BD. GYP.BD.	PT-2 PT-2	
102 103 104	SHO	WERS	RSF-1 RSF-1	RFB-1 RFB-1	CMU GYP.BD.	PT-1 PT-2	CMU GYP.BD.	PT-1 PT-2	CMU GYP.BD.	PT-1 PT-2	CMU GYP.BD.	PT-1 PT-2	\dashv
105 106	JAN	IITOR ON ROOM	SC-1 RSF-1	RB-1 RFB-1	GYP.BD. GYP.BD.	PT-2 PT-2	GYP.BD. GYP.BD.	PT-2 PT-2	CMU GYP.BD.	PT-2 PT-2	CMU GYP.BD.	PT-2 PT-2	_
107 108	STO	RAGE RESTROOM	VCT-1 RSF-1	RB-1 RFB-1	GYP.BD.	PT-2	GYP.BD. GYP.BD./CMU	PT-2	GYP.BD. CMU	PT-2 PT-2 PT-2	GYP.BD. GYP.BD./CMU	PT-2	
109 110	SHO	WERS RIDOR	RSF-1 VCT-1	RFB-1 RB-1	CMU GYP.BD.	PT-1 PT-2	CMU GYP.BD.	PT-1 PT-2	CMU GYP.BD.	PT-1 PT-2	CMU GYP.BD.	PT-1 PT-2	
111		RIDOR	VCT-1	RB-1	GTF.DD.	F 1-2	GTF.BD.		GYP.BD.	PT-2	GTF.BD.	F1-2	
112	COR	RIDOR	VCT-1	RB-1					GYP.BD.	PT-2			
113	ELEC.	TRICAL		RB-1			CMU	PT-2					_
114 115		ANCE AREA											
I			I	1 1			1	1		1	I		
						ΜΑΤ	ERIAL		LEGEN				
TYPE EILING	ACT-1		ERIAL AL CEILING	MANUFA ARMSTRON	ACTURER IG	FINE FISSURE	PATTE D SQUARE LAY			PATTERN 607	NO. WHITE	COLOR	
LOORING	RFT-1		FLOORING	STONEHAR		STONESHIELD					ASH		
OORING	SC-1	SEALED CO	ONCRETE	-		LIQUID SEALEI	R OVER EXPOS	ED CONCRE	TE		CLEAR		
OORING	VCT-1			TARKETT	I						527 MILIT		
ISC.	TP-1 UP-1	TOILET PA URINAL PA		BOBRICK BOBRICK		DURALINE DURALINE						WARP 5882 WARP 5882	
AINT	PT-1	PAINT		STONEHAR	D	STONGLAZE V	SE				ASH GRA	Y	
AINT	PT-2	PAINT		SHERWIN W		EMERALD						HITE SW70	14
AINT AINT	PT-3 PT-4	PAINT PAINT		SHERWIN W	VILLIAMS		ING PAINT	ED PRE CAT	ALYZED	SEMI GLOS	WHITE S INKWELL	SW6992	
							RASE			l			
ALL TRIM	RB-1 RFB-1	RUBBER W RESINOUS		JOHNSONIT STONEHAR		RUBBER WALL STONESHIELD					BLACK ASH		
						DOOR S	CHEDU	LE					
			DOOR				FRAME		FRAME				
NUMBER	ТҮРЕ			THICKNESS	DOOR MATERIA				AD JAMB	FIRE RA			:ON
104 105	F	3' - 0" 6' - 3' - 0" 6' -	· 8" 1	3/4" 3/4"	HM HM	1	PT-4 PT-4	H1 H1	J1 J1		2		
106 107	F	3' - 0" 6' - 3' - 0" 6' -	· 8" 1	3/4" 3/4"	HM HM	1	PT-4 PT-4	H1 H1	J1 J1		3		
	IF I	3' - 0" 6' -	· 8" 1	3/4"	HM	1	PT-4	H1	114		10		
 ALL ALL ALL SEE 	F GEN D VERIFY A METAL DOO WOOD DOO SCHEDULE		DOOR OPEN 3/4" HOLLOW 3/4" SOLID CO MATERIALS A	IINGS. / METAL (STE ORE WOOD.	EEL).	I I IS SUCH AS VI	PT-4		+	S SCHED.	2 3		C
110 1. FIEL 2. ALL 3. ALL 4. SEE LOU 5. SEE 6. COO SEE 7. TYP	F GEN D VERIFY A METAL DOO WOOD DOO SCHEDULE JVERS, REC SPECS FO DRDINATE A DOOR HAP DICAL UNDE	IERAL I ALL EXISTING ORS TO BE 1 ORS TO BE 1 E FOR DOOR QUIRED U.L. LA R DESCRIPTION ALL ELECTRIC ROWARE SPE RCUT AT DOO AX UNDERCU	DOOR OPEN 3/4" HOLLOW 3/4" SOLID CO MATERIALS A ABELS, ETC. ON OF HARD LATCHES AI CIFICATIONS ORS TO BE 3/ T AT FIRE RA	NOTE METAL (STE DRE WOOD. AND SPECIAL WARE GROU ND CARD RE 3. 8" AT THRES ATED DOORS	EEL). L CONDITION UPS. EADERS WITH	IS SUCH AS VI CARD ACCES 3/4" AT ALL OT	PT-4 SION PANELS, SS VENDOR.	H1	J1	F			C
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110 1. FIEL 2. ALL 3. ALL 4. SEE LOU 5. SEE 6. COO SEE 7. TYP	F GEN D VERIFY A METAL DOO WOOD DOO SCHEDULE JVERS, REC SPECS FO DRDINATE A DOOR HAP DICAL UNDE	IERAL I	DOOR OPEN 3/4" HOLLOW 3/4" SOLID CO MATERIALS A ABELS, ETC. ON OF HARD : LATCHES AI CIFICATIONS DRS TO BE 3/ T AT FIRE RA	NOTE: INGS. / METAL (STE DRE WOOD. AND SPECIAL WARE GROUND CARD RE 5. 8" AT THRES ATED DOORS	S EEL). L CONDITION UPS. EADERS WITH SHOLDS AND S IS 3/4" PER	IS SUCH AS VI CARD ACCES 3/4" AT ALL OT NFPA 80.	PT-4 SION PANELS, SS VENDOR.	H1	J1 AS SCHED V V V V V V V V V V V V V V V V V V V	F	3	THRESHO (RE: SPEC	
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ARCHITECTURE & ENGINEERING 6 SOUTH OLD ORCHARD AVE T. LOUIS, MO 63119 T: 314.918.8383 F: 314.918.1766 www.Introba.com MISSOURI STATE CERTIFICATE OF AUTHORITY #000148 BRADFORD ALAN PIERCE NUMBER AR005805 REDI **BRADFORD A. PIERCE** AR005805 The Professional Designer of Record (DOR), whose signature and personal seal appear on this document, assumes responsibility only for what appears hereon, and disclaims responsibility for all other plans, specifications, estimates, reports, documents or instruments not sealed by the Professional DOR relating to, or intended to be used for, any part or parts of the project to which this document refers. Prints sealed by the DOR bear the embossed or wet seal of the DOR across the signature and date. Copies of this document as signed and sealed, have been retained by the Professional DOR. The Professional DOR will not be responsible for subsequent changes to this document, unless the changes are made by the DOR or with the DOR's written authorization. **OFFICE OF** ADMINISTRATION **DIVISION OF FACILITIES REINF CMU PARTITION** MANAGEMENT, **DESIGN AND** CONSTRUCTION **MISSOURI ARMY** NATIONAL GUARD Latrines & Shower Renovations, Building 233 St. Louis Lambert Readiness Center 10800 Lambert International Rd. Bridgeton, MO 63044 PROJECT # T2417-01 6280 SITE # 81362800001 ASSET # **REVISION:** DATE: **REVISION:** DATE: **REVISION:** DATE: ISSUE DATE: 04-16-2025 CAD DWG FILE: DRAWN BY: CJM/DCR CHECKED BY: BAP DESIGNED BY: CJM/DCR SHEET TITLE: **INTERIOR LEGENDS &** SCHEDULES SHEET NUMBER: A701

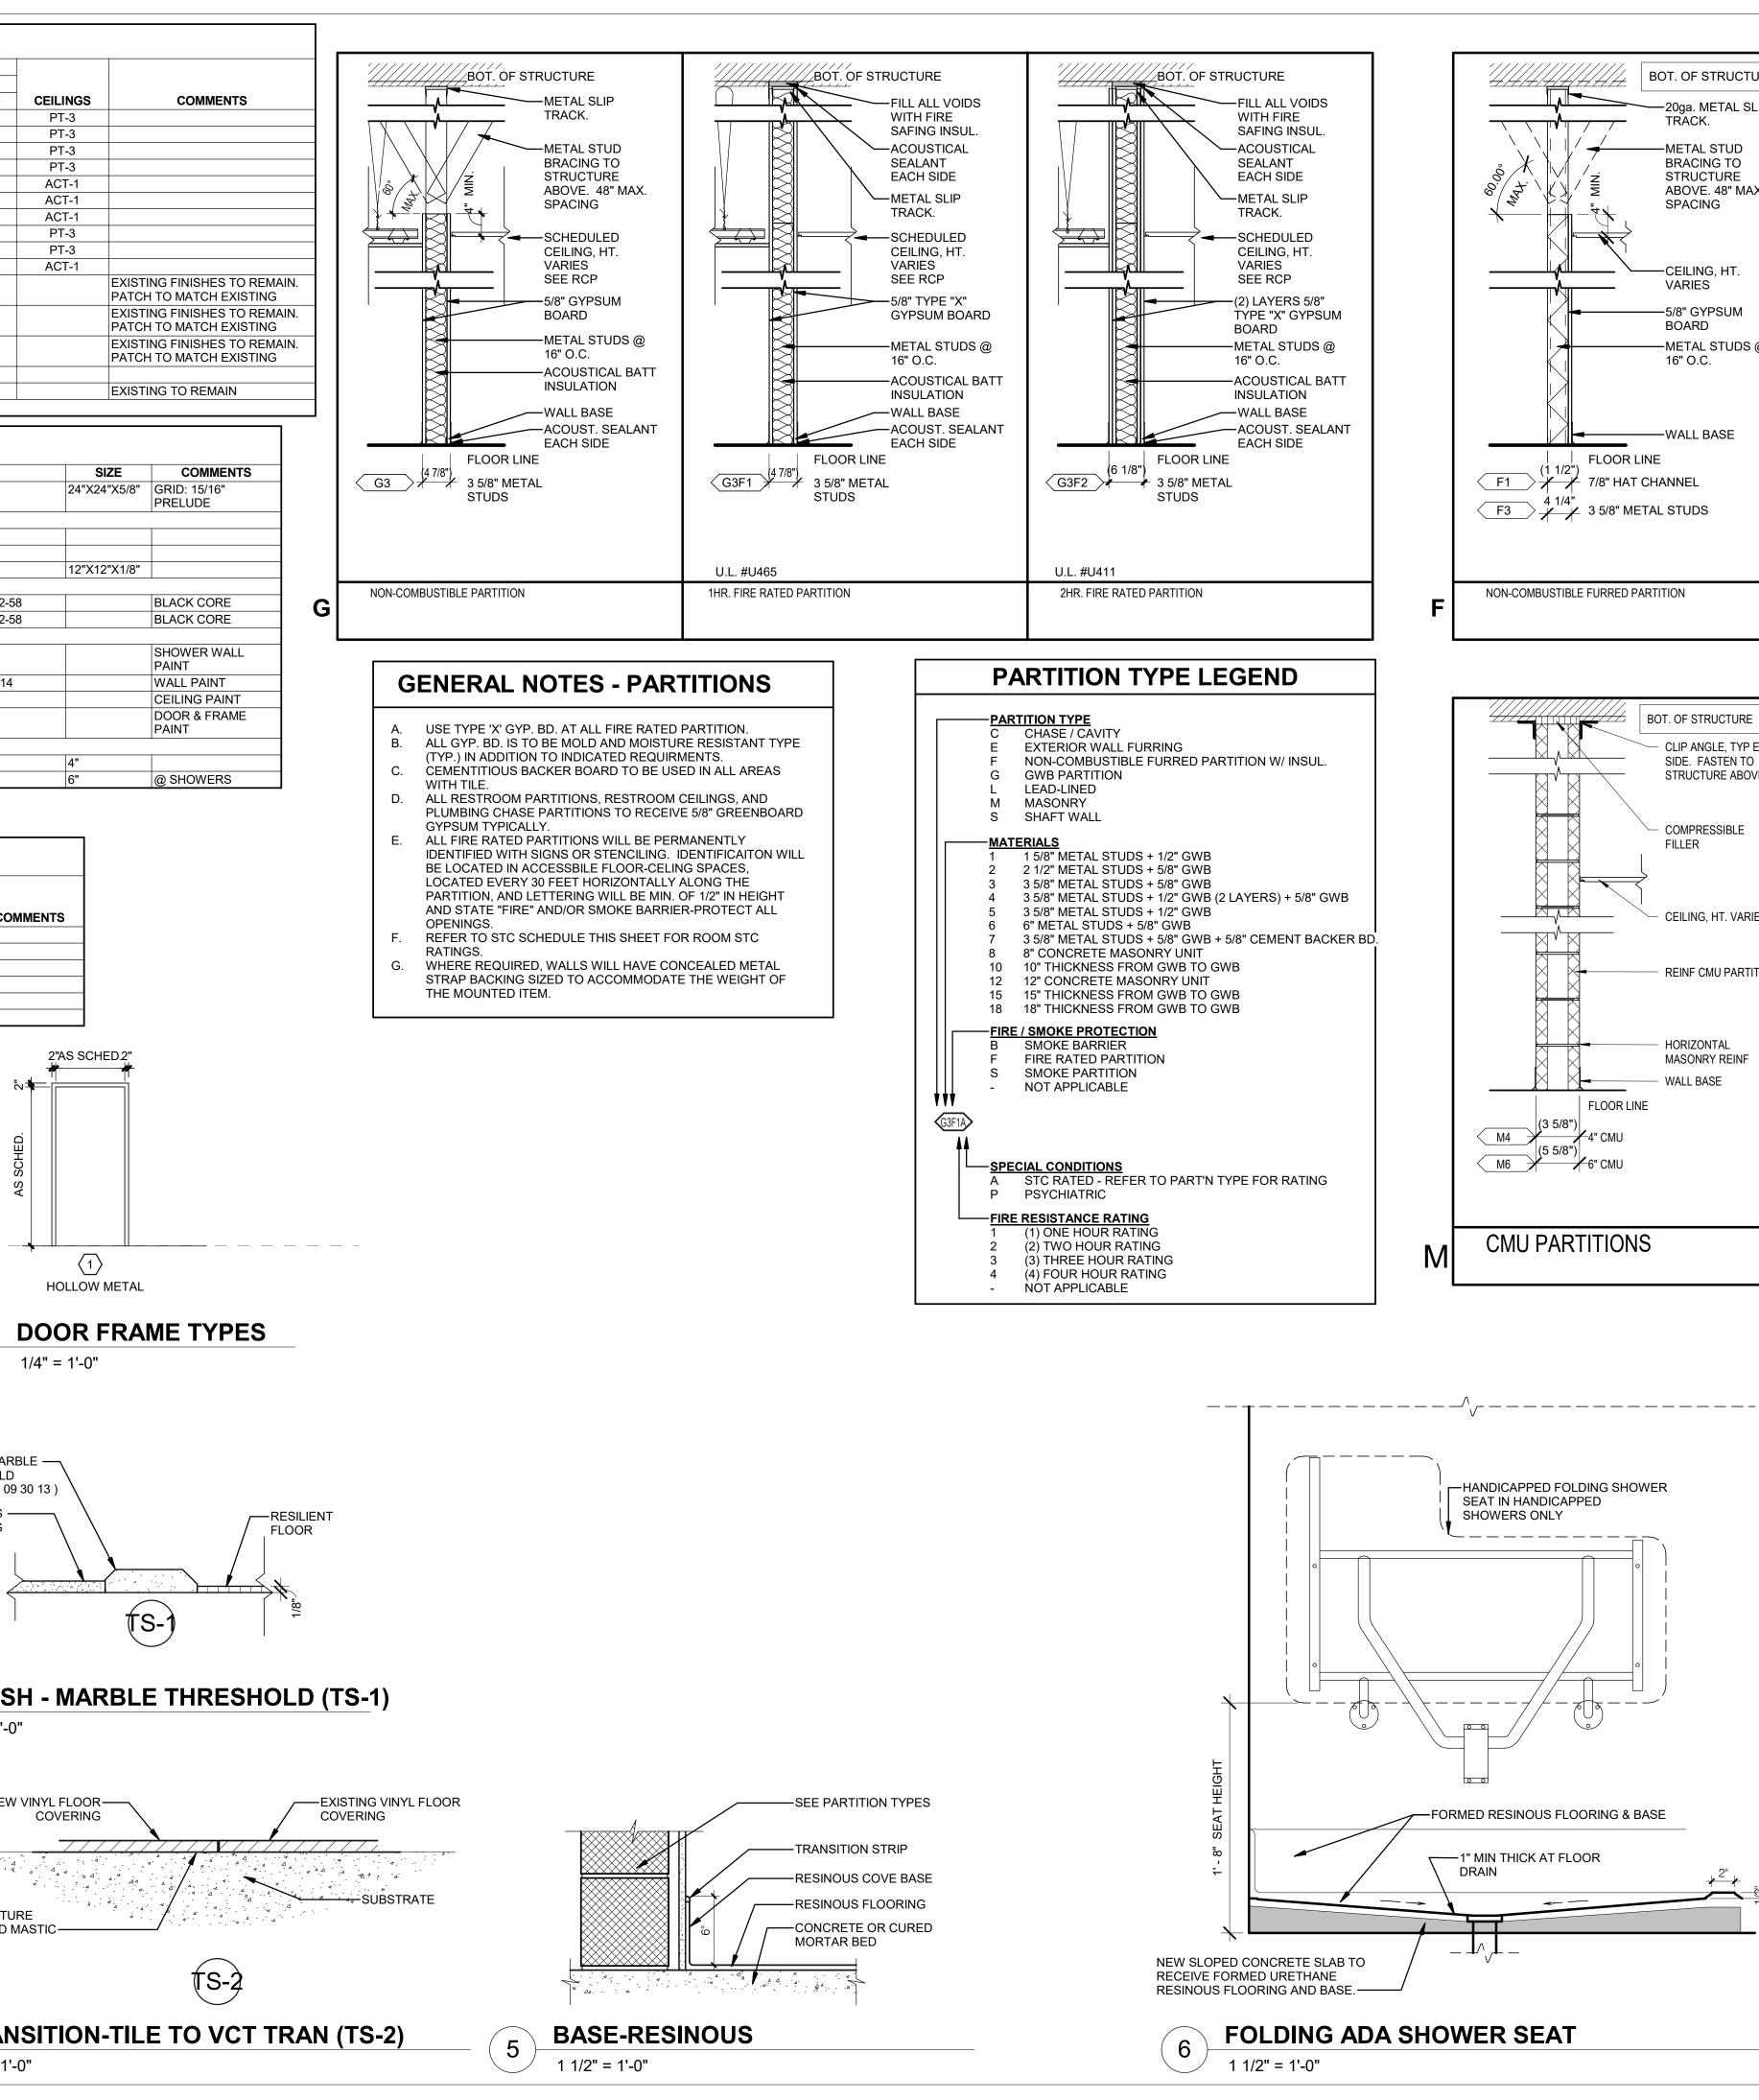STATE OF MISSOURI

MIKE KEHOE,

GOVERNOR

BOT. OF STRUCTURE

-20ga. METAL SLIP

-METAL STUD

BRACING TO

STRUCTURE

SPACING

-CEILING, HT.

-5/8" GYPSUM

-METAL STUDS @

VARIES

BOARD

16" O.C.

-WALL BASE

BOT. OF STRUCTURE

CLIP ANGLE, TYP EA.

STRUCTURE ABOVE.

SIDE. FASTEN TO

COMPRESSIBLE

CEILING, HT. VARIES

HORIZONTAL

MASONRY REINF

+-+

FILLER

ABOVE. 48" MAX.

TRACK.

04-16-2025

SHEET 8 OF 31

GENERAL NOTES

- 1. DUE TO THE LIMITED SPACE AVAILABLE FOR THE INSTALLATION OF ALL THE PLUMBING WORK, COORDINATION BETWEEN ALL OTHER TRADES IS OF UTMC IMPORTANCE.
- 2. THIS CONTRACTOR SHALL VISIT THE PROJECT SITE AND VERIFY LOCATIONS, ELEVATIONS AND SIZES OF ALL UTILITIES AT SITE PRIOR TO PROCEEDING WIT WORK. EXISTING SYSTEMS AND STRUCTURE SHALL BE INVESTIGATED FOR B POSSIBLE ROUTING OF COLD WATER, HOT WATER, SANITARY WASTE AND VE STORM AND MEDICAL LABORATORY GAS PIPING.
- 3. THESE PLANS ARE DIAGRAMMATIC IN NATURE SINCE THE ONLY AVAILABLE INFORMATION HAS BEEN OBTAINED FROM EXISTING PLANS, SPECIFICATIONS FIELD SURVEYS. THE EXACT LOCATION OF PIPING, FIXTURES AND EQUIPMEN DEVIATE FROM THE LOCATION INDICATED ON THESE DRAWINGS. EXTREME ACCURACY IS NOT GUARANTEED. THIS CONTRACTOR SHALL BE PREPARE TO ALTERATIONS TO NEW AND/OR EXISTING SERVICES TO FIT JOB CONDITIONS. CONTRACTOR SHALL FURNISH A COMPLETE CODE COMPLYING SYSTEM. THIS CONTRACTOR SHALL REPORT, IN WRITING, ANY DISCREPANCIES WHICH PRE THE INSTALLATION OF WORK AS SHOWN.
- 4. IF THIS CONTRACTOR DOES NOT CLEARLY UNDERSTAND THESE PLANS OR IS COMPLETELY SURE OF THEIR MEANING, THIS CONTRACTOR SHOULD OBTAIN ENGINEER'S WRITTEN EXPLANATION AND/OR INTERPRETATION PRIOR TO SUBMITTING BIDS, SINCE THIS CONTRACTOR WILL BE HELD RIGIDLY TO THE INTERPRETATION OF THE ENGINEER.
- 5. IT IS THE RESPONSIBILITY OF THIS CONTRACTOR TO REPAIR THE EXISTING SURFACES TO REMAIN WHERE THEIR WORK HAS BEEN COMPLETED. REPAIR INCLUDE, BUT NOT LIMITED TO, ANY EXISTING WALL, CEILING OR FLOOR THAT SCHEDULED TO REMAIN. REPAIR, PAINTING, AND PATCHING SHALL BE COMPL AN APPROPRIATE CONTRACTOR QUALIFIED FOR THIS TYPE OF WORK.
- 6. THE OWNER SHALL MAINTAIN ALL SALVAGE RIGHTS OF FIXTURES, EQUIPMEN MATERIALS REMOVED, HOWEVER, ALL FIXTURES, EQUIPMENT AND MATERIALS CLAIMED BY THE OWNER SHALL BE REMOVED FROM THE PREMISES AND PRO DISPOSED OF THE BY THE DEMOLITION CONTRACTOR.
- 7. CEILING REMOVAL, STORAGE AND REPLACEMENT FOR NEW PIPING INSTALLAT SHALL BE BY THE GENERAL CONTRACTOR.
- 8. IF HAZARDOUS MATERIALS ARE ENCOUNTERED DURING DEMOLITION OPERAT THE CONTRACTOR WILL NOTIFY BUILDING OWNER OF THE HAZARDOUS MATE
- 9. TEMPORARY CONNECTION SHALL BE PROVIDED BY RESPECTIVE PLUMBING A PROTECTION CONTRACTORS WHEN EXTENDED INTERRUPTIONS OF SERVICES UTILITIES SUCH AS WATER, WASTE AND FIRE PROTECTION WHICH SERVE OT AREAS ARE NECESSARY.
- 10. COORDINATE WITH MAINTENANCE PERSONNEL AS TO SOURCE OF UTILITIES A TEMPORARILY DISCONNECT OR SHUT OFF SERVICES OR UTILITIES AT NEARE TEMPORARY AND ACCESSIBLE ISOLATION VALVES SHALL BE INSTALLED CLOS THIS POINT OF WORK.
- 11. IT IS ESSENTIAL THAT BUILDING OPERATIONS CONTINUE WITH MINIMAL INTERRUPTIONS. IT IS NECESSARY THAT OPERATION OF EXISTING SYSTEMS INTERFACED WITH AS LITTLE DISRUPTION AS POSSIBLE EXCEPT IN AREAS VA FOR CONSTRUCTION WORK. WORK WHICH WILL INTERFERE WITH OPERATIO EXISTING FIRE SUPPRESSION AND PLUMBING SYSTEMS OR WHICH REQUIRE DOWNTIME WILL BE SCHEDULED ONLY AFTER CONSULTATION WITH AND PER GIVEN BY THE OWNER. ALLOW 10 DAYS PRIOR TO ANTICIPATED INTERRUPTIC SYSTEMS. WORK MAY BE REQUIRED TO BE PERFORMED OUTSIDE NORMAL W HOURS.
- 12. ARCHITECTURAL DEMOLITION DRAWINGS AND SPECIFICATIONS SHALL BE RE/ CONJUNCTION WITH THESE DRAWINGS.
- 13. ALL PIPING HANGERS AND SUPPORTS SHALL BE REMOVED ALONG WITH PIPING REMOVED.
- 14. THE CONTRACTOR SHALL COORDINATE DEMOLITION WORK WITH PROJECT'S PHASING SCHEDULE PRIOR TO COMMENCEMENT OF ANY WORK.
- 15. WHEN PLACING NEW PLUMBING FIXTURES, CONTRACTOR SHALL VERIFY LOC OF PLUMBING VENTS. OFFSET VENTS THAT TERMINATE WITHIN 25 FEET OF H UNITS OUTDOOR AIR INTAKES. CONTRACTOR SHALL FIELD VERIFY PRIOR TO WHERE THE INTERFERENCE'S ARE PRICE ACCORDINGLY OR MAKE ALLOWAN BID.
- 16. USE CAUTION WHEN SAW-CUTTING THROUGH EXISTING CONCRETE FLOOR C CONSTRUCTION FOR THE INSTALLATION OF PLUMBING SYSTEMS TO AVOID C REBAR AT EDGE OF OPENING. LEAVE SUFFICIENT REBAR EXPOSED TO TIE NEW REINFORCING REPLACEMENT CONCRETE AND/OR OTHER STRUCTURAL ATTACHMENTS FOR NEW CONSTRUCTION.
- 17. CONTRACTOR SHALL BE RESPONSIBLE FOR ANY REVISIONS, TRANSITIONS, C ETC., TO AVOID DUCTWORK, PIPING, EQUIPMENT OR STRUCTURE NEW OR EX AND TO MAKE A COMPLETE AND FUNCTIONING SYSTEM.

		LS & ABBREVIATIONS MBOLS ARE USED FOR THIS PROJECT		RENCES
x	ά	TRAPPED CONNECTION	TITLE	
	¢	STRAINER		PLAN DETAIL REFERENCE TITLE
e	ð ————	BALANCING VALVE		
		CLEANOUT (CO)	PLAN	KEYED NOTE DESIGNATION
▲▲	5	OS & Y GATE VALVE	NORTH	NORTH ARROW
ll	Ш Т	TEMPERATURE GAUGE	NORTH	
C	□	THERMOSTATIC MIXING VALVE		
		REDUCED PRESSURE BACKFLOW PREVENTER	AHU	PLAN MARK EQUIPMENT DESIGNATION REFER TO MEP
	+	HOSE BIBB/WALL HYDRANT		SCHEDULE FOR CIRCUITING AND DEVICE REQUIREMENTS AND FLOOR PLANS FOR
	4V- <u> </u>			LOCATIONS EQUIPMENT NUMBER
A	.W			
		DOMESTIC COLD WATER PIPING (CW) DOMESTIC HOT WATER PIPING (HW)	A101	PLAN MARK ENLARGED PLAN REFERENCE
		DOMESTIC HOT WATER RETURN PIPING (HWR)		SHEET NUMBER
r	D	DRAIN PIPING		SECTION
		DEIONIZED WATER PIPING	AD888	
	GV	GREASE VENT PIPING		INTERFACE, EXISTING TO NEW
-	GW	GREASE WASTE PIPING	\square	EXTENT OF DEMOLITION
(G	NATURAL GAS PIPING		MATCHLINE
N	VP	NON-POTABLE WATER PIPING		
	st	OVERFLOW STORM PIPING	<u></u>	REVISION TAG
)W	OIL WASTE PIPING	LINE TYPE LEGE	ND
	р — ——	PUMP DISCHARGE PIPING		
R	.0	REVERSE OSMOSIS PIPING (RO)		EXISTING TO REMAIN OR NEW WORK BY OTHERS (LIGHT, SOLID LINE)
	s	SANITARY PIPING		NEW WORK BY THIS CONTRACTOR (DARK, SOLID LINE)
sc	CW	SOFTENED COLD WATER PIPING		EXISTING TO BE REMOVED BY THIS CONTRACTOR
SH	HW	SOFTENED HOT WATER PIPING		(DARK, DASHED LINE, DEMOLITION PLANS)
S	SD	SUBSOIL DRAINAGE PIPING		
S	ST	STORM PIPING		
T	W	TEMPERED WATER PIPING		
		VENT PIPING		G SYMBOLS & ABBREVIATIO
V	 W	VENT PIPING WASTE PIPING		
V	— ₩			G SYMBOLS & ABBREVIATIO LL SYMBOLS ARE USED FOR THIS PROJECT
	— ₩ ☆	WASTE PIPING		
C		WASTE PIPING FLEXIBLE CONNECTION		LL SYMBOLS ARE USED FOR THIS PROJECT
C		WASTE PIPING FLEXIBLE CONNECTION FLOOR DRAIN/FLOOR SINK (FD/FS)		LL SYMBOLS ARE USED FOR THIS PROJECT DIRECTION OF FLOW
C		WASTE PIPING FLEXIBLE CONNECTION FLOOR DRAIN/FLOOR SINK (FD/FS)		LL SYMBOLS ARE USED FOR THIS PROJECT DIRECTION OF FLOW BRANCH CONNECTION, BOTTOM
Γ		WASTE PIPING FLEXIBLE CONNECTION FLOOR DRAIN/FLOOR SINK (FD/FS)		LL SYMBOLS ARE USED FOR THIS PROJECT DIRECTION OF FLOW BRANCH CONNECTION, BOTTOM BRANCH CONNECTION, TOP
C		WASTE PIPING FLEXIBLE CONNECTION FLOOR DRAIN/FLOOR SINK (FD/FS)		LL SYMBOLS ARE USED FOR THIS PROJECT DIRECTION OF FLOW BRANCH CONNECTION, BOTTOM BRANCH CONNECTION, TOP ELBOW, TURNED DOWN
C		WASTE PIPING FLEXIBLE CONNECTION FLOOR DRAIN/FLOOR SINK (FD/FS)		LL SYMBOLS ARE USED FOR THIS PROJECT DIRECTION OF FLOW BRANCH CONNECTION, BOTTOM BRANCH CONNECTION, TOP ELBOW, TURNED DOWN ELBOW TURNED UP
C		WASTE PIPING FLEXIBLE CONNECTION FLOOR DRAIN/FLOOR SINK (FD/FS)		LL SYMBOLS ARE USED FOR THIS PROJECT DIRECTION OF FLOW BRANCH CONNECTION, BOTTOM BRANCH CONNECTION, TOP ELBOW, TURNED DOWN ELBOW TURNED UP SHUTOFF VALVE
Γ		WASTE PIPING FLEXIBLE CONNECTION FLOOR DRAIN/FLOOR SINK (FD/FS)		LL SYMBOLS ARE USED FOR THIS PROJECT DIRECTION OF FLOW BRANCH CONNECTION, BOTTOM BRANCH CONNECTION, TOP ELBOW, TURNED DOWN ELBOW TURNED UP SHUTOFF VALVE CHECK VALVE
C		WASTE PIPING FLEXIBLE CONNECTION FLOOR DRAIN/FLOOR SINK (FD/FS)		LL SYMBOLS ARE USED FOR THIS PROJECT DIRECTION OF FLOW BRANCH CONNECTION, BOTTOM BRANCH CONNECTION, TOP ELBOW, TURNED DOWN ELBOW TURNED UP SHUTOFF VALVE CHECK VALVE PRESSURE REDUCING VALVE
C		WASTE PIPING FLEXIBLE CONNECTION FLOOR DRAIN/FLOOR SINK (FD/FS)		LL SYMBOLS ARE USED FOR THIS PROJECT DIRECTION OF FLOW BRANCH CONNECTION, BOTTOM BRANCH CONNECTION, TOP ELBOW, TURNED DOWN ELBOW TURNED UP SHUTOFF VALVE CHECK VALVE PRESSURE REDUCING VALVE PRESSURE GAUGE
C		WASTE PIPING FLEXIBLE CONNECTION FLOOR DRAIN/FLOOR SINK (FD/FS)		LL SYMBOLS ARE USED FOR THIS PROJECT DIRECTION OF FLOW BRANCH CONNECTION, BOTTOM BRANCH CONNECTION, TOP ELBOW, TURNED DOWN ELBOW TURNED UP SHUTOFF VALVE CHECK VALVE PRESSURE REDUCING VALVE PRESSURE REDUCING VALVE UNION PIPING CAP
C		WASTE PIPING FLEXIBLE CONNECTION FLOOR DRAIN/FLOOR SINK (FD/FS)		LL SYMBOLS ARE USED FOR THIS PROJECT DIRECTION OF FLOW BRANCH CONNECTION, BOTTOM BRANCH CONNECTION, TOP ELBOW, TURNED DOWN ELBOW TURNED UP SHUTOFF VALVE CHECK VALVE PRESSURE REDUCING VALVE PRESSURE REDUCING VALVE UNION
C		WASTE PIPING FLEXIBLE CONNECTION FLOOR DRAIN/FLOOR SINK (FD/FS)		LL SYMBOLS ARE USED FOR THIS PROJECT DIRECTION OF FLOW BRANCH CONNECTION, BOTTOM BRANCH CONNECTION, TOP ELBOW, TURNED DOWN ELBOW TURNED UP SHUTOFF VALVE CHECK VALVE PRESSURE REDUCING VALVE PRESSURE REDUCING VALVE UNION PIPING CAP
C		WASTE PIPING FLEXIBLE CONNECTION FLOOR DRAIN/FLOOR SINK (FD/FS)		LL SYMBOLS ARE USED FOR THIS PROJECT DIRECTION OF FLOW BRANCH CONNECTION, BOTTOM BRANCH CONNECTION, TOP ELBOW, TURNED DOWN ELBOW TURNED UP SHUTOFF VALVE CHECK VALVE PRESSURE REDUCING VALVE PRESSURE GAUGE UNION PIPING CAP
C		WASTE PIPING FLEXIBLE CONNECTION FLOOR DRAIN/FLOOR SINK (FD/FS)	NOT A	LL SYMBOLS ARE USED FOR THIS PROJECT DIRECTION OF FLOW BRANCH CONNECTION, BOTTOM BRANCH CONNECTION, TOP ELBOW, TURNED DOWN ELBOW TURNED UP SHUTOFF VALVE CHECK VALVE PRESSURE REDUCING VALVE PRESSURE GAUGE UNION PIPING CAP RISER DESIGNATION ABOVE FINISH FLOOR
C		WASTE PIPING FLEXIBLE CONNECTION FLOOR DRAIN/FLOOR SINK (FD/FS)	NOT A	LL SYMBOLS ARE USED FOR THIS PROJECT DIRECTION OF FLOW BRANCH CONNECTION, BOTTOM BRANCH CONNECTION, TOP ELBOW, TURNED DOWN ELBOW TURNED UP SHUTOFF VALVE CHECK VALVE PRESSURE REDUCING VALVE PRESSURE GAUGE UNION PIPING CAP RISER DESIGNATION ABOVE FINISH FLOOR AUTHORITIES HAVING JURISDICTION
Γ		WASTE PIPING FLEXIBLE CONNECTION FLOOR DRAIN/FLOOR SINK (FD/FS)	NOT A	LL SYMBOLS ARE USED FOR THIS PROJECT DIRECTION OF FLOW BRANCH CONNECTION, BOTTOM BRANCH CONNECTION, TOP ELBOW, TURNED DOWN ELBOW TURNED UP SHUTOFF VALVE CHECK VALVE PRESSURE REDUCING VALVE PRESSURE GAUGE UNION PIPING CAP RISER DESIGNATION ABOVE FINISH FLOOR AUTHORITIES HAVING JURISDICTION ACCESS PANEL
C		WASTE PIPING FLEXIBLE CONNECTION FLOOR DRAIN/FLOOR SINK (FD/FS)	NOT A	LL SYMBOLS ARE USED FOR THIS PROJECT DIRECTION OF FLOW BRANCH CONNECTION, BOTTOM BRANCH CONNECTION, TOP ELBOW, TURNED DOWN ELBOW TURNED UP SHUTOFF VALVE CHECK VALVE PRESSURE REDUCING VALVE PRESSURE GAUGE UNION PIPING CAP RISER DESIGNATION ABOVE FINISH FLOOR AUTHORITIES HAVING JURISDICTION ACCESS PANEL BOTTOM OF PIPE
C		WASTE PIPING FLEXIBLE CONNECTION FLOOR DRAIN/FLOOR SINK (FD/FS)	NOT A	LL SYMBOLS ARE USED FOR THIS PROJECT DIRECTION OF FLOW BRANCH CONNECTION, BOTTOM BRANCH CONNECTION, TOP ELBOW, TURNED DOWN ELBOW TURNED UP SHUTOFF VALVE CHECK VALVE PRESSURE REDUCING VALVE PRESSURE GAUGE UNION PIPING CAP RISER DESIGNATION ABOVE FINISH FLOOR AUTHORITIES HAVING JURISDICTION ACCESS PANEL BOTTOM OF PIPE DIAMETER
C		WASTE PIPING FLEXIBLE CONNECTION FLOOR DRAIN/FLOOR SINK (FD/FS)	NOT A	LL SYMBOLS ARE USED FOR THIS PROJECT DIRECTION OF FLOW BRANCH CONNECTION, BOTTOM BRANCH CONNECTION, TOP ELBOW, TURNED DOWN ELBOW TURNED UP SHUTOFF VALVE CHECK VALVE PRESSURE REDUCING VALVE PRESSURE GAUGE UNION PIPING CAP RISER DESIGNATION ABOVE FINISH FLOOR AUTHORITIES HAVING JURISDICTION ACCESS PANEL BOTTOM OF PIPE DIAMETER DOWN
Γ		WASTE PIPING FLEXIBLE CONNECTION FLOOR DRAIN/FLOOR SINK (FD/FS)	NOT A	LL SYMBOLS ARE USED FOR THIS PROJECT DIRECTION OF FLOW BRANCH CONNECTION, BOTTOM BRANCH CONNECTION, TOP ELBOW, TURNED DOWN ELBOW TURNED UP SHUTOFF VALVE CHECK VALVE PRESSURE REDUCING VALVE PRESSURE GAUGE UNION PIPING CAP RISER DESIGNATION ABOVE FINISH FLOOR AUTHORITIES HAVING JURISDICTION ACCESS PANEL BOTTOM OF PIPE DIAMETER DOWN EXISTING
C		WASTE PIPING FLEXIBLE CONNECTION FLOOR DRAIN/FLOOR SINK (FD/FS)	NOT A	LL SYMBOLS ARE USED FOR THIS PROJECT DIRECTION OF FLOW BRANCH CONNECTION, BOTTOM BRANCH CONNECTION, TOP ELBOW, TURNED DOWN ELBOW TURNED UP SHUTOFF VALVE CHECK VALVE PRESSURE REDUCING VALVE PRESSURE GAUGE UNION PIPING CAP RISER DESIGNATION ABOVE FINISH FLOOR AUTHORITIES HAVING JURISDICTION ACCESS PANEL BOTTOM OF PIPE DIAMETER DOWN EXISTING FINISHED FLOOR ELEVATION
Γ		WASTE PIPING FLEXIBLE CONNECTION FLOOR DRAIN/FLOOR SINK (FD/FS)	NOT A	LL SYMBOLS ARE USED FOR THIS PROJECT DIRECTION OF FLOW BRANCH CONNECTION, BOTTOM BRANCH CONNECTION, TOP ELBOW, TURNED DOWN ELBOW TURNED UP SHUTOFF VALVE CHECK VALVE PRESSURE REDUCING VALVE PRESSURE GAUGE UNION PIPING CAP RISER DESIGNATION ABOVE FINISH FLOOR AUTHORITIES HAVING JURISDICTION ACCESS PANEL BOTTOM OF PIPE DIAMETER DOWN EXISTING FINISHED FLOOR ELEVATION GALLONS PER HOUR
C		WASTE PIPING FLEXIBLE CONNECTION FLOOR DRAIN/FLOOR SINK (FD/FS)	NOT A	LL SYMBOLS ARE USED FOR THIS PROJECT DIRECTION OF FLOW BRANCH CONNECTION, BOTTOM BRANCH CONNECTION, TOP ELBOW, TURNED DOWN ELBOW TURNED UP SHUTOFF VALVE CHECK VALVE PRESSURE REDUCING VALVE PRESSURE GAUGE UNION PIPING CAP RISER DESIGNATION ABOVE FINISH FLOOR AUTHORITIES HAVING JURISDICTION ACCESS PANEL BOTTOM OF PIPE DIAMETER DOWN EXISTING FINISHED FLOOR ELEVATION GALLONS PER HOUR GALLONS PER MINUTE
C		WASTE PIPING FLEXIBLE CONNECTION FLOOR DRAIN/FLOOR SINK (FD/FS)	NOT A	LL SYMBOLS ARE USED FOR THIS PROJECT DIRECTION OF FLOW BRANCH CONNECTION, BOTTOM BRANCH CONNECTION, BOTTOM BRANCH CONNECTION, TOP ELBOW, TURNED DOWN ELBOW TURNED UP SHUTOFF VALVE CHECK VALVE PRESSURE REDUCING VALVE PRESSURE REDUCING VALVE PRESSURE GAUGE UNION PIPING CAP RISER DESIGNATION ABOVE FINISH FLOOR AUTHORITIES HAVING JURISDICTION ACCESS PANEL BOTTOM OF PIPE DIAMETER DOWN EXISTING FINISHED FLOOR ELEVATION GALLONS PER MINUTE HORSEPOWER
C		WASTE PIPING FLEXIBLE CONNECTION FLOOR DRAIN/FLOOR SINK (FD/FS)	NOT A	LL SYMBOLS ARE USED FOR THIS PROJECT DIRECTION OF FLOW BRANCH CONNECTION, BOTTOM BRANCH CONNECTION, BOTTOM BRANCH CONNECTION, TOP ELBOW, TURNED DOWN ELBOW TURNED UP SHUTOFF VALVE CHECK VALVE PRESSURE REDUCING VALVE PRESSURE GAUGE UNION PIPING CAP RISER DESIGNATION ABOVE FINISH FLOOR AUTHORITIES HAVING JURISDICTION ACCESS PANEL BOTTOM OF PIPE DIAMETER DOWN EXISTING FINISHED FLOOR ELEVATION GALLONS PER HOUR GALLONS PER HOUR GALLONS PER MINUTE HORSEPOWER INVERT ELEVATION
C		WASTE PIPING FLEXIBLE CONNECTION FLOOR DRAIN/FLOOR SINK (FD/FS)	NOT A	LL SYMBOLS ARE USED FOR THIS PROJECT DIRECTION OF FLOW BRANCH CONNECTION, BOTTOM BRANCH CONNECTION, BOTTOM BRANCH CONNECTION, TOP ELBOW, TURNED DOWN ELBOW TURNED UP SHUTOFF VALVE CHECK VALVE PRESSURE REDUCING VALVE PRESSURE REDUCING VALVE PRESSURE GAUGE UNION PIPING CAP RISER DESIGNATION ACCESS PANEL BOTTOM OF PIPE DIAMETER DOWN EXISTING FINISHED FLOOR ELEVATION GALLONS PER MINUTE HORSEPOWER INVERT ELEVATION NORMALLY CLOSED
Γ		WASTE PIPING FLEXIBLE CONNECTION FLOOR DRAIN/FLOOR SINK (FD/FS)	NOT A	LL SYMBOLS ARE USED FOR THIS PROJECT DIRECTION OF FLOW BRANCH CONNECTION, BOTTOM BRANCH CONNECTION, TOP ELBOW, TURNED DOWN ELBOW TURNED UP SHUTOFF VALVE CHECK VALVE PRESSURE REDUCING VALVE PRESSURE GAUGE UNION PIPING CAP RISER DESIGNATION ABOVE FINISH FLOOR AUTHORITIES HAVING JURISDICTION ACCESS PANEL BOTTOM OF PIPE DIAMETER DOWN EXISTING FINISHED FLOOR ELEVATION GALLONS PER HOUR GALLONS PER MINUTE HORSEPOWER INVERT ELEVATION NORMALLY CLOSED NOT TO SCALE
C		WASTE PIPING FLEXIBLE CONNECTION FLOOR DRAIN/FLOOR SINK (FD/FS)	NOT A	LL SYMBOLS ARE USED FOR THIS PROJECT DIRECTION OF FLOW BRANCH CONNECTION, BOTTOM BRANCH CONNECTION, TOP ELBOW, TURNED DOWN ELBOW TURNED UP SHUTOFF VALVE CHECK VALVE PRESSURE REDUCING VALVE PRESSURE GAUGE UNION PIPING CAP RISER DESIGNATION ABOVE FINISH FLOOR AUTHORITIES HAVING JURISDICTION ACCESS PANEL BOTTOM OF PIPE DIAMETER DOWN EXISTING FINISHED FLOOR ELEVATION GALLONS PER MINUTE HORSEPOWER INVERT ELEVATION NORMALLY CLOSED NOT TO SCALE POUNDS PER SQUARE INCH REVOLUTIONS PER MINUTE
C		WASTE PIPING FLEXIBLE CONNECTION FLOOR DRAIN/FLOOR SINK (FD/FS)	NOT A	LL SYMBOLS ARE USED FOR THIS PROJECT DIRECTION OF FLOW BRANCH CONNECTION, BOTTOM BRANCH CONNECTION, BOTTOM BRANCH CONNECTION, TOP ELBOW, TURNED DOWN ELBOW TURNED UP SHUTOFF VALVE CHECK VALVE PRESSURE REDUCING VALVE PRESSURE GAUGE UNION PIPING CAP RISER DESIGNATION ABOVE FINISH FLOOR AUTHORITIES HAVING JURISDICTION ACCESS PANEL BOTTOM OF PIPE DIAMETER DOWN EXISTING FINISHED FLOOR ELEVATION GALLONS PER MINUTE HORSEPOWER INVERT ELEVATION NORMALLY CLOSED NOT TO SCALE POUNDS PER SQUARE INCH REVOLUTIONS PER MINUTE ROUGH-IN
C		WASTE PIPING FLEXIBLE CONNECTION FLOOR DRAIN/FLOOR SINK (FD/FS)	NOT A	LL SYMBOLS ARE USED FOR THIS PROJECT DIRECTION OF FLOW BRANCH CONNECTION, BOTTOM BRANCH CONNECTION, TOP ELBOW, TURNED DOWN ELBOW TURNED UP SHUTOFF VALVE CHECK VALVE PRESSURE REDUCING VALVE PRESSURE GAUGE UNION PIPING CAP RISER DESIGNATION ABOVE FINISH FLOOR AUTHORITIES HAVING JURISDICTION ACCESS PANEL BOTTOM OF PIPE DIAMETER DOWN EXISTING FINISHED FLOOR ELEVATION GALLONS PER MINUTE HORSEPOWER INVERT ELEVATION NORMALLY CLOSED NOT TO SCALE POUNDS PER SQUARE INCH REVOLUTIONS PER MINUTE

VIF

VERIFY IN FIELD

ADA	AMERICANS WITH DISABILITIES ACT
A.F.F.	ABOVE FINISH FLOOR
AP BP	ACCESS PANEL BOOSTER PUMP
BT	BATHTUB
BTC	BRANCH TO CONNECTION
CBV	CALIBRATED BALANCING VALVE
CI	CAST IRON CLEANOUT
CO CSS	CLEANOUT CLINICAL SERVICE SINK
CW	COLD WATER
DCVA	DOUBLE CHECK VALVE ASSEMBLY
DF	DRINKING FOUNTAIN
DI DS	DEINOIZED WATER DOWNSPOUT
DW	DISHWASHER
DWH	DOMESTIC WATER HEATER
EEW	EMERGENCY EYE WASH
ESEW	EMERGENCY SHOWER & EYE WASH
ESH ET	EMERGENCY SHOWER EXPANSION TANK
EWC	ELECTRIC WATER COOLER
FCO	FLOOR CLEANOUT
FD	FLOOR DRAIN
F.F. FS	FINISH FLOOR ELEVATION FLOOR SINK
FS G	FLOOR SINK NATURAL GAS
GCO	GRADE CLEANOUT
GD	GARBAGE DISPOSAL
HB	HOSE BIBB
HW HWR	HOT WATER HOT WATER RETURN
HWRP	HOT WATER RETURN PUMP
HWST	HOT WATER STORAGE TANK
I.E.	INVERT ELEVATION
IM	
IW LA	INDIRECT WASTE LAVATORY
MB	MOP BASIN
NIC	NOT IN CONTRACT
NP	NON-POTABLE
OB	OUTLET BOX
ORD PG	OVERFLOW ROOF DRAIN PRESSURE GAUGE
PRV	PRESURE REDUCING VALVE
RD	ROOF DRAIN
RH	ROOF HYDRANT
ro RPZ	REVERSE OSMOSIS REDUCED PRESSURE BACKFLOW PREVENTER
S	SANITARY
SCW	SOFTENED COLD WATER
SH	SHOWER
SHW SK	SOFTENED HOT WATER SINK
sn SOV	SINK SHUT OFF VALVE
SP	SUMP PUMP
S/S	STAINLESS STEEL
SS	SANITARY STACK
SSD SSK	SUBSOIL DRAINAGE SHOP SINK
JON TD	TRENCH DRAIN
TMV	THERMOSTATIC MIXING VALVE
TP	
TW	
UR V	URINAL VENT
v VIV	VALVE IN VERTICAL
VB	VACUUM BREAKER
VS	VENT STACK
VTR W	VENT THRU ROOF WASTE
vv WC	WASTE WATER CLOSET
WCO	WALL CLEANOUT
WD	WASHER DRAIN
WH	
wha Wm	WATER HAMMER ARRESTOR WATER METER
WM WS	WATER METER WASTE STACK
WSV	WASTE STACK VENT
YCO	YARD CLEANOUT
YH	YARD HYDRANT



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Latrines & Shower Renovations, Building 233

St. Louis Lambert Readiness Center

10800 Lambert International Rd.

Bridgeton, MO 63044

PROJECT # T2417-01 SITE # ASSET #

6280 81362800001

REVISION: DATE: **REVISION**: DATE: **REVISION**: DATE:

ISSUE DATE: 4-16-2025

CAD DWG FILE: DRAWN BY: __MAS CHECKED BY: _AJH_ DESIGNED BY: MAS SHEET TITLE:

PLUMBING SYMBOLS AND ABBREVIATIONS


SHEET NUMBER:



4-16-2025

SHEET 9 OF 31

NS

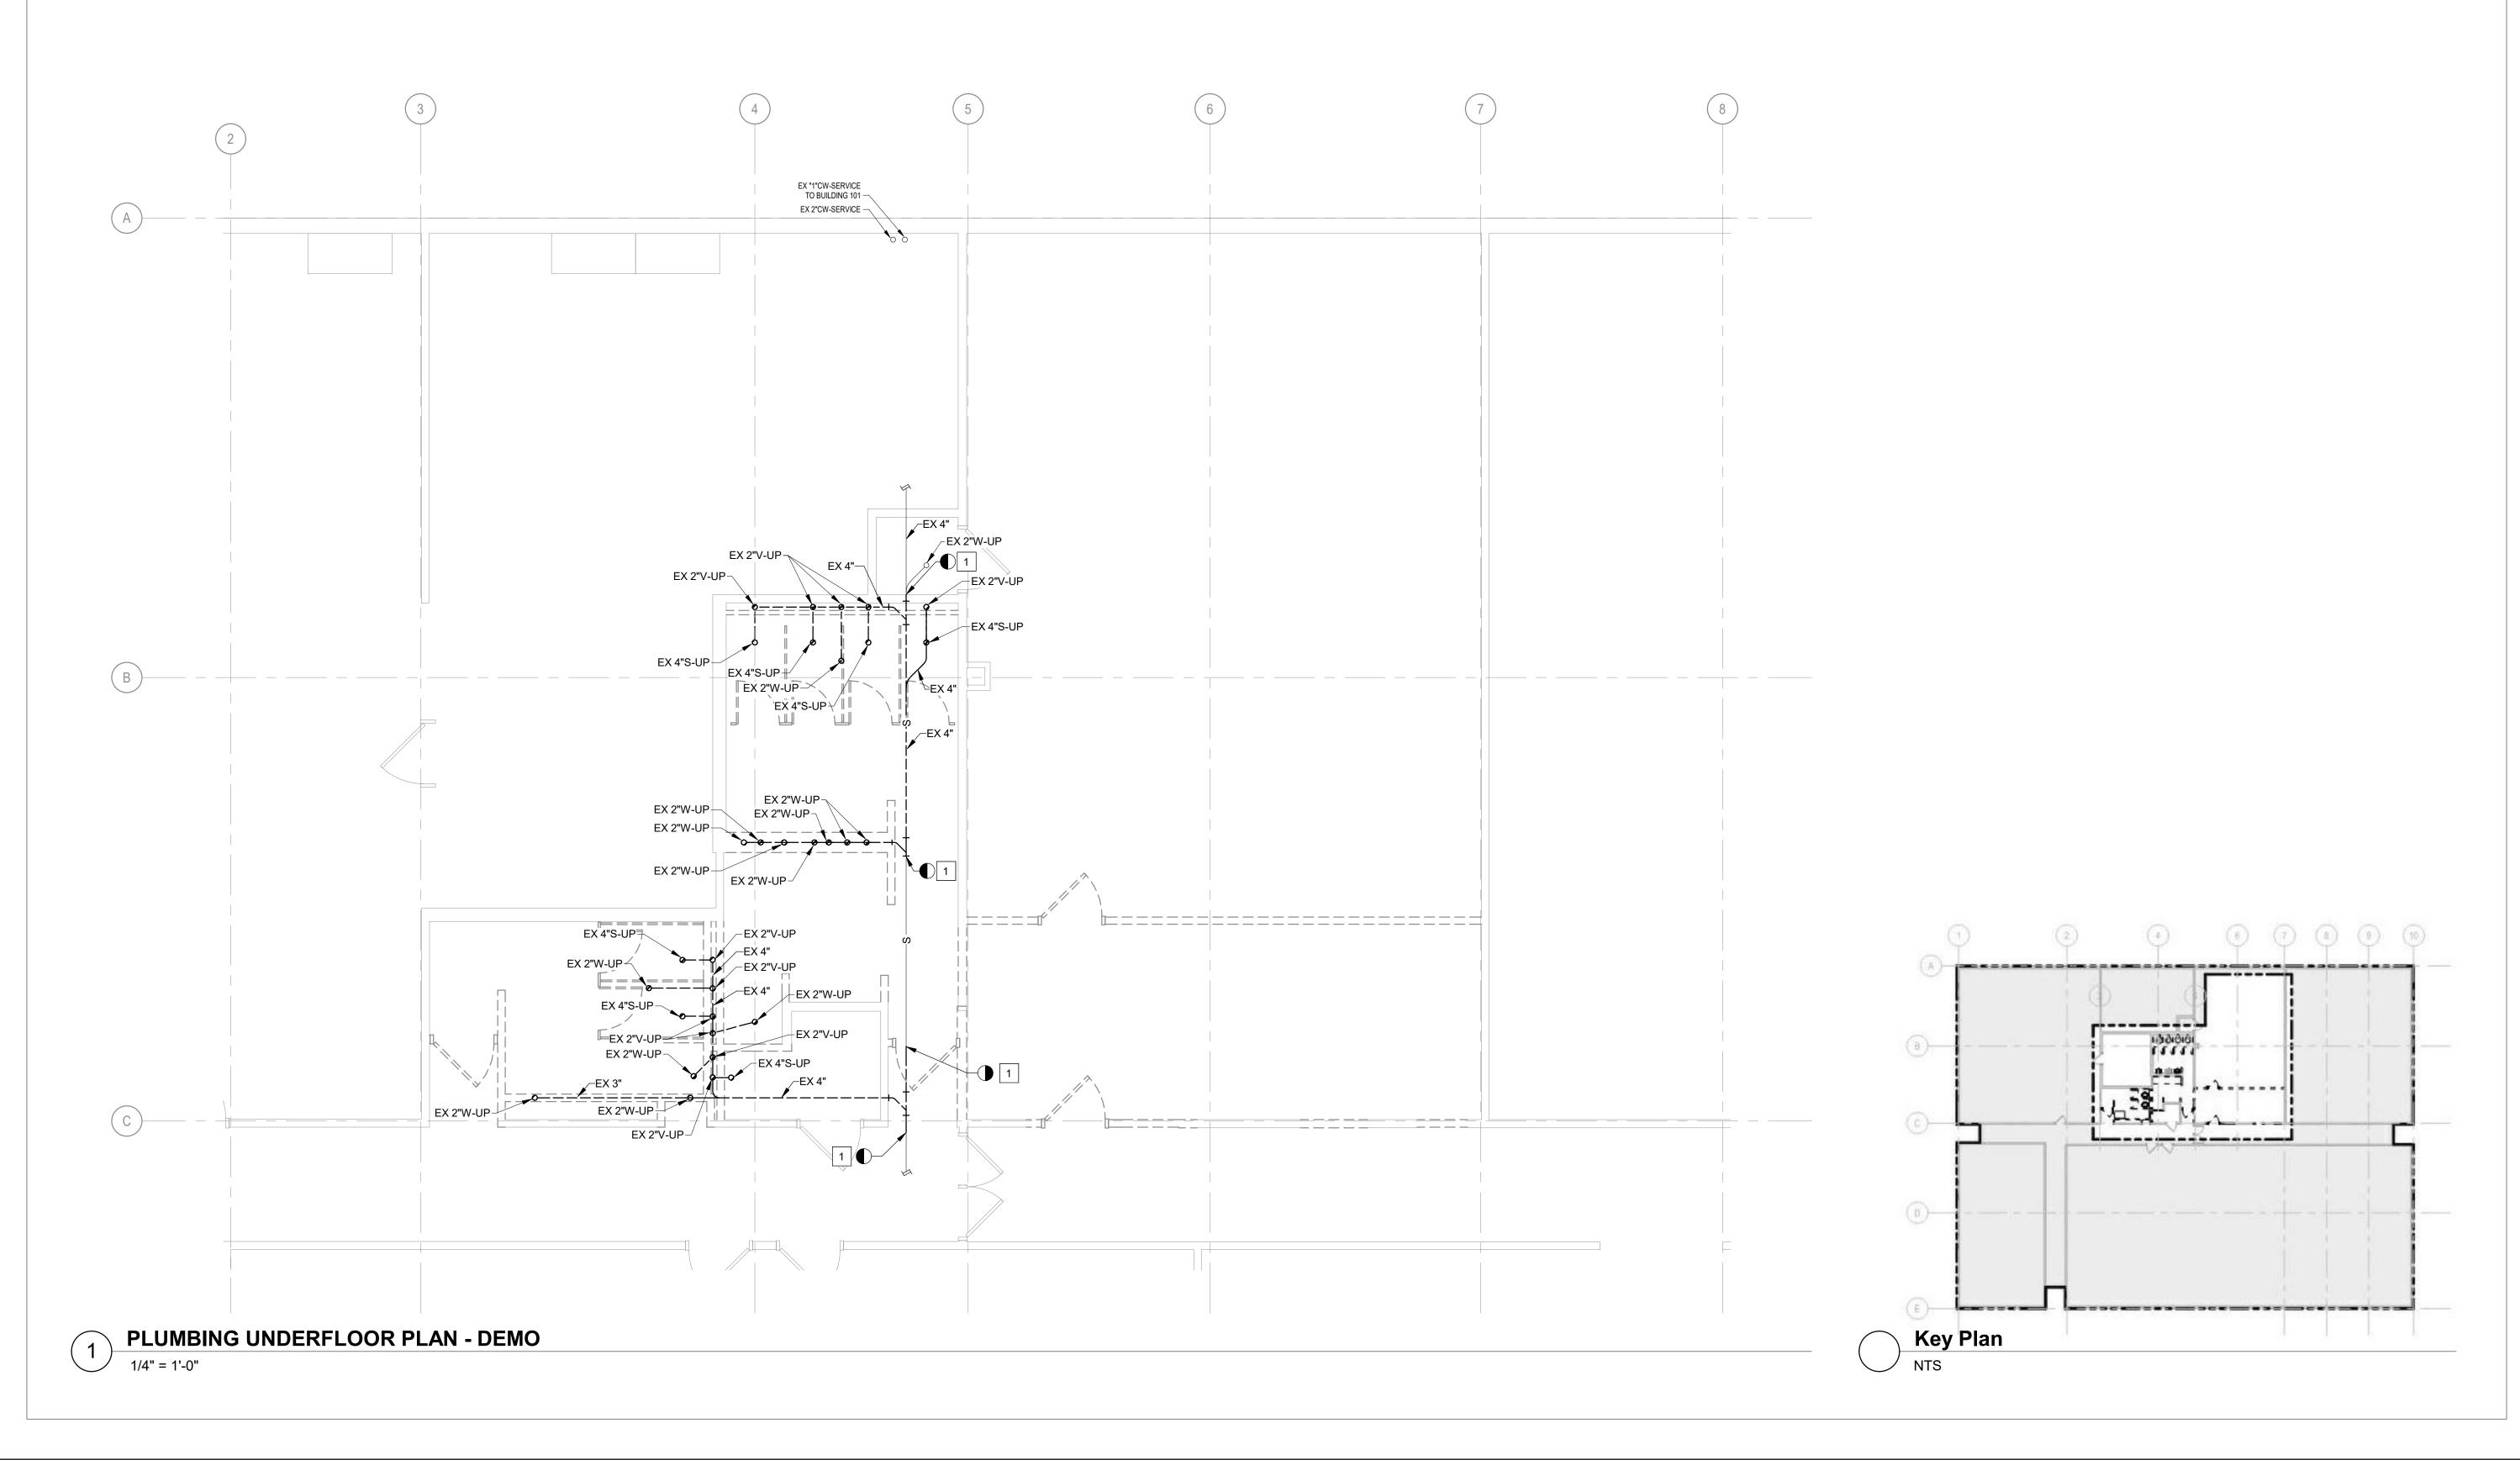

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SHEET KEYNOTES

1. TEMPORARILY CAP PIPING IN PREPARATION FOR A NEW CONNECTION.



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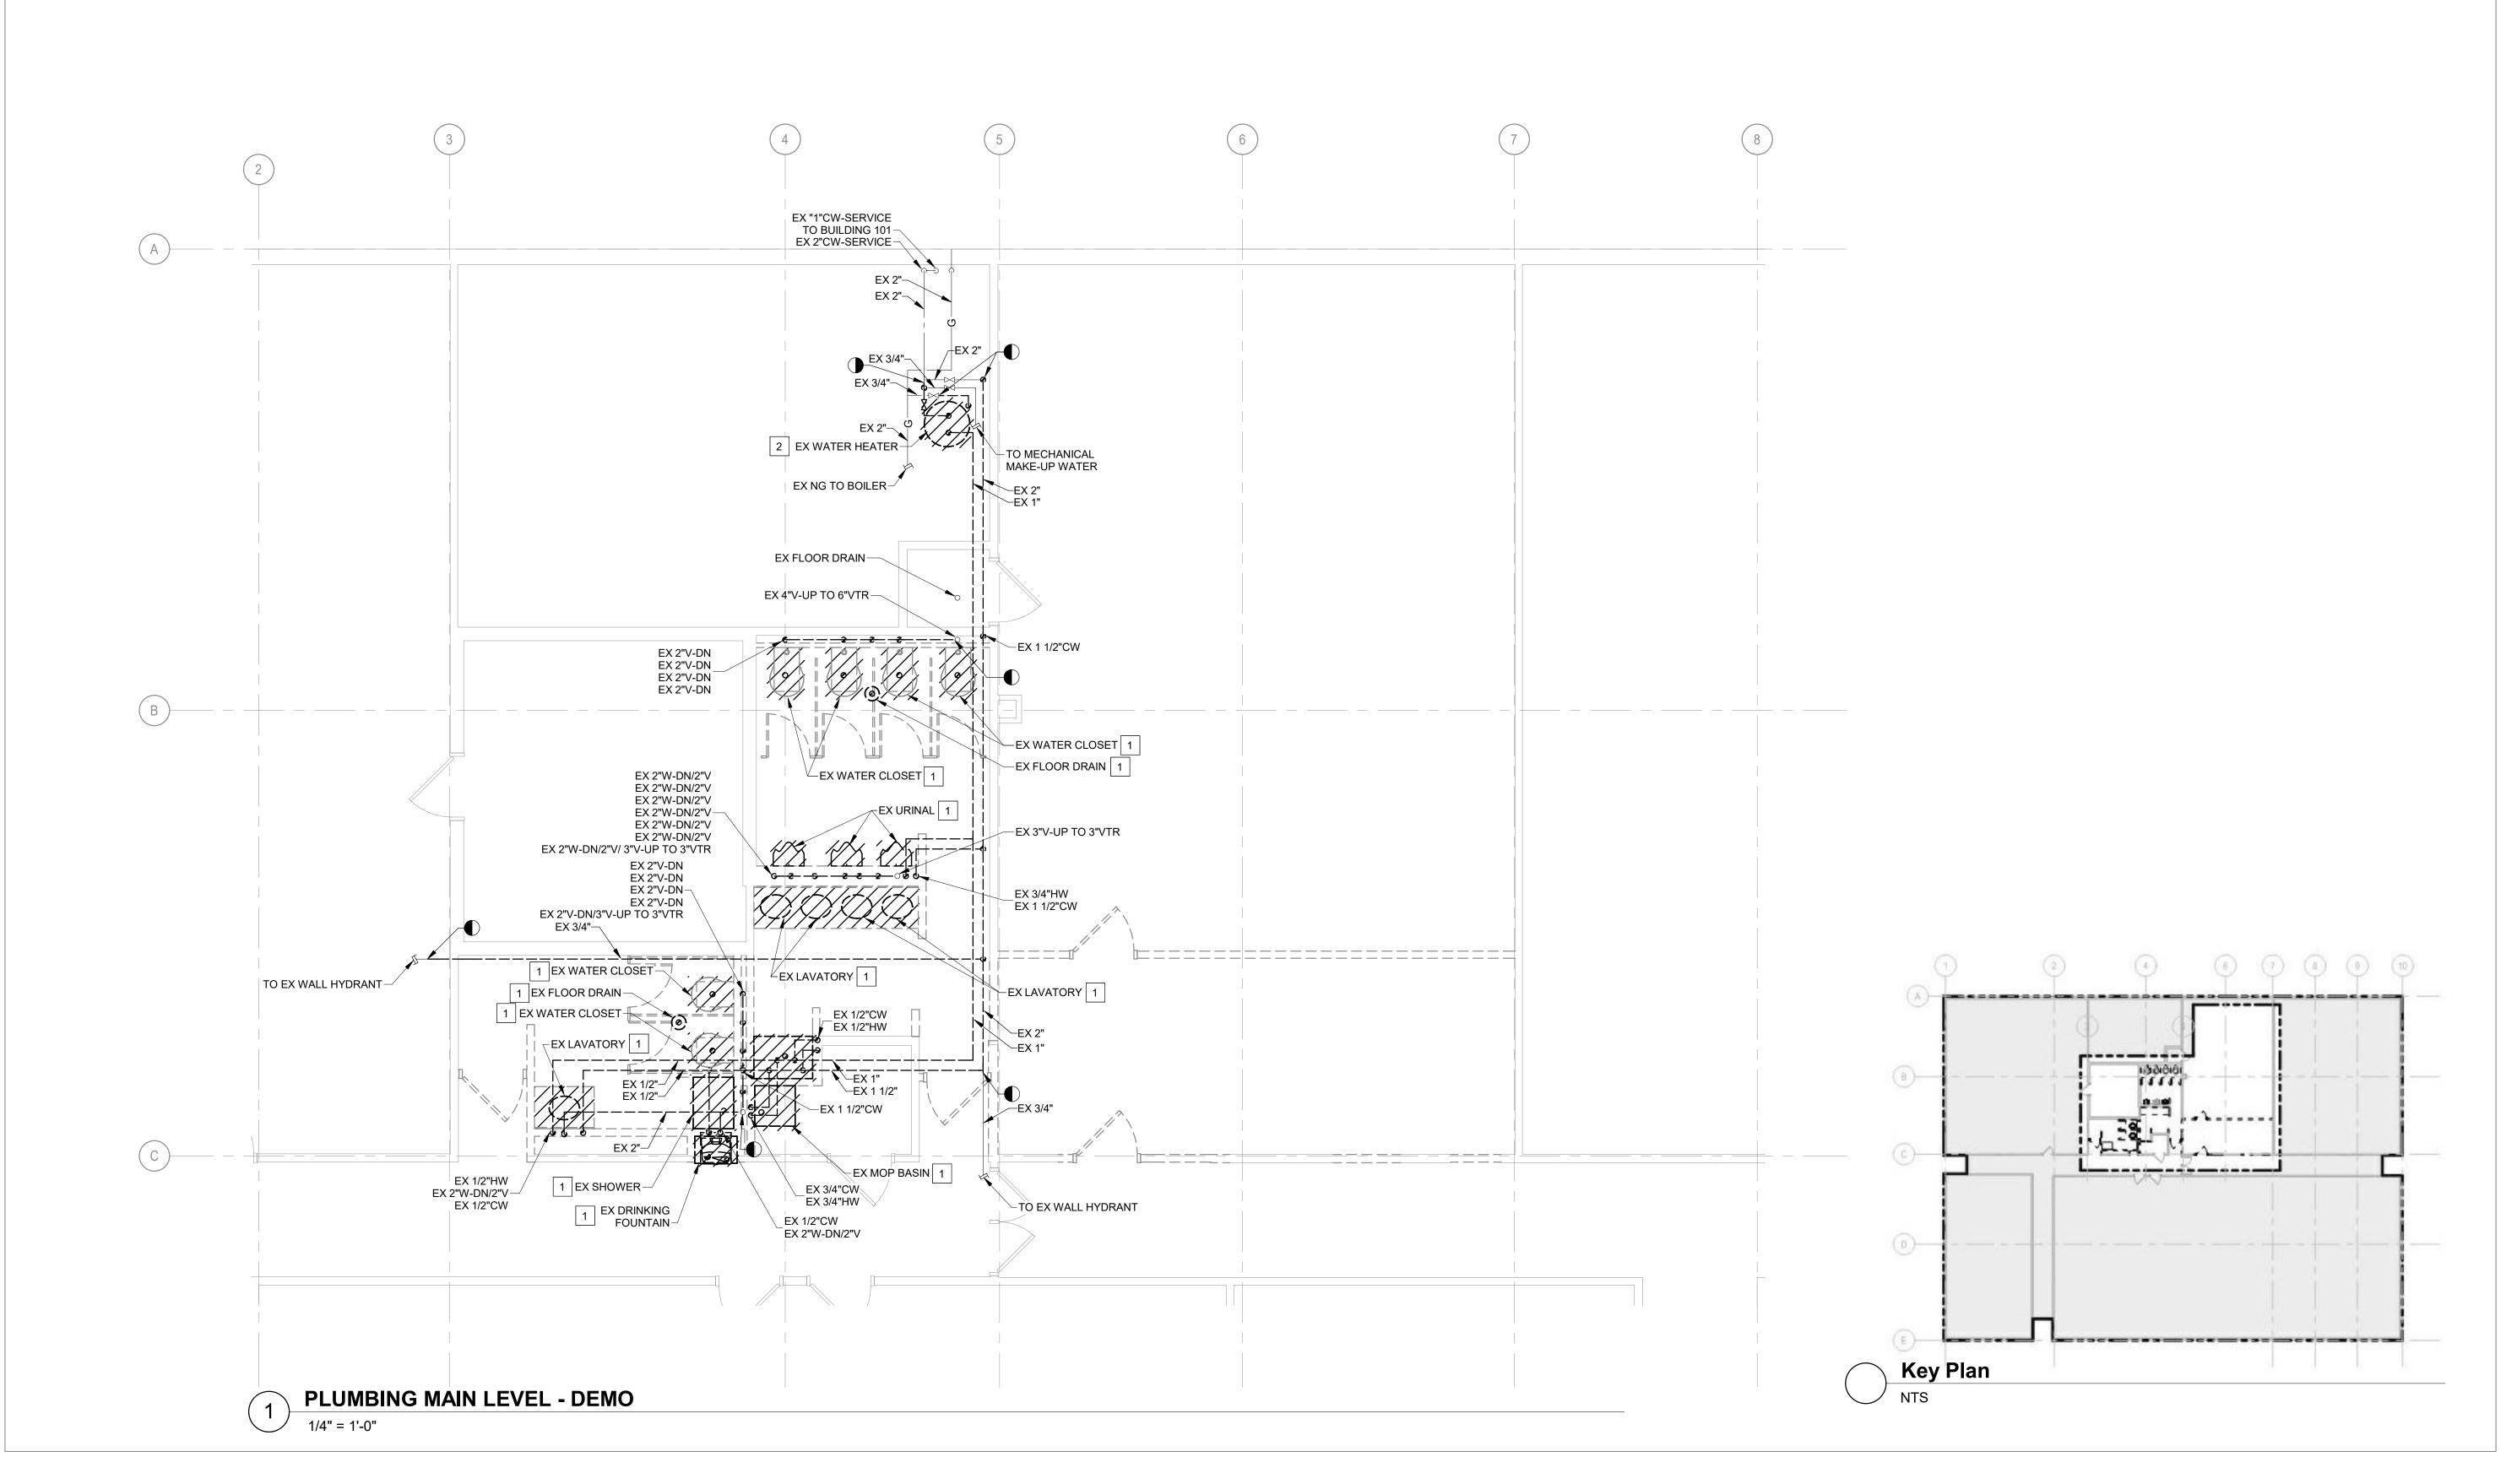
CAD DWG FILE: DRAWN BY: MAS CHECKED BY: AJH DESIGNED BY: MAS

SHEET TITLE: PLUMBING UNDERFLOOR PLANS -DEMO

SHEET NUMBER:



4-16-2025 SHEET 10 OF 31



#	SHEET KEYNOTES	
1.	EXISTING PLUMBING FIXTURE AND ALL ASSOCIATED COMPONENTS TO BE REMOVED. EXISTING DOMESTIC WATER TO BE REMOVED BACK TO NEAREST ACTIVE MAIN OR VALVE AND CAPPED. EXISTING SANITARY TO BE REMOVED BELOW FLOOR TO NEAREST MAIN AND CAPPED. EXISTING VENT TO BE REMOVED BACK TO NEAREST MAIN OR BRANCH ABOVE CEILING AND CAPPED.	
2.	EXISTING WATER HEATER AND ALL ASSOCIATED COMPONENTS TO BE REMOVED IN ENTIRETY. REFER TO MECHANICAL DRAWINGS FOR FLUE DEMOLITION.	

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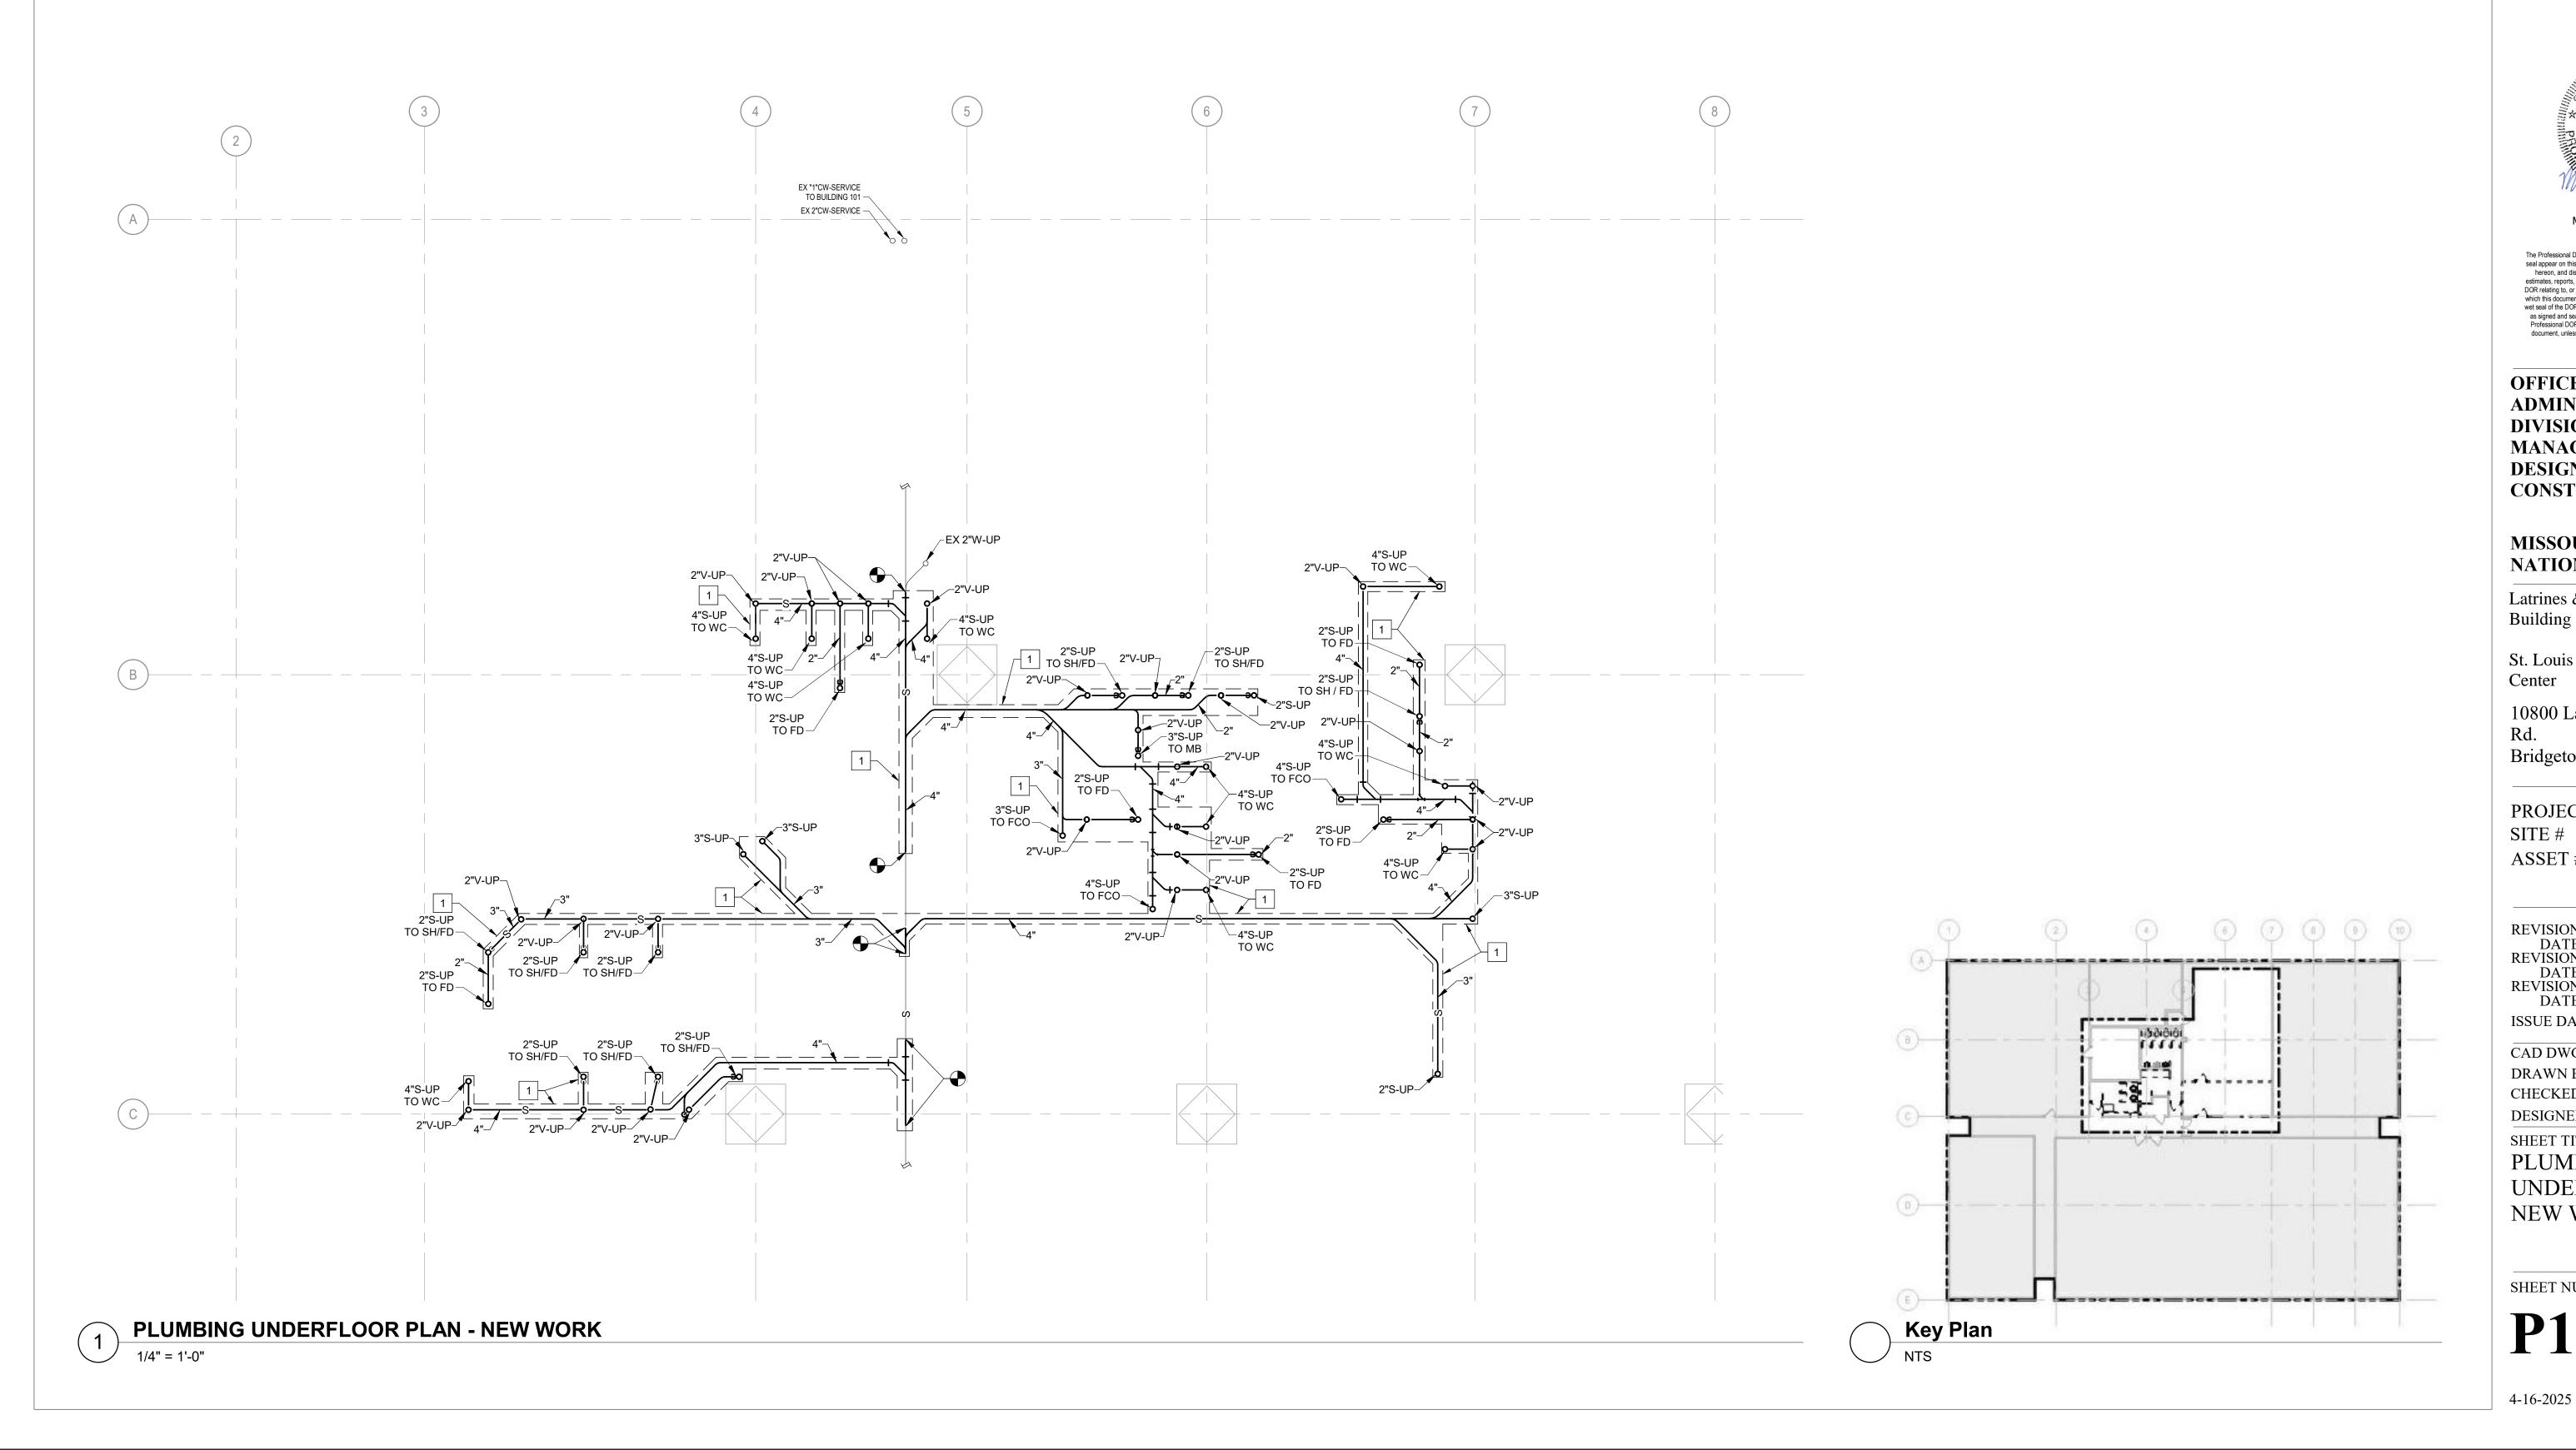
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PLUMBING FLOOR PLANS - DEMO

SHEET NUMBER:



4-16-2025 SHEET 11 OF 31



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SHEET KEYNOTES

SAW CUT CONCRETE SLAB FOR 1 INSTALLATION OF NEW WASTE AND/OR STORM SYSTEM (HOLDING CUTTING TO A MINIMUM). REFER TO ARCHITECTURAL DRAWINGS FOR ADDITIONAL INFORMATION.

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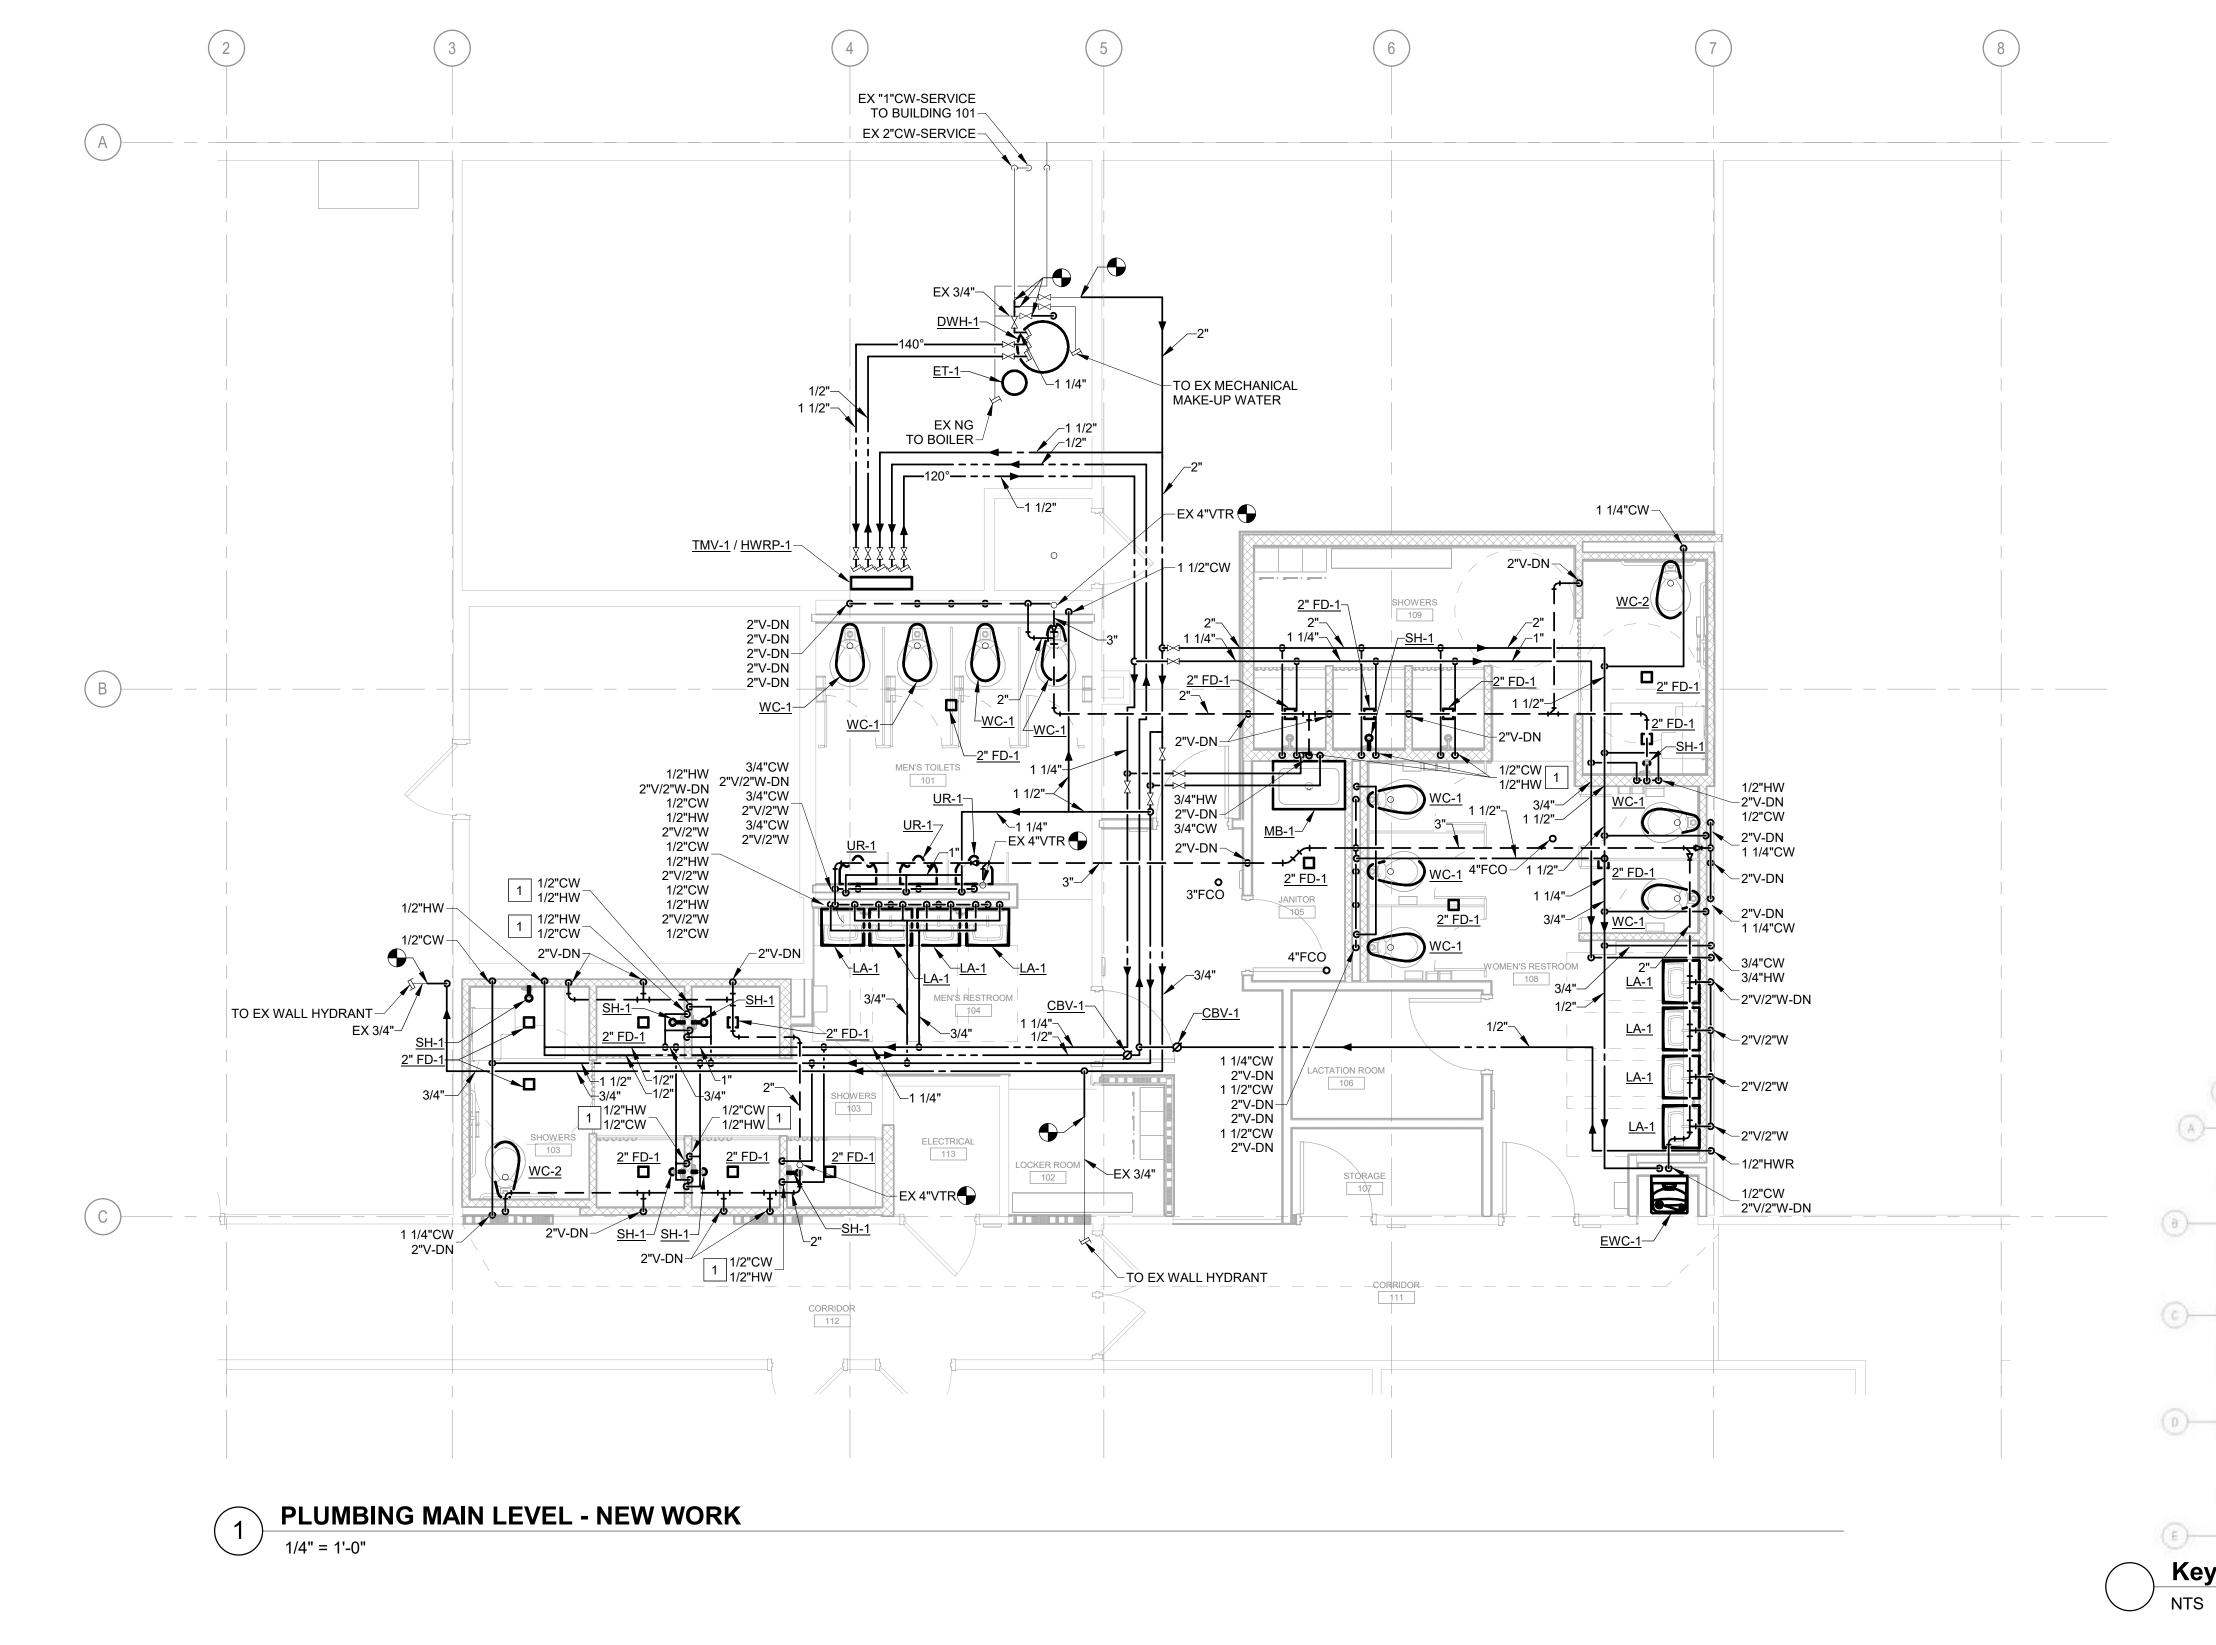
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SHEET TITLE: PLUMBING UNDERFLOOR PLANS -NEW WORK

SHEET NUMBER:







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SHEET KEYNOTES

MOUNT HOT AND COLD WATER ON WALL TO FEED SHOWER UNIT. PIPING LOCATION AND INSTALLATION TO BE COORDINATED WITH SHOWER ENCLOSURE.

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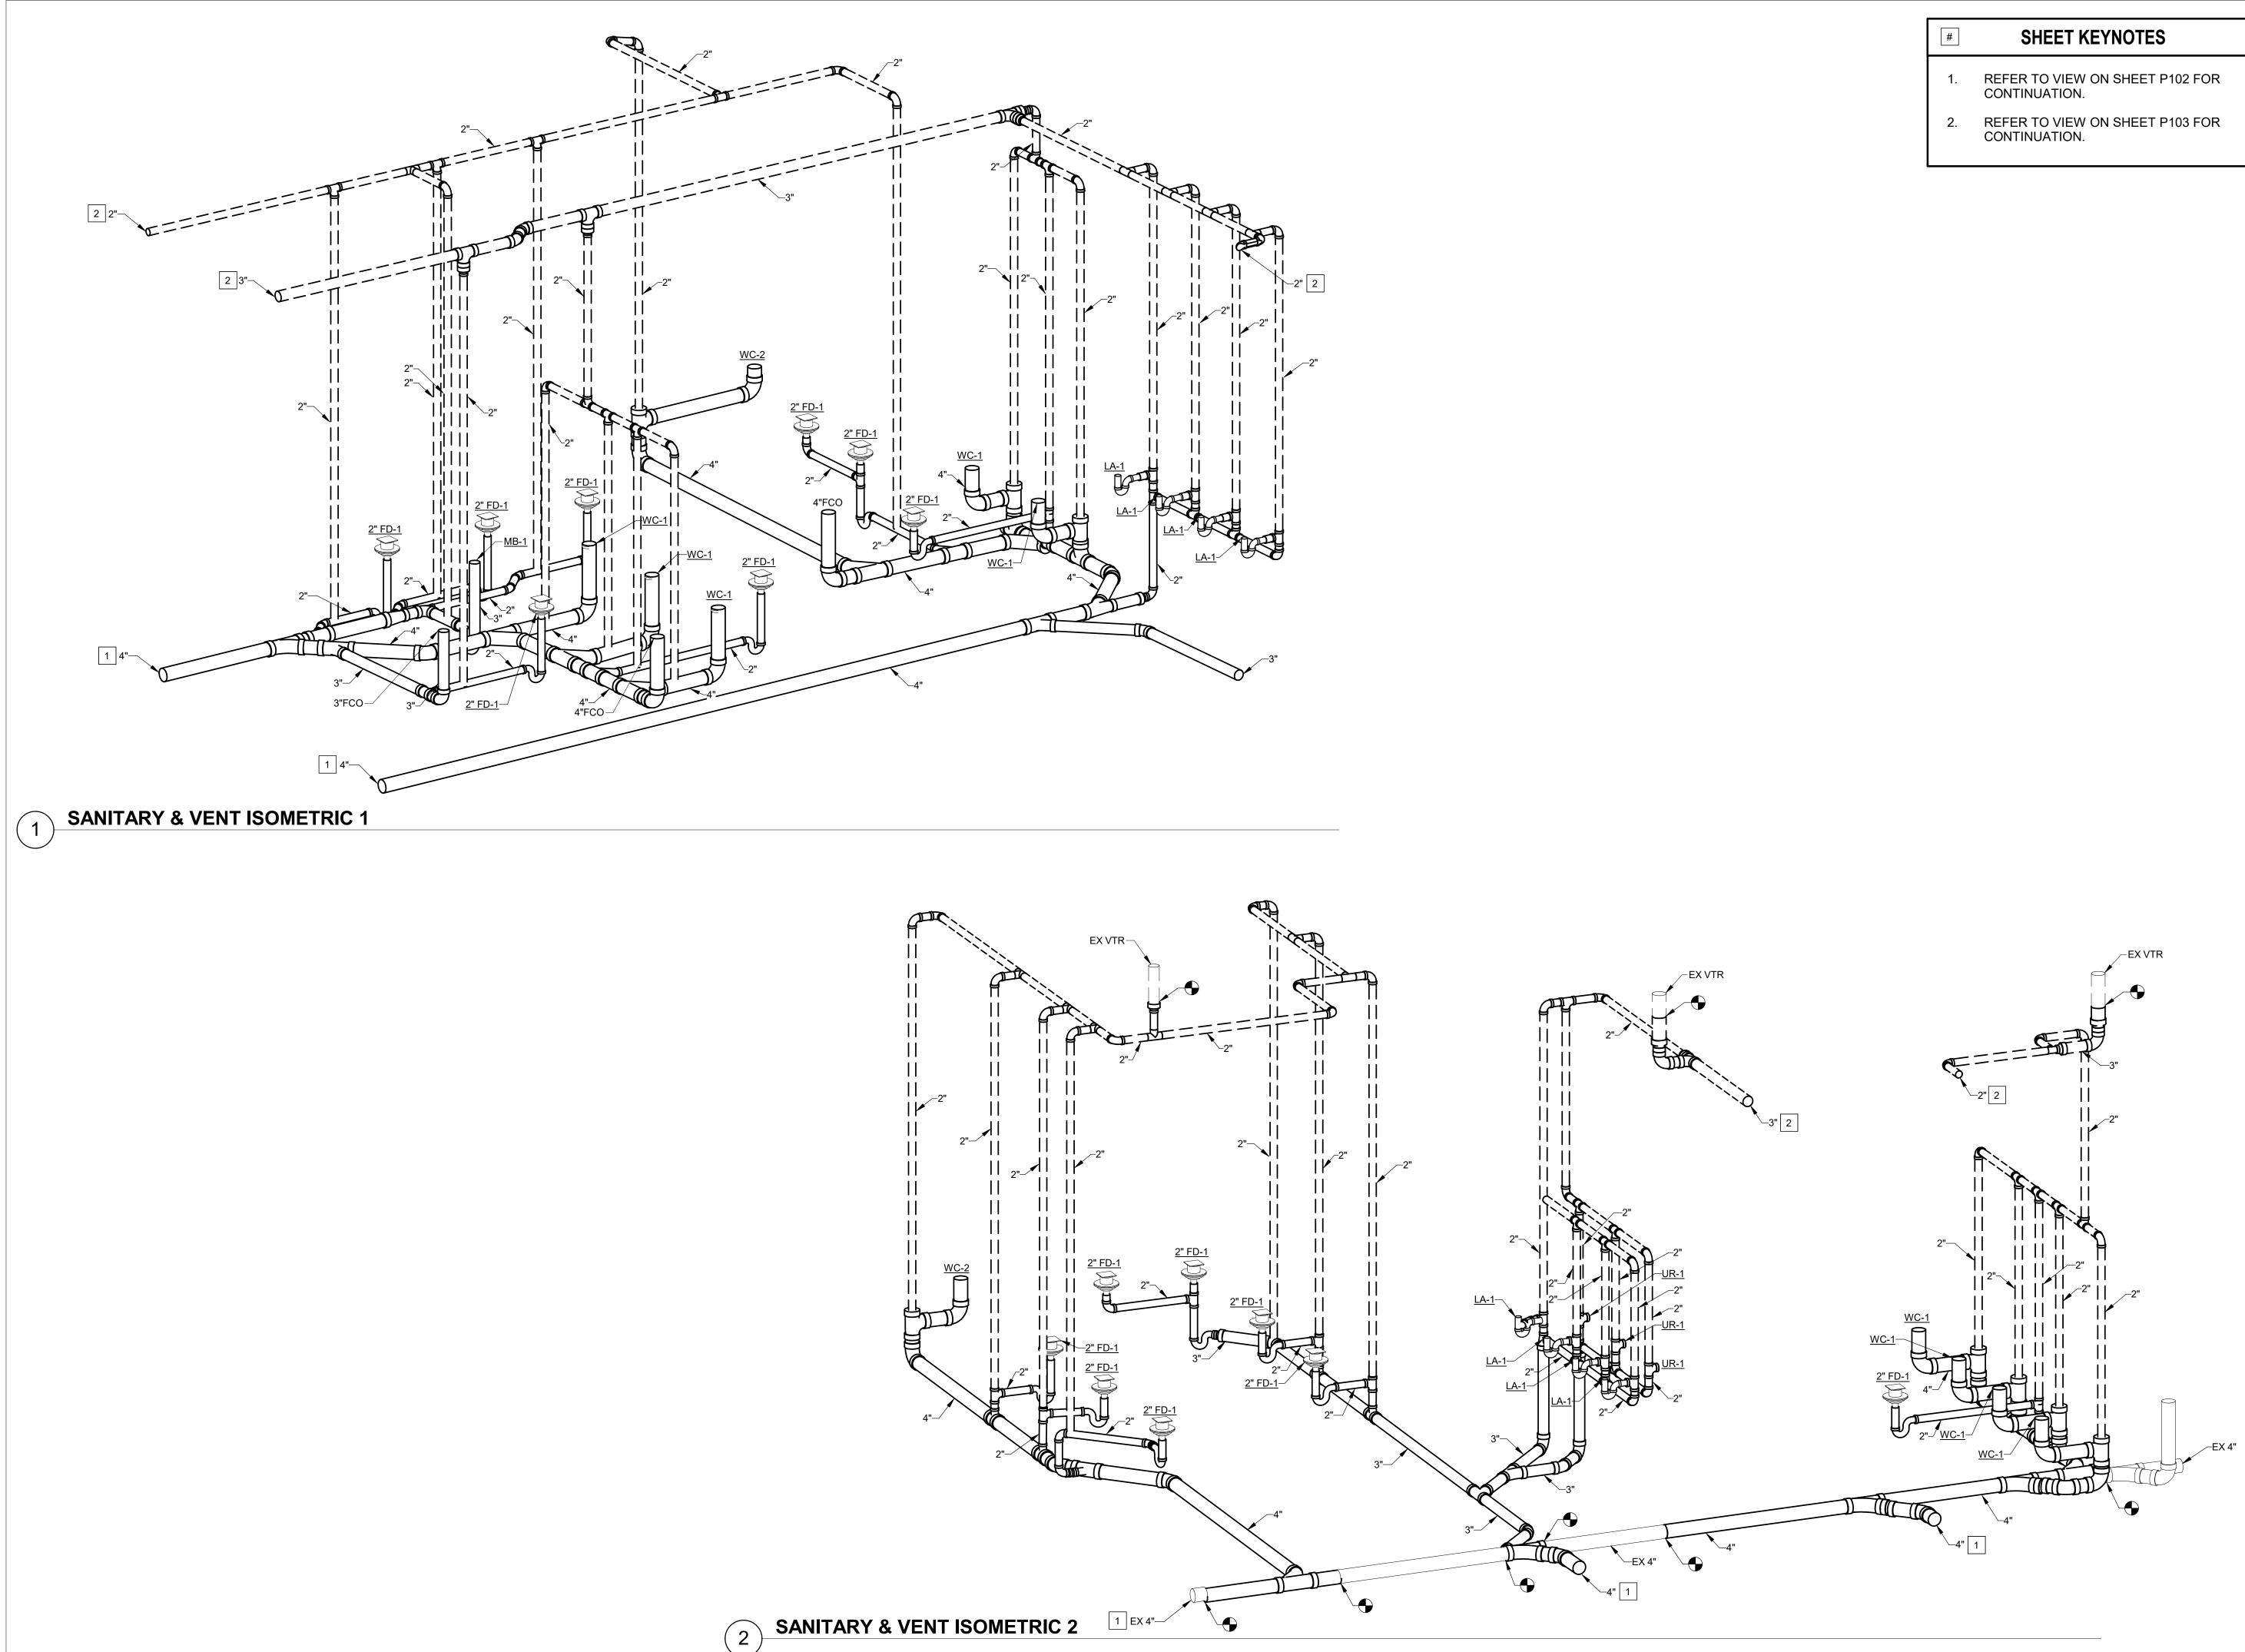
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SHEET TITLE: PLUMBING FLOOR PLANS - NEW WORK

SHEET NUMBER:



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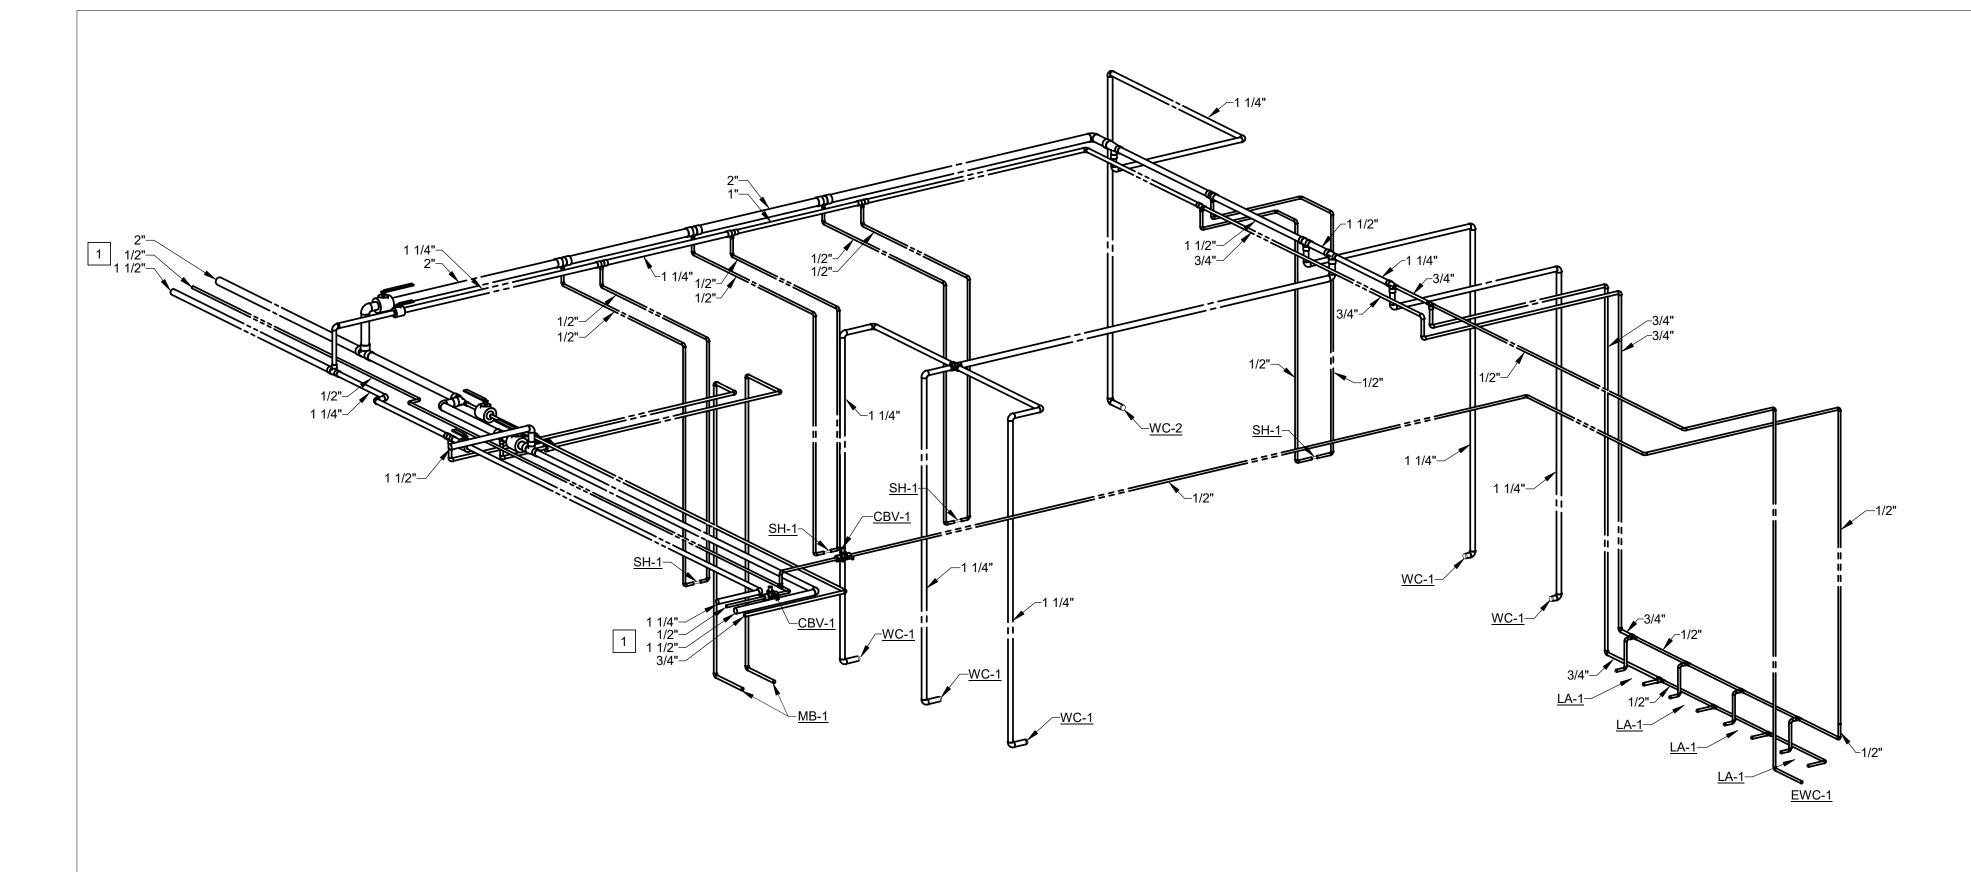
PLUMBING SANITARY & VENT ISOMETRICS

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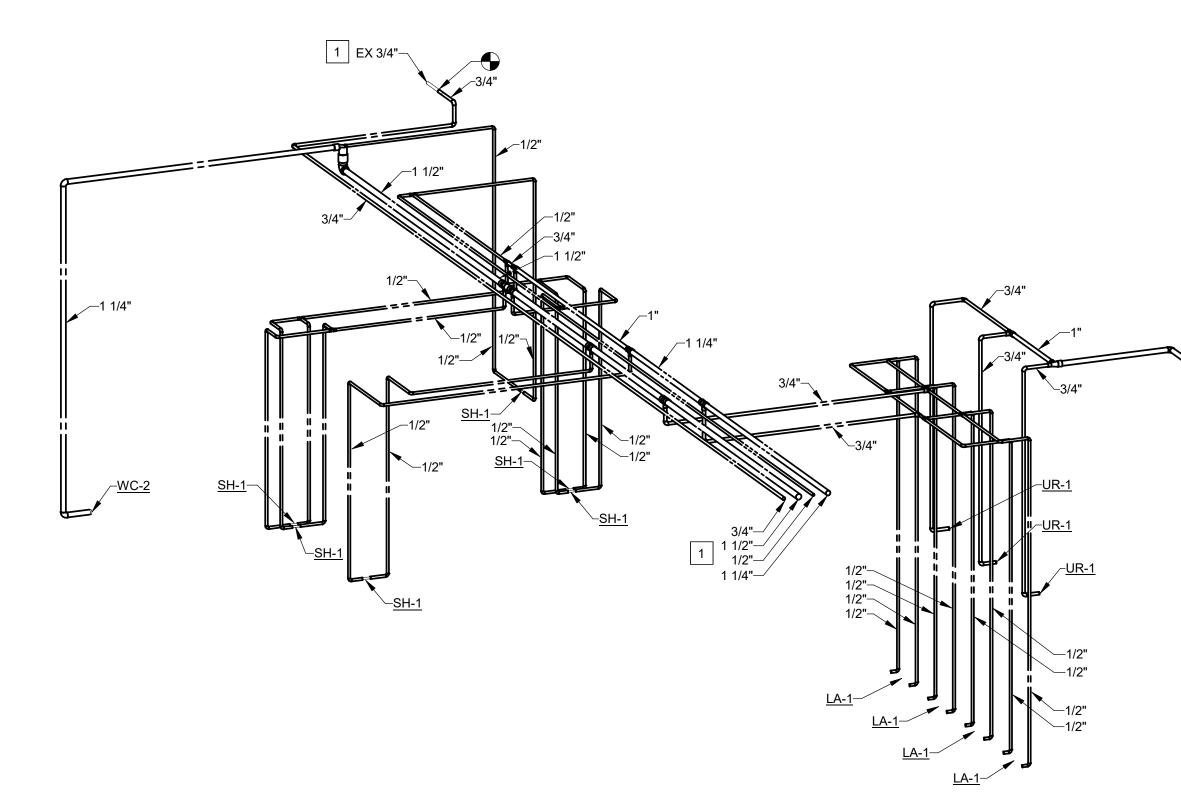


4-16-2025

SHEET 14 OF 31



1 DOMESTIC WATER ISOMETRIC 1



2

GENERAL NOTES

A. REFER TO VIEW ON SHEET P103 FOR CONTINUATION.

SHEET KEYNOTES

CONTINUATION.

REFER TO VIEW ON SHEET P103 FOR

#

1.

1 1/4"		-1 1/2"
	<u>WC-1</u> 1 1/4" <u>WC-1</u> 1 1/4" <u>WC-1</u> 1 1/4" <u>WC-1</u>	-1 1/4"



MISSOURI STATE CERTIFICATE OF AUTHORITY #000148



MICHAEL L. WYLAND PE-2004021220

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OFFICE OF ADMINISTRATION DIVISION OF FACILITIES MANAGEMENT, DESIGN AND CONSTRUCTION

MISSOURI ARMY NATIONAL GUARD

Latrines & Shower Renovations, Building 233

St. Louis Lambert Readiness Center

10800 Lambert International Rd.

Bridgeton, MO 63044

PROJECT #	T2417-01
SITE #	6280
ASSET #	81362800001

REVISION: DATE: REVISION: DATE: REVISION: DATE: ISSUE DATE: 4-16-2025

CAD DWG FILE: DRAWN BY: MAS CHECKED BY: AJH DESIGNED BY: MAS SHEET TITLE:


PLUMBING DOMESTIC WATER ISOMETRICS

SHEET NUMBER:



4-16-2025 SH

SHEET 15 OF 31

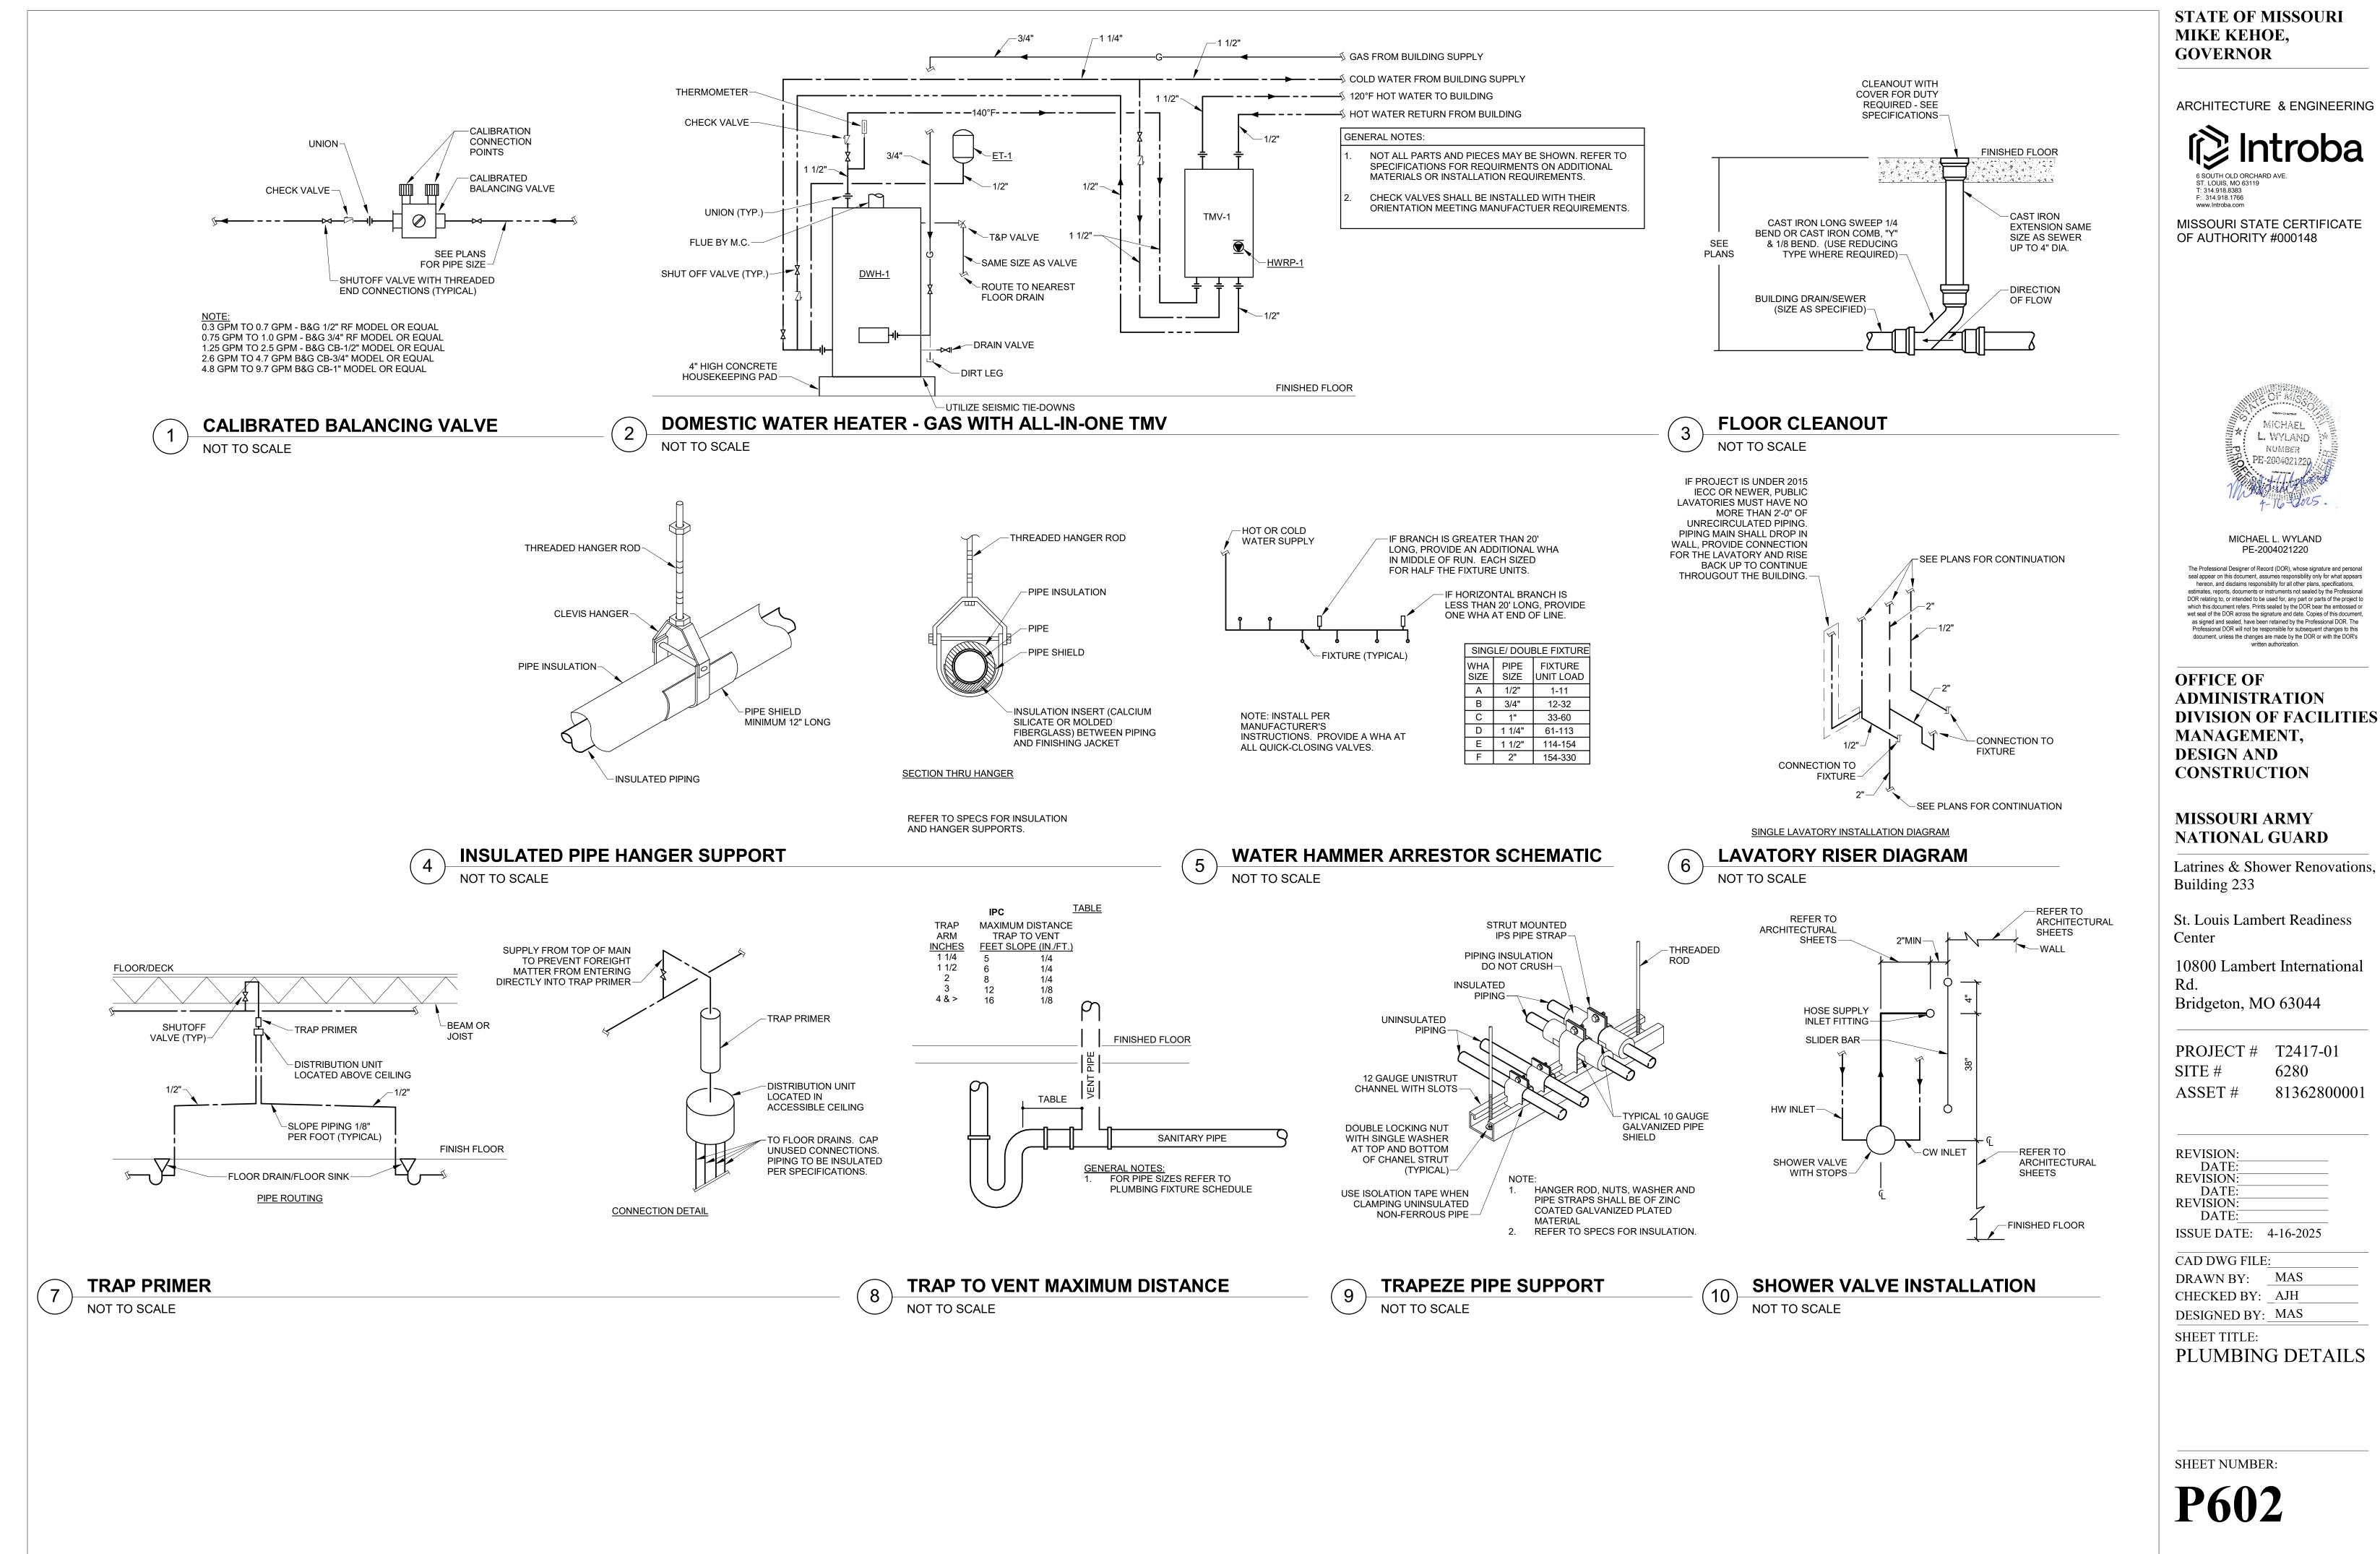

SHEET 16 OF 31

PLAN MARK	
EWC-1	
LA-1	
MB-1	
SH-1	
UR-1	
WC-1	
WC-2	١

				PLUM	BING FIXTURE	SCHEDU	LE						
DESCRIPTION	MANUFACTURER	MODEL	TRIM	DRAIN / TRAP	SUPPLIES	CARRIER	SEAT	HOT WATER	COLD WATER	TEMPERED WATER	SANITARY / WASTE	VENT	NOTES
ELECTRIC WATER COOLE	ELKAY	LZS8WS(VR)LP	-	CHROME PLATED P-TRAP	CHICAGO FAUCET LOOSE KEY ANGLE STOPS AND RISERS	ELKAY	-	-	1/2"	-	2"		
WALL HUNG LAVATORY	KOHLER	K-2054-N	KOHLER K-15243-4RA, MANUAL FAUCET, 0.5 GPM	MCGUIRE 155WC OFFSET GRID DRAIN WITH CHROME PLATED P-TRAP	CHICAGO FAUCET LOOSE KEY ANGLE STOPS AND RISERS	JAY R. SMITH	-	1/2"	1/2"	-	2"	2"	INSULATE SUPPLY AND WASTE PIPING WITH TRUBRO #102 WHITE INSULATION KIT WITH #105 OFFSET DRAIN INSULATION KIT. 0.5 GPM NON-AERATED OUTLET.
MOP BASIN	FIAT	MSB3624	STERN WILLIAMS MODEL T-15-VB, WALL MOUNTED MANUAL FAUCET W/ PALE HOOK, 2.5 GPM AT 60 PSI	3" PVC P-TRAP	INTEGRAL SUPPLY STOPS	-	-	1/2"	1/2"	-	3"	2"	#T-35 HOSE AND WALL BRACKET. 36" HOSE WITH 3/4" CHROME COUPLING. TYPE 302 STAINLESS STEEL BRACKET WITH SPRING LOADED RUBBER GRIP.
SHOWER	-	-	AMERICAN STANDARD 1662.04 WITH R110S T372.240 PRESSURE BALANCE VALVE WITH STOPS & 1660.400 IN-LINE VACUUM BREAKER.	-	-	-	-	1/2"	1/2"	-	2"	2"	
WALL HUNG URINAL ADA	KOHLER	K-4991-ET	SLOAN MODEL 186 MANUAL FLUSHOMETER 0.125 GPF	INTEGRAL	-	JAY R. SMITH	-	-	3/4"	-	2"	2"	
FLOOR MOUNT FLOOR OUTLET WATER CLOSET	KOHLER	K-96057	SLOAN MODEL 111, MANUAL FLUSHOMETER, 1.28 GPF	INTEGRAL	-	-	BEMIS	-	1 1/4"	-	4"	2"	
FLOOR MOUNT FLOOR OUTLET WATER CLOSET ADA	KOHLER	K-96057	SLOAN MODEL 111, MANUAL FLUSHOMETER, 1.28 GPF	INTEGRAL	-	-	BEMIS	-	1 1/4"	-	4"	2"	

PLAN MARK	MAR		MANUFACTURER	MODEL	STORAGE	RECOVERY	TEMPERATURE RISE	ELECTRICAL DATA	FUEL SOURCE	BTU/H		NOTES	
DWH	1	DOMESTIC WATER HEATER	AO SMITH	BTH-150(A)	100 GAL	178 GPH	100 F	120V / 60HZ, 5A	NATURAL GAS	150,000	KIT AND C	WITH CONC ONDENSAT	_
	_	PLAN MAR		MANUFACTU					Е НР	EL	ETRICAL	N	OTES
		MARKNUMEHWRP1	HOW WATER RETURN PUMP	TACO		E-SF4	1 10	4830	FRACTIC		DATA V/1PH,60HZ	MOUNT HORE	OT WATER
		PLAN MARK	DESCRIPTION	MANUFACTU		ISION TAI	NC	EDULE			/olume	NOTES	
			ET-1	EXPANSION TANK	AMTROL		DOMES	TIC R 12"	ER HEIGH	IT		6.4 GAL	NOTES

K ER	DESCRIPTION	MANUFACTURER	MODEL	STORAGE	RECOVER	v	ERATURE	ELECTRICAL DATA	FUEL SOURCE	BTU/	′Н	NOTE	6
ER	DOMESTIC WATER HEATER	AO SMITH	BTH-150(A)	100 GAL	178 GPH		100 F	120V / 60HZ, 5A	NATURAL GAS	150,0	00 KIT AND	E WITH CON CONDENSA LIZATION KI	
				CIRCI	JLATIN	g pui	MP SC	HEDULE	=				
PLAN MARI		DESCRIPTION	MANUFACTU	IRER MO	DDEL	GPM	HEAD (FT	.) RPM	F	IP	ELETRICAL DATA	1	NOTES
HWR	P 1	HOW WATER RETURN PUMP	TACO	007	E-SF4	1	10	4830	FRAC	TIONAL	120V/1PH,60H	Z RETURN	OT WATER PUMP ON KING STATIC
		PLAN MARK	DESCRIPTION	MANUFACT		ANSIC model	N TAN	DIAMET	OMINAL SIZE		CAPACITY	VOLUME	NOTES
		ET-1	EXPANSION TANK	AMTRC	L S1	-12C-DD	WATER		1	8"	3.2 GAL	6.4 GAL	

		V V			SCHEDUL	L					
M	ANUFACTURER	MODEL	STORAGE	RECOVERY	TEMPERATURE RISE	ELECTRICAL DATA	FUEL SOURCE	BTU/H	1	NOTES	6
	AO SMITH	BTH-150(A)	100 GAL	178 GPH	100 F	120V / 60HZ, 5A	NATURAL GAS	150,00	0 KIT AND	E WITH CON CONDENSA LIZATION KI	TE
			CIRCU	LATING	PUMP SC	HEDULE	1				
R	DESCRIPTION	MANUFACTU	IRER MOL	DEL GI	PM HEAD (F	T.) RPM	н	P	ELETRICAL DATA	1	OTES
	HOW WATER RETURN PUMP	TACO	007E-	-SF4	1 10	4830	FRACT		120V/1PH,60H	Z RETURN	OT WATER PUMP ON KING STATIC
1											
				EXPAN	ISION TAP	NK SCHE	EDULE				
	PLAN MARK	DESCRIPTION	MANUFACTU	RER MO	DEL SERVIC	E NO	MINAL SIZE		CAPACITY	VOLUME	NOTES
		DESCRIPTION	WANUFACTU				ER HEI	GHT	CAPACITI	VOLUME	NOTES
		EXPANSION	AMTROL	ST-12	C-DD DOMEST		18	3"	3.2 GAL	6.4 GAL	

	THERMOSTATIC MIXING VALVE SCHEDULE							
PLAN MARK	DESCRIPTION	MANUFACTURER	MODEL	FL MINIMUM GPM	.OW GPM @ 10PSI LOSS	LEAVING TEMPERATURE	NOTES	
TMV-1	THERMOSTATIC MIXING VALVE STATION	ACORN	CSMV-2-C-1-0-0-1-0	1	21.2	120 F		

PLAN MAR FD-1

	DRAIN SCHEDULE							
ARK	DESCRIPTION	MANUFACTURER	MODEL	BODY	STRAINER	NOTES		
	SQUARE FLOOR DRAIN	JAY R. SMITH	2005Y-NB	CAST IRON	NICKEL BRONZE	PROVIDE TRAP PRIMER CONNECTION (-P050)		

BA	BALANCING VALVE SCHEDULE							
PLAN MARK	DESCRIPTION	SIZE	ADJUSTED FLOW RATE	NOTES				
CBV-1	CALIBRATED BALANCING VALVE	1/2"	0.5 GPM					

STATE OF MISSOURI MIKE KEHOE, GOVERNOR

ARCHITECTURE & ENGINEERING



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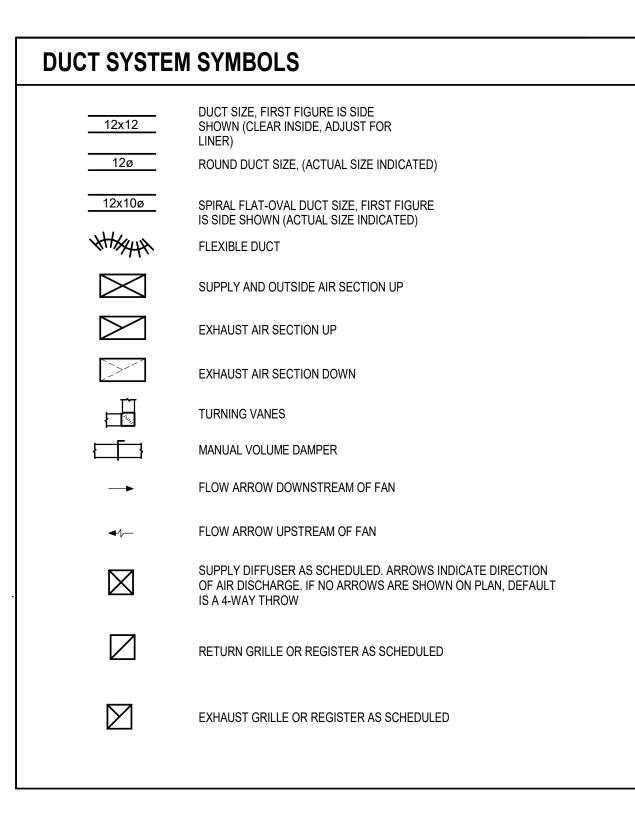
SHEET TITLE: PLUMBING SCHEDULES


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SHEET 17 OF 31






	CHANICAL ABBREVIATION	10	
	AIR OR AMP (PER CONTEXT)	JS	
C	ACCESSORIES	JS KW	JOIST SPACE KILOWATTS
F	ACCESS DOOR ABOVE FINISHED FLOOR	L LAT	LENGTH LEAVING AIR TEMPERATURE
S	AIR FLOW SWITCH	LB(S)	POUNDS
RI	AIR CONDITIONING, HEATING, AND REFRIGERATION INSTITUTE	LF LRA	LINEAR FEET LOCKED ROTOR AMPS
	ANALOG SIGNAL INPUT	LS	LIGHT SPACE
1B)	AMBIENT ANALOG SIGNAL OUTPUT	LVL LWT	LEVEL LEAVING WATER TEMPERATURE
	ACCESS PANEL	MAN	MANUAL
D LV	AIR PRESSURE DROP APPLICATION PART LOAD VALUE	MANU MAX	MANUFACTURER MAXIMUM
PROX	APPROXIMATE	MBH	THOUSAND BRITISH THERMAL UNITS PER
CH X	ARCHITECTURE/ARCHITECT AUXILIARY	MCA	HOUR MINIMUM CIRCUIT AMPS
	AUTOMATIC VENT	MCC	MOTOR CONTROL CENTER
G D	AVERAGE BACK DRAFT DAMPER	MECH MERV	MECHANICAL MINIMUM EFFICIENCY REPORTING VALUE
С			(ASHRAE 52.2)
P IP	BACKFLOW PREVENTER BRAKE HORSEPOWER	MFR MIN	MANUFACTURER MINIMUM OR MINUTE (PER CONTEXT)
	BINARY SIGNAL INPUT	MTD	MOUNTED
IS)	BUILDING MANAGEMENT SYSTEM BINARY SIGNAL OUTPUT	MTL MV	METAL MANUAL VENT
B	BOTTOM OF BEAM	NC	NORMALLY CLOSED OR NOISE CRITERIA
D P	BOTTOM OF DUCT BOTTOM OF PIPE	NIC	
	BEAM SPACE	NIC NO	NOT IN CONTRACT NORMALLY OPEN OR NUMBER (PER CONTEXT)
U UH		NOM	NOMINAL
UH /E	BRITISH THERMAL UNITS PER HOUR BAKED WHITE ENAMEL	NPLV NPSH	NON-STANDARD PART LOAD VALUE NET POSITIVE SUCTION HEAD
P	CAPACITY	NTS	NOT TO SCALE
N H	CONSTANT AIR VOLUME CUBIC FEET PER HOUR	OA OBD	OUTSIDE AIR OPPOSED BLADE DAMPER
M	CUBIC FEET PER MINUTE	OC	ON CENTER
G	CAST IRON COOLING DUCT (COLD DUCT)	OD OT	OUTSIDE DIAMETER OIL TRAP
)	CLEAN OUT	PA	PIPE ANCHOR
MP NC	COMPRESSOR CONCRETE	PBD PD	PARALLEL BLADE DAMPER PRESSURE DROP
ND	CONDENSATE	PENT	PENTHOUSE
NN RR	CONNECTION CORRIDOR	PH	PHASE
	CONTROL VALVE	PHC PLBG	PREHEAT COIL PLUMBING
	DEPTH	PNEU	PNEUMATIC
A	DRY BULB A-WEIGHTED DECIBELS	PPH PRESS	POUNDS PER HOUR PRESSURE
FL	DEFLECTION	PRV	PRESSURE REGULATING VALVE
G G F	DEGREES DEGREES FAHRENHEIT	PSI PSIA	POUNDS PER SQUARE INCH POUNDS PER SQUARE INCH ABSOLUTE
S	DESIGN	PSIG	POUNDS PER SQUARE INCH GAUGE
A M	DIAMETER DIMENSION	QTY RA	QUANTITY RETURN AIR
SCH	DISCHARGE	RAD	RADIATED
/	DIVISION DOWN	RD REFR	ROOF DRAIN REFRIGERANT
)	DIFFERENTIAL PRESSURE SENSOR	REQ	REQUIRED
'S 'T	DIFFERENTIAL PRESSURE SWITCH DIFFERENTIAL PRESSURE TRANSMITTER	RH	
Ľ	DETAIL	RLA RM	RUNNING LOAD AMPS ROOM
VG(S)		RND	ROUND
T	EXHAUST AIR OR EACH (PER CONTEXT) ENTERING AIR TEMPERATURE	RPM SA	REVOLUTIONS PER MINUTE SUPPLY AIR
R	ENERGY EFFICIENT RATIO	SAN	SANITARY
F EC	EFFICIENCY ELECTRIC	SEC'N SEER	SECTION SEASONAL ENERGY EFFICIENCY RATIO
EV	ELEVATION	SENS	SENSIBLE
) P	EQUAL EXTERNAL STATIC PRESSURE	SF SH	SQUARE FOOT SENSIBLE HEAT
/B	ENTERING AIR WET BULB TEMPERATURE	SHT	SENSIBLE HEAT SHEET
/T H	ENTERING WATER TEMPERATURE EXHAUST	SND	SOUND
IST, EX	EXISTING	SOL SP	SOLENOID STATIC PRESSURE
T	EXTERNAL	SPD	STATIC PRESSURE DIFFERENTIAL
т	FAHRENHEIT FLOAT AND THERMOSTATIC	SPT SQ	STATIC PRESSURE TRANSMITTER SQUARE
	FLEXIBLE CONNECTION	SST	STAINLESS STEEL
С	FLOOR DRAIN FIRE DEPARTMENT CONNECTION	STL STM	STEEL STEAM
1	FINISHED	T&P	TEMPERATURE AND PRESSURE
२ F	FLOOR FINS PER FOOT	TC TD	
М	FEET PER MINUTE	TD	THERMODYNAMIC OR TEMPERATURE DIFFERENTIAL (PER CONTEXT)
	FLOW SWITCH	TDH	TOTAL DYNAMIC HEAD
-HD	FEET HEAD IN FEET	TEMP TOT	TEMPERATURE TOTAL
1	GAUGE	TPD	TOTAL PRESSURE DROP
L LV	GALLONS GALVANIZED	TSP TYP	TOTAL STATIC PRESSURE TYPICAL
	GENERAL CONTRACTOR	UC	UNDERCUT DOOR
'H 'M	GALLONS PER HOUR GALLONS PER MINUTE	UG	
VI	HEIGHT	UNO V	UNLESS NOTED OTHERWISE VOLTS
	HEAD	VAC	VACUUM
V RIZ	HOSE END VALVE HORIZONTAL	VD VEL	VOLUME DAMPER (MANUAL) VELOCITY
)	HORSEPOWER	VERT	VERTICAL
G		VFD	VARIABLE FREQUENCY DRIVE
G AC	HEATING DUCT (HOT DECK) HEATING, VENTILATING & AIR	VOL VTR	VOLUME VENT THRU ROOF
	CONDITIONING	W	WATT OR WIDTH (PER CONTEXT)
1	HOT WATER HERTZ	W/ W/O	WITH WITHOUT
	INVERTED BUCKET	WB	WET BULB
		WC	WATER COLUMN
DIC	INCH/INCHES INDICATOR	WG WPD	WATER GAUGE WATER PRESSURE DIFFERENTIAL
V	INTEGRATED PART-LOAD VALUE	WT	WEIGHT

MECH EQUIPMENT DESIGNATION

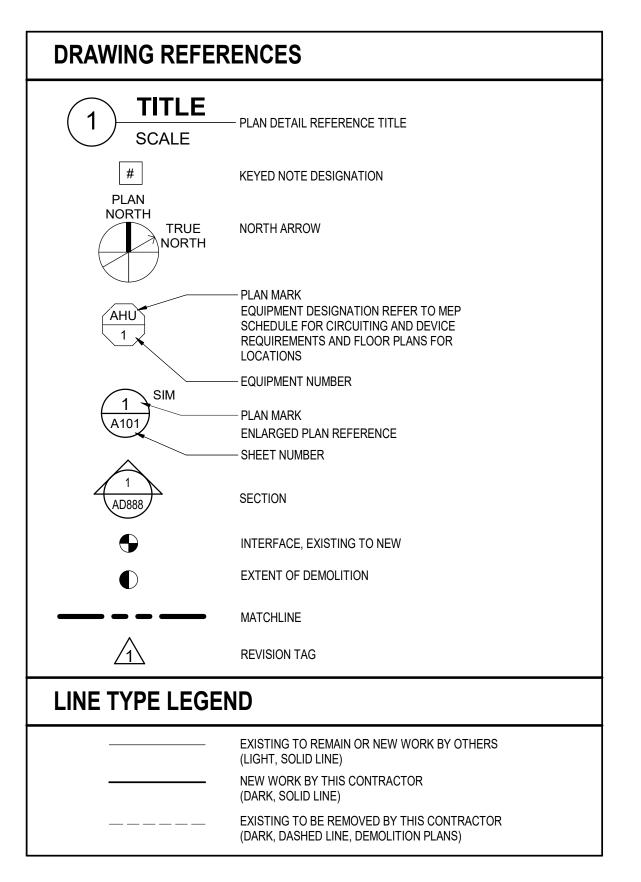MECH EQUIPMENT DESIGNATION EF EXHAUST FAN

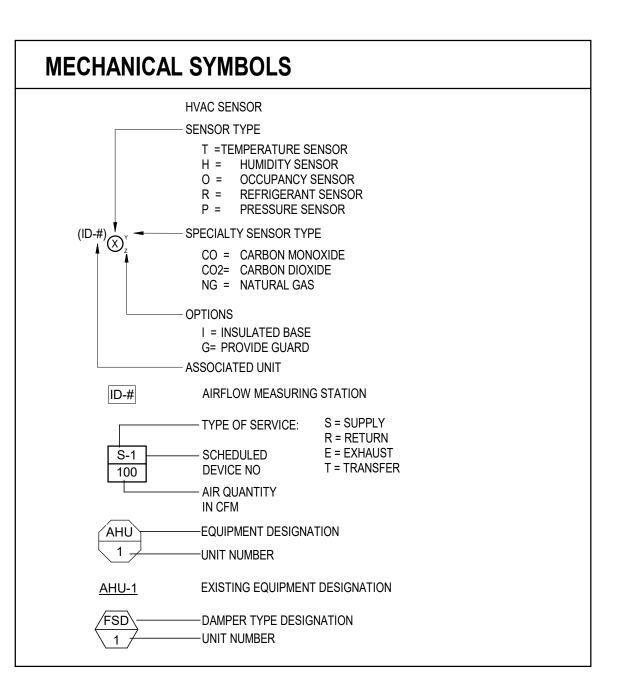

MECHANICAL PROJECT GENERAL NOTES

- 1. ALL ELBOWS, FITTINGS, ETC., IN DUCTWORK REQUIRED TO CLEAR ALL JOB OBSTRUCTIONS ARE NOT NECESSARILY INDICATED. ALL NECESSARY TRANSITIONS, FITTINGS AND OFFSETS ARE REQUIRED WHETHER SHOWN OR NOT.
- 2. BECAUSE OF THE LIMITED SPACE AVAILABLE TO INSTALL ALL OF THE MECHANICAL WORK, COORDINATION BETWEEN THE VARIOUS TRADES IS OF THE UTMOST IMPORTANCE. SEE SPECIFICATION 230100 FOR REQUIRED COORDINATION DRAWINGS.
- 3. THE CONTRACTOR SHALL COORDINATE STAGING AND SCHEDULING WITH THE OWNER'S REPRESENTATIVE.
- 4. EXISTING CONDITIONS ARE BASED ON INFORMATION OBTAINED FROM PREVIOUS CONSTRUCTION DOCUMENTS AND INFORMAL FIELD OBSERVATION AND SHALL NOT BE CONSTITUTED AS "AS BUILT." THE CONTRACTOR SHALL FIELD-VERIFY EXISTING CONDITIONS BEFORE THE ONSET OF CONSTRUCTION.
- 5. DEMOLISH ALL DUCTWORK EQUIPMENT, ETC., SHOWN TO BE REMOVED, IN ITS ENTIRETY, INCLUDING ALL HANGERS AND SUPPORTS.
- 6. WHERE CONTRACTOR IS REQUIRED TO CONCEAL NEW WORK, REMOVE OR MODIFY EXISTING CONSTRUCTION OR EQUIPMENT, OR ATTACH TO EXISTING CONSTRUCTION, THE CONTRACTOR SHALL REPAIR OR REPLACE EXISTING CONSTRUCTION AND MATERIALS TO MATCH CONDITIONS AT THE ONSET OF CONSTRUCTION. IT IS THE CONTRACTOR'S RESPONSIBILITY TO REMOVE AND REPLACE EXISTING CEILINGS AND WALLS REQUIRED FOR INSTALLATION OF MECHANICAL SYSTEMS.
- 7. THE OWNER SHALL MAINTAIN ALL SALVAGE RIGHTS OF EQUIPMENT AND MATERIALS REMOVED. ALL EQUIPMENT AND MATERIALS NOT CLAIMED BY THE OWNER SHALL BE REMOVED FROM THE PREMISES BY THIS CONTRACTOR.
- 8. CONTRACTOR SHALL PROVIDE SEISMIC BRACING AND MOUNTING OF EQUIPMENT AND MATERIALS IN COMPLIANCE WITH ALL LOCAL CODE REQUIREMENTS AND THE REQUIREMENTS OF SPECIFICATION SECTION SEISMIC PROTECTION.
- 9. ALL WORK SHALL BE INSTALLED PER THE REFERENCE DETAILS, REGARDLESS OF WHETHER OR NOT THE DETAILS ARE CALLED OUT ON THE PLANS.

MECHANICAL EQUIPMENT COMPO RISK CATEGORY (II) ANCHORAGE TO SWAY BI FLOORS, ROOFS, ETC LISTING OF EQUIPMENT AND PROVIDED PROVIDED NOT NOT SYSTEM COMPONENTS PROVIDED FOR FOR PROJECT PROJECT PROJECT AIR TERMINAL UNITS (lp = 1.0) DUCTWORK (Ip = 1.0) FAN (lp = 1.0)PIPE (lp = 1.0)

IT IS THE BASIC INTENT OF THIS CODE BLOCK TO DECLARE WHETHER OR NOT ANCHORAGE AND SWAY BRACING IS BEING PROVIDED ON THE PROJECT. IF SO, TO DECLARE WHETHER OR NOT THE DETAILS ARE SHOWN ON THE PLANS OR WILL BE SHOWN ON A SUBSEQUENT SUBMISSION. IF SEISMIC RESTRAINT OF A COMPONENT IS NOT REQUIRED BY CODE THIS SHOULD BE STATED IN COMMENTS. IF SEISMIC RESTRAINT, WHICH IS NOT REQUIRED BY CODE, IS BEING PROVIDED DUE TO OWNER/DESIGNER REQUIREMENTS THIS SHOULD BE STATED IN COMMENTS.

PLANS SIGNED AND SEALED BY A MISSOURI PROFESSIONAL ENGINEER NEED TO BE SUBMITTED.

COMMON PIPING SYMBOLS & ABBREVIATIONS

NOT ALL SYMBOLS ARE USED FOR THIS PROJECT

AFF	ABOVE FINISH FLOOR
DIA	DIAMETER
DN	DOWN
EX OR EXIST	EXISTING
FFE	FINISHED FLOOR ELEVATION
HP	HORSEPOWER
NTS	NOT TO SCALE
PSI	POUNDS PER SQUARE INCH
RPM	REVOLUTIONS PER MINUTE
VIF	VERIFY IN FIELD

10. DO NOT SCALE THE LOCATION OF HVAC CEILING ELEMENTS, SUCH AS AIR INLETS AND OUTLETS, FROM THE M-SERIES DRAWINGS. SEE ARCHITECTURAL REFLECTED CEILING PLANS FOR EXACT HVAC CEILING ELEMENT LOCATIONS. REFLECTED CEILING PLANS GOVERN THE LOCATION OF DIFFUSERS, REGISTERS, AND GRILLES. M-SERIES DRAWINGS GOVERN TYPE, STYLE, AND SIZE OF DIFFUSERS, REGISTERS, AND GRILLES.

11. ALL DUCTWORK SHALL COMPLY WITH "HVAC DUCT CONSTRUCTION STANDARDS -METAL AND FLEXIBLE," 3RD EDITION, SMACNA 2005, EXCEPT WHERE MORE RESTRICTIVE REQUIREMENTS ARE SPECIFIED. ANY PLAN REFERENCES TO "SMACNA FIGURE --- " REFERS TO THIS STANDARD. SEE SPECIFICATIONS FOR SCHEDULE OF DUCT PRESSURE CLASS AND SEAL CLASS.

12. IN GENERAL, THE FINAL FLEX DUCT RUNOUT TO EACH DIFFUSER, REGISTER, OR GRILLE IS NOT SIZED ON PLANS. FLEX DUCT RUNOUT SIZE SHALL MATCH AIR OUTLET NECK SIZE, UNO.

13. IT IS THE INTENT OF THESE DRAWINGS THAT A MANUAL BALANCING DAMPER BE PROVIDED AT EVERY INDIVIDUAL DUCTED CONNECTION TO AN AIR DEVICE, UNLESS A BALANCING DAMPER IS SCHEDULED TO BE FURNISHED WITH AIR DEVICE.

14. ALL NEW DUCTWORK SIZES SHOWN ON PLANS ARE CLEAR INSIDE DIMENSIONS. CONTRACTOR SHALL ADJUST SHEET METAL SIZES AS NECESSARY TO ACCOMMODATE INTERNAL DUCT LINER, IF SPECIFIED.

15. CONTRACTOR SHALL HAVE THE DOCUMENTS REVIEWED COMPLETELY BY A CERTIFIED BALANCING CONTRACTOR FOR THE INCLUSION OF THE NECESSARY ADDITIONAL AIR AND HYDRONIC SYSTEM BALANCING DEVICES NOT SHOWN IN THESE DOCUMENTS FOR COMPLETE HVAC SYSTEM BALANCING. REFER TO SPECIFICATION SECTION 230593 FOR CONSTRUCTION DOCUMENT EXAMINATION REPORT.

16. IT SHOULD BE NOTED THAT SOME SYSTEMS (I.E. GENERAL AND ISOLATION EXHAUST) ARE REQUIRED TO BE BALANCED MORE THAN ONCE TO ASSURE DESIGN AIRFLOWS ARE PROVIDED.

17. THESE PLANS ARE DIAGRAMMATIC IN NATURE. THE CONTRACTOR SHALL BE PREPARED TO MAKE SOME ALTERATIONS TO THE EXACT LOCATION OF DUCTWORK, PIPING AND EQUIPMENT FROM THE LOCATION INDICATED ON THESE DRAWINGS TO FIT ACTUAL JOB CONDITIONS.

NENTS E	EARTHQUAKE LO	DAD RESISTANCE	
		SEISMIC DESIG	N CATEGORY (D
RACING		FESSIONALLY SEALED WAY BRACING DETAILS	
PROVIDED FOR PROJECT	ON CONSTRUCTION DOCUMENTS: DRAWING # OR SPEC SECTION	SUBSEQUENT SUBMITTAL: SEPARATE PERMIT & PLANS	COMMENTS

STATE OF MISSOURI MIKE KEHOE, GOVERNOR

ARCHITECTURE & ENGINEERING



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JULIE ANN COULTER E-029040

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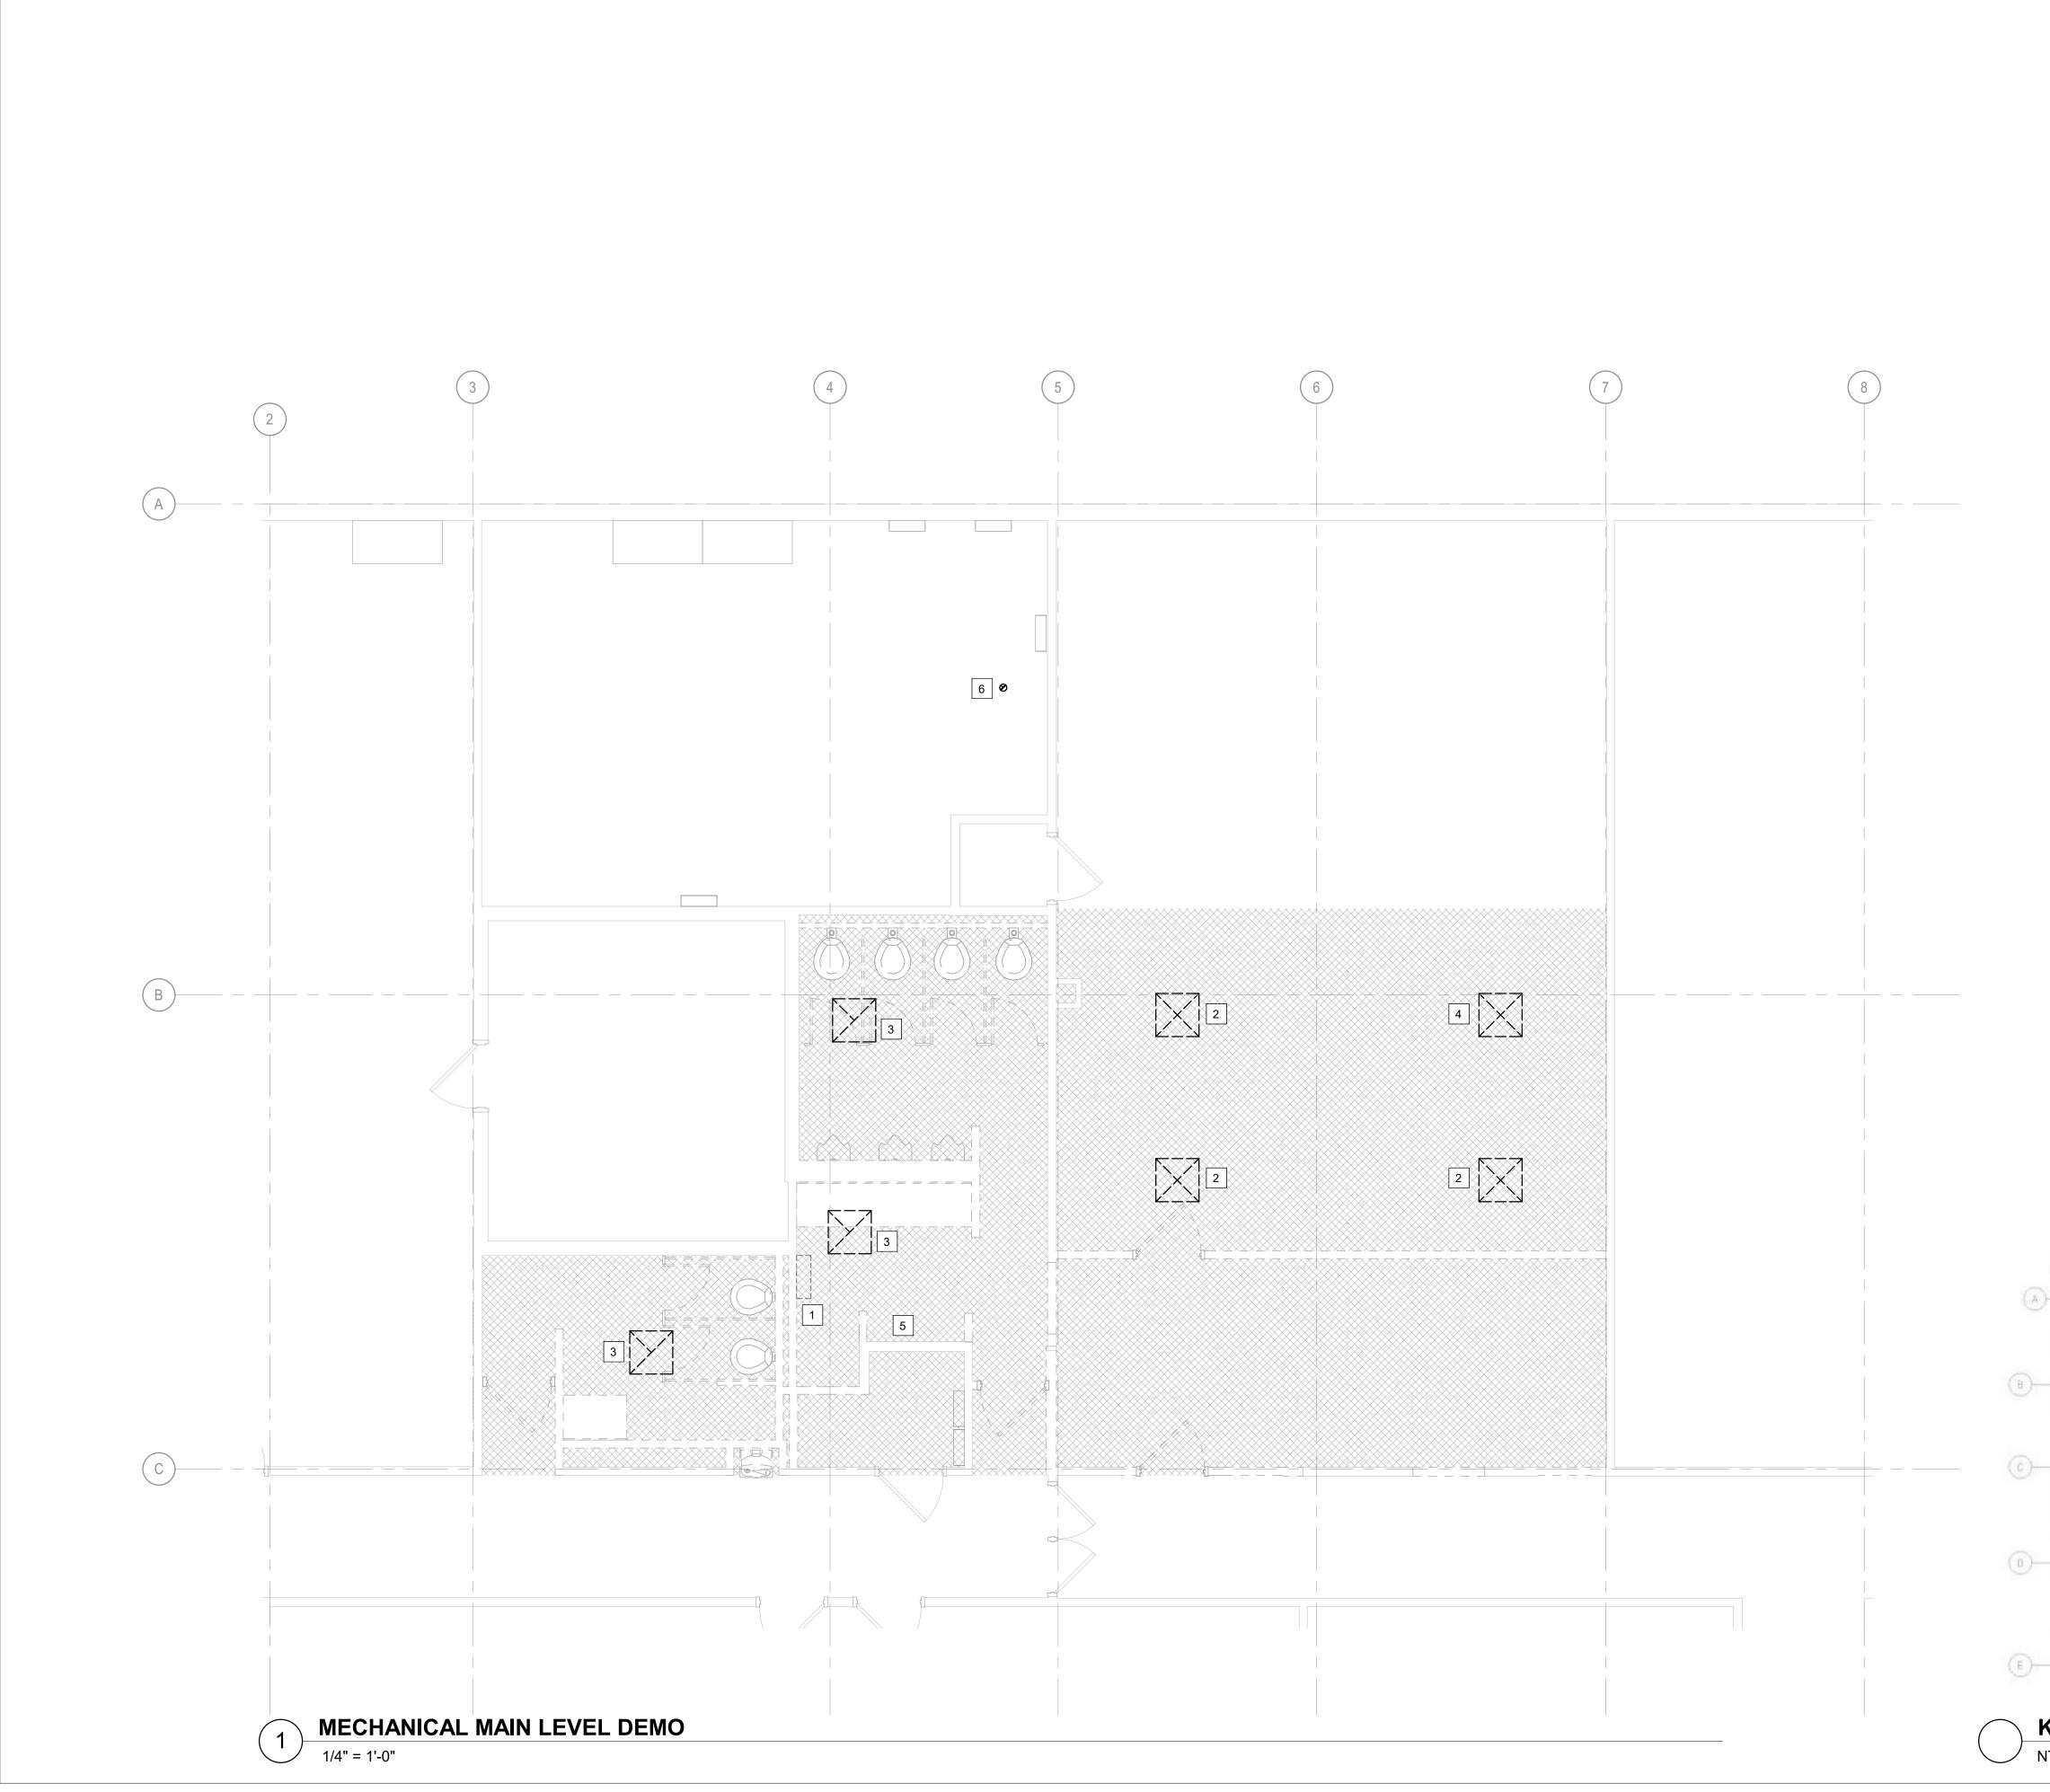
CAD DWG FILE: DRAWN BY: JAC CHECKED BY: MLW DESIGNED BY: JAC

SHEET TITLE: MECHANICAL SYMBOLS & ABBREVIATIONS

SHEET NUMBER:



SHEET 18 OF 31



#	SHEET KEYNOTES
1	REMOVE EXISTING WALL MOUNTED HEATER.
2	REMOVE EXISTING SUPPLY AIR DIFFUSER AND FLEX DUCTWORK TO MAIN. REUSE CONNECTION AT MAIN FOR NEW WORK.
3	REMOVE EXISTING EXHAUST AIR DIFFUSERS AND DUCTWORK TO EXHAUST FAN.
4	REMOVE EXISTING SUPPLY AIR DIFFUSER AND FLEX DUCTWORK TO MAIN. CAP AT MAIN.
5	REMOVE EXISTING EXHAUST FAN ON ROOF IN THIS LOCATION. REUSE EXISTING HOLE THROUGH ROOF FOR NEW FAN DUCTWORK.
6	REMOVE EXISTING WATER HEATER VENT PIPING FROM HEATER THROUGH ROOF. REUSE EXISTING HOLE THROUGH ROOF FOR NEW WATER HEATER VENT.



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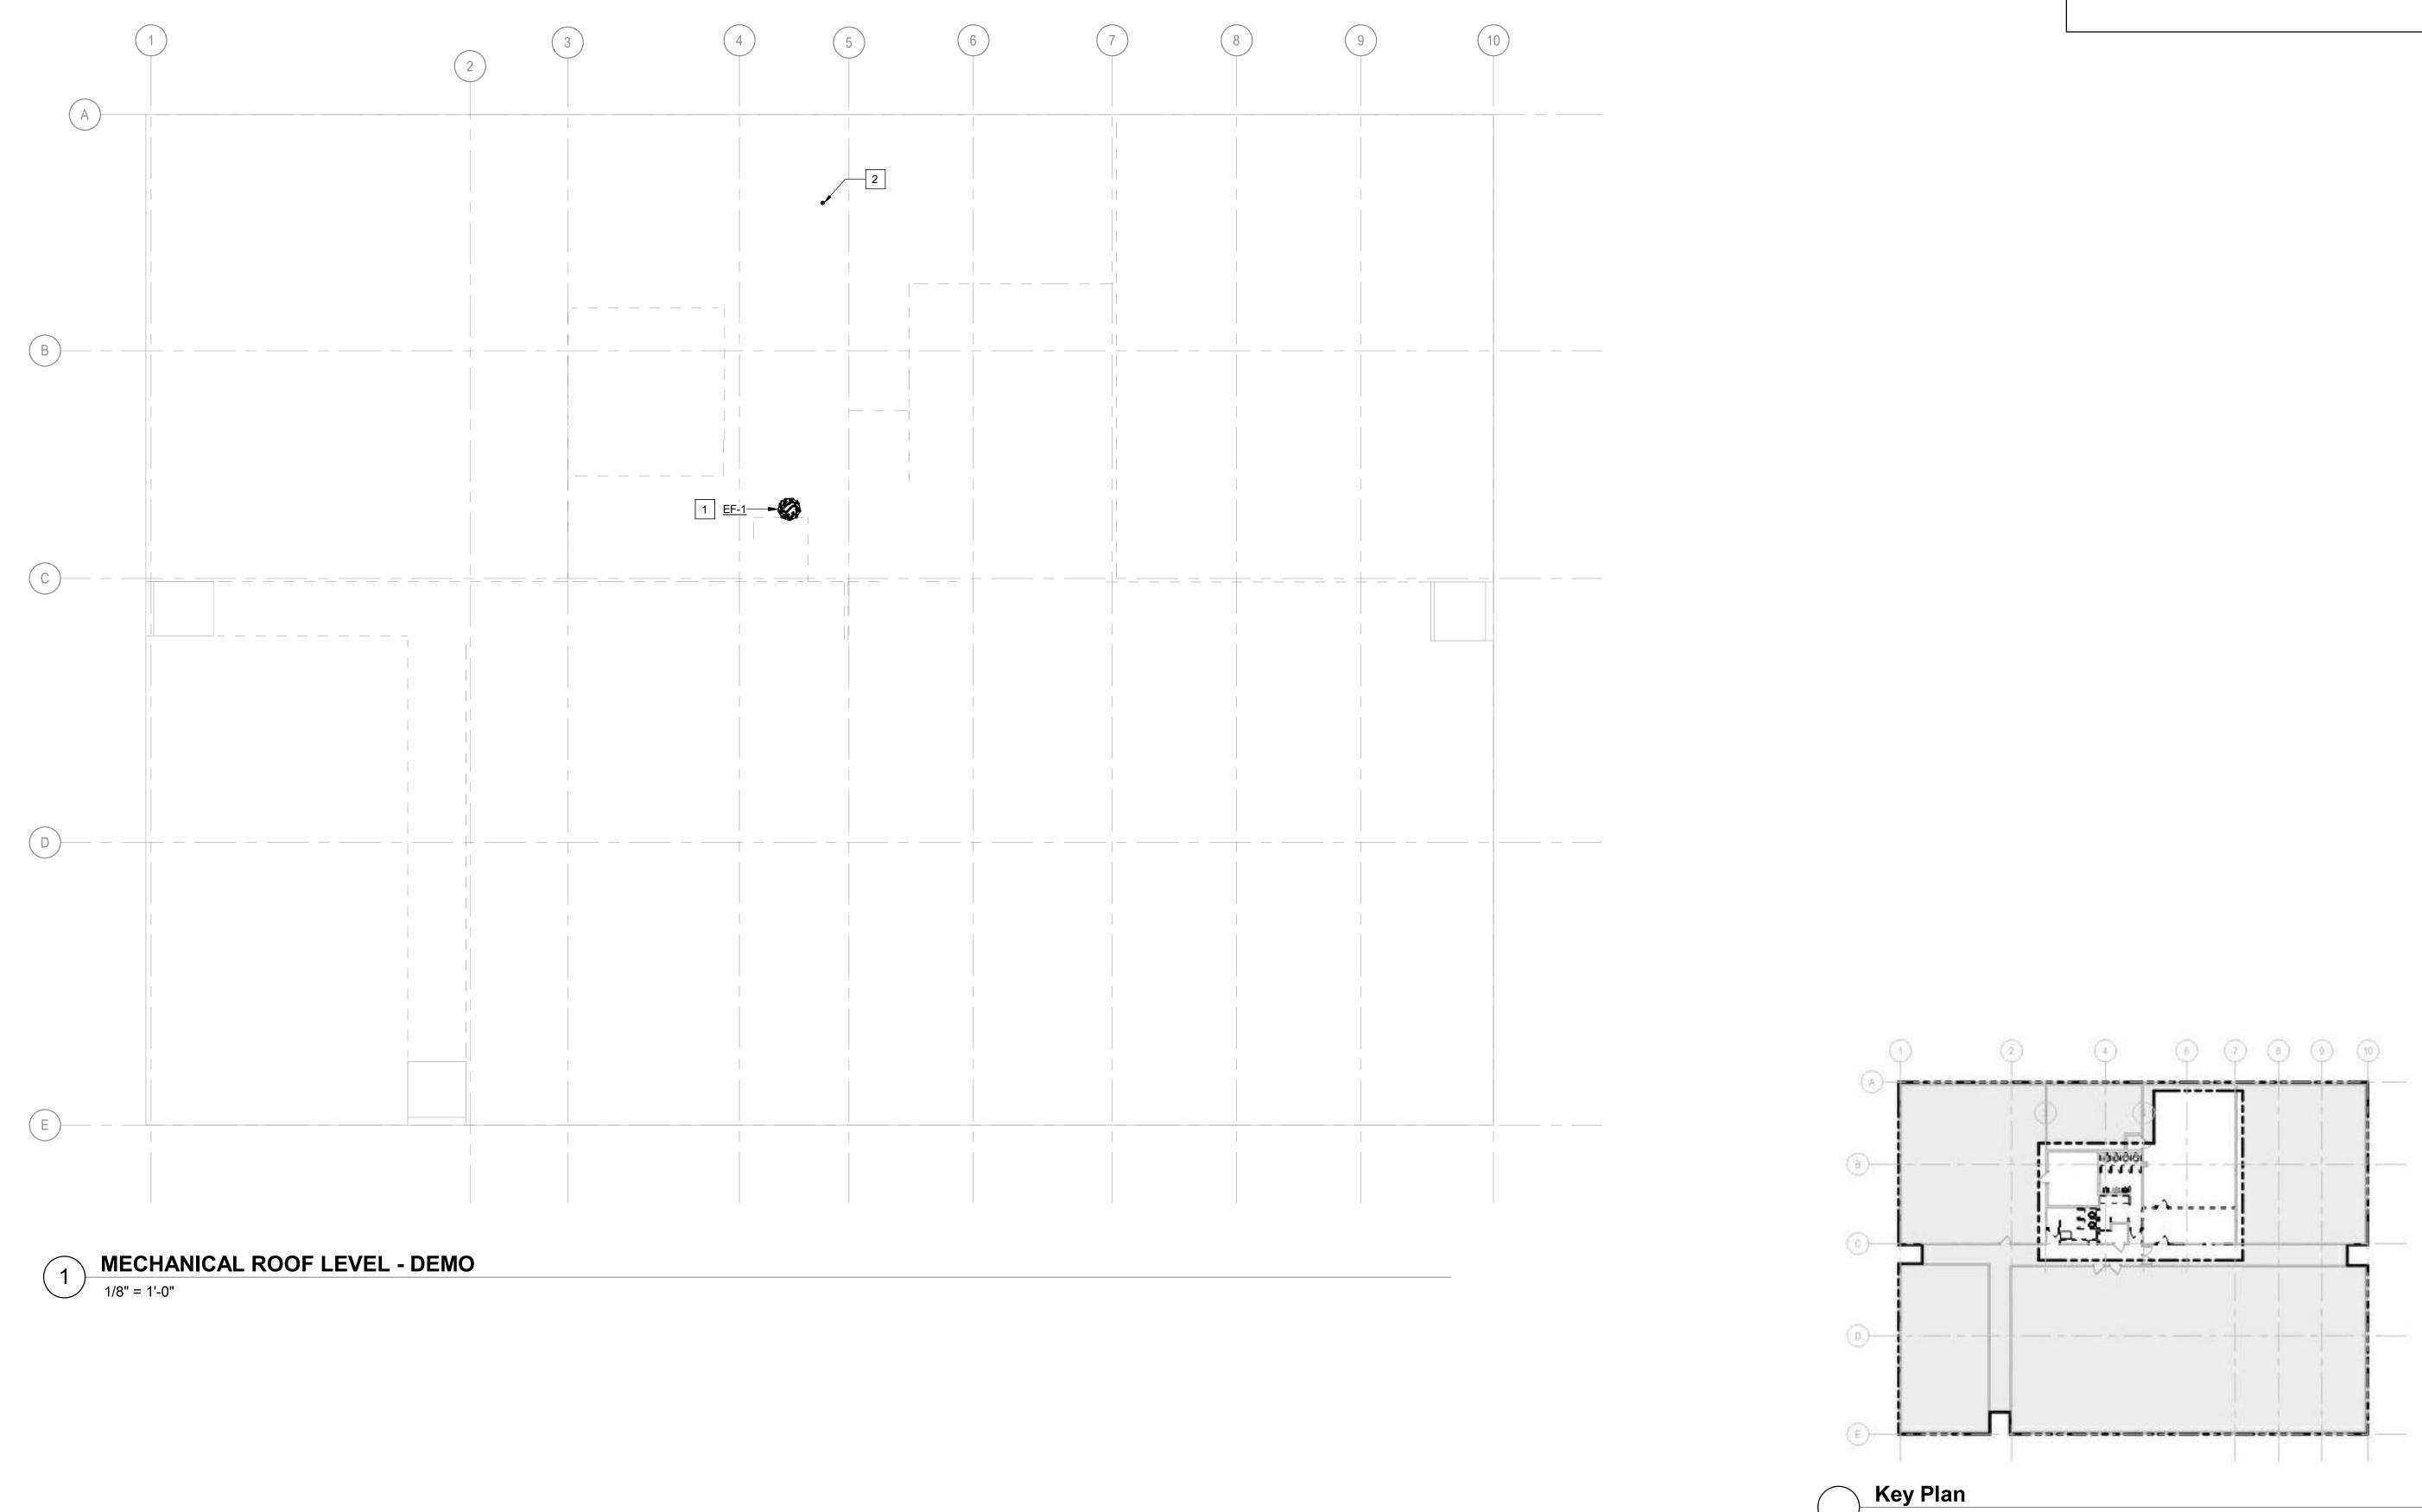
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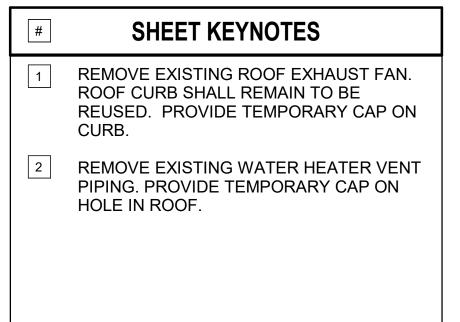
CAD DWG FILE: DRAWN BY: JAC CHECKED BY: MLW DESIGNED BY: JAC SHEET TITLE: MECHANICAL FLOOR

MECHANICAL FLOOR PLANS - DEMO

SHEET NUMBER:










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JULIE ANN COULTER E-029040



OFFICE OF ADMINISTRATION **DIVISION OF FACILITIES** MANAGEMENT, **DESIGN AND** CONSTRUCTION

MISSOURI ARMY NATIONAL GUARD

Latrines & Shower Renovations, Building 233

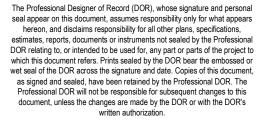St. Louis Lambert Readiness Center

10800 Lambert International Rd.

Bridgeton, MO 63044

PROJECT #	T2417-01
SITE #	6280
ASSET #	8136280000

REVISION: DATE: REVISION: DATE: REVISION: DATE: ISSUE DATE: 4-16-2025


CAD DWG FILE: DRAWN BY: JAC CHECKED BY: MLW DESIGNED BY: JAC SHEET TITLE: MECHANICAL ROOF

PLAN - DEMO

SHEET NUMBER:

M102

4-16-2025

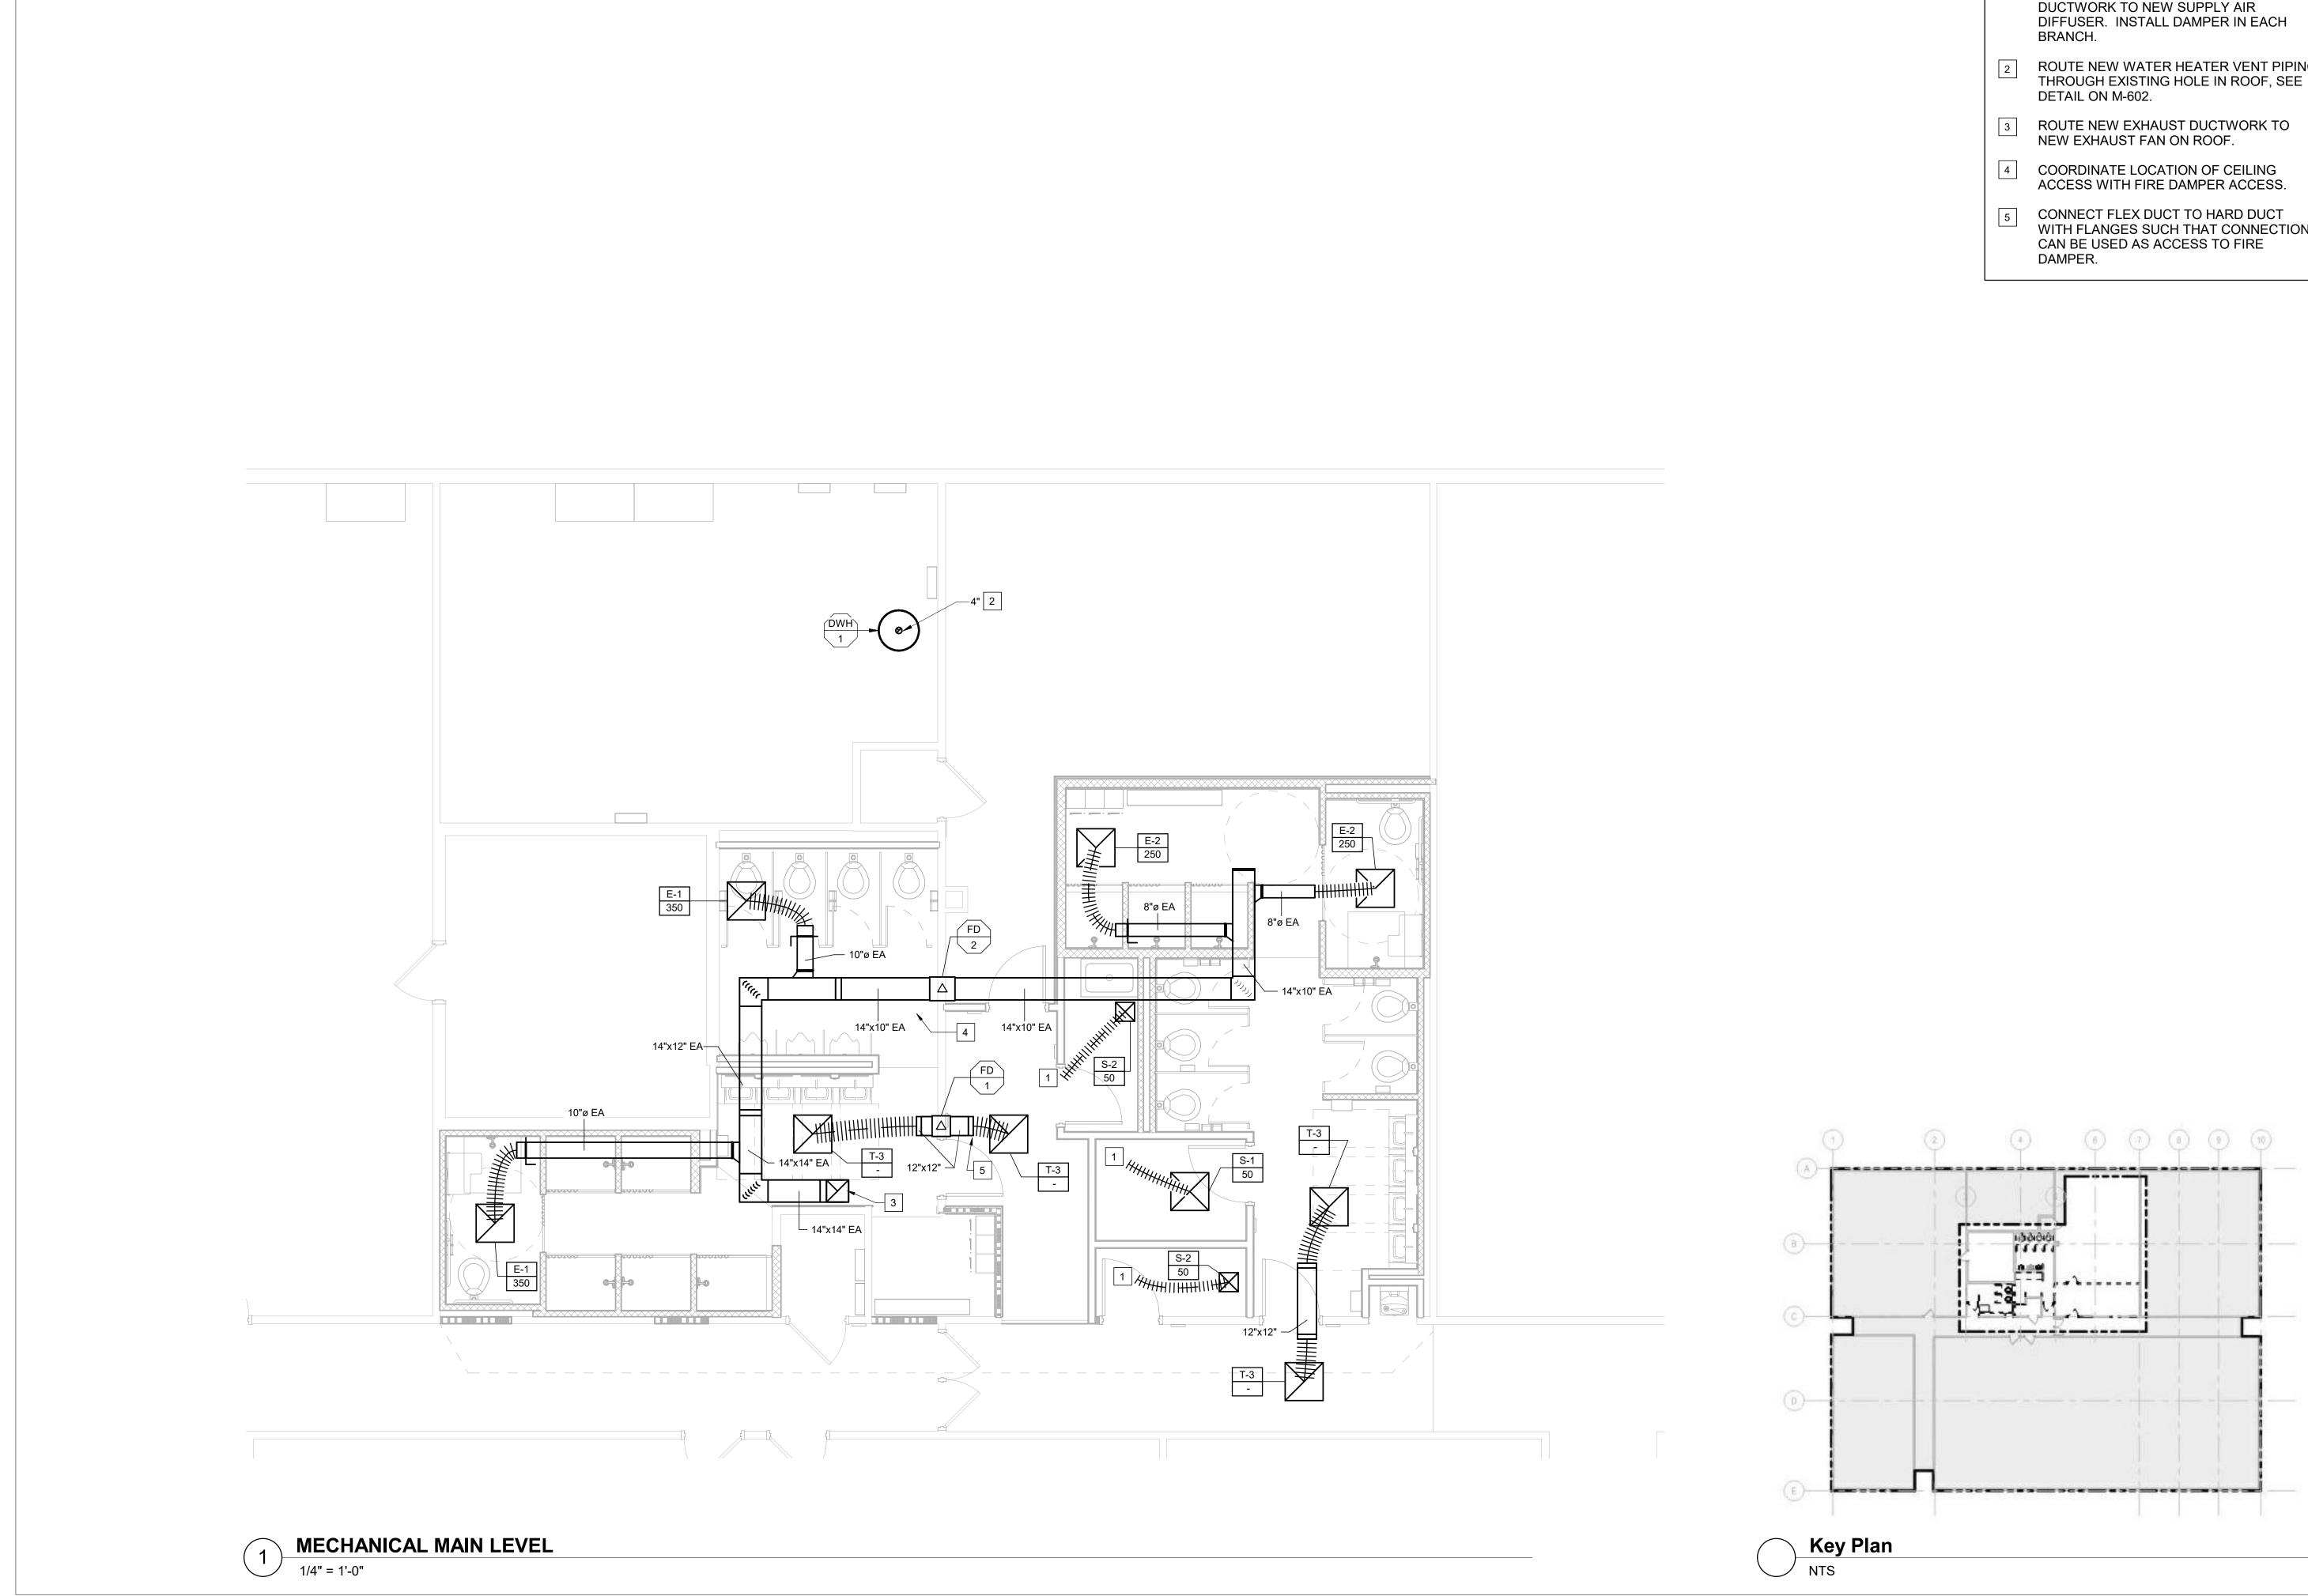

#	SHEET KEYNOTES
1	MODIFY EXISTING TAP LEFT FROM DEMOLITION WORK AND ROUTE 6" DUCTWORK TO NEW SUPPLY AIR DIFFUSER. INSTALL DAMPER IN EACH BRANCH.
2	ROUTE NEW WATER HEATER VENT PIPING THROUGH EXISTING HOLE IN ROOF, SEE DETAIL ON M-602.
3	ROUTE NEW EXHAUST DUCTWORK TO NEW EXHAUST FAN ON ROOF.
4	COORDINATE LOCATION OF CEILING ACCESS WITH FIRE DAMPER ACCESS.
5	CONNECT FLEX DUCT TO HARD DUCT WITH FLANGES SUCH THAT CONNECTION CAN BE USED AS ACCESS TO FIRE DAMPER.



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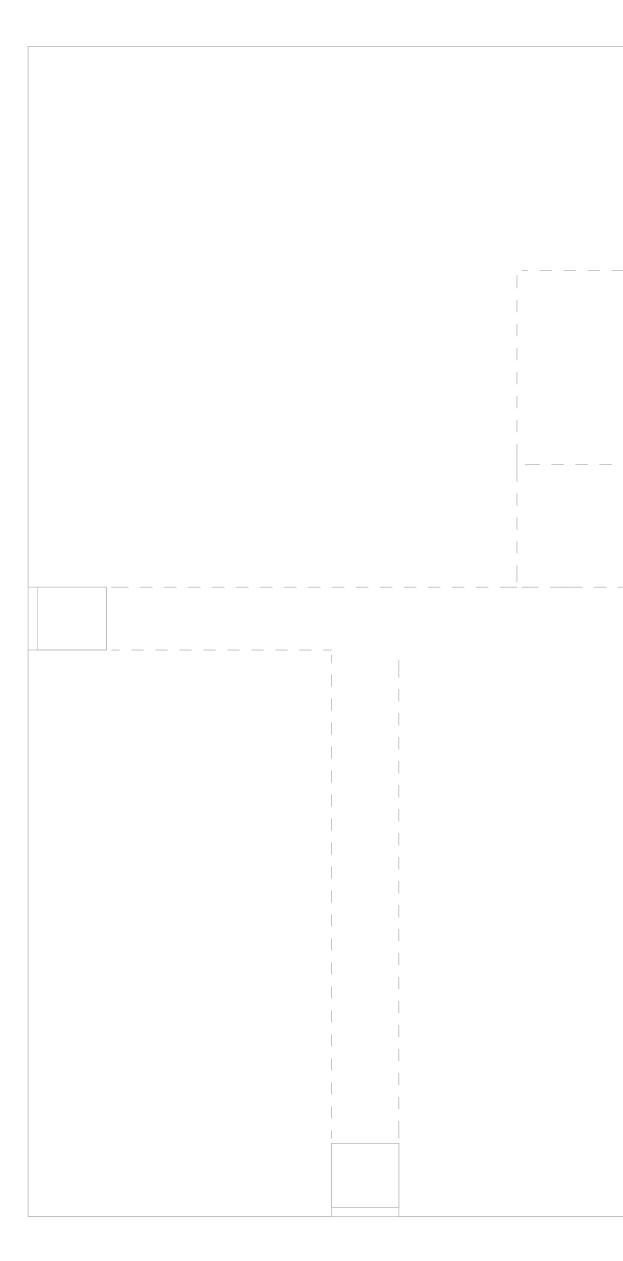
MECHANICAL FLOOR PLANS - NEW WORK

SHEET NUMBER:




4-16-2025

SHEET 21 OF 31






MECHANICAL ROOF LEVEL - NEW WORK 1/8" = 1'-0"

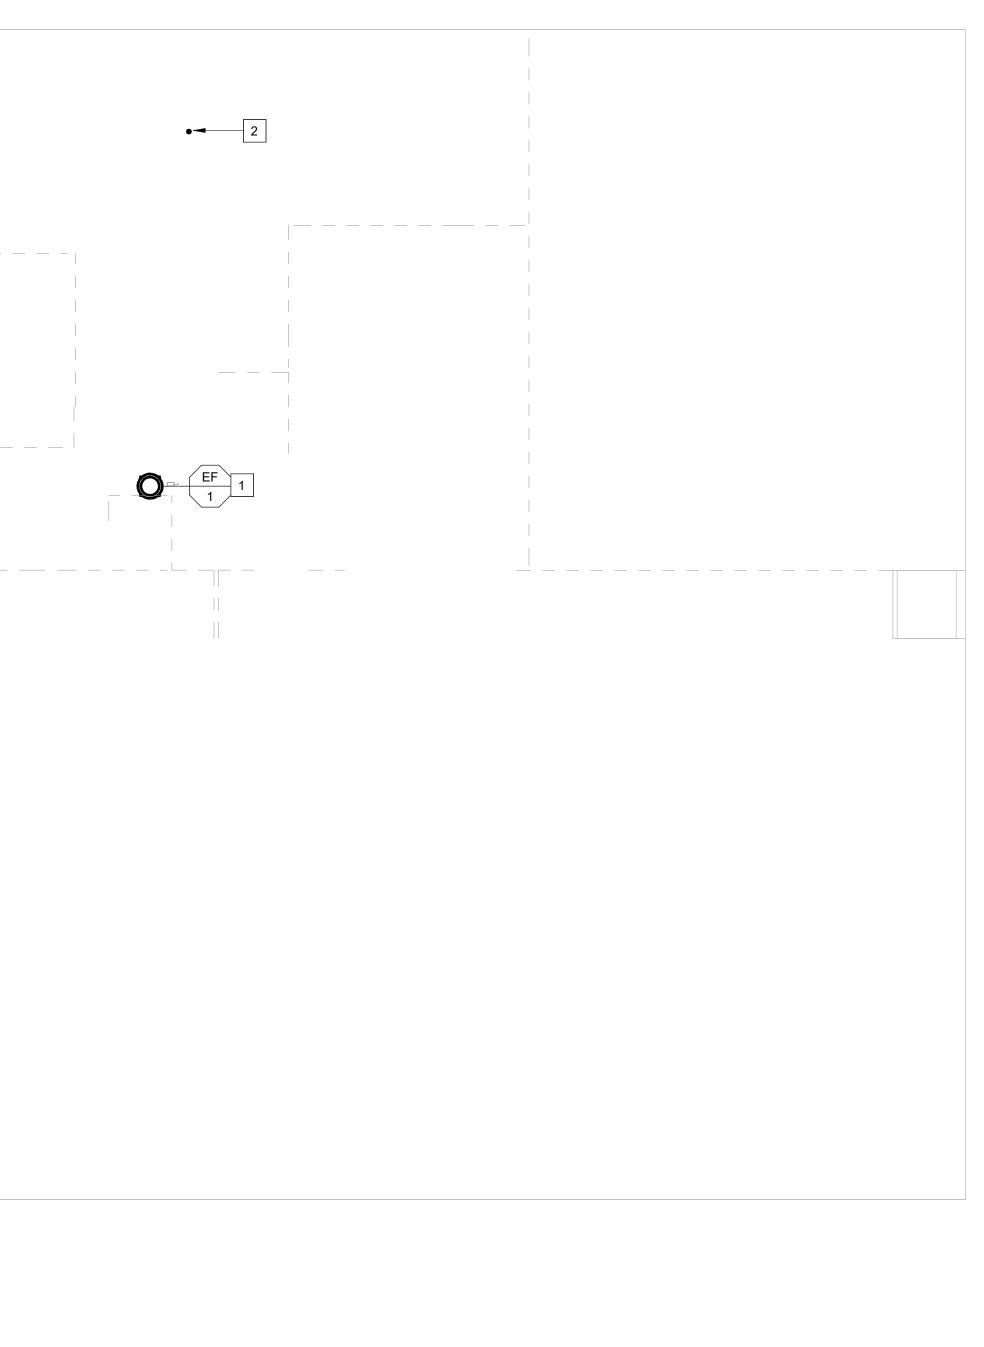

0-0-

(a)--

(E)-

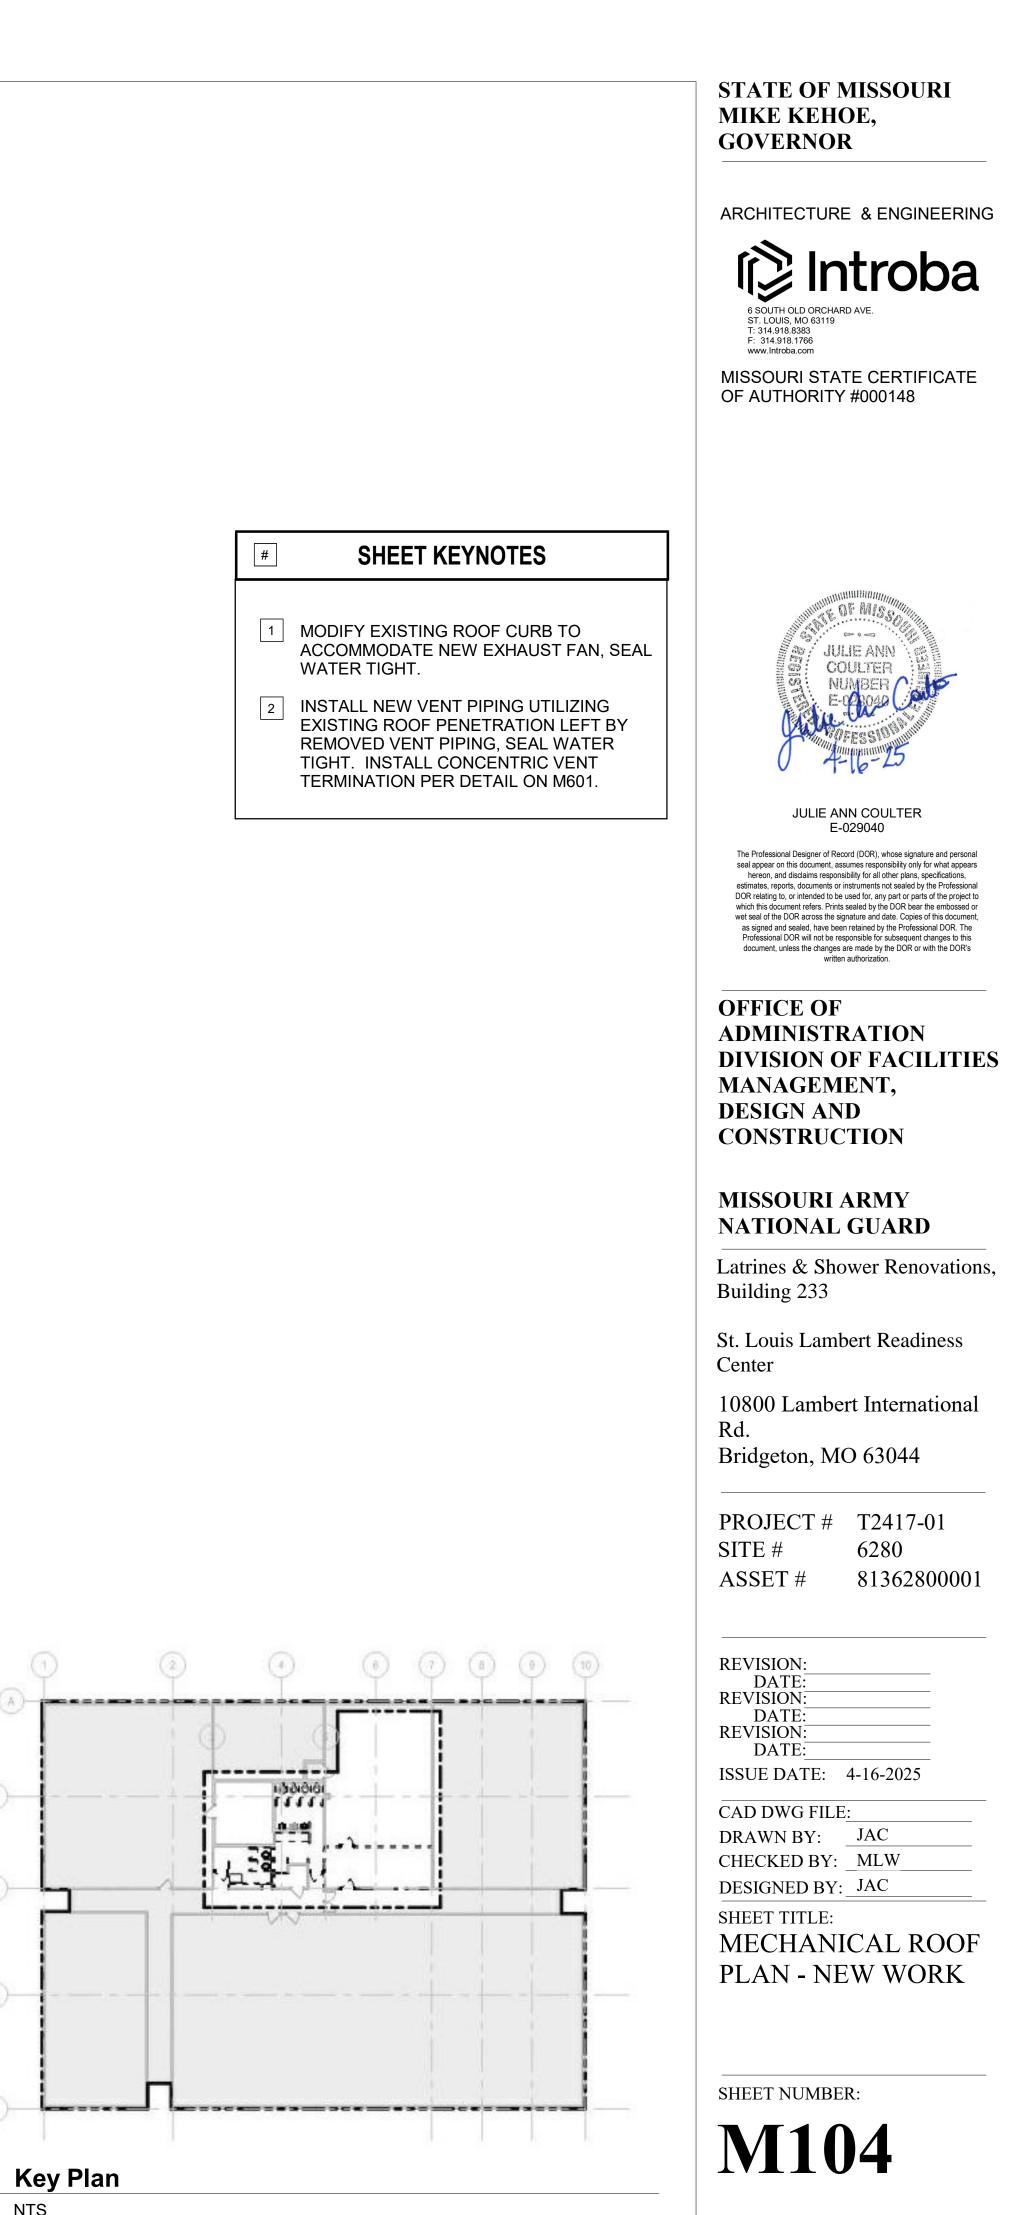

NTS

 $(\overline{1})$

4-16-2025

NOTES 1. 2.	<u>:</u> SOUN PROV	
MA	RK	
ID	#	
EF	1	

					AIR DE\	/ICE SCH	HEDUL	E					
<u>NOTE</u> 1. 2. 3. 4.	COC PRO PRO	VIDE WITH ACC	ESSORIES AS LI	I ARCHITECTURAL PLANS. STED IN THE SPECIFICATIONS ARE TO ROUND ADAPTER TO / IG DAMPER.		SCHEDULED NEC	K SIZE.						
MA	RK	MED	MODEL	7.05		050)//05	NECK	FACE SIZE		FINIOLI	MAX TPD	MAX	NOTEO
ID	#	MFR.	MODEL	TYPE	LOCATION	SERVICE	SIZE (IN)	(IN x IN)	MATERIAL	FINISH	(IN WC)	NOISE (NC)	NOTES
S	1	TITUS	OMNI	SQUARE PLAQUE	CEILING	SUPPLY AIR	6	24x24	ALUMINUM	WHITE	0.1	30	1, 2, 4
S	2	TITUS	OMNI	SQUARE PLAQUE	CEILING	SUPPLY AIR	6	12x12	ALUMINUM	WHITE	0.1	30	1, 2, 4
												•	
Е	1	TITUS	OMNI	SQUARE PLAQUE	CEILING	EXHAUST AIR	10	24x24	ALUMINUM	WHITE	0.1	30	1, 2, 4
E	2	TITUS	OMNI	SQUARE PLAQUE	CEILING	EXHAUST AIR	8	24x24	ALUMINUM	WHITE	0.1	30	1, 2, 4
Т	3	TITUS	OMNI	SQUARE PLAQUE	CEILING	TRANSFER AIR	12	24x24	ALUMINUM	WHITE	0.1	30	1, 2

EXHAUST FAN SCHEDULE

ID POWER LEVEL RATINGS SHOWN IN DECIBELS, REFERRED TO 10(-12) WATTS CALCULATED PER AMCA STANDARD 301. IDE GRAVITY BACKDRAFT DAMPER.

MFR.	MODEL	LOCATION	SERVICE	DRIVE	AIRFLOW (CFM)	ESP (IN WC)	MAX FAN SPEED (RPM)	MIN WHEEL DIA (IN)	MIN STATIC EFF (%)		MAX SOUND POWER RA OCTAVE			NG	
									LII (70)	63	125	250	500	1000	20
GREENHECK	G-120-VG	ROOF	RESTROOM VENTILATION	DIRECT	1200	0.5	1269	13	49	69	74	75	69	61	6

				FIRE	DAMPE	R SCHE	DULE			
<u>NOT</u> 1.	165° F H	EAT ACTUATED) CLOSURE DEVI	ICE. UNLESS NC	DTED OTHERWIS	SE				
MA		MFR.	MODEL	TYPE	LOCATION	ORIENTATION	DUCT SIZE		FUSIBLE LINK	NOTES
ID	#						WxH (IN)	RATINGS (HR)	TEMP (°F)	
FD	1	RUSKIN	DIBD2SS	DYNAMIC	MENS RESTROOM WALL	VERTICAL	12 x 12	1.5	165	1
FD	2	RUSKIN	DIBD2SS	DYNAMIC	MENS RESTROOM WALL	VERTICAL	14 x 10	1.5	165	1

SYSTEM DESCRIPTION BACKDRAFT DAMPER.


> FOR THESE 5 ZONES: 2 - MENS RESTROOM 2 - WOMENS RESTROOM 1 - LACTATION ROOM

<u>EXHAUST FAN STOP:</u> THE LIGHTS ARE SET TO TURN OFF AFTER 15 MINUTES OF NO OCCUPANCY. THE EXHAUST FAN SHALL STOP WHEN ALL 5 ZONES INDICATE ALL LIGHTS ARE OFF.



NOT TO SCALE

<u>c /INI</u>			1	ſ			TA	1
G (INL	ET)		MAX WEIGHT	E	ELECTR		TA	
G (INL	•		MAX WEIGHT					NOTES
-	ET) 4000	8000	MAX WEIGHT (LBS)	E MCA	ELECTR	RICAL DA	TA PHASE	NOTES
G (INL 2000 60	•	8000 53						
2000	4000		(LBS)		HP	VOLTS	PHASE	NOTES 1,2

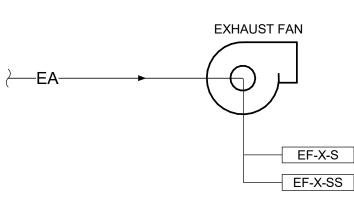

THE SYSTEM CONSISTS OF A CONSTANT VOLUME EXHAUST FAN AND A

EXHAUST FAN START: A CONTACT SHALL BE PROVIDED WITH THE LIGHTING TO NOTIFY THE EXHAUST FAN OF LIGHT STATUS. CONTACTS ARE PROVIDED

A LIGHT SWITCH ACTIVATING A LIGHT TO COME ON IN ANY OF THE 5 ZONES SHALL START THE EXHAUST FAN.

NOTE: REFER TO ELECTRICAL DRAWINGS FOR ADDITIONAL INFORMATION.


EXHAUST FAN (EF-1) CONTROL DIAGRAM

STATE OF MISSOURI MIKE KEHOE, GOVERNOR

ARCHITECTURE & ENGINEERING




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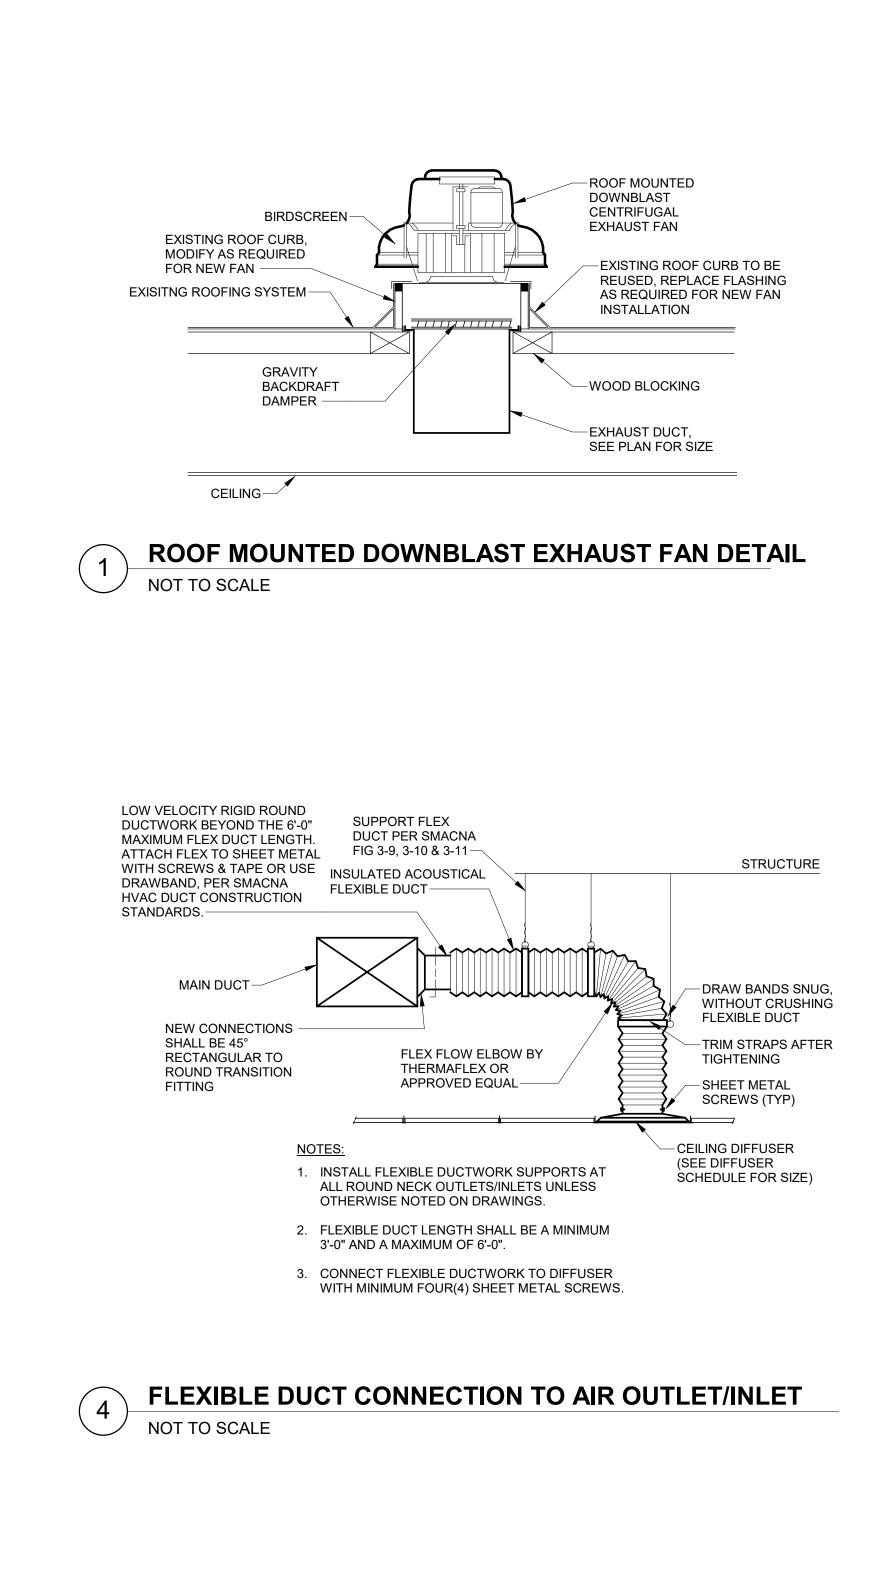
REVISION: DATE: REVISION: DATE: REVISION: DATE: ISSUE DATE: 4-16-2025

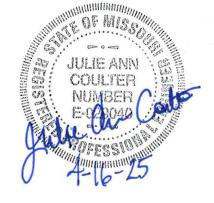
CAD DWG FILE: DRAWN BY: JAC CHECKED BY: _MLW_ DESIGNED BY: JAC

SHEET TITLE: MECHANICAL SCHEDULES & CONTROL DIAGRAM

SHEET NUMBER:

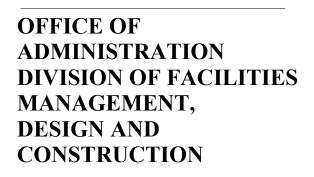



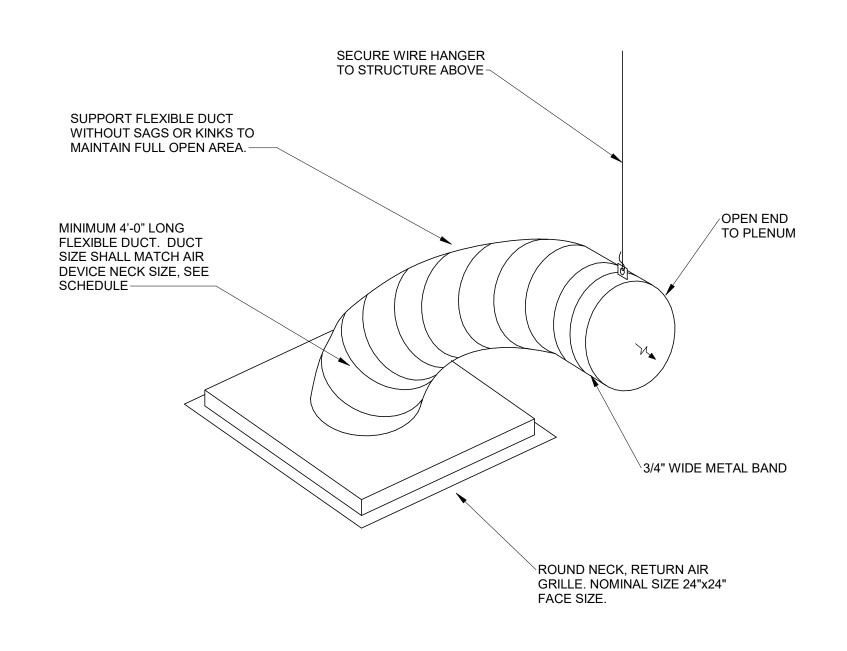



-CONCENTRIC VENT FURNISHED BY


WATER HEATER MANUFACTURER AND




RETURN AIR FLEXIBLE DUCT BOOT NOT TO SCALE

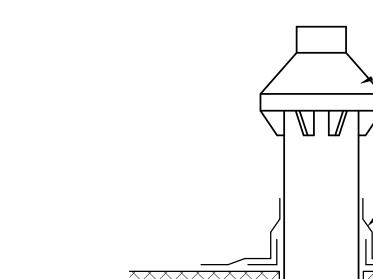


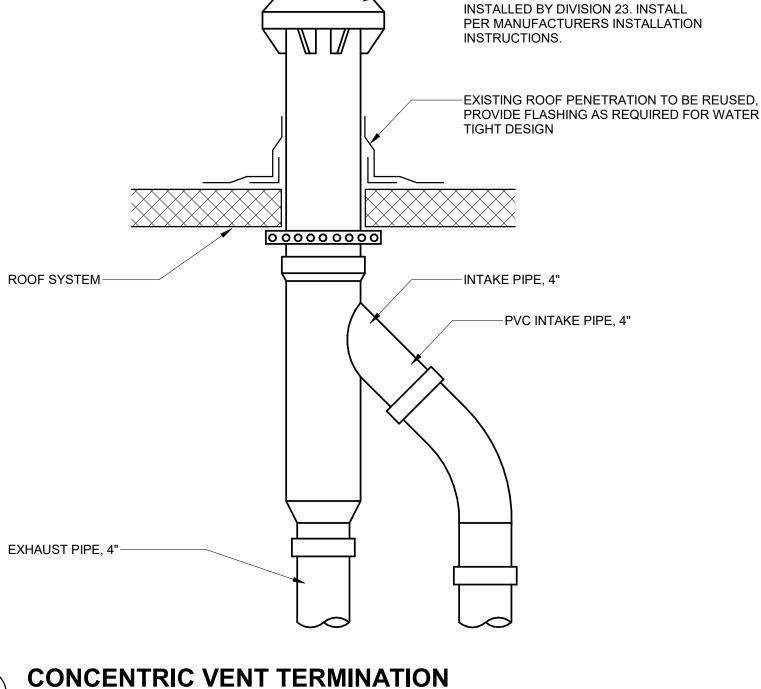

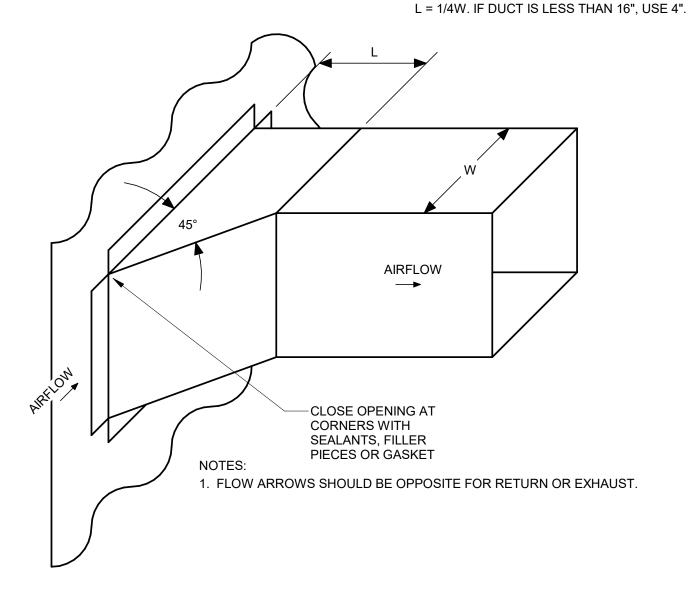

3 NOT TO SCALE

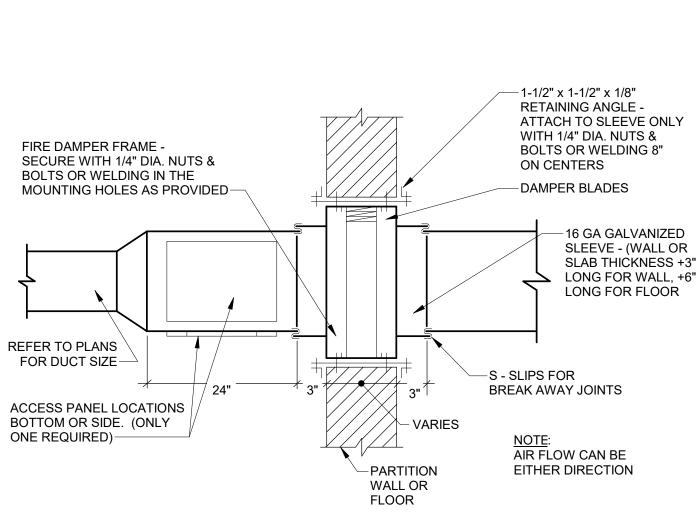

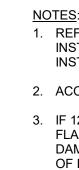

7 NTS

6 NOT TO SCALE

45 DEGREE BRANCH TAKE-OFF DETAIL

1. REFER TO APPROVED DAMPER MANUFACTURERS INSTALLATION INSTRUCTION FOR MANUFACTURERS APPROVED UL INSTALLATION ASSEMBLY.

2. ACCESS PANEL SHALL BE 12"x12" WHEREVER POSSIBLE.

3. IF 12"x182 ACCESS PANEL IS NOT POSSIBLE, PROVIDE 18" LONG FLANGED, REMOVABLE SEGMENT OF DUCT AT CONNECTION TO DAMPER WITH A 6"x6" VISUAL PANEL FOR VISUAL INSPECTION OF DAMPER.

FIRE DAMPER INSTALLATION DETAIL



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PROJECT # T2417-01 SITE # ASSET #

6280 81362800001

REVISION: DATE: **REVISION**: DATE: **REVISION**: DATE: ISSUE DATE: 4-16-2025

CAD DWG FILE: DRAWN BY: JAC CHECKED BY: _MLW DESIGNED BY: JAC SHEET TITLE:

MECHANICAL DETAILS

SHEET NUMBER:

M602

4-16-2025

SHEET 24 OF 31

				EXISTING / DEMOLITION	WALL	CEILING			LIGH	FING
				EXISTING EQUIPMENT TO REMAIN			RECES	SED MOUNT	ED TROFFE	२
	-///			EXISTING EQUIPMENT TO BE REMOVED			SURFA	CE MOUNTE	Ð	
				NEW EQUIPMENT		0	RECES	SED MOUNT	ED DOWNLI	GHT
€				EXISTING TO REMAIN						NDICATES ILLUMINAT AS INDICATED ON PL
Æ	प्रेयप्रेयप्रेयात्र 🕈	मुमाम्प्रमाम्		EXISTING TO BE REMOVED					ND TO PROV FOR THIS PF	IDE HIGH AND LOW ROJECT.
€				NEW EQUIPMENT, LIGHTING FIXTURE OR DEVICE						
		1			ON PLAN FOR CEII 2. REFER T INFORMA SOURCE	IS. PROVIDE MA LING TYPE AND O FIXTURE SCH ATION. SHADED	NUFACTURE MOUNTING L IEDULE FOR FIXTURE SY	ER RECOMM LOCATION. FIXTURE DE MBOLS INDIO	ENDED HARD SCRIPTION, CATE FIXTUR	EGARDLESS OF SYM DWARE AND ACCESS MOUNTING, AND LAN RE HAS SECONDARY H BATTERY BACK UF
OKE HRU			CEILING	ECEPTACLES / POWER	EXAMPLES:	0	۲			
EVICE A	AT 18".				_	NORMAL EN			NORMAL	
	ф т	₽	•	DUPLEX RECEPTACLES	LUMINAIRE NOMENCLAT	<u>Iure:</u> ()	A "	A" DENOTES	S FIXTURE TY	′PE
₩	₩ ¢	¶ ⊉×	₩ Ø	DOUBLE DUPLEX RECEPTACLES SPECIAL RECEPTACLES, NEMA TYPE AS INIDCATED			3a "		CIRCUIT NU SWITCH ZO	
	₩ ×	± x	₩ ^x							
		Ø		GROUND FAULT CIRCUIT INTERRUPTING RECEPTACLES						
		•		INSTALL ABOVE COUNTER OR DEFINED HEIGHT						
		G CO								
				ES ARE SHOWN ADJACENT TO EACH OTHER, PROVIDE A GLE, SEAMLESS FACEPLATE.						
	ovide ne Quired.	UTRAL ANI	O UNSWIT	CHED HOT TO LINE VOLTAGE CONTROL DEVICE WHEN						
	A			EME TAG G CONTROL SEQUENCE SCHEDULE						
		ROOM NA								
		(LC#	∕							
				REQUIREMENTS.						
(D		NOLOGY (SENSOR. UNLESS OTHERWISE NOTED, SENSOR SHALL BE PASSIVE INFRARED AND ULTRASONIC).						
	0			R CASE SUBCRIPT INDICATES SWITCH ZONE						
(5 ц	NE VOLTA	GE LIGHT	SWITCH, SINGLE POLE UNLESS						
	X O	UBSCRIPT	LEGEND:	VITH A SUBSCRIPT						
		4: 4-WAY C: MOME		ONTACT SWITCH						
		CON	TROL SW	NT COMBINATION OCCUPANCY SENSOR AND TCH ASE SUBCRIPT INDICATES SWITCH ZONE						
D				VALL LIGHT CONTROL DIMMER VALL LIGHT CONTROL SWITCH						
С				VALL MOUNT COMBINATION OCCUPANCY TROL SWITCH						
	SL	IBSCRIPT LCF		D: HTING CONTROL PANEL 'A'						
			TEN	IPORARY OVERRIDE SWITCH VERCASE SUBSCRIPT INDICATES SWITCH ZONE						

ELECTRICAL SYMBOLS AND LEGEND (NOT ALL USED)

FIRE	ALARM	SYSTEM
------	--------------	--------

- THE FIRE ALARM CONTENT SHOWN ON THE DRAWINGS REPRESENTS A SCHEMATIC LAYOUT WITH CERTAIN SPECIFIC REQUIREMENTS IDENTIFIED. PROVIDE ENGINEERED SHOP DRAWINGS (SIGNED AND SEALED) AND FINAL INSTALLATION IN COMPLIANCE WITH THESE FIRE ALARM GENERAL NOTES, THE SCHEMATIC FIRE ALARM CONTENT AND REQUIREMENTS SET FORTH BY THESE DRAWINGS, AND ANY ADDITIONAL REQUIREMENTS ESTABLISHED BY CODE, THE AUTHORITIES HAVING JURISDICTION, OR UNFORESEEN CONDITIONS. FURNISH THESE ENGINEERED FIRE ALARM SHOP DRAWINGS TO BOTH THE AUTHORITIES HAVING JURISDICTION (AHJ) AND THE ARCHITECT FOR REVIEW. PROVIDE ENGINEERED FIRE ALARM SHOP DRAWINGS THAT INCLUDE ALL DEVICES. EQUIPMENT, AND APPURTENANCES AS REQUIRED BY APPLICABLE CODES OR AS NECESSARY TO FOR A COMPLETE. FUNCTIONAL. FIRE ALARM SYSTEM INCLUDING INTERFACES WITH OTHER SYSTEMS AS DESCRIBED IN THE CONSTRUCTION DOCUMENTS. NOTIFICATION APPLIANCE CIRCUITS SHALL BE ROUTED IN A CLASS CONFIGURATION MATCHING EXISTING. FIRE ALARM CIRCUITS SHALL BE ROUTED IN CONDUIT WHERE INACCESSIBLE. WHERE
- ROUTED ABOVE ACCESSIBLE CEILINGS, FIRE ALARM CIRCUITS SHALL CONSIST OF PLENUM RATED CABLE SUPPORTED EVERY 4'-0" BETWEEN DEVICES. FOR VISUAL DEVICES, THE '#' WITHIN THE SYMBOL CORRESPONDS TO THE CANDELA RATING OF THE DEVICE: 1=15cd, 3=30cd, 5=75cd, 7=177cd.
- . WALL MOUNTED NOTIFICATION DEVICES SHALL BE MOUNTED WITH THE TOP OF THE DEVICE +90" A.F.F. OR 6" BELOW THE CEILING, WHICHEVER IS LOWER.
- F₫ WALL MOUNTED BELL
- F#⊲ WALL MOUNTED BELL WITH STROBE
- F# WALL MOUNTED STROBE
- **F**#∕ CEILING MOUNTED BELL WITH STROBE
- (F#) CEILING MOUNTED WITH STROBE
- $\langle F \rangle$ CEILING MOUNTED BELL
- FR ADDRESSABLE CONTROL RELAY
- FM ADDRESSABLE MONITOR MODULE
- SD SMOKE DAMPER

GENERAL ELECTRICAL SYMBOLS

	NON-FUSED DISCONNECT SWITCH, 30 AMP MINIMUM UNLESS NOTED OTHERWISE
	FUSED DISCONNECT SWITCH, 30 AMP MINIMUM UNLESS NOTED OTHERWISE
\overrightarrow{A}	COMBINATION DISCONNECT SWITCH MOTOR STARTED
Ń	MOTOR
Т	TRANSFORMER
	LIGHTING OR POWER PANELBOARD
S	MOTOR RATED TOGGLE SWITCH
E	ELECTRICAL CONNECTION
	FREE STANDING SWITCHBOARD, MOTOR CONTROL CENTER OR DISTRIBUTION BOARD
``	EDICATED ELECTRICAL CIRCUIT HOMERUN. NOTE: ONLY SHOWN FOR DEDICATED CIRCUITS.
GENE	RAL SHEET SYMBOLS
1	REFERENCE TO SHEET KEYNOTE "1" ON SAME SHEET
P 1	MECHANICAL EQUIPMENT DESIGNATION "P-1" INDICATED. REFER TO EQUIPMENT DATA SCHEDULE FOR CIRCUTING AND DEVICE REQUIREMENTS. REFER TO FLOOR PLANS FOR LOCATION.
+4'-6"	MOUNTING HEIGHT FROM FINISHED FLOOR TO CENTERLINE OF OUTLET OR EQUIPMENT
1 E-6	DETAIL REFERENCE NUMBER "1" ON DRAWING "E-6"
A E-6	SECTION OR ELEVATION REFERENCE LETTER "A" ON DRAWING "E-6"

ABBRIVIATIONS

Δ	
A AC	AMPERES ALTERNATING CURRENT
ACS ACSCP	ACCESS CONTROL SYSTEM ACCESS CONTROL SYSTEM CONTROL PANEL
ACSPS	ACCESS CONTROL SYSTEM POWER SUPPLY
AFF AIC	ABOVE FINISHED FLOOR AMPERES INTERRUPTING CAPACITY
AV	AUDIO/VIDEO
AWG BAS	AMERICAN WIRE GAUGE BUILDING AUTOMATION SYSTEM
C CAT	CONDUIT CATEGORY
CATV	CABLE TELEVISION
CBP CCTV	COPPER BACKBONE PATCH PANEL CLOSED CIRCUIT TELEVISION
CFCI	CONTRACTOR FURNISHED,
СОММ	CONTRACTOR INSTALLED COMMUNICATIONS
CPP	COPPER HORIZONTAL PATCH PANEL
CT CU	CABLE TRAY COPPER
CUH	CABINET UNIT HEATER
CO DC	COPIER DIRECT CURRENT
DPST	DUAL POLE, SINGLE THROW
DW EC	DISHWASHER EMPTY CONDUIT
EF EGC	EXHAUST FAN EQUIPMENT GROUNDING CONDUCTOR
EIA	ELECTRONICS INDUSTRIES ASSOCIATIONS
EMT EOC	ELECTRICAL METALLIC TUBING EMERGENCY OPERATIONS CENTER
EPO	EMERGENCY POWER OFF
ETR EWC	EXISTING TO REMAIN ELECTRIC WATER COOLER
FAAP FACP	FIRE ALARM ANNUNCIATOR PANEL FIRE ALARM CONTROL PANEL
FBO	FURNISHED BY OTHERS
FO FPD	FIBER OPTIC FLAT PANEL DISPLAY
FPP	FIBER OPTIC PATCH PANEL
FT GFI OR GFCI	FEET OR FOOT GROUND FAULT CIRCUIT INTERRUPTER
GC	GENERAL CONTRACTOR GROUND
G OR GND GFR	GROUND FAULT RELAY
GFP HZ	GROUND FAULT PROTECTION HERTZ
IG	ISOLATED GROUND
INV JBOX	INVERTER JUNCTION BOX
К	KILO
KCMIL KV	THOUSAND CIRCULAR MILS KILOVOLT AMPERES
KWH LC	KILOWATT HOURS LIGHTING CONTACTOR
LCP	LIGHTING CONTROL PANEL
LPI LSI	LIGHTNING PROTECTION INSTITUTE LONG TIME, SHORT TIME, INSTANTANEOUS
LSIG	LONG TIME, SHORT TIME, INSTANTANEOUS,
LSIA	GROUND FAULT LONG TIME, SHORT TIME, INSTANTANEOUS,
MAX	GROUND FAULT ALARM MAXIMUM
MCB	MAIN CIRCUIT BREAKER
MDP MH	MAIN DISTRIBUTION PANEL MANHOLE
MLO MM	MAIN LUGS ONLY MULTIMODE
MTD	MOUNTED
MW N	MICROWAVEASDFGASDF NEUTRAL CONDUCTOR
N.C.	NORMALLY CLOSED
NEC NEMA	NATIONAL ELECTRICAL CODE NATIONAL ELECTRICAL
MA NTC	MANUFACTURER'S ASSOCIATION NURSE CALL TERMINAL CABINET
NIC	NOT IN CONTRACT
NL N.O.	NIGHT LIGHT NORMALLY OPEN
NTS	NOT TO SCALE
OFCI	OWNER FURNISHED,
OFCI	CONTRACTOR INSTALLED
OFCI	CONTRACTOR INSTALLED OWNER FURNISHED, OWNER INSTALLED
OFCI	CONTRACTOR INSTALLED OWNER FURNISHED,
OFCI OFOI ONT P PR	CONTRACTOR INSTALLED OWNER FURNISHED, OWNER INSTALLED OPTICAL NETWORK TERMINAL POLE PAIR
OFCI OFOI ONT P PR PVC R	CONTRACTOR INSTALLED OWNER FURNISHED, OWNER INSTALLED OPTICAL NETWORK TERMINAL POLE PAIR POLYVINYL CHLORIDE RELAY
OFCI OFOI ONT P PR PVC R REF	CONTRACTOR INSTALLED OWNER FURNISHED, OWNER INSTALLED OPTICAL NETWORK TERMINAL POLE PAIR POLYVINYL CHLORIDE RELAY REFRIGERATOR
OFCI OFOI ONT P PR PVC R REF RGS RN	CONTRACTOR INSTALLED OWNER FURNISHED, OWNER INSTALLED OPTICAL NETWORK TERMINAL POLE PAIR POLYVINYL CHLORIDE RELAY REFRIGERATOR RIGID GALVANIZED STEEL CONDUIT REPLACE WITH NEW
OFCI OFOI ONT P PR PVC R REF RGS RN RMC SCCR	CONTRACTOR INSTALLED OWNER FURNISHED, OWNER INSTALLED OPTICAL NETWORK TERMINAL POLE PAIR POLYVINYL CHLORIDE RELAY REFRIGERATOR RIGID GALVANIZED STEEL CONDUIT REPLACE WITH NEW RIGID METAL CONDUIT SHORT CIRCUIT CURRENT RATING
OFCI OFOI ONT P PR PVC R REF RGS RN RMC SCCR SCH	CONTRACTOR INSTALLED OWNER FURNISHED, OWNER INSTALLED OPTICAL NETWORK TERMINAL POLE PAIR POLYVINYL CHLORIDE RELAY REFRIGERATOR RIGID GALVANIZED STEEL CONDUIT REPLACE WITH NEW RIGID METAL CONDUIT SHORT CIRCUIT CURRENT RATING SCHEDULE
OFCI OFOI ONT P PR PVC R REF RGS RN RMC SCCR SCH SCTP SE	CONTRACTOR INSTALLED OWNER FURNISHED, OWNER INSTALLED OPTICAL NETWORK TERMINAL POLE PAIR POLYVINYL CHLORIDE RELAY REFRIGERATOR RIGID GALVANIZED STEEL CONDUIT REPLACE WITH NEW RIGID METAL CONDUIT SHORT CIRCUIT CURRENT RATING SCHEDULE SHIELDED TWISTED PAIR SECURITY ELECTRONICS
OFCI OFOI ONT P PR PVC R REF RGS RN RMC SCCR SCH SCTP	CONTRACTOR INSTALLED OWNER FURNISHED, OWNER INSTALLED OPTICAL NETWORK TERMINAL POLE PAIR POLYVINYL CHLORIDE RELAY REFRIGERATOR RIGID GALVANIZED STEEL CONDUIT REPLACE WITH NEW RIGID METAL CONDUIT SHORT CIRCUIT CURRENT RATING SCHEDULE SHIELDED TWISTED PAIR
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OFCI OFOI ONT P PR PVC R REF RGS RN RMC SCCR SCH SCCR SCH SCCR SCH SCTP SE SM SPD SPECS SPST STR SWBD	CONTRACTOR INSTALLED OWNER FURNISHED, OWNER INSTALLED OPTICAL NETWORK TERMINAL POLE PAIR POLYVINYL CHLORIDE RELAY REFRIGERATOR RIGID GALVANIZED STEEL CONDUIT REPLACE WITH NEW RIGID METAL CONDUIT SHORT CIRCUIT CURRENT RATING SCHEDULE SHIELDED TWISTED PAIR SECURITY ELECTRONICS SINGLE MODE SURGE PROTECTION DEVICE CONTRACT SPECIFICATIONS SINGLE POLE SINGLE THROW STRAND SWITCHBOARD
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NORTH ARROW

PLAN NORTH

ELECTRICAL DEMOLITION NOTES

- 1. REMOVE, CAP AND RELOCATE EQUIPMENT, OUTLETS, CONDUIT, WIRE, ETC., AS SHOWN AND SPECIFIED ON DRAWINGS, AND AS MAY BECOME NECESSARY BECAUSE OF EXISTING FIELD CONDITIONS. VISIBLY EXAMINE ALL EXISTING WALLS DESIGNATED FOR REMOVAL TO DETERMINE THE CONDUIT AND THE WIRING THAT WILL REQUIRE CAPPING AND REMOVAL, WHETHER OR NOT SUCH CONDITIONS ARE INDICATED ON THE DRAWINGS. FAILURE TO VISIT THE SITE AND TO TAKE ALL EXISTING CONDITIONS INTO ACCOUNT WILL NOT ALLOW FOR CHANGES TO THE SCOPE OF WORK.
- 2. MAINTAIN CIRCUIT CONTINUITY TO ALL EXISTING FIXTURES, EQUIPMENT, OUTLETS, ETC., TO REMAIN IN USE WHETHER NOTED ON THE PLANS OR NOT. FIELD VERIFY EXISTING ITEMS TO REMAIN IN USE. RECONNECT RACEWAYS AND WIRING FOR EXISTING CIRCUITS WHICH MUST BE RE-ROUTED OR WHICH ARE PARTIALLY ABANDONED TO POWER THE REMAINING OUTLETS ON THE CIRCUIT.
- 3. REMOVE ALL UNUSED WIRING AND CABLES BACK TO THEIR SOURCE. REMOVE ALL UNUSED CONDUIT THAT IS EXPOSED OR ABOVE ACCESSIBLE CEILINGS WHICH IS AFFECTED BY OR IS IN THE AREA OF THE DEMOLITION WORK.
- 4. THE INTENTION OF THE ELECTRICAL DEMOLITION DRAWINGS IS TO DISCONNECT AND REMOVE ALL ELECTRICAL WORK MADE VOID BY THE SCOPE OF THE CONSTRUCTION AND ALTERATION. FIELD VERIFY EXACT MATERIAL QUANTITIES REQUIRED TO BE REMOVED.
- 5. DISCONNECT AND REMOVE ALL EXISTING ELECTRICAL EQUIPMENT, DEVICES, ASSOCIATED RACEWAYS, SUPPORTING HARDWARE, AND WIRING, WHICH HAVE BEEN MADE OBSOLETE BY THE WORK OR IS SHOWN DASHED ON THE ELECTRICAL DEMOLITION DRAWINGS, UNLESS OTHERWISE NOTED. ALTHOUGH AN ATTEMPT HAS BEEN MADE TO INDICATE ALL OF THIS WORK, TOTAL ACCURACY IS NOT GUARANTEED. VISIBLY EXAMINE ALL AREAS AND WALLS AND CEILINGS SCHEDULED FOR REMOVAL
- TO DETERMINE EXISTING ELECTRICAL ITEMS TO REMAIN. 6. WHERE ELECTRICAL EQUIPMENT, CONDUIT, BOXES, AND SUPPORTING HARDWARE ARE REMOVED. PATCH AND FINISH THE SURFACE AS REQUIRED TO MATCH THE
- EXISTING, USING WORKERS QUALIFIED IN THE APPROPRIATE TRADE. 7. WHERE BURIED CONDUITS EXTENDING OUT OF A CONCRETE SLAB BECOME ABANDONED, CUT AND GRIND THE CONDUITS OFF FLUSH WITH TOP OF SLAB AND
- PLUG WITH NON-SHRINK WATERPROOF GROUT FILL. 8. TAKE ALL REMOVED MATERIALS FROM THE PROJECT SITE, EXCEPT FOR THOSE TO BE RELOCATED, STORED, OR TURNED OVER TO THE OWNER.
- 9. ACCEPTANCE OF CONTRACT MEANS INSTALLER ACCEPTS EXISTING CONDITIONS. 10. COORDINATE ALL DEMOLITION WORK WITH ALL OTHER TRADES.
- 11. PROVIDE A BLANK COVER OVER THE OUTLET WHERE A FLUSH DEVICE IS BEING REMOVED FROM FLOORS AND WALLS THAT ARE TO REMAIN. MATCH THE COLOR AND MATERIAL TO THE EXISTING REMAINING COVERS IN THE ROOM OR SPACE. 12. LEGALLY DISPOSE OF HAZARDOUS MATERIALS AND BALLASTS OR OTHER EQUIPMENT
- CONTAINING PCBS AND LAMPS CONTAINING MERCURY. COMPLY WITH ALL FEDERAL, STATE, AND LOCAL LAWS. 13. MODIFY EXISTING PANEL DIRECTORIES (OR REPLACE) FOR PANELBOARDS WHICH HAVE HAD ALTERATIONS TO THE CIRCUITS ORIGINATING THEREIN. DESCRIBE THE LOAD AND LOCATION. TYPE, DO NOT HAND LETTER NEW PANELBOARD DIRECTORIES.

ELECTRICAL GENERAL NOTES

- 1. MAKE ALL INSTALLATIONS IN ACCORDANCE WITH THE AMERICANS WITH DISABILITIES ACT ACCESSIBILITY GUIDELINES (ADAAG) AND ARCHITECTURAL BARRIERS ACT (ABA). 2. MOUNTING HEIGHTS INDICATED WITHIN PLANS AND SCHEDULES ARE DIMENSIONED
- TO THE CENTER LINE OF THE DEVICE, EQUIPMENT, LUMINAIRE, ETC. UNLESS OTHERWISE NOTED. 3. COORDINATE EXACT EQUIPMENT LOCATIONS WITH OTHER TRADES. EQUIPMENT
- LOCATIONS SHOWN ON ELECTRICAL PLANS ARE DIAGRAMMATICAL ONLY AND MIGHT NOT BE EXACT. 4. CIRCUIT IDENTIFICATION NUMBERS BESIDE ELECTRICAL DEVICES AND CONNECTION
- POINTS ON PLANS CORRESPOND TO AN OVERCURRENT DEVICE IN THE DESIGNATED PANELBOARD. NOTE ALL CIRCUIT NUMBER CHANGES MADE IN THE FIELD AT EACH ELECTRICAL DEVICE AND CONNECTION POINT. ALSO CORRECT THE DIRECTORIES AND DEVICE MARKINGS AT PANELBOARDS, SWITCHBOARDS AND SWITCHGEAR TO ACCURATELY REFLECT THE AS-BUILT CONDITIONS.
- 5. INSTALL EMERGENCY AND EXIT LUMINAIRE WIRING IN A SEPARATE RACEWAY FROM THAT OF ANY NORMAL POWER DEVICE. 6. CONCEAL ALL CONDUIT IN WALLS, PARTITIONS, ABOVE CEILINGS, AND IN FLOOR SLABS, ETC. UNLESS OTHERWISE INDICATED ON THE PLANS OR IN THE
- SPECIFICATIONS. CONDUIT ROUTED IN MECHANICAL ROOMS, ELECTRICAL ROOMS AND STORAGE ROOMS WITHOUT CEILINGS MAY BE ROUTED EXPOSED. 7. COORDINATE VERTICAL CONDUIT ROUTING TO WALL MOUNTED DEVICES TO ENSURE
- DEVICES LOCATED WITHIN AN 18-INCH HORIZONTAL DIMENSION WILL BE CENTER-ALIGNED VERTICALLY. 8. CONCEAL ELECTRICAL CONNECTIONS FOR ELECTRIC WATER COOLERS (EWC) BEHIND
- WATER COOLER ACCESS PLATE OR DIRECTLY BELOW AND CENTERED ON WALL. CONFIRM CIRCUT WILL BE PROTECTED BY A READILY ACCESSIBLE GFCI DEVICE IN CIRCUIT BREAKER PANEBOARD OR GFCI WHEN MOUNTED BELOW, PRIOR TO INSTALLING CIRCUIT.
- 9. FIELD COORDINATE ALL ELECTRICAL AND TELECOMMUNICATIONS EQUIPMENT MOUNTING LOCATIONS TO AVOID ENCROACHMENT OF OPERATION AND ACCESS TO EQUIPMENT FROM OTHER TRADES. COORDINATE THE APPROPRIATE MOUNTING LOCATION WITH THE AFFECTED DISCIPLINES WHEN EQUIPMENT IS SPECIFIED TO BE MOUNTED ONTO THE SURFACE OF ANOTHER DISCIPLINE'S EQUIPMENT.
- 10. REPAIR ALL OPENINGS MADE IN EXISTING WALLS, PARTITIONS, ETC TO ACCOMMODATE WORK OF THIS DISCIPLINE TO MATCH THE SURROUNDING CONDITIONS, USING WORKERS QUALIFIED IN THE APPROPRIATE TRADE. APPROPRIATELY GROUT OR SEAL ALL CONDUITS THROUGH WALLS.
- 11. ALL MATERIALS USED TO SEAL PENETRATIONS OF FIRE RATED WALLS AND FLOORS MUST HAVE BEEN TESTED AND CERTIFIED AS A SYSTEM PER ASTM E814 STANDARDS FOR FIRE TESTS OF THROUGH-PENETRATION FIRESTOPS.
- 12. INSTALL A PERMANENT DIRECTORY ACCORDING TO THE NATIONAL ELECTRICAL CODE, ARTICLE 230 AT EACH SERVICE ENTRANCE AND POWER SOURCE.
- 13. PERFORM ALL WELDING ACCORDING TO AMERICAN WELDING SOCIETY STANDARDS. FURNISH CERTIFICATES QUALIFYING EACH WELDER TO THE ARCHITECT OR ENGINEER PRIOR TO START OF WORK. THE ARCHITECT OR ENGINEER RESERVES THE RIGHT TO REQUIRE QUALIFYING DEMONSTRATION, AT NO ADDITIONAL EXPENSE, OF ANY WELDERS ASSIGNED TO THE JOB.
- 14. REPLACE OR REINSTALL ALL PORTIONS OF THE BUILDING (CEILING TILES, WALLS, ETC) REMOVED TO ACCOMMODATE THE INSTALLATION OF ANY ELECTRICAL DEVICE, EQUIPMENT, ETC., USING WORKERS QUALIFIED IN THE APPROPRIATE TRADE.
- 15. COORDINATE LUMINAIRE LOCATIONS SUCH THAT LUMINAIRES RUN PARALLEL TO THE FACE OF THE EQUIPMENT AND OVER AISLES BETWEEN EQUIPMENT IN ALL MECHANICAL AND ELECTRICAL EQUIPMENT AREAS. INSTALL AT PROPER LOCATIONS AND HEIGHTS TO PROPERLY ILLUMINATE ALL GAGES, PANELS, ELECTRICAL EQUIPMENT, CONTROLS, VALVES, ETC. CHAIN HANGING, STEM HANGING, CHANNEL HANGING, ETC. ARE ACCEPTABLE METHODS.

STATE OF MISSOURI MIKE KEHOE, GOVERNOR

ARCHITECTURE & ENGINEERING



MISSOURI STATE CERTIFICATE OF AUTHORITY #000148



TIMOTHY J. BLOCH PE-2016019362

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OFFICE OF ADMINISTRATION **DIVISION OF FACILITIES** MANAGEMENT, **DESIGN AND** CONSTRUCTION

MISSOURI ARMY NATIONAL GUARD

Latrines & Shower Renovations, Building 233

St. Louis Lambert Readiness Center

10800 Lambert International Rd.

Bridgeton, MO 63044

PROJECT #	T2417-01
SITE #	6280
ASSET #	81362800001

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SHEET TITLE:

ELECTRICAL LEGEND, ABBREVIATIONS, AND GENERAL NOTES

SHEET NUMBER:



4-16-2025

SHEET 25 OF 31

MOUNTING:			LISTING:
CEILING MOUNTING: REC - RECESSED SUR - SURFACE SEMI - SEMI RECESSED STR - STRUT	EXTERIOR MOUNTING: W - WALL P - POLE BP - BOLLARD TOP IG - IN-GRADE	CEILING TYPE: ACT - ACOUSTIC CEILING TILE GYP - GYPSUM BOARD CEILING EXP - EXPOSED	#FR - FIRE RATED # - HOURS IC - INSULATED CONTACT CR - CHICAGO RATED DAMP OR WET
		EXAMPLE:	
SUSPENDED MOUNTING:	EXTERIOR POLE:	REC-GYP	EXAMPLE:
AC-# - AIRCRAFT CABLE CH-# - CHAIN HUNG RP-# - ROD PENDANT	AL - ALUMINUM ST - STEEL R - ROUND	RECESSED GYPSUM BOARD CEILING	IC-1.5FR INSULATED CONTACT WIT FIRE RATED FOR 90 MINU
CP-# - CONDUIT PENDANT (#ET) - DISTANCE FROM CEILING	SQ - SQUARE SA - STRAIGHT		

			FIXTURE INFOMATION						LED / LAMP INFOM	/IATION			DF	RIVER INFOMATION	١	1
TYPI	E MANUFACTURER	MODEL	DESCRIPTION	MOUNTING	LISTING	LENS	TRIM	LUMENS	DISTRIBUTION	TEMP (K)	CRI	VOLTAGE	VA	CONTROL	EMERGENCY	1
A1	WILLIAMS LIGHTING	DI SERIES	2 FOOT BY 2 FOOT VOLUMETRIC	REC-ACT		RIBBED ACRYLIC		3200		4000	80	UNV	26	NA		[
A1E	WILLIAMS LIGHTING	DI SERIES	2 FOOT BY 2 FOOT VOLUMETRIC WITH BATTERY BACKUP DRIVER	REC-ACT		RIBBED ACRYLIC		3200		4000	80	UNV	26	NA	7W	[
B1	WILLIAMS LIGHTING	39 SERIES	1 FOOT BY 4 FOOT WRAP	SUR-GYP		RIBBED ACRYLIC		3000		4000	80	UNV	23	NA		1
C1	WILLIAMS LIGHTING	PX SERIES	PERIMETER WALL GRAZER	REC-GYP				400		4000	80	UNV	4	NA		LUMENS AND WATTAGE LISTED PER I
D1	WILLIAMS LIGHTING	6DR SERIES	6 INCH DOWNLIGHT	REC-GYP			CS	1000	WIDE	4000	80	UNV	9	NA		[
D1E	WILLIAMS LIGHTING	6DR SERIES	6 INCH DOWNLIGHT WITH BATTERY BACKUP DRIVER	REC-GYP			CS	1000	WIDE	4000	80	UNV	9	NA	7W	[
D2	WILLIAMS LIGHTING	6DR SERIES	6 INCH DOWNLIGHT WITH NON-CONDUCTIVE FLUSH LENS	REC-GYP	WET	DIFUSE ACRYLIC	CS	1000	WIDE	4000	80	UNV	9	NA		[
V1	WILLIAMS LIGHTING	LLM SERIES	8 FOOT SURFACE ARCHITECTURAL ROUND LENS	SUR-W		FROSTED MATTE ACRYLIC	WHITE	600		4000	80	UNV	4	NA		LUMENS AND WATTAGE LISTED PER I

LIGHT FIXTURE SCHEDULE GENERAL NOTES:

(#AFF) - ABOVE FINISH FLOOR

- 1. ALL LIGHT FIXTURES SHALL BE BUY AMERICAN ACT COMPLIANT.
- 2. UNLESS OTHERWISE STATED IN REMARKS. ALL FIXTURES ARE LED.
- 3. LIGHT FIXTURE SHOP DRAWING AND LIGHTING CONTROL SHOP DRAWING SUBMITTAL SHALL BE SUBMITTED AT THE SAME TIME. APPROVAL WILL NOT BE GRANTED UNTIL BOTH ARE REVIEWED.
- REFER TO ARCHITECTURAL DOCUMENTS FOR EXACT MOUNTING LOCATIONS OF LUMINAIRES AND CEILING TYPES.

TA - TAPERED

(#FT) - POLE HEIGHT

(#IN) - DIAMETER POLE

- ALL RECESSED DOWNLIGHTS SHALL HAVE SELF-FLANGED REFLECTORS U.O.N. AND SHALL BE INSTALLED SO THAT THE BOTTOM OF THE THROAT IS EVEN WITH THE FINISHED CEILING PLANE. THE OVERLAPPING FLANGE MUST THEN FIT FLUSH TO THE CEILING PLANE/THROAT. NO LIGHT LEAK MUST BE VISIBLE. ALL MISCELLANEOUS HARDWARE ABOVE THE CEILING PLANE TO ACCOMPLISH THE ABOVE SHALL BE INCLUDED IN THE BASE BID.
- 6. ALL LUMINAIRES SHALL HAVE A UL LABEL.

DWH 1 DOMESTIC WATER HEATER

HWRP 1 HOT WATER RETURN PUMP

1

EXHAUST FAN

- IN ALL MECHANICAL ELECTRICAL EQUIPMENT AREAS, CONTRACTOR TO COORDINATE LUMINAIRE LOCATIONS SUCH THAT LIGHT LUMINAIRES RUN PARALLEL TO THE FACE OF THE EQUIPMENT AND OVER AISLES BETWEEN EQUIPMENT. INSTALL AT EXACT LOCATIONS AND AT EXACT HEIGHT TO ILLUMINATE ALL GAGES, PANELS, CONTROLS, VALVES, ETC. CHAIN HANGING, STEM HANGING, UNISTRURT HANGING, ETC. ARE ACCEPTABLE METHODS.
- 8. WHEN LUMINAIRES ARE INSTALLED IN CONTINUOUS ROWS OF TWO (2) OR MORE, LUMINAIRES SHALL BE APPROVED FOR USE AS WIREWAY.
- THE MANUFACTURER LISTED IS THE BASIS-OF-DESIGN. SEE SPECIFICATIONS FOR ADDITIONAL MANUFACTURERS. COMPLETE CATALOG NUMBER IN THIS LIGHT FIXTURE SCHEDULE ARE NOT BE LISTED. ORDER LUMINAIRE BASED ON DESCRIPTION, PARTIAL CATALOG NUMBER AND SPECIFICATIONS.
- 10. VERIFY COMPATIBILITY OF ALL DIMMING DRIVERS WITH SPECIFIED DIMMING CONTROLS PRIOR TO ORDERING AND PROVIDE APPROPRIATE COMPONENTS TO CREATE A COMPLETE AND FULLY FUNCTIONAL INSTALLATION.
- 11. ALL LUMINAIRES SHOWN ON THIS SCHEDULE MAY NOT BE USED ON THE VARIOUS PLANS. ALSO, THE USE OF ONLY CERTAIN NUMERICAL SUBSCRIPTS FOR LUMINAIRE TYPES (e.g. H2, H3, A2, A3, etc.) ON THIS PROJECT DOES NOT NECESSARILY MEAN THAT AN H1 OR A1 IS USED OR MISSING.
- 12. PROVIDE ALL MISCELLANEOUS HARDWARE, CLIPS, ANGLES, FRAMES, ETC. AS REQUIRED TO MOUNT THE LUMINAIRES IN OR ON THE SURFACES THEY ARE TO BE INSTALLED.
- 13. WHEN VARYING FROM BASIS-OF-DESIGN LUMINAIRE, PROVIDE A LUMINAIRE UTILIZING ±10% OF THE LED LUMENS INDICATED IN LUMINAIRE SCHEDULE.
- 14. REFER TO SPECIFICATION SECTION 265100 LIGHTING FOR ADDITIONAL INFORMATION CONCERNING LUMINAIRES, FINISHES, DRIVERS, ETC.
- 15. ALL LUMINAIRES SHALL OPERATE AT 120 OR 277 VOLTS OR OTHER VOLTAGE AS REQUIRED BY THE CIRCUITS AND/OR PANELS TO WHICH THEY ARE CONNECTED.
- 16. WHEN INSTALLING LUMINAIRES, USE THE LUMINAIRE MANUFACTURER'S MOUNTING HARDWARE AND FOLLOW ALL MANUFACTURER'S INSTALLATION DIRECTIONS.

1. 2. 3. 4. 5. 6.	AL TF IN DI IN	L MAGNETIC AND SOLID STATE JXILIARY CONTACTS, PILOT LIG ANSFORMERS. SEE SPECIFIC/ RE ALARM INTERLOCK. TEGRAL DISCONNECT SWITCH DUNT DISCONNECT SWITCH OI SCONNECT/CONTROL PANEL F TEGRAL CIRCUIT BREAKER DIS	SHTS AND FUSED CONT ATIONS FOR ADDITION N EQUIPMENT HOUSING PROVIDED BY MANUFAG	G. CTURER.	WER S RMATION. C D C	REFER TO FEE CHEDULE WHEN COLUMN CONTAI ESIGNATION IN CONDUCTOR SIZ	N THIS NS A FEED STEAD OF	F - FU TOG REC	NON FUS JSED - TOGGL - DUPLE	E	PTACLE		COMB COMB COMB FVNR MAN - SDS - PWCF VFD -
ID	#	EQUIPMENT	LOCATION	FURN. BY	AMPS	ĸw	HP	VOLTS	PHASE	MIN SCCR	INST. BY	CONN. BY	FED F

5

22

22 0.54

23

UTILITY

ROOF

UTILITY

Т	LENS TYPE / COLOR: #P - POLY LENS #T - TEMPERED GLASS	TRIM TYPE / COLOR: SG - SINGLE GASKET	TEMPERATURE (K):	COLOR RENDER INDEX (CRI):
ITH UTES.	#AC - ACYLIC OPTIONS: # - 0.125, 0.156, ETC	DG - DOUBLE GASKET IP - INGRESS PROTECTION AM - ANTIMICROBIAL CS - CLEAR SEMI-SPECULAR	K - KELIVN RGB WT (#K-#K) - WHITE TUNING (#K-#K) COLOR RANGE	80+ MIN TM-30 (CHROMATICITY): (Rf / Rg / Rfh1 / Rcshr) Rf - FIDELITY INDEX Rg - RELATIVE GAMUT INDEX Rfh1 - FIDELITY INDEX, HUE-BIM Rcsh1 - CHROMA SHIFT, HUE-BIM

LIGHTING CONTROL SEQUENCE

S - "INDIVIDUAL ZONE WALL CONTROLLER". REFER TO FLOOR PLAN FOR QUANTITY OF ZONES SHOWN IN THE AREA. EACH ZONE SHALL HAVE A ITS OWN INDEPENDENT CONTROLLER WITHIN THE WALL CONTROLLER. D - "INDIVIDUAL DIMMING ZONE WALL CONTROLLER". EACH ZONE SHALL HAVE ITS OWN INDEPENDENT CONTROLLER CAPABLE OF ON, OFF AND DIMMING WITIN THE WALL CONTROLLER. REFER TO FLOOR PLAN FOR QUANTITY OF ZONES SHOWN IN THE AREA.

	ENE CONTROLLER". NUMBER INDICATES QUANTI Y LIGHT PHOTO SENSOR". MUST AUTOMATICALL`					-	-						NING SCENE ON, OFF AND DIM. INTAIN MAXIMUM FOOT CANDLE RATING INDICATED AS MEASURED FROM
MAN - MANUAL	CONTROL. OCC - OCCUPANCY ON AND / OR	VACANC	Y OFF.	тс	- TIME C	LOCK.	ETI	D - EMEF	RGENCY	TRANS	FER DE	/ICE.	
			WALL			AUT	OMATIC	CONTR	ROLS				
		CO	NTROLL	ER	10	V (X=100	%)	0	FF (X=0%	%)	DL		
SEQUENCE ID	AREA DESCRIPTION	S	D	P	MAN	000	TC	MAN	OCC	TC	Ft. Cd.	ETD	REMARKS
LC01	RESTROOM, LOCKER, TOILETS	X	-	-	X	X	-	X	X	-	-	-	PROVIDE WITH CONTACT TO NOTIFIY FAN OF LIGHT STATUS WITHIN SPACE. COORDINATE WITH DIVISION 23 AND REFER TO MECHANICAL SEQUENCE OF OPERATIONS DRAWINGS AND EXHAUST FAN CONTROL DIAGRAMS FOR MORE INFORMATION AND REQUIREMENTS.
LC02	SHOWERS	X	-	-	X	X	-	-	X	-	-	-	PROVIDE WITH CONTACT TO NOTIFIY FAN OF LIGHT STATUS WITHIN SPACE. COORDINATE WITH DIVISION 23 AND REFER TO MECHANICAL SEQUENCE OF OPERATIONS DRAWINGS AND EXHAUST FAN CONTROL DIAGRAMS FOR MORE INFORMATION AND REQUIREMENTS.
LC03	LACTATION	X	-	-	X	-	-	X	X	-	-	-	PROVIDE WITH CONTACT TO NOTIFIY FAN OF LIGHT STATUS WITHIN SPACE. COORDINATE WITH DIVISION 23 AND REFER TO MECHANICAL SEQUENCE OF OPERATIONS DRAWINGS AND EXHAUST FAN CONTROL DIAGRAMS FOR MORE INFORMATION AND REQUIREMENTS.
LC04	JAN., STORAGE	Х	-	-	Х	-	-	Х	Х	-	-	-	
L	1	1	1	1	1	1	1	1		1		1	

LIGHTING CONTROL NOTES:

- LIGHT FIXTURE SHOP DRAWING AND LIGHTING CONTROL SHOP DRAWING SUBMITTAL SHALL BE SUBMITTED AT THE SAME TIME. APPROVAL WILL NOT BE GRANTED UNTIL BOTH ARE REVIEWED.
- 2. THE LIGHTING CONTROL SYSTEM SCHEDULE SHALL BE CONSIDERED PERFORMANCE CRITERIA. PROVIDE ALL CONTROL DEVICES, WIRING, RACEWAY, PROGRAMMING, AND LABOR AS REQUIRED TO OBTAIN THE SEQUENCES IDENTIFIED FOR EACH SPACE. PROVIDE CONTROL DRAWINGS, SEQUENCE DESCRIPTIONS, PUSHBUTTON CONFIGURATIONS (WITH LIGHITNG LOADS IDENTIFIED) AND WIRING DIAGRAMS INDICATING 3
- THE PROPOSED LIGHTING CONTROLS WITHIN THE SHOP DRAWING SUBMITTAL FOR APPROVAL. 4. MOUNT AREA CONTROLLERS AND POWER PACKS ABOVE CEILING, NEAR WALL CONTROLLERS IN THE INTERIOR SIDE OF THE SPACE SERVED. ROOM CONTROLLERS SERVING CORRIDORS MAY BE LOCATED IN ELECTRICAL ROOMS.
- PRIOR TO CONSTRUCTION CLOSEOUT, DEMONSTRATE LIGHTING CONTROLS TO OWNER FOR FINAL APPROVAL. MODIFY PROGRAMMING AND ILLUMINATION AS REQUIRED TO MEET OWNERS FINAL REQUIREMENTS.
- 6. EACH SWITCH LEG SHOWN ON LIGHTING DRAWINGS IS A ZONE, PROVIDE A TOGGLE/DIMMER SWITCH FOR EACH SWITCH LEG/ZONE SHOWN ON LIGHTING FLOOR PLANS.

EQUIPMENT DATA SCHEDULE - ELECTRICAL

115 1 5K 22 22

115 1 5K 23 26 115 1 5K 22 26

1/2

- TER TYPE: MB1 COMBINATION FULL VOLTAGE NON-REVERSING MAGNETIC STARTER WITH FUSED DISCONNECT SWITCH
- MB2 COMBINATION FULL VOLTAGE NON-REVERSING MAGNETIC STARTER WITH UNFUSED DISCONNECT SWITCH MB3 - COMBINATION FULL VOLTAGE NON-REVERSING MAGNETIC STARTER WITH THERMAL MAGNETIC MOLDED CASE CIRCUIT BREAKER DISCONNECT
- MB4 COMBINATION FULL VOLTAGE NON-REVERSING MAGNETIC STARTER WITH MAGNETIC ONLY MOLDED CASE CIRCUIT BREAKER DISCONNECT IR - FULL VOLTAGE NON-REVERSING MAGNETIC STARTER WITHOUT DISCONNECT
- I MANUAL MOTOR STARTER WITH DISCONNECT SWITCH AND REPLACEABLE THERMAL OVERLOAD CONTACTS - STAR DELTA STARTER

CP - PREWIRED CONTROL PANEL

- VARIABLE FREQUENCY DRIVE

			DISCONNECT	SWITCH AT EQUI	PMENT						STARTER					
FED FROM	BRANCH CIRCUIT	TYPE	NEMA ENCLOS. TYPE	SWITCH/ FUSE SIZE	FURN. By	INST. BY	CONN. BY	NEMA SIZE	NEMA ENCLOS. TYPE	TYPE	BREAKER/ TRIP	ACCES.	FURN. BY	CONN. BY	CONTROL WIRING	NOTES
I-LINE	(2)#12, (1)#12G, 3/4C	TOG	1	20/-	26	26	26	-	-	PWCP	-	-	22	26	22	
I-LINE	(2)#12, (1)#12G, 3/4C	NF	3R	30/-	26	26	26	1	3R	COMB2	-	HOAP	26	26	23	4
I-LINE	(2)#12, (1)#12G, 3/4C	TOG	1	20/-	26	26	26	-	-	PWCP	-	-	22	26	22	

VOLTAGE: CONTROL: EMERGENCY CONTROL: UNV - 100V TO 277V NA - ON / OFF # WATT (90 MINUTES) 120V STEP (0%, 50%, 100%) 208V 277V DIMMING: 480V W - WIRELESS 0-10V DMX DALI PC - PHASE CONTROL (#%) - MIN DIMMING REMARKS ER LINEAR FOOT. PROVIDE LENGTH AS REQUIRED FOR CONTINOUS PERIMETER. PER LINEAR FOOT

PB - STAR	A WITH F	RIES: PILOT LIGHT PUSH BUTTON CONTACT)	
DIVISION 1	4 - CON 1 - FIRE 2 - PLUN 3 - MECH	HANICAL	ENT
			NOTES



STATE OF MISSOURI

MIKE KEHOE,

GOVERNOR

TIMOTHY J. BLOCH PE-2016019362

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OFFICE OF ADMINISTRATION **DIVISION OF FACILITIES** MANAGEMENT, **DESIGN AND** CONSTRUCTION

MISSOURI ARMY NATIONAL GUARD

Latrines & Shower Renovations, Building 233

St. Louis Lambert Readiness Center

10800 Lambert International Rd.

Bridgeton, MO 63044

PROJECT # T2417-01 6280 SITE # 81362800001 ASSET #

REVISION: DATE: **REVISION:** DATE: **REVISION:**

DATE: ISSUE DATE: 4-16-2025


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ELECTRICAL **SCHEDULES**

SHEET NUMBER:



SHEET 26 OF 31

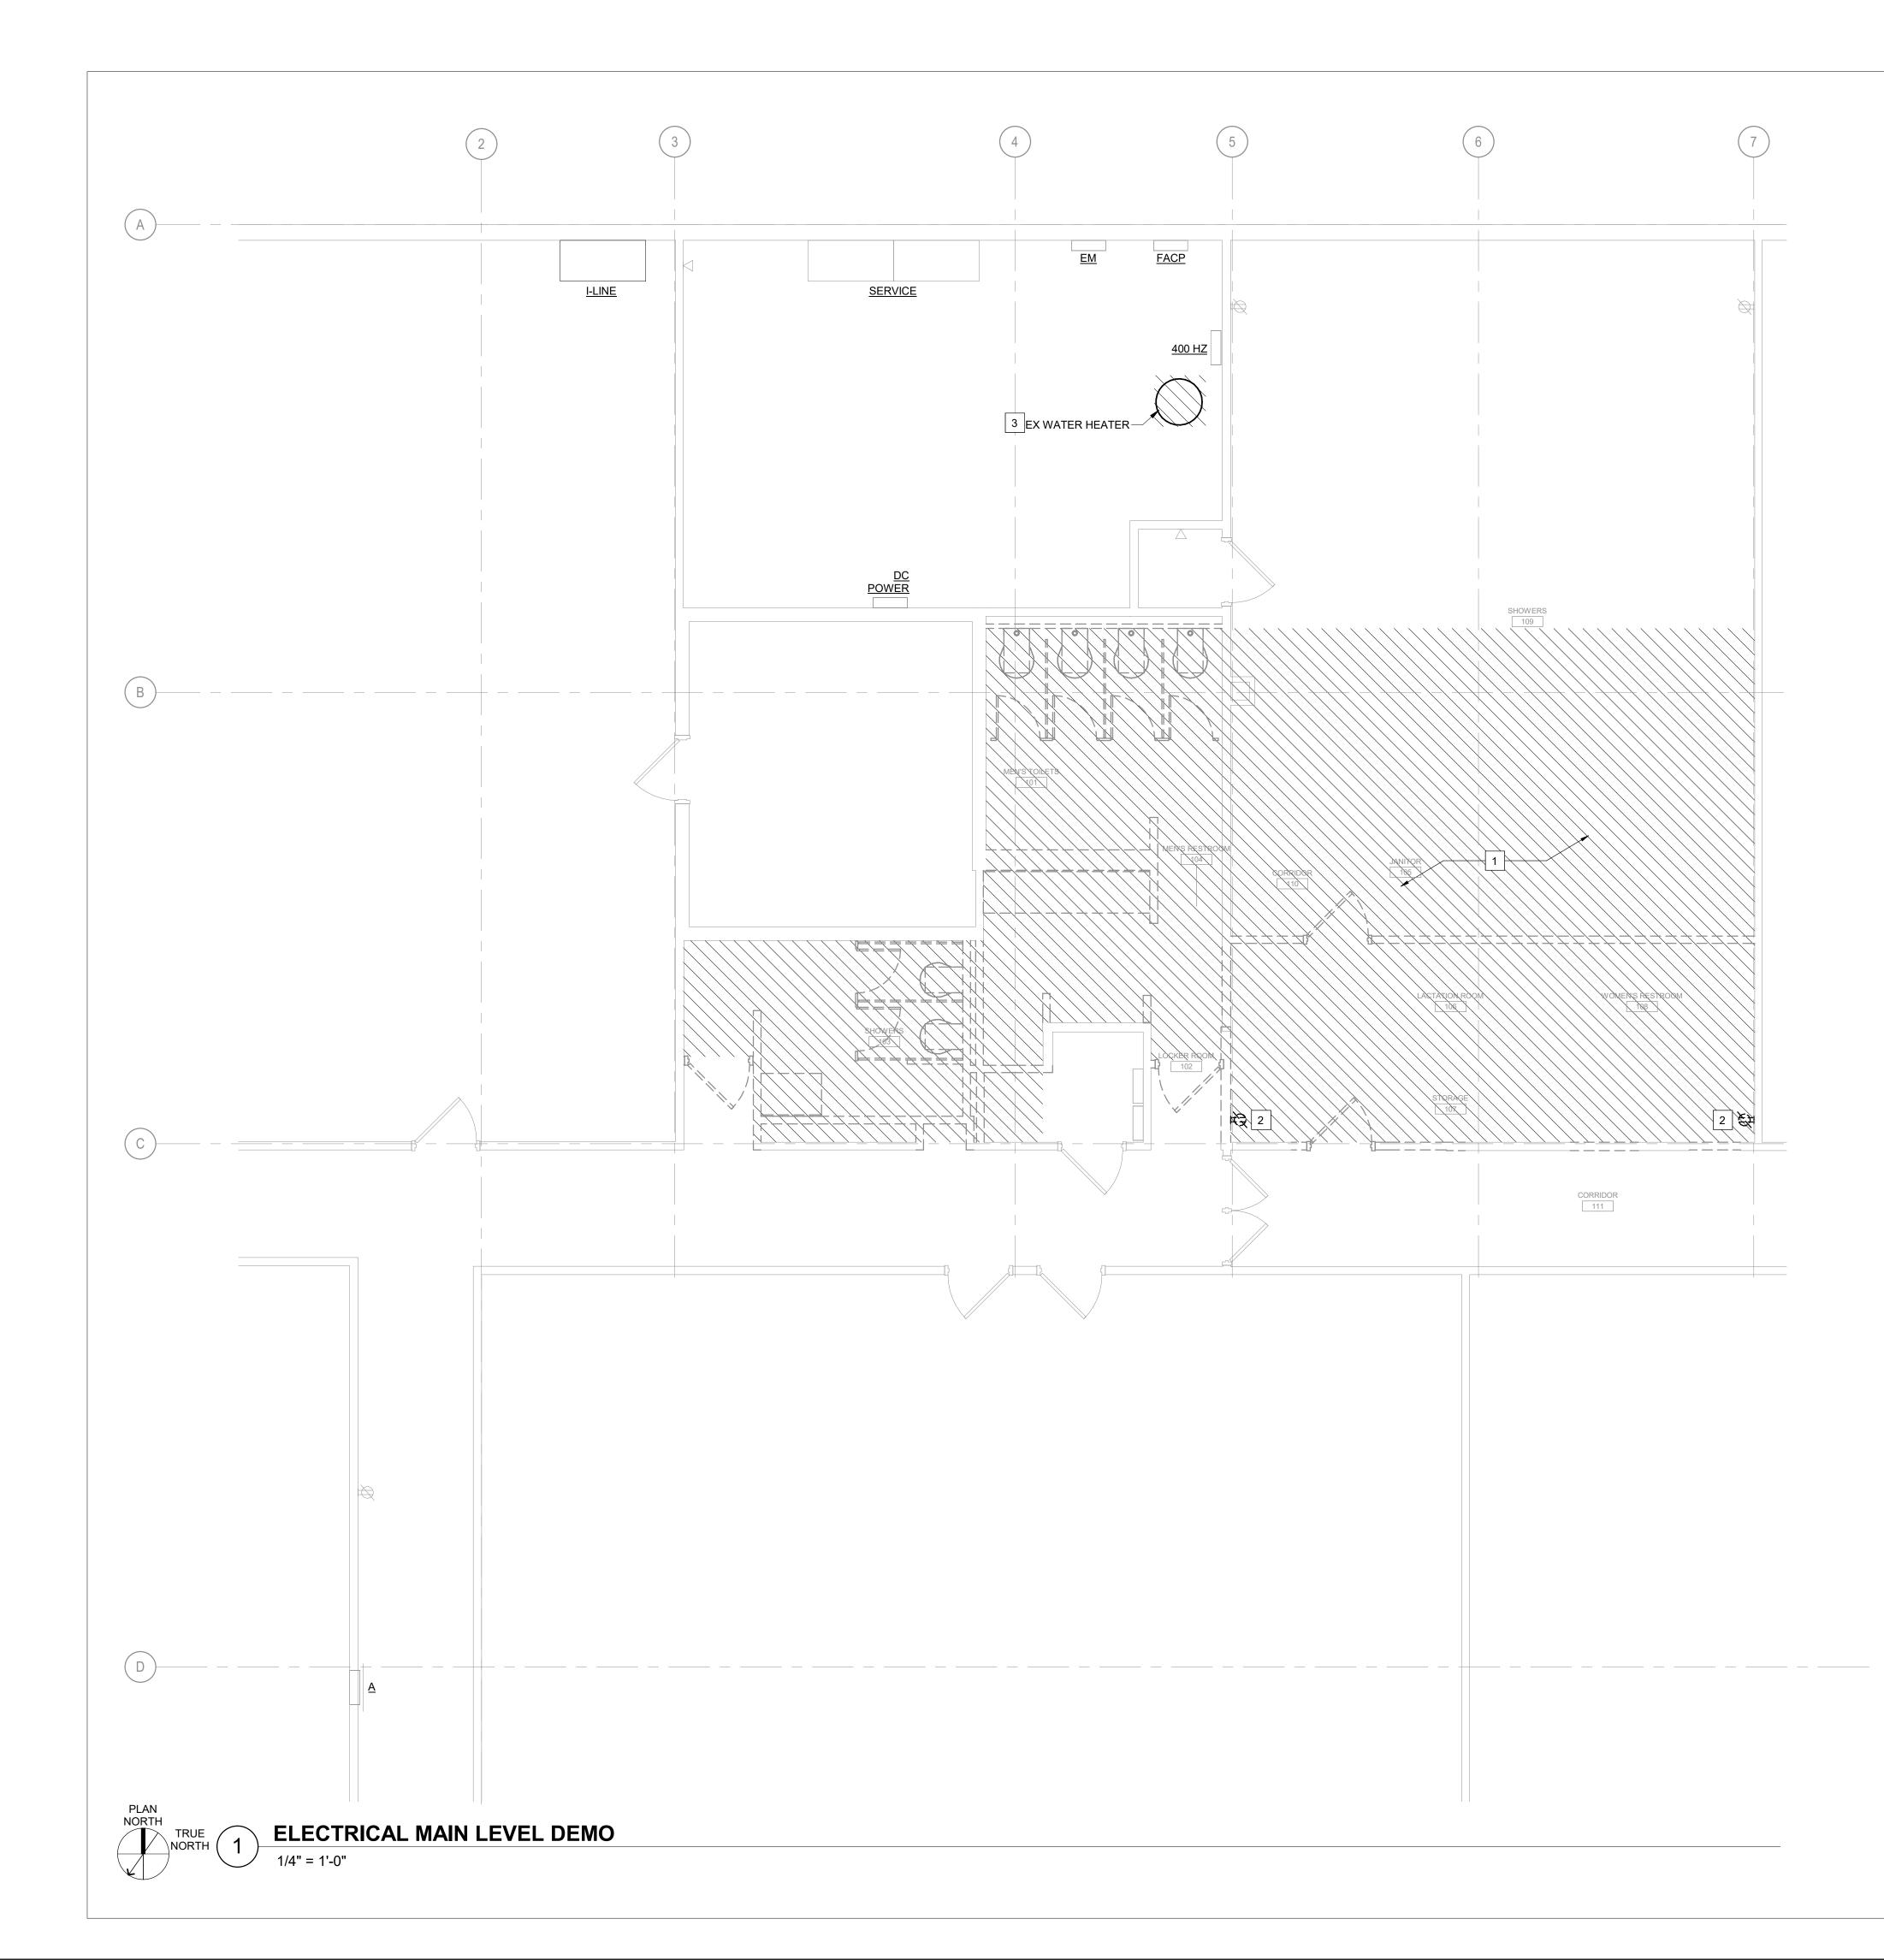

SHEET GENERAL NOTES

- A. NOT ALL ELECTRICAL DEVICES AND EQUIPMENT ARE SHOWN. REFER TO GENERAL DEMOLITION NOTES ON DRAWING E000 AND SPECIFICATIONS FOR MORE INFORMATION.
- B. MAINTAIN CIRCUIT CONTINUITY TO ALL EXISTING FIXTURES, EQUIPMENT, OUTLETS, ETC., TO REMAIN IN USE WHETHER NOTED ON THE PLANS OR NOT. FIELD VERIFY EXISTING ITEMS TO REMAIN IN USE. EXTEND AND RECONNECT RACEWAYS AND WIRING FOR EXISTING CIRCUIT(S) WHICH MUST BE RE-ROUTED OR WHICH ARE PARTIALLY ABANDONED TO POWER THE REMAINING DEVICES OR EQUIPMENT ON THE CIRCUIT(S).
- C. REPLACE OR RE-INSTALL ALL PORTIONS OF THE BUILDING (CEILING TILES, WALLS, ETC.) REMOVED TO ACCOMMODATE THE REMOVAL OR RE-INSTALLATION OF ANY ELECTRICAL DEVICE, EQUIPMENT, ETC. USING WORKERS QUALIFIED IN THE APPROPRIATE TRADE.

SHEET KEYNOTES

- 1. HATCHED AREA INDICATES SCOPE OF WORK AREA. UNLESS OTHERWISE NOTED, DISCONNECT AND REMOVE ALL ELECTRICAL DEVICES, SUCH AS BUT NOT LIMITED TO LIGHT FIXTURES, RECEPTACLES, SWITCHES, ETC., WITHIN PARTITIONS AND CEILINGS TO BE DEMOLISHED. DISCONNECT AND MAKE SAFE ALL MECHANICAL AND PLUMBING EQUIPMENT WITHIN SCOPE OF WORK AREA TO BE REMOVED. COORDINATE WITH DIV 22 AND DIV 23 FOR QUANTITIES AND LOCATIONS.
- 2. APPROXIMATE LOCATION OF WALL MOUNTED SPECIAL POWER (VDC AND 400 HZ) OUTLETS AND WALL AND FLOOR MOUNTED GROUNDING BOXES. DISCONNECT AND DEMOLISH SPECIAL POWER OUTLETS BACK TO LAST OUTLET REMAINING IN SERVICE. REMOVE GROUNDING BOXES AND REMOVE GROUNDING CABLING BACK TO SLAB AND CUT FLUSH WITH SLAB. UPDATE PANELBOARD DIRECTORY TO REMOVE IDENTIFICATION OF THIS LOAD.
- 3. DISCONNECT AND MAKE SAFE FOR REMOVAL OF EQUIPMENT BY DIVISION 22. REMOVE CONDUIT AND CONDUCTORS BACK TO LAST DEVICE REMAINING IN SERVICE OR BACK TO SOURCE. UPDATE PANELBOARD DIRECTORY TO REMOVE IDENTIFICATION OF THIS LOAD.

STATE OF MISSOURI MIKE KEHOE, GOVERNOR

ARCHITECTURE & ENGINEERING



MISSOURI STATE CERTIFICATE OF AUTHORITY #000148



TIMOTHY J. BLOCH PE-2016019362

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Bridgeton, MO 63044

PROJECT #T2417-01SITE #6280ASSET #81362800001

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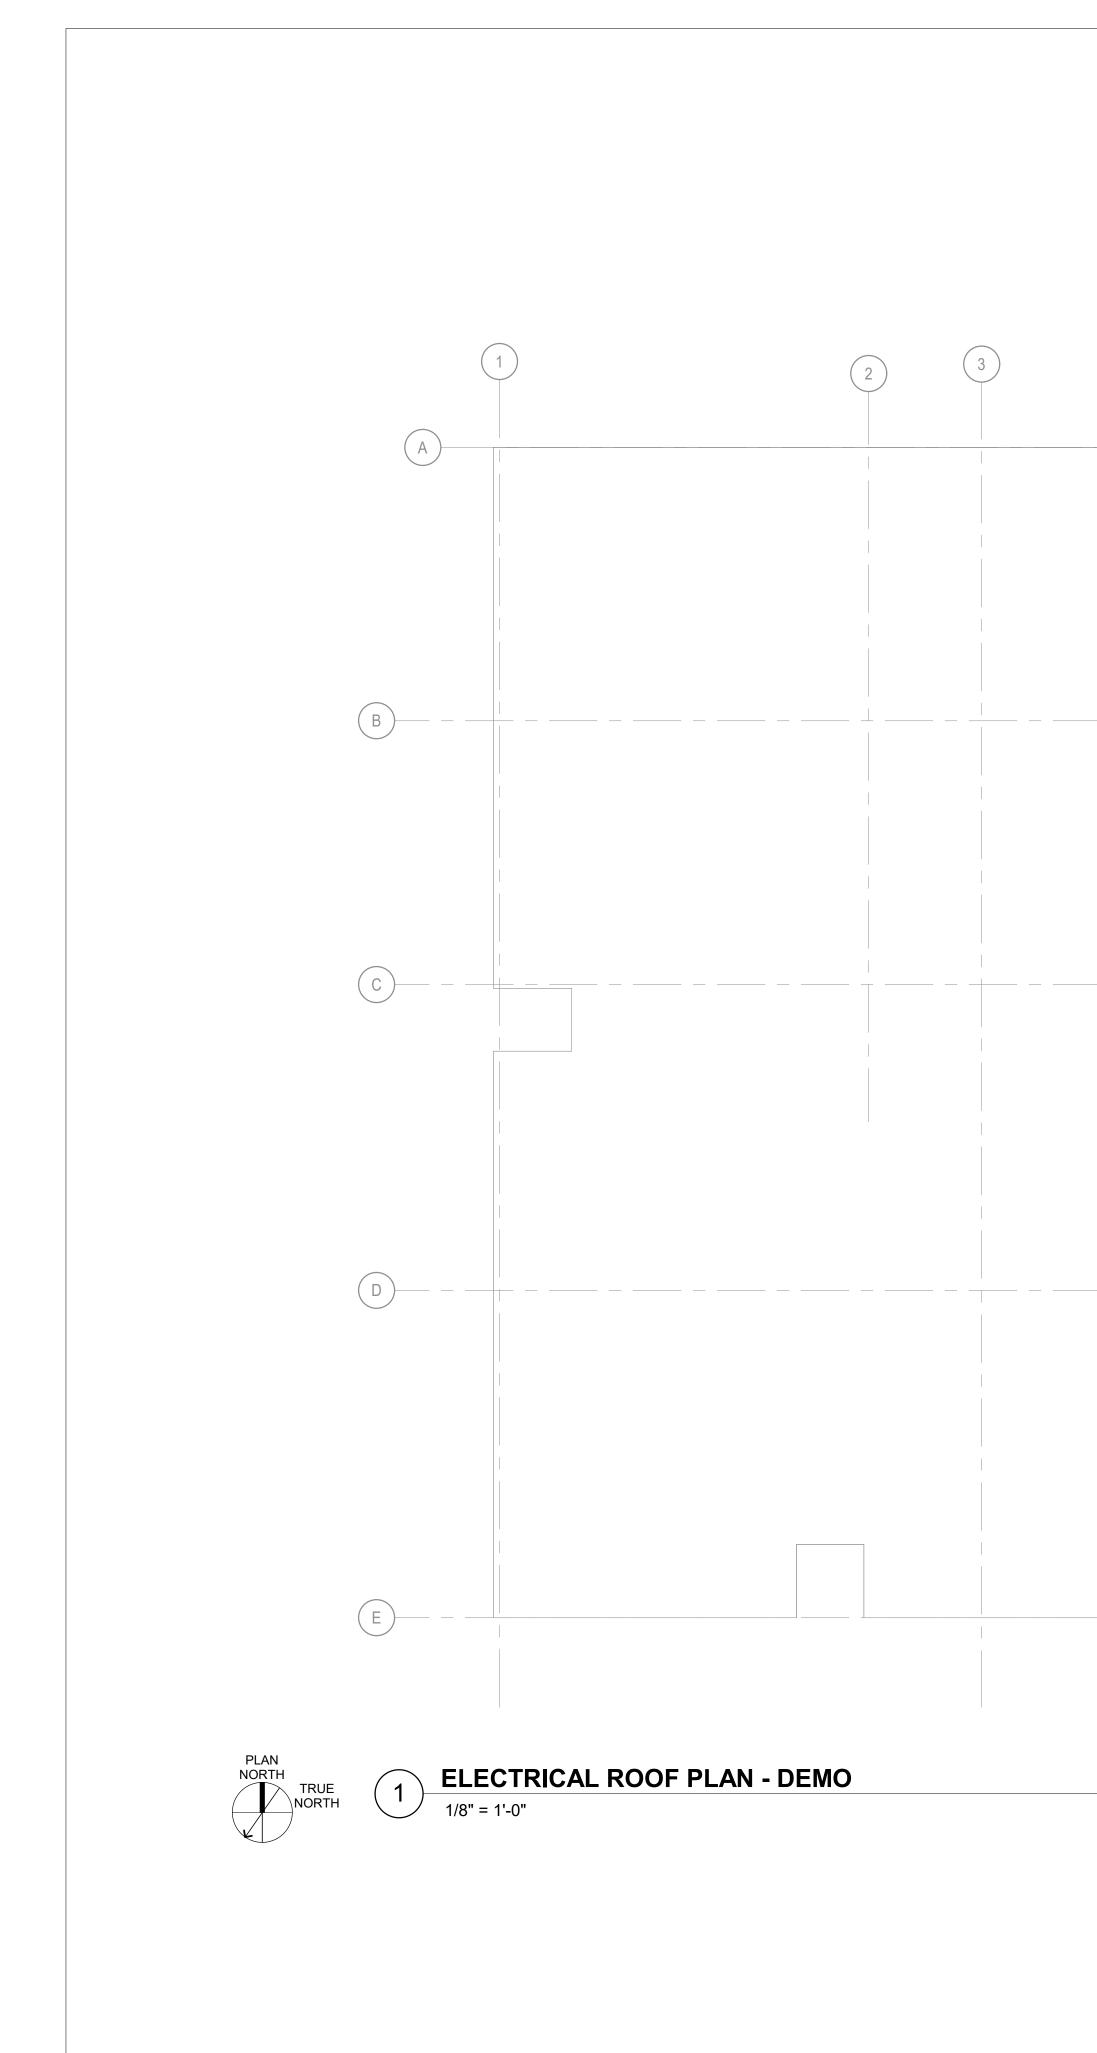
ELECTRICAL FLOOR PLAN - DEMO

SHEET NUMBER:



4-16-2025

SHEET 27 OF 31





#

SHEET KEYNOTES

1. DISCONNECT AND MAKE SAFE FOR REMOVAL OF EQUIPMENT BY DIVISION 23. REMOVE CONDUIT AND CONDUCTORS BACK TO LAST DEVICE REMAINING IN SERVICE OR BACK TO SOURCE.



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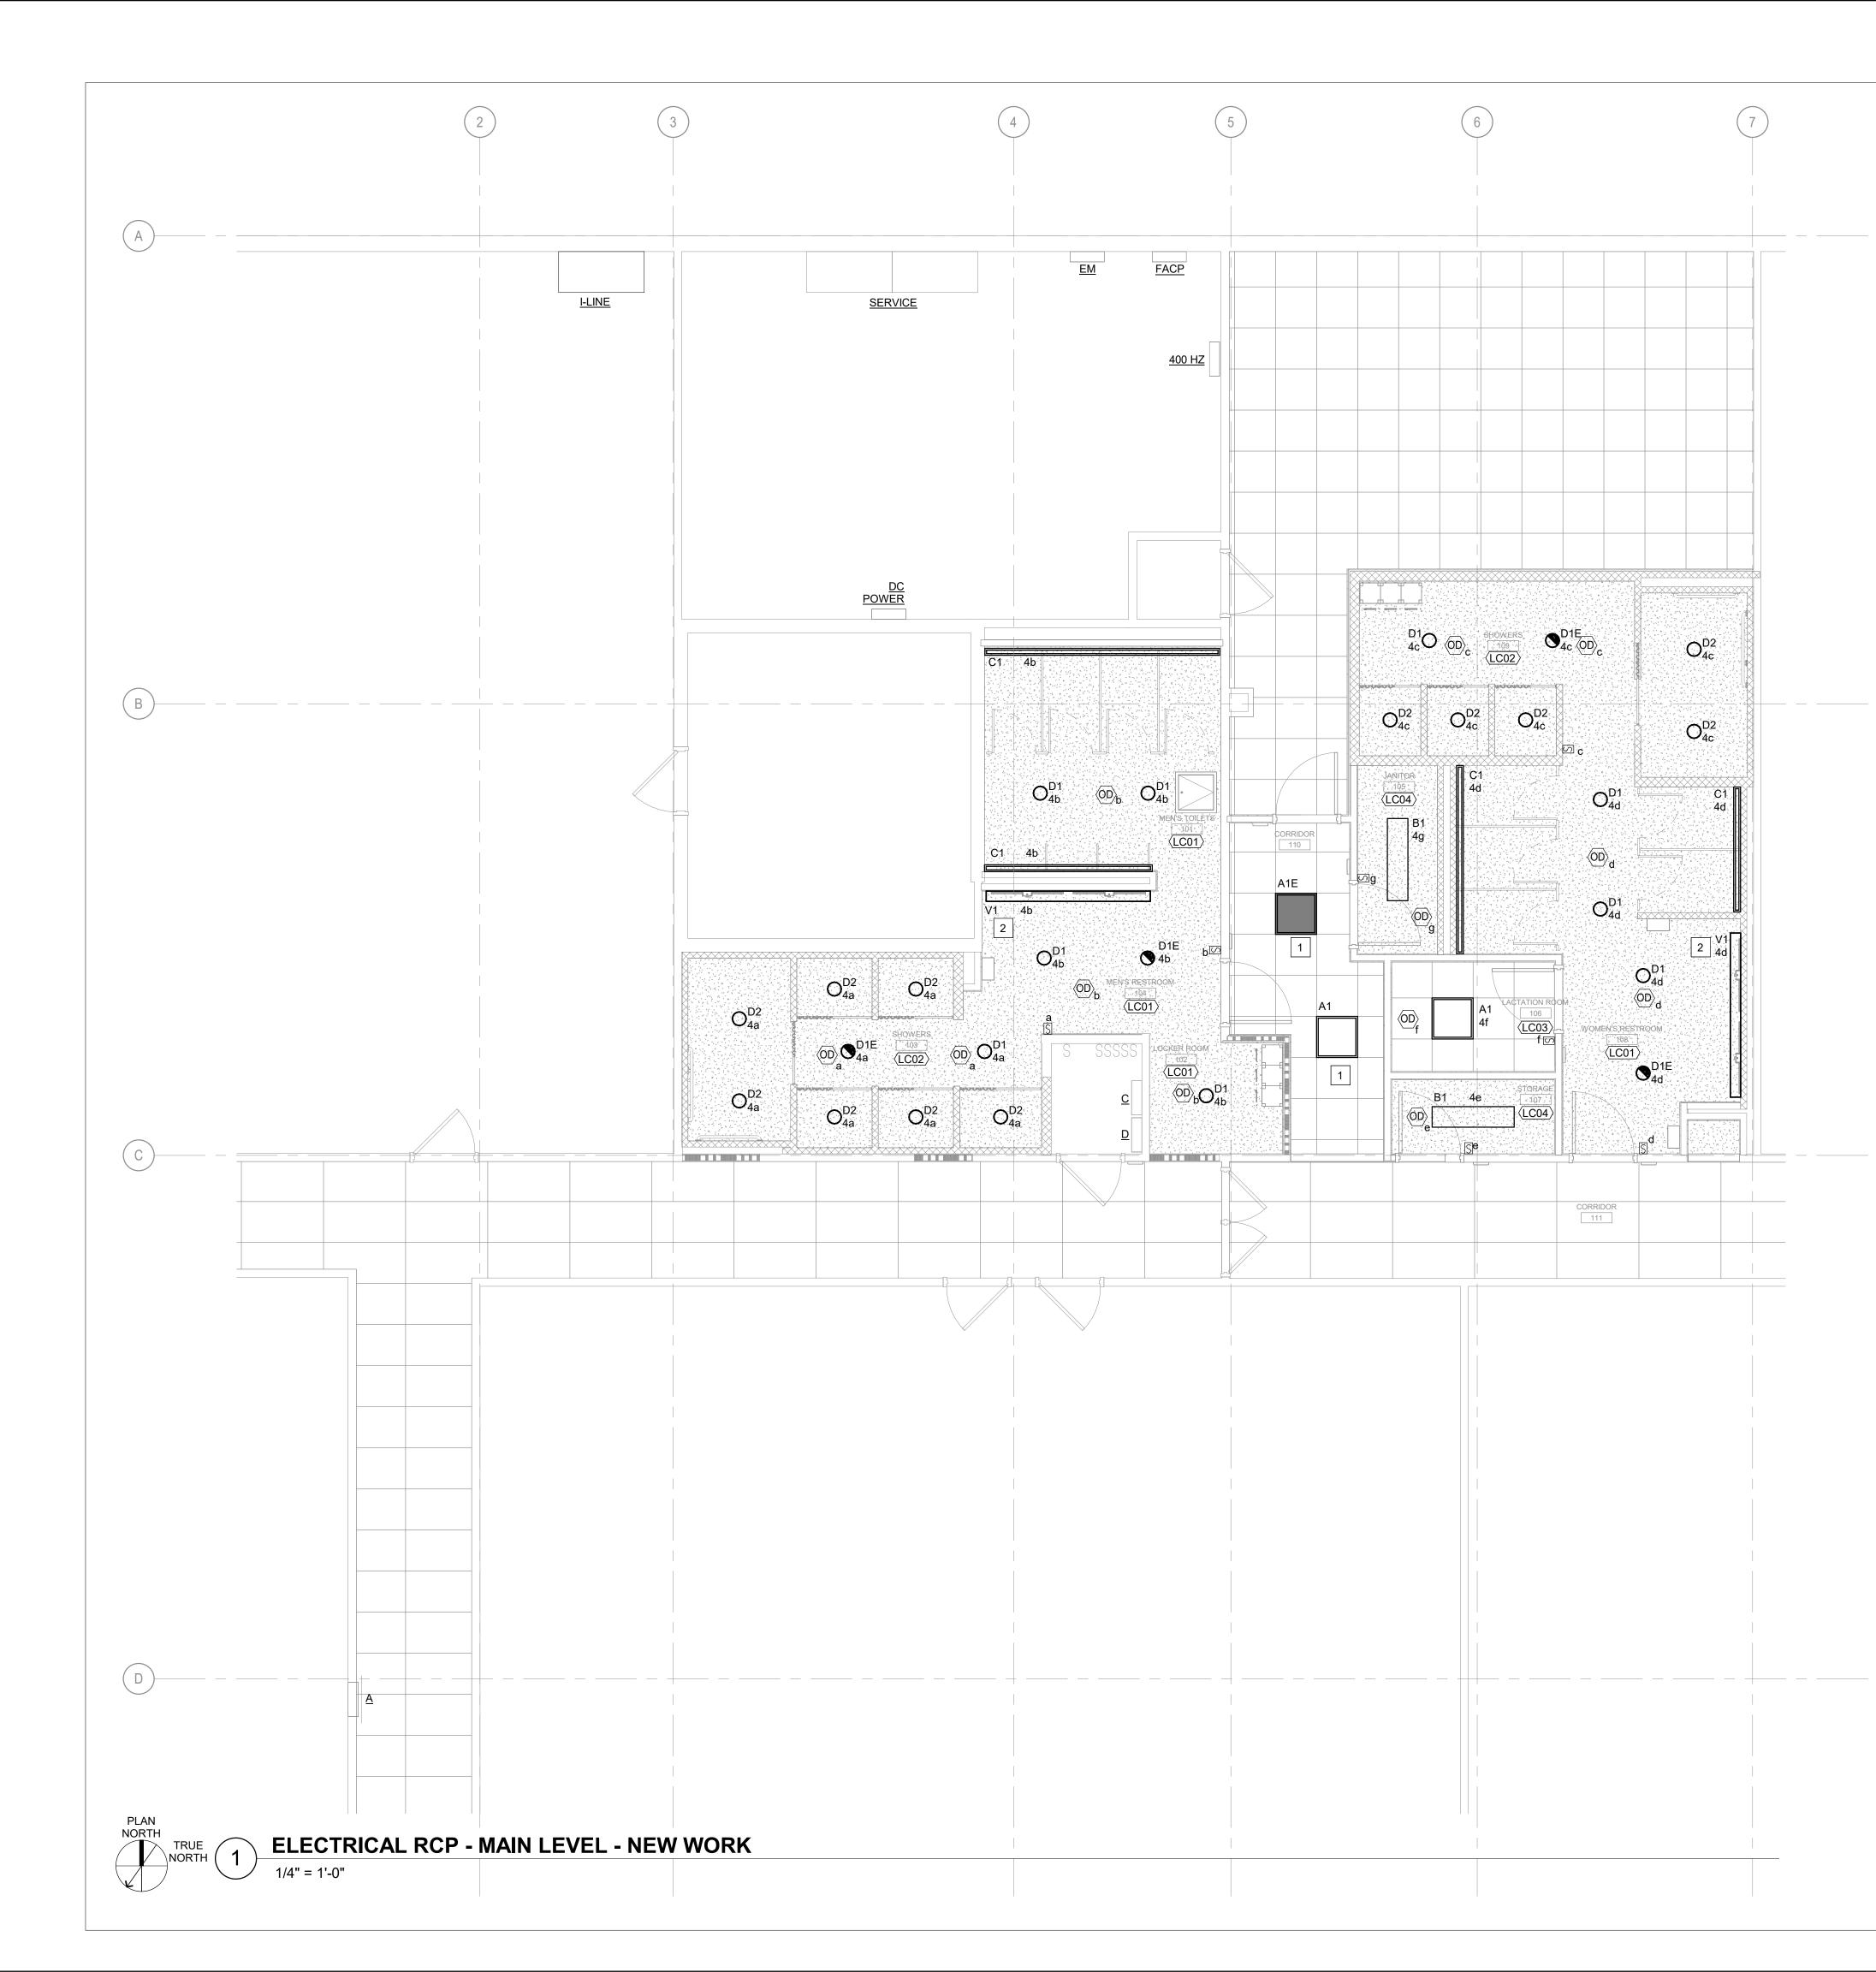
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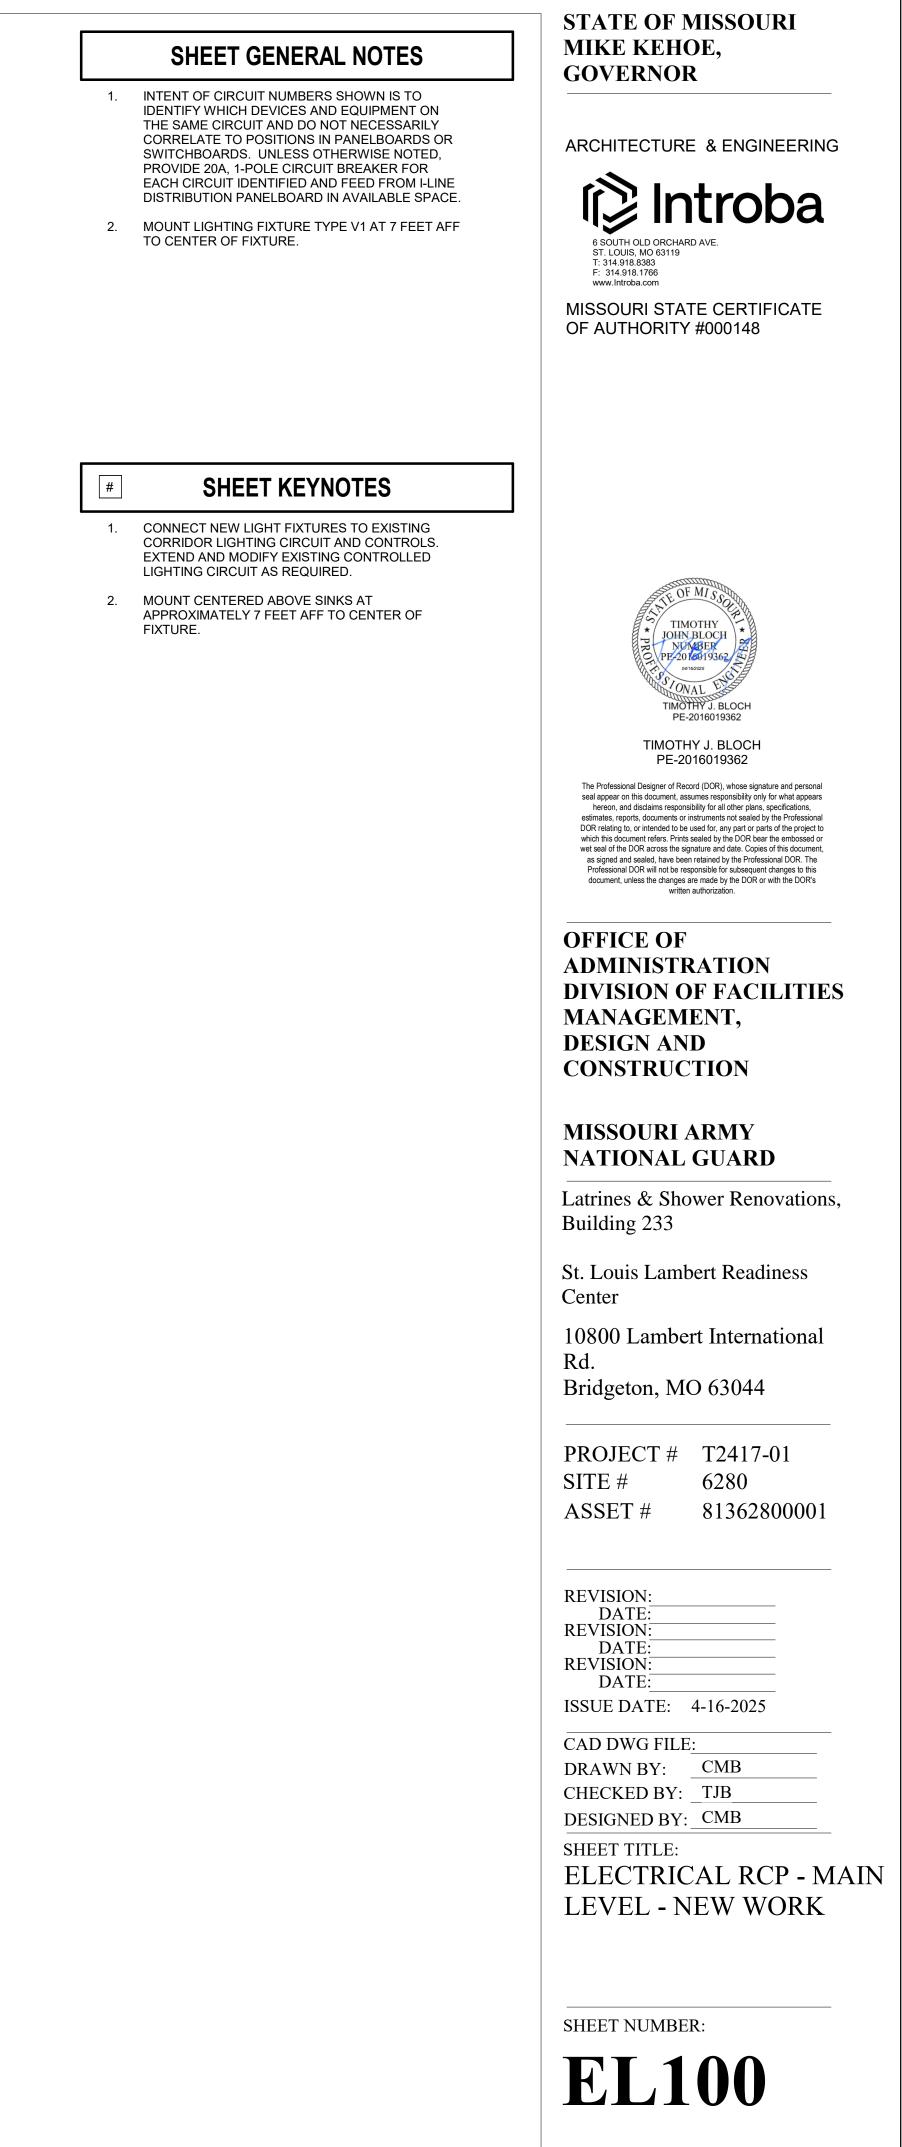
ELECTRICAL ROOF PLAN - DEMO

SHEET NUMBER:




4-16-2025





SHEET 29 OF 31

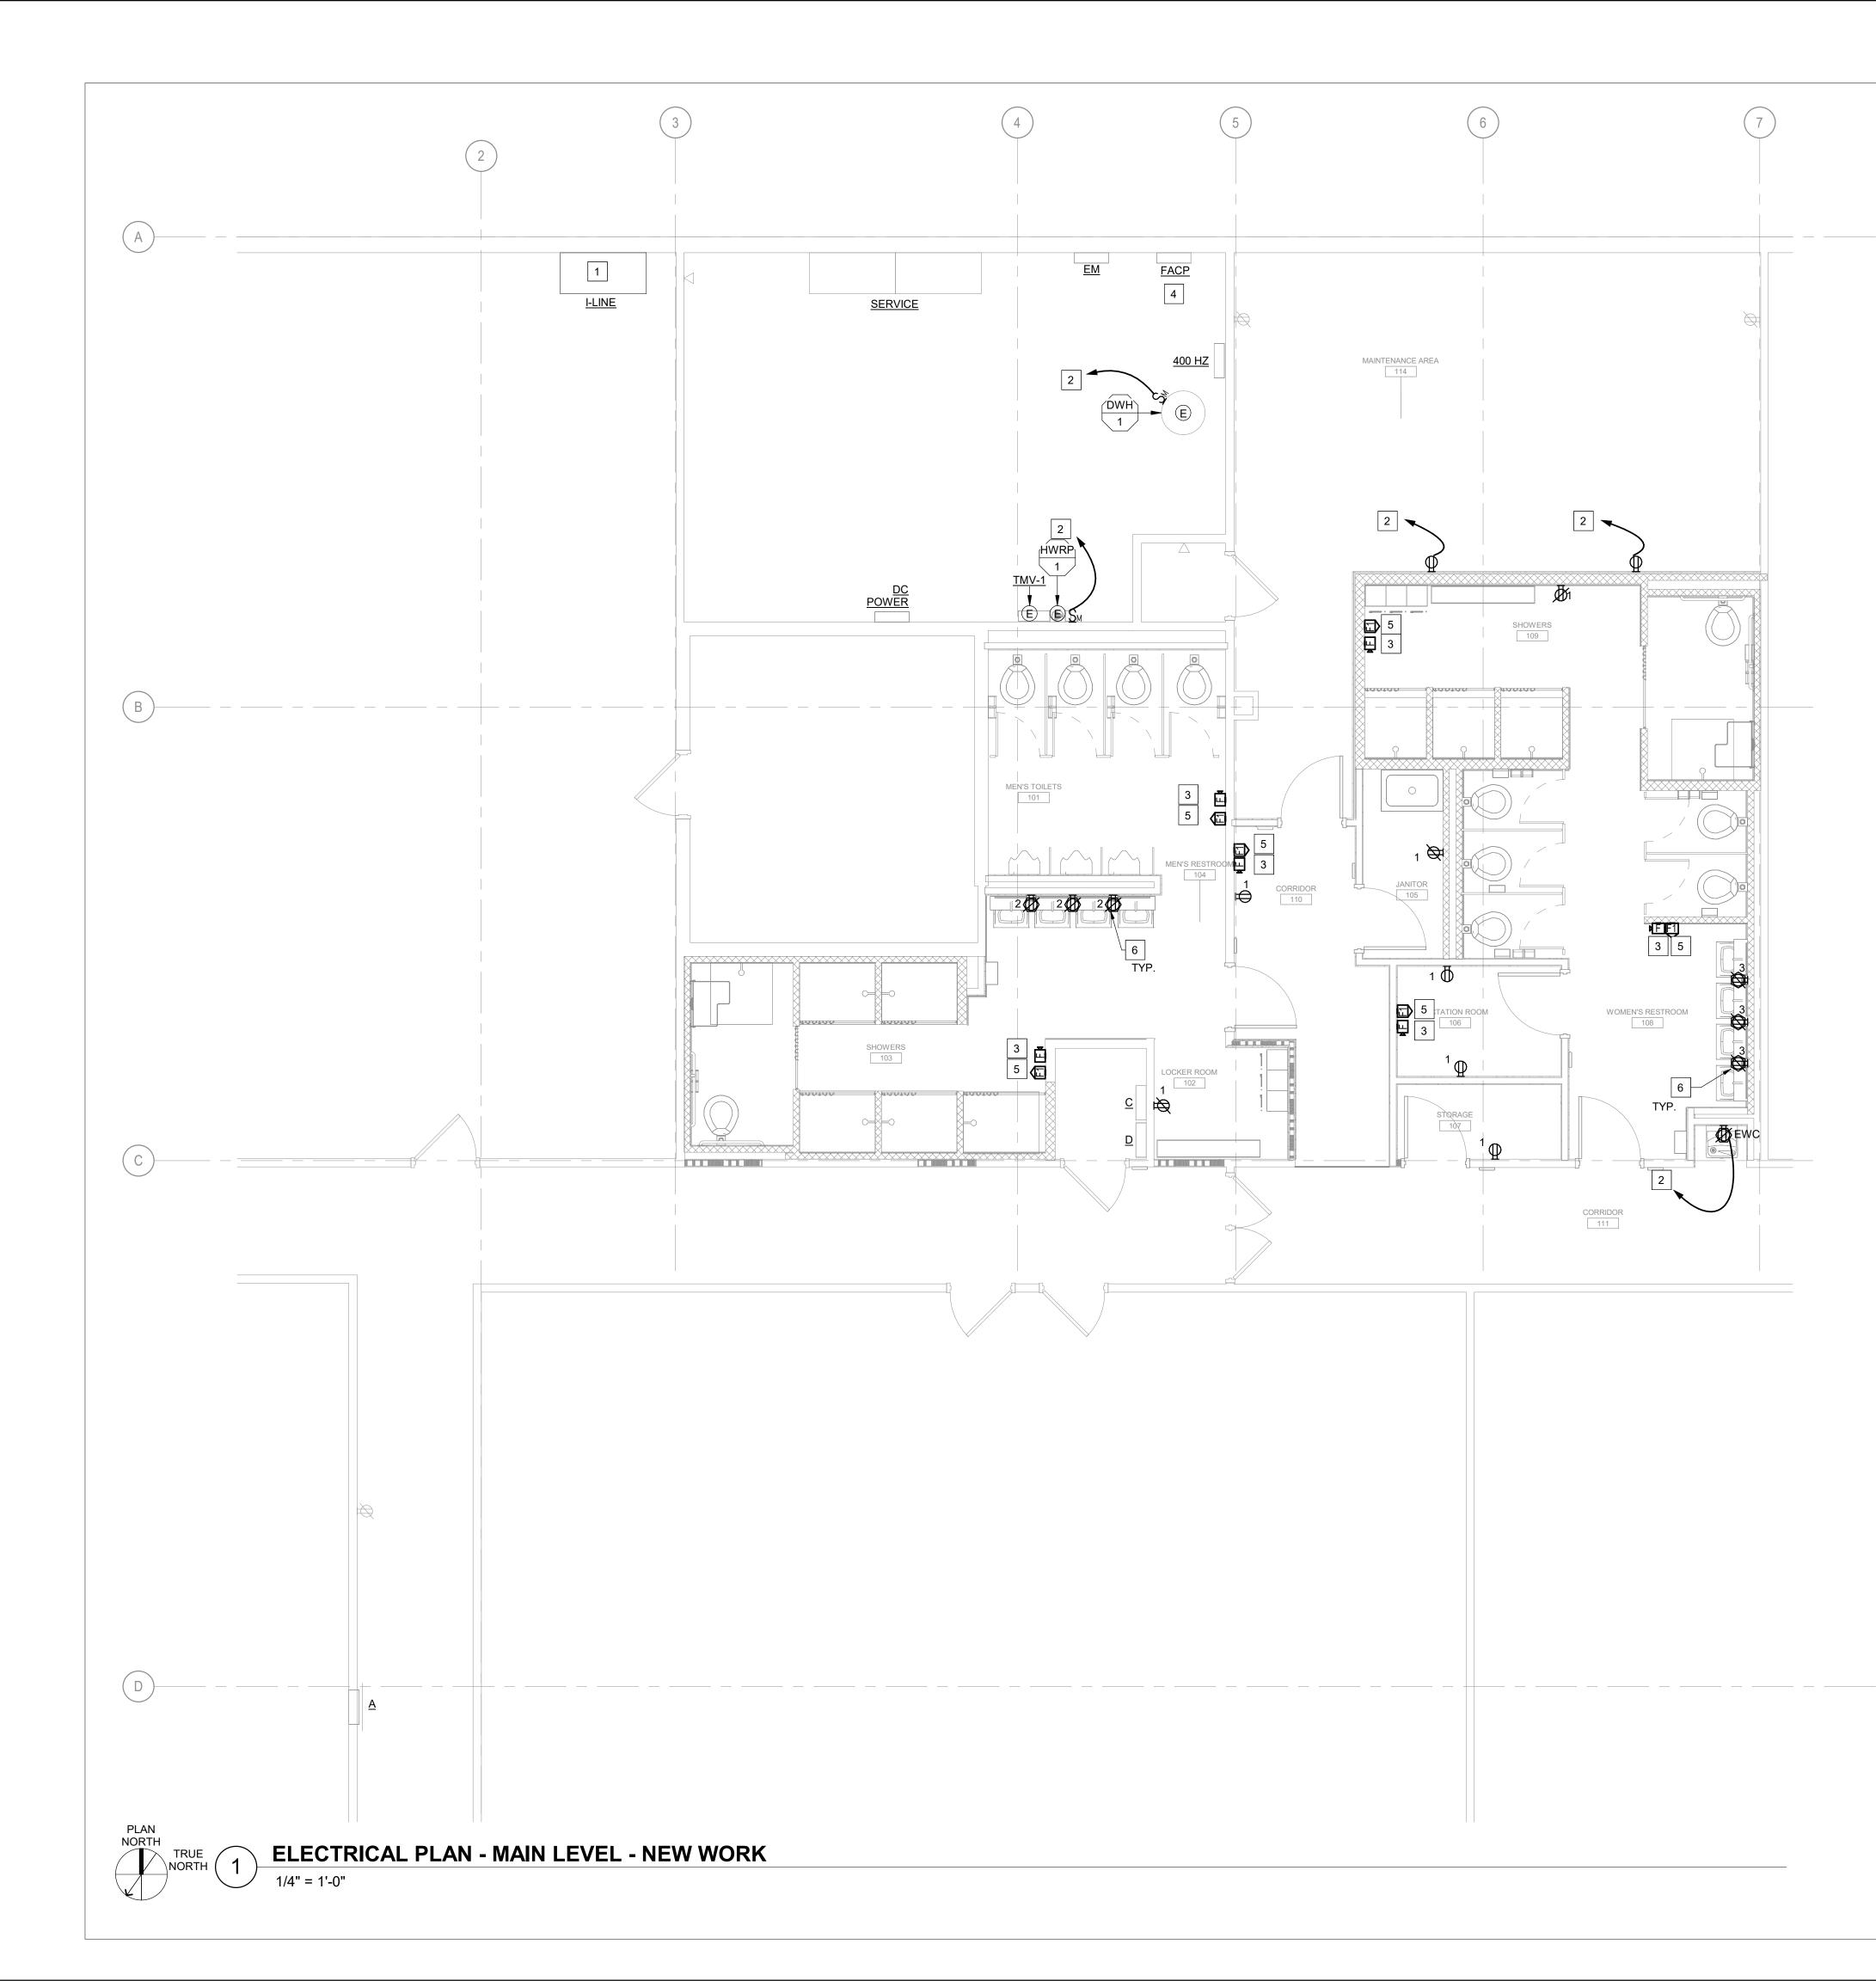

SHEET GENERAL NOTES

- INTENT OF CIRCUIT NUMBERS SHOWN IS TO IDENTIFY WHICH DEVICES AND EQUIPMENT ON THE SAME CIRCUIT AND DO NOT NECESSARILY CORRELATE TO POSITIONS IN PANELBOARDS OR SWITCHBOARDS. UNLESS OTHERWISE NOTED, PROVIDE 20A, 1-POLE CIRCUIT BREAKER FOR EACH CIRCUIT IDENTIFIED AND FEED FROM I-LINE DISTRIBUTION PANELBOARD IN AVAILABLE SPACE.
- 2. WHERE MULTIPLE FIRE ALARM STROBES ARE WITHIN THE SAME ROOM OR AREA, PROVIDE SYNCHRONIZATION MODULES.


1.

- 3. UNLESS OTHERWISE NOTED, ALL FIRE ALARM CABLING SHALL BE IN RED CONDUIT.
- 4. UNLESS OTHERWISE NOTED, ALL BRANCH CIRCUITS SHALL BE (2)#12 IN 3/4 INCH CONDUIT.



 EXISTING DISTRIBUTION PANELBOARD IS SQUARE D, HCW I-LINE TYPE, 208Y/120V, 800A. MODIFY AND RE-ARRANGE EXISTING CIRCUIT BREAKERS TO MAKE SPACE FOR NEW CIRCUIT BREAKERS AS REQUIRED.

- 2. PROVIDE DEDICATED 15A 1-POLE CIRCUIT BREAKER IN AVAILABLE SPACE IN I-LINE DISTRIBUTION PANELBOARD.
- 3. PROVIDE NEW FIRE ALARM BELL COMPATIBLE WITH EXISTING FIRE ALARM CONTROL PANEL LOCATED IN UTILITY ROOM. CONNECT TO EXISTING FIRE ALARM CIRCUIT SERVING ZONE OF AREA. MODIFY OR EXTEND EXISTING FIRE ALARM CIRCUIT AS REQUIRED. BELL SHALL BE 6 INCH, STEEL WITH RED POWDER COAT FINISH. FIELD VERIFY AND MATCH EXISTING BELLS VOLTAGE. INSTALL BELL AT MINIMUM 90 INCHES AFF FROM TOP OF BELL.
- 4. EXISTING FIRE ALARM CONTROL PANEL IS SIMPLEX 2001-3080.
- 5. PROVIDE NEW FIRE ALARM STROBE COMPATIBLE WITH EXISTING FIRE ALARM CONTROL PANEL LOCATED IN UTILITY ROOM. CONNECT TO EXISTING FIRE ALARM CIRCUIT SERVING ZONE OF AREA. MODIFY OR EXTEND EXISTING FIRE ALARM CIRCUIT AS REQUIRED. STROBE SHALL BE RED WITH CLEAR LENS WITH "FIRE" IN WHITE LETTERS. FIELD VERIFY AND MATCH EXISTING VOLTAGE OF EXISTING VISUAL NOTIFICATION DEVICES. INSTALL STROBE AT 90 INCHES AFF FROM TO OF DEVICE.
- 6. MOUNT AT 60 INCHES AFF TO MIDDLE OF RECEPTACLE.

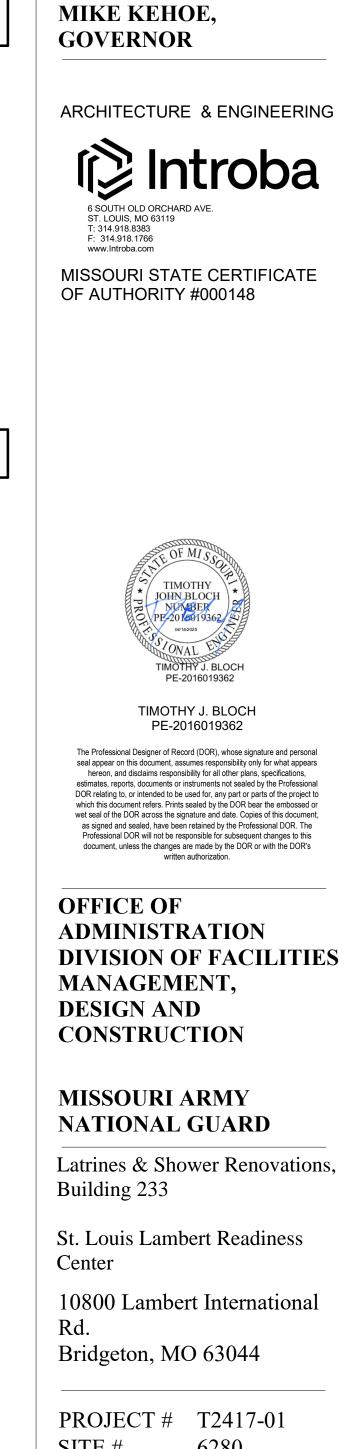

STATE OF MISSOURI

PROJECT #	12417-01
SITE #	6280
ASSET #	81362800001

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SHEET NUMBER:



4-16-2025

SHEET 30 OF 31

