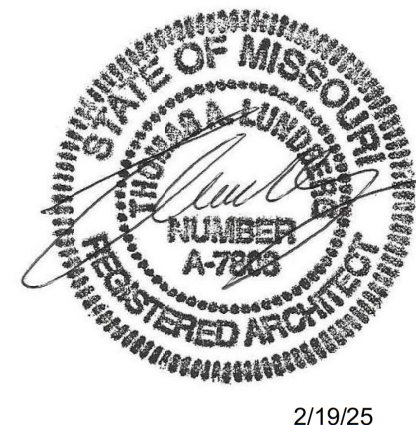
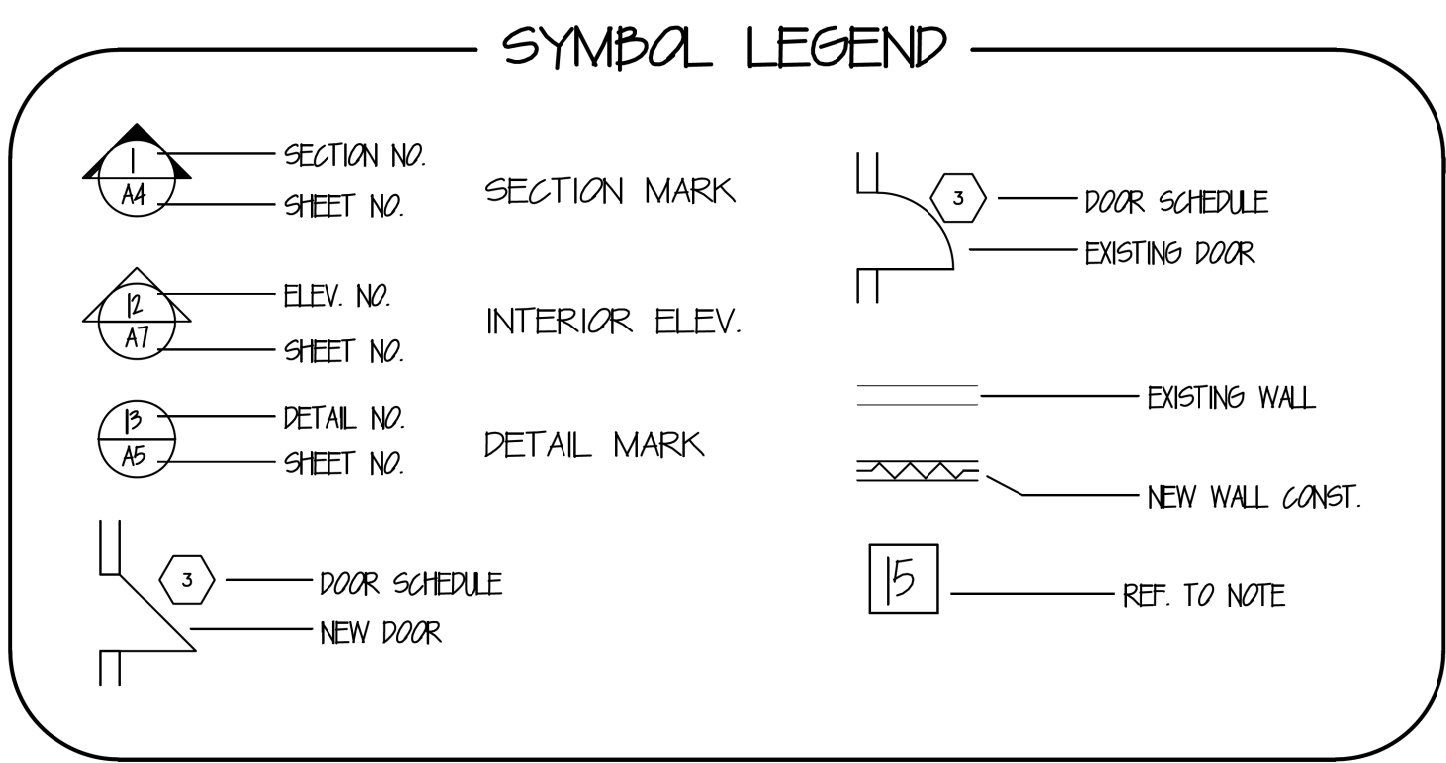


# Interior Renovation Missouri Veterans Home St. James, Missouri



2/19/25



**ESTERLY  
SCHNEIDER &  
ASSOCIATES, INC.**  
**AIA** architects & planners  
COMM. # 4860

1736 East Sunshine, Suite 417  
Springfield, Missouri 65804  
417.862.0558

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CERTIFICATE OF AUTHORITY # 000718

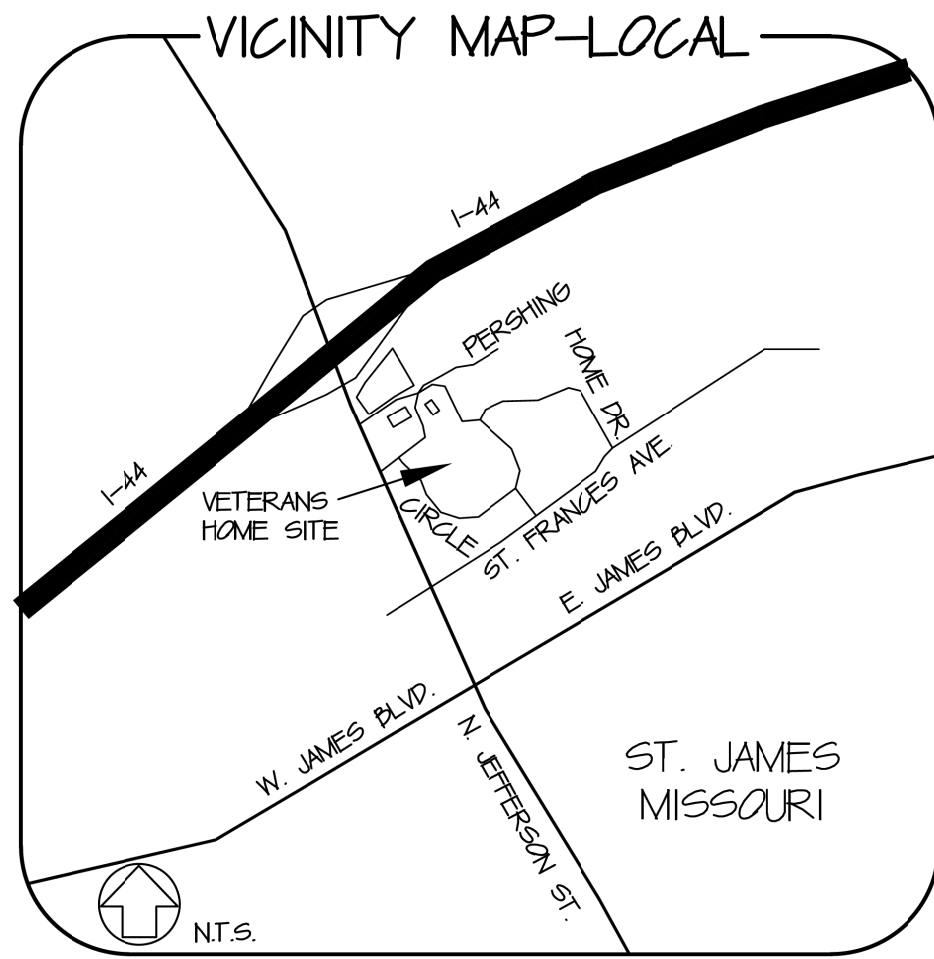
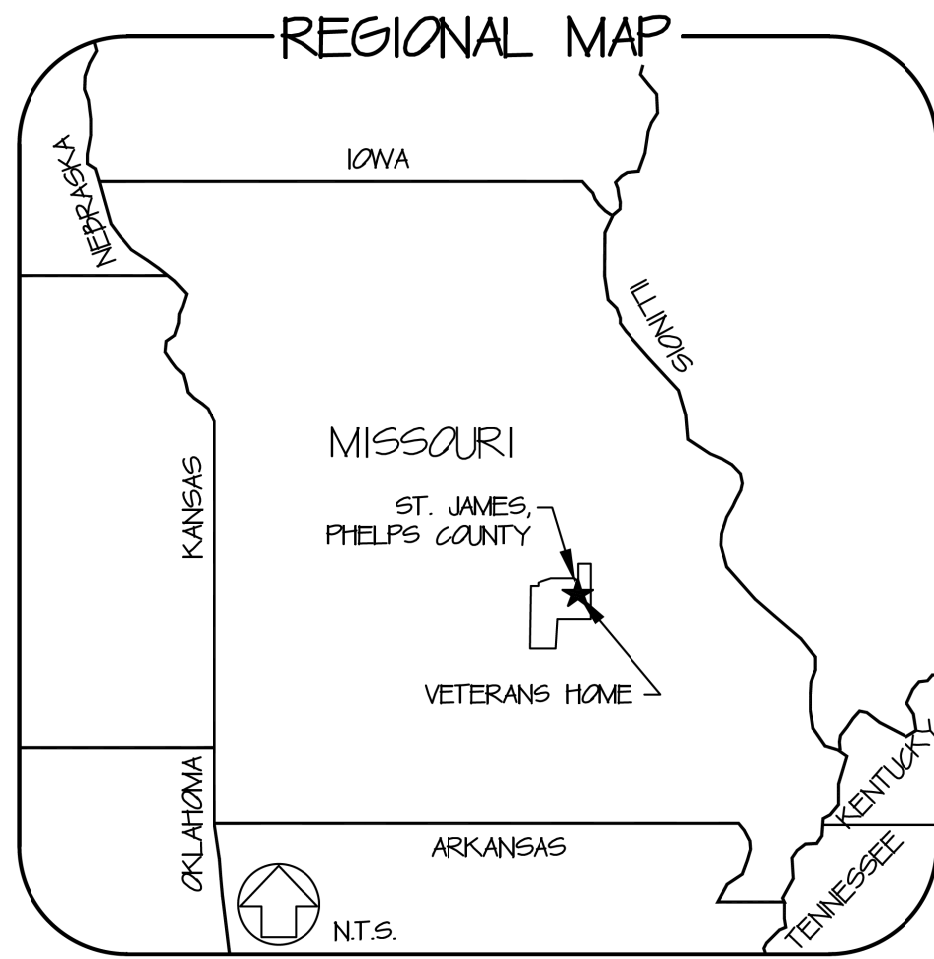
**OWNER:** STATE OF MISSOURI  
MIKE KEHOE,  
GOVERNOR  
DEPARTMENT OF PUBLIC SAFETY  
MISSOURI VETERANS COMMISSION

**DESIGNER:** ESTERLY, SCHNEIDER &  
ASSOCIATES, INC., AIA

**PROJECT  
MANAGEMENT:** OFFICE OF ADMINISTRATION  
DIVISION OF FACILITIES MANAGEMENT,  
DESIGN AND CONSTRUCTION

**PROJECT NUMBER:** U1503-01  
**FAI NUMBER:** 29-044

**SITE NUMBER:** 6801  
**ASSET NUMBER:** 8136801002



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A-114	FLOOR PLAN	M-128	HVAC PIPING & PLUMBING PLAN
A-115	FLOOR PLAN	M-129	HVAC PIPING & PLUMBING PLAN
A-116	FLOOR PLAN	M-130	HVAC PIPING & PLUMBING PLAN
A-117	FLOOR PLAN	M-131	HVAC PIPING & PLUMBING PLAN
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S-101	FOUNDATION PLAN	E-108	ELECTRICAL DEMOLITION PLAN
S-102	FOUNDATION PLAN	E-109	ELECTRICAL DEMOLITION PLAN
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S-104	FRAMING PLAN	E-111	ELECTRICAL PLAN
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M-105	HVAC & PLUMBING DEMO PLAN	E-120	ELECTRICAL PLAN
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SHEET NUMBER:

**G-001**

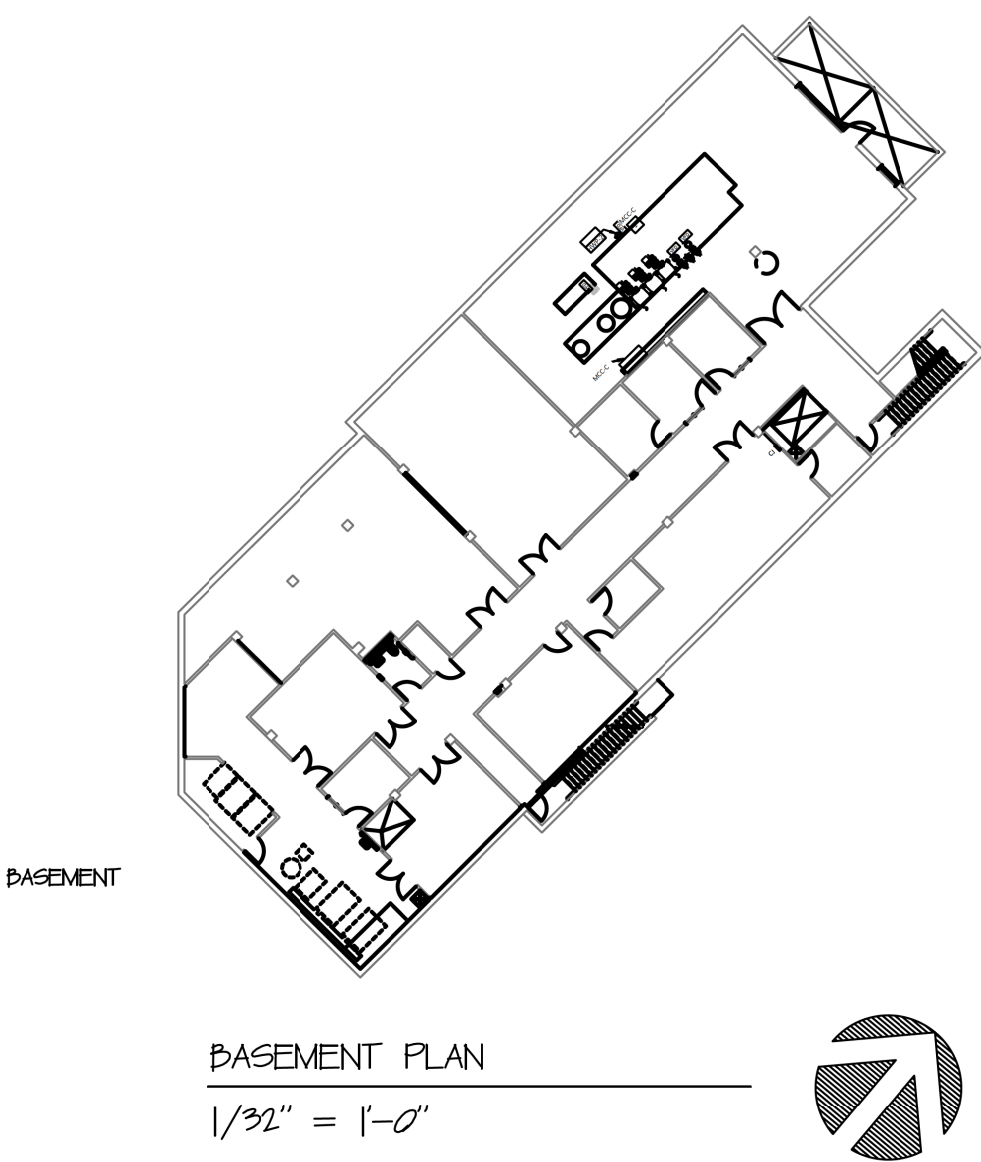
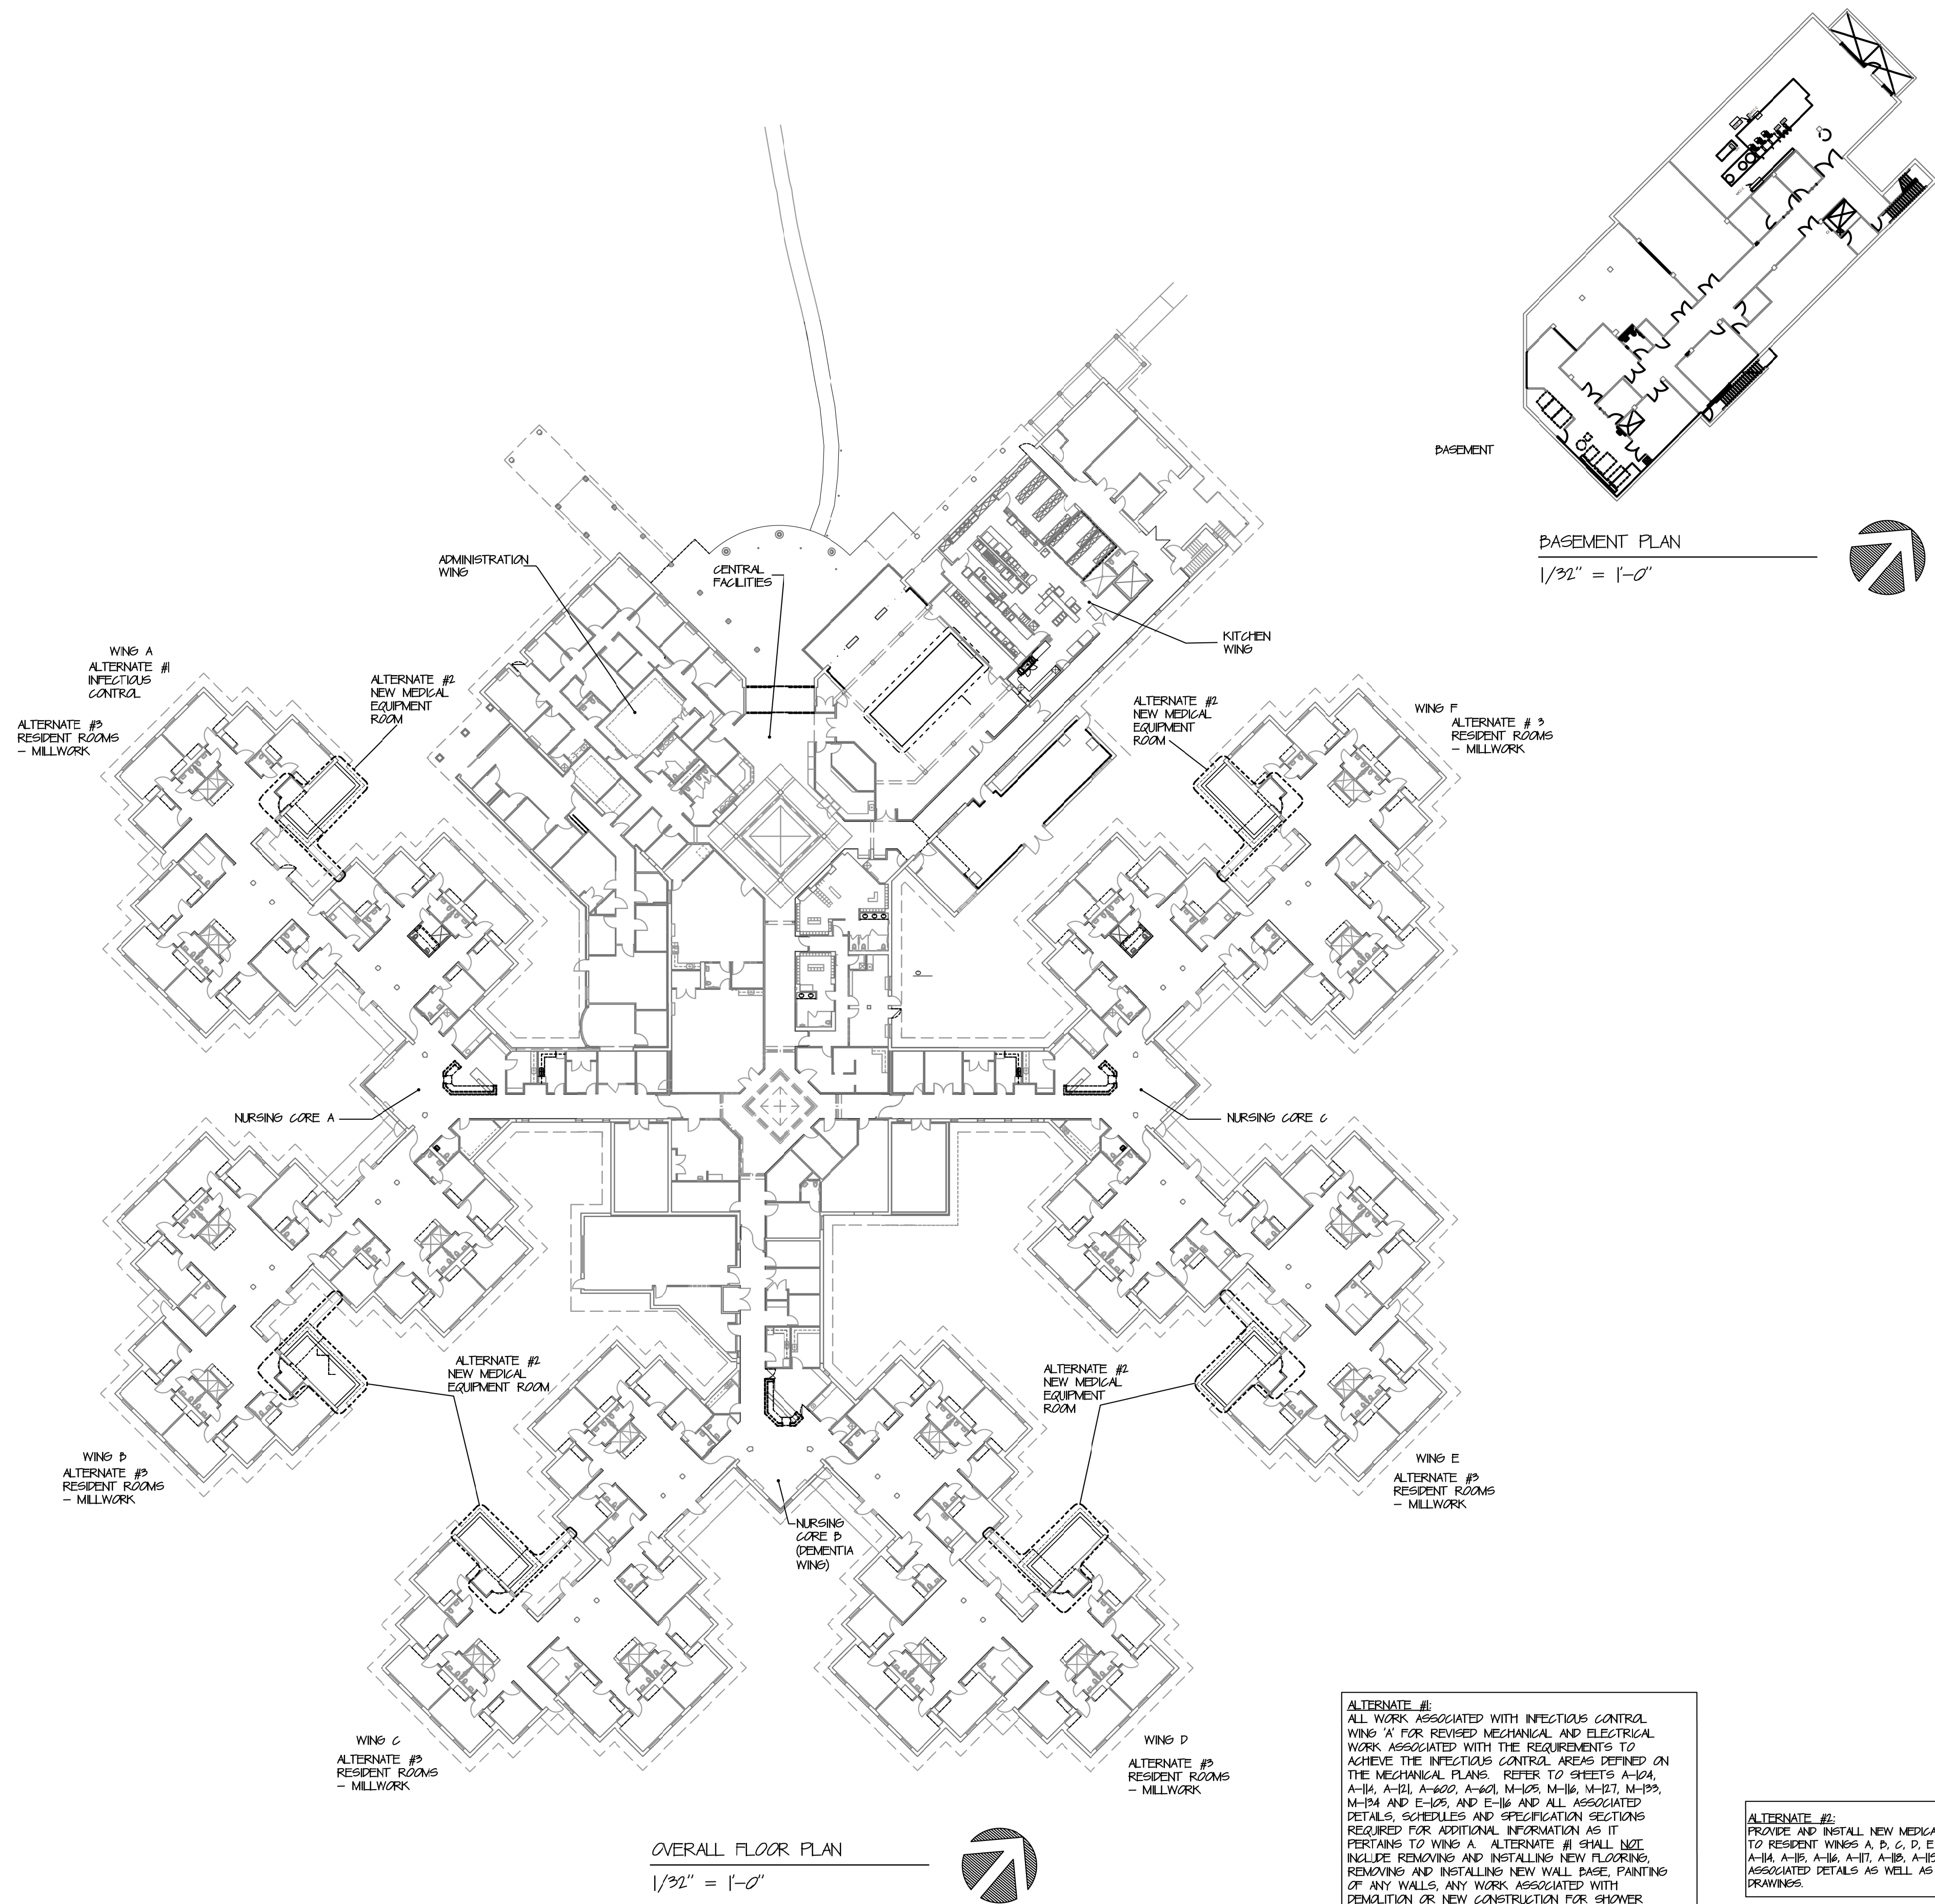
1 OF 120 SHEETS  
AUGUST 1, 2024

BID DOCUMENTS









ALTERNATE #1:  
ALL WORK ASSOCIATED WITH INFECTIOUS CONTROL WING 'A' FOR REVISED MECHANICAL AND ELECTRICAL WORK ASSOCIATED WITH THE REQUIREMENTS TO ACHIEVE THE INFECTIOUS CONTROL AREAS DEFINED ON THE MECHANICAL PLANS. REFER TO SHEETS A-104, A-114, A-121, A-200, A-201, M-105, M-116, M-127, M-133, M-134 AND E-105, AND E-116 AND ALL ASSOCIATED DETAILS, SCHEDULES AND SPECIFICATION SECTIONS REQUIRED FOR ADDITIONAL INFORMATION AS IT PERTAINS TO WING A. ALTERNATE #1 SHALL NOT INCLUDE REMOVING AND INSTALLING NEW FLOORING, REMOVING AND INSTALLING NEW WALL BASE, PAINTING OF ANY WALLS, ANY WORK ASSOCIATED WITH DEMOLITION OR NEW CONSTRUCTION FOR SHOWER ROOM 107. ALTERNATE SHALL NOT INCLUDE ANY WORK ASSOCIATED WITH NEW TV MOUNTING AND BULKHEADS, NOR WORK ASSOCIATED WITH OTHER ALTERNATE WORK IN THIS WING. THESE ITEMS REMAIN IN THE BASE BID AND AS DEFINED IN THE PHASING SCHEDULE. ANY ITEMS NOT LISTED SPECIFICALLY ABOVE, BUT SHOWN ON THE DRAWINGS/SPECIFICATIONS, SHALL REMAIN IN THE ALTERNATE BID #1.

ALTERNATE #2:  
PROVIDE AND INSTALL NEW MEDICAL EQUIPMENT ROOM ADDITION TO RESIDENT WINGS A, B, C, D, E AND F. REFER TO SHEETS A-114, A-115, A-116, A-117, A-118, A-119, A-121 AND A-202 AND ALL ASSOCIATED DETAILS AS WELL AS MEP AND STRUCTURAL DRAWINGS.

ALTERNATE #3:  
AT ALL RESIDENT ROOMS, REMOVE AND DISCARD EXISTING WARDROBE AND CABINETS. PATCH AND REPAIR WALL AS REQUIRED TO RECEIVE NEW MILLWORK AT RESIDENTS ROOMS AT WINGS A, B, C, D, E AND F. PROVIDE AND INSTALL NEW WARDROBE AND CABINETS PER SHEETS A-104, A-105, A-106, A-107, A-108, A-109, A-114, A-115, A-116, A-117, A-118, A-119, A-212, E-116, E-117, E-118, E-119, E-120 AND E-121 AS WELL AS ALL ASSOCIATED DETAILS.



2/19/25

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620 N. JEFFERSON  
ST. JAMES, MISSOURI

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SITE # 6801  
ASSET # 8136801002  
FEDERAL# 29-044

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REVISION: \_\_\_\_\_  
DATE: \_\_\_\_\_  
REVISION: \_\_\_\_\_  
DATE: \_\_\_\_\_  
ISSUE DATE: 8-1-24

CAD DWG FILE: G-101.DWG  
DRAWN BY: ZAC/MAH  
CHECKED BY: MAH/CAS  
DESIGNED BY: MAH/CAS

SHEET TITLE:  
**OVERALL PLAN**

SHEET NUMBER:

**G-101**

3 OF 120 SHEETS  
8-1-24





2/19/25

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REVISION: \_\_\_\_\_  
DATE: \_\_\_\_\_

ISSUE DATE: 8-1-24

CAD DWG FILE: G-102.DWG  
DRAWN BY: ZAC/MAH  
CHECKED BY: MAH/CAS  
DESIGNED BY: MAH/CAS

SHEET TITLE:

EXISTING FIRE  
PROTECTION  
PLAN

SHEET NUMBER:

G-102

4 OF 120 SHEETS  
8-1-24

CODE SUMMARY FOR NEW CONSTRUCTION

GOVERNING CODES:

2021 INTERNATIONAL BUILDING CODE  
2021 INTERNATIONAL MECHANICAL CODE  
2021 INTERNATIONAL PLUMBING CODE  
2021 INTERNATIONAL FIRE CODE  
2020 NATIONAL ELECTRIC CODE  
2021 INTERNATIONAL ENERGY CONSERVATION CODE  
2021 NFPA 101 LIFE SAFETY CODE NFPA 99 EQUIPMENT IN HEALTH CARE FACILITIES NFPA 13 INSTALLATION OF SPRINKLER SYSTEMS  
2007 ADAS

IN ADDITION TO CURRENT CODES:

2021 NFPA 101  
2021 NFPA 99  
2002 NFPA 72  
2002 NFPA 13  
2002 NFPA 10  
2002 NFPA 80  
2011 NFPA 96  
2012 NFPA 92

FOLLOWING IS A CODE SUMMARY OF THE BUILDING BASED  
ON THE CURRENT CODE AT THE TIME OF THE DEMENTIA  
ADDITION CONSTRUCTION PROJECT (2024)

CODE SUMMARY FOR EXISTING BUILDING DESIGN

GOVERNING CODES:

1999 BOCA BUILDING CODE  
1999 INTERNATIONAL MECHANICAL CODE  
1999 INTERNATIONAL PLUMBING CODE  
1999 BOCA FIRE PREVENTION CODE  
2009 NATIONAL ELECTRIC CODE  
2002 NFPA 101 LIFE SAFETY CODE NFPA 99 EQUIPMENT IN HEALTH CARE FACILITIES NFPA 13 INSTALLATION OF SPRINKLER SYSTEMS

BOCA LIFE GROUPS:

EXIST. ADMINISTRATION	D
EXIST. FOOD SERVICE	A-3
EXIST. LOBBIES	A-3
EXIST. PATIENT ROOMS & NURSING SUPPORT AREAS	I-2
DEMENTIA ADDITION	A-3

BOCA CONSTRUCTION CLASSIFICATION:

EXIST. ADMINISTRATION	TYPE 2C UNPROTECTED
EXIST. FOOD SERVICE	TYPE 2C UNPROTECTED
EXIST. LOBBIES	TYPE 2C UNPROTECTED
EXIST. PATIENT ROOMS & NURSING SUPPORT AREAS	5A PROTECTED
DEMENTIA ADDITION	5A PROTECTED

BOCA FIRE RESISTANCE RATINGS OF STRUCTURE ELEMENTS:

2C UNPROTECTED:	
ENCLOSURE OF EXITS:	1 HOUR
SHAFTS/ELEVATORS	1 HOUR
EXIT ACCESS CORR.	0 HOUR
SMOKE BARRIERS	1 HOUR

5A PROTECTED:

EXTERIOR LOAD BEARING WALLS	1 HOUR
FIRE WALLS	2 HOUR
ENCLOSURE OF EXITS	1 HOUR
SHAFTS/ELEVATORS	1 HOUR
EXIT ACCESS CORR.	1 HOUR SMOKE PARTITIONS
SMOKE BARRIERS	1 HOUR
INTERIOR LOAD BEARING STRUCTURE	1 HOUR
STRUCTURAL MEMBERS	1 HOUR
SUPPORTING WALL	1 HOUR
ROOF CONSTRUCTION	1 HOUR

NFPA CLASSIFICATION OF OCCUPANCY:

ASSEMBLY:  
CONFERENCE ROOMS FOR MORE THAN 50 PEOPLE  
LIBRARIES OF MORE THAN 50 PEOPLE  
RESTAURANTS/DINING FOR MORE THAN 50 PEOPLE  
DEMENTIA ADDITION

HEALTH CARE:  
PATIENT WINGS & THERAPY AREAS

BUSINESS:  
OFFICE AREAS

ORDINARY HAZARD CLASSIFICATION FOR ENTIRE BUILDING

NFPA LIFE GROUP:


NEW HEALTH CARE OCCUPANCIES

NFPA CONSTRUCTION CLASSIFICATION:  
TYPE II (2002): ADMINISTRATION FOOD SERVICE LOBBIES

TYPE VIII): PATIENT ROOMS & NURSING SUPPORT AREAS AND NEW:  
OUTPATIENT CLINIC ADDN. (2000)  
STORAGE ROOM ADDITIONS (2009)  
DEMENTIA DINING ADDITION (2024)


FIRE RATINGS:	
2 HOUR RATING	
1 HOUR RATING	
SMOKE BARRIER	

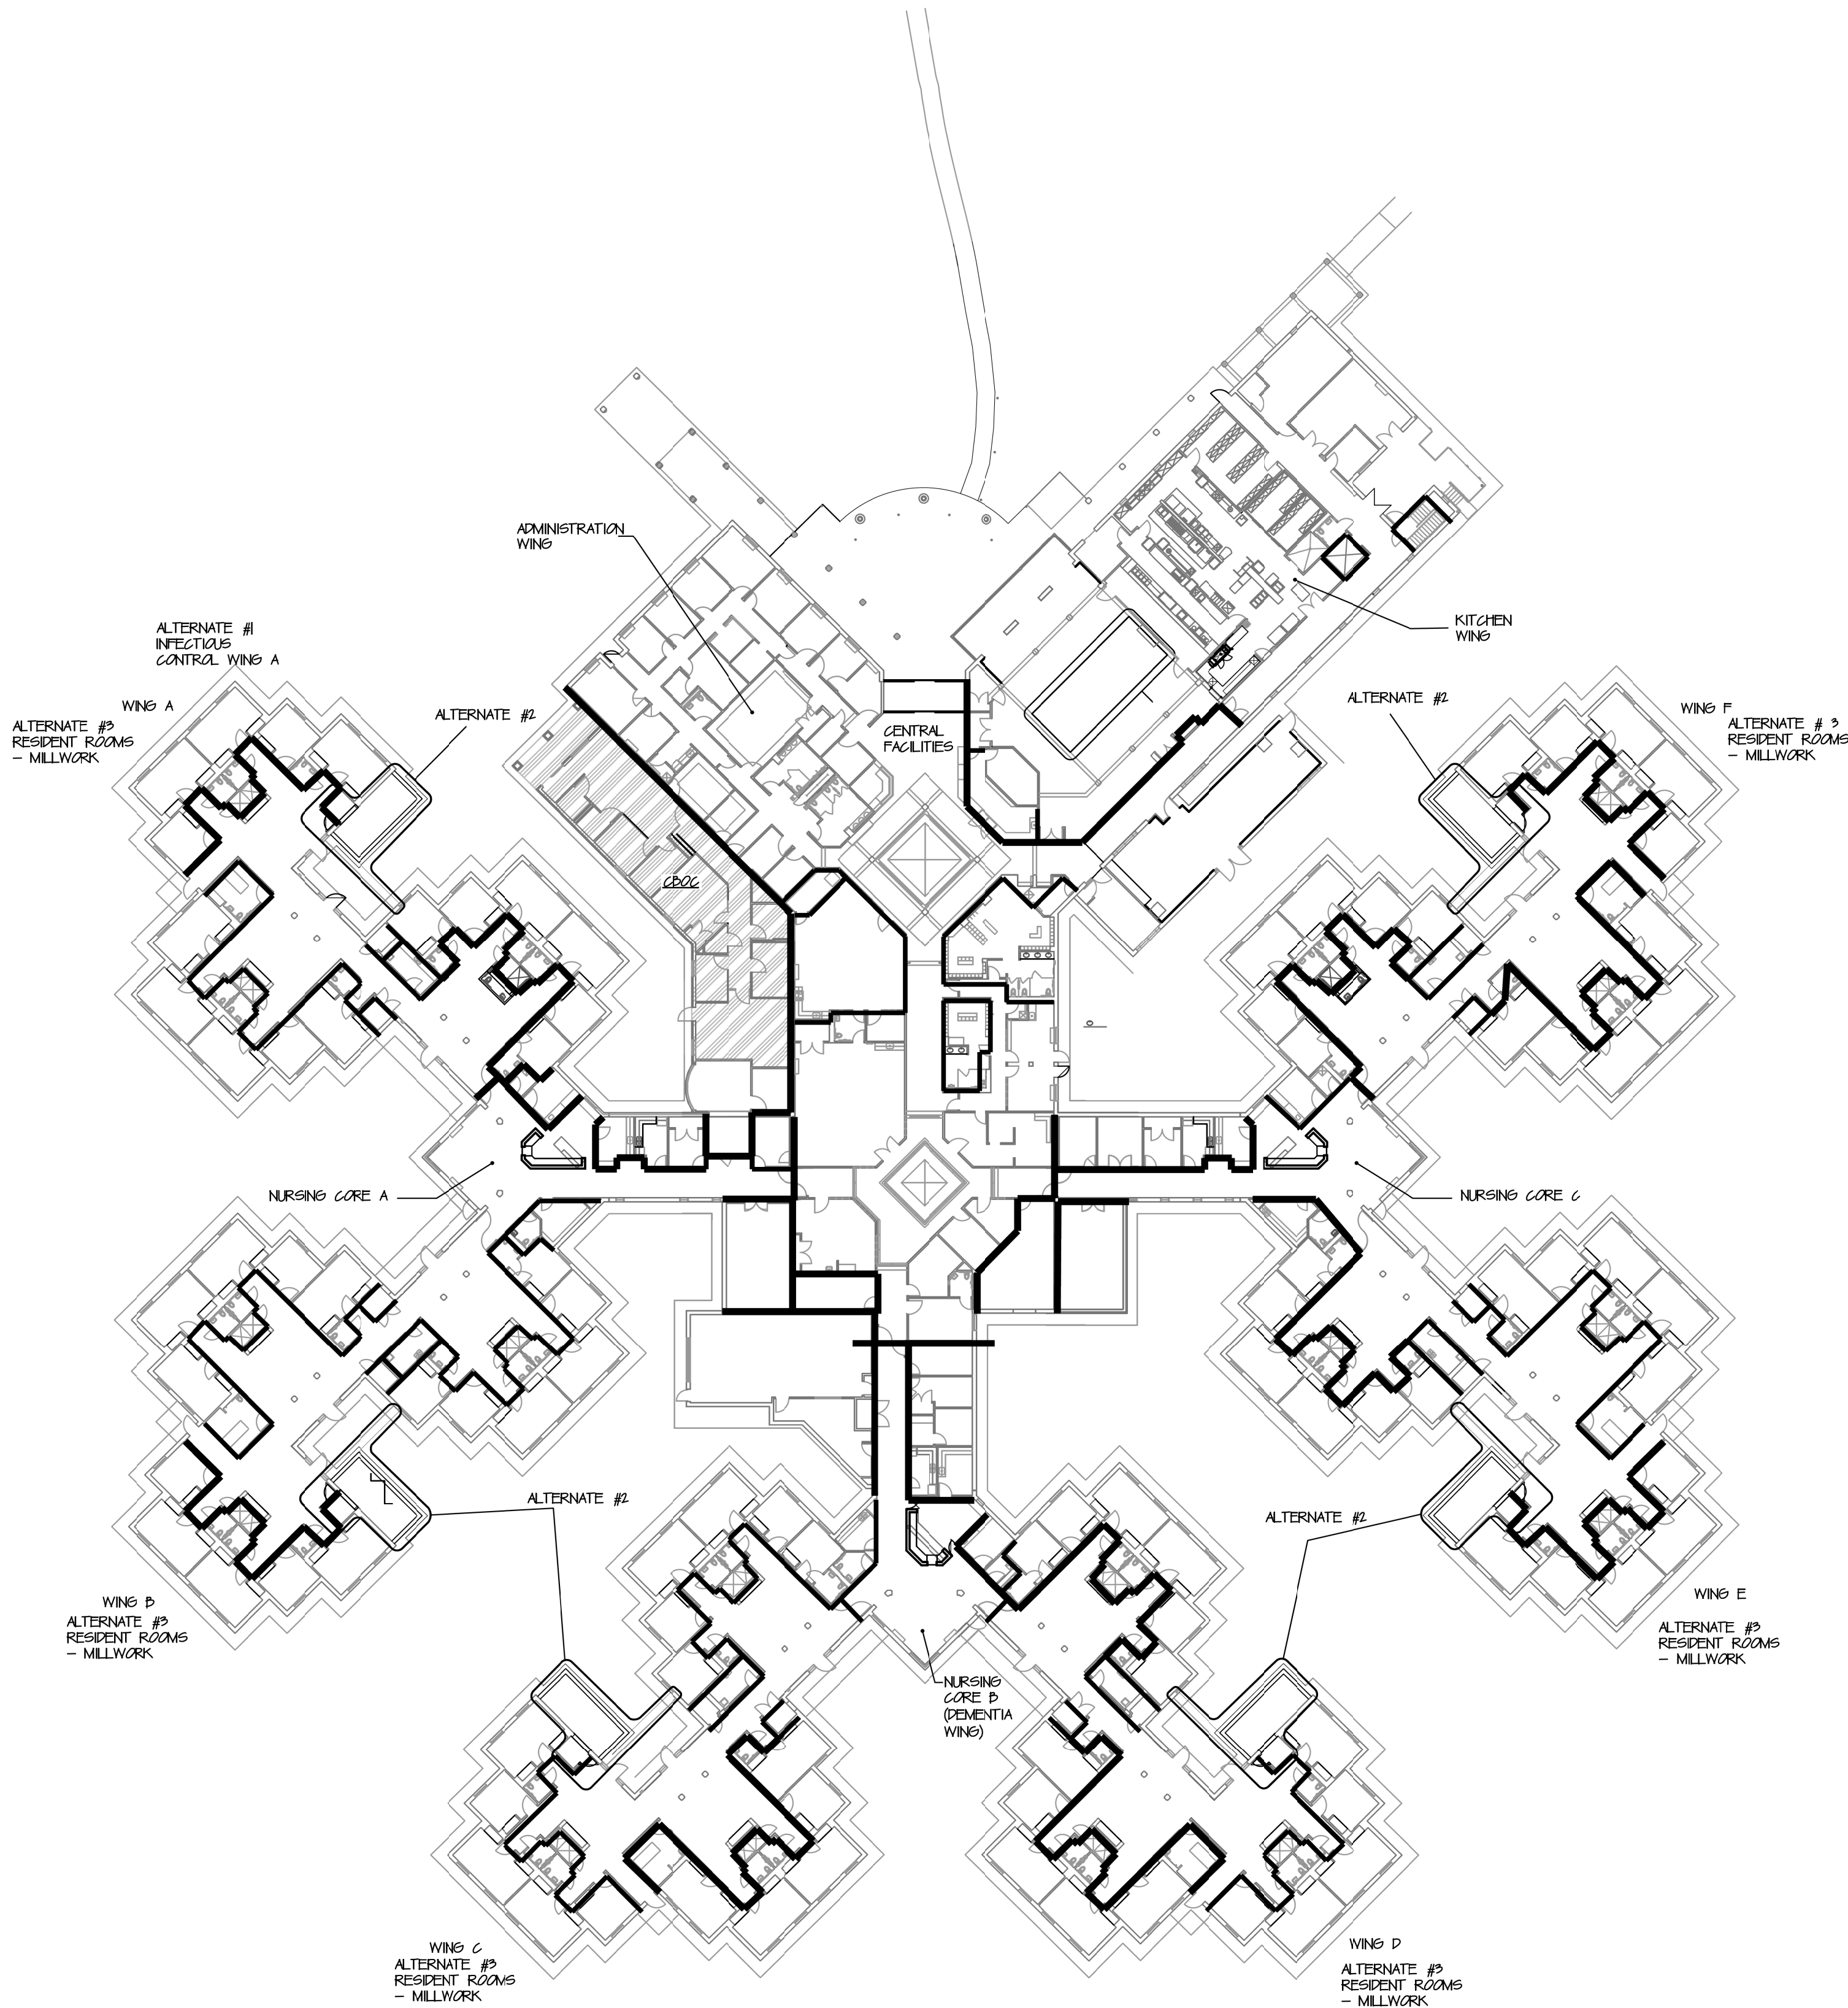EXISTING FIRST FLOOR = 84,740 SF.  
EXISTING DEMENTIA = 9,420 SF.  
TOTAL = 94,160 SF.




EXISTING FIRE PROTECTION PLAN

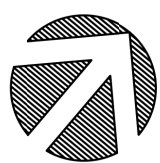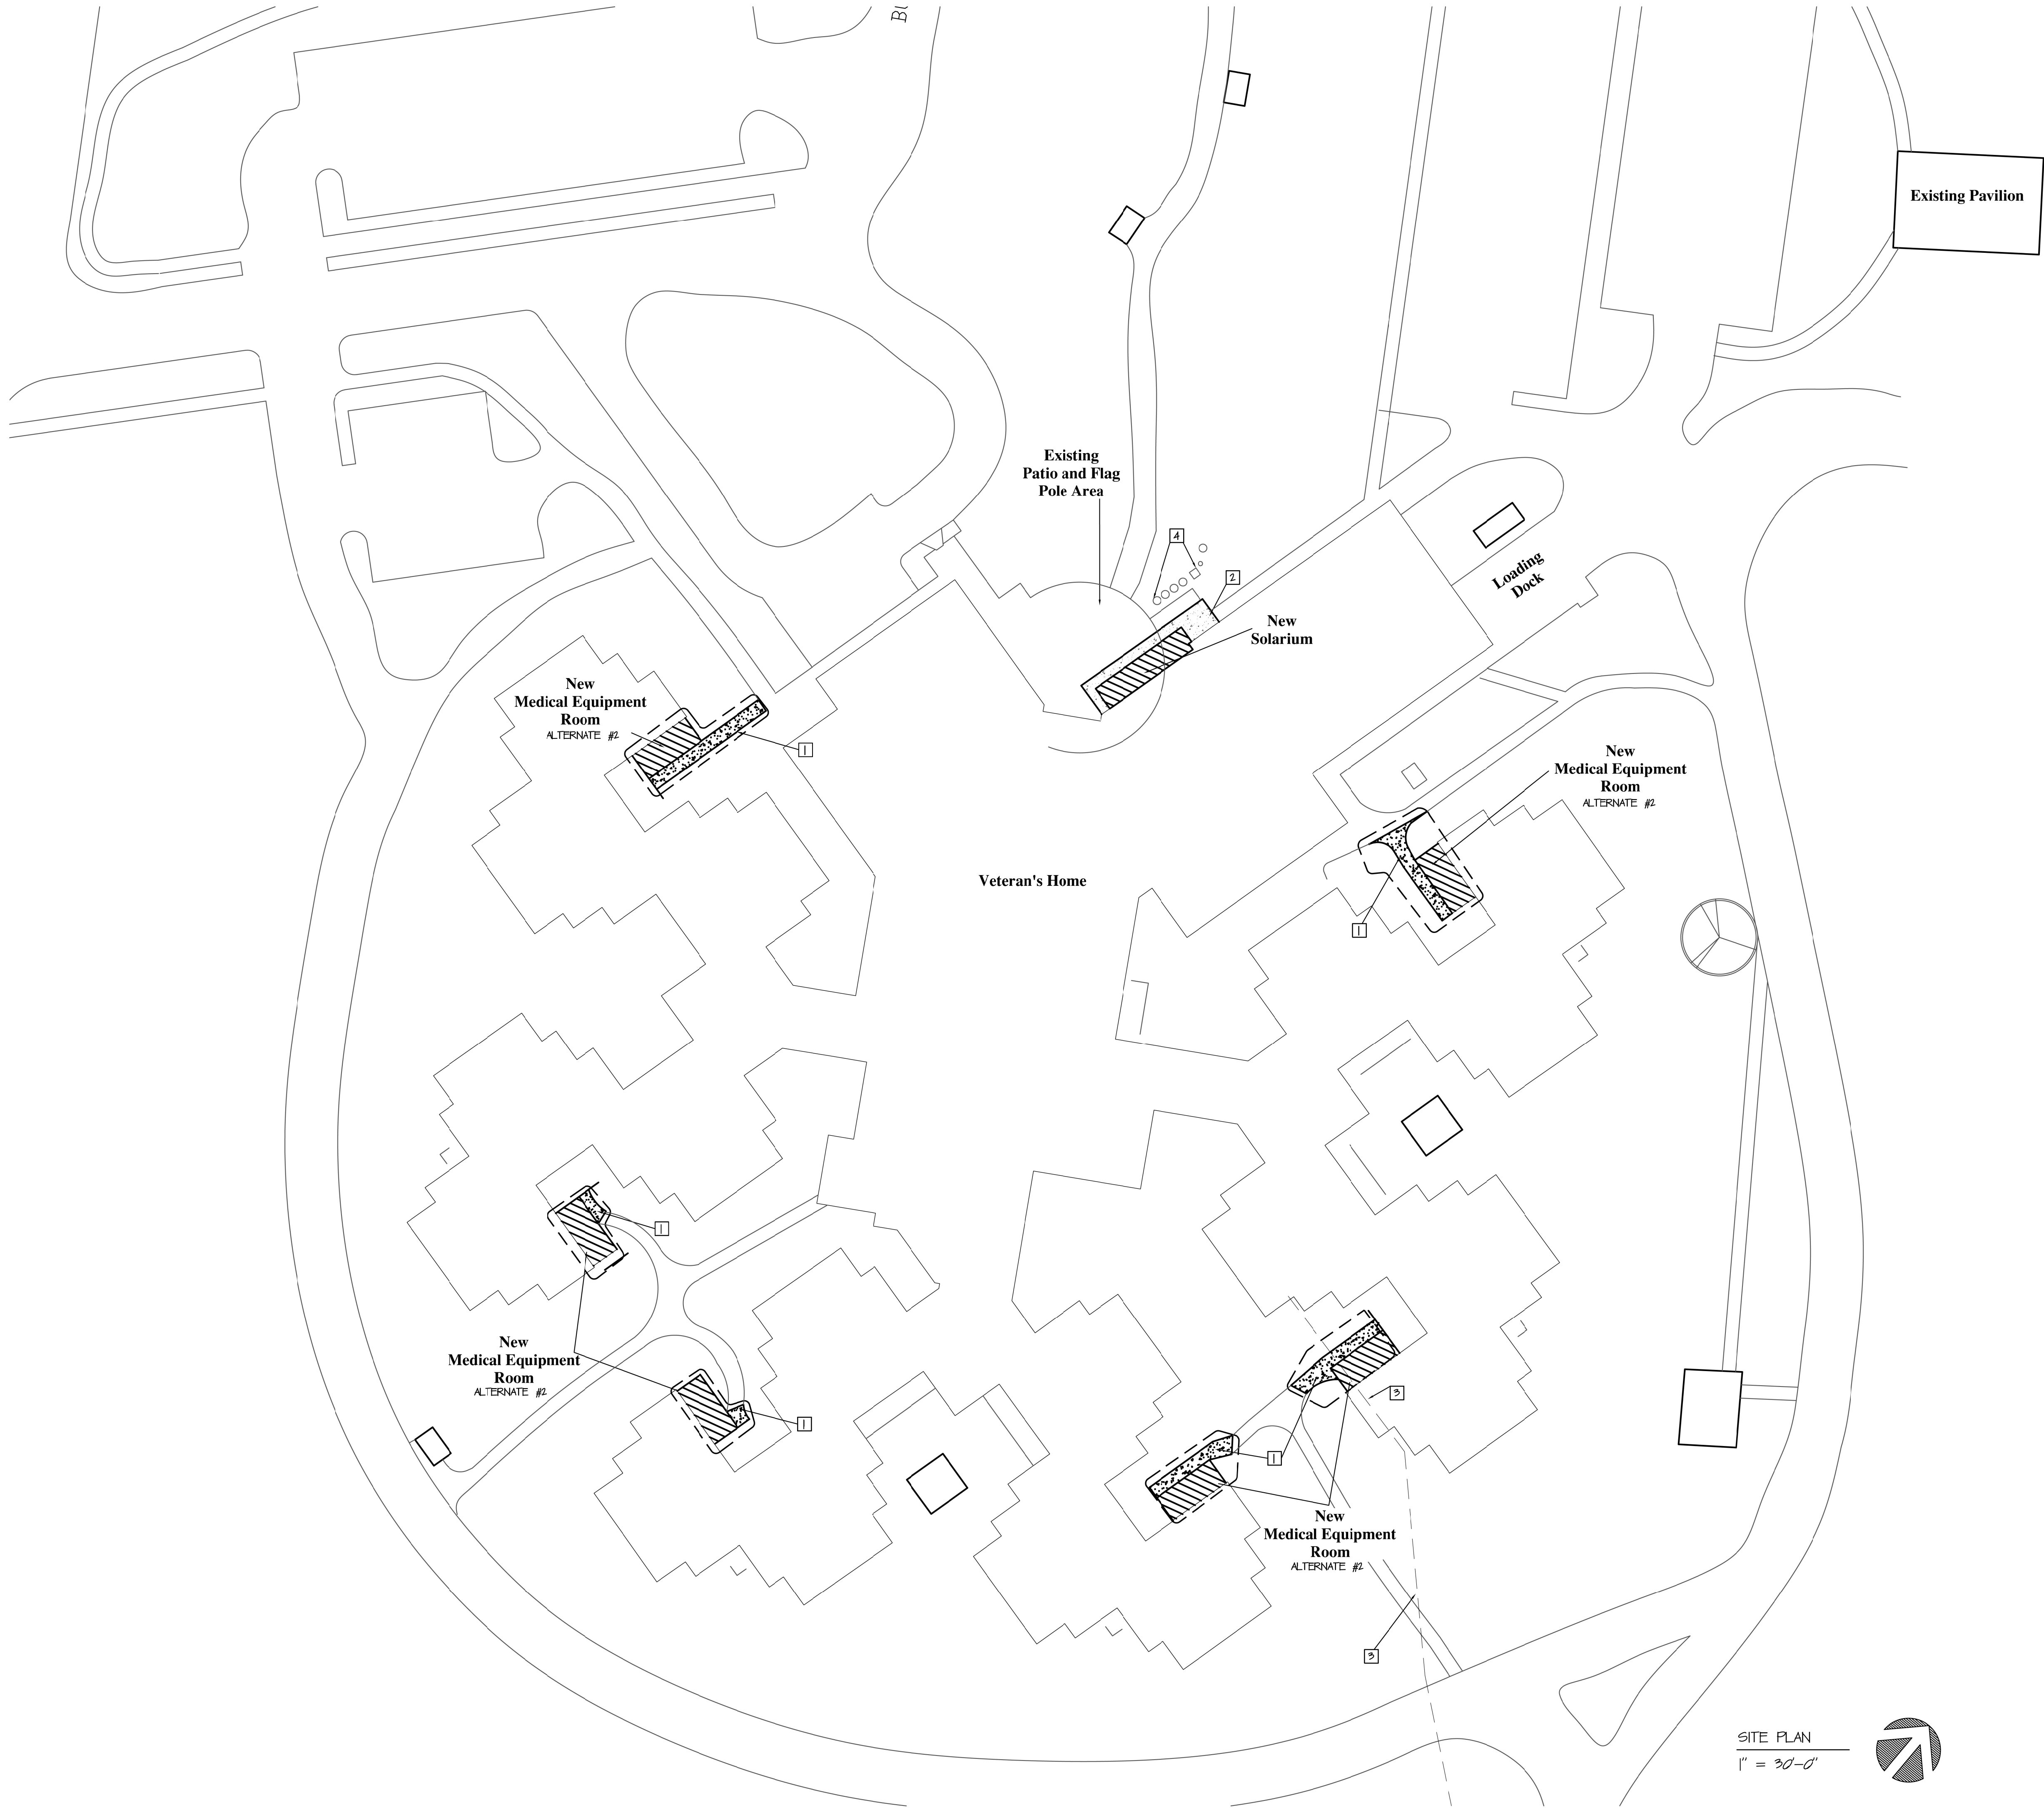1/32" = 1'-0"








SITE PLAN KEY NOTES

- [1] ALTERNATE #2 - REMOVE AND DISCARD PORTION OF EXISTING SIDEWALK AS REQUIRED FOR MEDICAL EQUIPMENT ROOM ADDITION. PROVIDE AND INSTALL NEW 5" THICK CONCRETE SIDEWALK TO CONNECT PATIO AREA TO EXISTING SIDEWALK. REFER TO SPECIFICATIONS AND DETAIL 3 OF C-100 (SIMILAR).
- [2] PROVIDE AND INSTALL 5" THICK CONCRETE SIDEWALK PATIO AT AREA SHOWN. SEE SHEET C-100 FOR EXACT EXTENTS OF WORK. SEE DETAILS 1/C-100, 2/C-100, 3/C-100 AND 4/C-100. REFER TO STRUCTURAL FOR ADDITIONAL INFORMATION.
- [3] EXISTING UNDERGROUND ELECTRICAL LINE (ENCASED IN CONCRETE) TO REMAIN. FIELD VERIFY EXACT LOCATION.
- [4] (1) EXISTING 350 GALLON GREASE INTERCEPTORS WITH ASSOCIATED MANHOLES TO REMAIN. PROTECT AS REQUIRED.

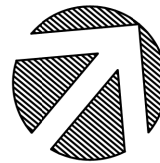SITE PLAN  
1" = 30'-0"



STATE OF MISSOURI  
MIKE KEHOE,  
GOVERNOR



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SITE # 6801  
ASSET # 8136801002  
FEDERAL# 29-044

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DATE: \_\_\_\_\_

ISSUE DATE: 8-1-24

CAD DWG FILE: C-100.DWG  
DRAWN BY: ZAC/MAH  
CHECKED BY: MAH/CAS  
DESIGNED BY: MAH/CAS

SHEET TITLE:

SITE PLAN

SHEET NUMBER:

C-100

5 OF 120 SHEETS  
8-1-24

BID DOCUMENTS

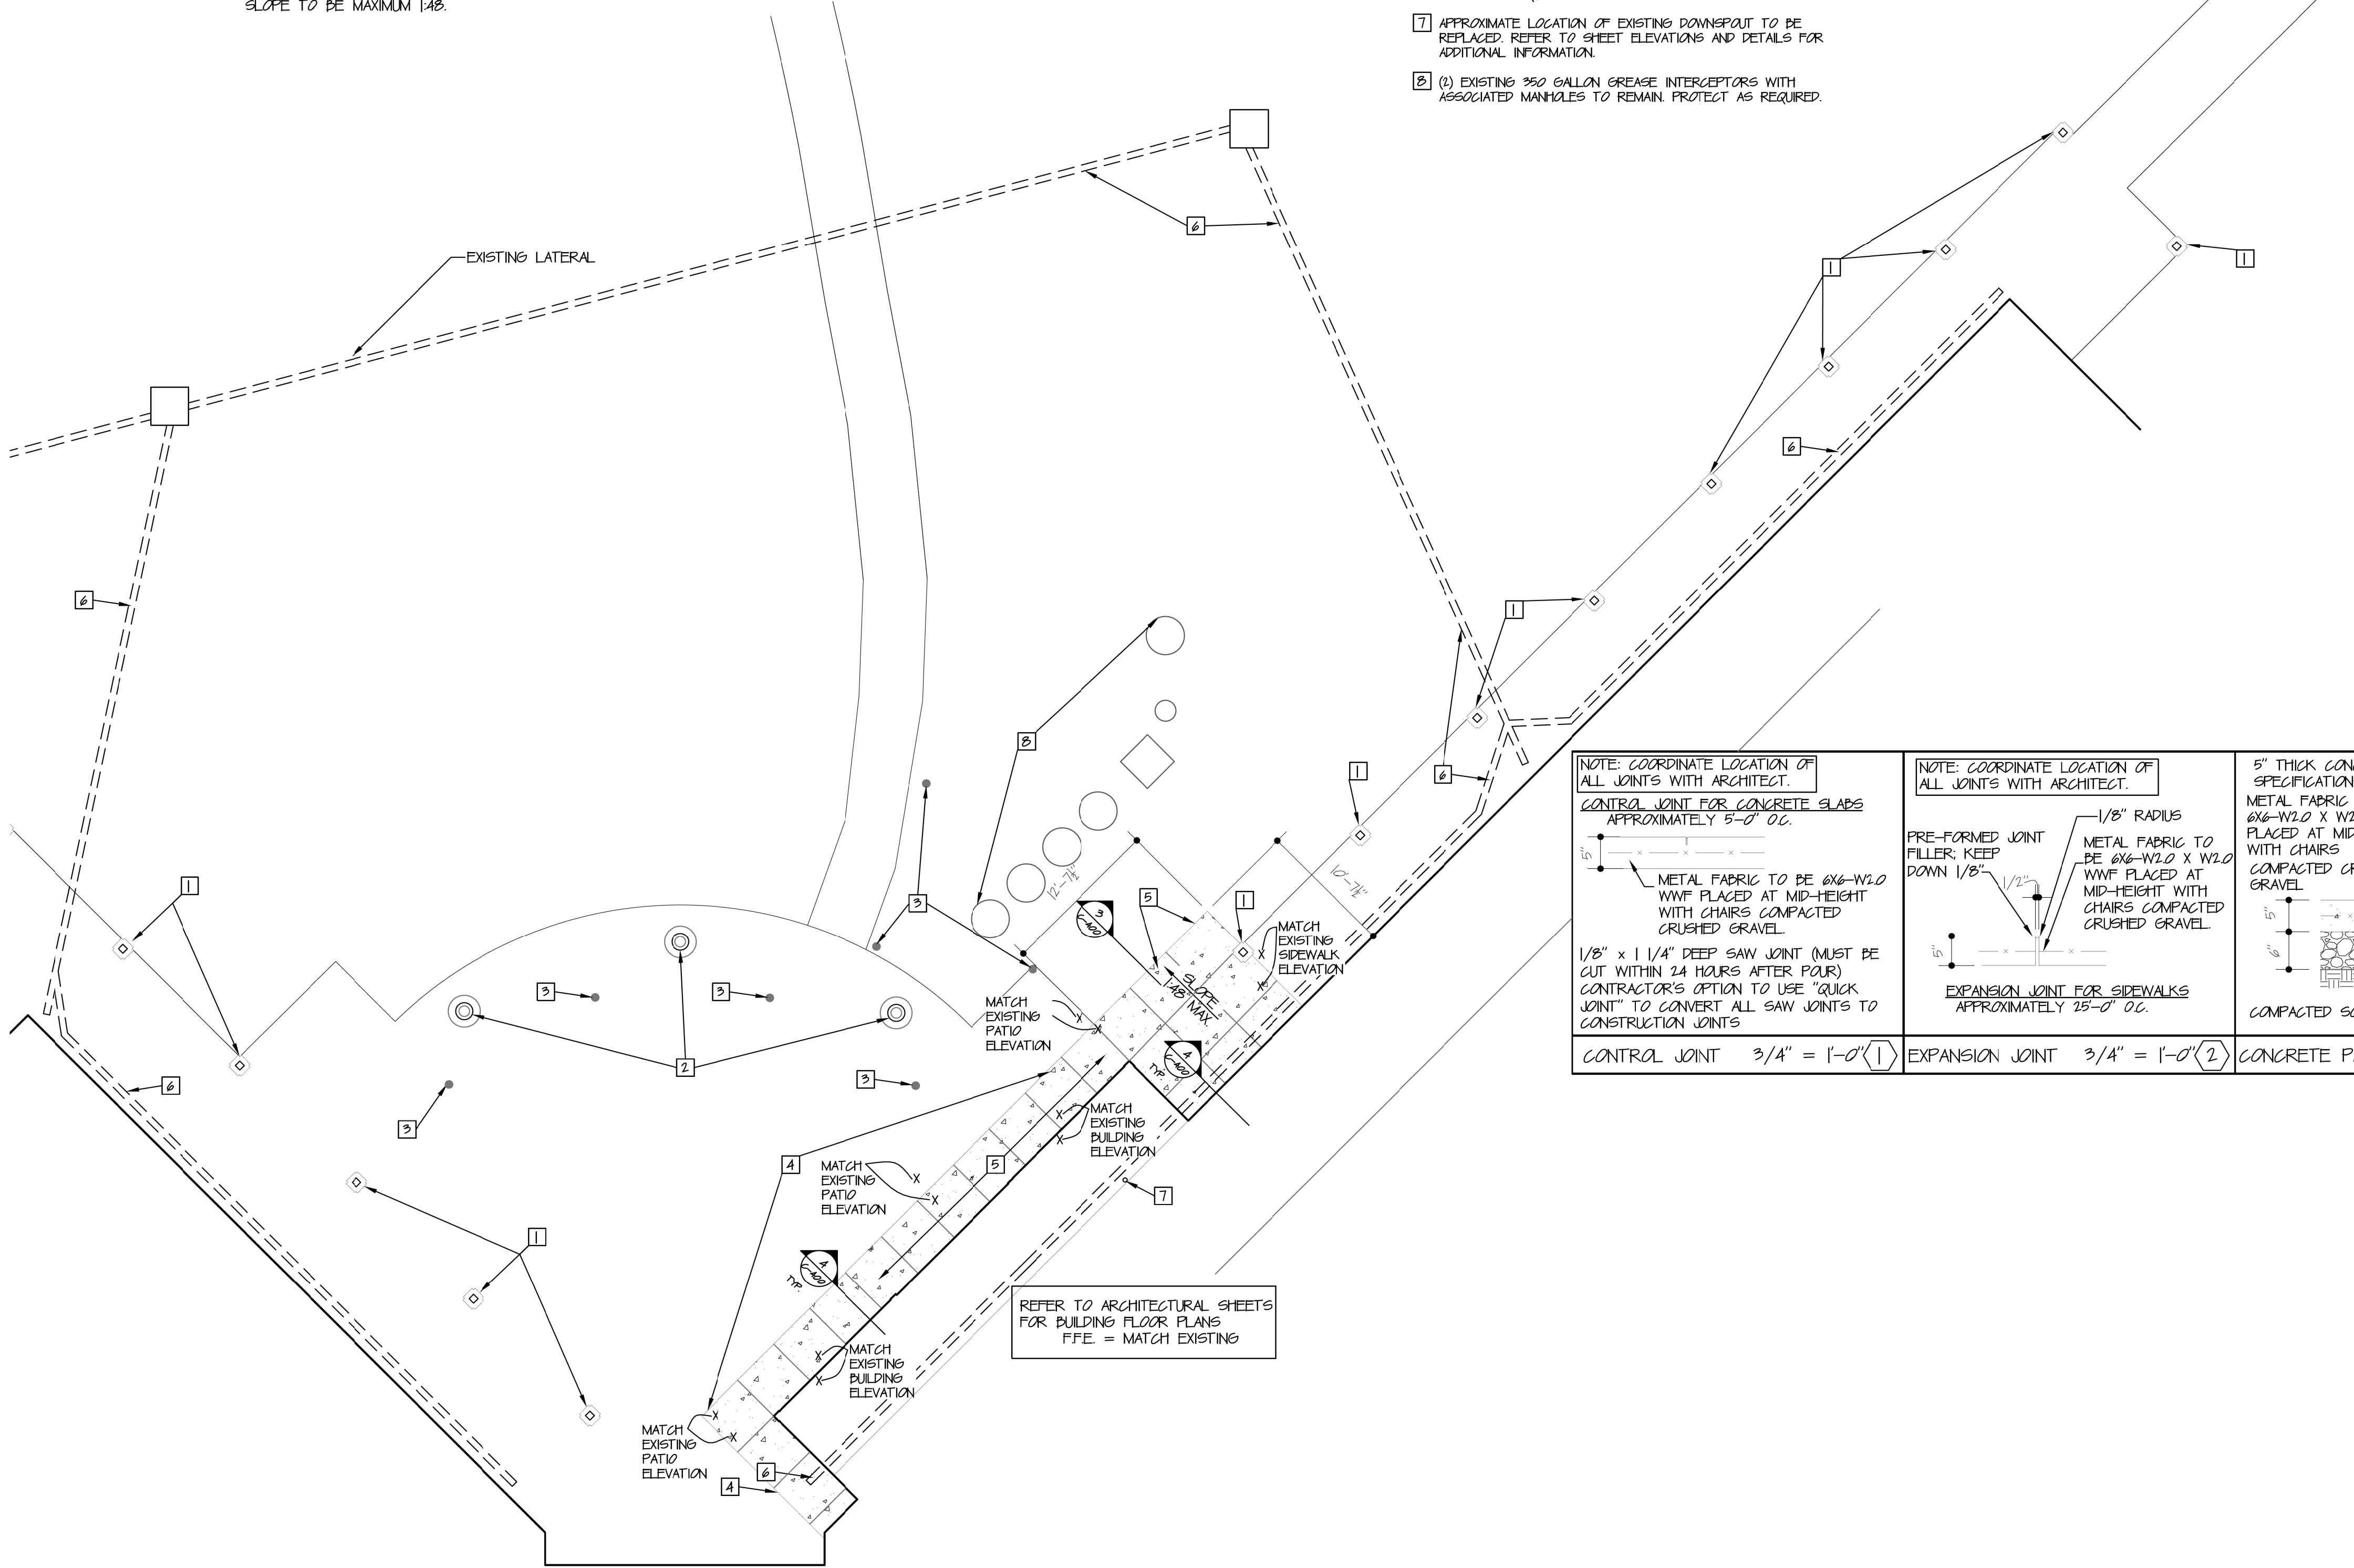
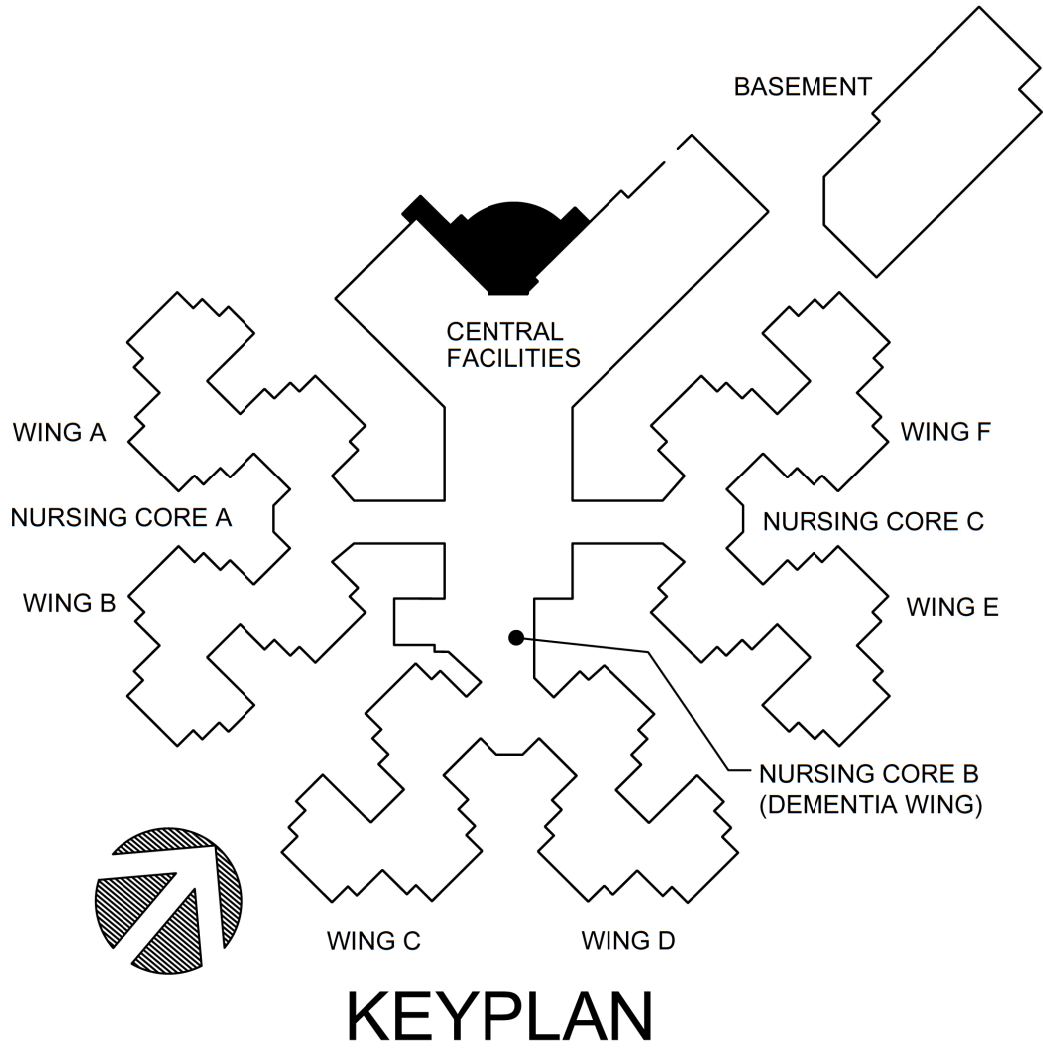


GENERAL NOTES

- a. CONTRACTOR TO INSTALL CONTROL JOINTS AND EXPANSION JOINTS PER DETAILS 1 AND 2 OF SHEET C-400.
- b. PROVIDE AND INSTALL 4" CLEAN TOP SOIL (FINE GRADED, NO ROCKS ALLOWED) AT ALL AREAS DISTURBED BY CONSTRUCTION (SEE SPECIFICATIONS). INSTALL HYDRO SEED AT ALL DISTURBED AREAS. HYDRO SEED MIXTURE EQUAL TO PICKSEED "TEAM" (TALL FESCUE) - DROUGHT TOLERANT (WATER SAVER) RECYCLED PAPER FIBER HYDROSEED MULCH TO BE PROVIDED AT AREA AFFECTED BY CUT AND FILL ACTIVITIES TO BE SPREAD AFTER FINAL GRADING.
- c. CONTRACTOR TO INSTALL NEW CONCRETE WHERE SHOWN, TO ENSURE POSITIVE DRAINAGE AWAY FROM BUILDING TYPICAL AT ALL LOCATIONS ADJACENT TO BUILDING. SLOPE TO BE MAXIMUM 1/4%.

SITE DEVELOPMENT PLAN KEY NOTES

- 1 EXISTING COLUMN TO REMAIN. PROTECT AS REQUIRED.
- 2 EXISTING FLAG POLES TO REMAIN. PROTECT AS REQUIRED DURING NEW CONSTRUCTION.
- 3 EXISTING LIGHT BOLLARDS TO REMAIN. PROTECT AS REQUIRED DURING NEW CONSTRUCTION.
- 4 SAWCUT EXISTING CONCRETE AT FIRST CONTROL JOINT CLOSEST TO EXISTING BUILDING. REMOVE AND DISCARD EXISTING CONCRETE PATIO TO PREPARE FOR NEW CONSTRUCTION. REFER TO STRUCTURAL FOR ADDITIONAL INFORMATION.
- 5 PROVIDE AND INSTALL 5" THICK CONCRETE SIDEWALK PATIO AT AREA SHOWN. SEE DETAILS 1/C400, 2/C400, 3/C400 AND 4/C400. REFER TO STRUCTURAL FOR ADDITIONAL INFORMATION.
- 6 APPROXIMATE LOCATION OF EXISTING DOWNSPOUT COLLECTION SYSTEM. CONTRACTOR TO FIELD VERIFY. CONTRACTOR TO COORDINATE CONNECTION OF NEW DOWN SPOUT. PROTECT IN PLACE AS REQUIRED.
- 7 APPROXIMATE LOCATION OF EXISTING DOWNSPOUT TO BE REPLACED. REFER TO SHEET ELEVATIONS AND DETAILS FOR ADDITIONAL INFORMATION.
- 8 (1) EXISTING 350 GALLON GREASE INTERCEPTORS WITH ASSOCIATED MANHOLE TO REMAIN. PROTECT AS REQUIRED.



NOTE: COORDINATE LOCATION OF ALL JOINTS WITH ARCHITECT.

CONTROL JOINT FOR CONCRETE SLABS APPROXIMATELY 5'-0" O.C.

METAL FABRIC TO BE 6X6-W2.0 WWF PLACED AT MID-HEIGHT WITH CHAIRS COMPACTED CRUSHED GRAVEL.

1/8" x 1 1/4" DEEP SAW JOINT (MUST BE CUT WITHIN 24 HOURS AFTER POUR) CONTRACTOR'S OPTION TO USE "QUICK JOINT" TO CONVERT ALL SAW JOINTS TO CONSTRUCTION JOINTS

CONTROL JOINT 3/4" = 1'-0" 1

NOTE: COORDINATE LOCATION OF ALL JOINTS WITH ARCHITECT.

PRE-FORMED JOINT FILLER; KEEP DOWN 1/8".

1/8" RADIUS METAL FABRIC TO BE 6X6-W2.0 X W2.0 WWF PLACED AT MID-HEIGHT WITH CHAIRS COMPACTED CRUSHED GRAVEL.

EXPANSION JOINT FOR SIDEWALKS APPROXIMATELY 25'-0" O.C.

EXPANSION JOINT 3/4" = 1'-0" 2

5" THICK CONCRETE REFER TO SPECIFICATIONS

METAL FABRIC TO BE 6X6-W2.0 X W2.0 WWF PLACED AT MID-HEIGHT WITH CHAIRS COMPACTED CRUSHED GRAVEL

COMPACTED CRUSHED GRAVEL

COMPACTED SOIL

CONCRETE PAVING 3/4" = 1'-0" 3

1/2" EXPANSION JOINT COMPRESSIBLE MATERIAL PROVIDE SELF LEVELING POLYURETHANE SEALANT FLUSH WITH THE TOP OF NEW SIDEWALK AROUND PERIMETER OF EXISTING BUILDING WITH AND/OR COLUMN AS REQUIRED

5" THICK CONCRETE PER SPECIFICATIONS AND DETAILS THIS SHEET

BUILDING OR COLUMN CONSTRUCTION

COMPACTED CRUSHED GRAVEL

COMPACTED SOIL

EXPANSION JOINT 1 1/2" = 1'-0" 4

CONCRETE PATIO SITE DEVELOPMENT & GRADING PLAN  
1/8" = 1'-0"



STATE OF MISSOURI  
MIKE KEHOE,  
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ISSUE DATE: 8-1-24

CAD DWG FILE: C-400.DWG  
DRAWN BY: ZAC/MAH  
CHECKED BY: MAH/CAS  
DESIGNED BY: MAH/CAS

SHEET TITLE:

SITE  
DEVELOPMENT &  
GRADING PLAN



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C-400

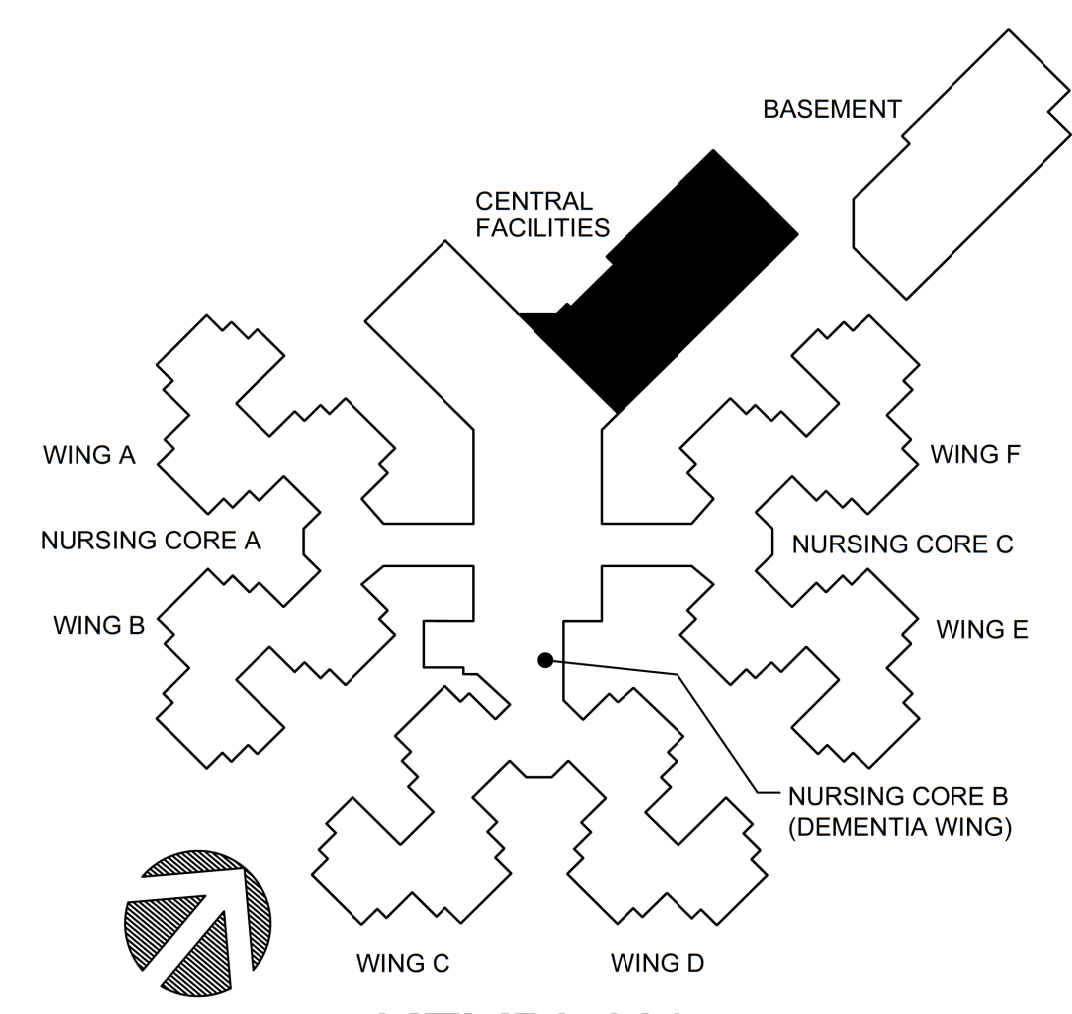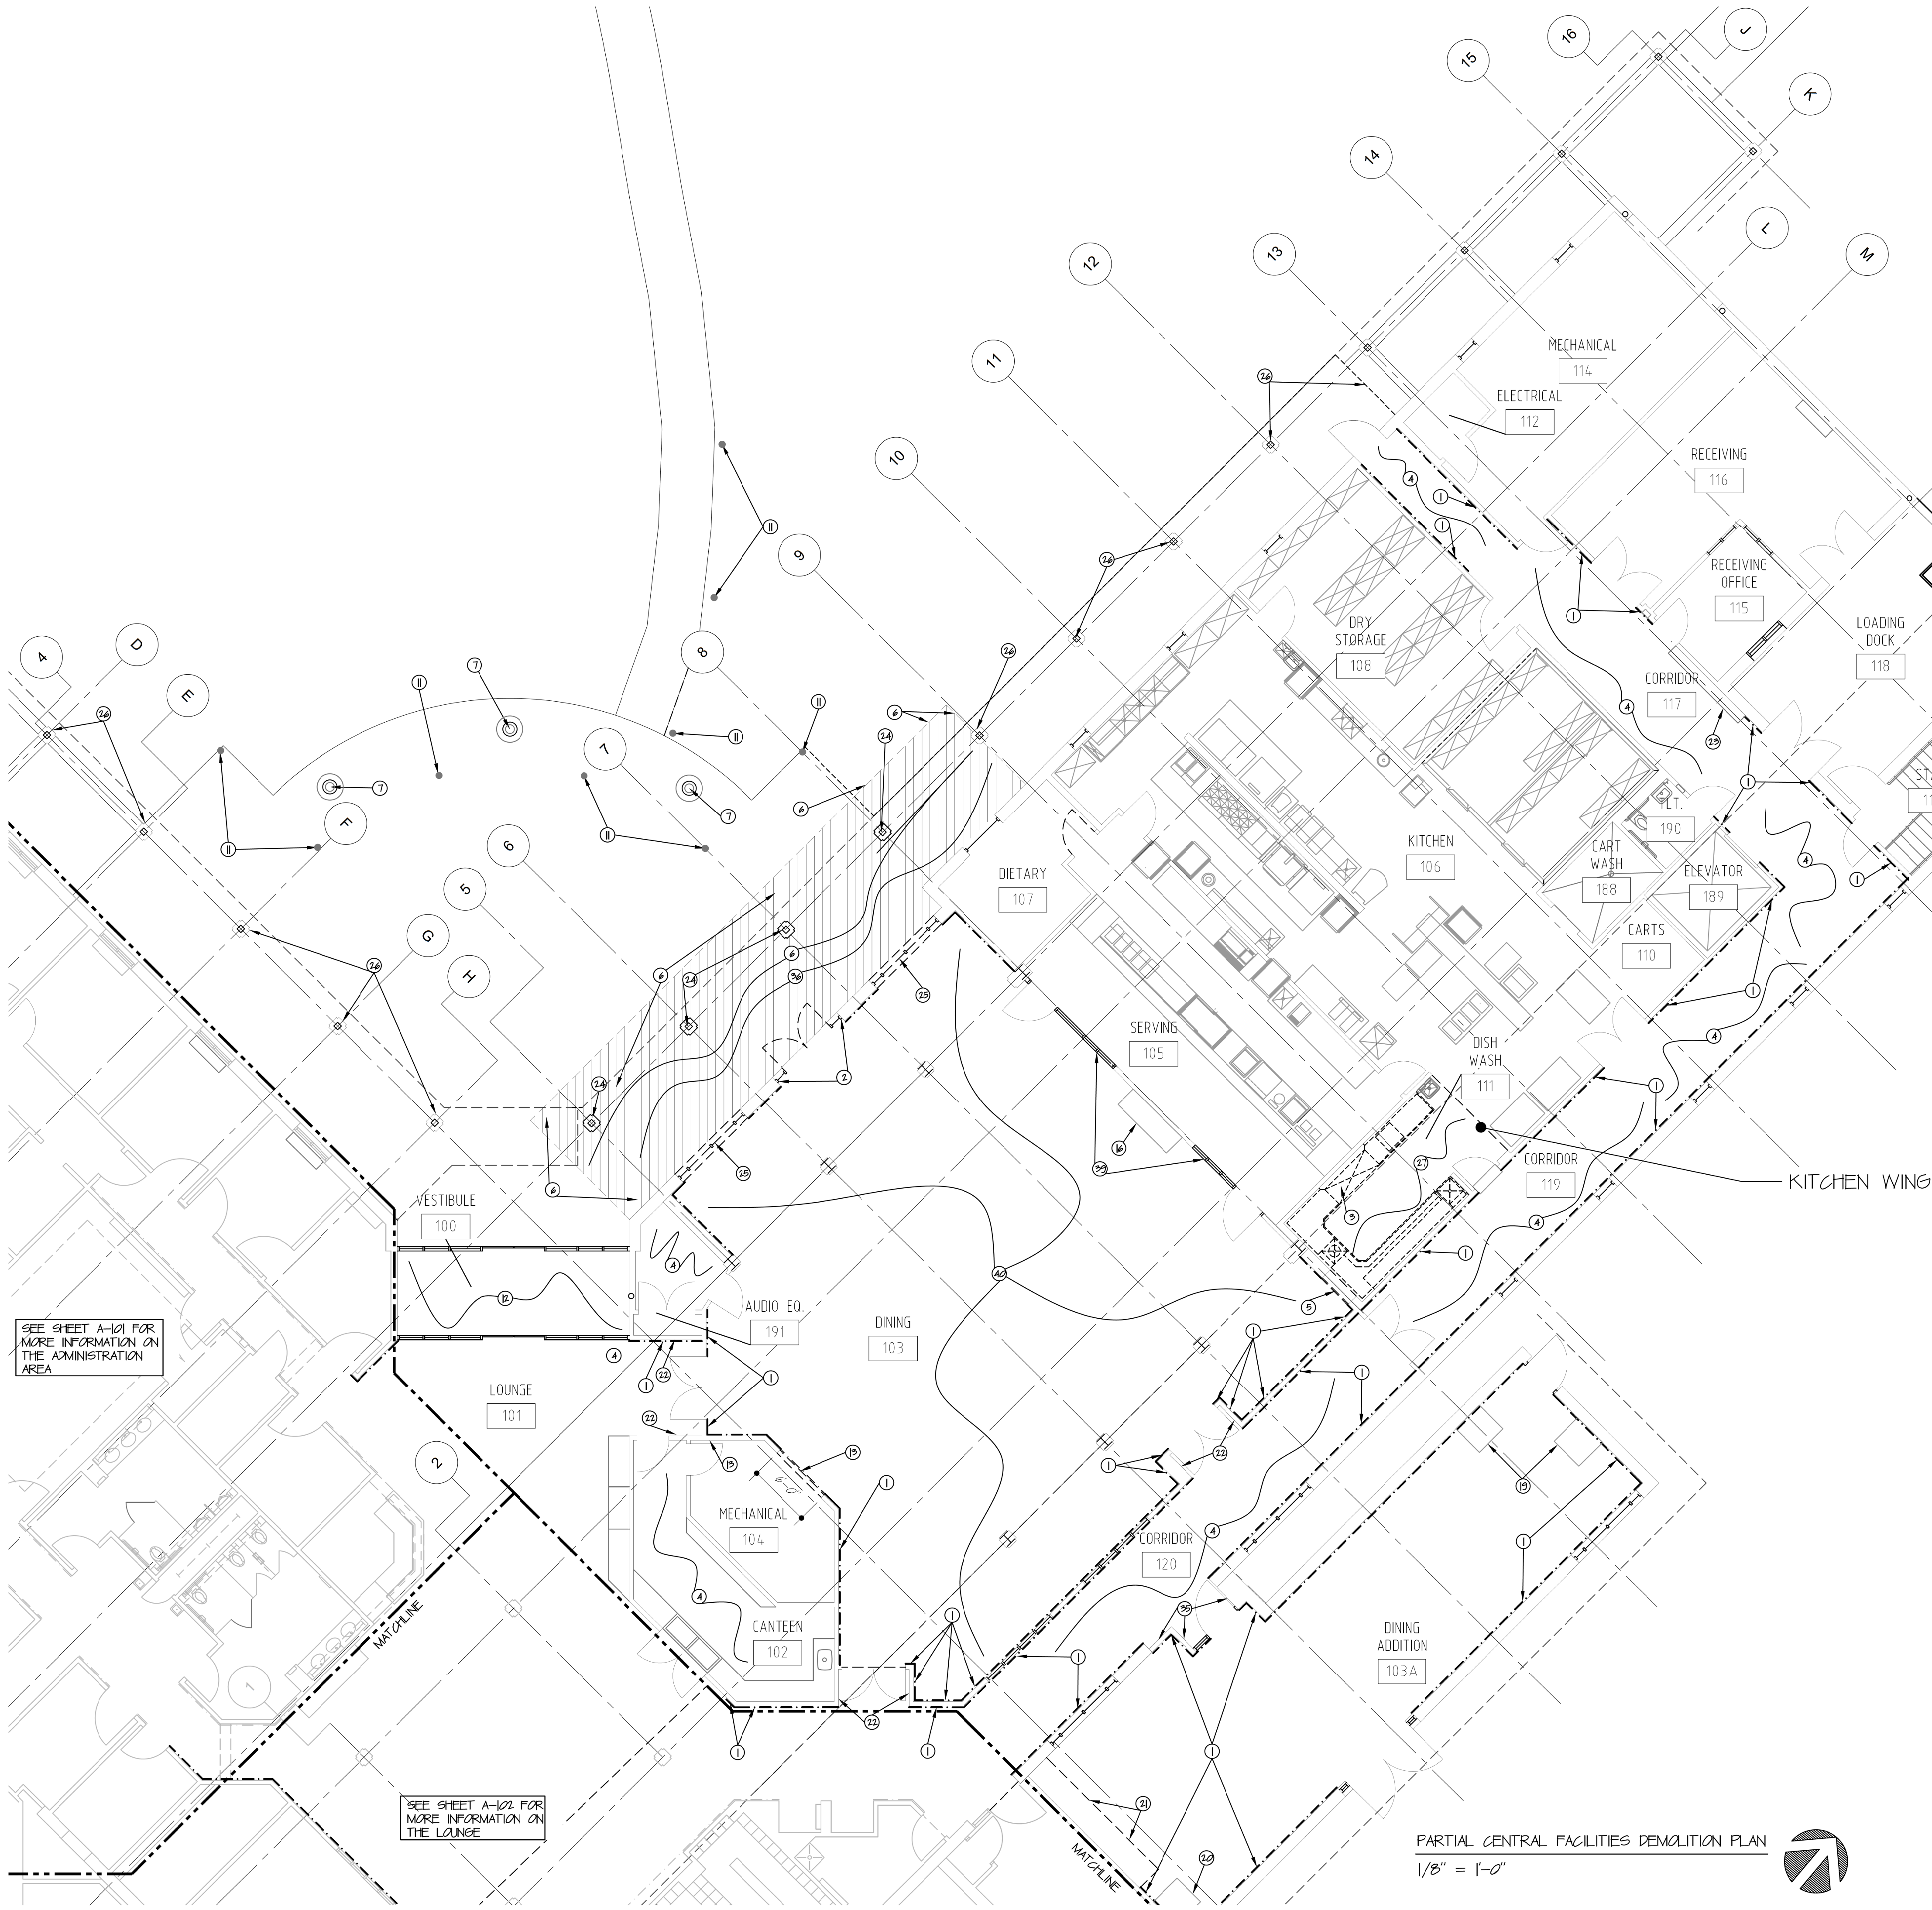6 OF 117 SHEETS  
8-1-24

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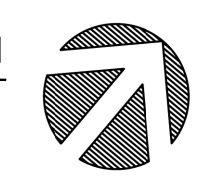


- GENERAL NOTES**
- a. PATCH AND REPAIR ALL DAMAGE CAUSED DURING DEMOLITION TO FLOORS AND WALLS. TO MATCH EXISTING. PREPARE WALLS AND FLOORS TO RECEIVE NEW CONSTRUCTION. CONTRACTOR SHALL BE RESPONSIBLE FOR ALL FLOOR PREPARATION TO RECEIVE NEW FLOORING.
  - b. PATCH AND REPAIR ALL DAMAGE CAUSED TO FLOOR, TO MATCH EXISTING, DURING DEMOLITION OF PLUMBING FIXTURES AND PIPING.
  - c. REFER TO STRUCTURAL, MECHANICAL, & ELECTRICAL FOR ADDITIONAL DEMOLITION WORK.
  - d. REMOVE AND DISCARD ALL EXISTING VINYL CORNER GUARD COVERS. ALUMINUM RETAINERS TO REMAIN, PROTECT AS REQUIRED.
  - e. PATCH AND REPAIR ALL EXISTING CONSTRUCTION SHOWN TO REMAIN WHERE AFFECTED BY DEMOLITION TO MATCH EXISTING ADJACENT CONSTRUCTION.
  - f. CONTRACTOR TO FIELD VERIFY ALL DIMENSIONS.
  - g. REMOVE BASE WHEREVER FLOORING IS TO BE REMOVED. PATCH AND REPAIR WALL TO MATCH EXISTING ADJACENT CONSTRUCTION. NEW WALL BASE AND PAINT PER FINISH SCHEDULE.
  - h. PROVIDE AND INSTALL TRANSITION STRIP BETWEEN FLOOR MATERIALS. REFER TO SHEET A-500 FOR ALL TRANSITION DETAILS.
  - i. REMOVE AND DISCARD ANY EXISTING WALL COVERING AND WALL COVERING BORDERS ALONG ENTIRE LENGTH OF THE AREA. PREPARE ALL WALLS TO RECEIVE NEW FINISHES. REFER TO FINISH SCHEDULE.
  - j. CONTRACTOR SHALL REMOVE ALL ITEMS OFF THE WALLS IN ORDER TO PATCH AND REPAIR WALLS TO RECEIVE NEW PAINT. REINSTALL ITEMS BACK ON WALL AFTER PAINTING IS COMPLETED. REMOVE FACE PLATES OF OUTLETS AND SWITCHES BEFORE PAINTING AND REINSTALL.

**DEMOLITION PLAN KEY NOTES (SHEETS A-100-A-103 ONLY)**

- 1 EXISTING WOOD HANDRAIL TO REMAIN AT LOCATION INDICATED BY (---). PROTECT AS REQUIRED.
- 2 REMOVE AND DISCARD EXISTING DOOR, FRAME AND HARDWARE. PATCH AND REPAIR ADJACENT CONSTRUCTION WHERE AFFECTED BY DEMOLITION TO MATCH EXISTING ADJACENT CONSTRUCTION.
- 3 REMOVE AND DISCARD EXISTING DISHWASHING MACHINE AND ASSOCIATED TRAYS.
- 4 REMOVE AND DISCARD EXISTING VGT AND BASE AT ENTIRE ROOM. PREPARE SUB FLOOR FOR NEW FLOORING PER THE FINISH SCHEDULE.
- 5 REMOVE AND DISCARD EXISTING PORTION OF WALL AND HANDRAIL FOR NEW PASS THRU. WHERE HANDRAILS ARE REMOVED, PATCH ALL ENDS OF EXISTING HANDRAIL TO MATCH COMPONENTS OF END TERMINATIONS.
- 6 SAWCUT EXISTING CONCRETE AT FIRST CONTROL JOINT CLOSEST TO EXISTING BUILDING. REMOVE AND DISCARD EXISTING CONCRETE PATIO WHERE REPRESENTED BY HATCH (XXXXXX). PREPARE FOR NEW CONSTRUCTION.
- 7 EXISTING FLAG POLES TO REMAIN. PROTECT AS REQUIRED.
- 8 THROUGH 10 NOTE NOT USED.
- 11 EXISTING PATHWAY LIGHTS TO REMAIN. PROTECT AS REQUIRED.
- 12 REMOVE AND DISCARD EXISTING WOOD BASE. PATCH AND REPAIR ADJACENT CONSTRUCTION AS REQUIRED TO RECEIVE TO FINISHES.
- 13 REMOVE AND DISCARD PORTION OF EXISTING WALL AND HANDRAIL TO ALLOW FOR CONSTRUCTION. PATCH AND REPAIR AFTER INSTALLATION OF NEW CONSTRUCTION. PROTECT ADJACENT CONSTRUCTION AS REQUIRED. WHERE HANDRAILS ARE REMOVED, PATCH ALL ENDS OF EXISTING HANDRAIL TO MATCH COMPONENTS OF END TERMINATIONS. REFER TO SHEET A-102 FOR ADDITIONAL INFORMATION.
- 14 THROUGH 16 NOTE NOT USED.
- 17 EXISTING FIREPLACE TO REMAIN. PROTECT AS REQUIRED.
- 18 THROUGH 20 NOTE NOT USED.
- 21 EXISTING VENDING MACHINES TO BE RELOCATED PER NEW FLOOR PLAN LAYOUT.
- 22 EXISTING VENDING MACHINE TO REMAIN. PROTECT AS REQUIRED.
- 23 REMOVE AND DISCARD EXISTING MILLWORK. PATCH AND REPAIR ADJACENT CONSTRUCTION TO MATCH EXISTING WHERE AFFECTED BY DEMOLITION.
- 24 EXISTING WALL STOPS TO REMAIN. PATCH AND REPAIR WALL AS REQUIRED TO RECEIVE NEW PAINT.
- 25 REMOVE AND DISCARD VINYL BASE ON EXISTING MILLWORK TO PREPARE FOR NEW BASE. PROTECT ADJACENT EXISTING CONSTRUCTION AS REQUIRED. PATCH AND REPAIR AS REQUIRED.
- 26 REMOVE AND DISCARD EXISTING BRICK WRAPPED AROUND EXISTING COLUMN. EXISTING COLUMN TO REMAIN. PROTECT AS REQUIRED.
- 27 REMOVE AND DISCARD EXISTING WINDOW FRAME, HARDWARE, GLAZING AND PORTION OF WALL BELOW THE WINDOW. PATCH AND REPAIR ADJACENT CONSTRUCTION WHERE AFFECTED BY DEMOLITION.
- 28 EXISTING BRICK COLUMN TO REMAIN. PROTECT AS REQUIRED.
- 29 REMOVE AND DISCARD EXISTING TILE FLOOR AT DISH WASH AREA TO END OF WALL AS SHOWN ON DRAWING. CONTRACTOR SHALL REMOVE QUARRY TILE TO AN EVEN JOINT (DO NOT CUT A TILE) AT THIS LOCATION. PROTECT DRAIN AT THIS AREA. REFER TO MEP FOR DRAIN INFORMATION.
- 30 THROUGH 34 NOTE NOT USED.
- 35 REMOVE AND DISCARD EXISTING WOOD PANELING. PATCH AND REPAIR WALL AS REQUIRED TO RECEIVE NEW FINISHES.
- 36 REMOVE AND DISCARD EXISTING METAL SOFFIT. COORDINATE EXTENTS OF REMOVAL WITH NEW CONSTRUCTION.
- 37 THROUGH 39 NOTE NOT USED.
- 40 EXISTING WINDOW FRAME, HARDWARE, GLAZING TO REMAIN. PATCH AND REPAIR TO RECEIVE NEW PAINT.
- 41 REMOVE AND DISCARD EXISTING SHEET VINYL FLOORING AND BASE AT ENTIRE ROOM. PREPARE SUB FLOOR FOR NEW FLOORING PER THE FINISH SCHEDULE.

PARTIAL CENTRAL FACILITIES DEMOLITION PLAN  
1/8" = 1'-0"



STATE OF MISSOURI  
MIKE KEHOE,  
GOVERNOR



2/19/25

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**ESTERLY & SCHNEIDER ASSOCIATES, INC.**  
AIA architects & planners

COMM. # 4860  
CERTIFICATE OF AUTHORITY # 000718

OFFICE OF ADMINISTRATION  
DIVISION OF FACILITIES  
MANAGEMENT,  
DESIGN AND CONSTRUCTION

DEPARTMENT OF  
PUBLIC SAFETY  
MISSOURI VETERANS  
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MISSOURI VETERANS  
HOME

620 N. JEFFERSON  
ST. JAMES, MISSOURI

PROJECT # U1503-01  
SITE # 6801  
ASSET # 8136801002  
FEDERAL# 29-044

REVISION: \_\_\_\_\_  
DATE: \_\_\_\_\_  
REVISION: \_\_\_\_\_  
DATE: \_\_\_\_\_  
REVISION: \_\_\_\_\_  
DATE: \_\_\_\_\_  
ISSUE DATE: 8-1-24

CAD DWG FILE: A-100.DWG  
DRAWN BY: ZAC/MAH  
CHECKED BY: MAH/CAS  
DESIGNED BY: MAH/CAS

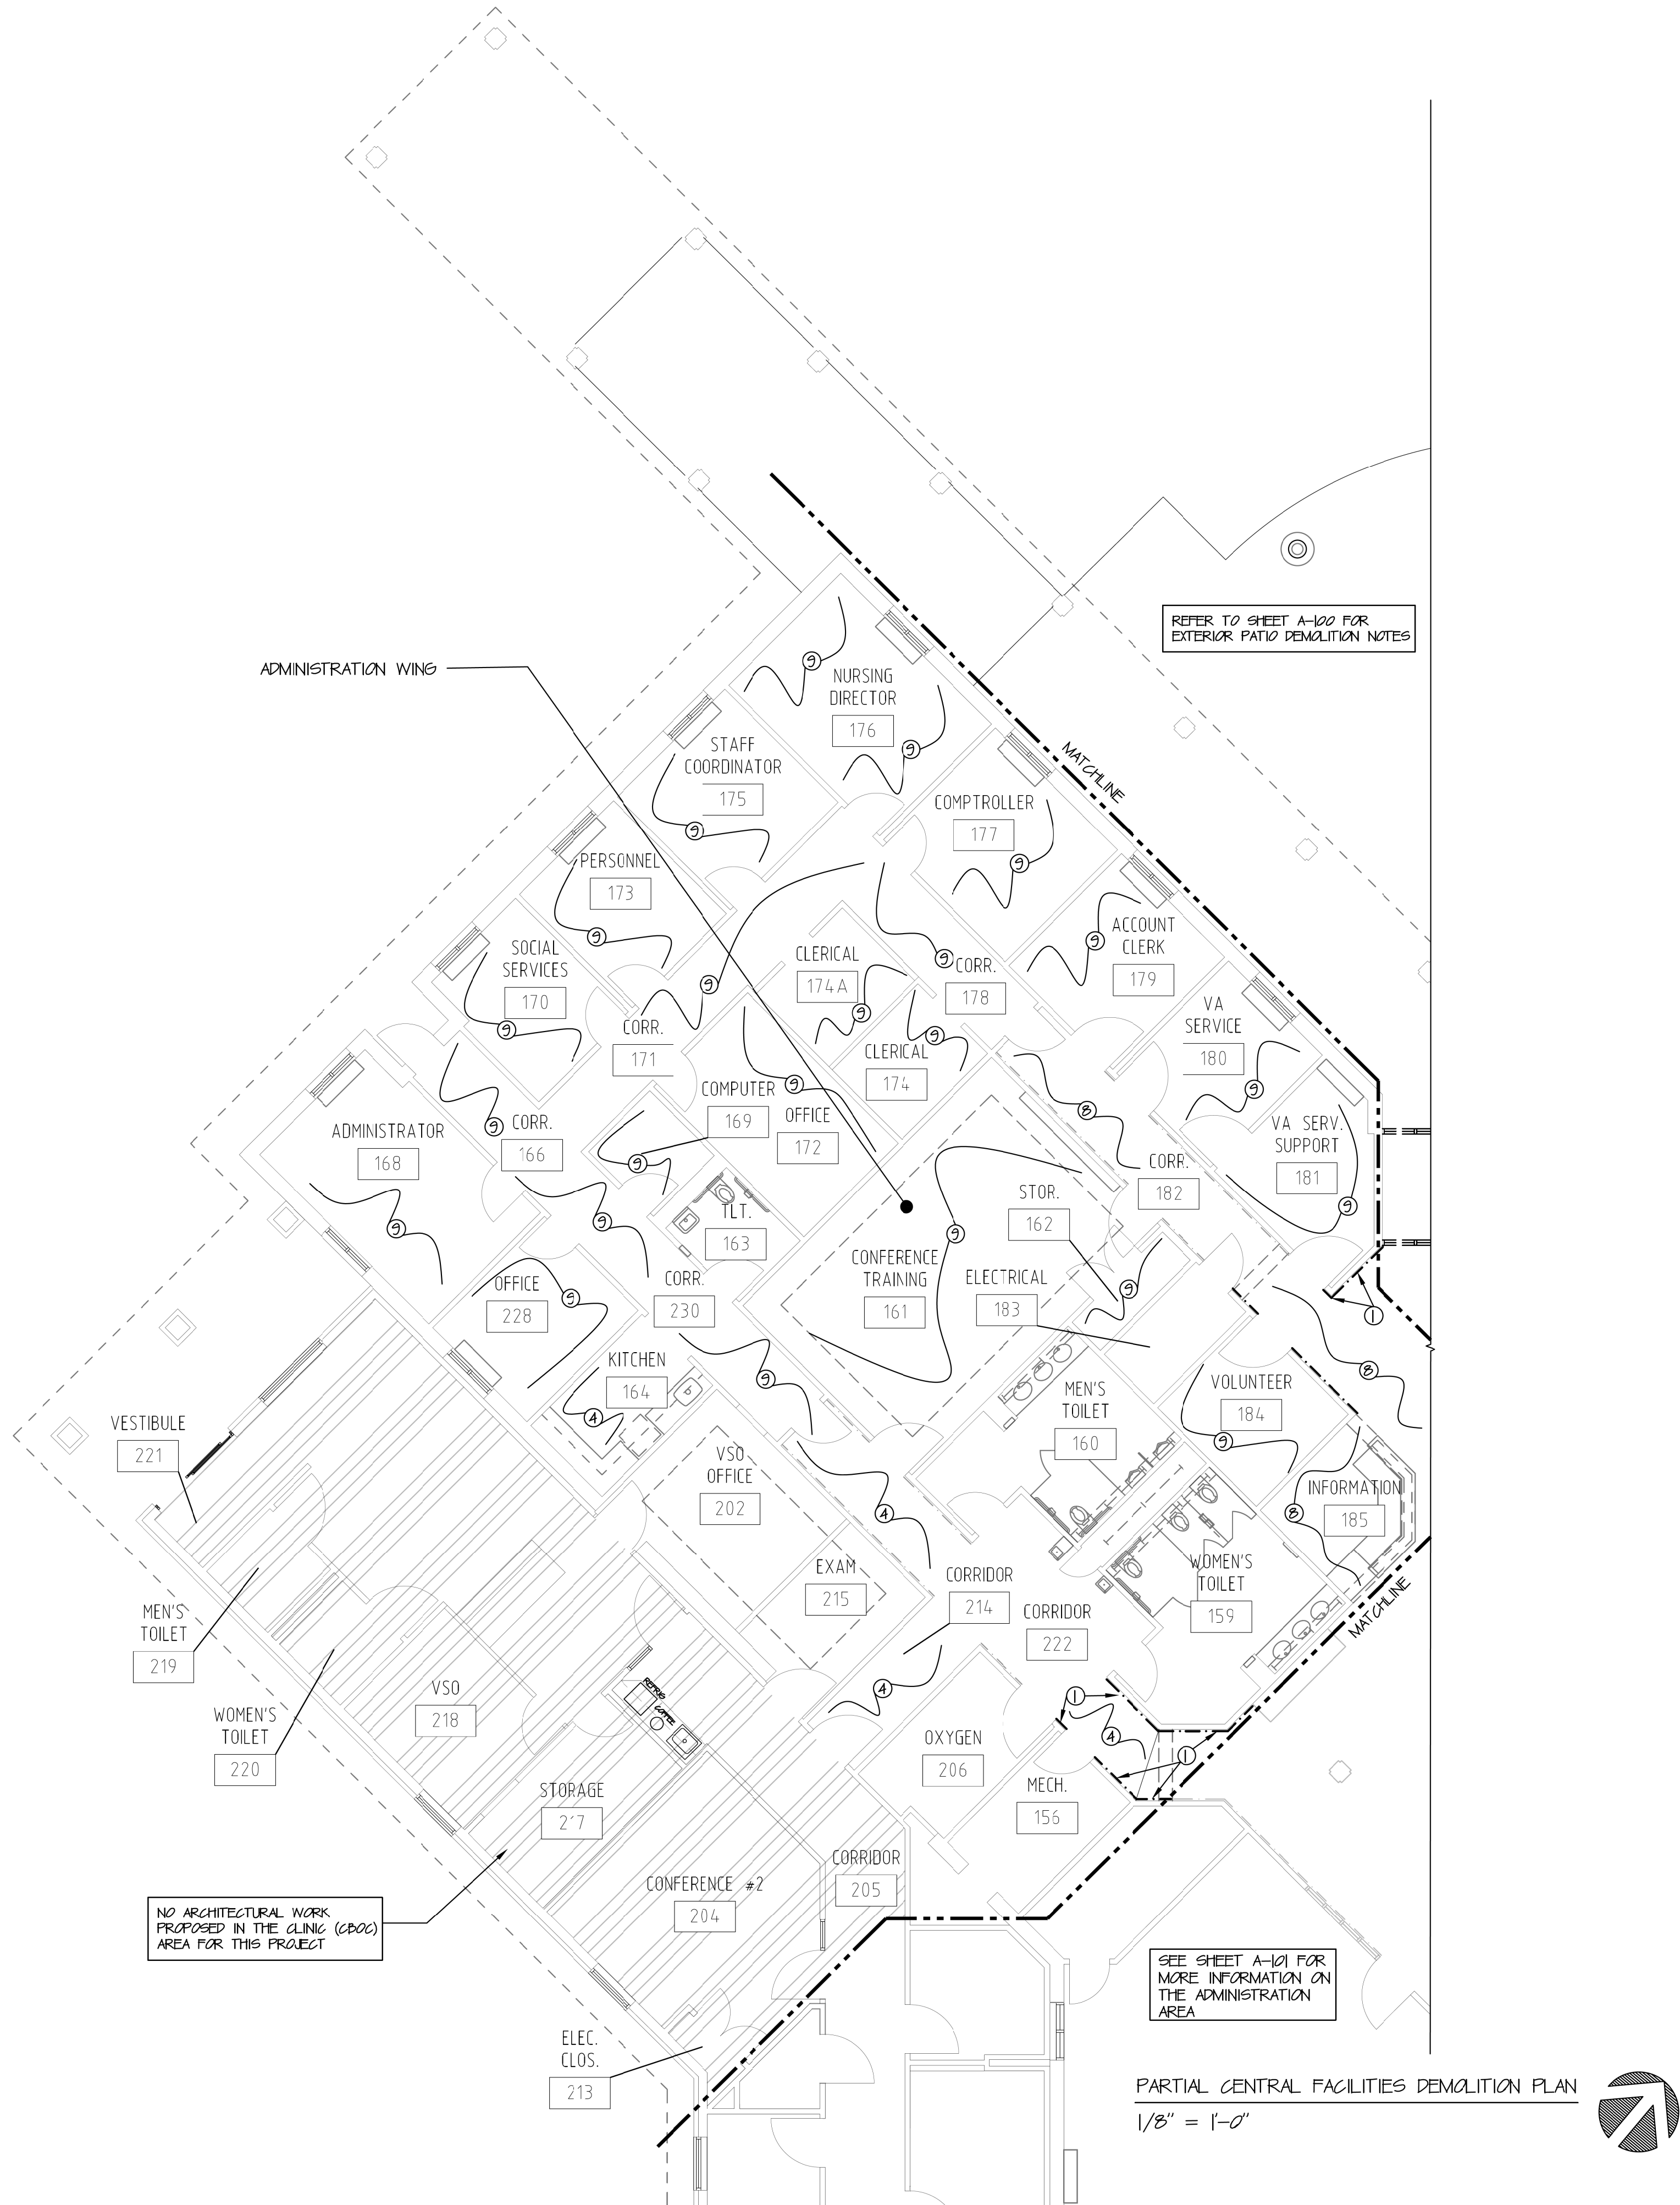
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**DEMOLITION PLAN**

SHEET NUMBER:

**A-100**  
7 OF 120 SHEETS  
8-1-24


BID DOCUMENTS





GENERAL NOTES

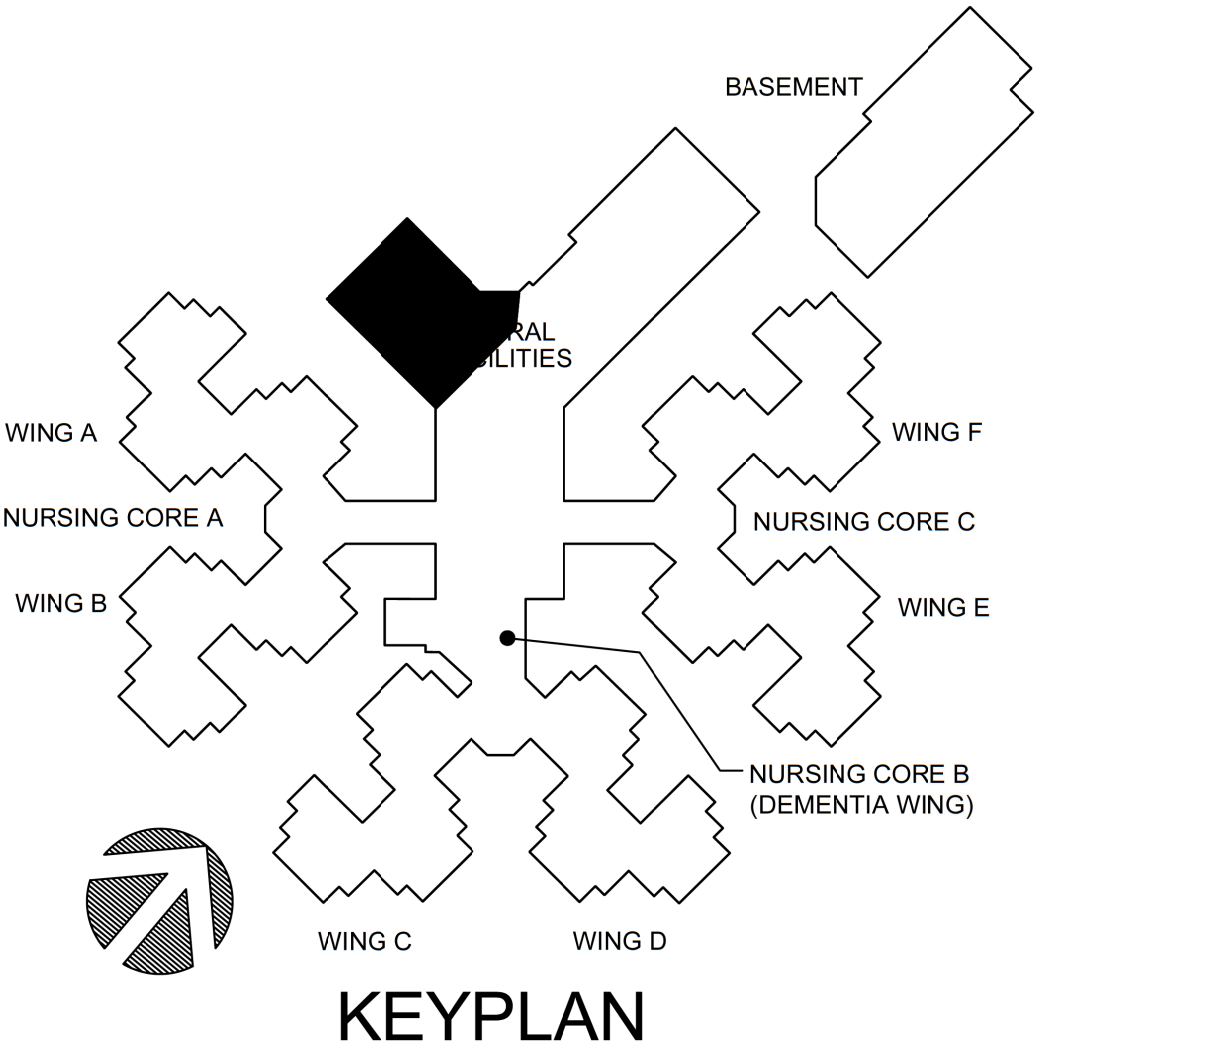- PATCH AND REPAIR ALL DAMAGE CAUSED DURING DEMOLITION TO FLOORS AND WALLS, TO MATCH EXISTING. PREPARE WALLS AND FLOORS TO RECEIVE NEW CONSTRUCTION. CONTRACTOR SHALL BE RESPONSIBLE FOR ALL FLOOR PREPARATION TO RECEIVE NEW FLOORING.
- PATCH AND REPAIR ALL DAMAGE CAUSED TO FLOOR, TO MATCH EXISTING, DURING DEMOLITION OF PLUMBING FIXTURES AND PIPING.
- REFER TO STRUCTURAL, MECHANICAL, & ELECTRICAL FOR ADDITIONAL DEMOLITION WORK.
- REMOVE AND DISCARD ALL EXISTING VINYL CORNER GUARD COVERS. ALUMINUM RETAINERS TO REMAIN, PROTECT AS REQUIRED.
- PATCH AND REPAIR ALL EXISTING CONSTRUCTION SHOWN TO REMAIN WHERE AFFECTED BY DEMOLITION TO MATCH EXISTING ADJACENT CONSTRUCTION.
- CONTRACTOR TO FIELD VERIFY ALL DIMENSIONS.
- REMOVE BASE WHEREVER FLOORING IS TO BE REMOVED; PATCH AND REPAIR WALL TO MATCH EXISTING ADJACENT CONSTRUCTION. NEW WALL BASE AND PAINT PER FINISH SCHEDULE.
- PROVIDE AND INSTALL TRANSITION STRIP BETWEEN FLOOR MATERIALS. REFER TO SHEET A-500 FOR ALL TRANSITION DETAILS.
- REMOVE AND DISCARD ANY EXISTING WALL COVERING AND WALL COVERING BORDERS ALONG ENTIRE LENGTH OF THE AREA. PREPARE WALL TO RECEIVE NEW FINISHES. REFER TO FINISH SCHEDULE.
- CONTRACTOR SHALL REMOVE ALL ITEMS OFF THE WALLS IN ORDER TO PATCH AND REPAIR WALLS TO RECEIVE NEW PAINT. REINSTALL ITEMS BACK ON WALL AFTER PAINTING IS COMPLETED. REMOVE FACE PLATES OF OUTLETS AND SWITCHES BEFORE PAINTING AND REINSTALL.



DEMO PLAN KEY NOTES (A-100-A-103)

- EXISTING WOOD HANDRAIL TO REMAIN AT LOCATION INDICATED BY (---), PROTECT AS REQUIRED.
- THROUGH ⑤ NOTE NOT USED
- REMOVE AND DISCARD EXISTING VGT AND BASE AT ENTIRE ROOM. PREPARE SUB FLOOR FOR NEW FLOORING PER THE FINISH SCHEDULE.
- THROUGH ⑦ NOTE NOT USED
- REMOVE AND DISCARD EXISTING CERAMIC FLOOR TILE AND BASE AT ENTIRE ROOM. PREPARE SUB FLOOR FOR NEW FLOORING PER THE FINISH SCHEDULE.
- REMOVE AND DISCARD EXISTING CARPET FLOORING AND BASE AT ENTIRE ROOM. PREPARE SUB FLOOR FOR NEW FLOORING PER THE FINISH SCHEDULE.
- THROUGH ⑩ NOTE NOT USED



2/19/25

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**ESTERLY  
&  
SCHNEIDER  
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CON. # 4860

OFFICE OF ADMINISTRATION  
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620 N. JEFFERSON  
ST. JAMES, MISSOURI

PROJECT # U1503-01  
SITE # 6801  
ASSET # 8136801002  
FEDERAL# 29-044

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DATE: \_\_\_\_\_  
REVISION: \_\_\_\_\_  
DATE: \_\_\_\_\_  
ISSUE DATE: 8-1-24

CAD DWG FILE: A-101.DWG  
DRAWN BY: ZAC/MAH  
CHECKED BY: MAH/CAS  
DESIGNED BY: MAH/CAS

SHEET TITLE:  
**DEMOLITION PLAN**


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8 OF 120 SHEETS  
8-1-24



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PARTIAL CENTRAL FACILITIES DEMOLITION PLAN

1/8" = 1'-0"



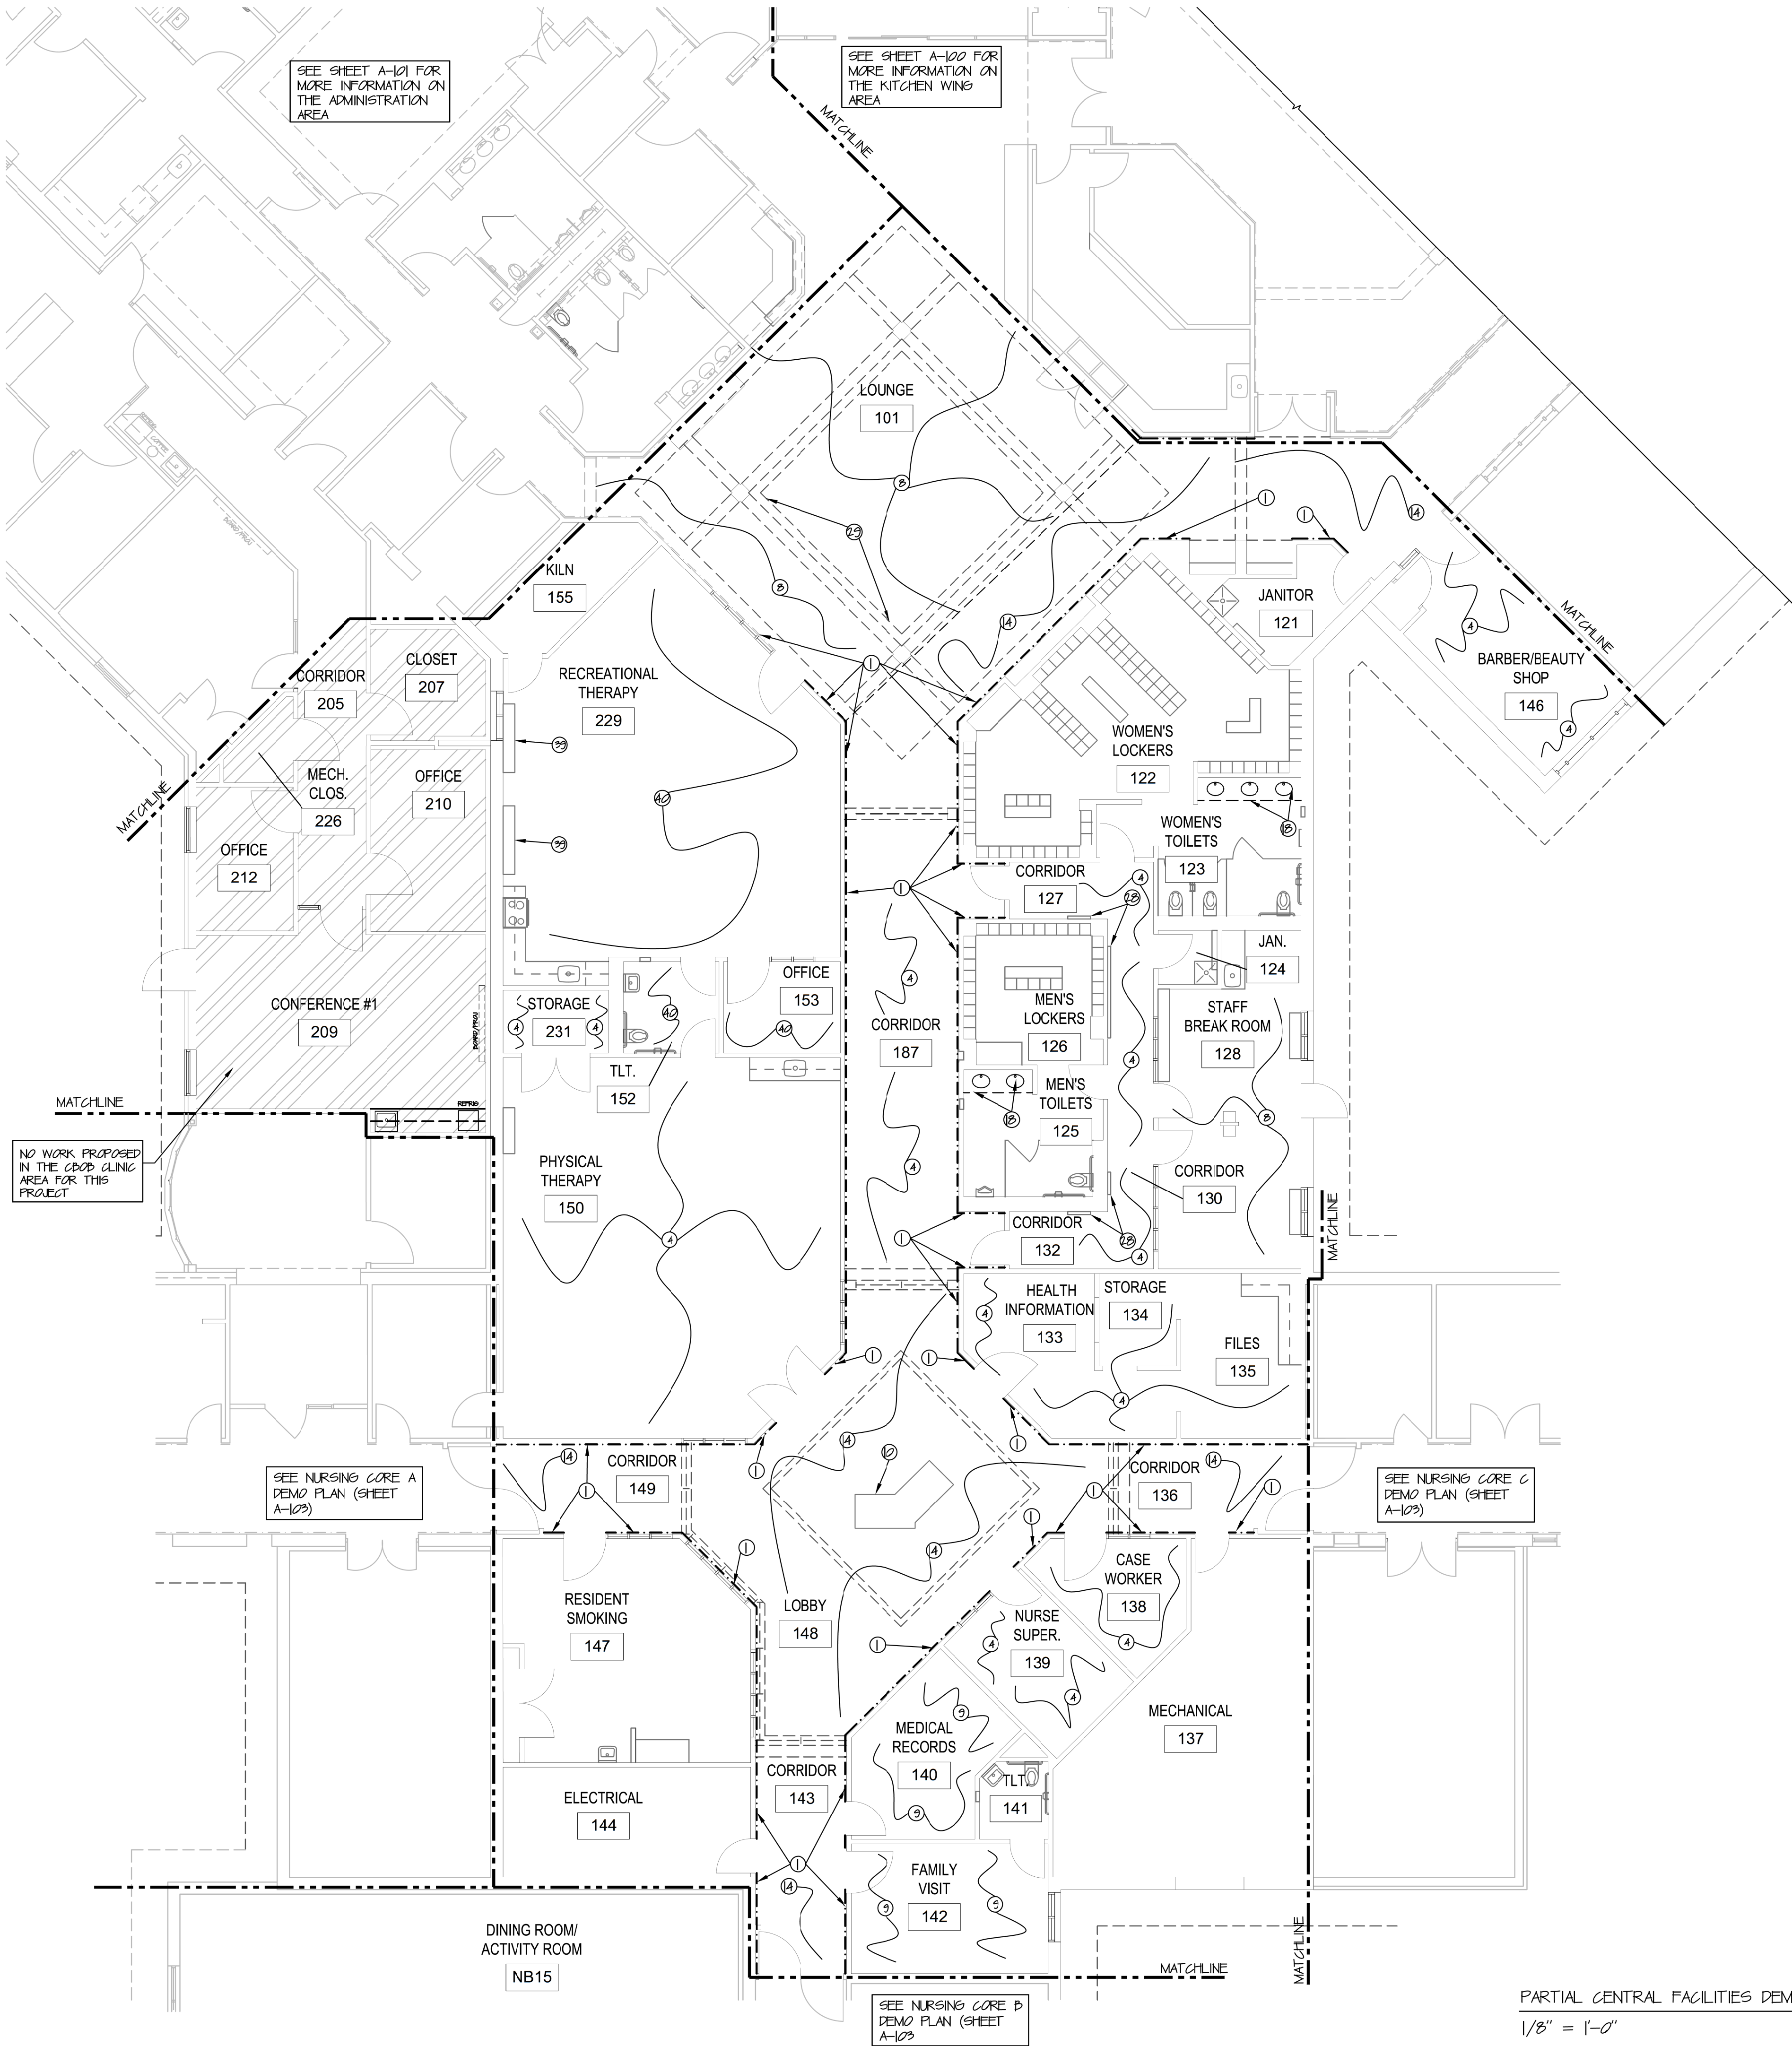KEYPLAN

GENERAL NOTES

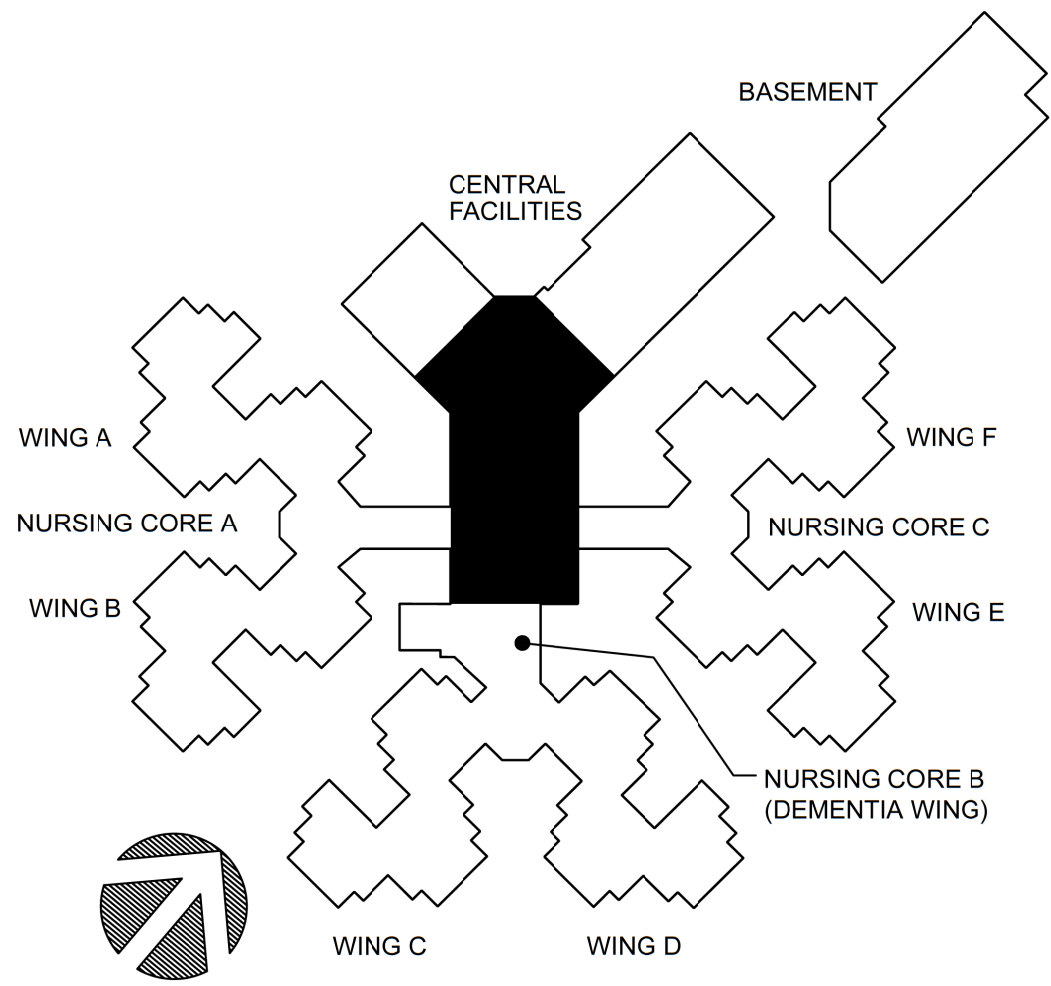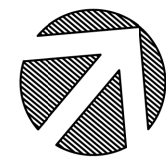- PATCH AND REPAIR ALL DAMAGE CAUSED DURING DEMOLITION TO FLOORS AND WALLS, TO MATCH EXISTING. PREPARE WALLS AND FLOORS TO RECEIVE NEW CONSTRUCTION. CONTRACTOR SHALL BE RESPONSIBLE FOR ALL FLOOR PREPARATION TO RECEIVE NEW FLOORING.
- PATCH AND REPAIR ALL DAMAGE CAUSED TO FLOOR, TO MATCH EXISTING, DURING DEMOLITION OF PLUMBING FIXTURES AND PIPING.
- REFER TO STRUCTURAL, MECHANICAL, & ELECTRICAL FOR ADDITIONAL DEMOLITION WORK.
- REMOVE AND DISCARD ALL EXISTING VINYL CORNER GUARD COVERS. ALUMINUM RETAINERS TO REMAIN, PROTECT AS REQUIRED.
- PATCH AND REPAIR ALL EXISTING CONSTRUCTION SHOWN TO REMAIN WHERE AFFECTED BY DEMOLITION TO MATCH EXISTING ADJACENT CONSTRUCTION.
- CONTRACTOR TO FIELD VERIFY ALL DIMENSIONS.
- REMOVE BASE WHEREVER FLOORING IS TO BE REMOVED, PATCH AND REPAIR WALL TO MATCH EXISTING ADJACENT CONSTRUCTION. NEW WALL BASE AND PAINT PER FINISH SCHEDULE.
- PROVIDE AND INSTALL TRANSITION STRIP BETWEEN FLOOR MATERIALS. REFER TO SHEET A-500 FOR ALL TRANSITION DETAILS.
- REMOVE AND DISCARD ANY EXISTING WALL COVERING AND WALL COVERING BORDERS ALONG ENTIRE LENGTH OF THE AREA. PREPARE WALL TO RECEIVE NEW FINISHES. REFER TO FINISH SCHEDULE.
- CONTRACTOR SHALL REMOVE ALL ITEMS OFF THE WALLS IN ORDER TO PATCH AND REPAIR WALLS TO RECEIVE NEW PAINT. REINSTALL ITEMS BACK ON WALL AFTER PAINTING IS COMPLETED. REMOVE FACE PLATES OF OUTLETS AND SWITCHES BEFORE PAINTING AND REINSTALL.

DEMO PLAN KEY NOTES (A-100-A-103)

- EXISTING WOOD HANDRAIL TO REMAIN AT LOCATION INDICATED BY (---) AT CORRIDOR 119 & 117. REMOVE BASE AT THESE LOCATIONS. AT DINING ROOM 103 AND 103A. EXISTING WOOD CHAIR RAIL TO REMAIN. PATCH AND REPAIR WALL TO RECEIVE NEW CONSTRUCTION.
- THROUGH (3) NOTE NOT USED
- REMOVE AND DISCARD EXISTING VGT AND BASE. PREPARE SUB FLOOR FOR NEW FLOORING PER THE FINISH SCHEDULE.
- THROUGH (7) NOTE NOT USED
- REMOVE AND DISCARD EXISTING FLOOR TILE AND BASE AT ENTIRE ROOM. PREPARE SUB FLOOR FOR NEW FLOORING PER THE FINISH SCHEDULE.
- REMOVE AND DISCARD EXISTING CARPET FLOORING. PREPARE SUB FLOOR FOR NEW FLOORING PER THE FINISH SCHEDULE.
- EXISTING FISH TANK TO REMAIN, PROTECT AS REQUIRED. ALL FLOORING TO BE CUT AND INSTALLED NEW TO THE TANK.
- THROUGH (10) NOTE NOT USED
- REMOVE AND DISCARD EXISTING VINYL AND BASE. PREPARE SUB FLOOR FOR NEW FLOORING PER THE FINISH SCHEDULE.
- THROUGH (11) NOTE NOT USED
- REMOVE AND DISCARD EXISTING SINK AND COUNTER TOP, SIDE SPLASH AND BACKSPASHES.
- THROUGH (21) NOTE NOT USED
- EXISTING BULLETIN BOARDS TO REMAIN, PROTECT AS REQUIRED.
- THROUGH (28) NOTE NOT USED
- REMOVE AND DISCARD CASEWORK COVERED FAN COIL UNIT. AFTER DEMOLITION OF UNIT, CONTRACTOR TO REINSTALL CASEWORK AND PROVIDE NEW MILLWORK COUNTER. REFER TO FLOOR PLAN FOR MORE INFORMATION.
- REMOVE AND DISCARD EXISTING SHEET VINYL FLOORING AND BASE. PREPARE SUB FLOOR FOR NEW FLOORING PER THE FINISH SCHEDULE.

STATE OF MISSOURI  
MIKE KEHOE,  
GOVERNOR



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CERTIFICATE OF AUTHORITY #000718

**ESTERLY & SCHNEIDER ASSOCIATES, INC.**  
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DESIGN AND CONSTRUCTION

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MISSOURI VETERANS  
HOME

620 N. JEFFERSON  
ST. JAMES, MISSOURI

PROJECT # U1503-01  
SITE # 6801  
ASSET # 8136801002  
FEDERAL# 29-044

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REVISION: \_\_\_\_\_  
DATE: \_\_\_\_\_

ISSUE DATE: 8-1-24

CAD DWG FILE: A-102.DWG  
DRAWN BY: ZAC/MAH  
CHECKED BY: MAH/CAS  
DESIGNED BY: MAH/CAS

SHEET TITLE:

DEMOLITION PLAN

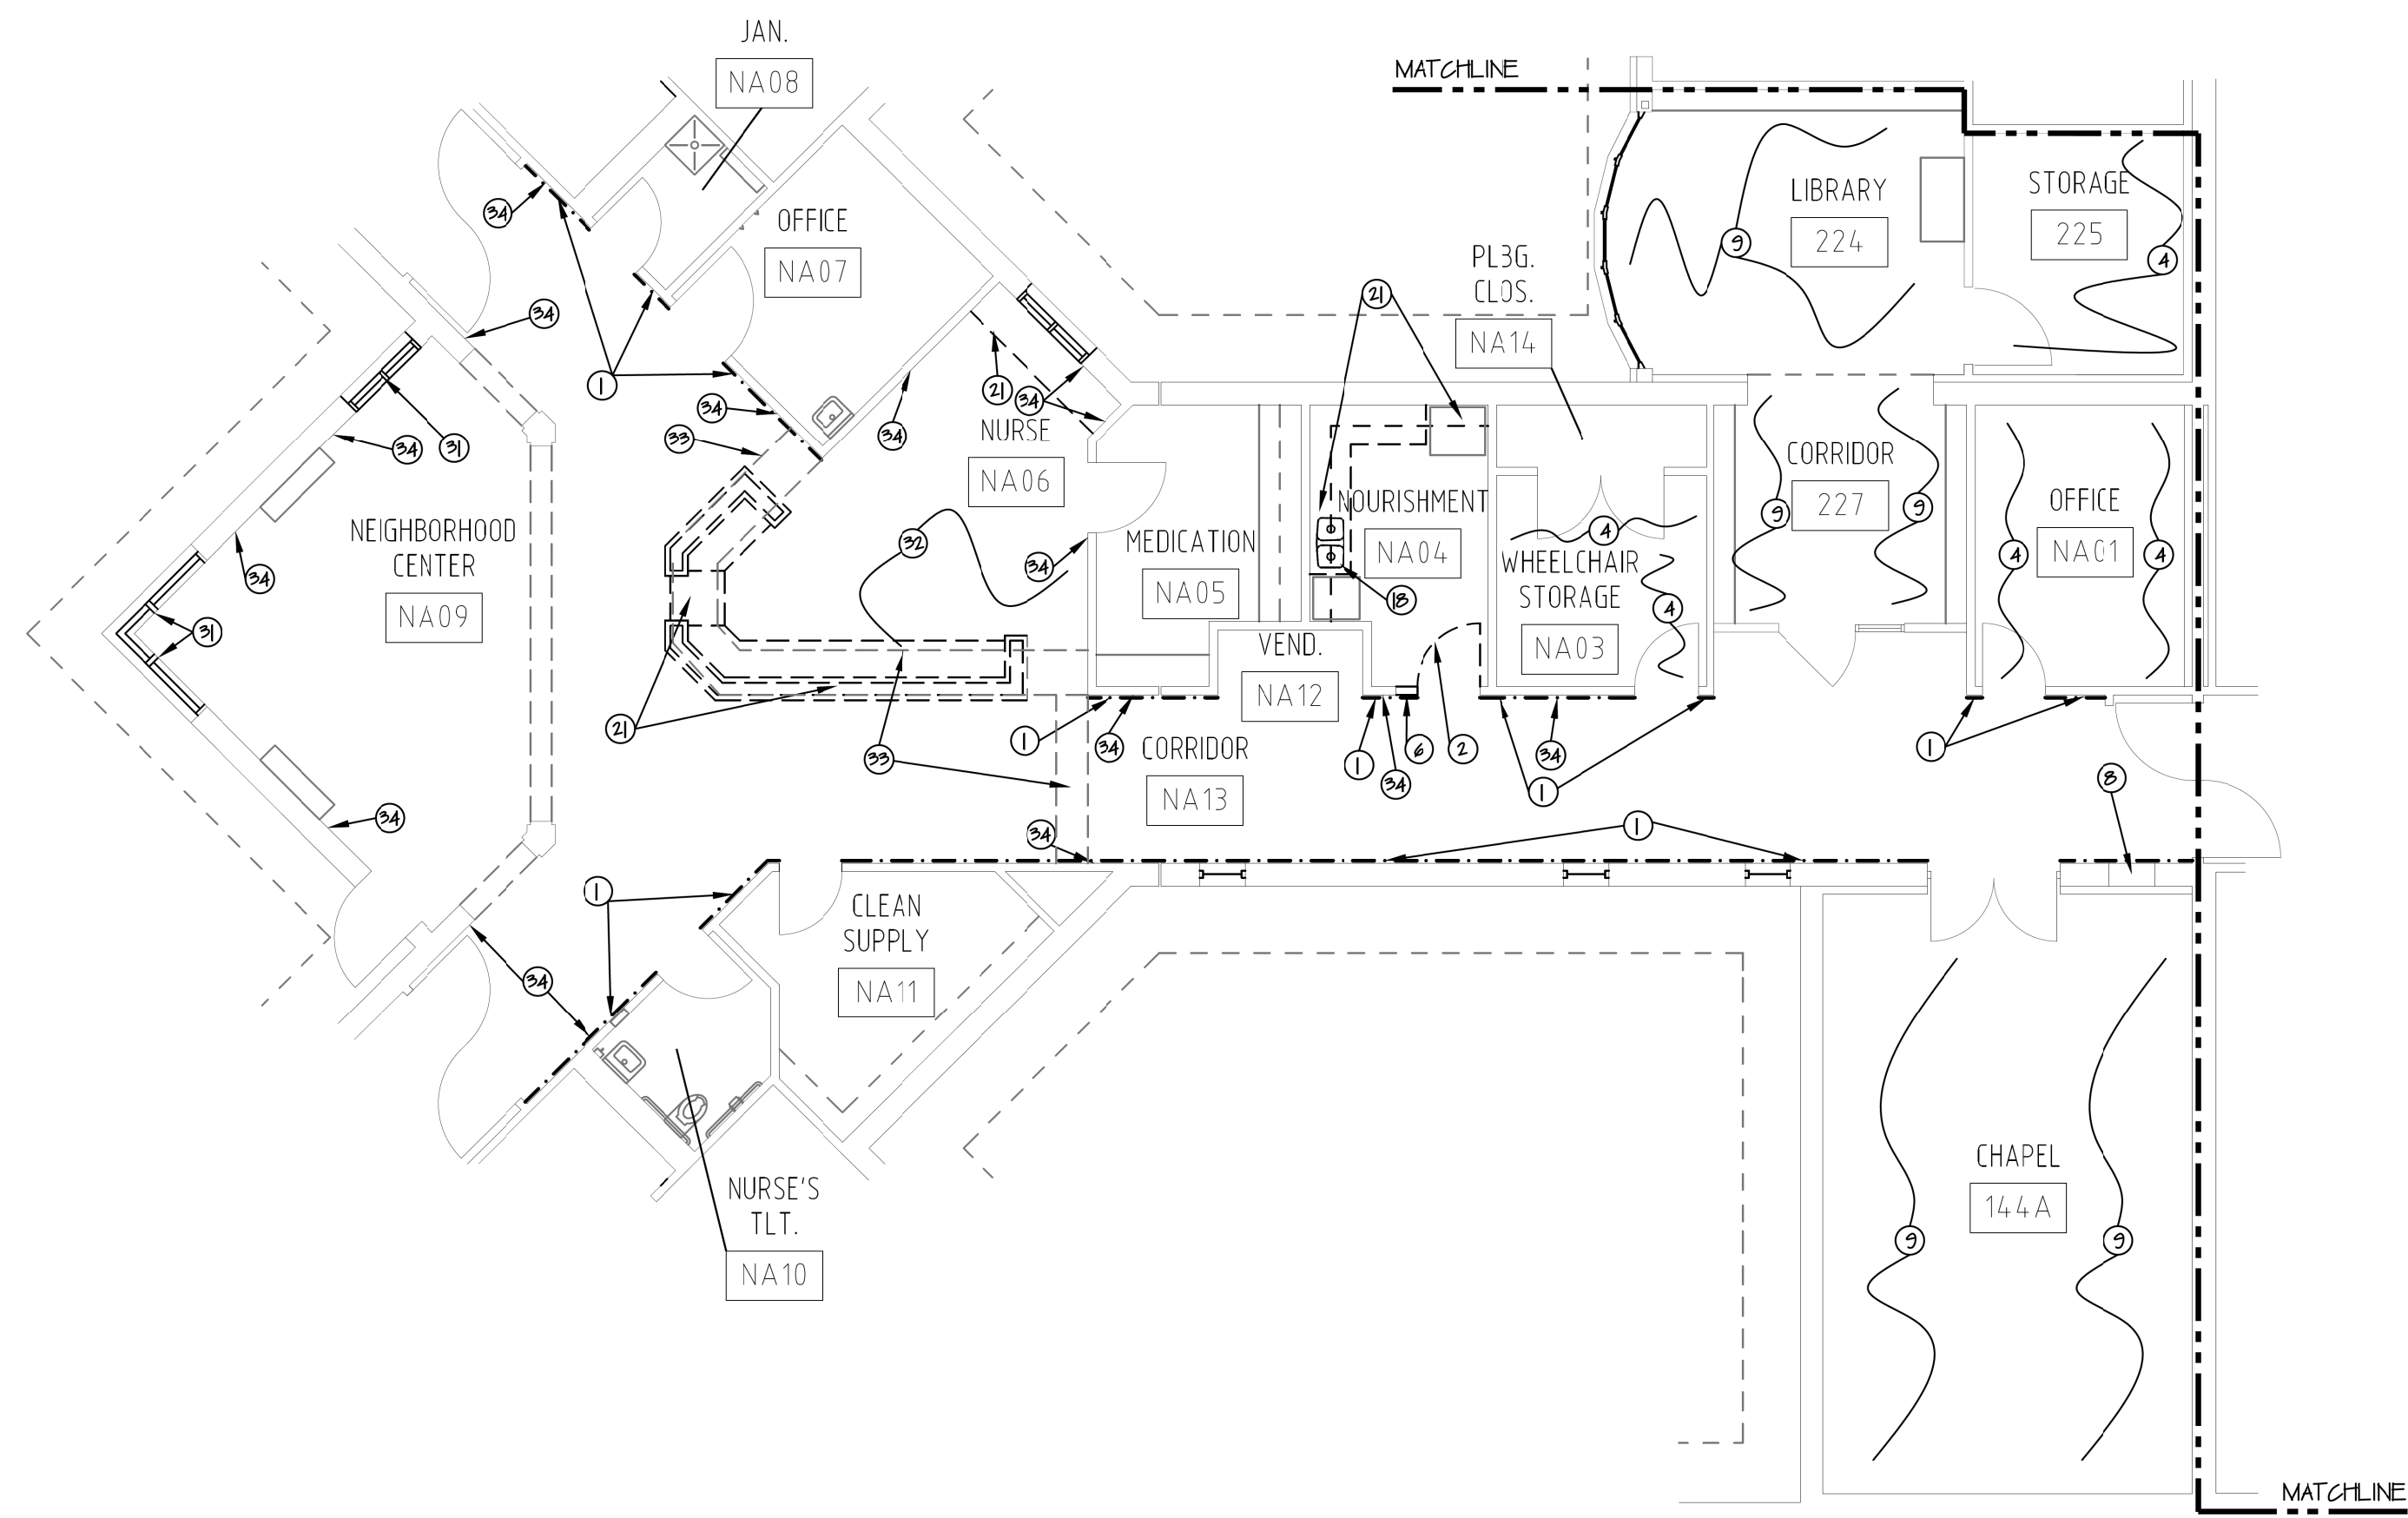
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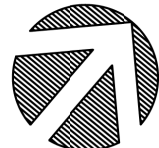
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8-1-24

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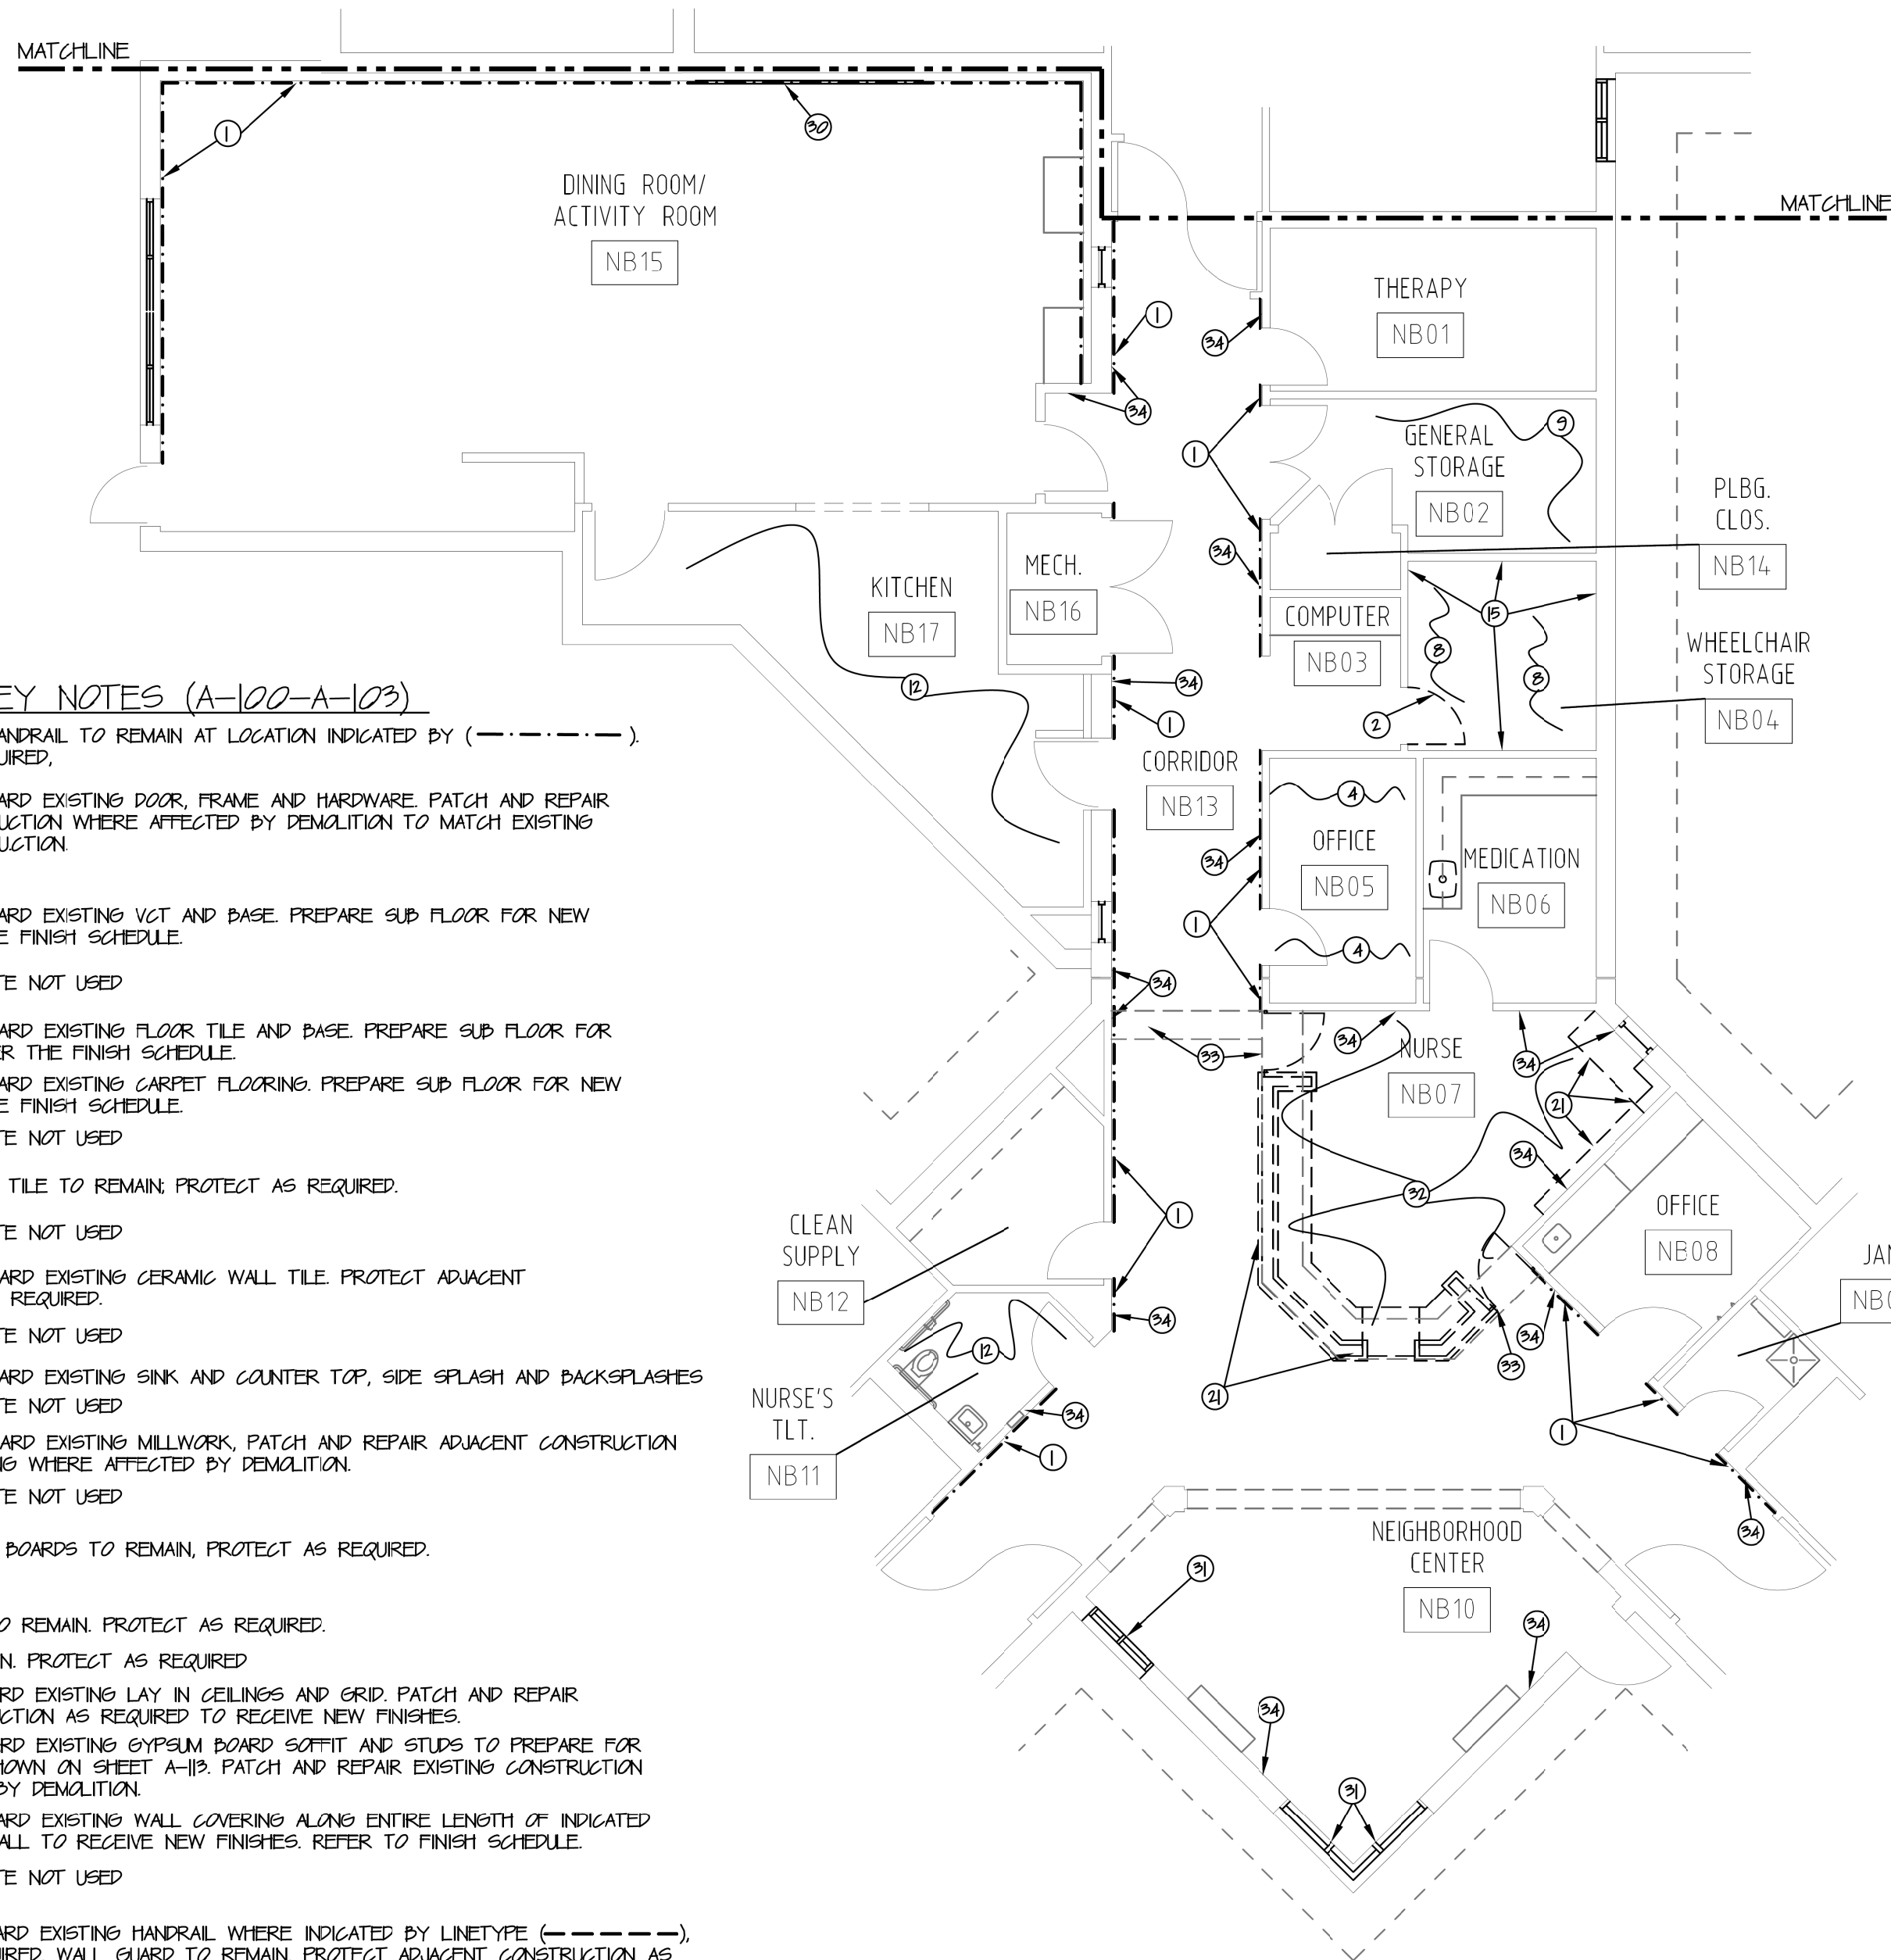


NURSING CORE A DEMO PLAN  
1/8" = 1'-0"




#### GENERAL NOTES

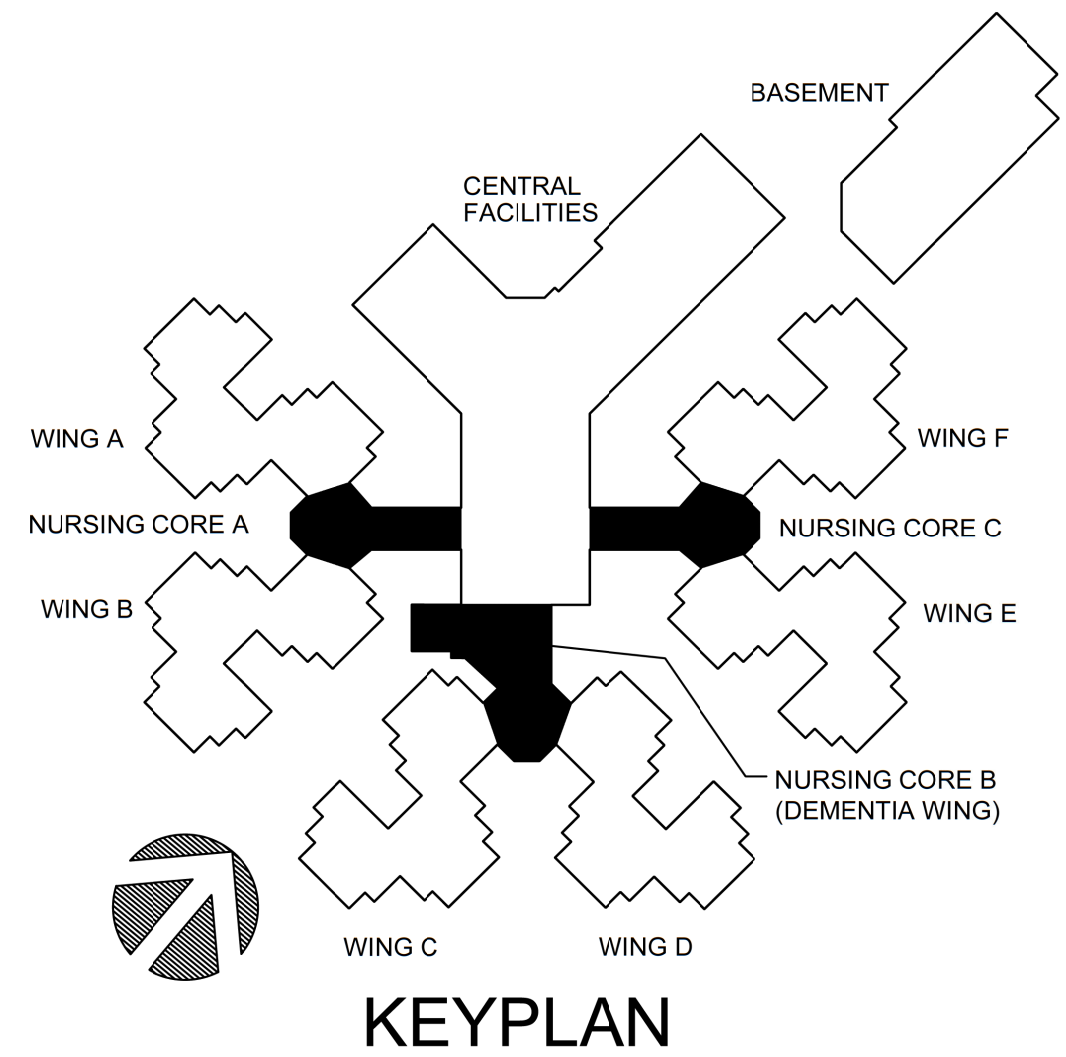- PATCH AND REPAIR ALL DAMAGE CAUSED DURING DEMOLITION TO FLOORS AND WALLS, TO MATCH EXISTING. PREPARE WALLS AND FLOORS TO RECEIVE NEW CONSTRUCTION. CONTRACTOR SHALL BE RESPONSIBLE FOR ALL FLOOR PREPARATION TO RECEIVE NEW FLOORING.
- PATCH AND REPAIR ALL DAMAGE CAUSED TO FLOOR, TO MATCH EXISTING, DURING DEMOLITION OF PLUMBING FIXTURES AND PIPING.
- REFER TO STRUCTURAL, MECHANICAL, & ELECTRICAL FOR ADDITIONAL DEMOLITION WORK.
- REMOVE AND DISCARD ALL EXISTING VINYL CORNER GUARD COVERS. ALUMINUM RETAINERS TO REMAIN, PROTECT AS REQUIRED.
- PATCH AND REPAIR ALL EXISTING CONSTRUCTION SHOWN TO REMAIN WHERE AFFECTED BY DEMOLITION TO MATCH EXISTING ADJACENT CONSTRUCTION.
- CONTRACTOR TO FIELD VERIFY ALL DIMENSIONS.
- REMOVE BASE WHEREVER FLOORING IS TO BE REMOVED, PATCH AND REPAIR WALL TO MATCH EXISTING ADJACENT CONSTRUCTION. NEW WALL BASE AND PAINT PER FINISH SCHEDULE.
- PROVIDE AND INSTALL TRANSITION STRIP BETWEEN FLOOR MATERIALS. REFER TO SHEET A-500 FOR ALL TRANSITION DETAILS.
- REMOVE AND DISCARD ANY EXISTING WALL COVERING AND WALL COVERING BORDERS ALONG ENTIRE LENGTH OF THE AREA. PREPARE WALL TO RECEIVE NEW FINISHES. REFER TO FINISH SCHEDULE.
- CONTRACTOR SHALL REMOVE ALL ITEMS OFF THE WALLS IN ORDER TO PATCH AND REPAIR WALLS TO RECEIVE NEW PAINT. REINSTALL ITEMS BACK ON WALL AFTER PAINTING IS COMPLETED. REMOVE FACE PLATES OF OUTLETS AND SWITCHES BEFORE PAINTING AND REINSTALL.




NURSING CORE B DEMO PLAN  
1/8" = 1'-0"



KEYPLAN

STATE OF MISSOURI  
MIKE KEHOE,  
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ISSUE DATE: 8-1-24

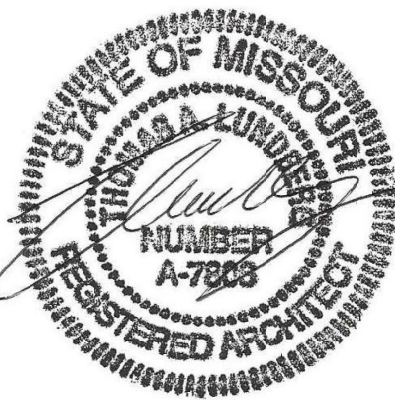CAD DWG FILE: A-103.DWG  
DRAWN BY: ZAC/MAH  
CHECKED BY: MAH/CAS  
DESIGNED BY: MAH/CAS

SHEET TITLE:  
**DEMOLITION PLANS**

SHEET NUMBER:

**A-103**

10 OF 120 SHEETS  
8-1-24

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PUBLIC SAFETY  
MISSOURI VETERANS  
COMMISSION**

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CAD DWG FILE: A-104.DWG  
DRAWN BY: ZAC/MAH  
CHECKED BY: MAH/CAS  
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## DEMOLITION PLAN

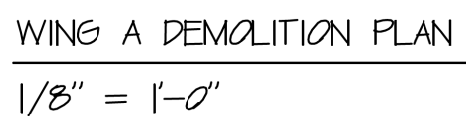
A-104

11 OF 120 SHEETS  
8-1-24



- a. AT ALL PRIVATE AND SEMI-PRIVATE RESIDENTS ROOMS REMOVE EXISTING SHEET VINYL FLOOR AND INTEGRAL WALL BASE. PREPARE CONCRETE SUBFLOOR AND WALLS AS REQUIRED TO ALLOW FOR NEW FLOOR AND BASE PER THE FINISH SCHEDULE. CONTRACTOR SHALL BE RESPONSIBLE FOR ALL FLOOR PREPARATION TO RECEIVE NEW FLOORING. FLOOR COATING SHALL BE PROVIDED AS REQUIRED FOR PREPARATION OF FLOOR.
- b. AT ALL LIVING ROOMS, SOLID UTILITY, MECHANICAL, AND STORAGE ROOMS. REMOVE EXISTING SHEET VINYL WALL BASE. PREPARE CONCRETE SUBFLOOR AND WALLS AS REQUIRED TO ALLOW FOR NEW FLOOR AND BASE PER THE FINISH SCHEDULE. CONTRACTOR SHALL BE RESPONSIBLE FOR ALL FLOOR PREPARATION TO RECEIVE NEW FLOORING. FLOOR COATING SHALL BE PROVIDED AS REQUIRED FOR PREPARATION OF FLOOR.
- c. AT ALL LIVING ROOM AREAS REMOVE AND DISCARD ALL WALLPAPER BORDERS. PATCH AND REPAIR ALL AREAS AFFECTED BY REMOVAL. PREPARE WALLS FOR NEW FINISHES.
- d. REMOVE AND DISCARD ALL EXISTING VINYL CORNER GUARD COVERS. ALUMINUM RETAINERS TO REMAIN, PROTECT AS REQUIRED.
- e. ALL WOOD PANELING LOCATED ON WALLS TO BE REMOVED AND DISCARDED. PATCH AND REPAIR WALLS AS REQUIRED TO RECEIVE NEW FINISHES.
- f. REMOVE AND DISCARD ANY EXISTING WALL COVERING AND WALL COVERING BORDERS ALONG ENTIRE LENGTH OF THE WING. PREPARE WALL TO RECEIVE NEW FINISHES. REFER TO FINISH SCHEDULE.
- g. ALTERNATE #1 - ALL WORK ASSOCIATED WITH WING A FOR INFECTIOUS CONTROL SHALL BE COORDINATED WITH MEP DRAWINGS.
- h. ALTERNATE #1 REMOVE AND DISCARD EXISTING LAY IN CEILINGS AND GRID. PATCH AND REPAIR ADJACENT CONSTRUCTION AS REQUIRED TO RECEIVE NEW FINISHES.
- i. CONTRACTOR SHALL REMOVE ALL ITEMS OFF THE WALLS IN ROGER TO PATCH AND REPAIR WALLS TO RECEIVE NEW PAINT. REMOVE ALL ITEMS OFF WALL WALL AFTER PAINTING IS COMPLETED. REMOVE FACE PLATES OF OUTLETS AND SWITCHES BEFORE PAINTING AND REINSTALL.

- (1) ALTERNATE #2: REMOVE AND DISCARD EXISTING MILLWORK, LIGHTS AND MIRRORS. PROTECT ADJACENT CONSTRUCTION AS REQUIRED. TV TO BE REMOVED AND RELOCATED AS SHOWN ON THE FLOOR PLANS. PATCH AND REPAIR ADJACENT WALL TO MATCH EXISTING WHERE AFFECTED BY DEMOLITION.
- (2) EXISTING MATERIAL DESIGNATED AS (---) ON THE PLANS TO REMAIN, PROTECT AS REQUIRED.
- (3) ALTERNATE #2: PORTION OF EXISTING CONCRETE PAD TO BE REMOVED AS SHOWN TO ALLOW FOR NEW CONSTRUCTION. REFER TO VINTS A FLOOR PLAN FOR ADDITIONAL INFORMATION.
- (4) ALTERNATE #2: REMOVE PORTION OF EXISTING EXTERIOR WALL AS REQUIRED TO ALLOW FOR NEW OPENING AS SHOWN. REFER TO STRUCTURAL PLANS FOR BRACING. PROTECT ADJACENT CONSTRUCTION AS REQUIRED. PATCH AND REPAIR ADJACENT WALL TO MATCH EXISTING WHERE AFFECTED BY DEMOLITION. REFER TO STRUCTURAL PLANS FOR ADDITIONAL INFORMATION.
- (5) REMOVE PORTION OF EXISTING WALL TO ALLOW FOR NEW CONSTRUCTION. PROTECT ADJACENT CONSTRUCTION AS REQUIRED. PATCH AND REPAIR ADJACENT WALL TO MATCH EXISTING WHERE AFFECTED BY DEMOLITION.
- (6) PATCH AND REPAIR CEILING TO MATCH ADJACENT CONSTRUCTION AFTER DEMOLITION AND NEW CONSTRUCTION WORK IS COMPLETED. PREPARE TO RECEIVE NEW PAINT.
- (7) EXISTING SHOWER AND TOILET ACCESSORIES TO BE REMOVED. PATCH AND PREPARE AREA FOR NEW SHOWER. REFER TO PLUMBING PLANS FOR ADDITIONAL INFORMATION.
- (8) EXISTING WOOD CORNER GUARD TO REMAIN. PROTECT AS REQUIRED.
- (9) REMOVE AND DISCARD EXISTING WALL COVERING ALONG ENTIRE LENGTH OF INDICATED WALL. PREPARE WALL TO RECEIVE NEW FINISHES. REFER TO FINISH SCHEDULE.
- (10) REMOVE AND DISCARD EXISTING WOOD PANEL/BASE LOCATED NEAR DOOR. PATCH AND REPAIR WALL AS REQUIRED TO RECEIVE NEW FINISHES.
- (11) SAND AND REPAIR EXISTING WALL TEXTURE AT INDICATED WALL. WALL TEXTURE TO MATCH EXISTING ADJACENT CONSTRUCTION.
- (12) REMOVE AND DISCARD SECTION OF EXISTING CONCRETE AS SHOWN TO ALLOW FOR CONSTRUCTION OF NEW RESTROOM.
- (13) REMOVE AND DISCARD EXISTING MILLWORK. PATCH AND REPAIR ADJACENT WALL AS REQUIRED.
- (14) NOTE NOT USED.
- (15) ALTERNATE #2: REMOVE AND DISCARD PORTION OF EXISTING WALL TO ALLOW FOR INSTALLATION OF NEW DOOR PER FLOOR PLAN AND DOOR SCHEDULE. PROTECT ADJACENT CONSTRUCTION AS REQUIRED.
- (16) ALTERNATE #2: REMOVE AND DISCARD EXISTING DOOR AND FRAME. PROTECT ADJACENT CONSTRUCTION AS REQUIRED.
- (17) REMOVE AND DISCARD EXISTING VINYL FLOORING AND BASE. PREPARE SUB FLOOR FOR NEW FLOORING PER THE FINISH SCHEDULE.
- (18) REMOVE AND DISCARD EXISTING VCT AND BASE. PREPARE SUB FLOOR FOR NEW FLOORING PER THE FINISH SCHEDULE.




ALTERNATE #1: ALL WORK ASSOCIATED WITH INFECTIOUS CONTROL WINGS 'A' FOR REVISED MECHANICAL AND ELECTRICAL WORK ASSOCIATED WITH THE REQUIREMENTS TO ACHIEVE THE INFECTIOUS CONTROL AREAS DEFINED ON THE MECHANICAL PLANS. REFER TO SHEETS A-10A, A-11A, A-21, A-600, A-601, A-602, A-1229, A-1

ALTERNATE #2--  
PROVIDE AND INSTALL NEW MEDICAL  
EQUIPMENT ROOM ADDITION ON TO RESIDENT  
WINGS A, B, C, D, E AND F. REFER TO  
SHEETS A-14, A-15, A-16, A-17, A-18, A-119,  
A-121 AND A-200 AND ALL ASSOCIATED  
DETAILS AS WELL AS MEP AND STRUCTURAL  
DRAWINGS.

ALTERNATE #2-  
AT ALL RESIDENT ROOMS, REMOVE AND  
DISCARD EXISTING WARDROBE AND CABINETS.  
PATCH AND REPAIR WALL AS REQUIRED TO  
RECEIVE NEW MILLWORK AT RESIDENTS  
ROOMS AT WINGS A, B, C, D, E AND F.  
PROVIDE AND INSTALL NEW WARDROBE AND  
CABINETS PER SHEETS A-104, A-105, A-106,  
A-107, A-108, A-109, A-114, A-115, A-116, A-117,  
A-118, A-119, A-210, E-116, E-117, E-118, E-119,  
E-120 AND E-121 AS WELL AS ALL  
ASSOCIATED DETAILS.

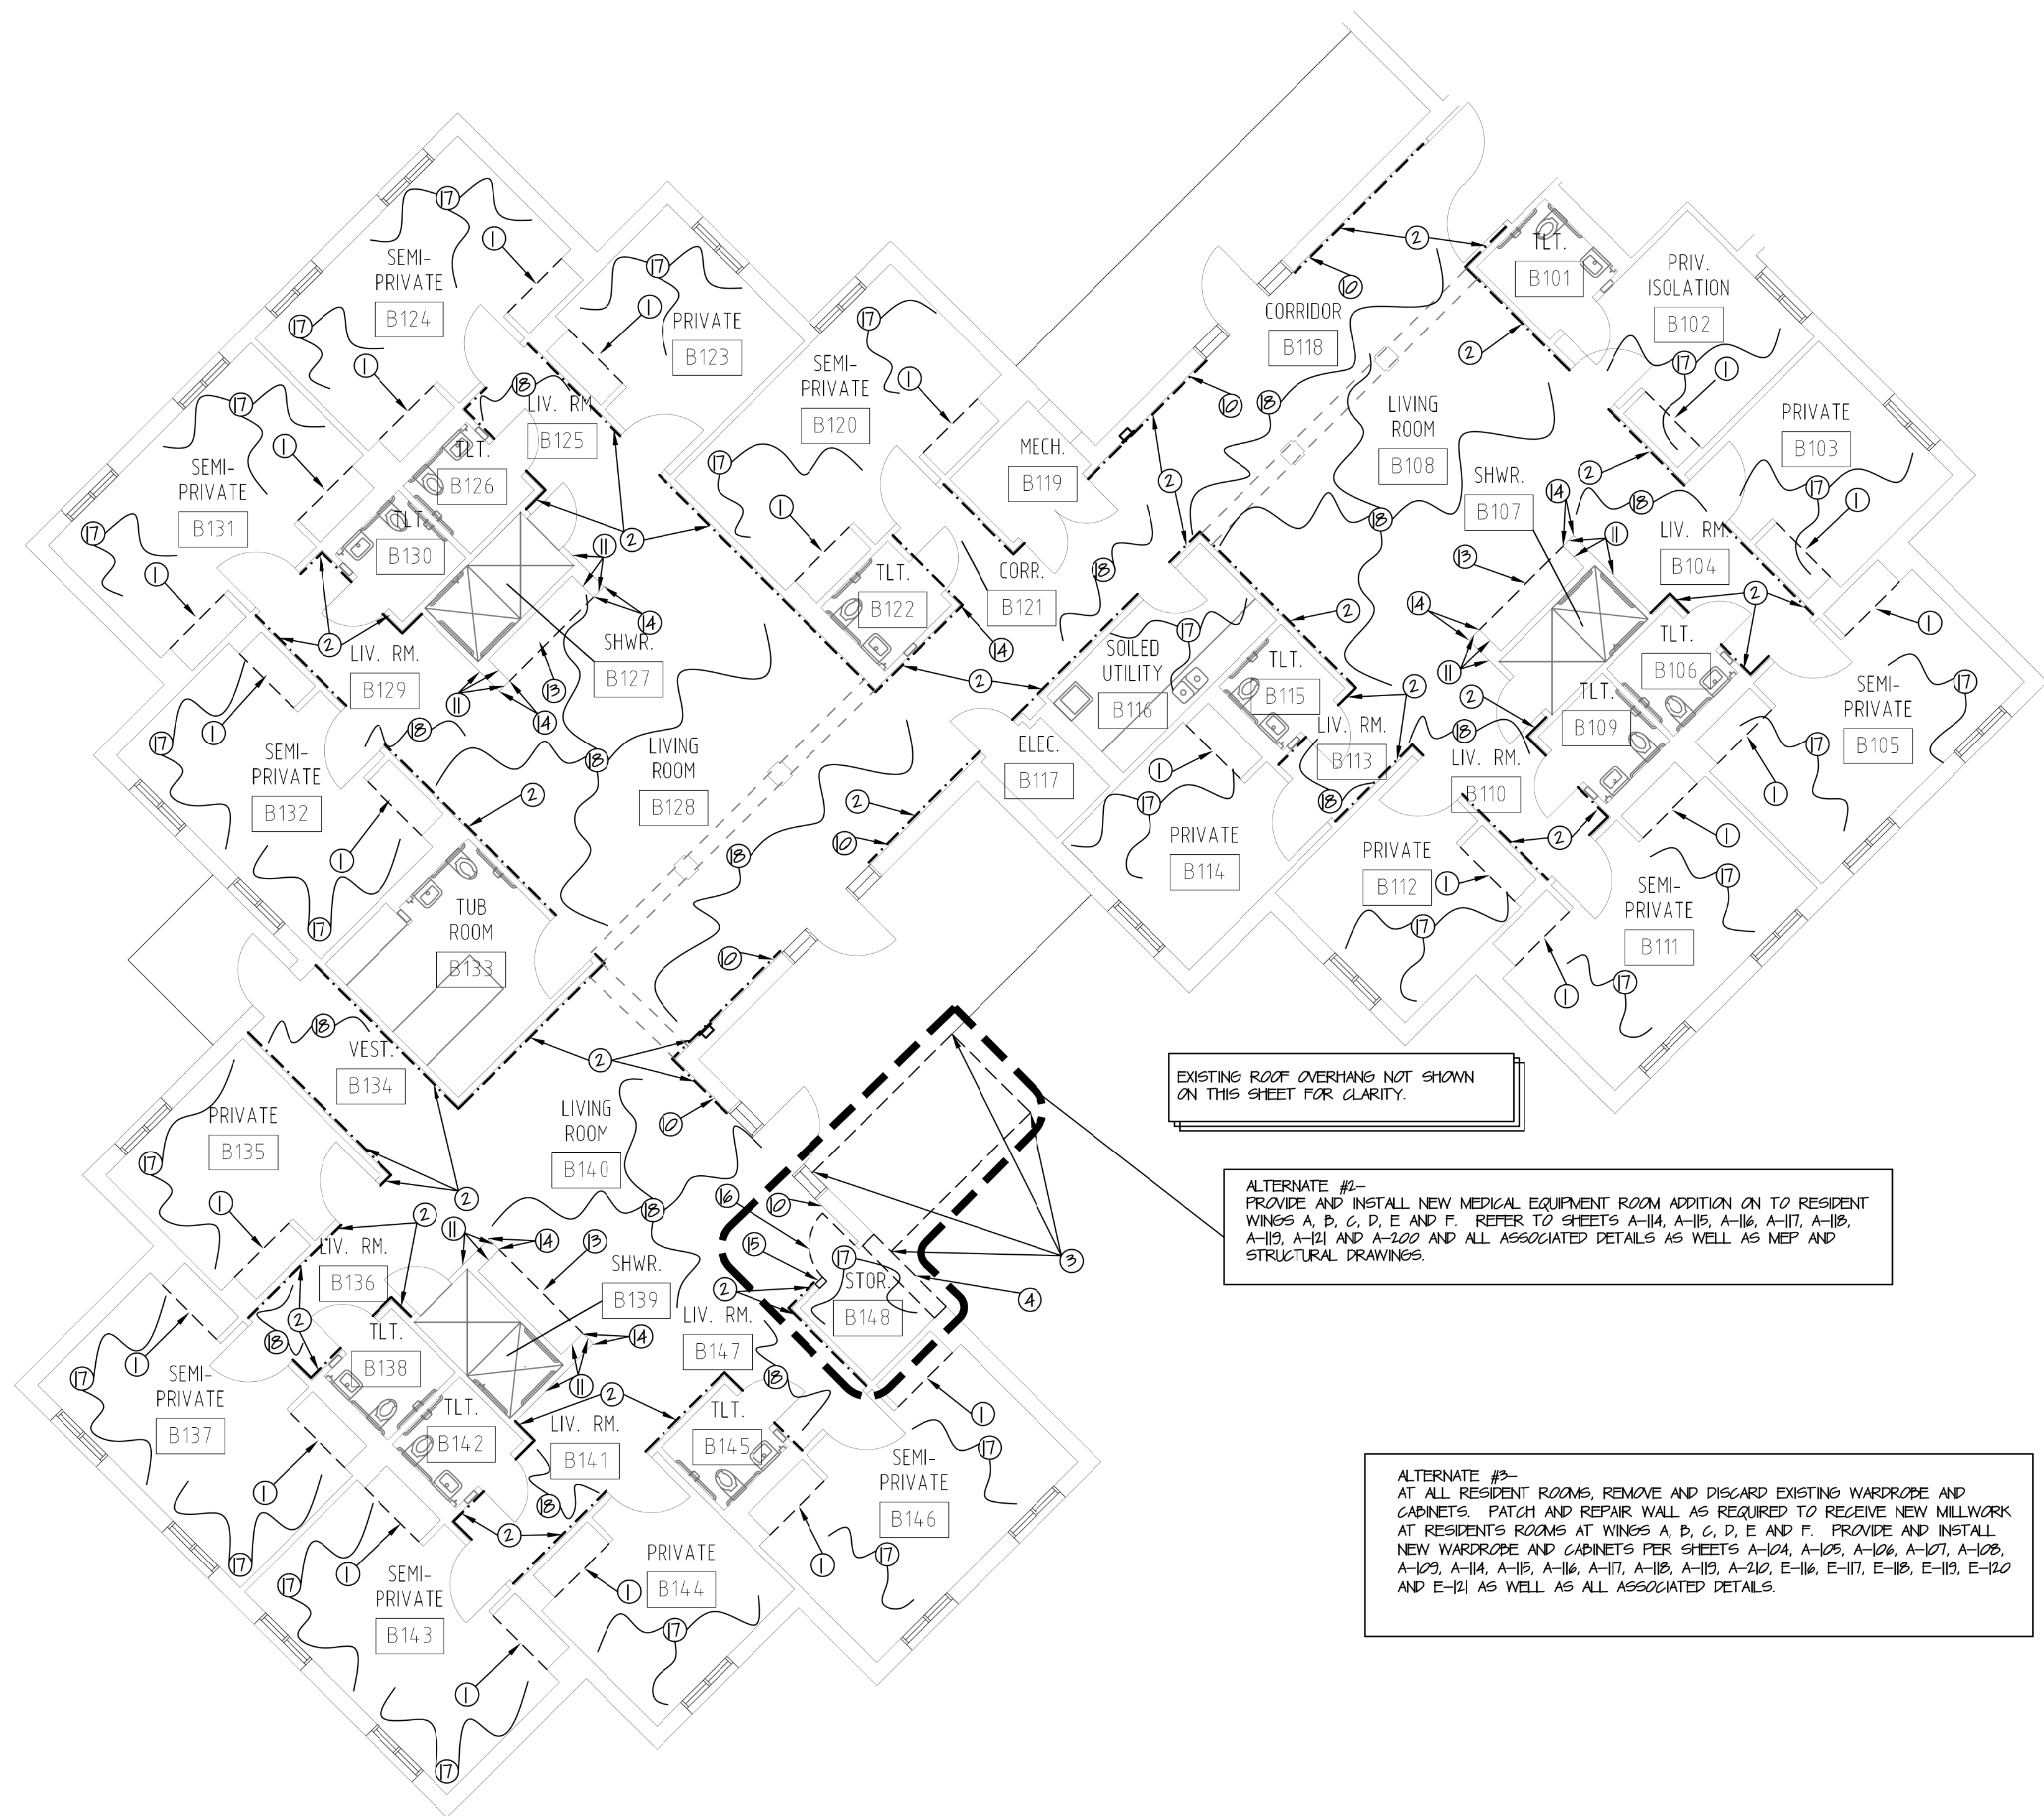EXISTING ROOF OVERHANG NOT  
SHOWN ON THIS SHEET FOR CLARITY.






EXISTING ROOF OVERHANG NOT SHOWN ON THIS SHEET FOR CLARITY.

ALTERNATE #2-  
PROVIDE AND INSTALL NEW MEDICAL EQUIPMENT ROOM ADDITION ON TO RESIDENT WINGS A, B, C, D, E AND F. REFER TO SHEETS A-114, A-115, A-116, A-117, A-118, A-119, A-121 AND A-200 AND ALL ASSOCIATED DETAILS AS WELL AS MEP AND STRUCTURAL DRAWINGS.

ALTERNATE #3-  
AT ALL RESIDENT ROOMS, REMOVE AND DISCARD EXISTING WARDROBE AND CABINETS. PATCH AND REPAIR WALL AS REQUIRED TO RECEIVE NEW MILLWORK. AT RESIDENTS ROOMS AT WINGS A, B, C, D, E AND F. PROVIDE AND INSTALL NEW WARDROBE AND CABINETS PER SHEETS A-104, A-105, A-106, A-107, A-108, A-109, A-114, A-115, A-116, A-117, A-118, A-119, A-210, E-116, E-117, E-118, E-119, E-120 AND E-121 AS WELL AS ALL ASSOCIATED DETAILS.

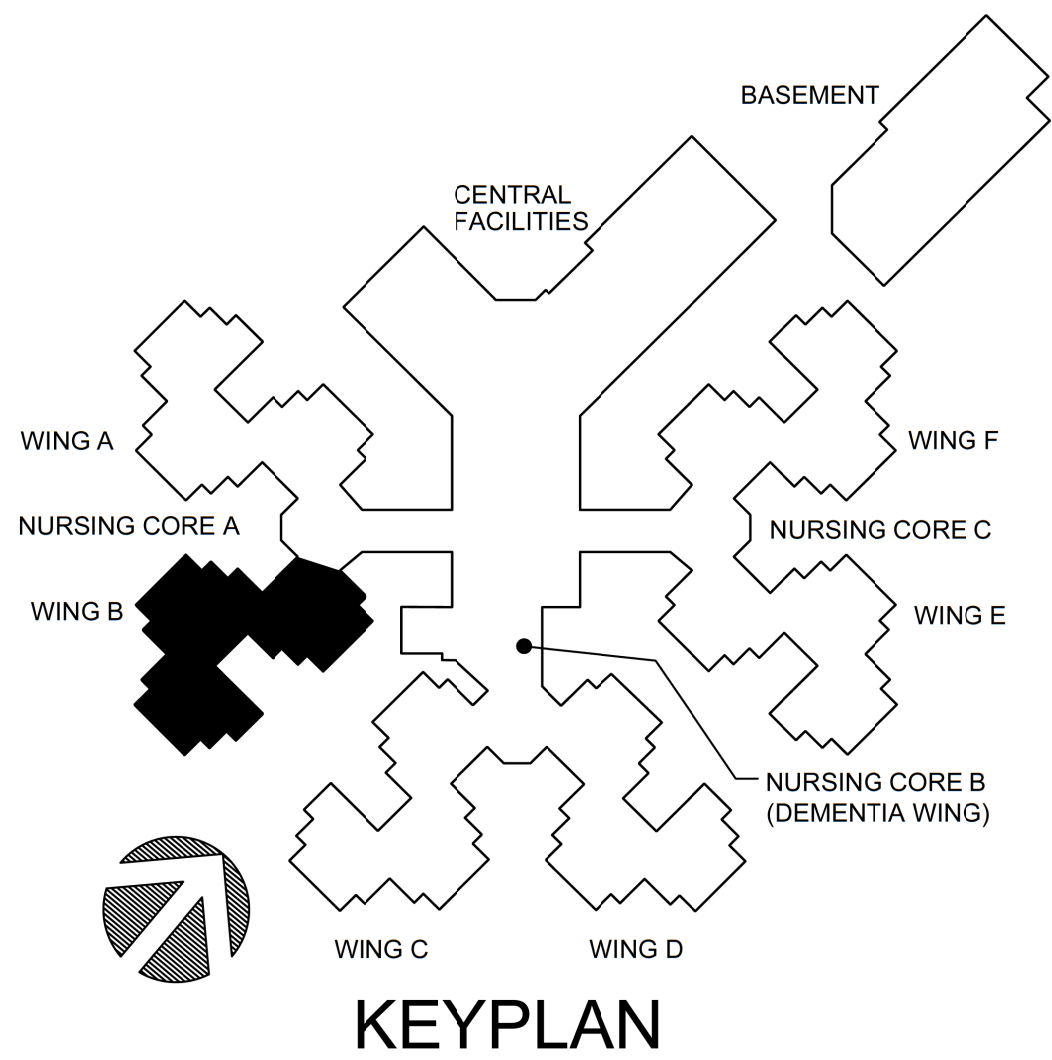WING B DEMOLITION PLAN  
1/8" = 1'-0"




### GENERAL NOTES

- AT ALL PRIVATE AND SEMI-PRIVATE RESIDENTS ROOMS REMOVE EXISTING SHEET VINYL FLOOR AND INTEGRAL WALL BASE. PREPARE CONCRETE SUBFLOOR AND WALLS AS REQUIRED TO ALLOW FOR NEW FLOOR AND BASE PER THE FINISH SCHEDULE. CONTRACTOR SHALL BE RESPONSIBLE FOR ALL FLOOR PREPARATION TO RECEIVE NEW FLOORING. FLOOR COATING SHALL BE PROVIDED AS REQUIRED FOR PREPARATION OF FLOOR.
- AT ALL LIVING ROOMS, SOILED UTILITY, MECHANICAL, AND STORAGE ROOMS REMOVE EXISTING VGT FLOOR AND VINYL WALL BASE. PREPARE CONCRETE SUBFLOOR AND WALLS AS REQUIRED TO ALLOW FOR NEW FLOOR AND BASE PER THE FINISH SCHEDULE. CONTRACTOR SHALL BE RESPONSIBLE FOR ALL FLOOR PREPARATION TO RECEIVE NEW FLOORING. FLOOR COATING SHALL BE PROVIDED AS REQUIRED FOR PREPARATION OF FLOOR.
- AT ALL LIVING ROOM AREAS REMOVE AND DISCARD ALL WALLPAPER BORDERS. PATCH AND REPAIR ALL AREAS AFFECTED BY DEMOLITION. PREPARE WALLS FOR NEW FINISHES.
- REMOVE AND DISCARD ALL EXISTING VINYL CORNER GUARD COVERS. ALUMINUM RETAINERS TO REMAIN, PROTECT AS REQUIRED.
- ALL WOOD PANELING LOCATED ON WALLS TO BE REMOVED AND DISCARDED. PATCH AND REPAIR WALLS AS REQUIRED TO RECEIVE NEW FINISHES.
- REMOVE AND DISCARD ANY EXISTING WALL COVERING AND WALL COVERING BORDERS ALONG ENTIRE LENGTH OF THE WING. PREPARE WALL TO RECEIVE NEW FINISHES. REFER TO FINISH SCHEDULE.
- CONTRACTOR SHALL REMOVE ALL ITEMS OFF THE WALLS IN ORDER TO PATCH AND REPAIR WALLS TO RECEIVE NEW PAINT. REINSTALL ALL ITEMS BACK ON WALL AFTER PAINTING IS COMPLETED. REMOVE FACE PLATES OF OUTLETS AND SWITCHES BEFORE PAINTING AND REINSTALL.

### DEMO PLAN KEY NOTES (SHEETS A104 THRU A109 ONLY)

- ALTERNATE #2: REMOVE AND DISCARD EXISTING MILLWORK, LIGHTS AND MIRRORS. PROTECT ADJACENT CONSTRUCTION AS REQUIRED. TV TO BE REMOVED AND RELOCATED AS SHOWN ON THE FLOOR PLANS. PATCH AND REPAIR ADJACENT WALL TO MATCH EXISTING WHERE AFFECTED BY DEMOLITION.
- EXISTING HANDRAIL DESIGNATED AS ( ) ON-THE PLANS TO REMAIN. PROTECT AS REQUIRED.
- ALTERNATE #2: PORTION OF EXISTING CONCRETE PAD TO BE REMOVED AS SHOWN TO ALLOW FOR NEW CONSTRUCTION. REFER TO WING A FLOOR PLAN FOR ADDITIONAL INFORMATION.
- ALTERNATE #2: REMOVE PORTION OF EXISTING EXTERIOR WALL AS REQUIRED TO ALLOW FOR NEW OPENING AS SHOWN. REFER TO STRUCTURAL PLANS FOR BRACING. PROTECT ADJACENT CONSTRUCTION AS REQUIRED. PATCH AND REPAIR ADJACENT WALL TO MATCH EXISTING WHERE AFFECTED BY DEMOLITION. REFER TO STRUCTURAL PLANS FOR ADDITIONAL INFORMATION.
- THROUGH ( ) NOTE NOT USED.
- REMOVE AND DISCARD EXISTING WOOD PANEL/BASE LOCATED NEAR DOOR. PATCH AND REPAIR WALL AS REQUIRED TO RECEIVE NEW FINISHES.
- SAND AND REPAIR EXISTING WALL TEXTURE AT INDICATED WALL. WALL TEXTURE TO MATCH EXISTING ADJACENT CONSTRUCTION.
- NOTE NOT USED.
- REMOVE AND DISCARD EXISTING MILLWORK. PATCH AND REPAIR ADJACENT WALL AS REQUIRED.
- EXISTING CORNER GUARD AND TRIM. PATCH AND REPAIR EXISTING WALL TO MATCH ADJACENT CONSTRUCTION. PREPARE FOR NEW CORNER GUARDS AND PAINT PER THE FINISH SCHEDULE.
- ALTERNATE #2: REMOVE AND DISCARD PORTION OF EXISTING WALL TO ALLOW FOR INSTALLATION OF NEW DOOR PER FLOOR PLAN AND DOOR SCHEDULE. PROTECT ADJACENT CONSTRUCTION AS REQUIRED.
- ALTERNATE #2: REMOVE AND DISCARD EXISTING DOOR AND FRAME, PROTECT ADJACENT CONSTRUCTION AS REQUIRED.
- REMOVE AND DISCARD EXISTING VINYL FLOORING AND BASE. PREPARE SUB FLOOR FOR NEW FLOORING PER THE FINISH SCHEDULE.
- REMOVE AND DISCARD EXISTING VGT AND BASE. PREPARE SUB FLOOR FOR NEW FLOORING PER THE FINISH SCHEDULE.

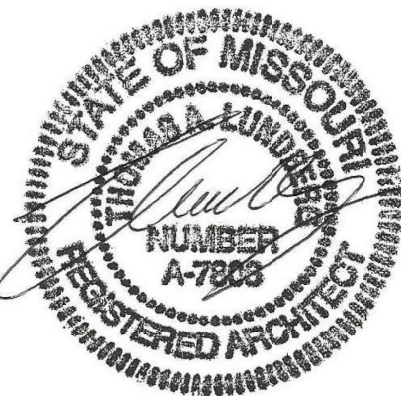STATE OF MISSOURI  
MIKE KEHOE,  
GOVERNOR



2/19/25

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CERTIFICATE OF AUTHORITY #000718

**ESTERLY & SCHNEIDER ASSOCIATES, INC.**  
architects & planners  
AIA

COMM. # 4860

OFFICE OF ADMINISTRATION  
DIVISION OF FACILITIES  
MANAGEMENT,  
DESIGN AND CONSTRUCTION

DEPARTMENT OF  
PUBLIC SAFETY  
MISSOURI VETERANS  
COMMISSION

INTERIOR RENOVATION  
MISSOURI VETERANS  
HOME

620 N. JEFFERSON  
ST. JAMES, MISSOURI

PROJECT # U1503-01  
SITE # 6801  
ASSET # 8136801002  
FEDERAL# 29-044

REVISION: \_\_\_\_\_  
DATE: \_\_\_\_\_  
REVISION: \_\_\_\_\_  
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REVISION: \_\_\_\_\_  
DATE: \_\_\_\_\_

ISSUE DATE: 8-1-24

CAD DWG FILE: A-105.DWG  
DRAWN BY: ZAC/MAH  
CHECKED BY: MAH/CAS  
DESIGNED BY: MAH/CAS

SHEET TITLE:

DEMOLITION PLAN

SHEET NUMBER:

A-105

12 OF 120 SHEETS  
8-1-24

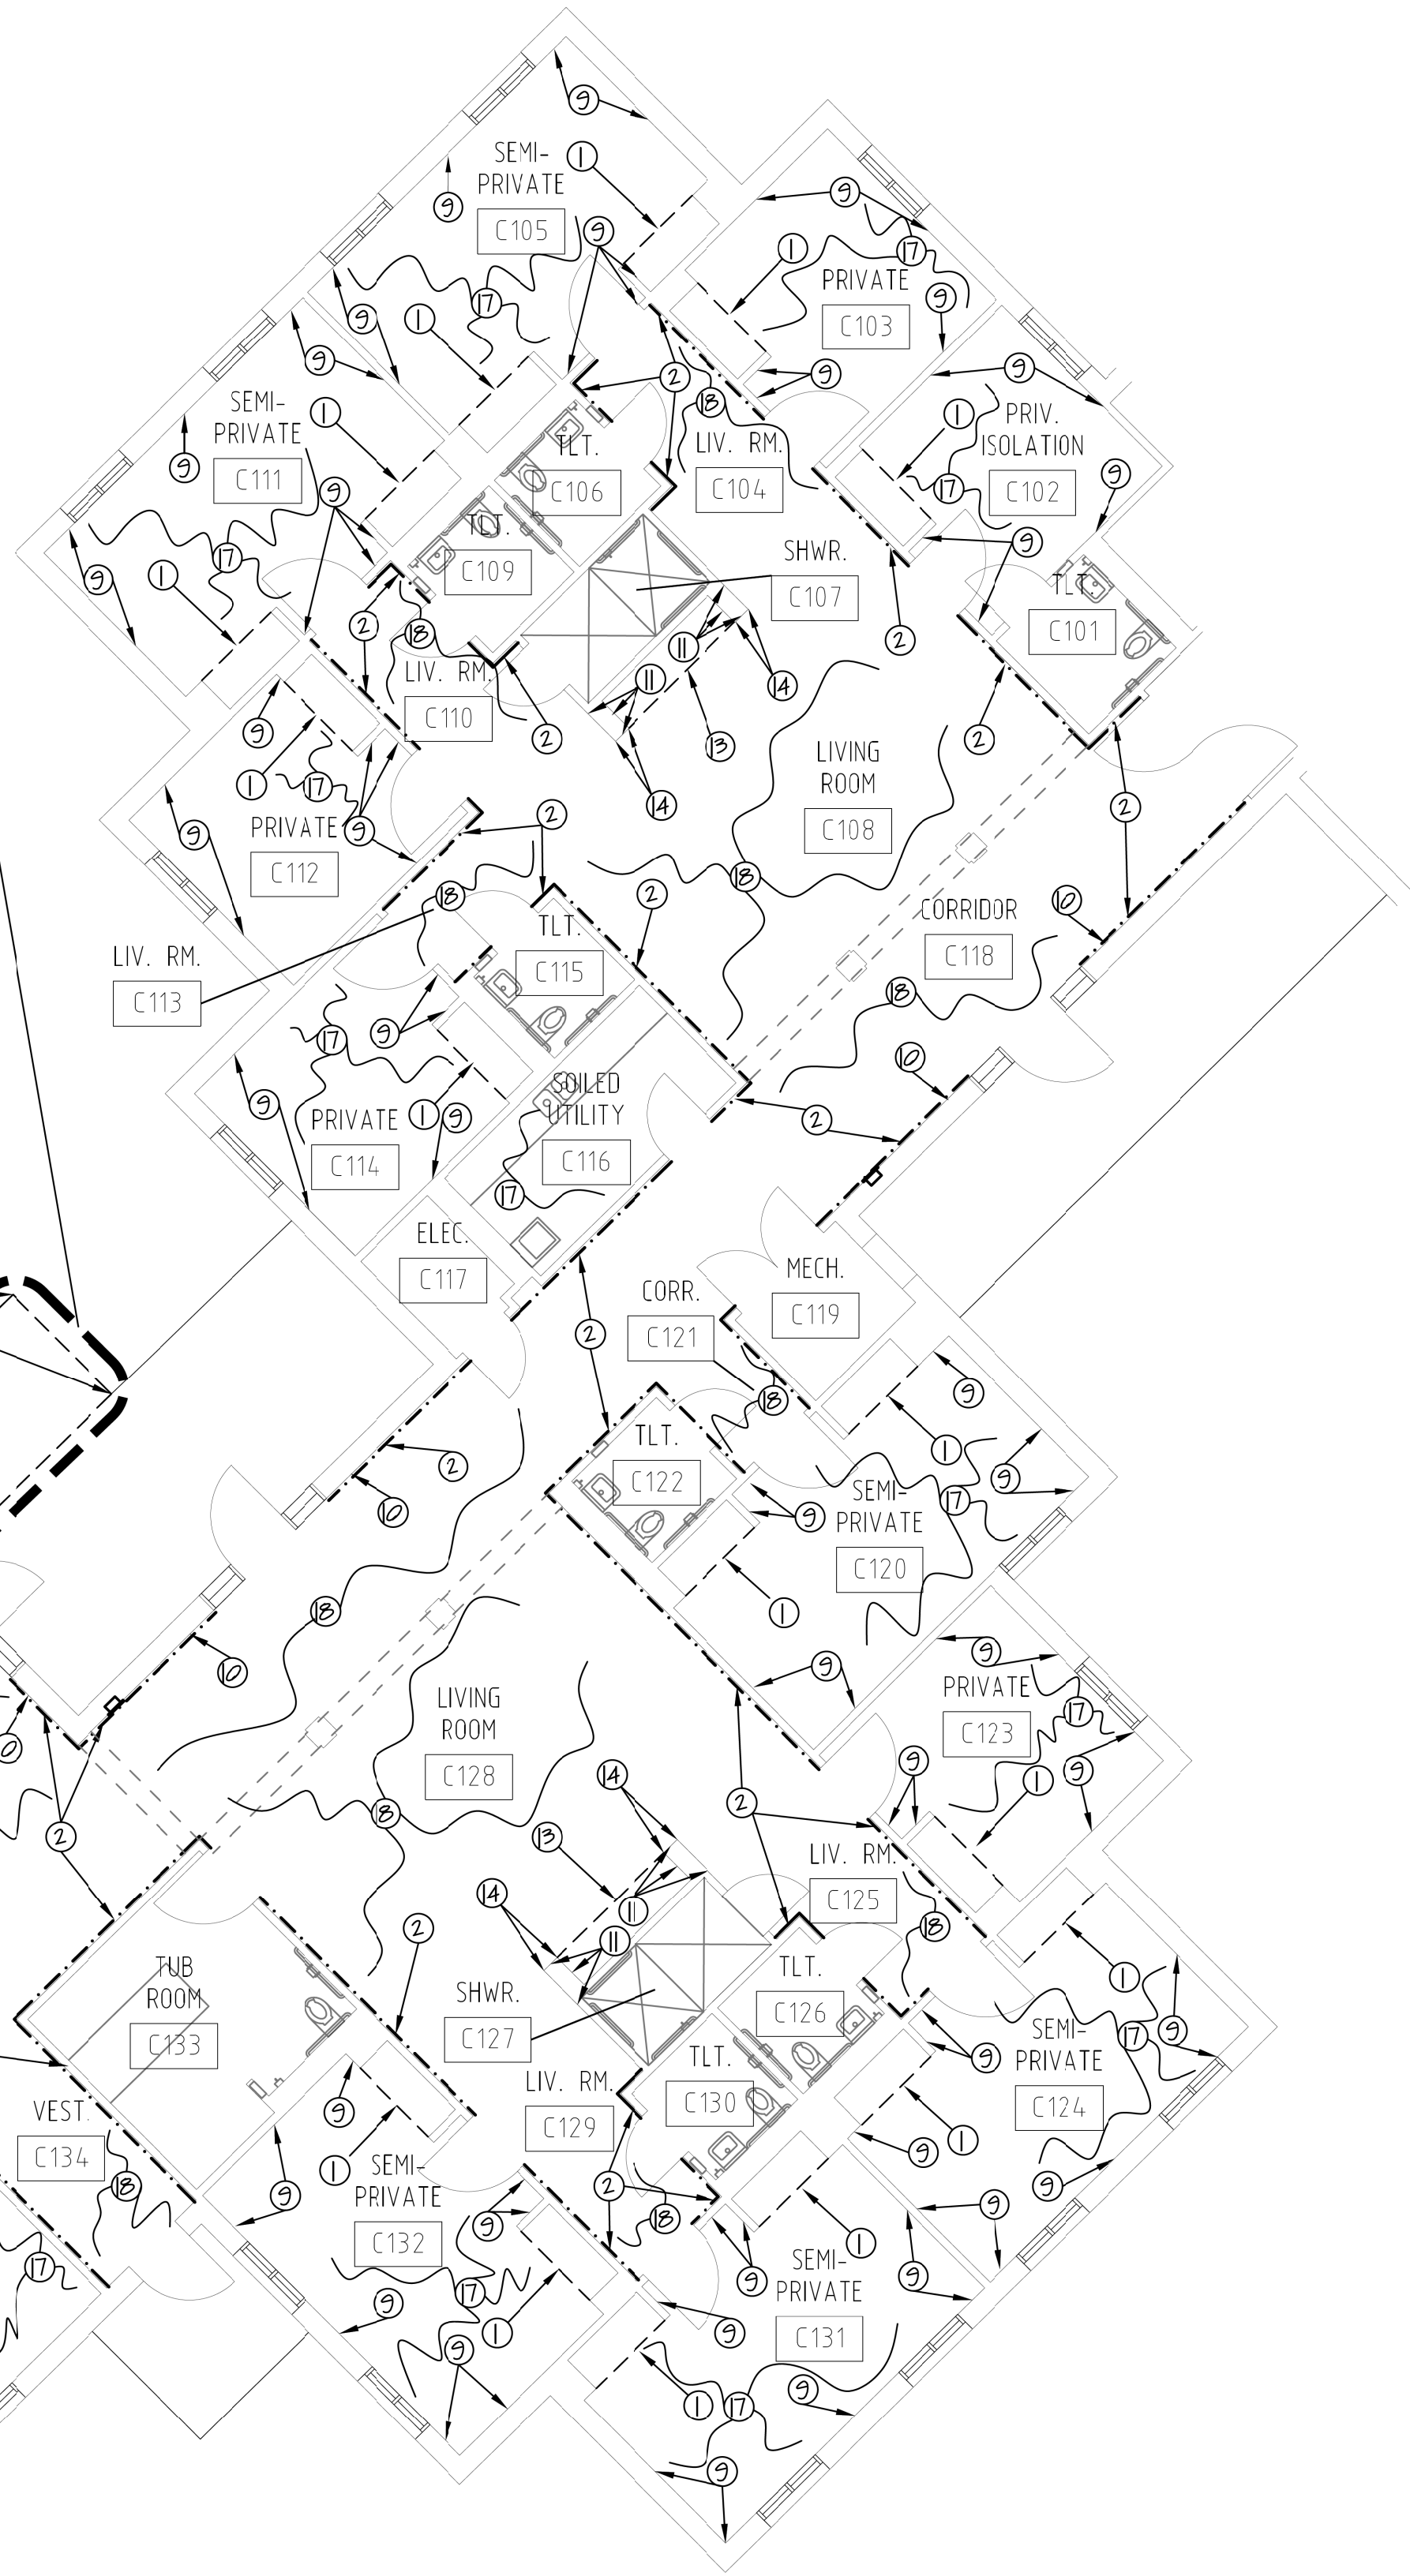
BID DOCUMENTS



ALTERNATE #2-  
PROVIDE AND INSTALL NEW MEDICAL EQUIPMENT ROOM ADDITION ON TO RESIDENT  
WINGS A, D, C, D, E AND F. REFER TO SHEETS A-114, A-115, A-116, A-117, A-118,  
A-119, A-121 AND A-200 AND ALL ASSOCIATED DETAILS AS WELL AS MEP AND  
STRUCTURAL DRAWINGS.



ALTERNATE #3-  
AT ALL RESIDENT ROOMS, REMOVE AND DISCARD EXISTING WARDROBE AND  
CABINETS. PATCH AND REPAIR WALL AS REQUIRED TO RECEIVE NEW MILLWORK  
AT RESIDENTS ROOMS AT WINGS A, D, C, D, E AND F. PROVIDE AND INSTALL  
NEW WARDROBE AND CABINETS PER SHEETS A-124, A-125, A-126, A-127, A-128,  
A-129, A-134, A-135, A-136, A-137, A-138, A-139, A-140, E-115, E-117, E-118, E-119, E-120  
AND E-121 AS WELL AS ALL ASSOCIATED DETAILS.

EXISTING ROOF OVERHANG NOT SHOWN  
ON THIS SHEET FOR CLARITY.



WING C DEMOLITION PLAN

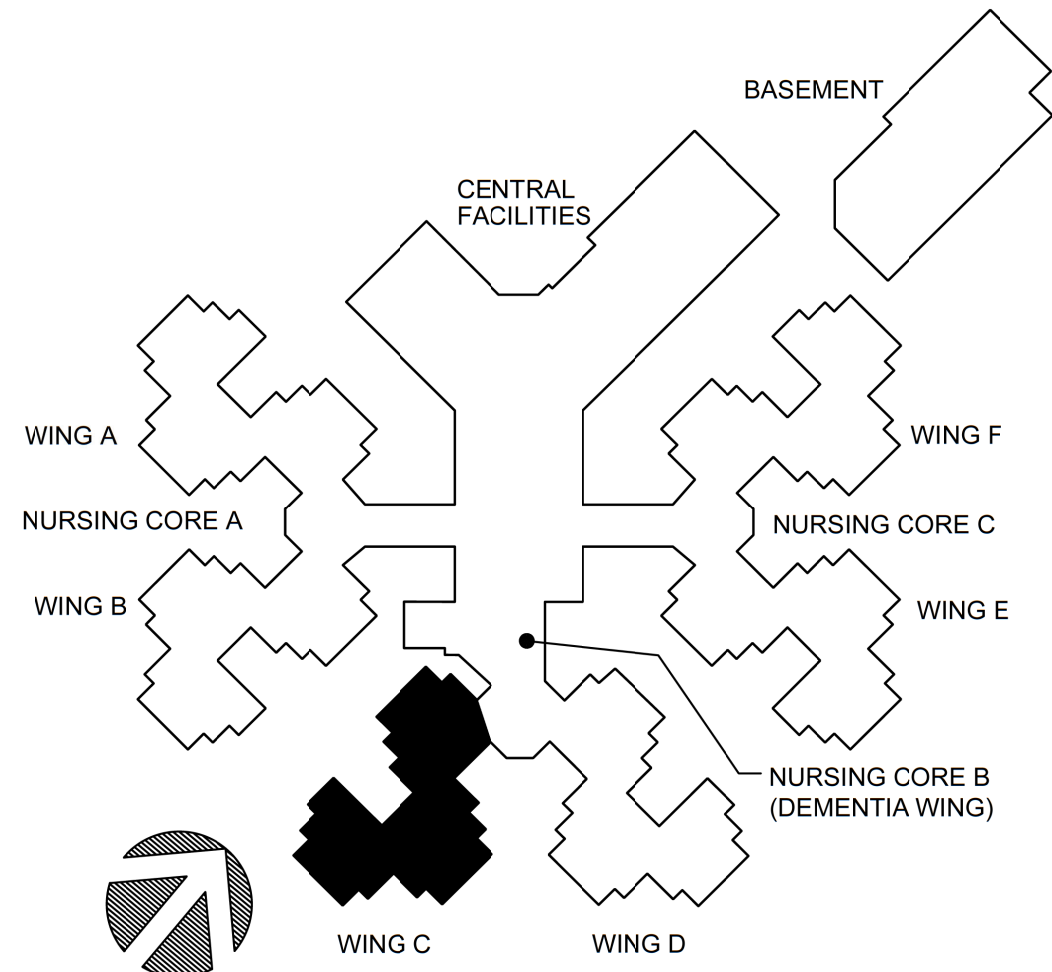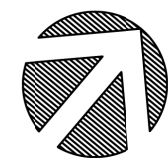1/8" = 1'-0"



KEYPLAN

### GENERAL NOTES

- AT ALL PRIVATE AND SEMI-PRIVATE RESIDENTS ROOMS REMOVE EXISTING SHEET VINYL FLOOR AND INTEGRAL WALL BASE. PREPARE CONCRETE SUBFLOOR AND WALLS AS REQUIRED TO ALLOW FOR NEW FLOOR AND BASE PER THE FINISH SCHEDULE. CONTRACTOR SHALL BE RESPONSIBLE FOR ALL FLOOR PREPARATION TO RECEIVE NEW FLOORING. FLOOR COATING SHALL BE PROVIDED AS REQUIRED FOR PREPARATION OF FLOOR.
- AT ALL LIVING ROOMS, SOLED UTILITY, MECHANICAL, AND STORAGE ROOMS REMOVE EXISTING VGT FLOOR AND VINYL WALL BASE. PREPARE CONCRETE SUBFLOOR AND WALLS AS REQUIRED TO ALLOW FOR NEW FLOOR AND BASE PER THE FINISH SCHEDULE. CONTRACTOR SHALL BE RESPONSIBLE FOR ALL FLOOR PREPARATION TO RECEIVE NEW FLOORING. FLOOR COATING SHALL BE PROVIDED AS REQUIRED FOR PREPARATION OF FLOOR.
- AT ALL LIVING ROOM AREAS REMOVE AND DISCARD ALL WALLPAPER BORDERS. PATCH AND REPAIR ALL AREAS AFFECTED BY DEMOLITION. PREPARE WALLS FOR NEW FINISHES.
- REMOVE AND DISCARD ALL EXISTING VINYL CORNER GUARD COVERS. ALUMINUM RETAINERS TO REMAIN, PROTECT AS REQUIRED.
- ALL WOOD PANELING LOCATED ON WALLS TO BE REMOVED AND DISCARDED. PATCH AND REPAIR WALLS AS REQUIRED TO RECEIVE NEW FINISHES.
- REMOVE AND DISCARD ANY EXISTING WALL COVERING AND WALL COVERING BORDERS ALONG ENTIRE LENGTH OF THE WING. PREPARE WALL TO RECEIVE NEW FINISHES. REFER TO FINISH SCHEDULE.
- CONTRACTOR SHALL REMOVE ALL ITEMS OFF THE WALLS IN RDER TO PATCH AND REPAIR WALLS TO RECEIVE NEW PAINT. REINSTALL ALL ITEMS BACK ON WALL AFTER PAINTING IS COMPLETED. REMOVE FACE PLATES OF OUTLETS AND SWITCHES BEFORE PAINTING AND REINSTALL.

### DEMO PLAN KEY NOTES (SHEETS A104 THRU A109 ONLY)

- ALTERNATE #2: REMOVE AND DISCARD EXISTING MILLWORK, LIGHTS AND MIRRORS. PROTECT ADJACENT CONSTRUCTION AS REQUIRED. TV TO BE REMOVED AND RELOCATED AS SHOWN ON THE FLOOR PLANS. PATCH AND REPAIR ADJACENT WALL TO MATCH EXISTING WHERE AFFECTED BY DEMOLITION.
- EXISTING HANDRAIL DESIGNATED AS (---) ON THE PLANS TO REMAIN. PROTECT AS REQUIRED.
- ALTERNATE #2: PORTION OF EXISTING CONCRETE PAD TO BE REMOVED AS SHOWN TO ALLOW FOR NEW CONSTRUCTION. REFER TO WING A FLOOR PLAN FOR ADDITIONAL INFORMATION.
- ALTERNATE #2: REMOVE PORTION OF EXISTING EXTERIOR WALL AS REQUIRED TO ALLOW FOR NEW OPENING AS SHOWN. REFER TO STRUCTURAL PLANS FOR BRACING. PROTECT ADJACENT CONSTRUCTION AS REQUIRED. PATCH AND REPAIR ADJACENT WALL TO MATCH EXISTING WHERE AFFECTED BY DEMOLITION. REFER TO STRUCTURAL PLANS FOR ADDITIONAL INFORMATION.
- THROUGH (2) NOTE NOT USED.
- REMOVE AND DISCARD EXISTING WALL COVERING ALONG ENTIRE LENGTH OF INDICATED WALL. PREPARE WALL TO RECEIVE NEW FINISHES. REFER TO FINISH SCHEDULE.
- REMOVE AND DISCARD EXISTING WOOD PANEL/BASE LOCATED NEAR DOOR. PATCH AND REPAIR WALL AS REQUIRED TO RECEIVE NEW FINISHES.
- SAND AND REPAIR EXISTING WALL TEXTURE AT INDICATED WALL. WALL TEXTURE TO MATCH EXISTING ADJACENT CONSTRUCTION.
- NOTE NOT USED.
- REMOVE AND DISCARD EXISTING MILLWORK. PATCH AND REPAIR WALL AS REQUIRED.
- EXISTING CORNER GUARD AND TRIM. PATCH AND REPAIR EXISTING WALL TO MATCH ADJACENT CONSTRUCTION. PREPARE FOR NEW CORNER GUARDS AND PAINT PER THE FINISH SCHEDULE.
- ALTERNATE #2: REMOVE AND DISCARD PORTION OF EXISTING WALL TO ALLOW FOR INSTALLATION OF NEW DOOR. PER FLOOR PLAN AND DOOR SCHEDULE. PROTECT ADJACENT CONSTRUCTION AS REQUIRED.
- ALTERNATE #2: REMOVE AND DISCARD EXISTING DOOR AND FRAME. PROTECT ADJACENT CONSTRUCTION AS REQUIRED.
- REMOVE AND DISCARD EXISTING VINYL FLOORING AND BASE. PREPARE SUB FLOOR FOR NEW FLOORING PER THE FINISH SCHEDULE.
- REMOVE AND DISCARD EXISTING VGT AND BASE. PREPARE SUB FLOOR FOR NEW FLOORING PER THE FINISH SCHEDULE.

STATE OF MISSOURI  
MIKE KEHOE,  
GOVERNOR



2/19/25

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**ESTERLY & SCHNEIDER ASSOCIATES, INC.**  
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CONNM. # 4860

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MANAGEMENT,  
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MISSOURI VETERANS  
HOME

620 N. JEFFERSON  
ST. JAMES, MISSOURI

PROJECT # U1503-01  
SITE # 6801  
ASSET # 8136801002  
FEDERAL# 29-044

REVISION: \_\_\_\_\_  
DATE: \_\_\_\_\_  
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REVISION: \_\_\_\_\_  
DATE: \_\_\_\_\_

ISSUE DATE: 8-1-24

CAD DWG FILE: A-106.DWG  
DRAWN BY: ZAC/MAH  
CHECKED BY: MAH/CAS  
DESIGNED BY: MAH/CAS

SHEET TITLE:

DEMOLITION PLAN

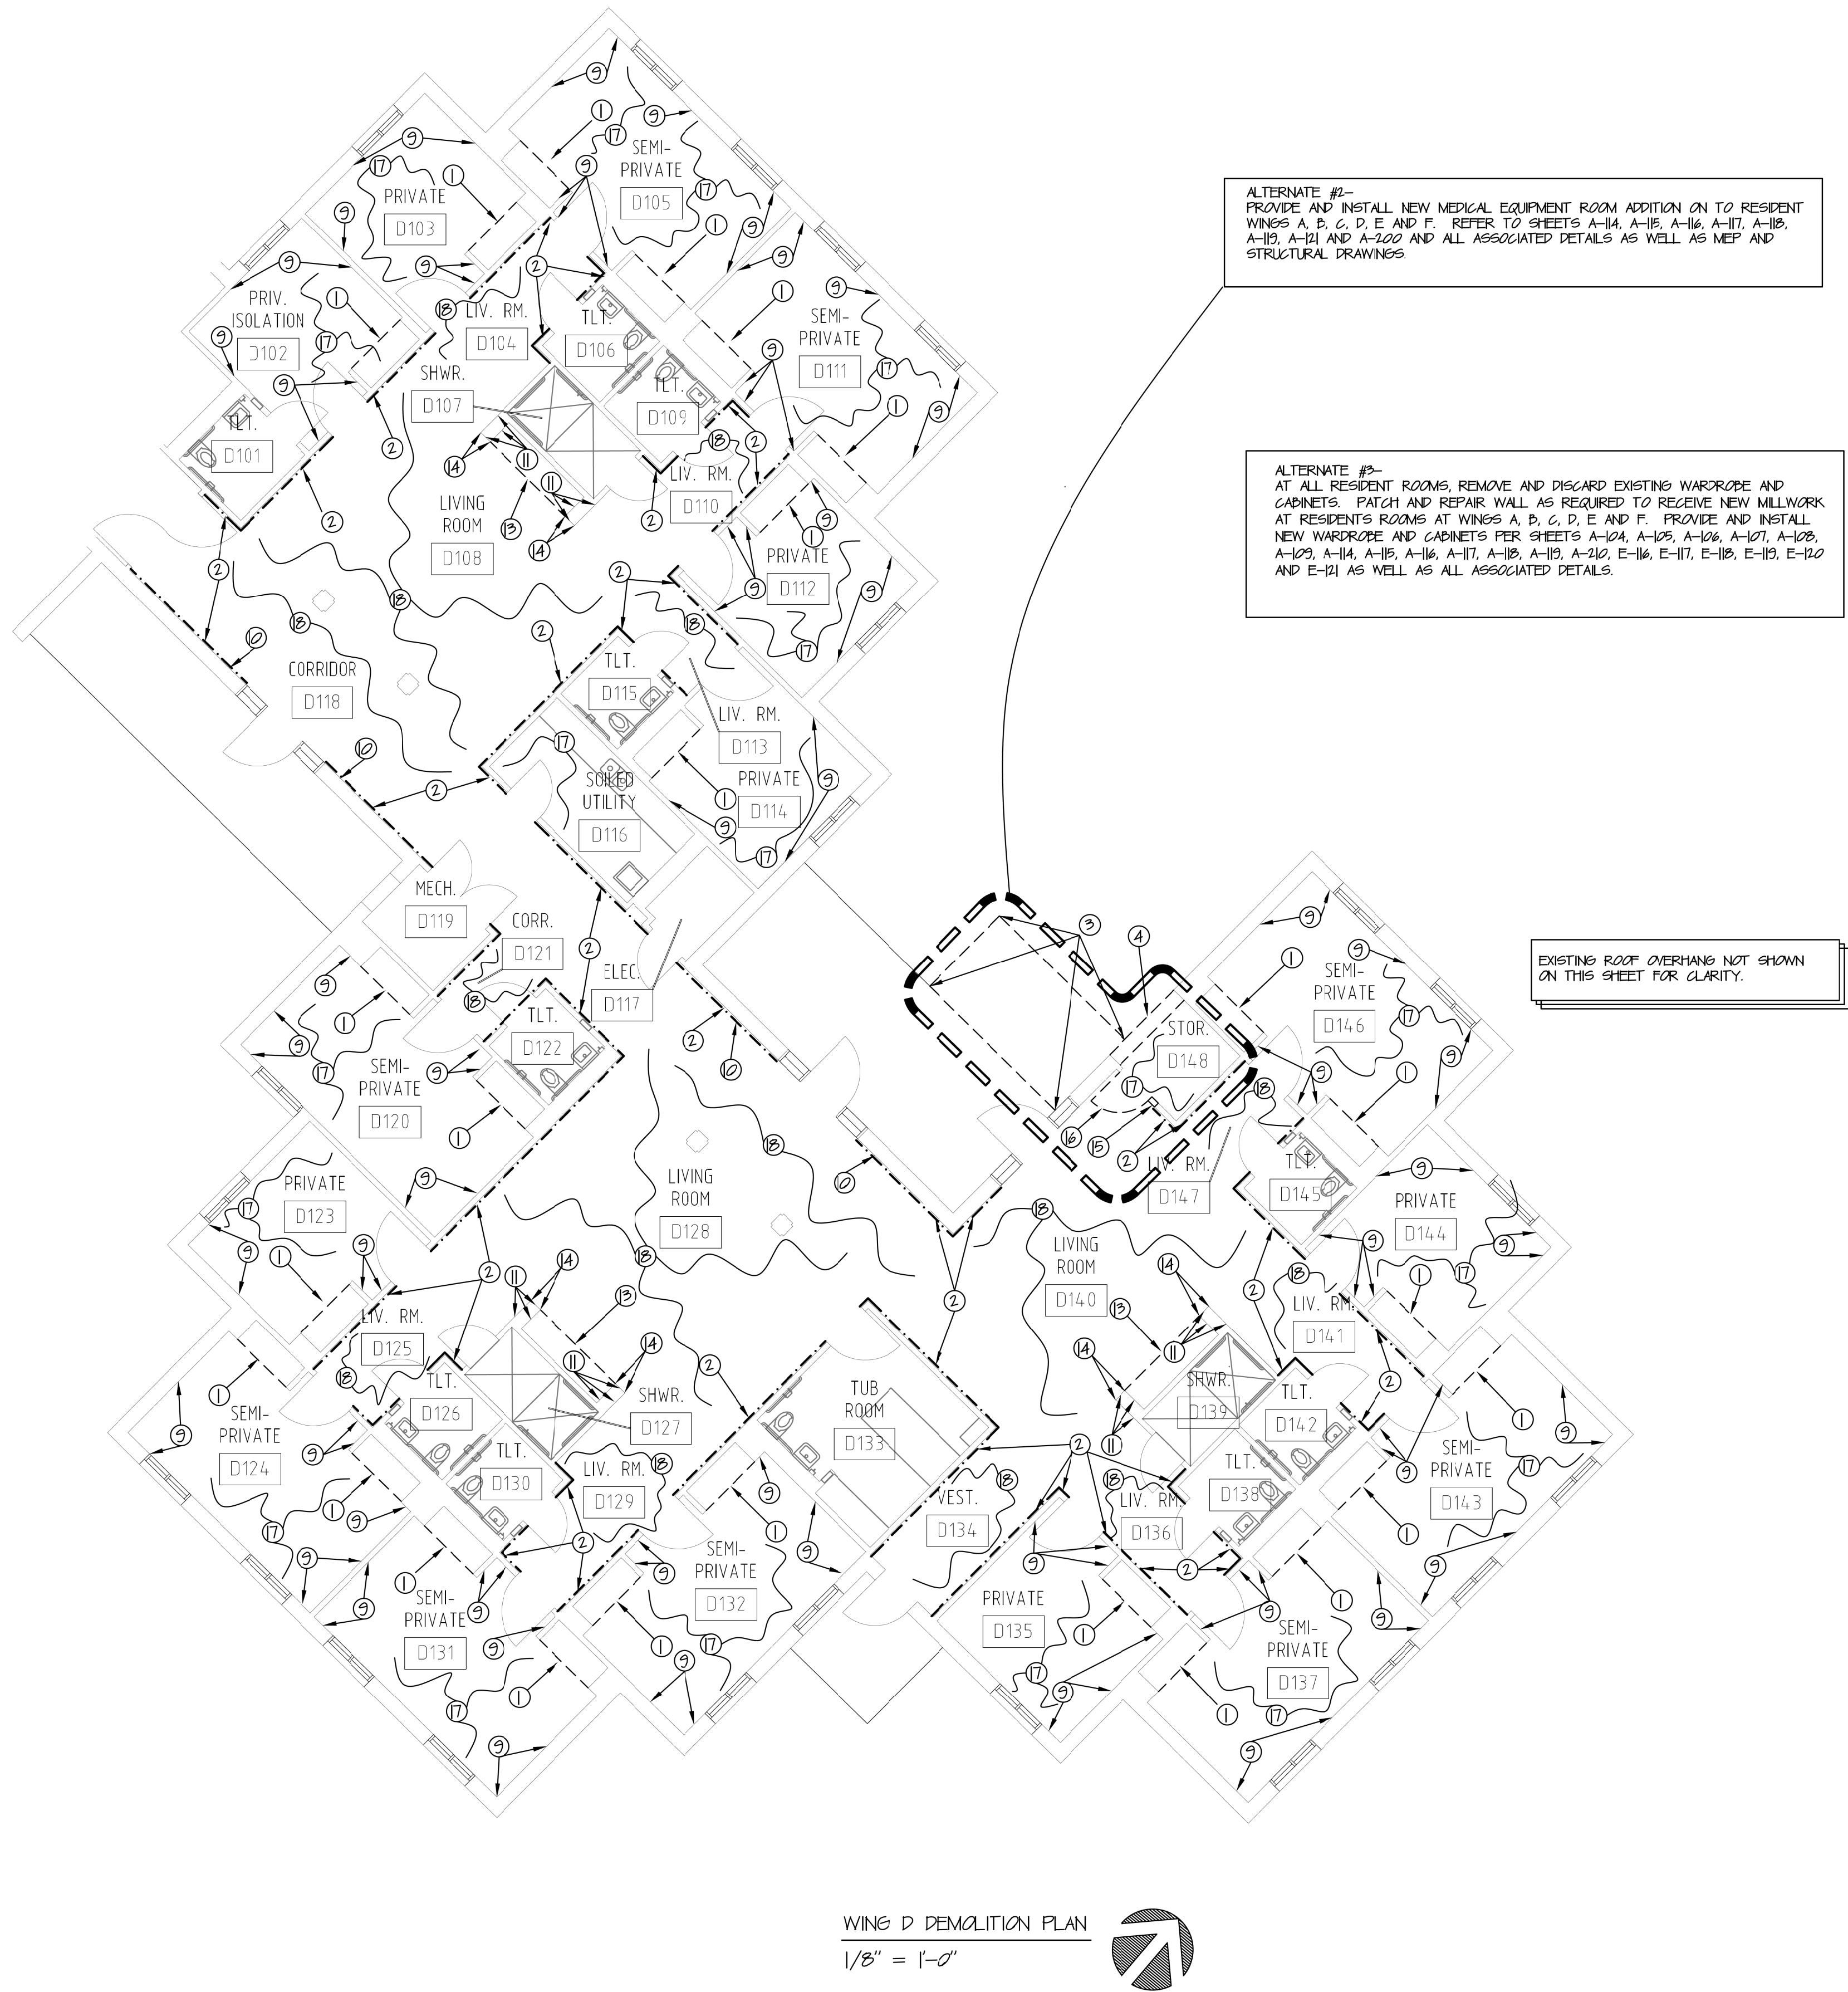
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A-106

13 OF 120 SHEETS  
8-1-24

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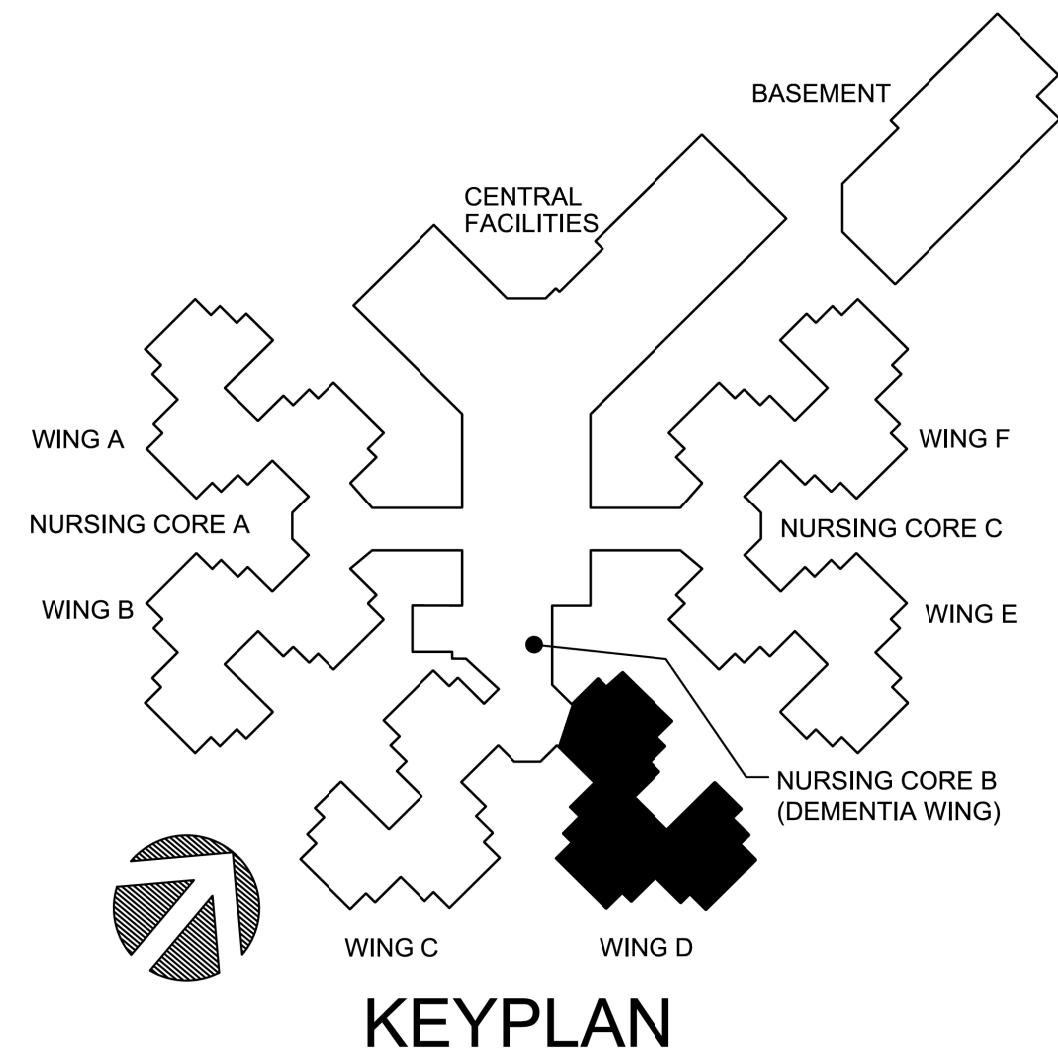


### GENERAL NOTES

- AT ALL PRIVATE AND SEMI-PRIVATE RESIDENTS ROOMS REMOVE EXISTING SHEET VINYL FLOOR AND INTEGRAL WALL BASE. PREPARE CONCRETE SUBFLOOR AND WALLS AS REQUIRED TO ALLOW FOR NEW FLOOR AND BASE PER THE FINISH SCHEDULE. CONTRACTOR SHALL BE RESPONSIBLE FOR ALL FLOOR PREPARATION TO RECEIVE NEW FLOORING. FLOOR COATING SHALL BE PROVIDED AS REQUIRED FOR PREPARATION OF FLOOR.
- AT ALL LIVING ROOMS, SOLED UTILITY, MECHANICAL AND STORAGE ROOMS REMOVE EXISTING VGT FLOOR AND VINYL WALL BASE. PREPARE CONCRETE SUBFLOOR AND WALLS AS REQUIRED TO ALLOW FOR NEW FLOOR AND BASE PER THE FINISH SCHEDULE. CONTRACTOR SHALL BE RESPONSIBLE FOR ALL FLOOR PREPARATION TO RECEIVE NEW FLOORING. FLOOR COATING SHALL BE PROVIDED AS REQUIRED FOR PREPARATION OF FLOOR.
- AT ALL LIVING ROOM AREAS REMOVE AND DISCARD ALL WALLPAPER BORDERS. PATCH AND REPAIR ALL AREAS AFFECTED BY DEMOLITION. PREPARE WALLS FOR NEW FINISHES.
- REMOVE AND DISCARD ALL EXISTING VINYL CORNER GUARD COVERS. ALUMINUM RETAINERS TO REMAIN. PROTECT AS REQUIRED.
- ALL WOOD PANELING LOCATED ON WALLS TO BE REMOVED AND DISCARDED. PATCH AND REPAIR WALLS AS REQUIRED TO RECEIVE NEW FINISHES.
- REMOVE AND DISCARD ANY EXISTING WALL COVERINGS AND WALL COVERING BORDERS ALONG ENTIRE LENGTH OF THE WING. PREPARE WALL TO RECEIVE NEW FINISHES. REFER TO FINISH SCHEDULE.
- CONTRACTOR SHALL REMOVE ALL ITEMS OFF THE WALLS IN ORDER TO PATCH AND REPAIR WALLS TO RECEIVE NEW PAINT. REINSTALL ALL ITEMS BACK ON WALL AFTER PAINTING IS COMPLETED. REMOVE FACE PLATES OF OUTLETS AND SWITCHES BEFORE PAINTING AND REINSTALL.

### DEMO PLAN KEY NOTES (SHEETS A104 THRU A109 ONLY)

- ALTERNATE #2: REMOVE AND DISCARD EXISTING MILLWORK, LIGHTS AND MIRRORS. PROTECT ADJACENT CONSTRUCTION AS REQUIRED. TV TO BE REMOVED AND RELOCATED AS SHOWN ON THE FLOOR PLANS. PATCH AND REPAIR ADJACENT WALL TO MATCH EXISTING WHERE AFFECTED BY DEMOLITION.
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ISSUE DATE: 8-1-24

CAD DWG FILE: A-107.DWG  
DRAWN BY: ZAC/MAH  
CHECKED BY: MAH/CAS  
DESIGNED BY: MAH/CAS

SHEET TITLE:  
**DEMOLITION PLAN**

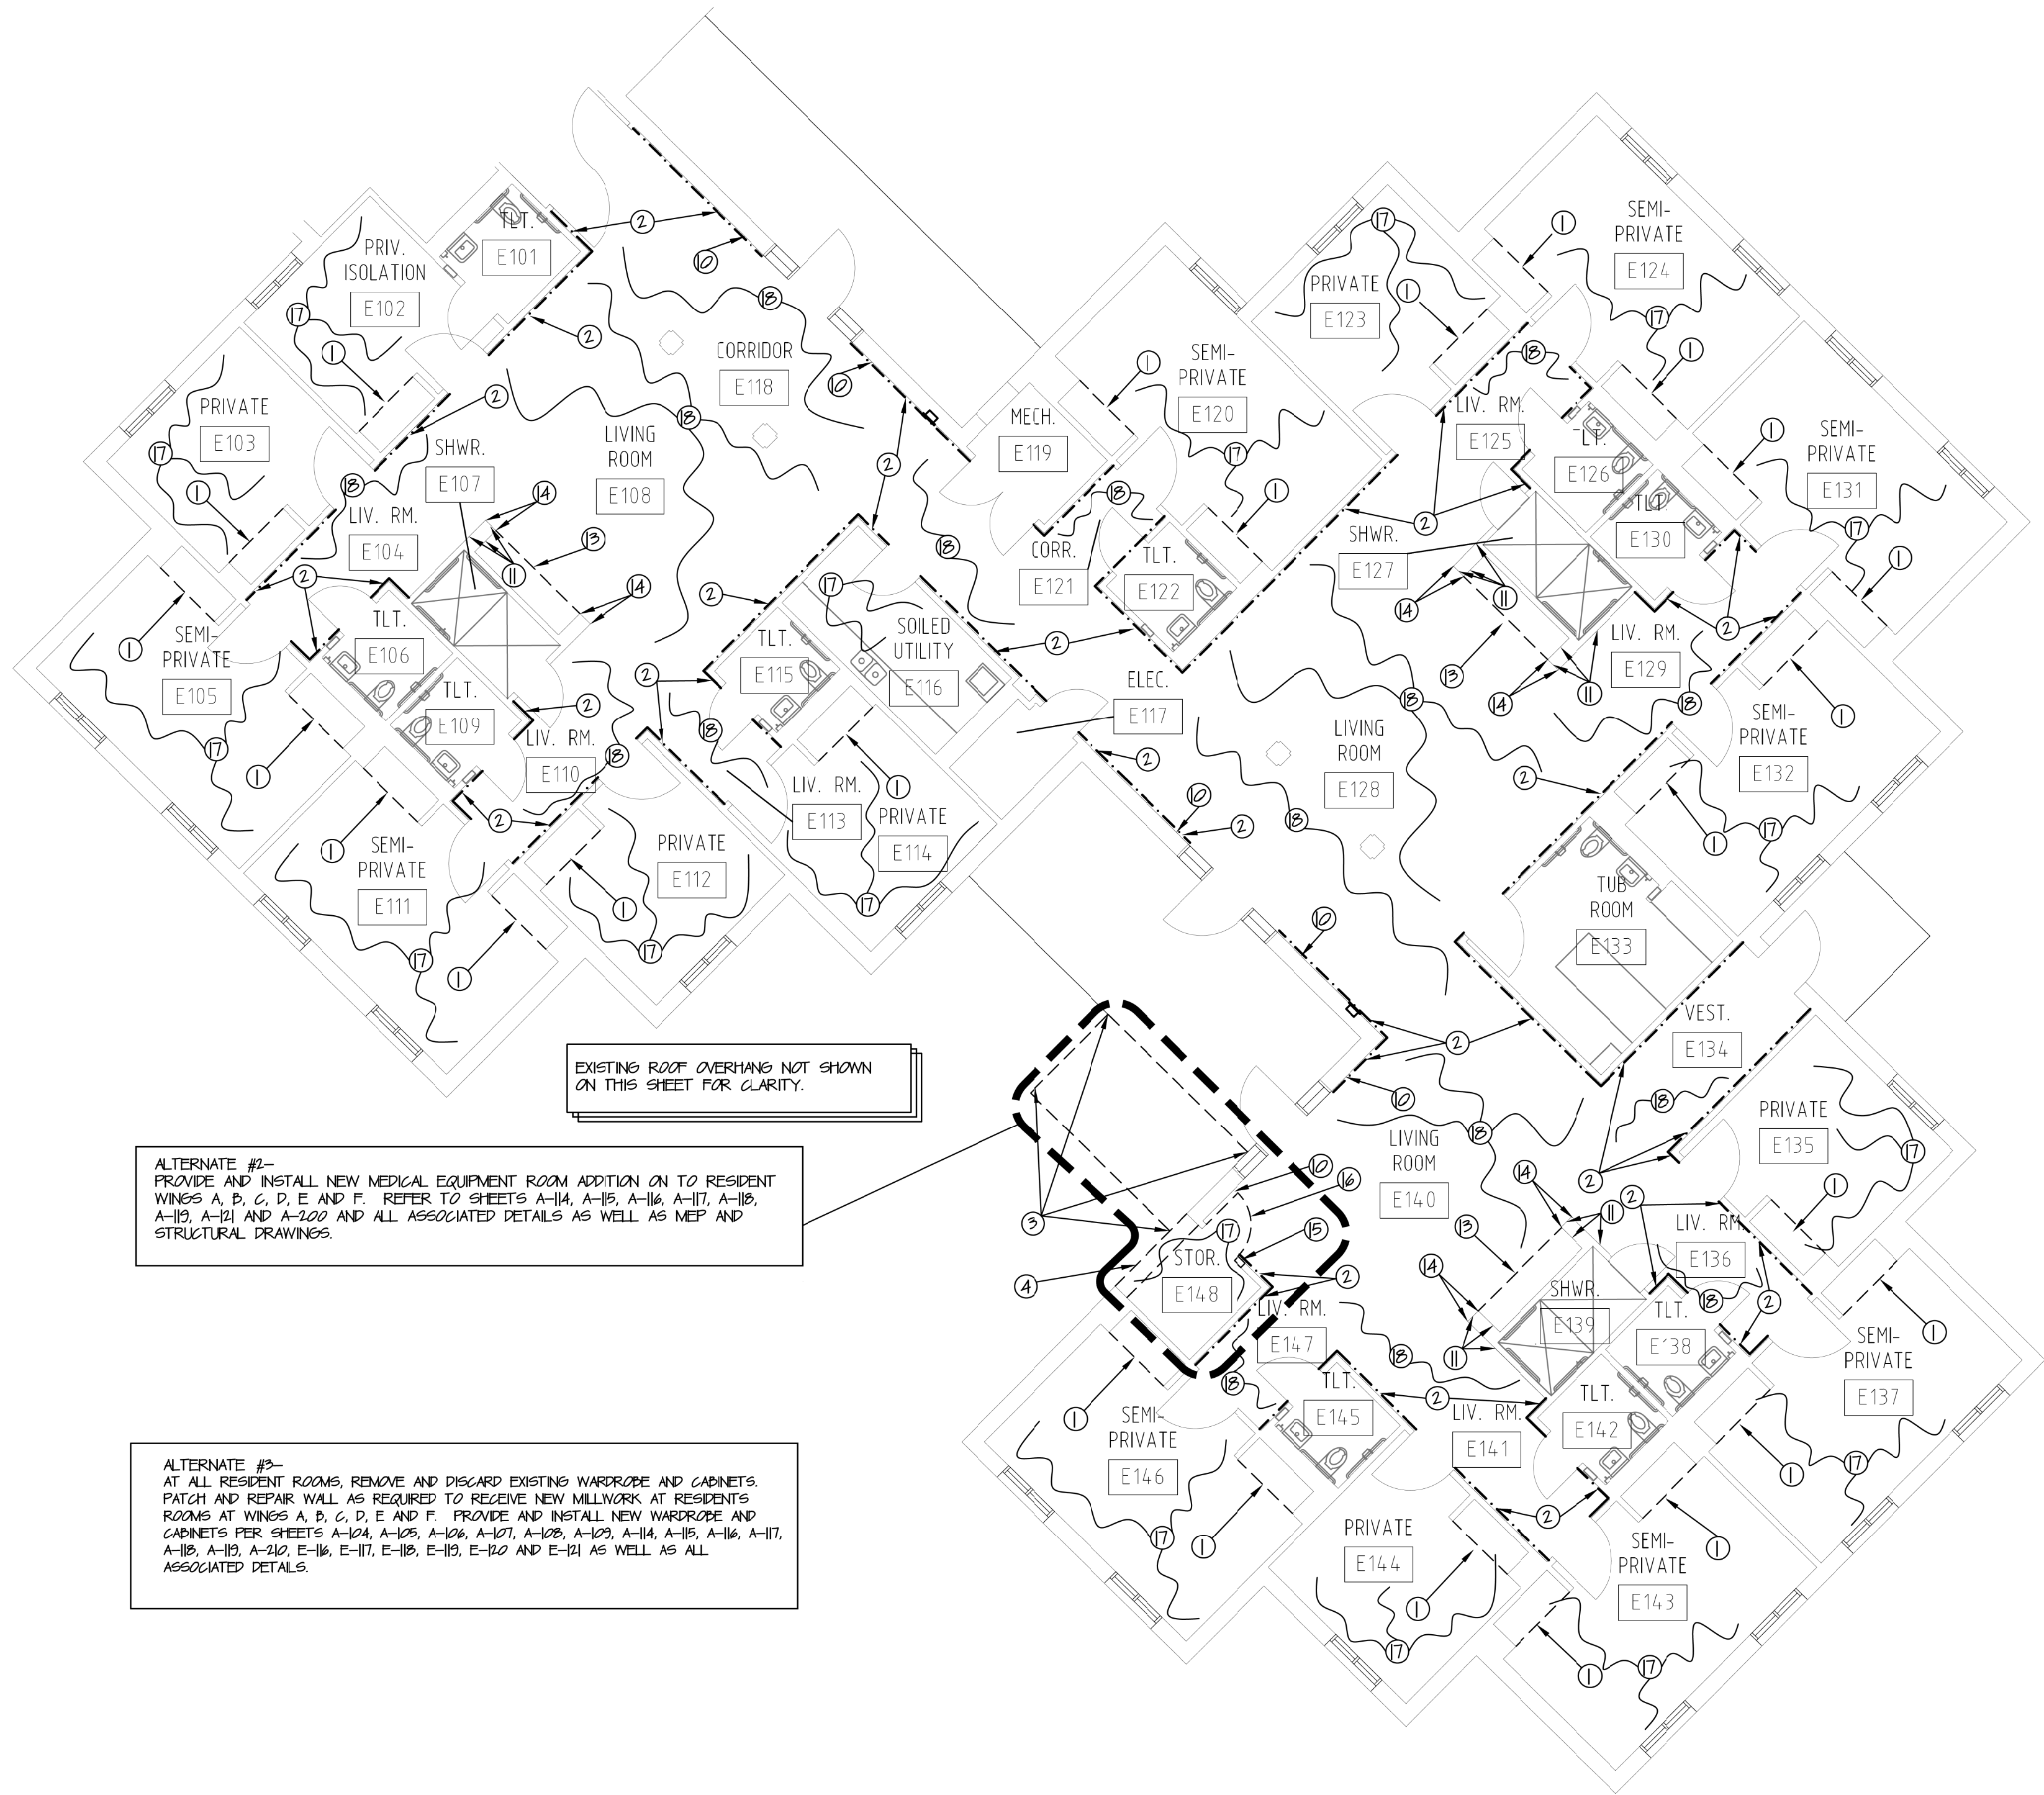
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**A-107**

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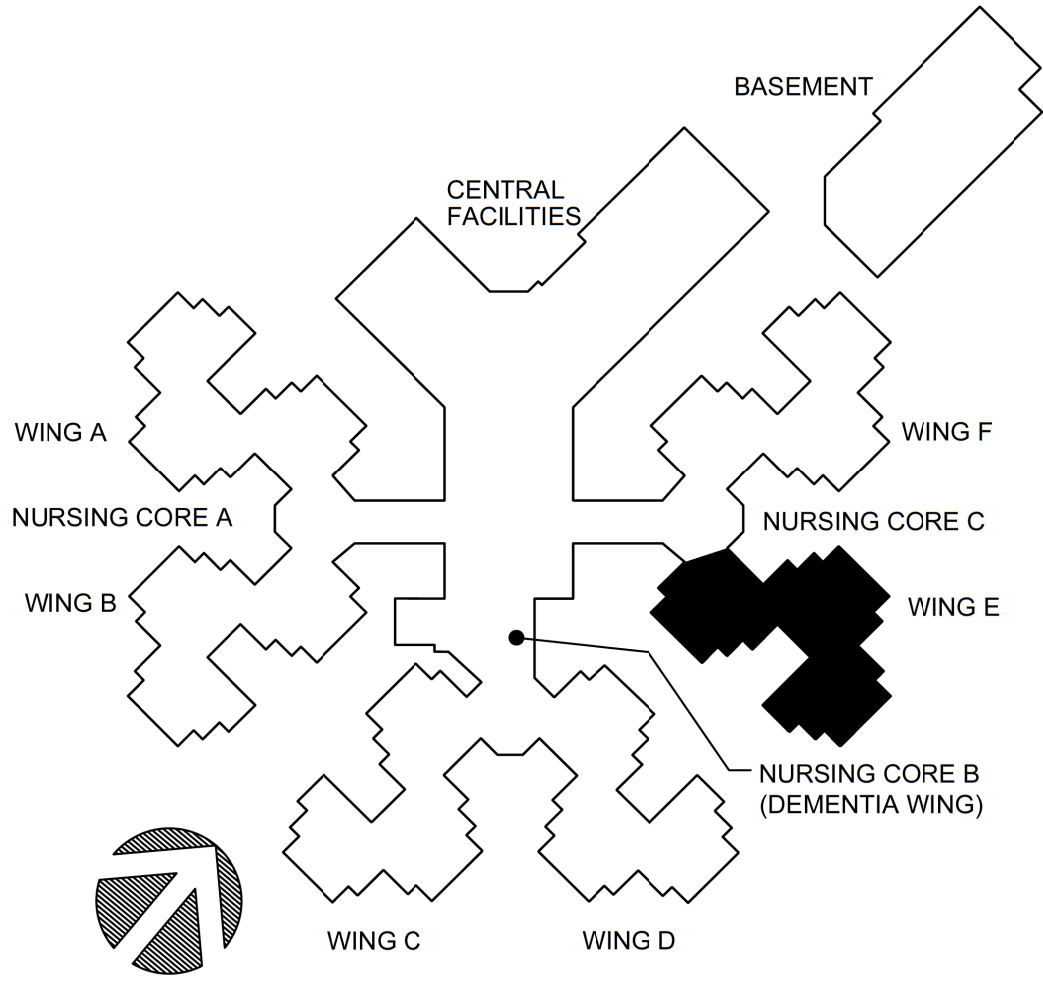


EXISTING ROOF OVERHANGS NOT SHOWN ON THIS SHEET FOR CLARITY.

ALTERNATE #2--  
PROVIDE AND INSTALL NEW MEDICAL EQUIPMENT ROOM ADDITION ON TO RESIDENT WINGS A, B, C, D, E AND F. REFER TO SHEETS A-114, A-115, A-116, A-117, A-118, A-119, A-121 AND A-202 AND ALL ASSOCIATED DETAILS AS WELL AS MEP AND STRUCTURAL DRAWINGS.

ALTERNATE #3--  
AT ALL RESIDENT ROOMS, REMOVE AND DISCARD EXISTING WARDROBE AND CABINETS. PATCH AND REPAIR WALL AS REQUIRED TO RECEIVE NEW MILLWORK AT RESIDENTS ROOMS AT WINGS A, B, C, D, E AND F. PROVIDE AND INSTALL NEW WARDROBE AND CABINETS PER SHEETS A-104, A-105, A-106, A-107, A-108, A-109, A-114, A-115, A-116, A-117, A-118, A-119, A-210, E-116, E-117, E-118, E-119, E-120 AND E-121 AS WELL AS ALL ASSOCIATED DETAILS.

WING E DEMOLITION PLAN  
1/8" = 1'-0"




KEYPLAN

GENERAL NOTES

- AT ALL PRIVATE AND SEMI-PRIVATE RESIDENTS ROOMS REMOVE EXISTING SHEET VINYL FLOOR AND INTEGRAL WALL BASE. PREPARE CONCRETE SUBFLOOR AND WALLS AS REQUIRED TO ALLOW FOR NEW FLOOR AND BASE PER THE FINISH SCHEDULE. CONTRACTOR SHALL BE RESPONSIBLE FOR ALL FLOOR PREPARATION TO RECEIVE NEW FLOORING. FLOOR COATING SHALL BE PROVIDED AS REQUIRED FOR PREPARATION OF FLOOR.
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2/19/25

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PROJECT # U1503-01  
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ISSUE DATE: 8-1-24

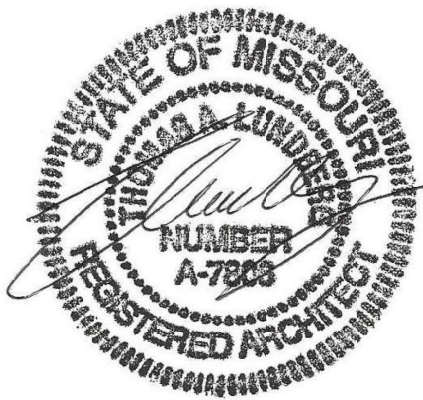CAD DWG FILE: A-108.DWG  
DRAWN BY: ZAC/MAH  
CHECKED BY: MAH/CAS  
DESIGNED BY: MAH/CAS

SHEET TITLE:  
DEMOLITION PLAN

SHEET NUMBER:

A-108

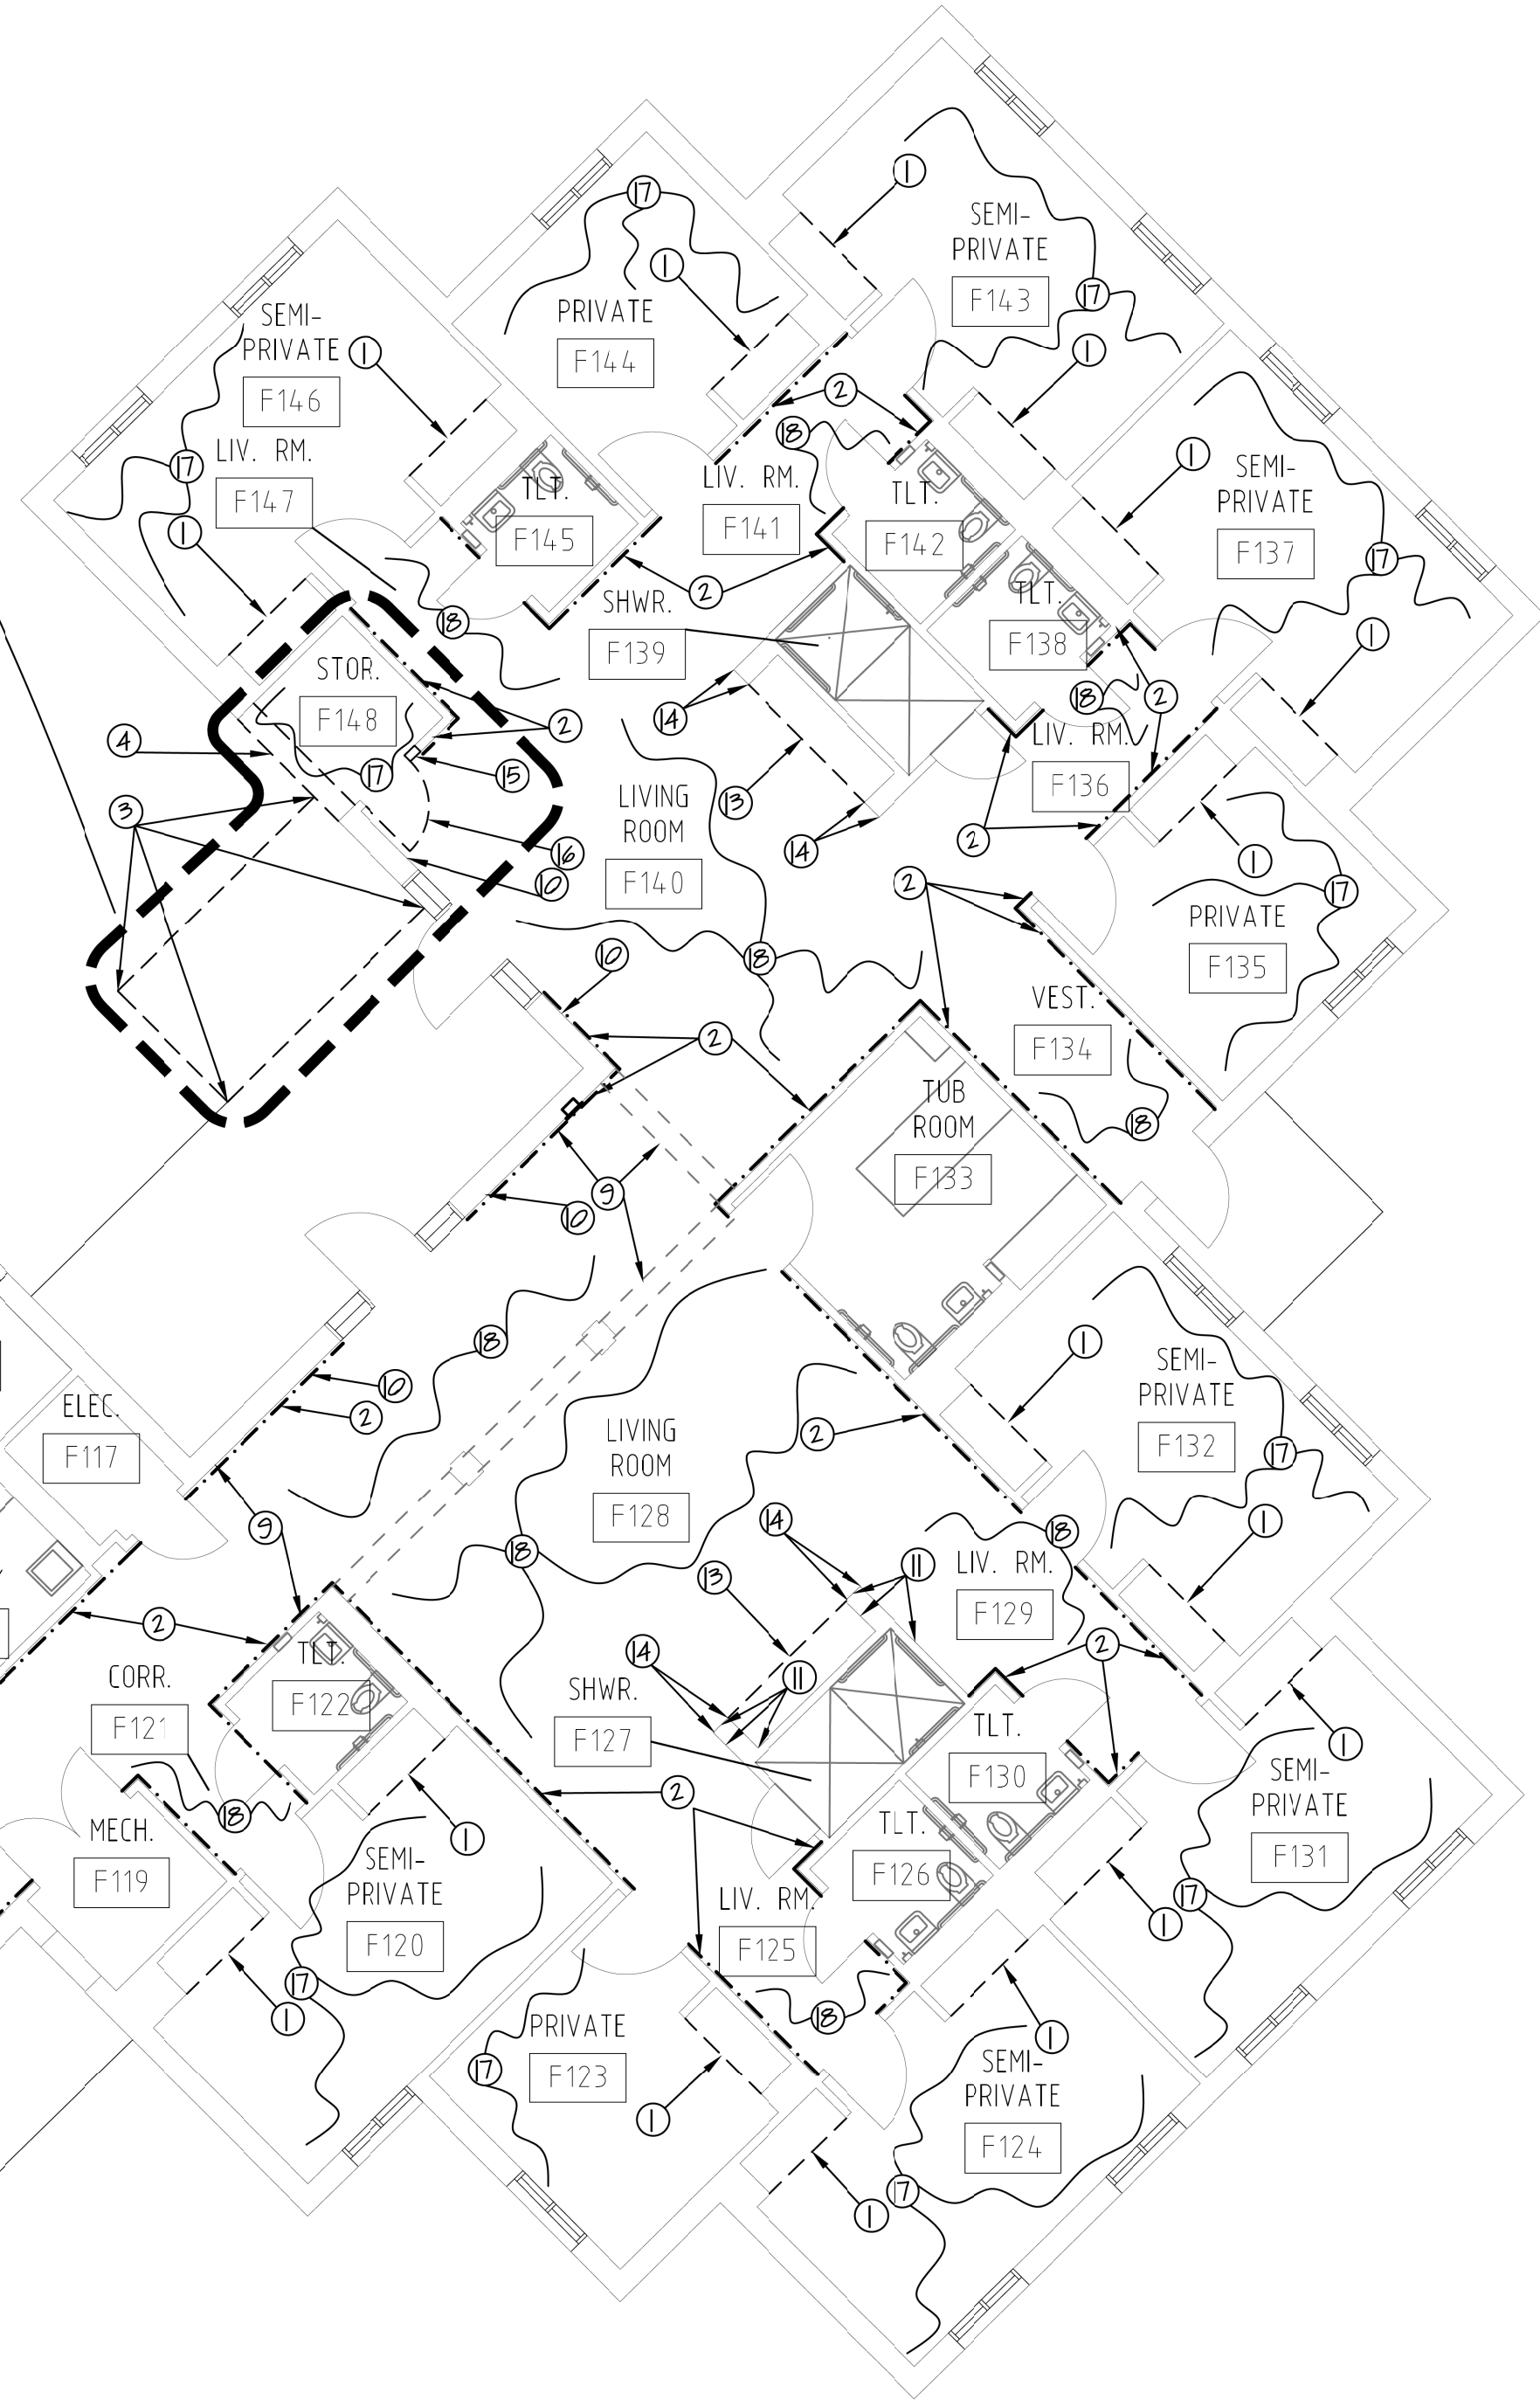
15 OF 120 SHEETS  
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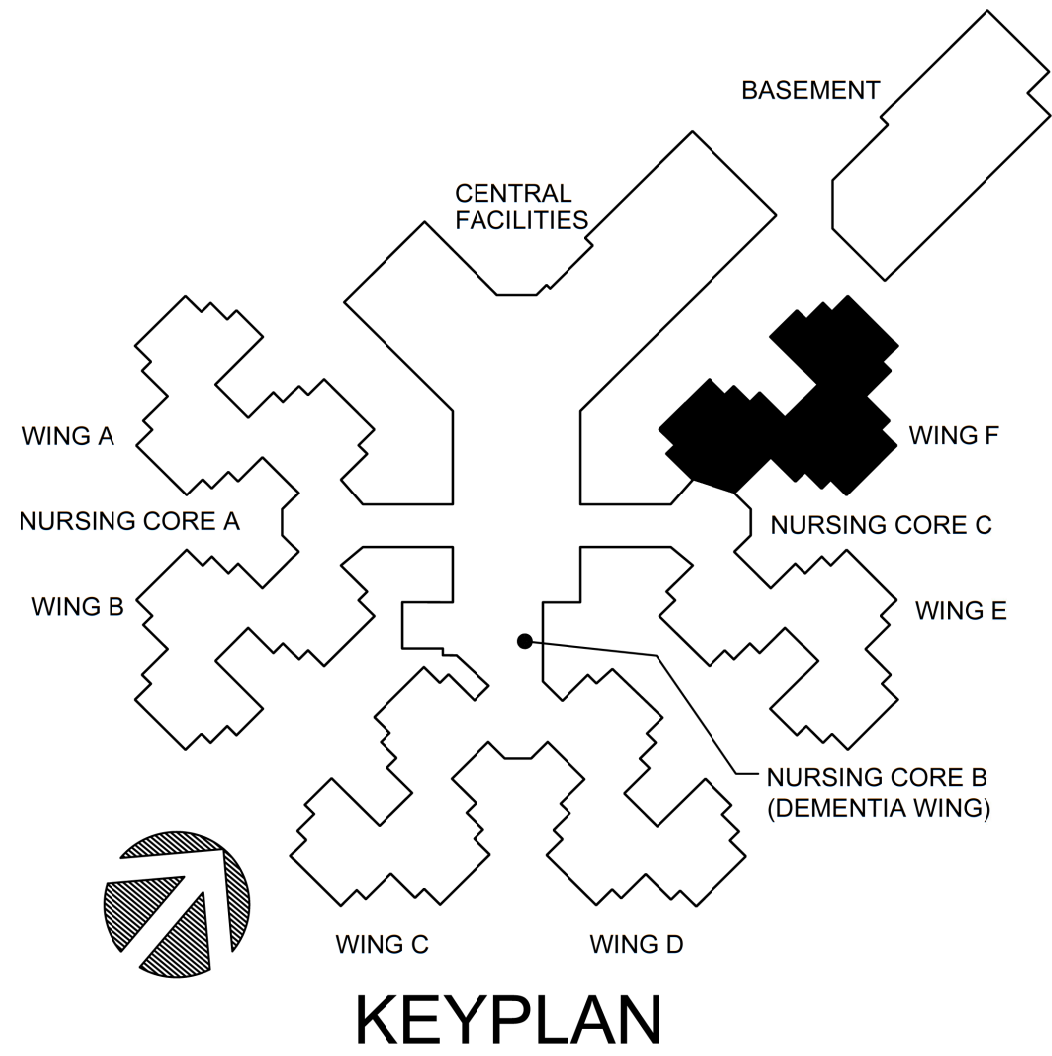
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EXISTING ROOF OVERHANG NOT SHOWN  
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WING F DEMOLITION PLAN  
1/8" = 1'-0"



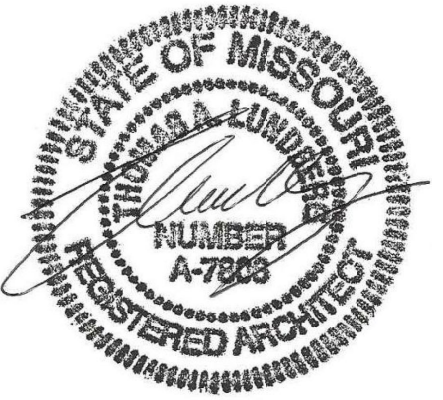
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- NOTE NOT USED.
- EXISTING SHOWER AND TOILET ACCESSORIES TO BE REMOVED. PATCH AND PREPARE AREA FOR NEW SHOWER. REFER TO PLUMBING PLANS FOR ADDITIONAL INFORMATION.
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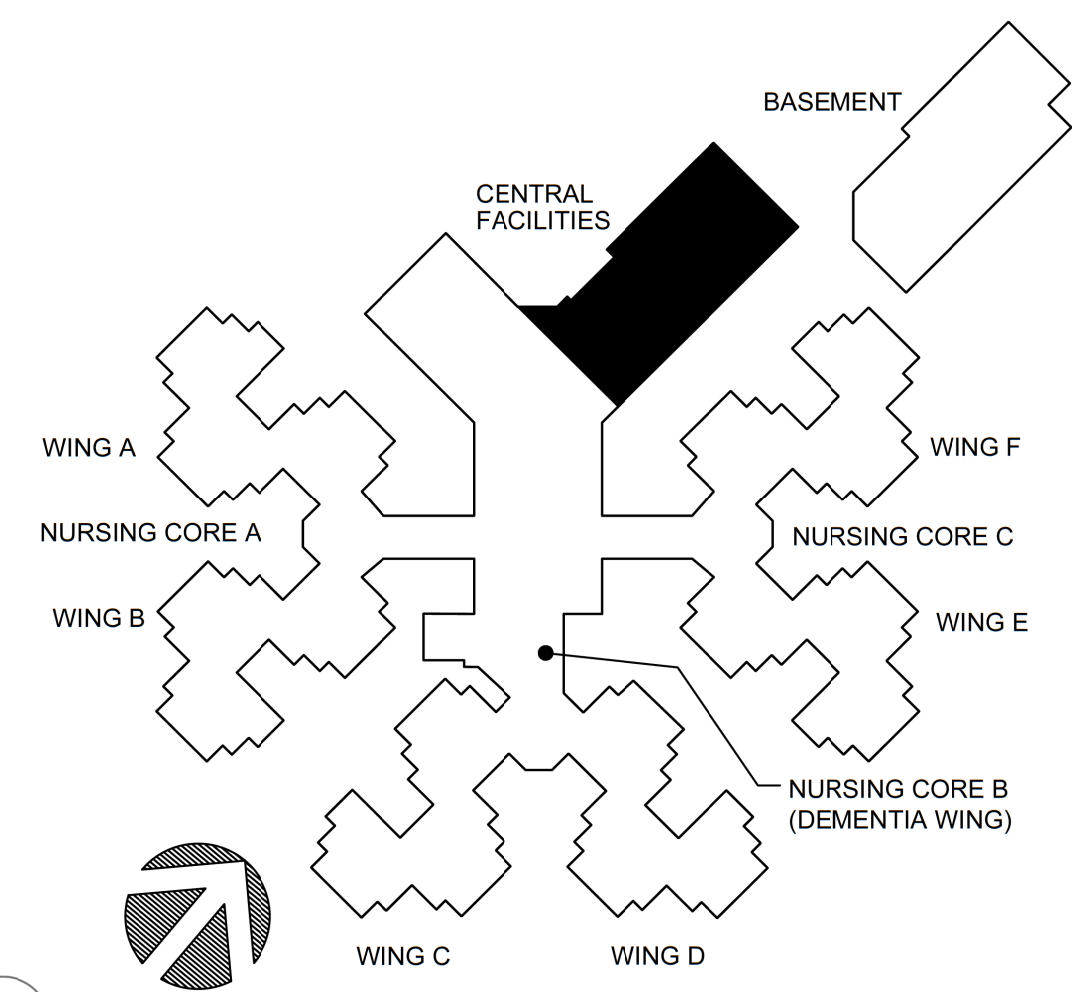
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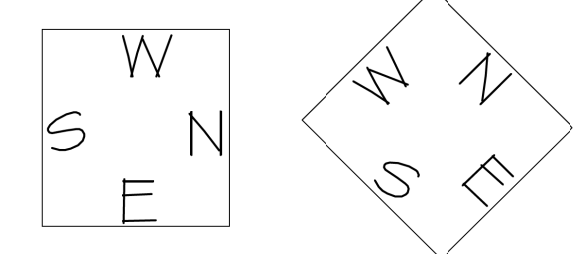




- GENERAL NOTES SHEET (A-110 ONLY)**
- a. PROVIDE AND INSTALL TRANSITION STRIP BETWEEN FLOOR MATERIALS. REFER TO SHEET A-500 FOR ALL TRANSITION DETAILS.
  - b. CONTRACTOR TO FIELD VERIFY ALL DIMENSIONS.
  - c. ALL INTERIOR STUDS ARE 3-5/8" 20 GAUGE METAL STUDS @ 16" O.C. UNLESS DIMENSIONED OTHERWISE.
  - d. CONTRACTOR TO PATCH AND REPAIR ALL CONSTRUCTION TO REMAIN, WHICH IS AFFECTED BY DEMOLITION (TO MATCH EXISTING).
  - e. REFER TO FINISH SCHEDULE FOR ALL FINISHES.
  - f. REFER TO DOOR SCHEDULE FOR ALL NEW DOORS AND FRAMES.
  - g. PROVIDE AND INSTALL NEW SOUND ATTENUATION BATT INSULATION IN ALL NEW INTERIOR WALLS UNLESS OTHERWISE NOTED. SEE SPEC.
  - h. CONTRACTOR TO PROTECT ALL EXISTING MILLWORK AND EQUIPMENT SHOWN TO REMAIN.
  - i. REFER TO SHEET C-400 FOR UNDERGROUND COLLECTOR SYSTEM.
  - j. FLOOR HATCH SHOWN AS (HATCH) TO BE NEW LUXURY VINYL TILE (LVT) FLOORING BY ARMSTRONG, COLOR NAGAZ WEATHERED ARBOR FAWN. GRANT TO RUN IN THE DIRECTION SHOWN ON PLANS WITH ARROW (→) REFER TO FINISH SCHEDULE FOR MORE INFORMATION.
  - k. CONTRACTOR TO PAINT ALL EXISTING INTERIOR HOLLOW METAL WINDOW FRAMES IPS-10, AND STAIN ALL NEW INTERIOR WOOD WINDOW FRAMES IPS-27, AT ALL AREAS WHERE WORK IS SHOWN. COLOR BY ARCHITECT AND TO MATCH EXISTING. REFER TO FINISH SCHEDULE.
  - l. CONTRACTOR TO PATCH AS REQUIRED, CLEAN AND PAINT ALL EXISTING HOLLOW METAL DOOR FRAMES IPS-10 AT ALL AREAS WHERE WORK IS SHOWN. REFER TO FINISH SCHEDULE. WHERE THEY EXIST, REMOVE ALL VINYL FRAME PROTECTION BEFORE PAINTING.
  - m. FLOOR HATCH SHOWN AS (HATCH) TO BE QUARRY TILE FLOORING. CONTRACTOR TO MATCH AND FIELD VERIFY COLOR. REFER TO FINISH SCHEDULE FOR MORE INFORMATION.

- FLOOR PLAN KEY NOTES (SHEET A-110 ONLY)**
- 1 EXISTING COLUMN TO REMAIN. PROTECT AS REQUIRED.
  - 2 PROVIDE AND INSTALL NEW CHAIR RAIL TO MATCH EXISTING WHERE EXISTING CHAIR RAIL WAS REMOVED DUE TO INSTALLATION OF NEW MECHANICAL UNIT.
  - 3 PROVIDE AND INSTALL NEW FULL HEIGHT VINYL CORNER GUARD (CG) EQUAL TO PAWLING, CG-12 WITH ALUMINUM RETAINER. COLOR TO BE EQUAL TO PAWLING #44B MONTEREY. REFER TO DETAIL 19 SHEET A-501.
  - 4 EXISTING HANDRAIL AND/OR CHAIR RAIL AT LOCATION INDICATED BY (---) AS REQUIRED WHERE IT IS CUT - FINISH END TO RETURN 48" BACK TO WALL AFTER CUTTING BACK TO CORNER GUARD. STAIN TO MATCH EXISTING.
  - 5 CHANGE IN DIRECTION OF GRAIN OF FLOORING AND DIRECTION RUN.
  - 6 TRANSITION STRIP. REFER TO SHEET A-500 FOR TYPE.
  - 7 THROUGH 21 NOTE NOT USED.
  - 22 RELOCATE EXISTING VENDING MACHINES AS SHOWN.
  - 23 AT EXISTING WOOD WINDOW JAMBS, CLEAN, SAND, AND PROVIDE GAP FILLER AT ANY GAPS PRIOR TO PAINTING. PAINT EXISTING WOOD WINDOW JAMBS, IPS-25 (SEE SPEC.) TO MATCH WALL. SEE FINISH SCHEDULE.
  - 24 PROVIDE AND INSTALL NEW WALL STOP EQUAL TO ROCKWOOD 40331D. SEE SPEC - QUANTITY (1) AT EACH DOOR.
  - 25 PROVIDE AND INSTALL NEW 4" BASE ON EXISTING MILLWORK TO MATCH ADJACENT WALL BASE PER THE FINISH SCHEDULE.
  - 26 PROVIDE AND INSTALL NEW 3/8" METAL STUD WALL (STUDS AT 16" O.C.) WITH 5/8" TYPE X GYPSUM BOARD ON BOTH SIDES TO MATCH EXISTING WALL. REFER TO FINISH SCHEDULE FOR ADDITIONAL INFORMATION. AFTER INSTALLATION OF NEW MECHANICAL UNIT PAINT "T" BOTH SIDES OF THE WALL.
  - 27 PAINT EXISTING HOLLOW METAL WINDOW FRAME IPS-10 (SEE SPEC.) REFER TO FINISH SCHEDULE FOR ADDITIONAL INFORMATION.
  - 28 EXISTING EXPOSED BRICK WALL TO REMAIN. PROTECT AS REQUIRED. DO NOT PAINT.
  - 29 EXISTING WALL TO BE FURRED OUT WITH 5/8" GYPSUM BOARD OVER 7/8" HAT CHANNELS AT 24" O.C. PAINT, SEE FINISH SCHEDULE.
  - 30 THROUGH 31 NOTE NOT USED.
  - 32 PROVIDE AND INSTALL STAINLESS STEEL TRAY COUNTER TOP AT NEW ROLLING COUNTER DOOR. SEE DETAIL 2 OF A-400.
  - 33 PROVIDE AND INSTALL NEW QUARRY TILE (QT) FLOORING IN THE ENTIRE DISH WASH ROOM (NOT SHOWN UNDER EQUIPMENT FOR CLARITY). SLOPE FLOOR TO DRAIN. REFER TO FINISH SCHEDULE.
  - 34 INSTALL LVT UNDER THRESHOLDS - REMOVE AND REINSTALL AS REQUIRED.
  - 35 PROVIDE AND INSTALL CHAIN RAIL INDICATED BY (-----) AT THESE LOCATIONS TO MATCH CHAIN RAIL IN THIS ROOM.
  - 36 PROVIDE AND INSTALL 5" CONCRETE SIDEWALK. SEE DETAILS 1, 2, 3 AND 4 ON SHEET C-400. MATCH EXISTING GRADE AND SIDEWALK ELEVATION.

DIAGRAM FOR FINISH SCHEDULE REFERENCE:



PARTIAL CENTRAL FACILITIES PLAN  
1/8" = 1'-0"

STATE OF MISSOURI  
MIKE KEHOE,  
GOVERNOR



2/19/25

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**ESTERLY & SCHNEIDER ASSOCIATES, INC.**  
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AIA

CERTIFICATE OF AUTHORITY #000718  
COMM. # 4860

OFFICE OF ADMINISTRATION  
DIVISION OF FACILITIES  
MANAGEMENT,  
DESIGN AND CONSTRUCTION

DEPARTMENT OF  
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MISSOURI VETERANS  
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INTERIOR RENOVATION  
MISSOURI VETERANS  
HOME

620 N. JEFFERSON  
ST. JAMES, MISSOURI

PROJECT # U1503-01  
SITE # 6801  
ASSET # 8136801002  
FEDERAL# 29-044

REVISION: \_\_\_\_\_  
DATE: \_\_\_\_\_  
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DATE: \_\_\_\_\_  
REVISION: \_\_\_\_\_  
DATE: \_\_\_\_\_  
ISSUE DATE: 8-1-24

CAD DWG FILE: A-110.DWG  
DRAWN BY: ZAC/MAH  
CHECKED BY: MAH/CAS  
DESIGNED BY: MAH/CAS

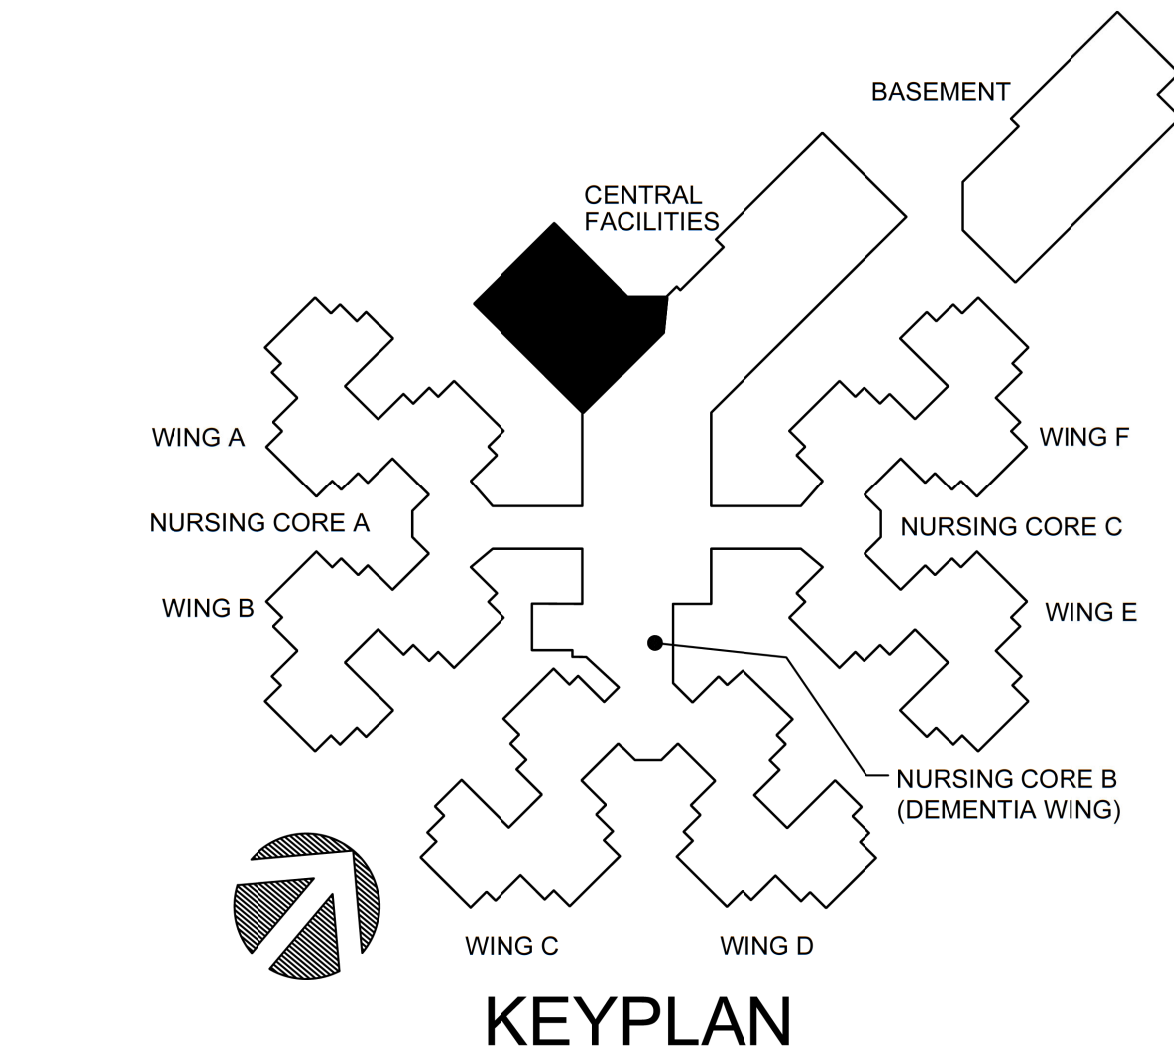
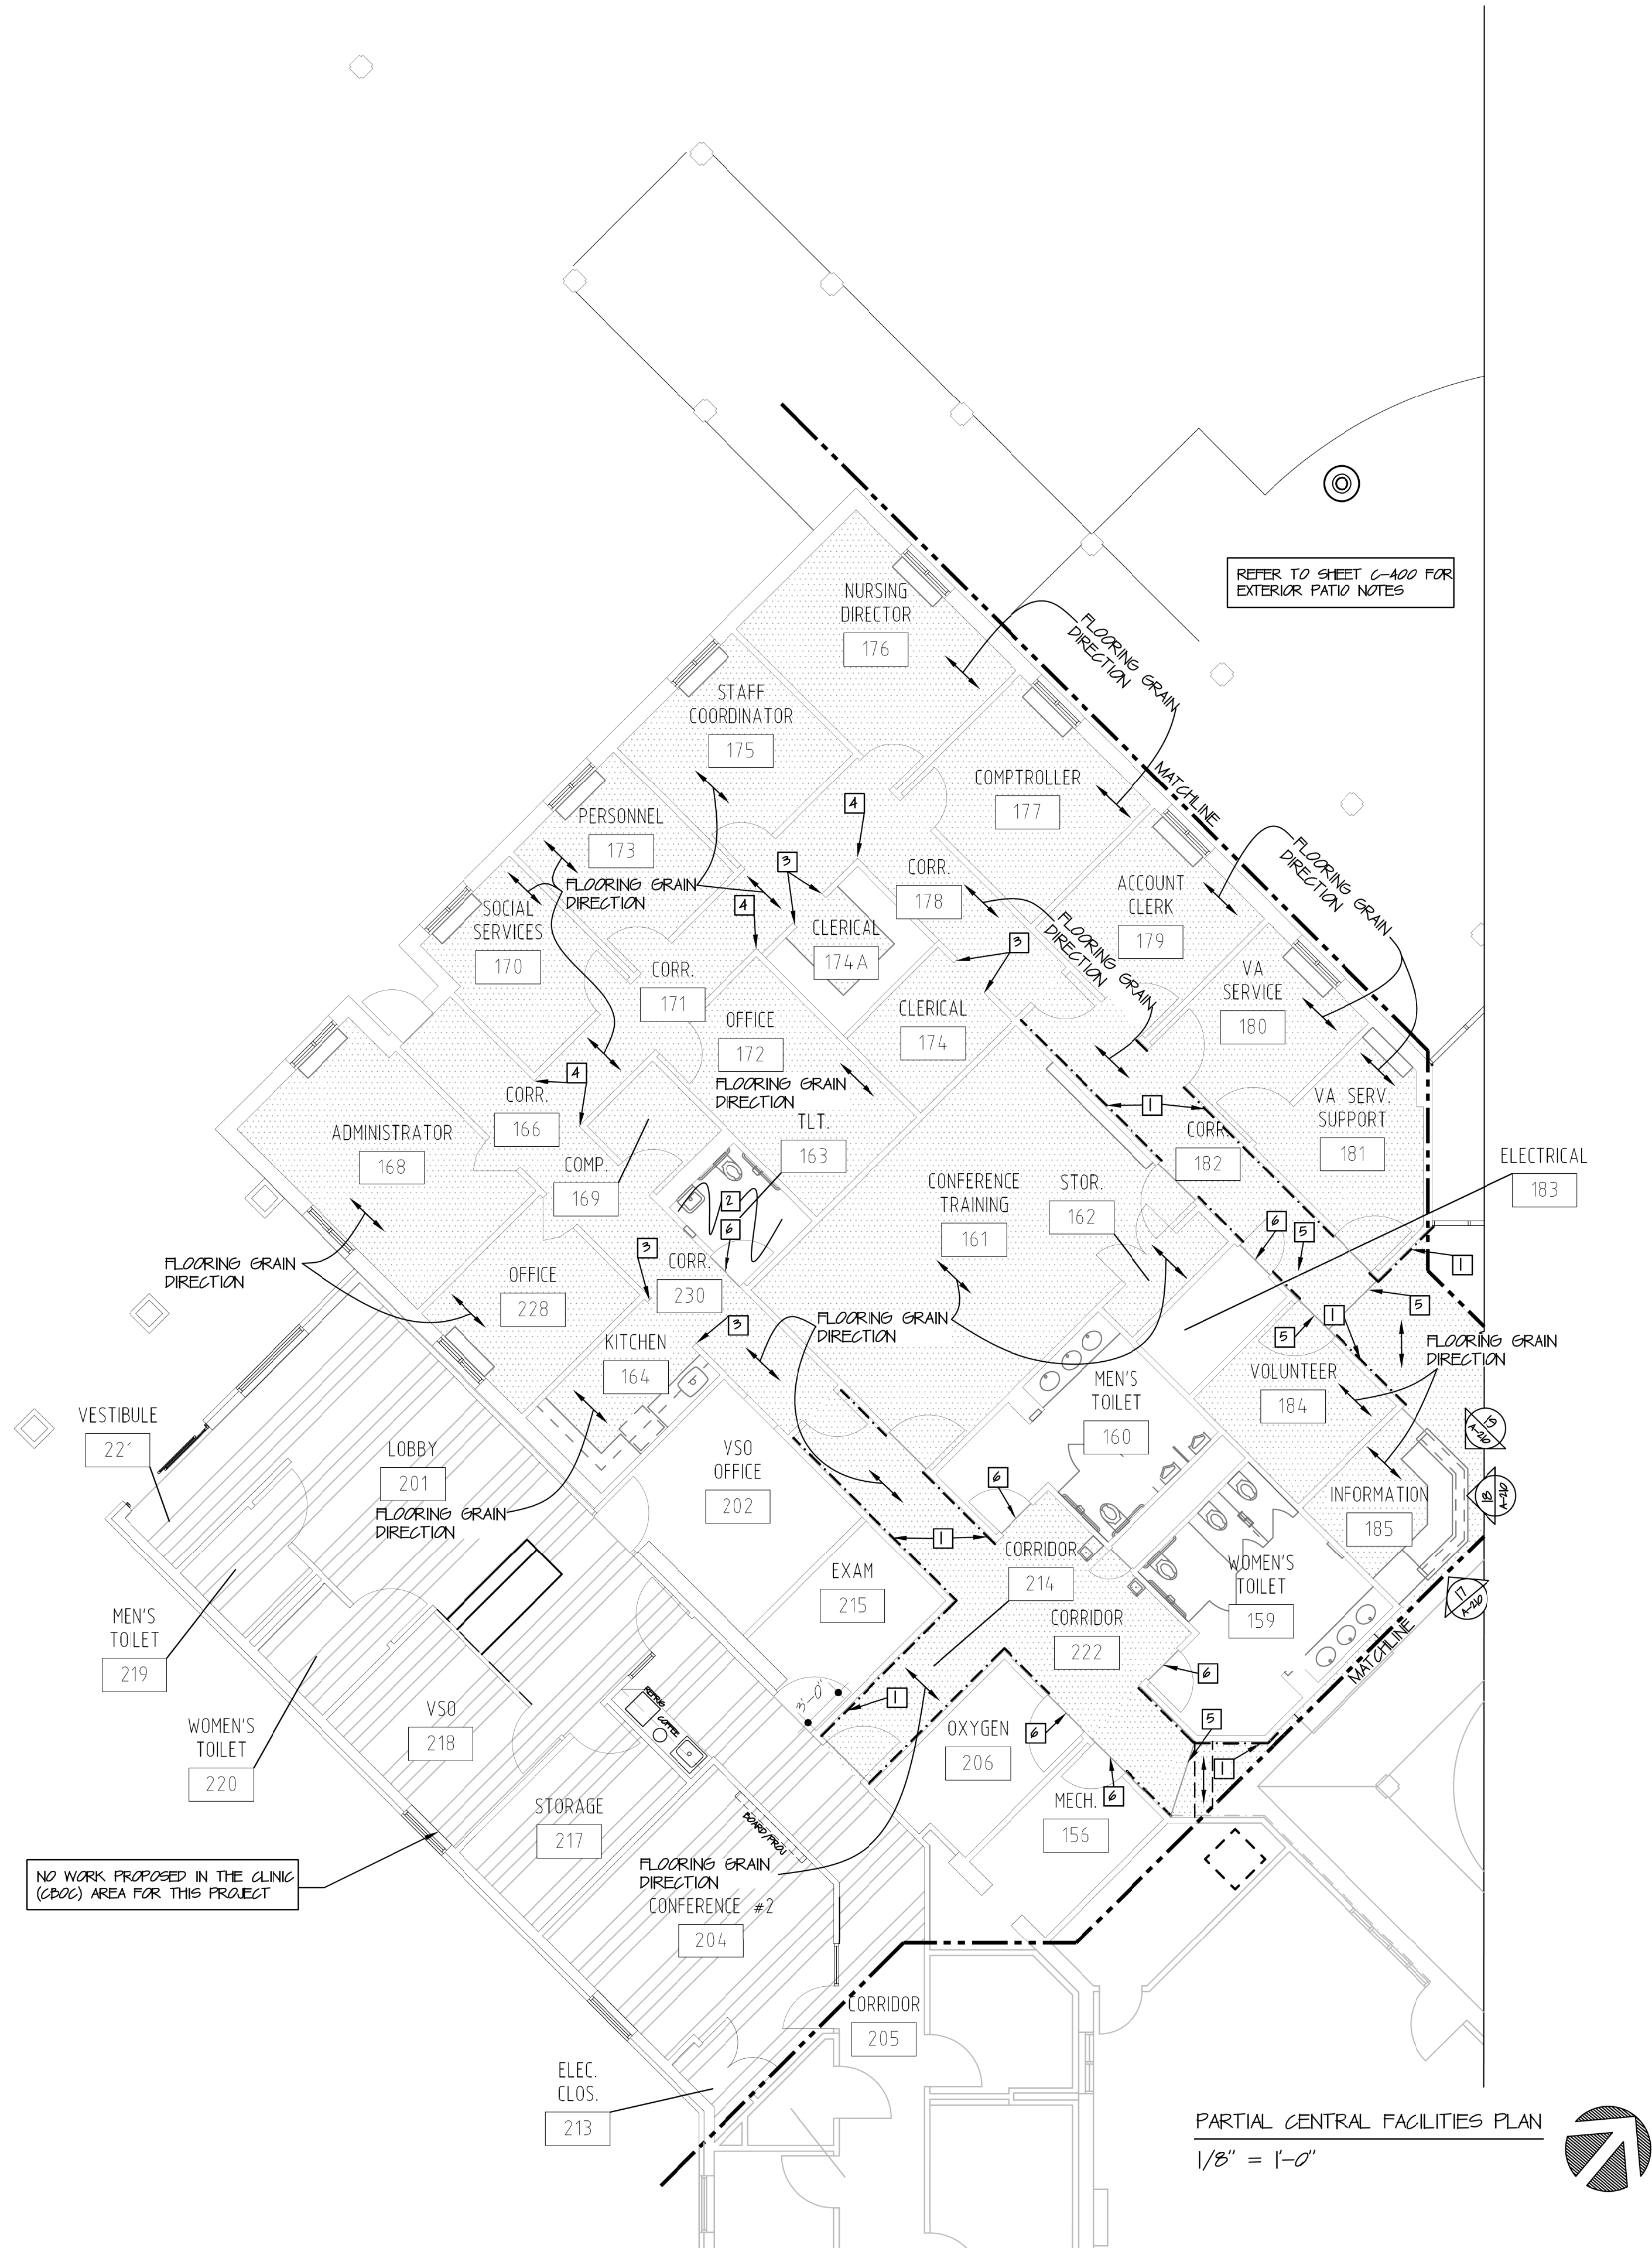
SHEET TITLE:  
**FLOOR PLAN**

SHEET NUMBER:

**A-110**  
17 OF 120 SHEETS  
8-1-24

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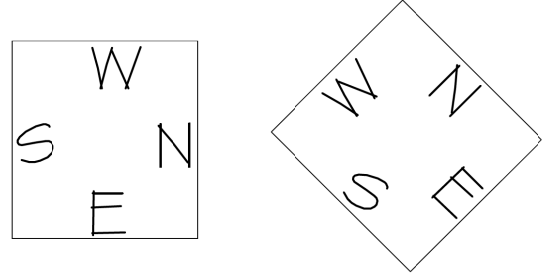





- GENERAL NOTES (SHEET A-III ONLY)**
- PROVIDE AND INSTALL TRANSITION STRIP BETWEEN FLOOR MATERIALS REFER TO SHEET A-500 FOR ALL TRANSITION DETAILS
  - CONTRACTOR TO FIELD VERIFY ALL DIMENSIONS
  - CONTRACTOR TO PAINT ALL EXISTING INTERIOR HOLLOW METAL WINDOW FRAMES IPS-20, AND STAIN ALL NEW INTERIOR WOOD WINDOW FRAMES IPS-21, AT ALL AREAS WHERE WORK IS SHOWN. COLOR BY ARCHITECT AND TO MATCH EXISTING. REFER TO FINISH SCHEDULE.
  - CONTRACTOR TO PATCH AND REPAIR ALL CONSTRUCTION TO REMAIN, AFFECTED BY DEMOLITION
  - REFER TO FINISH SCHEDULE FOR ALL FINISHES.
  - REFER TO DOOR SCHEDULE FOR ALL NEW DOORS AND FRAMES
  - PROVIDE AND INSTALL NEW SOUND ATTENUATION BATT INSULATION IN ALL NEW INTERIOR WALLS UNLESS OTHERWISE NOTED. SEE SPEC.
  - CONTRACTOR TO PROTECT ALL EXISTING MILLWORK AND EQUIPMENT SHOWN TO REMAIN.
  - CONTRACTOR TO PATCH AS REQUIRED, CLEAN AND PAINT ALL EXISTING HOLLOW METAL DOOR FRAMES IPS-20. REFER TO FINISH SCHEDULE. WHERE THEY EXIST, REMOVE ALL VINYL FRAME PROTECTION BEFORE PAINTING.

- FLOOR PLAN KEY NOTES (SHEET A-III ONLY)**
- EXISTING HANDRAIL AT LOCATION INDICATED BY (---). PROTECT AS REQUIRED.
  - CONTRACTOR SHALL STEAM CLEAN EXISTING FLOOR, WALL TILE AND GROUT AT INDICATED RESTROOM.
  - PROVIDE AND INSTALL FULL HEIGHT VINYL CORNER GUARD (CG) EQUAL TO PAWLING, CG-10 OVER EXISTING ALUMINUM RETAINER. AT BOTH SIDES OF EXISTING JAMB. COLOR TO BE EQUAL TO PAWLING #648 MONTEREY. SEE DETAIL 14 OF A-201.
  - PROVIDE AND INSTALL FULL HEIGHT VINYL CORNER GUARD (CG) EQUAL TO PAWLING, CG-10 OVER EXISTING ALUMINUM RETAINER. COLOR TO BE EQUAL TO PAWLING #648 MONTEREY. SEE DETAIL 15 OF A-201.
  - CHANGE IN DIRECTION OF GRAIN OF FLOORING AND DIRECTION RUN.
  - TRANSITION STRIP. REFER TO SHEET A-500 FOR TYPE.

DIAGRAM FOR FINISH SCHEDULE REFERENCE:



STATE OF MISSOURI  
MIKE KEHOE,  
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**ESTERLY  
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CERTIFICATE OF AUTHORITY #000718

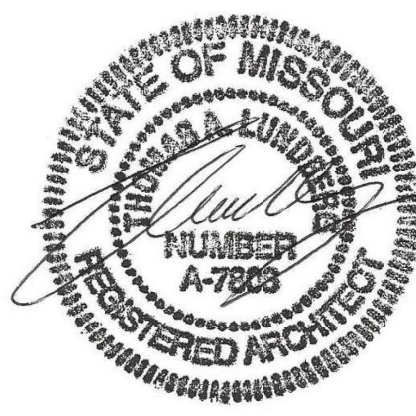CONM. # 4860

OFFICE OF ADMINISTRATION  
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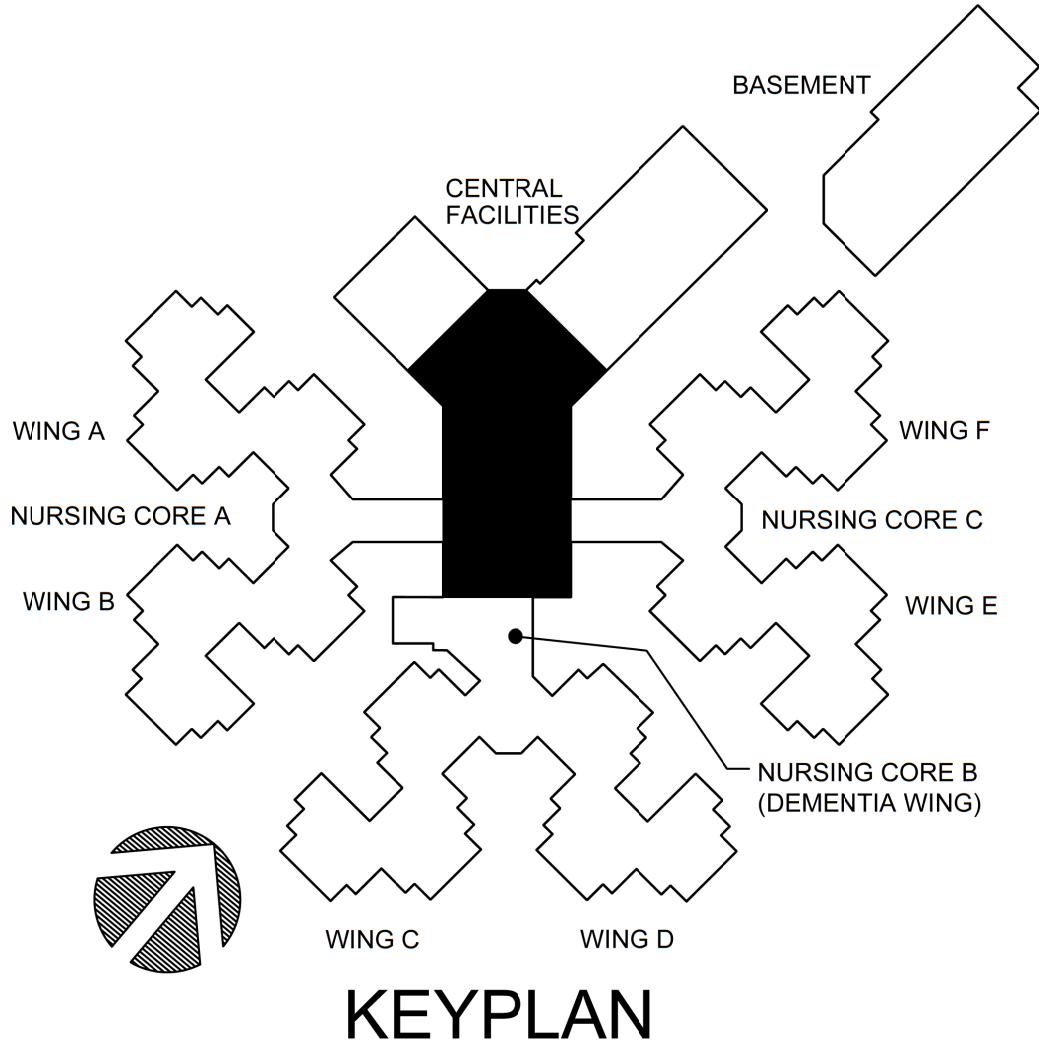
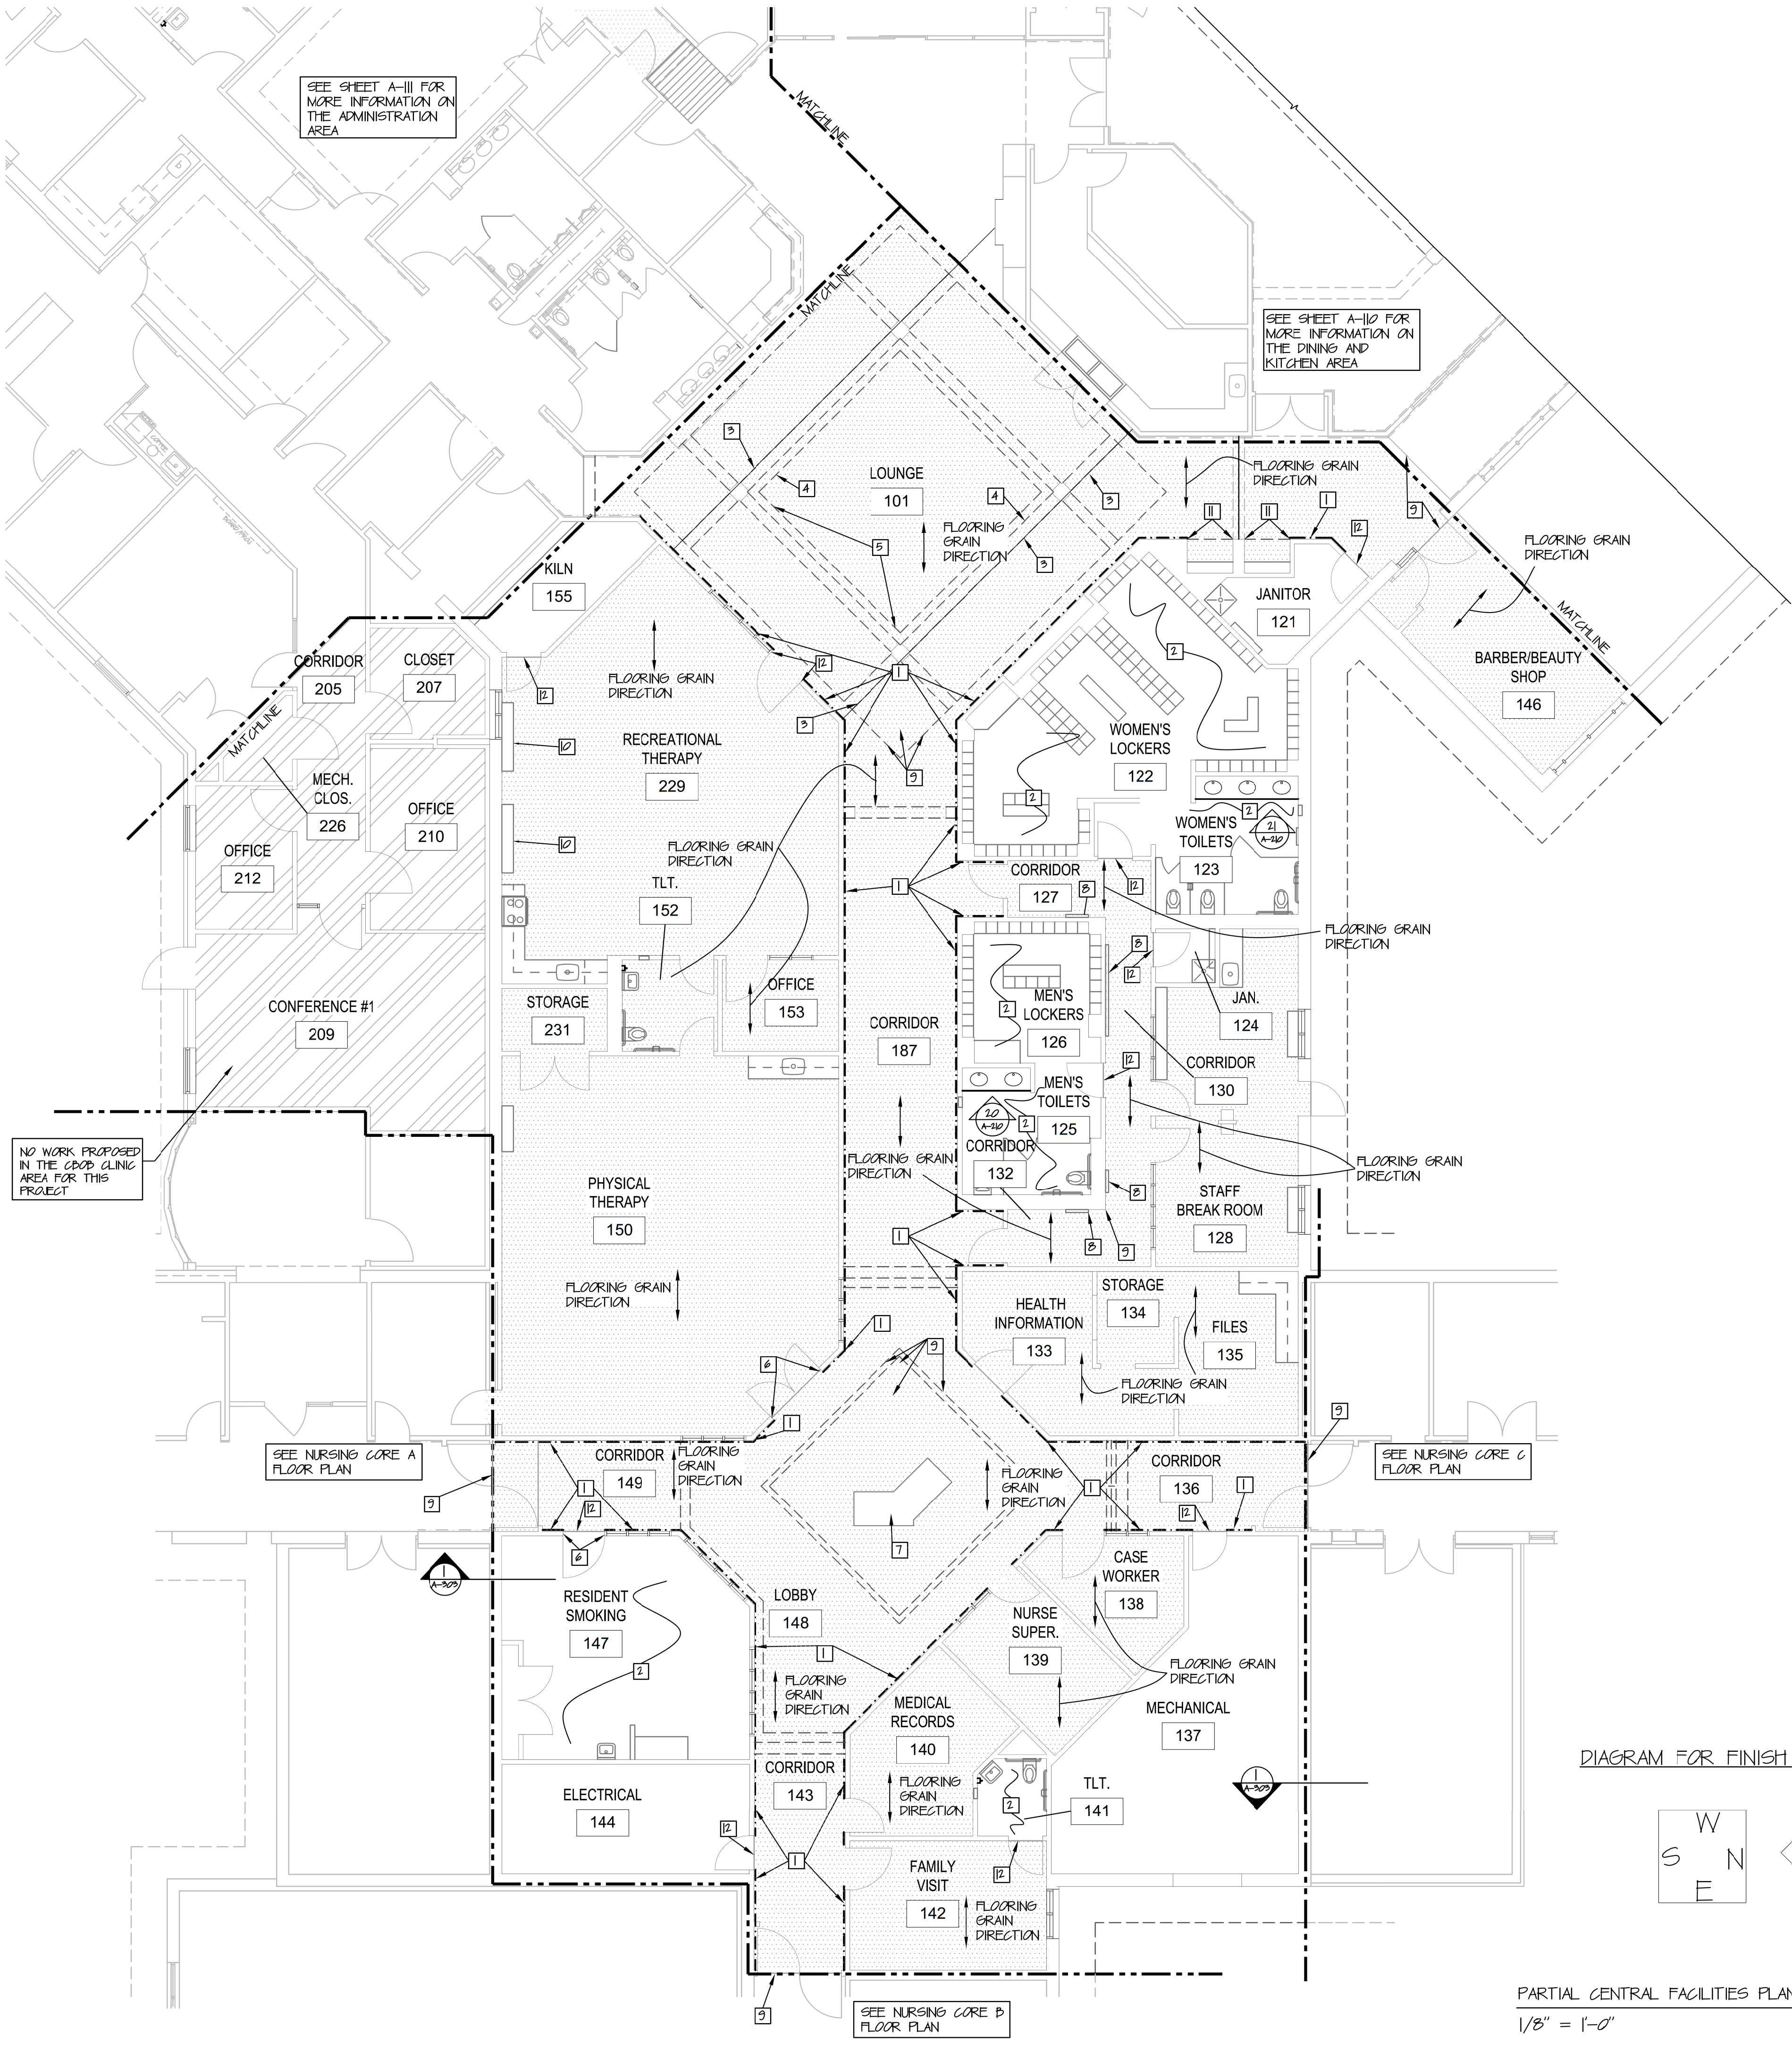
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DRAWN BY: ZAC/MAH  
CHECKED BY: MAH/CAS  
DESIGNED BY: MAH/CAS

SHEET TITLE:  
**FLOOR PLAN**

SHEET NUMBER:  
**A-111**  
18 OF 120 SHEETS  
8-1-24

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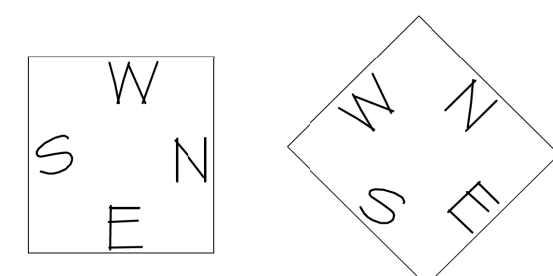




- GENERAL NOTES SHEET (A-112 ONLY)
- PROVIDE AND INSTALL TRANSITION STRIP BETWEEN FLOOR MATERIALS. REFER TO SHEET A-500 FOR ALL TRANSITION DETAILS.
  - CONTRACTOR TO FIELD VERIFY ALL DIMENSIONS.
  - CONTRACTOR TO PAINT ALL EXISTING INTERIOR HOLLOW METAL WINDOW FRAMES IPS-20, AND STAIN ALL NEW INTERIOR WOOD WINDOW FRAMES IPS-27, AT ALL AREAS WHERE WORK IS SHOWN. COLOR BY ARCHITECT AND TO MATCH EXISTING. REFER TO FINISH SCHEDULE.
  - CONTRACTOR TO PATCH AND REPAIR ALL CONSTRUCTION TO REMAIN, AFFECTED BY DEMOLITION.
  - REFER TO FINISH SCHEDULE FOR ALL FINISHES.
  - REFER TO DOOR SCHEDULE FOR ALL NEW DOORS AND FRAMES.
  - PROVIDE AND INSTALL NEW SOUND ATTENUATION BATT INSULATION IN ALL NEW INTERIOR WALLS UNLESS OTHERWISE NOTED. SEE SPEC.
  - CONTRACTOR TO PROTECT ALL EXISTING MILLWORK AND EQUIPMENT SHOWN TO REMAIN.
1. FLOOR HATCH SHOWN AS ( ) TO BE NEW LUXURY VINYL TILE (LVT) FLOORING BY ARMSTRONG, COLOR N4236 WEATHERED ARBOR FAWN. GRAIN TO RUN IN THE DIRECTION SHOWN ON PLANS WITH ARROW ( ). REFER TO FINISH SCHEDULE FOR MORE INFORMATION.

- FLOOR PLAN KEY NOTES (A-112 ONLY)
- EXISTING HANDRAIL AT LOCATION INDICATED BY (---) PROTECT AS REQUIRED.
  - CONTRACTOR SHALL STEAM CLEAN EXISTING TILE FLOOR, WALL TILE AND GROUT AT INDICATED RESTROOMS AND LOCKER ROOMS.
  - PROVIDE AND INSTALL NEW EXPANSION JOINT IN THE LVT FLOORING. REFER TO DETAIL 13 OF SHEET A-500.
  - PATCH AND REPAIR EXISTING GYPSUM BOARD SOFFIT (ABOVE) WHERE CRACKING HAS OCCURRED TO MATCH EXISTING, AND PROVIDE AND INSTALL NEW GYPSUM BOARD EXPANSION JOINT. EQUAL TO FRY REGLET DRYWALL EXPANSION JOINT.
  - EXISTING WOOD TRIM ON SOFFIT ABOVE TO BE REFINISHED AT LOCATION INDICATED TO REPAIR WATER DAMAGE. MATCH EXISTING COLOR/FINISH. COORDINATE THIS WORK WITH THE ARCHITECT.
  - PROVIDE AND INSTALL 060" THICK, TEXTURED, 3/8" TALL VINYL DOOR FRAME GUARD EQUAL TO PAWLING - PROTEK WALL PROTECTION SYSTEM, DFC-10 TYPE, COLOR #122 WOODLANDS. SEE FINISH SCHEDULE. INSTALL FROM FLOOR UP.
  - EXISTING FISH TANK TO REMAIN, PROTECT AS REQUIRED. CUT EXISTING FLOORING AROUND TANK TO RECEIVE NEW FLOORING.
  - EXISTING BULLETIN BOARDS TO REMAIN, PROTECT AS REQUIRED.
  - CHANGE IN DIRECTION OF GRAIN OF FLOORING AND DIRECTION RUN.
  - PROVIDE AND INSTALL NEW SOLID SURFACE COUNTER TOP WITH 4" TALL BACKSPLASH AT EXISTING MILLWORK COVERED FAN COIL UNIT. COLOR TO BE SSI. REFER TO FINISH SCHEDULE. EXISTING FAN COIL UNIT TO BE REMOVED PRIOR TO INSTALLING NEW COUNTER TOP. CONTRACTOR TO FIELD VERIFY EXISTING DIMENSIONS. REFER TO DETAIL 11 OF A-310 (SIMILAR).
  - PROVIDE AND INSTALL NEW SIX FOOT TALL VINYL CORNER GUARD (CG) EQUAL TO PAWLING, CG-10 WITH ALUMINUM RETAINER. COLOR TO BE EQUAL TO PAWLING #6418 MONTEREY. REFER TO DETAIL 13 SHEET A-301.
  - TRANSITION STRIP. REFER TO SHEET A-500 FOR TYPE.

DIAGRAM FOR FINISH SCHEDULE REFERENCE:



PARTIAL CENTRAL FACILITIES PLAN  
1/8" = 1'-0"

STATE OF MISSOURI  
MIKE KEHOE,  
GOVERNOR



2/19/25

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CERTIFICATE OF AUTHORITY #000718

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ASSOCIATES, INC.**  
AIA architects & planners

CONM. # 4860

OFFICE OF ADMINISTRATION  
DIVISION OF FACILITIES  
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DEPARTMENT OF  
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INTERIOR RENOVATION  
MISSOURI VETERANS  
HOME

620 N. JEFFERSON  
ST. JAMES, MISSOURI

PROJECT # U1503-01  
SITE # 6801  
ASSET # 8136801002  
FEDERAL# 29-044

REVISION: \_\_\_\_\_  
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DATE: \_\_\_\_\_  
REVISION: \_\_\_\_\_  
DATE: \_\_\_\_\_  
ISSUE DATE: 8-1-24

CAD DWG FILE: A-112.DWG  
DRAWN BY: ZAC/MAH  
CHECKED BY: MAH/CAS  
DESIGNED BY: MAH/CAS

SHEET TITLE:  
**FLOOR PLAN**

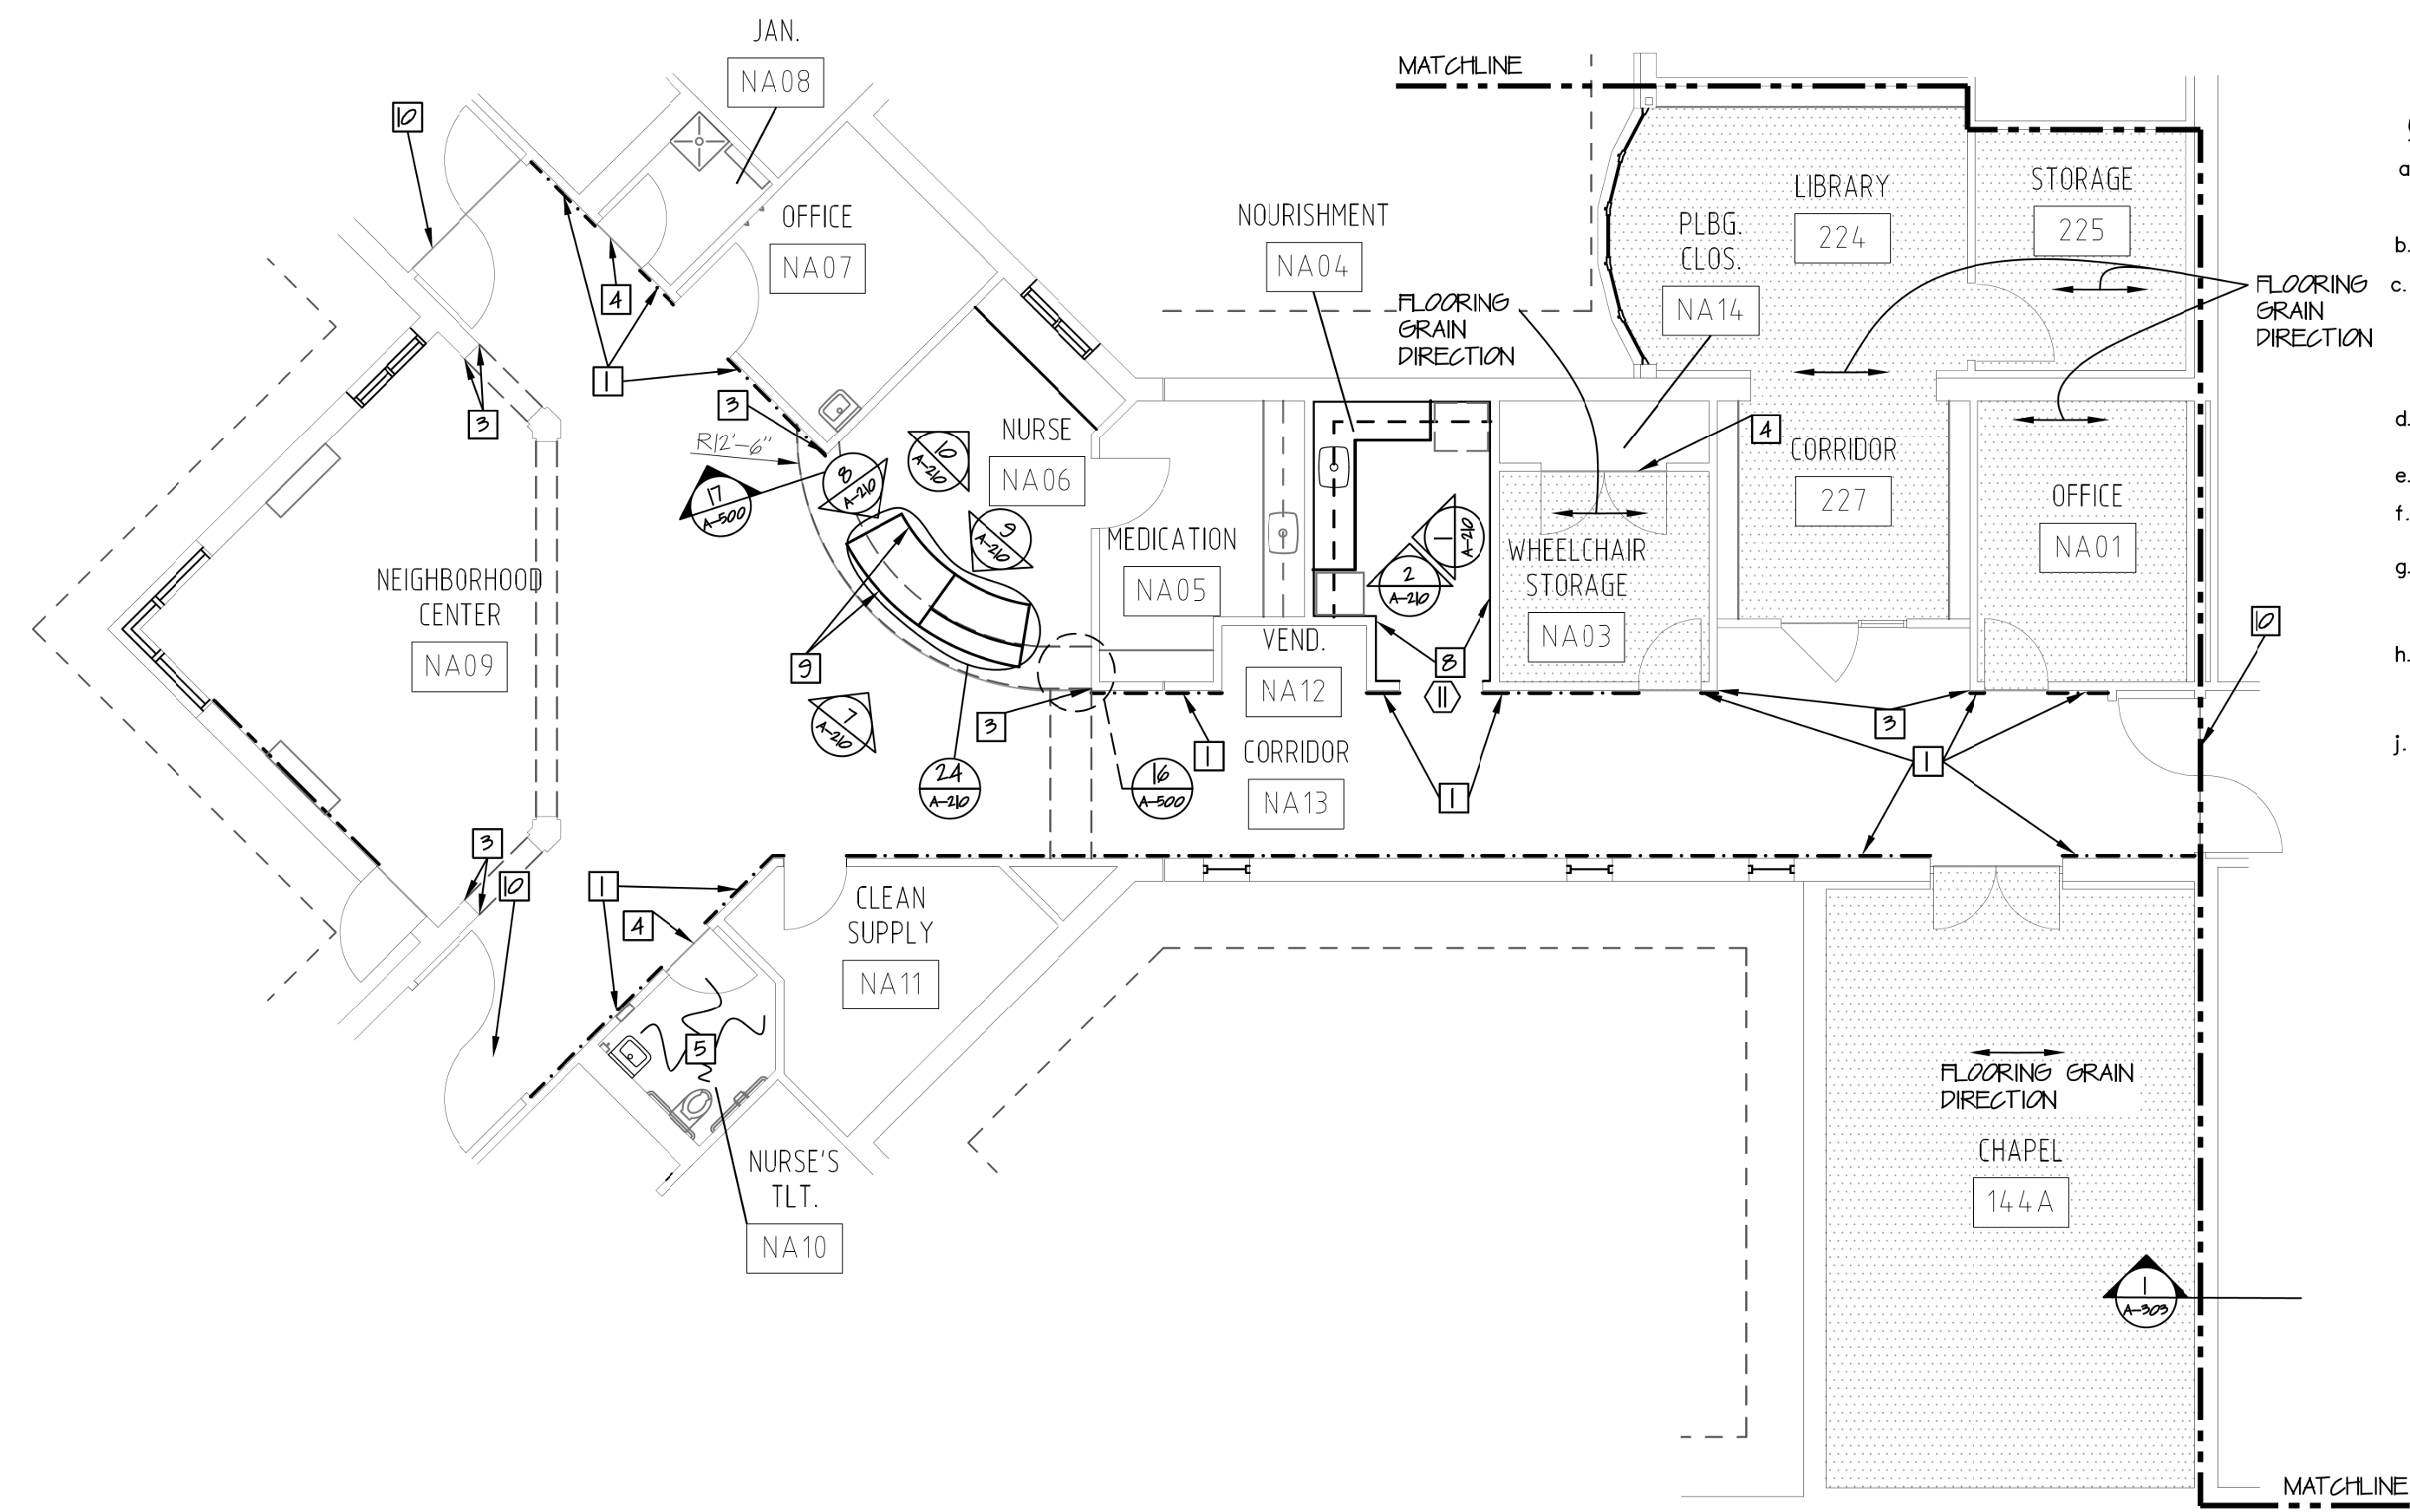
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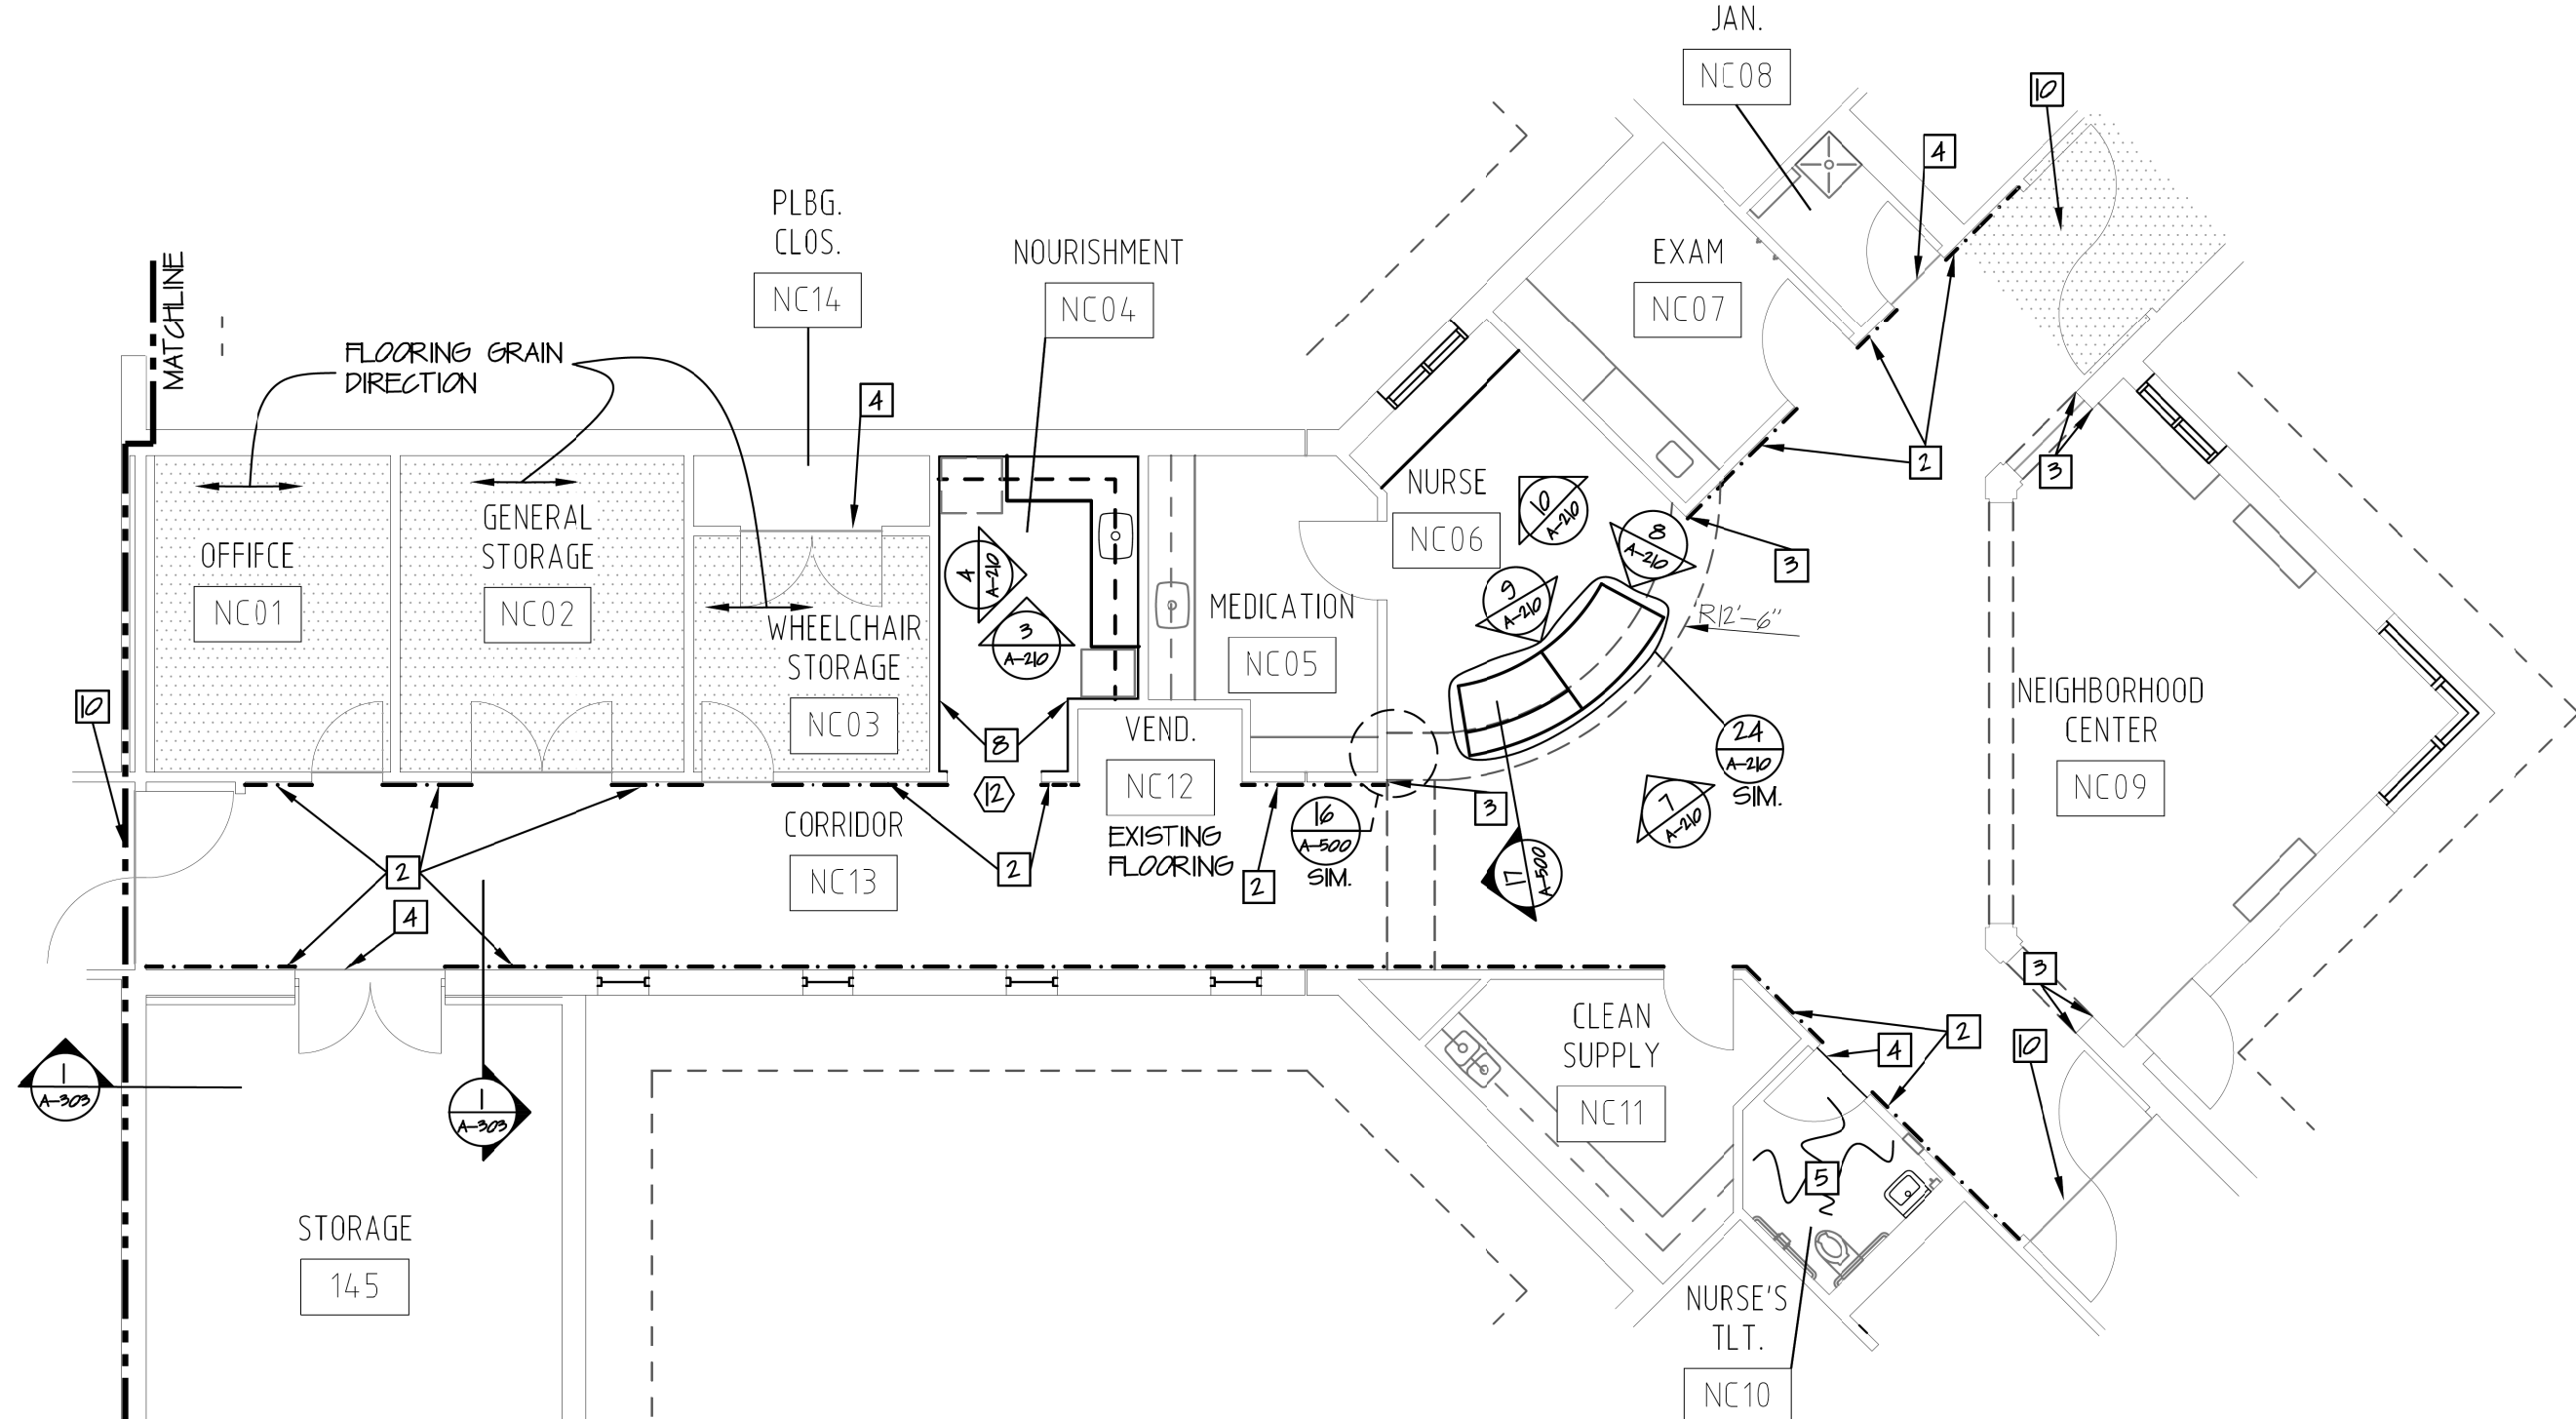
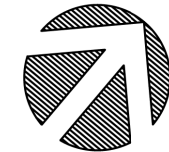
19 OF 120 SHEETS  
8-1-24

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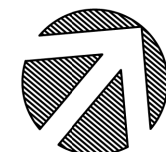




NURSING CORE A  
1/8" = 1'-0"



NURSING CORE C  
1/8" = 1'-0"





#### GENERAL NOTES SHEET (A-113 ONLY)

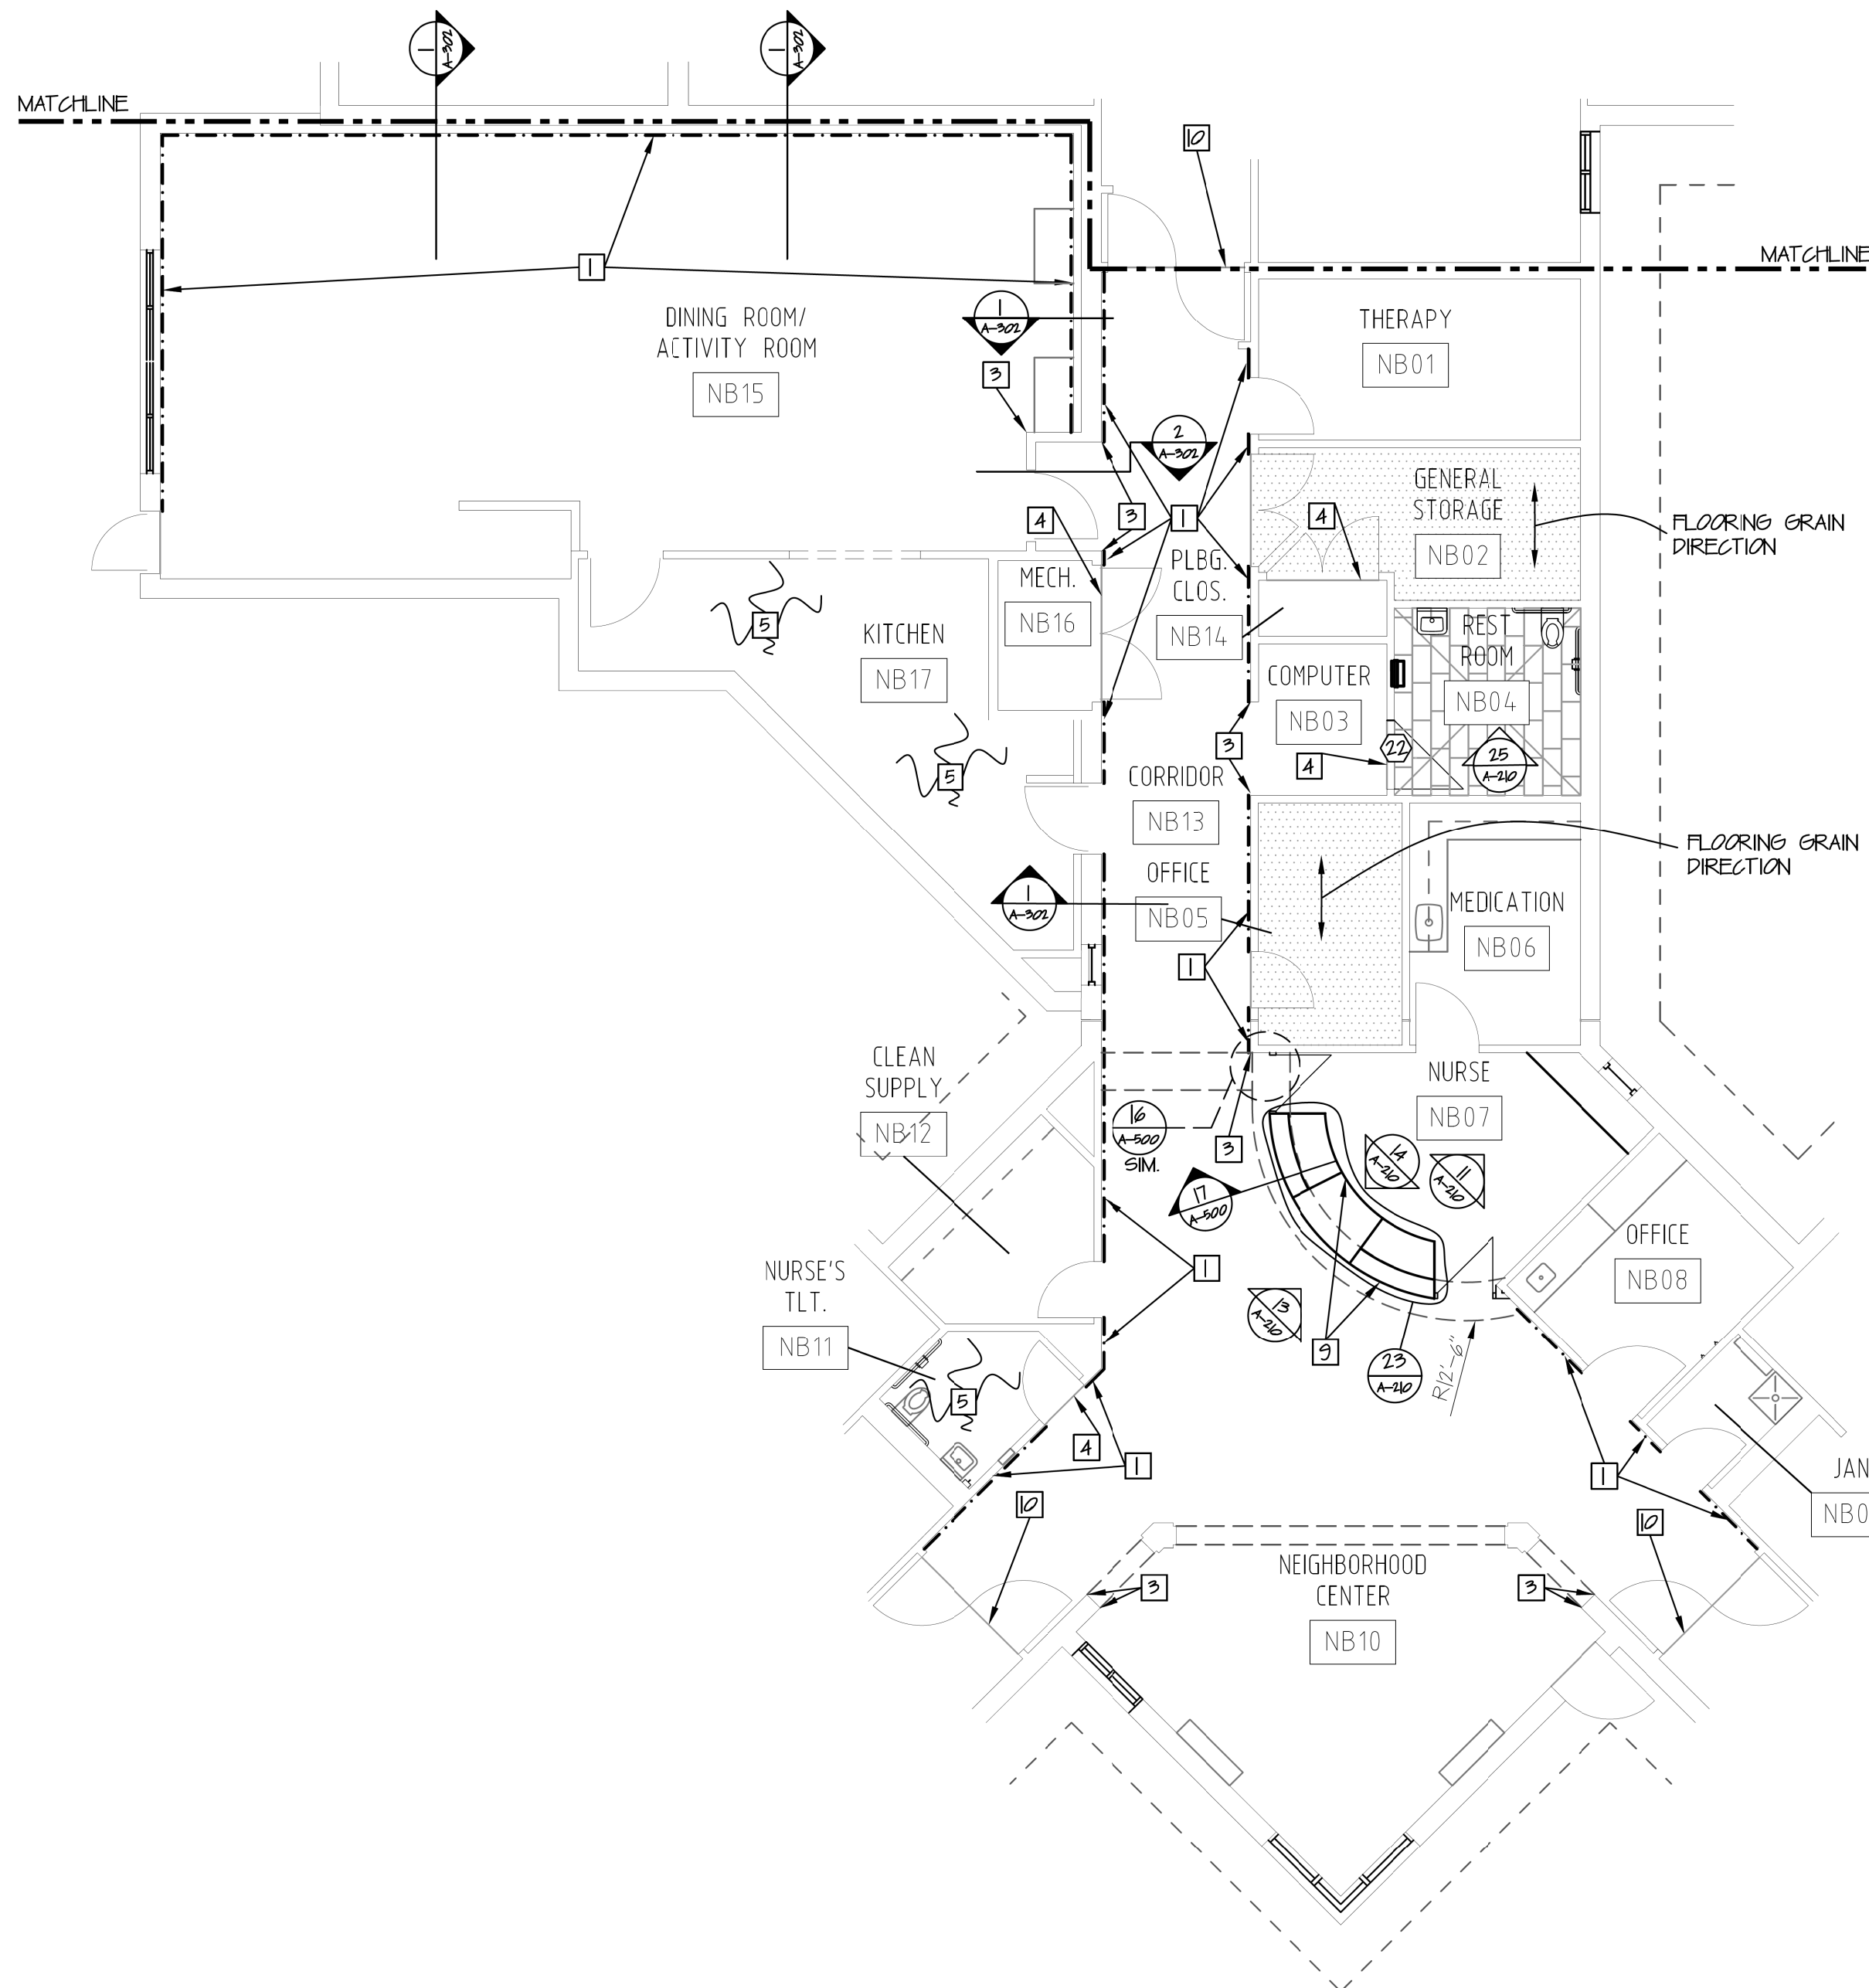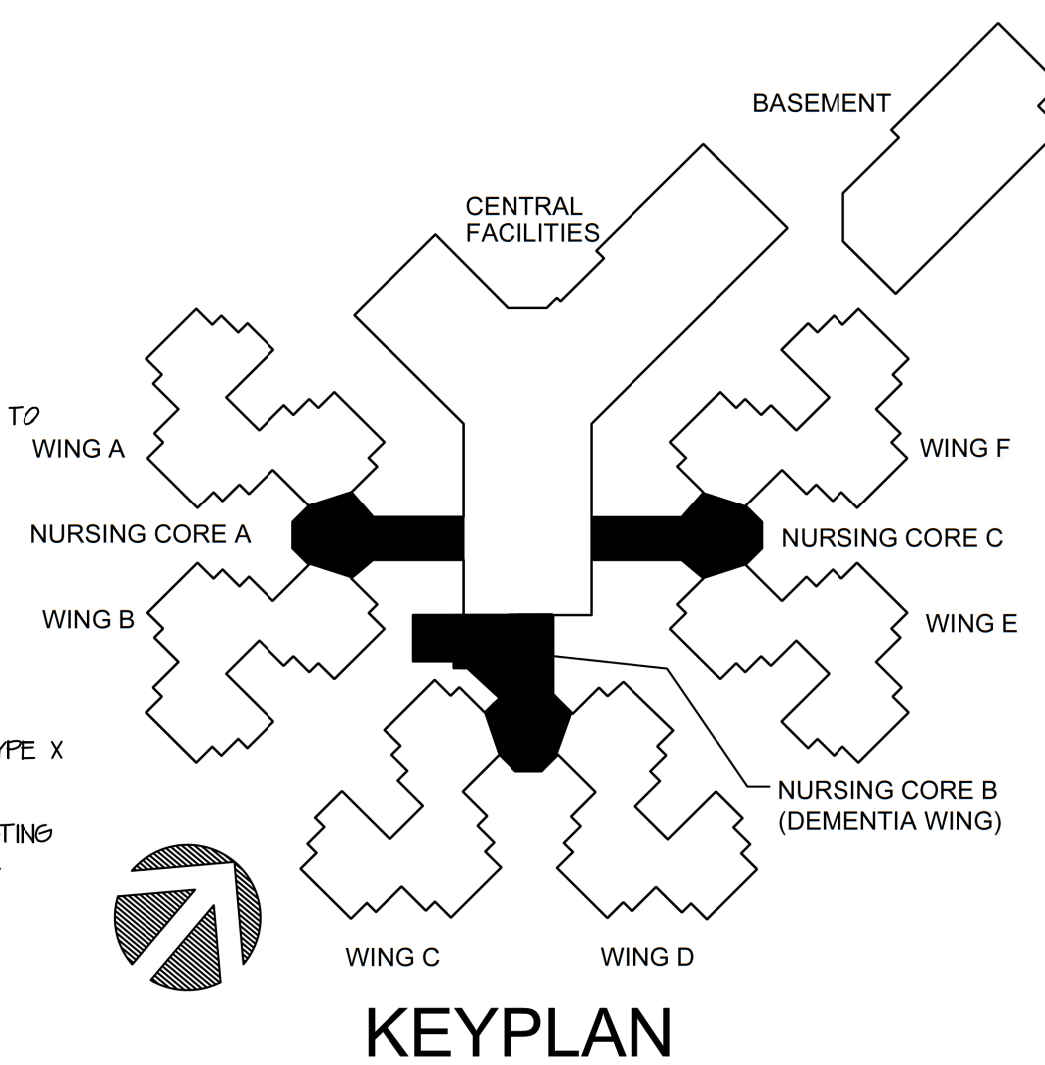
- PROVIDE AND INSTALL TRANSITION STRIP BETWEEN FLOOR MATERIALS REFER TO SHEET A-500 FOR ALL TRANSITION DETAILS
- CONTRACTOR TO FIELD VERIFY ALL DIMENSIONS
- CONTRACTOR TO PAINT ALL EXISTING INTERIOR HOLLOW METAL WINDOW FRAMES IPS-22, AND STAIN ALL NEW INTERIOR WOOD WINDOW FRAMES IPS-27, AT ALL AREAS WHERE WORK IS SHOWN. COLOR BY ARCHITECT AND TO MATCH EXISTING. REFER TO FINISH SCHEDULE.
- CONTRACTOR TO PATCH AND REPAIR ALL CONSTRUCTION TO REMAIN, AFFECTED BY DEMOLITION
- REFER TO FINISH SCHEDULE FOR ALL FINISHES.
- REFER TO DOOR SCHEDULE FOR ALL NEW DOORS AND FRAMES
- PROVIDE AND INSTALL NEW SOUND ATTENUATION BATT INSULATION IN ALL NEW INTERIOR WALLS UNLESS OTHERWISE NOTED. SEE SPEC.
- CONTRACTOR TO PROTECT ALL EXISTING MILLWORK AND EQUIPMENT SHOWN TO REMAIN.
- FLOOR HATCH SHOWN AS ( ) TO BE NEW LUXURY VINYL TILE (LVT) FLOORING BY ARMSTRONGS, COLOR NADA55 WEATHERED ARBOR FAWN GRAY TO RUN IN THE DIRECTION SHOWN ON PLANS WITH ARROW ( ) REFER TO FINISH SCHEDULE FOR MORE INFORMATION.

#### FLOOR PLAN KEY NOTES

- EXISTING WOOD HANDRAIL AT LOCATION INDICATED BY (---) PROTECT AS REQUIRED.
- PROVIDE AND INSTALL NEW HANDRAIL (HRI), ACCENT STRIP AND BUMPER GUARD OVER EXISTING ALUMINUM RETAINER EQUAL TO PAWLING, PR-500 WHERE INDICATED BY LINE TYPE (-----). COLOR OF HANDRAIL, ACCENT STRIP AND BUMPER GUARD TO BE PAWLING #648 MONTEREY.
- PROVIDE AND INSTALL NEW SIX FOOT TALL VINYL CORNER GUARD (CG) EQUAL TO PAWLING, CG-12 WITH ALUMINUM RETAINER. COLOR TO BE EQUAL TO PAWLING #648 MONTEREY. REFER TO DETAIL D SHEET A301.
- TRANSITION STRIP. REFER TO SHEET A-500 FOR TYPE.
- CONTRACTOR SHALL STEAM CLEAN EXISTING FLOOR, WALL TILE AND GROUT AT INDICATED ROOM.
- THROUGH
- NOT USED
- PROVIDE AND INSTALL 4'-0" TALL RIGID PVC SHEETS (WPI) OVER NEW 5/8" TYPE X GYPSUM BOARD. PAINT ABOVE PVC SHEET. SEE FINISH SCHEDULE.
- PATCH AND REPAIR EXISTING FLOOR AS REQUIRED DUE TO DEMOLITION OF EXISTING MILLWORK AND INSTALLATION OF NEW MILLWORK. REFER TO SHEET A-103 FOR ADDITIONAL INFORMATION.
- CHANGE IN DIRECTION OF GRAIN OF FLOORING AND DIRECTION RUN.



NURSING CORE B  
1/8" = 1'-0"

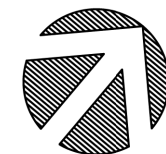

BID DOCUMENTS

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MIKE KEHOE,  
GOVERNOR



2/19/25

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CERTIFICATE OF AUTHORITY #00718

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CAD DWG FILE: A-113.DWG  
DRAWN BY: ZAC/MAH  
CHECKED BY: MAH/CAS  
DESIGNED BY: MAH/CAS

SHEET TITLE:  
FLOOR PLANS

SHEET NUMBER:

A-113

20 OF 120 SHEETS  
8-1-24



**DEPARTMENT OF  
PUBLIC SAFETY  
MISSOURI VETERANS  
COMMISSION**


620 N. JEFFERSON  
ST. JAMES, MISSOURI

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REVISION: \_\_\_\_\_  
DATE: \_\_\_\_\_  
ISSUE DATE: 8-1-24

SHEET TITLE:

## SHEET NUMBER:

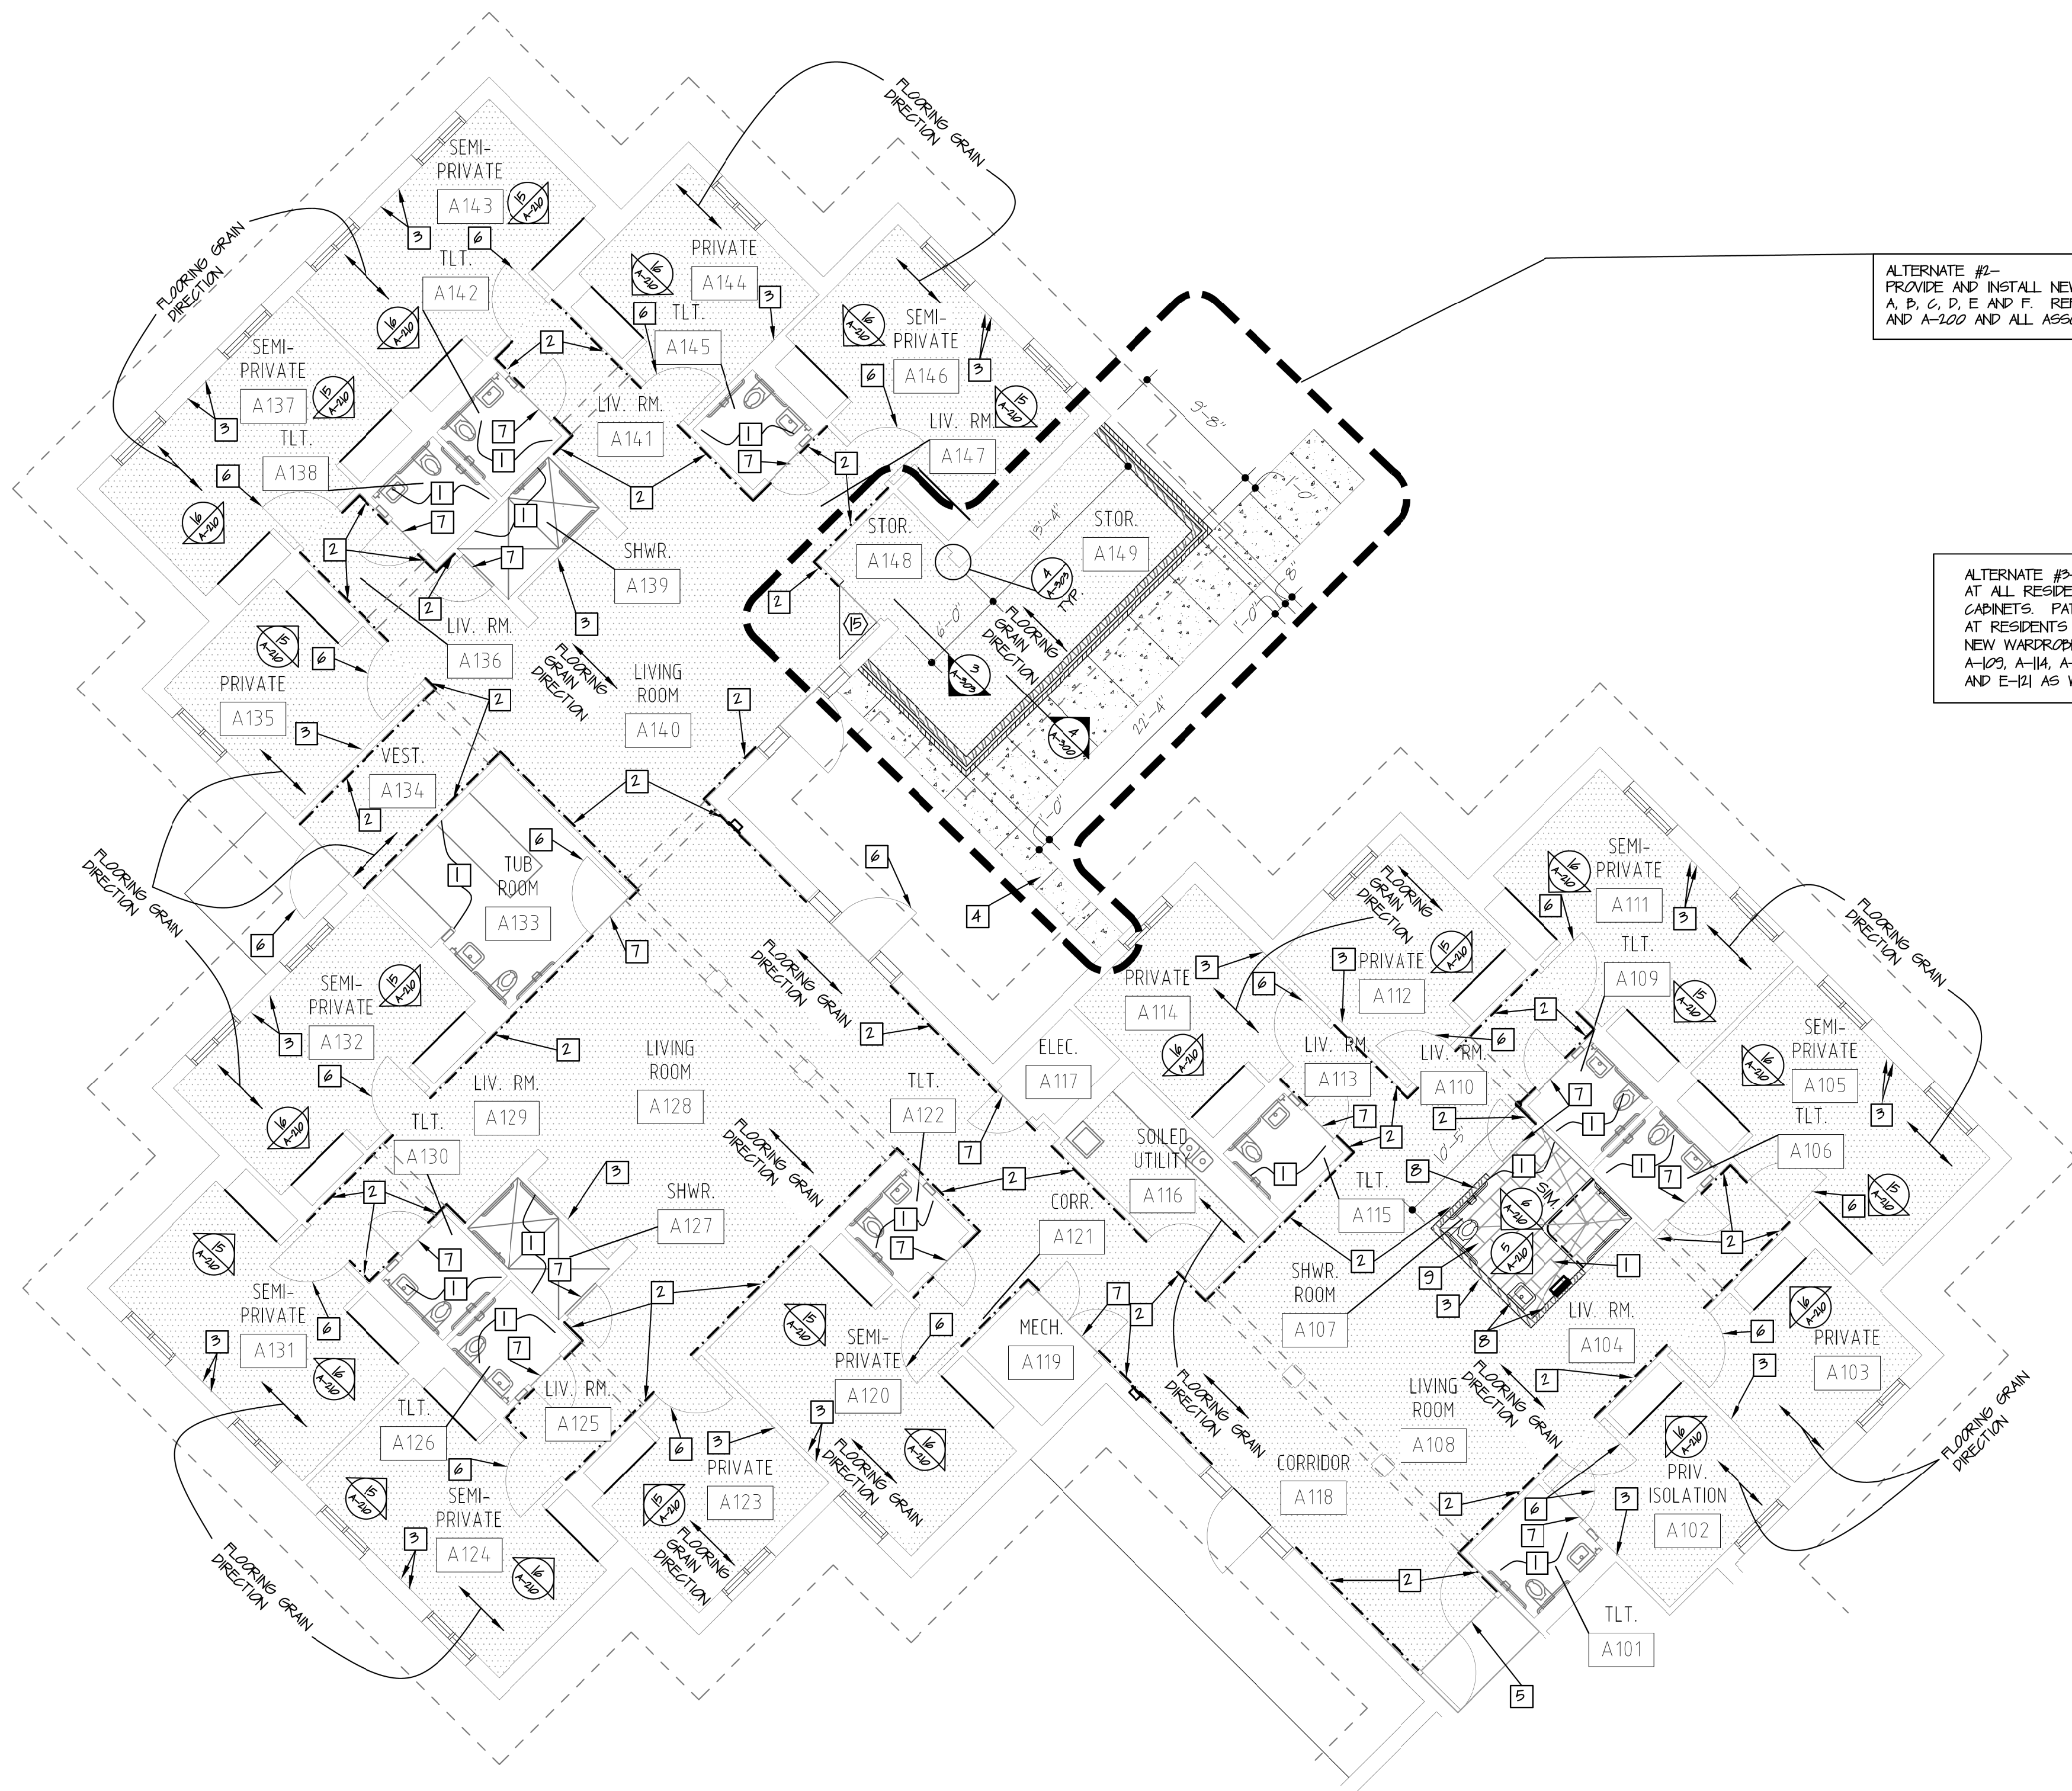A-114



ALTERNATE #3-  
AT ALL RESIDENT ROOMS, REMOVE AND DISCARD EXISTING WARDROBE AND  
CABINETS. PATCH AND REPAIR WALL AS REQUIRED TO RECEIVE NEW MILLWORK  
AT RESIDENTS ROOMS AT WINGS A, B, C, D, E AND F. PROVIDE AND INSTALL  
NEW WARDROBE AND CABINETS PER SHEETS A-104, A-105, A-106, A-107, A-108,  
A-109, A-114, A-115, A-116, A-117, A-118, A-119, A-210, E-116, E-117, E-118, E-119, E-120  
AND E-121 AS WELL AS ALL ASSOCIATED DETAILS.

1. CONTRACTOR TO PATCH AS REQUIRED, CLEAN AND PAINT ALL EXISTING HOLLOW METAL DOOR FRAMES IPS-20. REFER TO FINISH SCHEDULE WHERE THEY EXIST, REMOVE ALL VINYL FRAME PROTECTION BEFORE PAINTING.

- 3 CONTRACTOR SHALL STEAM CLEAN EXISTING FLOOR, WALL TILE AND GROUT AT INDICATED RESTROOM/SHOWERS.
- 4 EXISTING HANDRAIL AND/OR CHAIR RAIL AT LOCATION INDICATED BY (---) PROTECT AS REQUIRED. WHERE IT IS CUT - FINISH END TO RETURN 45° BACK TO WALL AFTER CUTTING BACK TO CORNER GUARD. STAIN TO MATCH EXISTING.
- 5 PROVIDE AND INSTALL 2X BLOCKING IN WALL FOR WALL MOUNTED TV. PATCH AND REPAIR WALL TO MATCH EXISTING ADJACENT CONSTRUCTION. SEE MEP FOR ADDITIONAL REQUIREMENTS. REFER TO ELEVATION 26 OF A-112.
- 6 PROVIDE AND INSTALL NEW 5" THICK CONCRETE PAVING WITH 6x6-W/4 X W/4 WYM OVER 4" CRUSHED GRAVEL. CONNECT TO EXISTING CONCRETE PAVING BY DRILLING 6" DEEP HOLES @ 36" OC. IN EDGE OF EXISTING CONCRETE AND EPOXY 12" LONG #4 REBAR INTO HOLES TO BE EMBEDDED INTO EDGE OF NEW CONCRETE PAVING. SEE SPEC AND STRUCTURAL.
- 7 CHANGE IN DIRECTION OF GRAIN OF FLOORING AND DIRECTION RUN.
- 8 ALTERNATE #1: AT RESIDENTIAL ROOMS ONLY, PROVIDE AND INSTALL ADJUSTABLE GASKETING AROUND EXISTING FRAME EQUAL TO ZERO B70AA AND ZERO 361AA ALONG BOTTOM OF DOOR. FIELD VERIFY LENGTH.
- 9 TRANSITION STRIP. REFER TO SHEET A-500 FOR TYPE.
- 10 PROVIDE AND INSTALL NEW WALL CONSISTING OF 2x4 WOOD STUDS @ 16" OC. WITH 5/8" TYPE "X" GYPSUM BOARD ON OUTSIDE FACE AND 5/8" GLASS-MAT, WATER-RESISTANT BACKING BOARD ON INSIDE FACE. FIELD VERIFY TO MATCH EXISTING ADJACENT WALL THICKNESS. MATCH THICKNESS OF EXISTING ADJACENT WALL AROUND ENTIRE PERIMETER OF OUTSIDE SURFACE OF THIS ROOM. PAINT WITH COLOR AS INDICATED IN NEW FINISH "P3" AND INSTALL NEW "VPS" BASE. PER FINISH SCHEDULE. SEE FINISH SCHEDULE FOR FINISHES ON INSIDE FACE OF WALL.
- 11 PROVIDE AND INSTALL NEW REINFORCED CONCRETE SLAB OVER 10 ML VAPOR BARRIER OVER EXISTING SUBGRADE. SLOPE AS NOTED ON FLOOR PLAN TO ALLOW FOR POSITIVE DRAINAGE TO THE FLOOR/SHOWER DRAIN. REFER TO MEP PLANS FOR ADDITIONAL INFORMATION. REFER TO FINISH SCHEDULE FOR FLOOR FINISH.

ALTERNATE #1: ALL WORK ASSOCIATED WITH INFECTIOUS CONTROL WING A FOR REVERSED MECHANICAL AND ELECTRICAL WORK ASSOCIATED WITH THE REQUIREMENTS TO ACHIEVE THE INFECTIONS CONTROL AREAS DEFINED ON THE MECHANICAL PLANS. REFER TO SECTS A-104, A-114, A-121, A-202, A-301, N-102, N-201, N-301, N-302, N-303, N-964, N-965

INFECTIOUS CONTROL ALTERNATE #1  
WING A FLOOR PLAN



## BID DOCUMENTS





**DEPARTMENT OF  
PUBLIC SAFETY  
MISSOURI VETERANS  
COMMISSION**

620 N. JEFFERSON  
ST. JAMES, MISSOURI

PROJECT # U1503-01  
SITE # 6801  
ASSET # 8136801002  
FEDERAL# 29-044

REVISION: \_\_\_\_\_  
DATE: \_\_\_\_\_  
REVISION: \_\_\_\_\_  
DATE: \_\_\_\_\_  
REVISION: \_\_\_\_\_  
DATE: \_\_\_\_\_

ISSUE DATE:8-1-24

CAD DWG FILE: A-115.DWG  
DRAWN BY: ZAC/MAH  
CHECKED BY: MAH/CAS  
DESIGNED BY: MAH/CAS

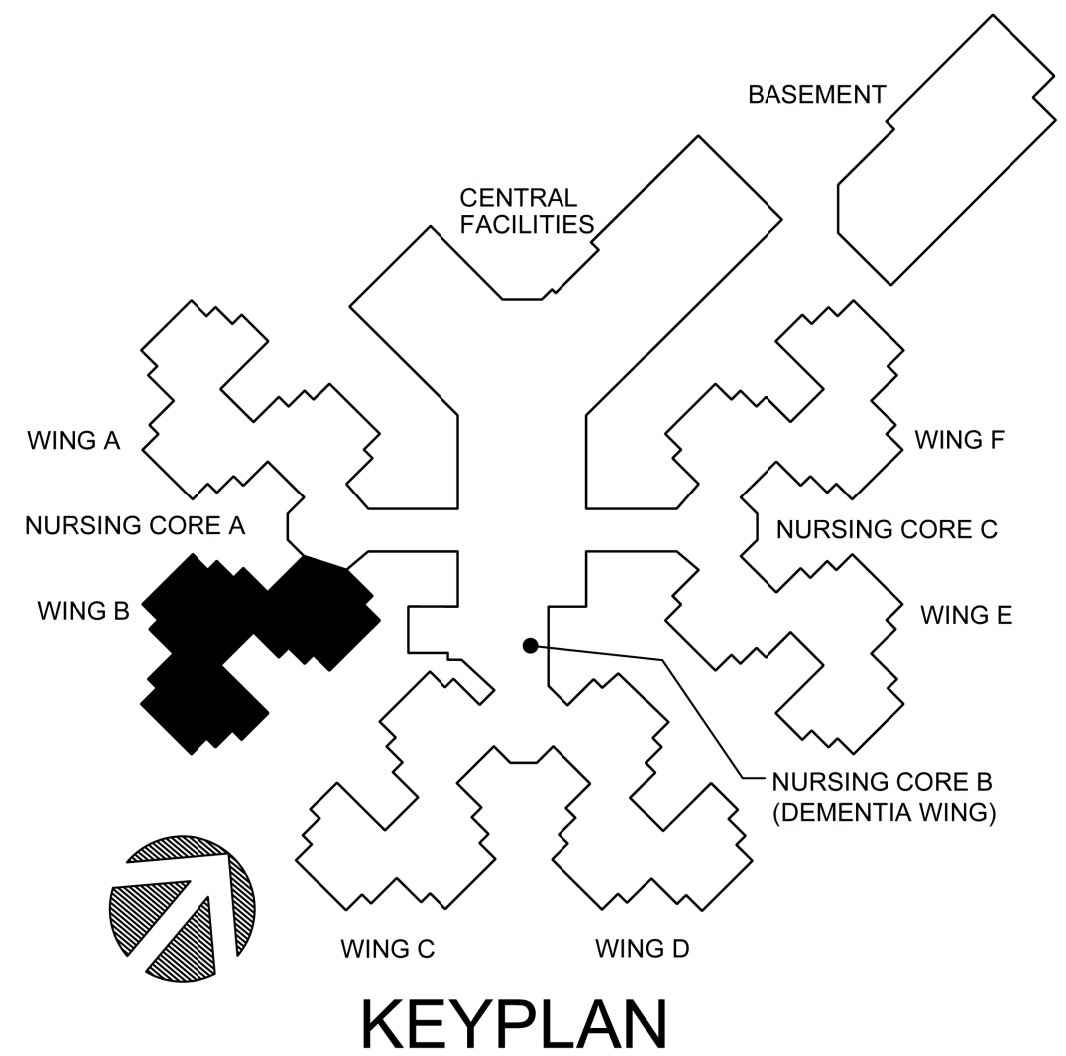
SHEET TITLE:  
FLOOR PLAN

SHEET NUMBER:

A-115

22 OF 120 SHEETS  
8-1-24

## BID DOCUMENTS



- a. PROVIDE AND INSTALL TRANSITION STRIP BETWEEN FLOOR MATERIALS REFER TO SHEET A-500 FOR ALL TRANSITION STRIP DETAILS
- b. CONTRACTOR TO FIELD VERIFY ALL DIMENSIONS
- c. CONTRACTOR TO PATCH AS REQUIRED; CLEAN AND PAINT ALL EXISTING INTERIOR DOOR FRAMES PS-50
- d. REFER TO FINISH SCHEDULE WHERE THEY EXIST, REMOVE ALL VINYL FLOOR PROTECTION BEFORE PAINTING.
- e. CONTRACTOR TO PATCH AND REPAIR ALL CONSTRUCTION TO REMAIN, AFFECTED BY DEMOLITION
- f. REFER TO FINISH SCHEDULE FOR ALL FINISHES.
- g. REFER TO DOOR SCHEDULE FOR ALL NEW DOORS AND FRAMES

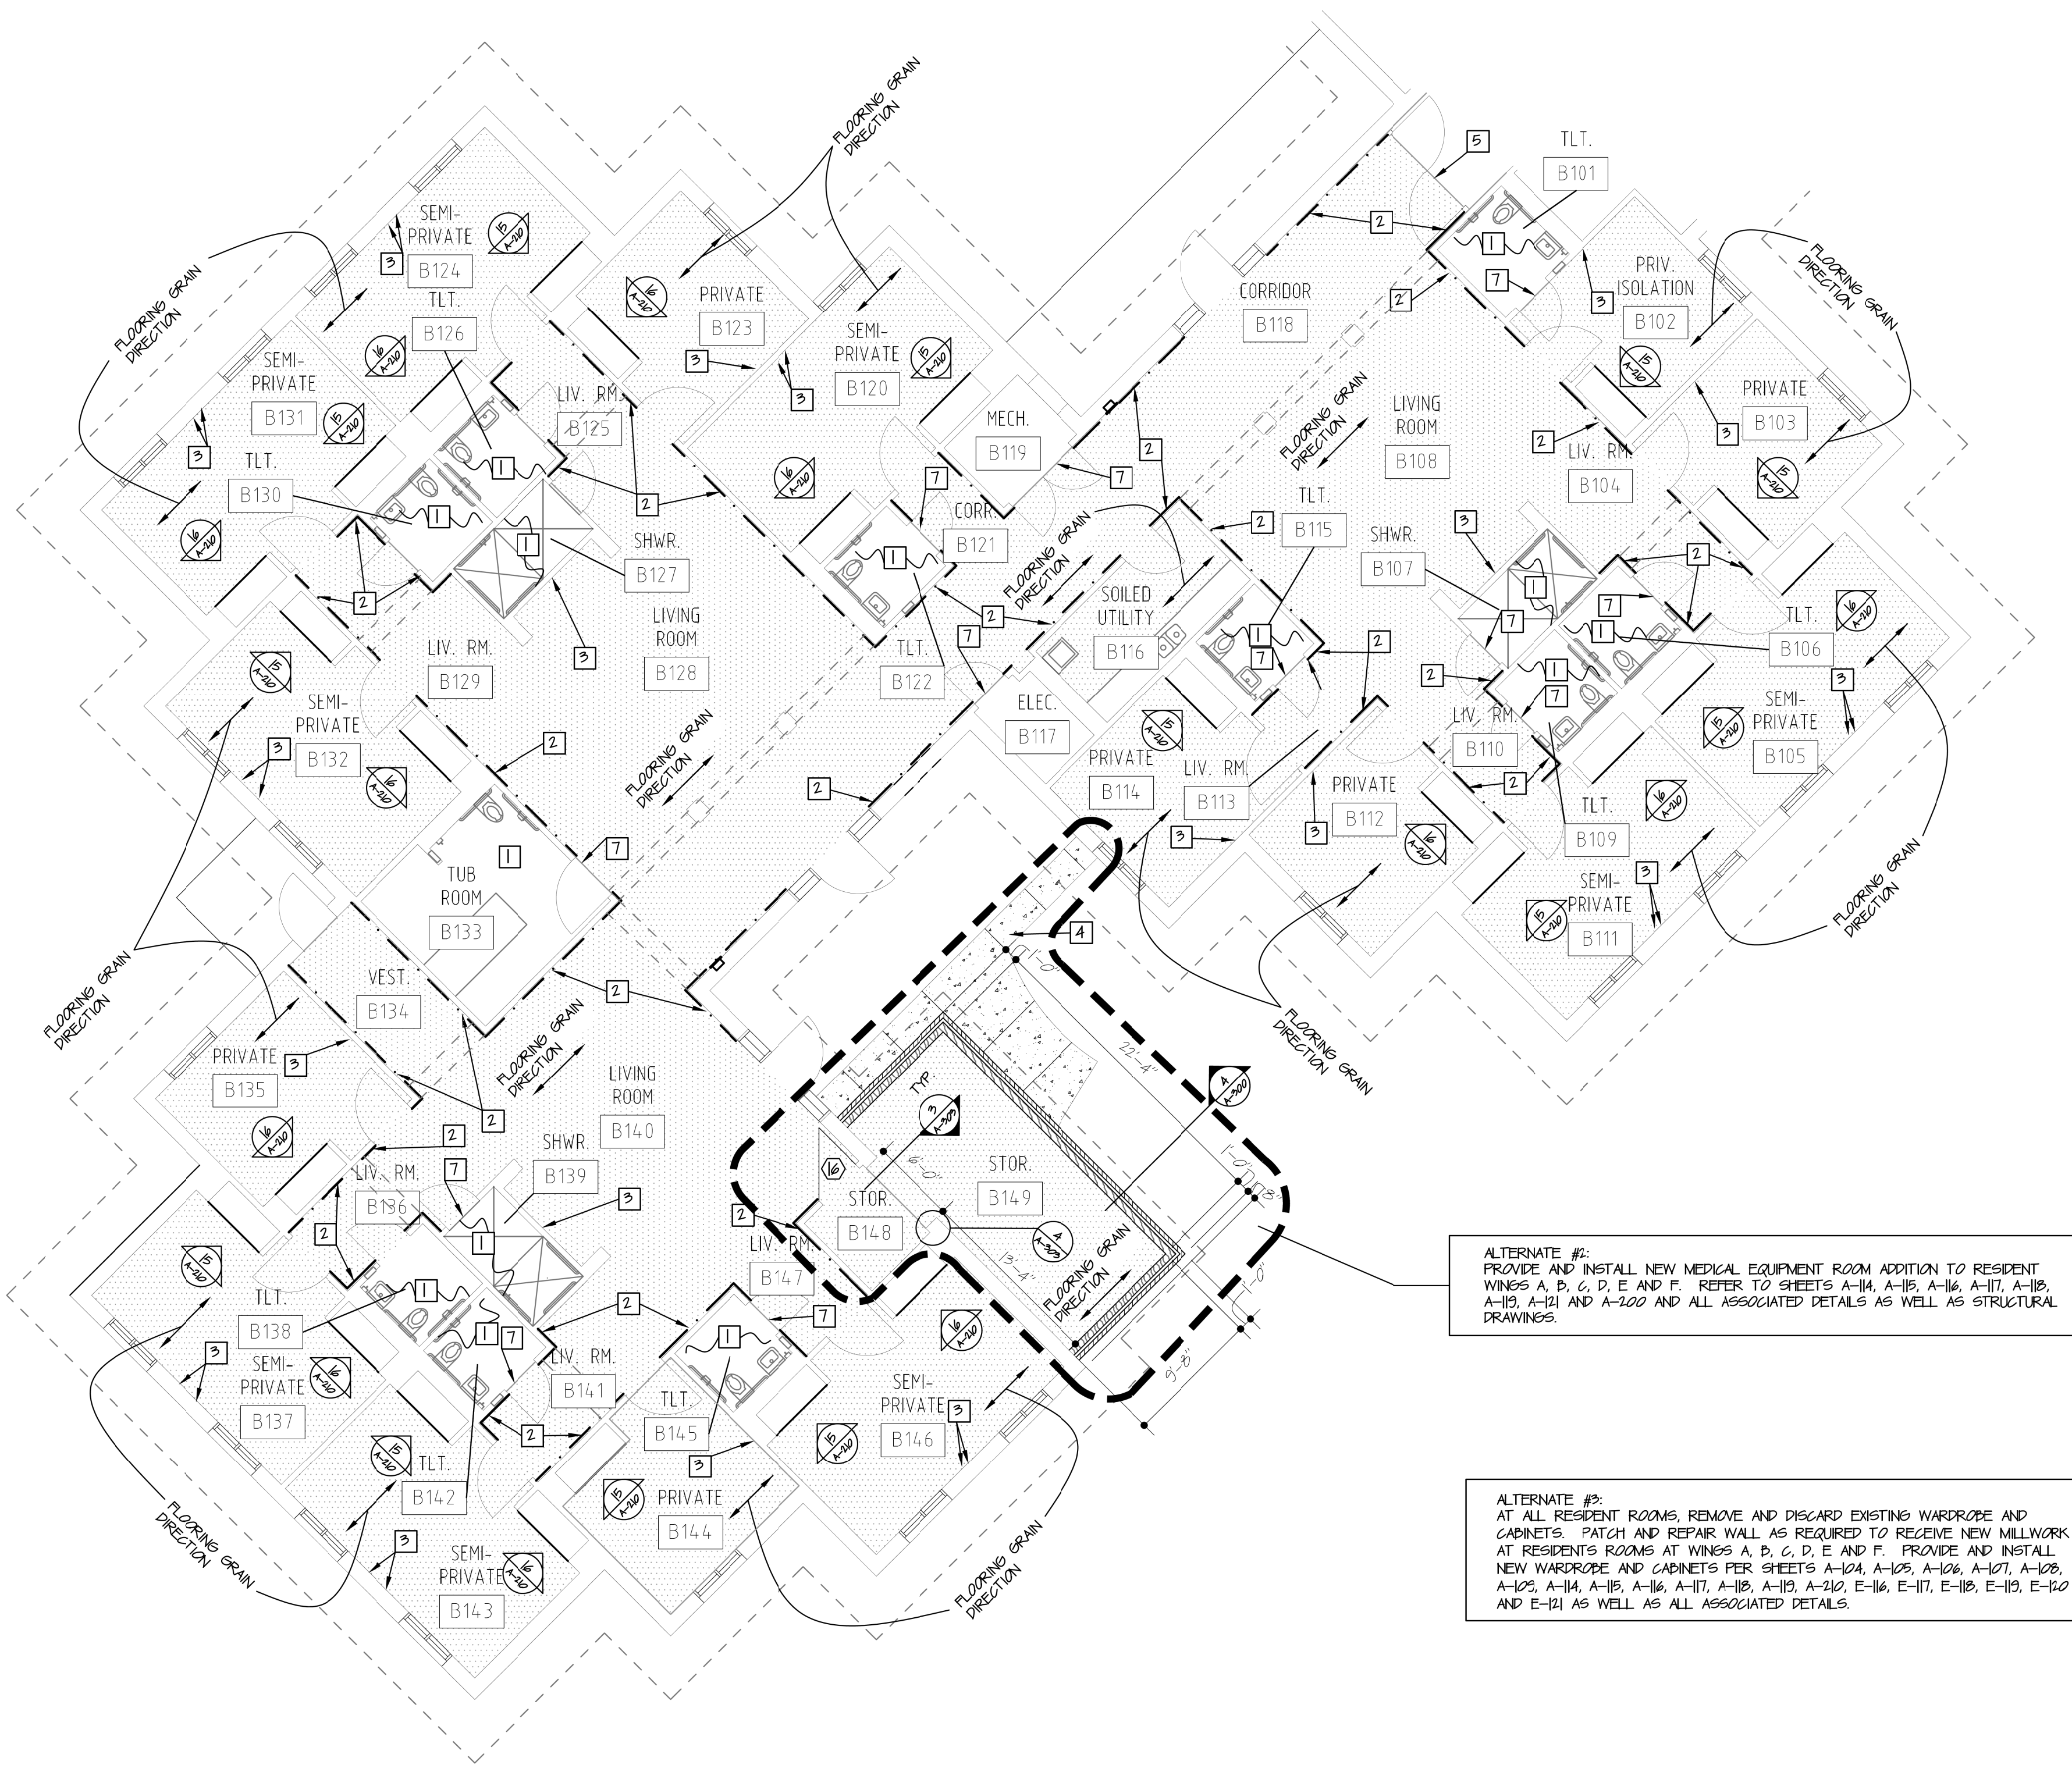
9. PROVIDE AND INSTALL NEW SOUND ATTENUATION DATT INSULATION IN ALL NEW INTERIOR WALLS UNLESS OTHERWISE NOTED SEE SPEC.

10. CONTRACTOR TO PROTECT ALL EXISTING MILLWORK AND EQUIPMENT SHOWN TO REMAIN FOR BASE BID.

11. CONTRACTOR TO PAINT ALL EXISTING INTERIOR MALLION METAL WINDOW FRAMES PS-20, AND STAIN ALL NEW INTERIOR WOOD WINDOW FRAMES PS-21, AT ALL AREAS WHERE WORK IS SHOWN. COLOR BY ARCHITECT AND TO MATCH EXISTING. REFER TO FINISH SCHEDULE

12. FLOOR PATCH SHOWN AS ( ) TO BE NEW LUXURY VINYL TILE (LVT) FLOORING BY ARMSTRONG, COLOR N4236 WEATHERED BORDO. PAINT GRANT TO RUN IN THE DIRECTION SHOWN ON PLANS WITH WORK AREA ( ). REFER TO FINISH SCHEDULE FOR MORE INFORMATION.

- 1 CONTRACTOR SHALL STEAM CLEAN EXISTING FLOOR, WALL TILE AND GROUT AT INDICATED RESTROOM/SHOWERS.
- 2 EXISTING HANDRAIL AND/OR CHAIR RAIL AT LOCATION INDICATED BY (---) PROTECT AS REQUIRED. WHERE IT IS CUT - FINISH END TO RETURN 45° BACK TO WALL AFTER CUTTING BACK TO CORNER GUARD. STAIN TO MATCH EXISTING.
- 3 PROVIDE AND INSTALL 2X BLOCKING IN WALL FOR WALL MOUNTED TV. PATCH AND REPAIR WALL TO MATCH EXISTING ADJACENT CONSTRUCTION. SEE MEP FOR ADDITIONAL REQUIREMENTS. REFER TO ELEVATION 26 OF A-212.
- 4 PROVIDE AND INSTALL NEW 5" THICK CONCRETE PAVING WITH 6x6-W4 X W4 WYM OVER 4" CRUSHED GRAVEL. CONNECT TO EXISTING CONCRETE PAVING BY DRILLING 6" DEEP HOLES @ 36" O.C. IN EDGE OF EXISTING CONCRETE AND EPOXY 12" LONG #4 REBAR INTO HOLES TO BE EMBEDDED INTO EDGE OF NEW CONCRETE PAVING. SEE SPEC AND STRUCTURAL.
- 5 CHANGE IN DIRECTION OF GRAIN OF FLOORING AND DIRECTION RUN.
- 6 NOTE NOT USED.
- 7 TRANSITION STRIP. REFER TO SHEET A-500 FOR TYPE.
- 8 PROVIDE AND INSTALL NEW WALL CONSISTING OF 2x4 WOOD STUDS @ 16" O.C. WITH 5/8" TYPE "X" GYPSUM BOARD ON OUTSIDE FACE AND 5/8" GLASS-MAT, WATER-RESISTANT BACKING BOARD ON INSIDE FACE (FIELD VERIFY TO MATCH EXISTING ADJACENT WALL THICKNESS). MATCH HEIGHT OF EXISTING ADJACENT WALL AROUND ENTIRE PERIMETER OF OUTSIDE SURFACE OF THIS ROOM. PAINT WITH COLOR AS INDICATED IN NEW FINISH "PS" AND INSTALL NEW "VBS" BASE, PER FINISH SCHEDULE. SEE FINISH SCHEDULE FOR FINISHES ON INSIDE FACE OF WALL.



ALTERNATE #2:  
 PROVIDE AND INSTALL NEW MEDICAL EQUIPMENT ROOM ADDITION TO RESIDENT  
 WINGS A, B, C, D, E AND F. REFER TO SHEETS A-114, A-115, A-116, A-117, A-118,  
 A-119, A-121 AND A-200 AND ALL ASSOCIATED DETAILS AS WELL AS STRUCTURAL  
 DRAWINGS.

ALTERNATE #2:  
AT ALL RESIDENT ROOMS, REMOVE AND DISCARD EXISTING WARDROBE AND CABINETS. PATCH AND REPAIR WALL AS REQUIRED TO RECEIVE NEW MILLWORK AT RESIDENTS ROOMS AT WINGS A, B, C, D, E AND F. PROVIDE AND INSTALL NEW WARDROBE AND CABINETS PER SHEETS A-104, A-105, A-106, A-107, A-108, A-109, A-114, A-115, A-116, A-117, A-118, A-119, A-210, E-116, E-117, E-118, E-119, E-210 AND E-211 AS WELL AS ALL ASSOCIATED DETAILS.

WING B FLOOR PLAN

$$1/8'' = 1'-0''$$




ALTERNATE #2:  
PROVIDE AND INSTALL NEW MEDICAL EQUIPMENT ROOM ADDITION TO RESIDENT WINGS  
A, B, C, D, E AND F. REFER TO SHEETS A-114, A-115, A-116, A-117, A-118, A-119, A-121  
AND A-122 AND ALL ASSOCIATED DETAILS AS WELL AS STRUCTURAL DRAWINGS.


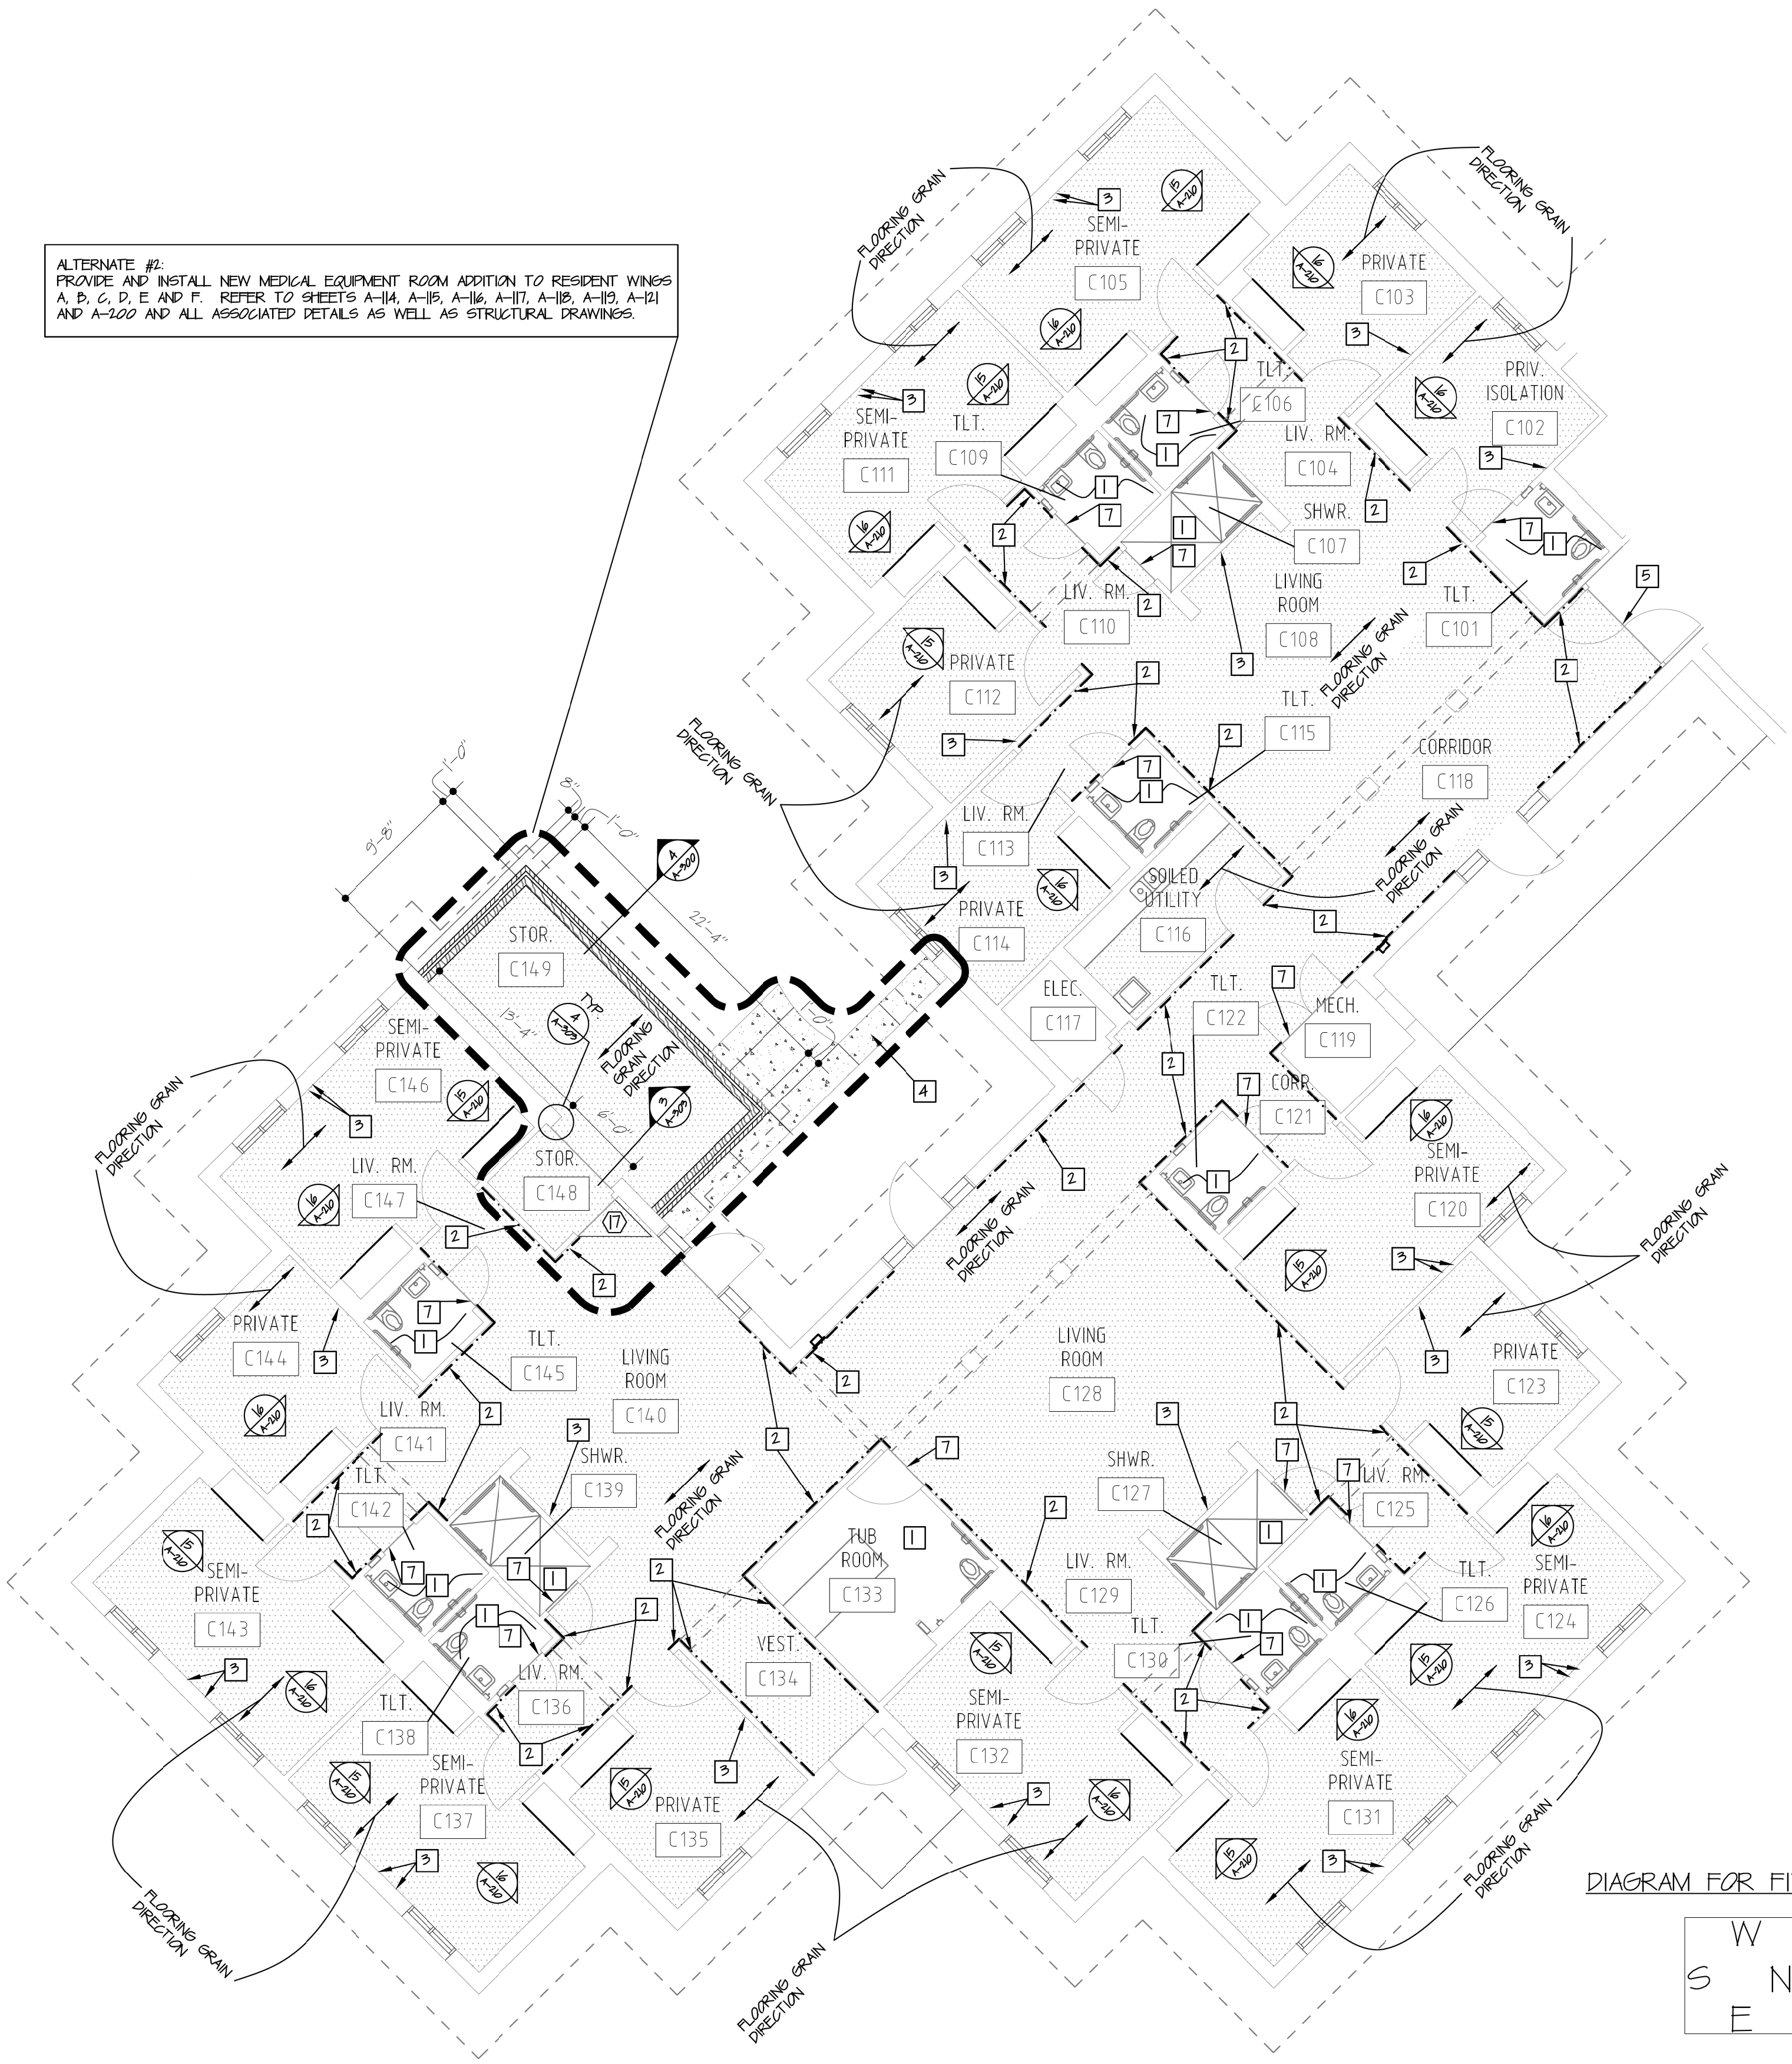


DIAGRAM FOR FINISH SCHEDULE REFERENCE:

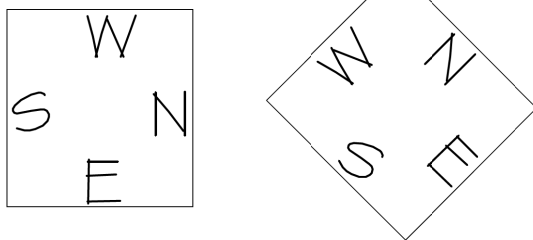


WING C FLOOR PLAN

1/8" = 1'-0"



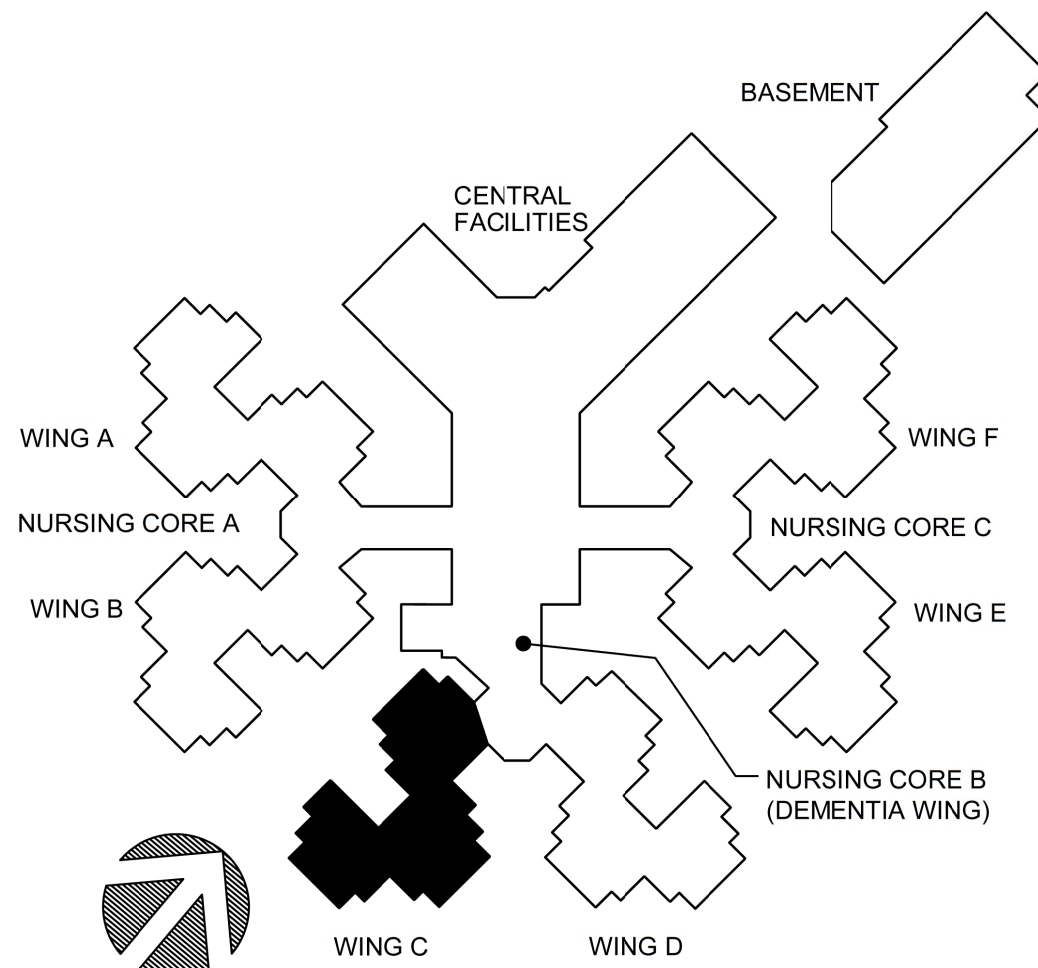ALTERNATE #3:  
AT ALL RESIDENT ROOMS, REMOVE AND DISCARD EXISTING WARDROBE AND  
CABINETS. PATCH AND REPAIR WALL AS REQUIRED TO RECEIVE NEW MILLWORK  
AT RESIDENTS ROOMS AT WINGS A, B, C, D, E AND F. PROVIDE AND INSTALL  
NEW WARDROBE AND CABINETS PER SHEETS A-104, A-105, A-106, A-107, A-108,  
A-109, A-114, A-115, A-116, A-117, A-118, A-119, A-120, E-116, E-117, E-118, E-119, E-120  
AND E-121 AS WELL AS ALL ASSOCIATED DETAILS.



KEYPLAN

GENERAL NOTES SHEET (A-116 ONLY)

- PROVIDE AND INSTALL TRANSITION STRIP BETWEEN FLOOR MATERIALS. REFER TO SHEET A-500 FOR ALL TRANSITION STRIP DETAILS.
- CONTRACTOR TO FIELD VERIFY ALL DIMENSIONS.
- CONTRACTOR TO PATCH AS REQUIRED, CLEAN AND PAINT ALL EXISTING HOLLOW METAL DOOR FRAMES IPS-10. REFER TO FINISH SCHEDULE WHERE THEY EXIST, REMOVE ALL VINYL FRAME PROTECTION BEFORE PAINTING.
- CONTRACTOR TO PATCH AND REPAIR ALL CONSTRUCTION TO REMAIN, AFFECTED BY DEMOLITION.
- REFER TO FINISH SCHEDULE FOR ALL FINISHES.
- REFER TO DOOR SCHEDULE FOR ALL NEW DOORS AND FRAMES.
- PROVIDE AND INSTALL NEW SOUND ATTENUATION BATT INSULATION IN ALL NEW INTERIOR WALLS UNLESS OTHERWISE NOTED. SEE SPEC.
- CONTRACTOR TO PROTECT ALL EXISTING MILLWORK AND EQUIPMENT SHOWN TO REMAIN FOR BASE BID.
- CONTRACTOR TO PAINT ALL EXISTING INTERIOR HOLLOW METAL WINDOW FRAMES IPS-20, AND STAIN ALL NEW INTERIOR WOOD WINDOW FRAMES IPS-27, AT ALL AREAS WHERE WORK IS SHOWN. COLOR BY ARCHITECT AND TO MATCH EXISTING. REFER TO FINISH SCHEDULE.
- FLOOR HATCH SHOWN AS ( ) TO BE NEW LUXURY VINYL TILE (LVT) FLOORING BY ARISTON. COLOR N43% WEATHERED ARBOR PAWN. GRAIN TO RUN IN THE DIRECTION SHOWN ON PLANS WITH ARROW ( ). REFER TO FINISH SCHEDULE FOR MORE INFORMATION.

FLOOR PLAN KEY NOTES (SHEET A-116 ONLY)

- CONTRACTOR SHALL STEAM CLEAN EXISTING FLOOR, WALL TILE AND GROUT AT INDICATED RESTROOM/SHOWERS.
- EXISTING HANDRAIL AND/OR CHAIR RAIL AT LOCATION INDICATED BY ( ). PROTECT AS REQUIRED WHERE IT IS CUT - FINISH END TO RETURN 45' BACK TO WALL AFTER CUTTING BACK TO CORNER GUARD. STAIN TO MATCH EXISTING.
- PROVIDE AND INSTALL 2X BLOCKING IN WALL FOR WALL MOUNTED TV. PATCH AND REPAIR WALL TO MATCH EXISTING ADJACENT CONSTRUCTION. SEE MEP FOR ADDITIONAL REQUIREMENTS. REFER TO ELEVATION 26 OF A-210.
- PROVIDE AND INSTALL NEW 5" THICK CONCRETE PAVING WITH 6X6-W14 X W14 WWM OVER 4" CRUSHED GRAVEL. CONNECT TO EXISTING CONCRETE PAVING BY DRILLING 6" DEEP HOLES @ 3/4" O.C. IN EDGE OF EXISTING CONCRETE AND EPOXY 12" LONG #4 REBAR INTO HOLES TO BE EMBEDDED INTO EDGE OF NEW CONCRETE PAVING. SEE SPEC AND STRUCTURAL.
- CHANGE IN DIRECTION OF GRAIN OF FLOORING AND DIRECTION RUN.
- NOTE NOT USED.
- TRANSITION STRIP. REFER TO SHEET A-500 FOR TYPE.
- PROVIDE AND INSTALL NEW WALL CONSISTING OF 2X4 WOOD STUDS @ 16" O.C. WITH 5/8" TYPE "X" GYPSUM BOARD ON OUTSIDE FACE AND 5/8" GLASS-MAT, WATER-RESISTANT BACKING BOARD ON INSIDE FACE (FIELD VERIFY TO MATCH EXISTING ADJACENT WALL THICKNESS). MATCH HEIGHT OF EXISTING ADJACENT WALL AROUND ENTIRE PERIMETER OF OUTSIDE SURFACE OF THIS ROOM. PAINT WITH COLOR AS INDICATED IN NEW FINISH "PS" AND INSTALL NEW "VBS" BASE, PER FINISH SCHEDULE. SEE FINISH SCHEDULE FOR FINISHES ON INSIDE FACE OF WALL.

STATE OF MISSOURI  
MIKE KEHOE,  
GOVERNOR



2/19/25

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CERTIFICATE OF AUTHORITY #000718

**ETERLY & SCHNEIDER ASSOCIATES, INC.**  
architects & planners  
AIA

COMM. # 4860

OFFICE OF ADMINISTRATION  
DIVISION OF FACILITIES  
MANAGEMENT,  
DESIGN AND CONSTRUCTION

DEPARTMENT OF  
PUBLIC SAFETY  
MISSOURI VETERANS  
COMMISSION

INTERIOR RENOVATION  
MISSOURI VETERANS  
HOME

620 N. JEFFERSON  
ST. JAMES, MISSOURI

PROJECT # U1503-01  
SITE # 8801  
ASSET # 8136801002  
FEDERAL# 29-044

REVISION: \_\_\_\_\_  
DATE: \_\_\_\_\_  
REVISION: \_\_\_\_\_  
DATE: \_\_\_\_\_  
REVISION: \_\_\_\_\_  
DATE: \_\_\_\_\_  
ISSUE DATE: 8-1-24

CAD DWG FILE: A-116.DWG  
DRAWN BY: ZAC/MAH  
CHECKED BY: MAH/CAS  
DESIGNED BY: MAH/CAS

SHEET TITLE:  
FLOOR PLAN

SHEET NUMBER:

A-116

23 OF 120 SHEETS  
8-1-24

BID DOCUMENTS





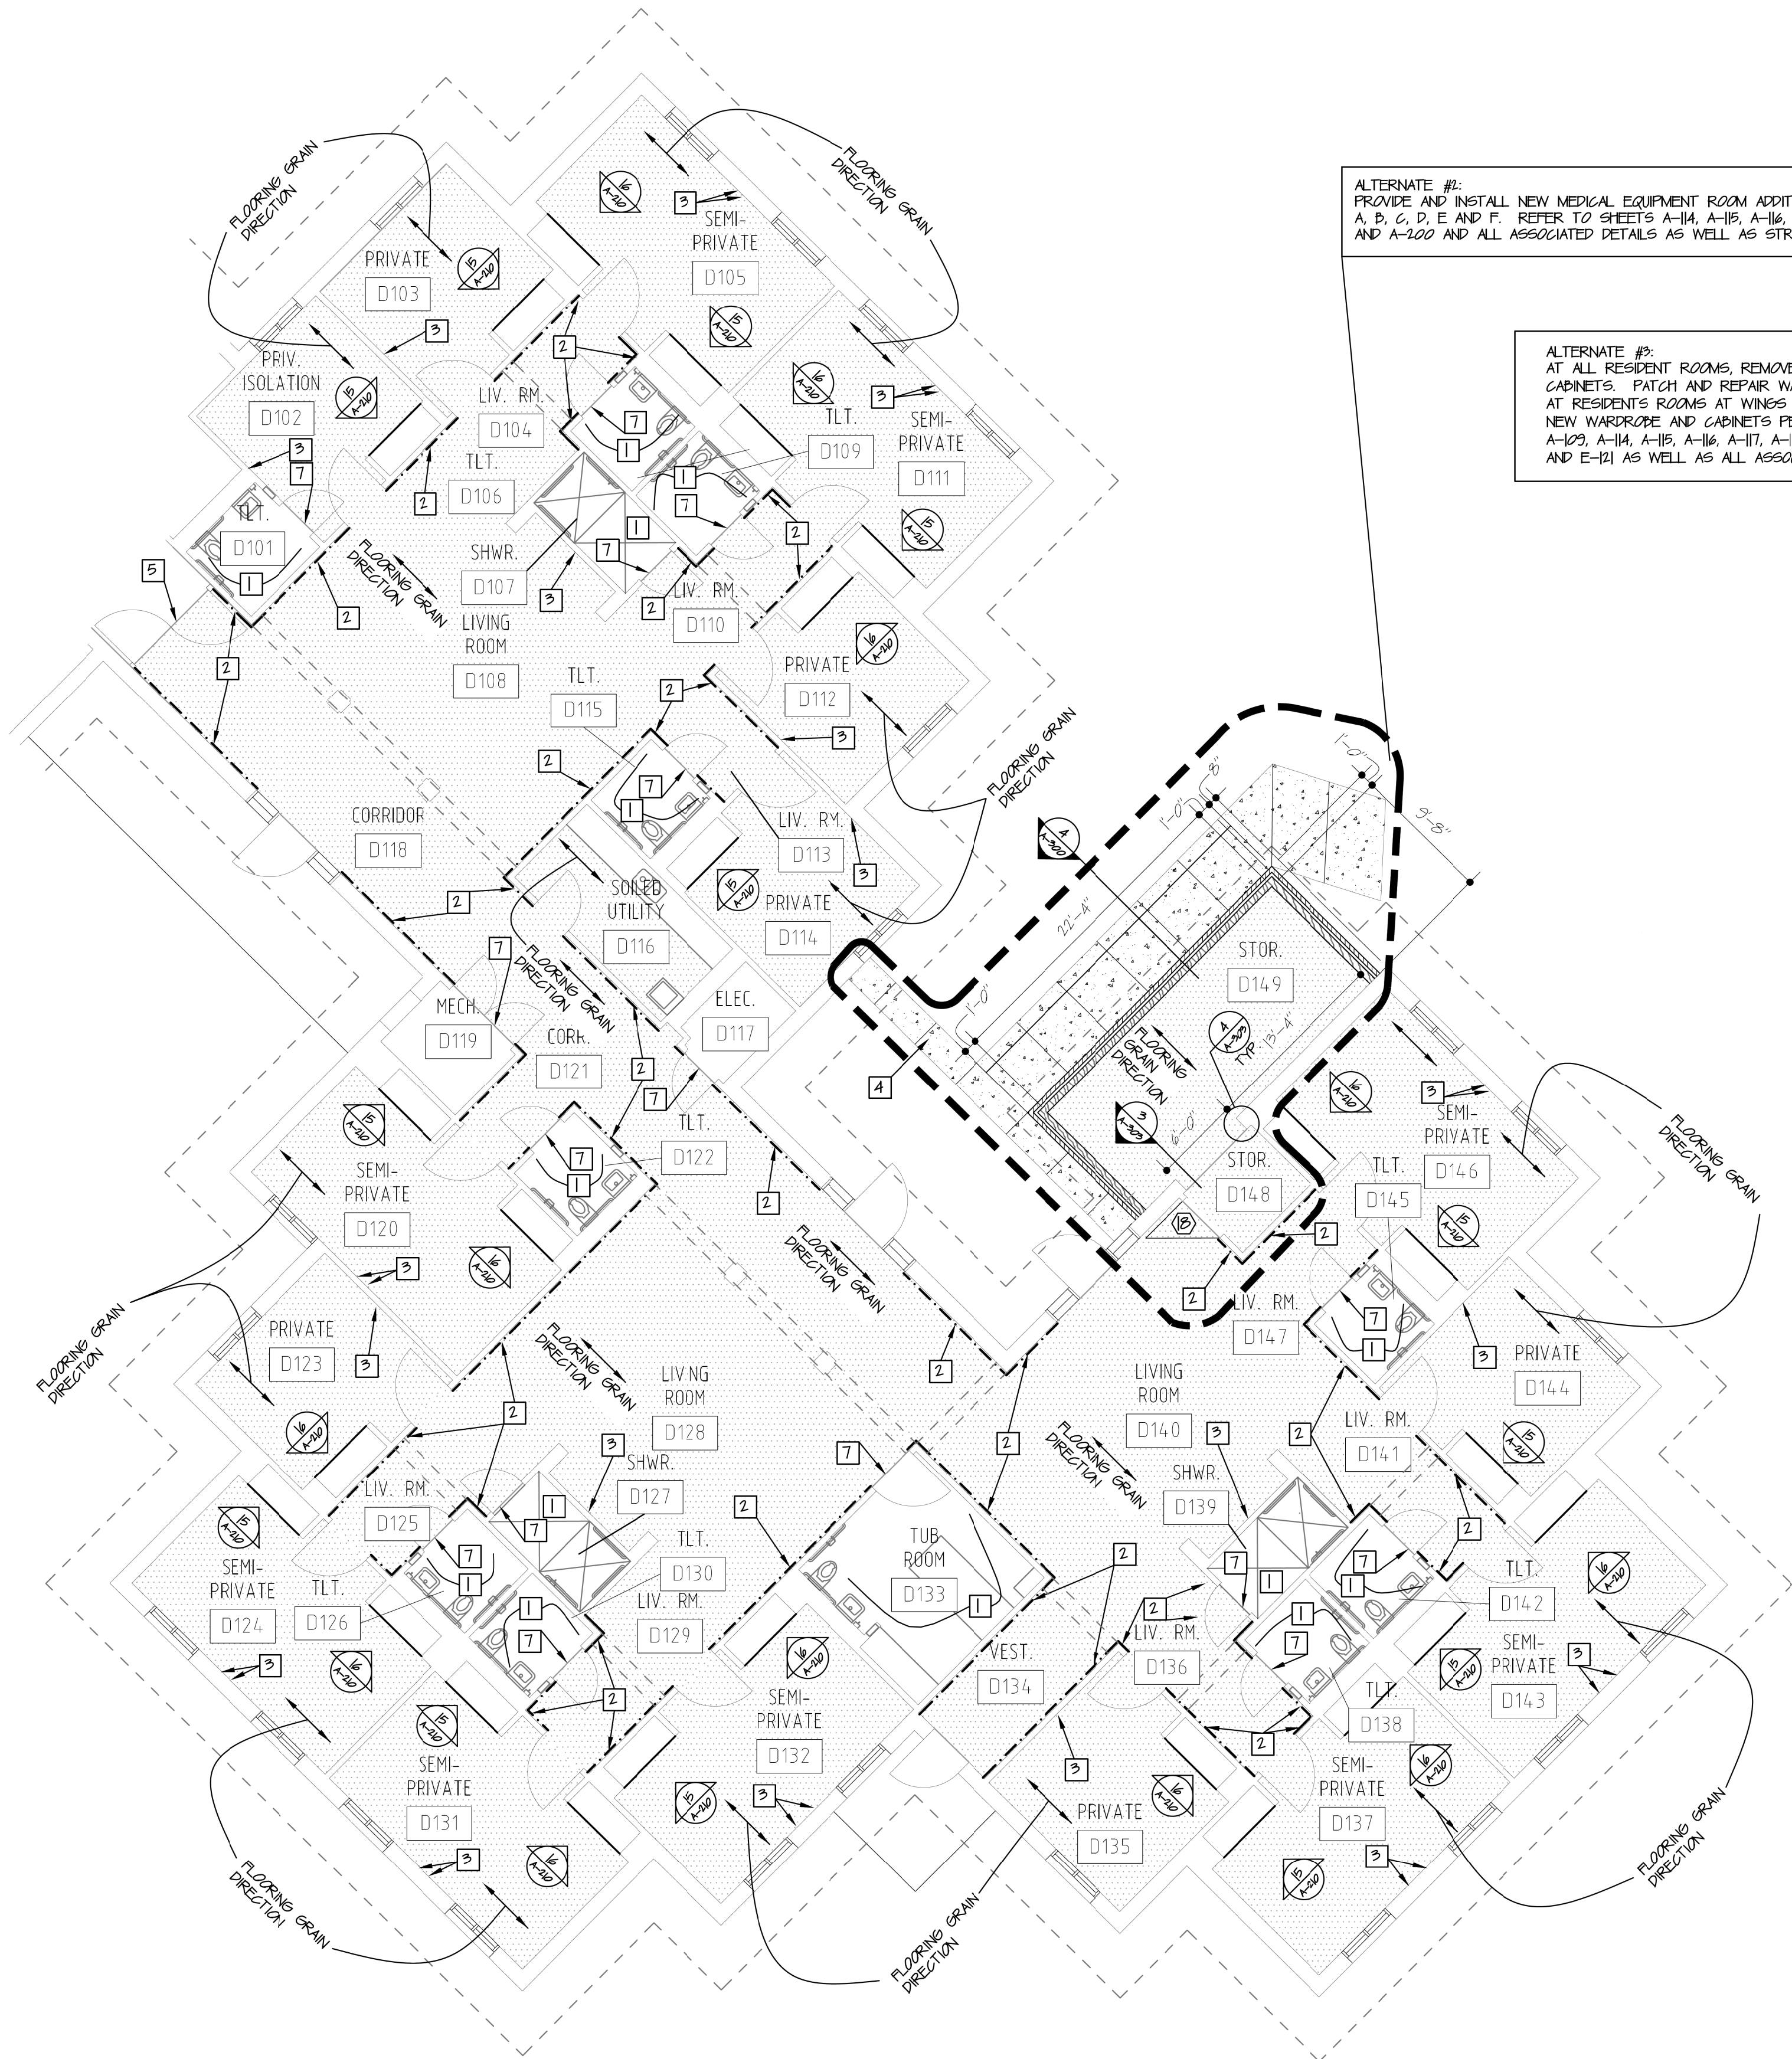


DIAGRAM FOR FINISH SCHEDULE REFERENCE:

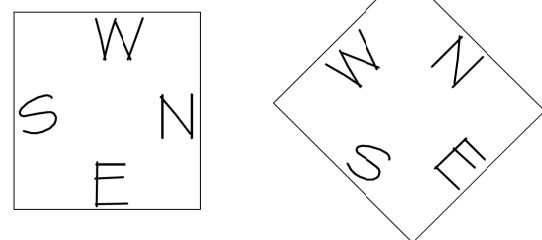


WING D FLOOR PLAN  
1/8" = 1'-0"

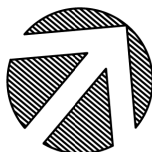

ALTERNATE #1:  
PROVIDE AND INSTALL NEW MEDICAL EQUIPMENT ROOM ADDITION TO RESIDENT WINGS  
A, B, C, D, E AND F. REFER TO SHEETS A-114, A-115, A-116, A-117, A-118, A-119, A-121  
AND A-122 AND ALL ASSOCIATED DETAILS AS WELL AS STRUCTURAL DRAWINGS.

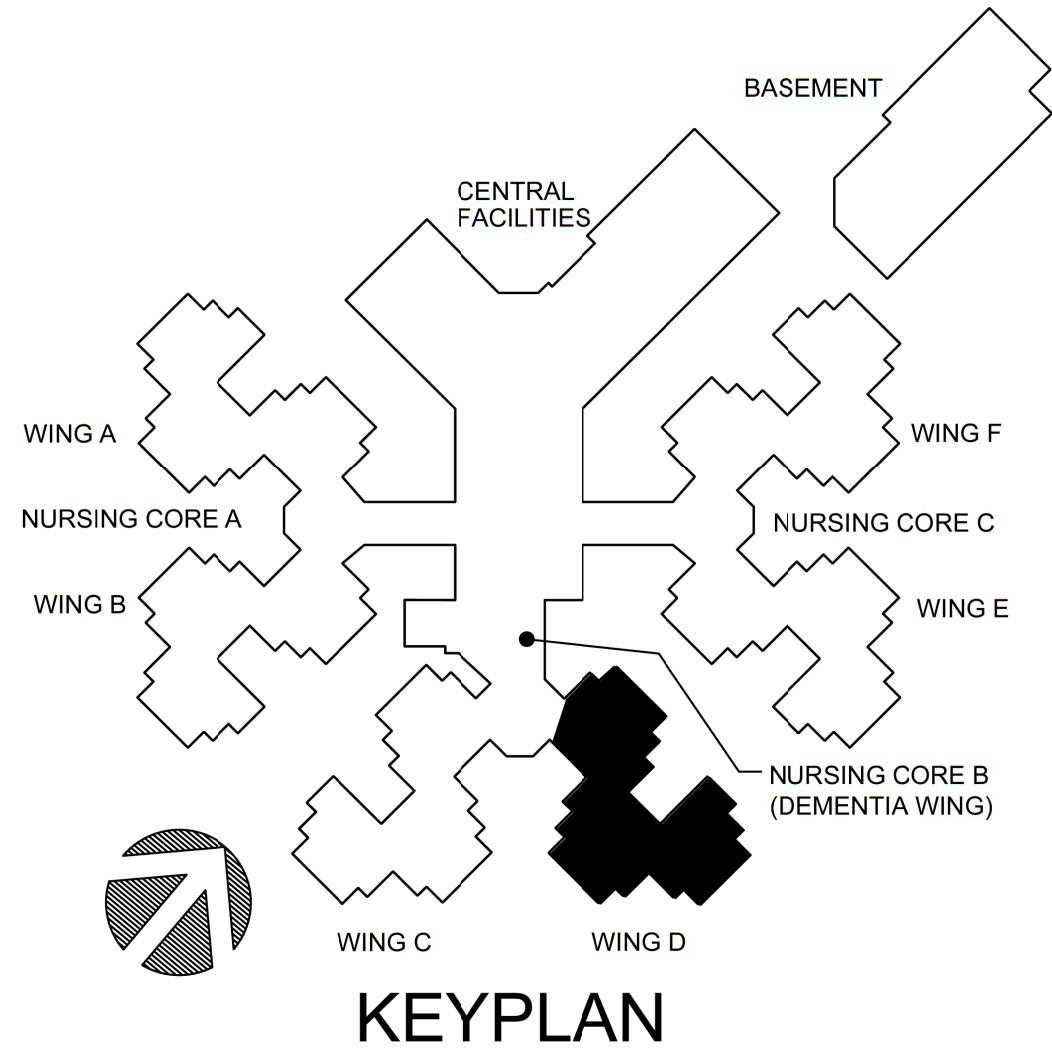ALTERNATE #2:  
AT ALL RESIDENT ROOMS, REMOVE AND DISCARD EXISTING WARDROBE AND  
CABINETS. PATCH AND REPAIR WALL AS REQUIRED TO RECEIVE NEW MILLWORK  
AT RESIDENTS ROOMS AT WINGS A, B, C, D, E AND F. PROVIDE AND INSTALL  
NEW WARDROBE AND CABINETS PER SHEETS A-124, A-125, A-126, A-127, A-128,  
A-129, A-134, A-135, A-136, A-137, A-138, A-139, A-210, E-116, E-117, E-118, E-119, E-120  
AND E-121 AS WELL AS ALL ASSOCIATED DETAILS.



GENERAL NOTES SHEET (A-117 ONLY)

- PROVIDE AND INSTALL TRANSITION STRIP BETWEEN FLOOR MATERIALS REFER TO SHEET A-500 FOR ALL TRANSITION STRIP DETAILS.
- CONTRACTOR TO FIELD VERIFY ALL DIMENSIONS.
- CONTRACTOR TO PATCH AS REQUIRED, CLEAN AND PAINT ALL EXISTING HOLLOW METAL DOOR FRAMES IPS-10. REFER TO FINISH SCHEDULE WHERE THEY EXIST. REMOVE ALL VINYL FRAME PROTECTION BEFORE PAINTING.
- CONTRACTOR TO PATCH AND REPAIR ALL CONSTRUCTION TO REMAIN, AFFECTED BY DEMOLITION.
- REFER TO FINISH SCHEDULE FOR ALL FINISHES.
- REFER TO DOOR SCHEDULE FOR ALL NEW DOORS AND FRAMES.
- PROVIDE AND INSTALL NEW SOUND ATTENUATION BATT INSULATION IN ALL NEW INTERIOR WALLS UNLESS OTHERWISE NOTED. SEE SPEC.
- CONTRACTOR TO PROTECT ALL EXISTING MILLWORK AND EQUIPMENT SHOWN TO REMAIN FOR PAGE D10.

- CONTRACTOR TO PAINT ALL EXISTING INTERIOR HOLLOW METAL WINDOW FRAMES IPS-20, AND STAIN ALL NEW INTERIOR WOOD WINDOW FRAMES IPS-27, AT ALL AREAS WHERE WORK IS SHOWN. COLOR BY ARCHITECT AND TO MATCH EXISTING. REFER TO FINISH SCHEDULE.
- FLOOR HATCH SHOWN AS ( ) TO BE NEW LUXURY VINYL TILE (LVT) FLOORING BY ARMSTRONG, COLOR N336 WEATHERED ARBOR FAWN. GRAIN TO RUN IN THE DIRECTION SHOWN ON PLANS WITH ARROW ( ) REFER TO FINISH SCHEDULE FOR MORE INFORMATION.

FLOOR PLAN KEY NOTES (SHEET A-117 ONLY)

- CONTRACTOR SHALL STEAM CLEAN EXISTING FLOOR, WALL TILE AND GROUT AT INDICATED RESTROOM/SHOWERS.
- EXISTING HANDRAIL AND/OR CHAIR RAIL AT LOCATION INDICATED BY ( ) PROTECT AS REQUIRED WHERE IT IS CUT - FINISH END TO RETURN 48" BACK TO WALL AFTER CUTTING BACK TO CORNER GUARD. STAIN TO MATCH EXISTING.
- PROVIDE AND INSTALL 2X BLOCKING IN WALL FOR WALL MOUNTED TV. PATCH AND REPAIR WALL TO MATCH EXISTING ADJACENT CONSTRUCTION. SEE MEP FOR ADDITIONAL REQUIREMENTS. REFER TO ELEVATION 26 OF A-210.
- PROVIDE AND INSTALL NEW 5" THICK CONCRETE PAVING WITH 6X6-W14 X W14 WMM OVER 4" CRUSHED GRAVEL. CONNECT TO EXISTING CONCRETE PAVING BY DRILLING 6" DEEP HOLES @ 36" O.C. IN EDGE OF EXISTING CONCRETE AND EPOXY 12" LONG #4 REBAR INTO HOLES TO BE EMBEDDED INTO EDGE OF NEW CONCRETE PAVING. SEE SPEC AND STRUCTURAL.
- CHANGE IN DIRECTION OF GRAIN OF FLOORING AND DIRECTION RUN.
- NOTE NOT USED.
- TRANSITION STRIP. REFER TO SHEET A-500 FOR TYPE.
- PROVIDE AND INSTALL NEW WALL CONSISTING OF 2x4 WOOD STUDS @ 16" O.C. WITH 5/8" TYPE "X" GYPSUM BOARD ON OUTSIDE FACE AND 5/8" GLASS-MAT, WATER-RESISTANT BACKING BOARD ON INSIDE FACE. FIELD VERIFY TO MATCH EXISTING ADJACENT WALL THICKNESS). MATCH HEIGHT OF EXISTING ADJACENT WALL. AROUND ENTIRE PERIMETER OF OUTSIDE SURFACE OF THIS ROOM. PAINT WITH COLOR AS INDICATED IN NEW FINISH "PS" AND INSTALL NEW "PS" BASE, PER FINISH SCHEDULE. SEE FINISH SCHEDULE FOR FINISHES ON INSIDE FACE OF WALL.

STATE OF MISSOURI  
MIKE KEHOE,  
GOVERNOR



2/19/25

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CERTIFICATE OF AUTHORITY #000718

**ESTERLY & SCHNEIDER ASSOCIATES, INC.**  
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OFFICE OF ADMINISTRATION  
DIVISION OF FACILITIES  
MANAGEMENT,  
DESIGN AND CONSTRUCTION

DEPARTMENT OF  
PUBLIC SAFETY  
MISSOURI VETERANS  
COMMISSION

INTERIOR RENOVATION  
MISSOURI VETERANS  
HOME

620 N. JEFFERSON  
ST. JAMES, MISSOURI

PROJECT # U1503-01  
SITE # 6801  
ASSET # 8136801002  
FEDERAL# 29-044

REVISION: \_\_\_\_\_  
DATE: \_\_\_\_\_  
REVISION: \_\_\_\_\_  
DATE: \_\_\_\_\_  
REVISION: \_\_\_\_\_  
DATE: \_\_\_\_\_  
ISSUE DATE: 8-1-24

CAD DWG FILE: A-117.DWG  
DRAWN BY: ZAC/MAH  
CHECKED BY: MAH/CAS  
DESIGNED BY: MAH/CAS

SHEET TITLE:

FLOOR PLAN

SHEET NUMBER:

A-117

24 OF 120 SHEETS  
8-1-24

BID DOCUMENTS



**DEPARTMENT OF  
PUBLIC SAFETY  
MISSOURI VETERANS  
COMMISSION**

620 N. JEFFERSON  
ST. JAMES, MISSOURI

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REVISION: \_\_\_\_\_  
DATE: \_\_\_\_\_

ISSUE DATE:8-1-24

CAD DWG FILE: A-118.DWG  
DRAWN BY: ZAC/MAH  
CHECKED BY: MAH/CAS  
DESIGNED BY: MAH/CAS


SHEET TITLE:

## FLOOR PLAN

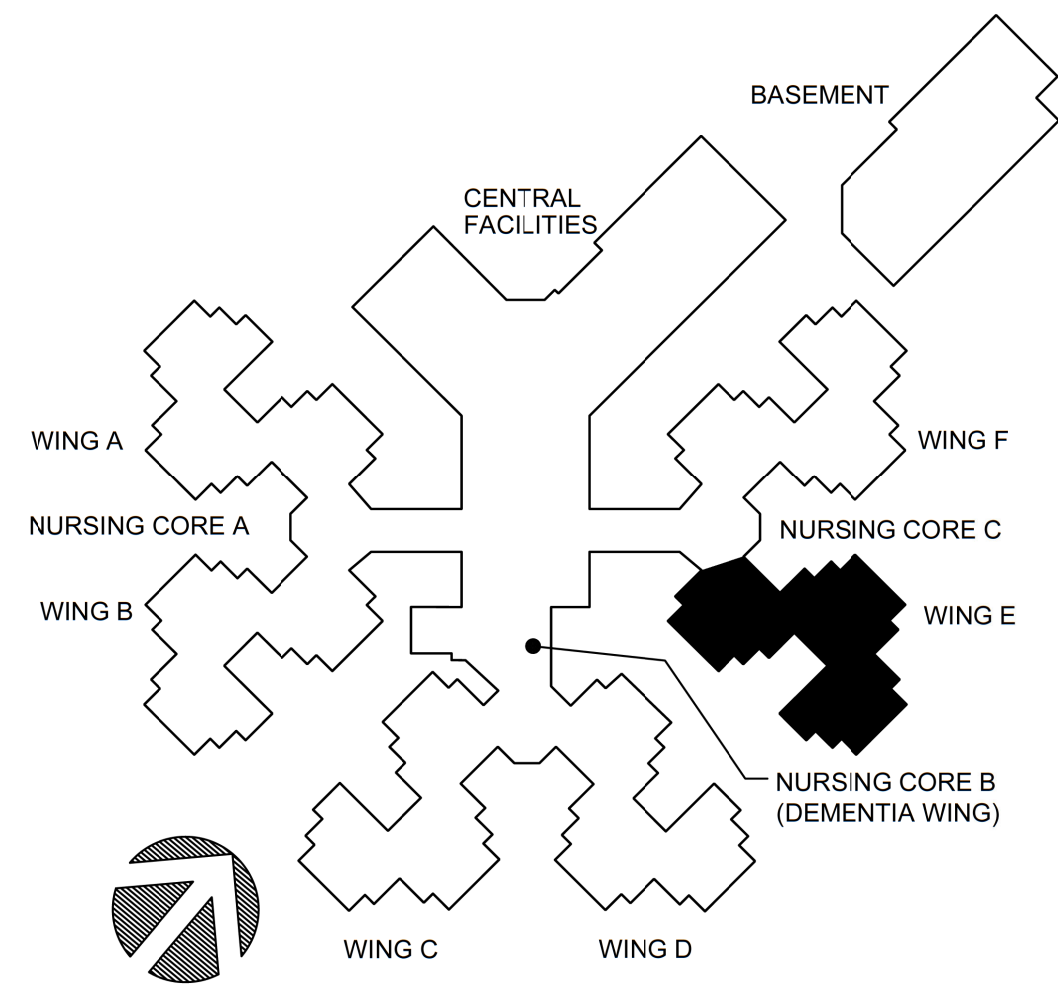SHEET NUMBER:

A-118

25 OF 120 SHEETS  
8-1-24



## KEYPLAN

- a. PROVIDE AND INSTALL TRANSITION STRIP BETWEEN FLOOR MATERIALS. REFER TO SHEET A-500 FOR ALL TRANSITION STRIP DETAILS
- b. CONTRACTOR TO FIELD VERIFY ALL DIMENSIONS
- c. CONTRACTOR TO PATCH AS REQUIRED, CLEAN AND PAINT ALL EXISTING DOOR AND NEW DOOR FRAMES PS-22
- d. REFER TO FINISH SCHEDULE, WHERE THEY EXIST, REMOVE ALL VINYL FRAME PROTECTION BEFORE PAINTING.
- e. CONTRACTOR TO PATCH AND REPAIR ALL CONSTRUCTION TO REMAIN, AFFECTED BY DEMOLITION
- f. REFER TO FINISH SCHEDULE FOR ALL FINISHES.
- g. REFER TO DOOR SCHEDULE FOR ALL NEW DOORS AND FRAMES
- h. PROVIDE AND INSTALL NEW SOUND ATTENUATION DASH INSTALLATION IN ALL NEW INTERIOR WALLS UNLESS OTHERWISE NOTED. SEE SPEC.
- i. CONTRACTOR TO PROTECT ALL EXISTING MILLWORK AND EQUIPMENT SHOWN TO REMAIN FOR BASE BID.
- j. CONTRACTOR TO PAINT ALL EXISTING INTERIOR HOLLOW METAL WINDOW FRAMES PS-22, AND STAIN ALL NEW INTERIOR WOOD WINDOW FRAMES PS-27, AT ALL AREAS WHERE WORK IS SHOWN. COLOR BY ARCHITECT AND TO MATCH EXISTING. REFER TO FINISH SCHEDULE
- k. FLOOR PATCH SHOWN AS ( ) TO BE NEW LUXURY VINYL TILE (LVT) FLOORING BY ARMSTRONG, COLOR N4326 WEATHERED ARBOR FAWN, GRAIN TO RUN IN THE DIRECTION SHOWN ON PLANS WITH GROUT TO MATCH ( ) REFER TO FINISH SCHEDULE FOR MORE INFORMATION.

- 1 CONTRACTOR SHALL STEAM CLEAN EXISTING FLOOR, WALL TILE AND GROUT AT INDICATED RESTROOM/SHOWERS.
- 2 EXISTING HANDRAIL AND/OR CHAIR RAIL AT LOCATION INDICATED BY  
(-----) PROTECT AS REQUIRED. WHERE IT IS CUT - FINISH END TO RETURN 45° BACK TO WALL AFTER CUTTING BACK TO CORNER GROUT. STAIN TO MATCH EXISTING.
- 3 PROVIDE AND INSTALL 2X BLOCKING IN WALL FOR WALL MOUNTED TV. PATCH AND REPAIR WALL TO MATCH EXISTING ADJACENT CONSTRUCTION. SEE MEP FOR ADDITIONAL REQUIREMENTS. REFER TO ELEVATION 16 OF A-10.
- 4 PROVIDE AND INSTALL NEW 5" THICK CONCRETE PAVING WITH 6x6-W/4 X W/4 WMM OVER 4" CRUSHED GRAVEL. CONNECT TO EXISTING CONCRETE PAVING BY DRILLING 6" DEEP HOLES @ 36" O.C. IN EDGE OF EXISTING CONCRETE AND EPOXY 12" LONG #4 REBAR INTO HOLES TO BE EMBEDDED INTO EDGE OF NEW CONCRETE PAVING. SEE SPEC AND STRUCTURAL.
- 5 CHANGE IN DIRECTION OF GRAIN OF FLOORING AND DIRECTION RUN.
- 6 NOTE NOT USED.
- 7 TRANSITION STRIP. REFER TO SHEET A-500 FOR TYPE.
- 8 PROVIDE AND INSTALL NEW WALL, CONSISTING OF 2x4 WOOD STUDS @ 16" O.C. WITH 5/8" TYPE "X" GYPSUM BOARD ON OUTSIDE FACE AND 5/8" GLASS-MAT, WATER-RESISTANT BACKING BOARD ON INSIDE FACE (VERIFY TO MATCH EXISTING ADJACENT WALL THICKNESS). MATCH HEIGHT OF EXISTING ADJACENT WALL. AROUND ENTIRE PERIMETER OF INSIDE SURFACE OF THIS ROOM, PAINT WITH COLOR AS INDICATED IN NEW FINISH "PS" AND INSTALL NEW "VDS" BASE, PER FINISH SCHEDULE. SEE FINISH SCHEDULE FOR FINISHES ON INSIDE FACE OF WALL.

$$\overline{1/8'' = 1'-0''}$$


ALTERNATE #12:  
 PROVIDE AND INSTALL NEW MEDICAL EQUIPMENT ROOM ADDITION TO RESIDENT  
 WINGS A, B, C, D, E AND F. REFER TO SHEETS A-114, A-115, A-116, A-117, A-118,  
 A-119, A-121 AND A-200 AND ALL ASSOCIATED DETAILS AS WELL AS STRUCTURAL  
 DRAWINGS.

ALTERNATE #3:  
AT ALL RESIDENT ROOMS, REMOVE AND DISCARD EXISTING WARDROBE AND CABINETS. PATCH AND REPAIR WALL AS REQUIRED TO RECEIVE NEW MILLWORK AT RESIDENTS ROOMS AT WINGS A, B, C, D, E AND F. PROVIDE AND INSTALL NEW WARDROBE AND CABINETS PER SHEETS A-104, A-105, A-106, A-107, A-108, A-109, A-114, A-115, A-116, A-117, A-118, A-119, A-210, E-116, E-117, E-118, E-119, E-120 AND E-121 AS WELL AS ALL ASSOCIATED DETAILS.

# BID DOCUMENTS



ALTERNATE #1:  
PROVIDE AND INSTALL NEW MEDICAL EQUIPMENT ROOM ADDITION TO RESIDENT WINGS A, B, C, D, E AND F. REFER TO SHEETS A-114, A-115, A-116, A-117, A-118, A-119, A-121 AND A-122 AND ALL ASSOCIATED DETAILS AS WELL AS STRUCTURAL DRAWINGS.

ALTERNATE #2:  
AT ALL RESIDENT ROOMS, REMOVE AND DISCARD EXISTING WARDROBE AND CABINETS. PATCH AND REPAIR WALL AS REQUIRED TO RECEIVE NEW MILLWORK AT RESIDENTS ROOMS AT WINGS A, B, C, D, E AND F. PROVIDE AND INSTALL NEW WARDROBE AND CABINETS PER SHEETS A-104, A-105, A-106, A-107, A-108, A-109, A-114, A-115, A-116, A-117, A-118, A-119, A-120, E-116, E-117, E-118, E-119, E-120 AND E-121 AS WELL AS ALL ASSOCIATED DETAILS.



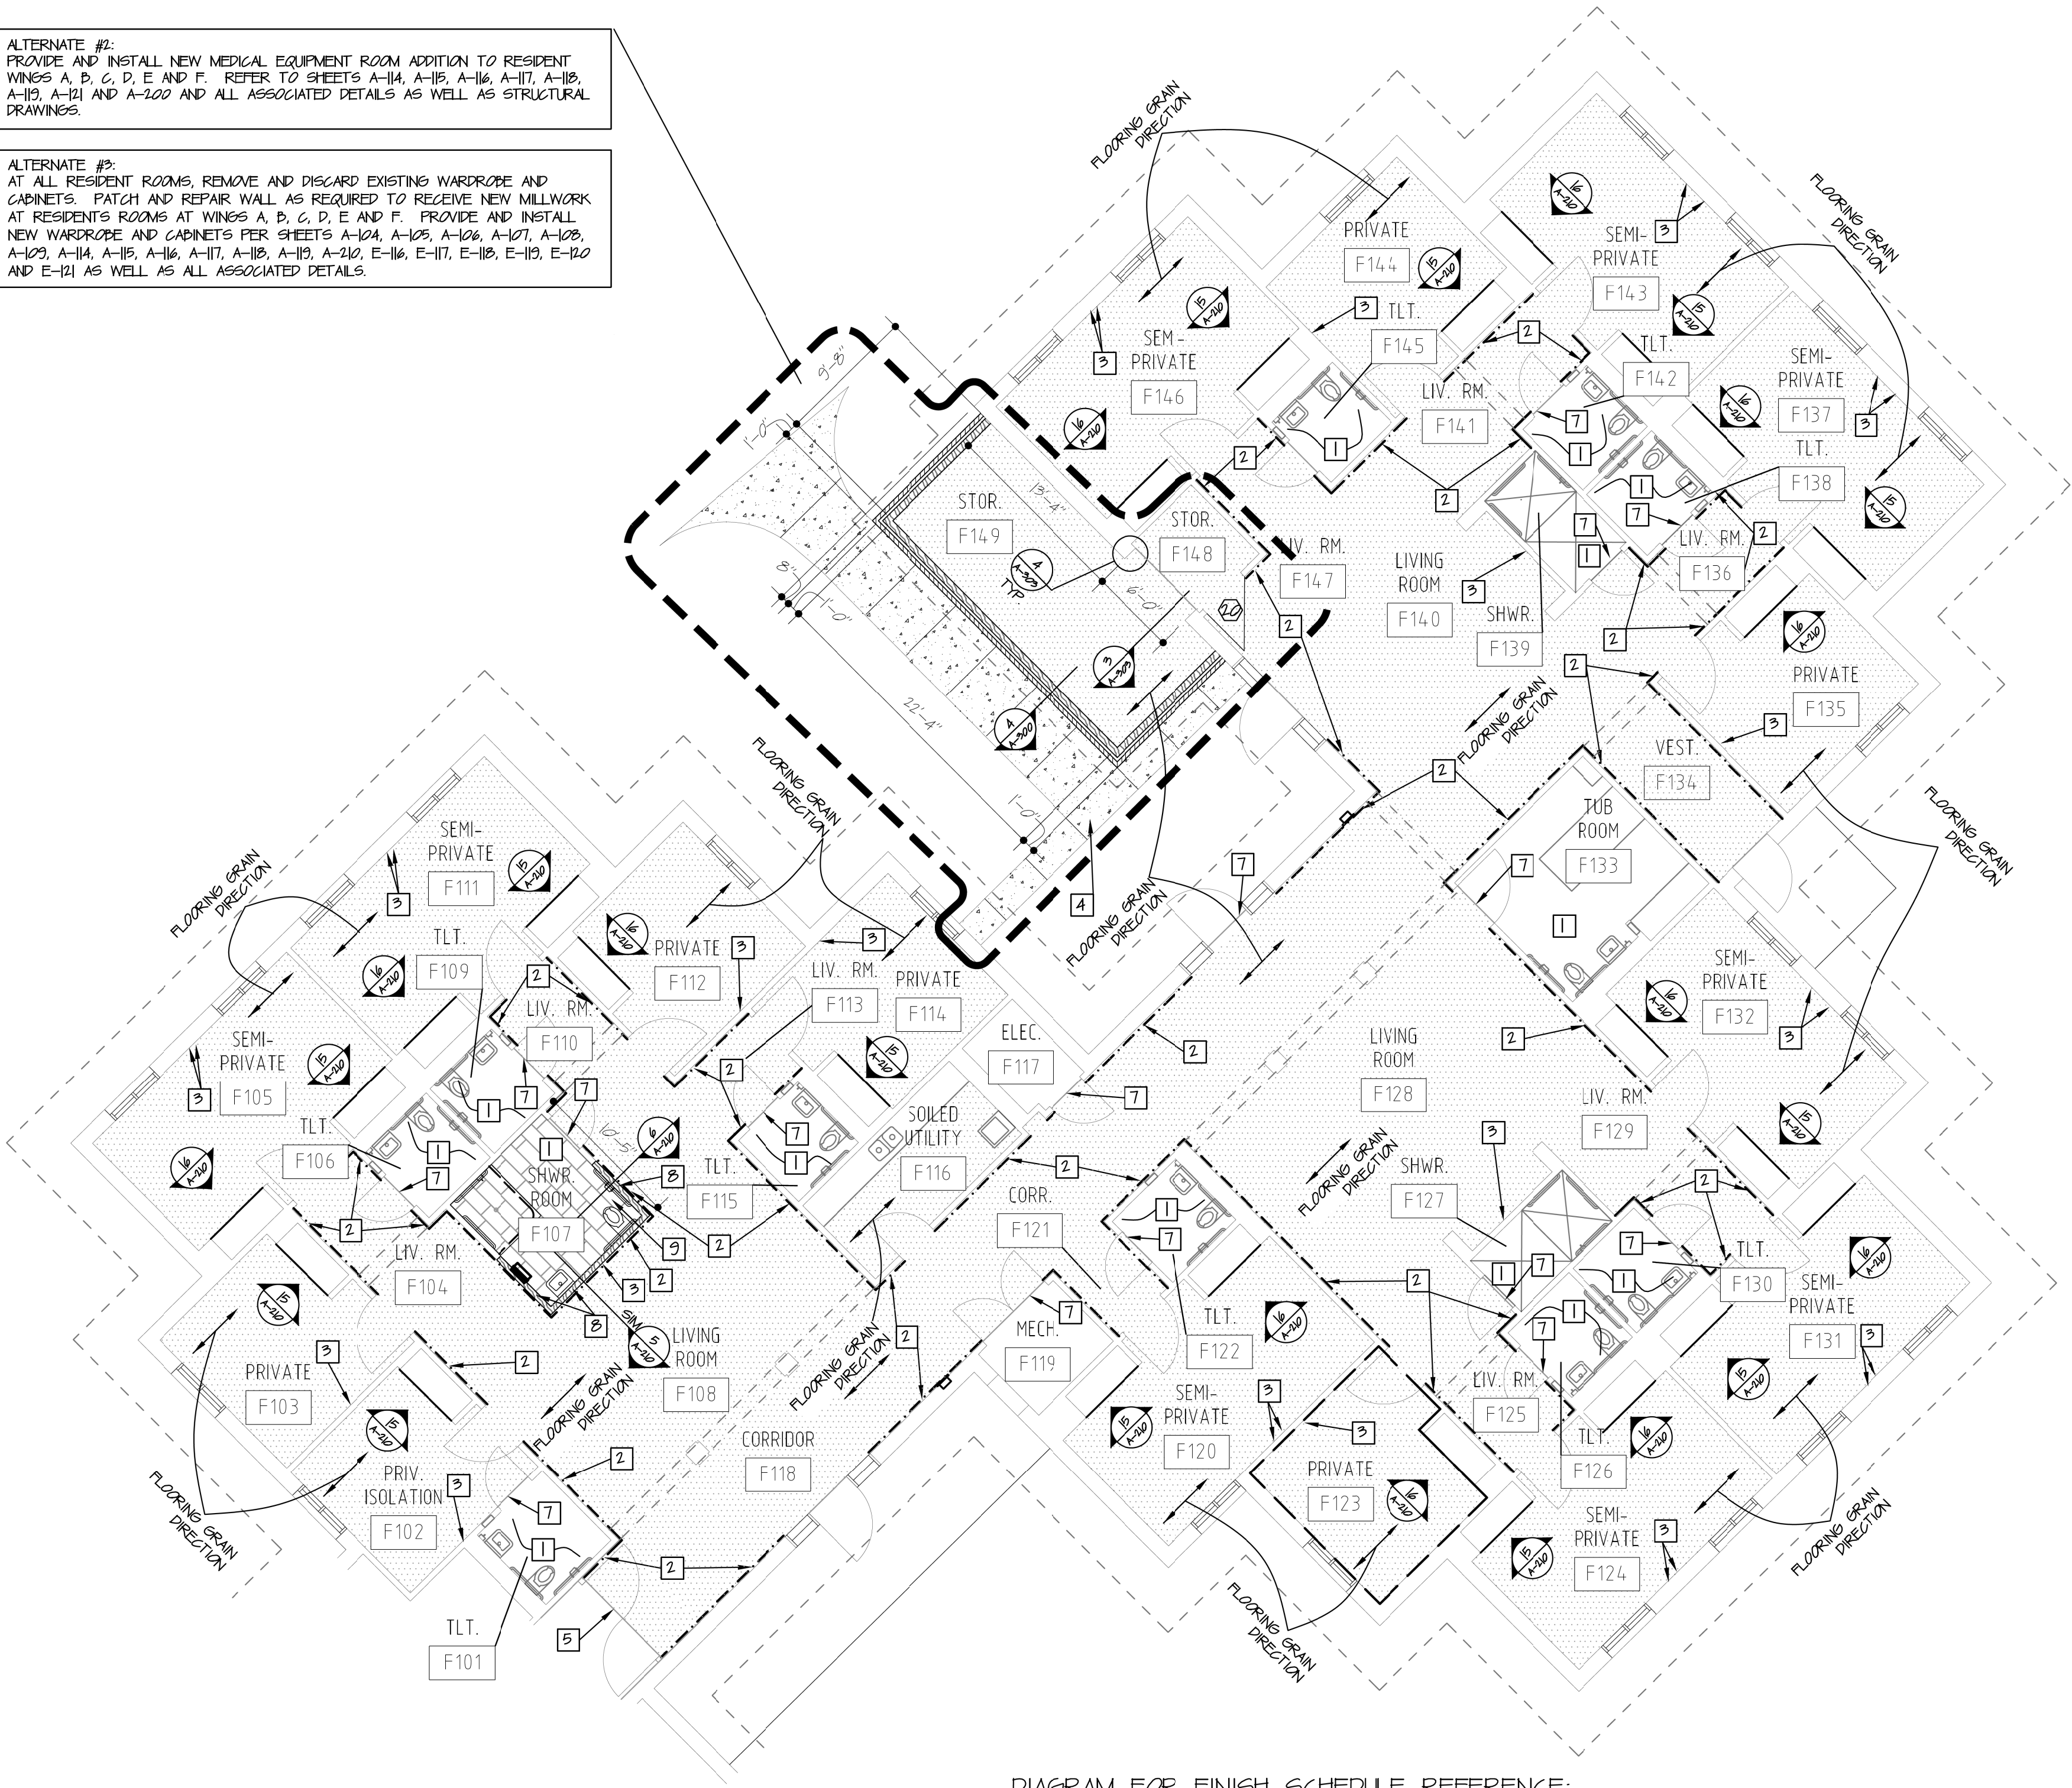


DIAGRAM FOR FINISH SCHEDULE REFERENCE:

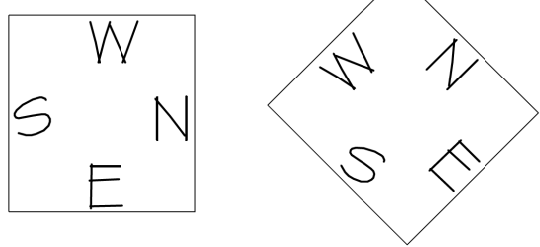

WING F FLOOR PLAN

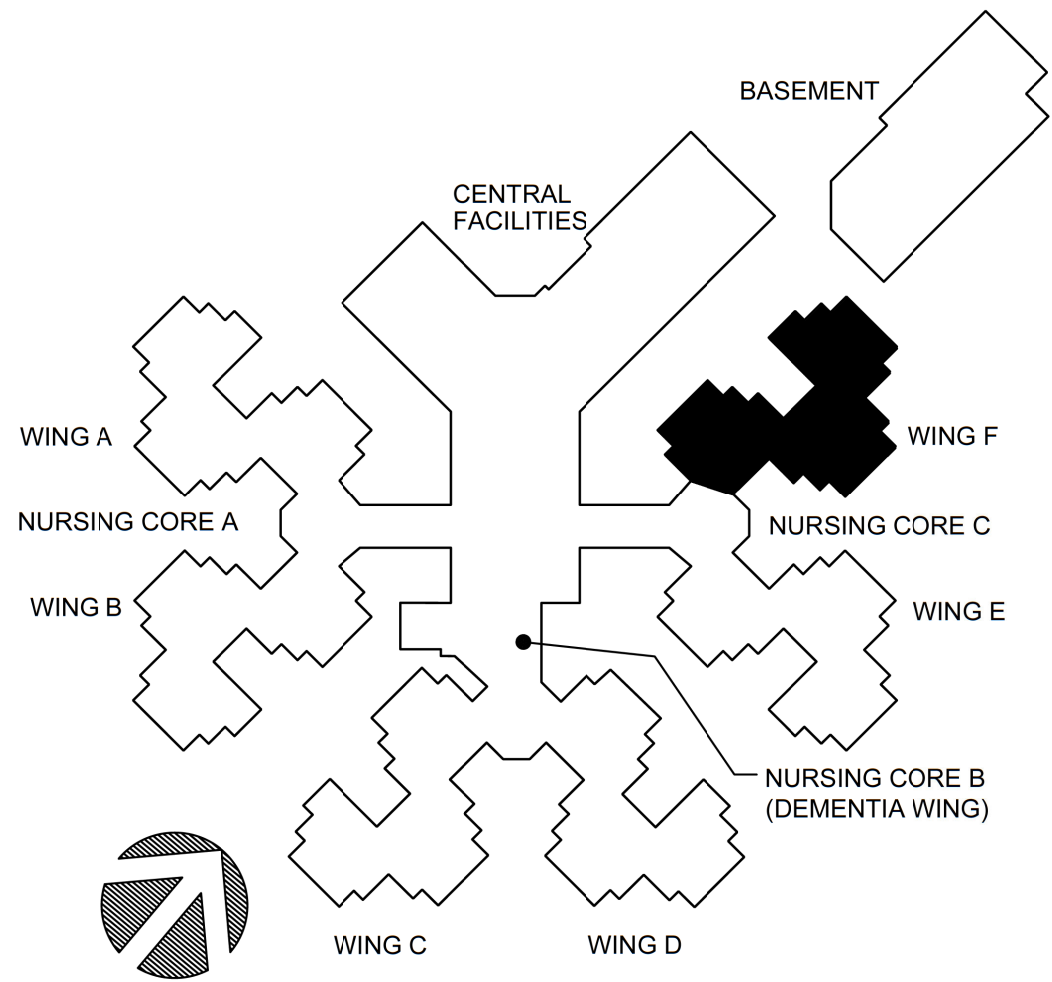1/8" = 1'-0"



KEYPLAN

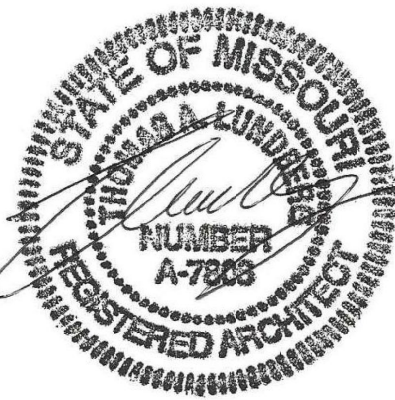
GENERAL NOTES SHEET (A-119 ONLY)

- PROVIDE AND INSTALL TRANSITION STRIP BETWEEN FLOOR MATERIALS.
- CONTRACTOR TO FIELD VERIFY ALL DIMENSIONS
- CONTRACTOR TO PATCH AS REQUIRED, CLEAN AND PAINT ALL EXISTING HOLLOW METAL DOOR FRAMES IPS-10. REFER TO FINISH SCHEDULE WHERE THEY EXIST. REMOVE ALL VINYL FRAME PROTECTION BEFORE PAINTING.
- CONTRACTOR TO PATCH AND REPAIR ALL CONSTRUCTION TO REMAIN, AFFECTED BY DEMOLITION
- REFER TO FINISH SCHEDULE FOR ALL FINISHES.
- REFER TO DOOR SCHEDULE FOR ALL NEW DOORS AND FRAMES
- PROVIDE AND INSTALL NEW SOUND ATTENUATION BATT INSULATION IN ALL NEW INTERIOR WALLS UNLESS OTHERWISE NOTED. SEE SPEC.
- CONTRACTOR TO PROTECT ALL EXISTING MILLWORK AND EQUIPMENT SHOWN TO REMAIN FOR BASE BID.
- CONTRACTOR TO PAINT ALL EXISTING INTERIOR HOLLOW METAL WINDOW FRAMES IPS-10, AND STAIN ALL NEW INTERIOR WOOD WINDOW FRAMES IPS-27, AT ALL AREAS WHERE WORK IS SHOWN. COLOR BY ARCHITECT AND TO MATCH EXISTING. REFER TO FINISH SCHEDULE.
- FLOOR HATCH SHOWN AS TO BE NEW LUXURY VINYL TILE (LVT) FLOORING BY ARMSTRONG, COLOR NA23 WEATHERED ARBOR FAWN. GRAIN TO RUN IN THE DIRECTION SHOWN ON PLANS WITH ARROW . REFER TO FINISH SCHEDULE FOR MORE INFORMATION.

FLOOR PLAN KEY NOTES (SHEET A-119 ONLY)

- CONTRACTOR SHALL STEAM CLEAN EXISTING FLOOR, WALL TILE AND GROUT AT INDICATED RESTROOM/SHOWERS.
- EXISTING HANDRAIL AND/OR CHAIR RAIL AT LOCATION INDICATED BY . PROTECT AS REQUIRED. WHERE IT IS CUT - FINISH END TO RETURN 45° BACK TO WALL AFTER CUTTING BACK TO CORNER GUARD. STAIN TO MATCH EXISTING.
- PROVIDE AND INSTALL 2X BLOCKING IN WALL FOR WALL MOUNTED TV. PATCH AND REPAIR WALL TO MATCH EXISTING ADJACENT CONSTRUCTION. SEE MEP FOR ADDITIONAL REQUIREMENTS. REFER TO ELEVATION 26 OF A-120.
- PROVIDE AND INSTALL NEW 5" THICK CONCRETE PAVING WITH 6x6-M4 X M4 W/M OVER 4" CRUSHED GRAVEL. CONNECT TO EXISTING CONCRETE PAVING BY DRILLING 6" DEEP HOLES @ 36" O.C. IN EDGE OF EXISTING CONCRETE AND EPOXY 12" LONG #4 REBAR INTO HOLES TO BE EMBEDDED INTO EDGE OF NEW CONCRETE PAVING. SEE SPEC AND STRUCTURAL.
- CHANGE IN DIRECTION OF GRAIN OF FLOORING AND DIRECTION RUN.
- NOTE NOT USED.
- TRANSITION STRIP. REFER TO SHEET A-500 FOR TYPE.
- PROVIDE AND INSTALL NEW WALL CONSISTING OF 2x4 WOOD STUDS @ 16" O.C. WITH 5/8" TYPE "X" GYPSUM BOARD ON OUTSIDE FACE AND 5/8" GLASS-MAT, WATER-RESISTANT BACKING BOARD ON INSIDE FACE (FIELD VERIFY TO MATCH EXISTING ADJACENT WALL THICKNESS). MATCH HEIGHT OF EXISTING ADJACENT WALL AROUND ENTIRE PERIMETER OF OUTSIDE SURFACE OF THIS ROOM. PAINT WITH COLOR AS INDICATED IN NEW FINISH "PS" AND INSTALL NEW "NDS" BASE, PER FINISH SCHEDULE. SEE FINISH SCHEDULE FOR FINISHES ON INSIDE FACE OF WALL.
- PROVIDE AND INSTALL NEW REINFORCED CONCRETE SLAB OVER 10 MIL VAPOR BARRIER OVER EXISTING SUBGRADE. SLOPE AS NOTED ON FLOOR PLAN TO ALLOW FOR POSITIVE DRAINAGE TO THE FLOOR/SHOWER DRAIN. REFER TO MEP PLANS FOR ADDITIONAL INFORMATION. REFER TO FINISH SCHEDULE FOR FLOOR FINISH.

STATE OF MISSOURI  
MIKE KEHOE,  
GOVERNOR



2/19/25

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CERTIFICATE OF AUTHORITY #000718

**ESTERLY  
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COMM. # 4860

OFFICE OF ADMINISTRATION  
DIVISION OF FACILITIES  
MANAGEMENT,  
DESIGN AND CONSTRUCTION

DEPARTMENT OF  
PUBLIC SAFETY  
MISSOURI VETERANS  
COMMISSION

INTERIOR RENOVATION  
MISSOURI VETERANS  
HOME

620 N. JEFFERSON  
ST. JAMES, MISSOURI

PROJECT # U1503-01  
SITE # 6801  
ASSET # 8136801002  
FEDERAL# 29-044

REVISION: \_\_\_\_\_  
DATE: \_\_\_\_\_  
REVISION: \_\_\_\_\_  
DATE: \_\_\_\_\_  
REVISION: \_\_\_\_\_  
DATE: \_\_\_\_\_  
ISSUE DATE: 8-1-24

CAD DWG FILE: A-119.DWG  
DRAWN BY: ZAC/MAH  
CHECKED BY: MAH/CAS  
DESIGNED BY: MAH/CAS

SHEET TITLE:

FLOOR PLAN

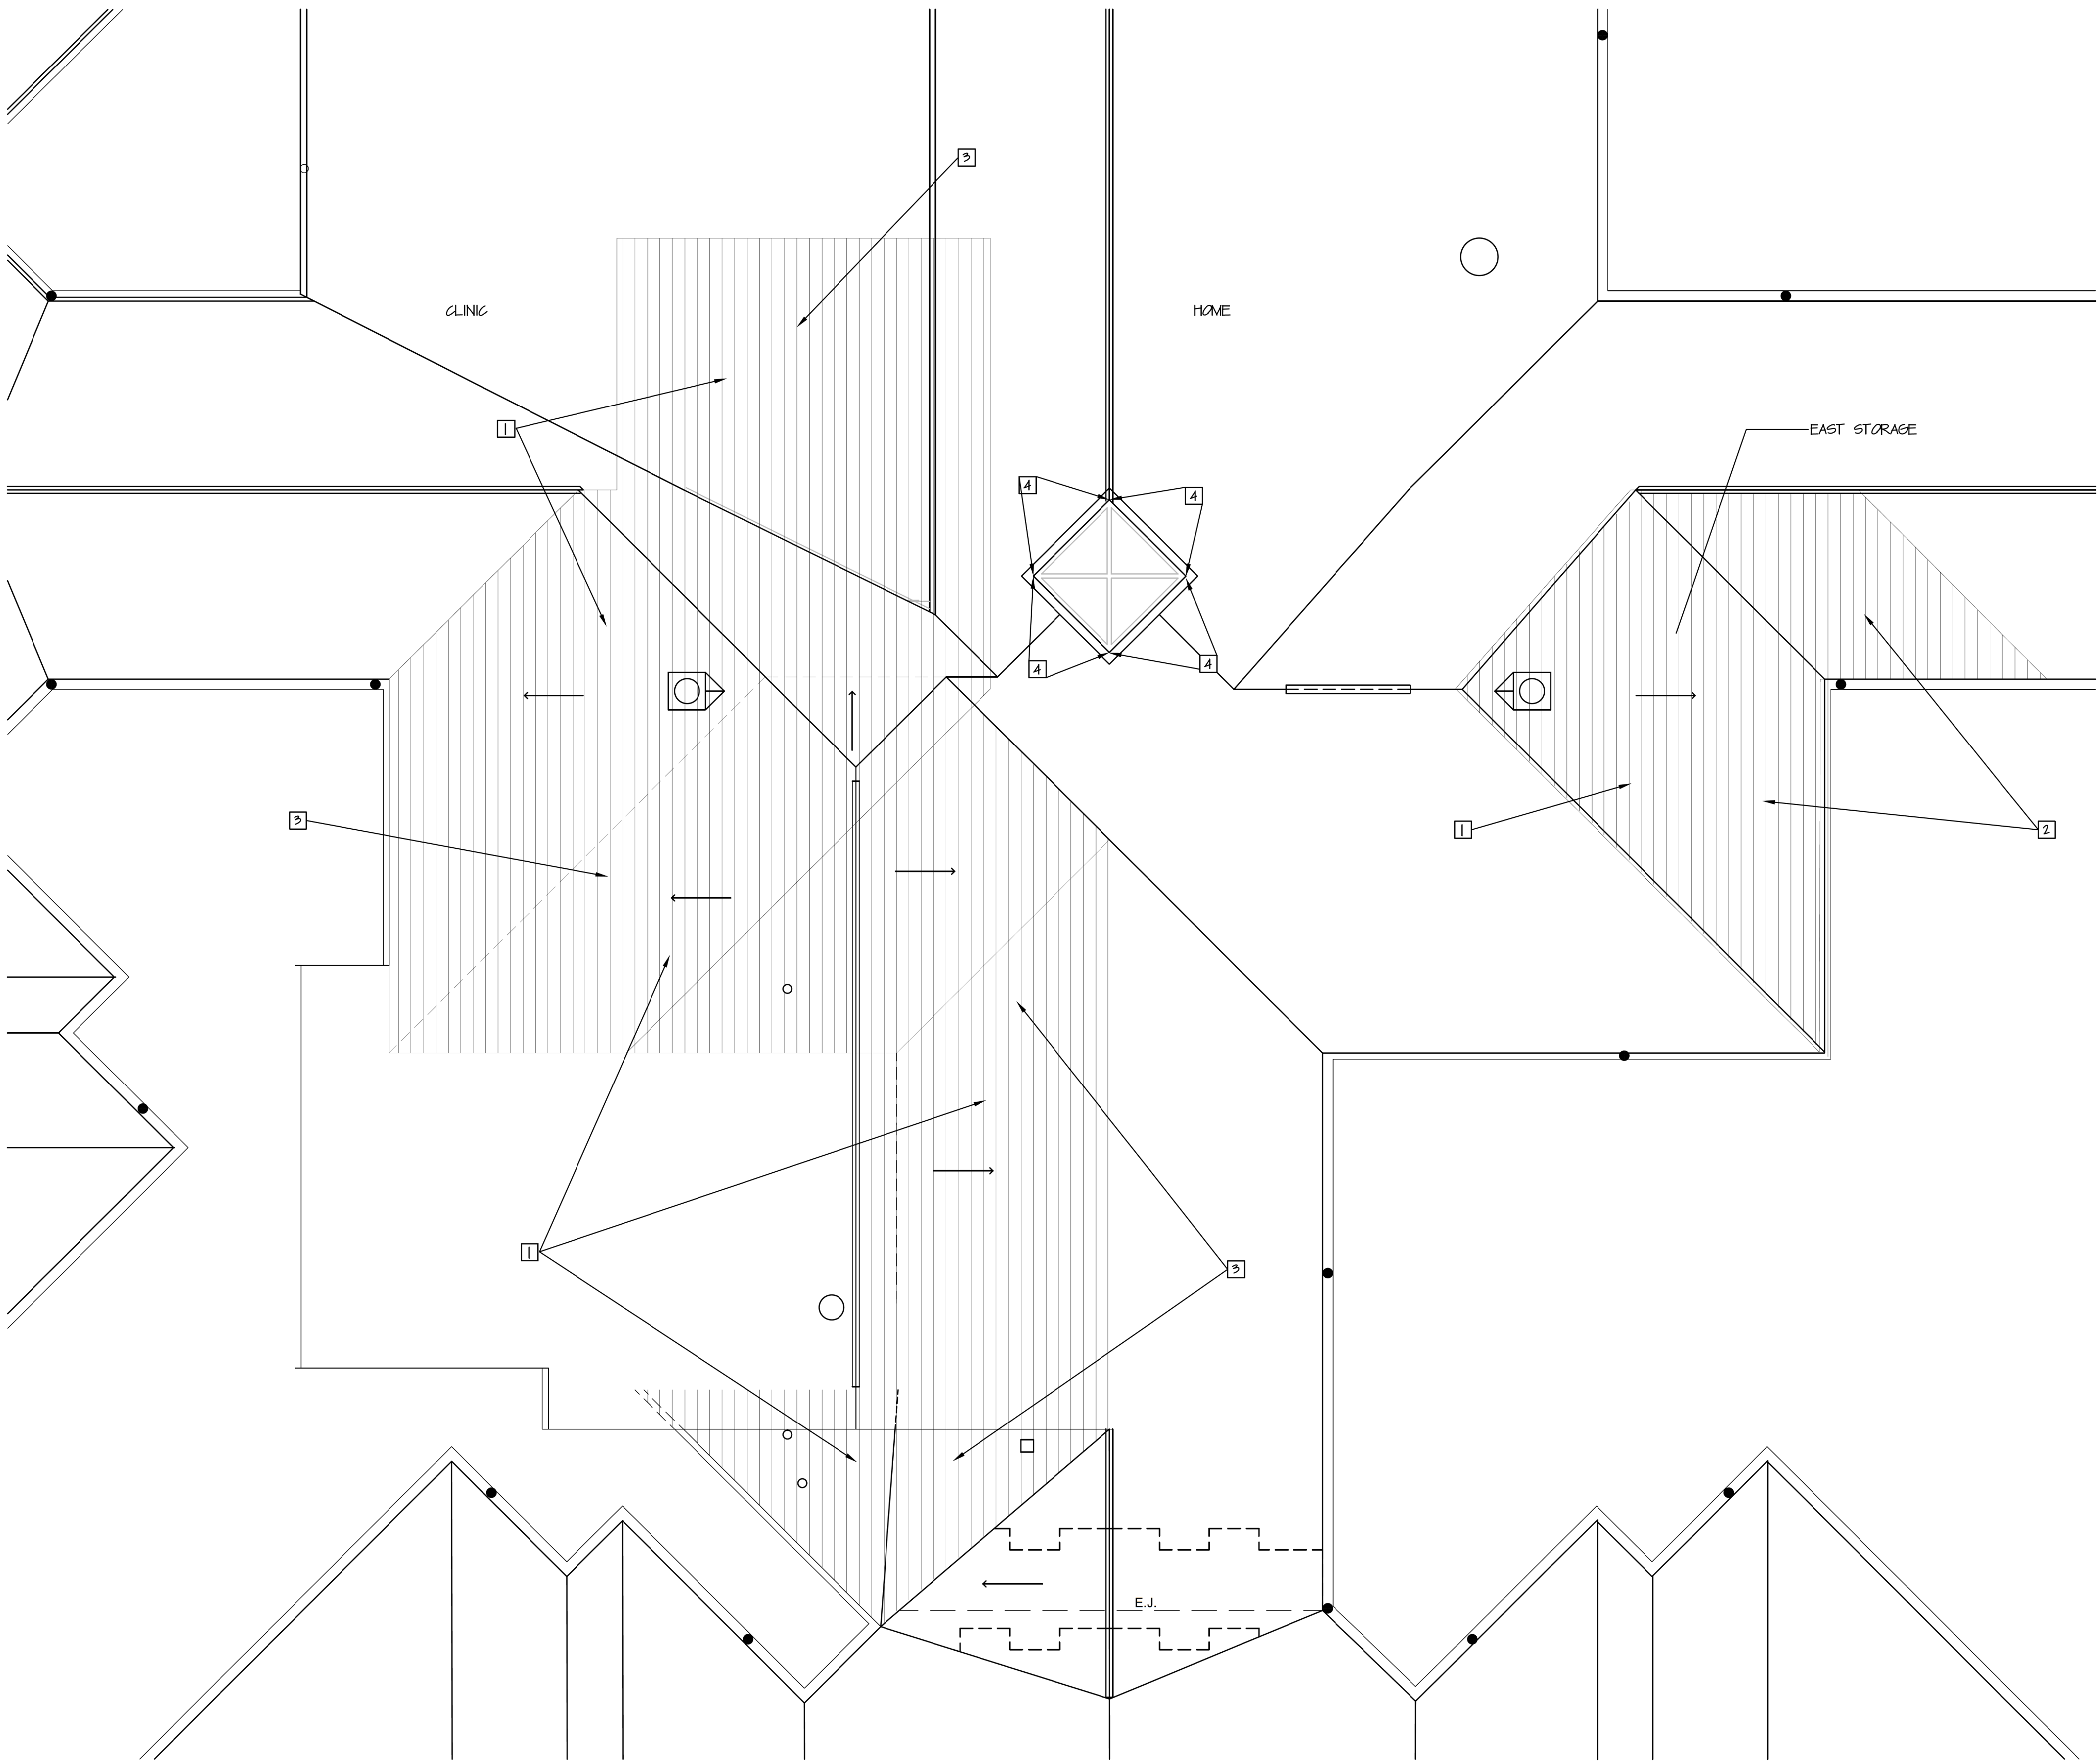
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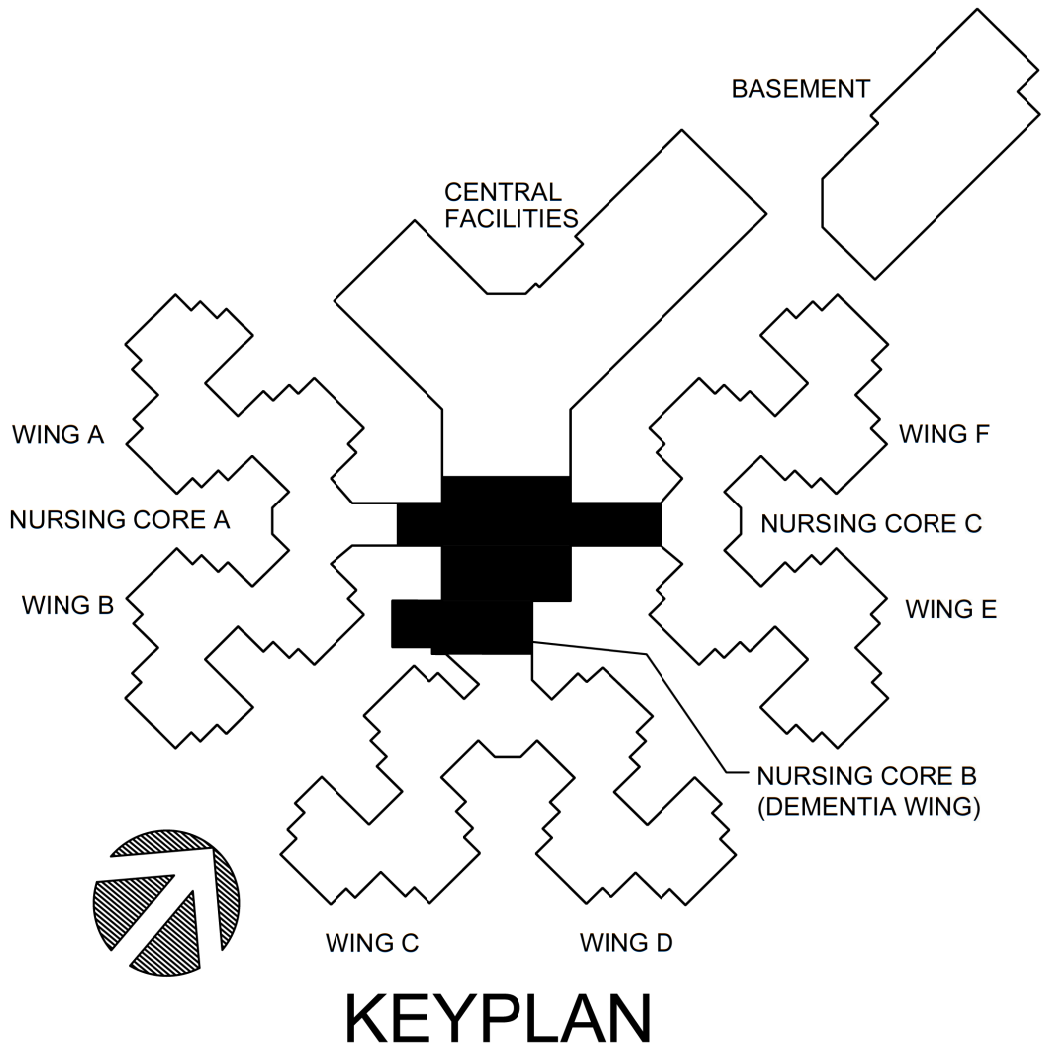
26 OF 120 SHEETS  
8-1-24

BID DOCUMENTS





PARTIAL ROOF PLAN  
1/8" = 1'-0"



GENERAL NOTES:

- a. CONTRACTOR TO FIELD VERIFY ALL DIMENSIONS
- b. CONTRACTOR TO PATCH AND REPAIR ALL CONSTRUCTION TO REMAIN AFFECTED BY DEMOLITION TO MATCH EXISTING ADJACENT CONSTRUCTION
- c. ROOF WARRANTY SHALL REMAIN IN EFFECT AFTER NEW CONSTRUCTION

ROOF/ATTIC VENTING REQUIREMENTS (REFER TO DETAILS FOR PLACEMENT):

ALL FIRE DAMPERS AND ROOF VENTS TO BE SPACED THROUGHOUT THE ATTIC AREA EVENLY, AND COORDINATED IN FIELD WITH STRUCTURE FOR PLACEMENT. COORDINATE LOCATIONS WITH THE ARCHITECT/OWNER.

ROOF/ATTIC PLAN KEY NOTES

- 1. EXISTING ASPHALT SHINGLE ROOFING THAT IS IN THE ENCLOSED ATTIC AREA AT THE AREAS DENOTED BY SHADING ON THE ROOF PLAN WILL REQUIRE THE REMOVAL OF ALL EXISTING INSULATION AND THE CONTRACTOR SHALL APPLY 3/4" OF SPRAY-APPLIED FIRE RESISTIVE MATERIAL EQUAL TO PLAZE-SHIELD II BY CAFCO OVER THE EXISTING ASPHALT SHINGLES.
- 2. EAST STORAGE ROOM - PROVIDE 16 SF TOTAL VENTING AREA FOR FIRE DAMPERS (MINIMUM OF 4 EQUALLY SPACED DAMPERS) AND 240 SQ IN. VENTING AREA TOTAL FOR ROOF VENTS (MINIMUM OF 4 EQUALLY SPACED VENTS). ALL FIRE DAMPERS AND ROOF VENTS TO BE SPACED THROUGHOUT THE ATTIC AREA EVENLY, COORDINATE WITH THE ARCHITECT/OWNER. REFER TO WALL SECTIONS 1 AND 2 OF A-302 AND 1 OF A-303.
- 3. DEMENTIA AND WEST STORAGE ROOM - PROVIDE 29 SF TOTAL VENTING AREA FOR FIRE DAMPERS (MINIMUM OF 6 EQUALLY SPACED DAMPERS) AND 480 SQ IN. VENTING AREA TOTAL FOR ROOF VENTS (MINIMUM OF 8 EQUALLY SPACED VENTS). ALL FIRE DAMPERS AND ROOF VENTS TO BE SPACED THROUGHOUT THE ATTIC AREA EVENLY, COORDINATE WITH THE ARCHITECT/OWNER. REFER TO WALL SECTIONS 1 AND 2 OF A-302 AND 1 OF A-303.
- 4. PROVIDE AND INSTALL FLASHING PER DETAIL 2 OF A-123. PATCH AND REPAIR ADJACENT CONSTRUCTION AS REQUIRED. ENSURE SHINGLE WARRANTY REMAINS IN PLACE AFTER WORK IS COMPLETE.

STATE OF MISSOURI  
MIKE KEHOE,  
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ISSUE DATE: 8-1-24

CAD DWG FILE: A-120.DWG  
DRAWN BY: ZAC/MAH  
CHECKED BY: MAH/CAS  
DESIGNED BY: MAH/CAS

SHEET TITLE:

ROOF PLAN


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A-120

27 OF 120 SHEETS  
8-1-24

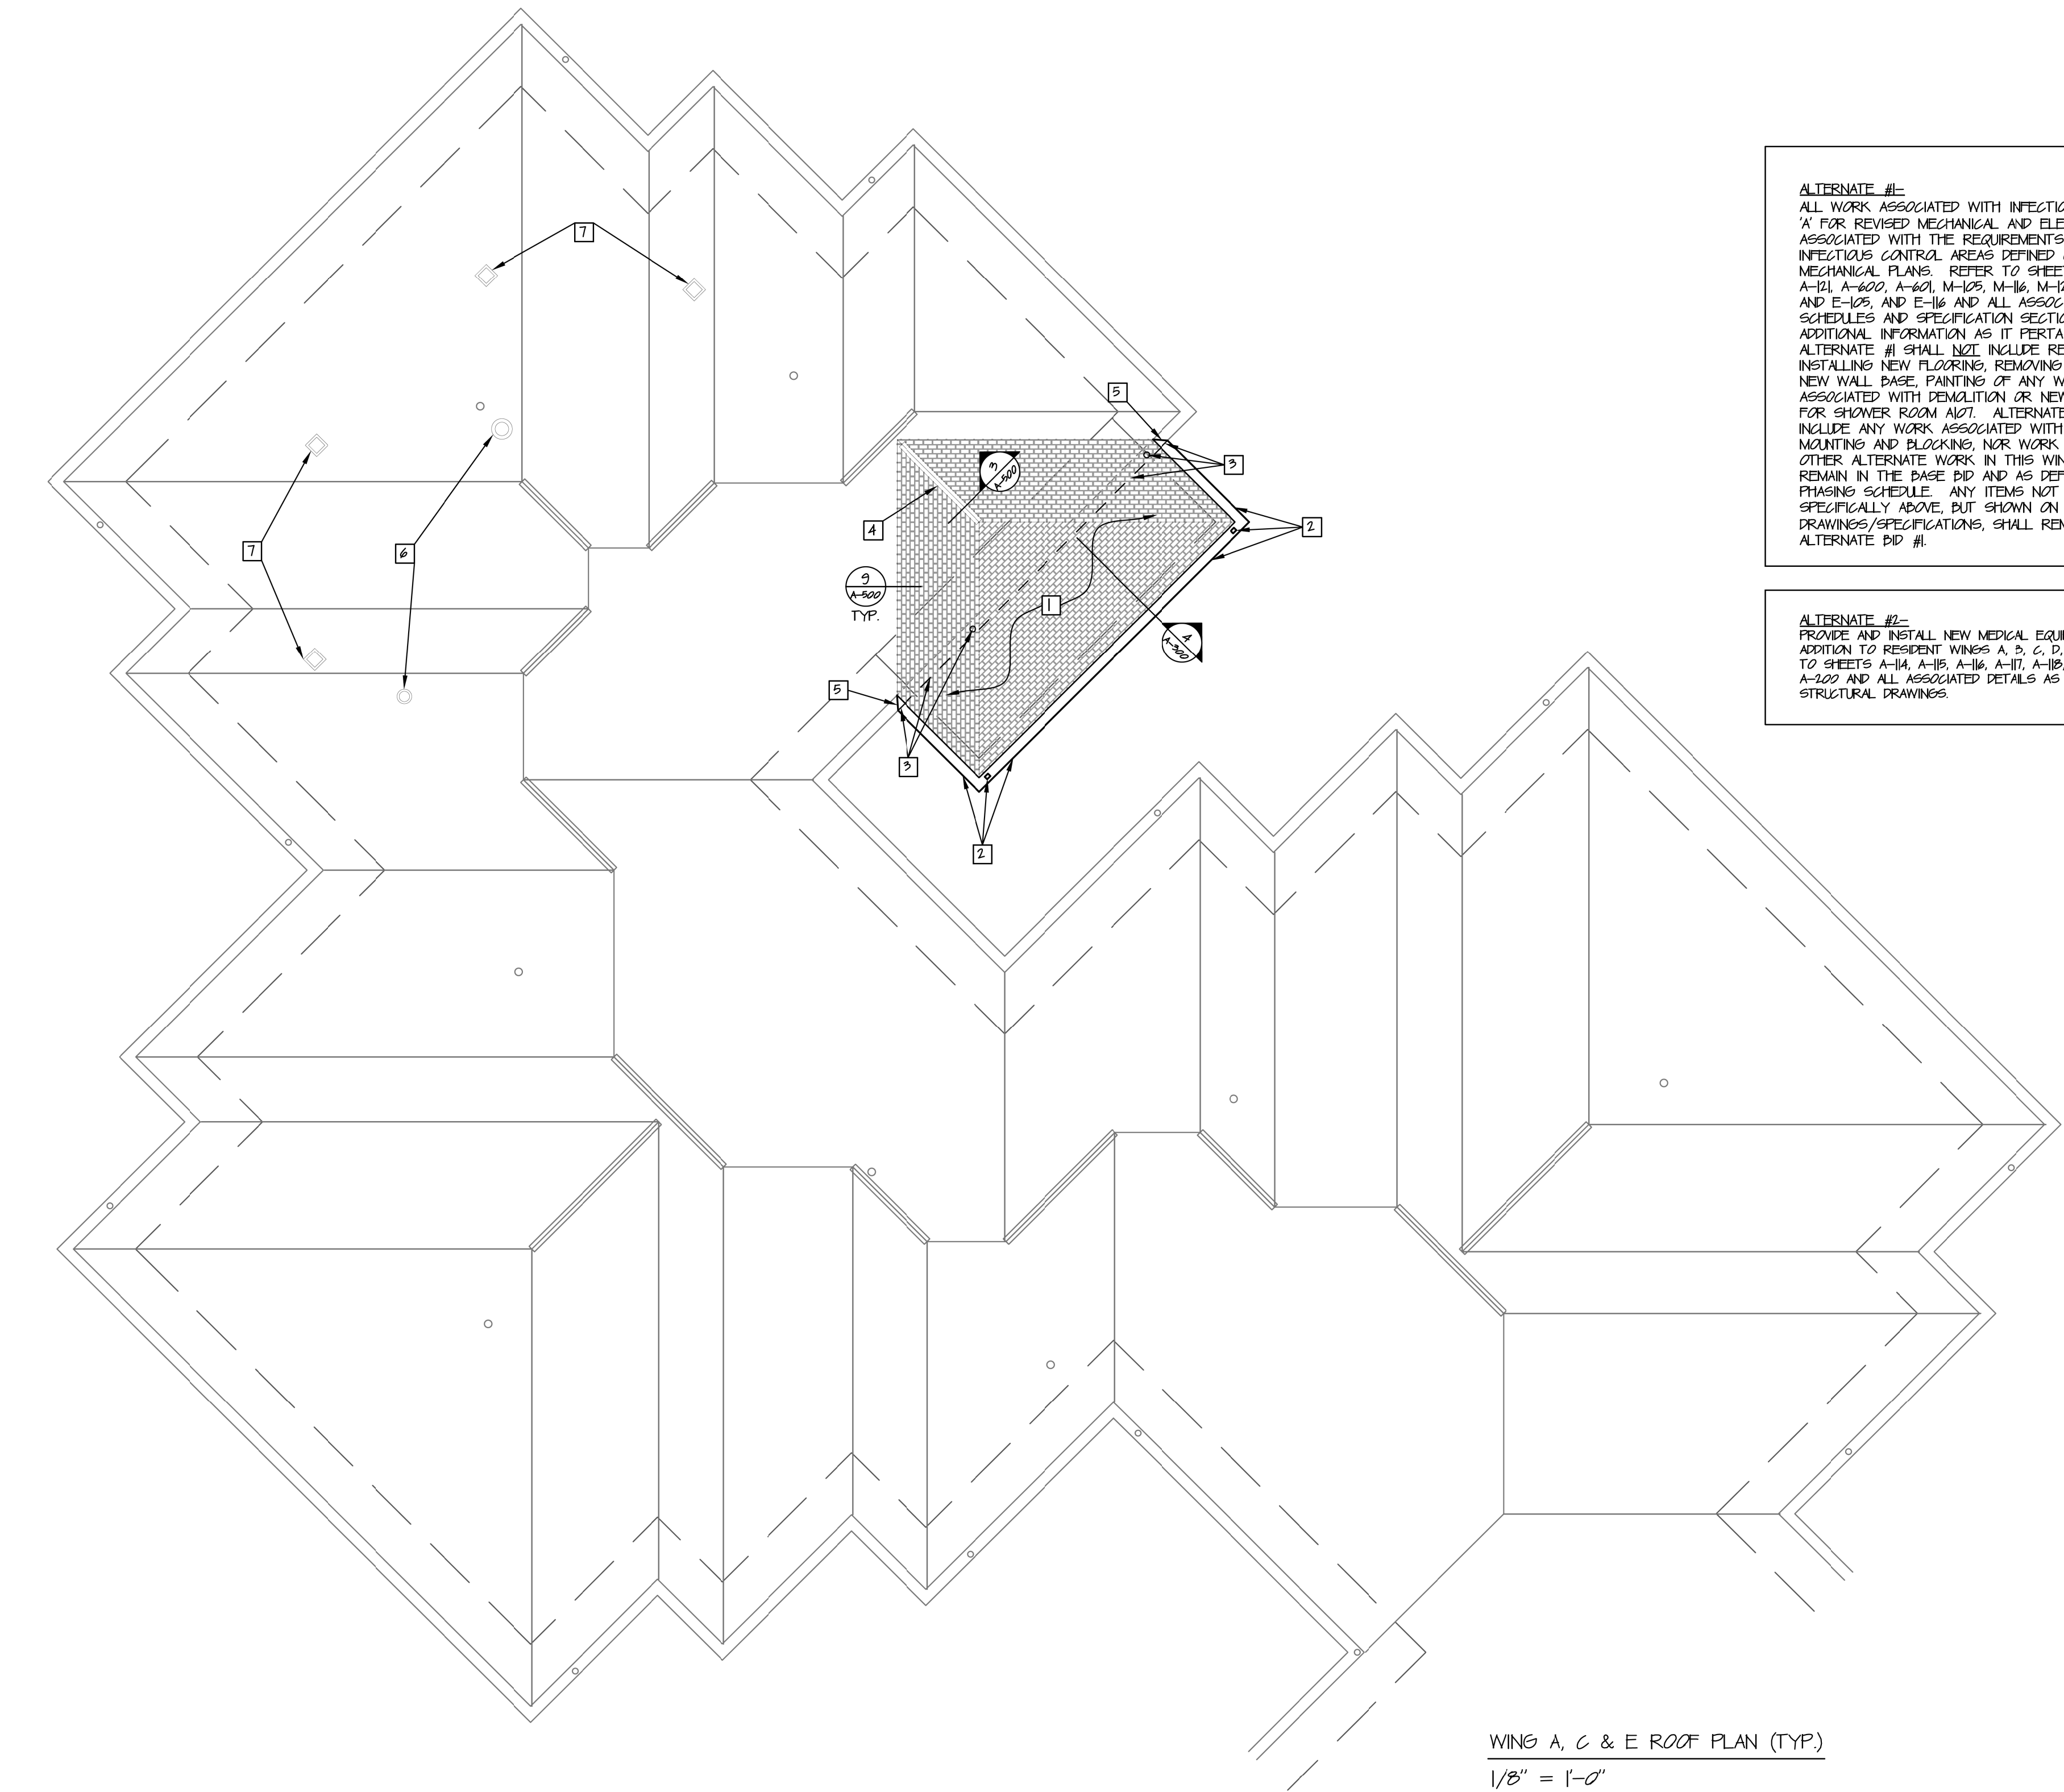BID DOCUMENTS







ALTERNATE #1=  
ALL WORK ASSOCIATED WITH INFECTIOUS CONTROL WING  
'A' FOR REVISED MECHANICAL AND ELECTRICAL WORK  
ASSOCIATED WITH THE REQUIREMENTS TO ACHIEVE THE  
INFECTIOUS CONTROL AREAS DEFINED ON THE  
MECHANICAL PLANS. REFER TO SHEETS A-104, A-114,  
A-121, A-600, A-601, M-105, M-116, M-121, M-123, M-134  
AND E-105, AND E-116 AND ALL ASSOCIATED DETAILS,  
SCHEDULES AND SPECIFICATION SECTIONS REQUIRED FOR  
ADDITIONAL INFORMATION AS IT PERTAINS TO WING A.  
ALTERNATE #1 SHALL NOT INCLUDE REMOVING AND  
INSTALLING NEW FLOORING, REMOVING AND INSTALLING  
NEW WALL BASE, PAINTING OF ANY WALLS, ANY WORK  
ASSOCIATED WITH DEMOLITION OR NEW CONSTRUCTION  
FOR SHOWER ROOM A01. ALTERNATE SHALL NOT  
INCLUDE ANY WORK ASSOCIATED WITH NEW TV  
MOUNTING AND BLOCKING, NOR WORK ASSOCIATED WITH  
OTHER ALTERNATE WORK IN THIS WING. THESE ITEMS  
REMAIN IN THE BASE BID AND AS DEFINED IN THE  
PHASING SCHEDULE. ANY ITEMS NOT LISTED  
SPECIFICALLY ABOVE, BUT SHOWN ON THE  
DRAWINGS/SPECIFICATIONS, SHALL REMAIN IN THE  
ALTERNATE BID #1.

ALTERNATE #2=  
PROVIDE AND INSTALL NEW MEDICAL EQUIPMENT ROOM  
ADDITION TO RESIDENT WINGS A, C, D, E AND F. REFER  
TO SHEETS A-114, A-115, A-116, A-117, A-118, A-119, A-121 AND  
A-202 AND ALL ASSOCIATED DETAILS AS WELL AS  
STRUCTURAL DRAWINGS.

WING A, C & E ROOF PLAN (TYP.)

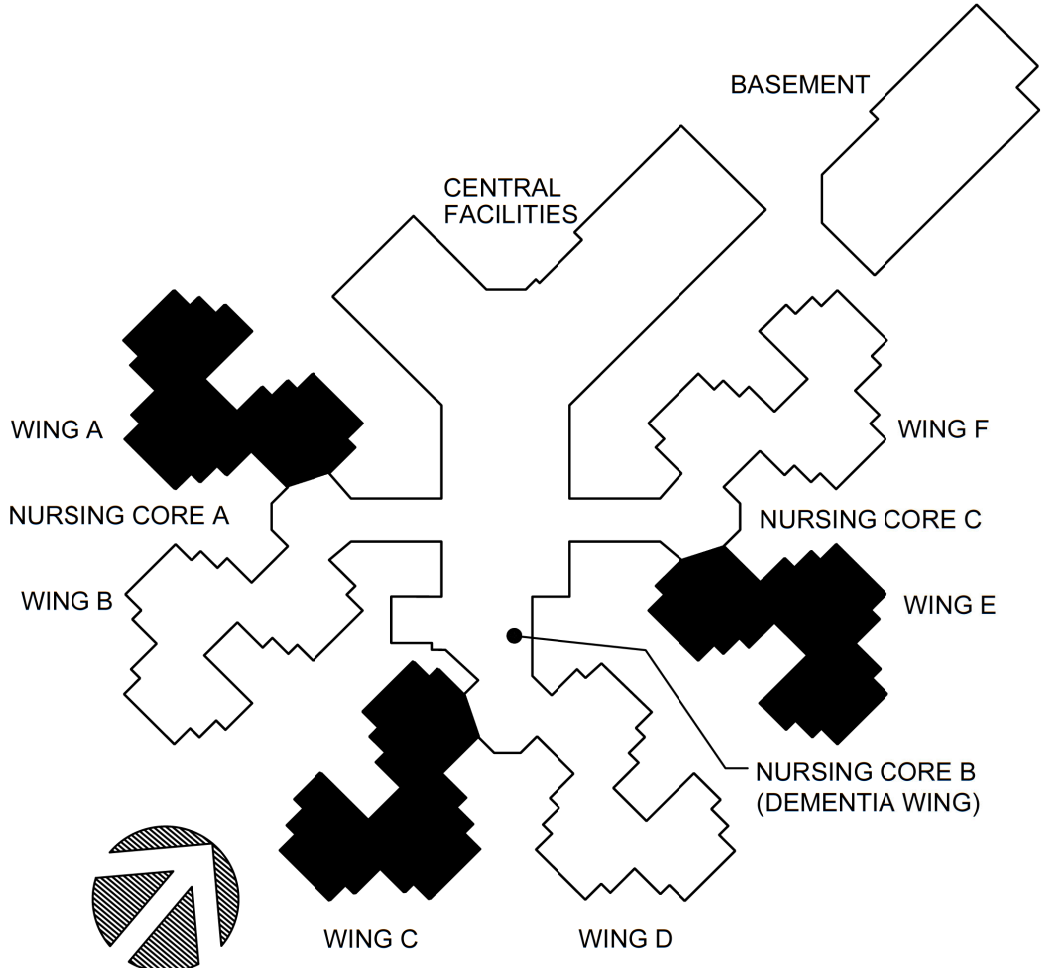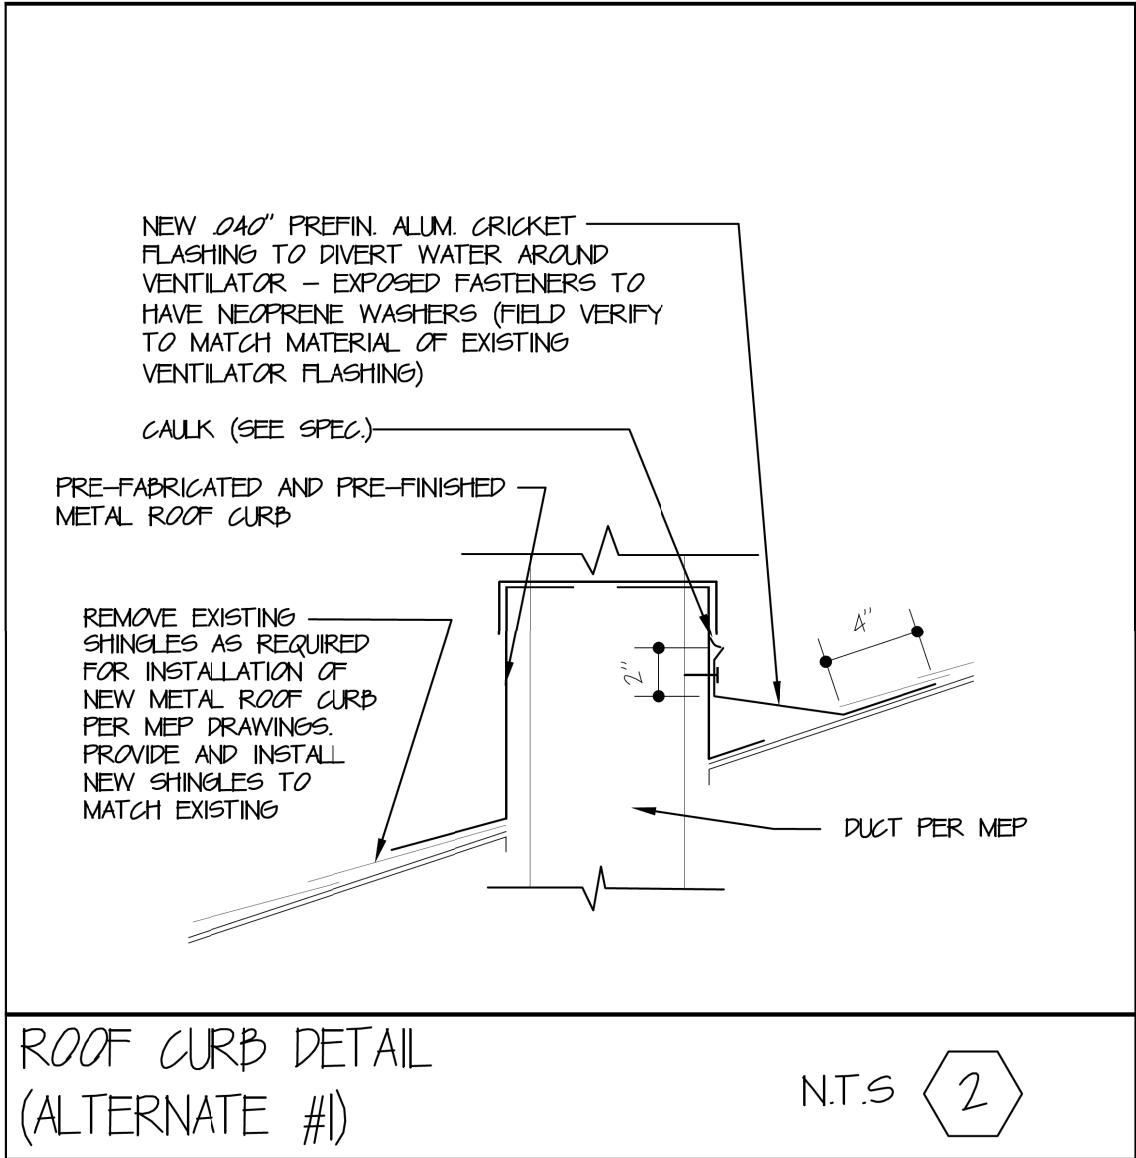1/8" = 1'-0"




KEYPLAN

GENERAL NOTES

- CONTRACTOR TO FIELD VERIFY ALL DIMENSIONS
- CONTRACTOR TO PATCH AND REPAIR ALL CONSTRUCTION TO REMAIN AFFECTED BY  
DEMOLITION TO MATCH EXISTING ADJACENT CONSTRUCTION
- ROOF WARRANTY SHALL REMAIN IN EFFECT AFTER NEW CONSTRUCTION

ROOF PLAN KEY NOTES

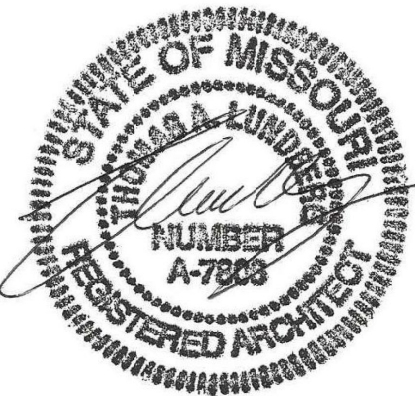- ALTERNATE #2: REMOVE AND DISCARD PORTION OF EXISTING ASPHALT SHINGLES AND  
FELT DOWN TO EXISTING DECK BELOW AREAS SHOWN TO RECEIVE NEW ROOFING.  
PROVIDE AND INSTALL CLASS 'A' FIBERGLASS COMPOSITION SHINGLES (3-TAB) OVER  
15# FELT OVER 5/8" PLYWOOD DECK (SEE SPEC). NEW SHINGLES TO MATCH EXISTING  
PROVIDE AND INSTALL ONE LAYER OF MOISTURE GUARD UNDERLAYMENT (MINIMUM OF  
3/8" WIDE) AT ALL EAVES AND RIDGES. (SEE SPECIFICATION).
- ALTERNATE #2: PROVIDE AND INSTALL NEW 6"X6"X240" PRE-FINISHED ALUMINUM GUTTER  
(VERIFY - MATCH SIZE AND PROFILE OF EXISTING ADJACENT EXISTING GUTTERS) AND  
4"X6"X240" PRE-FINISHED ALUMINUM DOWNSPOUTS WITH STRAPS AT 48" O.C. (ANCHOR  
STRAP INTO BRICK AND NOT MORTAR). COLOR TO MATCH EXISTING (VERIFY EXACT  
COLOR WITH ARCHITECT).
- ALTERNATE #2: REMOVE AND DISCARD EXISTING GUTTER AND DOWNSPOUTS TO ALLOW  
FOR NEW ROOF AND GUTTER.
- ALTERNATE #2: PROVIDE AND INSTALL NEW RIDGE VENT EQUAL TO COBRA RIGID VENT  
9" BY 64".
- ALTERNATE #2: CONNECT NEW GUTTER INTO EXISTING ADJACENT GUTTERS AT  
LOCATIONS INDICATED WITH NEW WATER-TIGHT SEAM.
- ALTERNATE #1: ONLY AT WING A, INSTALL NEW ROOF MOUNTED EXHAUST FAN. REFER  
TO MECHANICAL PLANS AND DETAIL 2 OF A-121 FOR ADDITIONAL INFORMATION. ENSURE  
SHINGLE WARRANTY REMAINS IN PLACE AFTER WORK IS COMPLETE.
- ALTERNATE #1: ONLY AT WING A, INSTALL NEW ROOF MOUNTED EXHAUST DUCT. REFER  
TO MECHANICAL PLANS AND DETAIL 2 OF A-121 FOR ADDITIONAL INFORMATION. ENSURE  
SHINGLE WARRANTY REMAINS IN PLACE AFTER WORK IS COMPLETE.



2/19/25

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CERTIFICATE OF AUTHORITY #000718



COMM. # 4860

OFFICE OF ADMINISTRATION  
DIVISION OF FACILITIES  
MANAGEMENT,  
DESIGN AND CONSTRUCTION

DEPARTMENT OF  
PUBLIC SAFETY  
MISSOURI VETERANS  
COMMISSION

INTERIOR RENOVATION  
MISSOURI VETERANS  
HOME

620 N. JEFFERSON  
ST. JAMES, MISSOURI

PROJECT # U1503-01  
SITE # 6801  
ASSET # 8136801002  
FEDERAL# 29-044

REVISION: \_\_\_\_\_  
DATE: \_\_\_\_\_  
REVISION: \_\_\_\_\_  
DATE: \_\_\_\_\_  
REVISION: \_\_\_\_\_  
DATE: \_\_\_\_\_

ISSUE DATE: 8-1-24

CAD DWG FILE: A-121.DWG  
DRAWN BY: ZAC/MAH  
CHECKED BY: MAH/CAS  
DESIGNED BY: MAH/CAS

SHEET TITLE:

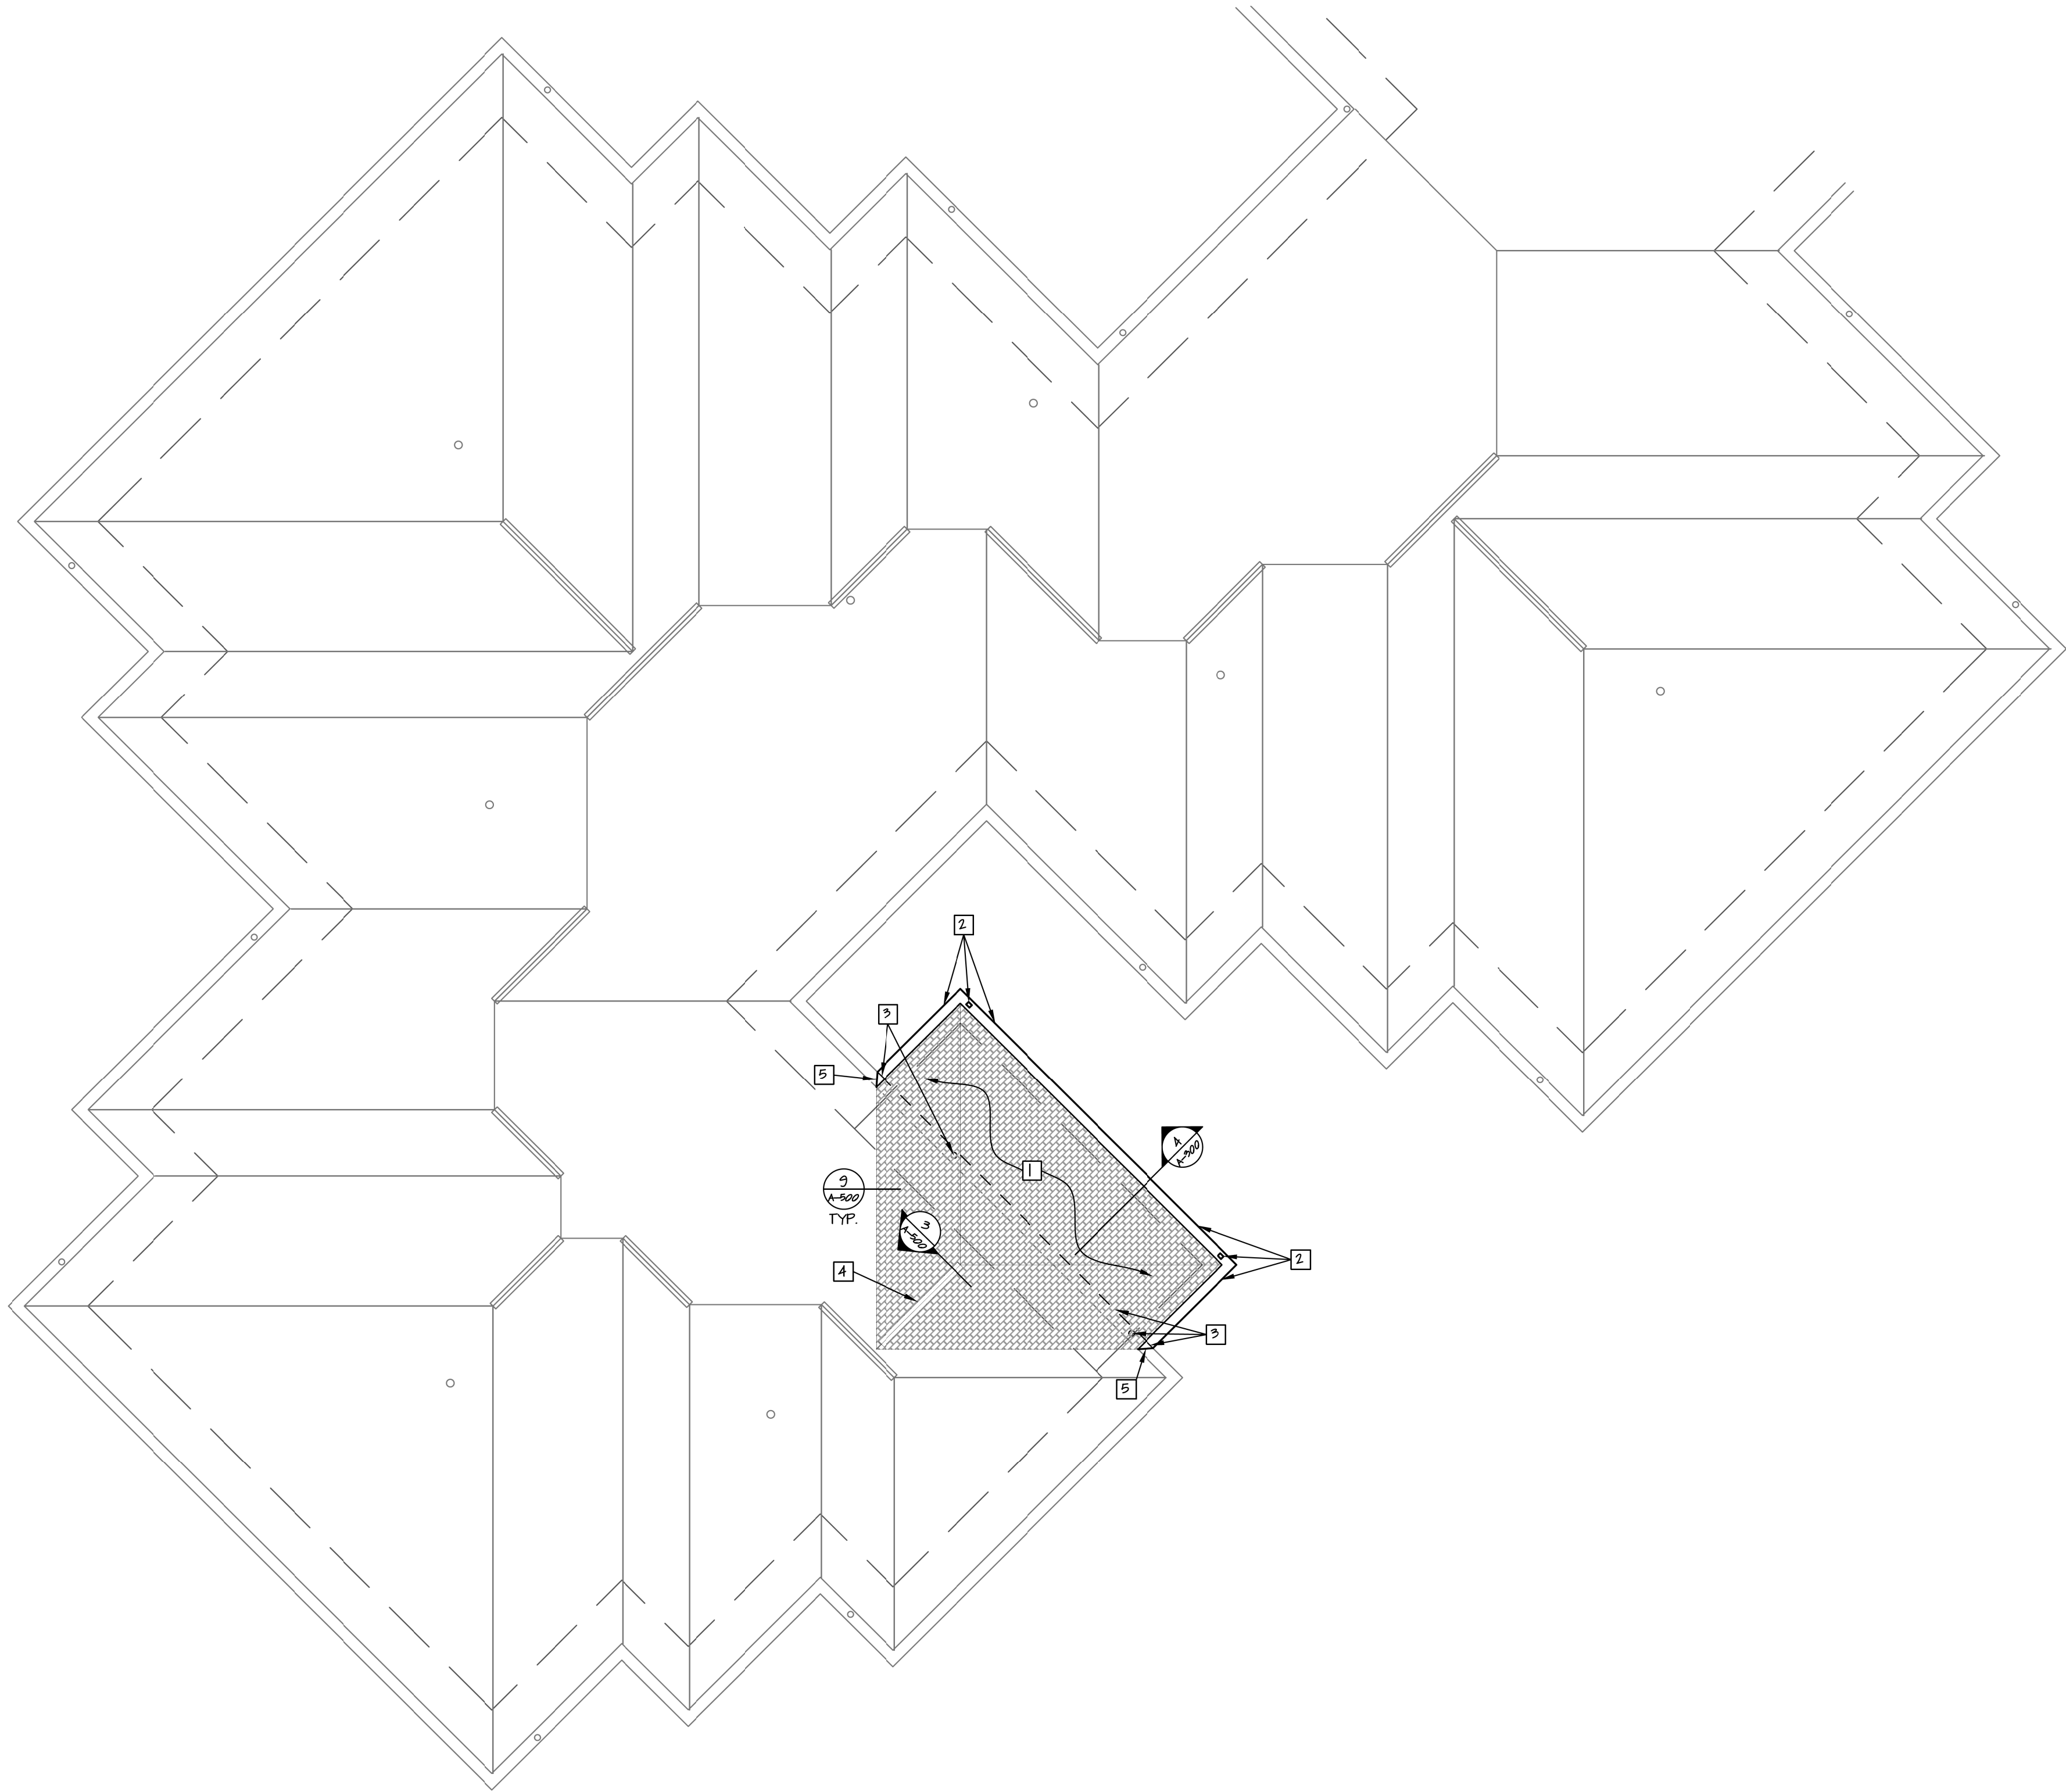
ROOF PLAN

SHEET NUMBER:


A-121

28 OF 120 SHEETS  
8-1-24





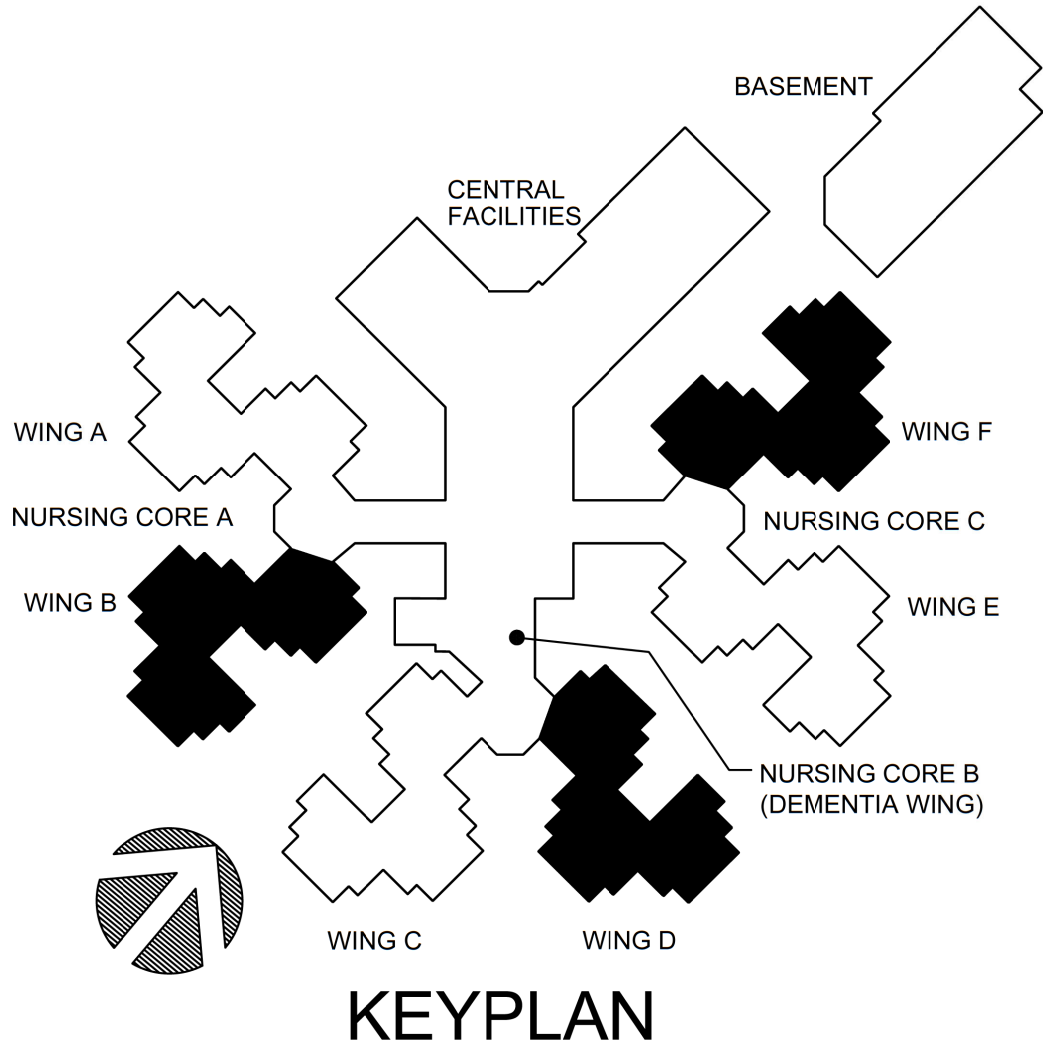ALTERNATE #2--  
PROVIDE AND INSTALL NEW MEDICAL EQUIPMENT ROOM  
ADDITION ON TO RESIDENT WINGS A, B, C, D, E AND F.  
REFER TO SHEETS A-114, A-115, A-116, A-117, A-118, A-119, A-120, A-121  
AND A-122 AND ALL ASSOCIATED DETAILS AS WELL AS  
STRUCTURAL DRAWINGS.



#### GENERAL NOTES

- CONTRACTOR TO FIELD VERIFY ALL DIMENSIONS
- CONTRACTOR TO PATCH AND REPAIR ALL CONSTRUCTION TO REMAIN AFFECTED BY DEMOLITION TO MATCH EXISTING ADJACENT CONSTRUCTION

#### ROOF PLAN KEY NOTES

- ALTERNATE #2: REMOVE AND DISCARD PORTION OF EXISTING ASPHALT SHINGLES AND FELT DOWN TO EXISTING DECK BELOW AREAS SHOWN TO RECEIVE NEW ROOFING. PROVIDE AND INSTALL CLASS "A" FIBERGLASS COMPOSITION SHINGLES (2-TAP) OVER 15# FELT OVER 5/8" PLYWOOD DECK (SEE SPEC). NEW SHINGLES TO MATCH EXISTING. PROVIDE AND INSTALL ONE LAYER OF MOISTURE GUARD UNDERLAYMENT (MINIMUM OF 3/8" WIDE) AT ALL EAVES AND RIDGES. (SEE SPECIFICATION).
- ALTERNATE #2: PROVIDE AND INSTALL NEW 6"X6"X24" PRE-FINISHED ALUMINUM GUTTER (VERIFY - MATCH SIZE AND PROFILE OF EXISTING ADJACENT EXISTING GUTTERS) AND 4"X6"X24" PRE-FINISHED ALUMINUM DOWNSPOUTS WITH STRAPS AT 48" O.C. (ANCHOR STRAP INTO BRICK AND NOT MORTAR). COLOR TO MATCH EXISTING (VERIFY EXACT COLOR WITH ARCHITECT).
- ALTERNATE #2: REMOVE AND DISCARD EXISTING GUTTER AND DOWNSPOUTS TO ALLOW FOR NEW ROOF AND GUTTER.
- ALTERNATE #2: PROVIDE AND INSTALL NEW RIDGE VENT EQUAL TO COBRA RIGID VENT 3" BY 64".
- ALTERNATE #2: CONNECT NEW GUTTER INTO EXISTING ADJACENT GUTTERS AT LOCATIONS INDICATED WITH NEW WATER-TIGHT SEAM.

WING B, D & F ROOF PLAN (TYP.)

1/8" = 1'-0"

STATE OF MISSOURI  
MIKE KEHOE,  
GOVERNOR



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AIA architects & planners

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PROJECT # U1503-01  
SITE # 6801  
ASSET # 8136801002  
FEDERAL# 29-044

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DATE: \_\_\_\_\_  
REVISION: \_\_\_\_\_  
DATE: \_\_\_\_\_

ISSUE DATE: 8-1-24

CAD DWG FILE: A-122.DWG  
DRAWN BY: ZAC/MAH  
CHECKED BY: MAH/CAS  
DESIGNED BY: MAH/CAS

SHEET TITLE:

ROOF PLAN

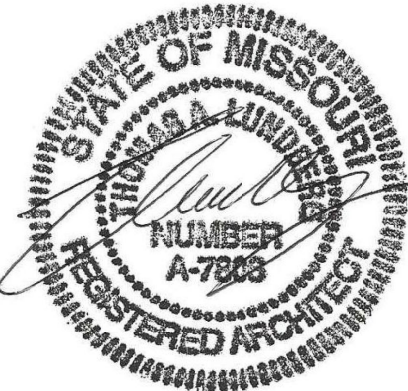
SHEET NUMBER:

A-122

29 OF 120 SHEETS  
8-1-24

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REVISION: \_\_\_\_\_  
DATE: \_\_\_\_\_

ISSUE DATE: 8-1-24

CAD DWG FILE: A-123.DWG  
DRAWN BY: ZAC/MAH  
CHECKED BY: MAH/CAS  
DESIGNED BY: MAH/CAS

SHEET TITLE:

OVERALL ROOF  
PLAN

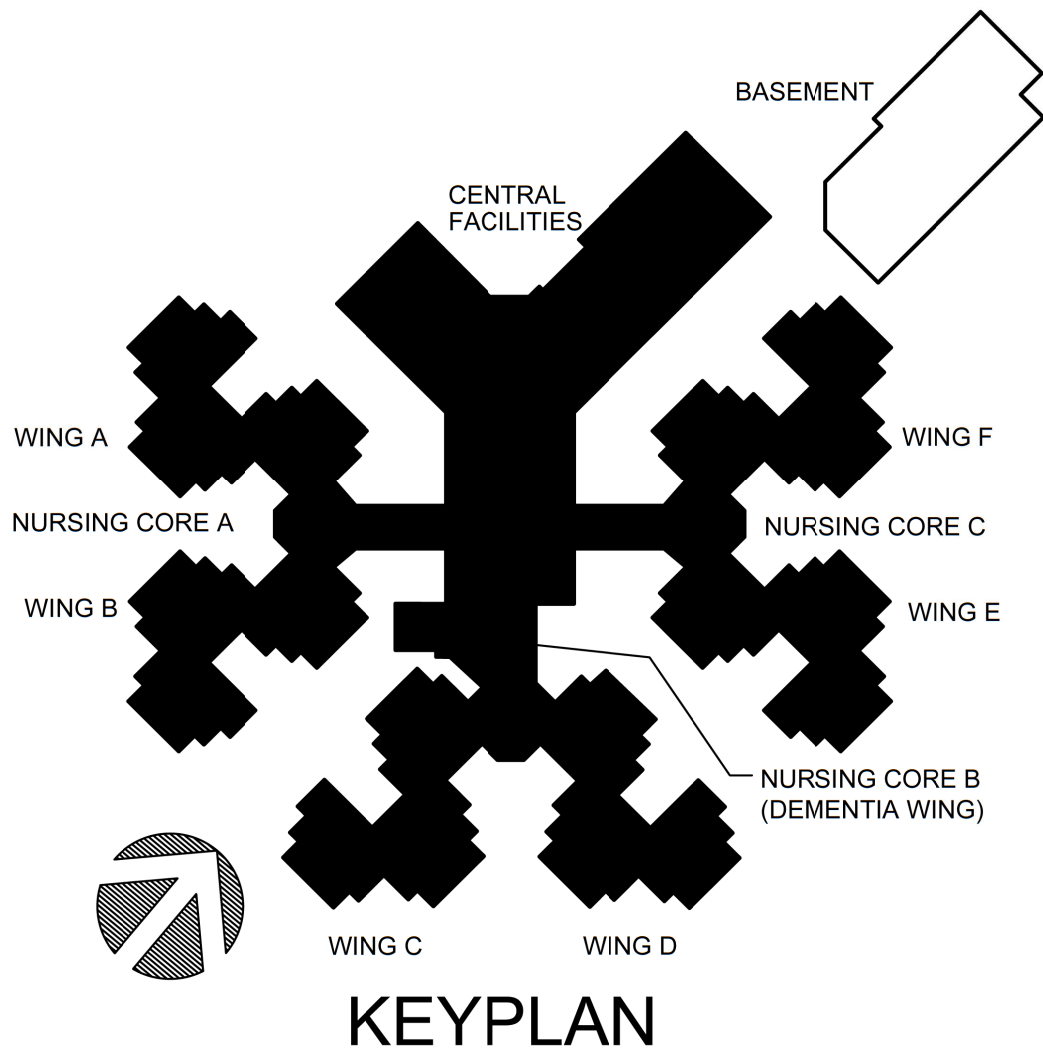
SHEET NUMBER:

A-123

30 OF 120 SHEETS  
8-1-24

ALTERNATE #1-  
ALL WORK ASSOCIATED WITH INFECTIOUS CONTROL WING  
A' FOR REVISED MECHANICAL AND ELECTRICAL WORK  
ASSOCIATED WITH THE REQUIREMENTS TO ACHIEVE THE  
INFECTIOUS CONTROL AREAS DEFINED ON THE  
MECHANICAL PLANS. REFER TO SHEETS A-104, A-114,  
A-121, A-200, A-201, M-105, M-116, M-127, M-133, M-134  
AND E-105, AND E-116 AND ALL ASSOCIATED DETAILS,  
SCHEDULES AND SPECIFICATION SECTIONS REQUIRED FOR  
ADDITIONAL INFORMATION AS IT PERTAINS TO WING A.  
ALTERNATE #1 SHALL NOT INCLUDE REMOVING AND  
INSTALLING NEW FLOORING, REMOVING AND INSTALLING  
NEW WALL BASE, PAINTING OF ANY WALLS. ANY WORK  
ASSOCIATED WITH DEMOLITION OR NEW CONSTRUCTION  
FOR SHOWER ROOM A107. ALTERNATE SHALL NOT  
INCLUDE ANY WORK ASSOCIATED WITH NEW TV  
MOUNTING AND BACKING NOR WORK ASSOCIATED WITH  
OTHER ALTERNATE WORK IN THIS WING. THESE ITEMS  
REMAIN IN THE BASE BID AND AS DEFINED IN THE  
PHASING SCHEDULE. ANY ITEMS NOT LISTED  
SPECIFICALLY ABOVE, BUT SHOWN ON THE  
DRAWINGS/SPECIFICATIONS, SHALL REMAIN IN THE  
ALTERNATE BID #1.

ALTERNATE #2-  
PROVIDE AND INSTALL NEW MEDICAL EQUIPMENT ROOM  
ADDITION ON TO RESIDENT WINGS A, B, C, D, E AND F.  
REFER TO SHEETS A-114, A-115, A-116, A-117, A-118, A-119,  
A-121 AND A-200 AND ALL ASSOCIATED DETAILS AS  
WELL AS STRUCTURAL DRAWINGS.



GENERAL NOTES:

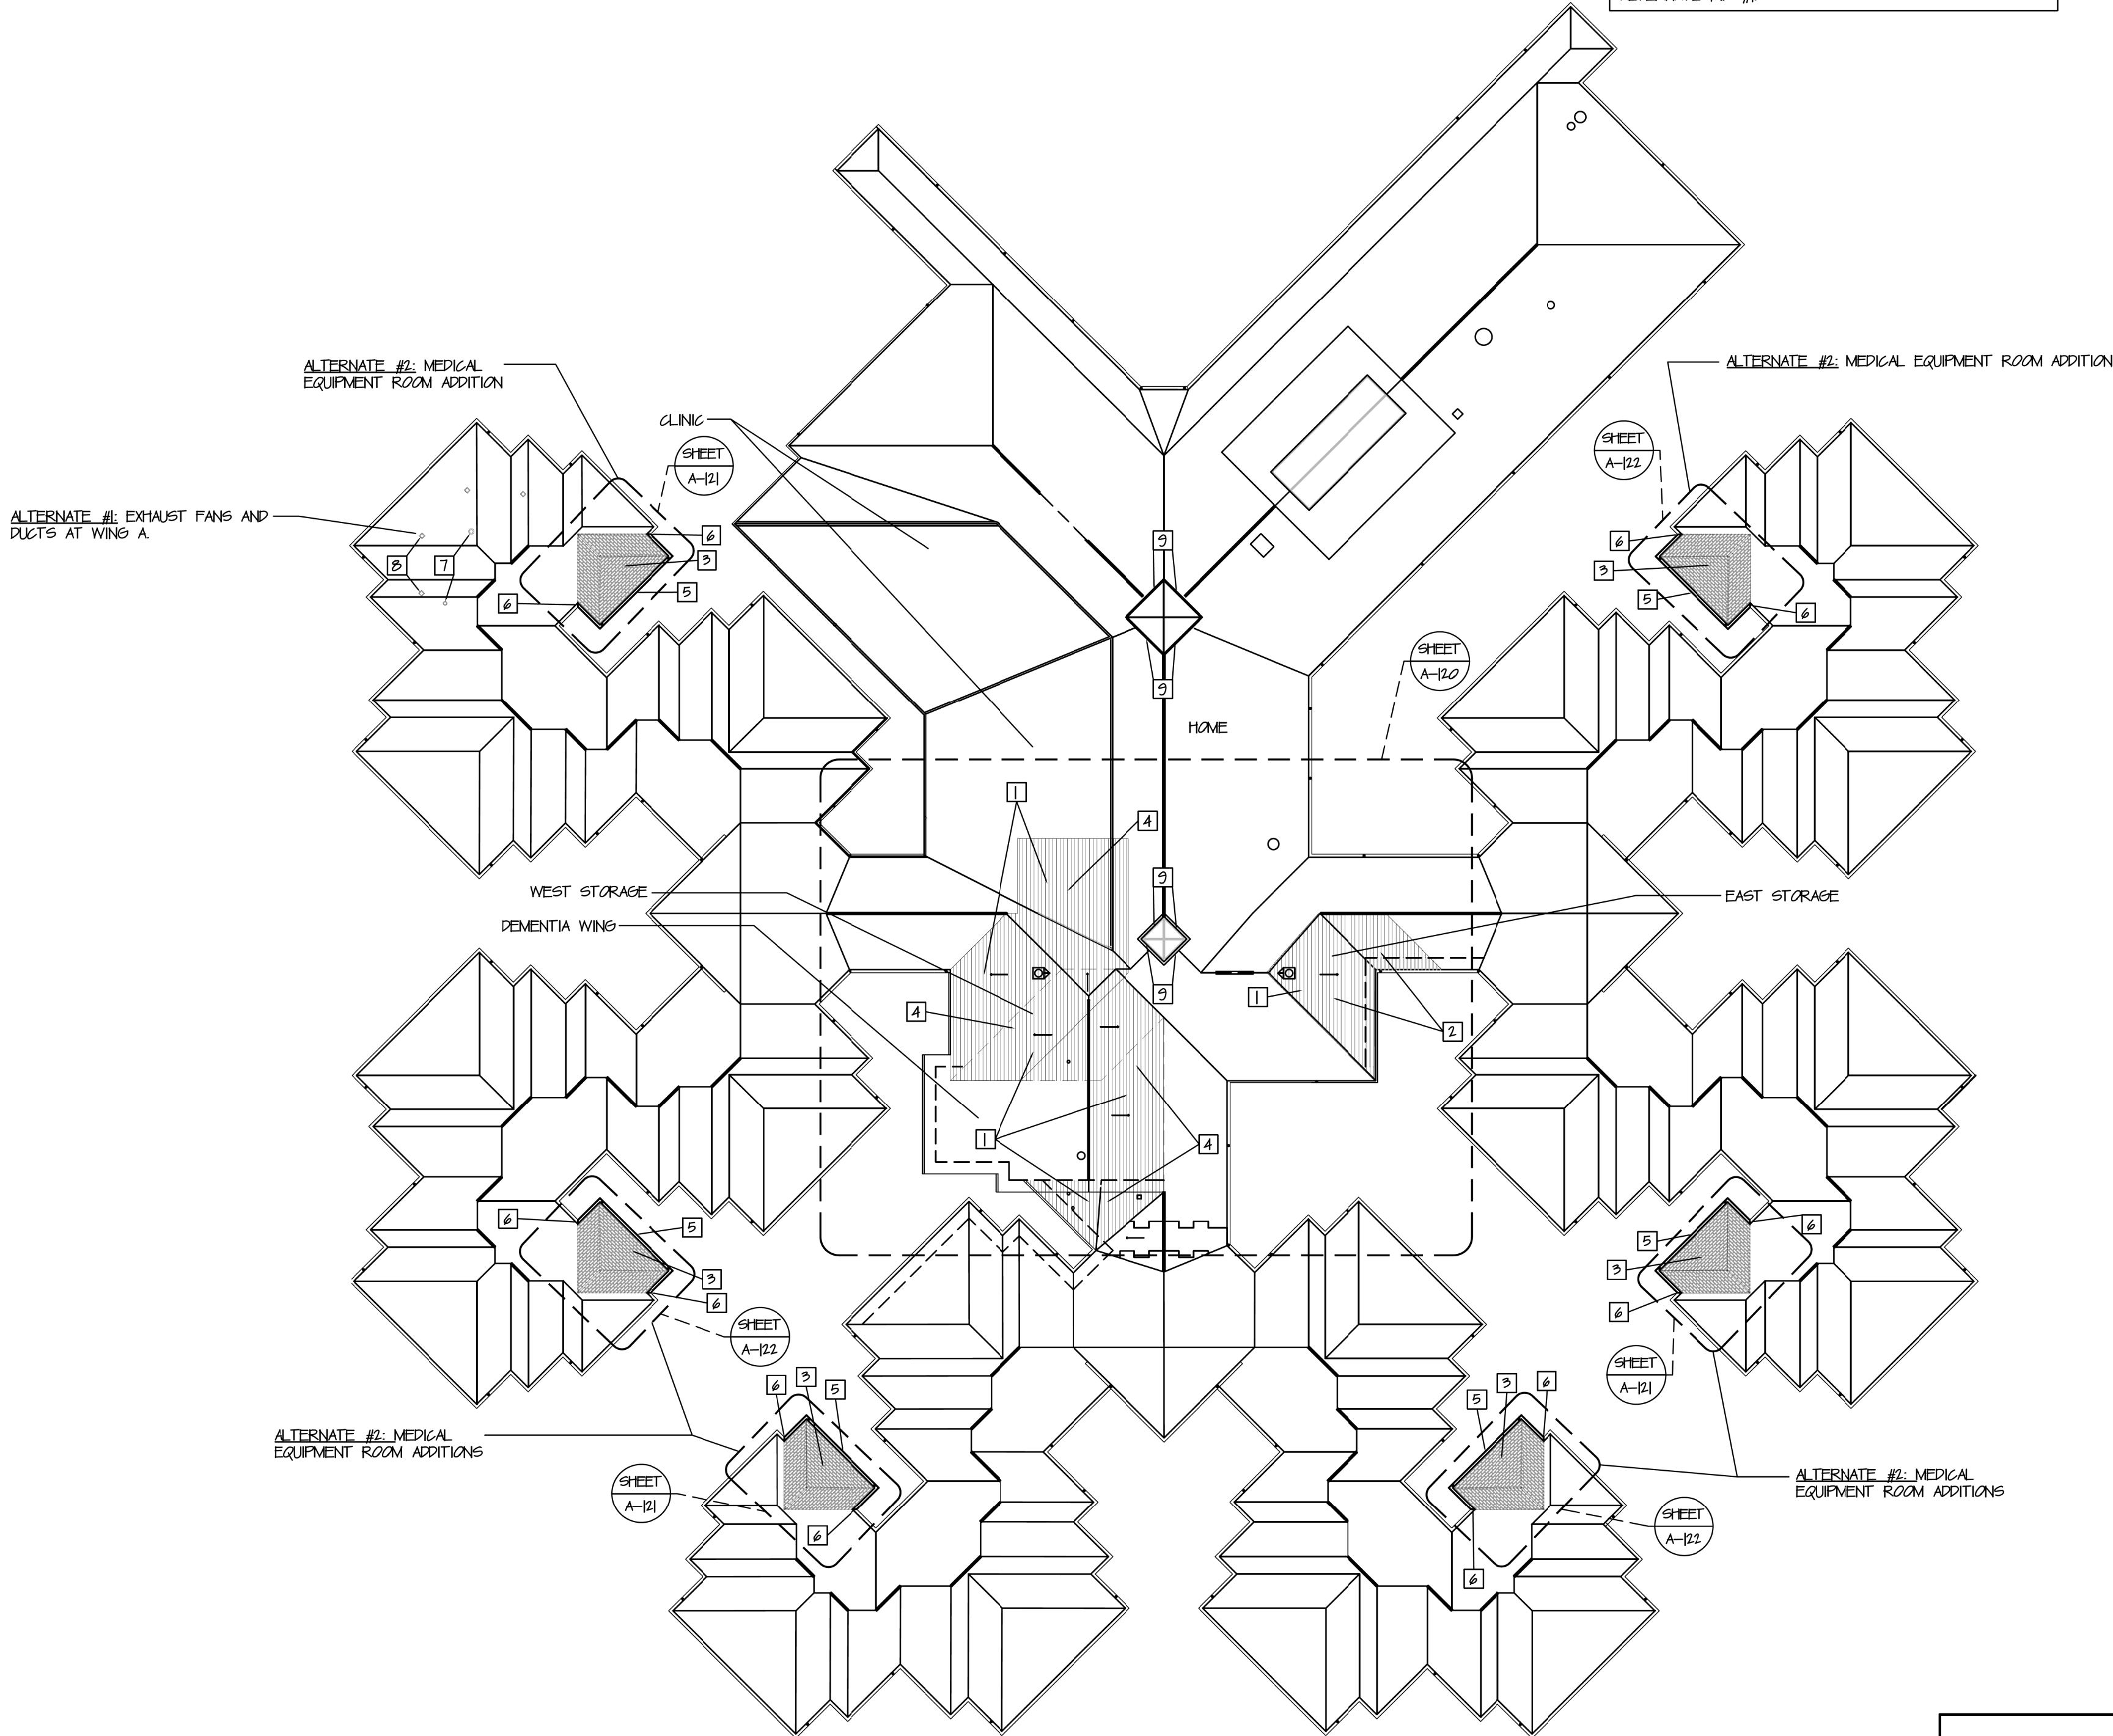
- CONTRACTOR TO FIELD VERIFY ALL DIMENSIONS
- CONTRACTOR TO PATCH AND REPAIR ALL CONSTRUCTION TO REMAIN AFFECTED BY DEMOLITION TO MATCH EXISTING ADJACENT CONSTRUCTION
- ROOF WARRANTY SHALL REMAIN IN EFFECT AFTER NEW CONSTRUCTION

ROOF/ATTIC VENTING REQUIREMENTS (REFER TO DETAILS FOR PLACEMENT):

ALL FIRE DAMPERS AND ROOF VENTS TO BE SPACED THROUGHOUT THE ATTIC AREA EVENLY, AND COORDINATED IN FIELD WITH STRUCTURE FOR PLACEMENT. COORDINATE LOCATIONS WITH THE ARCHITECT/OWNER.

ROOF/ATTIC PLAN KEY NOTES

- EXISTING ASPHALT SHINGLE ROOFING THAT IS IN THE ENCLOSED ATTIC AREA AT THE AREAS DENOTED BY SHADING ON THE ROOF PLAN WILL REQUIRE THE REMOVAL OF ALL EXISTING INSULATION AND THE CONTRACTOR SHALL APPLY 3/4" OF SPRAY-APPLIED FIRE RESISTIVE MATERIAL EQUAL TO PLAZE-SHIELD II BY CAFCO OVER THE EXISTING ASPHALT SHINGLES.
- EAST STORAGE ROOM - PROVIDE 16 SF TOTAL VENTING AREA FOR FIRE DAMPERS (MINIMUM OF 4 EQUALLY SPACED DAMPERS) AND 240 SQ IN VENTING AREA TOTAL FOR ROOF VENTS (MINIMUM OF 4 EQUALLY SPACED VENTS). ALL FIRE DAMPERS AND ROOF VENTS TO BE SPACED THROUGHOUT THE ATTIC AREA EVENLY, COORDINATE WITH THE ARCHITECT/OWNER. REFER TO WALL SECTIONS 1 AND 2 OF A-302 AND 1 OF A-303.
- ALTERNATE #2: REMOVE AND DISCARD PORTION OF EXISTING ASPHALT SHINGLES AND FELT DOWN TO EXISTING DECK BELOW AREAS SHOWN TO RECEIVE NEW ROOFING. PROVIDE AND INSTALL CLASS "A" FIBERGLASS COMPOSITION SHINGLES (5-TAB) OVER 5/8" FELT OVER 5/8" PLYWOOD DECK (SEE SPEC). NEW SHINGLES TO MATCH EXISTING. PROVIDE AND INSTALL ONE LAYER OF MOISTURE GUARD UNDERLAYMENT (MINIMUM OF 3/8" WIDE) AT ALL EAVES AND RIDGES. (SEE SPECIFICATION)
- DEMENTIA AND WEST STORAGE ROOM - PROVIDE 29 SF TOTAL VENTING AREA FOR FIRE DAMPERS (MINIMUM OF 6 EQUALLY SPACED DAMPERS) AND 480 SQ IN VENTING AREA TOTAL FOR ROOF VENTS (MINIMUM OF 8 EQUALLY SPACED VENTS). ALL FIRE DAMPERS AND ROOF VENTS TO BE SPACED THROUGHOUT THE ATTIC AREA EVENLY, COORDINATE WITH THE ARCHITECT/OWNER. REFER TO WALL SECTIONS 1 AND 2 OF A-302 AND 1 OF A-303.
- ALTERNATE #2: PROVIDE AND INSTALL NEW 6"x6"x24" PRE-FINISHED ALUMINUM GUTTER (VERIFY - MATCH SIZE AND PROFILE OF EXISTING ADJACENT EXISTING GUTTER) AND 4"x6"x24" PRE-FINISHED ALUMINUM DOWNSPOUTS WITH STRAPS AT 48" O.C. (ANCHOR STRAP INTO BRICK AND NOT MORTAR). COLOR TO MATCH EXISTING (VERIFY EXACT COLOR WITH ARCHITECT)
- ALTERNATE #2: TIE NEW GUTTER INTO EXISTING ADJACENT GUTTERS AT LOCATIONS INDICATED ON THE PLAN.
- ALTERNATE #1: ONLY AT WING A, INSTALL NEW ROOF MOUNTED EXHAUST FAN. REFER TO MECHANICAL PLANS AND DETAIL 2 OF A-121 FOR ADDITIONAL INFORMATION. ENSURE SHINGLE WARRANTY REMAINS IN PLACE AFTER WORK IS COMPLETE.
- ALTERNATE #1: ONLY AT WING A, INSTALL NEW ROOF MOUNTED EXHAUST DUCT. REFER TO MECHANICAL PLANS AND DETAIL 2 OF A-121 FOR ADDITIONAL INFORMATION. ENSURE SHINGLE WARRANTY REMAINS IN PLACE AFTER WORK IS COMPLETE.
- PROVIDE AND INSTALL FLASHING PER DETAIL 2 OF A-123. PATCH AND REPAIR ADJACENT CONSTRUCTION AS REQUIRED. ENSURE SHINGLE WARRANTY REMAINS IN PLACE AFTER WORK IS COMPLETE.



OVERALL ROOF PLAN

1/32" = 1'-0"



TEMPORARILY REMOVE EXISTING VINYL SIDING TO ALLOW FOR INSTALLATION OF NEW FLASHING. RE-INSTALL WHEN NEW FLASHING IS COMPLETE.  
NEW .092" PREFINISHED ALUMINUM FLASHING (COLOR TO MATCH SIDING - VERIFY WITH ARCHITECT)  
TEMPORARILY REMOVE PORTION OF EXISTING SHINGLES AS REQUIRED TO ALLOW FOR INSTALLATION OF NEW FLASHING. RE-INSTALL WHEN NEW FLASHING IS COMPLETE. REPLACE ANY DAMAGED SHINGLES WITH NEW TO MATCH EXISTING.  
NEW 3/4" WIDE STRIP OF GRADE OR EQUAL WATER SHIELD (OR EQUAL)

FLASHING DETAIL

NTS 2

BID DOCUMENTS





2/19/25

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620 N. JEFFERSON  
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PROJECT # U1503-01  
SITE # 6801  
ASSET # 8136801002  
FEDERAL# 29-044

REVISION: \_\_\_\_\_  
DATE: \_\_\_\_\_  
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DATE: \_\_\_\_\_  
REVISION: \_\_\_\_\_  
DATE: \_\_\_\_\_  
ISSUE DATE: 8-1-24

CAD DWG FILE: A-200.DWG  
DRAWN BY: ZAC/MAH  
CHECKED BY: MAH/CAS  
DESIGNED BY: MAH/CAS





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ELEVATIONS


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A-200

31 OF 120 SHEETS  
8-1-24



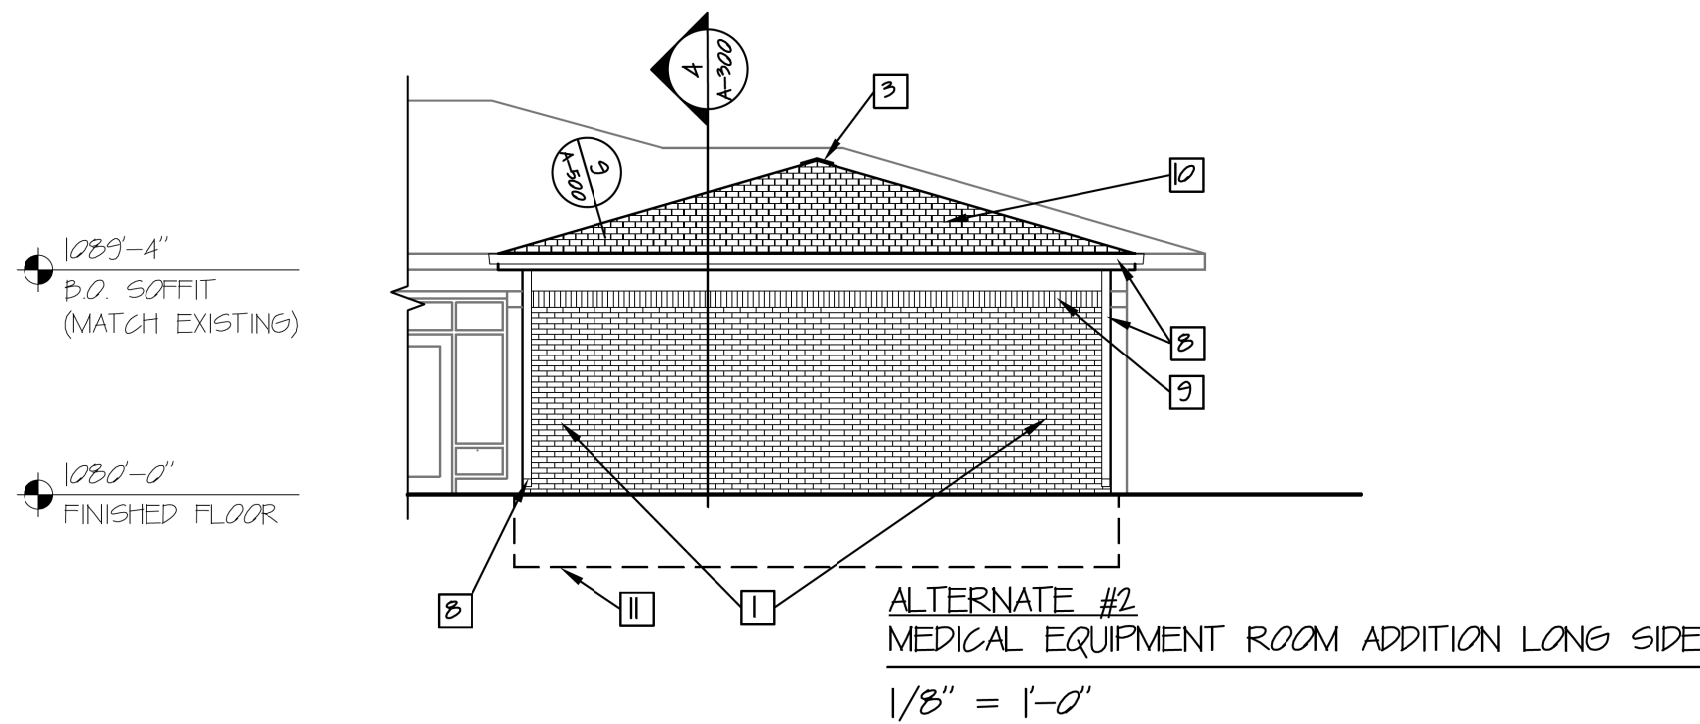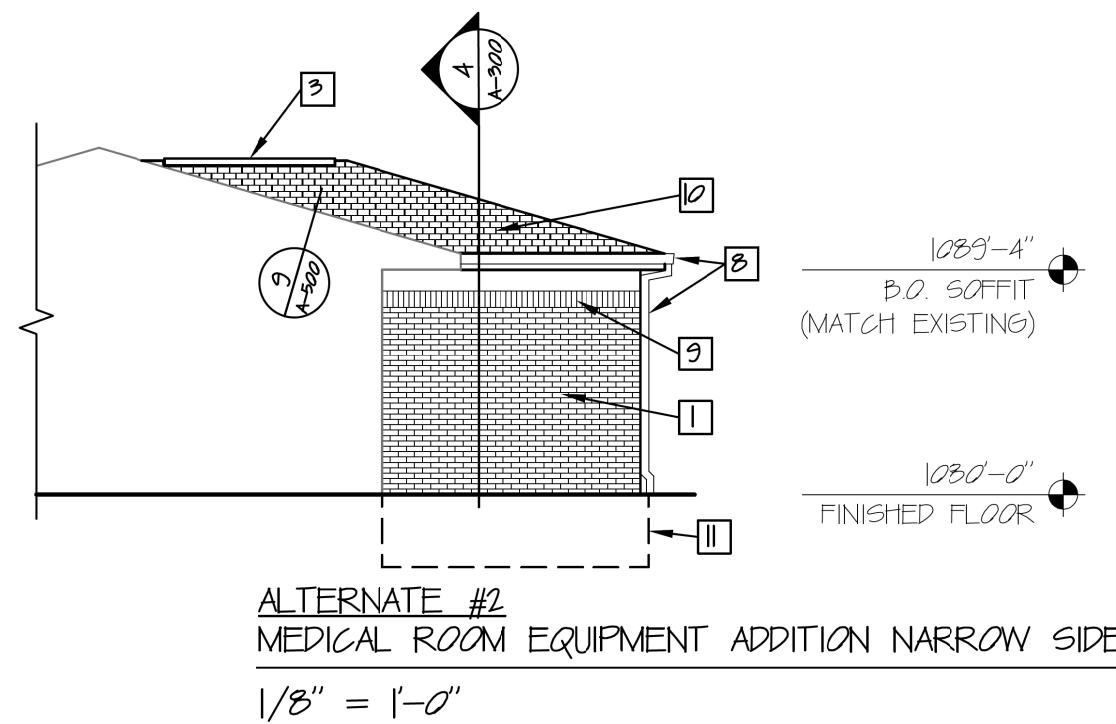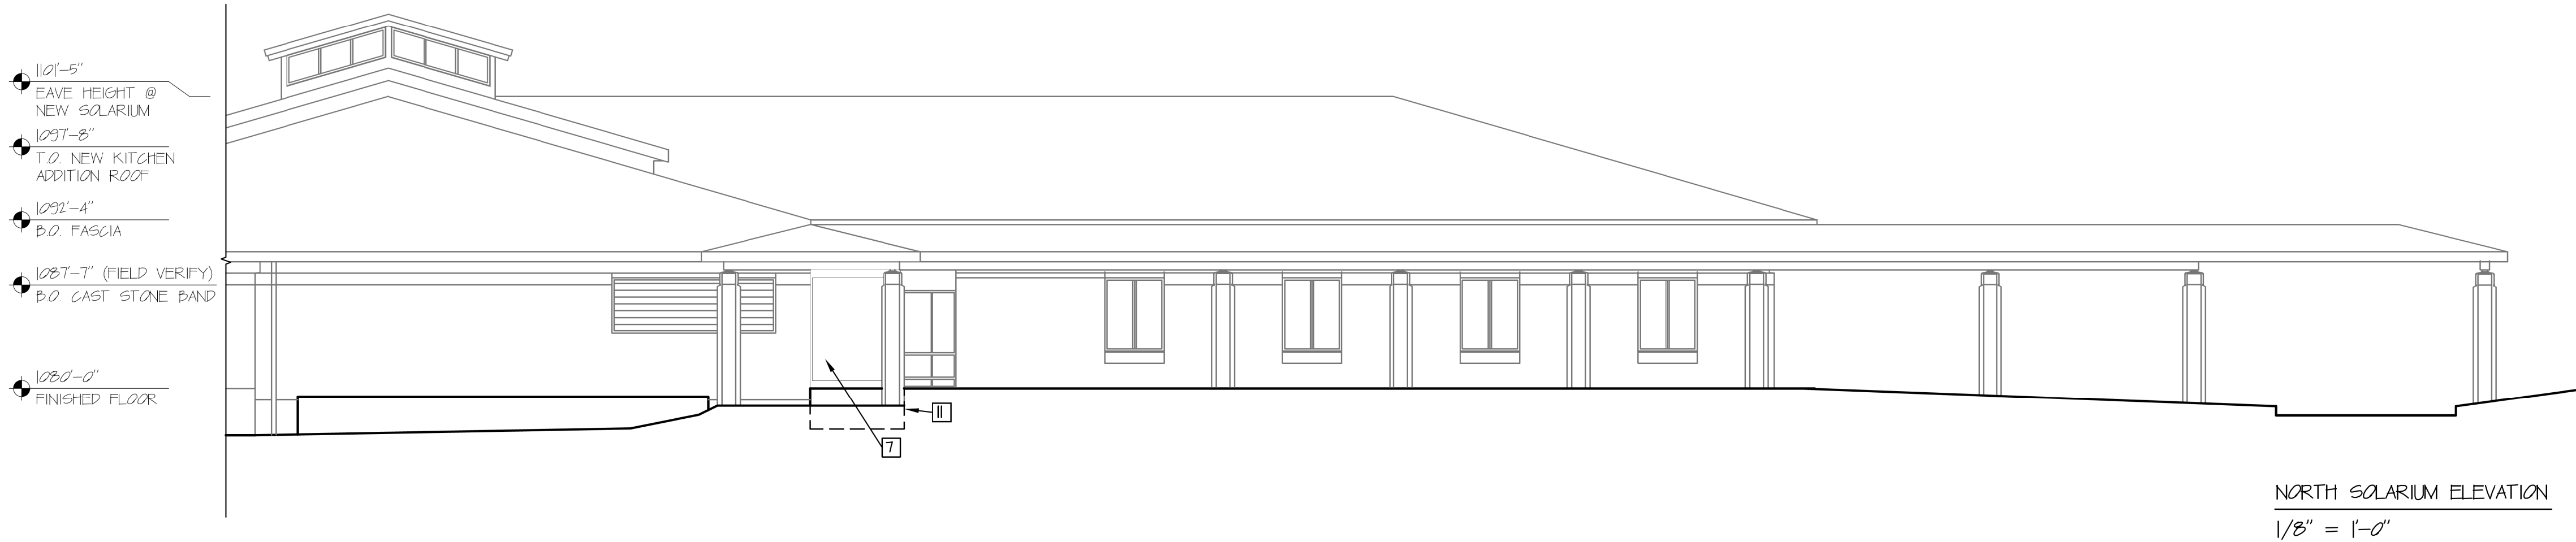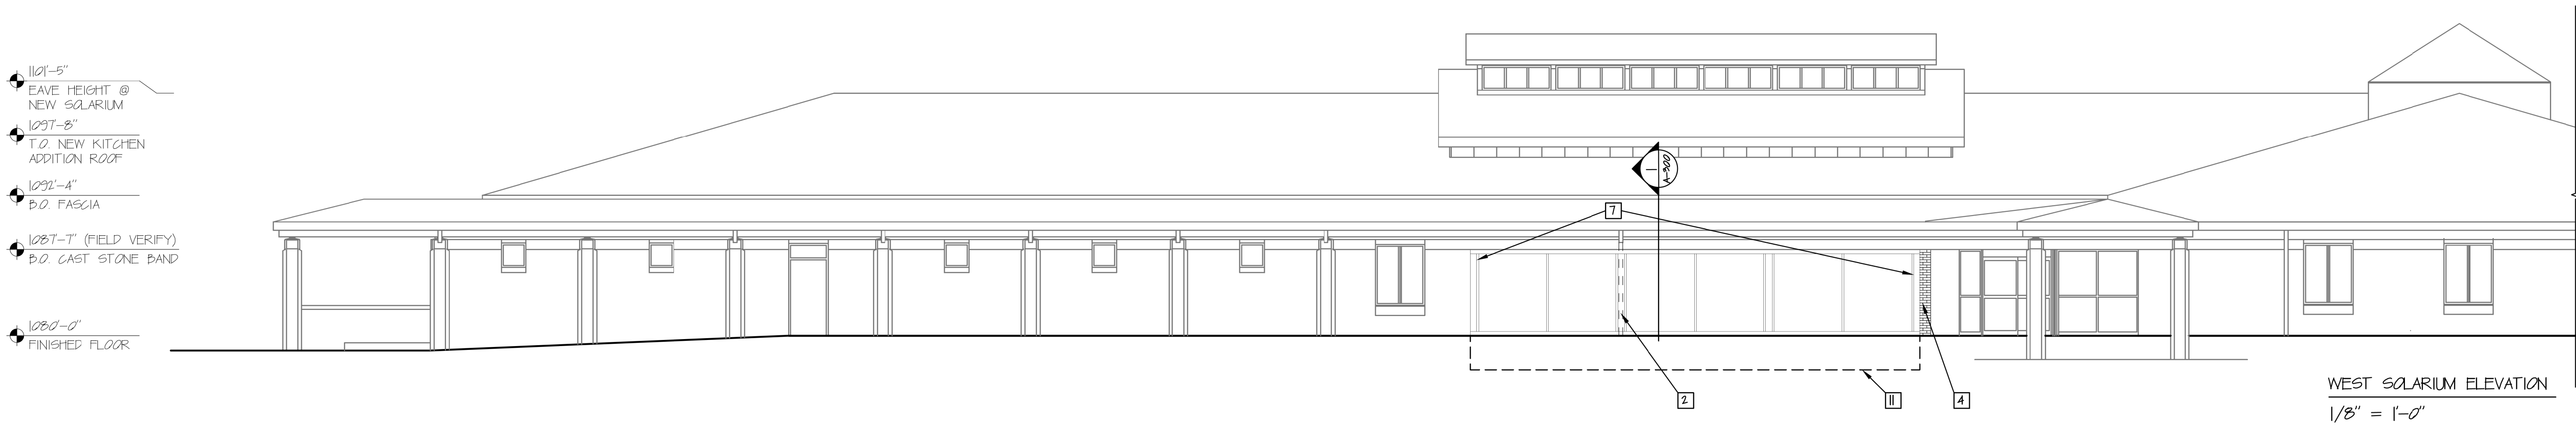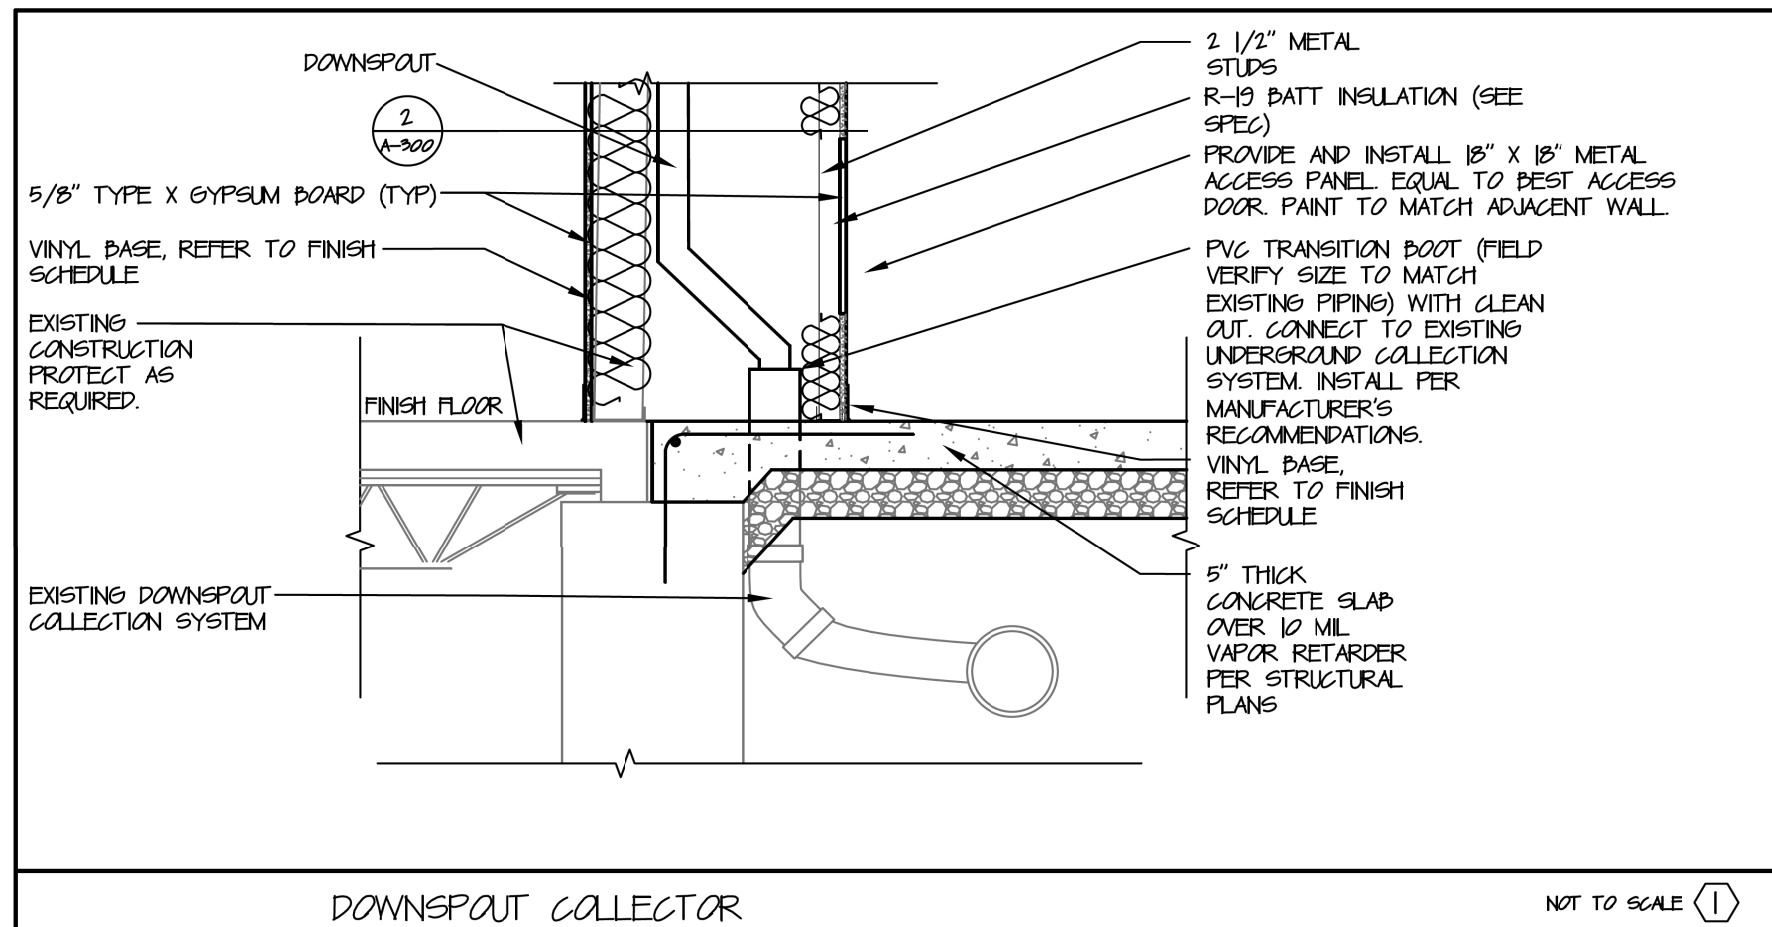**ALTERNATE #2:**  
PROVIDE AND INSTALL NEW MEDICAL EQUIPMENT ROOM  
ADDITION TO RESIDENT WINGS A, B, C, D, E AND F.  
REFER TO SHEETS A-114, A-115, A-116, A-117, A-118, A-119,  
A-121 AND A-200 AND ALL ASSOCIATED DETAILS AS WELL  
AS STRUCTURAL DRAWINGS




GENERAL NOTES

- CONTRACTOR TO FIELD VERIFY ALL DIMENSIONS
- CONTRACTOR TO PATCH AND REPAIR ALL CONSTRUCTION TO REMAIN AFFECTED BY DEMOLITION


ELEVATION KEY NOTES

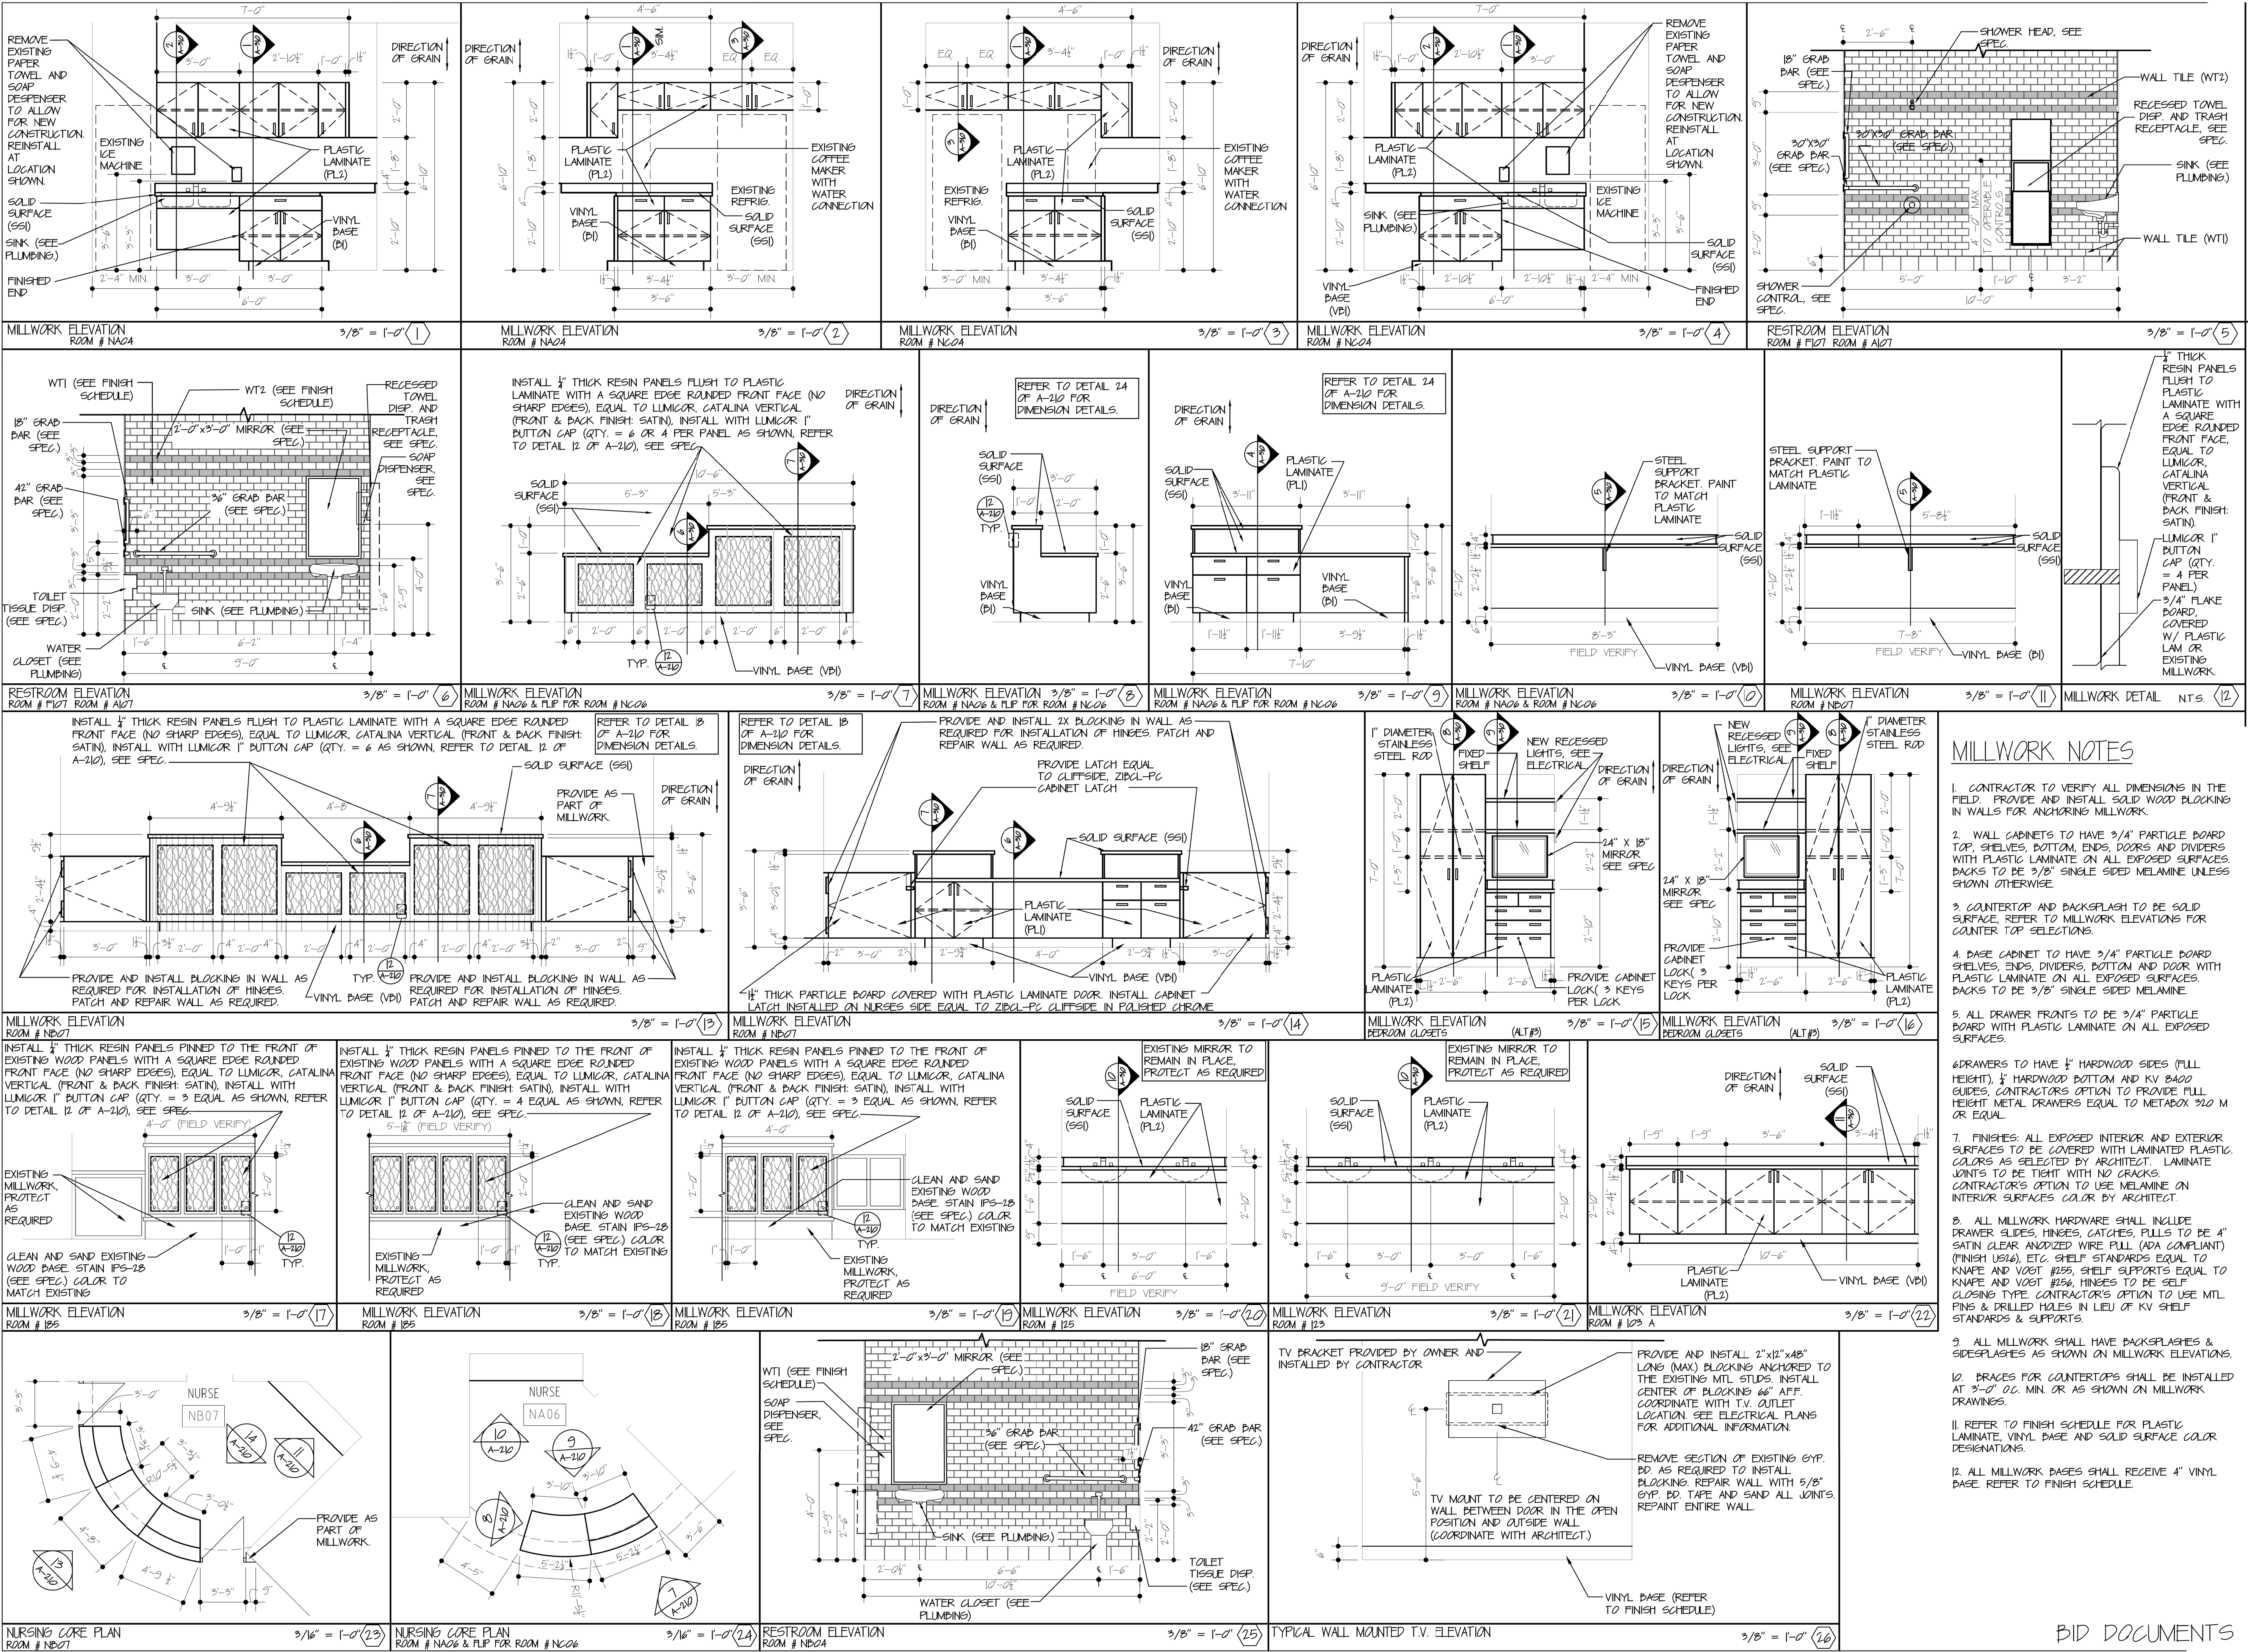- ALTERNATE #2:** PROVIDE AND INSTALL MODULAR BRICK TO MATCH EXISTING ADJACENT BRICK TEXTURE AND SIZE WHERE INDICATED ON PLAN BY (XXXXXXXXXX) COLOR TO BE EQUAL TO AGNE BRICK, PATRIOT RED. SEE SPEC.
- DOWNSPOUT (BEYOND):** REFER TO WALL SECTION 1 OF A-200 AND DOWNSPOUT DETAIL 2 OF A-202. TIE INTO EXISTING UNDERGROUND COLLECTION SYSTEM PER DETAIL 1 OF A-202.
- ALTERNATE #2:** PROVIDE AND INSTALL NEW RIDGE VENT EQUAL TO COBRA RIDGE VENT 9" BY 60", COLOR TO MATCH EXISTING ADJACENT VENTS. SEE DETAIL 3 OF A-202.
- PROVIDE AND INSTALL PROVIDE AND INSTALL MODULAR BRICK DUE TO REMOVAL OF EXISTING BRICK PER DEMOLITION PLANS AND STRUCTURAL PLANS. TO MATCH EXISTING ADJACENT BRICK TEXTURE AND SIZE WHERE INDICATED ON PLAN BY (XXXXXXXXXX) COLOR TO BE EQUAL TO AGNE BRICK, PATRIOT RED. SEE SPEC.
- NOTE NOT USED.
- NOTE NOT USED.
- ALTERNATE #2:** PROVIDE AND INSTALL NEW 2" X 4 1/2" THERMALLY BROKE ALUMINUM STOREFRONT SYSTEM W/ 4 1/2" SILL. EQUAL TO KAWNEER 481T SERIES WITH 1" GRAY SAFETY GLASS. COLOR TO BE CLEAR ANODIZED. (SEE SPEC.)
- ALTERNATE #2:** PROVIDE AND INSTALL NEW 6"x6"x240" PRE-FINISHED ALUMINUM GUTTER (VERIFY - MATCH SIZE AND PROFILE OF EXISTING ADJACENT EXISTING GUTTER) AND 4"x6"x240" PRE-FINISHED ALUMINUM DOWNSPOUTS WITH STRAPS AT 48" O.C. (ANCHOR STRAP INTO BRICK AND NOT MORTAR). COLOR TO MATCH EXISTING (VERIFY EXACT COLOR WITH ARCHITECT). PROVIDE CONCRETE SPLASH BLOCK AT EACH DOWN SPOUT.
- ALTERNATE #2:** PROVIDE AND INSTALL BRICK IN A SOLDIER COURSE TO MATCH EXISTING ADJACENT BRICK TEXTURE AND SIZE WHERE INDICATED ON ELEVATIONS BY (XXXXXXXXXX) COLOR TO BE EQUAL TO AGNE BRICK, PATRIOT RED. SEE SPEC.
- ALTERNATE #2:** REMOVE AND DISCARD PORTION OF EXISTING ASPHALT SHINGLES AND FELT DOWN TO EXISTING DECK BELOW AREAS SHOWN TO RECEIVE NEW ROOFING. PROVIDE AND INSTALL CLASS "A" FIBERGLASS COMPOSITION SHINGLES (5-TAB) OVER 15# FELT OVER 5/8" PLYWOOD DECK (SEE SPEC). NEW SHINGLES TO MATCH EXISTING. PROVIDE AND INSTALL ONE LAYER OF MOISTURE GUARD UNDERLAYMENT (MINIMUM OF 3/8" WIDE) AT ALL EAVES AND RIDGES. (SEE SPECIFICATION).
- CONCRETE FOUNDATION PER STRUCTURAL





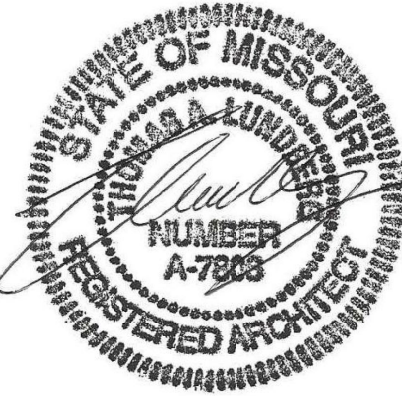STATE OF MISSOURI  
MIKE KEHOE,  
GOVERNOR



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SITE # 6801  
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REVISION:  
DATE: \_\_\_\_\_  
ISSUE DATE: 8-1-24

CAD DWG FILE: A-210.DWG  
DRAWN BY: ZAC/MAH  
CHECKED BY: MAH/CAS  
DESIGNED BY: MAH/CAS

SHEET TITLE:

**MILLWORK  
ELEVATIONS**

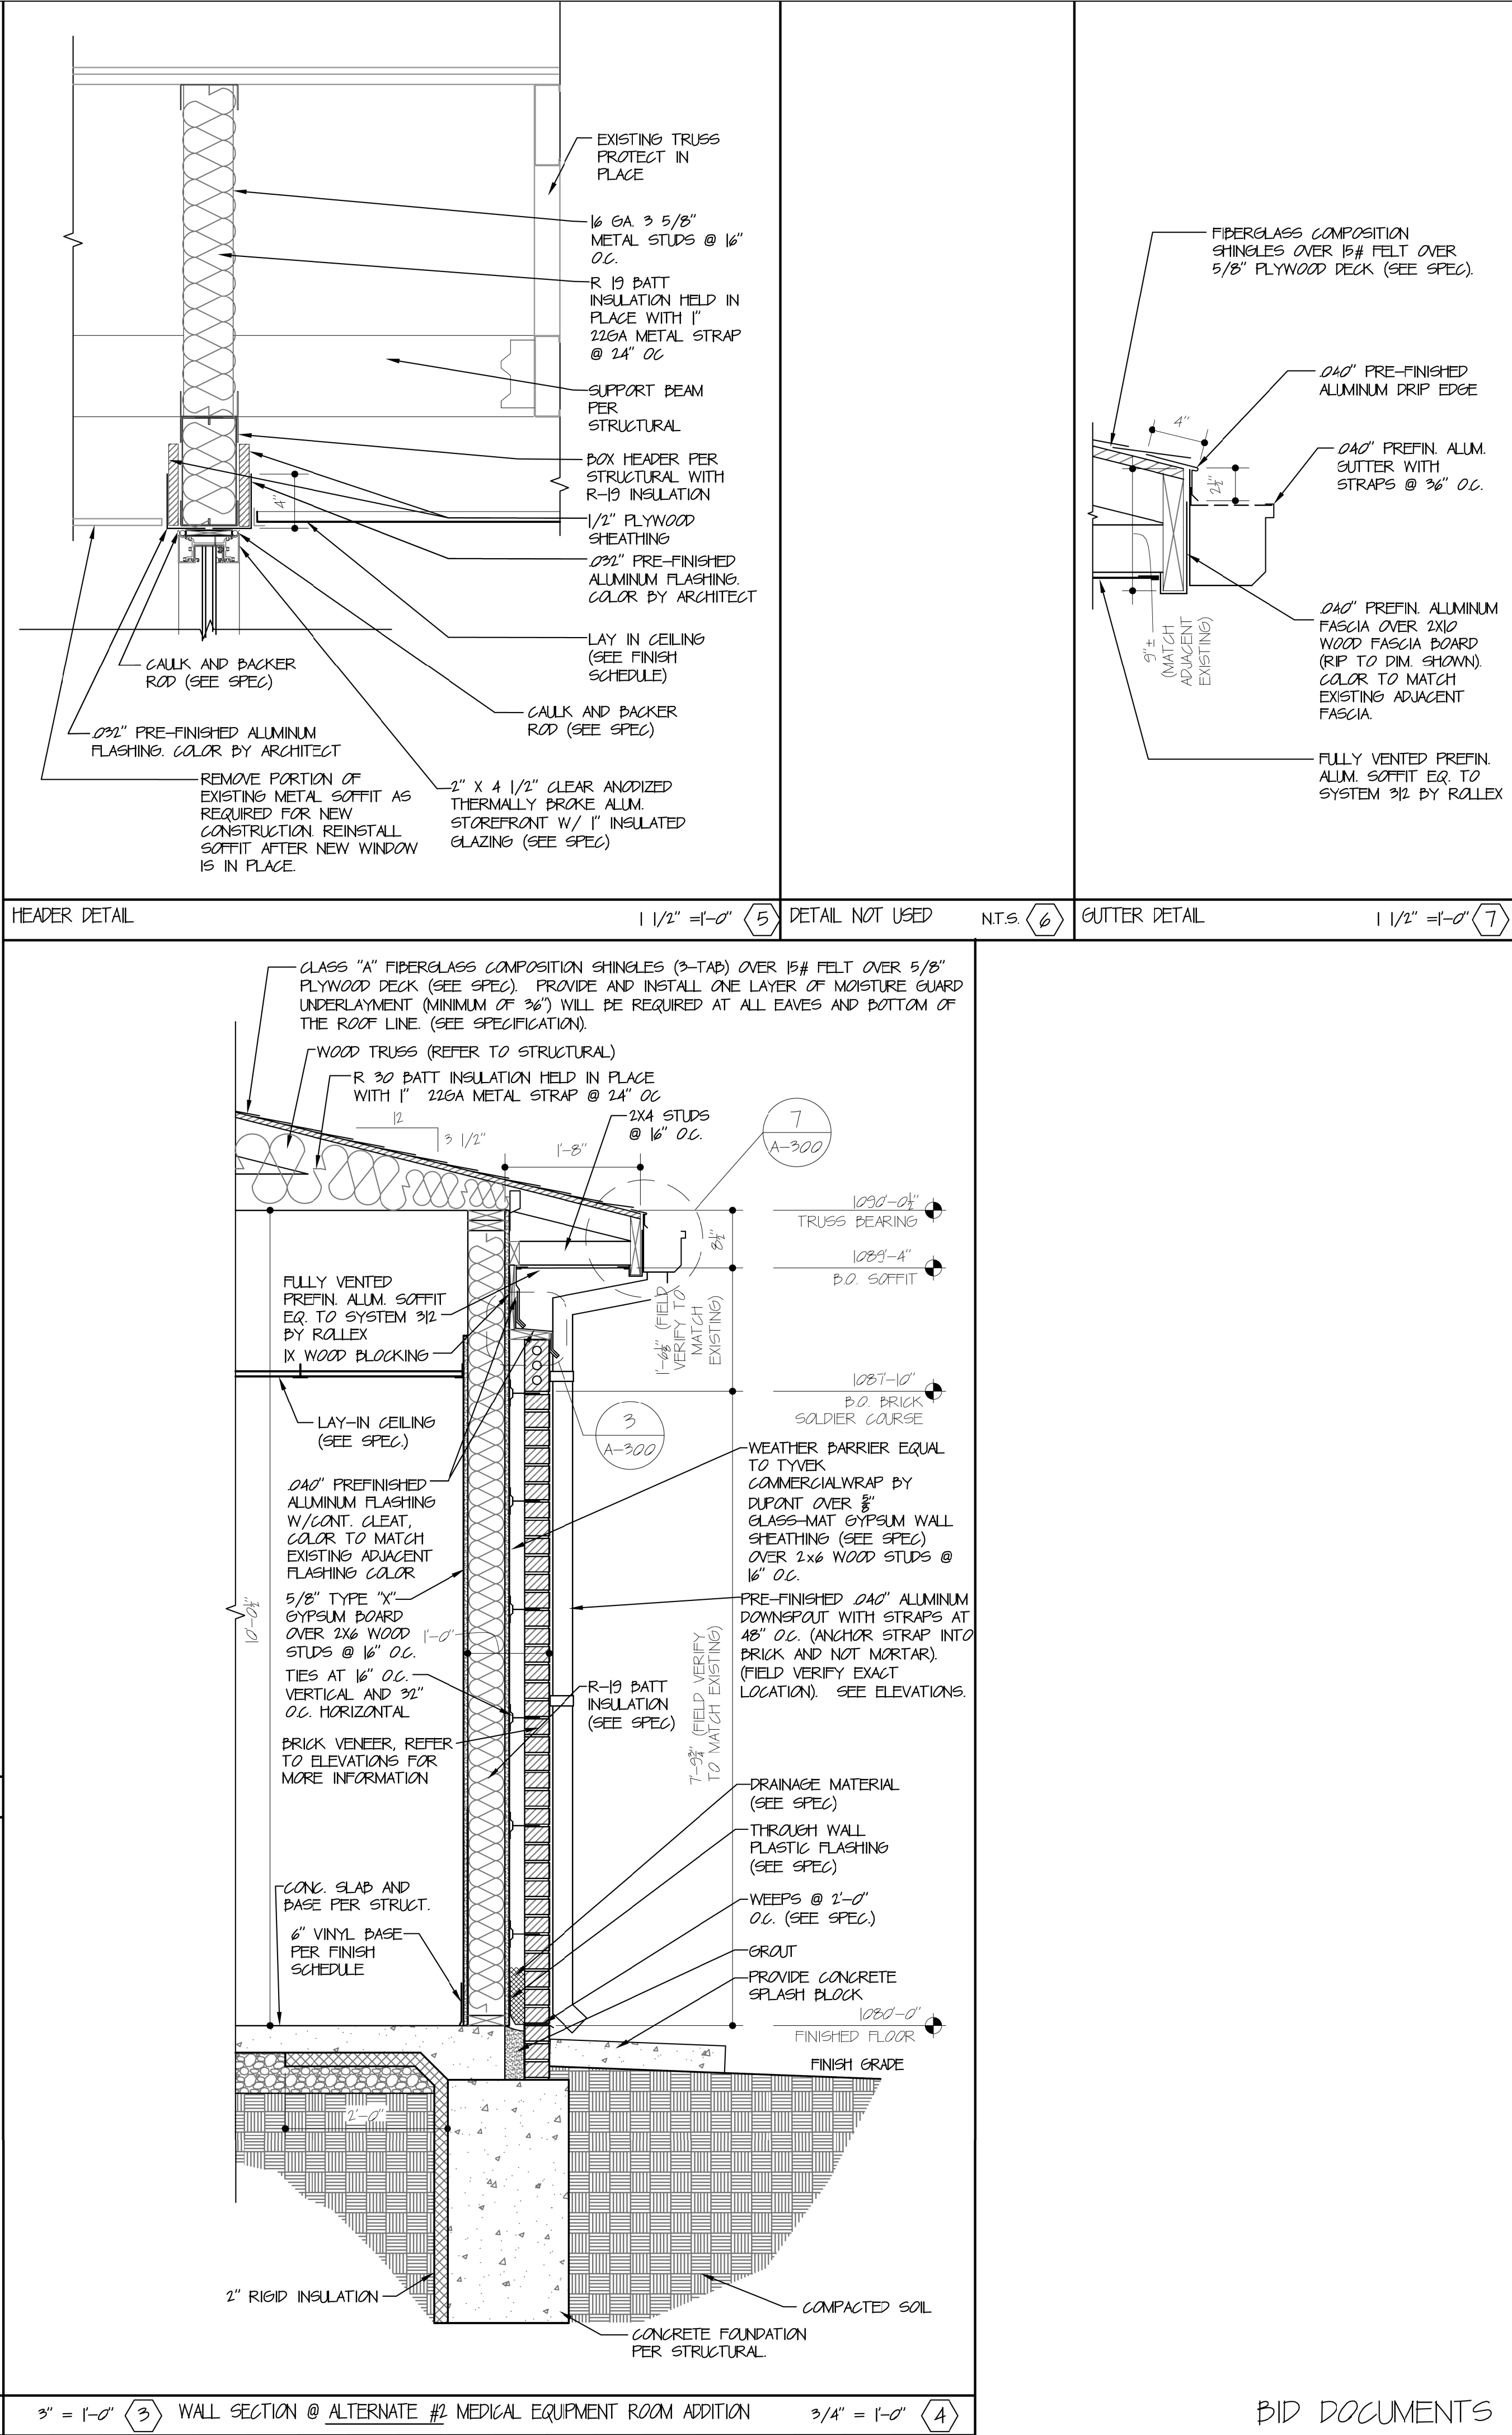
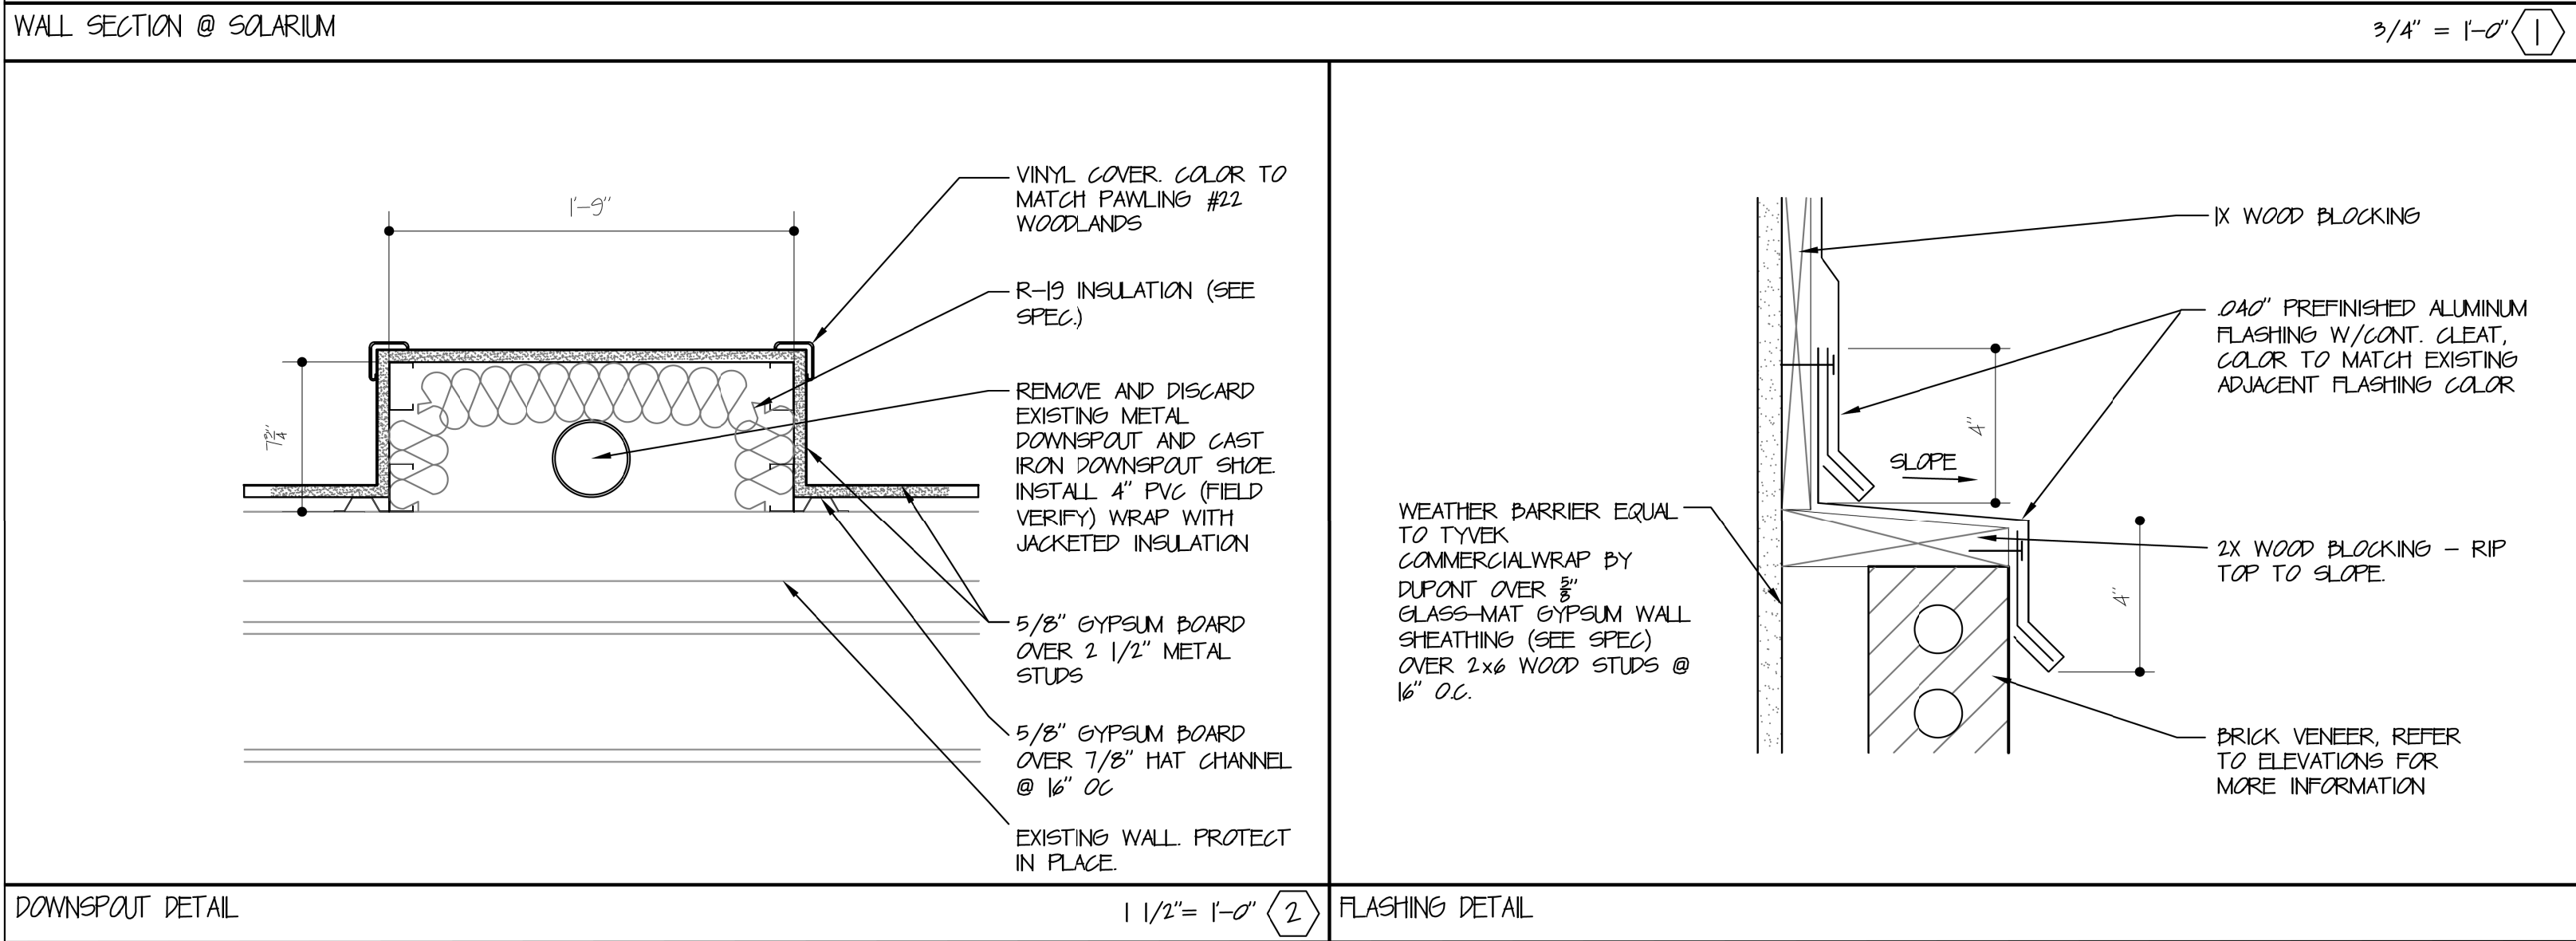
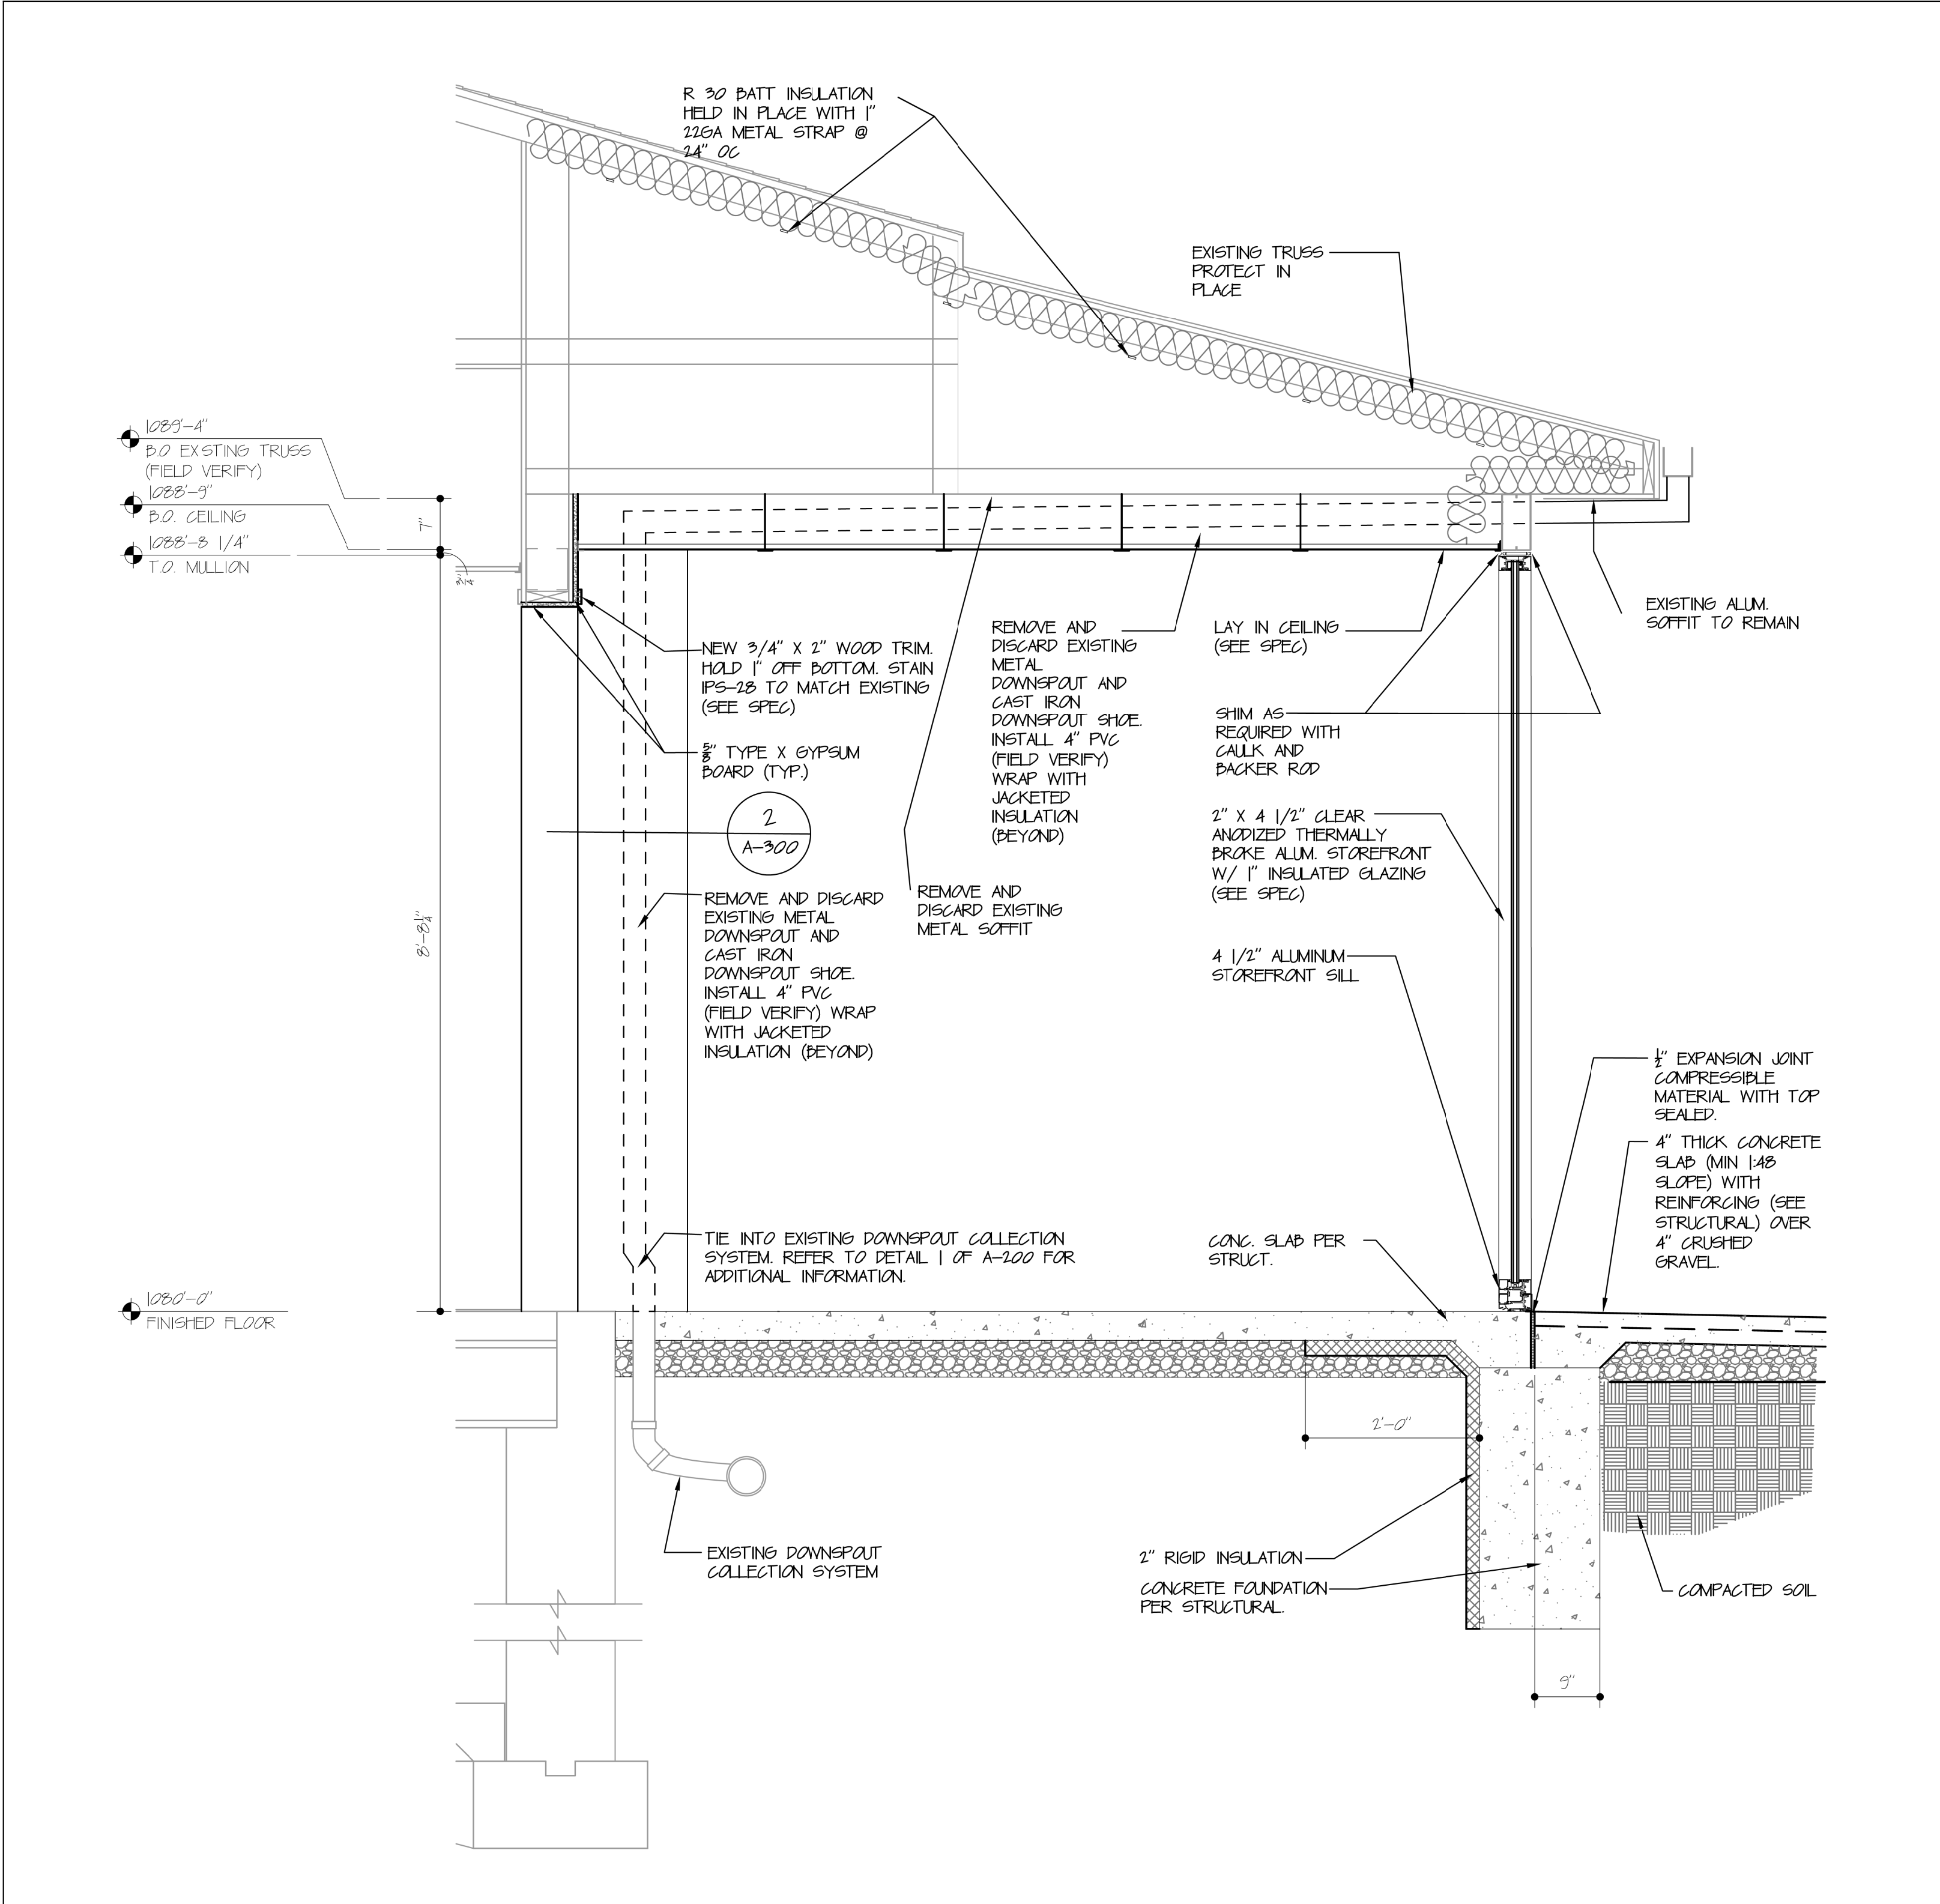
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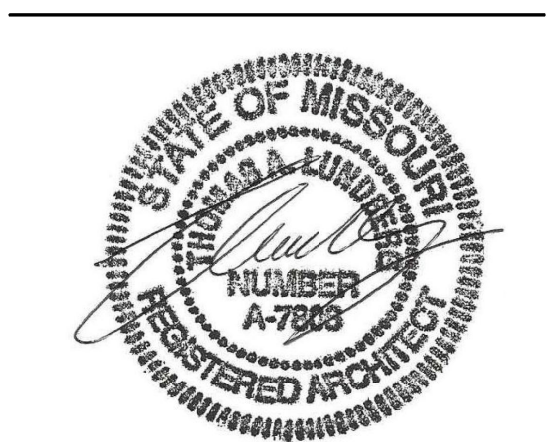
32 OF 120 SHEETS  
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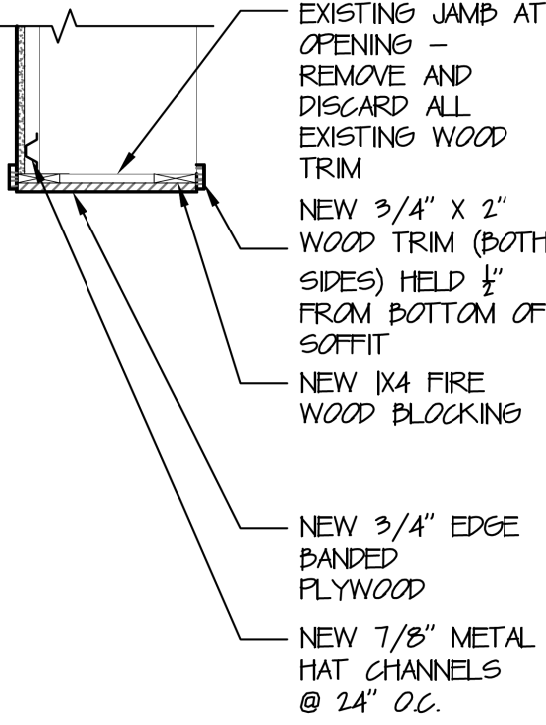
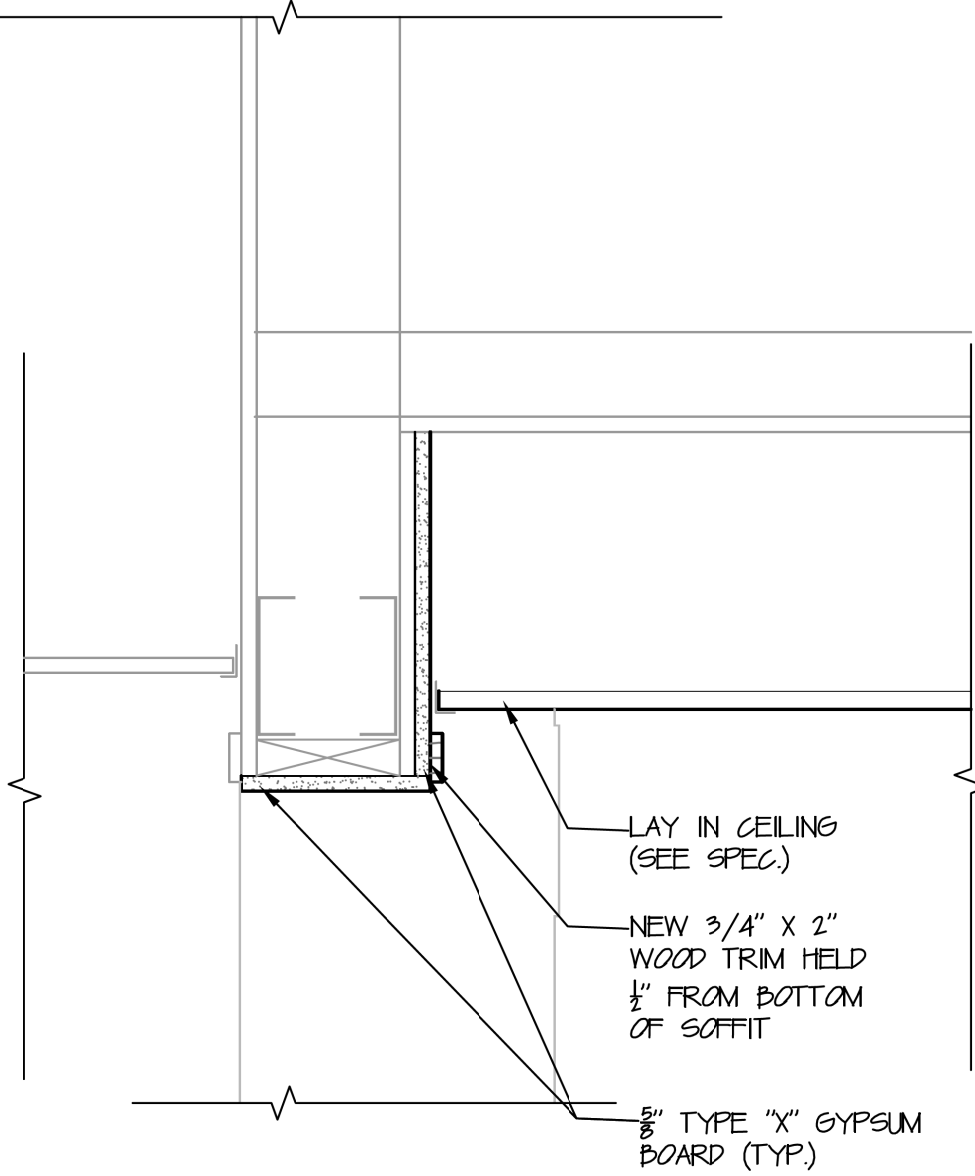
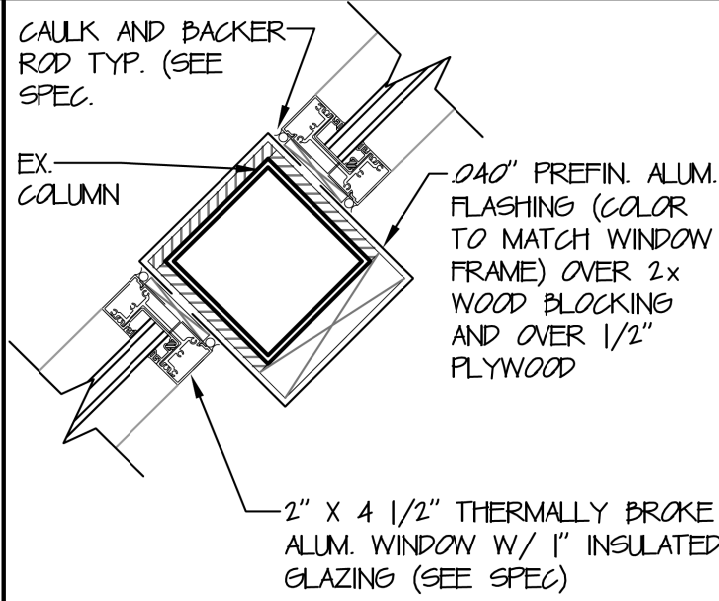
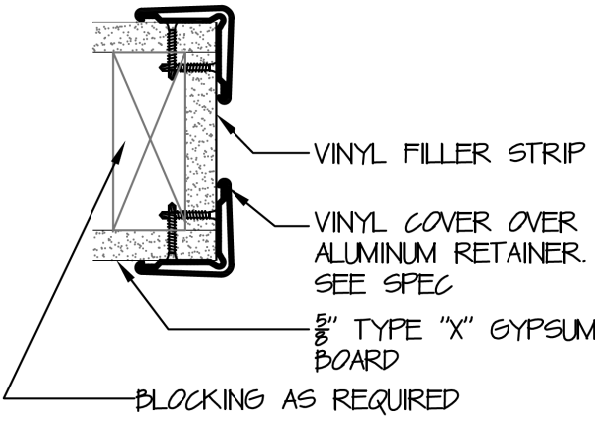
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DATE: \_\_\_\_\_  
ISSUE DATE: 8-1-24

CAD DWG FILE: A-300.DWG  
DRAWN BY: ZAC/MAH  
CHECKED BY: MAH/CAS  
DESIGNED BY: MAH/CAS


SHEET TITLE:  
**SECTIONS**

SHEET NUMBER:  
**A-300**  
33 OF 120 SHEETS  
8-1-24



				
JAMB DETAIL 3/4" = 1'-0" <span>4</span>	DETAIL NOT USED N.T.S. <span>5</span>	DETAIL NOT USED N.T.S. <span>6</span>	DETAIL NOT USED N.T.S. <span>7</span>	DETAIL NOT USED N.T.S. <span>8</span>
		DETAIL NOT USED N.T.S. <span>9</span>	DETAIL NOT USED N.T.S. <span>10</span>	 COLUMN FLASHING DETAIL 1 1/2" = 1'-0" <span>12</span>
		 CORNER GUARD DETAIL 3" = 1'-0" <span>14</span>		
DETAIL NOT USED N.T.S. <span>1</span>	HEADER DETAIL @ NEW SOLARIUM ADDITION 1 1/2" = 1'-0" <span>2</span>	DETAIL NOT USED N.T.S. <span>3</span>		

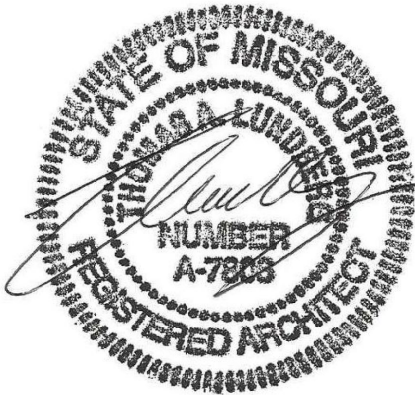STATE OF MISSOURI  
MIKE KEHOE,  
GOVERNOR



2/19/25

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CERTIFICATE OF AUTHORITY #000718

**ESTERLY  
&  
SCHNEIDER  
ASSOCIATES, INC.**  
AIA architects & planners

CONM. # 4860

OFFICE OF ADMINISTRATION  
DIVISION OF FACILITIES  
MANAGEMENT,  
DESIGN AND CONSTRUCTION

DEPARTMENT OF  
PUBLIC SAFETY  
MISSOURI VETERANS  
COMMISSION

INTERIOR RENOVATION  
MISSOURI VETERANS  
HOME

620 N. JEFFERSON  
ST. JAMES, MISSOURI

PROJECT # U1503-01  
SITE # 6801  
ASSET # 8136801002  
FEDERAL# 29-044

REVISION: \_\_\_\_\_  
DATE: \_\_\_\_\_  
REVISION: \_\_\_\_\_  
DATE: \_\_\_\_\_  
REVISION: \_\_\_\_\_  
DATE: \_\_\_\_\_

ISSUE DATE: 8-1-24

CAD DWG FILE: A-301.DWG  
DRAWN BY: ZAC/MAH  
CHECKED BY: MAH/CAS  
DESIGNED BY: MAH/CAS

SHEET TITLE:

SECTIONS

SHEET NUMBER:

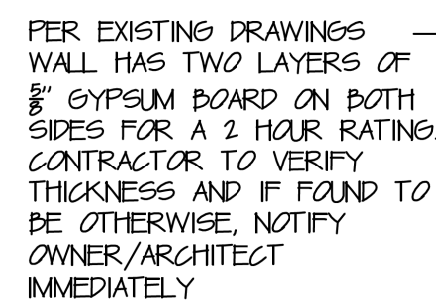
A-301

34 OF 120 SHEETS  
8-1-24

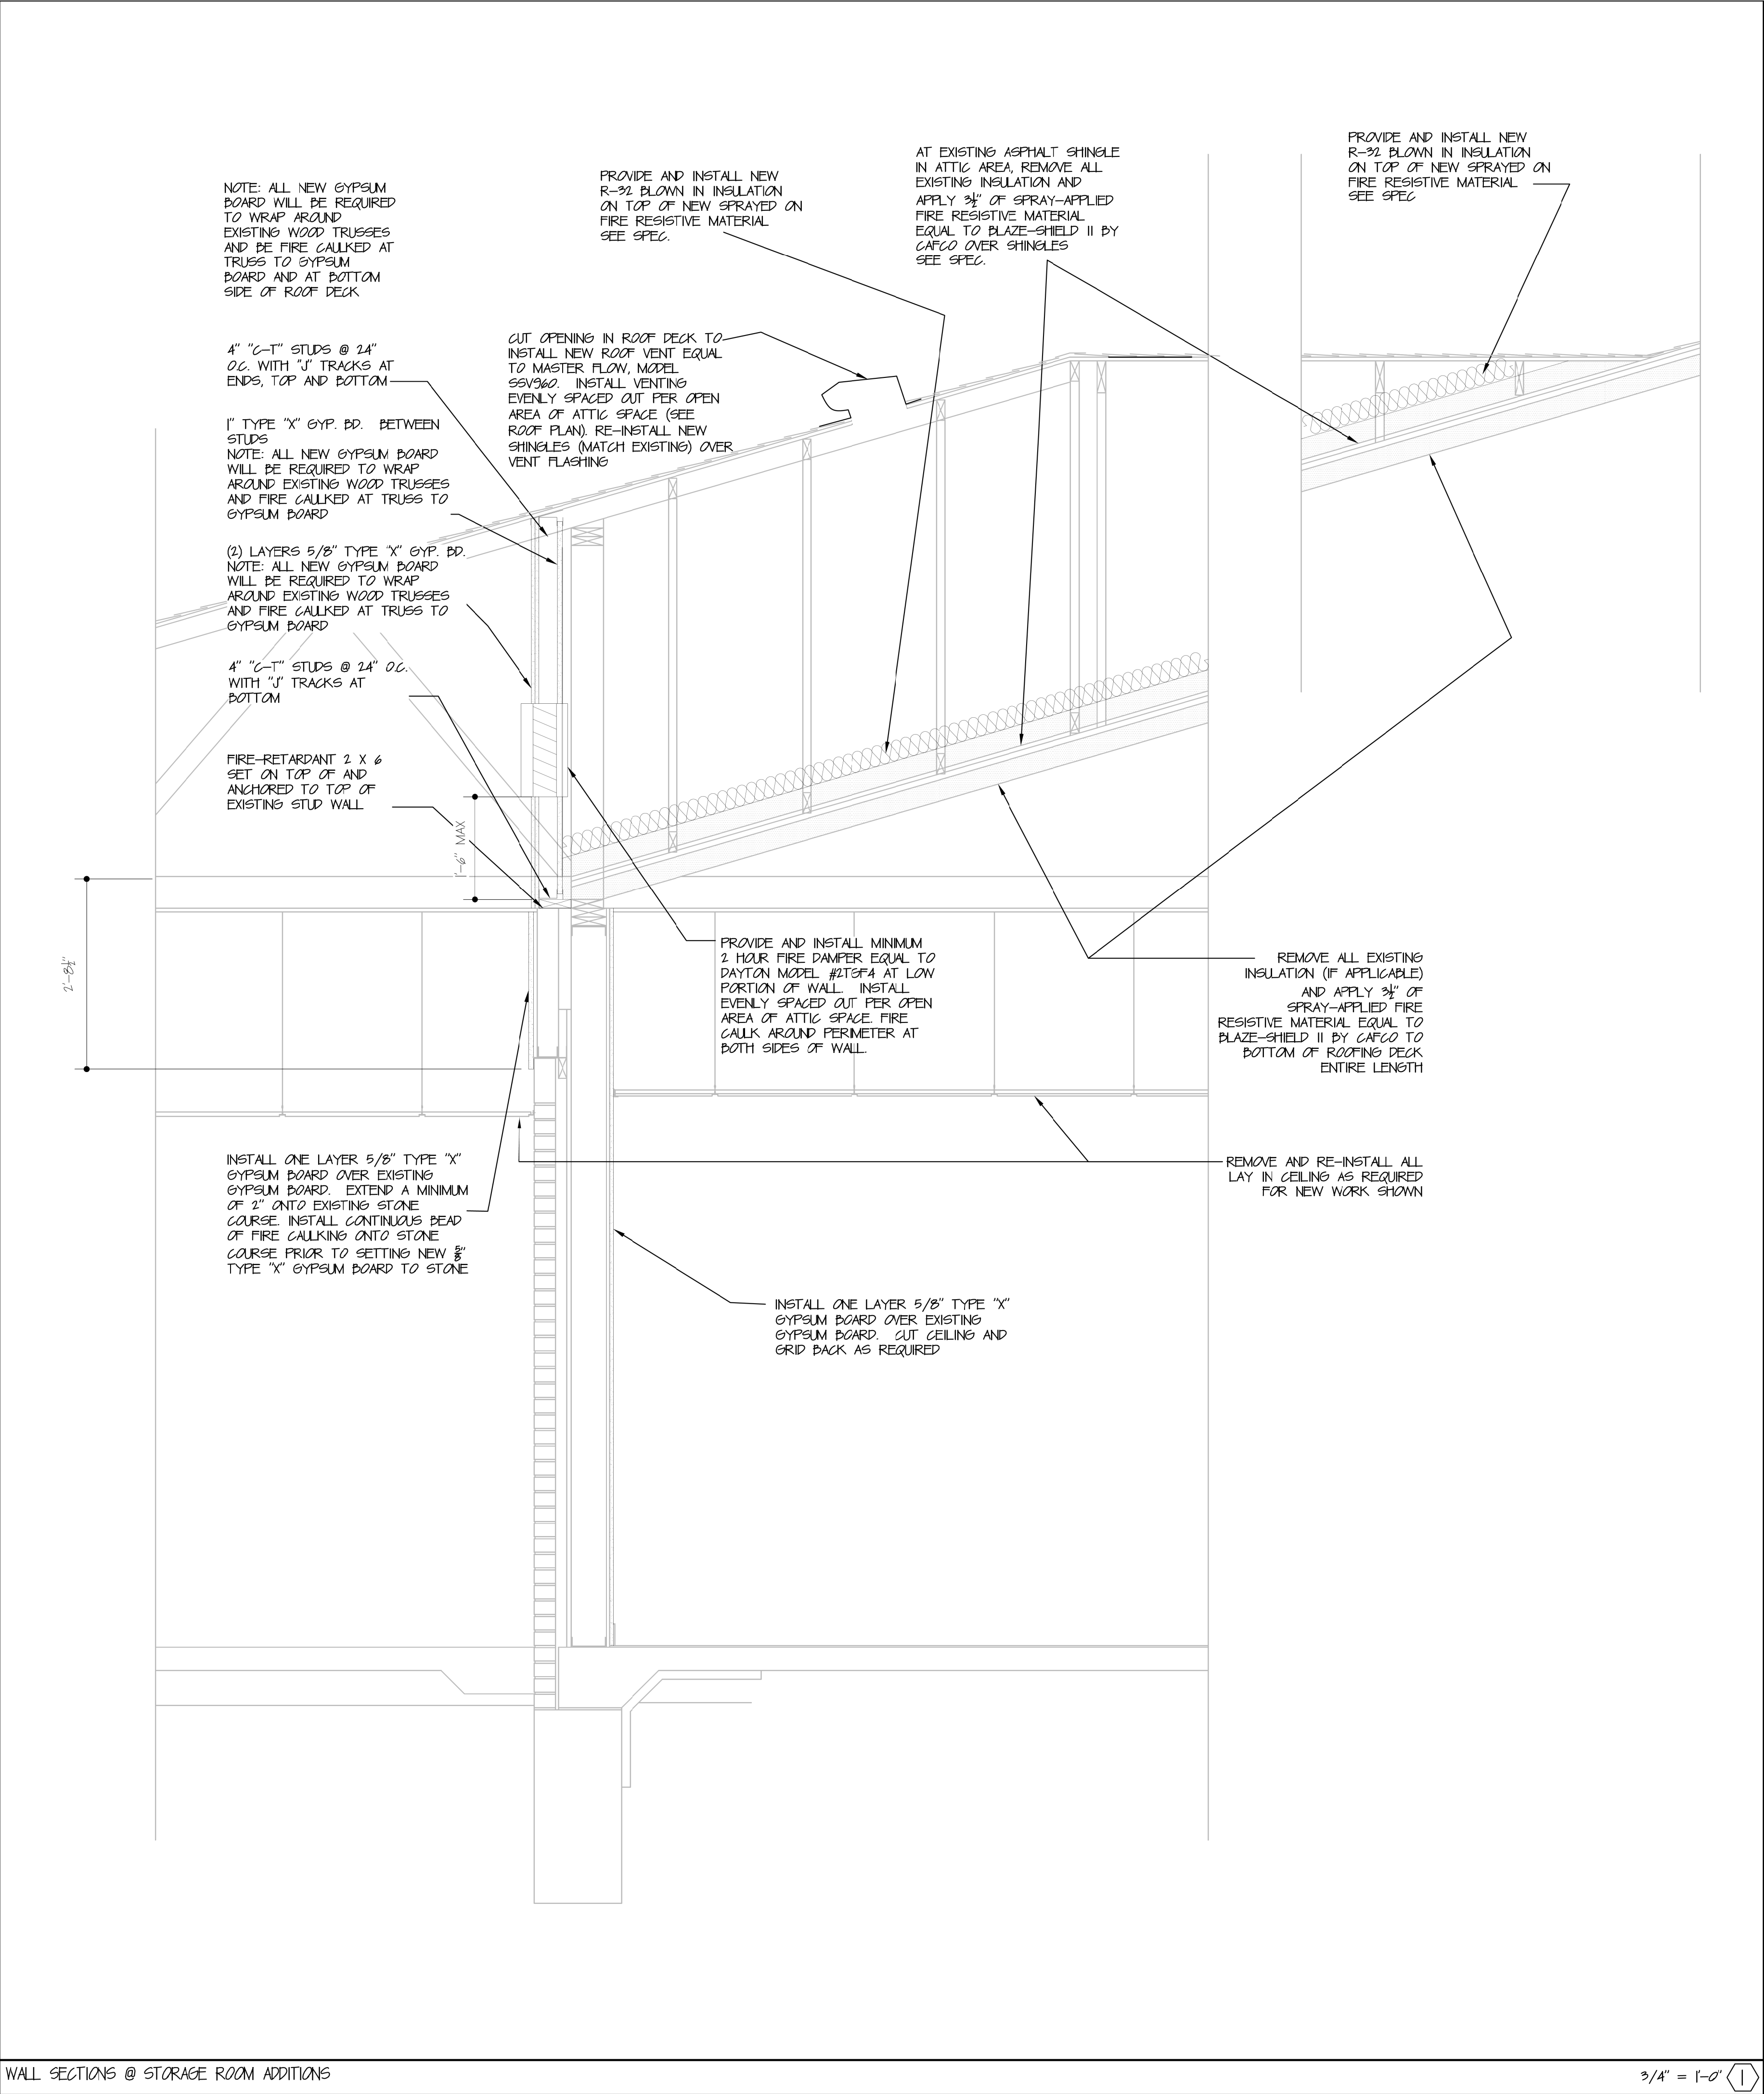
BID DOCUMENTS



35 OF 120 SHEETS  
8-1-24









DETAIL NOT USED

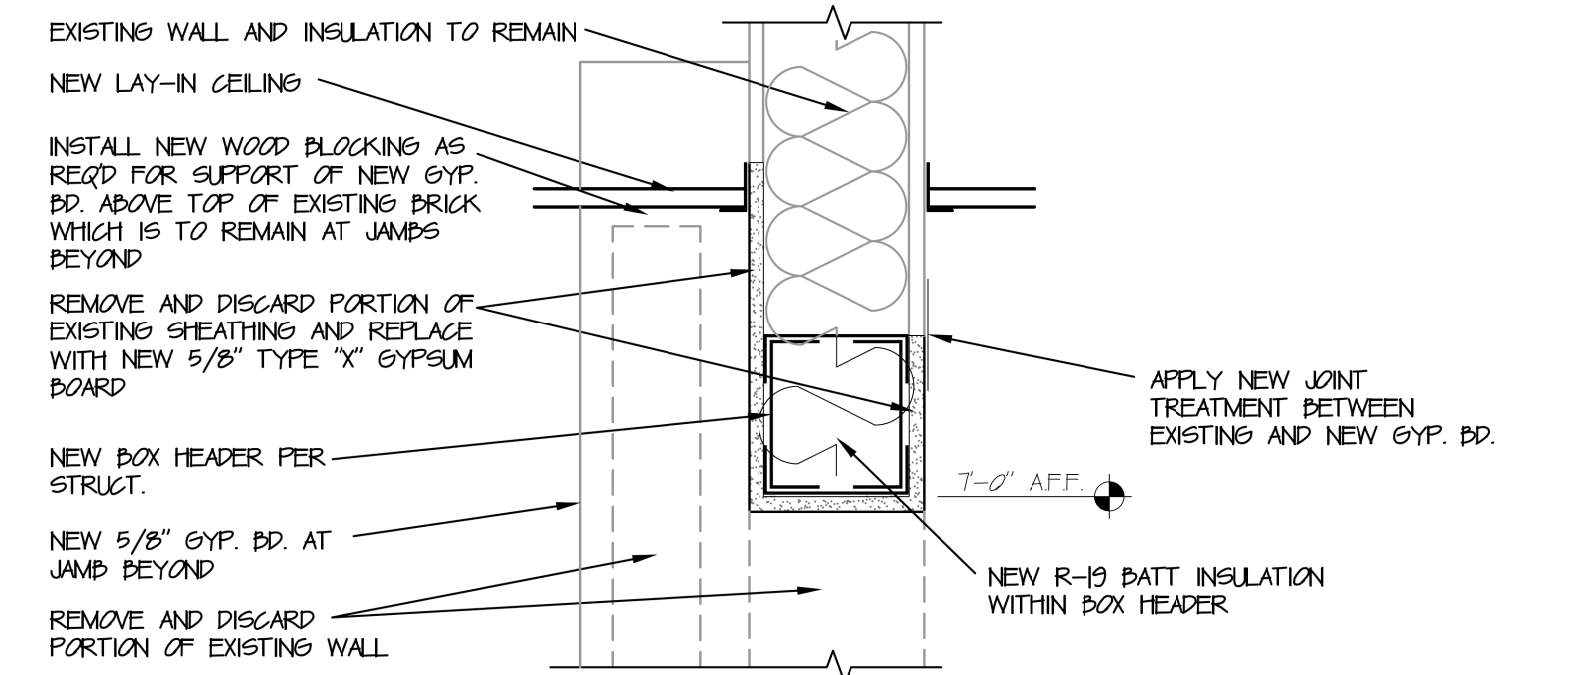N.T.S. (2)



OPENING HEAD DETAIL

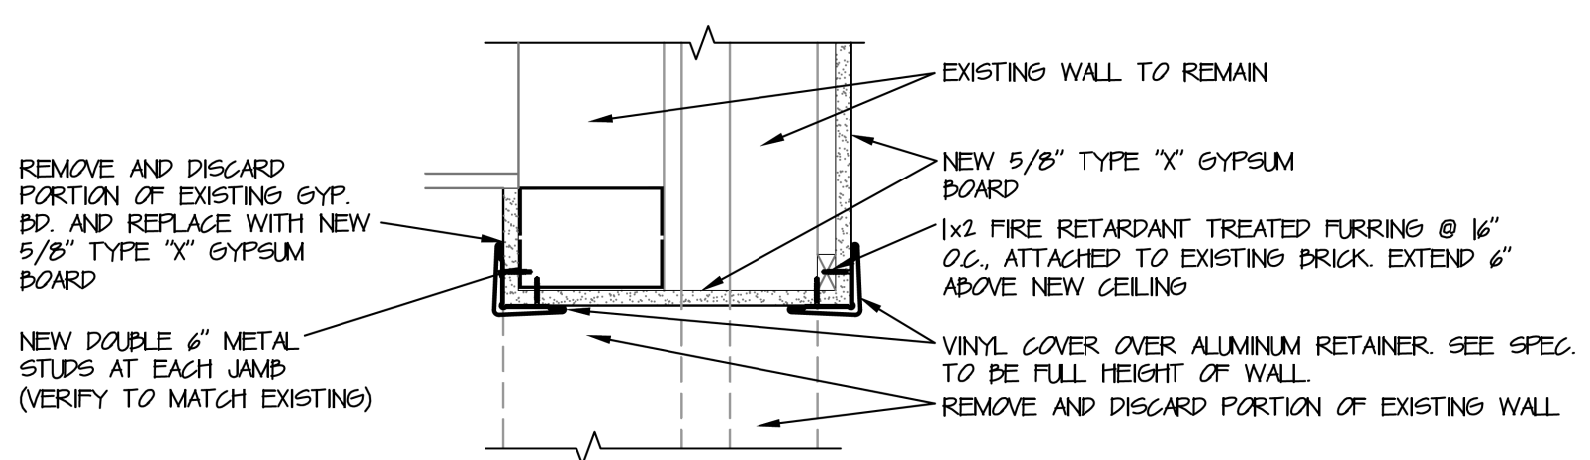1 1/2" = 1'-0" (3)



OPENING JAMB DETAIL

1 1/2" = 1'-0" (4)

STATE OF MISSOURI  
MIKE KEHOE,  
GOVERNOR



2/19/25

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DATE: \_\_\_\_\_  
REVISION: \_\_\_\_\_  
DATE: \_\_\_\_\_

ISSUE DATE: 8-1-24

CAD DWG FILE: A-303.DWG  
DRAWN BY: ZAC/MAH  
CHECKED BY: MAH/CAS  
DESIGNED BY: MAH/CAS

SHEET TITLE:

SECTIONS

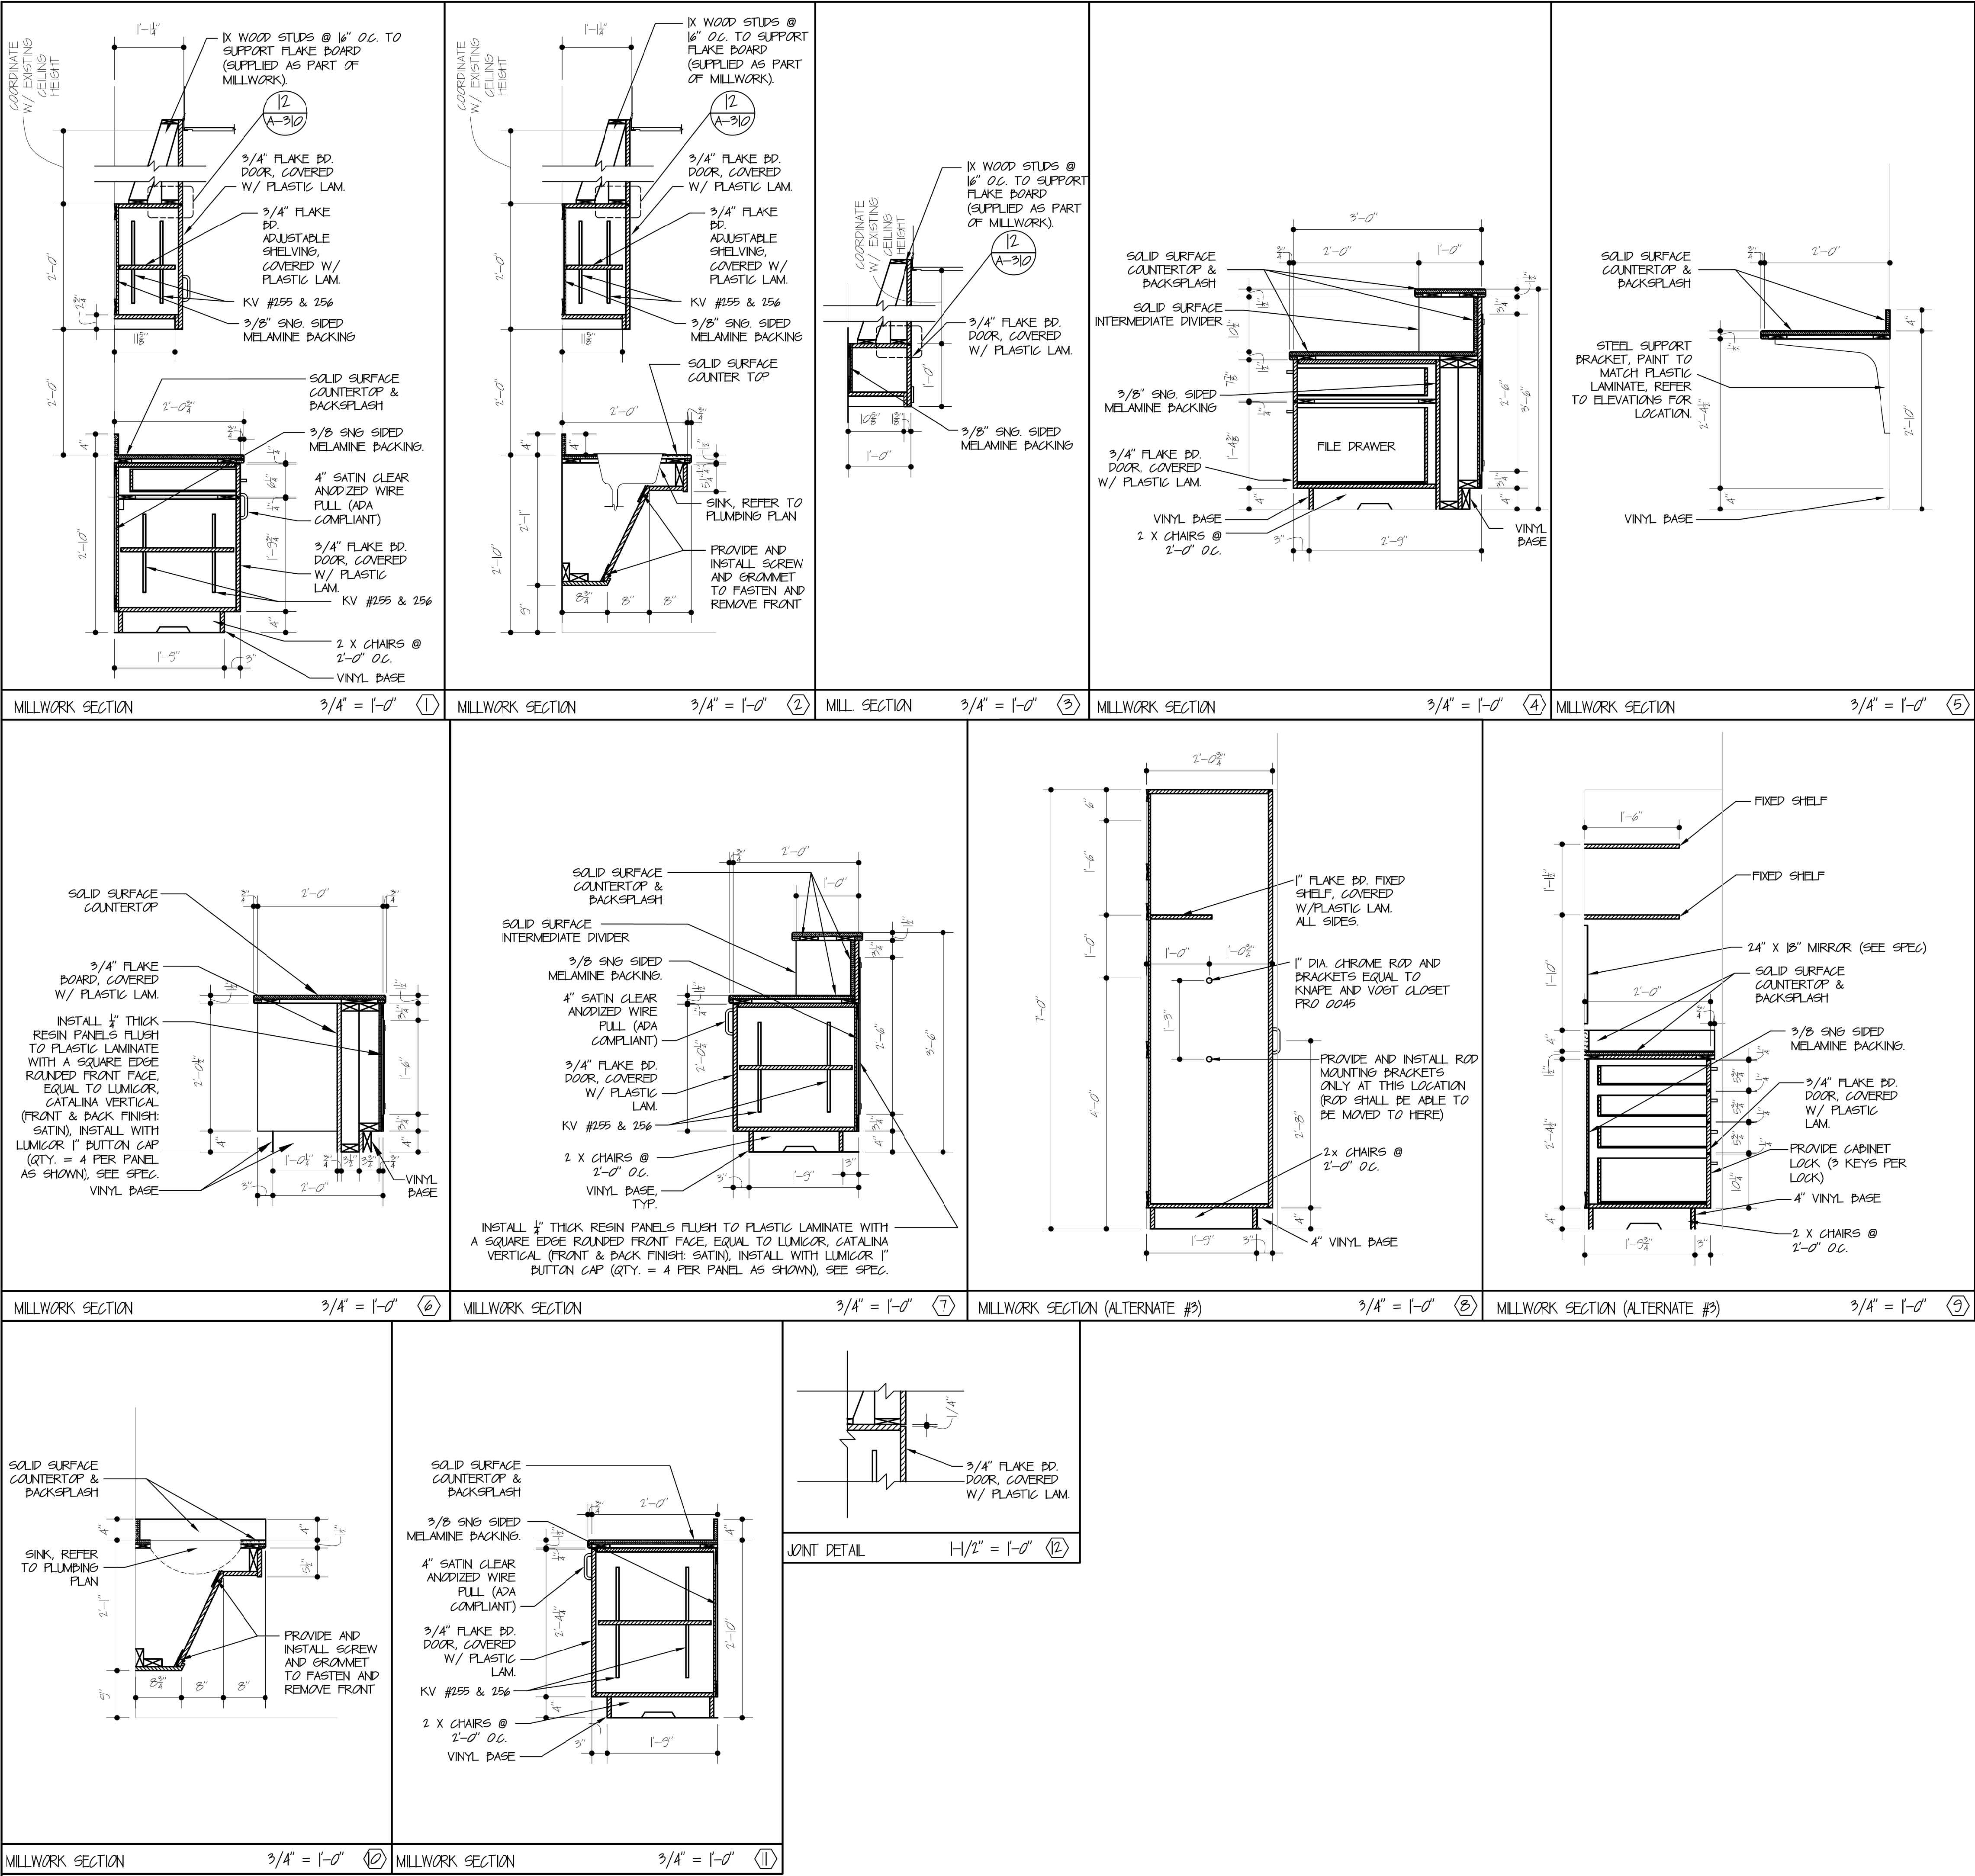
SHEET NUMBER:

A-303

36 OF 120 SHEETS  
8-1-24

BID DOCUMENTS





MILLWORK NOTES

- CONTRACTOR TO VERIFY ALL DIMENSIONS IN THE FIELD. PROVIDE AND INSTALL SOLID WOOD BLOCKING IN WALLS FOR ANCHORING MILLWORK.
- WALL CABINETS TO HAVE 3/4" PARTICLE BOARD TOP, SHELVES, BOTTOM, ENDS, DOORS AND DIVIDERS WITH PLASTIC LAMINATE ON ALL EXPOSED SURFACES. BACKS TO BE 3/8" SINGLE SIDED MELAMINE UNLESS SHOWN OTHERWISE.
- COUNTERTOP AND BACKSPLASH TO BE SOLID SURFACE. REFER TO MILLWORK ELEVATIONS FOR COUNTERTOP SELECTIONS.
- BASE CABINET TO HAVE 3/4" PARTICLE BOARD SHELVES, ENDS, DIVIDERS, BOTTOM AND DOOR WITH PLASTIC LAMINATE ON ALL EXPOSED SURFACES. BACKS TO BE 3/8" SINGLE SIDED MELAMINE.
- ALL DRAWER FRONTS TO BE 3/4" PARTICLE BOARD WITH PLASTIC LAMINATE ON ALL EXPOSED SURFACES.
- DRAWERS TO HAVE 1/2" HARDWOOD SIDES (FULL HEIGHT), 1/2" HARDWOOD BOTTOM AND KV 8400 GUIDES. CONTRACTORS OPTION TO PROVIDE FULL HEIGHT METAL DRAWERS EQUAL TO METABOX 320 M OR EQUAL.
- FINISHES: ALL EXPOSED INTERIOR AND EXTERIOR SURFACES TO BE COVERED WITH LAMINATED PLASTIC. COLORS AS SELECTED BY ARCHITECT. LAMINATE JOINTS TO BE TIGHT WITH NO CRACKS. CONTRACTOR'S OPTION TO USE MELAMINE ON INTERIOR SURFACES. COLOR BY ARCHITECT.
- ALL MILLWORK HARDWARE SHALL INCLUDE DRAWER SLIDES, HINGES, CATCHES, PULLS TO BE 4" SATIN CLEAR ANODIZED WIRE PULL (ADA COMPLIANT) (FINISH US26), ETC. SHELF STANDARDS EQUAL TO KNAPE AND VOGT #255, SHELF SUPPORTS EQUAL TO KNAPE AND VOGT #256, HINGES TO BE SELF CLOSING TYPE. CONTRACTOR'S OPTION TO USE MIL PINS & DRILLED HOLES IN LIEU OF KV SHELF STANDARDS & SUPPORTS.
- ALL MILLWORK SHALL HAVE BACKSPLASHES & SIDESPLASHES AS SHOWN ON MILLWORK ELEVATIONS.
- BRACES FOR COUNTERTOPS SHALL BE INSTALLED AT 3'-0" O.C. MIN. OR AS SHOWN ON MILLWORK DRAWINGS.
- REFER TO FINISH SCHEDULE FOR PLASTIC LAMINATE, VINYL BASE AND SOLID SURFACE COLOR DESIGNATIONS.
- ALL MILLWORK BASES SHALL RECEIVE 4" VINYL BASE. REFER TO FINISH SCHEDULE.

STATE OF MISSOURI  
MIKE KEHOE,  
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REVISION: \_\_\_\_\_  
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ISSUE DATE: 8-1-24

CAD DWG FILE: A-210.DWG  
DRAWN BY: ZAC/MAH  
CHECKED BY: MAH/CAS  
DESIGNED BY: MAH/CAS

SHEET TITLE:

MILLWORK  
SECTIONS

SHEET NUMBER:


A-310

37 OF 120 SHEETS  
8-1-24

BID DOCUMENTS




EQUIPMENT SCHEDULE				
NOTE: REFER TO SPECIFICATIONS FOR ALL DETAILS ON EQUIPMENT SPECIFICATIONS AND ADDITIONAL APPROVED MANUFACTURERS				
ITEM NO.	QTY.	MANUFACTURER OR APPROVED EQUAL	EQUIPMENT CATEGORY	NOTES
1	1	HOBART	DISHWASHER	PROVIDED AND INSTALLED BY CONTRACTOR
2	1	ADVANCE TABCO	STAINLESS STEEL DINI TABLE, SINKS AND ACCESSORIES	PROVIDED AND INSTALLED BY CONTRACTOR. FIELD VERIFY EXACT SIZES AND LENGTHS IN FIELD BEFORE ORDERING. NO GAPS AT WALLS ALLOWED

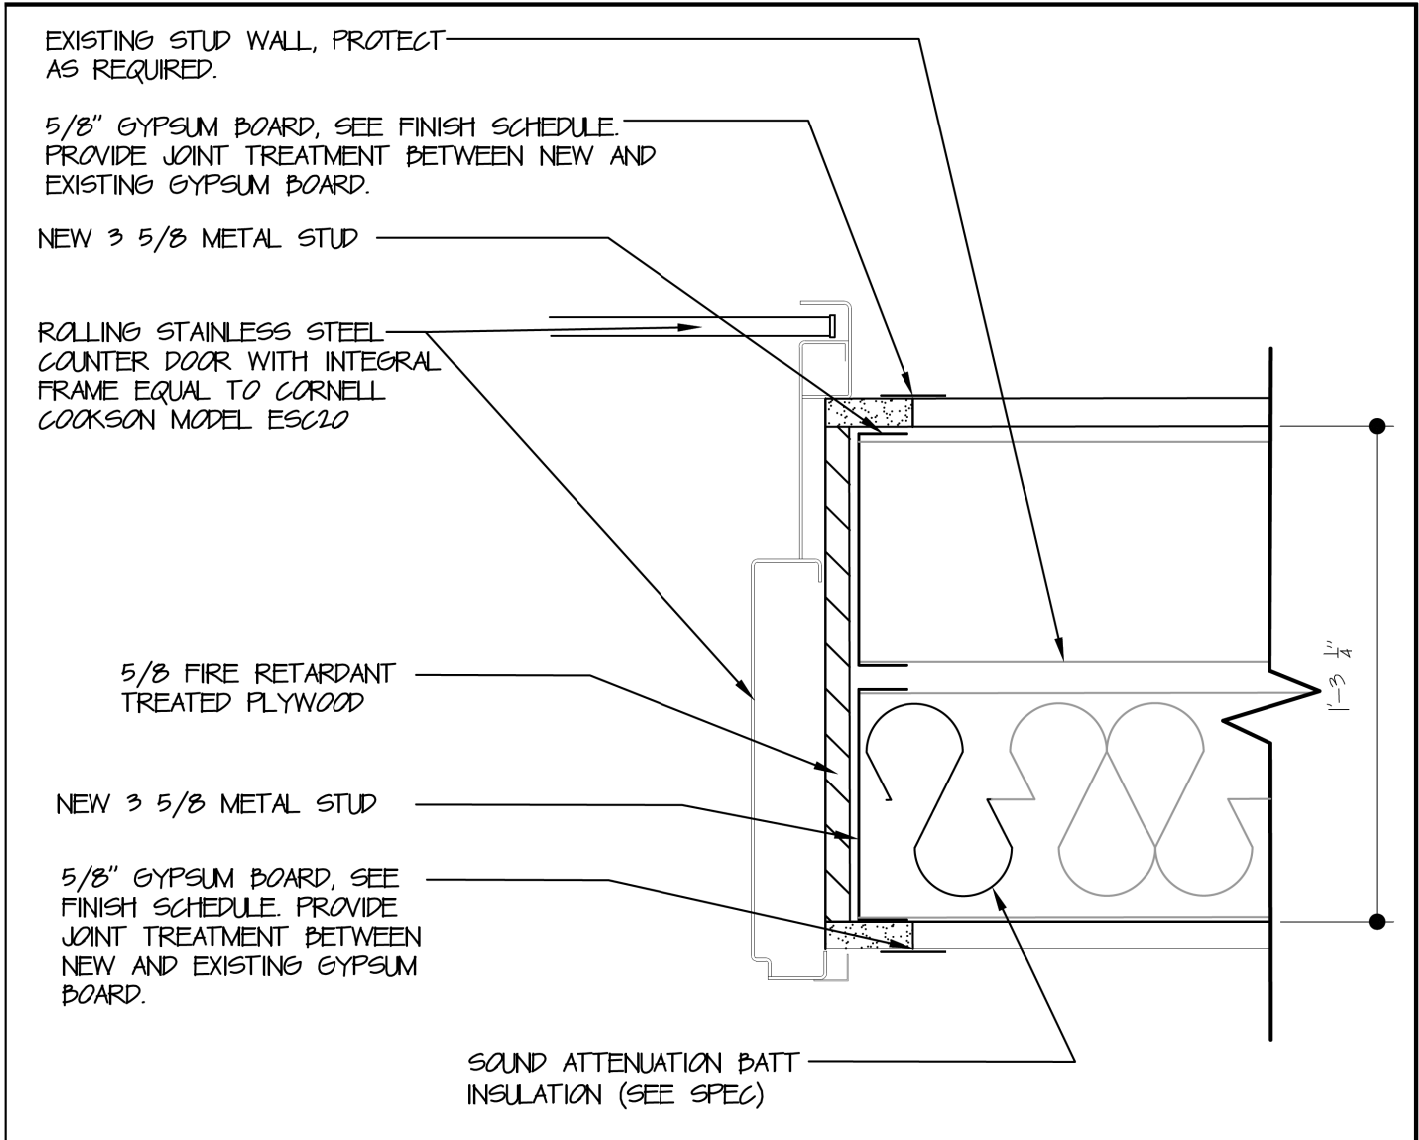

KITCHEN PASS THROUGH JAMB

3" = 1'-0"

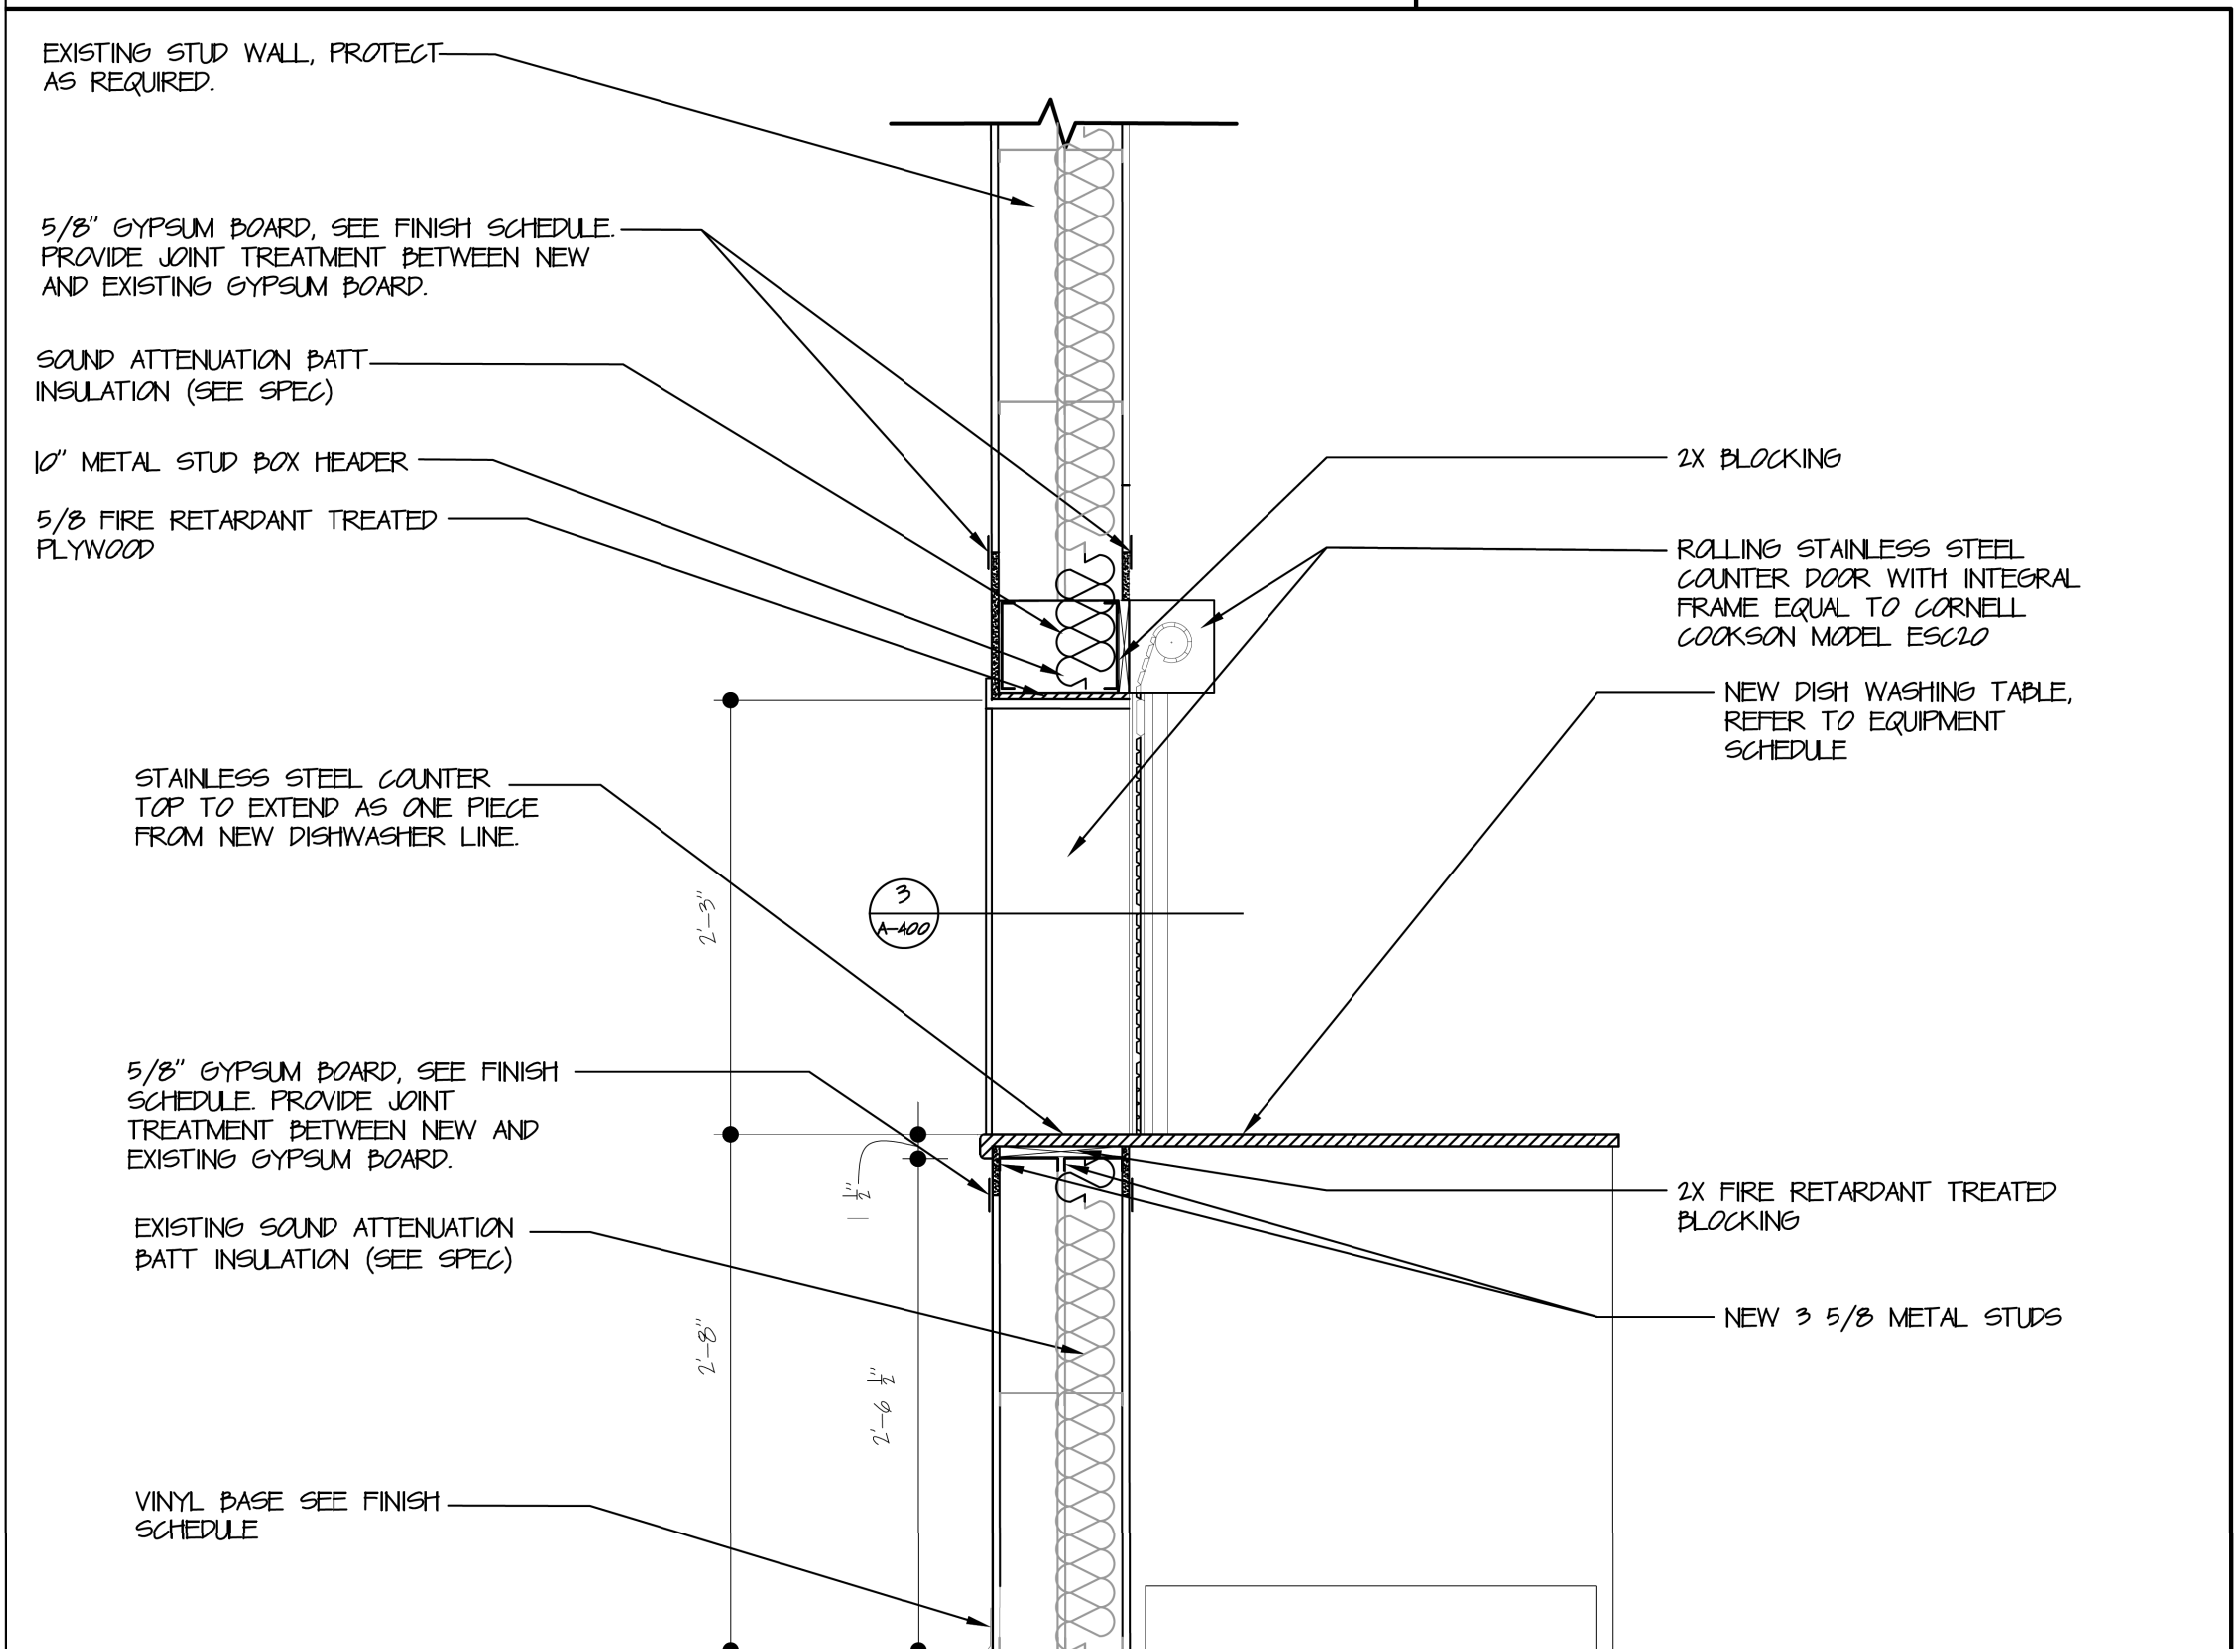
3



KITCHEN PASS THROUGH SECTION

3/4" = 1'-0"

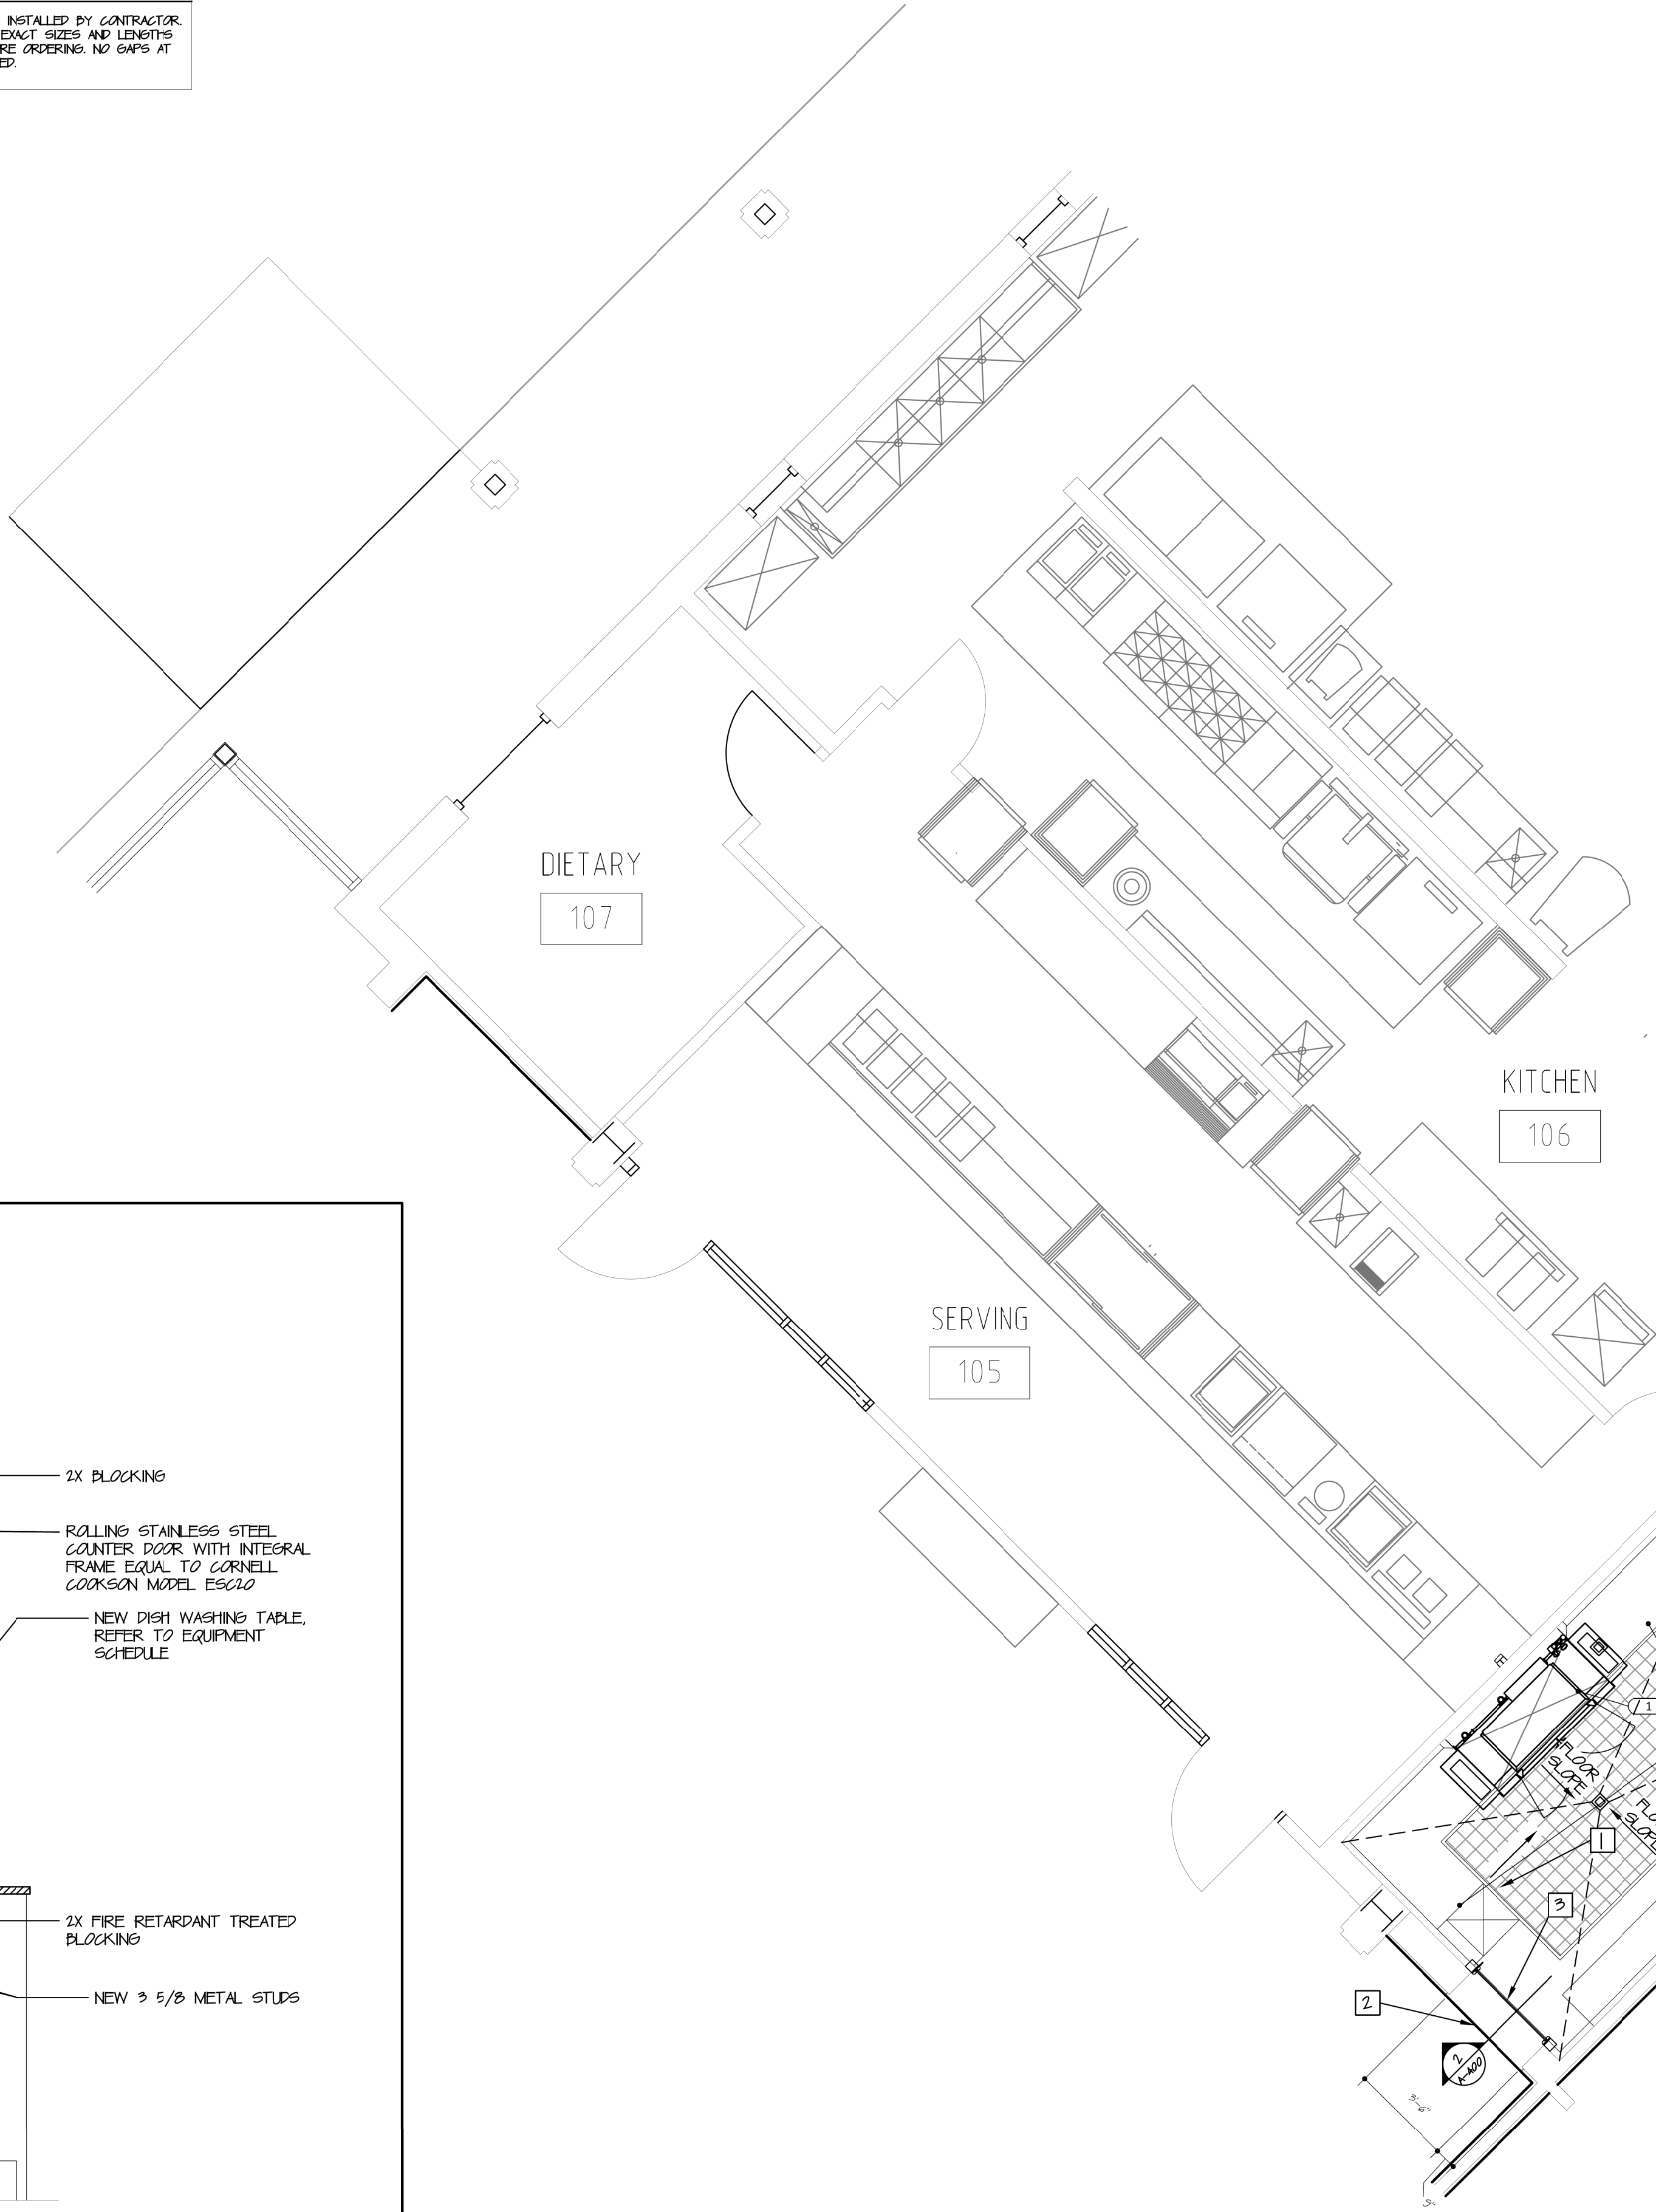2






PARTIAL KITCHEN PLAN

1/4" = 1'-0"



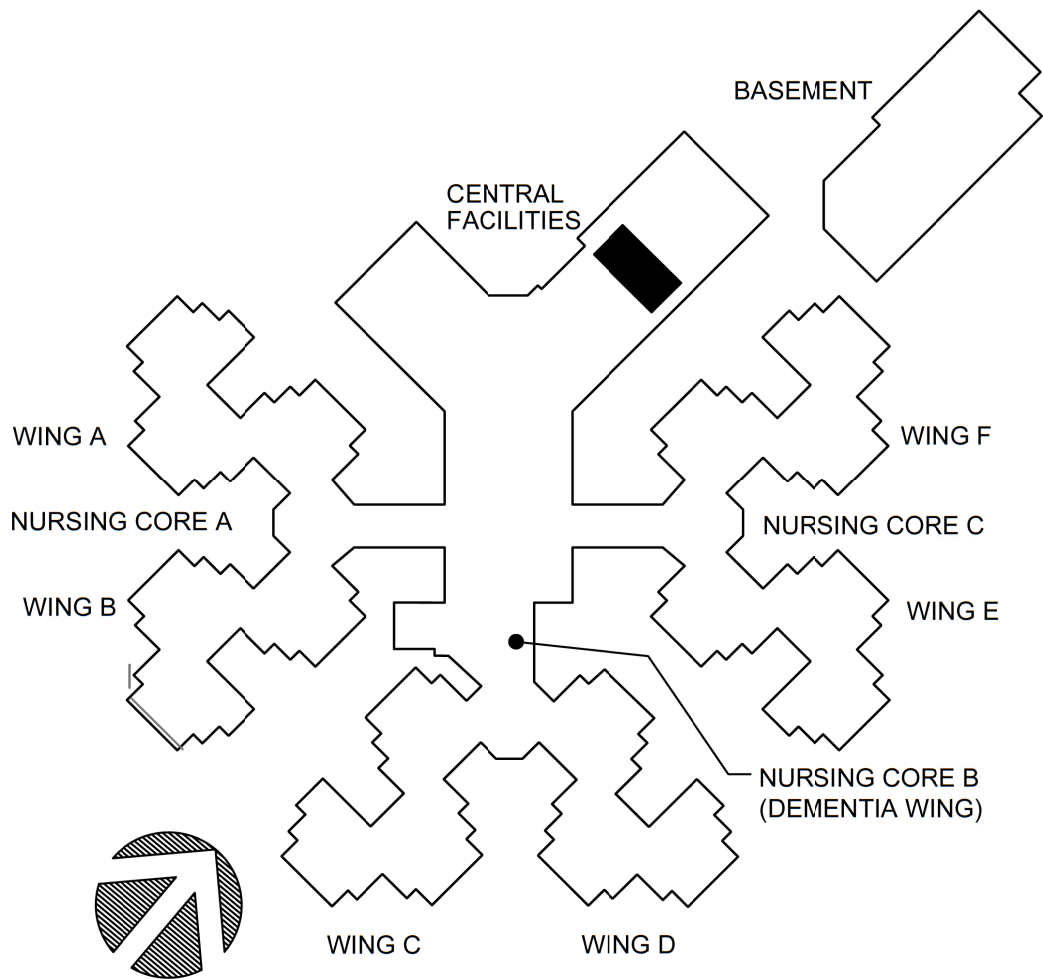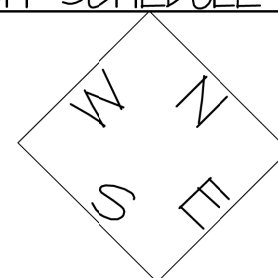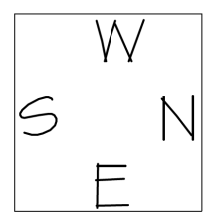DIAGRAM FOR FINISH SCHEDULE REFERENCE:



KEYPLAN

GENERAL NOTES

- CONTRACTOR TO FIELD VERIFY ALL DIMENSIONS AND COORDINATE ANY DISCREPANCIES WITH THE ARCHITECT/OWNER.
- CONTRACTOR TO PROTECT AS REQUIRED ALL EXISTING EQUIPMENT TO REMAIN.
- REFER TO SPECIFICATIONS FOR ALL NEW EQUIPMENT SCHEDULE INFORMATION.
- REFER TO MEP DRAWINGS FOR ADDITIONAL MEP REQUIREMENTS FOR KITCHEN WORK.
- PREP FLOOR AS REQUIRED TO RECEIVE NEW FLOORING ENSURE NEW AND EXISTING FLOORING MATCH. REFER TO FINISH SCHEDULE.

FLOOR PLAN KEY NOTES

- REMOVE ALL QUARRY TILE AT AREA INDICATED. CONFIRM EXISTING SLOPE - MUST BE POSITIVE FROM WALL TO DRAIN. COORDINATE IN FIELD ALL DIMENSIONS. PROVIDE AND INSTALL NEW QUARRY TILE. SEE FINISH SCHEDULE. MATCH FLOOR ELEVATIONS AT THIS LOCATION.
- PROVIDE AND INSTALL STAINLESS STEEL TRAY COUNTER TOP AT NEW ROLLING COUNTER DOOR AS PART OF NEW SOL DISHWASHER. SEE DETAIL 2 OF A-400.
- PROVIDE AND INSTALL 2'-8" CLEAR OPENING ROLLING STAINLESS STEEL COUNTER DOOR.
- CONTRACTOR SHALL REMOVE QUARRY TILE TO AN EVEN JOINT (DO NOT CUT A TILE) AT THIS LOCATION.
- TRANSITION STRIP REFER TO SHEET A-500 FOR TYPE.

STATE OF MISSOURI  
MIKE KEHOE,  
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ISSUE DATE: 8-1-24

CAD DWG FILE: A-400.DWG  
DRAWN BY: ZAC/MAH  
CHECKED BY: MAH/CAS  
DESIGNED BY: MAH/CAS

SHEET TITLE:

KITCHEN PLAN

SHEET NUMBER:

A-400

38 OF 120 SHEETS  
8-1-24

BID DOCUMENTS







RM NO.	ROOM NAME	FLOOR	WALLS					CEILING	CEILING HEIGHT	REMARKS
			BASE	N	E	S	W			
022	STAR	EX	EX	EX	EX	EX	EX	EX	EX	
020	VESTIBULE	EX	VB3	P1	P1	P1	P1	EX	EX	
01	LUNGE	SV1	VB4	P1	P1	P1	P1	EX	EX	
02	CANTEN	SV1	VB1	P1	P1	P1	P1	EX	EX	
025	DINING	SV1	VB4	P1/P2/P3	P1/P2/P3	P1/P2/P3	P1/P2/P3	EX	EX	PL AT ACCTN PANEL ABOVE PS BETWEEN WOOD TRIM
02A	DINING ADDITION	EX	VB1	P1	P1	P1	P1	EX	EX	DO NOT PAINT BRICK
02B	SOLARIUM	SV1	VB1	P1	P1	P1	P1	AI	8'-5"	PAINT SOFFIT P1
04	MECHANICAL	EX	EX	EX	EX	EX	EX	EX	EX	
05	SERVING	EX	B2	EX	EX	EX	EX	EX	EX	PAINT SOFFIT P1
06	KITCHEN	EX	EX	EX	EX	EX	EX	EX	EX	
07	DIETARY	EX	B2	PS	PS	PS	PS	EX	EX	
08	DRY STORAGE	EX	B2	PS	PS	PS	PS	EX	EX	
10	CARTS	EX	EX	PS	PS	PS	PS	EX	EX	
11	DEHWASH	QT	B2	PS	PS	PS	PS	EX	EX	
12	ELECTRICAL	EX	EX	EX	EX	EX	EX	EX	EX	
13	STAR	EX	EX	EX	EX	EX	EX	EX	EX	
14	MECHANICAL	EX	EX	EX	EX	EX	EX	EX	EX	
15	RECEIVING OFFICE	EX	EX	EX	EX	EX	EX	EX	EX	
16	RECEIVING	EX	EX	EX	EX	EX	EX	EX	EX	
17	CORRIDOR	SV1	VB4	P1	P1	P1	P1	EX	EX	
18	LOADING DOCK	EX	EX	EX	EX	EX	EX	EX	EX	
19	CORRIDOR	SV1	VB4	P1	P1	P1	P1	EX	EX	
20	CORRIDOR	SV1	VB4	P1	P1	P1	P1	EX	EX	
21	JANITOR	EX	EX	EX	EX	EX	EX	EX	EX	
22	WOMEN'S LOCKERS	EX	EX	P1	P1	P1	P1	EX	EX	
23	TOILETS	EX	EX	P1	P1	P1	P1	EX	EX	
24	JANITOR	EX	EX	EX	EX	EX	EX	EX	EX	
25	TOILETS	EX	EX	P1	P1	P1	P1	EX	EX	
26	MEN'S LOCKERS	EX	EX	P1	P1	P1	P1	EX	EX	
27	CORRIDOR	SV1	VB1	P1	P1	P1	P1	EX	EX	
28	STAFF BREAK ROOM	SV1	VB1	P2	P1	P1	P1	EX	EX	
30	CORRIDOR	SV1	VB1	P1	P1	P1	P1	EX	EX	
31	CORRIDOR	SV1	VB1	P1	P1	P1	P1	EX	EX	
33	HEALTH INFORMATION	SV1	VB1	P1	P1	P1	P2	EX	EX	
34	STORAGE	SV1	VB1	P1	P1	P1	P2	EX	EX	
35	FILES	SV1	VB1	P1	P1	P1	P2	EX	EX	
36	CORRIDOR	EX	VB4	P1	P1	P1	P1	EX	EX	
37	MECHANICAL	EX	EX	EX	EX	EX	EX	EX	EX	
38	CAGE WORKER	SV1	VB1	P2	P2	P1	P1	EX	EX	
39	NURSE SUPER	SV1	VB1	P1	P1	P2	P1	EX	EX	
40	MEDICAL RECORDS	QT	VB1	P2	P1	P2	P1	EX	EX	
41	TOILET	EX	EX	P1	P1	P1	P1	EX	EX	
42	FAMILY VISIT	SV1	VB1	P1	P2	P1	P1	EX	EX	
43	CORRIDOR	SV1	VB4	P1	P1	P1	P1	EX	EX	
44	ELECTRICAL	EX	EX	EX	EX	EX	EX	EX	EX	
44A	CHAPEL	EX	VB1	P1	P1	P1	P1	EX	EX	
45	STORAGE	EX	EX	EX	EX	EX	EX	EX	EX	
46	BARBER/BEAUTY SHOP	SV1	VB1	P1	P1	P1	P1	EX	EX	EXTEND ALL FINISHES INTO CLOSET
47	RESIDENT SMOKING	EX	EX	P1	P1	P1	P1	EX	EX	EXTEND ALL FINISHES INTO CLOSET
48	LOBBY	SV1	VB4	P1	P1	P1	P1	EX	EX	
49	CORRIDOR	EX	VB4	P1	P1	P1	P1	EX	EX	
50	PHYSICAL THERAPY	SV1	VB1	P1	P1	P2	P1	EX	EX	
52	TOILET	SV1	VB1	P1	P1	P1	P1	EX	EX	
53	OFFICE	SV1	VB1	P1	P1	P1	P1	EX	EX	
55	NLN	EX	EX	P1	P1	P1	P1	EX	EX	
56	MECHANICAL	EX	EX	EX	EX	EX	EX	EX	EX	
59	TOILET	EX	EX	EX	EX	EX	EX	EX	EX	
60	TOILET	EX	EX	EX	EX	EX	EX	EX	EX	
61	CONFERENCE TRAINING	SV1	VB1	P1	P1	P1	P1	EX	EX	
62	STORAGE	SV1	VB1	P1	P1	P1	P1	EX	EX	
63	TOILET	EX	EX	EX	EX	EX	EX	EX	EX	
64	CORRIDOR	SV1	VB3	P1	P1	P1	P1	EX	EX	
66	ADMINISTRATOR	SV1	VB1	EX	EX	EX	EX	EX	EX	
69	COMPUTER	SV1	VB1	EX	EX	EX	EX	EX	EX	
70	SOCIAL SERVICES	SV1	VB1	P1	P1	P2	P1	EX	EX	
71	CORRIDOR	SV1	VB3	P1	P1	P1	P1	EX	EX	
72	OFFICE	SV1	VB1	P2	P1	P1	P1	EX	EX	
73	PERSONNEL	SV1	VB1	P2	P1	P1	P1	EX	EX	
74	CLERICAL	SV1	VB3	P1	P1	P1	P1	EX	EX	
74A	CLERICAL	SV1	VB3	P1	P1	P1	P1	EX	EX	
75	STAFF COORDINATOR	SV1	VB1	P2	P1	P1	P1	EX	EX	
76	NURSING DIRECTOR	SV1	VB1	P2	P1	P1	P1	EX	EX	
77	CONTRROLLER	SV1	VB1	P1	P2	P1	P1	EX	EX	
78	CORRIDOR	SV1	VB3	P1	P1	P1	P1	EX	EX	
79	ACCOUNT CLERK	SV1	VB1	P1	P1	P2	P1	EX	EX	
80	VA SERVICE	SV1	VB1	P1	P2	P1	P1	EX	EX	
81	VA SERVICE SUPPORT	SV1	VB1	P1	P1	P2	P1	EX	EX	
82	CORRIDOR	SV1	VB4	P1	P1	P1	P1	EX	EX	
83	ELECTRICAL	EX	EX	EX	EX	EX	EX	EX	EX	
84	VOLUNTEER	SV1	VB1	P1	P2	P1	P1	EX	EX	
85	INFORMATION	SV1	VB4	P1	P1	P1	P1	EX	EX	
86	NOT APPLICABLE	-	-	-	-	-	-	-	-	
87	CORRIDOR	SV1	VB4	P1	P1	P1	P1	EX	EX	
88	CART WASH	EX	EX	EX	EX	EX	EX	EX	EX	
89	ELEVATOR	EX	EX	EX	EX	EX	EX	EX	EX	
90	TOILET	EX	EX	EX	EX	EX	EX	EX	EX	
91	ADD EQUIPMENT	SV1	VB2	P1	P1	P1	P1	EX	EX	

#### GENERAL NOTES:

- MATERIAL SELECTIONS ARE BASIS OF DESIGN. OTHER ACCEPTABLE MANUFACTURERS ARE LISTED IN SPECIFICATIONS, IF APPLICABLE.
- NOTIFY ARCHITECT OF ANY DISCREPANCIES FOUND IN THE FIELD.

#### DOOR/FRAME/WINDOW FINISH SCHEDULE:

PREPARE ALL EXISTING FRAMES TO RECEIVE NEW PAINT. PATCH/PUTTY ALL RUST AREAS BEFORE APPLYING NEW PRIMER. SAND AS REQUIRED FOR SMOOTH FINISH. PRIME BEFORE PAINTING. REMOVE HARDWARE BEFORE PAINTING. PAINT ALL NEW AND EXISTING HOLLOW METAL DOOR AND WINDOW FRAMES THROUGHOUT ENTIRE HOME FACILITY. AT ALL INTERIOR FRAMES PAINT IPS-10 GLOSS (SEE SPEC.) COLOR SHALL BE EQUAL TO SHERWIN WILLIAMS SW600 UNIVERSAL KHAKI. PAINT ALL EXTERIOR HOLLOW METAL FRAMES IPS-10 SEMI-GLOSS (SEE SPEC.) COLOR TO MATCH EXISTING DOOR. VERIFY WITH ARCHITECT AND PROVIDE FINISH SAMPLE FOR APPROVAL.

NOTE: CONTRACTOR SHALL REPAIR ANY DAMAGED HOLLOW METAL FRAMES AND RUST AREAS PRIOR TO NEW PAINT APPLICATION.

STAIN ALL NEW INTERIOR WOOD DOORS IPS-27 (SEE SPEC.) COLOR TO MATCH EXISTING WOOD DOORS. VERIFY FINISH WITH ARCHITECT AND PROVIDE FINISH SAMPLE FOR APPROVAL ON ACTUAL WOOD SAMPLE.

ALL ALUMINUM DOOR AND WINDOW FRAMES TO BE PRE-FINISHED DARK BRONZE ANODIZED AT INTERIOR AND EXTERIOR.

AT ALL EXISTING AND NEW INTERIOR WOOD WINDOWS, PAINT IPS-15 (SEE SPEC.) PREPARE WOOD TO RECEIVE PAINT AS REQUIRED. COLOR SHALL BE EQUAL TO SHERWIN WILLIAMS SW600 UNIVERSAL KHAKI.

RM NO.	ROOM NAME	FLOOR	WALLS					CEILING	CEILING HEIGHT	REMARKS
			BASE	N	E	S	W			
21	LOBBY	EX	EX	EX	EX	EX	EX	EX	EX	
22	VS2 OFFICE	EX	EX	EX	EX	EX	EX	EX	EX	
24	CONFERENCE #1	EX	EX	EX	EX	EX	EX	EX	EX	
25	CORRIDOR	EX	EX	EX	EX	EX	EX	EX	EX	
26	DAYCEN	EX	EX	EX	EX	EX	EX	EX	EX	
27	CLOSET	EX	EX	EX	EX	EX	EX	EX	EX	
29	CONFERENCE #1	EX	EX	EX	EX	EX	EX	EX	EX	
30	OFFICE	EX	EX	EX	EX	EX	EX	EX	EX	
31	OFFICE	EX	EX	EX	EX	EX	EX	EX	EX	
32	ELECTRICAL CLOSET	EX	EX	EX	EX	EX	EX	EX	EX	
34	CORRIDOR	SV1	VB4	P1	P1	P1	P1	EX	EX	
35	EXAM	EX	EX	EX	EX	EX	EX	EX	EX	
37	STORAGE	EX	EX	EX	EX	EX	EX	EX	EX	
38	VS2	EX	EX	EX	EX	EX	EX	EX	EX	
39	TOILET	EX	EX	EX	EX	EX	EX	EX	EX	
312	TOILET	EX	EX	EX	EX	EX	EX	EX	EX	
311	VESTIBULE	EX	EX	EX	EX	EX	EX	EX	EX	
313	CORRIDOR	SV1	VB4	P1	P1	P1	P1	EX	EX	
314	LIBRARY	SV1	VB1	P1	P1	P1	P1	EX	EX	
315	STORAGE	SV1	VB1	P1	P1	P1	P1	EX	EX	
316	MECHANICAL CLOSET	EX	EX	EX	EX	EX	EX	EX	EX	
317	CORRIDOR	SV1	VB1	P1	P1	P1	P1	EX	EX	
318	OFFICE	SV1	VB1	P1	P1	P1	P1	EX	EX	
319	RECREATIONAL THERAPY	SV1	VB1	P2	P2	P2	P2	EX	EX	
320	CORRIDOR	SV1	VB3	P1	P1	P1	P1	EX	EX	
321	STORAGE	SV1	VB1	P1	P1	P1	P1	EX	EX	

RM NO.	ROOM NAME	FLOOR	WALLS					CEILING	CEILING HEIGHT	REMARKS
			BASE	N	E	S	W			
N401	OFFICE	SV1	VB1	P2	P1	P1	P1	EX	EX	
N403	WHEELCHAIR STOR.	SV1	VB1	P1	P1	P1	P1	EX	EX	
N404	NURSEMENT	EX	EX	P1/WP1	P1/WP1	P1/WP1	P1/WP1	EX	EX	
N405	MEDICATION	EX	EX	P1	P1	P1	P1	EX	EX	
N406	NURSE	EX	EX	P1	P1	P1	P1	AI	2'-6"	
N407	OFFICE	EX	EX	P1	P2	P1	P1	EX	EX	
N408	JANITOR	EX	EX	EX	EX	EX	EX	EX	EX	
N409	NEIGHBORHOOD CTR	SV1	VB3	P1	P1	P2	P2	A4	2'-6"/EX	
N410	NURSE'S ILT.	EX	EX	P1	P1	P1	P1	EX	EX	
N411	CLEAN SUPPLY	EX	EX	P1	P1	P1	P1	EX	EX	
N412	VENDING	EX	EX	P1	P1	P1	P1	EX	EX	
N413	CORRIDOR	EX	EX	P1	P1	P1	P1	EX	EX	
N414	PLUMB. CLOS.	EX	EX	EX	EX	EX	EX	EX	EX	

N421	THERAPY	EX	EX	P1	P1	P1	P2	EX	EX	
N422	OFFICE	SV1	VB1	P1	P1	P1	P1	EX	EX	
N423	COMPUTER	EX	EX	P1	P1	P1	P1	EX	EX	
N424	RESTROOM	FT1	WT1	WT1/WT2	WT1/WT2	WT1/WT2	WT1/WT2	EX	EX	
N425	OFFICE	SV1	VB1	P1	P1	P1	P1	EX	EX	
N426	MEDICATION	EX	EX	P2	P1	P1	P1	EX	EX	
N427	NURSE	EX	EX	P1	P1	P1	P1	AI	2'-6"	
N428	OFFICE	EX	EX	P1	P1	P1	P2	EX	EX	
N429	JANITOR	EX	EX	EX	EX	EX	EX	EX	EX	
N430	NEIGHBORHOOD CTR	EX	EX	P1	P2	P2	P1	A4	2'-6"/EX	
N431	NURSE'S ILT.	EX	EX	P1	P1	P1	P1	EX	EX	
N432	CLEAN SUPPLY	EX	EX	P1	P1	P1	P1	EX	EX	
N433	CORRIDOR	EX	EX	P1	P1	P1	P1	EX	EX	
N434	PLUMBING CLOSET	EX	EX	EX	EX	EX	EX	EX	EX	
N435	DINING ROOM/ACTIVITY ROOM	EX	EX	P1	P1	P1	P1	EX	EX	
N436	MECHANICAL	EX	EX	EX	EX	EX	EX	EX	EX	
N437	KITCHEN	EX	EX	PS	PS	PS	PS	EX	EX	P2 AT ALL SOFFITS

N401	OFFICE	SV1	VB1	P1	P1	P2	P1	EX	EX	
N402	GENERAL STOR.	SV1	VB1	P1	P1	P1	P1	EX	EX	
N403	WHEELCHAIR STOR.	SV1	VB1	P1				P1	EX	EX
N404	NURSING	EX	EX	P1/WP1	P1/WP1	P1/WP1	P1/WP1	EX	EX	
N405	MEDICATION	EX	EX	P1	P1	P1	P1	EX	EX	
N406	NURSE	EX	EX	P1	P1	P1		AI	8'-6"	
N407	EXAM	EX	EX	P1	P1	P1	P1	EX	EX	
N408	JANITOR	EX	EX	EX	EX	EX	EX	EX	EX	
N409	NEIGHBORHOOD CTR	EX	EX	P2	P2		P1	A4	8'-6"/EX	
N410	NURSE'S TLT.	EX	EX	P1	P1	P1	P1	EX	EX	
N411	CLEAN SUPPLY	EX	EX	P1	P1	P1	P1	EX	EX	
N412	VENDING	EX	EX	P1	P1	P1	P1	EX	EX	
N413	CORRIDOR	EX	EX	P1	P1	P1	P1	EX	EX	
N414	PLUMBING CLOSET	EX	EX	EX	EX	EX	EX	EX	EX	



STATE OF MISSOURI  
MIKE KEHOE,  
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2/19/25

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DESIGN AND CONSTRUCTION

DEPARTMENT OF  
PUBLIC SAFETY  
MISSOURI VETERANS  
COMMISSION

INTERIOR RENOVATION  
MISSOURI VETERANS  
HOME

620 N. JEFFERSON  
ST. JAMES, MISSOURI

PROJECT # U1503-01  
SITE # 6801  
ASSET # 8136801002  
FEDERAL# 29-044

REVISION: \_\_\_\_\_  
DATE: \_\_\_\_\_  
REVISION: \_\_\_\_\_  
DATE: \_\_\_\_\_  
ISSUE DATE: 8-1-24

CAD DWG FILE: A-601.DWG  
DRAWN BY: ZAC/MAH  
CHECKED BY: MAH/CAS  
DESIGNED BY: MAH/CAS

SHEET TITLE:

FINISH SCHEDULE

SHEET NUMBER:

A-601

41 OF 120 SHEETS  
8-1-24

RM NO.	ROOM NAME	FLOOR	WALLS					CEILING	CEILING HEIGHT
			BASE	N	E	S	W		
A101	TOILET	EX	EX	EX/P5	EX/P5	EX/P5	EX/P5	P8	EX
A102	PRIV. ISOLATION	SVI	VBI	P1	P2	P1	P1	A9	8'-6"
A103	PRIVATE	SVI	VBI	P1	P2	P1	P1	A9	8'-6"
A104	LIVING ROOM	SVI	VP3/VB5	P1/P3	P1	P3	P3	A9	8'-6"
A105	SEMI-PRIVATE	SVI	VBI	P2	P1	P1	P1	A9	8'-6"
A106	TOILET	EX	EX	EX/P5	EX/P5	EX/P5	EX/P5	P8	EX
A107	SHOWER ROOM	FTI	WTI	WT1/WT2	WT1/WT2	WT1/WT2	WT1/WT2	P8/EX	MATCH EX
A108	LIVING ROOM	SVI	VP3/VB5	P3	P1	P1	P1	A9	8'-6"
A109	TOILET	EX	EX	EX/P5	EX/P5	EX/P5	EX/P5	P8	EX
A110	LIVING ROOM	SVI	VP3/VB5	P1/P3	P3	P3	P1	A9	8'-6"
A111	SEMI-PRIVATE	SVI	VBI	P2	P1	P1	P1	A9	8'-6"
A112	PRIVATE	SVI	VBI	P1	P1	P1	P2	A9	8'-6"
A113	LIVING ROOM	SVI	VP3	P1	-	P1	P1	A9	8'-6"
A114	PRIVATE	SVI	VBI	P1	P1	P1	P2	A9	8'-6"
A115	TOILET	EX	EX	EX/P5	EX/P5	EX/P5	EX/P5	P8/EX	EX
A116	SOLED UTILITY	SVI	VBI	EX/P5	EX/P5	EX/P5	EX/P5	A9	8'-6"
A117	ELECTRICAL	EX	EX	EX	EX	EX	EX	A9	8'-6"
A118	CORRIDOR	SVI	VP3	P1	P1	P1	P1	A9	8'-6"
A119	MECHANICAL	EX	EX	EX	EX	EX	EX	A9	8'-6"
A120	SEMI-PRIVATE	SVI	VBI	P1	P1	P2	P1	A9	8'-6"
A121	CORRIDOR	SVI	VP3	P1	P1	P1	P1	A9	8'-6"
A122	TOILET	EX	EX	EX/P5	EX/P5	EX/P5	EX/P5	P8/EX	EX
A123	PRIVATE	SVI	VBI	P1	P2	P1	P1	A9	8'-6"
A124	SEMI-PRIVATE	SVI	VBI	P3	P1	P2	P1	A9	8'-6"
A125	LIVING ROOM	SVI	VP3/VB5	P1	P1	P1/P3	P3	A9	8'-6"
A126	TOILET	EX	EX	EX/P5	EX/P5	EX/P5	EX/P5	P8/EX	EX
A127	SHOWER	EX	EX	EX/P5	EX/P5	EX/P5	EX/P5	P8/EX	EX
A128	LIVING ROOM	SVI	VP3/VB5	P1	P1	P3	P1	A9	8'-6"
A129	LIVING ROOM	SVI	VP3/VB5	P3	P3	P1/P3	P1	A9	8'-6"
A130	TOILET	EX	EX	EX/P5	EX/P5	EX/P5	EX/P5	P8/EX	EX
A131	SEMI PRIVATE	SVI	VBI	P1	P1	P2	P1	A9	8'-6"
A132	SEMI-PRIVATE	SVI	VBI	P1	P1	P1	P2	A9	8'-6"
A133	TUB ROOM	EX	EX	EX/P5	EX/P5	EX/P5	EX/P5	P8/EX	EX
A134	VESTIBULE	SVI	VP3	P1	P1	P1	P1	A9	8'-6"
A135	PRIVATE	SVI	VBI	P1	P1	P2	P1	A9	8'-6"
A136	LIVING ROOM	SVI	VP3/VB5	P3	P3	P1	P1/P3	A9	8'-6"
A137	SEMI-PRIVATE	SVI	VBI	P1	P1	P1	P2	A9	8'-6"
A138	TOILET	EX	EX	EX/P5	EX/P5	EX/P5	EX/P5	P8/EX	EX
A139	SHOWER	EX	EX	EX/P5	EX/P5	EX/P5	EX/P5	P8/EX	EX
A140	LIVING ROOM	SVI	VP3/VB5	P1	P1	P1	P3	A9	8'-6"
A141	LIVING ROOM	SVI	VP3/VB5	P1	P3	P3	P1/P3	A9	8'-6"
A142	TOILET	EX	EX	EX/P5	EX/P5	EX/P5	EX/P5	P8/EX	EX
A143	SEMI-PRIVATE	SVI	VBI	P1	P1	P1	P2	A9	8'-6"
A144	PRIVATE	SVI	VBI	P2	P1	P1	P1	A9	8'-6"
A145	TOILET	EX	EX	EX/P5	EX/P5	EX/P5	EX/P5	P8/EX	EX
A146	SEMI-PRIVATE	SVI	VBI	P2	P1	P1	P1	A9	8'-6"
A147	LIVING ROOM	SVI	VP3	P1	P1	P1	P1	A9	8'-6"
A148	STORAGE (ALT #2)	SVI	VBI	P1	P1	P1	P1	A2	8'-0"
A149	STORAGE (ALT #2)	SVI	VBI	P1	P1	P1	P1	A9	8'-0"

D101	TOILET	EX	EX	EX/P5	EX/P5	EX/P5	EX/P5	P8	EX
D102	PRIV. ISOLATION	SVI	VBI	P2	P1	P1	P1	EX	EX
D103	PRIVATE	SVI	VBI	P2	P1	P1	P1	EX	EX
D104	LIVING ROOM	SVI	VP3/VB5	P1	P1/P3	P3	P3	EX	EX
D105	SEMI-PRIVATE	SVI	VBI	P1	P2	P1	P1	EX	EX
D106	TOILET	EX	EX	EX/P5	EX/P5	EX/P5	EX/P5	P8	EX
D107	SHOWER	EX	EX	EX/P5	EX/P5	EX/P5	EX/P5	P8	EX
D108	LIVING ROOM	SVI	VP3/VB5	P1	P3	P1	P1	EX	EX
D109	TOILET	EX	EX	EX/P5	EX/P5	EX/P5	EX/P5	P8	EX
D110	LIVING ROOM	SVI	VP3/VB5	P3	P1/P3	P1	P3	EX	EX
D111	SEMI-PRIVATE	SVI	VBI	P1	P2	P1	P1	EX	EX
D112	PRIVATE	SVI	VBI	P1	P1	P2	P1	EX	EX
D113	LIVING ROOM	SVI	VP3	-	P1	P1	P1	EX	EX
D114	PRIVATE	SVI	VBI	P1	P1	P2	P1	EX	EX
D115	TOILET	EX	EX	EX/P5	EX/P5	EX/P5	EX/P5	P8	EX
D116	SOLED UTILITY	SVI	VB	EX/P5	EX/P5	EX/P5	EX/P5	EX	EX
D117	ELECTRICAL	EX	EX	EX	EX	EX	EX	EX	EX
D118	CORRIDOR	SVI	VP3	P1	P1	P1	P1	EX	EX
D119	MECHANICAL	EX	EX	EX	EX	EX	EX	EX	EX
D120	SEMI-PRIVATE	SVI	VBI	P2	P1	P1	P1	EX	EX
D121	CORRIDOR	SVI	VP3	P1	P1	P1	P1	EX	EX
D122	TOILET	EX	EX	EX/P5	EX/P5	EX/P5	EX/P5	P8	EX
D123	PRIVATE	SVI	VBI	P2	P1	P1	P1	EX	EX
D124	SEMI-PRIVATE	SVI	VBI	P1	P1	P2	P1	EX	EX
D125	LIVING ROOM	SVI	VP3/VB5	P1	P3	P3	P1/P3	EX	EX
D126	TOILET	EX	EX	EX/P5	EX/P5	EX/P5	EX/P5	P8	EX
D127	SHOWER	EX	EX	EX/P5	EX/P5	EX/P5	EX/P5	P8	EX
D128	LIVING ROOM	SVI	VP3/VB5	P1	P1	P1	P3	EX	EX
D129	LIVING ROOM	SVI	VP3/VB5	P3	P3	P1	P1/P3	EX	EX
D130	TOILET	EX	EX	EX/P5	EX/P5	EX/P5	EX/P5	P8	EX
D131	SEMI PRIVATE	SVI	VBI	P1	P1	P1	P2	EX	EX
D132	SEMI-PRIVATE	SVI	VBI	P1	P1	P2	P1	EX	EX
D133	TUB ROOM	EX	EX	EX/P5	EX/P5	EX/P5	EX/P5	P8	EX
D134	VESTIBULE	SVI	VP3	P1	P1	P1	P1	EX	EX
D135	PRIVATE	SVI	VBI	P1	P1	P2	P1	EX	EX
D136	LIVING ROOM	SVI	VP3/VB5	P3	P1/P3	P1	P3	EX	EX
D137	SEMI-PRIVATE	SVI	VBI	P1	P2	P1	P1	EX	EX
D138	TOILET	EX	EX	EX/P5	EX/P5	EX/P5	EX/P5	P8	EX
D139	SHOWER	EX	EX	EX/P5	EX/P5	EX/P5	EX/P5	P8	EX
D140	LIVING ROOM	SVI	VP3/VB5	P1	P3	P1	P1	EX	EX
D141	LIVING ROOM	SVI	VP3/VB5	P1	P1/P3	P3	P3	EX	EX
D142	TOILET	EX	EX	EX/P5	EX/P5	EX/P5	EX/P5	P8	EX
D143	SEMI-PRIVATE	SVI	VBI	P1	P2	P1	P1	EX	EX
D144	PRIVATE	SVI	VBI	P2	P1	P1	P1	EX	EX
D145	TOILET	EX	EX	EX/P5	EX/P5	EX/P5	EX/P5	P8	EX
D146	SEMI-PRIVATE	SVI	VBI	P2	P1	P1	P1	EX	EX
D147	LIVING ROOM	SVI	VP3	P1	P1	-	P1	EX	EX
D148	STORAGE (ALT #2)	SVI	VBI	P1	P1	P1	P1	A2	8'-0"
D149	STORAGE (ALT #2)	SVI	VBI	P1	P1	P1	P1	A2	8'-0"

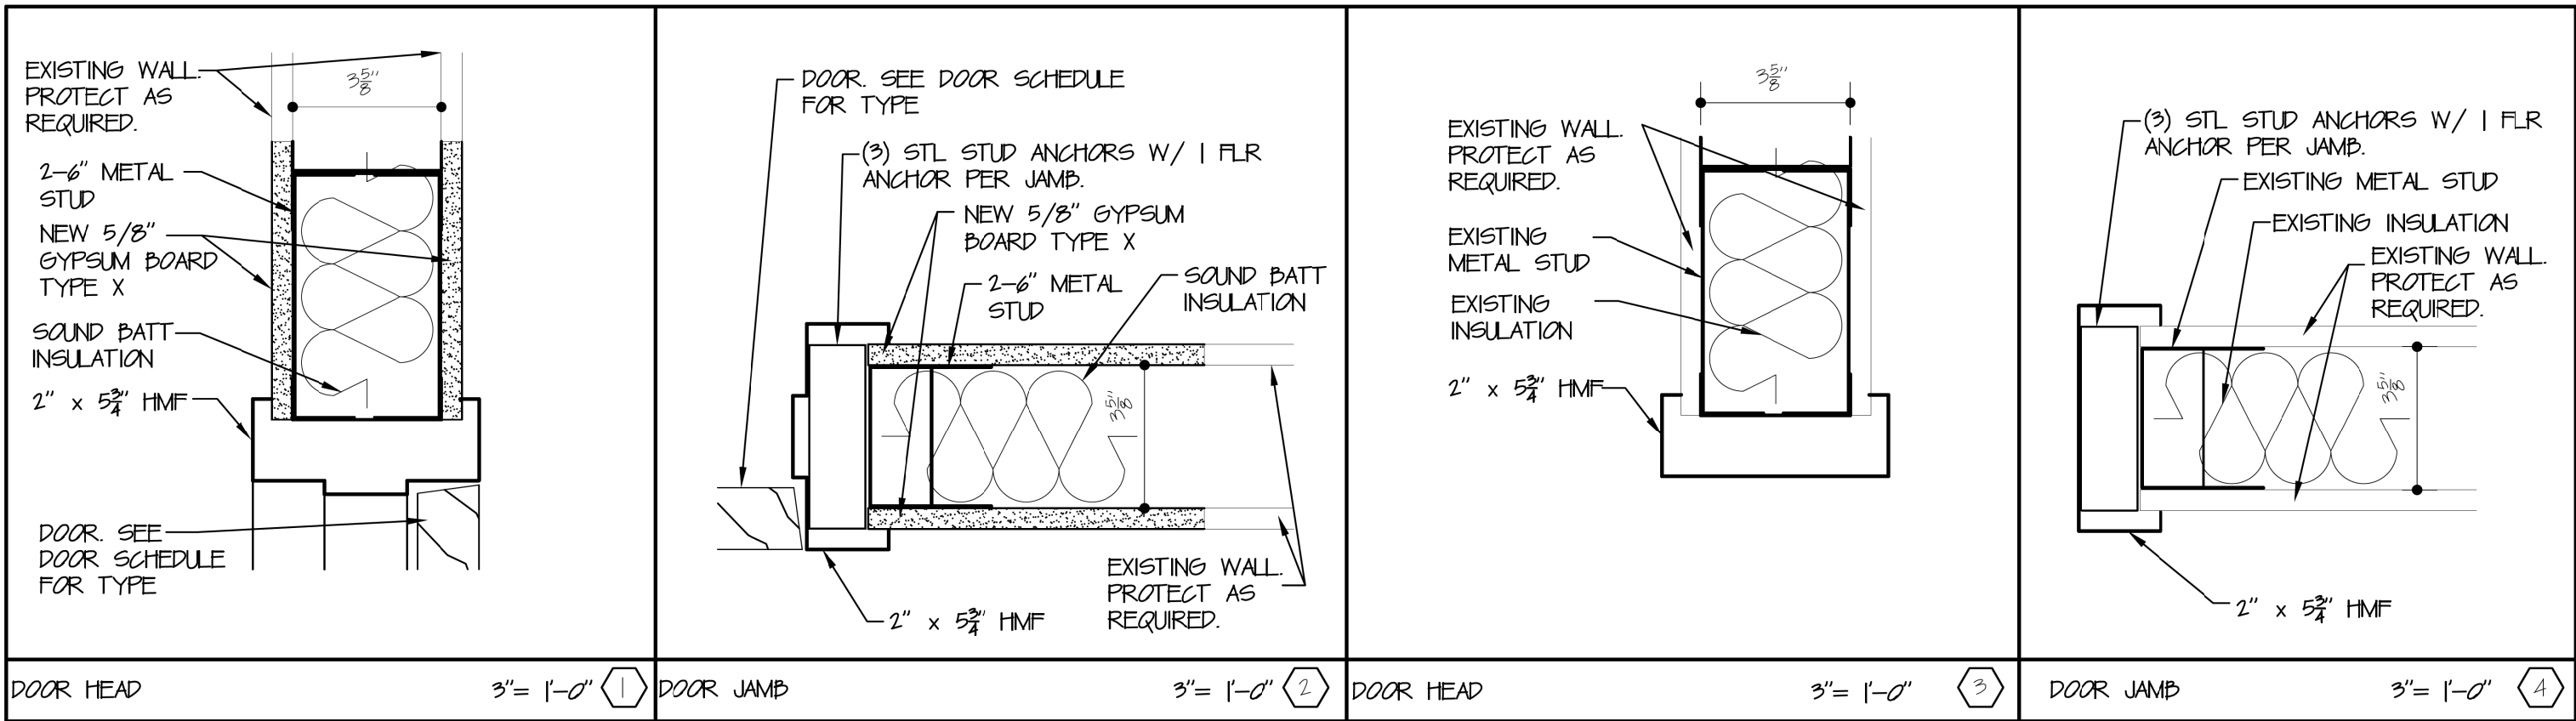
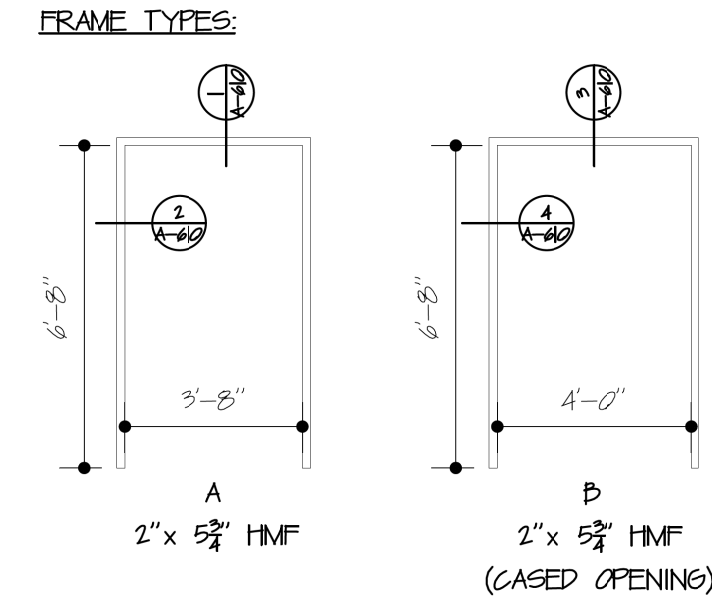
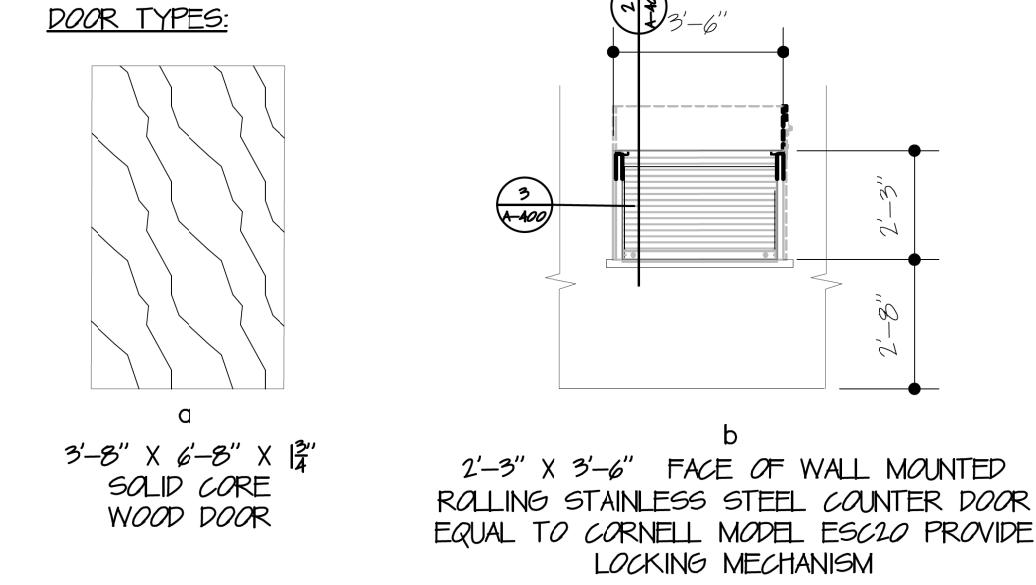
RM NO.	ROOM NAME	FLOOR	WALLS					CEILING	CEILING HEIGHT
			BASE	N	E	S	W		
E101	TOILET	EX	EX	EX/P5	EX/P5	EX/P5	EX/P5	P8	EX
E102	PRIV. ISOLATION	SVI	VBI	P1	P1	P1	P2	EX	EX
E103	PRIVATE	SVI	VBI	P1	P1	P1	P2	EX	EX
E104	LIVING ROOM	SVI	VP3/VB5	P3	P3	P1	P1/P3	EX	EX
E105	SEMI-PRIVATE	SVI	VBI	P1	P1	P1	P2	EX	EX
E106	TOILET	EX	EX	EX/P5	EX/P5	EX/P5	EX/P5	P8	EX
E107	SHOWER	EX	EX	EX/P5	EX/P5	EX/P5	EX/P5	P8	EX
E108	LIVING ROOM	SVI	VP3/VB5	P1	P1	P1	P3	EX	EX
E109	TOILET	EX	EX	EX/P5	EX/P5	EX/P5	EX/P5	P8	EX
E110	LIVING ROOM	SVI	VP3/VB5	P3	P3	P1	P1/P3	EX	EX
E111	SEMI-PRIVATE	SVI	VBI	P1	P1	P1	P1	EX	EX
E112	PRIVATE	SVI	VBI	P1	P1	P2	P1	EX	EX
E113	LIVING ROOM	SVI	VP3	P1	P1	P1	P1	EX	EX
E114	PRIVATE	SVI	VBI	P1	P2	P1	P1	EX	EX
E115	TOILET	EX	EX	EX/P5	EX/P5	EX/P5	EX/P5	P8	EX
E116	SOLED UTILITY	SVI	VBI	EX/P5	EX/P5	EX/P5	EX/P5	EX	EX
E117	ELECTRICAL	EX	EX	EX	EX	EX	EX	EX	EX
E118	CORRIDOR	SVI	VP3	P1	P1	P1	P1	EX	EX
E119	MECHANICAL	EX	EX	EX	EX	EX	EX	EX	EX
E120	SEMI-PRIVATE	SVI	VBI	P1	P1	P1	P1	EX	EX
E121	CORRIDOR	SVI	VP3	P1	P1	P1	-	EX	EX
E122	TOILET	EX	EX	EX/P5	EX/P5	EX/P5	EX/P5	P8	EX
E123	PRIVATE	SVI	VBI	P1	P1	P1	P1	EX	EX
E124	SEMI-PRIVATE	SVI	VBI	P2	P1	P1	P1	EX	EX
E125	LIVING ROOM	SVI	VP3/VB5	P1	P1/P3	P3	P3	EX	EX
E126	TOILET	EX	EX	EX/P5	EX/P5	EX/P5	EX/P5	P8	EX
E127	SHOWER	EX	EX	EX/P5	EX/P5	EX/P5	EX/P5	P8	EX
E128	LIVING ROOM	SVI	VP3/VB5	P3	P1	P1	P1	EX	EX
E129	LIVING ROOM	SVI	VP3/VB5	P1/P3	P1	P3	P3	EX	EX
E130	TOILET	EX	EX	EX/P5	EX/P5	EX/P5	EX/P5	P8	EX
E131	SEMI PRIVATE	SVI	VBI	P1	P2	P1	P1	EX	EX
E132	SEMI-PRIVATE	SVI	VBI	P1	P1	P2	P1	EX	EX
E133	TUB ROOM	EX	EX	EX/P5	EX/P5	EX/P5	EX/P5	P8	EX
E134	VESTIBULE	SVI	VP3	P1	P1	P1	P1	EX	EX
E135	PRIVATE	SVI	VBI	P2	P1	P1	P1	EX	EX
E136	LIVING ROOM	SVI	VP3/VB5	P1	P1/P3	P3	P3	EX	EX
E137	SEMI-PRIVATE	SVI	VBI	P1	P2	P1	P1	EX	EX
E138	TOILET	EX	EX	EX/P5	EX/P5	EX/P5	EX/P5	P8	EX
E139	SHOWER	EX	EX	EX/P5	EX/P5	EX/P5	EX/P5	P8	EX
E140	LIVING ROOM	SVI	VP3/VB5	P1	P3	P1	P1	EX	EX
E141	LIVING ROOM	SVI	VP3/VB5	P1	P1/P3	P3	P1	EX	EX
E142	TOILET	EX	EX	EX/P5	EX/P5	EX/P5	EX/P5	P8	EX
E143	SEMI-PRIVATE	SVI	VBI	P1	P2	P1	P1	EX	EX
E144	PRIVATE	SVI	VBI	P1	P1	P2	P1	EX	EX
E145	TOILET	EX	EX	EX/P5	EX/P5	EX/P5	EX/P5	P8	EX
E146	SEMI-PRIVATE	SVI	VBI	P1	P1	P2	P1	EX	EX
E147	LIVING ROOM	SVI	VP3	P1	P1	P1	P1	EX	EX
E148	STORAGE (ALT #2)	SVI	VBI	P1	P1	P1	P1	A2	8'-0"
E149	STORAGE (ALT #2)	SVI	VBI	P1	P1	P1	P1	A2	8'-0"

F101	TOILET	EX	EX	EX/P5	EX/P5	EX/P5	EX/P5	P8	EX
F102	PRIV. ISOLATION	SVI	VBI	P1	P1	P2	P1	EX	EX
F103	PRIVATE	SVI	VBI	P1	P1	P2	P1	EX	EX
F104	LIVING ROOM	SVI	VP3/P5	P3	P3	P1	F1/P3	EX	EX
F105	SEMI-PRIVATE	SVI	VBI	P1	P1	P1	P2	EX	EX
F106	TOILET	EX	EX	EX/P5	EX/P5	EX/P5	EX/P5	P8	EX
F107	SHOWER ROOM	FTI	WTI	WTI/WT2	WTI/WT2	WTI/WT2	WTI/WT2	P8	MATCH EX
F108	LIVING ROOM	SVI	VP3/P5	P1	P1	P1	P3	EX	EX
F109	TOILET	EX	EX	EX/P5	EX/P5	EX/P5	EX/P5	P8	EX
F110	LIVING ROOM	SVI	VP3/P5	P1	P3	P3	F1/P3	EX	EX
F111	SEMI-PRIVATE	SVI	VBI	P1	P1	P1	P2	EX	EX
F112	PRIVATE	SVI	VBI	P2	P1	P1	F1	EX	EX
F113	LIVING ROOM	SVI	VP3	P1	P1	-	F1	EX	EX
F114	PRIVATE	SVI	VBI	P2	P1	P1	P1	EX	EX
F115	TOILET	EX	EX	EX/P5	EX/P5	EX/P5	EX/P5	P8	EX
F116	SOLED UTILITY	SVI	VBI	EX/P5	EX/P5	EX/P5	EX/P5	EX	EX
F117	ELECTRICAL	EX	EX	EX	EX	EX	EX	EX	EX
F118	CORRIDOR	SVI	VP3	P1	P1	P1	F1	EX	EX
F119	MECHANICAL	EX	EX	EX	EX	EX	EX	EX	EX
F120	SEMI-PRIVATE	SVI	VBI	P1	P1	P2	P1	EX	EX
F121	CORRIDOR	SVI	VP3	P1	P1	-	-	EX	EX
F122	TOILET	EX	EX	EX/P5	EX/P5	EX/P5	EX/P5	P8	EX
F123	PRIVATE	SVI	VBI	P1	P1	P2	P1	EX	EX
F124	SEMI-PRIVATE	SVI	VBI	P1	P1	P2	P1	EX	EX
F125	LIVING ROOM	SVI	VP3/P5	P3	F1/P3	P1	P3	EX	EX
F126	TOILET	EX	EX	EX/P5	EX/P5	EX/P5	EX/P5	P8	EX
F127	SHOWER	EX	EX	EX/P5	EX/P5	EX/P5	EX/P5	P8	EX
F128	LIVING ROOM	SVI	VP3/P5	P1	P3	P1	F1	EX	EX
F129	LIVING ROOM	SVI	VP3/P5	P1	F1/P3	P3	P3	EX	EX
F130	TOILET	EX	EX	EX/P5	EX/P5	EX/P5	EX/P5	P8	EX
F131	SEMI-PRIVATE	SVI	VBI	P1	P2	P1	F1	EX	EX
F132	SEMI-PRIVATE	SVI	VBI	P2	P1	P1	F1	EX	EX
F133	TUB ROOM	EX	EX	EX/P5	EX/P5	EX/P5	EX/P5	P8	EX
F134	VESTIBULE	SVI	VP3	P1	P1	P1	F1	EX	EX
F135	PRIVATE	SVI	VBI	P1	P1	P1	F1	EX	EX
F136	LIVING ROOM	SVI	VP3/P5	F1/P3	P1	P3	P3	EX	EX
F137	SEMI-PRIVATE	SVI	VBI	P2	P1	P1	F1	EX	EX
F138	TOILET	EX	EX	EX/P5	EX/P5	EX/P5	EX/P5	P8	EX
F139	SHOWER	EX	EX	EX/P5	EX/P5	EX/P5	EX/P5	P8	EX
F140	LIVING ROOM	SVI	VP3/P5	P3	P1	P1	F1	EX	EX
F141	LIVING ROOM	SVI	VP3/P5	F1/P3	P3	P3	F1	EX	EX
F142	TOILET	EX	EX	EX/P5	EX/P5	EX/P5	EX/P5	P8	EX
F143	SEMI-PRIVATE	SVI	VBI	P2	P1	P1	F1	EX	EX
F144	PRIVATE	SVI	VBI	P1	P1	P1	P2	EX	EX
F145	TOILET	EX	EX	EX/P5	EX/P5	EX/P5	EX/P5	P8	EX
F146	SEMI-PRIVATE	SVI	VBI	P1	P1	P1	F1	EX	EX
F147	LIVING ROOM	SVI	VP3	P1	-	P1	P2	EX	EX
F148	STORAGE (ALT #2)	SVI	VBI	P1	P1	P1	F1	A2 (ALT #2)	8'-0"
F149	STORAGE (ALT #2)	SVI	VBI	P1	P1	P1	F1	A2	8'-0"




DOOR AND FRAME SCHEDULE				
DOOR NUMBER	DOOR TYPE	FRAME TYPE	HARDWARE SET	REMARKS
1	EX	EX	I	
2	EX	EX	I	
3	b	N/A	2	
N/A	N/A	N/A	N/A	
N/A	N/A	N/A	N/A	
N/A	N/A	N/A	N/A	
N/A	N/A	N/A	N/A	
N/A	N/A	N/A	N/A	
N/A	N/A	N/A	N/A	
11	—	B	—	CASED OPENING
12	—	B	—	CASED OPENING
N/A	N/A	N/A	N/A	
N/A	N/A	N/A	N/A	
15	a	A	5	ALTERNATE #2
16	a	A	5	ALTERNATE #2
17	a	A	5	ALTERNATE #2
18	a	A	5	ALTERNATE #2
19	a	A	5	ALTERNATE #2
20	a	A	5	ALTERNATE #2
21	N/A	N/A	N/A	
22	a	A	6	


GENERAL NOTE:  
A. ALL HM. FRAMES TO BE PAINTED IPS-23 (COLOR TO BE SELECTED BY ARCHITECT.) ALL WOOD DOORS TO BE STAINED IPS-27. COLOR TO BE SELECTED BY ARCHITECT. CONTRACTOR TO SUBMIT STAIN SAMPLE TO ARCH. ON ACTUAL WOOD SPECIES USED.  
B. ALTERNATE #1: ADD SEALS TO DOORS AT RESIDENT ROOMS ONLY IN WING A, FIELD VERIFY EXACT SIZE (SEE HARDWARE SPEC.)  
C. ALL WOOD DOORS TO BE RED OAK, STAINED IPS-27 (SEE SPEC.) COLOR TO MATCH EXISTING DOORS. CONTRACTOR TO SUBMIT STAIN SAMPLE TO ARCHITECT ON ACTUAL WOOD SPECIES USED.



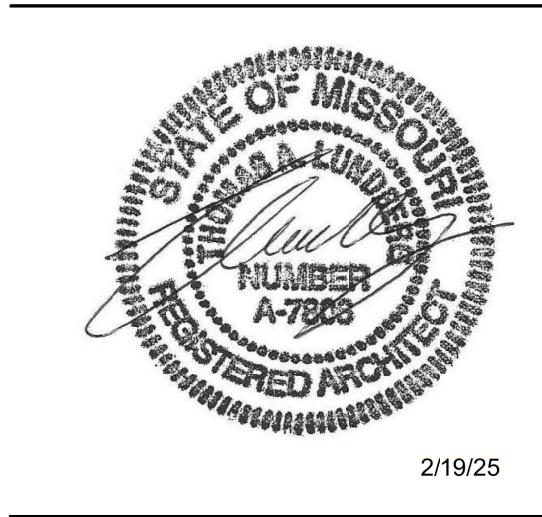STATE OF MISSOURI  
MIKE KEHOE,  
GOVERNOR



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620 N. JEFFERSON  
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PROJECT # U1503-01  
SITE # 6801  
ASSET # 8136801002  
FEDERAL# 29-044

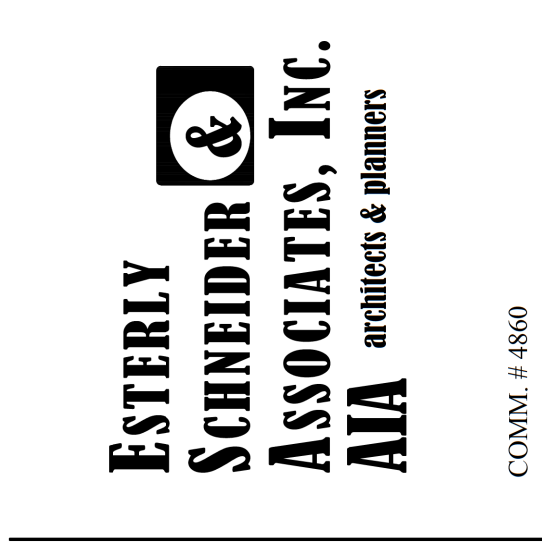REVISION: \_\_\_\_\_  
DATE: \_\_\_\_\_  
REVISION: \_\_\_\_\_  
DATE: \_\_\_\_\_  
REVISION: \_\_\_\_\_  
DATE: \_\_\_\_\_

ISSUE DATE: 8-1-24

CAD DWG FILE: A-610.DWG  
DRAWN BY: ZAC/MAH  
CHECKED BY: MAH/CAS  
DESIGNED BY: MAH/CAS

SHEET TITLE:

DOOR SCHEDULE

SHEET NUMBER:

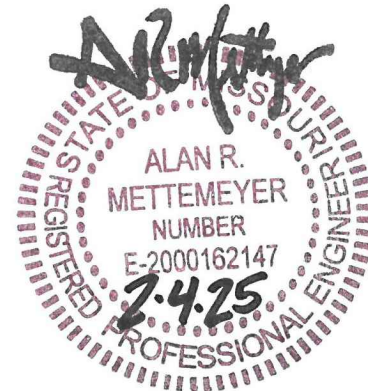
A-610

42 OF 120 SHEETS  
8-1-24









Alan R. Mettemeyer PE# E-2000162147  
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DATE: \_\_\_\_\_  
REVISION: \_\_\_\_\_  
DATE: \_\_\_\_\_  
ISSUE DATE: 8-1-24

CAD DWG FILE: S-101.dwg  
DRAWN BY: JDD  
CHECKED BY: BSW  
DESIGNED BY: BSW


SHEET TITLE:

## FOUNDATION PLAN

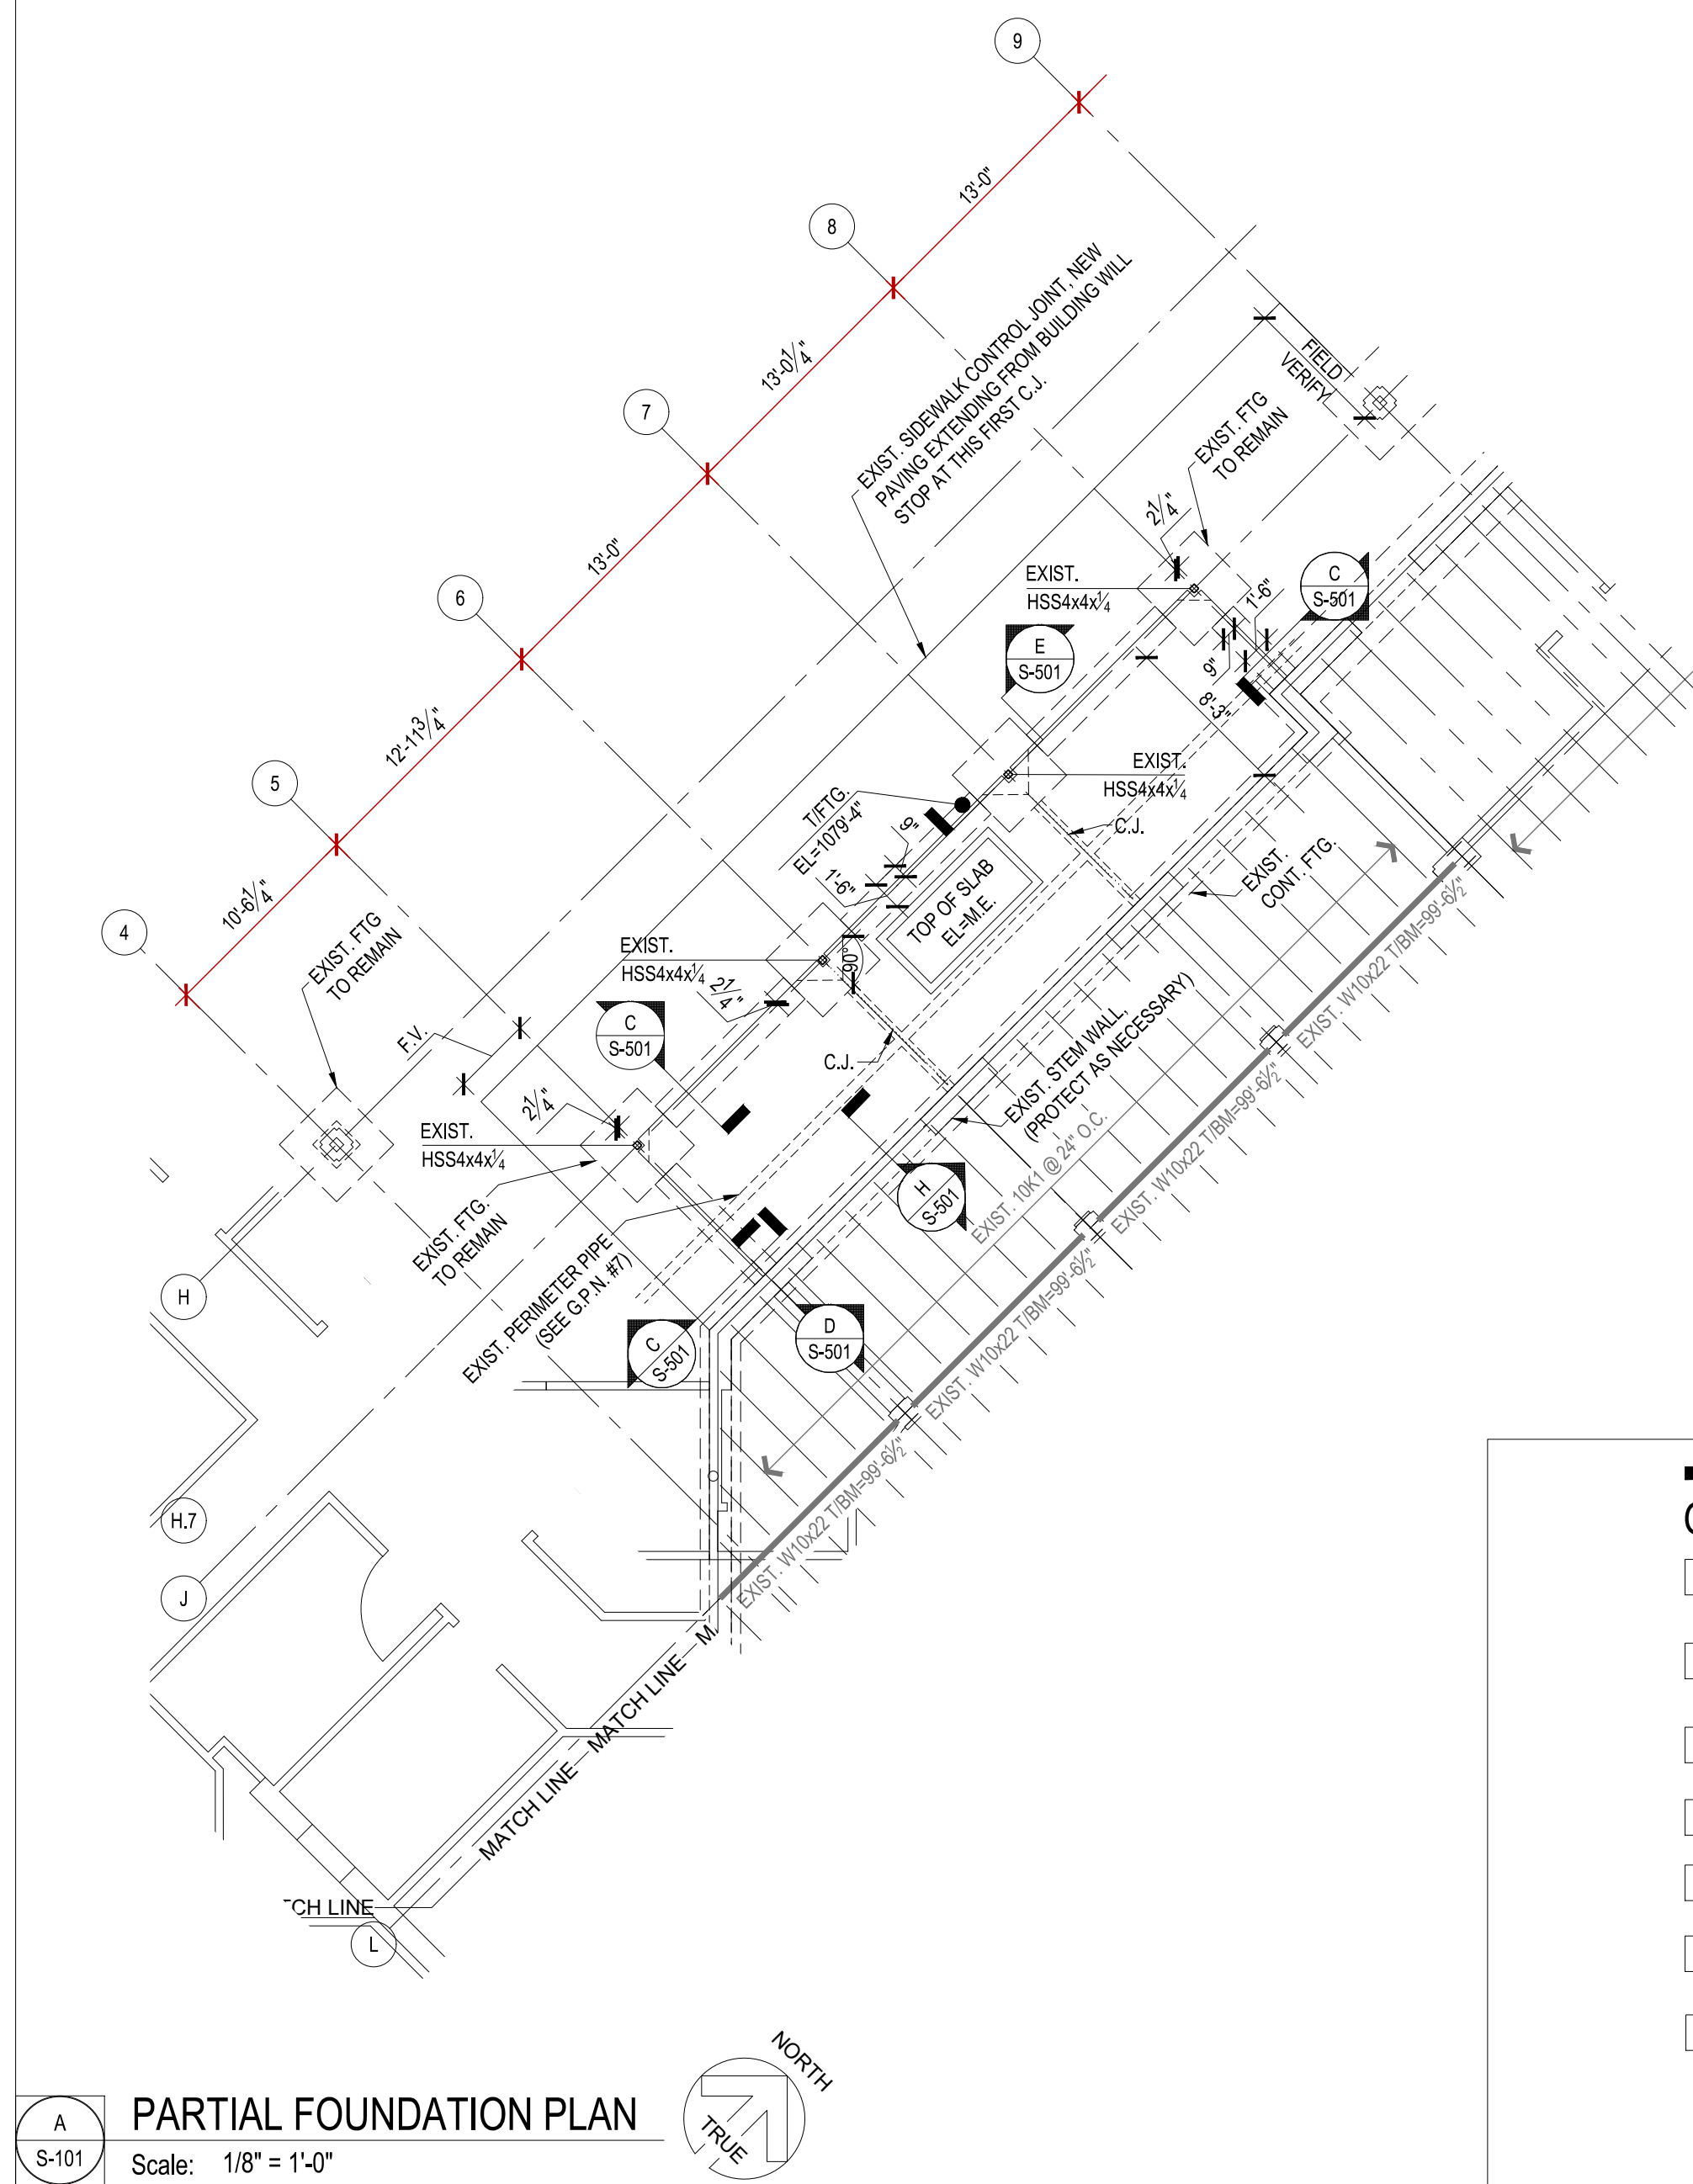SHEET NUMBER:

S-101


44 OF 117 SHEETS




## GENERAL PLAN NOTES

- |   |   |
|---|---|
| 1 | SLAB ON GRADE IS PER GENERAL NOTES ON S-000 AND SPECIFICATIONS  |
| 2 | CJ - CONTROL OR CONSTRUCTION JOINT IN FLOOR SLAB, SEE A/S-501 & B/S-501 RESPECTIVELY.   |
| 3 | SEE ARCHITECTURAL AND PLUMBING SHEETS FOR WATER-PROOFING AND STORM WATER DRAINAGE REQUIREMENTS.   |
| 4 | SEE SHEET S-000 FOR GENERAL STRUCTURAL NOTES AND SPECIFICATIONS   |
| 5 | CENTER ALL SPREAD FOOTINGS ON CENTERLINE OF STEEL COLUMNS. U.N.O  |
| 6 | GRID LINES ARE TO CENTERLINE OF COLUMN BASE PLATE, AS INDICATED ON PLAN.  |
| 7 | EXISTING RAIN WATER PIPING EXTENDS BELOW GRADE AND WILL BE ENCOUNTERED DURING EXCAVATION. CAUTION & CARE MUST BE USED TO ENSURE PIPE IS NOT DAMAGED, FOUNDATIONS WILL POUR AROUND PIPES. PROTECT AS REQUIRED. |
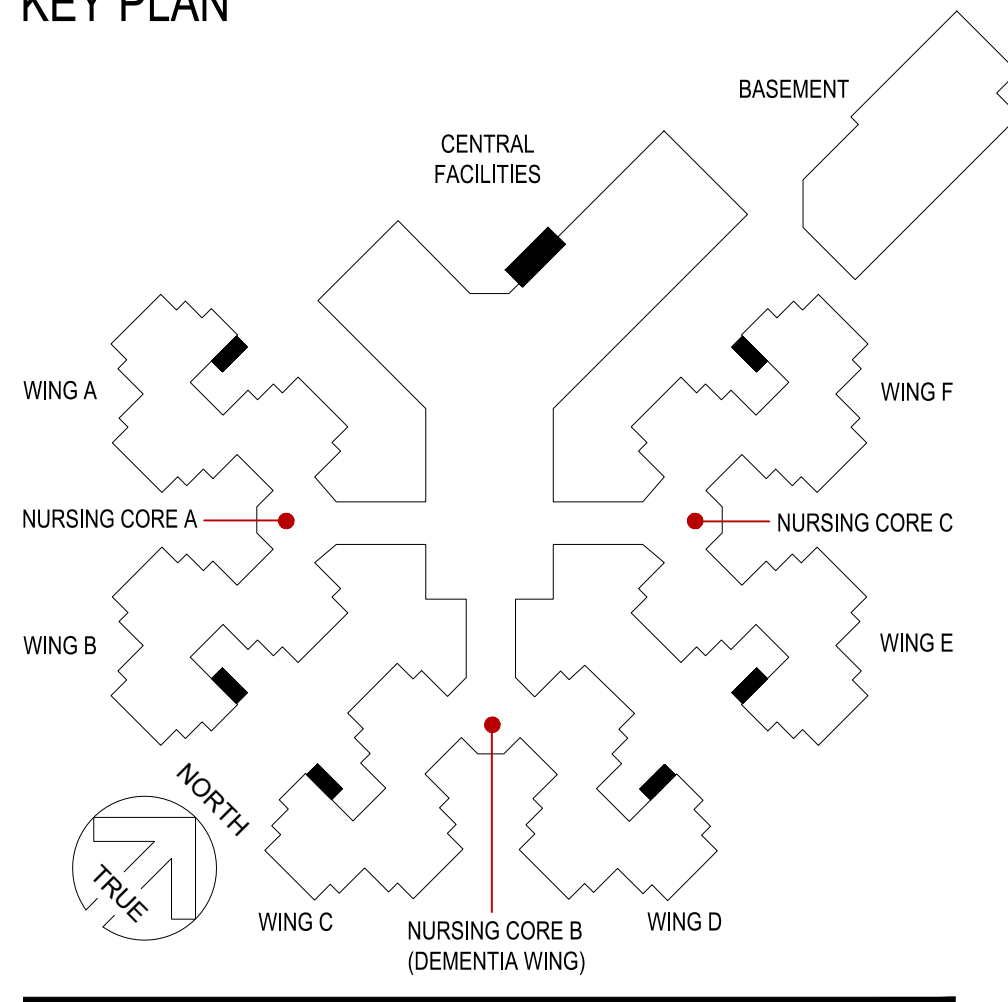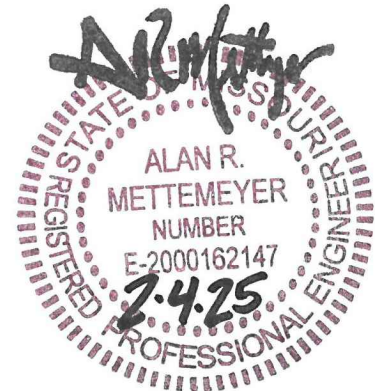
## KEY PLAN







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FEDERAL # 29-044

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DATE: \_\_\_\_\_  
REVISION:  
DATE: \_\_\_\_\_  
REVISION:  
DATE: \_\_\_\_\_  
ISSUE DATE: 8-1-24

CAD DWG FILE: S-102.dwg  
DRAWN BY: JDD  
CHECKED BY: BSW  
DESIGNED BY: BSW

SHEET TITLE:


**FOUNDATION  
PLAN**

SHEET NUMBER:

**S-102**

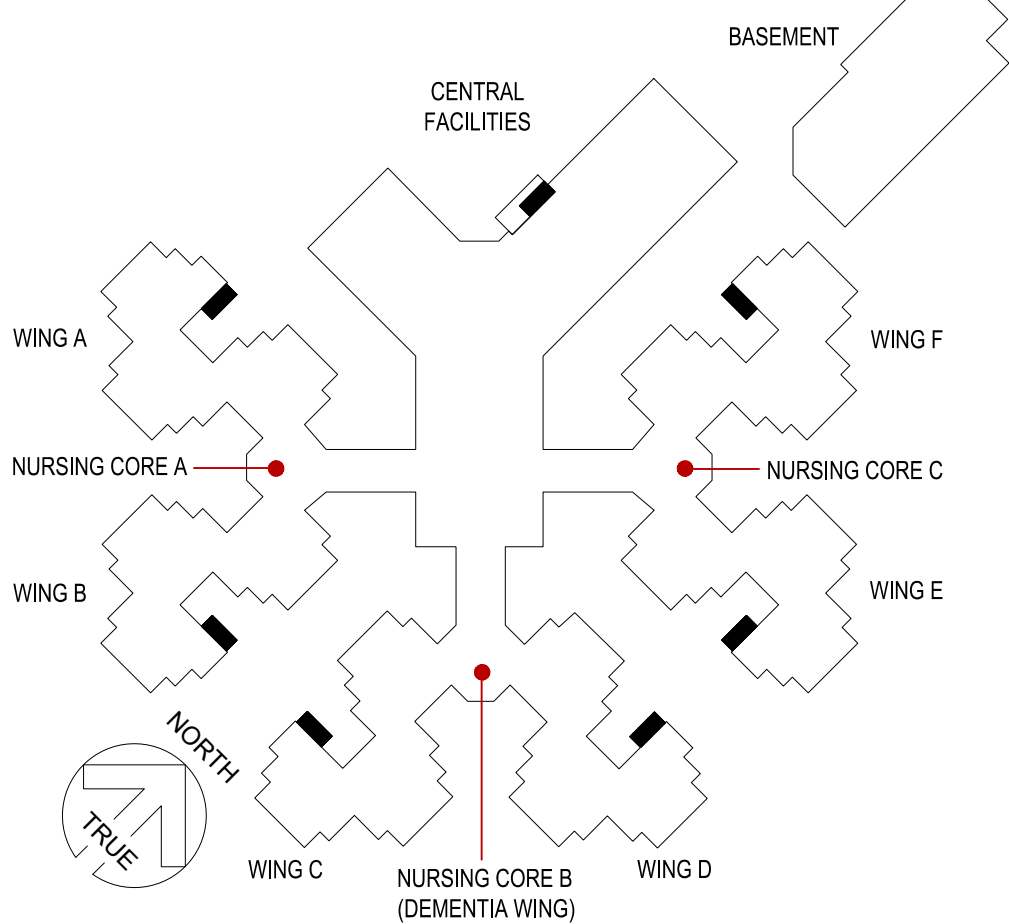45 OF 117 SHEETS

KEY PLAN




GENERAL PLAN NOTES


- SEE SHEET S-101 FOR GENERAL FOUNDATION PLAN NOTES.
- SEE SHEET S000 FOR GENERAL STRUCTURAL NOTES.

ALTERNATE #2

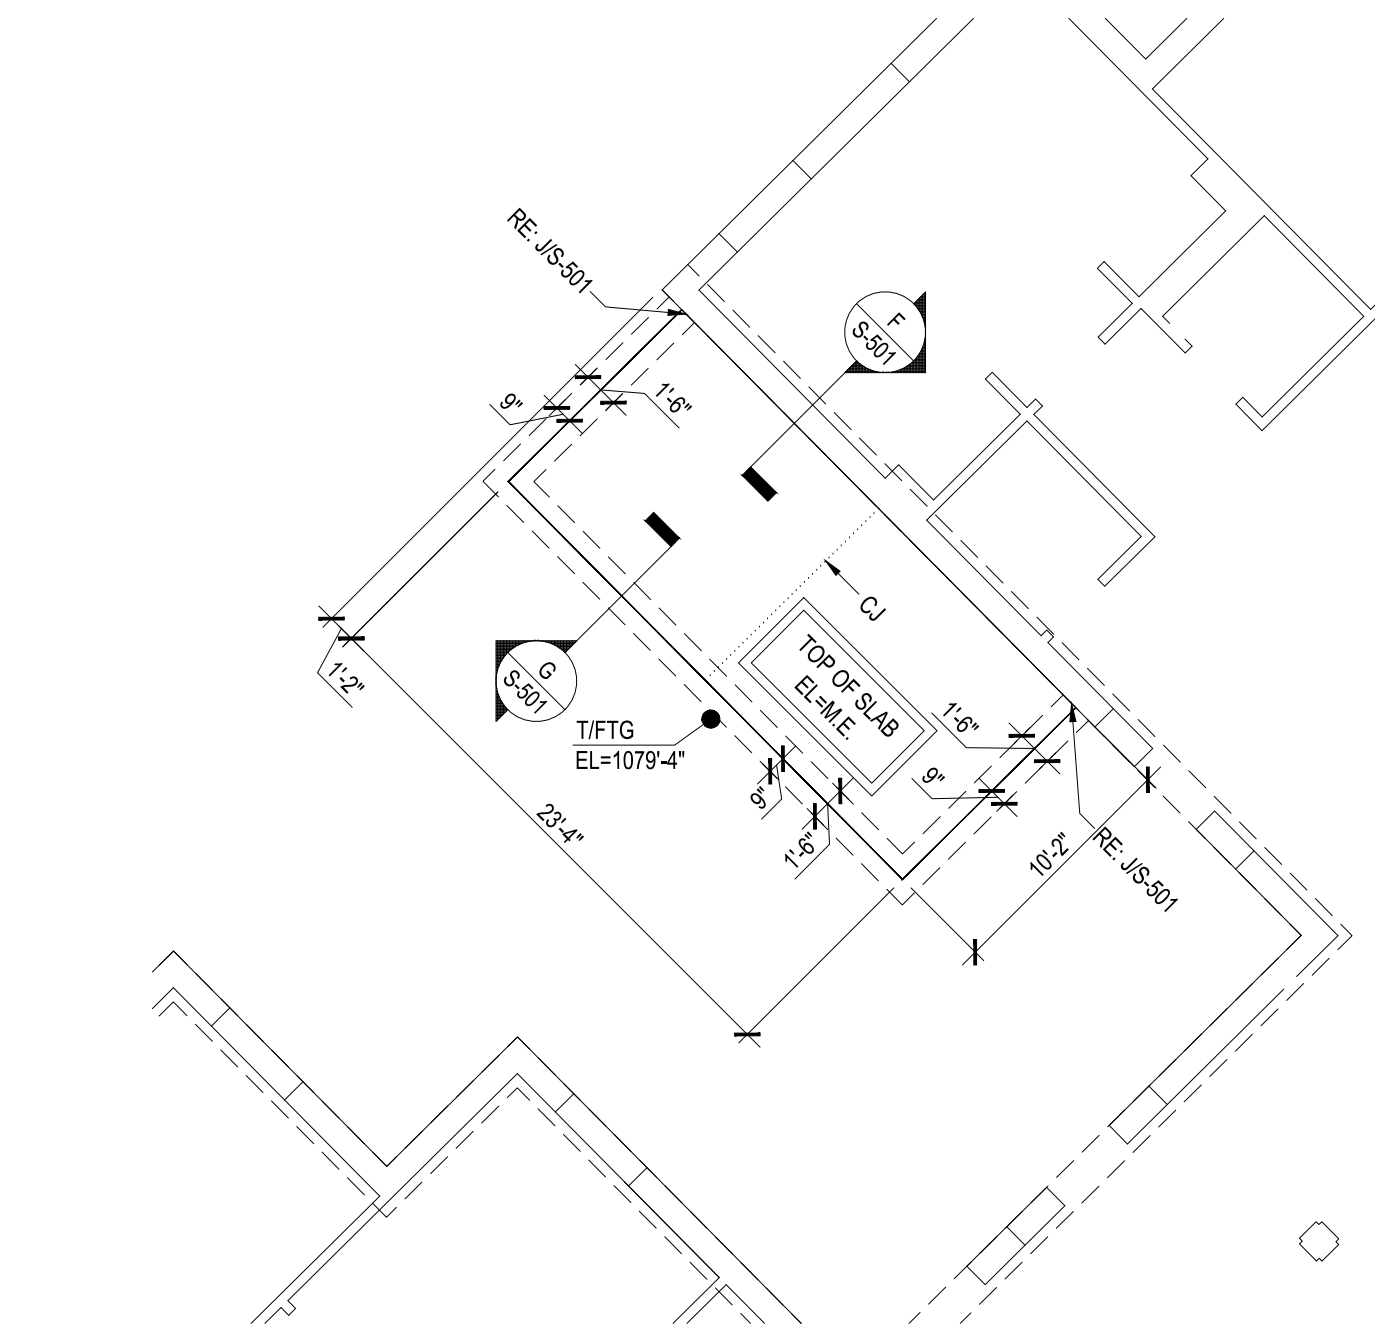
PROVIDE AND INSTALL NEW MEDICAL EQUIPMENT ROOM ADDITION ON  
TO RESIDENT WINGS A, B, C, D, E, AND F. REFER TO SHEETS A-114,  
A115, A-116, A-117, A118, AND A-119 AND ALL ASSOCIATED DETAILS.  
REFER TO ALL STRUCTURAL DRAWINGS ASSOCIATED WITH  
AFOREMENTIONED ARCHITECTURAL DRAWINGS



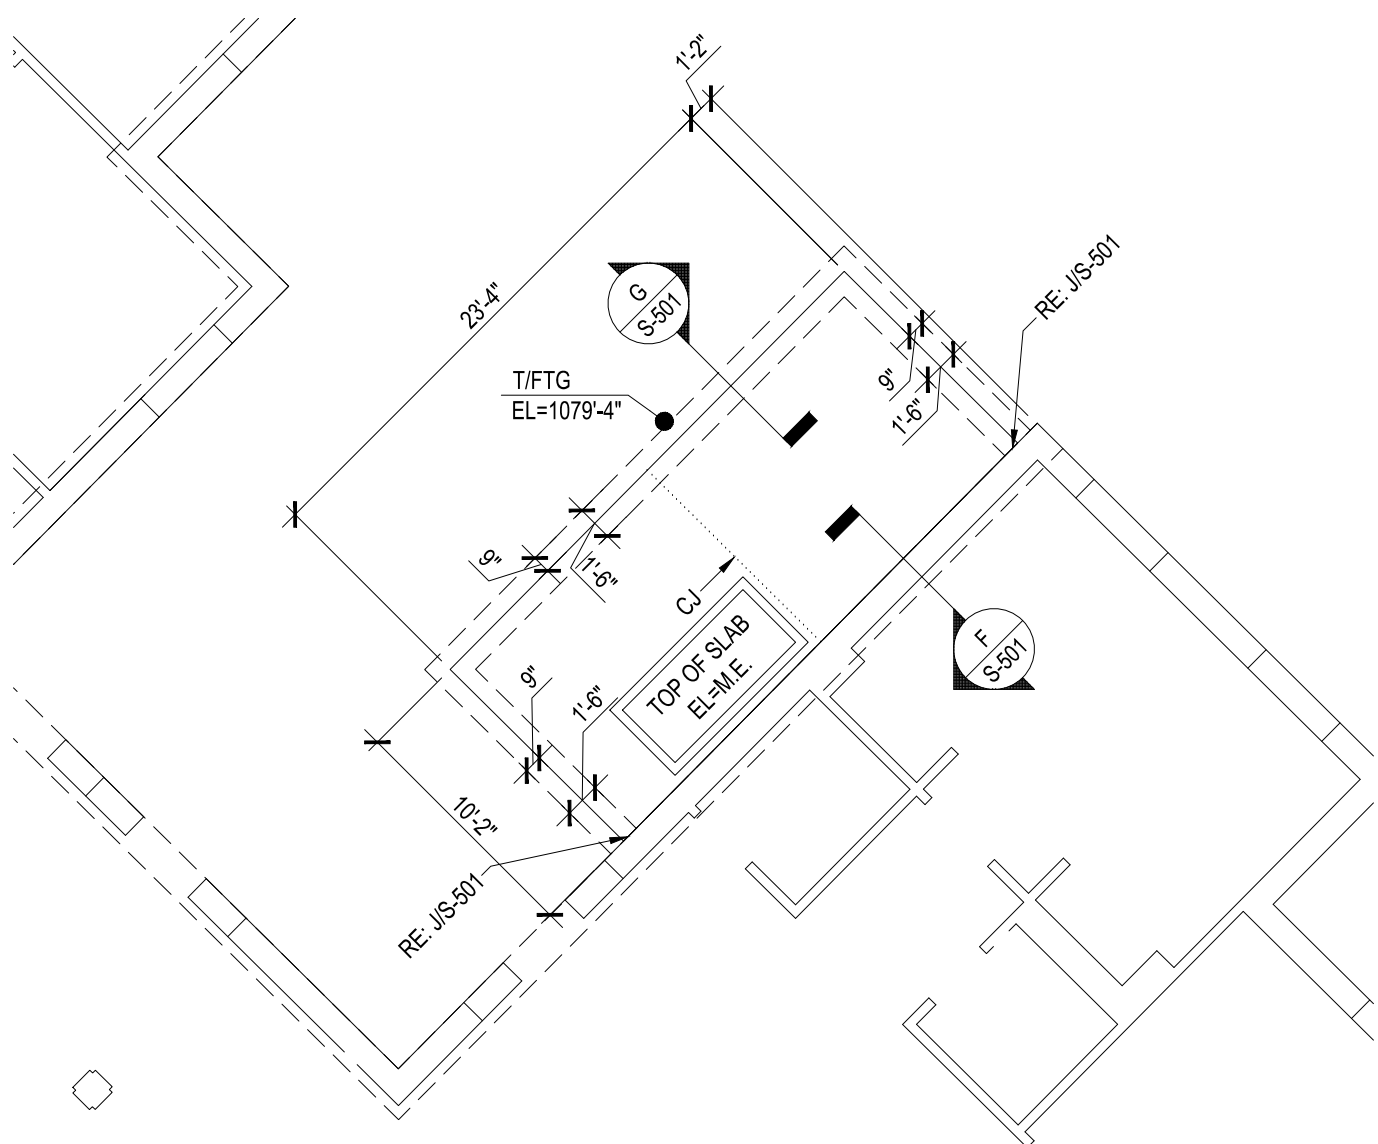
**F**  
S-102  
WING F - PARTIAL FOUNDATION PLAN  
Scale: 1/8" = 1'-0"  
NORTH  
TRUE



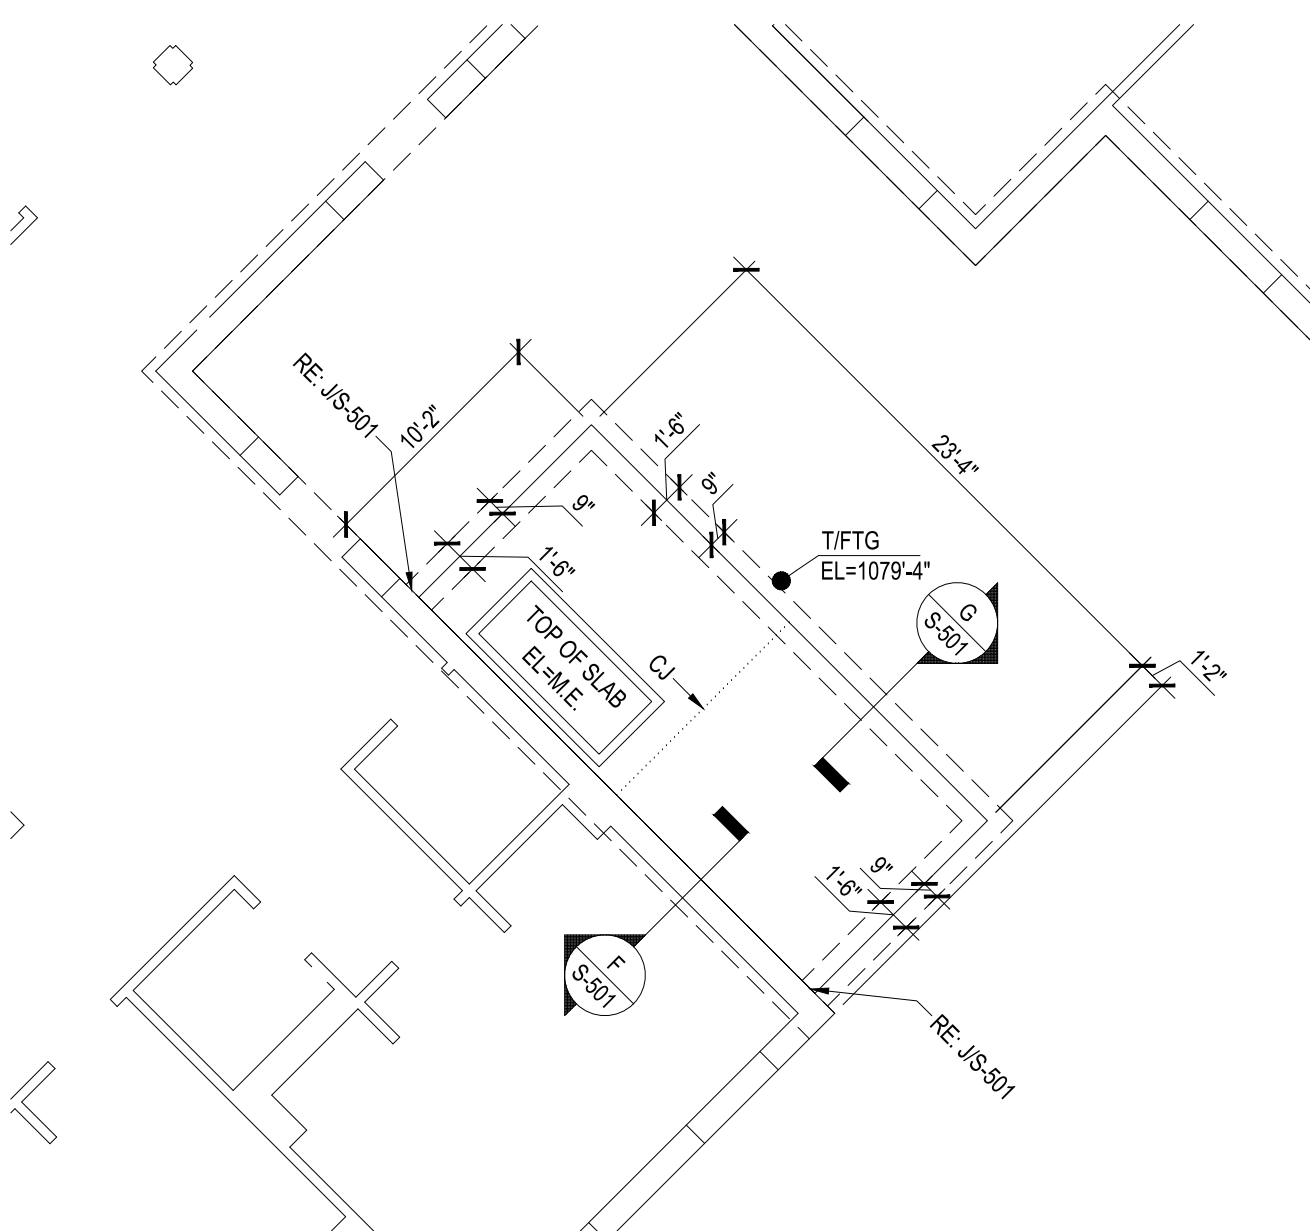
**D**  
S-102  
WING D - PARTIAL FOUNDATION PLAN  
Scale: 1/8" = 1'-0"  
NORTH  
TRUE



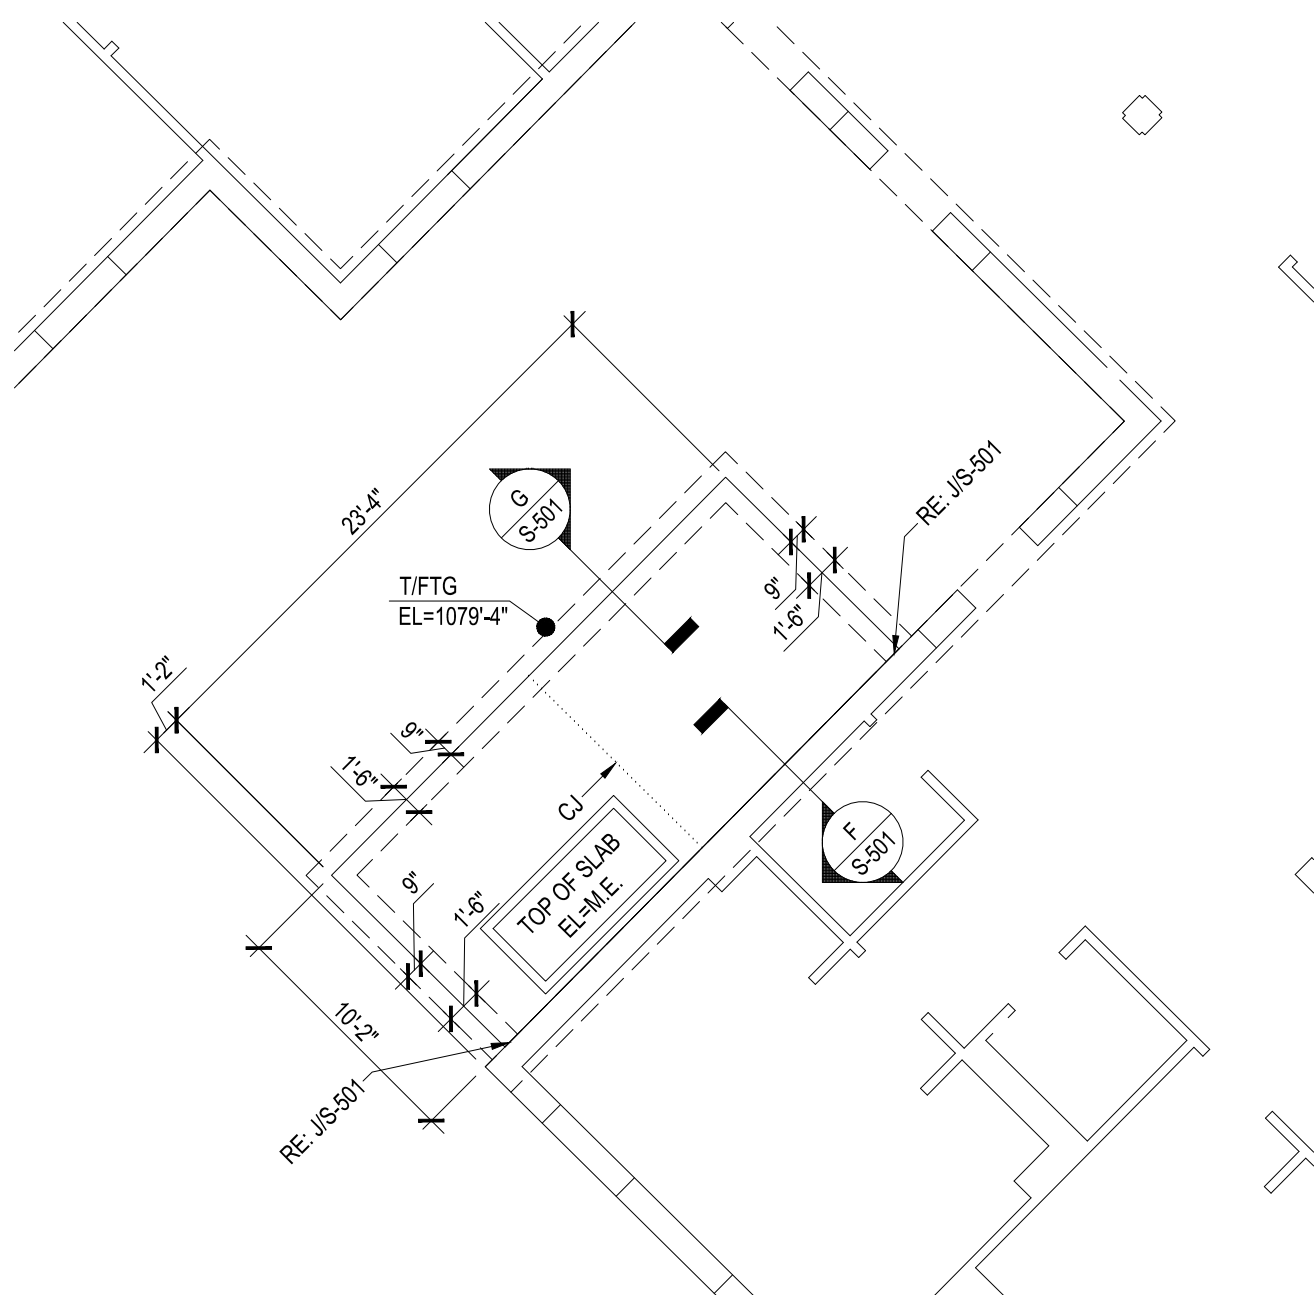
**B**  
S-102  
WING B - PARTIAL FOUNDATION PLAN  
Scale: 1/8" = 1'-0"  
NORTH  
TRUE



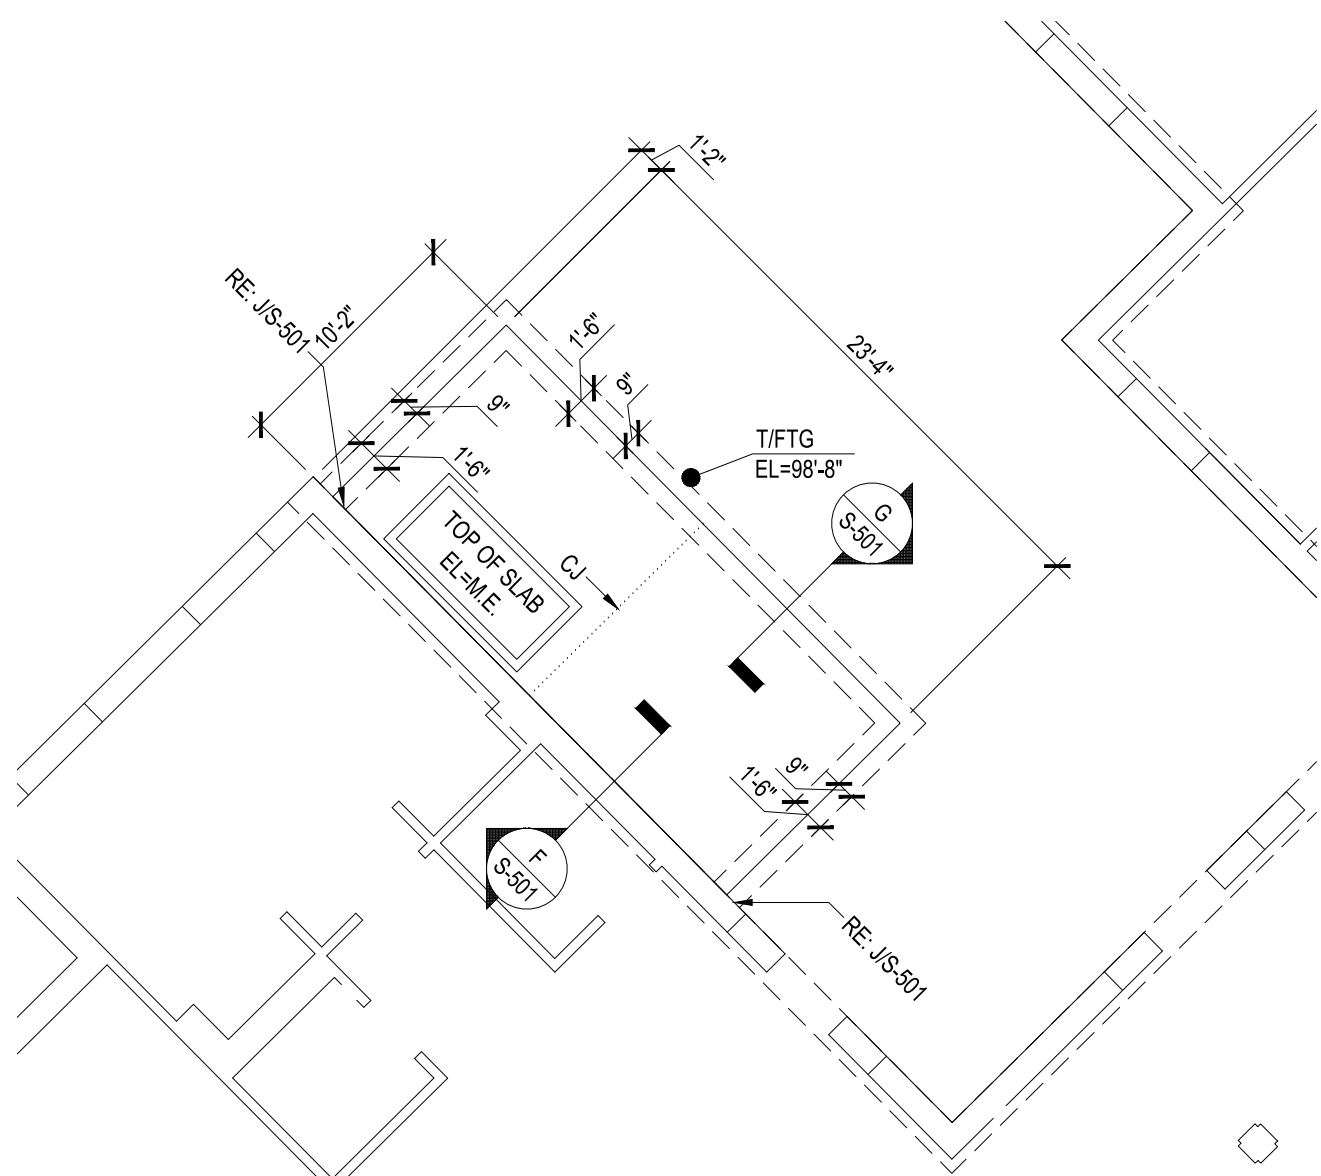**E**  
S-102  
WING E - PARTIAL FOUNDATION PLAN  
Scale: 1/8" = 1'-0"  
NORTH  
TRUE




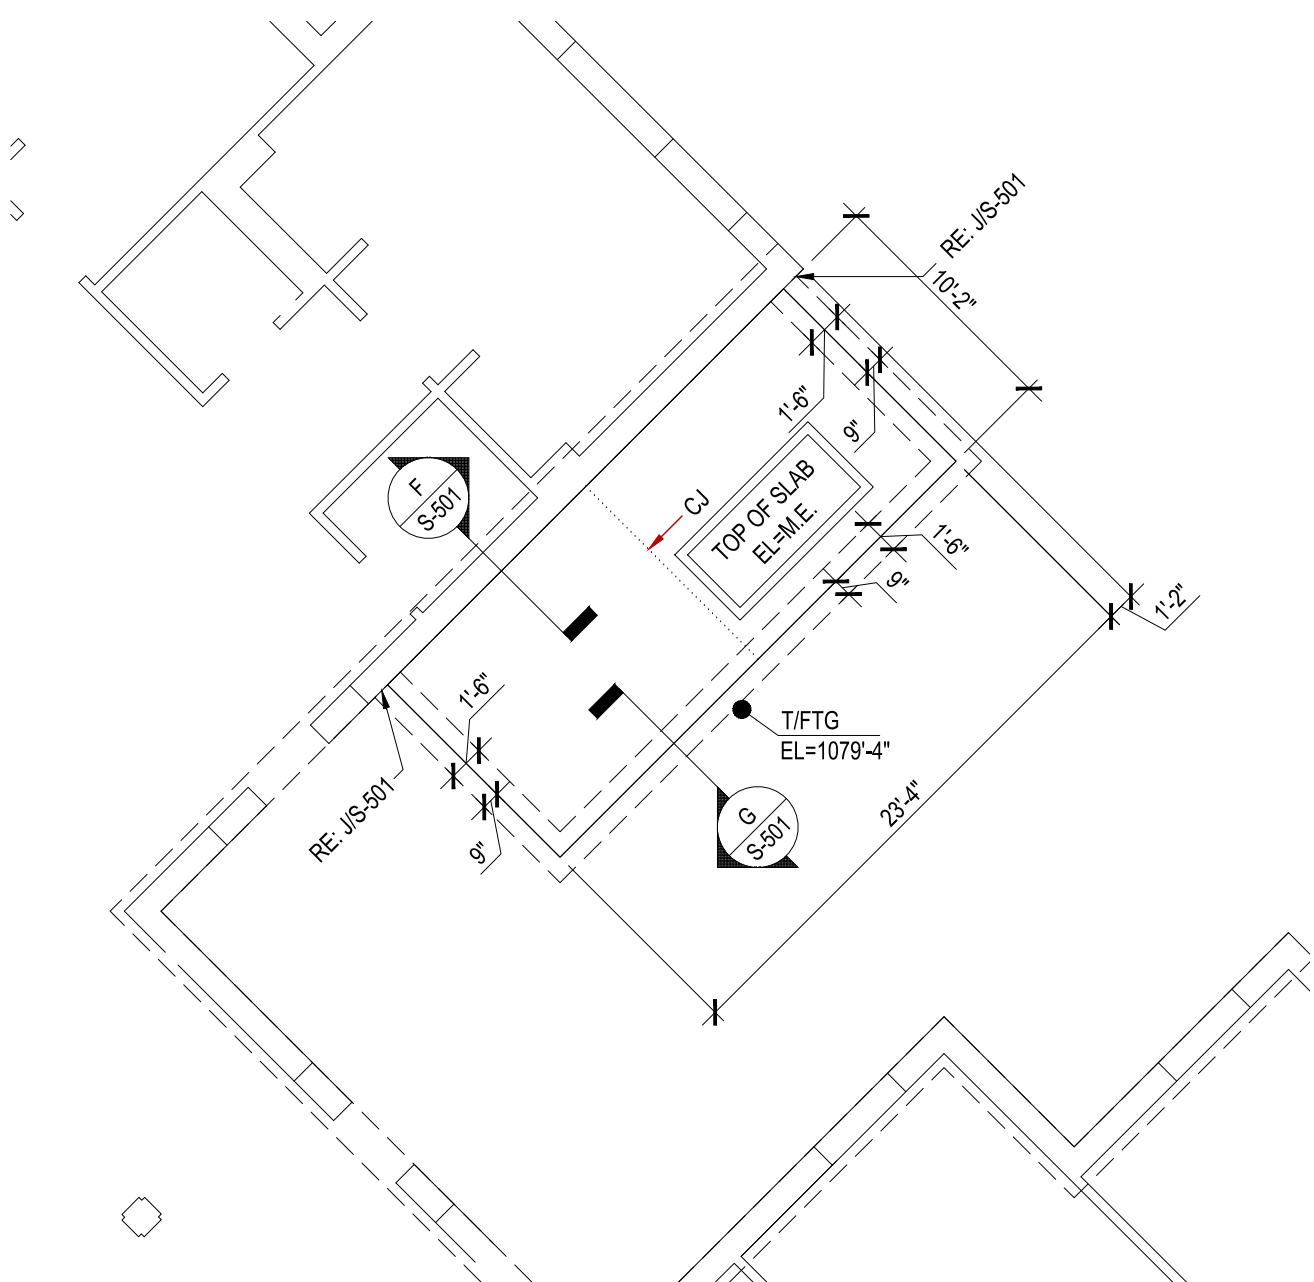**C**  
S-102  
WING C - PARTIAL FOUNDATION PLAN  
Scale: 1/8" = 1'-0"  
NORTH  
TRUE



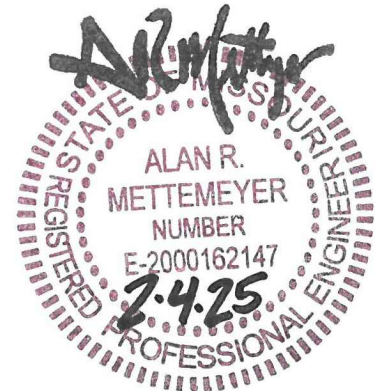**A**  
S-102  
WING A - PARTIAL FOUNDATION PLAN  
Scale: 1/8" = 1'-0"  
NORTH  
TRUE





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COMM. # 4860

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HOME

620 N. JEFFERSON  
ST. JAMES, MISSOURI

PROJECT # U1503-01  
SITE # 6801  
ASSET # 8136801002  
FEDERAL # 29-044

REVISION: \_\_\_\_\_  
DATE: \_\_\_\_\_  
REVISION: \_\_\_\_\_  
DATE: \_\_\_\_\_  
REVISION: \_\_\_\_\_  
DATE: \_\_\_\_\_

ISSUE DATE: 8-1-24

CAD DWG FILE: S-103.dwg  
DRAWN BY: JDD  
CHECKED BY: BSW  
DESIGNED BY: BSW

SHEET TITLE:

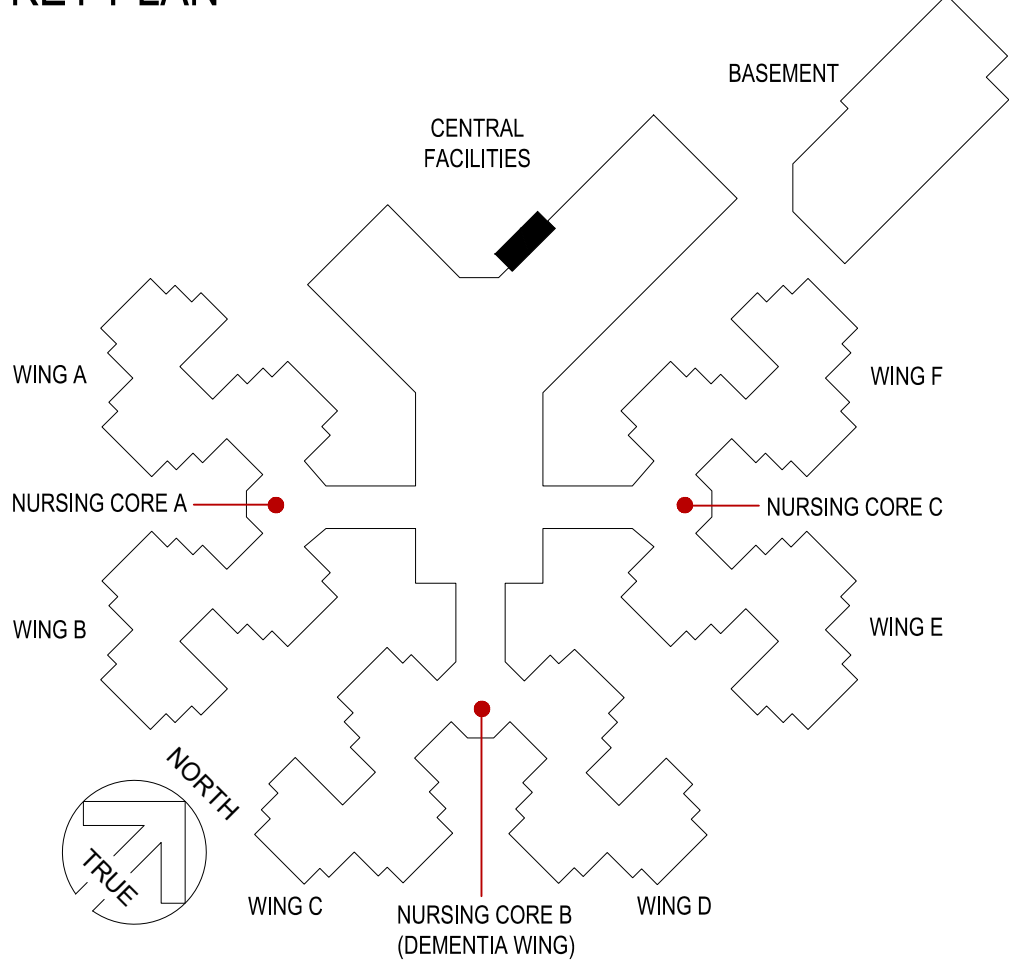
FRAMING PLAN

SHEET NUMBER:

S-103


46 OF 117 SHEETS  
8-1-24

KEY PLAN




GENERAL PLAN NOTES

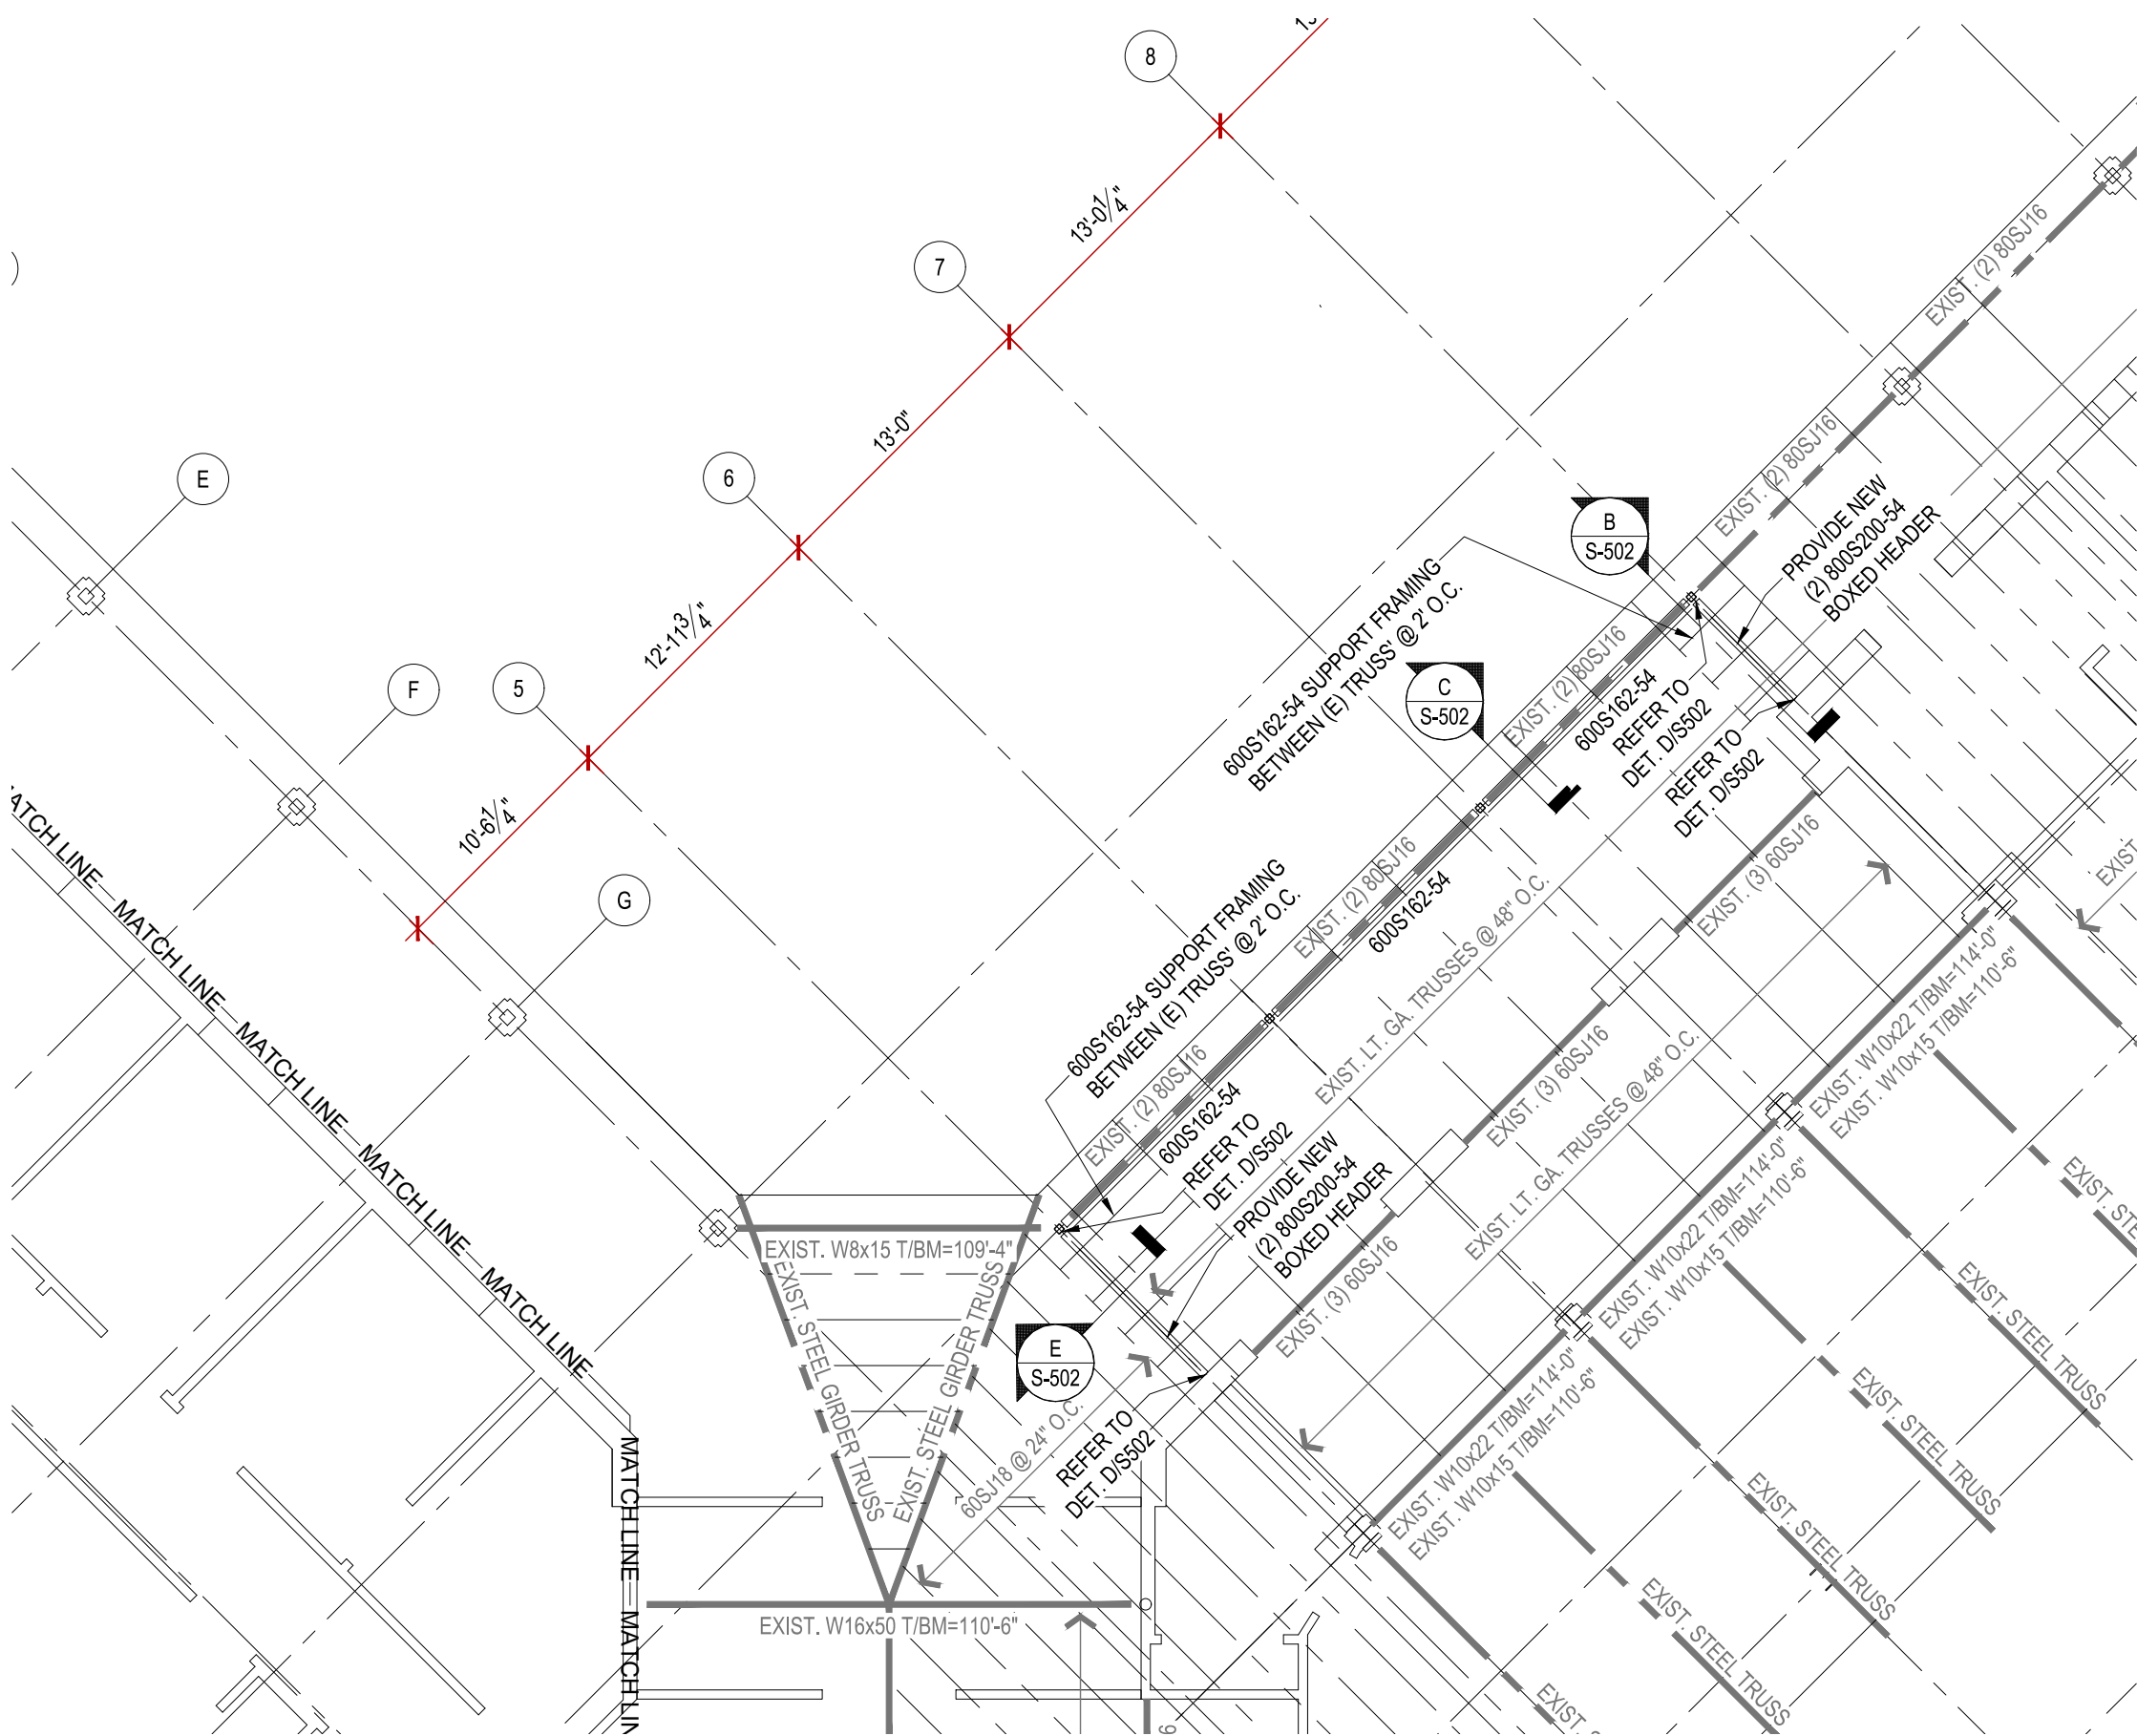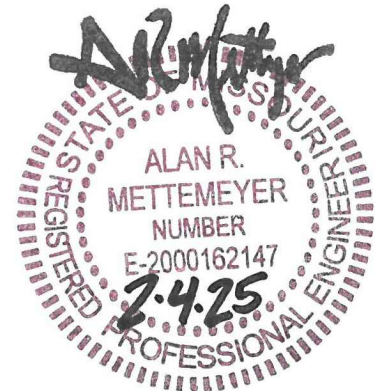- SEE SHEET S-000 FOR GENERAL NOTES AND S0.1 FOR REQUIRED INSPECTIONS.
- EXISTING ROOF FRAMING AT NEW SOLARIUM TO REMAIN







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DATE: \_\_\_\_\_  
REVISION: \_\_\_\_\_  
DATE: \_\_\_\_\_  
ISSUE DATE: 8-1-24

CAD DWG FILE: S-104.dwg  
DRAWN BY: JDD  
CHECKED BY: BSW  
DESIGNED BY: BSW

SHEET TITLE:

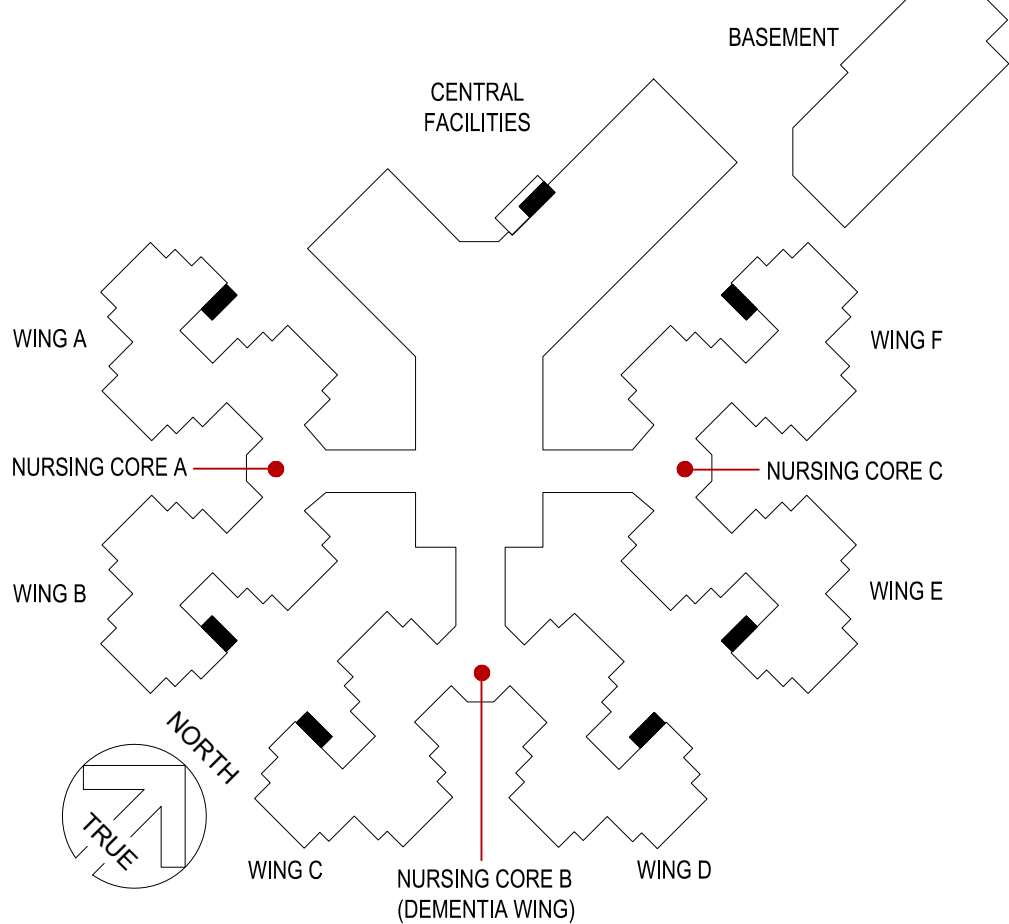
FRAMING PLAN

SHEET NUMBER:

S-104


47 OF 117 SHEETS  
8-1-24

KEY PLAN



GENERAL PLAN NOTES

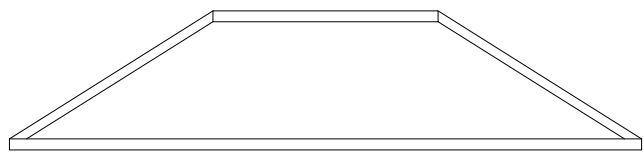
- 1 SEE SHEET S-103 FOR GENERAL FRAMING PLAN NOTES.
- 2 SEE SHEET S-000 FOR GENERAL STRUCTURAL NOTES.
- 3 OVERBUILD CALLED OUT ON THIS SHEET SHALL BE 2x6 JOISTS @ 24" O.C. WITH MAXIMUM SPAN OF 8'-0". PROVIDE CRIPPLE WALLS AS REQUIRED.




GIRDER TRUSS PROFILE  
SEE ARCH. ELEV. FOR ROOF  
SHAPE @ ADDITIONS

ALTERNATE #2

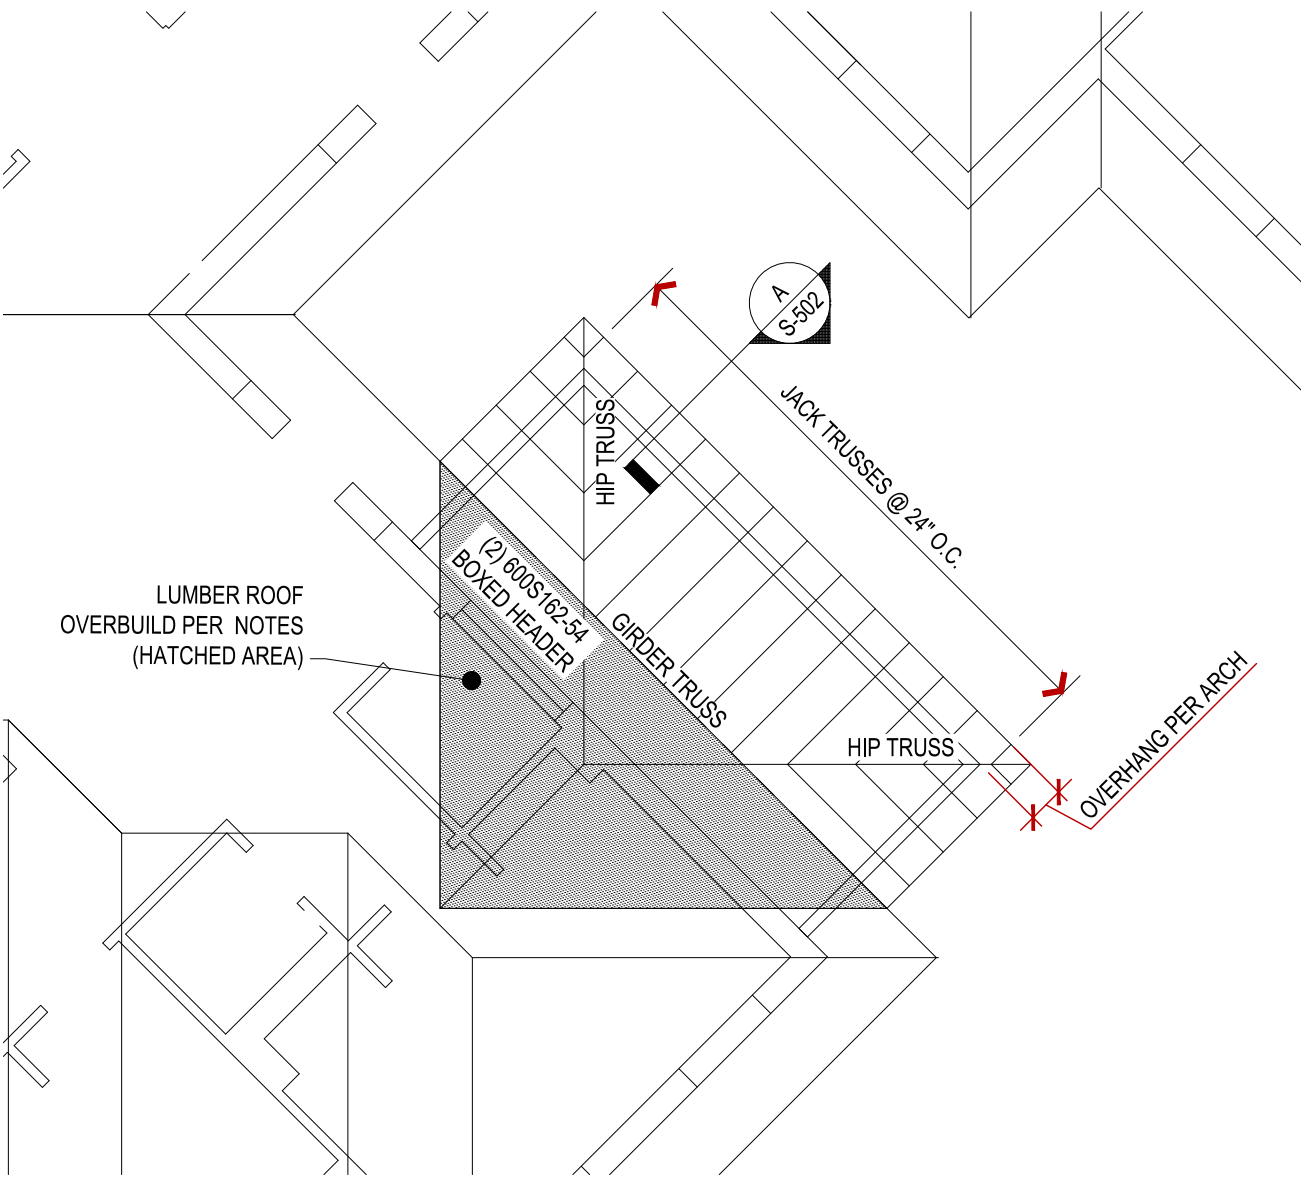
PROVIDE AND INSTALL NEW MEDICAL EQUIPMENT ROOM ADDITION ON TO RESIDENT WINGS A, B, C, D, E, AND F. REFER TO SHEETS A-114, A-115, A-116, A-117, A-118, AND A-119 AND ALL ASSOCIATED DETAILS. REFER TO ALL STRUCTURAL DRAWINGS ASSOCIATED WITH AFOREMENTIONED ARCHITECTURAL DRAWINGS



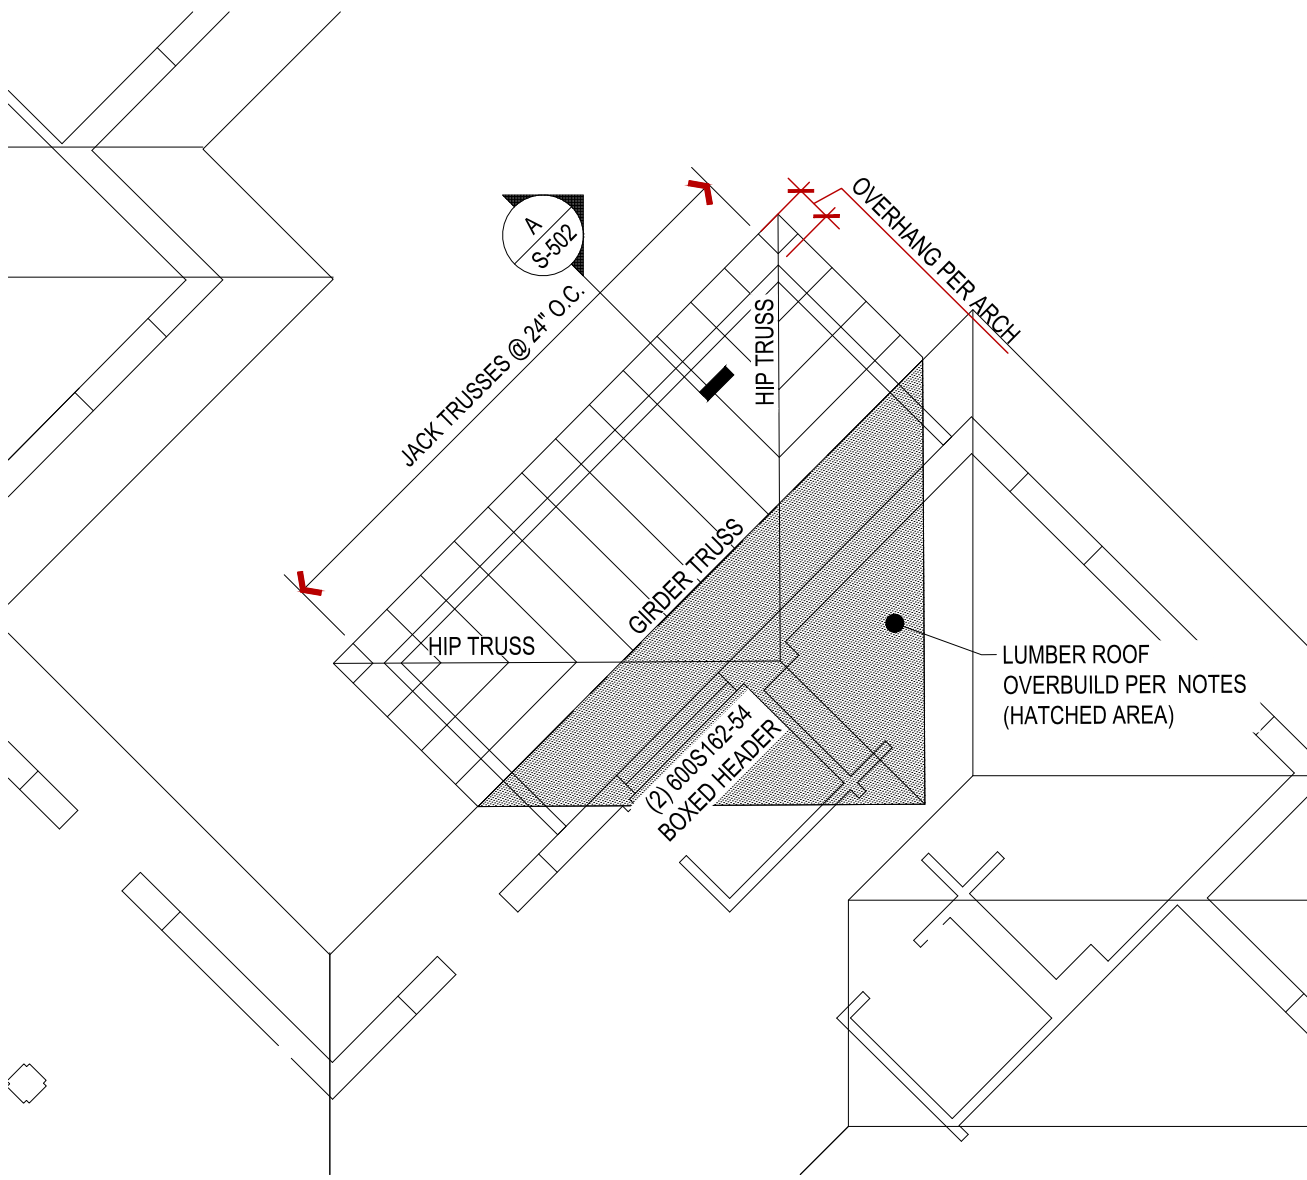
**B** WING B - PARTIAL FRAMING PLAN  
S-104 Scale: 1/8" = 1'-0"



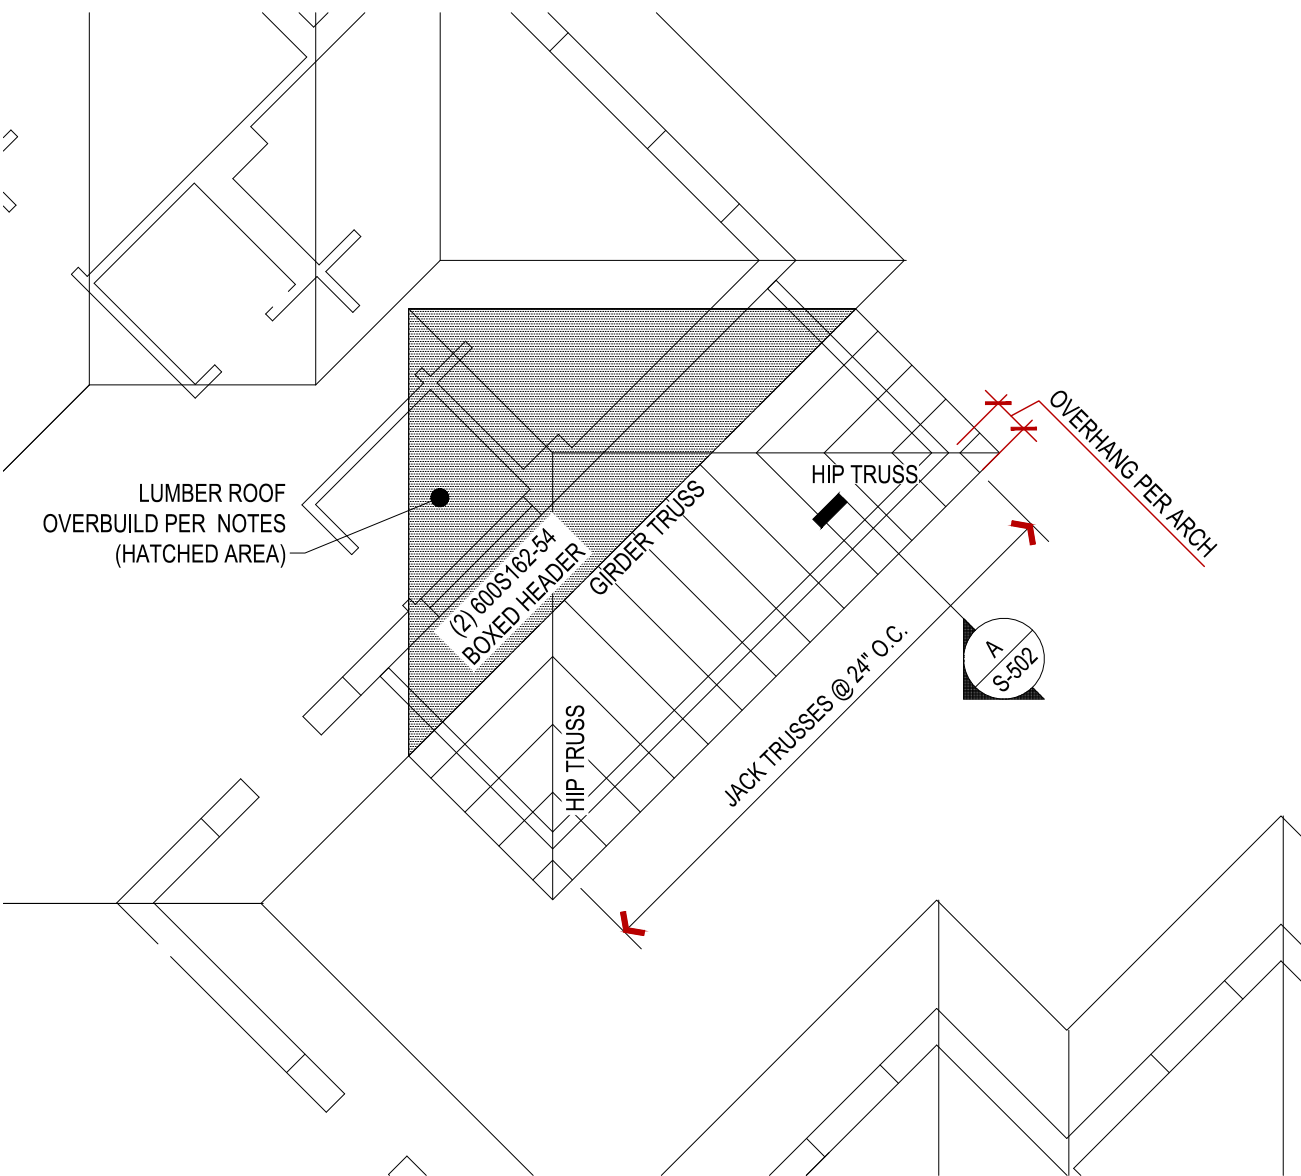
**D** WING D - PARTIAL FRAMING PLAN  
S-104 Scale: 1/8" = 1'-0"



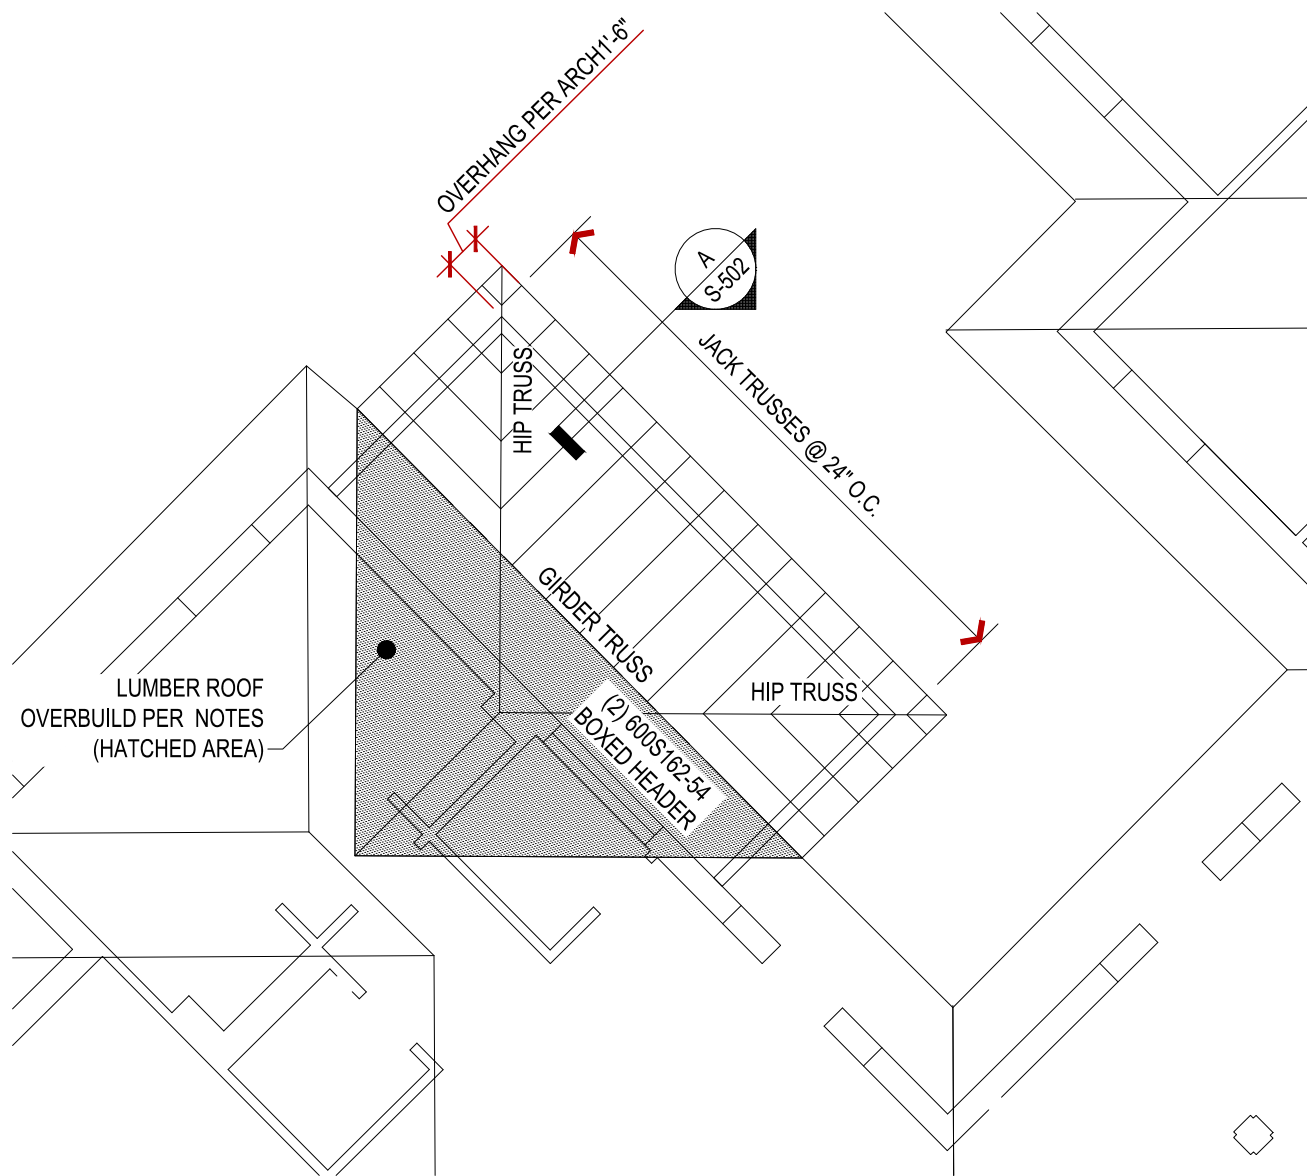
**A** WING A - PARTIAL FRAMING PLAN  
S-104 Scale: 1/8" = 1'-0"



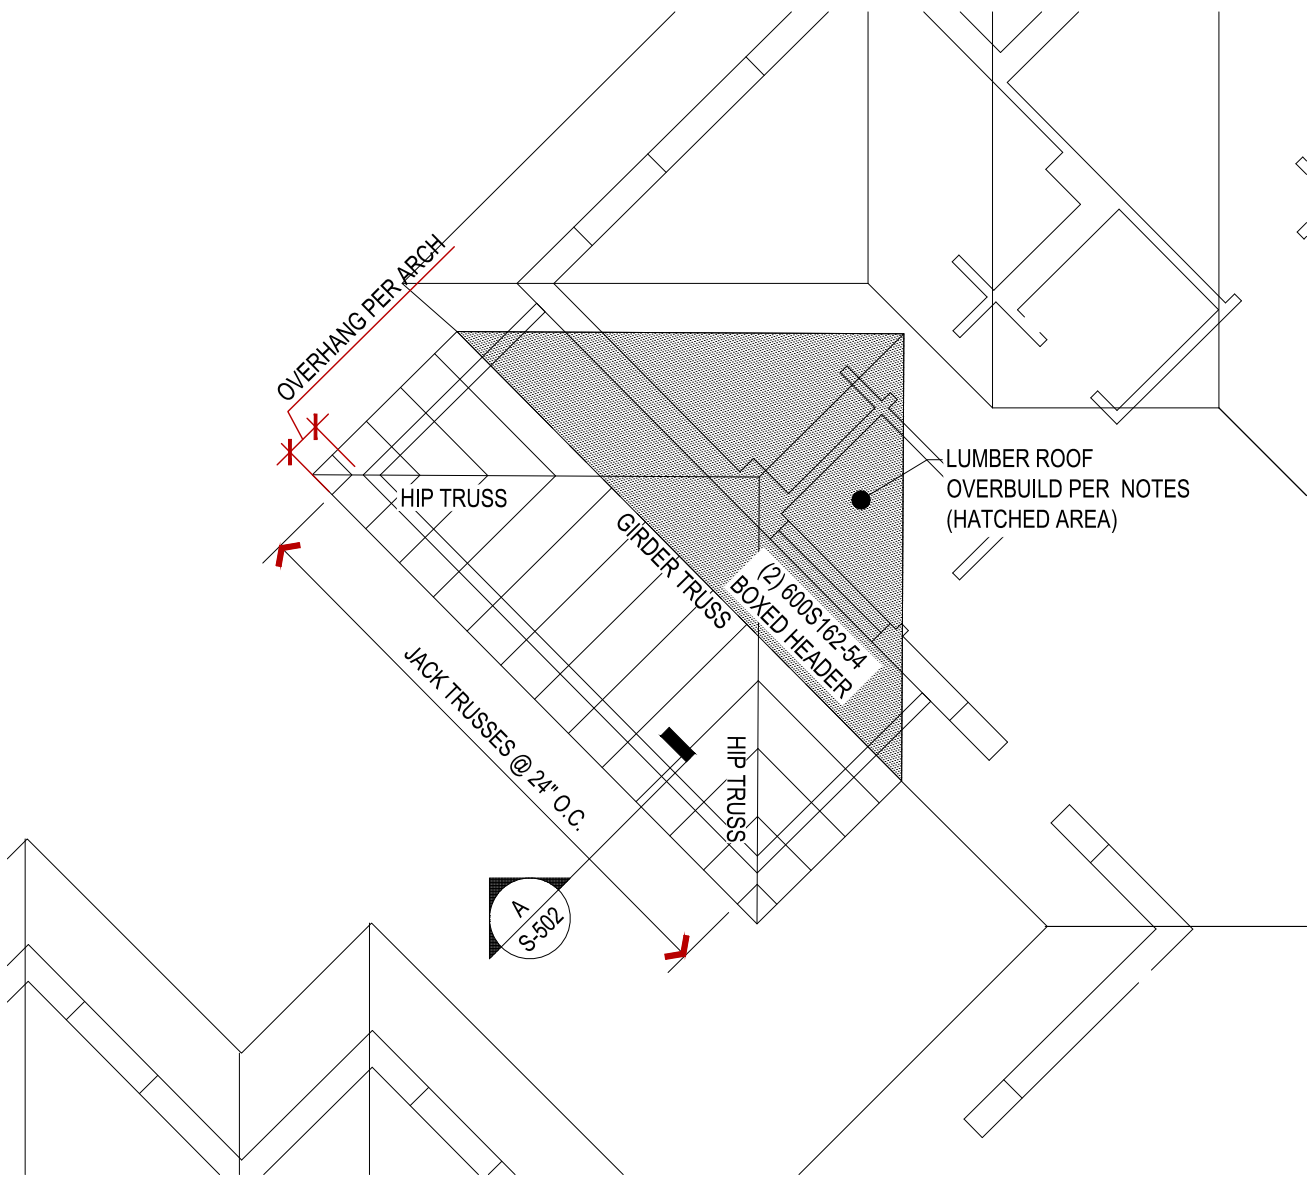**C** WING C - PARTIAL FRAMING PLAN  
S-104 Scale: 1/8" = 1'-0"




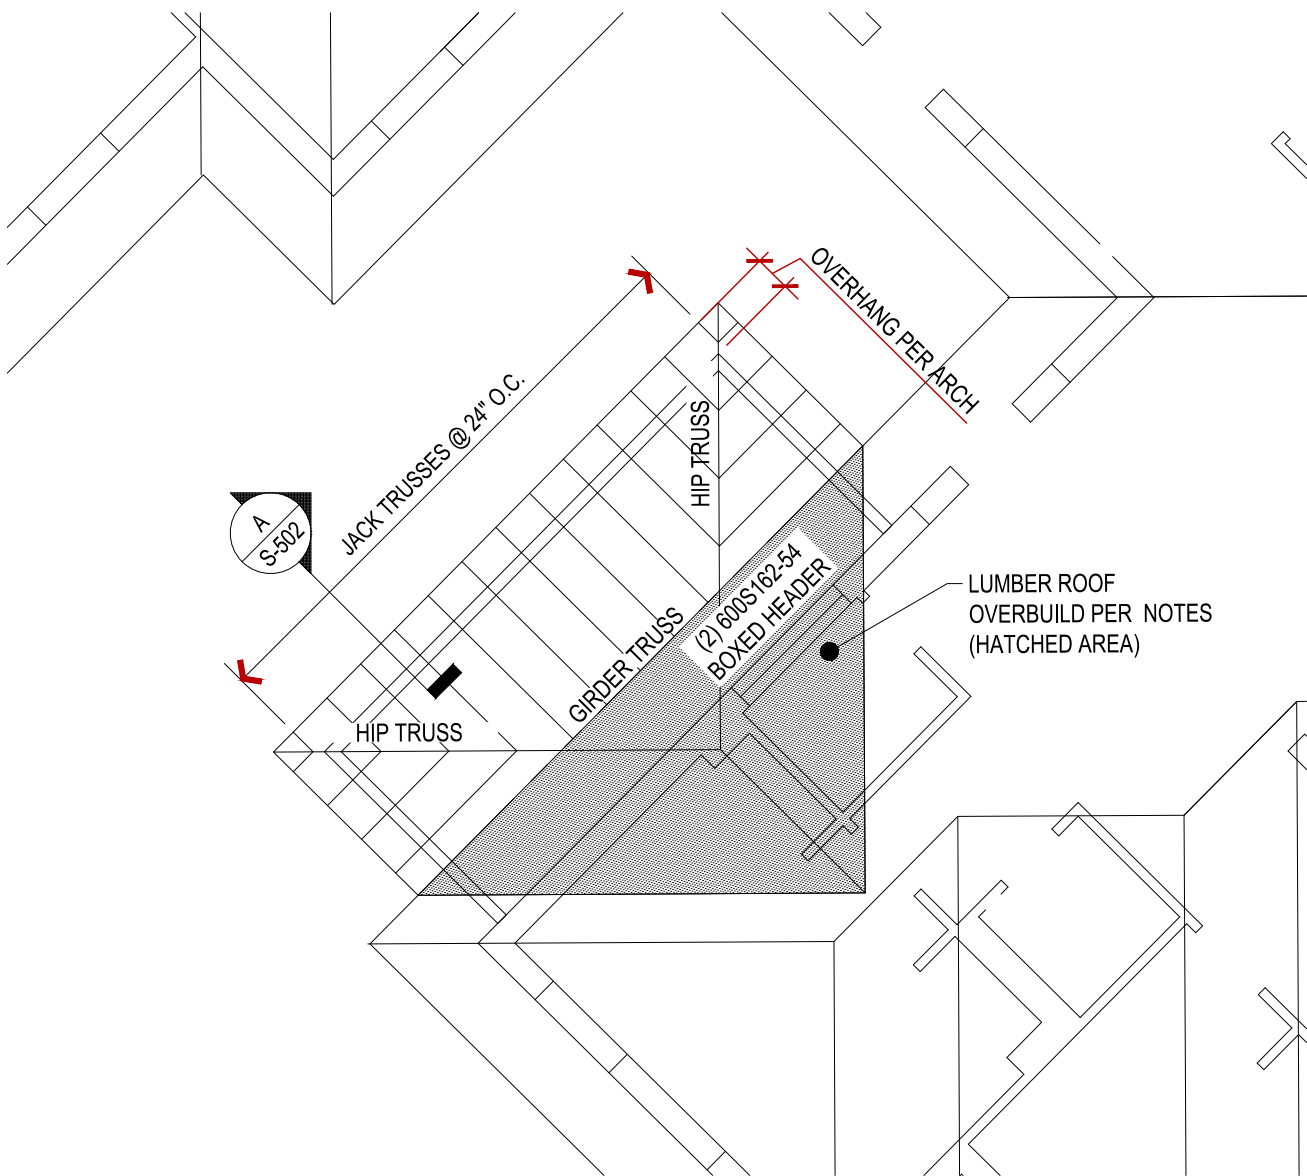**F** WING F - PARTIAL FRAMING PLAN  
S-104 Scale: 1/8" = 1'-0"



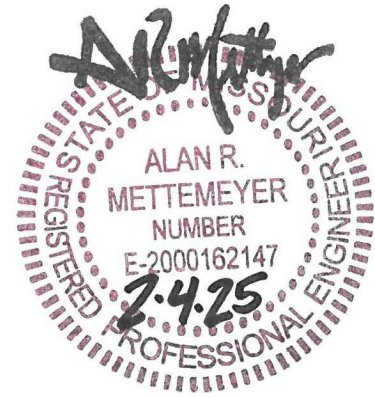**E** WING E - PARTIAL FRAMING PLAN  
S-104 Scale: 1/8" = 1'-0"





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REVISION: \_\_\_\_\_  
DATE: \_\_\_\_\_  
ISSUE DATE: 8-1-24

CAD DWG FILE: S-501.dwg  
DRAWN BY: JDD  
CHECKED BY: BSW  
DESIGNED BY: BSW


SHEET TITLE:

FOUNDATION  
DETAILS


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S-501

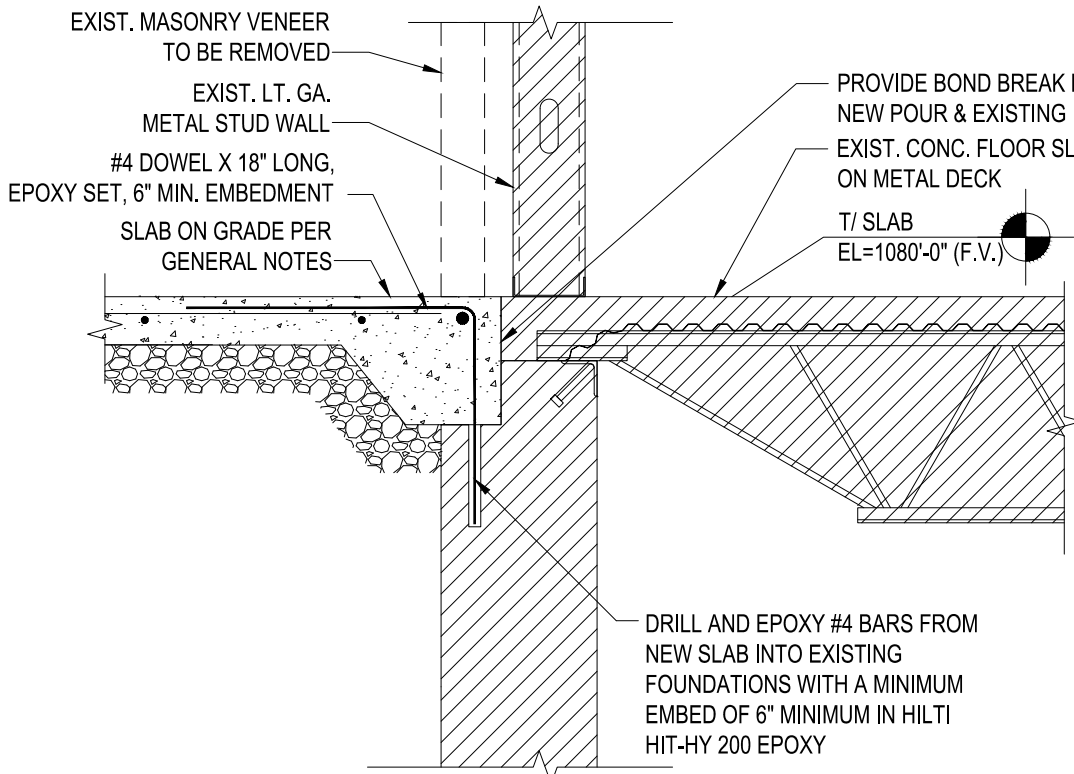
48 OF 117 SHEETS  
8-1-24



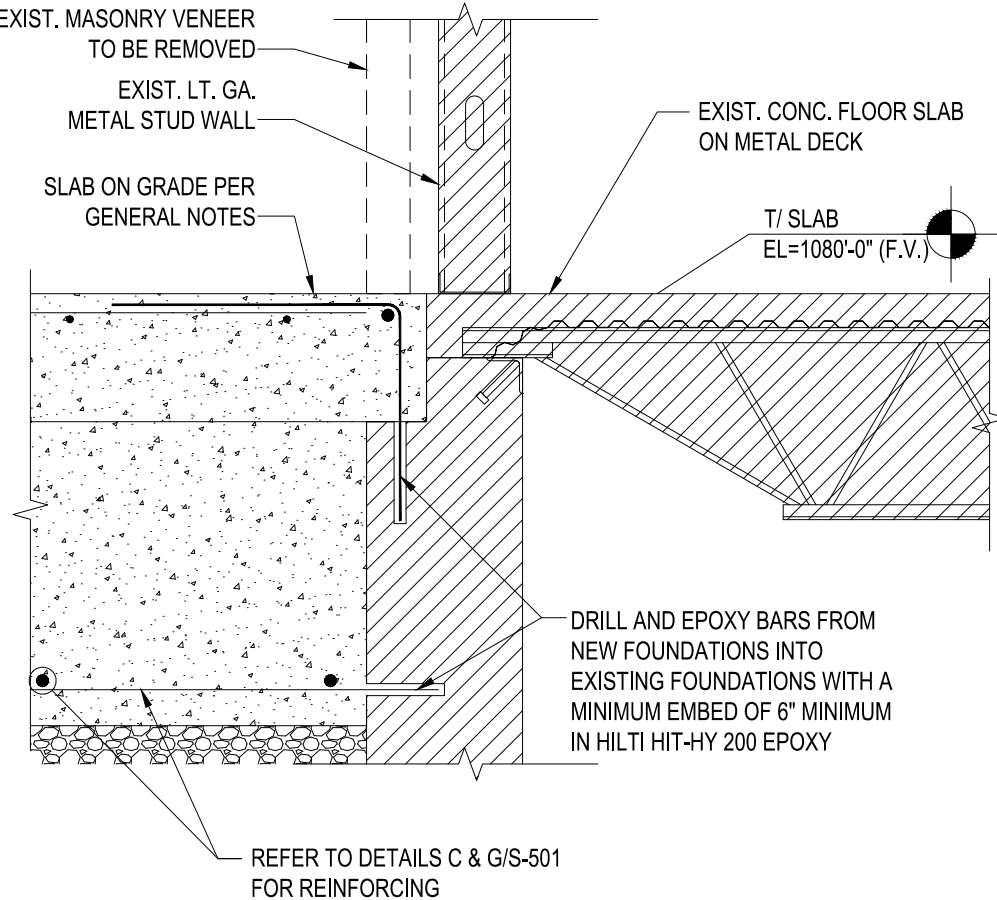
H  
S-501  
FOUNDATION DETAIL  
Scale: 3/4" = 1'-0"



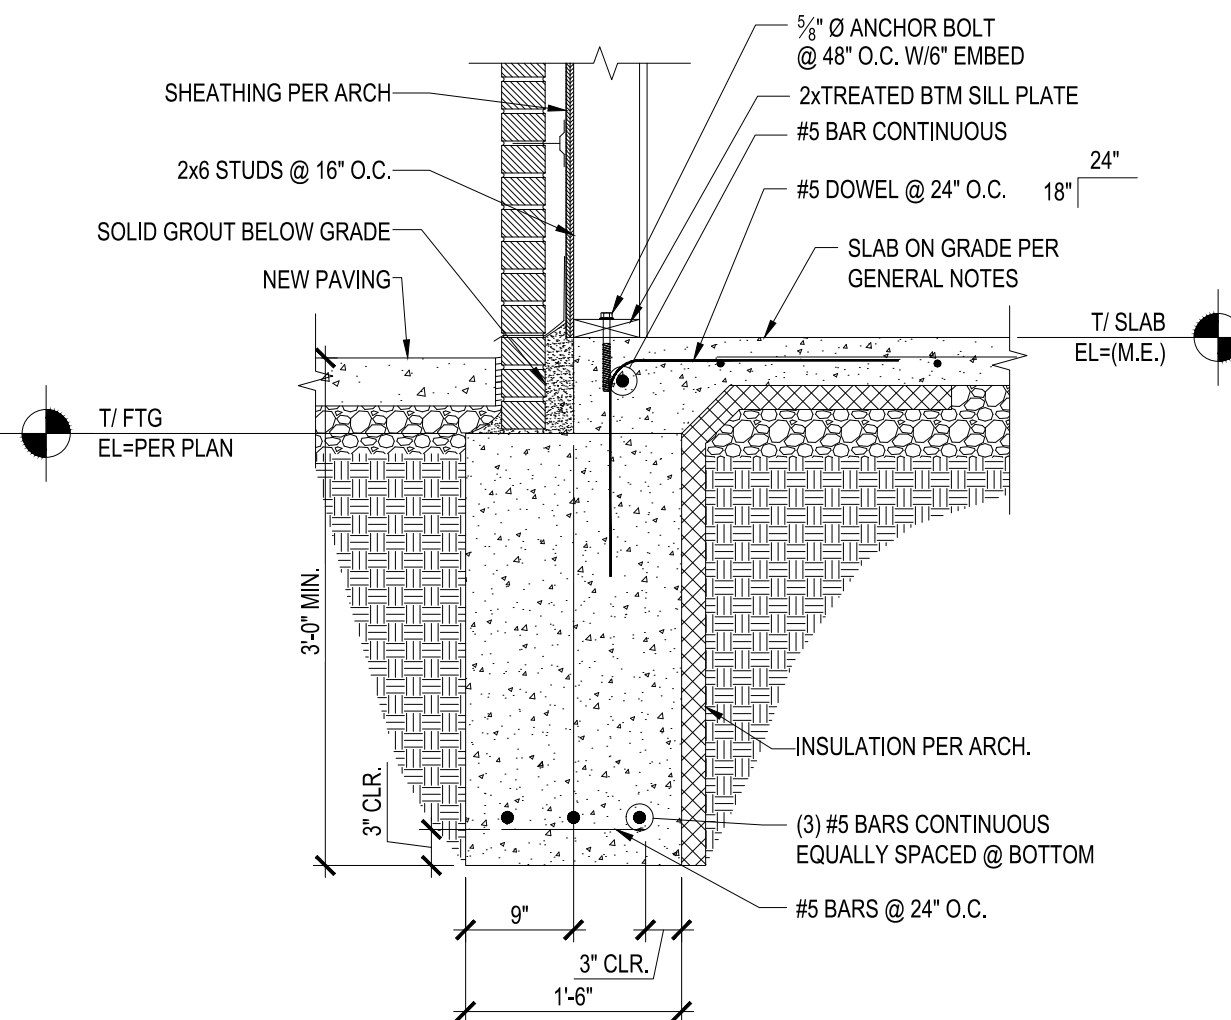
D  
S-501  
FOUNDATION TIE-IN  
Scale: 3/4" = 1'-0"




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S-501  
FOUNDATION DETAIL  
Scale: 3/4" = 1'-0"

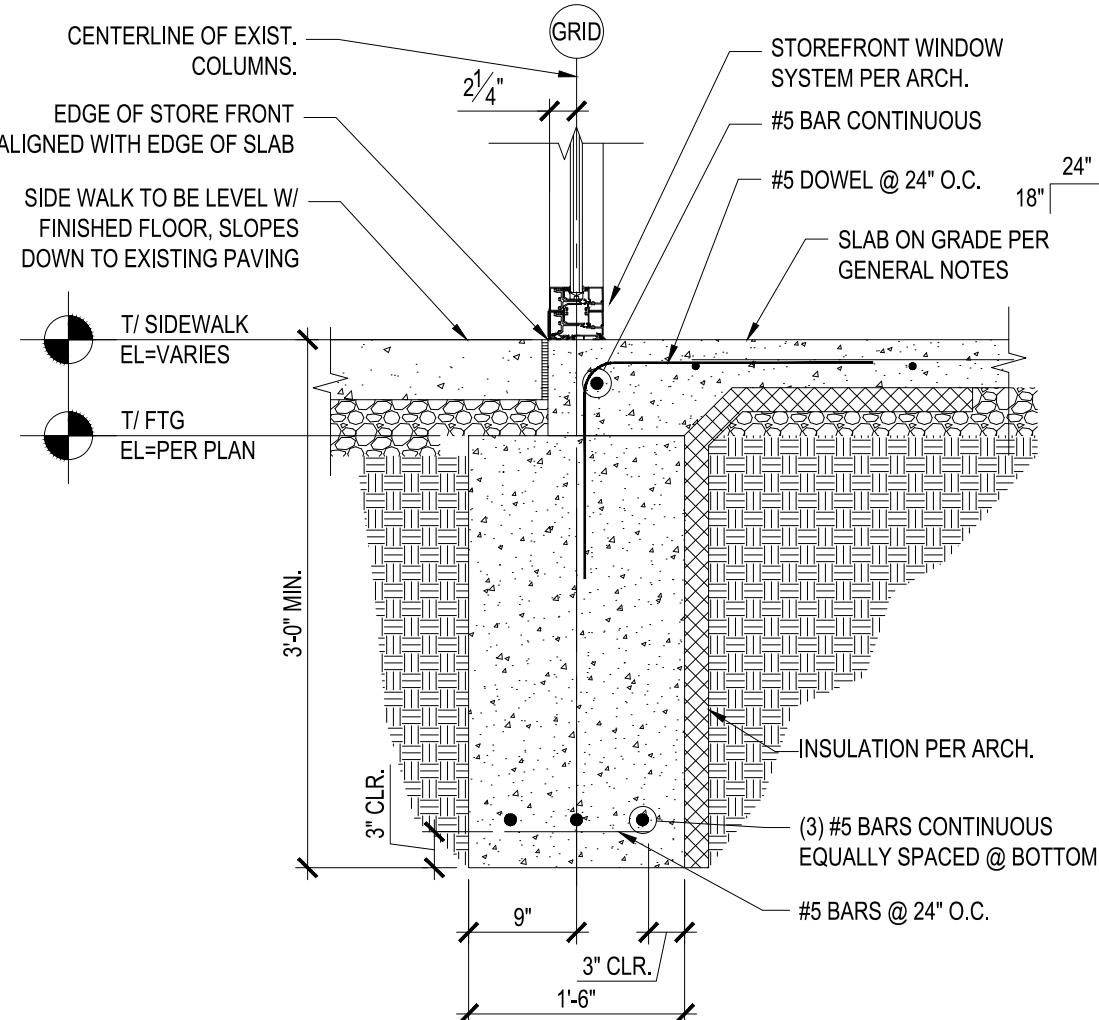

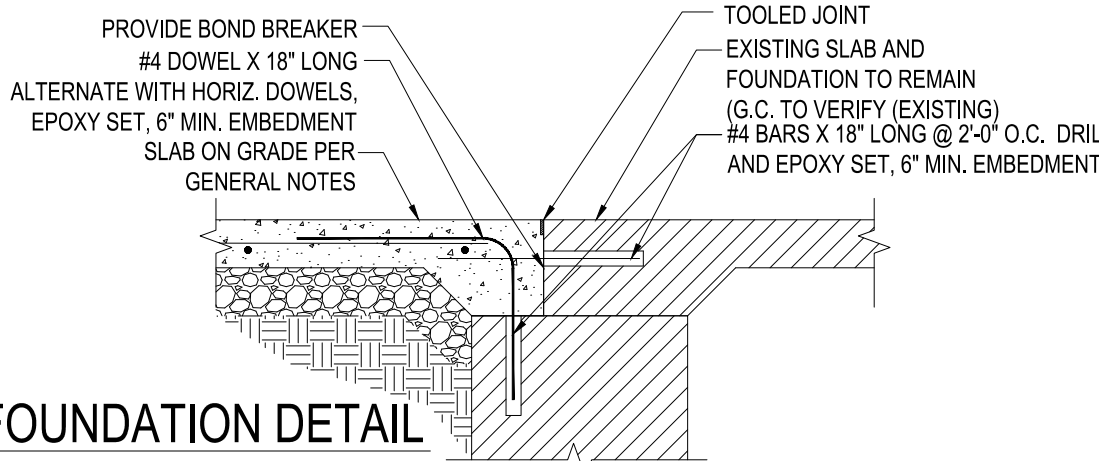
C  
S-501  
FOUNDATION DETAIL  
Scale: 3/4" = 1'-0"



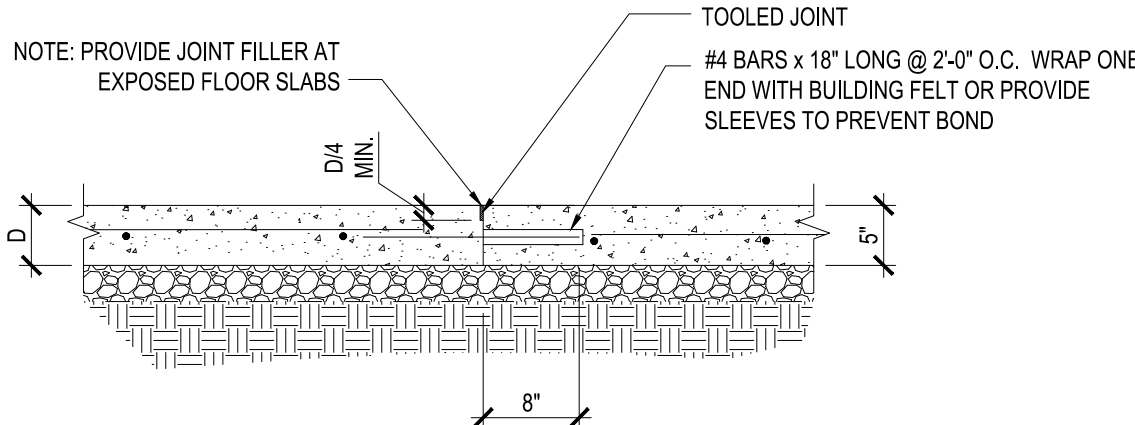
F  
S-501  
FOUNDATION DETAIL  
Scale: 3/4" = 1'-0"



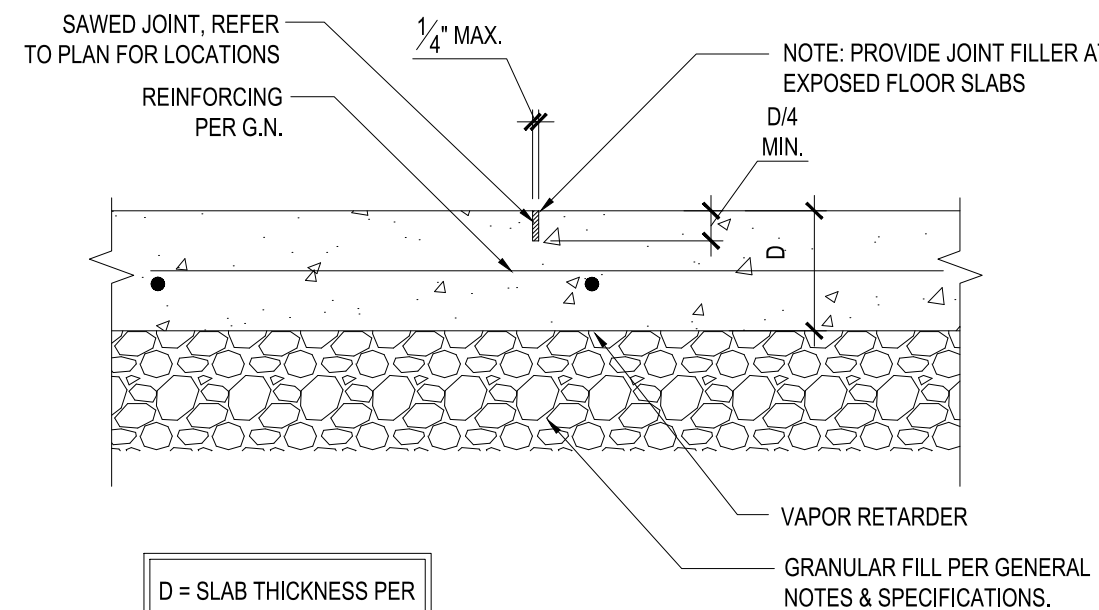
B  
S-501  
CONSTRUCTION JOINT  
Scale: 3/4" = 1'-0"



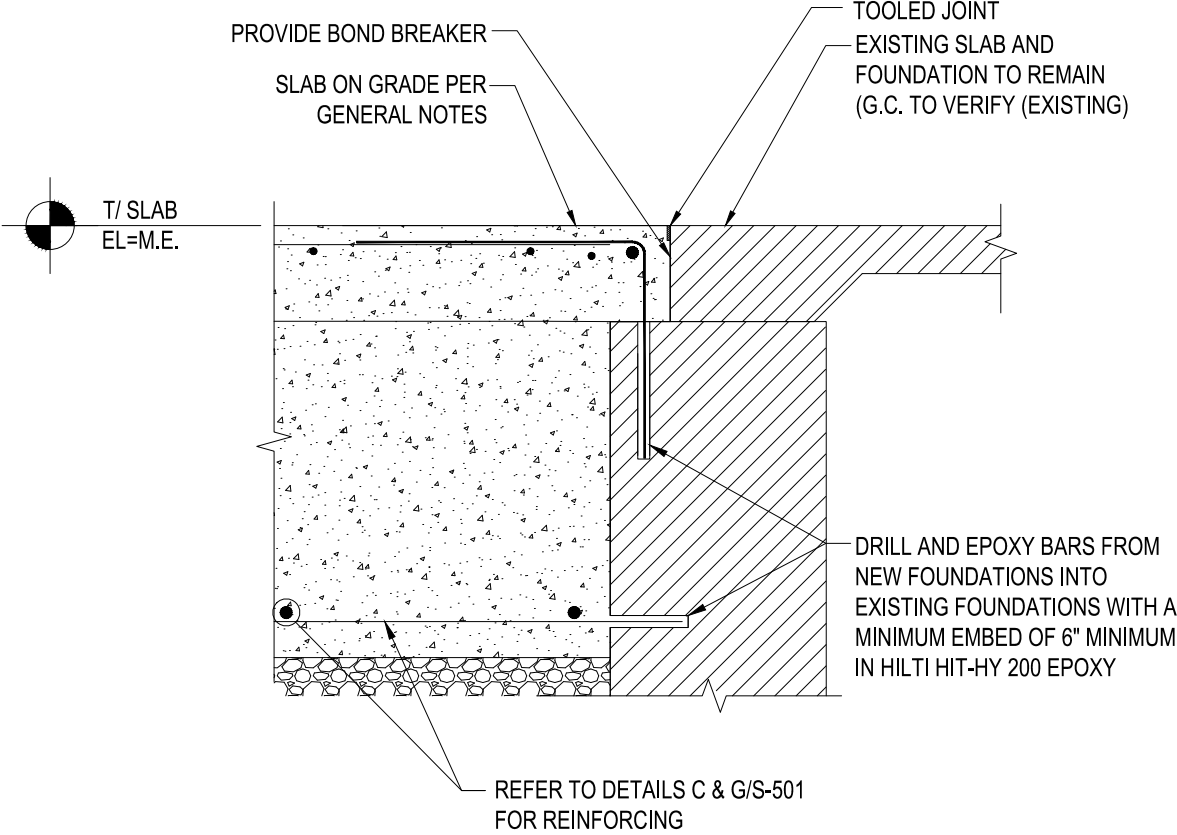A  
S-501  
CONTROL JOINT  
Scale: 1 1/2" = 1'-0"




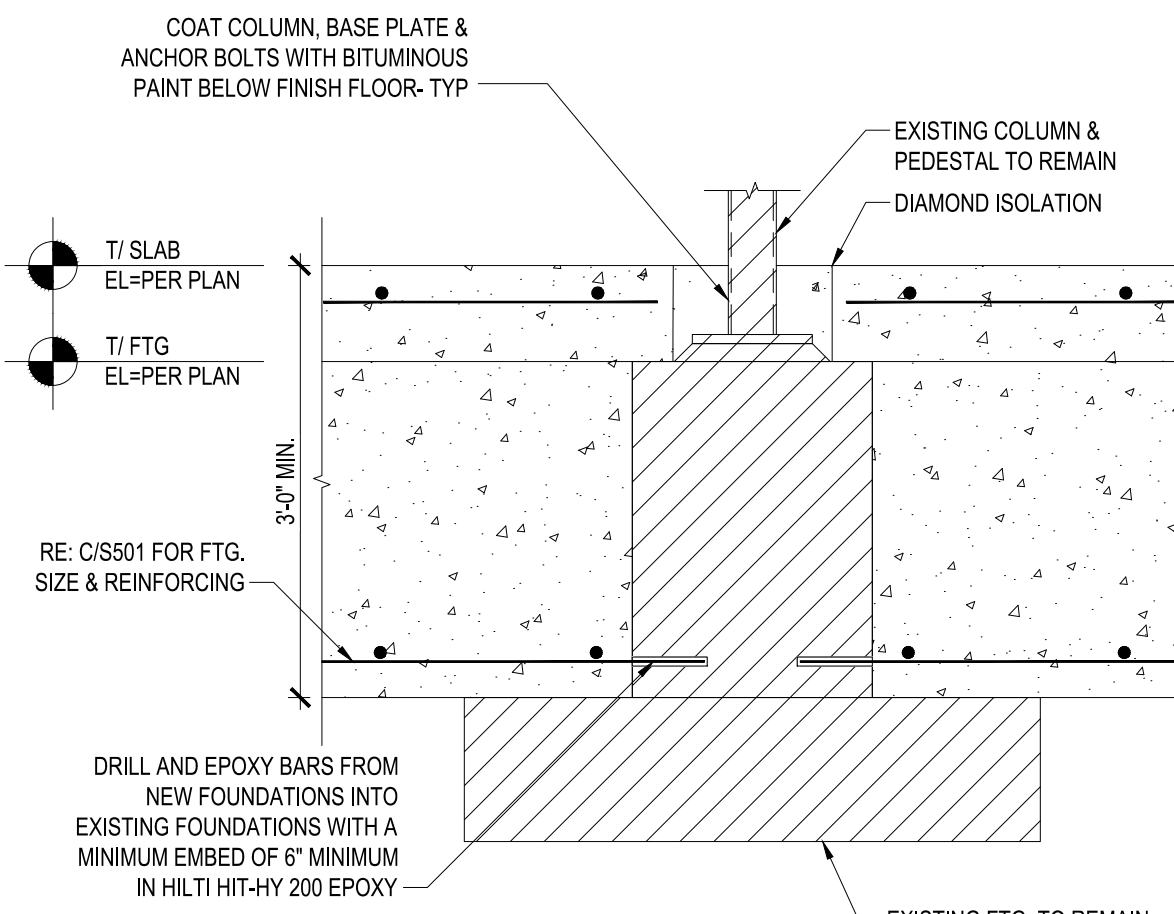J  
S-501  
FOUNDATION DETAIL  
Scale: 3/4" = 1'-0"



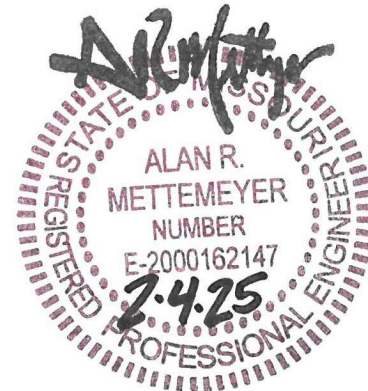E  
S-501  
FOUNDATION DETAIL  
Scale: 3/4" = 1'-0"





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DESIGN AND CONSTRUCTION

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DIVISION OF MISSOURI  
VETERANS COMMISSION

INTERIOR RENOVATION  
MISSOURI VETERANS  
HOME

620 N. JEFFERSON  
ST. JAMES, MISSOURI

PROJECT # U1503-01  
SITE # 6801  
ASSET # 8136801002  
FEDERAL # 29-044

REVISION: \_\_\_\_\_  
DATE: \_\_\_\_\_  
REVISION: \_\_\_\_\_  
DATE: \_\_\_\_\_  
REVISION: \_\_\_\_\_  
DATE: \_\_\_\_\_  
ISSUE DATE: 8-1-24

CAD DWG FILE: S-502.dwg  
DRAWN BY: JDD  
CHECKED BY: BSW  
DESIGNED BY: BSW


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**FRAMING  
DETAILS**


SHEET NUMBER:

**S-502**

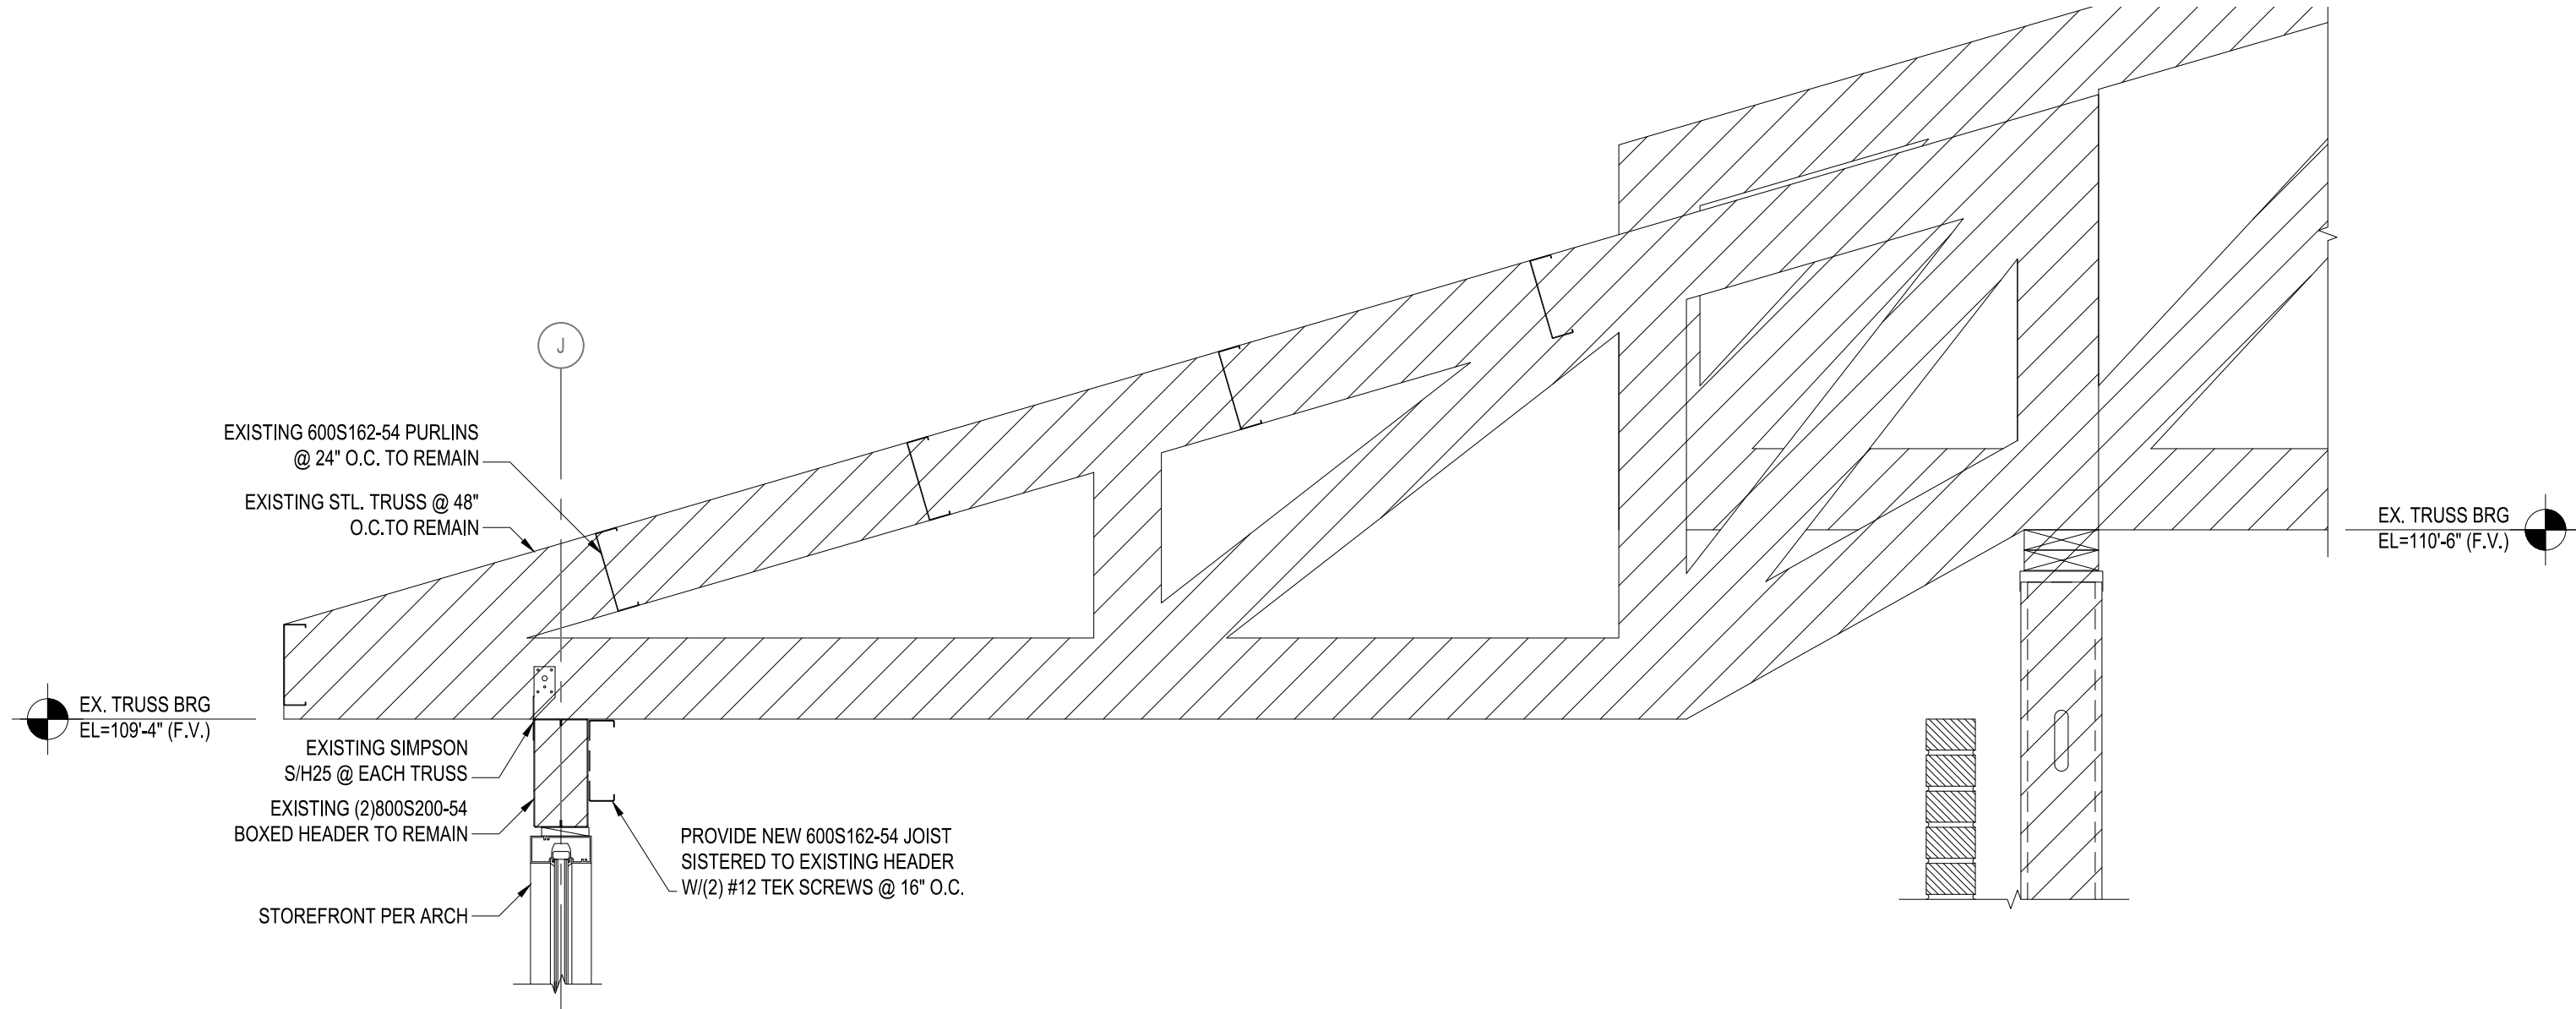
49 OF 117 SHEETS  
8-1-24



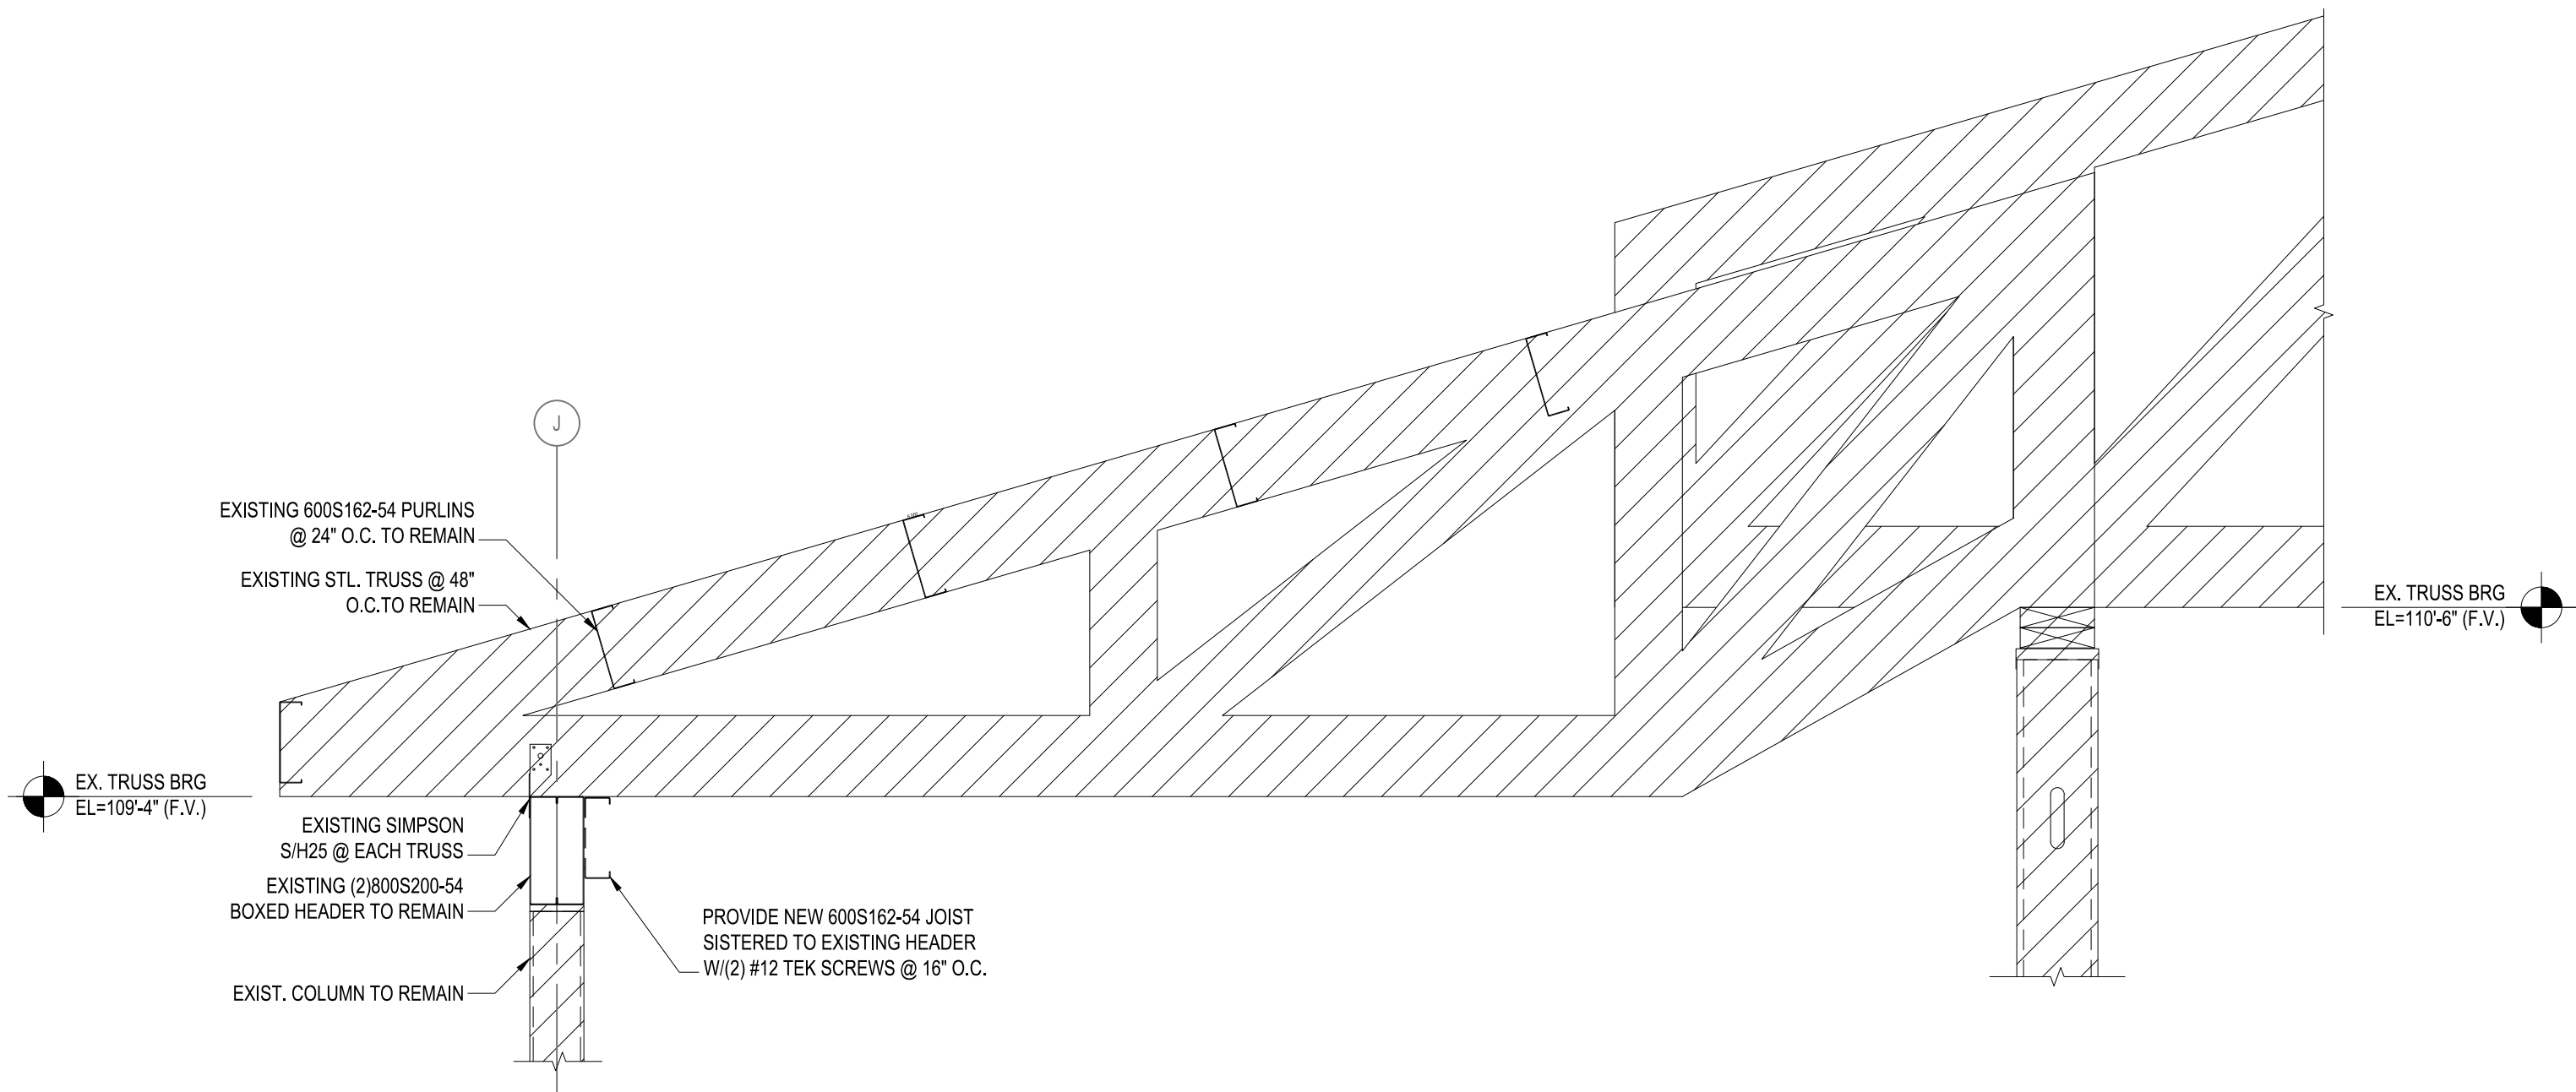
**C**  
S-502  
**FRAMING DETAIL**  
Scale: 1" = 1'-0"



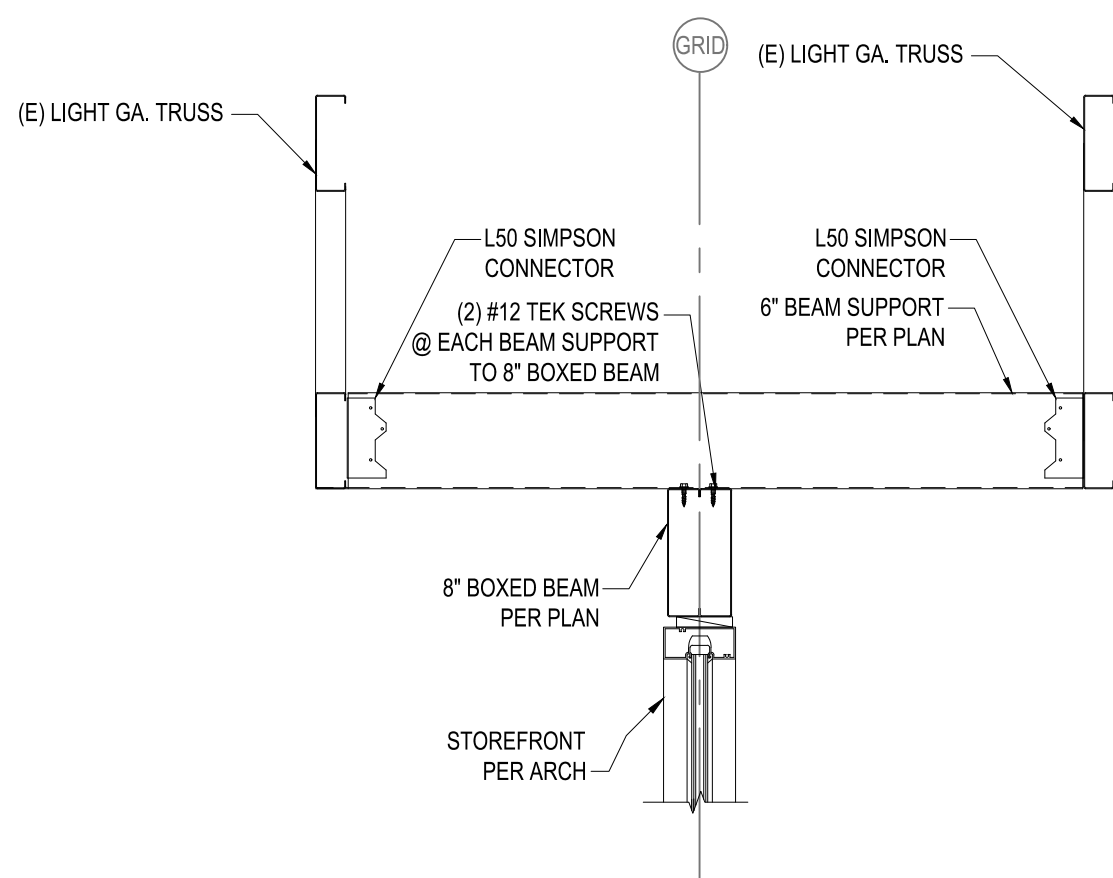
**B**  
S-502  
**FRAMING DETAIL**  
Scale: 1" = 1'-0"



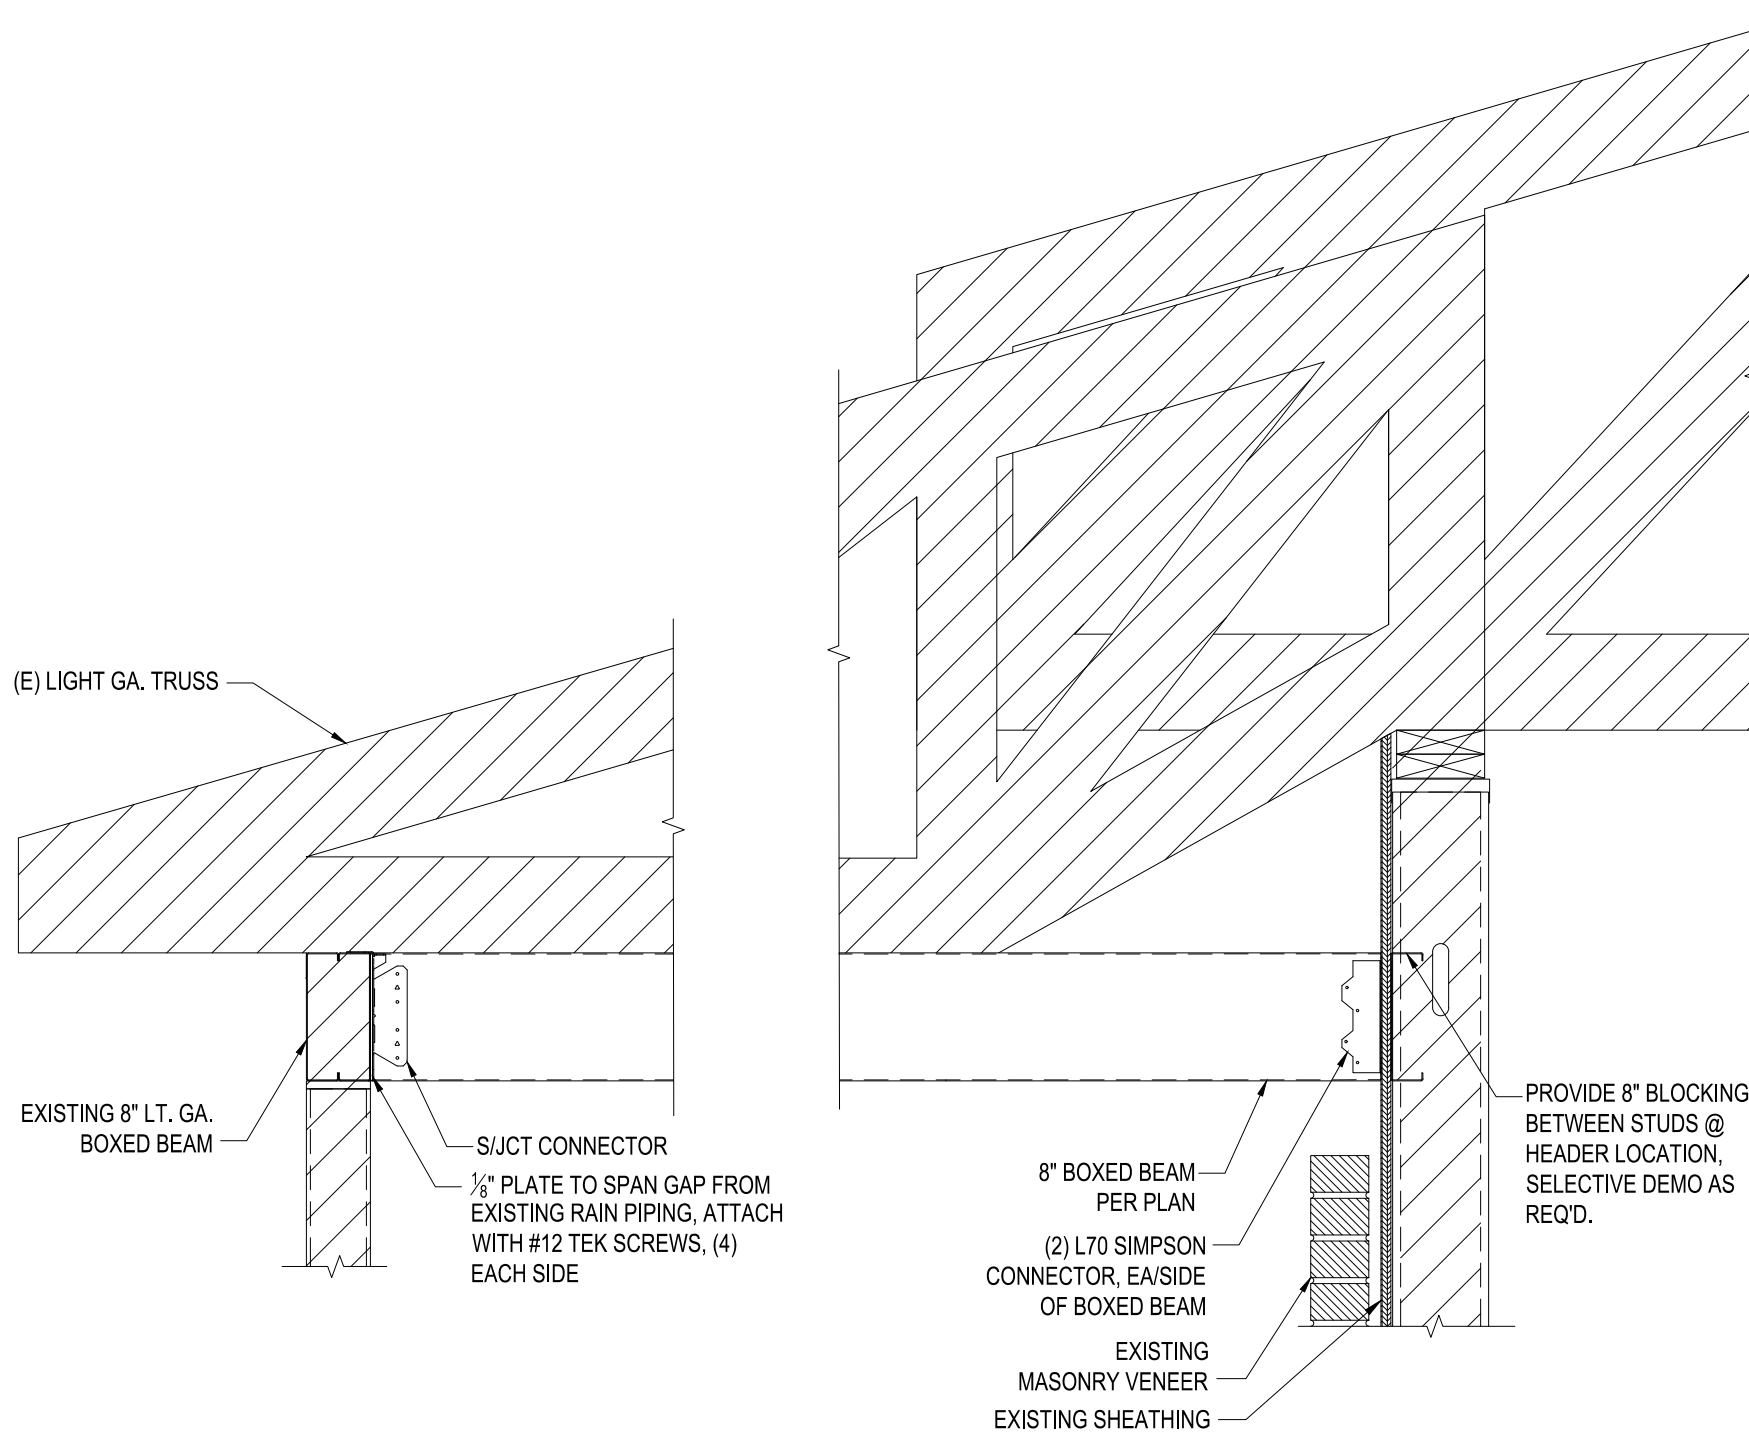**E**  
S-502  
**FRAMING DETAIL**  
Scale: 1" = 1'-0"



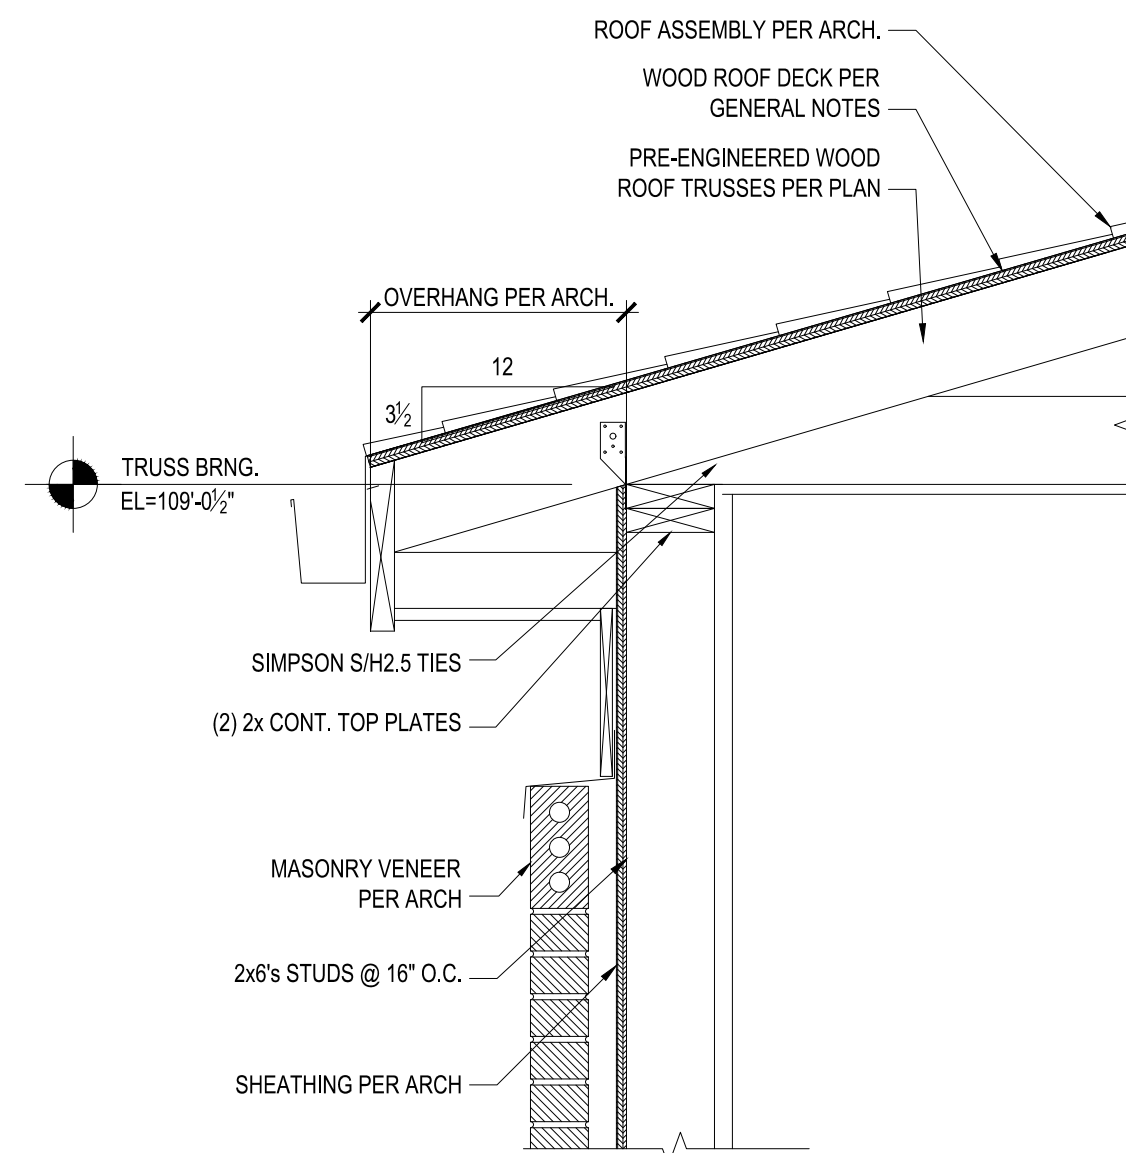**D**  
S-502  
**FRAMING DETAIL**  
Scale: 1" = 1'-0"



**A**  
S-502  
**WOOD TRUSS BEARING DETAIL**  
Scale: 1" = 1'-0"



MECHANICAL SYMBOLS:

— · —	DOMESTIC COLD WATER
— · · —	DOMESTIC HOT WATER
— · · · —	DOMESTIC HOT WATER RETURN
— T —	TEMPERED WATER
— DW —	CHILLED DRINKING WATER
— + —	WASTE PIPING — ABOVE FLOOR
— - —	WASTE PIPING — BELOW FLOOR
— + RD —	ROOF DRAIN — ABOVE FLOOR
— - RD —	ROOF DRAIN — BELOW FLOOR
— + AW —	ACID WASTE — ABOVE FLOOR
— - AW —	ACID WASTE — BELOW FLOOR
— + GW —	GREASE WASTE — ABOVE FLOOR
— - GW —	GREASE WASTE — BELOW FLOOR
— AV —	ACID VENT
— — —	VENT PIPING
— D —	DRAIN
— A —	COMPRESSED AIR
— G —	NATURAL GAS
— V —	VACUUM
— O —	OXYGEN
— LPG —	LIQUEFIED PETROLEUM GAS
— N —	NITROUS OXIDE
— W —	WATER SERVICE
— F —	FIRE SERVICE
— SP —	STANDPIPE
— · / —	FIRE SPRINKLER
— — / —	HIGH PRESSURE STEAM SUPPLY
— — / — —	HIGH PRESSURE STEAM RETURN
— — / — —	MEDIUM PRESSURE STEAM SUPPLY
— — / — —	MEDIUM PRESSURE STEAM RETURN
— LP —	LOW PRESSURE STEAM SUPPLY
— — LP — —	LOW PRESSURE STEAM RETURN
— — —	CONDENSATE PUMP DISCHARGE
— — —	FEEDWATER PUMP DISCHARGE
— HWS —	HOT WATER HEATING SUPPLY
— — HWR — —	HOT WATER HEATING RETURN
— — FOR — —	FUEL OIL RETURN
— FOG —	FUEL OIL GAGE LINE
— FOS —	FUEL OIL SUPPLY
— FOV —	FUEL OIL VENT
— HTWS —	HIGH TEMPERATURE WATER SUPPLY
— — HTWR — —	HIGH TEMPERATURE WATER RETURN
— CWS —	CHILLED WATER SUPPLY
— — CWR — —	CHILLED WATER RETURN
— CHS —	CHILLED / HOT WATER SUPPLY
— — CHR — —	CHILLED / HOT WATER RETURN
— C —	CONDENSER WATER SUPPLY
— — CR — —	CONDENSER WATER RETURN
— HPS —	HEAT PUMP SUPPLY
— — HPR — —	HEAT PUMP RETURN
— RL —	REFRIGERANT LIQUID
— RD —	REFRIGERANT DISCHARGE (HOT GAS)
— RS —	REFRIGERANT SUCTION
— RDB —	REFRIGERANT DISCHARGE BYPASS
— IN —	INTAKE PIPING
— EX —	EXHAUST PIPING
— — —	SHUT-OFF VALVE
— — —	CHECK VALVE
— — —	BALANCING VALVE W/ PRESSURE PORTS
— — —	TRIPLE DUTY VALVE W/ PRESSURE PORTS
— — —	STRAINER
— — —	RELIEF VALVE
— — —	AUTOMATIC FLOW CONTROL VALVE
— — —	MOTORIZED VALVES
— — —	TEMPERATURE REGULATING VALVE
— — —	SOLENOID VALVE
— — —	PRESSURE REDUCING VALVE
— — —	PIPE ANCHOR
— — —	SLIDING EXPANSION JOINT
— — —	BELLOWS EXPANSION JOINT
— — —	SPRINKLER HEAD
— — —	REDUCER
— — —	PIPE GUIDE
— — —	ROOF PIPING SUPPORT
— — —	F & T TRAP
— — —	BUCKET TRAP
— — —	IMPULSE TRAP
— — —	THERMOSTATIC TRAP
— — —	FLOAT TRAP
— — —	PRESSURE GAUGE
— — —	THERMOMETER
— — —	UNION
— — —	BACKFLOW PREVENTER
— — —	DOMESTIC WATER MIXING VALVE
— — —	METER

MECHANICAL SYMBOLS:

— HB —	HOSE BIBB
— WH —	WALL HYDRANT
— FFCO —	FLUSH FLOOR CLEANOUT
— FGCO —	FLUSH GRADE CLEANOUT
— CO —	CLEANOUT
— —S —	ELBOW UP WITH SHUT-OFF VALVE
— —S —	ELBOW DOWN WITH SHUT-OFF VALVE
— —S —	TEE UP WITH SHUT-OFF VALVE
— —S —	TEE DOWN WITH SHUT-OFF VALVE
— —S —	CAP
— —S —	SHOCK ABSORBER
— —S —	TEMPERATURE SENSOR
— —S —	FLOW SWITCH
— 2" 1 FS —	FLOOR SINK, TYPE & SIZE
— 2" 2 FD —	FLOOR DRAIN, TYPE & SIZE
— 24"x16" 3 FT —	FLOOR TROUGH, TYPE & SIZE
— 4" 4 RD —	ROOF DRAIN, TYPE & SIZE
1 1	WATER CLOSET & TYPE
1 1	WATER CLOSET & TYPE
1 1	WATER CLOSET & TYPE
1 1	URINAL & TYPE
1 1	WALL MOUNTED LAVATORY & TYPE
1 1	COUNTER TOP LAVATORY & TYPE
1 1	SINK & TYPE
1 1	BATHTUB & TYPE
1 1	SHOWER & TYPE
1 1	DRINKING FOUNTAIN & TYPE
1 1	JANITORS BASIN & TYPE
1 1	SHOWER HEADS & TYPE
1 1	LINEAR SLOT DIFFUSER
1 1	INSULATED FLEXIBLE DUCT
1 1	VOLUME DAMPER WITH LOCKING QUADRANT
1 1	BRANCH DUCT WITH 45° BOOT FITTING
1 1	ELBOW WITH TURNING VANES
1 1	BRANCH DUCT WITH BELLMOUTH SPIN-IN FITTING WITH MANUAL VOLUME DAMPER
1 1	EQUIP. WITH FLEXIBLE DUCT CONNECTION
1 1	RETURN, EXHAUST OR FRESH AIR DUCT UP
1 1	RETURN, EXHAUST OR FRESH AIR DUCT DOWN
1 1	SUPPLY AIR DUCT UP
1 1	SUPPLY AIR DUCT DOWN
1 1	REGISTER, SIZE, TYPE & CFM
1 1	REGISTER, SIZE, TYPE & CFM
1 1	REGISTER, SIZE, TYPE & CFM
1 1	REGISTER, SIZE, TYPE & CFM
1 1	FIRE DAMPER
1 1	SMOKE DAMPER
1 1	FIRE/SMOKE DAMPER
1 1	MOTORIZED DAMPER
1 1	CONTROL DAMPER
1 1	RELIEF DAMPER
1 1	AUTOFLOW DAMPER
1 1	TEMPERATURE SENSOR—MOUNT AT 4'-0" A.F.F.
1 1	TEMPERATURE SENSOR WITH ADJUSTABLE SETPOINT AND OVER RIDE BUTTON — MOUNT AT 4'-0" A.F.F.
1 1	HUMIDITY SENSOR—MOUNT AT 4'-0" A.F.F.
1 1	PNEUMATIC THERMOSTAT — MOUNT AT 4'-0" A.F.F. UNLESS NOTED OTHERWISE
1 1	PNEUMATIC NIGHT THERMOSTAT—MOUNT AT 4'-0" A.F.F.
1 1	CARBON DIOXIDE SENSOR—MOUNT AT 4'-0" A.F.F.
1 1	AVERAGING TEMPERATURE SENSOR—MOUNT AT 4'-0" A.F.F.
1 1	CARBON DIOXIDE SENSOR—PLENUM MOUNTED

ELECTRICAL SYMBOLS:


— A" —	FLUORESCENT LIGHT FIXTURE & TYPE
— A" —	FLUORESCENT LIGHT FIXTURE WITH INNER & OUTER BALLASTS SWITCHED SEPARATELY
— A1" —	EMERGENCY FLUORESCENT LIGHT FIXTURE
— A" —	FLUORESCENT NIGHT LIGHT — UNSWITCHED
— B" —	INCANDESCENT OR H.I.D. LIGHT FIXTURE & TYPE (CEILING OR WALL MOUNTED)
— X" —	EXIT LIGHT & TYPE (CEILING OR WALL MOUNTED)
— X" —	COMBINATION EXIT/EMERGENCY LIGHT & TYPE (CEILING OR WALL MOUNTED)
— —	ARROW INDICATES CHEVRON DIRECTION(S)
— —	FILLED SEGMENT SHOWS FACE DIRECTION(S)
— D" —	LIGHT TRACK WITH LIGHT TYPES AS INDICATED
— EM —	EMERGENCY LIGHT & TYPE
— J.B. —	JUNCTION BOX 4" SQUARE UNLESS NOTED OTHERWISE
— —	JUNCTION BOX — CEILING MOUNTED
— —	JUNCTION BOX ON STUBBED UP CONDUIT
— E —	ELECTRIC THERMOSTAT UP 4'-0" UNLESS NOTED OTHERWISE
— EN —	ELECTRIC NIGHT THERMOSTAT UP 4'-0" UNLESS NOTED OTHERWISE
— —	ELECTRIC HUMIDISTAT
— —	MOTOR — USE INDICATED
S	15AMP, SINGLE POLE 120/277V SWITCH
S <sub>3</sub>	15AMP, THREE-WAY 120/277V SWITCH
S <sub>4</sub>	15AMP, FOUR-WAY 120/277V SWITCH
S <sub>P</sub>	15AMP, SINGLE POLE 120/277V SWITCH WITH PILOT LAMP
\$	20AMP, SINGLE POLE 120/277V SWITCH
\$ <sub>3</sub>	20AMP, THREE-WAY 120/277V SWITCH
\$ <sub>4</sub>	20AMP, FOUR-WAY 120/277V SWITCH
\$ <sub>P</sub>	20AMP, SINGLE POLE 120/277V SWITCH WITH PILOT LAMP
\$ <sub>M</sub>	20AMP, MOMENTARY CONTACT 120/277V SWITCH
\$ <sub>K</sub>	20AMP, SINGLE POLE 120/277V SWITCH — KEY OPERATED
\$ <sub>2</sub>	20AMP, DOUBLE POLE 120/277V SWITCH
\$ <sub>3</sub>	30AMP, DOUBLE POLE 120/277V SWITCH
\$ <sub>0</sub>	DIMMER SWITCH — 120V
\$ <sub>HOA</sub>	"HAND-OFF-AUTO" SELECTOR SWITCH
\$ <sub>TO</sub>	MANUAL STARTER WITH THERMAL OVERLOADS
\$ <sub>OT</sub>	120V SPRING WOUND TIMER
\$ <sub>ET</sub>	120V ELECTRONIC TIMER
\$ <sub>LV</sub>	LOW VOLTAGE SWITCH
\$ <sub>N</sub>	NARROW SWITCH
\$ <sub>100</sub>	WALL SWITCH OCCUPANCY SENSOR AND TYPE PER SCHEDULE
\$ <sub>1A</sub>	WALL SWITCH VACANCY SENSOR AND TYPE PER SCHEDULE
1 1	WALL MOUNT OCCUPANCY SENSOR AND TYPE PER SCHEDULE
1 1	CEILING MOUNT OCCUPANCY SENSOR AND TYPE PER SCHEDULE
1 1	WALL MOUNT VACANCY SENSOR AND TYPE PER SCHEDULE
1 1	CEILING MOUNT VACANCY SENSOR AND TYPE PER SCHEDULE
1 1	DIMMING SYSTEM REMOTE STATION — SECOND LETTER DENOTES STATION DESIGNATION IN SCHEDULE
1 1	EXPOSED METAL RACEWAY — WIREMOLD
1 1	CONDUIT CONCEALED IN ROOF INSULATION
1 1	CONDUIT CONCEALED IN CEILING OR WALL
1 1	CONDUIT CONCEALED IN FLOOR SLAB
1 1	EXPOSED CONDUIT
1 1	HOME RUN — DIAGONAL LINES INDICATE NUMBER OF WIRES, ARROWS INDICATE NUMBER OF CIRCUITS
1 1	#18 WIRE
1 1	#16 WIRE
1 1	#14 WIRE
1 1	#12 WIRE
1 1	SHEATHED CABLE
1 1	BRANCH CIRCUIT OR FEEDER — SEE SCHEDULE FOR CONDUCTOR & CONDUIT QUANTITY & SIZE
1 1	FLEXIBLE CONDUIT
1 1	GROUND WIRE

ELECTRICAL SYMBOLS:

— —	SWITCHED RECEPTACLE WITH APPROPRIATE RECEPTACLE(S)
— —	DUPLEX 15AMP, 125V, 2P, 3W GROUNDING TYPE RECEPTACLE
— —	DUPLEX 20AMP, 125V, 2P, 3W GROUNDING TYPE RECEPTACLE
— —	4-PLEX 20AMP, 125V, 2P, 3W GROUNDING TYPE RECEPTACLE
— —	4-PLEX 20AMP, 125V, 2P, 3W GROUNDING TYPE RECEPTACLE WITH USB CHARGE PORT
— —	DUPLEX 20AMP, 250V, 2P, 3W GROUNDING TYPE RECEPTACLE
— —	DUPLEX 20AMP, 125V, 2P, 3W GROUNDING TYPE RECEPTACLE MOUNTED ABOVE CEILING
— —	RECESS MOUNTED FLOOR BOX WITH APPROPRIATE RECEPTACLE(S)
— —	TWO RECESS MOUNTED FLOOR BOXES WITH APPROPRIATE RECEPTACLE(S) INSTALLED TOGETHER
— —	STUBBED UP CONDUIT WITH APPROPRIATE RECEPTACLE(S) OUTLET BOX TO BE FS BOX
— —	SINGLE 15AMP, 125V, 2P, 3W GROUNDING TYPE RECEPTACLE
— —	SINGLE 20AMP, 125V, 2P, 3W GROUNDING TYPE RECEPTACLE
— —	SINGLE 15AMP, 250V, 2P, 3W GROUNDING TYPE RECEPTACLE
— —	SINGLE 20AMP, 250V, 2P, 3W GROUNDING TYPE RECEPTACLE
— —	SINGLE 50AMP, 250V, 2P, 3W GROUNDING TYPE RECEPTACLE
— —	SINGLE 20AMP, 125/250V, 3P, 4W GROUNDING TYPE RECEPTACLE
— —	SINGLE 30AMP, 125V, 2P, 3W GROUNDING TYPE RECEPTACLE
— —	SINGLE 30AMP, 250V, 2P, 3W GROUNDING TYPE RECEPTACLE
— —	SINGLE 30AMP, 125/250V, 3P, 4W GROUNDING TYPE RECEPTACLE
— —	SINGLE 20AMP, 250V, 3 PHASE, 3P, 4W GROUNDING TYPE RECEPTACLE
— —	SINGLE 60AMP, 125/250V, 3P, 4W GROUNDING TYPE RECEPTACLE
— —	SINGLE 50AMP, 250V, 3 PHASE, 3P, 4W GROUNDING TYPE RECEPTACLE
— —	SINGLE 20AMP, 120/208V, 3 PHASE, 4P, 4W GROUNDING TYPE RECEPTACLE
— —	SINGLE 60AMP, 120/208V, 3 PHASE, 4P, 4W GROUNDING TYPE RECEPTACLE
— —	PLUGMOLD — OUTLETS AT 12" O.C. UNLESS NOTED OTHERWISE
— —	CLOCK OUTLET (RECEPTACLE)
— —	** TELEPHONE OUTLET
— —	RECESS MOUNTED FLOOR TELEPHONE OUTLET
— —	SURFACE MOUNTED FLOOR TELEPHONE OUTLET
— —	** COMPUTER DATA OUTLET
— —	FLOOR MOUNTED COMPUTER DATA OUTLET
— —	** TELEVISION OUTLET — WALL MOUNT
— —	** TELEVISION OUTLET — TABLE/CABINET MOUNT
— —	UNLESS NOTED OTHERWISE ELSEWHERE ON THE DRAWINGS OR IN THE SPECIFICATIONS, THESE OUTLETS REQUIRE 4"x4"x2.5"D JUNCTION BOX WITH SINGLE GANG PLASTER RING AND 1" CONDUIT WITH 90° SWEEP AND DE-BURRED ENDS (MIN.) TO ABOVE THE NEAREST ACCESSIBLE LAY-IN CEILING
— —	CEILING FAN
— —	LIGHTING & APPLIANCE PANEL
— —	DISTRIBUTION, FEEDER OR POWER PANEL
— —	TELEPHONE TERMINAL CABINET ("TTC")
— —	PULL BOX
— —	MAGNETIC MOTOR CONTROLLER
— —	COMBINATION MAGNETIC MOTOR CONTROLLER
— —	DISCONNECT SWITCH
— —	MANUAL MOTOR CONTROLLER
— —	TIME SWITCH
— —	LIGHTING CONTACTOR
— —	PHOTOCELL
— —	TELE — POWER POLE
— —	POWER POLE
— —	UNDERGROUND ELECTRIC
— —	OVERHEAD ELECTRIC
— —	UNDERGROUND TELEPHONE
— —	OVERHEAD TELEPHONE
— —	*** SMOKE DAMPER
— —	*** FIRE/SMOKE DAMPER
— —	UNLESS NOTED OR SHOWN OTHERWISE ELSEWHERE ON THE DRAWINGS OR IN THE SPECIFICATIONS, THESE DEVICES REQUIRE A FIRE ALARM DUCT SMOKE DETECTOR AND A 120V POWER SOURCE FROM THE NEAREST RECEPTACLE CIRCUIT.

ELECTRICAL SYMBOLS:

— —	END OF LINE RELAY
— —	WATER FLOW SWITCH
— —	VALVE TAMPER SWITCH
— —	FAN SHUTDOWN RELAY
— —	MANUAL FIRE ALARM STATION — MOUNTING HEIGHT SHALL BE AS REQUIRED BY THE INTERNATIONAL BUILDING CODE. COORDINATE WITH EQUIPMENT MANUFACTURER BASED ON ACTUALLY PROVIDED EQUIPMENT.
— —	FIRE ALARM RELAY
— —	END OF LINE RESISTOR
— —	FIRE ALARM STROBE — MOUNTING HEIGHT SHALL BE AS REQUIRED BY THE LATEST EDITION OF NFPA 72. COORDINATE WITH EQUIPMENT MANUFACTURER BASED ON ACTUALLY PROVIDED EQUIPMENT.
— —	FIRE ALARM BELL
— —	BELL
— —	FIRE AUDIBLE AND VISUAL ALARM — MOUNTING HEIGHT SHALL BE AS REQUIRED BY THE LATEST EDITION OF NFPA 72. COORDINATE WITH EQUIPMENT MANUFACTURER BASED ON ACTUALLY PROVIDED EQUIPMENT.
— —	HORN
— —	FIRE ALARM CONTROL CABINET
— —	FIRE ALARM ANNUNCIATOR PANEL
— —	CARBON MONOXIDE SENSOR
— —	DUCT THERMOSTAT
— —	DUCT SMOKE DETECTOR
— —	CEILING SMOKE DETECTOR CENTRAL SYSTEM
— —	THERMAL DETECTOR (HEAT)
— —	CEILING SMOKE DETECTOR — STAND ALONE 120V, BATTERY BACKUP. UNLESS NOTED OR SHOWN DIFFERENTLY ON THE PLANS OR SPECIFICATIONS, PROVIDE 120V POWER FROM THE NEAREST RECEPTACLE CIRCUIT WHETHER SPECIFICALLY INDICATED OR NOT.
— —	ELECTRIC DOOR HOLDER
— —	FIREMAN'S TELEPHONE OUTLET
— —	NURSE CALL MASTER STATION
— —	NURSE CALL ANNUNCIATION PANEL
— —	NURSE CALL SYSTEM POWER SUPPLY
— —	NURSE CALL STATUS LIGHT ANNUNCIATION PANEL
— —	NURSE CALL SWITCH PANEL
— —	NURSE CALL ROOM STATUS CORRIDOR LIGHT — WALL MOUNT
— —	NURSE CALL ROOM STATUS CORRIDOR LIGHT — CEILING MOUNT
— —	NURSE CALL CORRIDOR LIGHT — WALL MOUNT
— —	NURSE CALL CORRIDOR LIGHT — CEILING MOUNT
— —	NURSE CALL PATIENT STATION — SINGLE CALL CORD
— —	NURSE CALL PATIENT STATION — DOUBLE CALL CORD
— —	NURSE CALL DUTY STATION
— —	NURSE CALL EMERGENCY STATION — PULL CORD
— —	NURSE CALL EMERGENCY STATION — PUSH BUTTON
— —	NURSE CALL CODE BLUE STATION
— —	DOOR ALARM CONTACT
— —	DOOR ALARM ANNUNCIATOR
— —	MONITOR JUNCTION BOX
— —	CLOSED CIRCUIT TELEVISION MONITOR
— —	CLOSED CIRCUIT TELEVISION CAMERA
— —	MASTER CLOCK
— —	SECONDARY CLOCK
— —	INTERCOM ADMINISTRATIVE CONTROL UNIT
— —	MUSIC SYSTEM AMP
— —	PAGING SYSTEM AMP
— —	WALL SPEAKER
— —	COMBINATION CLOCK SPEAKER
— —	CEILING SPEAKER
— —	COLUMN SPEAKER
— —	HORN TYPE SPEAKER
— —	MICROPHONE OUTLET — WALL
— —	MICROPHONE OUTLET — FLOOR
— —	LOCAL AMPLIFIER
— —	REMOTE VOLUME CONTROL
— —	CALL-IN STATION
— —	MOTION DETECTOR
— —	CLOSED CIRCUIT TELEVISION OUTLET
— —	PUSHBUTTON STATION
— —	PILOT LIGHT BANK
— —	RELAY CABINET
— —	AMPLIFIER
— —	LOW VOLTAGE CONTROL TRANSFORMER
— —	SOLENOID VALVE
— —	FREEZE STAT
— —	PLAN NOTATIONS:
— —	INDICATES DIRECTION OF NORTH
— —	DETAIL REFERENCE — UPPER NUMBER INDICATES DETAIL NUMBER, LOWER NUMBER INDICATES SHEET NUMBER.
— —	PLAN NOTE REFERENCE
— —	ROOM NUMBER REFERENCE
— —	INDICATES CONNECTION TO EXISTING SYSTEM



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ABBREVIATIONS:

AD	ACCESS DOOR
AFF	ABOVE FINISHED FLOOR
AFG	ABOVE FINISHED GRADE
AHU	AIR HANDLING UNIT
CU	CONDENSING UNIT
CUH	CABINET UNIT HEATER
CW	DOMESTIC COLD WATER
CWR	CHILLED WATER RETURN
CWS	CHILLED WATER SUPPLY
DF	DRINKING FOUNTAIN
DN	DOWN
EF	EXHAUST FAN
EWC	ELECTRIC WATER COOLER
E/M	EQUIPMENT MANUFACTURER
FCU	FAN COIL UNIT
FD	FLOOR DRAIN
FFCO	FINISHED FLOOR CLEANOUT
FGCO	FINISHED GRADE CLEANOUT
FTR	FINNED TUBE RADIATION
FWCO	FINISHED WALL CLEANOUT
HP	HYDRONIC HEAT PUMP
HW	DOMESTIC HOT WATER
HWR	HOT WATER RETURN
HWS	HOT WATER SUPPLY
OA	OUTSIDE AIR
RA	RETURN AIR
SA	SUPPLY AIR
UH	UNIT HEATER
UV	UNIT VENTILATOR
V	VENT
VTR	VENT THRU ROOF
W	WASTE

THESE LETTERS ADJACENT TO ANY SYMBOL INDICATES DEVICE BOTTOM TO BE MOUNTED 4" ABOVE COUNTERTOP BACKSPLASH

"G"

THESE LETTERS ADJACENT TO ANY SYMBOL INDICATES GROUND FAULT INTERRUPTER

"IG"

THESE LETTERS ADJACENT TO ANY SYMBOL INDICATES ISOLATED GROUND DEVICE

"SS"

THESE LETTERS ADJACENT TO ANY SYMBOL INDICATES SURGE SUPPRESSION DEVICE

"TL"

THESE LETTERS ADJACENT TO ANY SYMBOL INDICATES LOCKING OR TWIST-LOCK TYPE DEVICE

"WP"

THESE LETTERS ADJACENT TO ANY SYMBOL INDICATES WEATHER-PROOF ENCLOSURE

"WPI"

THESE LETTERS ADJACENT TO ANY SYMBOL INDICATES WEATHER-PROOF IN-USE ENCLOSURE

"XP"

THESE LETTERS ADJACENT TO ANY SYMBOL INDICATES EXPLOSION-PROOF ENCLOSURE

"TR"

THESE LETTERS ADJACENT TO ANY SYMBOL INDICATES TAMPER RESISTANT DEVICE

60"

DIMENSIONS ADJACENT TO ANY SYMBOL INDICATES MOUNTING HEIGHT TO CENTERLINE OF DEVICE

(TIE)

INDICATES HOMERUNS WITH SAME CIRCUIT NUMBER TO BE WIRED TOGETHER ON SAME CIRCUIT.

STATE OF MISSOURI

MIKE KEHOE,

GOVERNOR

STATE OF MISSOURI

GOVERNOR

CAMERON K. COLLINS

NUMBER E-24483

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ESTERY & SCHNEIDER ASSOCIATES, INC.

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OFFICE OF ADMINISTRATION

DIVISION OF FACILITIES

MANAGEMENT,

DESIGN AND CONSTRUCTION

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COMMISSION

INTERIOR RENOVATION

MISSOURI VETERANS

HOME

620 N. JEFFERSON

ST. JAMES, MISSOURI

PROJECT # U1503-01

SITE # 6801

ASSET # 8136801002

FEDERAL # 29-044

REVISION:

DATE:

REVISION:

DATE:

REVISION:

DATE:

ISSUE DATE: 8-1-24

CAD DWG FILE: M-001.DWG

DRAWN BY: JMO

CHECKED BY: CKO

DESIGNED BY: JMO

SHEET TITLE:

MEP

SYMBOLS

LIST


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M-001


50 OF 120 SHEETS

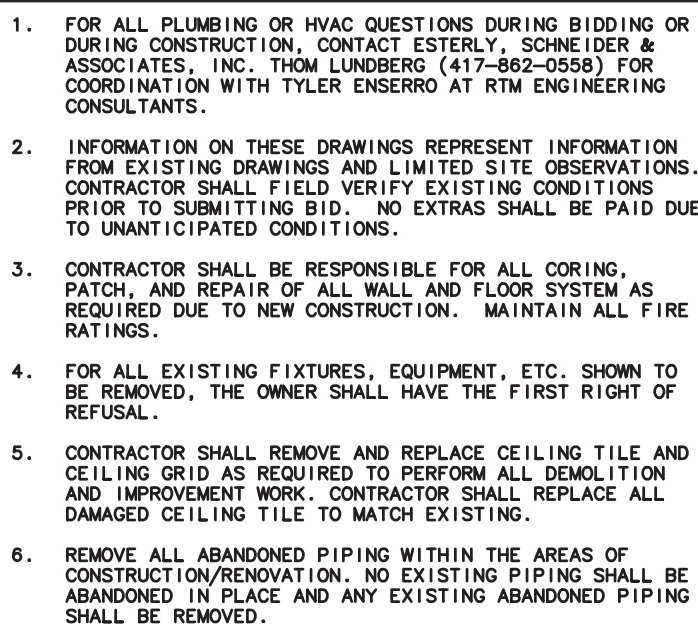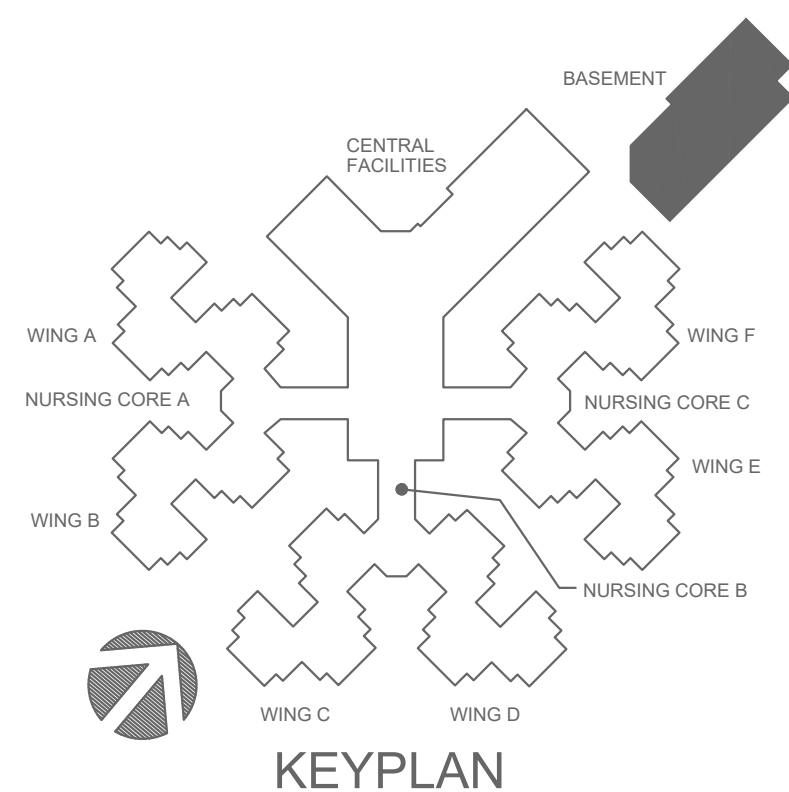8-1-24



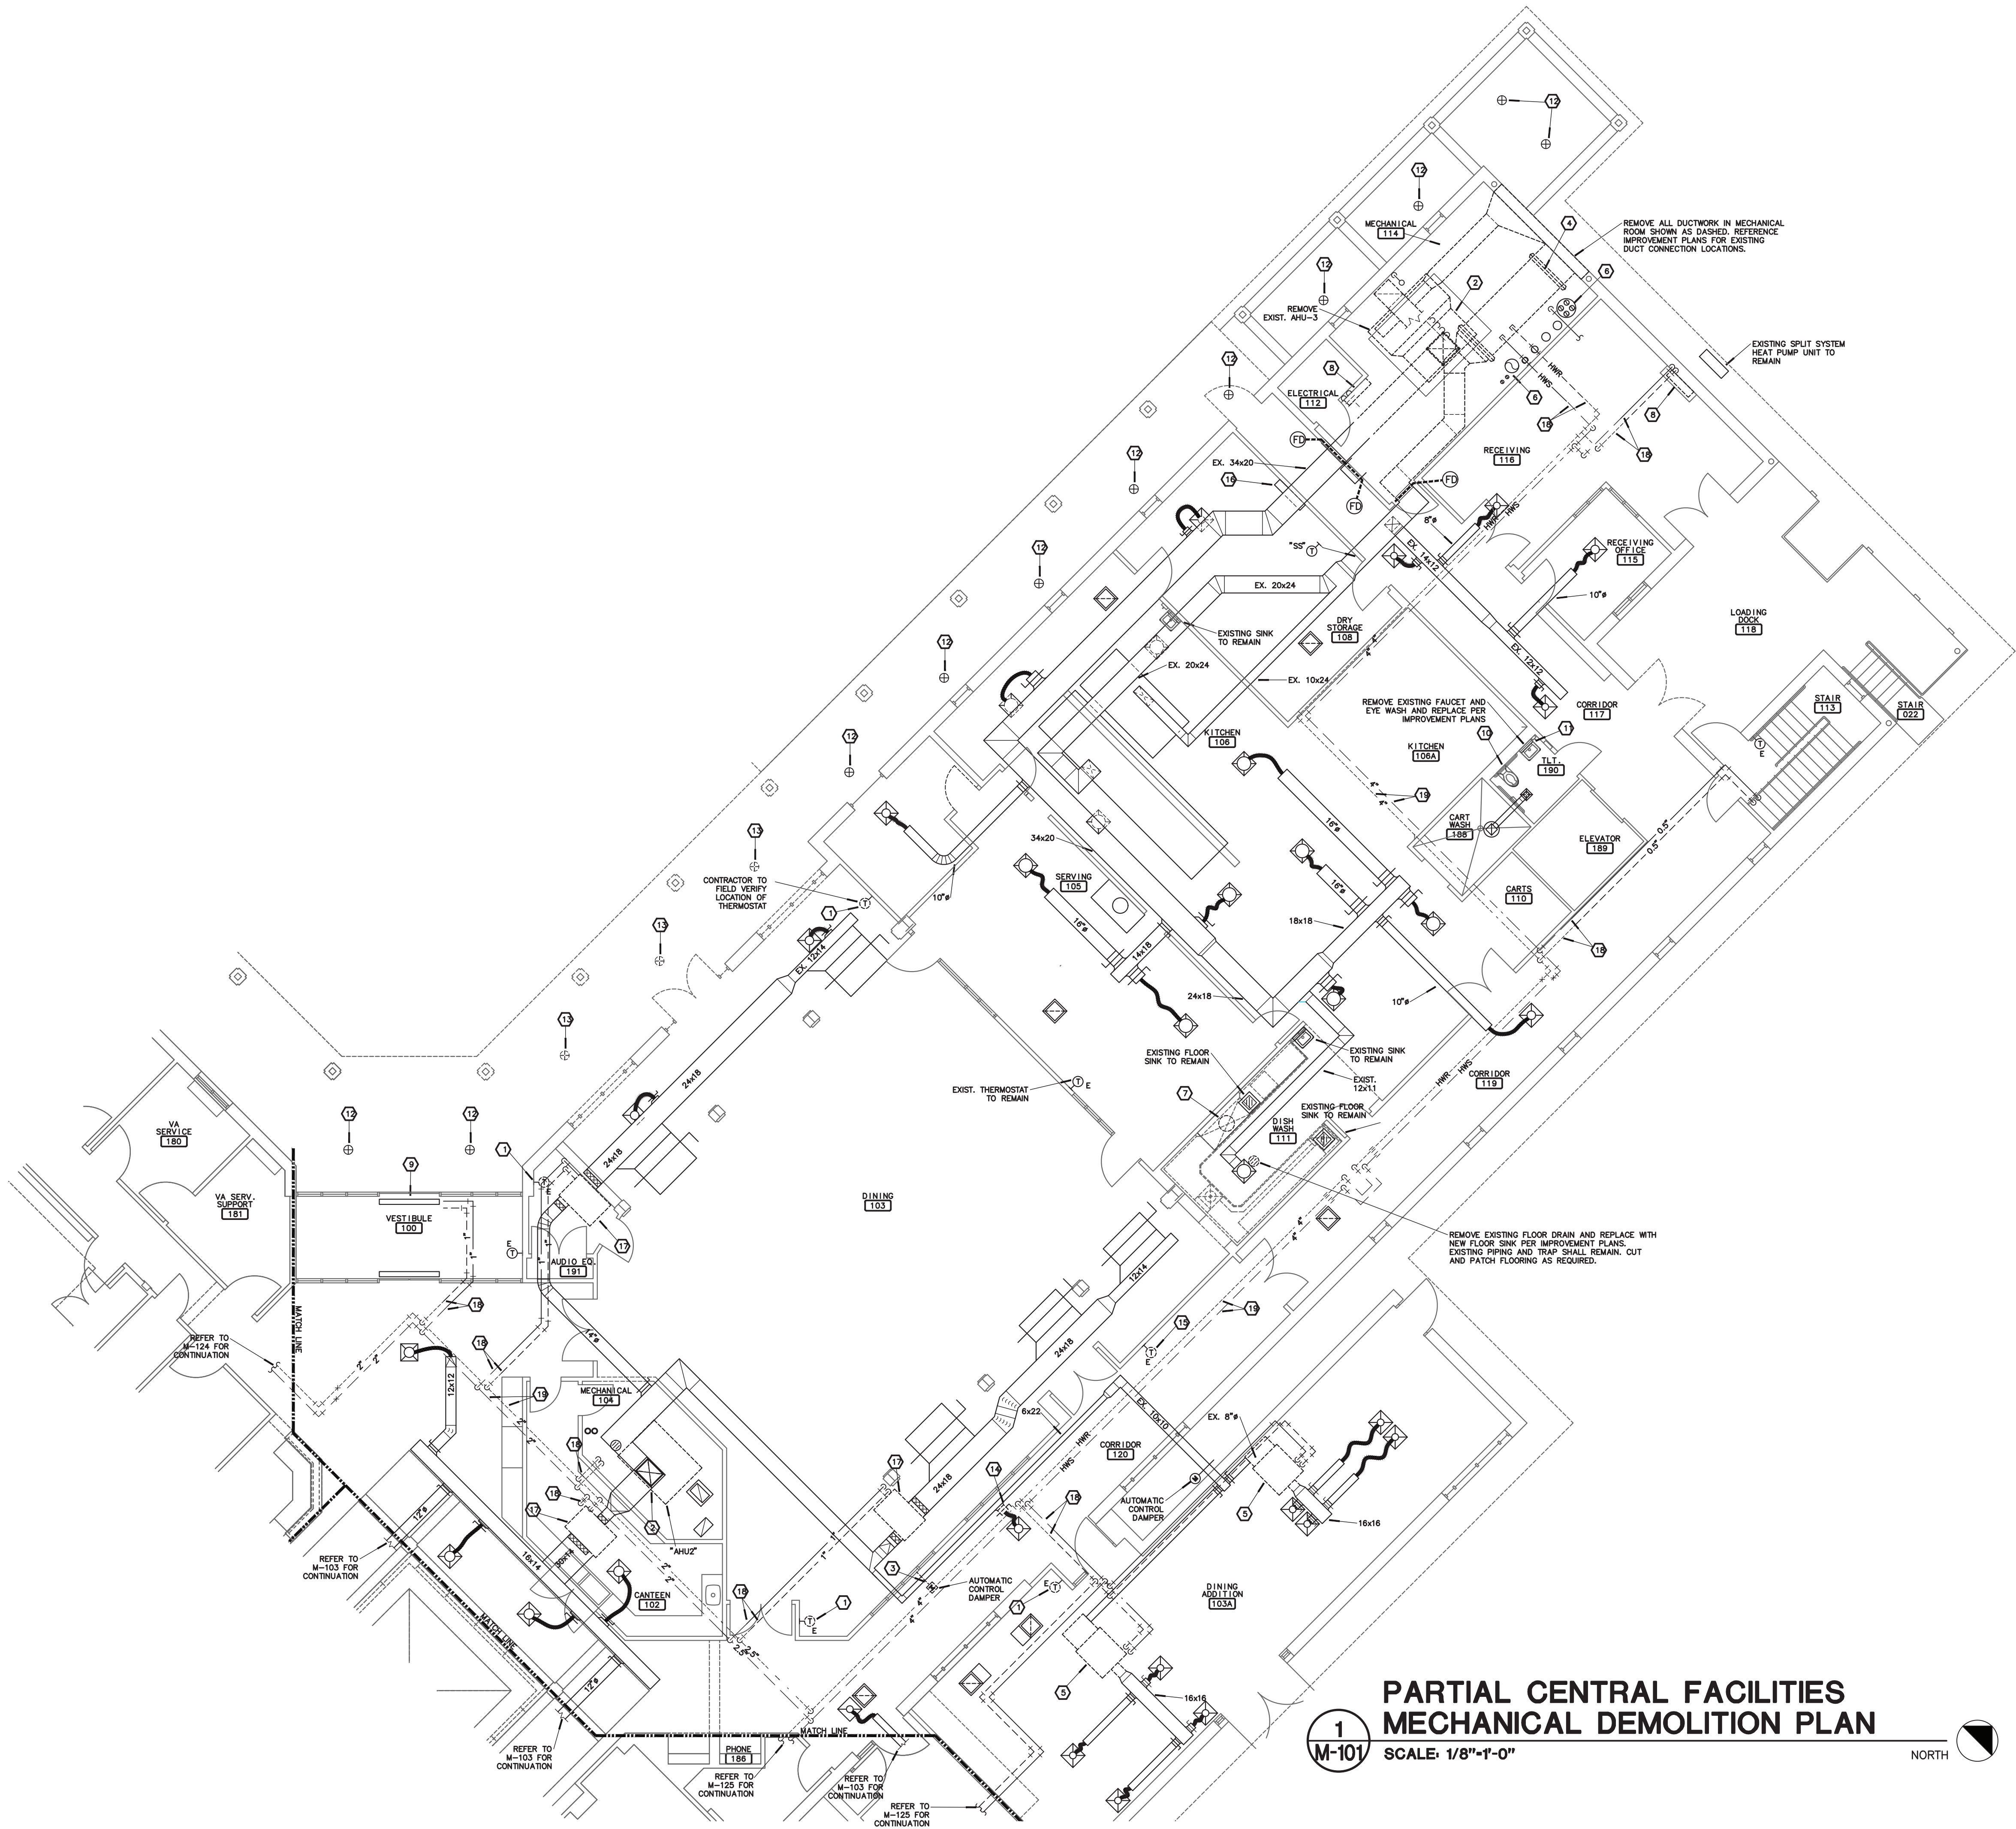


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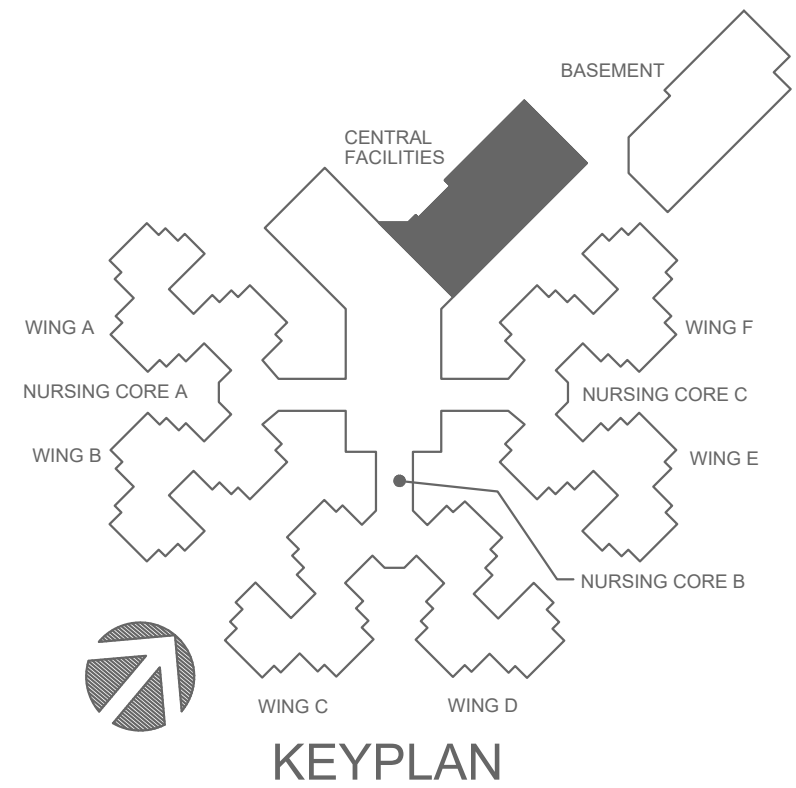


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**PARTIAL CENTRAL FACILITIES  
MECHANICAL DEMOLITION PLAN**

SCALE: 1/8"=1'-0"



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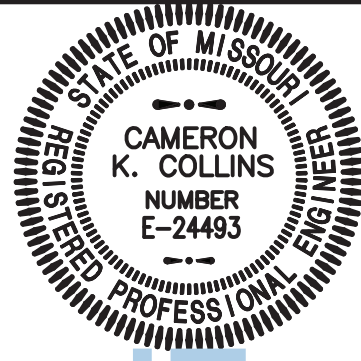
**NOTES:**

1. REMOVE EXISTING THERMOSTAT AND PREPARE WALL SURFACE FOR REPLACEMENT THERMOSTAT PER ARCHITECT'S DIRECTION.
2. REMOVE AND REPLACE EXISTING AIR HANDLING UNIT. REMOVE AND REPLACE ALL EXISTING VALVING AND PIPING LOCAL TO COIL, INCLUDING THE SHUT-OFF VALVES.
3. REMOVE EXISTING AUTOMATIC CONTROL DAMPER AND SEAL REMAINING EXISTING DUCTWORK.
4. REMOVE EXISTING KITCHEN MAKE-UP AIR UNIT "MAU-1". REPLACE WITH NEW PER IMPROVEMENT PLANS.
5. REMOVE EXISTING HORIZONTAL 4-PIPE FAN COIL UNIT/AIR HANDLING UNIT. REMOVE AND REPLACE ALL EXISTING VALVING AND PIPING LOCAL TO COIL, INCLUDING THE SHUT-OFF VALVES. REMOVE AND REPLACE EXISTING DIELECTRIC FITTINGS ON THE CWS, CWR, HWS & HWR BRANCH PIPING. REMOVE AND REPLACE SHEETMETAL WORK AS REQUIRED TO ACCOMMODATE NEW FAN COIL UNIT.
6. EXISTING FLUE UP TO ROOF SHALL REMAIN.
7. REMOVE EXISTING DISHWASHER EXHAUST FAN AND ALL ASSOCIATED DUCTWORK AND CONTROLS NOT REUTILIZED IN THE COMPLETED PROJECT. REPLACE WITH NEW FAN PER IMPROVEMENT PLANS.
8. REMOVE EXISTING VERTICAL FAN COIL UNIT. REMOVE AND REPLACE ALL EXISTING VALVING AND PIPING LOCAL TO COIL, INCLUDING THE SHUT-OFF VALVES. REMOVE AND REPLACE EXISTING DIELECTRIC FITTINGS ON THE HWS & HWR BRANCH PIPING. REMOVE AND REPLACE SHEETMETAL WORK AS REQUIRED TO ACCOMMODATE NEW VAV FAN TERMINAL UNIT.
9. EXISTING HOT WATER AIR CURTAIN SHALL REMAIN. REMOVE AND REPLACE ALL EXISTING VALVING AND PIPING LOCAL TO COIL, INCLUDING THE SHUT-OFF VALVES. REMOVE AND REPLACE EXISTING DIELECTRIC FITTINGS ON THE HWS & HWR BRANCH PIPING.
10. REMOVE EXISTING FLUSH VALVE AND REPLACE PER IMPROVEMENT PLAN M-112.
11. REMOVE EXISTING FAUCET AND REPLACE PER IMPROVEMENT PLAN M-112.
12. EXISTING SPRINKLER HEAD TO REMAIN.
13. REMOVE EXISTING SPRINKLER HEAD AND ANY ASSOCIATED SPRINKLER PIPING AND HANGERS NOT REUTILIZED IN THE COMPLETED PROJECT.
14. REMOVE EXISTING DUCT TAP. SEAL AND INSULATE REMAINING EXISTING DUCTWORK. REFER TO SHEET M-112 FOR CONNECTION OF NEW DUCT TO EXISTING DIFFUSER.
15. REMOVE THERMOSTAT AND PROVIDE NEW COVER PLATE. COVER PLATE MATERIAL/COLOR TO MATCH ELECTRICAL DEVICE COVER PLATES. REFERENCE DIVISION 26 SPECIFICATIONS.
16. EXISTING SPLIT SYSTEM A/C UNIT TO REMAIN.
17. REMOVE EXISTING HORIZONTAL 2-PIPE VAV FAN TERMINAL UNIT. REMOVE AND REPLACE ALL EXISTING VALVING AND PIPING LOCAL TO COIL, INCLUDING THE SHUT-OFF VALVES. REMOVE AND REPLACE EXISTING DIELECTRIC FITTINGS ON THE HWS & HWR BRANCH PIPING. REMOVE AND REPLACE SHEETMETAL WORK AS REQUIRED TO ACCOMMODATE NEW VAV FAN TERMINAL UNIT.
18. REMOVE EXISTING PORTION OF HOT WATER RETURN & SUPPLY PIPING SHOWN AS DASHED AND CAP PIPING AS SHOWN ON IMPROVEMENT PLAN M-123.
19. REMOVE EXISTING HOT WATER SUPPLY & RETURN PIPING NOT REUTILIZED IN COMPLETED PROJECT.

**GENERAL NOTES:**

1. FOR ALL PLUMBING OR HVAC QUESTIONS DURING BIDDING OR DURING CONSTRUCTION, CONTACT ESTERLY, SCHNEIDER & ASSOCIATES, INC. THOM LUNDERS (417-862-0558) FOR COORDINATION WITH TYLER ENSERO AT RVM ENGINEERING CONSULTANTS.
2. INFORMATION ON THESE DRAWINGS REPRESENT INFORMATION FROM EXISTING DRAWINGS AND LIMITED SITE OBSERVATIONS. CONTRACTOR SHALL FIELD VERIFY EXISTING CONDITIONS PRIOR TO SUBMITTING BID. NO EXTRAS SHALL BE PAID DUE TO UNANTICIPATED CONDITIONS.
3. CONTRACTOR SHALL BE RESPONSIBLE FOR ALL CORING, PATCH, AND REPAIR OF ALL WALL AND FLOOR SYSTEM AS REQUIRED DUE TO NEW CONSTRUCTION. MAINTAIN ALL FIRE RATINGS.
4. FOR ALL EXISTING FIXTURES, EQUIPMENT, ETC. SHOWN TO BE REMOVED, THE OWNER SHALL HAVE THE FIRST RIGHT OF REFUSAL.
5. CONTRACTOR SHALL REMOVE AND REPLACE CEILING TILE AND CEILING GRID AS REQUIRED TO PERFORM ALL DEMOLITION AND IMPROVEMENT WORK. CONTRACTOR SHALL REPLACE ALL DAMAGED CEILING TILE TO MATCH EXISTING.
6. REMOVE ALL ABANDONED PIPING WITHIN THE AREAS OF CONSTRUCTION/RENOVATION. NO EXISTING PIPING SHALL BE ABANDONED IN PLACE AND ANY EXISTING ABANDONED PIPING SHALL BE REMOVED.

STATE OF MISSOURI  
MIKE KEHOE,  
GOVERNOR



Cameron K. Collins  
Professional Engineer  
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#2014035826

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620 N. JEFFERSON  
ST. JAMES, MISSOURI

PROJECT # U1503-01  
SITE # 6801  
ASSET # 8136801002  
FEDERAL # 29-044

REVISION: \_\_\_\_\_  
DATE: \_\_\_\_\_  
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DATE: \_\_\_\_\_  
REVISION: \_\_\_\_\_  
DATE: \_\_\_\_\_  
ISSUE DATE: 8-1-24

CAD DWG FILE: M-101.DWG  
DRAWN BY: TSE  
CHECKED BY: CRC  
DESIGNED BY: TSE

SHEET TITLE:

**HVAC &  
PLUMBING  
DEMO PLAN**

SHEET NUMBER:

**M-101**

52 OF 120 SHEETS

8-1-24



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1  
M-102

## PARTIAL CENTRAL FACILITIES MECHANICAL DEMOLITION PLAN

SCALE: 1/8"=1'-0"

NORTH

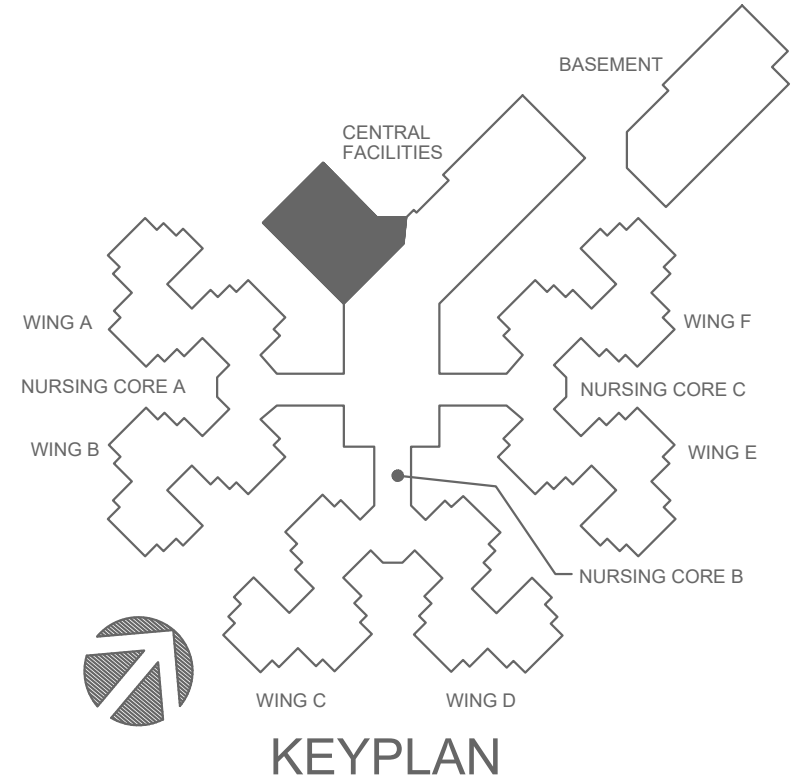
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### NOTES:


1. REMOVE AND REPLACE EXISTING THERMOSTAT AND CONTROL WIRING. PATCH, REPAIR AND PAINT WALL PER ARCHITECT'S DIRECTION.
2. REMOVE EXISTING 4-PIPE FAN COIL UNIT, ALL EXISTING VALVING AND PIPING LOCAL TO COIL INCLUDING THE SHUT-OFF VALVES AND EXISTING THERMOSTAT AND CONTROL WIRING. REFER TO IMPROVEMENT PLAN FOR NEW FAN COIL UNIT. REMOVE AND REPLACE ALL DIELECTRIC FITTINGS ON HWS, HWR, CWS AND CWR BRANCH PIPING.
3. REMOVE AND REPLACE EXISTING BYPASS AIR TERMINAL UNIT. REMOVE AND REPLACE ALL EXISTING VALVING AND PIPING LOCAL TO COIL INCLUDING THE SHUT-OFF VALVES. REMOVE AND REPLACE ALL DIELECTRIC FITTINGS.
4. REMOVE EXISTING FLUSH VALVE AND REPLACE PER IMPROVEMENT PLANS. REFER TO SHEET M-113.
5. REMOVE EXISTING FAUCET AND REPLACE PER IMPROVEMENT PLANS. REFER TO SHEET M-113.
6. EXISTING FAN COIL TO REMAIN.
7. EXISTING AIR HANDLING UNIT TO REMAIN.

### GENERAL NOTES:

1. FOR ALL PLUMBING OR HVAC QUESTIONS DURING BIDDING OR DURING CONSTRUCTION, CONTACT ESTERLY, SCHNEIDER & ASSOCIATES, INC. THOM LUNDBERG (417-862-0558) FOR COORDINATION WITH TYLER ENSERRO AT RTM ENGINEERING CONSULTANTS.
2. INFORMATION ON THESE DRAWINGS REPRESENT INFORMATION FROM EXISTING DRAWINGS AND LIMITED SITE OBSERVATIONS. CONTRACTOR SHALL FIELD VERIFY EXISTING CONDITIONS PRIOR TO SUBMITTING BID. NO EXTRAS SHALL BE PAID DUE TO UNANTICIPATED CONDITIONS.
3. CONTRACTOR SHALL BE RESPONSIBLE FOR ALL CORING, PATCH, AND REPAIR OF ALL WALL AND FLOOR SYSTEM AS REQUIRED DUE TO NEW CONSTRUCTION. MAINTAIN ALL FIRE RATINGS.
4. FOR ALL EXISTING FIXTURES, EQUIPMENT, ETC. SHOWN TO BE REMOVED, THE OWNER SHALL HAVE THE FIRST RIGHT OF REFUSAL.
5. CONTRACTOR SHALL REMOVE AND REPLACE CEILING TILE AND CEILING GRID AS REQUIRED TO PERFORM ALL DEMOLITION AND IMPROVEMENT WORK. CONTRACTOR SHALL REPLACE ALL DAMAGED CEILING TILE TO MATCH EXISTING.
6. REMOVE ALL ABANDONED PIPING WITHIN THE AREAS OF CONSTRUCTION/RENOVATION. NO EXISTING PIPING SHALL BE ABANDONED IN PLACE AND ANY EXISTING ABANDONED PIPING SHALL BE REMOVED.



STATE OF MISSOURI  
MIKE KEHOE,  
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Cameron K. Collins  
Professional Engineer  
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HOME

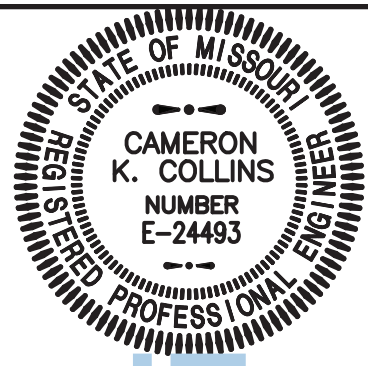620 N. JEFFERSON  
ST. JAMES, MISSOURI

PROJECT # U1503-01  
SITE # 6801  
ASSET # 8136801002  
FEDERAL # 29-044

REVISION: \_\_\_\_\_  
DATE: \_\_\_\_\_  
REVISION: \_\_\_\_\_  
DATE: \_\_\_\_\_  
REVISION: \_\_\_\_\_  
DATE: \_\_\_\_\_  
ISSUE DATE: 8-1-24

CAD DWG FILE: M-102.DWG  
DRAWN BY: TSE  
CHECKED BY: CKC  
DESIGNED BY: TSE

SHEET TITLE:

## HVAC & PLUMBING DEMO PLAN

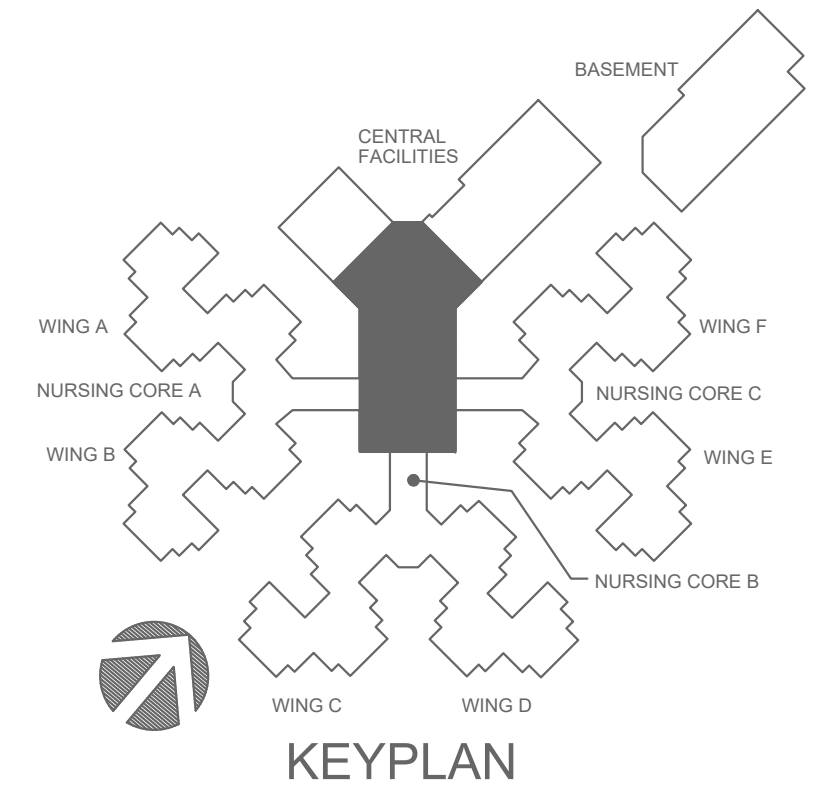
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53 OF 120 SHEETS

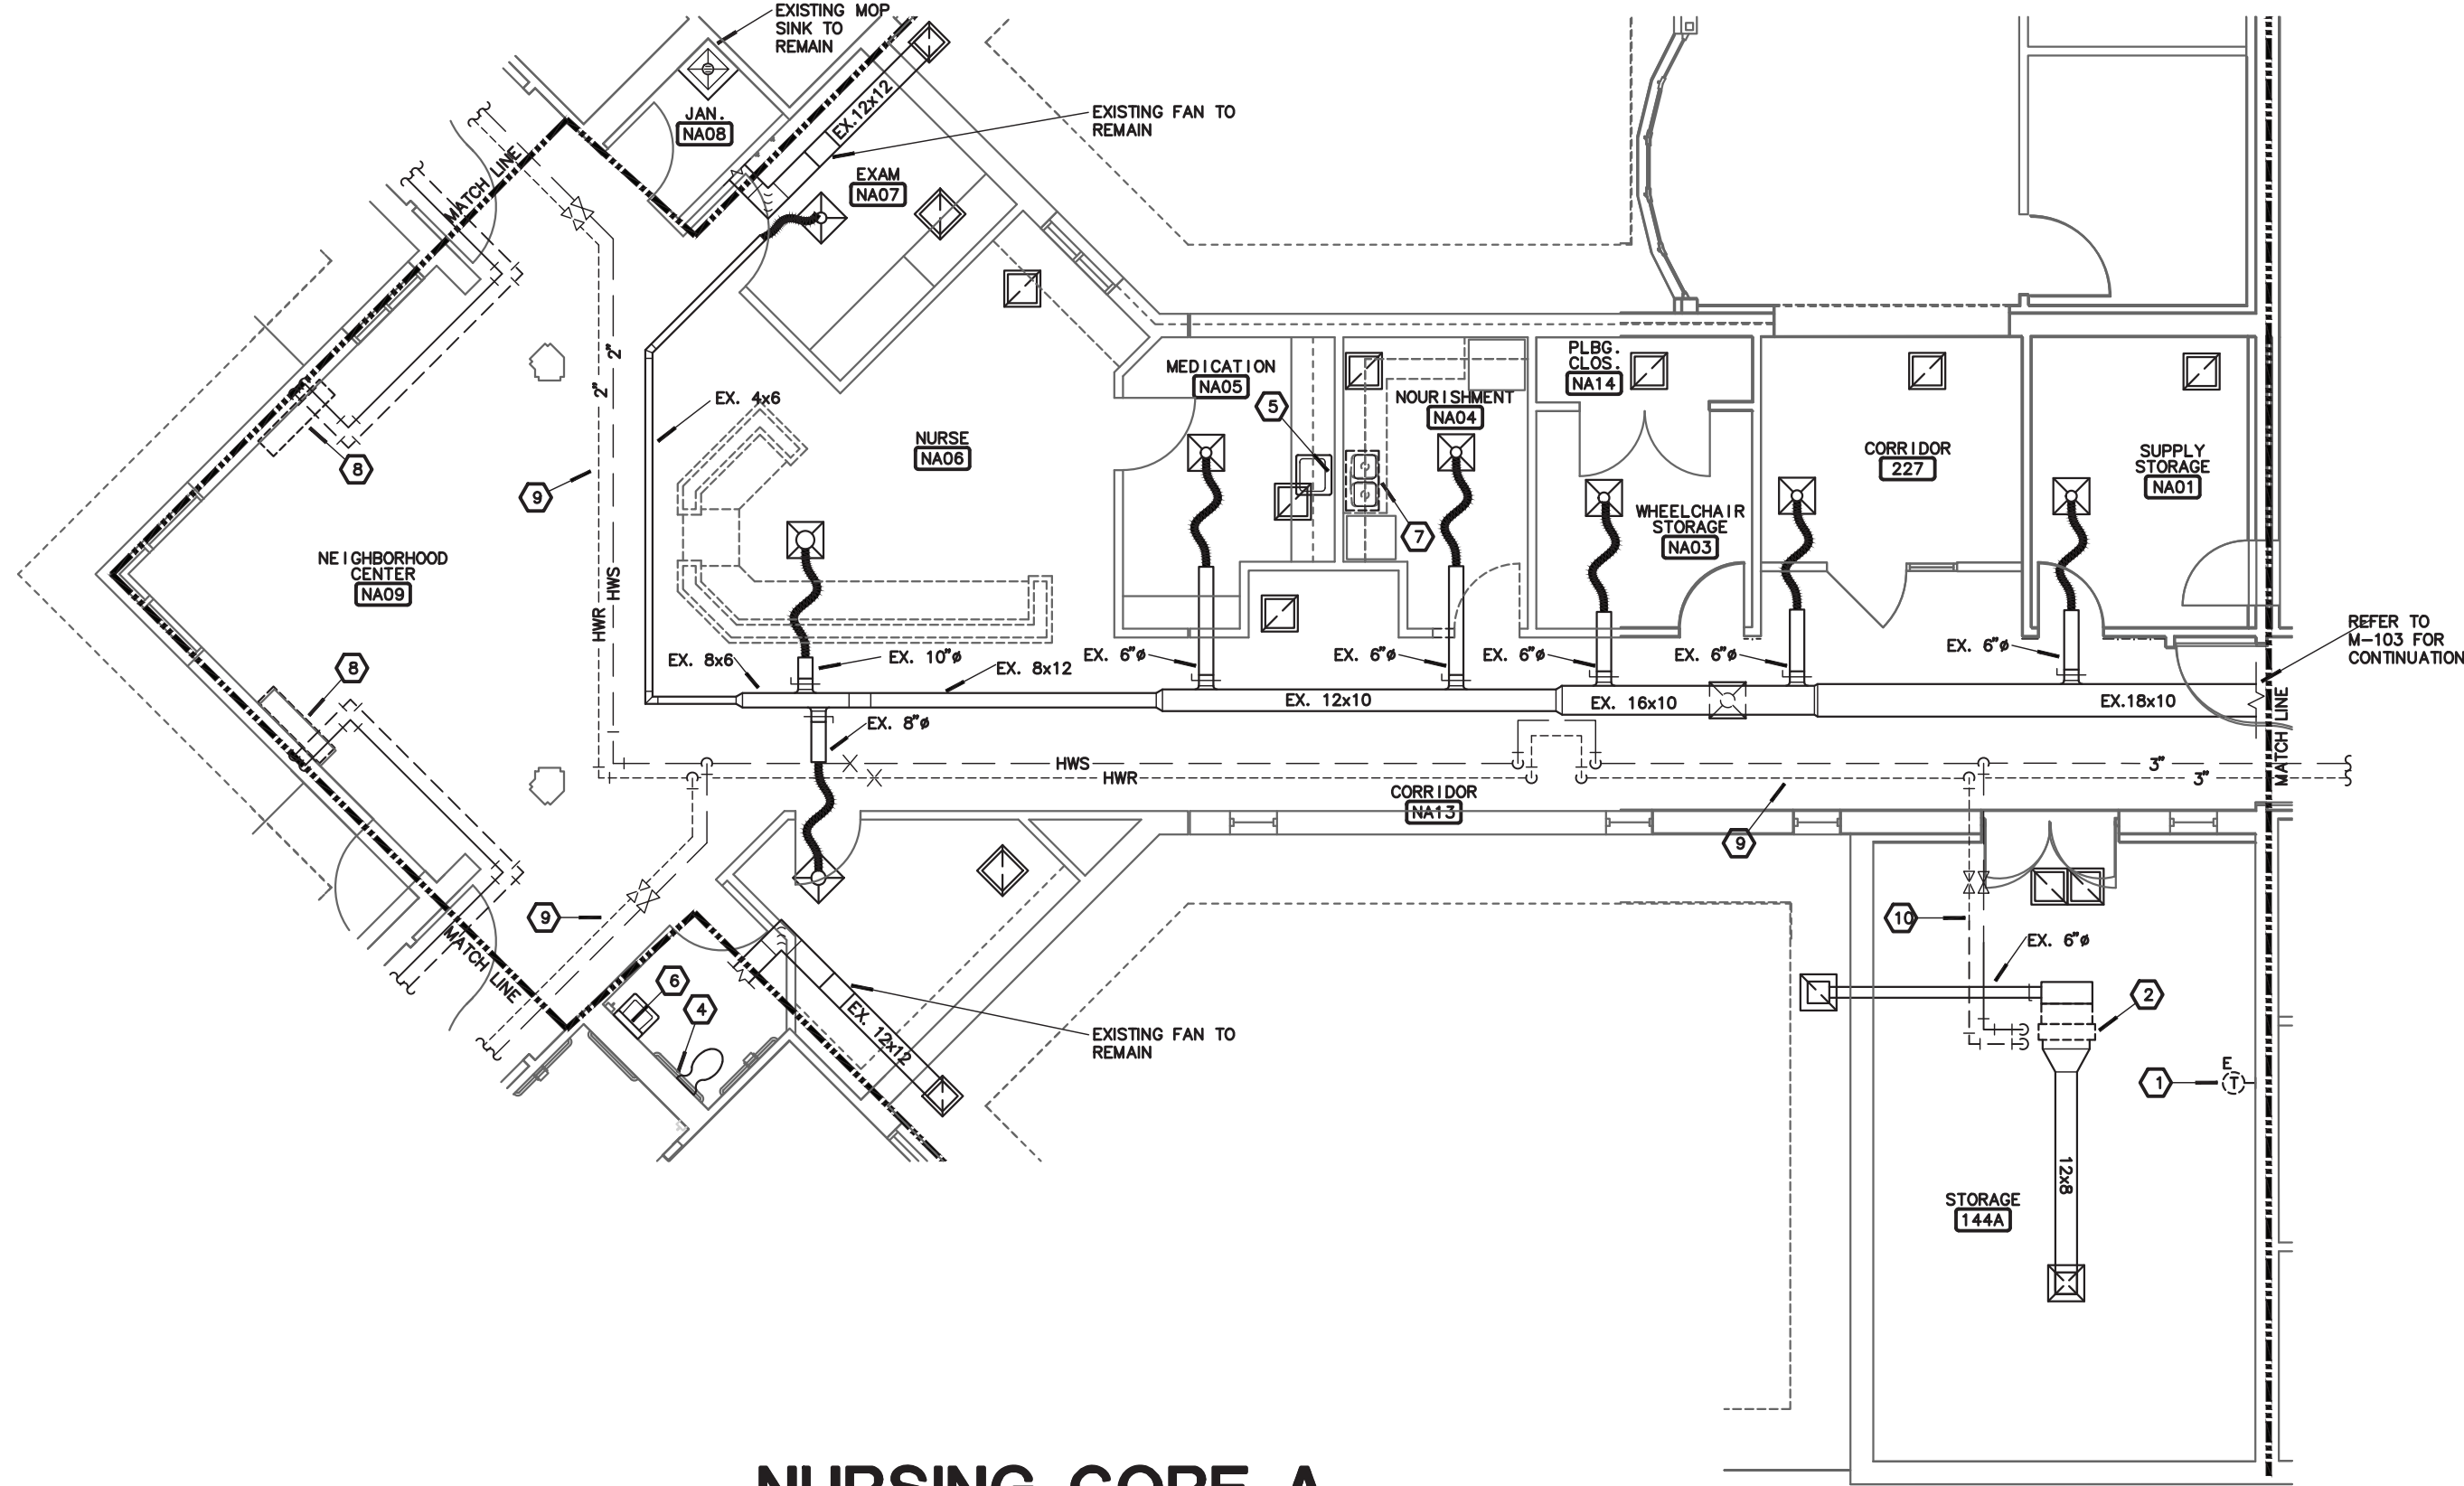
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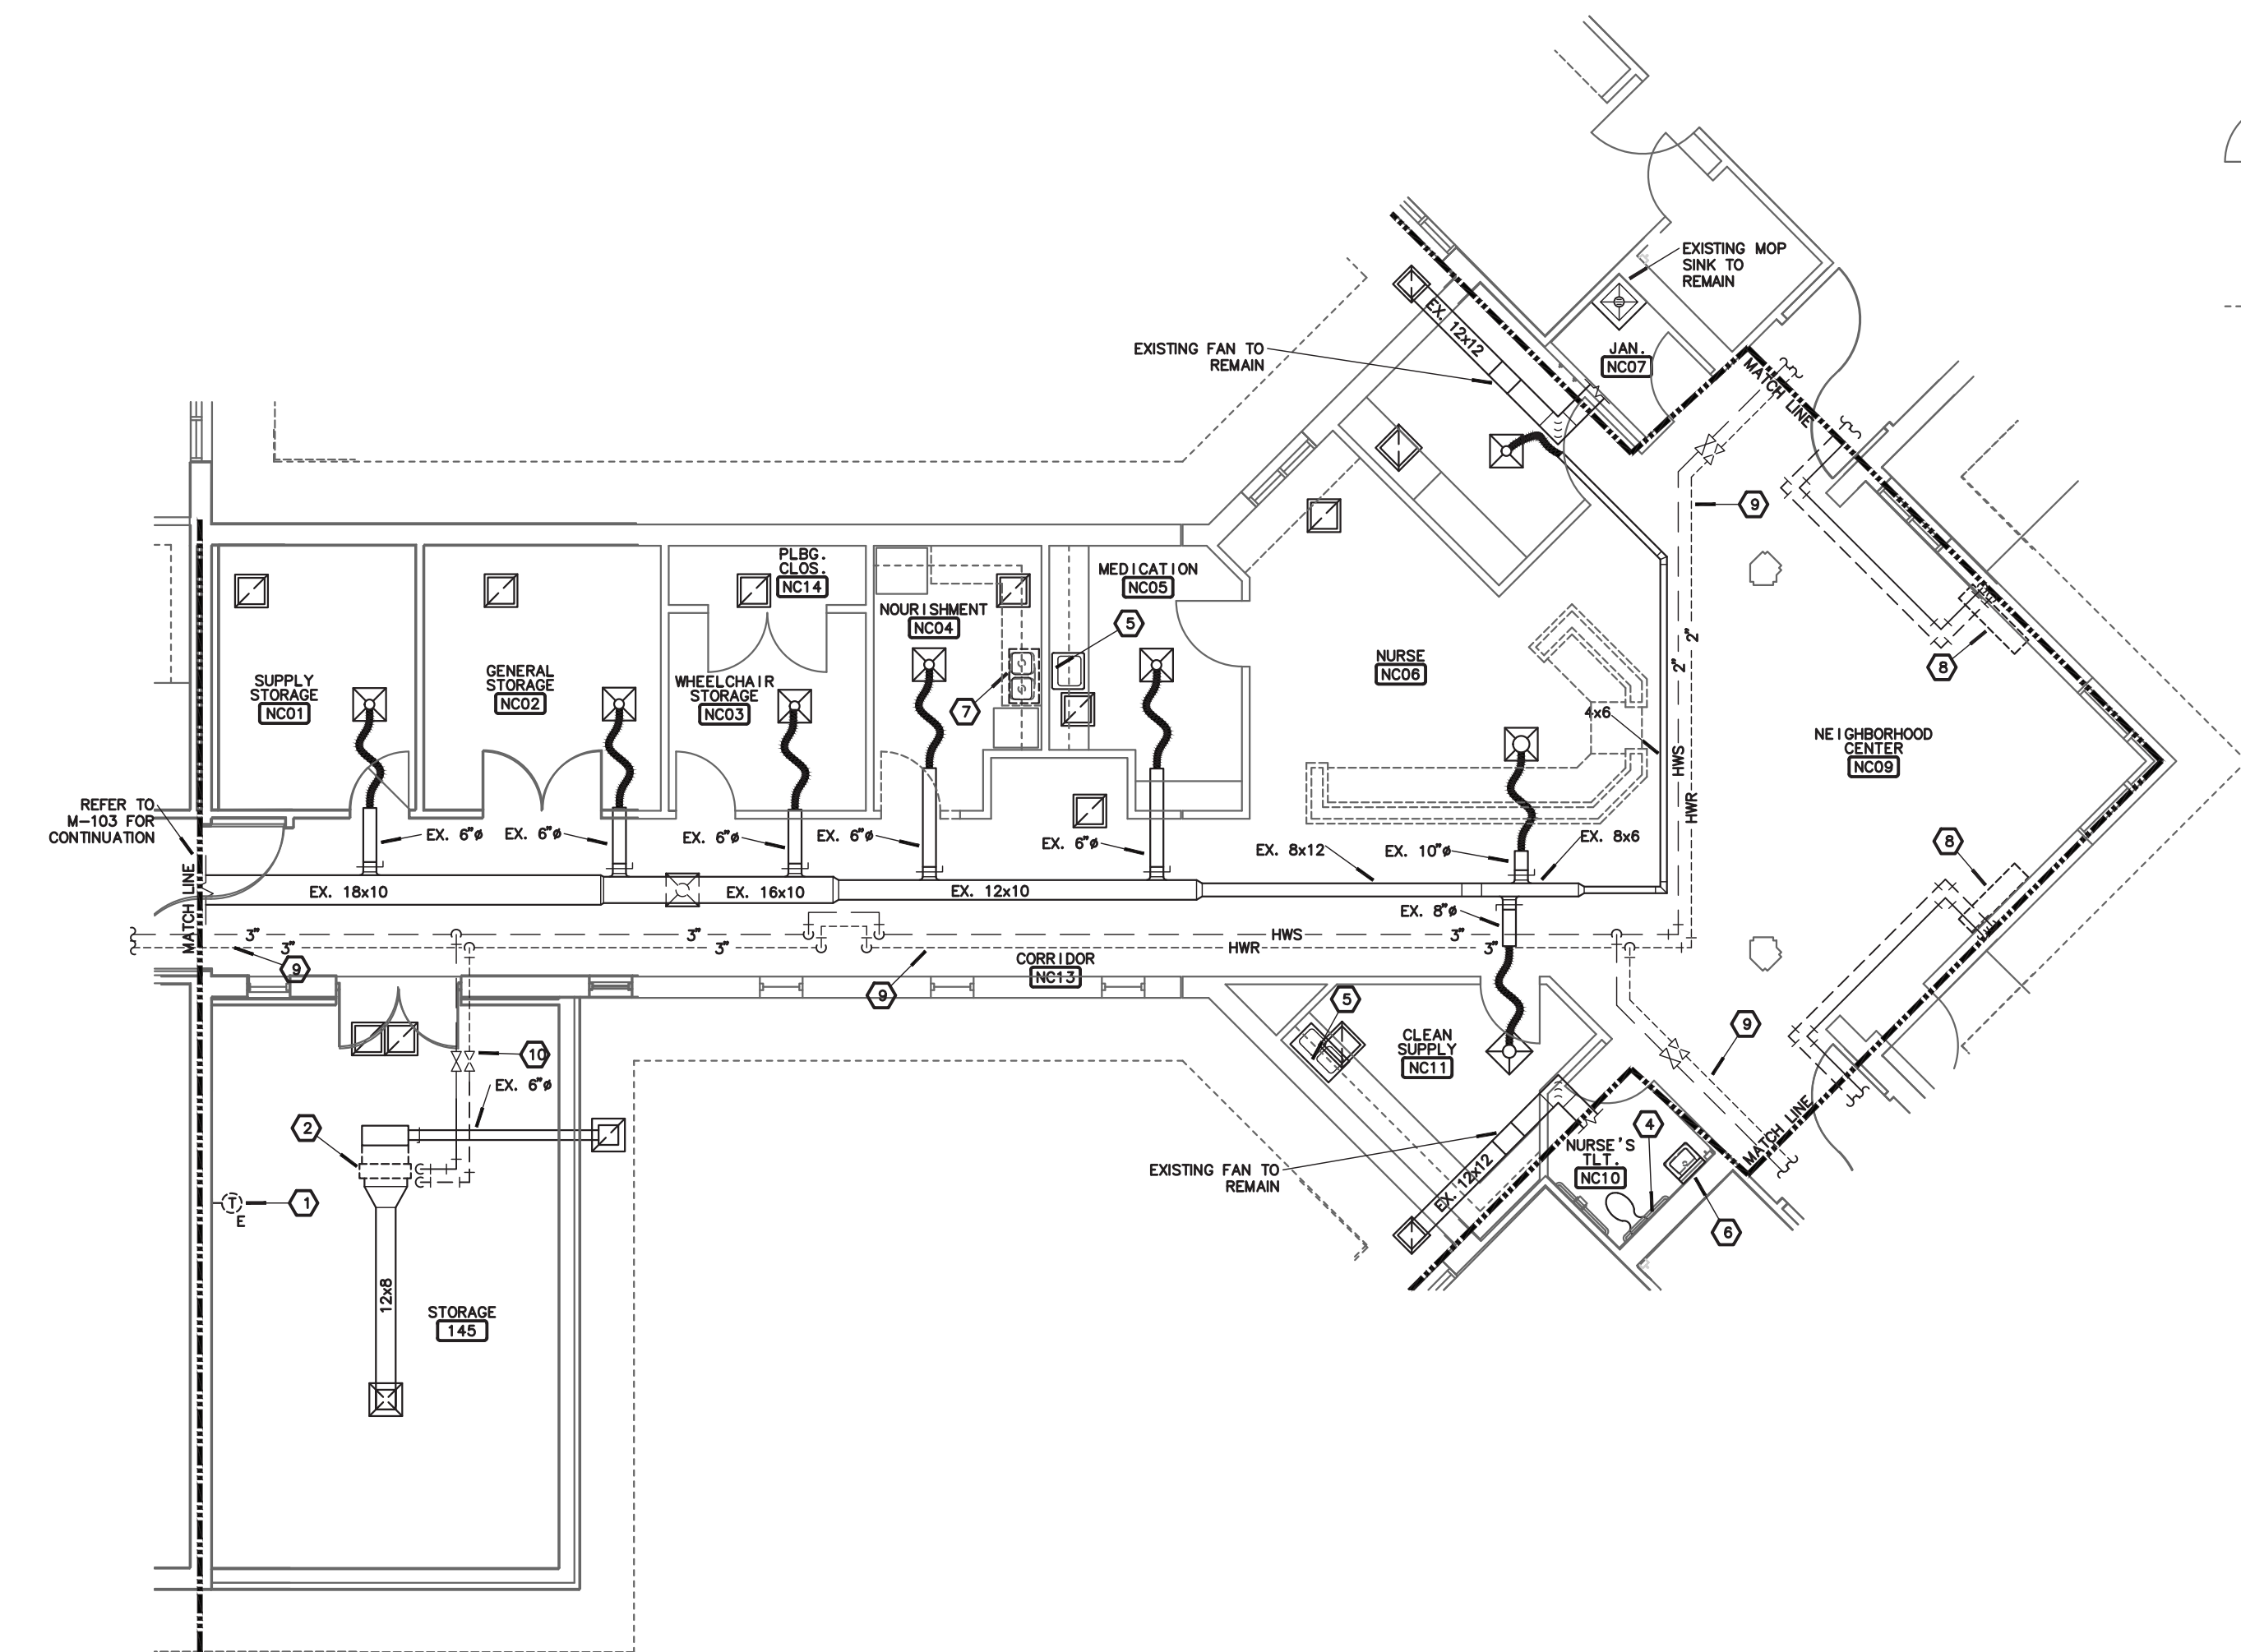





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**3**  
**M-104**  
**NURSING CORE A**  
**MECHANICAL DEMOLITION PLAN**  
SCALE: 1/8"=1'-0" NORTH



**2**  
**M-104**  
**NURSING CORE C**  
**MECHANICAL DEMOLITION PLAN**  
SCALE: 1/8"=1'-0" NORTH



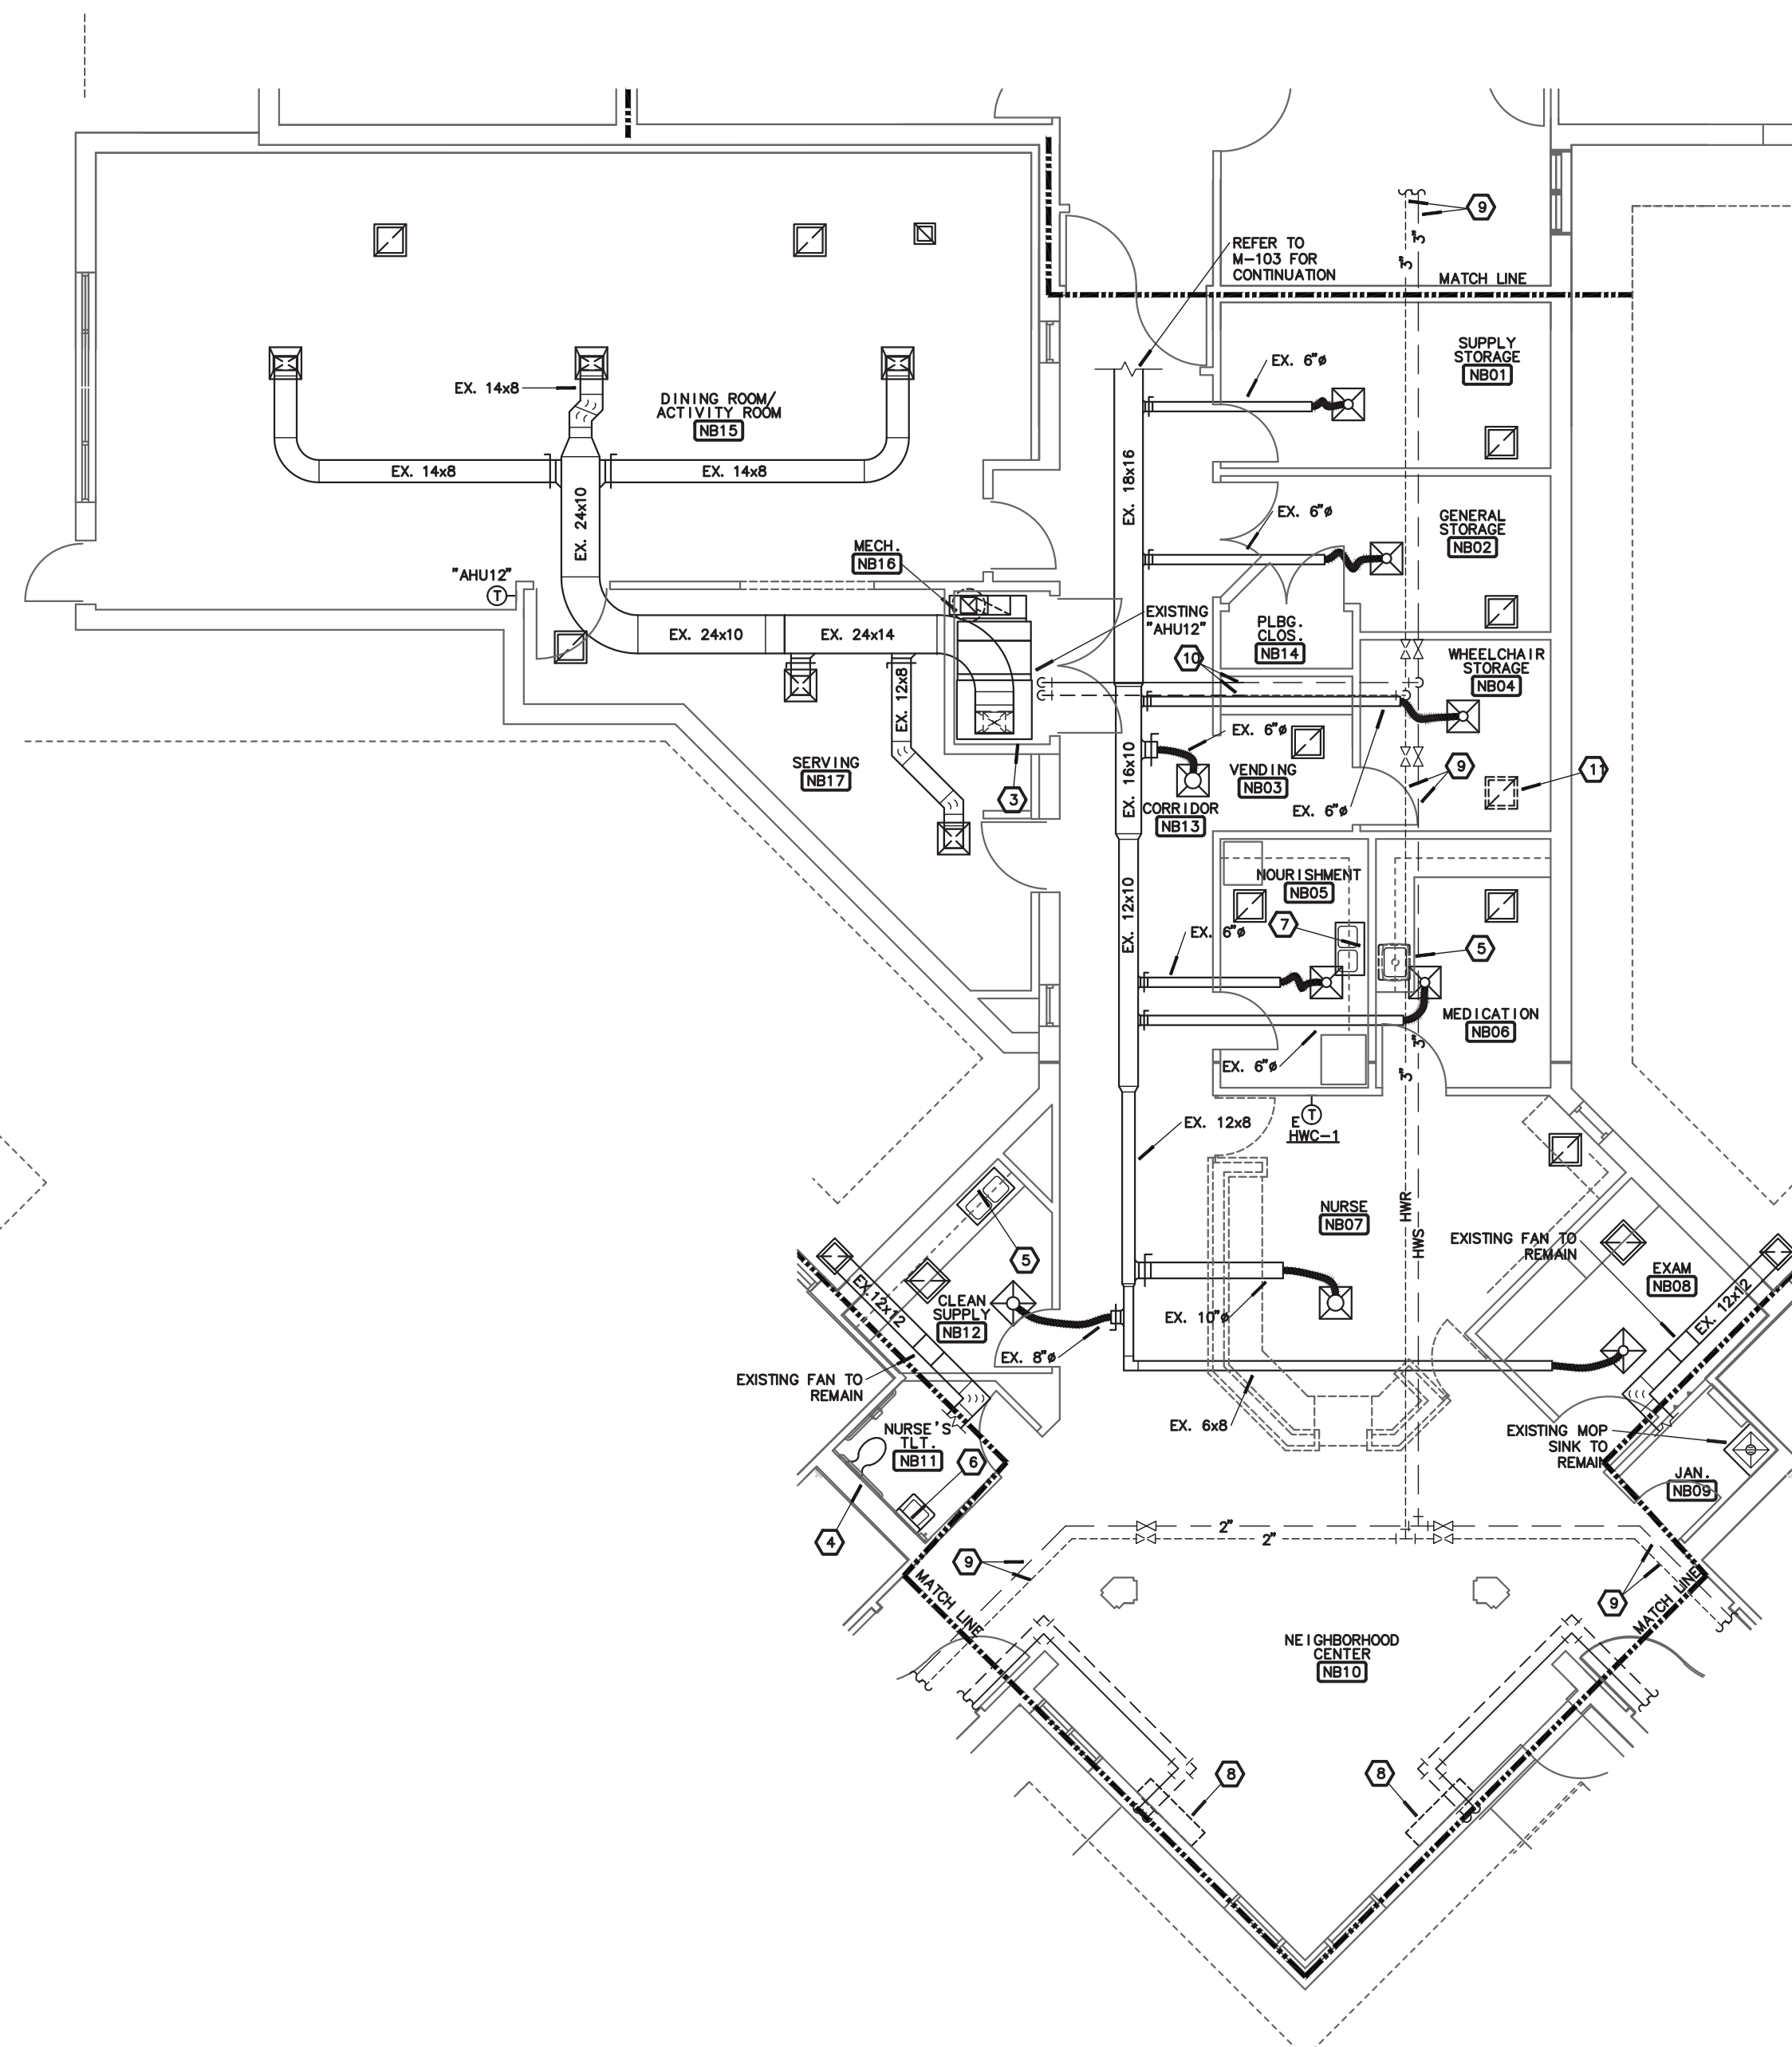**1**  
**M-104**  
**NURSING CORE B**  
**MECHANICAL DEMOLITION PLAN**  
SCALE: 1/8"=1'-0" NORTH




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Springfield, MO 65804  
rtmec.com | 417.881.0020  
State of Missouri certificate of authority  
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## NOTES:


1. REMOVE EXISTING THERMOSTAT AND PREPARE WALL SURFACE FOR REPLACEMENT THERMOSTAT.
2. REMOVE EXISTING HORIZONTAL 4-PIPE FAN COIL UNIT. REMOVE AND REPLACE ALL EXISTING VALVING AND PIPING LOCAL TO COIL, INCLUDING THE SHUT-OFF VALVES. REMOVE AND REPLACE EXISTING DIELECTRIC FITTINGS ON THE CWS, CWR, HWS & HMR BRANCH PIPING. REMOVE AND REPLACE SHEETMETAL WORK AS REQUIRED TO ACCOMMODATE NEW FAN COIL UNIT.
3. EXISTING AIR HANDLING UNIT "AHU12" SHALL REMAIN.
4. REMOVE EXISTING FLUSH VALVE AND REPLACE PER IMPROVEMENT PLAN M-115.
5. REMOVE EXISTING FAUCET AND REPLACE PER IMPROVEMENT PLAN M-115.
6. REMOVE EXISTING LAVATORY FAUCET AND REPLACE PER IMPROVEMENT PLAN M-115.
7. REMOVE EXISTING SINK AND FAUCET AND REPLACE PER IMPROVEMENT PLAN M-115.
8. REMOVE AND REPLACE EXISTING VERTICAL 4-PIPE FAN COIL UNIT PER IMPROVEMENT PLANS. REMOVE AND REPLACE ALL EXISTING VALVING AND PIPING LOCAL TO COIL, INCLUDING THE SHUT-OFF VALVES. REMOVE AND REPLACE EXISTING DIELECTRIC FITTINGS ON THE CWS, CWR, HWS & HMR BRANCH PIPING.
9. REMOVE EXISTING HOT WATER SUPPLY & RETURN PIPING NOT REUTILIZED IN THE COMPLETED PROJECT.
10. REMOVE EXISTING HOT WATER SUPPLY & RETURN PIPING AND CAP PIPING AS SHOWN ON IMPROVEMENT PLAN M-126.
11. REMOVE EXISTING RETURN DISFUSER. REPLACE WITH NEW CEILING TILE TO MATCH EXISTING.

## GENERAL NOTES:

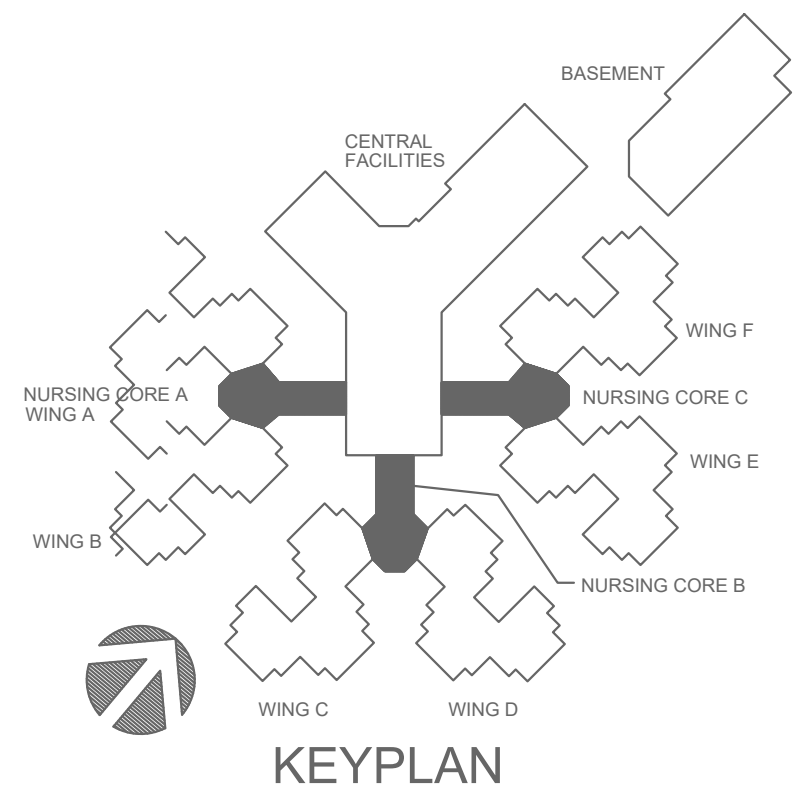1. FOR ALL PLUMBING OR HVAC QUESTIONS DURING BIDDING OR DURING CONSTRUCTION, CONTACT ESTERLY, SCHNEIDER & ASSOCIATES, INC. THOM LUNDBERG (417-862-0558) FOR COORDINATION WITH TYLER ENSERRO AT RTM ENGINEERING CONSULTANTS.
2. INFORMATION ON THESE DRAWINGS REPRESENT INFORMATION FROM EXISTING DRAWINGS AND LIMITED SITE OBSERVATIONS. CONTRACTOR SHALL FIELD VERIFY EXISTING CONDITIONS PRIOR TO SUBMITTING BID. NO EXTRAS SHALL BE PAID DUE TO UNANTICIPATED CONDITIONS.
3. CONTRACTOR SHALL BE RESPONSIBLE FOR ALL CORING, PATCH, AND REPAIR OF ALL WALL AND FLOOR SYSTEM AS REQUIRED DUE TO NEW CONSTRUCTION. MAINTAIN ALL FIRE RATINGS.
4. FOR ALL EXISTING FIXTURES, EQUIPMENT, ETC. SHOWN TO BE REMOVED, THE OWNER SHALL HAVE THE FIRST RIGHT OF REFUSAL.
5. CONTRACTOR SHALL REMOVE AND REPLACE CEILING TILE AND CEILING GRID AS REQUIRED TO PERFORM ALL DEMOLITION AND IMPROVEMENT WORK. CONTRACTOR SHALL REPLACE ALL DAMAGED CEILING TILE TO MATCH EXISTING.
6. REMOVE ALL ABANDONED PIPING WITHIN THE AREAS OF CONSTRUCTION/RENOVATION. NO EXISTING PIPING SHALL BE ABANDONED IN PLACE AND ANY EXISTING ABANDONED PIPING SHALL BE REMOVED.



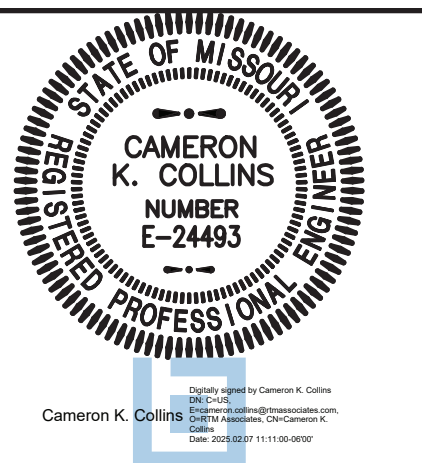STATE OF MISSOURI  
MIKE KEHOE,  
GOVERNOR



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620 N. JEFFERSON  
ST. JAMES, MISSOURI

PROJECT # **U1503-01**  
SITE # **6801**  
ASSET # **8136801002**  
FEDERAL # **29-044**

REVISION: \_\_\_\_\_  
DATE: \_\_\_\_\_  
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REVISION: \_\_\_\_\_  
DATE: \_\_\_\_\_  
ISSUE DATE: **8-1-24**

CAD DWG FILE: **M-104.DWG**  
DRAWN BY: **TSE**  
CHECKED BY: **CRK**  
DESIGNED BY: **TSE**

SHEET TITLE:  
**HVAC & PLUMBING DEMO PLAN**

SHEET NUMBER:

**M-104**

55 OF 120 SHEETS

8-1-24

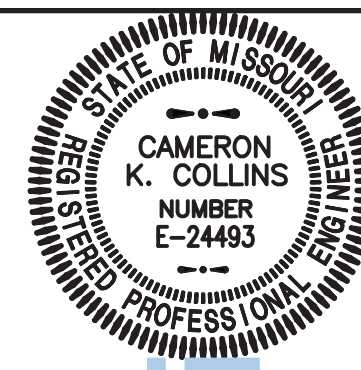
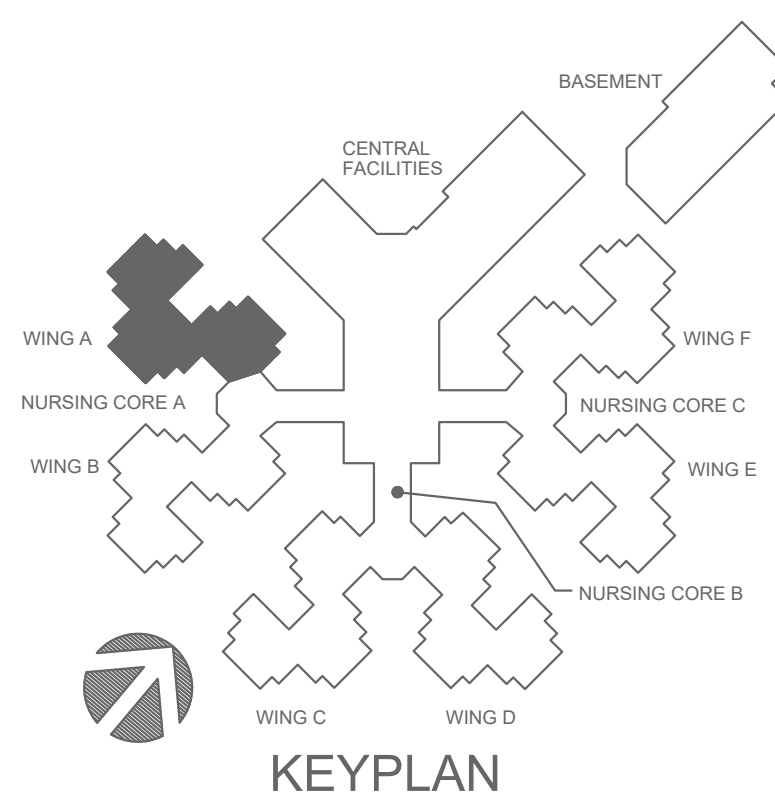




- ① REMOVE EXISTING THERMOSTAT AND PREPARE WALL SURFACE FOR REPLACEMENT THERMOSTAT.
- ② REMOVE EXISTING HORIZONTAL 4-PIPE FAN COIL UNIT. REMOVE ALL EXISTING VALVING AND PIPING LOGIC TO COIL. REMOVE THE SHUT OFF VALVE. REMOVE AND REPLACE EXISTING DIELECTRIC FITTINGS ON THE OWS, OPW, HMS & EXISTING STEEL METAL WORK AS REQUIRED TO ACCOMMODATE NEW FAN COIL UNIT. CUT AND PATCH HARD CEILING WHERE REQUIRED TO REMOVE UNIT AND PROVIDE ACCESS PANELS FOR NEW UNIT.
- ③ REMOVE EXISTING SHOWER VALVE AND SHOWER HEAD AND REPLACE PER IMPROVEMENT PLANS
- ④ EXISTING AIR HANDLING UNIT AND ALL ASSOCIATED SHEET METAL WORK, PIPING, VALVING, POWER AND CONTROLS TO REMAIN.
- ⑤ EXISTING HOT WATER COIL TO REMAIN. REMOVE ALL EXISTING VALVING AND PIPING LOGIC TO COIL INCLUDING 1/2-1/4" OFF WALL VALVE. REMOVE AND REPLACE IMPROVEMENT PLANS. REMOVE AND REPLACE EXISTING DIELECTRIC FITTINGS ON THE HMS & HMR BRANCH PIPING.
- ⑥ REMOVE EXISTING FLUSH VALVE AND REPLACE PER IMPROVEMENT PLAN
- ⑦ REMOVE EXISTING FAUCET AND REPLACE PER IMPROVEMENT PLAN M-118.
- ⑧ REMOVE AND REPLACE EXISTING EXHAUST FAN.
- ⑨ RELOCATE RETURN AIR GRILLE.
- ⑩ REMOVE EXISTING EXHAUST GRILLE. REFER TO IMPROVEMENT PLAN FOR NEW GRILLE
- ⑪ REMOVE EXISTING DUCTWORK FOR NEW DUCT REPLACEMENT. REFER TO 1/7A-116 FOR NEW DUCTWORK SIZE.
- ⑫ REMOVE EXISTING DUCT TAP. PATCH MAIN TRUNK WITH METAL AND INSULATION. REFER TO 1/7A-116 FOR CONNECTION TO NEW DUCTWORK
- ⑬ UNDER BASE BID, EXISTING EXHAUST FAN AND ASSOCIATED DUCTWORK AND SOFFIT GRILLE SHALL REMAIN. UNDER BASE BID ALTERNATE #1, REMOVE EXISTING EXHAUST FAN, DOWNSTREAM DUCTWORK AND SOFFIT GRILLE. REPLACE WITH NEW ROOF MOUNTED EXHAUST FAN. REFER TO 1/7A-133 FOR ALTERNATE #1 IMPROVEMENT PLAN.
- ⑭ UNDER BASE BID, EXISTING DIFFUSER AND FLEX DUCT SHALL REMAIN. UNDER NEW DUCTWORK ROUTED THROUGH THIS AREA, UNDER BASE BID ALTERNATE #2, REMOVE EXISTING STORAGE AREA, UNDER AND SOFFIT GRILLE. REPLACE WITH NEW DUCTWORK FOR NEW MEDICAL STORAGE ROOM ADDITION. REFER TO 1/7A-116 FOR ALTERNATE #2 AND BASE BID IMPROVEMENT PLAN.

**GENERAL NOTES:**

4. FOR ALL PLUMBING OR HVAC QUESTIONS DURING BIDDING OR DURING CONSTRUCTION, CONTACT ESTERLY, SCHNEIDER & ASSOCIATES, INC., 10000 W. 10TH AVE., SUITE 100, DENVER, CO 80233, FOR COORDINATION WITH TYLEE ENSERO AT RTM ENGINEERING CONSULTANTS.
5. INFORMATION ON THESE DRAWINGS REPRESENT INFORMATION PROVIDED BY THE ARCHITECT AND LIMITED SITE OBSERVATION. CONTRACTOR SHALL FIELD VERIFY EXISTING CONDITIONS PRIOR TO SUBMITTING ANY REQUESTS FOR PROPOSALS. CONTRACTOR SHALL BE RESPONSIBLE FOR ANY EXTRAS SHALL BE PAID DUE TO UNANTICIPATED CONDITIONS.
6. CONTRACTOR SHALL BE RESPONSIBLE FOR ALL CORING, PATCH, AND REPAIR OF ALL WALL AND FLOOR SYSTEM AS REQUIRED DUE TO NEW CONSTRUCTION. MAINTAIN ALL FIRE RATINGS.
7. FOR ALL EXISTING FIXTURES, EQUIPMENT, ETC. SHOWN TO BE REMOVED, THE OWNER SHALL HAVE THE FIRST RIGHT OF REUSE.
8. CONTRACTOR SHALL REMOVE AND REPLACE CEILING TILE AND CEILING GRID AS REQUIRED TO PERFORM ALL DEMOLITION AND IMPROVEMENT WORK. CONTRACTOR SHALL REPLACE ALL EXISTING CEILING TILE AND CEILING GRID AS REQUIRED.
9. REMOVE ALL ABANDONED PIPING WITHIN THE AREAS OF CONSTRUCTION/RENOVATION. NO EXISTING PIPING SHALL BE ABANDONED IN PLACE AND ANY EXISTING ABANDONED PIPING SHALL BE REMOVED.



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PROJECT # **U1503-01**  
SITE # **6801**  
ASSET # **8136801002**  
FEDERAL # **29-044**

REVISION: \_\_\_\_\_  
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REVISION: \_\_\_\_\_  
DATE: \_\_\_\_\_  
ISSUE DATE: **8-1-24**

CAD DWG FILE: **M-105.DWG**  
 DRAWN BY: **TSE**  
 CHECKED BY: **CKC**  
 DESIGNED BY: **TSE**

SHEET TITLE:

## HVAC & PLUMBING DEMO PLAN

SHEET NUMBER:

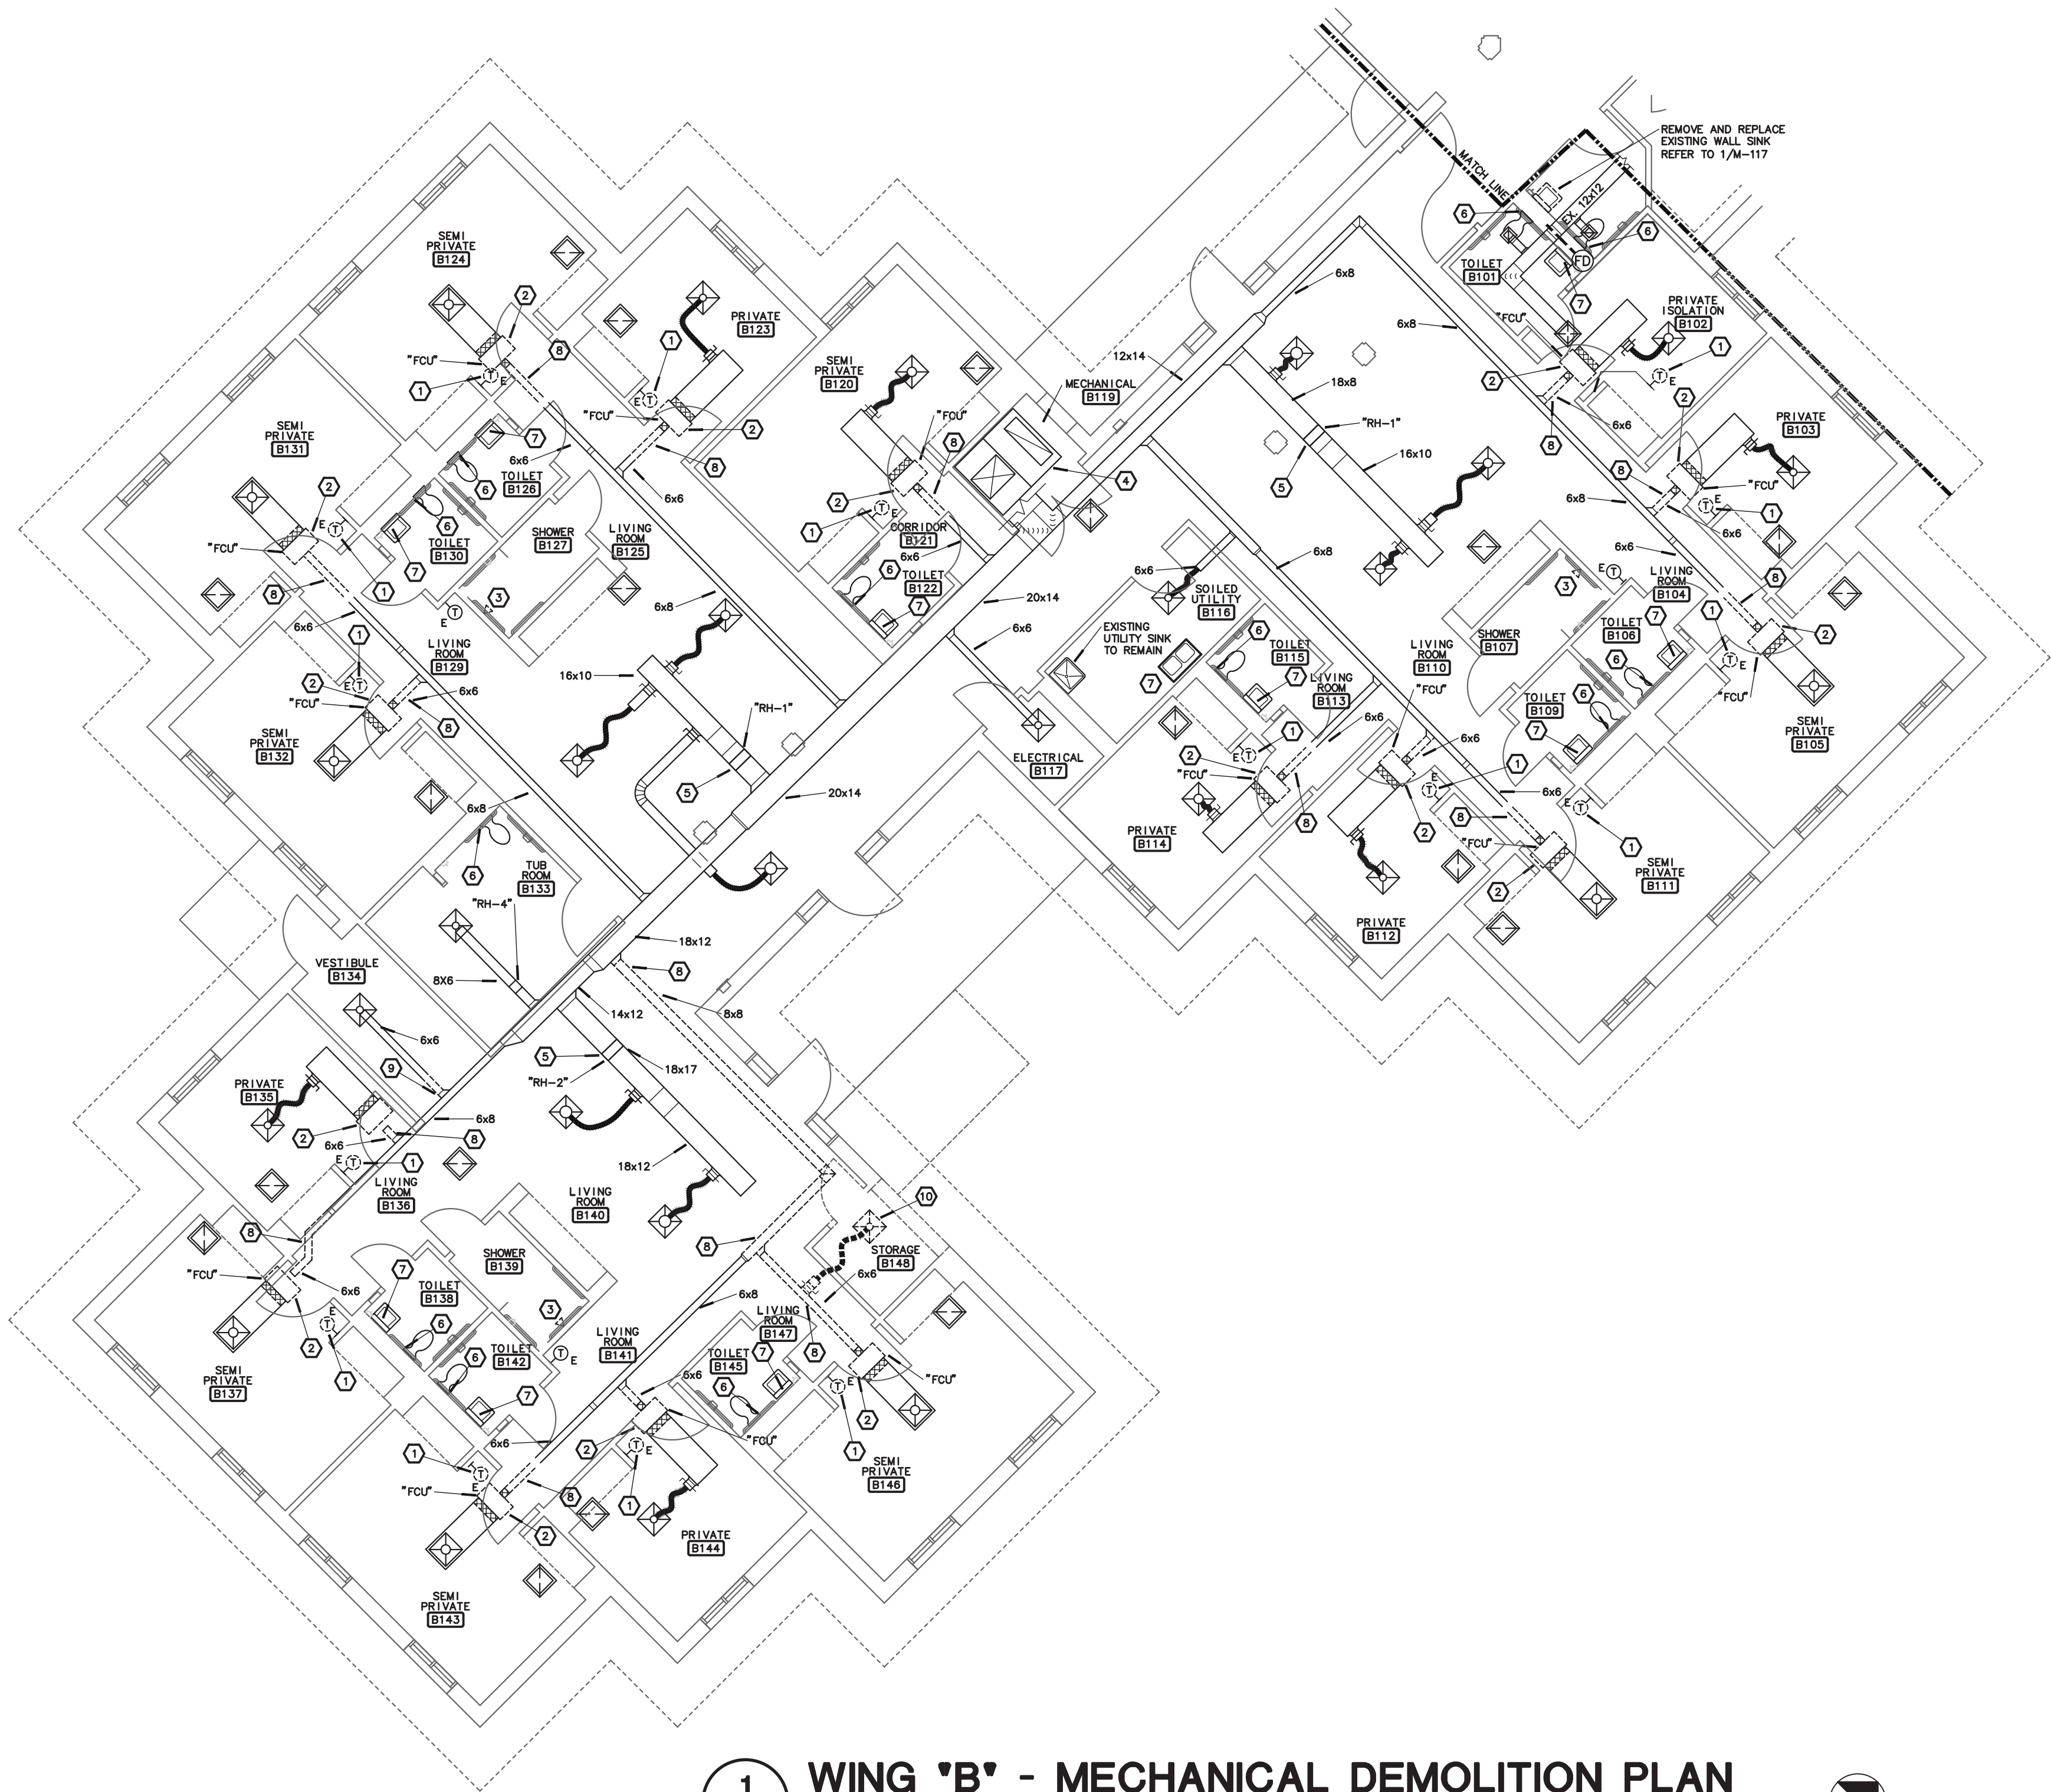
M-105

56 OF 120 SHEETS

8-1-24



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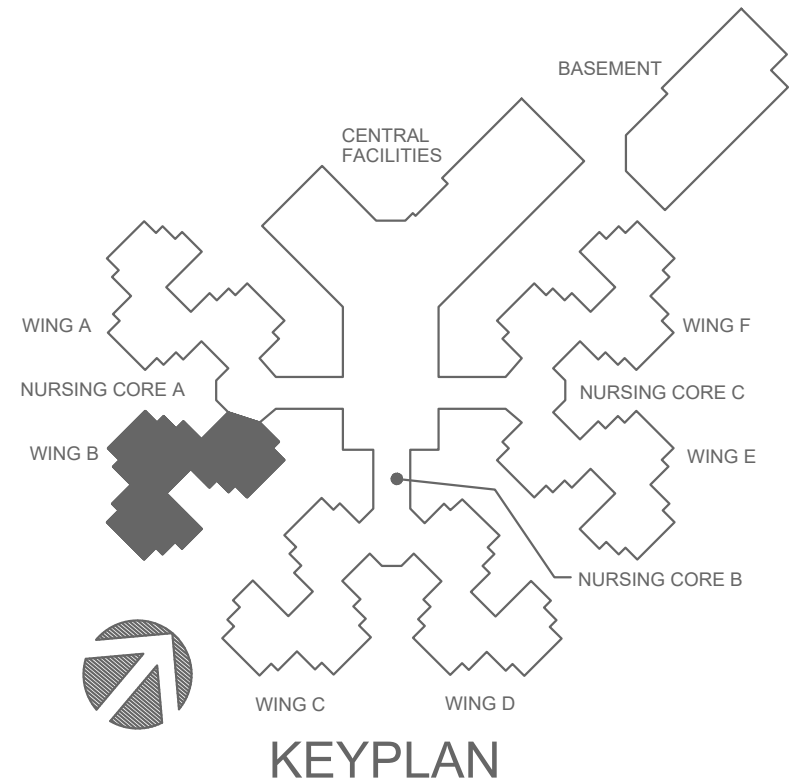


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M-106


## WING 'B' - MECHANICAL DEMOLITION PLAN

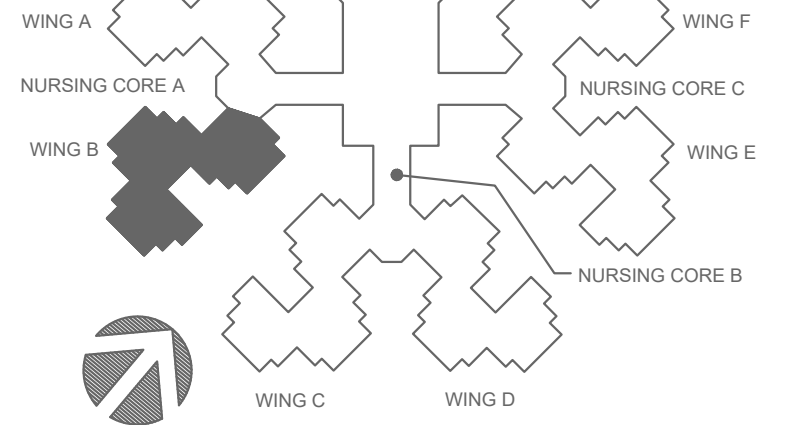SCALE: 1/8"=1'-0"

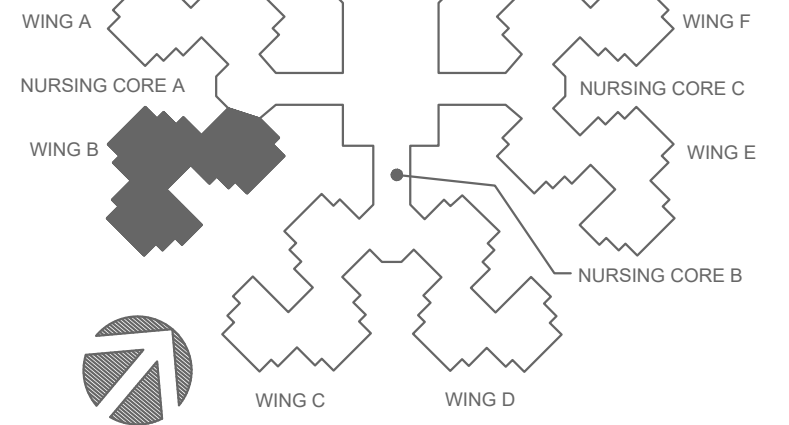
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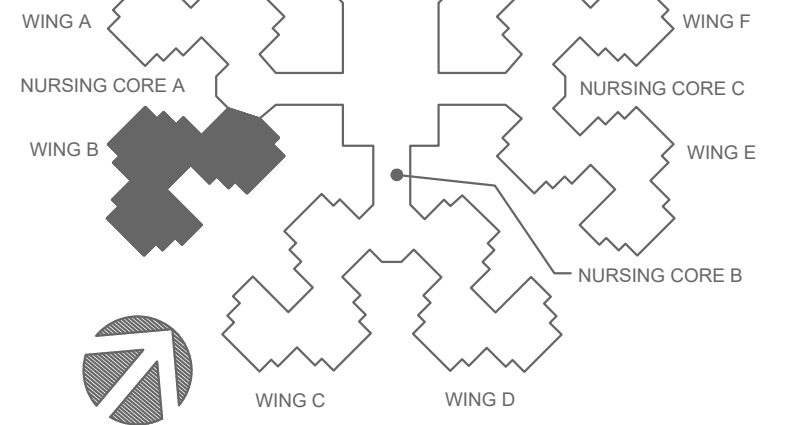
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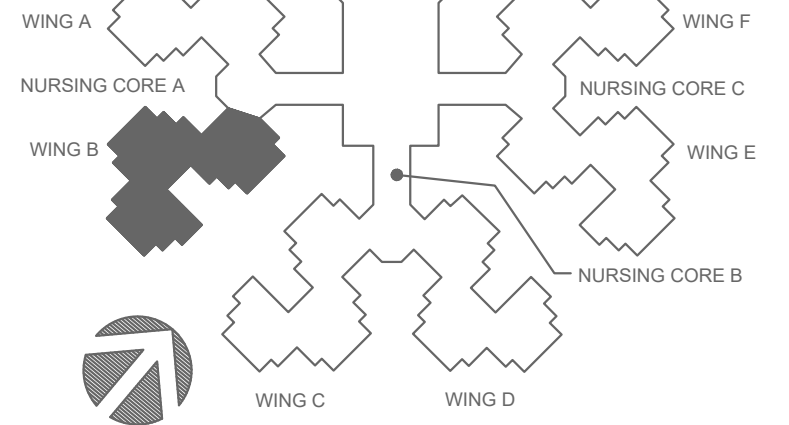
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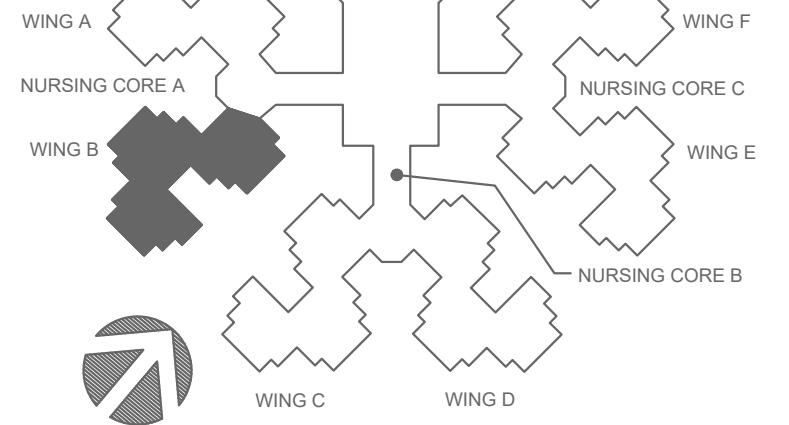
KEYPLAN



KEYPLAN



KEYPLAN









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1 WING 'D' - MECHANICAL DEMOLITION PLAN  
SCALE: 1/8"=1'-0"




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3333 E. Battlefield Road, Ste. 1000  
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rtm.com | 417.881.0020  
State of Missouri certificate of authority  
#2014035826 for engineering

## NOTES:

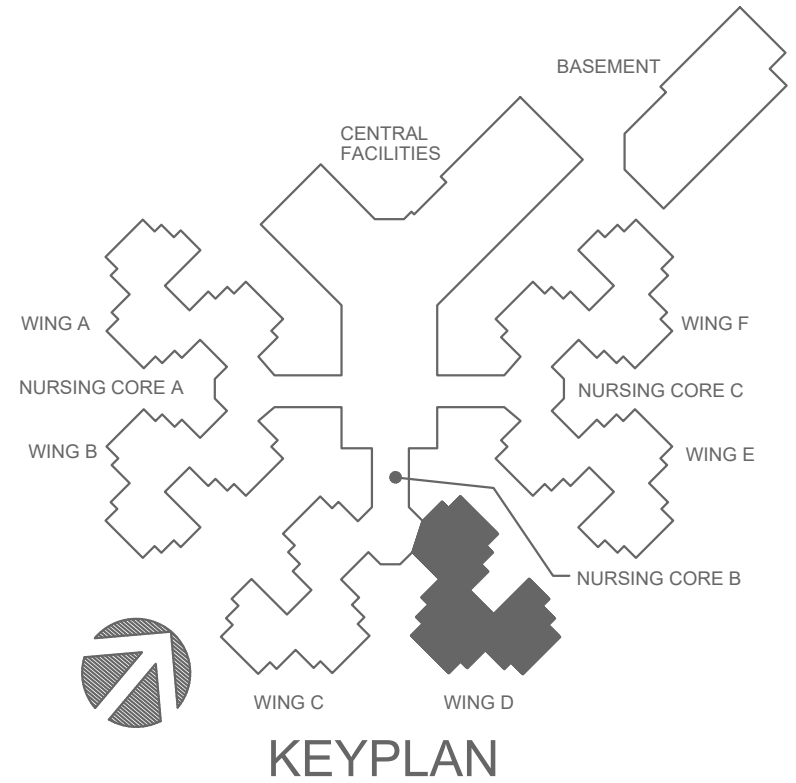
1. REMOVE EXISTING THERMOSTAT AND PREPARE WALL SURFACE FOR REPLACEMENT THERMOSTAT.
2. REMOVE EXISTING HORIZONTAL 4-PIPE FAN COIL UNIT. REMOVE ALL EXISTING VALVING AND PIPING LOCAL TO COIL INCLUDING THE SHUT-OFF VALVES. REMOVE AND REPLACE EXISTING DIELECTRIC FITTINGS ON THE CWS, CWR, HWS & HWR BRANCH PIPING. REMOVE, REPLACE, OR MODIFY EXISTING SHEET METAL WORK AS REQUIRED TO ACCOMMODATE NEW FAN COIL UNIT. CUT AND PATCH HARD CEILING WHERE REQUIRED TO REMOVE UNIT AND PROVIDE ACCESS PANEL FOR NEW UNIT.
3. REMOVE EXISTING SHOWER VALVE AND SHOWER HEAD AND REPLACE PER IMPROVEMENT PLAN M-119.
4. EXISTING AIR HANDLING UNIT AND ALL ASSOCIATED SHEET METAL WORK, PIPING, VALVING, POWER AND CONTROLS TO REMAIN.
5. EXISTING HOT WATER COIL TO REMAIN. REMOVE ALL EXISTING VALVING AND PIPING LOCAL TO COIL INCLUDING THE SHUT-OFF VALVES AND REPLACE PER IMPROVEMENT PLANS. REMOVE AND REPLACE EXISTING DIELECTRIC FITTINGS ON THE CWS, CWR, HWS & HWR BRANCH PIPING.
6. REMOVE EXISTING FLUSH VALVE AND REPLACE PER IMPROVEMENT PLAN M-119.
7. REMOVE EXISTING FAUCET AND REPLACE PER IMPROVEMENT PLAN M-119.
8. REMOVE EXISTING DUCTWORK FOR NEW DUCT REPLACEMENT. REFER TO 1/M-119 FOR NEW DUCTWORK SIZE.
9. REMOVE EXISTING DUCT TAP. PATCH MAIN TRUNK WITH METAL AND INSULATION. REFER TO 1/M-119 FOR CONNECTION TO EXISTING DUCTWORK.
10. UNDER BASE BID, THE EXISTING DIFFUSER AND FLEX DUCT SHALL REMAIN AND SHALL BE RECONNECTED TO NEW DUCTWORK PER THE IMPROVEMENT PLANS. UNDER ALTERNATE BID #2 REMOVE EXISTING DUCTWORK AND DIFFUSERS AND PROVIDE NEW PER IMPROVEMENT PLANS. REFER TO 1/M-119 FOR IMPROVEMENT PLANS.

## GENERAL NOTES:

1. FOR ALL PLUMBING OR HVAC QUESTIONS DURING BIDDING OR DURING CONSTRUCTION, CONTACT ESTERLY, SCHNEIDER & ASSOCIATES, INC. THOM LUNDGREN (417-862-0558) FOR COORDINATION WITH TYLER ENSERRO AT RTM ENGINEERING CONSULTANTS.
2. INFORMATION ON THESE DRAWINGS REPRESENT INFORMATION FROM EXISTING DRAWINGS AND LIMITED SITE OBSERVATIONS. CONTRACTOR SHALL FIELD VERIFY EXISTING CONDITIONS PRIOR TO SUBMITTING BID. NO EXTRAS SHALL BE PAID DUE TO UNANTICIPATED CONDITIONS.
3. CONTRACTOR SHALL BE RESPONSIBLE FOR ALL CORING, PATCH, AND REPAIR OF ALL WALL AND FLOOR SYSTEM AS REQUIRED DUE TO NEW CONSTRUCTION. MAINTAIN ALL FIRE RATINGS.
4. FOR ALL EXISTING FIXTURES, EQUIPMENT, ETC. SHOWN TO BE REMOVED, THE OWNER SHALL HAVE THE FIRST RIGHT OF REFUSAL.
5. CONTRACTOR SHALL REMOVE AND REPLACE CEILING TILE AND CEILING GRID AS REQUIRED TO PERFORM ALL DEMOLITION AND IMPROVEMENT WORK. CONTRACTOR SHALL REPLACE ALL DAMAGED CEILING TILE TO MATCH EXISTING.
6. REMOVE ALL ABANDONED PIPING WITHIN THE AREAS OF CONSTRUCTION/RENOVATION. NO EXISTING PIPING SHALL BE ABANDONED IN PLACE AND ANY EXISTING ABANDONED PIPING SHALL BE REMOVED.



STATE OF MISSOURI  
MIKE KEHOE,  
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architects & planners  
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DEPARTMENT OF  
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MISSOURI VETERANS  
COMMISSION

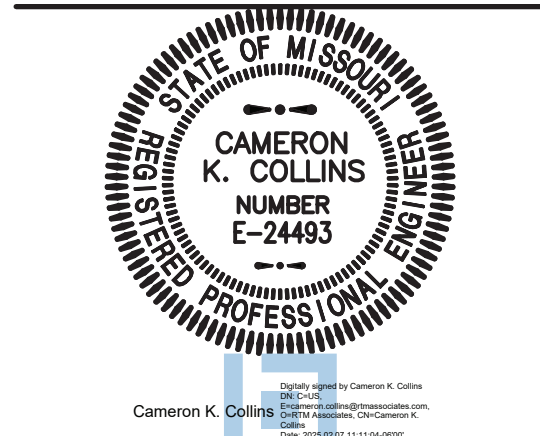INTERIOR RENOVATION  
MISSOURI VETERANS  
HOME

620 N. JEFFERSON  
ST. JAMES, MISSOURI

PROJECT # U1503-01  
SITE # 6801  
ASSET # 8136801002  
FEDERAL # 29-044

REVISION: \_\_\_\_\_  
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REVISION: \_\_\_\_\_  
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ISSUE DATE: 8-1-24

CAD DWG FILE: M-108.DWG  
DRAWN BY: TSE  
CHECKED BY: CRC  
DESIGNED BY: TSE

SHEET TITLE:  
**HVAC &  
PLUMBING  
DEMO PLAN**


SHEET NUMBER:

**M-108**  
59 OF 120 SHEETS

8-1-24



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1 WING 'E' - MECHANICAL DEMOLITION PLAN  
M-109 SCALE: 1/8"=1'-0" NORTH

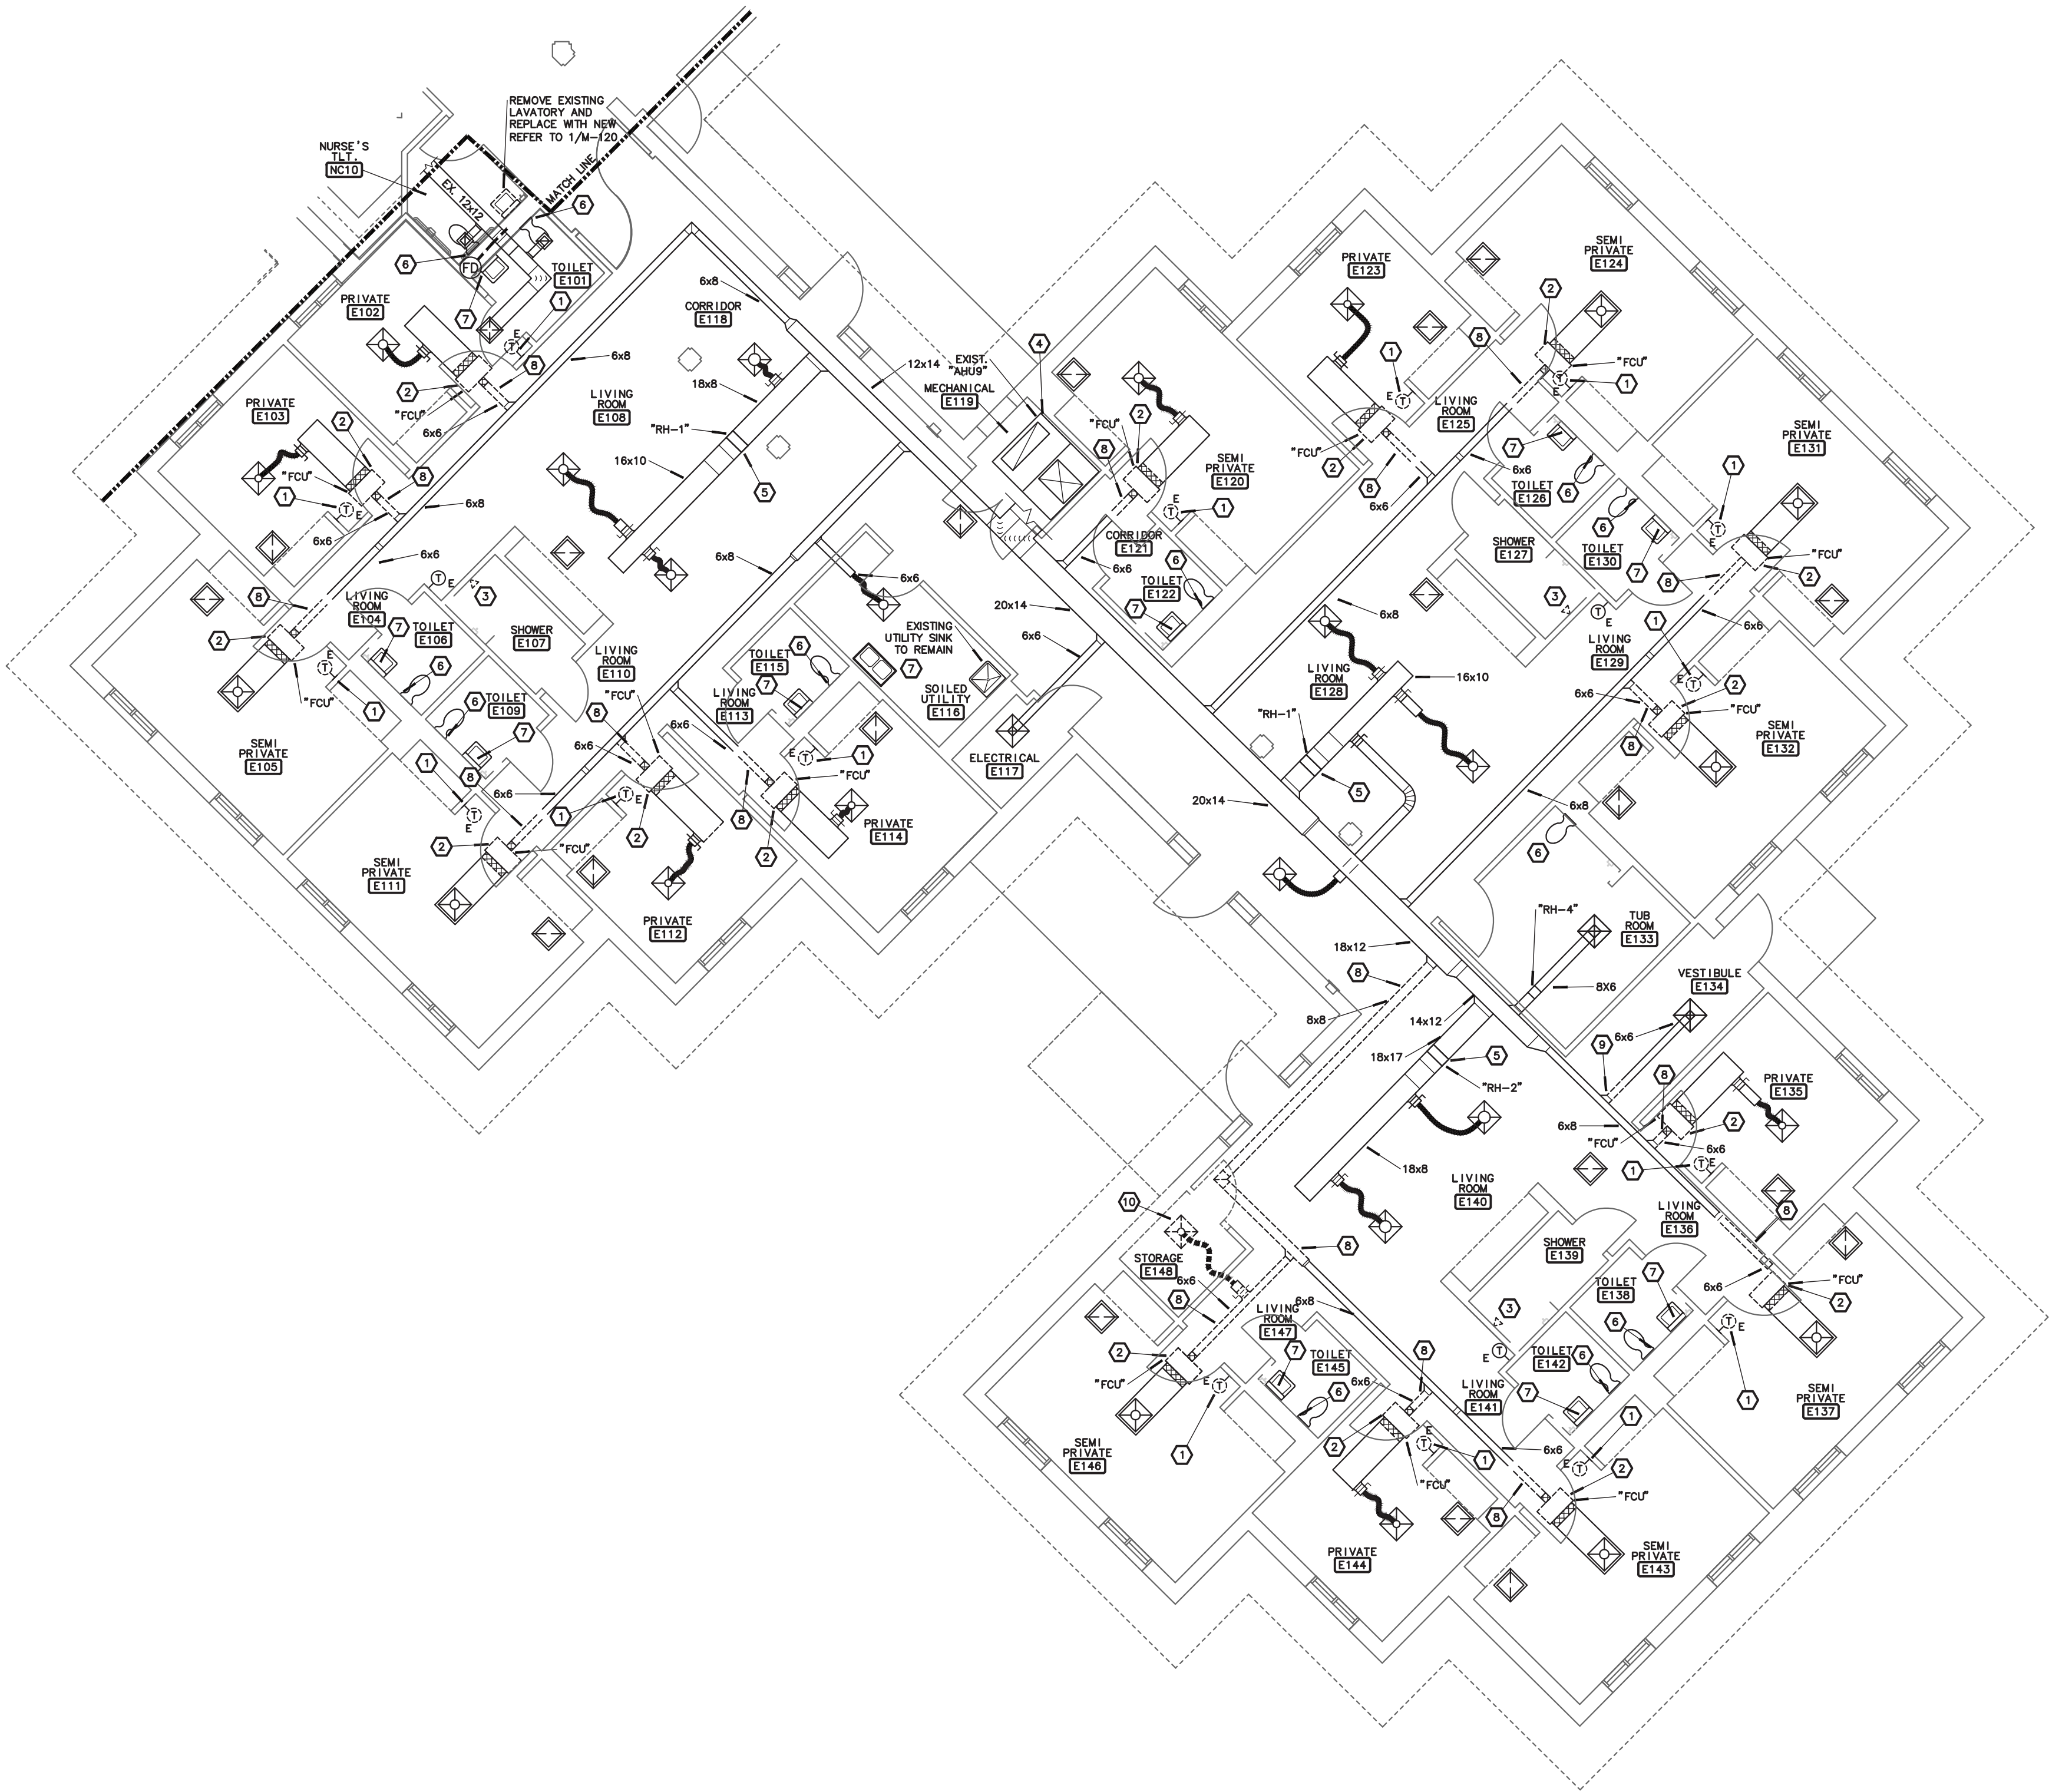
engineering consultants  
3333 E. Battlefield Road, Ste. 1000  
Springfield, MO 65804  
rtmec.com | 417.881.0020  
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## NOTES:


1. REMOVE EXISTING THERMOSTAT AND PREPARE WALL SURFACE FOR REPLACEMENT THERMOSTAT.
2. REMOVE EXISTING HORIZONTAL 4-PIPE FAN COIL UNIT. REMOVE ALL EXISTING VALVING AND PIPING LOCAL TO COIL INCLUDING THE SHUT-OFF VALVES. REMOVE AND REPLACE EXISTING DIELECTRIC FITTINGS ON THE CWS, CWR, HWS & HWR BRANCH PIPING. REMOVE, REPLACE, OR MODIFY EXISTING SHEET METAL WORK AS REQUIRED TO ACCOMMODATE NEW FAN COIL UNIT. CUT AND PATCH HARD CEILING WHERE REQUIRED TO REMOVE UNIT AND PROVIDE ACCESS PANEL FOR NEW UNIT.
3. REMOVE EXISTING SHOWER VALVE AND SHOWER HEAD AND REPLACE PER IMPROVEMENT PLAN M-120.
4. EXISTING AIR HANDLING UNIT AND ALL ASSOCIATED SHEETMETAL WORK, PIPING, VALVING, POWER AND CONTROLS TO REMAIN.
5. EXISTING HOT WATER COIL TO REMAIN. REMOVE ALL EXISTING VALVING AND PIPING LOCAL TO COIL INCLUDING THE SHUT-OFF VALVES AND REPLACE PER IMPROVEMENT PLANS. REMOVE AND REPLACE EXISTING DIELECTRIC FITTINGS ON THE CWS, CWR, HWS & HWR BRANCH PIPING.
6. REMOVE EXISTING FLUSH VALVE AND REPLACE PER IMPROVEMENT PLAN M-120.
7. REMOVE EXISTING FAUCET AND REPLACE PER IMPROVEMENT PLAN M-120.
8. REMOVE EXISTING DUCTWORK FOR NEW DUCT REPLACEMENT. REFER TO 1/M-120 FOR NEW DUCTWORK SIZE.
9. REMOVE EXISTING DUCT TAP. PATCH MAIN TRUNK WITH METAL AND INSULATION. REFER TO 1/M-120 FOR CONNECTION TO EXISTING DUCTWORK.
10. UNDER BASE BID, THE EXISTING DIFFUSER AND FLEX DUCT SHALL REMAIN AND SHALL BE RECONNECTED TO NEW DUCTWORK PER THE IMPROVEMENT PLANS. UNDER ALTERNATE BID #2 REMOVE EXISTING DUCTWORK AND DIFFUSERS AND PROVIDE NEW PER IMPROVEMENT PLANS. REFER TO 1/M-120 FOR IMPROVEMENT PLANS.

## GENERAL NOTES:

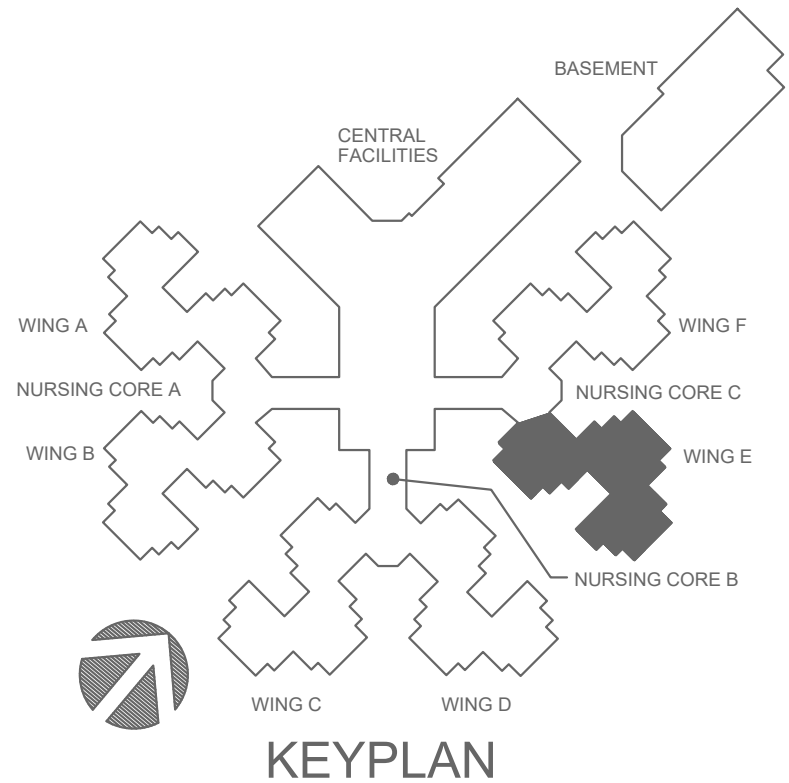1. FOR ALL PLUMBING OR HVAC QUESTIONS DURING BIDDING OR DURING CONSTRUCTION, CONTACT ESTERLY, SCHNEIDER & ASSOCIATES, INC. THOM LUNDGREN (417-862-0558) FOR COORDINATION WITH TYLER ENSERRO AT RTM ENGINEERING CONSULTANTS.
2. INFORMATION ON THESE DRAWINGS REPRESENT INFORMATION FROM EXISTING DRAWINGS AND LIMITED SITE OBSERVATIONS. CONTRACTOR SHALL FIELD VERIFY EXISTING CONDITIONS PRIOR TO SUBMITTING BID. NO EXTRAS SHALL BE PAID DUE TO UNANTICIPATED CONDITIONS.
3. CONTRACTOR SHALL BE RESPONSIBLE FOR ALL CORING, PATCH, AND REPAIR OF ALL WALL AND FLOOR SYSTEM AS REQUIRED DUE TO NEW CONSTRUCTION. MAINTAIN ALL FIRE RATINGS.
4. FOR ALL EXISTING FIXTURES, EQUIPMENT, ETC. SHOWN TO BE REMOVED, THE OWNER SHALL HAVE THE FIRST RIGHT OF REFUSAL.
5. CONTRACTOR SHALL REMOVE AND REPLACE CEILING TILE AND CEILING GRID AS REQUIRED TO PERFORM ALL DEMOLITION AND IMPROVEMENT WORK. CONTRACTOR SHALL REPLACE ALL DAMAGED CEILING TILE TO MATCH EXISTING.
6. REMOVE ALL ABANDONED PIPING WITHIN THE AREAS OF CONSTRUCTION/RENOVATION. NO EXISTING PIPING SHALL BE ABANDONED IN PLACE AND ANY EXISTING ABANDONED PIPING SHALL BE REMOVED.



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MIKE KEHOE,  
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620 N. JEFFERSON  
ST. JAMES, MISSOURI

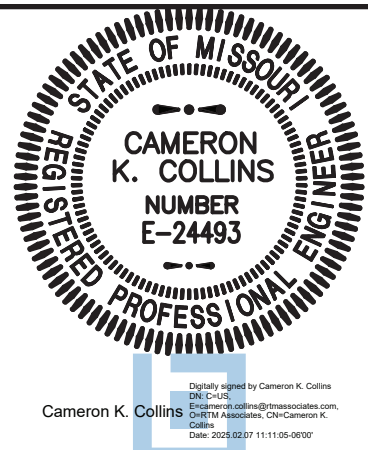PROJECT # U1503-01  
SITE # 6801  
ASSET # 8136801002  
FEDERAL # 29-044

REVISION: \_\_\_\_\_  
DATE: \_\_\_\_\_  
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DATE: \_\_\_\_\_  
ISSUE DATE: 8-1-24

CAD DWG FILE: M-109.DWG  
DRAWN BY: TSE  
CHECKED BY: CRC  
DESIGNED BY: TSE

SHEET TITLE:

HVAC &  
PLUMBING  
DEMO PLAN

SHEET NUMBER:


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60 OF 120 SHEETS

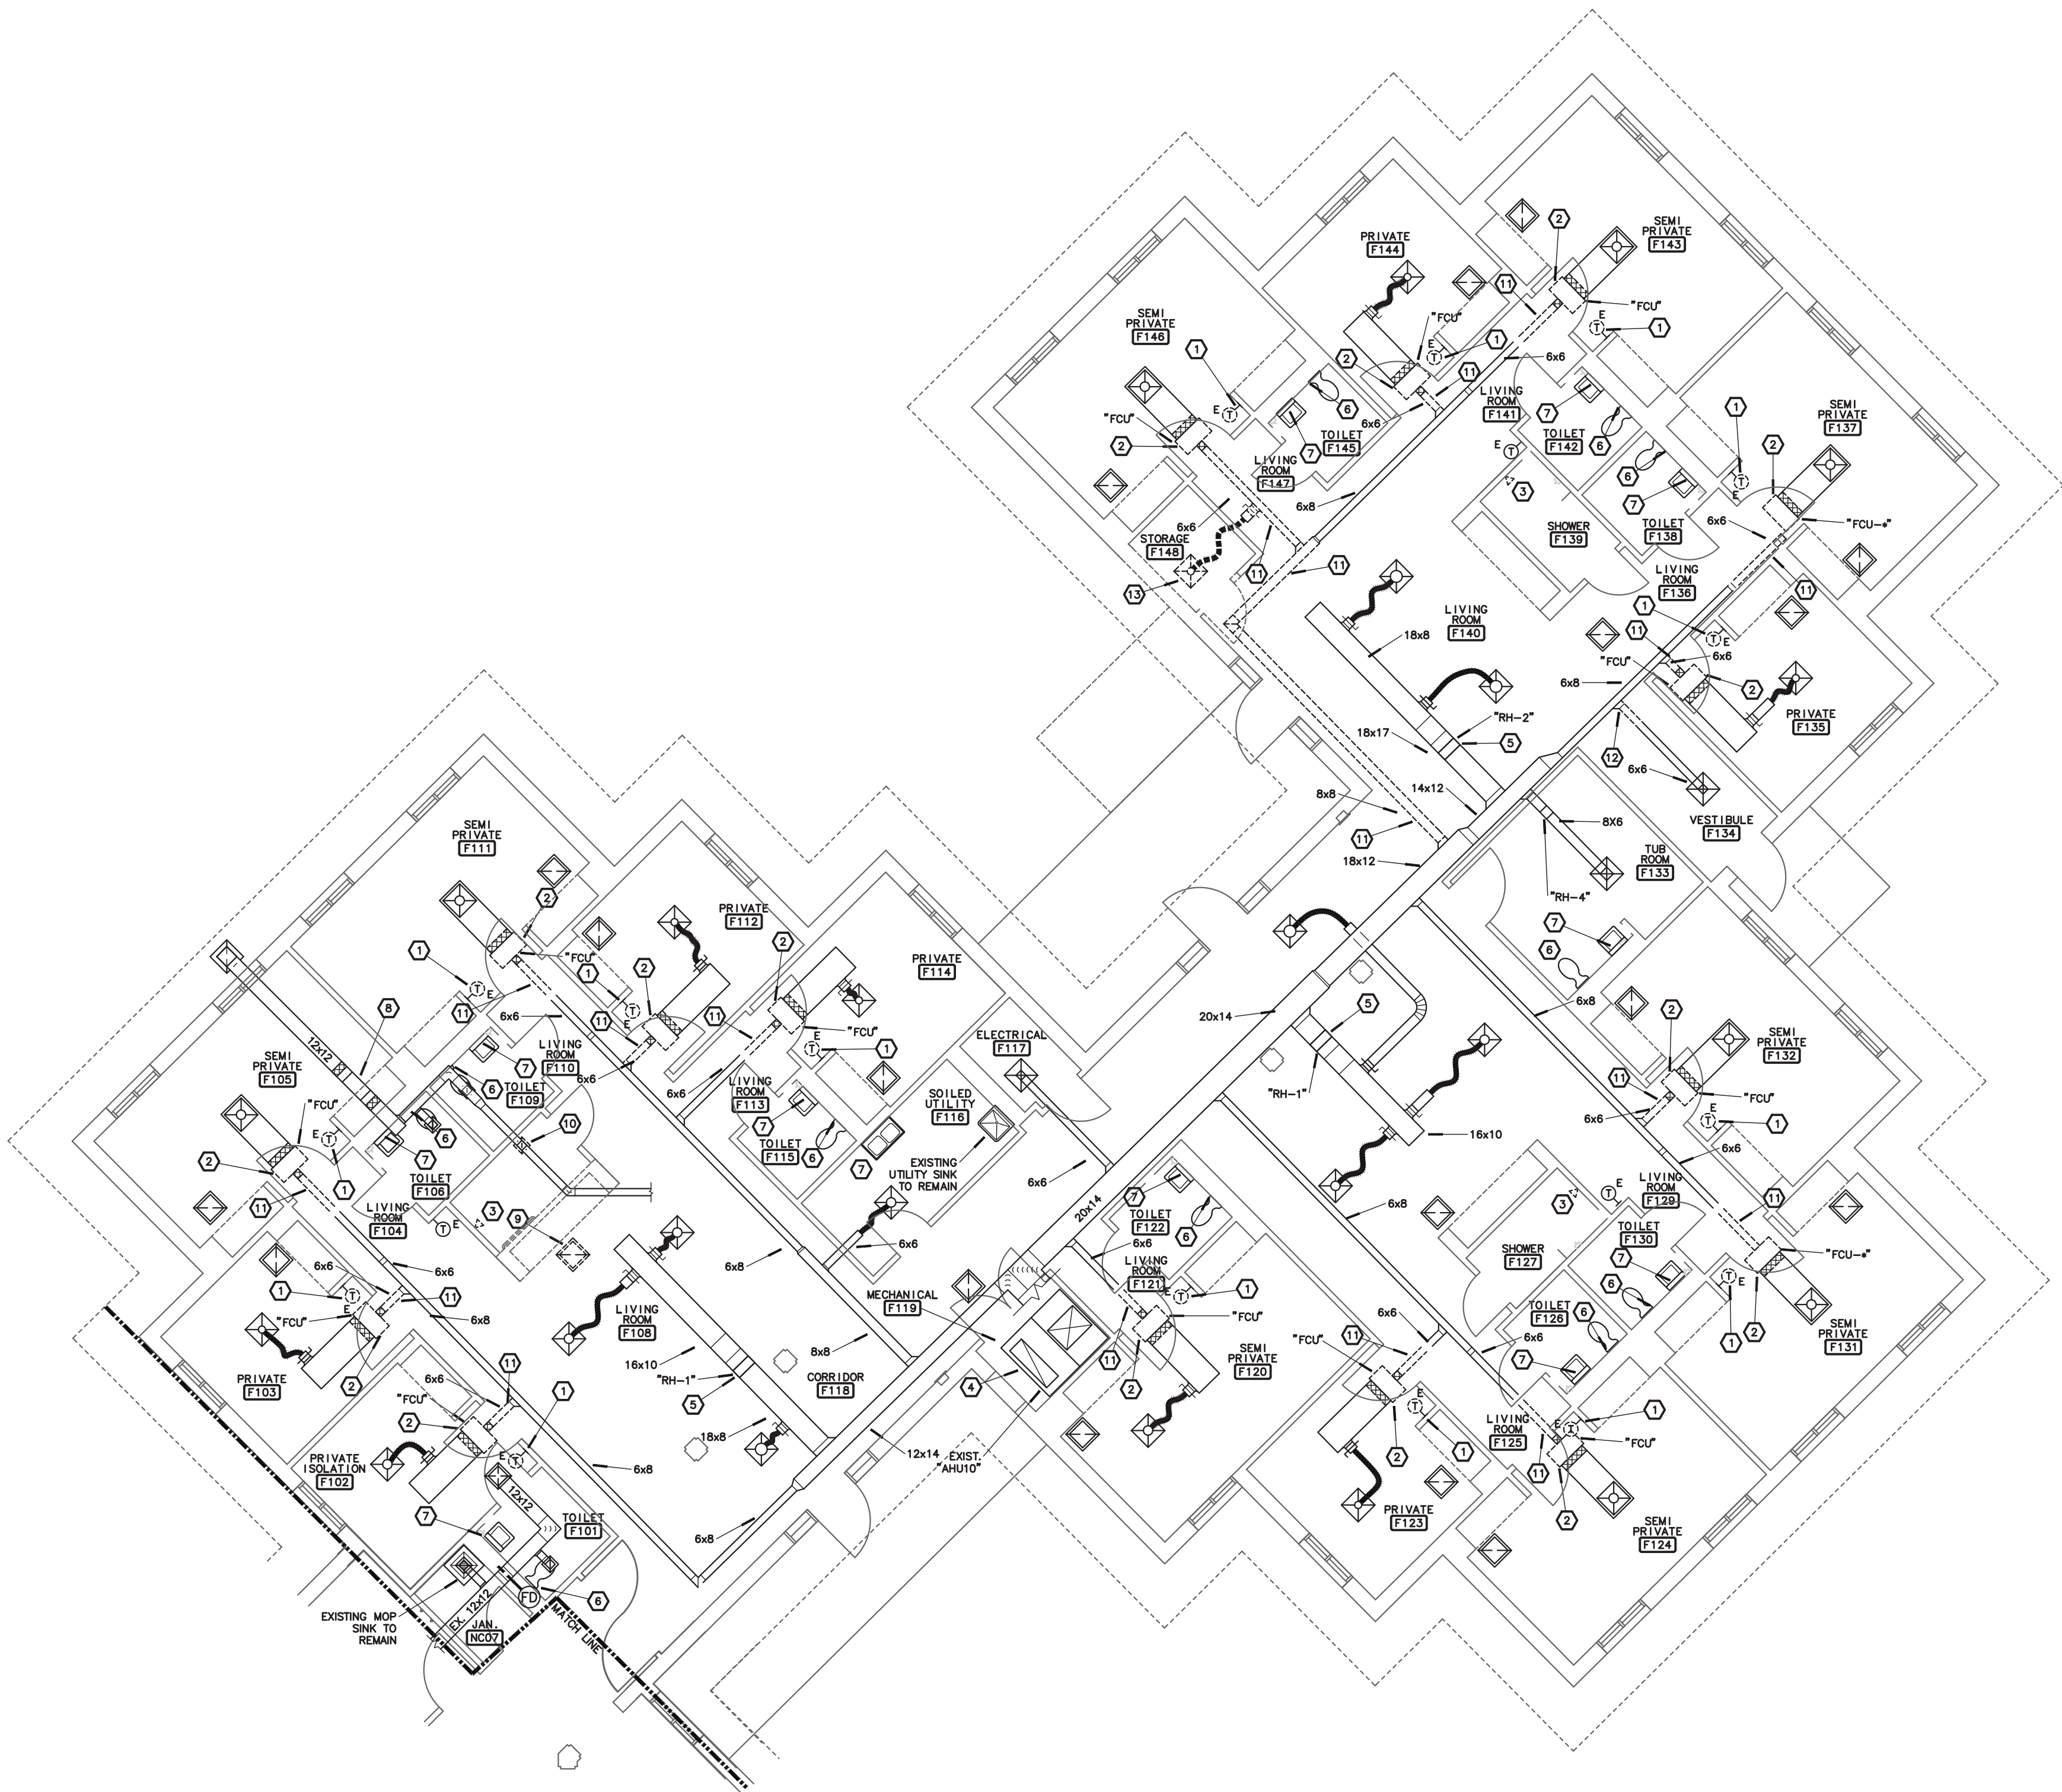8-1-24



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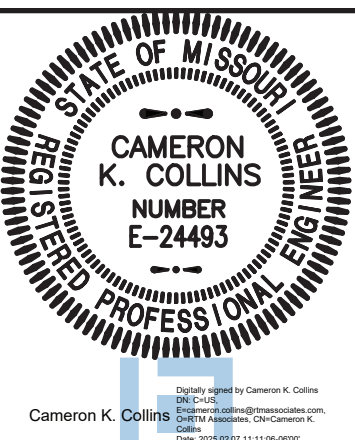
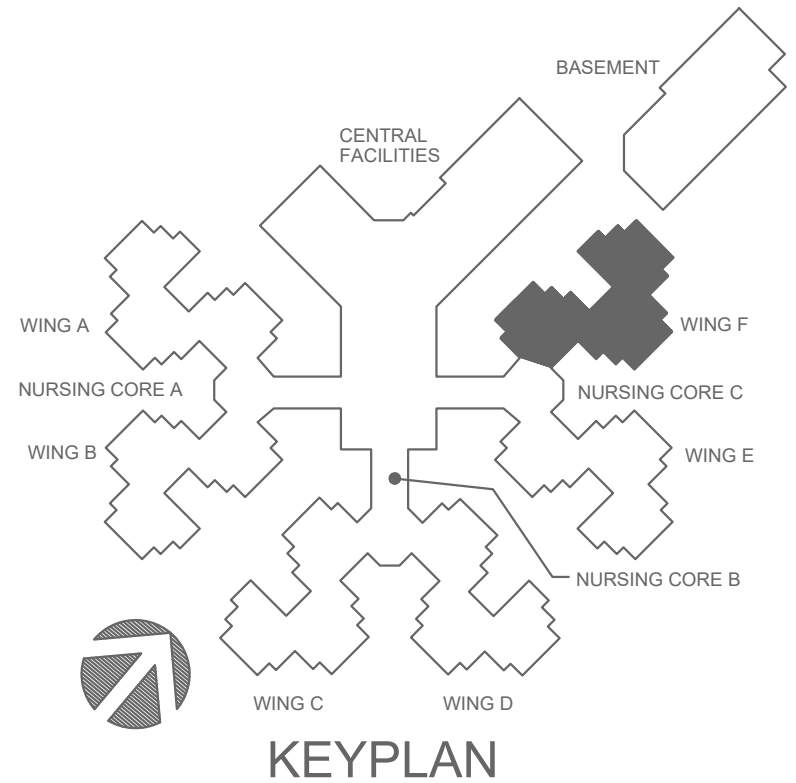
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**M-110** **WING 'F' - MECHANICAL DEMOLITION PLAN**  
SCALE: 1/8"=1'-0" NORTH

**NOTES:**

1. REMOVE EXISTING THERMOSTAT AND PREPARE WALL SURFACE FOR REPLACEMENT THERMOSTAT.
2. REMOVE EXISTING HORIZONTAL 4-PIPE FAN COIL UNIT. REMOVE ALL EXISTING VALVING AND PIPING LOCAL TO COIL INCLUDING THE SHUT-OFF VALVES. REMOVE AND REPLACE EXISTING DIELECTRIC FITTINGS ON THE CWS, CWR, HWS & HWR BRANCH PIPING. REMOVE, REPLACE, OR MODIFY EXISTING SHEET METAL WORK AS REQUIRED TO ACCOMMODATE NEW FAN COIL UNIT. CUT AND PATCH HARD CEILING WHERE REQUIRED TO REMOVE UNIT AND PROVIDE ACCESS PANEL FOR NEW UNIT.
3. REMOVE EXISTING SHOWER VALVE AND SHOWER HEAD AND REPLACE PER IMPROVEMENT PLAN M-121.
4. EXISTING AIR HANDLING UNIT AND ALL ASSOCIATED SHEETMETAL WORK, PIPING, VALVING, POWER AND CONTROLS TO REMAIN.
5. EXISTING HOT WATER COIL TO REMAIN. REMOVE ALL EXISTING VALVING AND PIPING LOCAL TO COIL INCLUDING THE SHUT-OFF VALVES AND REPLACE PER IMPROVEMENT PLANS. REMOVE AND REPLACE EXISTING DIELECTRIC FITTINGS ON THE CWS, CWR, HWS & HWR BRANCH PIPING.
6. REMOVE EXISTING FLUSH VALVE AND REPLACE PER IMPROVEMENT PLAN M-121.
7. REMOVE EXISTING FAUCET AND REPLACE PER IMPROVEMENT PLAN M-121.
8. REMOVE AND REPLACE EXISTING EXHAUST FAN.
9. RELOCATE RETURN AIR GRILLE.
10. REMOVE EXISTING EXHAUST GRILLE. REFER TO IMPROVEMENT PLAN M-121 FOR NEW GRILLE.
11. REMOVE EXISTING DUCTWORK FOR NEW DUCT REPLACEMENT. REFER TO 1/M-121 FOR NEW DUCTWORK SIZE.
12. REMOVE EXISTING DUCT TAP. PATCH MAIN TRUNK WITH METAL AND INSULATION. REFER TO 1/M-121 FOR CONNECTION TO EXISTING DUCTWORK.
13. UNDER BASE BID, THE EXISTING DIFFUSER AND FLEX DUCT SHALL REMAIN AND SHALL BE RECONNECTED TO NEW DUCTWORK PER THE IMPROVEMENT PLANS. UNDER ALTERNATE BID #2 REMOVE EXISTING DUCTWORK AND DIFFUSERS AND PROVIDE NEW PER IMPROVEMENT PLANS. REFER TO 1/M-121 FOR IMPROVEMENT PLANS.

**GENERAL NOTES:**

1. FOR ALL PLUMBING OR HVAC QUESTIONS DURING BIDDING OR DURING CONSTRUCTION, CONTACT ESTERLY, SCHNEIDER & ASSOCIATES, INC. THOM LUNDGREN (417-862-0558) FOR COORDINATION WITH TYLER ENSERRO AT RTM ENGINEERING CONSULTANTS.
2. INFORMATION ON THESE DRAWINGS REPRESENT INFORMATION FROM EXISTING DRAWINGS AND LIMITED SITE OBSERVATIONS. CONTRACTOR SHALL FIELD VERIFY EXISTING CONDITIONS PRIOR TO SUBMITTING BID. NO EXTRAS SHALL BE PAID DUE TO UNANTICIPATED CONDITIONS.
3. CONTRACTOR SHALL BE RESPONSIBLE FOR ALL CORING, PATCH, AND REPAIR OF ALL WALL AND FLOOR SYSTEM AS REQUIRED DUE TO NEW CONSTRUCTION. MAINTAIN ALL FIRE RATINGS.
4. FOR ALL EXISTING FIXTURES, EQUIPMENT, ETC. SHOWN TO BE REMOVED, THE OWNER SHALL HAVE THE FIRST RIGHT OF REFUSAL.
5. CONTRACTOR SHALL REMOVE AND REPLACE CEILING TILE AND CEILING GRID AS REQUIRED TO PERFORM ALL DEMOLITION AND IMPROVEMENT WORK. CONTRACTOR SHALL REPLACE ALL DAMAGED CEILING TILE TO MATCH EXISTING.
6. REMOVE ALL ABANDONED PIPING WITHIN THE AREAS OF CONSTRUCTION/RENOVATION. NO EXISTING PIPING SHALL BE ABANDONED IN PLACE AND ANY EXISTING ABANDONED PIPING SHALL BE REMOVED.



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PROJECT # **U1503-01**  
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REVISION: \_\_\_\_\_  
DATE: \_\_\_\_\_  
ISSUE DATE: **8-1-24**

CAD DWG FILE: **M-110.DWG**  
DRAWN BY: **TSE**  
CHECKED BY: **CRK**  
DESIGNED BY: **TSE**

SHEET TITLE:

**HVAC &  
PLUMBING  
DEMO PLAN**

SHEET NUMBER:

**M-110**

61 OF 120 SHEETS

8-1-24

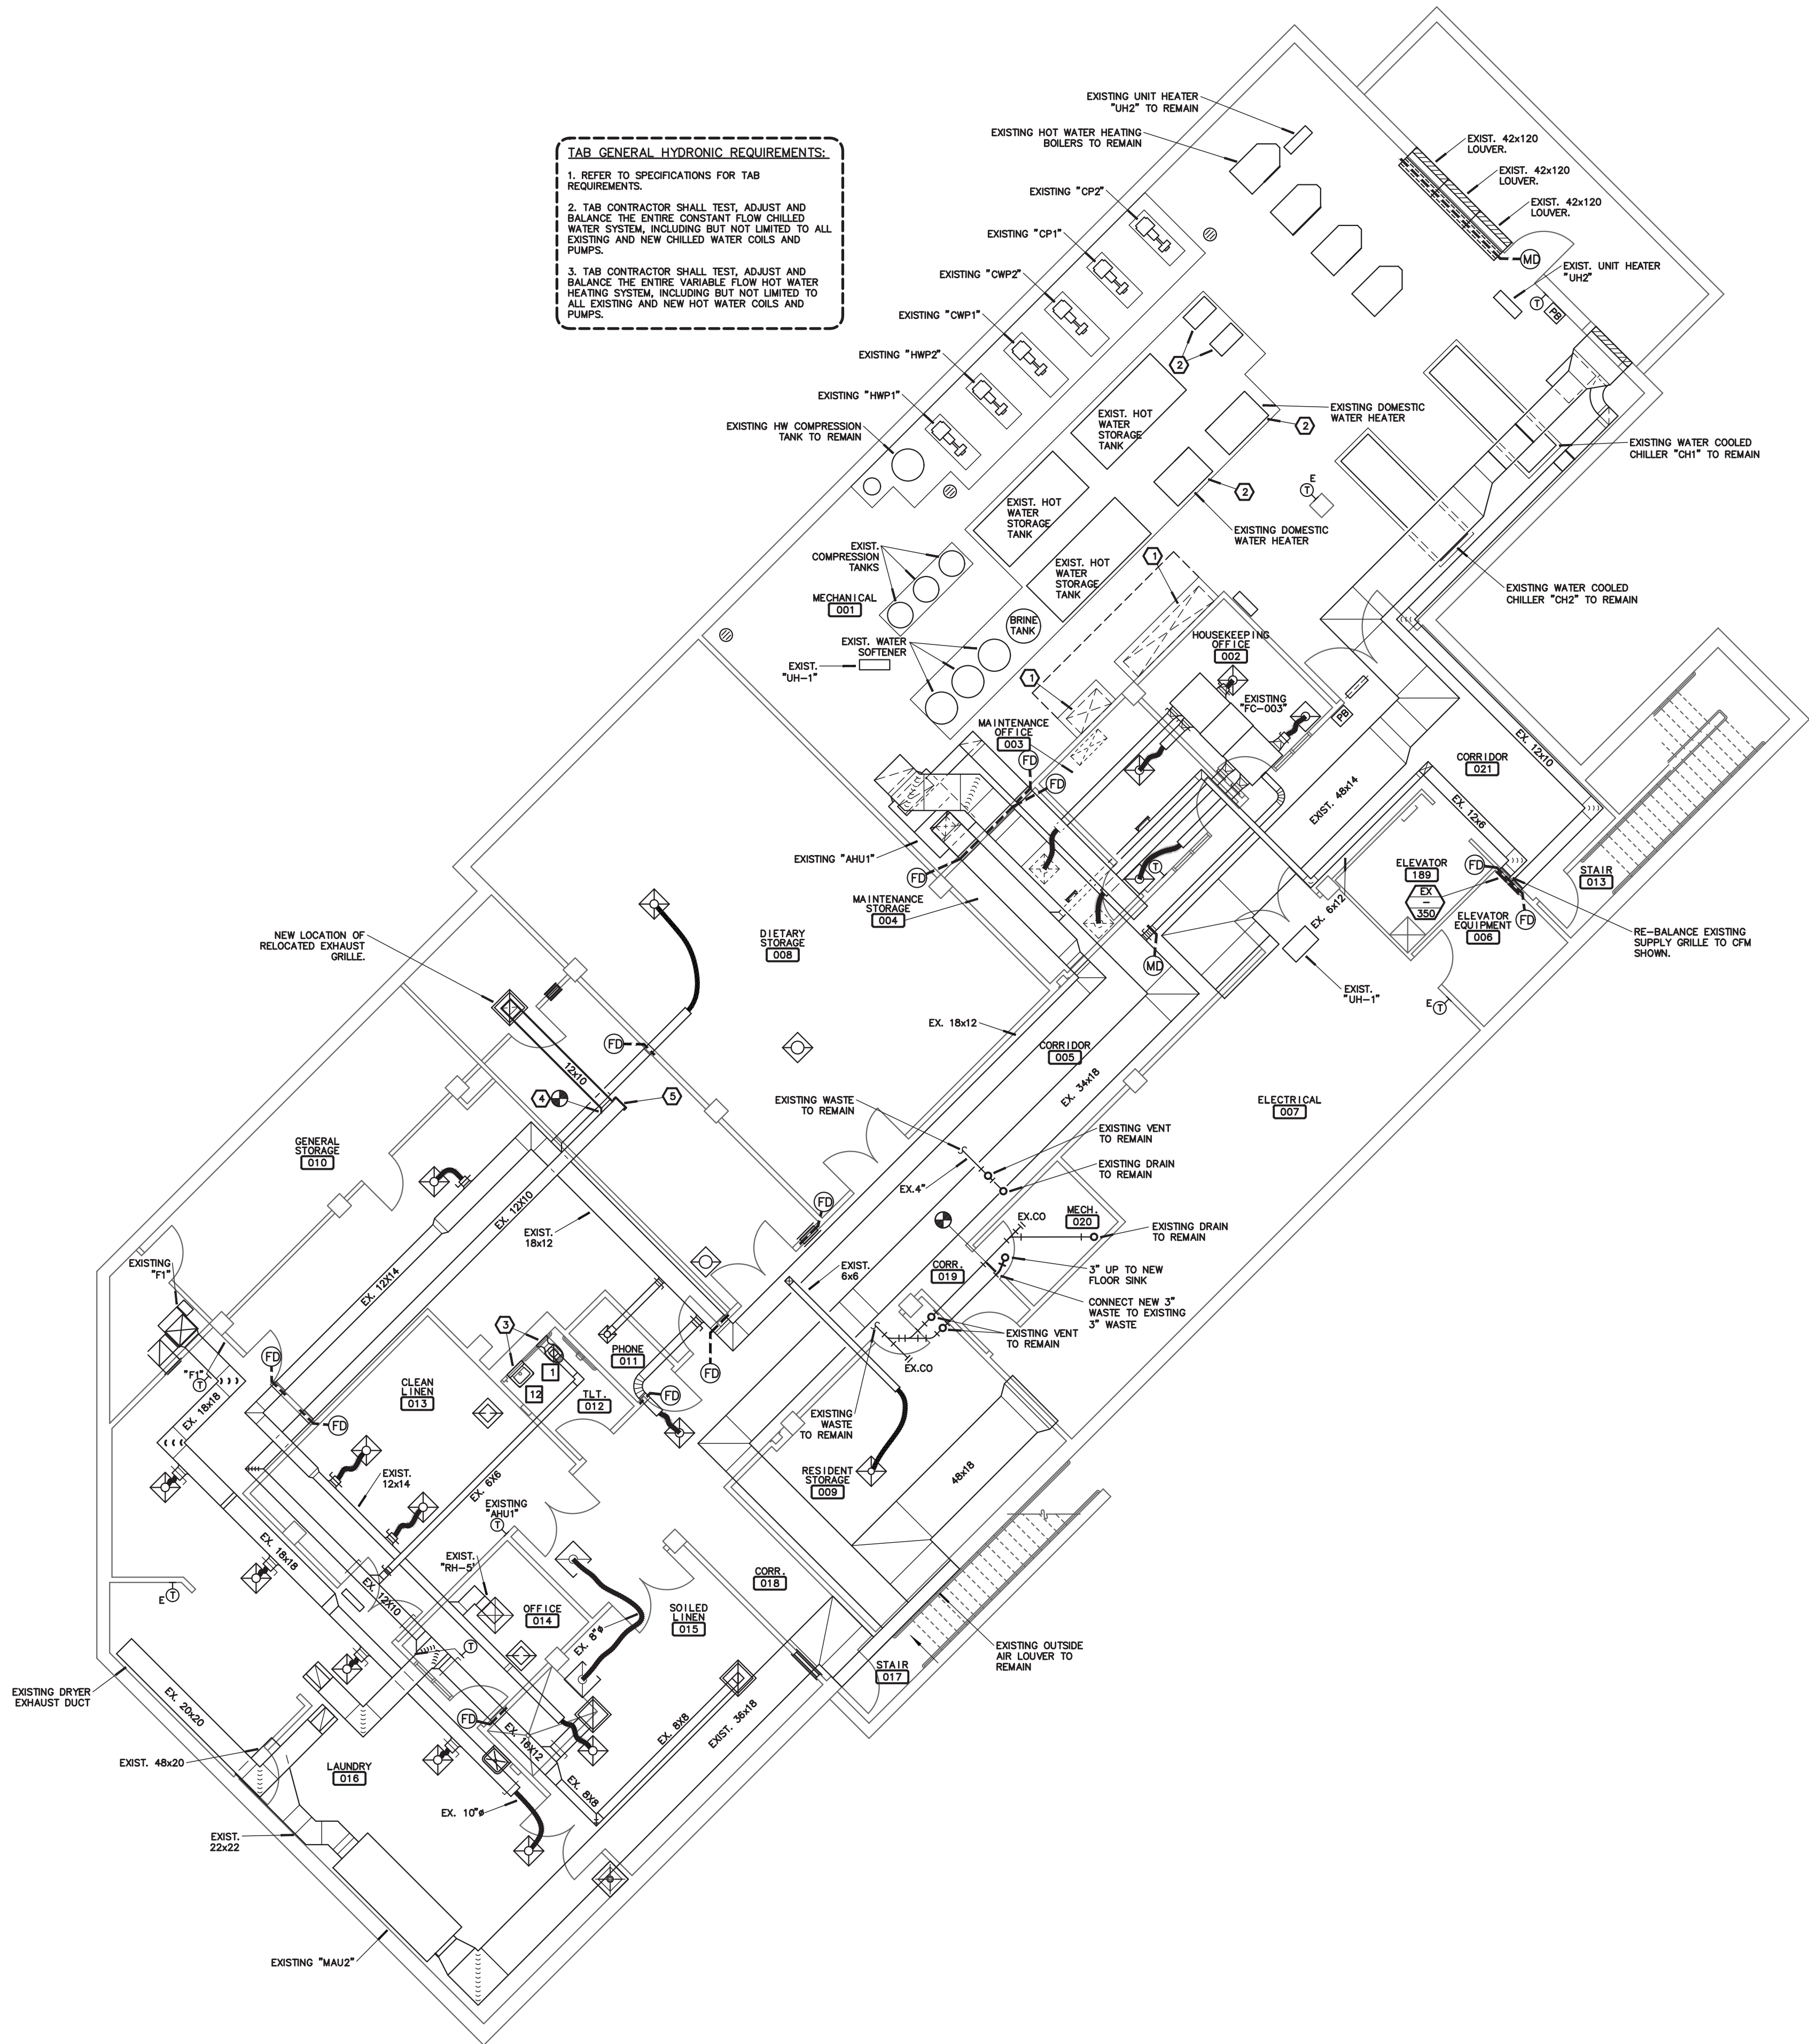


**TAB GENERAL HYDRONIC REQUIREMENTS:**

1. REFER TO SPECIFICATIONS FOR TAB REQUIREMENTS.

2. TAB CONTRACTOR SHALL TEST, ADJUST AND BALANCE THE ENTIRE CONSTANT FLOW CHILLED WATER SYSTEM, INCLUDING BUT NOT LIMITED TO ALL EXISTING AND NEW CHILLED WATER COILS AND PUMPS.

3. TAB CONTRACTOR SHALL TEST, ADJUST AND BALANCE THE ENTIRE VARIABLE FLOW HOT WATER HEATING SYSTEM, INCLUDING BUT NOT LIMITED TO ALL EXISTING AND NEW HOT WATER COILS AND PUMPS.



**BASEMENT LEVEL MECHANICAL IMPROVEMENT PLAN**

SCALE: 1/8"=1'-0"

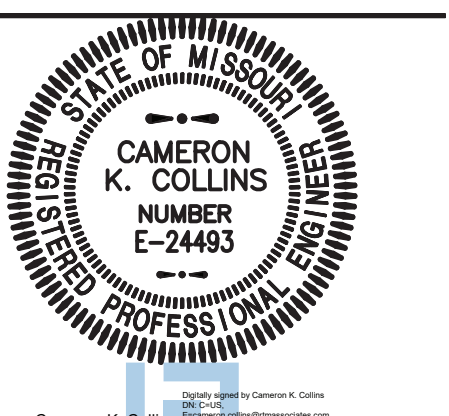
NORTH

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rtmec.com | 417.881.0020  
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- NOTES:**
- EXISTING ELECTRICAL PANELS TO REMAIN.
  - EXISTING DOMESTIC WATER HEATER TO REMAIN.
  - REFER TO PLAN M-113 FOR PLUMBING FIXTURE SCHEDULE.
  - CONNECT TO EXISTING DUCTWORK. FIELD VERIFY EXISTING DUCTWORK FOR CONNECTION.
  - CAP EXISTING DUCT.

- GENERAL NOTES:**
- FOR ALL PLUMBING OR HVAC QUESTIONS DURING BIDDING OR DURING CONSTRUCTION, CONTACT ESTERLY, SCHNEIDER & ASSOCIATES, INC. THOM LINDBERG (417-862-0558) FOR COORDINATION WITH TYLER ENSERRO AT RTM ENGINEERING CONSULTANTS.
  - CONTRACTOR SHALL FIELD VERIFY ALL EXISTING CONSTRUCTION PRIOR TO SUBMITTING HIS BID. NO EXTRAS WILL BE PAID DUE TO UNANTICIPATED EXISTING CONDITIONS.
  - CONTRACTOR SHALL SCHEDULE AND EXECUTE ALL WORK WITH REGARD TO THE OWNER'S USE OF THE BUILDING.
  - PLANS ARE DIAGRAMMATIC AND SHALL NOT BE SCALED. REFER TO ARCHITECTURAL DRAWINGS FOR DIMENSIONS.
  - CONTRACTOR SHALL REMOVE AND REPLACE CEILING TILE AND CEILING GRID AS REQUIRED TO PERFORM ALL DEMOLITION AND IMPROVEMENT WORK. CONTRACTOR SHALL REPLACE ALL DAMAGED CEILING TILE TO MATCH EXISTING.

STATE OF MISSOURI  
MIKE KEHOE,  
GOVERNOR



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architects & planners  
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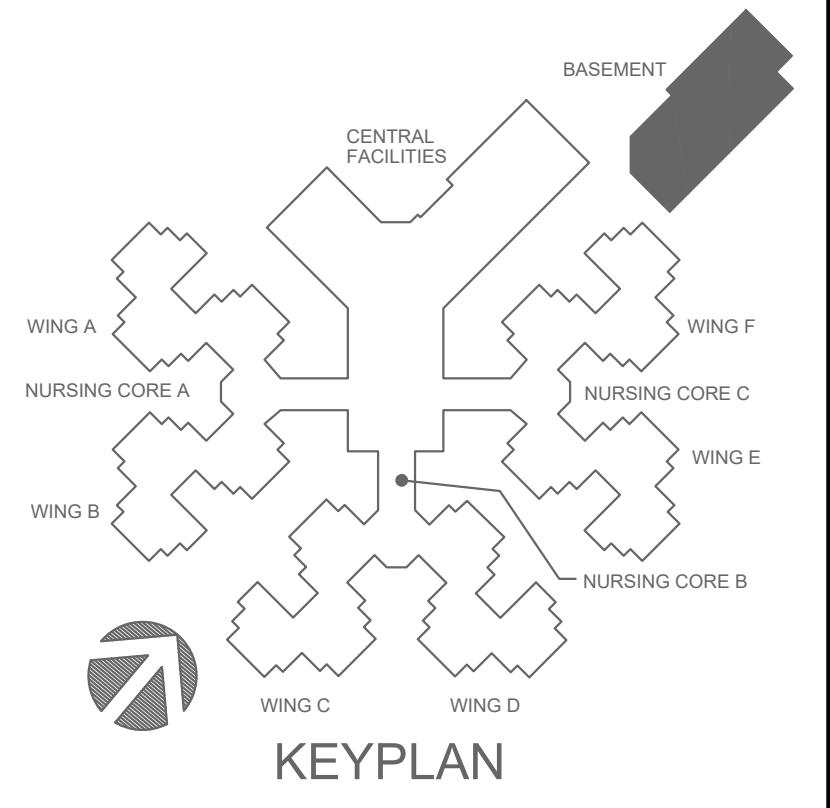
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DRAWN BY: **TSE**  
CHECKED BY: **CRK**  
DESIGNED BY: **TSE**

SHEET TITLE:  
**HVAC & PLUMBING PLAN**

SHEET NUMBER:

**M-111**  
62 OF 120 SHEETS


8-1-24







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NORTH

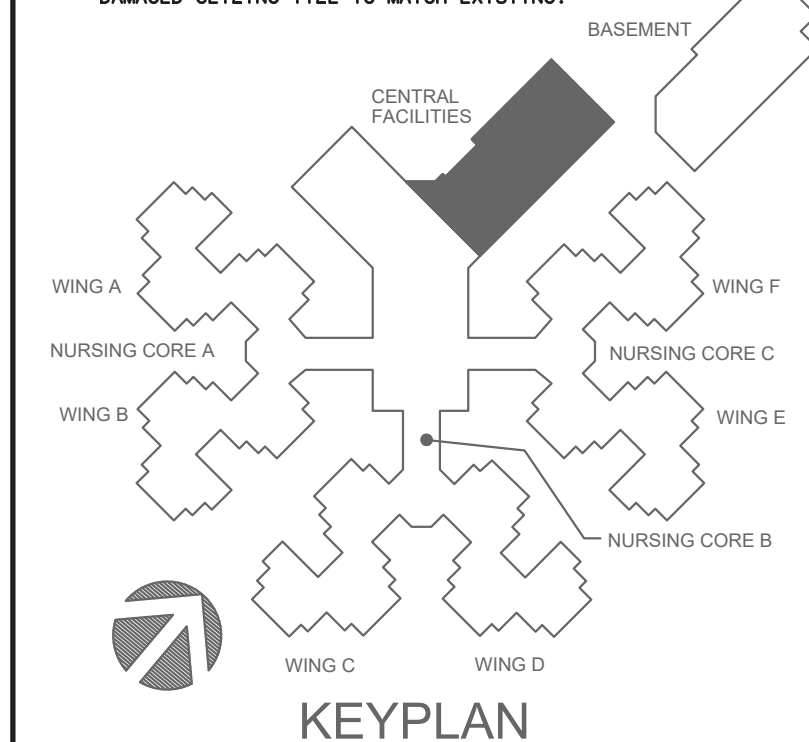

8-1-24





## PARTIAL CENTRAL FACILITIES MECHANICAL IMPROVEMENT PLAN

1  
M-113

SCALE: 1/8"=1'-0"

NORTH



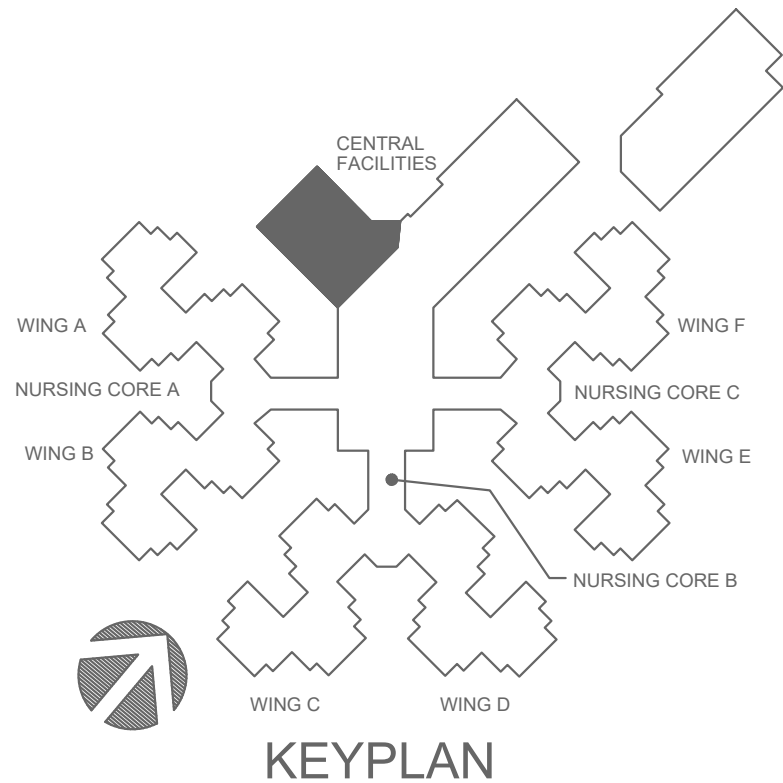
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### NOTES:


1. PROVIDE NEW THERMOSTAT AND CONTROL WIRING. REUTILIZED EXISTING CONDUIT. INTEGRATE TO BMS SYSTEM. PATCH, REPAIR AND PAINT WALL TO MATCH ADJACENT WALL, PER ARCHITECT'S DIRECTION.
2. PROVIDE NEW 4-PIPE FAN COIL UNIT. FIELD VERIFY EXISTING CONDITIONS, AVAILABLE WALL AND FLOOR SPACE, AND LOCATION OF CONNECTIONS TO ALL EXISTING PIPING AND POWER CONNECTIONS PRIOR TO SUBMITTAL OF FAN COIL UNITS. PROVIDE ALL MODIFICATIONS TO EXISTING CONDITIONS AS REQUIRED FOR NEW FAN COIL. RECONNECT TO EXISTING OUTSIDE AIR LOUVER AS REQUIRED. REFER TO PLAN M-400 FOR SCHEDULE.
3. REBALANCE ALL EXISTING SUPPLY DIFFUSERS SERVED BY THIS AIR HANDLING UNIT. CONTRACTOR SHALL CLEAN HEATING AND COOLING COILS IN THE AIR HANDLER AND NEW FILTERS SHALL BE REPLACED PRIOR TO REBALANCE PROCEDURE.
4. PROVIDE NEW BYPASS AIR TERMINAL UNIT. PROVIDE TRANSITION FROM EXISTING SUPPLY DUCT TO BOX INLET AND PROVIDE MAXIMUM 24" LENGTH FLEX CONNECTOR INTO THE INLET. PROVIDE DUCT TRANSITION FROM THE DISCHARGE TO A NEW FLEX DUCT AND RECONNECT TO THE EXISTING DIFFUSER. FIELD VERIFY ALL EXISTING CONDITIONS PRIOR TO BID AND SUBMITTAL. REBALANCE THE MAXIMUM AIR FLOW TO THE DIFFUSER PER THE "ATU" SCHEDULE. BALANCE THE BYPASS DAMPER PER THE EQUIPMENT MANUFACTURER'S RECOMMENDATIONS.
5. EXISTING CONTROLS AND THERMOSTAT FOR EXISTING FAN COIL UNIT TO REMAIN.

### PLUMBING FIXTURE SCHEDULE:

1. EXISTING HANDICAP, WALL MOUNT, FLUSH VALVE, BACK OUTLET WATER CLOSET: REPLACE EXISTING FLUSH VALVE WITH SLOAN ROYAL 113-1, 6 FLUSH VALVE AT 1.6 GPF. FLUSH LEVER SHALL BE INSTALLED OPPOSITE SIDE OF GRAB BARS.
2. EXISTING WALL MOUNT, BACK OUTLET, FLUSH VALVE WATER CLOSET: REPLACE EXISTING FLUSH VALVE WITH SLOAN ROYAL 113-1, 6 FLUSH VALVE AT 1.6 GPF. FLUSH LEVER SHALL BE INSTALLED OPPOSITE SIDE OF GRAB BARS.
3. EXISTING WALL HUNG, FLUSH VALVE, SIPHON JET URINAL: REPLACE EXISTING FLUSH VALVE WITH SLOAN ROYAL 186-0, 5-H-CO FLUSH VALVE AT 0.5 GPF.
4. WALL HUNG LAVATORY, 4" CENTERS: SLOAN SS-3003-STG 20"18" VITREOUS CHINA, WALL, HANGER, SUPPORT, WALL HUNG LAVATORY WITH FRONT OVERFLOW, INTEGRAL GRAB BAR, CENTER FAUCET HOLES, SUPPLIES, TRAP, WALL HANGER AND FAUCET TYPE 5. SEE ARCHITECTURAL DRAWINGS FOR MOUNTING HEIGHTS.
5. 4" CENTER, SINGLE LEVER, LAVATORY FAUCET, GRID DRAIN: CHICAGO FAUCETS 420-PMBCP, ONE PIECE BRASS BODY, SINGLE LEVER, LAVATORY FAUCET WITH 4" CENTER WITH INTEGRAL POP UP DRAIN CAST BRASS SPROUT, 1.5 GPM SOFTLED AERATOR RE-STRICTOR, PROVIDE WATTS MODEL LFUS-B THERMOSTATIC MIXING VALVE ASSE 1070 COMPLIANT OR APPROVED EQUAL, INSTALLED TIGHT UNDER SINK, SET DISCHARGE WATER TEMPERATURE FOR HOT WATER SERVICE AT 110 DEGREES. PROVIDE ADA INSULATION KIT FOR WATER AND DRAIN PIPING FOR HANDICAP ACCESSORY. FAUCET SHALL HAVE A 5-YEAR DRIP-FREE WARRANTY.
6. OVAL COUNTERTOP LAVATORY, 4" CENTERS: SLOAN SS-3002-STG SELF-RIMMING, 20"x17" OVAL, VITREOUS CHINA, COUNTERTOP LAVATORY WITH FITTING LEDGE, FRONT OVERFLOW, 4" CENTER FAUCET HOLES MOUNTING KIT, SUPPLIES, TRAP AND FAUCET TYPE 5. PROVIDE ADA INSULATION KIT FOR WATER AND DRAIN PIPING FOR HANDICAP ACCESSORY.
7. SINGLE LEVER SINK FAUCET: CHICAGO FAUCETS 350-GRAE29-317XAB CHROME PLATED, DECK MOUNTED WITH 4" FIXED CENTERS, WASHLESS SINK FAUCET WITH 8" GOOSENECK SWING SPOUT, NON-AERATING, SINGLE LEVER HANDLE. CONTRACTOR TO MATCH EXISTING HOLES.
8. DOUBLE COMPARTMENT, STAINLESS STEEL, SINK: ELKAY LA0318SS LUSTER-SS, 33"x19.5"x3.5", SEAMLESSLY DRAIN, #18 GAUGE, TYPE 304 STAINLESS STEEL, SELF-RIMMING DOUBLE COMPARTMENT SINK WITH 1-1/2" RADIUS COVED CORNERS, SATIN FINISH, FAUCET DECK, 3-1/2" DRAIN OPENINGS, LK09 STAINLESS STEEL DRAIN WITH BODY STRAINER, BASKET RUBBER SEAL AND TAIL-PIPER HOLES TO MATCH FAUCET, SUPPLIES, TRAP, UNDERCOATING, FAUCET TYPE 7, EQUIVALENT BY JUST.
9. TUB/SHOWER FAUCET: REPLACE EXISTING FAUCET WITH CHICAGO FAUCETS 1907-622LCP TUB AND SHOWER FAUCET WITH CONCEALED IN-WALL UNIVERSAL VALVE, INTEGRAL SCREWDRIVER STOPS, BACK TO BACK CAPABILITY, ADA COMPLIANT THERMOSTATIC CARTRIDGE SET AT 115 DEGREES, POLISHED CHROME PLATED FINISH, TEMPERATURE ADJUSTMENT DIAL, RED AND BLUE TEMPERATURE MARKINGS AND TUB SHOWER VALVE, THREE FUNCTION SHOWER HEAD AND METAL LEVER VOLUME CONTROL HANDLE, COORDINATE INSTALLATION OF SHOWER HEAD PER ARCHITECT PLANS.
10. ADA, FLOOR MOUNT, FLUSH VALVE, BACK OUTLET BARIATRIC SIPHON JET WATER CLOSET: WILLOUGHBY INDUSTRIES BETHNE 1490-FM-FA-TS, ELONGATED BOWL AND INTEGRAL CONTOURED SEAT, WINGED OPEN FRONT TOILET SEAT AND COVER SHALL BE RATED AT 1200 POUND WEIGHT CAPACITY. EXTERIOR SHALL HAVE GLOSS WHITE POWDER COAT ENAMEL FINISH, AND TOILET BOWL INTERIOR SHALL HAVE BEAD-BLAST STAINLESS STEEL FINISH. INTEGRAL OVER-FREE SELF-DRAINING FLUSHING RIM WITH POSITIVE AFTER FILL AND FULLY ENCLOSED 2 1/2 O.D. TRAP. PROVIDE SLOAN BPN 1100 1.6 GPF S/LIMLINE FLUSHMETER WITH VACUUM BREAKER AND BED PAN WASHER.
11. ADA LAVATORY: WILLOUGHBY INDUSTRIES BHS-3123, LAVATORY DECK SHALL BE MOLDED CAST POLYMER DENSIFIED SOLID SURFACE. LAVATORY DECK SHALL HAVE AN "E" SHAPED BOWL WITH AN INTEGRALLY CAST 4" COVERED BACKSLASH AND 4" APRON. LAVATORY PEDESTAL SHALL BE WELDED STAINLESS STEEL. EXTERIOR PANELS SHALL BE SOLID POLYMER. PROVIDE LAVATORY FAUCET, CHICAGO FAUCETS 895-317E29ABCP, GOOSENECK SPOUT, WRIST BLADE HANDLES, AND NON AERATING OUTLET. PROVIDE WATTS MODEL LFUS-B THERMOSTATIC MIXING VALVE OR APPROVED EQUAL UNDER THE SINK. SET DISCHARGE WATER TEMPERATURE FOR HOT WATER SERVICE AT 110 DEGREES. INCLUDE HEAVY DUTY FLOOR MOUNT CARRIER, ALL STOP VALVES, TRAP, GRID DRAIN FOR COMPLETE INSTALLATION. COLORS SHALL BE STANDARD AS SELECTED BY ARCHITECT.
12. EXISTING WALL MOUNTED LAVATORY: REPLACE FAUCET AND EYEWASH WITH 4" CENTER, DUAL HANDLE, LAVATORY FAUCET, GRID DRAIN: SPEARMAN MODEL SEF-1800-CA, GOOSENECK FAUCET WITH INDEPENDENTLY OPERATED EYEWASH DUAL HANDLE, LAVATORY FAUCET WITH 4" CENTERS, RENOVABLE SEATS, AERATOR WITH 2.6 GPM FLOW RE-STRICTOR, 8" GOOSENECK SPOUT, AND 4" CHROME WRIST BLADE HANDLES. PROVIDE WATTS MODEL LFUS-B THERMOSTATIC MIXING VALVE ASSE 1070 COMPLIANT OR APPROVED EQUAL UNDER THE SINK FOR EYE WASH AND INSTALL PER MANUFACTURER'S RECOMMENDATIONS. SET DISCHARGE WATER TEMPERATURE FOR HOT WATER SERVICE AT 100 DEGREES MAXIMUM. PROVIDE ADA INSULATION KIT FOR WATER AND DRAIN PIPING FOR HANDICAP ACCESSORY.



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OFFICE OF ADMINISTRATION  
DIVISION OF FACILITIES  
MANAGEMENT,  
DESIGN AND CONSTRUCTION

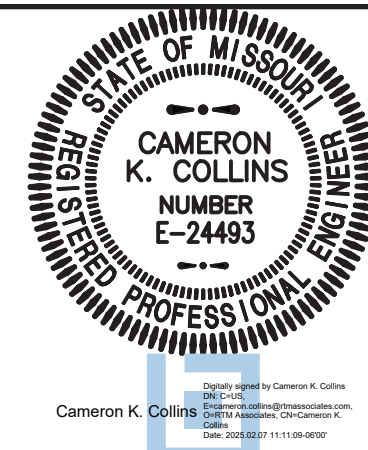DEPARTMENT OF  
PUBLIC SAFETY  
MISSOURI VETERANS  
COMMISSION

INTERIOR RENOVATION  
MISSOURI VETERANS  
HOME

620 N. JEFFERSON  
ST. JAMES, MISSOURI

PROJECT # U1503-01  
SITE # 6801  
ASSET # 8136801002  
FEDERAL # 29-044

REVISION: \_\_\_\_\_  
DATE: \_\_\_\_\_  
REVISION: \_\_\_\_\_  
DATE: \_\_\_\_\_  
REVISION: \_\_\_\_\_  
DATE: \_\_\_\_\_  
ISSUE DATE: 8-1-24

CAD DWG FILE: M-113.DWG  
DRAWN BY: JMO  
CHECKED BY: CKC  
DESIGNED BY: JMO

SHEET TITLE:

## HVAC & PLUMBING PLAN

SHEET NUMBER:

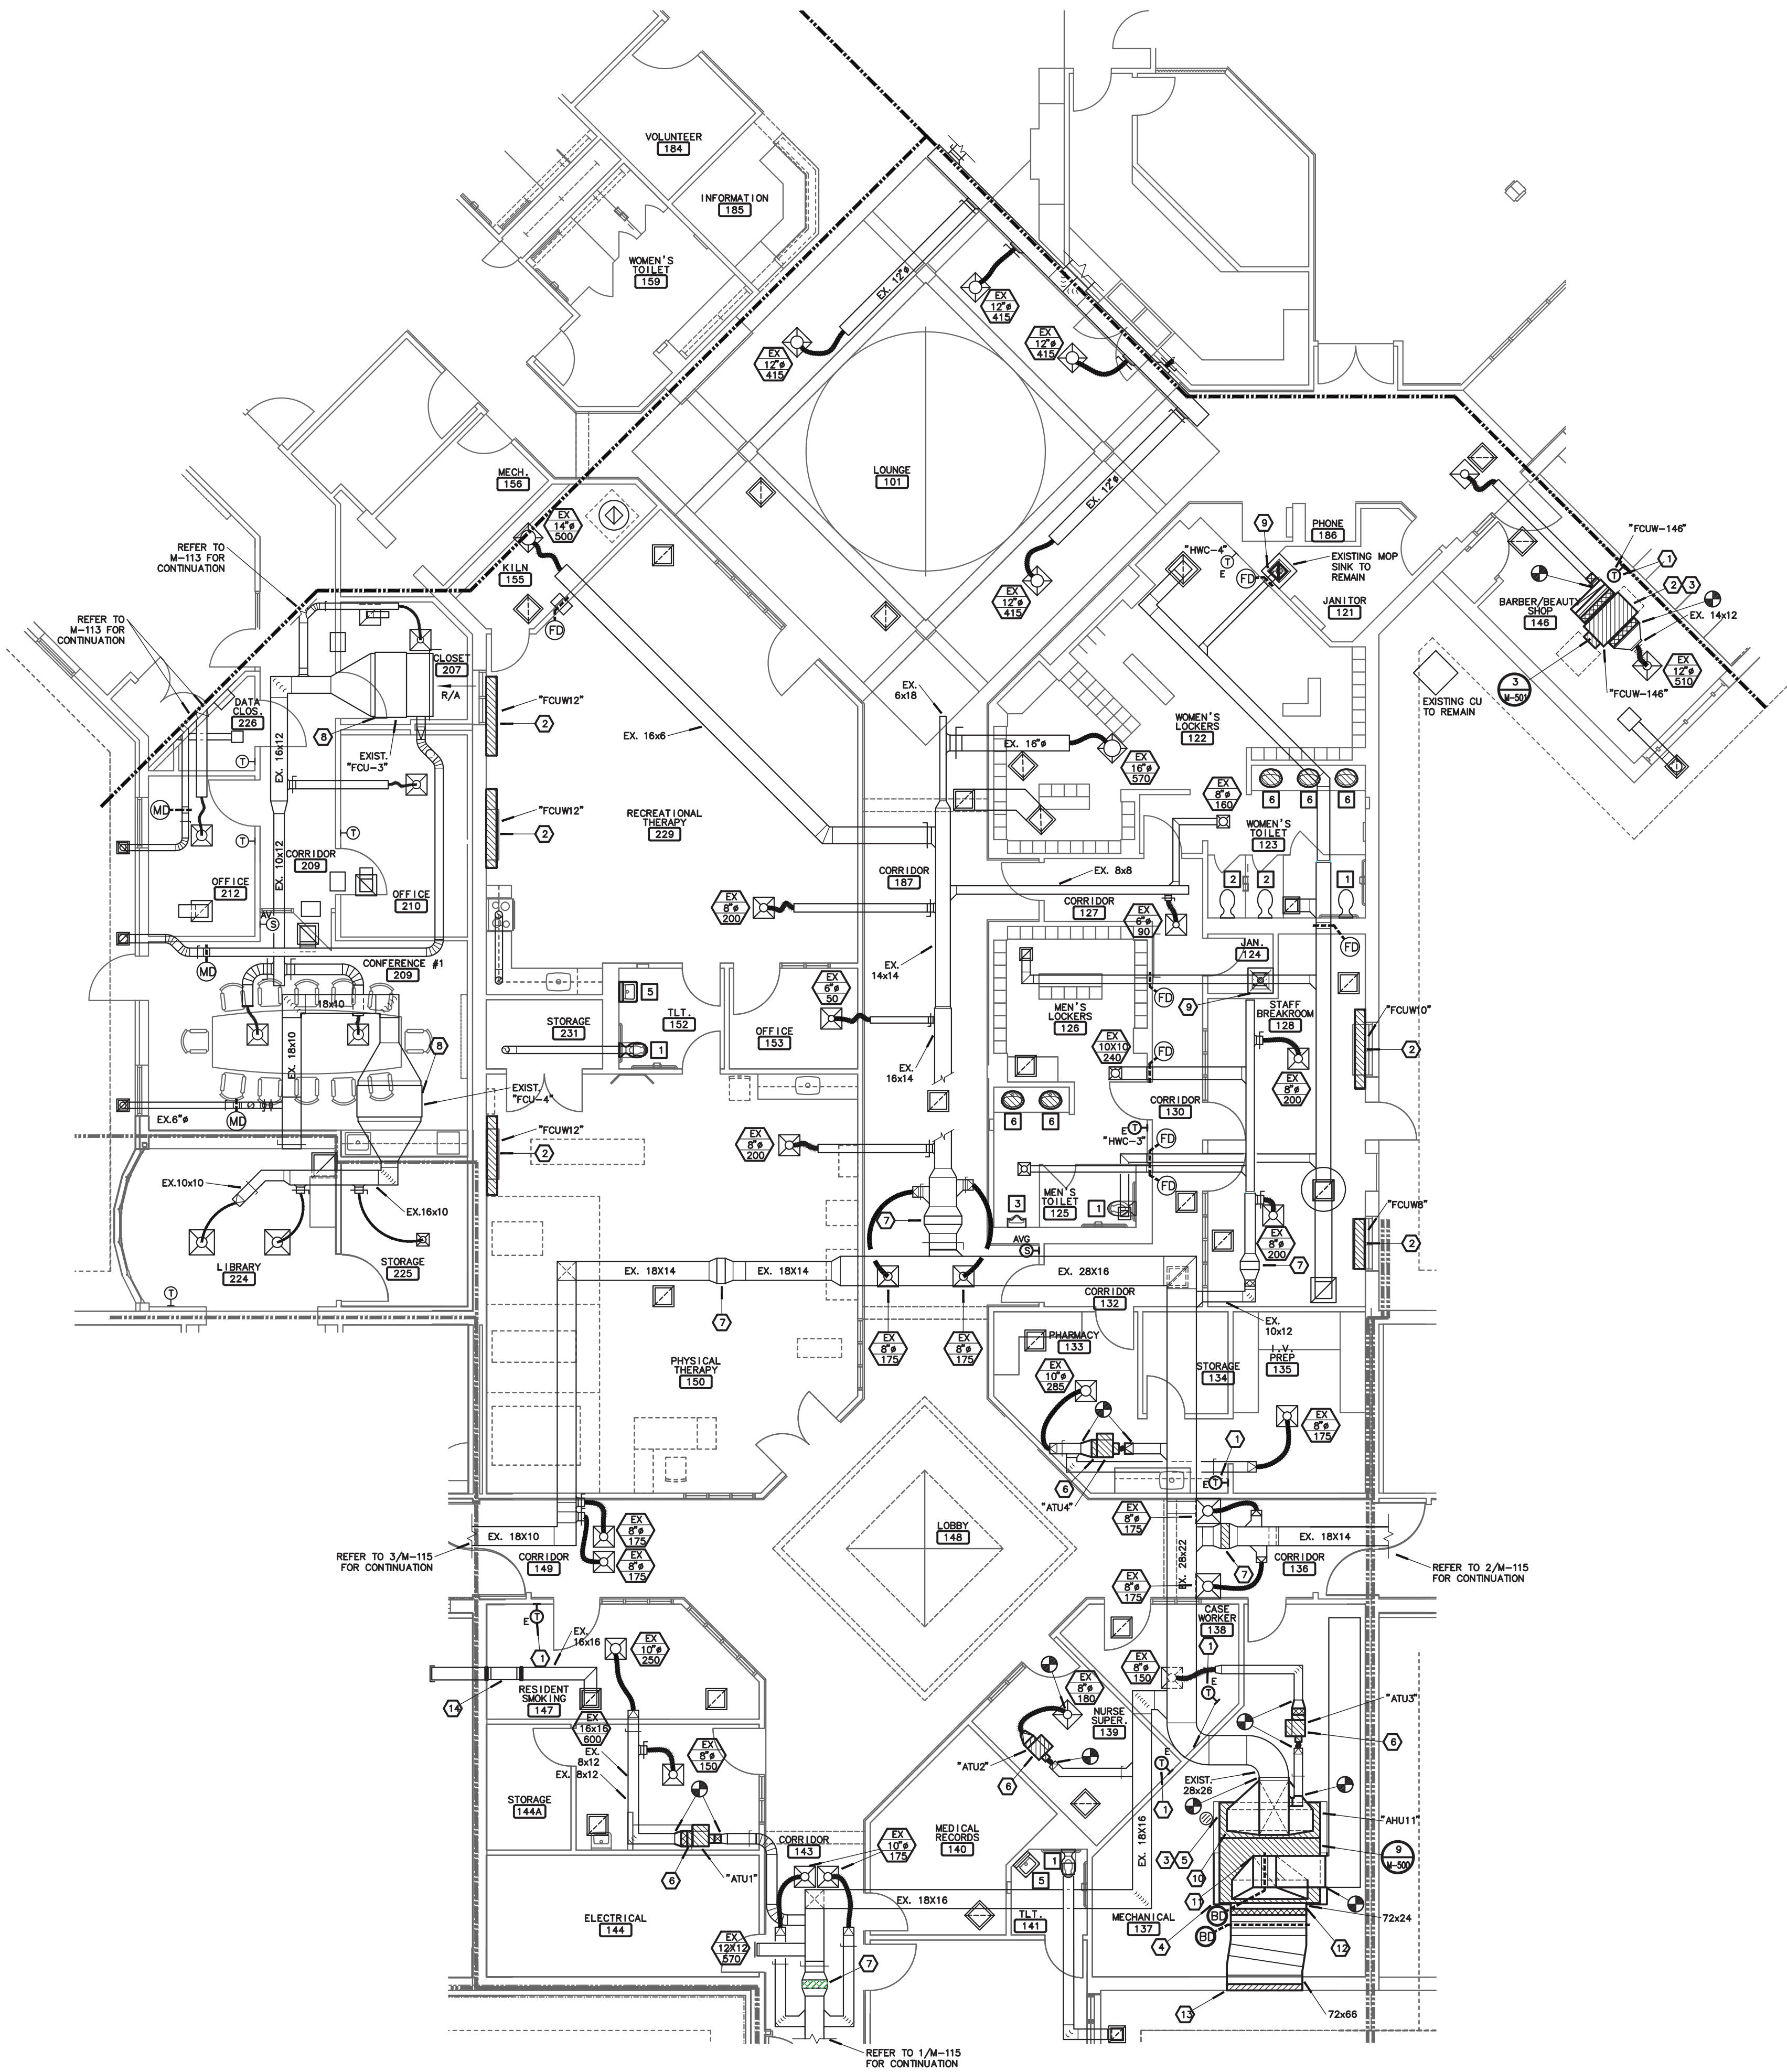
## M-113

64 OF 120 SHEETS

8-1-24



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M-114

## PARTIAL CENTRAL FACILITIES MECHANICAL IMPROVEMENT PLAN

SCALE: 1/8"=1'-0"




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Springfield, MO 65804  
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State of Missouri certificate of authority  
#2014035826 for engineering

### NOTES:

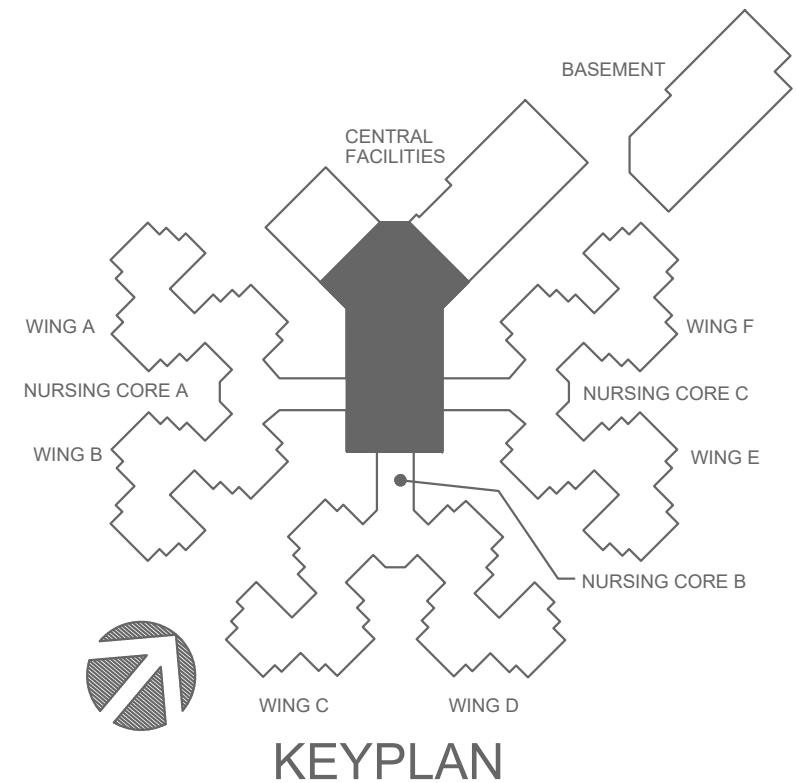
1. PROVIDE NEW THERMOSTAT AND CONTROL WIRING TO UNIT. REUTILIZE ANY EXISTING CONDUIT, PATCH, REPAIR AND PAINT WALL PER ARCHITECT'S DIRECTION.
2. PROVIDE NEW 4-PIPE FAN COIL UNIT. FIELD VERIFY EXISTING CONDITIONS, PIPING LOCATION, AVAILABLE SPACE AND CLEARANCE FOR MAINTENANCE AND EXISTING SHEETMETAL SIZES AND LOCATIONS PRIOR TO SUBMITTING EQUIPMENT. REFER TO PLAN M-800 FOR SCHEDULE.
3. REBALANCE ALL EXISTING SUPPLY DIFFUSERS SERVED BY THIS AIR HANDLING UNIT.
4. EXTEND CONCRETE EQUIPMENT PAD TO MATCH THE SIZE OF NEW UNIT. FIELD VERIFY THICKNESS OF EXISTING PAD TO MATCH NEW PAD.
5. PROVIDE NEW AIR HANDLING UNIT. PROVIDE REPLACEMENT HOT AND CHILLED WATER PIPING AND VALVING PER COIL PIPING DETAIL. FIELD VERIFY EXISTING CONDITIONS, PIPING LOCATION, AVAILABLE SPACE AND CLEARANCE FOR MAINTENANCE AND EXISTING SHEETMETAL SIZES AND LOCATIONS PRIOR TO SUBMITTING EQUIPMENT. CONNECT EXISTING SUPPLY AND RETURN DUCT TO NEW UNIT CONNECTIONS WITH FLEXIBLE CONNECTORS. PROVIDE ANY ADDITIONAL TRANSITION AS NECESSARY. REFER TO PLAN M-800 FOR SCHEDULE.
6. PROVIDE NEW BYPASS AIR TERMINAL UNIT. PROVIDE TRANSITION FROM EXISTING SUPPLY DUCT TO BOX INLET AND PROVIDE MAXIMUM 24" LENGTH FLEX CONNECTOR INTO THE INLET. PROVIDE DUCT TRANSITION FROM THE DISCHARGE TO A NEW FLEX DUCT AND RECONNECT TO THE EXISTING DIFFUSER. FIELD VERIFY ALL EXISTING CONDITIONS PRIOR TO BID AND SUBMITTAL. REBALANCE THE MAXIMUM AIRFLOW TO THE DIFFUSER PER THE "AHJ" SCHEDULE. BALANCE THE BYPASS DAMPER PER THE EQUIPMENT MANUFACTURER'S RECOMMENDATIONS. REFER TO PLAN M-801 FOR SCHEDULE.
7. EXISTING HOT WATER COIL TO REMAIN.
8. EXISTING FAN COIL UNIT TO REMAIN. EXISTING CONTROLS TO REMAIN.
9. INSTALL NEW CHECK VALVE IN COLD WATER SUPPLY PIPING THAT SERVES THE MOP SINK.
10. CONNECT NEW SUPPLY AIR DUCT TO EXISTING SUPPLY AIR DUCT. FIELD VERIFY SHEET METAL TRANSITION SIZE TO FIT TO NEW UNIT FROM EXISTING SUPPLY AIR DUCT.
11. CONNECT NEW RETURN AIR DUCT TO EXISTING RETURN AIR DUCT. FIELD VERIFY SHEET METAL TRANSITION SIZE TO FIT TO NEW UNIT FROM EXISTING RETURN AIR DUCT.
12. CONNECT NEW OUTSIDE AIR DUCT TO NEW MIXING BOX. FIELD VERIFY SHEET METAL TRANSITION SIZE TO FIT TO NEW MIXING BOX FROM NEW LOUVER.
13. REMOVE EXISTING 72X66 LOUVER AND REPLACE WITH NEW LOUVER. LOUVER FINISH SHALL BE SELECTED BY ARCHITECT. REMOVE EXISTING AIR HANDLER AND INSTALL NEW AIR HANDLER THRU OPENING OF WALL WHILE LOUVER IS BEING REPLACED. FIELD VERIFY EXACT SIZE OF EXISTING LOUVER.
14. EXISTING EXHAUST FAN TO REMAIN.

### GENERAL NOTES:

1. FOR ALL PLUMBING OR HVAC QUESTIONS DURING BIDDING OR DURING CONSTRUCTION, CONTACT ESTERLY, SCHNEIDER & ASSOCIATES, INC. THOM LINDBERG (417-862-0558) FOR COORDINATION WITH TYLER ENSERRO AT RTM ENGINEERING CONSULTANTS.
2. CONTRACTOR SHALL FIELD VERIFY ALL EXISTING CONSTRUCTION PRIOR TO SUBMITTING HIS BID. NO EXTRAS WILL BE PAID DUE TO UNANTICIPATED EXISTING CONDITIONS.
3. CONTRACTOR SHALL SCHEDULE AND EXECUTE ALL WORK WITH REGARD TO THE OWNER'S USE OF THE BUILDING.
4. PLANS ARE DIAGRAMMATIC AND SHALL NOT BE SCALED. REFER TO ARCHITECTURAL DRAWINGS FOR DIMENSIONS.
5. CONTRACTOR SHALL REMOVE AND REPLACE CEILING TILE AND CEILING GRID AS REQUIRED TO PERFORM ALL DEMOLITION AND IMPROVEMENT WORK. CONTRACTOR SHALL REPLACE ALL DAMAGED CEILING TILE TO MATCH EXISTING.



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OFFICE OF ADMINISTRATION  
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DEPARTMENT OF  
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HOME

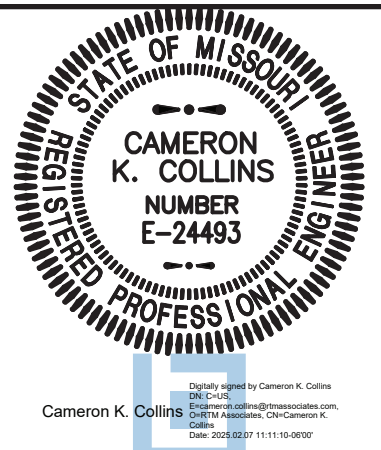620 N. JEFFERSON  
ST. JAMES, MISSOURI

PROJECT # U1503-01  
SITE # 6801  
ASSET # 8136801002  
FEDERAL # 29-044

REVISION: \_\_\_\_\_  
DATE: \_\_\_\_\_  
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DATE: \_\_\_\_\_  
REVISION: \_\_\_\_\_  
DATE: \_\_\_\_\_  
ISSUE DATE: 8-1-24

CAD DWG FILE: M-114.DWG  
DRAWN BY: TSE  
CHECKED BY: CKC  
DESIGNED BY: TSE

SHEET TITLE:

## HVAC & PLUMBING PLAN

SHEET NUMBER:

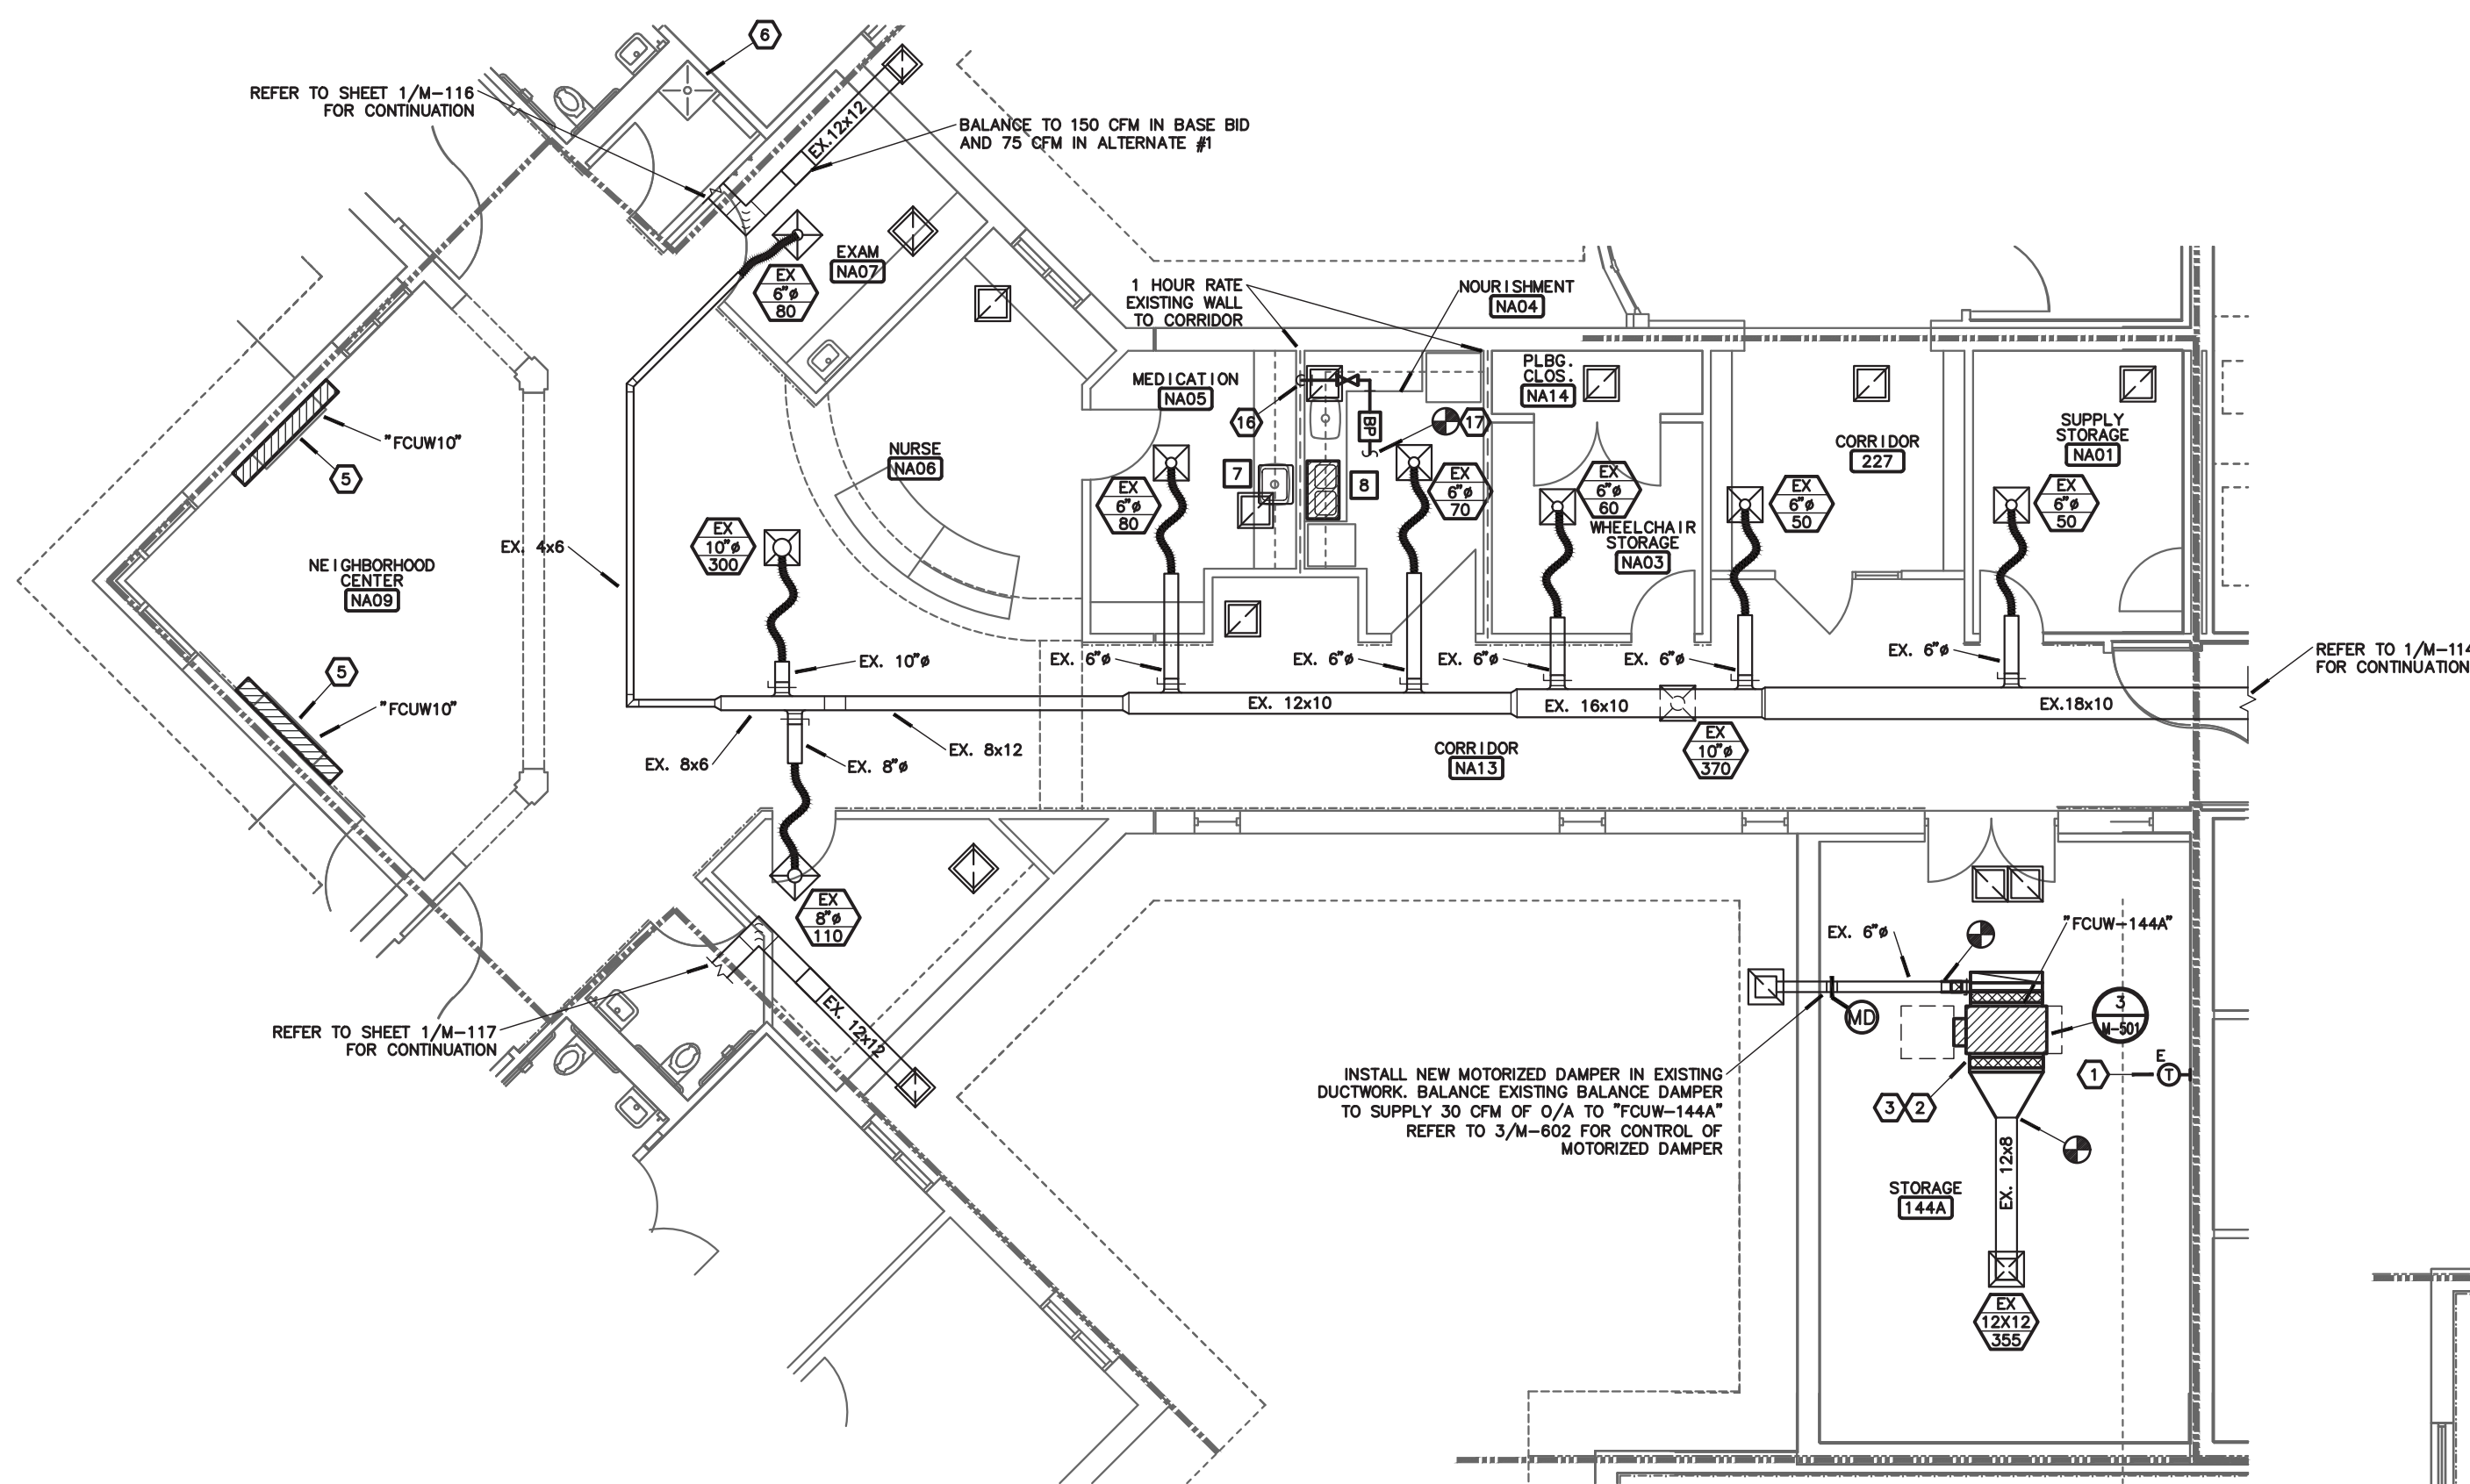
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65 OF 120 SHEETS

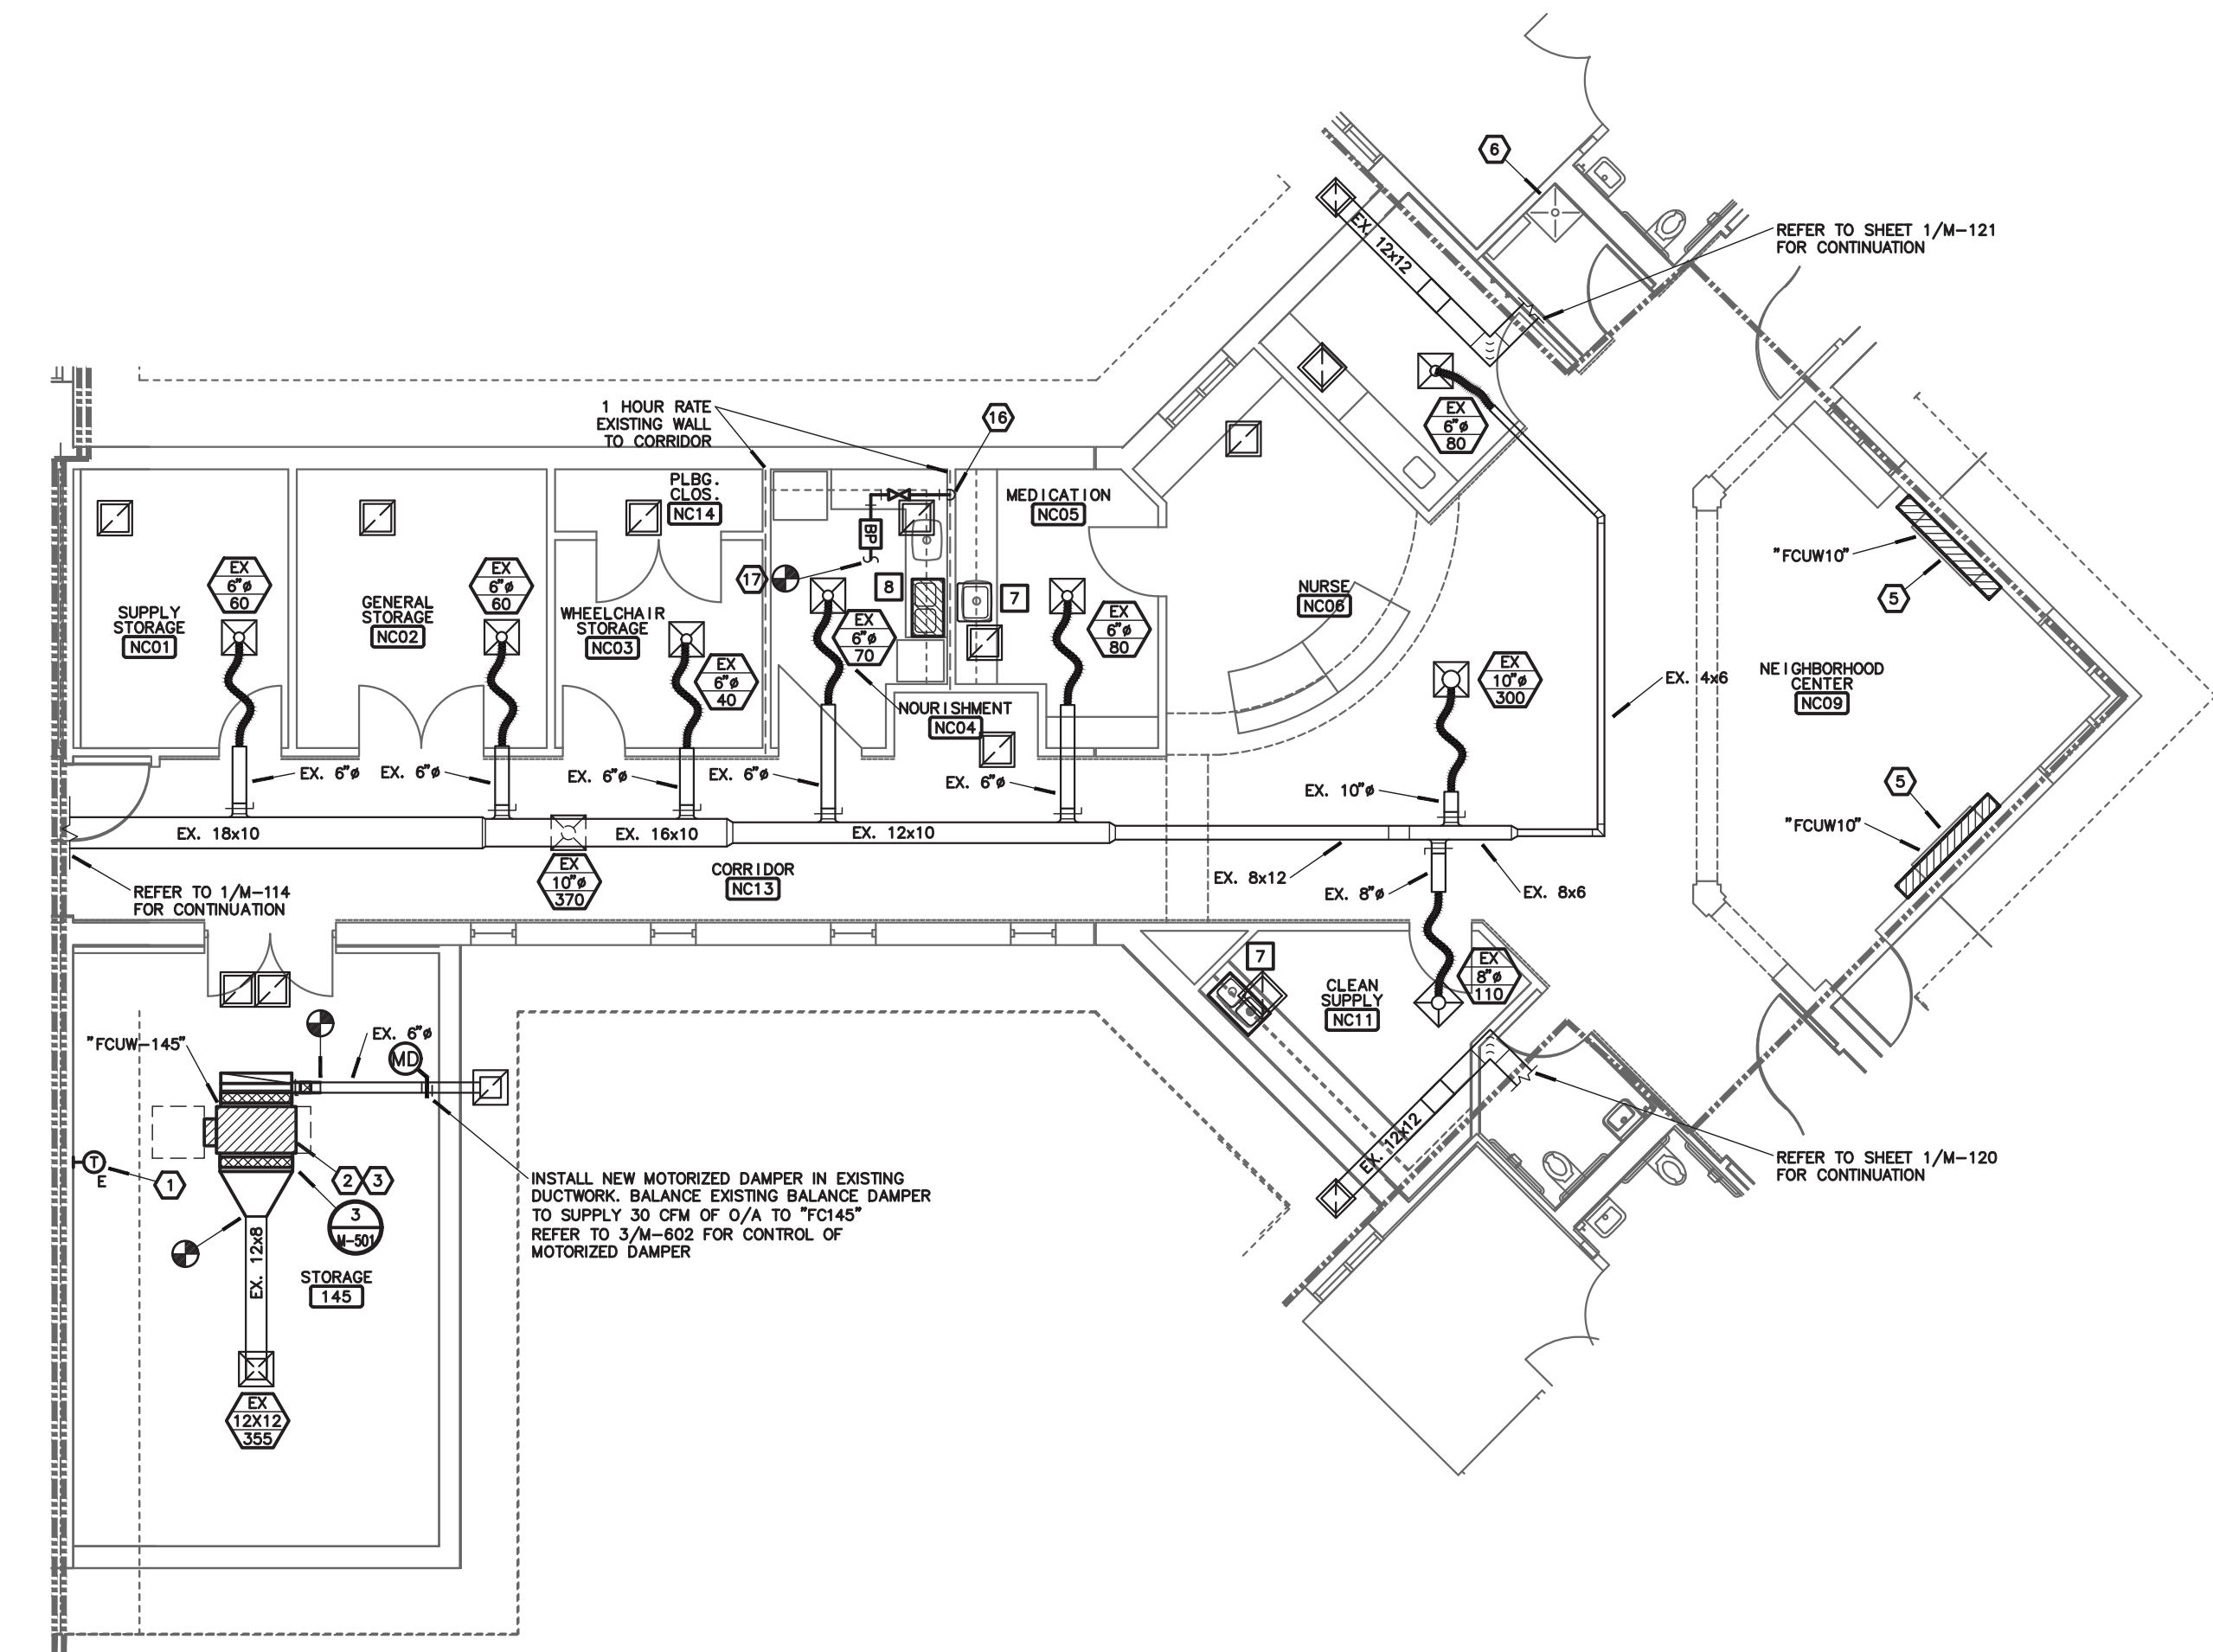
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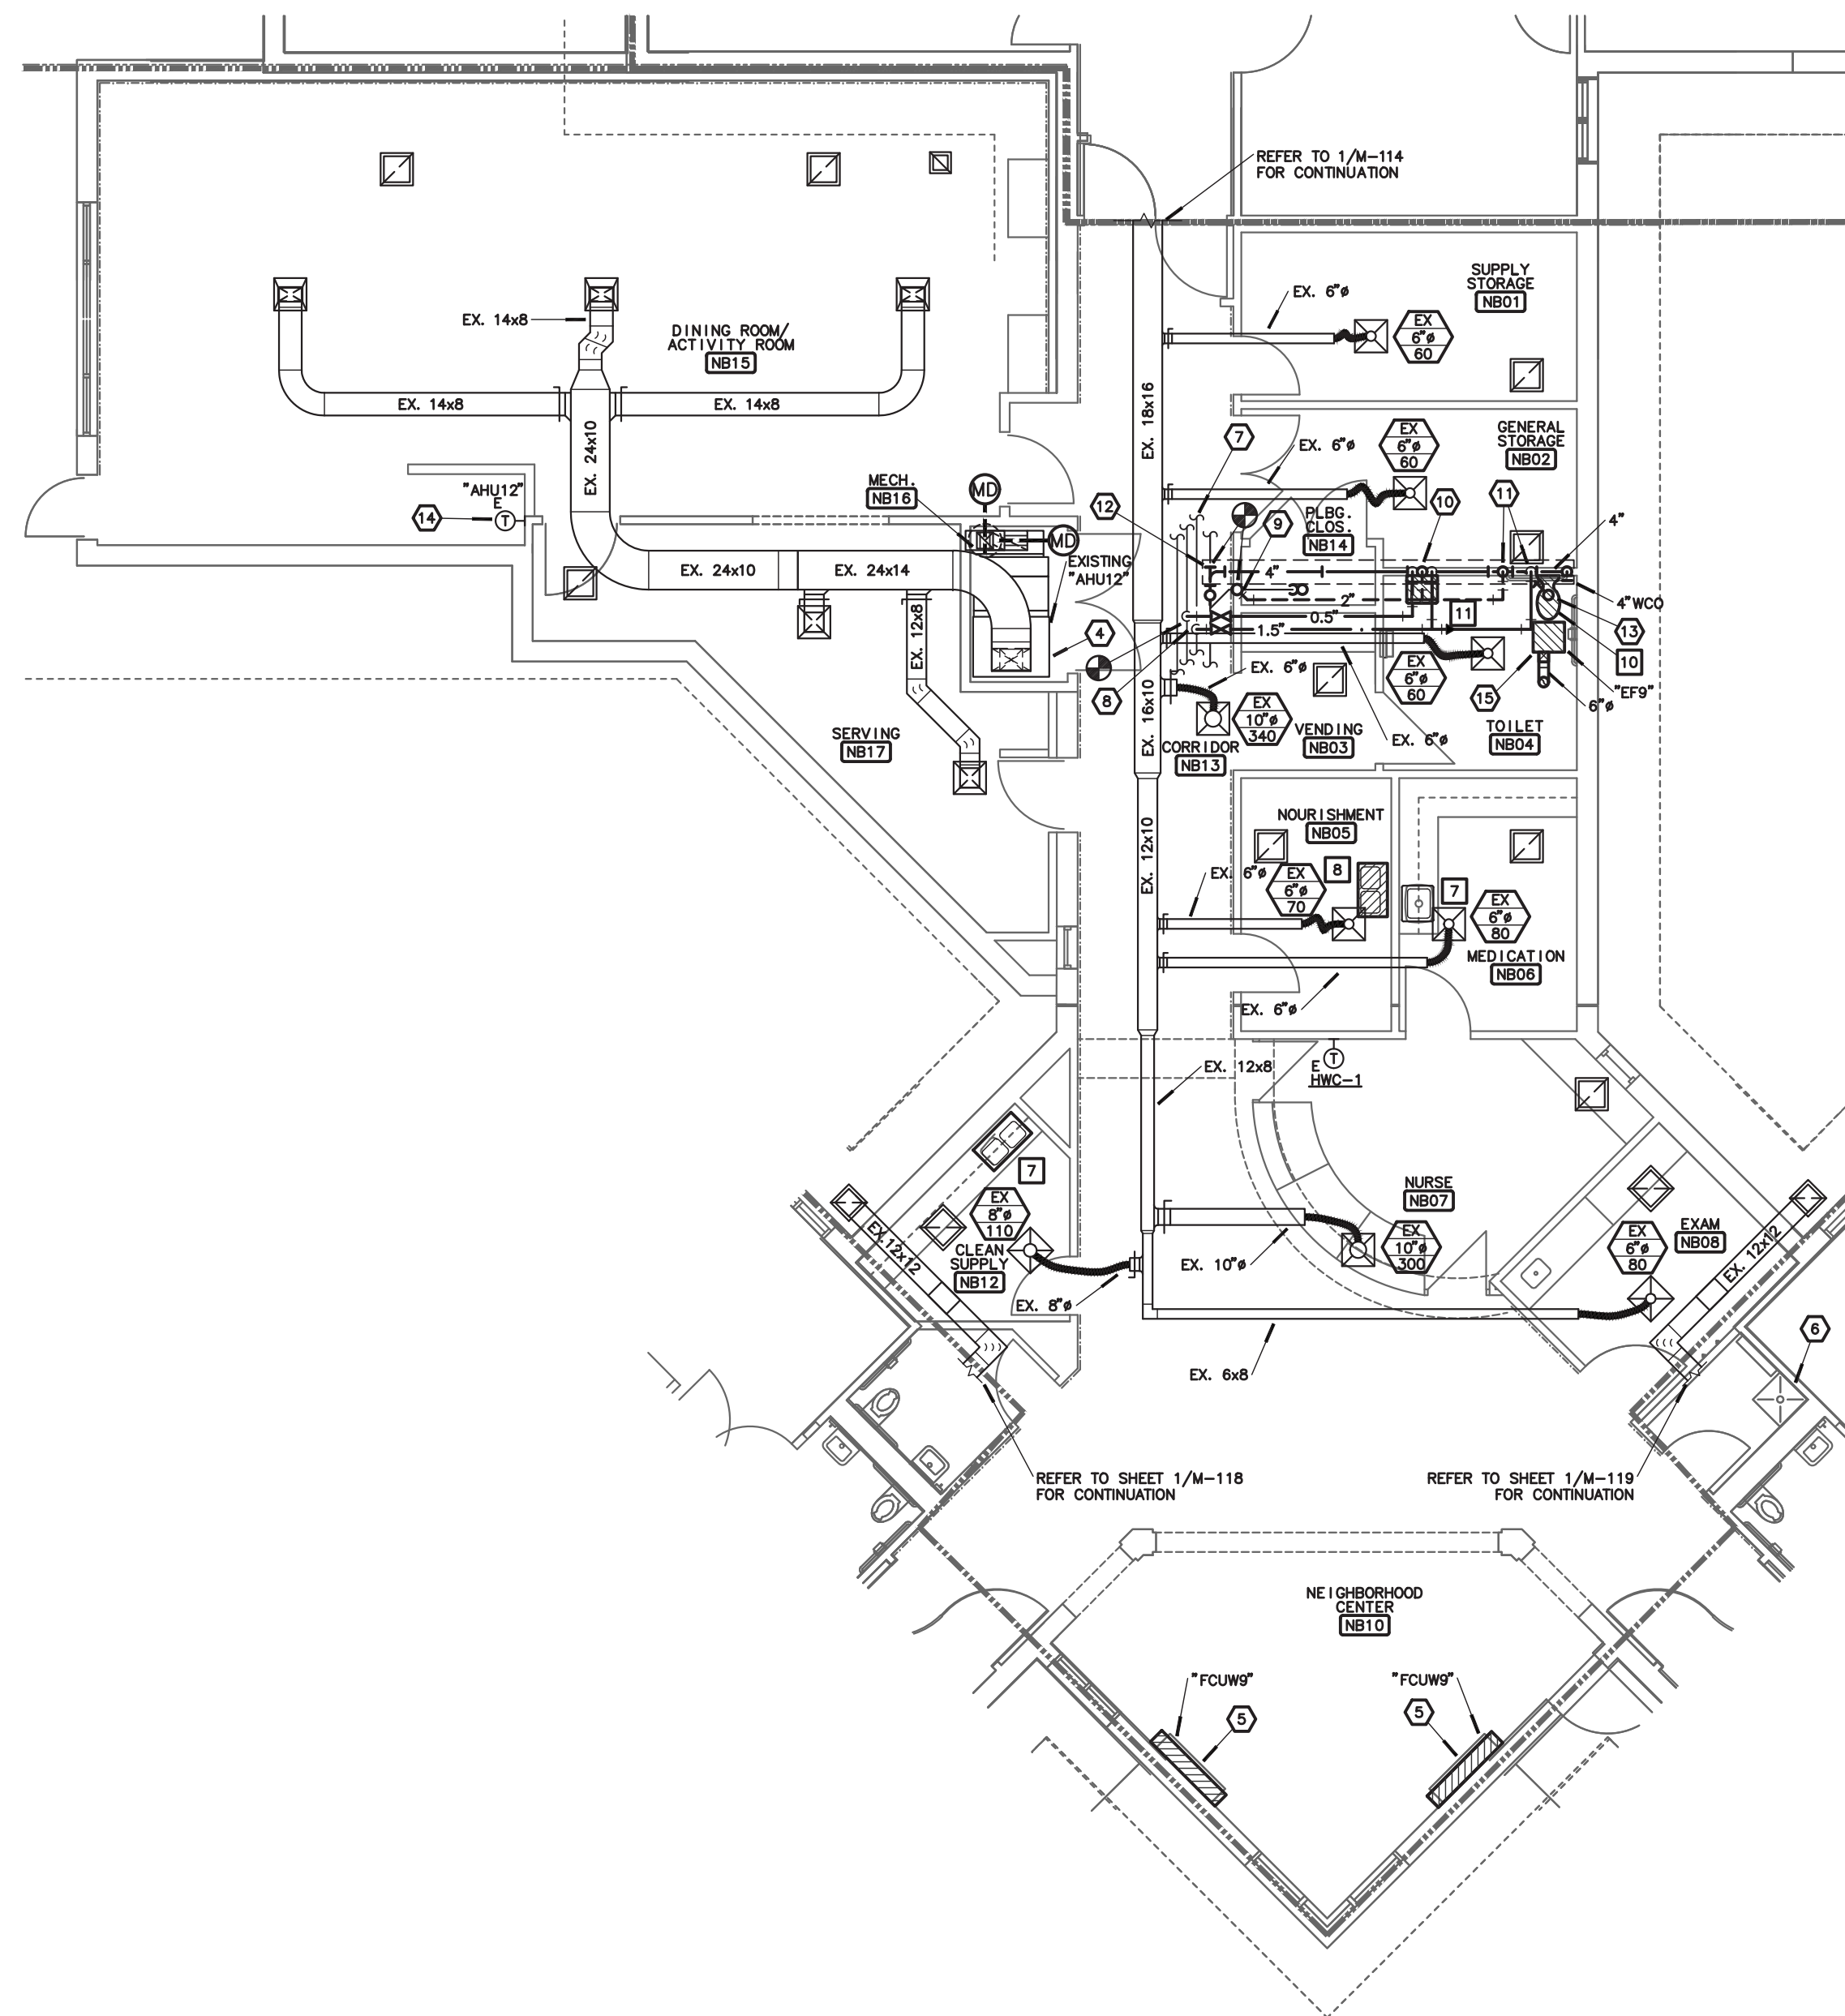
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**3**  
**M-115** **NURSING CORE A**  
**MECHANICAL IMPROVEMENT PLAN**  
SCALE: 1/8"=1'-0" NORTH



**2**  
**M-115** **NURSING CORE C**  
**MECHANICAL IMPROVEMENT PLAN**  
SCALE: 1/8"=1'-0" NORTH





**1**  
**M-115** **NURSING CORE B**  
**MECHANICAL IMPROVEMENT PLAN**  
SCALE: 1/8"=1'-0" NORTH

## NOTES:

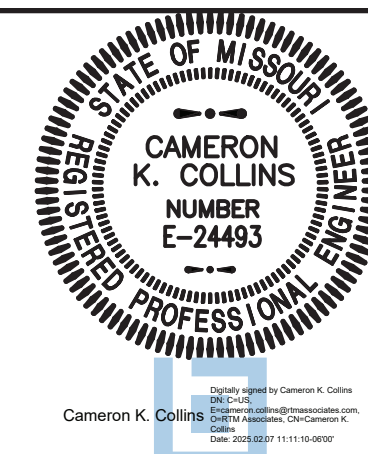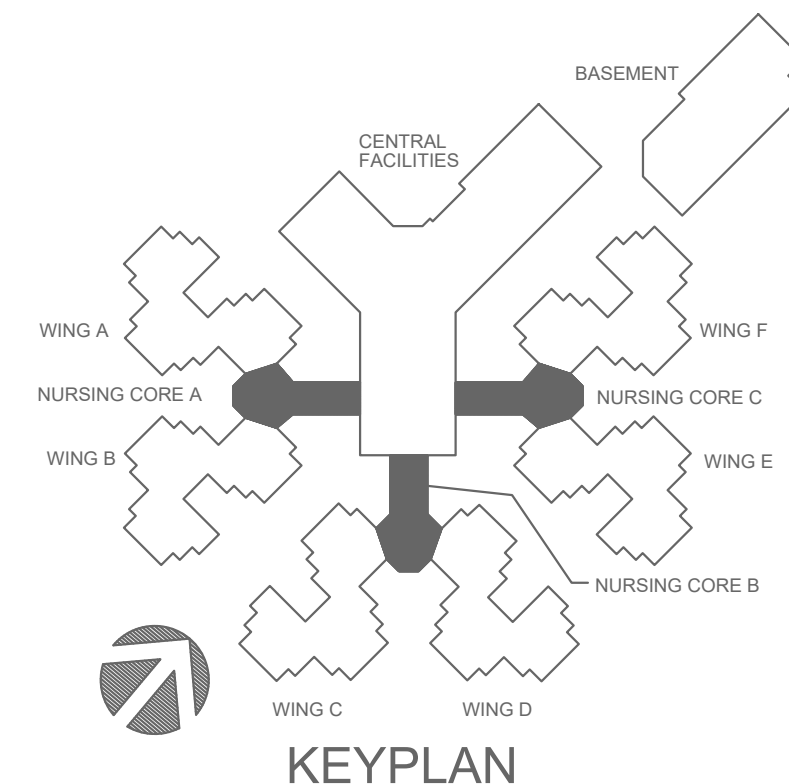1. PROVIDE NEW THERMOSTAT AND CONTROL WIRING TO UNIT. REUTILIZE ANY EXISTING CONDUIT, PATCH, REPAIR AND PAINT WALL PER ARCHITECT'S DIRECTION.
2. PROVIDE NEW 4-PIPE FAN COIL UNIT. FIELD VERIFY EXISTING CONDITIONS, AVAILABLE WALL AND FLOOR SPACE, AND LOCATION OF CONNECTIONS TO ALL EXISTING PIPING AND POWER CONNECTIONS PRIOR TO SUBMITTAL OF FAN COIL UNITS. REFER TO PLAN M-600 FOR SCHEDULE.
3. REBALANCE ALL EXISTING SUPPLY DIFFUSERS SERVED BY THIS AIR HANDLING UNIT.
4. EXISTING AIR HANDLING UNIT SHALL REMAIN.
5. PROVIDE NEW 4-PIPE FAN COIL UNIT. FIELD VERIFY EXISTING CONDITIONS, AVAILABLE WALL AND FLOOR SPACE, AND LOCATION OF CONNECTIONS TO ALL EXISTING PIPING AND POWER CONNECTIONS PRIOR TO SUBMITTAL OF FAN COIL UNITS. PROVIDE ALL MODIFICATIONS TO EXISTING PIPING CONDITIONS AS REQUIRED FOR NEW FAN COIL. RECONNECT TO EXISTING OUTSIDE AIR LOWER AS REQUIRED. REFER TO PLAN M-600 FOR SCHEDULE.
6. PROVIDE NEW CHECK VALVE IN COLD WATER SUPPLY PIPING THAT SERVES MOP SINK.
7. EXISTING 0.75" HWR, 1.5" HW AND 2.5" CW PIPING TO REMAIN.
8. CONNECT NEW 0.5" HW AND 1.5" CW TO EXISTING HOT AND COLD WATER PIPING. FIELD VERIFY EXISTING PIPE SIZES SHOWN.
9. CONNECT NEW 2" VENT TO EXISTING VENT. FIELD VERIFY EXACT LOCATION.
10. 0.5" CW, 0.5" HW AND 1.5" VENT DOWN AND 2" WASTE UP TO LAVATORY.
11. 1.25" CW AND 2" VENT DOWN FOR WATER CLOSET.
12. CONNECT NEW 4" WASTE TO EXISTING WASTE BELOW SLAB. SAW CUT EXISTING FLOOR FOR NEW WASTE TO EXISTING WASTE PIPING.
13. 4" WASTE UP TO WATER CLOSET.
14. EXISTING CONTROLS AND THERMOSTAT FOR EXISTING FAN COIL UNIT TO REMAIN.
15. PROVIDE NEW EXHAUST FAN. ROUTE 6" ROUND EXHAUST DUCT UP TO ROOF. PROVIDE ROOF JACK ON 18" CURB FOR EXHAUST FAN DUCT.
16. EXTEND 0.5" DOMESTIC COLD WATER CONNECTION TO COFFEE MAKER AND PROVIDE SHUTOFF VALVE AND APPROVED BACKFLOW PREVENTOR FOR CONNECTION. REFERENCE ARCHITECTS PLAN FOR EXACT LOCATION.
17. CONNECT NEW 0.5" DOMESTIC COLD WATER TO EXISTING DOMESTIC COLD WATER PIPING. FIELD VERIFY EXISTING PIPE LOCATION.

## GENERAL NOTES:

1. FOR ALL PLUMBING OR HVAC QUESTIONS DURING BIDDING OR DURING CONSTRUCTION, CONTACT ESTERLY SCHNEIDER & ASSOCIATES, INC. THOM LINDBERG (417-862-0558) FOR COORDINATION WITH TYLER ENSSERO AT RTM ENGINEERING CONSULTANTS.
2. FOR ALL REPLACEMENTS OF FAUCETS WITH NEW FAUCETS AND REPLACEMENT OF SINKS WITH NEW SINKS AND FAUCETS, CONTRACTOR SHALL CONNECT TO EXISTING WASTE, HOT WATER, COLD WATER AND VENT AND PROVIDE NEW STOPS FOR HOT AND COLD WATER.
3. CONTRACTOR SHALL FIELD VERIFY ALL EXISTING CONSTRUCTION PRIOR TO SUBMITTING HIS BID. NO EXTRAS WILL BE PAID DUE TO UNANTICIPATED EXISTING CONDITIONS.
4. CONTRACTOR SHALL SCHEDULE AND EXECUTE ALL WORK WITH REGARD TO THE OWNER'S USE OF THE BUILDING.
5. PLANS ARE DIAGRAMMATIC AND SHALL NOT BE SCALED. REFER TO ARCHITECTURAL DRAWINGS FOR DIMENSIONS.
6. CONTRACTOR SHALL REMOVE AND REPLACE CEILING TILE AND CEILING GRID AS REQUIRED TO PERFORM ALL DEMOLITION AND IMPROVEMENT WORK. CONTRACTOR SHALL REPLACE ALL DAMAGED CEILING TILE TO MATCH EXISTING.
7. REFER TO PLANS M-113, M-600, & M-601 FOR PLUMBING FIXTURE AND MECHANICAL SCHEDULES.



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OFFICE OF ADMINISTRATION  
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PROJECT # **U1503-01**  
SITE # **6801**  
ASSET # **8136801002**  
FEDERAL # **29-044**

REVISION: \_\_\_\_\_  
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DATE: \_\_\_\_\_  
ISSUE DATE: **8-1-24**

CAD DWG FILE: **M-115.DWG**  
DRAWN BY: **TSE**  
CHECKED BY: **CKC**  
DESIGNED BY: **TSE**

SHEET TITLE:

**HVAC &  
PLUMBING  
PLAN**


SHEET NUMBER:

**M-115**

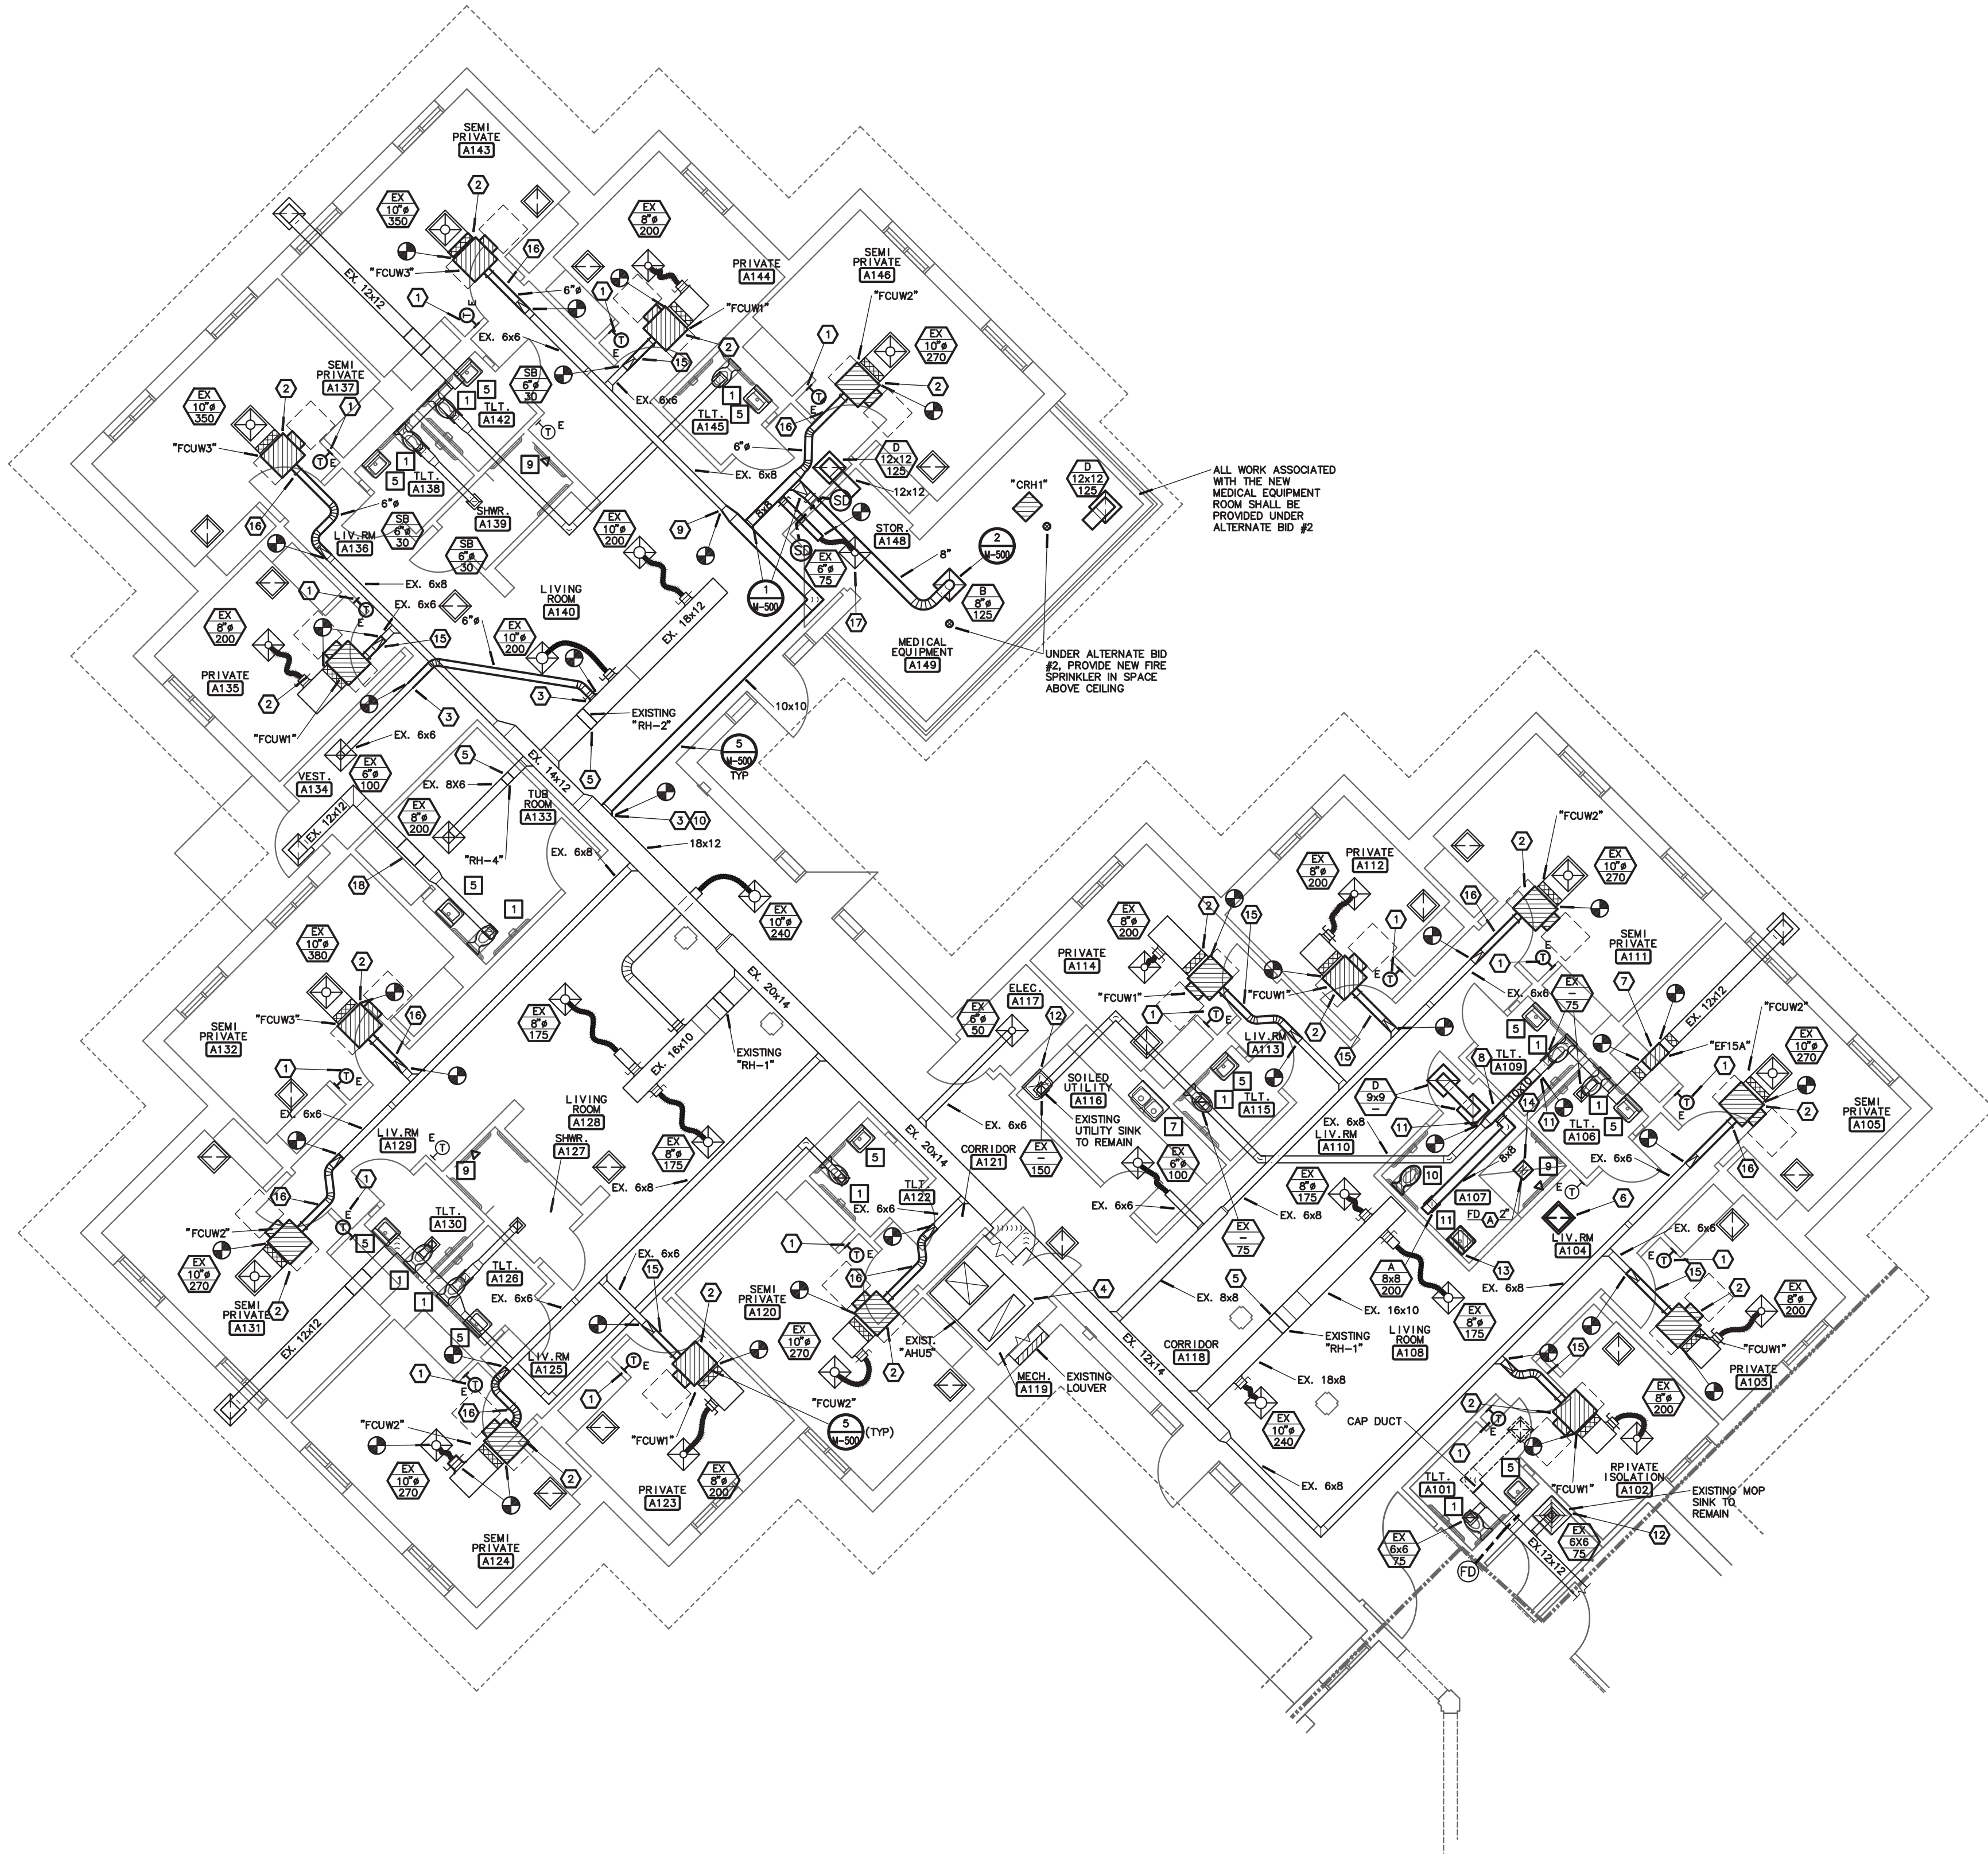66 OF 120 SHEETS

8-1-24





**1 BASE BID WING 'A' - MECHANICAL IMPROVEMENT PLAN**  
**M-116** SCALE: 1/8"=1'-0"



ALTERNATE #1:  
ALL WORK ASSOCIATED WITH INFECTIOUS CONTROL WING 'A' FOR REVISED MECHANICAL AND ELECTRICAL WORK ASSOCIATED WITH THE REQUIREMENTS TO ACHIEVE THE INFECTIOUS CONTROL AREAS DEFINED ON THE MECHANICAL PLANS. REFER TO SHEETS A-104, A-114, A-121, A-200, A-201, M-105, M-116, M-127, M-133, M-134 AND E-105, AND E-116 AND ALL ASSOCIATED DETAILS, SCHEDULES AND SPECIFICATION SECTIONS REQUIRED FOR ADDITIONAL INFORMATION AS IT PERTAINS TO WING A.  
ALTERNATE #1 SHALL NOT INCLUDE REMOVING AND INSTALLING NEW FLOORING, REMOVING AND INSTALLING NEW WALL BASE, PAINTING OF ANY WALLS, ANY WORK ASSOCIATED WITH DEMOLITION OR NEW CONSTRUCTION FOR SHOWER ROOM A107. ALTERNATE SHALL NOT INCLUDE ANY WORK ASSOCIATED WITH NEW TV MOUNTING AND BLOODING, NOR WORK ASSOCIATED WITH OTHER ALTERNATE WORK IN THIS WING. THESE ITEMS REMAIN IN THE BASE BID AND AS DEFINED IN THE PHASING SCHEDULE. ANY ITEMS NOT LISTED SPECIFICALLY ABOVE, BUT SHOWN ON THE DRAWINGS/SPECIFICATIONS, SHALL REMAIN IN THE ALTERNATE BID #1.


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State of Missouri certificate of authority  
#2014035826 for engineering

**NOTES:**

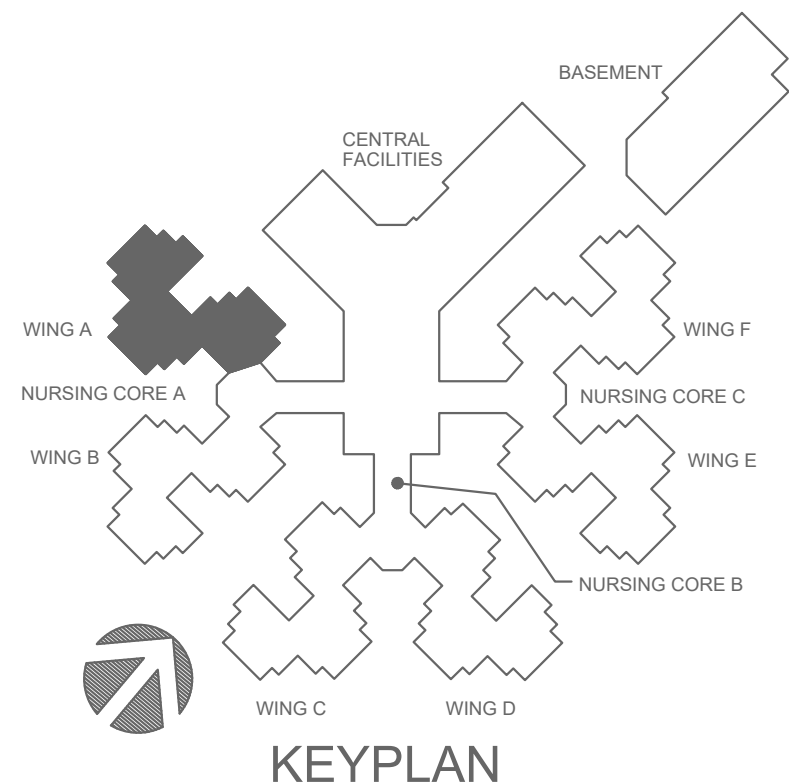
1. PROVIDE NEW TEMPERATURE SENSOR THERMOSTAT AND CONTROL WIRING TO UNIT. REUTILIZE ANY EXISTING CONDUIT. PATCH, REPAIR AND PAINT WALL PER ARCHITECT'S DIRECTION.
2. PROVIDE NEW HORIZONTAL 4-PIPE FAN COIL UNIT. FIELD VERIFY EXISTING CONDITIONS, PIPING LOCATION, AVAILABLE SPACE AND CLEARANCE FOR MAINTENANCE AND EXISTING SHEET METAL SIZES AND LOCATIONS PRIOR TO SUBMITTING EQUIPMENT. CONNECT EXISTING SUPPLY AND RETURN DUCT TO NEW UNIT CONNECTIONS WITH FLEXIBLE CONNECTORS. PROVIDE ANY ADDITIONAL TRANSITION AS NECESSARY. BALANCE FAN COIL TO SCHEDULED AIRFLOW. CUT AND PATCH HARD CEILING WHERE REQUIRED TO REMOVE UNIT AND PROVIDE ACCESS PANEL FOR NEW UNIT. REFER TO PLAN M-600 FOR SCHEDULE.
3. CONNECT TO EXISTING DUCTWORK. FIELD VERIFY EXISTING DUCTWORK FOR CONNECTION.
4. EXISTING AIR HANDLING UNIT AND CONTROLS TO REMAIN IN BASE BID. UNDER ALTERNATE BID #1, A/H SHALL BE REPLACED. TAB CONTRACTOR SHALL BALANCE AIR HANDLING UNIT AND ALL DIFFUSERS AND FAN COIL INTAKES TO THE VALUES INDICATED.
5. EXISTING HOT WATER COIL TO REMAIN. CONTRACTOR SHALL CLEAN EXISTING HEATING COIL.
6. NEW LOCATION OF RELOCATED RETURN AIR GRILLE.
7. REPLACE EXISTING EXHAUST FAN WITH NEW EXHAUST FAN. CONNECT TO EXISTING DUCTS AND FLEX CONNECTORS. REFER TO PLAN M-601 FOR SCHEDULE.
8. REMOVE EXISTING EXHAUST GRILLE AND CAP MAIN. PROVIDE NEW 8x8 TAP TO NEW EXHAUST GRILLE LOCATION.
9. CONNECT TRANSITION TO EXISTING DUCTWORK. FIELD VERIFY EXISTING DUCT SIZE.
10. UNDER BASE BID #1, ENLARGE EXISTING OPENING IN EXISTING SUPPLY AIR DUCT AND INSTALL NEW 10X10 SUPPLY AIR DUCT TAP.
11. REPLACE EXISTING DUCT WITH NEW 10X10 DUCT AND CONNECT TO EXISTING DUCT. FIELD VERIFY EXISTING DUCT SIZE.
12. ADD CHECK VALVE TO COLD WATER SUPPLY TO MOP SINK OR UTILITY SINK.
13. CONFIRM PRIOR TO BID THAT WASTE, HOT WATER AND COLD WATER FOR NEW SINK WILL BE ACCESSIBLE FOR CONNECTION TO NEW FIXTURE.
14. INSTALL NEW FLOOR DRAIN AT CENTER OF SHOWER PAN. CONNECT TO EXISTING WASTE BELOW FLOOR. COORDINATE FLOORING DEMOLITION WITH ARCHITECT AND GENERAL CONTRACTOR. REFER TO PLAN M-113 FOR FLOORING FIXTURE SCHEDULE.
15. CONNECT NEW 8" DUCT TO RETURN AIR PORTION OF FAN COIL UNIT. PROVIDE BALANCE DAMPER AND BALANCE TO 90 CFM.
16. CONNECT NEW 6" DUCT TO RETURN AIR PORTION OF FAN COIL UNIT. PROVIDE BALANCE DAMPER AND BALANCE TO 135 CFM.
17. UNDER BASE BID, EXISTING DIFFUSER AND FLEX DUCT IN STORAGE ROOM SHALL REMAIN. RECONNECT TO NEW 6x8 DUCT. UNDER ALTERNATE #2, REMOVE THIS DIFFUSER AND PROVIDE NEW DUCT AND DIFFUSER AS SHOWN FOR MEDICAL EQUIPMENT ROOM ADDITION.
18. EXISTING EXHAUST FAN AND ASSOCIATED DUCTWORK SHALL REMAIN IN BASE BID.

**GENERAL NOTES:**

1. PROVIDE DRY PIPE FIRE PROTECTION IN ATTIC AND NET PIPE FIRE PROTECTION IN ROOM, STORAGE A149. REFER TO SPECIFICATIONS.
2. RE-BALANCE ALL EXISTING EXHAUST GRILLES SERVED BY EXISTING EXHAUST FANS THAT ARE BEING REPLACED.
3. FOR ALL PLUMBING OR HVAC QUESTIONS DURING BIDDING OR DURING CONSTRUCTION, CONTACT ESTERLY, SCHNEIDER & ASSOCIATES, INC. (417-862-0558) FOR COORDINATION WITH TYLER ENSERRO AT RTM ENGINEERING CONSULTANTS.
4. CONTRACTOR SHALL FIELD VERIFY ALL EXISTING CONSTRUCTION PRIOR TO SUBMITTING HIS BID. NO EXTRAS WILL BE PAID DUE TO UNANTICIPATED EXISTING CONDITIONS.
5. CONTRACTOR SHALL SCHEDULE AND EXECUTE ALL WORK WITH REGARD TO THE OWNER'S USE OF THE BUILDING.
6. PLANS ARE DIAGRAMMATIC AND SHALL NOT BE SCALED. REFER TO ARCHITECTURAL DRAWINGS FOR DIMENSIONS.
7. CONTRACTOR SHALL REMOVE AND REPLACE CEILING TILE AND CEILING GRID AS REQUIRED TO PERFORM ALL DEMOLITION AND IMPROVEMENT WORK. CONTRACTOR SHALL REPLACE ALL DAMAGED CEILING TILE TO MATCH EXISTING.
8. REFER TO PLANS M-113, M-600, M-601 FOR PLUMBING FIXTURES AND MECHANICAL SCHEDULES.



STATE OF MISSOURI  
MIKE KEHOE,  
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AIA architects & planners
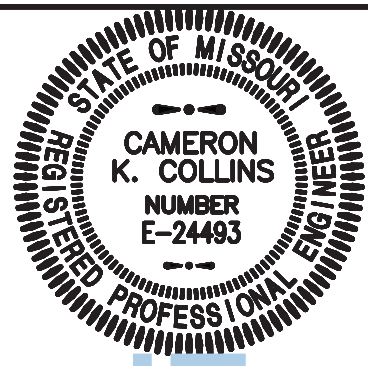
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DEPARTMENT OF  
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MISSOURI VETERANS  
HOME

620 N. JEFFERSON  
ST. JAMES, MISSOURI

PROJECT # **U1503-01**  
SITE # **6801**  
ASSET # **8136801002**  
FEDERAL # **29-044**

REVISION: \_\_\_\_\_  
DATE: \_\_\_\_\_  
REVISION: \_\_\_\_\_  
DATE: \_\_\_\_\_  
REVISION: \_\_\_\_\_  
DATE: \_\_\_\_\_  
ISSUE DATE: **8-1-24**

CAD DWG FILE: **M-116.DWG**  
DRAWN BY: **TSE**  
CHECKED BY: **CKC**  
DESIGNED BY: **TSE**

SHEET TITLE:

**HVAC &  
PLUMBING  
PLAN**

SHEET NUMBER:

**M-116**

67 OF 120 SHEETS

8-1-24



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1 WING 'B' - MECHANICAL IMPROVEMENT PLAN  
M-117 SCALE: 1/8"=1'-0" NORTH

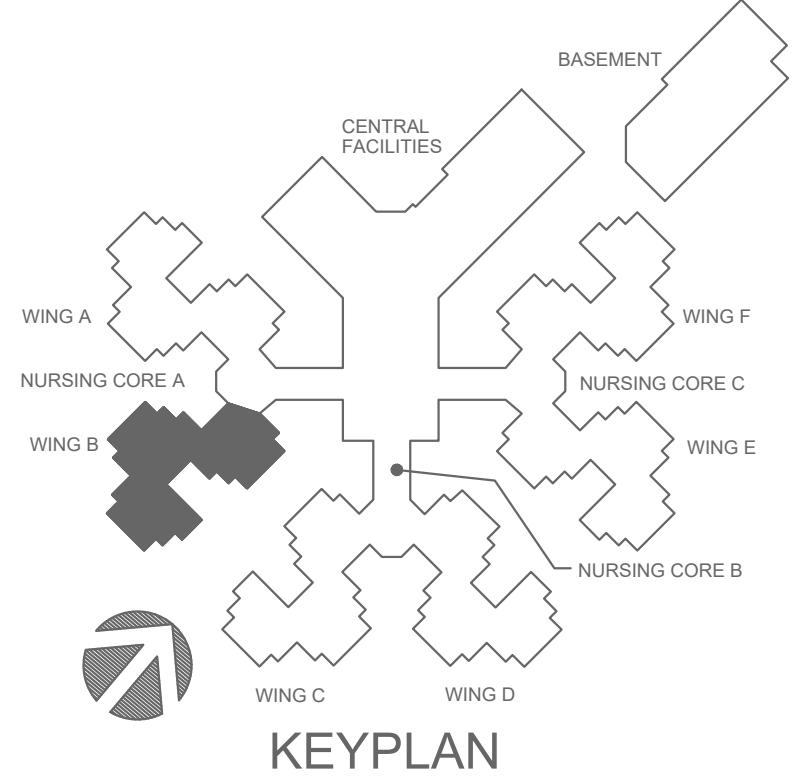
engineering consultants  
3333 E. Battlefield Road, Ste. 1000  
Springfield, MO 65804  
rtmec.com | 417.881.0020  
State of Missouri certificate of authority  
#2014035826 for engineering

## NOTES:


1. PROVIDE NEW THERMOSTAT AND CONTROL WIRING TO UNIT. REUTILIZE ANY EXISTING CONDUIT. PATCH, REPAIR AND PAINT WALL PER ARCHITECT'S DIRECTION.
2. PROVIDE NEW HORIZONTAL 4-PIPE FAN COIL UNIT. FIELD VERIFY EXISTING CONDITIONS, PIPING LOCATION, AVAILABLE SPACE AND CLEARANCE FOR MAINTENANCE AND EXISTING SHEETMETAL SIZES AND LOCATIONS PRIOR TO SUBMITTING EQUIPMENT. CONNECT EXISTING SUPPLY AND RETURN DUCT TO NEW UNIT CONNECTIONS WITH FLEXIBLE CONNECTORS. PROVIDE ANY ADDITIONAL TRANSITION AS NECESSARY. BALANCE FAN COIL TO SCHEDULED AIRFLOWS. CUT AND PATCH HARD CEILING WHERE REQUIRED TO REMOVE UNIT AND PROVIDE ACCESS PANEL FOR NEW UNIT. REFER TO PLAN M-400 FOR SCHEDULE.
3. ADD CHECK VALVE TO COLD WATER SUPPLY TO MOP SINK OR UTILITY SINK.
4. EXISTING AIR HANDLING UNIT. TAB CONTRACTOR SHALL BALANCE AIR HANDLING UNIT AND ALL DIFFUSERS AND FAN COIL INTAKES TO THE VALUES INDICATED.
5. EXISTING HOT WATER COIL TO REMAIN. CONTRACTOR SHALL CLEAN EXISTING HOT WATER COIL.
6. CONNECT TRANSITION TO EXISTING DUCTWORK. FIELD VERIFY EXISTING DUCT SIZE.
7. UNDER ALTERNATE BID #1, ENLARGE EXISTING OPENING IN EXISTING SUPPLY AIR DUCT AND INSTALL NEW 10X10 SUPPLY AIR DUCT TAP.
8. CONNECT TO EXISTING DUCTWORK. FIELD VERIFY EXISTING DUCTWORK FOR CONNECTION.
9. UNDER BASE BID, EXISTING DIFFUSER AND FLEX DUCT IN STORAGE ROOM SHALL REMAIN. RECONNECT TO NEW 8x8 DUCT. UNDER ALTERNATE #2, REMOVE THIS DIFFUSER AND PROVIDE NEW DUCT AND DIFFUSER AS SHOWN FOR MEDICAL EQUIPMENT ROOM ADDITION.
10. CONNECT NEW 6" DUCT TO RETURN AIR PORTION OF FAN COIL UNIT. PROVIDE BALANCE DAMPER AND BALANCE TO 90 CFM.
11. CONNECT NEW 6" DUCT TO RETURN AIR PORTION OF FAN COIL UNIT. PROVIDE BALANCE DAMPER AND BALANCE TO 135 CFM.

## GENERAL NOTES:

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2. FOR ALL PLUMBING OR HVAC QUESTIONS DURING BIDDING OR DURING CONSTRUCTION, CONTACT ESTERLY, SCHNEIDER & ASSOCIATES, INC. THOM LINDBERG (417-862-0558) FOR COORDINATION WITH TYLER ENSERRO AT RTM ENGINEERING CONSULTANTS.
3. CONTRACTOR SHALL FIELD VERIFY ALL EXISTING CONSTRUCTION PRIOR TO SUBMITTING HIS BID. NO EXTRAS WILL BE PAID DUE TO UNANTICIPATED EXISTING CONDITIONS.
4. CONTRACTOR SHALL SCHEDULE AND EXECUTE ALL WORK WITH REGARD TO THE OWNER'S USE OF THE BUILDING.
5. PLANS ARE DIAGRAMMATIC AND SHALL NOT BE SCALED. REFER TO ARCHITECTURAL DRAWINGS FOR DIMENSIONS.
6. CONTRACTOR SHALL REMOVE AND REPLACE CEILING TILE AND CEILING GRID AS REQUIRED TO PERFORM ALL DEMOLITION AND IMPROVEMENT WORK. CONTRACTOR SHALL REPLACE ALL DAMAGED CEILING TILE TO MATCH EXISTING.
7. REFER TO PLANS M-113, M-400, M-601 FOR PLUMBING FIXTURE AND MECHANICAL SCHEDULES.



STATE OF MISSOURI  
MIKE KEHOE,  
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MISSOURI VETERANS  
HOME

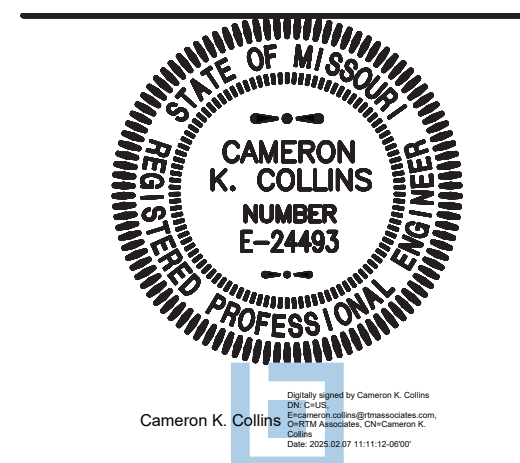620 N. JEFFERSON  
ST. JAMES, MISSOURI

PROJECT # U1503-01  
SITE # 6801  
ASSET # 8136801002  
FEDERAL # 29-044

REVISION: \_\_\_\_\_  
DATE: \_\_\_\_\_  
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DATE: \_\_\_\_\_  
REVISION: \_\_\_\_\_  
DATE: \_\_\_\_\_  
ISSUE DATE: 8-1-24

CAD DWG FILE: M-117.DWG  
DRAWN BY: TSL  
CHECKED BY: CKC  
DESIGNED BY: TSE

SHEET TITLE:  
**HVAC &  
PLUMBING  
PLAN**

SHEET NUMBER:

**M-117**  
68 OF 120 SHEETS

8-1-24







1 WING 'C' - MECHANICAL IMPROVEMENT PLAN  
M-118 SCALE: 1/8"=1'-0" NORTH

## NOTES:

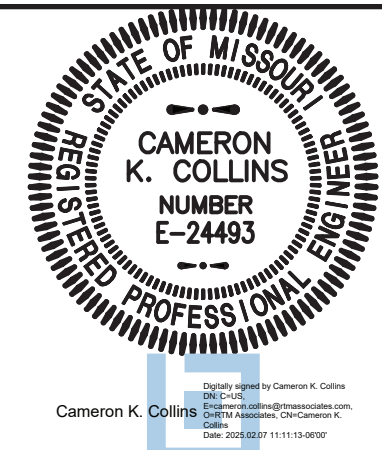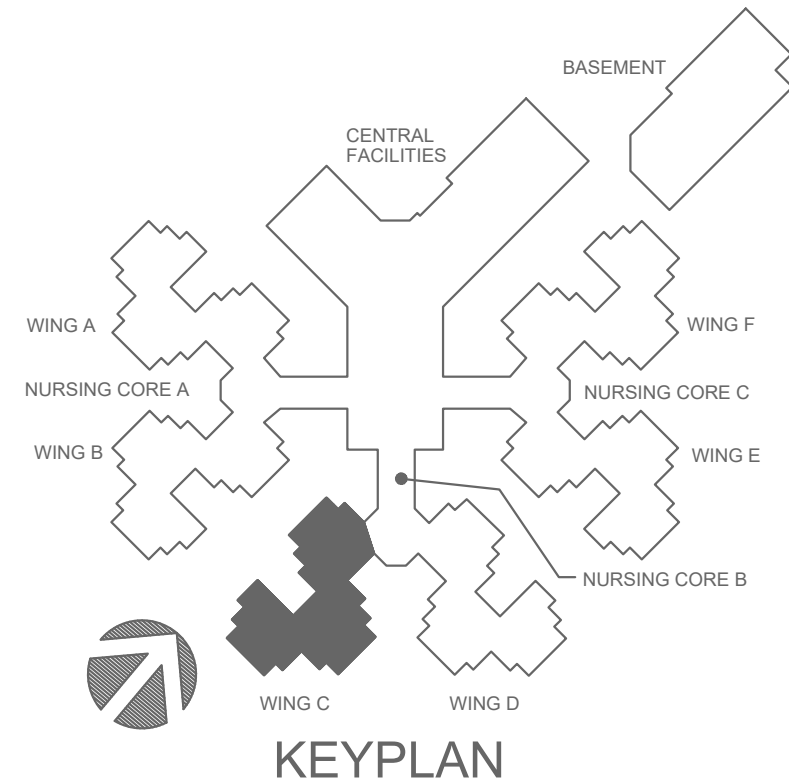1. PROVIDE NEW THERMOSTAT AND CONTROL WIRING TO UNIT. REUTILIZE ANY EXISTING CONDUIT, PATCH, REPAIR AND PAINT WALL PER ARCHITECT'S DIRECTION.
2. PROVIDE NEW HORIZONTAL 4-PIPE FAN COIL UNIT. FIELD VERIFY EXISTING CONDITIONS, PIPING LOCATION, AVAILABLE SPACE AND CLEARANCE FOR MAINTENANCE AND EXISTING SHEETMETAL SIZES AND LOCATIONS PRIOR TO SUBMITTING EQUIPMENT. CONNECT EXISTING SUPPLY AND RETURN DUCT TO NEW UNIT CONNECTIONS WITH FLEXIBLE CONNECTORS. PROVIDE ANY ADDITIONAL TRANSITION AS NECESSARY. BALANCE FAN COIL TO SCHEDULED AIRFLOW. CUT AND PATCH HARD CEILING WHERE REQUIRED TO REMOVE UNIT AND PROVIDE ACCESS PANEL FOR NEW UNIT.
3. ADD CHECK VALVE TO COLD WATER SUPPLY TO MOP SINK OR UTILITY SINK.
4. EXISTING AIR HANDLING UNIT. TAB CONTRACTOR SHALL BALANCE AIR HANDLING UNIT AND ALL DIFFUSERS AND FAN COIL INTAKES TO THE VALUES INDICATED.
5. EXISTING HOT WATER COIL TO REMAIN. CONTRACTOR SHALL CLEAN HEATING COILS.
6. CONNECT TRANSITION TO EXISTING DUCTWORK. FIELD VERIFY EXISTING DUCT SIZE.
7. UNDER BASE BID #1, ENLARGE EXISTING OPENING IN EXISTING SUPPLY AIR DUCT AND INSTALL NEW 10X10 SUPPLY AIR DUCT TAP.
8. CONNECT TO EXISTING DUCTWORK. FIELD VERIFY EXISTING DUCTWORK FOR CONNECTION.
9. UNDER BASE BID, EXISTING DIFFUSER AND FLEX DUCT IN STORAGE ROOM SHALL REMAIN. RECONNECT TO NEW 8X8 DUCT. UNDER ALTERNATE #2, REMOVE THIS DIFFUSER AND PROVIDE NEW DUCT AND DIFFUSER AS SHOWN FOR MEDICAL EQUIPMENT ROOM ADDITION.
10. CONNECT NEW 8" DUCT TO RETURN AIR PORTION OF FAN COIL UNIT. PROVIDE BALANCE DAMPER AND BALANCE TO 90 CFM.
11. CONNECT NEW 8" DUCT TO RETURN AIR PORTION OF FAN COIL UNIT. PROVIDE BALANCE DAMPER AND BALANCE TO 135 CFM.

## GENERAL NOTES:

1. RE-BALANCE ALL EXISTING EXHAUST GRILLES SERVED BY EXISTING EXHAUST FANS THAT ARE BEING REPLACED.
2. FOR ALL PLUMBING OR HVAC QUESTIONS DURING BIDDING OR DURING CONSTRUCTION, CONTACT ESTERLY SCHNEIDER & ASSOCIATES, INC. THOM LINDBERG (417-862-0558) FOR COORDINATION WITH TYLER ENDERRO AT RTM ENGINEERING CONSULTANTS.
3. CONTRACTOR SHALL FIELD VERIFY ALL EXISTING CONSTRUCTION PRIOR TO SUBMITTING HIS BID. NO EXTRAS WILL BE PAID DUE TO UNANTICIPATED EXISTING CONDITIONS.
4. CONTRACTOR SHALL SCHEDULE AND EXECUTE ALL WORK WITH REGARD TO THE OWNER'S USE OF THE BUILDING.
5. PLANS ARE DIAGRAMMATIC AND SHALL NOT BE SCALED. REFER TO ARCHITECTURAL DRAWINGS FOR DIMENSIONS.
6. CONTRACTOR SHALL REMOVE AND REPLACE CEILING TILE AND CEILING GRID AS REQUIRED TO PERFORM ALL DEMOLITION AND IMPROVEMENT WORK. CONTRACTOR SHALL REPLACE ALL DAMAGED CEILING TILE TO MATCH EXISTING.
7. REFER TO PLANS M-113, M-600, M-601 FOR PLUMBING FIXTURE AND MECHANICAL SCHEDULES.



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INTERIOR RENOVATION  
MISSOURI VETERANS  
HOME

620 N. JEFFERSON  
ST. JAMES, MISSOURI

PROJECT # U1503-01  
SITE # 6801  
ASSET # 8136801002  
FEDERAL # 29-044

REVISION: \_\_\_\_\_  
DATE: \_\_\_\_\_  
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DATE: \_\_\_\_\_  
REVISION: \_\_\_\_\_  
DATE: \_\_\_\_\_  
ISSUE DATE: 8-1-24

CAD DWG FILE: M-118.DWG  
DRAWN BY: TSE  
CHECKED BY: CKC  
DESIGNED BY: TSE

SHEET TITLE:

HVAC &  
PLUMBING  
PLAN

SHEET NUMBER:


M-118

69 OF 120 SHEETS

8-1-24



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1 WING 'D' - MECHANICAL IMPROVEMENT PLAN  
SCALE: 1/8"=1'-0" NORTH

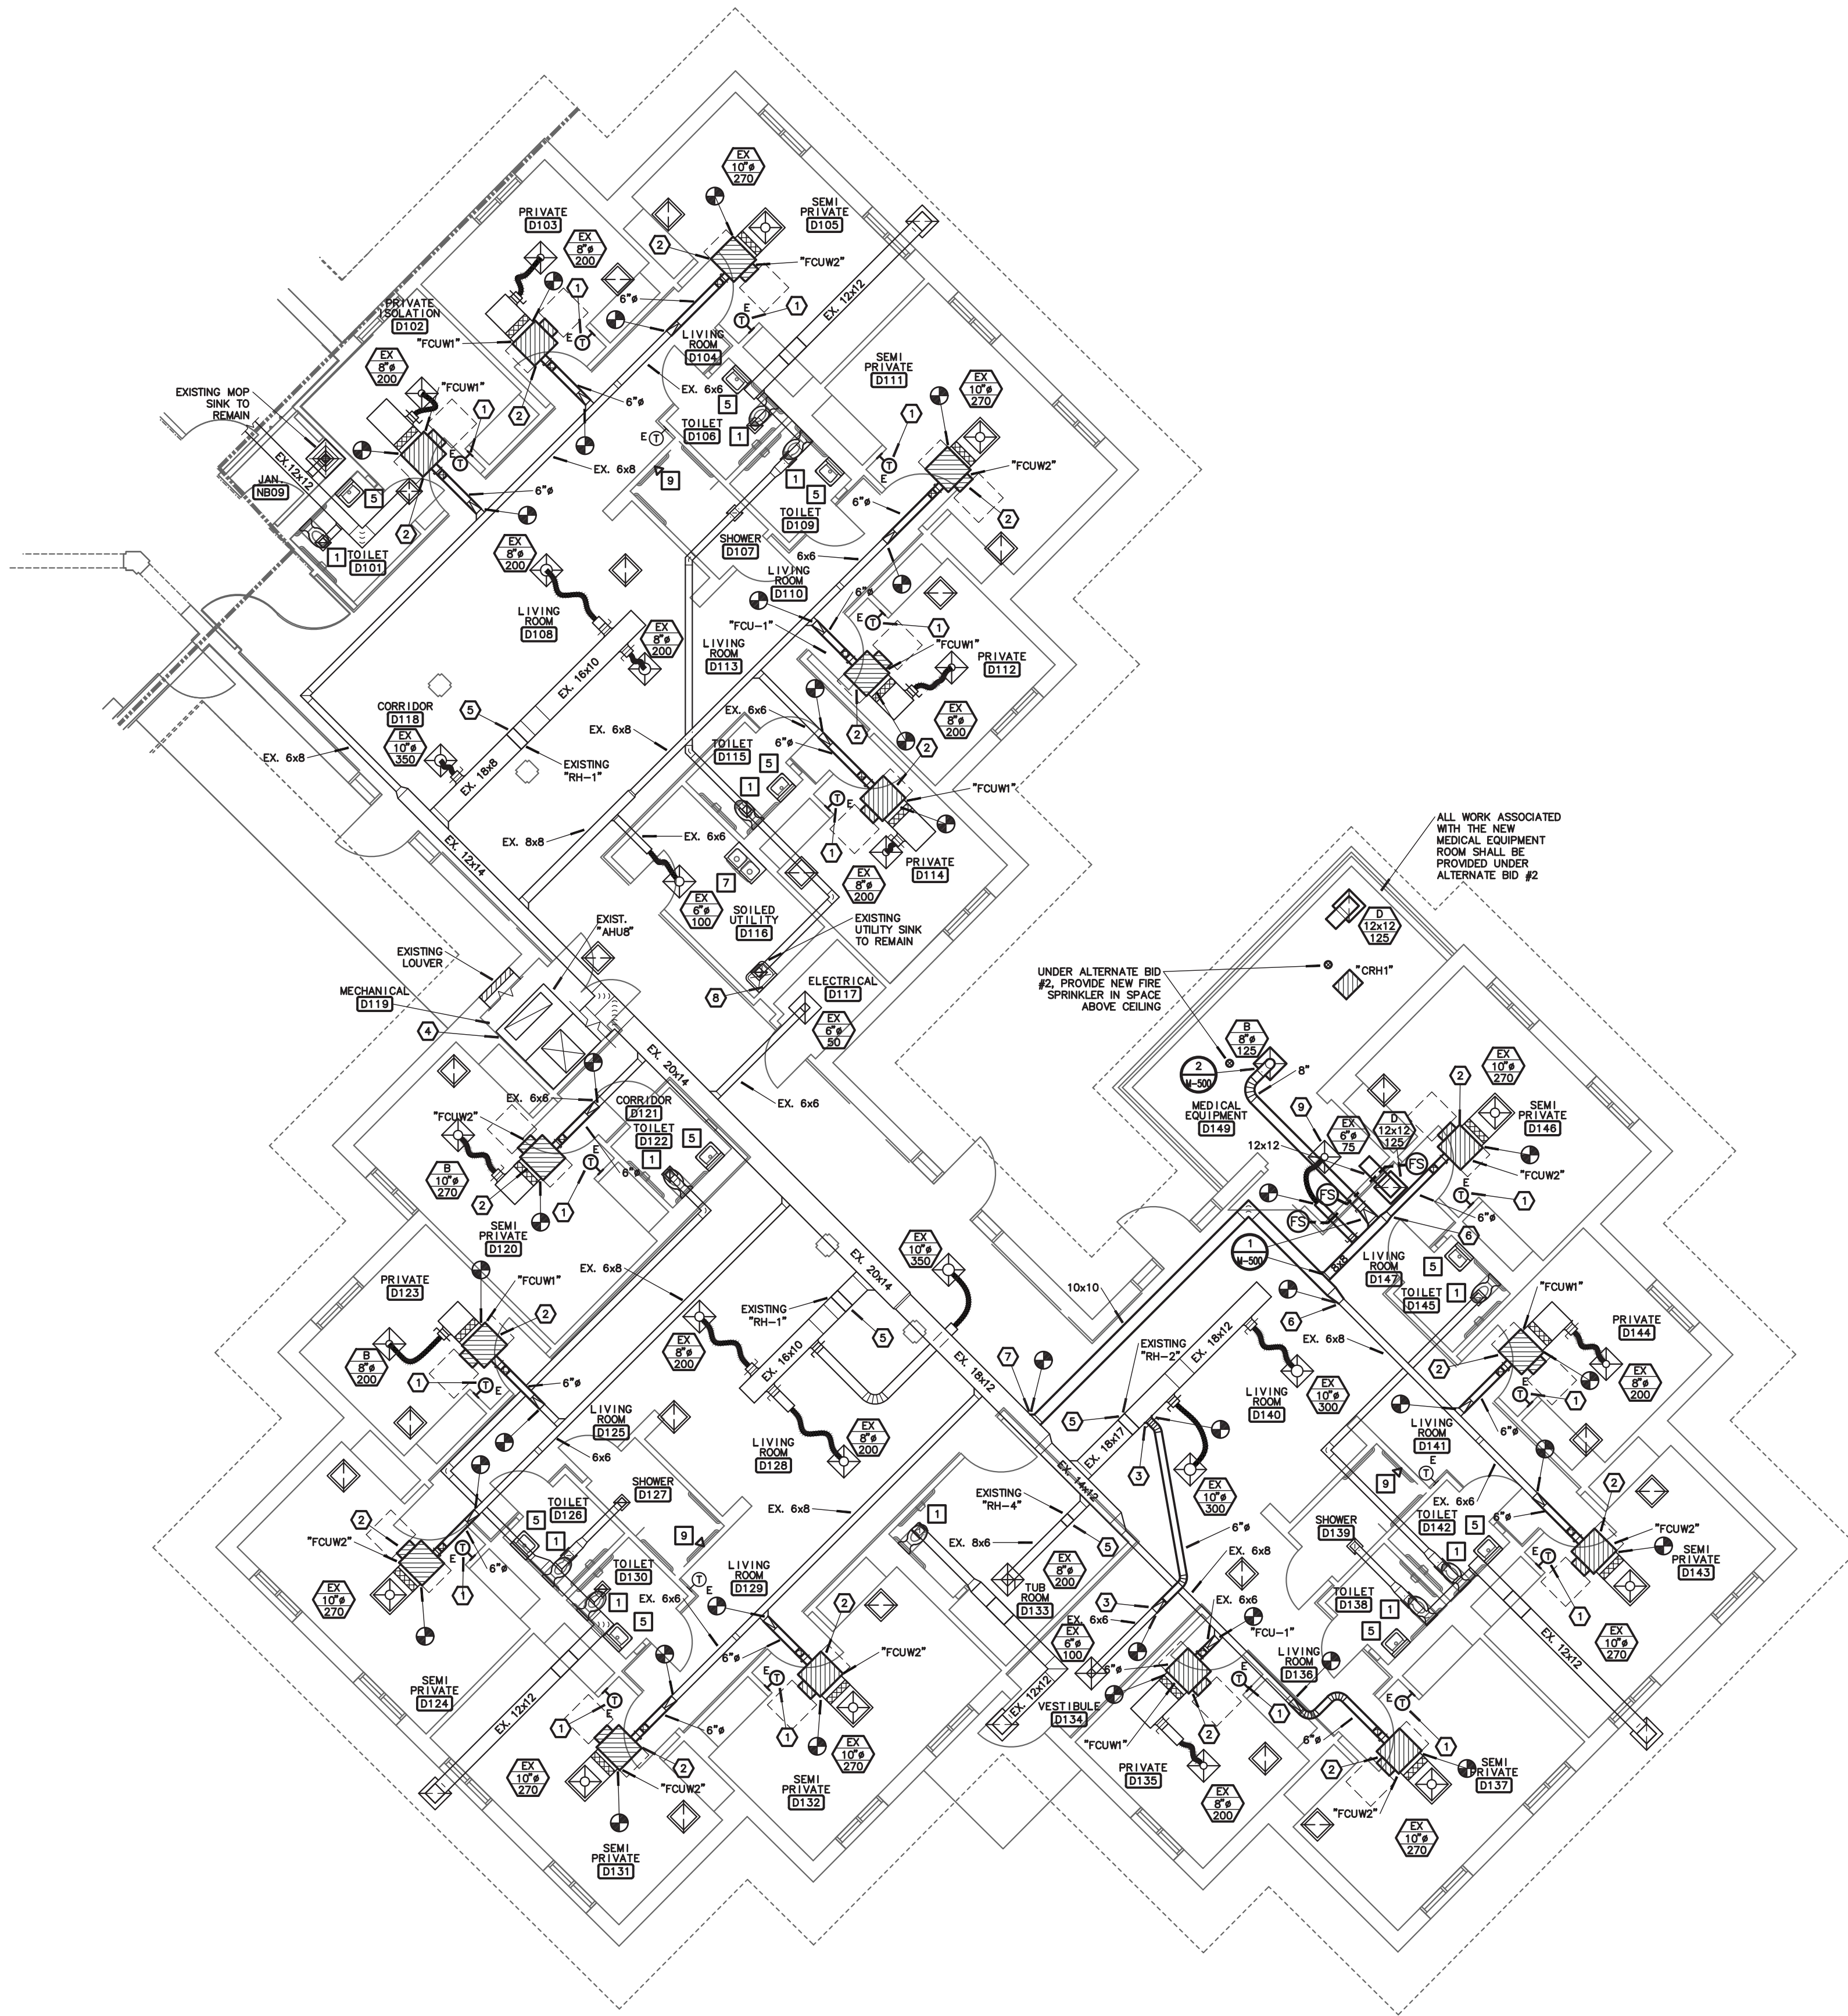
engineering consultants  
3333 E. Battlefield Road, Ste. 1000  
Springfield, MO 65804  
rtmec.com | 417.881.0020  
State of Missouri certificate of authority  
#2014035826 for engineering

## NOTES:

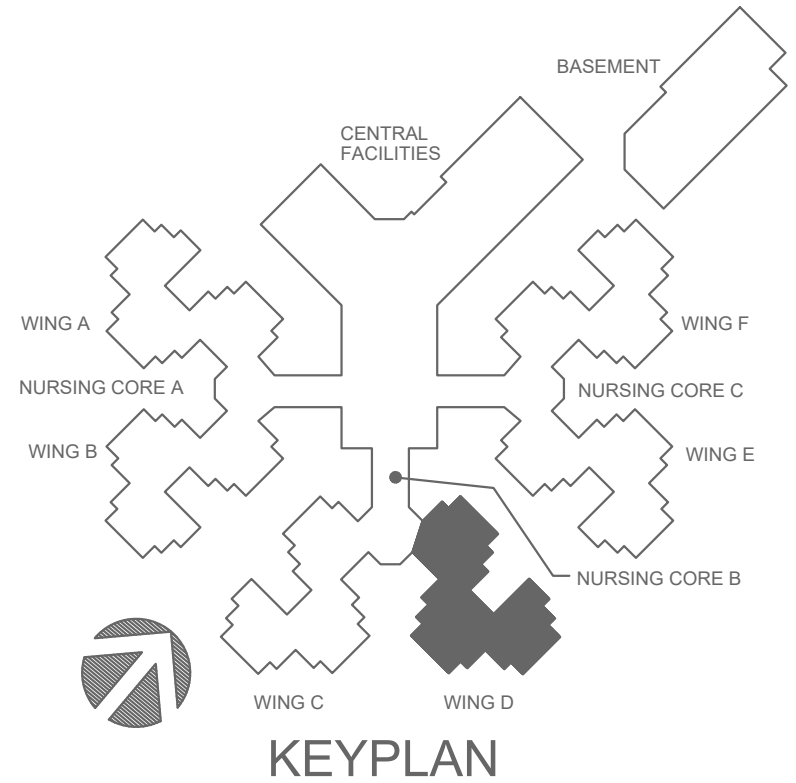
1. PROVIDE NEW THERMOSTAT AND CONTROL WIRING TO UNIT. REUTILIZE ANY EXISTING CONDUIT, PATCH, REPAIR AND PAINT WALL PER ARCHITECT'S DIRECTION.
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3. CONNECT TO EXISTING DUCTWORK. FIELD VERIFY EXISTING DUCTWORK FOR CONNECTION.
4. EXISTING AIR HANDLING UNIT. TAB CONTRACTOR SHALL BALANCE AIR HANDLING UNIT AND ALL DIFFUSERS AND FAN COIL INTAKES TO THE VALUES INDICATED.
5. EXISTING HOT WATER COIL TO REMAIN. CONTRACTOR SHALL CLEAN EXISTING HEATING COIL.
6. CONNECT TRANSITION TO EXISTING DUCTWORK. FIELD VERIFY EXISTING DUCT SIZE.
7. UNDER ALTERNATE BID #2, ENLARGE EXISTING OPENING IN EXISTING SUPPLY AIR DUCT AND INSTALL NEW 10X10 SUPPLY AIR DUCT TAP.
8. ADD CHECK VALVE TO COLD WATER SUPPLY TO MOP SINK OR UTILITY SINK.
9. UNDER BASE BID, EXISTING DIFFUSER AND FLEX DUCT IN STORAGE ROOM SHALL REMAIN. RECONNECT TO NEW 8x8 DUCT. UNDER ALTERNATE #2, REMOVE THIS DIFFUSER AND PROVIDE NEW DUCT AND DIFFUSER AS SHOWN FOR MEDICAL EQUIPMENT ROOM ADDITION.

## GENERAL NOTES:

1. RE-BALANCE ALL EXISTING EXHAUST GRILLES SERVED BY EXISTING EXHAUST FANS THAT ARE BEING REPLACED.
2. FOR ALL PLUMBING OR HVAC QUESTIONS DURING BIDDING OR DURING CONSTRUCTION, CONTACT ESTERLY SCHNEIDER & ASSOCIATES, INC. THOM LUNDBERG (417-862-0558) FOR COORDINATION WITH TYLER ENSERRO AT RTM ENGINEERING CONSULTANTS.
3. CONTRACTOR SHALL FIELD VERIFY ALL EXISTING CONSTRUCTION PRIOR TO SUBMITTING HIS BID. NO EXTRAS WILL BE PAID DUE TO UNANTICIPATED EXISTING CONDITIONS.
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6. CONTRACTOR SHALL REMOVE AND REPLACE CEILING TILE AND CEILING GRID AS REQUIRED TO PERFORM ALL DEMOLITION AND IMPROVEMENT WORK. CONTRACTOR SHALL REPLACE ALL DAMAGED CEILING TILE TO MATCH EXISTING.
7. REFER TO PLANS M-113, M-800, M-801 FOR PLUMBING FIXTURE AND MECHANICAL SCHEDULES.



STATE OF MISSOURI  
MIKE KEHOE,  
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PROJECT # U1503-01  
SITE # 6801  
ASSET # 8136801002  
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REVISION: \_\_\_\_\_  
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REVISION: \_\_\_\_\_  
DATE: \_\_\_\_\_  
ISSUE DATE: 8-1-24

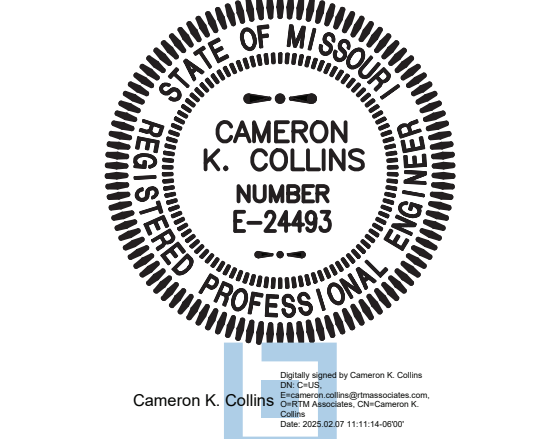CAD DWG FILE: M-119.DWG  
DRAWN BY: TSE  
CHECKED BY: CKC  
DESIGNED BY: TSE

SHEET TITLE:  
**HVAC &  
PLUMBING  
PLAN**

SHEET NUMBER:

**M-119**  
70 OF 120 SHEETS


8-1-24



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1 WING 'E' - MECHANICAL IMPROVEMENT PLAN  
M-120 SCALE: 1/8"=1'-0"





## NOTES:

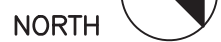1. PROVIDE NEW THERMOSTAT AND CONTROL WIRING TO UNIT. REUTILIZE ANY EXISTING CONDUIT. PATCH, REPAIR AND PAINT WALL PER ARCHITECT'S DIRECTION.
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3. ADD CHECK VALVE TO COLD WATER SUPPLY TO MOP SINK OR UTILITY SINK.
4. EXISTING AIR HANDLING UNIT. TAB CONTRACTOR SHALL BALANCE AIR HANDLING UNIT AND ALL DIFFUSERS AND FAN COIL INTAKES TO THE VALUES INDICATED.
5. EXISTING HOT WATER COIL TO REMAIN. CONTRACTOR SHALL CLEAN EXISTING HEATING COIL.
6. CONNECT TRANSITION TO EXISTING DUCTWORK. FIELD VERIFY EXISTING DUCT SIZE.
7. UNDER ALTERNATE BID #2, ENLARGE EXISTING OPENING IN EXISTING SUPPLY AIR DUCT AND INSTALL NEW 10X10 SUPPLY AIR DUCT TAP.
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## GENERAL NOTES:

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5. PLANS ARE DIAGRAMMATIC AND SHALL NOT BE SCALED. REFER TO ARCHITECTURAL DRAWINGS FOR DIMENSIONS.
6. CONTRACTOR SHALL REMOVE AND REPLACE CEILING TILE AND CEILING GRID AS REQUIRED TO PERFORM ALL DEMOLITION AND IMPROVEMENT WORK. CONTRACTOR SHALL REPLACE ALL DAMAGED CEILING TILE TO MATCH EXISTING.
7. REFER TO PLANS M-113, M-600, M-601 FOR PLUMBING FIXTURE AND MECHANICAL SCHEDULES.

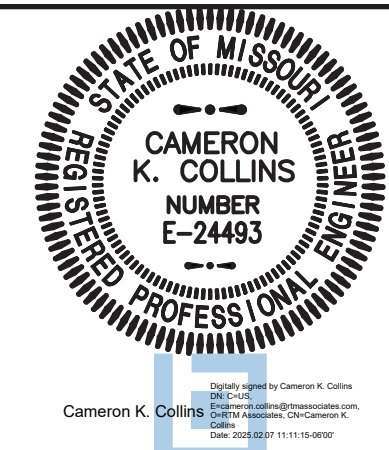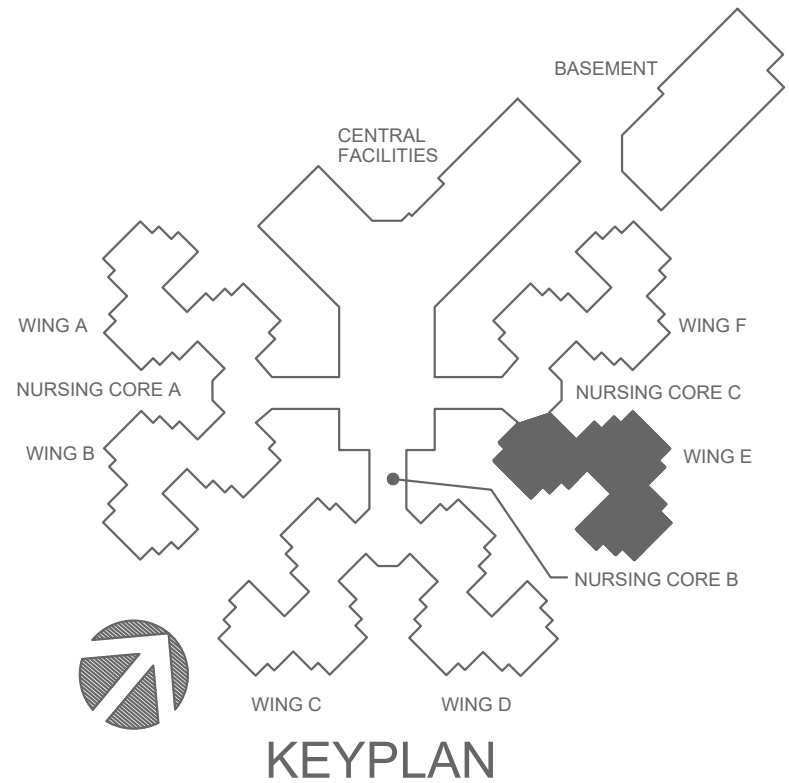

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COMM. #4860

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ISSUE DATE: 8-1-24

CAD DWG FILE: M-120.DWG  
DRAWN BY: TSE  
CHECKED BY: CKC  
DESIGNED BY: TSE

SHEET TITLE:

## HVAC & PLUMBING PLAN

SHEET NUMBER:

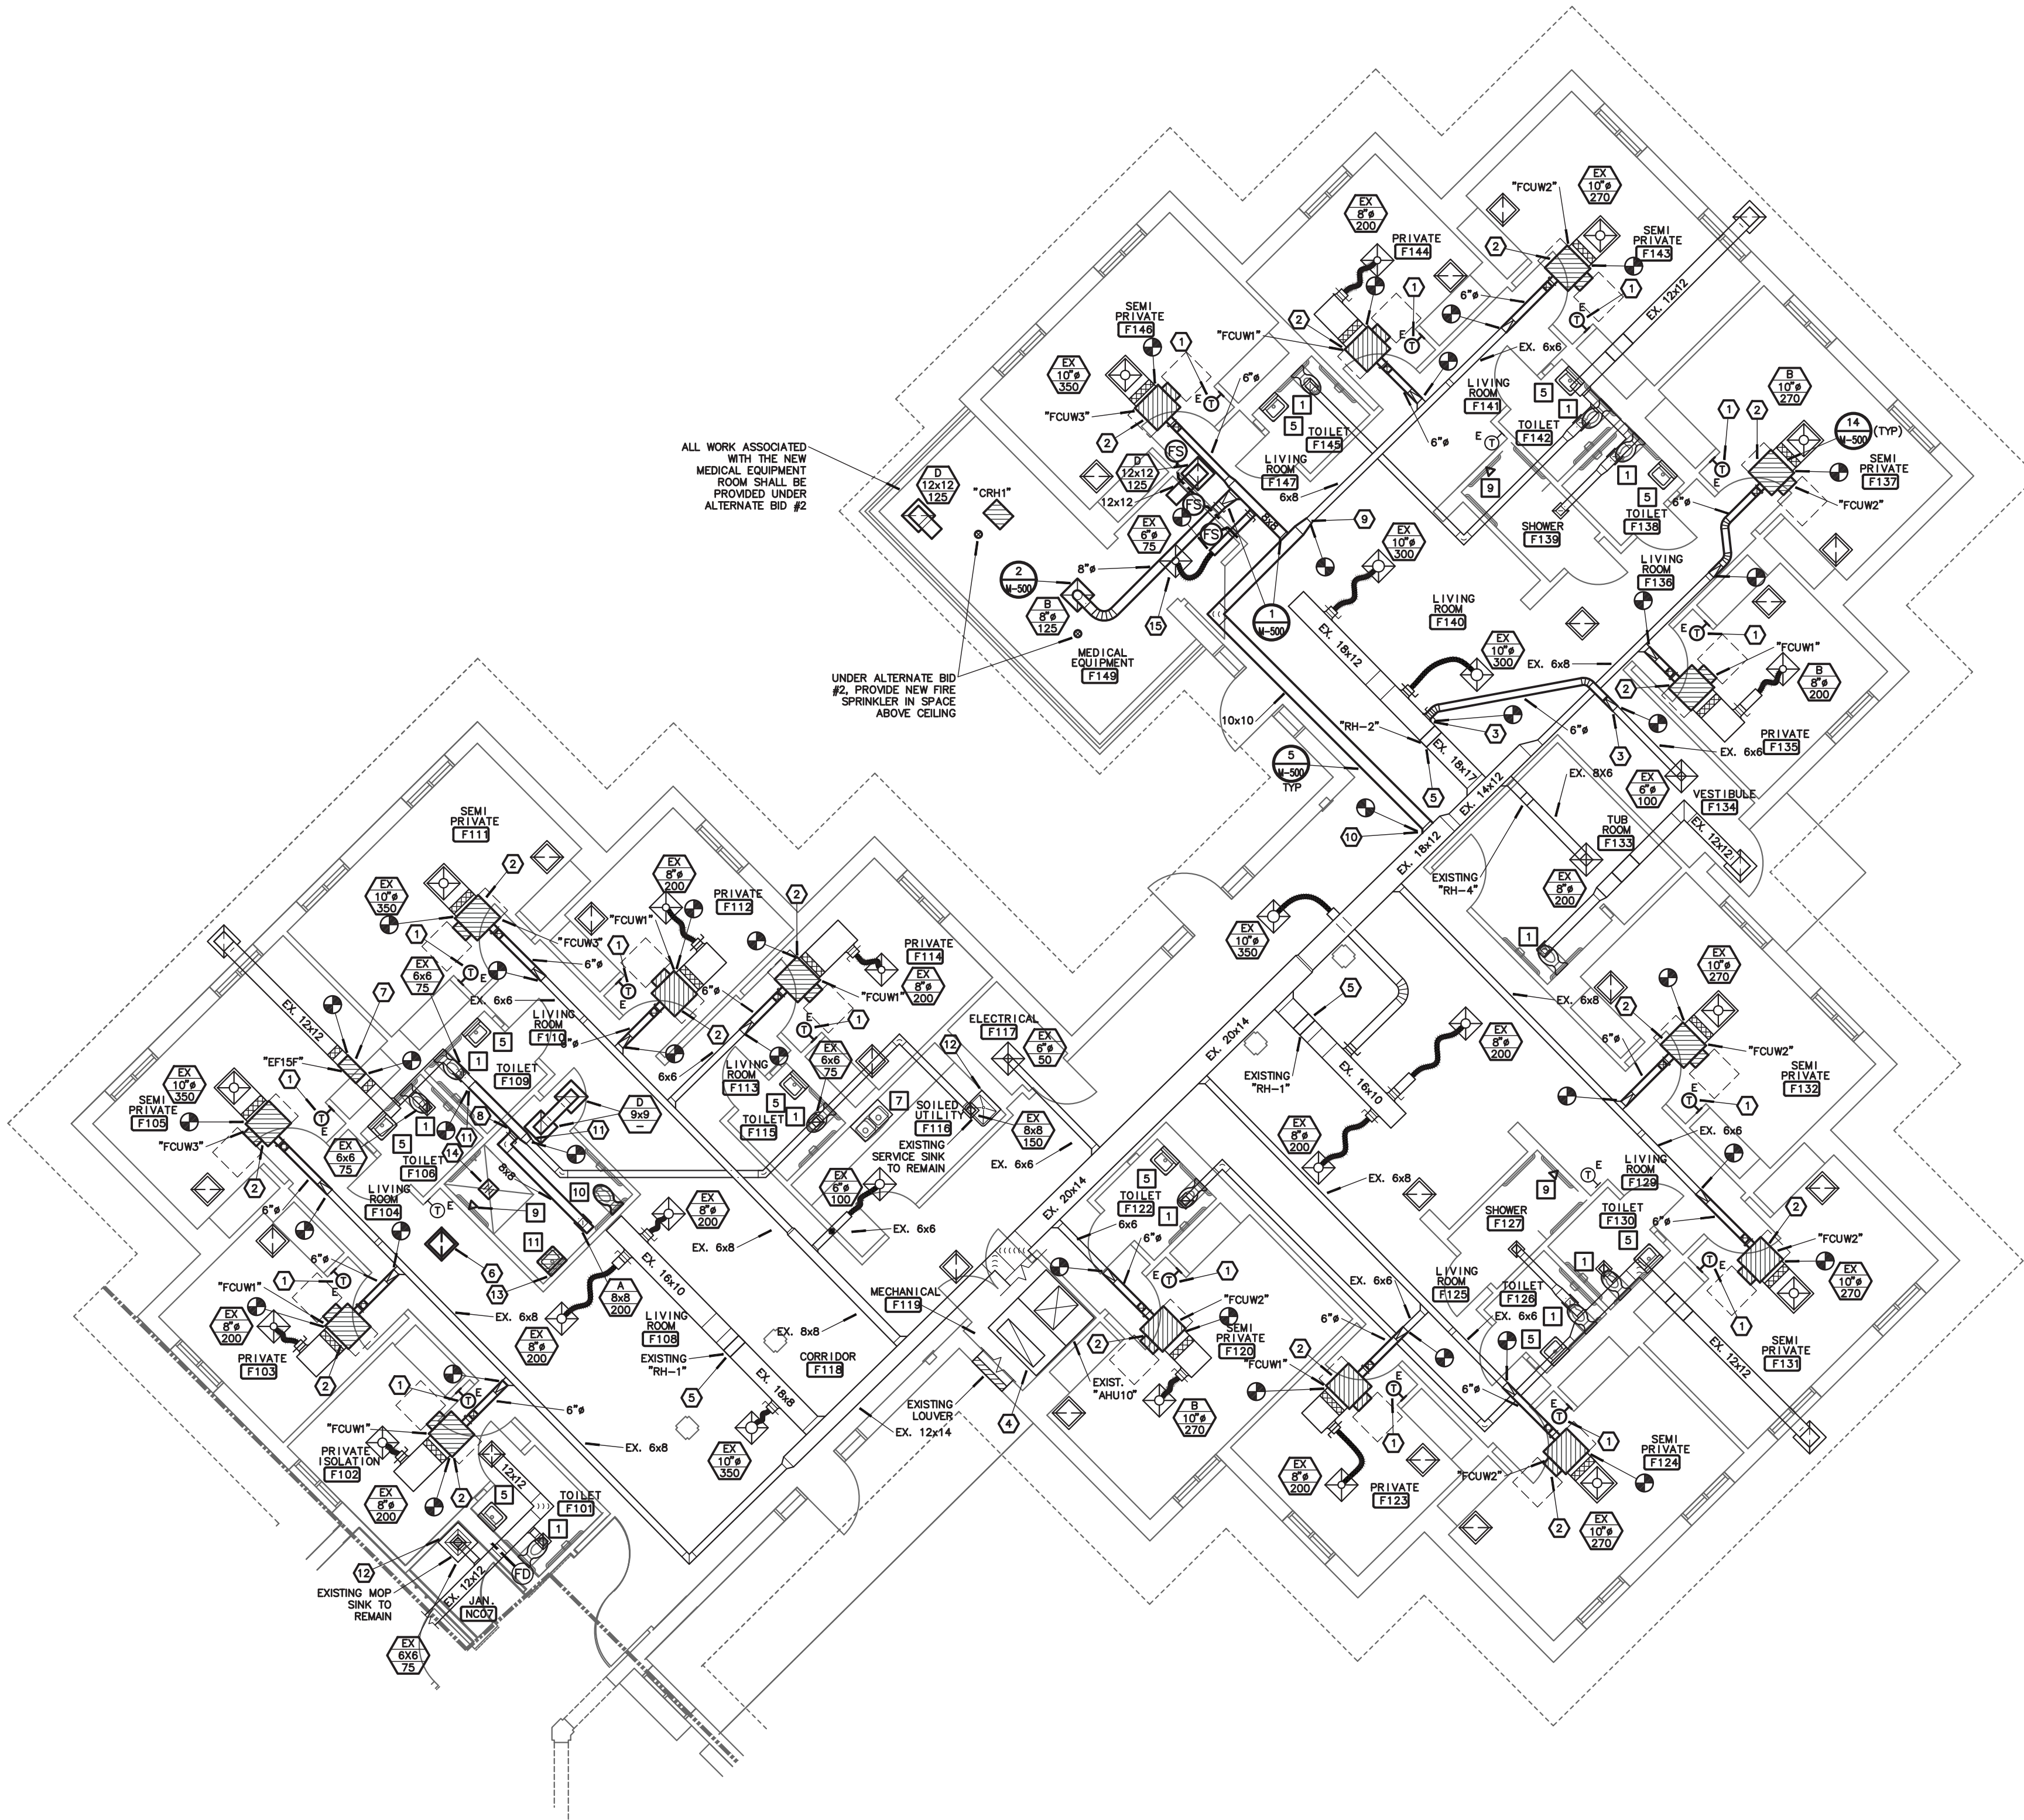
## M-120

71 OF 120 SHEETS

8-1-24



H:\ES&A\SWP\0\SURF-M-121 11 Sep 2024 - 6:52 am



**1 WING 'F' - MECHANICAL IMPROVEMENT PLAN**  
SCALE: 1/8"=1'-0" NORTH




engineering consultants  
3333 E. Battlefield Road, Ste. 1000  
Springfield, MO 65804  
rtmec.com | 417.881.0020  
State of Missouri certificate of authority  
#2014035826 for engineering

## NOTES:

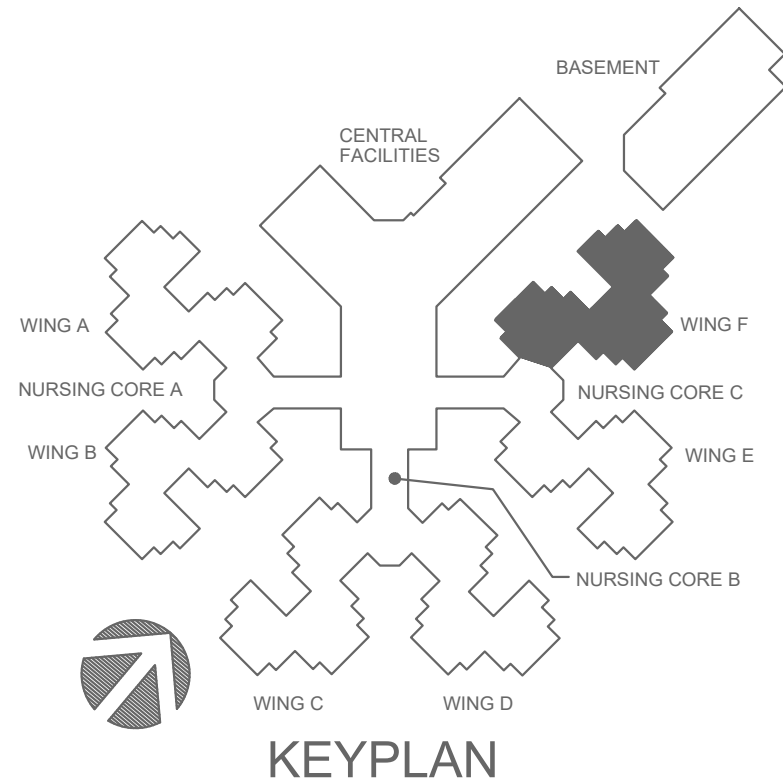
1. PROVIDE NEW THERMOSTAT AND CONTROL WIRING TO UNIT. REUTILIZE ANY EXISTING CONDUIT. PATCH, REPAIR AND PAINT WALL PER ARCHITECT'S DIRECTION.
2. PROVIDE NEW HORIZONTAL 4-PIPE FAN COIL UNIT. FIELD VERIFY EXISTING CONDITIONS, PIPING LOCATION, AVAILABLE SPACE AND CLEARANCE FOR MAINTENANCE AND EXISTING SHEETMETAL SIZES AND LOCATIONS PRIOR TO SUBMITTING EQUIPMENT. CONNECT EXISTING SUPPLY AND RETURN DUCT TO NEW UNIT CONNECTIONS WITH FLEXIBLE CONNECTORS. PROVIDE ANY ADDITIONAL TRANSITION AS NECESSARY. BALANCE FAN COIL TO SCHEDULED AIRFLOW. CUT AND PATCH HARD CEILING WHERE REQUIRED TO REMOVE UNIT AND PROVIDE ACCESS PANEL FOR NEW UNIT.
3. CONNECT TO EXISTING DUCTWORK. FIELD VERIFY EXISTING DUCTWORK FOR CONNECTION.
4. EXISTING AIR HANDLING UNIT. TAB CONTRACTOR SHALL BALANCE AIR HANDLING UNIT AND ALL DIFFUSERS AND FAN COIL INTAKES TO THE VALUES INDICATED.
5. EXISTING HOT WATER COIL TO REMAIN. CONTRACTOR SHALL CLEAN EXISTING HEATING COIL.
6. NEW LOCATION OF RELOCATED RETURN AIR GRILLE.
7. REPLACE EXISTING EXHAUST FAN WITH NEW EXHAUST FAN.
8. REMOVE EXISTING EXHAUST GRILLE AND CAP MAIN. PROVIDE NEW 8x8 TAP TO NEW EXHAUST GRILLE LOCATION.
9. CONNECT TRANSITION TO EXISTING DUCTWORK. FIELD VERIFY EXISTING DUCT SIZE.
10. UNDER ALTERNATE BID #2, ENLARGE EXISTING OPENING IN EXISTING SUPPLY AIR DUCT AND INSTALL NEW 10X10 SUPPLY AIR DUCT TAP.
11. REPLACE EXISTING DUCT WITH NEW 10x10 DUCT AND CONNECT TO EXISTING DUCT. FIELD VERIFY EXISTING DUCT SIZE.
12. ADD CHECK VALVE TO COLD WATER SUPPLY TO MOP SINK OR UTILITY SINK.
13. CONFIRM PRIOR TO BID THAT WASTE, HOT WATER AND COLD WATER FOR NEW SINK WILL BE ACCESSIBLE FOR CONNECTION TO NEW FIXTURE.
14. INSTALL NEW FLOOR DRAIN AT CENTER OF SHOWER PAN. CONNECT TO EXISTING WASTE BELOW FLOOR. COORDINATE FLOORING DEMOLITION WITH ARCHITECT AND GENERAL CONTRACTOR.
15. UNDER BASE BID, EXISTING DIFFUSER AND FLEX DUCT IN STORAGE ROOM SHALL REMAIN. RECONNECT TO NEW 8x8 DUCT. UNDER ALTERNATE #2, REMOVE THIS DIFFUSER AND PROVIDE NEW DUCT AND DIFFUSER AS SHOWN FOR MEDICAL EQUIPMENT ROOM ADDITION.

## GENERAL NOTES:

1. RE-BALANCE ALL EXISTING EXHAUST GRILLES SERVED BY EXISTING EXHAUST FANS THAT ARE BEING REPLACED.
2. FOR ALL PLUMBING OR HVAC QUESTIONS DURING BIDDING OR DURING CONSTRUCTION, CONTACT ESTERLY, SCHNEIDER & ASSOCIATES, INC. THOM LUNDBERG (417-862-0558) FOR COORDINATION WITH TYLER ENSERRO AT RTM ENGINEERING CONSULTANTS.
3. CONTRACTOR SHALL FIELD VERIFY ALL EXISTING CONSTRUCTION PRIOR TO SUBMITTING HIS BID. NO EXTRAS WILL BE PAID DUE TO UNANTICIPATED EXISTING CONDITIONS.
4. CONTRACTOR SHALL SCHEDULE AND EXECUTE ALL WORK WITH REGARD TO THE OWNER'S USE OF THE BUILDING.
5. PLANS ARE DIAGRAMMATIC AND SHALL NOT BE SCALED. REFER TO ARCHITECTURAL DRAWINGS FOR DIMENSIONS.
6. CONTRACTOR SHALL REMOVE AND REPLACE CEILING TILE AND CEILING GRID AS REQUIRED TO PERFORM ALL DEMOLITION AND IMPROVEMENT WORK. CONTRACTOR SHALL REPLACE ALL DAMAGED CEILING TILE TO MATCH EXISTING.
7. REFER TO PLANS M-113, M-800, M-801 FOR PLUMBING FIXTURES AND MECHANICAL SCHEDULES.



STATE OF MISSOURI  
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&  
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ASSOCIATES, INC.**  
AIA architects & planners

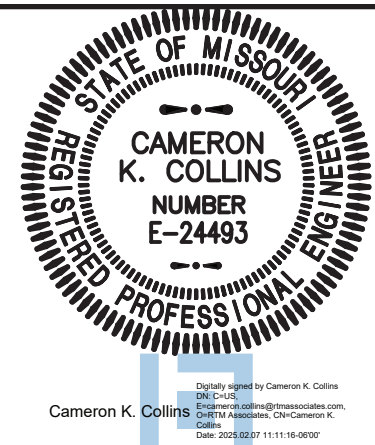COMM. #4860

OFFICE OF ADMINISTRATION  
DIVISION OF FACILITIES  
MANAGEMENT,  
DESIGN AND CONSTRUCTION

DEPARTMENT OF  
PUBLIC SAFETY  
MISSOURI VETERANS  
COMMISSION

INTERIOR RENOVATION  
MISSOURI VETERANS  
HOME

620 N. JEFFERSON  
ST. JAMES, MISSOURI

PROJECT # **U1503-01**  
SITE # **6801**  
ASSET # **8136801002**  
FEDERAL # **29-044**

REVISION: \_\_\_\_\_  
DATE: \_\_\_\_\_  
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REVISION: \_\_\_\_\_  
DATE: \_\_\_\_\_  
ISSUE DATE: **8-1-24**

CAD DWG FILE: **M-121.DWG**  
DRAWN BY: **TSE**  
CHECKED BY: **CKC**  
DESIGNED BY: **TSE**

SHEET TITLE:

**HVAC &  
PLUMBING  
PLAN**

SHEET NUMBER:

**M-121**

72 OF 120 SHEETS

8-1-24

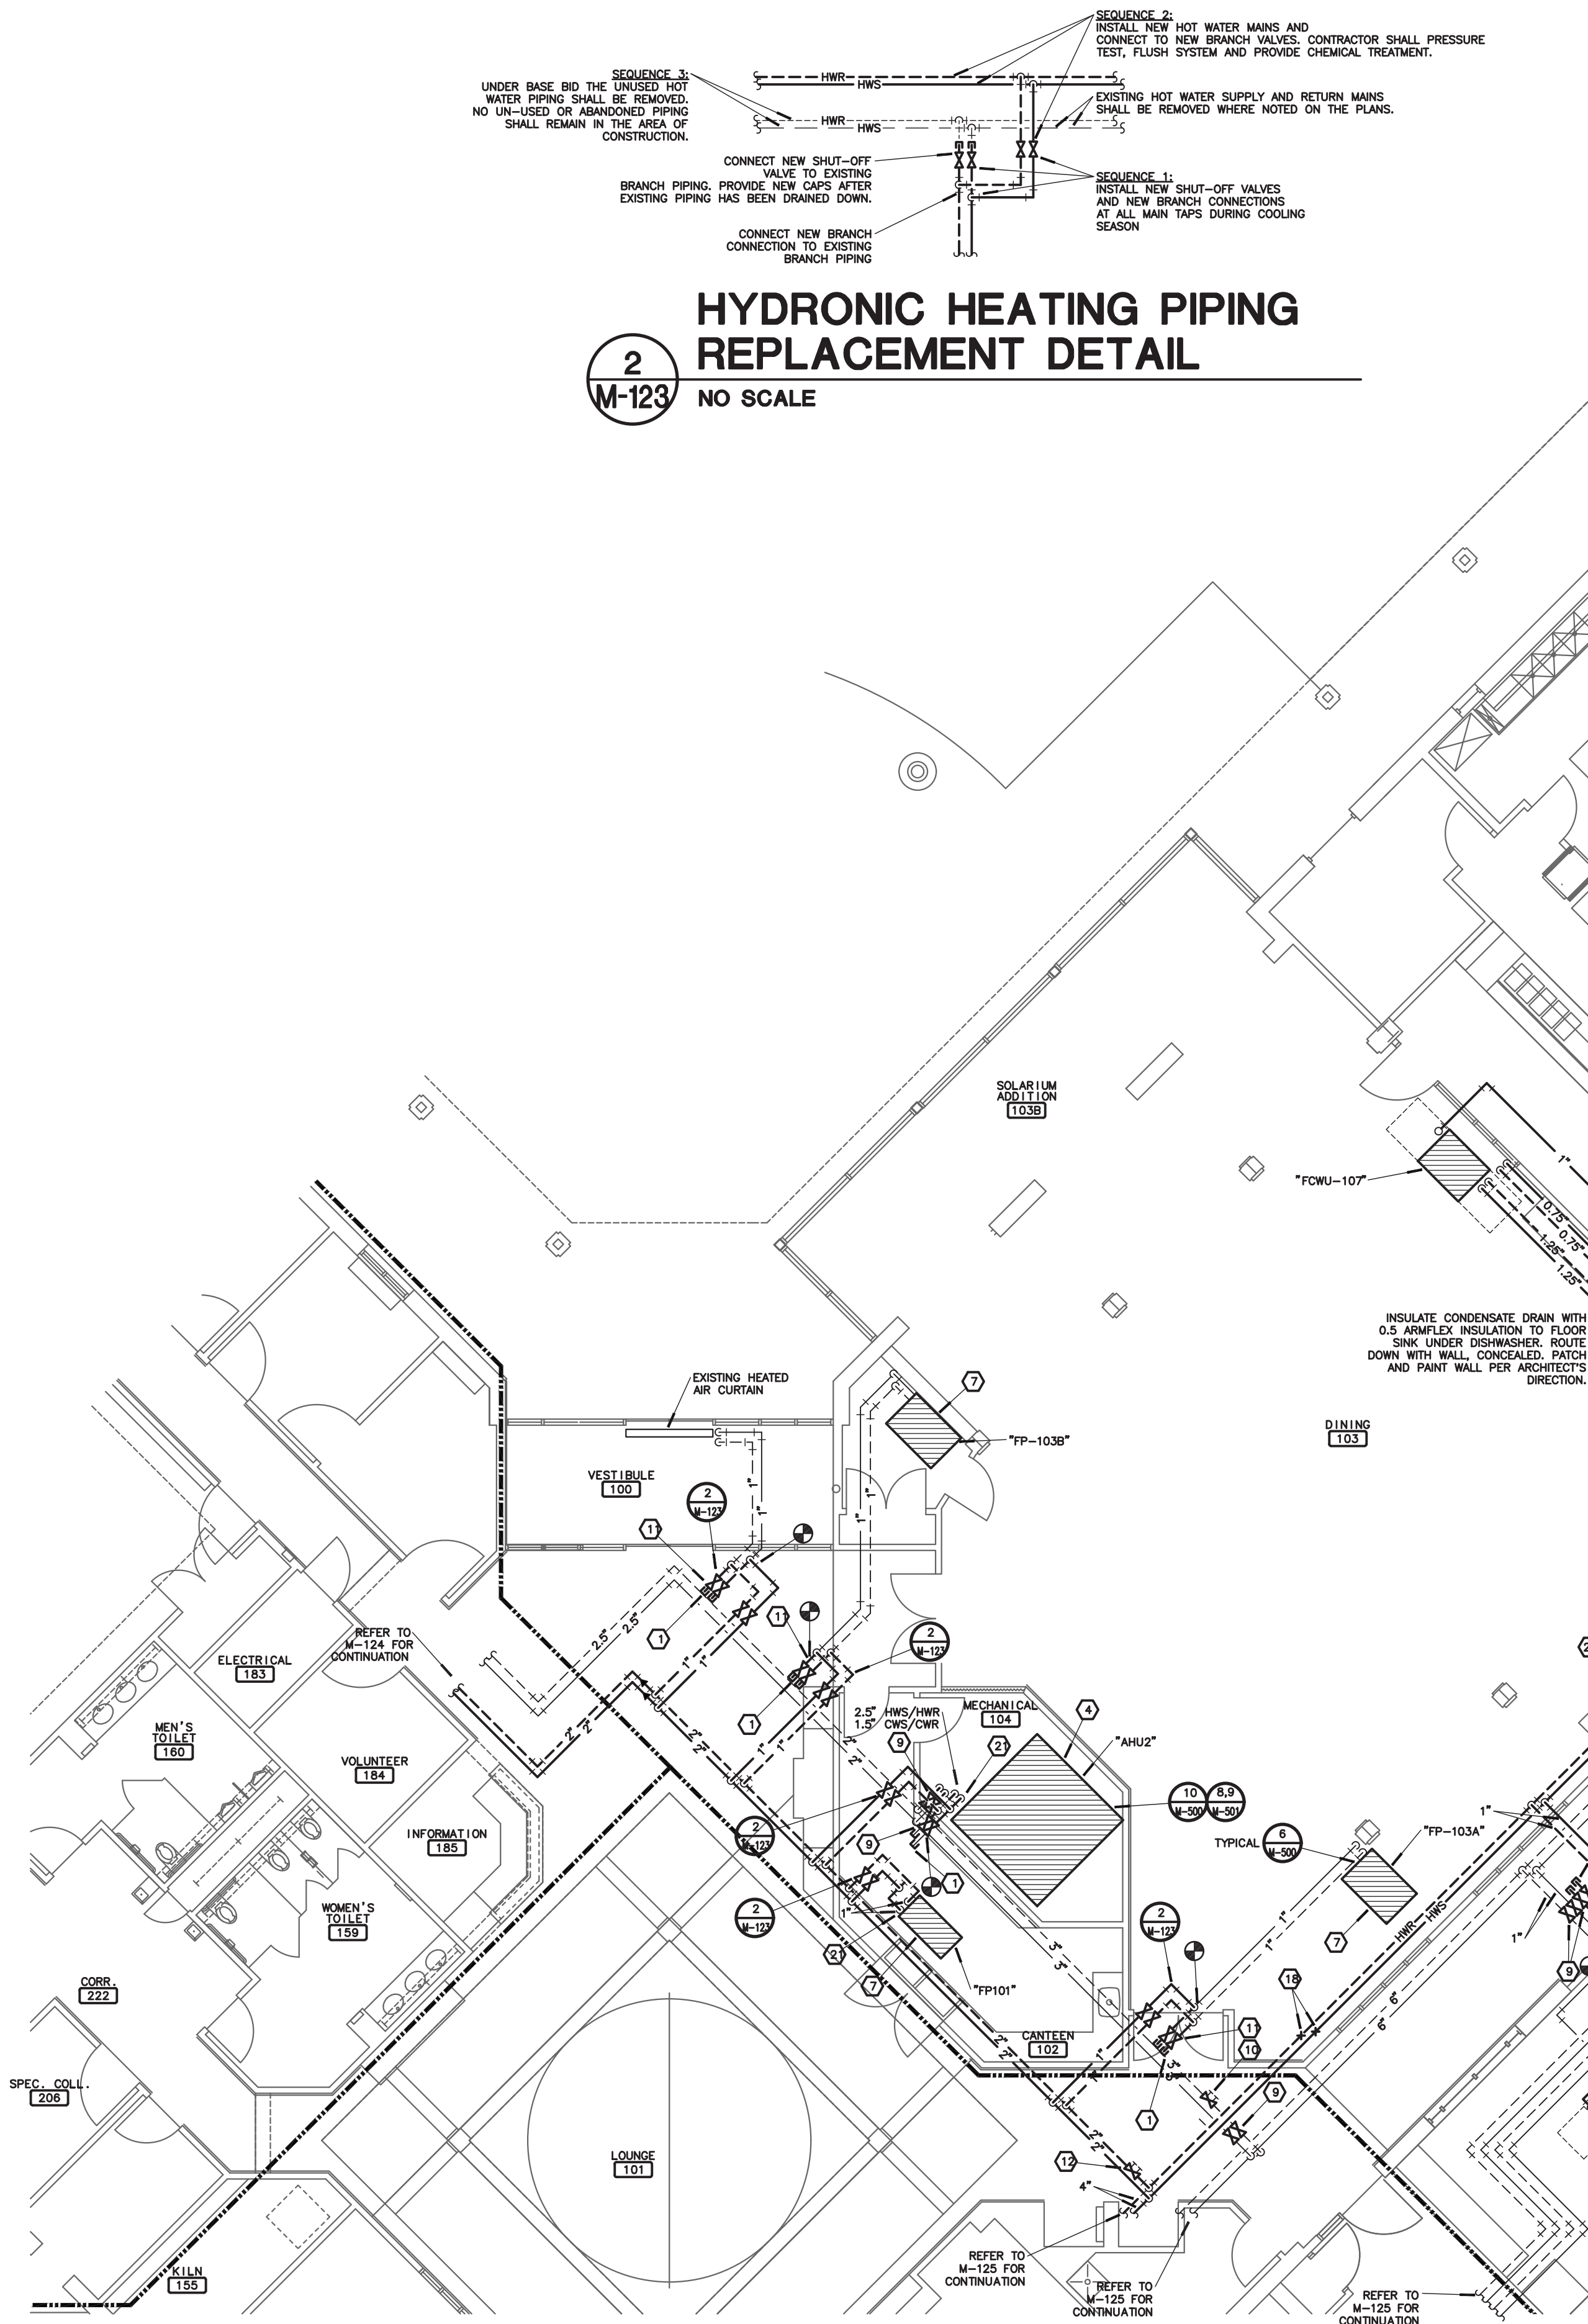




KEYPLAN




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## HYDRONIC HEATING PIPING REPLACEMENT DETAIL

2  
M-123  
NO SCALE



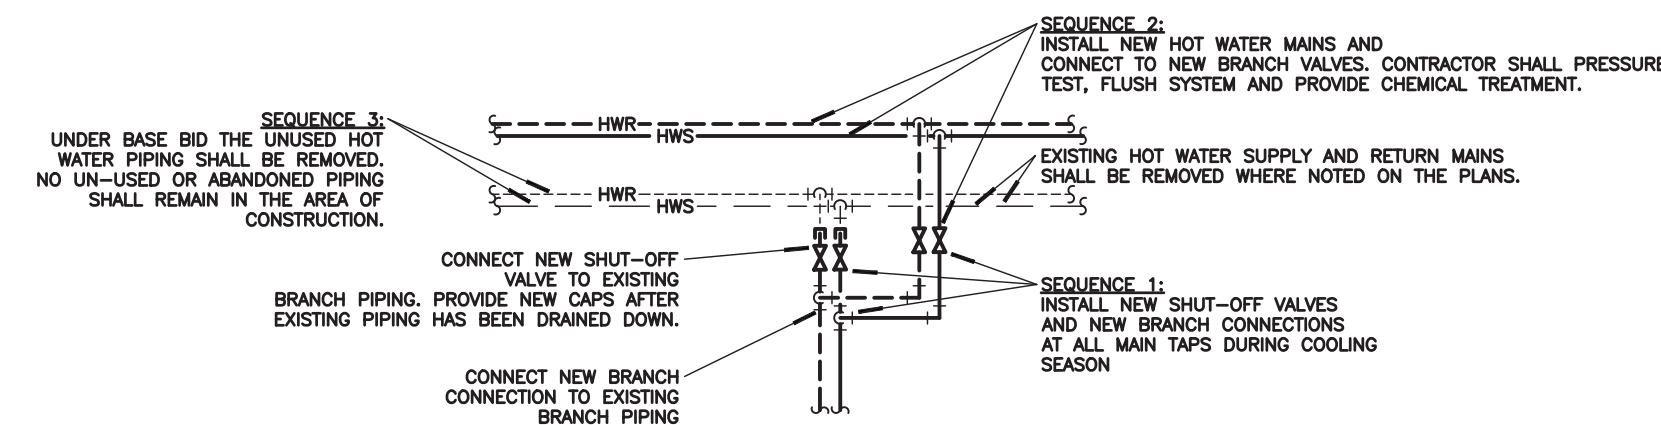- ### NOTES:
- GENERAL PIPING NOTES SHALL APPLY TO ALL EXISTING CHILLED WATER SUPPLY AND RETURN PIPING: A. PROVIDE BALL VALVES OFF OF THE MAIN PIPING, UPSTREAM OF ALL EXISTING DIELECTRIC FITTINGS AND WHERE SHOWN ON DRAWINGS, TALL ON FOR THE DIELECTRIC FITTINGS TO BE REPLACED IN THE FUTURE. B. PROVIDE BALL VALVES IN THE MAIN PIPING AT EVERY CORRIDOR AND AS SHOWN ON THE DRAWINGS TO ALLOW FOR ISOLATION OF PIPING. C. ADDITIONAL HANGERS SHALL BE PROVIDED TO MEET SPECIFICATIONS. AT A MINIMUM ADDITIONAL HANGERS SHALL BE PROVIDED EVERY 10'-0\"/>


## PARTIAL CENTRAL FACILITIES HYDRONIC IMPROVEMENT PLAN

1  
M-123  
SCALE: 1/8\"/>

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#2014035826 for engineering

- ### NOTES:
- CAP HWS AND HWR PIPING.
  - EXISTING FIN TUBE RADIATION HEATER TO REMAIN. REPLACE EXISTING PIPING PACKAGE FOR HEATER.
  - PROVIDE NEW 4-PIPE FAN COIL UNIT AND PIPING PACKAGE. RECONNECT TO EXISTING HWS, HWR, CWS, CWR AND CONDENSATE DRAIN PIPING. FIELD VERIFY EXISTING CONDITIONS, AND LOCATION OF CONNECTIONS TO ALL EXISTING PIPING CONNECTIONS PRIOR TO SUBMITTAL OF AIR HANDLING UNIT. PROVIDE ALL REQUIRED ADJUSTMENTS TO EXISTING PIPING TO ACCOMMODATE NEW FAN COIL UNIT.
  - PROVIDE NEW AIR HANDLING UNIT AND PIPING PACKAGE FOR BASE BID. RECONNECT TO EXISTING HWS, HWR, CWS, CWR AND CONDENSATE DRAIN PIPING. FIELD VERIFY EXISTING CONDITIONS, AND LOCATION OF CONNECTIONS TO ALL EXISTING PIPING CONNECTIONS PRIOR TO SUBMITTAL OF AIR HANDLING UNIT. PROVIDE ALL REQUIRED ADJUSTMENTS TO EXISTING PIPING TO ACCOMMODATE NEW AIR HANDLING UNIT.
  - EXISTING PIPING TO REMAIN.
  - PROVIDE NEW VERTICAL CABINET 4-PIPE FAN COIL UNIT AND PIPING PACKAGE. RECONNECT TO EXISTING HWS, HWR, CWS, CWR AND CONDENSATE DRAIN PIPING. FIELD VERIFY EXISTING CONDITIONS, AND LOCATION OF CONNECTIONS TO ALL EXISTING PIPING CONNECTIONS PRIOR TO SUBMITTAL OF AIR HANDLING UNIT. PROVIDE ALL REQUIRED ADJUSTMENTS TO EXISTING PIPING TO ACCOMMODATE NEW VAV FAN TERMINAL UNIT.
  - PROVIDE NEW VAV FAN TERMINAL UNIT AND PIPING PACKAGE. RECONNECT TO EXISTING HWS AND HWR PIPING. FIELD VERIFY EXISTING CONDITIONS AND LOCATION OF CONNECTIONS TO ALL EXISTING PIPING CONNECTIONS PRIOR TO SUBMITTAL OF VAV FAN TERMINAL UNITS. PROVIDE ALL REQUIRED ADJUSTMENTS TO EXISTING PIPING TO ACCOMMODATE NEW VAV FAN TERMINAL UNIT.
  - PROVIDE NEW VERTICAL CABINET 2-PIPE HOT WATER CABINET UNIT HEATER AND PIPING PACKAGE. RECONNECT TO EXISTING HWS AND HWR PIPING. FIELD VERIFY EXISTING CONDITIONS, AND LOCATION OF CONNECTIONS TO ALL EXISTING PIPING CONNECTIONS PRIOR TO SUBMITTAL OF CABINET UNIT HEATER. PROVIDE ALL REQUIRED ADJUSTMENTS TO EXISTING PIPING TO ACCOMMODATE CABINET UNIT HEATER.
  - REMOVE AND REPLACE ALL EXISTING SHUT-OFF VALVE WITH NEW BALL VALVE TYPE SHUT-OFF VALVES.
  - REMOVE AND REPLACE BOTH EXISTING BALANCE VALVES WITH CIRCUIT SETTER TYPE BALANCE VALVES. MEASURE FLOWRATE PRIOR TO DEMOLITION WORK AND REBALANCE VALVE BACK TO THE ORIGINAL VALUE.
  - PROVIDE BALL TYPE SHUT-OFF VALVES IN EXISTING BRANCH PIPING.
  - PROVIDE NEW BALANCE VALVE WITH CIRCUIT SETTER TYPE BALANCE VALVE. MEASURE ORIGINAL FLOWRATE PRIOR TO DEMOLITION WORK AND BALANCE NEW VALVE TO THE ORIGINAL VALUE.
  - CONNECT TO EXISTING HOT WATER SUPPLY AND RETURN PIPING.
  - CONNECT TO EXISTING CHILLED WATER SUPPLY AND RETURN PIPING.
  - CONNECT NEW 1\"/>

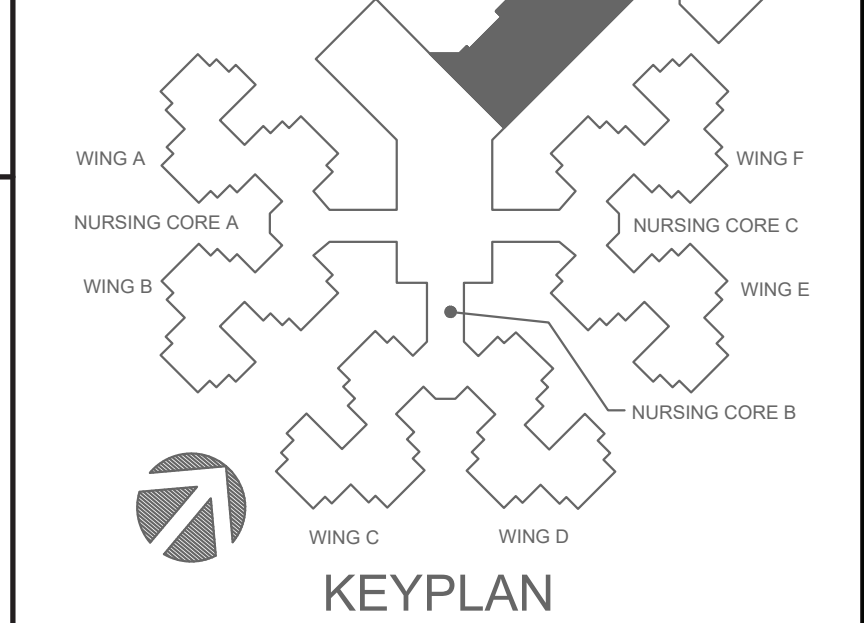- ### GENERAL NOTES:
- GENERAL PIPING NOTES SHALL APPLY TO ALL EXISTING MECHANICAL HOT WATER SUPPLY AND RETURN PIPING BEING RE-UTILIZED. THE EXISTING MAIN HWS AND HWR PIPING THAT IS BEING ABANDONED IN PLACE SHALL NOT BE RE-UTILIZED. THE BUILDING IS PRIMARILY GRUPOK COUPLINGS AND SOME ARE VICTALIC COUPLINGS. FROM FIELD OBSERVATION IT APPEARS THAT ALL PIPING 2.5\"/>



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AIA architects & planners  
COMM. #4860

OFFICE OF ADMINISTRATION  
DIVISION OF FACILITIES  
MANAGEMENT,  
DESIGN AND CONSTRUCTION

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PROJECT # U1503-01  
SITE # 6801  
ASSET # 8136801002  
FEDERAL # 29-044

REVISION: \_\_\_\_\_  
DATE: \_\_\_\_\_  
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DATE: \_\_\_\_\_  
ISSUE DATE: 8-1-24

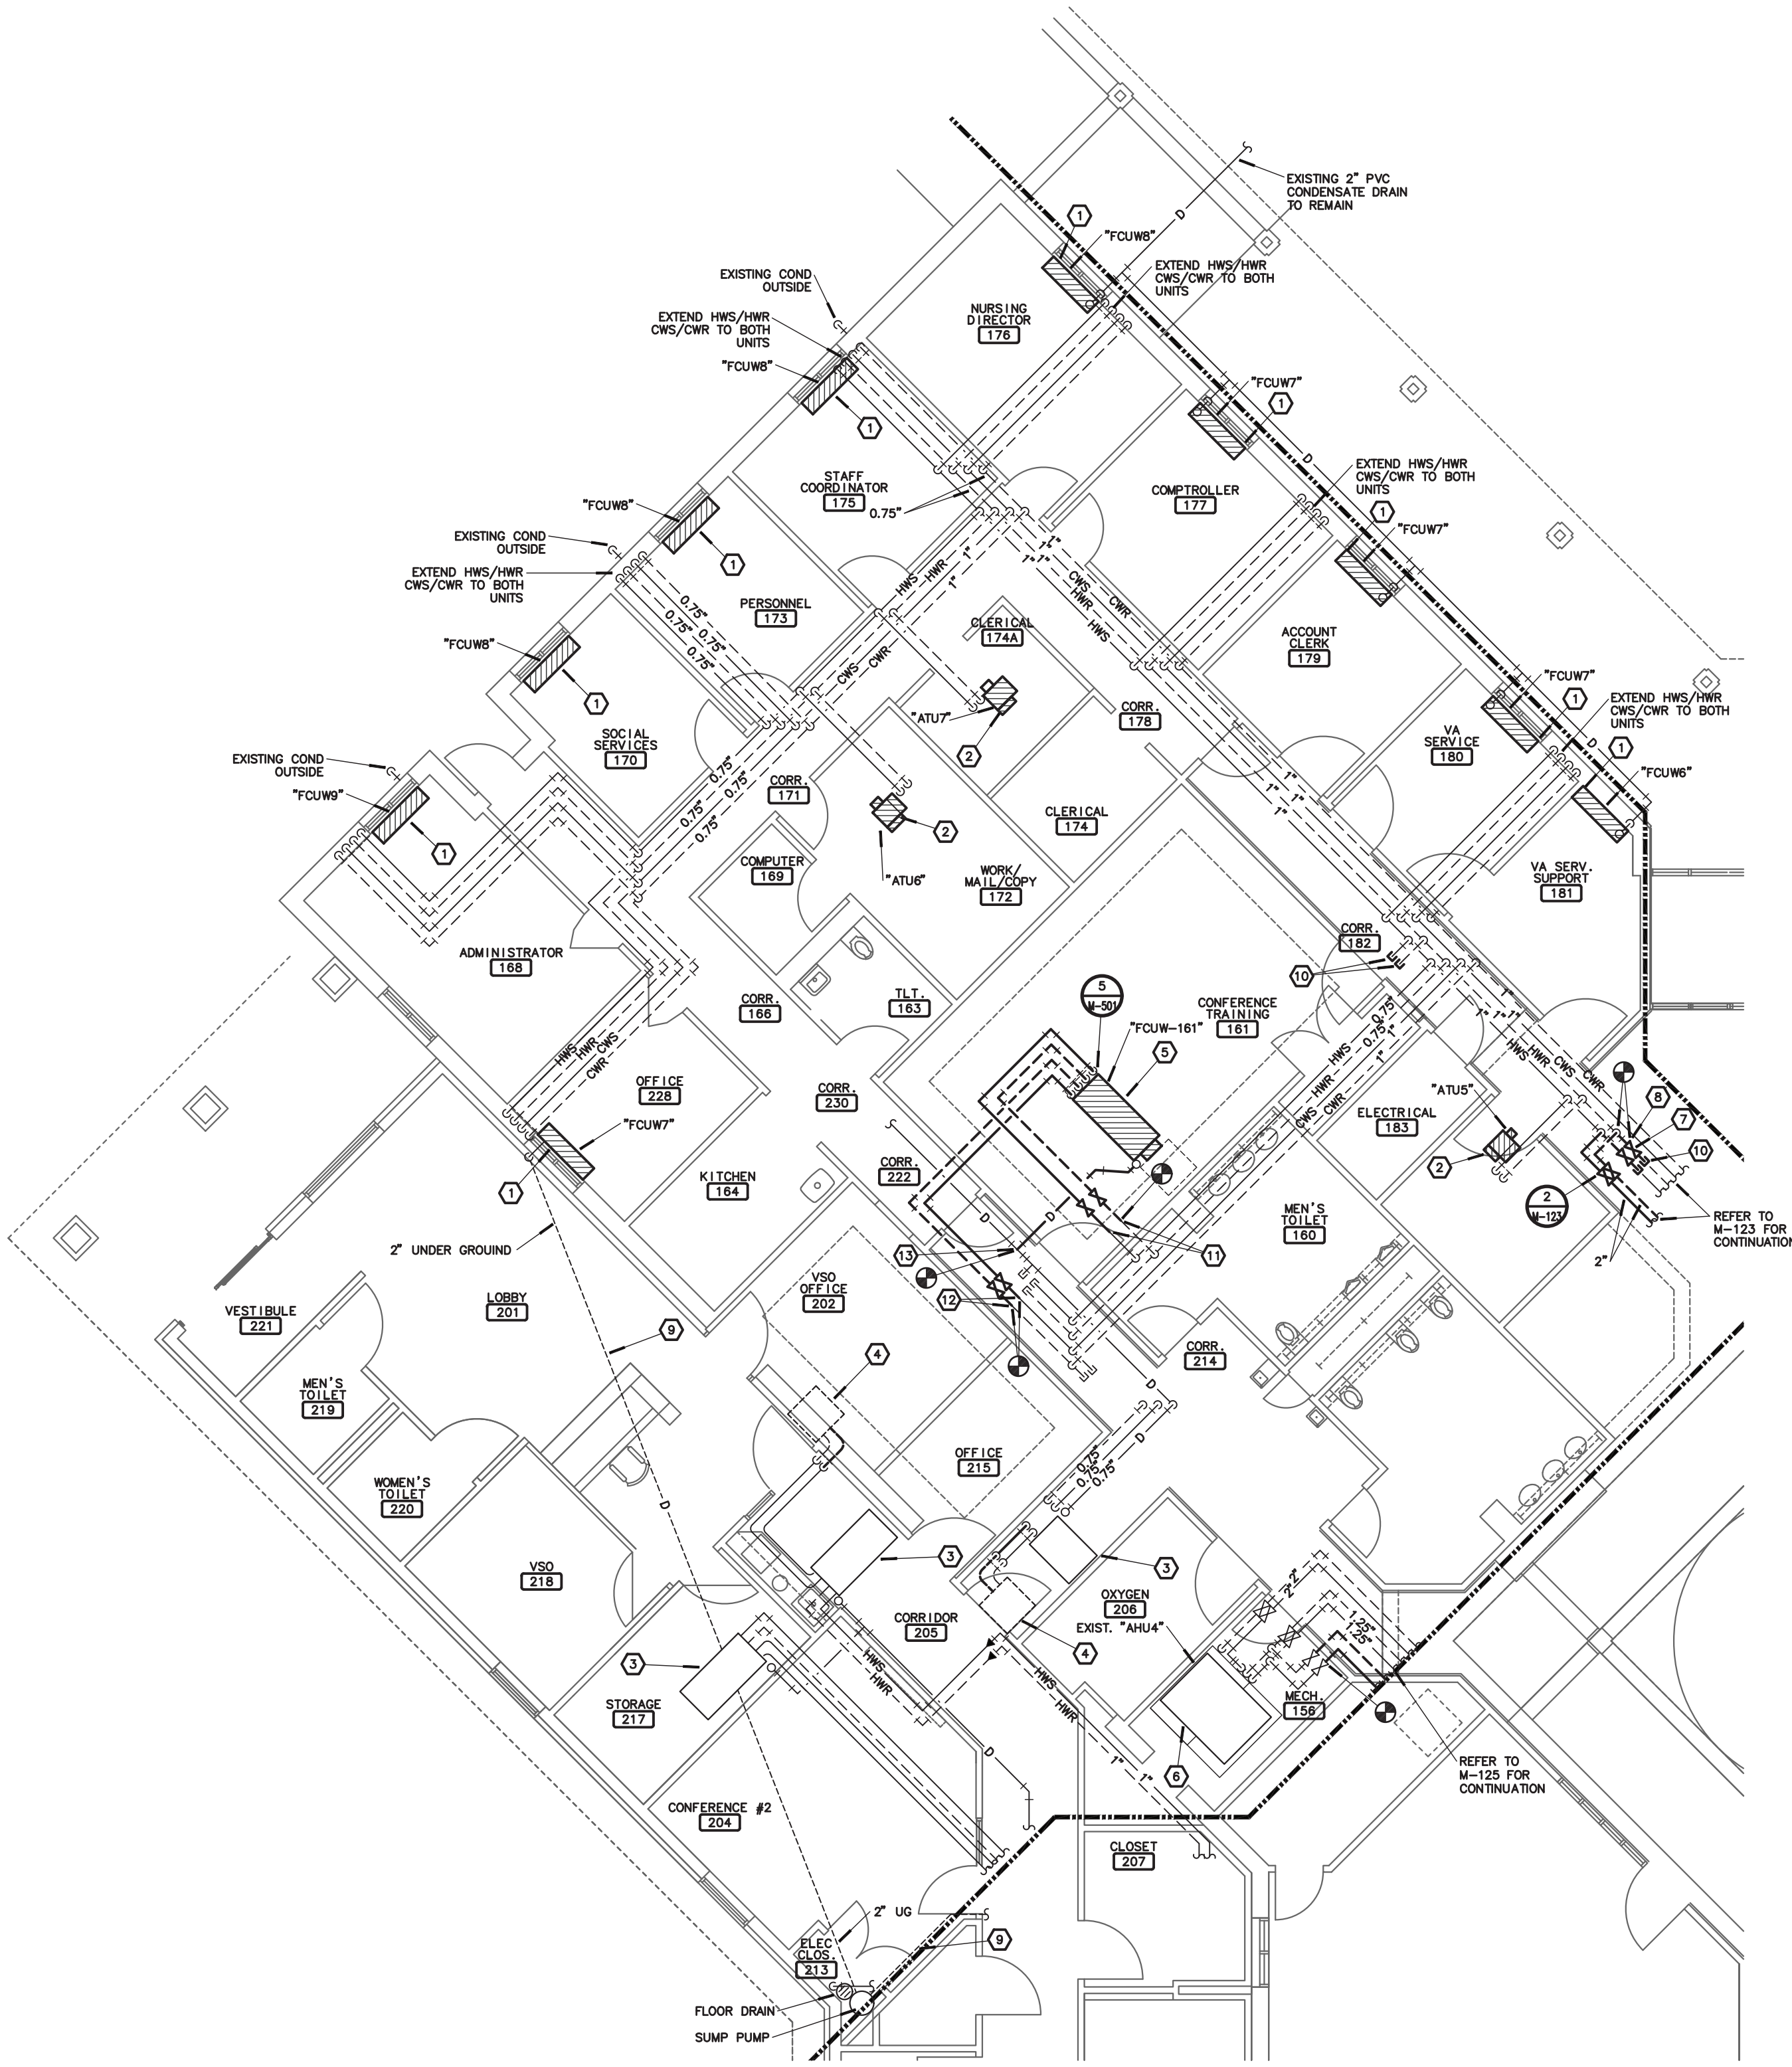
CAD DWG FILE: M-123.DWG  
DRAWN BY: TSE  
CHECKED BY: CKC  
DESIGNED BY: TSE

SHEET TITLE:  
**HVAC PIPING & PLUMBING PLAN**

SHEET NUMBER:  
**M-123**  
74 OF 116 SHEETS  
8-1-24



C:\RMA\SMH\DWG\HVAC-M-124 18 Sep 2019 - 10:25 am



## PARTIAL CENTRAL FACILITIES HYDRONIC IMPROVEMENT PLAN

1  
M-124

SCALE: 1/8"=1'-0"

NORTH



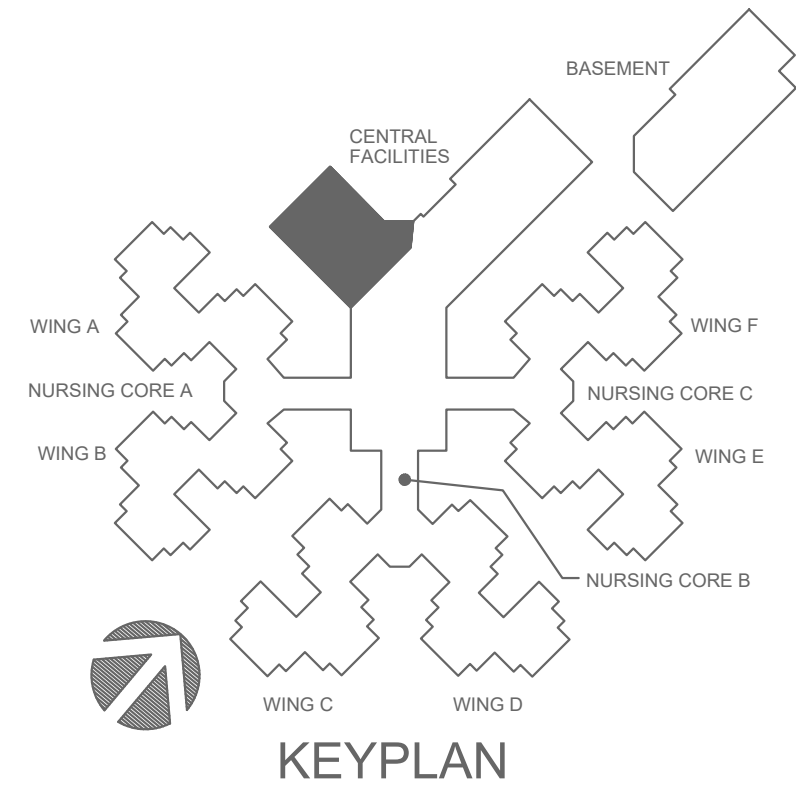
engineering consultants  
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### NOTES:


1. PROVIDE NEW 4-PIPE FAN COIL UNIT AND PIPING PACKAGE. RECONNECT NEW 0.75" PIPING TO EXISTING HWS, HWR, CWS, AND CONDENSATE DRAIN PIPING. FIELD VERIFY EXISTING PIPING CONDITIONS, AVAILABLE WALL AND FLOOR SPACE, AND LOCATION OF CONNECTIONS TO ALL EXISTING PIPING CONNECTIONS PRIOR TO SUBMITTAL OF FAN COIL UNITS. PROVIDE ALL REQUIRED ADJUSTMENTS TO EXISTING PIPING TO ACCOMMODATE NEW FAN COIL UNIT. RECONNECT TO EXISTING OUTSIDE AIR LOUVER AS REQUIRED.
2. PROVIDE NEW BYPASS AIR TERMINAL UNIT AND PIPING PACKAGE. RECONNECT TO EXISTING HWS, HWR, AND CONDENSATE DRAIN PIPING. FIELD VERIFY EXISTING PIPING CONDITIONS AND LOCATION OF CONNECTIONS TO ALL EXISTING PIPING CONNECTIONS PRIOR TO SUBMITTAL OF BYPASS AIR TERMINAL UNITS. PROVIDE ALL REQUIRED ADJUSTMENTS TO EXISTING PIPING TO ACCOMMODATE NEW BYPASS AIR TERMINAL UNIT.
3. EXISTING FAN COIL UNIT TO REMAIN. NO HYDRONIC WORK REQUIRED.
4. EXISTING CONDENSING UNIT ON ROOF TO REMAIN.
5. PROVIDE NEW 4-PIPE FAN COIL UNIT AND PIPING PACKAGE. RECONNECT TO EXISTING CWS, HWR, AND CONDENSATE DRAIN PIPING. FIELD VERIFY EXISTING PIPING CONDITIONS AND LOCATION OF CONNECTIONS TO ALL EXISTING PIPING CONNECTIONS PRIOR TO SUBMITTAL OF FAN COIL UNITS. PROVIDE ALL REQUIRED ADJUSTMENTS TO EXISTING PIPING TO ACCOMMODATE NEW FAN COIL UNIT. CONNECT NEW HWS AND HWR TO UNIT.
6. EXISTING AIR HANDLER TO REMAIN.
7. PROVIDE BALL TYPE SHUT-OFF VALVES IN EXISTING BRANCH PIPING.
8. CONNECT NEW HOT WATER HEATING SUPPLY AND RETURN PIPING TO EXISTING PIPING. FIELD VERIFY EXISTING PIPING SIZES. PROVIDE BALL TYPE SHUT-OFF VALVES.
9. EXISTING CONDENSATE DRAIN BELOW FINISHED FLOOR TO REMAIN.
10. CAP EXISTING HOT WATER SUPPLY AND RETURN PIPING.
11. CONNECT NEW HOT WATER SUPPLY AND HOT WATER RETURN PIPING TO EXISTING HOT WATER SUPPLY AND HOT WATER RETURN PIPING. FIELD VERIFY THAT EXISTING PIPE IS LARGE ENOUGH FOR CONNECTION TO NEW PIPING.
12. CONNECT NEW CHILLED WATER SUPPLY AND CHILLED WATER RETURN PIPING TO EXISTING CHILLED WATER SUPPLY AND CHILLED WATER RETURN PIPING. FIELD VERIFY THAT EXISTING PIPE IS LARGE ENOUGH FOR CONNECTION TO NEW PIPING.
13. CONNECT NEW 0.75" CONDENSATE DRAIN TO EXISTING 1" CONDENSATE DRAIN. FIELD VERIFY SIZE AND LOCATION OF EXISTING DRAIN.

### GENERAL NOTES:

1. GENERAL PIPING NOTES SHALL APPLY TO ALL EXISTING MECHANICAL HOT WATER SUPPLY AND RETURN PIPING BEING RE-UTILIZED. THE EXISTING MAIN HWS AND HWR PIPING THAT IS BEING ABANDONED IN PLACE SHALL NOT BE INCLUDED: A. THE ELASTOMERIC GASKET ON ALL GROOVED PIPE COUPLINGS AND VALVE COUPLINGS SHALL BE REMOVED AND REPLACED. THE REPLACEMENT GASKETS SHALL BE PROVIDED PER THE COUPLING MANUFACTURER'S RECOMMENDATION AND SHALL MEET THE APPLICATION FOR HOT WATER SYSTEM IN GENERAL. THE BUILDING IS PRIMARILY GROOVED COUPLINGS AND SOME ARE VITACULIC COUPLINGS. FROM FIELD OBSERVATION, IT APPEARS THAT ALL PIPING 2.5" AND LARGER IS GROOVED FITTINGS. B. ALL EXISTING DIELECTRIC FITTINGS TRANSITIONING FROM STEEL TO COPPER SHALL BE REPLACED. DIELECTRIC FITTINGS ARE LOCATED AT ALL HOT WATER COILS THROUGHOUT THE BUILDING. C. PROVIDE BALL VALVES OFF OF THE MAIN PIPING, UPSTREAM OF ALL DIELECTRIC FITTINGS AND WHERE SHOWN ON DRAWINGS, TO ALLOW FOR THE DIELECTRIC FITTINGS TO BE REPLACED IN THE FUTURE. D. PROVIDE BALL VALVES IN THE MAIN PIPING AT EVERY CORRIDOR AND AS SHOWN ON THE DRAWINGS TO ALLOW FOR ISOLATION OF PIPING. E. ADDITIONAL HANGERS SHALL BE PROVIDED TO MEET SPECIFICATIONS: AT A MINIMUM ADDITIONAL HANGERS SHALL BE PROVIDED EVERY 10'-0" OF PIPE LENGTH ON ALL EXISTING PIPING BEING RE-UTILIZED. FIELD VERIFY SIZE AND ROUTING OF EXISTING PIPING PRIOR TO BID. F. EXISTING INSULATION SHALL BE REMOVED AND REPLACED WHERE ALL PIPING WORK IS REQUIRED. TAPE AND SEAL INSULATION PER SPECIFICATIONS. G. UNDER EACH PHASE, AFTER ALL PIPING CHANGES HAVE BEEN COMPLETED, THE HOT WATER PIPING SHALL BE THOROUGHLY FLUSHED AND WATER TREATMENT INSTALLED. H. CONTRACTOR SHALL FIELD VERIFY EXISTING CONDITIONS PRIOR TO BID.
2. GENERAL PIPING NOTES SHALL APPLY TO ALL EXISTING CHILLED WATER SUPPLY AND RETURN PIPING: A. PROVIDE BALL VALVES OFF OF THE MAIN PIPING, UPSTREAM OF ALL EXISTING DIELECTRIC FITTINGS AND WHERE SHOWN ON DRAWINGS, TO ALLOW FOR THE DIELECTRIC FITTINGS TO BE REPLACED IN THE FUTURE. B. PROVIDE BALL VALVES IN THE MAIN PIPING AT EVERY CORRIDOR AND AS SHOWN ON THE DRAWINGS TO ALLOW FOR ISOLATION OF PIPING. C. ADDITIONAL HANGERS SHALL BE PROVIDED TO MEET SPECIFICATIONS: AT A MINIMUM ADDITIONAL HANGERS SHALL BE PROVIDED EVERY 10'-0" OF PIPE LENGTH ON ALL EXISTING PIPING. FIELD VERIFY SIZE AND ROUTING OF EXISTING PIPING PRIOR TO BID. D. EXISTING INSULATION SHALL BE REMOVED AND REPLACED WHERE ALL PIPING WORK IS REQUIRED. TAPE AND SEAL INSULATION PER SPECIFICATIONS. E. CONTRACTOR SHALL FIELD VERIFY EXISTING CONDITIONS PRIOR TO BID.
3. FOR ALL PLUMBING OR HVAC QUESTIONS DURING BIDDING OR DURING CONSTRUCTION, CONTACT ESTERLY, SCHNEIDER & ASSOCIATES, INC. THOM LUNDGREN (417-862-0558) FOR COORDINATION WITH TYLER ENGBERG AT RIM ENGINEERING CONSULTANTS.
4. CONTRACTOR SHALL FIELD VERIFY ALL EXISTING CONSTRUCTION PRIOR TO SUBMITTING HIS BID. NO EXTRAS WILL BE PAID DUE TO UNANTICIPATED EXISTING CONDITIONS.
5. CONTRACTOR SHALL SCHEDULE AND EXECUTE ALL WORK WITH REGARD TO THE OWNER'S USE OF THE BUILDING.
6. PLANS ARE DIAGRAMMATIC AND SHALL NOT BE SCALED. REFER TO ARCHITECTURAL DRAWINGS FOR DIMENSIONS.
7. CONTRACTOR SHALL INSPECT AREAS TO ACCESS ATTIC AREA AND PROVIDE TEMPORARY PLATFORMS ON EXISTING STRUCTURE ABOVE CEILING TO PERFORM WORK WITHOUT INTERRUPTING OPERATIONS IN OCCUPIED SPACES BELOW CEILING. ALL AREAS USED FOR ACCESS TO ATTIC SHALL BE COORDINATED WITH OWNER.
8. CONTRACTOR SHALL REMOVE AND REPLACE CEILING TILE AND CEILING GRID AS REQUIRED TO PERFORM ALL DEMOLITION AND IMPROVEMENT WORK. CONTRACTOR SHALL REPLACE ALL DAMAGED CEILING TILE TO MATCH EXISTING.
9. CONTRACTOR SHALL FIRE CAULK ANY PENETRATIONS.



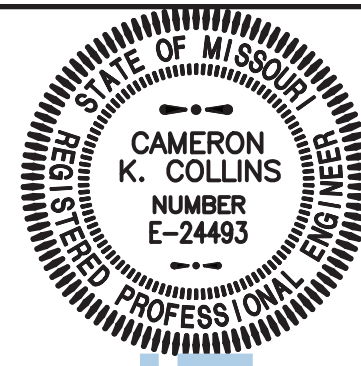STATE OF MISSOURI  
MIKE KEHOE,  
GOVERNOR



Cameron K. Collins, Professional Engineer, No. E-24483

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OFFICE OF ADMINISTRATION  
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PROJECT # U1503-01  
SITE # 6801  
ASSET # 8136801002  
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REVISION: \_\_\_\_\_  
DATE: \_\_\_\_\_  
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REVISION: \_\_\_\_\_  
DATE: \_\_\_\_\_  
ISSUE DATE: 8-1-24

CAD DWG FILE: M-124.DWG  
DRAWN BY: TSE  
CHECKED BY: CRC  
DESIGNED BY: TSE

SHEET TITLE:

## HVAC PIPING & PLUMBING PLAN

SHEET NUMBER:

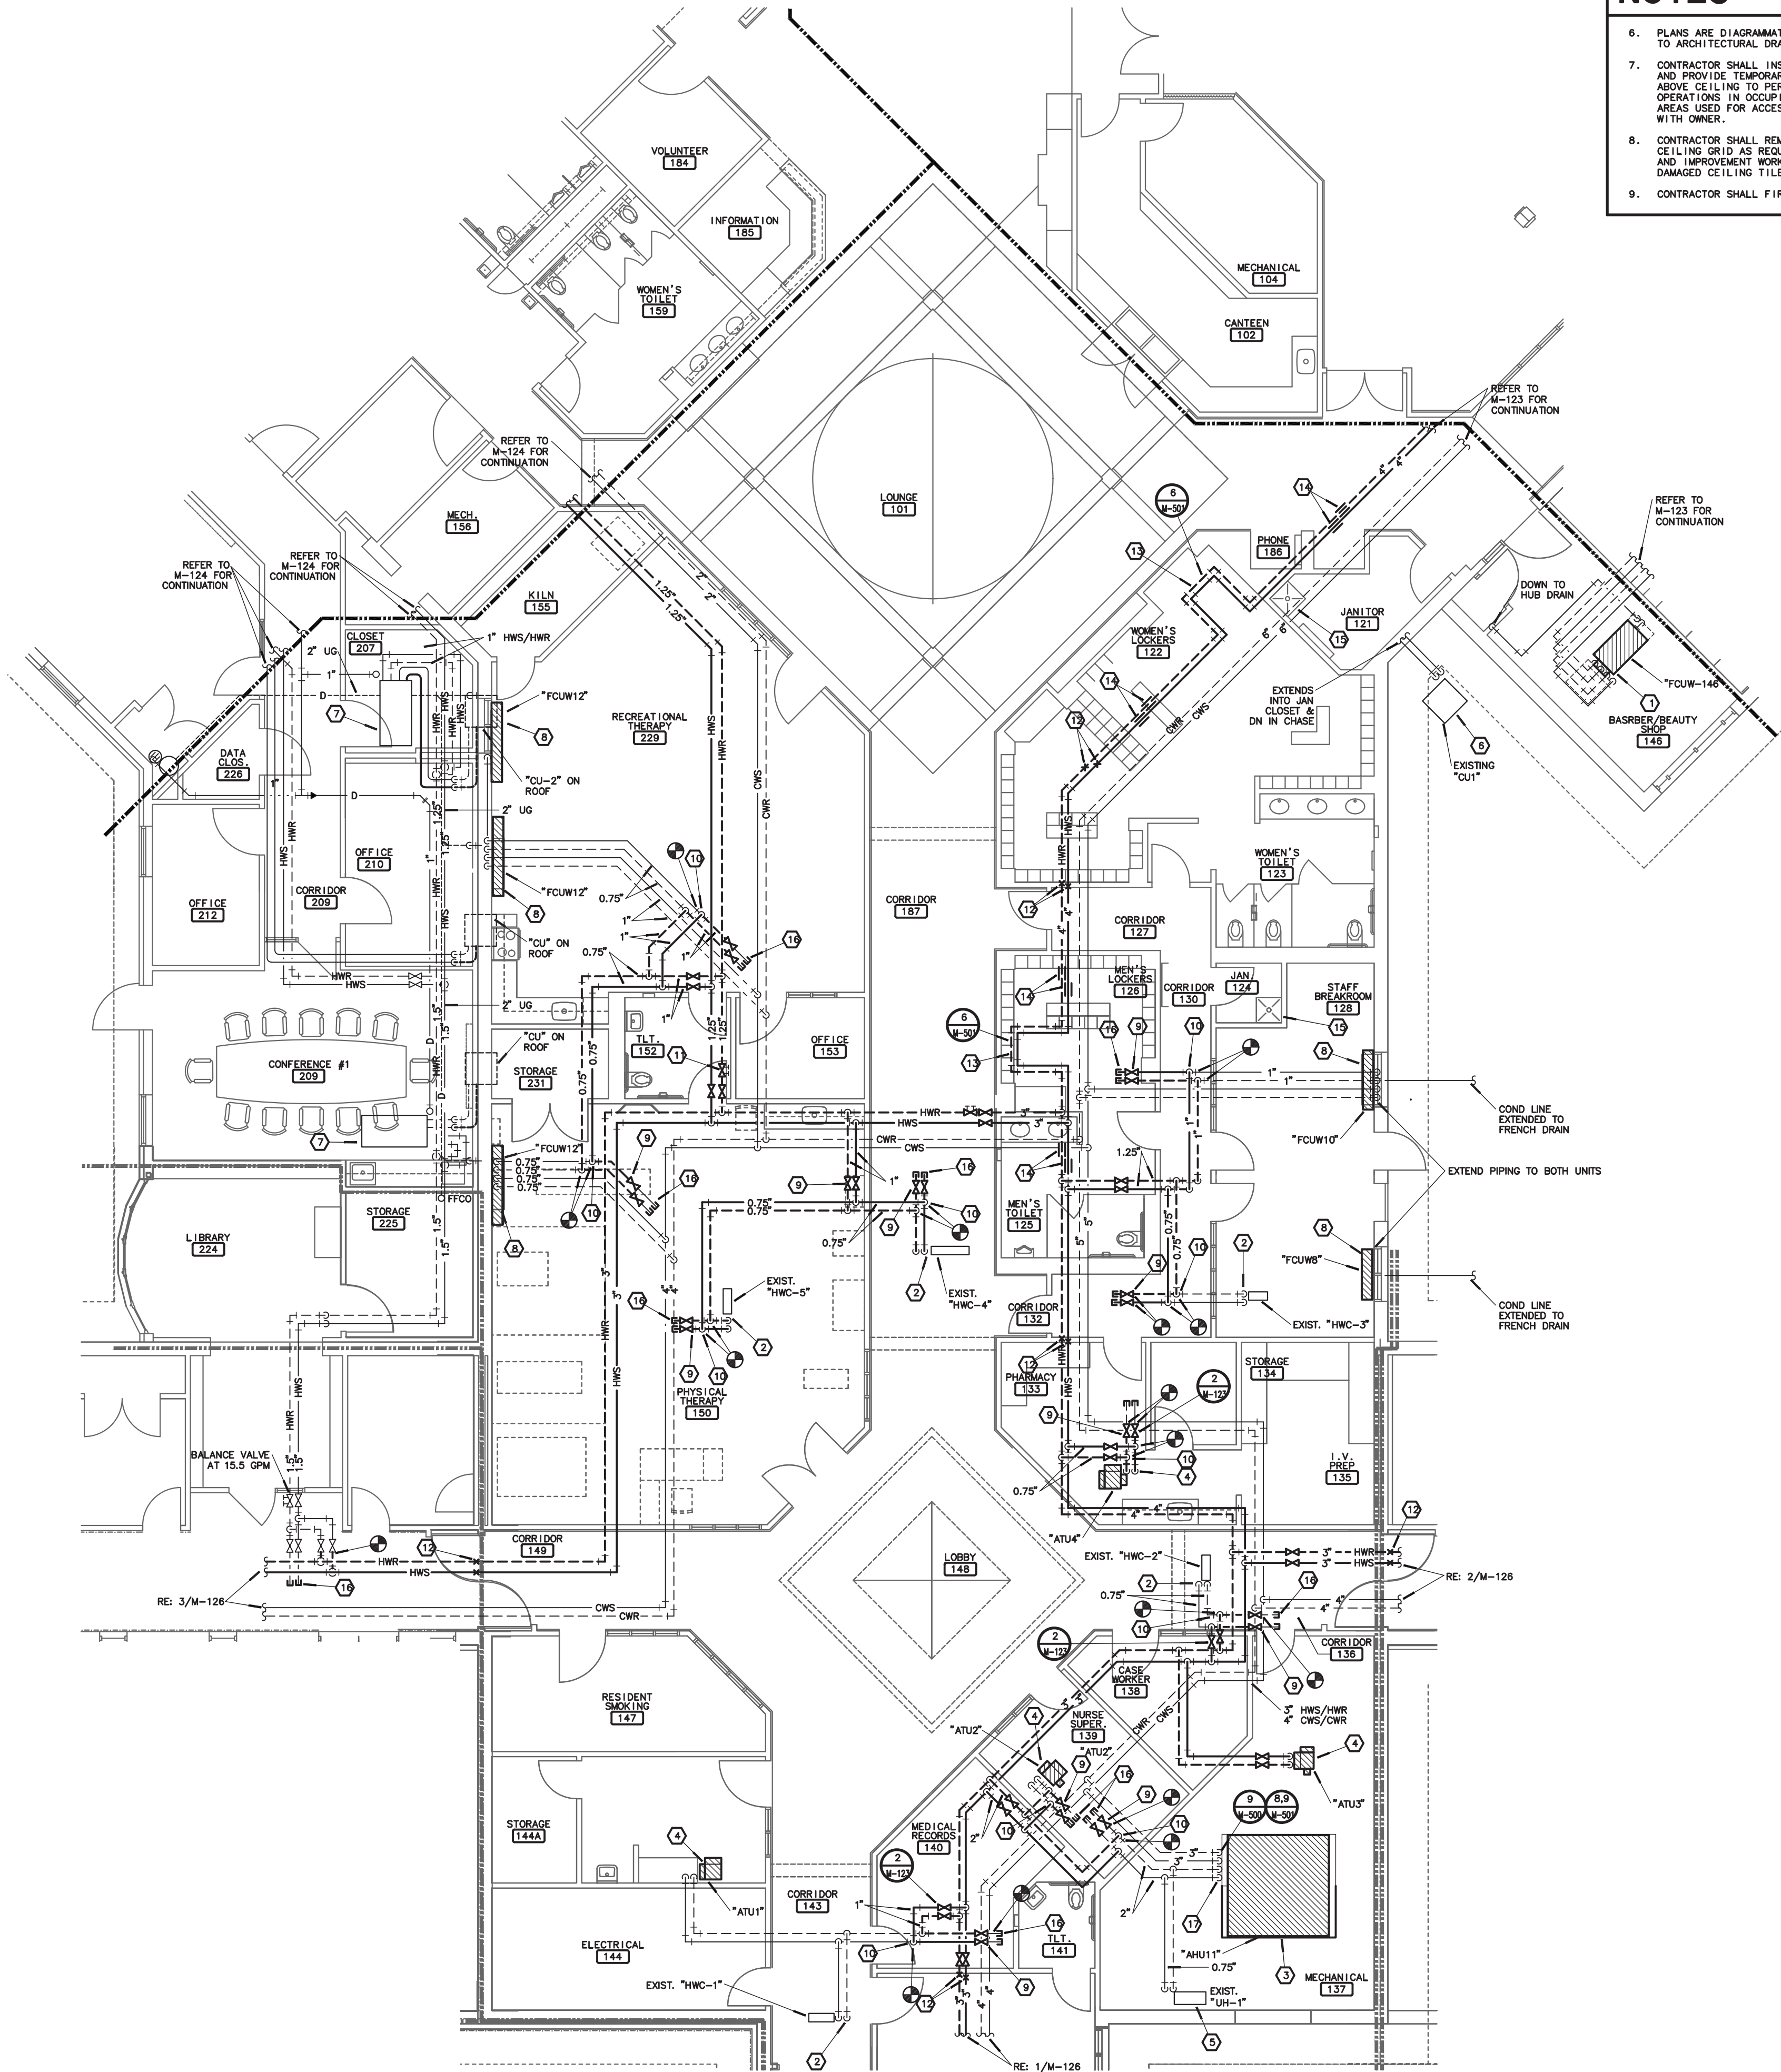
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75 OF 120 SHEETS

8-1-24



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**PARTIAL CENTRAL FACILITIES  
HYDRONIC IMPROVEMENT PLAN**

1  
M-125

SCALE: 1/8"=1'-0"

NORTH

**NOTES:**

- PLANS ARE DIAGRAMMATIC AND SHALL NOT BE SCALED. REFER TO ARCHITECTURAL DRAWINGS FOR DIMENSIONS.
- CONTRACTOR SHALL INSPECT AREAS TO ACCESS ATTIC AREA AND PROVIDE TEMPORARY PLATFORMS ON EXISTING STRUCTURE ABOVE CEILING TO PERFORM WORK WITHOUT INTERRUPTING OPERATIONS IN OCCUPIED SPACES BELOW CEILING. ALL AREAS USED FOR ACCESS TO ATTIC SHALL BE COORDINATED WITH OWNER.
- CONTRACTOR SHALL REMOVE AND REPLACE CEILING TILE AND CEILING GRID AS REQUIRED TO PERFORM ALL DEMOLITION AND IMPROVEMENT WORK. CONTRACTOR SHALL REPLACE ALL DAMAGED CEILING TILE TO MATCH EXISTING.
- CONTRACTOR SHALL FIRE CAULK ANY PENETRATIONS.



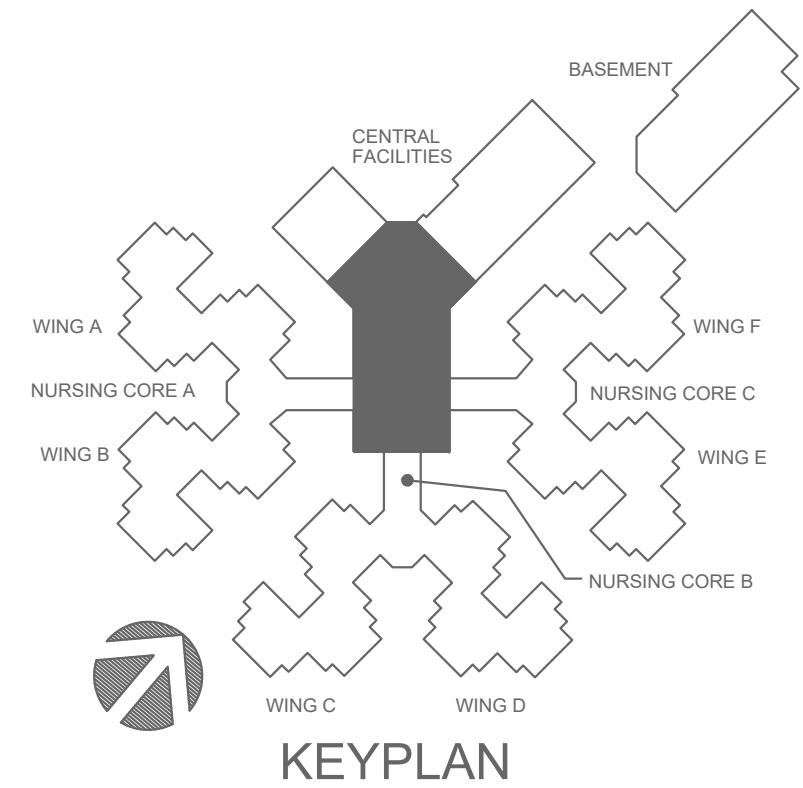
engineering consultants  
3333 E. Battlefield Road, Ste. 1000  
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rtmec.com | 417.881.0020  
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**NOTES:**


- PROVIDE NEW HORIZONTAL 4-PIPE FAN COIL UNIT AND PIPING PACKAGE. RECONNECT NEW 0.75" PIPING TO EXISTING HWS, CWR, COW AND CONDENSATE DRAIN PIPING. FIELD VERIFY EXISTING CONDITIONS, AND LOCATION OF CONNECTIONS TO ALL EXISTING PIPING CONNECTIONS PRIOR TO SUBMITTAL FAN COIL UNITS. PROVIDE ALL REQUIRED ADJUSTMENTS TO EXISTING PIPING TO ACCOMMODATE NEW FAN COIL UNIT.
- EXISTING REHEAT COIL TO REMAIN. REPLACE EXISTING PIPING PACKAGE FOR REHEAT COIL. RECONNECT TO EXISTING HWS AND HWR PIPING. FIELD VERIFY EXISTING CONDITIONS AND LOCATION OF CONNECTIONS TO ALL EXISTING PIPING CONNECTIONS PRIOR TO SUBMITTAL PIPING PACKAGES. PROVIDE ALL REQUIRED ADJUSTMENTS TO EXISTING PIPING TO ACCOMMODATE PIPING PACKAGE.
- PROVIDE NEW AIR HANDLING UNIT AND PIPING PACKAGE FOR BASE BID. RECONNECT TO EXISTING HWS, HWR, CWS, CWR AND CONDENSATE DRAIN PIPING. FIELD VERIFY EXISTING CONDITIONS, AND LOCATION OF CONNECTIONS TO ALL EXISTING PIPING CONNECTIONS PRIOR TO SUBMITTAL OF AIR HANDLING UNIT. PROVIDE ALL REQUIRED ADJUSTMENTS TO EXISTING PIPING TO ACCOMMODATE NEW AIR HANDLING UNIT.
- PROVIDE NEW BYPASS AIR TERMINAL UNIT AND PIPING PACKAGE. RECONNECT TO EXISTING HWS, HWR, AND CONDENSATE DRAIN PIPING. FIELD VERIFY EXISTING CONDITIONS AND LOCATION OF CONNECTIONS TO ALL EXISTING PIPING CONNECTIONS PRIOR TO SUBMITTAL OF BYPASS AIR TERMINAL UNITS. PROVIDE ALL REQUIRED ADJUSTMENTS TO EXISTING PIPING TO ACCOMMODATE NEW BYPASS AIR TERMINAL UNIT.
- EXISTING UNIT HEATER TO REMAIN. REPLACE EXISTING PIPING PACKAGE FOR HEATER.
- EXISTING CONDENSING UNIT AND PIPING TO REMAIN.
- EXISTING FAN COIL UNIT TO REMAIN. NO HYDRONIC WORK REQUIRED.
- PROVIDE NEW VERTICAL CABINET 4-PIPE FAN COIL UNIT AND PIPING PACKAGE. RECONNECT NEW 0.75" PIPING TO EXISTING HWS, HWR, CWS, CWR AND CONDENSATE DRAIN PIPING. FIELD VERIFY EXISTING CONDITIONS, AVAILABLE WALL AND FLOOR SPACE, AND LOCATION OF CONNECTIONS TO ALL EXISTING PIPING CONNECTIONS PRIOR TO SUBMITTAL OF FAN COIL UNITS. PROVIDE ALL REQUIRED ADJUSTMENTS TO EXISTING PIPING TO ACCOMMODATE NEW FAN COIL UNIT.
- PROVIDE BALL TYPE SHUT-OFF VALVES IN EXISTING BRANCH PIPING.
- CONNECT TO EXISTING HOT WATER SUPPLY AND RETURN PIPING.
- PROVIDE NEW BALANCE VALVE WITH CIRCUIT SETTER TYPE BALANCE VALVE. MEASURE ORIGINAL FLOWRATE PRIOR TO DEMOLITION WORK AND BALANCE NEW VALVE TO THE ORIGINAL VALUE.
- PROVIDE PIPE ANCHORS SUPPORTED FROM BUILDING STRUCTURE. SIZE AND INSTALL PER FLEXIBLE PIPING EXPANSION JOINT MANUFACTURER'S RECOMMENDATIONS.
- PROVIDE NESTED FLEXIBLE PIPE EXPANSION JOINTS.
- PROVIDE PIPE EXPANSION GUIDES FURNISHED AND INSTALLED PER FLEXIBLE PIPING EXPANSION JOINT MANUFACTURER'S RECOMMENDATIONS.
- PROVIDE NEW CHECK VALVE TO COLD WATER PIPING TO EXISTING MOP SINK.
- CAP EXISTING HOT WATER SUPPLY & RETURN.
- PROVIDE 3" CHILLED WATER AND 2" HOT WATER DOWN TO COILS WITH NEW COIL. BYPASS PUMPS COWP-11 AND HWCW-11 FOR FREEZE PROTECTION.

**GENERAL NOTES:**

- GENERAL PIPING NOTES SHALL APPLY TO ALL EXISTING MECHANICAL HOT WATER SUPPLY AND RETURN PIPING BEING RE-UTILIZED. THE EXISTING MAIN HWS AND HWR PIPING THAT IS BEING ABANDONED IN PLACE SHALL NOT BE INCLUDED: A. THE ELASTOMER GASKET ON ALL GROOVED PIPE COUPLINGS AND VALVE COUPLINGS SHALL BE REMOVED AND REPLACED. THE REPLACEMENT GASKETS SHALL BE PROVIDED PER THE COUPLING MANUFACTURER'S RECOMMENDATION AND SHALL MEET THE APPLICATION FOR HOT WATER SYSTEMS. IN GENERAL, THE BUILDING IS PRIMARILY GROUVED COUPLINGS AND SOME ARE VICTALIC COUPLINGS. FROM FIELD OBSERVATION, IT APPEARS THAT ALL PIPING 2.5" AND LARGER IS GROOVED FITTINGS. B. ALL EXISTING DIELECTRIC FITTINGS TRANSITIONING FROM STEEL TO COPPER SHALL BE REPLACED. DIELECTRIC FITTINGS ARE LOCATED AT ALL HOT WATER COILS THROUGHOUT THE BUILDING. C. PROVIDE BALL VALVES OFF OF THE MAIN PIPING, UPSTREAM OF ALL DIELECTRIC FITTINGS AND WHERE SHOWN ON DRAWINGS, TO ALLOW THE DIELECTRIC FITTINGS TO BE REPLACED IN THE FUTURE. D. PROVIDE BALL VALVES IN THE MAIN PIPING AT EVERY CORRIDOR AND AS SHOWN ON THE DRAWINGS TO ALLOW ISOLATION OF PIPING. E. ADDITIONAL HANGERS SHALL BE PROVIDED TO MEET SPECIFICATIONS. AT A MINIMUM ADDITIONAL HANGERS SHALL BE PROVIDED EVERY 10'-0" OF PIPE LENGTH ON ALL EXISTING PIPING BEING RE-UTILIZED. FIELD VERIFY SIZE AND ROUTING OF EXISTING PIPING PRIOR TO BID. F. EXISTING INSULATION SHALL BE REMOVED AND REPLACED WHERE ALL PIPING WORK IS REQUIRED. TAPE AND SEAL INSULATION PER SPECIFICATIONS. G. UNDER EACH PHASE, AFTER ALL PIPING CHANGES HAVE BEEN COMPLETED, THE HOT WATER PIPING SHALL BE THOROUGHLY FLUSHED AND WATER TREATMENT INSTALLED. H. CONTRACTOR SHALL FIELD VERIFY EXISTING CONDITIONS PRIOR TO BID.
- GENERAL PIPING NOTES SHALL APPLY TO ALL EXISTING CHILLED WATER SUPPLY AND RETURN PIPING: A. PROVIDE BALL VALVES OFF OF THE MAIN PIPING, UPSTREAM OF ALL EXISTING DIELECTRIC FITTINGS AND WHERE SHOWN ON DRAWINGS, TO ALLOW THE DIELECTRIC FITTINGS TO BE REPLACED IN THE FUTURE. B. PROVIDE BALL VALVES IN THE MAIN PIPING AT EVERY CORRIDOR AND AS SHOWN ON THE DRAWINGS TO ALLOW ISOLATION OF PIPING. C. ADDITIONAL HANGERS SHALL BE PROVIDED TO MEET SPECIFICATIONS. AT A MINIMUM ADDITIONAL HANGERS SHALL BE PROVIDED EVERY 10'-0" OF PIPE LENGTH ON ALL EXISTING PIPING. FIELD VERIFY SIZE AND ROUTING OF PIPING PRIOR TO BID. D. EXISTING INSULATION SHALL BE REMOVED AND REPLACED WHERE ALL PIPING WORK IS REQUIRED. TAPE AND SEAL INSULATION PER SPECIFICATIONS. E. CONTRACTOR SHALL FIELD VERIFY EXISTING CONDITIONS PRIOR TO BID.
- FOR ALL PLUMBING OR HVAC QUESTIONS DURING BIDDING OR DURING CONSTRUCTION, CONTACT ESTERLY, SCHNEIDER & ASSOCIATES, INC. THOM LINDBERG (417-862-0558) FOR COORDINATION WITH TYLER ENSERRO AT RTM ENGINEERING CONSULTANTS.
- CONTRACTOR SHALL FIELD VERIFY ALL EXISTING CONSTRUCTION PRIOR TO SUBMITTING HIS BID. NO EXTRAS WILL BE PAID DUE TO UNANTICIPATED EXISTING CONDITIONS.
- CONTRACTOR SHALL SCHEDULE AND EXECUTE ALL WORK WITH REGARD TO THE OWNER'S USE OF THE BUILDING.



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OFFICE OF ADMINISTRATION  
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DESIGN AND CONSTRUCTION

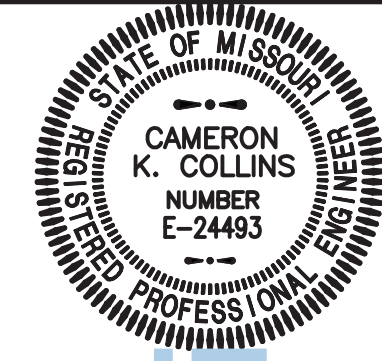DEPARTMENT OF  
PUBLIC SAFETY  
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MISSOURI VETERANS  
HOME

620 N. JEFFERSON  
ST. JAMES, MISSOURI

PROJECT # U1503-01  
SITE # 6801  
ASSET # 8136801002  
FEDERAL # 29-044

REVISION: \_\_\_\_\_  
DATE: \_\_\_\_\_  
REVISION: \_\_\_\_\_  
DATE: \_\_\_\_\_  
REVISION: \_\_\_\_\_  
DATE: \_\_\_\_\_  
ISSUE DATE: 8-1-24

CAD DWG FILE: M-125.DWG  
DRAWN BY: TSL  
CHECKED BY: CKC  
DESIGNED BY: TSE

SHEET TITLE:  
**HVAC PIPING  
& PLUMBING  
PLAN**

SHEET NUMBER:


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76 OF 120 SHEETS

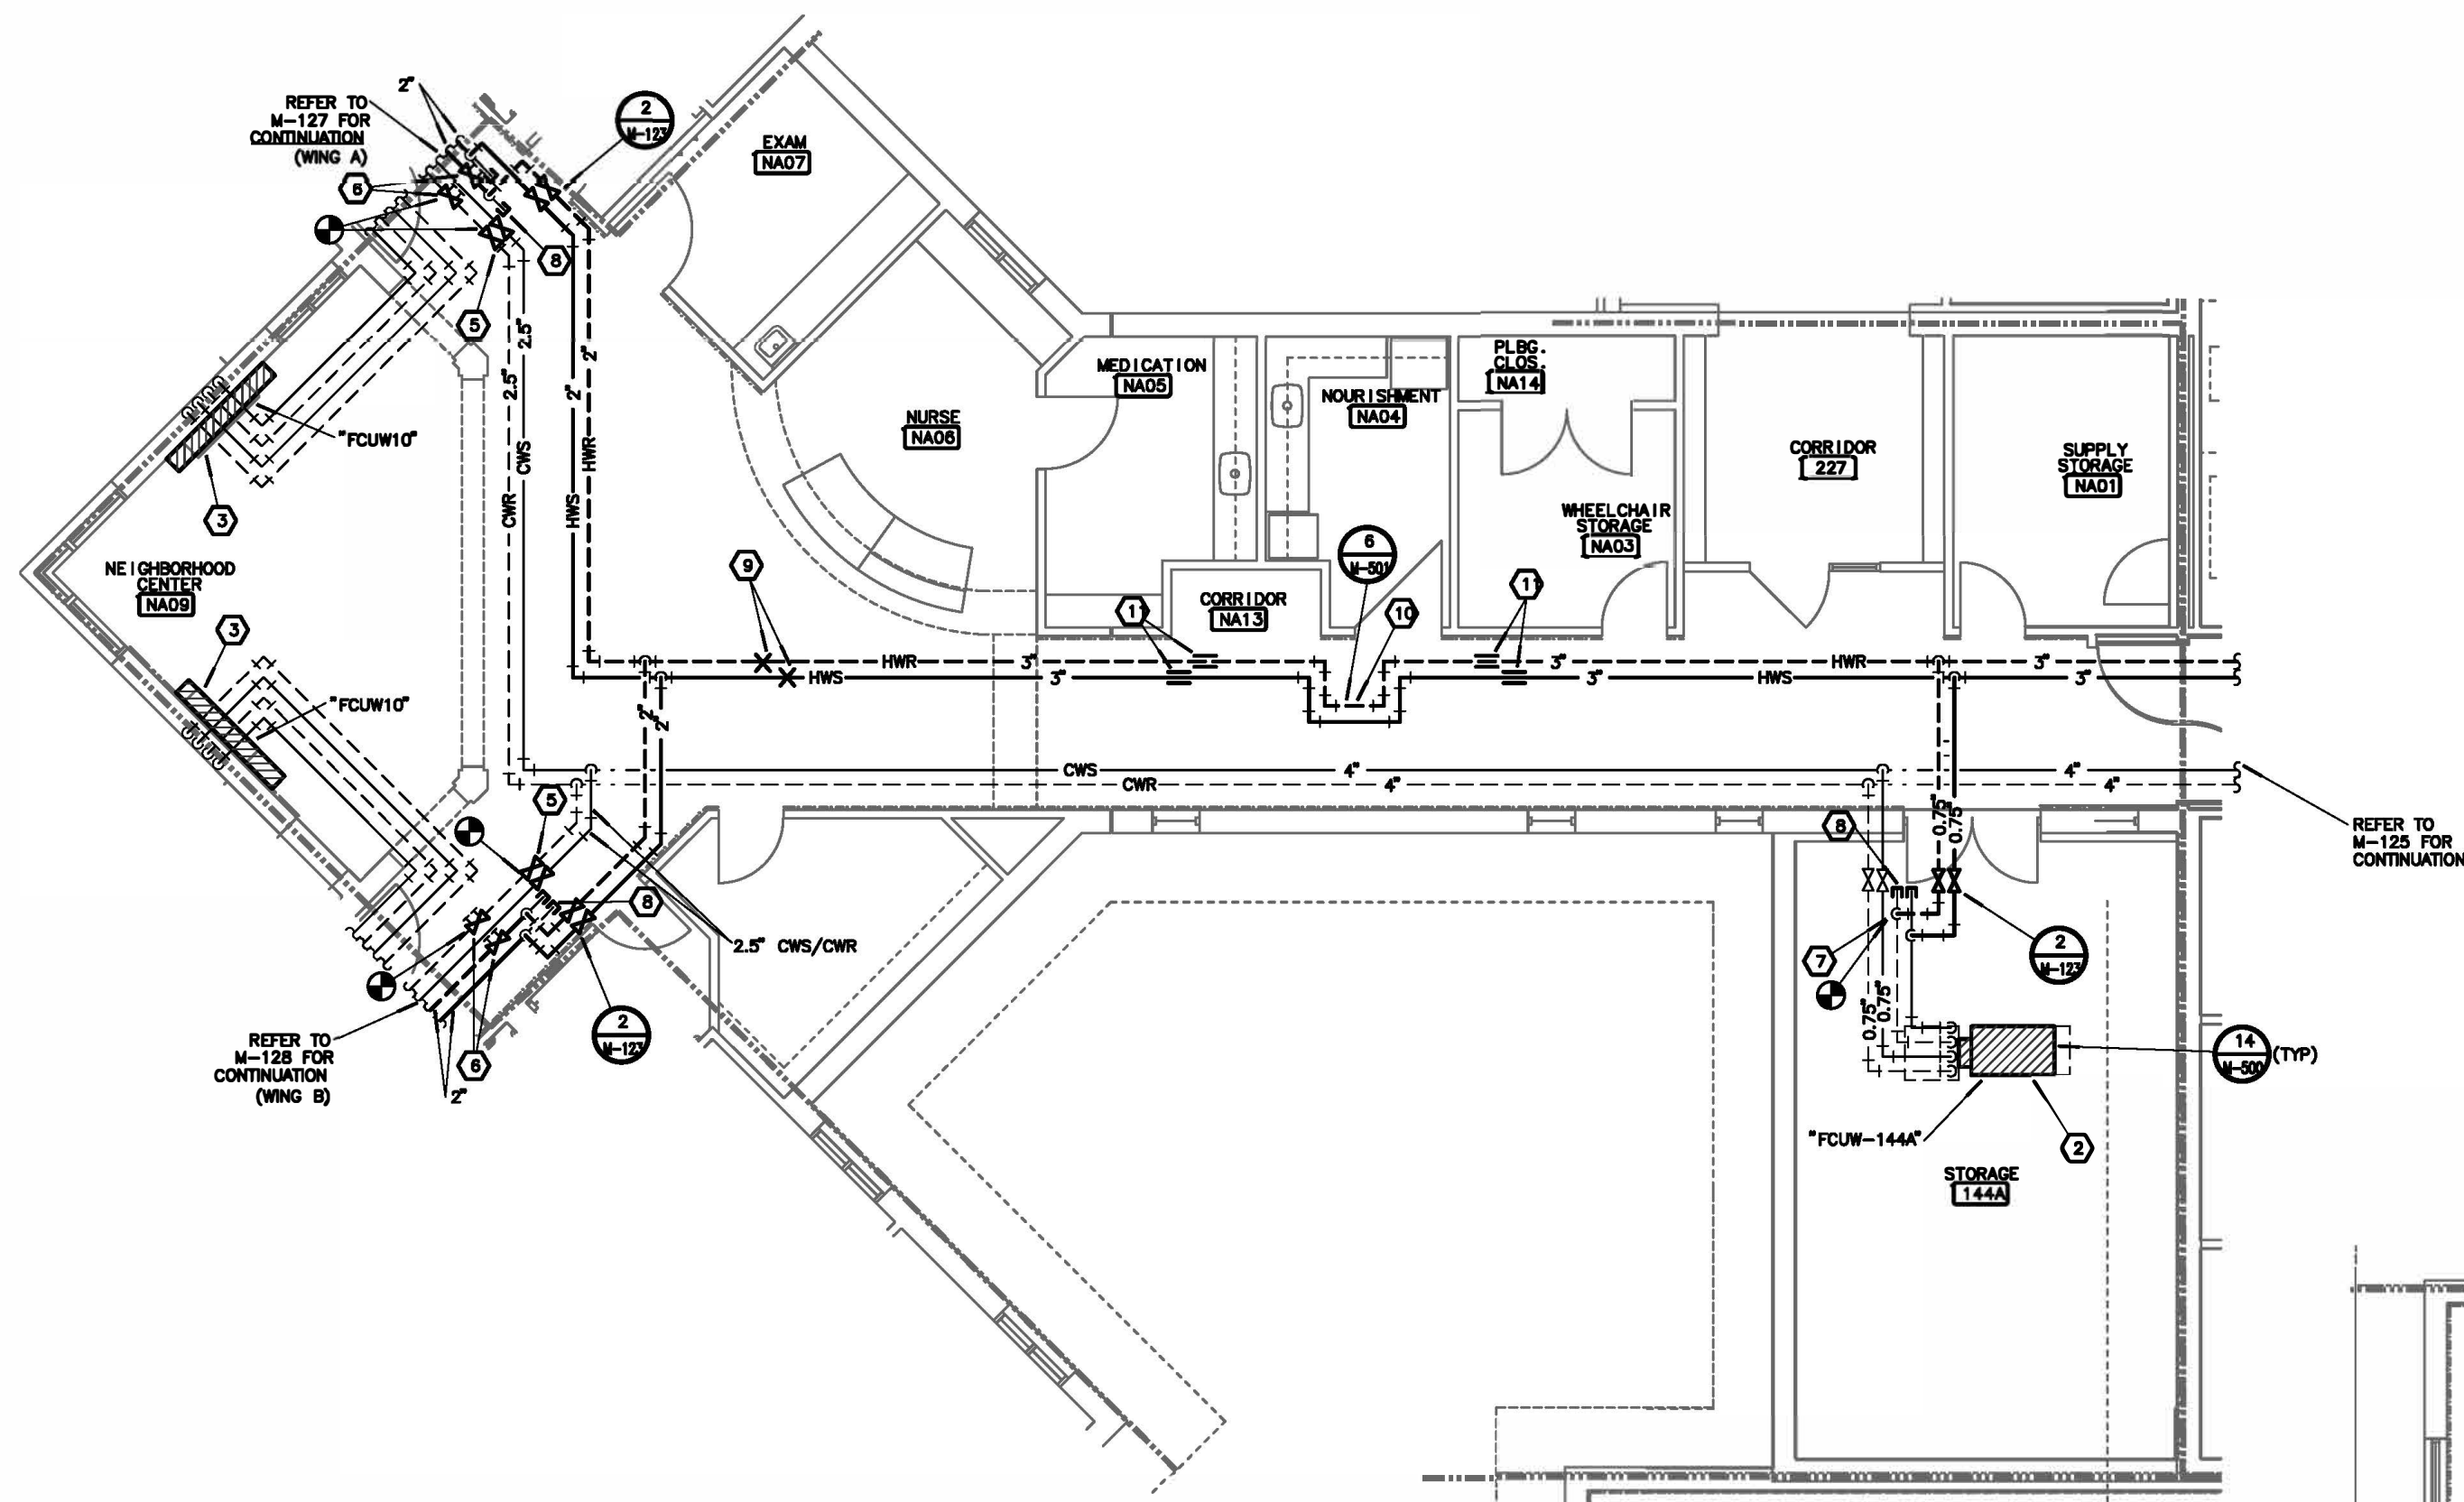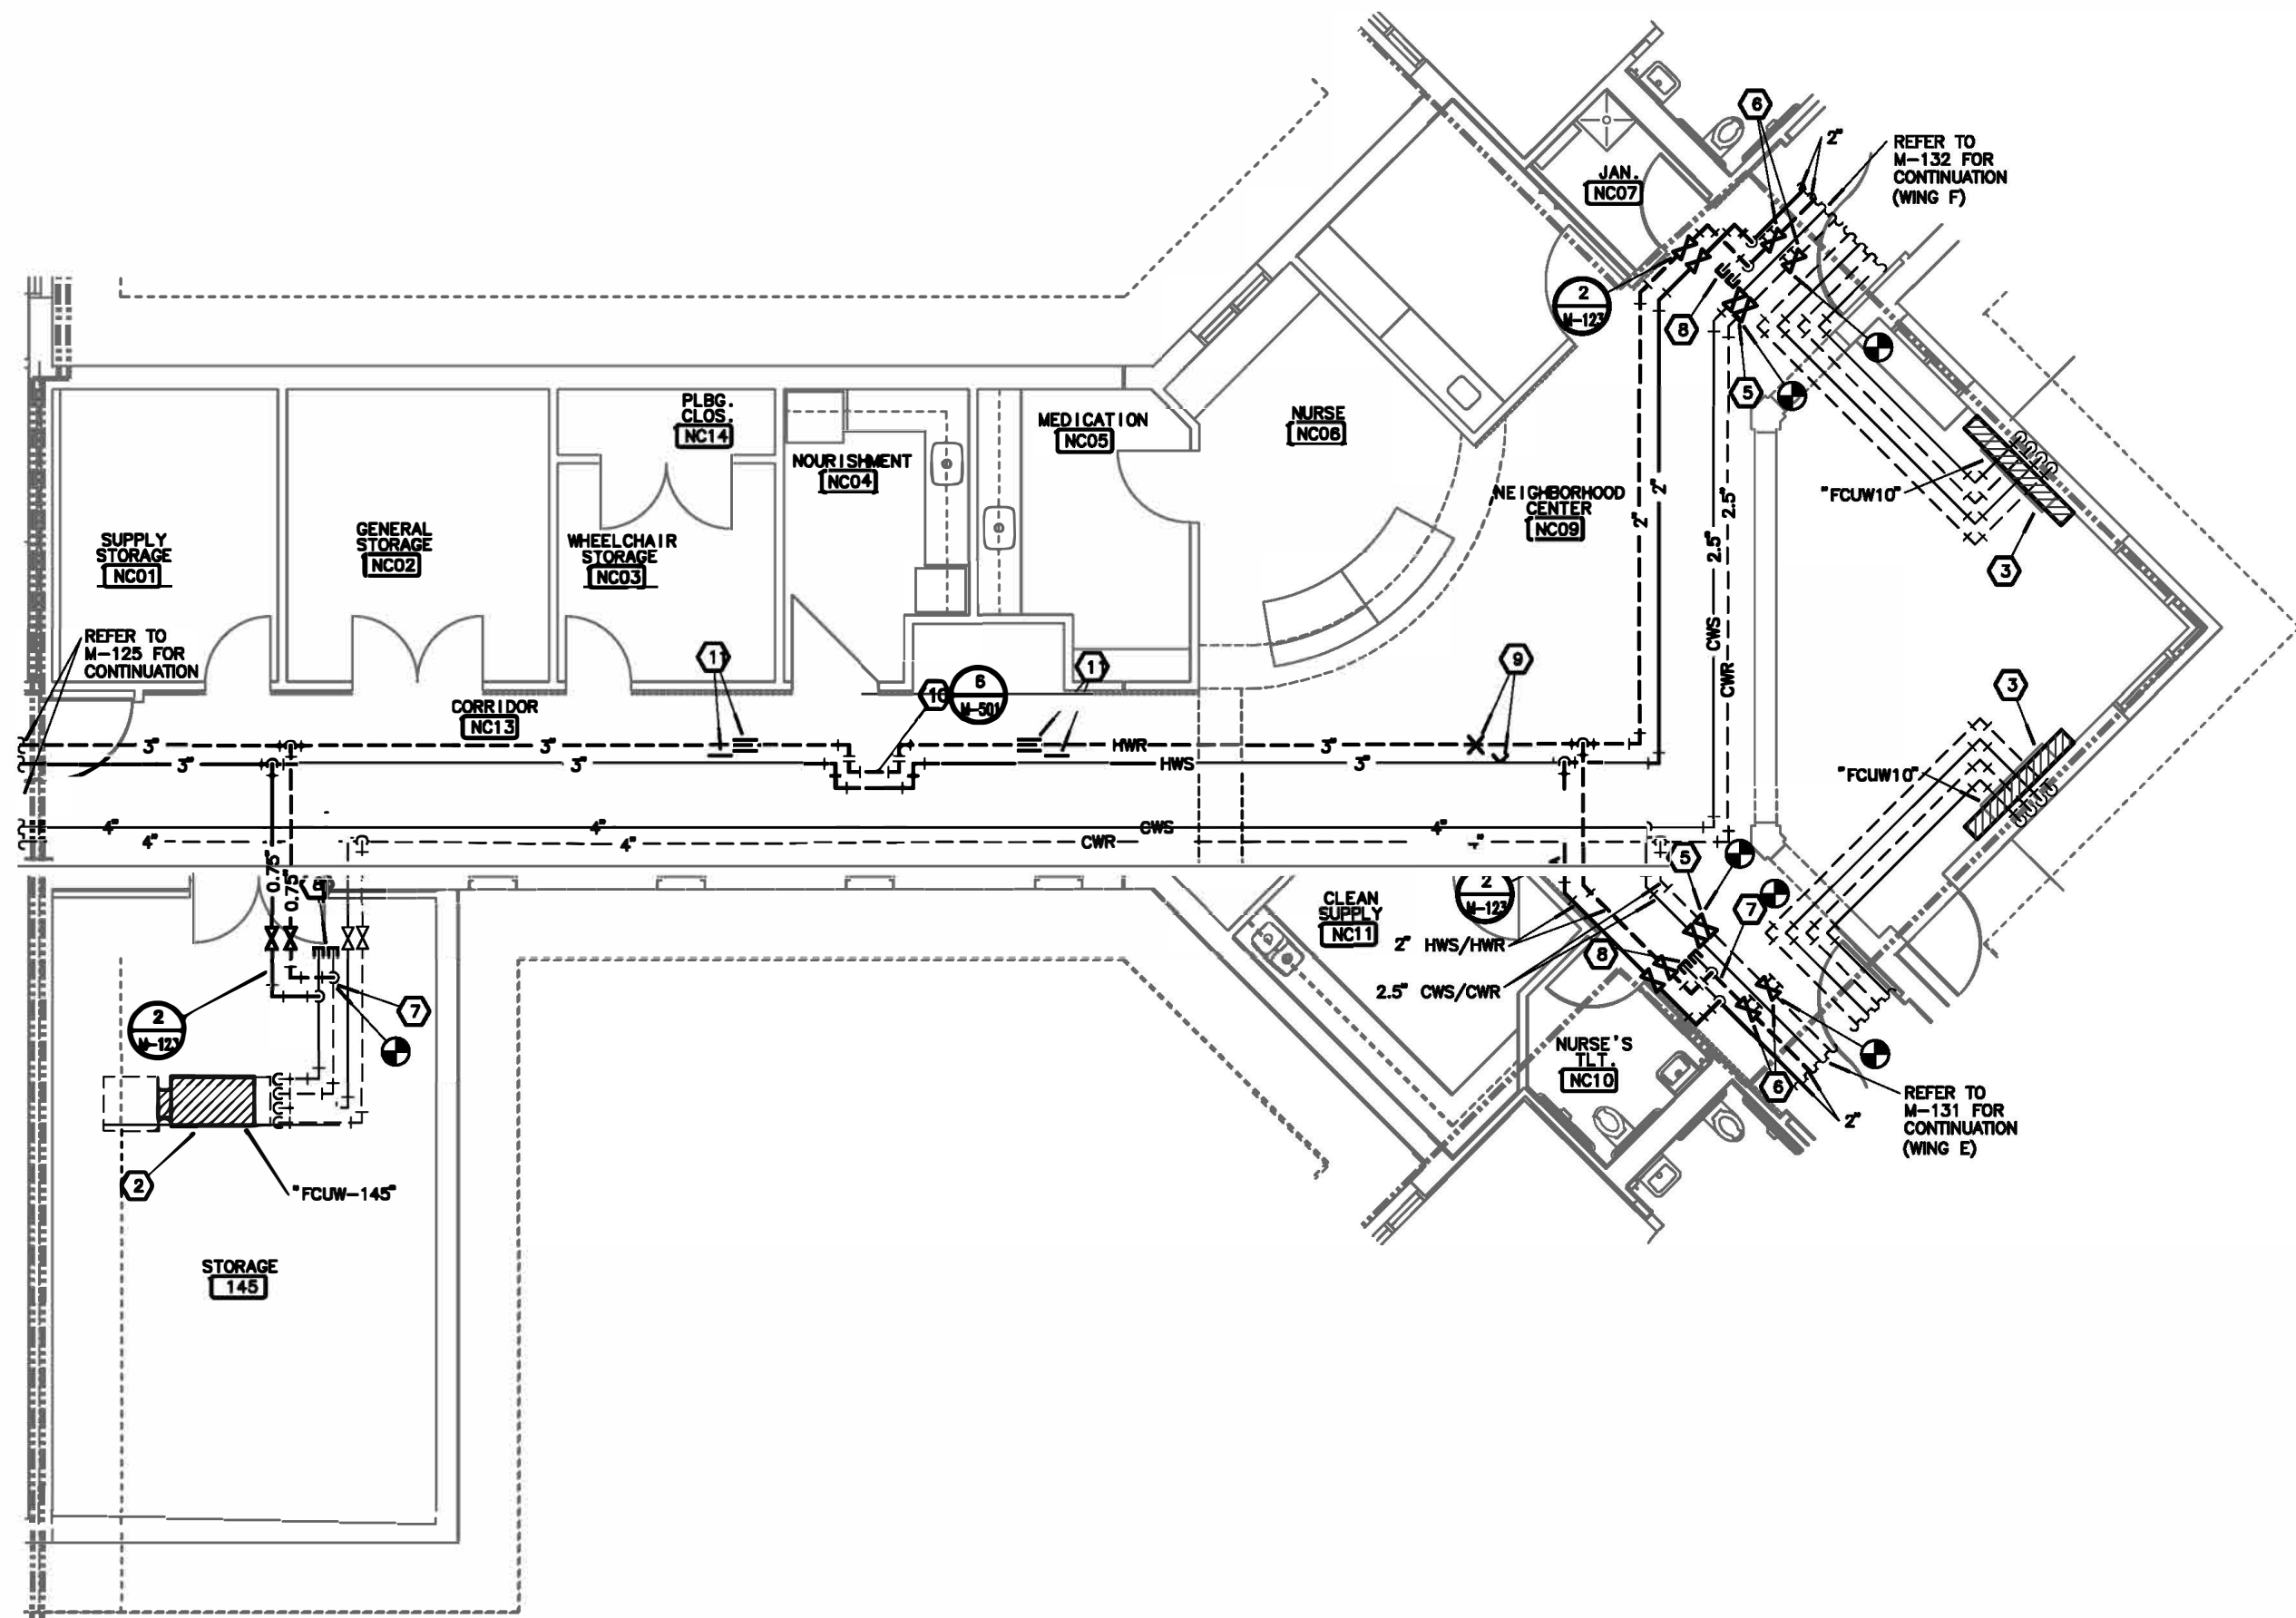
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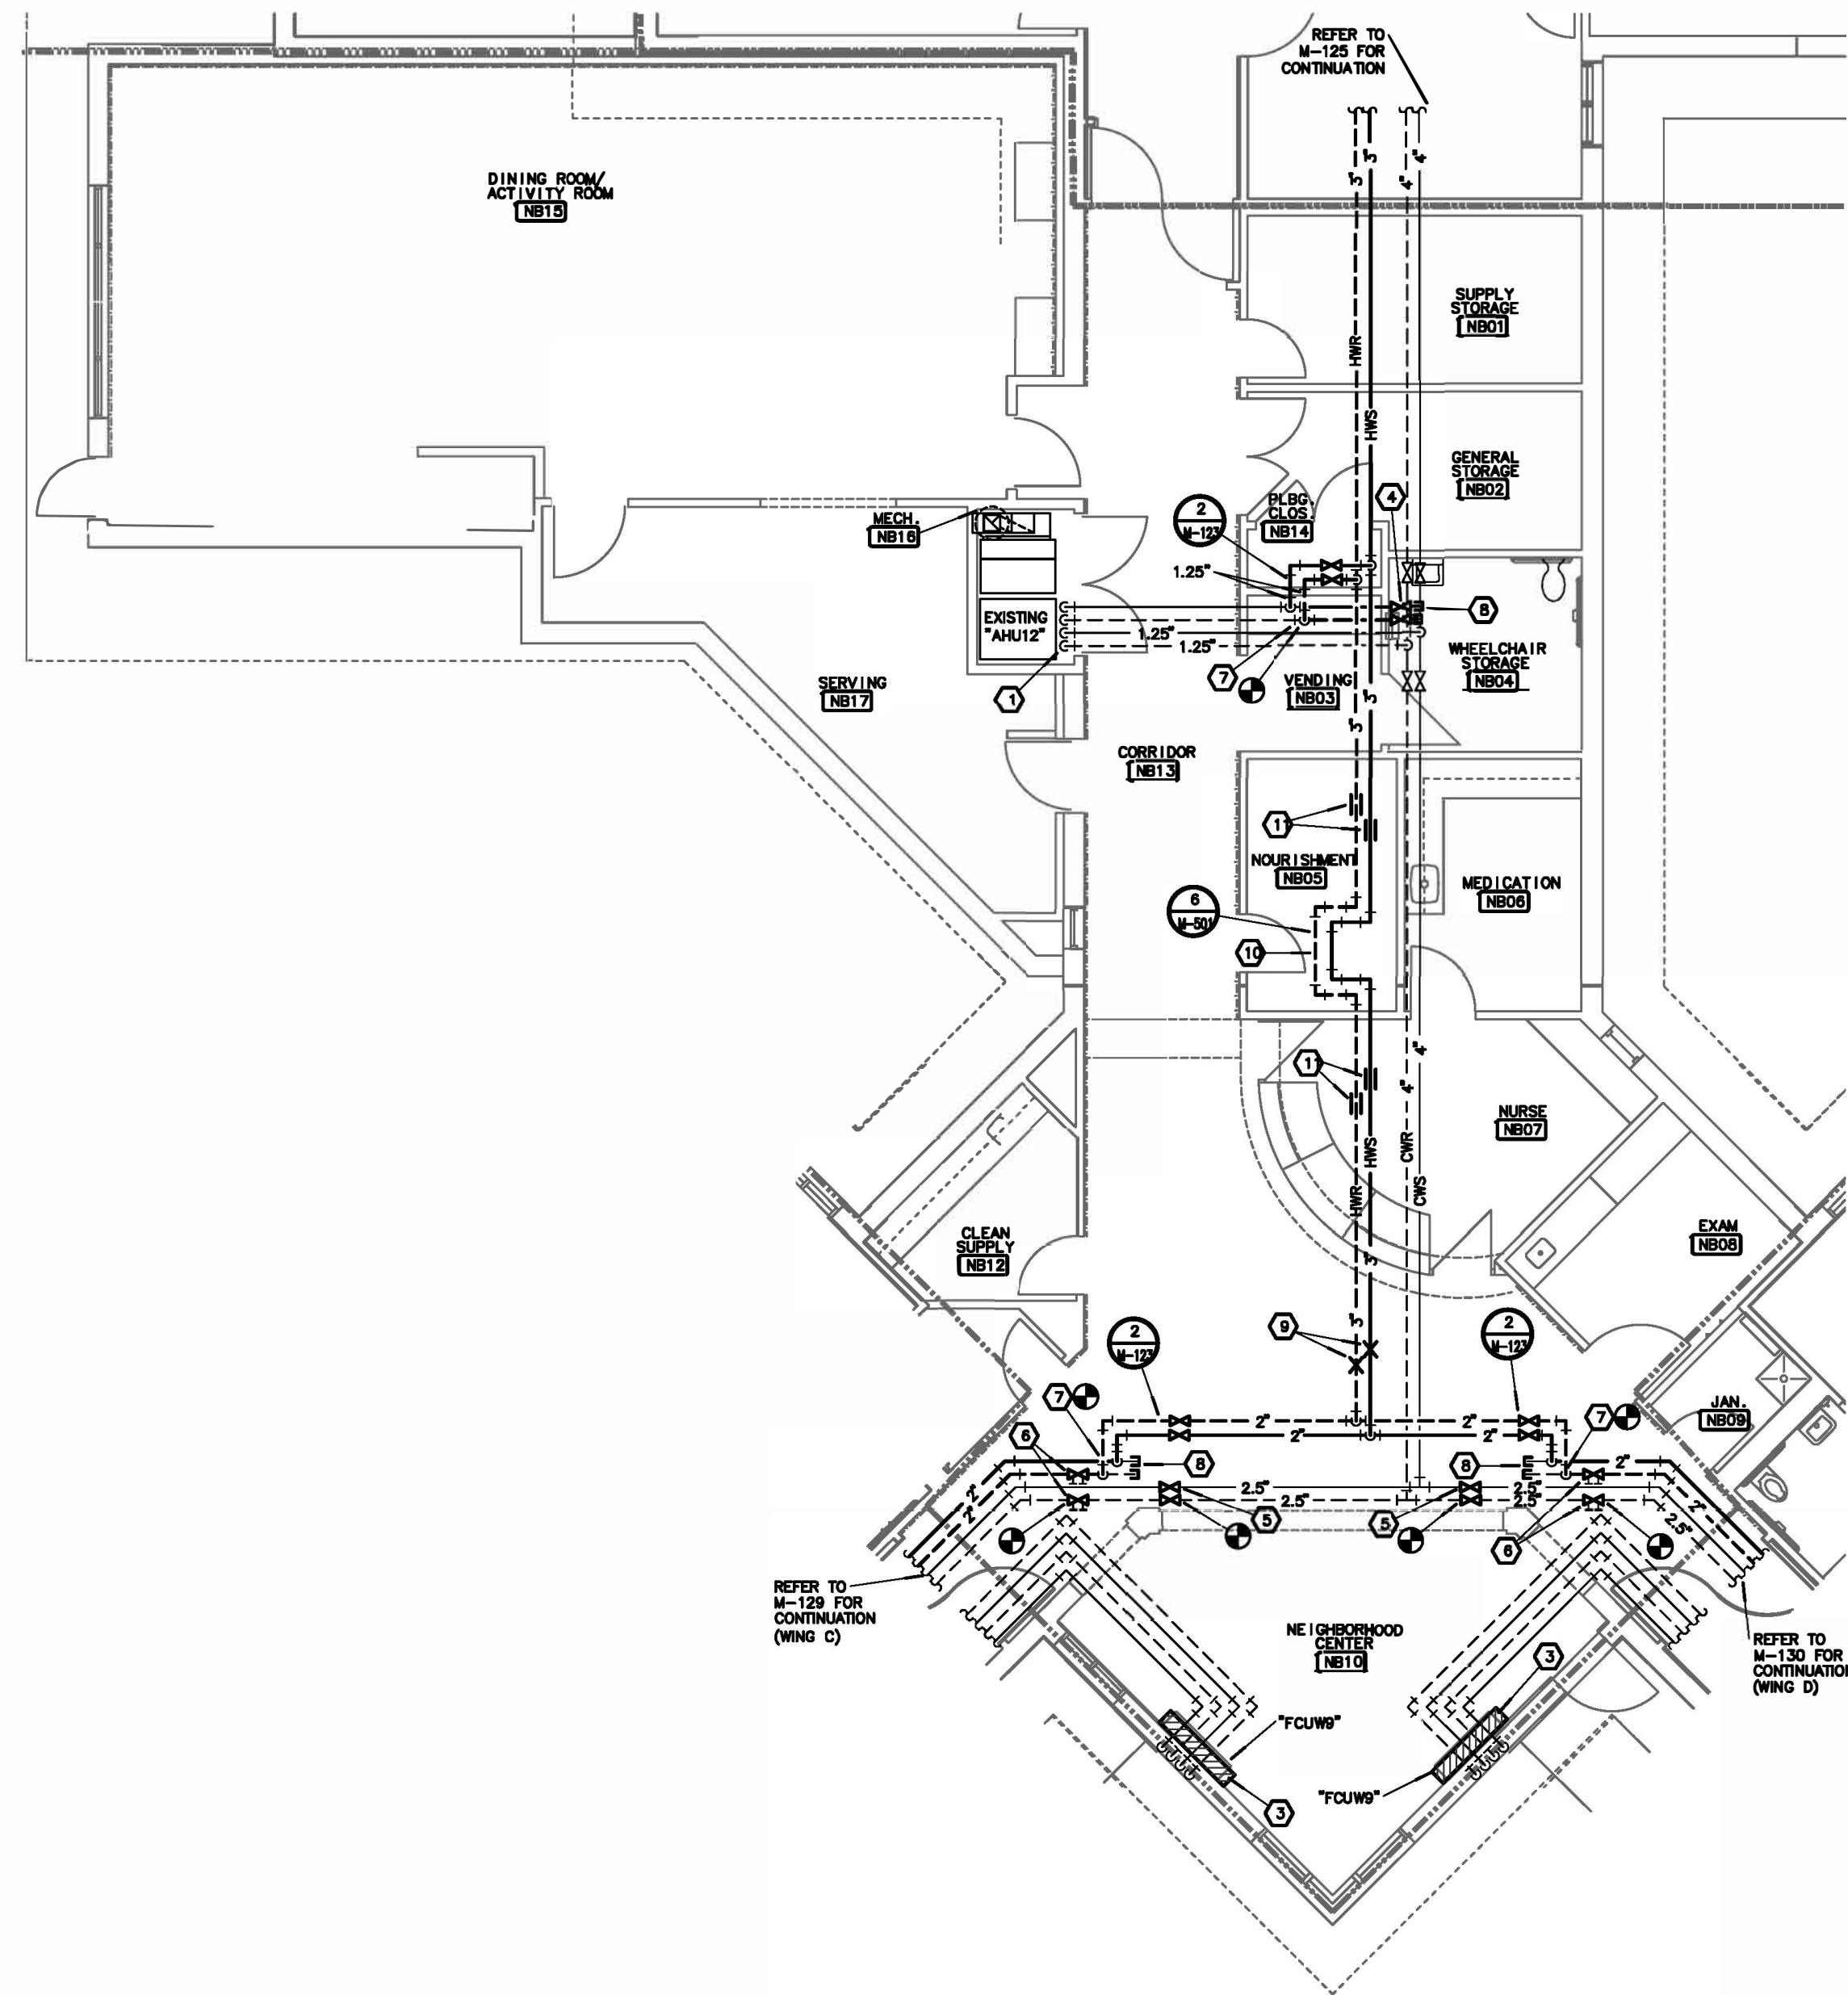
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**3**  
**M-126** **NURSING CORE A**  
**HYDRONIC IMPROVEMENT PLAN**  
SCALE: 1/8"=1'-0" NORTH



**2**  
**M-126** **NURSING CORE C**  
**HYDRONIC IMPROVEMENT PLAN**  
SCALE: 1/8"=1'-0" NORTH



**1**  
**M-126** **NURSING CORE B**  
**HYDRONIC IMPROVEMENT PLAN**  
SCALE: 1/8"=1'-0" NORTH




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State of Missouri certificate of authority  
#2014035826 for engineering

## NOTES:

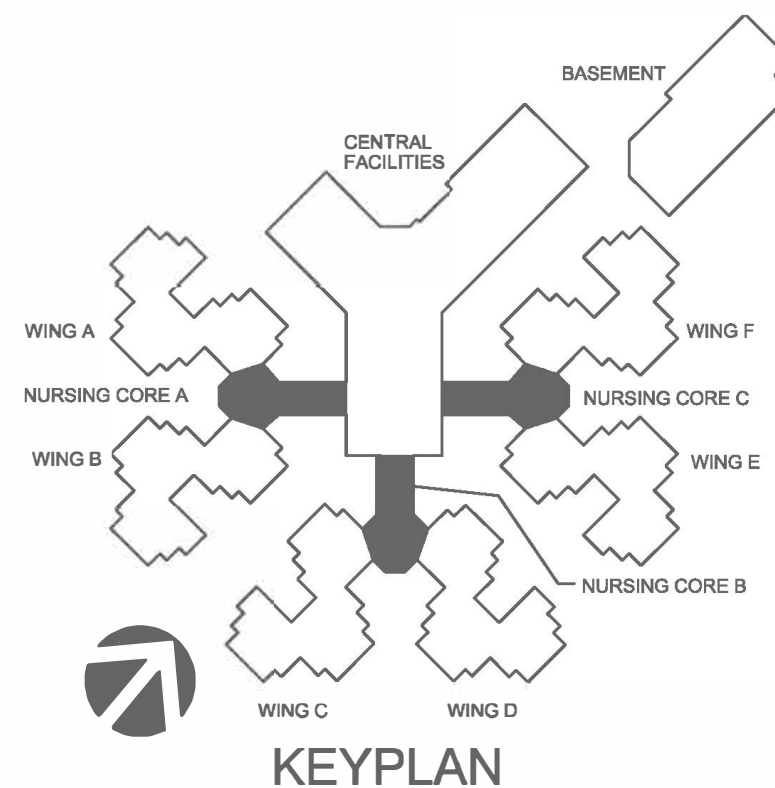
- EXISTING AIR HANDLING UNIT #12 TO REMAIN. REPLACE EXISTING PIPING PACKAGE FOR UNIT. RECONNECT TO EXISTING HWS, HWR, CWS AND CWR PIPING. PROVIDE ALL REQUIRED ADJUSTMENTS TO EXISTING PIPING TO ACCOMMODATE NEW AIR HANDLING UNIT. REBALANCE HOT WATER FLOWRATE TO 15.0 GPM AND CHILLED WATER TO 16.5 GPM.
- PROVIDE NEW HORIZONTAL 4-PIPE FAN COIL UNIT AND PIPING PACKAGE. RECONNECT TO EXISTING HWS, HWR, CWS, CWR AND CONDENSATE DRAIN PIPING. FIELD VERIFY EXISTING CONDITIONS, AND LOCATION OF CONNECTIONS TO ALL EXISTING PIPING CONNECTIONS PRIOR TO SUBMITTAL OF FAN COIL UNITS. PROVIDE ALL REQUIRED ADJUSTMENTS TO EXISTING PIPING TO ACCOMMODATE NEW FAN COIL UNIT.
- PROVIDE NEW VERTICAL CABINET 4-PIPE FAN COIL UNIT AND PIPING PACKAGE. RECONNECT TO EXISTING HWS, HWR, CWS, CWR AND CONDENSATE DRAIN PIPING. FIELD VERIFY EXISTING CONDITIONS, AVAILABLE WALL AND FLOOR SPACE, AND LOCATION OF CONNECTIONS TO ALL EXISTING PIPING CONNECTIONS PRIOR TO SUBMITTAL OF FAN COIL UNITS. PROVIDE ALL REQUIRED ADJUSTMENTS TO EXISTING PIPING TO ACCOMMODATE NEW FAN COIL UNIT.
- PROVIDE BALL TYPE SHUT-OFF VALVES IN EXISTING BRANCH PIPING.
- REMOVE AND REPLACE ALL EXISTING SHUT-OFF VALVES WITH NEW BALL VALVE TYPE SHUT-OFF VALVES.
- REMOVE AND REPLACE BOTH EXISTING BALANCE VALVES WITH CIRCUIT SETTER TYPE BALANCE VALVES. MEASURE FLOWRATE PRIOR TO DEMOLITION WORK AND REBALANCE VALVE BACK TO THE ORIGINAL VALUE.
- CONNECT TO EXISTING HOT WATER SUPPLY AND RETURN PIPING.
- CAP EXISTING HOT WATER SUPPLY AND RETURN PIPING.
- PROVIDE PIPE ANCHORS SUPPORTED FROM BUILDING STRUCTURE. SIZE AND INSTALL PER FLEXIBLE PIPING EXPANSION JOINT MANUFACTURER'S RECOMMENDATIONS.
- PROVIDE NESTED FLEXIBLE PIPE EXPANSION JOINTS.
- PROVIDE PIPE EXPANSION GUIDES FURNISHED AND INSTALLED PER FLEXIBLE PIPING EXPANSION JOINT MANUFACTURER'S RECOMMENDATIONS.

## GENERAL NOTES:

- GENERAL PIPING NOTES SHALL APPLY TO ALL EXISTING MECHANICAL HOT WATER SUPPLY AND RETURN PIPING BEING RE-UTILIZED. THE EXISTING MAIN HWS AND HWR PIPING THAT IS BEING ABANDONED IN PLACE SHALL NOT BE INCLUDED. A. THE ELASTIC GASKET ON ALL GROOVED PIPE COUPLINGS AND VALVE COUPLINGS SHALL BE REMOVED AND REPLACED. THE REPLACEMENT GASKETS SHALL BE PROVIDED PER THE COUPLING MANUFACTURER'S RECOMMENDATION AND SHALL MEET THE APPLICATION FOR HOT WATER SYSTEMS. IN GENERAL, THE BUILDING IS PRIMARILY GROOVED COUPLINGS AND SOME ARE VICTALIC COUPLINGS. FROM FIELD OBSERVATION, TRANSITION FROM STEEL TO COPPER SHALL BE REPLACED. DIELECTRIC FITTINGS ARE LOCATED AT ALL HOT WATER COILS THROUGHOUT THE BUILDING. C. PROVIDE BALL VALVES OFF OF THE MAIN PIPING, UPSTREAM OF ALL DIELECTRIC FITTINGS AND WHERE SHOWN ON DRAWINGS. TO ALLOW FOR THE DIELECTRIC FITTINGS TO BE REPLACED IN THE FUTURE. D. PROVIDE BALL VALVES IN THE MAIN PIPING AT EVERY CORRIDOR AND AS SHOWN ON THE DRAWINGS TO ALLOW FOR ISOLATION OF PIPING. E. ADDITIONAL HANGERS SHALL BE PROVIDED TO MEET SPECIFICATIONS. AT A MINIMUM ADDITIONAL HANGERS SHALL BE PROVIDED EVERY 10'-0" OF PIPE LENGTH ON ALL EXISTING PIPING BEING RE-UTILIZED. FIELD VERIFY SIZE AND ROUTING OF EXISTING PIPING PRIOR TO BID. F. EXISTING INSULATION SHALL BE REMOVED AND REPLACED WHERE ALL PIPING WORK IS REQUIRED. TAPE AND SEAL INSULATION PER SPECIFICATIONS. G. UNDER EACH PHASE, AFTER ALL PIPING CHANGES HAVE BEEN COMPLETED, THE HOT WATER PIPING SHALL BE THOROUGHLY FLUSHED AND WATER TREATMENT INSTALLED. H. CONTRACTOR SHALL FIELD VERIFY EXISTING CONDITIONS PRIOR TO BID.
- GENERAL PIPING NOTES SHALL APPLY TO ALL EXISTING CHILLED WATER SUPPLY AND RETURN PIPING. A. PROVIDE BALL VALVES OFF OF THE MAIN PIPING, UPSTREAM OF ALL EXISTING DIELECTRIC FITTINGS AND WHERE SHOWN ON DRAWINGS. TALL ON THE DIELECTRIC FITTINGS TO BE REPLACED IN THE FUTURE. B. PROVIDE BALL VALVES IN THE MAIN PIPING AT EVERY CORRIDOR AND AS SHOWN ON THE DRAWINGS TO ALLOW FOR ISOLATION OF PIPING. C. ADDITIONAL HANGERS SHALL BE PROVIDED TO MEET SPECIFICATIONS. AT A MINIMUM ADDITIONAL HANGERS SHALL BE PROVIDED EVERY 10'-0" OF PIPE LENGTH ON ALL EXISTING PIPING. FIELD VERIFY SIZE AND ROUTING OF PIPING PRIOR TO BID. D. EXISTING INSULATION SHALL BE REMOVED AND REPLACED WHERE IS REQUIRED. TAPE AND SEAL INSULATION PER SPECIFICATIONS. E. CONTRACTOR SHALL FIELD VERIFY EXISTING CONDITIONS PRIOR TO BID.
- FOR ALL PLUMBING OR HVAC QUESTIONS DURING BIDDING OR DURING CONSTRUCTION, CONTACT ESTERLY, SCHNEIDER & ASSOCIATES, INC. (417-862-0558) FOR COORDINATION WITH TYLER ENSERRO AT RTM ENGINEERING CONSULTANTS.
- CONTRACTOR SHALL FIELD VERIFY ALL EXISTING CONDITIONS PRIOR TO SUBMITTING HIS BID. NO EXTRAS WILL BE PAID DUE TO UNANTICIPATED EXISTING CONDITIONS.
- CONTRACTOR SHALL SCHEDULE AND EXECUTE ALL WORK WITH REGARD TO THE OWNER'S USE OF THE BUILDING.
- PLANS ARE DIAGRAMMATIC AND SHALL NOT BE SCALED. REFER TO ARCHITECTURAL DRAWINGS FOR DIMENSIONS.
- CONTRACTOR SHALL INSPECT AREAS TO ACCESS ATTIC AREA AND PROVIDE TEMPORARY PLATFORMS ON EXISTING STRUCTURE ABOVE CEILING TO PERFORM WORK WITHOUT INTERRUPTING OPERATIONS IN OCCUPIED SPACES BELOW CEILING. ALL AREAS USED FOR ACCESS TO ATTIC SHALL BE COORDINATED WITH OWNER.
- CONTRACTOR SHALL REMOVE AND REPLACE CEILING TILE AND CEILING GRID AS REQUIRED TO PERFORM ALL DEMOLITION AND IMPROVEMENT WORK. CONTRACTOR SHALL REPLACE ALL DAMAGED CEILING TILE TO MATCH EXISTING.
- CONTRACTOR SHALL FIRE CAULK ANY PENETRATIONS.



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architects & planners

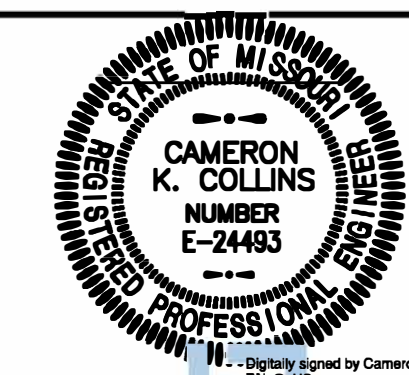COMM. #4860

OFFICE OF ADMINISTRATION  
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HOME

620 N. JEFFERSON  
ST. JAMES, MISSOURI

PROJECT # U1503-01  
SITE # 6801  
ASSET # 8136801002  
FEDERAL # 29-044

REVISION: \_\_\_\_\_  
DATE: \_\_\_\_\_  
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DATE: \_\_\_\_\_  
REVISION: \_\_\_\_\_  
DATE: \_\_\_\_\_  
ISSUE DATE: 8-1-24

CAD DWG FILE: M-126.DWG  
DRAWN BY: TSP  
CHECKED BY: CKC  
DESIGNED BY: TSP

SHEET TITLE:

**HVAC PIPING  
& PLUMBING  
PLAN**


SHEET NUMBER:

**M-126**

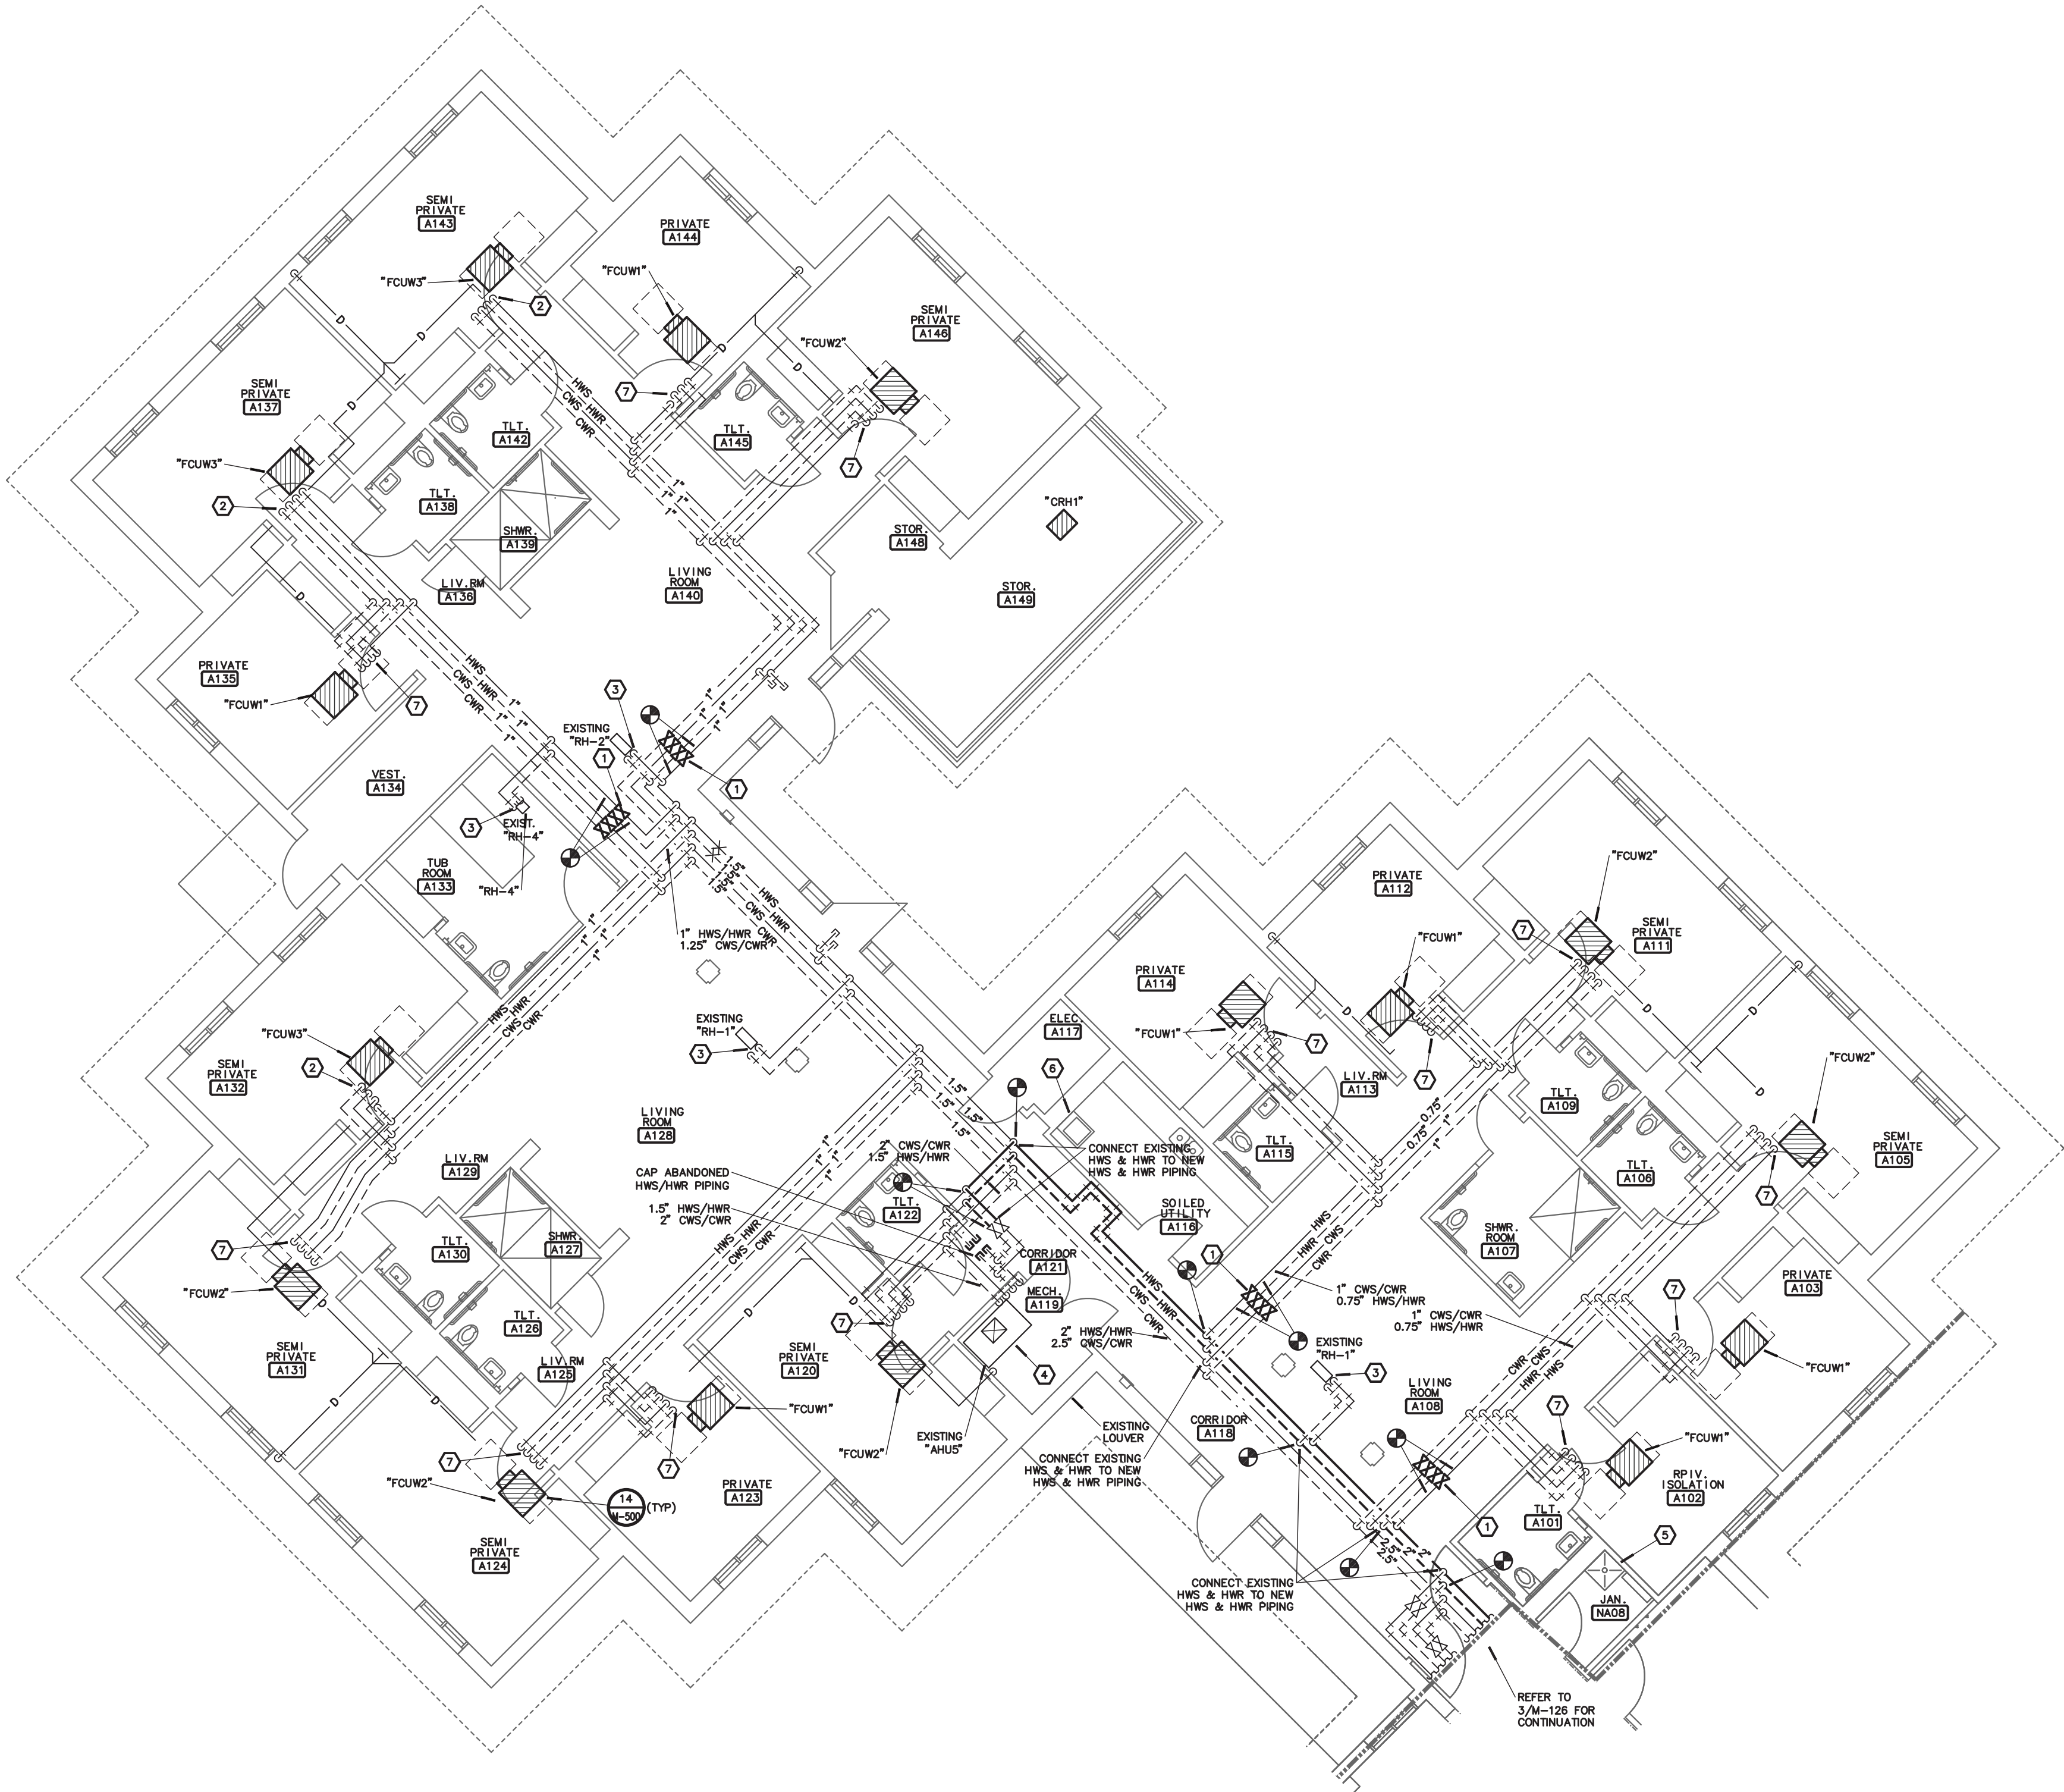77 OF 120 SHEETS

8-1-24






ALTERNATE #1:  
ALL WORK ASSOCIATED WITH INFECTIOUS CONTROL WING 'A' FOR REVISED MECHANICAL AND ELECTRICAL WORK ASSOCIATED WITH THE REQUIREMENTS TO ACHIEVE THE INFECTIOUS CONTROL AREAS DEFINED ON THE MECHANICAL PLANS. REFER TO SHEETS A-104, A-114, A-121, A-600, A-601, M-105, M-116, M-127, M-133, M-134 AND E-105, AND E-116 AND ALL ASSOCIATED DETAILS, SCHEDULES AND SPECIFICATION SECTIONS REQUIRED FOR ADDITIONAL INFORMATION AS IT PERTAINS TO WING A. ALTERNATE #1 SHALL NOT INCLUDE REMOVING AND INSTALLING NEW FLOORING, REMOVING AND INSTALLING NEW WALL BASE, PAINTING OF ANY WALLS, ANY WORK ASSOCIATED WITH DEMOLITION OR NEW CONSTRUCTION FOR SHOWER ROOM A107. ALTERNATE SHALL NOT INCLUDE ANY WORK ASSOCIATED WITH NEW TV MOUNTING AND BLOCKING, NOR WORK ASSOCIATED WITH OTHER ALTERNATE WORK IN THIS WING. THESE ITEMS REMAIN IN THE BASE BID AND AS DEFINED IN THE PHASING SCHEDULE. ANY ITEMS NOT LISTED SPECIFICALLY ABOVE, BUT SHOWN ON THE DRAWINGS/SPECIFICATIONS, SHALL REMAIN IN THE ALTERNATE BID #1.



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State of Missouri certificate of authority  
#2014035826 for engineering


- NOTES:**
1. INSTALL NEW ISOLATION BALL VALVES IN EXISTING LINES.
  2. PROVIDE NEW HORIZONTAL 4-PIPE FAN COIL UNIT AND PIPING PACKAGE. RECONNECT NEW 0.75" PIPING TO EXISTING HWS, HWR, CWS, CWR AND CONDENSATE DRAIN PIPING. FIELD VERIFY EXISTING CONDITIONS, AND LOCATION OF CONNECTIONS TO ALL EXISTING PIPING CONNECTIONS PRIOR TO SUBMITTAL OF FAN COIL UNITS. PROVIDE ALL REQUIRED ADJUSTMENTS TO EXISTING PIPING TO ACCOMMODATE NEW FAN COIL UNIT. EXTEND HOT AND CHILLED WATER AND CONDENSATE DRAIN AS REQUIRED FOR NEW FAN COIL UNIT LOCATION.
  3. EXISTING REHEAT COIL TO REMAIN. REPLACE EXISTING PIPING PACKAGE FOR REHEAT COIL. RECONNECT TO EXISTING HWS AND HWR PIPING. FIELD VERIFY EXISTING CONDITIONS AND LOCATION OF CONNECTIONS TO ALL EXISTING PIPING CONNECTIONS PRIOR TO SUBMITTAL OF PIPING PACKAGES. PROVIDE ALL REQUIRED ADJUSTMENTS TO EXISTING PIPE TO ACCOMMODATE PIPING PACKAGE. REFER TO PIPING DETAIL.
  4. EXISTING AIR HANDLING UNIT SHALL REMAIN. PROVIDE NEW PIPING, VALVES AND PUMPS.
  5. PROVIDE NEW CHECK VALVE TO COLD WATER PIPING TO EXISTING MOP SINK.
  6. PROVIDE NEW CHECK VALVE TO COLD WATER PIPING TO EXISTING SERVICE SINK.
  7. PROVIDE NEW HORIZONTAL 4-PIPE FAN COIL UNIT AND PIPING PACKAGE. RECONNECT NEW 0.75" CW AND 0.5" HW PIPING TO EXISTING HWS, HWR, CWS, CWR AND CONDENSATE DRAIN PIPING. FIELD VERIFY EXISTING CONDITIONS, AND LOCATION OF CONNECTIONS TO ALL EXISTING PIPING CONNECTIONS PRIOR TO SUBMITTAL OF FAN COIL UNITS. PROVIDE ALL REQUIRED ADJUSTMENTS TO EXISTING PIPING TO ACCOMMODATE NEW FAN COIL UNIT. EXTEND HOT AND CHILLED WATER AND CONDENSATE DRAIN AS REQUIRED FOR NEW FAN COIL UNIT LOCATION.

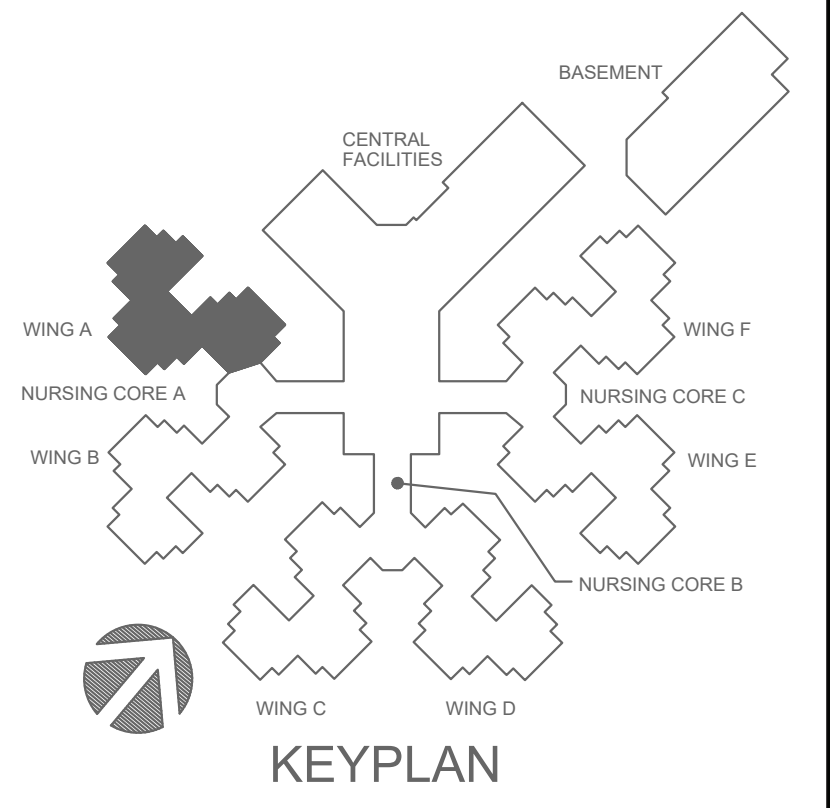- GENERAL NOTES:**
1. GENERAL PIPING NOTES SHALL APPLY TO ALL EXISTING MECHANICAL HOT WATER SUPPLY AND RETURN PIPING BEING RE-UTILIZED. THE EXISTING MAIN HWS AND HWR PIPING THAT IS BEING ABANDONED IN PLACE, SHALL NOT BE INCLUDED: A. THE ELASTOMERIC GASKET ON ALL GROOVED PIPE COUPLINGS AND VALVE COUPLINGS SHALL BE REMOVED AND REPLACED. THE REPLACEMENT GASKETS SHALL BE PROVIDED PER THE COUPLING MANUFACTURER'S RECOMMENDATION AND SHALL MEET THE APPLICATION FOR HOT WATER SYSTEMS. IN GENERAL, THE BUILDING IS PRIMARILY GYROLON COUPLINGS AND SOME ARE VICTALIC. FROM FIELD OBSERVATION, IT APPEARS THAT ALL PIPING 2.5" AND LARGER IS GROOVED. B. ALL EXISTING DIELECTRIC FITTINGS TRANSITIONING FROM STEEL TO COPPER SHALL BE REPEATED. DIELECTRIC FITTINGS ARE LOCATED AT ALL HOT WATER COILS THROUGHOUT THE BUILDING. C. PROVIDE BALL VALVES OFF OF THE MAIN PIPING, UPSTREAM OF ALL DIELECTRIC FITTINGS AND WHERE SHOWN ON DRAWINGS, TO ALLOW FOR THE DIELECTRIC FITTINGS TO BE REPLACED IN THE FUTURE. D. PROVIDE BALL VALVES IN THE MAIN PIPING AT EVERY CORRIDOR AND AS SHOWN ON THE DRAWINGS TO ALLOW FOR ISOLATION OF PIPING. E. ADDITIONAL HANGERS SHALL BE PROVIDED TO MEET SPECIFICATIONS. AT A MINIMUM ADDITIONAL HANGERS SHALL BE PROVIDED EVERY 10'-0" OF PIPE LENGTH ON ALL EXISTING PIPING BEING RE-UTILIZED. FIELD VERIFY SIZE AND ROUTING OF EXISTING PIPING PRIOR TO BID. F. EXISTING INSULATION SHALL BE REMOVED AND REPLACED WHERE ALL PIPING WORK IS REQUIRED. G. UNDER EACH PHASE, AFTER ALL PIPING CHANGES HAVE BEEN COMPLETED, THE HOT WATER PIPING SHALL BE THOROUGHLY FLUSHED AND WATER TREATMENT INSTALLED. H. CONTRACTOR SHALL FIELD VERIFY EXISTING CONDITIONS PRIOR TO BID.
  2. GENERAL PIPING NOTES SHALL APPLY TO ALL EXISTING CHILLED WATER SUPPLY AND RETURN PIPING: A. PROVIDE BALL VALVES OFF OF THE MAIN PIPING, UPSTREAM OF ALL EXISTING DIELECTRIC FITTINGS AND WHERE SHOWN ON DRAWINGS, TO ALLOW FOR THE DIELECTRIC FITTINGS TO BE REPLACED IN THE FUTURE. B. PROVIDE BALL VALVES IN THE MAIN PIPING AT EVERY CORRIDOR AND AS SHOWN ON THE DRAWINGS TO ALLOW FOR ISOLATION OF PIPING. C. ADDITIONAL HANGERS SHALL BE PROVIDED TO MEET SPECIFICATIONS. AT A MINIMUM ADDITIONAL HANGERS SHALL BE PROVIDED EVERY 10'-0" OF PIPE LENGTH ON ALL EXISTING PIPING. FIELD VERIFY SIZE AND ROUTING OF PIPING PRIOR TO BID. D. EXISTING INSULATION SHALL BE REMOVED AND REPLACED WHERE ALL PIPING WORK IS REQUIRED. E. CONTRACTOR SHALL FIELD VERIFY EXISTING CONDITIONS PRIOR TO BID.
  3. FOR ALL PLUMBING OR HVAC QUESTIONS DURING BIDDING OR DURING CONSTRUCTION, CONTACT ESTERLY, SCHNEIDER & ASSOCIATES, INC. THOM LUNDBERG (417-862-0558) FOR COORDINATION WITH TYLER ENBERG AT RTM ENGINEERING CONSULTANTS.
  4. CONTRACTOR SHALL FIELD VERIFY ALL EXISTING CONSTRUCTION PRIOR TO SUBMITTING HIS BID. NO EXTRAS WILL BE PAID DUE TO UNANTICIPATED EXISTING CONDITIONS.
  5. CONTRACTOR SHALL SCHEDULE AND EXECUTE ALL WORK WITH REGARD TO THE OWNER'S USE OF THE BUILDING.
  6. PLANS ARE DIAGRAMMATIC AND SHALL NOT BE SCALED. REFER TO ARCHITECTURAL DRAWINGS FOR DIMENSIONS.
  7. CONTRACTOR SHALL INSPECT AREAS TO ACCESS ATTIC AREA AND PROVIDE TEMPORARY PLATFORMS ON EXISTING STRUCTURE ABOVE CEILING TO PERFORM WORK WITHOUT INTERRUPTING OPERATIONS IN OCCUPIED SPACES BELOW CEILING. ALL AREAS USED FOR ACCESS TO ATTIC SHALL BE COORDINATED WITH OWNER.
  8. CONTRACTOR SHALL REMOVE AND REPLACE CEILING TILE AND CEILING GRID AS REQUIRED TO PERFORM ALL DEMOLITION AND IMPROVEMENT WORK. CONTRACTOR SHALL REPLACE ALL DAMAGED CEILING TILE TO MATCH EXISTING.
  9. CONTRACTOR SHALL FIRE CAULK ANY PENETRATIONS.



**1 BASE BID WING 'A' - HYDRONIC IMPROVEMENT PLAN**  
SCALE: 1/8"=1'-0"  
NORTH

STATE OF MISSOURI  
MIKE KEHOE,  
GOVERNOR



Cameron K. Collins  
Professional Engineer  
State of Missouri  
Number E-24481

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CAD DWG FILE: M-127.DWG  
DRAWN BY: TSE  
CHECKED BY: CRC  
DESIGNED BY: TSE

SHEET TITLE:  
**HVAC PIPING  
& PLUMBING  
PLAN**

SHEET NUMBER:  
**M-127**  
78 OF 120 SHEETS  
8-1-24



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**1**  
**M-128** **WING 'B' - HYDRONIC IMPROVEMENT PLAN**  
SCALE: 1/8"=1'-0"

NORTH


**rtm**  
engineering consultants  
3333 E. Battlefield Road, Ste. 1000  
Springfield, MO 65804  
rtmec.com | 417.881.0020  
State of Missouri certificate of authority  
#2014035826 for engineering

## NOTES:

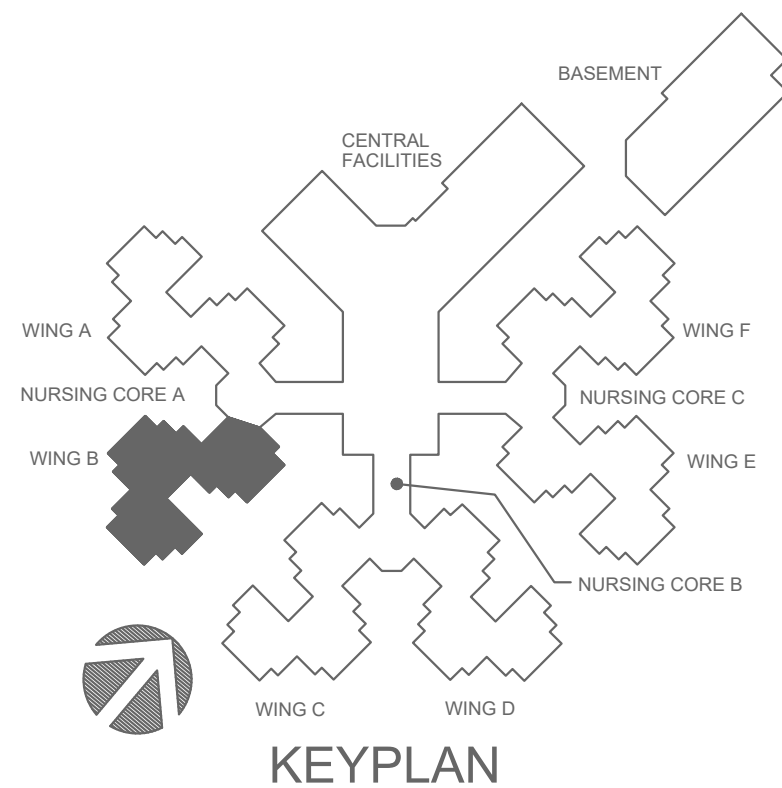
1. INSTALL NEW ISOLATION BALL VALVES IN EXISTING LINES.
2. PROVIDE NEW HORIZONTAL 4-PIPE FAN COIL UNIT AND PIPING PACKAGE. RECONNECT NEW 0.75" PIPING TO EXISTING HWS, HWR, CWS, CWR AND CONDENSATE DRAIN PIPING. FIELD VERIFY EXISTING CONDITIONS, AND LOCATION OF CONNECTIONS TO ALL EXISTING PIPING CONNECTIONS PRIOR TO SUBMITTAL OF FAN COIL UNITS. PROVIDE ALL REQUIRED ADJUSTMENTS TO EXISTING PIPING TO ACCOMMODATE NEW FAN COIL UNIT. EXTEND HOT AND CHILLED WATER AND CONDENSATE DRAIN AS REQUIRED FOR NEW FAN COIL UNIT LOCATION.
3. EXISTING REHEAT COIL TO REMAIN. REPLACE EXISTING PIPING PACKAGE FOR REHEAT COIL. RECONNECT TO EXISTING HWS AND HWR PIPING. FIELD VERIFY EXISTING CONDITIONS AND LOCATION OF CONNECTIONS TO ALL EXISTING PIPING CONNECTIONS PRIOR TO SUBMITTAL OF PIPING PACKAGES. PROVIDE ALL REQUIRED ADJUSTMENTS TO EXISTING PIPING TO ACCOMMODATE PIPING PACKAGE.
4. EXISTING AIR HANDLING UNIT AND PIPING PACKAGE SHALL REMAIN.
5. PROVIDE NEW CHECK VALVE TO COLD WATER PIPING TO EXISTING SERVICE SINK.
6. PROVIDE NEW HORIZONTAL 4-PIPE FAN COIL UNIT AND PIPING PACKAGE. RECONNECT NEW 0.75" CW 0.5" HW PIPING TO EXISTING HWS, HWR, CWS, CWR AND CONDENSATE DRAIN PIPING. FIELD VERIFY EXISTING CONDITIONS, AND LOCATION OF CONNECTIONS TO ALL EXISTING PIPING CONNECTIONS PRIOR TO SUBMITTAL OF FAN COIL UNITS. PROVIDE ALL REQUIRED ADJUSTMENTS TO EXISTING PIPING TO ACCOMMODATE NEW FAN COIL UNIT. EXTEND HOT AND CHILLED WATER AND CONDENSATE DRAIN AS REQUIRED FOR NEW FAN COIL UNIT LOCATION.

## GENERAL NOTES:

1. GENERAL PIPING NOTES SHALL APPLY TO ALL EXISTING MECHANICAL HOT WATER SUPPLY AND RETURN PIPING BEING RE-UTILIZED. THE EXISTING MAIN HWS AND HWR PIPING THAT IS BEING ABANDONED IN PLACE SHALL NOT BE RE-UTILIZED. INCLUDED: A. THE ELASTOMERIC GASKET ON ALL GROOVED PIPE COUPLINGS AND VALVE COUPLINGS SHALL BE REMOVED AND REPLACED. THE REPLACEMENT GASKETS SHALL BE PROVIDED PER THE COUPLING MANUFACTURER'S RECOMMENDATION AND SHOWN ON DRAWINGS. FROM FIELD OBSERVATION, IT APPEARS THAT ALL PIPING 2.5" AND LARGER IS GROOVED FITTINGS. B. ALL EXISTING DIELECTRIC FITTINGS TRANSITIONING FROM COPPER TO COPPER SHALL BE REPLACED. DIELECTRIC FITTINGS ARE LOCATED AT ALL HOT WATER COILS THROUGHOUT THE BUILDING. C. PROVIDE BALL VALVES OFF OF THE MAIN PIPING, UPSTREAM OF ALL DIELECTRIC FITTINGS AND WHERE SHOWN ON DRAWINGS, TO ALLOW FOR THE DIELECTRIC FITTINGS TO BE REPLACED IN THE FUTURE. D. PROVIDE BALL VALVES IN THE MAIN PIPING AT EVERY CORRIDOR AND AS SHOWN ON THE DRAWINGS TO ALLOW FOR ISOLATION OF PIPING. E. ADDITIONAL HANGERS SHALL BE PROVIDED TO MEET SPECIFICATIONS. AT A MINIMUM ADDITIONAL HANGERS SHALL BE PROVIDED EVERY 10'-0" OF PIPE LENGTH ON ALL EXISTING PIPING BEING RE-UTILIZED. FIELD VERIFY SIZE AND ROUTING OF EXISTING PIPING PRIOR TO BID. F. EXISTING INSULATION SHALL BE REMOVED AND REPLACED WHERE ALL PIPING WORK IS REQUIRED. TAPE AND SEAL INSULATION PER SPECIFICATIONS. G. UNDER EACH PHASE, AFTER ALL PIPING CHANGES HAVE BEEN COMPLETED, THE HOT WATER PIPING SHALL BE THOROUGHLY FLUSHED AND WATER TREATMENT INSTALLED. H. CONTRACTOR SHALL FIELD VERIFY EXISTING CONDITIONS PRIOR TO BID.
2. GENERAL PIPING NOTES SHALL APPLY TO ALL EXISTING CHILLED WATER SUPPLY AND RETURN PIPING: A. PROVIDE BALL VALVES OFF OF THE MAIN PIPING, UPSTREAM OF ALL EXISTING DIELECTRIC FITTINGS AND WHERE SHOWN ON DRAWINGS, TO ALLOW FOR ISOLATION OF PIPING. B. PROVIDE BALL VALVES IN THE MAIN PIPING AT EVERY CORRIDOR AND AS SHOWN ON THE DRAWINGS TO ALLOW FOR ISOLATION OF PIPING. C. ADDITIONAL HANGERS SHALL BE PROVIDED TO MEET SPECIFICATIONS. AT A MINIMUM ADDITIONAL HANGERS SHALL BE PROVIDED EVERY 10'-0" OF PIPE LENGTH ON ALL EXISTING PIPING. FIELD VERIFY SIZE AND ROUTING OF EXISTING PIPING PRIOR TO BID. D. EXISTING INSULATION SHALL BE REMOVED AND REPLACED WHERE ALL PIPING WORK IS REQUIRED. TAPE AND SEAL INSULATION PER SPECIFICATIONS. E. CONTRACTOR SHALL FIELD VERIFY EXISTING CONDITIONS PRIOR TO BID.
3. FOR ALL PLUMBING OR HVAC QUESTIONS DURING BIDDING OR DURING CONSTRUCTION, CONTACT ESTERLY SCHNEIDER & ASSOCIATES, INC. THOM LUNDBERG (417-862-0558) FOR COORDINATION WITH TYLER ENSERRO AT RTM ENGINEERING CONSULTANTS.
4. CONTRACTOR SHALL FIELD VERIFY ALL EXISTING CONSTRUCTION PRIOR TO SUBMITTING HIS BID. NO EXTRAS WILL BE PAID DUE TO UNANTICIPATED EXISTING CONDITIONS.
5. CONTRACTOR SHALL SCHEDULE AND EXECUTE ALL WORK WITH REGARD TO THE OWNER'S USE OF THE BUILDING.
6. PLANS ARE DIAGRAMMATIC AND SHALL NOT BE SCALED. REFER TO ARCHITECTURAL DRAWINGS FOR DIMENSIONS.
7. CONTRACTOR SHALL INSPECT AREAS TO ACCESS ATTIC AREA AND PROVIDE TEMPORARY PLATFORMS ON EXISTING STRUCTURE ABOVE CEILING TO PERFORM WORK WITHOUT INTERRUPTING OPERATIONS IN OCCUPIED SPACES BELOW CEILING. ALL AREAS USED FOR ACCESS TO ATTIC SHALL BE COORDINATED WITH OWNER.
8. CONTRACTOR SHALL REMOVE AND REPLACE CEILING TILE AND CEILING GRID AS REQUIRED TO PERFORM ALL DEMOLITION AND IMPROVEMENT WORK. CONTRACTOR SHALL REPLACE ALL DAMAGED CEILING TILE TO MATCH EXISTING.
9. CONTRACTOR SHALL FIRE CAULK ANY PENETRATIONS.



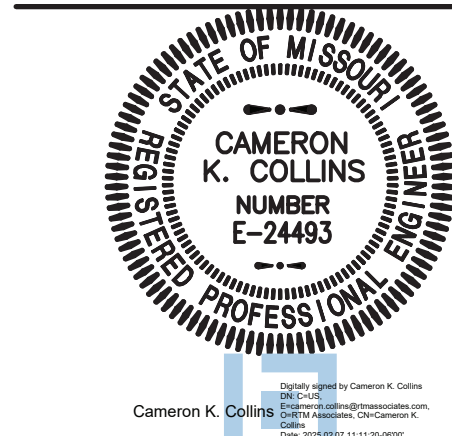STATE OF MISSOURI  
MIKE KEHOE,  
GOVERNOR



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**ESTERLY  
SCHNEIDER  
&  
ASSOCIATES, INC.**  
**AIA**  
architects & planners

COMM. #4860

OFFICE OF ADMINISTRATION  
DIVISION OF FACILITIES  
MANAGEMENT,  
DESIGN AND CONSTRUCTION

DEPARTMENT OF  
PUBLIC SAFETY  
MISSOURI VETERANS  
COMMISSION

INTERIOR RENOVATION  
MISSOURI VETERANS  
HOME

620 N. JEFFERSON  
ST. JAMES, MISSOURI

PROJECT # **U1503-01**  
SITE # **6801**  
ASSET # **8136801002**  
FEDERAL # **29-044**

REVISION: \_\_\_\_\_  
DATE: \_\_\_\_\_  
REVISION: \_\_\_\_\_  
DATE: \_\_\_\_\_  
REVISION: \_\_\_\_\_  
DATE: \_\_\_\_\_  
ISSUE DATE: **8-1-24**

CAD DWG FILE: **M-128.DWG**  
DRAWN BY: **TSE**  
CHECKED BY: **CRK**  
DESIGNED BY: **TSE**

SHEET TITLE:

**HVAC PIPING  
& PLUMBING  
PLAN**

SHEET NUMBER:

**M-128**

79 OF 120 SHEETS

8-1-24



C:\RMA\SMH\DWG\MH-129 19 Sep 2019 - 6:39 am



1  
M-129

## WING 'C' - HYDRONIC IMPROVEMENT PLAN

SCALE: 1/8"=1'-0"

NORTH



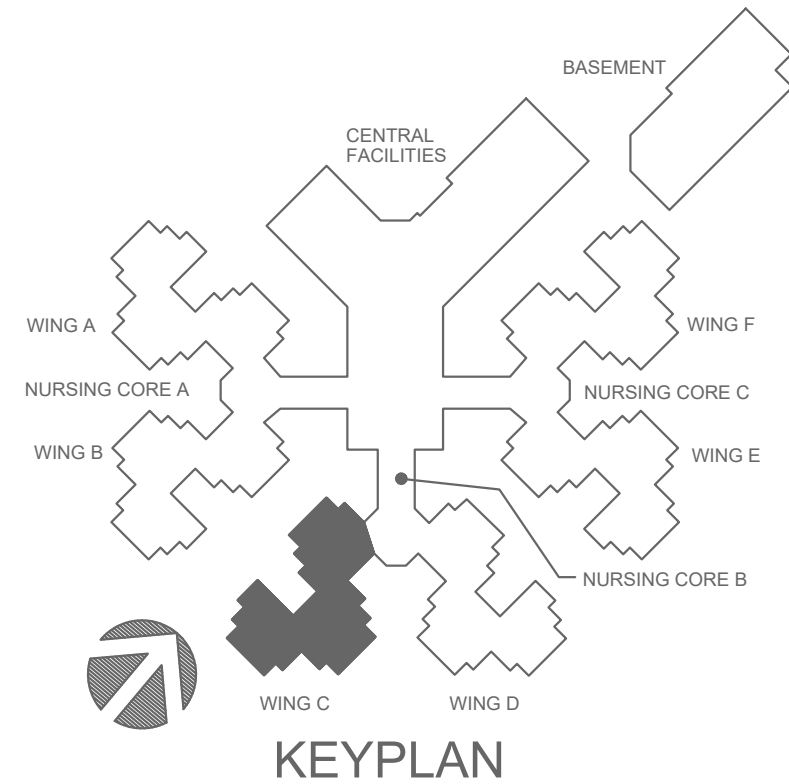
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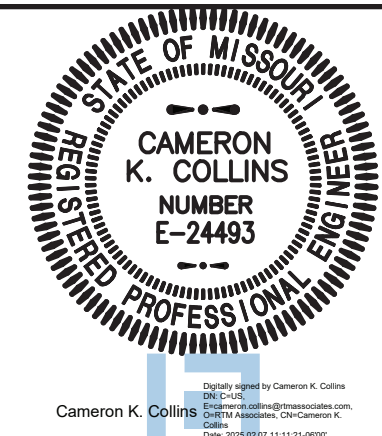
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9. CONTRACTOR SHALL FIRE CAULK ALL PENETRATIONS.



STATE OF MISSOURI  
MIKE KEHOE,  
GOVERNOR



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1736 East Sunshine, Suite 417  
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**ESTERLY  
SCHNEIDER  
&  
ASSOCIATES, INC.**  
AIA  
architects & planners

COMM. #4860

OFFICE OF ADMINISTRATION  
DIVISION OF FACILITIES  
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HOME

620 N. JEFFERSON  
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PROJECT # U1503-01  
SITE # 6801  
ASSET # 8136801002  
FEDERAL # 29-044

REVISION: \_\_\_\_\_  
DATE: \_\_\_\_\_  
REVISION: \_\_\_\_\_  
DATE: \_\_\_\_\_  
REVISION: \_\_\_\_\_  
DATE: \_\_\_\_\_  
ISSUE DATE: 8-1-24

CAD DWG FILE: M-129.DWG  
DRAWN BY: TSE  
CHECKED BY: CRC  
DESIGNED BY: TSE

SHEET TITLE:

## HVAC PIPING & PLUMBING PLAN

SHEET NUMBER:

M-129

80 OF 120 SHEETS

8-1-24



C:\RMA\SMV\DWG\HVAC-M-130 19 Sep 2019 - 8:43 am



**1**  
**M-130**  
**WING 'D' - HYDRONIC IMPROVEMENT PLAN**  
SCALE: 1/8"=1'-0"  
NORTH

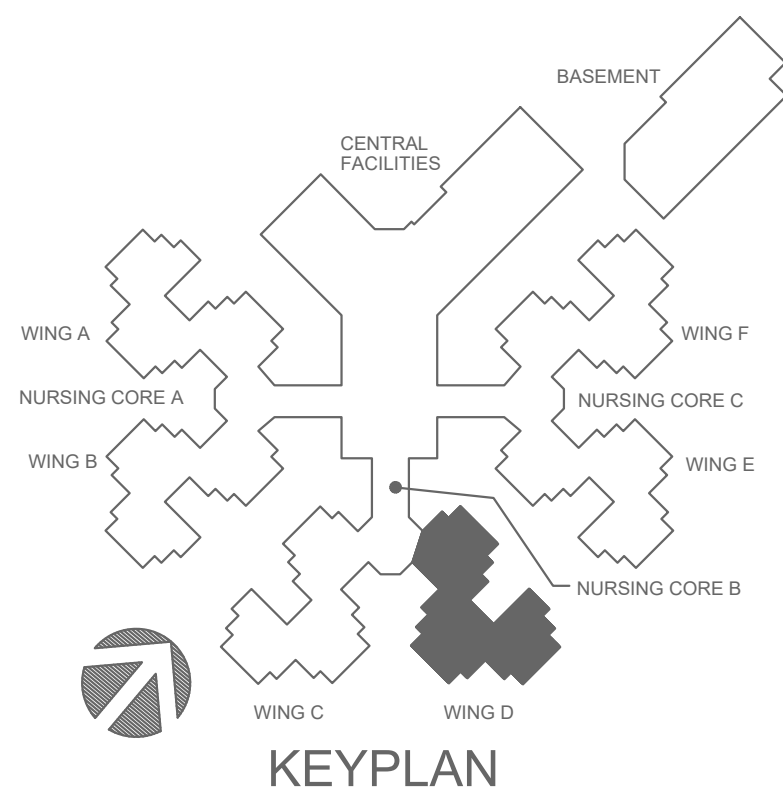
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**NOTES:**


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4. EXISTING AIR HANDLING UNIT AND PIPING PACKAGE SHALL REMAIN.
5. PROVIDE NEW CHECK VALVE TO COLD WATER PIPING TO EXISTING MOP SINK.
6. PROVIDE NEW CHECK VALVE TO COLD WATER PIPING TO EXISTING SERVICE SINK.

**GENERAL NOTES:**

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MIKE KEHOE,  
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ISSUE DATE: **8-1-24**

CAD DWG FILE: **M-130.DWG**  
DRAWN BY: **TSE**  
CHECKED BY: **CRK**  
DESIGNED BY: **TSE**

SHEET TITLE:

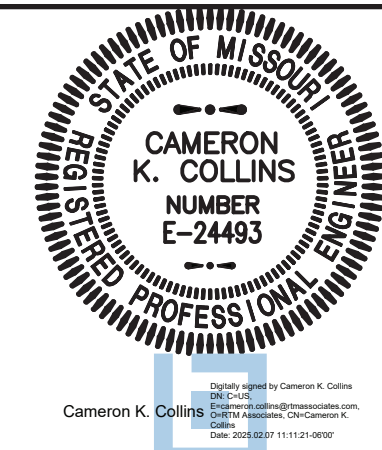**HVAC PIPING  
& PLUMBING  
PLAN**

SHEET NUMBER:


**M-130**

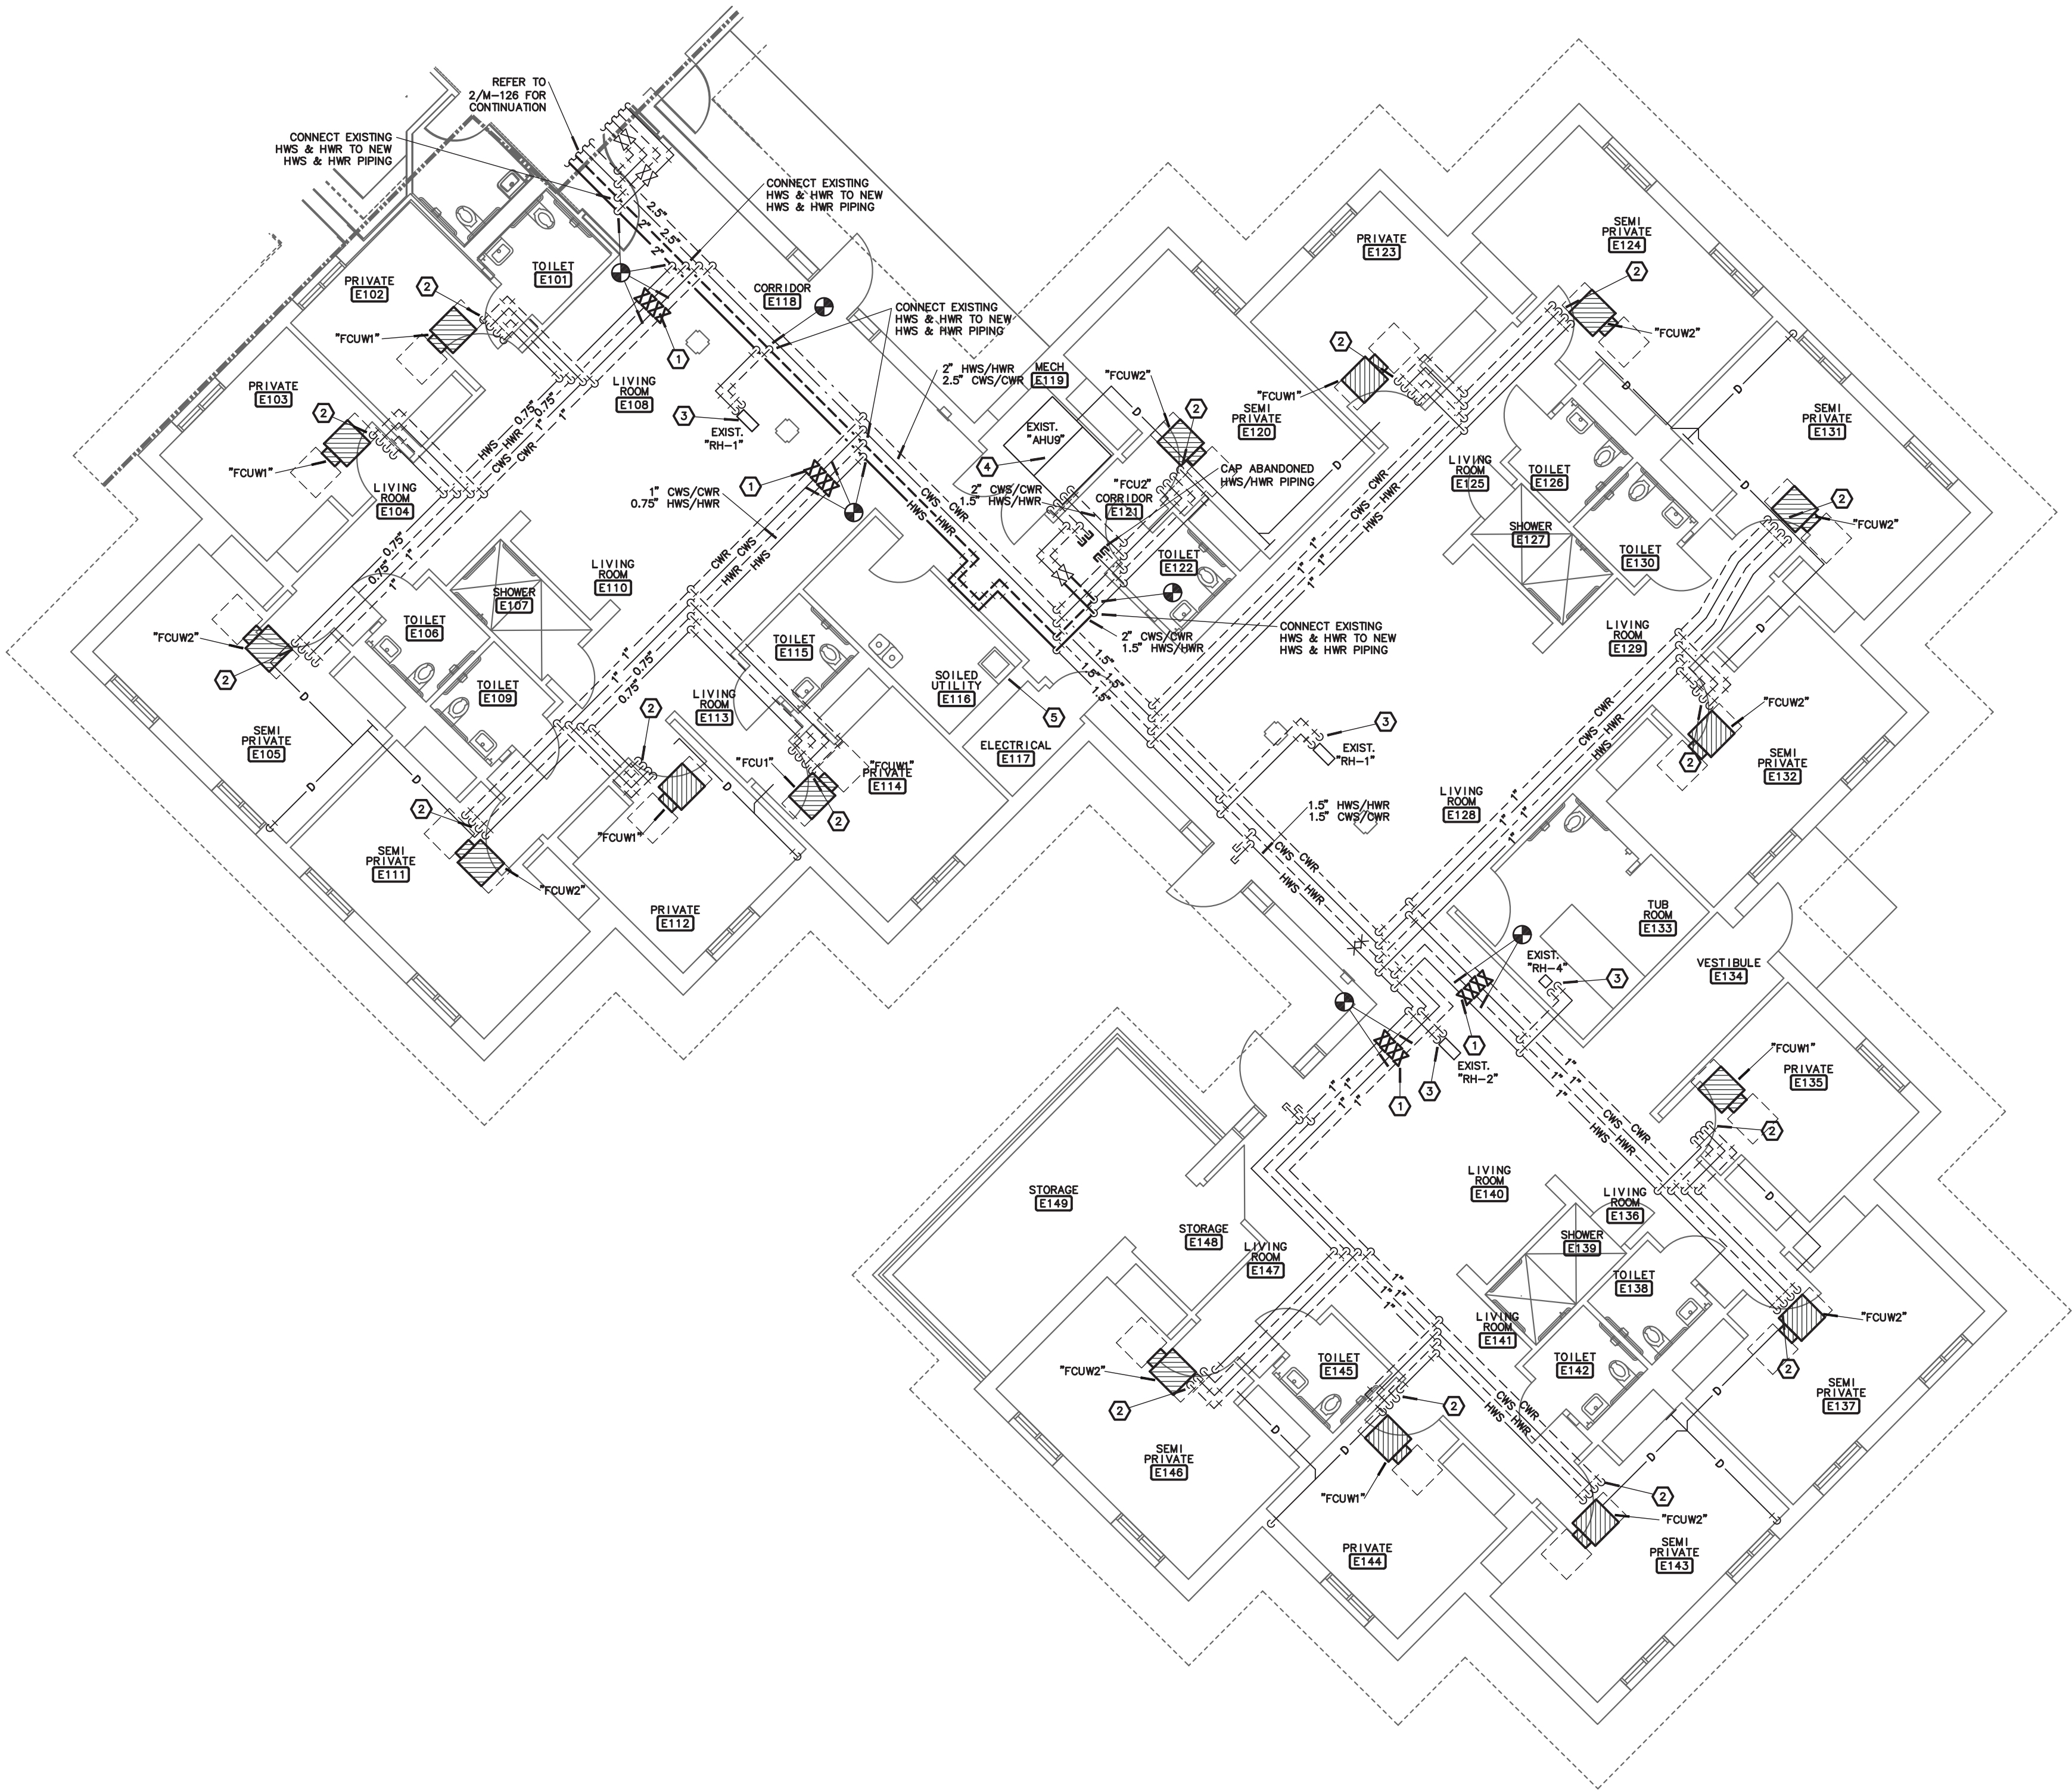81 OF 120 SHEETS

8-1-24



C:\RMA\SMH\DWG\HVAC-M-131 19 Sep 2019 - 8:51 am



1 WING 'E' - HYDRONIC IMPROVEMENT PLAN  
SCALE: 1/8"=1'-0" NORTH

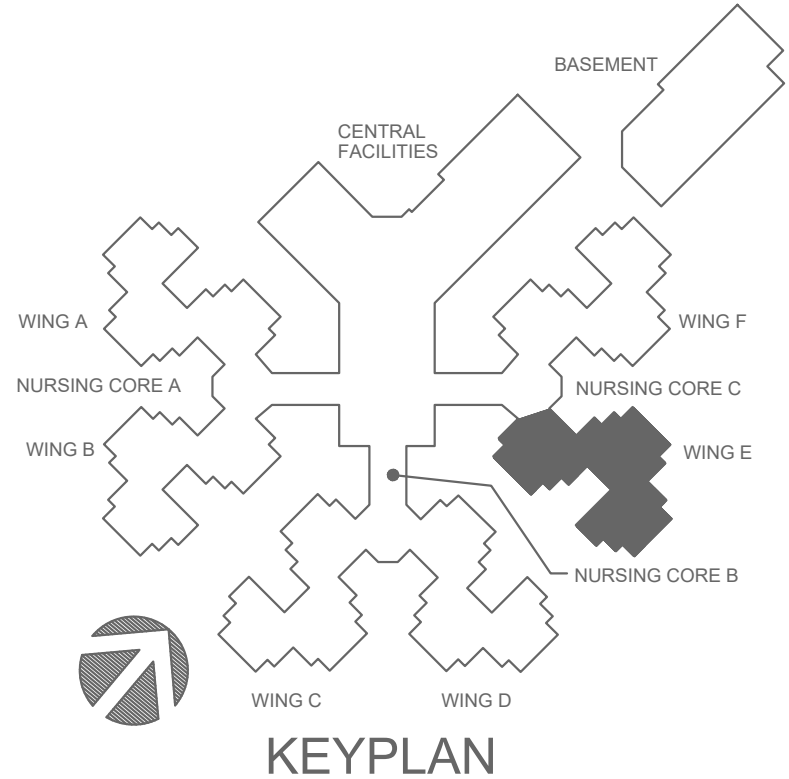
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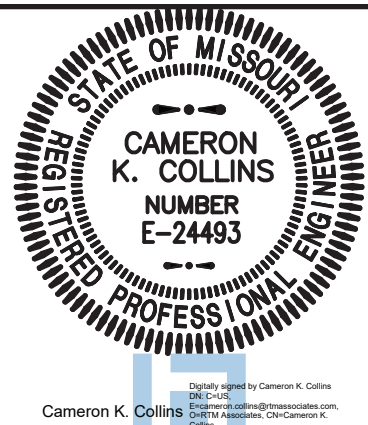
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5. PROVIDE NEW CHECK VALVE TO COLD WATER PIPING TO EXISTING SERVICE SINK.

## GENERAL NOTES:

1. GENERAL PIPING NOTES SHALL APPLY TO ALL EXISTING MECHANICAL HOT WATER SUPPLY AND RETURN PIPING BEING RE-UTILIZED. THE EXISTING MAIN HWS AND HWR PIPING THAT IS BEING ABANDONED IN PLACE, SHALL NOT BE INCLUDED: A. THE ELASTOMERIC GASKET ON ALL GROOVED PIPE COUPLINGS AND SOME VICTALIC COUPLERS SHALL BE REMOVED AND REPLACED. THE REPLACEMENT GASKETS SHALL BE PROVIDED PER THE COUPLING MANUFACTURER'S RECOMMENDATION AND SHALL MEET THE APPLICATION FOR HOT WATER SYSTEMS. IN GENERAL, THE BUILDING IS PRIMARILY GROOVED COUPLINGS AND SOME VICTALIC COUPLERS. FROM FIELD OBSERVATION, IT APPEARS THAT ALL PIPING 2.5" AND LARGER IS GROOVED. B. ALL EXISTING DIELECTRIC FITTINGS TRANSITIONING FROM STEEL TO COPPER SHALL BE REPLACED. DIELECTRIC FITTINGS ARE LOCATED AT ALL HOT WATER COILS THROUGHOUT THE BUILDING. C. PROVIDE BALL VALVES OFF OF THE MAIN PIPING, UPSTREAM OF ALL DIELECTRIC FITTINGS AND WHERE SHOWN ON DRAWINGS, TO ALLOW FOR THE DIELECTRIC FITTINGS TO BE REPLACED IN THE FUTURE. D. PROVIDE BALL VALVES IN THE MAIN PIPING AT EVERY CORRIDOR AND AS SHOWN ON THE DRAWINGS TO ALLOW FOR ISOLATION OF PIPING. E. ADDITIONAL HANGERS SHALL BE PROVIDED TO MEET SPECIFICATIONS. AT A MINIMUM ADDITIONAL HANGERS SHALL BE PROVIDED EVERY 10'-0" OF PIPE LENGTH ON ALL EXISTING PIPING BEING RE-UTILIZED. FIELD VERIFY SIZE AND ROUTING OF EXISTING PIPING PRIOR TO BID. F. EXISTING INSULATION SHALL BE REMOVED AND REPLACED WHERE ALL PIPING WORK IS REQUIRED. TAPE AND SEAL INSULATION PER SPECIFICATIONS. G. UNDER EACH PHASE, AFTER ALL PIPING CHANGES HAVE BEEN COMPLETED, THE HOT WATER PIPING SHALL BE THOROUGHLY FLUSHED AND WATER TREATMENT INSTALLED. H. CONTRACTOR SHALL FIELD VERIFY EXISTING CONDITIONS PRIOR TO BID.
2. GENERAL PIPING NOTES SHALL APPLY TO ALL EXISTING CHILLED WATER SUPPLY AND RETURN PIPING: A. PROVIDE BALL VALVES OFF OF THE MAIN PIPING, UPSTREAM OF ALL EXISTING DIELECTRIC FITTINGS AND WHERE SHOWN ON DRAWINGS, TO ALLOW FOR THE DIELECTRIC FITTINGS TO BE REPLACED IN THE FUTURE. B. PROVIDE BALL VALVES IN THE MAIN PIPING AT EVERY CORRIDOR AND AS SHOWN ON THE DRAWINGS TO ALLOW FOR ISOLATION OF PIPING. C. ADDITIONAL HANGERS SHALL BE PROVIDED TO MEET SPECIFICATIONS. AT A MINIMUM ADDITIONAL HANGERS SHALL BE PROVIDED EVERY 10'-0" OF PIPE LENGTH ON ALL EXISTING PIPING BEING RE-UTILIZED. FIELD VERIFY SIZE AND ROUTING OF EXISTING PIPING PRIOR TO BID. D. EXISTING INSULATION SHALL BE REMOVED AND REPLACED WHERE ALL PIPING WORK IS REQUIRED. TAPE AND SEAL INSULATION PER SPECIFICATIONS. E. CONTRACTOR SHALL FIELD VERIFY EXISTING CONDITIONS PRIOR TO BID.
3. FOR ALL PLUMBING OR HVAC QUESTIONS DURING BIDDING OR DURING CONSTRUCTION, CONTACT ESTERLY, SCHNEIDER & ASSOCIATES, INC. THOM LINDBERG (417-862-0558) FOR COORDINATION WITH TYLER ENDERRO AT RTM ENGINEERING CONSULTANTS.
4. CONTRACTOR SHALL FIELD VERIFY ALL EXISTING CONSTRUCTION PRIOR TO SUBMITTING HIS BID. NO EXTRAS WILL BE PAID DUE TO UNANTICIPATED EXISTING CONDITIONS.
5. CONTRACTOR SHALL SCHEDULE AND EXECUTE ALL WORK WITH REGARD TO THE OWNER'S USE OF THE BUILDING.
6. PLANS ARE DIAGRAMMATIC AND SHALL NOT BE SCALED. REFER TO ARCHITECTURAL DRAWINGS FOR DIMENSIONS.
7. CONTRACTOR SHALL INSPECT AREAS TO ACCESS ATTIC AREA AND PROVIDE TEMPORARY PLATFORMS ON EXISTING STRUCTURE ABOVE CEILING TO PERFORM WORK WITHOUT INTERRUPTING OPERATIONS IN OCCUPIED SPACES BELOW CEILING. ALL AREAS USED FOR ACCESS TO ATTIC SHALL BE COORDINATED WITH OWNER.
8. CONTRACTOR SHALL REMOVE AND REPLACE CEILING TILE AND CEILING GRID AS REQUIRED TO PERFORM ALL DEMOLITION AND IMPROVEMENT WORK. CONTRACTOR SHALL REPLACE ALL DAMAGED CEILING TILE TO MATCH EXISTING.
9. CONTRACTOR SHALL FIRE CAULK ALL PENETRATIONS.



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MISSOURI VETERANS  
HOME

620 N. JEFFERSON  
ST. JAMES, MISSOURI

PROJECT # U1503-01  
SITE # 6801  
ASSET # 8136801002  
FEDERAL # 29-044

REVISION: \_\_\_\_\_  
DATE: \_\_\_\_\_  
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REVISION: \_\_\_\_\_  
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ISSUE DATE: 8-1-24

CAD DWG FILE: M-131.DWG  
DRAWN BY: TSE  
CHECKED BY: CRC  
DESIGNED BY: TSE

SHEET TITLE:

HVAC PIPING  
& PLUMBING  
PLAN

SHEET NUMBER:

M-131

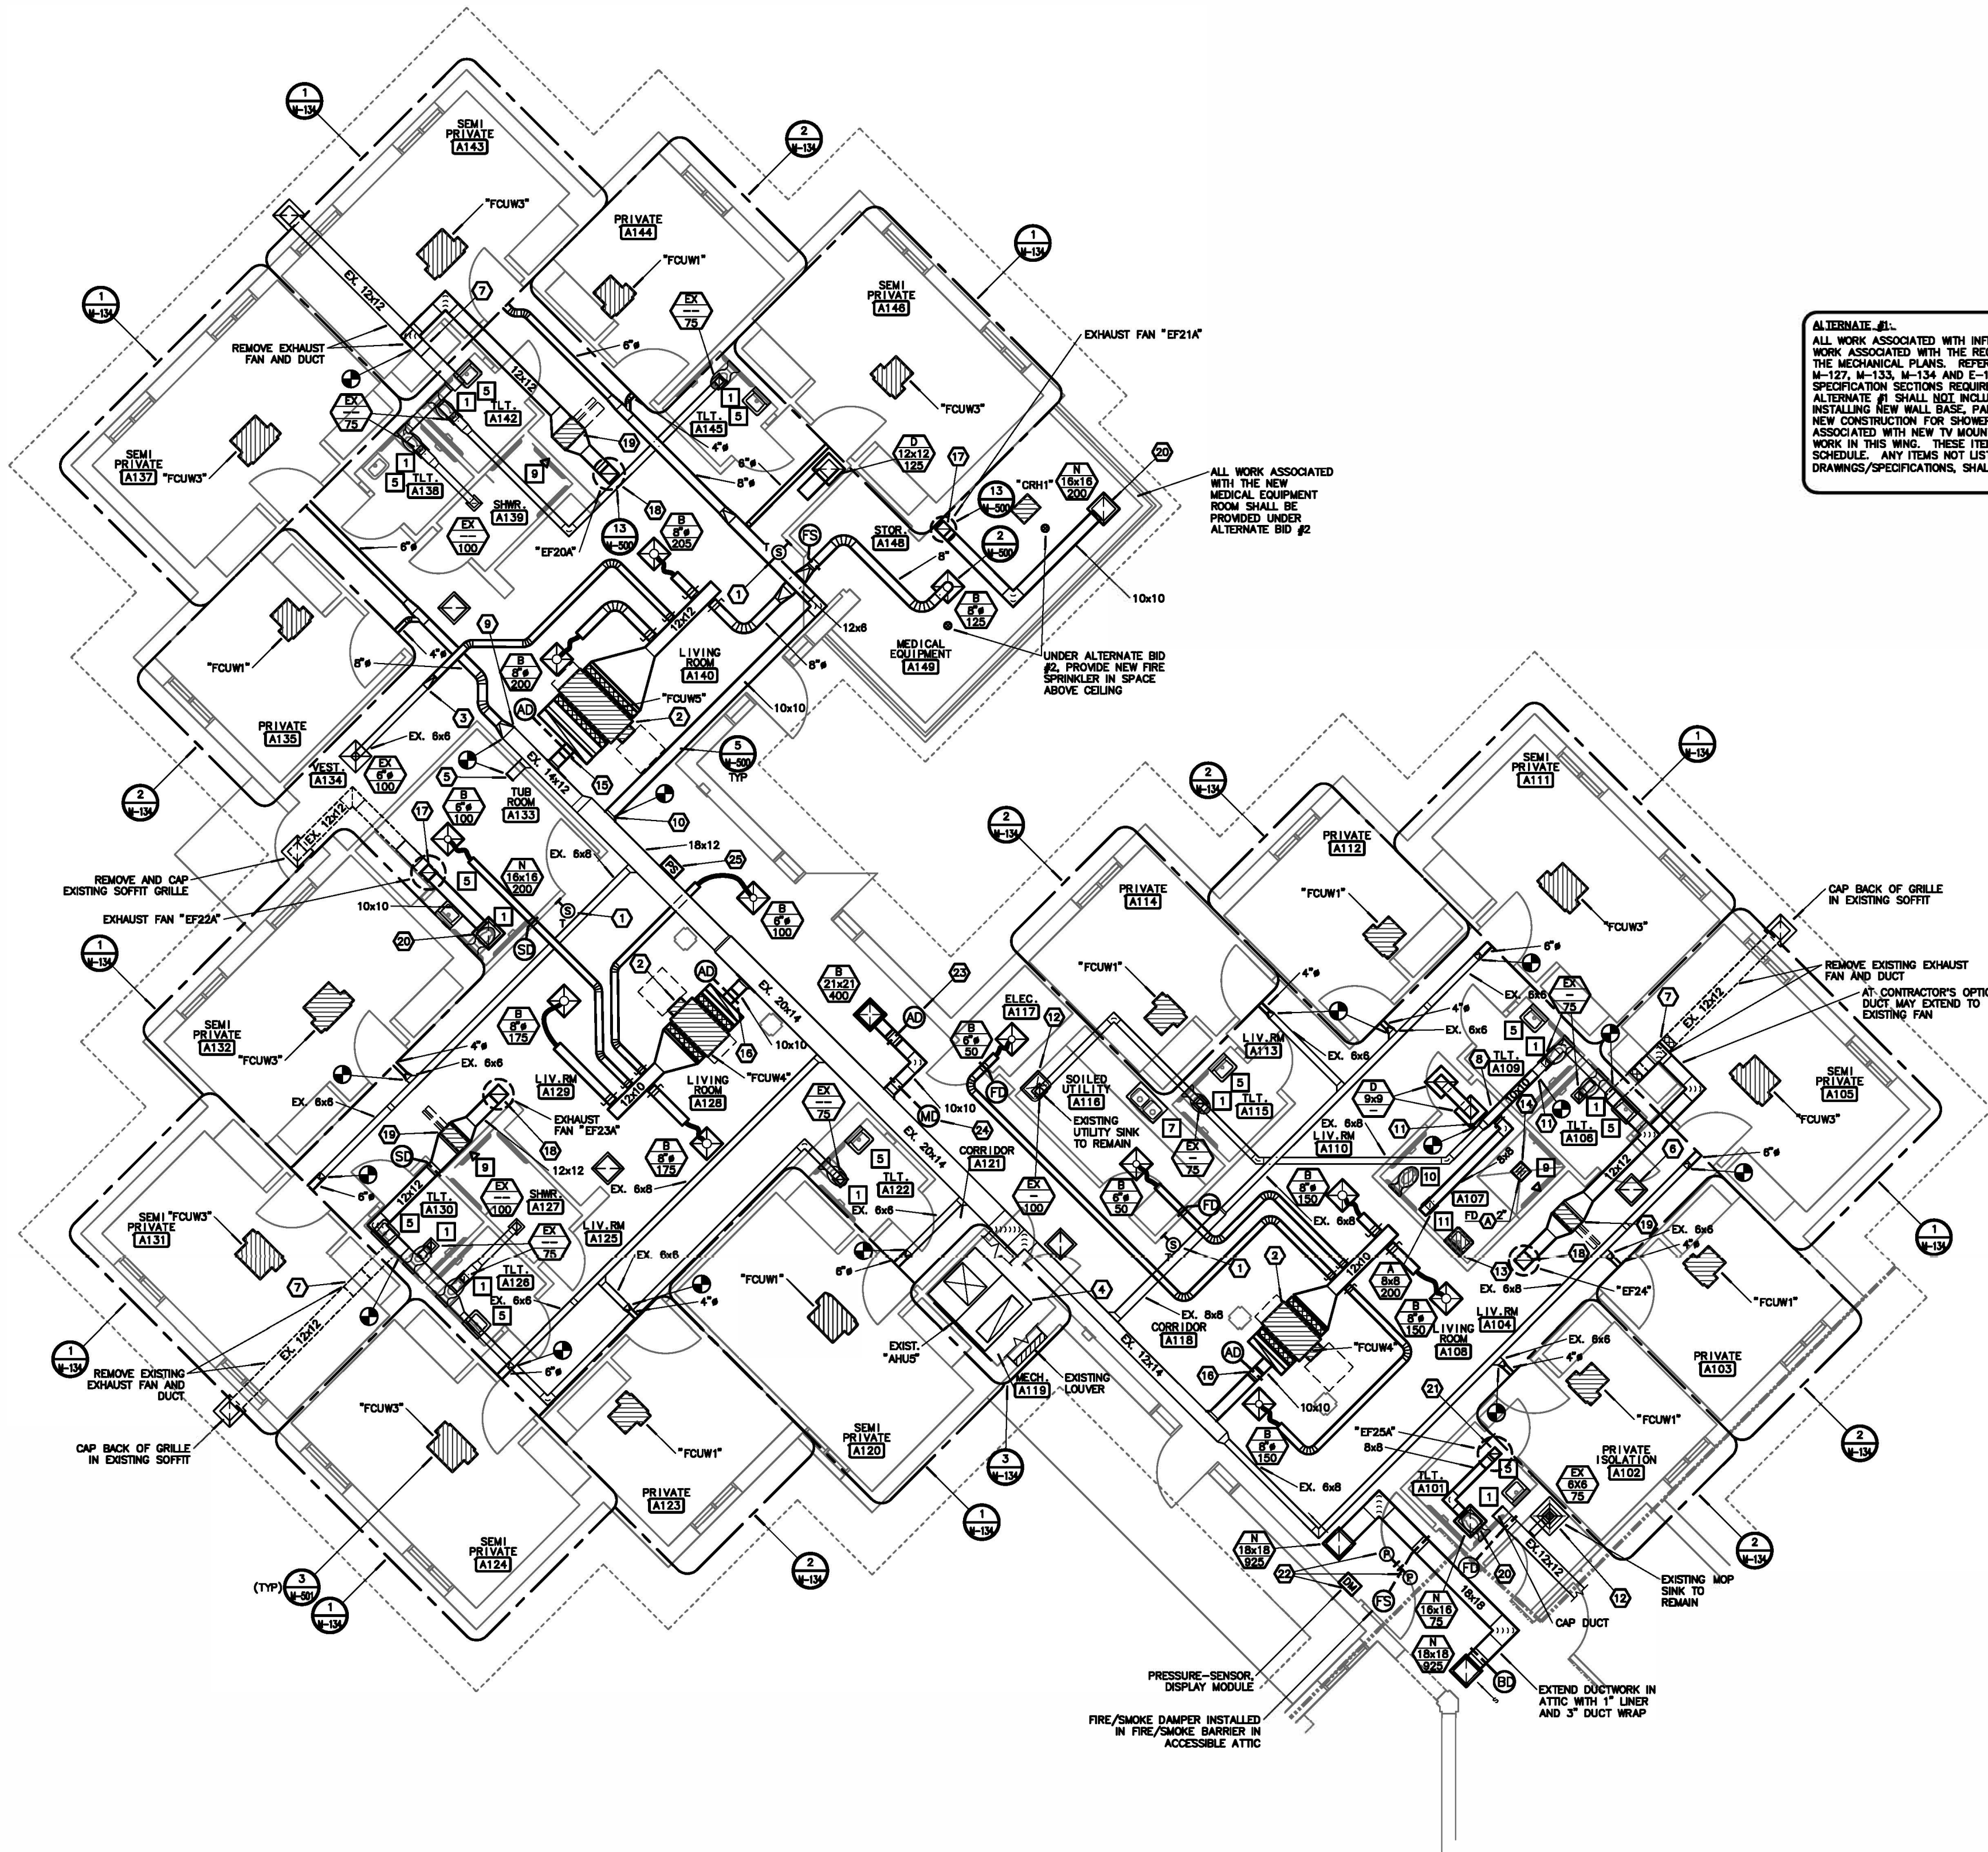
82 OF 120 SHEETS

8-1-24



NORTH





**INFECTIOUS CONTROL ALTERNATE #1**  
**WING 'A' - MECHANICAL IMPROVEMENT PLAN**  
SCALE: 1/8"=1'-0"  
1 M-133




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## NOTES:

- PROVIDE NEW TEMPERATURE SENSOR AND CONTROL WIRING TO UNIT. REUTILIZE ANY EXISTING CONDUIT. PATCH, REPAIR AND PAINT WALL PER ARCHITECT'S DIRECTION.
- PROVIDE NEW HORIZONTAL 4-PIPE FAN COIL UNIT. FIELD VERIFY EXISTING CONDITIONS. PIPING LOCATION, AVAILABLE SPACE AND CLEARANCE FOR MAINTENANCE AND EXISTING SHEET METAL SIZES AND LOCATIONS PRIOR TO SUBMITTING EQUIPMENT. CONNECT EXISTING SUPPLY AND RETURN DUCT TO NEW UNIT CONNECTIONS WITH FLEXIBLE CONNECTORS. PROVIDE ANY ADDITIONAL TRANSITION AS NECESSARY. CUT AND PATCH HARD CEILING WHERE REQUIRED TO REMOVE UNIT AND PROVIDE ACCESS PANEL FOR NEW UNIT.
- CONNECT TO EXISTING DUCTWORK. FIELD VERIFY EXISTING DUCTWORK FOR CONNECTION.
- EXISTING AIR HANDLING UNIT TO HAVE NEW VALVING, PUMPS AND CONTROLS. TAB CONTRACTOR SHALL BALANCE AIR HANDLING UNIT AND ALL DIFFUSERS AND FAN COIL INTAKES TO THE VALUES INDICATED. DUCTS SERVING FAN COIL UNITS IN THE RESIDENT ROOMS SHALL BE BALANCED TO 75 CFM FOR SEMI-PRIVATE ROOMS AND 50 CFM FOR PRIVATE ROOMS.
- EXISTING HOT WATER COIL TO REMAIN. CONTRACTOR SHALL CLEAN EXISTING HEATING COIL.
- NEW LOCATION OF RELOCATED RETURN AIR GRILLE.
- REMOVE EXISTING EXHAUST FAN AND ASSOCIATED DUCT.
- REMOVE EXISTING EXHAUST GRILLE AND CAP MAIN. PROVIDE NEW 8x8 TAP TO NEW EXHAUST GRILLE LOCATION.
- CONNECT TRANSITION TO EXISTING DUCTWORK. FIELD VERIFY EXISTING DUCT SIZE.
- UNDER ALTERNATE BID #2, ENLARGE EXISTING OPENING IN EXISTING SUPPLY AIR DUCT AND INSTALL NEW 10X10 SUPPLY. AIR DUCT TAP.
- REPLACE EXISTING DUCT WITH NEW 10X10 DUCT AND CONNECT TO EXISTING DUCT. FIELD VERIFY EXISTING DUCT SIZE.
- ADD CHECK VALVE TO COLD WATER SUPPLY TO MOP SINK OR UTILITY SINK.
- CONFIRM PRIOR TO BID THAT WASTE, HOT WATER AND COLD WATER FOR NEW SINK WILL BE ACCESSIBLE FOR CONNECTION TO NEW FILTERS.
- INSTALL NEW FLOOR DRAIN AT CENTER OF SHOWER PAN. CONNECT TO EXISTING WASTE BELOW FLOOR. COORDINATE FLOORING DEMOLITION WITH ARCHITECT AND GENERAL CONTRACTOR.
- ALDES CAR3-L10-SS-10X10 CONSTANT FLOW DAMPER SUPPLYING 475 CFM OA TO NEW FAN COIL UNIT.
- ALDES CAR3-L10-SS-10X10 CONSTANT FLOW DAMPER SUPPLYING 500 CFM OA TO NEW FAN COIL UNIT.
- 10x10 EXHAUST DUCT UP FROM WITHIN EXISTING ATTIC TO NEW EXHAUST FAN ON ROOF.
- 12x12 EXHAUST DUCT UP FROM WITHIN EXISTING ATTIC TO NEW EXHAUST FAN ON ROOF.
- 24x12 FILTER RACK WITH MERV-8 PRE-FILTER AND HEPA FINAL FILTER.
- PROVIDE A 2" THICK, HEPA FILTER IN GRILLE.
- 8x8 EXHAUST DUCT UP FROM WITHIN EXISTING ATTIC TO NEW EXHAUST FAN ON ROOF.
- PROVIDE THROUGH THE WALL PRESSURE SENSOR EQUAL TO A TSI MODEL 800243 AND LOCATE ABOVE THE DOOR INTO EACH BEDROOM. PROVIDE TSI DISPLAY MODULE RPW20 BESIDE THE DOOR AT 8' ABOVE THE FINISHED FLOOR AND ROUTE CONTROL WIRING BETWEEN THE MODULE AND PRESSURE SENSORS IN CORRIDOR AND BEDROOM. 120-VOLT POWER WITH 24-VOLT TRANSFORMER PROVIDED PER ELECTRICAL DRAWINGS. LOW-VOLTAGE CONTROL WIRING BY MECHANICAL/CONTROL CONTRACTOR.
- ALDES CAR3-L10-SS-10X10 CONSTANT FLOW DAMPER SUPPLYING 400 CFM OA TO NEW FAN COIL UNIT.
- MOTORIZED DAMPER TO OPEN IN ISOLATION MODE.
- DUCT PRESSURE SENSOR TO CONTROL SPEED OF AHS SPEED.

## GENERAL NOTES:

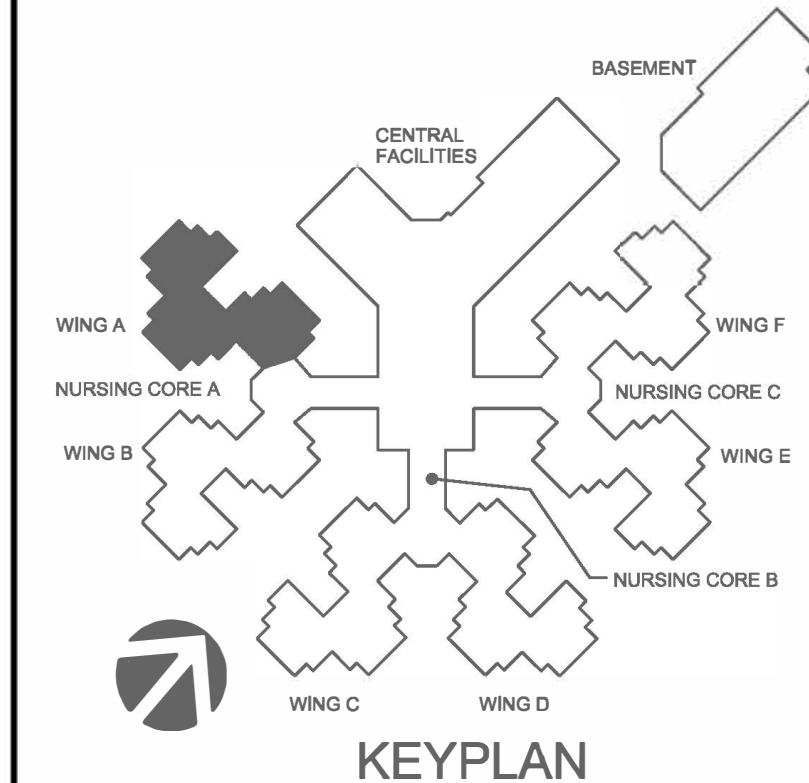- PROVIDE DRY PIPE FIRE PROTECTION IN ATTIC AND NET PIPE FIRE PROTECTION IN ROOM. STORAGE A148. REFER TO SPECIFICATIONS.
- RE-BALANCE ALL EXISTING EXHAUST GRILLES SERVED BY EXISTING EXHAUST FANS THAT ARE BEING REPLACED.
- FOR ALL PLUMBING OR HVAC QUESTIONS DURING BIDDING OR DURING CONSTRUCTION, CONTACT ESTERLY, SCHNEIDER & ASSOCIATES, INC. THOM LUNDBERG (417-862-0558) FOR COORDINATION WITH TYLER ENDRIGO AT RTM ENGINEERING CONSULTANTS.
- CONTRACTOR SHALL FIELD VERIFY ALL EXISTING CONSTRUCTION PRIOR TO SUBMITTING HIS BID. NO EXTRAS WILL BE PAID DUE TO UNANTICIPATED EXISTING CONDITIONS.
- CONTRACTOR SHALL SCHEDULE AND EXECUTE ALL WORK WITH REGARD TO THE OWNER'S USE OF THE BUILDING.
- PLANS ARE DIAGRAMMATIC AND SHALL NOT BE SCALED. REFER TO ARCHITECTURAL DRAWINGS FOR DIMENSIONS.
- CONTRACTOR SHALL REMOVE AND REPLACE CEILING TILE AND CEILING GRID AS REQUIRED TO PERFORM ALL DEMOLITION AND IMPROVEMENT WORK. CONTRACTOR SHALL REPLACE ALL DAMAGED CEILING TILE TO MATCH EXISTING.
- FOR ADDITIONAL DETAIL, REFER TO ENLARGED PLAN 1/M-134.
- ALL NEW AND EXISTING DUCT SYSTEMS TO BE BALANCED IN BASE BID.
- REFER TO ARCHITECTURAL PLANS FOR ROOM SEALING TESTING FOR AIR LEAKS. COORDINATE WITH TEST & BALANCE CONTRACTOR.



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ISSUE DATE: 8-1-24

CAD DWG FILE: M-133.DWG  
DRAWN BY: TSE  
CHECKED BY: CKC  
DESIGNED BY: TSE

SHEET TITLE:

**HVAC &  
PLUMBING  
PLAN**

SHEET NUMBER:

**M-133**

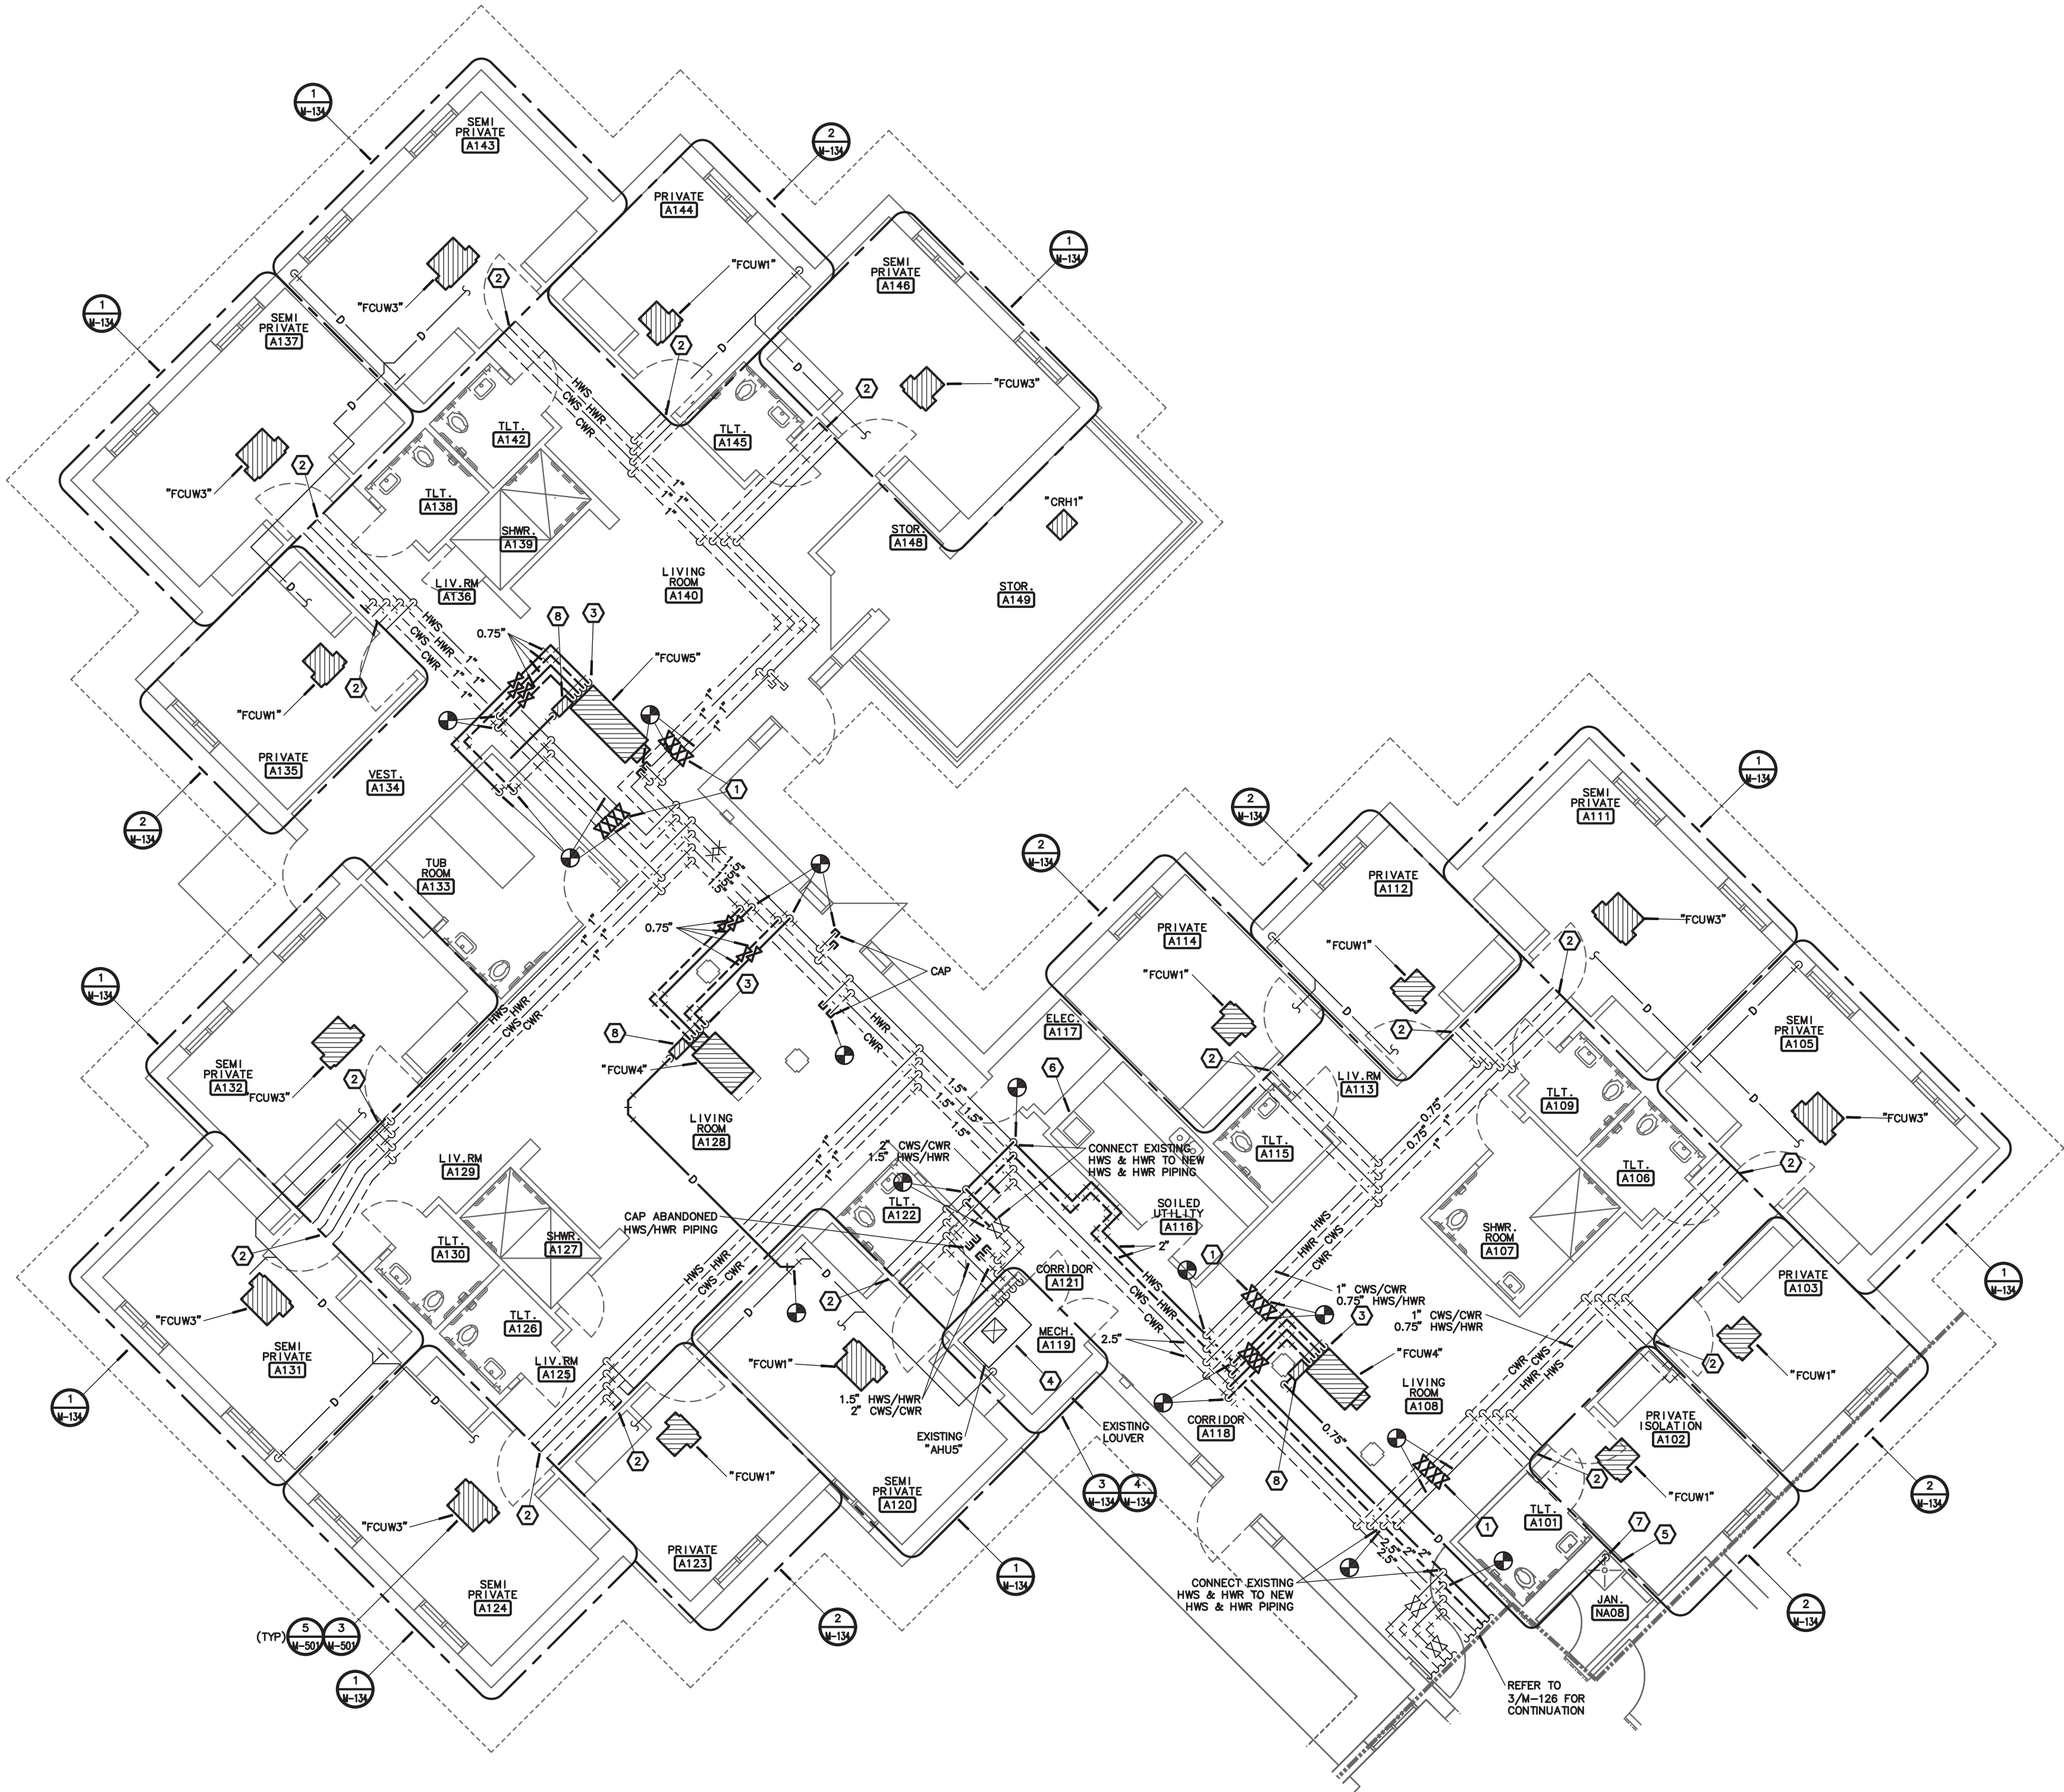
84 OF 120 SHEETS

8-1-24









**1**  
**M-135**

**INFECTION CONTROL ALTERNATE #1**  
**WING 'A' - HYDRONIC IMPROVEMENT PLAN**

SCALE: 1/8"=1'-0"

NORTH

**ALTERNATE #1:**  
ALL WORK ASSOCIATED WITH INFECTIOUS CONTROL WING 'A' FOR REVISED MECHANICAL AND ELECTRICAL WORK ASSOCIATED WITH THE REQUIREMENTS TO ACHIEVE THE INFECTIOUS CONTROL AREAS DEFINED ON THE MECHANICAL PLANS. REFER TO SHEETS A-104, A-114, A-121, A-800, A-801, M-105, M-116, M-127, M-133, M-134 AND E-105, AND E-116 AND ALL ASSOCIATED DETAILS, SCHEDULES AND SPECIFICATION SECTIONS REQUIRED FOR ADDITIONAL INFORMATION AS IT PERTAINS TO WING A. ALTERNATE #1 SHALL NOT INCLUDE REMOVING AND INSTALLING NEW FLOORING, REMOVING AND INSTALLING NEW WALL BASE, PAINTING OF ANY WALLS, ANY WORK ASSOCIATED WITH DEMOLITION OR NEW CONSTRUCTION FOR SHOWER ROOM A107. ALTERNATE SHALL NOT INCLUDE ANY WORK ASSOCIATED WITH NEW TV MOUNTING AND BLOCKING, NOR WORK ASSOCIATED WITH OTHER ALTERNATE WORK IN THIS WING. THESE ITEMS REMAIN IN THE BASE BID AND AS DEFINED IN THE PHASING SCHEDULE. ANY ITEMS NOT LISTED SPECIFICALLY ABOVE, BUT SHOWN ON THE DRAWINGS/SPECIFICATIONS, SHALL REMAIN IN THE ALTERNATE #1.




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## NOTES:


1. INSTALL NEW ISOLATION BALL VALVES IN EXISTING LINES.
2. PROVIDE NEW HORIZONTAL 4-PIPE FAN COIL UNIT AND PIPING PACKAGE. RECONNECT TO EXISTING 0.75" HWS, HWR, CWS, CWR AND CONDENSATE DRAIN PIPING. FIELD VERIFY EXISTING CONDITIONS, AND LOCATION OF CONNECTIONS TO ALL EXISTING PIPING CONNECTIONS PRIOR TO THE SUBMITTAL OF FAN COIL UNITS. PROVIDE ALL REQUIRED ADJUSTMENTS TO EXISTING PIPING TO ACCOMMODATE NEW FAN COIL UNIT.
3. 0.75" CHILLED WATER SUPPLY, CHILLED WATER RETURN, HOT WATER SUPPLY, HOT WATER RETURN, AND TRAPPED CONDENSATE DRAIN CONNECTED TO FAN COIL UNIT.
4. EXISTING AIR HANDLING UNIT SHALL REMAIN WITH NEW VALVES AND PUMPS. BALANCE TO ALTERNATE DESIGN WATER AND AIRFLOWS.
5. PROVIDE NEW CHECK VALVE IN COLD WATER PIPING TO EXISTING MOP SINK.
6. PROVIDE NEW CHECK VALVE IN COLD WATER PIPING TO EXISTING SERVICE SINK.
7. 0.75" CONDENSATE DRAIN DOWN TO JANITOR'S BASIN WITH AIR GAP.
8. PLENUM RATED, CONDENSATE PUMP EQUAL TO A LIBERTY, LCU-PR20S PUMP WITH 0.75" CONDENSATE DISCHARGE UP AND THEN SLOPING TO DRAIN.

## GENERAL NOTES:

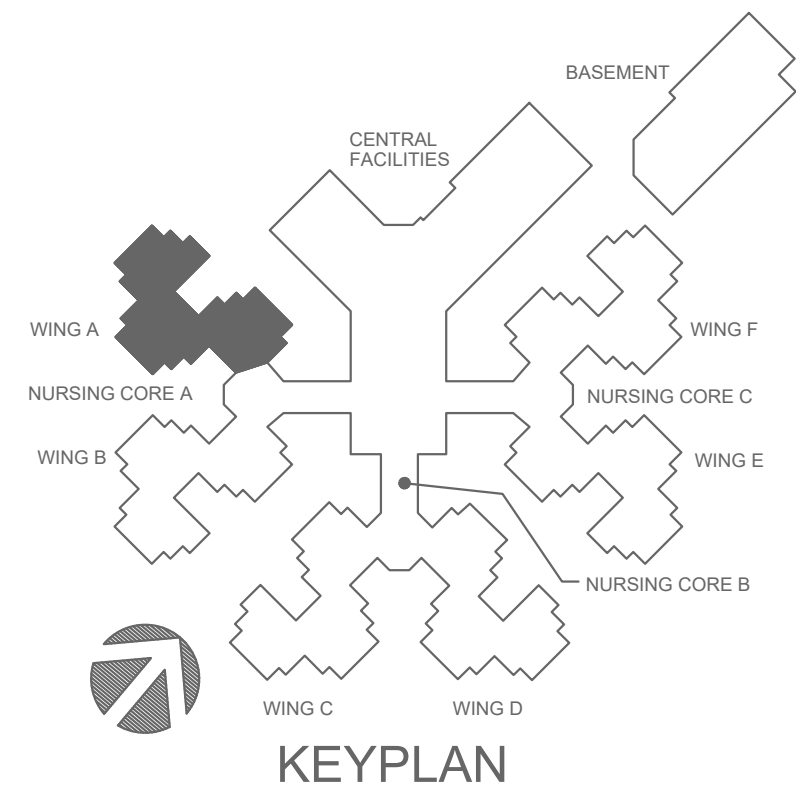1. GENERAL PIPING NOTES SHALL APPLY TO ALL EXISTING MECHANICAL HOT WATER SUPPLY AND RETURN PIPING BEING RE-UTILIZED. THE EXISTING MAIN HWS AND HWR PIPING THAT IS BEING ABANDONED IN PLACE SHALL NOT BE INCLUDED. THE ELASTOMERIC GASKET ON ALL GROOVED PIPE COUPLINGS AND VALVE COUPLINGS SHALL BE REMOVED AND REPLACED. THE REPLACEMENT GASKETS SHALL BE PROVIDED PER THE COUPLING MANUFACTURER'S RECOMMENDATION AND SHALL MEET THE APPLICATION FOR HOT WATER SYSTEMS. IN GENERAL, THE BUILDING IS PRIMARILY GROUVED COUPLINGS AND SOME ARE VITULIC COUPLINGS. FROM FIELD OBSERVATION, IT APPEARS THAT ALL PIPING 2.5" AND LARGER IS GROOVED FITTINGS. B. ALL EXISTING DIELECTRIC FITTINGS TRANSITIONING FROM STEEL TO COPPER SHALL BE REPLACED. DIELECTRIC FITTINGS ARE LOCATED AT ALL HOT WATER TRANSITION FROM STEEL TO BUILDING. C. PROVIDE BALL VALVES OFF OF THE MAIN PIPING, UPSTREAM OF ALL DIELECTRIC FITTINGS AND WHERE SHOWN ON DRAWINGS. TO ALLOW THE DIELECTRIC FITTINGS TO BE REPLACED IN THE FUTURE. D. PROVIDE BALL VALVES IN THE MAIN PIPING AT EVERY CORRIDOR AND AS SHOWN ON THE DRAWINGS TO ALLOW ISOLATION OF PIPING. E. ADDITIONAL HANGERS SHALL BE PROVIDED TO MEET SPECIFICATIONS. AT A MINIMUM ADDITIONAL HANGERS SHALL BE PROVIDED EVERY 10'-0" OF PIPE LENGTH ON ALL EXISTING PIPING BEING RE-UTILIZED. FIELD VERIFY SIZE AND ROUTING OF EXISTING PIPING PRIOR TO BID. F. EXISTING INSULATION SHALL BE REMOVED AND REPLACED WHERE ALL PIPING WORK IS REQUIRED. TAPE AND SEAL INSULATION PER SPECIFICATIONS. G. UNDER EACH PHASE, AFTER ALL PIPING CHANGES HAVE BEEN COMPLETED, THE HOT WATER PIPING SHALL BE THOROUGHLY FLUSHED AND WATER TREATMENT INSTALLED. H. CONTRACTOR SHALL FIELD VERIFY EXISTING CONDITIONS PRIOR TO BID.
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3. FOR ALL PLUMBING OR HVAC QUESTIONS DURING BIDDING OR DURING CONSTRUCTION, CONTACT ESTERLY, SCHNEIDER & ASSOCIATES, INC. THOM LUNDBERG (417-862-0558) FOR COORDINATION WITH TYLER ENSERRO AT RTM ENGINEERING CONSULTANTS.
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9. CONTRACTOR SHALL FIRE CAULK ANY RATED WALL PENETRATIONS.



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DRAWN BY: **TSE**  
CHECKED BY: **CRK**  
DESIGNED BY: **TSE**

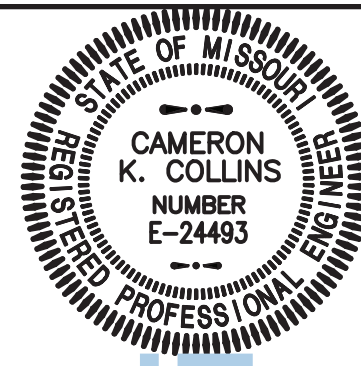SHEET TITLE:

**HVAC PIPING  
PLAN**

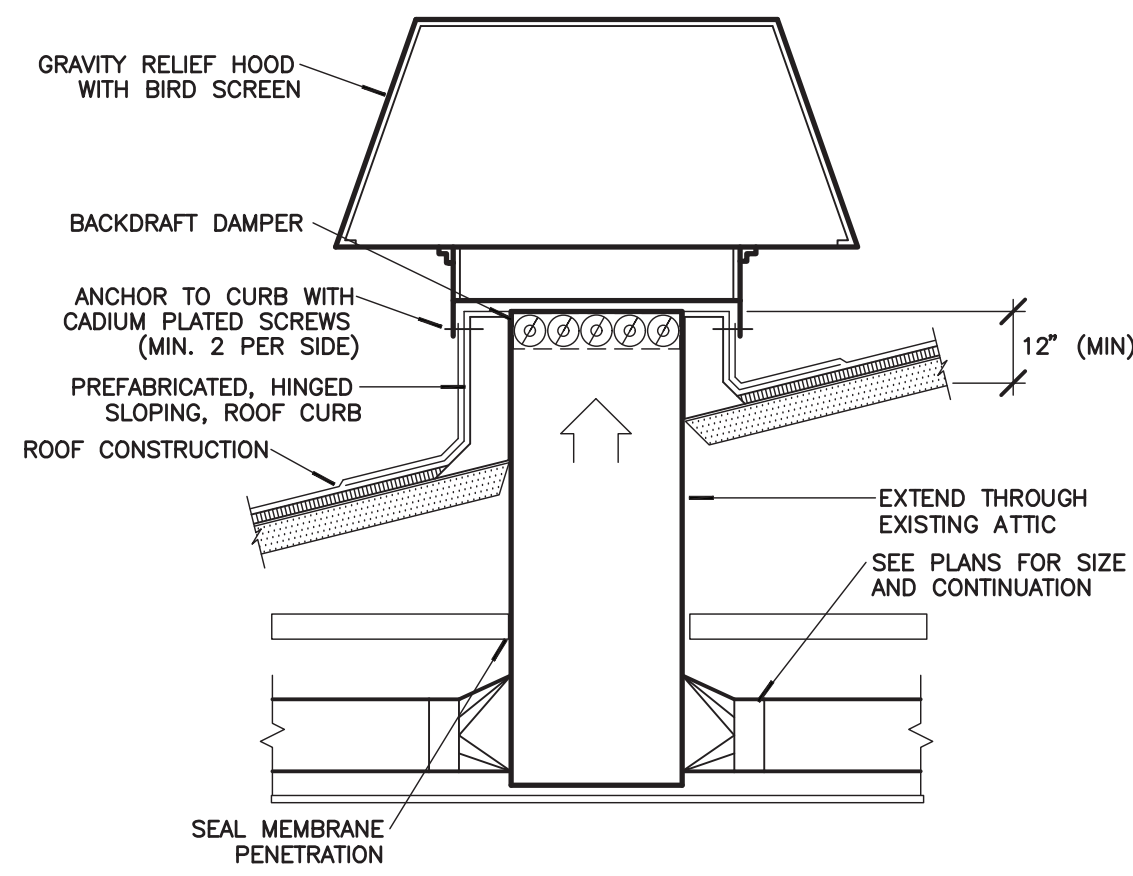
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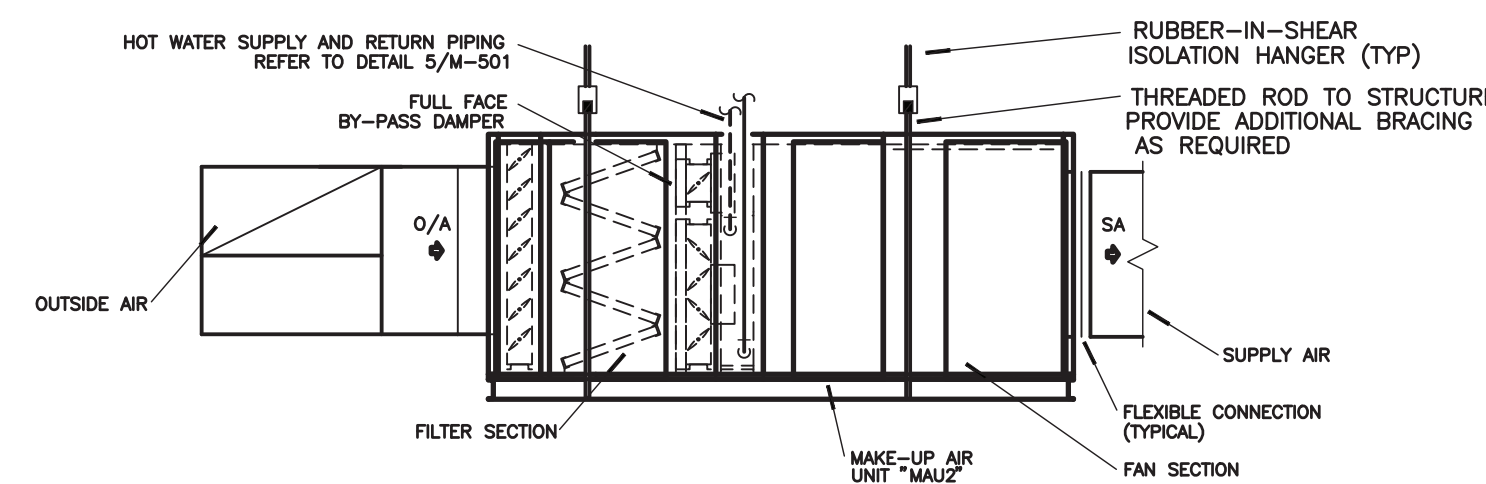
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8-1-24







**12 ROOF VENT DETAIL**  
M-500 NO SCALE




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M-500 NO SCALE

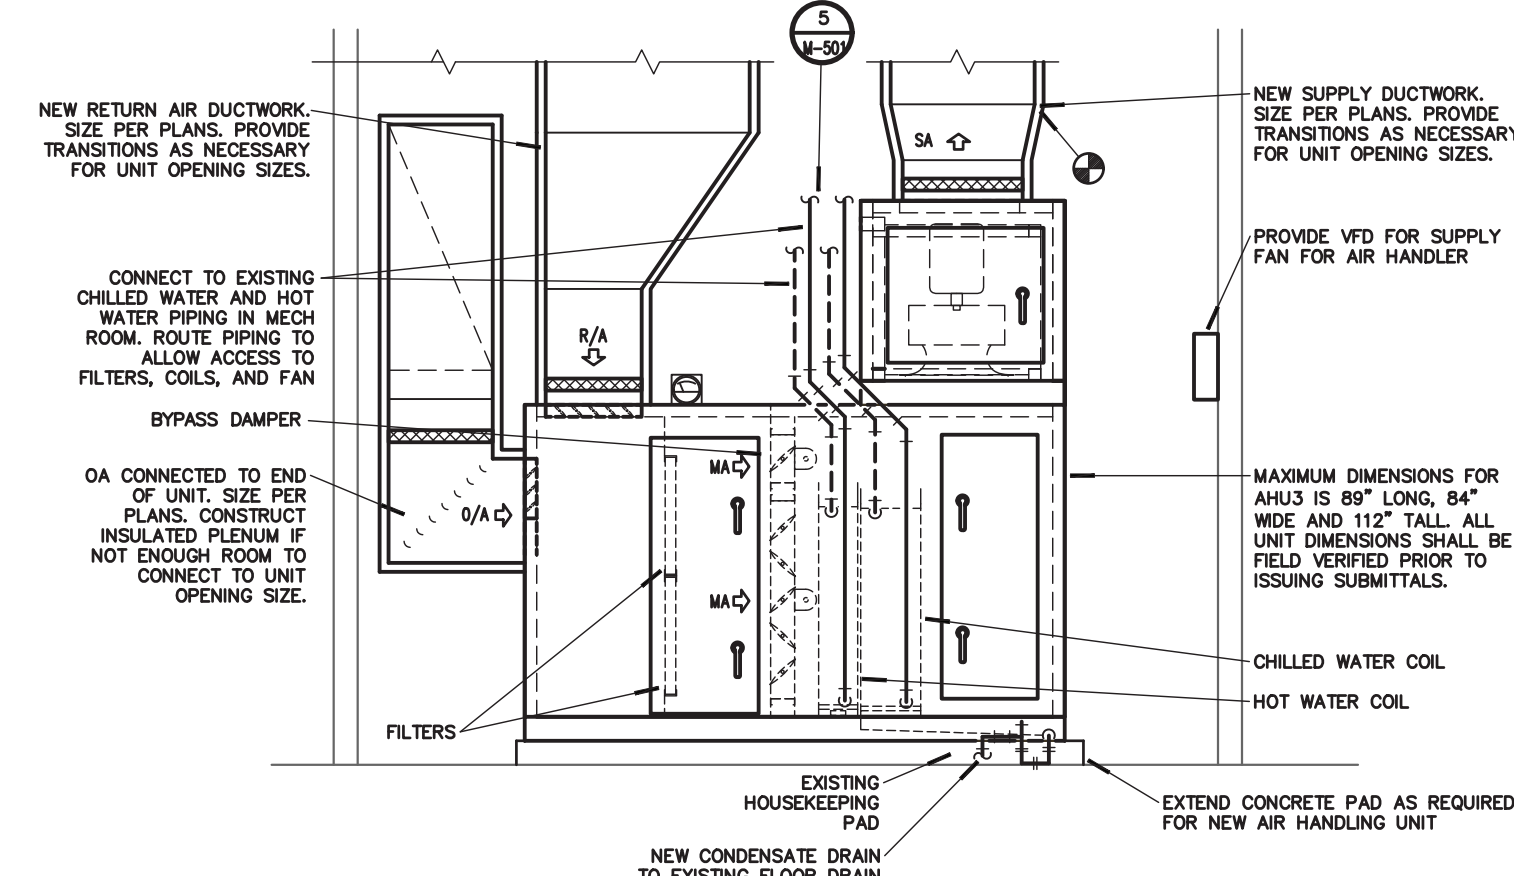


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M-500 NO SCALE

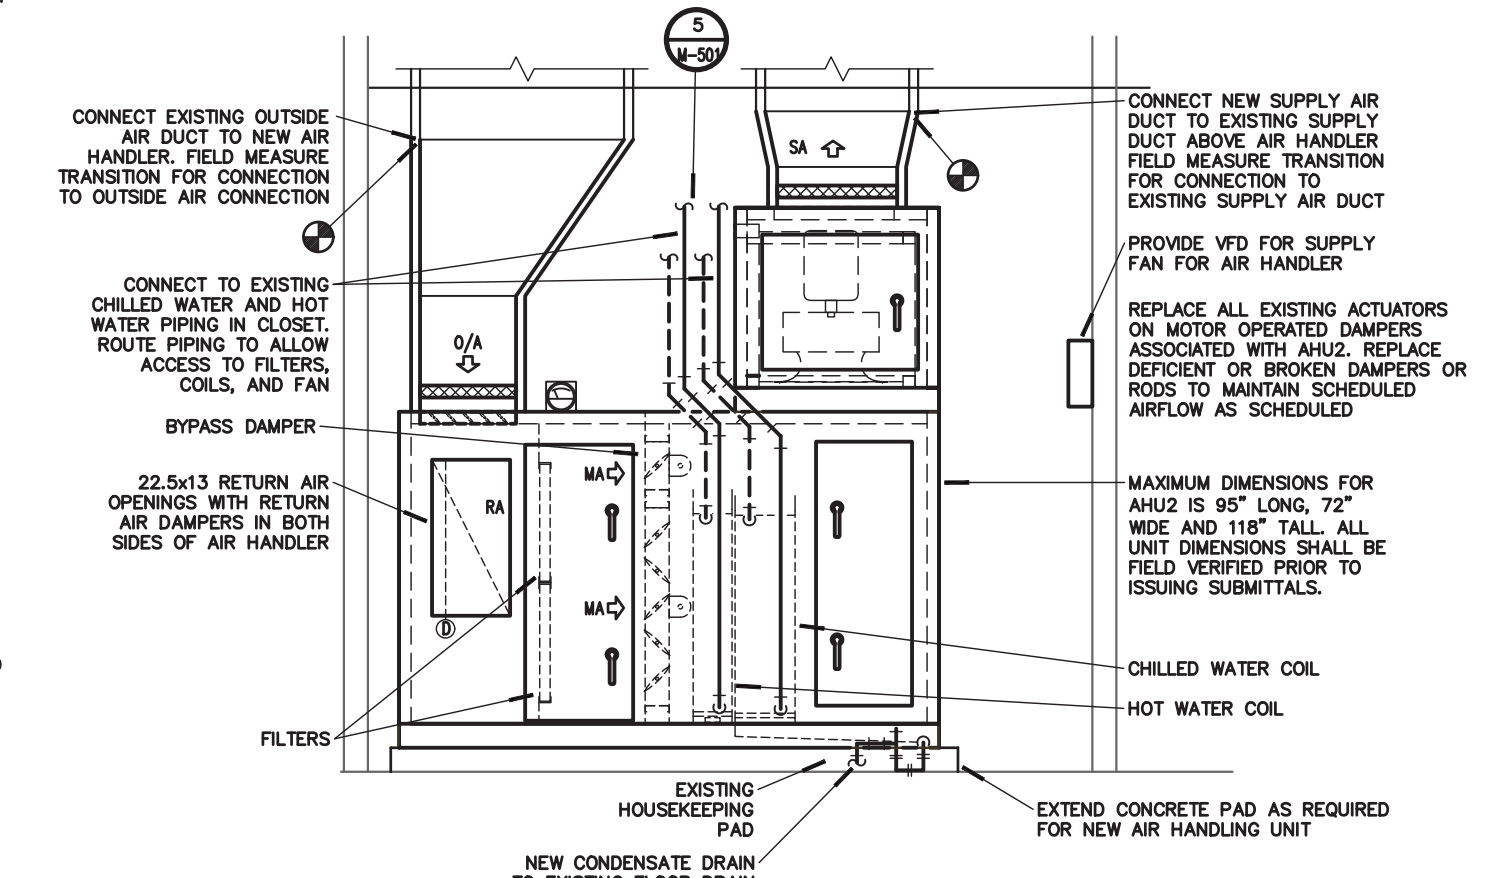

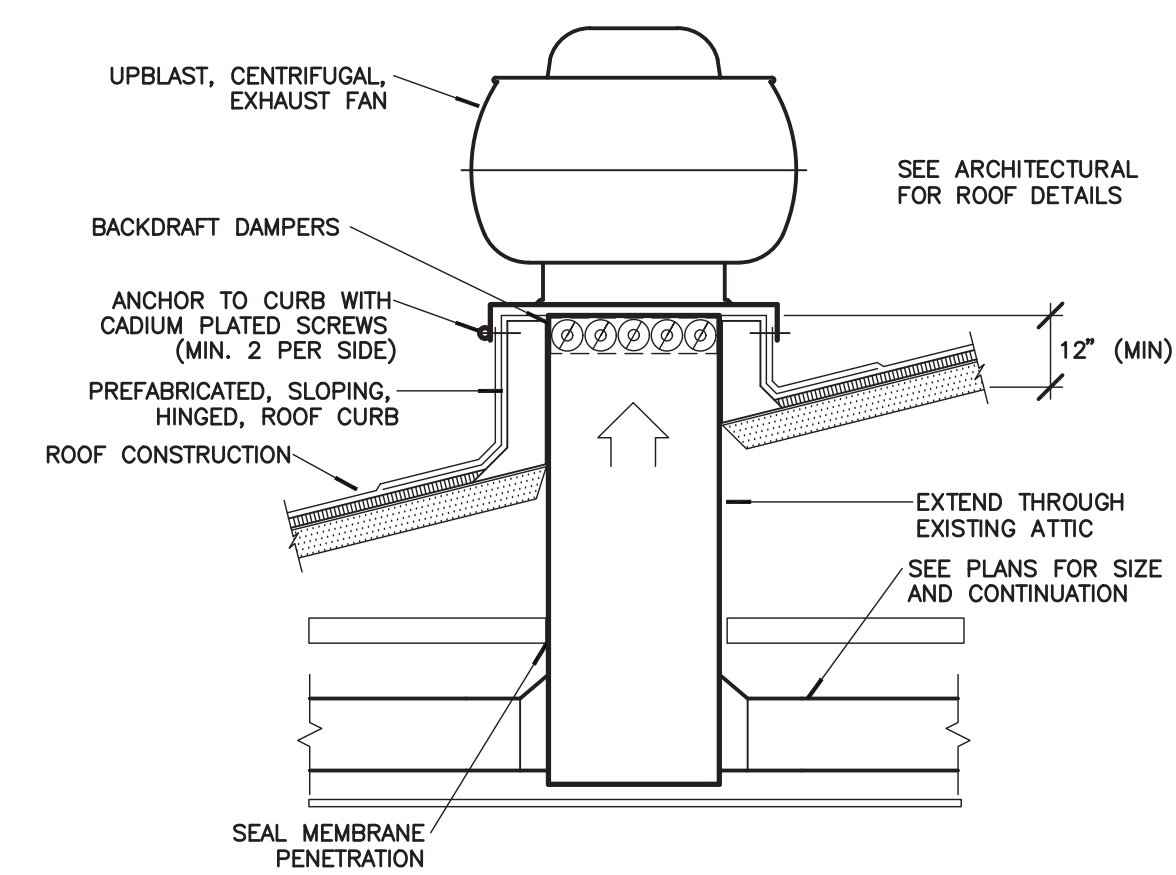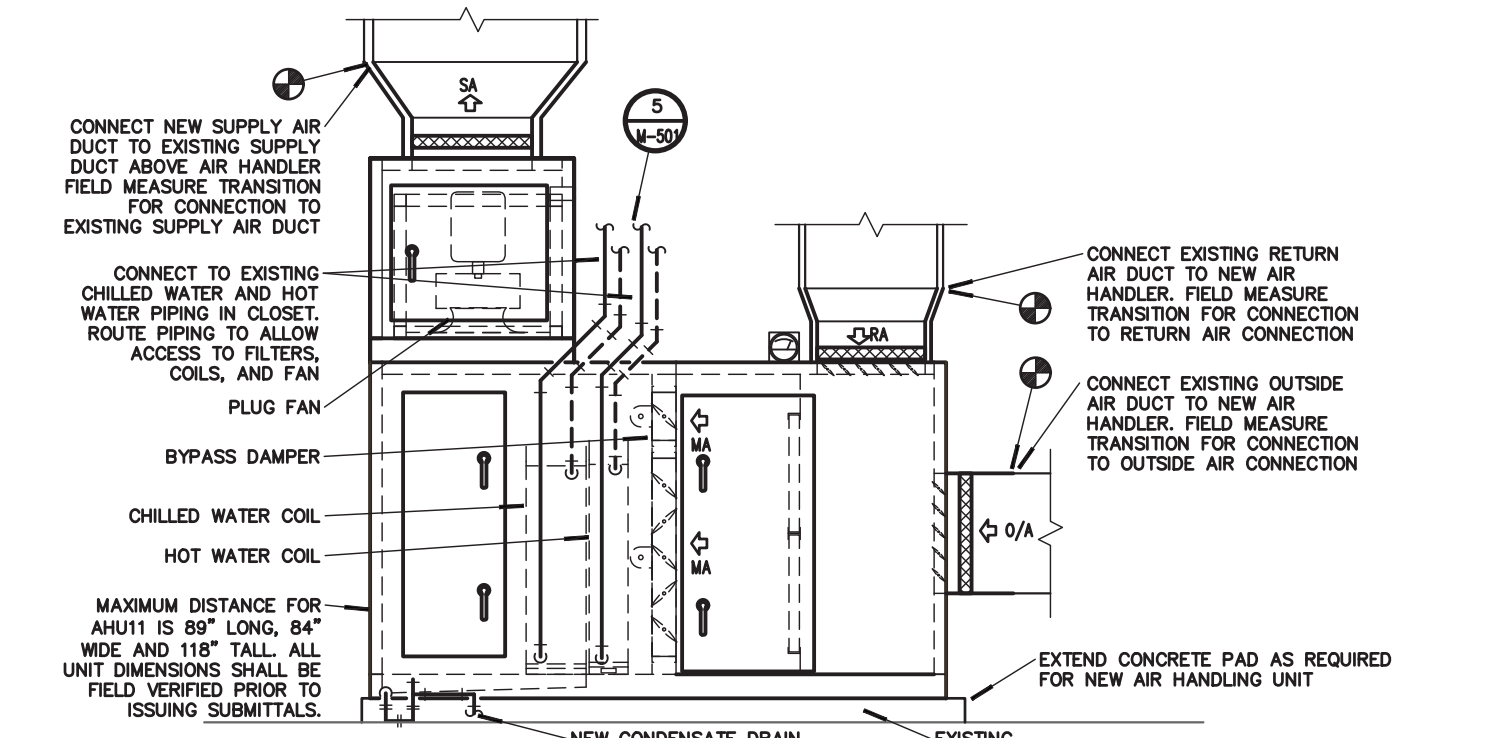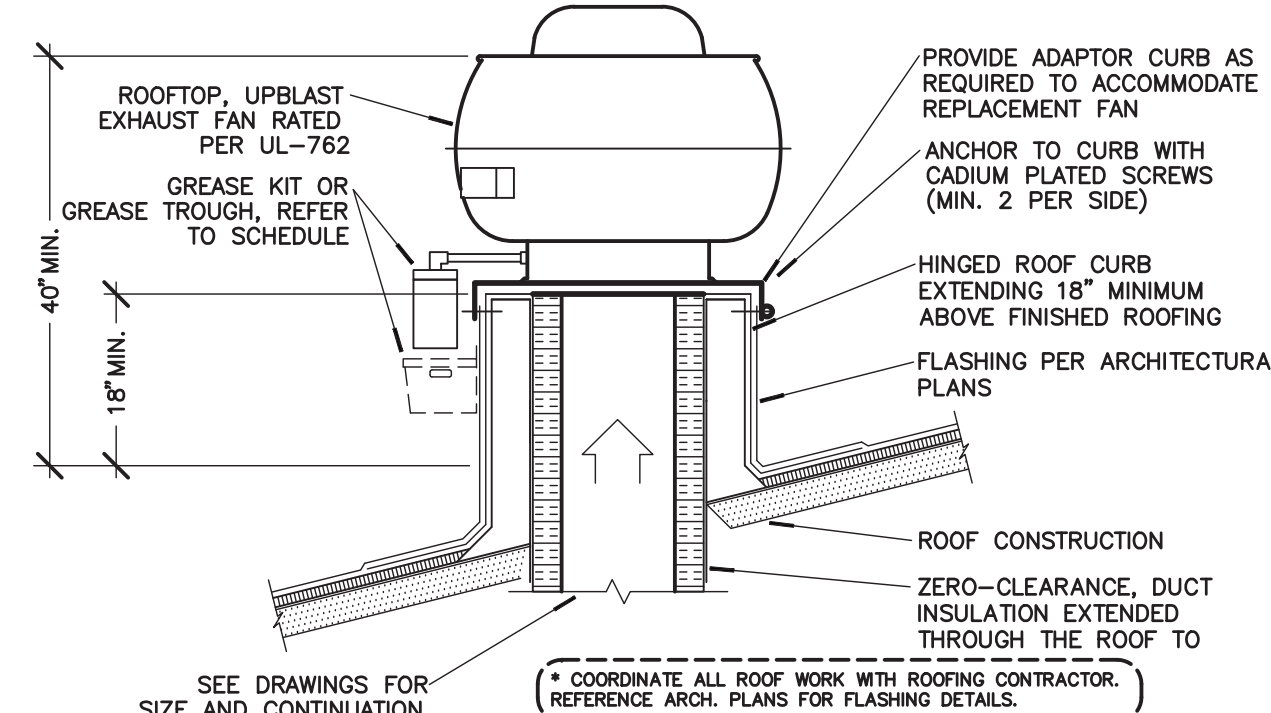
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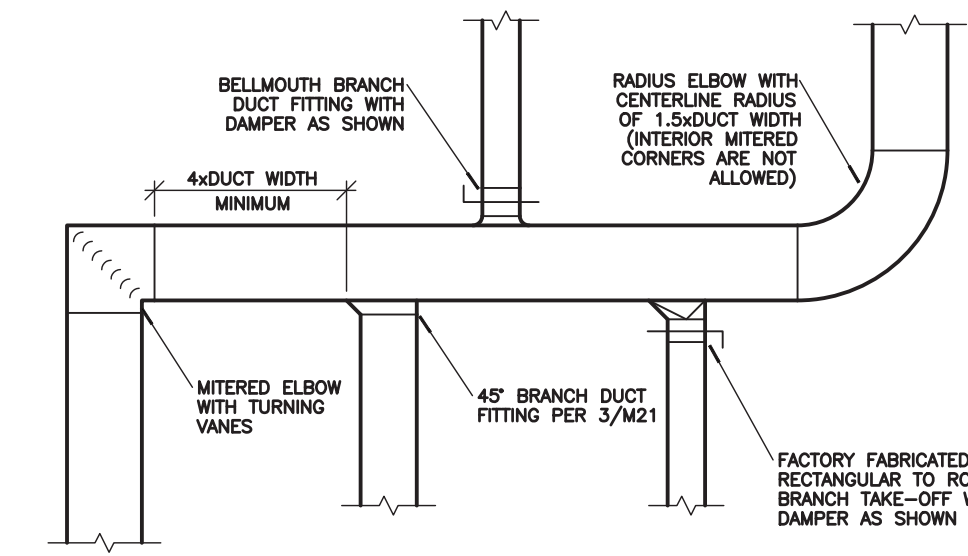
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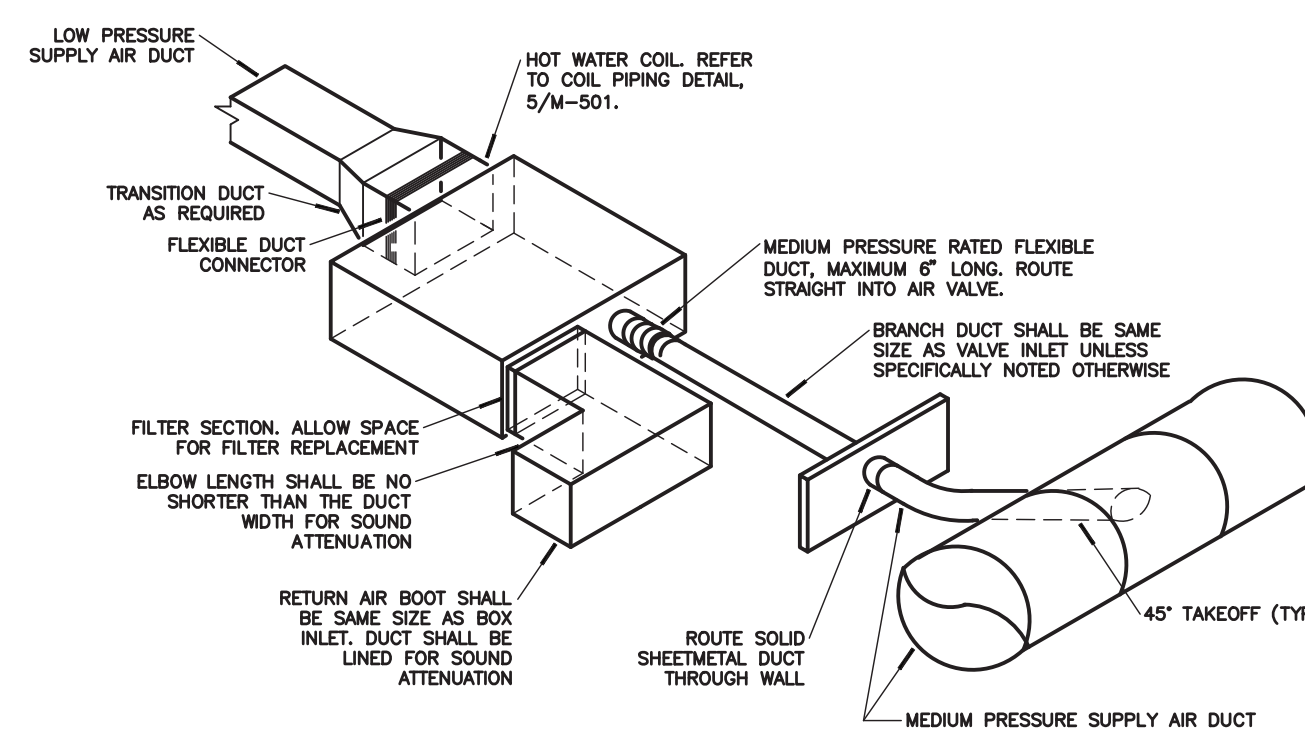
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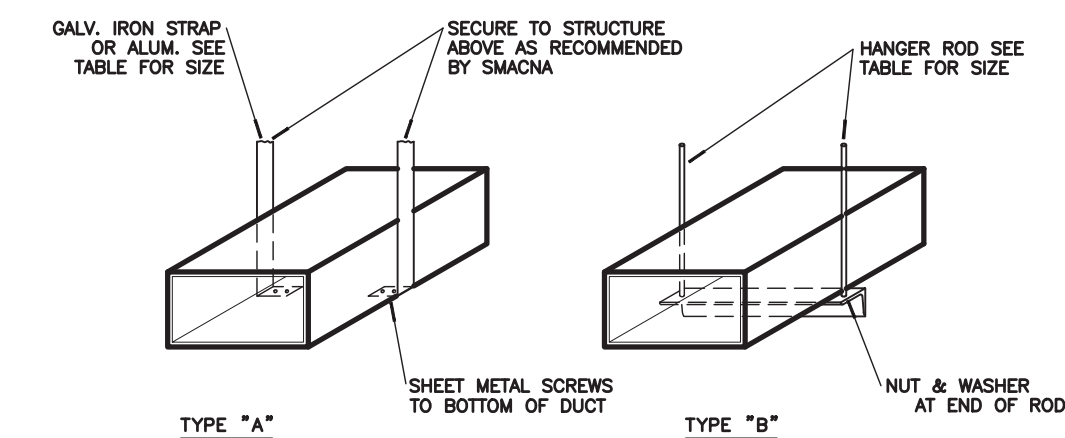
**8 KITCHEN GREASE EXHAUST FAN DETAIL**  
M-500 NO SCALE



**7 DUCTWORK CONSTRUCTION DETAIL**  
M-500 NO SCALE




**6 FAN POWERED VAV BOX DETAIL**  
M-500 NO SCALE




DUCT HANGER SCHEDULE					
DUCT SIZE (INCH)	TYPE OF HANGER	HANGER SPACING (FT)	STRAP SIZE (INCH)	ROD SIZE (INCH)	ANGLE FOR BRACING
UP TO 12	A	8'-0"	1"x16GA	N.A.	N.A.
13 TO 18	A	8'-0"	1"x16GA	N.A.	N.A.
19 TO 30	A	8'-0"	1"x16GA	1/4"	1-1/2"x1-1/2"x1/8"
31 TO 42	B	8'-0"	N.A.	1/4"	1-1/2"x1-1/2"x1/8"
43 TO 54	B	8'-0"	N.A.	1/4"	1-1/2"x1-1/2"x1/8"
55 TO 66	B	8'-0"	N.A.	1/4"	1-1/2"x1-1/2"x1/8"
67 TO 84	B	8'-0"	N.A.	1/4"	1-1/2"x1-1/2"x1/8"
85 TO 96	B	8'-0"	N.A.	3/8"	2"x2"x1/4"

- NOTES:
- FOR SEVERAL DUCTS ON ONE HANGER, TYPE "B" MAY BE USED. SIZE OF HANGER WILL BE SELECTED ON THE SUM OF DUCT WIDTHS EQUAL TO MAX WIDTH OF DUCT SCHEDULE.
  - ON TYPE "A" HANGER, PROVIDE 3 HANGERS AT EACH TAKE-OFF OR BRANCH.

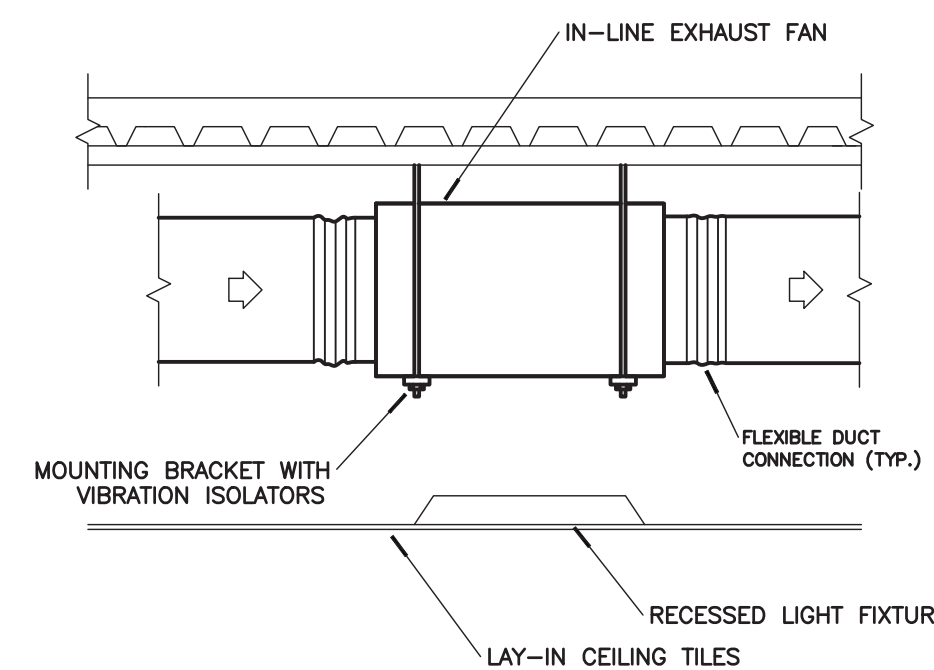
**5 DUCT SUPPORT DETAIL**  
M-500 NO SCALE



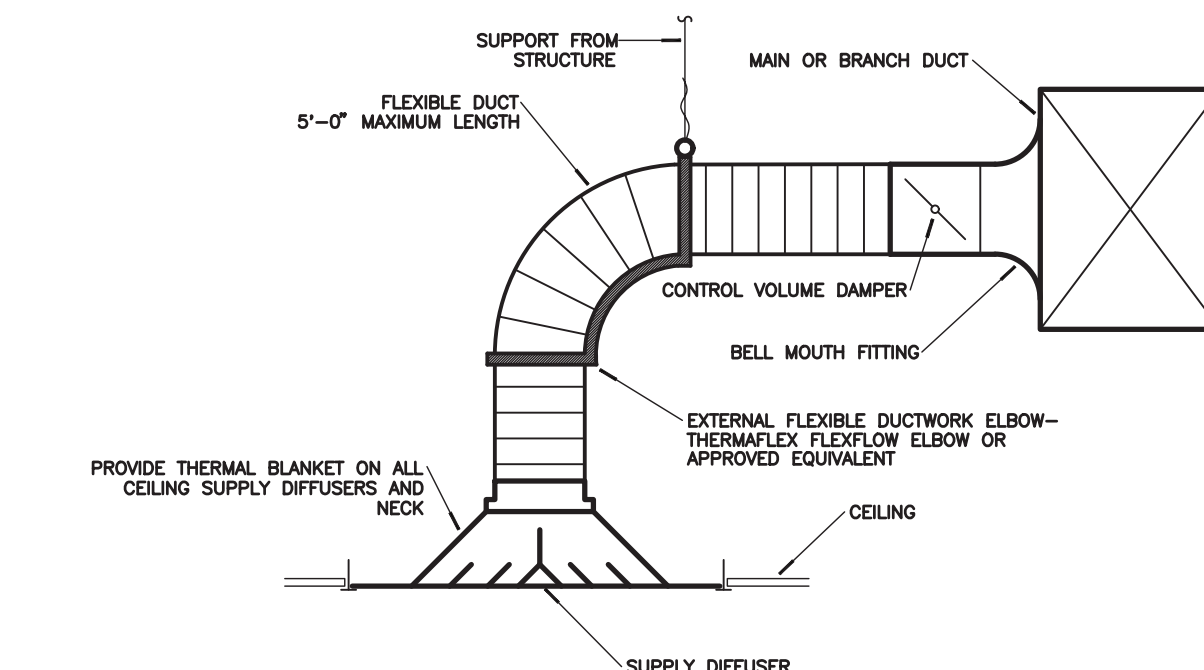
**4 IN-LINE EXHAUST FAN DETAIL**  
M-500 NO SCALE



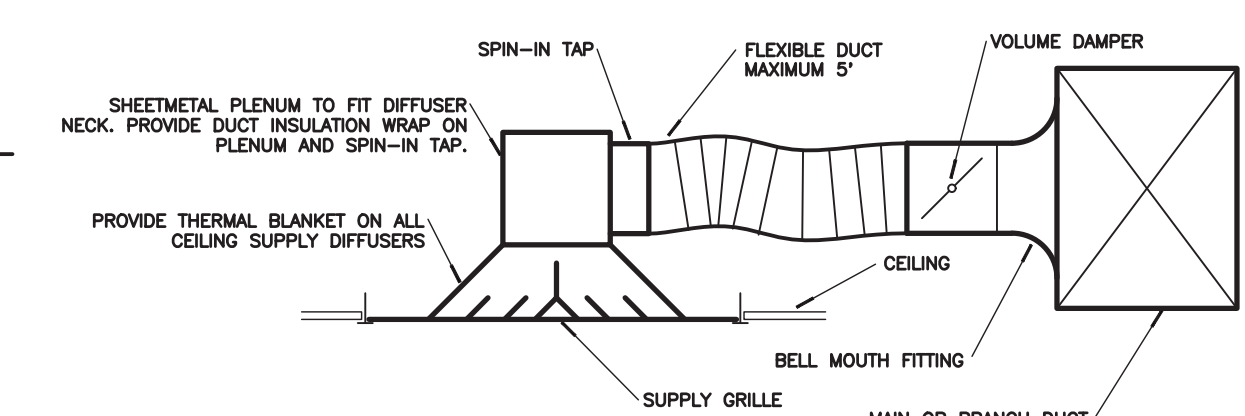**3 CEILING DIFFUSER DETAIL**  
M-500 NO SCALE





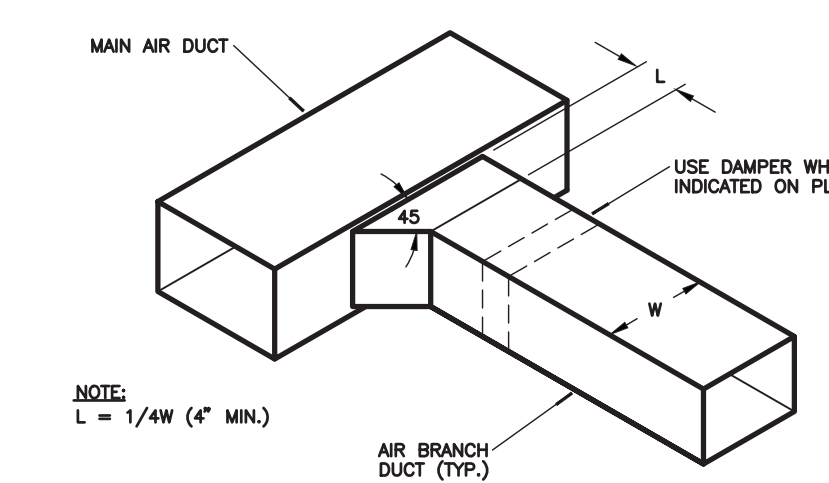**2 CEILING DIFFUSER DETAIL**  
M-500 NO SCALE




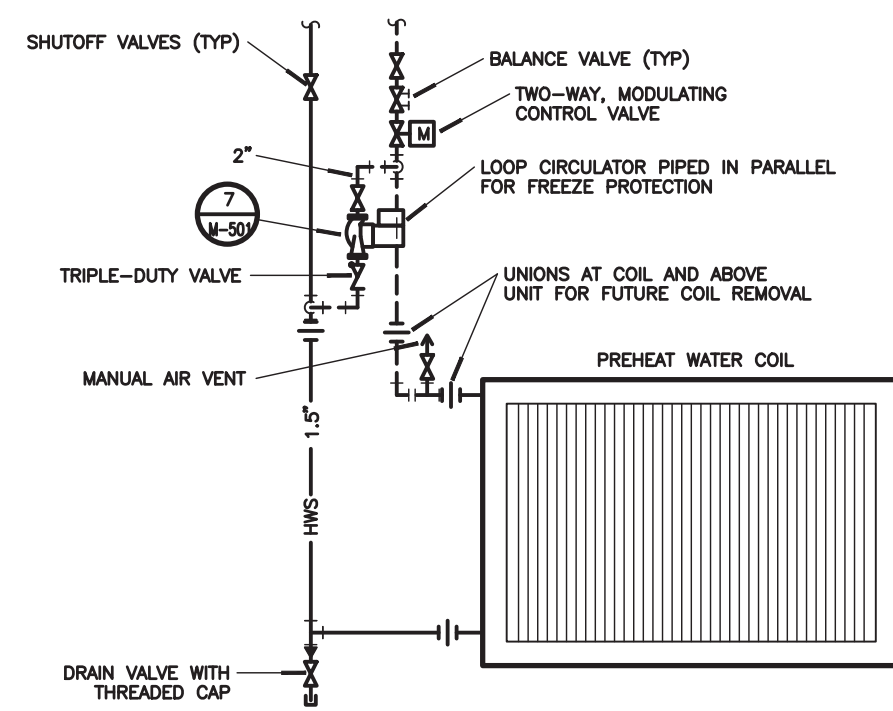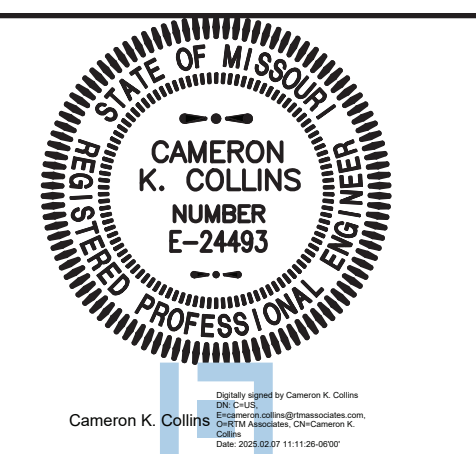**1 BRANCH DUCT DETAIL**  
M-500 NO SCALE






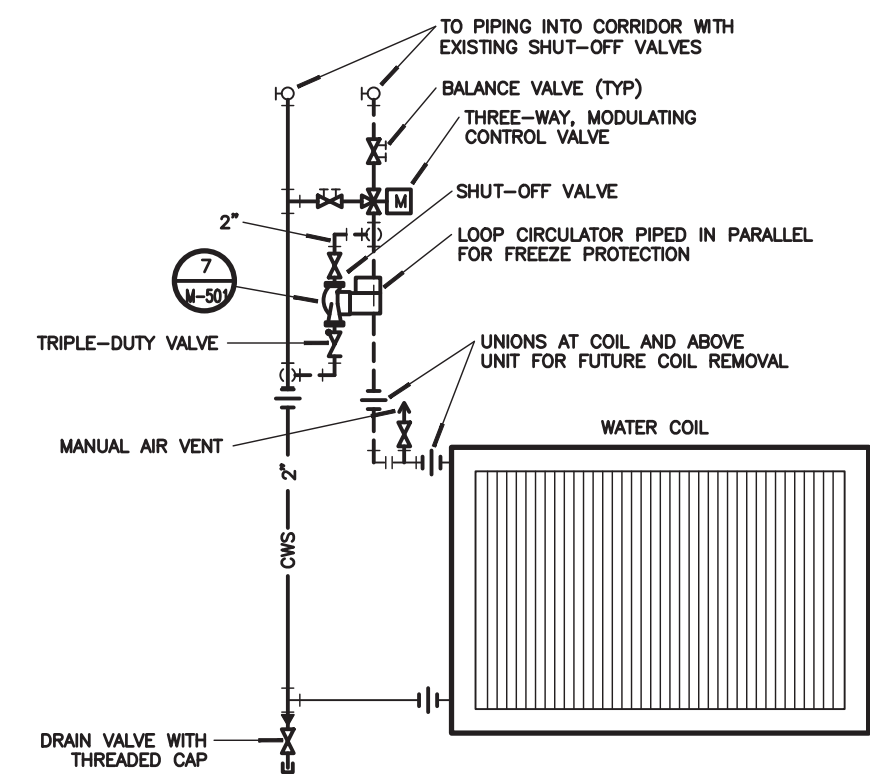
**9 AHU HOT WATER COIL PIPING DETAIL**  
NO SCALE



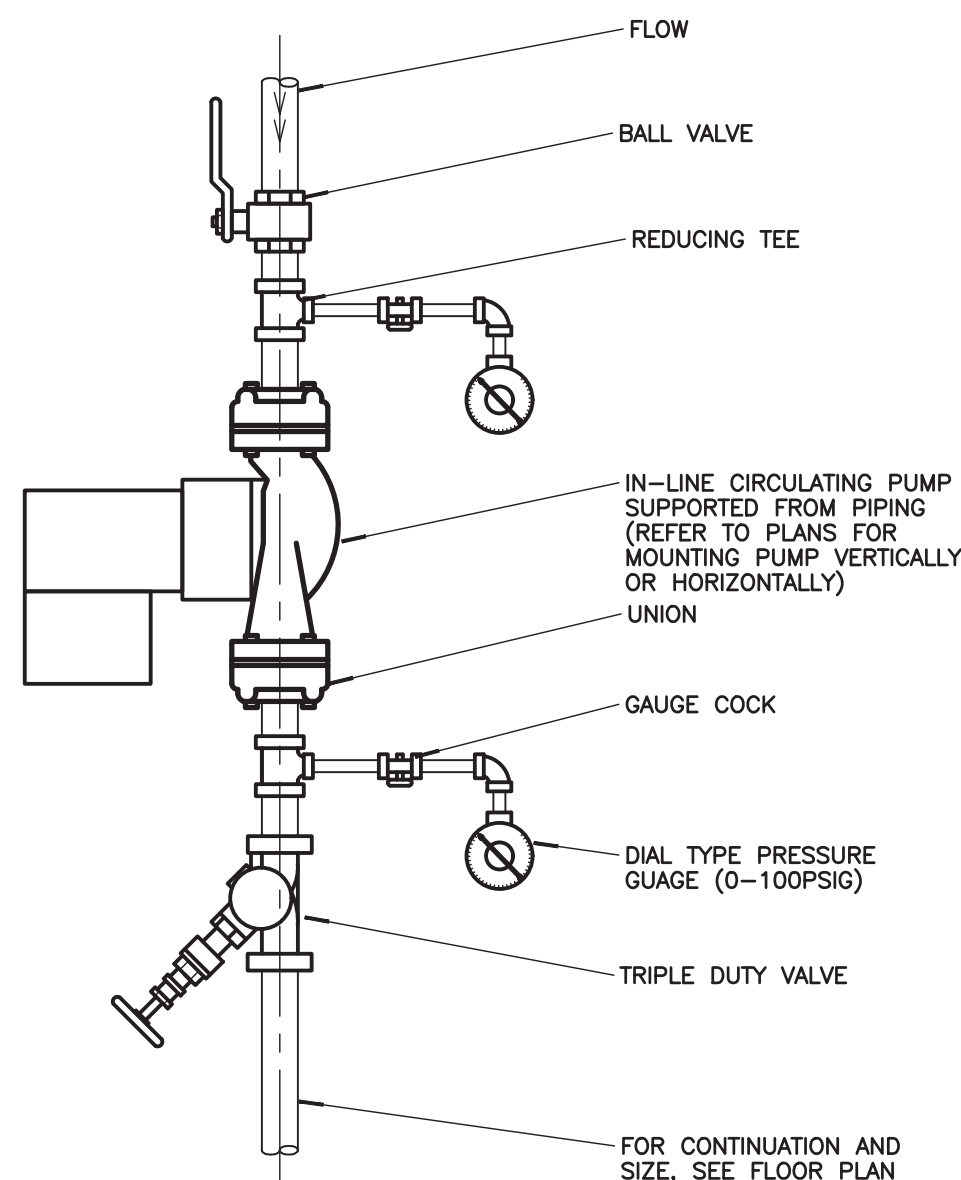**8 AHU CHILLED WATER COIL PIPING DETAIL**  
NO SCALE




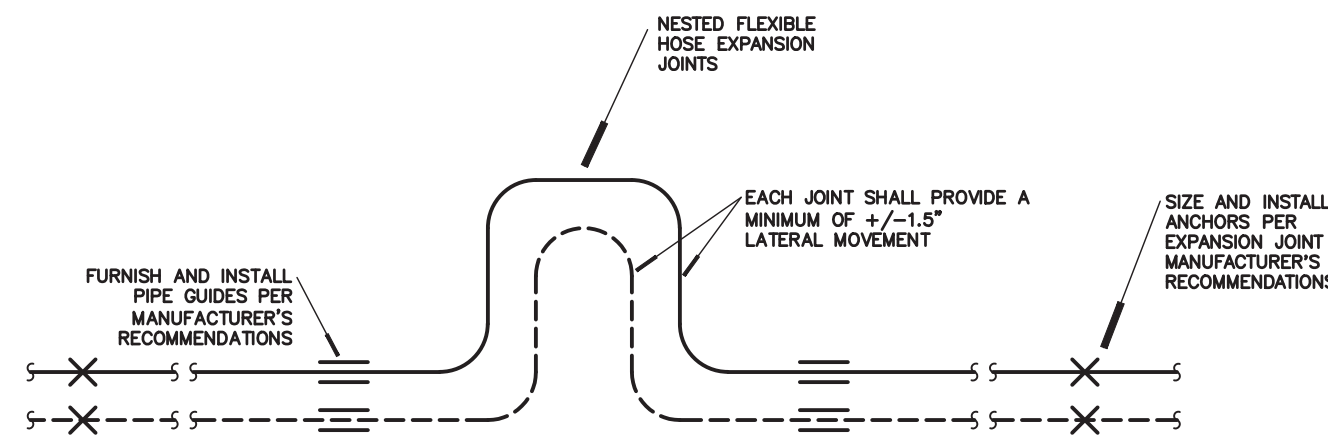**7 CIRCULATING PUMP DETAIL**  
NO SCALE




- NOTES:
- CONTRACTOR SHALL PROVIDE COMPENSATION FOR PIPING EXPANSION PER PIPING MANUFACTURER AND PER ASHRAE RECOMMENDATIONS. AT A MINIMUM, CONTRACTOR SHALL PROVIDE FLEXIBLE HOSE EXPANSION JOINTS WHERE SHOWN ON THE DRAWINGS.
  - REFER TO SPECIFICATIONS AND DRAWINGS FOR ADDITIONAL REQUIREMENTS FOR EXPANSION JOINTS, LOOPS, ANCHORS AND GUIDES.
  - ANCHOR AND GUIDE PIPING WHERE INDICATED AND WHERE REQUIRED TO CONTROL EXTENSION AND DIRECTION OF PIPE EXPANSION.
  - HOT WATER PIPING EXPANSION IS BASED ON 40°F MINIMUM AND 180°F MAXIMUM PIPE TEMPERATURE.
  - EXPANSION JOINTS SHALL BE FLEXICRAFT MODEL ML LOOPS OR APPROVED EQUIVALENT, SIZED PER MANUFACTURER'S RECOMMENDATIONS.

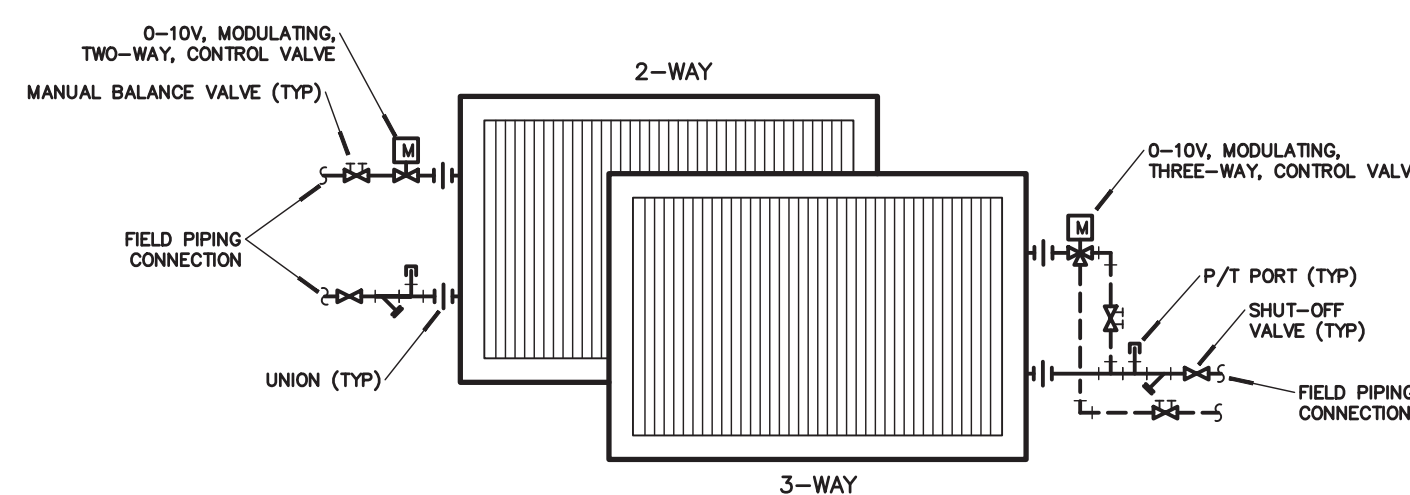**6 FLEXIBLE HOSE EXPANSION JOINT DETAIL**  
NO SCALE




- NOTES:
- REFER TO PLANS AND SCHEDULES FOR SPECIFIC UNIT REQUIREMENTS (CHILLED WATER, HOT WATER, TWO WAY VALVING, OR THREE WAY VALVING).
  - PIPING DIAGRAM SHALL APPLY TO ALL EXISTING AND NEW WATER COILS, INCLUDING BUT NOT LIMITED TO AIR HANDLERS, FAN POWERED VAV BOXES, BYPASS AIR TERMINAL BOXES, REHEAT COILS, VERTICAL AND HORIZONTAL FAN COIL UNITS, AND UNIT HEATERS.

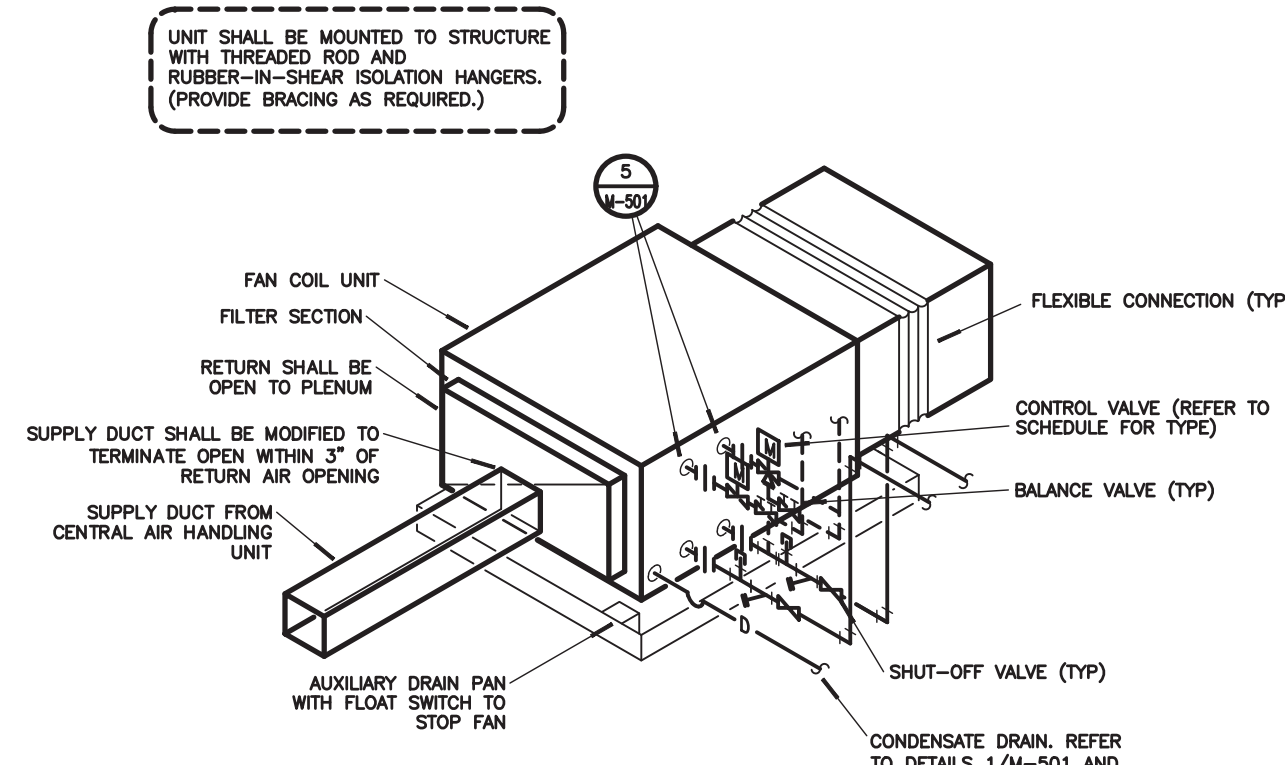**5 HOT AND CHILLED WATER COIL PIPING DIAGRAMS**  
NO SCALE




- NOTES:
- AUXILIARY DRAIN PAN ASSEMBLY IS ONLY REQUIRED FOR UNITS IN CONCEALED LOCATIONS. UNITS WITH INTEGRAL FLOAT SWITCH ARE NOT REQUIRED TO HAVE THE AUXILIARY DRAIN PAN.
  - REFER TO PLANS AND SCHEDULES FOR SPECIFIC UNIT REQUIREMENTS (CHILLED WATER, HOT WATER, CHILLED AND HOT WATER, TWO WAY VALVING, OR THREE WAY VALVING). REFER TO HOT AND CHILLED WATER COIL PIPING SCHEMATICS AND CONDENSATE DRAIN PIPING SCHEMATICS FOR VALVING REQUIREMENTS.
  - CONTRACTOR SHALL FIELD VERIFY THE PIPING CONNECTION SIDE PRIOR TO ORDERING EQUIPMENT.

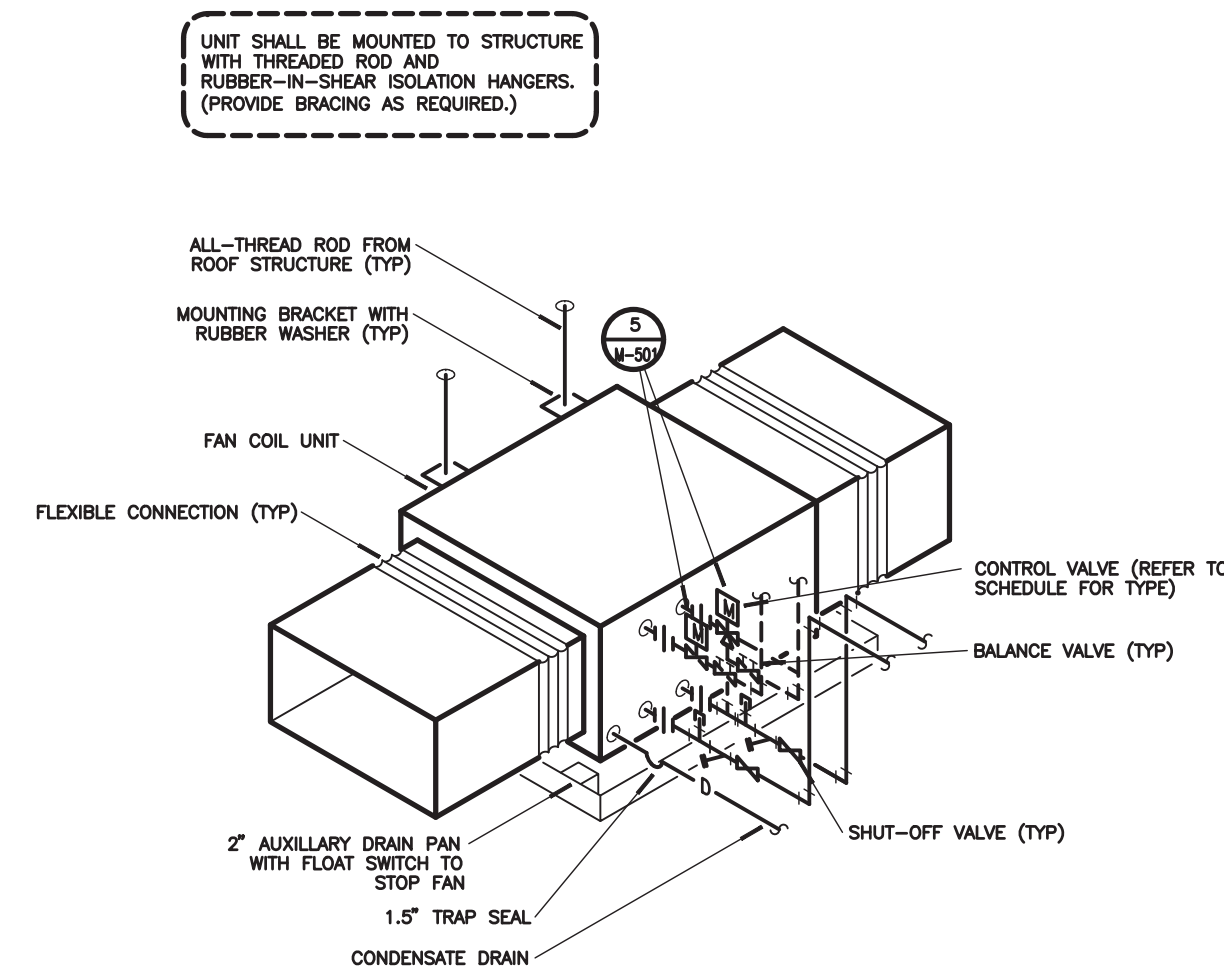**4 RESIDENT ROOM FAN COIL UNIT DETAIL**  
NO SCALE




- NOTES:
- AUXILIARY DRAIN PAN ASSEMBLY IS ONLY REQUIRED FOR UNITS IN CONCEALED LOCATIONS. UNITS WITH INTEGRAL FLOAT SWITCH ARE NOT REQUIRED TO HAVE THE AUXILIARY DRAIN PAN.
  - REFER TO PLANS AND SCHEDULES FOR SPECIFIC UNIT REQUIREMENTS (CHILLED WATER, HOT WATER, CHILLED AND HOT WATER, TWO WAY VALVING, OR THREE WAY VALVING). REFER TO HOT AND CHILLED WATER COIL PIPING SCHEMATICS AND CONDENSATE DRAIN PIPING SCHEMATICS FOR VALVING REQUIREMENTS.
  - CONTRACTOR SHALL FIELD VERIFY THE PIPING CONNECTION SIDE PRIOR TO ORDERING EQUIPMENT.

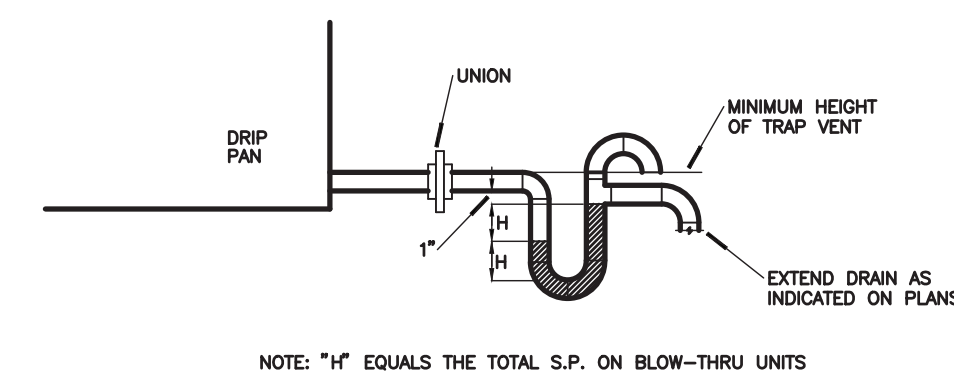**3 FAN COIL UNIT DETAIL**  
NO SCALE



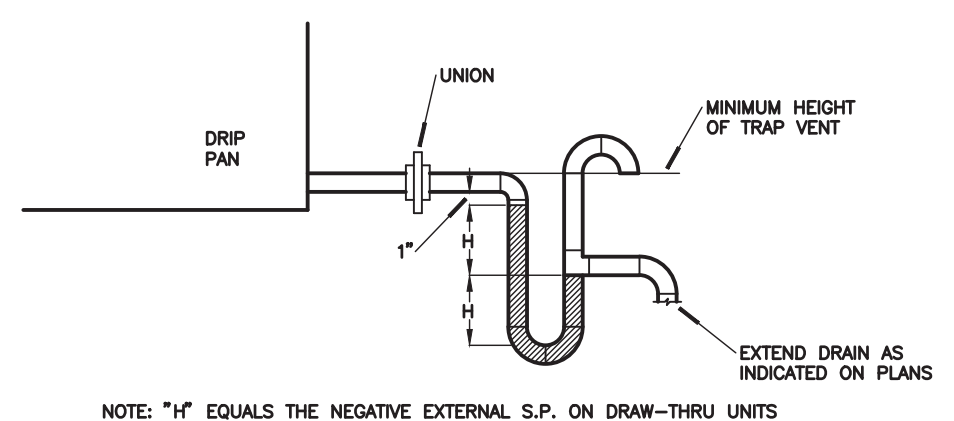**2 CONDENSATE DRAIN PIPING SCHEMATIC**  
NO SCALE



**1 CONDENSATE DRAIN PIPING SCHEMATIC**  
NO SCALE



4-PIPE FAN COIL UNIT SCHEDULE																					
MARK	"FCUW1"	"FCUW2"	"FCUW3"	"FCUW4"	"FCUW5"	"FCUW6"	"FCUW7"	"FCUW8"	"FCUW9"	"FCUW10"	"FCUW11"	"FCUW12"	"FCUW-103A1"	"FCUW-103A2"	"FCUW-107"	"FCUW-114"	"FCUW-144A"	"FCUW-145"	"FCUW-146"	"FCUW-161"	
MANUFACTURER	TRANE	TRANE	TRANE	TRANE	TRANE	TRANE	TRANE	TRANE	TRANE	TRANE	TRANE	TRANE	TRANE	TRANE	TRANE	TRANE	TRANE	TRANE	TRANE	TRANE	
MODEL NO.	FCCB040	FCCB040	FCCB040	FCCB080	FCCB100	FCCB040	FCCB040	FCCB060	FCCB080	FCCB100	FCCB100	FCCB120	FCCB120	FCCB120	BCH054	FCCB060	FCCB080	FCCB080	FCCB100	FCCB100	
CFM	200	270	350	550	630	240	240	460	650	740	850	770	1125	1125	2000	615	355	355	510	600	
E.S.P.	IN W.G.	0.3	0.3	0.3	0.5	0.5	0.05	0.05	0.05	0.05	0.05	0.05	0.05	0.5	0.5	0.8	0.05	0.4	0.4	0.3	0.5
CABINET TYPE	HORIZONTAL CONCEALED	HORIZONTAL CONCEALED	HORIZONTAL CONCEALED	HORIZONTAL CONCEALED	HORIZONTAL CONCEALED	VERTICAL FLOOR MOUNT	VERTICAL FLOOR MOUNT	VERTICAL FLOOR MOUNT	VERTICAL FLOOR MOUNT	VERTICAL FLOOR MOUNT	VERTICAL FLOOR MOUNT	VERTICAL FLOOR MOUNT	HORIZONTAL CONCEALED	HORIZONTAL CONCEALED	HORIZONTAL BLOWER COIL	VERTICAL FLOOR MOUNT	HORIZONTAL CONCEALED	HORIZONTAL CONCEALED	HORIZONTAL CONCEALED	HORIZONTAL CONCEALED	
COOLING DATA																					
E.W.T./L.W.T.	"F	44/56	44/56	44/56	44/56	44/56	44/56	44/56	44/56	44/56	44/56	44/56	44/56	44/56	44/52	—	44/56	44/56	44/56	44/56	
E.A.T. (DB/WB)	"F	75/63	75/63	75/63	75/63	75/63	75/63	75/63	75/63	75/63	75/63	75/63	75/63	75/63	75/63	—	80/67	80/67	75/63	75/63	
GPM		0.9	1.2	1.5	2.4	3.5	0.59	0.95	1.86	2.73	3.99	4.44	4.11	5.43	5.43	15.03	—	2.33	2.33	2.33	
MAX. COIL WPD	FT.	2.11	3.4	5.0	3.2	4.5	0.51	1.69	1.79	4.10	5.59	6.71	5.89	9.57	9.57	5.8	—	3.06	3.06	2.30	
MIN. SHC	MBH	4.4	5.9	7.4	11.7	15.5	3.42	4.88	9.61	13.56	17.9	20.15	18.53	25.36	25.36	49.6	—	9.48	9.48	12.26	
MIN. THC	MBH	5.6	7.4	9.1	14.2	21.1	3.54	5.71	11.17	16.46	24.02	26.72	24.77	32.72	32.72	66.4	—	14.02	14.02	16.34	
HEATING DATA																					
E.W.T./L.W.T.	"F	190/160	190/160	190/160	190/160	190/160	190/160	190/160	190/160	190/164	190/160	190/160	190/160	190/160	190/118	190/103	190/160	190/160	190/160	190/160	
E.A.T. (DB)	"F	70	70	70	70	70	70	70	70	70	70	70	70	70	66	66	60	60	70	70	
MIN. L.A.T.	"F	106	101	96	104	110	102	100	100	108	104	106	99	99	110	106	107	107	104	112	
GPM	"F	0.5	0.6	0.7	1.3	1.8	0.55	0.55	0.99	1.38	2.37	2.04	1.95	2.32	2.32	2.53	0.60	1.17	1.17	1.2	
MAX. COIL WPD	FT.	0.1	0.1	0.1	0.5	1.3	0.07	0.07	0.27	0.58	2.07	1.59	1.47	1.99	1.99	0.48	0.55	0.43	0.43	0.5	
MIN. HTG. CAP.	MBH	7.6	8.7	9.8	19.3	26.7	8.25	8.25	14.9	20.8	30.0	30.67	29.31	34.83	34.83	91.20	26.0	17.54	17.54	18.6	
ELECTRICAL DATA																					
VOLTS/PHASE	115/1	115/1	115/1	115/1	115/1	115/1	115/1	115/1	115/1	115/1	115/1	115/1	115/1	115/1	208/3	115/1	115/1	115/1	115/1	115/1	
MOTOR	53 W	78 W	115 W	171 W	183 W	43 W	46 W	101 W	161 W	147 W	196 W	159 W	411 W	411 W	11.2 A	158 W	111 W	111 W	138 W	167 W	
ADDITIONAL REQUIREMENTS																					
ACCESSORIES	C3W,H2W,DM	C3W,H2W,DM	C3W,H2W,DM	C3W,H2W,DM	C3W,H2W,DM	C3W,H2W,DM,FB	C3W,H2W,DM,FB	C3W,H2W,DM,FB	C3W,H2W,DM,FB	C3W,H2W,DM,FB	C3W,H2W,DM,FB	C3W,H2W,DM,FB	C3W,H2W,DM	C3W,H2W,DM	C3W,H2W,DM	H2W,DM,FB	C3W,H2W,DM	C3W,H2W,DM	C3W,H2W,DM	C3W,H2W,DM	
NOTES: 1. CONTRACTOR SHALL FIELD VERIFY COIL SIDE FOR EACH EXISTING PIPING CONNECTION PRIOR TO ORDERING EQUIPMENT. 2. ALL FAN COILS SHALL BE PROVIDED WITH MINIMUM MERV 7 FILTERS. ALL HORIZONTAL CONCEALED FAN COILS SHALL BE PROVIDED WITH 2" FILTER RACKS. 3. WHERE VERTICAL FAN COILS ARE REPLACING EXISTING VERTICAL FAN COILS, CONTRACTOR SHALL FULLY COORDINATE LOCATION OF EXISTING PIPING AND POWER ROUGH-INS AND PROVIDE ANY FALSE BACKS OR SIDE EXTENSIONS REQUIRED TO ACCOMMODATE EXISTING CONDITIONS PRIOR TO SUBMITTING EQUIPMENT FOR REVIEW. 4. ALL HORIZONTAL FAN COIL UNITS SHALL BE PROVIDED WITH WALL MOUNTED THERMOSTATS, FURNISHED BY CONTROL CONTRACTOR. 5. ALL VERTICAL FAN COIL UNITS SHALL BE PROVIDED WITH INTEGRAL, CABINET MOUNTED THERMOSTATS, FURNISHED BY CONTROL CONTRACTOR. 6. ALL FAN COILS UNIT SHALL BE PROVIDED WITH DELUXE VALVING PACKAGE FROM FACTORY. REFERENCE SPECIFICATIONS FOR REQUIREMENTS. 7. REFERENCE PLANS FOR ORIENTATION/HAND OF UNITS PRIOR TO ORDERING EQUIPMENT. 8. ALL VERTICAL FAN COILS SHALL HAVE SIDE PIPE CABINETS.																					
ABBREVIATIONS: C3W = CHILLED WATER 3-WAY VALVE PACKAGE H2W = HEATING HOT WATER 2-WAY VALVE PACKAGE DM = DISCONNECTING MEANS FB = FALSE BACK CABINET SECTION																					

MAKE-UP AIR UNIT SCHEDULE														
MARK	MANUF.	MODEL NUMBER	FURNACE			HEATING COIL				BLOWER			ELECTRICAL VOLT/PH	ACCESSORIES
			MBH	ΔT (°F)	FUEL	GPM	PD	E.W.T.	L.W.T.	CFM	E.S.P.	HP		
MAU1	CAPTVEAIRE	CAY-20	751.3	70	GAS	---	---	---	---	8000	1"	5	460/3	DM,FSR,SS
ABBREVIATIONS:														
CT - CONTROL TRANSFORMER														
DM - DISCONNECT MEANS														
VAV - VARIABLE VOLUME FAN CONTROL (MANUAL CONTROL) WITH MODULATING GAS VALVE														
RC - INSULATED 16" MINIMUM ROOF CURB														
FSR - FAN SHUT-DOWN RELAY														
OA - OUTSIDE AIR HOOD WITH DISPOSABLE 1" FILTERS														
T - SPACE THERMOSTAT WITH PLASTIC LOCKABLE COVER														
BD - FULL FACE AND BY-PASS DAMPER														
SS - STAINLESS STEEL HEAT EXCHANGER														

HOT WATER REHEAT COIL SCHEDULE										
MARK	ASSOCIATED AIR HANDLER	MANUFACTURER	AIRFLOW	ROWS	SIZE WxH	CAPACITY MBH	GPM	MAX. WPD (FT.)	MAX. APD (IN.)	ACCESSORIES
RH5	AHU5	EXISTING	2900	EXISTING	EXISTING	75.2	6.0	5.6	0.55	H3W
NOTES: 1. 100% WATER, 140F EWT, 55F EAT.										
ABBREVIATIONS: H2W – HEATING HOT WATER 2-WAY MODULATING VALVE										


CEILING RADIANT HEATER SCHEDULE									
MARK	MFG.	MODEL #	LAY-IN	HEATER MBH	HEATER WATTS	ELECTRICAL			ACCESSORIES
						VOLT/PH	MCA	MOCP	
*CRH1*	QMARK	F-1500	24/24	51.2	1500	120/1	12.5	20	DM,T,C
ABBREVIATIONS: DM = DISCONNECTING MEANS T = INTEGRAL HEATING ONLY THERMOSTAT C = F-TBF T-BAR FRAME KIT									

GRILLES, REGISTERS & DIFFUSER SCHEDULE										
MARK	MANUFACTURER	CATALOG #	APP	FINISH	FRAME TYPE	VOLUME DAMPER	MAX NO (DB)	MIN THROW (FT)	MAX THROW (FT)	MAX PRESS DROP
A	TITUS	300RL	SUP	WHITE	SURFACE	Y	30	10	15	0.03
B	TITUS	TDCA-24x24	SUP	WHITE	T-BAR	Y	30	11	14	0.04
C	TITUS	PCS 4 WAY	SUP	WHITE	T-BAR	Y	30	7	15	0.06
D	TITUS	PAR	RET	WHITE	T-BAR	N	30	--	--	0.02
E	TITUS	350R	RET	WHITE	SURFACE	N	30	--	--	0.08
F	TITUS	350RLF1 (F1)	RET	WHITE	SURFACE	N	30	--	--	0.08
G	TITUS	301RL	SUP	WHITE	SURFACE	Y	30	--	--	0.03
H	TITUS	301RL	SUP	WHITE	SURFACE	N	30	--	--	0.03
J	TITUS	TDCA-24x24 3-WAY	SUP	WHITE	T-BAR	Y	30	11	14	0.04
K	TITUS	TDCA-24x24 2-WAY	SUP	WHITE	T-BAR	Y	30	11	14	0.04
L	TITUS	TDCA-24x12 1-WAY	SUP	WHITE	T-BAR	Y	30	11	14	0.04
M	TITUS	350RLF1 (F1)	RET	WHITE	T-BAR	N	30	--	--	0.08
N	TITUS	350RLF2 (HF)	RET	WHITE	T-BAR	N	30	--	--	0.08
ABBREVIATIONS: EXH - EXHAUST RET - RETURN SUP - SUPPLY F1 - 1" MERV-8 FILTER HF - 2" HEPA FILTER NOTES: 1. THROWS ARE BASED ON 50 FEET PER MINUTE VELOCITY. 2. OPPOSED BLADE DAMPERS SHALL BE PROVIDED ON ALL DIFFUSERS REQUIRING VOLUME DAMPERS.										

NOTE:  
ALL EQUIPMENT AND MATERIALS SHALL MEET THE REQUIREMENTS OF THE "BUILD AMERICA, BUY AMERICA" ACT UNLESS NOTED ON THE ARCHITECT'S BID FORM OR SPECIFICATIONS. CONTRACTOR IS REQUIRED TO SUBMIT COMPLIANCE DOCUMENTATION WHEN PROVIDING SHOP DRAWINGS OR SUBMITTALS.

CUSTOM AIR HANDLING UNIT SCHEDULE				
AIR HANDLING UNIT	AHU2-BASE BID	AHU3-BASE BID	AHU11-BASE BID	AHU5-ALTERNATE #1
MANUFACTURER	TEMTROL	TEMTROL	TEMTROL	TEMTROL
MODEL	CUSTOM	CUSTOM	CUSTOM	EXISTING
UNIT SIZE	CUSTOM	CUSTOM	CUSTOM	EXISTING
ARRANGEMENT	DRAW THRU	DRAW THRU	DRAW THRU	DRAW THRU
MIN. OUTDOOR AIR (CFM)	825	700	900	2900
MAX. OUTDOOR AIR (CFM)	2410	950	3750	2900
MAX. UNIT WEIGHT (LBS.)	3700 LBS	4300 LBS	4300 LBS	--
SUPPLY FAN DATA				
FAN TYPE	SDDP	SDDP	SDDP	--
FAN WHEEL DIAMETER	(2)16"	(2)18"	(2)18"	--
FAN SPEED (RPM)	2244	2315	2315	--
SUPPLY AIR (CFM)	7560	9430	9430	2900
SUPPLY ESP (in w.g.)	1.0	1.0	1.0	--
SUPPLY TSP (in w.g.)	2.75	2.73	2.73	--
MOTOR HP	(2) 3	(2) 3.5	(2) 3.5	--
INITIAL FILTER DATA				
AIRFLOW (CFM)	7560	9430	9430	2900
MERV RATING	8	8	8	8
THICKNESS	2"	2"	2"	2"
CLEAN PD (IN. W.C.)	0.42	0.40	0.40	0.40
FINAL PD (IN. W.C.)	1.0	1.0	1.0	1.0
CHILLED WATER COOLING COIL DATA				
AIRFLOW (CFM)	7560	9430	9430	2900
MAX. FACE VEL. (FPM)	515	508	503	352
COIL ENTERING AIR (DB°F/WB°F)	81/68	77/64	83/70	105/76
COIL LEAVING AIR (DB°F/WB°F)	53.23/52.99	53.14/52.61	53.85/53.38	52.0/51.9
UNIT LEAVING AIR (DB°F/WB°F)	54.23/52.99	54.14/53.61	54.85/54.38	--
EWT/LWT	44/56	44/56	44/56	44/56
FLOWRATE (GPM)	60.8	53.8	82.5	26.4
MAX. WPD (FT. HEAD)	11.11	6.83	6.61	7.7
MAX. APD (IN. W.C.)	0.62	0.49	0.70	0.51
MAX. PFF	96	84	108	EXISTING
MAX. ROWS	6	6	6	EXISTING
CONTROL VALVE	3-WAY, MODULATING	3-WAY, MODULATING	3-WAY, MODULATING	3-WAY, MODULATING
PREHEAT HOT WATER COIL DATA				
AIRFLOW (CFM)	7560	9430	9430	2900
MAX. FACE VEL. (FPM)	515	508	508	352
COIL ENTERING AIR (DB°F)	44.50	62.00	38.20	0
COIL LEAVING AIR (DB°F)	93.5	92.3	90.61	85.6
EWT/LWT	190/160	190/160	190/160	190/160
FLOWRATE (GPM)	27.2	21.2	36.6	21.2
MAX. WPD (FT. HEAD)	5.14	3.69	4.81	2.4
MAX. APD (IN. W.C.)	0.12	0.09	0.12	0.11
MAX. PFF	72	108	72	--
MAX. ROWS	2	1	2	--
CONTROL VALVE	2-WAY, MODULATING	2-WAY, MODULATING	2-WAY, MODULATING	2-WAY, MODULATING
ELECTRICAL DATA				
VOLTAGE/PHASE	460/3	460/3	460/3	--
MCA	10	11.25	11.25	--
MOP	15	15	15	--
MFS	15	15	15	--
ACOUSTICAL DATA - UNIT SUPPLY DISCHARGE				
63 Hz (dB)	79	80	80	--
125 Hz (dB)	75	77	77	--
250 Hz (dB)	86	87	87	--
500 Hz (dB)	79	82	83	--
1000 Hz (dB)	76	82	82	--
2000 Hz (dB)	74	77	77	--
4000 Hz (dB)	70	73	73	--
8000 Hz (dB)	65	68	68	--
ACOUSTICAL DATA - UNIT RETURN INLET				
63 Hz (dB)	75	78	79	--
125 Hz (dB)	72	77	77	--
250 Hz (dB)	91	95	95	--
500 Hz (dB)	84	88	89	--
1000 Hz (dB)	77	82	82	--
2000 Hz (dB)	77	81	81	--
4000 Hz (dB)	75	79	79	--
8000 Hz (dB)	71	76	76	--
ABBREVIATIONS: SDDP - STACKED DIRECT DRIVE PLENUM FAN				
NOTES: 1. THE ENTIRE UNIT SHALL BE DOUBLE WALL, SOLID INNER LINER CONSTRUCTION. 2. CHILLED WATER SHALL BE 100% WATER. 3. HOT WATER SHALL BE 100% WATER. 4. SUPPLY FAN FOR AHU2 SHALL BE CONTROLLED BY VARIABLE FREQUENCY DRIVES. THE VFD'S SHALL BE FURNISHED BY THE CONTROL CONTRACTOR AND INSTALLED BY THE ELECTRICAL CONTRACTOR. THE ELECTRICAL CONTRACTOR SHALL FURNISH AND INSTALL ALL CONDUIT AND WIRE AND ROUGH-IN FAN CONNECTION WITHIN THE AIR HANDLER. INSTALLATION SHALL BE PER AHU MANUFACTURER'S RECOMMENDATIONS. 5. SUPPLY FANS SHALL BE MOUNTED ON SPRING ISOLATORS. 6. SUPPLY FAN EXTERNAL STATIC PRESSURE SHALL INCLUDE ALL SHEETMETAL WORK EXTERIOR TO THE UNIT ONLY. 7. SUPPLY FAN TOTAL STATIC PRESSURE SHALL INCLUDE EXTERNAL STATIC PRESSURE PLUS FILTER PRESSURE DROP PLUS AND ALL UNIT COMPONENTS. 8. UNIT SHALL BE SELECTED AT 1,250 FT. ELEVATION. 7. EACH FILTER BANK SHALL BE PROVIDE WITH A MAGNAHELIC FILTER GAUGE MOUNTED EXTERIOR TO UNIT. 8. ACOUSTICAL DATA LISTED IS MAXIMUM ALLOWABLE.				



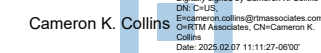

PROFESSIONAL SEAL

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**ESTERLY  
&  
SCHNEIDER  
ASSOCIATES, INC.**  
AIA architects & planners

COMM. #4860

**OFFICE OF ADMINISTRATION  
DIVISION OF FACILITIES  
MANAGEMENT,  
DESIGN AND CONSTRUCTION**

**DEPARTMENT OF  
PUBLIC SAFETY  
MISSOURI VETERANS  
COMMISSION**

INTERIOR RENOVATION  
MISSOURI VETERANS  
HOME

620 N. JEFFERSON  
ST. JAMES, MISSOURI

PROJECT # **U1503-01**  
SITE # **6801**  
ASSET # **8136801002**  
FEDERAL # **29-044**

REVISION: \_\_\_\_\_  
DATE: \_\_\_\_\_  
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DATE: \_\_\_\_\_  
ISSUE DATE: **8-1-24**

ISSUE DATE: 8-1-24

CAD DWG FILE: M-601.DWG  
 DRAWN BY: TSE  
 CHECKED BY: CKC  
 DESIGNED BY: TSE

SHEET TITLE:

## MECHANICAL SCHEDULES

SHEET NUMBER:

M-601

90 OF 120 SHEETS

8-1-24

EXHAUST FAN SCHEDULE										
MARK	AREA SERVED	MANUF.	TYPE	MODEL	CFM	EST. ESP.	VOLTS/ PHASE	MOTOR (HP)	CONTROL	ACCESSORIES
E8	DISHWASH 111	COOK	ROOF	101R17DEC	600	0.625	120/1	.25	SWITCH	DM,GBD,SC,RCa
EF9	NURSING CORE B	COOK	CEILING	GC-146	75	0.3	120/1	.25	SWITCH	C,DM,GBD,R
EF15A	WING "A" TUB ROOM	COOK	IN-LINE	100SQN17DEC	575	0.5	120/1	.25	CONT	DM,GBD,SC,HK
EF15F	WING "F" TUB ROOM	COOK	IN-LINE	100SQN17DEC	575	0.5	120/1	.25	CONT	DM,GBD,SC,HK
EF20A	WING "A" TOILETS	COOK	ROOF	101R28DOR70(VF)	325	1.25	120/1	0.5	BMS	DM,GBD,SRC,VF
EF21A	MEDICAL EQUIP A149	COOK	ROOF	100R17DL(VF)	200	0.75	120/1	.125	BMS	DM,GBD,SRC,VF
EF22A	TUB ROOM A149	COOK	ROOF	100R17DL(VF)	200	0.75	120/1	.125	BMS	DM,GBD,SRC,VF
EF23A	WING "A" BATHROOMS	COOK	ROOF	101R28DOR70(VF)	325	1.25	120/1	0.5	BMS	DM,GBD,SRC,VF
EF24A	WING "A" TOILETS	COOK	ROOF	135R17DOR91(VF)	525	1.25	120/1	0.5	BMS	DM,GBD,SRC,VF
EF25A	TOILET A101	COOK	ROOF	100R17DL(VF)	75	0.75	120/1	.125	BMS	DM,GBD,SRC,VF
ABBREVIATIONS:										
C = CEILING GRILL						R = ROOF JACK				
D = DISCONNECT MEANS						RCa = ROOF CURB ADAPTER				
GBD = GRAVITY BACKDRAFT DAMPER						SRC = SLOPED ROOF CURB				
I = VIBRATION ISOLATING HANGING KIT						BMS = BUILDING MANAGEMENT SYSTEM				
SC = SPEED CONTROLLER						VF = 0-10V, 24V, VARI-FLOW, ECM MOTOR				

[illegible]

EXISTING WATER COIL SCHEDULE					
MARK	EQUIPMENT	PRIMARY HW COIL (GPM)	CW COIL CW COIL (GPM)	SECONDARY HW COIL (GPM)	AREA SERVED
AHU1	AIR HANDLING UNIT	4.4	11.7	—	BASEMENT LEVEL
AHU3	AIR HANDLING UNIT	21.2	53.8	—	KITCHEN
AHU4	AIR HANDLING UNIT	7.9	17.5	—	ADMINISTRATION
AHU5	AIR HANDLING UNIT	19.3	40.0	5.5	WING "A"
AHU6	AIR HANDLING UNIT	19.3	40.0	5.5	WING "B"
AHU7	AIR HANDLING UNIT	19.3	40.0	5.5	WING "C"
AHU8	AIR HANDLING UNIT	19.3	40.0	5.5	WING "D"
AHU9	AIR HANDLING UNIT	19.3	40.0	5.5	WING "E"
AHU10	AIR HANDLING UNIT	19.3	40.0	5.5	WING "F"
AHU12	AIR HANDLING UNIT	15.0	16.5	—	DEMENTIA DINING
MAU-2	MAKEUP AIR UNIT	41.1	—	—	BASEMENT LAUNDRY
FC-003	FAN COIL UNIT	1.5	2.5	—	BASEMENT OFFICE
RH-1	REHEAT COIL	2.0	—	—	—
RH-2	REHEAT COIL	1.5	—	—	—
RH-3	REHEAT COIL	1.5	—	—	—
RH-4	REHEAT COIL	0.5	—	—	—
RH-5	REHEAT COIL	0.25	—	—	—
FTR-1	FINNED TUBE	0.5	—	—	—
FTR-2	FINNED TUBE	1.0	—	—	—
FCU-1	FAN COIL UNIT	2.2	—	—	CLINIC
FCU-2	FAN COIL UNIT	2.0	—	—	CLINIC
FCU-3	FAN COIL UNIT	2.0	—	—	CLINIC
FCU-4	FAN COIL UNIT	2.0	—	—	CLINIC
FCU-5	FAN COIL UNIT	1.8	—	—	CLINIC
AC-1	AIR CURTAIN	10.0	—	—	MAIN ENTRY
UH-1	UNIT HEATER	1.5	—	—	BASEMENT
UH-2	UNIT HEATER	5.0	—	—	BASEMENT
HWC-1	HOT WATER COIL	7.3	—	—	CORE AREA
HWC-2	HOT WATER COIL	7.0	—	—	CORE AREA
HWC-3	HOT WATER COIL	3.9	—	—	CORE AREA
HWC-4	HOT WATER COIL	9.7	—	—	CORE AREA
HWC-5	HOT WATER COIL	7.0	—	—	CORE AREA

NOTES:

- SCHEDULE IS INCLUDED TO PROVIDE ORIGINAL HOT AND CHILLED WATER FLOWRATES OF EXISTING EQUIPMENT TO REMAIN. TAB CONTRACTOR SHALL BALANCE TO FLOWRATES INDICATED.
- CONTACT ARCHITECT FOR ANY EXISTING COILS TO REMAIN THAT ARE NOT LISTED IN THIS SCHEDULE.

PIPING MATERIAL CATALOG												
PIPING							FITTINGS		MAX. WORKING	FIELD TEST		
SYSTEM	SIZE	TYPE	SCH	GRD	ASTM	MATERIAL	MAT.	TYPE	PRESS (PSI)	TEMP (°F)	PRESS (PSI)	TIME
CONDENSATE DRAIN	ALL	M	—	—	B88	CP	CP	DR/S	10FT	40-70	10FT	1 HR
HOT WATER SUPPLY & RETURN	0.5"-2.5"	L	—	—	B88	CP	CP	SJ	125	80-200	150	1 HR
HOT WATER SUPPLY & RETURN	0.5"-2.5"	L	—	—	B88	CP	CP	PF	125	80-200	150	1 HR
HOT WATER SUPPLY & RETURN	3" & UP	SL/W	40	A	A120	C5/BLK	CS	MJ	125	80-200	150	1 HR
CHILLED WATER SUPPLY & RETURN	0.5"-2.5"	L	—	—	B88	CP	CP	SJ	125	45-80	150	1 HR
CHILLED WATER SUPPLY & RETURN	0.5"-2.5"	L	—	—	B88	CP	CP	PF	125	45-80	150	1 HR
CHILLED WATER SUPPLY & RETURN	3" & UP	SL/W	40	A	A120	C5/BLK	CS	MJ	125	45-80	150	1 HR
TEMP. & PRESSURE RELIEF DRAIN	ALL	M	—	—	B88	CP	CP	DR/S	10FT	40-140	10FT	1 HR
DOMESTIC WATER PIPING ABOVE GRADE	ALL	L	—	—	B88	CP	CP	SJ	120	40-180	150	1 HR
WASTE AND VENT	ALL	NH	SS	—	A74	C1	C1	DR/NG	10FT	50-180	10FT	1 HR
FIRE SPRINKLER SERVICE	ALL	D1	—	—	MMAK15	D1	D1	MJ	200	50-90	200	2 HR
FIRE SPRINKLER	ALL	PER NFPA 13									200	2 HR
ATP — ARMO TRUSS PIPE BLK — BLACK BS — BELL & SPIOT CR — CRIMPED FITTING CI — CAST IRON CP — COPPER CS — CARBON STEEL CTD — PIPE LINE SERVICE COMPANY X-TRU-COAT HIGH DENSITY POLYETHYLENE COATING EXTRUDED OVER PIPE CW — CONTINUOUS WELD DN — DUCTILE IRON DR — DRAINAGE FITTING GLV — GALVANIZED HF — HEAT FUSED LC — LEAD CALKING M — MALLEABLE IRON MJ — MECHANICAL JOINT NG — NEOPRENE GASKET NH — NC-HUB PE — POLYETHYLENE PF — PRESS SEAL FITTINGS PVC — POLYVINYL CHLORIDE G — GRAZED JOINT — SILVER BRAZING ALLOY SJ — SOLDER JOINT 95-5 TIN-ANTIMONY SS — SEAMLESS SS — STANDARD STRENGTH — SERVICE WEIGHT SW — SOLVENT WELD TT — SEAL THRD — THREADED VCP — VITRIFIED CLAY PIPE WELD — WELDED XH — EXTRA HEAVY												

NOTES:

1. IF CONTRACTOR CHOICES THE OPTION TO USE ANY PRESSURE SEAL FITTINGS, THE CONTRACTOR SHALL FURNISH THE OWNER WITH ONE (1) PRESS SEAL FITTING TUBE OF THE SAME MAKE AND MODEL UTILIZED ON THE PROJECT.

FAN FILTER UNIT SCHEDULE									
MARK	AREA SERVED	MANUF.	TYPE	MODEL	CFM	EST. ESP.	VOLTS/ PHASE	MOTOR (WATTS)	ACCESSORIES
FFU1	ISOLATION ROOMS	PRICE	CEILING	PURAFLO-2424-BTR	250*	0.625	120/1	220	DO,M,PF,BAC,CF,SL,FF
FFU2	ISOLATION ROOMS	PRICE	CEILING	PURAFLO-2448-BTR	325*	0.625	120/1	220	DO,M,PF,BAC,CF,SL,FF

ABBREVIATIONS:

DM	- DISCONNECT MEANS	BAC	- BACNET FLOW CONTROLLER, MOTOR, AND FILTER STATUS
DO	- DUAL 10° DUCT COLLARS		WITH BACNET CONNECTION TO BUILDING MANAGEMENT SYSTEM
UV	- ULTRAVIOLET LIGHT	CF	- CONSTANT FLOW MOTOR TO COMPENSATE FOR FILTER ALLOWING
M	- ECM MOTOR	SL	- FILTER & MOTOR STATUS LIGHTS
PF	- MERV 8 PRE-FILTER	FF	- 2" TEST RP C0001 TYPE J HEPA FILTER
		*	- NOMINAL AIRFLOW, BALANCE TO AIRFLOW ON PLANS

## PUMP SCHEDULE

MARK	MAN.	SERIES	SIZE	INLET	DISCH.	GPM	TOTAL HEAD (ft.)	NPSH (ft.)	TYPE	WORK. CLASS (PSI)	HP	RPM	VOLT/PH	CONST.	FLUID PUMPED	FLUID TEMP.
CWCP-2	BG	XL55-45	1.5"	1.5"	1.5"	39.0	20	--	IL	125	1/2	4084	120/1	AI	CW	42
CWCP-3	BG	XL55-45	1.5"	1.5"	1.5"	39.0	20	--	IL	125	1/2	4084	120/1	AI	CW	42
CWCP-5	BG	XL55-45	1.5"	1.5"	1.5"	26.3	20	--	IL	125	1/3	3391	120/1	AI	CW	42
CWCP-11	BG	XL60-130	2"	2"	2"	63.0	20	--	IL	125	1	2285	208/3	AI	CW	42
HWCP-2	BG	PL-55	1.25"	1.25"	1.25"	20.0	20	--	IL	125	2/5	3476	120/1	AI	HW	180
HWCP-3	BG	PL-55	1.25"	1.25"	1.25"	16.0	20	--	IL	125	2/5	3476	120/1	AI	HW	180
HWCP-5	BG	PL-55	1.25"	1.25"	1.25"	20.0	20	--	IL	125	2/5	3476	120/1	AI	HW	180
HWCP-11	BG	PL-55	1.25"	1.25"	1.25"	20.0	20	--	IL	125	2/5	3476	120/1	AI	HW	180

ABBREVIATIONS:

NPSH	—	NET POSITIVE SUCTION HEAD	AB	—	ALL BRONZE
IL	—	IN-LINE	AI	—	ALL IRON
BMES	—	BASE MOUNTED, END SUCTION	HW	—	HOT WATER
BF	—	BRONZE FITTED	CW	—	CHILLED WATER
BG	—	BELL & GOSSETT	CDW	—	CONDENSER WATER

BYPASS VAV VAV AIR TERMINAL UNIT 'ATU'																	
MARK	MANU.	MODEL	FLOW	INLET (IN.)	UNIT		HOT WATER COIL										ACCESSORIES
					MIN	MAX	VOLT/PH	EXT	LAT	MBH	EWI	LWT	GPM	WPD (FT)	ROWS	APD (IN. W.C.)	
ATU1	NALOR	34RW	BP	8"	200	400	120/1	55	100	14.6	190	160	2.0	1.5	1	0.1	CT,DDC,T,2W
ATU2	NALOR	34RW	BP	8"	100	180	120/1	55	100	6.2	190	160	1.0	0.4	1	0.1	CT,DDC,T,2W
ATU3	NALOR	34RW	BP	8"	60	150	120/1	55	100	6.2	190	160	1.0	0.4	1	0.1	CT,DDC,T,2W
ATU4	NALOR	34RW	BP	10"	100	460	120/1	55	100	6.2	190	160	1.0	0.4	1	0.1	CT,DDC,T,2W
ATU5	NALOR	34RW	BP	8"	60	135	120/1	55	100	6.2	190	160	1.0	0.4	1	0.1	CT,DDC,T,2W
ATU6	NALOR	34RW	BP	8"	150	300	120/1	55	100	7.8	190	160	1.5	0.4	1	0.1	CT,DDC,T,2W
ATU7	NALOR	34RW	BP	8"	100	205	120/1	55	100	6.2	190	160	1.0	0.4	1	0.1	CT,DDC,T,2W

NOTES:

- EQUIPMENT SHALL BE SELECTED AT 1250 FT. ELEVATION.
- SELECT UNITS WITH 100% WATER.
- ALL UNITS SHALL BE PROVIDED WITH FACTORY MOUNTED CONTROL TRANSFORMER (120/24 VOLT (20VA)).
- OUTLET CONNECTION SHALL BE SLIP & DRIVE.

ABBREVIATIONS:

CT - CONTROL TRANSFORMER WITH DISCONNECTING MEANS  
DDC - DDC CONTROLLER, FURNISHED BY BAS CONTRACTOR AND FACTORY INSTALLED BY BOX MANUFACTURER  
T - THERMOSTAT BY CONTROLS CONTRACTOR  
BP - CONSTANT FLOW TO BOX WITH BY PASS "DUMP" DAMPER TO PLENUM, AND VAV FLOW TO SPACE.  
2W - 2-WAY, MODULATING CONTROL VALVE

MARK	MANUF.	MODEL	INLET	MAX. DEPTH (IN.)	(1) AIRFLOW CFM	UNIT VOLT/PH	FLA	HOT WATER COIL										PRESS. (IN. W.C.)		ACCESSORIES
								EAT	LAT	MBH	ENT	UNIT	GPM	WPD (FT)	APD (IN.WC)	ROWS	INLET	UNIT PD		
FP101	NAILOR	35SW	14" x	18	2590	208/1	7.9	69	105	95.8	180	128	3.8	0.94	0.16	2	1.0	0.5	AV, CV, T, VA, DDC, 2W	
FP103A	NAILOR	35SW	14" x	18	2480	208/1	7.9	69	105	92.4	180	127	3.6	0.84	0.15	2	1.0	0.5	AV, CV, T, VA, DDC, 2W	
FP103B	NAILOR	35SW	14" x	18	2200	208/1	7.9	69	105	82.2	180	124	3.0	0.59	0.12	2	1.0	0.5	AV, CV, T, VA, DDC, 2W	

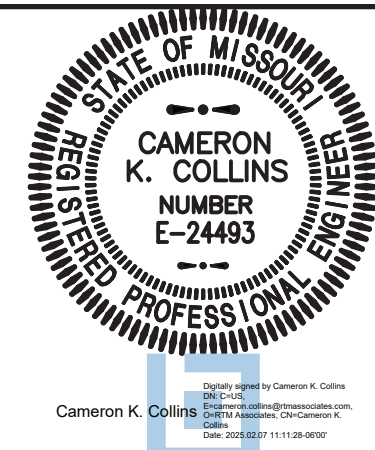
NOTES:

1. BALANCED AIRFLOW SHALL BE SUM OF SUPPLY DIFFUSERS.
2. EQUIPMENT SELECTED PER 1250 FT. ELEVATION.
3. AIRFLOW SHALL BE VARIABLE VOLUME.
4. ALL UNITS SHALL BE PROVIDED WITH FACTORY MOUNTED DDC CONTROLLER FURNISHED BY CONTROL CONTRACTOR, WHICH SHALL BE FACTORY COMMISSIONED.
5. ALL UNITS SHALL BE PROVIDED WITH FACTORY MOUNTED CONTROL TRANSFORMER, WHICH SHALL BE FACTORY COMMISSIONED.
6. OUTLET CONNECTIONS SHALL BE SLIP & DRIVE.
7. HYDRO-NATURAL UNIT ORIENTATION AND COIL SIDE CONNECTION WITH EXISTING CONDITIONS PRIOR TO RELEASE OF EQUIPMENT.

ABBREVIATIONS:

- AV = AIR VALVE DAMPER
- CV = CONTROL TRANSFORMER WITH DISCONNECTING MEANS
- T = THERMOSTAT BY CONTROLS CONTRACTOR
- VA = VALVE ACCESS PANEL
- DDC = DDC CONTROLLER, FURNISHED BY BAS CONTRACTOR AND FACTORY INSTALLED BY BOX MANUFACTURER.
- 2W = MODULATING 2-WAY CONTROL VALVE





## WING 'A' ALTERNATE #1 CONTROL NOTES

THIS FACILITY HAS AN EXISTING SCHNEIDER ELECTRIC BUILDING AUTOMATION SYSTEM. INTEGRATION OF EQUIPMENT CONTROL SHALL BE PROVIDED BY C&C GROUP:

BRIAN SCHEPERS  
2414 HYDE PARK ROAD  
JEFFERSON CITY, MO 65109  
573.632.4247

CONTROLS CONTRACTOR SHALL PROVIDE AND INSTALL ALL CONTROLLERS, CONTROL WIRING, AND SENSORS EXCEPT SENSORS PROVIDED BY EQUIPMENT MANUFACTURER.

CONTROLS CONTRACTOR SHALL PROVIDE ALL PROGRAMMING AND GRAPHICS REQUIRED TO INTEGRATE NEW EQUIPMENT INTO THE EXISTING CONTROLS SYSTEM:

- PROVIDE A RADIO BUTTON TO SET EACH MODULE INTO AIRBORNE INFECTION ISOLATION MODE (AIM) SEPARATELY. SEE SEQUENCE OF OPERATION FOR MORE INFORMATION.
- PROVIDE A GRAPHIC FOR AHU-S AND EACH FAN FILTER UNIT IN EACH ROOM. GRAPHIC SHALL GRAPHIC REPRESENT INSTALLED EQUIPMENT.
- PROVIDE A LINK FROM THE GRAPHIC TO A COPY OF THE SEQUENCE OF OPERATION WHICH SHALL ACCURATELY REPRESENT SEQUENCE PROGRAMMING.

### POINTS LIST

TYPE	POINT	DESCRIPTION	UNITS	TREND	ALARM	TOTALIZE
AI	DA-T	DISCHARGE AIR TEMPERATURE	DEG F	X	X	
AI	MA-T	MIXED AIR TEMPERATURE	DEG F	X	X	
AI	ZN-T	ZONE TEMPERATURE	DEG F	X	X	
AO	CWV-O	COOLING VALVE OUTPUT	%	X		
AO	HWV-O	HEATING VALVE OUTPUT	%	X		
DO	SF-C	SUPPLY FAN COMMAND	ON/OFF	X		
DI	SF-S	SUPPLY FAN STATUS	ON/OFF	X	X	
AO	RAD-C	RETURN AIR DAMPER COMMAND	OPEN/CLOSED	X		
DO	FFU-C	FFU SUPPLY FAN COMMAND	ON/OFF	X		
DI	FFU-S	FFU SUPPLY FAN STATUS	ON/OFF	X	X	
DI	FFU-A	FFU UNIT ALARMS			X	
AO	FFU-EAD	FFU UNIT EXHAUST DAMPER	OPEN/CLOSED	X	X	
DI	DP-R	ROOM DIFFERENTIAL PRESSURE		X	X	

## SEQUENCE OF OPERATION

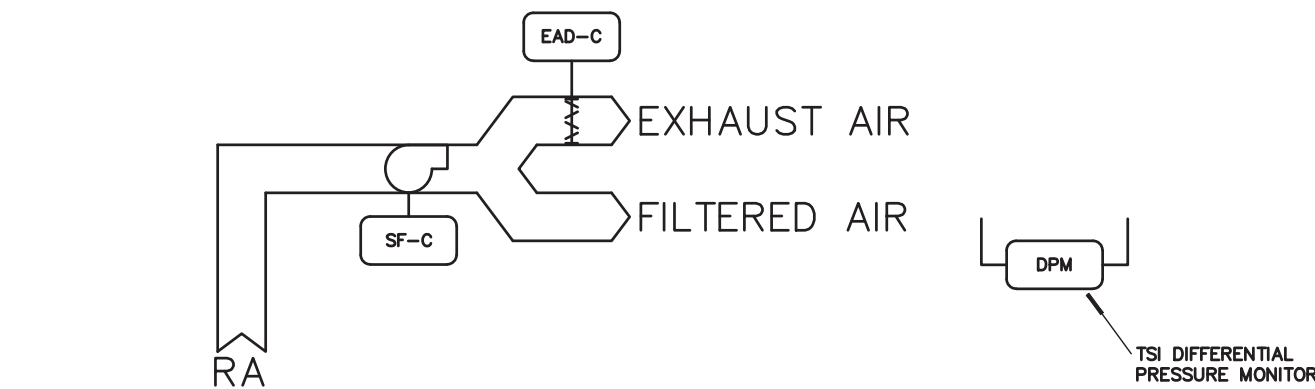
GENERAL: UNIT SHALL BE IN OCCUPIED/UNOCCUPIED MODE BASED ON AN ADJUSTABLE TIME SCHEDULE. UNIT SHALL BE SET INTO ISOLATION MODE BY BUILDING MANAGEMENT SYSTEM.

DISCHARGE AIR TEMP SENSOR: DUCT MOUNTED DISCHARGE AIR TEMPERATURE SENSOR SHALL BE UTILIZED FOR MONITORING PURPOSES.

UNOCCUPIED MODE: THE RETURN AIR DAMPER SHALL BE OPEN. THE SUPPLY FAN SHALL CYCLE ON/OFF IN CONJUNCTION WITH A CALL FOR HEATING OR COOLING. FAN FILTER UNIT SHALL BE OFF WITH EXHAUST AIR DAMPER CLOSED.


OCCUPIED MODE: THE RETURN AIR DAMPER SHALL BE FULL OPEN. THE SUPPLY FAN SHALL RUN CONTINUOUSLY. THE HEATING AND COOLING VALVES SHALL MODULATE AS REQUIRED TO MAINTAIN SPACE SETPOINT TEMPERATURE. HEATING AND COOLING SHALL NOT OCCUR SIMULTANEOUSLY. FAN FILTER UNIT SHALL BE OFF WITH EXHAUST AIR DAMPER CLOSED.

ISOLATION MODE: THE RETURN AIR DAMPER SHALL BE FULL CLOSED. THE SUPPLY FAN SHALL RUN CONTINUOUSLY. THE HEATING AND COOLING VALVES SHALL MODULATE AS REQUIRED TO MAINTAIN SPACE SETPOINT TEMPERATURE. HEATING AND COOLING SHALL NOT OCCUR SIMULTANEOUSLY. FAN FILTER UNIT SHALL BE ON. EXHAUST AIR DAMPER SHALL BE OPEN. BMS SHALL MONITOR NEGATIVE PRESSURE IN ROOM RELATIVE TO CORRIDOR AND FAN AND FILTER ALARMS.



## WING 'A' ALTERNATE #1 FAN FILTER UNIT CONTROL DIAGRAM

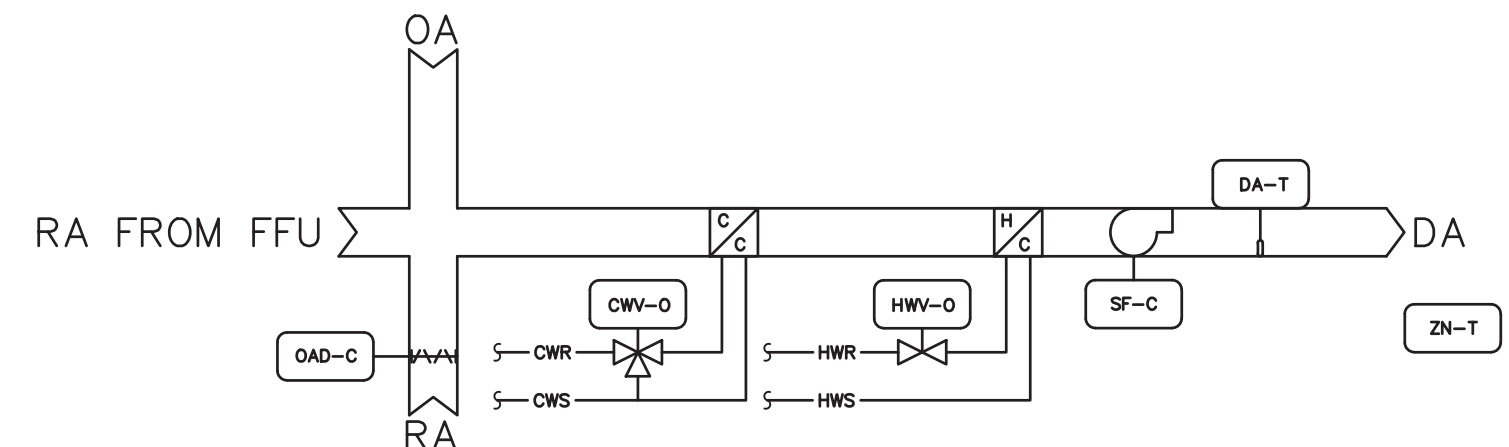M-602 NO SCALE



## WING 'A' ALTERNATE #1 FAN COIL UNIT CONTROL DIAGRAM

M-602 NO SCALE

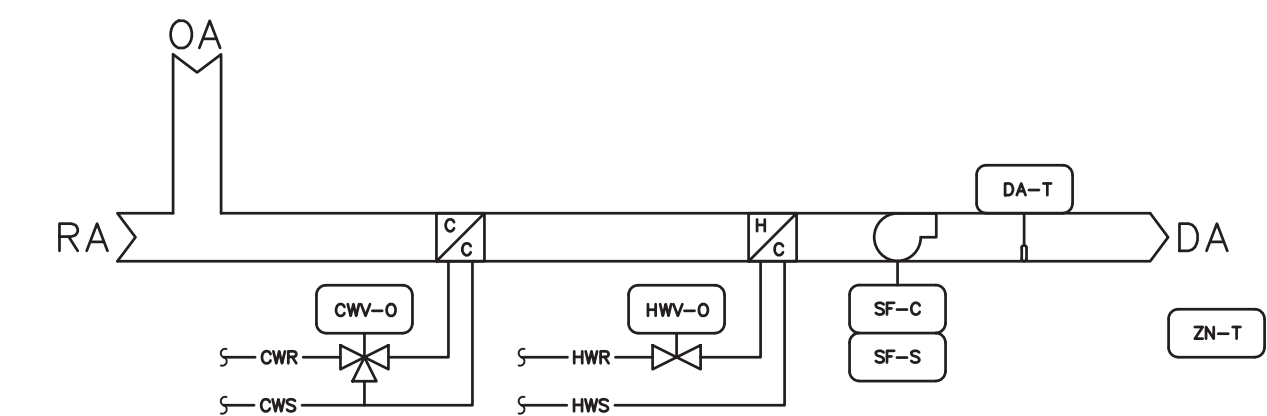
TYPE	POINT	DESCRIPTION	UNITS	TREND	ALARM	TOTALIZE
AI	DA-T	DISCHARGE AIR TEMPERATURE	DEG F	X	X	
AI	ZN-T	ZONE TEMPERATURE	DEG F	X	X	
AO	CWV-O	COOLING VALVE OUTPUT	%	X		
AO	HWV-O	HEATING VALVE OUTPUT	%	X		
BO	SF-C	SUPPLY FAN COMMAND	ON/OFF	X		
DI	SF-S	SUPPLY FAN STATUS	ON/OFF	X	X	

## SEQUENCE OF OPERATION

GENERAL: UNIT SHALL BE PROVIDED WITH AN OCCUPIED/UNOCCUPIED SCHEDULE. UNIT SHALL BE SCHEDULED TO OPERATE IN OCCUPIED MODE CONTINUOUSLY.

DISCHARGE AIR TEMP SENSOR: DUCT MOUNTED DISCHARGE AIR TEMPERATURE SENSOR SHALL BE UTILIZED FOR MONITORING PURPOSES.

OCCUPIED MODE: THE SUPPLY FAN SHALL RUN CONTINUOUSLY. THE HEATING AND COOLING VALVES SHALL MODULATE AS REQUIRED TO MAINTAIN SPACE SETPOINT TEMPERATURE. HEATING AND COOLING SHALL NOT OCCUR SIMULTANEOUSLY.



## RESIDENT ROOM 4-PIPE FAN COIL UNIT CONTROL DIAGRAM

M-602 NO SCALE

TYPE	POINT	DESCRIPTION	UNITS	TREND	ALARM	TOTALIZE
AI	DA-T	DISCHARGE AIR TEMPERATURE	DEG F	X	X	
AI	MA-T	MIXED AIR TEMPERATURE	DEG F	X	X	
AI	ZN-T	ZONE TEMPERATURE	DEG F	X	X	
AO	CWV-O	COOLING VALVE OUTPUT	%	X		
AO	HWV-O	HEATING VALVE OUTPUT	%	X		
BO	SF-C	SUPPLY FAN COMMAND	ON/OFF	X		
BO	OAD-C	OUTSIDE AIR DAMPER COMMAND	OPEN/CLOSED	X		
DI	SF-S	SUPPLY FAN STATUS	ON/OFF	X	X	

## SEQUENCE OF OPERATION

GENERAL: UNIT SHALL BE IN OCCUPIED/UNOCCUPIED MODE BASED ON AN ADJUSTABLE TIME SCHEDULE.

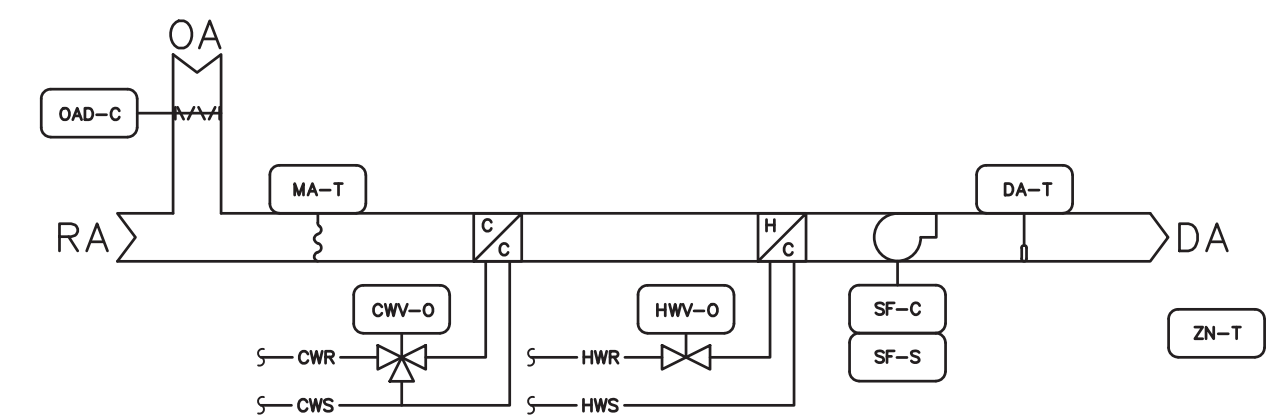
DISCHARGE AIR TEMP SENSOR: DUCT MOUNTED DISCHARGE AIR TEMPERATURE SENSOR SHALL BE UTILIZED FOR MONITORING PURPOSES.

UNOCCUPIED MODE: THE OUTSIDE AIR DAMPER SHALL BE CLOSED. THE SUPPLY FAN SHALL CYCLE ON/OFF IN CONJUNCTION WITH A CALL FOR HEATING OR COOLING.

OCCUPIED MODE: THE OUTSIDE AIR DAMPER SHALL BE FULL OPEN. THE SUPPLY FAN SHALL RUN CONTINUOUSLY. THE HEATING AND COOLING VALVES SHALL MODULATE AS REQUIRED TO MAINTAIN SPACE SETPOINT TEMPERATURE. HEATING AND COOLING SHALL NOT OCCUR SIMULTANEOUSLY.

FREEZE PROTECTION:  
IF THE MIXED AIR TEMPERATURE DROPS BELOW 40°F (ADJ.), THE OUTSIDE AIR DAMPER SHALL FULLY CLOSE.  
IF THE MIXED AIR TEMPERATURE DROPS BELOW 36°F (ADJ.), THE OUTSIDE AIR DAMPER SHALL FULLY CLOSE, THE SUPPLY FAN SHALL STOP, AND BOTH THE HOT WATER AND CHILLED WATER VALVES SHALL MOVE TO FULL OPEN POSITIONS.  
AN ALARM SHALL BE GENERATED AT THE CENTRAL WORKSTATION UPON ACTIVATION OF ANY OF THE THREE SETPOINTS ABOVE.

FREEZE/STAT CONTROL:  
IF THE FREEZE/STAT SENSES A TEMPERATURE BELOW 32°F, THE OUTSIDE AIR DAMPER SHALL FULLY CLOSE, THE SUPPLY FAN SHALL STOP AND BOTH THE HOT WATER AND CHILLED WATER VALVES SHALL MOVE TO FULL OPEN. AN ALARM SHALL BE GENERATED AT THE CENTRAL WORKSTATION.



## 4-PIPE FAN COIL UNIT w/ O.A. CONTROL DIAGRAM

M-602 NO SCALE

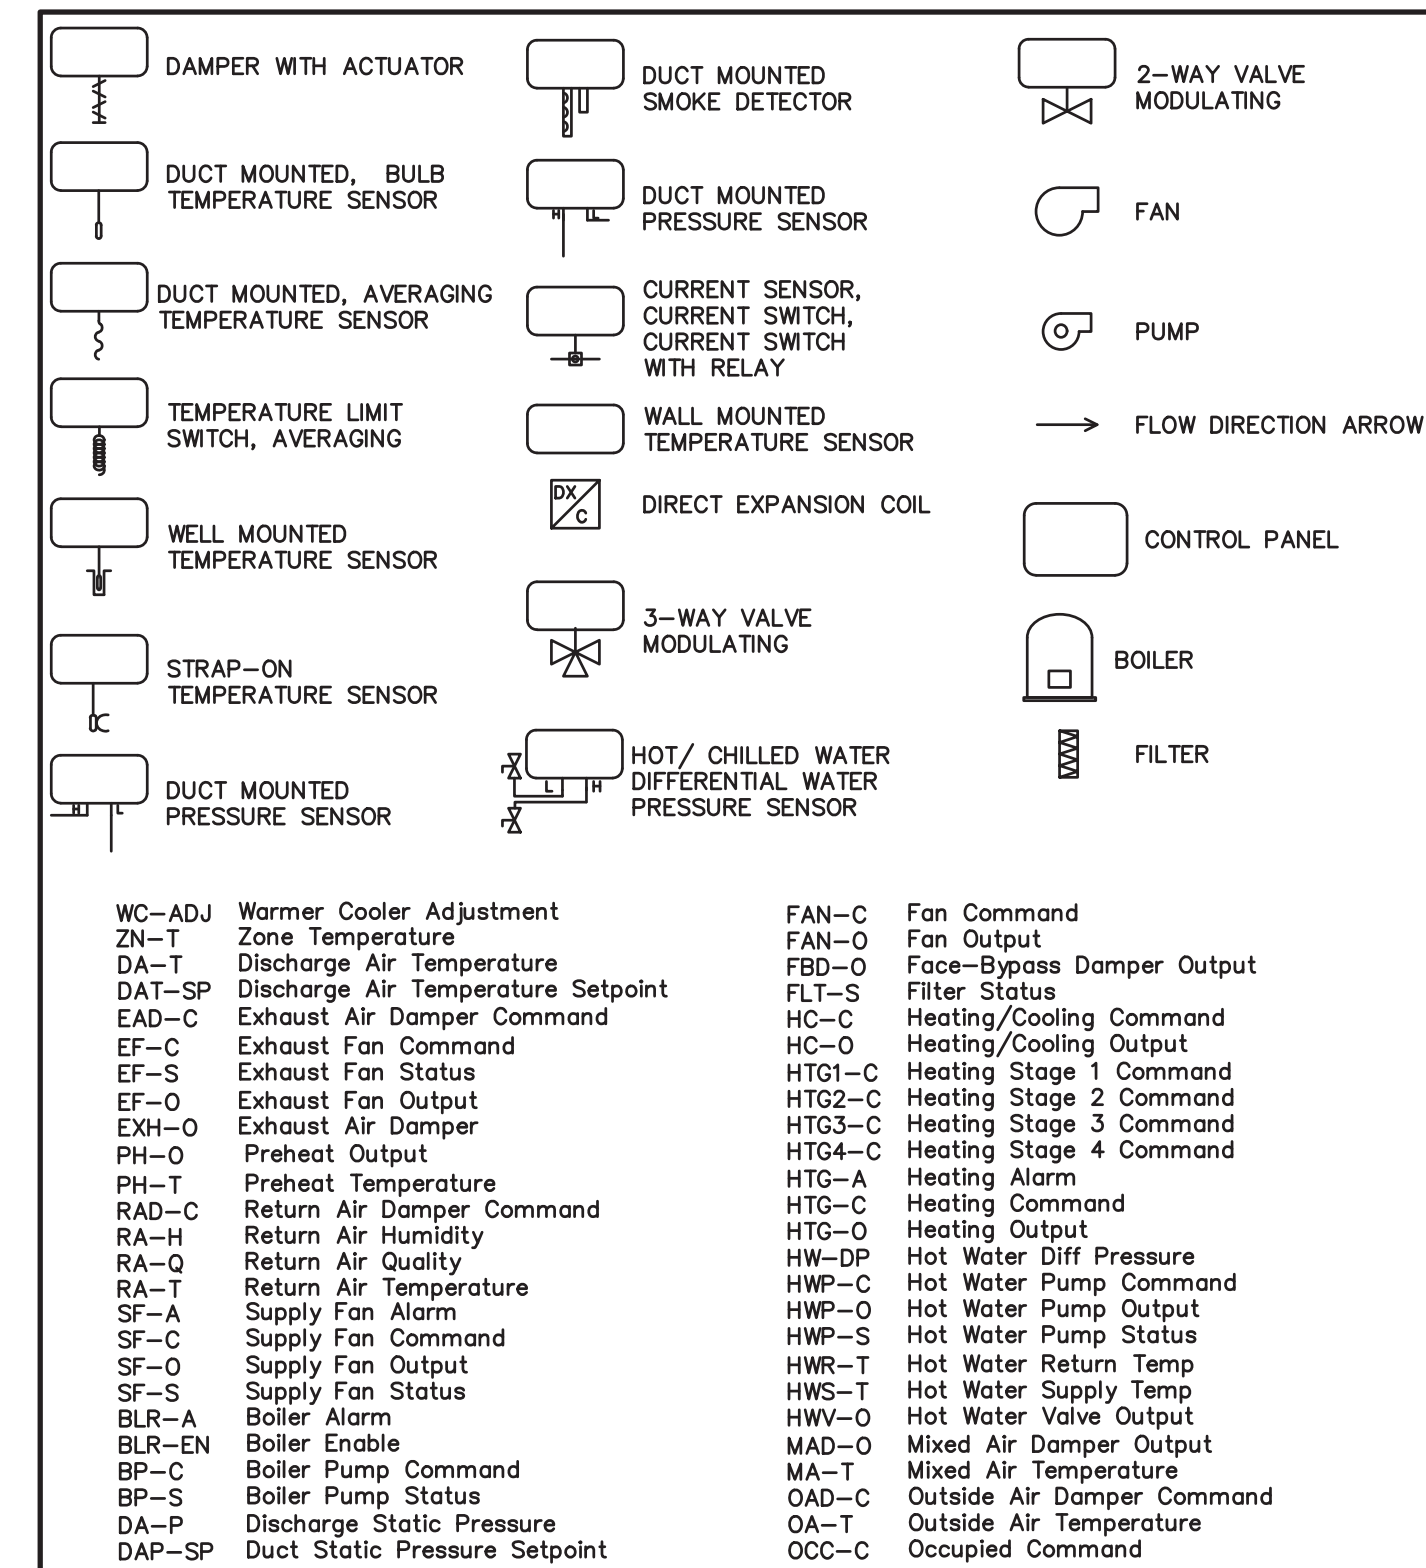
## BAS GENERAL REQUIREMENTS

### GENERAL REQUIREMENTS

- THE CONTROL SYSTEM SHALL BE A SCHNEIDER ELECTRIC ECOSTRUXURE SYSTEM FROM C&C GROUP AS INDICATED ON THE DRAWINGS AND DESCRIBED IN THE SPECIFICATIONS. THE BAS CONTRACTOR SHALL PROVIDE COMPLETE AND FULLY OPERATIONAL DDC SYSTEM BY SCHNEIDER ELECTRIC ONLY.
- ALL EXISTING DDC CONTROLLERS MAY BE RE-UTILIZED AND RE-PROGRAMMED TO MEET THE SEQUENCE OF OPERATION. IF ANY EXISTING CONTROLLER DOES NOT FIT WITHIN THE NEW EQUIPMENT, THEN THE CONTROLLER SHALL BE REPLACED. CONTRACTOR SHALL PROVIDE ANY ADDITIONAL CONTROLLERS AS REQUIRED TO ACCOMMODATE ALL POINTS SHOWN AND AS REQUIRED TO MEET THE SEQUENCE OF OPERATION. WHERE MECHANICAL EQUIPMENT IS BEING REMOVED AND REPLACED, THE CONTRACTOR SHALL REMOVE AND REPLACE ALL EXISTING ACTUATORS, CONTROL DEVICES AND SENSORS. EXISTING CONTROL WIRING, COMMUNICATION BUS, AND HUBS MAY BE REUTILIZED. CONTROL CONTRACTOR SHALL PROVIDE ALL ADDITIONAL SENSORS, ACTUATORS, DEVICES, COMMUNICATION BUS, HUBS, AND CONTROL WIRING AS REQUIRED TO MEET THE SEQUENCE OF OPERATION.
- ALL TEMPERATURE CONTROL INPUT/OUTPUT POINTS SHALL BE CAPABLE OF BEING MONITORED AND CONTROLLED THROUGH THE BUILDING AUTOMATION SYSTEM.
- RETURN AIR SMOKE DETECTORS:
  - ALL SMOKE DETECTORS WHERE SHOWN OR AS REQUIRED BY CODE SHALL BE FURNISHED AND WIRED INTO THE FIRE ALARM SYSTEM BY THE ELECTRICAL CONTRACTOR.
  - UPON DETECTION OF SMOKE AT THE UNIT, THE ASSOCIATED AIR HANDLER SHALL SHUT DOWN.
- ALARMS:
  - ALL HUMIDITY SENSORS SHALL HAVE HIGH LIMIT ALARMS, 60% (ADJUSTABLE).
  - ALL SPACE TEMPERATURE SENSORS SHALL HAVE HIGH LIMIT ALARMS, 80°F (ADJUSTABLE).
  - ALL SPACE TEMPERATURE SENSORS SHALL HAVE LOW LIMIT ALARMS, 80°F (ADJUSTABLE).
  - ALL MIXED AIR TEMPERATURE SENSORS SHALL HAVE LOW LIMIT ALARMS, 40°F (ADJUSTABLE).
  - ALL UNIT DISCHARGE AIR TEMPERATURE SENSORS SHALL HAVE LOW LIMIT ALARMS, 45°F (ADJUSTABLE).
  - ALL INITIAL FILTER PRESSURE DIFFERENTIAL SENSORS SHALL HAVE HIGH LIMIT ALARMS, 0.5" S.P. (ADJUSTABLE).
  - ALL FAN PROOF-OF-RUN SENSORS SHALL ALARM IF NOT ACKNOWLEDGED AFTER 30 SECONDS.
- GENERAL INSTALLATION REQUIREMENTS:
  - ALL LOW VOLTAGE TEMPERATURE CONTROL WIRING SHALL BE CONCEALED EITHER ABOVE CEILING, IN WALLS, IN CONDUIT OR IN WIREROOM. ALL WIRING SHALL BE PLENUM RATED. ALL EXPOSED CONTROL WIRING LOCATED MORE THAN NINE (9) FEET ABOVE THE FINISHED FLOOR SHALL BE ROUTED IN CONDUIT AND SHALL BE PAINTED TO MATCH ADJACENT SURFACE IN ALL PUBLIC AREAS. ALL EXPOSED CONTROL WIRING LOCATED BELOW NINE (9) FEET ABOVE FINISHED FLOOR SHALL BE ROUTED IN WIREROOM, COLOR TO MATCH ADJACENT SURFACE. ALL CONTROL WIRING LOCATED IN THE BASEMENT MECHANICAL ROOM SHALL BE ROUTED IN EMT CONDUIT.
- THERMOSTATS SENSORS:
  - ALL THERMOSTATS SHALL BE PROVIDED WITH A WARMER/COOLER ADJUSTMENT BUTTONS AND DIGITAL READOUT OF ACTUAL TEMPERATURE AND SETPOINT. ALL THERMOSTATS SHALL BE PROVIDED WITH AN OCCUPANCY OVERRIDE BUTTON. ALL TEMPERATURE SETPOINTS SHALL BE ADJUSTABLE THROUGH THE BAS. ALL WARMER/COOLER SLIDE VALVES SHALL BE ADJUSTABLE THROUGH THE BAS.
- TEMPERATURE SETPOINTS:
  - EACH INDIVIDUAL THERMOSTAT SHALL BE CAPABLE OF HAVING A UNIQUE TEMPERATURE SETPOINTS PROVIDED THROUGH THE BAS. THE CONTROL CONTRACTOR SHALL CONFIRM THE SETPOINTS OF EACH TEMPERATURE SETPOINT WITH THE OWNER'S REPRESENTATIVES. UNLESS GIVEN DIRECTION OTHERWISE PROVIDE THE FOLLOWING SETPOINTS:
    - RESIDENT ROOMS:
      - OCCUPIED HEATING - 74°F.
      - OCCUPIED COOLING - 78°F.
      - UNOCCUPIED HEATING - 60°F.
      - UNOCCUPIED COOLING - 84°F.
    - NON-RESIDENT ROOMS:
      - OCCUPIED HEATING - 72°F.
      - OCCUPIED COOLING - 74°F.
      - UNOCCUPIED HEATING - 60°F.
      - UNOCCUPIED COOLING - 84°F.
  - OCCUPANCY SCHEDULES:
    - ALL ROOMS OCCUPIED BY RESIDENTS SHALL BE SCHEDULED FOR CONTINUOUS OCCUPANCY. FOR ALL OTHER SPACES THE CONTROL CONTRACTOR SHALL SET THE OCCUPANCY SCHEDULE AS FOLLOWS:
      - ADMIN: M-F 7AM-6PM
      - KITCHEN: S-S 4AM-7PM
      - A.C. ALL OTHER NON-RESIDENT ROOMS: M-F 7AM-6PM

## 2 BAS GENERAL REQUIREMENTS

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## 1 BAS SYMBOLS LIST

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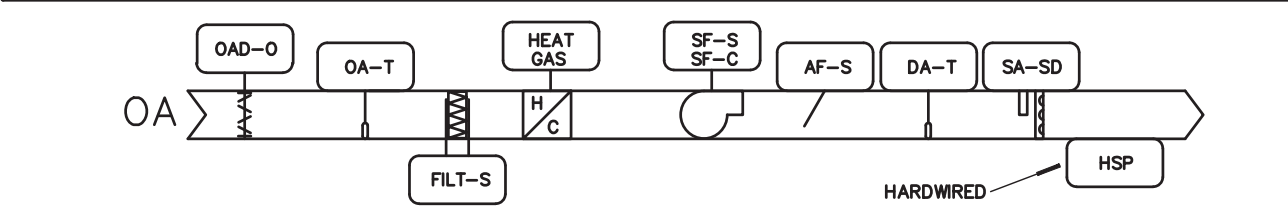


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SEQUENCE OF OPERATION

MAKE-UP AIR UNIT 1 (SERVING KITCHEN):  
  
SUPPLY FAN START/STOP: THE SUPPLY FAN SHALL START UPON THE START OF THE KITCHEN EXHAUST HOOD FAN. IF THE SUPPLY FAN STATUS DOES NOT MATCH THE COMMANDED VALUE, AN ALARM SHALL BE GENERATED. WHEN THE SUPPLY FAN STATUS INDICATES THE FAN STARTED, THE CONTROL SEQUENCE SHALL BE ENABLED.  
  
HEATING MODE:  
THE GAS HEATER SHALL MODULATE TO MAINTAIN 70°F (ADJ.). AN ALARM SHALL BE GENERATED AT THE CENTRAL WORKSTATION IF THE TEMPERATURE CANNOT BE MAINTAINED.  
  
SAFETY:  
ALL OF THE SAFETY DEVICES SHALL BE MANUAL RESET; THE DEVICE THAT HAS TRIPPED SHALL BE MANUALLY RESET BEFORE RESTARTING THE AIR HANDLING UNIT.  
  
HIGH STATIC:  
PROVIDE A HARD-WIRED, HIGH STATIC PRESSURE SENSOR ON SUPPLY DUCT TO SHUT DOWN UNIT UPON PRESSURE ABOVE 1.0" W.C. (ADJ.)

MAU-1 SYSTEM - POINTS LIST							
TYPE	POINT	DESCRIPTION	UNITS	TREND	ALARM	TOTALIZE	
AI	DA-T	DISCHARGE AIR TEMPERATURE	DEG F	X	X	X	
AI	OA-T	OUTDOOR AIR TEMPERATURE	DEG F	X	X	X	
AI	FILT-S	DIRTY FILTER STATUS	PSI	X	X	X	
AI	OAD-S	OUTDOOR AIR DAMPER STATUS	OPEN/CLOSE	X	X	X	
DI	SF-S	SUPPLY FAN STATUS	ON/OFF	X	X	X	
DO	SF-C	SUPPLY FAN COMMAND	ON/OFF	X			
AO	OAD-O	OUTDOOR AIR DAMPER	%	X			
AO	GAS-O	MODULATING GAS HEAT	%	X			
DI	EF-S	EXHAUST FAN STATUS	ON/OFF	X	X	X	
DI	HSP-S	HIGH STATIC PRESSURE STATUS	ON/OFF	X	X	X	



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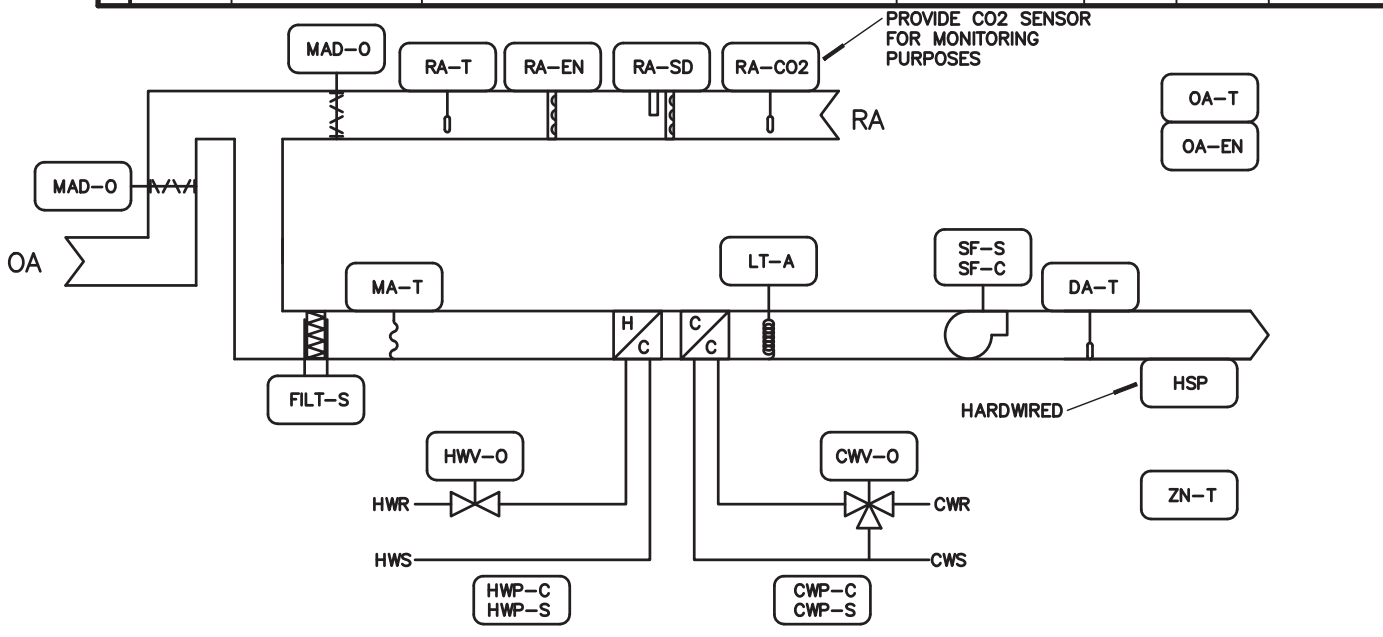
NO SCALE

MAU1 CONTROL DIAGRAM

SEQUENCE OF OPERATION

AIR HANDLING UNIT 3 (SERVING KITCHEN):  
  
SUPPLY FAN START/STOP: THE SUPPLY FAN SHALL RUN CONTINUOUSLY DURING OCCUPIED PERIODS AND CYCLE DURING UNOCCUPIED PERIODS. IF THE SUPPLY FAN STATUS DOES NOT MATCH THE COMMANDED VALUE, AN ALARM SHALL BE GENERATED. WHEN THE SUPPLY FAN STATUS INDICATES THE FAN STARTED, THE CONTROL SEQUENCE SHALL BE ENABLED.  
  
COOLING MODE:  
IF THE OUTDOOR ENTHALPY IS BELOW INTERIOR, THEN THE ECONOMIZER MODE SHALL BE THE FIRST SOURCE OF COOLING. IF THE OUTSIDE AIR TEMPERATURE IS GREATER THAN 55°F, ECONOMIZER MODE SHALL BE DISABLED AND THE CHILLED WATER VALVE SHALL MODULATE AS REQUIRED TO MAINTAIN UNIT DISCHARGE TEMPERATURE SETPOINT OF 55°F (ADJ.). THE HOT WATER PREHEAT VALVE SHALL REMAIN CLOSED. THE CHILLED WATER COIL PUMP SHALL BE ENABLED WHEN EITHER THE CHILLED WATER VALVE IS COMMANDED OPEN OR WHEN THE MIXED AIR TEMPERATURE DROPS BELOW 36°F (ADJ.).  
  
HEATING MODE:  
THE CHILLED WATER VALVE SHALL BE CLOSED AND THE HOT WATER PREHEAT VALVE SHALL MODULATE TO MAINTAIN UNIT DISCHARGE AIR TEMPERATURE SETPOINT OF 75°F (ADJ.). WHEN THE MIXED AIR TEMPERATURE DROPS BELOW 40°F, THE HOT WATER PREHEAT VALVE SHALL MOVE TO FULL OPEN AND THE BYPASS DAMPER SHALL MODULATE TO MAINTAIN UNIT DISCHARGE AIR TEMPERATURE SETPOINT. WHEN THE MIXED AIR TEMPERATURE IS GREATER THAN 45°F (ADJ.), THE BYPASS DAMPER SHALL MOVE TO FULL COIL POSITION AND THE HOT WATER PREHEAT VALVE SHALL MODULATE TO MAINTAIN UNIT DISCHARGE AIR TEMPERATURE SETPOINT.  
  
VENTILATION CONTROL:  
1. DURING UNOCCUPIED MODE THE OUTSIDE AIR DAMPER SHALL BE CLOSED.  
2. DURING OCCUPIED MODE THE OUTSIDE AIR DAMPER SHALL BE OPEN TO THE MINIMUM POSITION.  
  
FREEZE PROTECTION:  
IF THE MIXED AIR TEMPERATURE DROPS BELOW 40°F (ADJ.), THE OUTSIDE AIR DAMPER SHALL MODULATE CLOSED TO AVOID DROPPING BELOW 40°F (ADJ.).  
IF THE MIXED AIR TEMPERATURE DROPS BELOW 34°F (ADJ.), THE OUTSIDE AIR DAMPER SHALL FULLY CLOSE. THE RETURN AIR DAMPER SHALL FULLY OPEN, THE SUPPLY FAN SHALL STOP, BOTH THE HOT WATER AND CHILLED WATER VALVES SHALL FAIL TO FULL OPEN POSITIONS. AN ALARM SHALL BE GENERATED AT THE CENTRAL WORKSTATION UPON ACTIVATION OF ANY OF THE THREE SETPOINTS ABOVE.  
  
FREEZESTAT CONTROL:  
IF THE FREEZESTAT SENSES A TEMPERATURE BELOW 34°F, THE OUTSIDE AIR DAMPER SHALL FULLY CLOSE, THE RETURN AIR DAMPER SHALL FULLY OPEN, AND THE SUPPLY FAN SHALL STOP.  
  
SAFETY:  
ALL OF THE SAFETY DEVICES SHALL BE MANUAL RESET; THE DEVICE THAT HAS TRIPPED SHALL BE MANUALLY RESET BEFORE RESTARTING THE AIR HANDLING UNIT.  
  
HIGH STATIC:  
PROVIDE A HARD-WIRED, HIGH STATIC PRESSURE SENSOR ON SUPPLY DUCT TO SHUT DOWN UNIT UPON PRESSURE ABOVE 1.0" W.C. (ADJ.)

AHU-3 SYSTEM - POINTS LIST							
TYPE	POINT	DESCRIPTION	UNITS	TREND	ALARM	TOTALIZE	
AI	MA-T	MIXED AIR TEMPERATURE	DEG F	X	X	X	
AI	DA-T	DISCHARGE AIR TEMPERATURE	DEG F	X	X	X	
AI	RA-T	RETURN AIR TEMPERATURE	DEG F	X	X	X	
AI	RA-EN	RETURN AIR ENTHALPY	BTU/LB	X	X	X	
AI	RA-CO2	RETURN AIR CO2	PPM	X	X	X	
AI	OA-T	OUTDOOR AIR TEMPERATURE	DEG F	X	X	X	
AI	RA-EN	RETURN AIR ENTHALPY	BTU/LB	X	X	X	
AI	FILT-S	DIRTY FILTER STATUS	PSI	X	X	X	
AI	ZN-T	INDOOR AIR TEMPERATURE	DEG F	X	X	X	
DI	SF-S	SUPPLY FAN STATUS	ON/OFF	X	X	X	
DI	RA-SD	RETURN AIR SMOKE DETECTOR	ON/OFF	X	X	X	
DI	HSP-S	HIGH STATIC PRESSURE STATUS	ON/OFF	X	X	X	
DO	SF-C	SUPPLY FAN COMMAND	ON/OFF	X			
AO	MAD-O	MIXED AIR DAMPER	%	X			
AO	CWV-O	CHILLED WATER VALVE OUTPUT	%	X			



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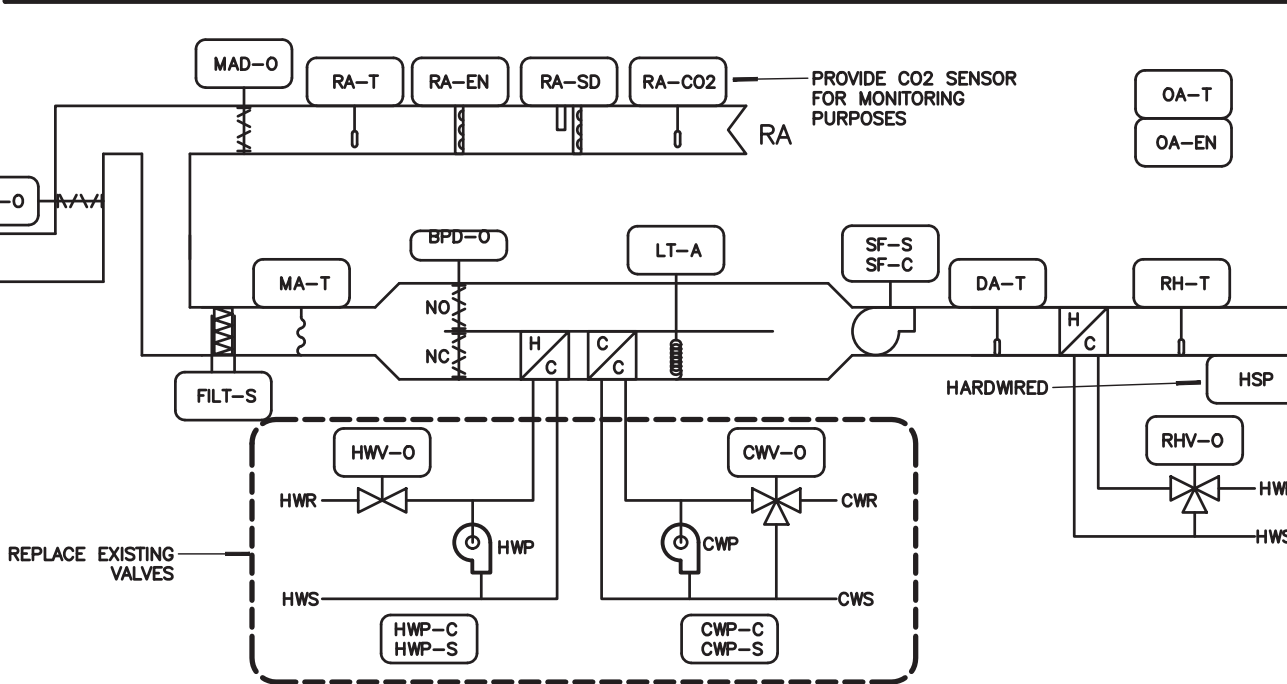
NO SCALE

AHU 3 CONTROL DIAGRAM

SEQUENCE OF OPERATION

AIR HANDLING UNITS 5 (SERVING RESIDENT WINGS):  
  
SUPPLY FAN START/STOP: THE SUPPLY FAN SHALL RUN CONTINUOUSLY. IF THE SUPPLY FAN STATUS DOES NOT MATCH THE COMMANDED VALUE, AN ALARM SHALL BE GENERATED. WHEN THE SUPPLY FAN STATUS INDICATES THE FAN STARTED, THE CONTROL SEQUENCE SHALL BE ENABLED.  
  
UNIT AND REHEAT COIL DISCHARGE AIR TEMPERATURE CONTROL:  
1. CONTINUOUSLY MONITOR ALL ZONE TEMPERATURE SENSORS SERVING THE HOT WATER ZONE REHEAT COILS.  
1.1. IF ANY ZONE IS IN COOLING MODE THE UNIT DISCHARGE TEMPERATURE SHALL BE SET TO 55°F (ADJ.).  
1.1.1. DURING THE COOLING MODE THE HOT WATER REHEAT COIL VALVE SHALL MODULATE TO MAINTAIN THE FOLLOWING REHEAT COIL DISCHARGE TEMPERATURE RESET SCHEDULE. WHEN THE OUTSIDE AIR TEMPERATURE IS BELOW 60°F (ADJ.) THE REHEAT COIL DISCHARGE TEMPERATURE SHALL BE 60°F (ADJ.). WHEN THE OUTSIDE AIR TEMPERATURE IS ABOVE 90°F (ADJ.) THE HOT WATER VALVE SHALL BE CLOSED. A LINEAR SLIDING SCALE SHALL RESET THE HOT WATER DISCHARGE TEMPERATURE FROM 60°F (ADJ.) AT 60°F (ADJ.) AMBIENT DOWN TO 55°F (ADJ.) AT 90°F (ADJ.) AMBIENT.  
1.2. IF THE RETURN AIR RELATIVE HUMIDITY RISES ABOVE 55% RH, THE DEHUMIDIFICATION SEQUENCE SHALL BE ENABLED AND THE UNIT DISCHARGE TEMPERATURE SHALL BE SET TO 55°F (ADJ.). WHEN THE RETURN AIR RELATIVE HUMIDITY DROPS BELOW 50% RH, THE DEHUMIDIFICATION SEQUENCE SHALL BE DISABLED.  
1.3. IF ALL ZONES ARE IN HEATING MODE THE UNIT DISCHARGE TEMPERATURE SHALL BE SET TO 75°F (ADJ.) AND THE REHEAT COIL VALVE SHALL BE CLOSED.  
  
COOLING MODE:  
IF THE OUTDOOR ENTHALPY IS BELOW INTERIOR, THEN THE ECONOMIZER MODE SHALL BE THE FIRST SOURCE OF COOLING. IF THE OUTSIDE AIR TEMPERATURE IS GREATER THAN 55°F, ECONOMIZER MODE SHALL BE DISABLED AND THE CHILLED WATER VALVE SHALL MODULATE AS REQUIRED TO MAINTAIN UNIT DISCHARGE TEMPERATURE SETPOINT OF 55°F (ADJ.). THE HOT WATER PREHEAT VALVE SHALL REMAIN CLOSED. THE CHILLED WATER COIL PUMP SHALL BE ENABLED WHEN EITHER THE CHILLED WATER VALVE IS COMMANDED OPEN OR WHEN THE MIXED AIR TEMPERATURE DROPS BELOW 36°F (ADJ.).  
  
HEATING MODE:  
THE CHILLED WATER VALVE SHALL BE CLOSED AND THE HOT WATER PREHEAT VALVE SHALL MODULATE TO MAINTAIN UNIT DISCHARGE AIR TEMPERATURE SETPOINT OF 75°F (ADJ.). WHEN THE MIXED AIR TEMPERATURE DROPS BELOW 40°F, THE HOT WATER PREHEAT VALVE SHALL MOVE TO FULL OPEN AND THE BYPASS DAMPER SHALL MODULATE TO MAINTAIN UNIT DISCHARGE AIR TEMPERATURE SETPOINT. WHEN THE MIXED AIR TEMPERATURE IS GREATER THAN 45°F (ADJ.), THE BYPASS DAMPER SHALL MOVE TO FULL COIL POSITION AND THE HOT WATER PREHEAT VALVE SHALL MODULATE TO MAINTAIN UNIT DISCHARGE AIR TEMPERATURE SETPOINT. THE HOT WATER COIL PUMP SHALL BE ENABLED WHEN EITHER THE HOT WATER VALVE IS COMMANDED OPEN OR WHEN THE OUTSIDE AIR TEMPERATURE DROPS BELOW 40°F (ADJ.).  
  
VENTILATION CONTROL:  
1. DURING UNOCCUPIED MODE THE OUTSIDE AIR DAMPER SHALL BE CLOSED.  
2. DURING OCCUPIED MODE THE OUTSIDE AIR DAMPER SHALL BE OPEN TO THE MINIMUM POSITION.  
  
FREEZE PROTECTION:  
IF THE MIXED AIR TEMPERATURE DROPS BELOW 40°F (ADJ.), THE OUTSIDE AIR DAMPER SHALL FULLY MODULATE TO MAINTAIN A MINIMUM OF 40°F (ADJ.).  
IF THE MIXED AIR TEMPERATURE DROPS BELOW 34°F (ADJ.), THE OUTSIDE AIR DAMPER SHALL FULLY CLOSE. THE RETURN AIR DAMPER SHALL FULLY OPEN, THE SUPPLY FAN SHALL STOP, BOTH THE HOT WATER AND CHILLED WATER VALVES SHALL MOVE TO FULL OPEN POSITIONS, AND BOTH COIL PUMPS SHALL BE ENABLED. AN ALARM SHALL BE GENERATED AT THE CENTRAL WORKSTATION UPON ACTIVATION OF ANY OF THE THREE SETPOINTS ABOVE.  
  
FREEZESTAT CONTROL:  
IF THE FREEZESTAT SENSES A TEMPERATURE BELOW 34°F, THE OUTSIDE AIR DAMPER SHALL FULLY CLOSE, THE RETURN AIR DAMPER SHALL FULLY OPEN, AND THE SUPPLY FAN SHALL STOP.  
  
SAFETY:  
ALL OF THE SAFETY DEVICES SHALL BE MANUAL RESET; THE DEVICE THAT HAS TRIPPED SHALL BE MANUALLY RESET BEFORE RESTARTING THE AIR HANDLING UNIT.

AHU-5 SYSTEM - POINTS LIST							
TYPE	POINT	DESCRIPTION	UNITS	TREND	ALARM	TOTALIZE	
AI	MA-T	MIXED AIR TEMPERATURE	DEG F	X	X	X	
AI	DA-T	DISCHARGE AIR TEMPERATURE	DEG F	X	X	X	
AI	RA-T	REHEAT COIL DISCHARGE TEMP.	DEG F	X	X	X	
AI	RA-T	RETURN AIR TEMPERATURE	DEG F	X	X	X	
AI	RA-EN	RETURN AIR ENTHALPY	BTU/LB	X	X	X	
AI	OA-EN	OUTDOOR AIR ENTHALPY	BTU/LB	X	X	X	
AI	RA-CO2	RETURN AIR CO2	PPM	X	X	X	
DI	SF-S	SUPPLY FAN STATUS	ON/OFF	X	X	X	
DI	RA-SD	RETURN AIR SMOKE DETECTOR	ON/OFF	X	X	X	
DO	SF-C	SUPPLY FAN COMMAND	%	X			
DI	HWP-C	HOT WATER PUMP COMMAND	ON/OFF	X			
DI	HWP-S	HOT WATER PUMP STATUS	ON/OFF	X	X	X	
DO	CWP-C	CHILLED WATER PUMP COMMAND	ON/OFF	X			
DI	CWP-S	CHILLED WATER PUMP STATUS	ON/OFF	X	X	X	
AO	MAD-O	MIXED AIR DAMPER	%	X			
AO	CWV-O	CHILLED WATER VALVE OUTPUT	%	X			
AO	HWV-O	HOT WATER PREHEAT VALVE OUTPUT	%	X			
AO	RHV-O	REHEAT COIL VALVE OUTPUT	%	X			
AO	BDP-O	BYPASS DAMPER OUTPUT	%	X			
DI	HSP-S	HIGH STATIC PRESSURE STATUS	ON/OFF	X	X	X	



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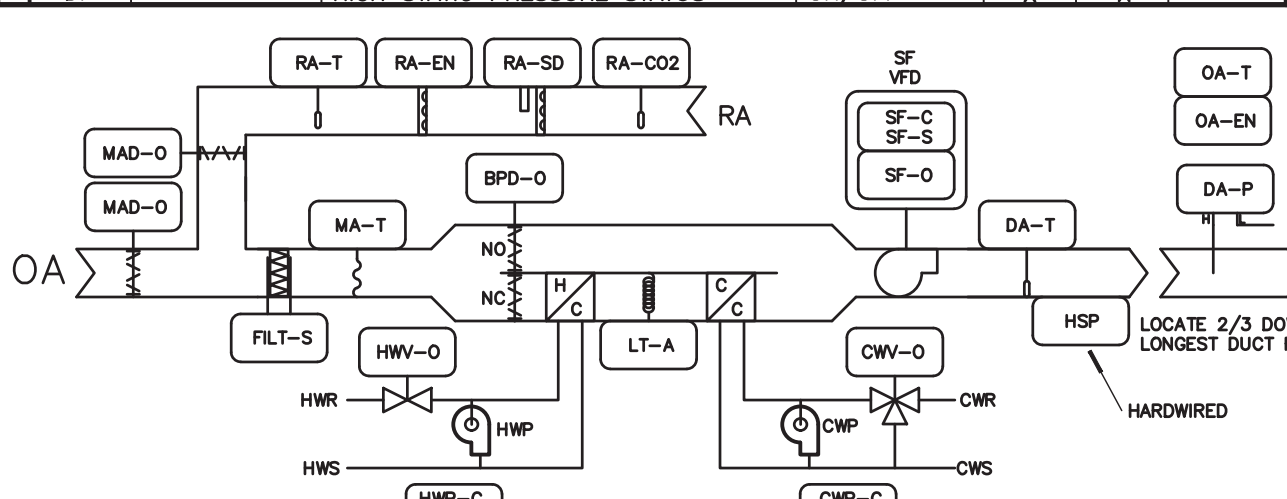
NO SCALE

AHU 5 CONTROL DIAGRAM

SEQUENCE OF OPERATION

AIR HANDLING UNIT 2 (SERVING DINING):  
  
OCCUPIED/UNOCCUPIED MODE: THE UNIT SHALL OPERATE BASED ON AN OCCUPANCY SCHEDULE. IN OCCUPIED MODE THE UNIT SHALL OPERATE AS INDICATED BELOW AND THE OUTSIDE AIR SHALL REMAIN AT THE MINIMUM INDICATED SET POINT. IN UNOCCUPIED MODE THE OUTSIDE AIR DAMPER SHALL BE CLOSED AND THE UNIT OPERATE TO MAINTAIN THE SET BACK TEMPERATURES.  
  
SUPPLY FAN CONTROL: THE SUPPLY FAN SHALL OPERATE CONTINUOUSLY WHENEVER THE AHU IS IN EITHER THE OCCUPIED COOLING MODE OR THE MORNING WARM-UP HEATING MODE. THE SUPPLY FAN SHALL SHUT-DOWN IF HIGH LIMIT STATIC PRESSURE IS ACTIVATED. IF THE SUPPLY FAN STATUS DOES NOT MATCH THE COMMANDED VALUE, AN ALARM SHALL BE GENERATED. WHEN THE SUPPLY FAN STATUS INDICATES THE FAN STARTED, THE CONTROL SEQUENCE SHALL BE ENABLED.  
  
SUPPLY FAN VARIABLE FREQUENCY DRIVE CONTROL: WHEN THE SUPPLY FAN IS ON, THE VARIABLE FREQUENCY DRIVE SHALL SLOWLY RAMP (ADJ.) UP AND MODULATE TO MAINTAIN THE PROPER DISCHARGE DUCT STATIC PRESSURE SETPOINT (ADJ.). DETERMINATION OF THE DISCHARGE DUCT STATIC PRESSURE SETPOINT SHALL BE PER THE DISCHARGE DUCT STATIC PRESSURE SETPOINT OPTIMIZATION. THE VARIABLE FREQUENCY DRIVE SHALL RESET TO ITS MINIMUM SPEED IF THE SUPPLY FAN IS OFF OR THE DUCT STATIC PRESSURE SENSOR FAILS.  
  
DISCHARGE AIR TEMPERATURE CONTROL:  
1. CONTINUOUSLY MONITOR ALL ZONE TEMPERATURE SENSORS SERVING THE FAN POWERED VAV BOXES.  
1.1. IF ANY ZONE IS IN COOLING MODE THE AHU DISCHARGE TEMPERATURE SHALL BE SET TO 55°F (ADJ.).  
1.2. IF THE RETURN AIR RELATIVE HUMIDITY RISES ABOVE 55% RH, THE DEHUMIDIFICATION SEQUENCE SHALL BE ENABLED AND THE AHU DISCHARGE TEMPERATURE SHALL BE SET TO 55°F (ADJ.). WHEN THE RETURN AIR RELATIVE HUMIDITY DROPS BELOW 50% RH, THE DEHUMIDIFICATION SEQUENCE SHALL BE DISABLED.  
1.3. IF ALL ZONES ARE IN HEATING MODE THE AHU DISCHARGE TEMPERATURE SHALL BE SET TO 75°F (ADJ.).  
  
COOLING MODE:  
IF THE OUTDOOR ENTHALPY IS BELOW INTERIOR, THEN THE ECONOMIZER MODE SHALL BE THE FIRST SOURCE OF COOLING. IF THE OUTSIDE AIR TEMPERATURE IS GREATER THAN 55°F, ECONOMIZER MODE SHALL BE DISABLED AND THE CHILLED WATER VALVE SHALL MODULATE AS REQUIRED TO MAINTAIN UNIT ZONE TEMPERATURE SETPOINT OF 75°F (ADJ.). THE HOT WATER VALVE SHALL REMAIN CLOSED. THE CHILLED WATER COIL PUMP SHALL BE ENABLED WHEN EITHER THE CHILLED WATER VALVE IS COMMANDED OPEN OR WHEN THE MIXED AIR TEMPERATURE DROPS BELOW 36°F (ADJ.).  
  
HEATING MODE:  
THE CHILLED WATER VALVE SHALL BE CLOSED AND THE HOT WATER VALVE SHALL MODULATE TO MAINTAIN UNIT DISCHARGE AIR TEMPERATURE SETPOINT OF 75°F (ADJ.). WHEN THE MIXED AIR TEMPERATURE DROPS BELOW 40°F, THE HOT WATER VALVE SHALL MOVE TO FULL OPEN AND THE BYPASS DAMPER SHALL MODULATE TO MAINTAIN UNIT DISCHARGE AIR TEMPERATURE SETPOINT. WHEN THE MIXED AIR TEMPERATURE IS GREATER THAN 45°F (ADJ.), THE BYPASS DAMPER SHALL MOVE TO FULL COIL POSITION AND THE HOT WATER VALVE SHALL MODULATE TO MAINTAIN UNIT DISCHARGE AIR TEMPERATURE SETPOINT. THE HOT WATER COIL PUMP SHALL BE ENABLED WHEN EITHER THE HOT WATER VALVE IS COMMANDED OPEN OR WHEN THE OUTSIDE AIR TEMPERATURE DROPS BELOW 40°F (ADJ.).  
  
VENTILATION CONTROL:  
1. DURING UNOCCUPIED MODE THE OUTSIDE AIR DAMPER SHALL BE CLOSED.  
2. DURING OCCUPIED MODE:  
2.1. WHEN THE CO2 LEVEL IS LESS THAN 1200 PPM (ADJ.) THE OUTSIDE AIR SETPOINT SHALL BE THE MINIMUM SETPOINT LISTED IN THE SCHEDULE.  
2.2. IF THE RETURN AIR CARBON DIOXIDE LEVEL EXCEEDS 1200 PPM (ADJ.), THE OUTSIDE AIR SETPOINT SHALL BE THE MAXIMUM SETPOINT LISTED IN THE SCHEDULE. WHEN THE CO2 LEVEL DROPS BELOW 800 PPM THE OUTSIDE AIR SETPOINT SHALL REVERT BACK TO THE MINIMUM POSITION.  
  
DISCHARGE DUCT STATIC PRESSURE SETPOINT OPTIMIZATION PER ASHRAE 90.1.  
  
1. THE BUILDING AUTOMATION SYSTEM SHALL CONTINUOUSLY MONITOR THE DAMPER POSITION OF ALL FAN POWERED VAV UNITS. THE DISCHARGE DUCT STATIC PRESSURE SHALL BE SENSED DIRECTLY AT THE DISCHARGE OF THE AIR HANDLER. THE SENSOR MUST BE MOUNTED IN A NON-TURBULENT LOCATION.  
  
2. WHEN ANY DAMPER IS MORE THAN 95% (ADJ.) OPEN, THE SUPPLY FAN DISCHARGE DUCT STATIC PRESSURE SETPOINT SHALL BE RESET UPWARD BY 5% (ADJ.) OF THE MAXIMUM SYSTEM STATIC PRESSURE SETPOINT OF 10 MINUTES (ADJ.) UNTIL NO DAMPER IS MORE THAN 95% OPEN OR THE STATIC PRESSURE SETPOINT HAS RESET UPWARD TO THE SYSTEM MAXIMUM SETTING OR VARIABLE FREQUENCY DRIVE ARE AT THEIR MAXIMUM SETTING.  
  
3. WHEN ALL DAMPERS ARE LESS THAN 85% (ADJ.) OPEN, THE SUPPLY FAN DISCHARGE DUCT STATIC PRESSURE SETPOINT SHALL BE RESET DOWNWARD BY 5% (ADJ.) OF THE MAXIMUM SYSTEM STATIC PRESSURE SETPOINT AT A FREQUENCY OF 10 MINUTES (ADJ.) UNTIL ANY DAMPER IS MORE THAN 85% OPEN OR THE STATIC PRESSURE SETPOINT HAS RESET DOWNWARD TO THE SYSTEM MINIMUM SETTING OR VARIABLE FREQUENCY DRIVE ARE AT THEIR MINIMUM SETTING.  
  
4. THE CONTROL BANDS, SETPOINT INCREMENT VALUES, SETPOINT DECREMENT VALUES AND ADJUSTMENT FREQUENCIES SHALL BE ADJUSTED TO MAINTAIN MAXIMUM STATIC PRESSURE OPTIMIZATION WITH STABLE SYSTEM CONTROL AND MAXIMUM COMFORT CONTROL.  
  
FREEZE PROTECTION:  
IF THE MIXED AIR TEMPERATURE (MAT) DROPS BELOW 40°F (ADJ.), THE OUTSIDE AIR DAMPER SHALL MODULATE TO MAINTAIN A MINIMUM OF 40°F (ADJ.).  
IF THE MIXED AIR TEMPERATURE DROPS BELOW 36°F (ADJ.), THE OUTSIDE AIR DAMPER SHALL FULLY CLOSE.  
IF THE MIXED AIR TEMPERATURE DROPS BELOW 34°F (ADJ.), THE OUTSIDE AIR DAMPER SHALL FULLY CLOSE, THE RETURN AIR DAMPER SHALL FULLY OPEN, THE SUPPLY FAN SHALL STOP, AND BOTH THE HOT WATER AND CHILLED WATER VALVES SHALL MOVE TO FULL OPEN POSITIONS. AN ALARM SHALL BE GENERATED AT THE CENTRAL WORKSTATION UPON ACTIVATION OF ANY OF THE THREE SETPOINTS ABOVE.  
  
FREEZESTAT CONTROL:  
IF THE FREEZESTAT SENSES A TEMPERATURE BELOW 32°F, THE OUTSIDE AIR DAMPER SHALL FULLY CLOSE, THE RETURN AIR DAMPER SHALL FULLY OPEN, THE SUPPLY FAN SHALL STOP AND BOTH THE HOT WATER AND CHILLED WATER VALVES SHALL MOVE TO FULL OPEN POSITIONS. AN ALARM SHALL BE GENERATED AT THE CENTRAL WORKSTATION UPON ACTIVATION OF ANY OF THE THREE SETPOINTS ABOVE.  
  
SAFETY:  
ALL OF THE SAFETY DEVICES SHALL BE MANUAL RESET; THE DEVICE THAT HAS TRIPPED SHALL BE MANUALLY RESET BEFORE RESTARTING THE AIR HANDLING UNIT.

AHU-2 SYSTEM - POINTS LIST							
TYPE	POINT	DESCRIPTION	UNITS	TREND	ALARM	TOTALIZE	
AI	MA-T	MIXED AIR TEMPERATURE	DEG F	X	X	X	
AI	DA-T	DISCHARGE AIR TEMPERATURE	DEG F	X	X	X	
AI	DA-P	DISCHARGE AIR STATIC PRESSURE	IN W.C.	X	X	X	
AI	RA-CO2	RETURN AIR CO2	PPM	X	X	X	
AI	RA-T	RETURN AIR TEMPERATURE	DEG F	X	X	X	
AI	RA-EN	RETURN AIR ENTHALPY	BTU/LB	X	X	X	
AI	OA-EN	OUTDOOR AIR ENTHALPY	BTU/LB	X	X	X	
AI	FILT-S	DIRTY FILTER STATUS	PSI	X	X	X	
DI	SF-S	SUPPLY FAN STATUS	ON/OFF	X	X	X	
DI	RA-SD	RETURN AIR SMOKE DETECTOR	ON/OFF	X	X	X	
AI	DA-SP	DISCHARGE AIR DIFFERENTIAL PRESS.	PSI	X			
AO	SF-O	SUPPLY FAN OUTPUT	%	X			
DO	SF-C	SUPPLY FAN COMMAND	ON/OFF	X			
AO	MAD-O	MIXED AIR DAMPER	%	X			
AO	BDP-O	BYPASS AIR DAMPER	%	X			
AO	CWV-O	CHILLED WATER VALVE OUTPUT	%	X			
AO	HWV-O	HOT WATER VALVE OUTPUT	%	X			
AO	BDP-O	BYPASS DAMPER OUTPUT	%	X			
DI	HSP-S	HIGH STATIC PRESSURE STATUS	ON/OFF	X	X	X	



2

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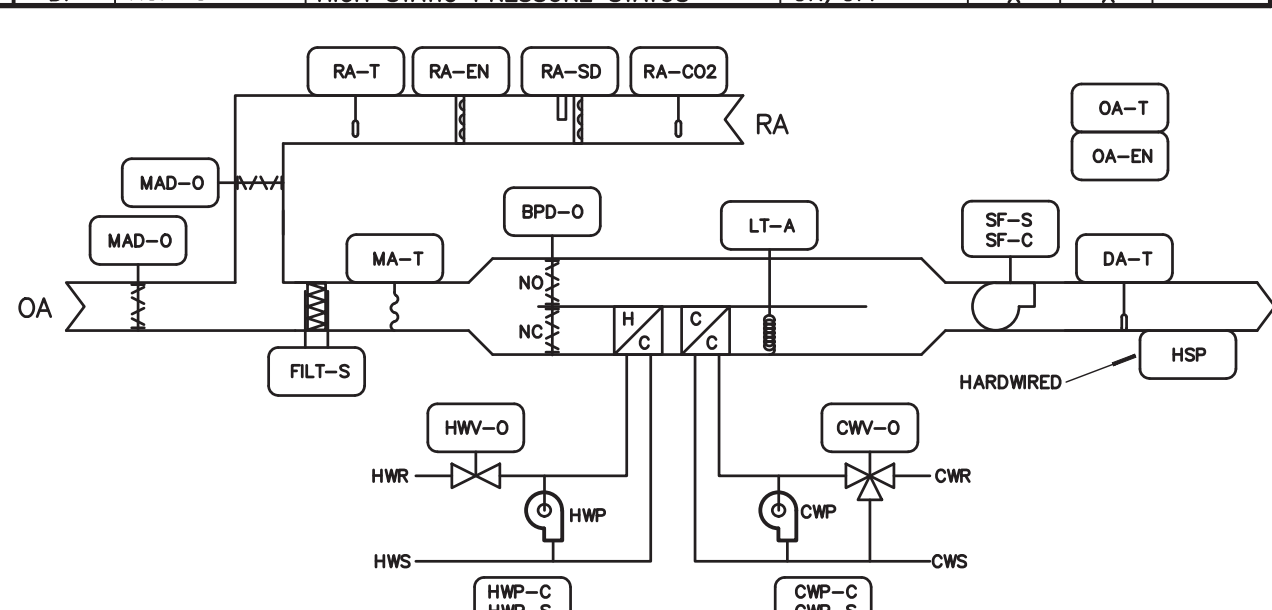
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AHU-2 CONTROL DIAGRAM

SEQUENCE OF OPERATION

AHU 11 (SERVING CORE AREAS):  
  
OCCUPIED/UNOCCUPIED MODE: THE UNIT SHALL OPERATE BASED ON AN OCCUPANCY SCHEDULE. IN OCCUPIED MODE THE UNIT SHALL OPERATE AS INDICATED BELOW AND THE OUTSIDE AIR SHALL REMAIN AT THE MINIMUM INDICATED SET POINT. IN UNOCCUPIED MODE THE OUTSIDE AIR DAMPER SHALL BE CLOSED AND THE UNIT OPERATE TO MAINTAIN THE SET BACK TEMPERATURES.  
  
SUPPLY FAN CONTROL: THE SUPPLY FAN SHALL OPERATE CONTINUOUSLY WHENEVER THE AHU IS IN EITHER THE OCCUPIED COOLING MODE OR THE MORNING WARM-UP HEATING MODE. THE SUPPLY FAN SHALL SHUT-DOWN IF HIGH LIMIT STATIC PRESSURE IS ACTIVATED. IF THE SUPPLY FAN STATUS DOES NOT MATCH THE COMMANDED VALUE, AN ALARM SHALL BE GENERATED. WHEN THE SUPPLY FAN STATUS INDICATES THE FAN STARTED, THE CONTROL SEQUENCE SHALL BE ENABLED.  
  
DISCHARGE AIR TEMPERATURE CONTROL:  
1. CONTINUOUSLY MONITOR ALL ZONE TEMPERATURE SENSORS SERVING THE HOT WATER ZONE REHEAT COILS AND BYPASS TERMINAL BOXES.  
1.1. IF ANY ZONE IS IN COOLING MODE THE AHU DISCHARGE TEMPERATURE SHALL BE SET TO 55°F (ADJ.).  
1.2. IF THE RETURN AIR RELATIVE HUMIDITY RISES ABOVE 55% RH, THE DEHUMIDIFICATION SEQUENCE SHALL BE ENABLED AND THE AHU DISCHARGE TEMPERATURE SHALL BE SET TO 55°F (ADJ.). WHEN THE RETURN AIR RELATIVE HUMIDITY DROPS BELOW 50% RH, THE DEHUMIDIFICATION SEQUENCE SHALL BE DISABLED.  
1.3. IF ALL ZONES ARE IN HEATING MODE THE AHU DISCHARGE TEMPERATURE SHALL BE SET TO 75°F (ADJ.).  
  
COOLING MODE:  
IF THE OUTDOOR ENTHALPY IS BELOW INTERIOR, THEN THE ECONOMIZER MODE SHALL BE THE FIRST SOURCE OF COOLING. IF THE OUTSIDE AIR TEMPERATURE IS GREATER THAN 55°F, ECONOMIZER MODE SHALL BE DISABLED AND THE CHILLED WATER VALVE SHALL MODULATE AS REQUIRED TO MAINTAIN UNIT DISCHARGE TEMPERATURE SETPOINT OF 55°F (ADJ.). THE HOT WATER VALVE SHALL REMAIN CLOSED. THE CHILLED WATER COIL PUMP SHALL BE ENABLED WHEN EITHER THE CHILLED WATER VALVE IS COMMANDED OPEN OR WHEN THE MIXED AIR TEMPERATURE DROPS BELOW 36°F (ADJ.).  
  
HEATING MODE:  
THE CHILLED WATER VALVE SHALL BE CLOSED AND THE HOT WATER VALVE SHALL MODULATE TO MAINTAIN UNIT DISCHARGE AIR TEMPERATURE SETPOINT OF 75°F (ADJ.). WHEN THE MIXED AIR TEMPERATURE DROPS BELOW 40°F, THE HOT WATER VALVE SHALL MOVE TO FULL OPEN AND THE BYPASS DAMPER SHALL MODULATE TO MAINTAIN UNIT DISCHARGE AIR TEMPERATURE SETPOINT. WHEN THE MIXED AIR TEMPERATURE IS GREATER THAN 45°F (ADJ.), THE BYPASS DAMPER SHALL MOVE TO FULL COIL POSITION AND THE HOT WATER VALVE SHALL MODULATE TO MAINTAIN UNIT DISCHARGE AIR TEMPERATURE SETPOINT. THE HOT WATER COIL PUMP SHALL BE ENABLED WHEN EITHER THE HOT WATER VALVE IS COMMANDED OPEN OR WHEN THE OUTSIDE AIR TEMPERATURE DROPS BELOW 40°F (ADJ.).  
  
VENTILATION CONTROL:  
1. DURING UNOCCUPIED MODE THE OUTSIDE AIR DAMPER SHALL BE CLOSED.  
2. DURING OCCUPIED MODE:  
2.1. WHEN THE CO2 LEVEL IS LESS THAN 1200 PPM (ADJ.) THE OUTSIDE AIR SETPOINT SHALL BE THE MINIMUM SETPOINT LISTED IN THE SCHEDULE.  
2.2. IF THE RETURN AIR CARBON DIOXIDE LEVEL EXCEEDS 1200 PPM (ADJ.), THE OUTSIDE AIR SETPOINT SHALL BE THE MAXIMUM SETPOINT LISTED IN THE SCHEDULE. WHEN THE CO2 LEVEL DROPS BELOW 800 PPM THE OUTSIDE AIR SETPOINT SHALL REVERT BACK TO THE MINIMUM POSITION.  
  
FREEZE PROTECTION:  
IF THE MIXED AIR TEMPERATURE DROPS BELOW 40°F (ADJ.), THE OUTSIDE AIR DAMPER SHALL FULLY MODULATE TO MAINTAIN A MINIMUM OF 40°F (ADJ.).  
IF THE MIXED AIR TEMPERATURE DROPS BELOW 34°F (ADJ.), THE OUTSIDE AIR DAMPER SHALL FULLY CLOSE. THE RETURN AIR DAMPER SHALL FULLY OPEN, THE SUPPLY FAN SHALL STOP, BOTH THE HOT WATER AND CHILLED WATER VALVES SHALL MOVE TO FULL OPEN POSITIONS, AND BOTH COIL PUMPS SHALL BE ENABLED. AN ALARM SHALL BE GENERATED AT THE CENTRAL WORKSTATION UPON ACTIVATION OF ANY OF THE THREE SETPOINTS ABOVE.  
  
FREEZESTAT CONTROL:  
IF THE FREEZESTAT SENSES A TEMPERATURE BELOW 34°F, THE OUTSIDE AIR DAMPER SHALL FULLY CLOSE, THE RETURN AIR DAMPER SHALL FULLY OPEN, AND THE SUPPLY FAN SHALL STOP.  
  
SAFETY:  
ALL OF THE SAFETY DEVICES SHALL BE MANUAL RESET; THE DEVICE THAT HAS TRIPPED SHALL BE MANUALLY RESET BEFORE RESTARTING THE AIR HANDLING UNIT.

AHU-11 - POINTS LIST							
TYPE	POINT	DESCRIPTION	UNITS	TREND	ALARM	TOTALIZE	
AI	MA-T	MIXED AIR TEMPERATURE	DEG F	X	X	X	
AI	DA-T	DISCHARGE AIR TEMPERATURE	DEG F	X	X	X	
AI	RA-CO2	RETURN AIR CO2	PPM	X	X	X	
AI	RA-T	RETURN AIR TEMPERATURE	DEG F	X	X	X	
AI	RA-EN	RETURN AIR ENTHALPY	BTU/LB	X	X	X	
AI	OA-EN	OUTDOOR AIR ENTHALPY	BTU/LB	X	X	X	
AI	FILT-S	DIRTY FILTER STATUS	PSI	X	X	X	
DI	SF-S	SUPPLY FAN STATUS	ON/OFF	X	X	X	
DI	RA-SD	RETURN AIR SMOKE DETECTOR	ON/OFF	X	X	X	
DO	SF-C	SUPPLY FAN COMMAND	%	X			
DI	HWP-C	HOT WATER PUMP COMMAND	ON/OFF	X			
DI	HWP-S	HOT WATER PUMP STATUS	ON/OFF	X	X	X	
DO	CWP-C	CHILLED WATER PUMP COMMAND	ON/OFF	X			
DI	CWP-S	CHILLED WATER PUMP STATUS	ON/OFF	X	X	X	
AO	MAD-O	MIXED AIR DAMPER	%	X			
AO	BDP-O	BYPASS AIR DAMPER	%	X			
AO	CWV-O	CHILLED WATER VALVE OUTPUT	%	X			
AO	HWV-O	HOT WATER VALVE OUTPUT	%	X			
AO	BDP-O	BYPASS DAMPER OUTPUT	%	X			
DI	HSP-S	HIGH STATIC PRESSURE STATUS	ON/OFF	X	X	X	



1

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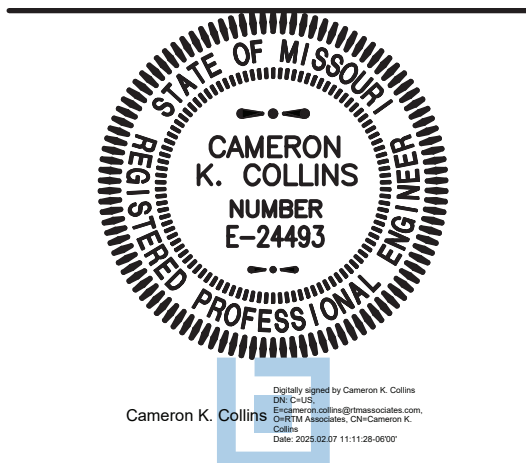
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AHU-11 CONTROL DIAGRAM

rtm

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DESIGN AND CONSTRUCTION

DEPARTMENT OF  
PUBLIC SAFETY  
MISSOURI VETERANS  
COMMISSION



POINTS LIST						
TYPE	POINT	DESCRIPTION	UNITS	TREND	ALARM	TOTALIZE
AI	DA-T	DISCHARGE AIR TEMPERATURE	DEG F	X	X	
AI	ZN-T	ZONE TEMPERATURE	DEG F	X	X	
AO	HWV-O	HEATING VALVE OUTPUT	%	X		
AO	BYP-O	BYPASS DAMPER OUTPUT	%	X		


### SEQUENCE OF OPERATION

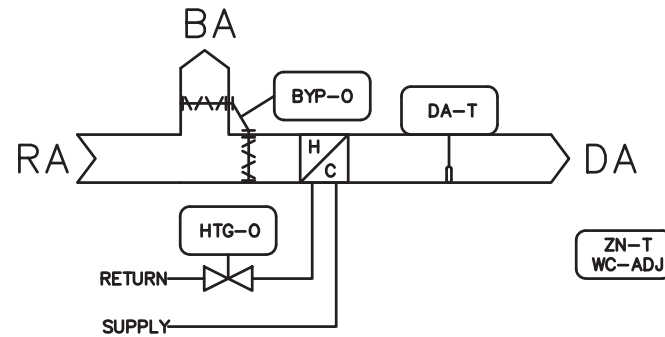**DISCHARGE AIR TEMP SENSOR:** A DUCT MOUNTED DISCHARGE AIR TEMPERATURE SENSOR SHALL BE FURNISHED AND INSTALLED FOR EACH TERMINAL BOX FOR MONITORING PURPOSES.

**OCCUPANCY SCHEDULE:** ALL TERMINAL BOXES SHALL BE PROVIDED WITH AN OCCUPANCY SCHEDULE AND SCHEDULED PER THE OCCUPANCY SCHEDULE.

**HEATING MODE:** WHEN THE ZONE TEMPERATURE DROPS BELOW SETPOINT, THE BYPASS DAMPER SHALL MODULATE OPEN TO BYPASS SUPPLY AIR TO THE RETURN AIR PLENUM. IF THE ZONE TEMPERATURE CONTINUES TO DROP AND THE BYPASS DAMPER IS AT MAXIMUM BYPASS POSITION, THEN THE HOT WATER VALVE SHALL MODULATE TO MAINTAIN SPACE SETPOINT.

**COOLING MODE:** WHEN THE ZONE TEMPERATURE RISES ABOVE SETPOINT, THE HOT WATER VALVE SHALL BE CLOSED AND THE BYPASS DAMPER SHALL MODULATE UP TO FULLY CLOSED AS REQUIRED TO MAINTAIN ZONE SETPOINT TEMPERATURE.



## BYPASS VAV TERMINAL BOX CONTROL DIAGRAM

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M-604  
NO SCALE

POINTS LIST						
TYPE	POINT	DESCRIPTION	UNITS	TREND	ALARM	TOTALIZE
AI	DA-T	DISCHARGE AIR TEMPERATURE	DEG F	X	X	
AI	ZN-T	ZONE TEMPERATURE	DEG F	X	X	
AI	DA-F	DISCHARGE AIRFLOW	CFM	X		
BO	SF-C	SUPPLY FAN COMMAND	ON/OFF	X		
AO	HWV-O	HEATING VALVE OUTPUT	%	X		
AO	DAF-SP	DISCHARGE AIRFLOW SETPOINT	CFM	X		
AO	DPR-O	DAMPER OUTPUT	%	X		
AO	ZT-SP	ZONE TEMPERATURE SETPOINT	DEG F	X		

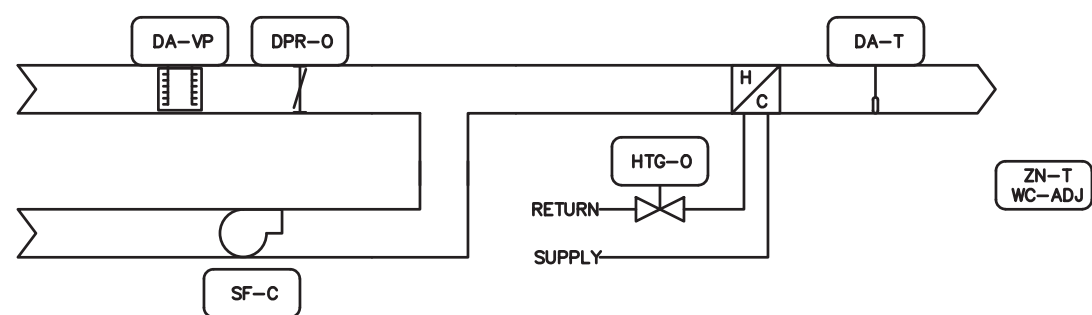
### SEQUENCE OF OPERATION

**DISCHARGE AIR TEMP SENSOR:** A DUCT MOUNTED DISCHARGE AIR TEMPERATURE SENSOR SHALL BE FURNISHED AND INSTALLED FOR EACH TERMINAL BOX FOR MONITORING PURPOSES.

**OCCUPANCY SCHEDULE:** ALL TERMINAL BOXES SHALL BE PROVIDED WITH AN OCCUPANCY SCHEDULE AND SCHEDULED PER THE OCCUPANCY SCHEDULE.

**OCCUPIED MODE:** WHEN THE ZONE TEMPERATURE IS BETWEEN THE OCCUPIED HEATING AND COOLING SETPOINTS (INSIDE OF THE BIAS), THE PRIMARY AIR DAMPER SHALL BE AT THE MINIMUM CFM AND THE REHEAT VALVE SHALL BE FULLY CLOSED. ON A RISE IN ZONE TEMPERATURE ABOVE THE COOLING SETPOINT, THE PRIMARY AIR DAMPER SHALL INCREASE THE CFM AND THE REHEAT VALVE REMAINS FULLY CLOSED. ON A DROP IN ZONE TEMPERATURE BELOW THE HEATING SETPOINT, THE FAN SHALL CYCLE ON, THE REHEAT VALVE MODULATES OPEN AND THE DAMPER IS CONTROLLED TO PROVIDE A MINIMUM CFM.

**UNOCCUPIED (NIGHT SETBACK) MODE:** WHEN THE AIR HANDLING UNIT SHUTS DOWN, ALL OF THE FAN-POWERED BOX CONTROLLERS ARE INDEXED TO UNOCCUPIED MODE. WHEN THE ZONE TEMPERATURE IS BETWEEN THE UNOCCUPIED HEATING AND COOLING SETPOINTS (INSIDE OF THE BIAS), THE PRIMARY AIR DAMPER SHALL BE AT THE MINIMUM CFM AND THE REHEAT VALVE SHALL BE FULLY CLOSED. ON A RISE IN ZONE TEMPERATURE ABOVE THE UNOCCUPIED COOLING SETPOINT, THE PRIMARY AIR DAMPER SHALL INCREASE THE CFM (IF AVAILABLE) AND THE REHEAT VALVE REMAINS FULLY CLOSED. ON A DROP IN ZONE TEMPERATURE BELOW THE UNOCCUPIED HEATING SETPOINT, THE FAN SHALL CYCLE ON, THE REHEAT VALVE MODULATES OPEN AND THE DAMPER REMAINS FULLY CLOSED.



## FAN TERMINAL UNIT WITH HW HEAT CONTROL DIAGRAM

1  
M-604  
NO SCALE

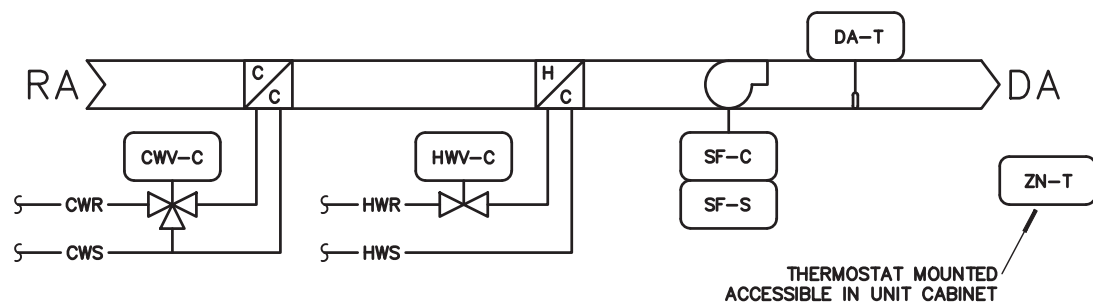
POINTS LIST						
TYPE	POINT	DESCRIPTION	UNITS	TREND	ALARM	TOTALIZE
AI	DA-T	DISCHARGE AIR TEMPERATURE	DEG F	X	X	
AI	ZN-T	ZONE TEMPERATURE	DEG F	X	X	
AO	CWV-C	COOLING VALVE COMMAND	OPEN/CLOSED	X		
AO	HWV-C	HEATING VALVE COMMAND	OPEN/CLOSED	X		
BO	SF-C	SUPPLY FAN COMMAND	ON/OFF	X		
DI	SF-S	SUPPLY FAN STATUS	ON/OFF	X	X	

### SEQUENCE OF OPERATION

**GENERAL:** UNIT SHALL BE IN OCCUPIED/UNOCCUPIED MODE BASED ON AN ADJUSTABLE TIME SCHEDULE AS SELECTED BY THE OWNER'S REPRESENTATIVES.

**UNOCCUPIED MODE:** THE SUPPLY FAN SHALL CYCLE ON/OFF IN CONJUNCTION WITH A CALL FOR HEATING OR COOLING.

**OCCUPIED MODE:** THE SUPPLY FAN SHALL CYCLE ON/OFF IN CONJUNCTION WITH A CALL FOR HEATING OR COOLING. HEATING AND COOLING SHALL NOT OCCUR SIMULTANEOUSLY.



## VERTICAL FLOOR MOUNTED 4-PIPE FAN COIL UNIT CONTROL DIAGRAM

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M-604  
NO SCALE

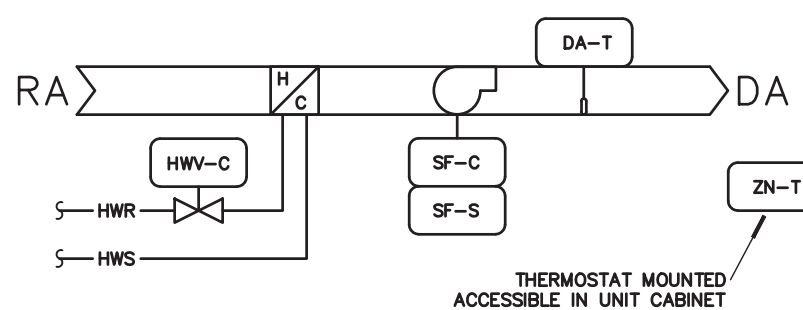
POINTS LIST						
TYPE	POINT	DESCRIPTION	UNITS	TREND	ALARM	TOTALIZE
AI	DA-T	DISCHARGE AIR TEMPERATURE	DEG F	X	X	
AI	ZN-T	ZONE TEMPERATURE	DEG F	X	X	
AO	HWV-C	HEATING VALVE COMMAND	OPEN/CLOSED	X		
BO	SF-C	SUPPLY FAN COMMAND	ON/OFF	X		
DI	SF-S	SUPPLY FAN STATUS	ON/OFF	X	X	

### SEQUENCE OF OPERATION

**GENERAL:** UNIT SHALL BE IN OCCUPIED/UNOCCUPIED MODE BASED ON AN ADJUSTABLE TIME SCHEDULE AS SELECTED BY THE OWNER'S REPRESENTATIVES.

**UNOCCUPIED MODE:** THE SUPPLY FAN SHALL CYCLE ON/OFF IN CONJUNCTION WITH A CALL FOR HEATING.

**OCCUPIED MODE:** THE SUPPLY FAN SHALL CYCLE ON/OFF IN CONJUNCTION WITH A CALL FOR HEATING.



## VERTICAL FLOOR MOUNTED HEATING FAN COIL UNIT CONTROL DIAGRAM

3  
M-604  
NO SCALE

EXHAUST FAN -- POINTS LIST						
TYPE	POINT	DESCRIPTION	UNITS	TREND	ALARM	TOTALIZE
DO	EF-20A	EXHAUST FAN 20A COMMAND	ON/OFF	X		
DO	EF-21A	EXHAUST FAN 21A COMMAND	ON/OFF	X		
DO	EF-22A	EXHAUST FAN 22A COMMAND	ON/OFF	X		
DO	EF-23A	EXHAUST FAN 23A COMMAND	ON/OFF	X		
DO	EF-24A	EXHAUST FAN 24A COMMAND	ON/OFF	X		
DO	EF-25A	EXHAUST FAN 25A COMMAND	ON/OFF	X		
DI	EF-20A	EXHAUST FAN 20A STATUS	ON/OFF	X	X	
DI	EF-21A	EXHAUST FAN 21A STATUS	ON/OFF	X	X	
DI	EF-22A	EXHAUST FAN 22A STATUS	ON/OFF	X	X	
DI	EF-23A	EXHAUST FAN 23A STATUS	ON/OFF	X	X	
DI	EF-24A	EXHAUST FAN 24A STATUS	ON/OFF	X	X	
DI	EF-25A	EXHAUST FAN 25A STATUS	ON/OFF	X	X	
AO	EF-20A	EXHAUST FAN 20A SPEED	0-10V	X		
AO	EF-21A	EXHAUST FAN 21A SPEED	0-10V	X		
AO	EF-22A	EXHAUST FAN 22A SPEED	0-10V	X		
AO	EF-23A	EXHAUST FAN 23A SPEED	0-10V	X		
AO	EF-24A	EXHAUST FAN 24A SPEED	0-10V	X		
AO	EF-25A	EXHAUST FAN 25A SPEED	0-10V	X		
AI	EF-20A	EXHAUST FAN 20A DIFF. PRESS.	%	X	X	
AI	EF-21A	EXHAUST FAN 21A DIFF. PRESS.	%	X	X	
AI	EF-22A	EXHAUST FAN 22A DIFF. PRESS.	%	X	X	
AI	EF-23A	EXHAUST FAN 23A DIFF. PRESS.	%	X	X	
AI	EF-24A	EXHAUST FAN 24A DIFF. PRESS.	%	X	X	
AI	EF-25A	EXHAUST FAN 25A DIFF. PRESS.	%	X	X	

### SEQUENCE OF OPERATION

- FAN STATUS SHALL BE PROVIDED BY CT SWITCH AND MONITOR FAN AMP DRAW AND ALARM WHEN OUT OF NORMAL RANGE OF OPERATION.
- EXHAUST FAN "EF-20A" SERVES RESTROOMS/SHOWER ROOM. MONITOR AIRFLOW WITH AIRFLOW SWITCH. FAN SHALL RUN CONTINUOUSLY AND SHALL ADJUST FAN SPEED AS FILTER LOADS.
- EXHAUST FAN "EF-21A" SERVES MEDICAL STORAGE. MONITOR AIRFLOW WITH AIRFLOW SWITCH. FANS SHALL RUN CONTINUOUSLY AND SHALL ADJUST FAN SPEED AS FILTER LOADS.
- EXHAUST FAN "EF-22A" SERVES BATH ROOM. FAN SHALL START/STOP WITH LIGHTS AND SHALL ADJUST FAN SPEED AS FILTER LOADS.
- EXHAUST FAN "EF-23A" SERVES RESTROOMS/SHOWER ROOM. MONITOR AIRFLOW WITH AIRFLOW SWITCH. FAN SHALL RUN CONTINUOUSLY AND SHALL ADJUST FAN SPEED AS FILTER LOADS.
- EXHAUST FAN "EF-24A" SERVES RESTROOMS/SHOWER ROOM. MONITOR AIRFLOW WITH AIRFLOW SWITCH. FAN SHALL RUN CONTINUOUSLY AND SHALL ADJUST FAN SPEED AS FILTER LOADS.
- EXHAUST FAN "EF-25A" SERVES PRIVATE ISOLATION ROOM. MONITOR AIRFLOW WITH AIRFLOW SWITCH. FAN SHALL RUN CONTINUOUSLY AND SHALL ADJUST FAN SPEED AS FILTER LOADS.

## WING 'A' ALTERNATE #1 EXHAUST FAN CONTROLS

6  
M-604  
NO SCALE

EXHAUST FAN -- POINTS LIST						
TYPE	POINT	DESCRIPTION	UNITS	TREND	ALARM	TOTALIZE
DO	EF8-C	EXHAUST FAN #8 COMMAND	ON/OFF	X		
DO	EF15A-C	EXHAUST FAN #15A COMMAND	ON/OFF	X		
DO	EF15F-C	EXHAUST FAN #15F COMMAND	ON/OFF	X		
AI	EF8-S	EXHAUST FAN #8 STATUS	ON/OFF	X	X	
AI	EF15A-S	EXHAUST FAN #15A STATUS	ON/OFF	X	X	
AI	EF15F-S	EXHAUST FAN #15F STATUS	ON/OFF	X	X	

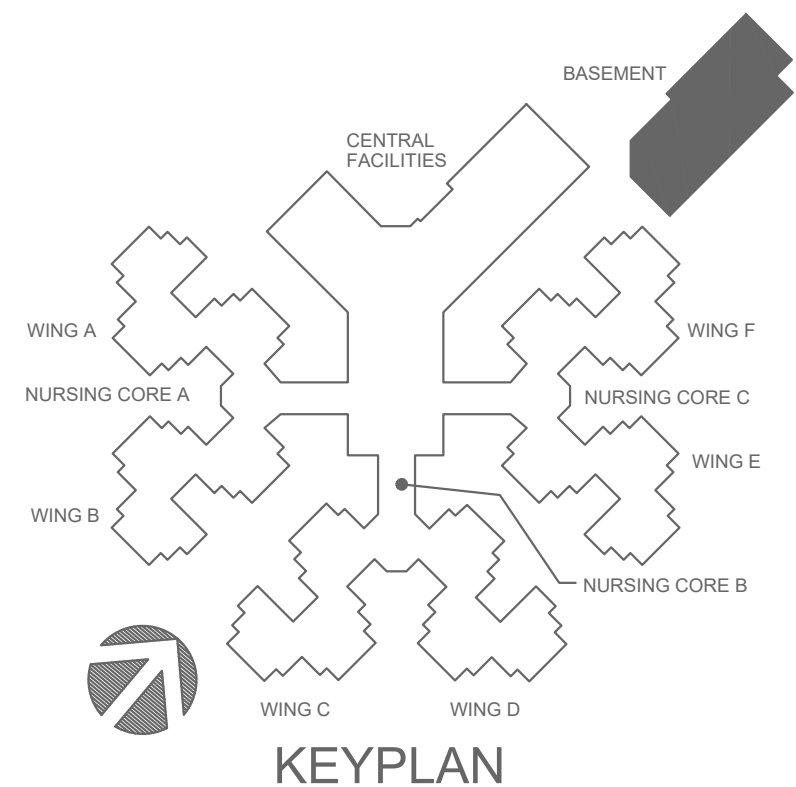
### SEQUENCE OF OPERATION

- FAN STATUS SHALL BE PROVIDED BY CT SWITCH AND MONITOR FAN AMP DRAW AND ALARM WHEN OUT OF NORMAL RANGE OF OPERATION.
- EXHAUST FAN "EF8" SERVES THE DISHWASHER HOOD. FAN SHALL BE CONTROLLED BY THE SWITCH AT THE HOOD.
- EXHAUST FAN "EF15A" & "EF15F" SERVES THE RESIDENT WINGS. FANS SHALL RUN CONTINUOUSLY.

## EXHAUST FAN CONTROLS

5  
M-604  
NO SCALE








## NOTES:

1. EXISTING LIGHT FIXTURE TO REMAIN.
2. REMOVE EXISTING LIGHT FIXTURE.
3. EXISTING PANEL "NP".
4. EXISTING PANEL "NN".
5. EXISTING UNIT TO BE REPLACED. PROVIDE REQUIRED ELECTRICAL DEMOLITION.
6. EXISTING AHUS TO BE REPLACED.
7. EXISTING MAU1 TO BE REPLACED.
8. EXISTING ANSUL PULL STATION TO REMAIN. TIE INTO NEW FIRE ALARM SYSTEM.
9. EXISTING HVAC UNIT TO BE REPLACED. PROVIDE REQUIRED ELECTRICAL DEMOLITION AND REUSE EXISTING CIRCUIT FOR NEW UNIT.
10. EXISTING EXHAUST FAN TO REMAIN.
11. THERMOSTAT TO BE REPLACED BY MECHANICAL. REUSE EXISTING BOX AND CONDUIT FOR NEW THERMOSTAT.

## GENERAL NOTES:

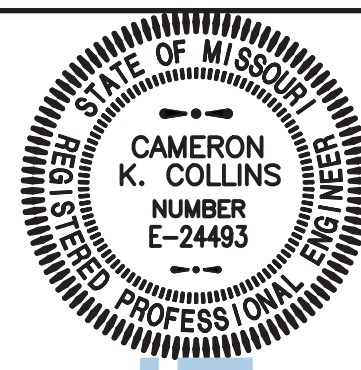1. FOR ALL ELECTRICAL QUESTIONS DURING BIDDING OR DURING CONSTRUCTION, CONTACT ESTERY, SCHNEIDER & ASSOCIATES, INC. THOM LUNDBERG (417) 862-0558 FOR COORDINATION WITH ANTHONY G. BEIER AT RTM ENGINEERING CONSULTANTS.
2. INFORMATION ON THESE DRAWINGS REPRESENT INFORMATION FROM EXISTING DRAWINGS AND LIMITED SITE OBSERVATIONS. CONTRACTOR SHALL FIELD VERIFY EXISTING CONDITIONS PRIOR TO SUBMITTING BID. NO EXTRAS SHALL BE PAID DUE TO UNANTICIPATED CONDITIONS.
3. CONTRACTOR SHALL BE RESPONSIBLE FOR ALL CORING, PATCHING, AND REPAIR OF ALL WALL AND FLOOR SYSTEM AS REQUIRED DUE TO NEW CONSTRUCTION. MAINTAIN ALL FIRE RATINGS.
4. FOR ALL EXISTING FIXTURES, RECEPTACLES, WIRING, EQUIPMENT, ETC. SHOWN TO BE REMOVED, THE OWNER SHALL HAVE THE FIRST RIGHT OF REFUSAL.
5. CONTRACTOR SHALL BE RESPONSIBLE FOR REMOVAL OF ALL ELECTRICAL DEVICES AND WIRING IN ALL DEMOLISHED WALLS WHETHER SPECIFICALLY INDICATED OR NOT.
6. WHERE DEMOLISHED DEVICES ARE PART OF A CIRCUIT THAT IS THRU-WIRED, OR HAS ADDITIONAL DEVICES ON THE CIRCUIT THAT ARE TO REMAIN UNCHANGED, THE CONTRACTOR IS RESPONSIBLE FOR MAINTAINING THE INTEGRITY OF THE EXISTING CIRCUIT. ANY ADDITIONAL CONDUIT, CONDUCTOR, BOXES, ETC. NEEDED TO MODIFY THE EXISTING CIRCUIT TO MAINTAIN THE INTEGRITY ARE THE RESPONSIBILITY OF THIS CONTRACTOR AND SHALL BE INCLUDED IN BID.
7. REMOVE CONDUIT IN ALL DEMOLISHED WALLS.
8. REMOVE ANY UNUSED CONDUCTORS, CONDUIT, AND WIRING IN DEMOLISHED WALLS LOCATED WITHIN THE AREA OF CONSTRUCTION. REMOVE ALL UNUSED WIRING. CONDUIT CAN BE ABANDONED IN PLACE WHERE IT WILL REMAIN CONCEALED.
9. REMOVE AND REPLACE DEVICES AS REQUIRED DUE TO NEW WALL OR CEILING FINISHES.



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OFFICE OF ADMINISTRATION  
DIVISION OF FACILITIES  
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DEPARTMENT OF  
PUBLIC SAFETY  
MISSOURI VETERANS  
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INTERIOR RENOVATION  
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HOME

620 N. JEFFERSON  
ST. JAMES, MISSOURI

PROJECT # **U1503-01**  
SITE # **6801**  
ASSET # **8136801002**  
FEDERAL # **29-044**

REVISION: \_\_\_\_\_  
DATE: \_\_\_\_\_  
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DATE: \_\_\_\_\_  
REVISION: \_\_\_\_\_  
DATE: \_\_\_\_\_  
ISSUE DATE: **8-1-24**

CAD DWG FILE: **E-101.DWG**  
DRAWN BY: **AGB**  
CHECKED BY: **CKB**  
DESIGNED BY: **AGB**

SHEET TITLE:


# ELECTRICAL DEMOLITION PLAN

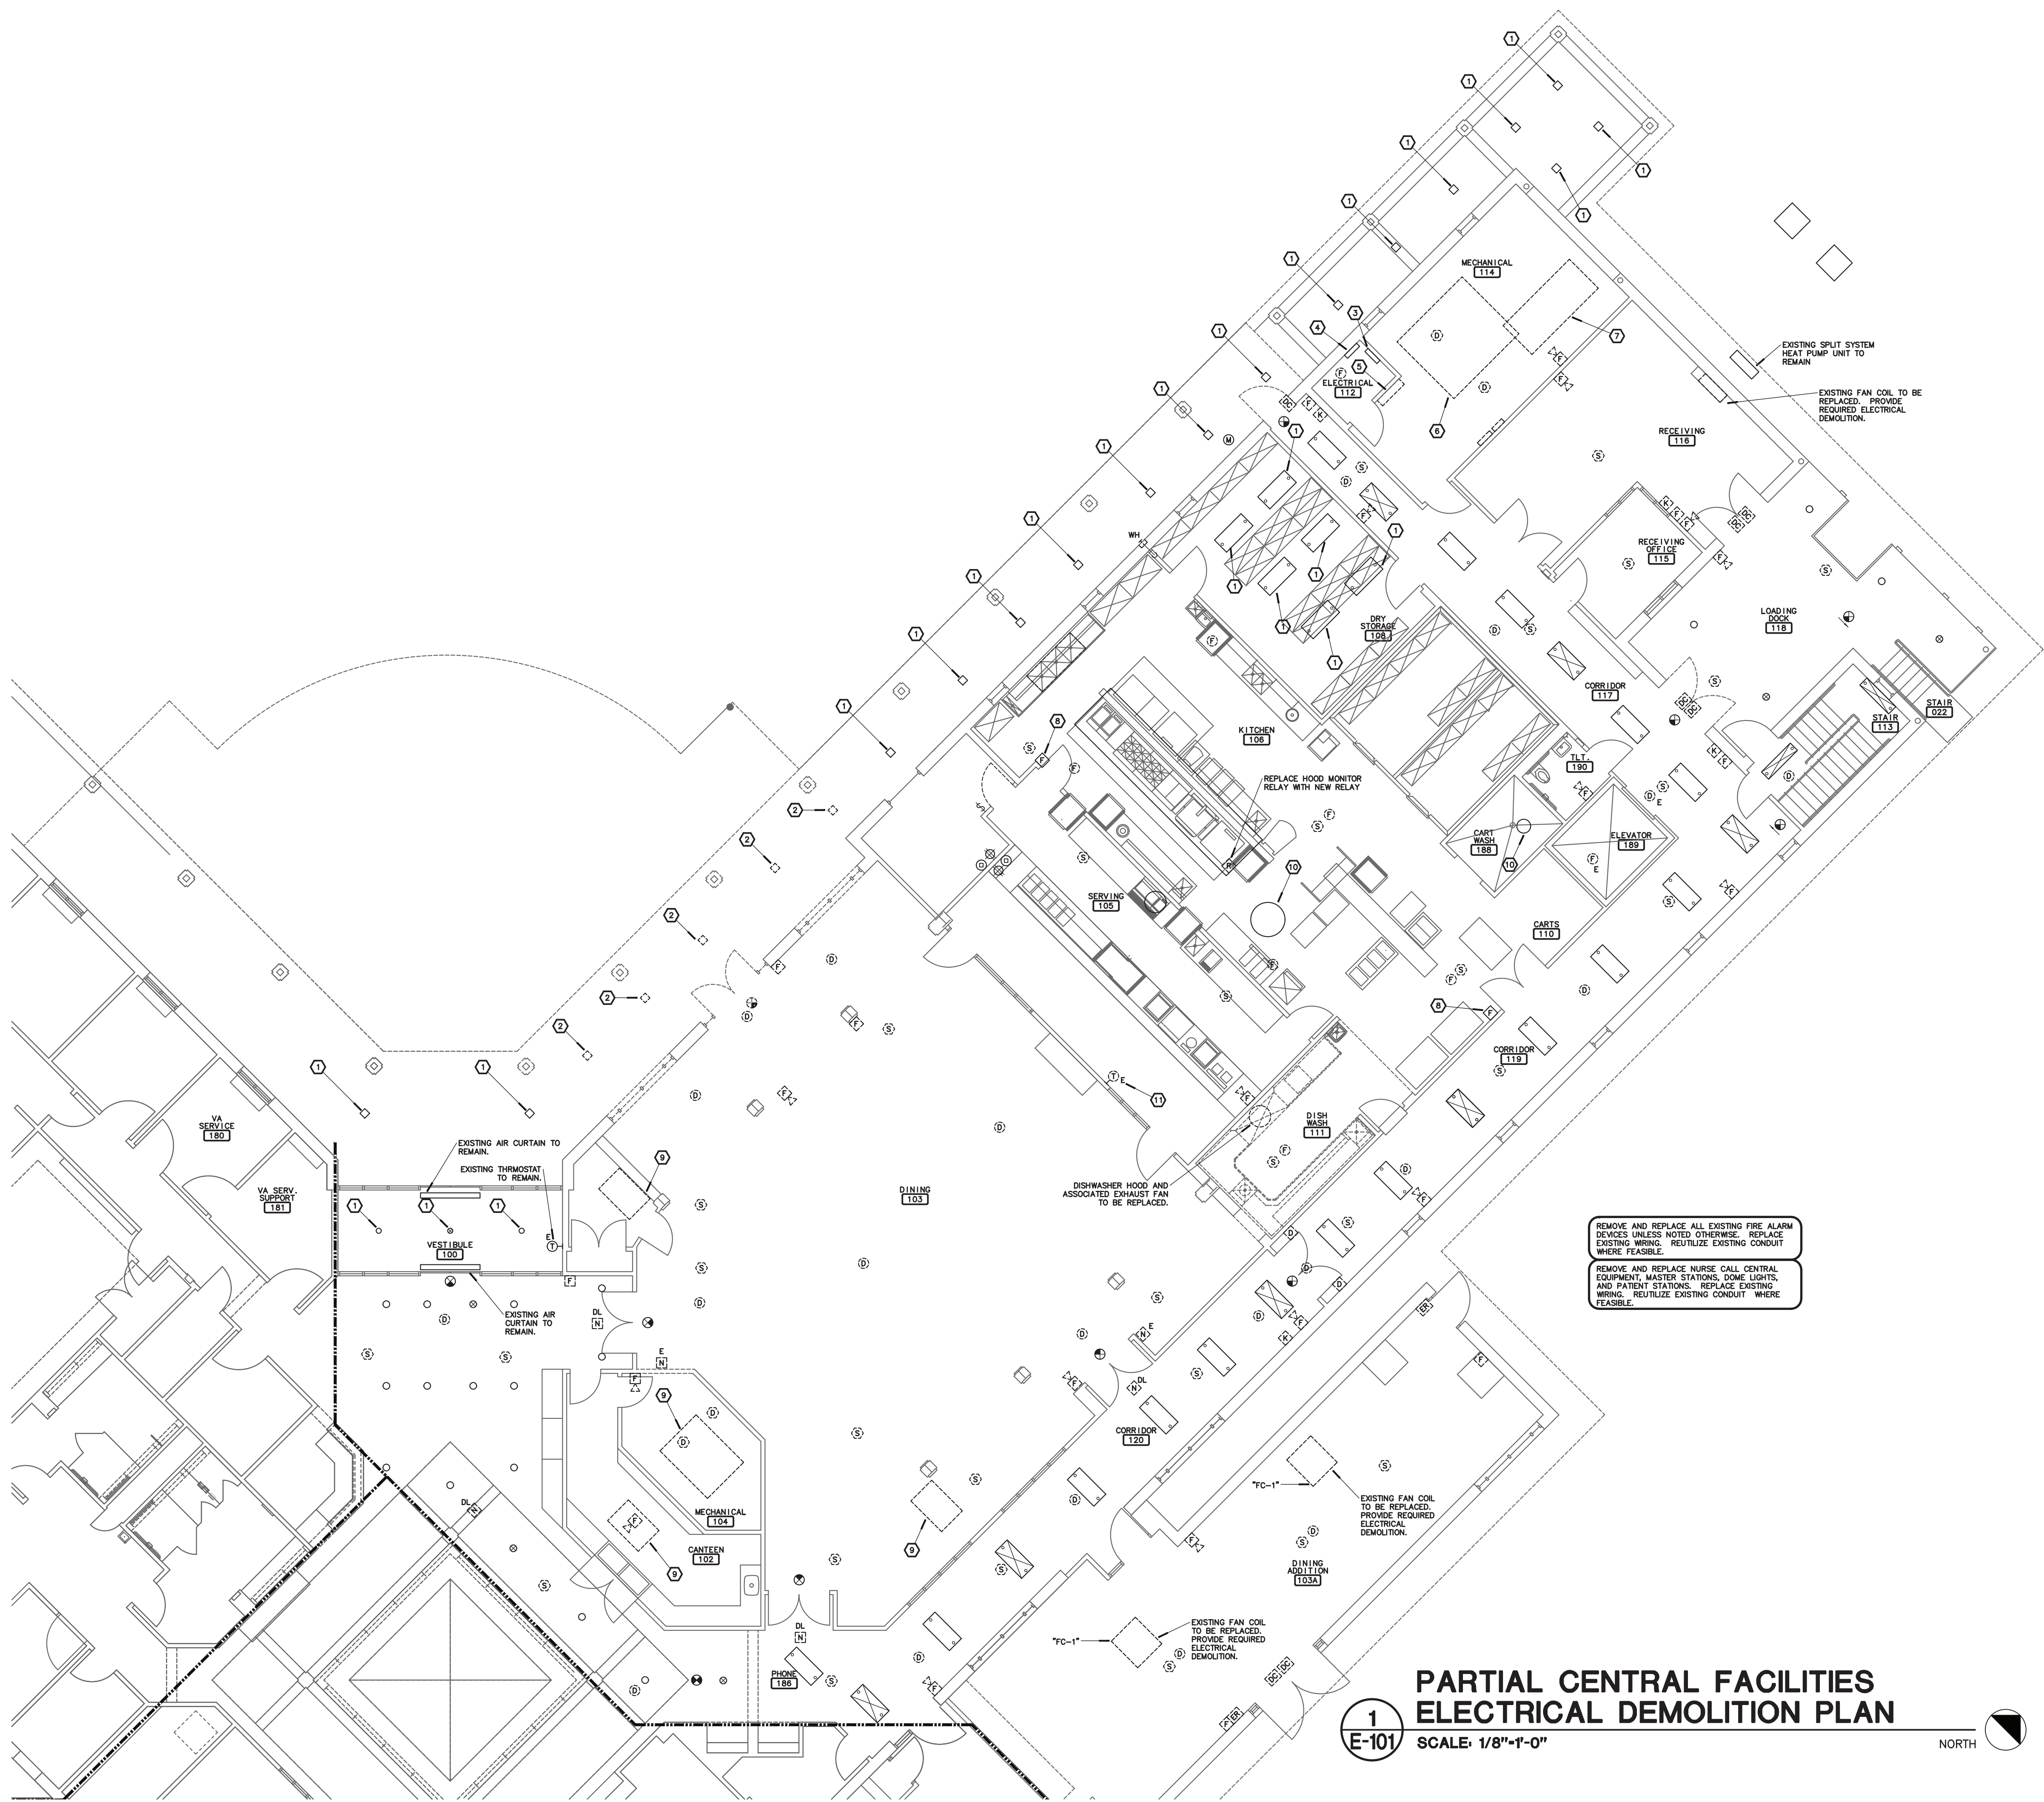SHEET NUMBER:

**E-101**

95 OF 120 SHEETS

8-1-24



## PARTIAL CENTRAL FACILITIES ELECTRICAL DEMOLITION PLAN

SCALE: 1/8"=1'-0"

1  
E-101

NORTH

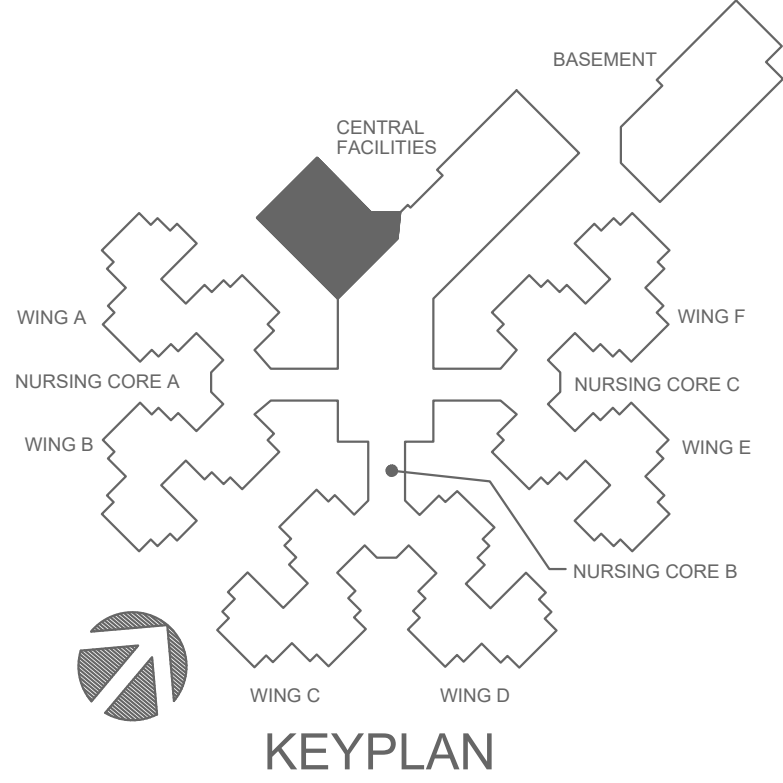


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REMOVE AND REPLACE ALL EXISTING FIRE ALARM DEVICES UNLESS NOTED OTHERWISE. REPLACE EXISTING WIRING. REUTILIZE EXISTING CONDUIT WHERE FEASIBLE.

REMOVE AND REPLACE NURSE CALL CENTRAL EQUIPMENT, MASTER STATIONS, DOME LIGHTS, AND PATIENT STATIONS. REPLACE EXISTING WIRING. REUTILIZE EXISTING CONDUIT WHERE FEASIBLE.



## PARTIAL CENTRAL FACILITIES ELECTRICAL DEMOLITION PLAN

1  
E-102

SCALE: 1/8"=1'-0"

NORTH

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Springfield, MO 65804  
rtmec.com | 417.881.0020  
State of Missouri certificate of authority  
#2014035826 for engineering


### NOTES:

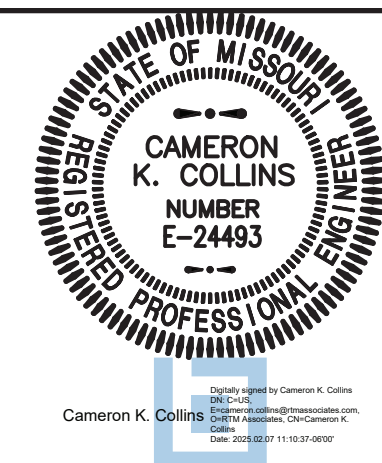- EXISTING HVAC UNIT TO BE REPLACED. PROVIDE REQUIRED ELECTRICAL DEMOLITION AND REUSE EXISTING CIRCUIT FOR NEW UNIT.
- EXISTING DUCT DETECTORS TO REMAIN AND TIED INTO NEW FIRE ALARM SYSTEM.

### GENERAL NOTES:

- FOR ALL ELECTRICAL QUESTIONS DURING BIDDING OR DURING CONSTRUCTION, CONTACT ESTERLY, SCHNEIDER & ASSOCIATES, INC. THOM LUNDBERG (417) 862-0558 FOR COORDINATION WITH ANTHONY G. BEIER AT RTM ENGINEERING CONSULTANTS.
- INFORMATION ON THESE DRAWINGS REPRESENT INFORMATION FROM EXISTING DRAWINGS AND LIMITED SITE OBSERVATIONS. CONTRACTOR SHALL FIELD VERIFY EXISTING CONDITIONS PRIOR TO SUBMITTING BID. NO EXTRAS SHALL BE PAID DUE TO UNANTICIPATED CONDITIONS.
- CONTRACTOR SHALL BE RESPONSIBLE FOR ALL CORING, PATCHING, AND REPAIR OF ALL WALL AND FLOOR SYSTEM AS REQUIRED DUE TO NEW CONSTRUCTION. MAINTAIN ALL FIRE RATINGS.
- FOR ALL EXISTING FIXTURES, RECEPTACLES, WIRING, EQUIPMENT, ETC. SHOWN TO BE REMOVED, THE OWNER SHALL HAVE THE FIRST RIGHT OF REFUSAL.
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- REMOVE AND REPLACE DEVICES AS REQUIRED DUE TO NEW WALL OR CEILING FINISHES.

STATE OF MISSOURI  
MIKE KEHOE,  
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REVISION: \_\_\_\_\_  
DATE: \_\_\_\_\_  
ISSUE DATE: **8-1-24**

CAD DWG FILE: **E-102.DWG**  
DRAWN BY: **AGB**  
CHECKED BY: **CKB**  
DESIGNED BY: **AGB**

SHEET TITLE:

## ELECTRICAL DEMOLITION PLAN

SHEET NUMBER:

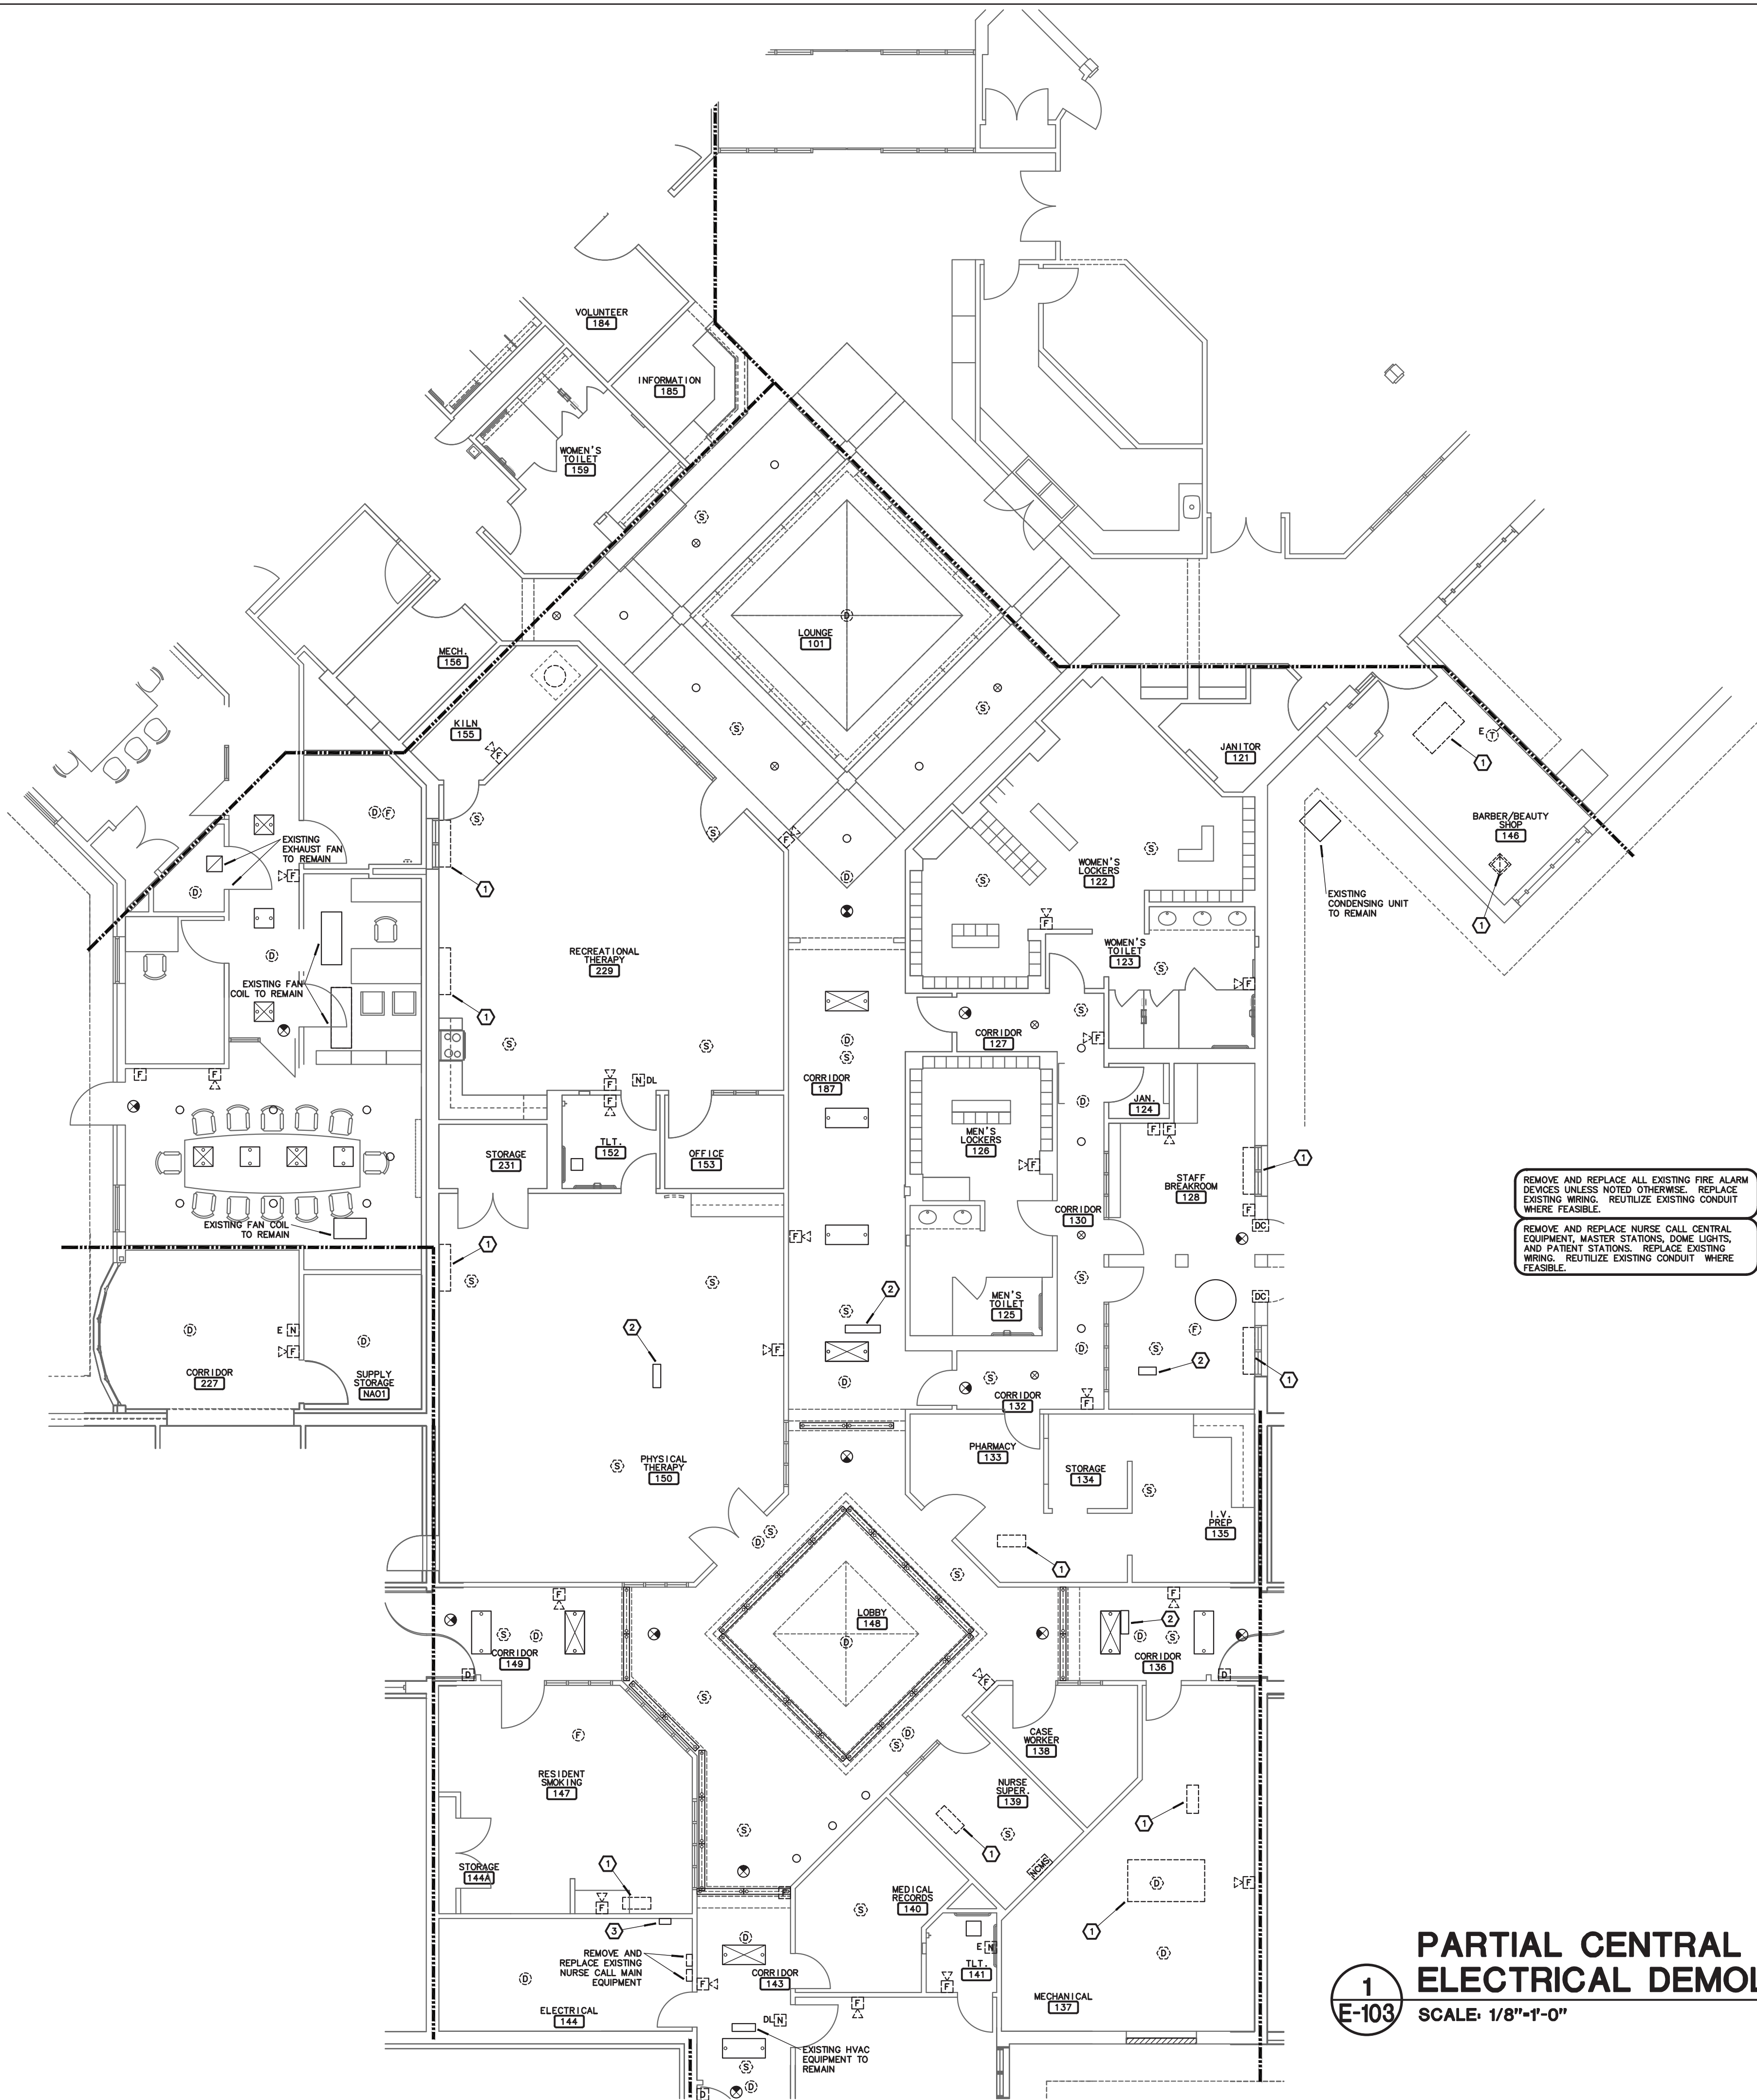
**E-102**

96 OF 120 SHEETS

8-1-24



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REMOVE AND REPLACE ALL EXISTING FIRE ALARM DEVICES UNLESS NOTED OTHERWISE. REPLACE EXISTING WIRING. REUTILIZE EXISTING CONDUIT WHERE FEASIBLE.


REMOVE AND REPLACE NURSE CALL CENTRAL EQUIPMENT, MASTER STATIONS, DOME LIGHTS, AND PATIENT STATIONS. REPLACE EXISTING WIRING. REUTILIZE EXISTING CONDUIT WHERE FEASIBLE.

1  
E-103

## PARTIAL CENTRAL FACILITIES ELECTRICAL DEMOLITION PLAN

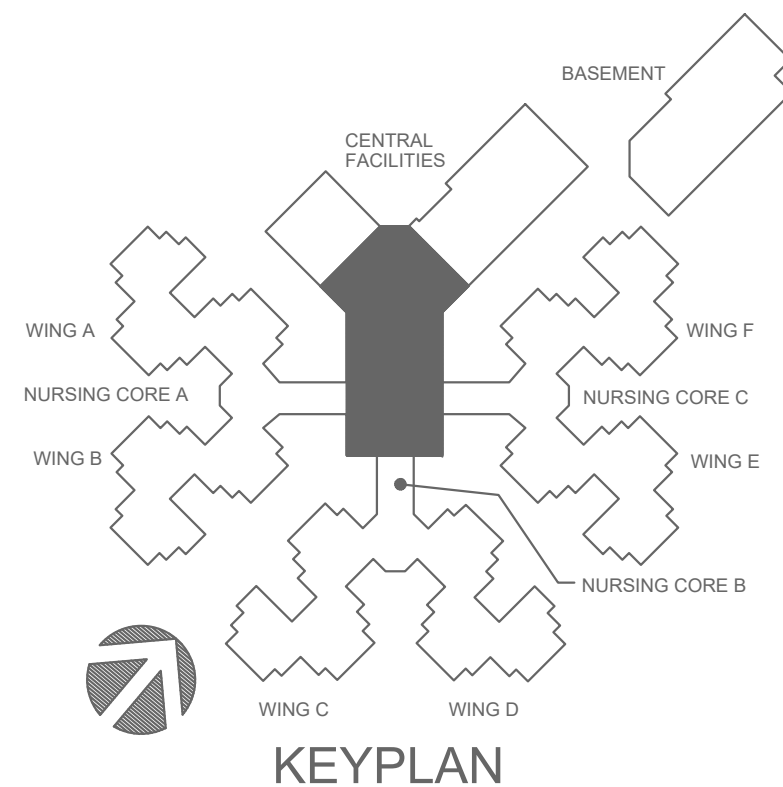SCALE: 1/8"=1'-0"

NORTH



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State of Missouri certificate of authority  
#2014035826 for engineering


### NOTES:

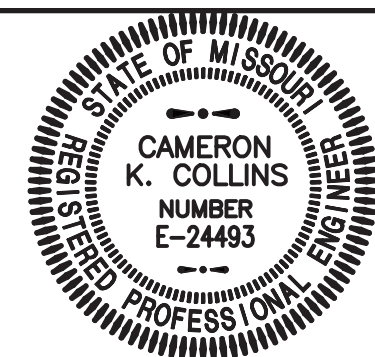- EXISTING HVAC UNIT SHALL BE REPLACED. PROVIDE REQUIRED ELECTRICAL DEMOLITION AND REUSE EXISTING CIRCUIT FOR NEW UNIT.
- EXISTING HVAC EQUIPMENT TO REMAIN.
- EXISTING TKCARE DURESS CALL SYSTEM CENTRAL EQUIPMENT TO REMAIN. TIE SYSTEM INTO NEW NURSE CALL SYSTEM.

### GENERAL NOTES:

- FOR ALL ELECTRICAL QUESTIONS DURING BIDDING OR DURING CONSTRUCTION, CONTACT ESTERLY, SCHNEIDER & ASSOCIATES, INC. (417) 862-0558 FOR COORDINATION WITH ANTHONY C. BEIER AT RTM ENGINEERING CONSULTANTS.
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STATE OF MISSOURI  
MIKE KEHOE,  
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DATE: \_\_\_\_\_  
ISSUE DATE: **8-1-24**

CAD DWG FILE: **E-103.DWG**  
DRAWN BY: **AGB**  
CHECKED BY: **CKB**  
DESIGNED BY: **AGB**

SHEET TITLE:

## ELECTRICAL DEMOLITION PLAN

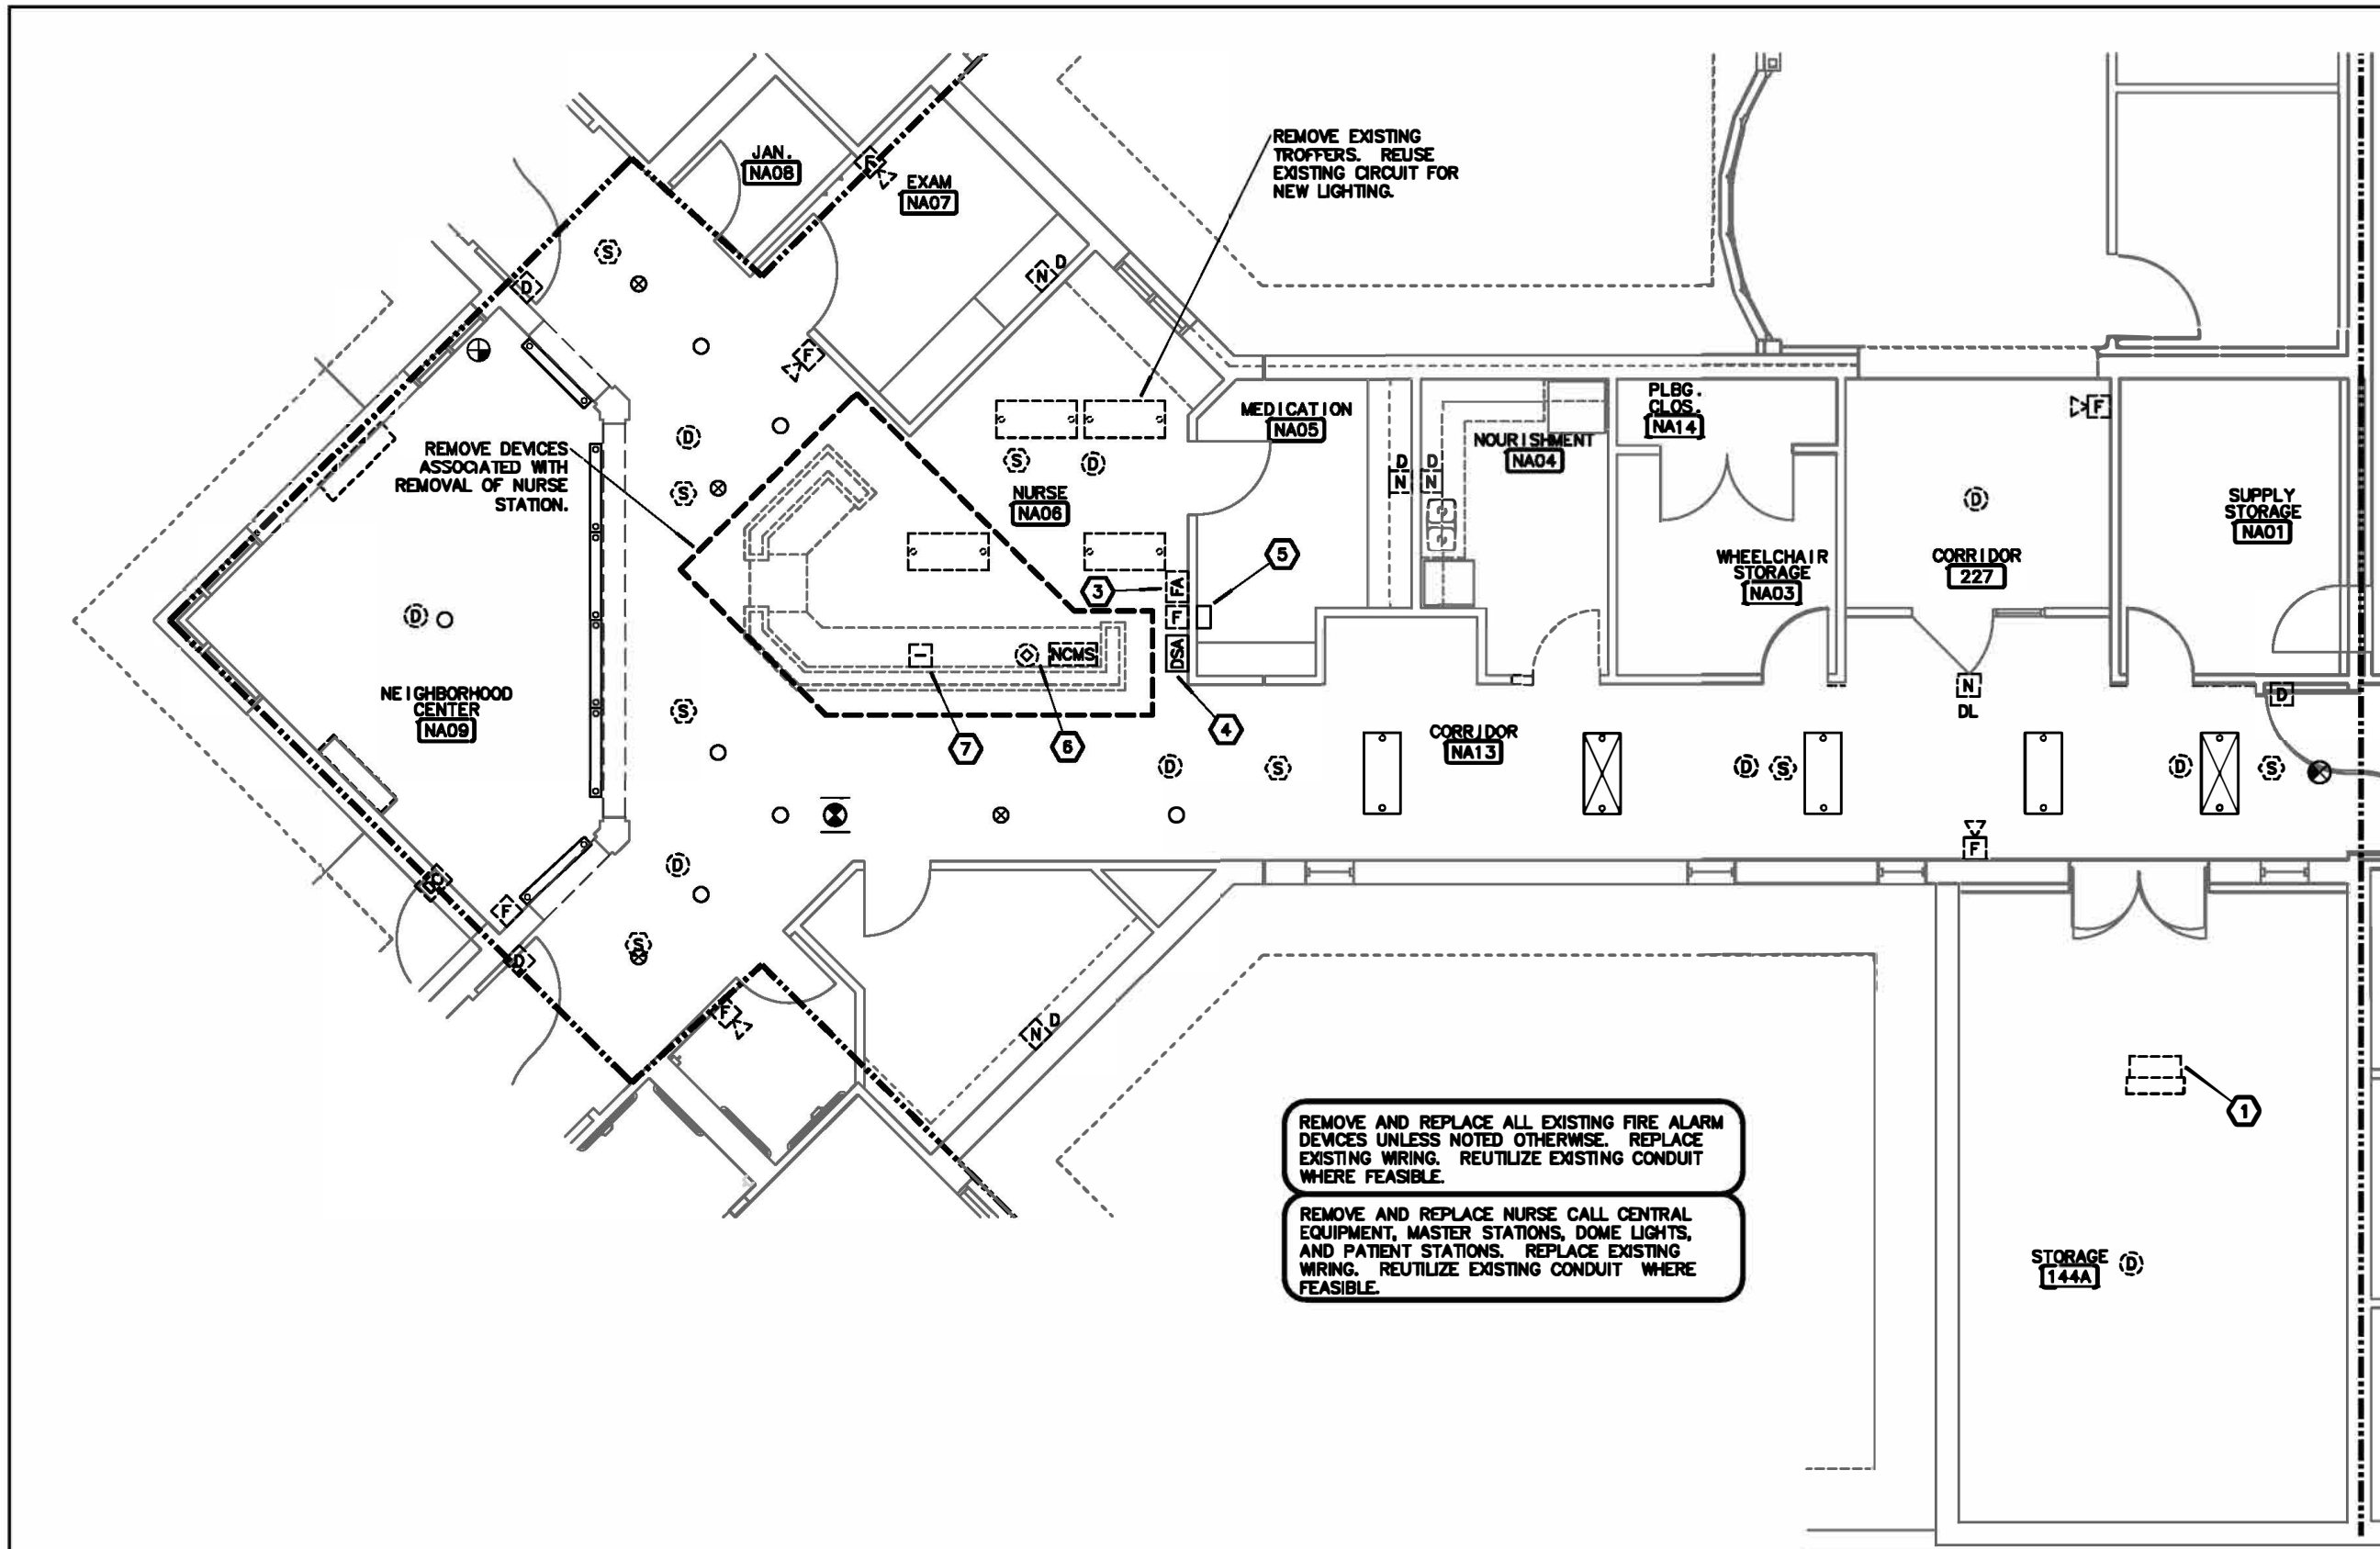
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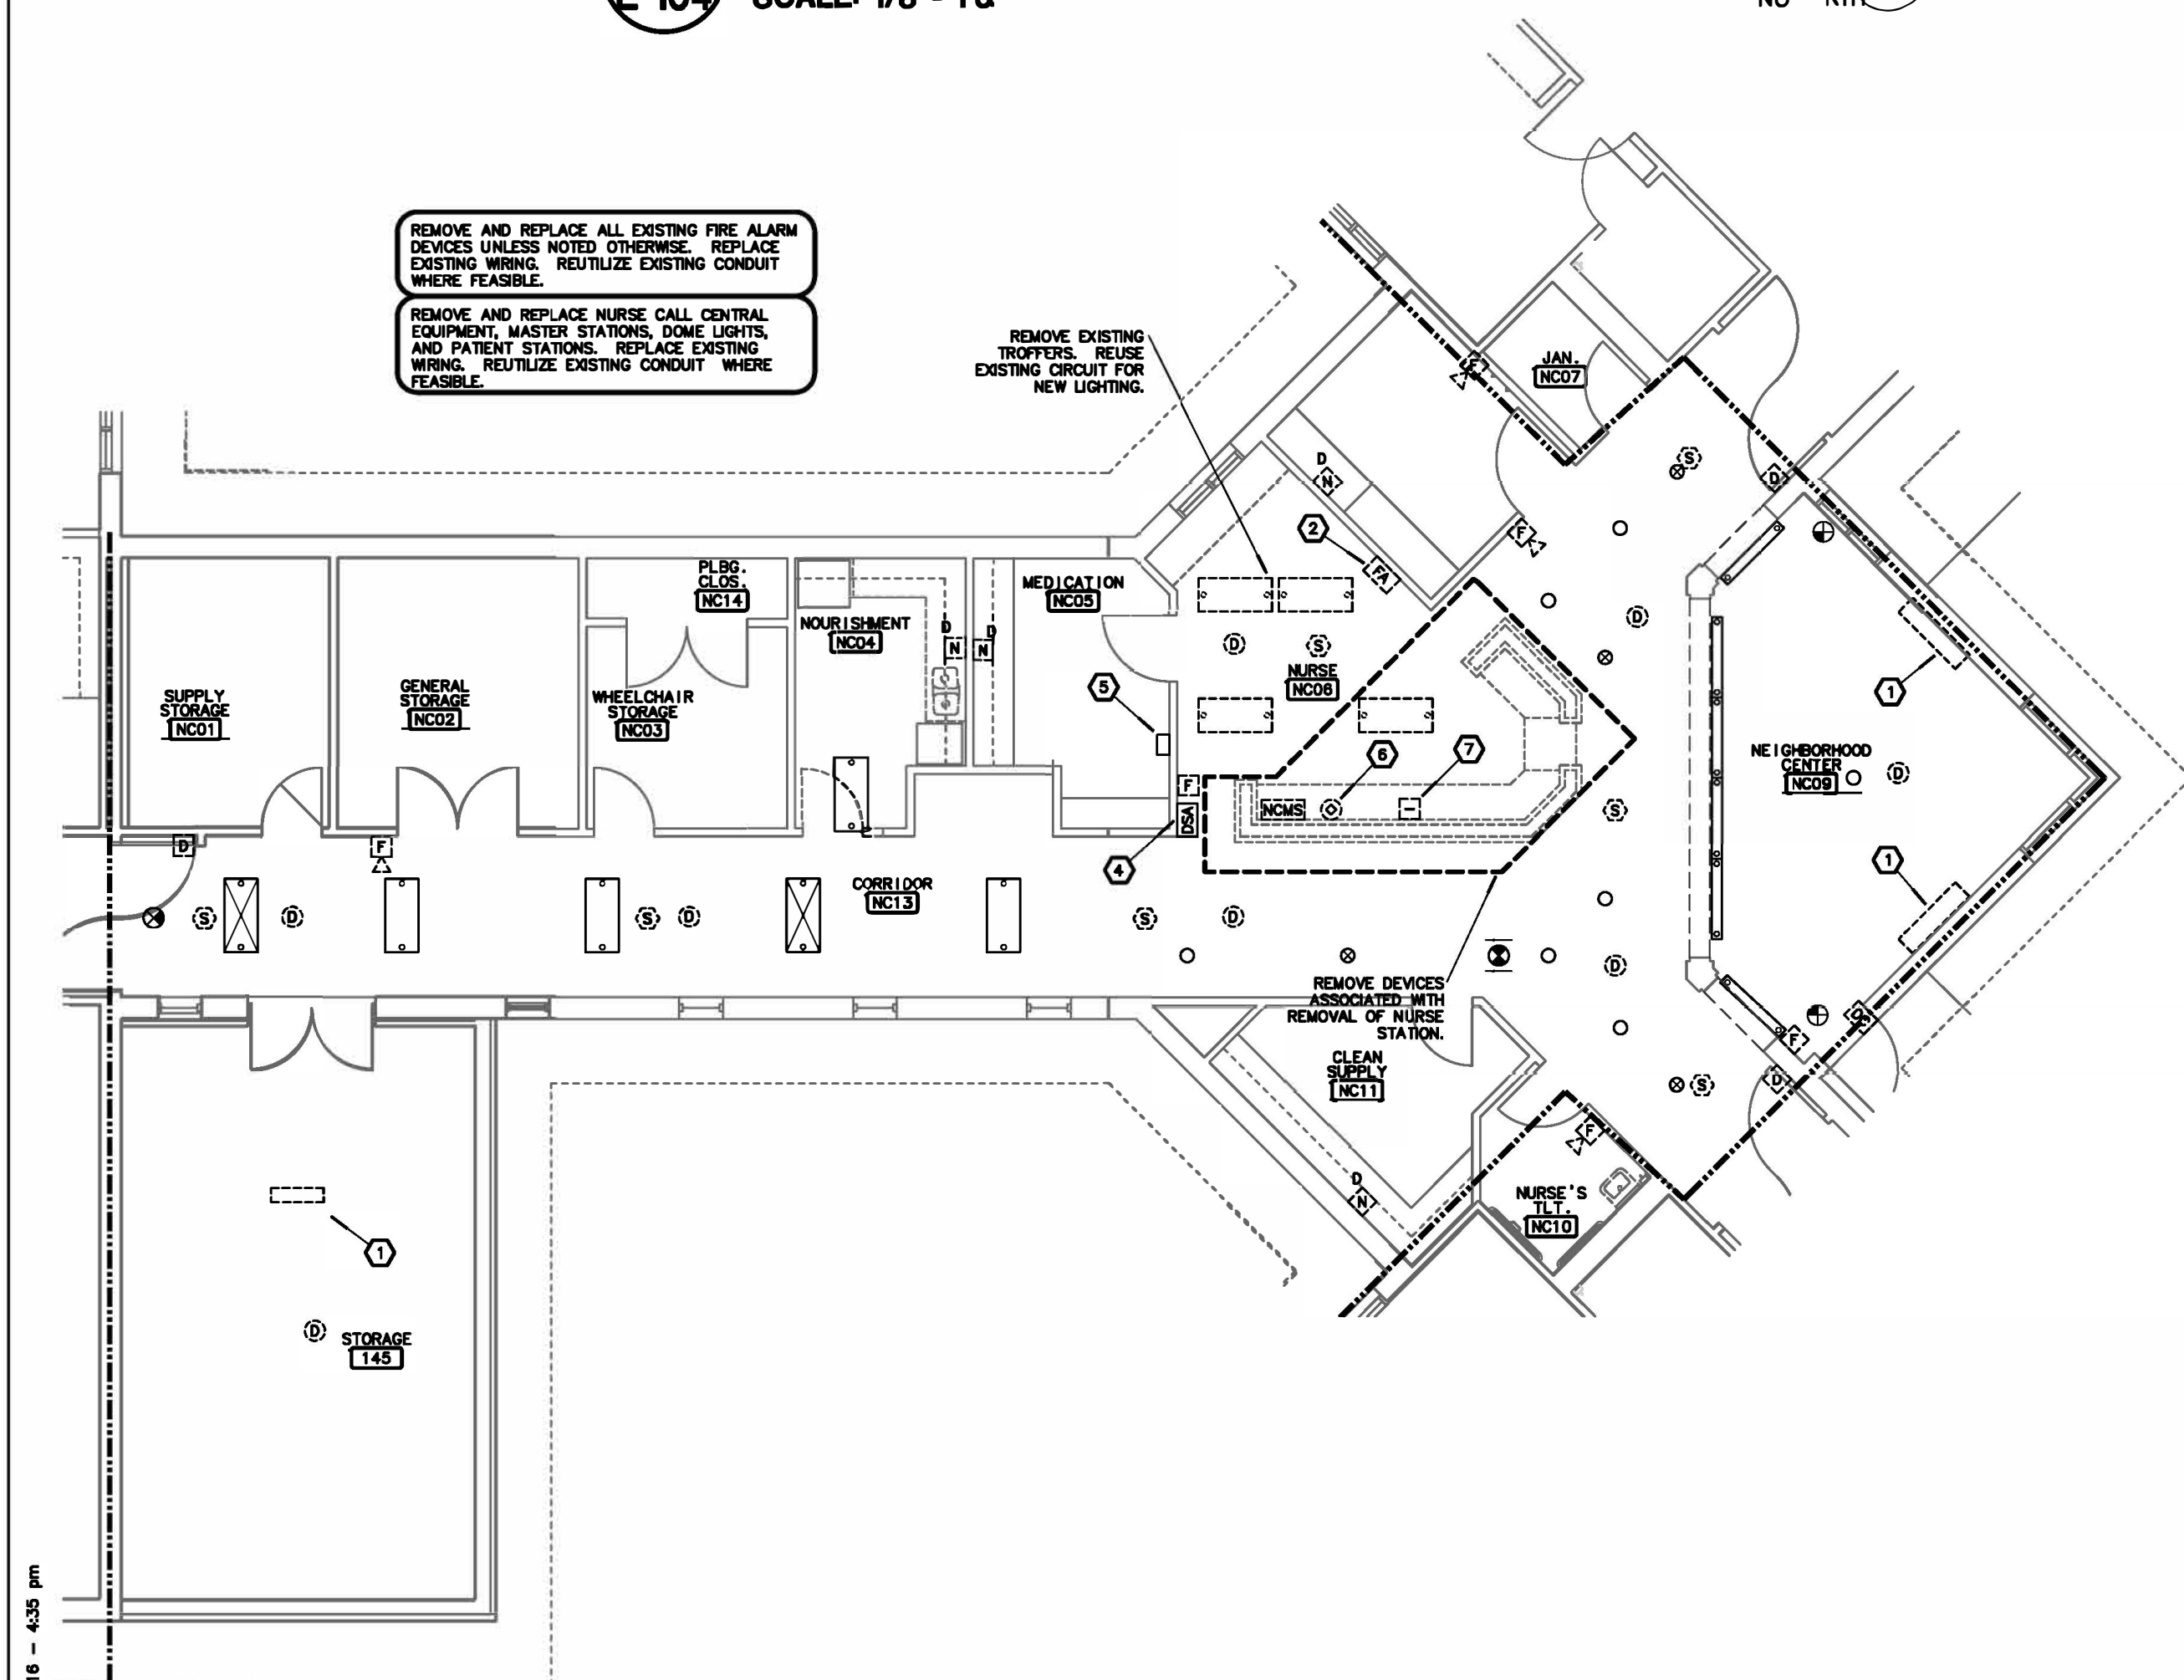
97 OF 120 SHEETS

8-1-24

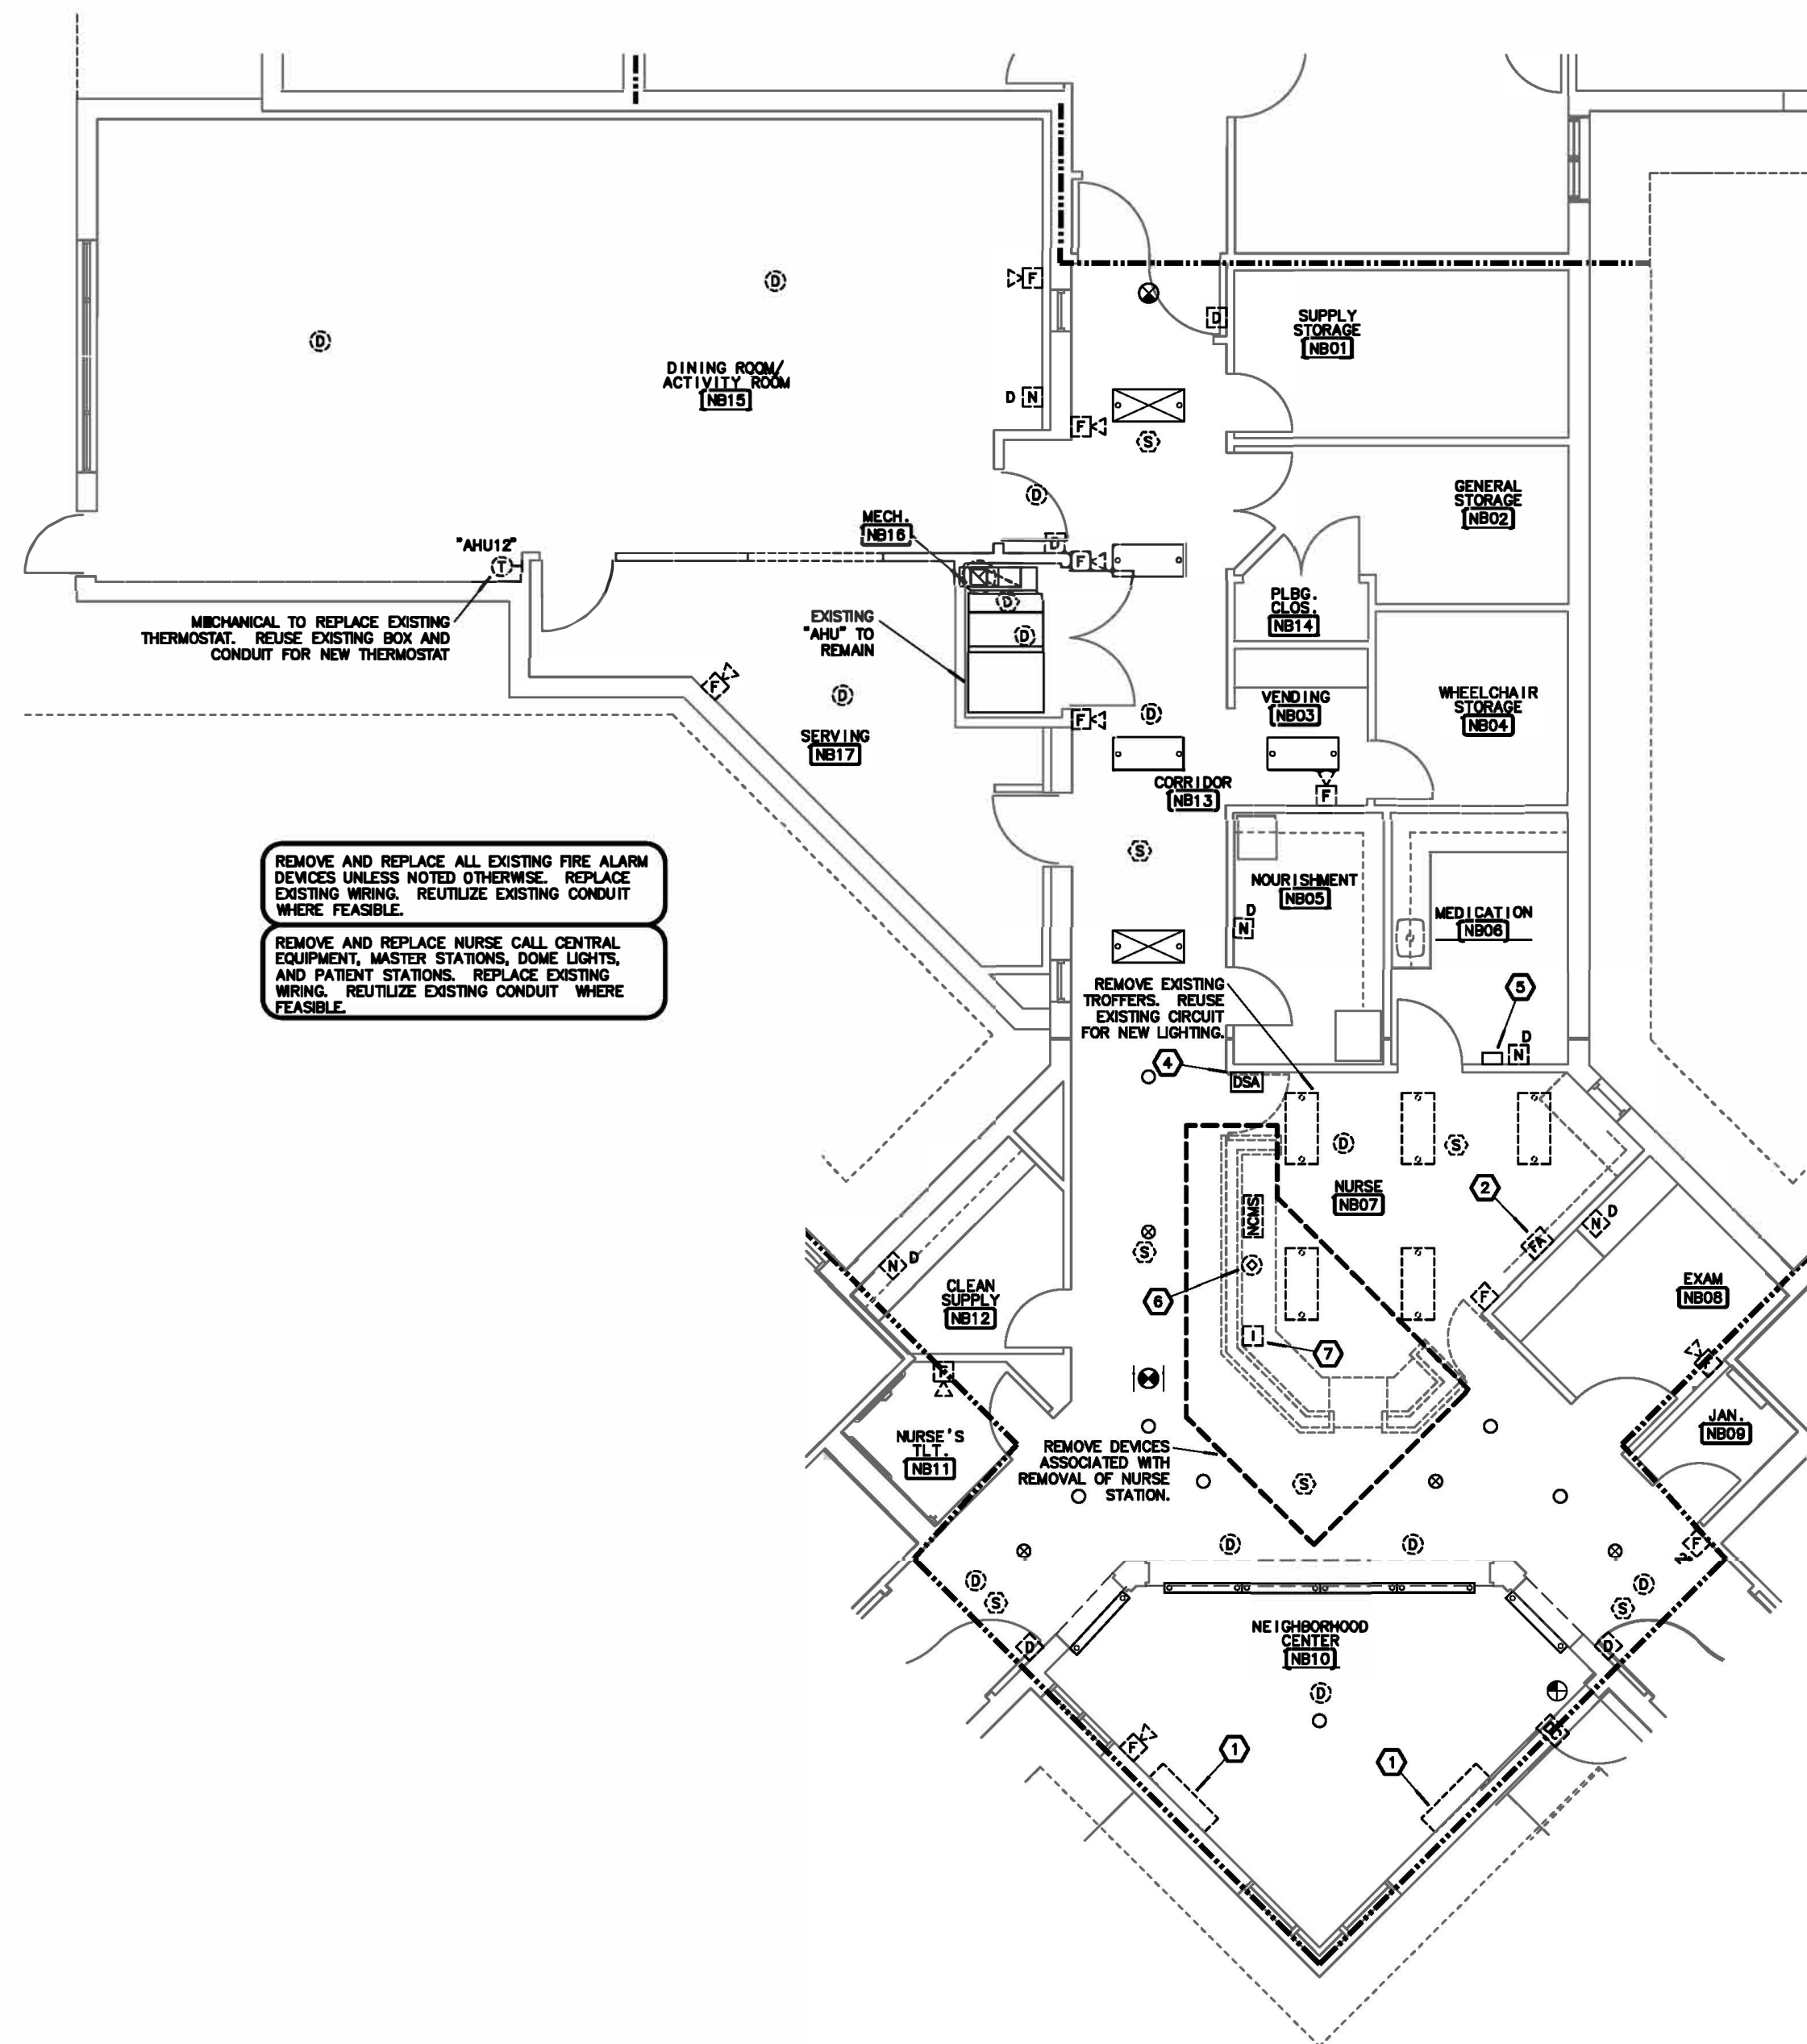




**3**  
**E-104** **NURSING CORE A**  
**ELECTRICAL DEMOLITION PLAN**  
SCALE: 1/8" = 1'-0"



**2**  
**E-104** **NURSING CORE C**  
**ELECTRICAL DEMOLITION PLAN**  
SCALE: 1/8" = 1'-0"





**1**  
**E-104** **NURSING CORE B**  
**ELECTRICAL DEMOLITION PLAN**  
SCALE: 1/8" = 1'-0"

**NOTES:**

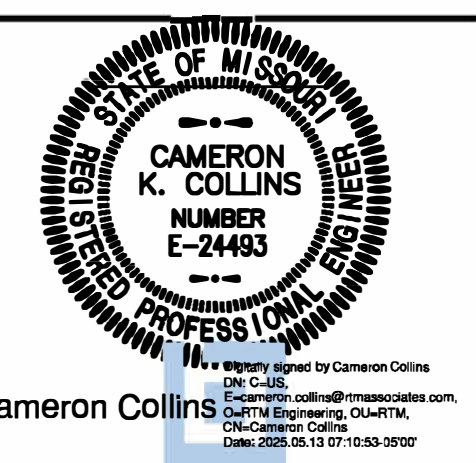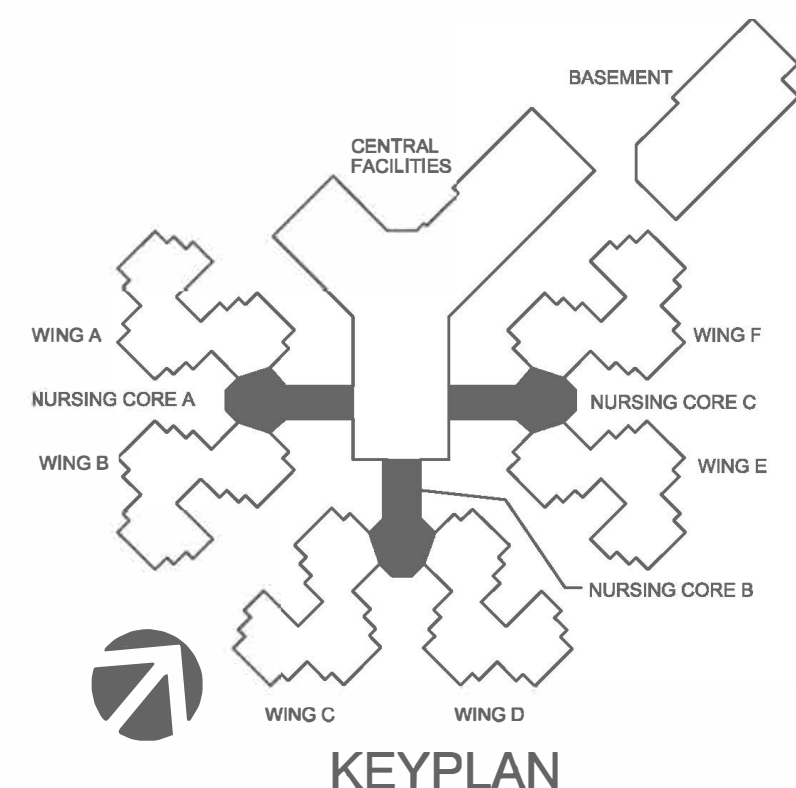- EXISTING HVAC UNIT TO BE REPLACED. PROVIDE REQUIRED ELECTRICAL DEMOLITION AND REUSE EXISTING CIRCUIT FOR NEW UNIT.
- EXISTING FIRE ALARM SUB-PANEL SHALL BE REMOVED AND REPLACED. REFER TO IMPROVEMENT PLANS.
- EXISTING FIRE ALARM MAIN PANEL SHALL BE REMOVED AND REPLACED. REFER TO IMPROVEMENT PLANS.
- EXISTING TEKCAR DURESS SYSTEM ANNUNCIATOR TO REMAIN.
- EXISTING WANDER MANAGEMENT SERVER TO REMAIN.
- WANDER MANAGEMENT DATA OUTLET. PROVIDE DEMOLITION REQUIRED FOR REMOVAL OF NURSE STATION. REUSE EXISTING DATA PORT AND CABLE FOR NEW DATA OUTLET IN NEW NURSE STATION.
- RELOCATE EXISTING TEKCAR DURESS CALL STATION TO NEW NURSE STATION.

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- CONTRACTOR SHALL BE RESPONSIBLE FOR ALL CORING, PATCHING, AND REPAIR OF ALL WALL AND FLOOR SYSTEM AS REQUIRED DUE TO NEW CONSTRUCTION. MAINTAIN ALL FIRE RATINGS.
- FOR ALL EXISTING FIXTURES, RECEPTACLES, WIRING, EQUIPMENT, ETC. SHOWN TO BE REMOVED, THE OWNER SHALL HAVE THE FIRST RIGHT OF REFUSAL.
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Cameron Collins

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**ESTERLY & SCHNEIDER ASSOCIATES, INC.**  
**AIA** architects & planners  
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CAD DWG FILE: E-104.DWG  
DRAWN BY: AGP  
CHECKED BY: AGP  
DESIGNED BY: AGP

SHEET TITLE:  
**ELECTRICAL  
DEMOLITION  
PLAN**


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**E-104**

98 OF 120 SHEETS

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**ALTERNATE #1:**  
ALL WORK ASSOCIATED WITH INFECTIOUS CONTROL WING 'A' FOR REVISED MECHANICAL AND ELECTRICAL WORK ASSOCIATED WITH THE REQUIREMENTS TO ACHIEVE THE INFECTIOUS CONTROL AREAS DERIVED ON THE MECHANICAL PLANS. REFER TO SHEETS A-104, A-114, A-121, A-800, A-801, M-105, M-116, M-127, M-133, M-134 AND E-105, AND E-116 AND ALL ASSOCIATED DETAILS, SCHEDULES AND SPECIFICATION SECTIONS REQUIRED FOR ADDITIONAL INFORMATION AS IT PERTAINS TO WING 'A'. ALTERNATE #1 SHALL NOT INCLUDE REMOVING AND INSTALLING NEW FLOORING, REMOVING AND INSTALLING NEW WALL BASE, PAINTING OF ANY WALLS, ANY WORK ASSOCIATED WITH DEMOLITION OR NEW CONSTRUCTION FOR SHOWER ROOM A107. ALTERNATE SHALL NOT INCLUDE ANY WORK ASSOCIATED WITH NEW TV MOUNTING AND BLOCKING, NOR WORK ASSOCIATED WITH OTHER ALTERNATE SCHEDULE. ANY ITEMS NOT LISTED SPECIFICALLY ABOVE, BUT SHOWN ON THE DRAWINGS/SPECIFICATIONS, SHALL REMAIN IN THE ALTERNATE BID #1.

REMOVE AND REPLACE ALL EXISTING FIRE ALARM DEVICES UNLESS NOTED OTHERWISE. REPLACE EXISTING WIRING. REUTILIZE EXISTING CONDUIT WHERE FEASIBLE.

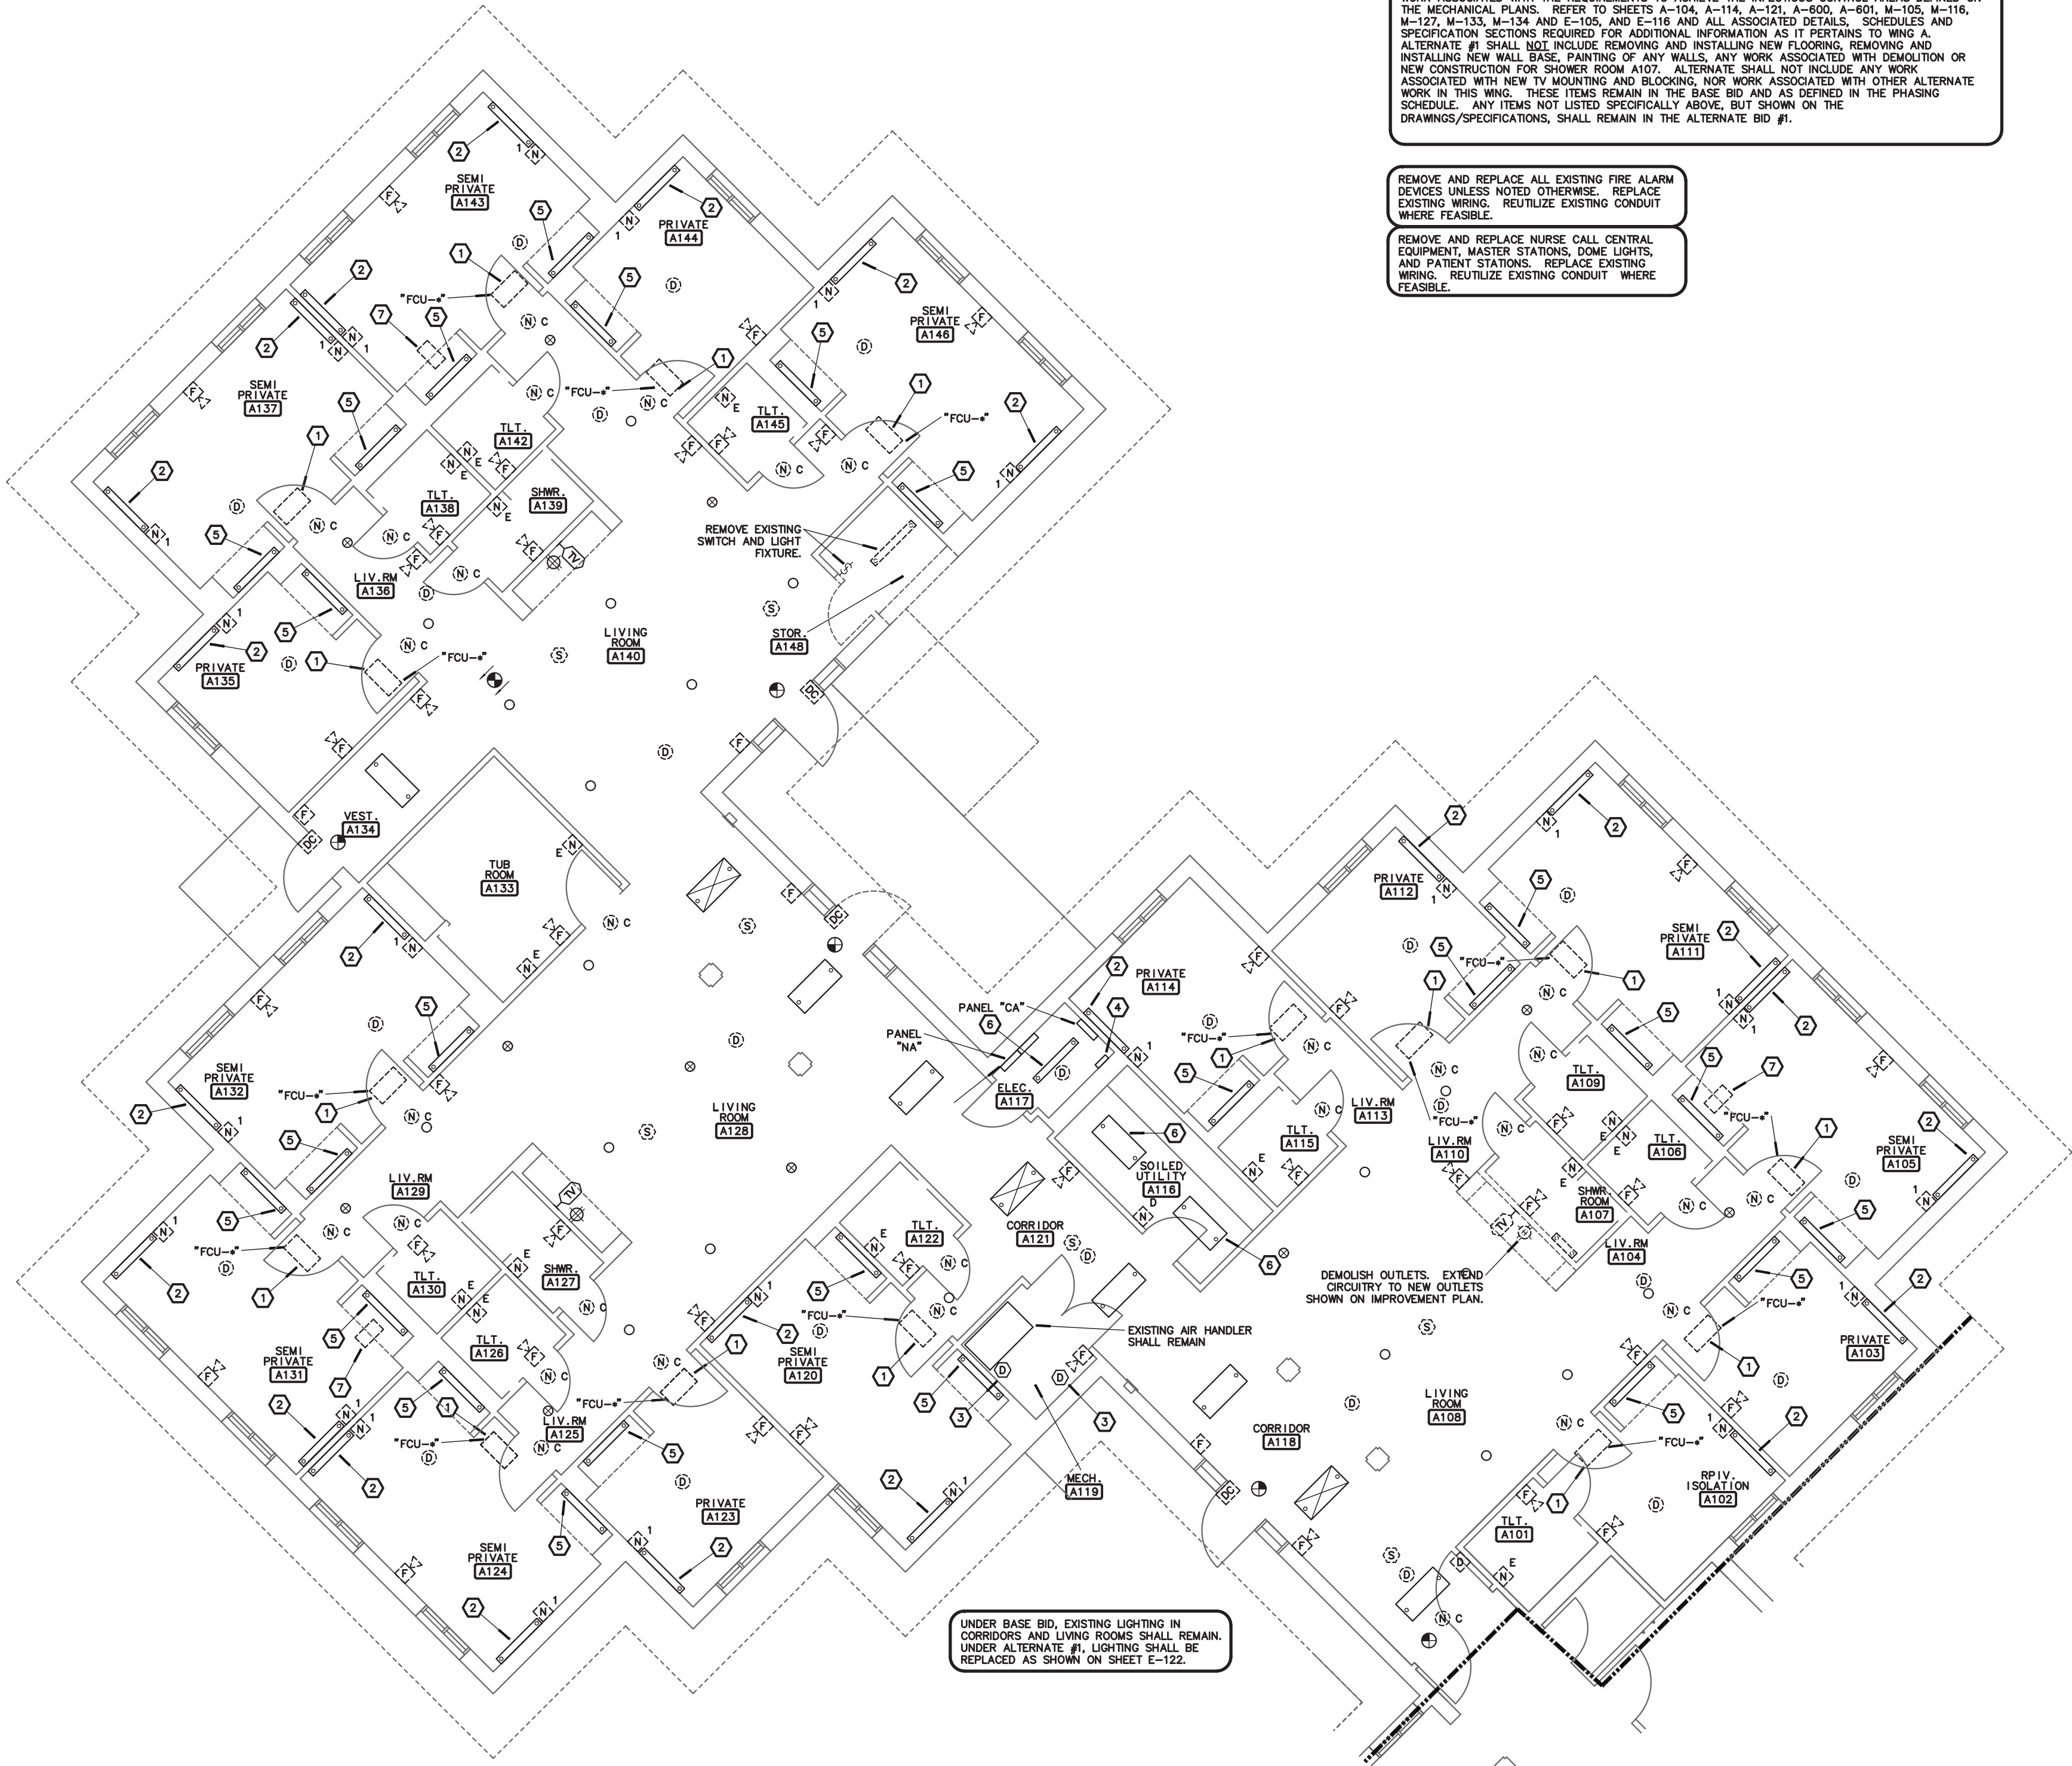REMOVE AND REPLACE NURSE CALL CENTRAL EQUIPMENT, MASTER STATIONS, DOME LIGHTS, AND PATIENT STATIONS. REPLACE EXISTING WIRING. REUTILIZE EXISTING CONDUIT WHERE FEASIBLE.

UNDER BASE BID, EXISTING LIGHTING IN CORRIDORS AND LIVING ROOMS SHALL REMAIN. UNDER ALTERNATE #1, LIGHTING SHALL BE REPLACED AS SHOWN ON SHEET E-122.

**1 WING 'A' - ELECTRICAL DEMOLITION PLAN**  
SCALE: 1/8"=1'-0"





**NOTES:**

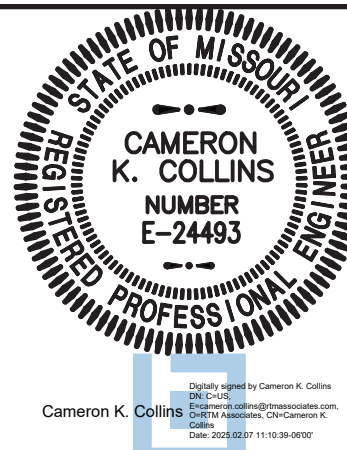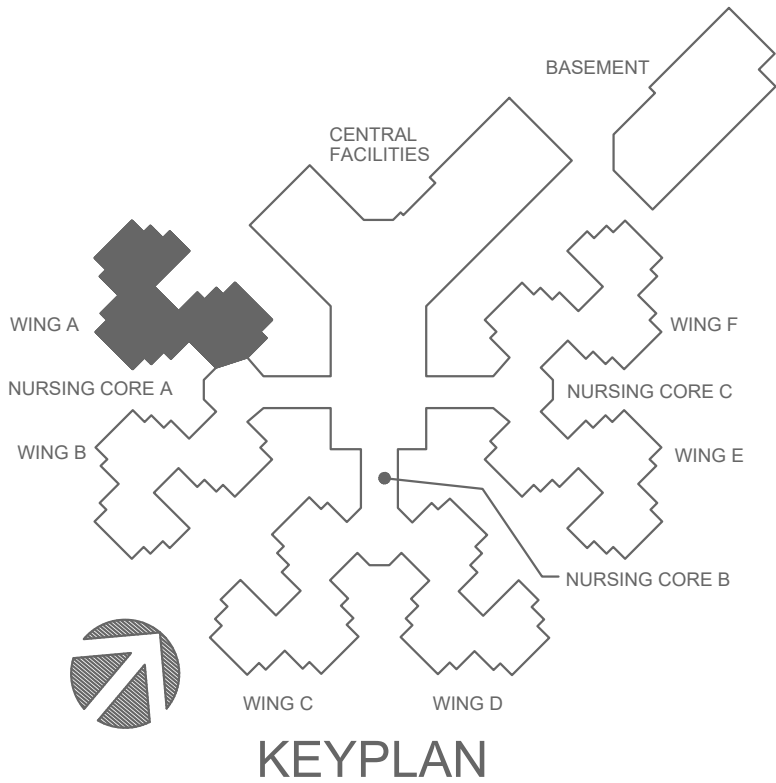- EXISTING HVAC UNIT TO BE REPLACED. PROVIDE REQUIRED ELECTRICAL DEMOLITION.
- LIGHT FIXTURE SHALL REMAIN.
- EXISTING DUCT DETECTOR TO REMAIN. TIE INTO NEW FIRE ALARM SYSTEM.
- EXISTING WANDER MANAGEMENT NETWORK PUNCHDOWN BLOCK FOR DOOR RELAY WIRING SHALL REMAIN.
- UNDER ALTERNATE BID, REPLACE EXISTING LIGHT FIXTURE WITH NEW FIXTURE INDICATED. CONNECT TO EXISTING CIRCUIT. UNDER BASE BID, EXISTING LIGHT FIXTURE TO REMAIN. CONTRACTOR SHALL CLEAN AND RE-LAMP FIXTURE.
- UNDER BASE BID, EXISTING LIGHT SHALL REMAIN. UNDER ALTERNATE #1, LIGHT SHALL BE REPLACED AS SHOWN ON SHEET E-122.
- PROVIDE REQUIRED ELECTRICAL DEMOLITION FOR EXHAUST FAN. REUSE EXISTING CIRCUIT FOR NEW ROOF MOUNTED EXHAUST FAN.

**GENERAL NOTES:**

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DESIGNED BY: **AGB**

SHEET TITLE:

**ELECTRICAL  
DEMOLITION  
PLAN**

SHEET NUMBER:

**E-105**

99 OF 120 SHEETS

8-1-24





1  
E-106

## WING 'B' - ELECTRICAL DEMOLITION PLAN

SCALE: 1/8"=1'-0"

NORTH

REMOVE AND REPLACE ALL EXISTING FIRE ALARM DEVICES UNLESS NOTED OTHERWISE. REPLACE EXISTING WIRING. REUTILIZE EXISTING CONDUIT WHERE FEASIBLE.

REMOVE AND REPLACE NURSE CALL CENTRAL EQUIPMENT, MASTER STATIONS, SMOKE LIGHTS, AND PATIENT STATIONS. REPLACE EXISTING WIRING. REUTILIZE EXISTING CONDUIT WHERE FEASIBLE.



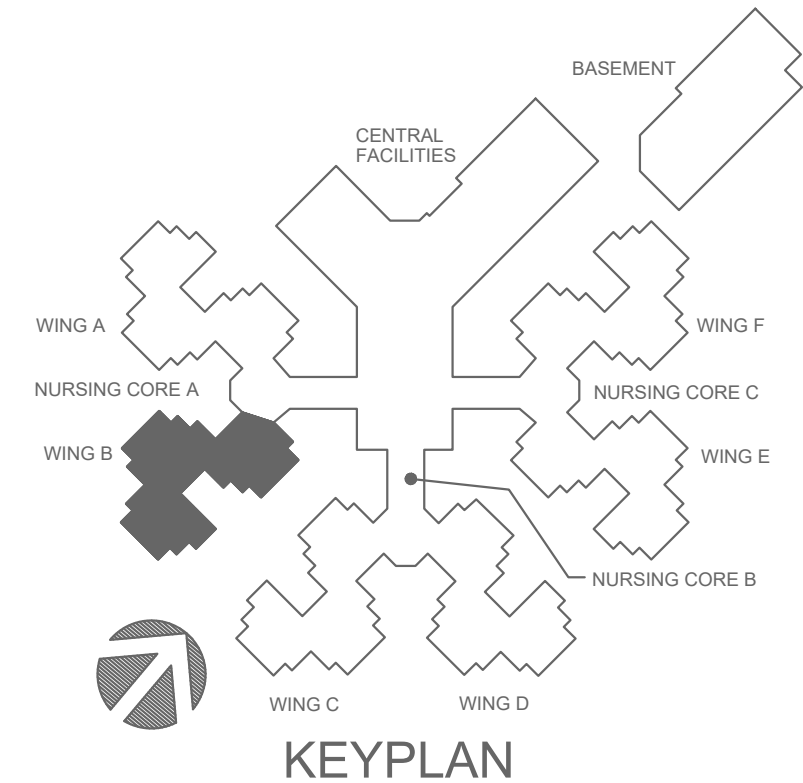
engineering consultants  
3333 E. Battlefield Road, Ste. 1000  
Springfield, MO 65804  
rtmec.com | 417.881.0020  
State of Missouri certificate of authority  
#2014035826 for engineering

### NOTES:


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- EXISTING LIGHT FIXTURE TO REMAIN.
- EXISTING DUCT DETECTOR TO REMAIN. TIE INTO NEW FIRE ALARM SYSTEM.
- EXISTING WANDER MANAGEMENT NETWORK PUNCHDOWN BLOCK FOR DOOR RELAY WIRING SHALL REMAIN.
- UNDER ALTERNATE BID, REPLACE EXISTING LIGHT FIXTURE WITH NEW FIXTURE INDICATED. CONNECT TO EXISTING CIRCUIT. UNDER BASE BID, EXISTING LIGHT FIXTURE TO REMAIN. CONTRACTOR SHALL CLEAN AND RE-LAMP FIXTURE.

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- FOR ALL ELECTRICAL QUESTIONS DURING BIDDING OR DURING CONSTRUCTION, CONTACT ESTERLY, SCHNEIDER & ASSOCIATES, INC. THOM LUNBERG (417) 862-0558 FOR COORDINATION WITH ANTHONY G. BEIER AT RTM ENGINEERING CONSULTANTS.
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MIKE KEHOE,  
GOVERNOR



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DEPARTMENT OF  
PUBLIC SAFETY  
MISSOURI VETERANS  
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INTERIOR RENOVATION  
MISSOURI VETERANS  
HOME

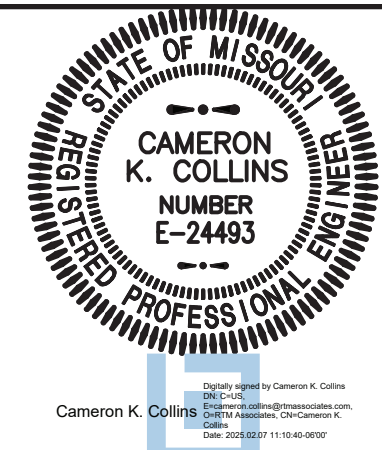620 N. JEFFERSON  
ST. JAMES, MISSOURI

PROJECT # U1503-01  
SITE # 6801  
ASSET # 8136801002  
FEDERAL # 29-044

REVISION: \_\_\_\_\_  
DATE: \_\_\_\_\_  
REVISION: \_\_\_\_\_  
DATE: \_\_\_\_\_  
REVISION: \_\_\_\_\_  
DATE: \_\_\_\_\_  
ISSUE DATE: 8-1-24

CAD DWG FILE: E-106.DWG  
DRAWN BY: AGB  
CHECKED BY: CKK  
DESIGNED BY: AGB

SHEET TITLE:

## ELECTRICAL DEMOLITION PLAN

SHEET NUMBER:

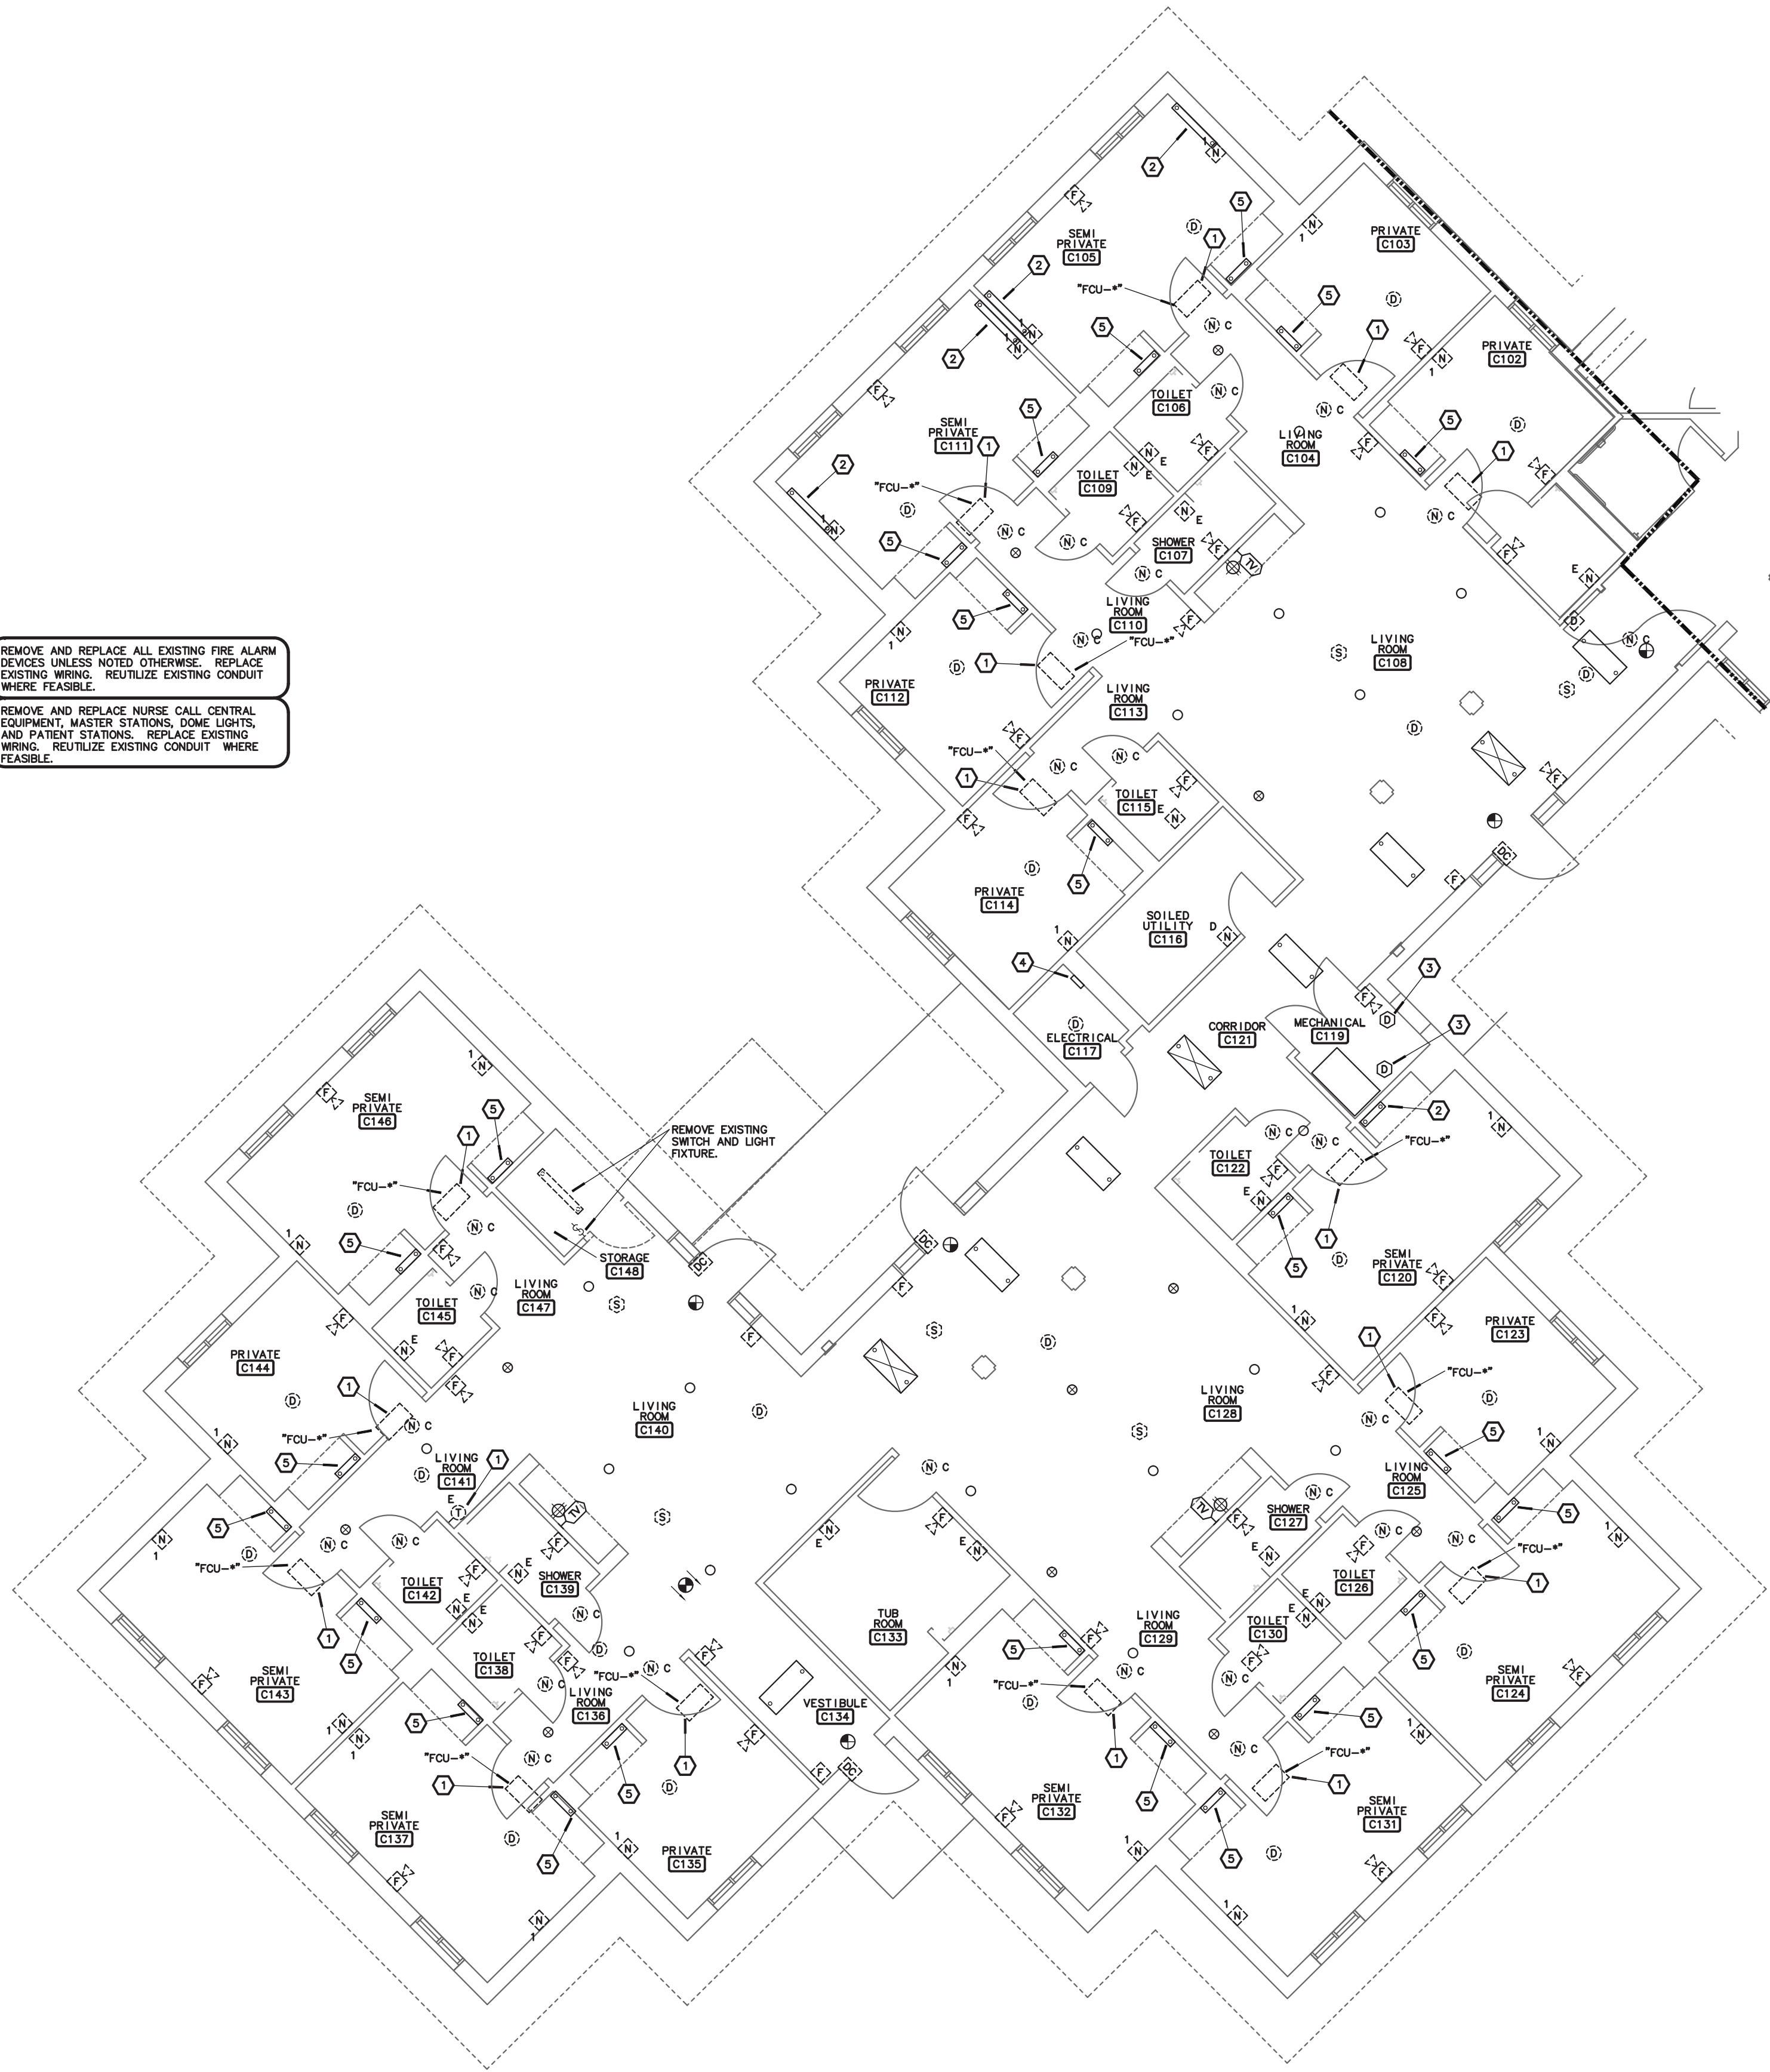
E-106

100 OF 120 SHEETS

8-1-24



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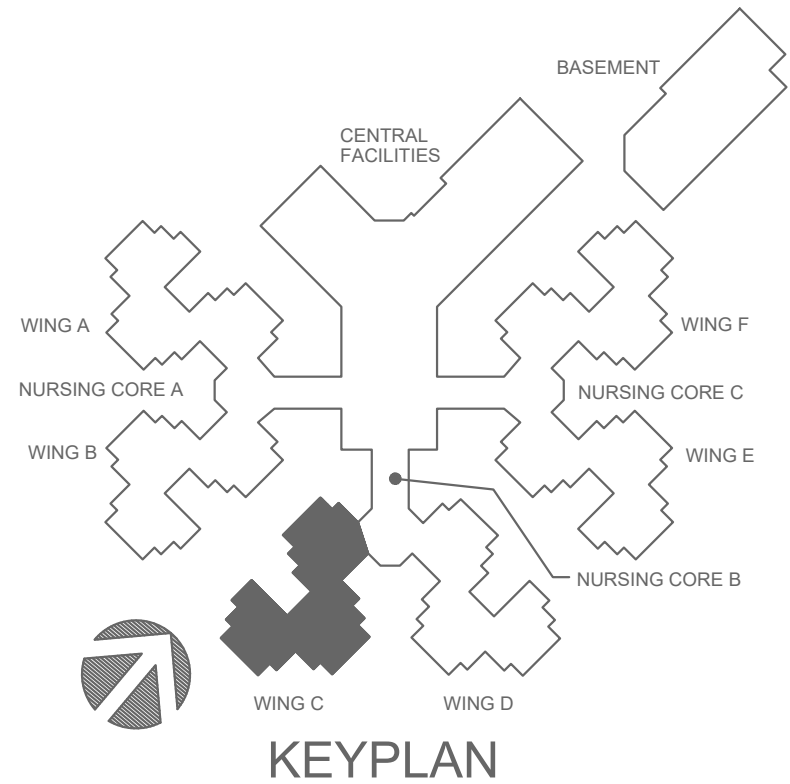


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E-107

## WING 'C' - ELECTRICAL DEMOLITION PLAN

SCALE: 1/8"=1'-0"

NORTH



KEYPLAN

engineering consultants  
3333 E. Battlefield Road, Ste. 1000  
Springfield, MO 65804  
rtmec.com | 417.881.0020  
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### NOTES:

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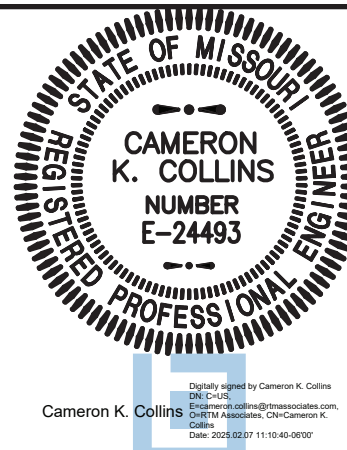
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620 N. JEFFERSON  
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PROJECT # U1503-01  
SITE # 6801  
ASSET # 8136801002  
FEDERAL # 29-044

REVISION: \_\_\_\_\_  
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ISSUE DATE: 8-1-24

CAD DWG FILE: E-107.DWG  
DRAWN BY: AGB  
CHECKED BY: TPM  
DESIGNED BY: AGB

SHEET TITLE:

## ELECTRICAL DEMOLITION PLAN

SHEET NUMBER:

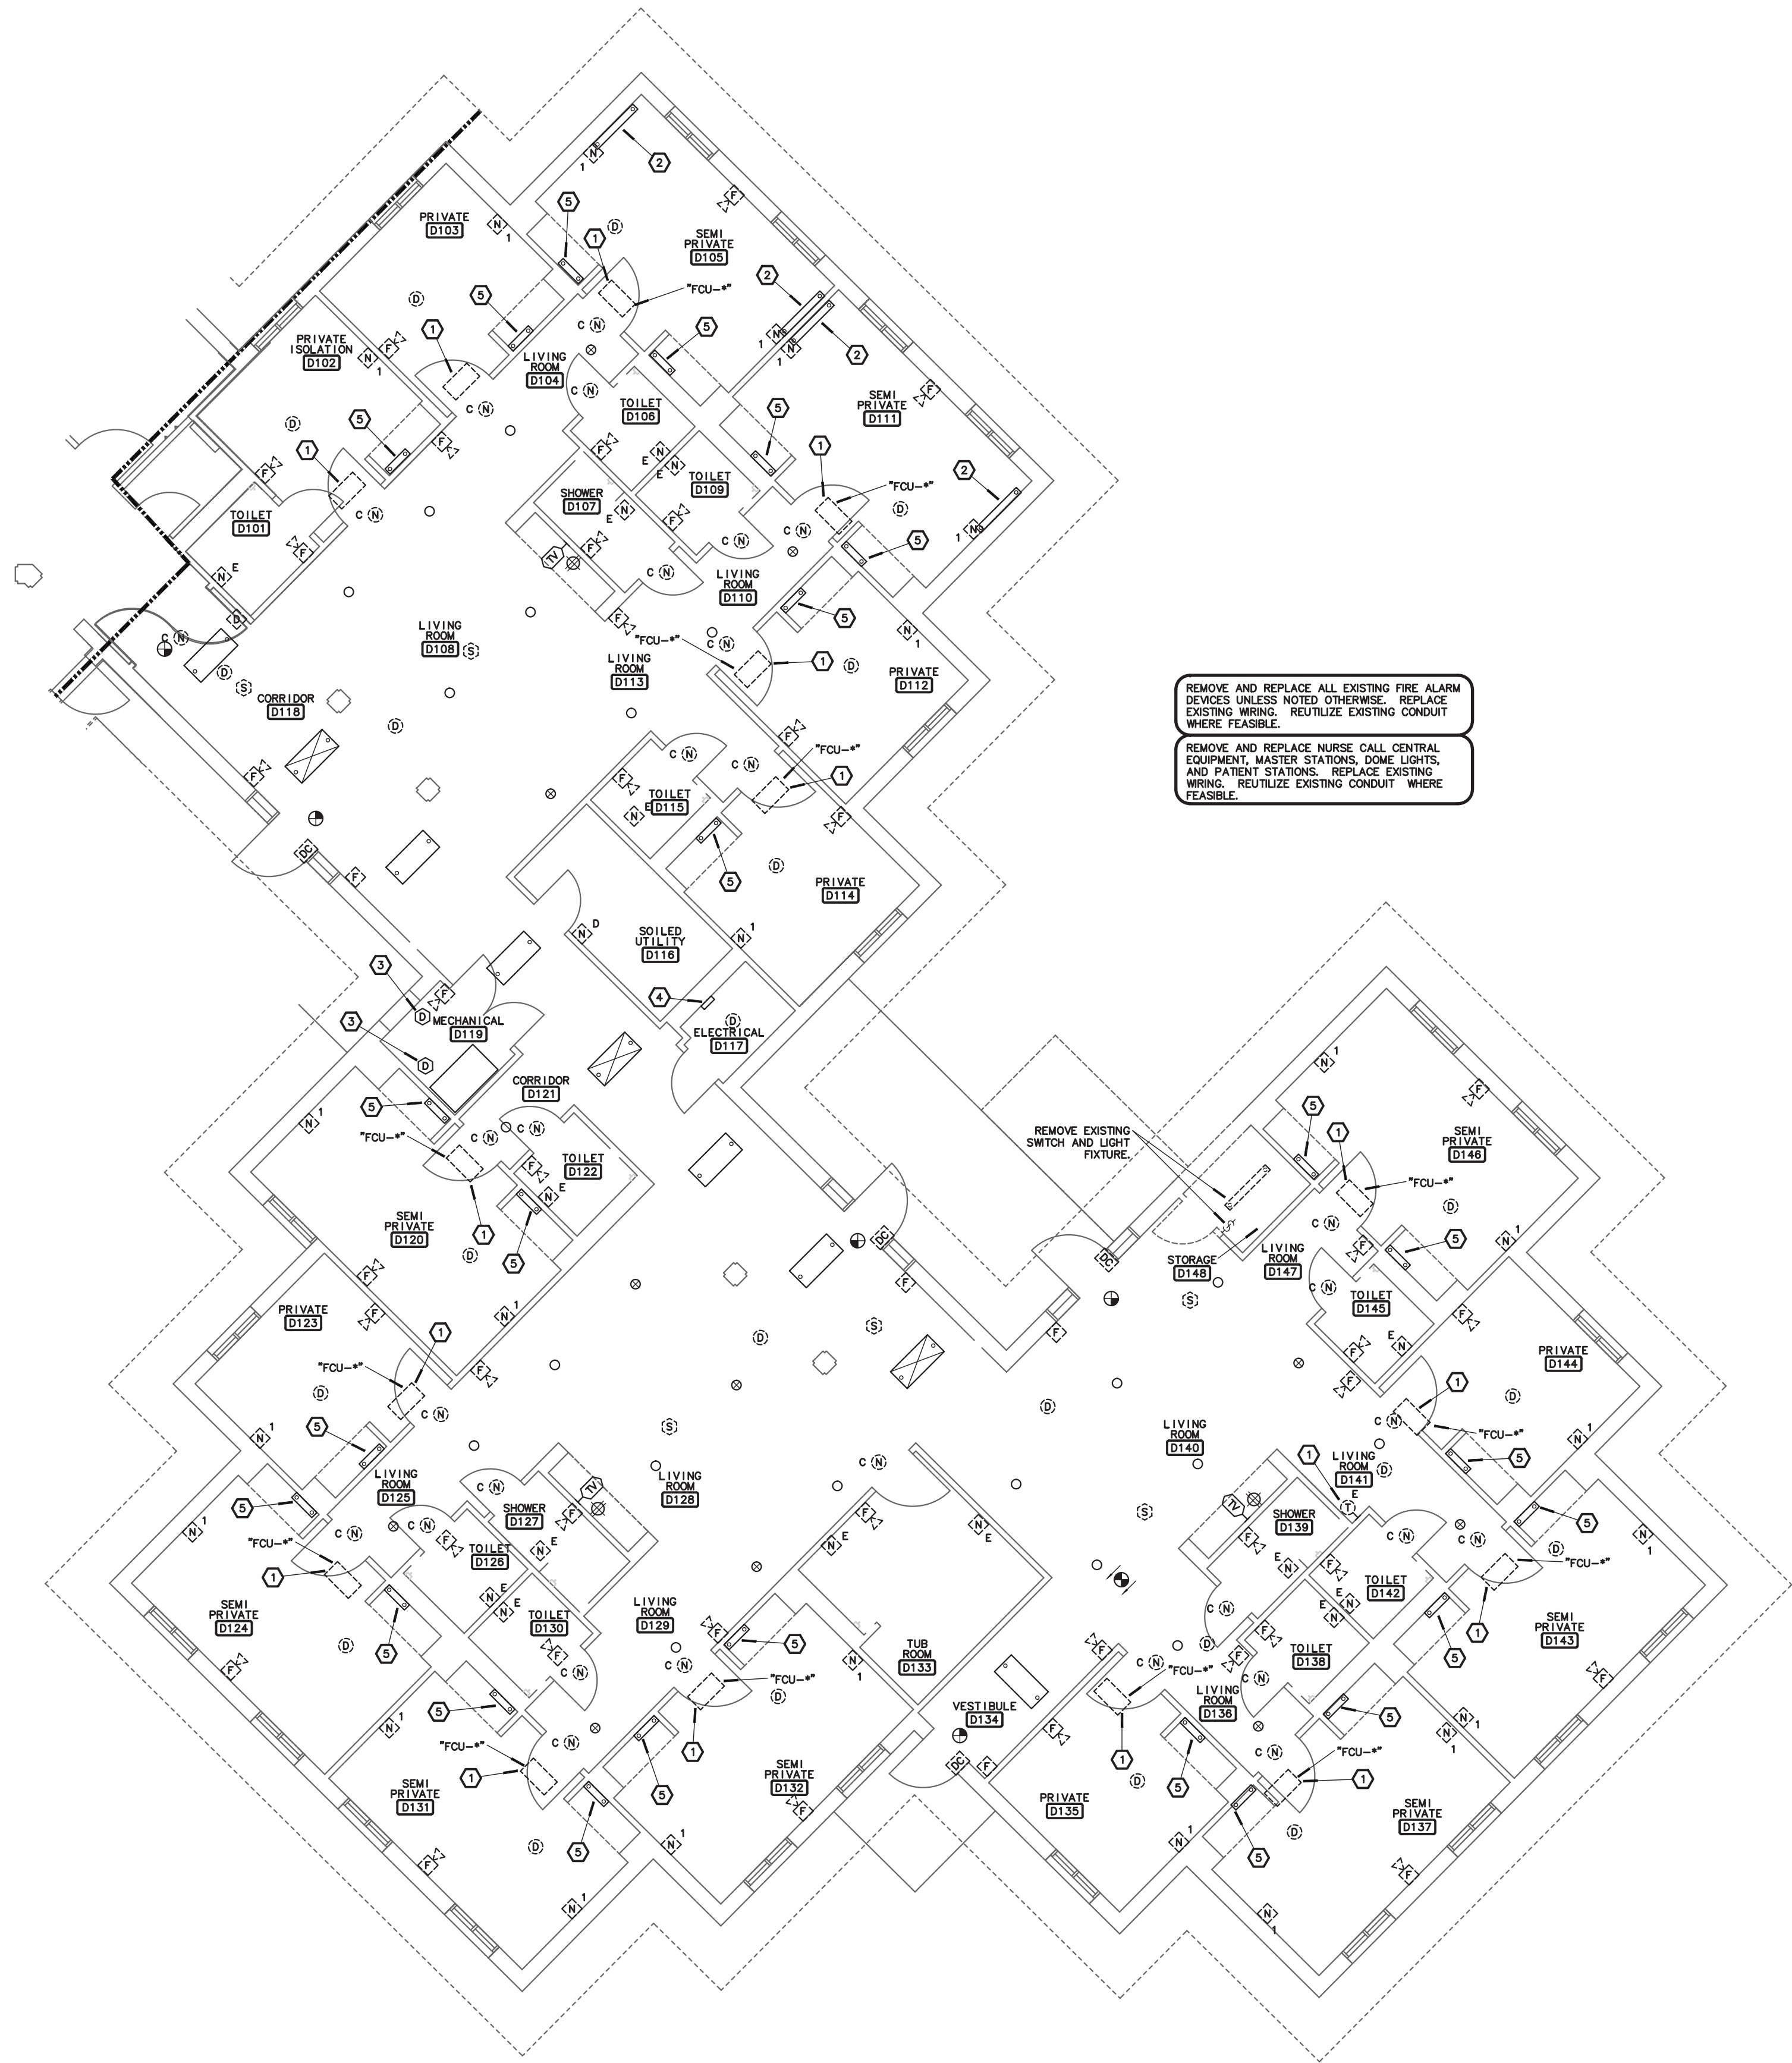
E-107

101 OF 120 SHEETS

8-1-24



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**E-108**

**WING 'D' - ELECTRICAL DEMOLITION PLAN**

SCALE: 1/8"=1'-0"




**rtm** engineering consultants  
3333 E. Battlefield Road, Ste. 1000  
Springfield, MO 65804  
rtmec.com | 417.881.0020  
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## NOTES:


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MIKE KEHOE,  
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HOME

620 N. JEFFERSON  
ST. JAMES, MISSOURI

PROJECT # **U1503-01**  
SITE # **6801**  
ASSET # **8136801002**  
FEDERAL # **29-044**

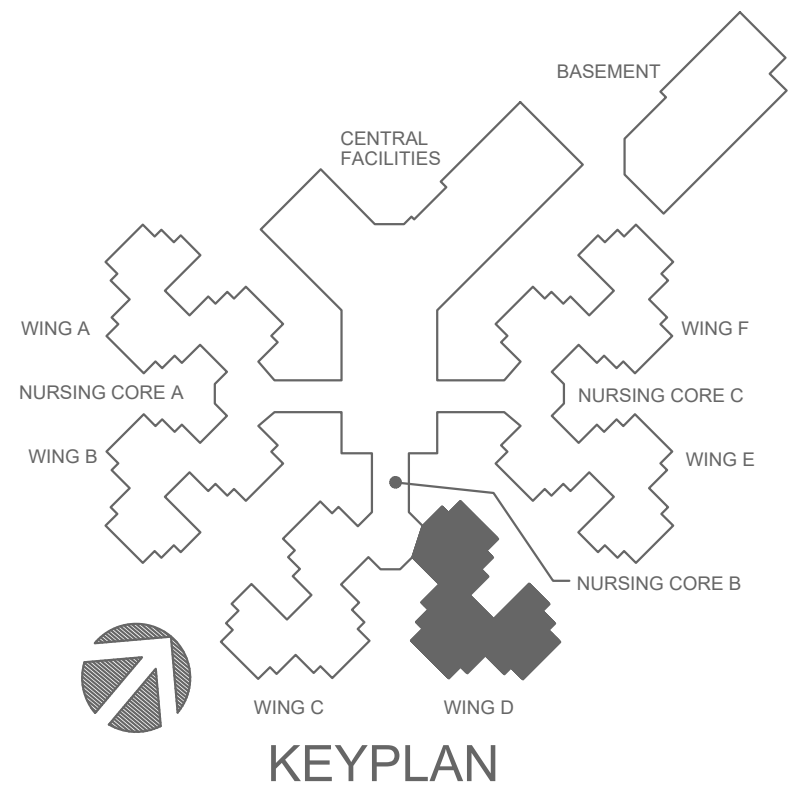REVISION: \_\_\_\_\_  
DATE: \_\_\_\_\_  
REVISION: \_\_\_\_\_  
DATE: \_\_\_\_\_  
REVISION: \_\_\_\_\_  
DATE: \_\_\_\_\_  
ISSUE DATE: **8-1-24**

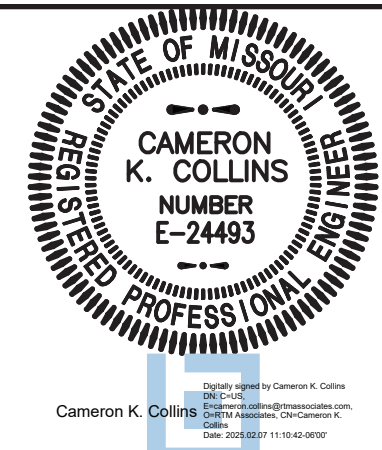CAD DWG FILE: **E-108.DWG**  
DRAWN BY: **AGB**  
CHECKED BY: **CKB**  
DESIGNED BY: **AGB**

SHEET TITLE:

**ELECTRICAL  
DEMOLITION  
PLAN**

SHEET NUMBER:


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102 OF 120 SHEETS

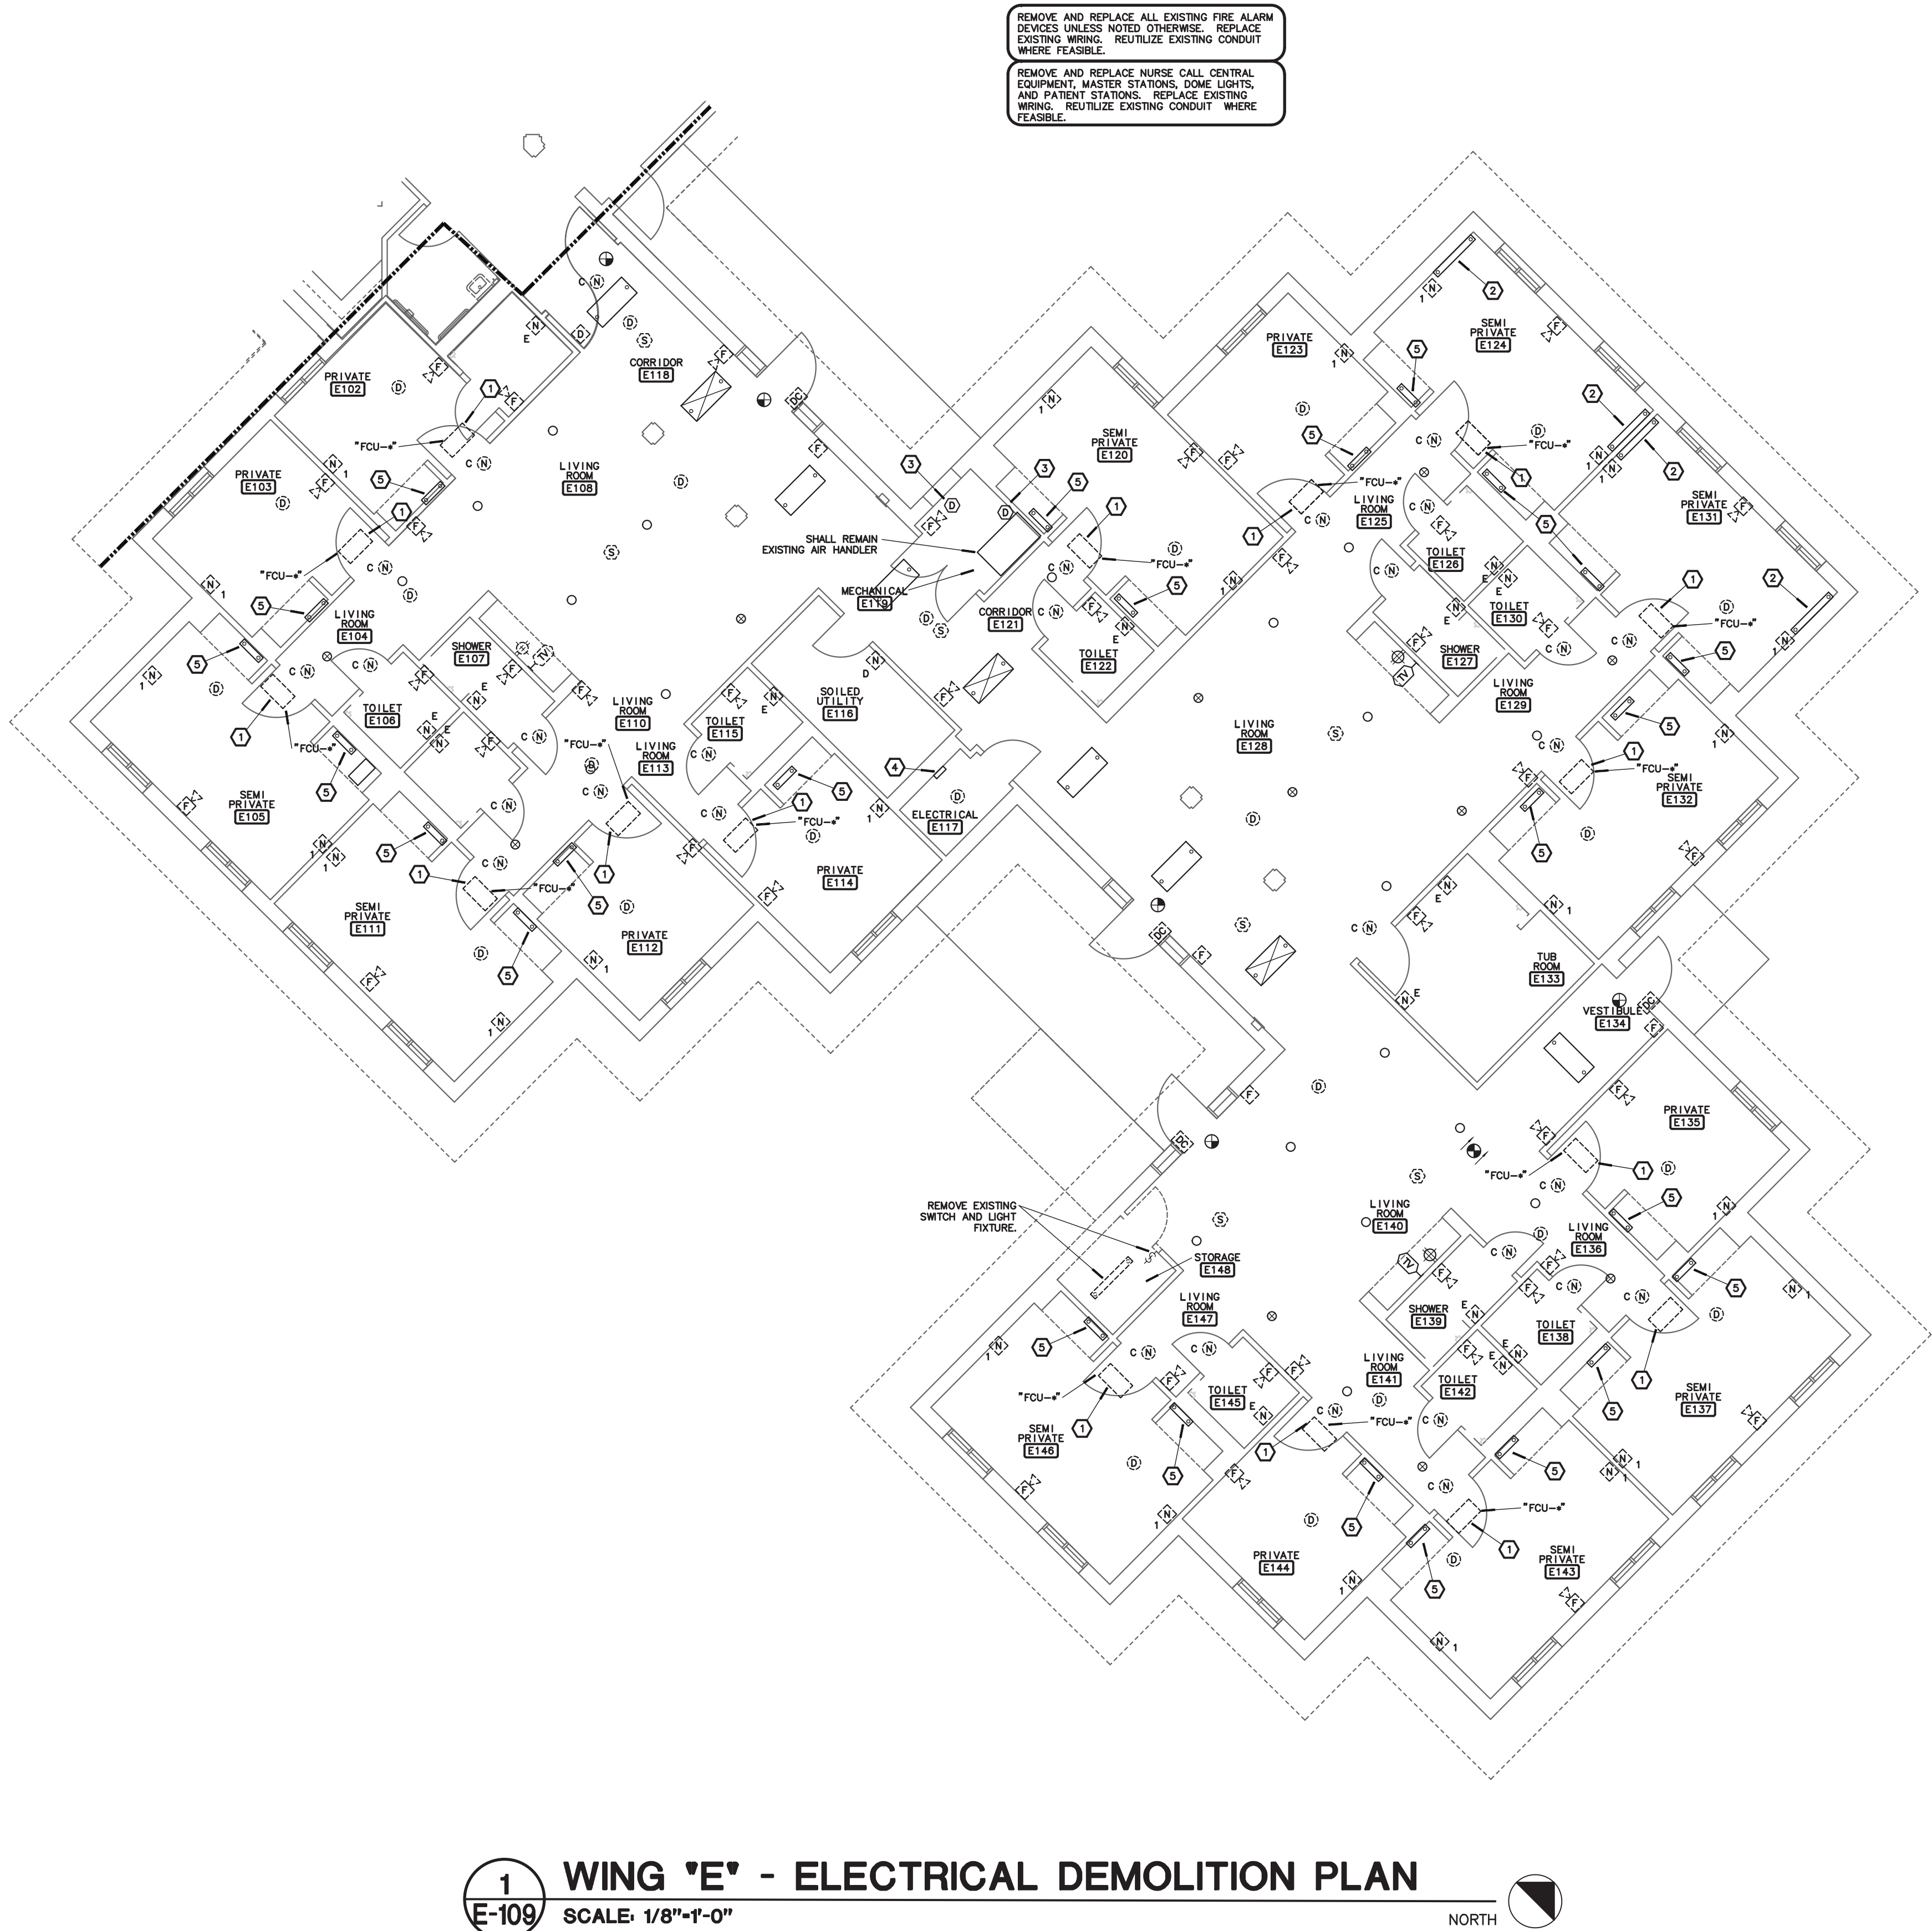8-1-24



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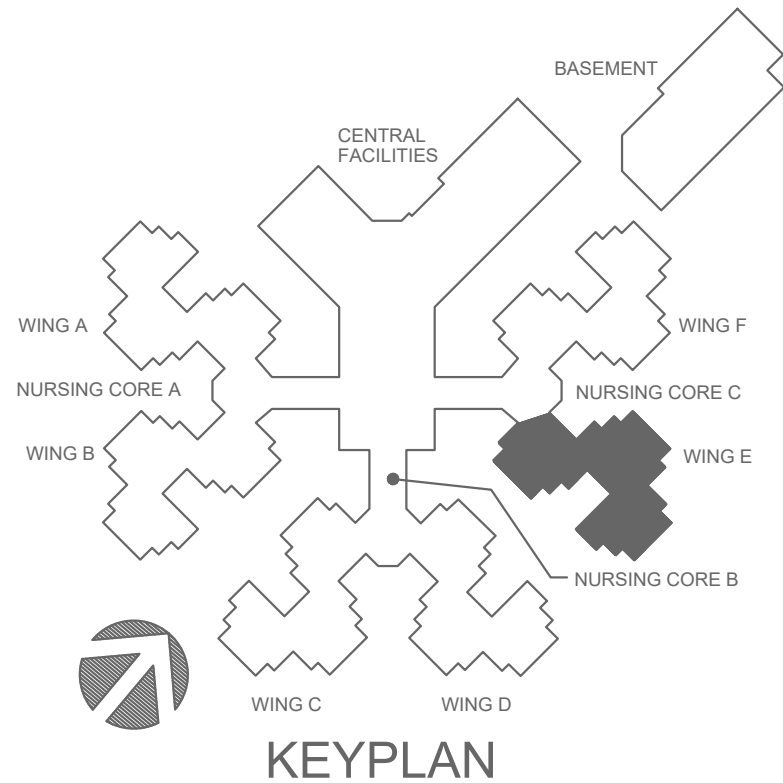
engineering consultants  
3333 E. Battlefield Road, Ste. 1000  
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## NOTES:


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STATE OF MISSOURI  
MIKE KEHOE,  
GOVERNOR



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620 N. JEFFERSON  
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PROJECT # U1503-01  
SITE # 6801  
ASSET # 8136801002  
FEDERAL # 29-044

REVISION: \_\_\_\_\_  
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DATE: \_\_\_\_\_  
ISSUE DATE: 8-1-24

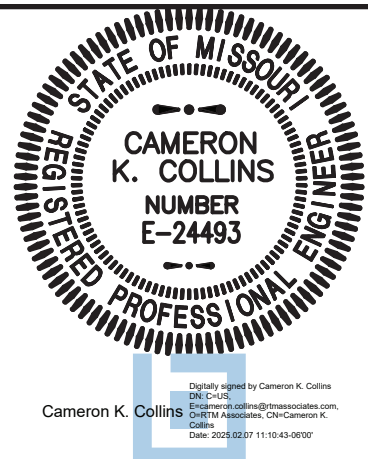CAD DWG FILE: E-109.DWG  
DRAWN BY: AGB  
CHECKED BY: CKB  
DESIGNED BY: AGB

SHEET TITLE:

**ELECTRICAL  
DEMOLITION  
PLAN**

SHEET NUMBER:


**E-109**

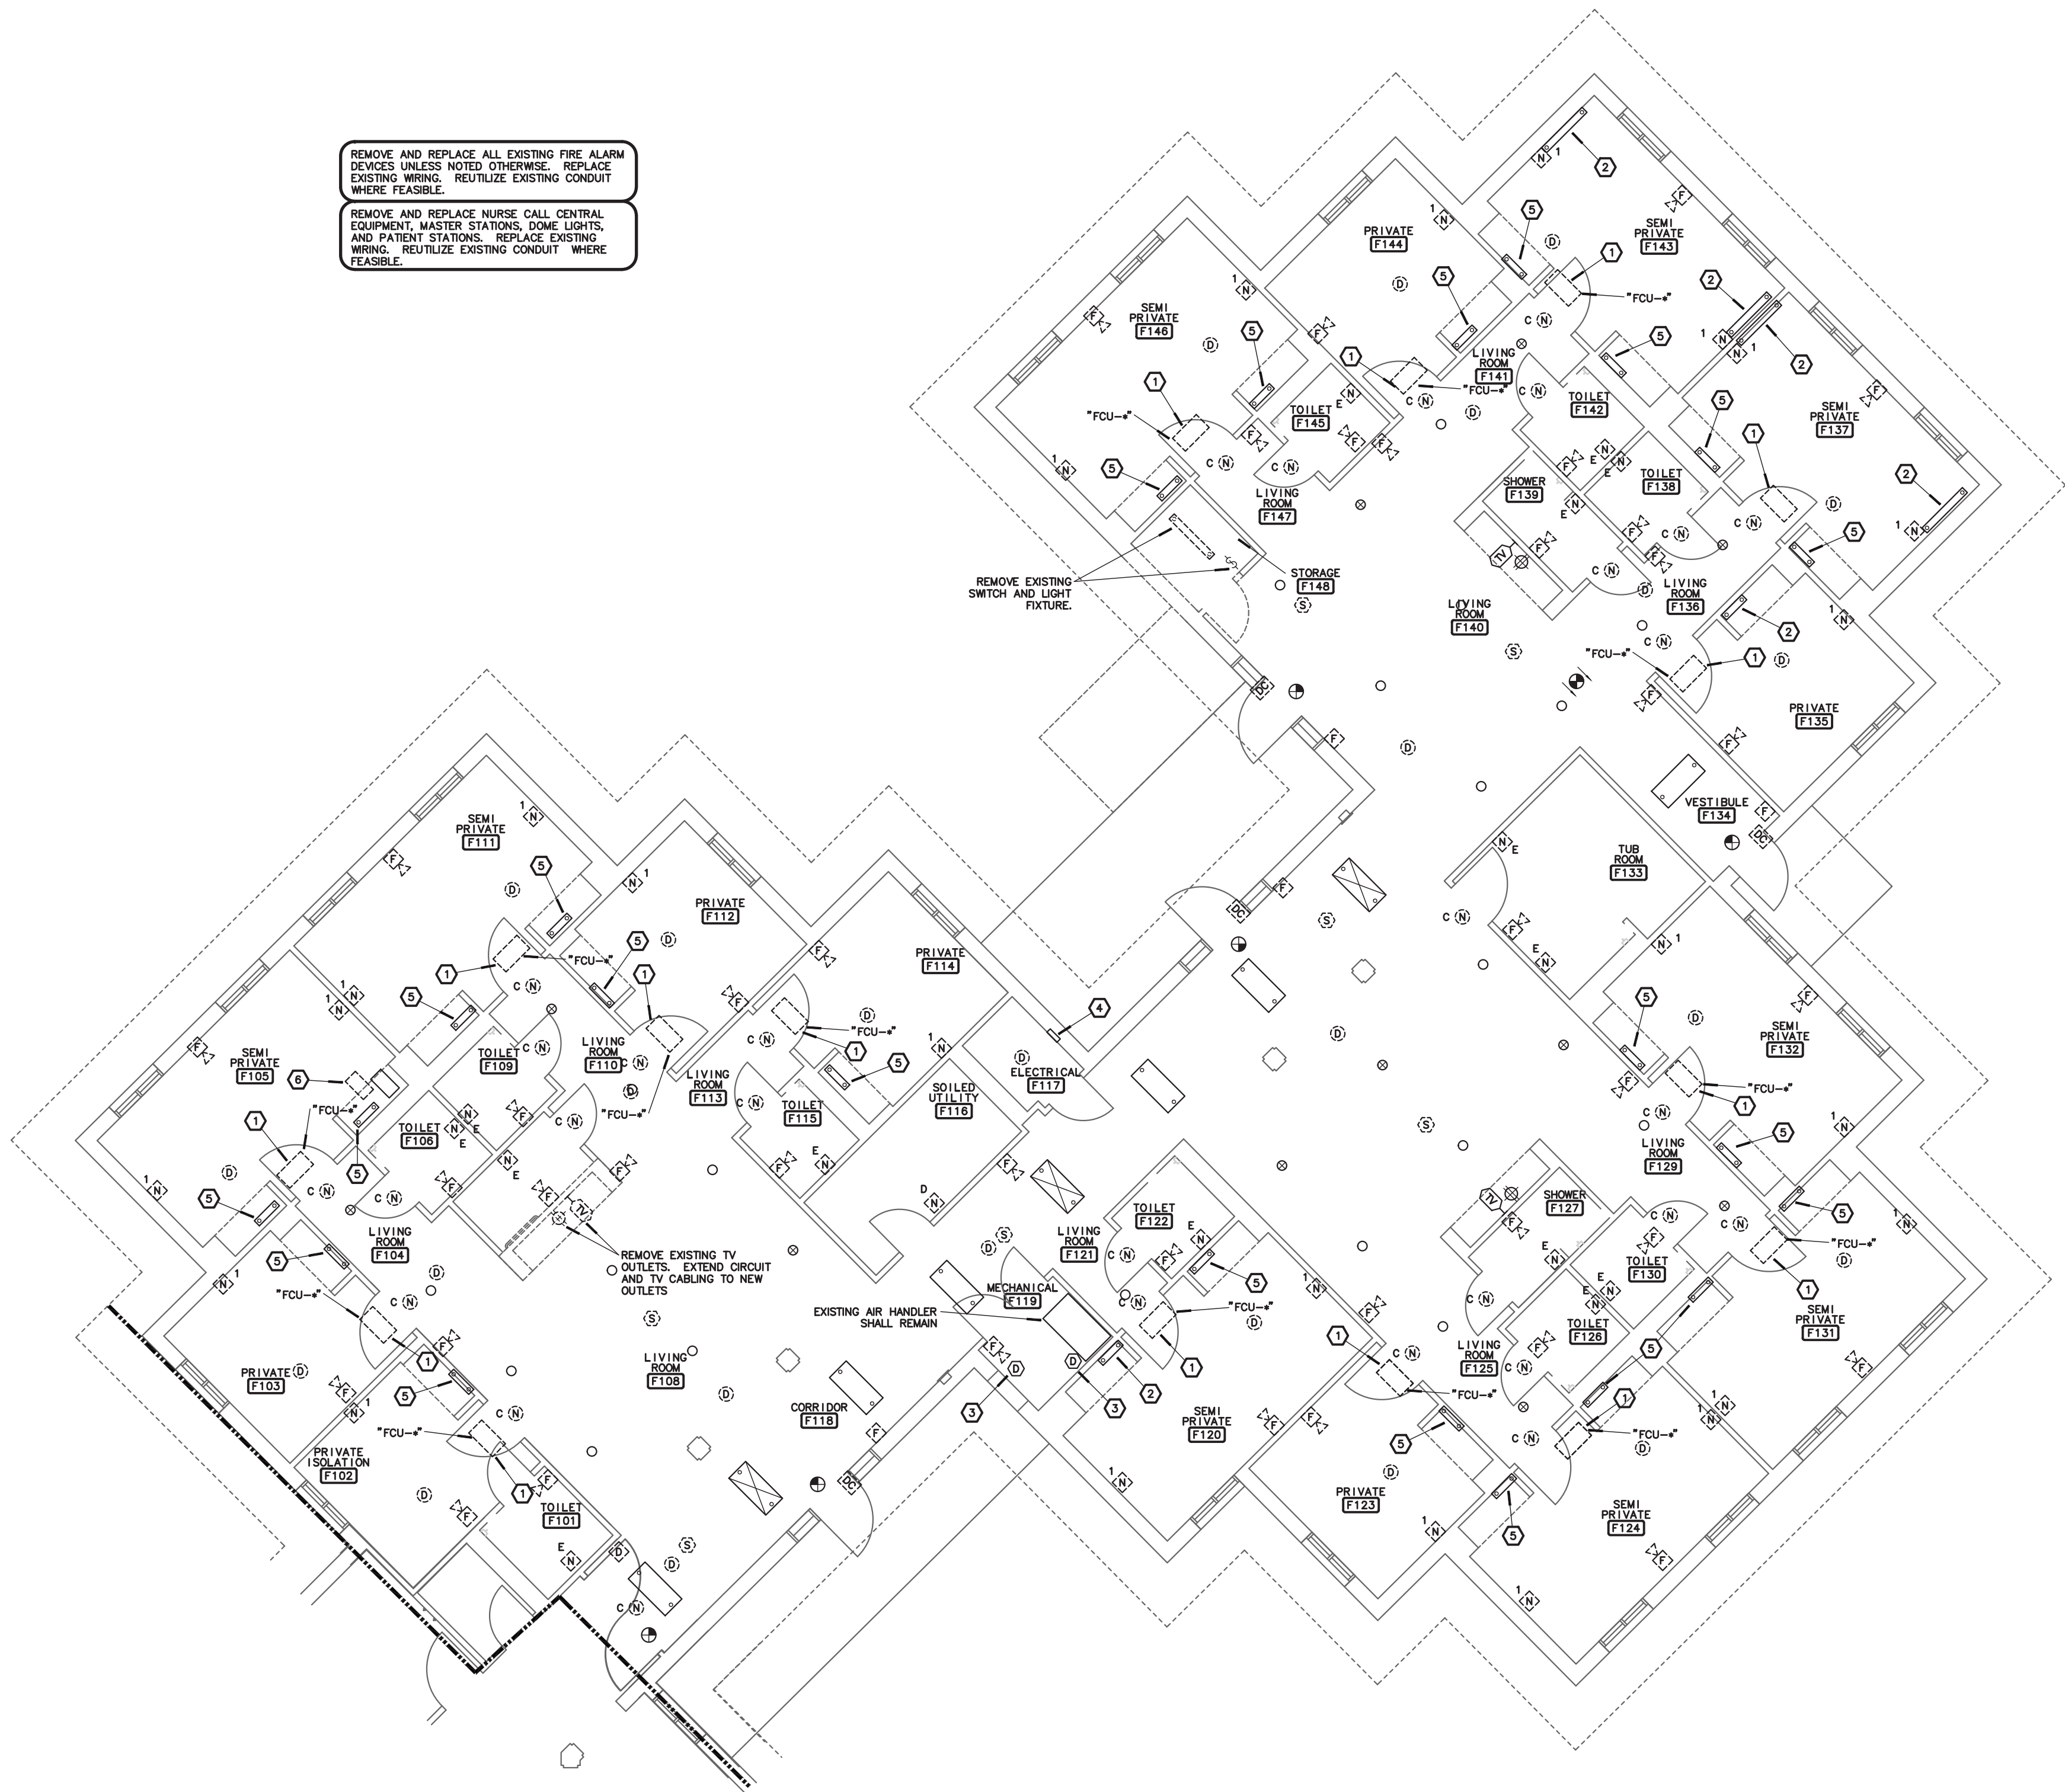103 OF 120 SHEETS

8-1-24



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REMOVE AND REPLACE ALL EXISTING FIRE ALARM DEVICES UNLESS NOTED OTHERWISE. REPLACE EXISTING WIRING. REUTILIZE EXISTING CONDUIT WHERE FEASIBLE.

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**1 WING 'F' -ELECTRICAL DEMOLITION PLAN**  
SCALE: 1/8"=1'-0" NORTH


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**NOTES:**


- EXISTING FCU TO BE REPLACED. PROVIDE REQUIRED ELECTRICAL DEMOLITION. REUSE EXISTING CIRCUIT FOR NEW FCU.
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PROJECT # **U1503-01**  
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CAD DWG FILE: **E-110.DWG**  
DRAWN BY: **AGB**  
CHECKED BY: **CKB**  
DESIGNED BY: **AGB**

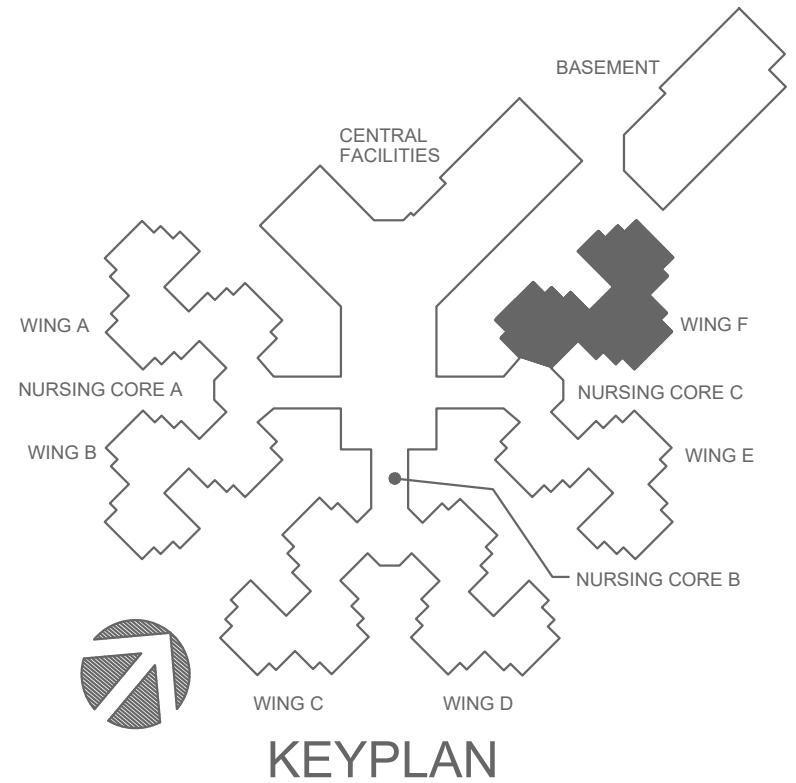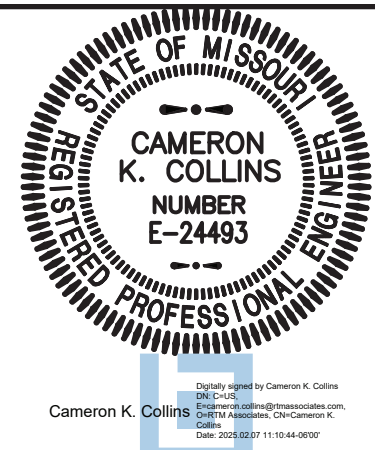SHEET TITLE:

**ELECTRICAL  
DEMOLITION  
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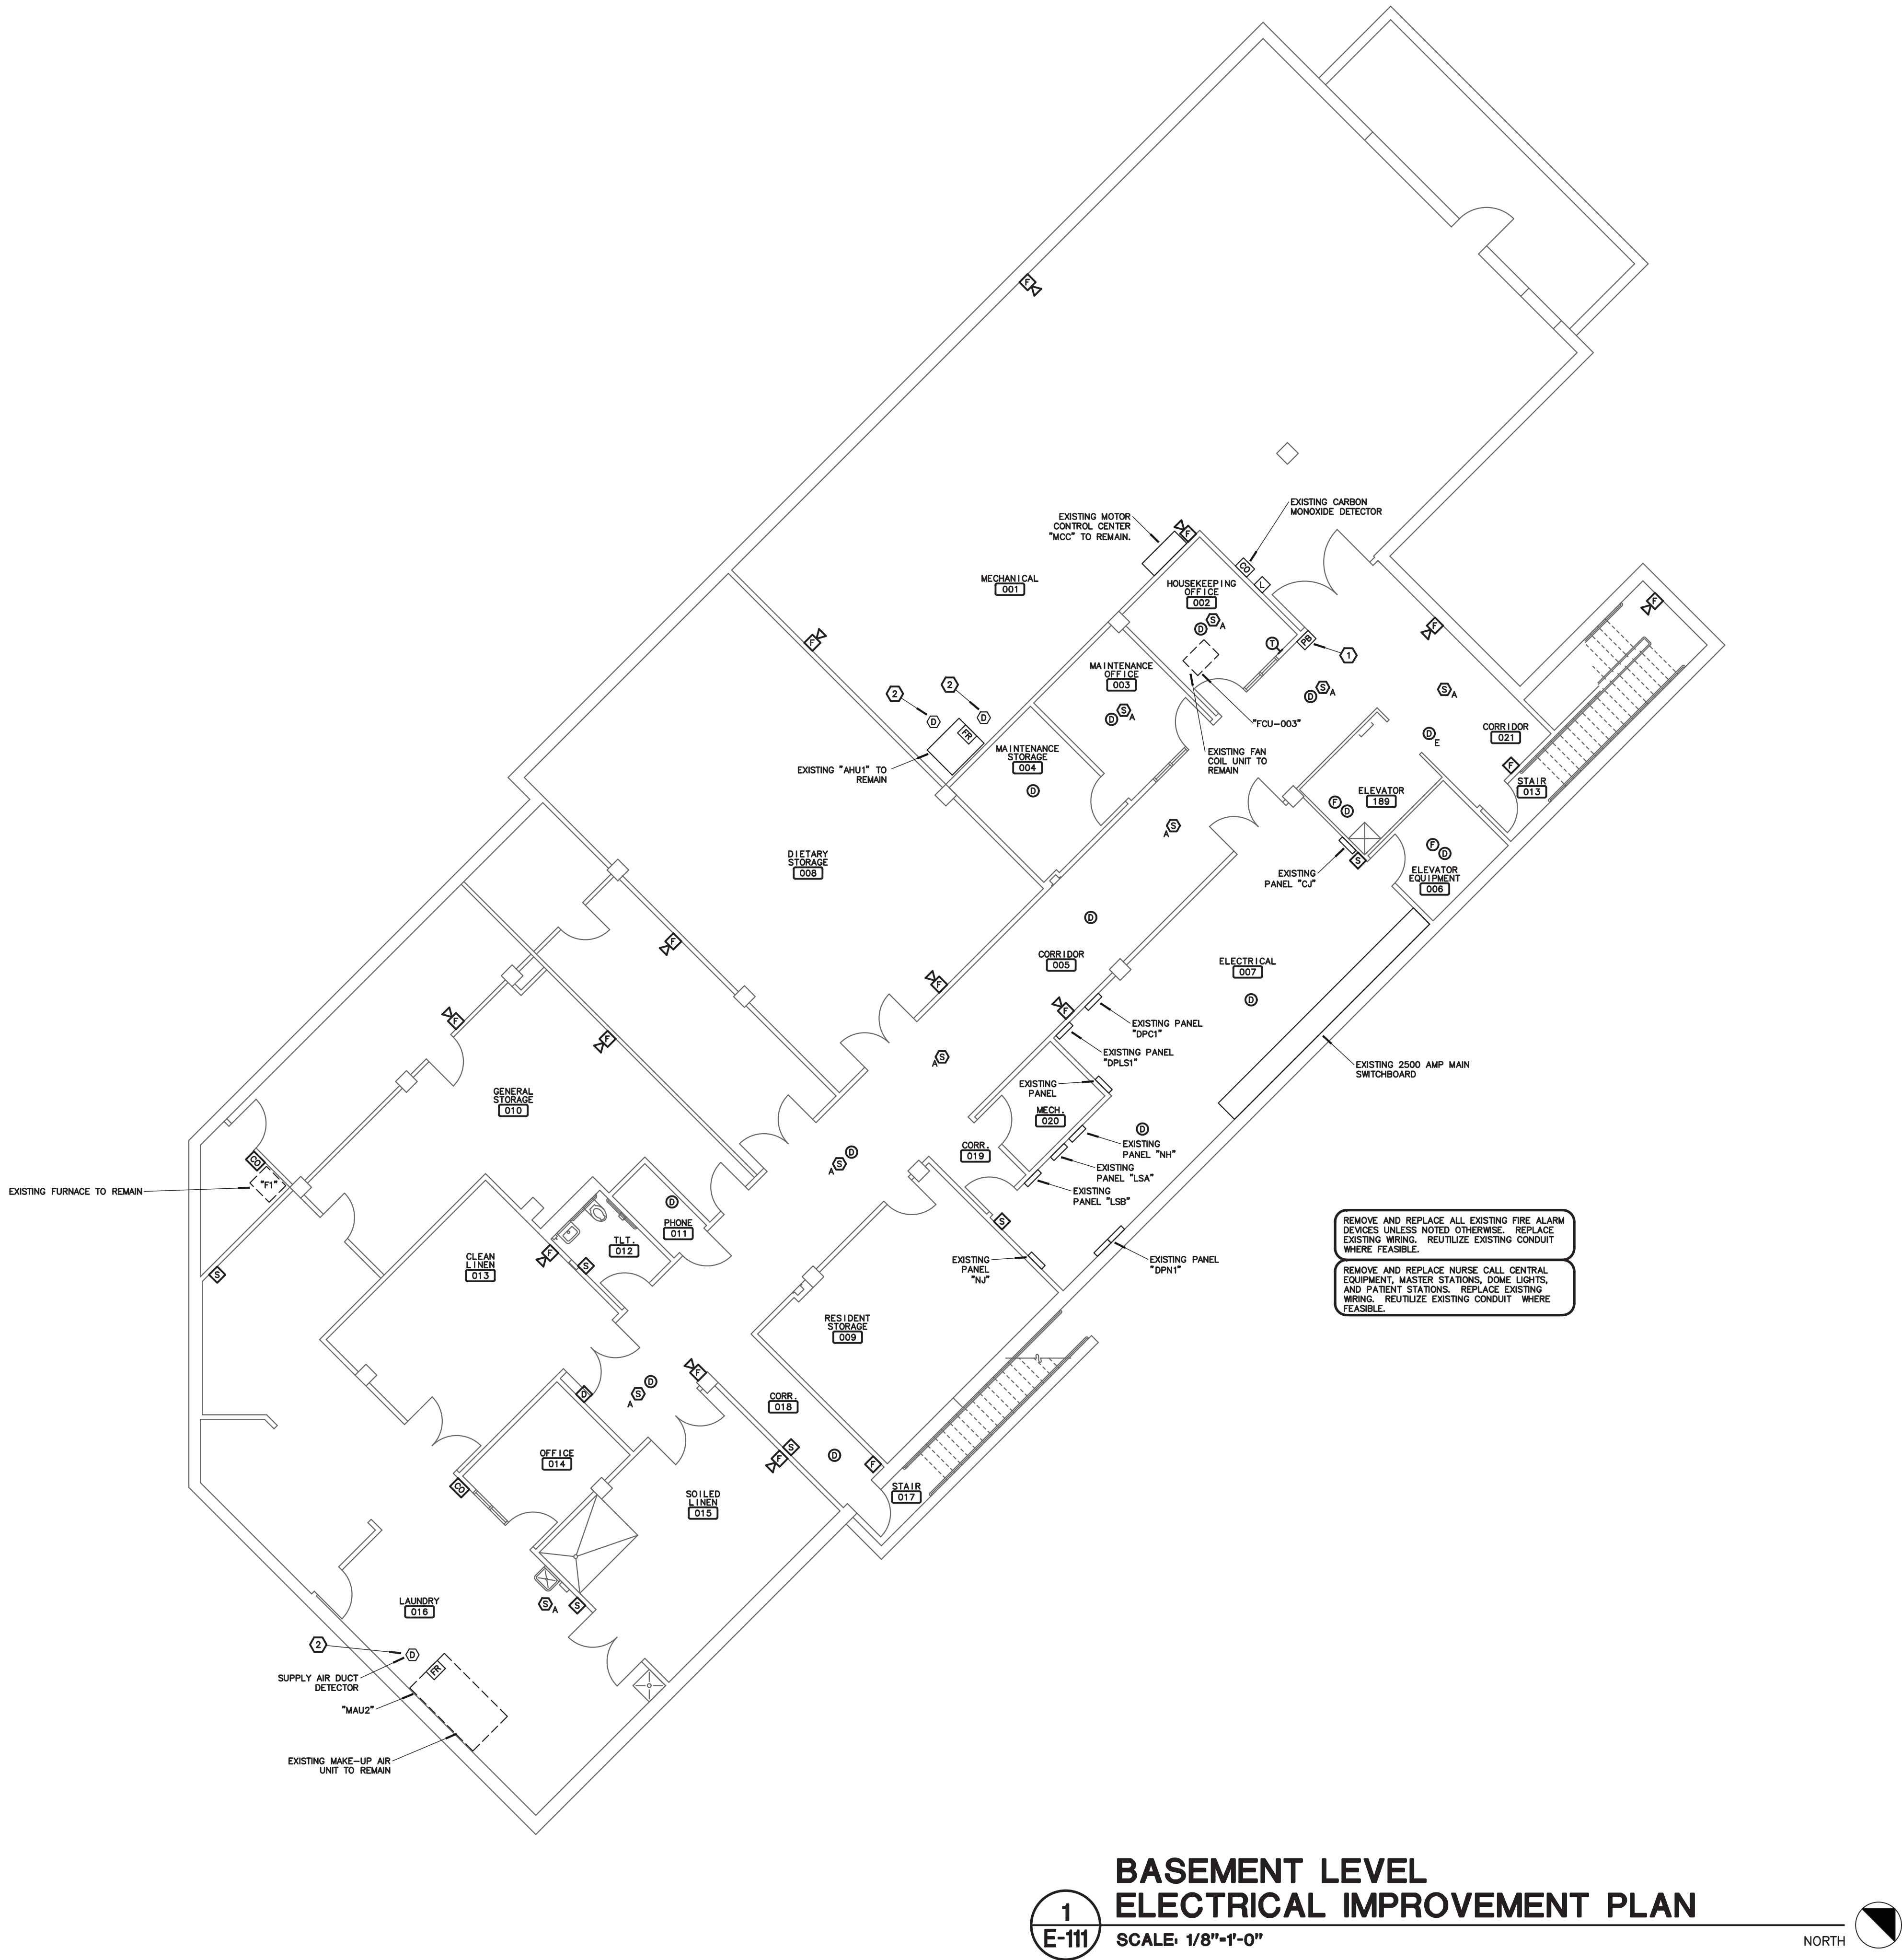
**E-110**

104 OF 120 SHEETS

8-1-24




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**BASEMENT LEVEL  
ELECTRICAL IMPROVEMENT PLAN**

SCALE: 1/8"=1'-0"

NORTH



**rtm** engineering consultants  
3333 E. Battleground Road, Ste. 1000  
Springfield, MO 65804  
rtmec.com | 417.881.0020  
State of Missouri certificate of authority  
#2014035826 for engineering

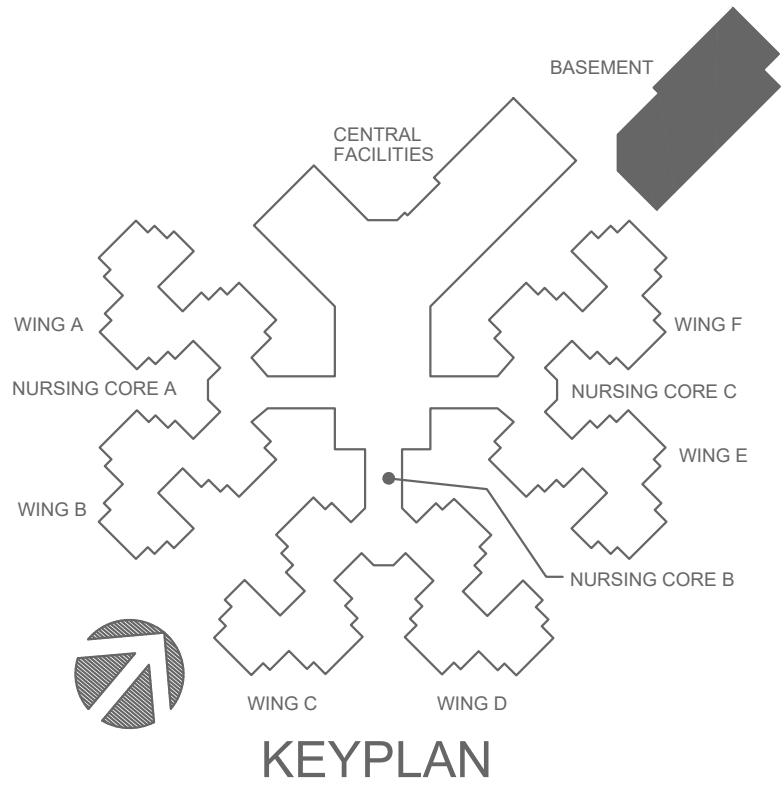
**NOTES:**

- EXISTING BOILER SHUTDOWN SWITCH TO REMAIN.
- EXISTING DUCT DETECTOR TO REMAIN. CONNECT TO NEW FIRE ALARM SYSTEM.

**GENERAL NOTES:**

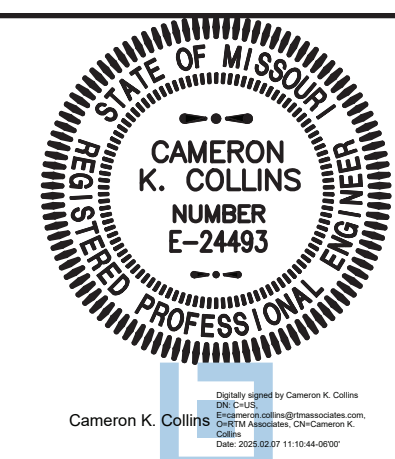- FOR ALL ELECTRICAL QUESTIONS DURING BIDDING OR DURING CONSTRUCTION, CONTACT ESTERLY, SCHNEIDER & ASSOCIATES, INC. THOM LUNDBERG (417) 862-0558 FOR COORDINATION WITH ANTHONY G. BEIER AT RTM ENGINEERING CONSULTANTS.
- SMOKE DETECTORS SHALL BE INSTALLED 36 INCHES OR MORE FROM ANY DIFFUSER OR REGISTER.

STATE OF MISSOURI  
MIKE KEHOE,  
GOVERNOR



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417.862.0558  
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e-mail: architect@esterlyschneider.com

**ESTERLY  
&  
SCHNEIDER  
ASSOCIATES, INC.**  
AIA architects & planners

COMM. #4860

OFFICE OF ADMINISTRATION  
DIVISION OF FACILITIES  
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DEPARTMENT OF  
PUBLIC SAFETY  
MISSOURI VETERANS  
COMMISSION

INTERIOR RENOVATION  
MISSOURI VETERANS  
HOME

620 N. JEFFERSON  
ST. JAMES, MISSOURI

PROJECT # **U1503-01**  
SITE # **6801**  
ASSET # **8136801002**  
FEDERAL # **29-044**

REVISION: \_\_\_\_\_  
DATE: \_\_\_\_\_  
REVISION: \_\_\_\_\_  
DATE: \_\_\_\_\_  
REVISION: \_\_\_\_\_  
DATE: \_\_\_\_\_  
ISSUE DATE: **8-1-24**

CAD DWG FILE: **E-111LDWG**  
DRAWN BY: **AGB**  
CHECKED BY: **CKB**  
DESIGNED BY: **AGB**

SHEET TITLE:

**ELECTRICAL  
PLAN**

SHEET NUMBER:


**E-111**

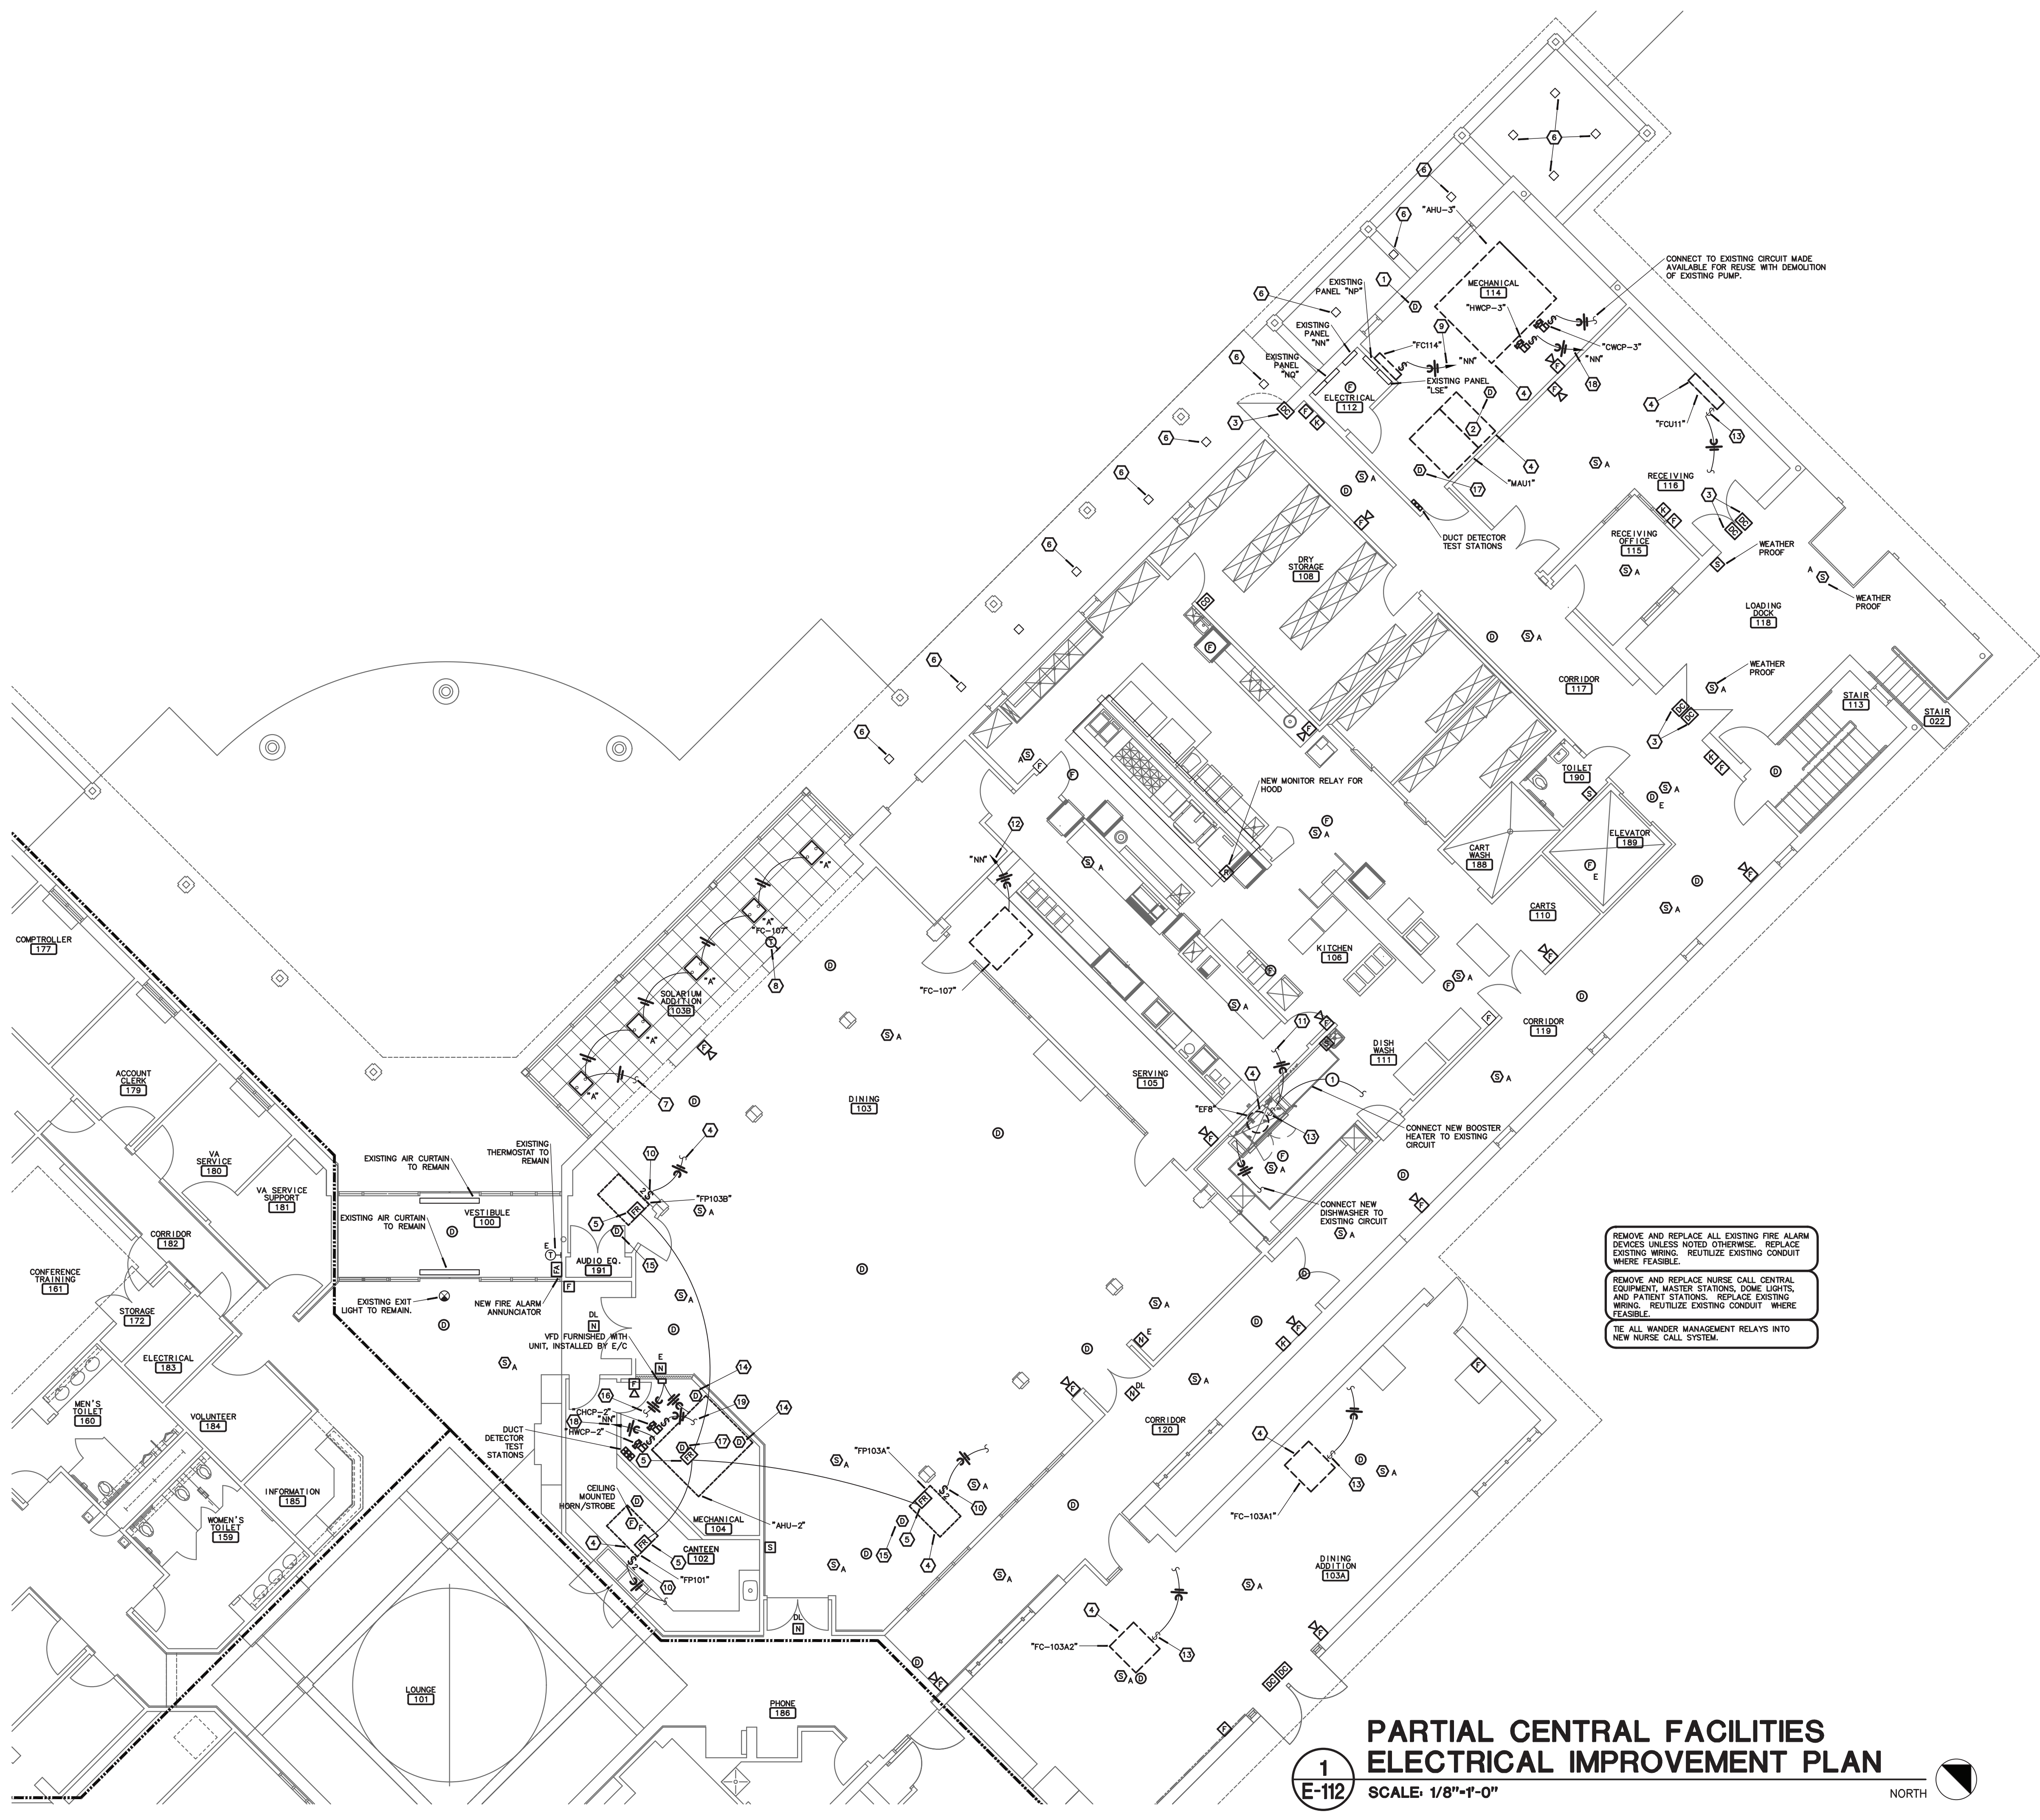105 OF 120 SHEETS

8-1-24



H:\ESAS\SWH\DWG\SWH-E-112 20 Aug 2018 - 9:08 am



**PARTIAL CENTRAL FACILITIES  
ELECTRICAL IMPROVEMENT PLAN**  
1  
E-112  
SCALE: 1/8"=1'-0"  
NORTH

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State of Missouri certificate of authority  
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**NOTES:**

1. MOUNT IN RETURN DUCT.
2. MOUNT IN SUPPLY DUCT.
3. DOOR WILL BE REPLACED. PROVIDE ALL REQUIRED ELECTRICAL CONNECTIONS TO NEW DOOR HARDWARE. DOOR CONTACTS SHALL TIE INTO NEW NURSE CALL SYSTEM.
4. CONNECT NEW UNIT TO EXISTING CIRCUIT MADE AVAILABLE WITH DEMOLITION OF EXISTING UNIT.
5. INTERLOCK FAN SHUTDOWN RELAYS SO THAT ACTIVATION OF DUCT DETECTOR SHUTS DOWN ALL INTERLOCKED UNITS.
6. EXISTING EXTERIOR CANOPY LIGHT TO REMAIN.
7. CONNECT TO EXISTING LIGHTING CIRCUIT IN DINING ROOM. NEW LIGHTS SHALL BE SWITCHED WITH DINING ROOM LIGHTING.
8. INSTALL THERMOSTAT ON EXISTING WALL. PROVIDE WIREMOLD FOR THERMOSTAT WIRING.
9. PROVIDE A NEW 15-AMP, 2-POLE CIRCUIT BREAKER IN PANEL "NN" AND MAKE ALL REQUIRE CONNECTIONS FOR CIRCUIT SERVING NEW FAN COIL UNITS.
10. PROVIDE NEW 20-AMP, 2-POLE DISCONNECT.
11. REUSE EXISTING CIRCUIT. MAINTAIN CONTROL THRU ASSOCIATED HOOD.
12. PROVIDE NEW 20-AMP, 3-POLE CIRCUIT BREAKER IN EXISTING PANEL.
13. DISCONNECT FURNISHED WITH UNIT. MAKE ALL FINAL CONNECTIONS.
14. MOUNT IN RETURN DUCT.
15. INSTALL IN RETURN AIR BOOT OF UNIT. COORDINATE WITH MECHANICAL CONTRACTOR TO PROVIDE ENOUGH DUCTWORK TO INSTALL. PER MANUFACTURER REQUIREMENTS.
16. REUSE EXISTING CIRCUIT FROM EXISTING MOTOR CONTROL CENTER "MCC" IN BASEMENT. MODIFY EXISTING STARTERS SO THAT THEY ARE LOCKED INTO THE "ON" POSITION. CONTROL OF UNIT SHALL BE BY NEW VFD.
17. MOUNT IN SUPPLY DUCT.
18. PROVIDE NEW 20-AMP, 1-POLE CIRCUIT BREAKER IN EXISTING PANEL.
19. CONNECT TO EXISTING CIRCUIT MADE AVAILABLE FOR REUSE WITH DEMOLITION OF EXISTING PUMP.

**BRANCH CIRCUIT & FEEDER SCHEDULE:**

1. 3 - #8 AND 1 - #10 GROUND IN 0.75" CONDUIT.

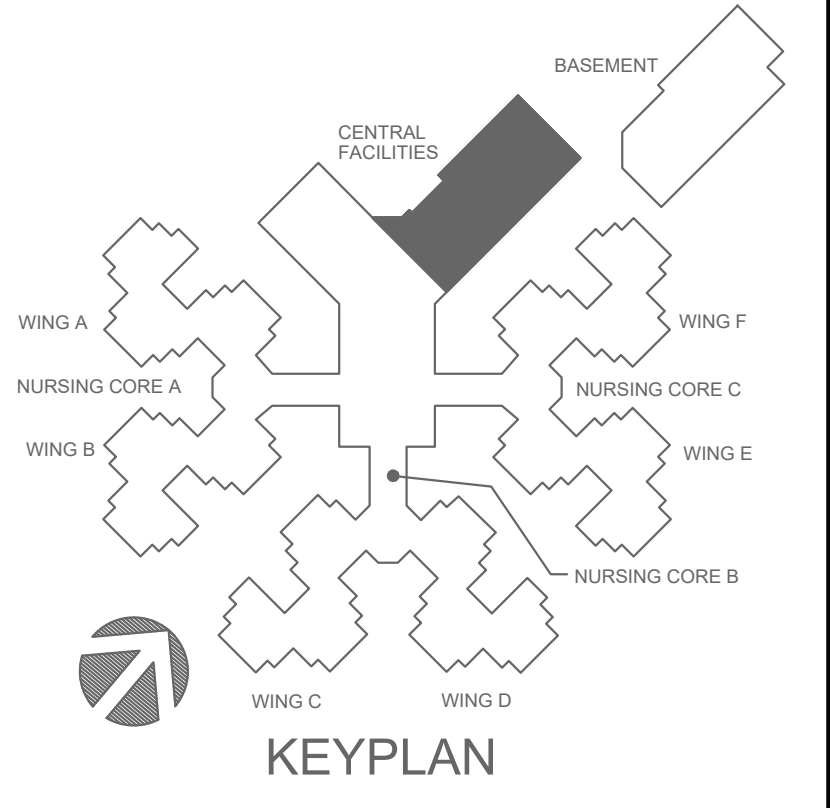
**GENERAL NOTES:**

1. FOR ALL ELECTRICAL QUESTIONS DURING BIDDING OR DURING CONSTRUCTION, CONTACT ESTERY, SCHNEIDER & ASSOCIATES, INC., THOM LUNDBERG (417) 862-0558 FOR COORDINATION WITH ANTHONY G. BEIER AT RTM ENGINEERING CONSULTANTS.
2. SMOKE DETECTORS SHALL BE INSTALLED 36 INCHES OR MORE FROM ANY DIFFUSER OR REGISTER.


REMOVE AND REPLACE ALL EXISTING FIRE ALARM DEVICES UNLESS NOTED OTHERWISE. REPLACE EXISTING WIRING. REUTILIZE EXISTING CONDUIT WHERE FEASIBLE.

REMOVE AND REPLACE NURSE CALL CENTRAL EQUIPMENT, MASTER STATIONS, DOME LIGHTS, AND PATIENT STATIONS. REPLACE EXISTING WIRING. REUTILIZE EXISTING CONDUIT WHERE FEASIBLE.

TIE ALL WANDER MANAGEMENT RELAYS INTO NEW NURSE CALL SYSTEM.



STATE OF MISSOURI  
MIKE KEHOE,  
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**ESTERY  
SCHNEIDER  
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ASSOCIATES, INC.**  
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COMM. #4860

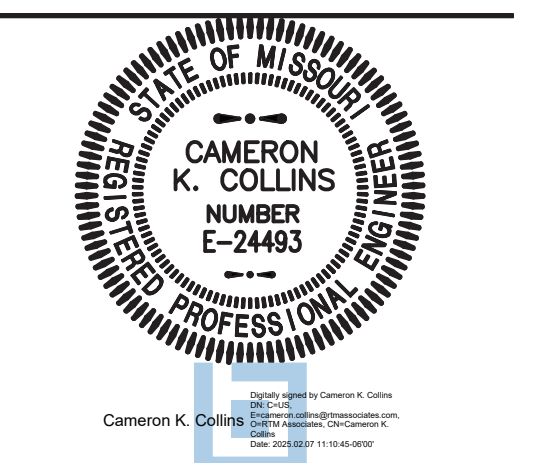OFFICE OF ADMINISTRATION  
DIVISION OF FACILITIES  
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620 N. JEFFERSON  
ST. JAMES, MISSOURI

PROJECT # **U1503-01**  
SITE # **6801**  
ASSET # **8136801002**  
FEDERAL # **29-044**

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DATE: \_\_\_\_\_  
REVISION: \_\_\_\_\_  
DATE: \_\_\_\_\_  
REVISION: \_\_\_\_\_  
DATE: \_\_\_\_\_  
ISSUE DATE: **8-1-24**

CAD DWG FILE: **E-112.DWG**  
DRAWN BY: **AGB**  
CHECKED BY: **CKB**  
DESIGNED BY: **AGB**

SHEET TITLE:

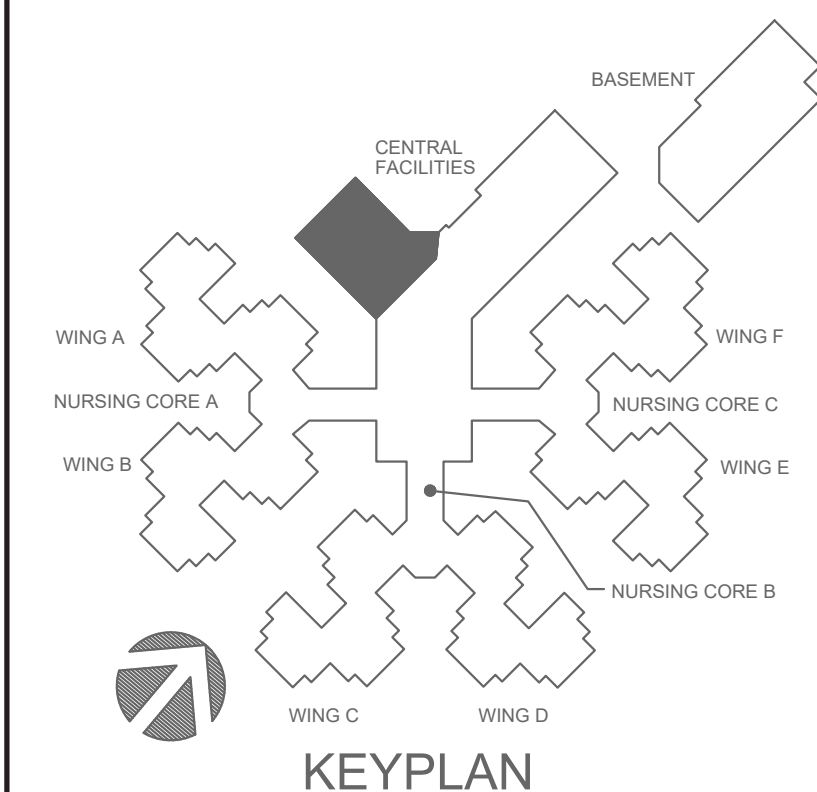
**ELECTRICAL  
PLAN**

SHEET NUMBER:

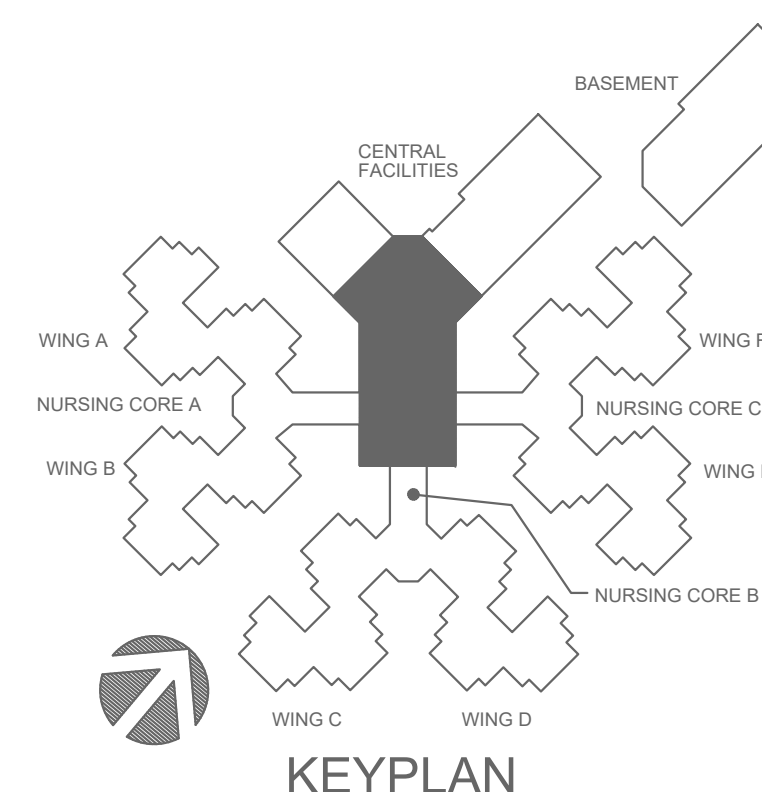
**E-112**  
106 OF 120 SHEETS

8-1-24

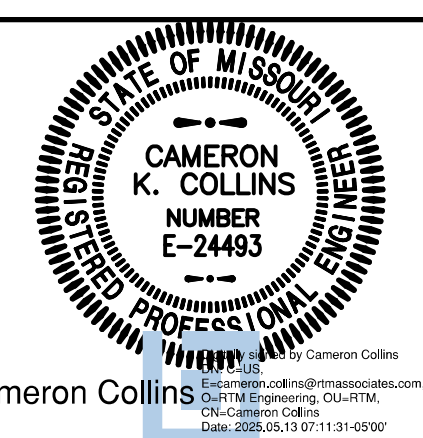












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Professional Engineer  
#E-24483  
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PROJECT # U1503-01  
SITE # 6801  
ASSET # 8136801002  
FEDERAL # 29-044

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REVISION:  
DATE: \_\_\_\_\_  
ISSUE DATE: 8-1-24

CAD DWG FILE: E-115.DWG  
DRAWN BY: AGP  
CHECKED BY: CKP  
DESIGNED BY: AGP

SHEET TITLE:

ELECTRICAL  
PLAN

SHEET NUMBER:

E-115

109 OF 120 SHEETS




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## NOTES:


- CONNECT TO NEAREST UNSWITCHED LIGHTING CIRCUIT.
- DOOR CONTACT SHALL TIE INTO NURSE CALL SYSTEM.
- EXISTING UNIT TO BE REPLACED WITH NEW. CONNECT NEW UNIT TO EXISTING CIRCUIT MADE AVAILABLE WITH DEMOLITION OF EXISTING UNIT.
- DISCONNECT FURNISHED WITH UNIT. MAKE FINAL CONNECTIONS.
- CONNECT TO EXISTING RECEPTACLE CIRCUIT.
- INSTALL NEW FIRE ALARM SUB-PANEL ADJACENT TO EXISTING. CUT AND PATCH WALL AS NECESSARY TO INSTALL NEW FIRE ALARM PANEL. EXISTING SUB-PANEL TO REMAIN IN OPERATION UNTIL CONSTRUCTION IS COMPLETE IN ASSOCIATED AREAS.
- PROVIDE NEW NURSE CALL HEAD-IN EQUIPMENT. EXISTING NURSE CALL SYSTEM SHALL REMAIN ACTIVE UNTIL ALL CIRCUITS ARE TRANSFERRED TO NEW HEAD-IN EQUIPMENT AND CONSTRUCTION IS COMPLETE.
- NEW FAN COIL UNIT.
- EXISTING AIR HANDLING UNIT TO REMAIN.
- CONNECT TO SPARE 20-AMP, 1-POLE CIRCUIT BREAKER IN EXISTING PANELBOARD.
- CONNECT TO EXISTING LIGHTING CIRCUIT MADE AVAILABLE WITH DEMOLITION OF EXISTING LIGHT FIXTURE.
- CONNECT TO EXISTING RECEPTACLE CIRCUIT MADE AVAILABLE WITH DEMOLITION OF EXISTING RECEPTABLES.
- INSTALL NEW FIRE ALARM MAIN PANEL ADJACENT TO EXISTING. CUT AND PATCH WALL AS NECESSARY TO INSTALL NEW FIRE ALARM PANEL. EXISTING MAIN PANEL TO REMAIN IN OPERATION UNTIL CONSTRUCTION IS COMPLETE IN ASSOCIATED AREAS.
- CONNECT TO EXISTING CIRCUIT SERVING EXISTING FIRE ALARM PANEL TO BE REPLACED.
- CONNECT TO EXISTING LIGHTING CIRCUIT SERVING THIS AREA. REUSE EXISTING SWITCHING FOR NEW LIGHT FIXTURES.
- EXISTING TEKCAR DURESS SYSTEM ANNUNCIATOR TO REMAIN.
- EXISTING WANDER MANAGEMENT SERVER TO REMAIN.
- WANDER MANAGEMENT DATA OUTLET. REUSE EXISTING DATA PORT AND CABLE. MAKE CONNECTION TO EXISTING SERVER AND ROUTE CABLE TO NEW DATA OUTLET LOCATION.
- NEW LOCATION FOR EXISTING NURSE CALL DURESS CALL STATION.
- EXISTING SWITCHES FOR WINGS IAE & IBE COMMON AREA LIGHTING TO REMAIN.
- EXISTING SWITCHES FOR WINGS ICE & IDE COMMON AREA LIGHTING TO REMAIN.
- EXISTING SWITCHES FOR WINGS IEE & IFE COMMON AREA LIGHTING TO REMAIN.
- PROVIDE NEW 20-AMP, 1-POLE CIRCUIT BREAKER IN EXISTING PANEL FOR NEW CIRCUIT.

## GENERAL NOTES:

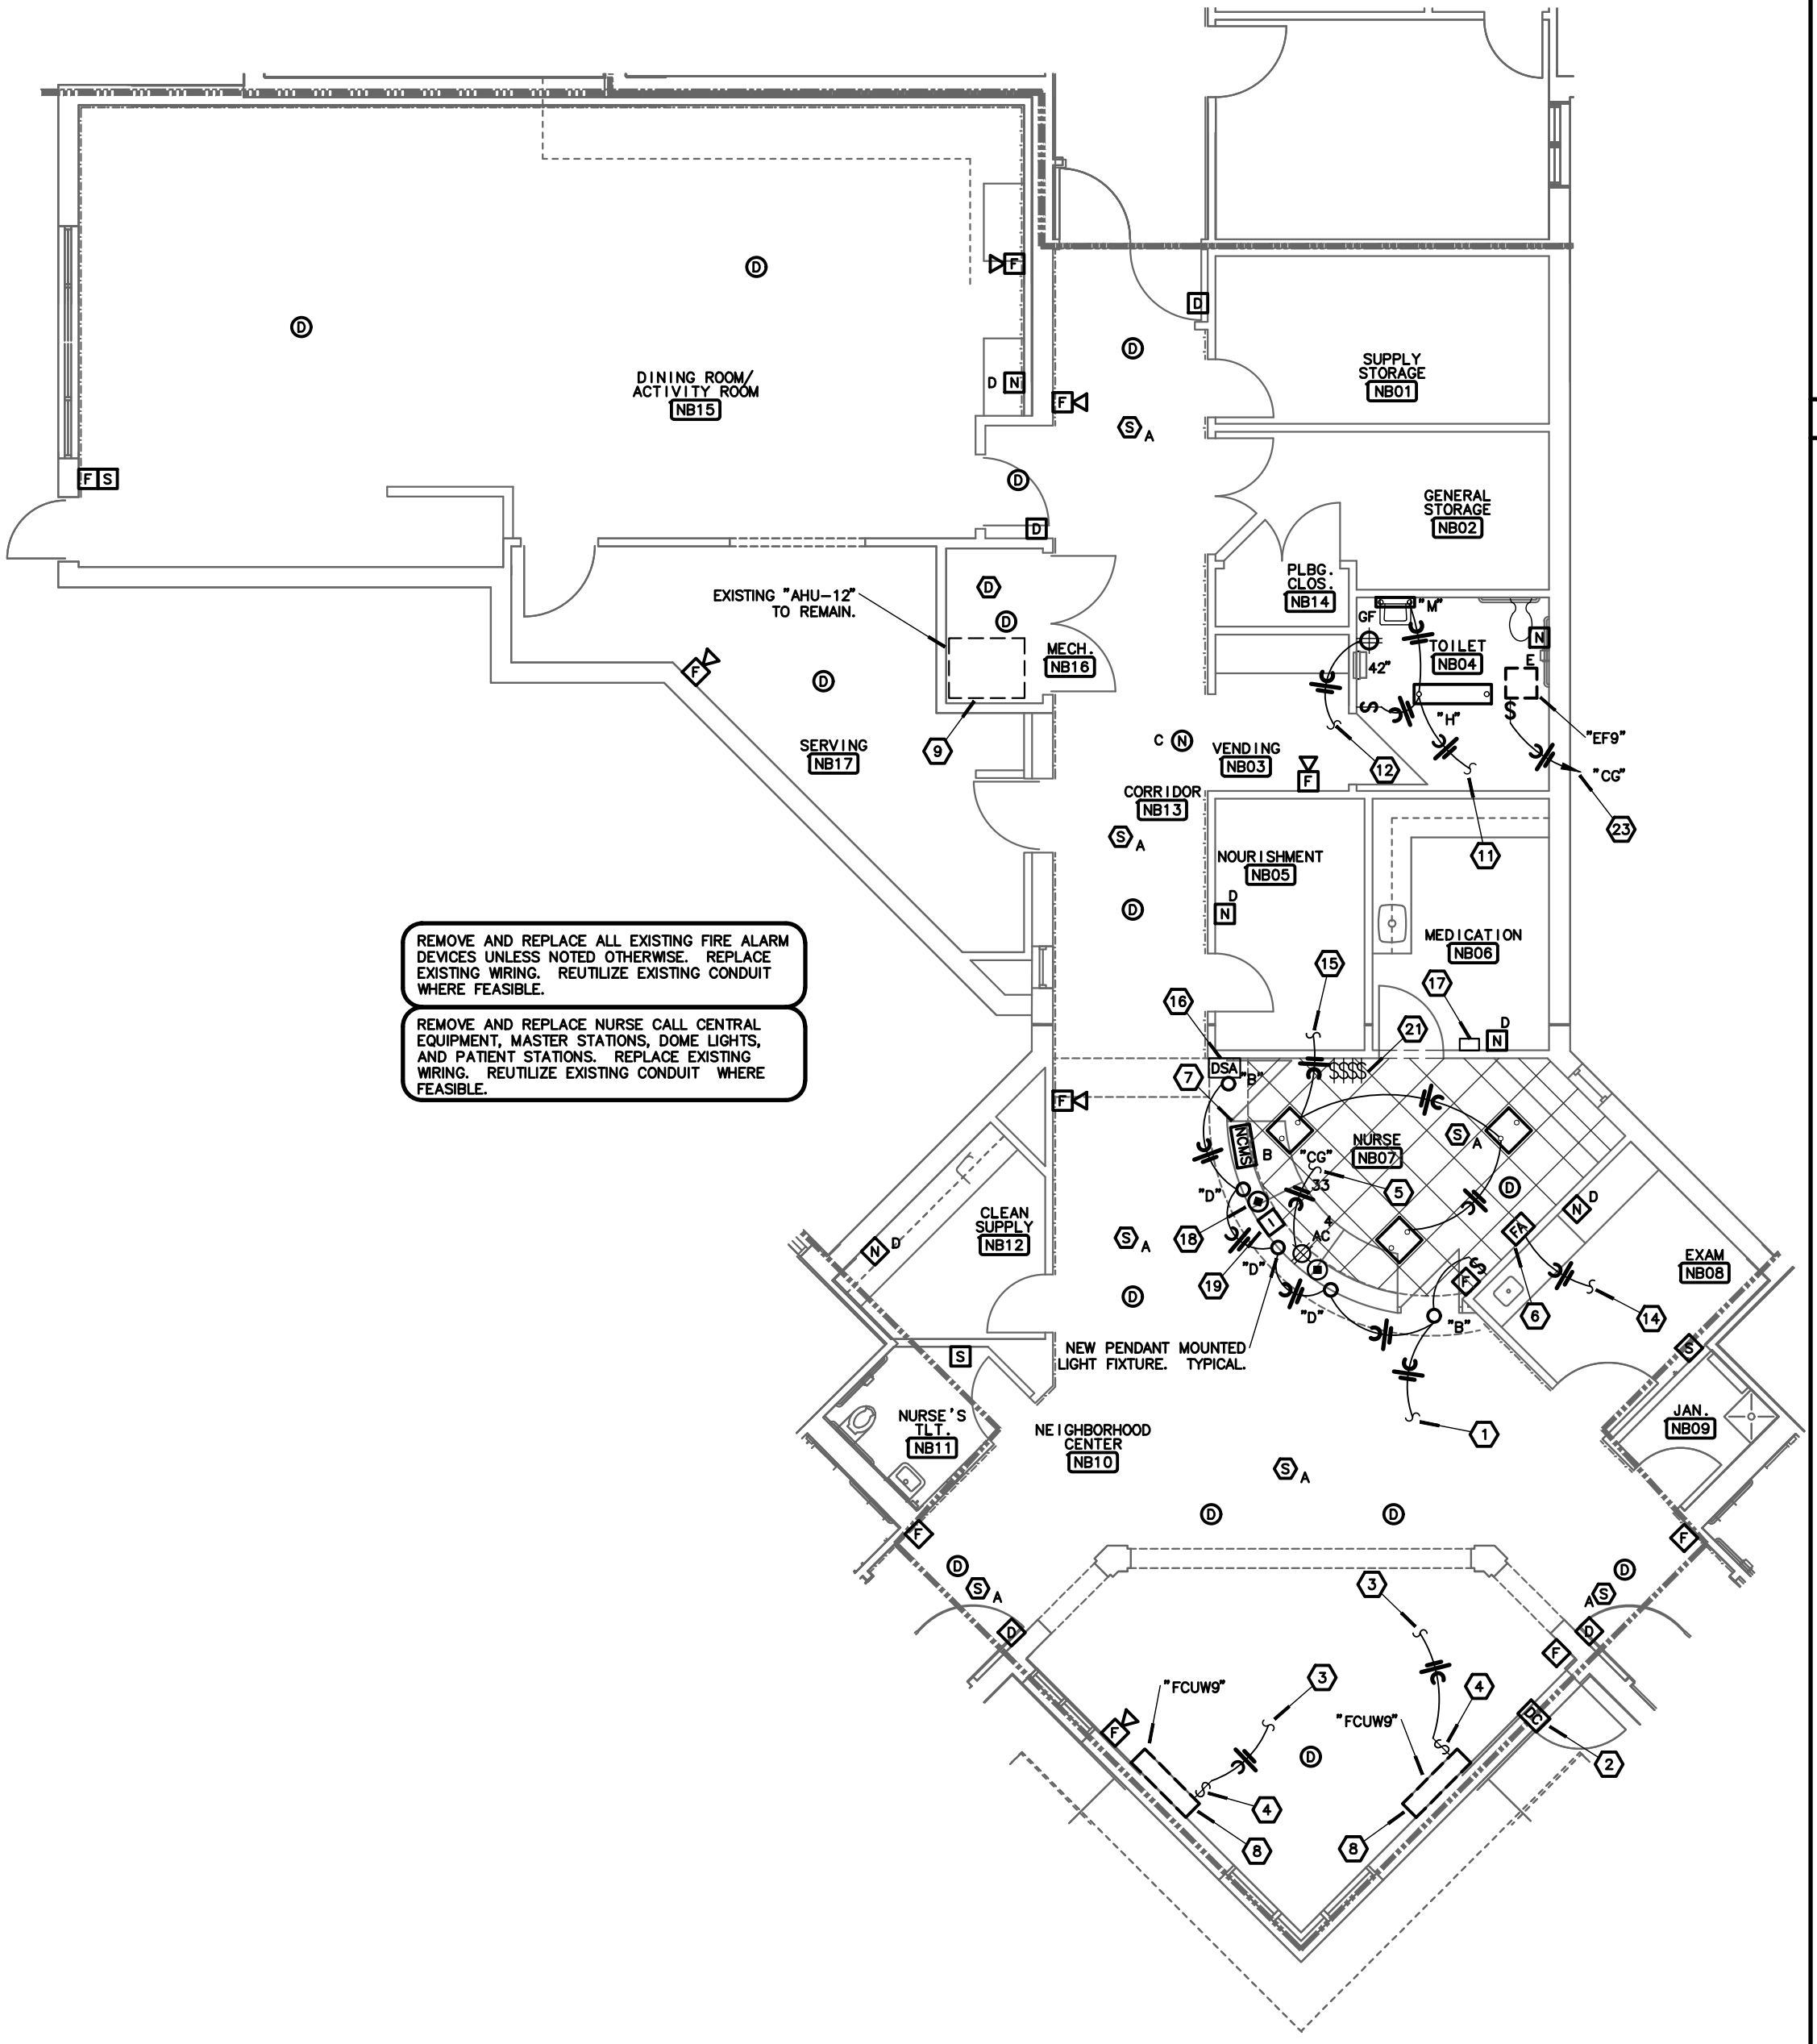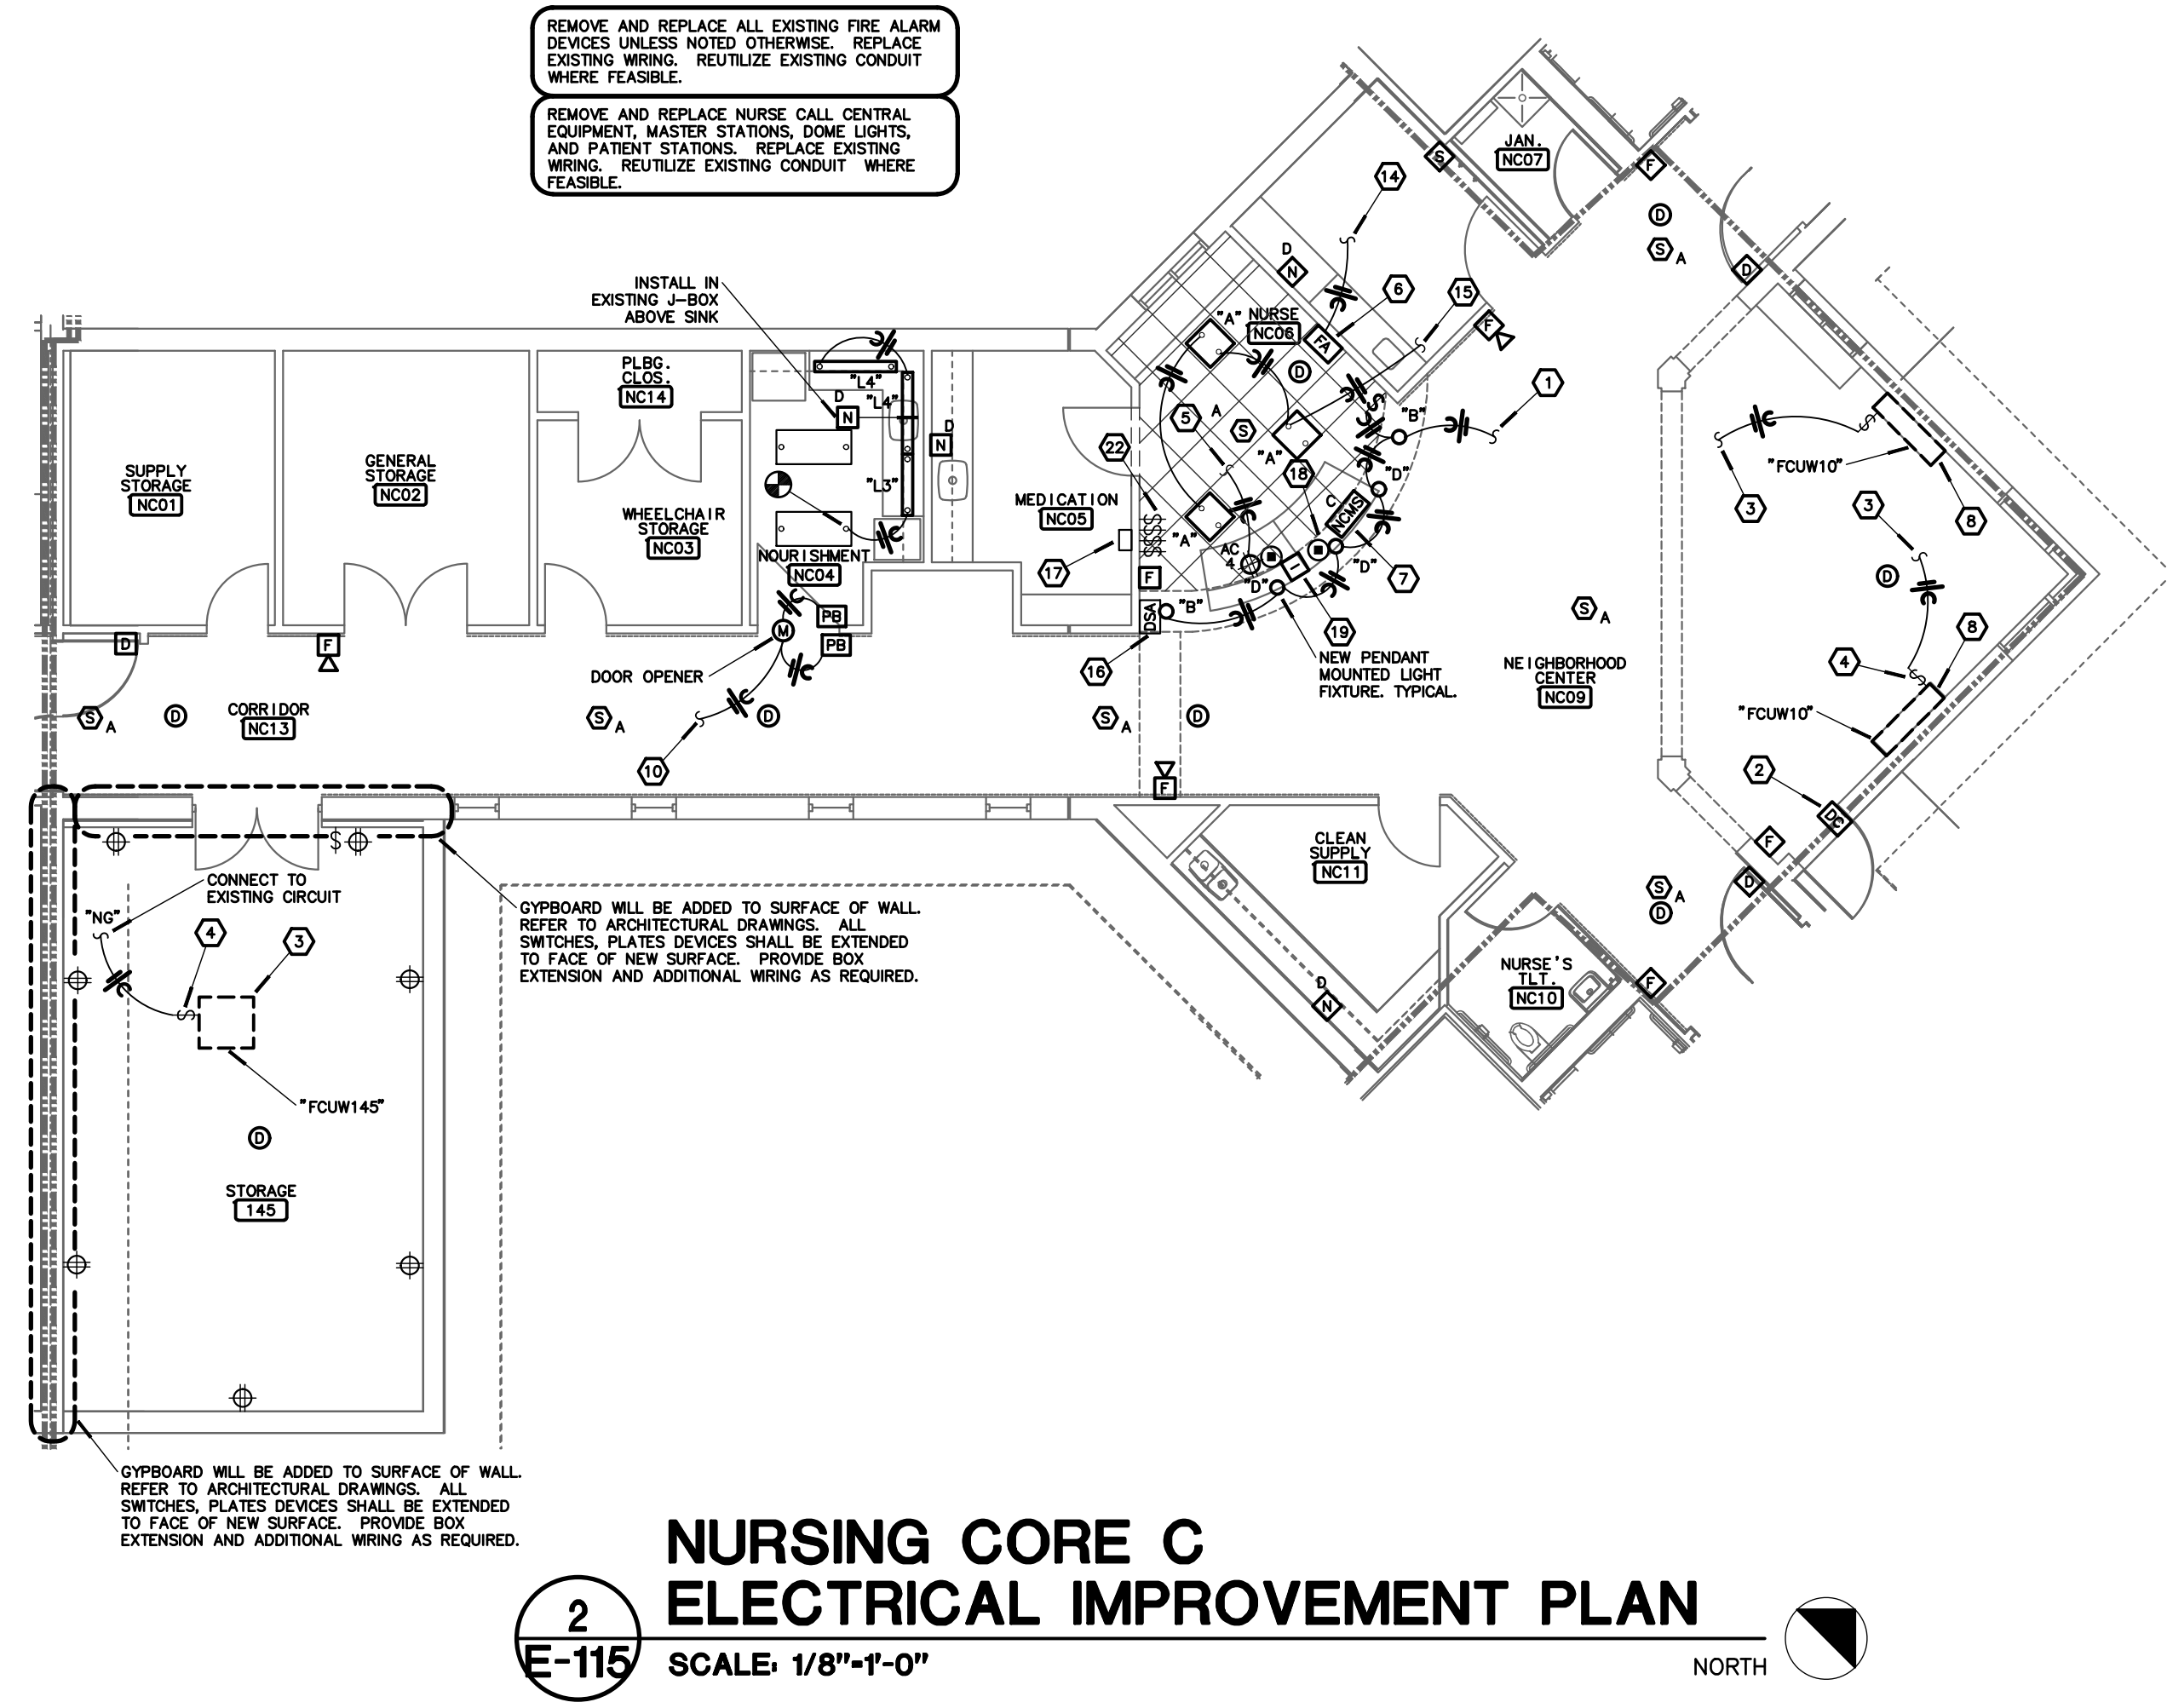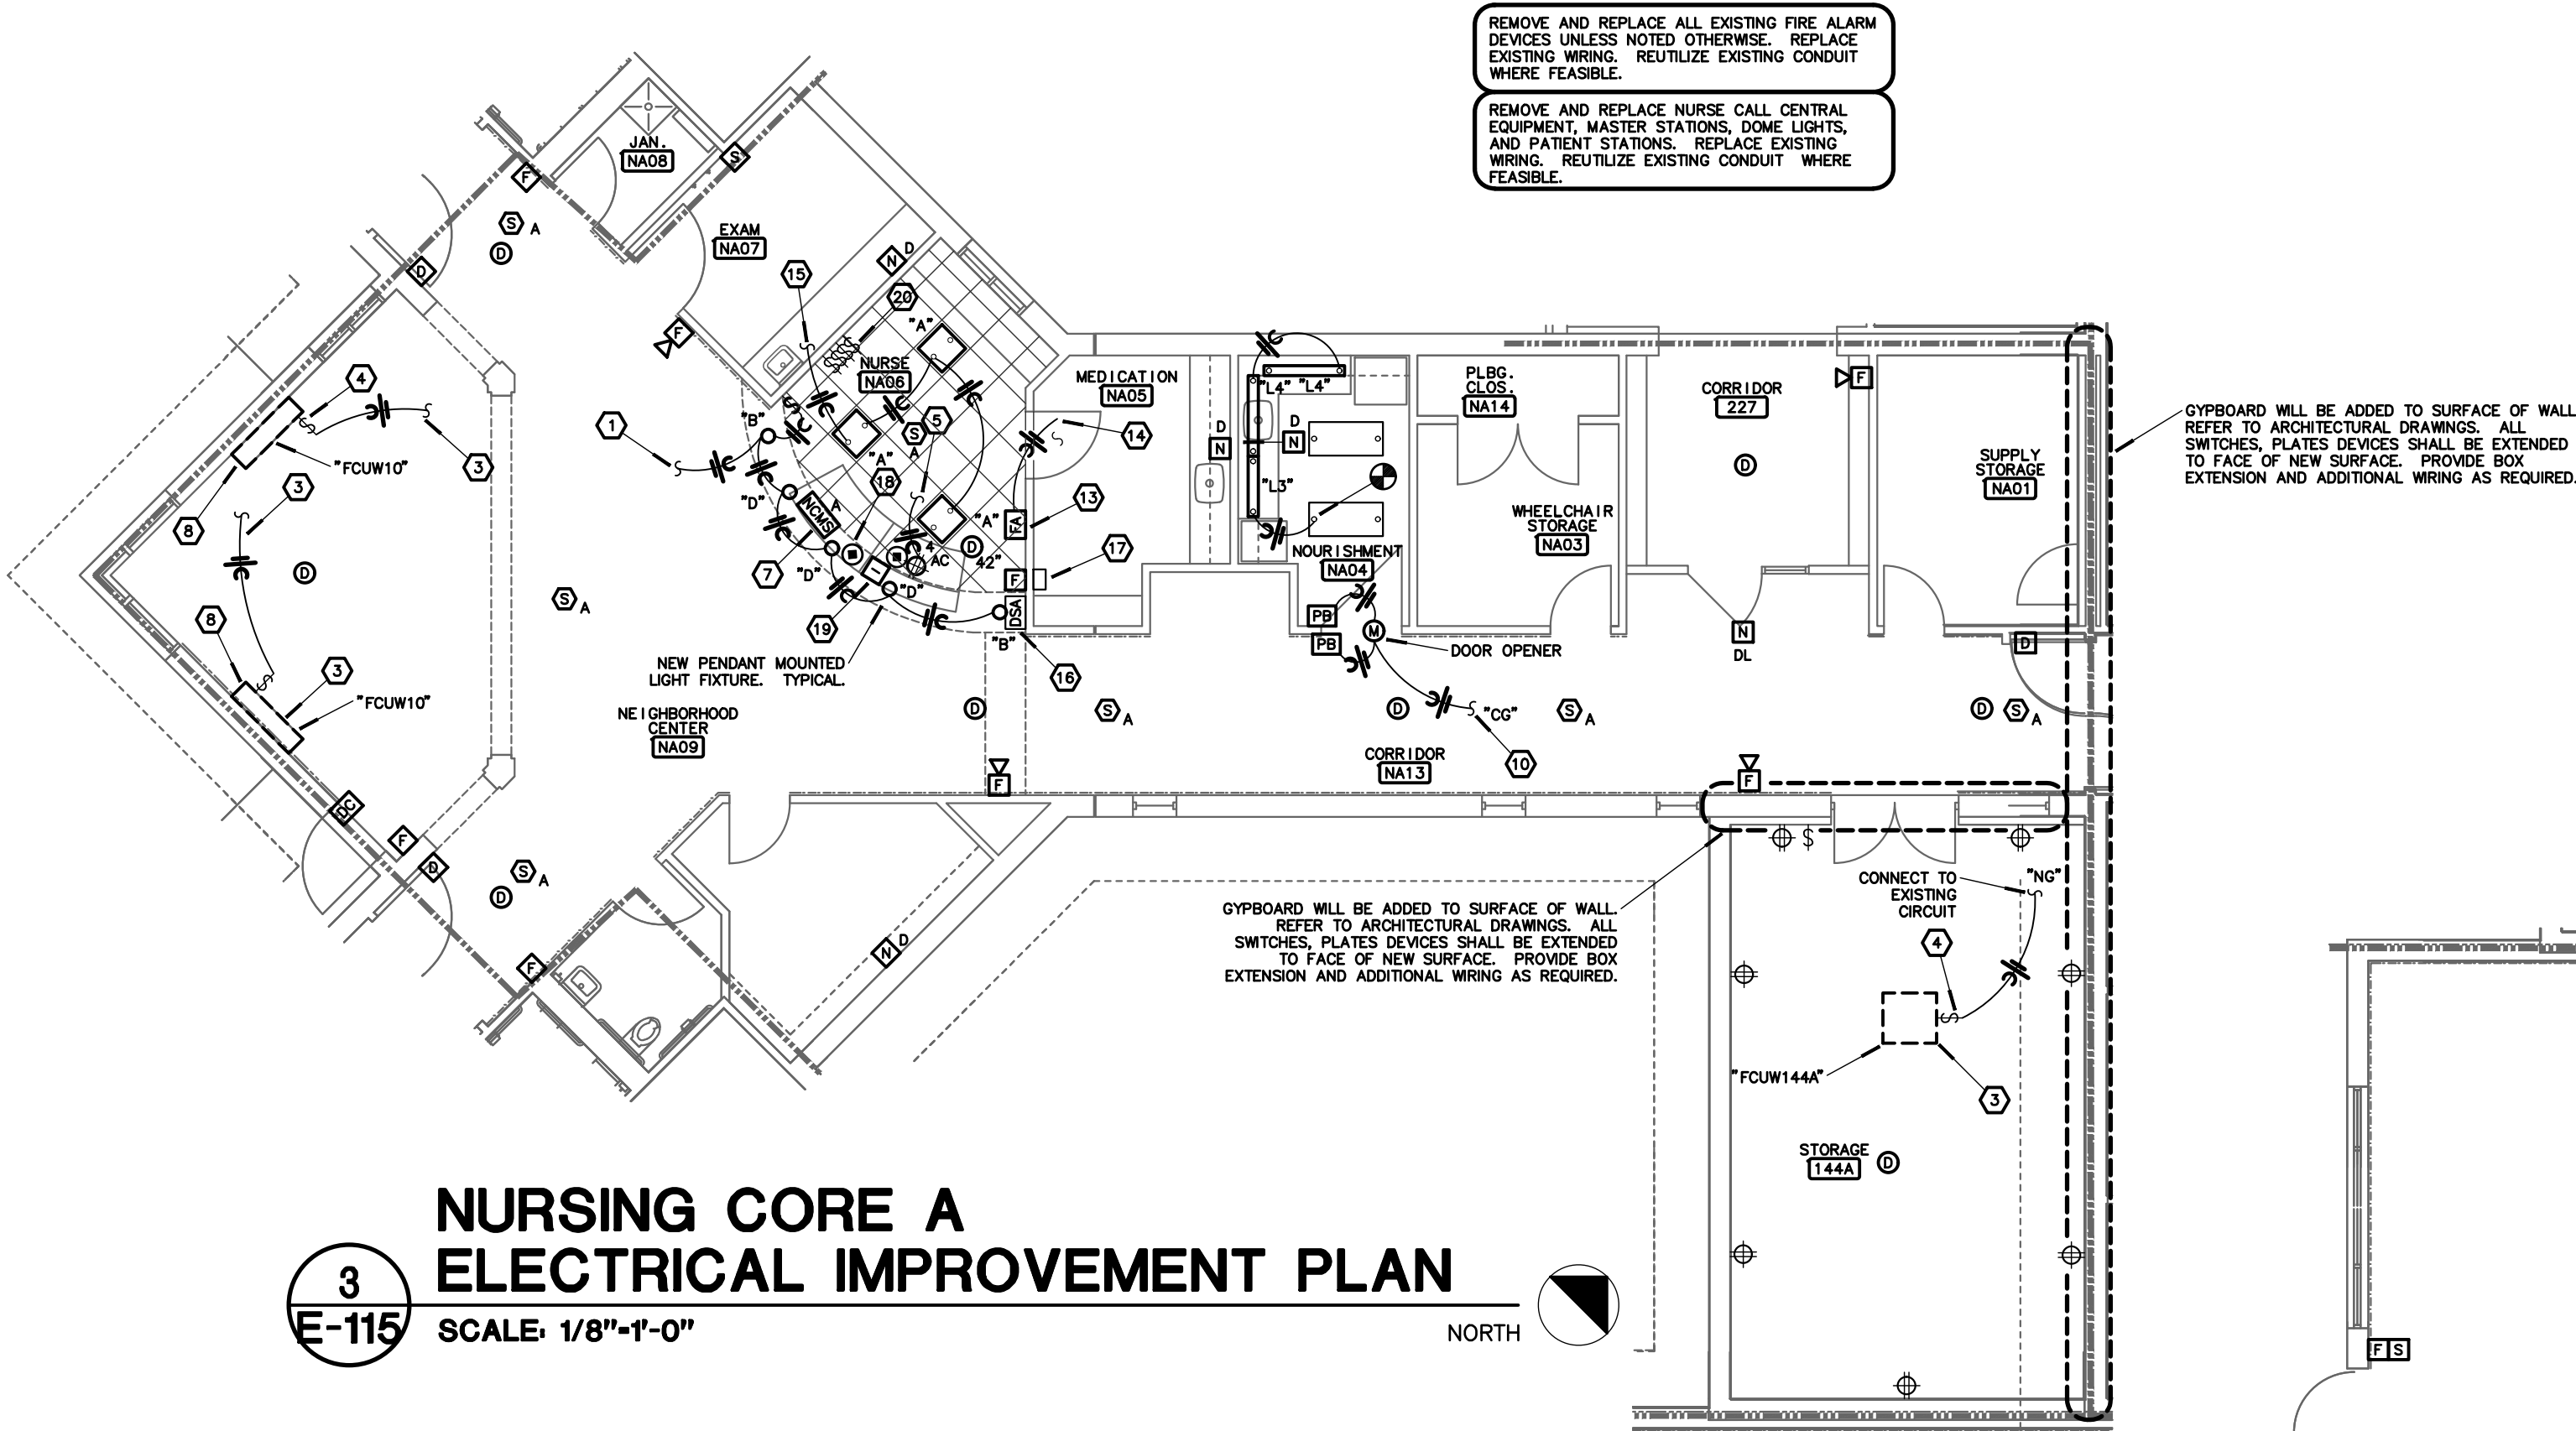
- FOR ALL ELECTRICAL QUESTIONS DURING BIDDING OR DURING CONSTRUCTION, CONTACT ESTERY, SCHNEIDER & ASSOCIATES, INC., THOM LUNDBERG (417) 862-0558 FOR COORDINATION WITH ANTHONY G. BEIER AT RTM ENGINEERING CONSULTANTS.
- SMOKE DETECTORS SHALL BE INSTALLED 36 INCHES OR MORE FROM ANY DIFFUSER OR REGISTER.




## NURSING CORE B ELECTRICAL IMPROVEMENT PLAN

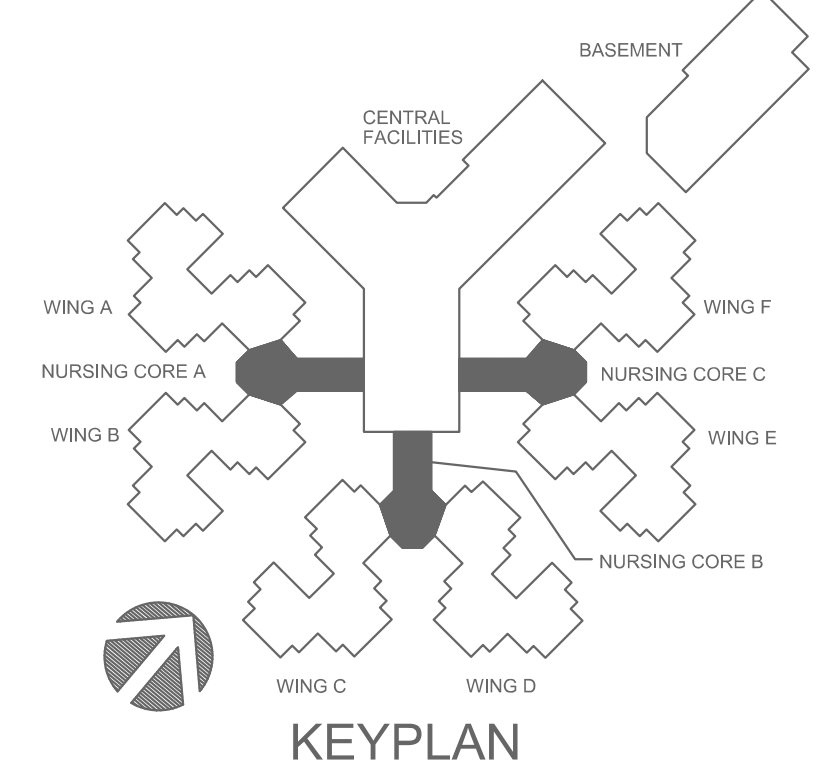




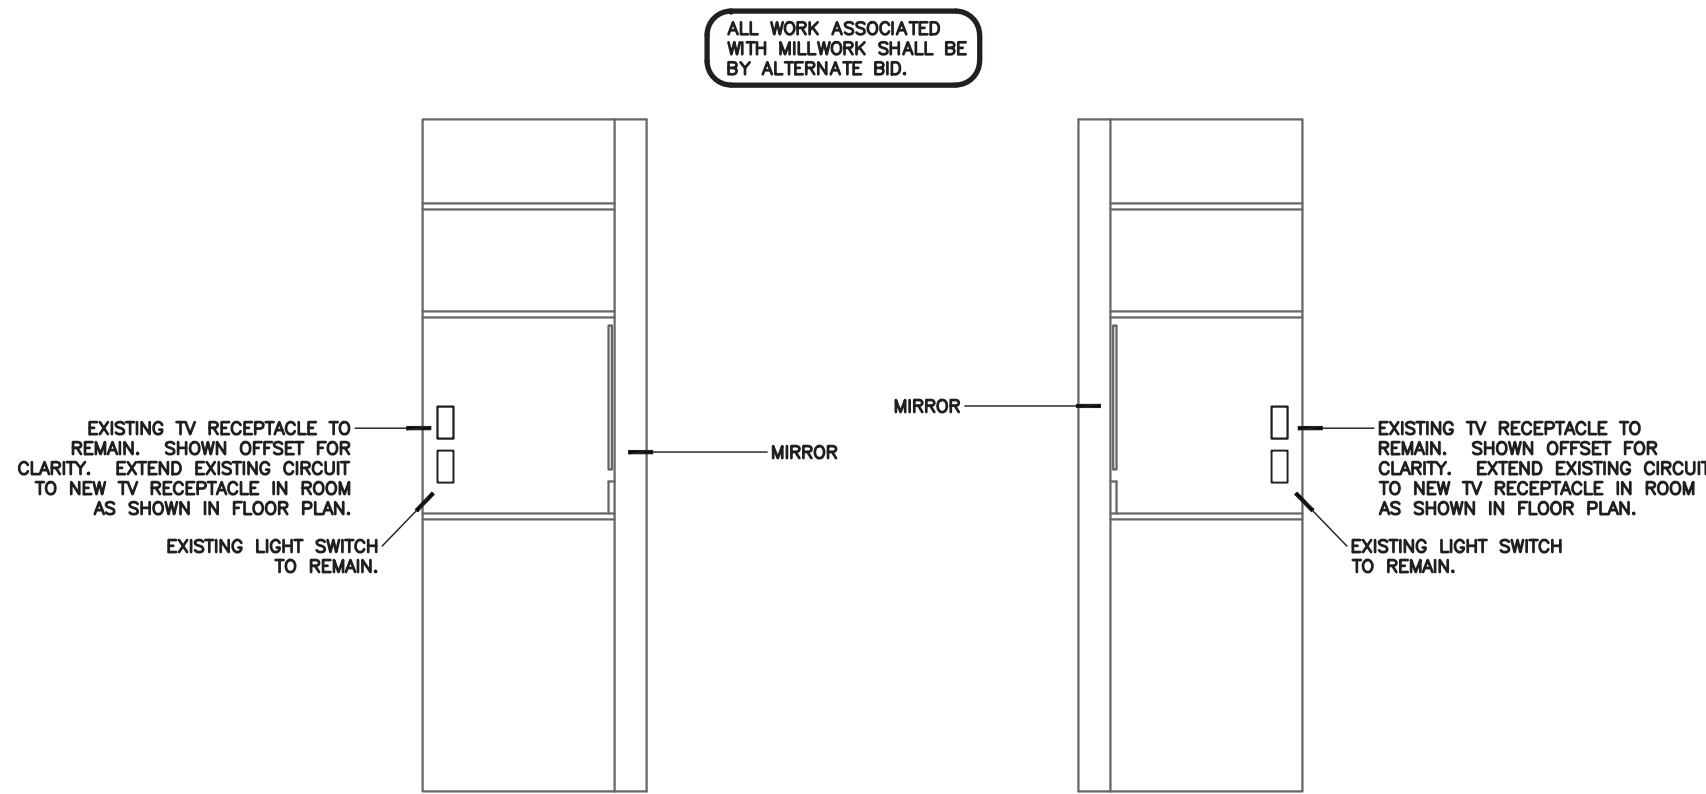

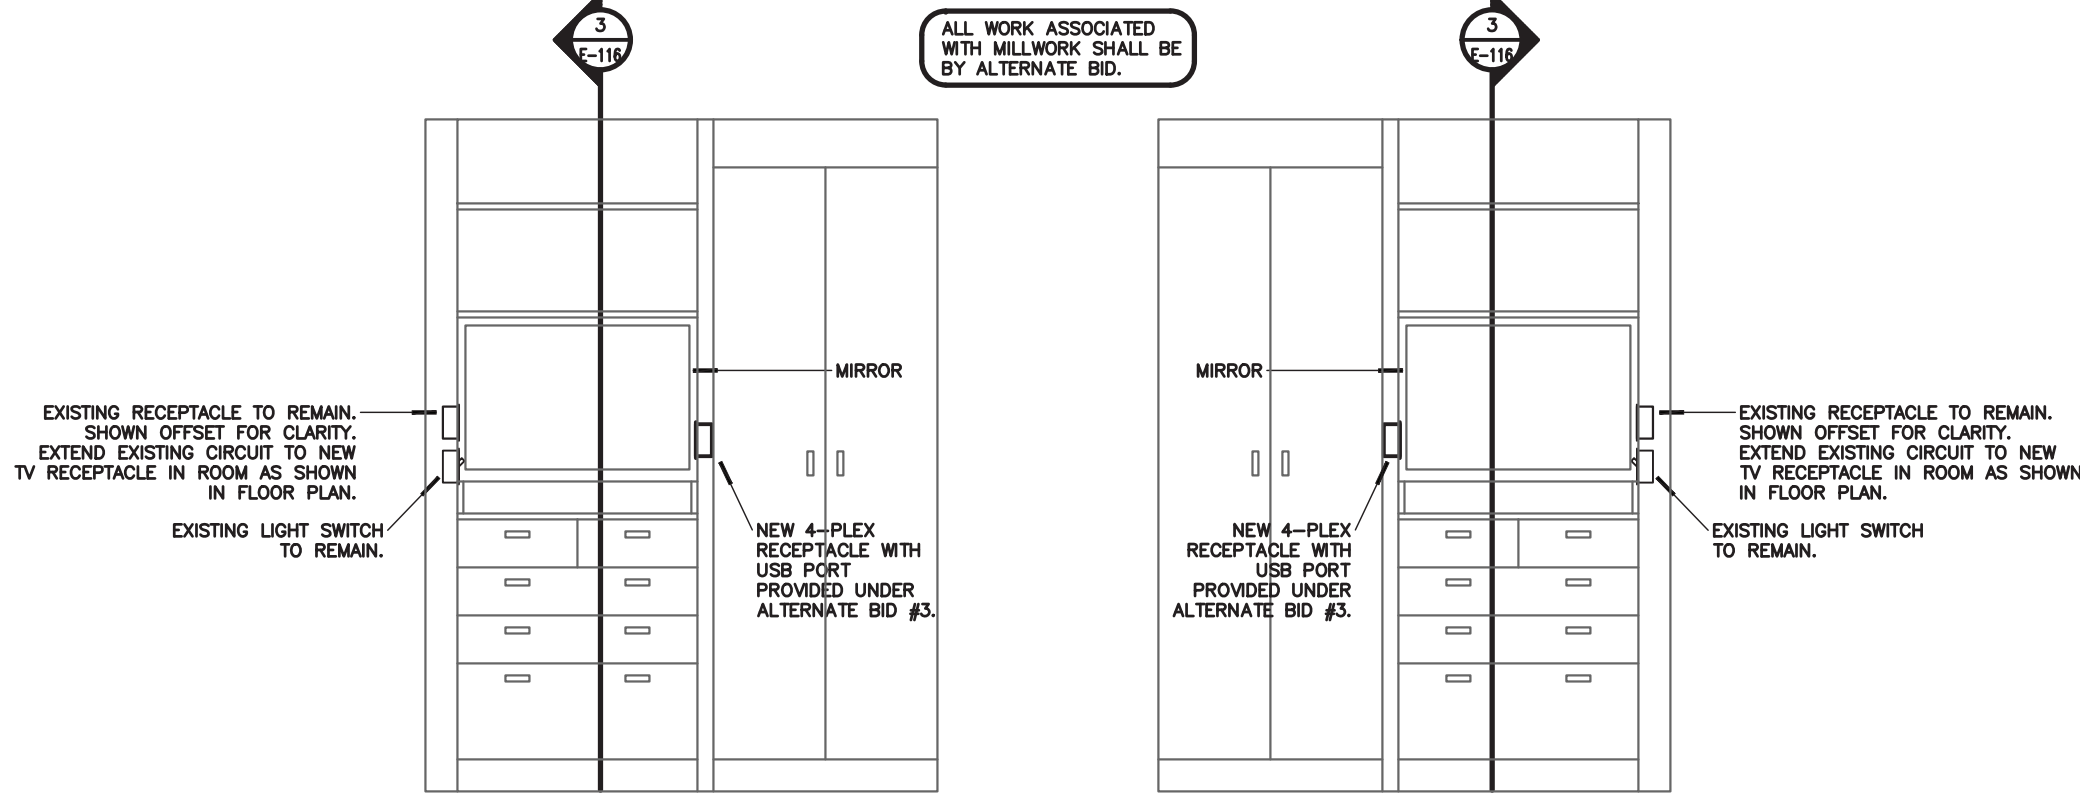3 MILLWORK ELEVATION  
E-116 SCALE: 1/2"=1'-0"



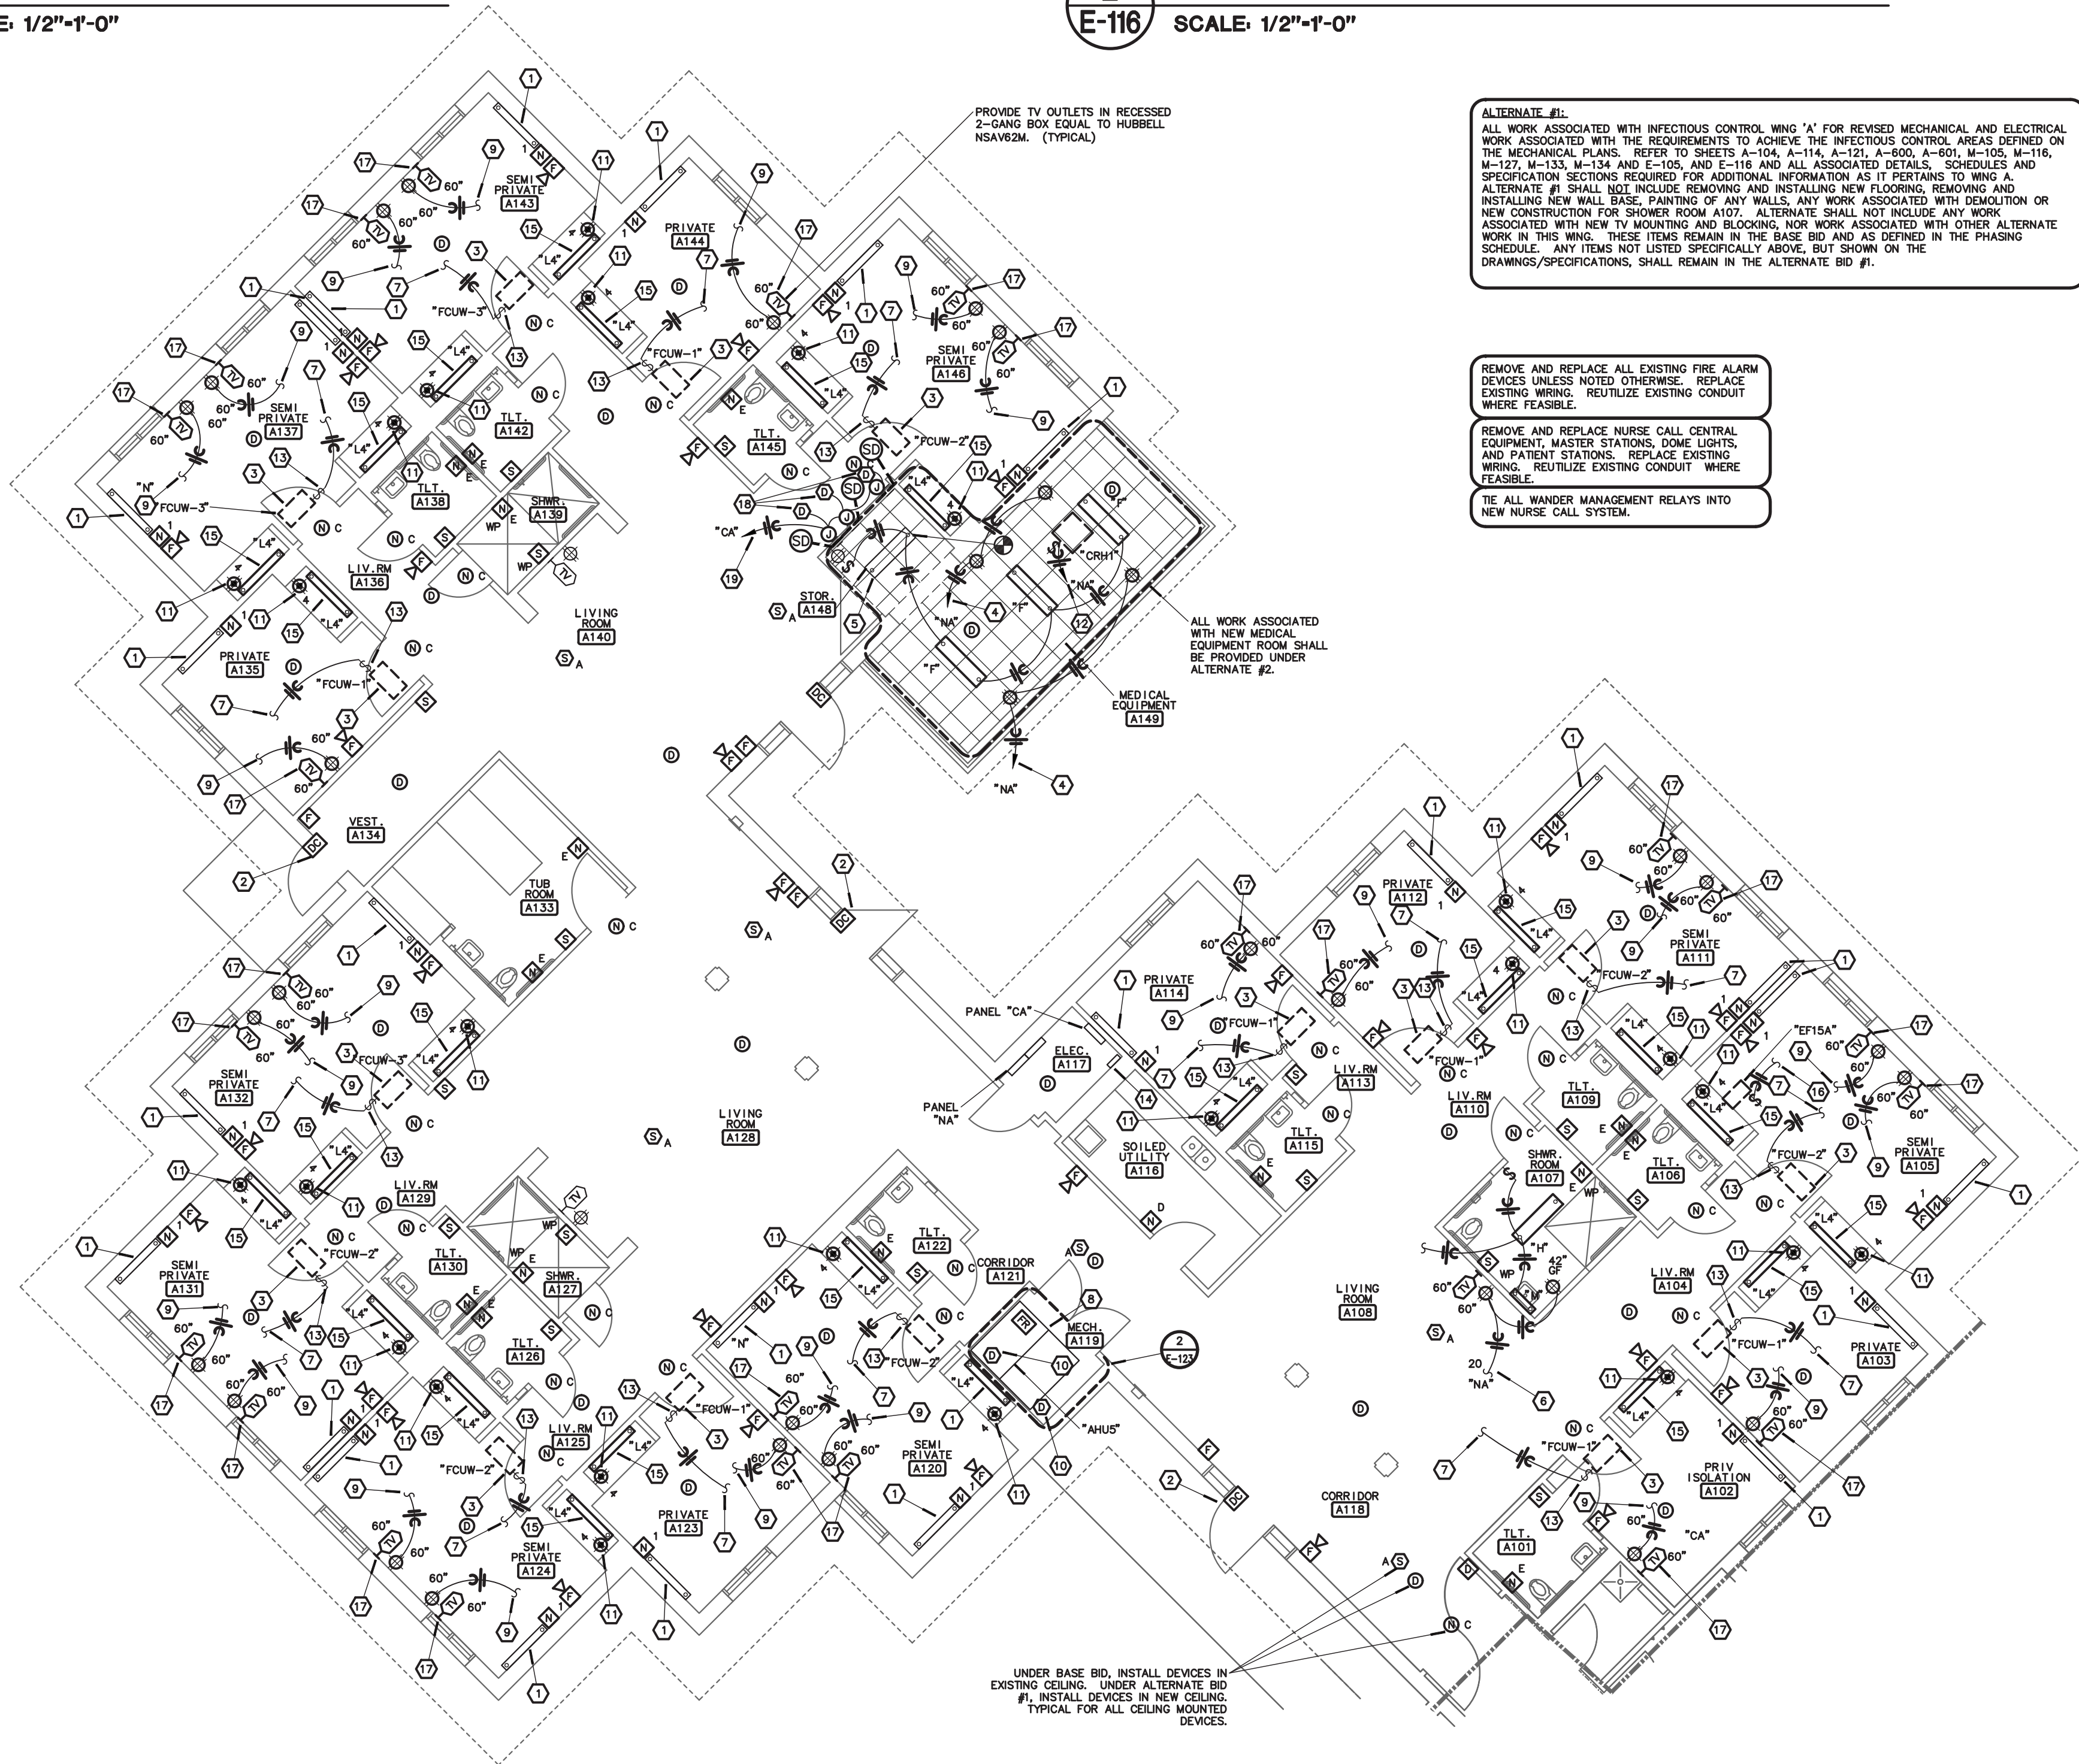2 MILLWORK ELEVATION (ALT BID)  
E-116 SCALE: 1/2"=1'-0"





1 WING 'A' - ELECTRICAL IMPROVEMENT PLAN  
E-116 SCALE: 1/8"=1'-0"

## NOTES:

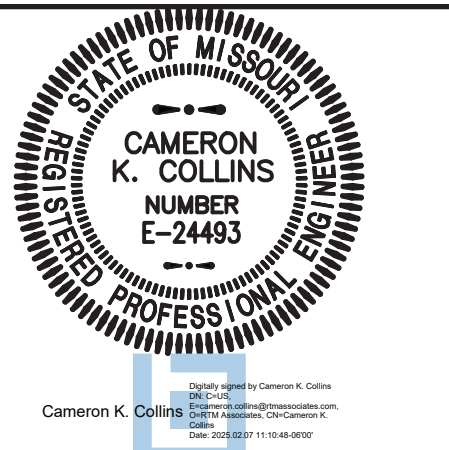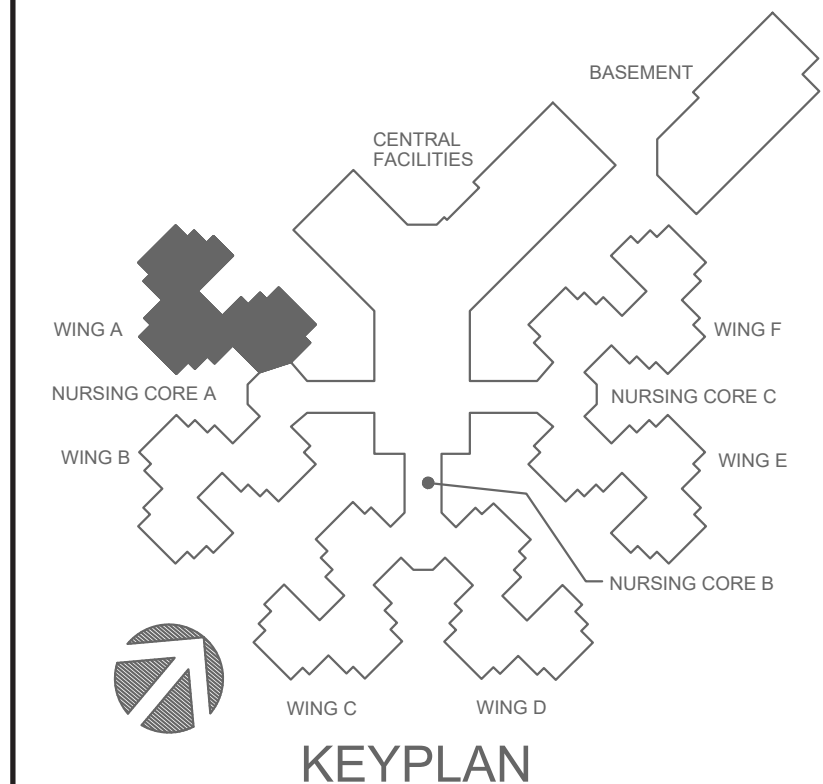- EXISTING LIGHT FIXTURE TO REMAIN.
- DOOR CONTACT SHALL TIE INTO NURSE CALL SYSTEM.
- EXISTING UNIT TO BE REPLACED. CONNECT NEW UNIT TO EXISTING CIRCUIT.
- CONNECT TO EXISTING SPARE 20-AMP, 1-POLE CIRCUIT BREAKER IN EXISTING PANELBOARD.
- REVISE SWITCHING FOR EXISTING LIGHT AS SHOWN. CONNECT NEW LIGHTS TO EXISTING FIXTURE.
- RECONNECT TO EXISTING RECEPTACLE CIRCUIT.
- RECONNECT TO EXISTING EQUIPMENT CIRCUIT.
- EXISTING HVAC EQUIPMENT TO REMAIN.
- CONNECT CIRCUIT TO EXISTING TV RECEPTACLE IN MILLWORK IN FRONT OF MIRROR. REFER TO DETAIL 2/E-116.
- NEW DUCT DETECTORS SHALL REPLACE EXISTING.
- UNDER ALTERNATE #3, PROVIDE NEW RECEPTACLE ABOVE COUNTER AND CIRCUIT WITH EXISTING RECEPTACLE AT OPPOSITE SIDE OF COUNTER. REFER TO MILLWORK ELEVATION 2/E-116.
- PROVIDE NEW 15-AMP, 1-POLE CIRCUIT BREAKER IN EXISTING PANEL. REMOVE SPARE 20-AMP, 1-POLE BREAKER TO MAKE ROOM.
- DISCONNECT FURNISHED WITH EQUIPMENT.
- EXISTING WANDER MANAGEMENT NETWORK PUNCHDOWN BLOCK FOR DOOR RELAY WIRING SHALL REMAIN.
- UNDER ALTERNATE BID, REPLACE EXISTING LIGHT FIXTURE WITH NEW FIXTURE INDICATED. CONNECT TO EXISTING CIRCUIT. UNDER BASE BID, EXISTING LIGHT FIXTURE TO REMAIN.
- CONNECT TO EXISTING EQUIPMENT CIRCUIT MADE AVAILABLE WITH DEMOLITION OF IN-LINE FAN.
- EXTEND COAX CABLE TO NEW OUTLET FROM EXISTING TV OUTLET.
- DUCT DETECTORS SHALL INTERFACE WITH FIRE/SMOKE DAMPERS. PROVIDE ALL REQUIRED CONNECTIONS TO FIRE/SMOKE DAMPERS. PANELBOARD AND USE FOR NEW CIRCUIT.
- PROVIDE NEW 20-AMP, 1-POLE CIRCUIT BREAKER IN EXISTING PANELBOARD AND USE FOR NEW CIRCUIT.

## GENERAL NOTES:

- IN ALL RESIDENT SLEEPING ROOMS, THE REPLACEMENT CEILING SMOKE DETECTOR SHALL BE LOCATED A MINIMUM OF 36" FROM THE SUPPLY DIFFUSER.
- FOR ALL ELECTRICAL QUESTIONS DURING BIDDING OR DURING CONSTRUCTION, CONTACT ESTERLY, SCHNEIDER & ASSOCIATES, INC., THOM LUNDBERG (417) 862-0558 FOR COORDINATION WITH ANTHONY G. BEIER AT RTM ENGINEERING CONSULTANTS.
- CUT AND PATCH EXISTING WALLS AS NECESSARY FOR INSTALLATION OF NEW DEVICES.
- ALL WORK ASSOCIATED WITH THE NEW MEDICAL EQUIPMENT ROOM SHALL BE PROVIDED UNDER ALTERNATE #2.
- SMOKE DETECTORS SHALL BE INSTALLED 36 INCHES OR MORE FROM ANY DIFFUSER OR REGISTER.



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PROJECT # U1503-01  
SITE # 6801  
ASSET # 8136801002  
FEDERAL # 29-044

REVISION: \_\_\_\_\_  
DATE: \_\_\_\_\_  
REVISION: \_\_\_\_\_  
DATE: \_\_\_\_\_  
REVISION: \_\_\_\_\_  
DATE: \_\_\_\_\_  
ISSUE DATE: 8-1-24

CAD DWG FILE: E-116.DWG  
DRAWN BY: AGP  
CHECKED BY: CKP  
DESIGNED BY: AGP

SHEET TITLE:

# ELECTRICAL PLAN

SHEET NUMBER:

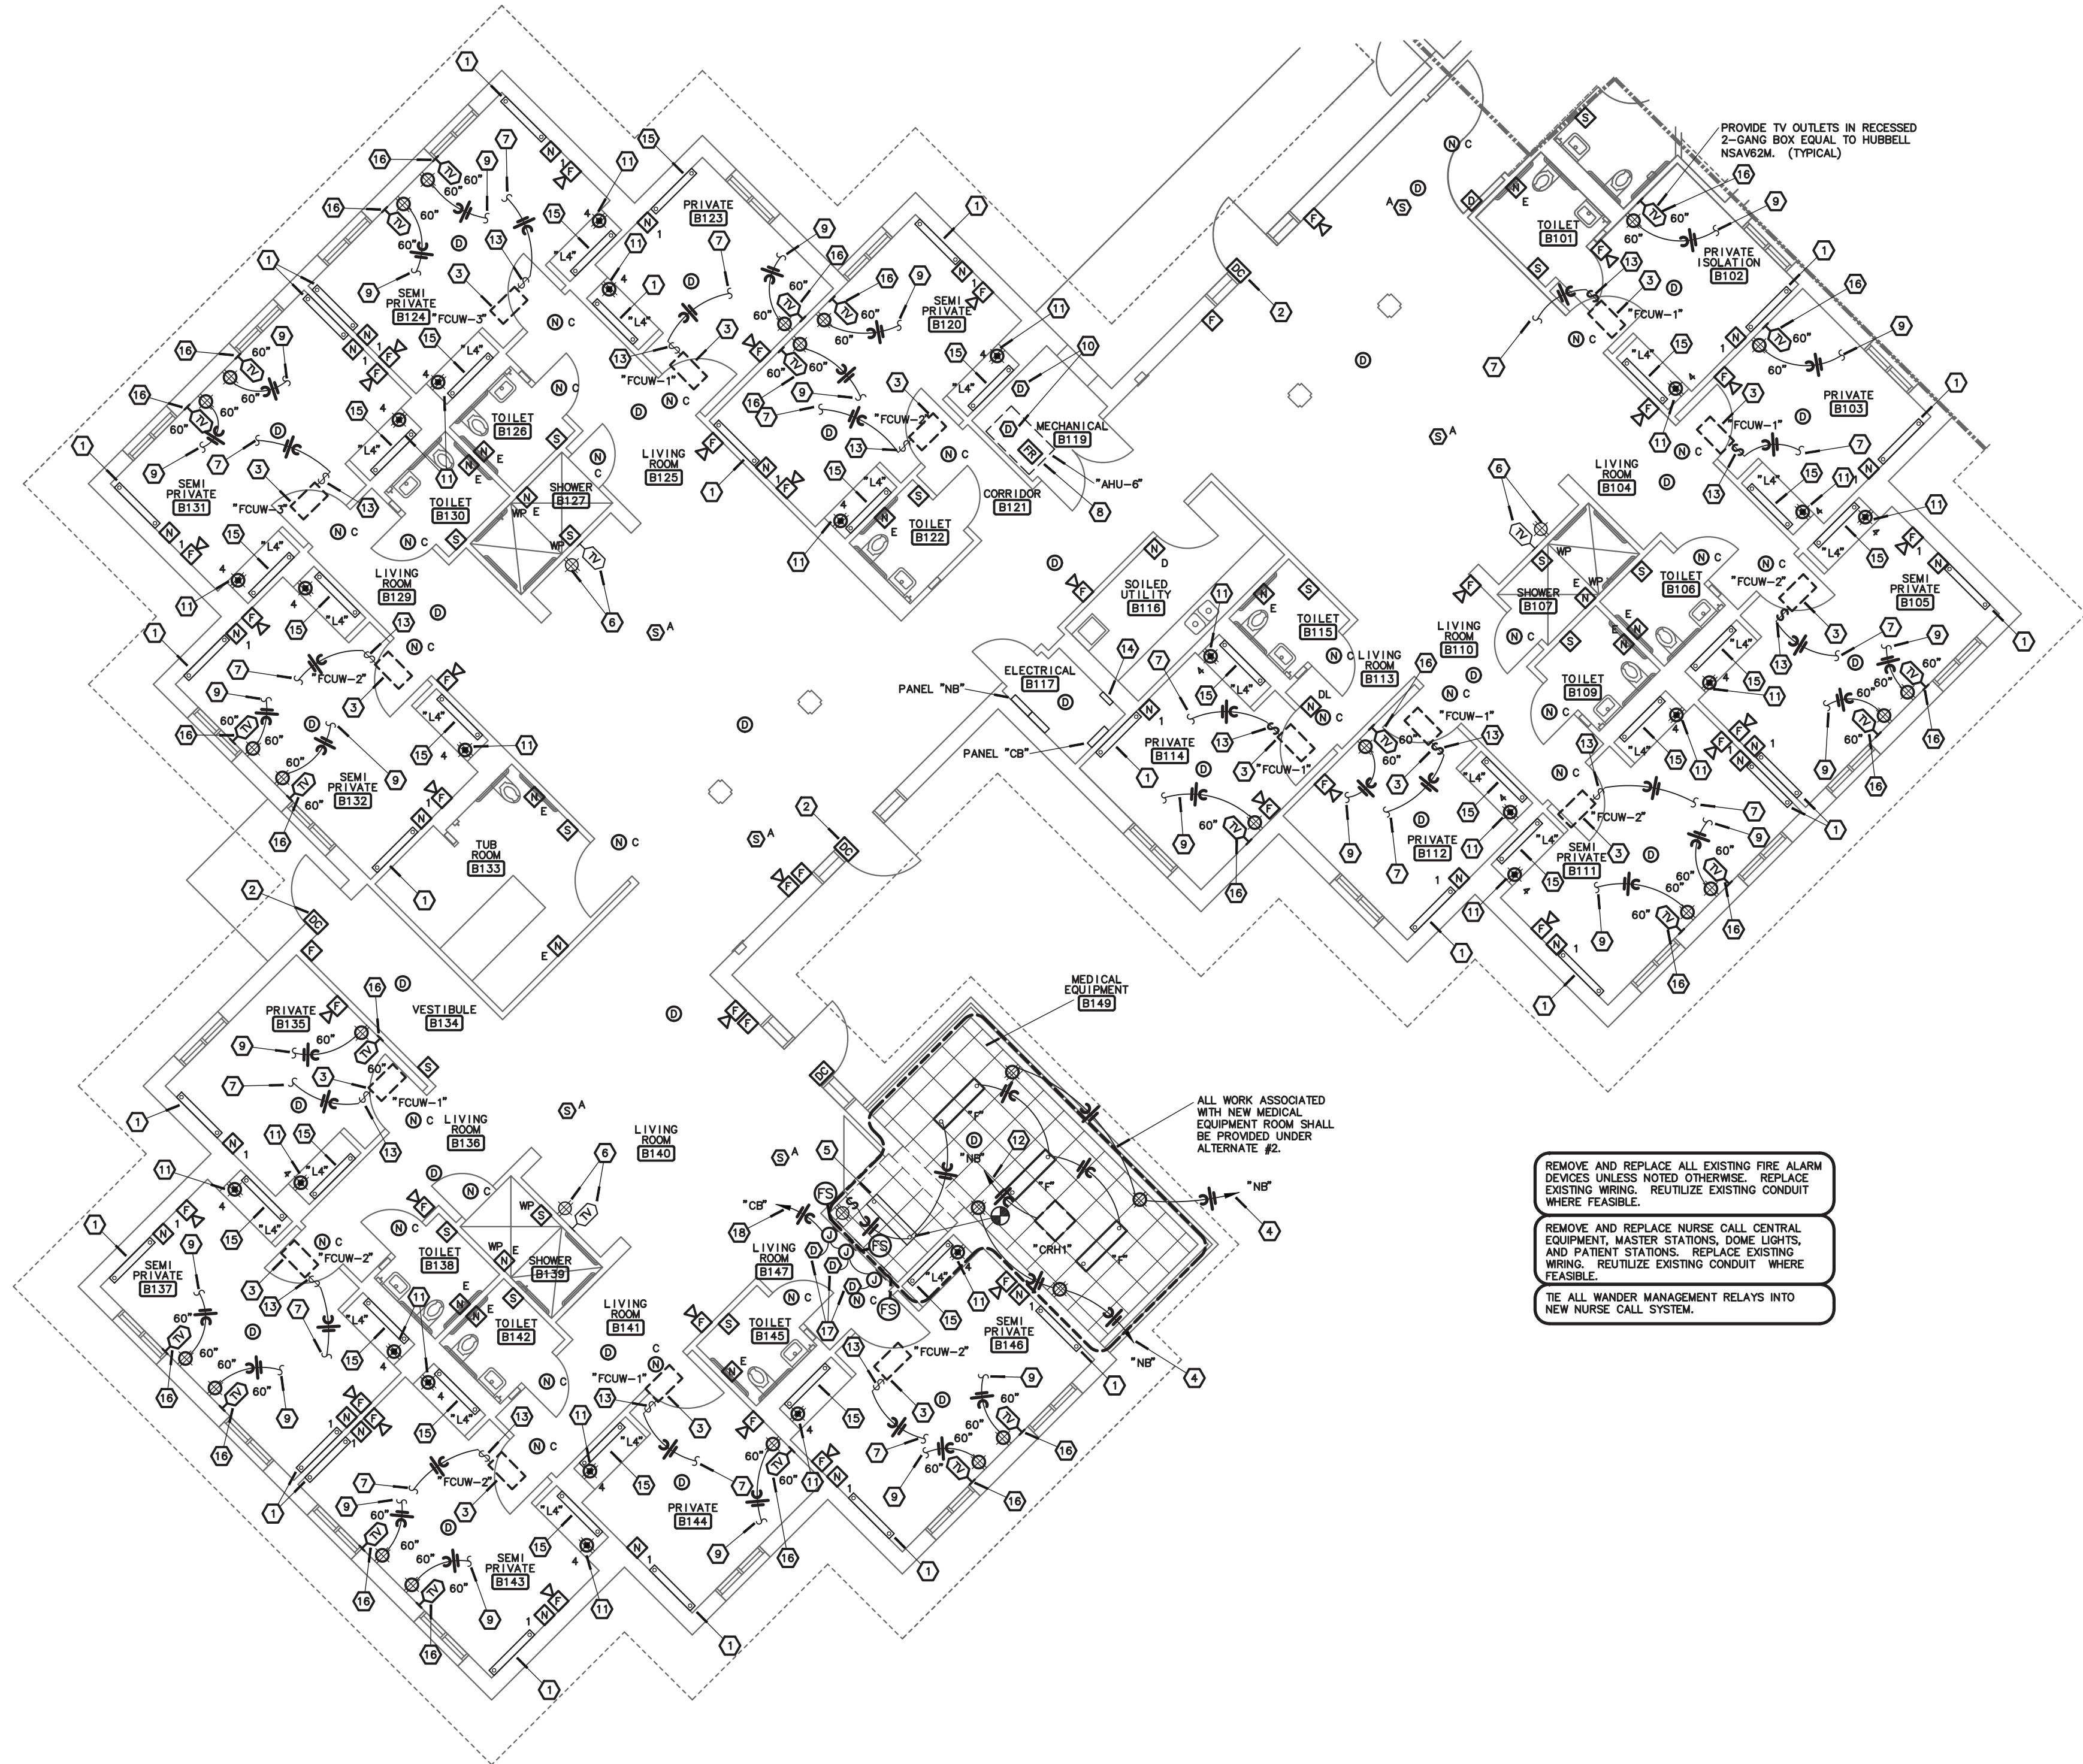
## E-116

110 OF 120 SHEETS

8-1-24



H:\ES&A\SMVA\DWG\E-117 10 Oct 2016 - 3:40 am



**1 WING 'B' - ELECTRICAL IMPROVEMENT PLAN**  
SCALE: 1/8"=1'-0" NORTH


**rtm** engineering consultants  
3333 E. Battlefield Road, Ste. 1000  
Springfield, MO 65804  
rtmec.com | 417.881.0020  
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## NOTES:


- EXISTING LIGHT FIXTURE TO REMAIN. CONTRACTOR SHALL CLEAN AND RE-LAMP FIXTURE.
- DOOR CONTACT SHALL TIE INTO NURSE CALL SYSTEM.
- EXISTING UNIT TO BE REPLACED. CONNECT NEW UNIT TO EXISTING CIRCUIT.
- CONNECT TO EXISTING SPARE 20-AMP, 1-POLE CIRCUIT BREAKER IN EXISTING PANELBOARD.
- REVISE SWITCHING FOR EXISTING LIGHT AS SHOWN. CONNECT NEW LIGHTS TO EXISTING FIXTURE.
- EXISTING TV OUTLETS TO REMAIN.
- RECONNECT TO EXISTING EQUIPMENT CIRCUIT.
- EXISTING HVAC EQUIPMENT TO REMAIN.
- CONNECT CIRCUIT TO EXISTING TV RECEPTACLE IN MILLWORK IN FRONT OF MIRROR. REFER TO DETAIL 2/E-116.
- NEW DUCT DETECTORS SHALL REPLACE EXISTING.
- UNDER ALTERNATE #3, PROVIDE NEW RECEPTACLE ABOVE COUNTER AND CIRCUIT WITH EXISTING RECEPTACLE AT OPPOSITE SIDE OF COUNTER. REFER TO MILLWORK ELEVATION 2/E-116.
- CONNECT TO EXISTING 20-AMP, 1-POLE SPARE CIRCUIT BREAKER.
- DISCONNECT FURNISHED WITH EQUIPMENT.
- EXISTING WANDER MANAGEMENT NETWORK PUNCHDOWN BLOCK FOR DOOR RELAY WIRING SHALL REMAIN.
- UNDER ALTERNATE BID, REPLACE EXISTING LIGHT FIXTURE WITH NEW FIXTURE INDICATED. CONNECT TO EXISTING CIRCUIT. UNDER BASE BID, EXISTING LIGHT FIXTURE TO REMAIN. CONTRACTOR SHALL CLEAN AND RE-LAMP FIXTURE.
- EXTEND COAX CABLE TO NEW OUTLET FROM EXISTING TV OUTLET.
- DUCT DETECTORS SHALL INTERFACE WITH FIRE/SMOKE DAMPERS. PROVIDE ALL REQUIRED CONNECTIONS TO FIRE/SMOKE DAMPERS.
- PROVIDE NEW 20-AMP, 1-POLE CIRCUIT BREAKER IN EXISTING PANELBOARD AND USE FOR NEW CIRCUIT.

## GENERAL NOTES:

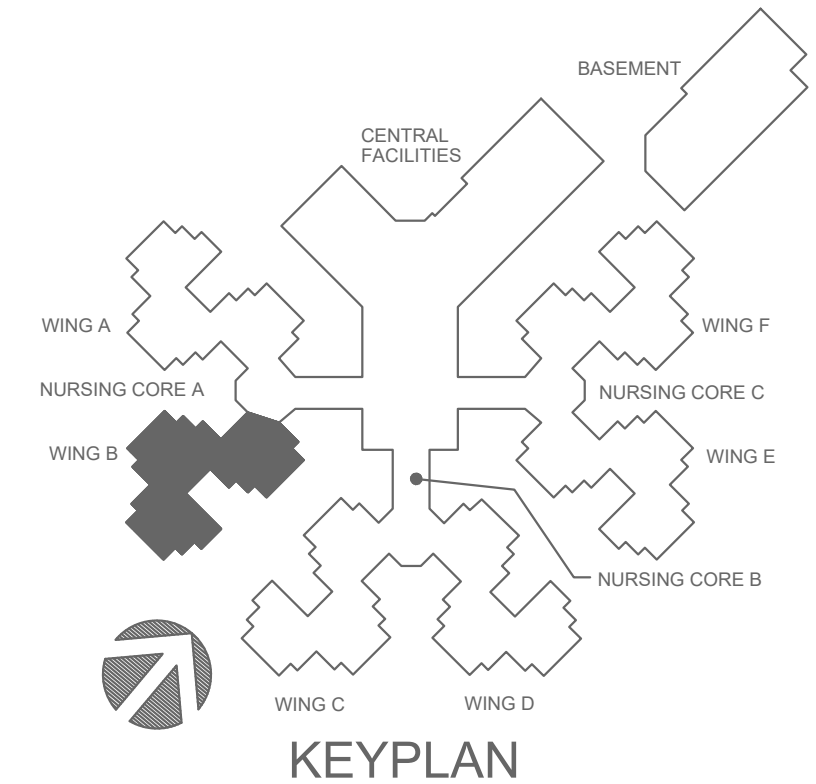- IN ALL RESIDENT SLEEPING ROOMS, THE REPLACEMENT CEILING SMOKE DETECTOR SHALL BE LOCATED A MINIMUM OF 36" FROM THE SUPPLY DIFFUSER.
- FOR ALL ELECTRICAL QUESTIONS DURING BIDDING OR DURING CONSTRUCTION, CONTACT ESTERLY SCHNEIDER & ASSOCIATES, INC. THOM LUNDBERG (417) 862-0558 FOR COORDINATION WITH ANTHONY G. BEIER AT RTM ENGINEERING CONSULTANTS.
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**ESTERLY SCHNEIDER & ASSOCIATES, INC.**  
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PROJECT # **U1503-01**  
SITE # **6801**  
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FEDERAL # **29-044**

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REVISION: \_\_\_\_\_  
DATE: \_\_\_\_\_  
ISSUE DATE: **8-1-24**

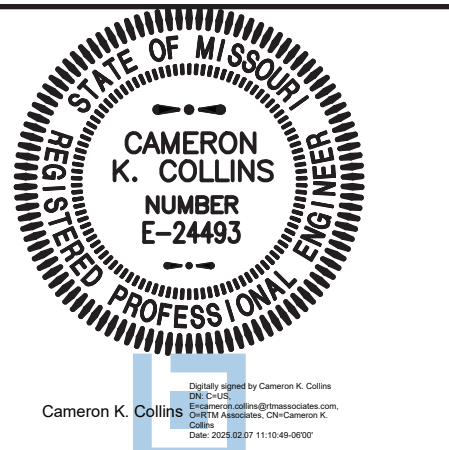CAD DWG FILE: **E-117.DWG**  
DRAWN BY: **AGB**  
CHECKED BY: **CKB**  
DESIGNED BY: **AGB**

SHEET TITLE:

**ELECTRICAL  
PLAN**


SHEET NUMBER:

**E-117**


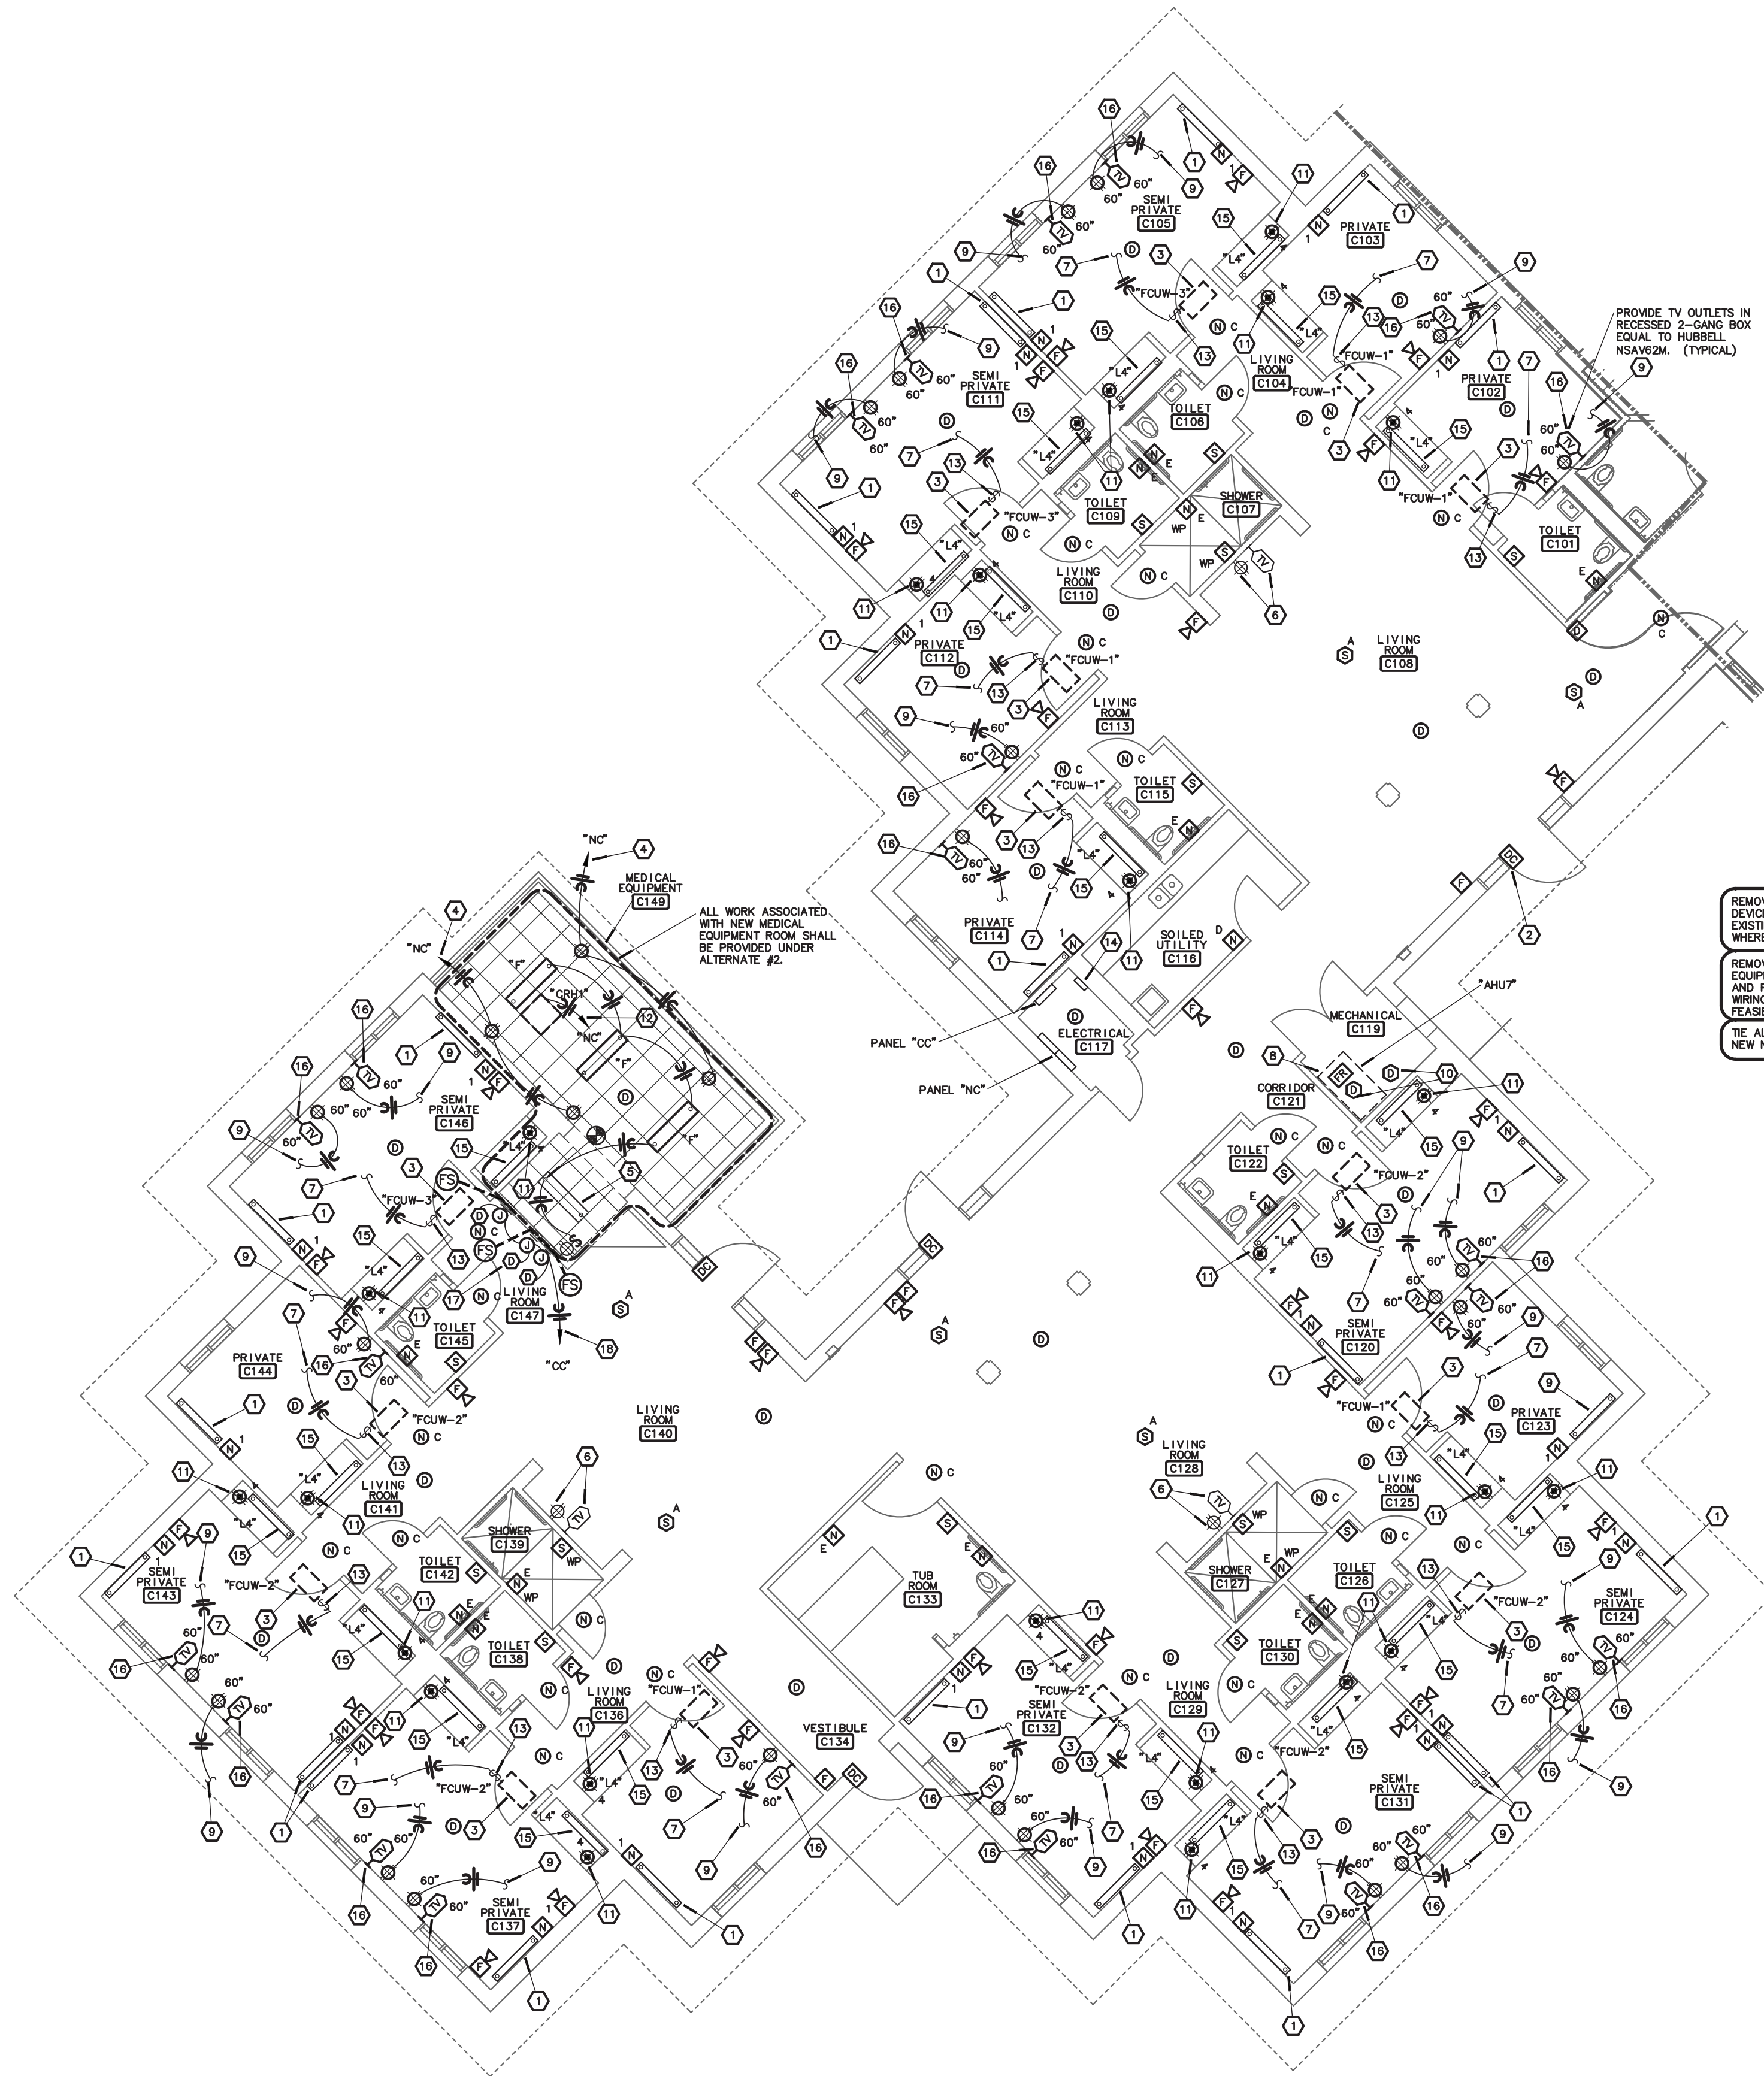
111 OF 120 SHEETS

8-1-24





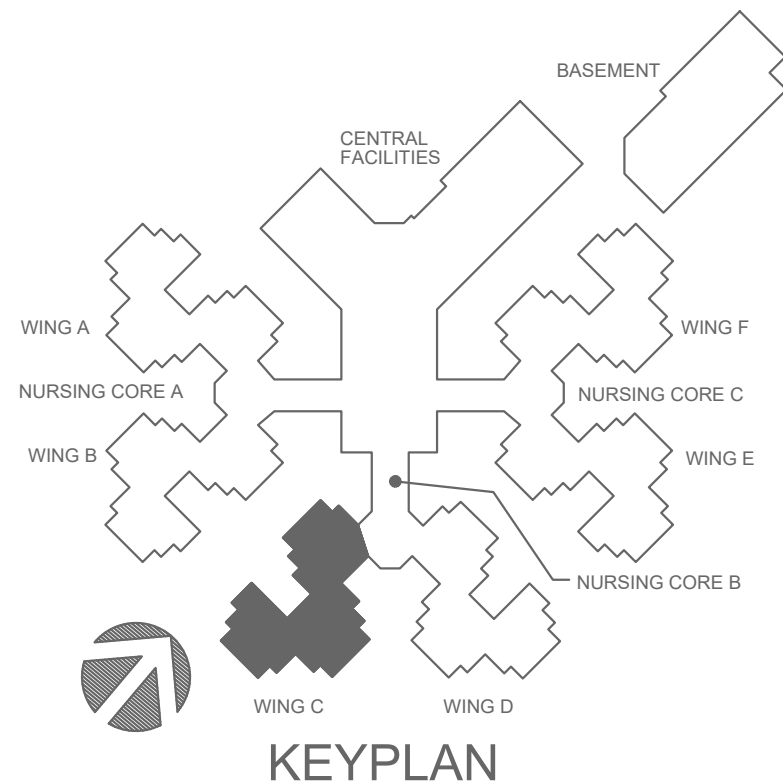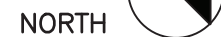**1 WING 'C' - ELECTRICAL IMPROVEMENT PLAN**  
E-118 SCALE: 1/8"=1'-0"



**NOTES:**

- EXISTING LIGHT FIXTURE TO REMAIN. CONTRACTOR SHALL CLEAN AND RE-LAMP FIXTURE.
- DOOR CONTACT SHALL TIE INTO NURSE CALL SYSTEM.
- EXISTING UNIT TO BE REPLACED. CONNECT NEW UNIT TO EXISTING CIRCUIT.
- CONNECT TO EXISTING SPARE 20-AMP, 1-POLE CIRCUIT BREAKER IN EXISTING PANELBOARD.
- REVISE SWITCHING FOR EXISTING LIGHT AS SHOWN. CONNECT NEW LIGHTS TO EXISTING FIXTURE.
- EXISTING TV OUTLETS TO REMAIN.
- RECONNECT TO EXISTING EQUIPMENT CIRCUIT.
- EXISTING HVAC EQUIPMENT TO REMAIN.
- CONNECT CIRCUIT TO EXISTING TV RECEPTACLE IN MILLWORK IN FRONT OF MIRROR. REFER TO DETAIL 2/E-116.
- NEW DUCT DETECTORS SHALL REPLACE EXISTING.
- UNDER ALTERNATE #3, PROVIDE NEW RECEPTACLE ABOVE COUNTER AND CIRCUIT WITH EXISTING RECEPTACLE AT OPPOSITE SIDE OF COUNTER. REFER TO MILLWORK ELEVATION 2/E-116.
- CONNECT TO EXISTING 20-AMP, 1-POLE SPARE CIRCUIT BREAKER.
- DISCONNECT FURNISHED WITH EQUIPMENT.
- EXISTING WANDER MANAGEMENT NETWORK PUNCHDOWN BLOCK FOR DOOR RELAY WIRING SHALL REMAIN.
- UNDER ALTERNATE BID, REPLACE EXISTING LIGHT FIXTURE WITH NEW FIXTURE INDICATED. CONNECT TO EXISTING CIRCUIT. UNDER BASE BID, EXISTING LIGHT FIXTURE TO REMAIN. CONTRACTOR SHALL CLEAN AND RE-LAMP FIXTURE.
- EXTEND COAX CABLE TO NEW OUTLET FROM EXISTING TV OUTLET.
- DUCT DETECTORS SHALL INTERFACE WITH FIRE/SMOKE DAMPERS. PROVIDE ALL REQUIRED CONNECTIONS TO FIRE/SMOKE DAMPERS.
- PROVIDE NEW 20-AMP, 1-POLE CIRCUIT BREAKER IN EXISTING PANELBOARD AND USE FOR NEW CIRCUIT.

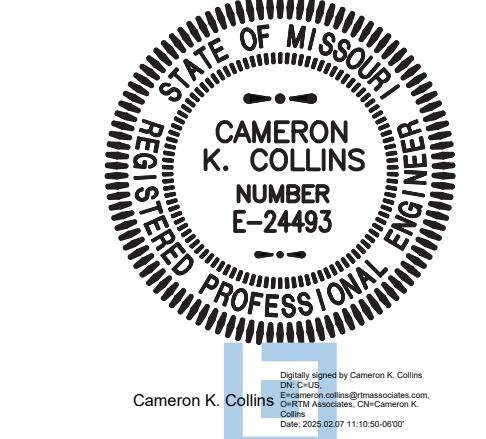
**GENERAL NOTES:**

- IN ALL RESIDENT SLEEPING ROOMS, THE REPLACEMENT CEILING SMOKE DETECTOR SHALL BE LOCATED A MINIMUM OF 36" FROM THE SUPPLY DIFFUSER.
- FOR ALL ELECTRICAL QUESTIONS DURING BIDDING OR DURING CONSTRUCTION, CONTACT ESTERLY, SCHNEIDER & ASSOCIATES, INC. THOM LUNDBERG (417) 862-0558 FOR COORDINATION WITH ANTHONY G. BEIER AT RTM ENGINEERING CONSULTANTS.
- CUT AND PATCH EXISTING WALLS AS NECESSARY FOR INSTALLATION OF NEW DEVICES.
- SMOKE DETECTORS SHALL BE INSTALLED 36 INCHES OR MORE FROM ANY DIFFUSER OR REGISTER.

REMOVE AND REPLACE ALL EXISTING FIRE ALARM DEVICES UNLESS NOTED OTHERWISE. REPLACE EXISTING WIRING. REUTILIZE EXISTING CONDUIT WHERE FEASIBLE.

REMOVE AND REPLACE NURSE CALL CENTRAL EQUIPMENT, MASTER STATIONS, DOME LIGHTS, AND PATIENT STATIONS. REPLACE EXISTING WIRING. REUTILIZE EXISTING CONDUIT WHERE FEASIBLE.

TIE ALL WANDER MANAGEMENT RELAYS INTO NEW NURSE CALL SYSTEM.



**PROFESSIONAL SEAL**

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OFFICE OF ADMINISTRATION  
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DESIGN AND CONSTRUCTION

DEPARTMENT OF  
PUBLIC SAFETY  
MISSOURI VETERANS  
COMMISSION

INTERIOR RENOVATION  
MISSOURI VETERANS  
HOME

620 N. JEFFERSON  
ST. JAMES, MISSOURI

PROJECT # **U1503-01**  
SITE # **6801**  
ASSET # **8136801002**  
FEDERAL # **29-044**

REVISION: \_\_\_\_\_  
DATE: \_\_\_\_\_  
REVISION: \_\_\_\_\_  
DATE: \_\_\_\_\_  
REVISION: \_\_\_\_\_  
DATE: \_\_\_\_\_  
ISSUE DATE: **8-1-24**

CAD DWG FILE: **E-118.DWG**  
DRAWN BY: **AGB**  
CHECKED BY: **CKB**  
DESIGNED BY: **AGB**

SHEET TITLE:

**ELECTRICAL  
PLAN**

SHEET NUMBER:

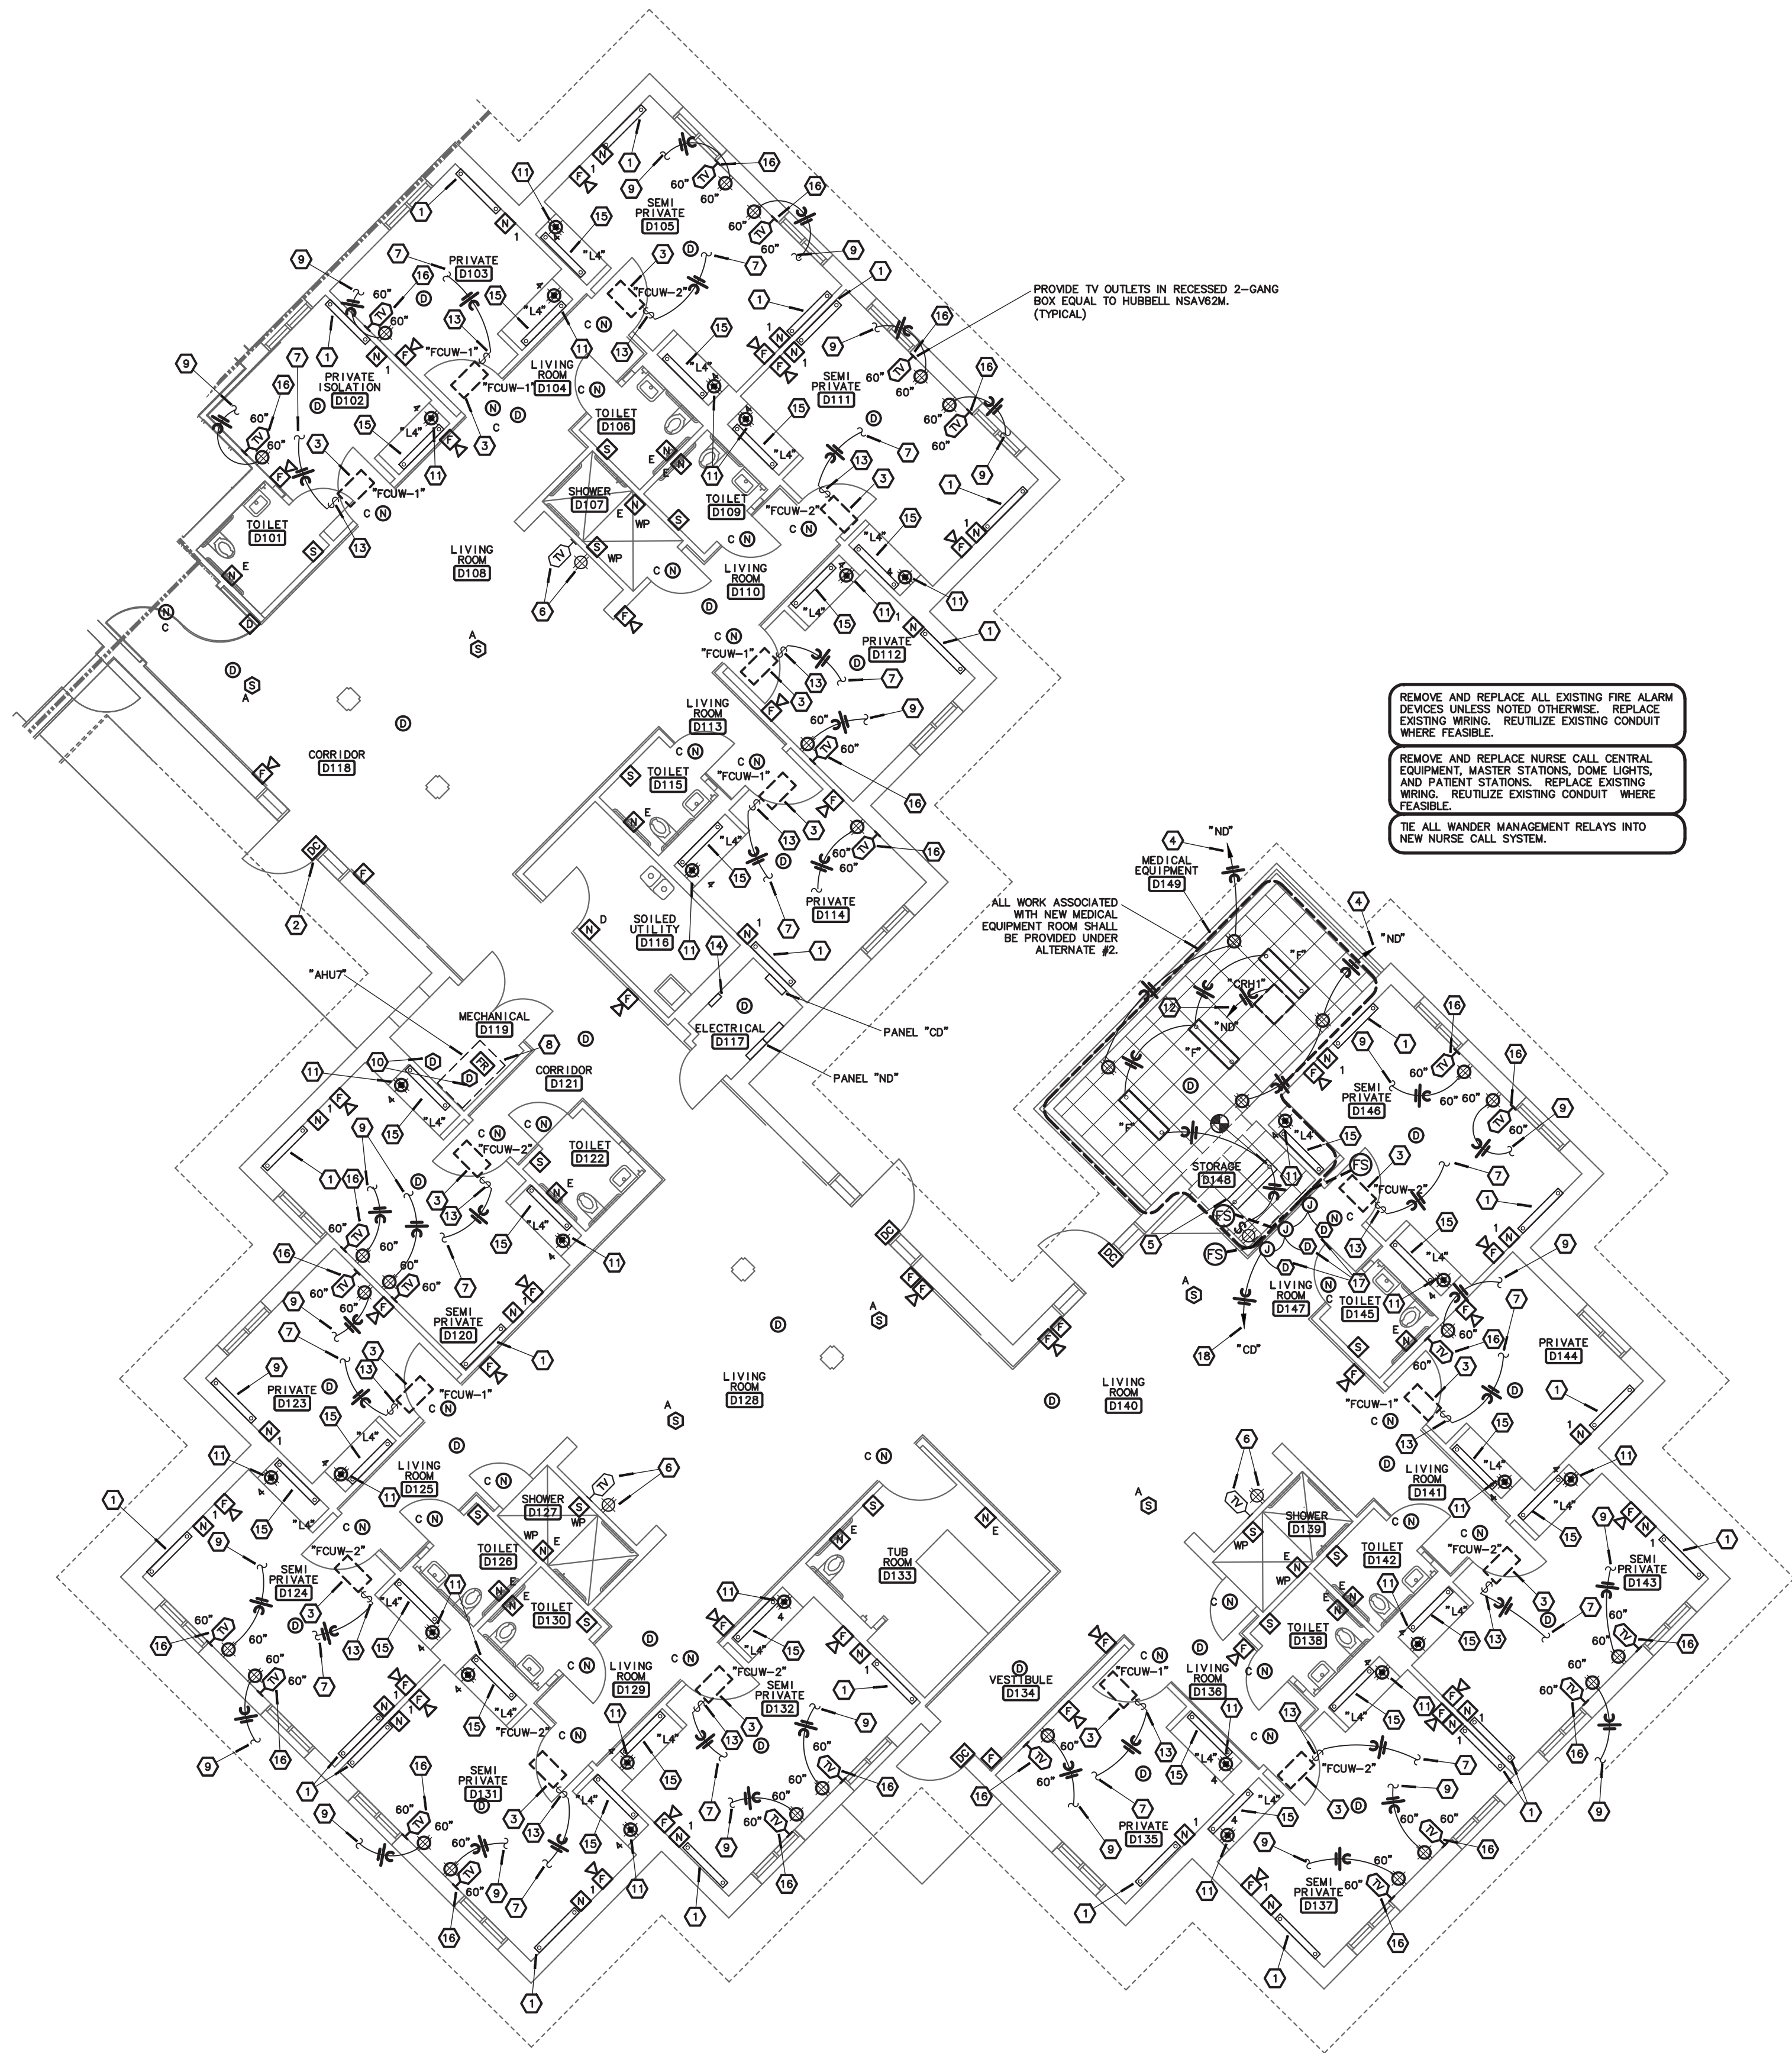
**E-118**

112 OF 120 SHEETS

8-1-24



H:\ESAS\SAN\03\SAN-E-119 16 Aug 2018 = 3:42 pm



1  
E-119

## WING 'D' - ELECTRICAL IMPROVEMENT PLAN

SCALE: 1/8"=1'-0"

NORTH

**rtm**  
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3333 E. Battlefield Road, Ste. 1000  
Springfield, MO 65804  
rtmec.com | 417.881.0020  
State of Missouri certificate of authority  
#2014035826 for engineering

### NOTES:

- EXISTING LIGHT FIXTURE TO REMAIN. CONTRACTOR SHALL CLEAN AND RE-LAMP FIXTURE.
- DOOR CONTACT SHALL TIE INTO NURSE CALL SYSTEM.
- EXISTING UNIT TO BE REPLACED. CONNECT NEW UNIT TO EXISTING CIRCUIT.
- CONNECT TO EXISTING SPARE 20-AMP, 1-POLE CIRCUIT BREAKER IN EXISTING PANELBOARD.
- REVISE SWITCHING FOR EXISTING LIGHT AS SHOWN. CONNECT NEW LIGHTS TO EXISTING FIXTURE.
- EXISTING TV OUTLETS TO REMAIN.
- RECONNECT TO EXISTING EQUIPMENT CIRCUIT.
- EXISTING HVAC EQUIPMENT TO REMAIN.
- CONNECT CIRCUIT TO EXISTING TV RECEPTACLE IN MILLWORK IN FRONT OF MIRROR. REFER TO DETAIL 2/E-116.
- NEW DUCT DETECTORS SHALL REPLACE EXISTING.
- UNDER ALTERNATE #3, PROVIDE NEW RECEPTACLE ABOVE COUNTER AND SWITCH WITH EXISTING RECEPTACLE AT OPPOSITE SIDE OF COUNTER. REFER TO MILLWORK ELEVATION 2/E-116.
- CONNECT TO EXISTING 20-AMP, 1-POLE SPARE CIRCUIT BREAKER.
- DISCONNECT FURNISHED WITH EQUIPMENT.
- EXISTING WANDER MANAGEMENT NETWORK PUNCHDOWN BLOCK FOR DOOR RELAY WIRING SHALL REMAIN.
- UNDER ALTERNATE BID, REPLACE EXISTING LIGHT FIXTURE WITH NEW FIXTURE INDICATED. CONNECT TO EXISTING CIRCUIT. UNDER BASE BID, EXISTING LIGHT FIXTURE TO REMAIN. CONTRACTOR SHALL CLEAN AND RE-LAMP FIXTURE.
- EXTEND COAX CABLE TO NEW OUTLET FROM EXISTING TV OUTLET.
- DUCT DETECTORS SHALL INTERFACE WITH FIRE/SMOKE DAMPERS. PROVIDE ALL REQUIRED CONNECTIONS TO FIRE/SMOKE DAMPERS.
- PROVIDE NEW 20-AMP, 1-POLE CIRCUIT BREAKER IN EXISTING PANELBOARD AND USE FOR NEW CIRCUIT.

### GENERAL NOTES:

- IN ALL RESIDENT SLEEPING ROOMS, THE REPLACEMENT CEILING SMOKE DETECTOR SHALL BE LOCATED A MINIMUM OF 36" FROM THE SUPPLY DIFFUSER.
- FOR ALL ELECTRICAL QUESTIONS DURING BIDDING OR DURING CONSTRUCTION, CONTACT ESTERLY, SCHNEIDER & ASSOCIATES, INC., THOM LUNDBERG (417) 862-0558 FOR COORDINATION WITH ANTHONY G. BEIER AT RTM ENGINEERING CONSULTANTS.
- CUT AND PATCH EXISTING WALLS AS NECESSARY FOR INSTALLATION OF NEW DEVICES.
- SMOKE DETECTORS SHALL BE INSTALLED 36 INCHES OR MORE FROM ANY DIFFUSER OR REGISTER.

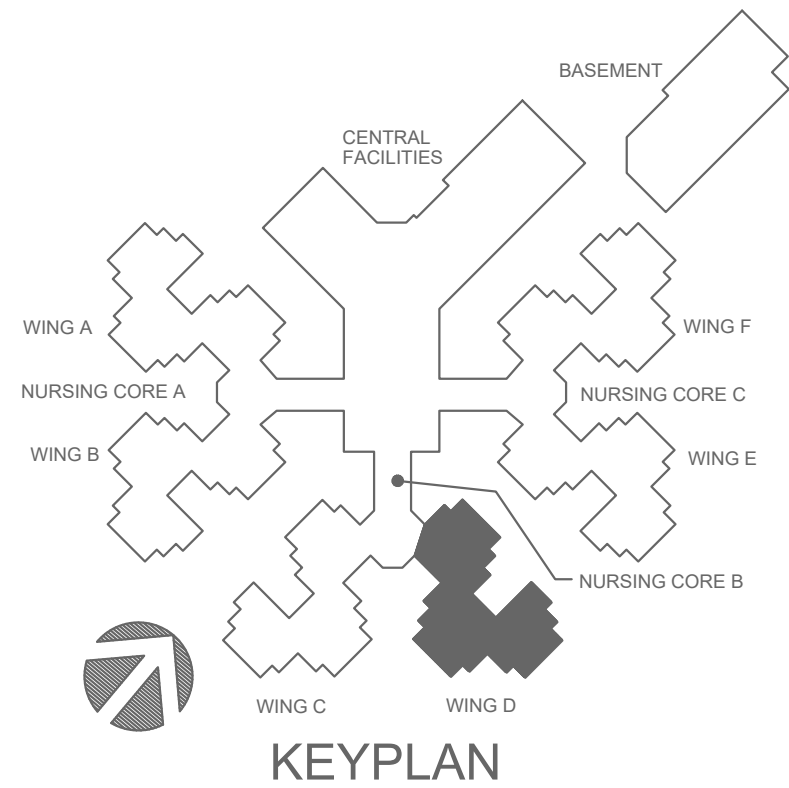
REMOVE AND REPLACE ALL EXISTING FIRE ALARM DEVICES UNLESS NOTED OTHERWISE. REPLACE EXISTING WIRING. REUTILIZE EXISTING CONDUIT WHERE FEASIBLE.

REMOVE AND REPLACE NURSE CALL CENTRAL EQUIPMENT, MASTER STATIONS, DOME LIGHTS, AND PATIENT STATIONS. REPLACE EXISTING WIRING. REUTILIZE EXISTING CONDUIT WHERE FEASIBLE.


TIE ALL WANDER MANAGEMENT RELAYS INTO NEW NURSE CALL SYSTEM.

PROVIDE TV OUTLETS IN RECESSED 2-GANG BOX EQUAL TO HUBBELL NSAV2M. (TYPICAL)

ALL WORK ASSOCIATED WITH NEW MEDICAL EQUIPMENT ROOM SHALL BE PROVIDED UNDER ALTERNATE #2.



STATE OF MISSOURI  
MIKE KEHOE,  
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AIA architects & planners
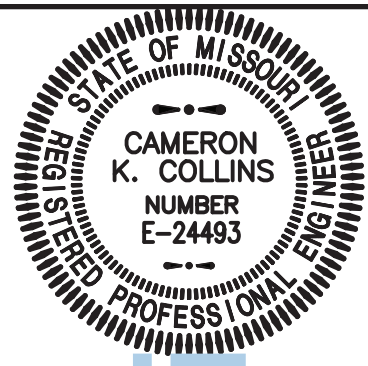
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MISSOURI VETERANS  
HOME

620 N. JEFFERSON  
ST. JAMES, MISSOURI

PROJECT # U1503-01  
SITE # 6801  
ASSET # 8136801002  
FEDERAL # 29-044

REVISION: \_\_\_\_\_  
DATE: \_\_\_\_\_  
REVISION: \_\_\_\_\_  
DATE: \_\_\_\_\_  
REVISION: \_\_\_\_\_  
DATE: \_\_\_\_\_  
ISSUE DATE: 8-1-24

CAD DWG FILE: E-119.DWG  
DRAWN BY: AGB  
CHECKED BY: CKB  
DESIGNED BY: AGB

SHEET TITLE:

## ELECTRICAL PLAN

SHEET NUMBER:

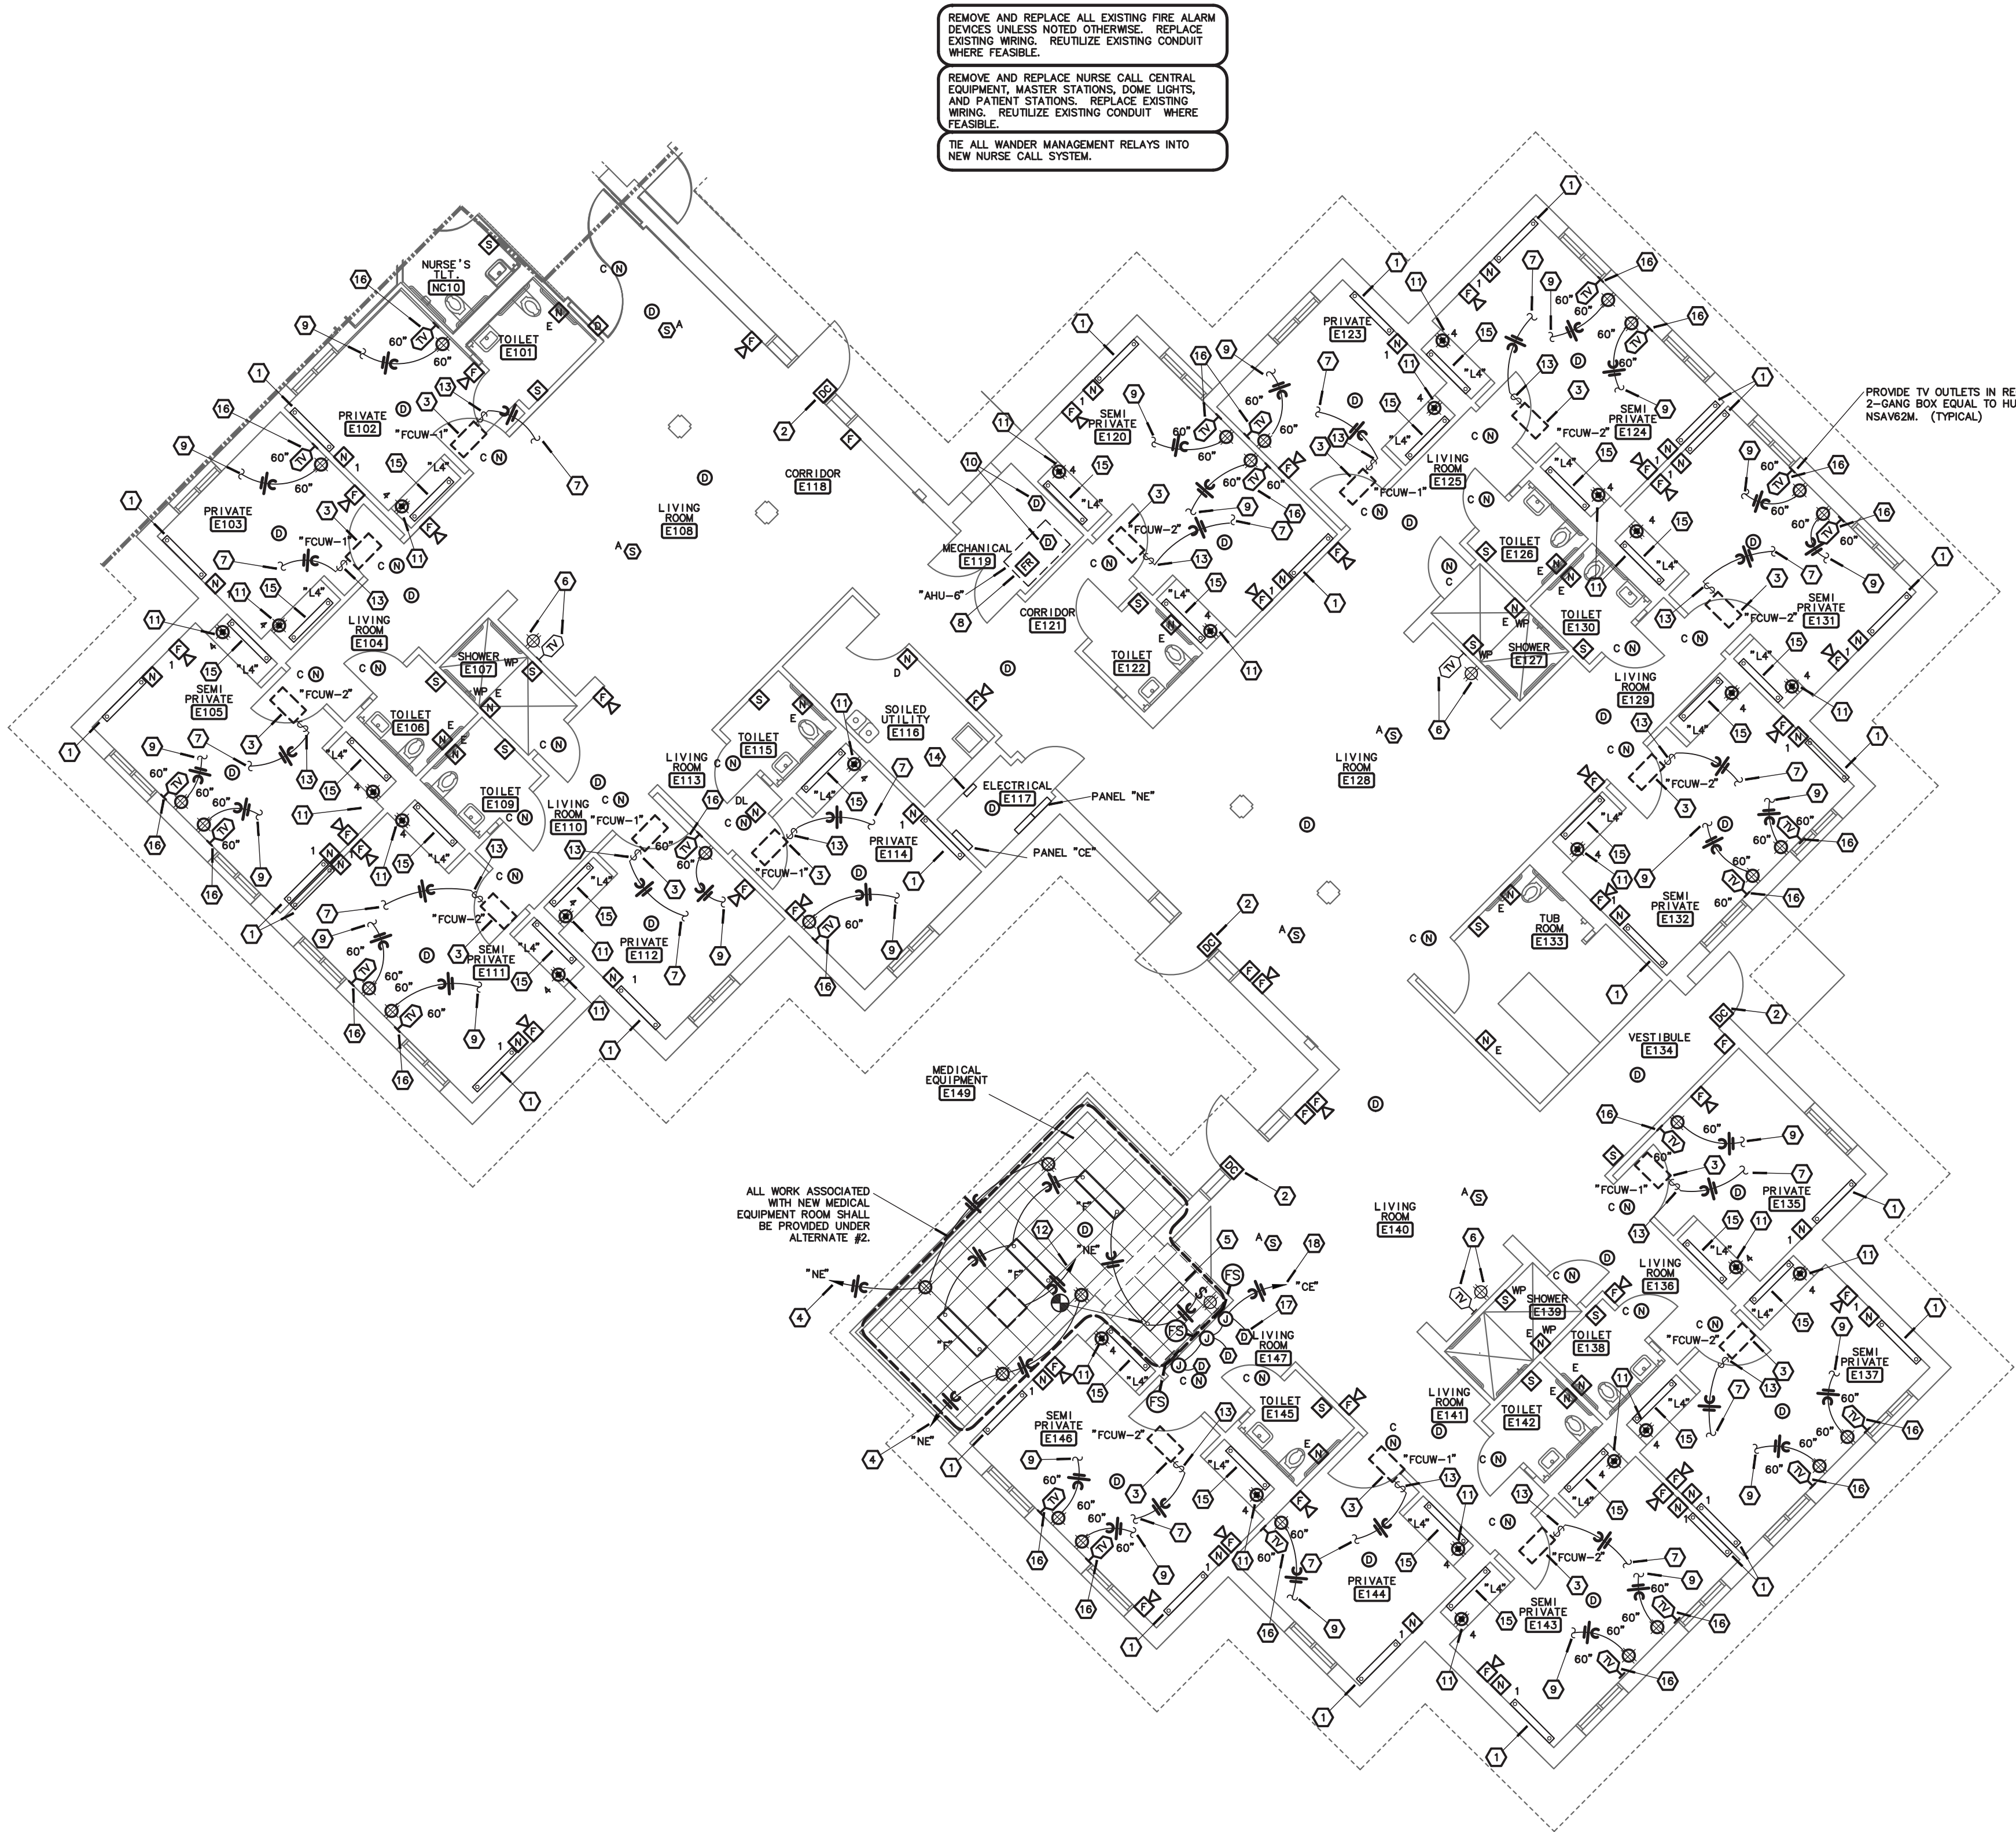
### E-119

113 OF 120 SHEETS

8-1-24



H:\LSA\SMVA\DWG\SMVE-120 10 Oct 2016 - 3:41 am



**1**  
**E-120** **WING 'E' - ELECTRICAL IMPROVEMENT PLAN**  
SCALE: 1/8"=1'-0"


**rtm** engineering consultants  
3333 E. Battlefield Road, Ste. 1000  
Springfield, MO 65804  
rtmec.com | 417.881.0020  
State of Missouri certificate of authority  
#2014035826 for engineering

## NOTES:

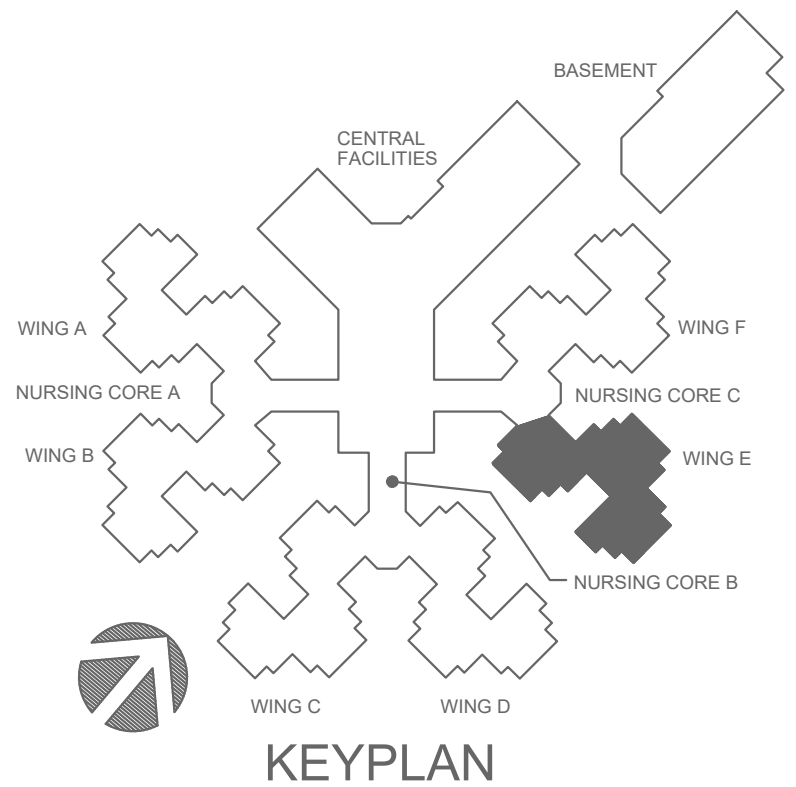
- EXISTING LIGHT FIXTURE TO REMAIN. CONTRACTOR SHALL CLEAN AND RE-LAMP FIXTURE.
- DOOR CONTACT SHALL TIE INTO NURSE CALL SYSTEM.
- EXISTING UNIT TO BE REPLACED. CONNECT NEW UNIT TO EXISTING CIRCUIT.
- CONNECT TO EXISTING SPARE 20-AMP, 1-POLE CIRCUIT BREAKER IN EXISTING PANELBOARD.
- REVISE SWITCHING FOR EXISTING LIGHT AS SHOWN. CONNECT NEW LIGHTS TO EXISTING FIXTURE.
- EXISTING TV OUTLETS TO REMAIN.
- RECONNECT TO EXISTING EQUIPMENT CIRCUIT.
- EXISTING HVAC EQUIPMENT TO REMAIN.
- CONNECT CIRCUIT TO EXISTING TV RECEPTACLE IN MILLWORK IN FRONT OF MIRROR. REFER TO DETAIL 2/E-116.
- NEW DUCT DETECTORS SHALL REPLACE EXISTING.
- UNDER ALTERNATE #3, PROVIDE NEW RECEPTACLE ABOVE COUNTER AND CIRCUIT WITH EXISTING RECEPTACLE AT OPPOSITE SIDE OF COUNTER. REFER TO MILLWORK ELEVATION 2/E-116.
- CONNECT TO EXISTING 20-AMP, 1-POLE SPARE CIRCUIT BREAKER.
- DISCONNECT FURNISHED WITH EQUIPMENT.
- EXISTING WANDER MANAGEMENT NETWORK PUNCHDOWN BLOCK FOR DOOR RELAY WIRING SHALL REMAIN.
- UNDER ALTERNATE BID, REPLACE EXISTING LIGHT FIXTURE WITH NEW FIXTURE INDICATED. CONNECT TO EXISTING CIRCUIT. UNDER BASE BID, EXISTING LIGHT FIXTURE TO REMAIN. CONTRACTOR SHALL CLEAN AND RE-LAMP FIXTURE.
- EXTEND COAX CABLE TO NEW OUTLET FROM EXISTING TV OUTLET.
- DUCT DETECTORS SHALL INTERFACE WITH FIRE/SMOKE DAMPERS. PROVIDE ALL REQUIRED CONNECTIONS TO FIRE/SMOKE DAMPERS.
- PROVIDE NEW 20-AMP, 1-POLE CIRCUIT BREAKER IN EXISTING PANELBOARD AND USE FOR NEW CIRCUIT.

## GENERAL NOTES:

- IN ALL RESIDENT SLEEPING ROOMS, THE REPLACEMENT CEILING SMOKE DETECTOR SHALL BE LOCATED A MINIMUM OF 36" FROM THE SUPPLY DIFFUSER.
- FOR ALL ELECTRICAL QUESTIONS DURING BIDDING OR DURING CONSTRUCTION, CONTACT ESTERLY, SCHNEIDER & ASSOCIATES, INC., THOM LUNDBERG (417) 862-0558 FOR COORDINATION WITH ANTHONY G. BEIER AT RTM ENGINEERING CONSULTANTS.
- CUT AND PATCH EXISTING WALLS AS NECESSARY FOR INSTALLATION OF NEW DEVICES.
- SMOKE DETECTORS SHALL BE INSTALLED 36 INCHES OR MORE FROM ANY DIFFUSER OR REGISTER.



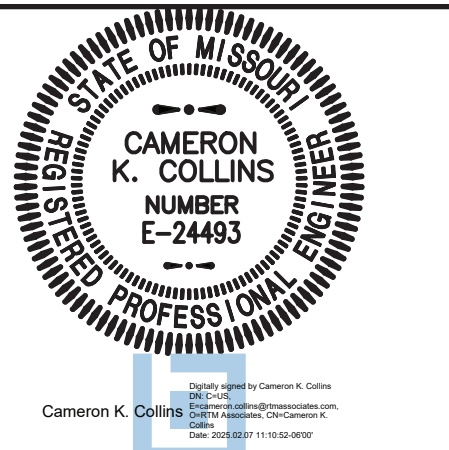STATE OF MISSOURI  
MIKE KEHOE,  
GOVERNOR



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**ESTERLY  
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SCHNEIDER  
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COMM. #4860

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MISSOURI VETERANS  
HOME

620 N. JEFFERSON  
ST. JAMES, MISSOURI

PROJECT # **U1503-01**  
SITE # **6801**  
ASSET # **8136801002**  
FEDERAL # **29-044**

REVISION: \_\_\_\_\_  
DATE: \_\_\_\_\_  
REVISION: \_\_\_\_\_  
DATE: \_\_\_\_\_  
REVISION: \_\_\_\_\_  
DATE: \_\_\_\_\_  
ISSUE DATE: **8-1-24**

CAD DWG FILE: **E-120.DWG**  
DRAWN BY: **AGB**  
CHECKED BY: **CKB**  
DESIGNED BY: **AGB**

SHEET TITLE:

# ELECTRICAL PLAN

SHEET NUMBER:

## E-120

114 OF 120 SHEETS

8-1-24



H:\LSA\SWH\DWG\SWHE-121 10 Oct 2016 - 3:41 am



**1**  
**E-121** **WING 'F' - ELECTRICAL IMPROVEMENT PLAN**  
SCALE: 1/8"=1'-0"  
NORTH

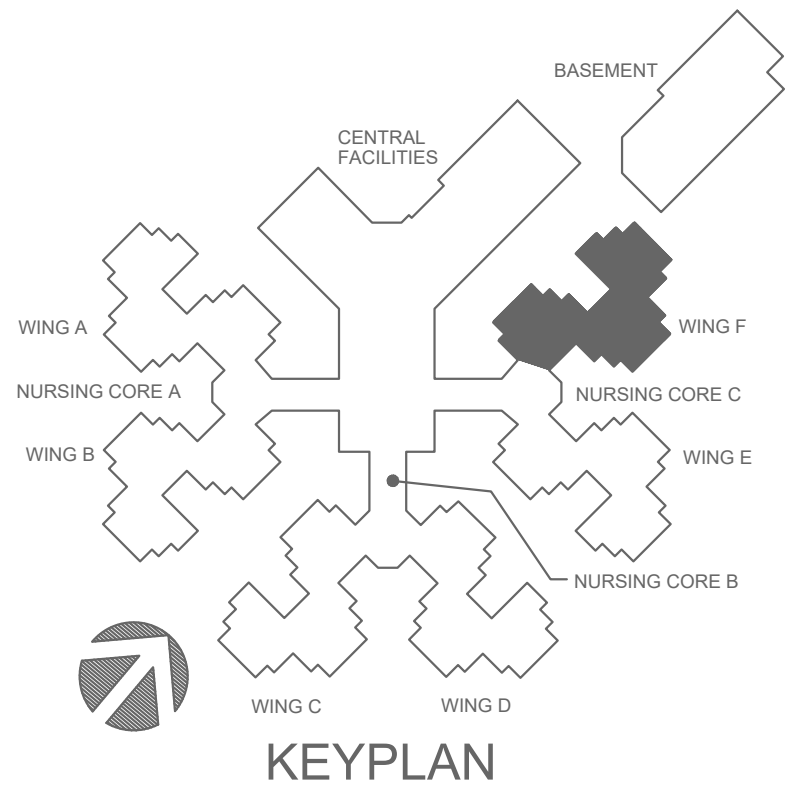
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engineering consultants  
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Springfield, MO 65804  
rtmec.com | 417.881.0020  
State of Missouri certificate of authority  
#2014035826 for engineering

## NOTES:


- EXISTING LIGHT FIXTURE TO REMAIN. CONTRACTOR SHALL CLEAN AND RE-LAMP FIXTURE.
- DOOR CONTACT SHALL TIE INTO NURSE CALL SYSTEM.
- EXISTING UNIT TO BE REPLACED. CONNECT NEW UNIT TO EXISTING CIRCUIT.
- CONNECT TO EXISTING SPARE 20-AMP, 1-POLE CIRCUIT BREAKER IN EXISTING PANELBOARD.
- REVISE SWITCHING FOR EXISTING LIGHT AS SHOWN. CONNECT NEW LIGHTS TO EXISTING FIXTURE.
- RECONNECT TO EXISTING RECEPTACLE CIRCUIT.
- RECONNECT TO EXISTING EQUIPMENT CIRCUIT.
- EXISTING HVAC EQUIPMENT TO REMAIN.
- CONNECT CIRCUIT TO EXISTING TV RECEPTACLE IN MILLWORK IN FRONT OF MIRROR. REFER TO DETAIL 2/E-116.
- NEW DUCT DETECTORS SHALL REPLACE EXISTING.
- UNDER ALTERNATE #3, PROVIDE NEW RECEPTACLE ABOVE COUNTER AND CIRCUIT WITH EXISTING RECEPTACLE AT OPPOSITE SIDE OF COUNTER. REFER TO MILLWORK ELEVATION 2/E-116.
- CONNECT TO EXISTING 20-AMP, 1-POLE SPARE CIRCUIT BREAKER.
- DISCONNECT FURNISHED WITH EQUIPMENT.
- EXISTING WANDER MANAGEMENT NETWORK PUNCHDOWN BLOCK FOR DOOR RELAY WIRING SHALL REMAIN.
- UNDER ALTERNATE BID, REPLACE EXISTING LIGHT FIXTURE WITH NEW FIXTURE INDICATED. CONNECT TO EXISTING CIRCUIT. UNDER BASE BID, EXISTING LIGHT FIXTURE TO REMAIN. CONTRACTOR SHALL CLEAN AND RE-LAMP FIXTURE.
- CONNECT TO EXISTING CIRCUIT MADE AVAILABLE WITH DEMOLITION OF EXISTING EXHAUST FAN.
- EXTEND COAX CABLE TO NEW OUTLET FROM EXISTING TV OUTLET.
- DUCT DETECTORS SHALL INTERFACE WITH FIRE/SMOKE DAMPERS. PROVIDE ALL REQUIRED CONNECTIONS TO FIRE/SMOKE DAMPERS.
- PROVIDE NEW 20-AMP, 1-POLE CIRCUIT BREAKER IN EXISTING PANELBOARD AND USE FOR NEW CIRCUIT.

## GENERAL NOTES:

- IN ALL RESIDENT SLEEPING ROOMS, THE REPLACEMENT CEILING SMOKE DETECTOR SHALL BE LOCATED A MINIMUM OF 36" FROM THE SUPPLY DIFFUSER.
- FOR ALL ELECTRICAL QUESTIONS DURING BIDDING OR DURING CONSTRUCTION, CONTACT ESTERY, SCHNEIDER & ASSOCIATES, INC., THOM LUNDBERG (417) 862-0558 FOR COORDINATION WITH ANTHONY G. BEIER AT RTM ENGINEERING CONSULTANTS.
- CUT AND PATCH EXISTING WALLS AS NECESSARY FOR INSTALLATION OF NEW DEVICES.
- SMOKE DETECTORS SHALL BE INSTALLED 36 INCHES OR MORE FROM ANY DIFFUSER OR REGISTER.



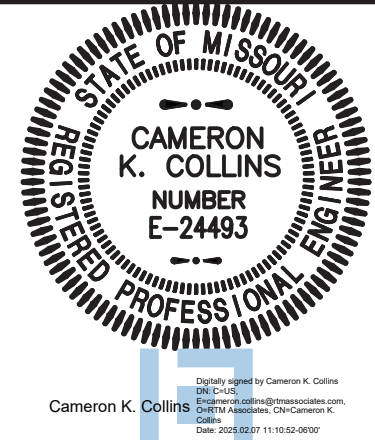STATE OF MISSOURI  
MIKE KEHOE,  
GOVERNOR



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e-mail: architect@esteryschneider.com

**ESTERY  
&  
SCHNEIDER  
ASSOCIATES, INC.**  
AIA architects & planners

COMM. #4860

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DIVISION OF FACILITIES  
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MISSOURI VETERANS  
HOME

620 N. JEFFERSON  
ST. JAMES, MISSOURI

PROJECT # **U1503-01**  
SITE # **6801**  
ASSET # **8136801002**  
FEDERAL # **29-044**

REVISION: \_\_\_\_\_  
DATE: \_\_\_\_\_  
REVISION: \_\_\_\_\_  
DATE: \_\_\_\_\_  
REVISION: \_\_\_\_\_  
DATE: \_\_\_\_\_  
ISSUE DATE: **8-1-24**

CAD DWG FILE: **E-121.DWG**  
DRAWN BY: **AGB**  
CHECKED BY: **CKB**  
DESIGNED BY: **AGB**

SHEET TITLE:

**ELECTRICAL  
PLAN**

SHEET NUMBER:

**E-121**

115 OF 120 SHEETS

8-1-24



H:\ES&A\SWP\0\SUPRIM-133 21 Aug 2024 - 12:04 pm



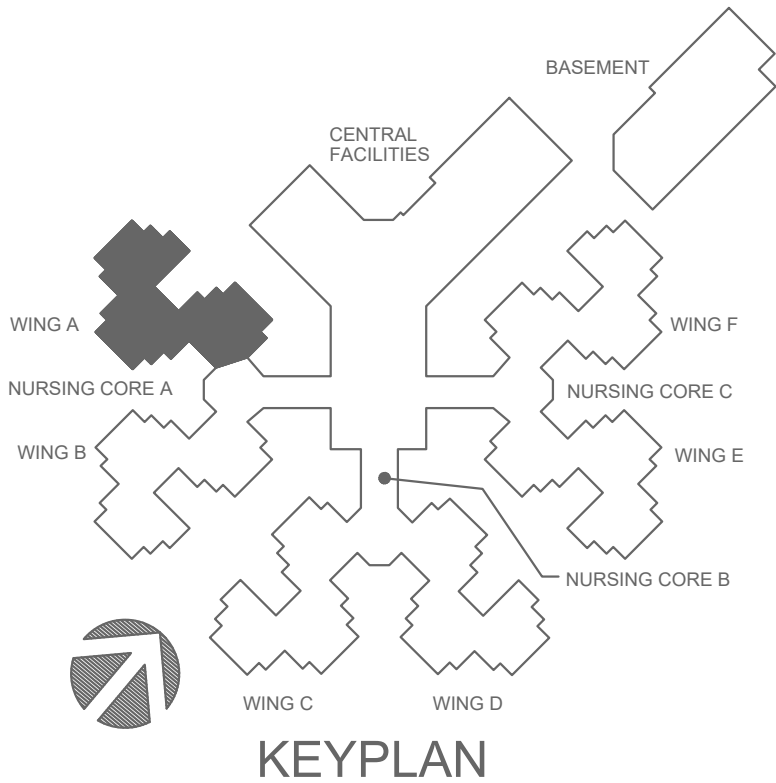
ALTERNATE #1:  
ALL WORK ASSOCIATED WITH INFECTIOUS CONTROL WING 'A' FOR REVISED MECHANICAL AND ELECTRICAL WORK ASSOCIATED WITH THE REQUIREMENTS TO ACHIEVE THE INFECTIOUS CONTROL AREAS DEFINED ON THE MECHANICAL PLANS. REFER TO SHEETS A-104, A-114, A-121, A-800, A-801, M-105, M-116, M-127, M-133, M-134, M-135 AND E-105, AND E-116 AND ALL ASSOCIATED DETAILS, SCHEDULES AND SPECIFICATION SECTIONS REQUIRED FOR ADDITIONAL INFORMATION AS IT PERTAINS TO WING A. ALTERNATE #1 SHALL NOT INCLUDE REMOVING AND INSTALLING NEW FLOORING, REMOVING AND INSTALLING NEW WALL BASE, PAINTING OF ANY WALLS, ANY WORK ASSOCIATED WITH DEMOLITION OR NEW CONSTRUCTION FOR SHOWER ROOM A107. ALTERNATE SHALL NOT INCLUDE ANY WORK ASSOCIATED WITH NEW TV MOUNTING AND BLOCCING, NOR WORK ASSOCIATED WITH OTHER ALTERNATE WORK IN THIS WING. THESE ITEMS REMAIN IN THE BASE BID AND AS DEFINED IN THE PHASING SCHEDULE. ANY ITEMS NOT LISTED SPECIFICALLY ABOVE, BUT SHOWN ON THE DRAWINGS/SPECIFICATIONS, SHALL REMAIN IN THE ALTERNATE BID #1.

1  
E-122  
INFECTIONOUS CONTROL ALTERNATE #1  
WING 'A' - LIGHTING IMPROVEMENT PLAN  
SCALE: 1/8"=1'-0"  
NORTH


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engineering consultants  
3333 E. Battlefield Road, Ste. 1000  
Springfield, MO 65804  
rtmec.com | 417.881.0020  
State of Missouri certificate of authority  
#2014035826 for engineering

NOTES:

1. NEW NORMAL POWER LIGHT FIXTURES SHALL CONNECT TO EXISTING NORMAL POWER LIGHTING CIRCUIT SERVING THIS AREA.
2. NEW EMERGENCY POWER LIGHT FIXTURES SHALL CONNECT TO EXISTING LIFE SAFETY LIGHTING CIRCUIT SERVING THIS AREA.
3. NEW EXIT LIGHT SHALL CONNECT TO EXISTING LIFE SAFETY LIGHTING CIRCUIT SERVING THIS AREA.
4. CONNECT TO EXISTING UNSWITCHED LIFE SAFETY LIGHTING CIRCUIT SERVING THIS AREA.
5. CONNECT TO EXISTING SWITCHED NORMAL POWER LIGHTING CIRCUIT SERVING THIS AREA. SWITCH LOCATED AT NURSE STATION SHOWN ON SHEET E-115.
6. EXISTING SWITCH TO REMAIN.
7. CONNECT TO EXISTING NORMAL POWER LIGHTING CIRCUIT SERVING THIS AREA.



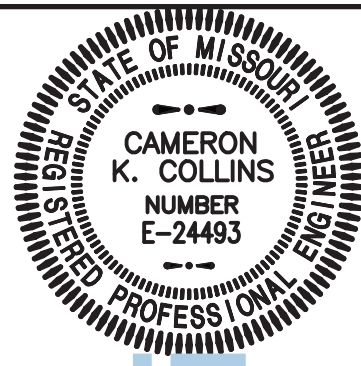STATE OF MISSOURI  
MIKE KEHOE,  
GOVERNOR



Cameron K. Collins  
Professional Engineer  
State of Missouri  
License Number E-24483

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SCHNEIDER  
ASSOCIATES, INC.  
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COMM. #4860

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PROJECT # U1503-01  
SITE # 6801  
ASSET # 8136801002  
FEDERAL # 29-044

REVISION: \_\_\_\_\_  
DATE: \_\_\_\_\_  
REVISION: \_\_\_\_\_  
DATE: \_\_\_\_\_  
REVISION: \_\_\_\_\_  
DATE: \_\_\_\_\_  
ISSUE DATE: 8-1-24

CAD DWG FILE: E-122.DWG  
DRAWN BY: AGB  
CHECKED BY: CKP  
DESIGNED BY: AGB

SHEET TITLE:

ELECTRICAL  
PLAN

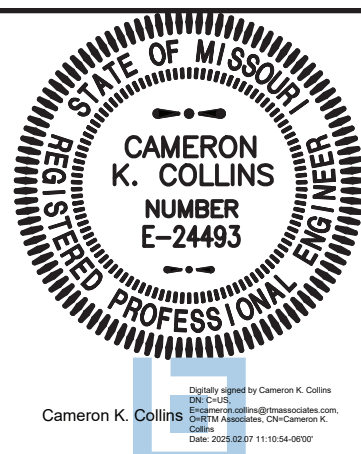
SHEET NUMBER:

E-122

116 OF 120 SHEETS

8-1-24





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MANAGEMENT,  
DESIGN AND CONSTRUCTION**

**DEPARTMENT OF  
PUBLIC SAFETY  
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COMMISSION**

# INTERIOR RENOVATION MISSOURI VETERANS HOME

620 N. JEFFERSON  
ST. JAMES, MISSOURI

PROJECT # **U1503-01**  
SITE # **6801**  
ASSET # **8136801002**  
FEDERAL # **29-044**

REVISION: \_\_\_\_\_  
DATE: \_\_\_\_\_  
REVISION: \_\_\_\_\_  
DATE: \_\_\_\_\_  
REVISION: \_\_\_\_\_  
DATE: \_\_\_\_\_  
ISSUE DATE: **8-1-24**

CAD DWG FILE: **E-123.DWG**  
 DRAWN BY: **AGB**  
 CHECKED BY: **CKC**  
 DESIGNED BY: **AGB**

SHEET TITLE:

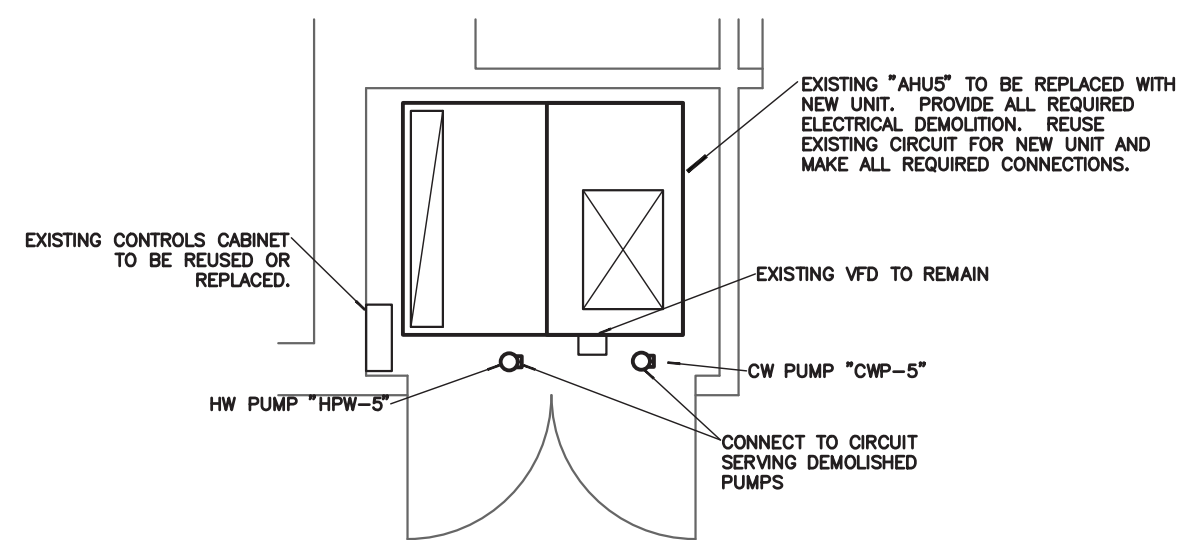
# ELECTRICAL PLAN

SHEET NUMBER:

E-123

117 OF 120 SHEETS

8-1-24




## ENLARGED MECH CLOSET PLAN

**SCALE: 1/4"=1'-0"**


ALTERNATE #1:

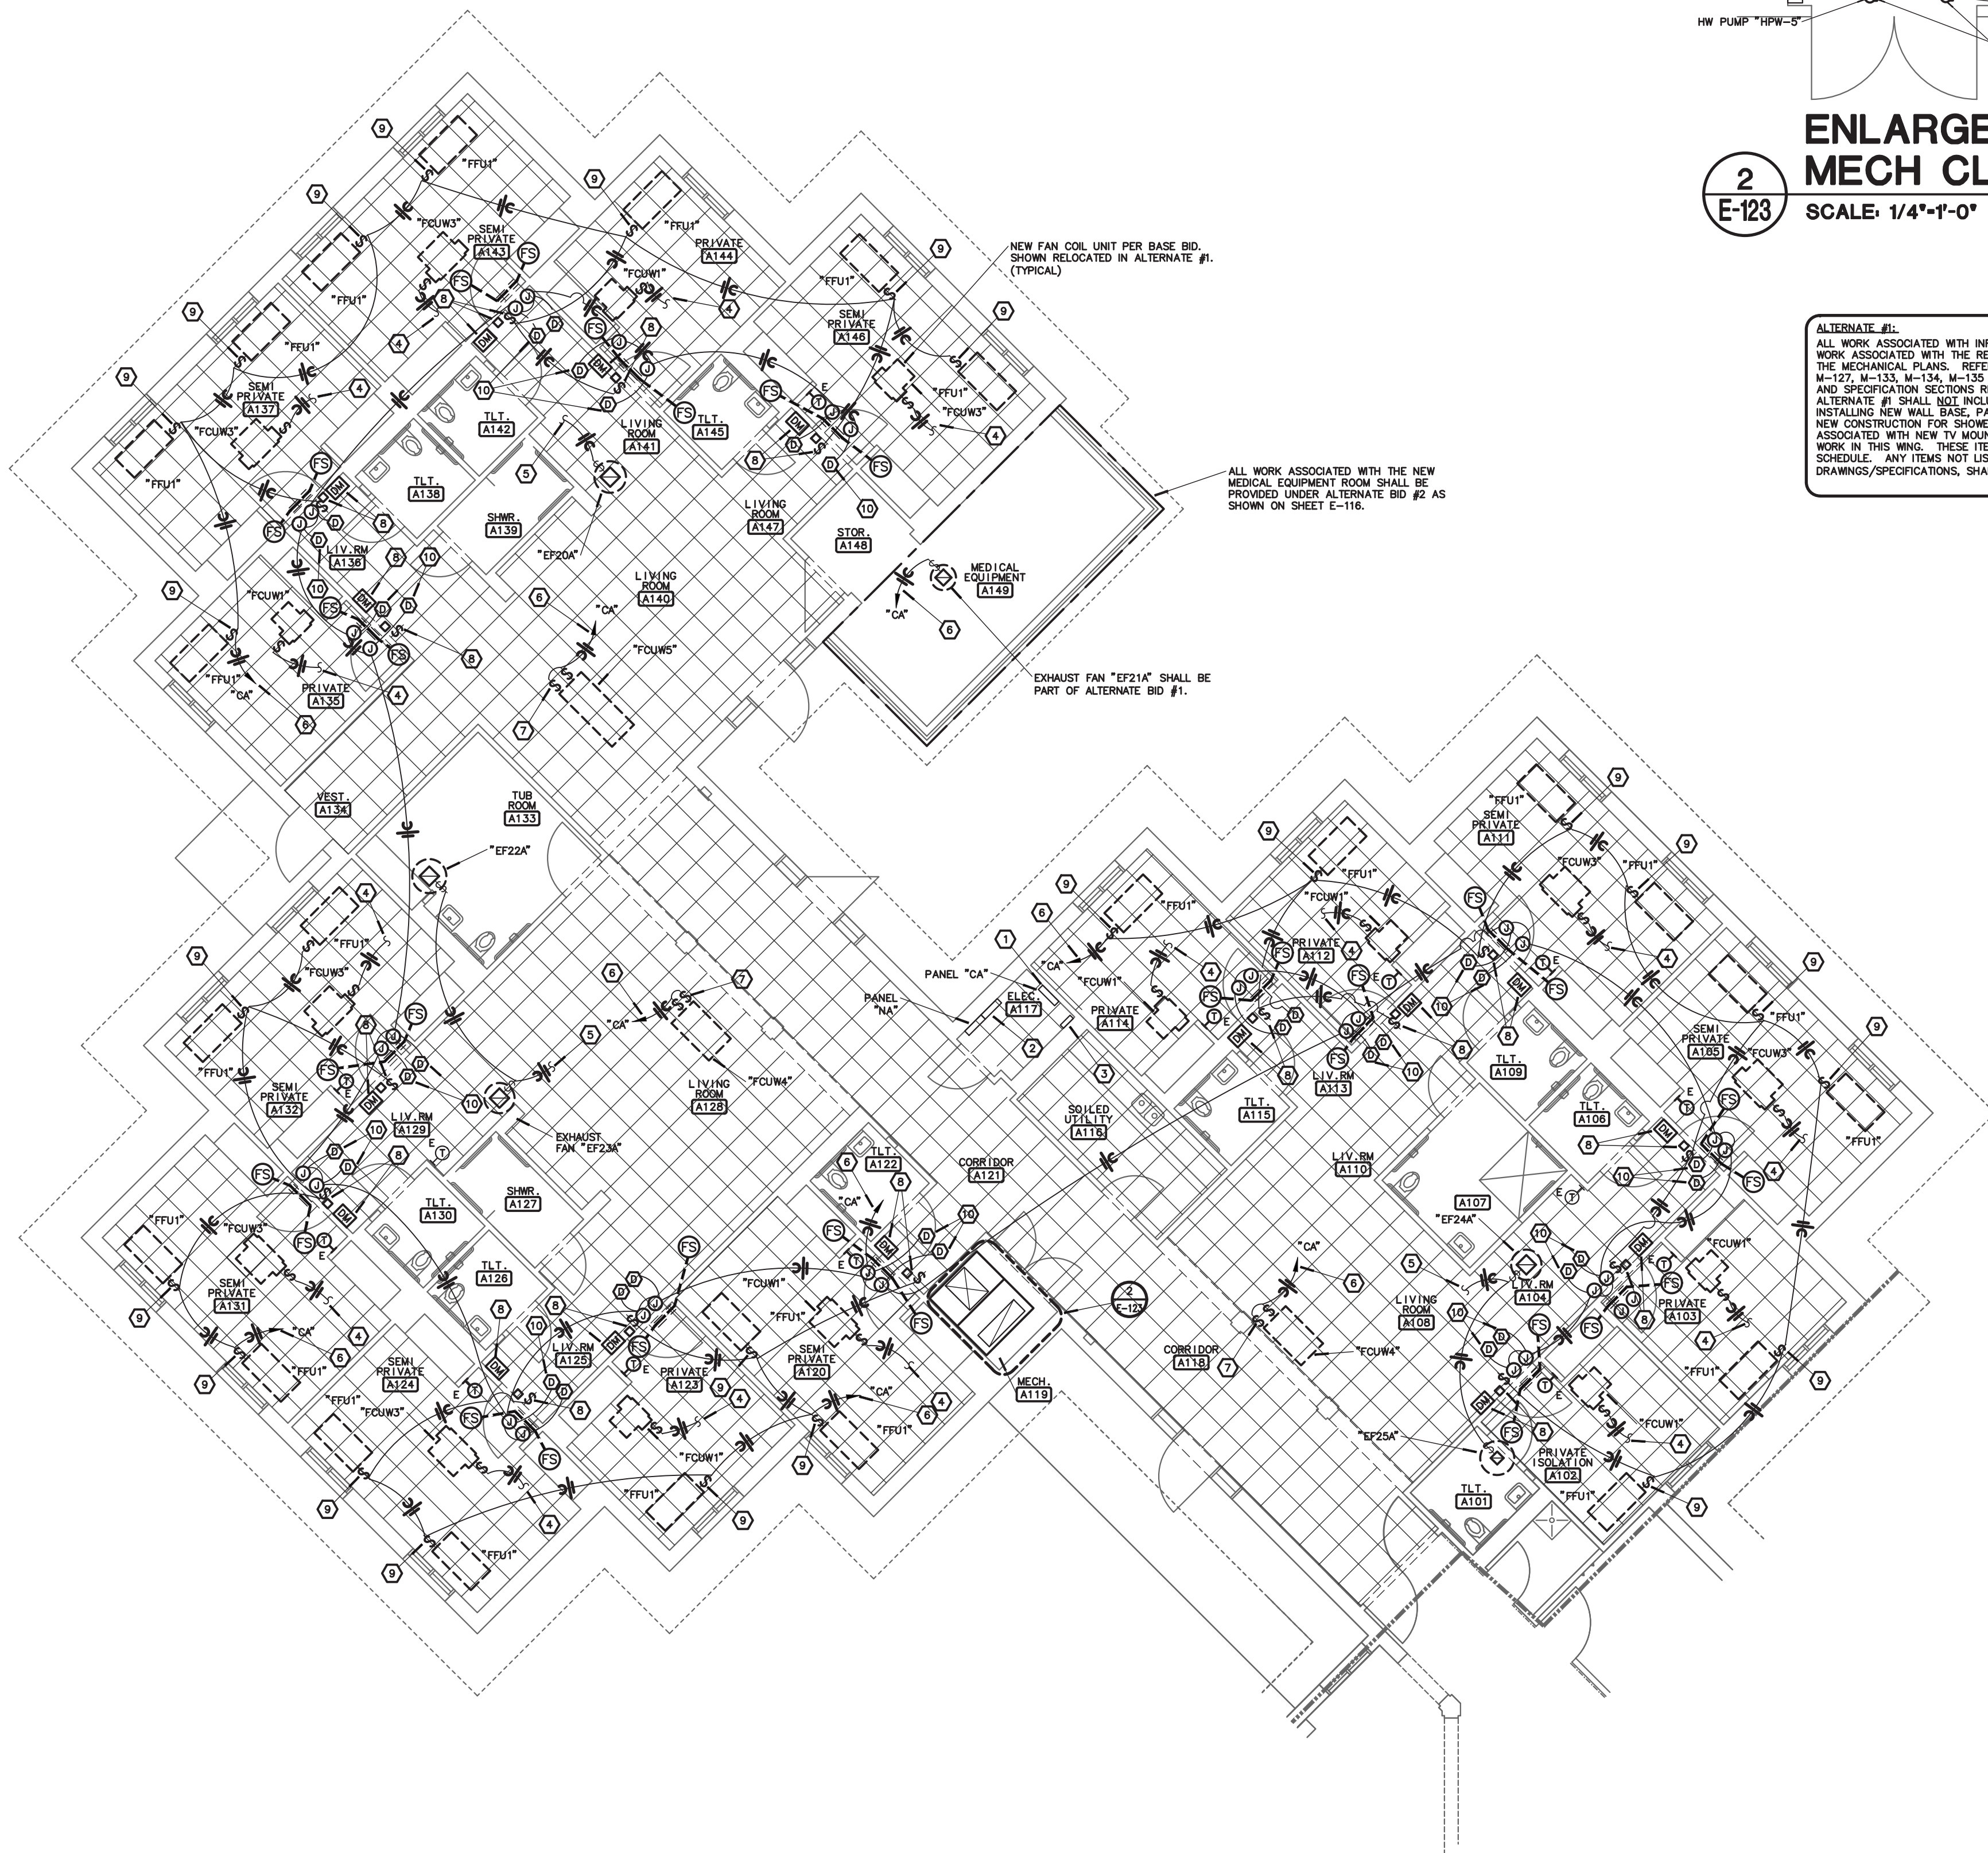ALL WORK ASSOCIATED WITH INFECTIOUS CONTROL, W/IN 'A' FOR REVISED MECHANICAL AND ELECTRICAL WORK ASSOCIATED WITH THE REQUIREMENTS TO ACHIEVE THE INFECTIOUS CONTROL AREAS DEFINED ON THE PHASING PLAN. THIS SHALL INCLUDE, BUT NOT BE LIMITED TO, THE FOLLOWING: (1) M-113, M-114, M-127, M-130, M-134, M-135 AND E-105, AND E-116 AND ALL ASSOCIATED DETAILS, SCHEDULES AND SPECIFICATION SECTIONS REQUIRED FOR ADDITIONAL INFORMATION AS IT PERTAINS TO THE REMOVAL OF THE EXISTING SHAFTS AND THE INSTALLATION OF NEW SHAFTS. (2) THE REMOVAL OF THE EXISTING WALLS AND THE INSTALLATION OF NEW WALL BASE, PAINTING OF ANY WALLS, ANY WORK ASSOCIATED WITH DEMOLITION OR CONSTRUCTION OF THE EXISTING WALLS AND THE INSTALLATION OF NEW WALLS. (3) ANY WORK ASSOCIATED WITH NEW TV MOUNTING AND BLOCKING, NEW WORK ASSOCIATED WITH OTHER ALTERNATE WORK IN THIS WING. THESE ITEMS REMAIN IN THE BASE BID AND AS DEFINED IN THE PHASING PLAN. THE CONTRACTOR SHALL NOT LIST SPECIFICATIONS OR DETAILS FROM THE DRAWINGS/SPECIFICATIONS, SHALL REMAIN IN THE ALTERNATE BID #1.




## INFECTIOUS CONTROL ALTERNATE #1

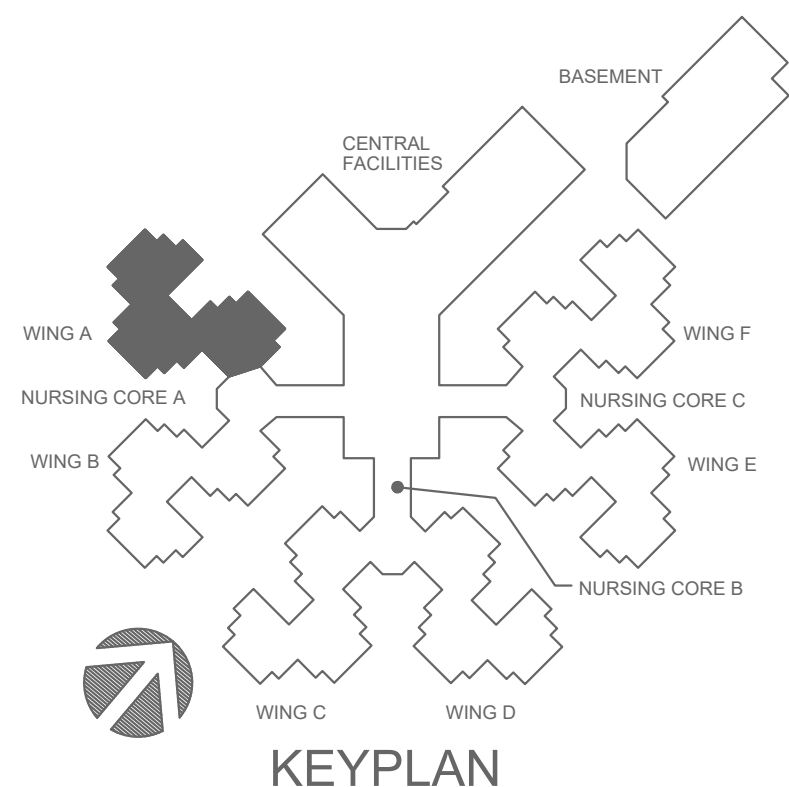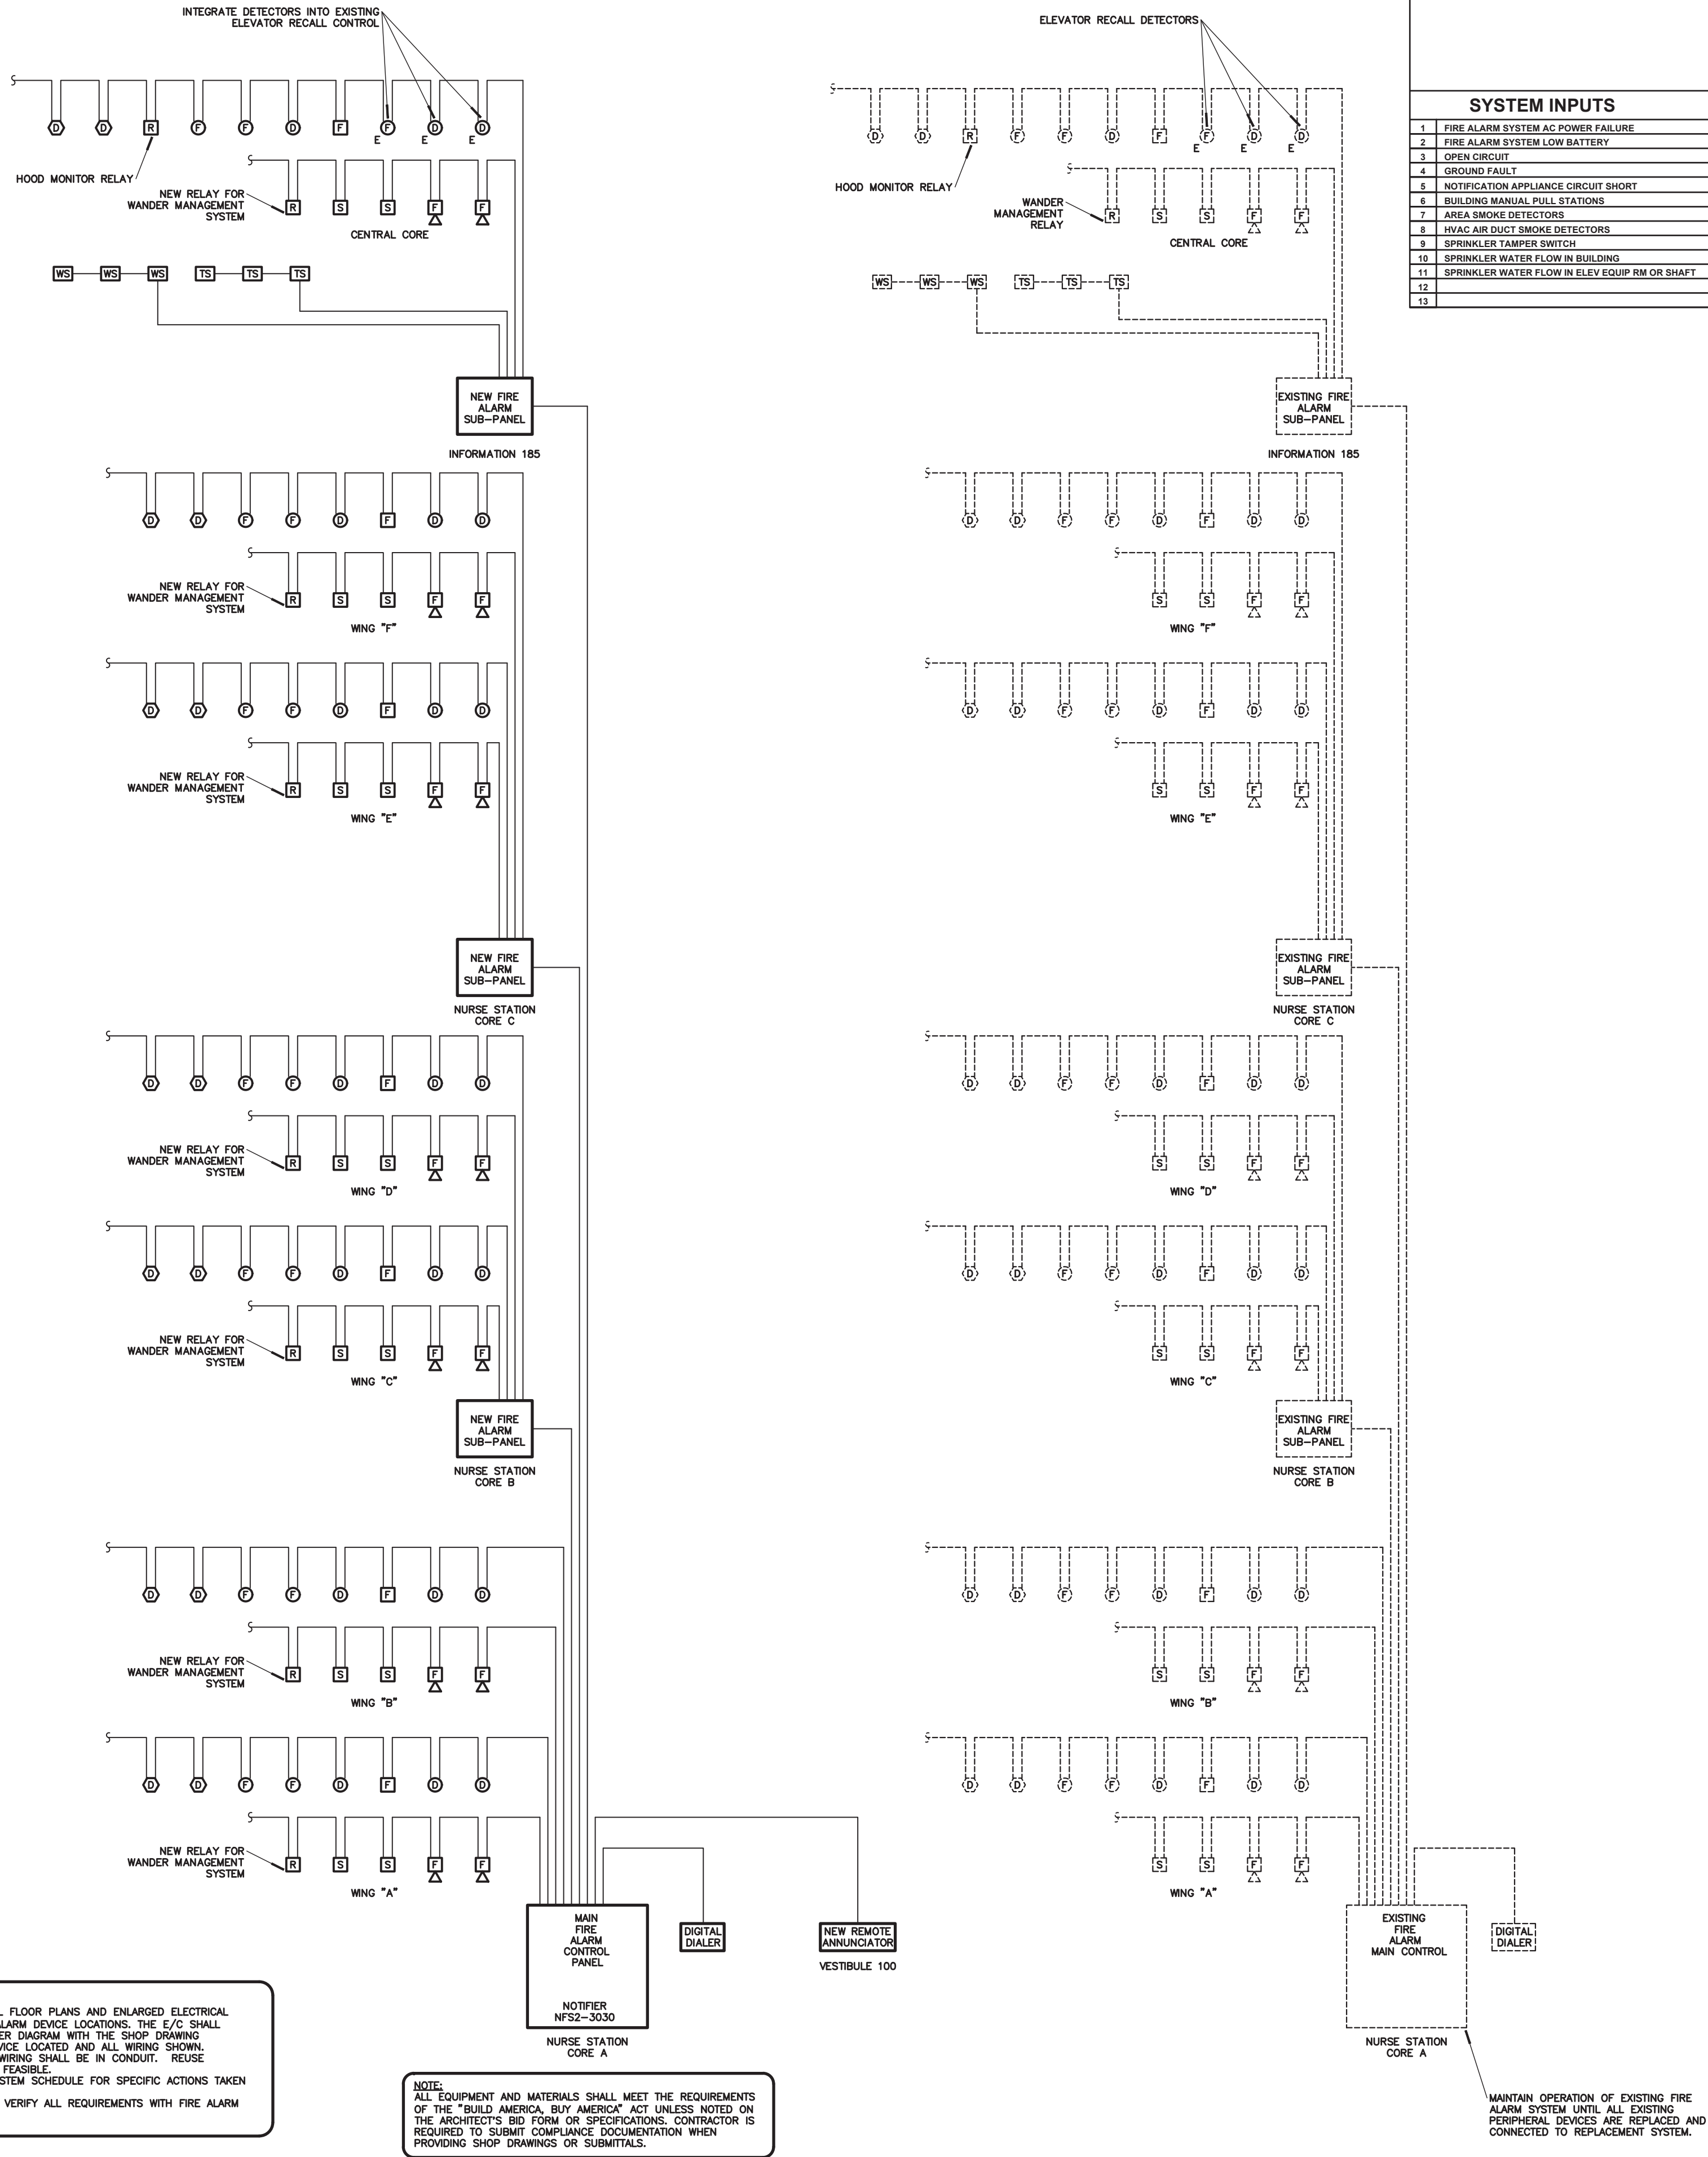**SCALE: 1/8"=1'-0"**








FIRE ALARM SYSTEM INPUT/OUTPUT MATRIX		SYSTEM OUTPUTS																									
		FACP ANNUNCIATION										NOTIFICATION										REQUIRED FIRE SAFETY CONTROL					
SYSTEM INPUTS		<div><div>MANUAL COMMON ALARM INDICATOR</div><div>MANUAL COMMON ALARM INDICATOR</div><div>MANUAL COMMON 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NOTES:

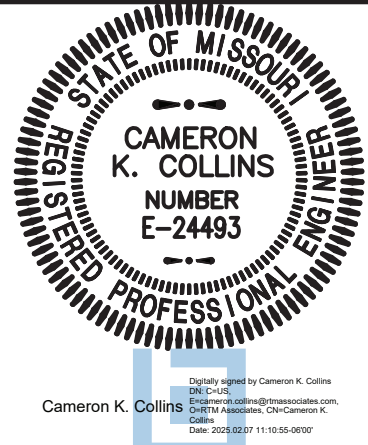

PROFESSIONAL SEAL

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COMM. #4860

OFFICE OF ADMINISTRATION  
DIVISION OF FACILITIES  
MANAGEMENT,  
DESIGN AND CONSTRUCTION

DEPARTMENT OF  
PUBLIC SAFETY  
MISSOURI VETERANS  
COMMISSION

INTERIOR RENOVATION  
MISSOURI VETERANS  
HOME

620 N. JEFFERSON  
ST. JAMES, MISSOURI

PROJECT # U1503-01  
SITE # 6801  
ASSET # 8136801002  
FEDERAL # 29-044

REVISION: \_\_\_\_\_  
DATE: \_\_\_\_\_  
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DATE: \_\_\_\_\_  
REVISION: \_\_\_\_\_  
DATE: \_\_\_\_\_  
ISSUE DATE: 8-1-24

CAD DWG FILE: E-500.DWG  
DRAWN BY: AGB  
CHECKED BY: TPM  
DESIGNED BY: AGB

SHEET TITLE:  
**FIRE ALARM  
RISER  
DIAGRAM**

SHEET NUMBER:

**E-500**  
118 OF 120 SHEETS

8-1-24






**1 NURSE CALL RISER DIAGRAM**  
E-501 NO SCALE



DISCONNECT SWITCH SCHEDULE										
MARK	LOAD		SWITCH			FUSE		ENCLOSURE NEMA TYPE	NOTES	
	EQUIPMENT SERVED	VOLTS	DUTY	AMP	POLE	AMP	TYPE			
DS1	CWCP-11	208	GD	30	2	20	FRN-R	NEMA 1	BABA	
ABBREVIATIONS: GD - GENERAL DUTY HD - HEAVY DUTY BABA - COMPLY WITH BUILD AMERICA BUY AMERICA ACT. PROVIDE LETTER OF COMPLIANCE.										

LIGHT FIXTURE SCHEDULE										
MARK	MFG.	CATALOG #	MTG.	FINISH	LAMPS			EQUIVALENT		
					TYPE	CODE	QTY			
A	WILLIAMS	D1LG-822-L25/835-F-MPR-UNV NOTE 1	REC	WHITE	LED	2,500 LUMEN, 23 WATT, 35K	—	AC,LS1,SIG		
B	WILLIAMS	8FDB-L5-8-CS-CS-DIM-UNV NOTE 1	REC	CLEAR SPECULAR	LED	2,000 LUMEN, 18 WATT, 35K	—	AC,LS1,SIG		
BEM	WILLIAMS	8FDB-L5-8-CS-EM/10W-DIM-UNV NOTE 1	REC	CLEAR SPECULAR	LED	2,000 LUMEN, 18 WATT, 35K	—	AC,LS1,SIG		
C	WILLIAMS	80-4-L63/835-UNV NOTE 1	CHAIN	WHITE	LED	8,300 LUMEN, 52 WATT, 35K	—	AC,LS1,SIG		
D	ULTRALIGHTS	CLASSICS 10187-10 NOTE 1	PEND	BY ARCH	LED	20-WATT, E26LED, DIM, 35K	—	SUBMIT		
F	WILLIAMS	17-4-L55/835-AF-UNV NOTE 1	SURF	WHITE	LED	5,500 LUMEN, 53 WATT, 35K	—	AC,LS1,SIG		
G	WILLIAMS	SLF-4-L26/835-H1A-UNV NOTE 1	WALL	WHITE	LED	2,600 LUMEN, 28 WATT, 35K	—	AC,LS1,SIG		
H	WILLIAMS	11-4-L52/835-FAF12125-UNV NOTE 1	SURF	WHITE	LED	5,200 LUMEN, 59 WATT, 35K	—	AC,LS1,SIG		
L3	WILLIAMS	1SF-3-L18/835-AF12125-UNV NOTE 1	SURF	WHITE	LED	1,800 LUMEN, 21 WATT, 35K	—	AC,LS1,SIG		
L4	WILLIAMS	1SF-4-L24/835-AF12125-UNV NOTE 1	SURF	WHITE	LED	2,400 LUMEN, 29 WATT, 35K	—	AC,LS1,SIG		
M	WILLIAMS	SLF-2-L13/835-H1A-UNV NOTE 1	WALL	WHITE	LED	1,300 LUMEN, 12 WATT, 35K	—	AC,LS1,SIG		
N	WILLIAMS	50-G-S-22-L26/835-S-AF12125- UNV NOTE 1	REC	WHITE	LED	2,600 LUMEN, 22 WATT, 35K	—	AC,LS1,SIG		
X	LITHONIA	LE-S-R-SD NOTE 1	SURF	BRUSHED ALUM BLACK HOUSING	LED	FURNISHED WITH UNIT	—	SUBMIT		
NOTES: 1. ALL LIGHT FIXTURES SHALL COMPLY WITH BUILD AMERICA BUY AMERICA ACT. PROVIDE LETTER OF COMPLIANCE WITH SUBMITTALS.										
ABBREVIATIONS: Ab - ABSOLUTE GE - GENERAL ELEC LC - LITECONTROL Pg - PROGRESS MTG - MOUNTING Ac - ACUITY Gu - GUTH Ld - LEVITON Pf - PRESOLITE REC - RECESSED Ap - APPLETON Ho - HALO Li - LITHONIA Ps - PASS & SEYMOUR SURF - SURFACE Aaf - ARCH AREA LIGHTING Hs - HESLOPANE Ll - LONG LIGHTS Rb - ROBERTS GRD - GROUND Ch - CHLORIDE Hu - HUBBELL Ln - LINEAR LIGHTING St - STAFF TRK - TRACK Cl - COAST LIGHTING Hy - HYDREL Lf - LIGHTOLIER Sg - SIGNIFY CABL - CABLE Co - COLUMBIA Ice - ICE Lu - LUMARK SPl - SPI MFG - MANUFACTURER Ch - CROUSE-HINDS In - INDALUX Mg - MARCO St - STERNER QTY - QUANTITY De - DEYNE Ke - KENALL Me - METALUX SL - SURE-LITES FLR - FLUORESCENT DL - DUAL-LITE KIM - KIM MG - MCGRAW EDISON Sv - SYLVAN INC - INCANDESCENT EP - EDISON PRICE KV - KURT VERSEN Nu - NU-LITE Tl - TIVOLI HID - HIGH INTENSITY EL - EMERG-LITE LAM - LAM Pe - PEERLESS WI - WILLIAMS DISCHARGE FS - FAIL-SAFE Lo - LIGHTALARMS Pd - PRUDENTIAL UNIV - UNIVERSAL										

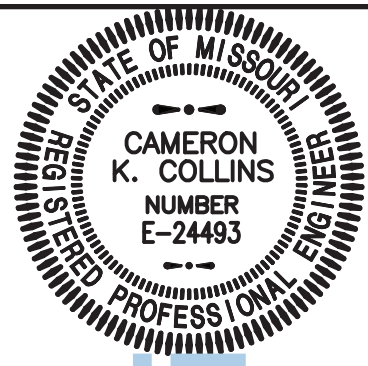NOTES:



Cameron K. Collins, Professional Engineer, License No. E-24483, State of Missouri

PROFESSIONAL SEAL

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REVISION: \_\_\_\_\_  
DATE: \_\_\_\_\_  
ISSUE DATE: 8-1-24

CAD DWG FILE: E-601.DWG  
DRAWN BY: AGB  
CHECKED BY: TPM  
DESIGNED BY: AGB

SHEET TITLE:

SCHEDULES

SHEET NUMBER:

E-600

120 OF 120 SHEETS

8-1-24