HVAC IMPROVEMENTS FOR INFECTION CONTROL MEXICO VETERANS HOME MEXICO, MISSOURI

OWNER:

STATE OF MISSOURI

MICHAEL L. PARSON,

GOVERNOR

DEPARTMENT OF

MISSOURI VETERANS

COMMISSION

PROJECT

OFFICE OF ADMINISTRATION

MANAGEMENT: DIVISION OF FACILITIES MANAGEMENT,

DESIGN AND CONSTRUCTION

DESIGNER:

STATE OF MISSOURI - OFFICE OF ADMINISTRATION

DIVISION OF FACILITIES MANAGEMENT DESIGN

AND CONSTRUCTION: 301 W. HIGH STREET,

JEFFERSON CITY, MO. 65102

PROJECT NUMBER:

U2301-03


ASSET NUMBER:


8136802001

SITE NUMBER:

6802

APRIL 11, 2024

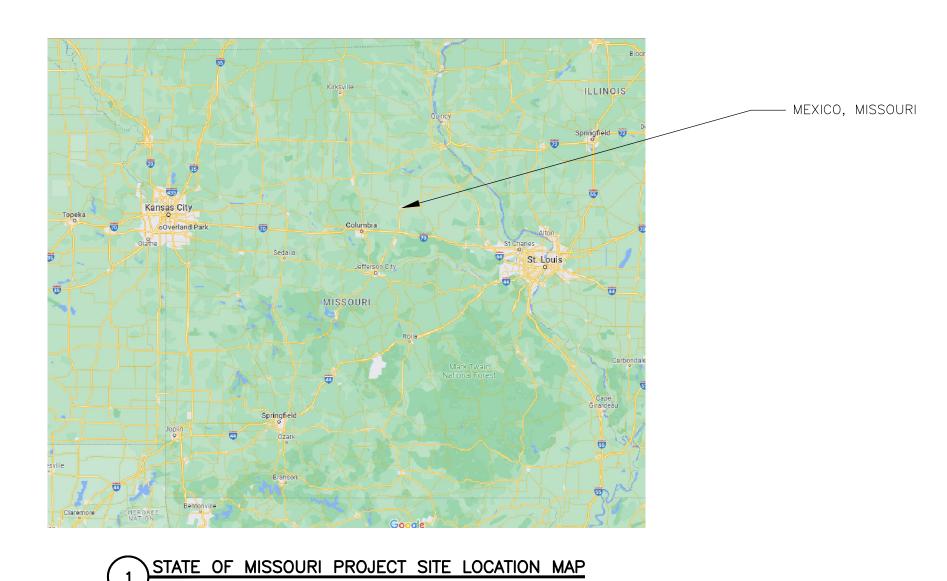

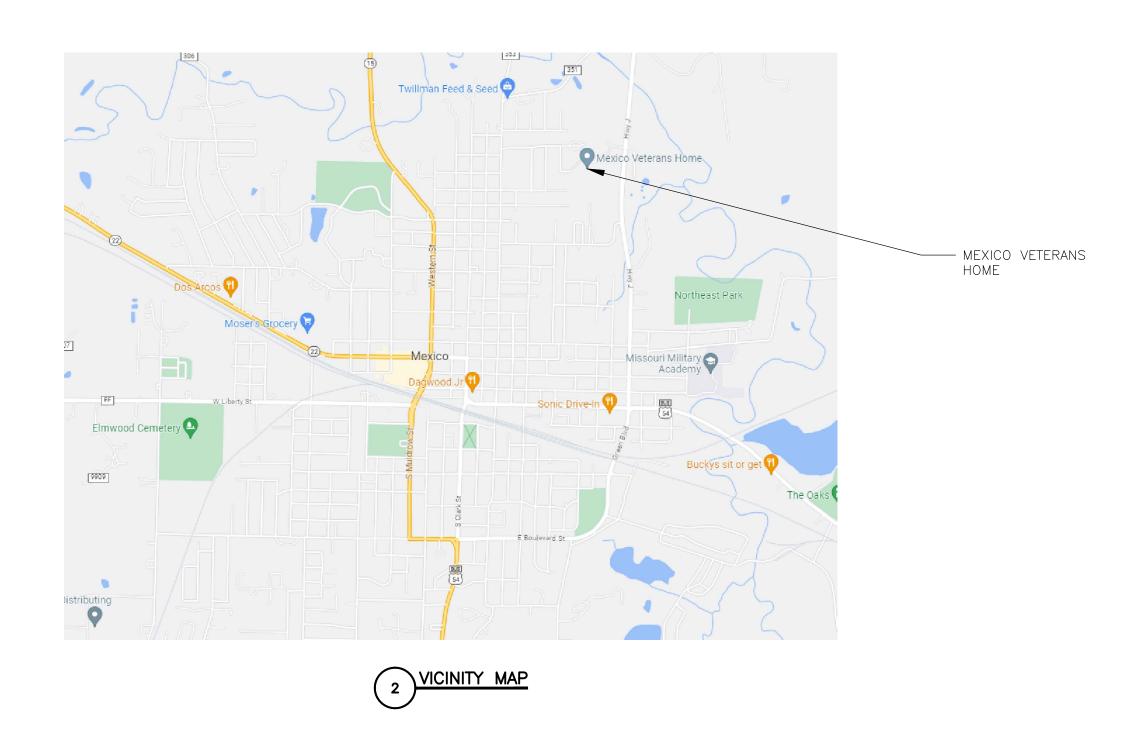

OWNER REQUESTED MOVING SERVICE

- 1. CONTRACTOR TO BE RESPONSIBLE FOR MOVING EXISTING FURNITURE OUT OF AREAS OF WORK PRIOR TO THE START OF DEMOLITION, AND MOVING FURNITURE BACK INTO THE SPACES AFTER CONSTRUCTION IS COMPLETE. PROTECT FURNITURE FROM DAMAGE.
- 2. CONTRACTOR TO PROVIDE TEMPORARY SHIPPING/ STORAGE CONTAINERS ON SITE FOR THE FURNITURE FOR THE DURATION OF DEMOLITION AND CONSTRUCTION, TO BE REMOVED FROM SITE UPON COMPLETION OF THE PROJECT. LOCATION OF TEMPORARY STORAGE CONTAINERS TO BE SPECIFIED BY OWNER.


GENERAL CONSTRUCTION NOTES

- 1. THE GENERAL CONTRACTOR (GC) SHALL EXERCISE CAUTION WHEN INSTALLING ANCHORS IN EXISTING REINFORCED CONCRETE STRUCTURAL ELEMENTS (I.E. FLOOR SLABS, BEAMS, COLUMNS, ETC.) ALL POST—INSTALLED ANCHORS SHALL BE PLACED A MINIMUM OF 1—1/2 INCHES AWAY FROM ANY EXISTING REINFORCING BARS. THE GENERAL CONTRACTOR SHALL DETECT AND VERIFY THE LOCATION OF REINFORCEMENT BEFORE ANCHOR INSTALLATION USING GROUND PENETRATING RADAR (GPR) OR OTHER APPROVED NON—DESTRUCTIVE METHOD.
- 2. TESTING AND BALANCING CONTRACTOR TO PERFORM BLOWER DOOR TESTING ON EACH BEDROOM. TESTING SHALL BE PERFORMED AFTER ROOM HAS BEEN SEALED PER DRAWINGS AND SPECIFICATIONS, BUT PRIOR TO THE INSTALLATION OF THE CEILING GRID. COVER ALL SUPPLY AND EXHAUST AIR OPENINGS IN THE SPACE PRIOR TO PERFORMING TEST. GENERAL CONTRACTOR SHALL PROVIDE ANY LABOR REQUIRED DURING TESTING TO SEAL ANY PENETRATIONS THAT HAVE BEEN FOUND TO LEAK. TAB CONTRACTOR SHALL PERFORM TESTS AGAIN AT GC'S EXPENSE IF ROOM IS FOUND TO NEED ADDITIONAL SEALING.

SHEET INDEX

1	G-001	COVER SHEET
2	G-002	GENERAL NOTES AND DRAWING INDEX
3	S-151	FRAMING PLAN
4	A-101	RCP DEMOLITION - 1ST FLOOR
5	A-102	FLOOR PLAN DEMOLITION - 2ND & 3RD FLOORS
6	A-103	RCP RENOVATION — 1ST FLOOR
7	A-104	FLOOR PLAN RENOVATION - 2ND & 3RD FLOORS
8	A-201	ARCHITECTURAL ELEVATIONS
9	A-401	WINDOW SCHEDULE - DEMOLITION
10	A-402	WINDOW & ACCESS PANEL SCHEDULE
11	A-501	ARCHITECTURAL DETAILS
12	F-101	FIRE PROTECTION PLAN - 1ST FLOOR
13	P-101	PLUMBING PLAN - 3RD FLOOR
14	M - 101	MECHANICAL DEMOLITION PLAN - 1ST FLOOR
15	M-102	MECHANICAL DEMOLITION PLAN - 2ND & 3RD FLOORS
16	M-103	MECHANICAL DEMOLITION PLAN - ROOF
17	M - 104	MECHANICAL RENOVATION PLAN - PARTIAL 1ST FLOOR
18	M - 105	MECHANICAL RENOVATION PLAN — PARTIAL 1ST FLOOR
19	M - 106	MECHANICAL RENOVATION PLAN - 2ND & 3RD FLOORS
20	M - 107	MECHANICAL RENOVATION PLAN - ROOF
21	M - 601	MECHANICAL DETAILS AND SCHEDULES
22	M-602	MECHANICAL DETAILS AND CONTROLS DIAGRAMS
23	E-101	FIRST FLOOR ELECTRICAL DEMOLITION PLAN
24	E-102	FIRST FLOOR ELECTRICAL RENOVATION PLAN
25	E-103	SECOND AND THIRD FLOOR ELECTRICAL RENOVATION PLAN
26	E-104	ROOF ELECTRICAL POWER RENOVATION PLAN
27	E-501	ELECTRICAL RISER DETAIL
28	E-601	ELECTRICAL PANEL SCHEDULES

- MEXICO VETERANS HOME

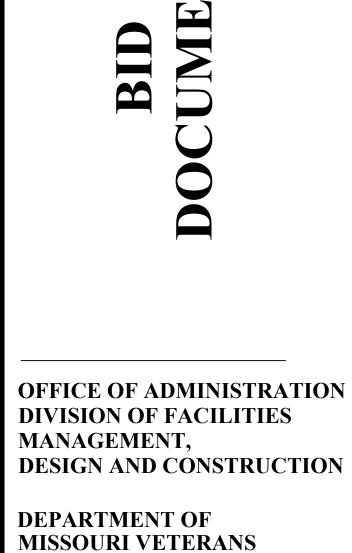

STATE OF MISSOURI

TRACIE L.

SIEBENECK

NUMBER PE-2013019114

Tracie L. Siebeneck - Engineer MO# PE-2013019114

GOVERNOR

MICHAEL L. PARSON,

HVAC IMPROVEMENTS FOR INFECTION CONTROL

MEXICO VETERANS HOME 1 VETERANS DR MEXICO, MO 65265

COMMISSION

PROJECT # U2301-03 SITE # 6802 ASSET # 8136802001

REVISION:
DATE:
REVISION:
DATE:
REVISION:
DATE:
REVISION:
DATE:
ISSUE DATE: 04/11/2024

CAD DWG FILE:M-U2301-

CAD DWG FILE:M-U2301-03
DRAWN BY: TS/AH
CHECKED BY: TS
DESIGNED BY: TS/AH

SHEET TITLE:

GENERAL NOTES
AND DRAWING
INDEX


SHEET NUMBER:


G-00

2 OF 28 SHEETS

4/11/2024

3 BUILDING LOCATION MAP

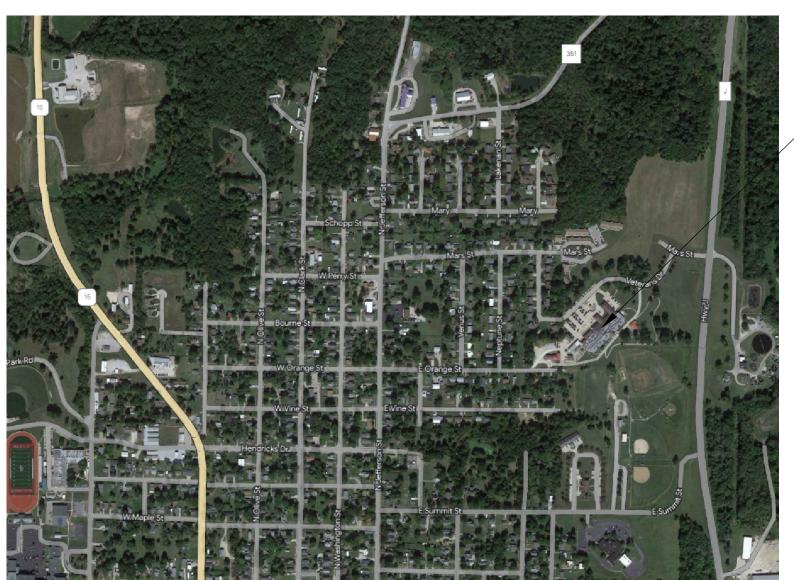


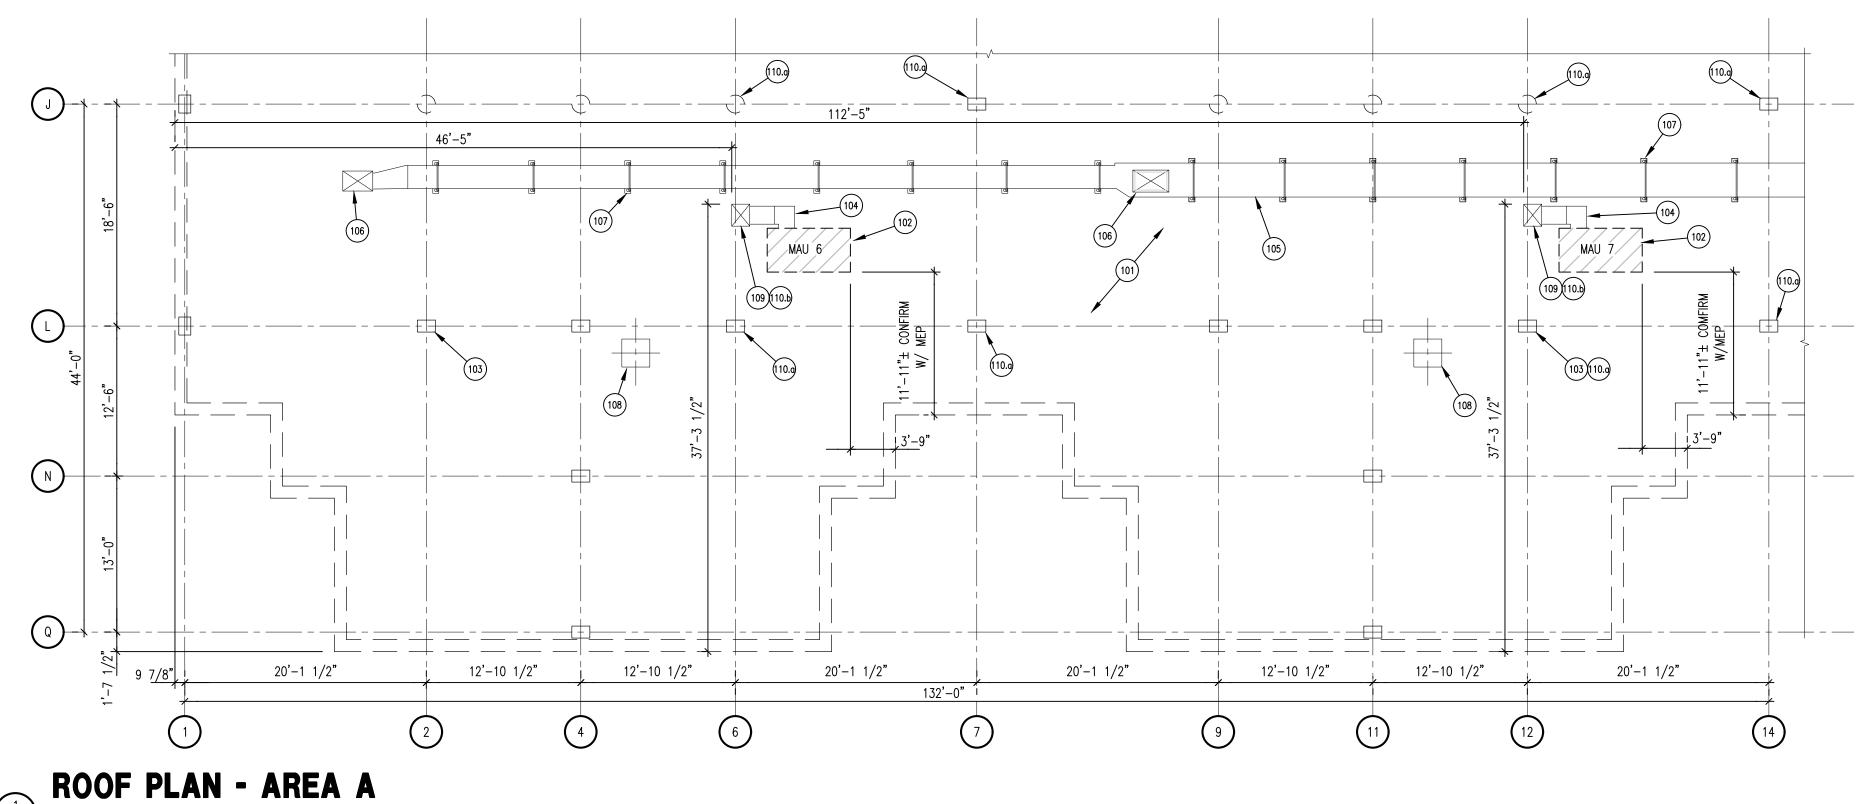

1 (5-151)

1/8" = 1'-0'

THE GC SHALL EXERCISE CAUTION WHEN INSTALLING ANCHORS IN REINFORCED CONCRETE STRUCTURAL ELEMENTS (I.E., FLOOR SLABS, BEAMS, COLUMNS, ETC.) ALL POST—INSTALLED ANCHORS SHALL BE PLACED A MINIMUM OF 1 1/2" AWAY FROM ANY EXISTING REINFORCING BARS. THE GC SHALL DETECT AND VERIFY THE LOCATIONS OF REINFORCEMENT BEFORE ANCHOR INSTALLATION USING GROUND PENETRATING RADAR (GPR) OR OTHER APPROVED NON—DESTRUCTIVE METHODS.

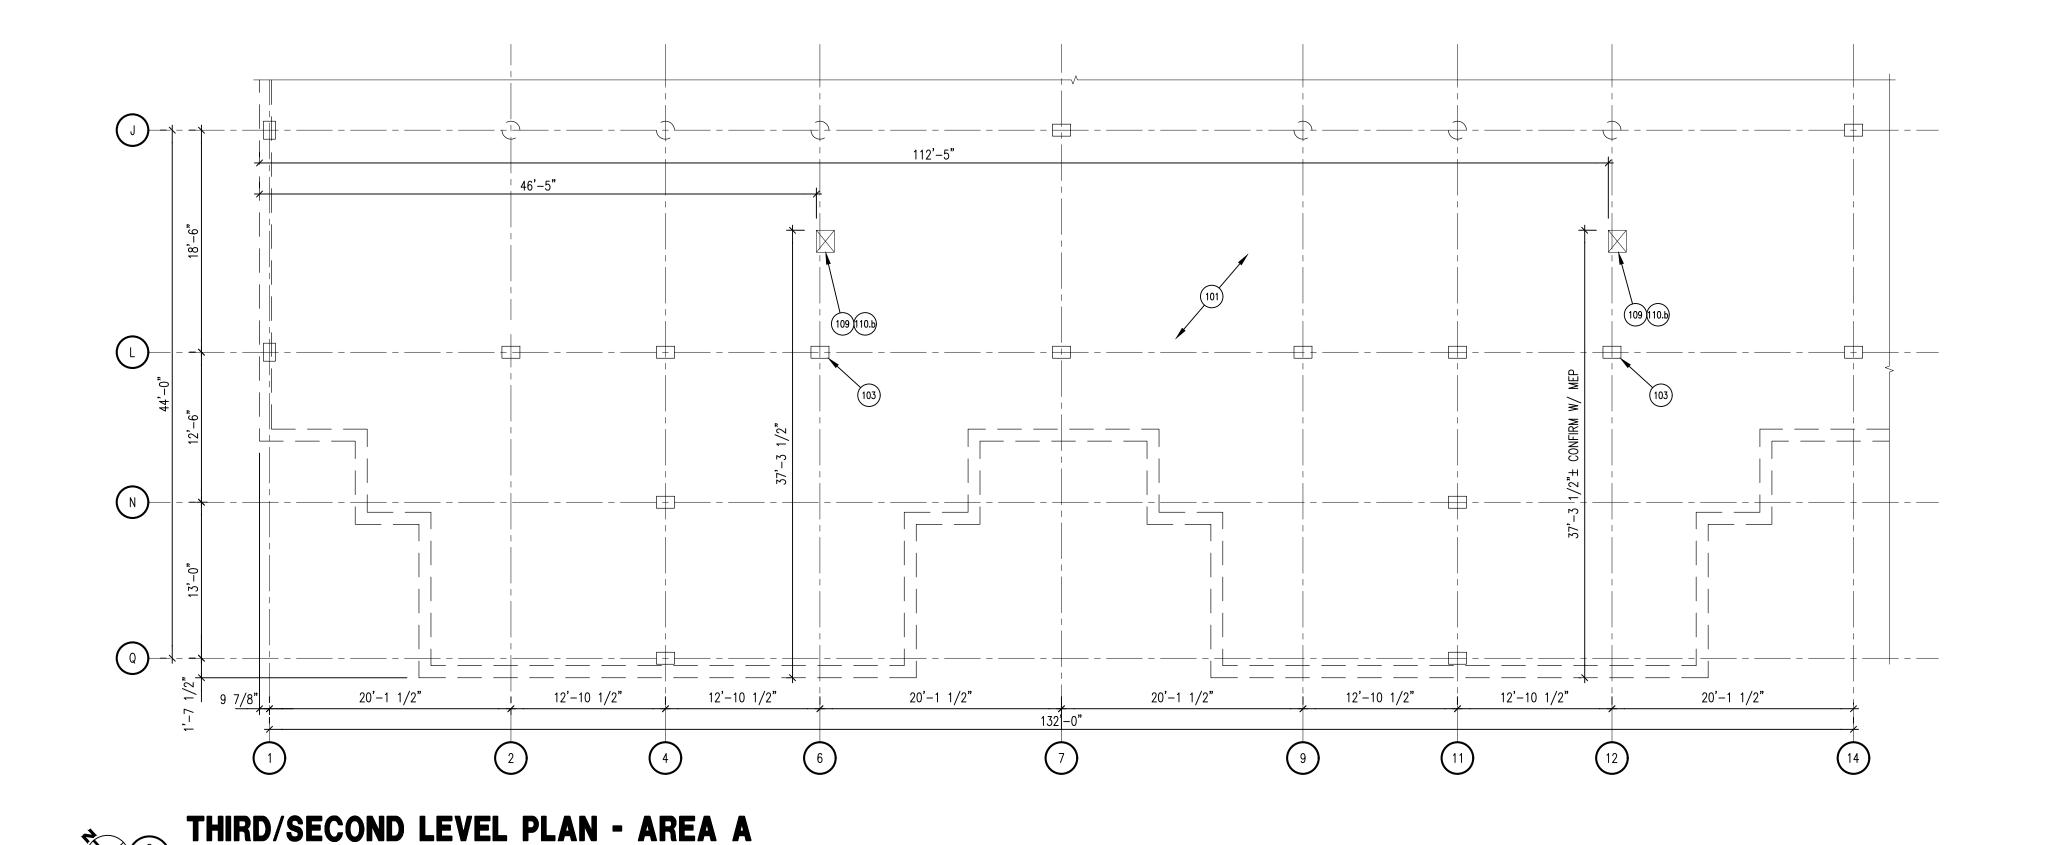

GENERAL NOTES


- 1. THESE NOTES AND KEYNOTES ON THIS SHEET APPLY TO ALL STRUCTURAL ELEMENTS.
- STRUCTURAL DESIGN NOTES AND CRITERIA
 a. SEE BUILDING PLANS DATED 11/15/82 FOR DESIGN ROOF LIVE AND SNOW LOADING AND FLOOR LIVE AND PARTITION LOADS
 b. ROOF DEAD LOAD = 10 PSF + ROOF SLAB SELF-WEIGHT
 c. FLOOR DEAD LOAD = 15 PSF + FLOOR SLAB SELF-WEIGHT
- 3. TAPERED ROOF INSULATION SHOULD BE INSTALLED AS REQUIRED TO PROVIDE POSITIVE DRAINAGE AND PREVENT WATER PONDING AT NEW RTU LOCATIONS.
- . ROOF MAUS AND ROOF/FLOOR SLAB OPENINGS ARE SHOWN FOR REFERENCE. CONTRACTOR SHALL CONFIRM LOCATIONS WITH MEP PLANS, REPORT DISCREPANCIES TO ENGINEER BEFORE EXECUTING WORK.
- 5. MECH UNIT SIZE, WEIGHT, AND LOCATION SHALL BE VERIFIED BY MECHANICAL PLANS AND GENERAL CONTRACTOR.
- 6. CONTRACTOR SHALL SUBMIT THE FOLLOWING TO ENGINEER:
 a. UTILIZING GPR OR OTHER APPROVED METHODS, A LOG OF THE REINFORCING QUANTITY AND DEPTH AT THE COLUMN LOCATIONS AS DEFINED ON THE PLANS. CLEARLY LABEL LOCATION, NUMBER OF REINFORCING BARS, AND DEPTH AT EACH REQUESTED LOCATION. (8 LOCATIONS TOTAL AT ROOF)
 b. UTILIZING GPR OR OTHER APPROVED METHODS, A LOG OF THE SLAB REINFORCING BARS TO BE INTERRUPTED IN EACH ORTHOGONALLY HORIZONTAL DIRECTION AT EACH OF THE PROPOSED SLAB OPENINGS. (2 LOCATIONS AT EACH OF ROOF 3RD FLOOR AND 2ND FLOOR).
- 7. SELECT EXISTING ROOF/FLOOR OPENINGS/MECHANICAL UNITS/DUCTS/ETC. ARE SHOWN HEREIN FOR REFERENCE. CONTRACTOR SHALL VERIFY SIZE/LOCATION OF EXISTING ITEMS, AS REQUIRED, TO COMPLETE WORK.
- 8. OWNER IS RESPONSIBLE FOR ANY ADDITIONAL DESIGN CALCULATIONS REQUIRED DUE TO UNFORESEEN DIFFERENCES IN THE NUMBER OR DEPTH OF REINFORCING BARS. CONTRACTOR IS RESPONSIBLE FOR ANY ADDITIONAL DESIGN CALCULATION REQUIRED DUE TO EQUIPMENT SUBSTITUTION THAT IS LARGER OR WEIGHS MORE THAN BASIS OF DESIGN EQUIPMENT.

KEYED NOTES

- 101. EXISTING ROOF/FLOOR, 7" FLAT CONCRETE SLAB.
- 102. NEW MAU'S 6 & 7 = 1,614 LB. OUTSIDE CURB DIMENSIONS = 44"x82". SIZE, WEIGHT AND LOCATION SHALL BE VERIFIED BY MECHANICAL PLANS AND GENERAL CONTRACTOR, NOTIFY ENGINEER OF ANY DISCREPANCIES.
- 103. EXISTING CONCRETE COLUMN, TYPICAL. VERIFY-IN-FIELD COLUMN SIZE AND
- LOCATION. <u>DO NOT PLACE PENETRATION WITHIN 5' OF COL TYP.</u>

 104. PROPOSED DUCT, SEE MEP FOR SIZE AND LOCATION.
- 105. EXISTING DUCT.
- 106. EXISTING ROOF SLAB PENETRATION.
- 107. EXISTING DUCT SUPPORT FRAME TYPICAL.
- 108. EXISTING EXHAUST FAN.
- 109. PROPOSED ROOF/FLOOR SLAB PENETRATION, SEE MEP FOR SIZE AND LOCATION, MAX ALLOWABLE PENETRATION IS 22"x18", NOTIFY ENGINEER OF ANY DISCREPANCIES.
- 110. USING NON-DESTRUCTIVE METHODS, CONTRACTOR SHALL:
- a. COLUMNS: UTILIZING GPR OR OTHER APPROVED METHODS DETERMINE QUANTITY AND DEPTH WITHIN SLAB OF REINFORCING BARS IN EACH DIRECTION TO A DISTANCE 5'-O" FROM CENTER OF COLUMN. REPORT QUANTITY AND DEPTH TO ENGINEER. ADDITIONAL CALCULATIONS MAY BE REQUIRED IF DEPTH
- OF REINFORCING DOES NOT COINCIDE WITH PLANS.

 b. PROPOSED SLAB OPENINGS: UTILIZING GPR OR OTHER APPROVED METHODS DETERMINE QUANTITY AND DEPTH OF SLAB REINFORCING BARS IN EACH DIRECTION TO BE INTERRUPTED BY OPENINGS. REPORT QUANTITY TO ENGINEER. CONTRACTOR SHALL NOT PLACE PROPOSED OPENINGS IN SLAB(S) UNTIL NUMBER OF REINFORCING BARS, TO BE INTERRUPTED BY OPENINGS, ARE DETERMINED, REPORTED TO, AND APPROVED BY ENGINEER. ADDITIONAL CALCULATIONS MAY BE REQUIRED.

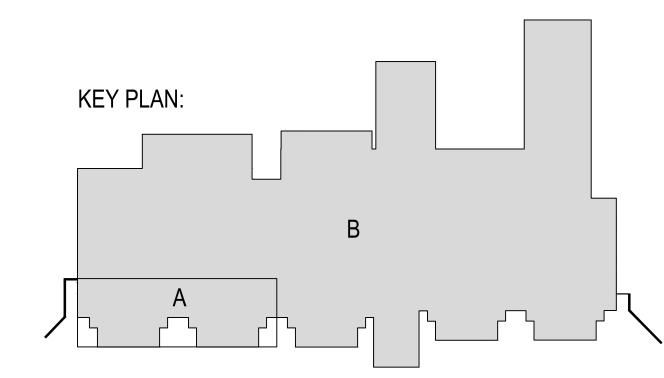

STATE OF MISSOURI MICHAEL L. PARSON, GOVERNOR



04/11/2024 JASON KLEMME - ENGINEER MO # 2016017643



3312 LEMONE INDUSTRIAL BLVD.
COLUMBIA, MO 65201
(573) 875-8799

P.O. BOX 156, 30601 HIGHWAY 5 MARCELINE, MO 64658 (660) 376-2941

410 SE THIRD ST., SUITE 103C LEE'S SUMMIT, MO 64063 (816) 895-2310

OFFICE OF ADMINISTRATION DIVISION OF FACILITIES MANAGEMENT, DESIGN AND CONSTRUCTION

DEPARTMENT OF MISSOURI VETERANS COMMISSION

HVAC IMPROVEMENTS FOR INFECTION CONTROL

MEXICO VETERANS HOME 1 VETERANS DR MEXICO, MO 65265

PROJECT # U2301-03 SITE # 6802 ASSET # 8136802001

REVISION:
DATE:
REVISION:
DATE:
REVISION:
DATE:
REVISION:
DATE:
ISSUE DATE: 04/11/2024

MEXICO VETERANS
CAD DWG FILE: HOME-S-S151
DRAWN BY: jpk
CHECKED BY: brh
DESIGNED BY: jpk

SHEET TITLE:

FRAMING PLAN

SHEET NUMBER:

S-151

SYMBOL LEG	END
W->	WINDOW SCHEDULE REFERENCE
<u>_</u>	DEMOLITION KEYNOTE
SD	SMOKE DETECTOR
	PENDANT FIRE SPRINKLER HEAD
	ACCESS PANEL - TO BE REMOVED
	CURTAIN TRACK - TO BE REMOVED
	CEILING GRID - TO BE REMOVED
	AREA OF WORK BOUNDARY
	GYPSUM CEILING TO BE REMOVED

	GENERAL NOTES:
1.	CONTRACTOR SHALL VERIFY ALL DIMENSIONS AND EXISTING CONDITIONS.
2.	CONTRACTOR SHALL USE CARE DURING CONSTRUCTION SO AS NOT TO DAMAGE EXISTING ADJACENT FINISHES AND EXISTING CONDITIONS NOT INCLUDED IN SCOPE OF WORK.

3. CONTRACTOR SHALL REMOVE ALL TRASH AND DEBRIS FROM SITE ON A DAILY BASIS. COORDINATE DUMPSTER/ DUMP TRUCK LOCATION AND ACCESS WITH THE OWNER.

4. CONTRACTOR IS RESPONSIBLE FOR WATER TIGHTENING THE PROPERTY AT THE END OF EACH DAY REGARDLESS OF THE WEATHER FORECAST.

5. CONTRACTOR IS RESPONSIBLE FOR SITE SECURITY AT ANY BUILDING OPENINGS UNDER CONSTRUCTION AND SHALL ENSURE THE LOCKED SECURE CLOSURE AT THE END OF EACH WORKING DAY.

REMOVED FOR THE EXECUTION OF THE PROJECT SHALL BE LEFT IN PLACE AND PROTECTED FROM DAMAGE DURING CONSTRUCTION.

6. ALL MATERIALS AND EQUIPMENT NOT REQUIRED TO BE


7. ALL REMOVED AND SALVAGED MATERIALS IN LIKE-NEW

CONDITION SHALL BE OFFERED TO OWNER FOR REUSE.

DEMOLITION KEYNOTES:

- REMOVE EXISTING ACOUSTIC CEILING TILES AND SUSPENDED GRID SYSTEM TO EXTENTS SHOWN. RELINQUISH FULL AND UNDAMAGED ACOUSTIC CEILING TILES TO OWNER.
- 2 EXISTING DRYWALL AND STEEL STUD SOFFIT TO BE REMOVED UP TO CONCRETE STRUCTURE SLAB ABOVE. ATTACHED LIGHT FIXTURES AND SPRINKLER HEADS TO BE REMOVED IN COORDINATION WITH MEP DRAWINGS.
- 3 EXISTING WINDOW COVE DRYWALL AND FRAMING TO BE REMOVED UP TO CONCRETE STRUCTURE SLAB ABOVE.
- 4 WINDOW TO BE MODIFIED. SELECTIVELY REMOVE WINDOWS/TRANSOMS AS NOTED ON A-401 TO ROUGH OPENING. FIELD VERIFY ROUGH OPENING PRIOR TO MATERIAL PROCUREMENT. SEE A-401 FOR INDIVIDUAL MODIFICATIONS PER LOCATION. ATTACHED WINDOW TREATMENTS TO BE REMOVED AND RELINQUISHED TO OWNER FOR DISPOSAL.
- 5 REMOVE EXISTING CURTAIN TRACK, WOOD BLOCKING, AND ATTACHED CURTAINS, AND RELINQUISH TO OWNER.
- 6 EXISTING SOFFIT TO REMAIN IN PLACE. PROTECT FROM DAMAGE DURING CONSTRUCTION.
- 7 EXISTING WALL MOUNTED LIGHT FIXTURE TO BE REMOVED. REFER TO MEP DRAWINGS.
- 8 EXISTING ACCESS PANEL TO BE REMOVED AND RELINQUISHED TO OWNER FOR DISPOSAL. CONTRACTOR TO NOTE THE SIZE AND LOCATION TO COORDINATE WITH THE NEW ACCESS PANELS TO BE INSTALLED.
- 9 CONTRACTOR TO VERIFY AND NOTE EXISTING CEILING HEIGHT FOR NEW CEILING TO BE INSTALLED AT SAME HEIGHT.
- COORDINATE POTENTIAL REMOVAL OF EXISTING CEILING AS NEEDED; REFER TO MECHANICAL DRAWINGS AND SUBSEQUENT MEANS AND METHODS DETERMINED BY INSTALLING CONTRACTOR.


UNIT #2 UNIT #1 AREA OF WORK AREA OF WORK BOUNDARY BOUNDARY 7"-8" AFF ↑7'-9" AFF 7'-8" AFF $\langle W1 \rangle$ $\langle 4 \rangle$ $\sqrt{8}$

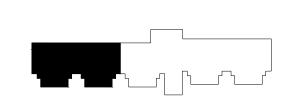



2 KEYPLAN - 1ST FLOOR SCALE: NTS

STATE OF MISSOURI MICHAEL L. PARSON, GOVERNOR

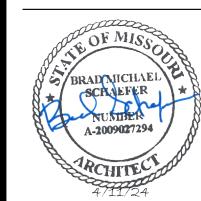

Brad M. Schaefer - Architect MO# A-2009027294

DOCUMENTS

OFFICE OF ADMINISTRATION DIVISION OF FACILITIES MANAGEMENT, DESIGN AND CONSTRUCTION

DEPARTMENT OF MISSOURI VETERANS COMMISSION

HVAC IMPROVEMENTS FOR INFECTION CONTROL

MEXICO VETERANS HOME 1 VETERANS DR MEXICO, MO 65265

PROJECT # U2301-03 SITE # 6802 ASSET # 8136802001

REVISION:
DATE:
REVISION:
DATE:
REVISION:
DATE:
DATE:

CAD DWG FILE: A-U2301-03
DRAWN BY: CL
CHECKED BY: BS


DESIGNED BY: C


SHEET TITLE:

RCP DEMOLITION -1ST FLOOR

SHEET NUMBER:

A-101

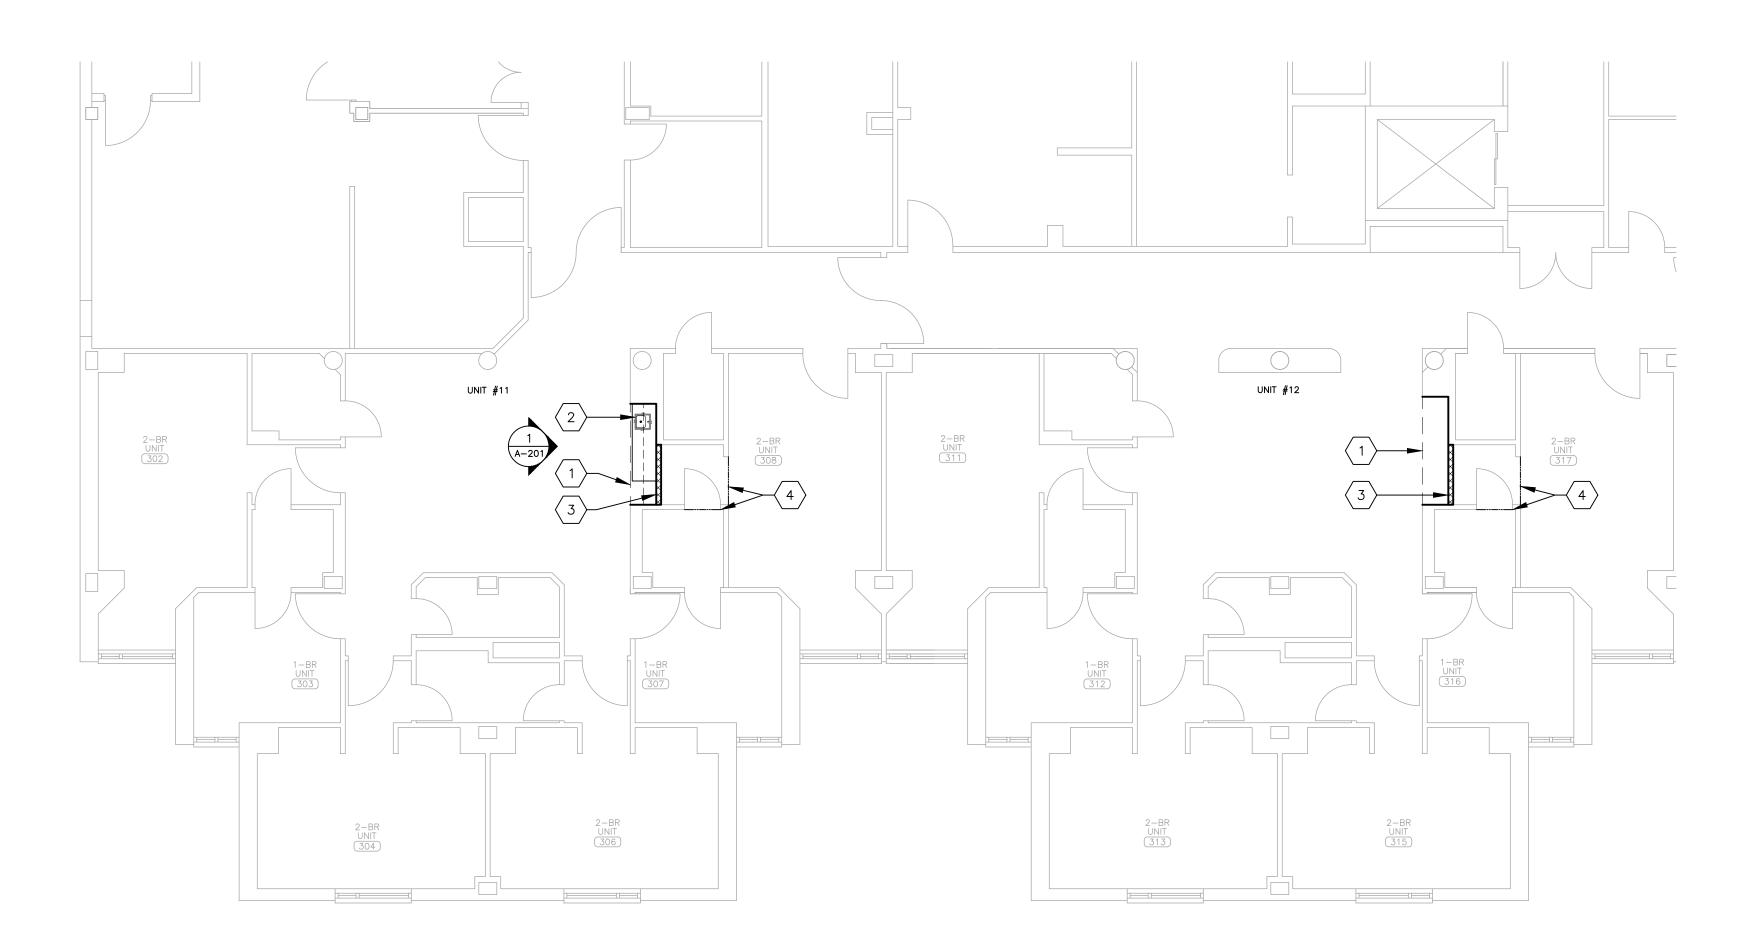

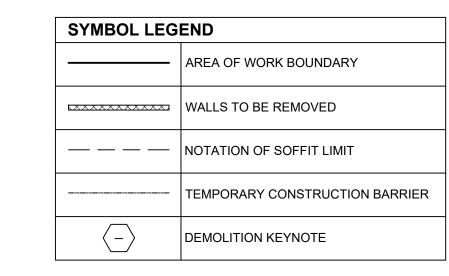


GENERAL NOTES:

- CONTRACTOR SHALL VERIFY ALL DIMENSIONS AND EXISTING CONDITIONS.
- CONTRACTOR SHALL USE CARE DURING CONSTRUCTION SO AS NOT TO DAMAGE EXISTING ADJACENT FINISHES AND EXISTING CONDITIONS NOT INCLUDED IN SCOPE OF WORK.
- CONTRACTOR SHALL REMOVE ALL TRASH AND DEBRIS FROM SITE ON A DAILY BASIS. COORDINATE DUMPSTER/ DUMP TRUCK LOCATION AND ACCESS WITH THE OWNER.
- CONTRACTOR IS RESPONSIBLE FOR WATER TIGHTENING THE PROPERTY AT THE END OF EACH DAY REGARDLESS OF THE WEATHER FORECAST.
- CONTRACTOR IS RESPONSIBLE FOR SITE SECURITY AT ANY BUILDING OPENINGS UNDER CONSTRUCTION AND SHALL ENSURE THE LOCKED SECURE CLOSURE AT THE END OF EACH WORKING DAY.
- ALL MATERIALS AND EQUIPMENT NOT REQUIRED TO BE REMOVED FOR THE EXECUTION OF THE PROJECT SHALL BE LEFT IN PLACE AND PROTECTED FROM DAMAGE DURING CONSTRUCTION.
- ALL REMOVED AND SALVAGED MATERIALS IN LIKE-NEW CONDITION SHALL BE OFFERED TO OWNER FOR REUSE.

EXISTING ALCOVE WALLS AND SOFFIT TO BE MODIFIED. REFER TO A-501 AND A-201 FOR DETAILS.

DEMOLITION KEYNOTES:

- 2 REMOVE EXISTING CABINETRY AND SINK ASSEMBLY. OFFER TO OWNER FOR REUSE.
- $\langle 3 \rangle$ EXISTING WALL TO BE REMOVED TO EXTENTS SHOWN.
- 4 > TEMPORARY CONSTRUCTION BARRIER TO BE INSTALLED DURING DEMOLITION AND CONSTRUCTION FOR THE SAFETY OF RESIDENTS. COORDINATE WITH OWNER FOR OPTIMAL LOCATION OF BARRIER. CONTRACTOR TO SUBMIT A SAFETY BARRIER PLAN.

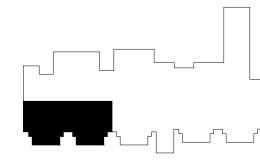

UNIT #7

2-BR UNIT 213

3 KEYPLAN - 2ND FLOOR SCALE: NTS

STATE OF MISSOURI MICHAEL L. PARSON, **GOVERNOR**



Brad M. Schaefer - Architect MO# A-2009027294

OFFICE OF ADMINISTRATION **DIVISION OF FACILITIES** MANAGEMENT, **DESIGN AND CONSTRUCTION**

DEPARTMENT OF MISSOURI VETERANS **COMMISSION**

HVAC IMPROVEMENTS FOR INFECTION CONTROL

MEXICO VETERANS HOME 1 VETERANS DR MEXICO, MO 65265

PROJECT # U2301-03 6802 8136802001 ASSET#

REVISION: DATE: **REVISION:** DATE: **REVISION:** DATE:

ISSUE DATE: 04/11/2024

CAD DWG FILE: A-U2301-03
DRAWN BY: CL
CHECKED BY: BS DESIGNED BY: C

SHEET TITLE:

FLOOR PLAN **DEMOLITION** -2ND & 3RD FLOORS

SHEET NUMBER:

5 OF 28 SHEETS 4/11/2024



2 FLOOR PLAN DEMOLITION — 3RD FLOOR SCALE: 1/8 = 1'-0"

2-BR UNIT 202

UNIT #6


2-BR UNIT (206)

GENERAL NOTES:


- CONTRACTOR SHALL VERIFY ALL DIMENSIONS AND EXISTING CONDITIONS.
- CONTRACTOR SHALL USE CARE DURING CONSTRUCTION SO AS NOT TO DAMAGE EXISTING ADJACENT FINISHES AND EXISTING CONDITIONS NOT INCLUDED IN SCOPE OF WORK.
- 3. CONTRACTOR SHALL REMOVE ALL TRASH AND DEBRIS FROM SITE ON A DAILY BASIS. COORDINATE DUMPSTER/ DUMP TRUCK LOCATION AND ACCESS WITH THE OWNER.
- CONTRACTOR IS RESPONSIBLE FOR WATER TIGHTENING THE PROPERTY AT THE END OF EACH DAY REGARDLESS OF THE WEATHER FORECAST.
- 5. CONTRACTOR IS RESPONSIBLE FOR SITE SECURITY AT ANY BUILDING OPENINGS UNDER CONSTRUCTION AND SHALL ENSURE THE LOCKED SECURE CLOSURE AT THE END OF EACH WORKING DAY.
- 6. ALL MATERIALS AND EQUIPMENT NOT REQUIRED TO BE REMOVED FOR THE EXECUTION OF THE PROJECT SHALL BE LEFT IN PLACE AND PROTECTED FROM DAMAGE DURING CONSTRUCTION.
- ALL REMOVED AND SALVAGED MATERIALS IN LIKE-NEW CONDITION SHALL BE OFFERED TO OWNER FOR REUSE.

RENOVATION KEYNOTES:

- INSTALL NEW SUSPENSION SYSTEM CEILING GRID WITH 2'x4'
 LAY-IN ACOUSTIC CEILING TILE TO EXTENTS SHOWN BY GRID.
 REFER TO A-501 FOR DETAILS.
- 2 INSTALL NEW SOFFIT WITH 2'x4' LAY-IN ACOUSTIC CEILING TILE AND SUSPENSION GRID TO EXTENTS SHOWN BY GRID. SEE A-501 FOR DETAILS.
- WINDOW TO BE MODIFIED. REFER TO A-402 FOR MODIFICATION DETAILS. INSTALL NEW WINDOW TREATMENT AS SPECIFIED.
- 4 INSTALL NEW CURTAIN TRACK AS SPECIFIED TO LOCATION SHOWN.
- 5 PATCH, SEAL, AND PAINT APPROPRIATE MATERIALS AS NEEDED FOR WORK COORDINATED ON MECHANICAL DRAWINGS USING LIKE EXISTING FINISHES APPROPRIATE FOR MOISTURE EXPOSURE IN SHOWER ROOM.
- ALL WALL PENETRATIONS ABOVE OR ADJACENT TO DROP CEILING NEED TO BE AIRTIGHT TO ACCOMMODATE HVAC SYSTEM REQUIREMENTS. REFER TO MEP DRAWINGS.
- 7 INSTALL NEW 1/2" GYPSUM BOARD CEILING TO EXTENTS SHOWN.
- 8 INSTALL NEW STEEL STUDS SOFFIT WITH 1/2" GYPSUM BOARD. SEE A-501 FOR DETAILS.
- GENERAL CONTRACTOR SHALL PROVIDE AND INSTALL
 AIRTIGHT/WATERTIGHT ACCESS DOOR FOR ACCESS TO
 EXISTING BALANCE DAMPERS. COORDINATE WITH MECHANICAL
 CONTRACTOR TO PROVIDE FINAL ACCESS DOOR LOCATION TO
 ALLOW FOR OPTIMAL ACCESS TO DAMPER. REFER TO ACCESS
 PANEL SCHEDULE PART AD-1 ON SHEET A-402.
- GENERAL CONTRACTOR SHALL PROVIDE AND INSTALL
 AIRTIGHT/WATERTIGHT ACCESS DOOR IN THE SAME LOCATION
 AND THE SAME SIZE AS THE CORRESPONDING REMOVED
 EXISTING ACCESS PANELS. REFER TO ACCESS PANEL
 SCHEDULE PART AD-1 ON SHEET A-402.
- NEW 1/2" GYPSUM BOARD CEILING TO BE INSTALLED AT SAME HEIGHT AS PREVIOUSLY REMOVED CEILING TILES WITHIN THE ROOM, TO ACCOMMODATE THE SAME LOCATION OF FIRE SPRINKLER HEAD.

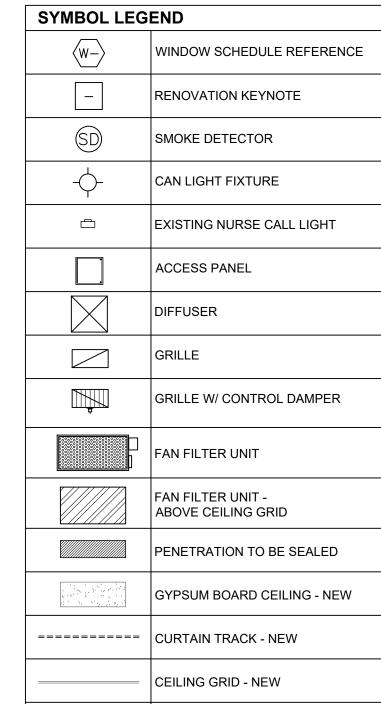

AREA OF WORK BOUNDARY

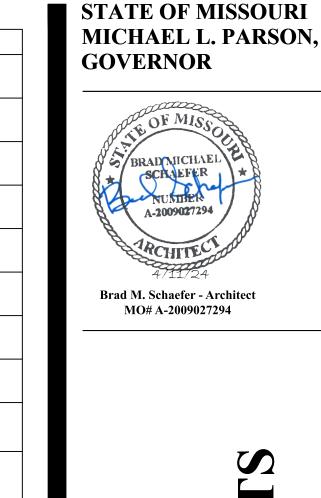

DOCUMENTS

OFFICE OF ADMINISTRATION DIVISION OF FACILITIES MANAGEMENT, DESIGN AND CONSTRUCTION

DEPARTMENT OF MISSOURI VETERANS COMMISSION

HVAC IMPROVEMENTS FOR INFECTION CONTROL

MEXICO VETERANS HOME 1 VETERANS DR MEXICO, MO 65265

PROJECT # U2301-03 SITE # 6802 ASSET # 8136802001

REVISION:
DATE:
REVISION:
DATE:
REVISION:
DATE:
DATE:

ISSUE DATE: 04/11/2024


CAD DWG FILE: A-U2301-03
DRAWN BY: CL
CHECKED BY: BS
DESIGNED BY: CL


SHEET TITLE:


RCP RENOVATION -1ST FLOOR

SHEET NUMBER:

A-103

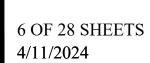

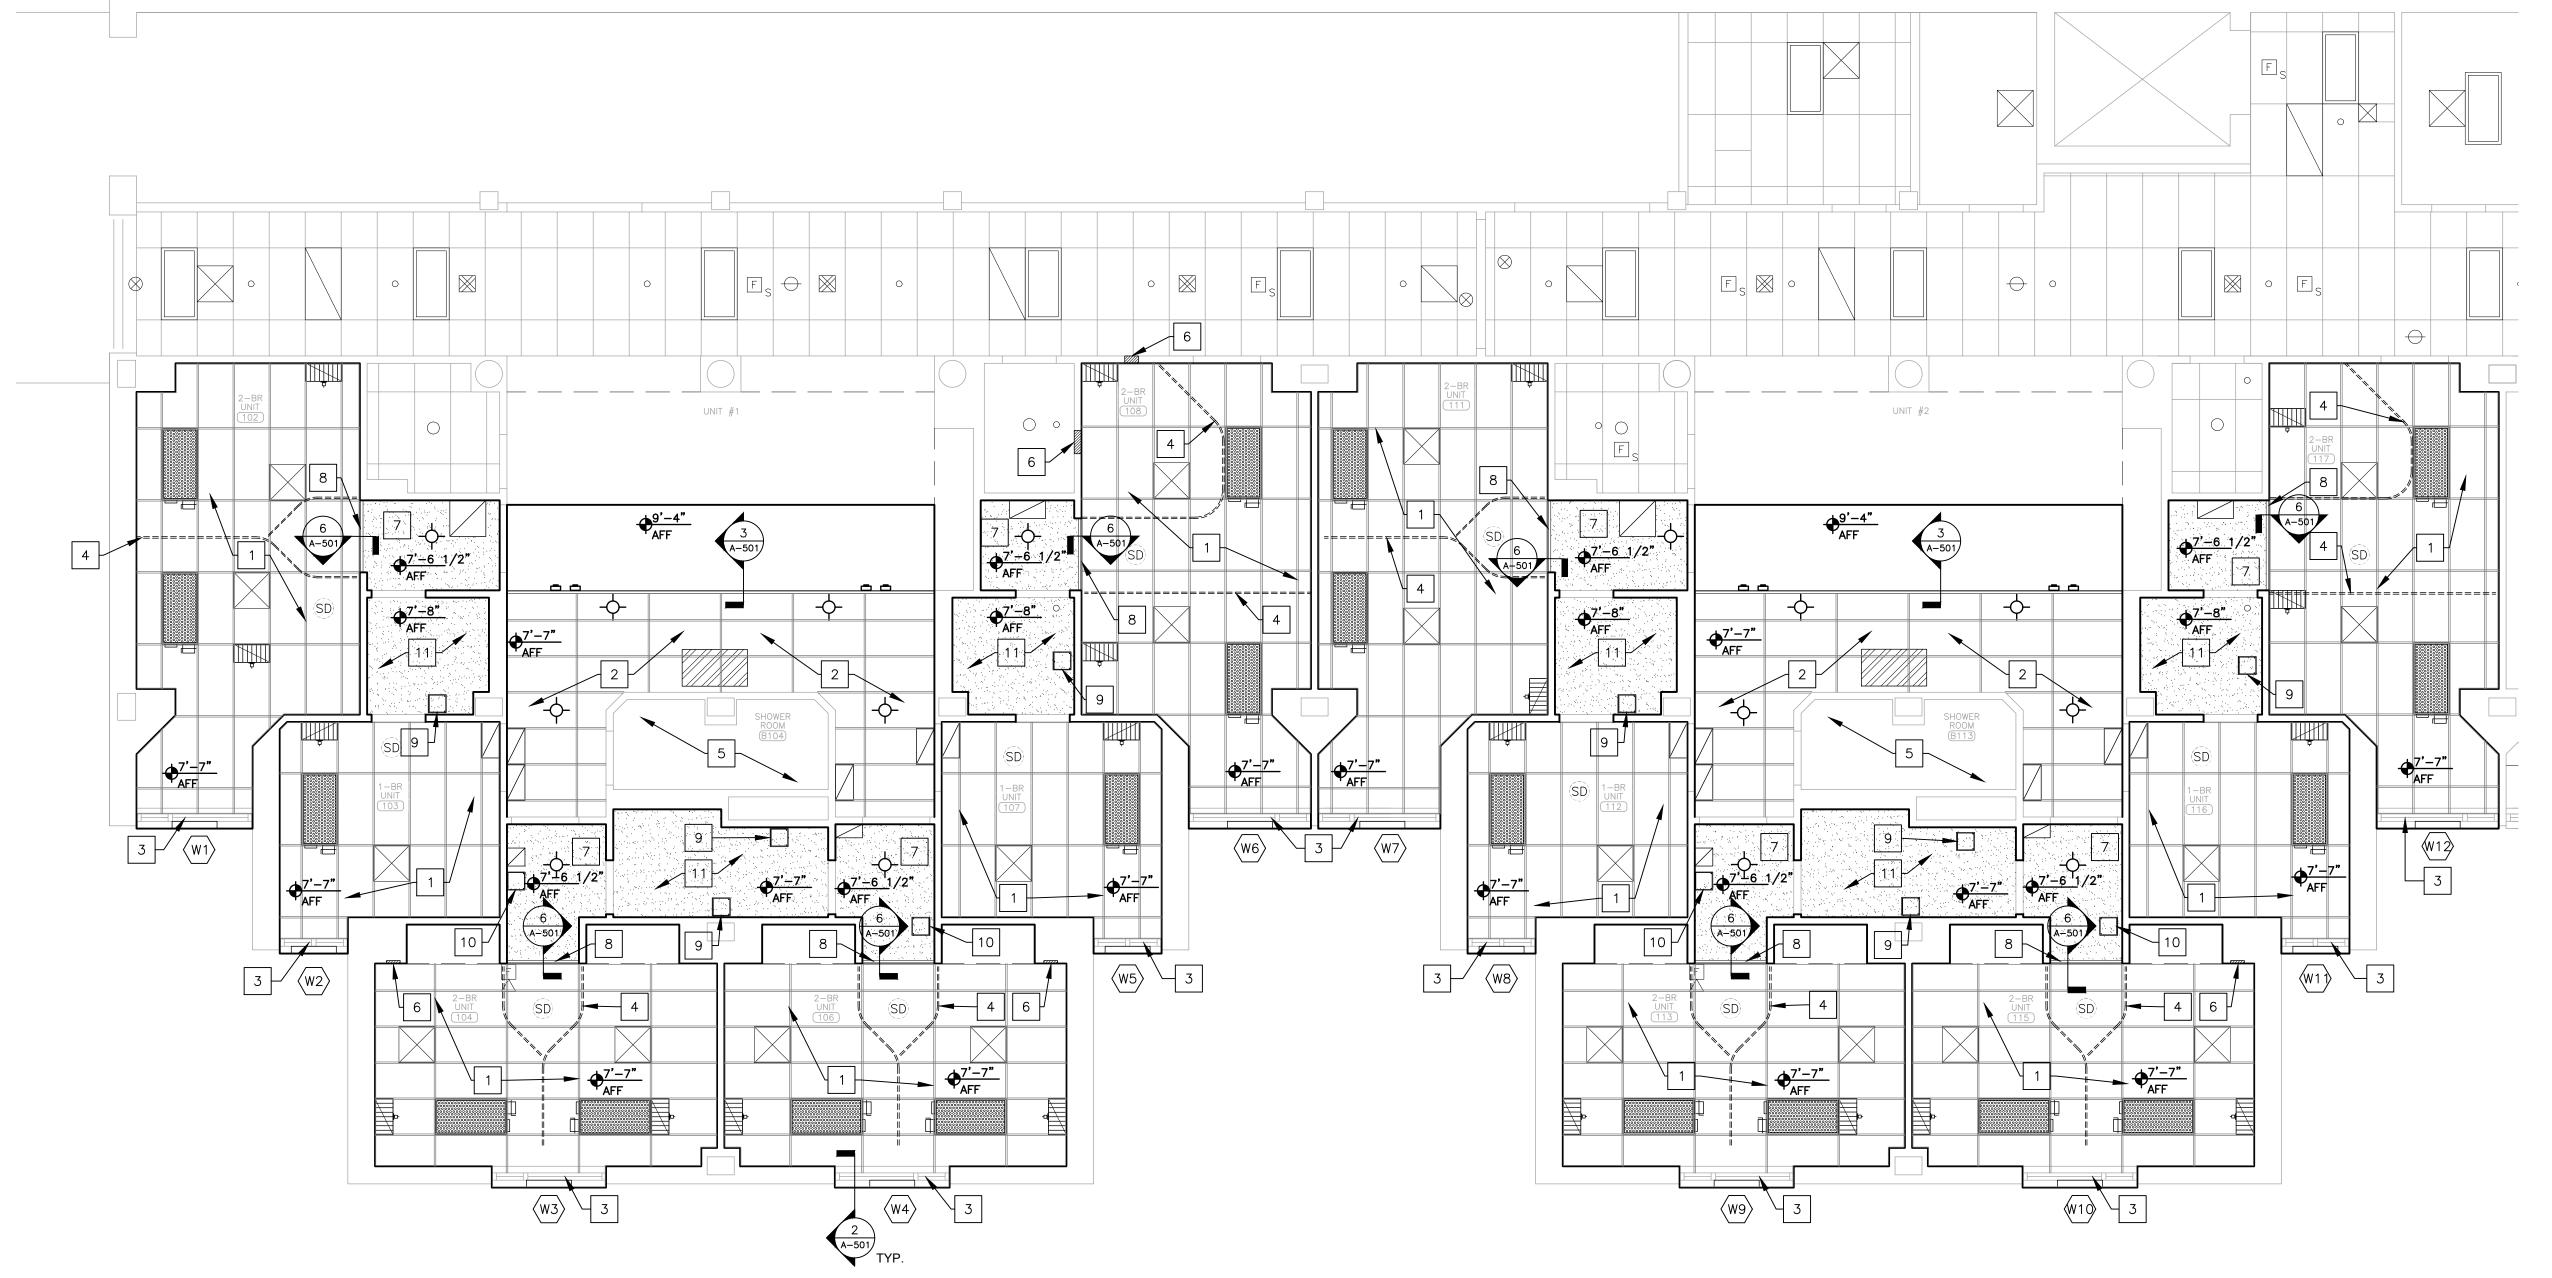

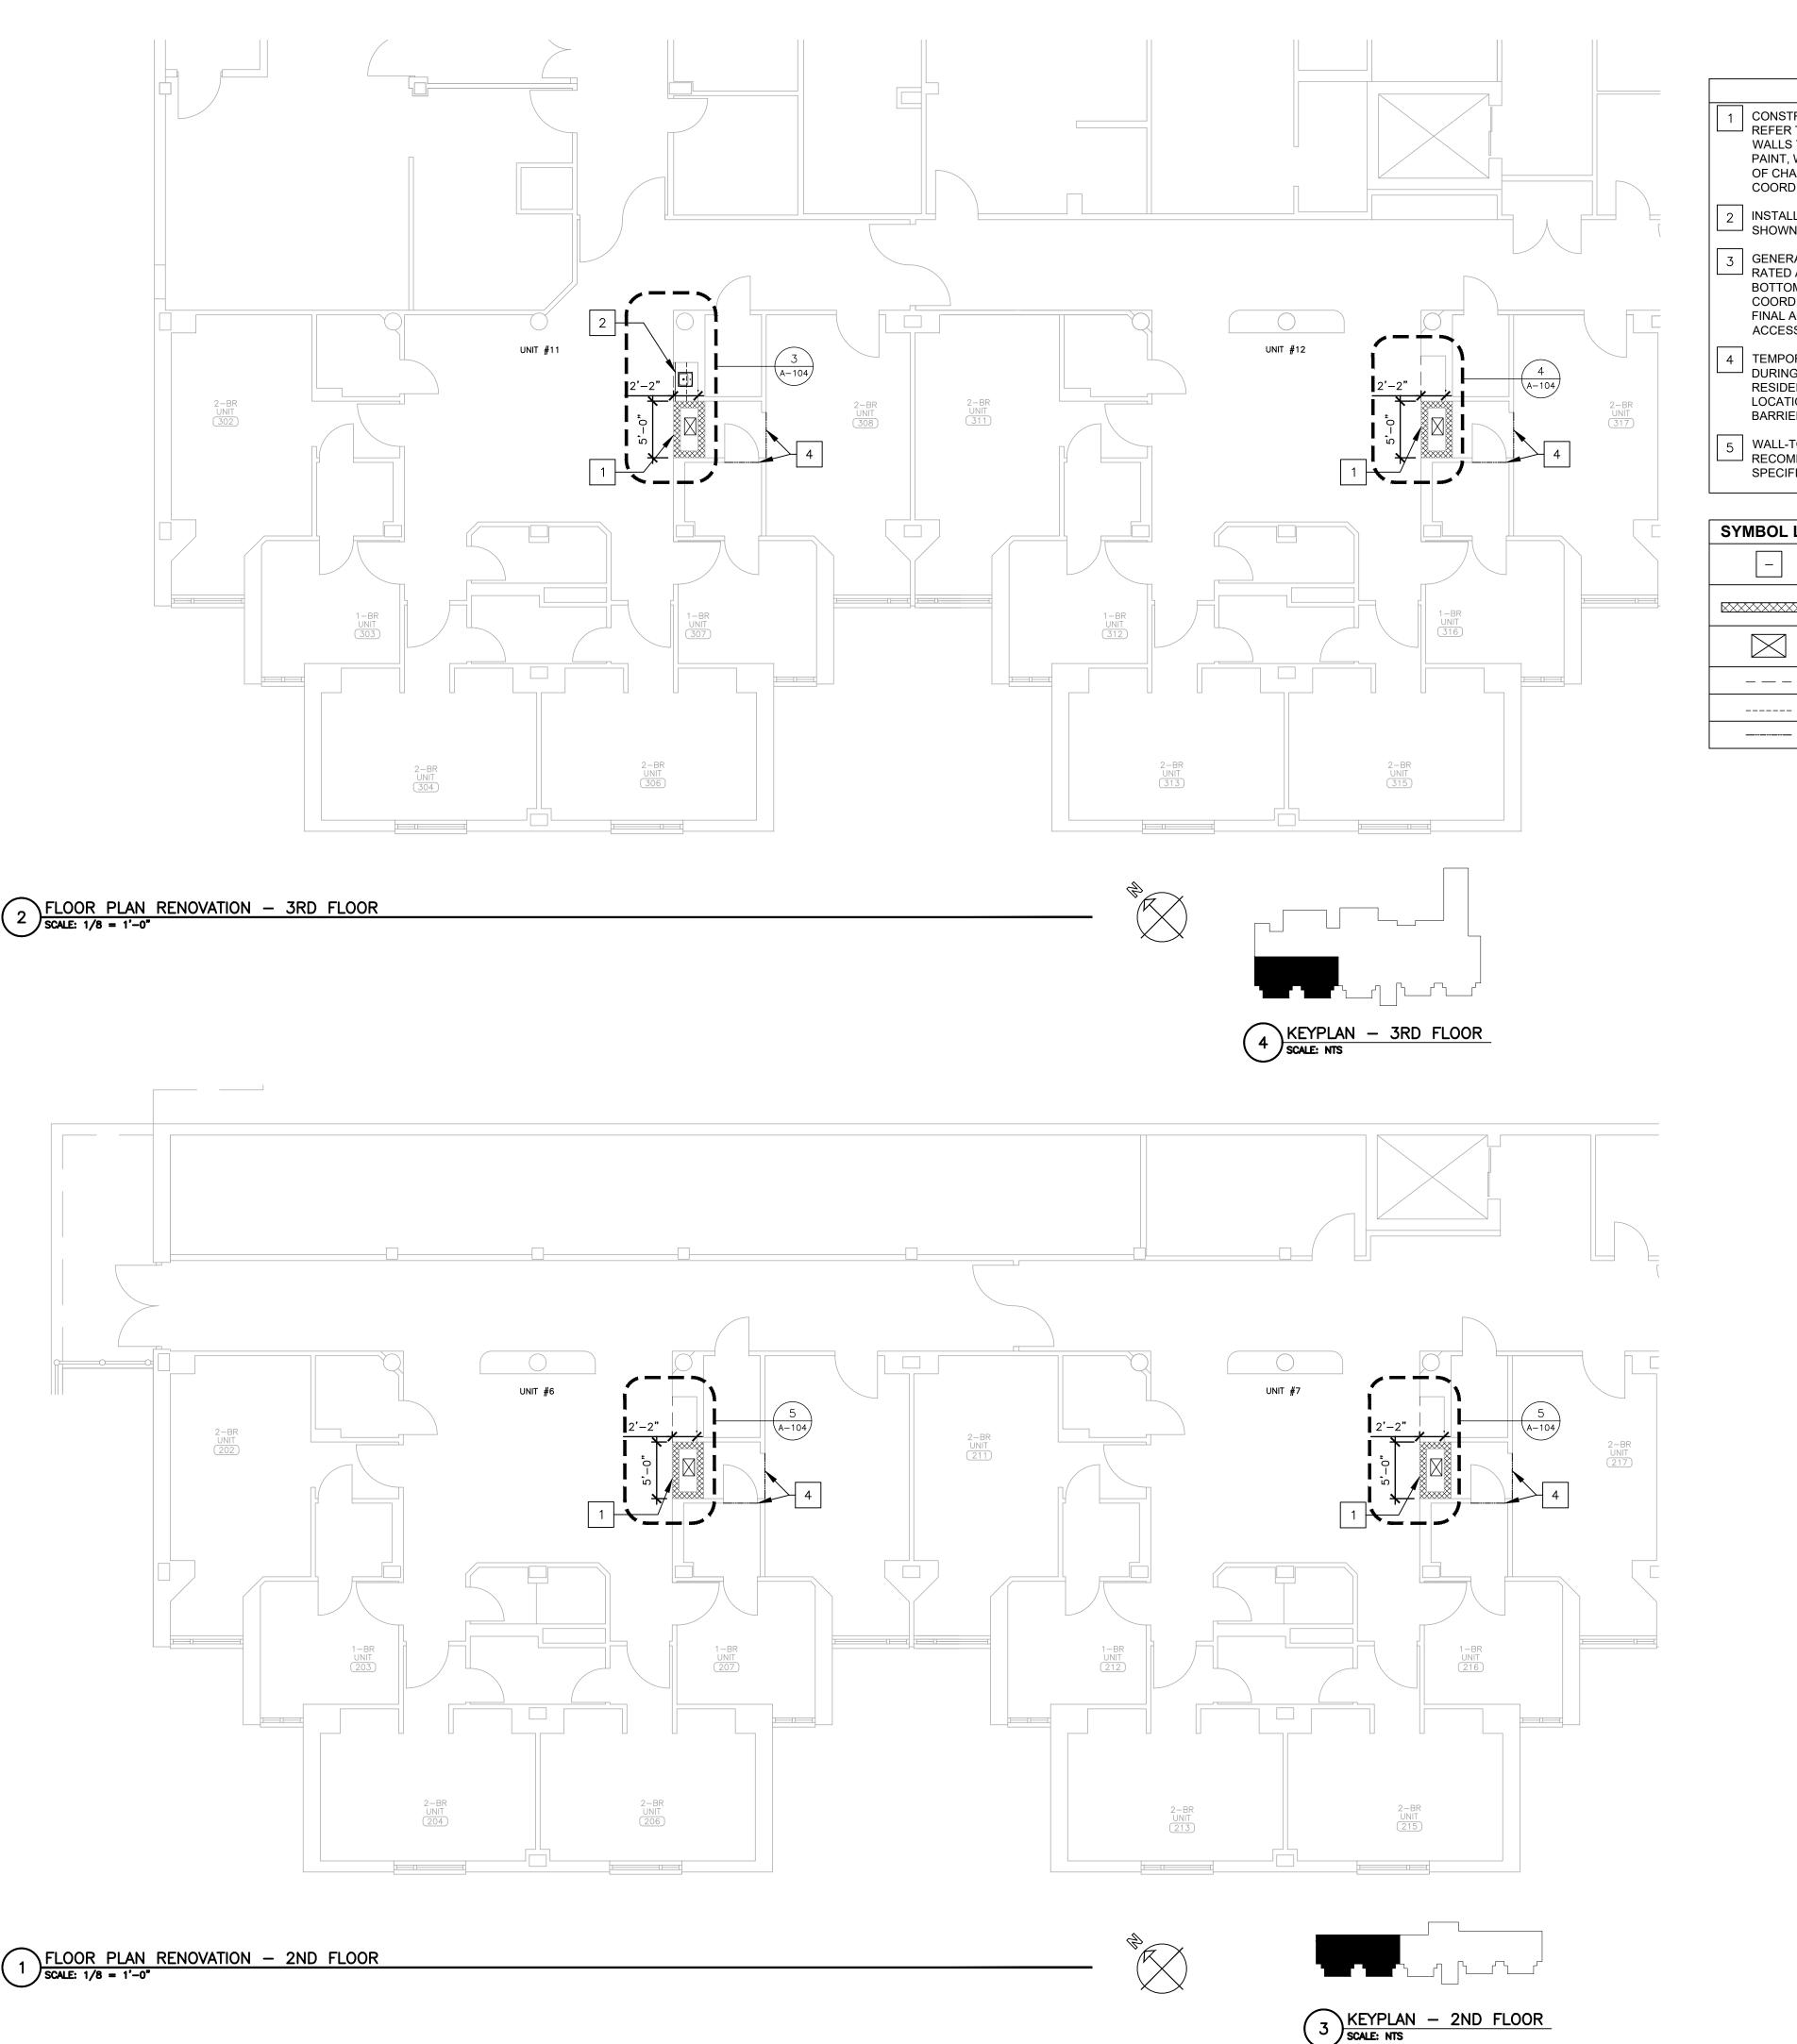

RENOVATION KEYNOTES:

- CONSTRUCT 1-HOUR FIRE-RATED WALL, UL U493, FOR CHASE.
 REFER TO A-501 FOR DETAILS. MATCH EXISTING FINISH OF NEW
 WALLS TO EXISTING ADJACENT WALLS INCLUDING INTERIOR
 PAINT, WALL BASE, AND PROTECTIVE COVERINGS. INTERIOR
 OF CHASE NEEDS A MINIMUM AREA OF 18"x22" CLEAR SPACE IN
 COORDINATION WITH MEP REQUIREMENTS.
- 2 INSTALL NEW CABINETRY AND SINK ASSEMBLY TO LOCATION SHOWN. REFER TO A-201 FOR DETAILS.
- GENERAL CONTRACTOR SHALL PROVIDE AND INSTALL FIRE RATED ACCESS DOOR FOR ACCESS TO BALANCE DAMPERS. BOTTOM OF ACCESS DOOR TO BE 1" ABOVE NEW WALL BASE COORDINATE WITH MECHANICAL CONTRACTOR TO PROVIDE FINAL ACCESS DOOR LOCATION TO ALLOW FOR OPTIMAL ACCESS TO DAMPER.
- TEMPORARY CONSTRUCTION BARRIER TO BE INSTALLED DURING DEMOLITION AND CONSTRUCTION FOR THE SAFETY OF RESIDENTS. COORDINATE WITH OWNER FOR OPTIMAL LOCATION OF BARRIER. CONTRACTOR TO SUBMIT A SAFETY BARRIER PLAN.
- WALL-TO-WALL JOINT FIRESTOPPING TO BE APPLIED AS RECOMMENDED BY MANUFACTURER. REFER TO SPECIFICATIONS SECTION 078443.

SYMBOL LEGEND						
_	RENOVATION KEYNOTE					
	WALLS - NEW CONSTRUCTION					
	MAKE-UP AIR SUPPLY DUCT					
	NOTATION OF SOFFIT LIMIT					
	NOTATION OF WALL CABINET OVERHANG					
	TEMPORARY CONSTRUCTION BARRIER					

EXISTING ADJACENT WALL —

EXISTING ADJACENT WALL

CORNER TRIM

EXISTING ADJACENT WALL

CORNER TRIM

BACKSPLASH —

NEW CABINETRY WITH

SOLID SURFACE

COUNTERTOR

GENERAL NOTES:

- 1. CONTRACTOR SHALL VERIFY ALL DIMENSIONS AND EXISTING CONDITIONS.
- CONTRACTOR SHALL USE CARE DURING CONSTRUCTION SO AS NOT TO DAMAGE EXISTING ADJACENT FINISHES AND EXISTING CONDITIONS NOT INCLUDED IN SCOPE OF WORK.
- CONTRACTOR SHALL REMOVE ALL TRASH AND DEBRIS FROM SITE ON A DAILY BASIS. COORDINATE DUMPSTER/ DUMP TRUCK LOCATION AND ACCESS WITH THE OWNER.
- CONTRACTOR IS RESPONSIBLE FOR WATER TIGHTENING THE PROPERTY AT THE END OF EACH DAY REGARDLESS OF THE WEATHER FORECAST.
- CONTRACTOR IS RESPONSIBLE FOR SITE SECURITY AT ANY BUILDING OPENINGS UNDER CONSTRUCTION AND SHALL ENSURE THE LOCKED SECURE CLOSURE AT THE END OF EACH WORKING DAY.

FINISH TO MATCH ADJACENT
 WALL INCLUDING PAINT, AND
 WELDED SHEET VINYL COVE BASE

EXISTING ADJACENT WALL

2-1/2" STEEL STUDS, STAGGERED, 16" O.C., WITH

----- EXISTING ADJACENT WALL

2-1/2" STEEL STUDS,

FIBERGLASS INSULATION

— EXISTING ADJACENT WALL

2-1/2" STEEL STUDS, STAGGERED, 16" O.C., WITH FIBERGLASS INSULATION

— EXISTING ADJACENT WALL

→ 5/8" GYPSUM

BOARD, TYPE X

— 5/8" GYPSUM BOARD, TYPE X

— FINISH TO MATCH

FINISH TO MATCH ADJACENT

ADJACENT WALL INCLUDING PAINT, PROTECTIVE VINYL

RIGID SHEET, CRASH RAIL,

AND RUBBER COVE BASE

WALL INCLUDING PAINT, AND WELDED SHEET VINYL COVE BASE

FINISH TO MATCH
ADJACENT WALL INCLUDING
PAINT, PROTECTIVE VINYL
RIGID SHEET, CRASH RAIL,

AND RUBBER COVE BASE

STAGGERED, 16" O.C., WITH

— EXISTING ADJACENT WALL

- 6. ALL MATERIALS AND EQUIPMENT NOT REQUIRED TO BE REMOVED FOR THE EXECUTION OF THE PROJECT SHALL BE LEFT IN PLACE AND PROTECTED FROM DAMAGE DURING CONSTRUCTION.
- 7. ALL REMOVED AND SALVAGED MATERIALS IN LIKE-NEW CONDITION SHALL BE OFFERED TO OWNER FOR REUSE.



STATE OF MISSOURI MICHAEL L. PARSON,

GOVERNOR

BRADMICHAE

SCHAEFER

A-2009027294

Brad M. Schaefer - Architect MO# A-2009027294

OFFICE OF ADMINISTRATION DIVISION OF FACILITIES MANAGEMENT, DESIGN AND CONSTRUCTION

DEPARTMENT OF MISSOURI VETERANS COMMISSION

HVAC IMPROVEMENTS FOR INFECTION CONTROL

MEXICO VETERANS HOME 1 VETERANS DR MEXICO, MO 65265

PROJECT # U2301-03 SITE # 6802 ASSET # 8136802001

REVISION:
DATE:
REVISION:
DATE:
REVISION:
DATE:
REVISION:
DATE:
ISSUE DATE: 04/11/2024

CAD DWG FILE: A-U2301-03
DRAWN BY: CL
CHECKED BY: BS
DESIGNED BY: CL


SHEET TITLE:

FLOOR PLAN
RENOVATION 2ND & 3RD FLOORS

SHEET NUMBER:

A-104

7 OF 28 SHEETS 4/11/2024

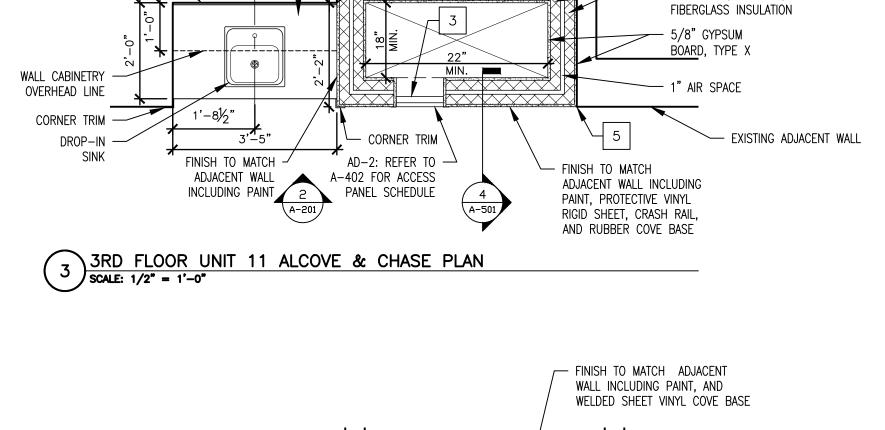

AD-2: REFER TO -

PANEL SCHEDULE

A-402 FOR ACCESS

ADJACENT WALL

INCLUDING PAINT

3RD FLOOR UNIT 12 ALCOVE & CHASE PLAN
SCALE: 1/2" = 1'-0"

AD-2: REFER TO -A-402 FOR ACCESS


PANEL SCHEDULE

4 A-201

4'-0"

FINISH TO MATCH -ADJACENT WALL INCLUDING PAINT

5 2ND FLOOR TYP. ALCOVE & CHASE PLAN SCALE: 1/2" = 1'-0"

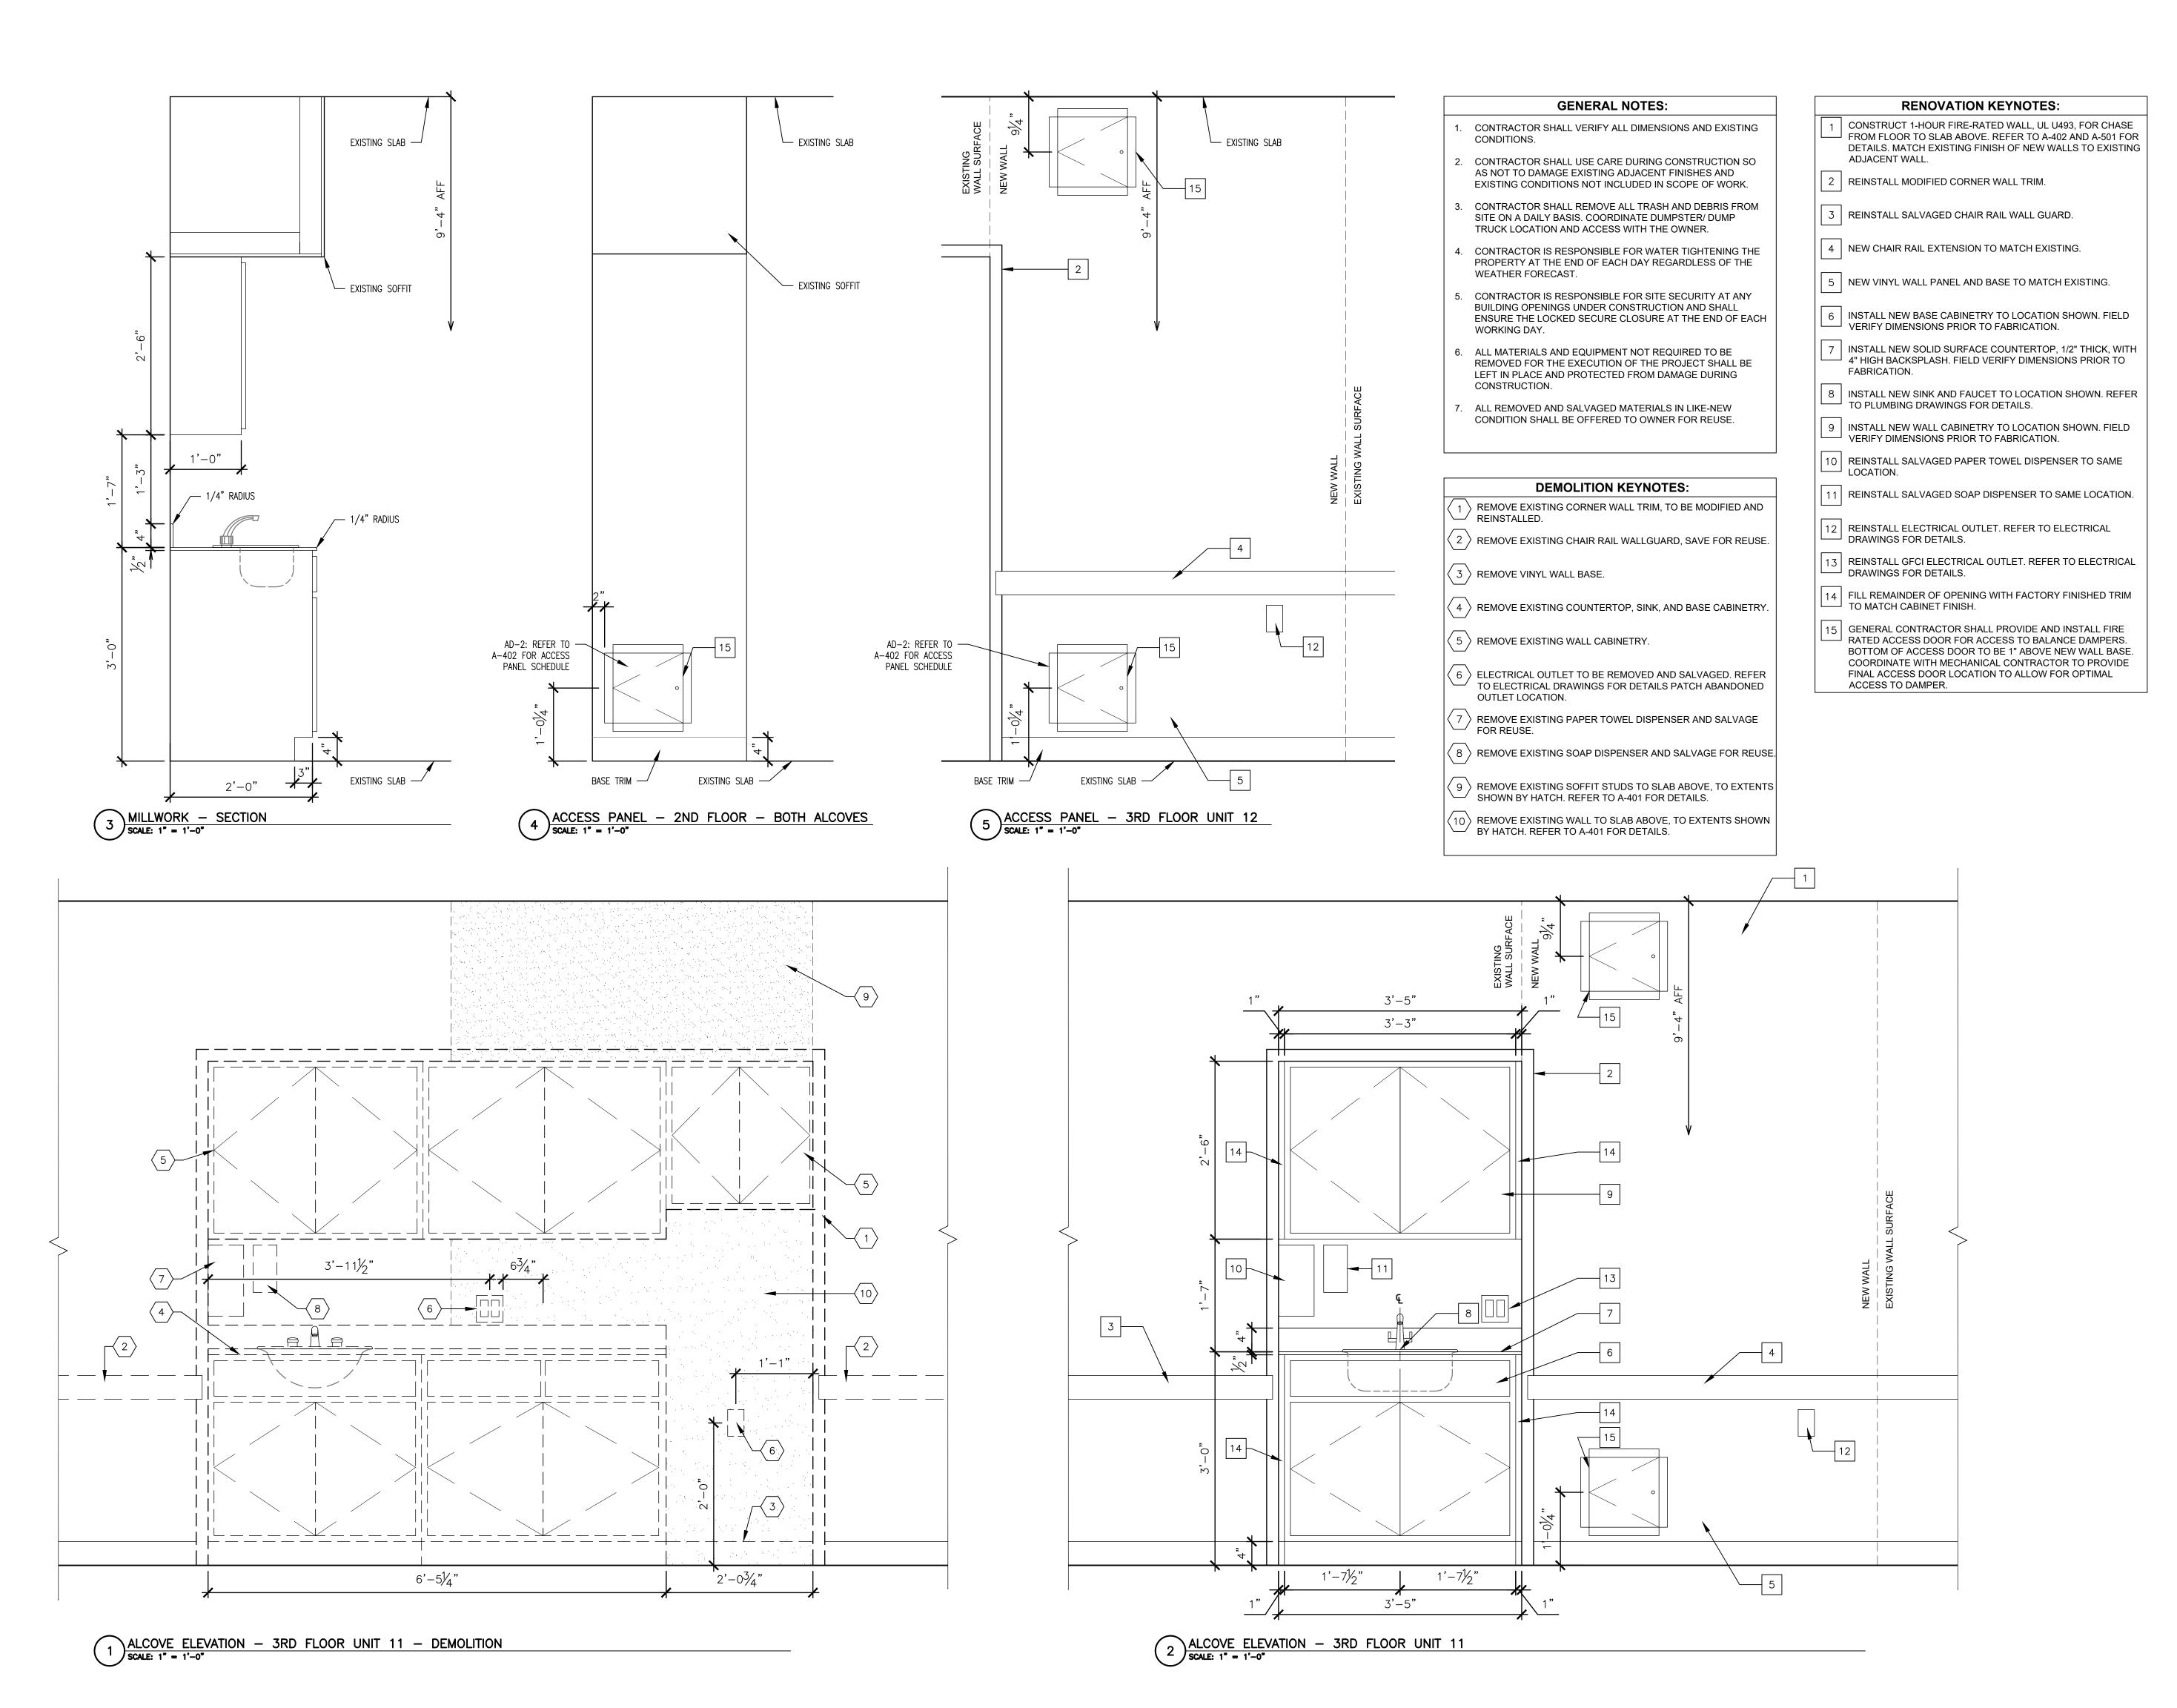

STATE OF MISSOURI MICHAEL L. PARSON, GOVERNOR



Brad M. Schaefer - Architect MO# A-2009027294

> BID DOCUMENTS

OFFICE OF ADMINISTRATION DIVISION OF FACILITIES MANAGEMENT, DESIGN AND CONSTRUCTION

DEPARTMENT OF MISSOURI VETERANS COMMISSION

HVAC IMPROVEMENTS FOR INFECTION CONTROL

MEXICO VETERANS HOME 1 VETERANS DR MEXICO, MO 65265

PROJECT # U2301-03 SITE # 6802 ASSET # 8136802001

REVISION:
DATE:
REVISION:
DATE:
REVISION:
DATE:
DATE:

ISSUE DATE: 04/11/2024

CAD DWG FILE: A-U2301-03
DRAWN BY: CL
CHECKED BY: BS
DESIGNED BY: CL

SHEET TITLE:

ARCHITECTURAL ELEVATIONS

SHEET NUMBER:

A-20





Brad M. Schaefer - Architect MO# A-2009027294

OFFICE OF ADMINISTRATION DIVISION OF FACILITIES MANAGEMENT, **DESIGN AND CONSTRUCTION**

DEPARTMENT OF MISSOURI VETERANS **COMMISSION**


HVAC IMPROVEMENTS FOR INFECTION CONTROL

MEXICO VETERANS HOME 1 VETERANS DR

PROJECT # U2301-03

ASSET#

REVISION:

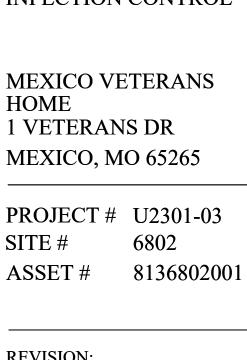

REVISION: DATE: DATE: **REVISION:** DATE: ISSUE DATE: 04/11/2024

CAD DWG FILE: A-U2301-03 DRAWN BY: CHECKED BY:


DESIGNED BY: C

SHEET TITLE:

WINDOW SCHEDULE -DEMOLITION

SHEET NUMBER:

9 OF 28 SHEETS 4/11/2024

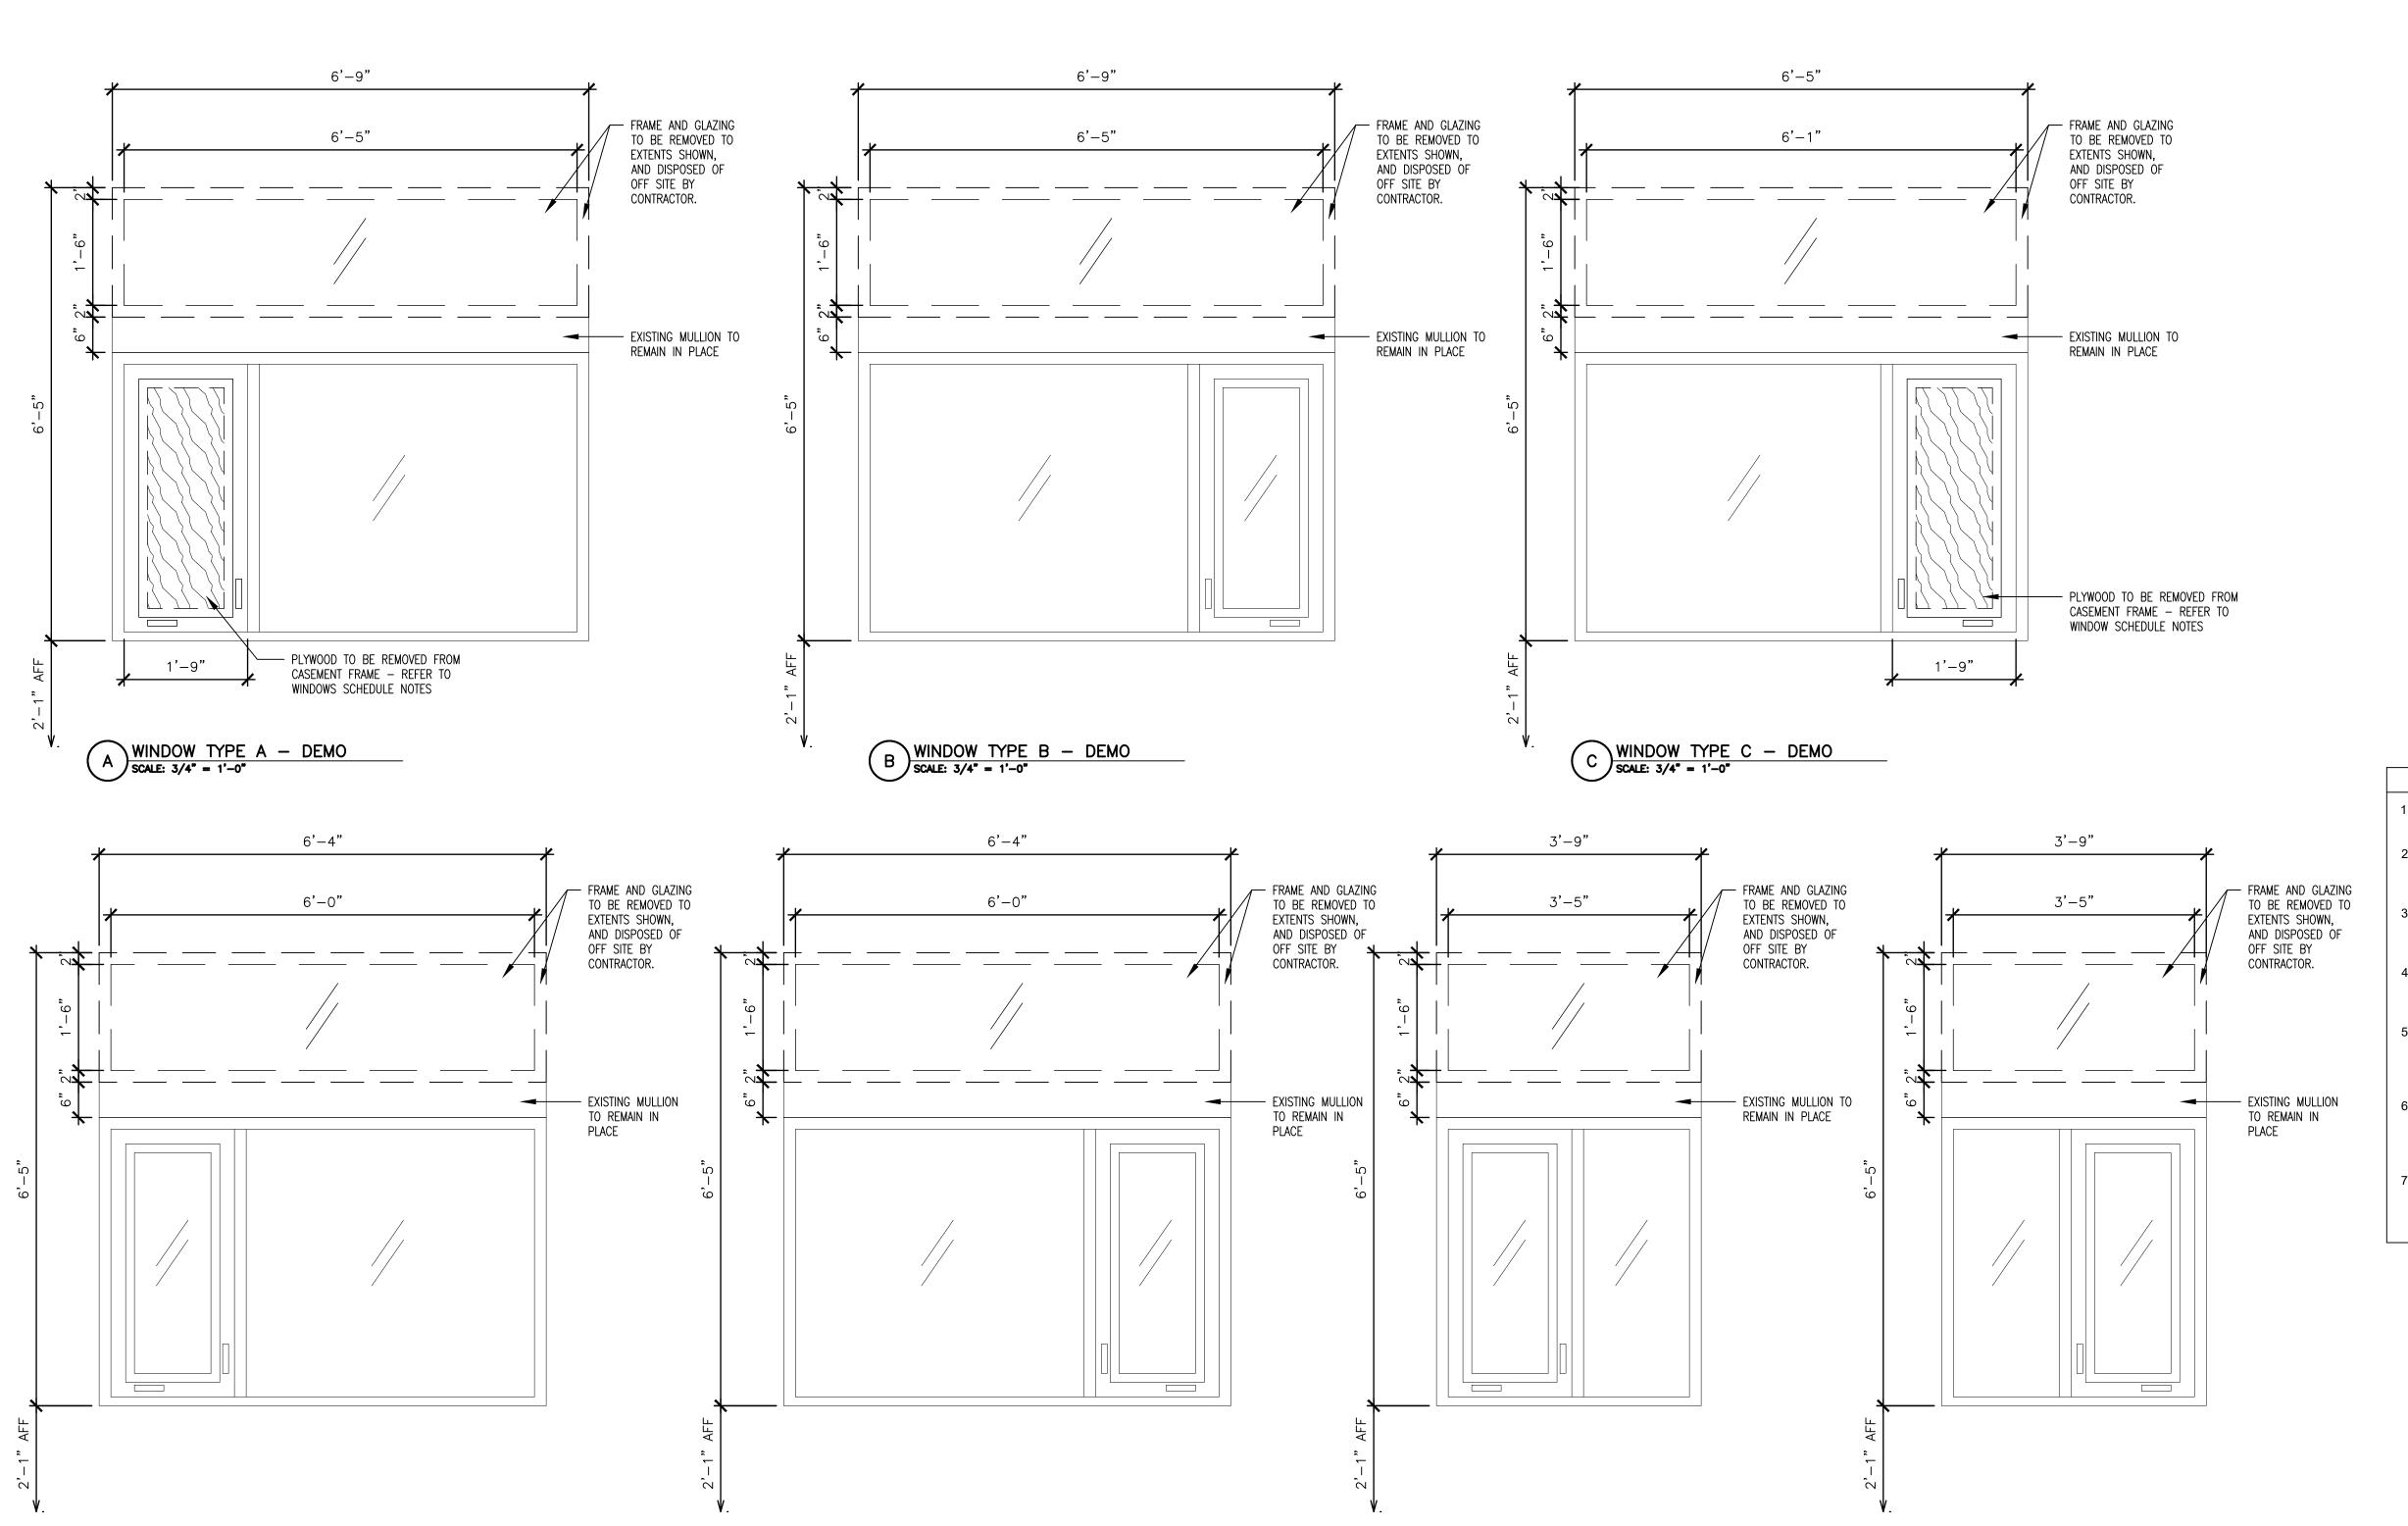

WINDOW TYPE E - DEMO
SCALE: 3/4" = 1'-0"

W3 | 104 | 6'-4" x 6'-5" | E | 1 W4 | 106 | 6'-4" x 6'-5" | D | 1 W5 | 107 | 3'-9" x 6'-5" | F W6 | 108 | 6'-9" x 6'-5" | A | 1, 2 W7 | 111 | 6'-9" x 6'-5" | B | 1 W8 | 112 | 3'-9" x 6'-5" | G | 1 W9 113 6'-4" x 6'-5" E 1 W10 | 115 | 6'-4" x 6'-5" | D | 1 W11 | 116 | 3'-9" x 6'-5" | F | 1 W12 | 117 | 6'-9" x 6'-5" | A | 1 1 REMOVE TOP TRANSOM FRAME & GLASS. 2 REMOVE PLYWOOD FROM CASEMENT FRAME.

WINDOW SCHEDULE - DEMO

MARK ROOM SIZE TYPE NOTES


W1 102 6'-5" x 6'-5" C 1, 2

W2 | 103 | 3'-9" x 6'-5" | G | 1

- CONTRACTOR SHALL VERIFY ALL DIMENSIONS AND EXISTING CONDITIONS.
- 2. CONTRACTOR SHALL USE CARE DURING CONSTRUCTION SO AS NOT TO DAMAGE EXISTING ADJACENT FINISHES AND EXISTING CONDITIONS NOT INCLUDED IN SCOPE OF WORK.
- CONTRACTOR SHALL REMOVE ALL TRASH AND DEBRIS FROM SITE ON A DAILY BASIS. COORDINATE DUMPSTER/ DUMP TRUCK LOCATION AND ACCESS WITH THE OWNER.
- CONTRACTOR IS RESPONSIBLE FOR WATER TIGHTENING THE PROPERTY AT THE END OF EACH DAY REGARDLESS OF THE WEATHER FORECAST.
- . CONTRACTOR IS RESPONSIBLE FOR SITE SECURITY AT ANY BUILDING OPENINGS UNDER CONSTRUCTION AND SHALL ENSURE THE LOCKED SECURE CLOSURE AT THE END OF EACH WORKING DAY.
- 6. ALL MATERIALS AND EQUIPMENT NOT REQUIRED TO BE REMOVED FOR THE EXECUTION OF THE PROJECT SHALL BE LEFT IN PLACE AND PROTECTED FROM DAMAGE DURING CONSTRUCTION.
- ALL REMOVED AND SALVAGED MATERIALS IN LIKE-NEW CONDITION SHALL BE OFFERED TO OWNER FOR REUSE.

G WINDOW TYPE G - DEMO
SCALE: 3/4" = 1'-0"

WINDOW TYPE D - DEMO
SCALE: 3/4" = 1'-0"

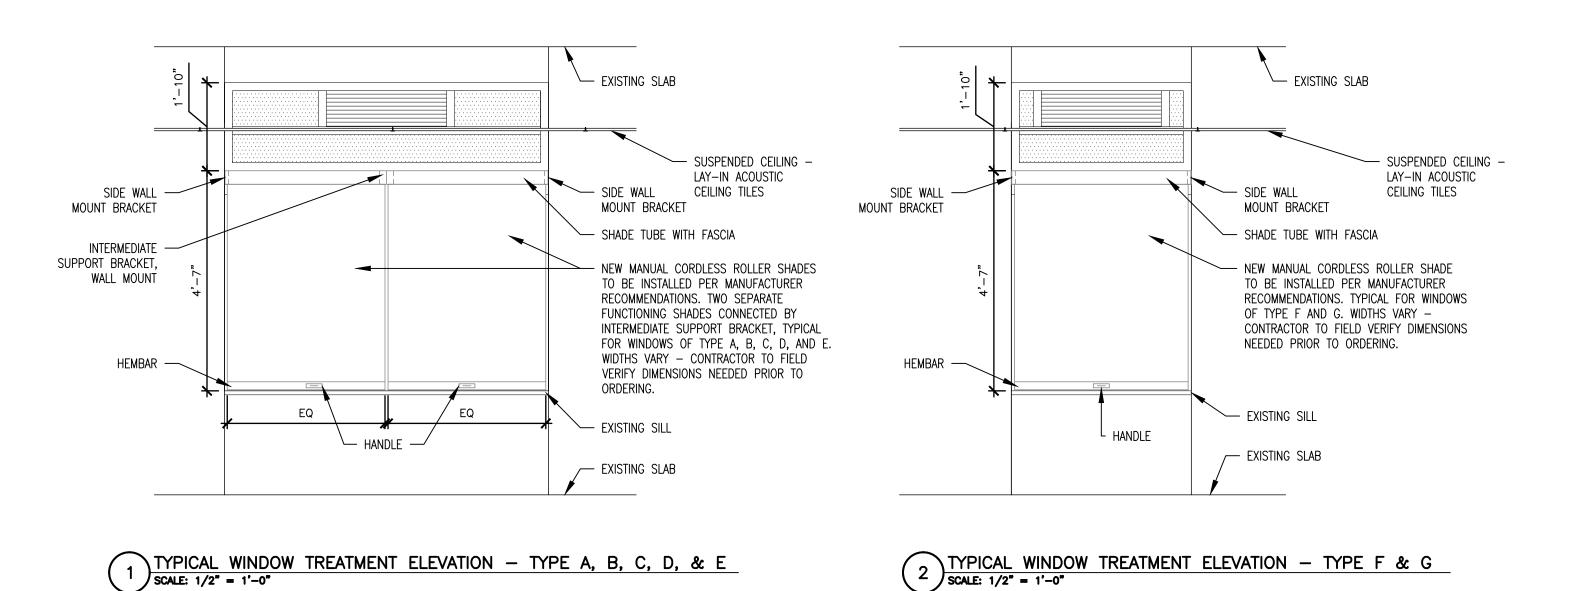

TYPICAL WINDOW TREATMENT ELEVATION — TYPE A, B, C, D, & E

SCALE: 1/2" = 1'-0"

ACCESS PANEL SCHEDULE MARK MANUFACTURER MODEL NOMINAL SPECIFICATION SIZE AD-1 ACUDOR AIRTIGHT AND DOOR: 16 GAUGE STEEL; FRAME: 16 GAUGE STEEL; AWDT 12" x 12" WATERTIGHT HINGE: CONTINUOUS EXPOSED PIANO HINGE. ACCESS DOOR AD-2 ACUDOR FB-5060-DW 12" x 12" DOOR: 16 GAUGE STEEL; FRAME: 16 GAUGE STEEL W/ FIRE RATED -REINFORCED EDGES; HINGE: CONCEALED; FIRE RATING: FOR WALLS UL 1-1/2 HOUR "B" LABEL; LATCH: UNIVERSAL SELF LATCHING BOLT

1. PRODUCTS LISTED ARE BASIS OF DESIGN, FOLLOW ALL MANUFACTURERS RECOMMENDED INSTALLATION SPECIFICATIONS.

INSULATED — $1'-9\frac{1}{2}$ " 2 " $2'-6$ " 2 " $1'-9\frac{1}{2}$ " INFILL PANEL — L-1: REFER TO	Insulated — Infill Panel	1'-9½" 2" 2'-6" L-1: REFER TO	2" 1'-9½"		1'-7½" 2"	2'-6" 2" 1-1: PEFFR TO	1'-7½"	/— Insulated Infill Panel
M-601 FOR LOUVER SCHEDULE	NEW ALUMINUM FRAME	M-601 FOR LOUVER SCHEDULE		NEW ALUMINUM FRAME		L-1: REFER TO M-601 FOR LOUVER SCHEDULE		<u> </u>
1, -e,	INSULATED INFILL PANEL "9 - 1 2 2 2 2 2 2 2 2 2 2 2 2 2 2 2 2 2 2			INSULATED INFILL PANEL			2 " 2 " 2	7 , 1
	WINDOW TREATMENT	/		WINDOW TREATMENT —				NEW CLEAR GLAZING TO FIT EXISTING
	TO BE INSTALLED AT THE TOP OF EXISTING 6" MULLION. REFER TO TYPICAL WINDOW TREATMENT ELEVATION			TO BE INSTALLED AT THE TOP OF EXISTING 6" MULLION. REFER TO TYPICAL WINDOW TREATMENT ELEVATION				CASEMENT FRAME — REFER TO WINDOW SCHEDULE NOTES
3,-17,	A-402:1			A-402:1				3'-1½"
NEW CLEAR GLAZING TO FIT 1'-1" EXISTING CASEMENT FRAME							1'-1"	*

OM SIZE 2 6'-5" x 6'-5" 3 3'-9" x 6'-5" 4 6'-4" x 6'-5" 6 6'-4" x 6'-5" 7 3'-9" x 6'-5" 8 6'-9" x 6'-5"	TYPE C G E D	NOTES 1, 2, 3 1, 2 1, 2 1, 2 1, 2
3 3'-9" x 6'-5" 4 6'-4" x 6'-5" 6 6'-4" x 6'-5" 7 3'-9" x 6'-5"	G E D	1, 2 1, 2 1, 2
4 6'-4" x 6'-5" 6 6'-4" x 6'-5" 7 3'-9" x 6'-5"	E D F	1, 2 1, 2
6 6'-4" x 6'-5" 7 3'-9" x 6'-5"	D F	1, 2
7 3'-9" x 6'-5"	F	
		1, 2
8 6'-9" x 6'-5"	_	
1	A	1, 2, 3
1 6'-9" x 6'-5"	В	1, 2
2 3'-9" x 6'-5"	G	1, 2
3 6'-4" x 6'-5"	Е	1, 2
5 6'-4" x 6'-5"	D	1, 2
6 3'-9" x 6'-5"	F	1, 2
7 6'-9" x 6'-5"	А	1, 2
	6'-4" x 6'-5" 6'-4" x 6'-5" 3'-9" x 6'-5"	3 6'-4" x 6'-5" E 5 6'-4" x 6'-5" D 6 3'-9" x 6'-5" F

1 REFER TO MEP DRAWINGS FOR LOUVER SIZE, LOCATION, AND DETAILS. INSTALL NEW LOUVER AND INSULATED INFILL PANEL INTO NEW ALUMINUM FRAME CUSTOM TO WINDOW SIZE. SEE SPECIFICATIONS. VERIFY WINDOW SIZE PRIOR TO ORDERING.

INSTALL NEW CLEAR GLAZING INTO EXISTING CASEMENT FRAME.

GENERAL NOTES:

- CONTRACTOR SHALL VERIFY ALL DIMENSIONS AND EXISTING CONDITIONS.
- CONTRACTOR SHALL USE CARE DURING CONSTRUCTION SO AS NOT TO DAMAGE EXISTING ADJACENT FINISHES AND EXISTING CONDITIONS NOT INCLUDED IN SCOPE OF WORK.
- CONTRACTOR SHALL REMOVE ALL TRASH AND DEBRIS FROM SITE ON A DAILY BASIS. COORDINATE DUMPSTER/ DUMP TRUCK LOCATION AND ACCESS WITH THE OWNER.

WEATHER FORECAST.

- CONTRACTOR IS RESPONSIBLE FOR WATER TIGHTENING THE PROPERTY AT THE END OF EACH DAY REGARDLESS OF THE
- CONTRACTOR IS RESPONSIBLE FOR SITE SECURITY AT ANY BUILDING OPENINGS UNDER CONSTRUCTION AND SHALL ENSURE THE LOCKED SECURE CLOSURE AT THE END OF EACH WORKING DAY.
- ALL MATERIALS AND EQUIPMENT NOT REQUIRED TO BE REMOVED FOR THE EXECUTION OF THE PROJECT SHALL BE LEFT IN PLACE AND PROTECTED FROM DAMAGE DURING CONSTRUCTION.
- ALL REMOVED AND SALVAGED MATERIALS IN LIKE-NEW CONDITION SHALL BE OFFERED TO OWNER FOR REUSE.

MICHAEL L. PARSON, **GOVERNOR**

STATE OF MISSOURI



Brad M. Schaefer - Architect MO# A-2009027294

OFFICE OF ADMINISTRATION **DIVISION OF FACILITIES** MANAGEMENT, **DESIGN AND CONSTRUCTION**

DEPARTMENT OF MISSOURI VETERANS **COMMISSION**

HVAC IMPROVEMENTS FOR INFECTION CONTROL

MEXICO VETERANS **HOME** 1 VETERANS DR

MEXICO, MO 65265

PROJECT # U2301-03 6802

ASSET#

REVISION:

8136802001

DATE: **REVISION:** DATE: **REVISION:** DATE:


ISSUE DATE: 04/11/2024


CAD DWG FILE: <u>A-U2301-03</u> DRAWN BY: CHECKED BY: DESIGNED BY: \overline{C}

SHEET TITLE:

WINDOW & **ACCESS PANEL** SCHEDULE

SHEET NUMBER:

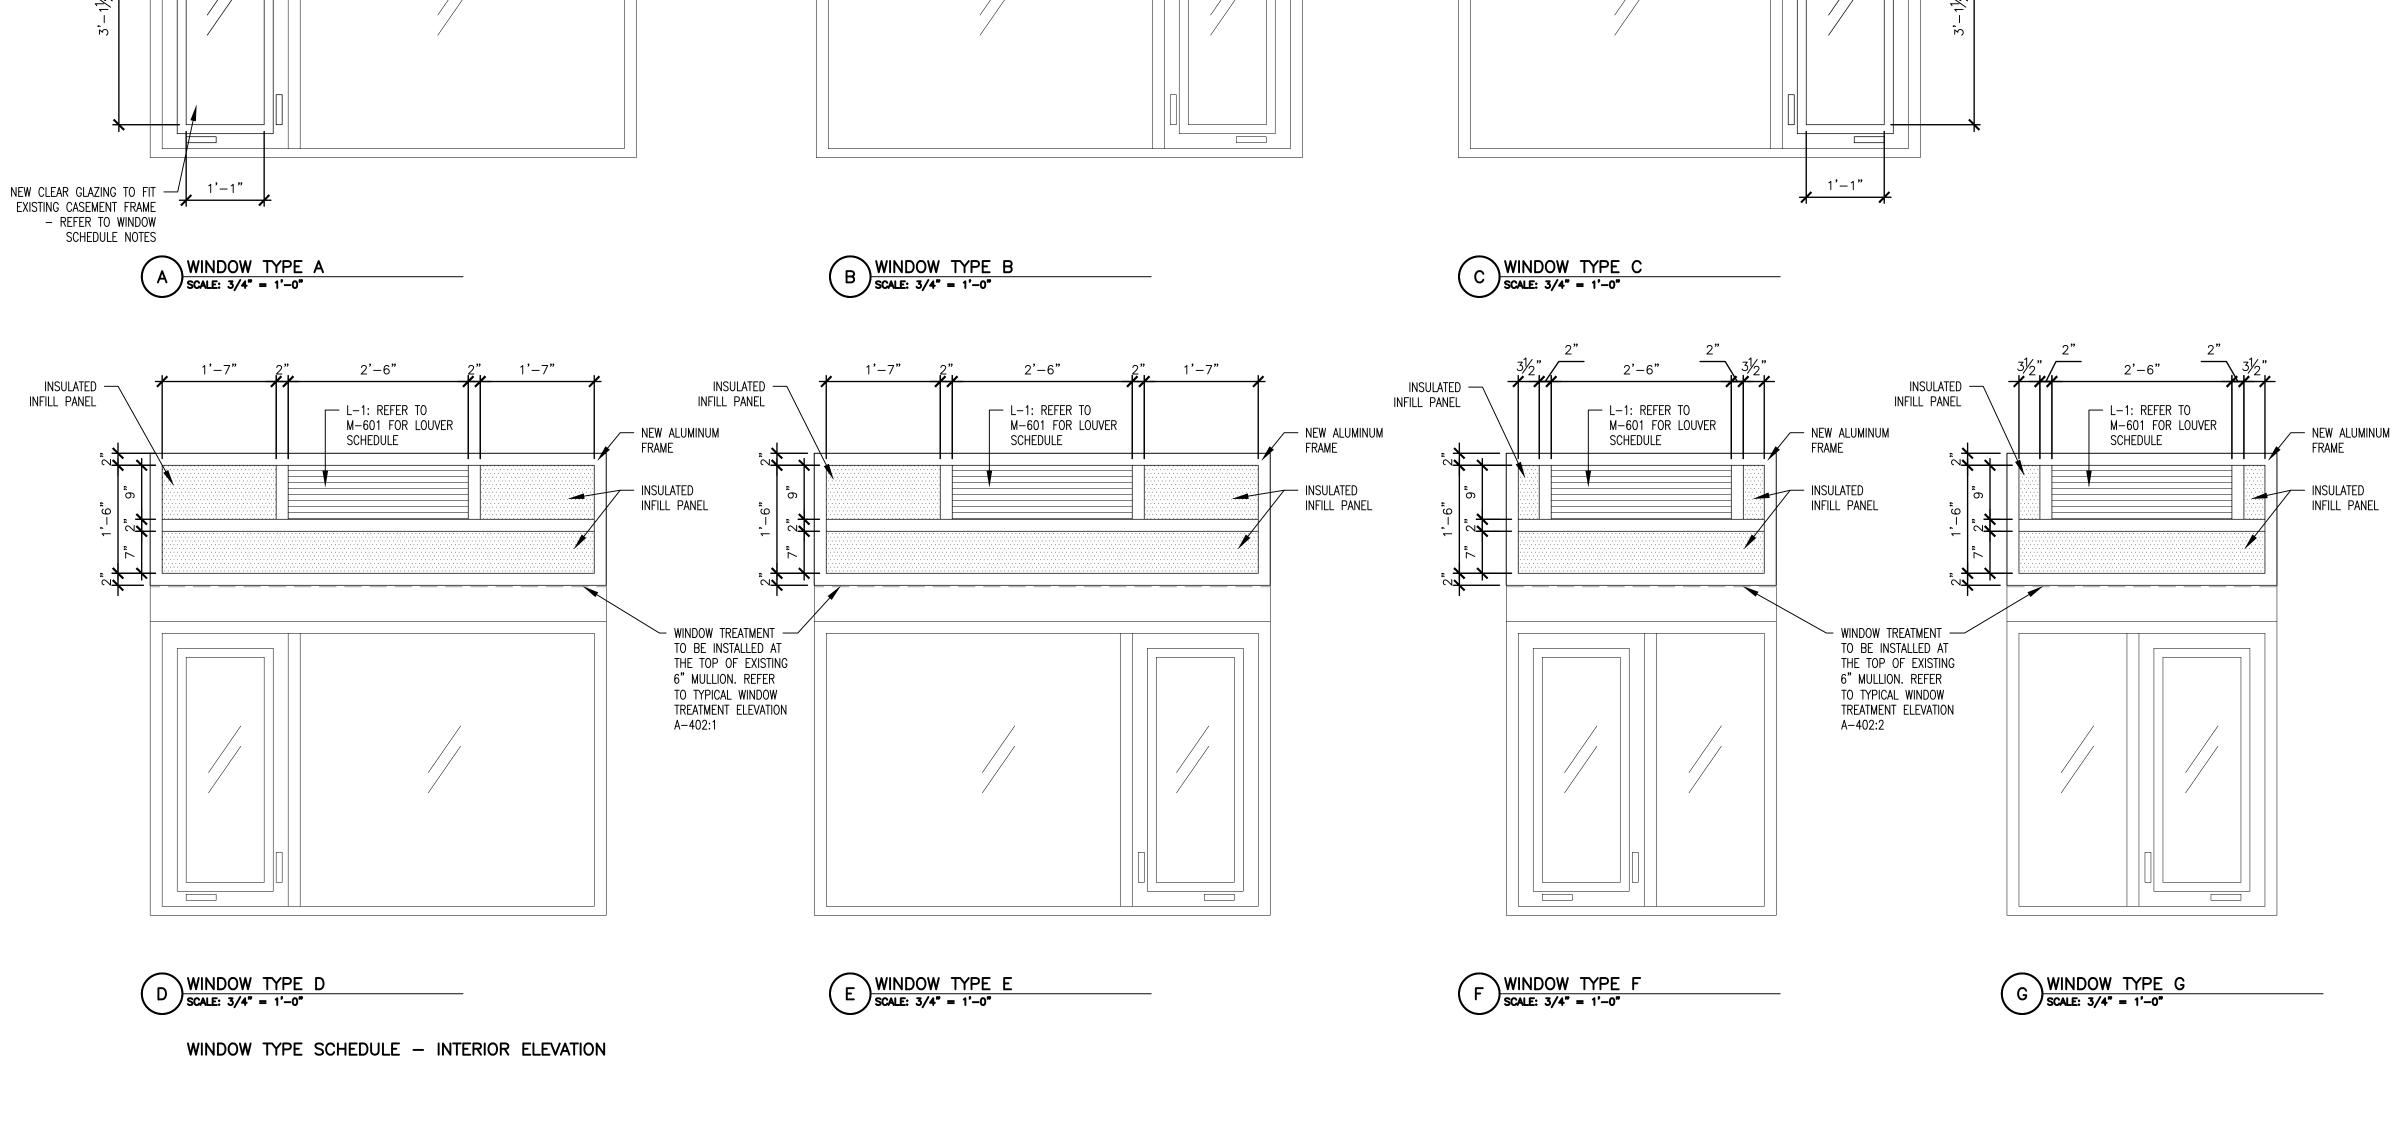

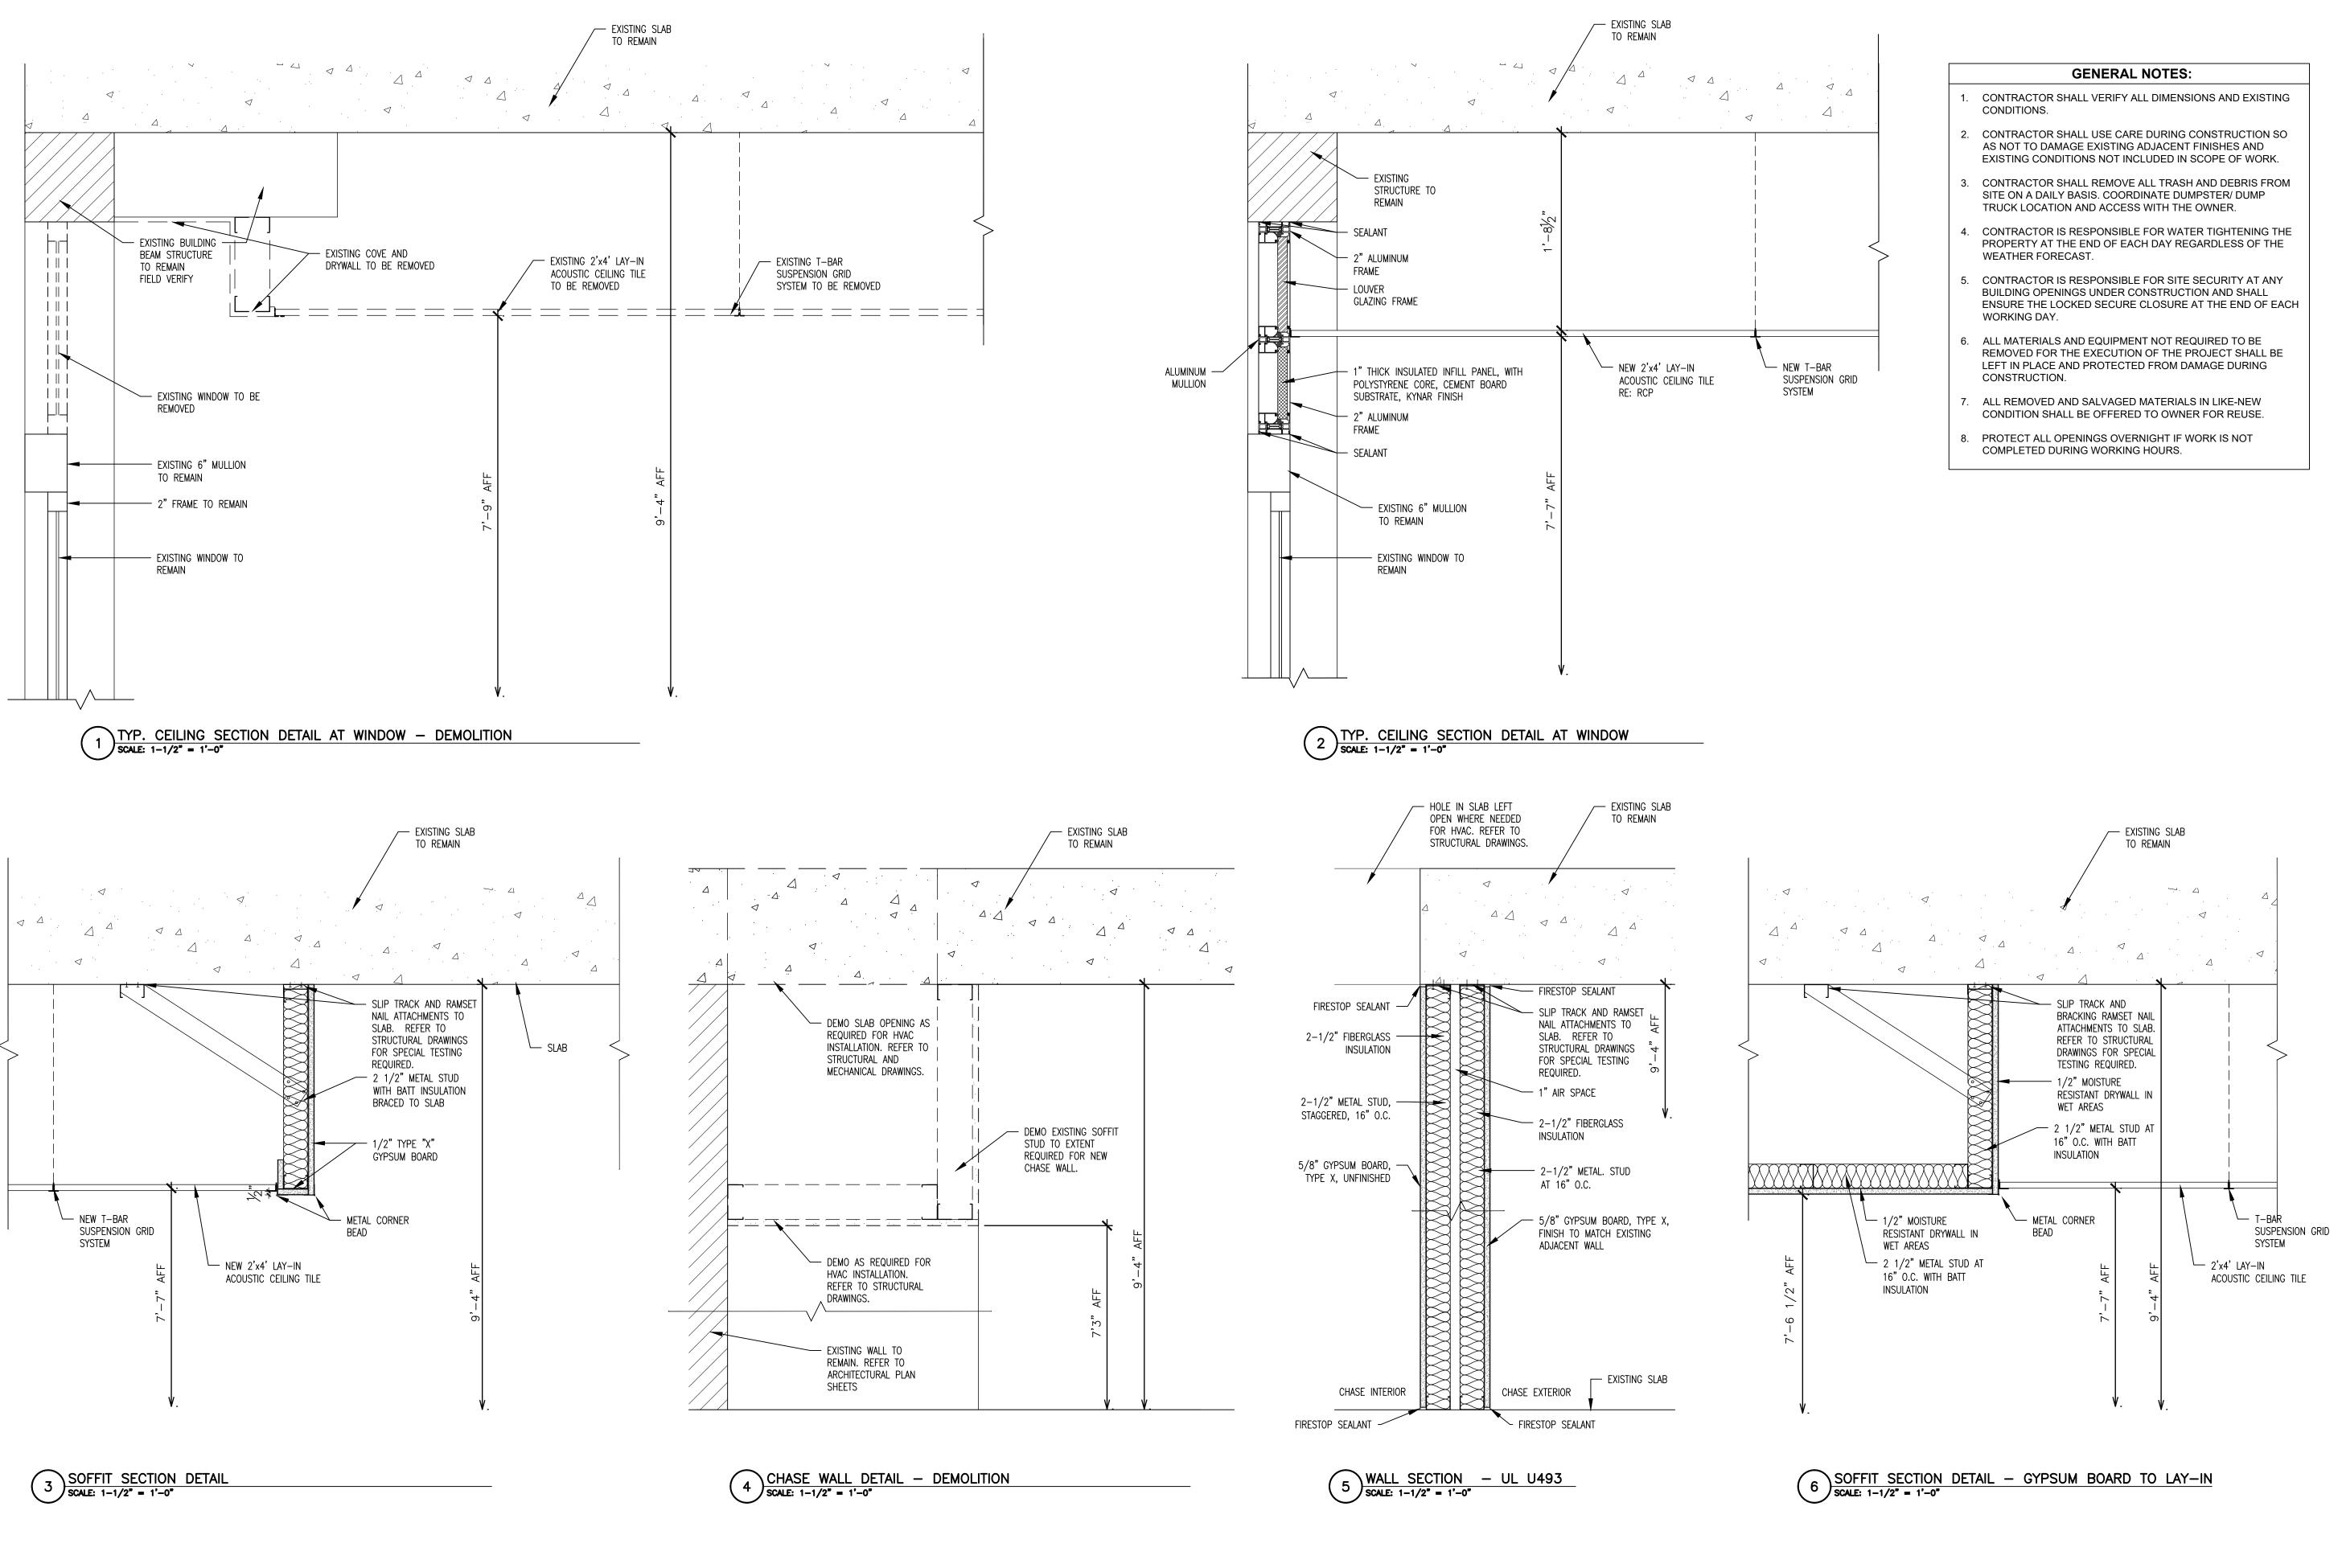

STATE OF MISSOURI MICHAEL L. PARSON, GOVERNOR



Brad M. Schaefer - Architect MO# A-2009027294

BOCUMENTS

OFFICE OF ADMINISTRATION DIVISION OF FACILITIES MANAGEMENT, DESIGN AND CONSTRUCTION

DEPARTMENT OF MISSOURI VETERANS COMMISSION

HVAC IMPROVEMENTS FOR INFECTION CONTROL

MEXICO VETERANS HOME 1 VETERANS DR MEXICO, MO 65265

PROJECT # U2301-03 SITE # 6802 ASSET # 8136802001

REVISION:	
DATE:	
REVISION:	
DATE:	
REVISION:	
DATE:	
ISSUE DATE: 04/11/2024	

CAD DWG FILE: A-U2301-03
DRAWN BY: CL
CHECKED BY: BS


SHEET TITLE:

DESIGNED BY: \overline{C}

ARCHITECTURAL DETAILS


SHEET NUMBER:

A-501

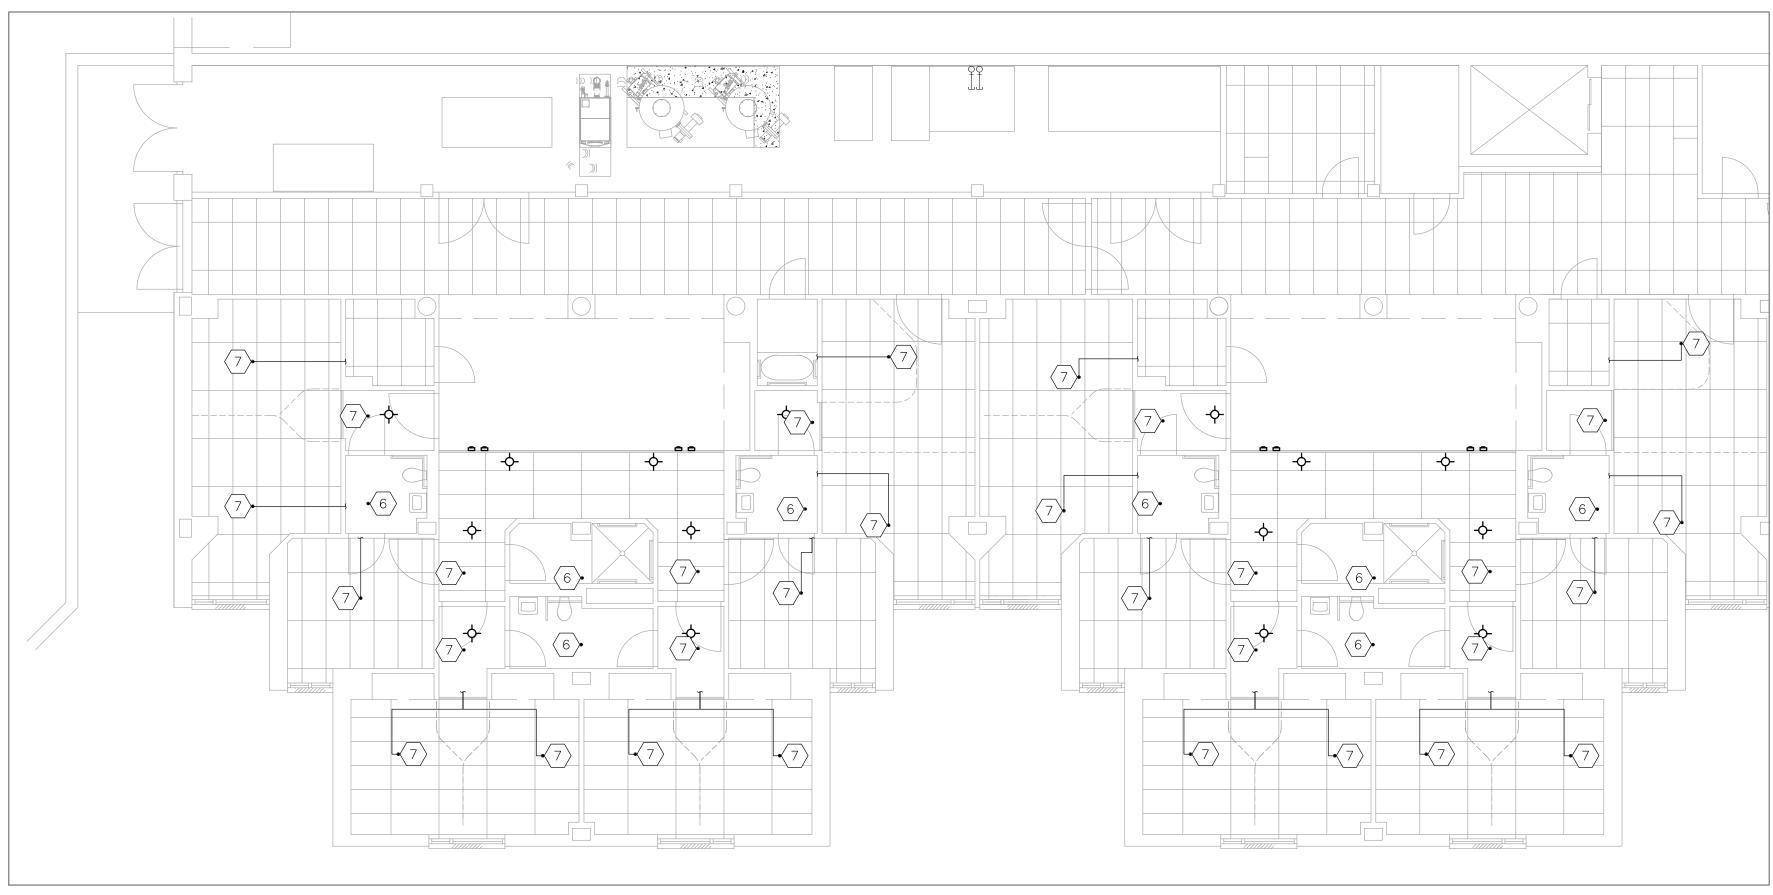

FIRE PROTECTION RENOVATION PLAN - 1ST FLOOR
SCALE: 1/8 = 1'-0'



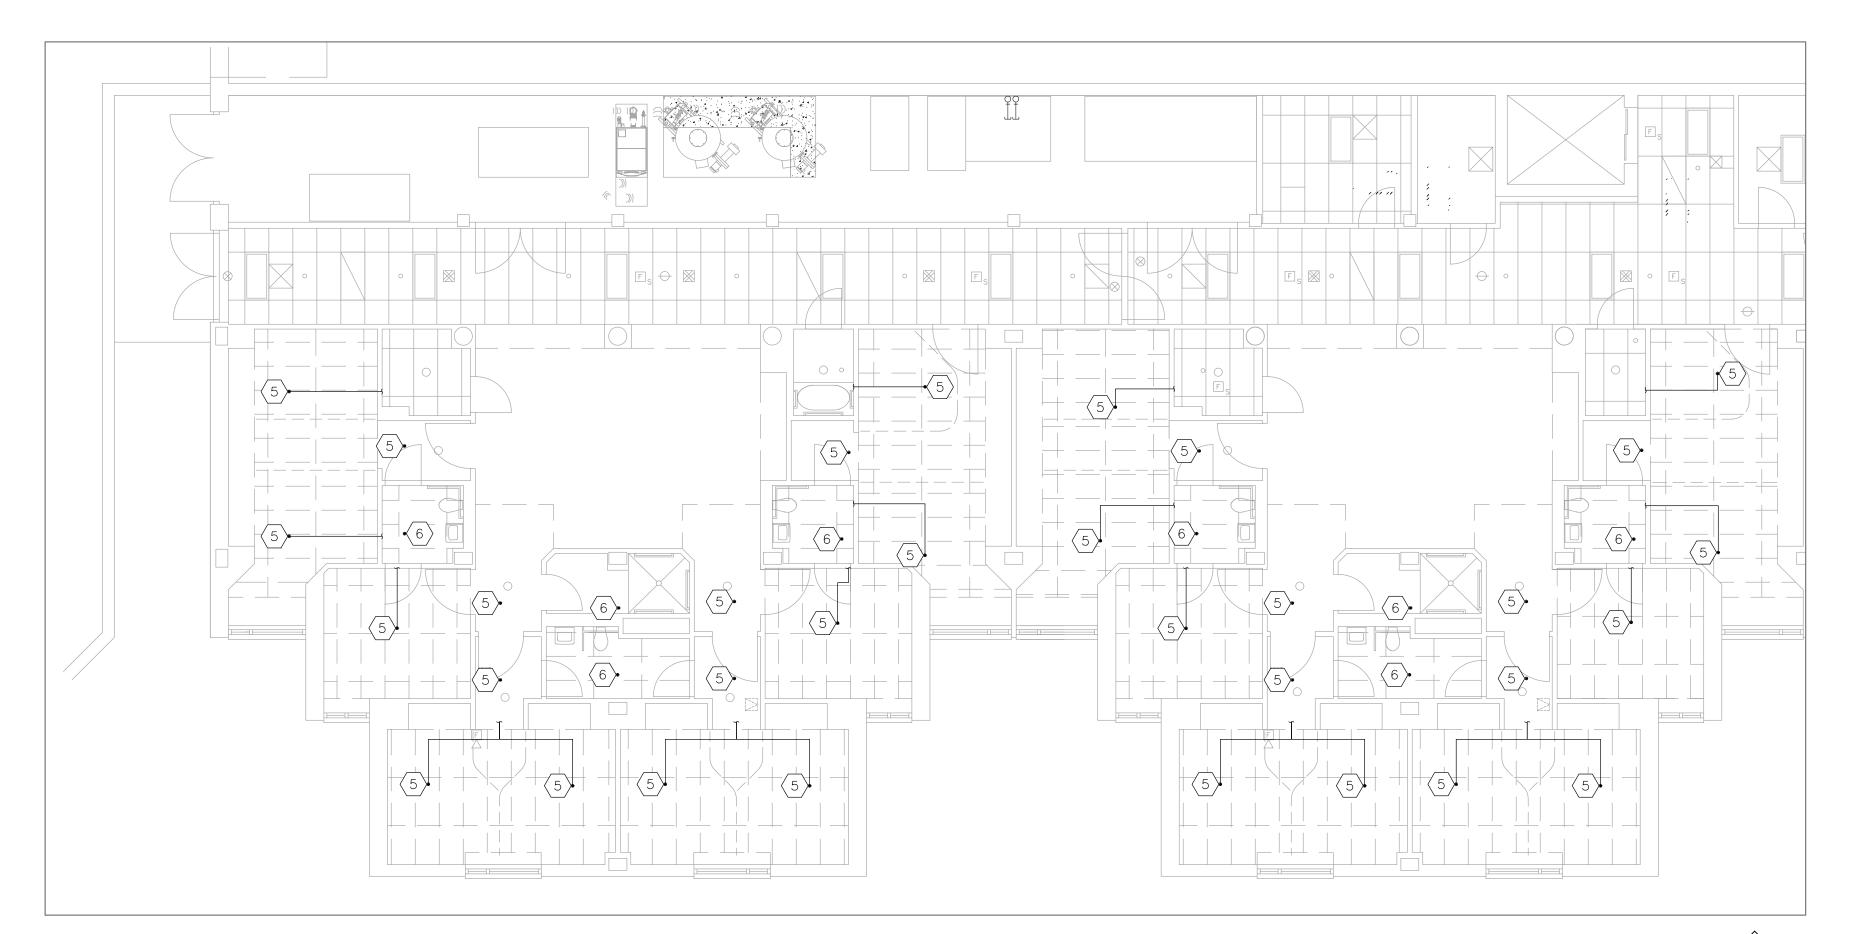

FIRE PROTECTION DEMOLITION PLAN - 1ST FLOOR

SCALE: 1/8 = 1'-0'



FIRE PROTECTION NOTES

N INDICATES KEYED NOTES

- FABRICATION, INSTALLATION, AND TESTING OF ALL FIRE PROTECTION DEVICES SHALL BE DONE IN ACCORDANCE WITH THE LATEST VERSION OF NATIONAL FIRE PROTECTION ASSOCIATION'S STANDARD FOR THE INSTALLATION OF SPRINKLER SYSTEMS (NFPA-13), NATIONAL ELECTRIC CODE (NEC) AND ALL MANUFACTURER INSTALLATION GUIDELINES.
- 2 RENOVATION DRAWINGS AND PLANS ARE FROM FIELD TAKE—OFF AND ORIGINAL DRAWINGS. CONTRACTOR IS RESPONSIBLE FOR FIELD VERIFYING PRIOR TO BIDDING AND/OR CONSTRUCTION.
- ONTRACTOR IS RESPONSIBLE FOR REMOVAL AND DISPOSAL OF ALL DEMOLISHED MATERIAL, AS WELL AS REPAIRING ANY DAMAGE TO ANY SURFACE IN THE AREA OF CONSTRUCTION THAT IS A RESULT OF CONSTRUCTION ACTIVITY. SURFACE SHALL BE REPAIRED AND FINISHED TO MATCH EXISTING CONDITIONS.
- THERE ARE NO ISOLATION VALVES IN THE SPRINKLER SYSTEM. THE ENTIRE SYSTEM SHALL BE DRAINED AND FILLED EACH WORK DAY. COORDINATE WITH OWNER TO SHUT OFF FIRE ALARM SYSTEM PRIOR TO SPRINKLER SYSTEM DEMOLITION AND CONSTRUCTION ACTIVITIES. DRAIN SPRINKLER SYSTEM AS NEEDED TO COMPLETE THE WORK. AT THE END OF EACH WORK DAY, FILL SPRINKLER SYSTEM AND ENSURE FIRE ALARM SYSTEM IS ACTIVE. FIRE ALARM AND SPRINKLER SYSTEMS SHALL BE INACTIVE NO MORE THAN 8 HOURS IN A 24 HOUR PERIOD.
- REMOVE AND DISPOSE OF PENDENT TYPE FIRE SPRINKLER HEAD. REMOVE AND DISPOSE OF SPRINKLER PIPE AS NEEDED, AND PROVIDE TEMPORARY CAP FOR SPRINKLER PIPE. REFER TO DETAIL 2 OF THIS SHEET FOR FIRE SPRINKLER RENOVATION NOTES.
- 6 PENDENT TYPE FIRE SPRINKLER TO REMAIN. CEILING TO BE DEMOLISHED AND GYPSUM BOARD CEILING TO BE INSTALLED AT THE SAME HEIGHT.
- CEILING TO BE INSTALLED APPROXIMATELY 2 INCHES LOWER THAN PREVIOUS INSTALLATION. PROVIDE AND INSTALL NEW PENDENT TYPE FIRE SPRINKLER HEAD, ESCUTCHEON AND ALL REQUIRED PIPE. LOCATE SPRINKLER HEAD TO AVOID NEW CEILING GRID T—BAR AS NEEDED OR AS SHOWN. EXTEND PIPE AS REQUIRED TO COMPLETE THE WORK. ALL MATERIALS SHALL MATCH EXISTING FINISH AND PERFORMANCE.

STATE OF MISSOURI MICHAEL L. PARSON, GOVERNOR



Tracie L. Siebeneck - Engineer MO# PE-2013019114

DOCUMENTS

OFFICE OF ADMINISTRATION DIVISION OF FACILITIES MANAGEMENT, DESIGN AND CONSTRUCTION

DEPARTMENT OF MISSOURI VETERANS COMMISSION

HVAC IMPROVEMENTS FOR INFECTION CONTROL

MEXICO VETERANS HOME 1 VETERANS DR MEXICO, MO 65265

PROJECT # U2301-03 SITE # 6802 ASSET # 8136802001

REVISION:
DATE:
REVISION:
DATE:
REVISION:
DATE:
REVISION:
DATE:
ISSUE DATE: 04/11/2024

FIRE	PROTECTION LEGEND
	PENDENT FIRE SPRINKLER HEAD/ESCUTCHEON
•	CONNECT TO EXISTING EQUIPMENT

STING EQUIPMENT SHEET TITLE:

FIRE PROTECTION
PLAN - 1ST FLOOR


CAD DWG FILE:M-U2301-03
DRAWN BY: TS/AH
CHECKED BY: TS

DESIGNED BY: TS/AH


SHEET NUMBER:




4/11/2024

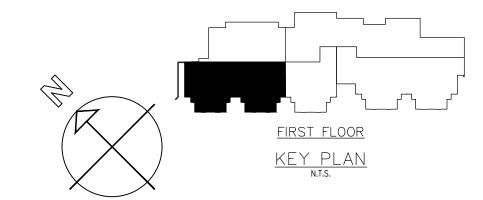


SPRINKLER PIPE

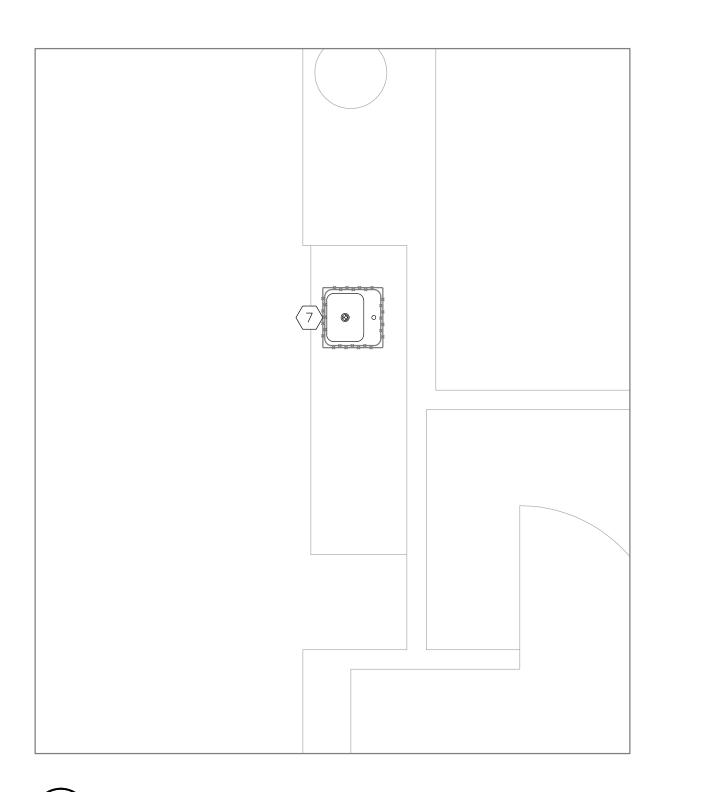

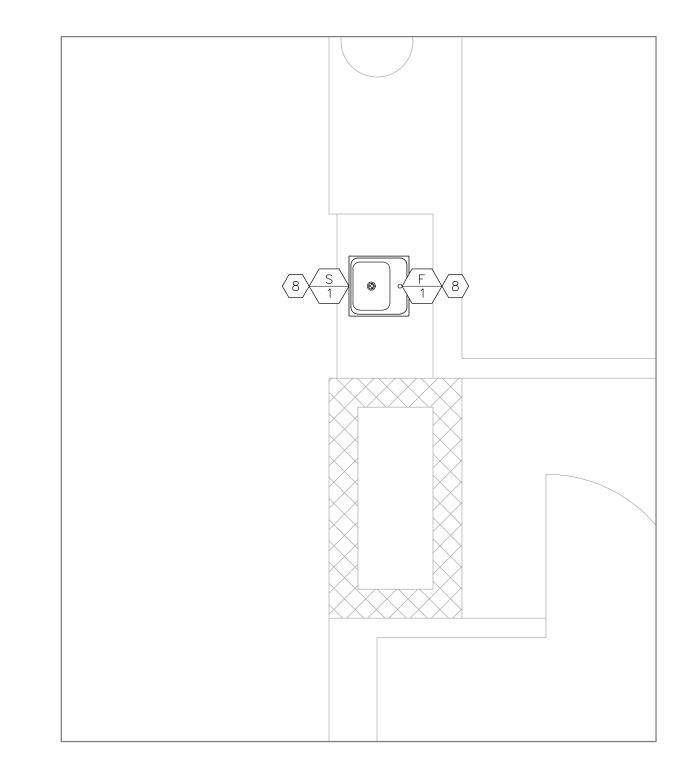

2 3RD FLOOR KITCHENETTE DEMOLITION
SCALE: 1/2' = 1'-0'

3RD FLOOR KITCHENETTE RENOVATION
SCALE: 1/2' = 1'-0'

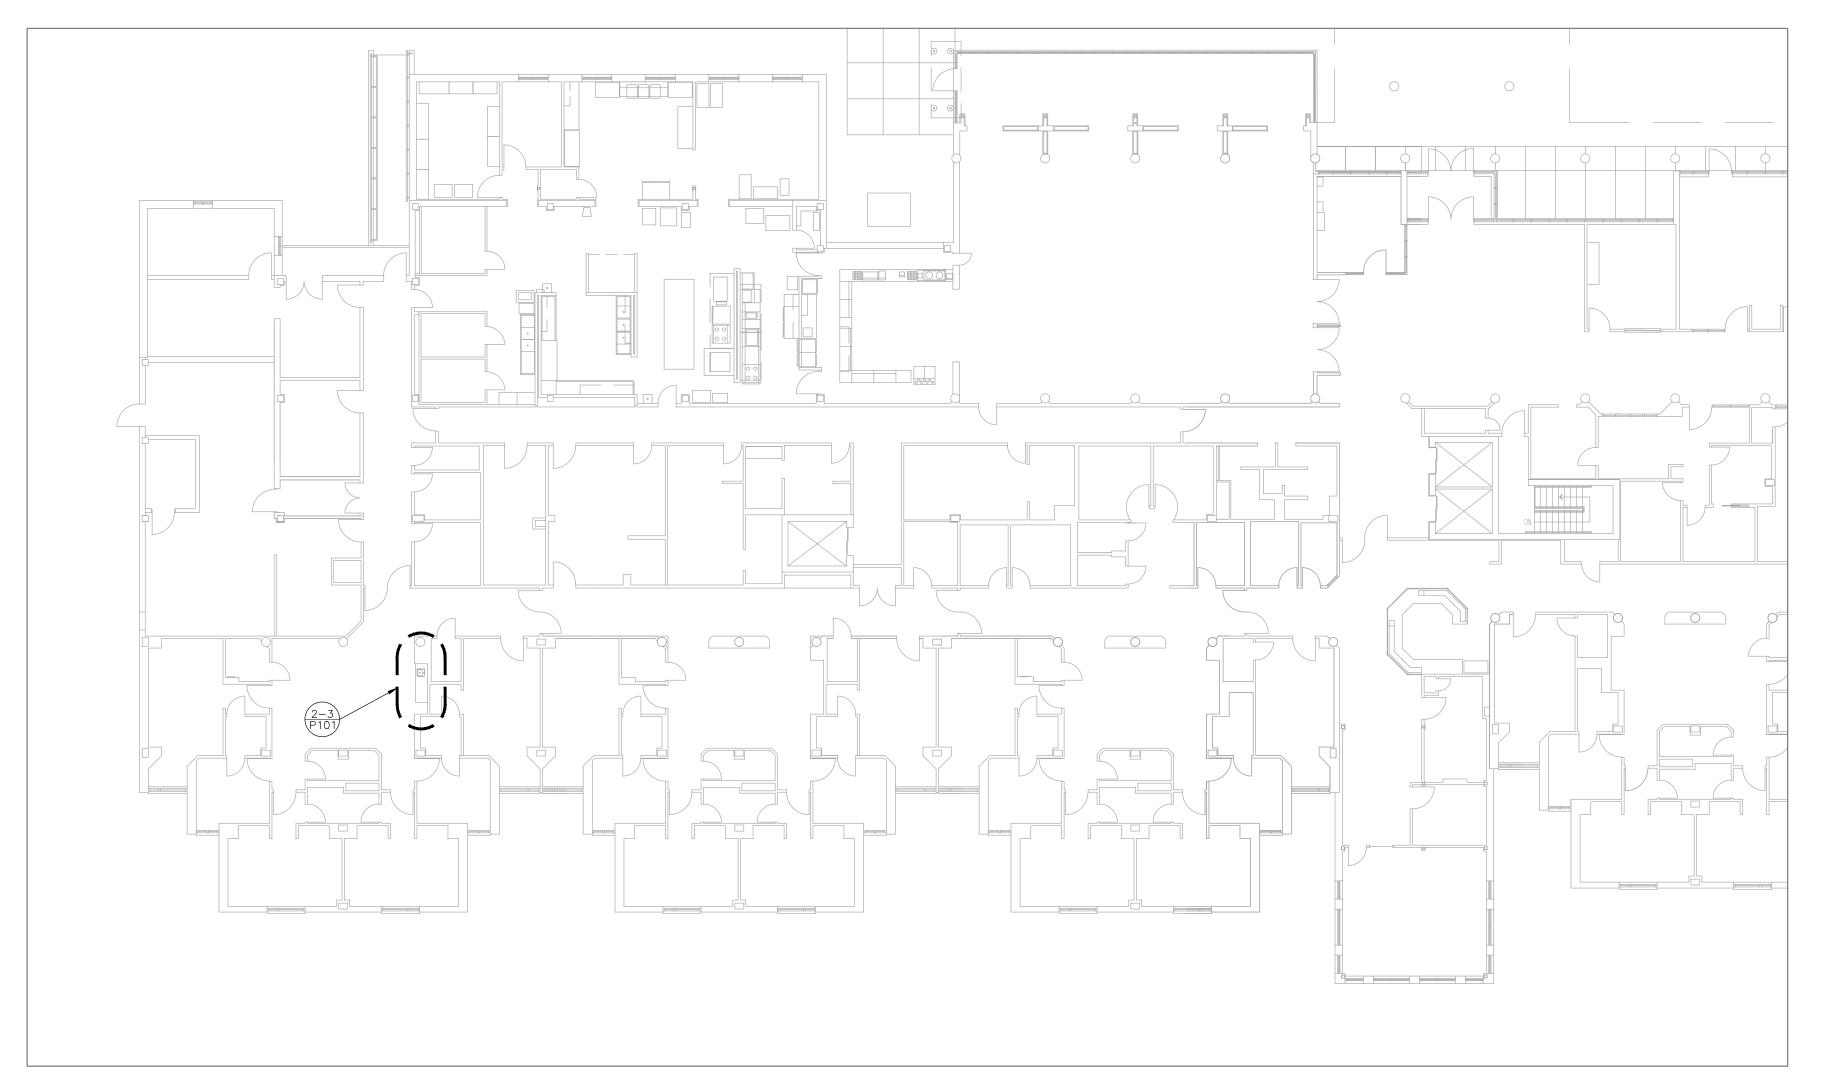

MEXICO VETERANS HOME FLOOR PLAN - 3RD FLOOR SCALE: 1/16' = 1'-0'



NOTES

- N INDICATES KEYED NOTES
- 1 COORDINATE WITH EXISTING SYSTEMS WHICH SHALL REMAIN IN OPERATION DURING DEMOLITION AND CONSTRUCTION PHASES. INSTALL TEMPORARY CAPS AT TERMINATION POINTS OF EXISTING PIPES TO REMAIN DURING DEMOLITION PHASES.
- CONTRACTOR IS RESPONSIBLE FOR REPAIRING ANY DAMAGE TO ANY SURFACE IN THE AREA OF CONSTRUCTION THAT IS A RESULT OF CONSTRUCTION ACTIVITY. SURFACE SHALL BE REPAIRED AND FINISHED TO MATCH EXISTING CONDITIONS.
- 4 FABRICATION, INSTALLATION AND TESTING OF ALL PLUMBING SYSTEMS SHALL BE IN ACCORDANCE WITH THE LATEST VERSION OF THE INTERNATIONAL PLUMBING CODE (IPC), ANSI CONSTRUCTION STANDARDS AND ALL MANUFACTURER INSTALLATION GUIDELINES.
- 5 ALL POTABLE WATER PIPE SHALL BE TYPE M COPPER. ALL SANITARY DRAIN PIPE SHALL BE SCHEDULE
- 6 PROVIDE SUITABLE SUPPORTS FOR STABILITY OF ALL PLUMBING FIXTURES, EQUIPMENT AND PIPE. FOLLOW ALL MANUFACTURER INSTALLATION RECOMMENDATIONS.
- REMOVE AND DISPOSE OF EXISTING SINK AND FAUCET. REMOVE AND DISPOSE OF ASSOCIATED PIPE FOR HOT AND COLD WATER SUPPLY AND SANITARY DRAIN.
- PROVIDE AND INSTALL SINK (S-1) AND FAUCET (F-1). PROVIDE AND INSTALL NEW SUPPLY STOPS AND RISERS AND CONNECT COLD AND HOT WATER SUPPLY AND DRAIN TO EXISTING.

STATE OF MISSOURI

SIEBENECK

NUMBER PE-2013019114

Tracie L. Siebeneck - Engineer MO# PE-2013019114

GOVERNOR

MICHAEL L. PARSON,

OFFICE OF ADMINISTRATION DIVISION OF FACILITIES MANAGEMENT, **DESIGN AND CONSTRUCTION**

DEPARTMENT OF MISSOURI VETERANS COMMISSION

HVAC IMPROVEMENTS FOR INFECTION CONTROL

MEXICO VETERANS **HOME** 1 VETERANS DR MEXICO, MO 65265

PROJECT # U2301-03 8136802001

REVISION: DATE: **REVISION: REVISION:** DATE:

CAD DWG FILE:M-U2301-03
DRAWN BY: TS/AH
CHECKED BY: TS

ISSUE DATE: 04/11/2024


DESIGNED BY: TS/AH


SHEET TITLE: PLUMBING

PLAN - 3RD FLOOR

SHEET NUMBER:

13 OF 28 SHEETS 4/11/2024

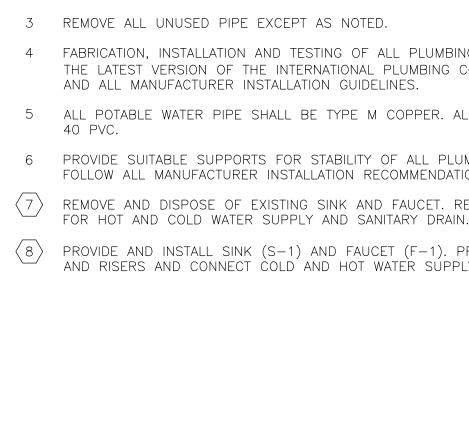

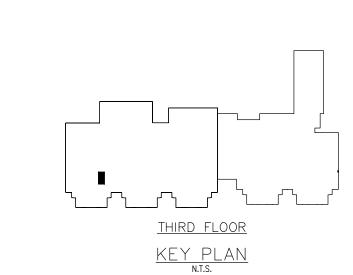

PLUM	BING LEGEND
AA N	DEVICE SCHEDULE TAG
LNNN	DETAIL REFERENCE, NUMBER/SHEET
	PLUMBING FIXTURE — NEW
	MATERIALS TO BE REMOVED

MARK	MANUFACTURER	SINK MODEL	DIMENSIONS	DESCRIPTION	NOTES
S-1	ELKAY	BLR150C	15"x15"x7-1/8" 2" DRAIN	MOUNTING TYPE: DROP-IN COUNTER MOUNTED; MATERIAL: 18 GAUGE 304 STAINLESS STEEL; FINISH: LUSTROUS SATIN; BOWL: 12"x 9-1/4"x 7-1/8" SINGLE BOWL; SOUND DEADENING: BOTTOM ONLY PADS	1,2

PROVIDE 20 GAUGE BRASS TUBULAR 1-1/4" P-TRAP WITHOUT CLEANOUT BY DEARBORN BRASS OR EQUAL, CHROME FINISH

		MODEL	CONNECTIONS	DESCRIPTION	NOTES
F-1	ELKAY	LKD2223C	3/8" HOT/COLD	TYPE: DECK MOUNT, GOOSE NECK SPOUT, 13" HEIGHT, 360° SWING; FINISH: CHROME; CONSTRUCTION: SOLID BRASS; 2.6" LEVER HANDLES; VALVE: 1/4 TURN CERAMIC DISC	1

GENERAL DEMOLITION NOTES

- 1 DEMOLITION DRAWINGS AND PLANS ARE FROM FIELD TAKE-OFF AND ORIGINAL DRAWINGS. CONTRACTOR IS RESPONSIBLE FOR FIELD VERIFYING PRIOR TO BIDDING AND/OR CONSTRUCTION.
- 2 COVER ALL OPENINGS INTO THE BUILDING FROM THE WORK AREA. ENSURE DEBRIS IS REMOVED FROM THE CONSTRUCTION AND DEMOLITION AREA AND AIR BORN DEBRIS IS NOT ALLOWED TO TRAVEL TO THE REMAINDER OF THE BUILDING. CONTRACTOR IS RESPONSIBLE FOR REMOVAL AND DISPOSAL OF ALL DEMOLISHED MATERIAL.
- 3 COORDINATE WITH EXISTING SYSTEMS WHICH SHALL REMAIN IN OPERATION DURING DEMOLITION AND CONSTRUCTION PHASES. INSTALL TEMPORARY CAPS AT TERMINATION POINTS OF EXISTING DUCTWORK/PIPES TO REMAIN DURING DEMOLITION PHASES.
- 4 UNLESS NOTED OTHERWISE ALL AIR DEVICES REMOVED WITH SUSPENDED CEILING DEMOLITION AND RENOVATION ARE TO BE RETAINED AND PLACED IN THE SAME OR COMPARABLE LOCATION.
- 5 CONTRACTOR IS RESPONSIBLE FOR REPAIRING ANY DAMAGE TO ANY SURFACE IN THE AREA OF CONSTRUCTION THAT IS A RESULT OF CONSTRUCTION ACTIVITY. SURFACE SHALL BE REPAIRED AND FINISHED TO MATCH EXISTING CONDITIONS.

DEMOLITION KEY NOTES

- (N) INDICATES KEYED NOTES
- REMOVE AND DISPOSE OF CONDENSATE DRAIN PIPE AS SHOWN OR AS NEEDED TO COMPLETE THE WORK.
- CREATE PENETRATION FOR OUTDOOR AIR DUCT CHASE FROM MAKE—UP AIR UNIT (MAU) LOCATED ON ROOF. REFERENCE SHEET M—104 FOR DUCT SIZE.
- 3 CREATE PENETRATION IN WALL TO ALLOW PATHS FOR DUCT/AIR DEVICES. REFERENCE SHEET M-104 FOR DUCT/AIR DEVICE SIZE.
- $\langle 4 \rangle$ REMOVE AND DISPOSE OF DUCT AS SHOWN OR AS NEEDED TO COMPLETE THE WORK.
- REMOVE AND RETAIN AIR DEVICE AND ASSOCIATED FLEXIBLE DUCT FOR USE IN NEW CONSTRUCTION. REMOVE AND RETAIN RETURN AIR DEVICE FOR USE IN NEW CONSTRUCTION.
- REMOVE AND DISPOSE OF EXHAUST GRILLE. COORDINATE WITH GENERAL CONTRACTOR TO PATCH WALL
 - REMOVE AND DISPOSE OF CEILING MOUNTED EXHAUST GRILLE. PROVIDE AND INSTALL NEW CEILING
- PREMOVE AND RETAIN HIGH EFFICIENCY TAKE-OFF AND DUCT SCRUBBER FOR USE IN NEW CONSTRUCTION. REMOVE AND DISPOSE OF RECTANGULAR DUCT AS SHOWN.
- $\langle 10 \rangle$ refer to architectural plans for window modification.
- (11) PATCH DUCT AND PROVIDE INSULATION TO MATCH EXISTING.

TO MATCH EXISTING PERFORMANCE AND FINISH.

STATE OF MISSOURI MICHAEL L. PARSON, **GOVERNOR**



Tracie L. Siebeneck - Engineer MO# PE-2013019114

OFFICE OF ADMINISTRATION DIVISION OF FACILITIES MANAGEMENT, **DESIGN AND CONSTRUCTION**

DEPARTMENT OF MISSOURI VETERANS **COMMISSION**

HVAC IMPROVEMENTS FOR INFECTION CONTROL

MEXICO VETERANS HOME 1 VETERANS DR MEXICO, MO 65265

PROJECT # U2301-03 8136802001 ASSET#

REVISION: DATE: **REVISION:** DATE: **REVISION:** DATE:

CAD DWG FILE:M-U2301-03
DRAWN BY: TS/AH
CHECKED BY: TS


ISSUE DATE: 04/11/2024


DESIGNED BY: TS/AH

SHEET TITLE:


MECHANICAL DEMOLITION PLAN -1ST FLOOR

SHEET NUMBER:

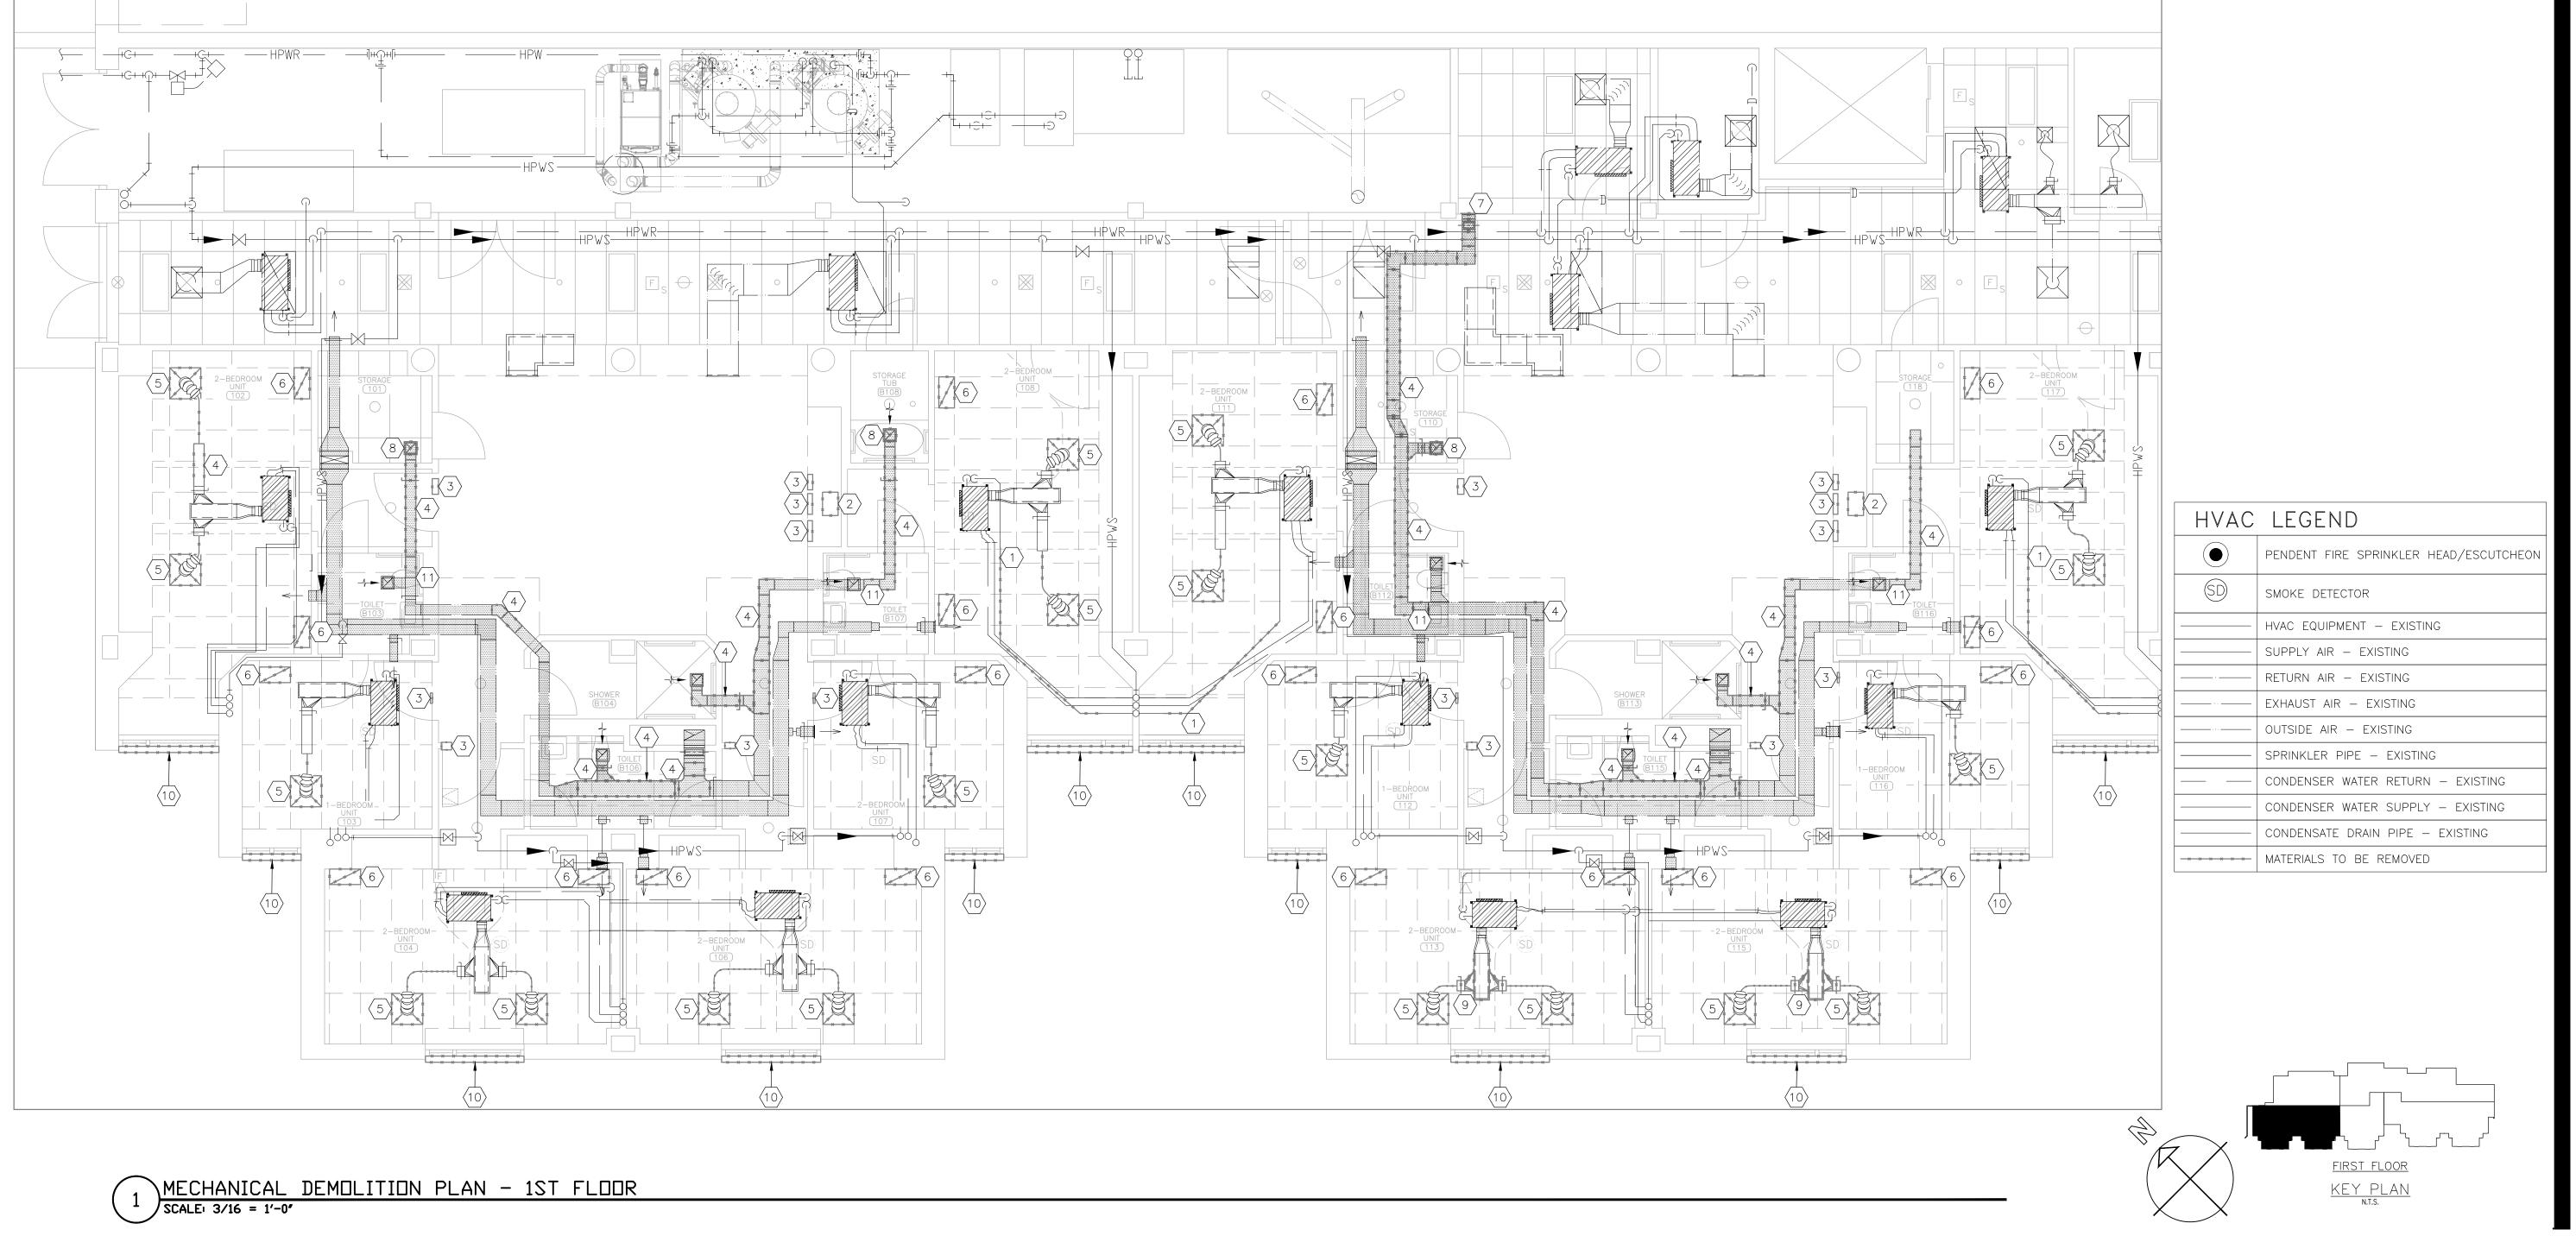

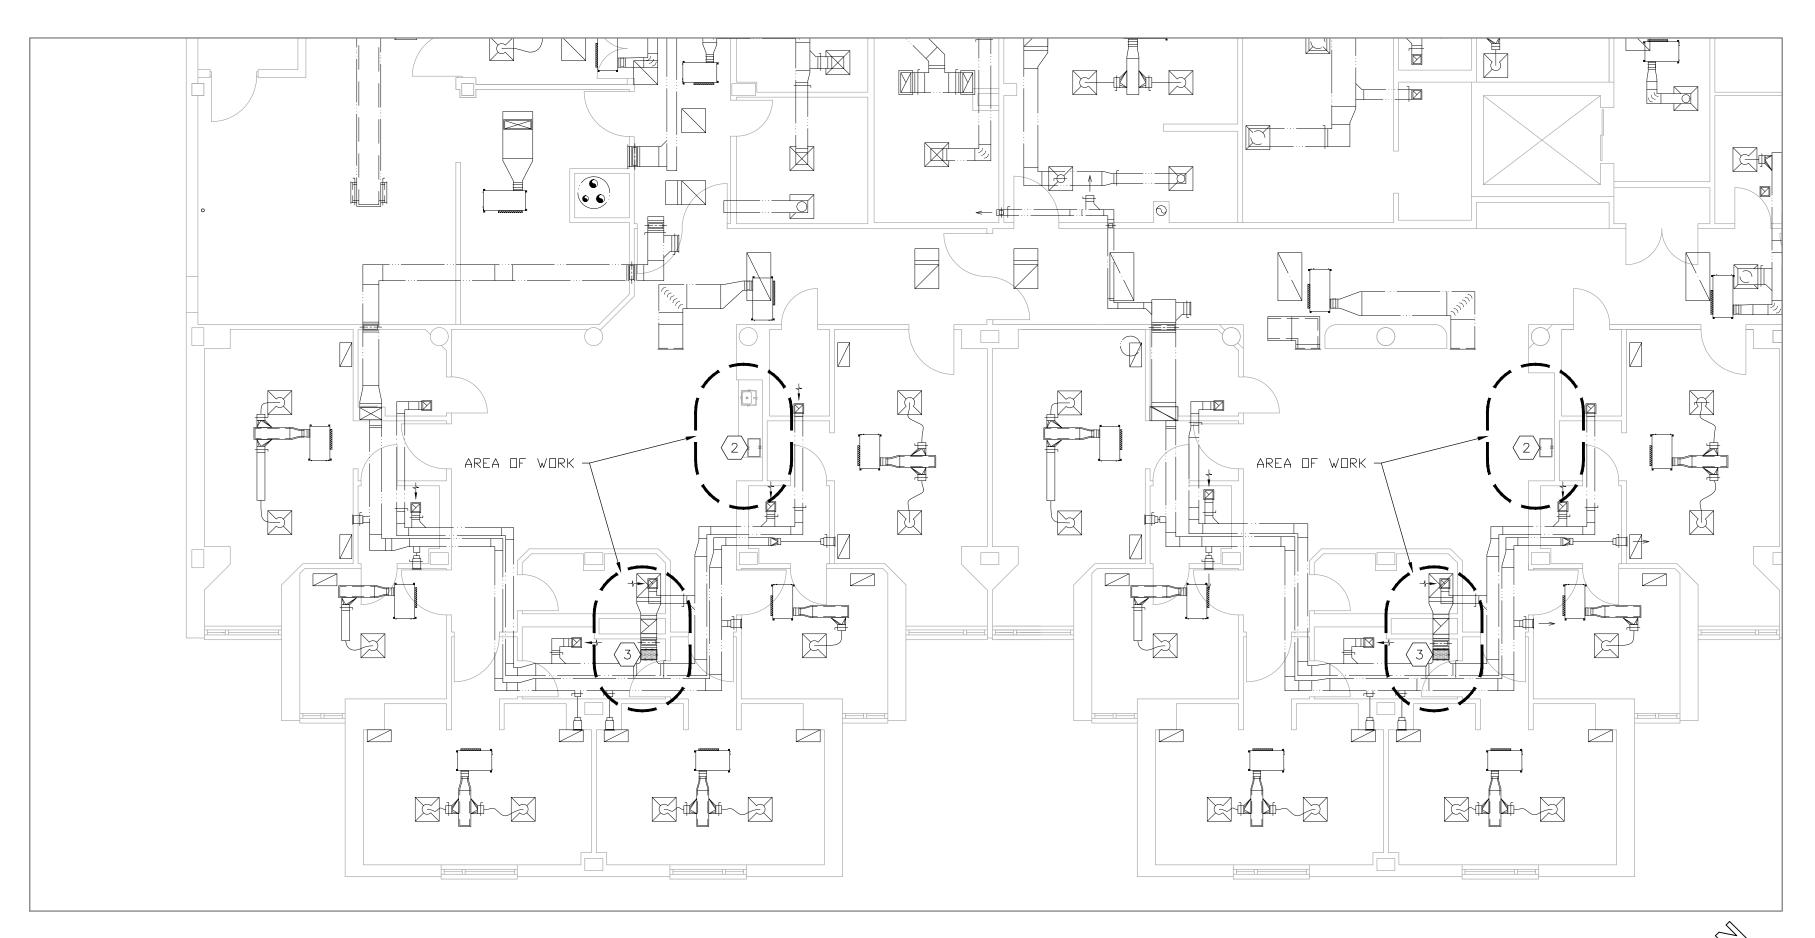

2 MECHANICAL DEMOLITION PLAN - 3RD FLOOR
SCALE: 1/8 = 1'-0'

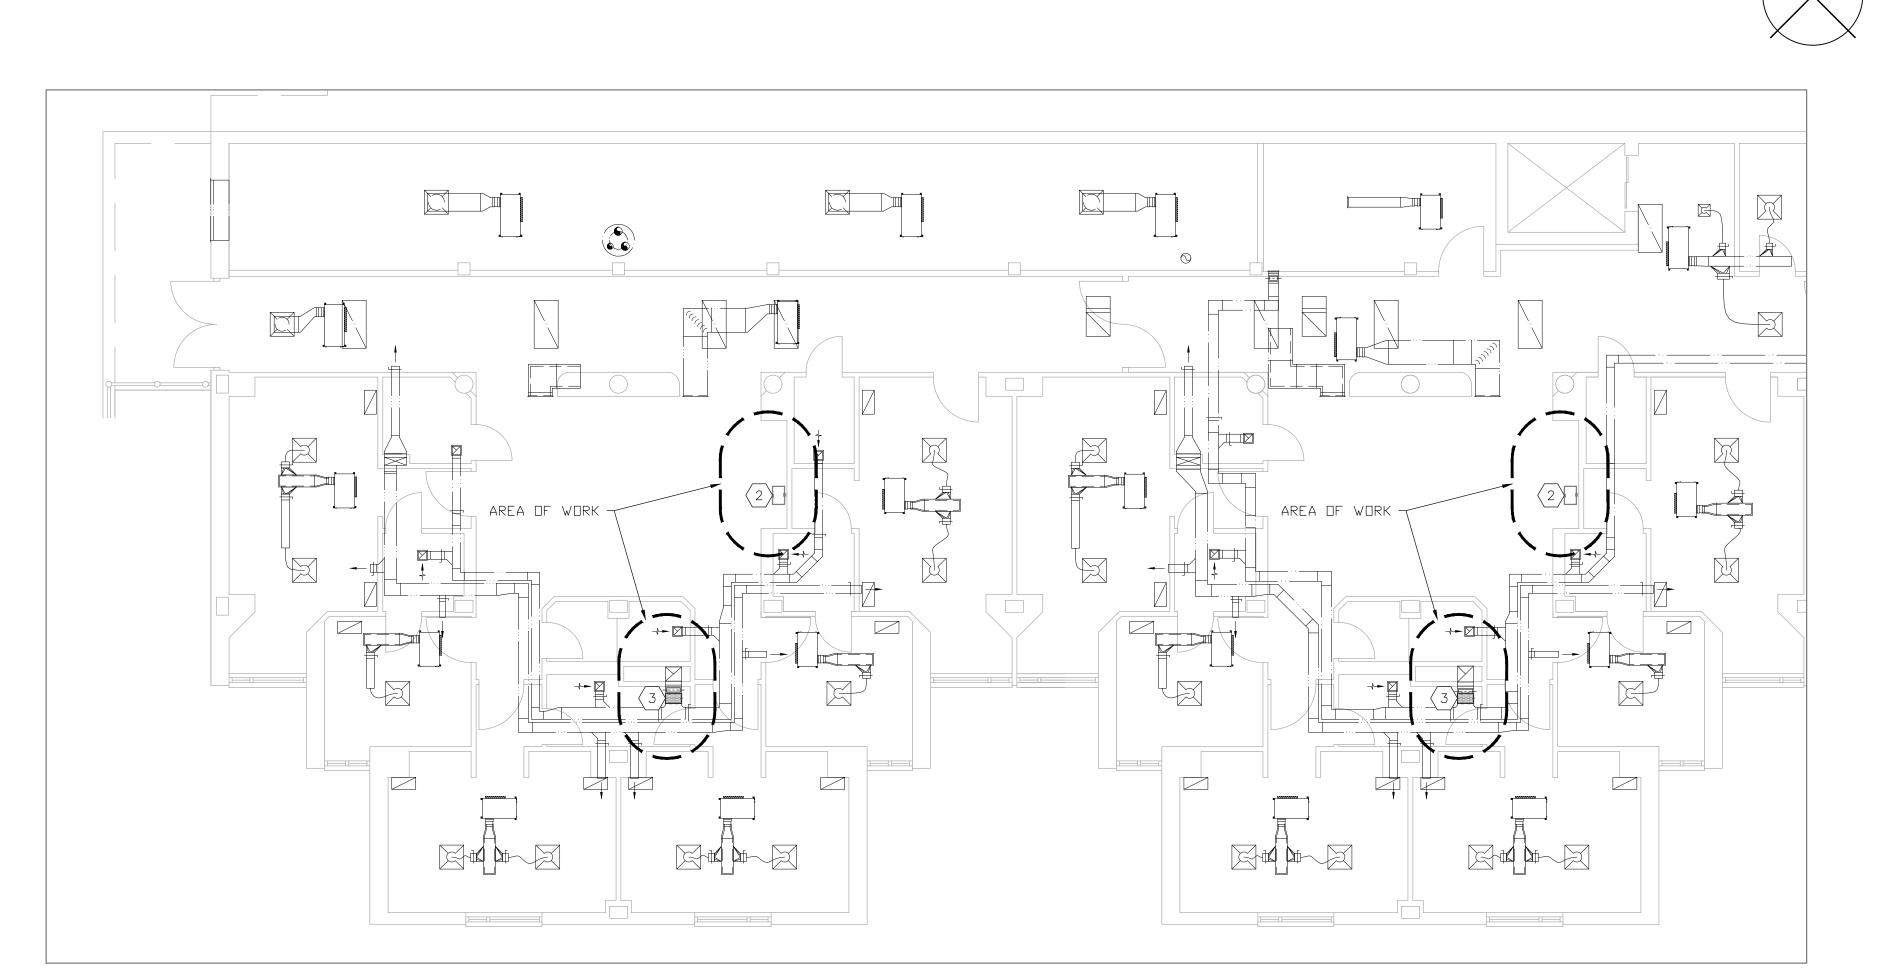

1 MECHANICAL DEMOLITION PLAN - 2ND FLOOR
SCALE: 1/8 = 1'-0"



NOTES

(N) INDICATES KEYED NOTES

1 REFERENCE SHEET M-101 FOR GENERAL DEMOLITION NOTES.

- SAWCUT CONCRETE FLOOR SLAB TO CREATE PENETRATION FOR MAKE—UP AIR DUCT. REFER TO SHE
- $\overline{3}$ remove duct as shown or as needed for installation of backdraft damper (bD-1).

GOVERNOR

TRACIE L.

SIEBENECK

STATE OF MISSOURI

MICHAEL L. PARSON,

PE-2013019114

Tracie L. Siebeneck - Engineer MO# PE-2013019114

SOCUMENTS

OFFICE OF ADMINISTRATION DIVISION OF FACILITIES MANAGEMENT, DESIGN AND CONSTRUCTION

DEPARTMENT OF MISSOURI VETERANS COMMISSION

HVAC IMPROVEMENTS FOR INFECTION CONTROL

MEXICO VETERANS HOME 1 VETERANS DR MEXICO, MO 65265

PROJECT # U2301-03 SITE # 6802 ASSET # 8136802001

REVISION:
DATE:
REVISION:
DATE:
REVISION:
DATE:
ISSUE DATE: 04/11/2024

CAD DWG FILE:M-U2301-03
DRAWN BY: TS/AH
CHECKED BY: TS/AH
DESIGNED BY: TS/AH

SHEET TITLE:

MECHANICAL
DEMOLITION PLAN 2ND & 3RD FLOORS

SHEET NUMBER:

M-102

15 OF 28 SHEETS 4/11/2024



THIRD FLOOR

KEY PLAN N.T.S.

HVAC LEGEND

HVAC EQUIPMENT - EXISTING


SUPPLY AIR - EXISTING


RETURN AIR - EXISTING

EXHAUST AIR - EXISTING

OUTSIDE AIR - EXISTING

----- MATERIALS TO BE REMOVED

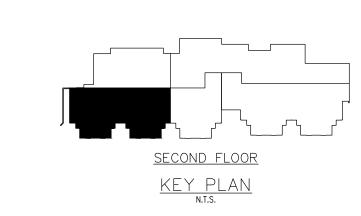

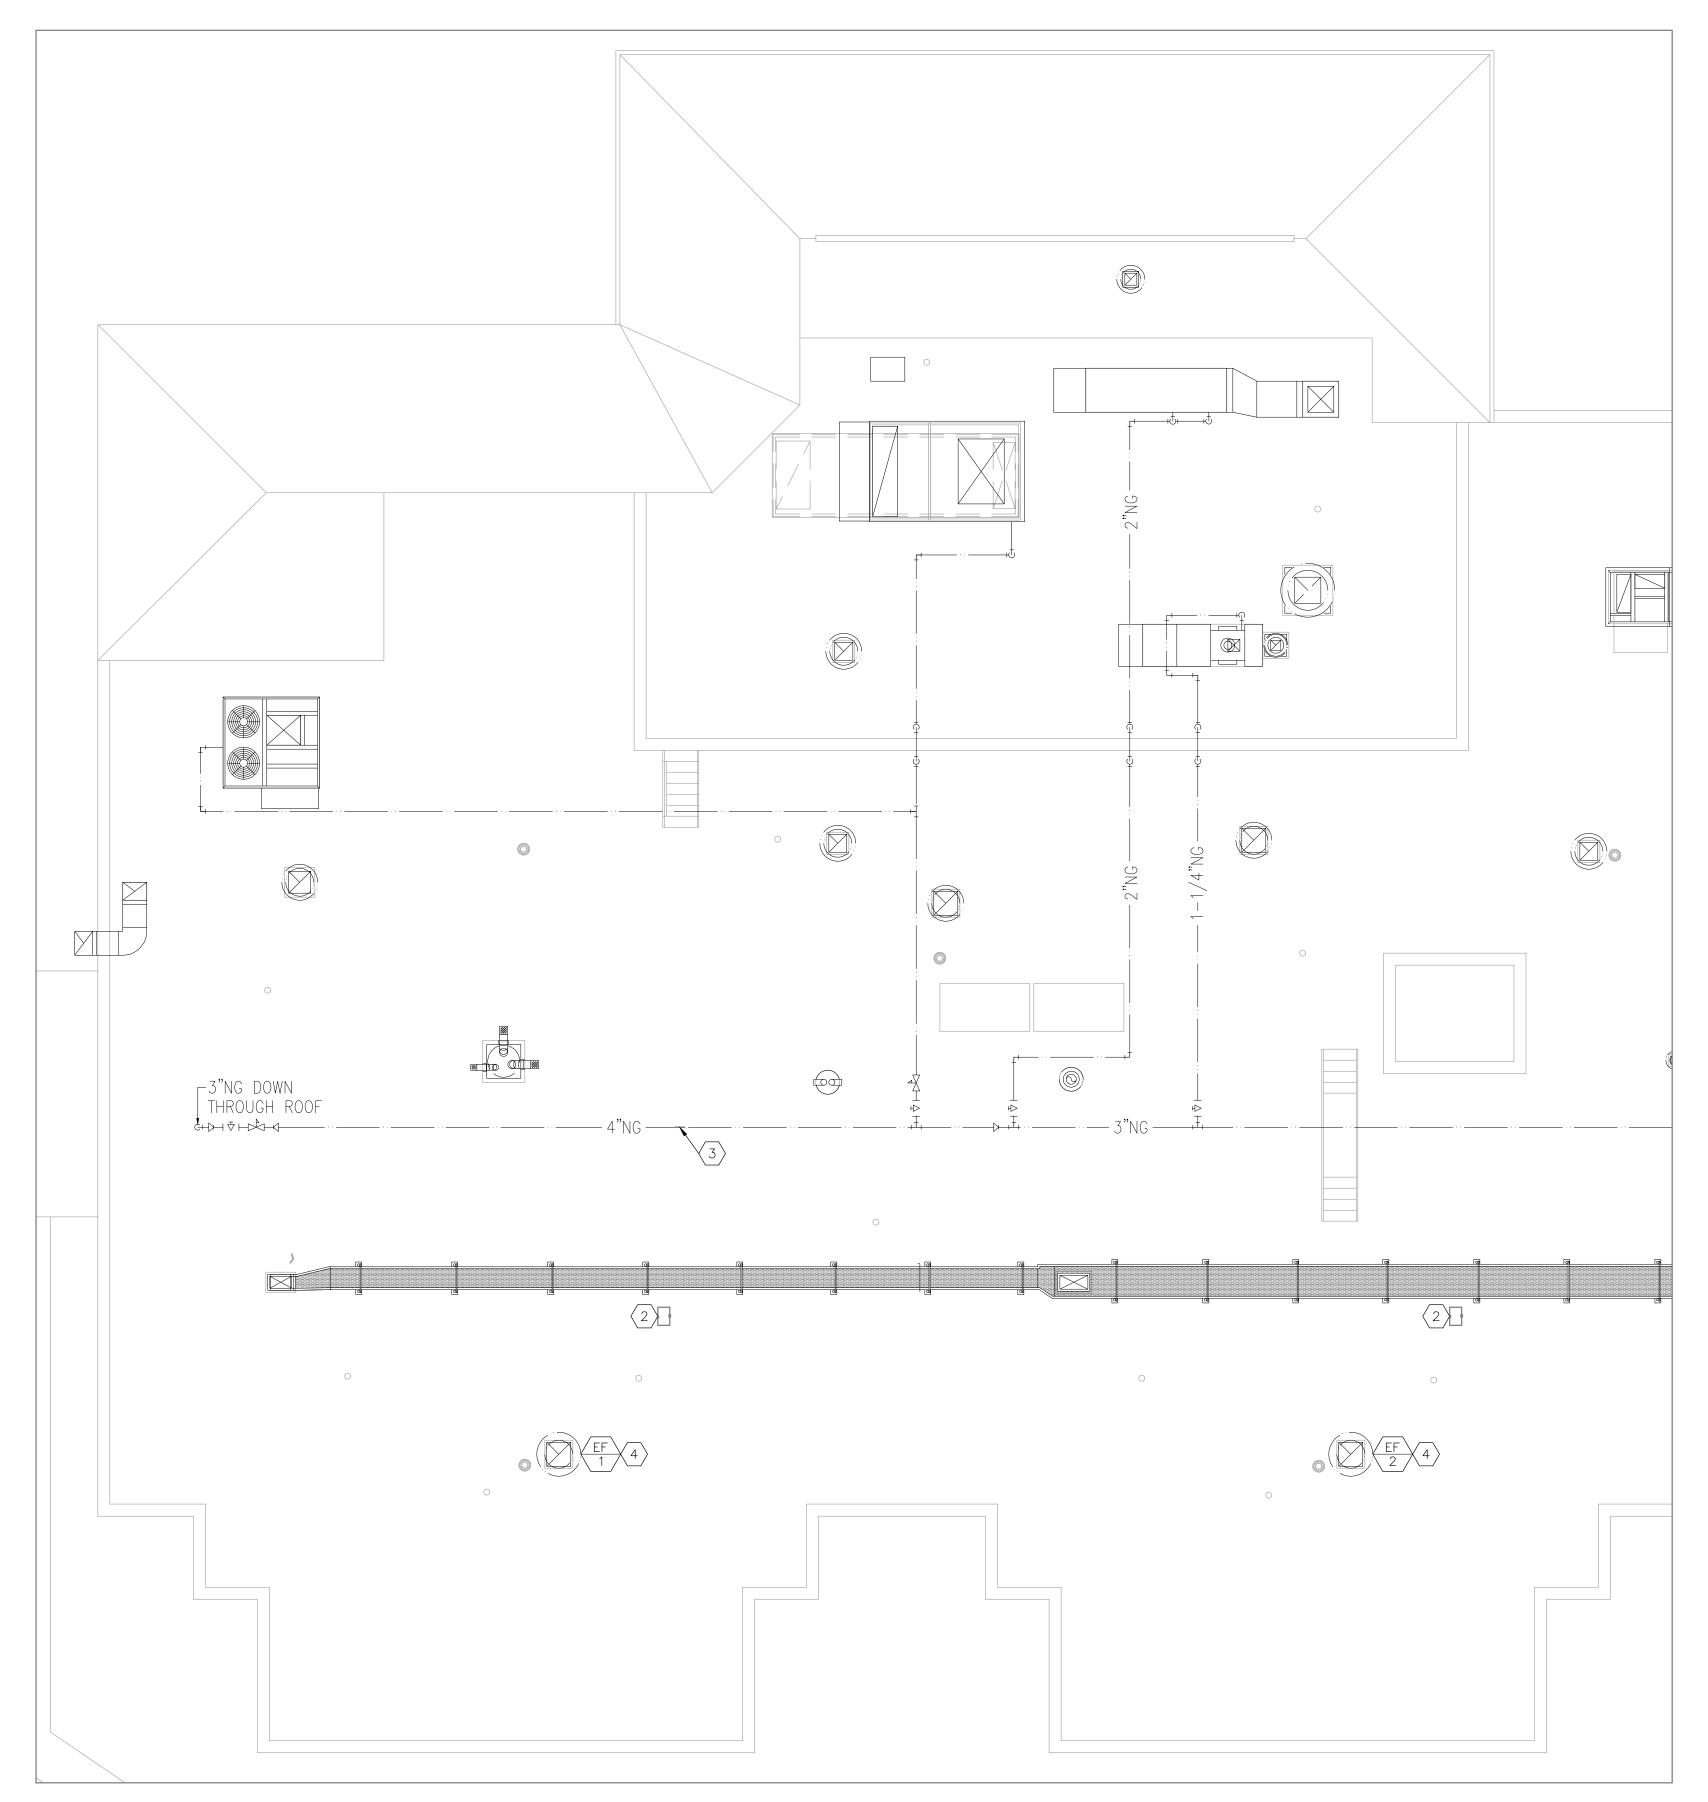

MECHANICAL DEMOLITION PLAN - ROOF SCALE: 1/8 = 1'-0"



NOTES

N INDICATES KEYED NOTES

- 1 REFERENCE SHEET M-101 FOR GENERAL DEMOLITION NOTES.
- SAWCUT CONCRETE ROOF SLAB TO CREATE PENETRATION FOR MAKE-UP AIR DUCT. REFER TO SHEET M-107 FOR DUCT SIZE. REFER TO FRAMING PLAN S-151 FOR ADDITIONAL INFORMATION.
- PREPARE NATURAL GAS PIPE FOR INSTALLATION OF GAS PIPE FOR NEW MAKE—UP AIR UNITS. REFER TO SHEET M—107 FOR PIPE SIZE AND ROUTE TO NEW EQUIPMENT. COORDINATE WITH OWNER FOR ANY REQUIRED SHUTDOWN OF HEATING SYSTEM. SHUTDOWN TIME SHOULD BE LIMITED AS MUCH AS PRACTICAL.
- TEST AND BALANCING CONTRACTOR SHALL MEASURE EXHAUST FAN AIRFLOW PRIOR TO DEMOLITION ACTIVITIES AND PREPARE A REPORT TO BE SUBMITTED TO THE ENGINEER FOR REVIEW. AT A MINIMUM, THE REPORT SHALL INCLUDE FAN MAKE AND MODEL NUMBER, INSTALLED DRIVE, AND ELECTRICAL CHARACTERISTICS AS WELL AS MEASURED STATIC PRESSURE AND AIRFLOW RATE. TEST SHALL BE REPEATED AND FAN SHALL BE ADJUSTED AFTER CONSTRUCTION ACTIVITIES TO ENSURE EXISTING CONDITIONS ARE MAINTAINED. DESIGN AIRFLOW: EF-1: 1950 CFM; EF-2: 2088 CFM

STATE OF MISSOURI MICHAEL L. PARSON, **GOVERNOR**



Tracie L. Siebeneck - Engineer MO# PE-2013019114

OFFICE OF ADMINISTRATION DIVISION OF FACILITIES MANAGEMENT, **DESIGN AND CONSTRUCTION**

DEPARTMENT OF MISSOURI VETERANS **COMMISSION**

HVAC IMPROVEMENTS FOR INFECTION CONTROL

MEXICO VETERANS HOME 1 VETERANS DR MEXICO, MO 65265

PROJECT # U2301-03 8136802001 ASSET#

REVISION: DATE: **REVISION: REVISION:** DATE:

CAD DWG FILE:M-U2301-03
DRAWN BY: TS/AH
CHECKED BY: TS

ISSUE DATE: 04/11/2024

DESIGNED BY: TS/AH


SHEET TITLE:

MECHANICAL DEMOLITION PLAN -ROOF

SHEET NUMBER:

16 OF 28 SHEETS

4/11/2024

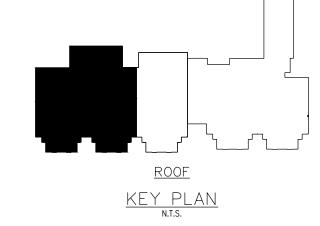

HVAC LEGEND

HVAC EQUIPMENT — EXISTING

SUPPLY AIR — EXISTING

RETURN AIR - EXISTING

— EXHAUST AIR — EXISTING

---- MATERIALS TO BE REMOVED

- 1 FABRICATION, INSTALLATION AND TESTING OF ALL HVAC SYSTEMS SHALL BE IN ACCORDANCE WITH LATEST VERSION OF THE INTERNATIONAL MECHANICAL CODE (IMC), NATIONAL ELECTRIC CODE (NEC), AND ALL MANUFACTURER INSTALLATION GUIDELINES.
- 2 ALL METALLIC AND FLEXIBLE DUCTS SHALL BE CONSTRUCTED AND INSTALLED AS SPECIFIED IN THE IMC AND SMACNA HVAC DUCT CONSTRUCTION STANDARDS.
- DUCT HAS BEEN DESIGNED TO FIT IN THE SPACE AVAILABLE AND TO AVOID CONFLICTS. CONTRACTOR SHALL FIELD VERIFY FOR ANY UNFORESEEN CONFLICTS PRIOR TO FABRICATING DUCT. CONTRACTOR SHALL COORDINATE WITH OTHER DISCIPLINES TO ENSURE ADEQUATE SPACE IS AVAILABLE FOR DUCT. DESIGN INSULATION THICKNESS IS 1.5 INCH.
- 4 ELECTRICAL CONTRACTOR SHALL PROVIDE AND INSTALL ALL LINE VOLTAGE WIRING AND CONDUIT.
 MECHANICAL CONTRACTOR SHALL PROVIDE AND INSTALL ALL LOW VOLTAGE WIRING FOR MECHANICAL
 SYSTEMS. COORDINATE WITH ELECTRICAL CONTRACTOR TO PROVIDE AND INSTALL ALL CONDUIT FOR
- THIRD PARTY, AABC OR NEBB CERTIFIED TESTING, ADJUSTING, AND BALANCING CONTRACTOR SHALL TEST AND BALANCE ALL SYSTEMS TO SPECIFIED VALUES AND PREPARE A BALANCE REPORT PER ASHRAE STANDARD 111 OR EQUAL. REPORT SHALL BE SENT TO THE ENGINEER FOR APPROVAL PRIOR TO FINAL COMPLETION. BALANCE DAMPERS ARE REQUIRED ON ALL SUPPLY AIR DEVICES. REFERENCE SPECIFICATIONS FOR ADDITIONAL INFORMATION.
- ALL DUCTWORK WITH TWO DIMENSION <WxD> INDICATES RECTANGULAR DUCT. ALL <DØ> INDICATES ROUND DUCT. DIMENSIONS ARE INCHES MEASURED INSIDE. PROVIDE STANDARD TURNING VANES OR CURVED ELBOW WITH SQUARE THROAT ON RECTANGULAR DUCTS. ROUND DUCT SHALL MAINTAIN A CENTERLINE TURNING RADIUS OF 1.5 X DUCT DIAMETER. FLEXIBLE DUCT SHALL BE 5 FEET MAXIMUM LENGTH AND BE SUPPORTED TO MINIMIZE STATIC PRESSURE DROP.

GENERAL RENOVATION NOTES CONTINUED

- ALL INSULATION SHALL MEET THE ASTM E 84 FLAME/SMOKE SPREAD INDEX OF 25/50 MAXIMUM. DUCT SEAMS SHALL BE SEALED. THERMAL CONDUCTIVITY VALUES PROVIDED BELOW ARE "AS INSTALLED" VALUES:
- CONCEALED OUTDOOR AIR DUCT LOCATED INSIDE: EXTERNAL INSULATION; 2 INCH THICK WITH MINIMUM THERMAL CONDUCTIVITY OF 0.25 BTU-IN/HR/SF/°F (R6) WITH VAPOR BARRIER.
 OUTSIDE AIR DUCT LOCATED OUTSIDE: EXTERNAL INSULATION; 3 INCHES THICK WITH MINIMUM THERMAL CONDUCTIVITY OF 0.27 BTU-IN/HR/SF/°F (R8) WITH VAPOR BARRIER. ALUMINUM JACKET;
- SMOOTH 0.016 INCH THICK.

 EXHAUST AIR DUCT SERVING FAN FILTER UNITS (FFU-1A, 1B, 1C) AND EXHAUST LOUVER PLENUM: EXTERNAL INSULATION; 1-1/2 INCH THICK WITH MINIMUM THERMAL CONDUCTIVITY OF 0.25 BTU-IN/HR/SF/°F (R4.5) WITH VAPOR BARRIER.
- PROVIDE SUITABLE SUPPORTS FOR STABILITY OF ALL HVAC DEVICES AND DUCT. AIR HANDLING EQUIPMENT SHALL BE PROVIDED WITH FLEXIBLE SUPPLY AND RETURN AIR DUCT CONNECTORS AT UNITS. HORIZONTAL UNITS SHALL BY SUPPORTED FROM THE STRUCTURE ABOVE THE UNIT USING UNI—STRUT OR EQUAL. COORDINATE WITH GENERAL CONTRACTOR AND REFER TO KEY NOTES FOR ADDITIONAL REQUIREMENTS.
- ADDITIONAL REQUIREMENTS.

 PROVIDE A TRAPPED CONDENSATE DRAIN PIPE FOR ALL EVAPORATORS. SLOPE IN THE DIRECTION OF DISCHARGE A MINIMUM OF 1/8" PER FOOT. COORDINATE CONDENSATE DRAIN DISCHARGE LOCATION
- WITH ROOF DRAIN LOCATION.
 MAU: CONDENSATE PIPE SHALL BE 0.75 INCH INSIDE DIAMETER SCHEDULE 40 PVC.
 EXISTING HEAT PUMPS: CONDENSATE PIPE SHALL BE 1 INCH INSIDE DIAMETER TYPE M COPPER WITH 1/2 INCH FIBER GLASS INSULATION.
- ANY EXHAUST AIR DISCHARGE SHALL BE 3 FEET HIGHER THAN ANY INTAKE OPENING WITHIN 10 HORIZONTAL FEET.

RENOVATION NOTES

- 1 INSTALL ALL TRANSFER GRILLES AS SHOWN IN DETAIL 3 ON SHEET M-601.

2 COORDINATE FFU, AIR DEVICE, AND DUCT LOCATIONS WITH SHEET M-105.

- COORDINATE DUCT ELEVATION WITH NEW CONDENSATE DRAIN PIPE AND EXISTING CONDENSER PIPE
- HEIGHTS. REFER TO SHEET M-105.

 4 GENERAL CONTRACTOR SHALL PROVIDE AND INSTALL AIRTIGHT/WATERTIGHT ACCESS DOOR FOR EXISTING
- BALANCE DAMPER(S). PROVIDE GENERAL CONTRACTOR WITH FINAL ACCESS DOOR LOCATION TO ALLOW FOR OPTIMAL ACCESS TO DAMPER OPERATOR.

 5 COORDINATE WITH GENERAL CONTRACTOR FOR GROUND PENETRATING RADAR OR OTHER APPROVED NON-DESTRUCTIVE METHOD TO BE PERFORMED ON THE CONCRETE SLAB PRIOR TO HANGING THE FAN FILTER UNIT (FFU). FFU SHALL BE SUPPORTED FROM THE CONCRETE SLAB USING UNISTRUT OR
- REINFORCING BARS. REFER TO DETAIL 4 OF SHEET M-601. REFER TO STRUCTURAL DRAWINGS FOR ADDITIONAL REQUIREMENTS.


 (6) INSTALL CONTROL DAMPER (CD-1) ON RETAINED RETURN GRILLE PER DETAIL 2, SHEET M-601. INSTALL DAMPER/GRILLE ASSEMBLY AS SHOWN. COORDINATE FINAL LOCATION WITH EXISTING

EQUAL. THE ANCHORS SHALL BE PLACED A MINIMUM OF 1-1/2 INCHES FROM ANY EXISTING

 $\overline{\langle 7 \rangle}$ outdoor air duct from Make-up air unit (Mau) located on Roof.

CONDITIONS TO ENSURE ADEQUATE SPACE FOR ASSEMBLY AND AIR MOVEMENT.


- COORDINATE WITH GENERAL CONTRACTOR TO PROVIDE AND INSTALL LOUVER IN EACH TRANSOM WINDOW. PROVIDE AND INSTALL INSULATED DUCT BOX AROUND LOUVER. ROUTE EXHAUST DUCT FROM THE FFU(S) LOCATED IN ROOM AS SHOWN.
- (9) CONTRACTOR SHALL ROUTE DUCT SUCH THAT THERE IS ROOM TO PROVIDE SERVICE TO THE FAN FILTER UNIT (FFU) PER THE MANUFACTURER'S INSTRUCTIONS.
- O) INSTALL RETAINED SUPPLY AIR DEVICE AS SHOWN. WHERE POSSIBLE USE RETAINED FLEXIBLE DUCT.
 PROVIDE AND INSTALL NEW 8 INCH FLEXIBLE DUCT WHERE APPLICABLE.
- TAB CONTRACTOR SHALL PERFORM BLOWER DOOR TESTING AFTER BEDROOM WALLS ARE SEALED AND BEFORE GRID CEILING IS INSTALLED TO ENSURE EACH ROOM IS COMPLETELY SEALED. REFER TO GENERAL CONSTRUCTION NOTE 2 ON SHEET G-002 FOR ADDITIONAL INFORMATION. AFTER CONSTRUCTION IS COMPETE, TAB CONTRACTOR SHALL BALANCE SYSTEM SO THAT THERE IS NEGATIVE PRESSURE RELATIONSHIP FROM THE LIVING ROOM TO EACH BEDROOM OF -0.01 IN WG (MINIMUM). ENSURE BUILDING IS NOT NEGATIVE RELATIVE TO OUTSIDE. ADJUST EACH SYSTEM INDEPENDENTLY AND CONFIRM RESULTS WITH BOTH IN OPERATION AT THE SAME TIME. EACH SYSTEM CONSISTS OF ONE MAKE-UP AIR UNIT (MAU-6 AND MAU-7) AND ALL THE FAN FILTER UNITS IN BEDROOMS THAT COMMUNICATE WITH THE LIVING ROOM. SEE SEQUENCE OF OPERATION ON SHEET M-602 AND SECTION 230593 FOR ADDITIONAL INFORMATION. CONFIRM WITH ENGINEER FOR ANY REQUIRED CLARIFICATION PRIOR TO TAB ACTIVITIES.

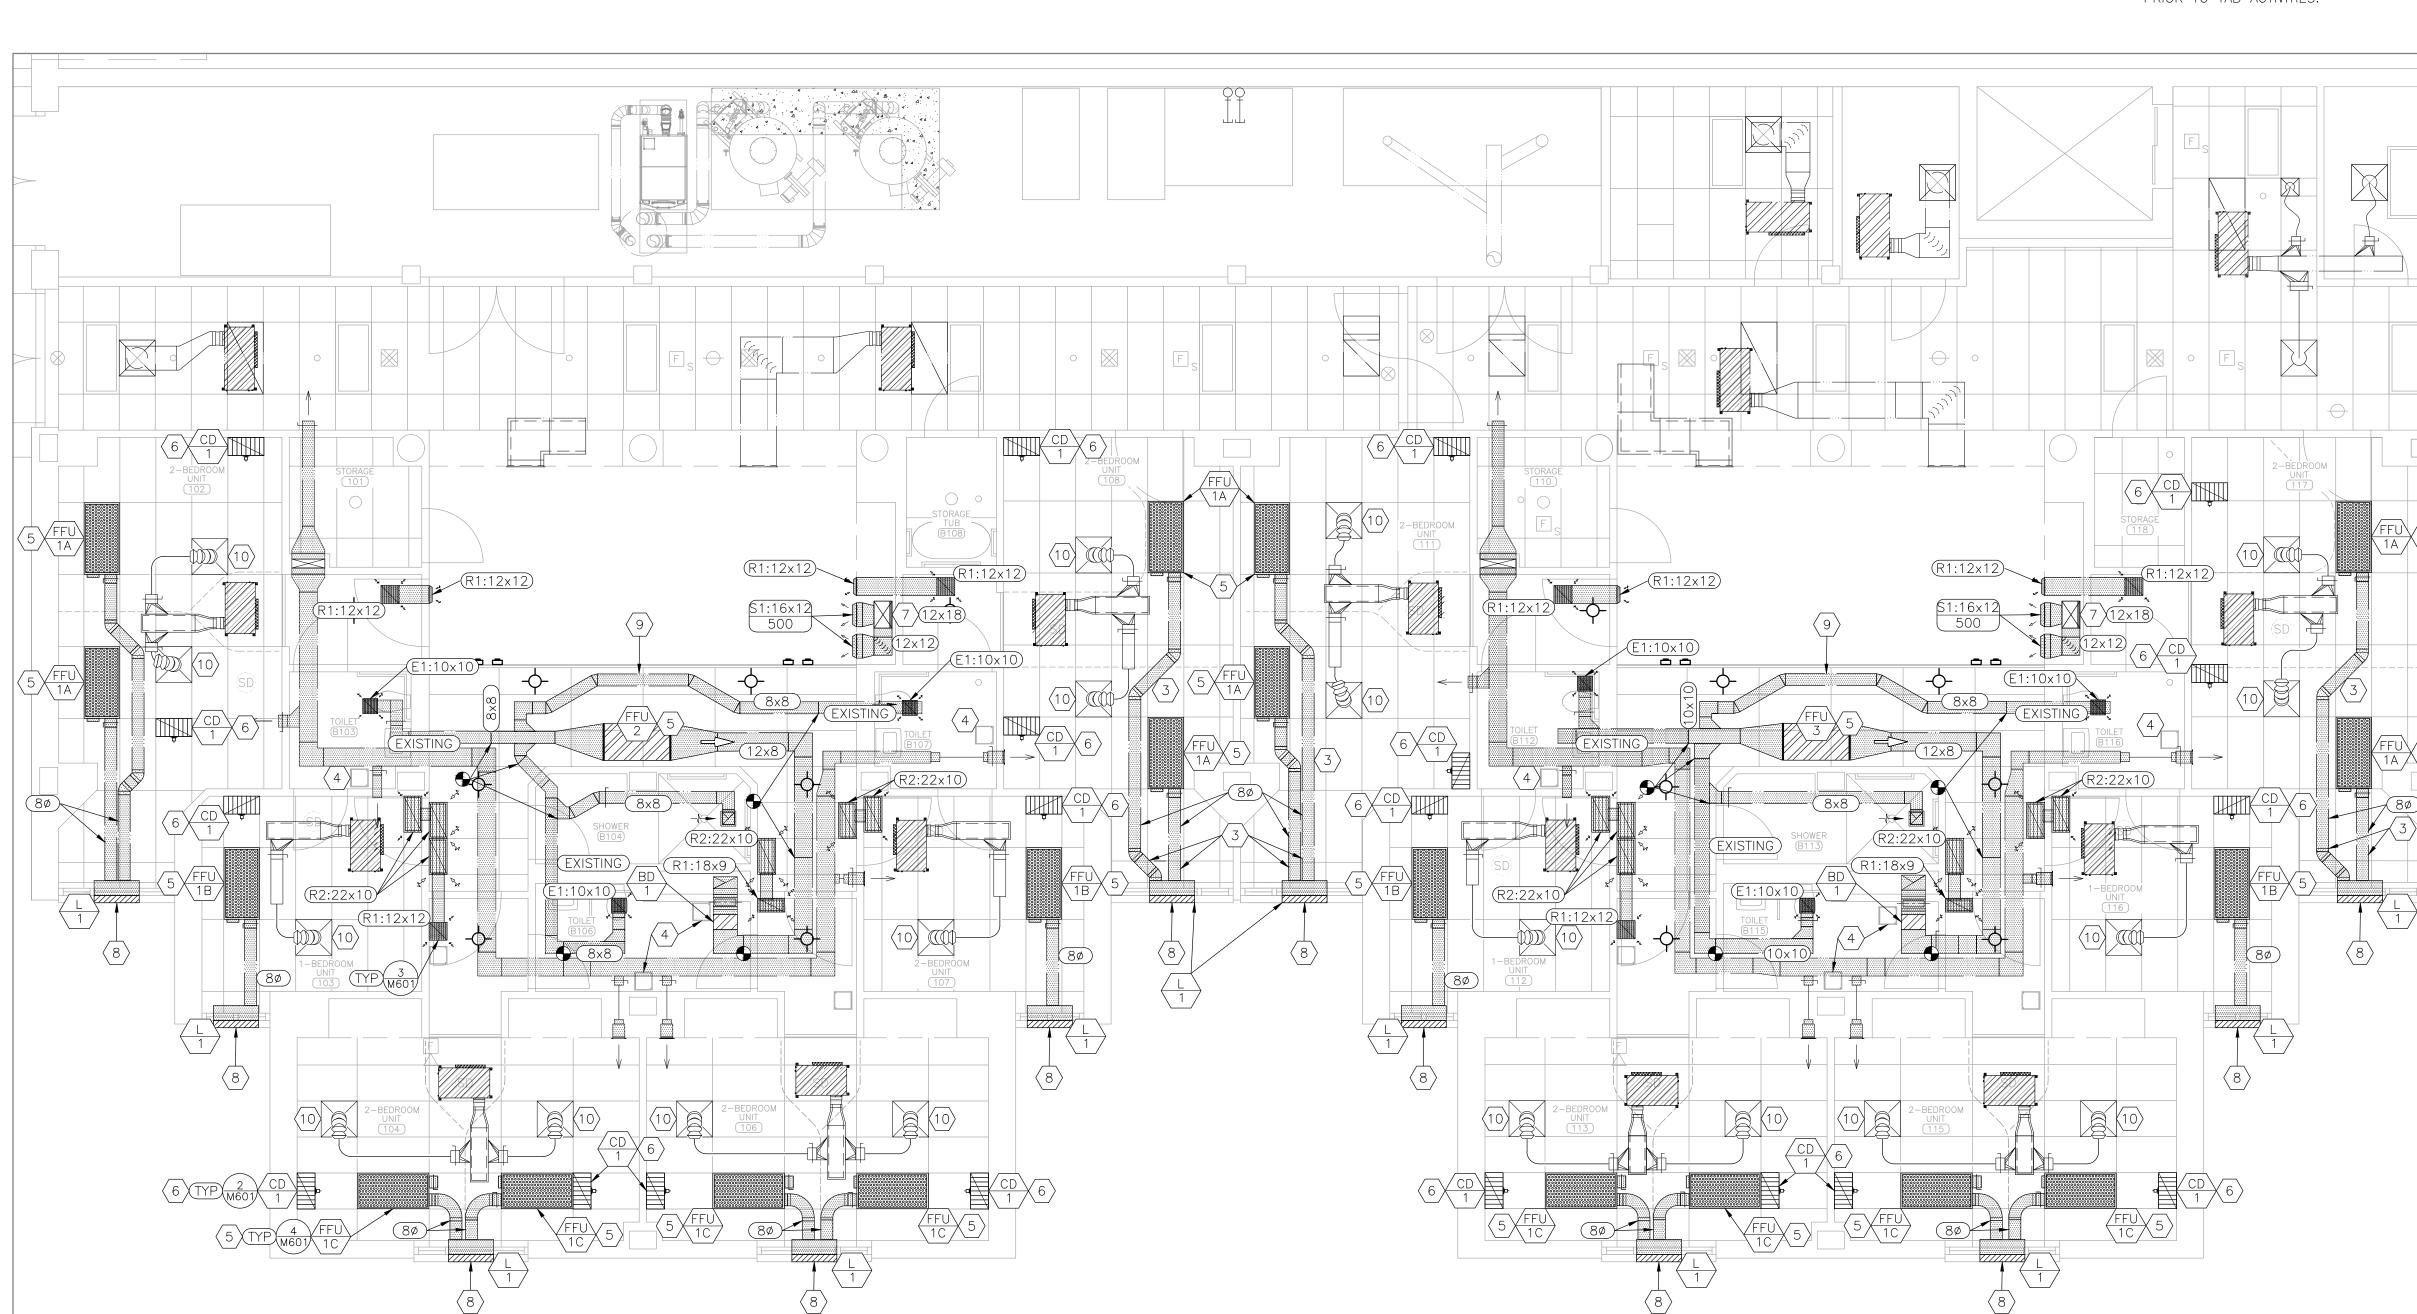

HVAC	LEGEND
•	CONNECT TO EXISTING EQUIPMENT
	DIRECTION OF FLOW
$\left\langle \begin{array}{c} AA \\ N \end{array} \right\rangle$	DEVICE SCHEDULE TAG
N LNNN	DETAIL REFERENCE, NUMBER/SHEET
TYP	TYPICAL INSTALLATION
S1:6ø 50	AIR DEVICE: NECK SIZE (INCHES)/CFM
R1:18x30	RETURN AIR DEVICE: SIZE (INCHES)
(EXISTING)	EXISTING DUCT TO REMAIN
(12x12)	DUCT SIZE-RECTANGULAR (INCHES X INCHES)
(8ø)	DUCT SIZE-ROUND (INCHES DIAMETER)
	HVAC EQUIPMENT — NEW
	SUPPLY AIR
	EXHAUST AIR
	OUTSIDE AIR
	HVAC EQUIPMENT — EXISTING
	SUPPLY AIR — EXISTING
	RETURN AIR — EXISTING
	EXHAUST AIR — EXISTING
	OUTSIDE AIR — EXISTING

FIRST FLOOR
KEY PLAN
N.T.S.

STATE OF MISSOURI MICHAEL L. PARSON, GOVERNOR

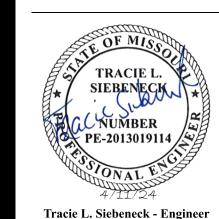

MO# PE-2013019114

DOCUMENTS

OFFICE OF ADMINISTRATION DIVISION OF FACILITIES MANAGEMENT, DESIGN AND CONSTRUCTION

DEPARTMENT OF MISSOURI VETERANS COMMISSION

HVAC IMPROVEMENTS FOR INFECTION CONTROL

MEXICO VETERANS HOME 1 VETERANS DR MEXICO, MO 65265

PROJECT # U2301-03 SITE # 6802 ASSET # 8136802001

REVISION:
DATE:
REVISION:
DATE:
REVISION:
DATE:
REVISION:

CAD DWG FILE:M-U2301-03
DRAWN BY: TS/AH
CHECKED BY: TS
DESIGNED BY: TS/AH

ISSUE DATE: 04/11/2024

SHEET TITLE:

MECHANICAL RENOVATION PLAN -PARTIAL 1ST FLOOR


SHEET NUMBER:

M-104

17 OF 28 SHEETS 4/11/2024

MECHANICAL RENOVATION PLAN - PARTIAL 1ST FLOOR

- N INDICATES KEYED NOTES
- 1 REFERENCE SHEET M-104 FOR GENERAL CONSTRUCTION NOTES.
- COORDINATE NEW FAN FILTER UNIT (FFU) AND DUCT INSTALLATION SHOWN ON SHEET M-104 WITH EXISTING CONDENSER PIPE AND CONDENSATE PIPE LOCATIONS.
- REROUTE HEAT PUMP CONDENSATE DRAIN PIPE AS SHOWN OR AS NEEDED TO ACCOMMODATE INSTALLATION OF NEW FAN FILTER UNIT. REUSE EXISTING CONDENSATE PIPE AND INSULATION WHERE POSSIBLE. PROVIDE MATERIALS TO MATCH EXISTING FINISH AND PERFORMANCE.
- CAULK ANY PENETRATIONS MADE BY CONDENSER PIPE, CONDENSATE DRAIN PIPE, SPRINKLER PIPE, CONDUIT, WIRE, OR DUCT TO ENSURE AIR DOES NOT PASS BETWEEN ROOMS. SEE SHEET F-101 FOR GENERAL SPRINKLER PIPE LOCATIONS. REFER TO ARCHITECTURAL PLANS FOR PATCHING LARGER OPENINGS IN DRYWALL. NOT ALL PENETRATIONS THAT REQUIRE SEALANT ARE SHOWN ON PLANS. REFERENCE GENERAL CONSTRUCTION NOTE 2 ON SHEET G-002 FOR ADDITIONAL INFORMATION.
- PROVIDE THROUGH THE WALL PRESSURE SENSOR TSI MODEL 800243 OR EQUAL AND LOCATE ABOVE DOOR TO EACH BEDROOM. PROVIDE TSI DISPLAY MODEL RPM20 OR EQUAL. ROUTE CONTROL WIRING AS NEEDED TO MONITOR THE THREE NEAREST PRESSURE SENSORS. CAREFULLY FOLLOW ALL MANUFACTURER'S INSTALLATION INSTRUCTIONS. ELECTRICAL CONTRACTOR SHALL PROVIDE AND INSTALL 120V TO 24V TRANSFORMER REQUIRED TO PROVIDE 24V POWER TO PRESSURE MONITORING SYSTEM. MECHANICAL CONTRACTOR TO PROVIDE AND INSTALL LOW VOLTAGE WIRING.

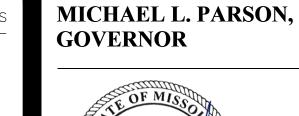

STATE OF MISSOURI



MO# PE-2013019114

DOCUMENTS

OFFICE OF ADMINISTRATION DIVISION OF FACILITIES MANAGEMENT, DESIGN AND CONSTRUCTION

DEPARTMENT OF MISSOURI VETERANS COMMISSION

HVAC IMPROVEMENTS FOR INFECTION CONTROL

MEXICO VETERANS HOME 1 VETERANS DR MEXICO, MO 65265

PROJECT # U2301-03 SITE # 6802 ASSET # 8136802001

REVISION:
DATE:
REVISION:
DATE:
REVISION:
DATE:
REVISION:
DATE:
ISSUE DATE: 04/11/2024

CAD DWG FILE:M-U2301-03
DRAWN BY: TS/AH
CHECKED BY: TS
DESIGNED BY: TS/AH

SHEET TITLE:

MECHANICAL
RENOVATION PLAN PARTIAL 1ST FLOOR


SHEET NUMBER:


18 OF 28 SHEETS

4/11/2024


FIRST FLOOR

KEY PLAN N.T.S. M-105

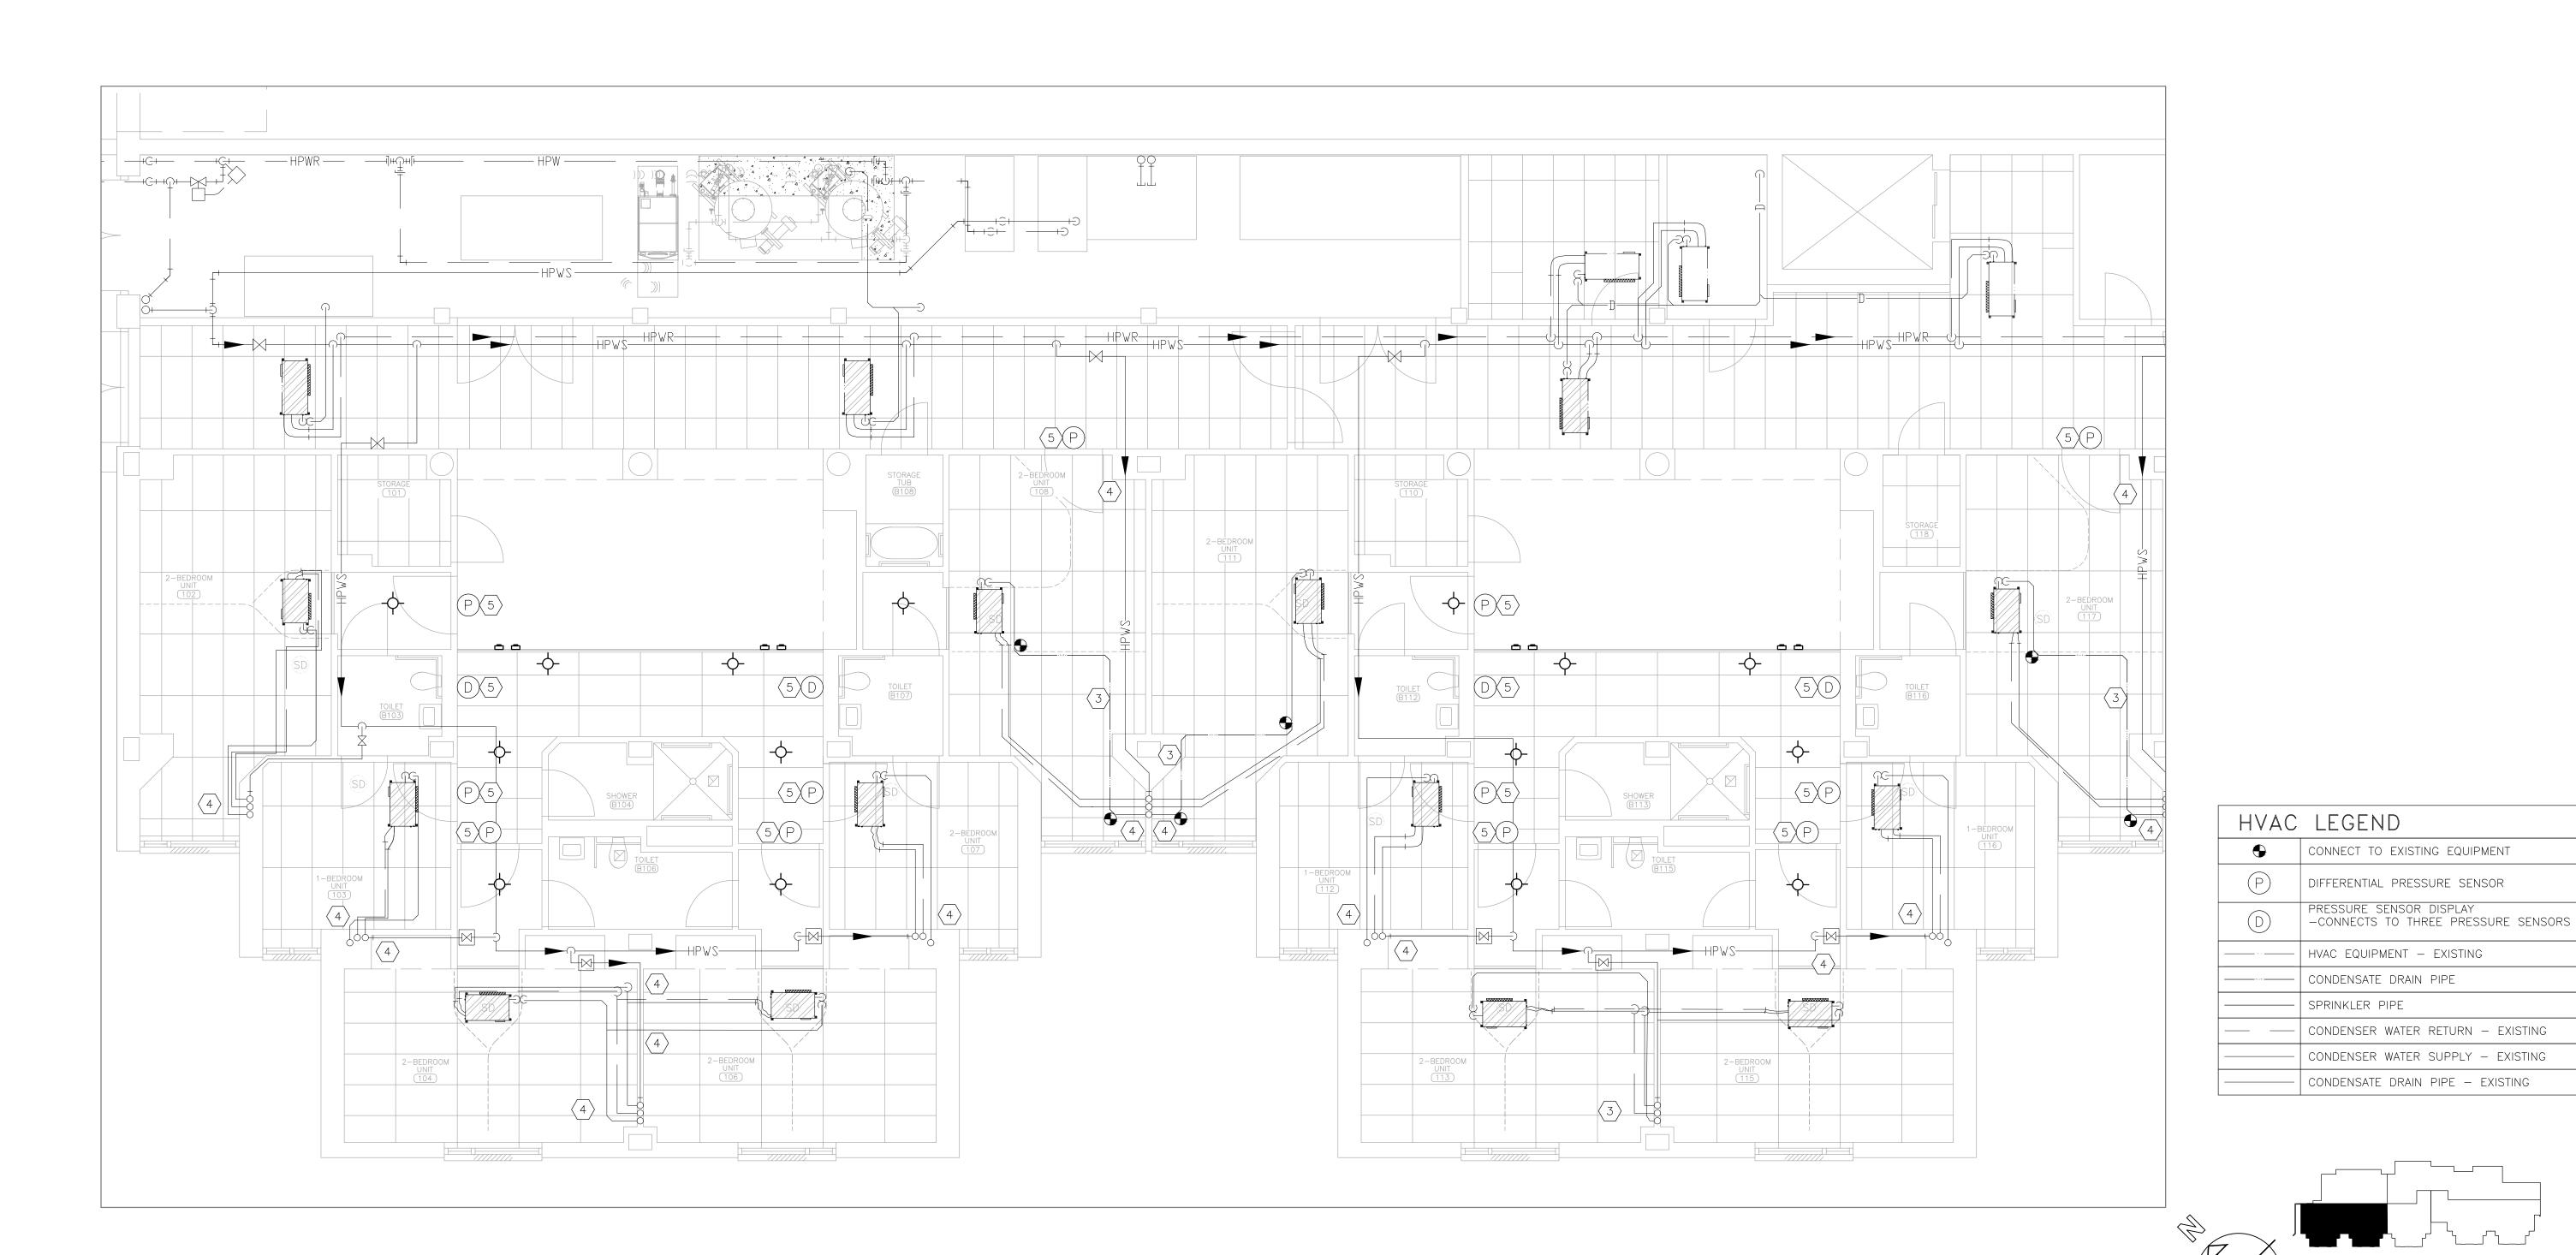


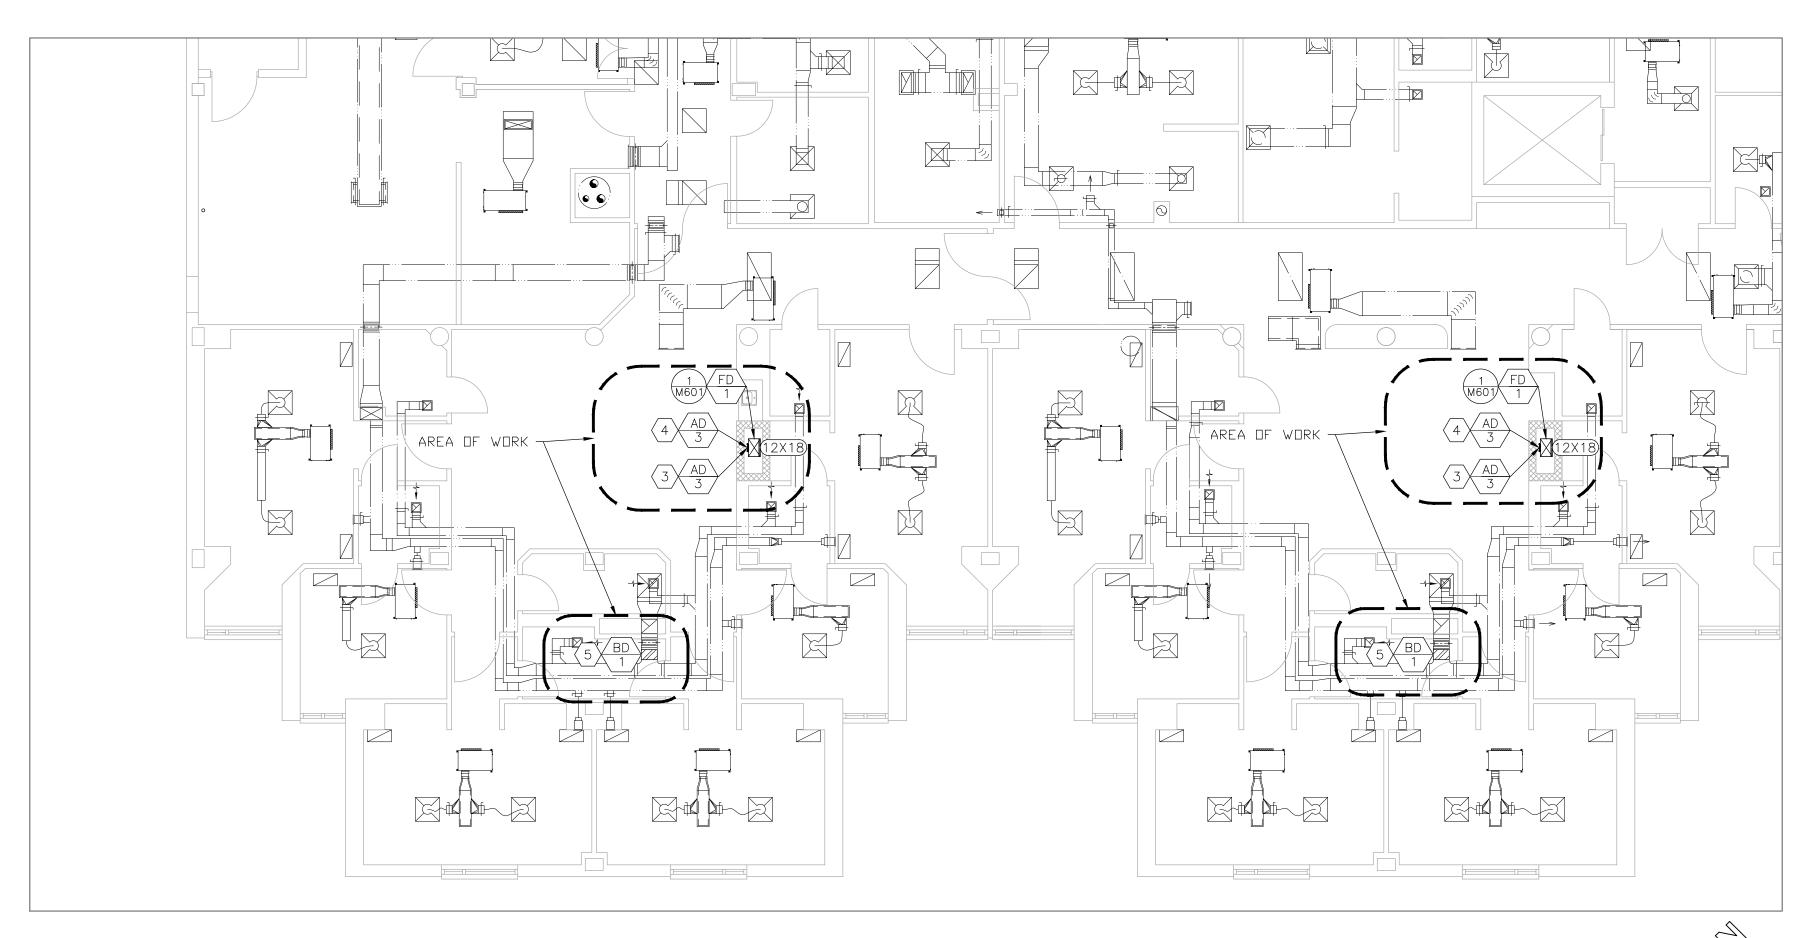

2 MECHANICAL RENOVATION PLAN - 3RD FLOOR
SCALE: 1/8 = 1'-0'

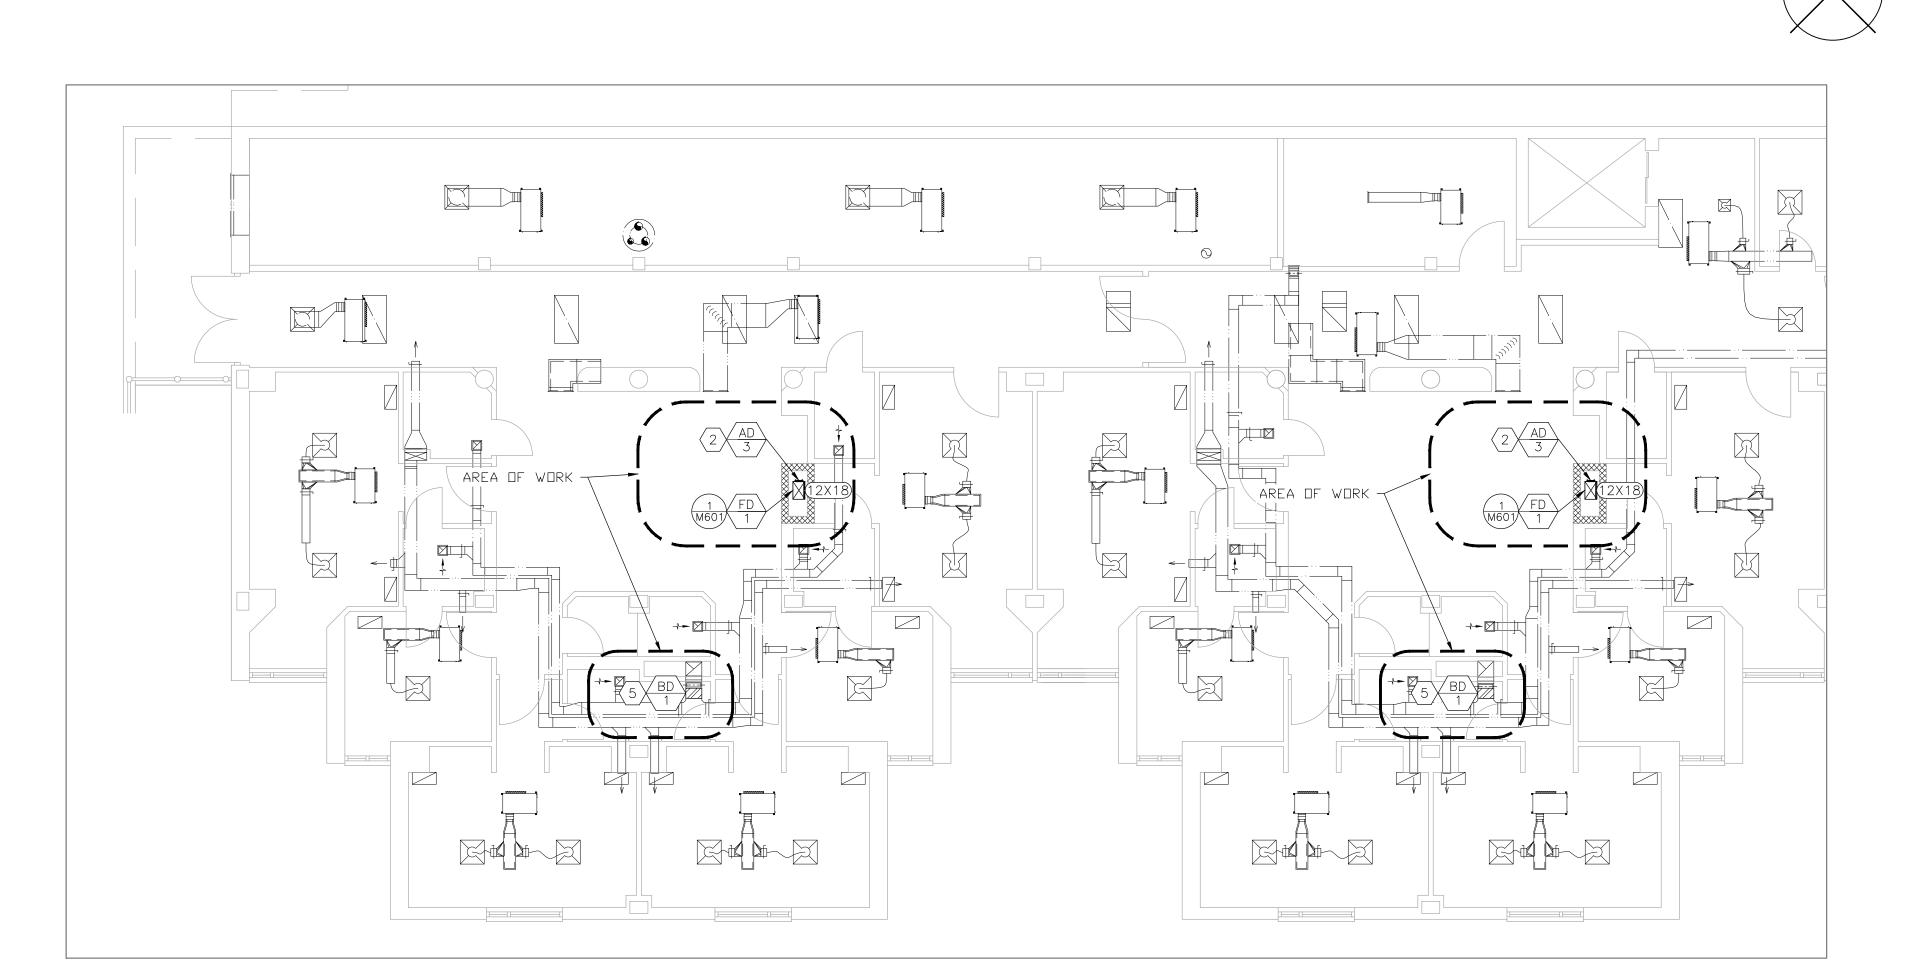

1 MECHANICAL RENOVATION PLAN - 2ND FLOOR
SCALE: 1/8 = 1'-0'

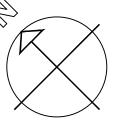

NOTES

N INDICATES KEYED NOTES

- 1 REFERENCE SHEET M-104 FOR GENERAL CONSTRUCTION NOTES.
- PROVIDE AND INSTALL FIRE DAMPER (FD-1) IN 2ND FLOOR SLAB. ENSURE INSTALLATION IS SERVICEABLE FROM 2ND FLOOR DUCT ACCESS DOOR (AD-3). COORDINATE WITH GENERAL CONTRACTOR TO INSTALL FIRE RATED ACCESS DOOR (AD-2) IN NEW CHASE WALL IN LINE WITH AD-3. REFER TO ARCHITECTURAL PLANS FOR CHASE AND AD-2 REQUIREMENTS.
- PROVIDE AND INSTALL FIRE DAMPER (FD-1) IN 3RD FLOOR SLAB. ENSURE INSTALLATION IS SERVICEABLE FROM 3RD FLOOR DUCT ACCESS DOOR (AD-3). COORDINATE WITH GENERAL CONTRACTOR TO INSTALL FIRE RATED ACCESS DOOR (AD-2) IN NEW CHASE WALL IN LINE WITH AD-3. REFER TO ARCHITECTURAL PLANS FOR CHASE AND AD-2 REQUIREMENTS.
- PROVIDE AND INSTALL FIRE DAMPER (FD-1) IN ROOF SLAB. ENSURE INSTALLATION IS SERVICEABLE FROM 3RD FLOOR DUCT ACCESS DOOR (AD-3). COORDINATE WITH GENERAL CONTRACTOR TO INSTALL FIRE RATED ACCESS DOOR (AD-2) IN NEW CHASE WALL IN LINE WITH AD-3. REFER TO ARCHITECTURAL PLANS FOR CHASE AND AD-2 REQUIREMENTS.
- (5) INSTALL BACKDRAFT DAMPER IN EXHAUST DUCT PRIOR TO CHASE.





Tracie L. Siebeneck - Engineer MO# PE-2013019114

DOCUMENTS

OFFICE OF ADMINISTRATION DIVISION OF FACILITIES MANAGEMENT, DESIGN AND CONSTRUCTION

DEPARTMENT OF MISSOURI VETERANS COMMISSION

HVAC IMPROVEMENTS FOR INFECTION CONTROL

MEXICO VETERANS HOME 1 VETERANS DR MEXICO, MO 65265

PROJECT # U2301-03 SITE # 6802 ASSET # 8136802001

REVISION:
DATE:
REVISION:
DATE:
REVISION:
DATE:
REVISION:
DATE:
ISSUE DATE: 04/11/2024

CAD DWG FILE:M-U2301-03
DRAWN BY: TS/AH
CHECKED BY: TS/AH
DESIGNED BY: TS/AH

SHEET TITLE:

MECHANICAL RENOVATION PLAN -2ND & 3RD FLOORS

SHEET NUMBER:

M-10


19 OF 28 SHEETS


4/11/2024

SECOND FLOOR


KEY PLAN

N.T.S.

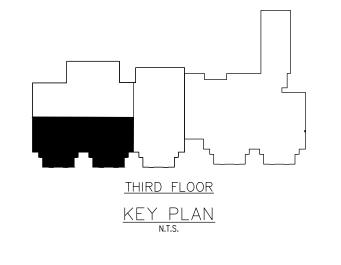

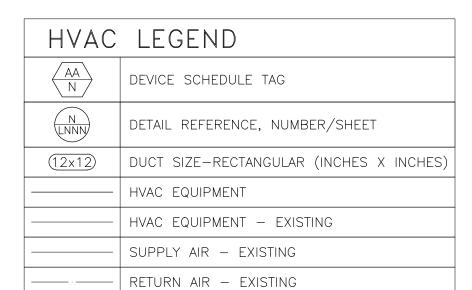

EXHAUST AIR — EXISTING

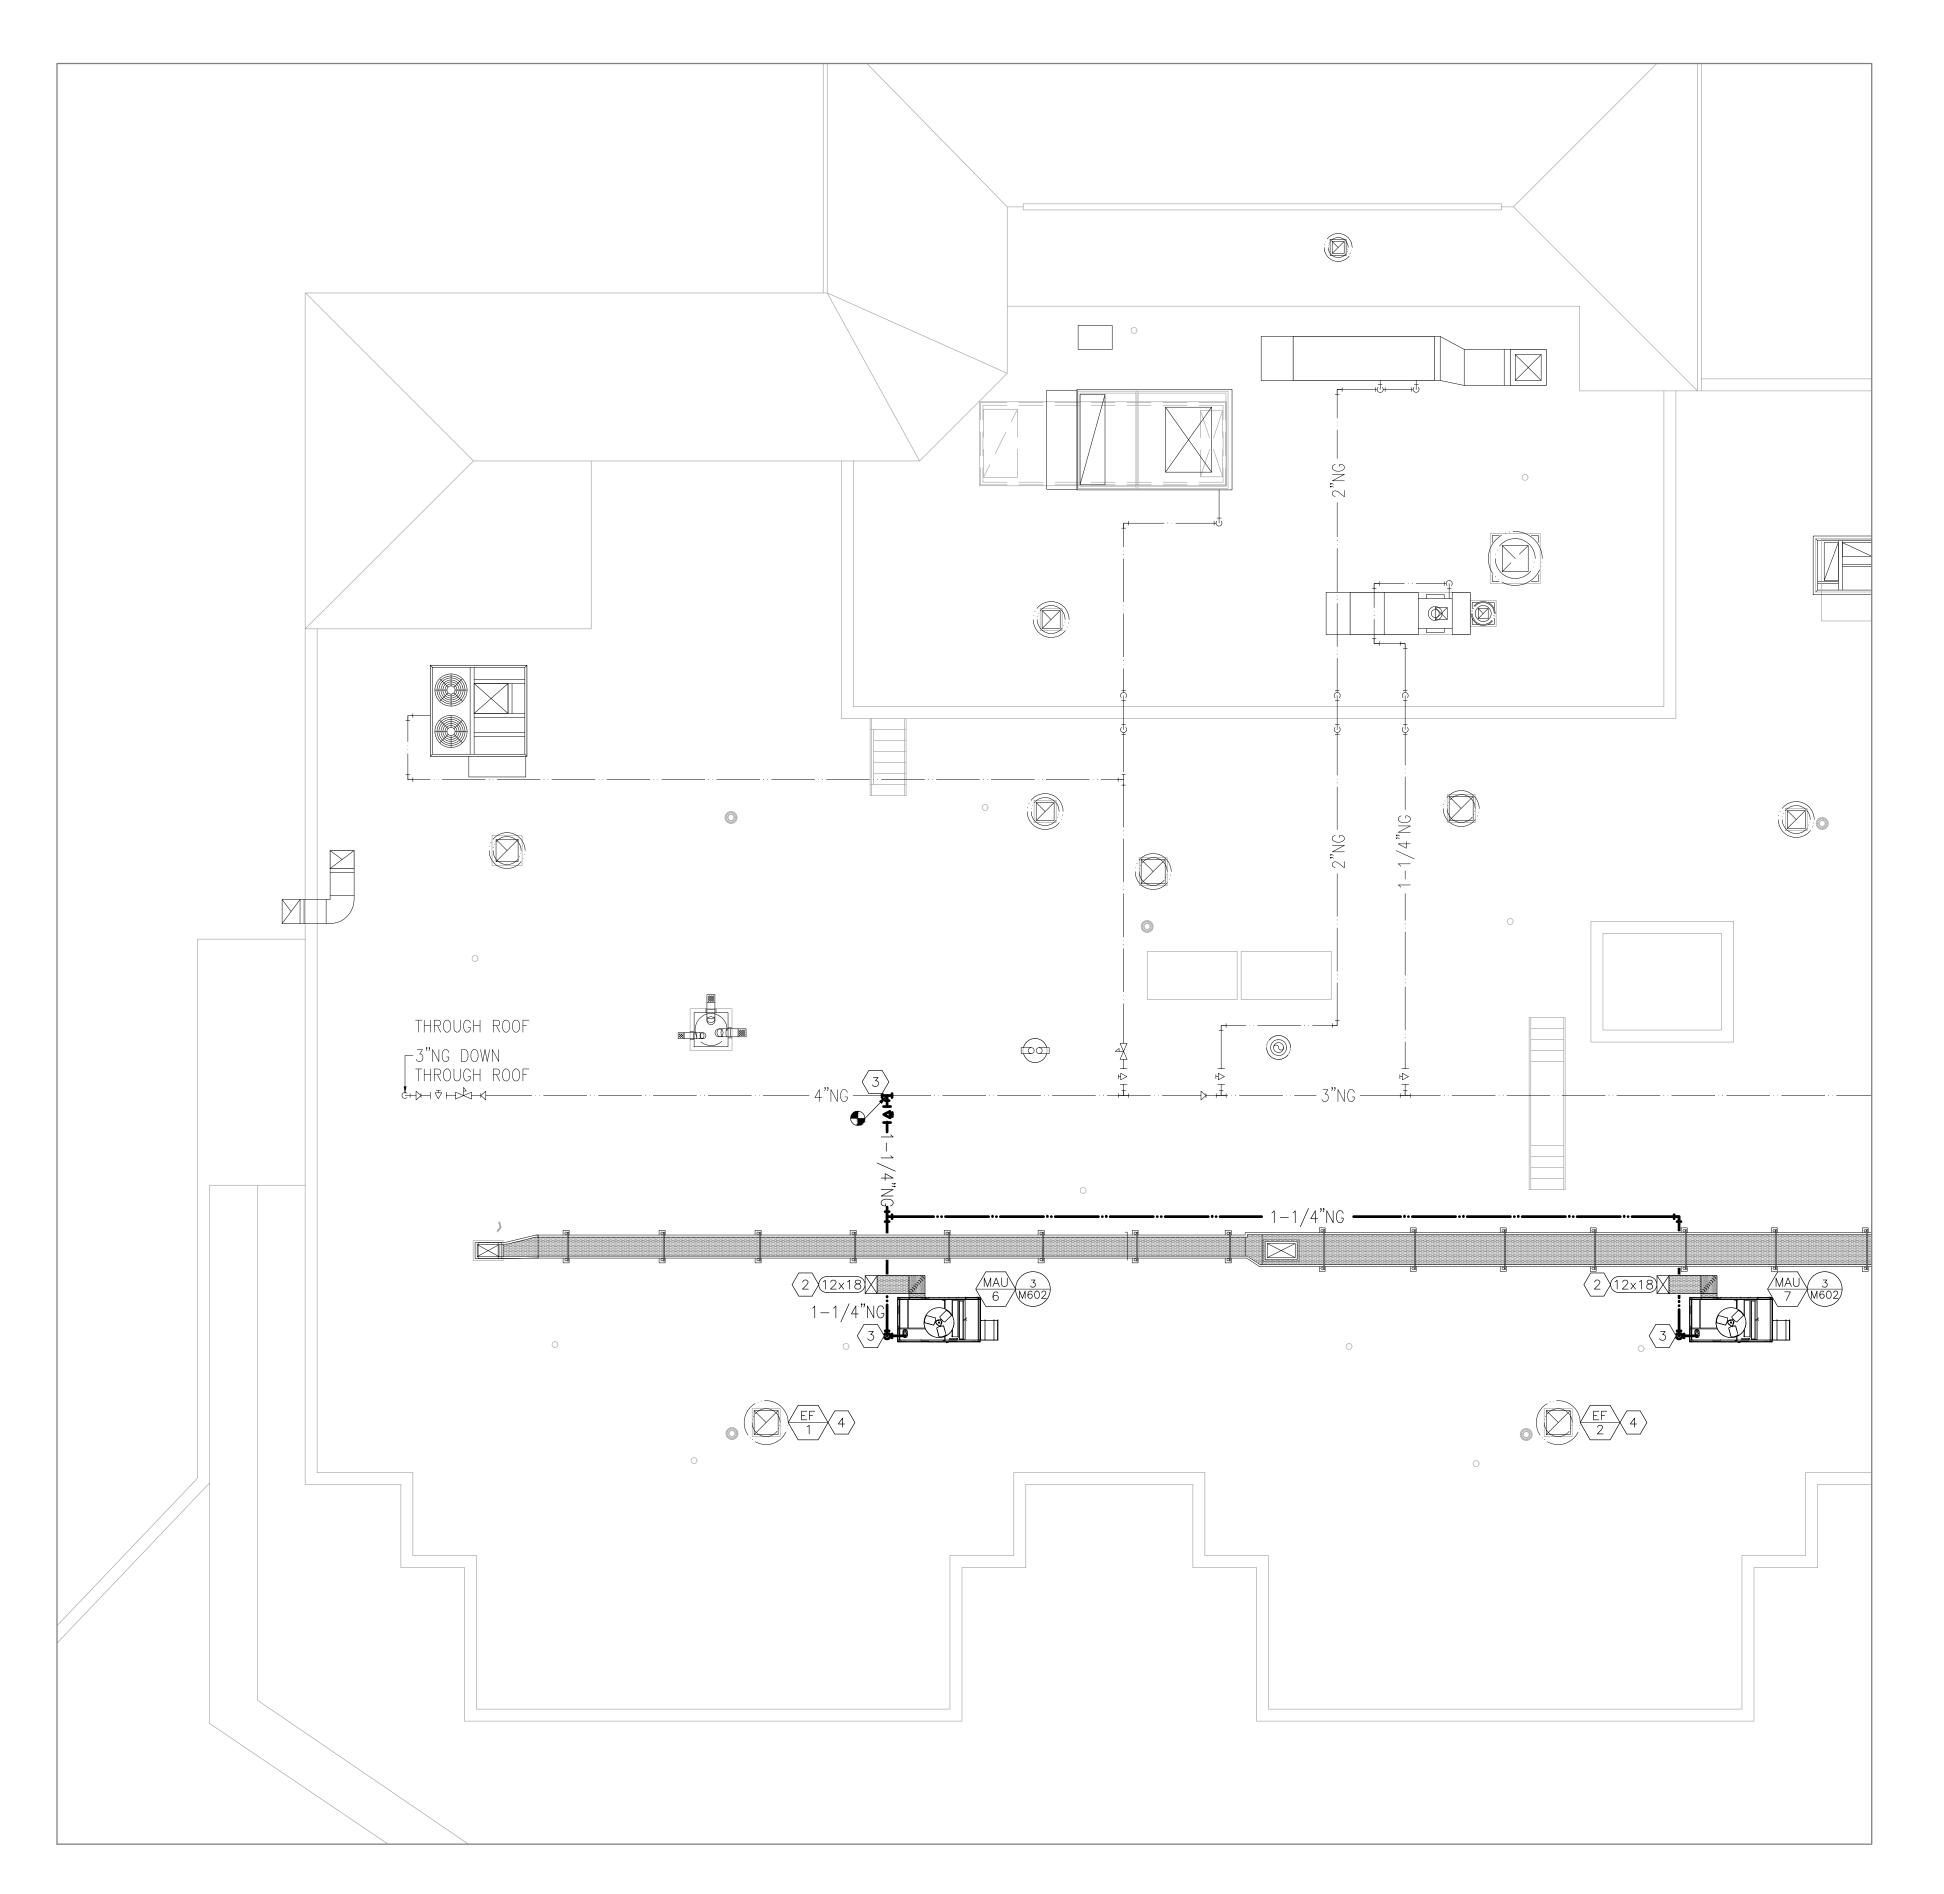

1 MECHANICAL RENOVATION PLAN - ROOF SCALE: 1/8 = 1'-0' NOTES

N INDICATES KEYED NOTES

- INDICATES INCIDENT
- MAKE-UP AIR DUCT. PENETRATE ROOF AND ROUTE TO FIRST FLOOR. REFER TO DETAILS 4, 5, AND 6 OF SHEET M-602 FOR ADDITIONAL INFORMATION.
- CONNECT NEW NATURAL GAS PIPE TO EXISTING 4 INCH PIPE AND PROVIDE ISOLATION VALVE. ROUTE PIPE TO NEW MAKE UP AIR UNITS AS SHOWN. REFER TO SPECIFICATIONS FOR IDENTIFICATION REQUIREMENTS. REFER TO DETAILS 1 AND 2 OF SHEET M-602 FOR ADDITIONAL INFORMATION.
- $\overline{\langle 4 \rangle}$ refer to note 4 on sheet M-103 for tab requirements.

1 REFERENCE SHEET M-104 FOR GENERAL CONSTRUCTION NOTES.

STATE OF MISSOURI MICHAEL L. PARSON, GOVERNOR



Tracie L. Siebeneck - Engineer MO# PE-2013019114

DOCUMENTS

OFFICE OF ADMINISTRATION DIVISION OF FACILITIES MANAGEMENT, DESIGN AND CONSTRUCTION

DEPARTMENT OF MISSOURI VETERANS COMMISSION

HVAC IMPROVEMENTS FOR INFECTION CONTROL

MEXICO VETERANS HOME 1 VETERANS DR MEXICO, MO 65265

PROJECT # U2301-03 SITE # 6802 ASSET # 8136802001

REVISION:
DATE:
REVISION:
DATE:
REVISION:
DATE:
DATE:

CAD DWG FILE:M-U2301-03
DRAWN BY: TS/AH
CHECKED BY: TS
DESIGNED BY: TS/AH

ISSUE DATE: 04/11/2024

SHEET TITLE:


MECHANICAL RENOVATION PLAN -ROOF

SHEET NUMBER:

M-107

20 OF 28 SHEETS

4/11/2024

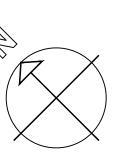



HVAC LEGEND

CONNECT TO EXISTING EQUIPMENT

DETAIL REFERENCE, NUMBER/SHEET

12x12 DUCT SIZE-RECTANGULAR (INCHES X INCHES)

DEVICE SCHEDULE TAG

- HVAC EQUIPMENT


----- NATURAL GAS PIPE - EXISTING


---- NATURAL GAS PIPE — NEW


— OUTSIDE AIR

MAKE	UP AIR UNIT	r schedul	.E																		
							REF	RIGERANT COO	LING					NATURAL GAS	HEATING			ELECTRICA	Ĺ		
MARK	MANUFACTURER	MODEL	OUTDOOR AIRFLOW (CFM)	ESP (IN WG)	TOTAL	CAPACITY SENSIBLE (MBH)	IFΔT	COIL LAT (db°F/wb°F)	REHEAT COIL CAPACITY (MBH)	REHEAT COIL LAT (db°F/wb°F)	EER/IEER	CAPACITY TOTAL (MBH)	INPUT (MBH)	EAT (db°F/wb°F)	COIL LAT (db°F/wb°F)	TURNDOWN RATIO	VOLTS PHASE	MCA	МОР	WEIGHT (LBS)	NOTES
MAU-6	AAON	RQ006	1000-1300	1.00	79.6	38.4	82.2/73.6	54.6/54.5	24.1	72/61.2	11.8/15	113.4	140	0/0	80.7/50.1	11.6:1	208/3	36	50	1049	1,2,3,4,5,6
MAU-7	AAON	RQ006	1000-1300	1.00	79.6	38.4	82.2/73.6	54.6/54.5	24.1	72/61.2	11.8/15	113.4	140	0/0	80.7/50.1	11.6:1	208/3	36	50	1049	1,2,3,4,5,6
NOTES																					


- DESIGN CONDITIONS: SUMMER (DEHUMIDIFICATION) 82.2/73.6°F; WINTER 0°F
 - DESIGN AIRFLOW IS 1000 CFM, UNIT SHALL HAVE CAPACITY UP TO 1300 CFM; TAB: ADJUST TO AIRFLOW REQUIRED TO ACHIEVE -0.01 IN WG BEDROOM NEGATIVE PRESSURE (MINIMUM)
 - PROVIDE TERMINAL STRIP FOR FIELD SUPPLIED DDC CONTROLS BY OTHERS
- 4 PROVIDE VARIABLE CAPACITY COMPRESSOR WITH MODULATING HOT GAS REHEAT; STAINLESS STEEL DRAIN PAN; STAINLESS STEEL HEAT EXCHANGER; SUPPLY BLOWER WITH FACTORY VFD; ECM CONDENSER FAN
- PROVIDE FACTORY MOUNTED, NON-FUSED DISCONNECT; FACTORY INSTALLED CONVENIENCE OUTLET
- PROVIDE UV LIGHTING FOR COIL SANITIZING; 30% EFFICIENT PREFILTER, MERV 14 FINAL FILTER; CLOGGED FILTER SWITCH

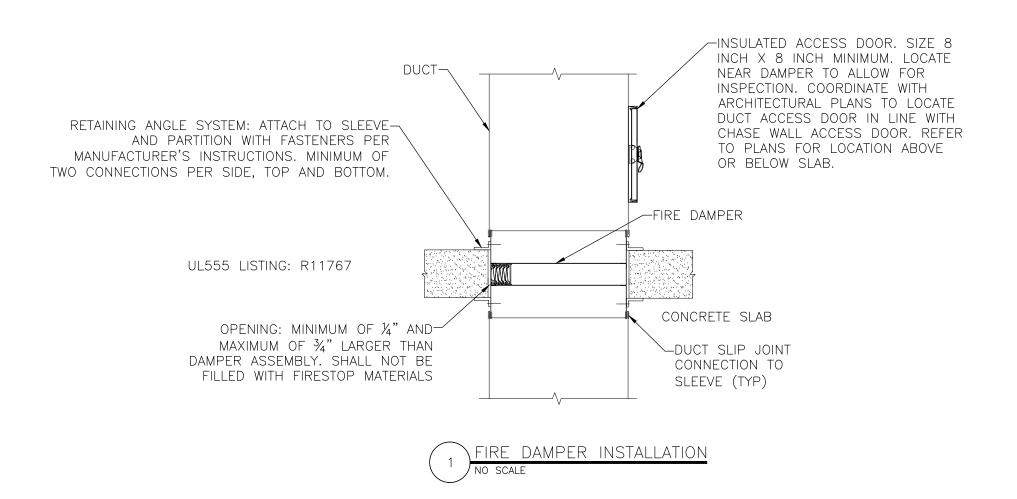

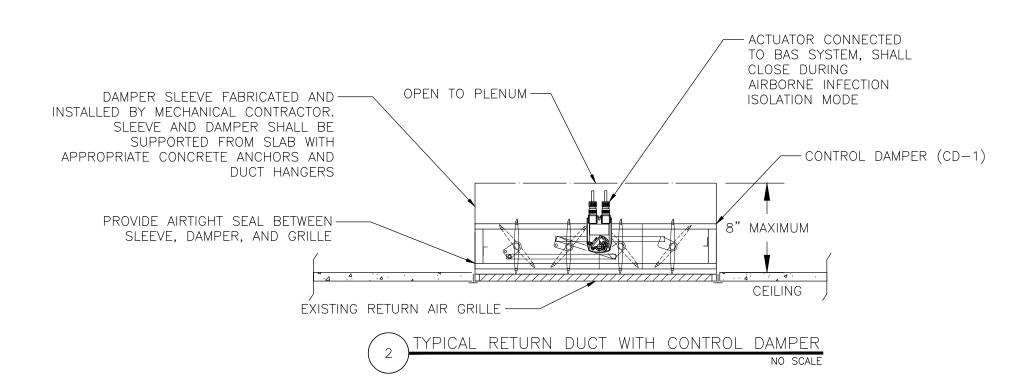

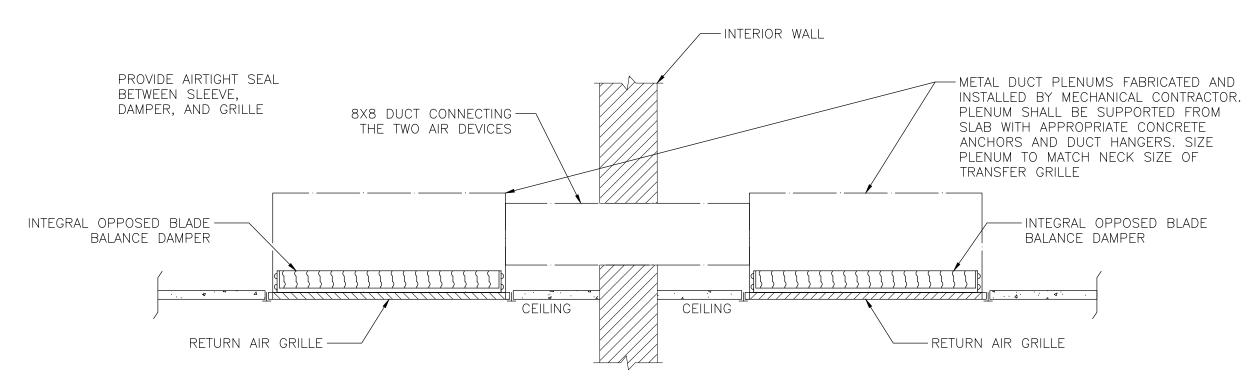

TYPICAL CEILING TO CEILING TRANSFER GRILLE

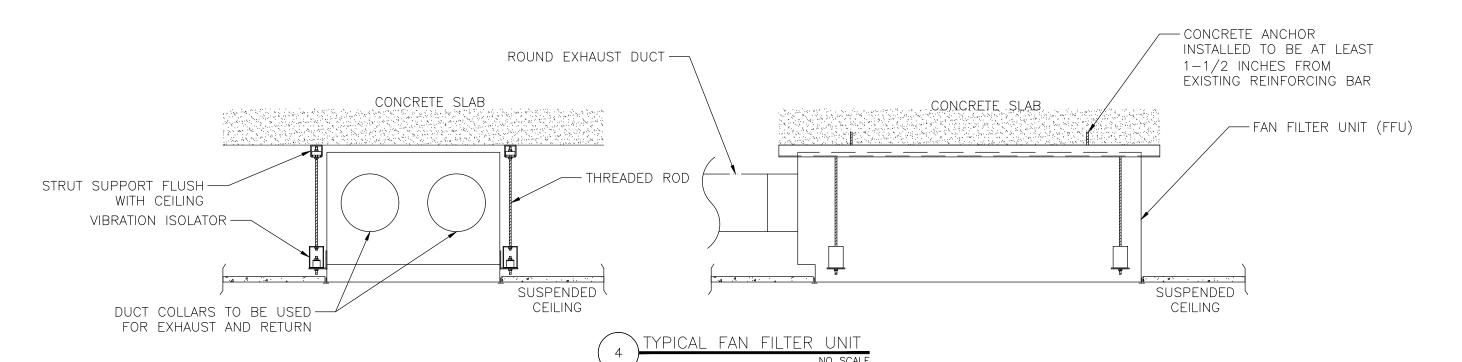

FAN FI	LTER UNIT SO	CHEDULE								
MARK	MANUFACTURER	MODEL	SIZE (INCHES)	FILTERS	EXTERNAL STATIC PRESSURE (IN WG)	EXHAUST SIZE (INCH) AIRFLOW (CFM)	RETURN SIZE (INCH) AIRFLOW (CFM)	VOLTAGE	DESCRIPTION	NOTES
FFU-1A	PRICE	PURAFLO	24x48	MERV 8 HEPA	0.20-0.25	8 Ø 125	8 Ø 145	208/1	HOUSING: ALUMINUM PLENUM; ROOMSIDE ACCESS FOR FILTER REPLACEMENT AND MAINTENANCE; FILTER: EXTRUDED ALUMINUM FRAME WITH URETHANE GEL; CONSTANT FLOW	1,2,4
FFU-1B	PRICE	PURAFLO	24x48	MERV 8 HEPA	0.20-0.25	8 Ø 190	8 Ø 250	208/1	HOUSING: ALUMINUM PLENUM; ROOMSIDE ACCESS FOR FILTER REPLACEMENT AND MAINTENANCE; FILTER: EXTRUDED ALUMINUM FRAME WITH URETHANE GEL; CONSTANT FLOW	1,2,4
FFU-1C	PRICE	PURAFLO	24x48	MERV 8 HEPA	0.20-0.25	8 Ø 112	8 Ø 150	208/1	HOUSING: ALUMINUM PLENUM; ROOMSIDE ACCESS FOR FILTER REPLACEMENT AND MAINTENANCE; FILTER: EXTRUDED ALUMINUM FRAME WITH URETHANE GEL; CONSTANT FLOW	1,2,4
FFU-2	PRICE	ОАР	24x44	MERV 8 HEPA	0.60	24x12 540	-	208/1	HOUSING: ZINC COATED 20 GAUGE STEEL; INTERNAL INSULATION: 1/2 INCH THICK FIBERGLASS; MOTOR: EC WITH SPEED CONTROLLER	1,2,3,4
FFU-3	PRICE	ОАР	24x44	MERV 8 HEPA	0.50	24x12 570	-	208/1	HOUSING: ZINC COATED 20 GAUGE STEEL; INTERNAL INSULATION: 1/2 INCH THICK FIBERGLASS; MOTOR: EC WITH SPEED CONTROLLER	1,2,3,4

NOTES ***FAN FILTER UNITS ARE SOLE SOURCE ONLY*** PROVIDE FACTORY MOUNTED DISCONNECT

- PROVIDE HANGER BRACKETS SHIPPED LOOSE. BRACKETS CAN NOT BE INSTALLED ON THE TOP OF THE UNIT. CONTRACTOR SHALL INSTALL BRACKES PER DETAIL 3 THIS SHEET. ENSURE INSTALLATION DOES NOT DAMAGE FILTERS.
- PROVIDE LEFT HAND CONTROLS
- 4 PROVIDE BACnet FLOW CONTROLLER WITH MOTOR AND FILTER STATUS

DAMP	DAMPER SCHEDULE								
MARK	MANUFACTURER	MODEL	SIZE (INCHxINCH)	ТҮРЕ	SPECIFICATION	NOTES			
BD-1	POTTORFF	BD-150	MATCH DUCT	DAMPER	FRAME: EXTRUDED ALUMINUM CHANNEL; BLADES: EXTRUDED ALUMINUM; SEALS: EXTRUDED VINYL BLADE EDGE; LINKS: EXPOSED ON BLADE; BEARINGS: SYNTHETIC	1			
CD-1	POTTORFF	CD-52	24x12	OPPOSED BLADE RECTANGULAR	FRAME: 13 GAUGE GALVANIZED STEEL CHANNEL; BLADES: 6"X16 GAUGE EXTRUDED ALUMINUM AIRFOIL OPPOSED BLADE WITH PVC BLADE SEALS; SLEEVE: FACTORY INSTALLED 16"X20 GAUGE ALUMINUM.	2			

1-1/2 HOUR

DYNAMIC

FRAME: 22 GAUGE GALV STEEL; BLADES: 24 GAUGE GALV STEEL;

FUSIBLE LINK; BLADE STACK HEIGHT: 1-7/16"; UL LISTED

FD-1

PROVIDE 10"x 20 GAUGE GALVANIZED STEEL SLEEVE (INTAKE)

VFD-10D-A

PROVIDE FACTORY INSTALLED 24V ACTUATOR

POTTORFF

PROVIDE FACTORY INSTALLED 12"x 20 GAUGE SLEEVE WITH DUCT CONNECTIONS AND RETAINING ANGLE SYSTEM

HEIGHT: 12"

WIDTH: 18"


MARK	MANUFACTURER	MODEL	SIZE (INCHxINCH)	TYPE	SPECIFICATION	NOTES
L-1	POTTORFF	EXA-645	30x9	LOUVER W/ CONTROL DAMPER	MATERIAL: MILL FINISH 6063-T5 EXTRUDED ALUMINUM; FRAME 6" DEEPx0.081" THICK CHANNEL; FRONT BLADES: 37-1/2°x0.081" THICK DRAINABLE STYLE; BACK BLADES: 45°x0.125" THICK OPERABLE AIRFOIL STYLE; SCREEN: MESH ALUMINUM INSECT SCREEN; AXLES: 1/2" DIAMETER STEEL HEX.	1,2

PROVIDE FACTORY INSTALLED 24V ACTUATOR

DUCT	ACCESS DOO	R SCHEDULE			
MARK	MANUFACTURER	MODEL	SIZE (INCH x INCH)	TYPE	SPECIFICATION
AD-3	ACUDOR	CD-5080	8 x 8	DUCT ACCESS DOOR	DOOR: 24 GAUGE GALVANIZED STEEL; FRAME: 24 GAUGE GALVANIZED STEEL; GASKETING: 1/8" THICK BY 1/2" WIDE CLOSED NEOPRENE; CAM LATCH: SELF TIGHTENING

MARK	MANUFACTURER	MODEL	TYPE	SPECIFICATION	NOTES	
S1	PRICE	520D	SUPPLY W/DAMPER SURFACE MOUNT	STEEL, WHITE, LOUVER FACE, DOUBLE DEFLECTION, 3/4 INCH BLADE SPACING, BLADES PARALLEL TO LONG DIMENSION	1	
R1	PRICE	535D	RETURN W/DAMPER SURFACE MOUNT	STEEL, WHITE, LOUVER FACE, 45° DEFLECTION, 1/2 INCH BLADE SPACING, BLADES PARALLEL TO LONG DIMENSION	CH BLADE 1	
R2	PRICE	535D	RETURN W/DAMPER LAYIN MOUNT	STEEL, WHITE, LOUVER FACE, 45° DEFLECTION, 1/2 INCH BLADE SPACING, BLADES PARALLEL TO LONG DIMENSION	1	
E1	PRICE	535D	EXHAUST W/DAMPER SURFACE MOUNT	ISPACING BLADES PARALLEL TO LONG DIMENSION		

STATE OF MISSOURI MICHAEL L. PARSON, **GOVERNOR**

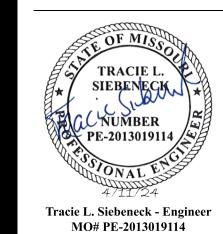

OFFICE OF ADMINISTRATION DIVISION OF FACILITIES MANAGEMENT, **DESIGN AND CONSTRUCTION**

DEPARTMENT OF MISSOURI VETERANS **COMMISSION**

HVAC IMPROVEMENTS FOR INFECTION CONTROL

MEXICO VETERANS HOME 1 VETERANS DR MEXICO, MO 65265

PROJECT # U2301-03 ASSET# 8136802001


REVISION: DATE: **REVISION:** DATE: **REVISION:** DATE: ISSUE DATE: 04/11/2024


CAD DWG FILE:M-U2301-03 DRAWN BY: TS/AH CHECKED BY: TS DESIGNED BY: TS/AH


SHEET TITLE:


MECHANICAL DETAILS AND SCHEDULES


SHEET NUMBER:

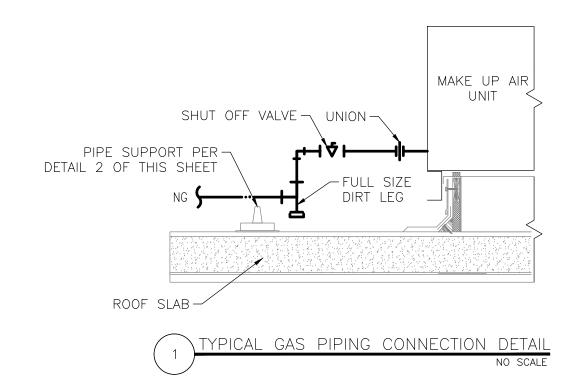

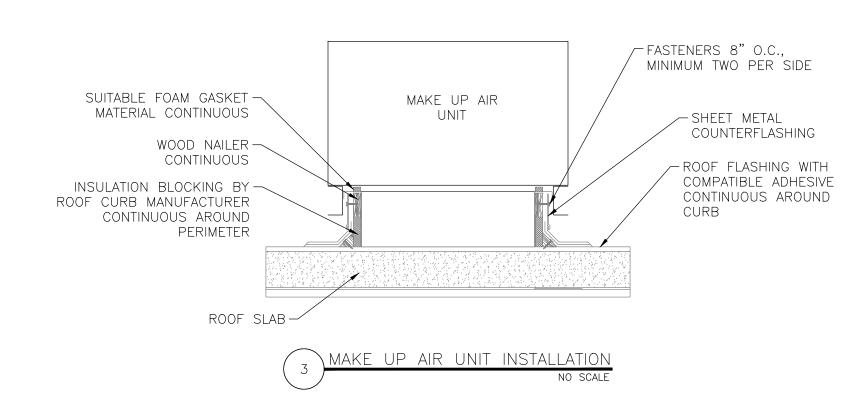

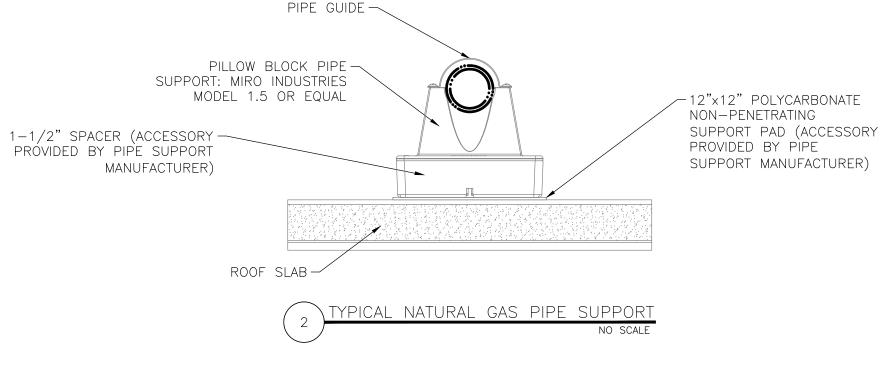


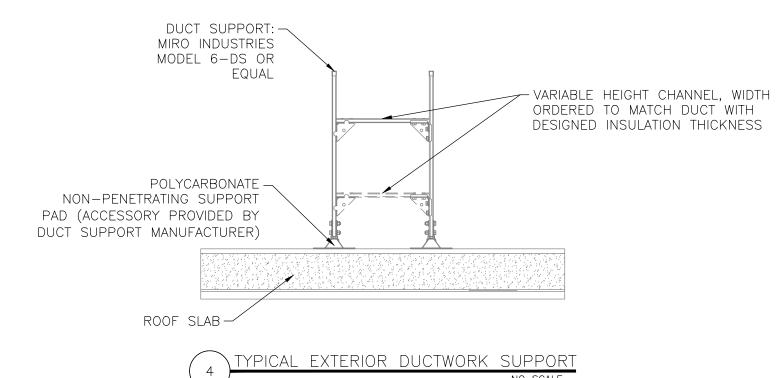

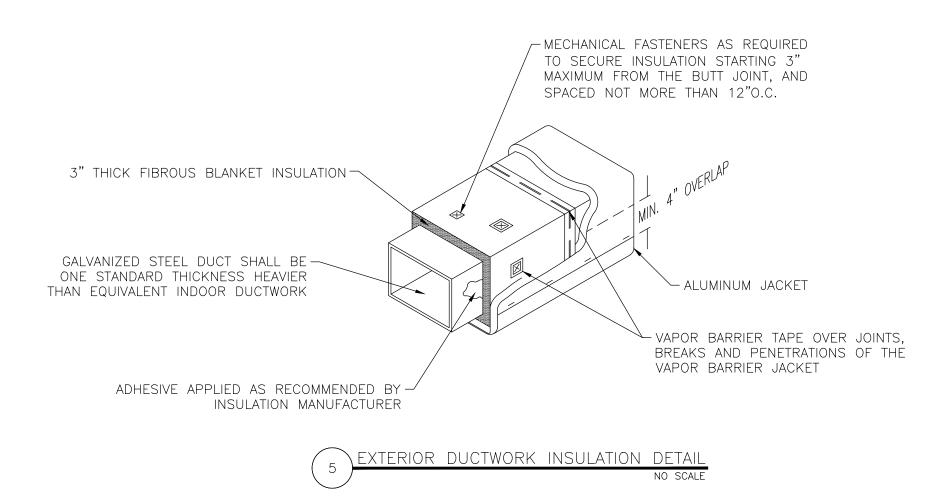


RELATIVE HUMIDITY SENSOR

DIFFERENTIAL PRESSURE SENSOR

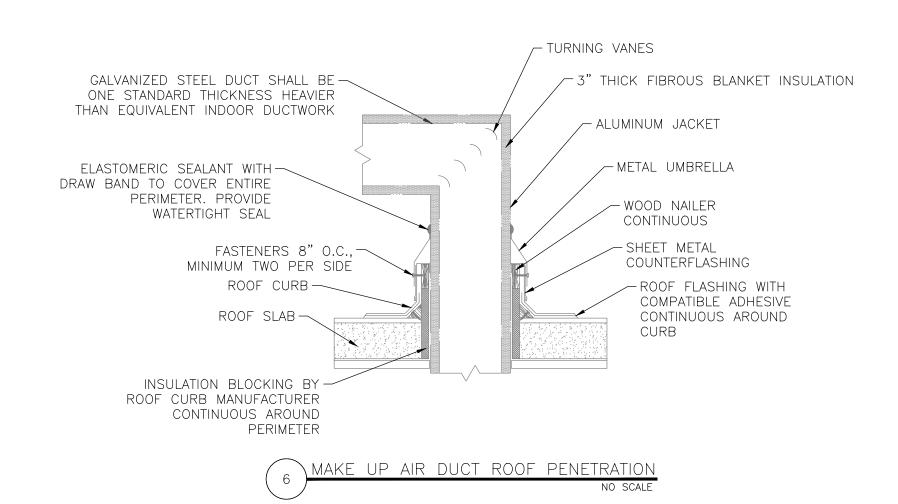

					⟨DO1⟩		
	ROL LEGEND		MAU-6,7		AO2 DI3		
VFD	VARIABLE SPEED FAN			PRE-FILTER / MERV 14	VFD		
	FILTER						
C C	REFRIGERANT COOLING COIL			С 1 / н			-
R H	MODULATING HOT-GAS REHEAT COIL	T H	D		DP T		
N G	NATURAL GAS HEATING COIL			___\DO2\>		DI4	
	CONTROL DAMPER	AI1 \ AI2 \	AO1>	DI1 A04	DI2 AI5	/ ١١٠	<
Ţ	TEMPERATURE SENSOR			AI3 AI4	AI6		
•							

CONTROLS DIAGRAMS

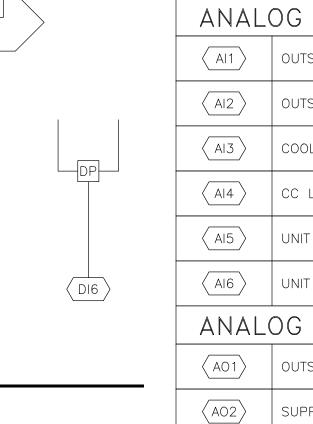

FFU-1,2,3

(DI5)

CD-1

ANAL	OG INPUTS		DIGITA	AL INPUTS
AI1	OUTSIDE AIR TEMPERATURE		(DI1)	FILTER PRESSURE DROP
AI2	OUTSIDE AIR RELATIVE HUMIDITY		DI2	SUPPLY FAN PRESSURE DROP
AI3	COOLING COIL (CC) LEAVING AIR TEMPERATURE		(DI3)	SUPPLY FAN STATUS
AI4	CC LEAVING AIR TEMPERATURE SETPOINT		(DI4)	SMOKE DETECTOR STATUS
AI5	UNIT LEAVING AIR TEMPERATURE		(DI5)	FAN FILTER UNIT STATUS
AI6	UNIT LEAVING AIR TEMPERATURE SETPOINT		(DI6)	ROOM PRESSURE DIFFERENTIAL
ANAL	OG OUTPUTS		(DI7)	COMPRESSOR STATUS
(AO1)	OUTSIDE AIR DAMPER COMMAND		DIGITA	AL OUTPUTS
(AO2)	SUPPLY FAN SPEED		(D01)	SUPPLY FAN START/STOP COMMAND
(AO3)	HEAT PUMP RETURN AIR DAMPER COMMAND		(D02)	COMPRESSOR START/STOP COMMAND
(AO4)	COMPRESSOR SPEED		(D03)	FAN FILTER UNIT START/STOP COMMAND

CONTROL NOTES

THIS FACILITY HAS AN EXISTING SCHNEIDER ELECTRIC BUILDING AUTOMATION SYSTEM. INTEGRATION OF EQUIPMENT CONTROL SHALL BE PROVIDED BY C&C GROUP:

BRIAN SCHEPERS 2414 HYDE PARK RD. JEFFERSON CITY, MO 65109 573.632.4247

CONTROLS CONTRACTOR SHALL PROVIDE AND INSTALL ALL CONTROLLERS, CONTROL WIRING, AND SENSORS EXCEPT SENSORS PROVIDED BY EQUIPMENT MANUFACTURER.

CONTROLS CONTRACTOR SHALL PROVIDE ALL PROGRAMMING AND GRAPHICS REQUIRED TO INTEGRATE NEW EQUIPMENT INTO THE EXISTING CONTROLS SYSTEM:

- 1. PROVIDE A RADIO BUTTON TO SET EACH MODULE INTO AIRBORNE INFECTION ISOLATION MODE (AIIM) SEPARATELY. SEE SEQUENCE OF OPERATION FOR MORE INFORMATION.
- 2. PROVIDE A GRAPHIC FOR MAU-6, MAU-7, AND EACH FAN FILTER UNIT IN EACH ROOM (FFU-1A THROUGH FFU-1C, FFU-2, AND FFU-3). GRAPHIC SHALL ACCURATELY REPRESENT INSTALLED EQUIPMENT.
- 3. PROVIDE A LINK FROM THE GRAPHIC TO A COPY OF THE SEQUENCE OF OPERATION WHICH SHALL ACCURATELY REPRESENT SEQUENCE PROGRAMMING.

SEQUENCE OF OPERATION

MODULE 1 — BEDROOMS, LIVING ROOM, AND ALL ASSOCIATED ANTEROOMS SERVED BY MAU-6. BOUNDARY IS BETWEEN FIRE DOORS IN CORRIDOR.

MODULE 2 — BEDROOMS, LIVING ROOM, AND ALL ASSOCIATED ANTEROOMS SERVED BY MAU-7. BOUNDARY IS BETWEEN FIRE DOORS IN CORRIDOR.

AIRBORNE INFECTION ISOLATION MODE (AIIM) — A STATE OF OPERATION FOR THE HVAC SYSTEM THAT CREATES A NEGATIVE PRESSURE RELATIONSHIP BETWEEN THE BEDROOMS, THE LIVING ROOMS, AND THE ADJACENT MODULE. HEPA FILTRATION IS PROVIDED FOR ALL EXHAUST AIR AND ALL AIR THAT IS RETURNED TO THE HEAT PUMPS IN EACH BEDROOM. AIIM IS ESTABLISHED VIA A SETTING IN THE BUILDING AUTOMATION SYSTEM (BAS).

EQUIPMENT IN EACH MODULE SHALL OPERATE AS FOLLOWS DURING AIIM:

EACH MODULE SHALL BE SET TO AIIM INDEPENDENT FROM EACH OTHER.

HEAT PUMPS: SHALL OPERATE PER EXISTING SEQUENCE OF OPERATION TO MAINTAIN EXISTING SETPOINTS IN THE SPACE. FAN SHALL OPERATE CONTINUOUSLY.

MAKEUP AIR UNIT: SHALL BE ENERGIZED AND FAN SHALL OPERATE CONTINUOUSLY.

FAN FILTER UNITS (FFU-1A, 1B, 1C): SHALL BE ENERGIZED AND FAN SHALL OPERATE CONTINUOUSLY PROVIDING HEPA FILTRATION. ONLY THOSE FAN FILTER UNITS IN THE MODULE THAT IS IN AIIM SHALL OPERATE.

FFU-2: SHALL BE ENERGIZED AND FAN SHALL OPERATE CONTINUOUSLY PROVIDING HEPA FILTRATION IF MAU-6 IS OPERATING.

FFU-3: SHALL BE ENERGIZED AND FAN SHALL OPERATE CONTINUOUSLY PROVIDING HEPA FILTRATION IF MAU-7 IS OPERATING.

UNFILTERED RETURN AIR FROM ENTERING THE HEAT PUMP. ROOM PRESSURE SENSORS: SHALL BE PLACED IN OCCUPIED MODE. WHEN SYSTEM IS NOT IN AIIM, SENSORS SHALL BE PLACED IN UNOCCUPIED MODE TO PREVENT UNNECESSARY ALARMS.

RETURN AIR CONTROL DAMPERS (CD-1): SHALL MOVE TO A CLOSED POSITION TO PREVENT

MAKEUP AIR UNIT (MAU-6 AND MAU-7) SEQUENCE OF OPERATION: WHEN MAU IS ENERGIZED, THE SUPPLY FAN SHALL OPERATE CONTINUOUSLY AT THE DESIGN AIRFLOW AND THE UNIT SHALL HEAT OR COOL TO MAINTAIN MAU LEAVING AIR TEMPERATURE

IF THE OUTDOOR AIR (OA) TEMPERATURE RISES ABOVE 72°F (ADJ), THE VARIABLE CAPACITY COMPRESSOR SHALL MODULATE TO PROVIDE A LAT OF 70°F (ADJ).

IF THE OA HUMIDITY RISES ABOVE 55%, THE VARIABLE CAPACITY COMPRESSOR SHALL MODULATE TO PROVIDE 55°F COOLING COIL LEAVING AIR TEMPERATURE AND THE MODULATING HOT GAS REHEAT SHALL MODULATE TO PROVIDE A MAU LEAVING AIR TEMPERATURE OF 70°F

IF THE OA TEMPERATURE FALLS BELOW 68°F, THE MODULATING NATURAL GAS HEATER SHALL ENERGIZE AND MODULATE TO PROVIDE A MAU LEAVING AIR TEMPERATURE OF 80°F (ADJ). ALARMS:

IF THE MAU SMOKE DETECTOR IS ACTIVATED THE FAN SHALL SHUT DOWN VIA A HARD-WIRED INTERLOCK AND AN ALARM SHALL BE SENT TO THE FIRE ALARM CONTROL SYSTEM.

IF THE MAU FAN IS COMMANDED ON AND NO CURRENT IS REALIZED THROUGH A CURRENT RELAY SENSOR, AN ALARM SHALL BE GENERATED AT THE BAS. FFUS SHALL NOT ENERGIZE IF MAU FAN IS NOT OPERATING.

IF THE FFU FAN IS COMMANDED ON AND NO CURRENT IS REALIZED THROUGH A CURRENT

RELAY SENSOR, AN ALARM SHALL BE GENERATED AT THE BAS.

STATE OF MISSOURI MICHAEL L. PARSON, **GOVERNOR**



Tracie L. Siebeneck - Engineer MO# PE-2013019114

OFFICE OF ADMINISTRATION DIVISION OF FACILITIES MANAGEMENT, **DESIGN AND CONSTRUCTION**

DEPARTMENT OF MISSOURI VETERANS COMMISSION

HVAC IMPROVEMENTS FOR INFECTION CONTROL

MEXICO VETERANS HOME 1 VETERANS DR

PROJECT # U2301-03 6802

MEXICO, MO 65265

8136802001 ASSET#

REVISION: DATE: **REVISION:** DATE: **REVISION:** DATE:

ISSUE DATE: 04/11/2024 CAD DWG FILE:M-U2301-03 DRAWN BY: TS/AH

CHECKED BY: TS DESIGNED BY: TS/AH

SHEET TITLE:

MECHANICAL DETAILS AND CONTROLS DIAGRAMS

SHEET NUMBER:

DEMOLITION NOTES


N INDICATES KEYED NOTES


- CEILINGS SHOWN DASHED AND DARKER ARE TO BE REMOVED COMPLETELY AND REPLACED WITH NEW LOWERED LAY—IN CEILING—SEE ARCHITECT SHEETS. ELC TO DISCONNECT AND REMOVE ALL CEILING MOUNTED DEVICES THAT REQUIRE POWER. COORDINATE WITH GENERAL CONTRACTOR TO HAVE STATE STAFF FORCES REMOVE AND REINSTALL ALL ACCESS POINTS AND SECURITY CAMERAS. ALL REMOVED DEVICES ARE TO BE CLEANED AND KEPT FOR REINSTALLATION IN NEW CEILING UNLESS NOTED. REMOVE ANY WALL MOUNTED DEVICES THAT ARE CONFLICTING WITH NEW LOWERED CEILING AND MOUNT LOWER ON WALL. EXTEND ALL WIRING AS NEEDED. ALL EXISTING LIGHTS THAT ARE WALL MOUNTED OR IN CEILINGS NOT BEING REPLACED SHALL REMAIN AS IS. ELC TO ENSURE ALL LIGHT SWITCH WIRES AND POWER WIRES AND CONDUITS ARE EXTENDED AS NEEDED. ALL DEVICES SHOWN ARE FROM FIELD TAKE—OFF AND EXISTING DRAWINGS AND MAY NOT BE 100 PERCENT ACCURATE. CONTRACTOR TO VERIFY ALL ITEMS.
- 2 ELECTRICAL CONTRACTOR (ELC) TO REMOVE AND CLEAN THIS NURSE CALL LIGHT AND RETAIN FOR INSTALLATION ON NEW CEILING EXTENSION. NO WORK ON THE CONTROLS.
- WALL MOUNTED AUDIO/VISUAL FIRE ALARM DEVICE TO BE RELOCATED LOWER ON WALL. EXTEND WIRING AS NEEDED. THE REMAINING WALL MOUNTED AUDIO/VISUAL DEVICES SHOWN SHALL BE EVALUATED BY OWNER TO BE LOWERED AS NEEDED. ALL CEILING MOUNTED DEVICES TO BE REMOVED, CLEANED AND REPLACED IN NEW CEILING. COORDINATE WITH MECHANICAL.
- 4 EXISTING LIGHT FIXTURE TO BE DEMOLISHED. LIGHT TO BE REPLACED WITH NEW. SEE SHEET E-102.
- 5 REMOVE THIS LIGHT FIXTURE, WIRE AND CONDUIT TO NEXT ACTIVE DEVICE OR JUNCTION BOX.
- THIS PANEL TO BE REPLACED. ELC TO DISCONNECT POWER TO PANEL "NH1" AND TEMPORARILY REMOVE BREAKERS, CLEAN AND SET ASIDE FOR ALL ROUGH IN WORK TO BE DONE UP FRONT TO HELP MINIMIZE DOWN TIME. POWER FROM THIS PANEL FEEDS ALL CORRIDOR HVAC LOADS ON THE WEST HALF OF THE BUILDING ALONG WITH ELEVATOR ROOM AND RESTROOMS. COORDINATE WITH OWNER ON TIMING TO SWITCH OVER TO NEW PANEL. TIMING SHALL BE CONSIDERED CRITICAL AND CONTRACTOR SHALL HAVE ADEQUATE LABOR FORCE TO PERFORM PANEL CHANGE OVER AS FAST AS REASONABLY POSSIBLE TO GET HVAC UNITS BACK UP AND RUNNING. SEE SHEET E-501.

		ELECTRICAL ROOM 151
	ELEV. 03 HALL WHIRLPOOT ITILITY TO SOILED UTILITY TIT. HSKPC.	NOUR. KITCHEN MED. ROOM (152)
		· Fs
_	STOR. UNIT 101 POR STOR. STOR STOR. STO	TLT. B127
		6 2-BR UNIT (127)
		-BR INIT 125)
	3	

PARTIAL FIRST FLOOR PLAN

ELECTRICAL DEMOLITION

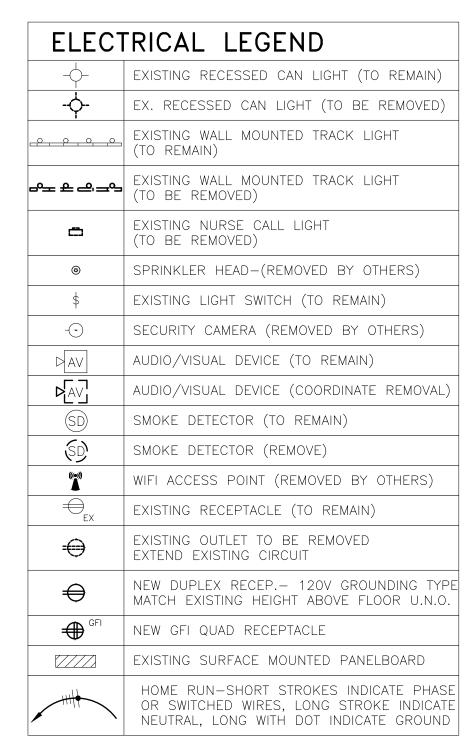

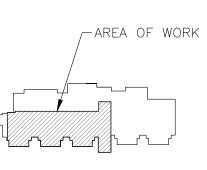



STATE OF MISSOURI MICHAEL L. PARSON, GOVERNOR





Columbia, MO. 65202 (573) 875-0045 Phone (573) 875-0046 FAX WWW.MOENGINEERING.COM Midwest Engineering & Design Missouri State Certificate of Authority #2010032467

OFFICE OF ADMINISTRATION DIVISION OF FACILITIES MANAGEMENT, DESIGN AND CONSTRUCTION

DEPARTMENT OF MISSOURI VETERANS COMMISSION

HVAC IMPROVEMENTS FOR INFECTION CONTROL

8136802001

MEXICO VETERANS HOME #1 VETERANS' DRIVE MEXICO, MO 65265

PROJECT # U2301-03 SITE # 6802

ASSET#

REVISION:
DATE:
REVISION:
DATE:
REVISION:
DATE:
ISSUE DATE:


CAD DWG FILE:MIFIC-e.dwg
DRAWN BY: MDS
CHECKED BY: JLD
DESIGNED BY: JLD

SHEET TITLE:

FIRST FLOOR
ELECTRICAL
DEMOLITION PLAN

SHEET NUMBER:


E-101

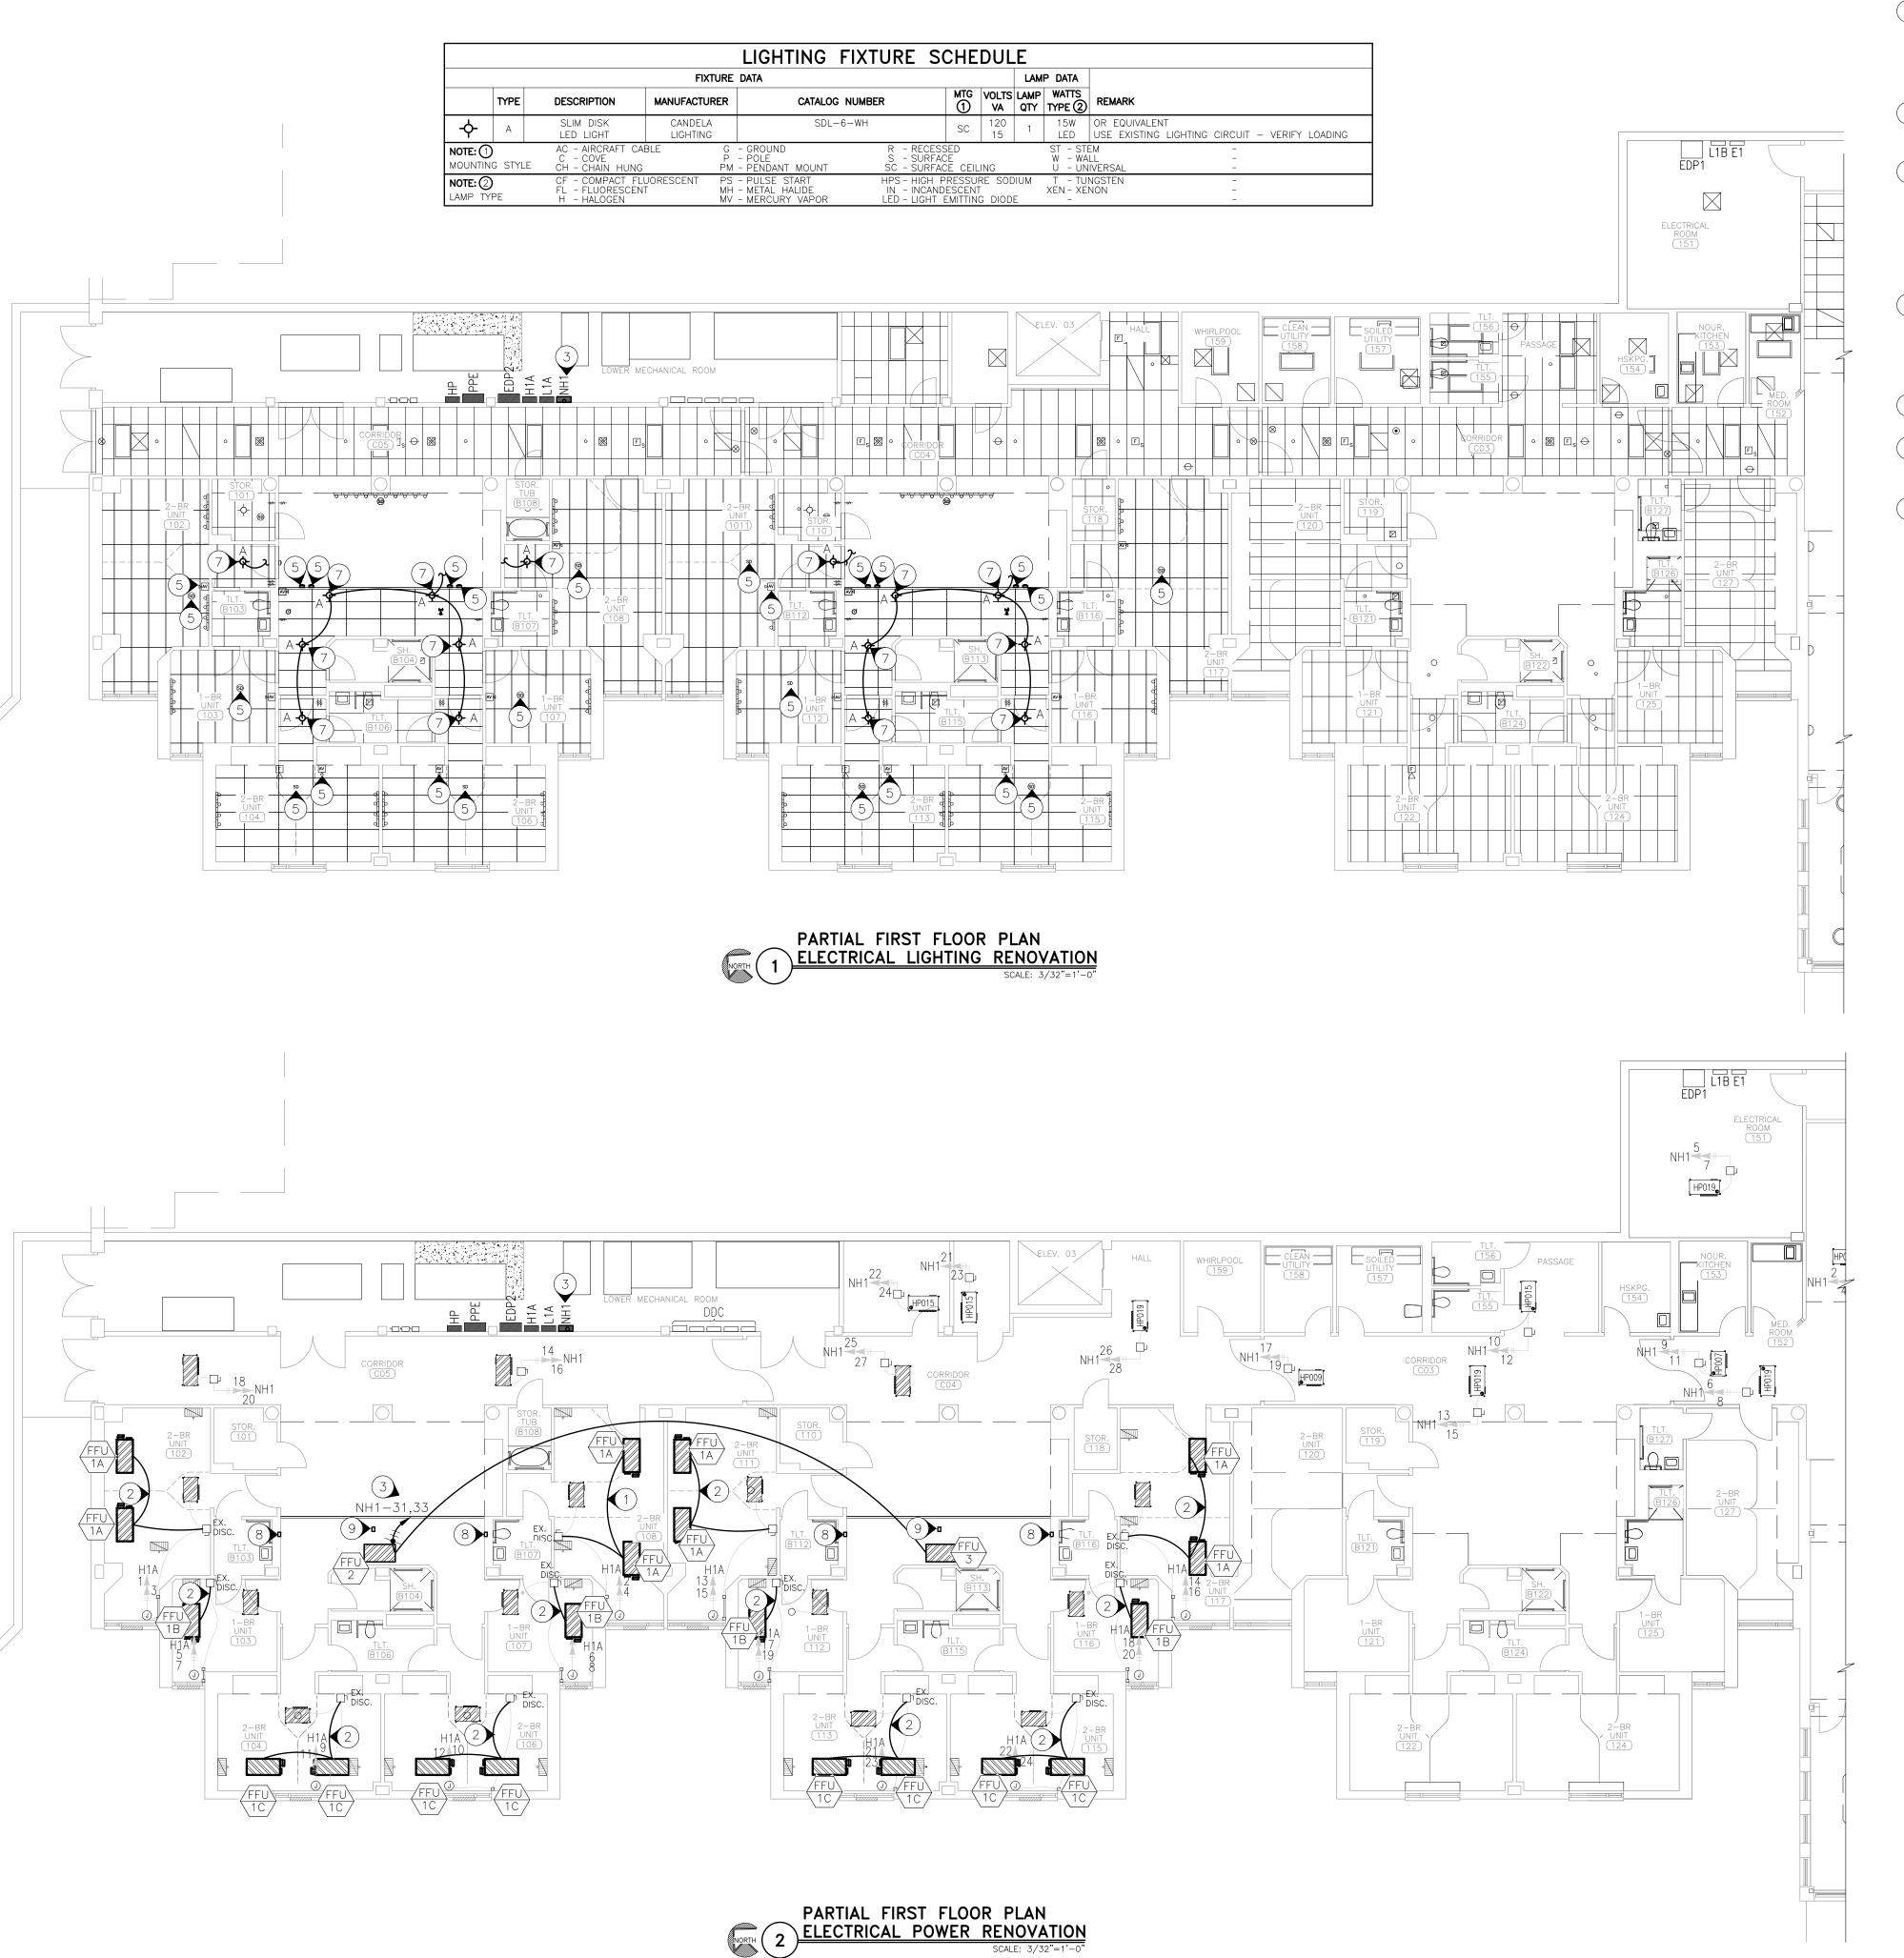

CONSTRUCTION NOTES

(N) INDICATES KEYED NOTES


- 1 ELECTRICAL CONTRACTOR (ELC) SHALL RUN (2) #12 CU THHN AND (1) #12 CU GROUND IN (1) 1/2" EMT FROM NEW FFU TO EXISTING HVAC UNIT DISCONNECT. DISCONNECT LOCATION TO BE VERIFIED IN THE FIELD. ELC SHALL INSTALL CLASS 2 TRANSFORMER WITH OVERLOAD PROTECTION TO PROTECT NEW CONTROLS TRANSFORMER. INSTALL A JUNCTION BOX WITH A 208V TO 24V TRANSFORMER DOWNSTREAM, ABOVE THE CEILING FOR CONTROLS. THE TRANSFORMER WILL POWER NEW CONTROLLER FOR UNIT. MECHANICAL CONTRACTOR TO PROVIDE ALL LOW VOLTAGE WIRING. COORDINATE WITH MECHANICAL TO SIZE TRANSFORMER.
- 2 ELC SHALL RUN (2) #12 CU THHN AND (1) #12 CU GROUND IN (1) 1/2" EMT FROM NEW UNIT TO EXISTING ROOM CIRCUIT DISCONNECT. EXISTING CIRCUITING TO REMAIN. DISCONNECT LOCATION TO BE VERIFIED IN THE
- (3) ELC TO RUN (2) #12 CU THHN AND (1) #12 CU GROUND IN (1) 1/2" EMT FROM FFU-2 FACTORY DISCONNECT TO NEW PANEL "NH1". ROUTE TO FACTORY DISCONNECT AT NEW FFU-3. SEE SHEETS E-103 E-501 AND E-601. MAKE CONTROL MODIFICATIONS AS NEEDED. ADD 20A/2P BREAKER IN "NH1" FOR THE NEW UNITS.
- ELECTRICAL CONTRACTOR (ELC) IS TO SUPPLY AND INSTALL ALL CONDUIT AND ALL LINE VOLTAGE WIRING. COORDINATE WITH MECHANICAL CONTRACTOR TO RUN ALL CONDUIT AND ANY WALL BOXES FOR MECHANICAL SYSTEM LOW VOLTAGE WIRING. MECHANICAL CONTRACTOR TO RUN ALL LOW VOLTAGE WIRE.
- (5) DEVICE SALVAGED AND CLEANED DURING DEMO PHASE TO BE INSTALLED HERE. ALL WIRING AND CONDUIT TO BE EXTENDED AS NEEDED.
- ALL CIRCUITING SHOWN IS FROM DRAWINGS OBTAINED FROM THE STATE OF MISSOURI AND HAVE NOT BEEN VERIFIED FOR ACCURACY. CIRCUITING SHOWN DOES NOT AGREE WITH PANEL SCHEDULES. ELC SHALL VERIFY ALL EXISTING CIRCUITING.
- (7) ELC TO INSTALL NEW SURFACE MOUNTED LED LIGHT FIXTURE IN THIS LOCATION. CIRCUIT TO EXISTING LIGHTING CIRCUIT. SWITCHING TO REMAIN AS IS. EXTEND WIRE AND CONDUIT AS NEEDED. ELC TO VERIFY LOADING.
- (8) ELC TO PROVIDE AND INSTALL A 3-GANG CUT-IN BOX FOR NEW PRESSURE CONTROL SYSTEM MONITOR (RPM20) AT EACH LOCATION SHOWN ON MECHANICAL SHEET M-105 (4 TOTAL). COORDINATE WITH MECHANICAL SHEETS AND CONTROLS CONTRACTOR FOR EXACT LOCATIONS.
- (9) PROVIDE AND INSTALL A 4-SQUARE JUNCTION BOX ABOVE CEILING NEAR CENTER OF ROOM AND INSTALL (1) 120V TO 24V 30W OUTPUT TRANSFORMER FOR MONITOR POWER. EACH LOW VOLTAGE TRANSFORMER WILL PROVIDE POWER FOR (2) MONITORS. MECHANICAL AND CONTROLS CONTRACTOR TO RUN ALL LOW VOLTAGE WIRE TO THE PRESSURE SENSORS ABOVE THE DOORS AND ELC TO PROVIDE ANY NEEDED CONDUIT. CIRCUIT FROM EXISTING ROOM LIGHT OR OUTLET POWER.

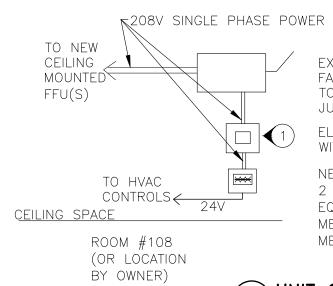

EXISTING ROOM DISCONNECT OR NEW UNIT FACTORY SUPPLIED DISCONNECT IN CEILING NEXT TO EXISTING UNIT. ELC TO RUN 208V POWER TO JUNCTION BOX WITH TRANSFORMER. ELC TO PROVIDE AND INSTALL NEW CLASS 2 TRANSFORMER WITH THERMAL OVERLOAD PROTECTION IN NEW JUNCTION BOX. NEW JUNCTION BOX WITH NEW JOHNSON CONTROLS CLASS 2 50VA, 208V TO 24V TRANSFORMER (Y63T22-0) OR EQUAL. THIS WILL POWER THE NEW CONTROLS (BY MECHANICAL EQUIPMENT SUPPLIER).(LOW VOLTAGE WIRE MY MECHANICAL)

3 UNIT CONTROL DETAIL

SCALE: NONE

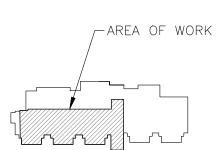

STATE OF MISSOURI MICHAEL L. PARSON, **GOVERNOR**





Columbia, MO. 65202 (573) 875-0045 Phone (573) 875-0046 FAX WWW.MOENGINEERING.COM Midwest Engineering & Design Missouri State Certificate of Authority #2010032467

OFFICE OF ADMINISTRATION DIVISION OF FACILITIES MANAGEMENT, DESIGN AND CONSTRUCTION

DEPARTMENT OF MISSOURI VETERANS COMMISSION

HVAC IMPROVEMENTS FOR INFECTION CONTROL

MEXICO VETERANS HOME **#1 VETERANS' DRIVE** MEXICO, MO 65265

PROJECT # U2301-03 8136802001 ASSET#

REVISION:
DATE:
REVISION:
DATE:
REVISION:
DATE:
ISSUE DATE:


CAD DWG FILE:MIFIC-e.dwg
DRAWN BY: MDS
CHECKED BY: JLD DESIGNED BY: JLD

SHEET TITLE:


FIRST FLOOR ELECTRICAL RENOVATION PLAN

SHEET NUMBER:

E-102

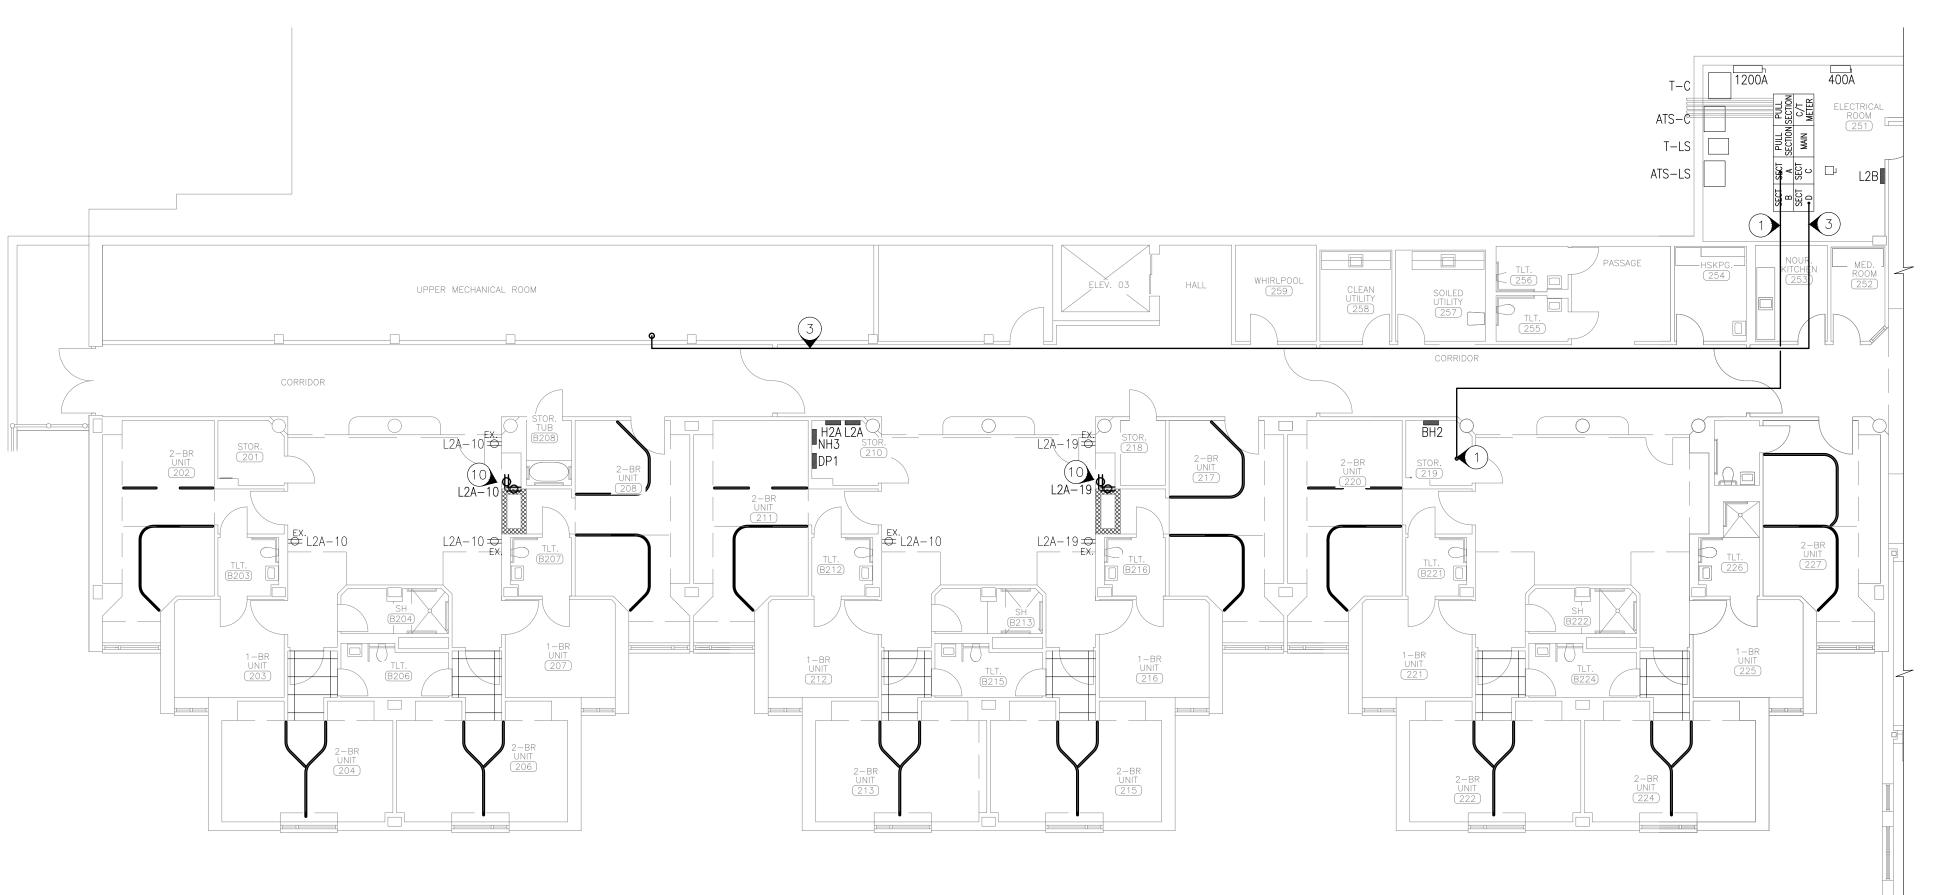

PARTIAL SECOND FLOOR PLAN ELECTRICAL POWER RENOVATION SCALE: 3/30"-11'.0"

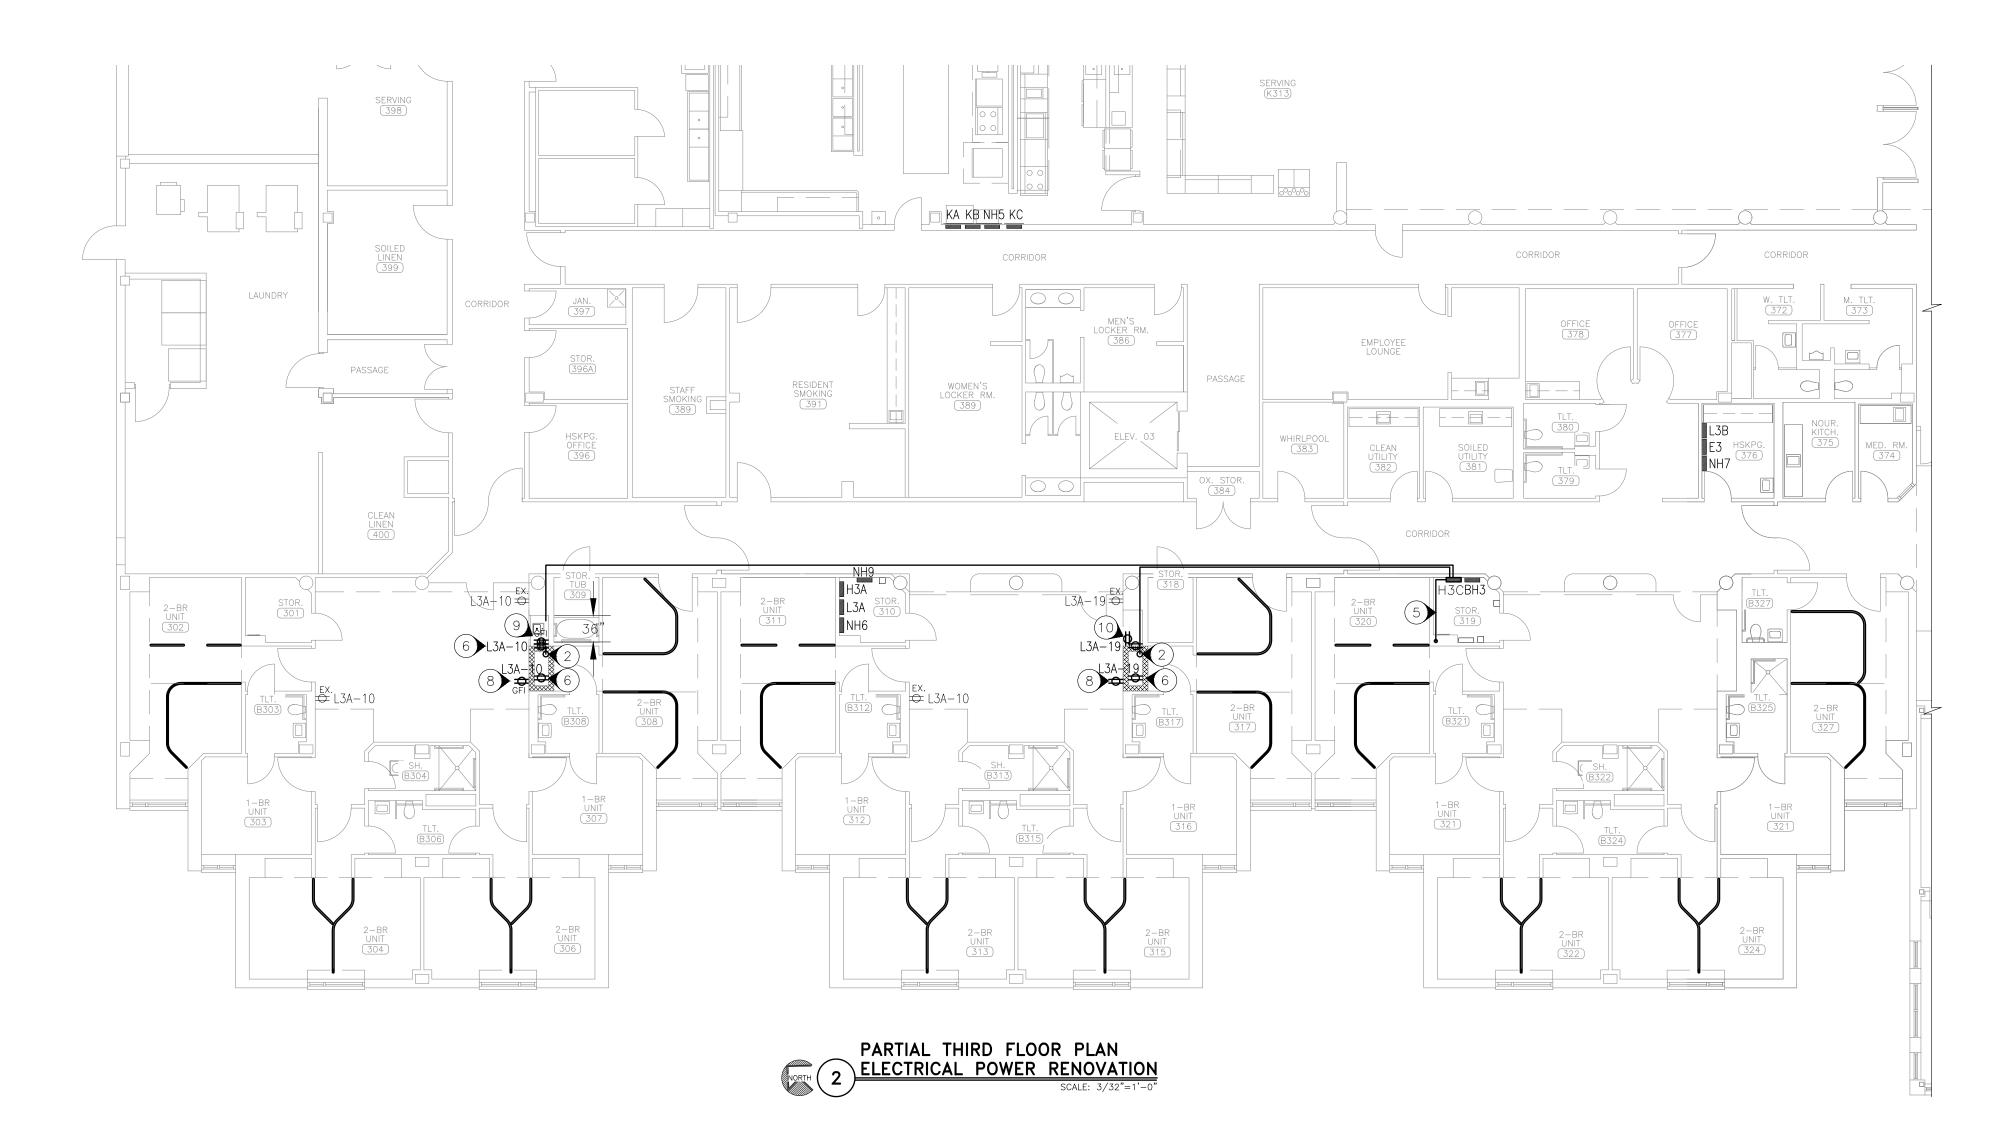


CONSTRUCTION NOTES





- ELC TO RUN (3) #8 CU THHN, (1) #10 CU THHN AND (1) #10 CU GROUND IN (1) 1" EMT FROM NEW ROOF MOUNTED MAKEUP AIR UNIT (FED THRU CHASE FOR UNIT DUCTWORK) TO NEW PANEL "H3C". PROVIDE NEW 60A 3P BREAKERS AND 20A SPARES IN PANEL. USE RUBBER BOOT AT CONDUIT PENETRATION ON ROOF. SEAL PENETRATIONS TO WATER TIGHT CONDITION. COORDINATE WITH MECHANICAL EQUIPMENT. SEE M106.
- RUN (3) 4/0 CU THWN AND (1) 3/0 CU THWN AND (1) #6 CU GROUND IN (1) 2" CONDUIT FROM 200A SPARE IN SECTION "D" OF 4000A MAIN DISTRIBUTION PANEL TO NEW PANEL "NH1" IN THE ELECTRIC ROOM ON FIRST FLOOR. SEE SHEETS E-102 AND E-501.
- 4 CONTRACTOR SHALL VERIFY WITH OWNER ON TIMELINE OF CONSTRUCTION ACTIVITIES TO MINIMIZE DISRUPTION TO OWNER'S STAFF OPERATIONS.
- SEE NOTE 1 ABOVE. RUN (3) 4/0 CU THWN AND (1) 3/0 CU THWN AND (1) #6 CU GROUND IN (1) 2" CONDUIT ABOVE FROM CHASE AND ABOVE CEILING TO NEW 225A ELECTRIC PANEL "H3C". SEE SHEET E-501 FOR RISER INFORMATION.
- (6) THIS EXISTING OUTLET IS TO BE REMOVED. TEMPORARILY WIRE NUT AND TAPE WIRE AS NEEDED. EXISTING CIRCUIT TO BE EXTENDED TO NEW OUTLET. COORDINATE WITH GENERAL CONTRACTOR TO REPAIR WALL.
- IF ANY MECHANICAL OR ELECTRICAL EQUIPMENT SPECIFIED IN THE DRAWINGS IS SUBSTITUTED BY A CONTRACTOR, THAT CONTRACTOR SHALL BE RESPONSIBLE FOR PROVIDING THE EQUIPMENT'S ELECTRICAL PROTECTION PER THE MANUFACTURER'S NAMEPLATE, AND THE CURRENT NEC, ALONG WITH ALL EXPENSES INCURRED DUE TO SAID SUBSTITUTION. THE CONTRACTOR WHO IS PROVIDING THE SUBSTITUTION SHALL COORDINATE WITH ALL DISCIPLINES AFFECTED BY THIS CHANGE.
- PROVIDE AND INSTALL NEW OUTLET AT 24"AFF ON NEW FIRE WALL FOR CHASE. SEE PLAN TO DETERMINE IF OUTLET IS GFI. COORDINATE EXACT LOCATION WITH ARCHITECTURAL DRAWINGS. OUTLET ON NEW CHASE WALL TO RECEIVE 3M FIRE BARRIER MOLDABLE PUTTY PADS MPP+. FORM PAD AROUND THE ENTIRE BOX AND ALL BOX CONDUITS AND WIRES SO AS TO LEAVE NO OPENINGS. EXTEND EXISTING CIRCUIT.
- 9 PROVIDE AND INSTALL A NEW GFI QUAD OUTLET AT 36" FROM END OF WALL AT 44"AFF. COORDINATE WITH ARCHITECTURAL DRAWINGS AND SECTIONS. EXTEND EXISTING CIRCUIT FROM OUTLET REMOVED.
- REMOVE EXISTING OUTLET. PLACE NEW OUTLET ON THE SHORT SIDE OF THE NEW FIRE WALL AS SHOWN AND AT SAME LOCATION ABOVE THE FLOOR. SEE NOTE 8 ABOVE FOR FIRE PUTTY INSTALLATION. EXTEND EXISTING CIRCUIT. COORDINATE WITH GENERAL CONTRACTOR TO HAVE WALL REPAIRED.

STATE OF MISSOURI MICHAEL L. PARSON, GOVERNOR

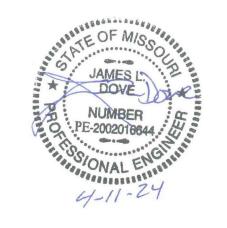



Columbia, MO. 65202 (573) 875-0045 Phone (573) 875-0046 FAX WWW.MOENGINEERING.COM Midwest Engineering & Design Missouri State Certificate of Authority #2010032467

OFFICE OF ADMINISTRATION DIVISION OF FACILITIES MANAGEMENT, DESIGN AND CONSTRUCTION

DEPARTMENT OF MISSOURI VETERANS COMMISSION

HVAC IMPROVEMENTS FOR INFECTION CONTROL

MEXICO VETERANS HOME #1 VETERANS' DRIVE MEXICO, MO 65265

PROJECT # U2301-03 SITE # 6802 ASSET # 8136802001

REVISION:
DATE:
REVISION:
DATE:
REVISION:
DATE:
ISSUE DATE:

CAD DWG FILE:MIFIC-e.dwg
DRAWN BY: MDS
CHECKED BY: JLD
DESIGNED BY: JLD

SHEET TITLE:

SECOND AND THIRD FLOOR ELECTRICAL RENOVATION PLAN


SHEET NUMBER:

E-103

25 OF 28 SHEETS 04/11/2024

AREA OF WORK

| KEY MAP | | SCALE: 1"=200"

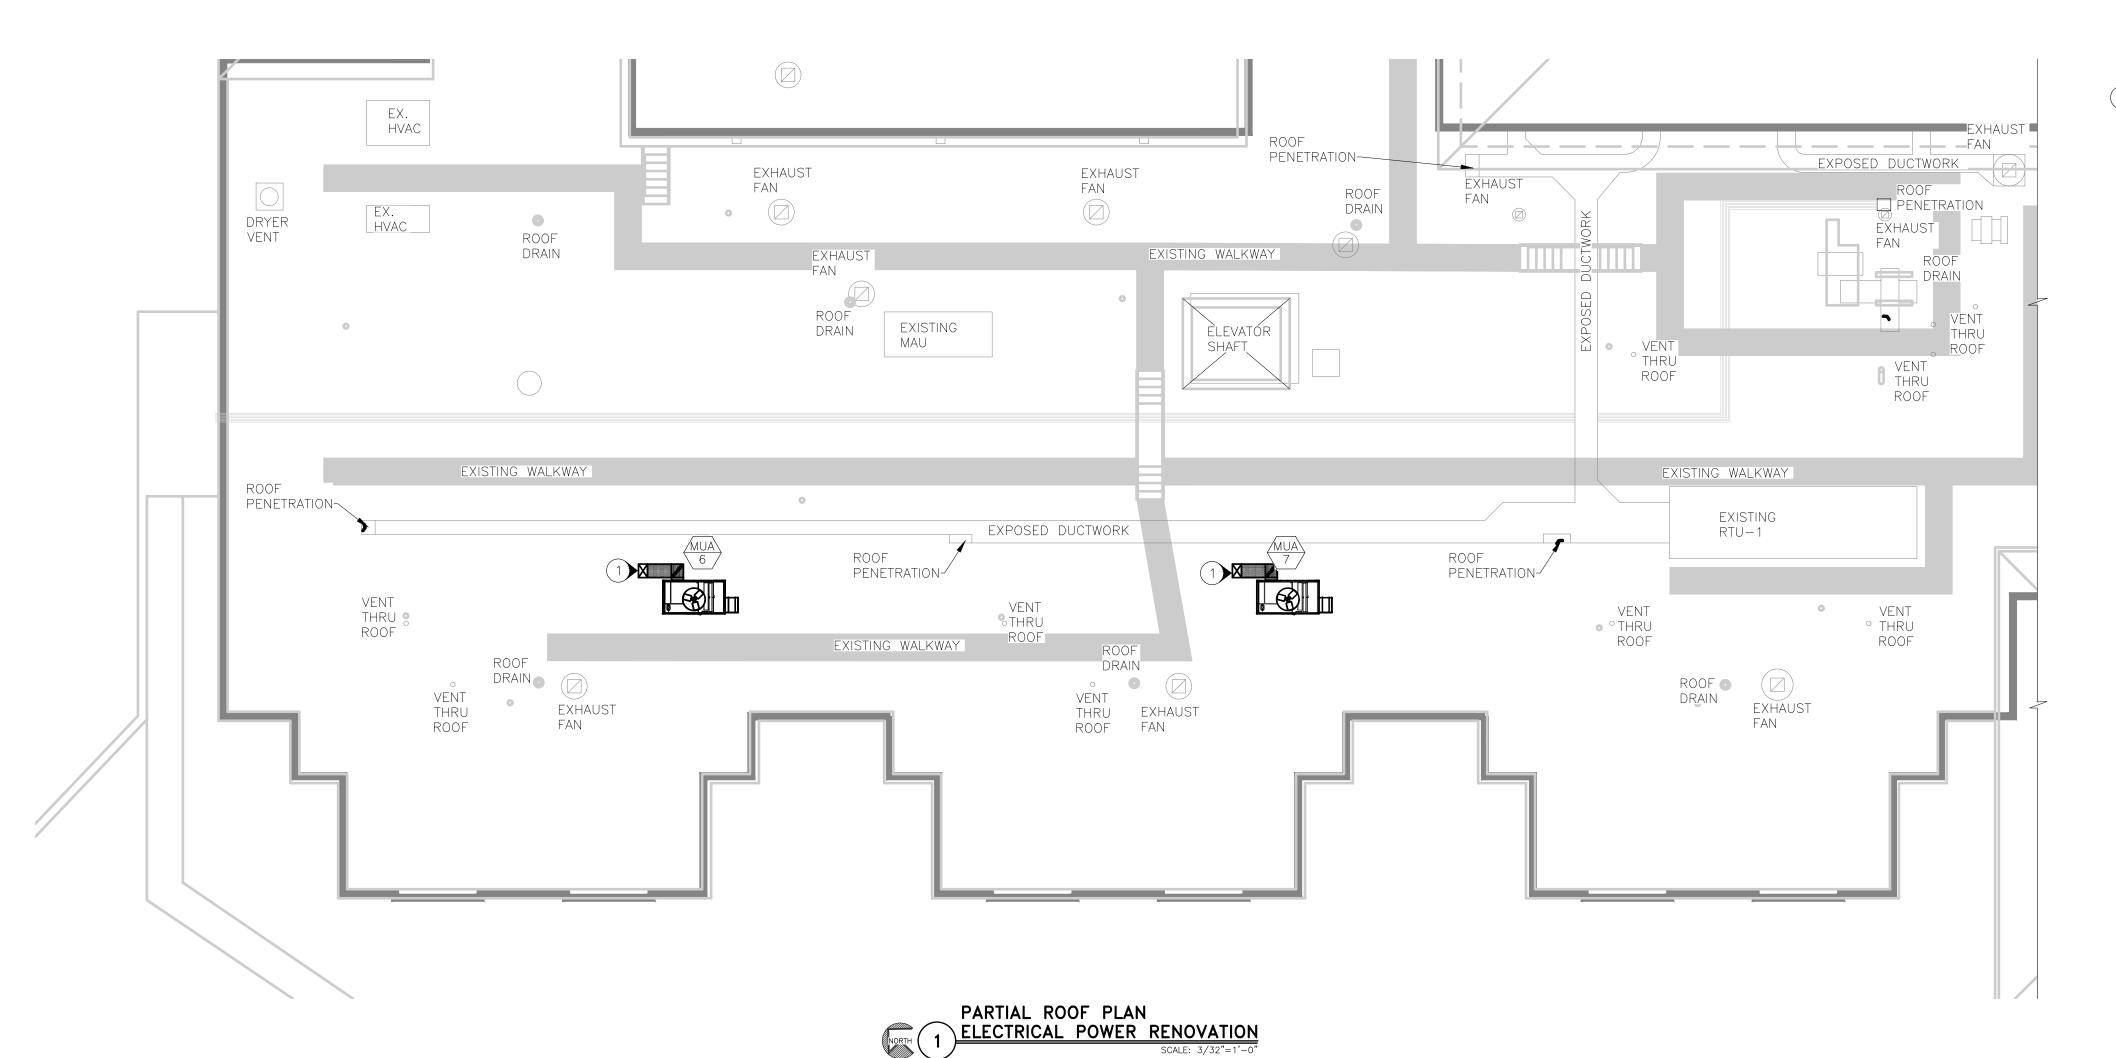

3M #CP 25N/S OR

RATED CAULK. 1/4"

(MIN.) OVERLAP ON

CARRIER PIPE &

WALL ASSEMBLY -

APPROVED EQUAL FIRE

3 HOUR (MAX.)

4 1/2" THICK (MIN.)

FIRE RATED MASONRY

WALL ASSEMBLY —

(2) FIRE CAULK TO BE CP 25WB AS MANUFACTURED BY 3M

—1 OR 2 HR RATED

(1 OR 2 LAYERS)

WOOD OR STEEL STUD

WALL WITH SHEET ROCK

-DIAMETER OF CIRCULAR

MAX 1/2" LARGER THAN

OUTSIDE DIAMETER OF

PIPE/CONDUIT.

OPENING TO BE MIN. 1/4" TO

COMPANY OR APPROVED EQUIVALENT.

2 UNINSULATED CONDUIT THRU 1-2 HR FIRE RATED GYPSUM WALL ASSEMBLY DETAIL
U.L. SYSTEM #W-I-1085

NOM. 12"Ø OR SMALLER,

SCHED. 10 OR THICKER

OR ECCENTRICALLY IN

PENETRATING HOLE.

OF ASSEMBLY. —

FIRE CAULK TO BE

MATERIAL TO BE

FORCED INTO ANNULUS

TO MAXIMUM EXTENT

 $\langle 2 \rangle$ installed such that a

MIN. 1/2" CROWN IS

FORMED AROUND PIPE,

AND CAULK OVERLAPS

WALL OPENINGS 1/4"-/

POSSIBLE. ADDITIONAL

STEEL PIPE; OR NOM. 6"Ø OR SMALLER STEEL CONDUIT

PIPE/CONDUIT TO BE RIGIDLY

SUPPORTED ON BOTH SIDES

INSTALLED CONCENTRICALLY

CONSTRUCTION NOTES

(N) INDICATES KEYED NOTES

(1) ELC TO RUN (2) #8 CU THHN, (1) #10 CU THHN AND (1) #10 CU GROUND IN (1) 1" EMT FROM NEW ROOF MOUNTED MAKEUP AIR UNIT (FED THRU OPENING FOR UNIT DUCTWORK) TO NEW PANEL "H3C" ON THIRD FLOOR. SEE SHEET E-103. PROVIDE NEW 60A/3P BREAKERS AND 20A/1P SPARES IN PANEL AS SHOWN ON E-601. COORDINATE WITH MECHANICAL CONTRACTOR TO RUN A ADDITIONAL 1" CONDUIT FROM EACH UNIT DOWN TO ACCESSIBLE CEILING SPACE NEXT TO THE 1" POWER CONDUIT FOR CONTROL WIRING. COORDINATE WITH CONTROLS CONTRACTOR. USE RUBBER BOOT(S) AT CONDUIT PENETRATION ON ROOF. SEAL PENETRATIONS TO WATER TIGHT CONDITION. COORDINATE WITH GENERAL CONTRACTOR ON ROOF WARRANTY.







3100 Brown Station Rd. Suite C Columbia, MO. 65202 (573) 875-0045 Phone (573) 875-0046 FAX WWW.MOENGINEERING.COM Midwest Engineering & Design Missouri State Certificate of Authority #2010032467

OFFICE OF ADMINISTRATION DIVISION OF FACILITIES MANAGEMENT, DESIGN AND CONSTRUCTION

DEPARTMENT OF MISSOURI VETERANS COMMISSION

HVAC IMPROVEMENTS FOR INFECTION CONTROL

MEXICO VETERANS HOME #1 VETERANS' DRIVE MEXICO, MO 65265

PROJECT # U2301-03 6802

8136802001

REVISION: DATE: REVISION: DATE: **REVISION**: DATE:

ASSET#

CAD DWG FILE:MIFIC-e.dwg DRAWN BY: MDS CHECKED BY: JLD

DESIGNED BY: JLD

ISSUE DATE:

SHEET TITLE:


POWER RENOVATION PLAN

ROOF ELECTRICAL

SHEET NUMBER:

26 OF 28 SHEETS

04/11/2024

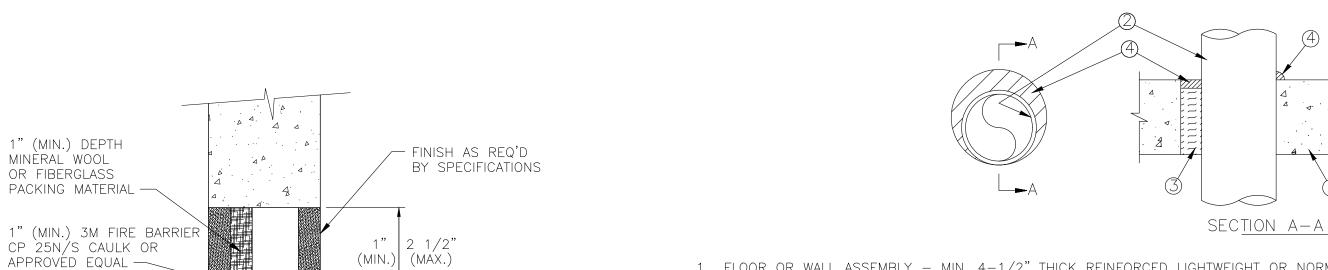

— 20"ø (MAX.) SCHED. 10 (MIN.)

STEEL PIPE, 6"Ø (MAX.)

COPPER, OR 4"Ø (MAX.)

EMT CONDUIT, RIGIDLY

OF ASSEMBLY


3 CONDUIT THROUGH FIRE RATED MASONRY WALL DETAIL

GRS CONDUIT OR TYPE L


CAST IRON PIPE OR STÉEL

SUPPORTED ON BOTH SIDES

- 1. FLOOR OR WALL ASSEMBLY MIN. 4—1/2" THICK REINFORCED LIGHTWEIGHT OR NORMAL WEIGHT (100—150 PCF) CONCRETE. WALL MAY ALSO BE CONSTRUCTED OF ANY UL CLASSIFIED CONCRETE BLOCKS MAX. DIA. OF OPENING IS 12 IN.
- 2. THROUGH PENETRATIONS ONE METALLIC PIPE, CONDUIT OR TUBING TO BE INSTALLED WITHIN THE FIRESTOP SYSTEM. PIPE, CONDUIT OR TUBING TO BE RIGIDLY SUPPORTED ON BOTH SIDES OF FLOOR OR WALL ASSEMBLY. THE ANNULAR SPACE SHALL BE 0 IN. TO MAX 1-1/4 IN. THE FOLLOWING TYPES OF SIZES OF METALLIC PIPES, CONDUIT OR TUBING MAY BE USED:
- A. STEEL PIPE NOM. 10 IN. DIA. OR SMALLER SCHEDULE 10 OR HEAVIER STEEL PIPE. B. IRON PIPE - NOM. 10 IN. DIA. OR SMALLER CAST OR DUCTILE IRON PIPE.
- C. CONDUIT NOM. 4 IN. DIA OR SMALLER STEEL ELECTRICAL METALLIC TUBING OR STEEL CONDUIT.
- D. COPPER TUBING NOM. 4 IN. DIA OR SMALLER TYPE L OR HEAVIER COPPER TUBING.
- E. COPPER PIPE NOM. 4 IN. DIA. OR SMALLER REGULAR OR HEAVIER COPPER PIPE.
 3. PACKING MATERIAL MIN. 3 IN. THICKNESS OF MIN. 4 PCF MINERAL WOOL BATT INSULATION FOR NOM. 4 IN. DIA. OR SMALLER PIPES, CONDUITS OR TUBINGS AND A MIN 4 IN. THICKNESS OF MIN. 4 PCF MINERAL WOOL BATT INSULATION FOR PIPE GREATER THAN NOM. 4 IN. DIA. FIRMLY PACKED INTO OPENING AS A PERMANENT FORM. PACKING MATERIAL TO BE RECESSED FROM TOP SURFACE OF FLOOR OR FROM BOTH SURFACES OF WALL AS REQUIRED TO ACCOMMODATE THE REQUIRED THICKNESS OF FILL MATERIAL.
- 4. FILL, VOID OR CAVITY MATERIAL SEALANT MIN. 1/2 IN. THICKNESS OF FILL MATERIAL APPLIED WITHIN THE ANNULUS, FLUSH WITH THE TOP SURFACE OF FLOOR OR BOTH SURFACES OF WALL. AT THE POINT OF CONTACT LOCATION BETWEEN PIPE AND CONCRETE, A MIN. 1/2 IN. DIA. BEAD OF FILL MATERIAL SHALL BE APPLIED AT THE CONCRETE/PIPE INTERFACE ON THE TOP SURFACE OF FLOOR AND ON BOTH SURFACES OF WALL. W RATING APPLIES ONLY WHEN CP601S OR CP604 SEALANT IS USED.
 - 2 HR METALLIC PIPE THROUGH CONCRETE FIRE RATED PENETRATION

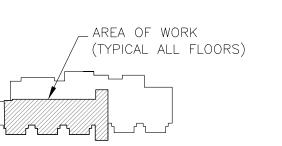



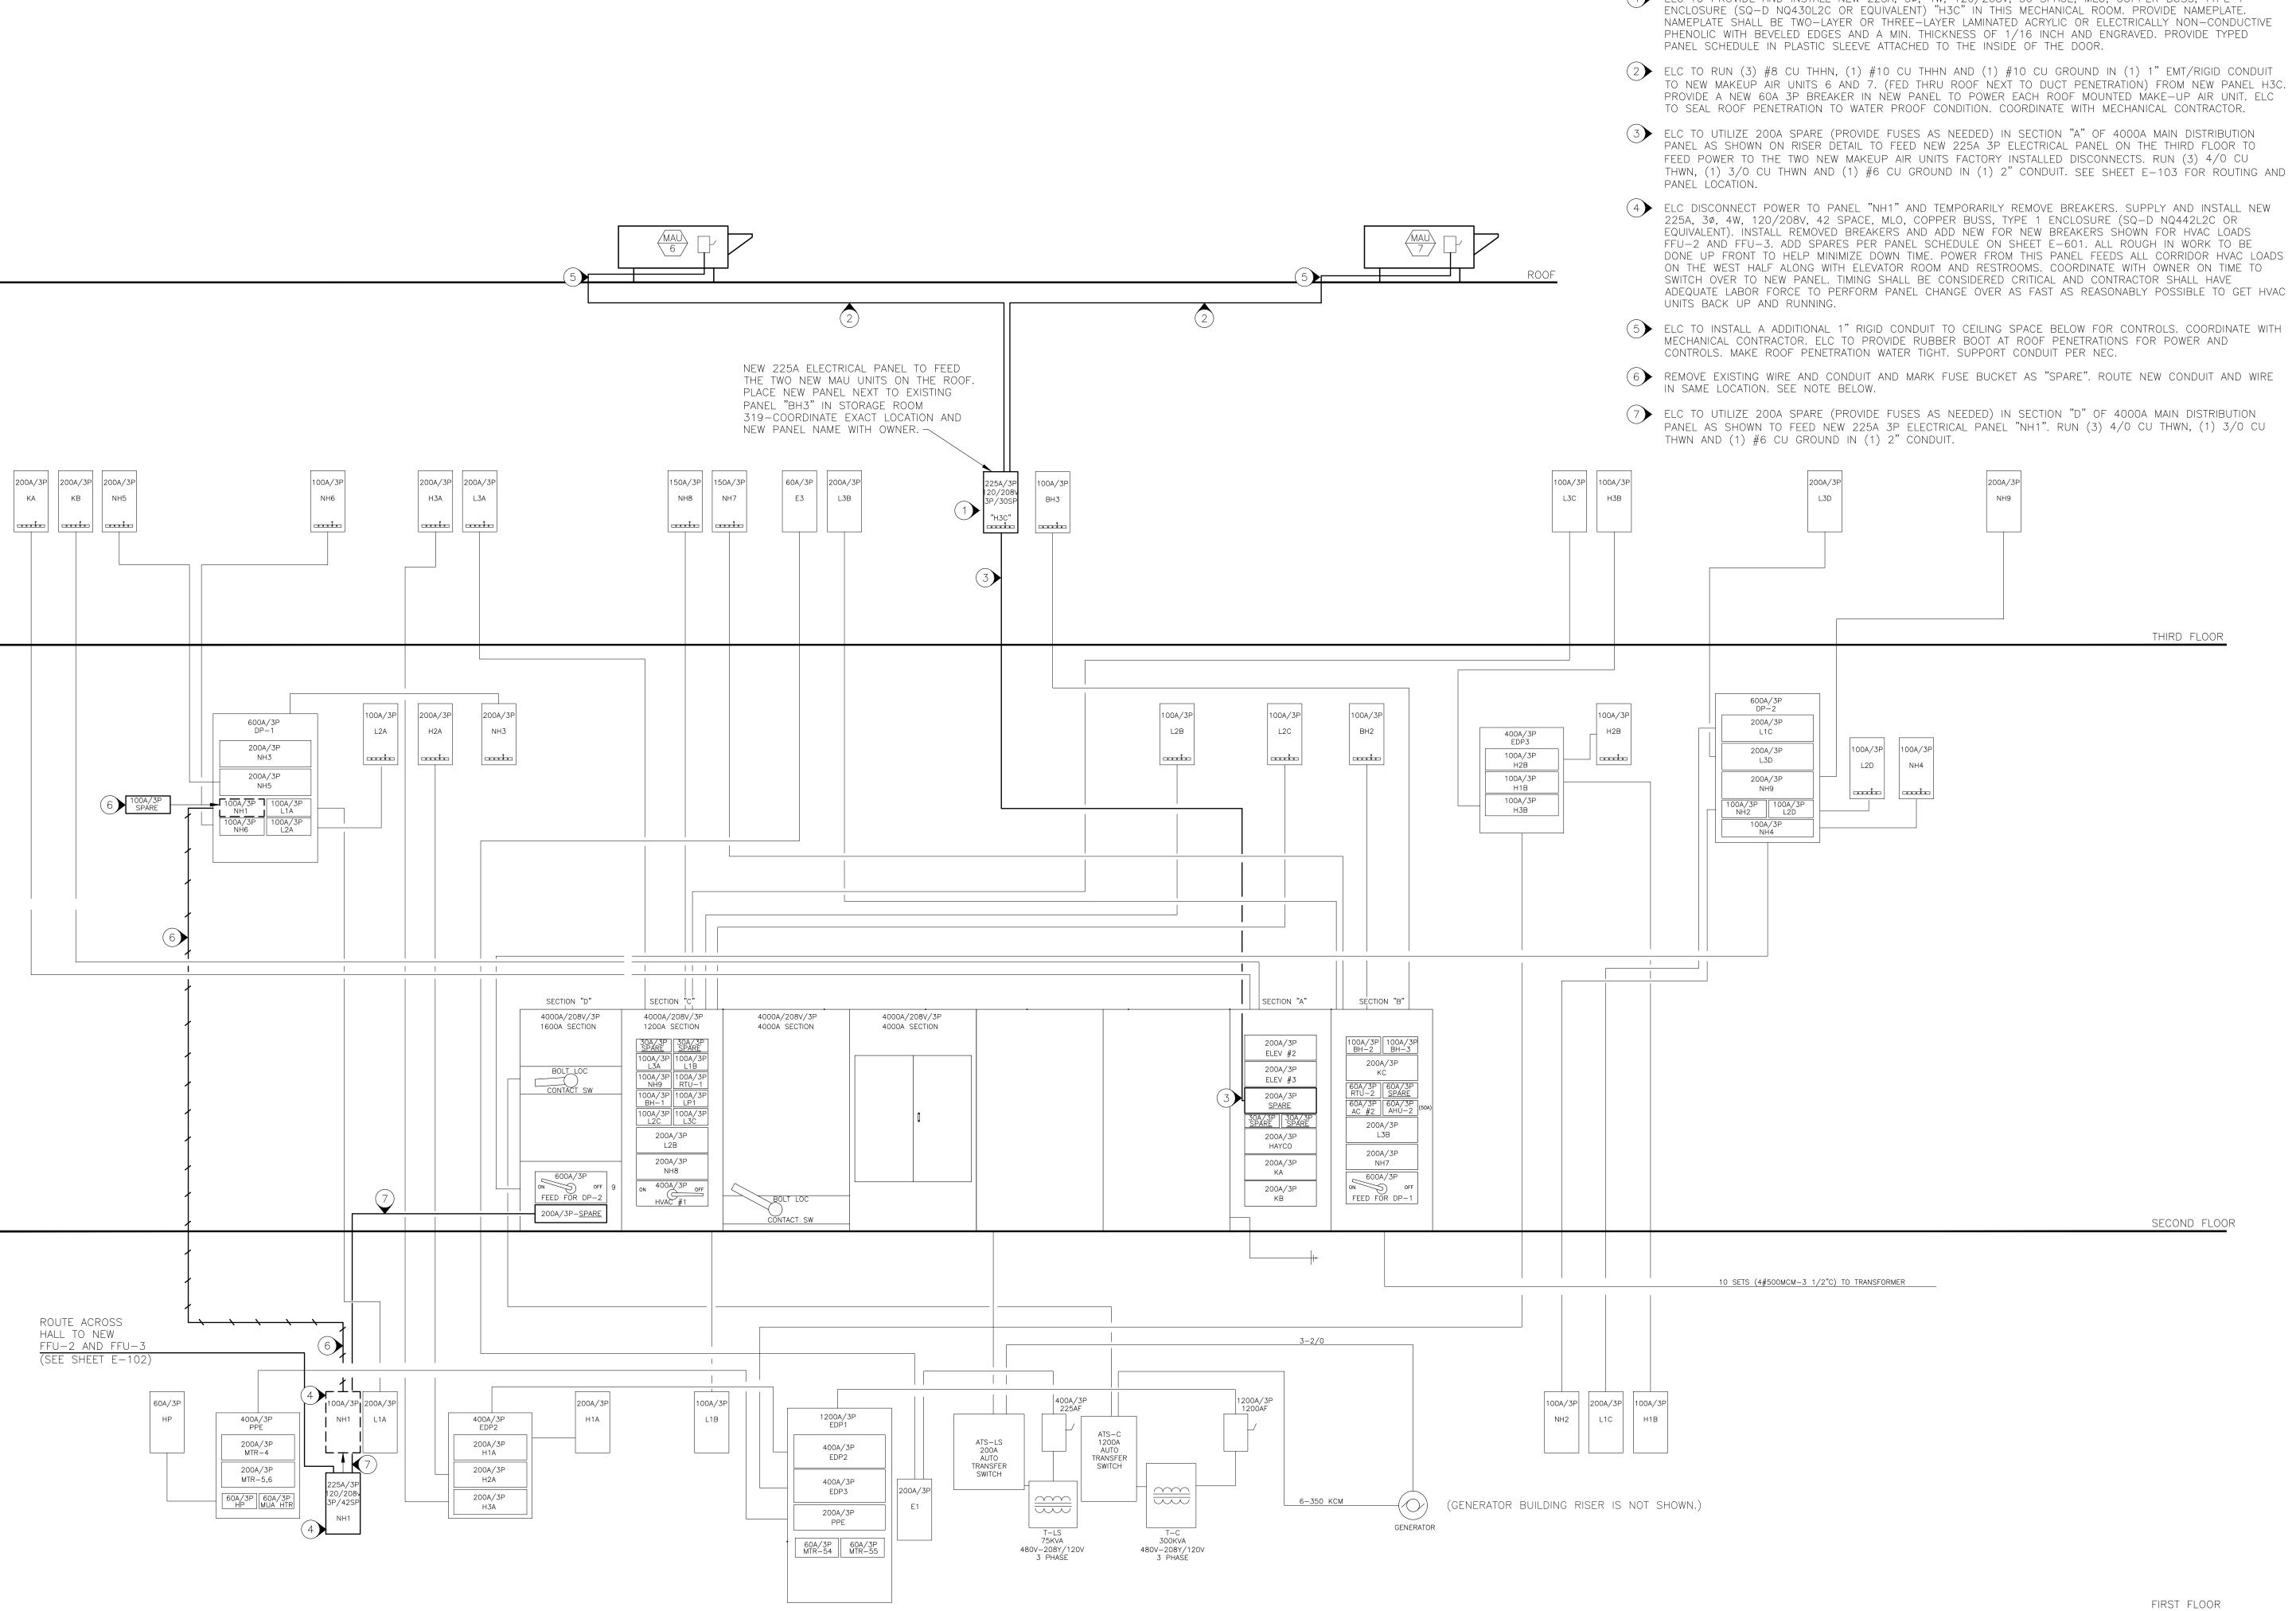

CONSTRUCTION NOTES

(N) INDICATES KEYED NOTES

1 ELC TO PROVIDE AND INSTALL NEW 225A, 30, 4W, 120/208V, 30 SPACE, MLO, COPPER BUSS, TYPE 1 ENCLOSURE (SQ-D NQ430L2C OR EQUIVALENT) "H3C" IN THIS MECHANICAL ROOM. PROVIDE NAMEPLATE. NAMEPLATE SHALL BE TWO-LAYER OR THREE-LAYER LAMINATED ACRYLIC OR ELECTRICALLY NON-CONDUCTIVE



- THWN, (1) 3/0 CU THWN AND (1) #6 CU GROUND IN (1) 2" CONDUIT. SEE SHEET E-103 FOR ROUTING AND
 - DONE UP FRONT TO HELP MINIMIZE DOWN TIME. POWER FROM THIS PANEL FEEDS ALL CORRIDOR HVAC LOADS ADEQUATE LABOR FORCE TO PERFORM PANEL CHANGE OVER AS FAST AS REASONABLY POSSIBLE TO GET HVAC

STATE OF MISSOURI MICHAEL L. PARSON, **GOVERNOR**





Columbia, MO. 65202 (573) 875-0045 Phone (573) 875-0046 FAX WWW.MOENGINEERING.COM Midwest Engineering & Design Missouri State Certificate of Authority #2010032467

OFFICE OF ADMINISTRATION DIVISION OF FACILITIES MANAGEMENT, DESIGN AND CONSTRUCTION

DEPARTMENT OF MISSOURI VETERANS COMMISSION

HVAC IMPROVEMENTS FOR INFECTION CONTROL

MEXICO VETERANS HOME #1 VETERANS' DRIVE MEXICO, MO 65265

PROJECT # U2301-03 ASSET# 8136802001

-	-
REVISION:	
DATE:	
REVISION:	
DATE:	
REVISION:	
DATE:	
ISSUE DATE:	

CAD DWG FILE:<u>MIFIC-e.dwg</u> DRAWN BY: <u>MDS</u> CHECKED BY: JLD DESIGNED BY: JLD

SHEET TITLE:

ELECTRICAL RISER **DETAIL**

SHEET NUMBER:

THIS IS THE EXISTING PANEL "NH1" BEING REMOVED AND REPLACED WITH NEW 42 SPACE PANEL SHOWN BELOW

PANEL DESIGNATION: NH1												
VOLTAGE: 208 3PHASE 4WIRE	PANE	L LOCATI	ON: 1ST FLOC	CAL ROOM		TOTAL VOLTAMPS THIS PANEL				0		
MAINS: 100 A _ CB X MLO	MOUN	NTING:	_FLUSH X	SURFACE	PANEL SPACES: 30			TOTAL CONNECTED LOAD (AMPS)				0
			C	ONNECTED L	OAD	CKT.	С	ONNECTED L				
CIRCUIT DESIGNATION	WIRE	TRIP	Α	В	С	NO.	Α	В	С	TRIP	WIRE	CIRCUIT DESIGNATION
HEAT PUMP IN CEILING & RM 156		20A/2P				1 2				15A/2P		H.P. IN CEILING & CORR. 1-050
HEAT PUMP IN CEILING & RM 156						3 4						H.P. IN CEILING & CORR. 1-050
HEAT PUMP IN CEILING & RM 157		20A/2P				5 6				20A/2P		H.P. IN CEILING & CORR. 1-050
HEAT PUMP IN CEILING & RM 157						7 8						H.P. IN CEILING & CORR. 1-050
H.P. IN CEILING & CORR. 1-050		15A/2P				9 10				20A/2P		H.P. IN CEILING & CORR. 1-094
H.P. IN CEILING & CORR. 1-050						11 12						H.P. IN CEILING & CORR. 1-094
H.P. IN CEILING & CORR. 1-049		20A/2P				13 14				20A/2P		H.P. IN CEILING & CORR. 1-001
H.P. IN CEILING & CORR. 1-049						15 16						H.P. IN CEILING & CORR. 1-001
H.P. IN CEILING & CORR. 1-049		15A/2P				17 18				20A/2P		H.P. IN CEILING & CORR. 1-001
H.P. IN CEILING & CORR. 1-049						19 20						H.P. IN CEILING & CORR. 1-001
HEAT PUMP IN ROOM 166		20A/2P				21 22				20A/2P		HEAT PUMP IN CEILING & RM 163
HEAT PUMP IN ROOM 162						23 24						HEAT PUMP IN CEILING & RM 163
H.P. IN CEILING & CORR. 1-033		20A/2P				25 26				20A/2P		H.P. IN CEILING & CORR. 1-033
H.P. IN CEILING & CORR. 1-033						27 28						H.P. IN CEILING & CORR. 1-033
HOT WATER HEATER (RES.+KIT.)		20A/1P				29 30				20A/1P		UNKNOWN (BREAKER IS ON)
			0				0			PHA	ASE A	0
				0				0		PHA	ASE B	0
					0				0	PHA	ASE C	0

THIS IS THE NEW PANEL "NH1". ALL EXISTING LOADS TO BE TRANSFERRED. NEW LOADS SHOWN BOLDED. PANEL SCHEDULE SHALL BE REPLACED WITH NEW TYPED SCHEDULE. ELC TO UPDATE AS NEEDED.

PANEL DESIGNATION: NEW NH1												
VOLTAGE: 208 3PHASE 4WIRE	PANEI	L LOCATION	ON: 1ST FLOC	OR MECHANI	CAL ROOM			TOTAL VOLT	AMPS THIS P	ANEL		1790
MAINS: 225 A _ CB <u>X</u> MLO	MOUN	ITING:	FLUSH X	SURFACE	PANEL SPAC		TOTAL CONN	NECTED LOA	D (AMPS)		5	
			C	CONNECTED LOAD CKT.				CONNECTED LOAD				
CIRCUIT DESIGNATION	WIRE	TRIP	Α	В	С	NO.	А	В	С	TRIP	WIRE	CIRCUIT DESIGNATION
HEAT PUMP IN CEILING & RM 156		20A/2P				1 2				15A/2P		H.P. IN CEILING & CORR. 1-050
HEAT PUMP IN CEILING & RM 156						3 4						H.P. IN CEILING & CORR. 1-050
HEAT PUMP IN CEILING & RM 157		20A/2P				5 6				20A/2P		H.P. IN CEILING & CORR. 1-050
HEAT PUMP IN CEILING & RM 157						7 8						H.P. IN CEILING & CORR. 1-050
H.P. IN CEILING & CORR. 1-050		15A/2P				9 10				20A/2P		H.P. IN CEILING & CORR. 1-094
H.P. IN CEILING & CORR. 1-050						11 12						H.P. IN CEILING & CORR. 1-094
H.P. IN CEILING & CORR. 1-049		20A/2P				13 14				20A/2P		H.P. IN CEILING & CORR. 1-001
H.P. IN CEILING & CORR. 1-049						15 16						H.P. IN CEILING & CORR. 1-001
H.P. IN CEILING & CORR. 1-049		15A/2P				17 18				20A/2P		H.P. IN CEILING & CORR. 1-001
H.P. IN CEILING & CORR. 1-049						19 20						H.P. IN CEILING & CORR. 1-001
HEAT PUMP IN ROOM 166		20A/2P				21 22				20A/2P		HEAT PUMP IN CEILING & RM 163
HEAT PUMP IN ROOM 162						23 24						HEAT PUMP IN CEILING & RM 163
H.P. IN CEILING & CORR. 1-033		20A/2P				25 26				20A/2P		H.P. IN CEILING & CORR. 1-033
H.P. IN CEILING & CORR. 1-033						27 28						H.P. IN CEILING & CORR. 1-033
HOT WATER HEATER (RES.+KIT.)		20A/1P				29 30				20A/1P		UNKNOWN (BREAKER IS ON)
NEW UNITS FFU-2	#12	20A/2P	895			31 32				20A/1P		SPARE
AND FFU-3 IN CORRIDOR	#12			895		33 34				20A/1P		SPARE
SPARE		20A/1P				35 36				20A/1P		SPARE
SPARE		20A/1P				37 38				20A/1P		SPARE
SPARE		20A/1P				39 40				20A/1P		SPARE
SPARE		20A/1P				41 42				20A/1P		SPARE
			895				0			PHAS	SE A	895
				895				0		PHA	SE B	895
					0				0	PHAS	SE C	0

NOTES

- 1 ALL NEW ELECTRICAL PANELS ARE TO HAVE NEW PANEL SCHEDULES. EACH SCHEDULE SHALL BE TYPED OUT AND PLACED IN PANEL WITH PROTECTIVE SLEEVE.
- 2 ALL NEW ELECTRICAL PANELS ARE TO HAVE COPPER BUSSING. ALL NEW WIRE TO BE COPPER. NEW PANEL TO HAVE ENGRAVED NAMEPLATE, (PER SPECIFICATION SECTION 260553), AFFIXED TO EXTERIOR NEAR THE TOP CENTER OF THE PANEL.

STATE OF MISSOURI MICHAEL L. PARSON, GOVERNOR





3100 Brown Station Rd. Suite C Columbia, MO. 65202 (573) 875-0045 Phone (573) 875-0046 FAX WWW.MOENGINEERING.COM Midwest Engineering & Design Missouri State Certificate of Authority #2010032467

OFFICE OF ADMINISTRATION DIVISION OF FACILITIES MANAGEMENT, DESIGN AND CONSTRUCTION

DEPARTMENT OF MISSOURI VETERANS COMMISSION

HVAC IMPROVEMENTS FOR INFECTION CONTROL

MEXICO VETERANS HOME #1 VETERANS' DRIVE MEXICO, MO 65265

PROJECT # U2301-03 SITE # 6802 ASSET # 8136802001

REVISION:
DATE:
REVISION:
DATE:
REVISION:
DATE:
ISSUE DATE:

CAD DWG FILE:MIFIC-e.dwg
DRAWN BY: MDS
CHECKED BY: JLD
DESIGNED BY: JLD

SHEET TITLE:

ELECTRICAL PANEL SCHEDULES

SHEET NUMBER:

E-60

28 OF 28 SHEETS 04/11/2024

THIS IS THE NEW PANEL "H3C".

PANEL DESIGNATION: "H3C"												
VOLTAGE: 208 3PHASE 4WIRE	PANE	L LOCATION	ON: STORAG	E ROOM 319			TOTAL VOLTAMPS THIS PANEL				19320	
MAINS: 225 A _ CB X MLO	MOUN	NTING:	FLUSH X	SURFACE	PANEL SPA		TOTAL CONNECTED LOAD (AMPS)				54	
			C	ONNECTED L	.OAD	CKT.	C	ONNECTED L	LOAD			
CIRCUIT DESIGNATION	WIRE	TRIP	Α	В	С	NO.	Α	В	С	TRIP	WIRE	CIRCUIT DESIGNATION
	#8		3220			1 2	3220				#8	
MAKEUP AIR UNIT (MAU-6)	#8	60A/3P		3220		3 4		3220		60A/3P	#8	MAKEUP AIR UNIT (MAU-7)
	#8				3220	5 6			3220		#8	
SPARE		20A/1P				7 8				20A/1P		SPARE
SPARE		20A/1P				9 10				20A/1P		SPARE
SPARE		20A/1P				11 12				20A/1P		SPARE
SPARE		20A/1P				13 14				20A/1P		SPARE
SPARE		20A/1P				15 16				20A/1P		SPARE
SPARE		20A/1P				17 18				20A/1P		SPARE
SPARE		20A/1P				19 20				20A/1P		SPARE
SPARE		20A/1P				21 22				20A/1P		SPARE
SPARE		20A/1P				23 24				20A/1P		SPARE
SPARE		20A/1P				25 26				20A/1P		SPARE
SPARE		20A/1P				27 28				20A/1P		SPARE
SPARE		20A/1P				29 30				20A/1P		SPARE
			3220				3220			PHA	SE A	6440
				3220				3220		PHA	SE B	6440
					3220				3220	PHA	SE C	6440