HVAC IMPROVEMENTS FOR INFECTION CONTROL WARRENSBURG VETERANS HOME WARRENSBURG, MISSOURI

OWNER:

STATE OF MISSOURI

MIKE KEHOE, GOVERNOR

DEPARTMENT OF PUBLIC SAFETY/


VETERANS COMMISSION

PROJECT

OFFICE OF ADMINISTRATION

MANAGEMENT: DIVISION OF FACILITIES MANAGEMENT,

DESIGN AND CONSTRUCTION

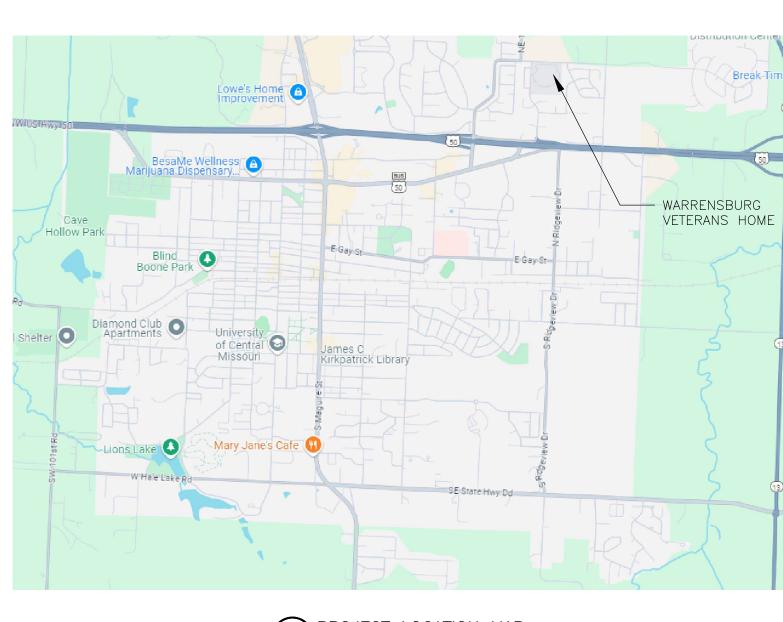

1 PROJECT LOCATION MAP

DESIGNER:

STATE OF MISSOURI - OFFICE OF ADMINISTRATION

DIVISION OF FACILITIES MANAGEMENT DESIGN AND CONSTRUCTION: 301 W. HIGH STREET,

JEFFERSON CITY, MO. 65102

PROJECT NUMBER:


U2301-07

ASSET NUMBER:

8136806001

SITE NUMBER:

6806

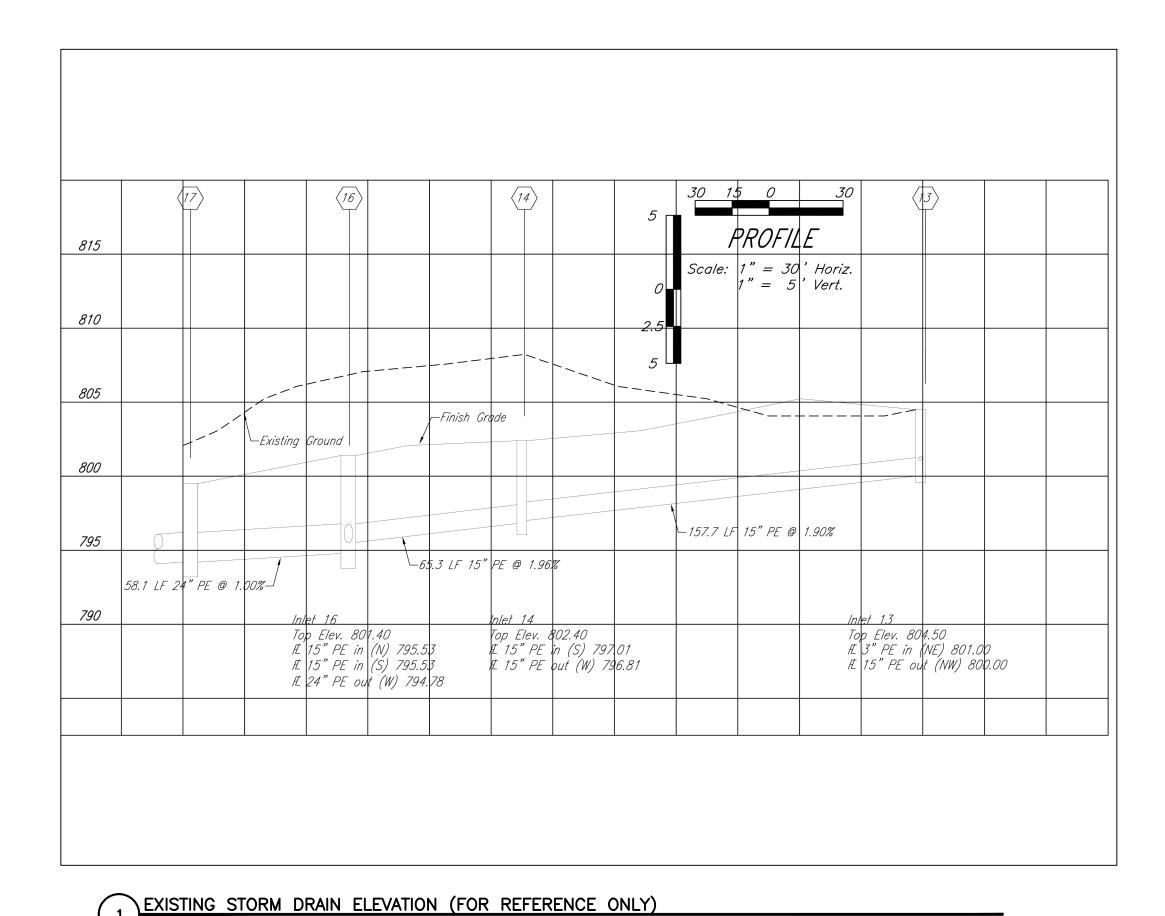

APPLICABLE CODES:

- GENERAL CONSTRUCTION: • IBC - INTERNATIONAL BUILDING CODE; 2012 ADA STANDARDS FOR ACCESSIBLE DESIGN; 2010
- FIRE PROTECTION:
- NFPA 13 STANDARD FOR THE INSTALLATION OF SPRINKLER SYSTEMS; 2010 NFPA 70 - NATIONAL ELECTRIC CODE (NEC) AS PERTAINING TO SPRINKLER SYSTEMS; 2011
- MECHANICAL:
- IMC INTERNATIONAL MECHANICAL CODE; 2012 • IFGC - INTERNATIONAL FUEL GAS CODE; 2012
- ELECTRICAL: NFPA 70 - NATIONAL ELECTRIC CODE (NEC); 2011
- AND LIGHTING ALONG THE PATH OF EGRESS; 2012
- NFPA 101 LIFE SAFETY CODE AS PERTAINING TO EMERGENCY EXIT SIGNS


- GENERAL NOTES
- 1. ROOF IS CURRENTLY UNDER WARRANTY. COORDINATE WITH ROOF MANUFACTURER TO ENSURE ROOF WARRANTY REMAINS IN EFFECT. REFER TO APPENDIX A IN PROJECT MANUAL FOR ADDITIONAL INFORMATION.
- 2. CONTRACTOR SHALL PROVIDE TEMPORARY SHIPPING/ STORAGE CONTAINERS ON SITE FOR FURNITURE FOR THE DURATION OF DEMOLITION AND CONSTRUCTION, TO BE REMOVED FROM SITE UPON COMPLETION OF THE PROJECT. LOCATION OF TEMPORARY STORAGE CONTAINERS TO BE COORDINATED WITH OWNER.
- 3. CONTRACTOR SHALL BE RESPONSIBLE FOR MOVING EXISTING FURNITURE OUT OF AREAS OF WORK PRIOR TO THE START OF DEMOLITION, AND MOVING FURNITURE BACK INTO THE SPACES AFTER CONSTRUCTION IS COMPLETE. PROTECT FURNITURE FROM DAMAGE.
- 4. THE CONTRACTOR SHALL ENGAGE A PRIVATE AND PUBLIC UTILITY LOCATE SERVICE IN AREAS WHERE EXCAVATION OR TRENCHING WILL TAKE PLACE. MISSOURI ONE CALL DOES NOT LOCATE ON THIS ENTIRE PROPERTY AS IT IS CONSIDERED PRIVATE PROPERTY. THERE COULD BE PRIVATE UTILITIES THAT ARE NOT SHOWN.
- 5. REMOVE SIDEWALK AS NEEDED TO ROUTE NATURAL GAS PIPE AND ELECTRICAL CONDUIT TO NEW EQUIPMENT. REPLACE SIDEWALK WITH LIKE MATERIALS AND CONSTRUCTION. REFER TO SHEET M-103 FOR ADDITIONAL
- 6. GENERAL CONTRACTOR SHALL COMPLETE GASKETED LAY-IN CEILING INSTALLATION FOR ONE BEDROOM/BATHROOM AS EARLY IN CONSTRUCTION AS POSSIBLE. UPON COMPLETION, TESTING AND BALANCING CONTRACTOR SHALL PERFORM BLOWER DOOR TESTING ON BEDROOM. COVER ALL SUPPLY AND EXHAUST AIR OPENINGS IN THE SPACE PRIOR TO PERFORMING TEST. REMAINING ROOMS SHALL NOT RECEIVE CEILING INSTALLATION UNTIL BLOWER DOOR TEST REPORT IS
- 7. HYDRONIC PIPE SHALL BE CLEANED AND FLUSHED PRIOR TO PLACING INTO OPERATION. OBTAIN CLEANING AND FLUSHING PROCEDURES AND CHEMICALS FROM OWNER'S WATER TREATMENT SERVICES COMPANY (WALTER LOUIS FLUID TECHNOLOGIES, 217-223-2017, ROGER SMITH, DENNIS GIER). CLEANING CHEMICALS SHALL BE A BLEND OF INORGANIC PHOSPHATE, CORROSION INHIBITOR, DISPERSANT, AND OIL EMULSIFIER APPROVED FOR DISPOSAL IN SANITARY SEWER SYSTEM.

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4	AD-102	DEMOLITION REFLECTED CEILING PLAN
5	A-101	RENOVATION REFLECTED CEILING PLAN
6	A-102	RENOVATION REFLECTED CEILING PLAN
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8	F-101	FIRE PROTECTION PLAN
9	MD-101	MECHANICAL DEMOLITION PLAN - BASEMENT
10	MD-102	MECHANICAL DEMOLITION PLAN - LOUNGE A156
11	MD-103	MECHANICAL DEMOLITION PLAN - LOUNGE A146
12	MD-104	MECHANICAL DEMOLITION PLAN - LOUNGE A155
13	M-101	MECHANICAL TESTING AND BALANCING PLAN
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15	M-103	MECHANICAL RENOVATION PLAN - EXTERIOR
16	M - 104	MECHANICAL RENOVATION PLAN - LOUNGE A156
17	M-105	MECHANICAL RENOVATION PLAN - LOUNGE A146
18	M-106	MECHANICAL RENOVATION PLAN - LOUNGE A155
19	M-501	MECHANICAL DETAILS
20	M-601	MECHANICAL SCHEDULES AND DETAILS
21	M-602	MECHANICAL CONTROLS DIAGRAMS
22	E-101	FIRST FLOOR ELECTRICAL DEMOLITION PLAN
23	E-102	FIRST FLOOR ELECTRICAL RENOVATION PLAN
24	E-103	BASEMENT MAU-3 ELECTRICAL RENOVATION PLAN
25	E-501	ELECTRICAL RISER AND FIRE RATED DETAILS

ELECTRICAL PANEL SCHEDULES

STATE OF MISSOURI MIKE KEHOE, **GOVERNOR**

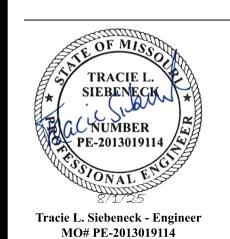

OFFICE OF ADMINISTRATION DIVISION OF FACILITIES MANAGEMENT, DESIGN AND CONSTRUCTION

DEPARTMENT OF PUBLIC SAFETY/ VETERANS COMMISSION

HVAC IMPROVEMENTS FOR INFECTION CONTROL

WARRENSURG VETERANS HOME 1300 VETERANS DRIVE, WARRENSBURG, MO 64093

PROJECT # U2301-07 8136806001

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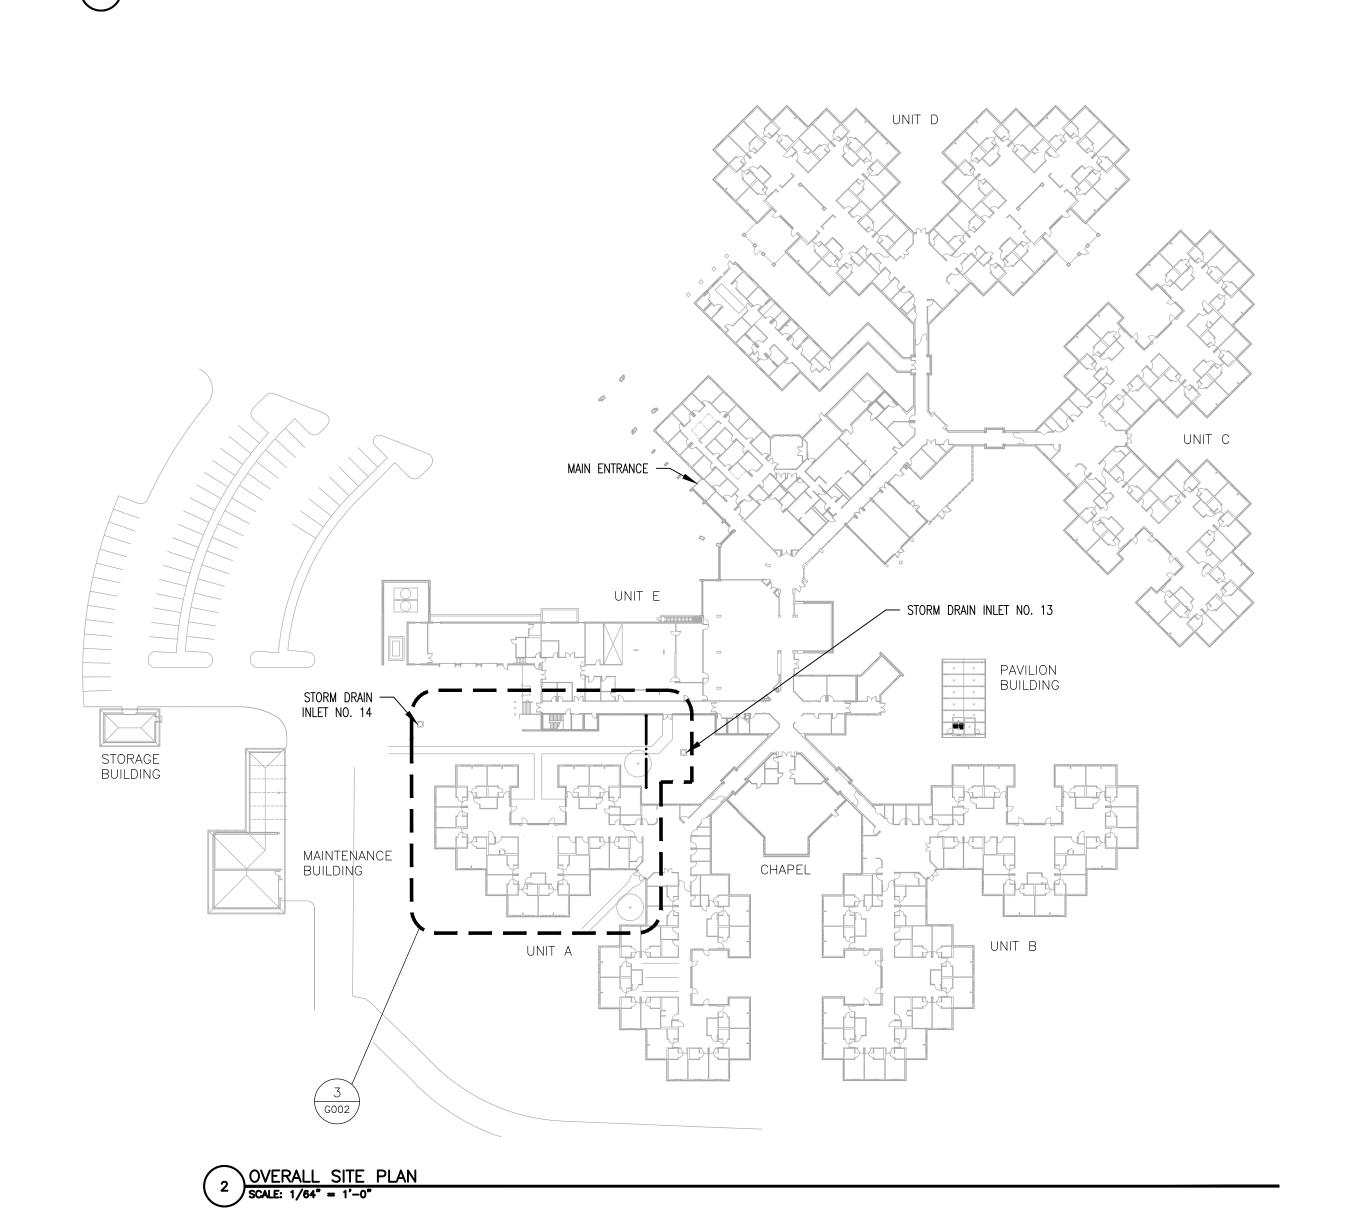
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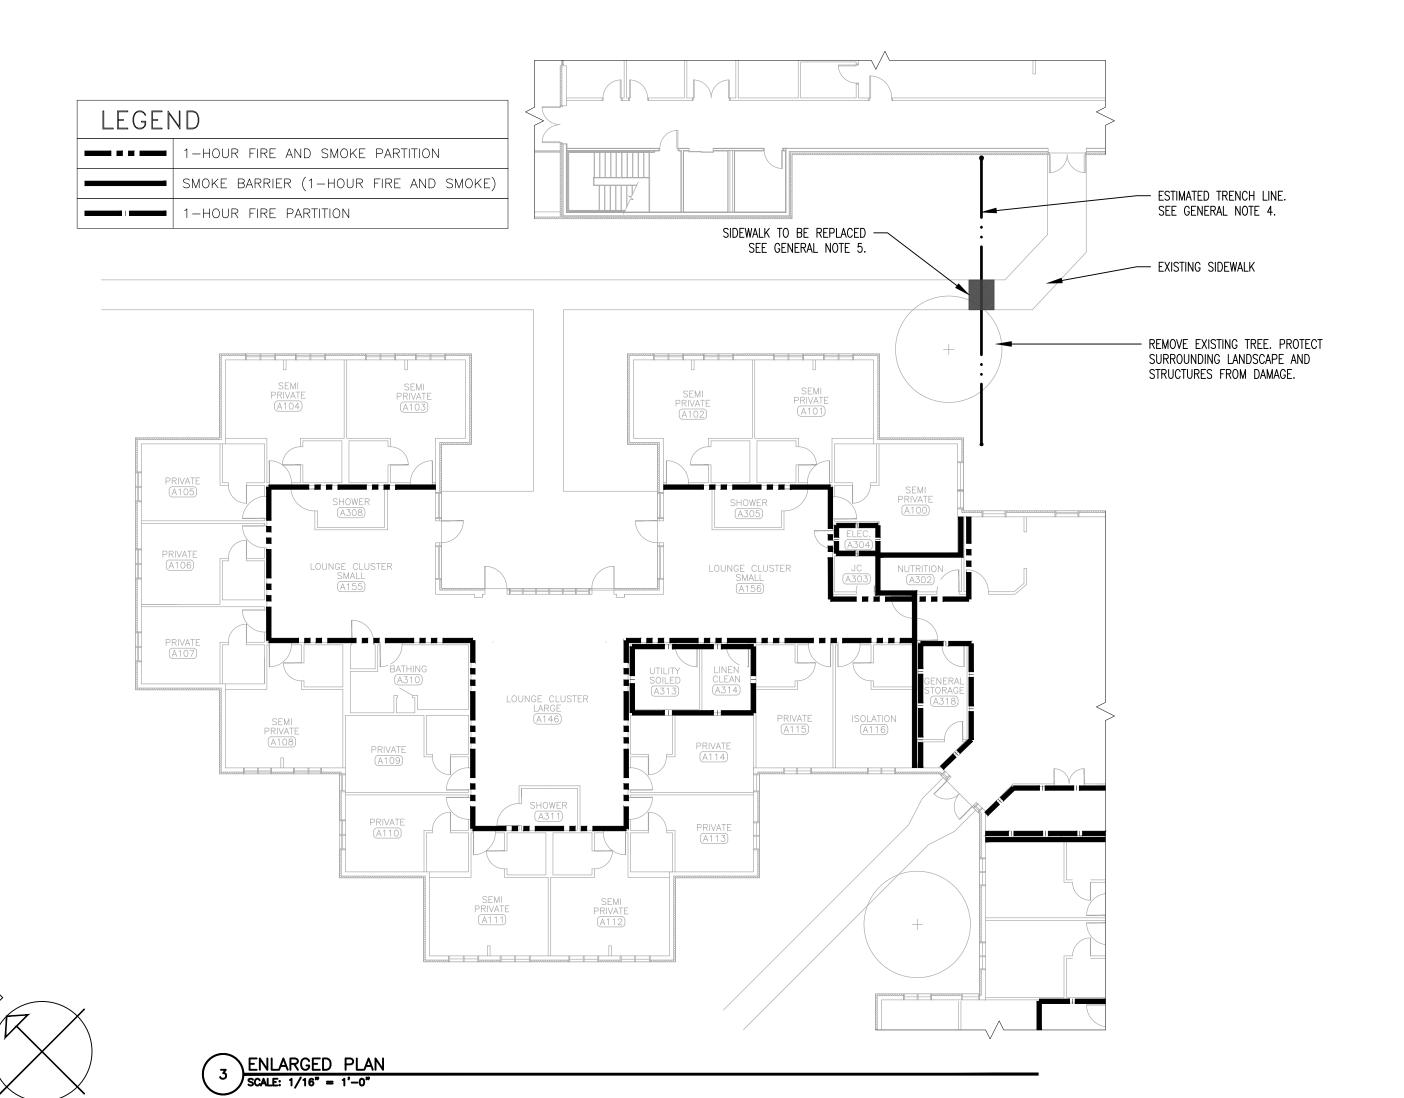
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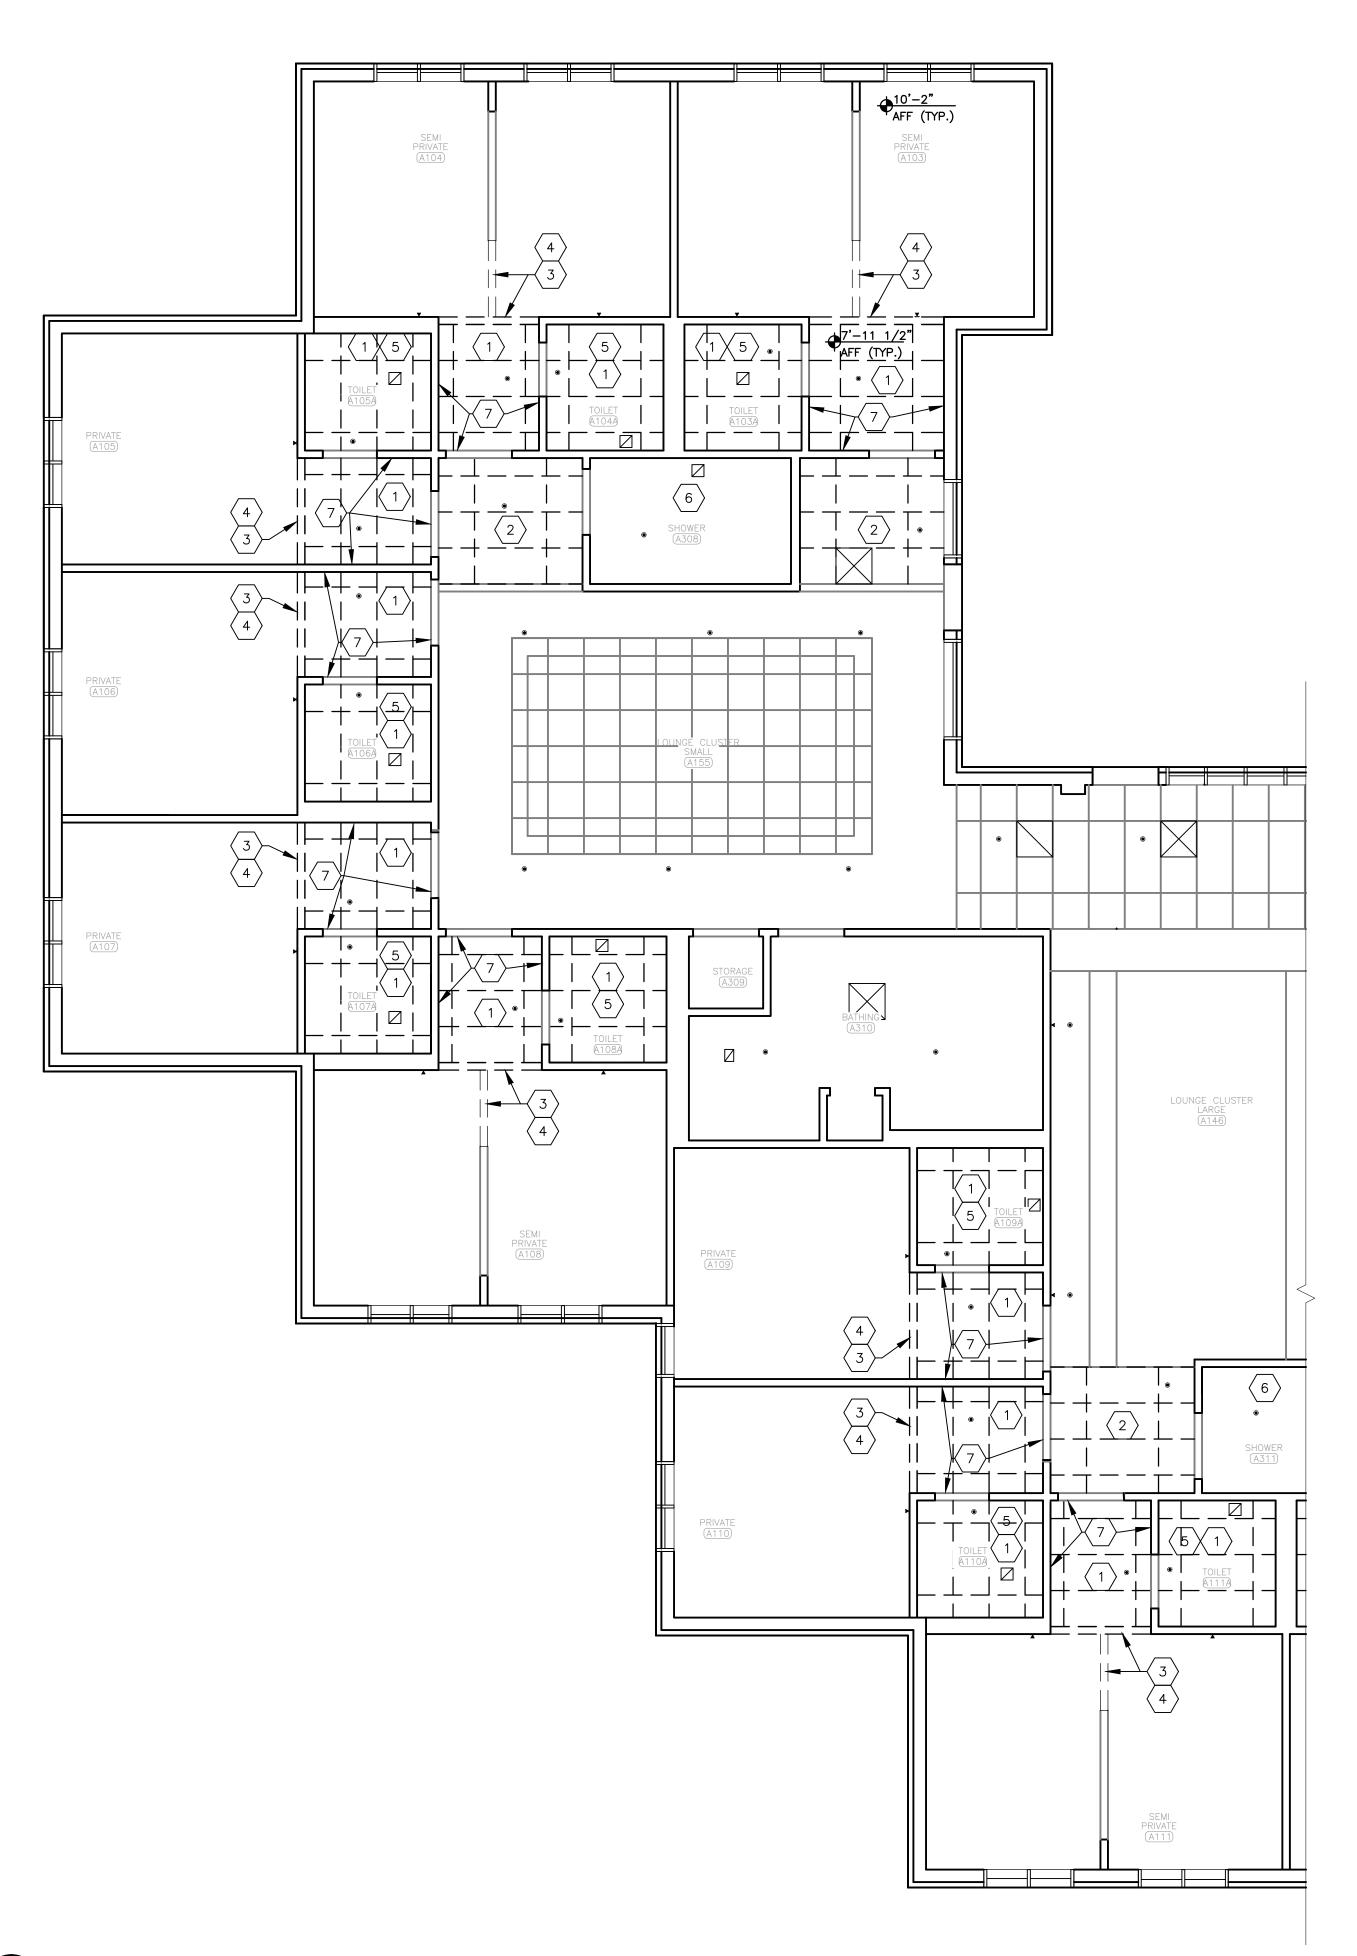
SHEET TITLE:

GENERAL NOTES AND DRAWING **INDEX**

SHEET NUMBER:








GENERAL NOTES:

- 1. VERIFY DIMENSIONS OF EXISTING SPACE PRIOR TO BID.
- PROTECT EXISTING FIXTURES AND MATERIAL FROM DAMAGE DURING DEMOLITION AND INSTALLATION.
- COORDINATE PATHS THROUGH BUILDING FOR DELIVERY OF CONSTRUCTION MATERIAL AND WORKERS WITH FACILITY STAFF PRIOR TO COMMENCEMENT OF WORK.
- COORDINATE WITH FACILITY STAFF WHEN REMOVING FURNITURE TO DETERMINE EXACT LAYOUT FOR ACCURATE REPLACEMENT.
- 5. REPAIR ANY DAMAGE INCURRED DURING DEMOLITION AND INSTALLATION.

DEMOLITION KEYNOTES:


- 1 REMOVE EXISTING ACOUSTIC CEILING TILES AND SUSPENDED GRID SYSTEM TO EXTENTS SHOWN. RELINQUISH FULL AND UNDAMAGED ACOUSTIC CEILING TILES TO OWNER.
- 2 REMOVE EXISTING ACOUSTIC CEILING TILES TO EXTENTS SHOWN. SALVAGE FOR REUSE.
- REMOVE EXISTING DRYWALL AND SOFFIT STUDS TO EXTENTS SHOWN.
 COORDINATE REMOVAL OF ATTACHED LIGHT FIXTURES AND SPRINKLER HEADS WITH MEP DRAWINGS.
- $\left\langle \begin{array}{c} 4 \end{array} \right
 angle$ REMOVE EXISTING CURTAIN TRACK AND ATTACHED CURTAINS.
- 5 VERIFY AND NOTE EXISTING CEILING HEIGHT FOR NEW CEILING TO BE INSTALLED AT SAME HEIGHT.
- 6 COORDINATE POTENTIAL REMOVAL OF EXISTING CEILING AS NEEDED; REFER TO MEP DRAWINGS AND SUBSEQUENT MEANS AND METHODS DETERMINED BY INSTALLING CONTRACTOR.
- 7 REMOVE EXISTING WALLPAPER FROM ENTIRE WALL SURFACE WITHIN AREA OF CEILING GRID REMOVAL.

	OVADOL LEGEND.
	SYMBOL LEGEND:
	RETURN AIR DEVICE
	SUPPLY AIR DEVICE
•	FIRE SPRINKLER HEAD - PENDANT TYPE
	FIRE SPRINKLER HEAD - SIDEWALL TYPE

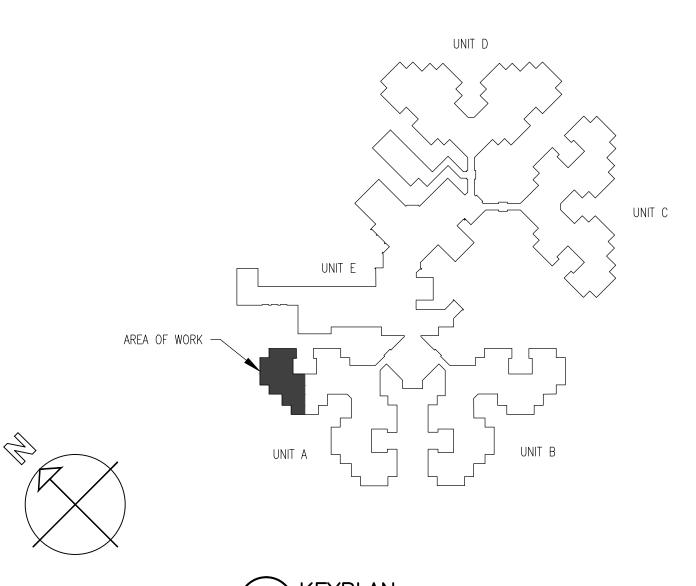

2 KEYPLAN
SCALE: N.T.S.

STATE OF MISSOURI MIKE KEHOE, GOVERNOR

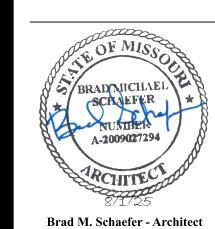

MO# A-2009027294

SOCUMENT:

OFFICE OF ADMINISTRATION DIVISION OF FACILITIES MANAGEMENT, DESIGN AND CONSTRUCTION

DEPARTMENT OF PUBLIC SAFETY/ VETERANS COMMISSION

HVAC IMPROVEMENTS FOR INFECTION CONTROL

WARRENSURG VETERANS HOME 1300 VETERANS DRIVE, WARRENSBURG, MO 64093

PROJECT # U2301-07 SITE # 6806

ASSET # 8136806001

REVISION:
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ISSUE DATE: 08/01/2025

CAD DWG FILE:A U2301-07
DRAWN BY: CL
CHECKED BY: BMS
DESIGNED BY: CL

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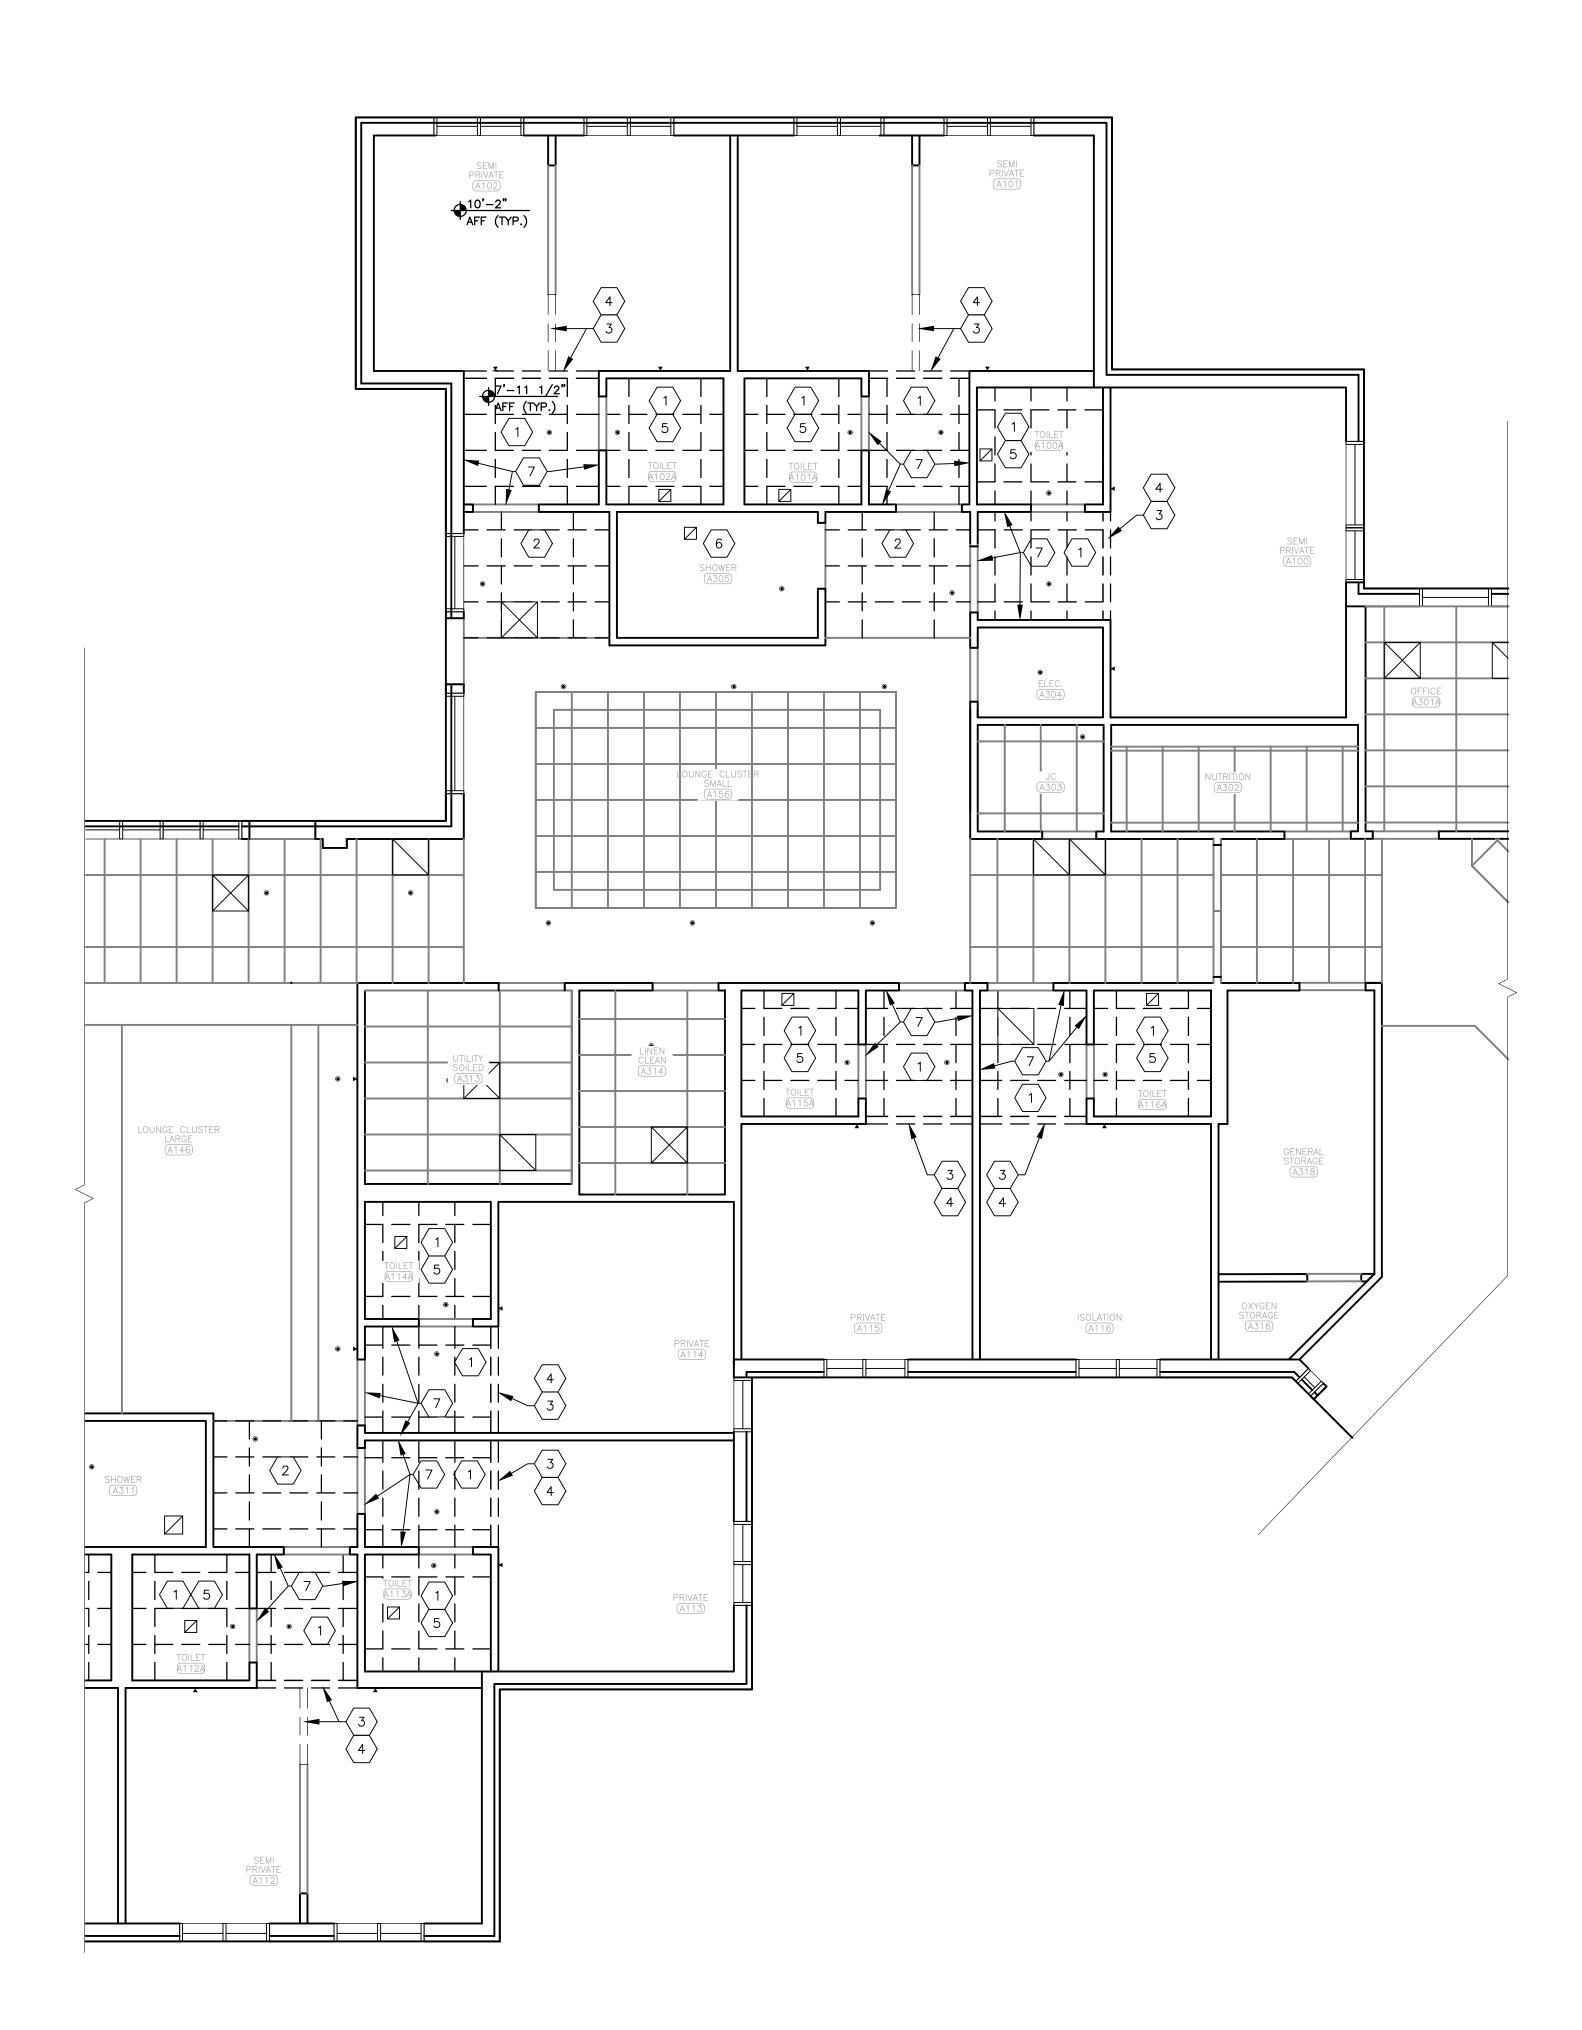
DEMOLITION
REFLECTED
CEILING PLAN

SHEET NUMBER:

AD-101

3 OF 26 SHEETS 08/01/2025

1 REFLECTED CEILING PLAN — DEMO SCALE: 3/16 = 1'-0"



1 REFLECTED CEILING PLAN — DEMO SCALE: 3/16 = 1'-0"


GENERAL NOTES:


- 1. VERIFY DIMENSIONS OF EXISTING SPACE PRIOR TO BID.
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DEMOLITION KEYNOTES:

- REMOVE EXISTING ACOUSTIC CEILING TILES AND SUSPENDED GRID SYSTEM TO EXTENTS SHOWN. RELINQUISH FULL AND UNDAMAGED ACOUSTIC CEILING TILES TO OWNER.
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- REMOVE EXISTING DRYWALL AND SOFFIT STUDS TO EXTENTS SHOWN.
 COORDINATE REMOVAL OF ATTACHED LIGHT FIXTURES AND SPRINKLER HEADS WITH MEP DRAWINGS.
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- 7 REMOVE EXISTING WALLPAPER FROM ENTIRE WALL SURFACE WITHIN AREA OF CEILING GRID REMOVAL.

	SYMBOL LEGEND:
	RETURN AIR DEVICE
	SUPPLY AIR DEVICE
•	FIRE SPRINKLER HEAD - PENDANT TYPE
V	FIRE SPRINKLER HEAD - SIDEWALL TYPE



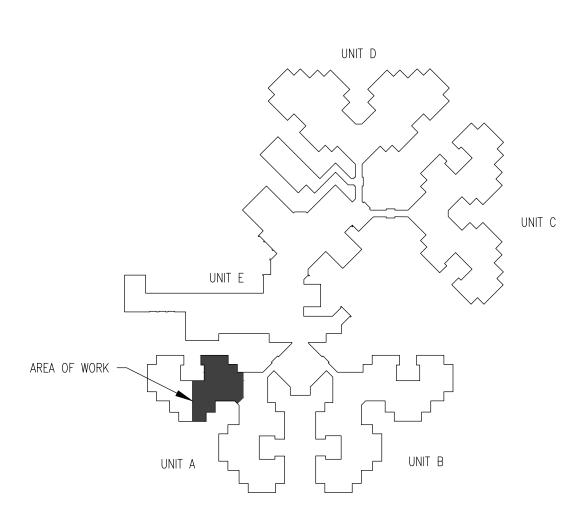

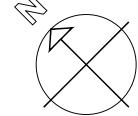

STATE OF MISSOURI MIKE KEHOE, GOVERNOR



Brad M. Schaefer - Architect MO# A-2009027294

SOCUMENTS

OFFICE OF ADMINISTRATION DIVISION OF FACILITIES MANAGEMENT, DESIGN AND CONSTRUCTION

DEPARTMENT OF PUBLIC SAFETY/ VETERANS COMMISSION

HVAC IMPROVEMENTS FOR INFECTION CONTROL

8136806001

WARRENSURG VETERANS HOME 1300 VETERANS DRIVE, WARRENSBURG, MO 64093

PROJECT # U2301-07 SITE # 6806

REVISION:
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ASSET#

ISSUE DATE: 08/01/2025


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DRAWN BY: CL
CHECKED BY: BMS
DESIGNED BY: CL

SHEET TITLE:

DEMOLITION
REFLECTED
CEILING PLAN

SHEET NUMBER:

AD-102

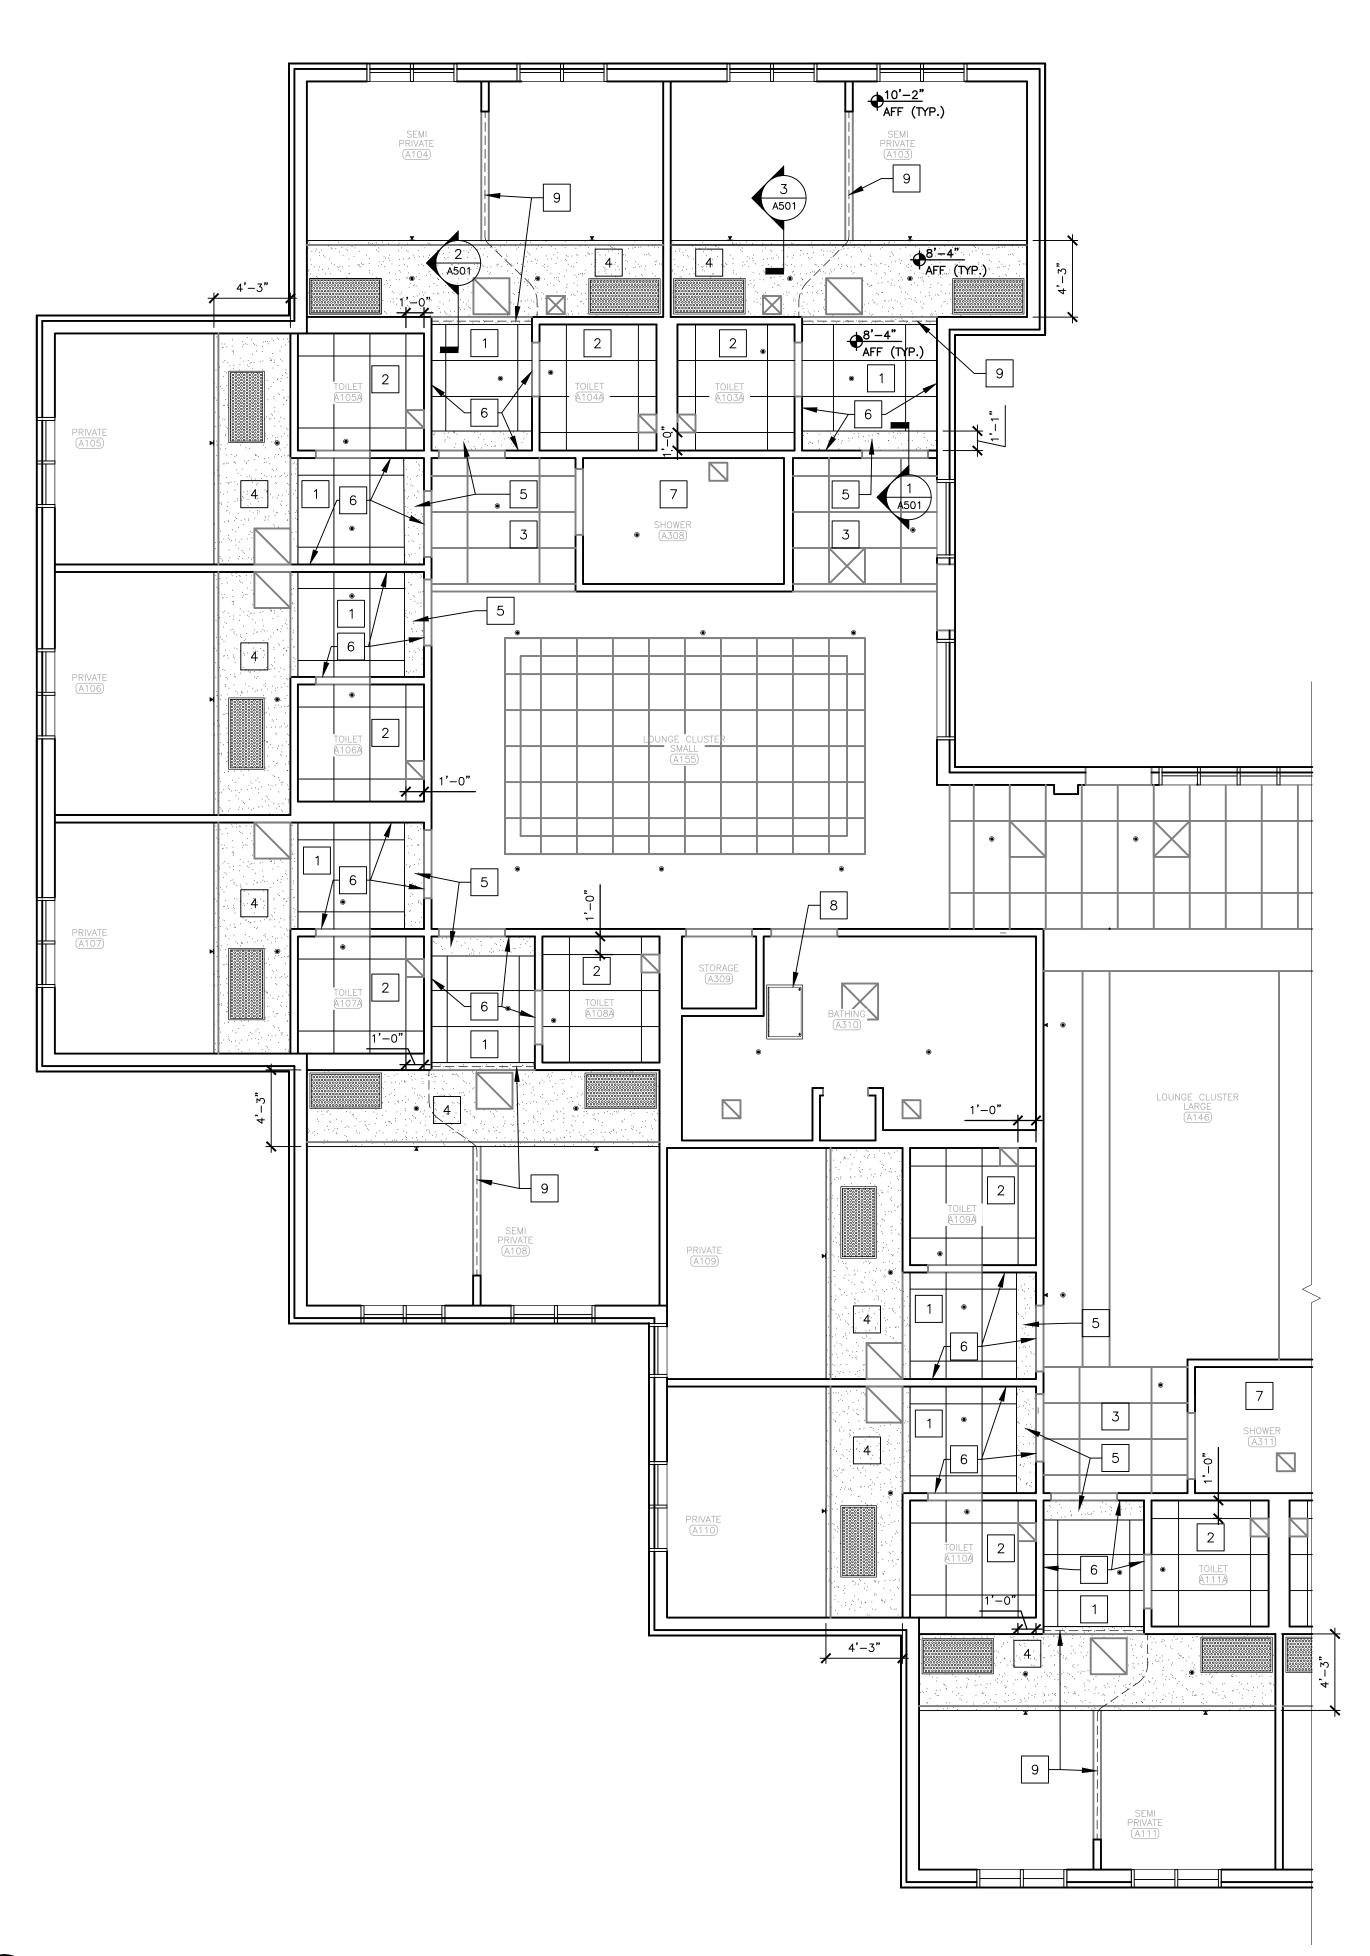


GENERAL NOTES:

- VERIFY DIMENSIONS OF EXISTING SPACE PRIOR TO BID.
- PROTECT EXISTING FIXTURES AND MATERIAL FROM DAMAGE DURING DEMOLITION AND INSTALLATION.
- COORDINATE PATHS THROUGH BUILDING FOR DELIVERY OF CONSTRUCTION MATERIAL AND WORKERS WITH FACILITY STAFF PRIOR TO COMMENCEMENT OF
- COORDINATE WITH FACILITY STAFF WHEN REMOVING FURNITURE TO DETERMINE EXACT LAYOUT FOR ACCURATE REPLACEMENT.
- 5. REPAIR ANY DAMAGE INCURRED DURING DEMOLITION AND INSTALLATION.

RENOVATION KEYNOTES:

- INSTALL NEW SUSPENSION SYSTEM CEILING GRID AND 2'x4' LAY-IN ACOUSTIC CEILING TILES WITH FACTORY APPLIED GASKET, TO EXTENTS SHOWN BY GRID. INSTALL AT TYPICAL HEIGHT INDICATED.
- INSTALL NEW SUSPENSION SYSTEM CEILING GRID AND 2'x4' LAY-IN ACOUSTIC CEILING TILES WITH FACTORY APPLIED GASKET, TO EXTENTS SHOWN BY GRID. INSTALL AT SAME HEIGHT AS THE REMOVED GRID.
- REINSTALL SALVAGED ACOUSTIC CEILING TILES.
- INSTALL NEW STEEL STUD SOFFIT WITH GYPSUM BOARD AT TYPICAL HEIGHT INDICATED. PAINT EXPOSED GYPSUM BOARD TO LEVEL 4 FINISH. SEE A-501 FOR DETAILS.
- INSTALL NEW STEEL STUD SOFFIT WITH GYPSUM BOARD. INSTALLATION HEIGHT TO BE AT TOP OF EXISTING DOOR FRAME. PAINT EXPOSED GYPSUM BOARD TO LEVEL 4 FINISH. SEE A-501 FOR DETAILS.
- REPAIR AND PAINT EXPOSED WALL SURFACE WITHIN AREA OF CEILING GRID
- PATCH, SEAL, AND PAINT CEILING AS NEEDED FOR WORK COORDINATED ON ☐ MEP DRAWINGS USING LIKE FINISHES APPROPRIATE FOR MOISTURE EXPOSURE IN SHOWER ROOM.
- 1 INSTALL NEW 24"X36" AIRTIGHT/WATERTIGHT ACCESS PANEL. COORDINATE WITH MECHANICAL CONTRACTOR FOR FINAL LOCATION. REFER TO ACCESS PANEL SCHEDULE ON SHEET A-501.
- 9 INSTALL NEW CUBICLE CURTAIN TRACK AND CURTAIN.

SYMBOL LEGEND:					
	FAN FILTER UNIT				
	RETURN AIR DEVICE				
	SUPPLY AIR DEVICE				
•	FIRE SPRINKLER HEAD - PENDANT TYPE				
	FIRE SPRINKLER HEAD - SIDEWALL TYPE				
	CUBICLE CURTAIN TRACK				

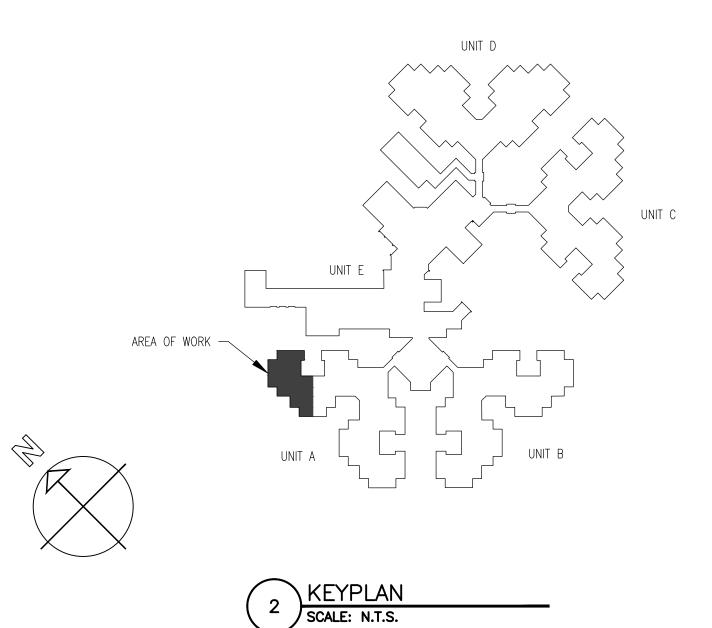

STATE OF MISSOURI MIKE KEHOE, **GOVERNOR**



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OFFICE OF ADMINISTRATION DIVISION OF FACILITIES MANAGEMENT, DESIGN AND CONSTRUCTION

DEPARTMENT OF PUBLIC SAFETY/ VETERANS COMMISSION

HVAC IMPROVEMENTS FOR INFECTION CONTROL

WARRENSURG VETERANS HOME 1300 VETERANS DRIVE, WARRENSBURG, MO 64093

PROJECT # U2301-07 6806

ASSET # 8136806001

REVISION: DATE: **REVISION:** DATE: **REVISION:** DATE:

CAD DWG FILE:A U2301-07
DRAWN BY: CL
CHECKED BY: BMS
DESIGNED BY: CL

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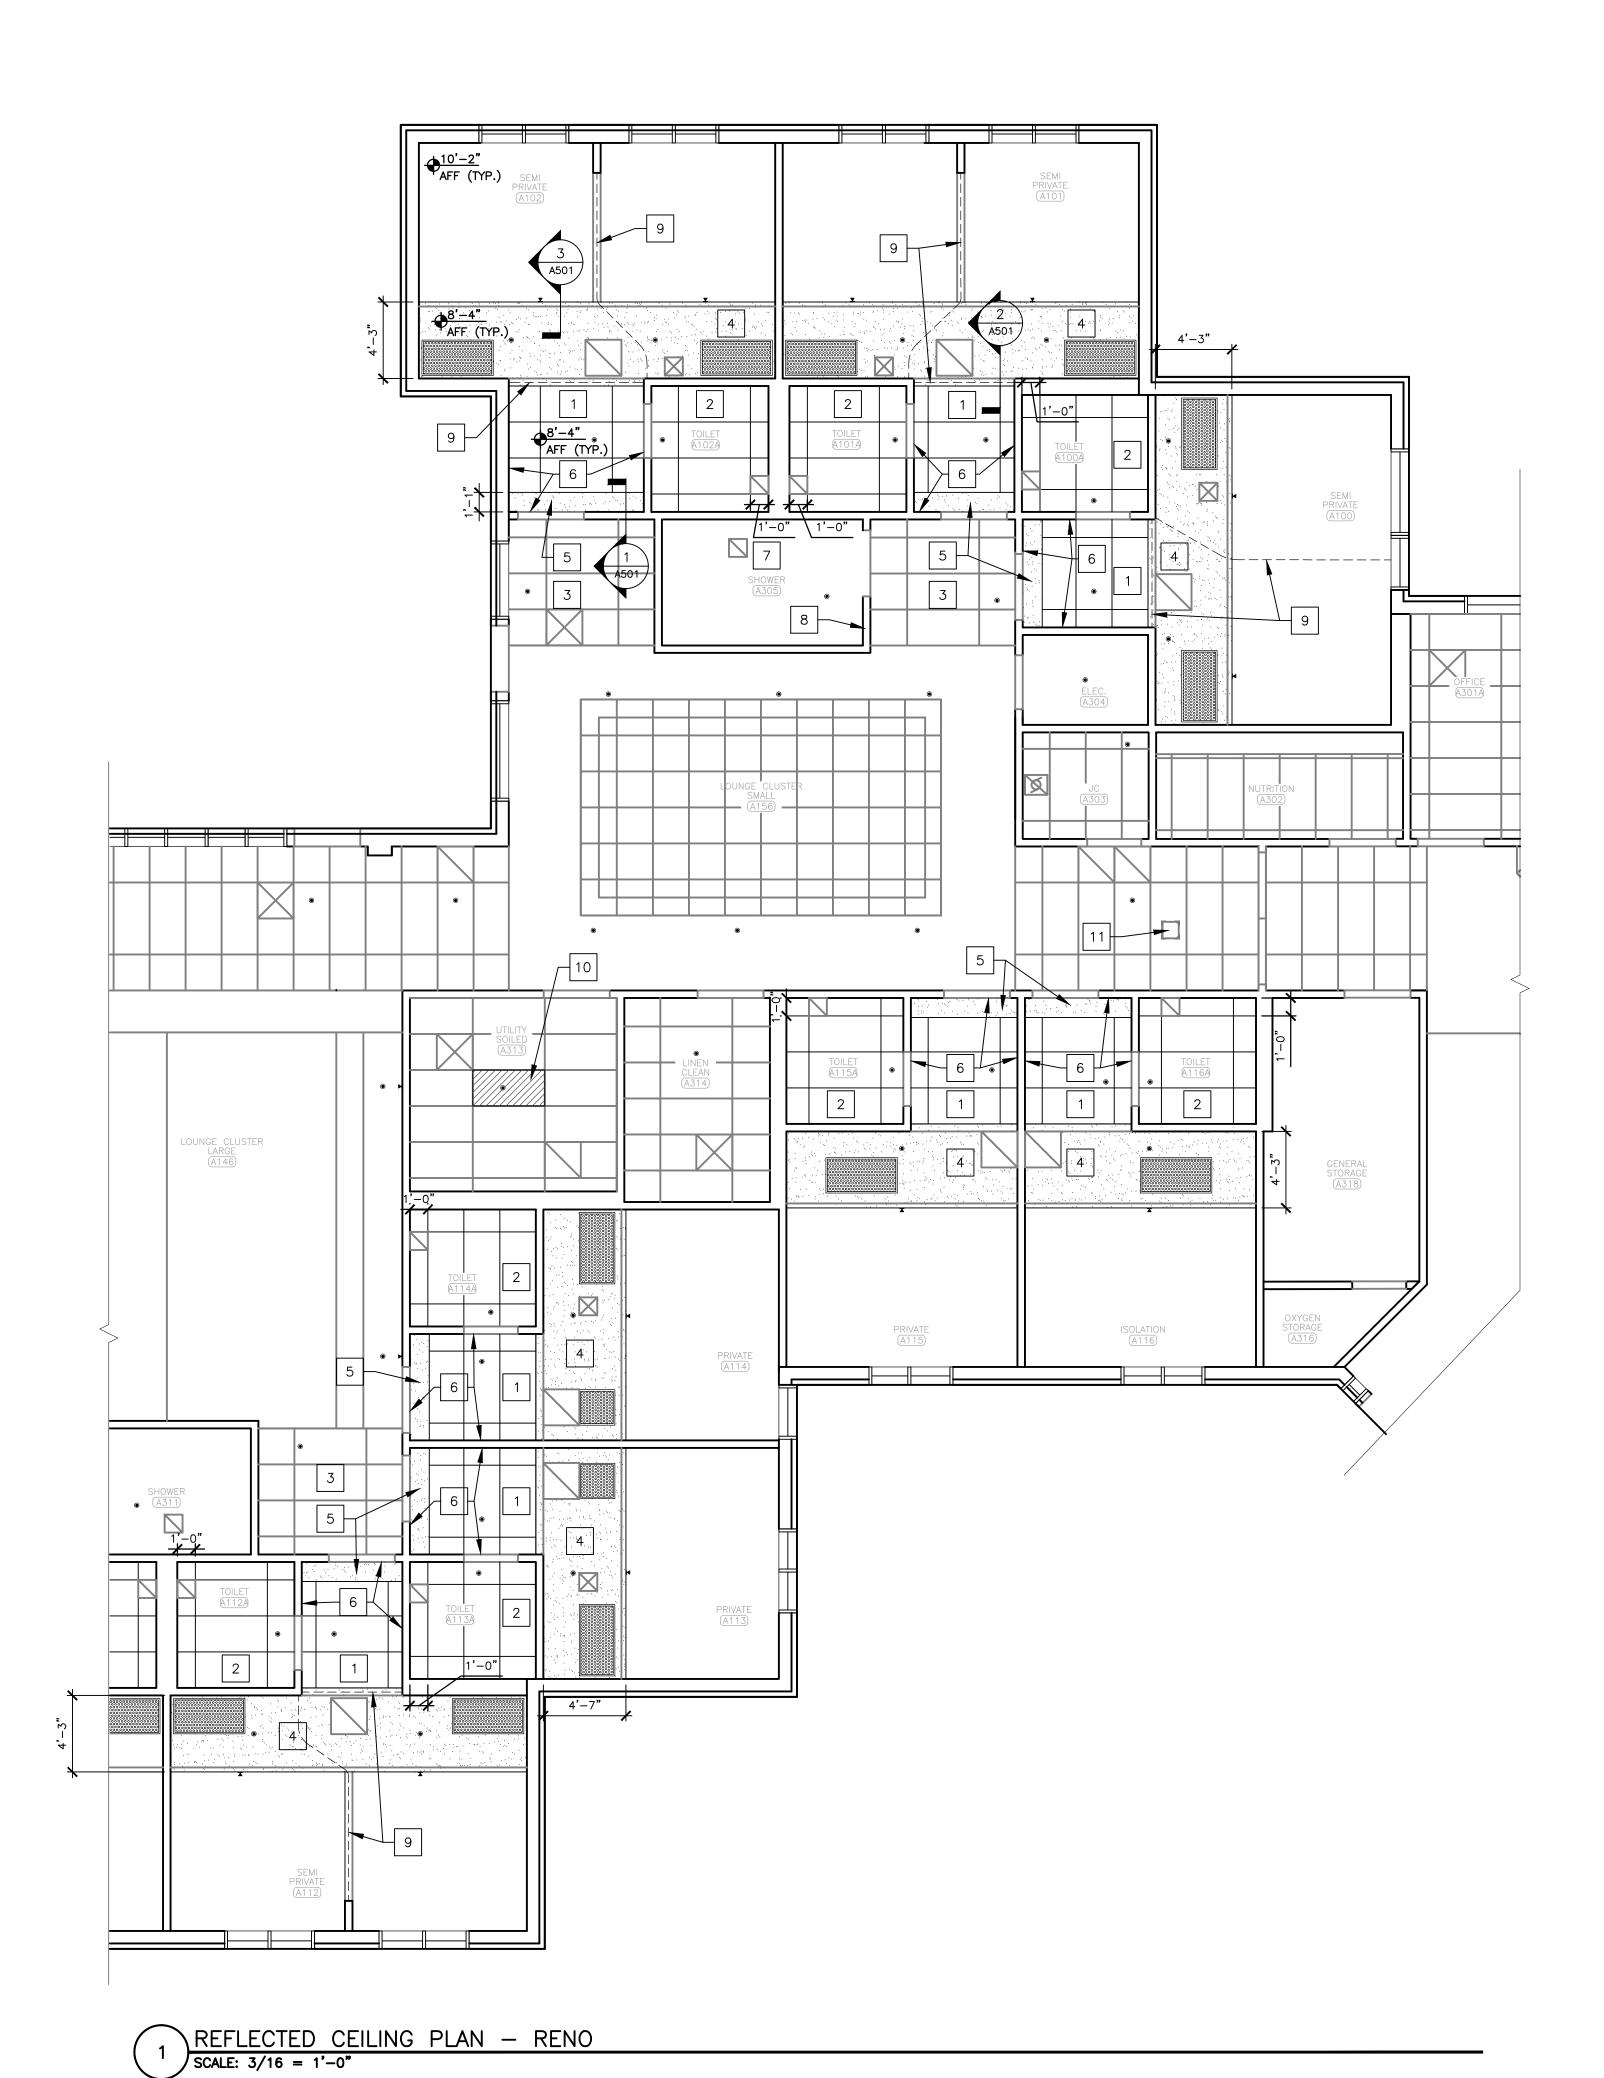
SHEET TITLE:

RENOVATION REFLECTED CEILING PLAN

SHEET NUMBER:

5 OF 26 SHEETS 08/01/2025

REFLECTED CEILING PLAN - RENO SCALE: 3/16 = 1'-0"



GENERAL NOTES:

- 1. VERIFY DIMENSIONS OF EXISTING SPACE PRIOR TO BID.
- PROTECT EXISTING FIXTURES AND MATERIAL FROM DAMAGE DURING DEMOLITION AND INSTALLATION.
- 3. COORDINATE PATHS THROUGH BUILDING FOR DELIVERY OF CONSTRUCTION MATERIAL AND WORKERS WITH FACILITY STAFF PRIOR TO COMMENCEMENT OF
- 4. COORDINATE WITH FACILITY STAFF WHEN REMOVING FURNITURE TO DETERMINE EXACT LAYOUT FOR ACCURATE REPLACEMENT.
- 5. REPAIR ANY DAMAGE INCURRED DURING DEMOLITION AND INSTALLATION.

RENOVATION KEYNOTES:

- INSTALL NEW SUSPENSION SYSTEM CEILING GRID AND 2'x4' LAY-IN ACOUSTIC CEILING TILES WITH FACTORY APPLIED GASKET, TO EXTENTS SHOWN BY GRID. INSTALL AT TYPICAL HEIGHT INDICATED.
- INSTALL NEW SUSPENSION SYSTEM CEILING GRID AND 2'x4' LAY-IN ACOUSTIC CEILING TILES WITH FACTORY APPLIED GASKET, TO EXTENTS SHOWN BY GRID. INSTALL AT SAME HEIGHT AS THE REMOVED GRID.
- 3 REINSTALL SALVAGED ACOUSTIC CEILING TILES.
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- INSTALL NEW STEEL STUD SOFFIT WITH GYPSUM BOARD. INSTALLATION
 HEIGHT TO BE AT TOP OF EXISTING DOOR FRAME. PAINT EXPOSED GYPSUM
 BOARD TO LEVEL 4 FINISH. SEE A-501 FOR DETAILS.
- REPAIR AND PAINT EXPOSED WALL SURFACE WITHIN AREA OF REMOVED WALLPAPER, TO LEVEL 4 FINISH.
- PATCH, SEAL, AND PAINT CEILING AS NEEDED FOR WORK COORDINATED ON MEP DRAWINGS USING LIKE FINISHES APPROPRIATE FOR MOISTURE EXPOSURE IN SHOWER ROOM.
- 8 PATCH HOLES IN DRYWALL ABOVE SUSPENDED CEILING.
- INSTALL NEW CUBICLE CURTAIN TRACK AND CURTAIN.
- REINSTALL SALVAGED ACOUSTIC CEILING TILE. USE A FULL, UNDAMAGED TILE SALVAGED FROM RESTROOM CEILING DEMOLITION.
 - 1 INSTALL NEW 12"X12" AIRTIGHT/WATERTIGHT ACCESS PANEL ON ATTIC STRUCTURE ABOVE SUSPENDED CEILING. COORDINATE WITH MECHANICAL CONTRACTOR FOR FINAL LOCATION. REFER TO ACCESS PANEL SCHEDULE ON SHEET A-501.

SYMBOL LEGEND:

FAN FILTER UNIT


RETURN AIR DEVICE

SUPPLY AIR DEVICE

FIRE SPRINKLER HEAD - PENDANT TYPE

FIRE SPRINKLER HEAD - SIDEWALL TYPE

____ CUBICLE CURTAIN TRACK

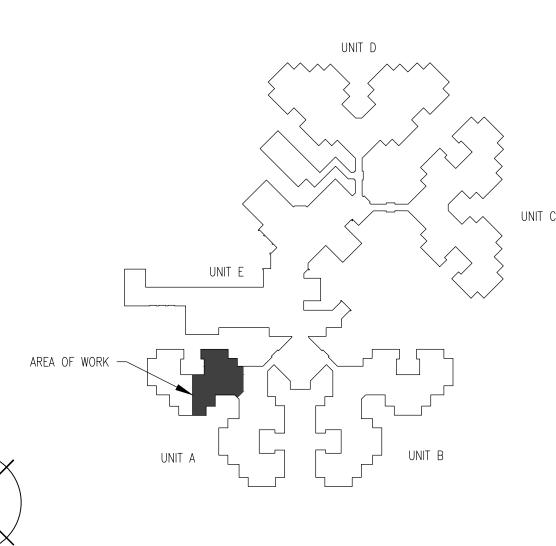



STATE OF MISSOURI MIKE KEHOE, GOVERNOR



Brad M. Schaefer - Architect MO# A-2009027294

DOCUMENTS

OFFICE OF ADMINISTRATION DIVISION OF FACILITIES MANAGEMENT, DESIGN AND CONSTRUCTION

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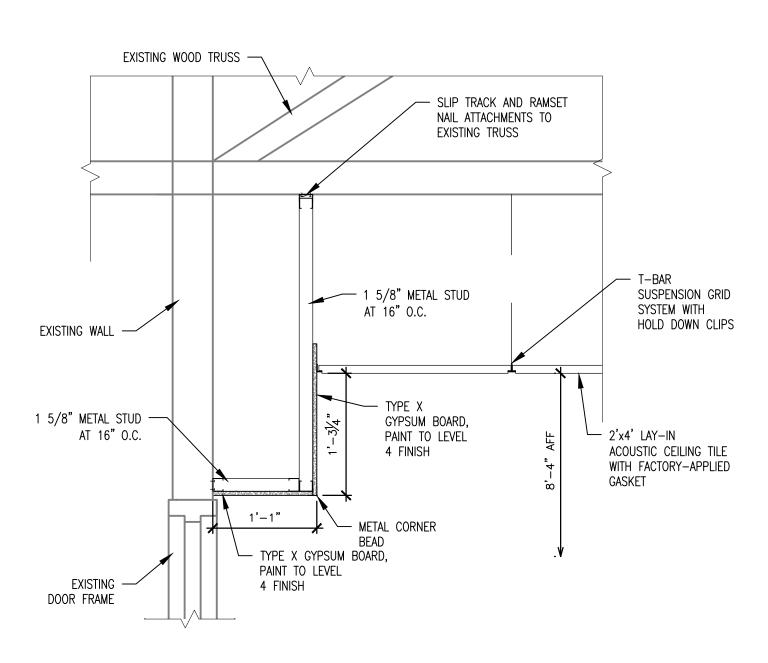
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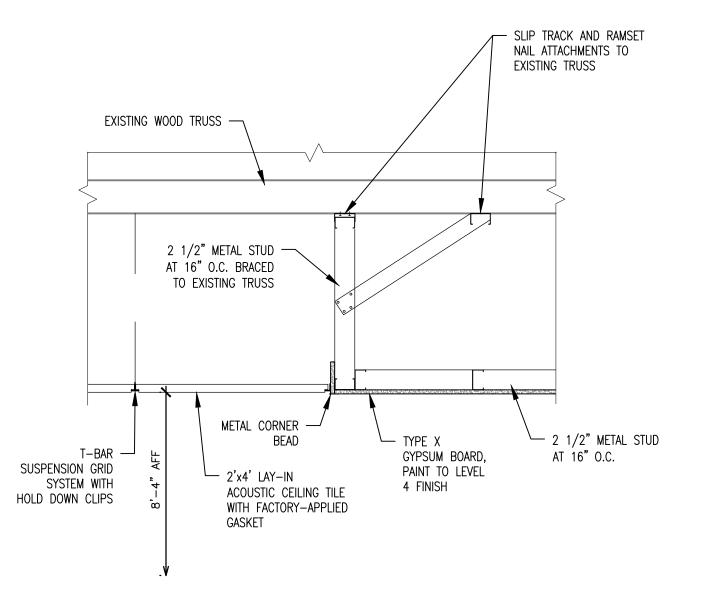
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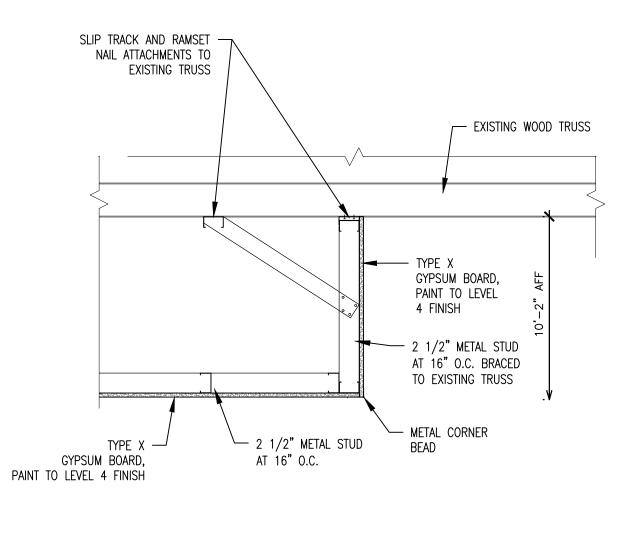
RENOVATION REFLECTED CEILING PLAN

SHEET NUMBER:

A-102







TYPICAL SOFFIT DETAIL AT DOORWAY

TYPICAL LAY-IN CEILING TO GYPSUM BOARD DETAIL

7	TYPICAL	SOFFIT	SECTION	DETAIL
(3)	SCALE: 1" =	1'-0"		

	ACCESS PANEL SCHEDULE						
MARK	MANUFACTURER	MODEL	NOMINAL SIZE	TYPE	SPECIFICATION		
AD-1	ACUDOR	AWDT	VARIES - REFER TO PLANS	AIRTIGHT AND WATERTIGHT ACCESS DOOR	DOOR: 16 GAUGE STEEL; FRAME: 16 GAUGE STEEL; HINGE: CONTINUOUS EXPOSED PIANO HINGE.		

1. PRODUCTS LISTED ARE BASIS OF DESIGN, FOLLOW ALL MANUFACTURERS RECOMMENDED INSTALLATION SPECIFICATIONS.

STATE OF MISSOURI MIKE KEHOE, **GOVERNOR**



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DIVISION OF FACILITIES MANAGEMENT, DESIGN AND CONSTRUCTION

OFFICE OF ADMINISTRATION

DEPARTMENT OF PUBLIC SAFETY/ VETERANS COMMISSION

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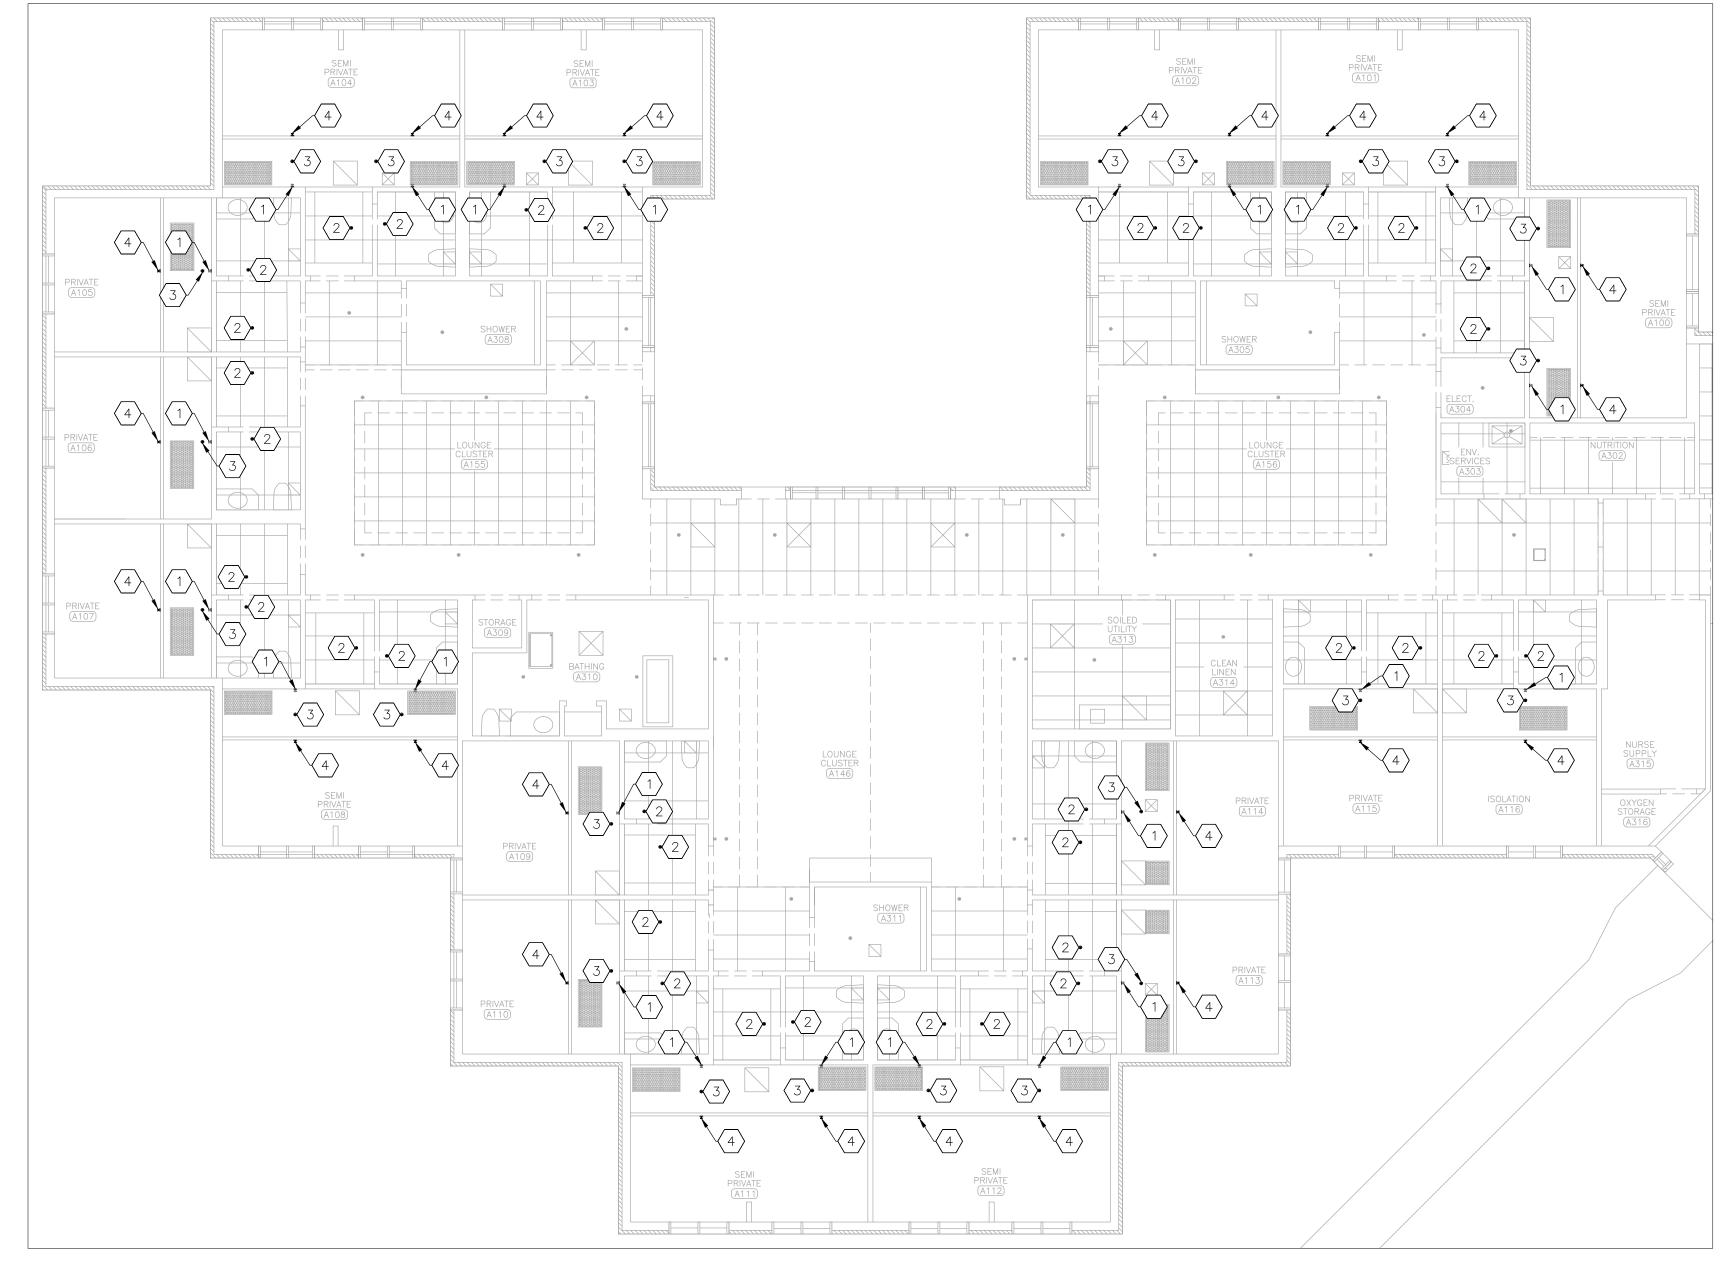
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DRAWN BY: CL
CHECKED BY: BMS

DESIGNED BY: CL

SHEET TITLE:

SOFFIT DETAILS

SHEET NUMBER:



GENERAL NOTES

- 1 FABRICATION, INSTALLATION, AND TESTING OF ALL FIRE PROTECTION DEVICES SHALL BE DONE IN ACCORDANCE WITH ALL MANUFACTURER INSTALLATION GUIDELINES. REFER TO SHEET G-002 FOR APPLICABLE CODES AND STANDARDS.
- 2 DRAWINGS AND PLANS ARE FROM FIELD TAKE-OFF AND ORIGINAL DRAWINGS. CONTRACTOR IS RESPONSIBLE FOR FIELD VERIFYING PRIOR TO BIDDING AND/OR CONSTRUCTION.
- 3 CONTRACTOR IS RESPONSIBLE FOR REMOVAL AND DISPOSAL OF ALL DEMOLISHED MATERIAL, AS WELL AS REPAIRING ANY DAMAGE TO ANY SURFACE IN THE AREA OF CONSTRUCTION THAT IS A RESULT OF CONSTRUCTION ACTIVITY. SURFACE SHALL BE REPAIRED AND FINISHED TO MATCH EXISTING CONDITIONS.
- 4 COORDINATE WITH OWNER TO SHUT OFF FIRE ALARMS AND FIRE SUPPRESSION SYSTEM IN WORK AREA PRIOR TO BEGINNING CONSTRUCTION. CONSTRUCTION SHALL BE DONE SUCH THAT THE FIRE ALARM AND FIRE SUPPRESSION SYSTEMS ARE ACTIVE OVERNIGHT.
- 5 DELEGATED DESIGN: LOCATION OF NEW SPRINKLER HEADS ARE FOR REFERENCE ONLY. FIRE PROTECTION CONTRACTOR IS RESPONSIBLE FOR DESIGNING AND PROVIDING COMPLETE, FUNCTIONAL, AND CODE COMPLIANT

NOTES

- 1) DEMOLISH SIDE-WALL TYPE FIRE SPRINKLER HEAD. EXTEND PIPE TO NEW SPRINKLER HEAD LOCATION AS
- DEMOLISH PENDENT TYPE FIRE SPRINKLER HEAD. DEMOLISH PIPE TO NEW CEILING HEIGHT. PROVIDE AND INSTALL NEW PENDENT TYPE FIRE SPRINKLER HEAD, ESCUTCHEON, AND ALL REQUIRED PIPE. ALL MATERIALS SHALL MATCH EXISTING FINISH AND PERFORMANCE.
- PROVIDE AND INSTALL PENDENT TYPE FIRE SPRINKLER HEAD, ESCUTCHEON, AND ALL REQUIRED PIPE. ALL MATERIALS SHALL MATCH EXISTING FINISH AND PERFORMANCE.
- PROVIDE AND INSTALL SIDE—WALL TYPE FIRE SPRINKLER HEAD, ESCUTCHEON, AND ALL REQUIRED PIPE. ALL MATERIALS SHALL MATCH EXISTING FINISH AND PERFORMANCE.

FIRE PROTECTION LEGEND

FIRE SPRINKLER HEAD WITH ESCUTCHEON

- PENDENT TYPE

- NEW

FIRE SPRINKLER HEAD WITH ESCUTCHEON


- SIDE-WALL TYPE


- NEW

FIRE SPRINKLER HEAD WITH ESCUTCHEON


- SIDE-WALL TYPE

- TO BE REMOVED

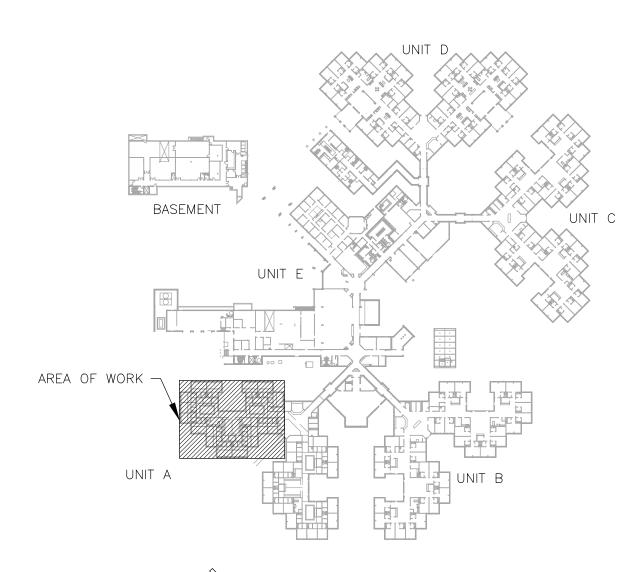

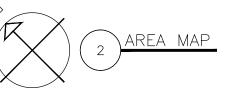

STATE OF MISSOURI MIKE KEHOE, **GOVERNOR**

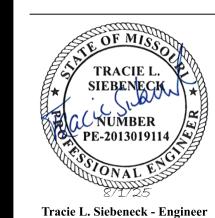

MO# PE-2013019114

OFFICE OF ADMINISTRATION DIVISION OF FACILITIES MANAGEMENT, **DESIGN AND CONSTRUCTION**

DEPARTMENT OF PUBLIC SAFETY/ VETERANS COMMISSION

HVAC IMPROVEMENTS FOR INFECTION CONTROL

WARRENSURG VETERANS **HOME** 1300 VETERANS DRIVE, WARRENSBURG, MO 64093

PROJECT # U2301-07 8136806001 ASSET#

REVISION: DATE: **REVISION:** DATE: **REVISION:** DATE: ISSUE DATE: 08/01/2025

CAD DWG FILE:M U2301-07
DRAWN BY: AH
CHECKED BY: TS

DESIGNED BY: TS/AH SHEET TITLE:

FIRE PROTECTION

SHEET NUMBER:

PLAN

- 1 DEMOLITION DRAWINGS AND PLANS ARE FROM FIELD TAKE—OFF AND ORIGINAL DRAWINGS. CONTRACTOR $race{1}$ DEMOLISH SEC
- COVER ALL OPENINGS INTO THE BUILDING FROM THE WORK AREA. ENSURE DEBRIS IS REMOVED FROM THE CONSTRUCTION AND DEMOLITION AREA AND AIR BORN DEBRIS IS NOT ALLOWED TO TRAVEL TO THE REMAINDER OF THE BUILDING. CONTRACTOR IS RESPONSIBLE FOR REMOVAL AND DISPOSAL OF ALL DEMOLISHED MATERIAL.

IS RESPONSIBLE FOR FIELD VERIFYING PRIOR TO BIDDING AND/OR CONSTRUCTION.

- COORDINATE WITH EXISTING SYSTEMS WHICH SHALL REMAIN IN OPERATION DURING DEMOLITION AND CONSTRUCTION PHASES. INSTALL TEMPORARY CAPS AT TERMINATION POINTS OF EXISTING DUCTWORK/PIPES TO REMAIN DURING DEMOLITION PHASES.
- 4 CONTRACTOR IS RESPONSIBLE FOR REPAIRING ANY DAMAGE TO ANY SURFACE IN THE AREA OF CONSTRUCTION THAT IS A RESULT OF CONSTRUCTION ACTIVITY. SURFACE SHALL BE REPAIRED AND FINISHED TO MATCH EXISTING CONDITIONS.
- 5 REMOVE ALL UNUSED DUCTWORK AND AIR DEVICES EXCEPT AS NOTED.
- 6 ALL BALANCE, FIRE, AND SMOKE DAMPERS TO REMAIN EXCEPT AS NOTED.

DEMOLITION NOTES

N INDICATES KEYED NOTES

DEMOLISH SECTION OF NATURAL GAS PIPE FOR INSTALLATION OF NEW BRANCH. PERFORM WORK TO MINIMIZE DOWNTIME OF EXISTING BOILERS TO REMAIN.

STATE OF MISSOURI MIKE KEHOE, GOVERNOR



DOCUMENTS

OFFICE OF ADMINISTRATION DIVISION OF FACILITIES MANAGEMENT, DESIGN AND CONSTRUCTION

DEPARTMENT OF PUBLIC SAFETY/ VETERANS COMMISSION

HVAC IMPROVEMENTS FOR INFECTION CONTROL

WARRENSURG VETERANS HOME 1300 VETERANS DRIVE, WARRENSBURG, MO 64093

PROJECT # U2301-07 SITE # 6806 ASSET # 8136806001

REVISION:
DATE:
REVISION:
DATE:
REVISION:
DATE:
DATE:

ISSUE DATE: 08/01/2025

CAD DWG FILE:M_U230

CAD DWG FILE:M_U2301-07
DRAWN BY: AH
CHECKED BY: TS
DESIGNED BY: TS/AH


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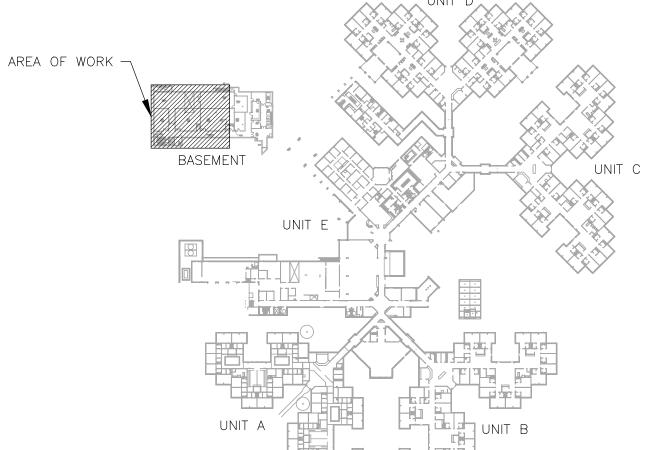
MECHANICAL
DEMOLITION PLAN
BASEMENT

SHEET NUMBER:

9 OF 26 SHEETS 08/01/2025

MD-10



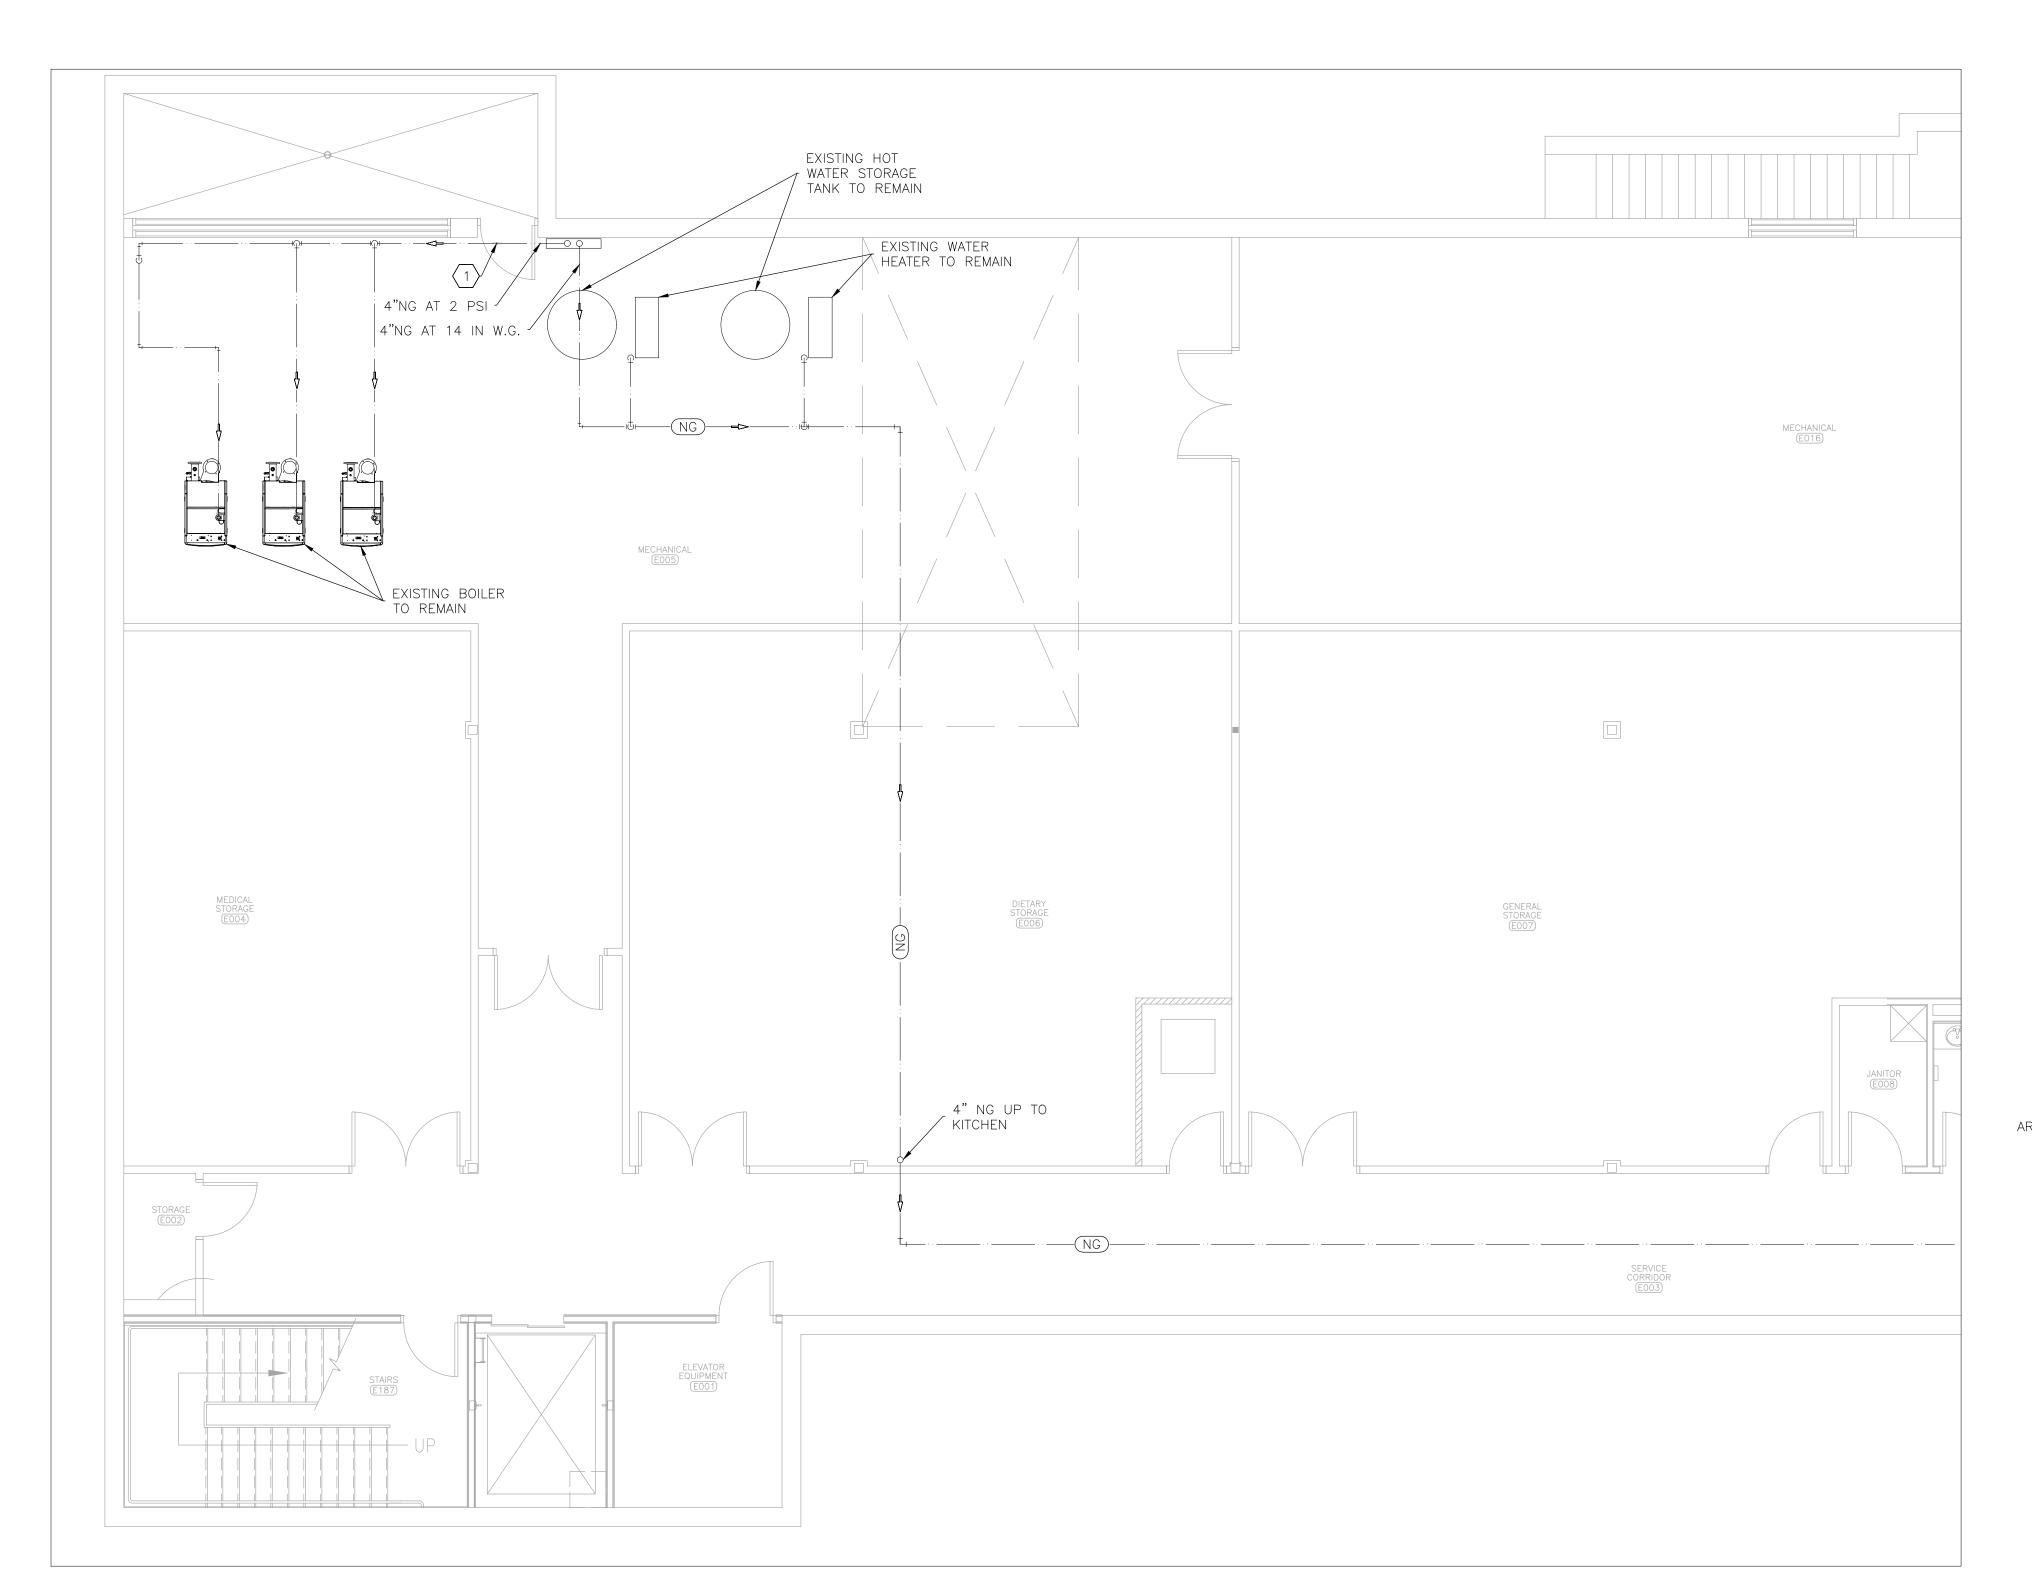


HVAC LEGEND

DIRECTION OF FLOW

EQUIPMENT - EXISTING

EXISTING MATERIALS TO BE REMOVED


MECHANICAL DEMOLITION PLAN — BASEMENT

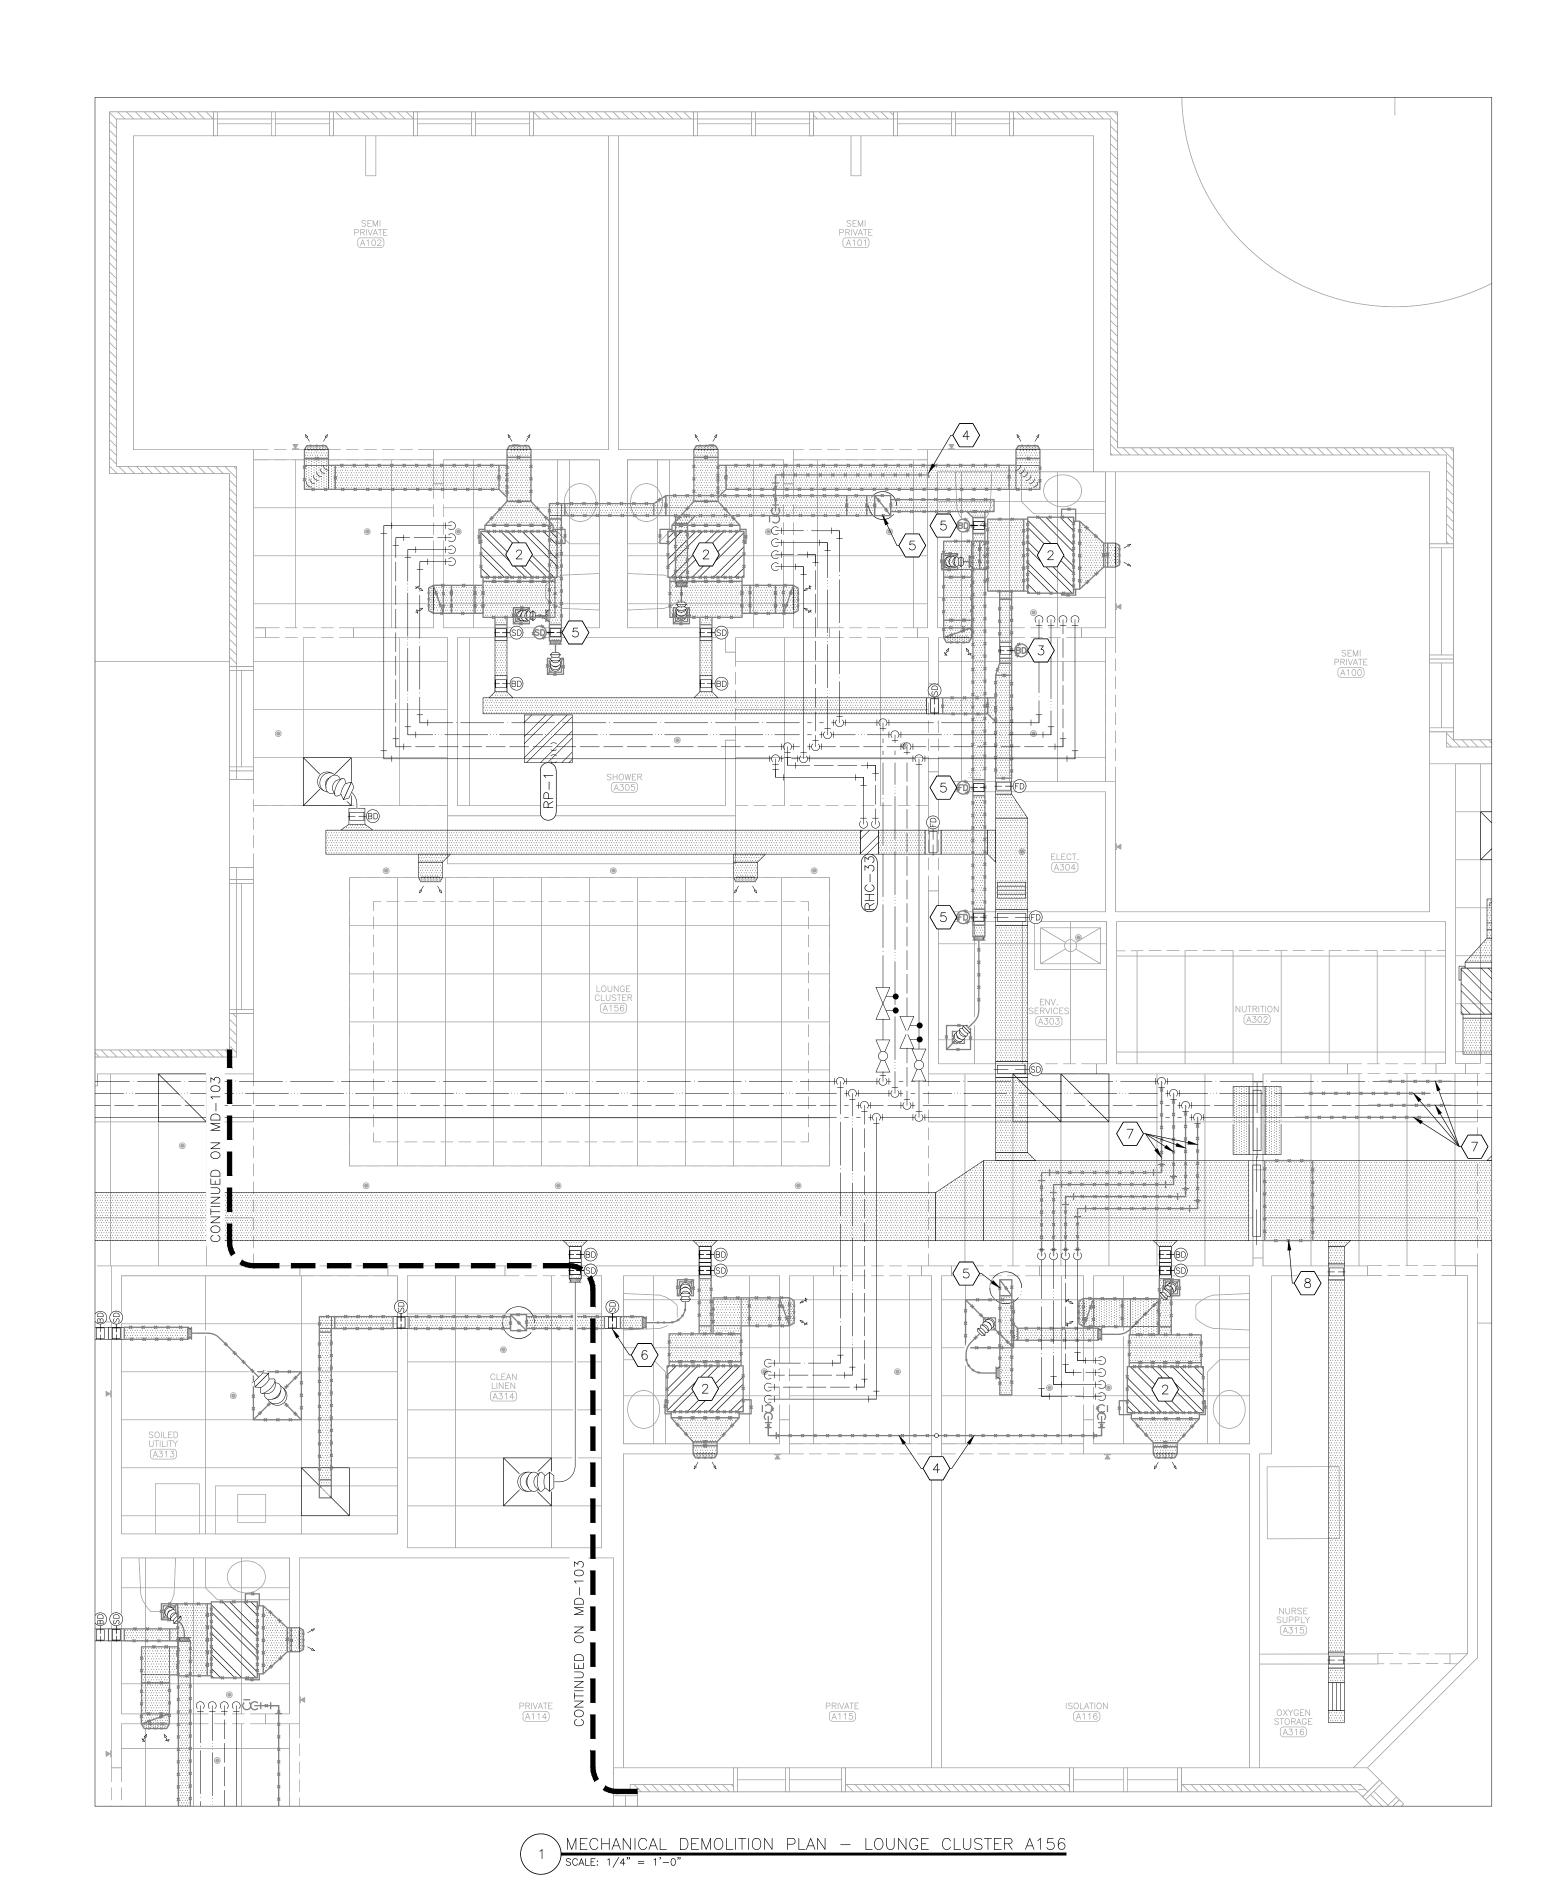


1 REFER TO MD-101 FOR GENERAL DEMOLITION NOTES.

DEMOLITION NOTES

- N INDICATES KEYED NOTES
- DEMOLISH EXISTING FAN COIL UNIT, ALL ASSOCIATED DUCT, AND AIR DEVICES AS SHOWN. CONTROLS SHALL REMAIN FOR USE IN NEW CONSTRUCTION.
- $\langle 3 \rangle$ demolish balance damper and associated duct as shown.
- DEMOLISH CONDENSATE DRAIN PIPE AS SHOWN OR AS NEEDED FOR CEILING TO BE RAISED IN NEW CONSTRUCTION.
- DEMOLISH EXHAUST FAN. UNLESS OTHERWISE NOTED, DEMOLISH ALL ASSOCIATED DUCT, SMOKE DAMPERS, AND AIR DEVICES. SEAL CEILING/ROOF AND WALL PENETRATIONS TO MATCH EXISTING FINISH AND PERFORMANCE. ENSURE ALL FIRE/SMOKE WALLS AND PARTITIONS ARE SEALED IN ACCORDANCE WITH THEIR RATING.
- 6 SMOKE DAMPER TO REMAIN FOR USE IN NEW CONSTRUCTION.
- $\overline{\langle 7 \rangle}$ DEMOLISH HYDRONIC PIPE AS SHOWN.
- $\langle 8 \rangle$ demolish duct as shown or as needed to complete the work.

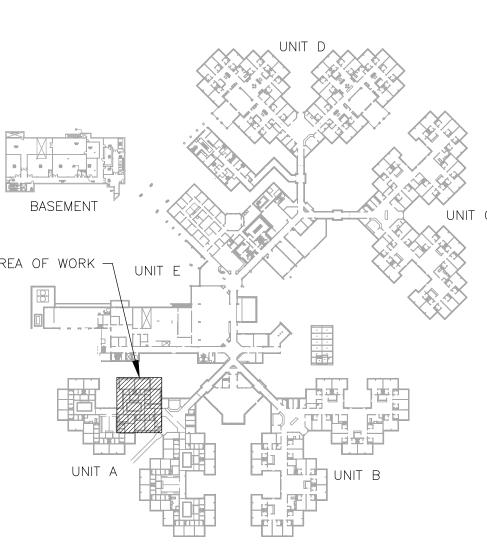

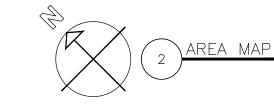

HVAC	LEGEND						
	DIRECTION OF FLOW						
RHC-##	EXISTING EQUIPMENT LABEL						
—FD	FIRE DAMPER						
—(SD)	SMOKE DAMPER						
—BD	BALANCE DAMPER						
	BALANCING VALVE						
	BALL VALVE						
	EQUIPMENT — EXISTING						
	SUPPLY AIR — EXISTING						
	RETURN AIR — EXISTING						
	EXHAUST AIR — EXISTING						
	CHILLED WATER SUPPLY - EXISTING						
	CHILLED WATER RETURN — EXISTING						
	HEATING WATER SUPPLY - EXISTING						
	HEATING WATER RETURN — EXISTING						
	EXISTING MATERIALS TO BE REMOVED						

STATE OF MISSOURI MIKE KEHOE, **GOVERNOR**



Tracie L. Siebeneck - Engineer MO# PE-2013019114

OFFICE OF ADMINISTRATION DIVISION OF FACILITIES MANAGEMENT, **DESIGN AND CONSTRUCTION**

DEPARTMENT OF PUBLIC SAFETY/ VETERANS COMMISSION

HVAC IMPROVEMENTS FOR INFECTION CONTROL

WARRENSURG VETERANS HOME 1300 VETERANS DRIVE, WARRENSBURG, MO 64093

PROJECT # U2301-07 8136806001 ASSET#

REVISION: DATE: **REVISION: REVISION:**

DATE: ISSUE DATE: 08/01/2025


CAD DWG FILE:M U2301-07
DRAWN BY: AH
CHECKED BY: TS DESIGNED BY: TS/AH

SHEET TITLE:

MECHANICAL DEMOLITION PLAN LOUNGE A156

SHEET NUMBER:



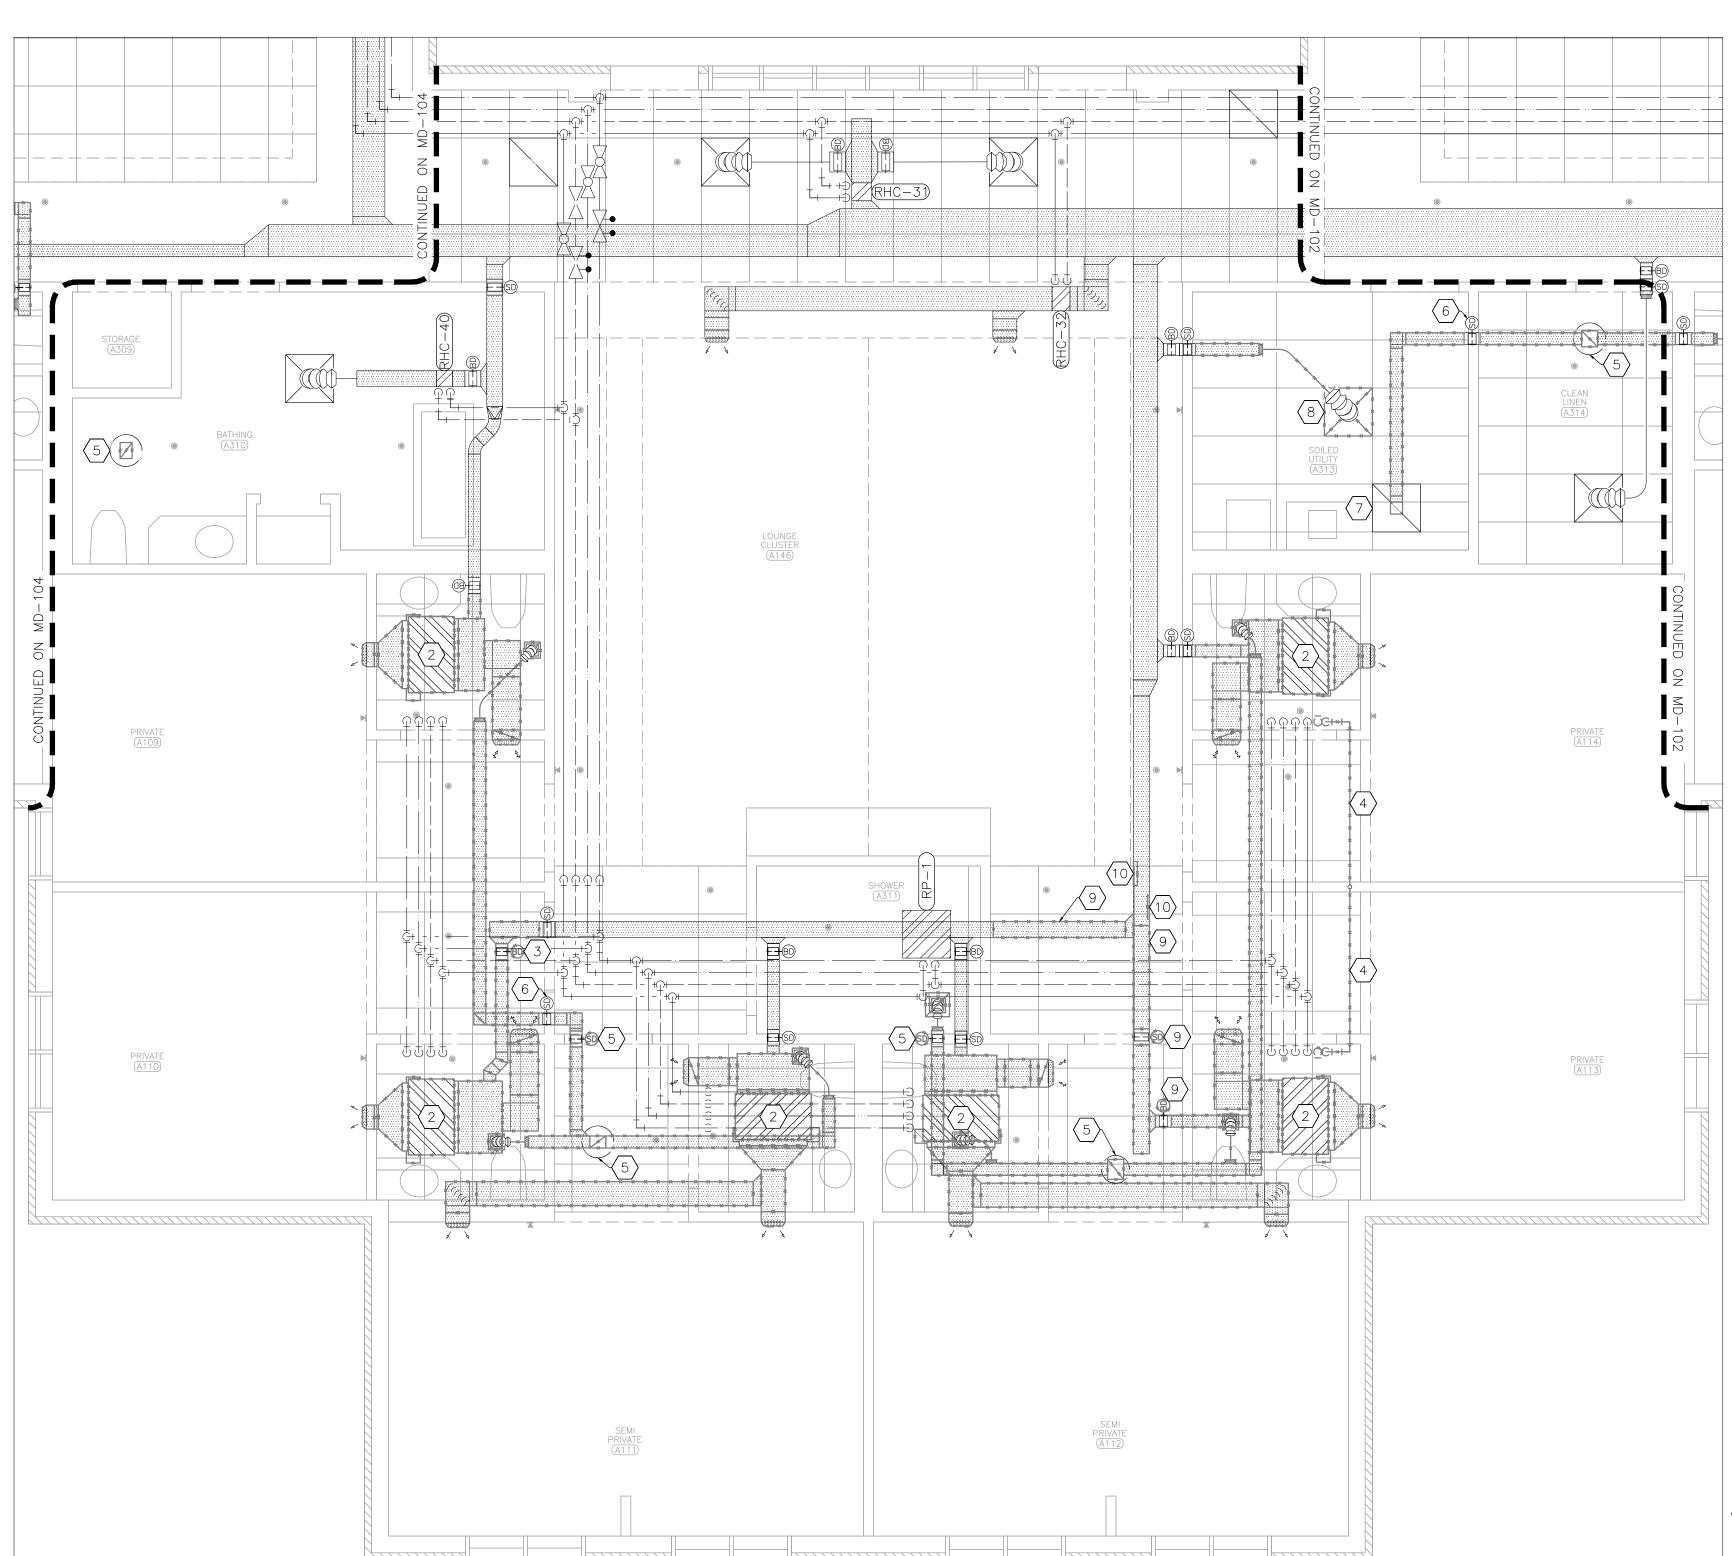

MECHANICAL DEMOLITION PLAN — LOUNGE CLUSTER A146


SCALE: 1/4" = 1'-0"

DEMOLITION NOTES

N INDICATES KEYED NOTES

1 REFER TO MD-101 FOR GENERAL DEMOLITION NOTES.

- DEMOLISH EXISTING FAN COIL UNIT, ALL ASSOCIATED DUCT, AND AIR DEVICES AS SHOWN. CONTROLS SHALL REMAIN FOR USE IN NEW CONSTRUCTION.
- 3 DEMOLISH BALANCE DAMPER AND ASSOCIATED DUCT AS SHOWN.
- DEMOLISH CONDENSATE DRAIN PIPE AS SHOWN OR AS NEEDED FOR CEILING TO BE RAISED IN NEW CONSTRUCTION.
- DEMOLISH EXHAUST FAN. UNLESS OTHERWISE NOTED, DEMOLISH ALL ASSOCIATED DUCT, SMOKE DAMPERS, AND AIR DEVICES. SEAL CEILING/ROOF AND WALL PENETRATIONS TO MATCH EXISTING FINISH AND PERFORMANCE. ENSURE ALL FIRE/SMOKE WALLS AND PARTITIONS ARE SEALED IN ACCORDANCE WITH THEIR RATING.
- 6 SMOKE DAMPER TO REMAIN FOR USE IN NEW CONSTRUCTION.
- 7 EXHAUST AIR DEVICE TO REMAIN FOR USE IN NEW CONSTRUCTION.
- REMOVE AND RETAIN AIR DEVICE. DEMOLISH ASSOCIATED DUCT BACK TO SMOKE DAMPER AS SHOWN. SMOKE DAMPER TO REMAIN.
- 9) DEMOLISH BALANCE DAMPER, SMOKE DAMPER, AND ASSOCIATED DUCT AS SHOWN. PROVIDE AND INSTALL INSULATED SHEET METAL CAP ON DUCT TO REMAIN.
- (10) CREATE PENETRATION IN EXISTING DUCT FOR NEW BRANCH.

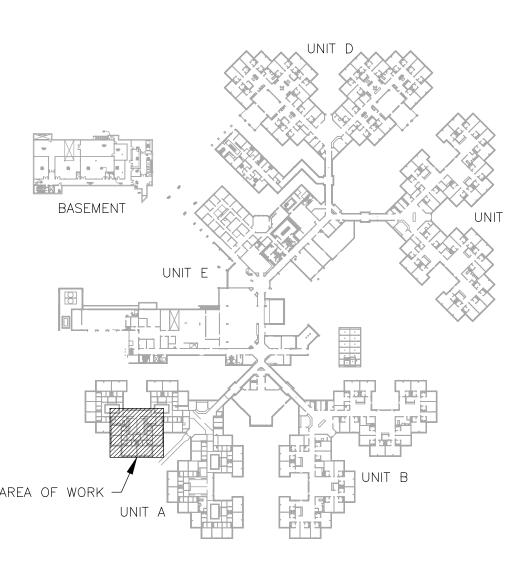

HVAC	LEGEND
\	DIRECTION OF FLOW
RHC−##)	EXISTING EQUIPMENT LABEL
—FD	FIRE DAMPER
—SD	SMOKE DAMPER
—BD	BALANCE DAMPER
••	BALANCING VALVE
	BALL VALVE
	EQUIPMENT — EXISTING
	SUPPLY AIR — EXISTING
	RETURN AIR — EXISTING
	EXHAUST AIR — EXISTING
	CHILLED WATER SUPPLY - EXISTING
	CHILLED WATER RETURN — EXISTING
	HEATING WATER SUPPLY — EXISTING
	HEATING WATER RETURN — EXISTING
	EXISTING MATERIALS TO BE REMOVED

STATE OF MISSOURI MIKE KEHOE, GOVERNOR



Tracie L. Siebeneck - Engineer MO# PE-2013019114

BOCUMENTS

OFFICE OF ADMINISTRATION DIVISION OF FACILITIES MANAGEMENT, DESIGN AND CONSTRUCTION

DEPARTMENT OF PUBLIC SAFETY/ VETERANS COMMISSION

HVAC IMPROVEMENTS FOR INFECTION CONTROL

WARRENSURG VETERANS HOME 1300 VETERANS DRIVE, WARRENSBURG, MO 64093

PROJECT # U2301-07 SITE # 6806 ASSET # 8136806001

REVISION:
DATE:
REVISION:
DATE:
REVISION:
DATE:

ISSUE DATE: 08/01/2025


CAD DWG FILE:M_U2301-07
DRAWN BY: AH
CHECKED BY: TS
DESIGNED BY: TS/AH

SHEET TITLE:

MECHANICAL
DEMOLITION PLAN
LOUNGE A146

SHEET NUMBER:

MD-103

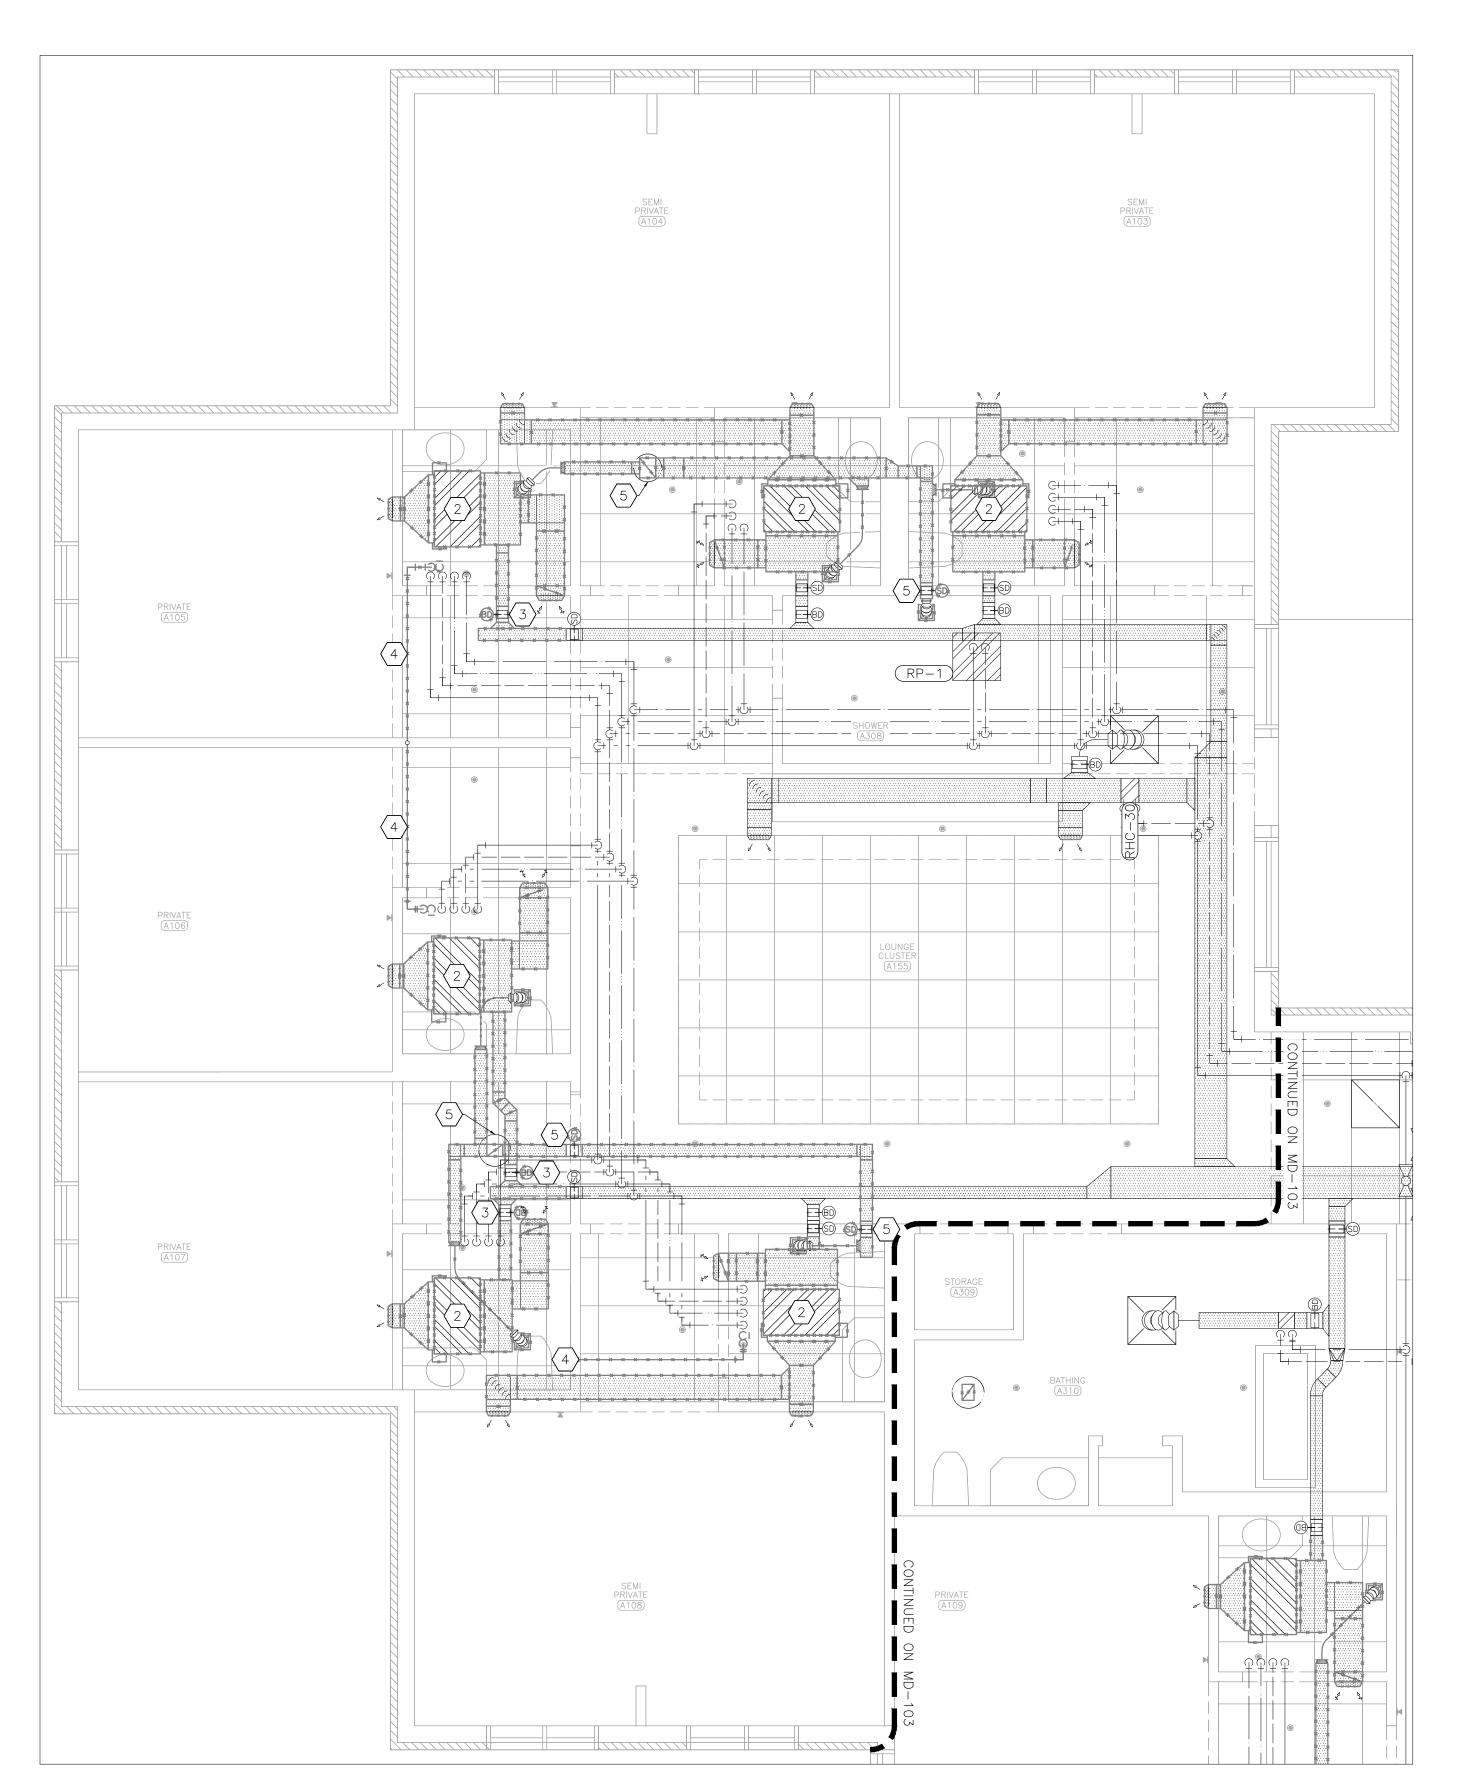

MECHANICAL DEMOLITION PLAN - LOUNGE CLUSTER A155

DEMOLITION NOTES

N INDICATES KEYED NOTES

1 REFER TO MD-101 FOR GENERAL DEMOLITION NOTES.

- DEMOLISH EXISTING FAN COIL UNIT, ALL ASSOCIATED DUCT, AND AIR DEVICES AS SHOWN. CONTROLS SHALL REMAIN FOR USE IN NEW CONSTRUCTION.
- 3 DEMOLISH BALANCE DAMPER AND ASSOCIATED DUCT AS SHOWN.
- DEMOLISH CONDENSATE DRAIN PIPE AS SHOWN OR AS NEEDED FOR CEILING TO BE RAISED IN NEW CONSTRUCTION.
- DEMOLISH EXHAUST FAN. UNLESS OTHERWISE NOTED, DEMOLISH ALL ASSOCIATED DUCT, SMOKE DAMPERS, AND AIR DEVICES. SEAL CEILING/ROOF AND WALL PENETRATIONS TO MATCH EXISTING FINISH AND PERFORMANCE. ENSURE ALL FIRE/SMOKE WALLS AND PARTITIONS ARE SEALED IN ACCORDANCE WITH THEIR RATING.

STATE OF MISSOURI MIKE KEHOE, **GOVERNOR**



Tracie L. Siebeneck - Engineer MO# PE-2013019114

OFFICE OF ADMINISTRATION DIVISION OF FACILITIES MANAGEMENT, DESIGN AND CONSTRUCTION

DEPARTMENT OF PUBLIC SAFETY/ VETERANS COMMISSION

HVAC IMPROVEMENTS FOR INFECTION CONTROL

WARRENSURG VETERANS HOME 1300 VETERANS DRIVE, WARRENSBURG, MO 64093

PROJECT # U2301-07 ASSET# 8136806001

REVISION: DATE: **REVISION:** DATE: **REVISION:** DATE:

ISSUE DATE: 08/01/2025

CAD DWG FILE:M U2301-07
DRAWN BY: AH
CHECKED BY: TS

DESIGNED BY: TS/AH


SHEET TITLE:

MECHANICAL DEMOLITION PLAN LOUNGE A155


SHEET NUMBER:

08/01/2025

12 OF 26 SHEETS

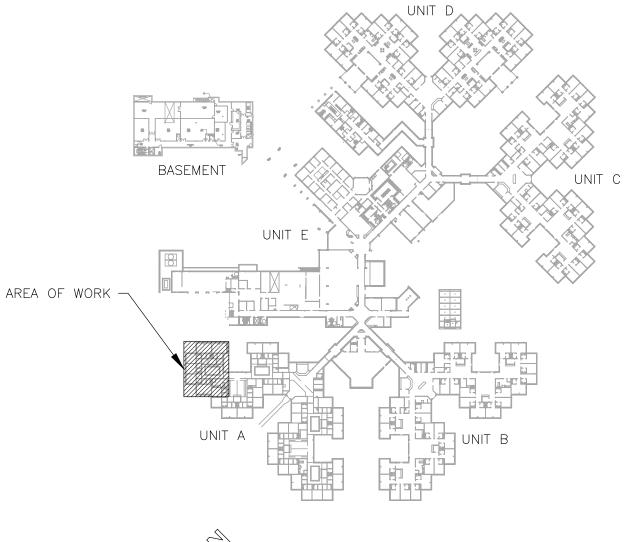

	HVAC	LEGEND
	\	DIRECTION OF FLOW
A A A UNIT D	RHC-##	EXISTING EQUIPMENT LABEL
	—FD	FIRE DAMPER
	—(SD)	SMOKE DAMPER
	—(BD)	BALANCE DAMPER
BASEMENT UNIT C		BALANCING VALVE
UNIT E		BALL VALVE
		EQUIPMENT - EXISTING
WORK —		SUPPLY AIR — EXISTING
WORK -		RETURN AIR — EXISTING
		EXHAUST AIR — EXISTING
		CHILLED WATER SUPPLY — EXISTING
		CHILLED WATER RETURN — EXISTING
UNIT A UNIT B		HEATING WATER SUPPLY - EXISTING
		HEATING WATER RETURN — EXISTING
		EXISTING MATERIALS TO BE REMOVED

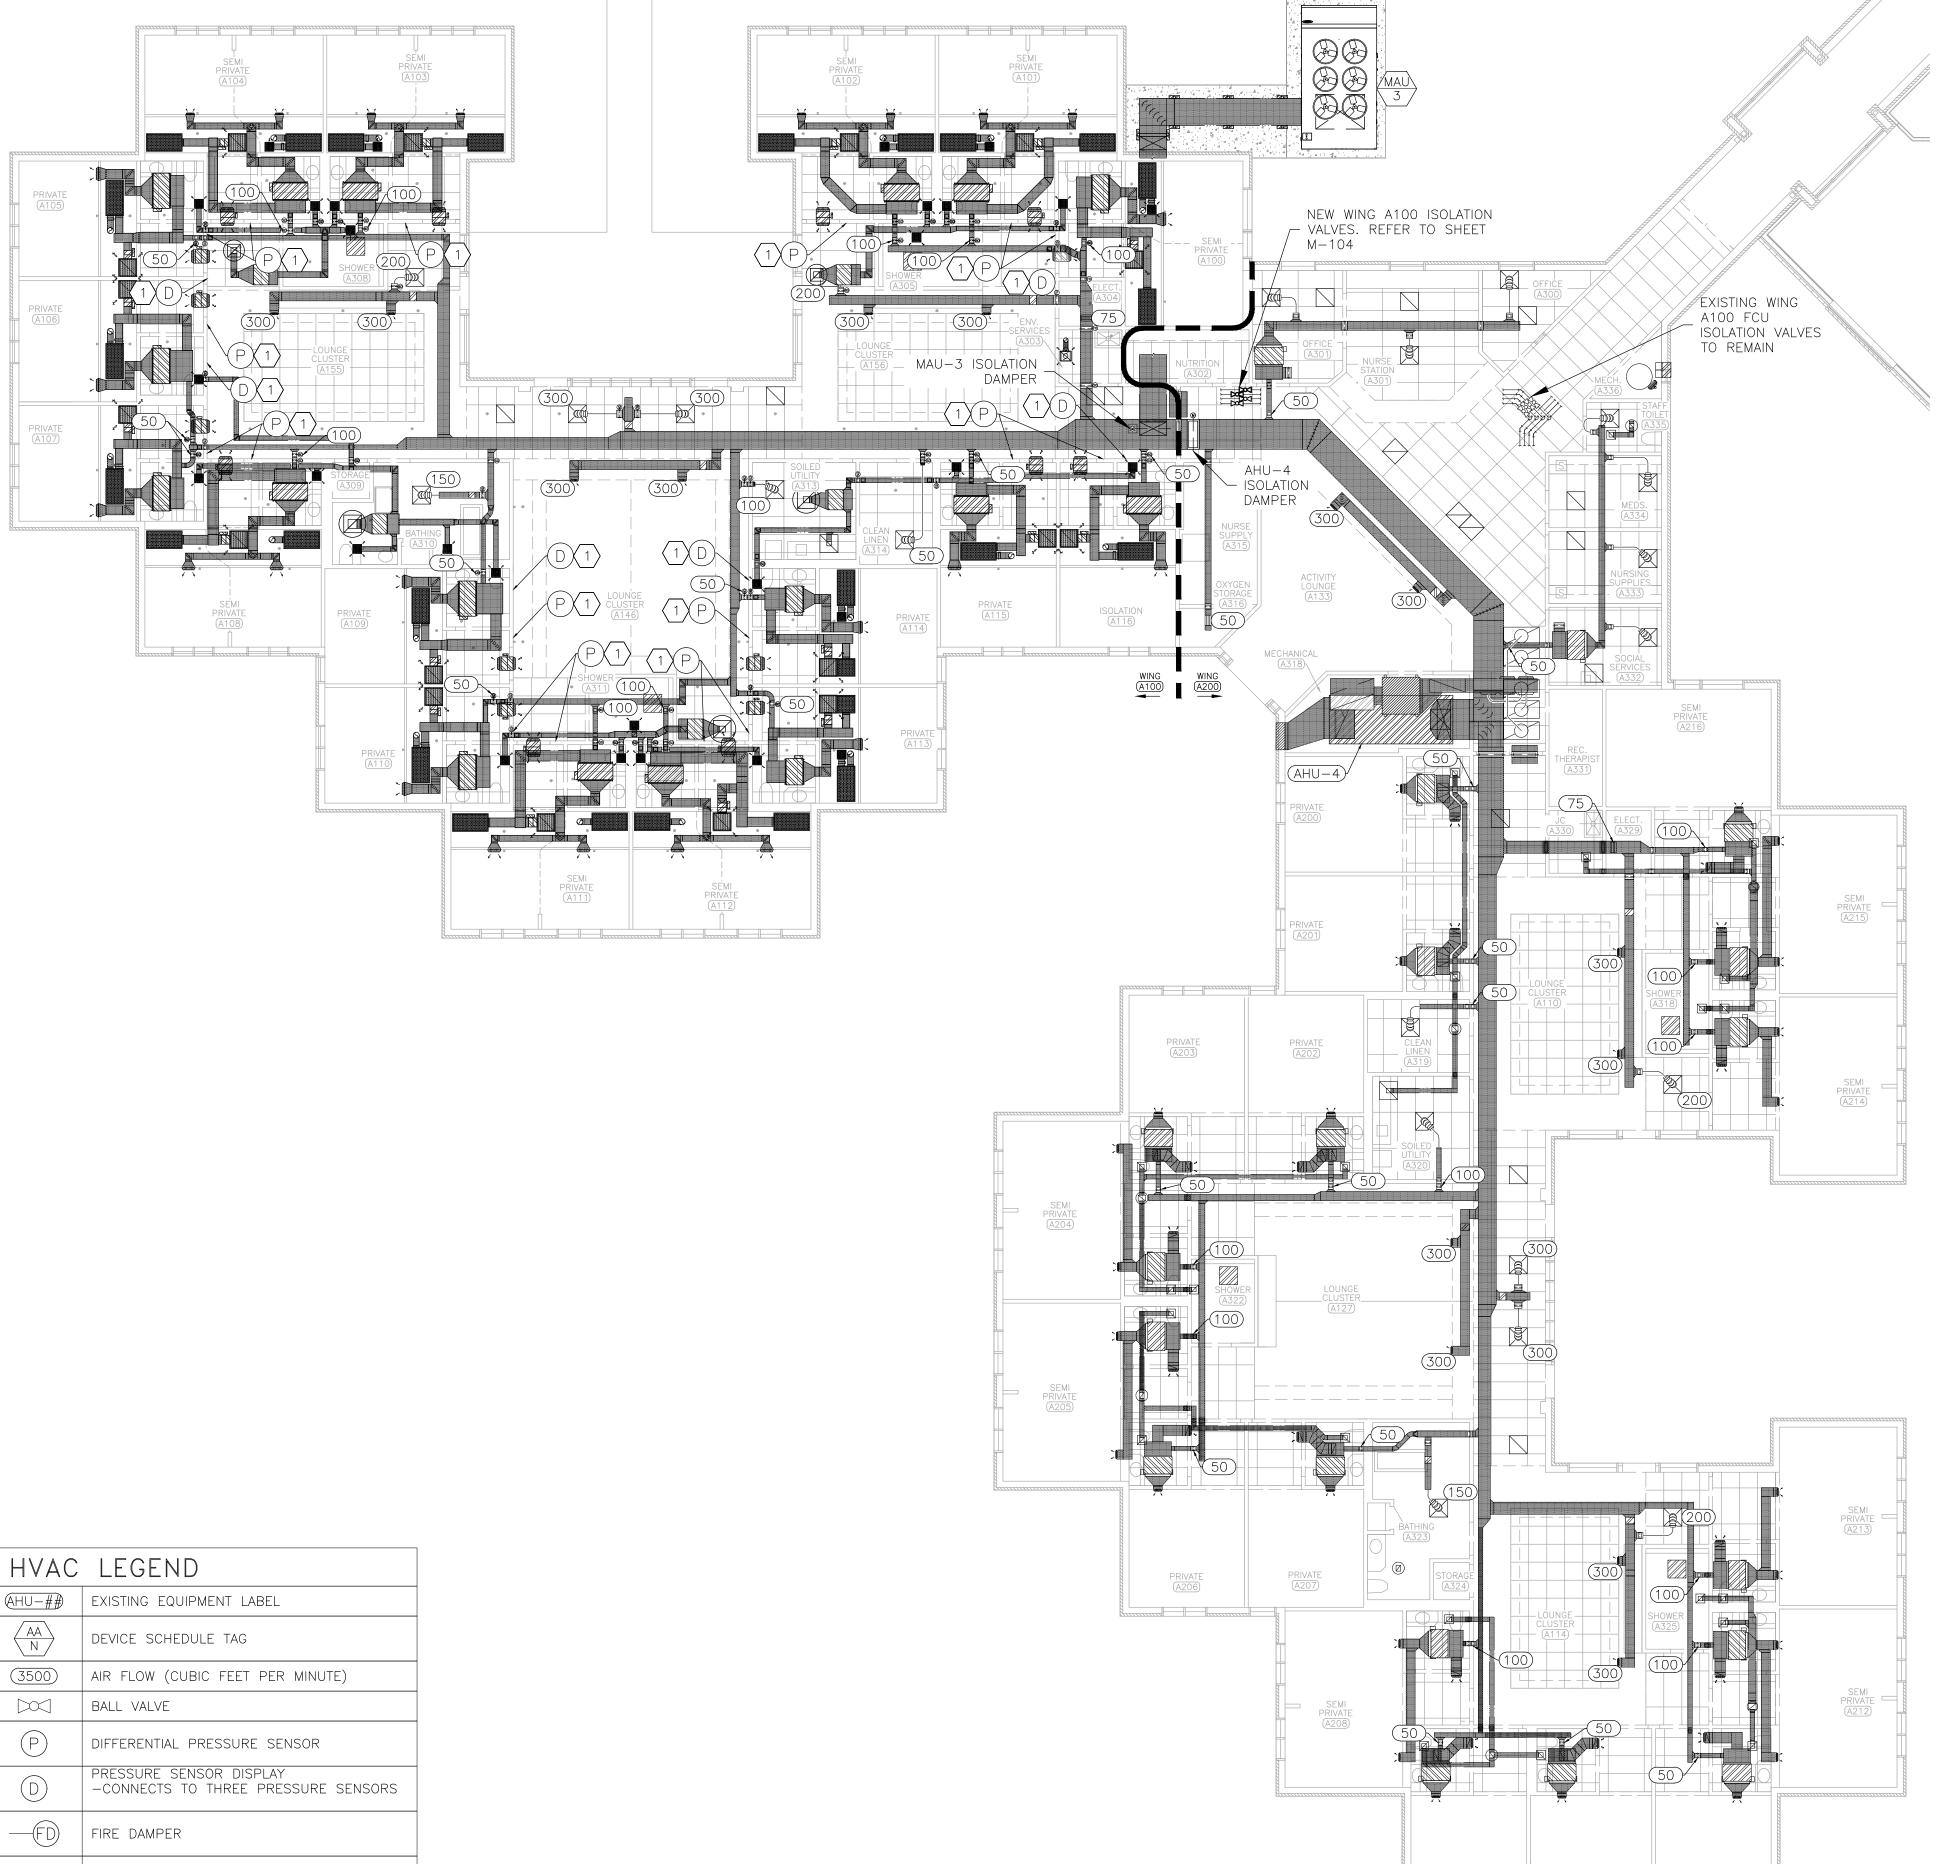

GENERAL RENOVATION NOTES


- 1 FABRICATION, INSTALLATION, AND TESTING OF ALL HVAC SYSTEMS SHALL BE IN ACCORDANCE WITH ALL MANUFACTURER INSTALLATION GUIDELINES. REFER TO SHEET G-002 FOR APPLICABLE CODES AND STANDARDS.
- 2 ALL METALLIC AND FLEXIBLE DUCTS SHALL BE CONSTRUCTED AND INSTALLED AS SPECIFIED IN THE IMC AND SMACNA HVAC DUCT CONSTRUCTION STANDARDS.
- JUCT HAS BEEN DESIGNED TO FIT IN THE SPACE AVAILABLE AND TO AVOID CONFLICTS. CONTRACTOR SHALL FIELD VERIFY FOR ANY UNFORESEEN CONFLICTS PRIOR TO FABRICATING DUCT. CONTRACTOR SHALL COORDINATE WITH OTHER DISCIPLINES TO ENSURE ADEQUATE SPACE IS AVAILABLE FOR DUCT. IF DUCT IS ROUTED ABOVE OTHER DUCT, COORDINATE ELEVATION OF EACH DUCT PRIOR TO INSTALLATION TO ENSURE IT WILL FIT IN THE SPACE AVAILABLE. DESIGN INSULATION THICKNESS IS 1.5 INCH.
- 4 ELECTRICAL CONTRACTOR SHALL PROVIDE AND INSTALL ALL LINE VOLTAGE WIRING AND CONDUIT. COORDINATE WITH ELECTRICAL CONTRACTOR TO PROVIDE AND INSTALL ALL CONDUIT FOR LOW VOLTAGE WIRING.
- THIRD PARTY, AABC OR NEBB CERTIFIED TESTING, ADJUSTING, AND BALANCING CONTRACTOR SHALL TEST AND BALANCE ALL SYSTEMS TO SPECIFIED VALUES AND PREPARE A BALANCE REPORT PER ASHRAE STANDARD 111 OR EQUAL. REPORT SHALL BE SENT TO THE ENGINEER FOR APPROVAL PRIOR TO FINAL COMPLETION. BALANCE DAMPERS ARE REQUIRED ON ALL SUPPLY AND EXHAUST AIR DEVICES.
- ALL DUCTWORK WITH TWO DIMENSION <WxD> INDICATES RECTANGULAR DUCT. ALL <DØ> INDICATES ROUND DUCT. DIMENSIONS ARE INCHES MEASURED INSIDE. PROVIDE STANDARD TURNING VANES OR CURVED ELBOW WITH SQUARE THROAT ON RECTANGULAR DUCTS. ROUND DUCT SHALL MAINTAIN A CENTERLINE TURNING RADIUS OF 1.5 X DUCT DIAMETER. FLEXIBLE DUCT SHALL BE 5 FEET MAXIMUM LENGTH AND BE SUPPORTED TO MINIMIZE STATIC PRESSURE DROP.
- 7 ALL INSULATION SHALL MEET THE ASTM E 84 FLAME/SMOKE SPREAD INDEX OF 25/50 MAXIMUM. DUCT SEAMS SHALL BE SEALED.
- PROVIDE SUITABLE SUPPORTS FOR STABILITY OF ALL HVAC DEVICES AND DUCT. AIR HANDLING EQUIPMENT SHALL BE PROVIDED WITH FLEXIBLE SUPPLY AND RETURN AIR DUCT CONNECTORS AT UNITS. HORIZONTAL UNITS SHALL BY SUPPORTED FROM THE STRUCTURE ABOVE THE UNIT.
- PROVIDE A TRAPPED CONDENSATE DRAIN PIPE FOR ALL EVAPORATORS. CONDENSATE PIPE SHALL BE 0.75 INCH INSIDE DIAMETER. SLOPE IN THE DIRECTION OF DISCHARGE A MINIMUM OF 1/8" PER FOOT. CONDENSATE PIPE SHALL BE INSULATED. CONNECT TO EXISTING CONDENSATE DRAIN SYSTEM.


RENOVATION NOTES

PRIVATE (A211)



- CONTROLS CONTRACTOR SHALL PROVIDE THROUGH THE WALL PRESSURE SENSOR TSI MODEL 800243 OR EQUAL AND LOCATE NEXT TO DOOR OF EACH BEDROOM. PROVIDE TSI DISPLAY MODEL RPM20 OR EQUAL. ROUTE CONTROL WIRING AS NEEDED TO MONITOR THE THREE NEAREST PRESSURE SENSORS. CAREFULLY FOLLOW ALL MANUFACTURER'S INSTALLATION INSTRUCTIONS. CONTROLS CONTRACTOR SHALL PROVIDE AND INSTALL 120V TO 24V TRANSFORMER REQUIRED TO PROVIDE 24V POWER TO PRESSURE MONITORING SYSTEM.
- PRIOR TO DEMOLITION OR CONSTRUCTION ACTIVITIES, TESTING AND BALANCING CONTRACTOR SHALL TEST EXISTING AIRFLOW FOR AHU-4 AND ALL FAN COIL UNITS IN WING A100 AND WING A200. PROVIDE EXISTING AIRFLOW RATES FOR ALL SUPPLY, RETURN, AND EXHAUST IN EACH SPACE. BUILDING PRESSURE SHALL BE MEASURED AT EACH OUTSIDE DOOR AND AT THE ENTRANCE TO EACH WING. PROVIDE A REPORT TO THE ENGINEER. REPORT SHALL INCLUDE THE FLOOR PLAN WITH AN AIRFLOW LABELED FOR EACH INLET AND OUTLET AND PRESSURE LABELED AT EACH DOOR. LABELS SHALL BY TYPE WRITTEN AND CLEARLY INDICATE WHICH AIR DEVICE OR DOOR THEY ARE ASSOCIATED WITH.
- 3 A PRE-BALANCE MEETING IS REQUIRED BEFORE TESTING AND BALANCING ACTIVITIES FOR NEW CONSTRUCTION TAB WORK. REFER TO SECTION 230593 FOR ADDITIONAL REQUIREMENTS.
- GENERAL CONTRACTOR SHALL COMPLETE GASKETED LAY-IN CEILING INSTALLATION FOR ONE BEDROOM/BATHROOM AS EARLY IN CONSTRUCTION AS POSSIBLE. UPON COMPLETION, TESTING AND BALANCING CONTRACTOR SHALL PERFORM BLOWER DOOR TESTING ON BEDROOM. COVER ALL SUPPLY AND EXHAUST AIR OPENINGS IN THE SPACE PRIOR TO PERFORMING TEST. REMAINING ROOMS SHALL NOT RECEIVE CEILING INSTALLATION UNTIL BLOWER DOOR TEST REPORT IS APPROVED.
- WITH MAKE UP AIR UNIT (MAU-3) OFF, MAU-3 ISOLATION DAMPER CLOSED, AND AIR HANDLER (AHU-4) ISOLATION DAMPER OPEN, TAB CONTRACTOR SHALL TEST AND BALANCE AHU-4 TO AIRFLOWS SHOWN. AHU-4 SUPPLY FAN SPEED IS CONTROLLED BY DUCT STATIC PRESSURE. PROVIDE DUCT STATIC PRESSURE SETPOINT TO CONTROLS CONTRACTOR. AFTER THE STATIC PRESSURE SETPOINT IS ESTABLISHED, TEST THE ENTIRE SYSTEM AGAIN WITH MAKE UP AIR UNIT (MAU-3) ON, MAU-3 ISOLATION DAMPER OPEN, AND AIR HANDLER (AHU-4) ISOLATION DAMPER CLOSED. CONFIRM THE AIRFLOW TO EACH SPACE HAS NOT CHANGED.
- AFTER COMPLETION OF TAB PROCEDURE FROM NOTE 3, TAB CONTRACTOR SHALL COORDINATE WITH CONTROLS CONTRACTOR TO PLACE SYSTEM INTO AIRBORNE INFECTION ISOLATION MODE (AIIM) AND BALANCE WING A100 TO PROVIDE A NEGATIVE PRESSURE RELATIONSHIP FROM THE LIVING ROOM TO EACH BEDROOM OF -0.01 IN WG (MINIMUM). ENSURE BUILDING IS NOT NEGATIVE RELATIVE TO OUTSIDE. DURING THIS TEST, TAB IS NOT REQUIRED IN WING A200. SEE SEQUENCE OF OPERATION ON SHEET M-602 AND SECTION 230593 FOR ADDITIONAL INFORMATION. CONFIRM WITH ENGINEER FOR ANY REQUIRED CLARIFICATION PRIOR TO TAB ACTIVITIES.
- 7 TEST AND BALANCE FAN COIL UNITS IN WING A100 WITH AHU-4 OPERATING AND MAU-3 OFF. CONFIRM AIRFLOWS HAVE NOT CHANGED DURING AIIM.
- TEST AND BALANCE EXHAUST FANS IN WING A100 WITH HEPA FILTERS INSTALLED IN FILTER BOXES TO ESTABLISH DESIGN AIRFLOW. REMOVE FILTERS AND TEST AGAIN TO ENSURE EXHAUST FAN SPEED ADJUSTS BASED ON DUCT PRESSURE AND EXHAUST AIRFLOW HAS NOT CHANGED.
- 9 REFER TO SHEETS M-104, M-105, AND M-106 FOR SUPPLY AND EXHAUST AIR DEVICE FLOW RATES WITHIN

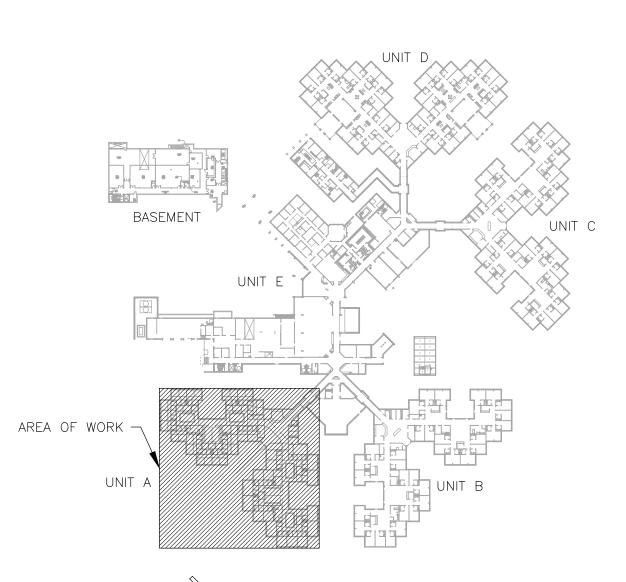

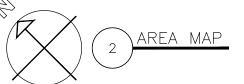

STATE OF MISSOURI MIKE KEHOE, GOVERNOR



Tracie L. Siebeneck - Engineer MO# PE-2013019114

BOCUMENTS

OFFICE OF ADMINISTRATION DIVISION OF FACILITIES MANAGEMENT, DESIGN AND CONSTRUCTION

DEPARTMENT OF PUBLIC SAFETY/ VETERANS COMMISSION

HVAC IMPROVEMENTS FOR INFECTION CONTROL

WARRENSURG VETERANS HOME 1300 VETERANS DRIVE,

WARRENSBURG, MO 64093

8136806001

PROJECT # U2301-07 SITE # 6806

REVISION:	
DATE:	
REVISION:	
DATE:	
REVISION:	
DATE:	

ISSUE DATE: 08/01/2025

ASSET#

CAD DWG FILE:M_U2301-07
DRAWN BY: AH
CHECKED BY: TS
DESIGNED BY: TS/AH

SHEET TITLE:

MECHANICAL
TESTING AND
BALANCING PLAN

SHEET NUMBER:

M-101

13 OF 26 SHEETS 08/01/2025

MECHANICAL TESTING AND BALANCING PLAN


SMOKE DAMPER

BALANCE DAMPER

N INDICATES KEYED NOTES

- 1 REFER TO M-101 FOR GENERAL RENOVATION NOTES.
- PROVIDE AND INSTALL BRANCH PIPE WITH ISOLATION VALVE FOR NEW MAKE-UP AIR UNIT INSTALLATION. PERFORM WORK TO MINIMIZE DOWNTIME OF EXISTING BOILERS TO REMAIN.
- ROUTE NATURAL GAS PIPE ABOVE CEILING TO EXTERIOR WALL. USE EXISTING TRAPEZE HANGERS IN SERVICE CORRIDOR E003. PENETRATE WALL BELOW GRADE. REFER TO SHEET M-103 FOR CONTINUATION.

STATE OF MISSOURI MIKE KEHOE, GOVERNOR

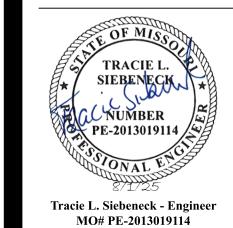

SOCUMENTS

OFFICE OF ADMINISTRATION DIVISION OF FACILITIES MANAGEMENT, DESIGN AND CONSTRUCTION

DEPARTMENT OF PUBLIC SAFETY/ VETERANS COMMISSION

HVAC IMPROVEMENTS FOR INFECTION CONTROL

WARRENSURG VETERANS HOME 1300 VETERANS DRIVE, WARRENSBURG, MO 64093

PROJECT # U2301-07 SITE # 6806 ASSET # 8136806001

REVISION:
DATE:
REVISION:
DATE:
REVISION:
DATE:

ISSUE DATE: 08/01/2025

CAD DWG FILE:M_U2301-07
DRAWN BY: AH
CHECKED BY: TS
DESIGNED BY: TS/AH

SHEET TITLE:


MECHANICAL RENOVATION PLAN BASEMENT


SHEET NUMBER:

14 OF 26 SHEETS

08/01/2025

M-102

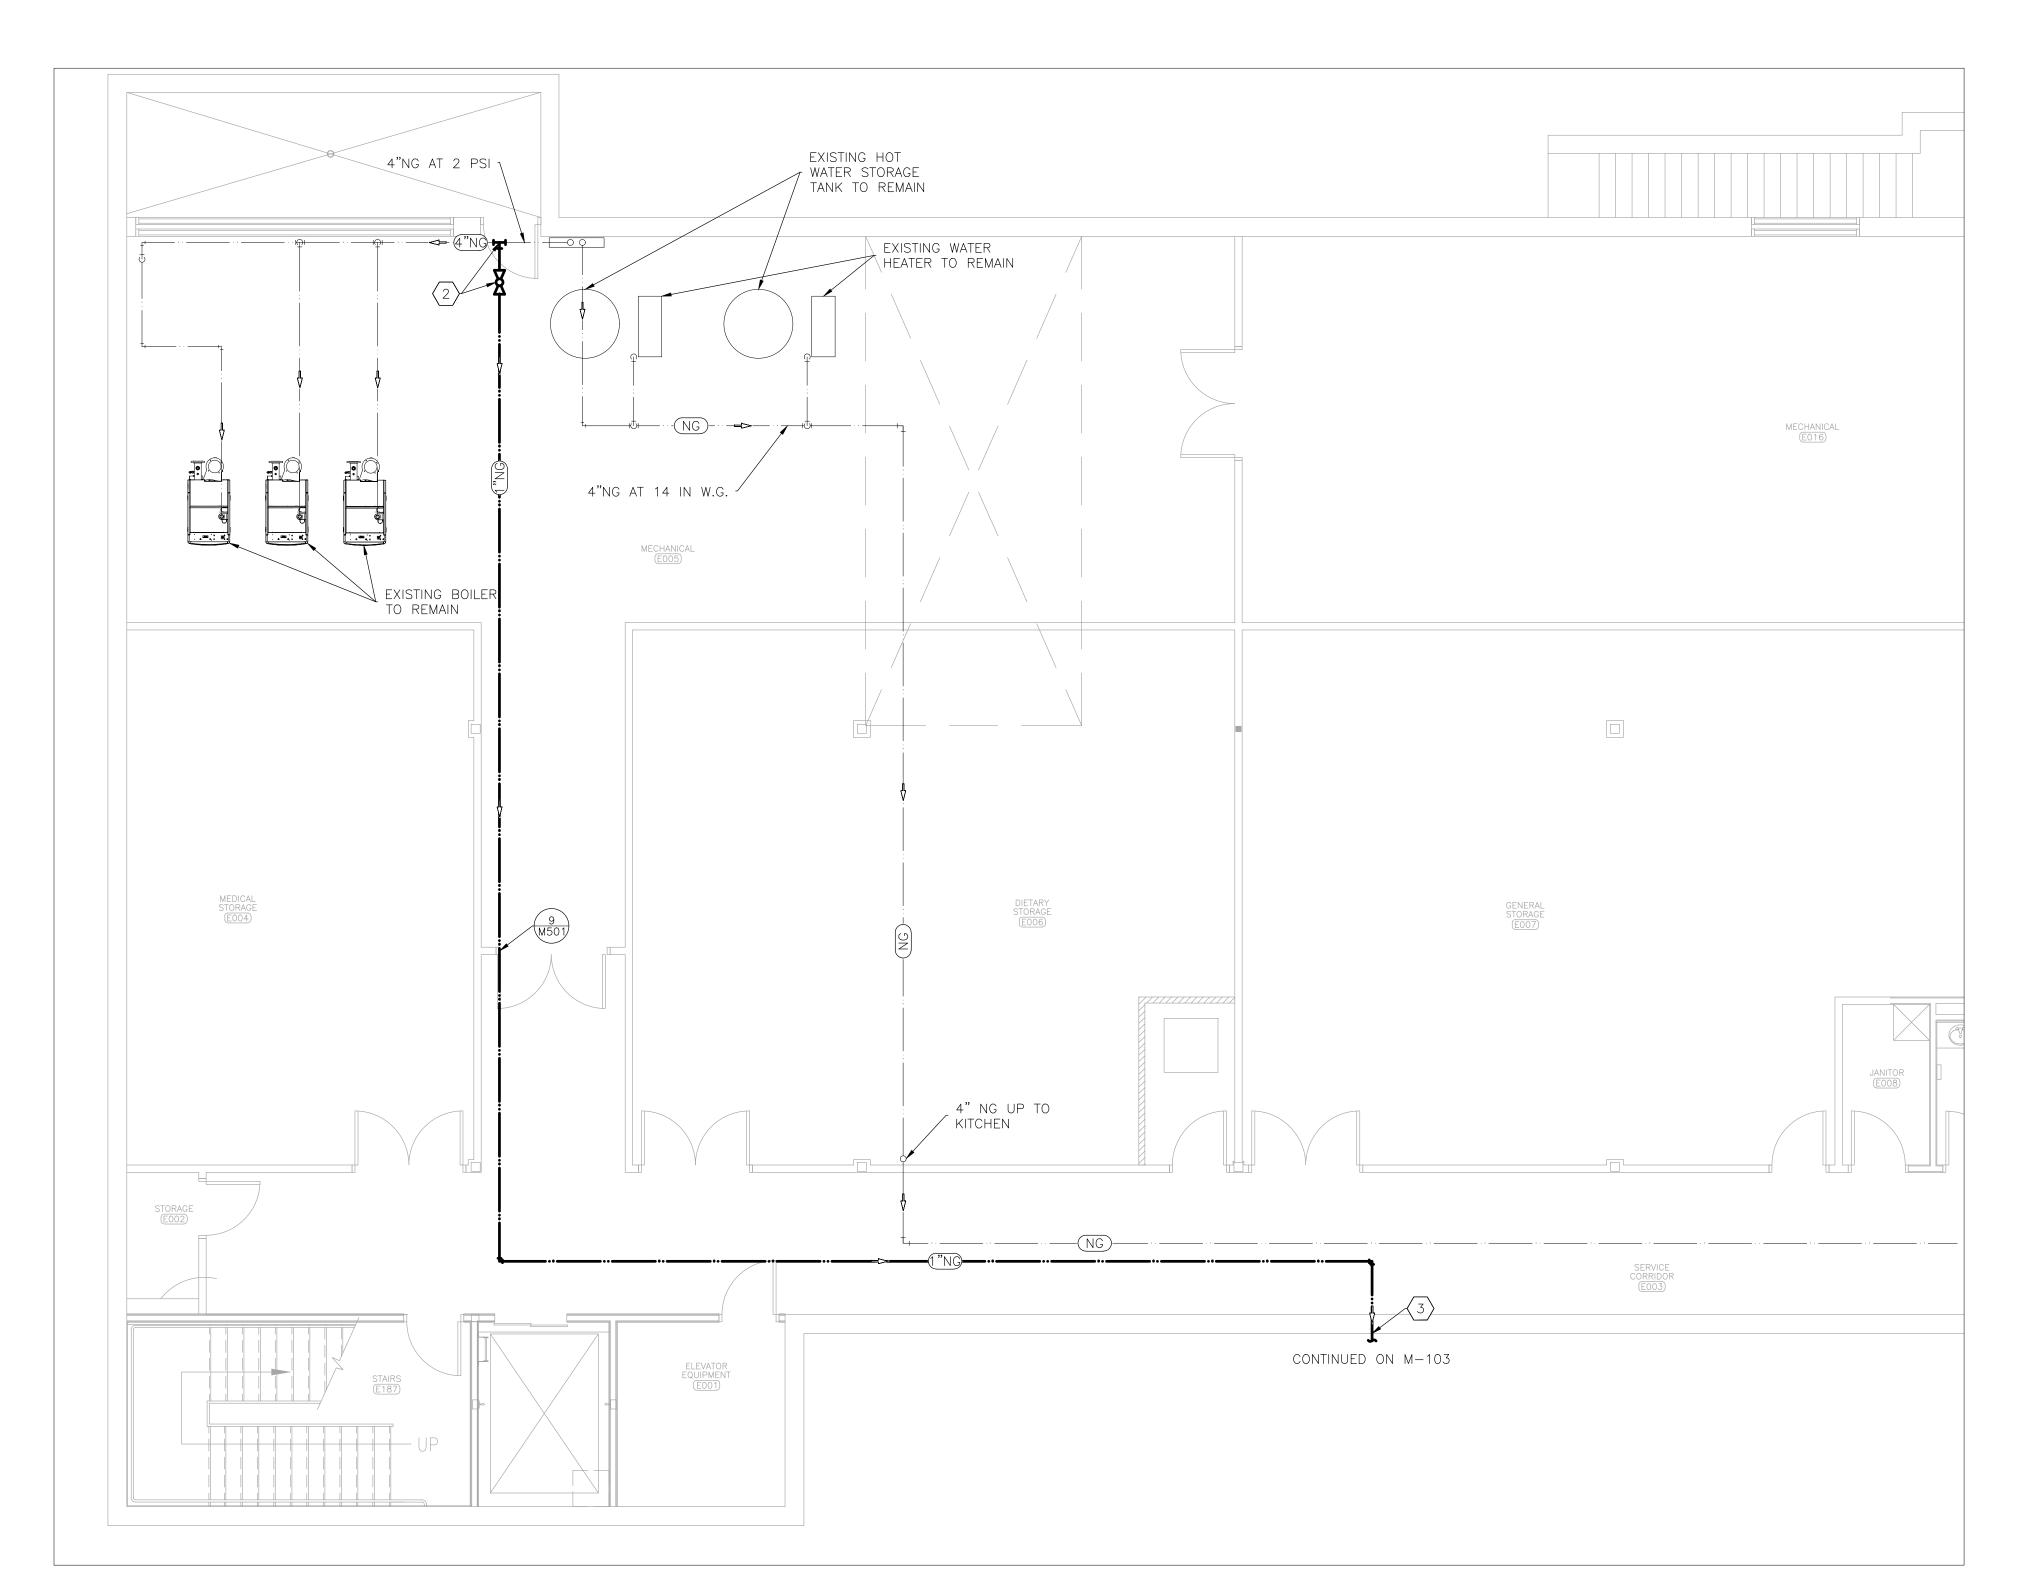

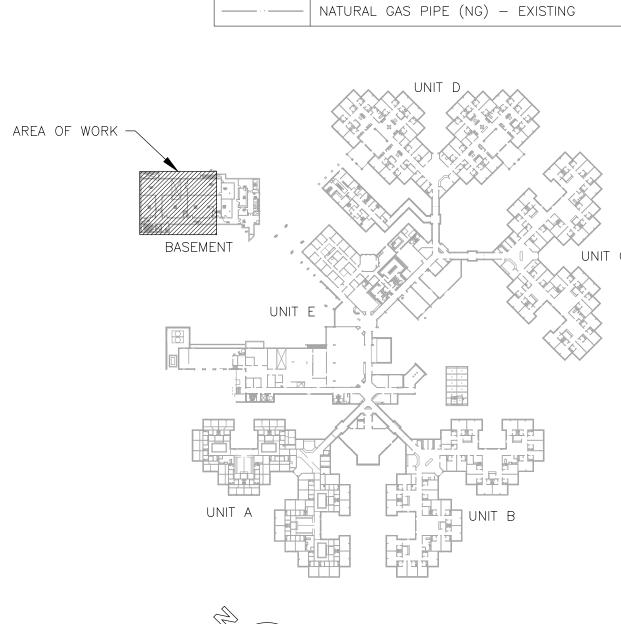

HVAC LEGEND

DIRECTION OF FLOW

NATURAL GAS PIPE (NG) — NEW


DETAIL REFERENCE, NUMBER/SHEET

NATURAL GAS PIPE SIZE (INCHES DIAMETER)


RENOVATION NOTES

- N INDICATES KEYED NOTES
- 1 REFER TO M-101 FOR GENERAL RENOVATION NOTES.
- ROUTE NATURAL GAS PIPE IN TRENCH TO NEW LOCATION. TRENCH TO CONTAIN ELECTRICAL CONDUIT AND NATURAL GAS PIPE. COORDINATE WITH GENERAL CONTRACTOR TO PROVIDE TRENCH.
- PROVIDE AND INSTALL LINE PRESSURE REGULATOR. PROVIDE MAXITROL MODEL 325-7AL OR EQUAL WITH INLET PRESSURE OF 2 PSI AND OUTLET PRESSURE OF 7-11 IN WC. PROVIDE VENT PROTECTOR.
- PROVIDE AND INSTALL SUPPLY AIR DUCT AND ROUTE TO EXTERIOR WALL. PENETRATE EXTERIOR WALL WITHIN ATTIC SPACE.
- COORDINATE WITH ELECTRICAL CONTRACTOR TO PROVIDE DUCT SMOKE DETECTOR FOR MAKE-UP AIR UNIT (MAU-3). COORDINATE WITH FIRE PROTECTION CONTRACTOR TO INTEGRATE SMOKE DETECTOR INTO EXISTING FIRE ALARM SYSTEM.
- 6 Existing equipment to remain.

HVAC	LEGEND
	DIRECTION OF FLOW
AA N	DEVICE SCHEDULE TAG
# M###	DETAIL REFERENCE, NUMBER/SHEET
(12×12)	DUCT SIZE-RECTANGULAR (INCHES X INCHES)
1"NG	NATURAL GAS PIPE SIZE (INCHES DIAMETER)
S	DUCT SMOKE DETECTOR
	BALL VALVE
	PRESSURE REGULATOR
	EQUIPMENT - NEW
	OUTDOOR AIR - NEW
	NATURAL GAS PIPE — NEW

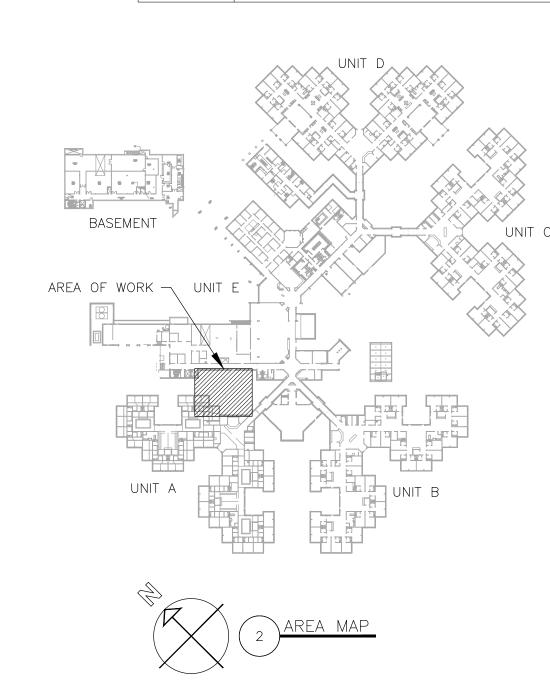

STATE OF MISSOURI MIKE KEHOE, GOVERNOR

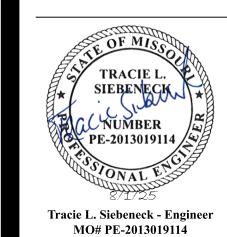

SID UMENTS

OFFICE OF ADMINISTRATION DIVISION OF FACILITIES MANAGEMENT, DESIGN AND CONSTRUCTION

DEPARTMENT OF PUBLIC SAFETY/ VETERANS COMMISSION

HVAC IMPROVEMENTS FOR INFECTION CONTROL

WARRENSURG VETERANS HOME 1300 VETERANS DRIVE, WARRENSBURG, MO 64093

PROJECT # U2301-07 SITE # 6806 ASSET # 8136806001

REVISION:
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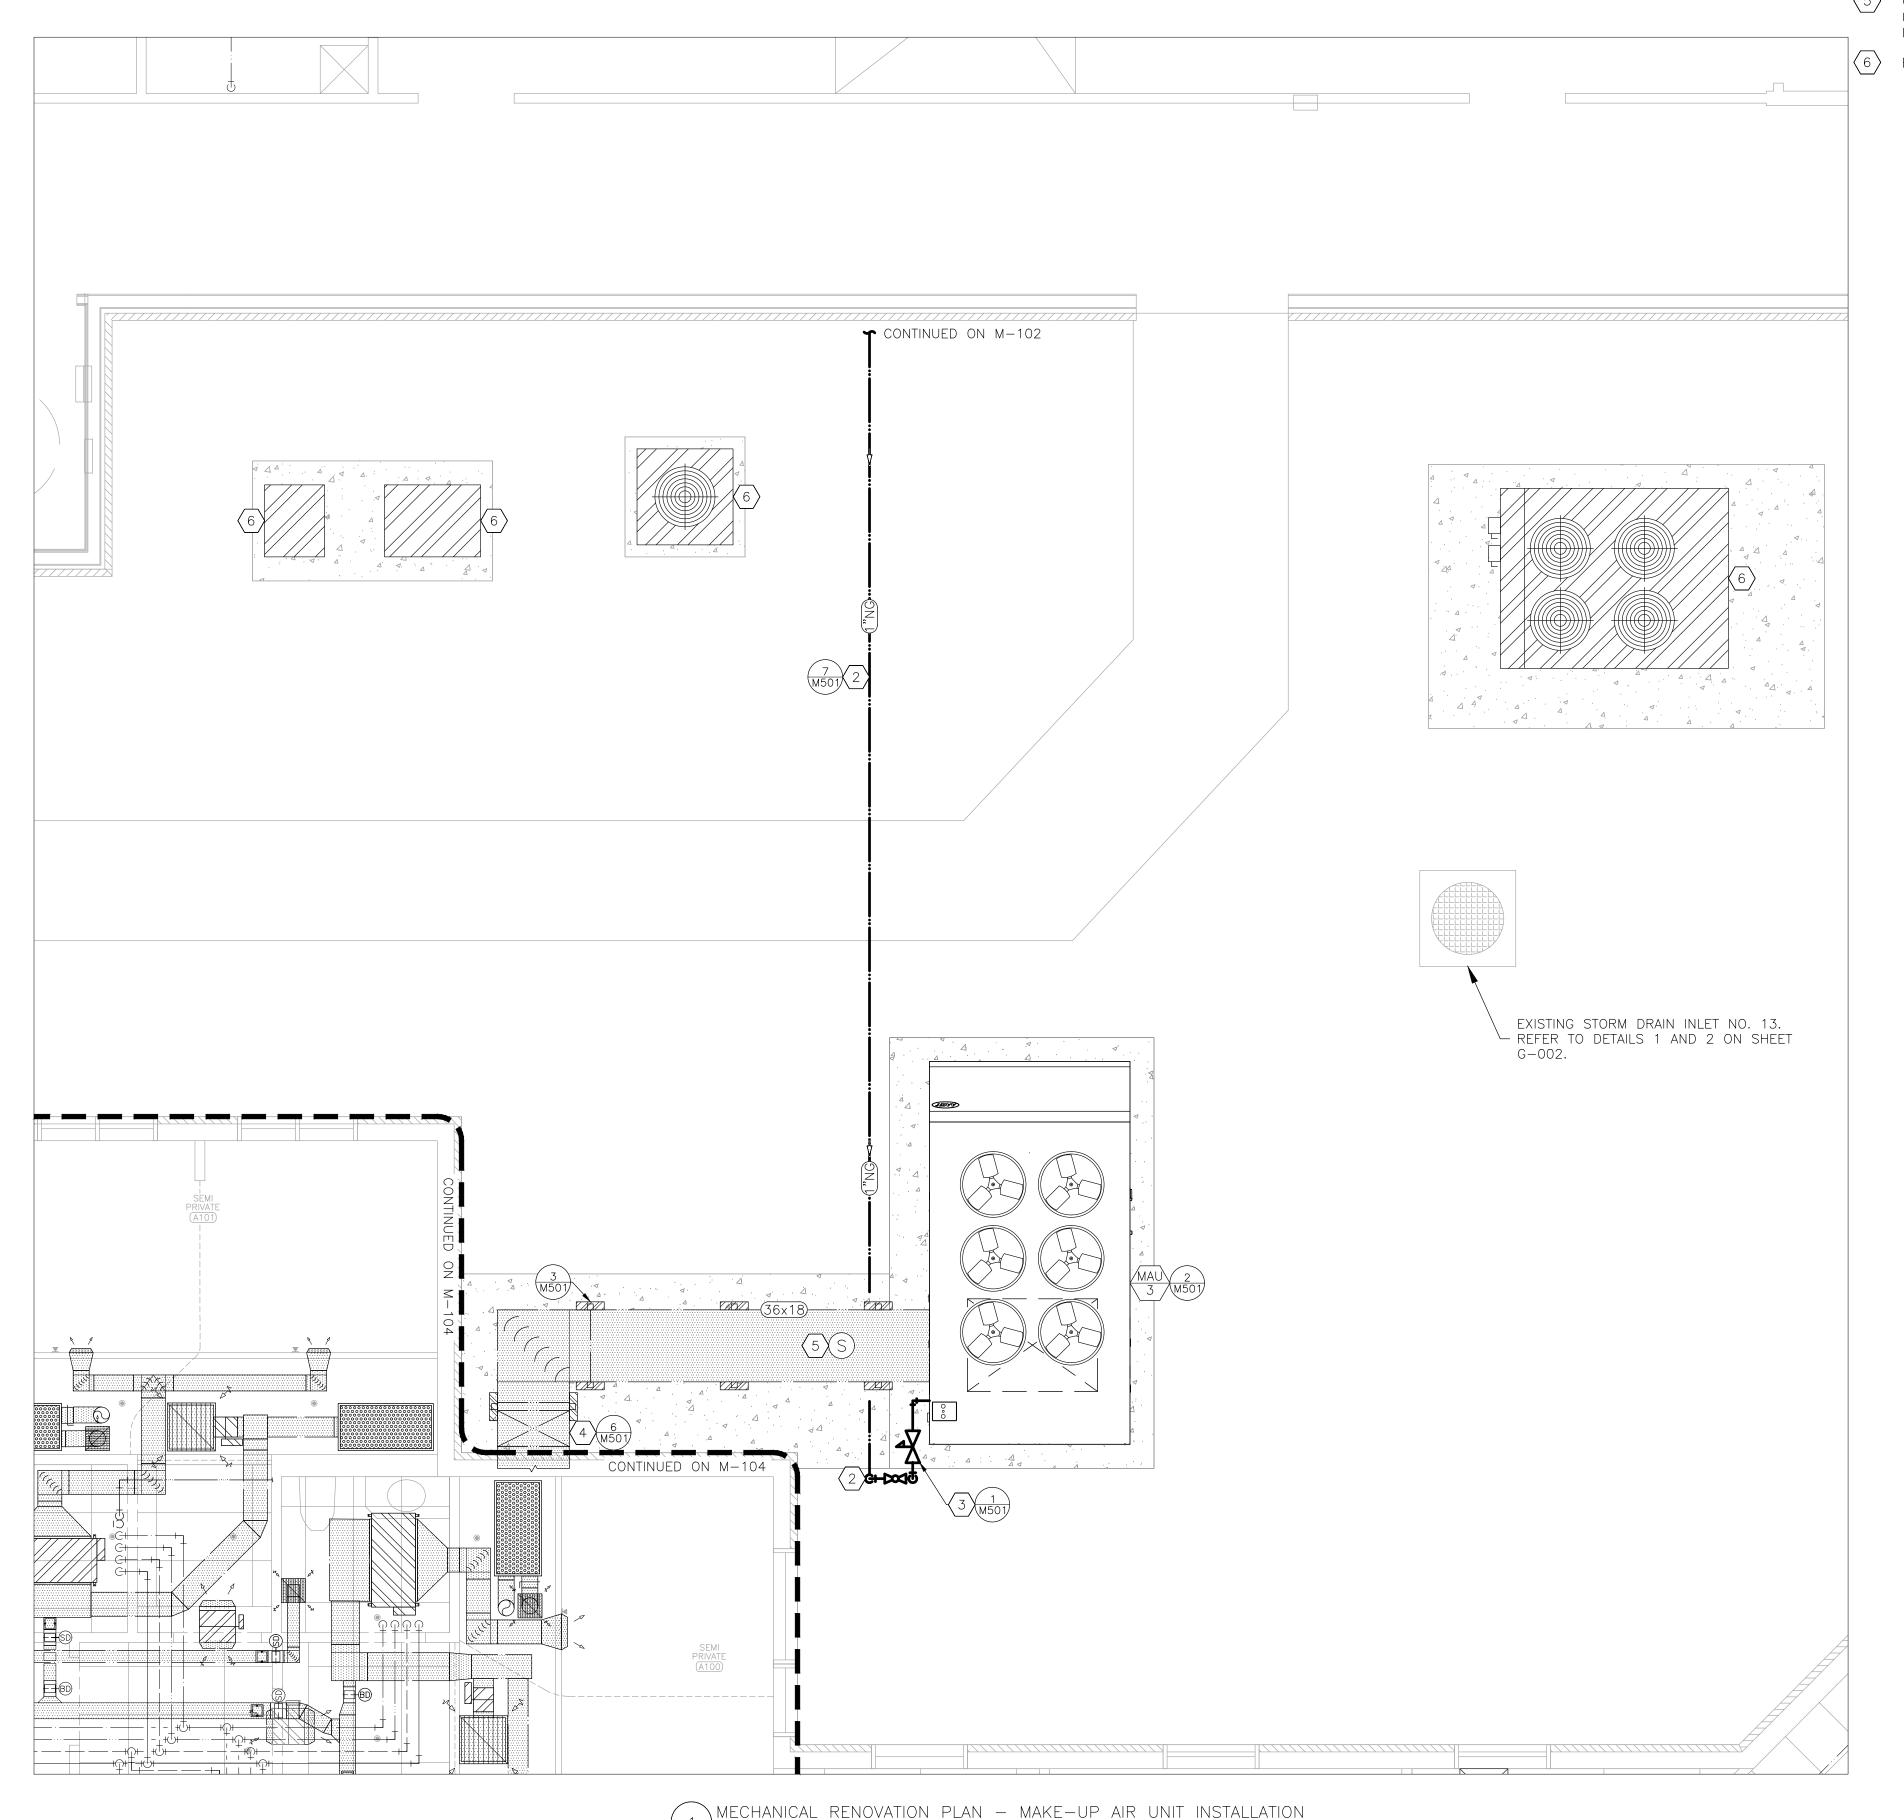
CAD DWG FILE:M_U2301-07
DRAWN BY: AH
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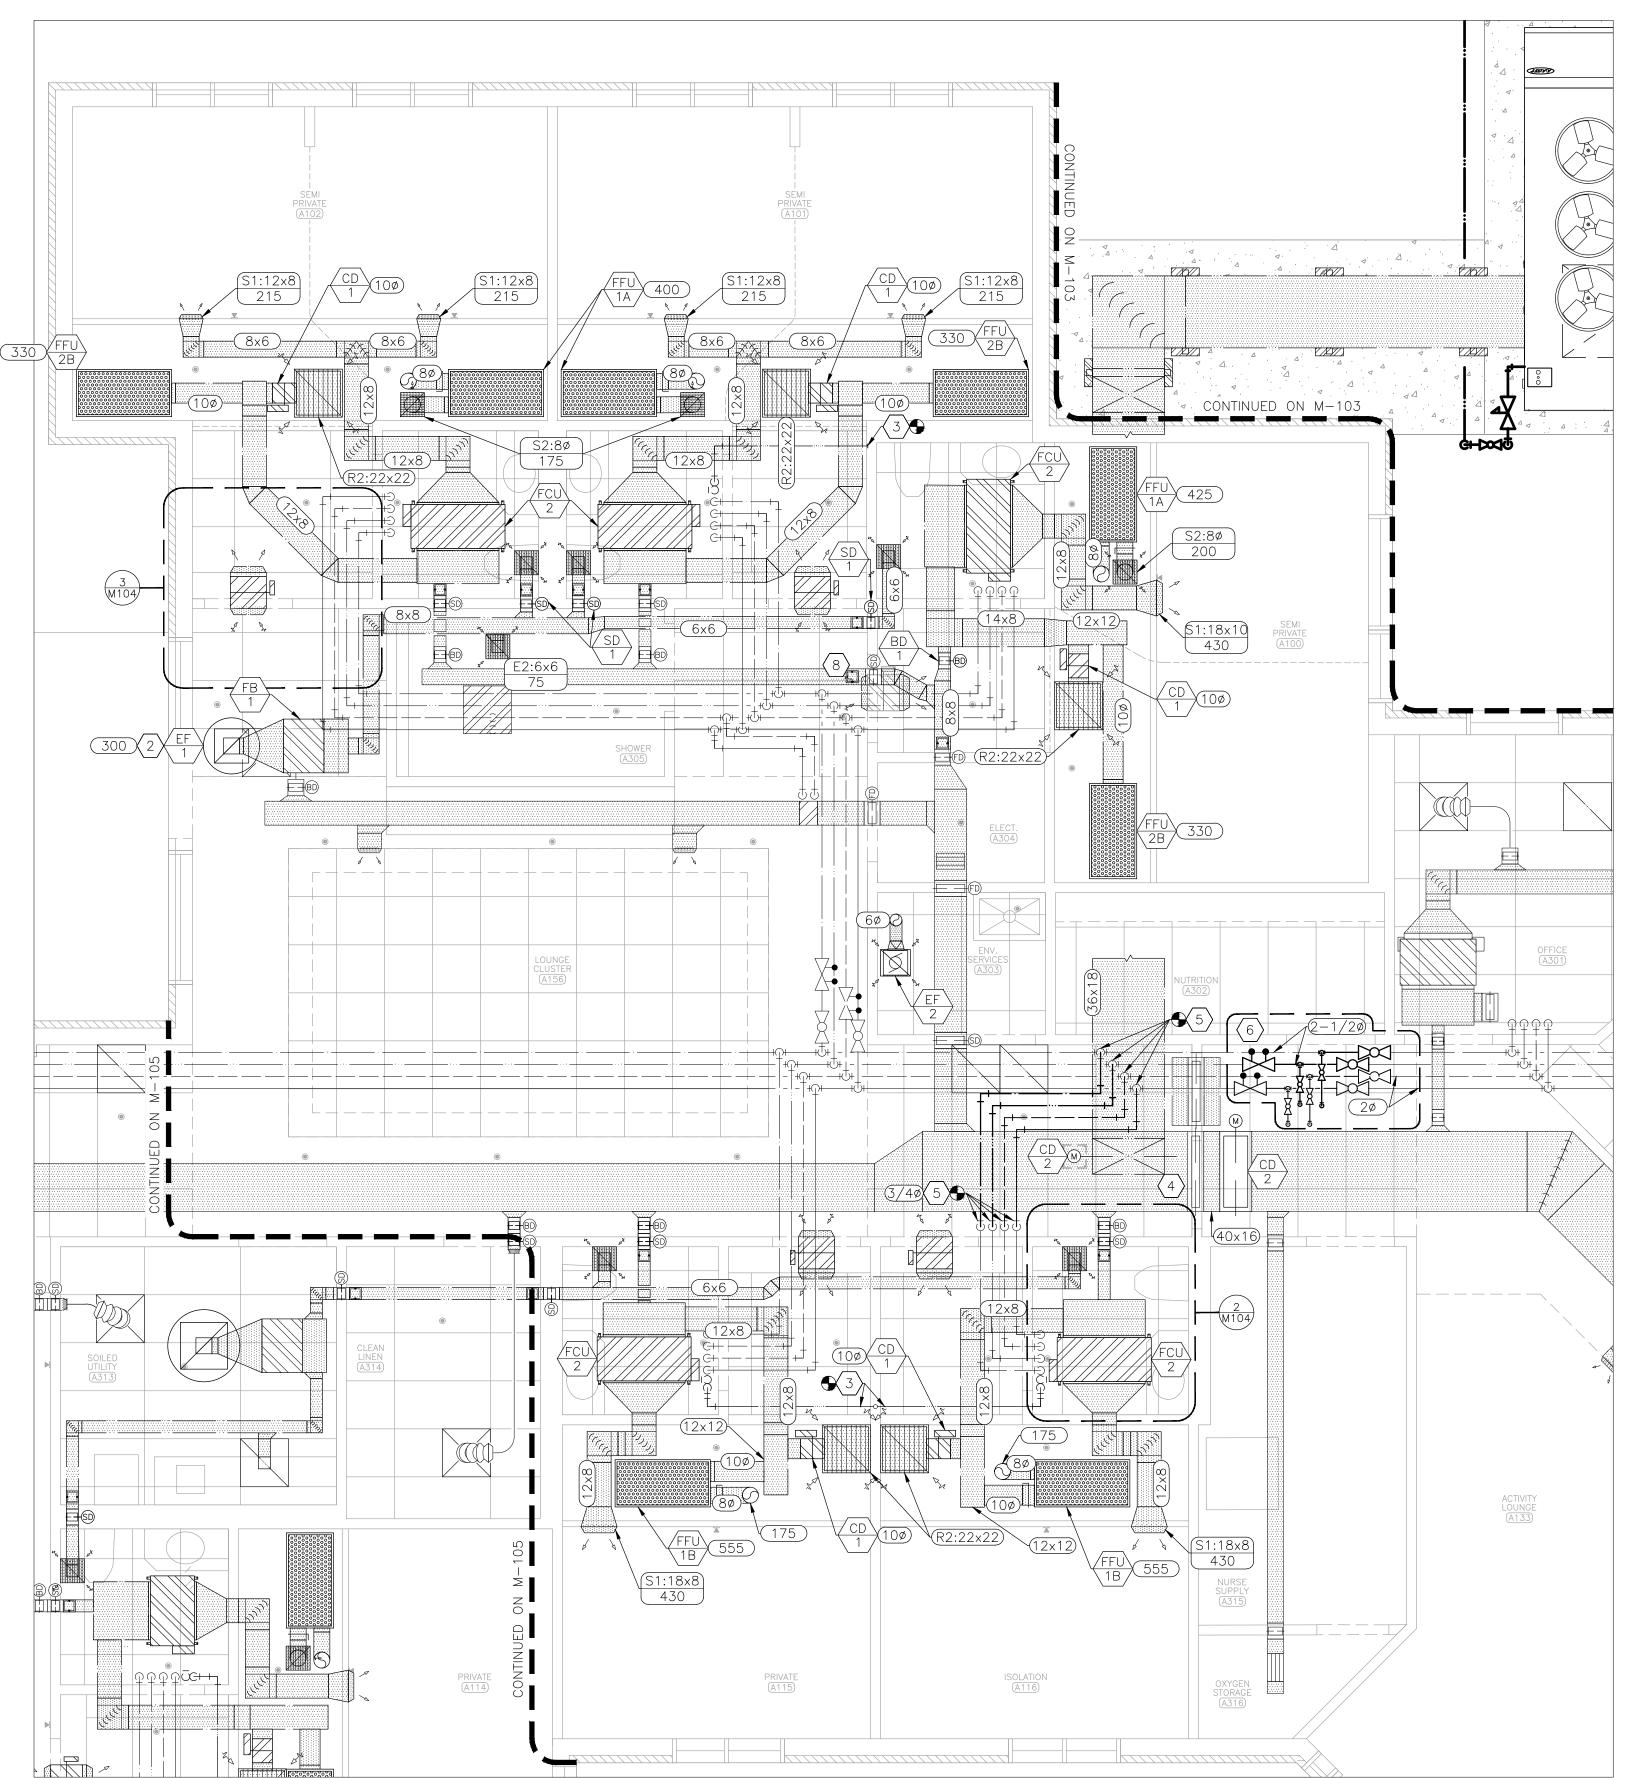
DESIGNED BY: TS/AH
SHEET TITLE:

MECHANICAL RENOVATION PLAN EXTERIOR

SHEET NUMBER:

M-103





MECHANICAL RENOVATION PLAN — LOUNGE CLUSTER A156

RENOVATION NOTES

- N INDICATES KEYED NOTES
- REFER TO M-101 FOR GENERAL RENOVATION NOTES. LOCATE ALL CONTROL DAMPERS (CD-1) SUCH THAT THE ACTUATOR IS ACCESSIBLE FROM THE LAYIN CEILING OF THE BEDROOM ENTRY. PROVIDE ACCESS DOOR AD-2 FOR ALL DUCT MOUNTED SMOKE OR FIRE DAMPERS.
- ROUTE EXHAUST DUCT THROUGH ATTIC TO ROOF AND INSTALL NEW EXHAUST FAN WITH ASSOCIATED ROOF CURB. REFER TO DETAIL 1 OF SHEET M-601 FOR ROOF CURB INSTALLATION.
- PROVIDE AND INSTALL NEW CONDENSATE DRAIN PIPE ABOVE NEW CEILING HEIGHT. ROUTE AS SHOWN AND CONNECT TO EXISTING DRAIN PIPE.
- ROUTE DUCT IN ATTIC SPACE TO PENETRATE CEILING ABOVE EXISTING SUPPLY DUCT. ROUTE TO CONNECT WITH EXISTING SUPPLY DUCT. COORDINATE WITH GENERAL CONTRACTOR TO PROVIDE ACCESS DOOR IN ATTIC ABOVE ACTUATOR FOR FUTURE ACCESS TO ACTUATOR AND DAMPER. REFER TO ARCHITECTURAL SHEETS FOR ADDITIONAL INFORMATION.
- $\overline{5}$ ROUTE NEW HYDRONIC PIPE AS SHOWN.
- PROVIDE AND INSTALL ISOLATION BALL VALVES ON THE CHILLED AND HEATING WATER SUPPLY AND RETURN PIPES. INSTALL BALANCE VALVES ON EACH RETURN PIPE. INSTALL 1 INCH PIPE TEE ON TOP OF PIPE AS SHOWN WITH BALL VALVE AND HOSE BIBB FOR CONNECTION TO PORTABLE PUMP FOR CLEANING AND FLUSHING.

HVAC LEGEND

DIRECTION OF FLOW

FIRE DAMPER

SMOKE DAMPER

BALANCE DAMPER

BALANCING VALVE

DEVICE SCHEDULE TAG

(R1:18x30) RETURN AIR DEVICE: NECK SIZE (INCHES)

PIPE SIZE (INCHES DIAMETER)

EQUIPMENT - EXISTING

SUPPLY AIR - EXISTING

RETURN AIR — EXISTING

EXHAUST AIR — EXISTING

----- CHILLED WATER RETURN - NEW

———— HEATING WATER RETURN — NEW

CHILLED WATER SUPPLY - EXISTING

CHILLED WATER RETURN — EXISTING

HEATING WATER SUPPLY - EXISTING

HEATING WATER RETURN — EXISTING

- CONDENSATE DRAIN PIPE - NEW

HEATING WATER SUPPLY - NEW

EQUIPMENT - NEW

SUPPLY AIR - NEW

RETURN AIR — NEW

------ EXHAUST AIR - NEW

------ OUTSIDE AIR - NEW

BALL VALVE

CONNECT TO EXISTING EQUIPMENT

DETAIL REFERENCE, NUMBER/SHEET

CONTROL DAMPER - MOTORIZED


AIR DEVICE: NECK SIZE (INCHES)/CFM

DUCT SIZE-ROUND (INCHES DIAMETER)


AIR FLOW (CUBIC FEET PER MINUTE)

DUCT SIZE-RECTANGULAR (INCHES X INCHES)


- SIZE EQUAL TO FAN COIL UNIT RETURN DUCT OPENING AND TO ALLOW FOR RETURN BRANCH DUCT CONNECTION.
- $\langle 8 \rangle$ Provide and install duct access door (AD-2) in existing duct.

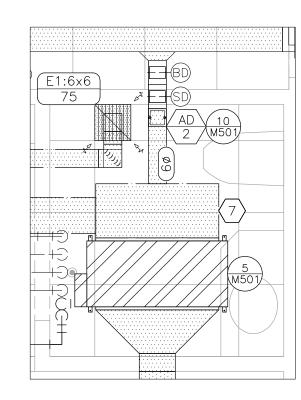

TYPICAL FAN COIL UNIT INSTALLATION

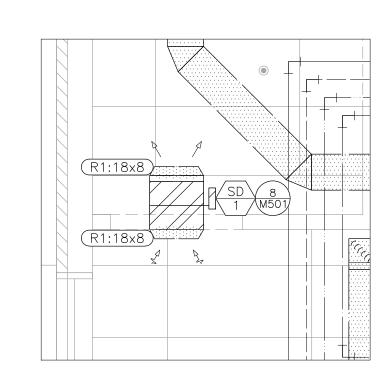

TYPICAL TRANSFER GRILLE INSTALLATION

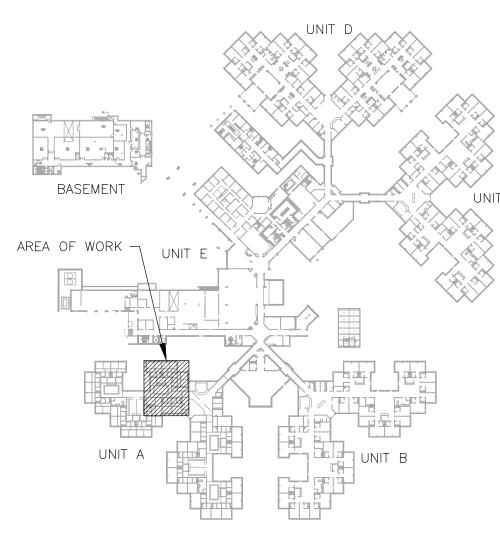

4 AREA MAP	
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(A)	PE-2013019114
٧	FISTONAL ENCE
Trac	cie L. Siebeneck - Engineer
	MO# PE-2013019114

STATE OF MISSOURI

MIKE KEHOE,

GOVERNOR

DOCUMENTS

OFFICE OF ADMINISTRATION DIVISION OF FACILITIES MANAGEMENT, DESIGN AND CONSTRUCTION

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CAD DWG FILE:M_U2301-07
DRAWN BY: AH
CHECKED BY: TS
DESIGNED BY: TS/AH

SHEET TITLE:

MECHANICAL RENOVATION PLAN LOUNGE A156

SHEET NUMBER:

M-104

PRIVATE (A109) R2:22×22 PRIVATE (A110) SEMI PRIVATE (A111)

MECHANICAL RENOVATION PLAN — LOUNGE CLUSTER A146

RENOVATION NOTES

- N INDICATES KEYED NOTES
- REFER TO M-101 FOR GENERAL RENOVATION NOTES. LOCATE ALL CONTROL DAMPERS (CD-1) SUCH THAT THE ACTUATOR IS ACCESSIBLE FROM THE LAYIN CEILING OF THE BEDROOM ENTRY. PROVIDE ACCESS DOOR AD-2 FOR ALL DUCT MOUNTED SMOKE OR FIRE DAMPERS. REFER TO M-104 DETAIL 2 FOR TYPICAL FAN COIL UNIT INSTALLATION AND DETAIL 3 FOR TYPICAL TRANSFER GRILLE INSTALLATION.
- PROUTE EXHAUST DUCT THROUGH ATTIC TO ROOF AND INSTALL NEW EXHAUST FAN WITH ASSOCIATED ROOF CURB. REFER TO DETAIL 1 OF SHEET M-601 FOR ROOF CURB INSTALLATION.

HVAC LEGEND

DIRECTION OF FLOW

FIRE DAMPER

SMOKE DAMPER

BALANCE DAMPER

BALANCING VALVE

DEVICE SCHEDULE TAG

EQUIPMENT - EXISTING

SUPPLY AIR — EXISTING

RETURN AIR — EXISTING

EQUIPMENT - NEW

SUPPLY AIR - NEW

RETURN AIR — NEW

EXHAUST AIR - NEW

AIR DEVICE: NECK SIZE (INCHES)/CFM

DUCT SIZE-ROUND (INCHES DIAMETER)

AIR FLOW (CUBIC FEET PER MINUTE)

- CHILLED WATER SUPPLY - EXISTING

CHILLED WATER RETURN — EXISTING

HEATING WATER SUPPLY — EXISTING

HEATING WATER RETURN — EXISTING

CONDENSATE DRAIN PIPE — NEW

RETURN AIR DEVICE: NECK SIZE (INCHES)

DUCT SIZE-RECTANGULAR (INCHES X INCHES)

BALL VALVE

CONNECT TO EXISTING EQUIPMENT

- PROVIDE AND INSTALL NEW CONDENSATE DRAIN PIPE ABOVE NEW CEILING HEIGHT. ROUTE AS SHOWN AND CONNECT TO EXISTING DRAIN PIPE.
- 4 INSTALL RETAINED SUPPLY AIR DEVICE IN NEW LOCATION. ROUTE DUCT BACK TO EXISTING SMOKE DAMPER AS SHOWN.

STATE OF MISSOURI MIKE KEHOE, GOVERNOR



Tracie L. Siebeneck - Engineer MO# PE-2013019114

DOCUMENTS

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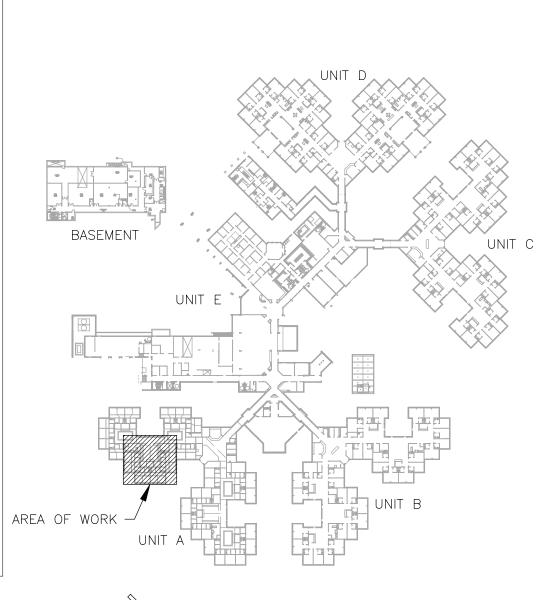
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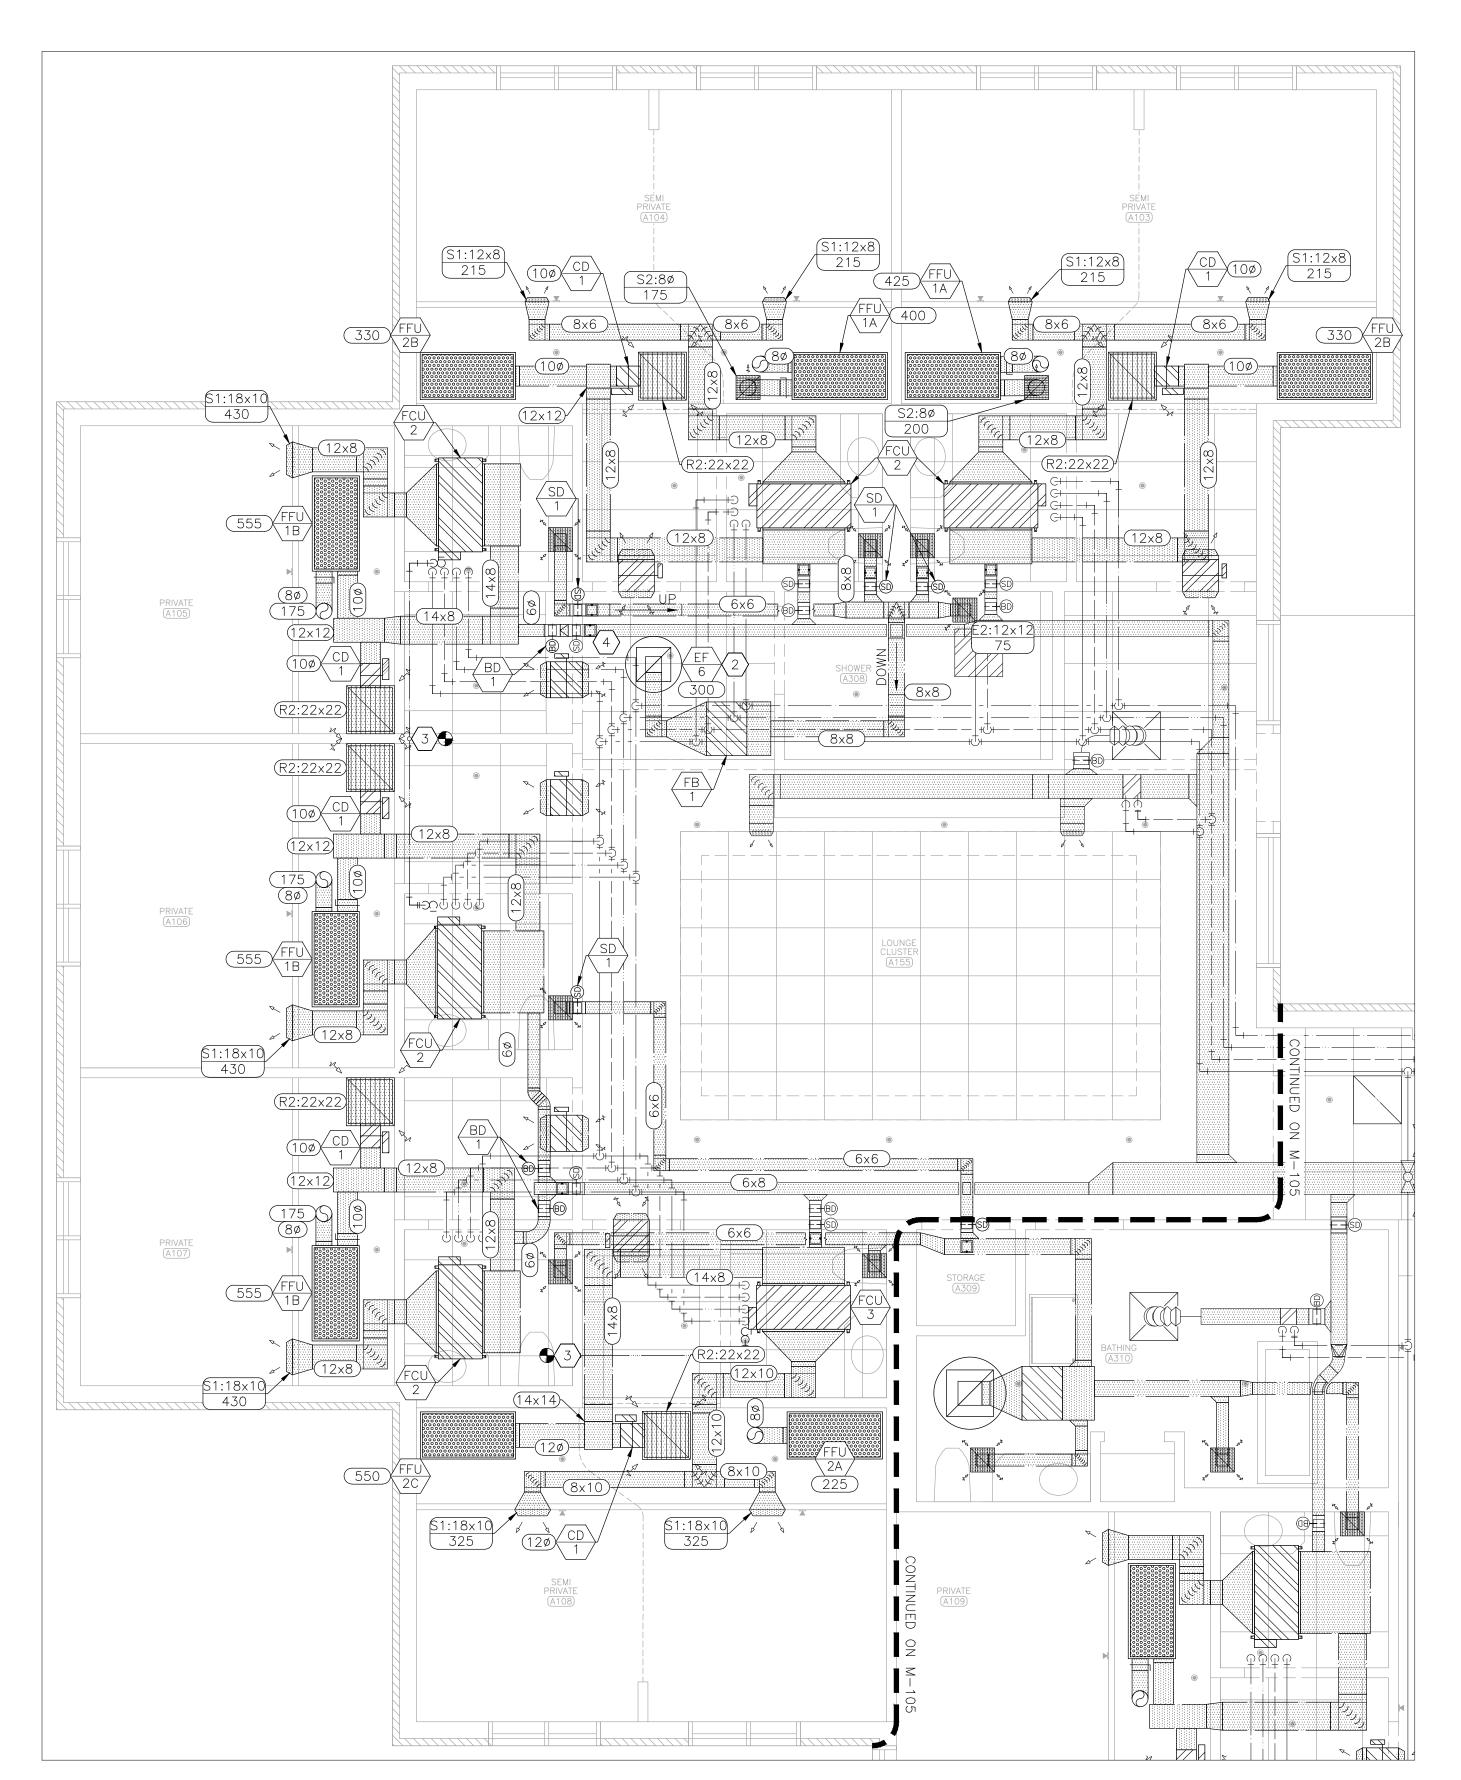
SHEET TITLE:

MECHANICAL RENOVATION PLAN LOUNGE A146

SHEET NUMBER:

M-105





MECHANICAL RENOVATION PLAN — LOUNGE CLUSTER A155

RENOVATION NOTES

- N INDICATES KEYED NOTES
- REFER TO M-101 FOR GENERAL RENOVATION NOTES. LOCATE ALL CONTROL DAMPERS (CD-1) SUCH THAT THE ACTUATOR IS ACCESSIBLE FROM THE LAYIN CEILING OF THE BEDROOM ENTRY. PROVIDE ACCESS DOOR AD-2 FOR ALL DUCT MOUNTED SMOKE OR FIRE DAMPERS. REFER TO M-104 DETAIL 2 FOR TYPICAL FAN COIL UNIT INSTALLATION AND DETAIL 3 FOR TYPICAL TRANSFER GRILLE INSTALLATION.

HVAC LEGEND

DIRECTION OF FLOW

FIRE DAMPER

SMOKE DAMPER

BALANCE DAMPER

BALANCING VALVE

DEVICE SCHEDULE TAG

(R1:18x30) RETURN AIR DEVICE: NECK SIZE (INCHES)

EQUIPMENT - EXISTING

SUPPLY AIR — EXISTING

RETURN AIR — EXISTING

EQUIPMENT - NEW

SUPPLY AIR - NEW

RETURN AIR - NEW

EXHAUST AIR - NEW

AIR DEVICE: NECK SIZE (INCHES)/CFM

DUCT SIZE-ROUND (INCHES DIAMETER)

AIR FLOW (CUBIC FEET PER MINUTE)

- CHILLED WATER SUPPLY - EXISTING

CHILLED WATER RETURN — EXISTING

HEATING WATER SUPPLY — EXISTING

HEATING WATER RETURN — EXISTING


- CONDENSATE DRAIN PIPE - NEW

DUCT SIZE-RECTANGULAR (INCHES X INCHES)

BALL VALVE

CONNECT TO EXISTING EQUIPMENT

- ROUTE EXHAUST DUCT THROUGH ATTIC TO ROOF AND INSTALL NEW EXHAUST FAN WITH ASSOCIATED ROOF CURB. REFER TO DETAIL 1 OF SHEET M-601 FOR ROOF CURB INSTALLATION.
- PROVIDE AND INSTALL NEW CONDENSATE DRAIN PIPE ABOVE NEW CEILING HEIGHT. ROUTE AS SHOWN AND CONNECT TO EXISTING DRAIN PIPE.
- 4 PROVIDE AND INSTALL DUCT ACCESS DOOR (AD-2) IN EXISTING DUCT.

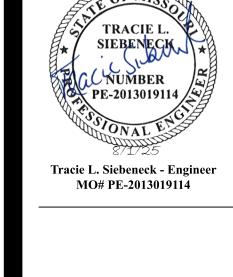

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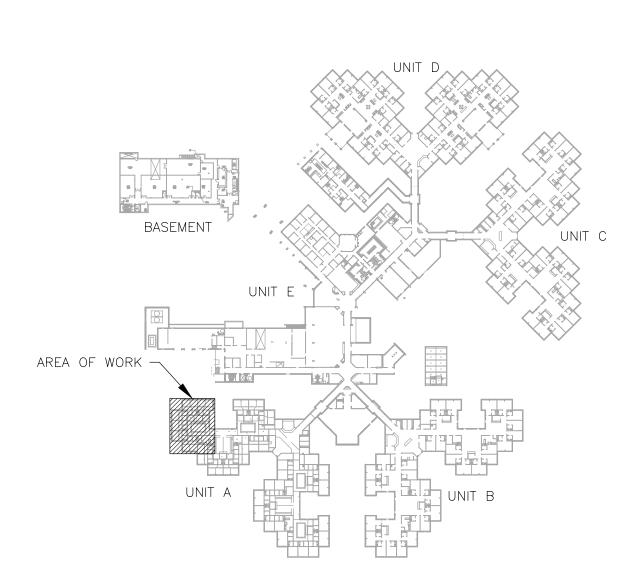
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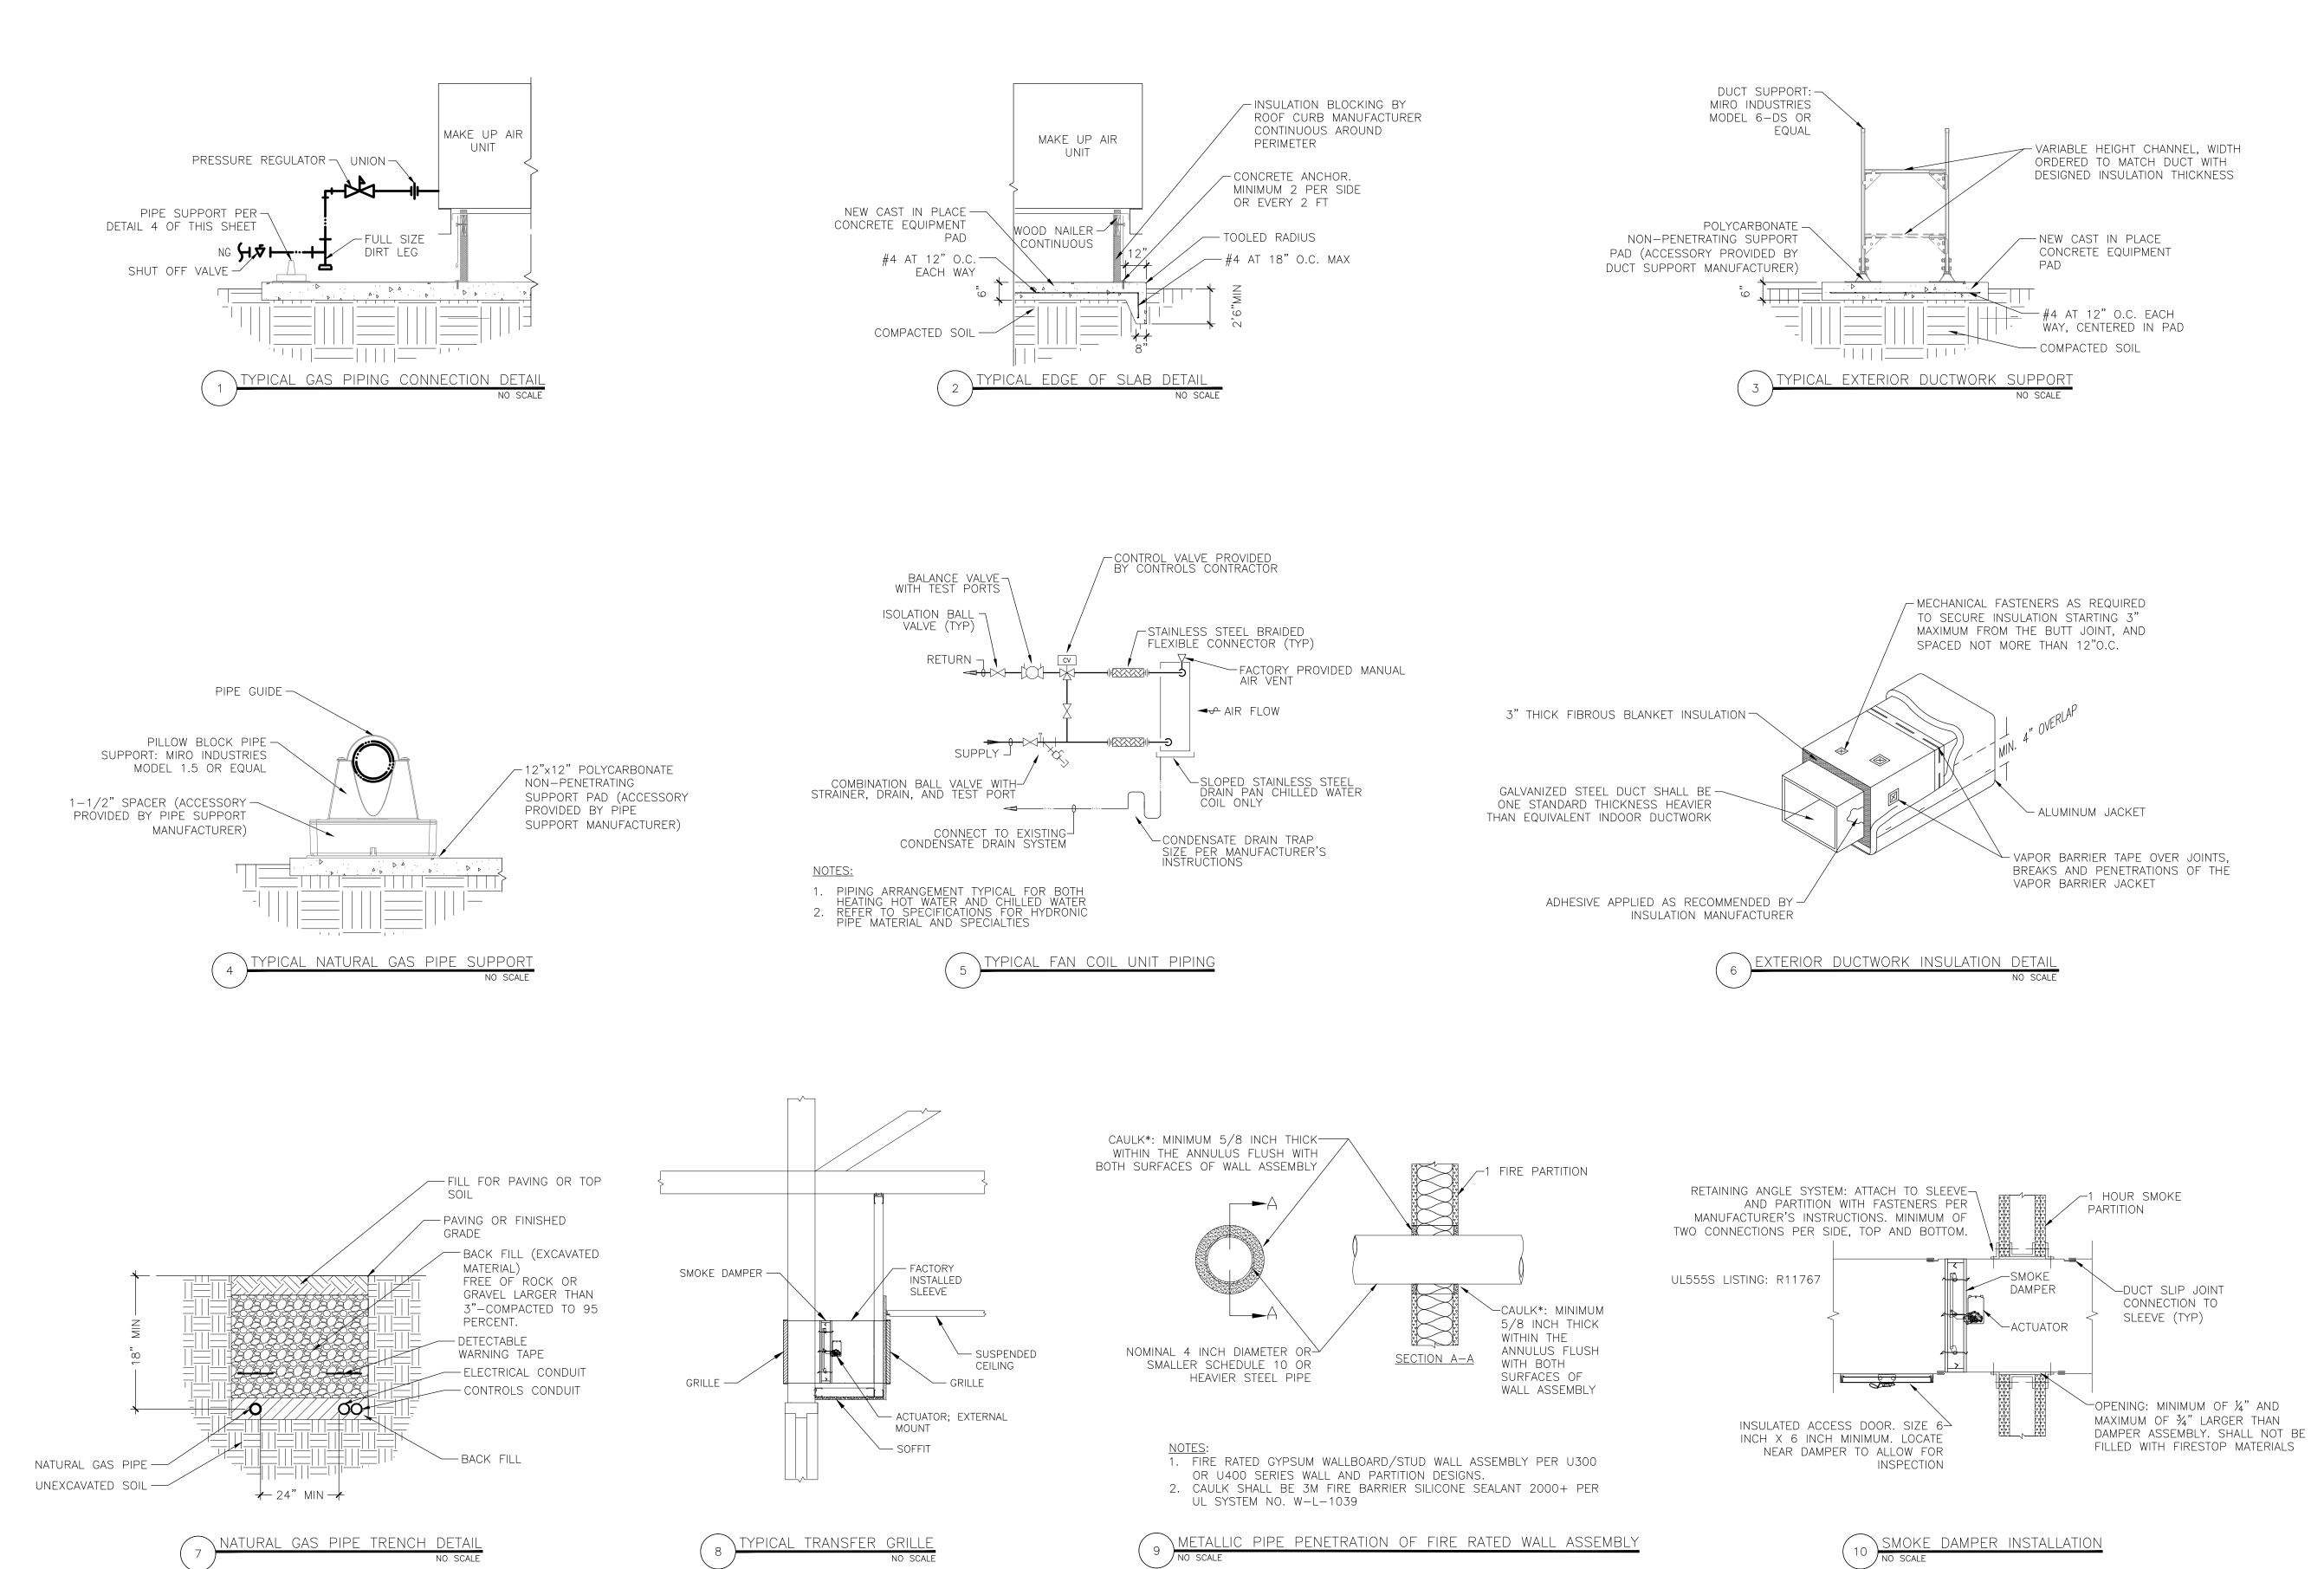
SHEET TITLE:

MECHANICAL RENOVATION PLAN LOUNGE A155

SHEET NUMBER:

M-106





STATE OF MISSOURI MIKE KEHOE, GOVERNOR



Tracie L. Siebeneck - Engineer MO# PE-2013019114

SOCUMENTS

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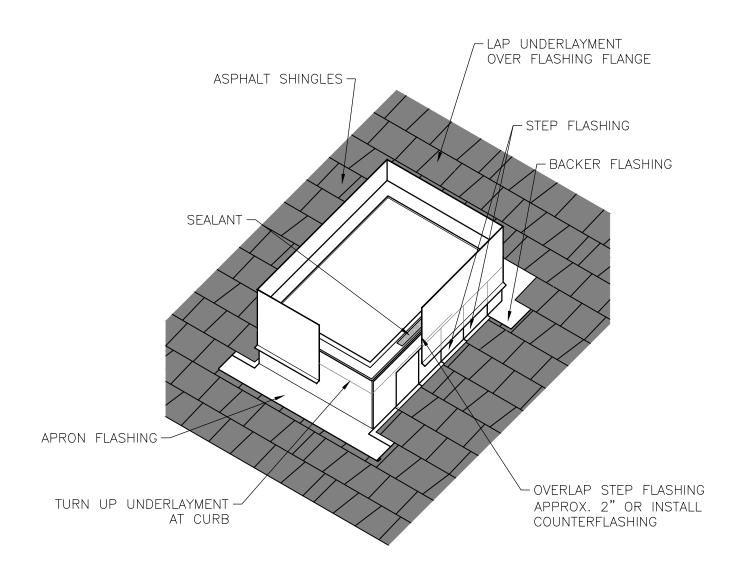
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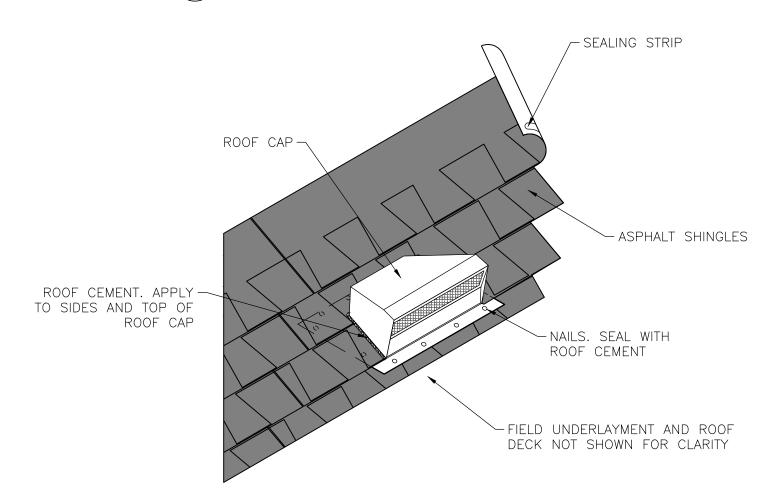
MECHANICAL DETAILS

SHEET NUMBER:

M-50



EXHAUST FAN ROOF CURB INSTALLATION NO SCALE



EXHAUST ROOF CAP INSTALLATION NO SCALE

MAKE	UP AIR UNIT S	SCHEDULE																			
								COOLING						HEATING				ELECTRICAL			
MARK	MANUFACTURER	MODEL	OUTDOOR AIRFLOW (CFM)	ESP (IN WG)	CAPACITY TOTAL (MBH)	CAPACITY SENSIBLE (MBH)	EAT (db°F/wb°F)	COIL LAT (db°F/wb°F)	REHEAT COIL CAPACITY (MBH)	REHEAT COIL LAT (db°F/wb°F)	EER/IEER	CAPACITY TOTAL (MBH)	INPUT (MBH)	EAT (db°F/wb°F)		TURNDOWN RATIO	VOLTS PHASE	MCA	МОР	WEIGHT (LBS)	NOTES
MAU-3	AAON	RNA-040-D-A-3	4910-6000	1	465.3	294.8	94.6/73.3	46.1/46	179.4	75/58.2	9.99/13.23	486	600	4.9/4.9	79.8/50.2	10.0:1	480/3	96	110	5990	1,2,3,4,5,6, 7

DESIGN CONDITIONS: SUMMER (COOLING): 94.6/73.3°F; SUMMER (DEHUMIDIFICATION) 86/76.8°F; WINTER 4.9°F

- DESIGN AIRFLOW IS 4910 CFM, UNIT SHALL HAVE CAPACITY UP TO 6000 CFM; TAB: ADJUST TO AIRFLOW REQUIRED TO ACHIEVE -0.01 IN WG BEDROOM NEGATIVE PRESSURE (MINIMUM)
- 3 PROVIDE TERMINAL STRIP FOR FIELD SUPPLIED DDC CONTROLS BY OTHERS
- 4 PROVIDE VARIABLE CAPACITY COMPRESSOR WITH MODULATING HOT GAS REHEAT; STAINLESS STEEL DRAIN PAN; STAINLESS STEEL HEAT EXCHANGER; SUPPLY BLOWER WITH FACTORY VFD; ECM CONDENSOR FAN
- 5 PROVIDE FACTORY MOUNTED, NON-FUSED DISCONNECT; FACTORY INSTALLED CONVENIENCE OUTLET
 6 PROVIDE UV LIGHTING FOR COIL SANATIZING; 30% EFFICIENT PREFILTER, MERV 14 FINAL FILTER
- 7 PROVIDE FACTORY INSULATED, HORIZONTAL DISCHARGE ROOF CURB FOR CONCRETE PAD MOUNTING

FAN C	OIL UNIT SCH	IEDULE																		
					FAN DATA				COOLI	NG COIL DAT	·A			НО	T WATER CO	IL DATA				
MARK	MANUFACTURER	MODEL	AIRFLOW (CFM)	ESP	MOTOR (HP)	MOTOR AMPS		CAPACITY SENSIBLE (MBH)	GPM	EWT/LWT (°F)	EAT (db°F/wb°F)	COIL LAT (db°F/wb°F)	CAPACITY TOTAL (MBH)	GPM	EWT/LWT (°F)	EAT (db°F)	COIL LAT (db°F)	VOLTS PHASE	LENGTH x WIDTH x HEIGHT (INCHES)	NOTES
FCU-1	ENGINEERED AIR	HFC4	314	0.5	0.17	3.7	13.48	8.91	2.3	44/54	80/67	53.7/52.9	19.5	2.7	180/165.2	62	119.6	120/1	22x35x10.5	1,2
FCU-2	ENGINEERED AIR	HFC6	440	0.5	0.17	3.7	18.01	12.27	3.6	44/54	80/67	54.2/53.6	27.09	2.9	180/160.9	62	119.0	120/1	22x47x10.5	1,2
FCU-3	ENGINEERED AIR	HFC6	655	0.5	0.17	3.7	22.21	16.27	3.8	44/55.7	80/67	57.3/56.3	32.13	2.2	180/150.1	62	107.4	120/1	22x47x10.5	1,2
NOTES																				

1	PROVIDE WITHOUT AIR FILTER
2	PROVIDE RIGHT OR LEFT HAND CONFIGURATION AS SHOWN ON PLANS; STAINLESS STEEL DRAIN PAN; FACTORY MOUNTED AIR VENT
	FAN FILTER UNITS SCHEDULE

MARK	MANUFACTURER	MODEL	SIZE (INCHES)	FILTERS	EXTERNAL STATIC PRESSURE (IN WG)	EXHAUST RETURN DUCT SIZE (INCH)	VOLTAGE/PHASE	DESCRIPTION	NOTES
FFU-1A	PRICE	PURAFLO DUAL OUTLET	24x48	MERV 8 HEPA	0.20-0.25	8 Ø 8 Ø	208/1	HOUSING: ALUMINUM PLENUM; ROOMSIDE ACCESS FOR FILTER REPLACEMENT AND MAINTENANCE; FILTER: EXTRUDED ALUMINUM FRAME WITH URETHANE GEL; CONSTANT FLOW	1,2,3,4
FFU-1B	PRICE	PURAFLO DUAL OUTLET	24x48	MERV 8 HEPA	0.20-0.25	8 Ø 10 Ø	208/1	HOUSING: ALUMINUM PLENUM; ROOMSIDE ACCESS FOR FILTER REPLACEMENT AND MAINTENANCE; FILTER: EXTRUDED ALUMINUM FRAME WITH URETHANE GEL; CONSTANT FLOW	1,2,3,4
FFU-2A	PRICE	PURAFLO SINGLE OUTLET	24x48	MERV 8 HEPA	0.20-0.25	8 Ø	208/1	HOUSING: ALUMINUM PLENUM; ROOMSIDE ACCESS FOR FILTER REPLACEMENT AND MAINTENANCE; FILTER: EXTRUDED ALUMINUM FRAME WITH URETHANE GEL; CONSTANT FLOW	1,2,3
FFU-2B	PRICE	PURAFLO SINGLE OUTLET	24x48	MERV 8 HEPA	0.20-0.25	10 Ø	208/1	HOUSING: ALUMINUM PLENUM; ROOMSIDE ACCESS FOR FILTER REPLACEMENT AND MAINTENANCE; FILTER: EXTRUDED ALUMINUM FRAME WITH URETHANE GEL; CONSTANT FLOW	1,2,3
FFU-2C	PRICE	PURAFLO SINGLE OUTLET	24x48	MERV 8 HEPA	0.20-0.25	12 Ø	208/1	HOUSING: ALUMINUM PLENUM; ROOMSIDE ACCESS FOR FILTER REPLACEMENT AND MAINTENANCE; FILTER: EXTRUDED ALUMINUM FRAME WITH URETHANE GEL; CONSTANT FLOW	1,2,3
FFU-3	PRICE	PURAFLO SINGLE OUTLET	24x24	MERV 8 HEPA	0.20-0.25	10 Ø	208/1	HOUSING: ALUMINUM PLENUM; ROOMSIDE ACCESS FOR FILTER REPLACEMENT AND MAINTENANCE; FILTER: EXTRUDED ALUMINUM FRAME WITH URETHANE GEL; CONSTANT FLOW	1,2,3,5

NOTES ***FAN FILTER UNITS ARE SOLE SOURCE ONLY***

- 1 PROVIDE FACTORY MOUNTED DISCONNECT SWITCH, PRICE HOSPITAL GRADE MOUNTING FRAME MODEL HGMF
- PROVIDE HANGER BRACKETS, BROAN NUTONE ROOF CAP MODEL 634 OR EQUAL FOR ALL EXHAUST DUCT
 PROVIDE BACnet FLOW CONTROLLER WITH MOTOR AND FILTER STATUS
- 4 PROVIDE METROPOLITAN AIR TECHNOLOGY UNIVERSAL DAMPER DRIVE MODEL RT-WGA OR EQUAL FOR REMOTE BALANCE DAMPER OPERATION
- 5 PROVIDE BACnet FLOW CONTROLLER SERVICE TOOL TO OWNER; PROVIDE TWO TOTAL SERVICE TOOLS WITH PROJECT

FILTER	BOX SCHEDU	JLE					
MARK	MANUFACTURER	MODEL	DIMENSIONS LxWxD	FILTERS	MAXIMUM AIRFLOW ACROSS FILTER (CFM)	INLET/OUTLET SIZE (INCHxINCH)	DESCRIPTION
FB-1	CANARM HVAC	HFB-12	26-13/16"x20-1/8" x12-1/5"	MERV 8 HEPA	930	22-1/2x10-1/2"	HOUSING: SHEET METAL FRAME; SIDE ACCESS FOR FILTER REPLACEMENT AND MAINTENANCE; FILTER: EXTURDED ALUMINUM FRAME WITH SEAMLESS GASKET

EXHA	UST FAN SCHI	EDULE						
MARK	MANUFACTURER	MODEL	AIRFLOW (CFM)	ESP (IN WG)	VOLTS/PHASE	НР	WEIGHT (LBS)	NOTES
EF-1	PENNBARRY	PRD-080	300	0.64	120/1	1/6	38	1,2
EF-2	PENNBARRY	Z8-GP	75	0.25	120/1	1/10	20	3,4
EF-3	PENNBARRY	PRD-150	375	0.92	120/1	1/2	53	1,2
EF-4	PENNBARRY	PRD-150	375	0.92	120/1	1/2	53	1,2
EF-5	PENNBARRY	PRD-150	525	1.5	120/1	1/2	53	1,2,5
EF-6	PENNBARRY	PRD-080	300	0.64	120/1	1/6	38	1,2
NOTES								
1	PROVIDE BACDRAFT	DAMPER, BIRD SCRI	EEN, AND MANUFAC	TURER ROOF CURB	FOR SLOPED ROOF INS	TALLATION		
2	UNIT TO BE CONTRO	LLED BY STATIC PRE	SSURE SENSOR TO M	1AINTAIN CONSTAN	T FLOWRATE			
3	PROVIDE ALUMINUM	I PERFORATED GRIL	LE WITH WHITE FINIS	SH				
4	PROVIDE ROOF CAP I	FOR SLOPED ROOF II	NSTALLATION, ROOF	CAP SHALL HAVE BI	RD SCREEN AND BACK	DRAFT DAMPER; R	REFERENCE DETAIL 2	, M-601
5	PROVIDE FACTORY M	MOUNT VFD TO CON	VERT PROVIDED 120	V/1Ø TO 203V/3Ø				

SMOK	E DAMPER SO	CHEDULE				
MARK	MANUFACTURER	MODEL	SIZE (INCHxINCH)	TYPE	SPECIFICATION	NOTES
SD-1	POTTORFF	SD-141	MATCH DUCT	DYNAMIC TRIPLE-V	FRAME: 13 GAUGE CHANNEL FRAME; BLADES: 6"x16 GAUGE GALVANIZED STEEL-TRIPLE V; SLEEVE: 16"x18 GAUGE GALVANIZED STEEL	1
NOTES						
1	PROVIDE BELIMO 12	0 VAC ACTUATOR M	ODEL FSLF120			

DUCT	ACCESS DOO	R			
MARK	MANUFACTURER	MODEL	SIZE (INCH x INCH)	TYPE	SPECIFICATION
AD-2	ACUDOR	CD-5080	6 x 6	DUCT ACCESS DOOR	DOOR: 24 GAUGE GALVANIZED STEEL; FRAME: 24 GAUGE GALVANIZED STEEL; GASKETING: 1/8" THICK BY 1/2" WIDE CLOSED NEOPRENE; CAM LATCH: SELF TIGHTENING

AIK D	EVICE SCHEDL	ILE	1			
MARK	MANUFACTURER	MODEL	FACE SIZE (INCHxINCH)	TYPE	SPECIFICATION	NOTE
S1	PRICE	520D	SEE PLANS	SUPPLY SURFACE MOUNT LOUVERED	MATERIAL: STEEL; FINISH: WHITE; BLADES: DOUBLE DEFLECTION W/ 3/4 INCH BLADE SPACING AND PARALLEL TO LONG DIMENSION; DAMPER: INTEGRAL	1
S2	PRICE	SMD	14x14	SUPPLY SURFACE MOUNT LOUVERED	MATERIAL: STEEL; FINISH: WHITE; CORE: "1S", ONE WAY THROW; FRAME: SURFACE MOUNT TYPE 6 BEVELLED	2
R1	PRICE	535	SEE PLANS	RETURN SURFACE MOUNT LOUVERED	MATERIAL: STEEL; FINISH: WHITE; BLADES: SINGLE 45° DEFLECTION W/ 1/2 INCH BLADE SPACING AND PARALLEL TO LONG DIMENSION	
R2	PRICE	10FF	24x24	RETURN SURFACE MOUNT PERFORATED	MATERIAL: STEEL; FINISH: WHITE; FILTER FRAME: SURFACE MOUNT W/ BELOW CEILING ACCESS, 2 INCH FILTER MEDIA	3
E1	PRICE	PDDR	12x12	EXHAUST LAY-IN MOUNT PERFORATED	MATERIAL: STEEL; FINISH: WHITE	1
E2	PRICE	PDDR	12x12	EXHAUST SURFACE MOUNT PERFORATED	MATERIAL: STEEL; FINISH: WHITE; FRAME: SURFACE MOUNT STYLE 1	1
BD-1	POTTORFF	CD-10R	N/A	BALANCE DAMPER SINGLE BLADE ROUND	FRAME: 2"x20 GAUGE GALVANIZED STEEL; BLADES: 22 GAUGE GALVANIZED STEEL SQUARE/RECTANGULAR; AXLES: 3/8" SQUARE PLATED STEEL; LINKAGE: CONCEALED IN FRAME; BEARINGS: SYNTHETIC; CONTROL SHAFT: 3/8"x3" SQUARE DRIVE AXLE	4
CD-1	POTTORFF	CD-25R	N/A	CONTROL DAMPER SINGLE BLADE ROUND	FRAME: 12"x20 GAUGE GALVANIZED STEEL; BLADES: 14 GAUGE GALVANIZED STEEL ROUND; AXLES: 1/2" DIAMETER PLATED STEEL; CONTROL SHAFT: 1/2"x3" DRIVE AXLE	5
CD-2	POTTORFF	CD-52	N/A	CONTROL DAMPER OPPOSED BLADE RECTANGULAR	FRAME: 5"x1" 13 GAUGE GALVANIZED STEEL; BLADES: 6" HEAVY GAUGE, DUAL WALL EXTRUDED ALUMINUM AIRFOIL; AXLES: 1/2" DIAMETER PLATED STEEL; CONTROL SHAFT: 1/2"x6" DRIVE AXLE	5,6
OTES			,	1	, ·	
1	PROVIDE INTEGRAL O					
2	PROVIDE SQUARE TO					
3				<u>′</u>	RACTOR SHALL PROVIDE MERV 13 FILTER	
4	PROVIDE 1-1/2 INCH (N.	
5 6	PROVIDE FACTORY IN			<u> </u>	JL	

STATE OF MISSOURI MIKE KEHOE, GOVERNOR



Tracie L. Siebeneck - Engineer MO# PE-2013019114

> BID DOCUMENTS

OFFICE OF ADMINISTRATION DIVISION OF FACILITIES MANAGEMENT, DESIGN AND CONSTRUCTION

DEPARTMENT OF PUBLIC SAFETY/ VETERANS COMMISSION

HVAC IMPROVEMENTS FOR INFECTION CONTROL

WARRENSURG VETERANS HOME 1300 VETERANS DRIVE, WARRENSBURG, MO 64093

ASSET # 8136806001

PROJECT # U2301-07 SITE # 6806

REVISION:
DATE:
REVISION:
DATE:
REVISION:
DATE:
DATE:

ISSUE DATE: 08/01/2025

CAD DWG FILE:M_U2301-07
DRAWN BY: AH
CHECKED BY: TS

DESIGNED BY: TS/AH
SHEET TITLE:

MECHANICAL SCHEDULES AND

SHEET NUMBER:

DETAILS

M-601

CONTROL NOTES


THIS FACILITY HAS AN EXISTING SCHNEIDER ELECTRIC BUILDING AUTOMATION SYSTEM. INTEGRATION OF EQUIPMENT CONTROL SHALL BE PROVIDED BY DYNAMIC CONTROLS INC .:

STEVE BEVERLY 1214 NE WINDSOR ST. LEE'S SUMMIT, MO 64086 816.820.2815

CONTROLS CONTRACTOR SHALL PROVIDE AND INSTALL ALL CONTROL ITEMS REQUIRED TO IMPLEMENT THE SEQUENCE OF OPERATION INCLUDING, BUT NOT LIMITED TO, CONTROLLERS, CONTROL WIRING, CONTROL DAMPER ACTUATORS, CONTROL VALVE ACTUATORS, AND ROOM PRESSURE SENSORS, EXCEPT SENSORS PROVIDED BY EQUIPMENT MANUFACTURER.

REFER TO RENOVATION NOTE 1 ON SHEET M-101 FOR ROOM PRESSURE SENSOR MODEL INFORMATION. REFER TO DETAIL 1 ON SHEET M-101 FOR ROOM PRESSURE SENSOR AND DISPLAY LOCATIONS. CONTROLS CONTRACTOR SHALL PROVIDE ALL PROGRAMMING AND GRAPHICS REQUIRED TO INTEGRATE NEW EQUIPMENT INTO THE EXISTING CONTROLS SYSTEM:

- 1. PROVIDE A RADIO BUTTON TO SET WING A100 INTO AIRBORNE INFECTION ISOLATION MODE (AIIM).
- SEE SEQUENCE OF OPERATION FOR MORE INFORMATION. 2. PROVIDE A GRAPHIC FOR MAU-3 AND EACH FAN FILTER UNIT IN EACH ROOM (FFU-1A, FFU-1B, FFU-2A, FFU-2B, FFU-2C, AND FFU-3). UPDATE FAN COIL UNIT GRAPHIC TO SHOW ADDITIONAL
- CONTROL DAMPER. ALL GRAPHICS SHALL ACCURATELY REPRESENT INSTALLED EQUIPMENT. 3. PROVIDE A LINK FROM THE GRAPHIC TO A COPY OF THE SEQUENCE OF OPERATION WHICH SHALL ACCURATELY REPRESENT SEQUENCE PROGRAMMING.

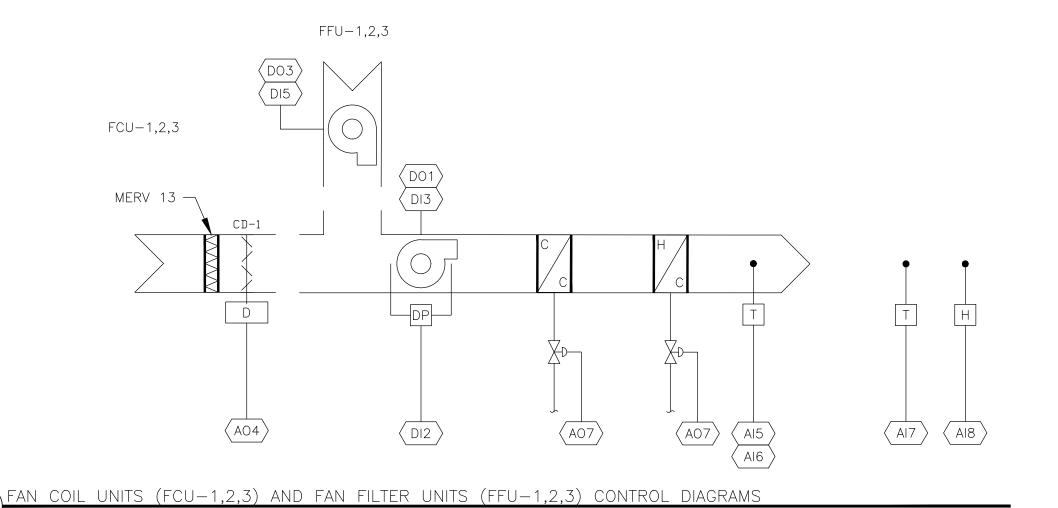

 $\MAKE-UP$ AIR UNIT 3 (MAU-3) CONTROL DIAGRAM

CONT	ROL LEGEND
VFD VFD	VARIABLE SPEED FAN
	CONSTANT SPEED FAN
	FILTER
CC	REFRIGERANT/CHILLED WATER COOLING COIL
HC	HOT WATER COIL
R H	MODULATING HOT-GAS REHEAT COIL
N G	NATURAL GAS HEATING COIL
والمحمط	CONTROL DAMPER
Ţ	TEMPERATURE SENSOR
I	RELATIVE HUMIDITY SENSOR
	DIFFERENTIAL PRESSURE SENSOR
K	CHILLED/HOT WATER CONTROL VALVE

OUTSIDE AIR TEMPERATURE OUTSIDE AIR RELATIVE HUMIDITY COOLING COIL (CC) LEAVING AIR TEMPERATURE CC LEAVING AIR TEMPERATURE SETPOINT UNIT LEAVING AIR TEMPERATURE UNIT LEAVING AIR TEMPERATURE SETPOINT ROOM AIR TEMPERATURE ROOM AIR RELATIVE HUMIDITY ANALOG OUTPUTS OUTSIDE AIR DAMPER COMMAND SUPPLY FAN SPEED COMPRESSOR SPEED

ANALOG INPUTS

DI2 SUPPLY FAN PRESSURE DROP DI3 SUPPLY FAN STATUS DI4 SMOKE DETECTOR STATUS DI5 FAN FILTER UNIT STATUS DI6 ROOM PRESSURE DIFFERENTIAL DI7 COMPRESSOR STATUS DIGITAL OUTPUTS DO1 SUPPLY FAN START/STOP COMMAND DO2 COMPRESSOR START/STOP COMMAND DO3 FAN FILTER UNIT START/STOP COMMAND	DI3 SUPPLY FAN STATUS DI4 SMOKE DETECTOR STATUS DI5 FAN FILTER UNIT STATUS DI6 ROOM PRESSURE DIFFERENTIAL DI7 COMPRESSOR STATUS DIGITAL OUTPUTS DO1 SUPPLY FAN START/STOP COMMAND DO2 COMPRESSOR START/STOP COMMAND	<u> </u>	FILTER PRESSURE DROP
DI4 SMOKE DETECTOR STATUS DI5 FAN FILTER UNIT STATUS DI6 ROOM PRESSURE DIFFERENTIAL DI7 COMPRESSOR STATUS DIGITAL OUTPUTS DO1 SUPPLY FAN START/STOP COMMAND DO2 COMPRESSOR START/STOP COMMAND	DI4 SMOKE DETECTOR STATUS DI5 FAN FILTER UNIT STATUS DI6 ROOM PRESSURE DIFFERENTIAL DI7 COMPRESSOR STATUS DIGITAL OUTPUTS DO1 SUPPLY FAN START/STOP COMMAND DO2 COMPRESSOR START/STOP COMMAND	DI2	SUPPLY FAN PRESSURE DROP
DIS FAN FILTER UNIT STATUS DIG ROOM PRESSURE DIFFERENTIAL DIT COMPRESSOR STATUS DIGITAL OUTPUTS DO1 SUPPLY FAN START/STOP COMMAND DO2 COMPRESSOR START/STOP COMMAND	DIS FAN FILTER UNIT STATUS DIG ROOM PRESSURE DIFFERENTIAL DIT COMPRESSOR STATUS DIGITAL OUTPUTS DO1 SUPPLY FAN START/STOP COMMAND DO2 COMPRESSOR START/STOP COMMAND	(DI3)	SUPPLY FAN STATUS
DIGITAL OUTPUTS DO1 SUPPLY FAN START/STOP COMMAND COMPRESSOR START/STOP COMMAND	DIGITAL OUTPUTS DO1 SUPPLY FAN START/STOP COMMAND COMPRESSOR START/STOP COMMAND	(DI4)	SMOKE DETECTOR STATUS
DIGITAL OUTPUTS DO1 SUPPLY FAN START/STOP COMMAND DO2 COMPRESSOR START/STOP COMMAND	DIGITAL OUTPUTS DO1 SUPPLY FAN START/STOP COMMAND DO2 COMPRESSOR START/STOP COMMAND	(DI5)	FAN FILTER UNIT STATUS
DIGITAL OUTPUTS DO1 SUPPLY FAN START/STOP COMMAND DO2 COMPRESSOR START/STOP COMMAND	DIGITAL OUTPUTS DO1 SUPPLY FAN START/STOP COMMAND DO2 COMPRESSOR START/STOP COMMAND	(DI6)	ROOM PRESSURE DIFFERENTIAL
\(\begin{aligned} \Do1 \rightarrow & SUPPLY FAN START/STOP COMMAND \\ \Do2 \rightarrow & COMPRESSOR START/STOP COMMAND \\ \end{aligned}	\(\begin{aligned} \Do1 \rightarrow & SUPPLY FAN START/STOP COMMAND \\ \Do2 \rightarrow & COMPRESSOR START/STOP COMMAND \\ \end{aligned}	(DI7)	COMPRESSOR STATUS
DO2 COMPRESSOR START/STOP COMMAND	DO2 COMPRESSOR START/STOP COMMAND	DIGIT	AL OUTPUTS
		(DO1)	SUPPLY FAN START/STOP COMMAND
(DO3) FAN FILTER UNIT START/STOP COMMAN	(DO3) FAN FILTER UNIT START/STOP COMMAN	(DO2)	COMPRESSOR START/STOP COMMAND
		(DO3)	FAN FILTER UNIT START/STOP COMMAN

SEQUENCE OF OPERATION

DEFINITIONS:

WING A100 - BEDROOMS, LIVING ROOMS, AND ALL ASSOCIATED ANTEROOMS SERVED BY AHU-4 DURING NORMAL OPERATION AND MAU-3 DURING AIRBORNE INFECTION ISOLATION OPERATION. BOUNDARY IS BETWEEN FIRE DOORS IN CORRIDOR.

WING A200 - BEDROOMS, LIVING ROOMS, AND ALL ASSOCIATED ANTEROOMS SERVED BY AHU-4 DURING NORMAL OPERATION AND DURING AIRBORNE INFECTION ISOLATION OPERATION. BOUNDARY IS BETWEEN FIRE DOORS IN CORRIDOR. FOR THE PURPOSE OF THIS PLAN SET, A200 INCLUDES ACTIVITY LOUNGE A133, NURSE STATION A301, AND ALL ASSOCIATED ANTEROOMS.

AIRBORNE INFECTION ISOLATION MODE (AIIM) - A STATE OF OPERATION FOR THE HVAC SYSTEM THAT CREATES A NEGATIVE PRESSURE RELATIONSHIP BETWEEN THE BEDROOMS, THE LIVING ROOMS, AND WING A200. HEPA FILTRATION IS PROVIDED FOR ALL EXHAUST AIR AND ALL AIR THAT IS RETURNED TO THE FAN COIL UNITS IN EACH BEDROOM. AIIM IS ESTABLISHED VIA A SETTING IN THE BUILDING AUTOMATION SYSTEM (BAS).

EQUIPMENT IN A100 SHALL OPERATE AS FOLLOWS DURING AIIM:

FAN COIL UNITS: SHALL OPERATE PER EXISTING SEQUENCE OF OPERATION TO MAINTAIN EXISTING SETPOINTS IN THE SPACE. FAN SHALL OPERATE CONTINUOUSLY.

CONTROL DAMPER IN DUCT FOR AHU-4 SHALL CLOSE AND CONTROL DAMPER IN DUCT FOR MAU-3 SHALL OPEN.

MAKEUP AIR UNIT (MAU-3): SHALL BE ENERGIZED AND FAN SHALL OPERATE CONTINUOUSLY.

FAN FILTER UNITS (FFU-1A, FFU-1B, FFU-2A, FFU-2B, FFU-2C, AND FFU-3): SHALL BE ENERGIZED AND FAN SHALL OPERATE CONTINUOUSLY PROVIDING HEPA FILTRATION.

RETURN AIR CONTROL DAMPERS (CD-1): SHALL MOVE TO A CLOSED POSITION TO PREVENT UNFILTERED RETURN AIR FROM ENTERING THE FAN COIL UNIT.

ROOM PRESSURE SENSORS: SHALL BE PLACED IN OCCUPIED MODE. WHEN SYSTEM IS NOT IN AIIM, SENSORS SHALL BE PLACED IN UNOCCUPIED MODE TO PREVENT UNNECESSARY ALARMS.

MAKEUP AIR UNIT (MAU-3) SEQUENCE OF OPERATION:

WHEN MAU IS ENERGIZED, THE SUPPLY FAN SHALL OPERATE CONTINUOUSLY AT THE DESIGN AIRFLOW AND THE UNIT SHALL HEAT OR COOL TO MAINTAIN MAU LEAVING AIR TEMPERATURE (LAT).

IF THE OUTDOOR AIR (OA) TEMPERATURE RISES ABOVE 72°F (ADJ), THE VARIABLE CAPACITY COMPRESSOR SHALL MODULATE TO PROVIDE A LAT OF 70°F (ADJ).

IF THE OA HUMIDITY RISES ABOVE 55%, THE VARIABLE CAPACITY COMPRESSOR SHALL MODULATE TO PROVIDE 55°F COOLING COIL LEAVING AIR TEMPERATURE AND THE MODULATING HOT GAS REHEAT SHALL MODULATE TO PROVIDE A MAU LEAVING AIR TEMPERATURE OF 70°F (ADJ).

IF THE OA TEMPERATURE FALLS BELOW 68°F, THE MODULATING NATURAL GAS HEATER SHALL ENERGIZE AND MODULATE TO PROVIDE A MAU LEAVING AIR TEMPERATURE OF 80°F (ADJ).

ALARMS:

IF THE MAU SMOKE DETECTOR IS ACTIVATED THE FAN SHALL SHUT DOWN VIA A HARD-WIRED INTERLOCK AND AN ALARM SHALL BE SENT TO THE FIRE ALARM CONTROL SYSTEM.

IF THE MAU FAN IS COMMANDED ON AND NO CURRENT IS REALIZED THROUGH A CURRENT RELAY SENSOR, AN ALARM SHALL BE GENERATED AT THE BAS. FFUS SHALL NOT ENERGIZE IF MAU FAN IS NOT OPERATING.

IF THE FFU FAN IS COMMANDED ON AND NO CURRENT IS REALIZED THROUGH A CURRENT RELAY SENSOR, AN ALARM SHALL BE GENERATED AT THE BAS.

AHU-4


MAU-3 ISOLATION DAMPER COMMAND

AHU-4 ISOLATION DAMPER COMMAND

CHILLED/HOT WATER VALVE COMMAND

AIR HANDLING UNIT (AHU-4) SHALL OPERATE PER EXISTING SEQUENCE OF OPERATION TO MAINTAIN EXISTING SETPOINTS IN THE SPACE DURING NORMAL MODE AND AIRBORNE INFECTION ISOLATION MODE. DURING AIRBORNE INFECTION ISOLATION MODE OUTSIDE AIR DAMPER SHALL OPEN TO PROVIDE 90%

SUPPLY FAN VFD AND RETURN FAN VFD SHALL BE CONTROLLED BY A DUCT PRESSURE SENSOR. WHEN THE DUCT DAMPER IS CLOSED TO WING A100, THE FANS SHALL SLOW BASED ON DUCT STATIC PRESSURE TO MAINTAIN AIRFLOW TO WING A200.

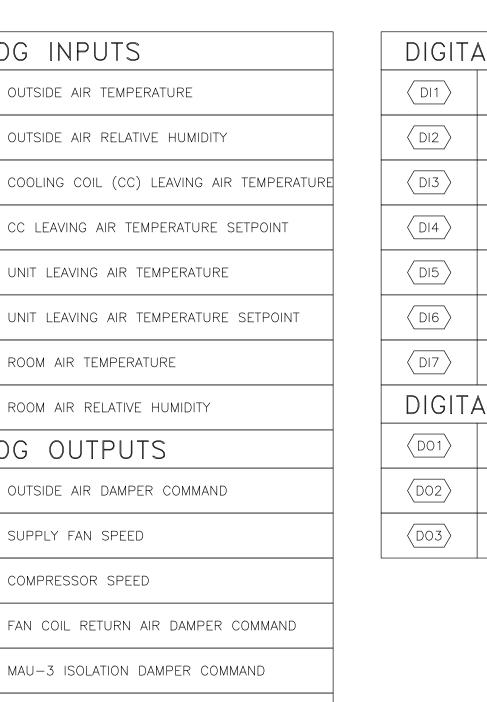

STATE OF MISSOURI MIKE KEHOE, **GOVERNOR**



Tracie L. Siebeneck - Engineer MO# PE-2013019114

OFFICE OF ADMINISTRATION DIVISION OF FACILITIES MANAGEMENT, **DESIGN AND CONSTRUCTION**

DEPARTMENT OF PUBLIC SAFETY/ **VETERANS COMMISSION**

HVAC IMPROVEMENTS FOR INFECTION CONTROL

WARRENSURG VETERANS HOME 1300 VETERANS DRIVE, WARRENSBURG, MO 64093

8136806001

PROJECT # U2301-07 6806

REVISION: DATE: **REVISION: REVISION:** DATE:

ASSET#


ISSUE DATE: 08/01/2025


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SHEET TITLE:

MECHANICAL CONTROLS DIAGRAMS

SHEET NUMBER:



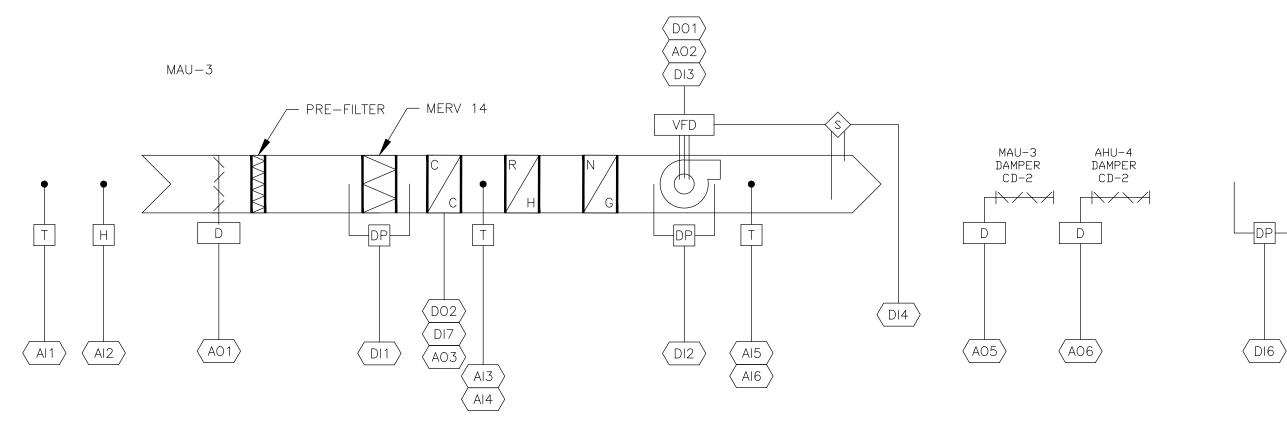

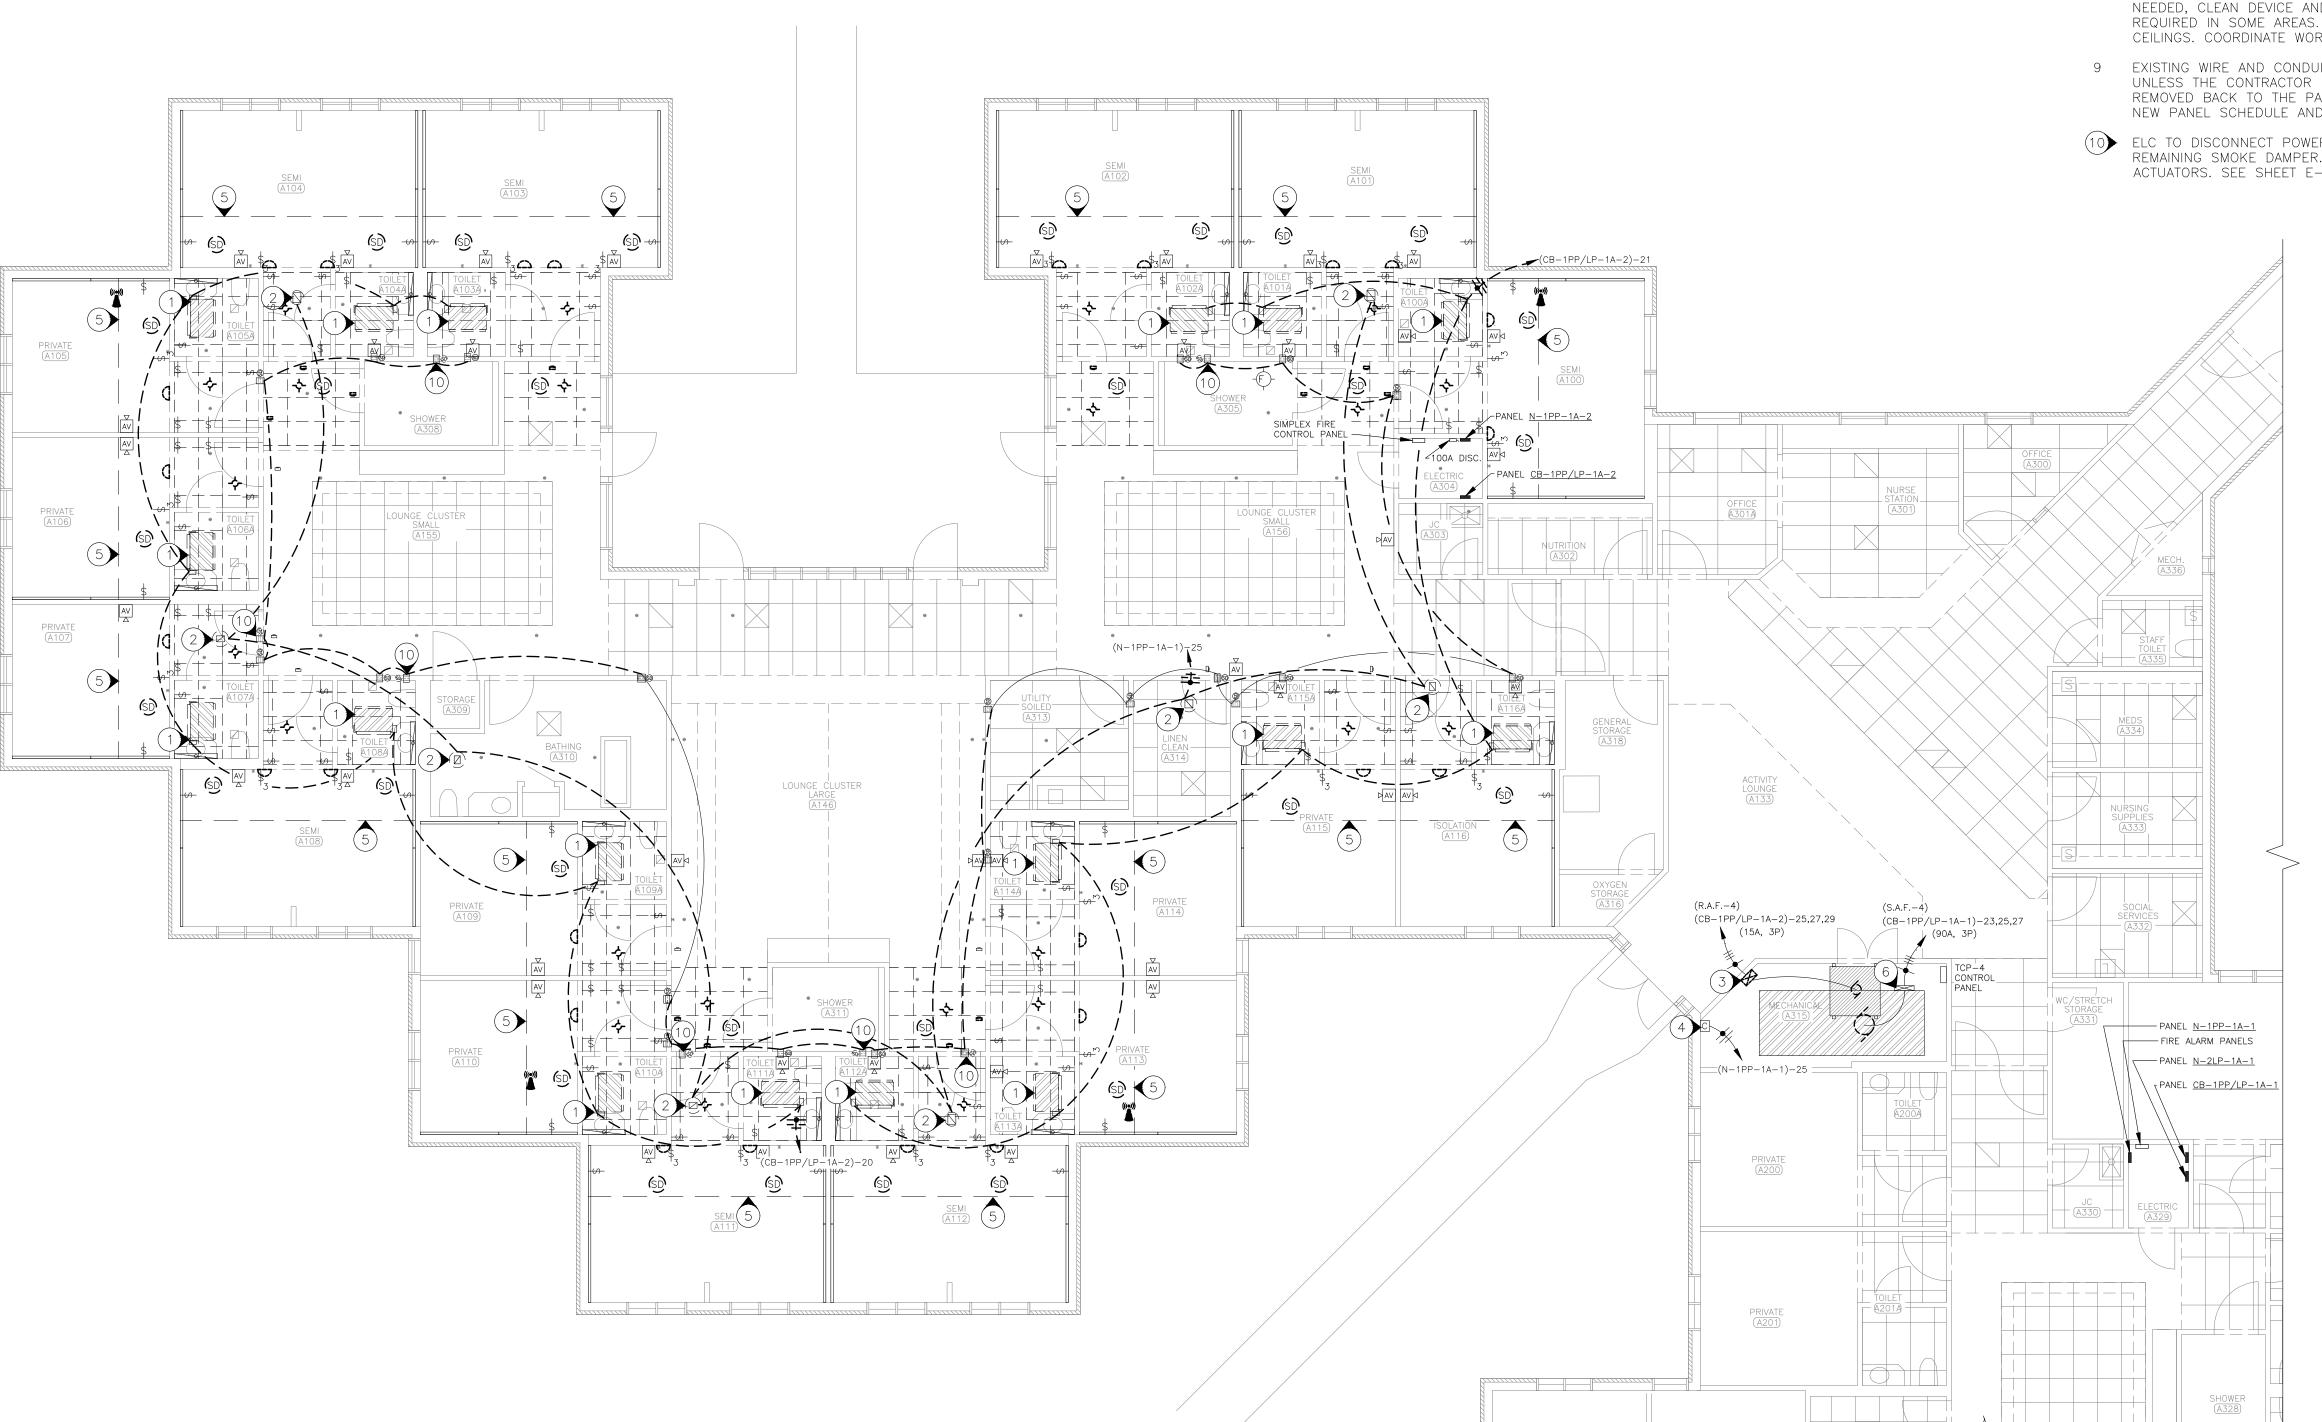
PARTIAL FIRST FLOOR PLAN ELECTRICAL DEMOLITION

DEMOLITION NOTES

N INDICATES KEYED NOTES

- ELECTRICAL CONTRACTOR (ELC) TO REMOVE EXISTING POWER TO THIS FAN COIL UNIT. COORDINATE WITH MECHANICAL CONTRACTOR. REMOVE CONDUIT AND WIRE AND ALL APPURTENANCES BACK TO ELECTRICAL PANEL AND MARK BREAKER AS SPARE. CONTRACTOR MAY REUSE CONDUIT IF BENEFICIAL (TYPICAL)
- ELC TO REMOVE POWER TO THIS EXHAUST FAN. COORDINATE WITH MECHANICAL CONTRACTOR. REMOVE CONDUIT AND WIRE AND ALL APPURTENANCES BACK TO ELECTRICAL PANEL UNLESS IT WILL BE USED IN THE NEW DESIGN
- 3 REMOVE EXISTING RELIEF AIR FAN MOTOR STARTER AND POWER CONNECTION. (TO BE REPLACED WITH VFD IN SAME LOCATION)
- EXISTING NEMA "O" SINGLE PHASE FULL VOLTAGE CONTACTOR. ALL EXHAUST FANS 47, 8, 9, & 10 ARE CIRCUITED TO HERE. CONTACTS ARE FED FROM PANEL (N-1PP-1A-1)-25. COIL IS ACTIVATED BY POWER ON AT AHU-4. COORDINATE WITH MECHANICAL ON NEW FAN ACTIVATION.
- THERE WILL BE CEILING/ELECTRICAL DEMOLITION FOR A NEW SOFFIT (LOCATION FOR NEW FFU'S)
 APPROXIMATELY 51" INTO EACH PATIENT ROOM. THE BOTTOM OF THE NEW SOFFIT IS TO MATCH THE EXISTING ENTRY CEILING HEIGHT. THERE ARE EXISTING WALL MOUNTED LIGHTS, SPRINKLER HEADS, CEILING MOUNTED SMOKE/CO2 SENSORS AND WIFI ACCESS POINTS THAT ARE IN AREA OF CONSTRUCTION IN SLIGHTLY DIFFERENT CONFIGURATIONS. POWER WIRING AND CONDUIT WILL NEED TO BE DISCONNECTED TO ALL THESE DEVICES. THESE DEVICES WILL BE RELOCATED TO A SIMILAR LOCATION IN NEW CEILING. ALL WIRE AND CONDUIT TO BE EXTENDED TO THE NEW DEVICE LOCATIONS. MOST OF THE FIRE ALARM STROBES ARE BELOW THE NEW SOFFIT LINE. IF THESE DEVICES ARE ABOVE THE NEW SOFFIT LINE, THEY TOO WILL NEED TO BE EXTENDED TO THE NEW LOCATION. NOT ALL ROOMS WERE VERIFIED. THE PLANS PROVIDED BY THE STATE WERE USED TO PLACE THE DEVICES AND MAY NOT BE ACCURATE OR COMPLETE. ELC TO VERIFY ALL DEVICES TO BE MOVED DURING BIDDING PHASE AND INCLUDED IN THE WORK. WIFI HAS BEEN ADDED SINCE THE PLANS WERE DRAWN.
- 6 EXISTING SUPPLY AIR FAN STARTER FOR AHU-4 IS TO BECOME A JUNCTION BOX AND REPLACED WITH NEW VFD ON WALL NEXT TO RAF-4 VFD. SEE E-102 FOR DETAILS.
- 7 IN EACH OF THE PATIENT RESTROOMS, THE EXISTING CEILING IS TO BE REMOVED TO ALLOW FOR NEW FCU LOCATIONS. GENERAL CONTRACTOR TO UPDATE SPRINKLER HEADS AS NEEDED TO MEET NEW CEILING AND SOFFIT LOCATIONS.
- WHERE CEILINGS ARE SHOWN TO BE REMOVED, HEAVIER DASHED LINES, ELC TO RELOCATE ANY AND ALL ELECTRICAL DEVICES TO NEW CEILING. ALL DEVICES MAY NOT BE SHOWN. ELC TO VERIFY. REMOVE POWER IF NEEDED, CLEAN DEVICE AND RELOCATE INTO EXISTING CEILING. SOME ADDITIONAL WIRE AND CONDUIT MAY BE REQUIRED IN SOME AREAS. ELC TO PROVIDE AND INSTALL ALL WIRE AND CONDUIT TO DEVICES IN NEW CEILINGS. COORDINATE WORK WITH GENERAL CONTRACTOR.
- 9 EXISTING WIRE AND CONDUIT SHOWN FOR DEMOLITION SHALL BE REMOVED BACK TO THE ELECTRICAL PANELS UNLESS THE CONTRACTOR PLANS TO REUSE IN NEW DESIGN. ALL UNUSED WIRE AND CONDUIT TO BE TOTALLY REMOVED BACK TO THE PANEL. IF A BREAKER NOW HAS NO LOADS, MARK AS SPARE AND TURN OFF. RETYPE NEW PANEL SCHEDULE AND PLACE IN PROTECTIVE SLEEVE.
- ELC TO DISCONNECT POWER TO THIS DUCT MOUNTED SMOKE DAMPER. REMOVE WIRE AND CONDUIT TO NEXT REMAINING SMOKE DAMPER. ALSO DEMO EXISTING WIRE TO MAKE NEW CONNECTIONS TO NEW SMOKE ACTUATORS. SEE SHEET E-102 FOR NEW SMOKE DAMPER LOCATIONS.

ELECT	TRICAL LEGEND
\$	EXISTING LIGHT SWITCH (TO REMAIN)
\$ ₃	EXISTING 3-WAY LIGHT SWITCH (TO REMAIN)
DAV	AUDIO/VISUAL DEVICE (TO REMAIN)
⊳ [AV]	AUDIO/VISUAL DEVICE (RELOCATE)
SD	SMOKE/CO2 DETECTOR (TO REMAIN)
(SD)	SMOKE/CO2 DETECTOR (RELOCATE)
((•)))	WIFI ACCESS POINT (RELOCATE)
	NURSE CALL LIGHT (TO REMAIN)
	NURSE CALL LIGHT (RELOCATE TO NEW CLG.
-\$-	CAN LIGHT (TO BE RELOCATED TO NEW CLG.
	EXISTING SURFACE MOUNTED PANELBOARD
	HOME RUN-SHORT STROKES INDICATE PHAS OR SWITCHED WIRES, LONG STROKE INDICAT NEUTRAL, LONG WITH DOT INDICATE GROUNI
•	CLG MTD SPKLR HEAD-(COORD. RELOCATION
	WALL SPKLR HEAD (COORDINATE RELOCATION
	DEMO EX FAN BY OTHERS(ELC DEMO POWER
	MECHANICAL EQUIPMENT REMOVED BY OTHERS. (ELC TO REMOVE POWER)
	ELECTRICAL WIRE/CONDUIT (TO REMAIN)
/	ELECTRICAL WIRE/CONDUIT (TO BE REMOVED)
——————————————————————————————————————	EXISTING CEILING GRID BEING REPLACED. ELC TO RELOCATE ALL ELECTRICAL DEVICES
9	EXISTING MOTOR TO BE REMOVED/REPLACED
	EXISTING MOTOR STARTER TO BE REMOVED
® =	EXISTING DUCT SMOKE DAMPER (REMOVE)
₽ 9	EXISTING DUCT SMOKE DAMPER (REMAINS)

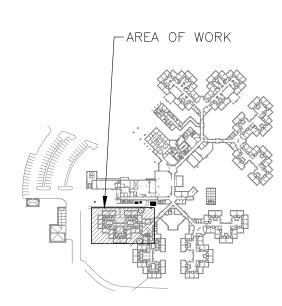



STATE OF MISSOURI MIKE KEHOE, GOVERNOR





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OFFICE OF ADMINISTRATION
DIVISION OF FACILITIES
MANAGEMENT,
DESIGN AND CONSTRUCTION

DEPARTMENT OF PUBLIC SAFETY/ VETERANS COMMISSION

HVAC IMPROVEMENTS FOR INFECTION CONTROL

WARRENSBURG VETERANS HOME 1300 VETERANS ROAD WARRENSBURG, MO 64093

PROJECT # U2301-07 SITE # 6806 FACILITY # 8136806001

REVISION:
DATE:
REVISION:
DATE:
REVISION:
DATE:
ISSUE DATE: 08-01-25

CAD DWG FILE:MIFIC-e.dwg
DRAWN BY: MDS
CHECKED BY: JLD
DESIGNED BY: JLD

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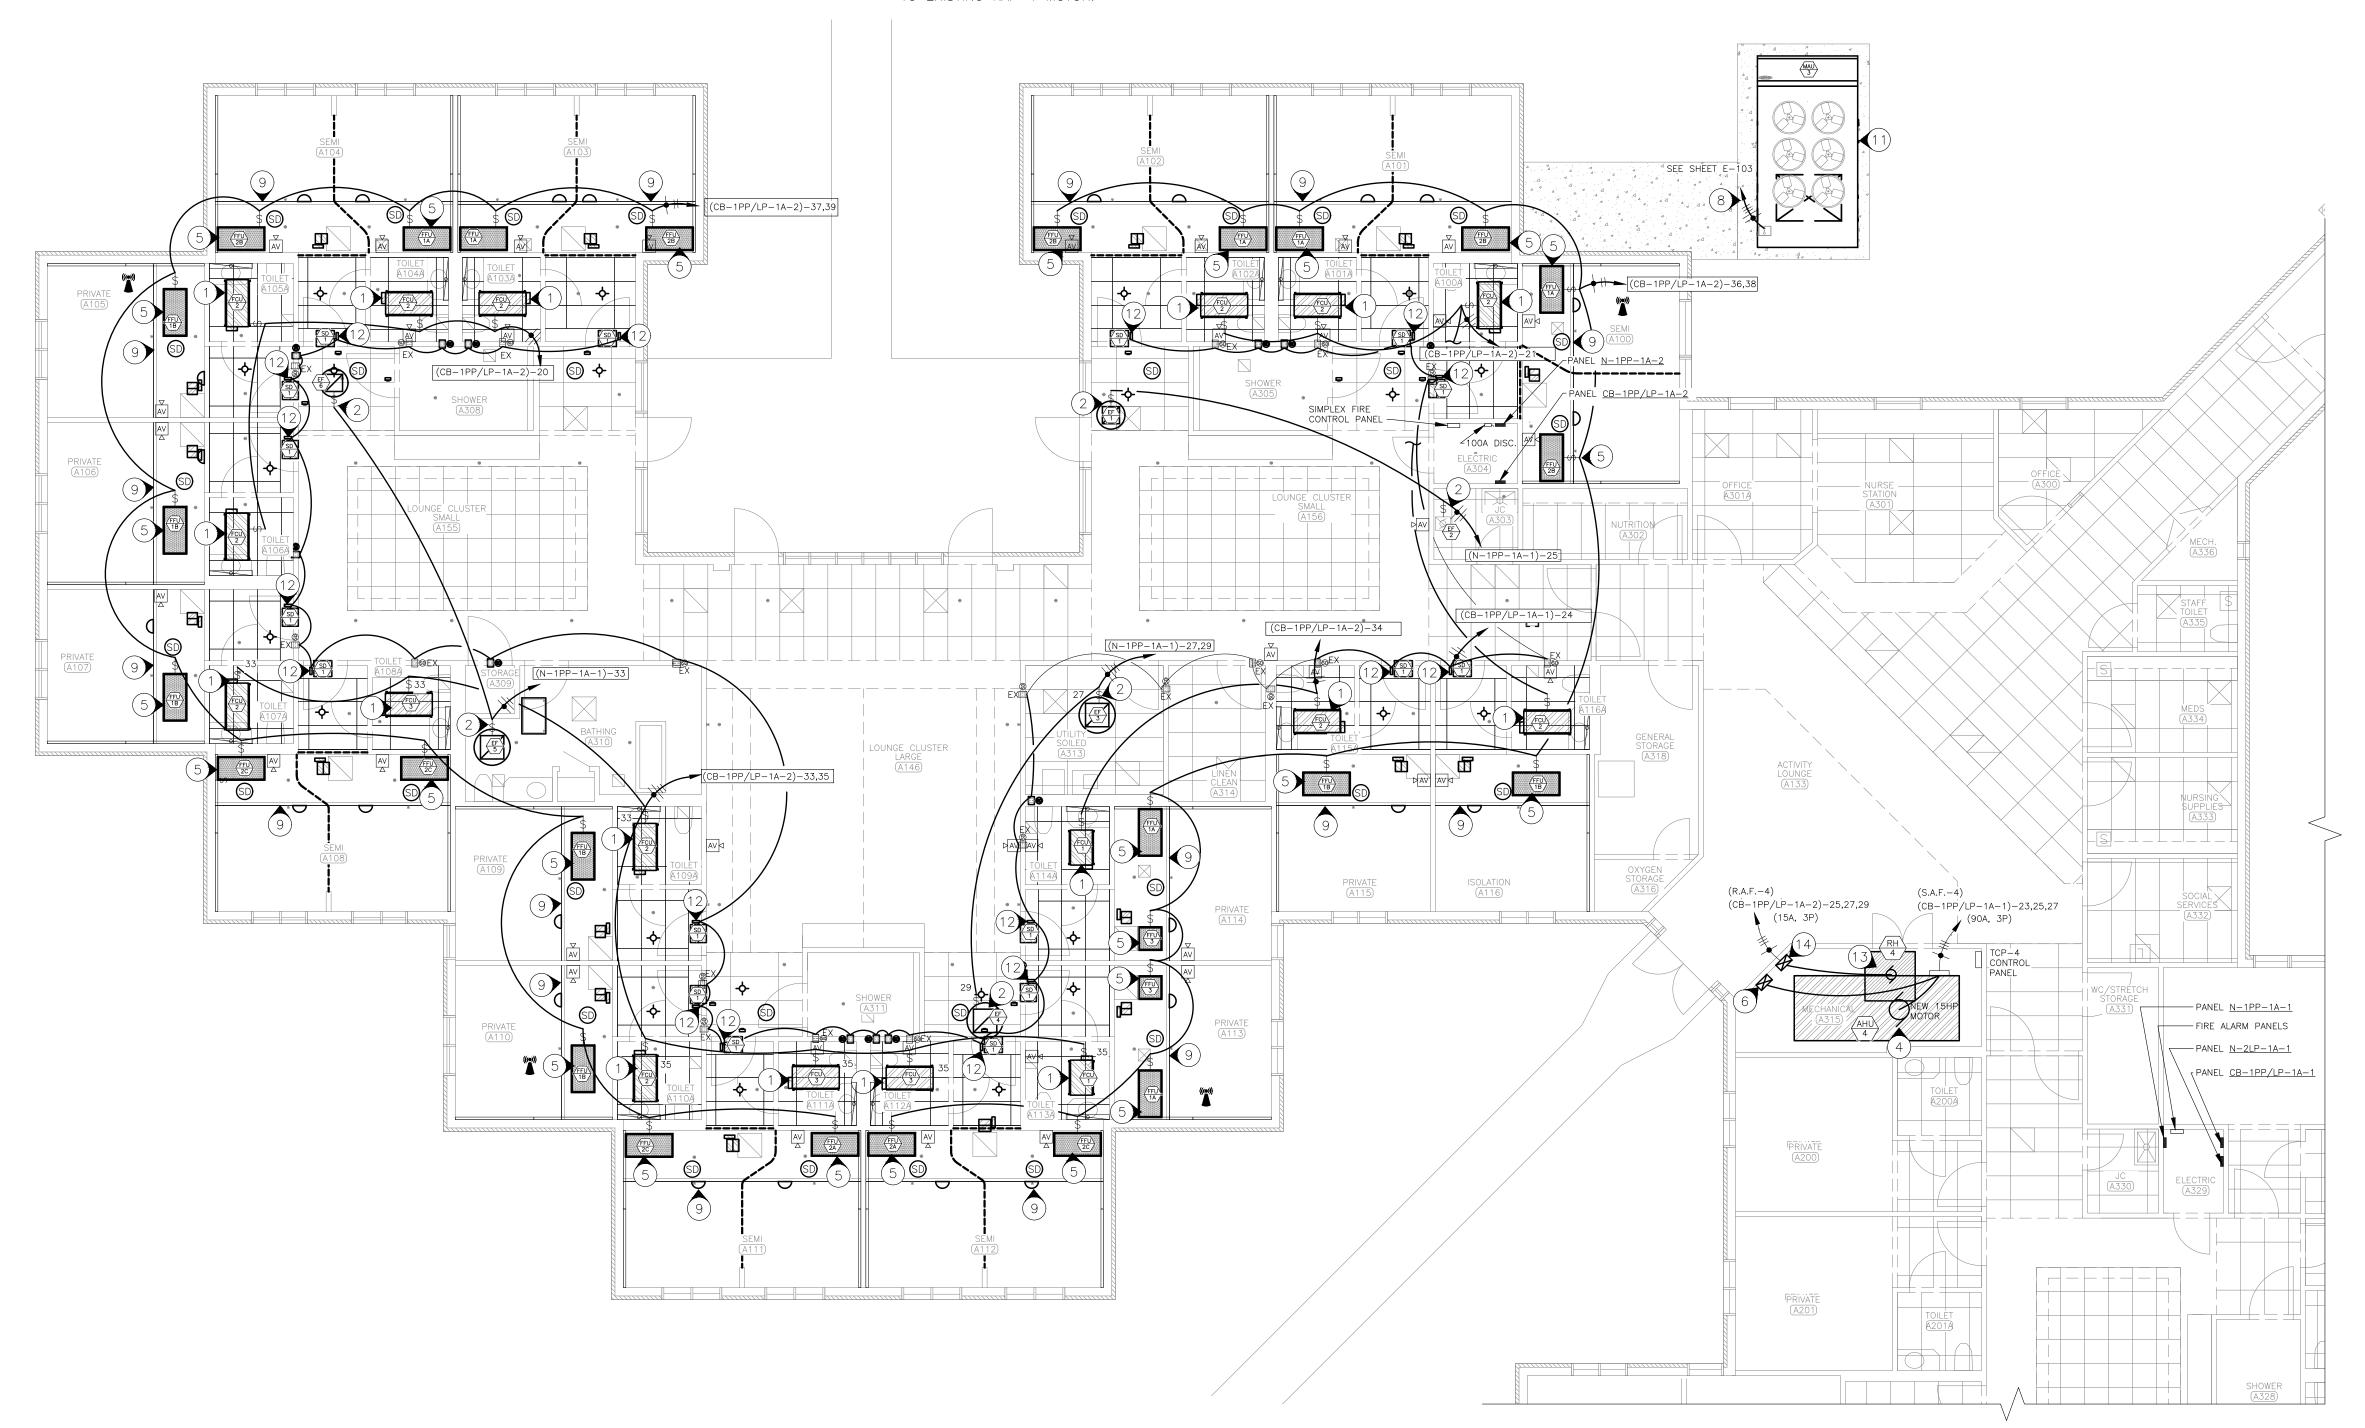
FIRST FLOOR
ELECTRICAL
DEMOLITION PLAN

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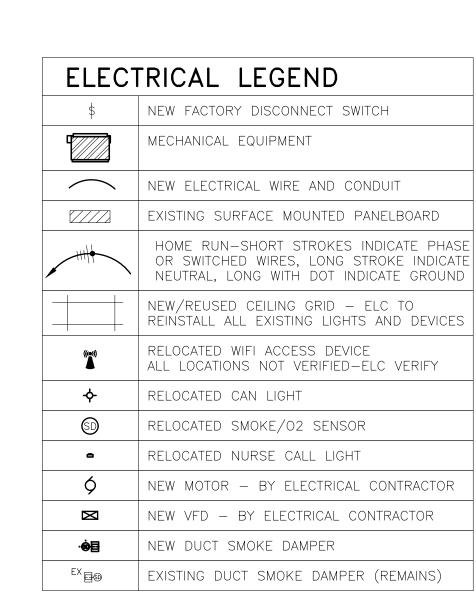
E-101


- 1) ELC TO EXTEND AND CONNECT POWER TO NEW FAN COIL UNITS FACTORY PROVIDED DISCONNECT.
- 2 ELC TO INSTALL EACH EXHAUST FAN DISCONNECT SWITCHE PROVIDED BY THE FACTORY. PROVIDE WIRE AND CONDUIT AND CONNECT POWER TO NEW DISCONNECT AS SHOWN.
- 3 COORDINATE WITH MECHANICAL CONTROLS PROVIDER TO RUN CONDUIT FOR ALL LOW VOLTAGE WIRE.
- EXISTING AHU TO REMAIN. ELC TO SUPPLY AND INSTALL NEW 15HP MOTOR AS A DIRECT REPLACEMENT. MOTOR TO BE A 15HP, 1800RPM, PREMIUM EFFICIENT, VFD RATED, 208V, 3 PHASE 60 HERTZ, FACTORY INSTALLED AEGIS RING OR EQUAL WITH APPROPRIATE MOUNTING AND BRACKET.

 REUSE EXISTING PULLEY ABB/BALDOR OR EQUAL. ALL CONTROLS OTHER THAN STARTING SHALL REMAIN AS IS. COORDINATE WITH MECHANICAL. BREAKER TO REMAIN THE SAME (90A 3P) IN CB-1PP-LP-1A-1. ENSURE WIRE IS 3-#4 CU THHN AND 1 #6 CU GND IN 1 1/4" EMT.
- (5) ELECTRICAL CONTRACTOR SHALL RUN NEW WIRE AND CONDUIT IN 3/4" EMT FROM NEW FFU DISCONNECT, (FACTORY PROVIDED), TO PANEL AS SHOWN.
- SUPPLY AND INSTALL NEW VFD FOR AHU-4 SUPPLY FAN WITH SHAFT GROUNDING RING. USE AFTER MARKET KIT FROM AEGIS TO ADD GROUND RINGS TO THE NEW VFD. VFD TO BE ABB 15HP 200-230V/3¢ ACH 580-VCR-046A-2 OR EQUAL. ELC TO PROVIDE AND INSTALL ALL CONDUIT AND WIRE TO CONNECT VFD TO EXISTING AHU-4 FAN MOTOR. EXISTING STARTER TO BE CONVERTED TO JUNCTION BOX. EXTEND WIRE AND CONDUIT FROM THERE TO NEW VFD.
- 7 ELECTRICAL CONTRACTOR (ELC) IS TO SUPPLY AND INSTALL ALL LINE VOLTAGE WIRING AND CONDUIT. COORDINATE WITH MECHANICAL CONTRACTOR TO RUN ALL LOW VOLTAGE CONDUIT AS NEEDED. BALANCE DAMPERS HAVE NO CONTROLS. CONTROL DAMPERS AND EXHAUST FANS WILL BE
 CONTROLLED BY THE EXISTING BUILDING AUTOMATION SYSTEM. THE CONTROL DAMPERS WILL HAVE LOW VOLTAGE ACTUATORS. ELC SHALL PROVIDE ANY AND ALL CONDUIT AS NEEDED FOR THE MECHANICAL CONTRACTOR.
- 8 SEE NOTE 1 ON SHEET E-103 FOR ELECTRICAL WIRE AND CONDUIT. IF ANY MECHANICAL ELECTRICAL EQUIPMENT SPECIFIED IN THE DRAWINGS IS SUBSTITUTED BY A CONTRACTOR, THAT CONTRACTOR SHALL BE RESPONSIBLE FOR PROVIDING THE EQUIPMENT'S ELECTRICAL PROTECTION PER THE MANUFACTURER'S NAMEPLATE, AND THE CURRENT NEC, ALONG WITH ALL EXPENSES INCURRED DUE TO SAID SUBSTITUTION. THE CONTRACTOR WHO IS PROVIDING THE SUBSTITUTION SHALL COORDINATE WITH ALL DISCIPLINES AFFECTED BY THIS CHANGE.
- TYPICAL MOUNT WALL LIGHTS ON OUTSIDE WALL OF NEW SOFFITS SIMILAR TO LOCATIONS OF EXISTING FIXTURES. COORDINATE EXACT LOCATIONS FOR LIGHTS, WIFI ACCESS POINTS AND SMOKE/CO2 SENSORS WITH OWNER AND NEW SPRINKLER HEAD LOCATIONS. EXTEND ALL WIRE AND CONDUIT AS NEEDED. COORDINATE WITH GENERAL CONTACTOR FOR SPRINKLER HEAD RELOCATE PARTITION CURTAINS AND RAILS AS NEEDED.
- 10 EXISTING LIGHT SWITCHES NOT SHOWN FOR CLARITY.
- ELECTRICAL CONTRACTOR TO SUPPLY AND INSTALL A NEW DUCT SMOKE DETECTOR FOR MAU-3 AND IT SHALL BE ADDRESSABLE. CONNECT TO EXISTING FIRE ALARM CONTROL PANEL FOR MONITORING. COORDINATE WITH MECHANICAL CONTRACTOR FOR LOCATION. COORDINATE WITH OWNER ON FIRE ALARM PANEL LOCATION.
- ELC TO PROVIDE 3/4" EMT AND (3) #12 CU FROM EXISTING SMOKE DAMPER JUNCTION BOX IN ELECTRICAL ROOM A329 TO EACH PATIENT ROOM SMOKE DAMPER ACTUATOR AND DAISY CHAIN ALL OTHER SMOKE DETECTORS AS SHOWN. SEE DETAIL #4 ON SHEET E-501. POWER IS TO BE FROM EXISTING ELECTRICAL PANEL CB-1PP/LP-1A-1, CIRCUIT #24. ELC TO VERIFY.
- EXISTING RAF-4 TO REMAIN. ELC TO SUPPLY AND INSTALL NEW 3HP MOTOR AS A DIRECT REPLACEMENT. MOTOR TO BE A 3HP, PREMIUM EFFICIENT, VFD RATED, 208V, 3 PHASE 60 HERTZ, WITH APPROPRIATE MOUNTING AND BRACKET, ABB/BALDOR OR EQUAL. PULLEY MAY BE REUSED. FACTORY INSTALLED AEGIS RING OR EQUAL. REUSE EXISTING PULLEY. ALL CONTROLS OTHER THAN STARTING SHALL REMAIN AS IS. COORDINATE WITH MECHANICAL. BREAKER TO REMAIN THE SAME (15A 3P) IN CB-1PP-LP-1A-2 (25,27,29).
- SUPPLY AND INSTALL NEW VFD FOR RAF-4 RETURN AIR FAN WITH SHAFT GROUNDING RING. USE AFTER MARKET KIT FROM AEGIS TO ADD GROUND RINGS TO THE NEW VFD. VFD TO BE ABB 3HP 208V/3¢ OR EQUAL. ELC TO PROVIDE AND INSTALL ALL CONDUIT AND WIRE TO CONNECT VFD TO EXISTING RAF-4 MOTOR.



PARTIAL FIRST FLOOR PLAN ELECTRICAL RENOVATION



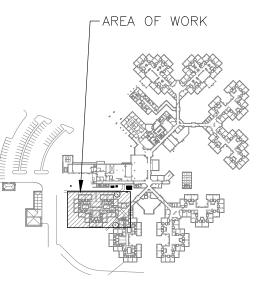



STATE OF MISSOURI MIKE KEHOE, GOVERNOR

(N) INDICATES KEYED NOTES





Columbia, MO. 65202 (573) 875-0045 Phone (573) 875-0046 FAX WWW.MOENGINEERING.COM Midwest Engineering & Design Missouri State Certificate of Authority #2010032467

OFFICE OF ADMINISTRATION DIVISION OF FACILITIES MANAGEMENT, DESIGN AND CONSTRUCTION

PUBLIC SAFETY/ VETERANS COMMISSION

DEPARTMENT OF

HVAC IMPROVEMENTS FOR INFECTION CONTROL

WARRENSBURG VETERANS HOME 1300 VETERANS ROAD WARRENSBURG, MO 64093

PROJECT # U2301-07 SITE # 6806 FACILITY # 8136806001

REVISION:
DATE:
REVISION:
DATE:
REVISION:
DATE:
ISSUE DATE: 08-01-25


CAD DWG FILE:MIFIC-e.dwg
DRAWN BY: MDS
CHECKED BY: JLD
DESIGNED BY: JLD

SHEET TITLE:

FIRST FLOOR
ELECTRICAL
RENOVATION PLAN

SHEET NUMBER:

E-102

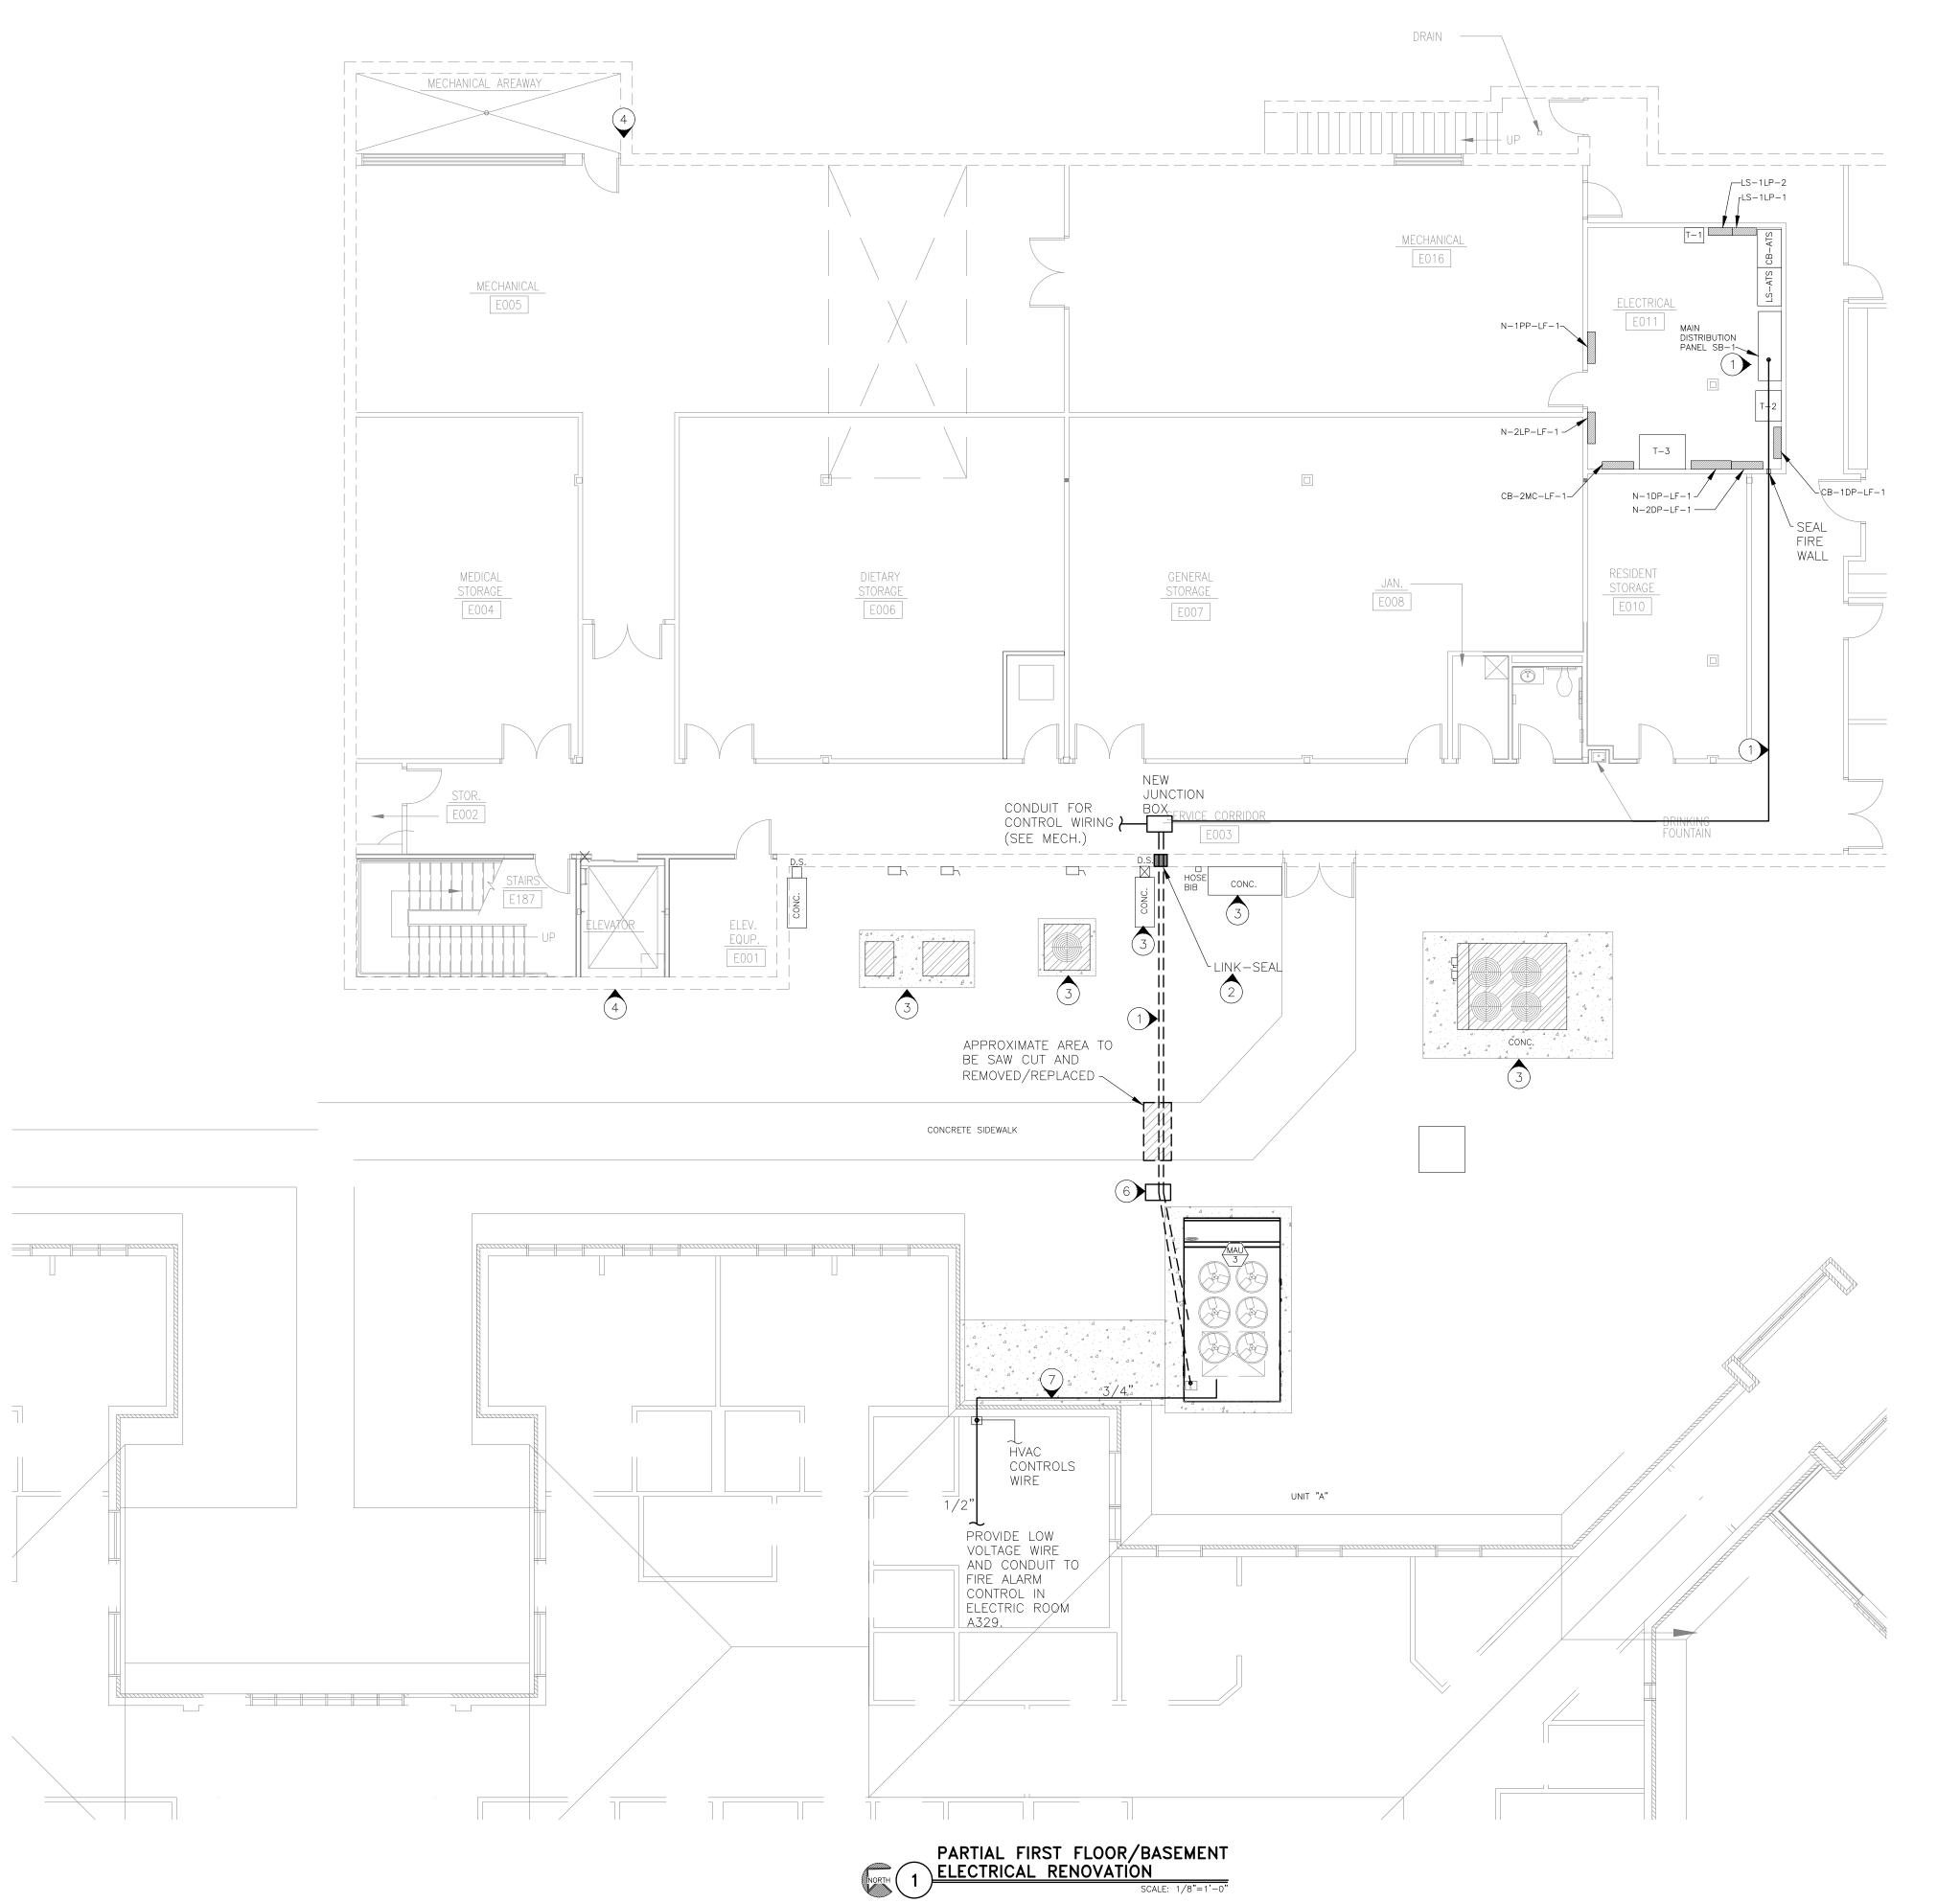

CONSTRUCTION NOTES

N INDICATES KEYED NOTES

ELC TO PROVIDE AND COORDINATE WITH THE FACILITY MAINTENANCE STAFF TO PLACE (3)-100A FUSES IN THE SPARE 100A BUCKET IN EXISTING SB-1. (REFERENCE SHEET E-501) RUN (3)-1/0 CU THWN AND (1)-#6 CU GROUND IN 2" CONDUIT INTO EXISTING EMPTY CONDUIT TO HALLWAY IF AVAILABLE. IF THERE IS NO EXISTING EMPTY CONDUIT FROM THE ELECTRIC ROOM, ELC TO PROVIDE NEW 2" CONDUIT FROM SB-1 OUT TO HALLWAY THRU THE FIREWALL AND MEET UP WITH MECHANICAL'S NEW GAS LINE FOR MAU-3 BEFORE LEAVING BUILDING AND TRENCHED UNDERGROUND IN 2" PVC TO THE ELECTRICAL DISCONNECT IN MAU-3 WITH 12" MIN. CLEAR TO GAS LINE. ELC TO PROVIDE AND INSTALL NEW JUNCTION BOX IN HALLWAY NEAR LOCATION SHOWN. ELC TO PROVIDE AND INSTALL (1) 3/4" CONDUIT FOR MECHANICAL CONTROL WIRING NEXT TO 2" CONDUIT. ROUTE FROM NEW JUNCTION BOX TO MAU-3. COORDINATE WITH MECHANICAL TO PROVIDE LOW VOLTAGE CONDUIT TO LOCATION ON MECHANICAL SHEETS. PATCH FIREWALL IN ELECTRIC ROOM TO 3M STANDARDS SHOWN ON E-501. COORDINATE WITH GENERAL CONTRACTOR TO REPAIR CONCRETE SIDEWALK AND SEED AND MULCH THE GRASSED AREAS.


- 2 ELC TO SEAL FOUNDATION WALL PENETRATION WITH MODEL "C" LINK—SEAL MECHANICAL SEAL OR EQUAL. ENSURE PENETRATION IS LARGE ENOUGH FOR CONDUIT AND LINK—SEAL. INSTALL PER MANUFACTURER'S INSTRUCTIONS
- 3 ITEMS SHOWN IN THIS AREA WERE DRAWN FROM PHOTOGRAPHS AND ARE NOT GUARANTEED TO BE ACCURATE OR COMPLETE. ELC RESPONSIBLE FOR EQUIPMENT VERIFICATION IN THIS YARD AREA.
- THIS IS THE FIRST FLOOR LEVEL BUT THE BASEMENT FLOOR PLAN IS SHOWN BELOW FOR THE PURPOSES OF IDENTIFYING THE ROUTING OF THE ELECTRICAL WIRE AND CONDUIT FROM SB-1 TO THE NEW MAU-3. THIS MAY NOT BE ENTIRELY ACCURATE. ELC TO VERIFY ROUTING AND DISTANCES.
- FOR GAS LINE AND ELECTRIC LINE IN THE SAME TRENCH, LEAVE 12" CLEARANCE MIN. AROUND NEW ELECTRIC LINE. AFTER THE SIDEWALK TURN TO UTILITY CONNECTION BOX AND UP. COORDINATE WITH MECHANICAL TO CONNECT POWER TO UNIT. COORDINATE EXACT LOCATION WITH UNIT PROVIDED. REFERENCE TRENCH DETAIL ON MECHANICAL SHEETS. COORDINATE WITH GENERAL CONTRACTOR TO SAW CUT AND REMOVE EXISTING CONCRETE SIDEWALK, POUR NEW SIDEWALK, SEED AND MULCH THE AREA DISTURBED BY CONSTRUCTION.
- GROUND BOX AS NEEDED. BOX TO BE QUAZITE UNDERGROUND ENCLOSURE OR EQUAL. SIZED AS NEEDED.
- ELC TO PROVIDE AND INSTALL (1) 3/4" CONDUIT FOR SMOKE DETECTOR MONITORING. ROUTE OUT FROM JUNCTION BOX IN NEW SOFFIT ALONG NEW DUCT WORK AND TO UNIT. NEW MAKEUP AIR UNIT COMES STANDARD WITH A NON ADDRESSABLE SMOKE DETECTOR. ELC TO PROVIDE AN ADDRESSABLE MODULE AND ALL WIRE AND CONDUIT TO CONNECT TO EXISTING FIRE ALARM PANEL IN ROOM A329 (SEE E-102). RUN 1/2" CONDUIT FROM ELC PROVIDED AND INSTALLED 4X4 JUNCTION BOX IN NEW SOFFIT TO FIRE ALARM PANEL IN A304. COORDINATE WITH OWNER AND MECHANICAL CONTRACTOR. COORDINATE WITH GENERAL CONTRACTOR TO SEAL PENETRATIONS TO WATER TIGHT SEAL.

ELECTRICAL LEGEND

--- NEW UNDERGROUND CONDUIT AND WIRE

NEW CONDUIT AND WIRE INSIDE OF BUILDING

EXISTING SURFACE MOUNTED PANELBOARD

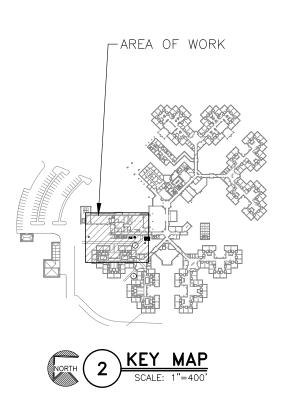

STATE OF MISSOURI MIKE KEHOE, GOVERNOR





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WARRENSBURG VETERANS HOME 1300 VETERANS ROAD WARRENSBURG, MO 64093

PROJECT # U2301-07 SITE # 6806 FACILITY # 8136806001

REVISION:
DATE:
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REVISION:
DATE:
ISSUE DATE: 08-01-25

CAD DWG FILE: MIFIC-e.dwg
DRAWN BY: MDS
CHECKED BY: JLD
DESIGNED BY: JLD

SHEET TITLE:

BASEMENT
MAU-3 ELECTRICAL
RENOVATION PLAN

SHEET NUMBER:

E-103

N INDICATES KEYED NOTES


ELC TO PROVIDE (3) 100A FUSES IN EXISTING 100A EMPTY BUCKET ONCE ALL WIRE AND CONDUIT HAS BEEN INSTALLED TO NEW MAU-3. FUSES ARE TO BE ADS TYPE T OR J. COORDINATE EXACT FUSE WITH EQUIPMENT NAMEPLATE AND MANUFACTURER'S SPECIFICATIONS.

EXISTING 2000A 277/480V 3P 4W SWITCHBOARD SB-1

400A N-2PP-1F-1

400A EMPTY

2000A MAIN BREAKER

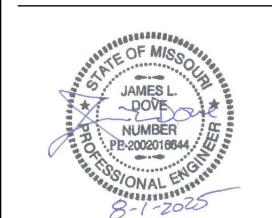

STATE OF MISSOURI

MIKE KEHOE,

GOVERNOR



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WARRENSBURG VETERANS 1300 VETERANS ROAD WARRENSBURG, MO 64093

PROJECT # U2301-07 6806

FACILITY # 8136806001

REVISION: DATE: **REVISION:** DATE: **REVISION:** DATE:


ISSUE DATE: 08-01-25


CAD DWG FILE:<u>MIFIC-e.dwg</u> DRAWN BY: <u>MDS</u> CHECKED BY: JLD DESIGNED BY: JLD


SHEET TITLE:

ELECTRICAL RISER AND FIRE RATED DETAILS

SHEET NUMBER:

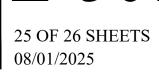


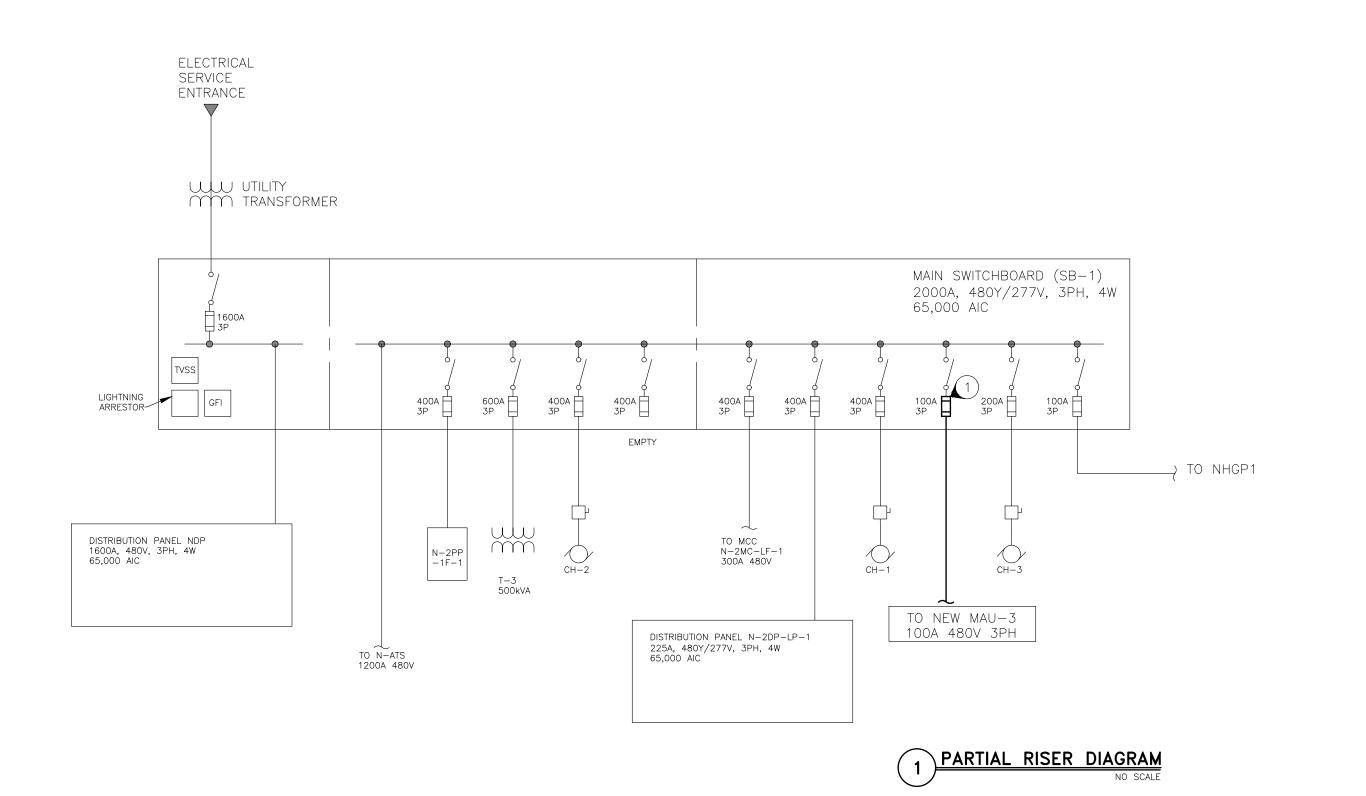

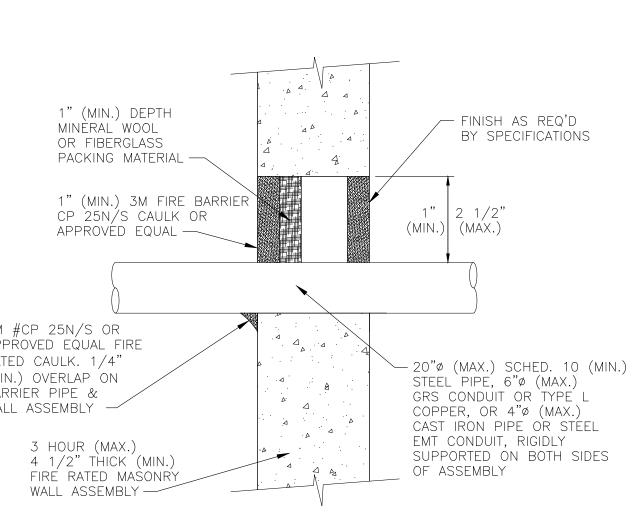

CONDUIT THROUGH FIRE RATED MASONRY WALL DETAIL

3M #CP 25N/S OR APPROVED EQUAL FIRE RATED CAULK. 1/4" (MIN.) OVERLAP ON CARRÍER PIPE & WALL ASSEMBLY -

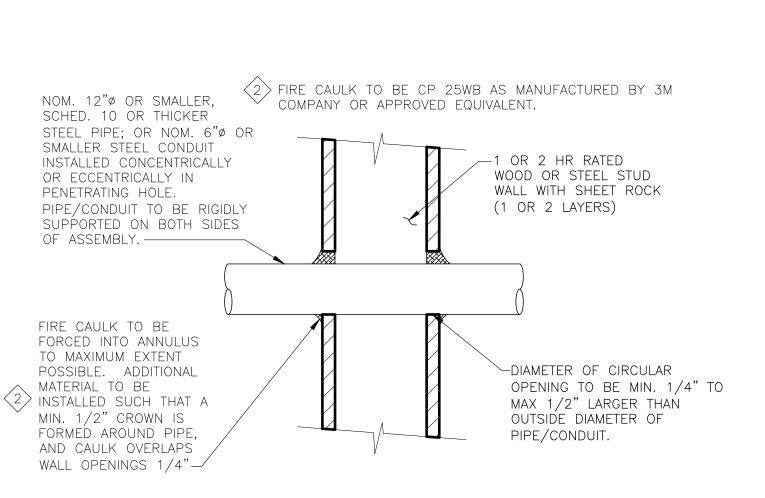

UNINSULATED CONDUIT THRU 1-2 HR FIRE RATED GYPSUM WALL ASSEMBLY DETAIL

ELECTRICAL ROOM 7 ELC TO VERIFY THAT THIS JUNCTION BOX IS FOR SMOKE NEW 4X4 JUNCTION BOX DAMPER ACTUATORS ON AND WHIP TO ACTUATOR $^{-1}$ CIRCUIT NUMBER 24 EXISTING ELECTRICAL PANEL CB-1PP/LP-1A-1 DAISY CHAIN ALL SMOKE (CIRCUIT #24) DAMPERS TOGETHER ON ONE CIRCUIT. ELC TO VERIFY CIRCUIT LOAD. PATIENT ROOM(S) | ELECTRIC ROOM A329 PATIENT ROOM SMOKE DAMPER CONNECTION DETAIL

400A MCC

400A N-2DP-LP-1

200A CH-1

200A CH-3

ELC TO PROVIDE 3/4" EMT AND (3) #12

CU FROM ELECTRICAL ROOM A329 TO EACH PATIENT ROOM SMOKE DAMPER

ETECTORS | EXISTING JUNCTION BOX IN

ACTUATOR —

NEW BELIMO 120V

ACTUATOR

NEW PATIENT ROOM

SMOKE DAMPER-

NHGP1

EXISTING PANELS WITH EXISTING LOADS

PANEL DESIGNATION: CB-1PP-LF													
VOLTAGE: 208 3PHASE 4WIRE					ECTRICAL ROOM 105			TOTAL VOLT	AMPS THIS F	PANEL	0		
MAINS: 225 A _ CB X MLO	MOUN	ITING: _	FLUSH X	SURFACE	PANEL SPA	CES: 42		TOTAL CONNECTED LOAD (AMPS)			0		
			C	ONNECTED L	OAD	CKT.	C	ONNECTED L	OAD				
CIRCUIT DESIGNATION	WIRE	TRIP	Α	В	С	NO.	Α	В	С	TRIP WI	RE CIRCUIT DESIGNATION		
EMG. REC. RM A-213		20A/1P				1 2				20A/1P	EMG. REC. RM A-210		
EMG. REC. RM A-212		20A/1P				3 4				20A/1P	EMG. REC. RM A-209		
EMG. REC. RM A-211		20A/1P				5 6				20A/1P	EMG. REC. RM A-204		
EMG. REC. RM A-207		20A/1P				7 8				20A/1P	EMG. REC. RM A-206		
EMG. REC. RM A-208		20A/1P				9 10				20A/1P	EMG. REC. RM A-205		
EMG. REC. RM A-203		20A/1P				11 12				20A/1P	EMG. REC. RM A-201		
EMG. REC. RM A-202		20A/1P				13 14				20A/1P	EMG. REC. RM A-200		
EMG. REC. RM A-216		20A/1P				15 16				20A/1P	EMG. REC. RM A-215		
EMG. REC. RM A-214		20A/1P				17 18				20A/1P	EMG. FRIG. REC. RM A-334		
SOUTH BEDROOM LIGHTS		20A/1P				19 20				20A/1P	FAN MOTORS SOUTH MIDDLE		
FAN MOTORS SOUTH		25A/1P				21 22				20A/1P	TEMPERATURE CONTROL PANEL		
						23 24				20A/1P	FIRE DAMPER RM A-329		
AHU-4		90A/3P				25 26				20A/1P	FREEZE PUMP RM A-318		
						27 28				20A/1P	HEATER RM A-336		
SPARE		20A/1P				29 30				20A/1P	SIMPLEX FIRE CONTROL		
SPARE		20A/1P				31 32				20A/1P	SPARE		
FAN MOTOR SOUTH FRONT		20A/1P				33 34				20A/1P	SPARE		
SPARE		20A/1P				35 36				20A/1P	SPARE		
SPARE		20A/1P				37 38				20A/1P	SPARE		
SPARE		20A/1P				39 40				20A/1P	SPARE		
SPARE		20A/1P				41 42				20A/1P	SPARE		
			0				0			PHASE	E A 0		
				0				0		PHASE	B 0		
					0				0	PHASE	E C 0		

PANEL DESIGNATION: N-1PP-1A-1												
VOLTAGE: 208 3PHASE 4WIRE	PANE	L LOCATIO	N: HOUSING	AREA "A" EL	ECTRICAL RO	OOM 105		TOTAL VOLT	AMPS THIS P	ANEL		0
MAINS: 225 A _ CB X MLO	MOUN	ITING: _	FLUSH XS	URFACE	PANEL SPACE	CES: 42		TOTAL CON	NECTED LOA	D (AMPS)		0
			CC	NNECTED I	_OAD	CKT.	CC	NNECTED L	OAD			
CIRCUIT DESIGNATION	WIRE	TRIP	Α	В	С	NO.	Α	В	С	TRIP	WIRE	CIRCUIT DESIGNATION
REC. RM A-213		20A/1P				1 2				20A/1P		REC. RM A-210
REC. RM A-212		20A/1P				3 4				20A/1P		REC. RM A-209
REC. RM A-211		20A/1P				5 6				20A/1P		REC. RM A-204
REC. RM A-206		20A/1P				7 8				20A/1P		REC. RM A-207
REC. RM A-205		20A/1P				9 10				20A/1P		REC. RM A-208
REC. RM A-203		20A/1P				11 12				20A/1P		REC. RM A-201
REC. RM A-202		20A/1P				13 14				20A/1P		REC. RM A-200
REC. RM A-216		20A/1P				15 16				20A/1P		REC. RM A-215
REC. RM A-214		20A/1P				17 18				20A/1P		REC. POD #2-3, RM A-323
REC. COMMOM SOUTH, A318-20, A330, A331		20A/1P				19 20				20A/1P		REC. RMS A-332-35
SOUTH MIDDLE BEDROOM LIGHTS		20A/1P				21 22				20A/1P		SOUTH END BEDROOM LIGHTS
RM C-328 HEAT LAMP		20A/1P				23 24				20A/1P		CIRC. PUMP RM A-336
EXHAUST FAN		20A/1P				25 26				20A/1P		SPARE
SPARE		20A/1P				27 28				20A/1P		SPARE
SPARE		20A/1P				29 30				20A/1P		SPARE
REC. RM A-329		20A/1P				31 32				20A/1P		WATER HEATER RM A-336
SPARE		20A/1P				33 34				20A/1P		SPARE
SPARE		20A/1P				35 36				20A/1P		SPARE
SPARE		20A/1P				37 38				20A/1P		SPARE
SPARE		20A/1P				39 40				20A/1P		SPARE
SPARE		20A/1P				41 42				20A/1P		SPARE
			0				0			PH	ASE A	0
				0				0		PH	ASE B	0
					0				0	PHA	ASE C	0

PANEL DESIGNATION: CB-1PP-L	P-1A-2											
VOLTAGE: 208 3PHASE 4WIRE	PANEL	L LOCATIO	N: HOUSING	AREA "A" ELI	ECTRICAL RO	OM 161		TOTAL VOLT		0		
MAINS: 225 A _ CB X MLO	MOUN	TING: _	FLUSH XS	URFACE	PANEL SPA	CES: 42		TOTAL CON	NECTED LOA		0	
			CONNECTED LOAD			CKT.	C	ONNECTED L	OAD			
CIRCUIT DESIGNATION	WIRE	TRIP	Α	В	С	NO.	Α	В	С	TRIP	WIRE	CIRCUIT DESIGNATION
EMG. REC. RM A-103		20A/1P				1 2				20A/1P		EMG. REC. RM A-106
EMG. REC. RM A-104		20A/1P				3 4				20A/1P		EMG. REC. RM A-107
EMG. REC. RM A-105		20A/1P				5 6				20A/1P		EMG. REC. RM A-110
EMG. REC. RM A-109		20A/1P				7 8				20A/1P		EMG. REC. RM A-112
EMG. REC. RM A-108		20A/1P				9 10				20A/1P		EMG. REC. RM A-111
EMG. REC. RM A-113		20A/1P				11 12				20A/1P		EMG. REC. RM A-115
EMG. REC. RM A-114		20A/1P				13 14				20A/1P		EMG. REC. RM A-116
EMG. REC. RM A-100		20A/1P				15 16				20A/1P		EMG. REC. RM A-101
EMG. REC. RM A-102		20A/1P				17 18				20A/1P		EMG. FRIG. REC. RM A-302
WEST END BEDROOM LIGHTS		20A/1P				19 20				20A/1P		FAN MOTORS WEST END
AN MOTORS WEST MIDDLE		20A/1P				21 22				20A/1P		TV REC. RM A-304
FIRE DAMPER RM A-304		20A/1P				23 24				20A/1P		EMG. REC. RM A-301
						25 26				20A/1P		WANDER GUARD RM A-304
RETURN AIR FAN #4		15A/3P				27 28				20A/1P		DVR A-304
						29 30				25A/1P		SPARE
RM A-304 NURSE CALL		20A/1P				31 32				20A/1P		SPARE
SPARE		20A/1P				33 34				20A/1P		SPARE
SPARE		20A/1P				35 36				20A/1P		SPARE
SPARE		20A/1P				37 38				20A/1P		SPARE
SPARE		20A/1P				39 40				20A/1P		SPARE
SPARE		20A/1P				41 42				20A/1P		SPARE
			0				0			PHA	ASE A	0
				0				Ö		PHA	ASE B	0
					0				0	PHA	ASE C	0

EXISTING PANELS WITH NEW LOADS SHOWN BOLD

/OLTAGE: 208 3PHASE 4WIRE	PANFI	LOCATIO	N·HOUSING	ARFA "A" FI	ECTRICAL RO	OOM 105		TOTAL VOLT	AMPS THIS F	ANFI		0	
MAINS: 225 A CB X MLO	MOUNTING: FLUSH X SURFACE PANEL SPACE							TOTAL CONN					
		_	CC	NNECTED I		CKT.	C	ONNECTED L		- (· · · · · · · ·)			
CIRCUIT DESIGNATION	WIRE	TRIP	Α	В	С	NO.	Α	В	С	TRIP	WIRE	CIRCUIT DESIGNATION	
EMG. REC. RM A-213		20A/1P				1 2				20A/1P		EMG. REC. RM A-210	
EMG. REC. RM A-212		20A/1P				3 4				20A/1P		EMG. REC. RM A-209	
EMG. REC. RM A-211		20A/1P				5 6				20A/1P		EMG. REC. RM A-204	
EMG. REC. RM A-207		20A/1P				7 8				20A/1P		EMG. REC. RM A-206	
EMG. REC. RM A-208		20A/1P				9 10				20A/1P		EMG. REC. RM A-205	
EMG. REC. RM A-203		20A/1P				11 12				20A/1P		EMG. REC. RM A-201	
EMG. REC. RM A-202		20A/1P				13 14				20A/1P		EMG. REC. RM A-200	
EMG. REC. RM A-216		20A/1P				15 16				20A/1P		EMG. REC. RM A-215	
EMG. REC. RM A-214		20A/1P				17 18				20A/1P		EMG. FRIG. REC. RM A-334	
SOUTH BEDROOM LIGHTS		20A/1P				19 20				20A/1P		FAN MOTORS SOUTH MIDDLE	
FAN MOTORS SOUTH		25A/1P				21 22				20A/1P		TEMPERATURE CONTROL PAN	
						23 24				20A/1P	#12	FIRE DAMPER RM A-329-(S.D.)	
AHU-4		90A/3P				25 26				20A/1P		FREEZE PUMP RM A-318	
						27 28				20A/1P		HEATER RM A-336	
SPARE		20A/1P				29 30				20A/1P		SIMPLEX FIRE CONTROL	
SPARE		20A/1P				31 32				20A/1P		SPARE	
FAN MOTOR SOUTH FRONT		20A/1P				33 34				20A/1P		SPARE	
SPARE		20A/1P				35 36				20A/1P		SPARE	
SPARE		20A/1P				37 38				20A/1P		SPARE	
SPARE		20A/1P				39 40				20A/1P		SPARE	
SPARE		20A/1P				41 42				20A/1P		SPARE	
			0				0			PH	ASE A	0	
				0				0		DL	ASE B	0	

PANEL DESIGNATION: N-1PP-1A-1												
VOLTAGE: 208 3PHASE 4WIRE	PANE	L LOCATIO	N: HOUSING	AREA "A" EL	ECTRICAL RO	OOM 105		TOTAL VOLT	AMPS THIS F	PANEL		4494
MAINS: 225 A _ CB X MLO	MOUN	ITING: _	FLUSH XS	URFACE	PANEL SPA	CES: 42		TOTAL CON	NECTED LOA	D (AMPS)		12
			CC	ONNECTED L	.OAD	CKT.	C	ONNECTED L	OAD			
CIRCUIT DESIGNATION	WIRE	TRIP	A	В	С	NO.	Α	В	С	TRIP V	VIRE	CIRCUIT DESIGNATION
REC. RM A-213		20A/1P				1 2				20A/1P		REC. RM A-210
REC. RM A-212		20A/1P				3 4				20A/1P		REC. RM A-209
REC. RM A-211		20A/1P				5 6				20A/1P		REC. RM A-204
REC. RM A-206		20A/1P				7 8				20A/1P		REC. RM A-207
REC. RM A-205		20A/1P				9 10				20A/1P		REC. RM A-208
REC. RM A-203		20A/1P				11 12				20A/1P		REC. RM A-201
REC. RM A-202		20A/1P				13 14				20A/1P		REC. RM A-200
REC. RM A-216		20A/1P				15 16				20A/1P		REC. RM A-215
REC. RM A-214		20A/1P				17 18				20A/1P		REC. POD #2-3, RM A-323
REC. COMMOM SOUTH, A318-20, A330, A331		20A/1P				19 20				20A/1P		REC. RMS A-332-35
SOUTH MIDDLE BEDROOM LIGHTS		20A/1P				21 22				20A/1P		SOUTH END BEDROOM LIGHTS
RM C-328 HEAT LAMP		20A/1P				23 24				20A/1P		CIRC. PUMP RM A-336
NEW EXHAUST FANS (EF-1) (EF-2)	#10	20A/1P	738			25 26				20A/1P		SPARE
NEW EXHAUST FAN (EF-3)	#10	20A/1P		1176		27 28				20A/1P		SPARE
NEW EXHAUST FAN (EF-4)	#10	20A/1P			1176	29 30				20A/1P		SPARE
REC. RM A-329		20A/1P				31 32				20A/1P		WATER HEATER RM A-336
NEW EXHAUST FANS (EF-5) (EF-6)	#10	20A/1P		1404		33 34				20A/1P		SPARE
SPARE		20A/1P				35 36				20A/1P		SPARE
SPARE		20A/1P				37 38				20A/1P		SPARE
SPARE		20A/1P				39 40				20A/1P		SPARE
SPARE		20A/1P				41 42				20A/1P		SPARE
			738				0			PHA	SE A	738
				2580				0		PHA	SE B	2580
					1176				0	PHAS	SE C	1176

VOLTAGE: 208 3PHASE 4WIRE	PANEI	LOCATION	ON: HOUSING A	REA "A" EL	ECTRICAL RO	OM 161		TOTAL VOLT	L VOLTAMPS THIS PANEL			12414
MAINS: 225 A _ CB X MLO	MOUN	TING:	FLUSH XS	URFACE	PANEL SPACE	CES: 42		TOTAL CONNECTED LOAD (AMPS)				34
			CC	NNECTED L	OAD	CKT.	C	ONNECTED L	.OAD	Ì		
CIRCUIT DESIGNATION	WIRE	TRIP	Α	В	С	NO.	Α	В	С	TRIP	WIRE	CIRCUIT DESIGNATION
EMG. REC. RM A-103		20A/1P				1 2				20A/1P		EMG. REC. RM A-106
EMG. REC. RM A-104		20A/1P				3 4				20A/1P		EMG. REC. RM A-107
EMG. REC. RM A-105		20A/1P				5 6				20A/1P		EMG. REC. RM A-110
EMG. REC. RM A-109		20A/1P				7 8				20A/1P		EMG. REC. RM A-112
EMG. REC. RM A-108		20A/1P				9 10				20A/1P		EMG. REC. RM A-111
EMG. REC. RM A-113		20A/1P				11 12				20A/1P		EMG. REC. RM A-115
EMG. REC. RM A-114		20A/1P				13 14				20A/1P		EMG. REC. RM A-116
EMG. REC. RM A-100		20A/1P				15 16				20A/1P		EMG. REC. RM A-101
EMG. REC. RM A-102		20A/1P				17 18				20A/1P		EMG. FRIG. REC. RM A-302
WEST END BEDROOM LIGHTS		20A/1P				19 20	1776			20A/1P	#10	FCU WEST SIDE
FCU EAST SIDE	#10	20A/1P		1776		21 22				20A/1P		TV REC. RM A-304
FIRE DAMPER RM A-304		20A/1P				23 24				20A/1P		EMG. REC. RM A-301
						25 26				20A/1P		WANDER GUARD RM A-304
RETURN AIR FAN #4		15A/3P				27 28				20A/1P		DVR A-304
						29 30				25A/1P		SPARE
RM A-304 NURSE CALL		20A/1P				31 32				20A/1P		SPARE
FCU MIDDLE NORTH	#10	20A/1P		1332		33 34		888		20A/1P	#12	FCU SOUTH EAST
FCU MIDDLE SOUTH	#10	20A/1P			1776	35 36			1230	20A/2P	#12	FFU EAST SIDE
FFU WEST SIDE	#10	20A/2P	1203			37 38	1230				#12	
	#10			1203		39 40				20A/1P		SPARE
SPARE		20A/1P				41 42				20A/1P		SPARE
			1203				3006			PH	IASE A	4209
				4311				888		PH	IASE B	5199
					1776				1230	PH	ASE C	3006

NOTES

- 1 ALL NEW OR REWORKED ELECTRICAL PANELS ARE TO HAVE NEW PANEL SCHEDULES. EACH SCHEDULE SHALL BE TYPED OUT AND PLACED IN PANEL WITH PROTECTIVE SLEEVE.
- 2 ONLY THE PANELS THAT WILL BE CHANGING ARE SHOWN ON THIS SHEET.







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OFFICE OF ADMINISTRATION DIVISION OF FACILITIES MANAGEMENT, DESIGN AND CONSTRUCTION

DEPARTMENT OF PUBLIC SAFETY/ VETERANS COMMISSION

HVAC IMPROVEMENTS FOR INFECTION CONTROL

WARRENSBURG VETERANS HOME 1300 VETERANS ROAD WARRENSBURG, MO 64093

PROJECT # U2301-07 SITE # 6806 FACILITY # 8136806001

REVISION:
DATE:
REVISION:
DATE:
REVISION:
DATE:
ISSUE DATE: 08-01-25

CAD DWG FILE:MIFIC-e.dwg
DRAWN BY: MDS/JJS
CHECKED BY: JLD
DESIGNED BY: JLD

SHEET TITLE:

ELECTRIC
PANEL
SCHEDULES

SHEET NUMBER:

E-601