DESIGN & INSTALL NEW DOMESTIC WATER PLANT

VETERANS HOME BUILDING ST. JAMES, MISSOURI

CASCO

ARCHITECTS / ENGINEERS 314-821-1100

CASCO DIVERSIFIED CORPORATION MISSOURI STATE CERTIFICATE OF AUTHORITY #000613 (ENG) MISSOURI STATE CERTIFICATE OF AUTHORITY #000329 (ARCH)

OWNER:

STATE OF MISSOURI MICHAEL L. PARSON,

GOVERNOR

DEPARTMENT OF PUBLIC SAFETY


PROJECT

OFFICE OF ADMINISTRATION

MANAGEMENT:

DIVISION OF FACILITIES MANAGEMENT,

DESIGN AND CONSTRUCTION

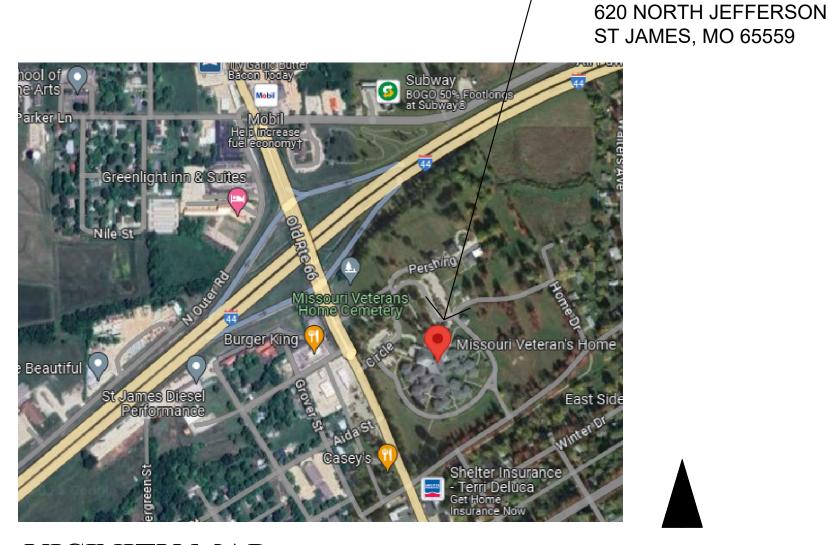

VICINITY MAP



ADDRESS:

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DESIGNER: CASCO DIVERSIFIED CORP.

PROJECT NUMBER: U2409-01

6801 SITE NUMBER:

8136801002 FACILITY NUMBER:

KEYED NOTES

- 1. REMOVE PORTION OF HOT WATER RETURN PIPING FOR LAUNDRY
- 2. REMOVE ALL ASSOCIATED PIPING, VALVES, PUMPS, ETC. FOR EXISTING BOILERS DURING PHASE 1.
- 3. REMOVE PORTION OF HOT WATER RETURN PIPING FOR MAIN BUILDING. PREPARE PIPING FOR NEW CONNECTION.
- 4. REMOVE PORTION OF HOT WATER PIPING. PREPARE PIPING FOR NEW CONNECTION IN PHASE 1
- 5. VALVE NORMALLY CLOSED UNTIL PHASE 2.
- 6. ROUTE 1"HOT WATER RETURN (160°F) PIPING TO DWRP-2. ROUTE PIPING DOWNSTREAM OF DWRP-2 TO TMV-1 & 3"SOFT COLD WATER PIPING ROUTING TO THE DOMESTIC WATER STORAGE TANKS.
- 7. PROVIDE VALVE AND CAP FOR CONNECTION IN PHASE 2.
- 8. BACKFLOW PREVENTER FOR BOILER MAKE-UP WATER.
- $_{\it \Gamma}$ EX TMV TO REMAIN $\,\,$ 9. REMOVE PORTION OF COLD WATER PIPING. PREPARE PIPING FOR NEWCONNECTION.

ALTERNATE #1 (THIS SHEET):


ALTERNATE NO. 1: USE ELECTRONICALLY OPERATED THERMOSTATIC MIXING VALVES IN LIEU OF MECHANICALLY OPERATED MIXING VALVES FOR THE SUITES, KITCHEN AND LAUNDRY AREAS.

- ETMV-1 (SUITES): LEONARD NUCLEUS NV-150-LF. 72 GPM AT 10 PSI PRESSURE DROP, 1-1/4" SUPPLIES, 1-1/2" MIXED OUTLET.
- ETMV-2 (KITCHEN): LEONARD NUCLEUS NV-150-LF, 72 GPM AT 10
- ETMV-3 (LAUNDRY): LEONARD NUCLEUS NV-150-LF, 72 GPM AT 10

PSI PRESSURE DROP, 1-1/4" SUPPLIES, 1-1/2" MIXED OUTLET.

PSI PRESSURE DROP, 1-1/4" SUPPLIES, 1-1/2" MIXED OUTLET.

PLUMBING LEGEND

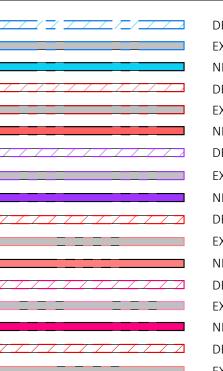

STAGING MAP

WING A

NURSING CORE A

SCALE: NONE

DEMO SOFT COLD WATER PIPING (EX SCW) EXISTING SOFT COLD WATER PIPING (EX SCW) NEW SOFT COLD WATER PIPING (SCW) DEMO HOT WATER PIPING (EX HW) EXISTING HOT WATER PIPING (EX HW) NEW HOT WATER PIPING (HW) DEMO HOT WATER PIPING (140°F) (EX HW(140°F)) EXISTING HOT WATER PIPING (140°F) (EX HW(140°F)) NEW HOT WATER PIPING (140°F) (HW(140°F)) DEMO HOT WATER RETURN PIPING (EX HWR) EXISTING HOT WATER RETURN PIPING (EX HWR) NEW HOT WATER RETURN PIPING (HWR) DEMO HOT WATER PIPING (160°F) (EX HW(160°F)) EXISTING HOT WATER PIPING (160°F) (EX HW(160°F)) NEW HOT WATER PIPING (160°F) (HW(160°F)) DEMO HOT WATER RETURN PIPING (160°F) (EX HWR(160°F)) EXISTING HOT WATER RETURN PIPING (160°F) (EX HWR(160°F) NEW HOT WATER RETURN PIPING (160°F) (HWR(160°F))

NOTE: HX = HEAT EXCHANGER

OFFICE OF ADMINISTRATION DIVISION OF FACILITIES HX: NEW HOT WATER PIPING (170°F) (HW(170°F)) MANAGEMENT, HX: NEW HOT WATER RETURN PIPING (170°F) (HWR(170°F)) **DESIGN AND** CONSTRUCTION

> **DESIGN & INSTALL** NEW DOMESTIC WATER **PLANT VETERANS HOME** BUILDING

STATE OF MISSOURI

MICHAEL L. PARSON,

GOVERNOR

GRASSI

NUMBER PE-23938

LICENSE #: E-23938 EXPIRATION DATE: 12/31/24

PROFESSIONAL SEAL

CASCO Diversified Corporation

MO Certificate of Authority #000329 Arch.

MO Certificate of Authority #000613 Eng. Exp. Date: 12/31/25

ST. JAMES VETERANS HOME 620 NORTH JEFFERSON ST. JAMES, MO

PROJECT # U2409-01 6801 SITE# FACILITY # 8136801002

REVISION: DATE **REVISION:** DATE: **REVISION:** DATE: ISSUE DATE: 08.15.2024

CAD DWG FILE:
DRAWN BY:
CHECKED BY:
TMG **DESIGNED BY:**

SHEET TITLE:


NURSING CORE C

KEY PLAN

PLUMBING - PHASE 1 **DEMOLITION & NEW**


SHEET NUMBER:

P-101 2 of 18 SHEETS 08.15.2024

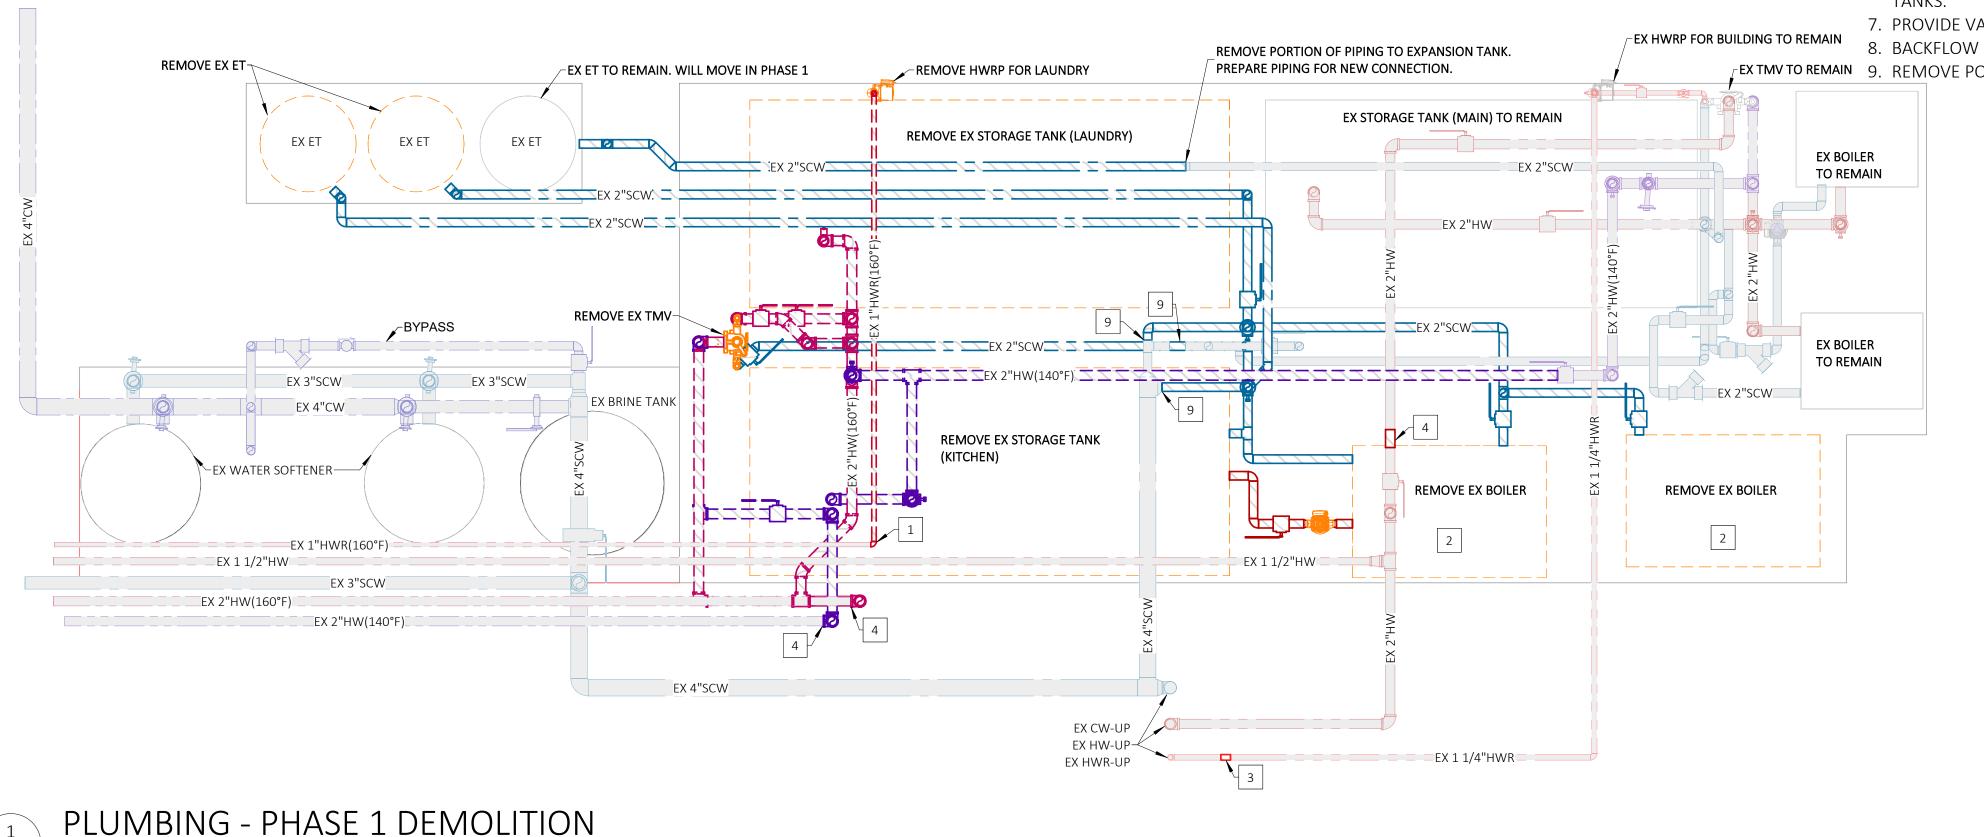

NOTE: MATTERPORT SURVEY LINK PROVIDED BELOW IS FOR REFERENCE ONLY, AND IS NOT INTENDED TO BE A SUBSTITUTE FOR FIELD INVESTIGATIONS BY THE CONTRACTOR.


MATTERPORT LINK: https://my.matterport.com/show/?m=vyscquW6hsr

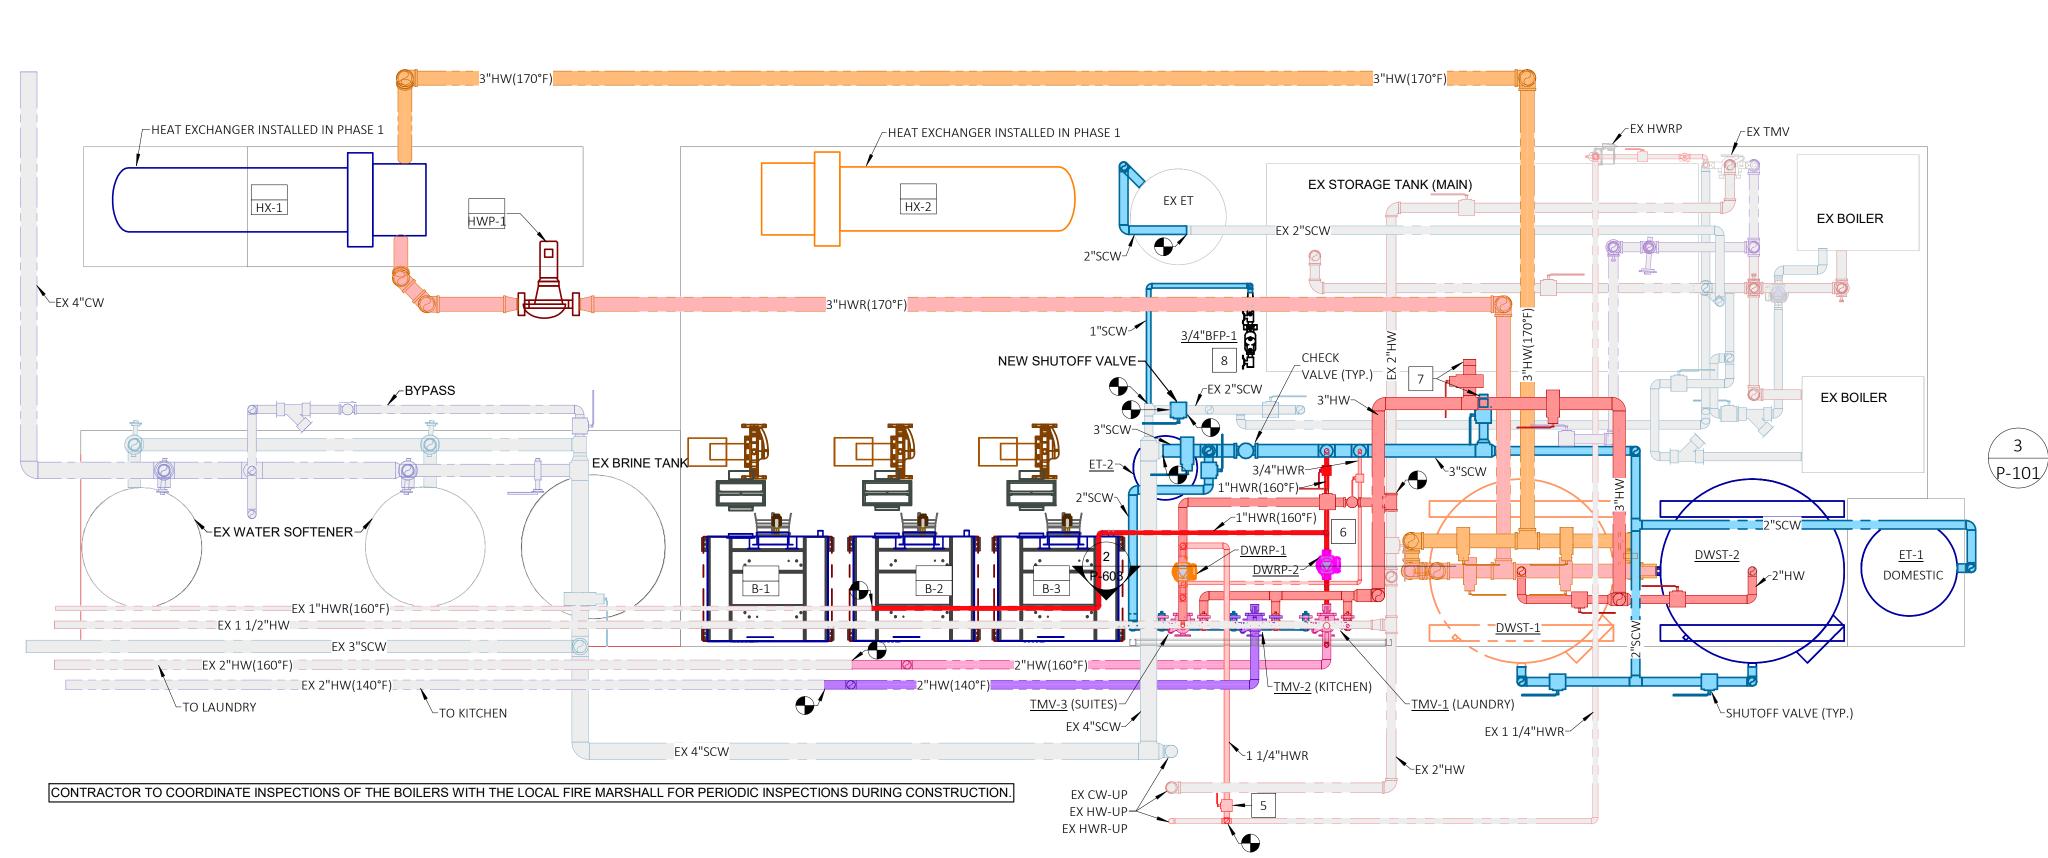


PLUMBING - PHASE 1 NEW WORK P-101 SCALE: 1/2" = 1'-0"

P-101 SCALE: 1/2" = 1'-0"

NOTE TO PRINTER THIS DRAWING PREPARED IN COLOR. TO IMPROVE READIBILITY, ADJUST PRINTER SETTINGS TO COLOR AND BE SURE THE QUALITY IS SET TO PRESENTATION OR SIMILAR.

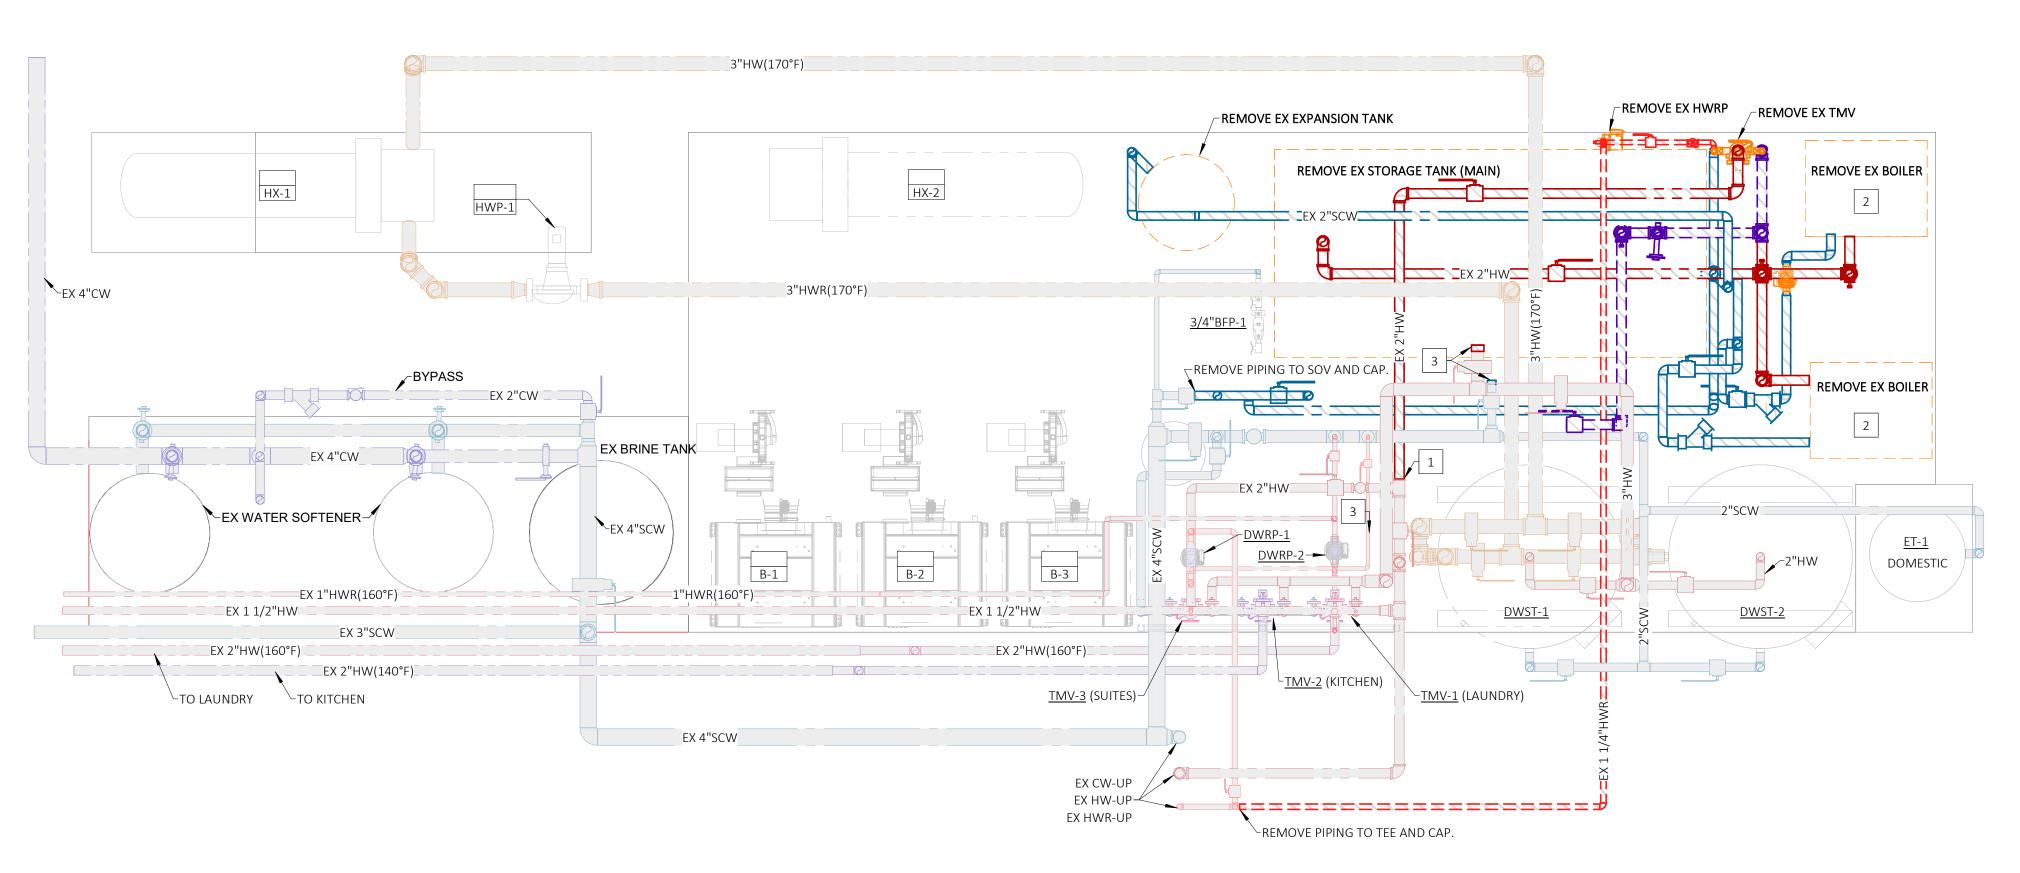

PLUMBING - PHASE 2 DEMOLITION SCALE: 1/2" = 1'-0"

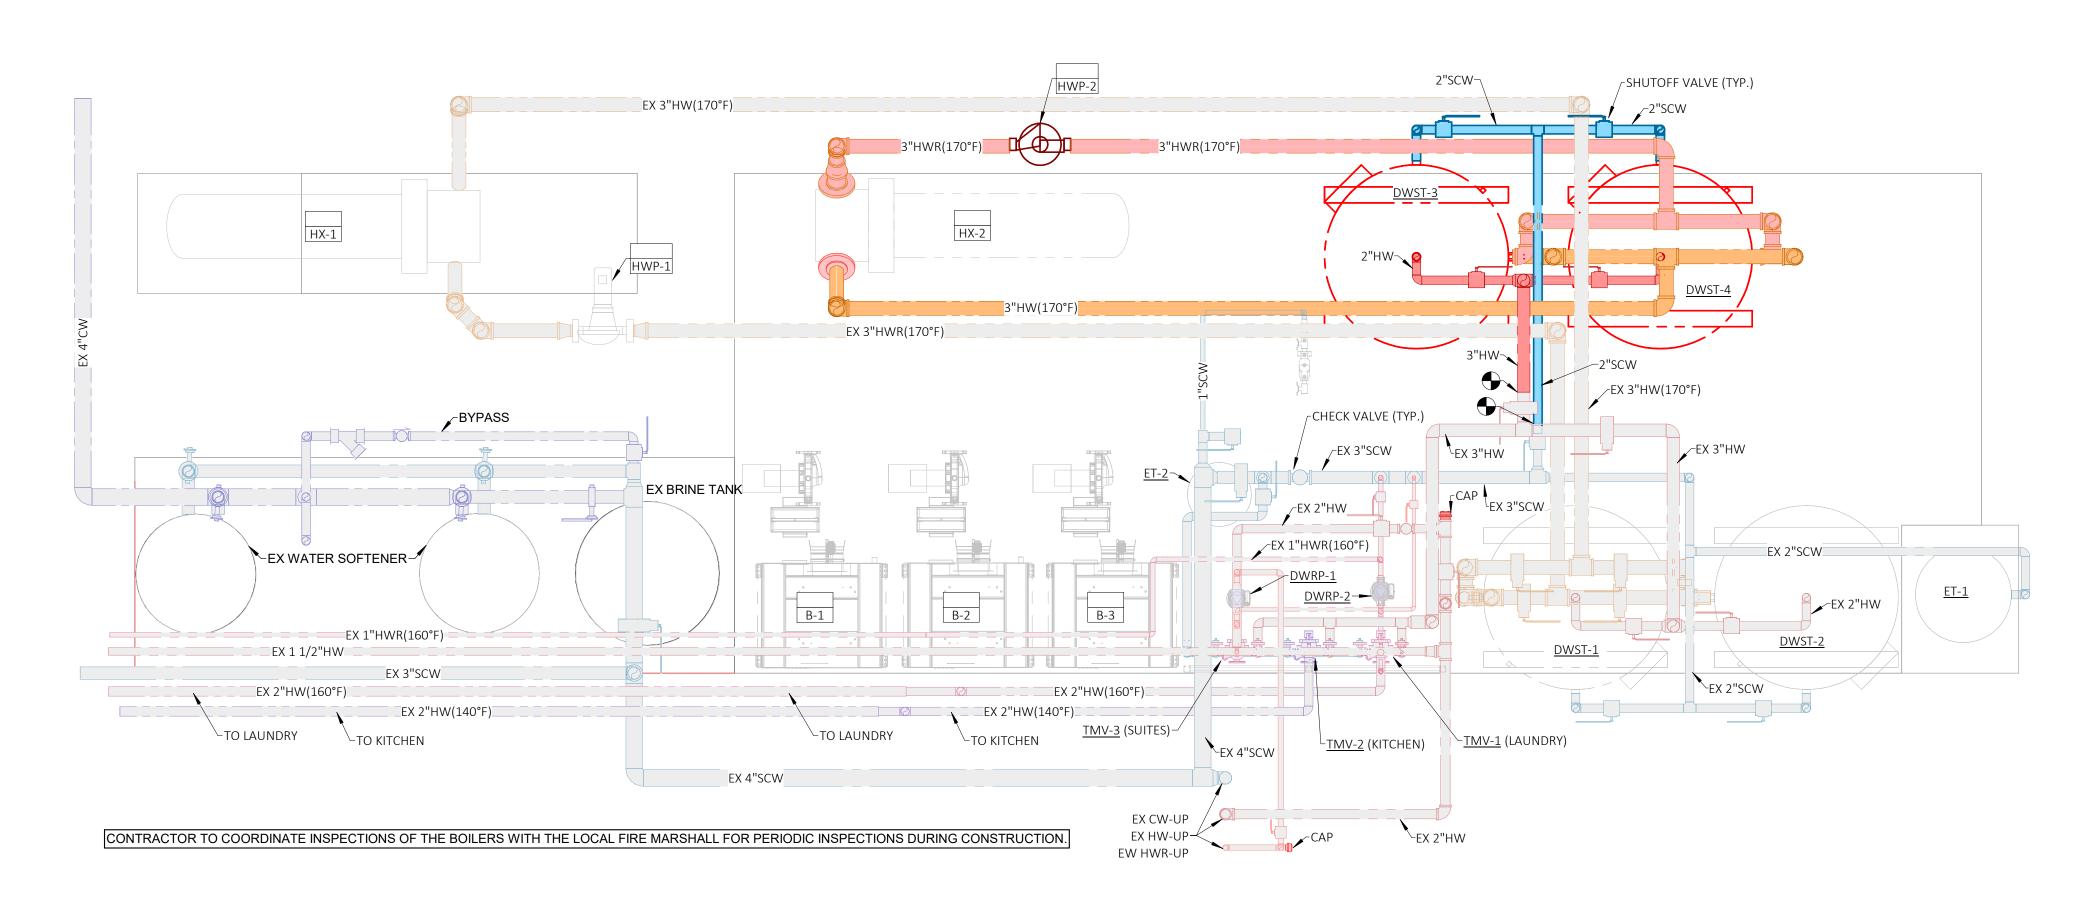

PLUMBING - PHASE 2 NEW WORK


GENERAL NOTES

A. RETURN EXISTING BOILERS TO BE REMOVED BACK TO THE OWNER.

KEYED NOTES

- 1. REMOVE PORTION OF PIPING. PREPARE PIPING FOR NEW CONNECTION.
- 2. REMOVE EXISTING INTAKE & VENT PIPING FOR EXISTING BOILERS TO BE REMOVED.
- 3. REMOVE EXISTING CAPS FOR CONNECTION TO PHASE 2 DOMESTIC WATER STORAGE TANKS.

PLUMBING LEGEND DEMO SOFT COLD WATER PIPING (EX SCW) EXISTING SOFT COLD WATER PIPING (EX SCW) NEW SOFT COLD WATER PIPING (SCW) DEMO HOT WATER PIPING (EX HW) EXISTING HOT WATER PIPING (EX HW) NEW HOT WATER PIPING (HW) DEMO HOT WATER PIPING (140°F) (EX HW(140°F)) EXISTING HOT WATER PIPING (140°F) (EX HW(140°F)) NEW HOT WATER PIPING (140°F) (HW(140°F)) DEMO HOT WATER RETURN PIPING (EX HWR) EXISTING HOT WATER RETURN PIPING (EX HWR) NEW HOT WATER RETURN PIPING (HWR) DEMO HOT WATER PIPING (160°F) (EX HW(160°F)) EXISTING HOT WATER PIPING (160°F) (EX HW(160°F)) NEW HOT WATER PIPING (160°F) (HW(160°F)) DEMO HOT WATER RETURN PIPING (160°F) (EX HWR(160°F)) EXISTING HOT WATER RETURN PIPING (160°F)(EX HWR(160°F)) NEW HOT WATER RETURN PIPING (160°F) (HWR(160°F)) HX: NEW HOT WATER PIPING (170°F) (HW(170°F)) HX: NEW HOT WATER RETURN PIPING (170°F) (HWR(170°F)) NOTE: HX = HEAT EXCHANGER

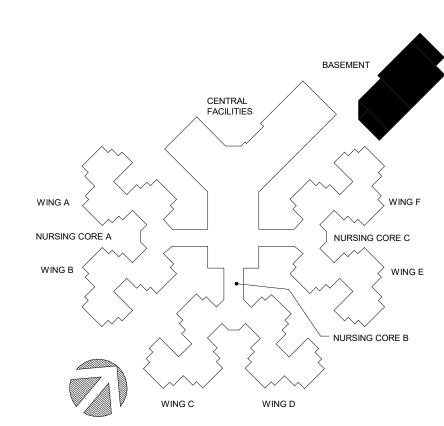


KEY PLAN

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STATE OF MISSOURI MICHAEL L. PARSON, GOVERNOR



Professional of Record:
THOMAS M. GRASSI
LICENSE #: E-23938
EXPIRATION DATE: 12/31/24
PROFESSIONAL SEAL

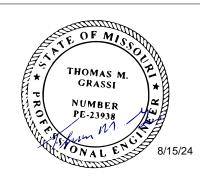CASCO Diversified Corporation
MO Certificate of Authority #000329 Arch.
MO Certificate of Authority #000613 Eng.
Exp. Date: 12/31/25

CASCO DIVERSIFIED CORPORATION
12 Sunnen Drive, Suite 100, St. Louis, MO 63143

OFFICE OF ADMINISTRATION DIVISION OF FACILITIES MANAGEMENT, DESIGN AND CONSTRUCTION

DESIGN & INSTALL
NEW DOMESTIC WATER
PLANT
VETERANS HOME
BUILDING

ST. JAMES VETERANS HOME 620 NORTH JEFFERSON ST. JAMES, MO

PROJECT # U2409-01 SITE # 6801 FACILITY # 8136801002

REVISION:
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DATE:
REVISION:
DATE:
REVISION:
DATE:
ISSUE DATE: 08.15.2024


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CHECKED BY:
DESIGNED BY:

SHEET TITLE:

PLUMBING - PHASE 2 DEMOLITION & NEW

SHEET NUMBER:

P-102
3 of 18 SHEETS
08.15.2024

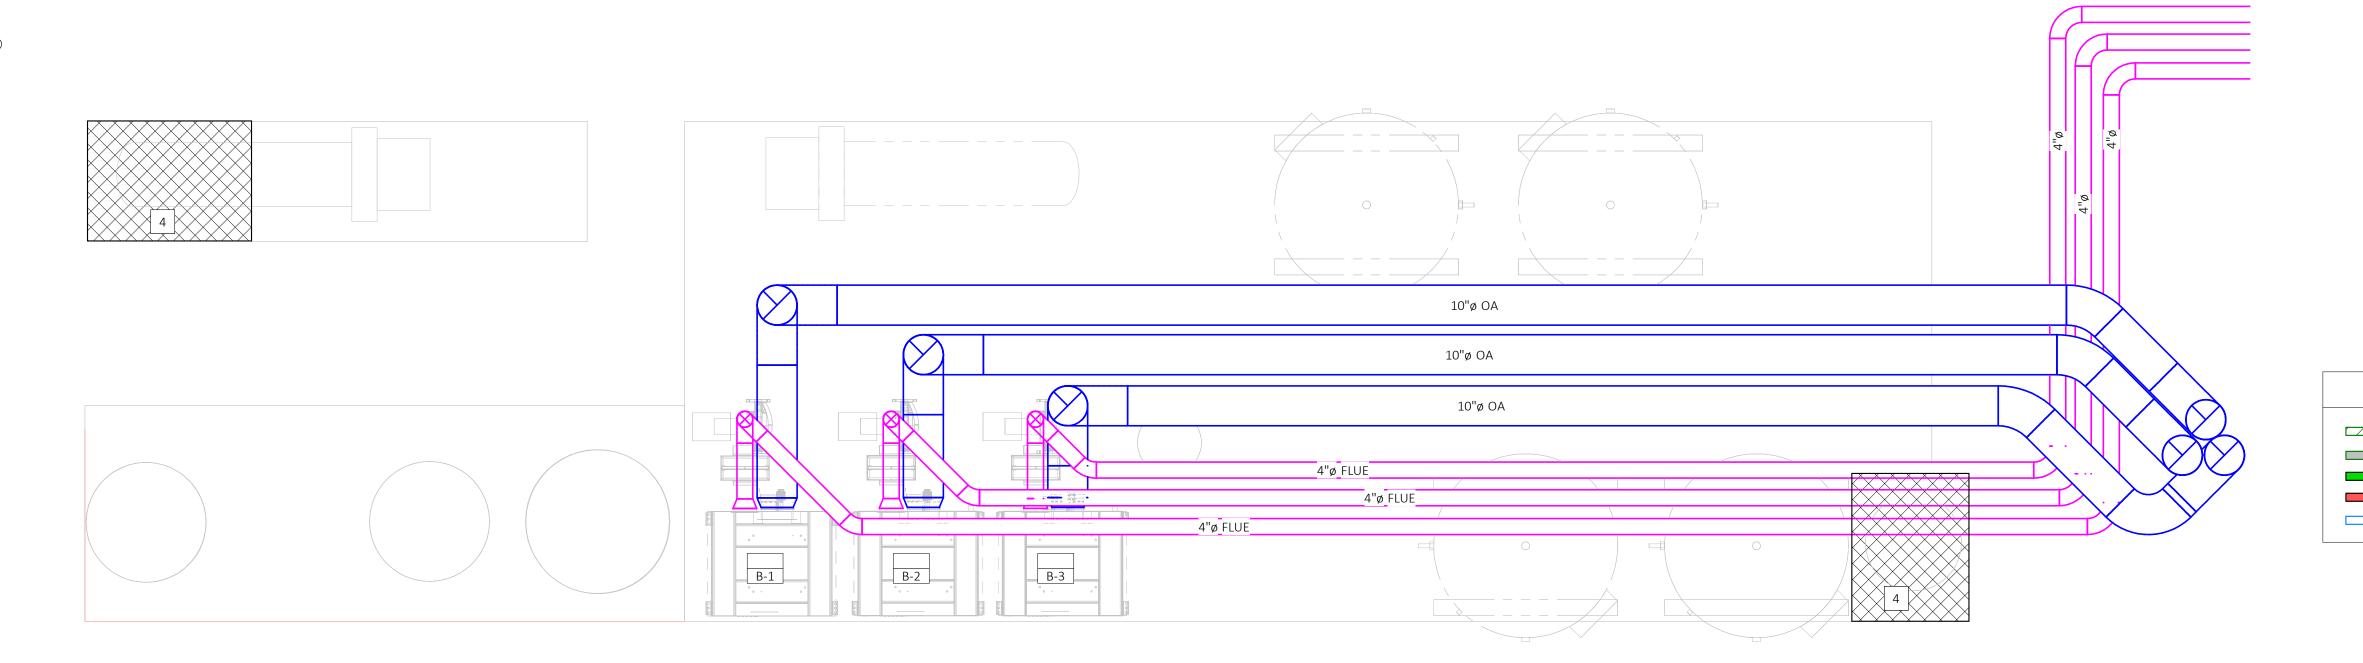

GENERAL NOTES


- A. AFTER 10" DIAMETER FLUES FROM BOILERS PENETRATE THE ROOF, THEY SHALL BE OFFSETTED TO ALLOW RAIN CAPS TO BE INSTALLED.
- CAPS TO BE INSTALLED.

 B. REFER TO THE RISER DIAGRAM LOCATED ON SHEET P-603 FOR LOCATIONS OF ALL VALVES & ACCESSORIES
- TO THE BOILERS & HEAT EXCHANGERS.

 C. BOILER CONNECTIONS SHALL BE FLANGED TO ALLOW EASE OF MAINTENANCE.


KEYED NOTES

- 1. CONNECT NEW 2" NATURAL GAS TO EXISTING NATURAL GAS TEE IN PHASE 1.
- 2. INSTALL NEW 2" NATURAL GAS TAP INTO EXISTING 4" NATURAL GAS MAIN IN PHASE 1.
- 3. REMOVE EXISTING 2" NATURAL GAS PIPING IN PHASE 2 BACK TO ACTIVE MAIN & CAP.
- 4. EXTEND 4" HOUSEKEEPING PAD AS SHOWN. BLOCK OUT EXISTING FLOOR DRAIN(S) AS REQUIRED TO MAINTAIN PROPER DRAINAGE.

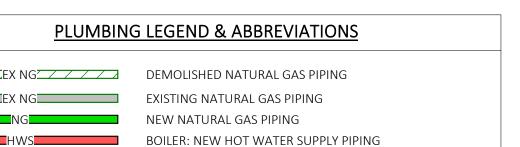


BOILER: NEW HOT WATER RETURN PIPING

ENLARGED FLOOR PLAN - DOMESTIC WATER SOURCE HEATING EXHAUST, FLUE & PAD ENLARGEMENT - PHASE 1

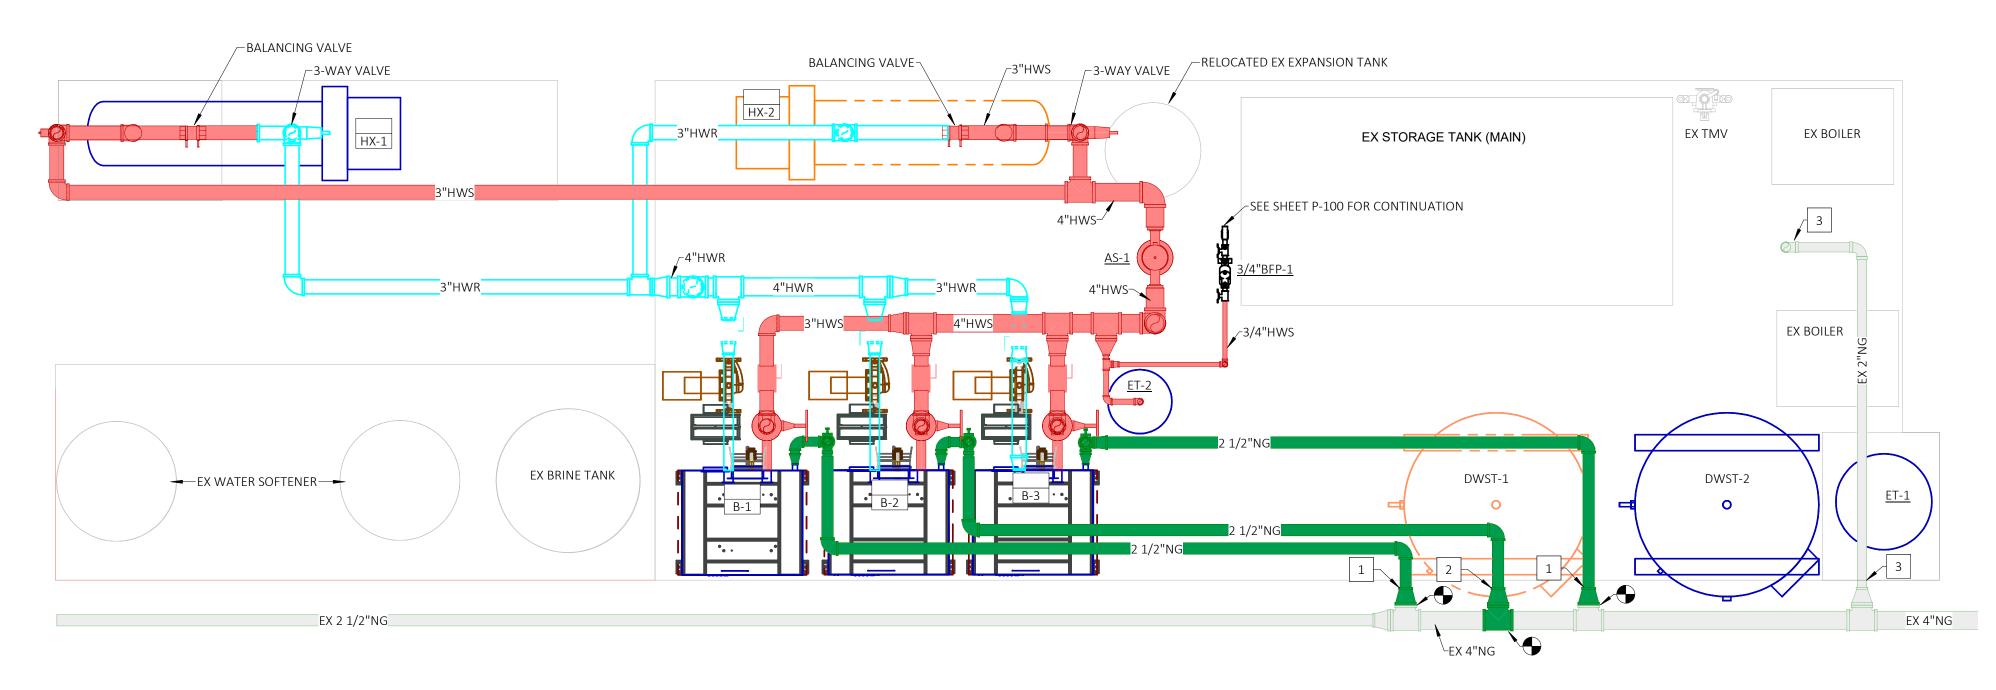


ENLARGED FLOOR PLAN - DOMESTIC WATER SOURCE HEATING - PHASE 1

P-103 SCALE: 1/2" = 1'-0"

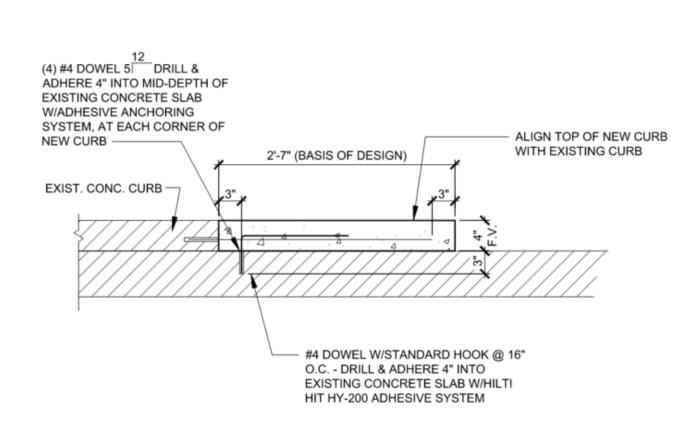


NEW CONC. CURB DETAIL
P-103 SCALE: NONE

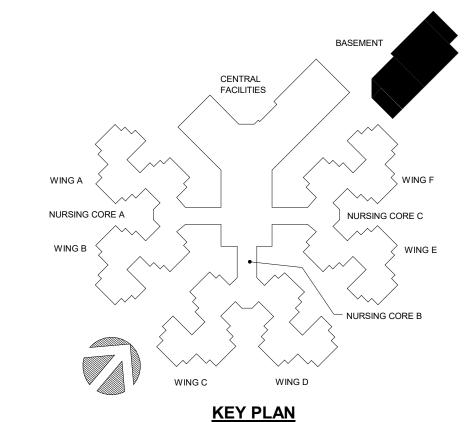

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12 Sunnen Drive, Suite 100, St. Louis, MO 63143 T:

OFFICE OF ADMINISTRATION DIVISION OF FACILITIES MANAGEMENT, DESIGN AND CONSTRUCTION

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ST. JAMES VETERANS HOME 620 NORTH JEFFERSON ST. JAMES, MO
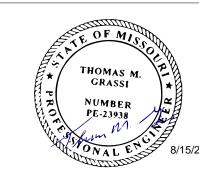
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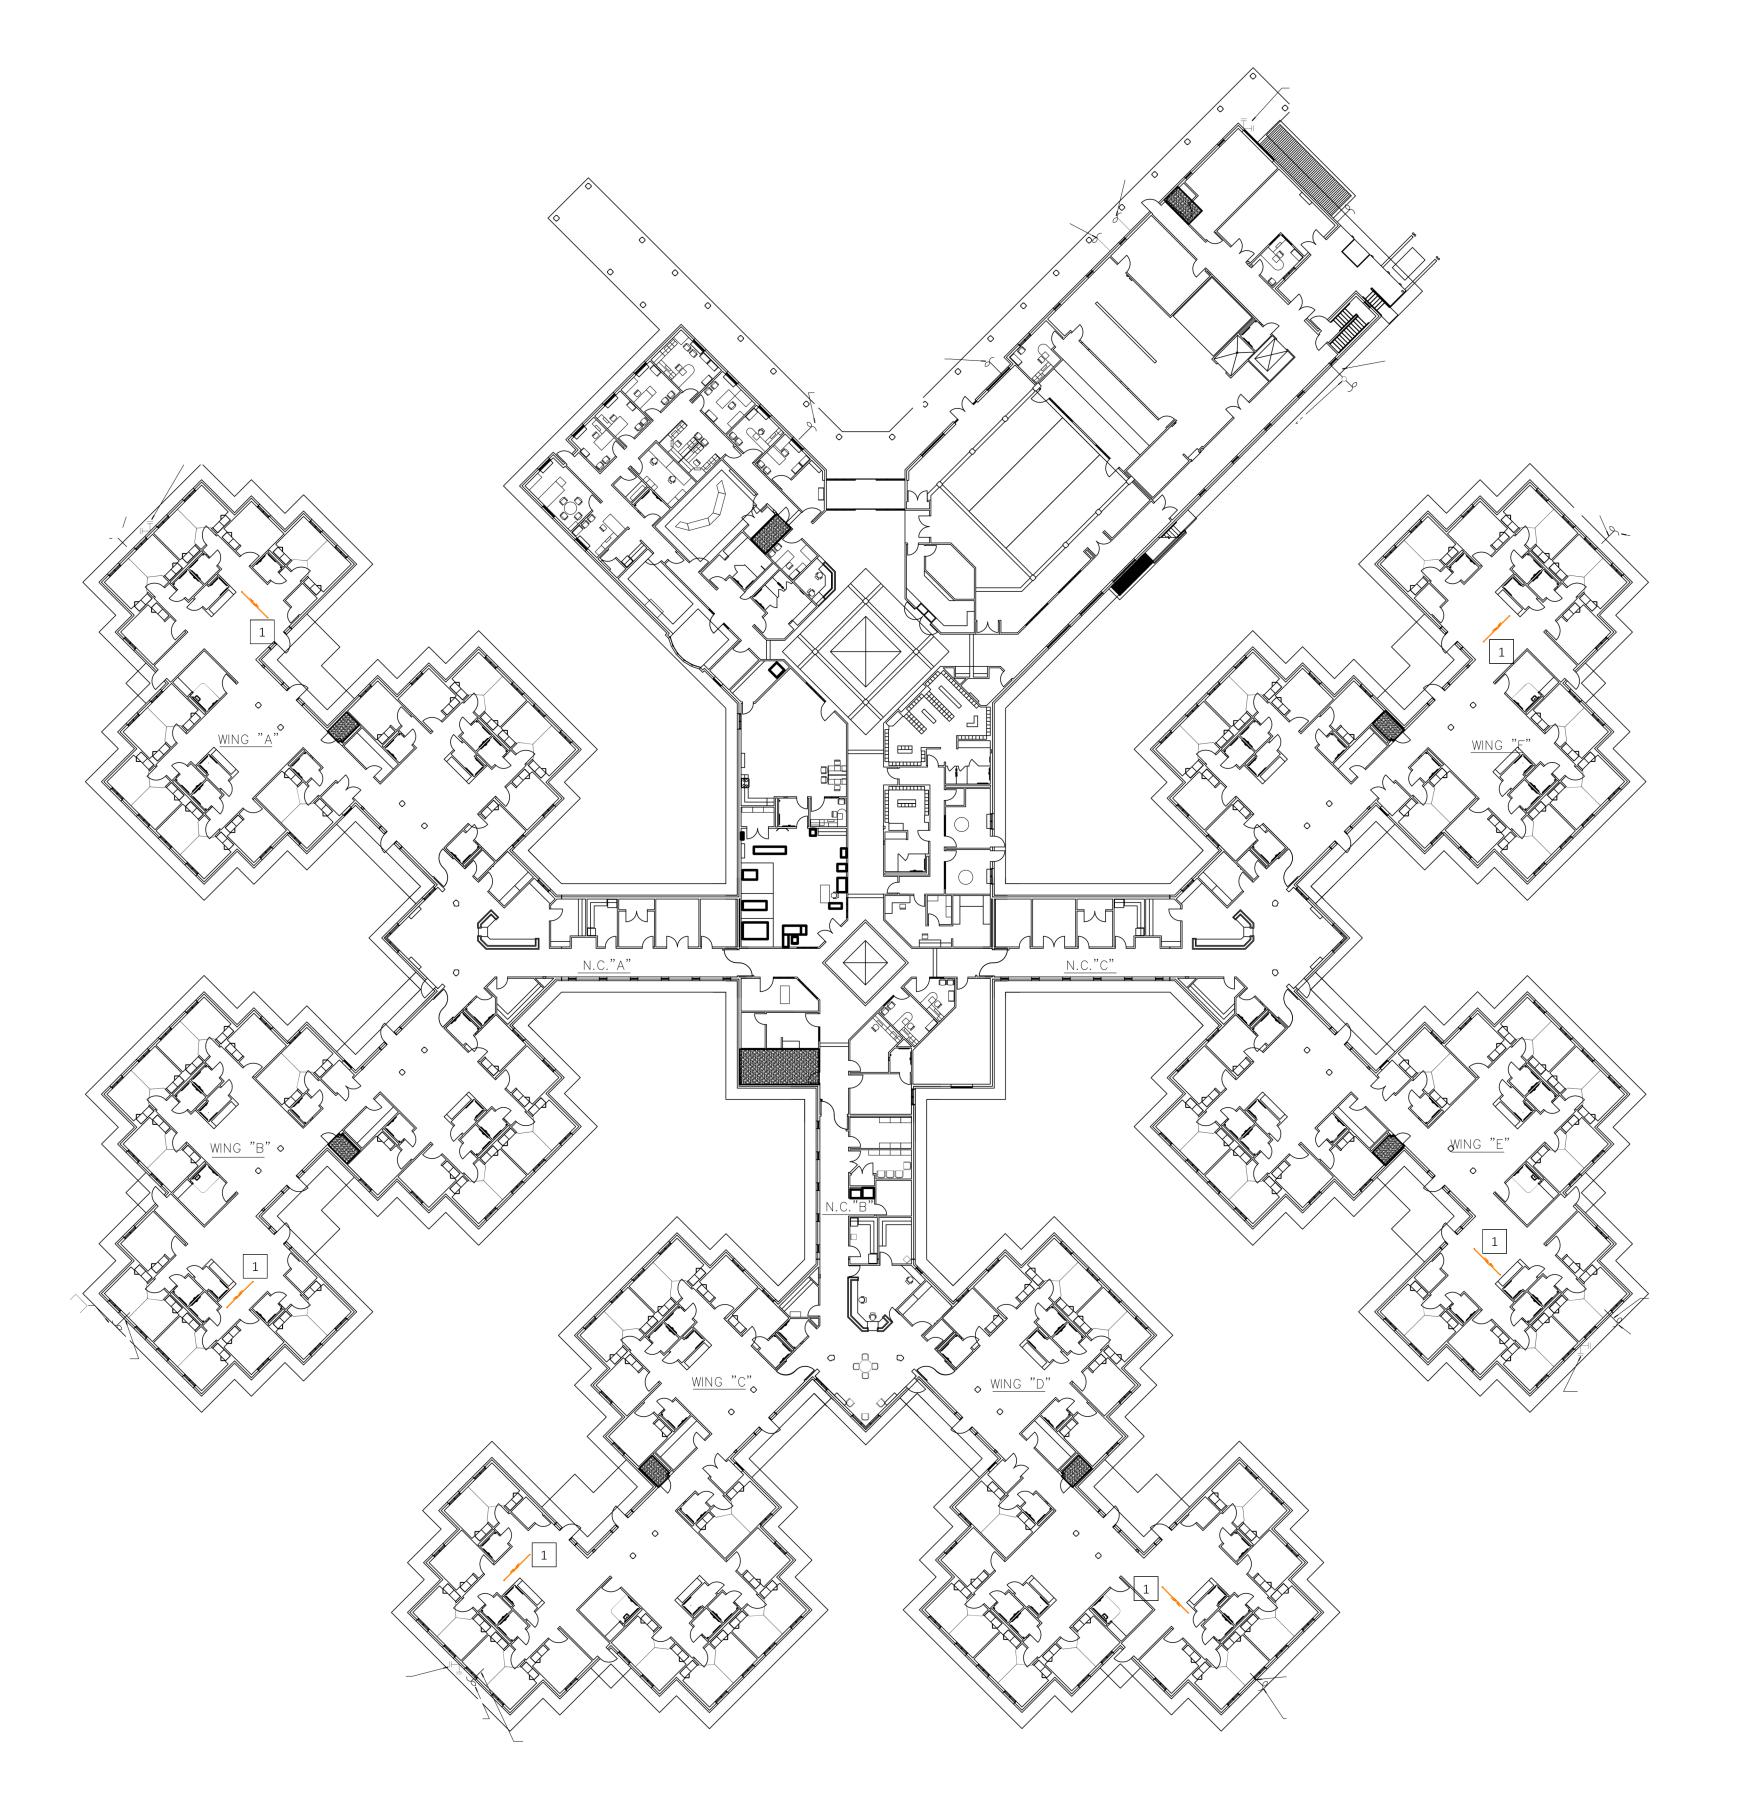
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SHEET TITLE:

PLUMBING BASEMENT FLOOR PLANS

SHEET NUMBER:

P-103
4 of 18 SHEETS
08.15.2024



FIRST FLOOR OVERALL - PLUMBING - ALTERNATE #2


P-104 SCALE: 3/32" = 1'-0"

ALTERNATE #2 (THIS SHEET):

ALTERNATE NO. 2: REPLACE THE EXISTING BALANCING VALVES WITH THERMOSTATICALLY OPERATED BALANCING VALVE STATIONS, INCLUDING CHECK VALVES, THERMOMETER, AND STOP VALVES.

NOTE: CONTRACTOR TO FIELD VERIFY EXACT LOCATIONS OF EXISTING BALANCING VALVES.

STATE OF MISSOURI MICHAEL L. PARSON, GOVERNOR

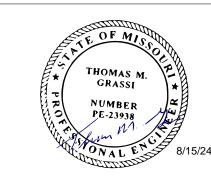

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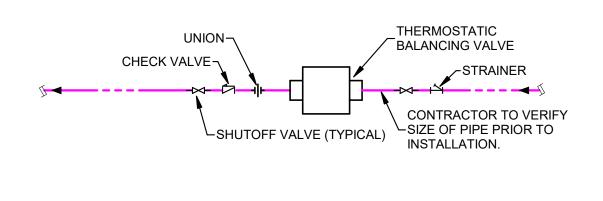
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TMG
DESIGNED BY:

SHEET TITLE:

PLUMBING FIRST FLOOR PLAN -ALTERNATE #2


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08.15.2024



NOTE: THERMOSTATIC BALANCING VALVE MAY BE PROVIDED WITH PACKAGED CHECK VALVE, STRAINER, & SHUTOFF VALVES.

UNION OR FLANGE(TYP.)-FLEXIBLE CONNECTION (TYP.) THERMOMETER-PRESSURE GAUGE (TYP)-**∽**STRAINER —CHECK VALVE VALVE (TYP.) -SUPPORT EACH SIDE OF PUMP

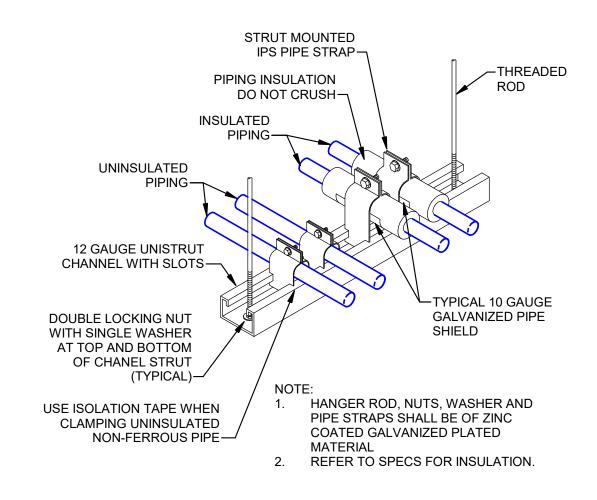



BACKFLOW PREVENTER



DOMESTIC HOT WATER RECIRCULATING PUMP (4) TRAPEZE PIPE SUPPORT


P-501 SCALE: NONE

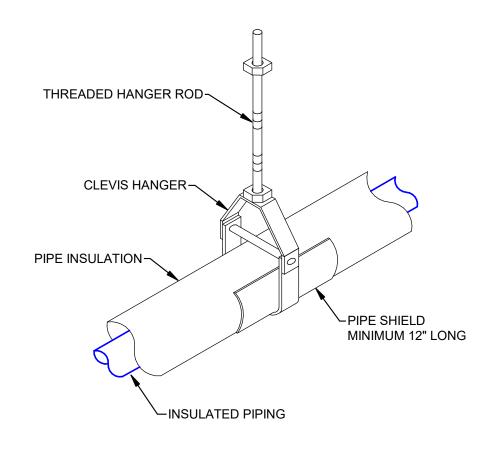

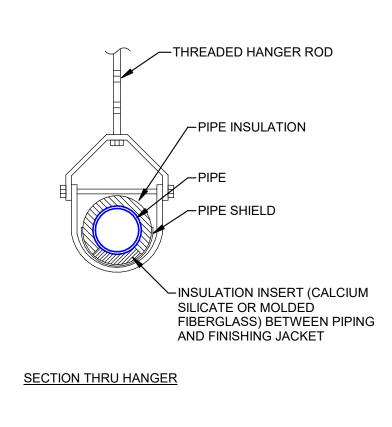

REFER TO SPECS FOR INSULATION

BOILER -SHUTOFF VALVE -SEE PLANS FOR SIZING

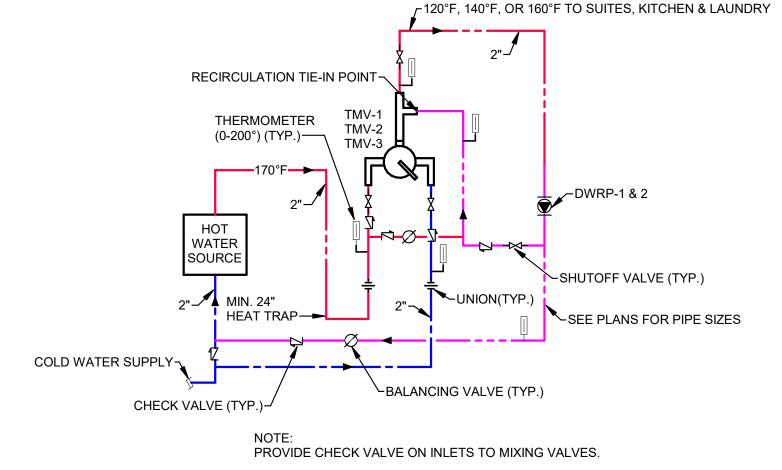

NO HOT WATER RETURN LINE FOR THE KITCHEN.

COMPLY WITH MANUFACTURER'S PIPING SCHEMATIC.

INSULATED PIPE HANGER SUPPORT

P-501 SCALE: NONE P-501/ SCALE: NONE

GAS CONNECTION AT BOILERS

THERMOSTATIC MIXING VALVE (TMV-1, 2, & 3) P-501 SCALE: NONE

> 620 NORTH JEFFERSON ST. JAMES, MO

OFFICE OF

DIVISION OF

FACILITIES

DESIGN AND

PLANT

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MANAGEMENT,

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VETERANS HOME

NEW DOMESTIC WATER

ST. JAMES VETERANS HOME

ADMINISTRATION

STATE OF MISSOURI

MICHAEL L. PARSON,

GOVERNOR

GRASSI

NUMBER PE-23938

Professional of Record: THOMAS M. GRASSI LICENSE #: E-23938 EXPIRATION DATE: 12/31/24

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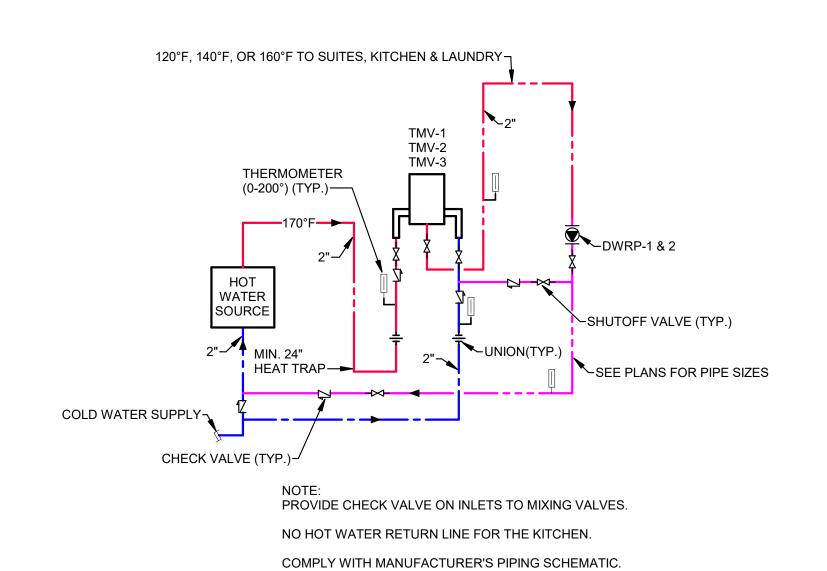
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TMG DESIGNED BY

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PLUMBING DETAILS

SHEET NUMBER:

P-501 6 of 18 SHEETS 08.15.2024



ELECTRONIC THERMOSTATIC MIXING VALVE (TMV-1, 2, & 3) - ALTERNATE #1 8 P-501

SEQUENCES OF OPERATION - DOMESTIC WATER HEATING SYSTEM:

SYSTEM GENERAL DESCRIPTION:

THIS PRIMARY DOMESTIC WATER HEATING SYSTEM SHALL BE CONTROLLED BY THE BOILER MANUFACTURER'S PACKAGED CONTROL SYSTEM. ALL SYSTEM ALARMS AND TEMPERATURE SENSORS SHALL REPORT BACK TO THE OWNER'S EXISTING SCHNEIDER ELECTRIC BUILDING AUTOMATION SYSTEM (BAS).

SCHNEIDER ELECTRIC CONTACT: C&C GROUP - BRIAN SCHEPERS, (573) 632-4247

THE SYSTEM SHALL BE BROKEN UP INTO TWO CIRCUITS- THE PRIMARY DOMESTIC WATER HEATING LOOP, AND THE DOMESTIC HOT WATER SYSTEM.

THE PRIMARY DOMESTIC WATER HEATING SYSTEM SHALL CONSIST OF THREE BOILERS, THREE PUMPS, TWO HEAT EXCHANGERS, PIPING AND VARIOUS CONTROL VALVES, DAMPERS AND OTHER CONTROL COMPONENTS.

THE DOMESTIC HOT WATER SYSTEM SHALL CONSIST OF FOUR DOMESTIC WATER STORAGE TANKS, TWO DOMESTIC WATER PUMPS, THREE DOMESTIC WATER TEMPERATURE SYSTEMS WITH ASSOCIATED THERMAL MIXING VALVES, AND TWO DOMESTIC WATER RECIRCULATING PUMPS.

PRIMARY DOMESTIC WATER HEATING SYSTEM:

BOILERS:

MANUFACTURER'S BOILER CONTROL SYSTEM SHALL STAGE BOILERS AND MODULATE HEATING INPUT AS REQUIRED TO PROVIDE A 190F (ADJUSTABLE) SUPPLY WATER TEMPERATURE IN THE PRIMARY LOOP AS SENSED BY TS-1. BOILERS SHALL BE STAGED TO ENSURE EQUAL RUN TIME / LOADING ON ALL THREE BOILERS AND THEIR ASSOCIATED PUMPS.

A MINIMUM OF ONE BOILER AND ONE PUMP SHALL PROVIDE CONTINUOUS CIRCULATION THROUGH THE PRIMARY LOOP AT ALL TIMES.

WHEN A DISABLED BOILER IS REQUIRED TO BE ENERGIZED, THE MANUFACTURERS PROGRAM SHALL:

- 1. OPEN THE ASSOCIATED BOILER MOTORIZED ISOLATION VALVE (CV-1, CV-2, OR CV-3),
- 2. ENERGIZE THE ASSOCIATED BOILERS PUMP (BP-1, BP-2, OR BP-3),
- 3. OPEN THE ASSOCIATED BOILERS FOWE (BF-1, BF-2, OR BF-3),

 3. OPEN THE ASSOCIATED OUTSIDE AIR AND FLUE DAMPERS (WHILE ENERGIZING BURNER BLOWER).
- 4. ENERGIZE BURNER SEQUENCE.

WHEN A BOILER IS REQUIRED TO BE DE-ENERGIZED, A REVERSE SEQUENCE SHALL BE FOLLOWED.

WHEN ONE OR MORE BOILERS ARE OPERATING TOGETHER, THE MANUFACTURER'S CONTROL SYSTEM SHALL MODULATE HEATING OUTPUT AS REQUIRED AND STAGE THE BOILERS TO MAINTAIN PROPER PRIMARY LOOP TEMPERATURE.

BOILER SAFETIES:

BOILERS SHALL OPERATE WITH THEIR OWN SAFETIES AND CONTROLS. MASTER ALARMS SHALL BE ANNUNCIATED IN OWNERS EXISTING BAS.

BOILER PUMP FAILURE- IF AN ASSOCIATED PUMP IS ENABLED AND THE CURRENT SWITCH IS OFF FOR MORE THAN 30 SECONDS (ADJ), THE SYSTEM SHALL ANNUNCIATE A BOILER CIRCULATION PUMP FAILURE ALARM TO THE BAS AND DISABLE THE ASSOCIATED BOILER.

HEAT EXCHANGERS:

THE HEAT EXCHANGERS THREE WAY VALVES SHALL MODULATE THE PRIMARY DOMESTIC WATER FLOW TO MAINTAIN THE TEMPERATURE INSIDE THEIR RESPECTIVE DOMESTIC HOT WATER STORAGE TANKS (DWST-1, DWST-2, DWST-3, & DWST-4). THE TEMPERATURE INSIDE THE TANKS SHALL BE MAINTAINED AT 170F (ADJ) AT ALL TIMES AS SENSED BY TS-3, TS-4, TS-14, & TS-15 (DWST TEMPERATURES).

DOMESTIC HOT WATER SYSTEM:

DOMESTIC HOT WATER PUMPS (HWP-1 AND HWP-2) SHALL RUN CONTINUOUSLY.

DOMESTIC HOT WATER RECIRCULATION PUMPS (DWRP-1 AND DWRP-2) SHALL RUN CONTINUOUSLY. CONTROLLER SHALL MODULATE PUMP SPEED VIA VFD TO MAINTAIN A MINIMUM RECIRCULATION TEMPERATURE OF 105°F & 140°F (ADJ) AS SENSED BY TS-12 AND TS-13.

ADDITIONAL SYSTEM MONITORING AND ALARMS:

TS-5 / TS-7 / TS-6 / (DWST'S ENTERING WATER TEMPERATURE) AND TS-6 / TS-8 (DWST'S LEAVING WATER TEMPERATURE) SHALL BE MONITORED FOR TREND ANALYSIS.

TS-9 / TS-10 / TS-11 (DOWNSTREAM THERMAL MIXING VALVE TEMPERATURES) SHALL BE MONITORED FOR TREND ANALYSIS.

TS-3 / TS-4 / TS-14 / TS-15 (DWST TEMPERATURES):


- HIGH TEMPERATURE ALARM 175F (ADJ).
- HIGH TEMPERATURE SAFETY: ABOVE 185F (ADJ), THE APPROPRIATE PRIMARY HEATING VALVE (CV-4 OR CV-5) FOR THE HEAT EXCHANGER SHALL BE MOVED TO FULL BYPASS POSITION. ABOVE 190F, ALL BOILERS SHALL BE DE-ENERGIZED.

- LOW TEMPERATURE ALARM 160F (ADJ).

NOTE: MATTERPORT SURVEY LINK PROVIDED BELOW IS FOR REFERENCE ONLY,
AND IS NOT INTENDED TO BE A SUBSTITUTE FOR FIELD INVESTIGATIONS BY THE CONTRACTOR.

MATTERPORT LINK: https://my.matterport.com/show/?m=vyscquW6hsr

STATE OF MISSOURI MICHAEL L. PARSON, GOVERNOR

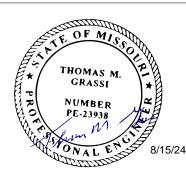

Professional of Record:
THOMAS M. GRASSI
LICENSE #: E-23938
EXPIRATION DATE: 12/31/24
PROFESSIONAL SEAL

CASCO Diversified Corporation
MO Certificate of Authority #000329 Arch.
MO Certificate of Authority #000613 Eng.
Exp. Date: 12/31/25

CASCO DIVERSIFIED CORPORATION
12 Sunnen Drive, Suite 100, St. Louis, MO 63143

OFFICE OF ADMINISTRATION DIVISION OF FACILITIES MANAGEMENT, DESIGN AND CONSTRUCTION

DESIGN & INSTALL
NEW DOMESTIC WATER
PLANT
VETERANS HOME
BUILDING

ST. JAMES VETERANS HOME 620 NORTH JEFFERSON ST. JAMES, MO

PROJECT # U2409-01 SITE # 6801 FACILITY # 8136801002

REVISION:
DATE:
REVISION:
DATE:
REVISION:
DATE:
ISSUE DATE: 08.15.2024

CAD DWG FILE:
DRAWN BY:
CHECKED BY:
TMG
DESIGNED BY:

SHEET TITLE:

PLUMBING SEQUENCE OF OPERATIONS

SHEET NUMBER:

P-601
7 of 18 SHEETS
08.15.2024

								235233 FIRE	TUBE BOILER	SCHEDULE								
LAN DESIG.	SERVES	LOCATION	MFGR	MODEL	TYPE	FUEL	INPUT (MBH)	OUTPUT	DESIGN	EWT (F)	LWT (F)	FLOWRATE (GPM)	MAX WPD (FT	VOLTAGE	POWER	N40A	OPERATING	NOTES
							, ,	(MBH)	PRESS	, ,		,	HD)	VOLTAGE	PHASE	MCA	WEIGHT (LBS)	
B-1	DOM HTG	SEE PLAN	RAYPAK	MVB-1253A	NOTE 1	NAT GAS	1,250	1,078	ASME 160	170	190	100	2.5	120	1	9	780	1-5
B-2	DOM HTG	SEE PLAN	RAYPAK	MVB-1253A	NOTE 1	NAT GAS	1,250	1,078	ASME 160	170	190	100	2.5	120	1	9	780	1-5
B-3	DOM HTG	SEE PLAN	RAYPAK	MVB-1253A	NOTE 1	NAT GAS	1,250	1,078	ASME 160	170	190	100	2.5	120	1	9	780	1-5

1. TYPE: NON-CONDENSING COPPER FIN TUBE.

2. BACNET INTERFACE.

3. PROVIDE GAS TRAIN: ASME CSD-1.

4. OPTIONAL ACCESSORIES SHALL INCLUDE: ASME RELIEF VALVE, FULL MODULATING CONTROLS WITH OUTPUTS TO OWNERS BUILDING AUTOMATION SYSTEM, MULTI-BOILER STAGING, AND CODE REQUIRED BOILER SAFETIES.

5. ALL FITTINGS, VALVES, AND SURFACES TOUCHING FLUIDS SHALL MEET AWWA STANDARDS FOR USE IN DOMESTIC WATER SYSTEMS.

						232123 I	HYDRONIC PU	MP SCHEDULE							
PLAN DESIG.	MFGR	MODEL	TYPE	SERVICE	CAPACITY (GPM)	TOTAL HEAD (FT)	MAX FLUID TEMP. (F)	FLUID TYPE	MOTOR HP	RPM	EFFICIENCY (%)	VOLTS / PHASE /	PUMF SUCTION (IN)	P SIZE DISCHARGE	NOTES
BP-1	B&G	E-80, 4X4X7B	INLINE	190F	100	80	190	DOMESTIC	5	1760	72.5	480/3	2	2	1, 3, 4
BP-2	B&G	E-80, 4X4X7B	INLINE	190F	100	80	190	DOMESTIC	5	1760	72.5	480/3	2	2	1, 3, 4
BP-3	B&G	E-80, 4X4X7B	INLINE	190F	100	80	190	DOMESTIC	5	1760	72.5	480/3	2	2	1, 3, 4
HWP-1	TACO	KV-3009D	INLINE	190F	150	55	190	DOMESTIC	5	1760	67	480/3	3	3	1, 3, 4
HWP-2	TACO	KV-3009D	INLINE	190F	150	55	190	DOMESTIC	5	1760	67	480/3	3	3	1, 3, 4
DWRP-1	B&G	ECOCIRC XL 36-45	INLINE	120 F	15	25	140	DOMESTIC	1/6	-	-	115/1	1.25	1.25	1, 2, 3, 4, 5
DWRP-2	B&G	ECOCIRC XL 20-35	INLINE	160 F	3	12	160	DOMESTIC	1/12	-	-	115/1	1.25	1.25	1, 2, 3, 4, 5

1. MOTOR STARTER AND LOCAL NON-FUSED DISCONNECT SHALL BE PROVIDED BY MANUFACTURER.

2. ECM AND DRIVE SHALL BE PROVIDED.

SUITES: 120°F & KITCHEN: 140°F

3. SUCTION DIFFUSER WITH INTEGRAL STRAINER.

4. ALL FITTINGS, VALVES, AND PUMP COMPONENTS TOUCHING FLUIDS SHALL MEET AWWA STANDARDS FOR USE IN DOMESTIC WATER SYSTEMS.

5. DWRP-1 & DWRP-2 SHALL BE OPERATED PER PROPORTIONAL PRESSURE MODE.

					232	116 AIR SEPAF	RATOR SCHEE	ULE					
PLAN DESIG.	MFGR	MODEL	TYPE	SERVICE	FLOWRATE (GPM)	TANK VOL (GAL)	MAX HEAD LOSS (FT)	CONNECTION (IN)	TK (IN)	MAXIMUN TEMP (F)	M DESIGN PRESS	OPERATING WEIGHT (LBS)	NOTES
AS-1	B&G	RL-4F	TANGENTIAL	DOMESTIC	300	13	3	4	12.75	350	125	287	1

1. ALL FITTINGS AND VALVES SHALL MEET AWWA STANDARDS FOR USE IN DOMESTIC WATER SYSTEMS.

			ET-1	B&G	
			ET-2	B&G	
		1			
_E			NOTES:		
			1. ALL FITTING	S, VALVES, AN	L
LEAVING TEMPERATURE	NOTES				

	ELECTRONIC T	HERMOSTA	ATIC MIXING	VALVE SO	CHEDULE - A	LTERNATE #1	
PLAN MARK	DESCRIPTION	MANUFACTURER	MODEL		FLOW	LEAVING TEMPERATURE	NOTES
IVIARK				MINIMUM GPM	GPM @ 10 PSI LOSS		
ETMV-1	ELECTRONIC THERMOSTATIC MIXING VALVE	LEONARD	NUCLEUS NV-150-LF	0.25	72	120°F	
ETMV-2	ELECTRONIC THERMOSTATIC MIXING VALVE	LEONARD	NUCLEUS NV-150-LF	0.25	72	140°F	
ETM\/-3	ELECTRONIC THERMOSTATIC MIXING VALVE	LEONARD	NUCLEUS NV-150-LE	0.25	72	160°F	

FLOW
MINIMUM GPM GPM @ 10 PSI LOSS

THERMOSTATIC MIXING VALVE SCHEDULE

0.5

TM-2020B-LF-DT

TM-820B-LF-DT

PLAN MARK

DESCRIPTION

TMV-1 THERMOSTATIC MIXING VALVE

TMV-2 & 3 THERMOSTATIC MIXING VALVE

MANUFACTURER

LEONARD

LEONARD

				2321	116 EXPANSIO	ON TANK SCHED	ULE				
PLAN DESIG.	MFGR	MODEL	TYPE	SERVICE	TANK VOL	ACCEPTANCE		TK		/ DESIGN	NOTES
,					(GAL)	VOL (GAL)	(IN)	(IN)	TEMP (F)	PRESS	
ET-1	B&G	PTA-210	DIAPHRAGM	DOMESTIC	90	60	53	24	240	150	1
ET-2	B&G	PTA-30	DIAPHRAGM	DOMESTIC	15	10	25	16	240	150	1
NOTES:											

ND SURFACES TOUCHING FLUIDS SHALL MEET AWWA STANDARDS FOR USE IN DOMESTIC WATER SYSTEMS.

223450 DOMESTIC HOT WATER STORAGE TANK SCHEDULE

PLAN DESIG.	MFGR	MODEL	TYPE	SERVICE	GAL	REMARKS
DWST-1	PVI	AQUAPLEX	DOMESTIC	НОТ	300	1, 2, 3, 4
DWST-2	PVI	AQUAPLEX	DOMESTIC	НОТ	300	1, 2, 3, 4
DWST-3	PVI	AQUAPLEX	DOMESTIC	НОТ	300	1, 2, 3, 4
DWST-4	PVI	AQUAPLEX	DOMESTIC	НОТ	300	1, 2, 3, 4

REMARKS:

1. PROVIDE UNIT WITH THE FOLLOWING OPTIONS: ASME RATED VESSEL, INSULATION.

2. DIFFUSER TUBES ON COLD WATER MAKEUP AND HEATED WATER RETURN CONNECTIONS (1.0 PSI MAX PRESSURE DROP).

3. MANWAY ACCESS.


4. ALL FITTINGS, VALVES, AND SURFACES TOUCHING FLUIDS SHALL MEET AWWA STANDARDS FOR USE IN DOMESTIC WATER SYSTEMS.

					235700 SHELL A	AND TUBE HEA	AT EXCHANGER	SCHEDULE					
PLAN DESIG.	MFGR	MODEL	SHELL DIAM.		FLUID 1 / FLUID			TEMP. (F) / PRESS. (#)		MAX PRESSURE LOSS (PSI)		CAPACITY	NOTES
	WII OI (LENGTH (IN)		2	FLUID 1	FLUID 2	FLUID 1	FLUID 2	FLUID 1	FLUID 2	(MBH)	
HX-1	TACO	G26408-6L	26 / 62	4	WATER /	150	150	190/170	140/160	0.5	0.12	1,500	1, 2, 3
HX-2	TACO	G26408-6L	26 / 62	4	WATER /	150	150	190/170	140/160	0.5	0.12	1,500	1, 2, 3

1. BASED ON A FOULING FACTOR OF 0.001. 2. ALL FITTINGS, VALVES, AND SURFACES TOUCHING FLUIDS SHALL MEET AWWA STANDARDS FOR USE IN DOMESTIC WATER SYSTEMS.

3. DOUBLE WALL HEAT EXCHANGER.

STATE OF MISSOURI MICHAEL L. PARSON, **GOVERNOR**

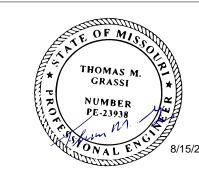

LICENSE #: E-23938 EXPIRATION DATE: 12/31/24 PROFESSIONAL SEAL CASCO Diversified Corporation MO Certificate of Authority #000329 Arch. MO Certificate of Authority #000613 Eng. Exp. Date: 12/31/25

OFFICE OF ADMINISTRATION DIVISION OF FACILITIES MANAGEMENT, **DESIGN AND CONSTRUCTION**

DESIGN & INSTALL NEW DOMESTIC WATER **PLANT VETERANS HOME** BUILDING

ST. JAMES VETERANS HOME 620 NORTH JEFFERSON ST. JAMES, MO

PROJECT # U2409-01 6801 SITE# FACILITY # 8136801002

REVISION: DATE: **REVISION:** DATE: **REVISION:** DATE: ISSUE DATE: 08.15.2024

CAD DWG FILE:
DRAWN BY:
CHECKED BY:
DESIGNED BY:

SHEET TITLE:


PLUMBING SCHEDULES


SHEET NUMBER:

P-602 8 of 18 SHEETS 08.15.2024

THE WINNING CONTRACTOR SHALL BE RESPONSIBLE FOR HIRING WALTER LOUIS FLUID TECHNOLOGIES FOR THE WATER TREATMENT CONTRACTOR AND INCLUDE ALL COSTS ASSOCIATED WITH INSTALLATION. EQUIPMENT, LABOR AND CHEMICALS ASSOCIATED WITH PROVIDING A COMPLETE AND OPERATIONAL SYSTEM AS DESCRIBED ON THESE DOCUMENTS AND SPECIFICATIONS.

CONTACT INFO: WALTER LOUIS FLUID TECHNOLOGIES, SALES@WALTERLOUIS.COM, PH (217)-223-2017.

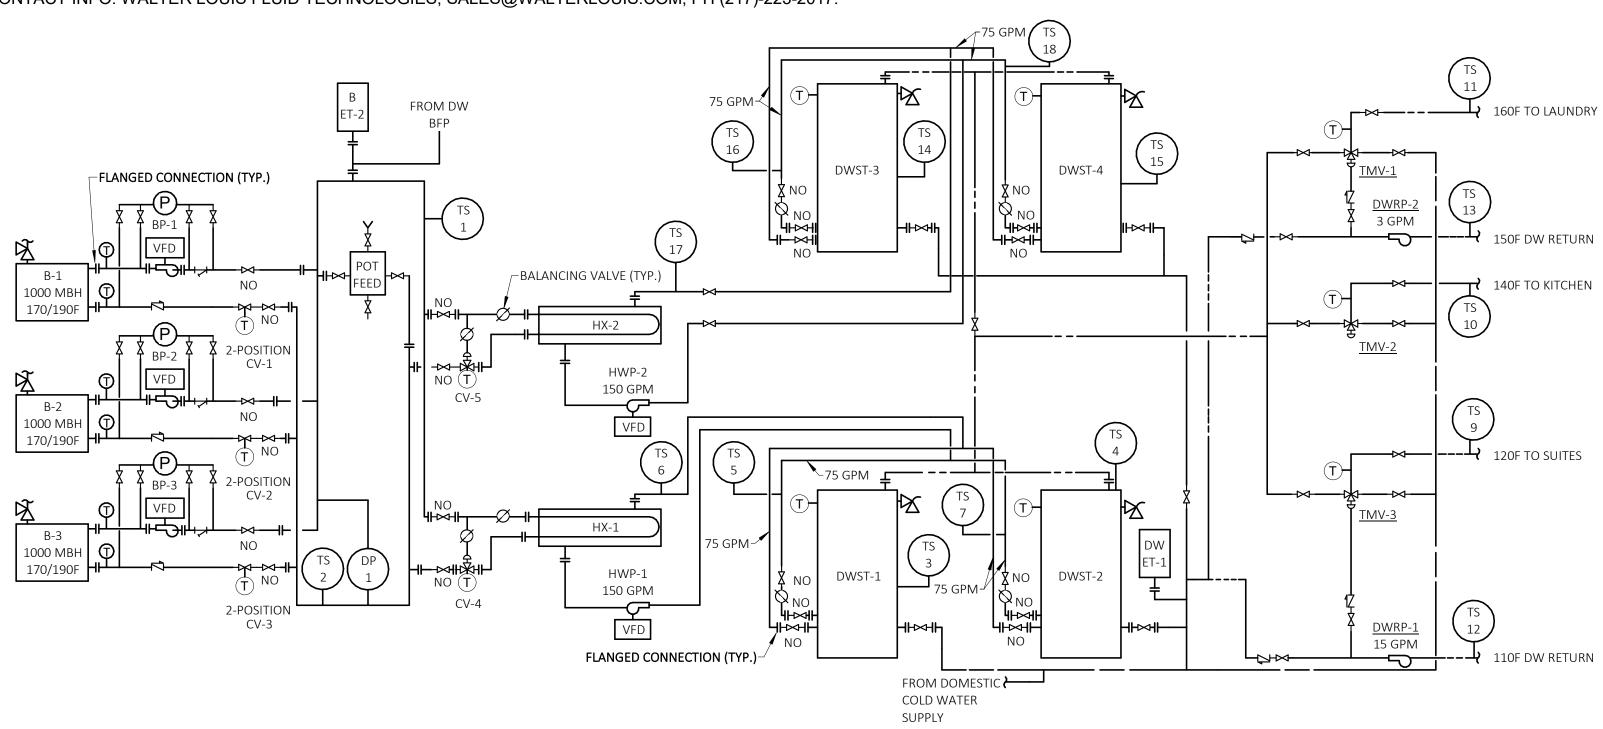

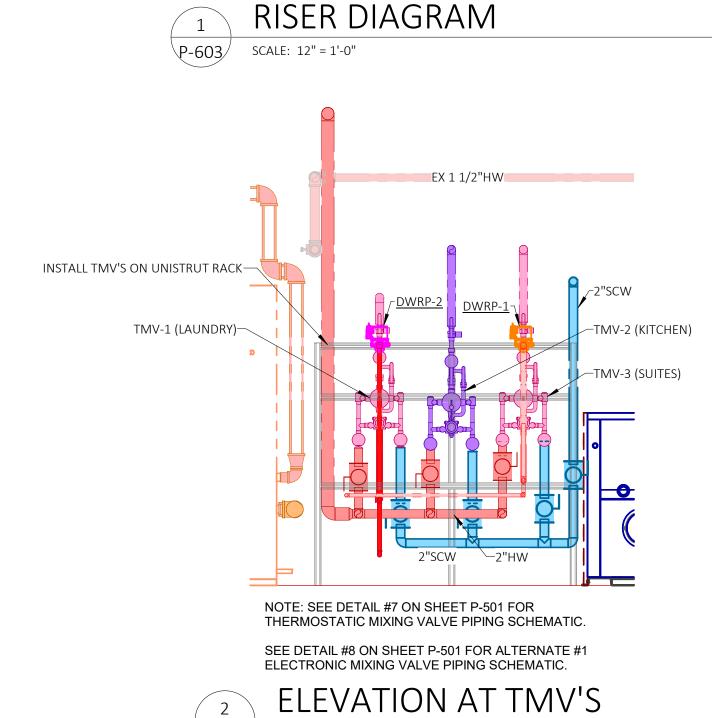

SCALE: 1/2" = 1'-0"


Points List: HEATING PLANT SYSTEM **Points** Alarms **System Point Description** OILER 1 ALARM B1 ALM BOILER 1 ENABLE COMMAND B1 ENB **BOILER 1 STATUS** B1 STS BOILER 2 ALARM B2 ALM **BOILER 2 ENABLE COMMAND** B2 ENB BOILER 2 STATUS B2 STS BOILER 3 ALARM B3 ALM BOILER 3 ENABLE COMMAND B3 ENB BOILER 3 STATUS B3 STS BOILER LOOP ENTERING TEMPERATURE TS-1 BOILER LOOP LEAVING TEMPERATURE TS-2 BOILER PUMP 1 START STOP OUTPUT BP-1 BOILER PUMP 1 STATUS BOILER PUMP 2 START STOP OUTPUT BP-2 BOILER PUMP 2 STATUS BOILER PUMP 3 START STOP OUTPUT BP-3 BOILER PUMP 3 STATUS BP-3 BOILER ISOLATION VALVE OPEN SHUT CV-1 BOILER ISOLATION VALVE STATUS CV-1 BOILER ISOLATION VALVE OPEN SHUT CV-2 BOILER ISOLATION VALVE STATUS CV-2 BOILER ISOLATION VALVE OPEN SHUT CV-3 BOILER ISOLATION VALVE STATUS CV-3 OT WATER DIFFERENTIAL PRESSURE DP-1 OMESTIC WATER STORAGE TANK 1 TEMP TS-3 DOMESTIC WATER STORAGE TANK 2 TEMP TS-4 х х TS-14 DOMESTIC WATER STORAGE TANK 4 TEMP TS-15 3-WAY CONTROL VALVE MODULATION CV-4 3-WAY CONTROL VALVE POSITION CV-4 -WAY CONTROL VALVE MODULATION CV-5 3-WAY CONTROL VALVE POSITION CV-5 DWP-1 OMESTIC HOT WATER PUMP 1 STATUS DWP-1 DOMESTIC HOT WATER PUMP 2 START STOP DWP-2 DOMESTIC HOT WATER PUMP 2 STATUS DWP-2 DWST-1 ENTERING TEMP TS-5 DWST-1/2 LEAVING TEMP TS-6 DWST-2 ENTERING TEMP TS-7 DWST-3 ENTERING TEMP TS-16 DWST-3/4 LEAVING TEMP TS-17 x x DWST-4 ENTERING TEMP TS-18 L10F LOOP SUPPLY TEMPERATURE TS-9 140F LOOP SUPPLY TEMPERATURE TS-10 150F LOOP SUPPLY TEMPERATURE TS-11 DWRP-1 DWRP-1 OOM HOT WATER RECIRC PUMP 1 SPEED DWRP-1 DOM HOT WATER RECIRC PUMP 2 START STOF DWRP-2 DOM HOT WATER RECIRC PUMP 2 STATUS DWRP-2 DOM HOT WATER RECIRC PUMP 2 SPEED BAS COMMUNICATION STATE BAS COM **BOILER PUMP 1 FAILURE** BP1 FAIL BOILER PUMP 1 FAILURE BP2 FAIL BOILER PUMP 1 FAILURE BP3 FAIL DOMESTIC HOT WATER PUMP 1 FAIL DWP1 FAIL DOMESTIC HOT WATER PUMP 2 FAIL DWP2 FAIL 110F HOT WATER RESET HIGH LIMIT 110F HW RES HL 110F HOT WATER RESET LOW LIMIT 110F HW RES LL 110F HOT WATER SUPPLY TEMP SETPOINT 110F HW SP 140F HW RES HL 140F HOT WATER RESET LOW LIMIT 140F HW RES LL 140F HOT WATER SUPPLY TEMP SETPOINT 140F HW SP 150F HOT WATER RESET HIGH LIMIT 150F HW RES HL

150F HW RES LL

150F HW SP

150F HOT WATER RESET LOW LIMIT

150F HOT WATER SUPPLY TEMP SETPOINT

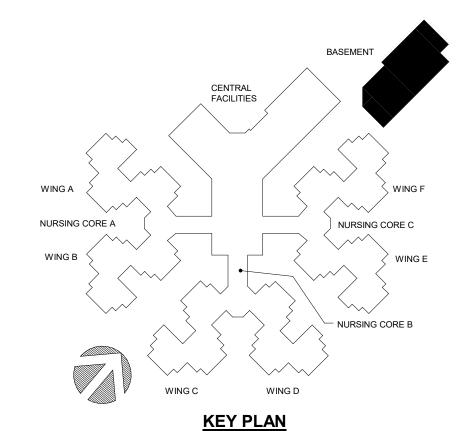

NOTE TO PRINTER

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STATE OF MISSOURI MICHAEL L. PARSON, GOVERNOR



Professional of Record:
THOMAS M. GRASSI
LICENSE #: E-23938
EXPIRATION DATE: 12/31/24
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CASCO DIVERSIFIED CORPORATION
12 Sunnen Drive, Suite 100, St. Louis, MO 63143

OFFICE OF ADMINISTRATION DIVISION OF FACILITIES MANAGEMENT, DESIGN AND CONSTRUCTION

DESIGN & INSTALL
NEW DOMESTIC WATER
PLANT
VETERANS HOME
BUILDING

ST. JAMES VETERANS HOME 620 NORTH JEFFERSON ST. JAMES, MO

PROJECT # U2409-01 SITE # 6801 FACILITY # 8136801002

REVISION:
DATE:
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DATE:
ISSUE DATE: 08.15.2024

CAD DWG FILE:
DRAWN BY:
CHECKED BY:
DESIGNED BY:

SHEET TITLE:


PLUMBING DIAGRAMS

SHEET NUMBER:

P-603
9 of 18 SHEETS
08.15.2024

DOMESTIC HOT WATER RISER ISOMETRIC - PHASE 1 & 2

2 DC P-901 SCALE: STATE OF MISSOURI MICHAEL L. PARSON, GOVERNOR

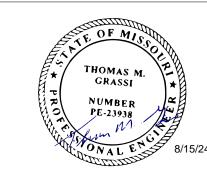

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OFFICE OF ADMINISTRATION DIVISION OF FACILITIES MANAGEMENT, DESIGN AND CONSTRUCTION

DESIGN & INSTALL NEW DOMESTIC WATER PLANT VETERANS HOME

BUILDING

ST. JAMES VETERANS HOME 620 NORTH JEFFERSON ST. JAMES, MO

PROJECT # U2409-01 SITE # 6801 FACILITY # 8136801002

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CAD DWG FILE:

DRAWN BY:

CHECKED BY:

DESIGNED BY:

SHEET TITLE:

PLUMBING RISER ISOMETRICS

SHEET NUMBER:


KEY PLAN

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NOTE TO PRINTER

P-901
10 of 18 SHEETS
08.15.2024



EX 1 1/2"HW¬ REMOVE EX EXPANSION TANKS PLUMBING LEGEND EX 2"HW(160°F)--EX ET TO MOVE IN PHASE 1 DEMO SOFT COLD WATER PIPING (EX SCW) EX 2"HW(140°F)-NEW SOFT COLD WATER PIPING (SCW) _EX 1"HWR(160°F) EX WATER SOFTENER DEMO HOT WATER PIPING (EX HW) REMOVE EX STORAGE TANK (LAUNDRY) EXISTING HOT WATER PIPING (EX HW) -REMOVE PORTION OF PIPING. PREPARE PIPING FOR NEW CONNECTION. NEW HOT WATER PIPING (HW) DEMO HOT WATER PIPING (140°F) (EX HW(140°F)) REMOVE EX HWRP FOR LAUNDRY EXISTING HOT WATER PIPING (140°F) (EX HW(140°F)) REMOVE PORTION OF PIPING. PREPARE PIPING FOR NEW CONNECTION. DEMO HOT WATER RETURN PIPING (EX HWR) NEW HOT WATER RETURN PIPING (HWR) ∠EX 1"HWR NEW HOT WATER PIPING (160°F) (HW(160°F)) REMOVE PORTION OF PIPING. PREPARE PIPING FOR NEW CONNECTION. NEW HOT WATER RETURN PIPING (160°F) (HWR(160°F)) HX: NEW HOT WATER PIPING (170°F) (HW(170°F)) EX WATER SOFTENER HX: NEW HOT WATER RETURN PIPING (170°F) (HWR(170°F)) EX HWRP TO REMAIN REMOVE PORTION OF PIPING AND CAP. REMOVE PORTION OF PIPING. PREPARE PIPING FOR NEW CONNECTION. REMOVE EX TMV-EX TMV TO REMAIN REMOVE PORTION OF PIPING. PREPARE PIPING FOR NEW CONNECTION. REMOVE EX STORAGE TANK (KITCHEN) EX BOILER TO REMAIN EX STORAGE TANK (MAIN) TO REMAIN REMOVE EX BOILER

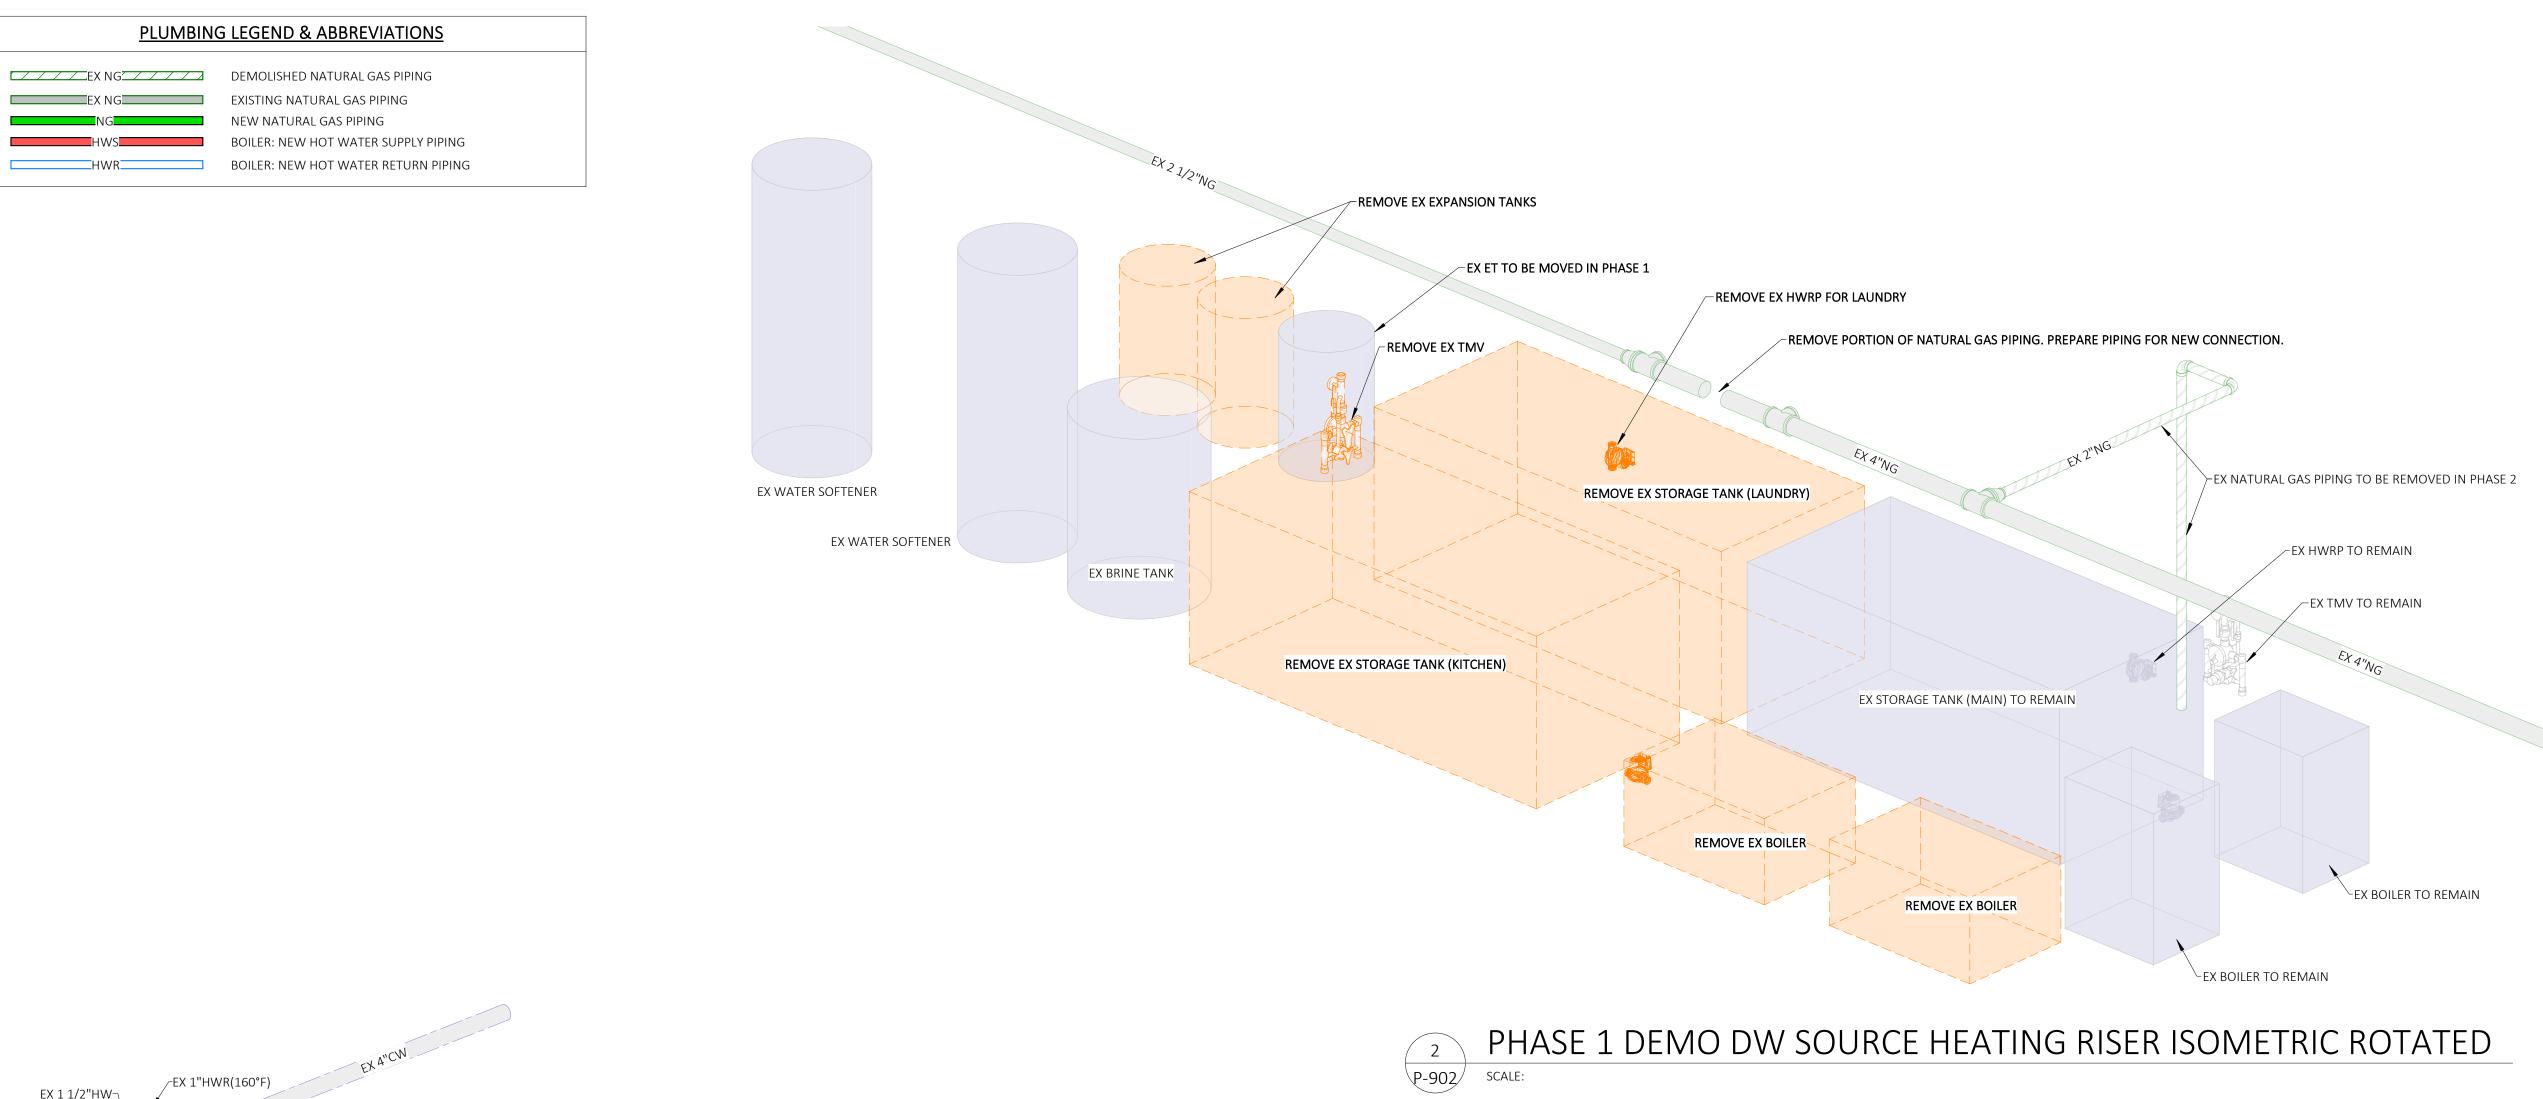PHASE 1 DEMO DW HOT WATER RISER ISOMETRIC ROTATED

REMOVE EX BOILER

EX BOILER TO REMAIN


DESCRIPTION OF THE PROPERTY OF

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KEY PLAN

STATE OF MISSOURI MICHAEL L. PARSON, GOVERNOR



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CASCO DIVERSIFIED CORPORATION
12 Sunnen Drive, Suite 100, St. 1 ouis, MO 63143 T: 3

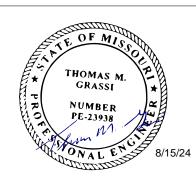OFFICE OF ADMINISTRATION DIVISION OF FACILITIES MANAGEMENT, DESIGN AND CONSTRUCTION

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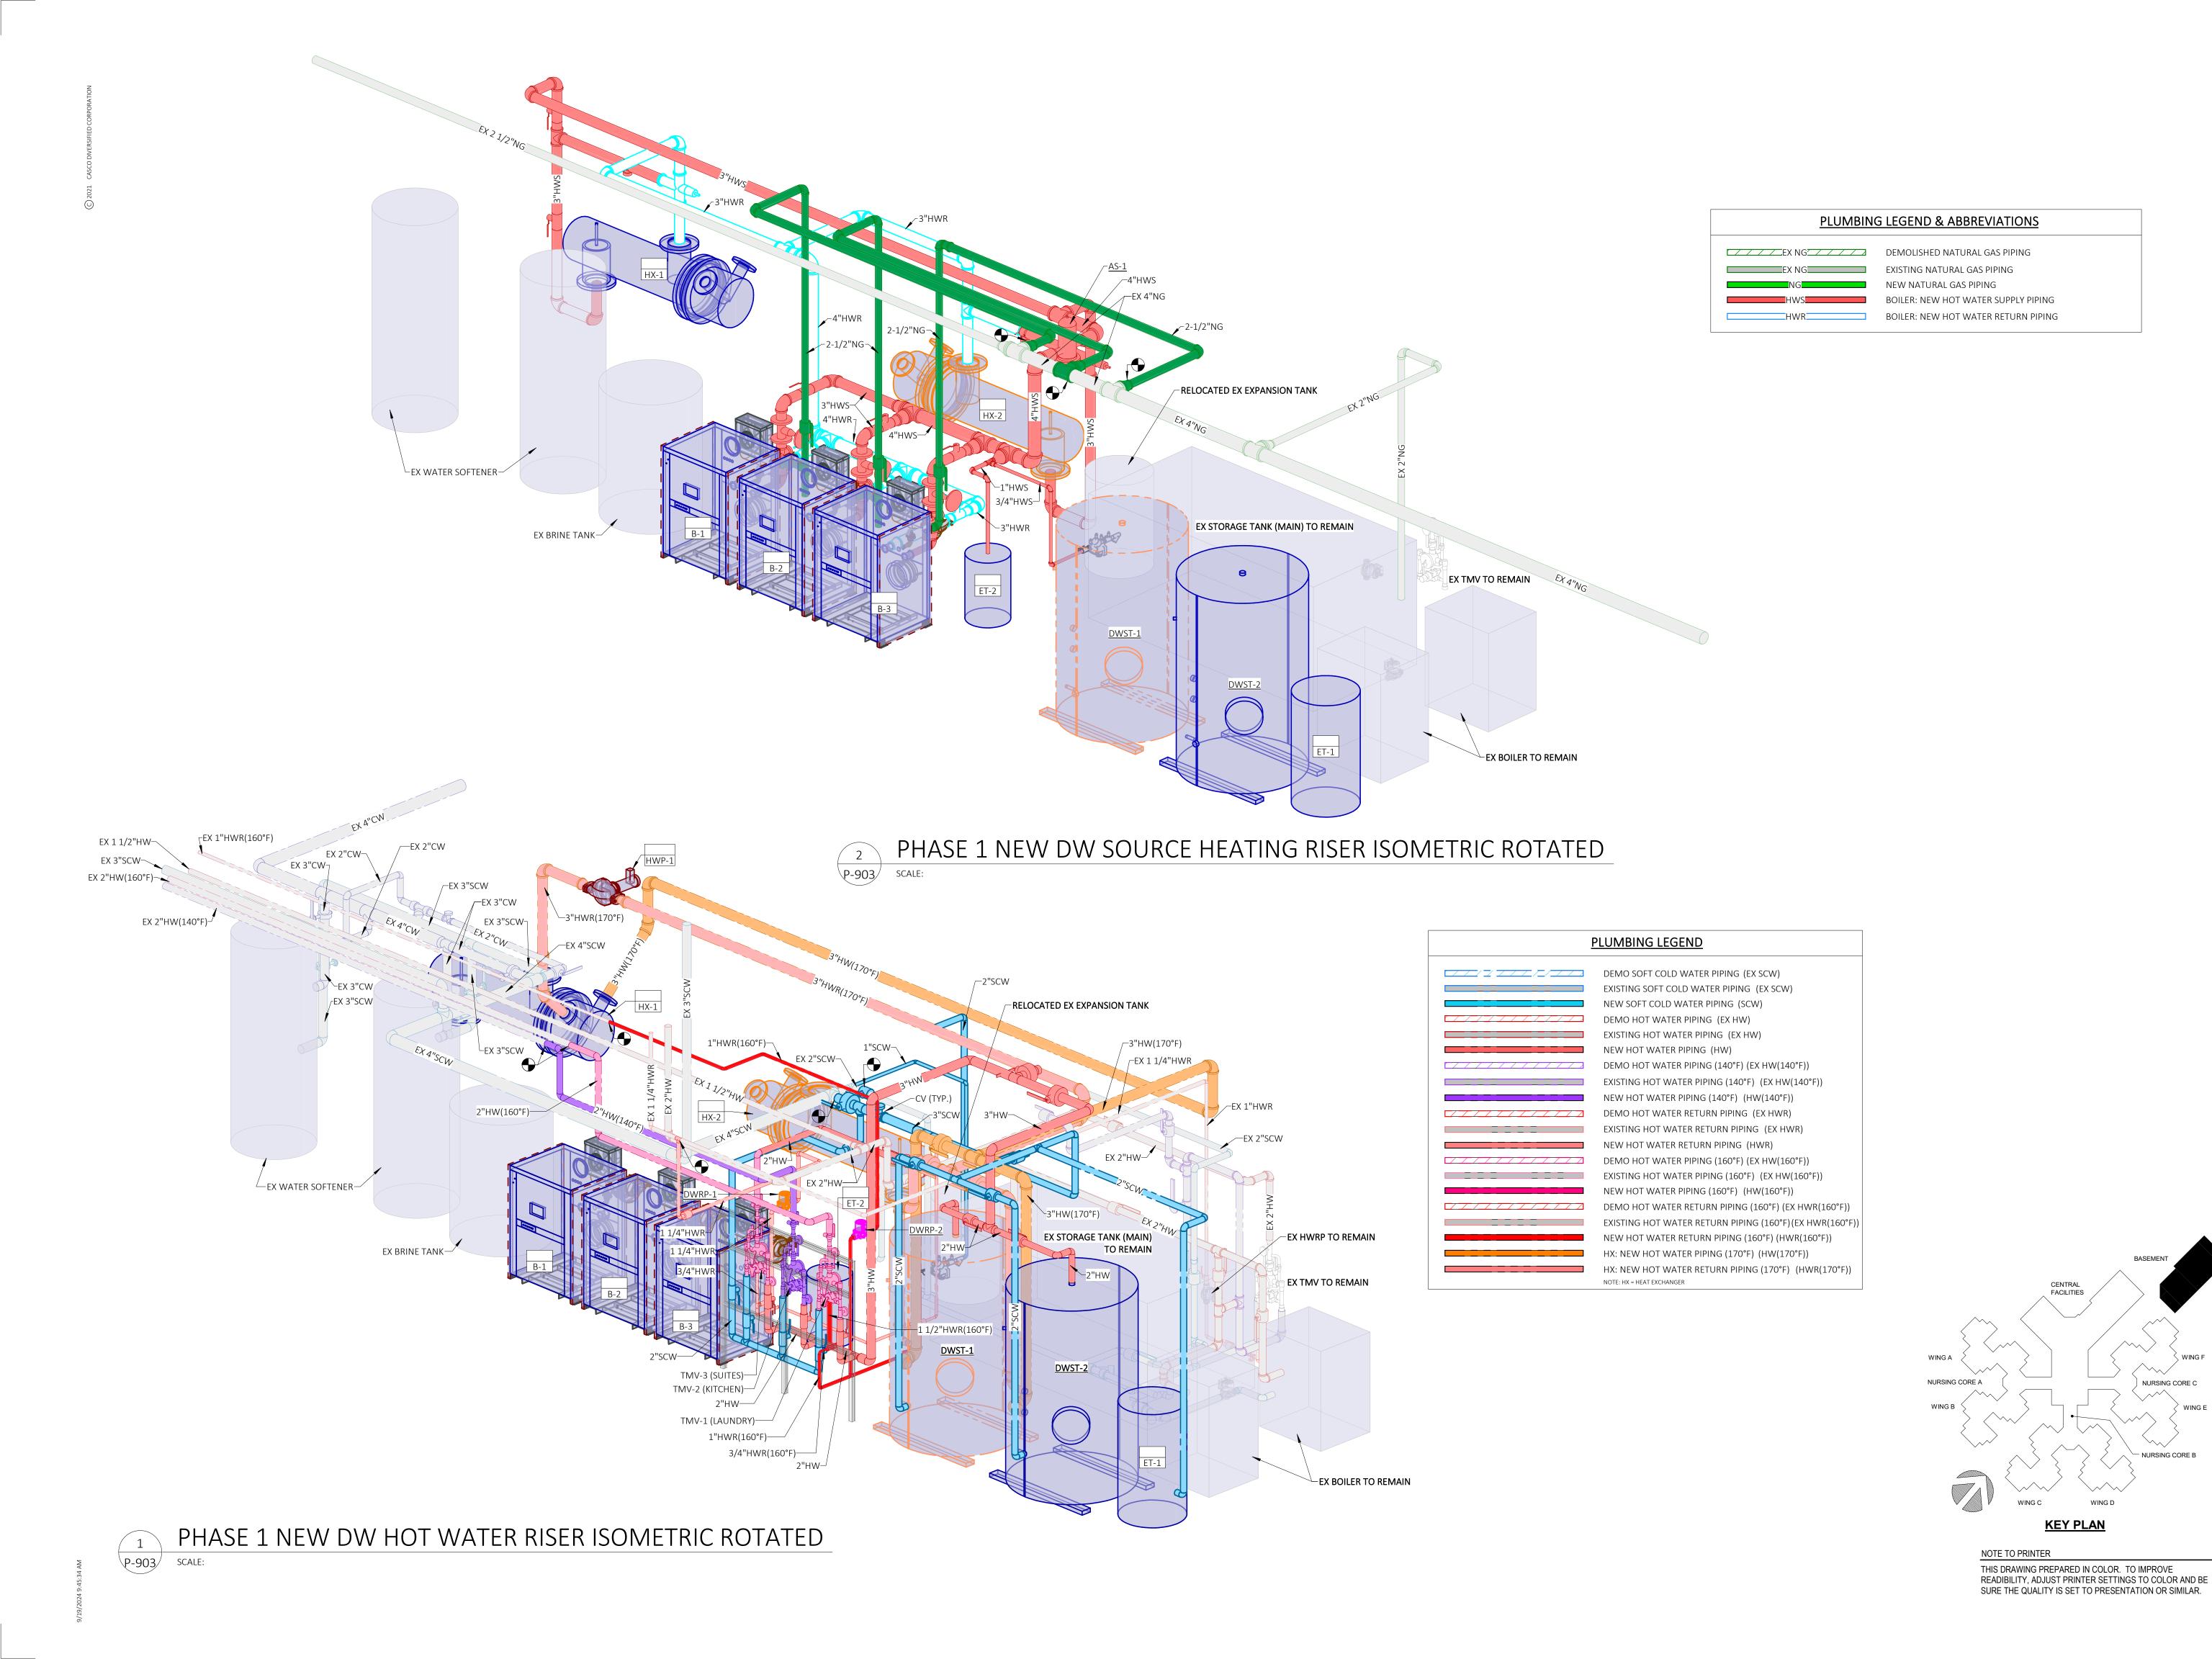
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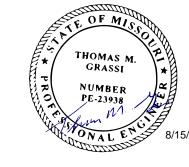
SHEET TITLE:
PLUMBING PHASE 1
DEMO RISER
ISOMETRICS
ROTATED

SHEET NUMBER:

P-902
11 of 18 SHEETS
08.15.2024



STATE OF MISSOURI MICHAEL L. PARSON, GOVERNOR



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CASCO DIVERSIFIED CORPORATION
12 Sunnen Drive, Suite 100, St. Louis, MO 63143 T: 3

OFFICE OF ADMINISTRATION DIVISION OF FACILITIES MANAGEMENT, DESIGN AND CONSTRUCTION

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PLANT
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DRAWN BY:
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TMG
DESIGNED BY:

SHEET TITLE:
PLUMBING PHASE 1
NEW RISER
ISOMETRICS
ROTATED

SHEET NUMBER:

P-903
12 of 18 SHEETS
08.15.2024

-1 1/2"HWR(160°F)

DWST-1

ET-1

1 1/4"HWR

B-2

1 1/4"HWR—

1 1/4"HWR~

B-3

2"SCW—

> TMV-1 (LAUNDRY)— 3/4"HWR(160°F)——

> > 1"HWR(160°F)----

LEX WATER SOFTENER—

EX BRINE TANK

PHASE 2 DEMO DW HOT WATER RISER ISOMETRIC ROTATED


P-904 SCALE:

P-904 SCALE:

DEMO SOFT COLD WATER PIPING (EX SCW)
EXISTING SOFT COLD WATER PIPING (EX SCW)
P-905 SOFT COLD WATER PIPING (EX SCW)
EXISTING SOFT COLD WATER PIPING (EX SCW)
DEMO HOT WATER PIPING (EX SCW)
DEMO HOT WATER PIPING (EX HW)
NEW HOT WATER PIPING (EX HW)
NEW HOT WATER PIPING (EX HW)
NEW HOT WATER PIPING (160°F) (EX HW(140°F))
EXISTING HOT WATER PIPING (140°F) (EX HW(140°F))
DEMO HOT WATER PIPING (140°F) (EX HW(140°F))
DEMO HOT WATER PIPING (160°F) (EX HW(160°F))
NEW HOT WATER PIPING (160°F) (EX HW(160°F))
DEMO HOT WATER RETURN PIPING

REMOVE EX BOILER


REMOVE EX BOILER

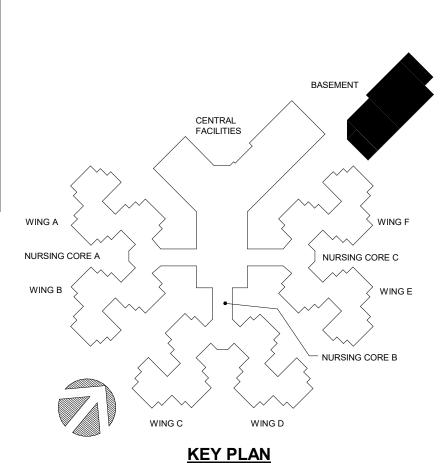

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STATE OF MISSOURI MICHAEL L. PARSON, GOVERNOR



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CASCO DIVERSIFIED CORPORATION

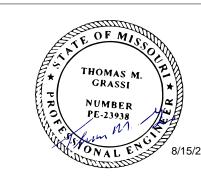12 Support Drive, Suite 100, St. Louis, MO 63143, T. 3.

OFFICE OF
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DIVISION OF
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NEW DOMESTIC WATER
PLANT
VETERANS HOME
BUILDING

ST. JAMES VETERANS HOME 620 NORTH JEFFERSON ST. JAMES, MO

PROJECT # U2409-01 SITE # 6801 FACILITY # 8136801002

REVISION:
DATE:
REVISION:
DATE:
REVISION:
DATE:
ISSUE DATE: 08.15.2024

CAD DWG FILE:

DRAWN BY: DDP

CHECKED BY: TMG

DESIGNED BY:

PLUMBING PHASE 2
DEMO RISER
ISOMETRICS
ROTATED

SHEET NUMBER:

P-904
13 of 18 SHEETS
08.15.2024

STATE OF MISSOURI MICHAEL L. PARSON, GOVERNOR



Professional of Record:
THOMAS M. GRASSI
LICENSE #: E-23938
EXPIRATION DATE: 12/31/24
PROFESSIONAL SEAL

CASCO Diversified Corporation
MO Certificate of Authority #000329 Arch.
MO Certificate of Authority #000613 Eng.
Exp. Date: 12/31/25

CASCO DIVERSIFIED CORPORATION

12 Support Drive, Suite 100, St. Louis, MO 63143

OFFICE OF ADMINISTRATION DIVISION OF FACILITIES MANAGEMENT, DESIGN AND CONSTRUCTION

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NOTE TO PRINTER

THIS DRAWING PREPARED IN COLOR. TO IMPROVE READIBILITY, ADJUST PRINTER SETTINGS TO COLOR AND BE SURE THE QUALITY IS SET TO PRESENTATION OR SIMILAR.

KEY PLAN

MARK INDICATES "NEUTRAL" WIRE, LONG SLASH WITH SOLID CIRCLE INDICATES GREEN GROUNDING CONDUCTOR

BRANCH CIRCUITRY AS ABOVE, CONCEALED IN FLOOR SLAB OR UNDERGROUND
BRANCH CIRCUITRY AS ABOVE, CONCEALED IN WALLS OR ABOVE CEILINGS

CIRCUITRY UP (LEFT) AND CIRCUITRY DOWN (RIGHT)

BRANCH CIRCUITRY. ARROW INDICATES HOME RUN TO PANEL. SHORT SLASH MARKS INDICATE "HOT" WIRES, LONG SLASH

FIF	ECTRICAL SYMBOLS LEGEND						
	RICAL GENERAL NOTES						
1. ALL MC	DUNTING HEIGHTS ARE TO THE CENTER OF THE REFERENCED FIXTURE/DEVICE, UNLESS OTHERWISE NOTED. DUNTED HEIGHTS ARE STANDARD UNLESS OTHERWISE NOTED.						
	NG FIXTURE GENERAL NOTES		AUXILIARY SYSTEMS		FIRE ALARM SYSTEM		
1. ALPHA-	NUMERIC DESIGNATIONS DENOTES TYPE; SEE LIGHTING FIXTURE SCHEDULE FOR DESCRIPTION. HITING FIXTURE SCHEDULE FOR FIXTURE DESCRIPTION AND MOUNTING HEIGHTS.	(S)	SPEAKER - CEILING MOUNTED	FACP FIRE ALARM CONTROL PANEL - MOUNT TOP 72" AFF			
2.311 110	LIGHTING FIXTURES	\$	SPEAKER - WALL MOUNT 84" AFF	FAAP	FIRE ALARM ANNUNCIATOR PANEL - MOUNT TOP 72" AFF		
A1	CEILING MOUNTED LUMINAIRE	- SM)	SPEAKER - CEILING MOUNTED SOUND MASKING	DACT	DIGITAL ALARM COMMUNICATOR TRANSMITTER		
B2	WALL MOUNTED LUMINAIRE	INT	INTERCOM STATION - MOUNT 46" AFF	FAPS	FIRE ALARM POWER SUPPLY - MOUNTED 72" AFF		
C3 (CEILING MOUNTED OR PENDANT MOUNTED LUMINAIRE	<u> </u>	VOLUME CONTROL - MOUNT 46" AFF	(SD)	MANUAL PULL STATION - MOUNT 46" AFF SMOKE DETECTOR - CEILING MOUNTED		
D4 OH	WALL MOUNTED LUMINAIRE CEILING MOUNTED (LEFT) AND WALL MOUNTED (RIGHT) EXIT SIGNS. SHADED PORTION INDICATES FACE; WITH	M	DUPLEX MICROPHONE OUTLET - MOUNT 18" AFF DUPLEX MICROPHONE OUTLET - FLOOR MOUNTED	(SD) _{CO}	SINGLE STATION SMOKE ALARM - CEILING MOUNTED - "CO" INDICATES COMBINATION CARBON MONOXIDE ALARM		
	DIRECTIONAL ARROW(S) AS INDICATED	M		SD	DUCT MOUNTED SMOKE DETECTOR WITH SAMPLING TUBES		
	COMBINATION EXIT LIGHT WITH EMERGENCY LIGHTING HEADS	TC TC	MICROPHONE OUTLET - CEILING MOUNTED FOR CORD HUNG DEVICE	F	DUCT MOUNTED SMOKE DETECTOR'S REMOTE ANNUNCIATOR LAMP AND TEST SWITCH-MOUNT ON CEILING, (UNO)		
	WALL MOUNTED EMERGENCY LIGHT BOLLARD FIXTURE	•••	TIME CLOCK PUSHBUTTON, TRIPLE (LEFT) AND SINGLE (RIGHT) AS INDICATED - MOUNT 46" AFF	H	HEAT DETECTOR - CEILING MOUNTED		
	LIGHT POLE WITH SINGLE HEAD LUMINAIRE		BELL - MOUNT 84" AFF	(co)	CARBON MONOXIDE DETECTOR - CEILING MOUNTED		
0	LIGHT POLE WITH MULTIPLE HEADS (NUMBER OF HEADS AS INDICATED BY SYMBOL) SHADING DENOTES NIGHT (INL) FIXTURE		VOICE OUTLET - MOUNT 18" AFF; W INDICATES WALL MOUNT 46" AFF		WALL MOUNTED VISUAL STROBE - MOUNT 80" AFF TO BOTTOM OF FLASHER; (NUMERALS INDICATE CANDELA)		
•	SHADING DENOTES EMERGENCY LIGHT (EM) FIXTURE	V	DATA OUTLET - MOUNT 18" AFF	□ □ 0 c	WALL MOUNTED HORN OR SPEAKER - MOUNT 80" AFF; SHADING DENOTES COMBINATION AUDIBLE/VISUAL APPLIANCE (NUMERALS INDICATE CANDELA)		
LB-1a,b	FIXTURE CIRCUITRY NOTATION: $LB-1$ - PANEL AND CIRCUIT NUMBER TO WHICH FIXTURE IS CONNECTED a,b - LETTER(S) OF SWITCH(ES) CONTROLLING FIXTURE	V	FLOOR MOUNTED DATA OUTLET COMBINATION VOICE & DATA OUTLET - MOUNT 18" AFF	(€0 cd	VISUAL STROBE - CEILING MOUNTED; (NUMERALS INDICATE CANDELA). FINISH TO MATCH CEILING HORN OR SPEAKER - CEILING MOUNTED; SHADING DENOTES COMBINATION AUDIBLE/VISUAL APPLIANCE. (NUMERALS		
NL	NL - NIGHT LIGHT (UNSWITCHED CIRCUIT)	lacksquare	FLOOR MOUNTED COMBINATION VOICE & DATA OUTLET		INDICATE CANDELA). FINISH TO MATCH CEILING		
	WIRING DEVICES	✓ / ▼WAP	WIRELESS ACCESS POINT - CEILING MOUNTED	F	CHIME - MOUNT 90" AFF, AS ABOVE EXTERIOR FA BELL - MOUNT 90" AFF		
\$ XX	SWITCH - "XX" INDICATES SWITCH TYPE, EACH TYPE IS DESCRIBED AS BELOW: D DIMMER SWITCH - AS ABOVE, 1000 WATT RATING OR 0-10V	TTB	TELEPHONE TERMINAL CABINET 24" x 28" x 6" (LINO) WITH FIRE RETARDANT DIVINOOD BACK	F DH	FIRE ALARM MAGNETIC DOOR HOLDER		
\$	DOUBLE POLE WALL SWITCH - AS ABOVE \$\ AS REQUIRED	πс	TELEPHONE TERMINAL CABINET 24" x 36" x 6" (UNO) WITH FIRE RETARDANT PLYWOOD BACK AND HINGED DOOR WITH KEY LOCK	FR	INTERFACE RELAY FOR CODE REQUIRED ACTION, OR AS NOTED ON PLANS; SEE SPECIFICATION		
_ 3 \$	THREE-WAY SWITCH - AS ABOVE OS WALL MOUNTED OCCUPANCY SENSOR SWITCH - AS ABOVE. "OS2" INDICATES DUAL RELAY	TV	RECESSED T.V. OUTLET - MOUNT BEHIND TV LOCATION	FCM	CONTROL MODULE FOR CODE REQUIRED ACTION; SEE SPECIFICATION		
4	FOUR-WAY SWITCH - AS ABOVE \$\frac{\f	Ю	CLOCK OUTLET - MOUNT 78" AFF	F	MONITOR MODULE FOR CODE REQUIRED ACTION, OR AS NOTED ON PLANS; SEE SPECIFICATION		
K t	P	GAP	GENERATOR ANNUNCIATOR PANEL		SPRINKLER TAMPER SWITCH (FURNISHED BY FPC)		
+ + + + + + + + + +	SWITCH WITH PILOT LIGHT - AS ABOVE M MANUAL MOTOR STARTER WITH OVERLOAD PROTECTION -		ONE-LINE DIAGRAMS	FS	SPRINKLER FLOW SWITCH (FURNISHED BY FPC)		
\$	WALL BOX TIMER SWITCH - AS ABOVE \$ MOUNT ON SIDE OF UNIT OR AT 46" AFF	ulu	TRANSFORMER	PS	SPRINKLER PRESSURE SWITCH (FURNISHED BY FPC)		
D	DIMMER CONTROLLER, AS NOTED ON PLAN	m C	CURRENT TRANSFORMER		ABBREVIATIONS		
TS	TIME SWITCH - MOUNT 60" AFF		CURRENT TRANSFORMER POTENTIAL TRANSFORMER	AC	ABOVE COUNTER; +42" AFF UNLESS NOTED OTHERWISE AMP INTERRUPTING CURRENT		
			PANEL (1 OR 2 SECTIONS AS INDICATED)	AIC AFC	AVAILABLE FAULT CURRENT		
PC / (PC)	PHOTOCELL WALL MOUNTED (LEFT) OR CEILING MOUNTED (RIGHT)	/ 30	FUSE - 30 = DISCONNECT SWTICH AM RATING	AFF	ABOVE FINISHED FLOOR ARC FAULT CIRCUIT INTERRUPTER TYPE DEVICE		
LC	LIGHTING CONTROLLER	[] (20) 30	(20) = FUSE RATING MOLDED CASE CIRCUIT BREAKER - 30 = AMP FRAME "AF" RATING	AFI/AF ATS	Cl		
(OS)	CEILING MOUNTED OCCUPANCY SENSOR SWITCH. "OS2" INDICATES DUAL RELAY	(20)	(20) = AMP FRAME "AT" RATING	CATV	CABLE TELEVISION ELECTRICAL CONTRACTOR		
	JUNCTION BOX OR POINT OF CONNECTION - MOUNT 18" AFF OR AT HEIGHT REQUIRED BY RESPECTIVE EQUIPMENT ITEM MFR CEILING MOUNTED VACCANCY SENSOR. MANUAL-ON / AUTO-OFF		CIRCUIT BREAKER, DRAWOUT TYPE - AS ABOVE	EC ELEV			
VS	CEILING MOUNTED VACCANCY SENSOR. MANUAL-ON / AUTO-OFF	W	KILOWATT HOUR METER	EM	EMERGENCY		
<u> </u>		(T) (GP)	SHUNT TRIP GROUND FAULT RELAY	EWC EWH			
	DUPLEX RECEPTACLE - MOUNT 18" AFF	GFP	GROUND FAULT PROTECTION	EX	EXISTING		
#	QUADPLEX RECEPTACLE - AS ABOVE	N E	AUTOMATIC TRANSFER SWITCH	FLA FPC	FULL LOAD AMPS FIRE PROTECTION CONTRACTOR		
	SINGLEPLEX RECEPTACLE - AS ABOVE		POTHEAD	FSS	FUSIBLE SAFETY SWITCH		
	DUPLEX RECEPTACLE AS ABOVE - SPLIT WIRED, TOP HALF SWITCHED GFI DUPLEX RECEPTACLE - AS ABOVE		STRESS CONES	GC GFI/GF	GENERAL CONTRACTOR GROUND FAULT CIRCUIT INTERRUPTER TYPE DEVICE		
+	GFI QUADPLEX RECEPTACLE - AS ABOVE	V ~	LIGHTNING ARRESTER VOLTMETER	HID	HIGH INTENSITY DISCHARGE		
	CEILING MOUNTED DUPLEX RECEPTACLE, FLUSH IN CEILING	VMS	VOLTMETER SWITCH	IG KEC	ISOLATED GROUND TYPE DEVICE KITCHEN EQUIPMENT CONTRACTOR		
	FLOOR MOUNTED DUPLEX RECEPTACLE WITH BRASS PLATE AND CARPET FLANGE	AS	AMMETER AMMETER SWITCH	MAX			
	RECEPTACLE - "XX" INDICATES RECETPACLE TYPE, EACH TYPE IS DESCRIBED BELOW:	7 30	PLUG-IN DISCONNECT SWITCH, FUSED: 30 = DISCONNECT SWTICH AMP RATING	MC MFR	MECHANICAL CONTRACTOR MANUFACTURER		
	AC - ABOVE COUNTER RECEPTACLE - AS ABOVE, 42" AFF UNLESS NOTED OTHERWISE CR - CONTROLLED RECEPTACLE	(20)	(20) = FUSE RATING	МН	MOUNTING HEIGHT		
	GFI - GROUND FAULT CURRENT INTERRUPTING	<u></u>	MOTOR STARTER, SINGLE SPEED, 0 = STARTER SIZE	MIN NF	MINIMUM NON-FUSED SWITCH		
	HG - HOSPITAL GRADE TP - TEMPER PROOF	\$ 80	MOTOR STARTER, MULTIPLE SPEED, 0 = STARTER SIZE	NTS	NOT TO SCALE		
	USB - RECEPTACLE WITH USB OUTLETS WP - WEATHER PROOF	L _{ALT}	ALTERNATING MOTOR CONTROLLER	PC RT	PLUMBING CONTRACTOR RAINTIGHT		
		KK	KIRK KEY INTERLOCK	ТР	TAMPER PROOF TYPE DEVICE		
1	SPECIAL PURPOSE OUTLET - AS ABOVE. TYPE AS REQUIRED BY RESPECTIVE EQUIPMENT MFR PLUG-IN STRIP - AS ABOVE	IAP	SECURITY SYSTEM INTRUSION ALARM PANEL	TCC	TEMPERATURE CONTROL CONTRACTOR TYPICAL		
		KP	KEY PAD	UNO	UNLESS NOTED OTHERWISE		
	COMBINATION POWER & DATA/VOICE FLOOR BOX OR POKE THRU - "FF" INDICATES FURNITURE FEED POWER POLE WITH 120 VOLT DUPLEX RECEPTACLES	MD <	MOTION DETECTOR	UPS USB			
	POWER POLE WITH 120 VOLT DUPLEX RECEPTACLES POWER POLE, TWO COMPARTMENT- ONE WITH 120 VOLT DUPLEX RECEPTACLES AND ONE WITH TELEPHONE OUTLETS	DH C	DOOR CONTACT MAGNETIC DOOR HOLD	WP	WEATHERPROOF		
	POWER POLE, TWO COMPARTMENT- ONE WITH 120 VOLT DUPLEX RECEPTACLES AND ONE WITH DATA OUTLETS	PP	PUSH PLATE		MISCELLANEOUS		
	POWER POLE, TWO COMPARTMENT- ONE WITH 120 VOLT DUPLEX RECEPTACLES AND ONE WITH DATA AND	ADO	AUTOMATIC DOOR OPERATOR	XX #	MECHANICAL EQUIPMENT ITEM IDENTIFICATION PER EQUIPMENT SCHEDULE ON DRAWINGS		
	MOTORS AND EQUIPMENT	CR	CARD READER/PROX READER				
	DISCONNECT SWITCH, FUSED (LEFT) OR NON-FUSED (RIGHT) AS INDICATED - MOUNT 60" AFF. 30/20/3 INDICATES SWITCH AMPS/FUSE AMPS/POLES	SCP	SECURITY CONTROL PANEL	#>	IVII SCELLAINE OOS EQUIFIVIENT IN UIVIDEN. SEE IVII SCELLAINE OUS EQUIPIVIENT SCHEDULE		
	MOTOR STARTER, NEMA SIZE TO SUIT EQUIPMENT SERVED, WITH HAND-OFF-AUTO SELECTOR SWITCH	RTE	REQUEST TO EXIT	#	KEYNOTE SYMBOL		
□ FCB	COMBINATION MOTOR STARTER, AS ABOVE AND DISCONNECT SWITCH	IC ES	INTERCOM ELECTRIC STRIKE (FURNISHED BY DIVISION 8)				
l '	ENCLOSED CIRCUIT BREAKER; AMPS/POLES RATING AS INDICATED	EH	ELECTRIFIED HARDWARE (FURNISHED BY DIVISION 8)				
CP VFD	CONTROL PANEL FOR EQUIPMENT ITEM INDICATED ON PLAN VARIABLE FREQUENCY DRIVE FOR EQUIPMENT ITEM INDICATED ON PLAN	EH ML	MAGNETIC LOCK (FURNISHED BY DIVISION 8)				
•••	MULTIPLE PUSH BUTTONS - MOUNT 46" AFF, AS INDICATED	GB	GLASS BREAK SENSOR				
	ELECTRIC MOTOR NEW BRANCH CIRCUIT PANELBOARD - MOUNT TOP 78" AFF		VIDEO SURVEILLANCE CAMERA				
	EXISTING BRANCH CIRCUIT PANELBOARD	A	DURESS/HOLD UP ALARM				
	SWITCHBOARD, DISTRIBUTION PANEL OR MOTOR CONTROL CENTER	P PB	PANIC BUTTON PUSH BUTTON				
	DRY-TYPE TRANSFORMER KILOWATT HOUR METER BASE	LD	NURSE CALL SYSTEMS				
	CIRCUITRY DESIGNATIONS	N	NURSE CALL STSTEIVIS NURSE CALL PUSH BUTTON, UNLESS NOTED OTHERWISE				

NURSE CALL PUSH BUTTON, UNLESS NOTED OTHERWISE

NURSE CALL LIGHT MOUNTED AT 90" UNLESS NOTED OTHERWISE

NURSE CALL CONTROL PANEL

NCCP

STATE OF MISSOURI MICHAEL L. PARSON, GOVERNOR



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EXPIRATION DATE: 12/31/25
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ELECTRICAL LEGEND & SYMBOLS

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15 of 18 SHEETS
08.15.2024

) 2021 CASCO DIVERSIFIED CORPO

GENERAL CONSTRUCTION NOTES

- 1. ELECTRICAL CONTRACTOR SHALL BE RESPONSIBLE FOR NECESSARY PERMITS, LICENSES, INSPECTIONS AND FEES FROM THE LOCAL AUTHORITIES HAVING JURISDICTION. CONTRACTOR SHALL BE LICENSED BY LOCAL AND/OR STATE AUTHORITIES HAVING JURISDICTION.
- 2. ALL MATERIAL AND WORKMANSHIP SHALL CONFORM TO THE NATIONAL FIRE PROTECTION ASSOCIATION (NFPA), NATIONAL ELECTRICAL CODE (NEC), INTERNATIONAL BUILDING CODE (IBC) AND OTHER APPLICABLE LOCAL, STATE AND NATIONAL CODES.
- 3. ALL ELECTRICAL MATERIALS USED ON THIS PROJECT SHALL BE "UL" LISTED AND LABELED.
- 4. THE ENTIRE ELECTRICAL SYSTEM AND ALL ELECTRICAL EQUIPMENT SHALL BE GROUNDED IN STRICT ACCORDANCE WITH THE NATIONAL ELECTRICAL CODE AND AS SHOWN ON THE DRAWINGS. PROVIDE A GROUND WIRE IN EACH POWER CONDUIT. SIZED PER THE NEC.
- 5. CONTRACTOR SHALL BE RESPONSIBLE FOR INSTALLING A COMPLETE SYSTEM PER CONTRACT DRAWINGS AND ENSURING THAT THE SYSTEM IS OPERATIONAL UPON JOB COMPLETION, PRIOR TO TURNOVER.
- 6. CONTRACTOR SHALL BE RESPONSIBLE FOR COORDINATING WITH ALL OTHER TRADES AND DISCIPLINES TO AVOID CONFLICTS AND TO VERIFY ALL EQUIPMENT CONNECTIONS. COORDINATE ALL WIRING DEVICE LOCATIONS AND ELEVATIONS INDICATED ON THE PLANS WITH THE OWNER, ARCHITECT AND FINAL FURNITURE/EQUIPMENT LAYOUTS, PRIOR TO ROUGH-IN.
- 7. CONTRACTOR SHALL GUARANTEE ALL LABOR AND MATERIALS INSTALLED OR FURNISHED UNDER THIS CONTRACT FOR A PERIOD OF NOT LESS THAN ONE YEAR AFTER FINAL ACCEPTANCE OF THE BUILDING.
- 8. MAINTAIN AND VERIFY ELECTRICAL EQUIPMENT CLEARANCES AND WORKING SPACE PER NEC.
- 9. PROVIDE ELECTRICAL SYSTEMS WITH IDENTIFICATION AS INDICATED IN THE SPECIFICATIONS AND REQUIRED BY THE NEC.
- 10. IF ANYTHING ON THE PLANS IS NOT IN COMPLIANCE WITH NATIONAL, STATE OR LOCAL CODES, THE ENGINEER SHALL BE ADVISED BY THE ELECTRICAL CONTRACTOR DURING THE BIDDING PROCESS. THERE ARE TO BE NO CHANGES TO THE CONTRACT DOCUMENTS WITHOUT WRITTEN PERMISSION FROM THE ENGINEER.
- 11. CONTRACTOR SHALL BE RESPONSIBLE FOR ALL MEANS AND METHODS FOR NEW WORK, SAFETY, ETC., IN ACCORDANCE WITH ALL AUTHORITIES HAVING JURISDICTION. (I.E. OSHA, NEC, ETC.)
- 12. THE CONTRACTOR SHALL REFER TO ARCHITECTURAL DRAWINGS FOR PHASING AND SCHEDULING OF THIS PROJECT. COORDINATE WITH OWNER'S FIELD REPRESENTATIVE.
- 13. VERIFY ALL INDICATED DIMENSIONS BY FIELD MEASUREMENTS. NOTIFY ENGINEER OF ANY DISCREPANCIES.
- 14. PROVIDE ACCESS PANELS OR DOORS WHERE EQUIPMENT OR DEVICES ARE REQUIRED TO BE ACCESSIBLE ARE CONCEALED BEHIND INACCESSIBLE SURFACES.
- 15. PRIOR TO TURNOVER, THE CONTRACTOR SHALL REMOVE ALL RUBBISH, DIRT, DEBRIS AND STAINS ON THEIR WORK OR CAUSED BY THEIR WORK AND SHALL THOROUGHLY CLEAN ALL EQUIPMENT, FIXTURES, DEVICES, ETC. CONTRACTOR SHALL REPLACE, TOUCH-UP OR REFINISH THE FACTORY FINISH ON EQUIPMENT, FIXTURES, DEVICES, ETC. MARRED DURING SHIPMENT, INSTALLATION OR CONSTRUCTION.
- 16. PANELBOARD SHALL BE EQUIPPED WITH BOLT-ON TYPE BREAKERS, PHENOLIC NAME TAGS AND KEYED LOCK AND LATCH. EACH PANEL SHALL BE PROVIDED WITH TWO KEYS WITH ALL PANELS KEYED ALIKE. ALL CIRCUIT BREAKERS USED TO SWITCH LIGHT FIXTURES SHALL BE TYPE SWD AND SHALL BE APPROVED FOR THE PURPOSE. ALL CIRCUIT BREAKERS SERVING HVAC EQUIPMENT SHALL BE HACR TYPE.
- 17. ALL CIRCUITS INDICATED ON THESE DRAWINGS ARE 20A, 1P CIRCUIT BREAKERS IN PANELS UNLESS NOTED OTHERWISE.

 THE ELECTRICAL CONTRACTOR SHALL BE RESPONSIBLE FOR THE PROPER IDENTIFICATION AND LABELING OF ALL CIRCUIT BREAKERS. EACH PANELBOARD SHALL BE EQUIPPED WITH A TYPE WRITTEN CIRCUIT DIRECTORY.
- 18. MINIMUM WIRE SIZE SHALL BE #12 AWG UNLESS OTHERWISE NOTED. MINIMUM CONDUIT SIZE SHALL BE 1/2" UNLESS OTHERWISE NOTED. ALL CONDUIT BELOW SLABS OR EXTERIOR TO BUILDING SHALL BE MINIMUM 1". PROVIDE A NYLON/POLY PULL CORD IN ALL EMPTY CONDUITS.
- 19. ELECTRICAL CONTRACTOR SHALL PROVIDE TYPE THHN OR THWN COPPER CONDUCTORS FOR ALL INTERIOR BUILDING WIRE AND SHALL PROVIDE TYPE XHHW-2 COPPER CONDUCTORS FOR ALL EXTERIOR FEEDERS AND BRANCH CIRCUITS.
- 20. VOLTAGE DROP MINIMUM WIRE SIZING (20A CIRCUIT) USE: 120V CIRCUIT OVER 100' SHALL BE #10 MINIMUM; 120V CIRCUIT OVER 175' SHALL BE #8 MINIMUM; 208V CIRCUIT OVER 200' SHALL BE #10 MINIMUM; 277V CIRCUIT OVER 200' SHALL BE #10 MINIMUM. MINIMUM WIRE SIZE FOR ANY 20A BRANCH CIRCUIT SHALL BE #12. FURTHERMORE, CONSIDER ALL DERATING OF CONDUCTORS AS REQUIRED IN ACCORDANCE WITH THE APPLICABLE NEC.
- 21. ELECTRICAL CONTRACTOR SHALL HAVE THE OPTION OF GROUPING HOME RUNS IN ONE CONDUIT, PER THE REQUIREMENTS OF SECTION 310 OF THE NATIONAL ELECTRICAL CODE. NO MORE THAN FOUR (4) CIRCUITS SHALL BE ALLOWED TO BE GROUPED AND INSTALLED IN A SINGLE JUNCTION BOX. EC SHALL BE RESPONSIBLE FOR INCREASING CONDUCTOR SIZE AND DERATING. HOME RUNS WITH MORE THAN THREE CIRCUITS SHALL BE #10 AWG. CONDUCTOR MINIMUM. PROVIDE DEDICATED NEUTRALS FOR EACH PHASE CONDUCTOR AND CONSIDER THEM AS A CURRENT CARRYING CONDUCTOR FOR DERATING.
- 22. ALL HOME RUNS SHALL BE IN EMT CONDUIT. MC CABLE IS PERMITTED ABOVE CEILINGS FROM HOMERUNS TO FIXTURES AND WIRING DEVICES WITHIN WALLS AND FURRED COLUMNS. REFER TO ELECTRICAL SPECIFICATIONS FOR MORE DETAILED INFORMATION.
- 23. SUPPORT ALL CONDUITS FROM STRUCTURAL WALLS, SLABS, MEMBERS AND ROOF JOISTS. DO NOT SUPPORT CONDUITS FROM CEILING TIE WIRES, DUCTWORK, PIPING, ROOF DECK OR OTHER NON-STRUCTURAL MEMBERS.
- 24. SUPPORTING OF ELECTRICAL CONDUITS: THE INDIVIDUAL BRANCH CIRCUIT CONDUIT AND ASSOCIATED 4" X 4" JUNCTION BOXES MAY BE SUPPORTED FROM FLOOR/ROOF JOISTS. ALL LARGER FEEDER CONDUITS AND/OR CLUSTER OR GROUPS OF BRANCH CIRCUIT CONDUITS SHALL BE SUPPORTED ON STEEL TRAPEZE WITH STEEL CHANNEL ATTACHED TO STEEL OR WOOD JOIST/BEAMS WITH PROPER ATTACHMENTS. NO SUPPORT SHALL BE ATTACHED TO THE ROOF DECK (NO EXCEPTIONS). HANG CONDUIT FROM TOP CHORD OF BAR JOIST WHEN ATTACHING HOME RUNS TO JOIST.
- 25. INTERIOR AND EXTERIOR LIGHT FIXTURES SHALL BE FURNISHED AND INSTALLED AS SHOWN ON THE DRAWINGS AND AS CALLED OUT IN THE
- 26. ALL WIRING DEVICES SHALL BE FLUSH MOUNTED, UNLESS NOTED OTHERWISE. ALL CONDUIT SHALL BE RUN WITHIN WALL CAVITIES, BELOW FLOOR AND ABOVE CEILINGS. SURFACE MOUNTED ELECTRICAL WORK SHALL NOT BE USED UNLESS SPECIFICALLY NOTED ON THE PLANS.
- 27. ALL WALL AND CEILING FIXTURES AND DEVICES SHALL BE INDEPENDENTLY AND SECURELY MOUNTED SO THEY ARE NOT DEPENDENT ON CEILING FINISH FOR SUPPORT AND CAN NOT BE ROTATED OR DISPLACED. FIXTURES AND DEVICES MOUNTED IN SUSPENDED ACOUSTICAL CEILING TILE SHALL HAVE CHANNEL SUPPORTS ACROSS THE MAIN GRID RUNNERS OR GRID SUPPORTS SECURELY ANCHORED SO AS NOT TO CAUSE TILE TO SAG OR SO FIXTURE OR DEVICE CAN NOT BE LIFTED, ROTATED OR DISPLACED.
- 28. ALL OPENINGS IN FIRE AND/OR SMOKE RATED WALLS, FLOORS, AND PARTITIONS FOR CONDUITS SHALL BE SEALED WITH RED FIRE RESISTANT FOAM OR PUTTY TO MAINTAIN THE FIRE AND/OR SMOKE RATING. ALL OPENINGS IN FIRE RATED AND/OR SMOKE WALLS, FLOORS, AND PARTITIONS FOR CABLING SHALL BE SEALED WITH WIREMOLD FLAMESTOPPER, STI EZ-PATH, HILTI SPEED SLEEVE OR EQUIVALENT.
- 29. RECEPTACLES/WIRING DEVICES SHALL NOT BE INSTALLED BACK-TO-BACK, INSTALL ON OPPOSITE SIDES OF WALL STUDS; WHERE DEVICES EXIST ALONG FIRE WALLS, COVER WITH UL LISTED PUTTY PACKS.
- 30. REFER TO ARCHITECTURAL DRAWINGS FOR EXACT LOCATION OF LIGHT FIXTURES, DIMENSIONAL LOCATION OF FIXTURES IN DRYWALL CEILING, ETC. LOCATION OF FLOOR BOXES AND RECEPTACLES, INCLUDING MOUNTING HEIGHTS. ALL RECEPTACLES AND COVER PLATE COLORS SHALL BE APPROVED BY ARCHITECT.
- 31. OWNER RESERVES THE RIGHT TO RELOCATE ANY LIGHT FIXTURE, RECEPTACLE, ETC., BEFORE BEING INSTALLED 10'-0" FROM LOCATION AS SHOWN ON PLANS AT NO ADDITIONAL EXPENSE TO THE OWNER.
- 32. NO CONDUIT OR CABLES SHALL BE INSTALLED EXPOSED IN FINISHED AREA. NON-CEILING AREA CONDUITS SHALL BE INSTALLED EXPOSED IN A NEAT WORKMAN LIKE MANNER AND SHALL BE PAINTED TO MATCH ADJACENT FINISHES.
- 33. TELEPHONE, IT, AUDIO, VIDEO, SECURITY AND FIRE ALARM CABLE WIRING IN WALLS AND FLOOR SHALL BE ROUTED IN CONDUIT FROM DEVICE/JUNCTION BOX TO ABOVE AN ACCESSIBLE CEILING OR IN ATTIC SPACE; 1" EMT MINIMUM. NO SPLICING OF TELEPHONE OR DATA CABLES SHALL BE PERMITTED. ALL CABLES SHALL BE BUNDLED AND SUPPORTED FROM STRUCTURE ABOVE, NO MORE THAN 60" O.C. DO NOT LAY CABLES ON CEILING SYSTEM. PROVIDE J-HOOKS AND/OR CABLE TRAY SYSTEM. MAINTAIN 12" CLEARANCE ABOVE CEILING. COLOR CODE EACH CABLE BY USAGE.
- 34. ALL SIGNAL AND CONTROL CABLES SHALL BE MINIMUM #18 STRANDED COPPER, UNLESS NOTED OTHERWISE. ALL CONNECTIONS AND SPLICES TO BE MADE BY USE OF "STA-KON" CONNECTORS AND TERMINAL STRIPS. PROVIDE SHORT CIRCUIT RATING OF REPLACEMENT EQUIPMENT TO MATCH EXISTING OR AS NOTED ON THESE DRAWINGS. PROVIDE ARC-FLASH LABEL FOR REPLACEMENT AND NEW EQUIPMENT. PROVIDE COORDINATION STUDY DEMONSTRATING NEW AND REPLACEMENT EQUIPMENT IS COORDINATED WITH EXISTING EQUIPMENT THAT IS IMMEDIATELY UPSTREAM AND DOWNSTREAM.

GENERAL DEMO NOTES

- 1. THE ELECTRICAL CONTRACTOR SHALL REMOVE, CAP AND/OR RELOCATE EQUIPMENT, OUTLETS, CONDUIT, WIRE, TC., AS SHOWN AND SPECIFIED ON THE DRAWINGS, AND AS MAY BECOME NECESSARY BECAUSE OF EXISTING FIELD CONDITIONS. IT SHALL BE THE RESPONSIBILITY OF THE ELECTRICAL CONTRACTOR TO VISIBLY EXAMINE ALL EXISTING WALLS DESIGNATED FOR REMOVAL OR MODIFICATION TO DETERMINE THE CONDUIT AND THE WIRING THAT WILL REQUIRE CAPPING AND/OR REMOVAL. THE CONTRACTOR SHALL BE HELD TO HAVING VISITED THE SITE AND TAKEN ALL EXISTING CONDITIONS INTO CONSIDERATION.
- 2. PROTECT ADJACENT MATERIALS INDICATED TO REMAIN. INSTALL AND MAINTAIN DUST AND NOISE BARRIERS TO KEEP DIRT, DUST, AND NOISE FROM BEING TRANSMITTED TO ADJACENT AREAS. REMOVE PROTECTION AND BARRIERS AFTER DEMOLITION OPERATIONS ARE COMPLETE.
- 3. LOCATE, IDENTIFY, AND PROTECT ELECTRICAL SERVICES PASSING THROUGH DEMOLITION AREA AND SERVING OTHER AREAS OUTSIDE THE DEMOLITION LIMITS. MAINTAIN SERVICES TO AREAS OUTSIDE DEMOLITION LIMITS. WHEN SERVICES MUST BE INTERRUPTED, INSTALL TEMPORARY SERVICES FOR AFFECTED AREAS.
- 4. MAINTAIN AND PROTECT EXISTING BUILDING SERVICES WHICH TRANSIT THE AREA AFFECTED BY SELECTIVE DEMOLITION.
- 5. MAINTAIN CIRCUIT CONTINUITY TO ALL EXISTING FIXTURES, EQUIPMENT, OUTLETS, ETC., TO REMAIN IN USE WHETHER NOTED ON THE PLANS OR NOT. FIELD VERIFY EXISTING ITEMS TO REMAIN IN USE. WIRING FOR EXISTING CIRCUITS WHICH MUST BE RE-ROUTED OR WHICH ARE PARTIALLY ABANDONED, SHALL BE RECONNECTED TO SERVICE THE REMAINING OUTLETS ON THE CIRCUIT.
- 6. IN THE DEMOLITION WORK, REMOVE ALL UNUSED WIRING AND CABLES AND UNUSED CONDUIT THAT IS EXPOSED OR WITHIN ACCESSIBLE CEILINGS WHICH IS AFFECTED BY AND IS IN THE AREA OF THE WORK OF THIS CONTRACT.
- 7. THE INTENTION OF THE ELECTRICAL DEMOLITION IS TO DISCONNECT AND REMOVE ALL ELECTRICAL WORK MADE VOID BY THE SCOPE OF THE CONSTRUCTION AND ALTERATION. FIELD VERIFY EXACT MATERIAL QUANTITIES REQUIRED TO BE REMOVED.
- 8. WHERE ELECTRICAL EQUIPMENT, CONDUIT, BOXES, AND SUPPORTING HARDWARE ARE REMOVED, PATCH, AND FINISH THE SURFACE AS REQUIRED TO MATCH THE EXISTING, UNLESS OTHERWISE NOTED.
- 9. WHERE BURIED CONDUITS EXTENDING OUT OF A CONCRETE SLAB BECOME ABANDONED, CUT AND GRIND THE CONDUITS OFF FLUSH WITH TOP OF SLAB AND PLUG WITH NON-SHRINK WATERPROOF GROUT FILL.
- 10. ALL REMOVED MATERIALS, OTHER THAN REMOVED MATERIALS TO BE RELOCATED, OR STORED, OR TURNED OVER TO THE OWNER, SHALL BECOME THE PROPERTY OF THE CONTRACTOR AND SHALL BE REMOVED FROM THE PROJECT SITE.
- 11. ACCEPTANCE OF CONTRACT MEANS INSTALLER ACCEPTS EXISTING CONDITIONS.
- 12. CONTRACTOR SHALL COORDINATE ALL DEMOLITION WORK WITH ALL OTHER TRADES.
- 13. IN WALLS OR FLOORS WHERE A FLUSH DEVICE IS BEING REMOVED, BUT THE WALL OR FLOOR REMAINS OR FOR ANY OUTLET WHICH MUST REMAIN, BUT HAS A DEVICE REMOVED, PROVIDE A BLANK COVER OVER THE OUTLET. MATCH THE COLOR AND MATERIAL OF EXISTING REMAINING COVERS IN THE ROOM OR SPACE.
- 14. LEGALLY DISPOSE OF HAZARDOUS MATERIALS AND BALLASTS OR OTHER EQUIPMENT CONTAINING PCB'S AND LAMPS CONTAINING MERCURY. COMPLY WITH ALL FEDERAL, STATE, AND LOCAL LAWS.
- 15. MODIFY EXISTING PANEL DIRECTORIES (OR REPLACE) FOR PANELS WHICH HAVE HAD ALTERATIONS TO THE CIRCUITS ORIGINATING THEREIN. DESCRIBE THE LOAD AND LOCATION.
- 16. WHERE WORK IS TO BE PERFORMED ABOVE EXISTING ACCESSIBLE CEILINGS, CONTRACTOR SHALL BE RESPONSIBLE FOR REMOVING CEILING TILES AND GRID WITHOUT DAMAGE; STORAGE OF EXISTING TILES AND GRID WHILE WORK IS BEING PERFORMED, AND INSTALLATION OF EXISTING GRID AND TILES AFTER DIVISION 26, 27 AND 28 WORK IS COMPLETED.
- 17. ALL EXISTING ELECTRICAL WORK AND ASSOCIATED RACEWAY AND WIRING WHICH HAS BEEN MADE OBSOLETE BY THE WORK AND/OR IS SHOWN DASHED ON THE ELECTRICAL DEMOLITION DRAWINGS, SHALL BE DISCONNECTED AND REMOVED, UNLESS OTHERWISE NOTED. ALTHOUGH AN ATTEMPT HAS BEEN MADE TO INDICATE ALL OF THIS WORK, TOTAL ACCURACY IS NOT GUARANTEED. CONTRACTOR SHALL VISIBLY EXAMINE ALL AREAS AND WALLS AND CEILINGS SCHEDULED FOR REMOVAL TO DETERMINE EXISTING ELECTRICAL ITEMS TO REMAIN.

		EL	.ECTRIC	AL EQUIP	MENT S	SCHEDUL	E	
							DISC.	
PLAN MARK	VOLTAGE	PHASE	FED BY	MCA/HP	MOCP	DISC BY	TYPE	FEEDER
BP-3	480 V	3	MCC-C	5 HP	20	FWU		3 #12 & #12 GRD, 3/4" C.
BP-2	480 V	3	MCC-C	5 HP	20	FWU		3 #12 & #12 GRD, 3/4" C.
BP-1	480 V	3	MCC-C	5 HP	20	FWU		3 #12 & #12 GRD, 3/4" C.
B-1	120 V	1	CJ	9 MCA	20	EC	30A/NF	2 #12 & #12 GRD, 3/4" C.
B-2	120 V	1	Cl	9 MCA	20	EC	30A/NF	2 #12 & #12 GRD, 3/4" C.
B-3	120 V	1	CJ	9 MCA	20	EC	30A/NF	2 #12 & #12 GRD, 3/4" C.
HWP-1	480 V	3	MCC-C	5 HP	20	FWU		3 #12 & #12 GRD, 3/4" C.
HWP-2	480 V	3	MCC-C	5 HP	20	FWU		3 #12 & #12 GRD, 3/4" C.
DWRP-1	120 V	1	CJ	1/6 HP	20	FWU		2 #12 & #12 GRD, 3/4" C.
DWRP-2	120 V	1	CJ	1/12 HP	20	FWU		2 #12 & #12 GRD, 3/4" C.
TMV-3		1	CJ	1 MCA	20	EC	RECP	2 #12 & #12 GRD, 3/4" C.
TMV-2		1	CJ	1 MCA	20	EC	RECP	2 #12 & #12 GRD, 3/4" C.
TMV-1		1	CJ	1 MCA	20	EC	RECP	2 #12 & #12 GRD, 3/4" C.

FWU: FURNISHED WITH UNIT

STATE OF MISSOURI MICHAEL L. PARSON, GOVERNOR



Professional of Record:
DAVID A. TRETTER
LICENSE #: 021293
EXPIRATION DATE: 12/31/25
PROFESSIONAL SEAL

CASCO Diversified Corporation
MO Certificate of Authority #000329 Arch.
MO Certificate of Authority #000613 Eng.

Exp. Date: 12/31/25

CASCO DIVERSIFIED CORPORATION
12 Sunnen Drive, Suite 100, St. Louis, MO 63143

OFFICE OF ADMINISTRATION DIVISION OF FACILITIES MANAGEMENT, DESIGN AND CONSTRUCTION

DESIGN & INSTALL
NEW DOMESTIC WATER
PLANT
VETERANS HOME

BUILDING

ST. JAMES VETERANS HOME 620 NORTH JEFFERSON ST. JAMES, MO

PROJECT # U2409-01 SITE # 6801 FACILITY # 8136801002

REVISION:
DATE:
REVISION:
DATE:
REVISION:
DATE:
ISSUE DATE: 08.15.2024

CAD DWG FILE:
DRAWN BY:
CHECKED BY:
DESIGNED BY:
KJC


SHEET TITLE:

ELECTRICAL
GENERAL NOTES &
SCHEDULES

SHEET NUMBER:

E-002
16 of 18 SHEETS

08.15.2024

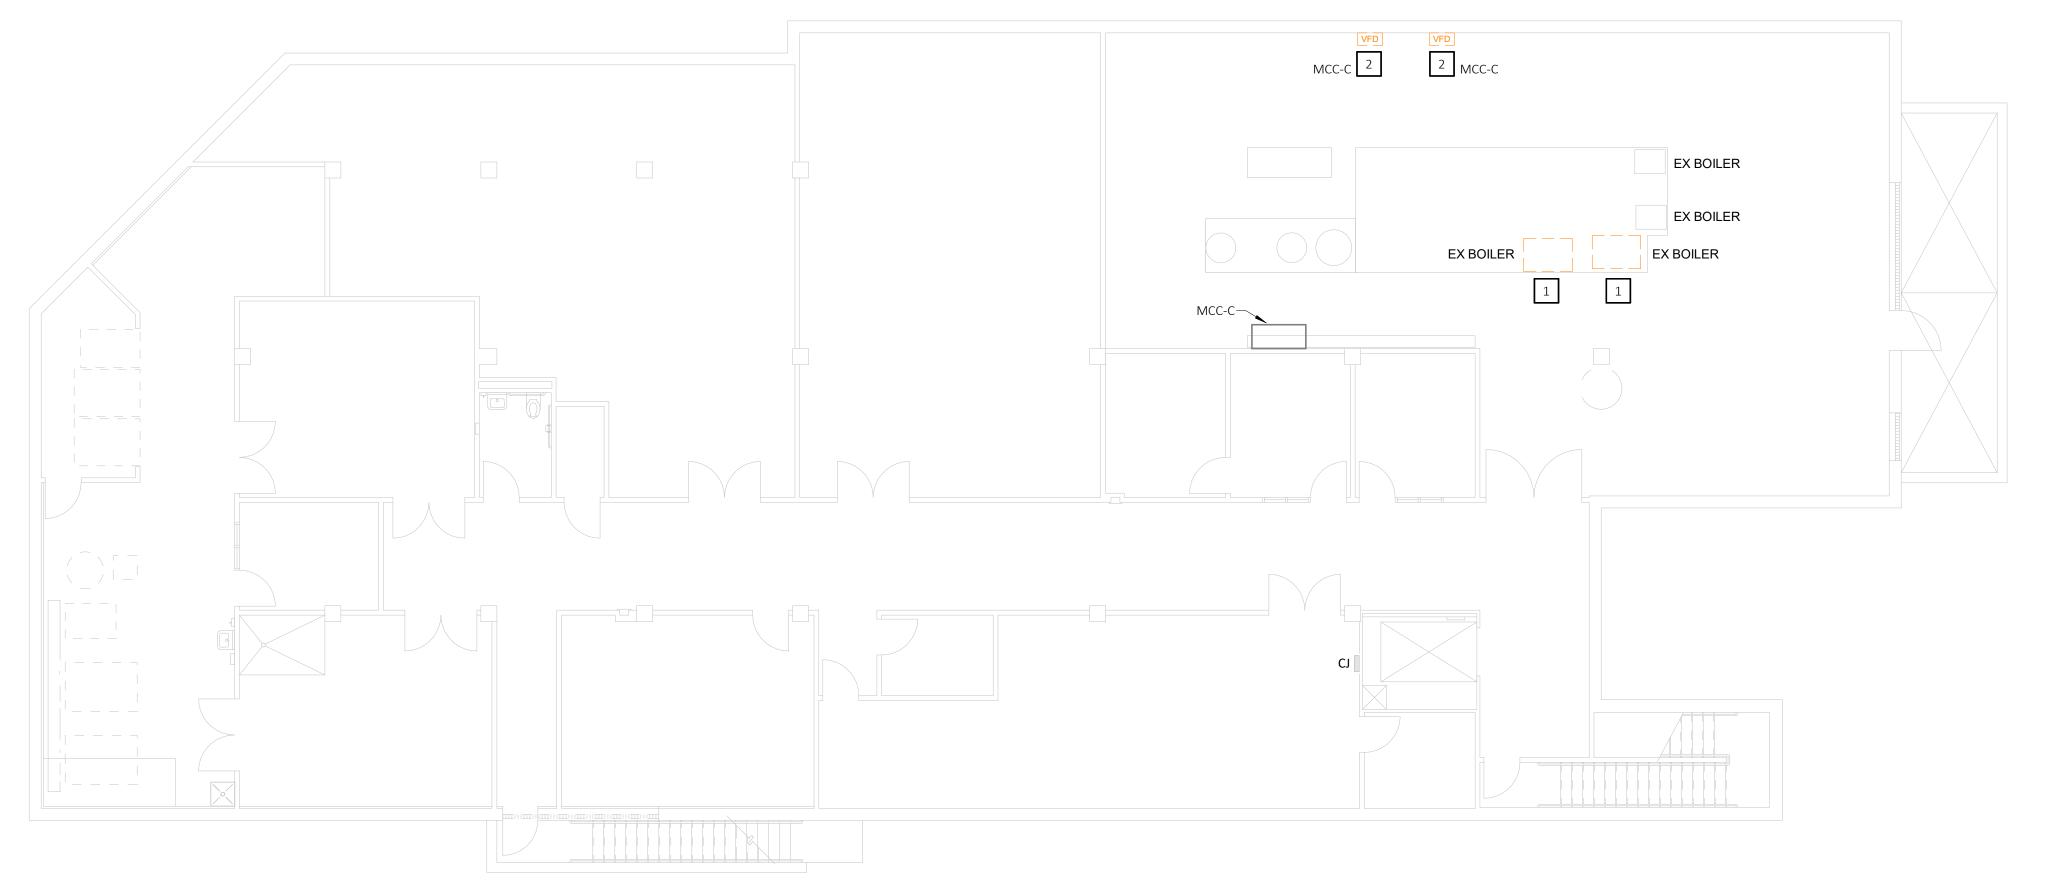

BASEMENT FLOOR PLAN - ELECTRICAL DEMOLITION - PHASE 1 1 BASEIVIE E-101 SCALE: 1/8" = 1'-0"

MCC-C TMV-2 (KITCHEN) 1 5 PB

Keynotes - Reno

WATER PUMP FACTORY FURNISHED VFD.

SHUTDOWN SEQUENCE.

THERMOSTATIC MIXING VALVES.

1 EC SHALL MAINTAIN EXISTING WATER HEATER WIRING AND EXTEND IF NEED FOR RECONNECTION WITH NEW BOILER. VERIFY EXISTING CIRCUIT IS ROUTED THROUGH CONTACTOR "LC1" FOR

2 EC SHALL PROVIDE CIRCUIT FROM MCC-C SPARE BUCKET FOR (3) NEW BOILER PUMPS. PROVIDE 3#8 CU & 1#8 GND, 3/4"C. FROM MCC-C TO JUNCTION BOX WITH TERMINAL BLOCK. EC SHALL PROVIDE

3 EC SHALL EXTEND EXISTING HOT WATER PUMP CIRCUIT AND MAKE CONNECTION TO NEW HOT

4 EC SHALL PROVIDE NEW 20A, 120V CIRCUIT FROM SPARE BREAKER IN PANEL "CJ" FOR NEW BOILER.

5 EXISTING EMERGENCY BOILER SHUTDOWN BUTTON INTERLOCKS WITH CONTACTOR "LC1" SO THAT

KEY PLAN

30A FUSED DISCONNECT WITH 20A FUSES FOR EACH BOILER PUMP.

* Keynotes - Reno Alternate #1

ROUTE CIRCUIT THROUGH CONTACTOR "LC1" FOR SHUTDOWN SEQUENCE.

GAS FIRED EQUIPMENT IN BOILER ROOMS SHUTS DOWN UPON ACTIVATION.

- **Keynotes Demo** 1 EXISTING BOILER TO BE DEMOLISHED. EC SHALL DISCONNECT EXISTING BOILER WIRING AND MAINTAIN CIRCUIT FOR RECONNECTION WITH NEW BOILER.
- 2 EXISTING HOT WATER PUMP AND VFD TO BE DEMOLISHED. EC SHALL DISCONNECT EXISTING CIRCUIT FROM VFD AND MAINTAIN FOR RECONNECTION WITH NEW PUMP.

STATE OF MISSOURI

MICHAEL L. PARSON, **GOVERNOR**

Professional of Record: DAVID A. TRETTER LICENSE #: 021293 EXPIRATION DATE: 12/31/25 PROFESSIONAL SEAL CASCO Diversified Corporation MO Certificate of Authority #000329 Arch.
MO Certificate of Authority #000613 Eng.
Exp. Date: 12/31/25

OFFICE OF ADMINISTRATION DIVISION OF FACILITIES MANAGEMENT, **DESIGN AND CONSTRUCTION**

DESIGN & INSTALL NEW DOMESTIC WATER **PLANT VETERANS HOME**

BUILDING

ST. JAMES VETERANS HOME 620 NORTH JEFFERSON ST. JAMES, MO

PROJECT # U2409-01 6801 SITE# FACILITY # 8136801002

REVISION: REVISION: DATE: **REVISION:** DATE: ISSUE DATE: 08.15.2024

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DRAWN BY:
CHECKED BY:
DAT DESIGNED BY: KJC

SHEET TITLE:

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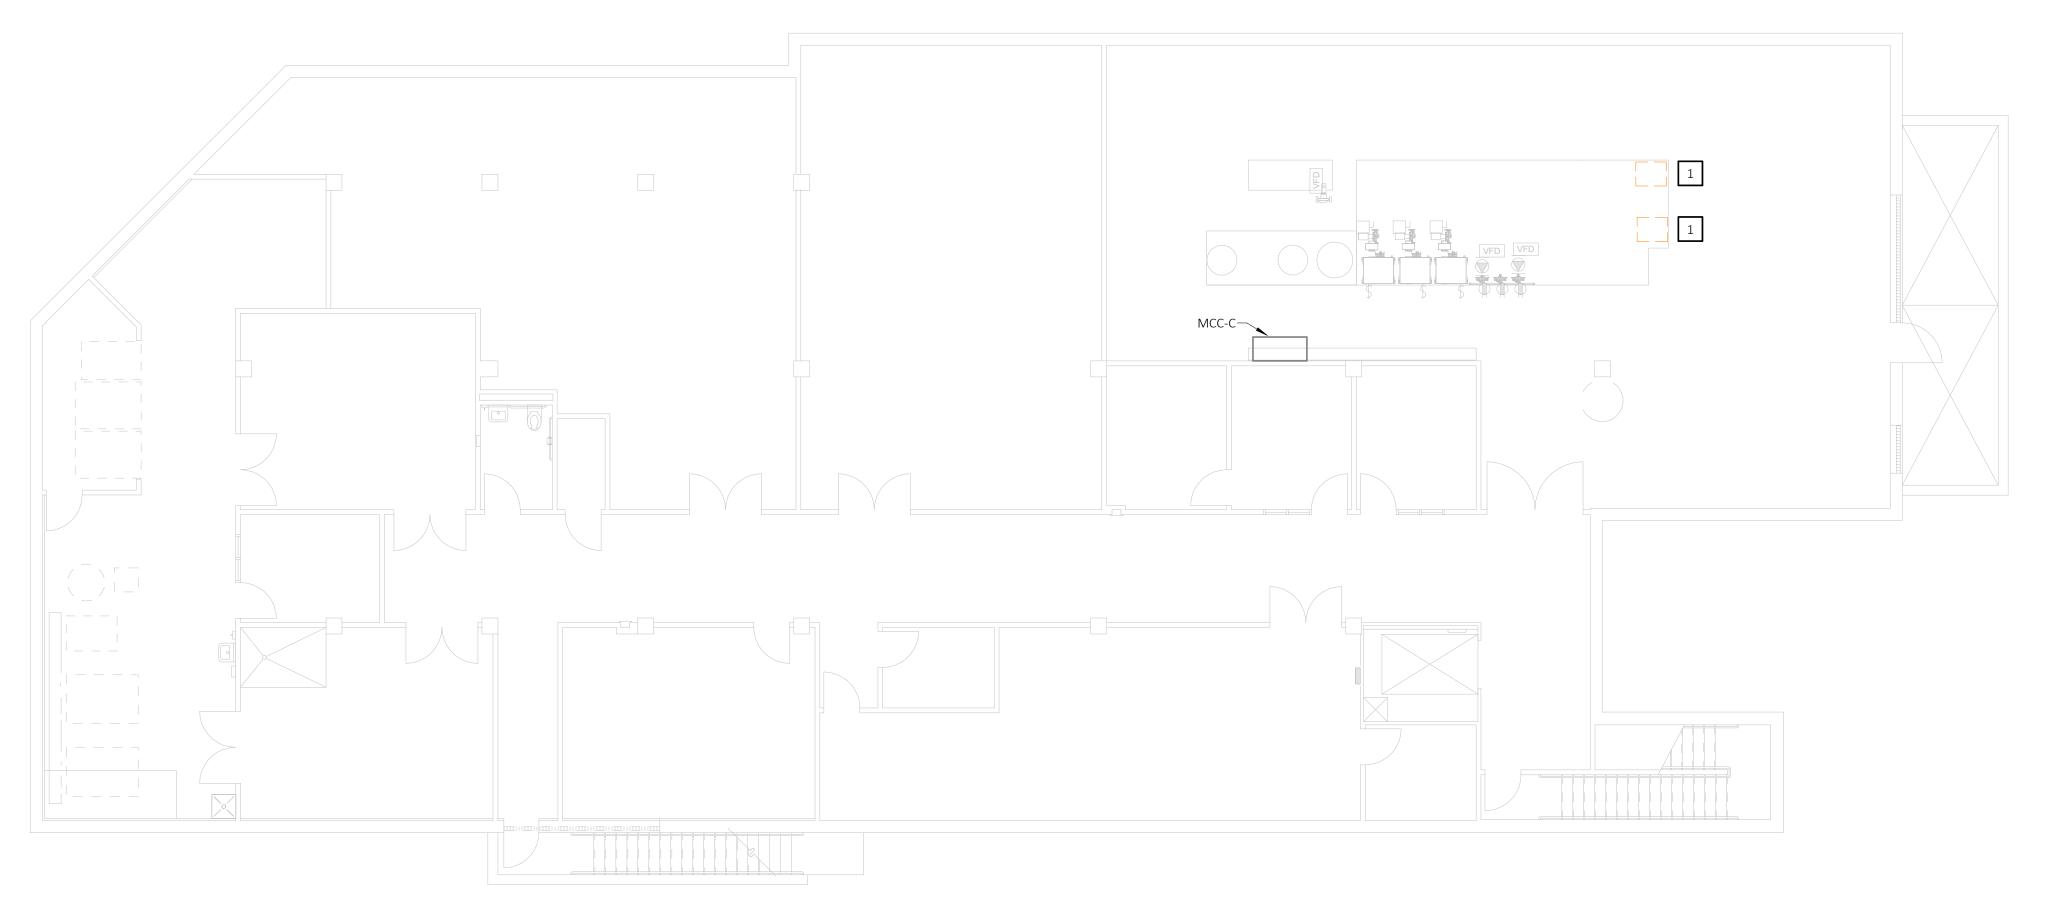
ELECTRICAL BASEMENT FLOOR PLAN - PHASE 1

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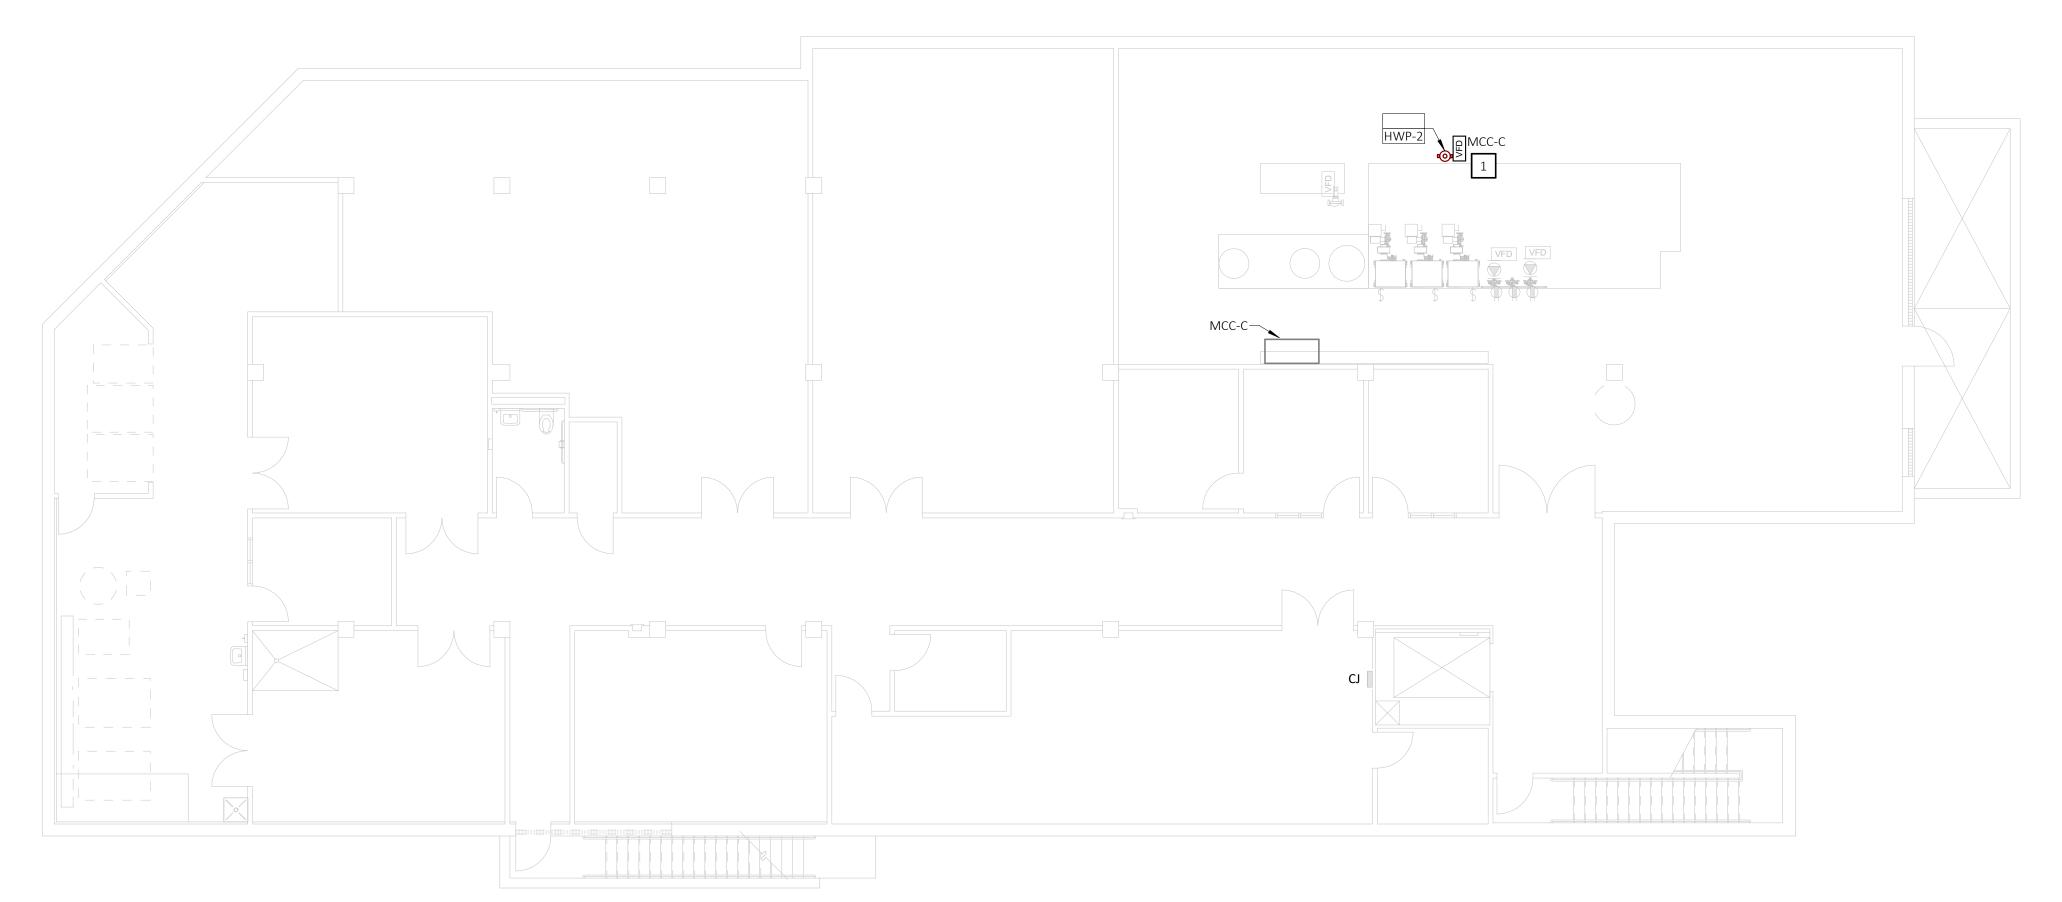
E-10117 of 18 SHEETS 08.15.2024

BASEMENT FLOOR PLAN - ELECTRICAL RENOVATION - PHASE 1

2 BASEME E-101 SCALE: 1/8" = 1'-0"



BASEMENT FLOOR PLAN - ELECTRICAL DEMOLITION - PHASE 2 E-102 SCALE: 1/8" = 1'-0"




Keynotes - Demo

1 EXISTING BOILER TO BE DEMOLISHED. EC SHALL DISCONNECT BOILER AND REMOVE CONDUIT AND WIRING BACK

Keynotes - Reno

1 EC SHALL EXTEND EXISTING HOT WATER PUMP CIRCUIT AND MAKE CONNECTION TO NEW HOT WATER PUMP

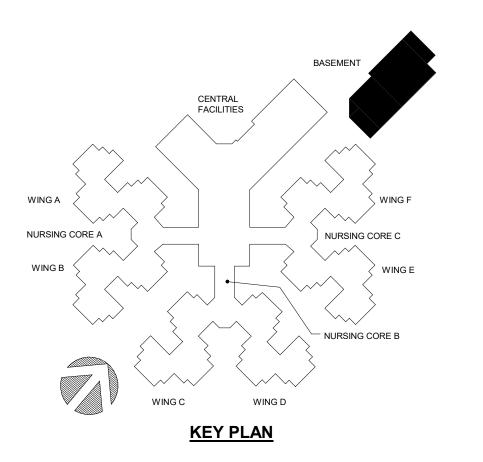

STATE OF MISSOURI MICHAEL L. PARSON, **GOVERNOR**



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Exp. Date: 12/31/25

OFFICE OF ADMINISTRATION DIVISION OF FACILITIES MANAGEMENT, **DESIGN AND** CONSTRUCTION

DESIGN & INSTALL NEW DOMESTIC WATER **PLANT** VETERANS HOME BUILDING

ST. JAMES VETERANS HOME 620 NORTH JEFFERSON ST. JAMES, MO

PROJECT # U2409-01 SITE# 6801 FACILITY # 8136801002

REVISION:
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DATE:
ISSUE DATE: 08.15.2024

CAD DWG FILE:
DRAWN BY:
CHECKED BY:
DESIGNED BY:
KJC

SHEET TITLE:

ELECTRICAL BASEMENT FLOOR PLAN - PHASE 2

SHEET NUMBER:

E-10218 of 18 SHEETS 08.15.2024

BASEMENT FLOOR PLAN - ELECTRICAL RENOVATION - PHASE 2 2 BASEME E-102 SCALE: 1/8" = 1'-0"