REBID DESIGN & INSTALL NEW DOMESTIC WATER PLANT VETERANS HOME BUILDING ST. JAMES, MISSOURI

CASCO

ST. LOUIS, MO 63143 ARCHITECTS / ENGINEERS 314-821-1100

CASCO DIVERSIFIED CORPORATION MISSOURI STATE CERTIFICATE OF AUTHORITY #000613 (ENG) MISSOURI STATE CERTIFICATE OF AUTHORITY #000329 (ARCH)

OWNER:

STATE OF MISSOURI

MIKE KEHOE, **GOVERNOR**

DEPARTMENT OF PUBLIC SAFETY


PROJECT

OFFICE OF ADMINISTRATION

MANAGEMENT:

DIVISION OF FACILITIES MANAGEMENT,

DESIGN AND CONSTRUCTION

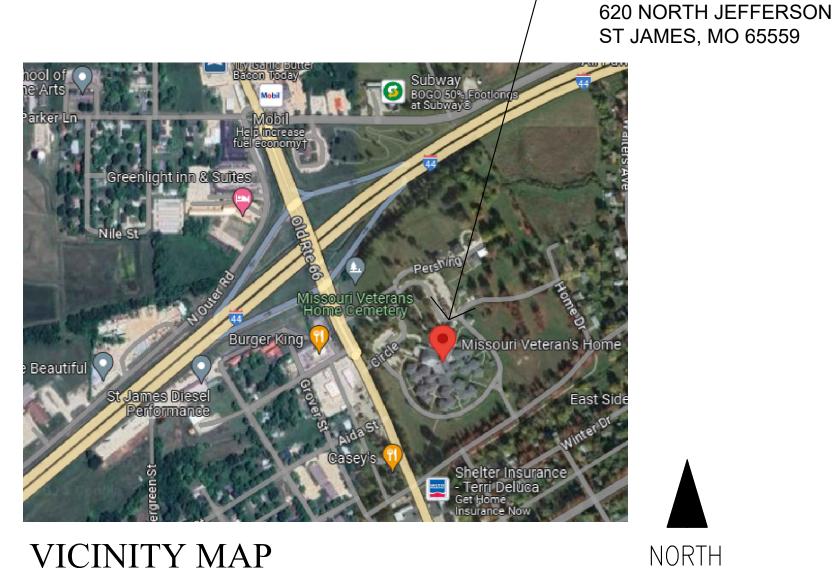

VICINITY MAP



ADDRESS:

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DESIGNER: CASCO DIVERSIFIED CORP.

PROJECT NUMBER: U2409-01

6801 SITE NUMBER:

8136801002 FACILITY NUMBER:

KEYED NOTES


- 1. REMOVE PORTION OF HOT WATER RETURN PIPING FOR LAUNDRY
- 2. REMOVE ALL ASSOCIATED PIPING, VALVES, PUMPS, ETC. FOR EXISTING BOILERS DURING PHASE 1.
- 3. REMOVE PORTION OF HOT WATER RETURN PIPING FOR MAIN BUILDING. PREPARE PIPING FOR NEW CONNECTION.
- 4. REMOVE PORTION OF HOT WATER PIPING. PREPARE PIPING FOR NEW CONNECTION IN PHASE 1
- 5. VALVE NORMALLY CLOSED UNTIL PHASE 2.
- 6. ROUTE 1"HOT WATER RETURN (160°F) PIPING TO DWRP-2. ROUTE PIPING DOWNSTREAM OF DWRP-2 TO TMV-1 & 3"SOFT COLD WATER PIPING ROUTING TO THE DOMESTIC WATER STORAGE
- 7. PROVIDE VALVE AND CAP FOR CONNECTION IN PHASE 2.
- 8. BACKFLOW PREVENTER FOR BOILER MAKE-UP WATER.
- $_{\it \Gamma}$ EX TMV TO REMAIN $\,\,$ 9. REMOVE PORTION OF COLD WATER PIPING. PREPARE PIPING FOR NEWCONNECTION.

ALTERNATE #1 (THIS SHEET):

ALTERNATE NO. 1: USE ELECTRONICALLY OPERATED THERMOSTATIC MIXING VALVES IN LIEU OF MECHANICALLY OPERATED MIXING VALVES FOR THE SUITES, KITCHEN AND LAUNDRY AREAS.

- ETMV-1 (SUITES): LEONARD NUCLEUS NV-150-LF. 72 GPM AT 10 PSI PRESSURE DROP, 1-1/4" SUPPLIES, 1-1/2" MIXED OUTLET.
- ETMV-2 (KITCHEN): LEONARD NUCLEUS NV-150-LF, 72 GPM AT 10 PSI PRESSURE DROP. 1-1/4" SUPPLIES. 1-1/2" MIXED OUTLET.
- ETMV-3 (LAUNDRY): LEONARD NUCLEUS NV-150-LF, 72 GPM AT 10
- PSI PRESSURE DROP, 1-1/4" SUPPLIES, 1-1/2" MIXED OUTLET.

PLUMBING LEGEND

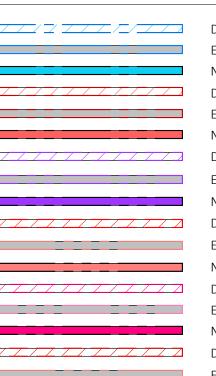

STAGING MAP


WING A

NURSING CORE A

SCALE: NONE

DEMO SOFT COLD WATER PIPING (EX SCW) EXISTING SOFT COLD WATER PIPING (EX SCW) DEMO HOT WATER PIPING (140°F) (EX HW(140°F)) EXISTING HOT WATER PIPING (140°F) (EX HW(140°F)) NEW HOT WATER PIPING (140°F) (HW(140°F)) DEMO HOT WATER RETURN PIPING (EX HWR) EXISTING HOT WATER RETURN PIPING (EX HWR) NEW HOT WATER RETURN PIPING (HWR) DEMO HOT WATER PIPING (160°F) (EX HW(160°F)) EXISTING HOT WATER PIPING (160°F) (EX HW(160°F)) NEW HOT WATER PIPING (160°F) (HW(160°F)) DEMO HOT WATER RETURN PIPING (160°F) (EX HWR(160°F)) EXISTING HOT WATER RETURN PIPING (160°F)(EX HWR(160°F)) NEW HOT WATER RETURN PIPING (160°F) (HWR(160°F)) HX: NEW HOT WATER PIPING (170°F) (HW(170°F))

HX: NEW HOT WATER RETURN PIPING (170°F) (HWR(170°F))

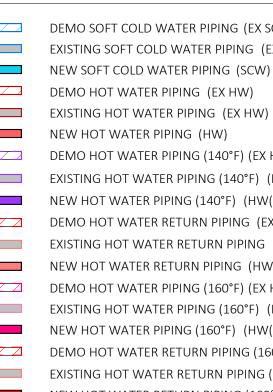

NOTE: HX = HEAT EXCHANGER

OFFICE OF ADMINISTRATION DIVISION OF FACILITIES MANAGEMENT, **DESIGN AND** CONSTRUCTION

STATE OF MISSOURI

MICHAEL L. KEHOE,

GOVERNOR

LICENSE #: 2003015013 EXPIRATION DATE: 12/31/25

PROFESSIONAL SEAL

CASCO Diversified Corporation


MO Certificate of Authority #000329 Arch.

MO Certificate of Authority #000613 Eng. Exp. Date: 12/31/25

REBID **DESIGN & INSTALL** NEW DOMESTIC WATER **PLANT VETERANS HOME** BUILDING

ST. JAMES VETERANS HOME 620 NORTH JEFFERSON ST. JAMES, MO

PROJECT # U2409-01 6801 SITE# FACILITY # 8136801002

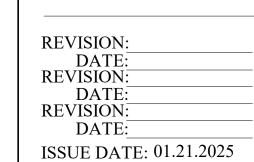

CAD DWG FILE:
DRAWN BY:
CHECKED BY:
SAM DESIGNED BY:


SHEET TITLE:

NURSING CORE C

PLUMBING - PHASE 1 **DEMOLITION & NEW**

SHEET NUMBER:

P-101 2 of 18 SHEETS 03.05.2025

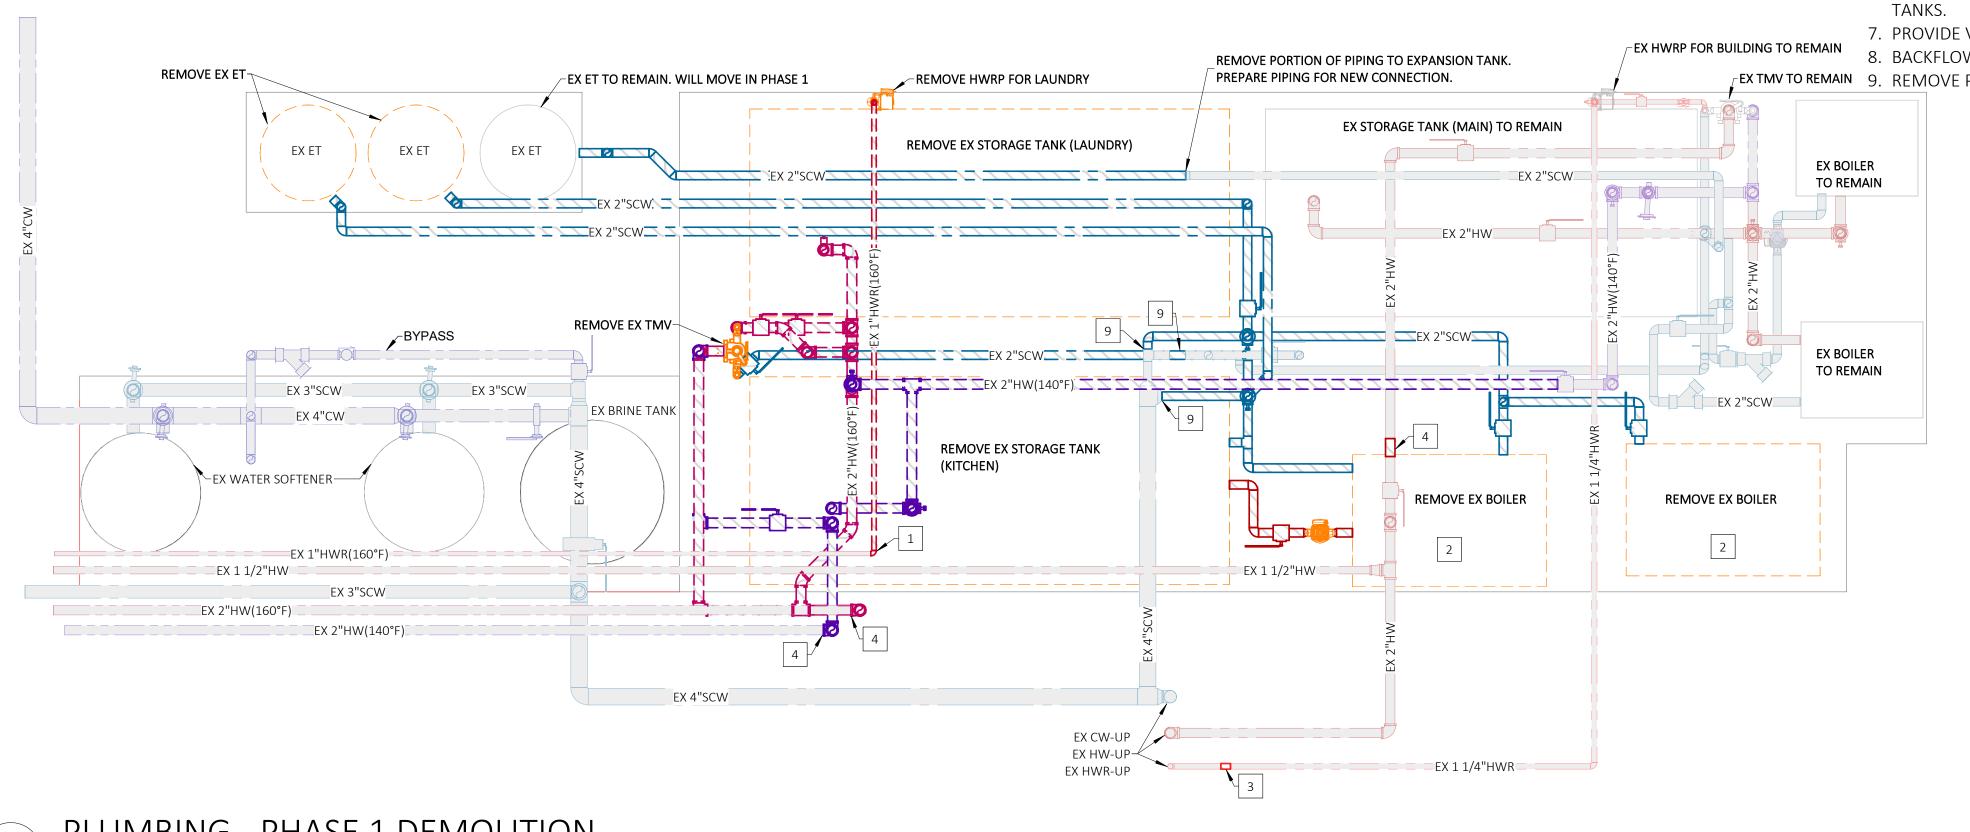


PLUMBING - PHASE 1 DEMOLITION

P-101 SCALE: 1/2" = 1'-0"

NOTE: MATTERPORT SURVEY LINK PROVIDED BELOW IS FOR REFERENCE ONLY, AND IS NOT INTENDED TO BE A SUBSTITUTE FOR FIELD INVESTIGATIONS BY THE CONTRACTOR.

MATTERPORT LINK: https://my.matterport.com/show/?m=vyscquW6hsr

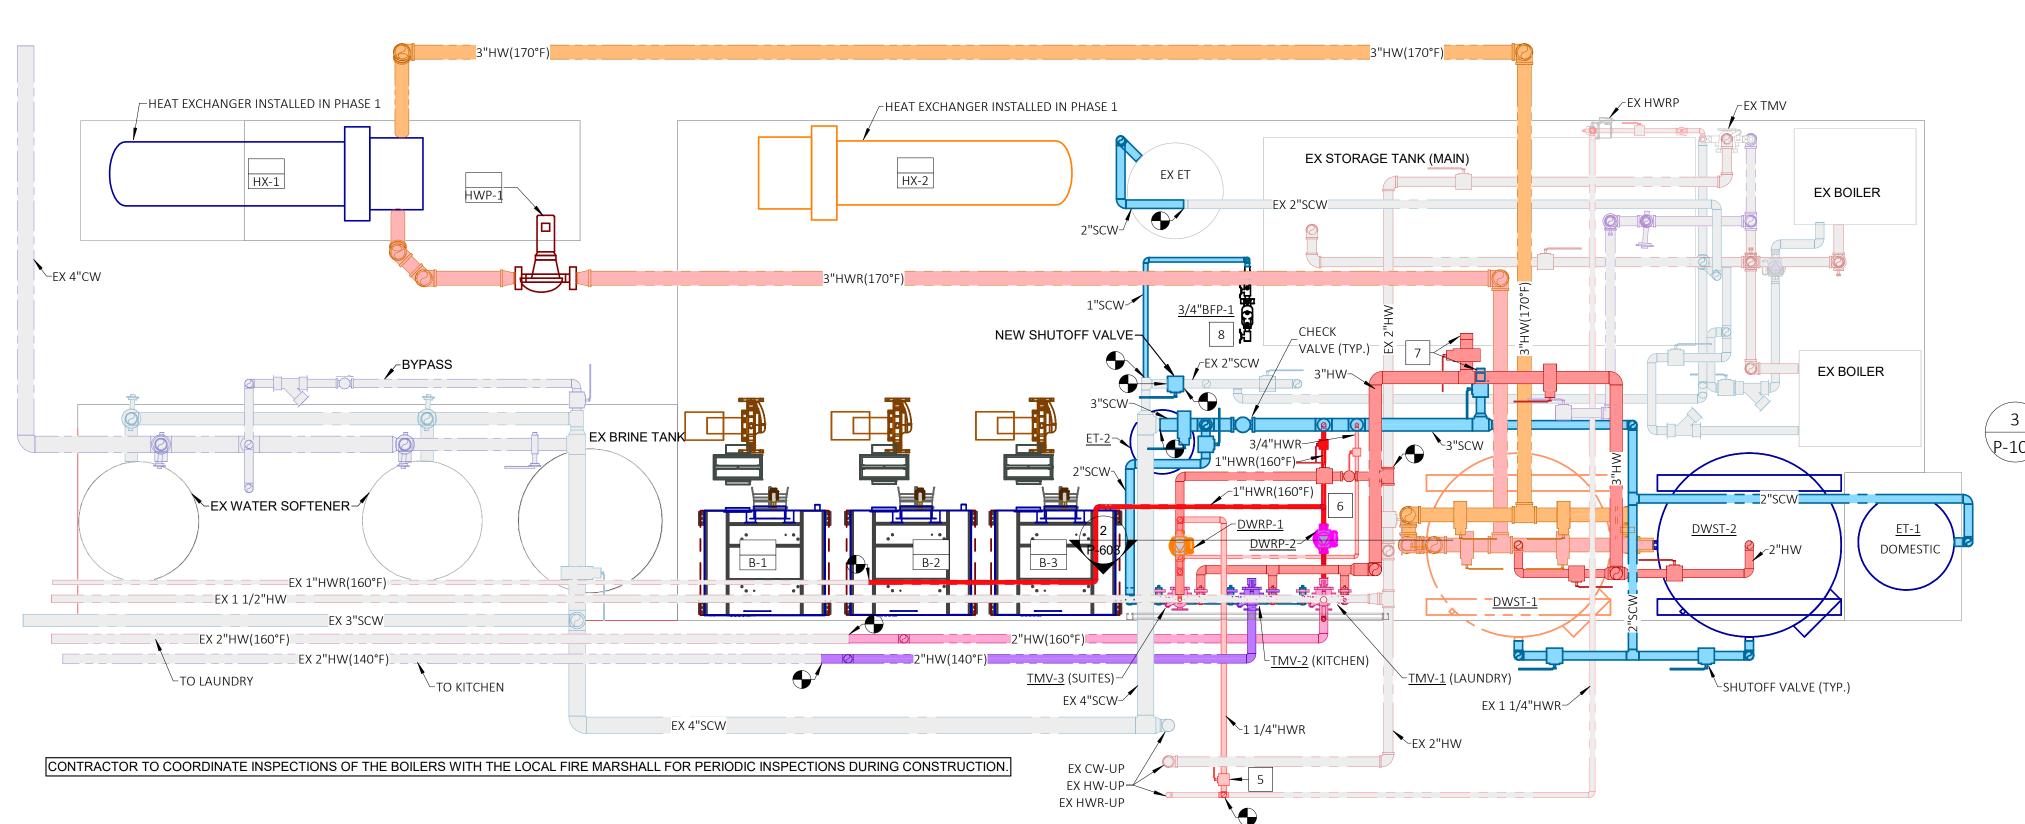


P-101/

PLUMBING - PHASE 1 NEW WORK


NOTE TO PRINTER

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KEY PLAN

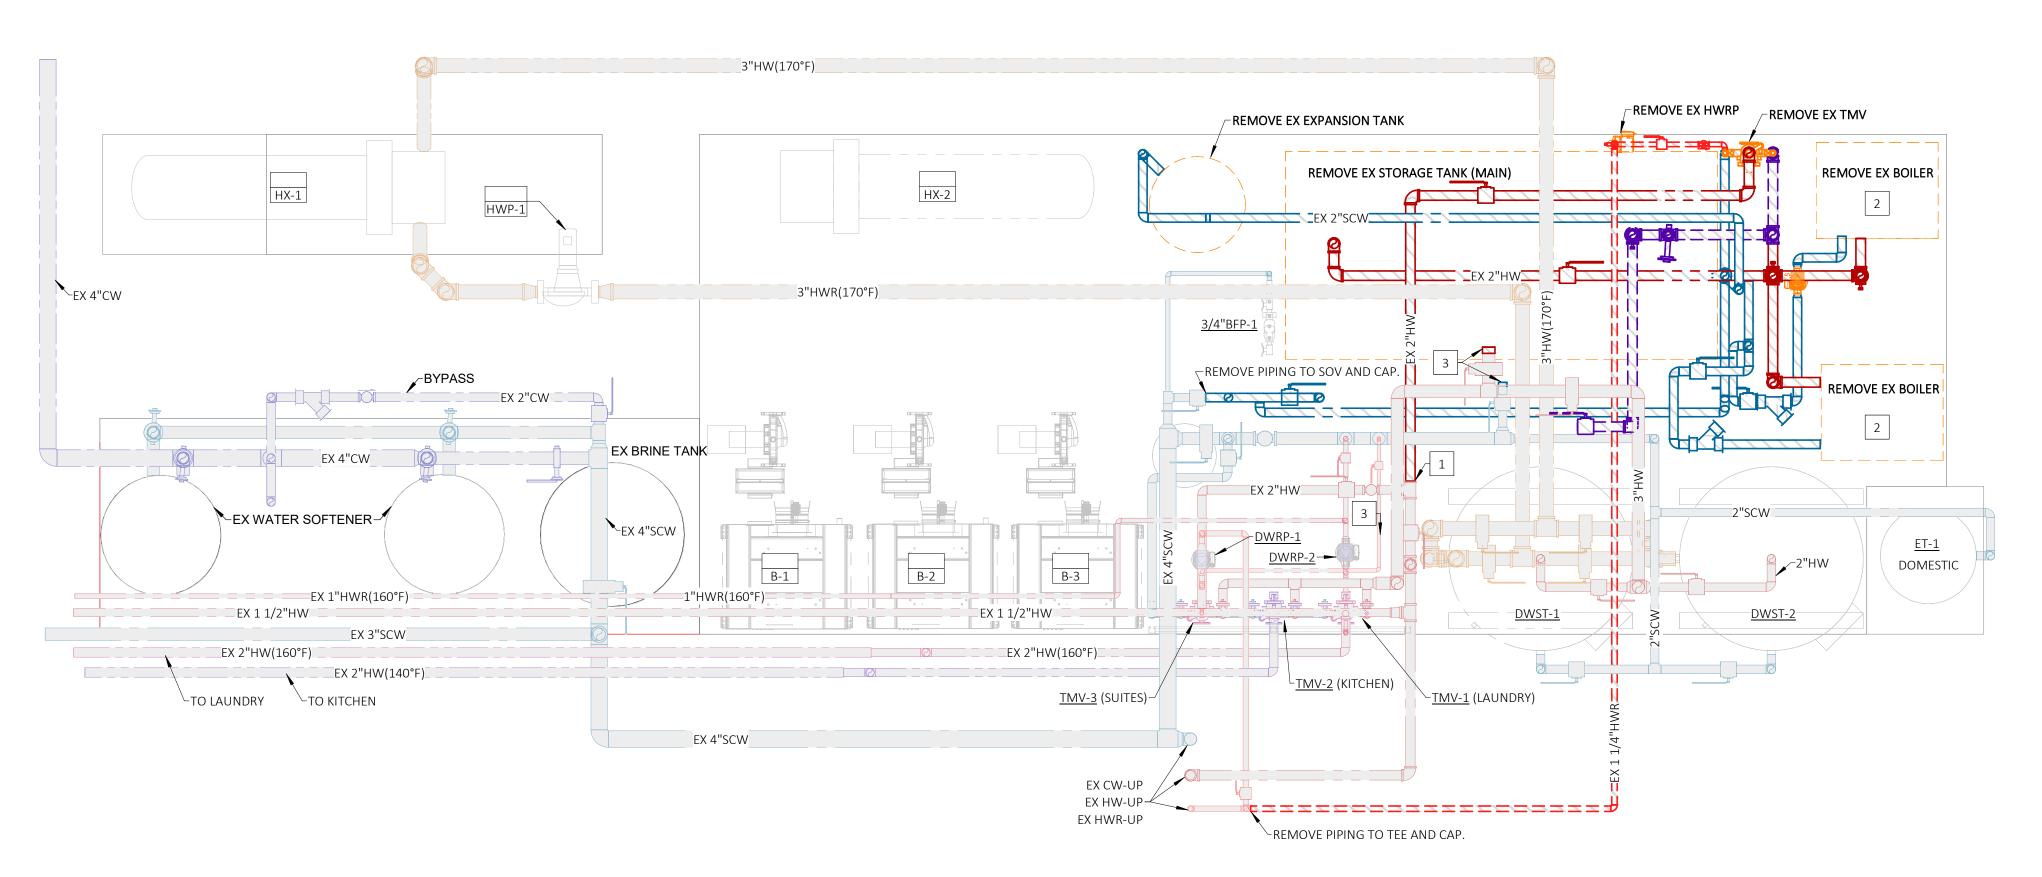

PLUMBING - PHASE 2 DEMOLITION SCALE: 1/2" = 1'-0"

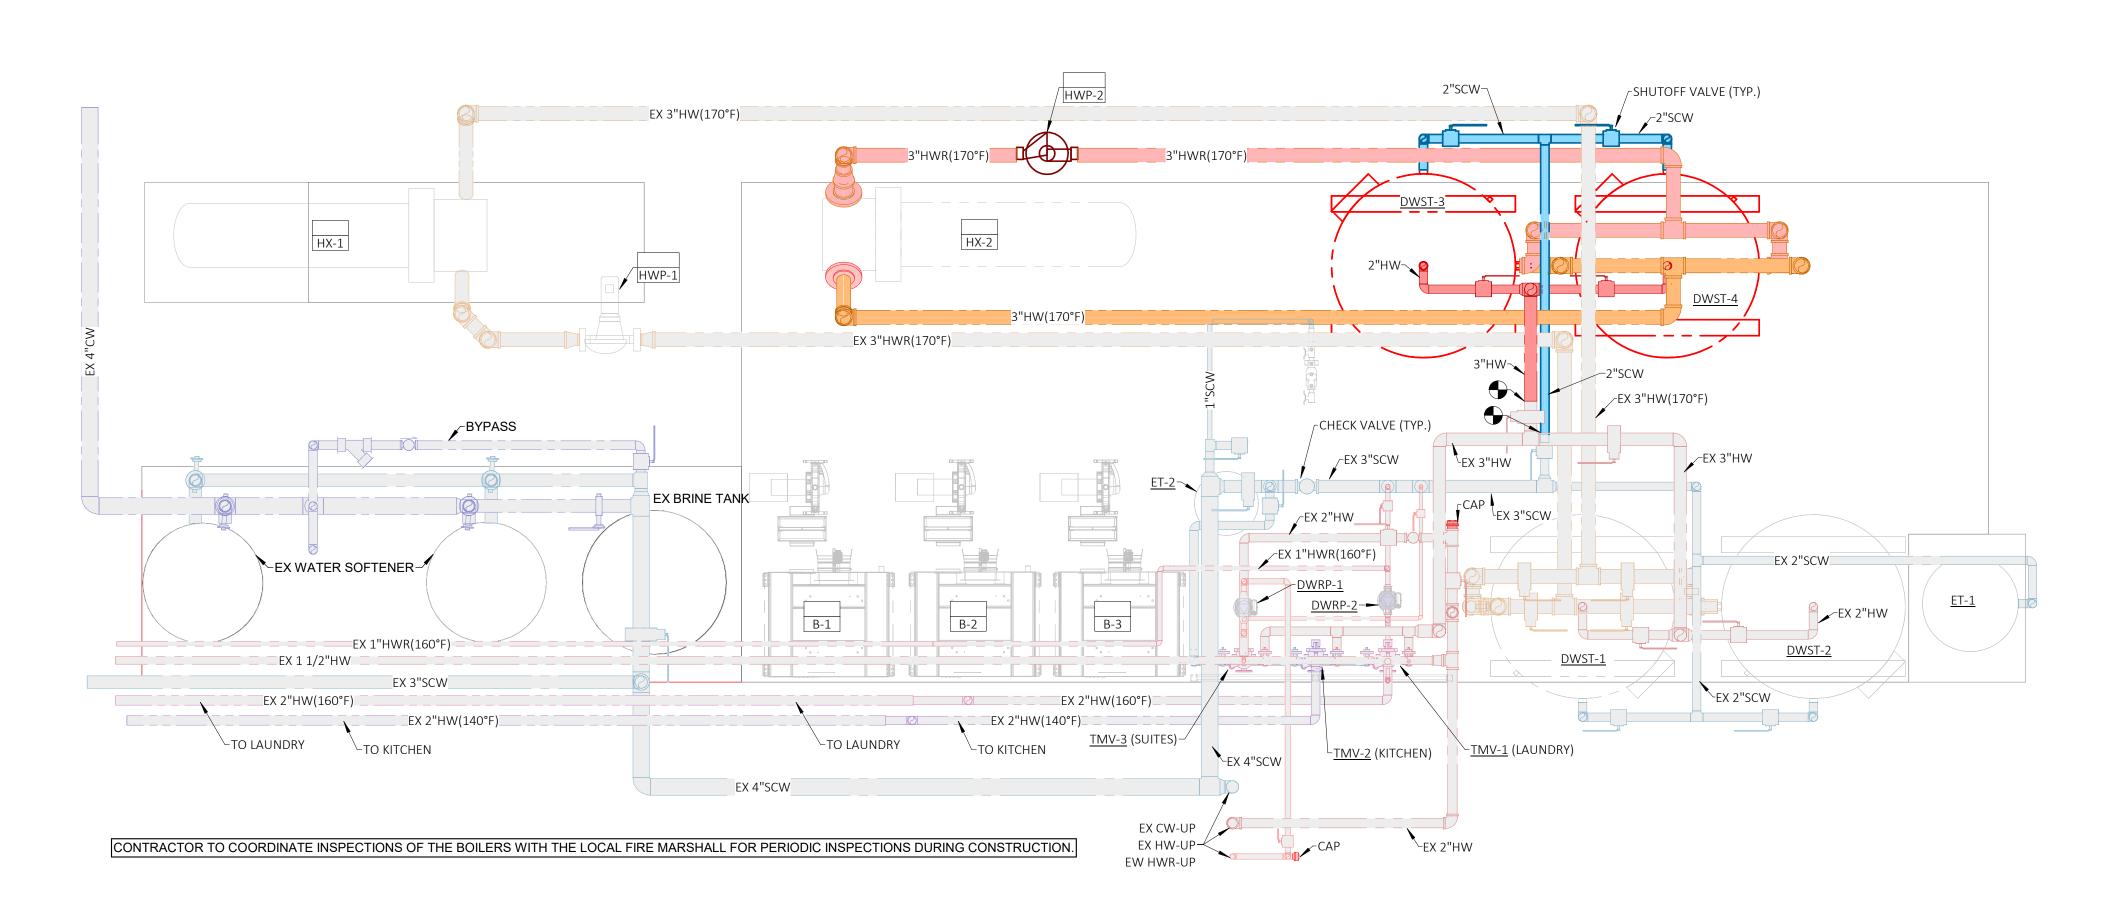

PLUMBING - PHASE 2 NEW WORK


GENERAL NOTES

A. RETURN EXISTING BOILERS TO BE REMOVED BACK TO THE OWNER.

KEYED NOTES

- 1. REMOVE PORTION OF PIPING. PREPARE PIPING FOR NEW CONNECTION.
- 2. REMOVE EXISTING INTAKE & VENT PIPING FOR EXISTING BOILERS TO BE REMOVED.
- 3. REMOVE EXISTING CAPS FOR CONNECTION TO PHASE 2 DOMESTIC WATER STORAGE TANKS.

PLUMBING LEGEND DEMO SOFT COLD WATER PIPING (EX SCW) EXISTING SOFT COLD WATER PIPING (EX SCW) NEW SOFT COLD WATER PIPING (SCW) DEMO HOT WATER PIPING (EX HW) EXISTING HOT WATER PIPING (EX HW) NEW HOT WATER PIPING (HW) DEMO HOT WATER PIPING (140°F) (EX HW(140°F)) EXISTING HOT WATER PIPING (140°F) (EX HW(140°F)) NEW HOT WATER PIPING (140°F) (HW(140°F)) DEMO HOT WATER RETURN PIPING (EX HWR) EXISTING HOT WATER RETURN PIPING (EX HWR) NEW HOT WATER RETURN PIPING (HWR) DEMO HOT WATER PIPING (160°F) (EX HW(160°F)) EXISTING HOT WATER PIPING (160°F) (EX HW(160°F)) NEW HOT WATER PIPING (160°F) (HW(160°F)) DEMO HOT WATER RETURN PIPING (160°F) (EX HWR(160°F)) EXISTING HOT WATER RETURN PIPING (160°F)(EX HWR(160°F)) NEW HOT WATER RETURN PIPING (160°F) (HWR(160°F)) HX: NEW HOT WATER PIPING (170°F) (HW(170°F)) HX: NEW HOT WATER RETURN PIPING (170°F) (HWR(170°F)) NOTE: HX = HEAT EXCHANGER

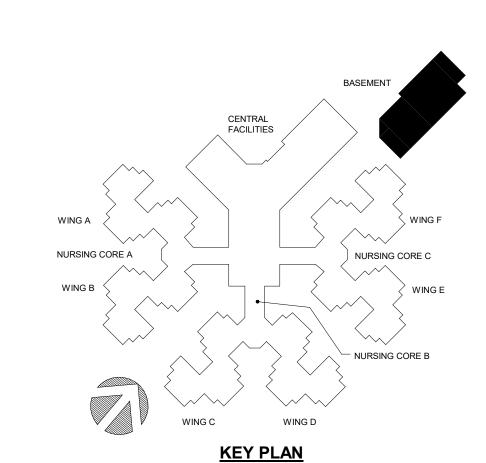


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STATE OF MISSOURI MICHAEL L. KEHOE, GOVERNOR



Professional of Record:
SCOTT A. MOSELEY
LICENSE #: 2003015013
EXPIRATION DATE: 12/31/25
PROFESSIONAL SEAL

CASCO Diversified Corporation
MO Certificate of Authority #000329 Arch.
MO Certificate of Authority #000613 Eng.
Exp. Date: 12/31/25

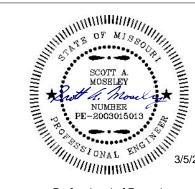CASCO DIVERSIFIED CORPORATION
12 Sunnen Drive, Suite 100, St. Louis, MO 63143

OFFICE OF ADMINISTRATION DIVISION OF FACILITIES MANAGEMENT, DESIGN AND CONSTRUCTION

REBID
DESIGN & INSTALL
NEW DOMESTIC WATER
PLANT
VETERANS HOME
BUILDING

ST. JAMES VETERANS HOME 620 NORTH JEFFERSON ST. JAMES, MO

PROJECT # U2409-01 SITE # 6801 FACILITY # 8136801002

REVISION:
DATE:
REVISION:
DATE:
REVISION:
DATE:
ISSUE DATE: 01.21.2025

CAD DWG FILE:

DRAWN BY: DDP

CHECKED BY: SAM


DESIGNED BY:

SHEET TITLE:

PLUMBING - PHASE 2 DEMOLITION & NEW

SHEET NUMBER:

P-102
3 of 18 SHEETS
03.05.2025

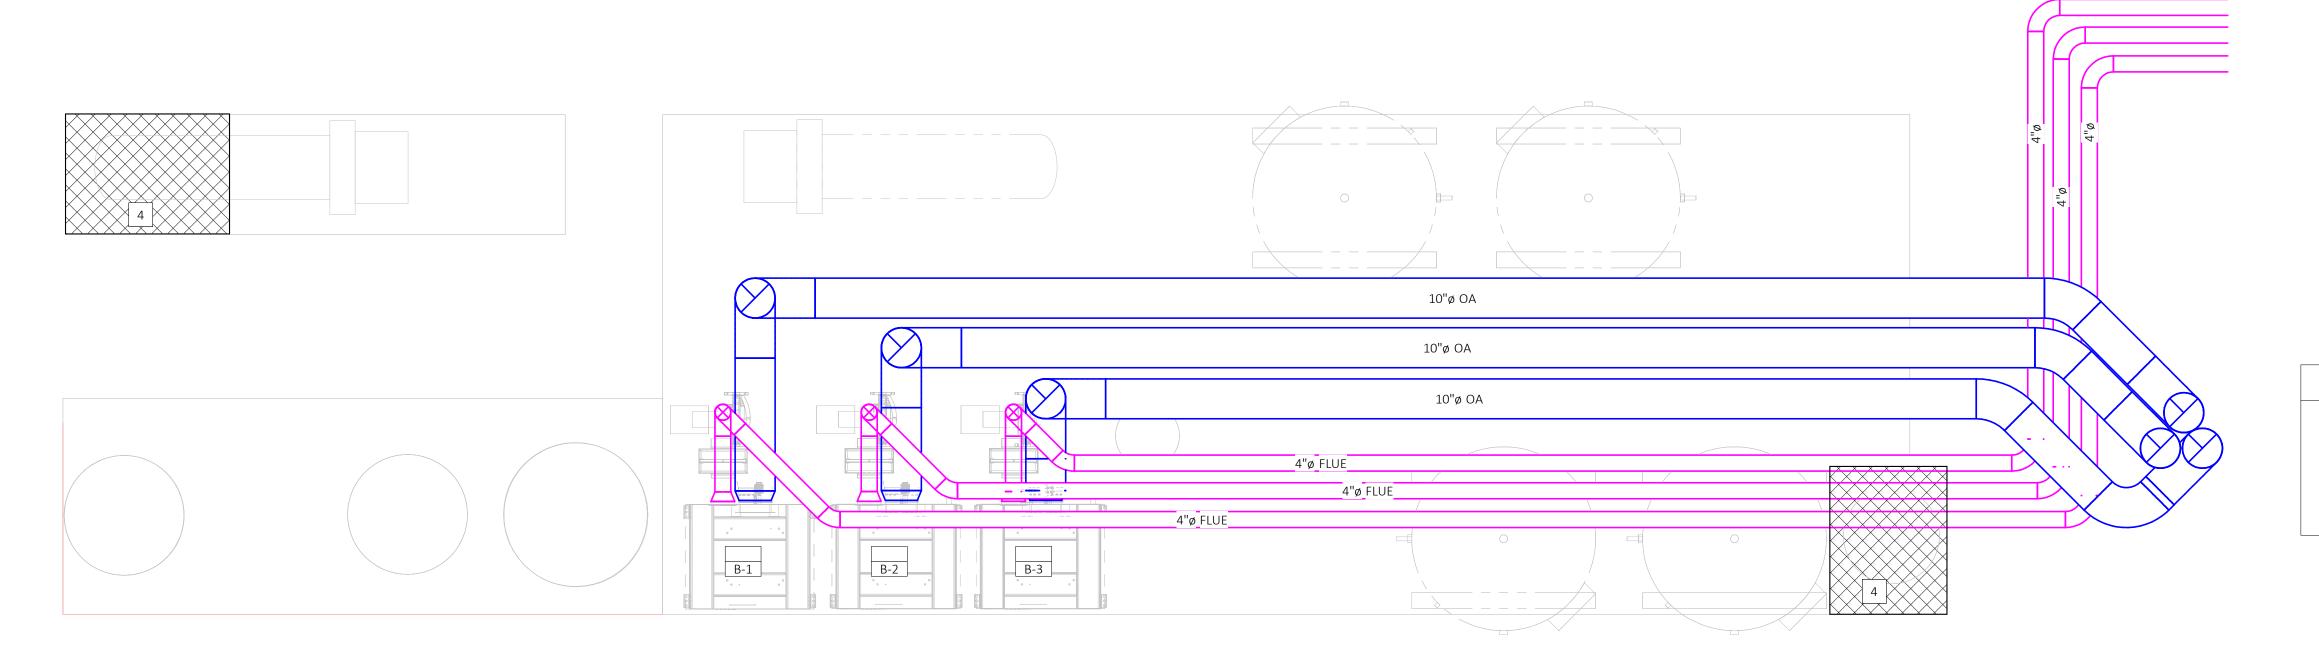


GENERAL NOTES

- A. AFTER 10" DIAMETER FLUES FROM BOILERS PENETRATE THE ROOF, THEY SHALL BE OFFSETTED TO ALLOW RAIN CAPS TO BE INSTALLED.
- B. REFER TO THE RISER DIAGRAM LOCATED ON SHEET P-603 FOR LOCATIONS OF ALL VALVES & ACCESSORIES TO THE BOILERS & HEAT EXCHANGERS.
- C. BOILER CONNECTIONS SHALL BE FLANGED TO ALLOW EASE OF MAINTENANCE.

KEYED NOTES

- 1. CONNECT NEW 2" NATURAL GAS TO EXISTING NATURAL GAS TEE IN PHASE 1.
- 2. INSTALL NEW 2" NATURAL GAS TAP INTO EXISTING 4" NATURAL GAS MAIN IN PHASE 1.
- 3. REMOVE EXISTING 2" NATURAL GAS PIPING IN PHASE 2 BACK TO ACTIVE MAIN & CAP.
- 4. EXTEND 4" HOUSEKEEPING PAD AS SHOWN. BLOCK OUT EXISTING FLOOR DRAIN(S) AS REQUIRED TO MAINTAIN PROPER DRAINAGE.

PLUMBING LEGEND & ABBREVIATIONS

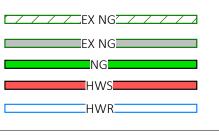


DEMOLISHED NATURAL GAS PIPING EXISTING NATURAL GAS PIPING NEW NATURAL GAS PIPING BOILER: NEW HOT WATER SUPPLY PIPING BOILER: NEW HOT WATER RETURN PIPING

ENLARGED FLOOR PLAN - DOMESTIC WATER SOURCE HEATING EXHAUST, FLUE & PAD ENLARGEMENT - PHASE 1


BALANCING VALVE -RELOCATED EX EXPANSION TANK BALANCING VALVE¬ ∕-3-WAY VALVE ∕-3-WAY VALVE HX-2 EX TMV EX BOILER EX STORAGE TANK (MAIN) SEE SHEET P-100 FOR CONTINUATION <u>3/4"BFP-1</u> EX BOILER EX BRINE TANK DWST-2 DWST-1 EX WATER SOFTENER -EX 2 1/2"NG EX 4"NG

ENLARGED FLOOR PLAN - DOMESTIC WATER SOURCE HEATING - PHASE 1

P-103 SCALE: 1/2" = 1'-0"

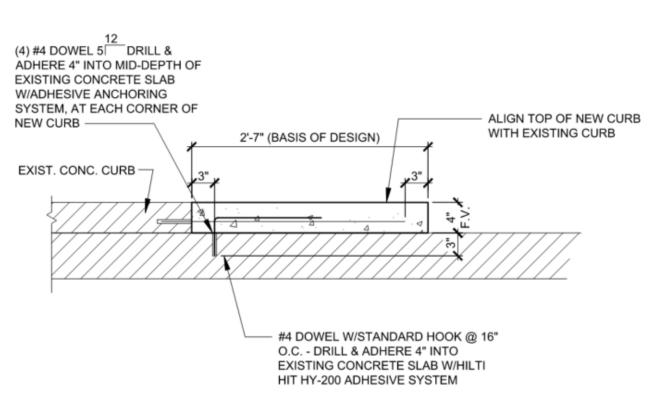


NEW CONC. CURB DETAIL P-103 SCALE: NONE

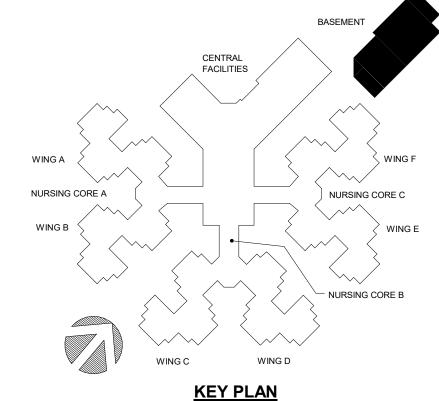

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STATE OF MISSOURI MICHAEL L. KEHOE, **GOVERNOR**



Professional of Record: SCOTT A. MOSELEY LICENSE #: 2003015013 EXPIRATION DATE: 12/31/25 PROFESSIONAL SEAL **CASCO** Diversified Corporation MO Certificate of Authority #000329 Arch. MO Certificate of Authority #000613 Eng. Exp. Date: 12/31/25

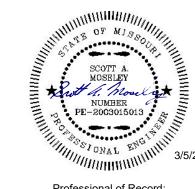OFFICE OF ADMINISTRATION DIVISION OF FACILITIES MANAGEMENT, **DESIGN AND CONSTRUCTION**

REBID DESIGN & INSTALL NEW DOMESTIC WATER PLANT **VETERANS HOME** BUILDING

ST. JAMES VETERANS HOME 620 NORTH JEFFERSON ST. JAMES, MO

PROJECT # U2409-01 FACILITY # 8136801002

REVISION:
DATE:
REVISION:
DATE:
REVISION:
DATE:
ISSUE DATE: 01.21.2025


CAD DWG FILE:
DRAWN BY:
CHECKED BY:
SAM **DESIGNED BY:**

SHEET TITLE:

PLUMBING BASEMENT FLOOR **PLANS**

SHEET NUMBER:

4 of 18 SHEETS 03.05.2025

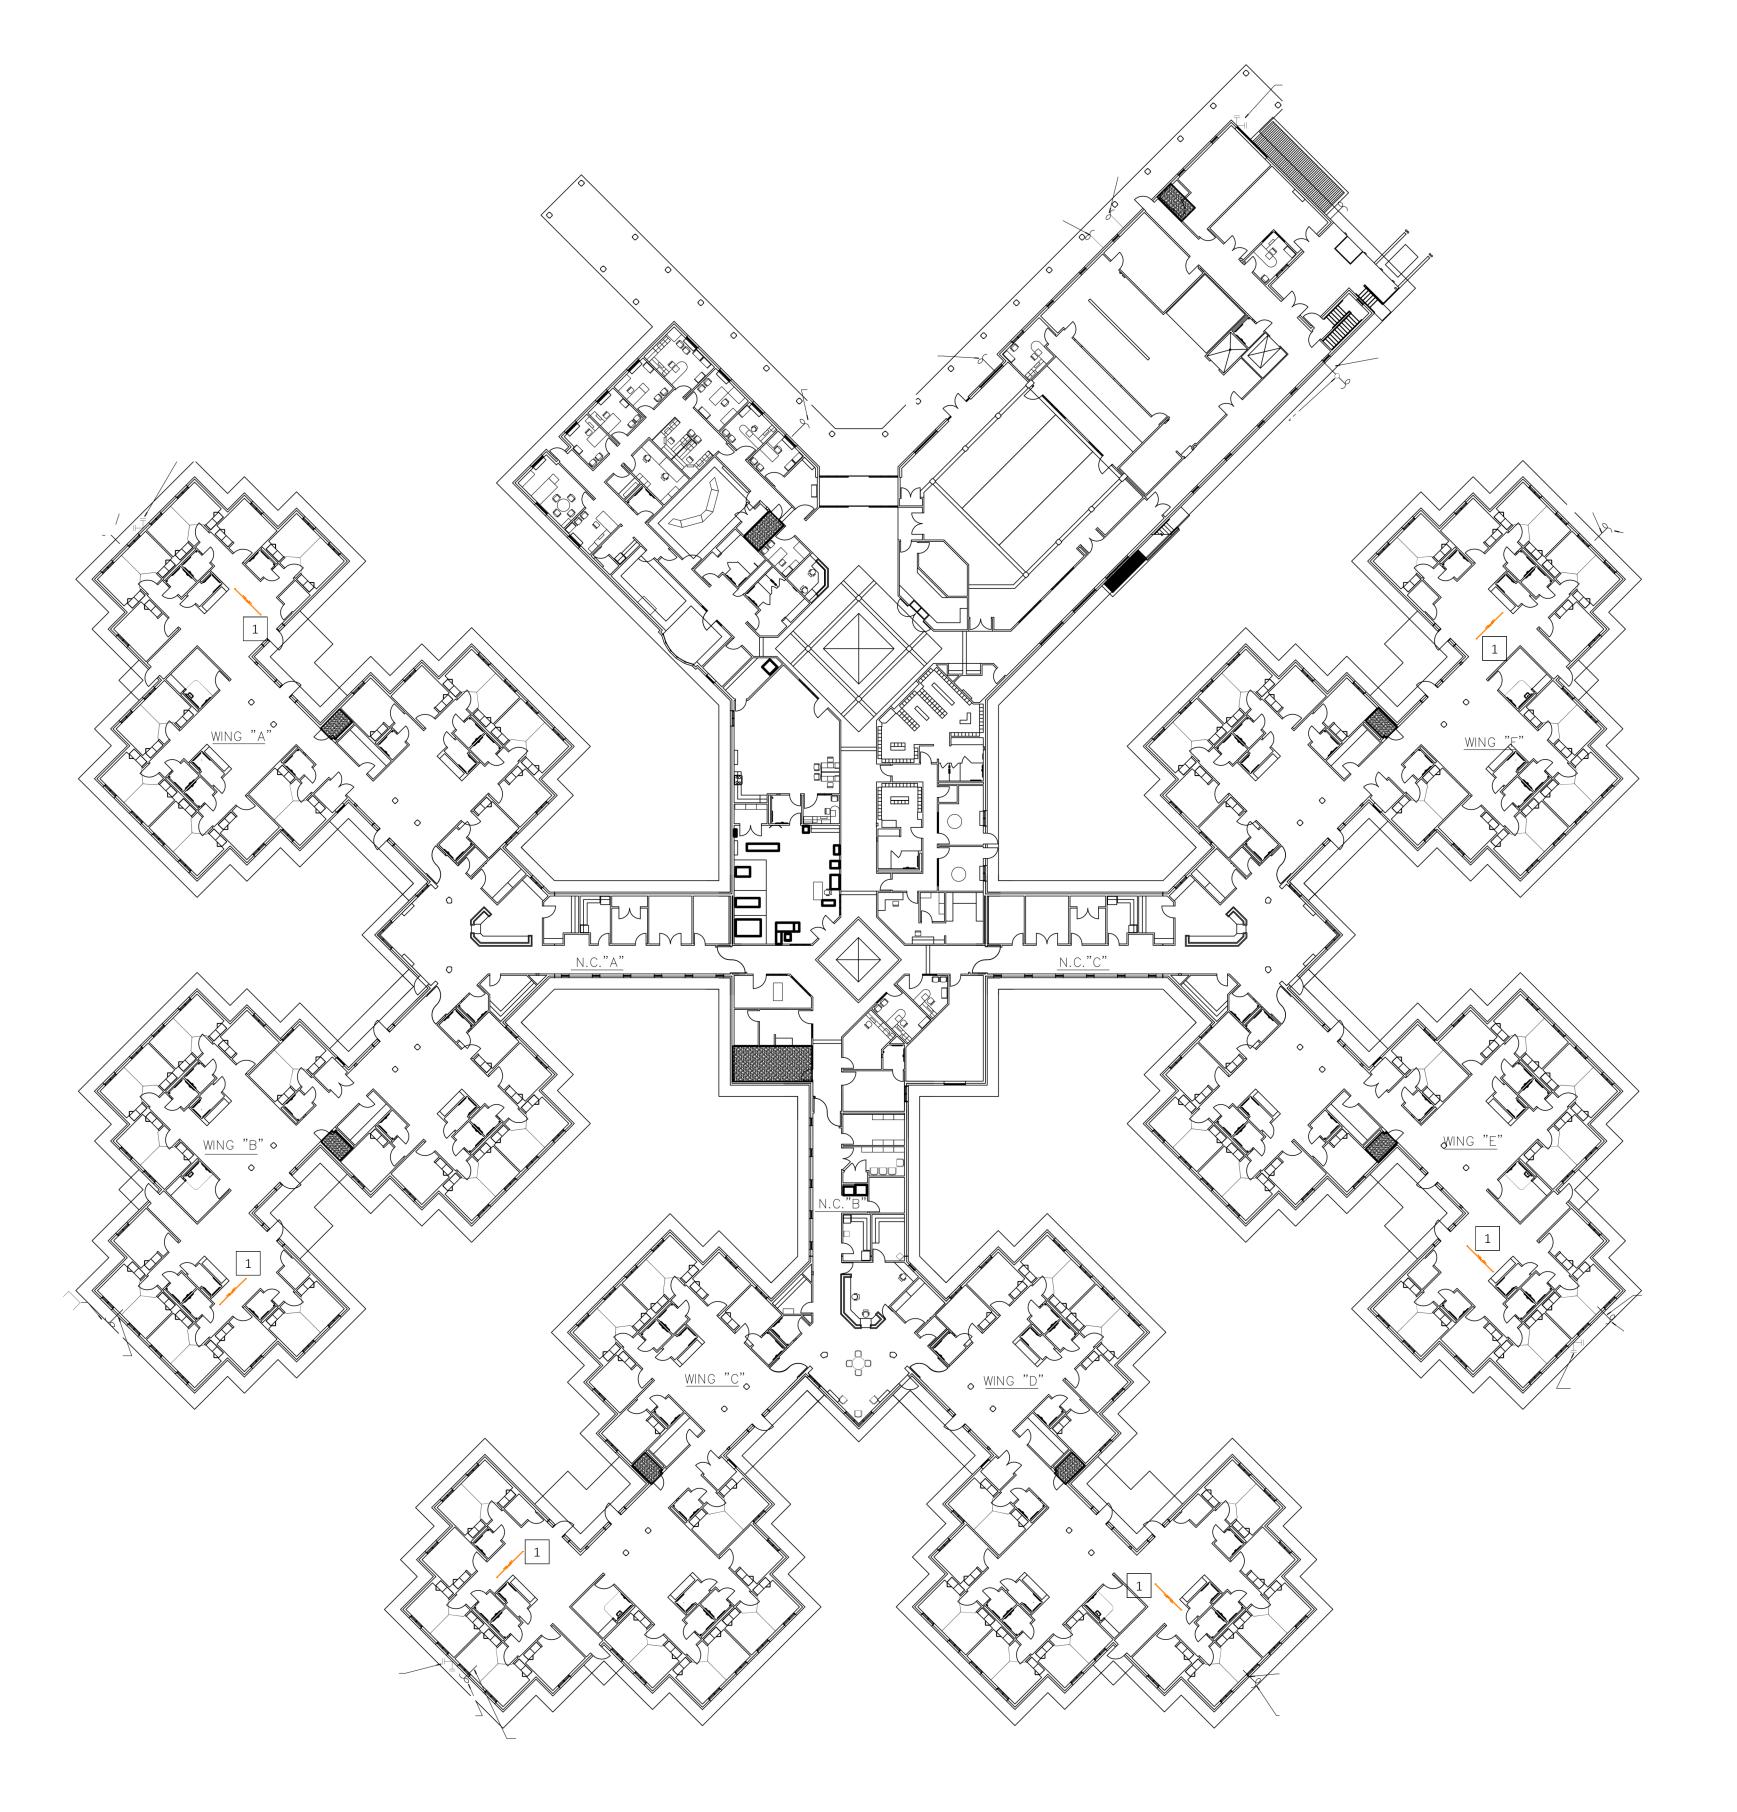

FIRST FLOOR OVERALL - PLUMBING - ALTERNATE #2


P-104 SCALE: 3/32" = 1'-0"

ALTERNATE #2 (THIS SHEET):

ALTERNATE NO. 2: REPLACE THE EXISTING BALANCING VALVES WITH THERMOSTATICALLY OPERATED BALANCING VALVE STATIONS, INCLUDING CHECK VALVES, THERMOMETER, AND STOP VALVES.

NOTE: CONTRACTOR TO FIELD VERIFY EXACT LOCATIONS OF EXISTING BALANCING VALVES.

STATE OF MISSOURI MICHAEL L. KEHOE, GOVERNOR

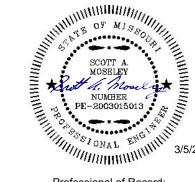

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CASCO DIVERSIFIED CORPORATION
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OFFICE OF ADMINISTRATION DIVISION OF FACILITIES MANAGEMENT, DESIGN AND CONSTRUCTION

REBID
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ST. JAMES VETERANS HOME 620 NORTH JEFFERSON ST. JAMES, MO

PROJECT # U2409-01 SITE # 6801 FACILITY # 8136801002

REVISION:
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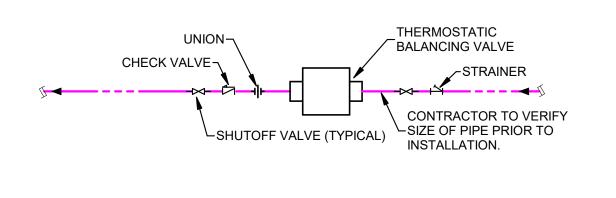
CAD DWG FILE:
DRAWN BY:
CHECKED BY:
DESIGNED BY:

SHEET TITLE:

PLUMBING FIRST FLOOR PLAN -ALTERNATE #2


SHEET NUMBER:

P-104
5 of 18 SHEETS
03.05.2025



NOTE: THERMOSTATIC BALANCING VALVE MAY BE PROVIDED WITH PACKAGED CHECK VALVE, STRAINER, & SHUTOFF VALVES.

UNION OR FLANGE(TYP.)-FLEXIBLE CONNECTION (TYP.) THERMOMETER-PRESSURE GAUGE (TYP)-**∽**STRAINER -CHECK VALVE VALVE (TYP.) -SUPPORT EACH SIDE OF PUMP

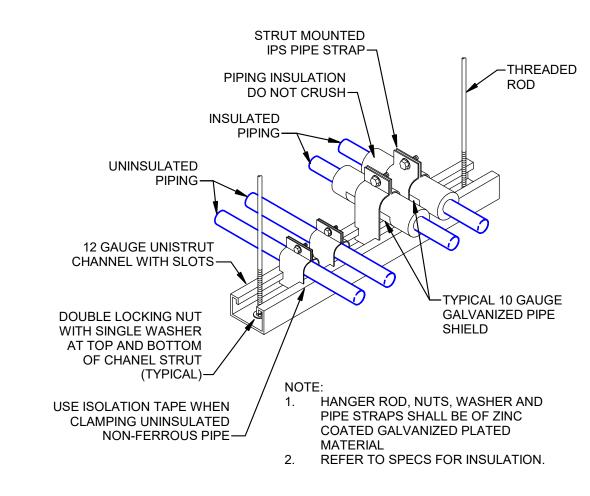


BACKFLOW PREVENTER


THERMOSTATIC BALANCING VALVE - ALTERNATE #2

P-501

DOMESTIC HOT WATER RECIRCULATING PUMP (4) TRAPEZE PIPE SUPPORT


P-501 SCALE: NONE

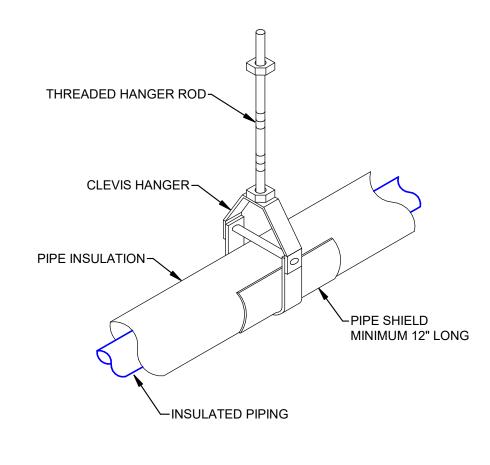

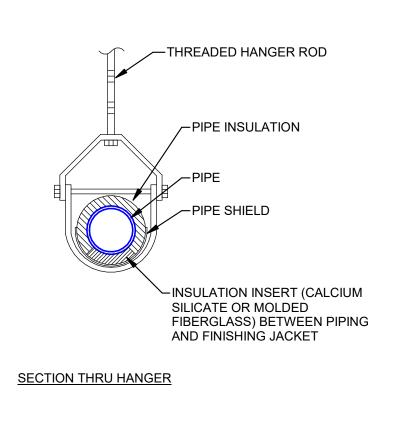

REFER TO SPECS FOR INSULATION

BOILER -SHUTOFF VALVE -SEE PLANS FOR SIZING

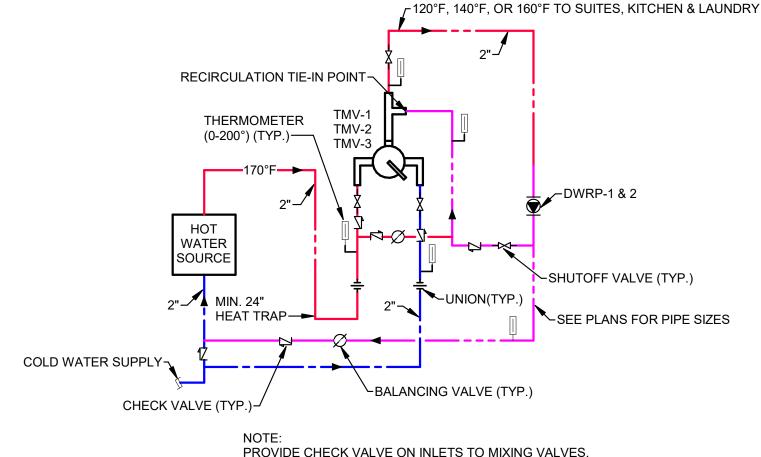

PROVIDE CHECK VALVE ON INLETS TO MIXING VALVES. NO HOT WATER RETURN LINE FOR THE KITCHEN. COMPLY WITH MANUFACTURER'S PIPING SCHEMATIC.


INSULATED PIPE HANGER SUPPORT

P-501 SCALE: NONE GAS CONNECTION AT BOILERS SCALE: NONE

P-501/


THERMOSTATIC MIXING VALVE (TMV-1, 2, & 3)

P-501 SCALE: NONE

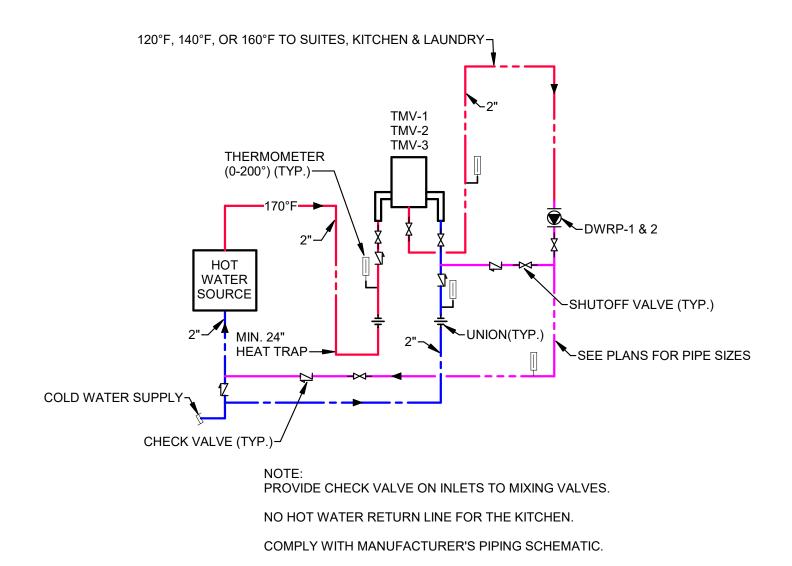


ELECTRONIC THERMOSTATIC MIXING VALVE (TMV-1, 2, & 3) - ALTERNATE #1 8 P-501



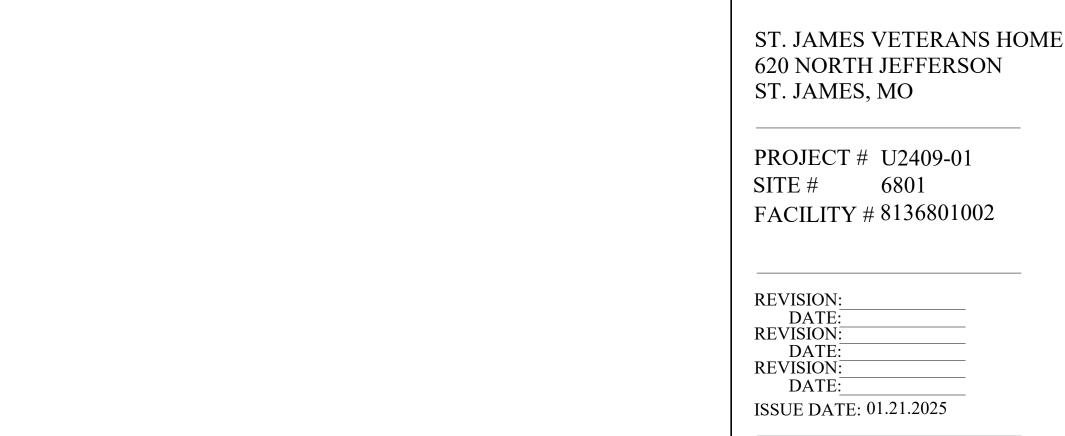

STATE OF MISSOURI MICHAEL L. KEHOE, **GOVERNOR**

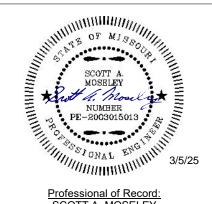

LICENSE #: 2003015013 EXPIRATION DATE: 12/31/25 PROFESSIONAL SEAL CASCO Diversified Corporation MO Certificate of Authority #000329 Arch. MO Certificate of Authority #000613 Eng. Exp. Date: 12/31/25

OFFICE OF ADMINISTRATION DIVISION OF FACILITIES MANAGEMENT, **DESIGN AND CONSTRUCTION**

REBID DESIGN & INSTALL NEW DOMESTIC WATER **PLANT** VETERANS HOME BUILDING

620 NORTH JEFFERSON

CAD DWG FILE:
DRAWN BY:
CHECKED BY:
SAM DESIGNED BY

SHEET TITLE:

PLUMBING DETAILS

SHEET NUMBER:

P-501 6 of 18 SHEETS 03.05.2025

SEQUENCES OF OPERATION - DOMESTIC WATER HEATING SYSTEM:

SYSTEM GENERAL DESCRIPTION:

THIS PRIMARY DOMESTIC WATER HEATING SYSTEM SHALL BE CONTROLLED BY THE BOILER MANUFACTURER'S PACKAGED CONTROL SYSTEM. ALL SYSTEM ALARMS AND TEMPERATURE SENSORS SHALL REPORT BACK TO THE OWNER'S EXISTING SCHNEIDER ELECTRIC BUILDING AUTOMATION SYSTEM (BAS).

SCHNEIDER ELECTRIC CONTACT: C&C GROUP - BRIAN SCHEPPERS

THE SYSTEM SHALL BE BROKEN UP INTO TWO CIRCUITS- THE PRIMARY DOMESTIC WATER HEATING LOOP, AND THE DOMESTIC HOT WATER SYSTEM.

THE PRIMARY DOMESTIC WATER HEATING SYSTEM SHALL CONSIST OF THREE BOILERS, THREE PUMPS, TWO HEAT EXCHANGERS, PIPING AND VARIOUS CONTROL VALVES, DAMPERS AND OTHER CONTROL COMPONENTS.

THE DOMESTIC HOT WATER SYSTEM SHALL CONSIST OF FOUR DOMESTIC WATER STORAGE TANKS, TWO DOMESTIC WATER PUMPS, THREE DOMESTIC WATER TEMPERATURE SYSTEMS WITH ASSOCIATED THERMAL MIXING VALVES, AND TWO DOMESTIC WATER RECIRCULATING PUMPS.

PRIMARY DOMESTIC WATER HEATING SYSTEM:

BOILERS:

MANUFACTURER'S BOILER CONTROL SYSTEM SHALL STAGE BOILERS AND MODULATE HEATING INPUT AS REQUIRED TO PROVIDE A 190F (ADJUSTABLE) SUPPLY WATER TEMPERATURE IN THE PRIMARY LOOP AS SENSED BY TS-1. BOILERS SHALL BE STAGED TO ENSURE EQUAL RUN TIME / LOADING ON ALL THREE BOILERS AND THEIR ASSOCIATED PUMPS.

A MINIMUM OF ONE BOILER AND ONE PUMP SHALL PROVIDE CONTINUOUS CIRCULATION THROUGH THE PRIMARY LOOP AT ALL TIMES.

WHEN A DISABLED BOILER IS REQUIRED TO BE ENERGIZED, THE MANUFACTURERS PROGRAM SHALL:

- 1. OPEN THE ASSOCIATED BOILER MOTORIZED ISOLATION VALVE (CV-1, CV-2, OR CV-3),
- 2. ENERGIZE THE ASSOCIATED BOILERS PUMP (BP-1, BP-2, OR BP-3),
- 3. OPEN THE ASSOCIATED OUTSIDE AIR AND FLUE DAMPERS (WHILE ENERGIZING BURNER BLOWER).
- 4. ENERGIZE BURNER SEQUENCE.

WHEN A BOILER IS REQUIRED TO BE DE-ENERGIZED, A REVERSE SEQUENCE SHALL BE FOLLOWED.

WHEN ONE OR MORE BOILERS ARE OPERATING TOGETHER, THE MANUFACTURER'S CONTROL SYSTEM SHALL MODULATE HEATING OUTPUT AS REQUIRED AND STAGE THE BOILERS TO MAINTAIN PROPER PRIMARY LOOP TEMPERATURE.

BOILER SAFETIES:

BOILERS SHALL OPERATE WITH THEIR OWN SAFETIES AND CONTROLS. MASTER ALARMS SHALL BE ANNUNCIATED IN OWNERS EXISTING BAS.

BOILER PUMP FAILURE- IF AN ASSOCIATED PUMP IS ENABLED AND THE CURRENT SWITCH IS OFF FOR MORE THAN 30 SECONDS (ADJ), THE SYSTEM SHALL ANNUNCIATE A BOILER CIRCULATION PUMP FAILURE ALARM TO THE BAS AND DISABLE THE ASSOCIATED BOILER.

HEAT EXCHANGERS:

THE HEAT EXCHANGERS THREE WAY VALVES SHALL MODULATE THE PRIMARY DOMESTIC WATER FLOW TO MAINTAIN THE TEMPERATURE INSIDE THEIR RESPECTIVE DOMESTIC HOT WATER STORAGE TANKS (DWST-1, DWST-2, DWST-3, & DWST-4). THE TEMPERATURE INSIDE THE TANKS SHALL BE MAINTAINED AT 170F (ADJ) AT ALL TIMES AS SENSED BY TS-3, TS-4, TS-14, & TS-15 (DWST TEMPERATURES).

DOMESTIC HOT WATER SYSTEM:

DOMESTIC HOT WATER PUMPS (HWP-1 AND HWP-2) SHALL RUN CONTINUOUSLY.

DOMESTIC HOT WATER RECIRCULATION PUMPS (DWRP-1 AND DWRP-2) SHALL RUN CONTINUOUSLY. CONTROLLER SHALL MODULATE PUMP SPEED VIA VFD TO MAINTAIN A MINIMUM RECIRCULATION TEMPERATURE OF 105°F & 140°F (ADJ) AS SENSED BY TS-12 AND TS-13.

ADDITIONAL SYSTEM MONITORING AND ALARMS:

TS-5 / TS-7 / TS-6 / (DWST'S ENTERING WATER TEMPERATURE) AND TS-6 / TS-8 (DWST'S LEAVING WATER TEMPERATURE) SHALL BE MONITORED FOR TREND ANALYSIS.

TS-9 / TS-10 / TS-11 (DOWNSTREAM THERMAL MIXING VALVE TEMPERATURES) SHALL BE MONITORED FOR TREND ANALYSIS.

TS-3 / TS-4 / TS-14 / TS-15 (DWST TEMPERATURES):

- HIGH TEMPERATURE ALARM 175F (ADJ).
- HIGH TEMPERATURE SAFETY: ABOVE 185F (ADJ), THE APPROPRIATE PRIMARY HEATING VALVE (CV-4 OR CV-5) FOR THE HEAT EXCHANGER SHALL BE MOVED TO FULL BYPASS POSITION. ABOVE 190F, ALL BOILERS SHALL BE DE-ENERGIZED.

- LOW TEMPERATURE ALARM 160F (ADJ).

NOTE: MATTERPORT SURVEY LINK PROVIDED BELOW IS FOR REFERENCE ONLY,
AND IS NOT INTENDED TO BE A SUBSTITUTE FOR FIELD INVESTIGATIONS BY THE CONTRACTOR.

MATTERPORT LINK: https://my.matterport.com/show/?m=vyscquW6hsr

STATE OF MISSOURI MICHAEL L. KEHOE, GOVERNOR



Professional of Record:
SCOTT A. MOSELEY
LICENSE #: 2003015013
EXPIRATION DATE: 12/31/25
PROFESSIONAL SEAL

CASCO Diversified Corporation
MO Certificate of Authority #000329 Arch.
MO Certificate of Authority #000613 Eng.
Exp. Date: 12/31/25

CASCO DIVERSIFIED CORPORATION
12 Sunnen Drive, Suite 100, St. Louis, MO 63143

OFFICE OF
ADMINISTRATION
DIVISION OF
FACILITIES
MANAGEMENT,
DESIGN AND
CONSTRUCTION

REBID
DESIGN & INSTALL
NEW DOMESTIC WATER
PLANT
VETERANS HOME
BUILDING

ST. JAMES VETERANS HOME 620 NORTH JEFFERSON ST. JAMES, MO

PROJECT # U2409-01 SITE # 6801 FACILITY # 8136801002

REVISION:
DATE:
REVISION:
DATE:
REVISION:
DATE:
REVISION:
DATE:
ISSUE DATE: 01.21.2025

CAD DWG FILE:
DRAWN BY:
CHECKED BY:
DESIGNED BY:

SHEET TITLE:

PLUMBING SEQUENCE OF OPERATIONS

SHEET NUMBER:

P-601
7 of 18 SHEETS
03.05.2025

WIDTH = 30" DEPTH = 32"

								235233 FIR	E TUBE BOILER SO	HEDULE								
PLAN DESIG.	SERVES	LOCATION	MFGR	MODEL	TYPE	FUEL	INPUT (MBH) OUTP	OLITPLIT (MRH)	OUTPUT (MBH) DESIGN PRESS.		LWT (F)	FLOWRATE	MAX WPD (FT	POWER			OPERATING	NOTES
FLAN DESIG.	SLITVLS	LOCATION	IVII GIX	WODLL	IIFL	TOLL	INFOT (MDIT)	OUTFUT (MIDIT)	(PSIG)			(GPM)	HD)	VOLTAGE	PHASE	MCA	WEIGHT (LBS)	NOTES
B-1	DOMESTIC HOT WATER	SEE PLAN	-	-	NOTE 1	NAT GAS	1,250	1,078	ASME 160	170	190	100	2.5	120	1	9	780	1-5
B-2	DOMESTIC HOT WATER	SEE PLAN	-	-	NOTE 1	NAT GAS	1,250	1,078	ASME 160	170	190	100	2.5	120	1	9	780	1-5
B-3	DOMESTIC HOT WATER	SEE PLAN	-	-	NOTE 1	NAT GAS	1,250	1,078	ASME 160	170	190	100	2.5	120	1	9	780	1-5
					·						·					·		

OTES:

ALL DIMENSIONS SHOWN ARE BASED ON DESIGN LAYOUT.

PROPOSED EQUIPMENT AND MANUFACTURERS' REQUIRED

SHALL PROVIDE MECHANICAL ROOM DRAWINGS (@ 1/4" PER

FOOT SCALE) TO SHOW LOCATIONS OF ALL THE PROPOSED

CLEARANCES PRIOR TO SUBMITTAL OF EQUIPMENT SHOP

EQUIPMENT AND MANUFACTURERS MAINTENANCE

DRAWINGS.

CONTRACTOR SHALL BE RESPONSIBLE FOR FIELD VERIFYING

CLEARANCES WILL FIT WITHIN ALLOWED SPACE. CONTRACTOR

1. TYPE: NON-CONDENSING COPPER FIN TUBE.

2. BACNET INTERFACE.

3. PROVIDE GAS TRAIN: ASME CSD-1.

4. OPTIONAL ACCESSORIES SHALL INCLUDE: ASME RELIEF VALVE, FULL MODULATING CONTROLS WITH OUTPUTS TO OWNERS BUILDING AUTOMATION SYSTEM, MULTI-BOILER STAGING, AND CODE REQUIRED BOILER SAFETIES.

5. ALL FITTINGS, VALVES, AND SURFACES TOUCHING FLUIDS SHALL MEET AWWA STANDARDS FOR USE IN DOMESTIC WATER SYSTEMS.

						232123	HYDRONIC PU	MP SCHEDULE							
PLAN DESIG.	MFGR	MODEL	TYPE	SERVICE	CAPACITY (GPM)	TOTAL HEAD (FT)	MAX FLUID TEMP. (F)	FLUID TYPE	MOTOR HP	RPM	EFFICIENCY (%)	VOLTS / PHASE /		P SIZE DISCHARGE	NOTES
BP-1	-	-	INLINE	190F	100	80	190	DOMESTIC	5	1760	72.5	480/3	2	2	1, 3, 4
BP-2	-	-	INLINE	190F	100	80	190	DOMESTIC	5	1760	72.5	480/3	2	2	1, 3, 4
BP-3	-	-	INLINE	190F	100	80	190	DOMESTIC	5	1760	72.5	480/3	2	2	1, 3, 4
HWP-1	-	-	INLINE	190F	150	55	190	DOMESTIC	5	1760	67	480/3	3	3	1, 3, 4
HWP-2	-	-	INLINE	190F	150	55	190	DOMESTIC	5	1760	67	480/3	3	3	1, 3, 4
DWRP-1	-	-	INLINE	120 F	15	25	140	DOMESTIC	1/6	-	-	115/1	1.25	1.25	1, 2, 3, 4, 5
DWRP-2	-	-	INLINE	160 F	3	12	160	DOMESTIC	1/12	-	-	115/1	1.25	1.25	1, 2, 3, 4, 5

NOTES:

1. MOTOR STARTER AND LOCAL NON-FUSED DISCONNECT SHALL BE PROVIDED BY MANUFACTURER.

2. ECM AND DRIVE SHALL BE PROVIDED.

3. SUCTION DIFFUSER WITH INTEGRAL STRAINER.

4. ALL FITTINGS, VALVES, AND PUMP COMPONENTS TOUCHING FLUIDS SHALL MEET AWWA STANDARDS FOR USE IN DOMESTIC WATER SYSTEMS.

5. DWRP-1 & DWRP-2 SHALL BE OPERATED PER TEMPERATURE BASED (MINIMUM RETURN TEMPERATURE) MODE.

						232	2116 AIR SEPAR	RATOR SCHED	ULE					
	PLAN DESIG.	MFGR	MODEL	TYPE	SERVICE	FLOWRATE (GPM)	TANK VOL (GAL)	MAX HEAD LOSS (FT)	CONNECTION (IN)	TK. DIAMETER (IN)		M DESIGN PRESS. (PSIG)	OPERATING WEIGHT (LBS)	NOTES
DIMENSIONS OF AIR SEPARATOR: HEIGHT = 32" DIAMETER = 12.75"	AS-1	-	-	TANGENTIAL	DOMESTIC	300	13	3	4	12.75	350	125	287	1

NOTES

1. ALL FITTINGS AND VALVES SHALL MEET AWWA STANDARDS FOR USE IN DOMESTIC WATER SYSTEMS.

				232	116 EXPANSIO	N TANK SCHEDU	JLE				
PLAN DESIG.	MFGR	MODEL	TYPE	SERVICE	TANK VOL (GAL)	ACCEPTANCE VOL (GAL)	TK. HEIGHT (IN)	TK. DIAMETER (IN)	MAXIMUI TEMP (F)	M DESIGN PRESS. (PSIG)	NOTES
ET-1	-	-	DIAPHRAGM	DOMESTIC	90	60	53	24	240	150	1
ET-2	-	-	DIAPHRAGM	DOMESTIC	15	10	25	16	240	150	1

NOTES

1. ALL FITTINGS, VALVES, AND SURFACES TOUCHING FLUIDS SHALL MEET AWWA STANDARDS FOR USE IN DOMESTIC WATER SYSTEMS.

		THERMOS	TATIC MI	XING VA	LVE SCHED	ULE	
PLAN MARK	DESCRIPTION	MANUFACTURER	MODEL	MINIMUM GPM	FLOW GPM @ 10 PSI LOSS	LEAVING TEMPERATURE	NOTES
TMV-1	THERMOSTATIC MIXING VALVE	-	-	0.5	113	160°F	
TMV-2 & 3	THERMOSTATIC MIXING VALVE	_	_	0.5	40	SUITES: 120°F & KITCHEN: 140°F	

	ELECTRONIC T	HERMOSTA	ATIC MIXING Y	VALVE SO	CHEDULE - A	ALTERNATE #1	
PLAN MARK	DESCRIPTION	MANUFACTURER	MODEL	MINIMUM GPM	FLOW GPM @ 10 PSI LOSS	LEAVING TEMPERATURE	NOTES
ETMV-1	ELECTRONIC THERMOSTATIC MIXING VALVE	-	-	0.25	72	120°F	
ETMV-2	ELECTRONIC THERMOSTATIC MIXING VALVE	-	-	0.25	72	140°F	
ETMV-3	ELECTRONIC THERMOSTATIC MIXING VALVE	-	-	0.25	72	160°F	

PLAN DESIG.	MFGR	MODEL	TYPE	SERVICE
DWST-1	-	-	DOMESTIC	НОТ
DWST-2	-	-	DOMESTIC	НОТ
DWST-3	-	-	DOMESTIC	НОТ
DWST-4	-	-	DOMESTIC	НОТ

REMARKS:

DIMENSIONS OF VERTICAL DOMESTIC WATER STORAGE

TANKS:

HEIGHT = 75" DIAMETER = 46"

- 1. PROVIDE UNIT WITH THE FOLLOWING OPTIONS: ASME RATED VESSEL, INSULATION.
- 2. DIFFUSER TUBES ON COLD WATER MAKEUP AND HEATED WATER RETURN CONNECTIONS (1.0 PSI MAX PRESSURE DROP).

223450 DOMESTIC HOT WATER STORAGE TANK SCHEDULE

GAL

300

300

300

REMARKS

1, 2, 3, 4

1, 2, 3, 4

1, 2, 3, 4

1, 2, 3, 4

- 3. MANWAY ACCESS.
- 4. ALL FITTINGS, VALVES, AND SURFACES TOUCHING FLUIDS SHALL MEET AWWA STANDARDS FOR USE IN DOMESTIC WATER SYSTEMS.


					235700 SHELL /	AND TUBE HEA	AT EXCHANGER S	SCHEDULE					
LAN DESIG.	DESIG. MFGR M		SHELL DIAM. / LENGTH (IN)	# OF PASSES	FLUID 1 / FLUID 2			TEMP. (F) / PRESS. (#)		MAX PRESSURE LOSS (PSI)		CAPACITY (MBH)	NOTES
HX-1	_	-	26 / 73	4	WATER / WATER	FLUID 1 (GPM) 150	150	FLUID 1 190/170	FLUID 2 140/160	FLUID 1 0.5	FLUID 2 0.12	1,500	1, 2, 3
HX-2	-	-	26 / 73	4	WATER / WATER	150	150	190/170	140/160	0.5	0.12	1,500	1, 2, 3
OTFS:													

1. BASED ON A FOULING FACTOR OF 0.001.

2. ALL FITTINGS, VALVES, AND SURFACES TOUCHING FLUIDS SHALL MEET AWWA STANDARDS FOR USE IN DOMESTIC WATER SYSTEMS.

3. DOUBLE WALL HEAT EXCHANGER.

STATE OF MISSOURI MICHAEL L. KEHOE, GOVERNOR

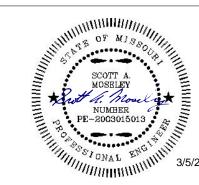

Professional of Record:
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ASCO DIVERSIFIED CORPORATION

2 Supper Drive Suite 100 St. Louis MO 63143

OFFICE OF ADMINISTRATION DIVISION OF FACILITIES MANAGEMENT, DESIGN AND CONSTRUCTION

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ST. JAMES VETERANS HOME 620 NORTH JEFFERSON ST. JAMES, MO

PROJECT # U2409-01 SITE # 6801 FACILITY # 8136801002

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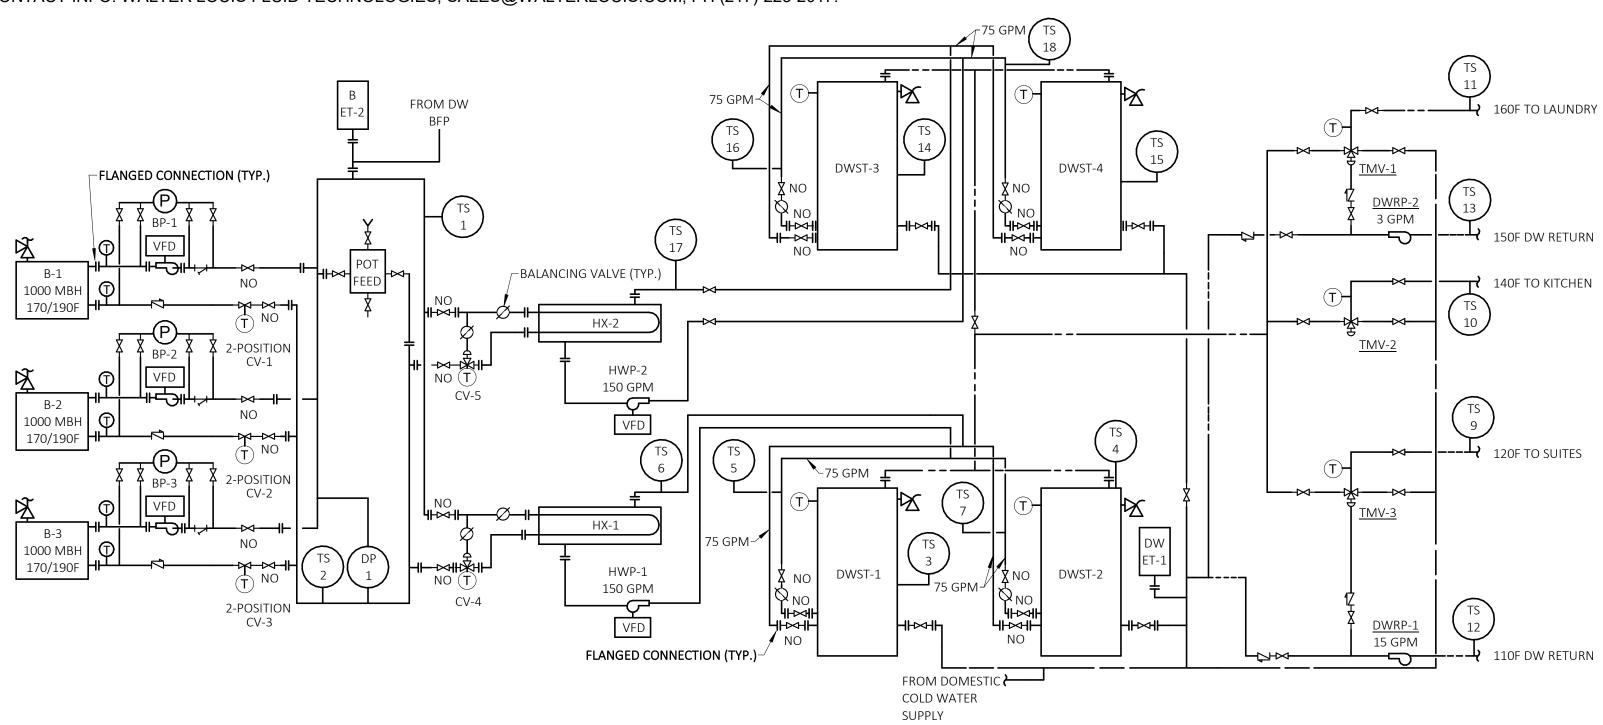
PLUMBING SCHEDULES


SHEET NUMBER:


P-602
8 of 18 SHEETS
03.05.2025

THE WINNING CONTRACTOR SHALL BE RESPONSIBLE FOR HIRING WALTER LOUIS FLUID TECHNOLOGIES FOR THE WATER TREATMENT CONTRACTOR AND INCLUDE ALL COSTS ASSOCIATED WITH INSTALLATION, EQUIPMENT, LABOR AND CHEMICALS ASSOCIATED WITH PROVIDING A COMPLETE AND OPERATIONAL SYSTEM AS DESCRIBED ON THESE DOCUMENTS AND SPECIFICATIONS.

CONTACT INFO: WALTER LOUIS FLUID TECHNOLOGIES, SALES@WALTERLOUIS.COM, PH (217)-223-2017.



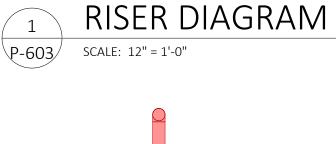

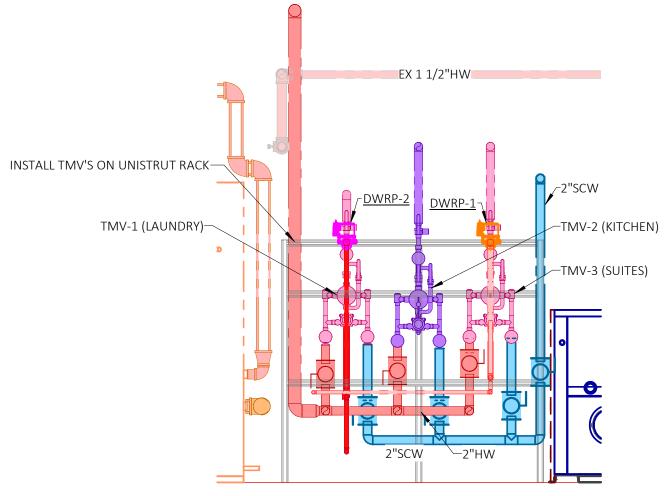

NOTE: SEE DETAIL #7 ON SHEET P-501 FOR THERMOSTATIC MIXING VALVE PIPING SCHEMATIC.


SEE DETAIL #8 ON SHEET P-501 FOR ALTERNATE #1 ELECTRONIC MIXING VALVE PIPING SCHEMATIC.

ELEVATION AT TMV'S

P-603 SCALE: 1/2" = 1'-0"

	Points List:	<u> HE</u>	<u>ATIN</u>	IG P	LAN'	T SYS	STEN	VI								
System Point Description	Tag					Point	S						Ala	rms		
		GRAPHIC	ANALOG HARDWARE INPUT (AI)	BINARY HARDWARE INPUT (BI)	ANALOG HARDWARE OUTPUT (AO)	BINARY HARDWARE OUTPUT (BO)	SOFTWARE POINT (SFT)	HARDWARE INTERLOCK (HDW)	TREND DATA	NETWORK (NET)	HIGH ANALOG LIMIT	LOW ANALOG LIMIT	BINARY	LATCH DIAGNOSTIC	SENSOR FAIL	
BOILER 1 ALARM	B1 ALM	Х		X					Х				Х			T
BOILER 1 ENABLE COMMAND	B1 ENB	Х				Х			Х							Ī
BOILER 1 STATUS	B1 STS	Х		Х					Χ							
BOILER 2 ALARM	B2 ALM	Х		X					Х				Х			
BOILER 2 ENABLE COMMAND	B2 ENB	Х				X			Χ							
BOILER 2 STATUS	B2 STS	X		X					X				.,,			
BOILER 3 ALARM BOILER 3 ENABLE COMMAND	B3 ALM B3 ENB	X		X		X			X				Х			
BOILER 3 STATUS	B3 STS	X		X					X							
BOILER LOOP ENTERING TEMPERATURE	TS-1	X	X						X		Х	X			Х	1
BOILER LOOP LEAVING TEMPERATURE	TS-2	Х	X						X		Х	X			Х	
BOILER PUMP 1 START STOP OUTPUT	BP-1	Х				Х										1
BOILER PUMP 1 STATUS	BP-1	X		Х												
BOILER PUMP 2 START STOP OUTPUT	BP-2	Х				Х										
BOILER PUMP 2 STATUS	BP-2	Х		X												
BOILER PUMP 3 START STOP OUTPUT	BP-3	X				X										
BOILER PUMP 3 STATUS	BP-3	X		X		V										
BOILER ISOLATION VALVE OPEN SHUT BOILER ISOLATION VALVE STATUS	CV-1 CV-1	X		X		X										
BOILER ISOLATION VALVE STATUS	CV-1 CV-2	X		^		X										
BOILER ISOLATION VALVE OF EN SHOT	CV-2	X		X												
BOILER ISOLATION VALVE OPEN SHUT	CV-3	X		X												
BOILER ISOLATION VALVE STATUS	CV-3	Х				Х										
HOT WATER DIFFERENTIAL PRESSURE	DP-1	Х		Х											Х	
DOMESTIC WATER STORAGE TANK 1 TEMP	TS-3	Х	Х						Χ							
DOMESTIC WATER STORAGE TANK 2 TEMP	TS-4	Х	X						Х							
DOMESTIC WATER STORAGE TANK 3 TEMP	TS-14	X	X						X							
DOMESTIC WATER STORAGE TANK 4 TEMP B-WAY CONTROL VALVE MODULATION	TS-15 CV-4	X	X		Х				X							+
B-WAY CONTROL VALVE POSITION	CV-4	X	X		^				X							
B-WAY CONTROL VALVE MODULATION	CV-5	X			Х				X							1
B-WAY CONTROL VALVE POSITION	CV-5	Х	Х						Х							1
DOMESTIC HOT WATER PUMP 1 START STOP	DWP-1	Х				Х										
DOMESTIC HOT WATER PUMP 1 STATUS	DWP-1	Х		Х												
DOMESTIC HOT WATER PUMP 2 START STOP	DWP-2	Х				Х										
DOMESTIC HOT WATER PUMP 2 STATUS	DWP-2	X		X												-
DWST-1 ENTERING TEMP	TS-5	X	X						X							
DWST-1/2 LEAVING TEMP DWST-2 ENTERING TEMP	TS-6 TS-7	X	X						X							
DWST-3 ENTERING TEMP	TS-16	X	X						X							
DWST-3/4 LEAVING TEMP	TS-17	X	X						X							
DWST-4 ENTERING TEMP	TS-18	X	X						Х							
L10F LOOP SUPPLY TEMPERATURE	TS-9	Х	Х						Х							
40F LOOP SUPPLY TEMPERATURE	TS-10	Х	Х						Х							
L50F LOOP SUPPLY TEMPERATURE	TS-11	Х	Х						Х							
DOM HOT WATER RECIRC PUMP 1 START STOP	DWRP-1	X				X										
DOM HOT WATER RECIRC PUMP 1 STATUS	DWRP-1	Х		X	V											
DOM HOT WATER RECIRC PUMP 1 SPEED DOM HOT WATER RECIRC PUMP 2 START STOP	DWRP-1 DWRP-2	Х			X	X										
DOM HOT WATER RECIRC PUMP 2 START STOP	DWRP-2	X		X		^										
DOM HOT WATER RECIRC PUMP 2 SPEED	DWRP-1				Х											
BAS COMMUNICATION STATE	BAS COM						Х									1
BOILER PUMP 1 FAILURE	BP1 FAIL	Х					Х						Х			
BOILER PUMP 1 FAILURE	BP2 FAIL	Х					Х						Х			
BOILER PUMP 1 FAILURE	BP3 FAIL	Х					Х						Х			
DOMESTIC HOT WATER PUMP 1 FAIL	DWP1 FAIL	X					X						X			
DOMESTIC HOT WATER PUMP 2 FAIL	DWP2 FAIL	X					X						Х			
L10F HOT WATER RESET HIGH LIMIT L10F HOT WATER RESET LOW LIMIT	110F HW RES HL	X					X									
LIOF HOT WATER RESET LOW LIMIT LIOF HOT WATER SUPPLY TEMP SETPOINT	110F HW RES LL 110F HW SP	X					X									
L40F HOT WATER SOFFET TEMP SETFORM	140F HW RES HL	X					X									
L40F HOT WATER RESET LOW LIMIT	140F HW RES LL	X					X									
L40F HOT WATER SUPPLY TEMP SETPOINT	140F HW SP	X					X									
L50F HOT WATER RESET HIGH LIMIT	150F HW RES HL	Х					Х									
150F HOT WATER RESET LOW LIMIT	150F HW RES LL	Х					Х									
A FOR LIGHT WATER CURRING TENAN CETROINET																-


150F HOT WATER SUPPLY TEMP SETPOINT

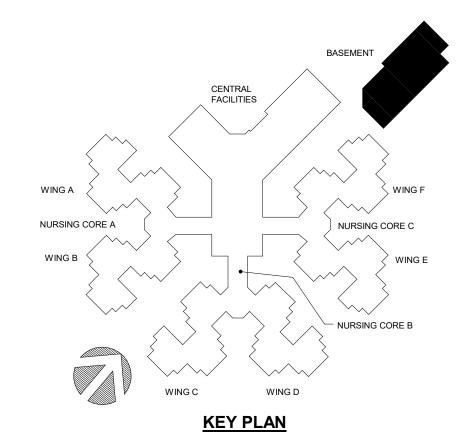

NOTE TO PRINTER

THIS DRAWING PREPARED IN COLOR. TO IMPROVE READIBILITY, ADJUST PRINTER SETTINGS TO COLOR AND BE SURE THE QUALITY IS SET TO PRESENTATION OR SIMILAR.

STATE OF MISSOURI MICHAEL L. KEHOE, GOVERNOR

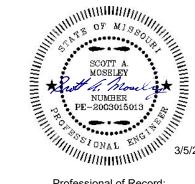

Professional of Record:
SCOTT A. MOSELEY
LICENSE #: 2003015013
EXPIRATION DATE: 12/31/25
PROFESSIONAL SEAL

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OFFICE OF
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REBID
DESIGN & INSTALL
NEW DOMESTIC WATER
PLANT
VETERANS HOME
BUILDING

ST. JAMES VETERANS HOME 620 NORTH JEFFERSON ST. JAMES, MO

PROJECT # U2409-01 SITE # 6801 FACILITY # 8136801002

REVISION:
DATE:
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DATE:
REVISION:
DATE:
ISSUE DATE: 01.21.2025

CAD DWG FILE:
DRAWN BY:
CHECKED BY:
DESIGNED BY:

SHEET TITLE:

PLUMBING DIAGRAMS

SHEET NUMBER:

P-603
9 of 18 SHEETS
03.05.2025

DOMESTIC HOT WATER RISER ISOMETRIC - PHASE 1 & 2
P-901 SCALE:

DWST-4

ET-2

DWST-1

DWST-2

ET-1

STATE OF MISSOURI MICHAEL L. KEHOE, GOVERNOR



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TE

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CHECKED BY:
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NURSING CORE A

KEY PLAN

THIS DRAWING PREPARED IN COLOR. TO IMPROVE READIBILITY, ADJUST PRINTER SETTINGS TO COLOR AND BE


SURE THE QUALITY IS SET TO PRESENTATION OR SIMILAR.

NOTE TO PRINTER

PLUMBING RISER ISOMETRICS

SHEET NUMBER:

P-901
10 of 18 SHEETS
03.05.2025

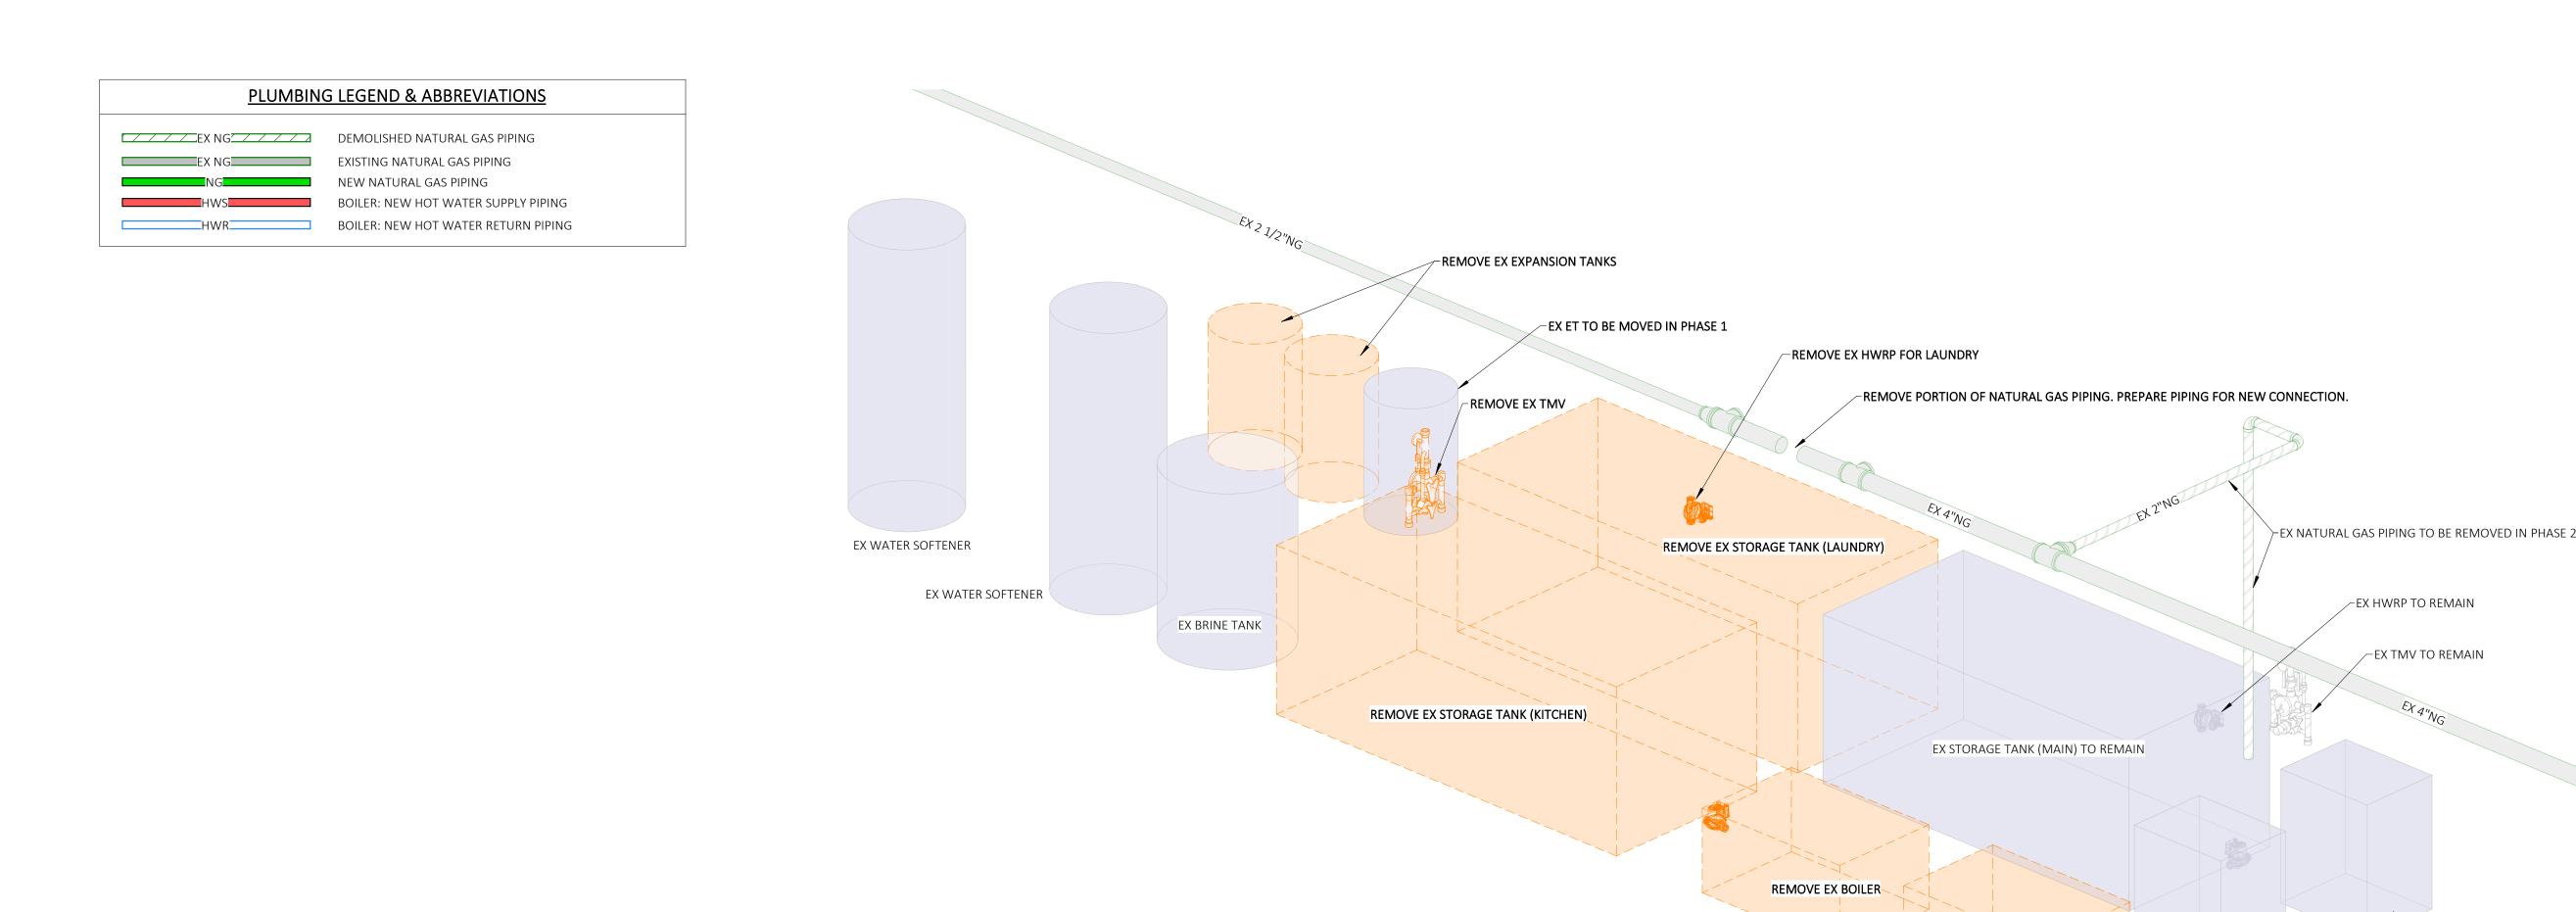

P-902 PHASE 1 DEMO DW SOURCE HEATING RISER ISOMETRIC ROTATED


SCALE: EX 1 1/2"HW¬ REMOVE EX EXPANSION TANKS PLUMBING LEGEND EX 2"HW(160°F)--EX ET TO MOVE IN PHASE 1 DEMO SOFT COLD WATER PIPING (EX SCW) EX 2"HW(140°F)-EXISTING SOFT COLD WATER PIPING (EX SCW) NEW SOFT COLD WATER PIPING (SCW) _EX 1"HWR(160°F) EX WATER SOFTENER DEMO HOT WATER PIPING (EX HW) REMOVE EX STORAGE TANK (LAUNDRY) NEW HOT WATER PIPING (HW) -REMOVE PORTION OF PIPING. PREPARE PIPING FOR NEW CONNECTION. REMOVE EX HWRP FOR LAUNDRY EXISTING HOT WATER PIPING (140°F) (EX HW(140°F)) REMOVE PORTION OF PIPING. PREPARE PIPING FOR NEW CONNECTION. DEMO HOT WATER RETURN PIPING (EX HWR) NEW HOT WATER RETURN PIPING (HWR) ∠EX 1"HWR EXISTING HOT WATER PIPING (160°F) (EX HW(160°F)) REMOVE PORTION OF PIPING. PREPARE PIPING FOR NEW CONNECTION. EX 2"HW EX WATER SOFTENER HX: NEW HOT WATER RETURN PIPING (170°F) (HWR(170°F)) REMOVE PORTION OF PIPING AND CAP. EX HWRP TO REMAIN REMOVE PORTION OF PIPING. PREPARE PIPING FOR NEW CONNECTION. REMOVE EX TMV-EX TMV TO REMAIN REMOVE PORTION OF PIPING. PREPARE PIPING FOR NEW CONNECTION. REMOVE EX STORAGE TANK (KITCHEN) EX BOILER TO REMAIN EX STORAGE TANK (MAIN) TO REMAIN NURSING CORE A REMOVE EX BOILER

PHASE 1 DEMO DW HOT WATER RISER ISOMETRIC ROTATED

REMOVE EX BOILER

EX BOILER TO REMAIN

STATE OF MISSOURI MICHAEL L. KEHOE, **GOVERNOR**

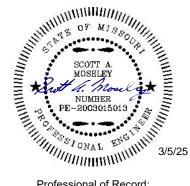

LICENSE #: 2003015013 EXPIRATION DATE: 12/31/25 PROFESSIONAL SEAL MO Certificate of Authority #000329 Arch. MO Certificate of Authority #000613 Eng. Exp. Date: 12/31/25

OFFICE OF ADMINISTRATION DIVISION OF FACILITIES MANAGEMENT, **DESIGN AND CONSTRUCTION**

EX BOILER TO REMAIN

EX BOILER TO REMAIN

REMOVE EX BOILER

REBID **DESIGN & INSTALL** NEW DOMESTIC WATER **PLANT VETERANS HOME** BUILDING

ST. JAMES VETERANS HOME 620 NORTH JEFFERSON ST. JAMES, MO

PROJECT # U2409-01 SITE# FACILITY # 8136801002

REVISION:
DATE:
REVISION:
DATE:
REVISION:
DATE:
ISSUE DATE: 01.21.2025

CAD DWG FILE:
DRAWN BY:
CHECKED BY:
SAM

DESIGNED BY: SHEET TITLE: PLUMBING PHASE 1

DEMO RISER ISOMETRICS ROTATED

SHEET NUMBER:


KEY PLAN

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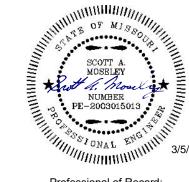
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NOTE TO PRINTER

11 of 18 SHEETS 03.05.2025



STATE OF MISSOURI MICHAEL L. KEHOE, GOVERNOR

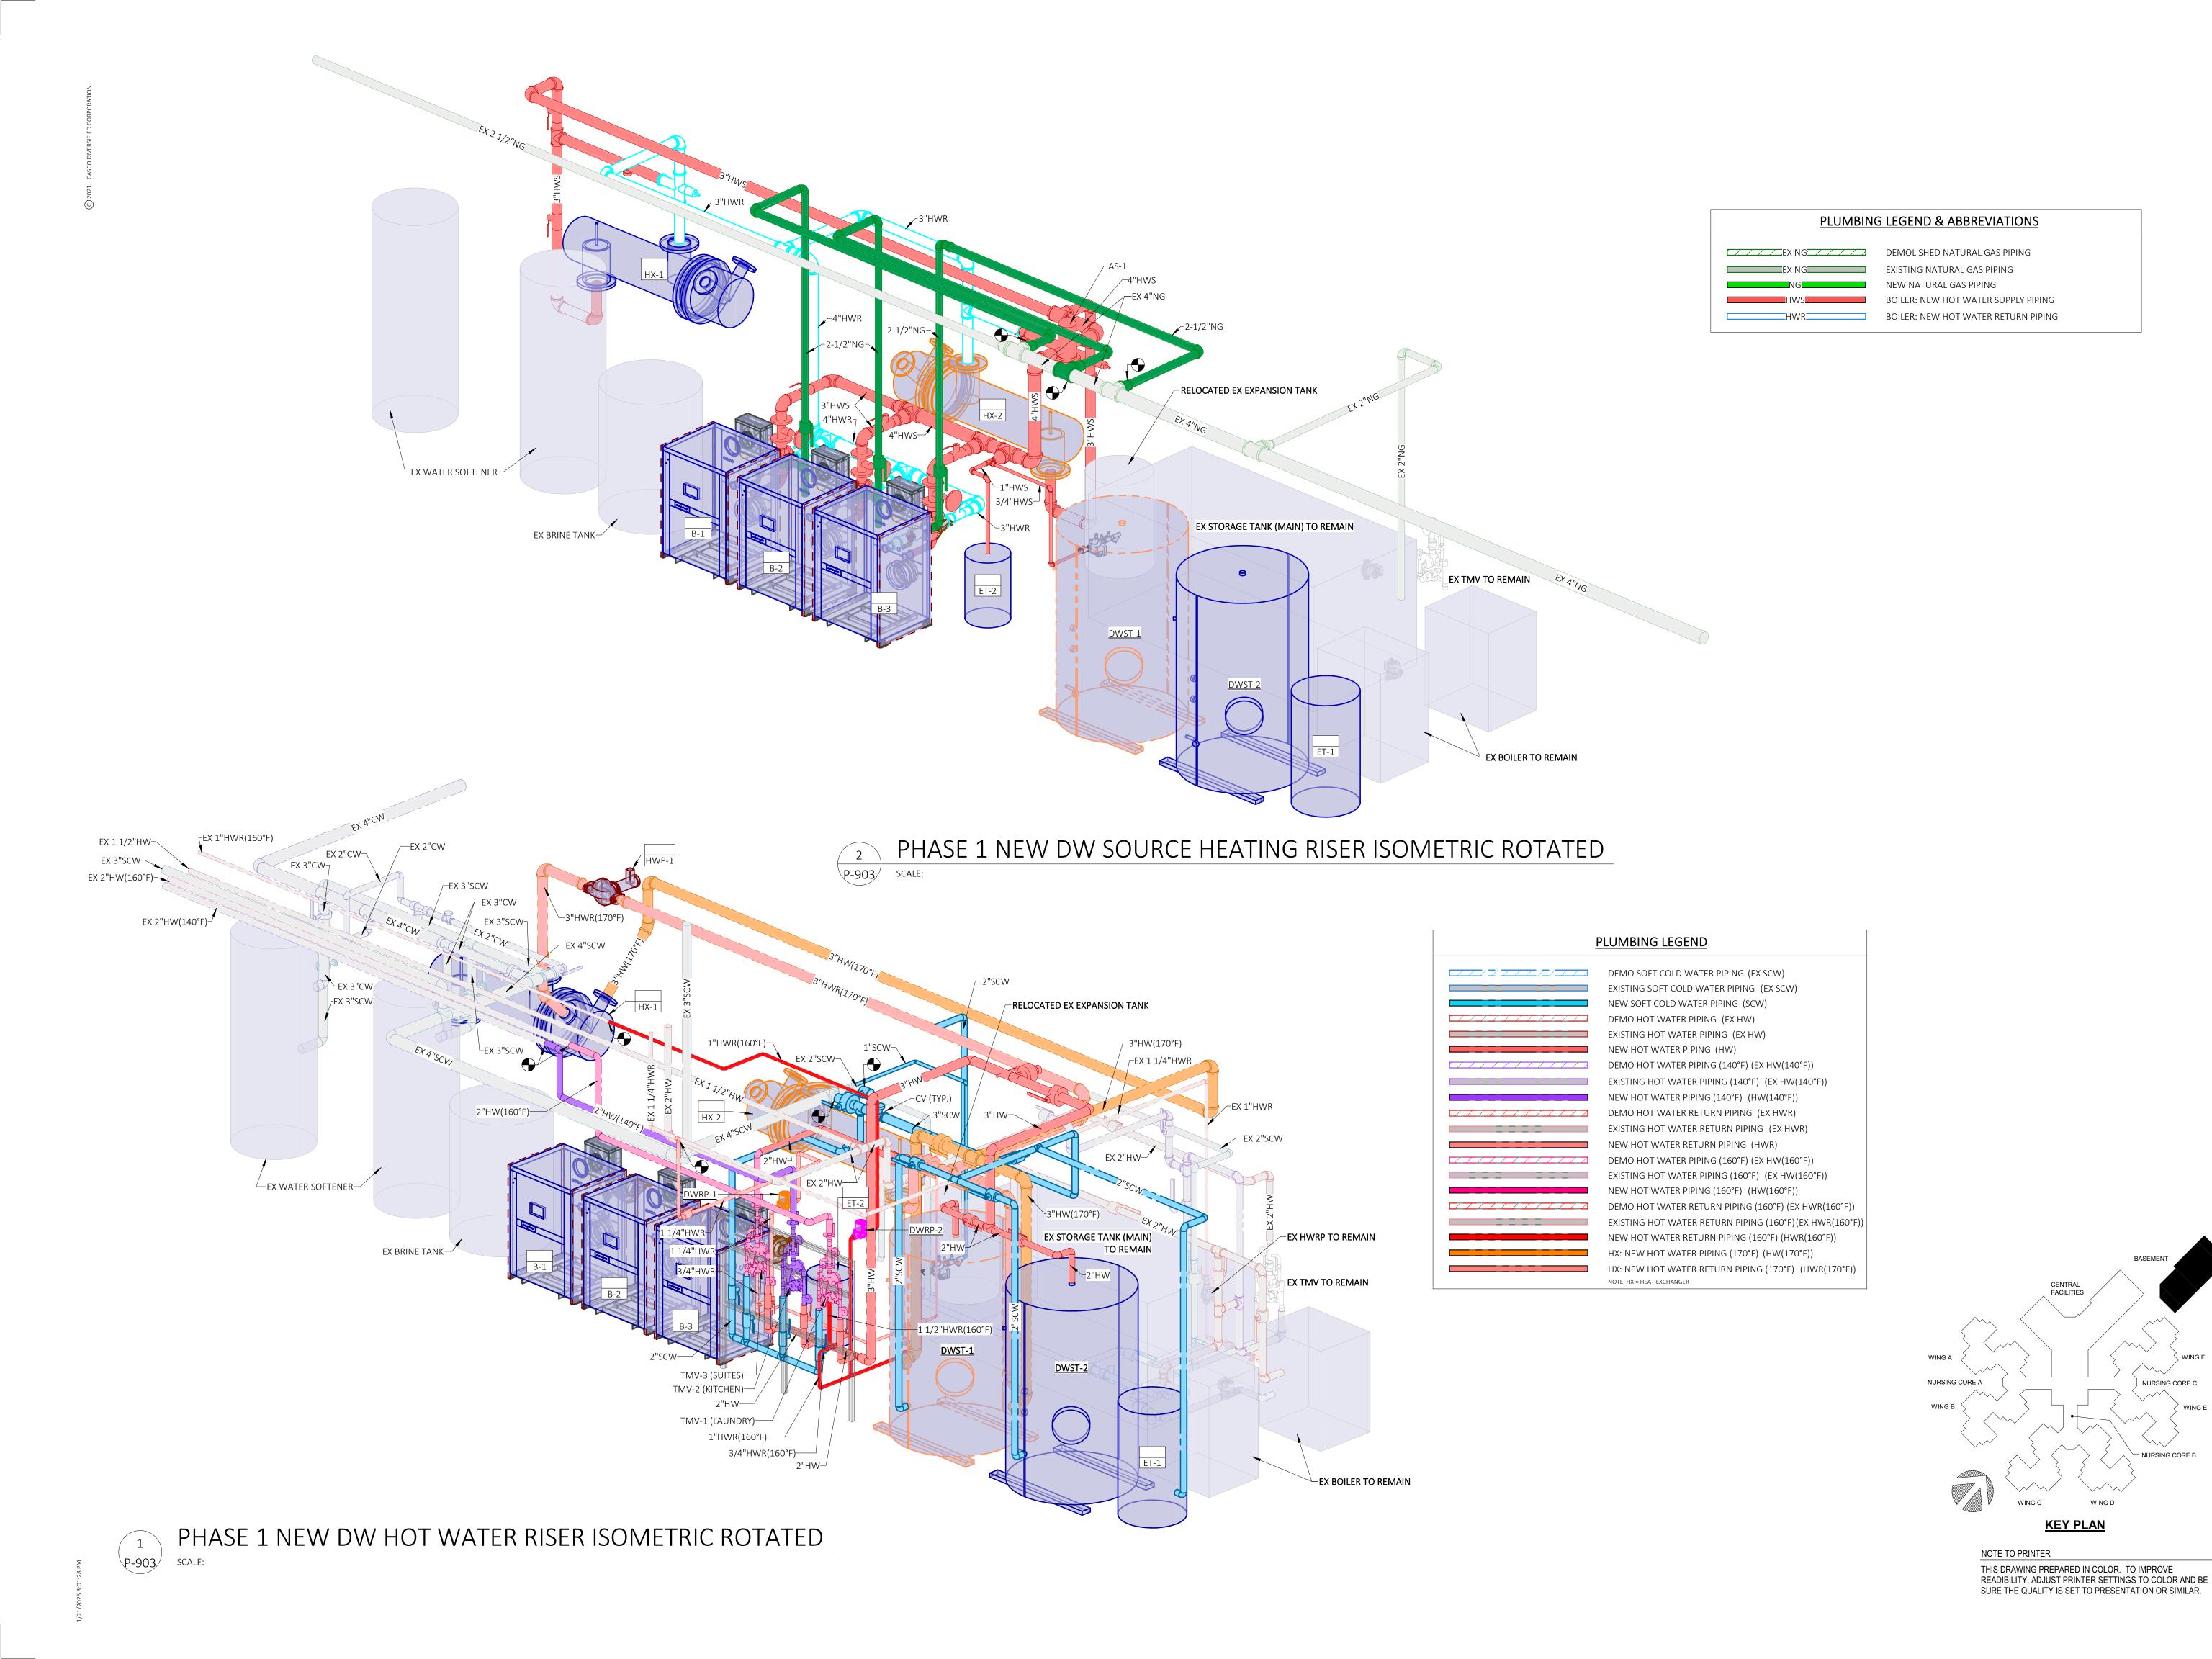

Professional of Record:
SCOTT A. MOSELEY
LICENSE #: 2003015013
EXPIRATION DATE: 12/31/25
PROFESSIONAL SEAL

CASCO Diversified Corporation
MO Certificate of Authority #000329 Arch.
MO Certificate of Authority #000613 Eng.
Exp. Date: 12/31/25

ASCO DIVERSIFIED CORPORATION
Suite 100, St. Louis, MO 63143 T: 31-

OFFICE OF
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MANAGEMENT,
DESIGN AND
CONSTRUCTION

REBID
DESIGN & INSTALL
NEW DOMESTIC WATER
PLANT
VETERANS HOME
BUILDING

ST. JAMES VETERANS HOME 620 NORTH JEFFERSON ST. JAMES, MO

PROJECT # U2409-01 SITE # 6801 FACILITY # 8136801002

REVISION:
DATE:
REVISION:
DATE:
REVISION:
DATE:
ISSUE DATE: 01.21.2025

CAD DWG FILE:
DRAWN BY: DDP
CHECKED BY: SAM
DESIGNED BY:

SHEET TITLE:
PLUMBING PHASE 1
NEW RISER
ISOMETRICS
ROTATED

SHEET NUMBER:

P-903
12 of 18 SHEETS
03.05.2025

ET-1

REMOVE EX BOILER

REMOVE EX BOILER

TMV-1 (LAUNDRY)——3/4"HWR(160°F)——

PHASE 2 DEMO DW HOT WATER RISER ISOMETRIC ROTATED

1"HWR(160°F)----

WING A

WING F

NURSING CORE A

WING B

WING C

WING D


KEY PLAN

NOTE TO PRINTER

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STATE OF MISSOURI MICHAEL L. KEHOE, GOVERNOR



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CASCO DIVERSIFIED CORPORATION
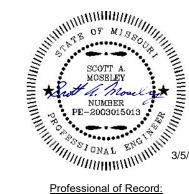
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ISSUE DATE: 01.21.2025

CAD DWG FILE:

DRAWN BY:

CHECKED BY:

DESIGNED BY:

SHEET TITLE:
PLUMBING PHASE 2
DEMO RISER
ISOMETRICS

ROTATED

SHEET NUMBER:

P-904
13 of 18 SHEETS
03.05.2025

STATE OF MISSOURI MICHAEL L. KEHOE, GOVERNOR



Professional of Record:
SCOTT A. MOSELEY
LICENSE #: 2003015013
EXPIRATION DATE: 12/31/25
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ST. JAMES VETERANS HOME 620 NORTH JEFFERSON ST. JAMES, MO

PROJECT # U2409-01 SITE # 6801 FACILITY # 8136801002

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DATE:
ISSUE DATE: 01.21.2025

CAD DWG FILE:

DRAWN BY: DDP

CHECKED BY: SAM

DESIGNED BY:

SHEET TITLE:
PLUMBING PHASE 2
NEW RISER
ISOMETRICS

ROTATED

SHEET NUMBER:

KEY PLAN

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P-905
14 of 18 SHEETS
03.05.2025

CIRCUITRY DESIGNATIONS

MARK INDICATES "NEUTRAL" WIRE, LONG SLASH WITH SOLID CIRCLE INDICATES GREEN GROUNDING CONDUCTOR

BRANCH CIRCUITRY AS ABOVE, CONCEALED IN FLOOR SLAB OR UNDERGROUND
BRANCH CIRCUITRY AS ABOVE, CONCEALED IN WALLS OR ABOVE CEILINGS

CIRCUITRY UP (LEFT) AND CIRCUITRY DOWN (RIGHT)

BRANCH CIRCUITRY. ARROW INDICATES HOME RUN TO PANEL. SHORT SLASH MARKS INDICATE "HOT" WIRES, LONG SLASH

NURSE CALL PUSH BUTTON, UNLESS NOTED OTHERWISE

NURSE CALL LIGHT MOUNTED AT 90" UNLESS NOTED OTHERWISE

NURSE CALL CONTROL PANEL

NCCP

STATE OF MISSOURI MICHAEL L. KEHOE, GOVERNOR



Professional of Record:
DAVID A. TRETTER
LICENSE #: 021293
EXPIRATION DATE: 12/31/25
PROFESSIONAL SEAL

CASCO Diversified Corporation
MO Certificate of Authority #000329 Arch
MO Certificate of Authority #000613 Eng
Exp. Date: 12/31/25



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PROJECT # U2409-01 SITE # 6801 FACILITY # 8136801002

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DATE:
ISSUE DATE: 03.05.2025

CAD DWG FILE:
DRAWN BY:
CHECKED BY:
DESIGNED BY:
KJC

SHEET TITLE:

ELECTRICAL LEGEND & SYMBOLS

SHEET NUMBER:

E-001

15 of 18 SHEETS
03.05.2025

2021 CASCO DIVERSIFIED COR

GENERAL CONSTRUCTION NOTES

- 1. ELECTRICAL CONTRACTOR SHALL BE RESPONSIBLE FOR NECESSARY PERMITS, LICENSES, INSPECTIONS AND FEES FROM THE LOCAL AUTHORITIES HAVING JURISDICTION. CONTRACTOR SHALL BE LICENSED BY LOCAL AND/OR STATE AUTHORITIES HAVING JURISDICTION.
- 2. ALL MATERIAL AND WORKMANSHIP SHALL CONFORM TO THE NATIONAL FIRE PROTECTION ASSOCIATION (NFPA), NATIONAL ELECTRICAL CODE (NEC), INTERNATIONAL BUILDING CODE (IBC) AND OTHER APPLICABLE LOCAL, STATE AND NATIONAL CODES.
- 3. ALL ELECTRICAL MATERIALS USED ON THIS PROJECT SHALL BE "UL" LISTED AND LABELED.
- 4. THE ENTIRE ELECTRICAL SYSTEM AND ALL ELECTRICAL EQUIPMENT SHALL BE GROUNDED IN STRICT ACCORDANCE WITH THE NATIONAL ELECTRICAL CODE AND AS SHOWN ON THE DRAWINGS. PROVIDE A GROUND WIRE IN EACH POWER CONDUIT, SIZED PER THE NEC.
- 5. CONTRACTOR SHALL BE RESPONSIBLE FOR INSTALLING A COMPLETE SYSTEM PER CONTRACT DRAWINGS AND ENSURING THAT THE SYSTEM IS OPERATIONAL UPON JOB COMPLETION, PRIOR TO TURNOVER.
- 6. CONTRACTOR SHALL BE RESPONSIBLE FOR COORDINATING WITH ALL OTHER TRADES AND DISCIPLINES TO AVOID CONFLICTS AND TO VERIFY ALL EQUIPMENT CONNECTIONS. COORDINATE ALL WIRING DEVICE LOCATIONS AND ELEVATIONS INDICATED ON THE PLANS WITH THE OWNER, ARCHITECT AND FINAL FURNITURE/EQUIPMENT LAYOUTS, PRIOR TO ROUGH-IN.
- 7. CONTRACTOR SHALL GUARANTEE ALL LABOR AND MATERIALS INSTALLED OR FURNISHED UNDER THIS CONTRACT FOR A PERIOD OF NOT LESS THAN ONE YEAR AFTER FINAL ACCEPTANCE OF THE BUILDING.
- 8. MAINTAIN AND VERIFY ELECTRICAL EQUIPMENT CLEARANCES AND WORKING SPACE PER NEC.
- 9. PROVIDE ELECTRICAL SYSTEMS WITH IDENTIFICATION AS INDICATED IN THE SPECIFICATIONS AND REQUIRED BY THE NEC.
- 10. IF ANYTHING ON THE PLANS IS NOT IN COMPLIANCE WITH NATIONAL, STATE OR LOCAL CODES, THE ENGINEER SHALL BE ADVISED BY THE ELECTRICAL CONTRACTOR DURING THE BIDDING PROCESS. THERE ARE TO BE NO CHANGES TO THE CONTRACT DOCUMENTS WITHOUT WRITTEN PERMISSION FROM THE ENGINEER.
- 11. CONTRACTOR SHALL BE RESPONSIBLE FOR ALL MEANS AND METHODS FOR NEW WORK, SAFETY, ETC., IN ACCORDANCE WITH ALL AUTHORITIES HAVING JURISDICTION. (I.E. OSHA, NEC, ETC.)
- 12. THE CONTRACTOR SHALL REFER TO ARCHITECTURAL DRAWINGS FOR PHASING AND SCHEDULING OF THIS PROJECT. COORDINATE WITH OWNER'S FIELD REPRESENTATIVE.
- 13. VERIFY ALL INDICATED DIMENSIONS BY FIELD MEASUREMENTS. NOTIFY ENGINEER OF ANY DISCREPANCIES.
- 14. PROVIDE ACCESS PANELS OR DOORS WHERE EQUIPMENT OR DEVICES ARE REQUIRED TO BE ACCESSIBLE ARE CONCEALED BEHIND INACCESSIBLE SURFACES.
- 15. PRIOR TO TURNOVER, THE CONTRACTOR SHALL REMOVE ALL RUBBISH, DIRT, DEBRIS AND STAINS ON THEIR WORK OR CAUSED BY THEIR WORK AND SHALL THOROUGHLY CLEAN ALL EQUIPMENT, FIXTURES, DEVICES, ETC. CONTRACTOR SHALL REPLACE, TOUCH-UP OR REFINISH THE FACTORY FINISH ON EQUIPMENT, FIXTURES, DEVICES, ETC. MARRED DURING SHIPMENT, INSTALLATION OR CONSTRUCTION.
- 16. PANELBOARD SHALL BE EQUIPPED WITH BOLT-ON TYPE BREAKERS, PHENOLIC NAME TAGS AND KEYED LOCK AND LATCH. EACH PANEL SHALL BE PROVIDED WITH TWO KEYS WITH ALL PANELS KEYED ALIKE. ALL CIRCUIT BREAKERS USED TO SWITCH LIGHT FIXTURES SHALL BE TYPE SWD AND SHALL BE APPROVED FOR THE PURPOSE. ALL CIRCUIT BREAKERS SERVING HVAC EQUIPMENT SHALL BE HACR TYPE.
- 17. ALL CIRCUITS INDICATED ON THESE DRAWINGS ARE 20A, 1P CIRCUIT BREAKERS IN PANELS UNLESS NOTED OTHERWISE.
 THE ELECTRICAL CONTRACTOR SHALL BE RESPONSIBLE FOR THE PROPER IDENTIFICATION AND LABELING OF ALL CIRCUIT BREAKERS. EACH PANELBOARD SHALL BE EQUIPPED WITH A TYPE WRITTEN CIRCUIT DIRECTORY.
- 18. MINIMUM WIRE SIZE SHALL BE #12 AWG UNLESS OTHERWISE NOTED. MINIMUM CONDUIT SIZE SHALL BE 1/2" UNLESS OTHERWISE NOTED. ALL CONDUIT BELOW SLABS OR EXTERIOR TO BUILDING SHALL BE MINIMUM 1". PROVIDE A NYLON/POLY PULL CORD IN ALL EMPTY CONDUITS.
- 19. ELECTRICAL CONTRACTOR SHALL PROVIDE TYPE THHN OR THWN COPPER CONDUCTORS FOR ALL INTERIOR BUILDING WIRE AND SHALL PROVIDE TYPE XHHW-2 COPPER CONDUCTORS FOR ALL EXTERIOR FEEDERS AND BRANCH CIRCUITS.
- 20. VOLTAGE DROP MINIMUM WIRE SIZING (20A CIRCUIT) USE: 120V CIRCUIT OVER 100' SHALL BE #10 MINIMUM; 120V CIRCUIT OVER 175' SHALL BE #8 MINIMUM; 208V CIRCUIT OVER 200' SHALL BE #10 MINIMUM; 277V CIRCUIT OVER 200' SHALL BE #10 MINIMUM. MINIMUM WIRE SIZE FOR ANY 20A BRANCH CIRCUIT SHALL BE #12. FURTHERMORE, CONSIDER ALL DERATING OF CONDUCTORS AS REQUIRED IN ACCORDANCE WITH THE APPLICABLE NEC.
- 21. ELECTRICAL CONTRACTOR SHALL HAVE THE OPTION OF GROUPING HOME RUNS IN ONE CONDUIT, PER THE REQUIREMENTS OF SECTION 310 OF THE NATIONAL ELECTRICAL CODE. NO MORE THAN FOUR (4) CIRCUITS SHALL BE ALLOWED TO BE GROUPED AND INSTALLED IN A SINGLE JUNCTION BOX. EC SHALL BE RESPONSIBLE FOR INCREASING CONDUCTOR SIZE AND DERATING. HOME RUNS WITH MORE THAN THREE CIRCUITS SHALL BE #10 AWG. CONDUCTOR MINIMUM. PROVIDE DEDICATED NEUTRALS FOR EACH PHASE CONDUCTOR AND CONSIDER THEM AS A CURRENT CARRYING CONDUCTOR FOR DERATING.
- 22. ALL HOME RUNS SHALL BE IN EMT CONDUIT. MC CABLE IS PERMITTED ABOVE CEILINGS FROM HOMERUNS TO FIXTURES AND WIRING DEVICES WITHIN WALLS AND FURRED COLUMNS. REFER TO ELECTRICAL SPECIFICATIONS FOR MORE DETAILED INFORMATION.
- 23. SUPPORT ALL CONDUITS FROM STRUCTURAL WALLS, SLABS, MEMBERS AND ROOF JOISTS. DO NOT SUPPORT CONDUITS FROM CEILING TIE WIRES, DUCTWORK, PIPING, ROOF DECK OR OTHER NON-STRUCTURAL MEMBERS.
- 24. SUPPORTING OF ELECTRICAL CONDUITS: THE INDIVIDUAL BRANCH CIRCUIT CONDUIT AND ASSOCIATED 4" X 4" JUNCTION BOXES MAY BE SUPPORTED FROM FLOOR/ROOF JOISTS. ALL LARGER FEEDER CONDUITS AND/OR CLUSTER OR GROUPS OF BRANCH CIRCUIT CONDUITS SHALL BE SUPPORTED ON STEEL TRAPEZE WITH STEEL CHANNEL ATTACHED TO STEEL OR WOOD JOIST/BEAMS WITH PROPER ATTACHMENTS. NO SUPPORT SHALL BE ATTACHED TO THE ROOF DECK (NO EXCEPTIONS). HANG CONDUIT FROM TOP CHORD OF BAR JOIST WHEN ATTACHING HOME RUNS TO JOIST.
- 25. INTERIOR AND EXTERIOR LIGHT FIXTURES SHALL BE FURNISHED AND INSTALLED AS SHOWN ON THE DRAWINGS AND AS CALLED OUT IN THE
- 26. ALL WIRING DEVICES SHALL BE FLUSH MOUNTED, UNLESS NOTED OTHERWISE. ALL CONDUIT SHALL BE RUN WITHIN WALL CAVITIES, BELOW FLOOR AND ABOVE CEILINGS. SURFACE MOUNTED ELECTRICAL WORK SHALL NOT BE USED UNLESS SPECIFICALLY NOTED ON THE PLANS.
- 27. ALL WALL AND CEILING FIXTURES AND DEVICES SHALL BE INDEPENDENTLY AND SECURELY MOUNTED SO THEY ARE NOT DEPENDENT ON CEILING FINISH FOR SUPPORT AND CAN NOT BE ROTATED OR DISPLACED. FIXTURES AND DEVICES MOUNTED IN SUSPENDED ACOUSTICAL CEILING TILE SHALL HAVE CHANNEL SUPPORTS ACROSS THE MAIN GRID RUNNERS OR GRID SUPPORTS SECURELY ANCHORED SO AS NOT TO CAUSE TILE TO SAG OR SO FIXTURE OR DEVICE CAN NOT BE LIFTED, ROTATED OR DISPLACED.
- 28. ALL OPENINGS IN FIRE AND/OR SMOKE RATED WALLS, FLOORS, AND PARTITIONS FOR CONDUITS SHALL BE SEALED WITH RED FIRE RESISTANT FOAM OR PUTTY TO MAINTAIN THE FIRE AND/OR SMOKE RATING. ALL OPENINGS IN FIRE RATED AND/OR SMOKE WALLS, FLOORS, AND PARTITIONS FOR CABLING SHALL BE SEALED WITH WIREMOLD FLAMESTOPPER, STI EZ-PATH, HILTI SPEED SLEEVE OR EQUIVALENT.
- 29. RECEPTACLES/WIRING DEVICES SHALL NOT BE INSTALLED BACK-TO-BACK, INSTALL ON OPPOSITE SIDES OF WALL STUDS; WHERE DEVICES EXIST ALONG FIRE WALLS, COVER WITH UL LISTED PUTTY PACKS.
- 30. REFER TO ARCHITECTURAL DRAWINGS FOR EXACT LOCATION OF LIGHT FIXTURES, DIMENSIONAL LOCATION OF FIXTURES IN DRYWALL CEILING, ETC. LOCATION OF FLOOR BOXES AND RECEPTACLES, INCLUDING MOUNTING HEIGHTS. ALL RECEPTACLES AND COVER PLATE COLORS SHALL BE APPROVED BY ARCHITECT.
- 31. OWNER RESERVES THE RIGHT TO RELOCATE ANY LIGHT FIXTURE, RECEPTACLE, ETC., BEFORE BEING INSTALLED 10'-0" FROM LOCATION AS SHOWN ON PLANS AT NO ADDITIONAL EXPENSE TO THE OWNER.
- 32. NO CONDUIT OR CABLES SHALL BE INSTALLED EXPOSED IN FINISHED AREA. NON-CEILING AREA CONDUITS SHALL BE INSTALLED EXPOSED IN A NEAT WORKMAN LIKE MANNER AND SHALL BE PAINTED TO MATCH ADJACENT FINISHES.
- 33. TELEPHONE, IT, AUDIO, VIDEO, SECURITY AND FIRE ALARM CABLE WIRING IN WALLS AND FLOOR SHALL BE ROUTED IN CONDUIT FROM DEVICE/JUNCTION BOX TO ABOVE AN ACCESSIBLE CEILING OR IN ATTIC SPACE; 1" EMT MINIMUM. NO SPLICING OF TELEPHONE OR DATA CABLES SHALL BE PERMITTED. ALL CABLES SHALL BE BUNDLED AND SUPPORTED FROM STRUCTURE ABOVE, NO MORE THAN 60" O.C. DO NOT LAY CABLES ON CEILING SYSTEM. PROVIDE J-HOOKS AND/OR CABLE TRAY SYSTEM. MAINTAIN 12" CLEARANCE ABOVE CEILING. COLOR CODE EACH CABLE BY USAGE.
- 34. ALL SIGNAL AND CONTROL CABLES SHALL BE MINIMUM #18 STRANDED COPPER, UNLESS NOTED OTHERWISE. ALL CONNECTIONS AND SPLICES TO BE MADE BY USE OF "STA-KON" CONNECTORS AND TERMINAL STRIPS. PROVIDE SHORT CIRCUIT RATING OF REPLACEMENT EQUIPMENT TO MATCH EXISTING OR AS NOTED ON THESE DRAWINGS. PROVIDE ARC-FLASH LABEL FOR REPLACEMENT AND NEW EQUIPMENT. PROVIDE COORDINATION STUDY DEMONSTRATING NEW AND REPLACEMENT EQUIPMENT IS COORDINATED WITH EXISTING EQUIPMENT THAT IS IMMEDIATELY UPSTREAM AND DOWNSTREAM.

GENERAL DEMO NOTES

- 1. THE ELECTRICAL CONTRACTOR SHALL REMOVE, CAP AND/OR RELOCATE EQUIPMENT, OUTLETS, CONDUIT, WIRE, TC., AS SHOWN AND SPECIFIED ON THE DRAWINGS, AND AS MAY BECOME NECESSARY BECAUSE OF EXISTING FIELD CONDITIONS. IT SHALL BE THE RESPONSIBILITY OF THE ELECTRICAL CONTRACTOR TO VISIBLY EXAMINE ALL EXISTING WALLS DESIGNATED FOR REMOVAL OR MODIFICATION TO DETERMINE THE CONDUIT AND THE WIRING THAT WILL REQUIRE CAPPING AND/OR REMOVAL. THE CONTRACTOR SHALL BE HELD TO HAVING VISITED THE SITE AND TAKEN ALL EXISTING CONDITIONS INTO CONSIDERATION.
- 2. PROTECT ADJACENT MATERIALS INDICATED TO REMAIN. INSTALL AND MAINTAIN DUST AND NOISE BARRIERS TO KEEP DIRT, DUST, AND NOISE FROM BEING TRANSMITTED TO ADJACENT AREAS. REMOVE PROTECTION AND BARRIERS AFTER DEMOLITION OPERATIONS ARE COMPLETE.
- 3. LOCATE, IDENTIFY, AND PROTECT ELECTRICAL SERVICES PASSING THROUGH DEMOLITION AREA AND SERVING OTHER AREAS OUTSIDE THE DEMOLITION LIMITS. MAINTAIN SERVICES TO AREAS OUTSIDE DEMOLITION LIMITS. WHEN SERVICES MUST BE INTERRUPTED, INSTALL TEMPORARY SERVICES FOR AFFECTED AREAS.
- 4. MAINTAIN AND PROTECT EXISTING BUILDING SERVICES WHICH TRANSIT THE AREA AFFECTED BY SELECTIVE DEMOLITION.
- 5. MAINTAIN CIRCUIT CONTINUITY TO ALL EXISTING FIXTURES, EQUIPMENT, OUTLETS, ETC., TO REMAIN IN USE WHETHER NOTED ON THE PLANS OR NOT. FIELD VERIFY EXISTING ITEMS TO REMAIN IN USE. WIRING FOR EXISTING CIRCUITS WHICH MUST BE RE-ROUTED OR WHICH ARE PARTIALLY ABANDONED, SHALL BE RECONNECTED TO SERVICE THE REMAINING OUTLETS ON THE CIRCUIT.
- 6. IN THE DEMOLITION WORK, REMOVE ALL UNUSED WIRING AND CABLES AND UNUSED CONDUIT THAT IS EXPOSED OR WITHIN ACCESSIBLE CEILINGS WHICH IS AFFECTED BY AND IS IN THE AREA OF THE WORK OF THIS CONTRACT.
- 7. THE INTENTION OF THE ELECTRICAL DEMOLITION IS TO DISCONNECT AND REMOVE ALL ELECTRICAL WORK MADE VOID BY THE SCOPE OF THE CONSTRUCTION AND ALTERATION. FIELD VERIFY EXACT MATERIAL QUANTITIES REQUIRED TO BE REMOVED.
- 8. WHERE ELECTRICAL EQUIPMENT, CONDUIT, BOXES, AND SUPPORTING HARDWARE ARE REMOVED, PATCH, AND FINISH THE SURFACE AS REQUIRED TO MATCH THE EXISTING, UNLESS OTHERWISE NOTED.
- 9. WHERE BURIED CONDUITS EXTENDING OUT OF A CONCRETE SLAB BECOME ABANDONED, CUT AND GRIND THE CONDUITS OFF FLUSH WITH TOP OF SLAB AND PLUG WITH NON-SHRINK WATERPROOF GROUT FILL.
- 10. ALL REMOVED MATERIALS, OTHER THAN REMOVED MATERIALS TO BE RELOCATED, OR STORED, OR TURNED OVER TO THE OWNER, SHALL BECOME THE PROPERTY OF THE CONTRACTOR AND SHALL BE REMOVED FROM THE PROJECT SITE.
- 11. ACCEPTANCE OF CONTRACT MEANS INSTALLER ACCEPTS EXISTING CONDITIONS.
- 12. CONTRACTOR SHALL COORDINATE ALL DEMOLITION WORK WITH ALL OTHER TRADES.
- 13. IN WALLS OR FLOORS WHERE A FLUSH DEVICE IS BEING REMOVED, BUT THE WALL OR FLOOR REMAINS OR FOR ANY OUTLET WHICH MUST REMAIN, BUT HAS A DEVICE REMOVED, PROVIDE A BLANK COVER OVER THE OUTLET. MATCH THE COLOR AND MATERIAL OF EXISTING REMAINING COVERS IN THE ROOM OR SPACE.
- 14. LEGALLY DISPOSE OF HAZARDOUS MATERIALS AND BALLASTS OR OTHER EQUIPMENT CONTAINING PCB'S AND LAMPS CONTAINING MERCURY. COMPLY WITH ALL FEDERAL, STATE, AND LOCAL LAWS.
- 15. MODIFY EXISTING PANEL DIRECTORIES (OR REPLACE) FOR PANELS WHICH HAVE HAD ALTERATIONS TO THE CIRCUITS ORIGINATING THEREIN. DESCRIBE THE LOAD AND LOCATION.
- 16. WHERE WORK IS TO BE PERFORMED ABOVE EXISTING ACCESSIBLE CEILINGS, CONTRACTOR SHALL BE RESPONSIBLE FOR REMOVING CEILING TILES AND GRID WITHOUT DAMAGE; STORAGE OF EXISTING TILES AND GRID WHILE WORK IS BEING PERFORMED, AND INSTALLATION OF EXISTING GRID AND TILES AFTER DIVISION 26, 27 AND 28 WORK IS COMPLETED.
- 17. ALL EXISTING ELECTRICAL WORK AND ASSOCIATED RACEWAY AND WIRING WHICH HAS BEEN MADE OBSOLETE BY THE WORK AND/OR IS SHOWN DASHED ON THE ELECTRICAL DEMOLITION DRAWINGS, SHALL BE DISCONNECTED AND REMOVED, UNLESS OTHERWISE NOTED. ALTHOUGH AN ATTEMPT HAS BEEN MADE TO INDICATE ALL OF THIS WORK, TOTAL ACCURACY IS NOT GUARANTEED. CONTRACTOR SHALL VISIBLY EXAMINE ALL AREAS AND WALLS AND CEILINGS SCHEDULED FOR REMOVAL TO DETERMINE EXISTING ELECTRICAL ITEMS TO REMAIN.

ELECTRICAL EQUIPMENT SCHEDULE PHASE | FED BY | MCA/HP | MOCP | DISC BY PLAN MARK VOLTAGE TYPE FEEDER 480 V MCC-C 5 HP 20 FWU 3 #12 & #12 GRD, 3/4" C. BP-2 480 V MCC-C 5 HP 20 FWU 3 #12 & #12 GRD, 3/4" C. BP-1 480 V MCC-C 5 HP 20 FWU 3 #12 & #12 GRD, 3/4" C. 120 V 9 MCA 20 30A/NF 2 #12 & #12 GRD, 3/4" C. 120 V 9 MCA 20 EC 30A/NF 2 #12 & #12 GRD, 3/4" C. 120 V 9 MCA 20 30A/NF 2 #12 & #12 GRD, 3/4" C. HWP-1 480 V MCC-C 5 HP 20 FWU 3 #12 & #12 GRD, 3/4" C. HWP-2 480 V MCC-C 5 HP 20 FWU 3 #12 & #12 GRD, 3/4" C. DWRP-1 120 V 1/6 HP 20 FWU 2 #12 & #12 GRD, 3/4" C. DWRP-2 120 V 1/12 HP | 20 FWU 2 #12 & #12 GRD, 3/4" C. TMV-3 1 MCA 20 EC RECP 2 #12 & #12 GRD, 3/4" C. TMV-2 1 MCA 20 EC RECP 2 #12 & #12 GRD, 3/4" C. TMV-1 1 MCA 20 EC RECP 2 #12 & #12 GRD, 3/4" C.

FWU: FURNISHED WITH UNIT

STATE OF MISSOURI MICHAEL L. KEHOE, GOVERNOR



CASCO DIVERSIFIED CORPORATION
12 Sunnen Drive, Suite 100, St. Louis, MO 63143

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OFFICE OF

REBID
DESIGN & INSTALL
NEW DOMESTIC WATER
PLANT
VETERANS HOME
BUILDING

ST. JAMES VETERANS HOME 620 NORTH JEFFERSON ST. JAMES, MO

PROJECT # U2409-01 SITE # 6801 FACILITY # 8136801002

REVISION:
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CAD DWG FILE:
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KJC


SHEET TITLE:

ELECTRICAL
GENERAL NOTES &
SCHEDULES

SHEET NUMBER:

E-002
16 of 18 SHEETS

03.05.2025

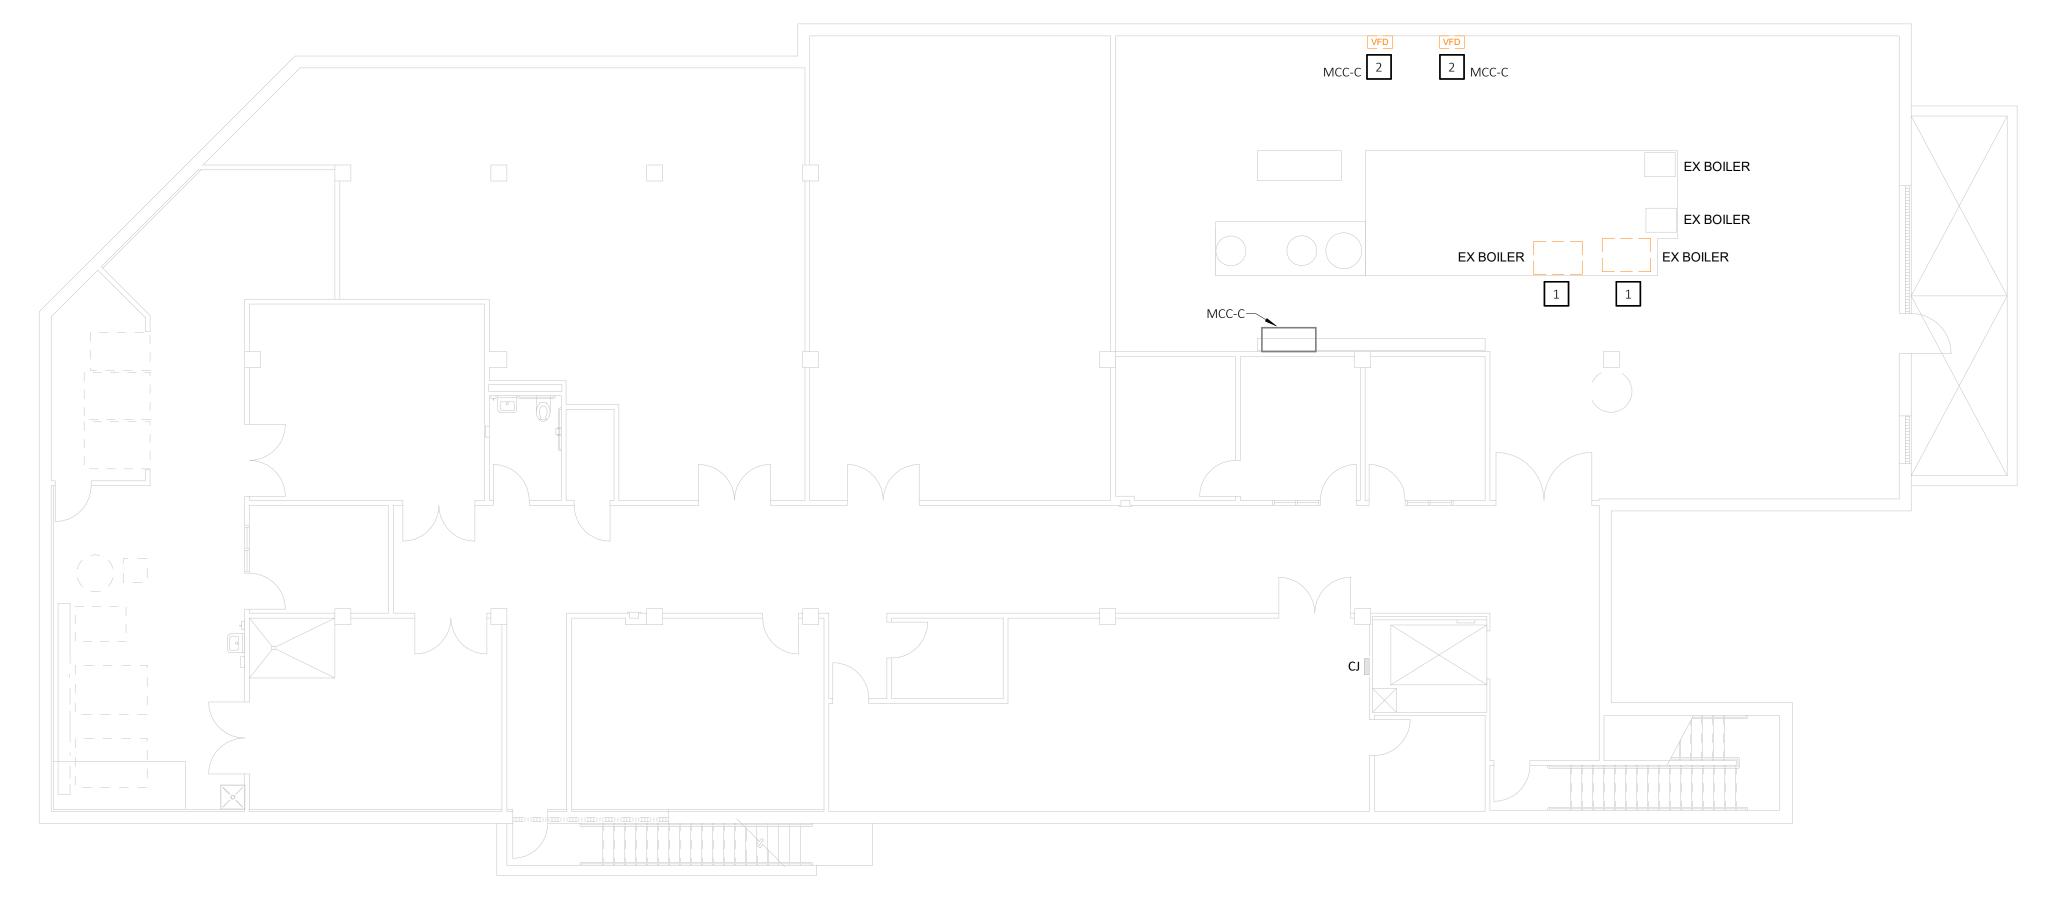

BASEMENT FLOOR PLAN - ELECTRICAL DEMOLITION - PHASE 1 1 BASEIVIE E-101 SCALE: 1/8" = 1'-0"

MCC-C TMV-2 (KITCHEN) 1 5 PB

BASEMENT FLOOR PLAN - ELECTRICAL RENOVATION - PHASE 1 2 BASEME E-101 SCALE: 1/8" = 1'-0"

Keynotes - Demo

- 1 EXISTING BOILER TO BE DEMOLISHED. EC SHALL DISCONNECT EXISTING BOILER WIRING AND MAINTAIN CIRCUIT FOR RECONNECTION WITH NEW BOILER.
- 2 EXISTING HOT WATER PUMP AND VFD TO BE DEMOLISHED. EC SHALL DISCONNECT EXISTING CIRCUIT FROM VFD AND MAINTAIN FOR RECONNECTION WITH NEW PUMP.

STATE OF MISSOURI MICHAEL L. KEHOE, **GOVERNOR**



Professional of Record: DAVID A. TRETTER LICENSE #: 021293 EXPIRATION DATE: 12/31/25 PROFESSIONAL SEAL CASCO Diversified Corporation MO Certificate of Authority #000329 Arch.
MO Certificate of Authority #000613 Eng.
Exp. Date: 12/31/25

OFFICE OF ADMINISTRATION DIVISION OF FACILITIES MANAGEMENT, **DESIGN AND CONSTRUCTION**

REBID **DESIGN & INSTALL** NEW DOMESTIC WATER **PLANT** VETERANS HOME BUILDING

ST. JAMES VETERANS HOME 620 NORTH JEFFERSON ST. JAMES, MO

PROJECT # U2409-01 6801 SITE# FACILITY # 8136801002

REVISION: DATE: **REVISION:** DATE: **REVISION:** DATE: ISSUE DATE: 03.05.2025

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DAT DESIGNED BY: KJC

SHEET TITLE:

ELECTRICAL BASEMENT FLOOR PLAN - PHASE 1

SHEET NUMBER:


E-10117 of 18 SHEETS 03.05.2025

Keynotes - Reno

- 1 EC SHALL MAINTAIN EXISTING WATER HEATER WIRING AND EXTEND IF NEED FOR RECONNECTION WITH NEW BOILER. VERIFY EXISTING CIRCUIT IS ROUTED THROUGH CONTACTOR "LC1" FOR SHUTDOWN SEQUENCE.
- 2 EC SHALL PROVIDE CIRCUIT FROM MCC-C SPARE BUCKET FOR (3) NEW BOILER PUMPS. PROVIDE 3#8 CU & 1#8 GND, 3/4"C. FROM MCC-C TO JUNCTION BOX WITH TERMINAL BLOCK. EC SHALL PROVIDE 30A FUSED DISCONNECT WITH 20A FUSES FOR EACH BOILER PUMP.
- 3 EC SHALL EXTEND EXISTING HOT WATER PUMP CIRCUIT AND MAKE CONNECTION TO NEW HOT WATER PUMP FACTORY FURNISHED VFD.
- 4 EC SHALL PROVIDE NEW 20A, 120V CIRCUIT FROM SPARE BREAKER IN PANEL "CJ" FOR NEW BOILER. ROUTE CIRCUIT THROUGH CONTACTOR "LC1" FOR SHUTDOWN SEQUENCE.
- 5 EXISTING EMERGENCY BOILER SHUTDOWN BUTTON INTERLOCKS WITH CONTACTOR "LC1" SO THAT GAS FIRED EQUIPMENT IN BOILER ROOMS SHUTS DOWN UPON ACTIVATION.


* Keynotes - Reno Alternate #1

1 EC SHALL PROVIDE NEW 20A, 120V CIRCUIT FROM SPARE BREAKER IN PANEL "CJ" FOR (3) NEW THERMOSTATIC MIXING VALVES.

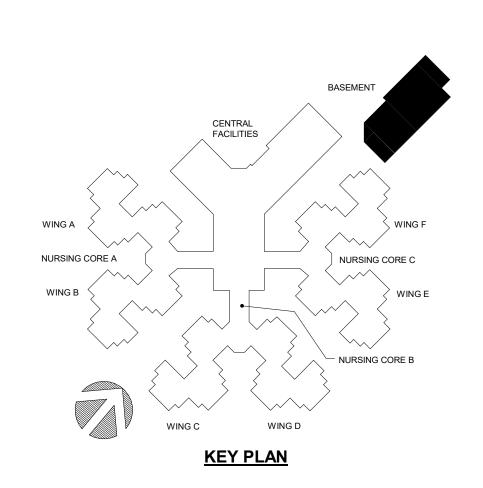




BASEMENT FLOOR PLAN - ELECTRICAL DEMOLITION - PHASE 2 E-102 SCALE: 1/8" = 1'-0"

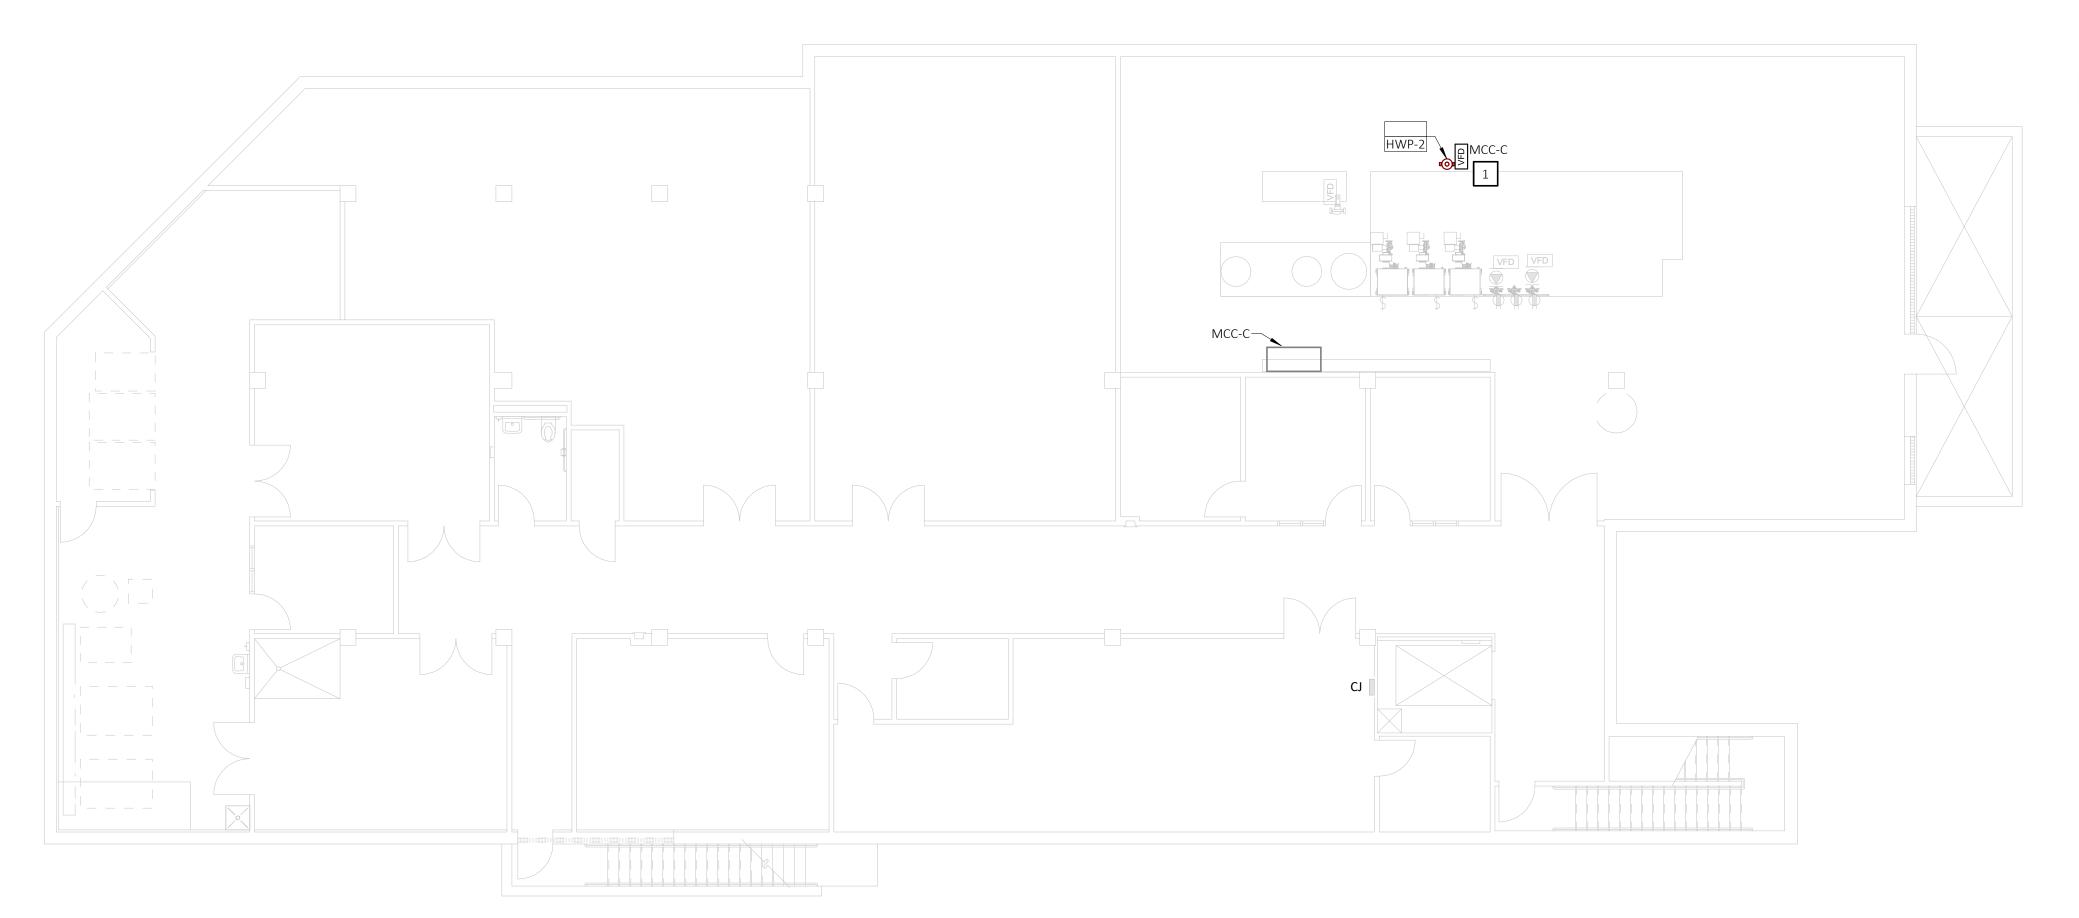

Keynotes - Demo 1 EXISTING BOILER TO BE DEMOLISHED. EC SHALL DISCONNECT BOILER AND REMOVE CONDUIT AND WIRING BACK

Keynotes - Reno

1 EC SHALL EXTEND EXISTING HOT WATER PUMP CIRCUIT AND MAKE CONNECTION TO NEW HOT WATER PUMP

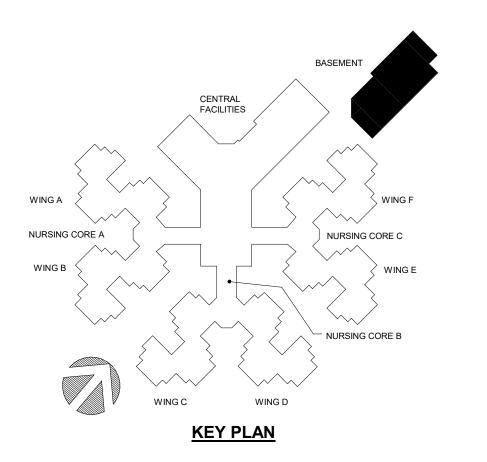

STATE OF MISSOURI MICHAEL L. KEHOE, **GOVERNOR**



<u>Professional of Record:</u> DAVID A. TRETTER LICENSE #: 021293 EXPIRATION DATE: 12/31/25 PROFESSIONAL SEAL CASCO Diversified Corporation MO Certificate of Authority #000329 Arch.
MO Certificate of Authority #000613 Eng.
Exp. Date: 12/31/25

OFFICE OF ADMINISTRATION DIVISION OF FACILITIES MANAGEMENT, **DESIGN AND** CONSTRUCTION

REBID DESIGN & INSTALL NEW DOMESTIC WATER **PLANT** VETERANS HOME BUILDING

ST. JAMES VETERANS HOME 620 NORTH JEFFERSON ST. JAMES, MO

PROJECT # U2409-01 SITE# 6801 FACILITY # 8136801002

REVISION:
DATE:
REVISION:
DATE:
REVISION:
DATE:
ISSUE DATE: 03.05.2025

CAD DWG FILE:
DRAWN BY:
CHECKED BY:
DESIGNED BY:
KJC

SHEET TITLE:

ELECTRICAL BASEMENT FLOOR PLAN - PHASE 2

SHEET NUMBER:

E-10218 of 18 SHEETS 03.05.2025

BASEMENT FLOOR PLAN - ELECTRICAL RENOVATION - PHASE 2 2 BASEME E-102 SCALE: 1/8" = 1'-0"