

OUTDOOR PAVILION

MISSOURI VETERANS HOME

Cape Girardeau, Missouri




20 Allen Avenue, Suite 200 - St Louis, Missouri 63119 - Phone: (314) 962-7900 / info@f-w.com

MISSOURI STATE CERTIFICATE OF AUTHORITY #000744

OWNER: STATE OF MISSOURI
MICHAEL L. PARSON,
GOVERNOR

MISSOURI VETERAN'S
COMMISSION

**PROJECT
MANAGEMENT:** OFFICE OF ADMINISTRATION
DIVISION OF FACILITIES MANAGEMENT,
DESIGN AND CONSTRUCTION

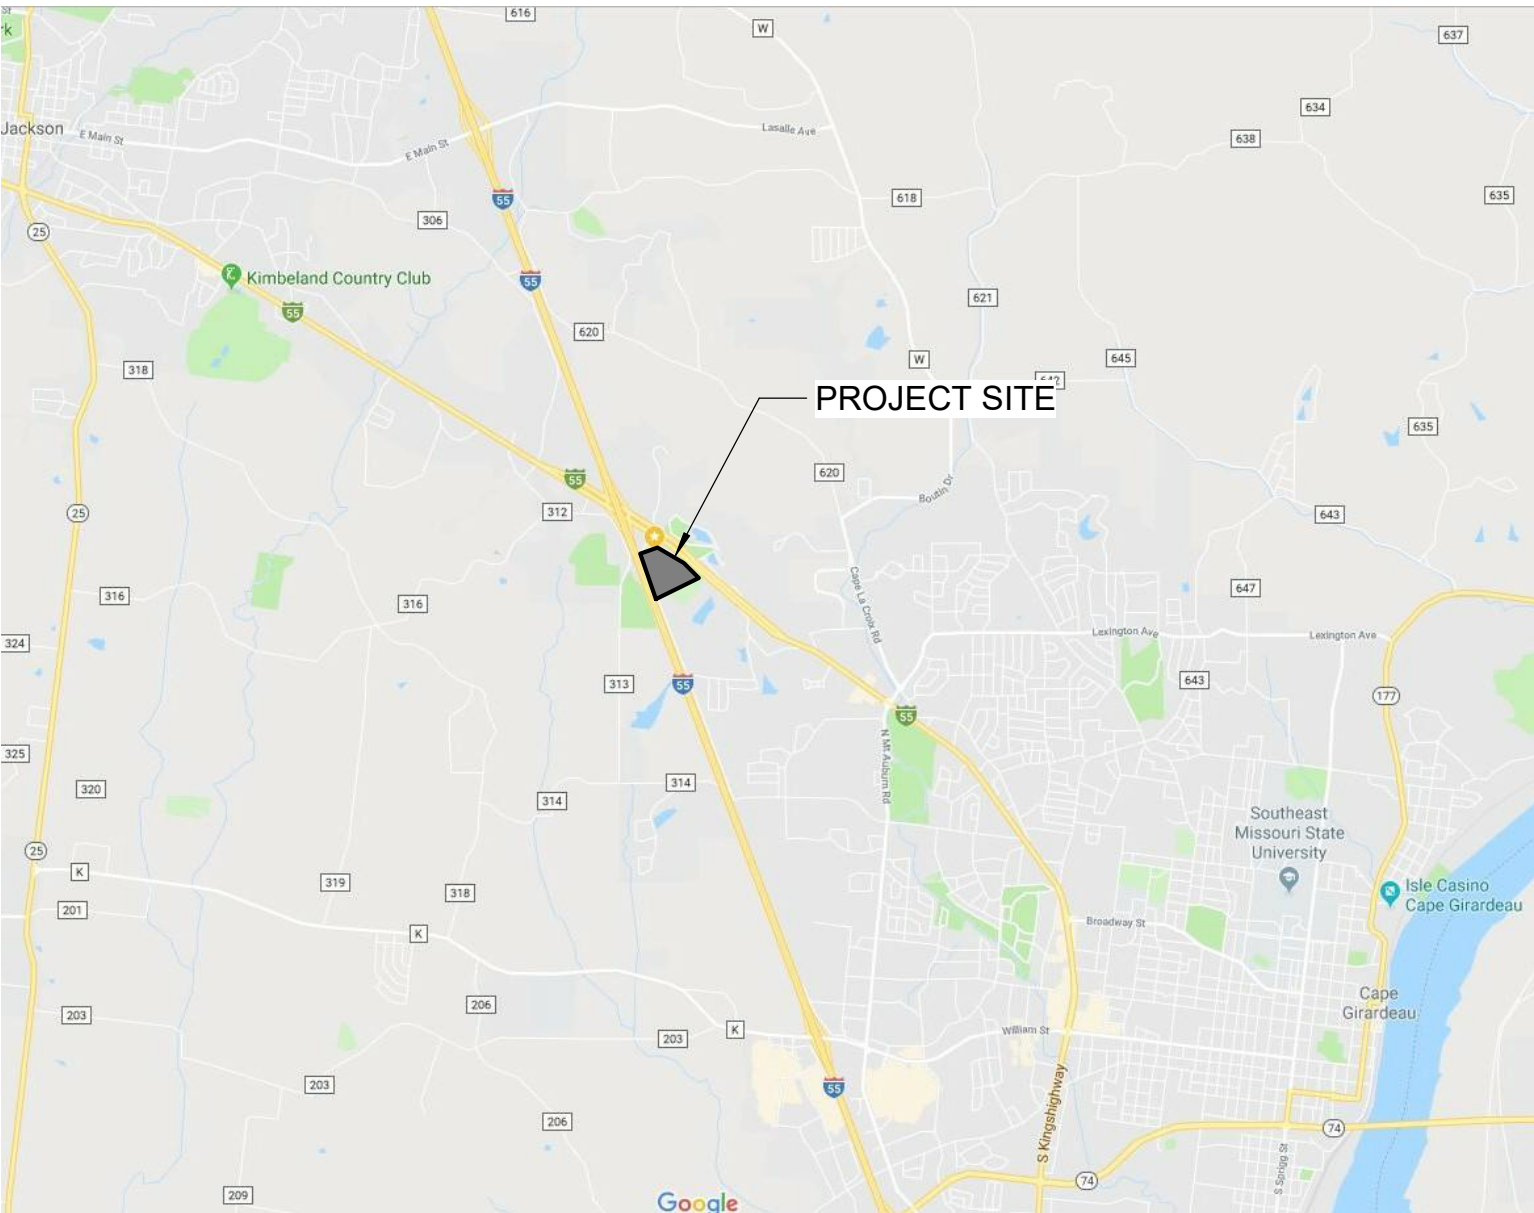

DESIGNER: FARNSWORTH GROUP

PROJECT NUMBER: #U2415.01
FAI NUMBER: 29-043

SITE NUMBER: 6803
ASSET NUMBER: 8136803002

SHEET NUMBER:


ABBREVIATIONS

AFF	ABOVE FINISHED FLOOR	FD	FLOOR DRAIN	PEB	PRE-ENGINEERED BUILDING
ACP/APC	ACOUSTIC CEILING PANEL/	FE	FIRE EXTINGUISHER	PJF	PREFORMED JOINT FILLER
	ACOUSTIC PANEL CEILING	FFE	FINISH FLOOR ELEVATION	PT	PRESSURE TREATED
ACT	ADJUSTABLE	FV	FIELD VERIFY	PERIM	PERIMETER
ADJ	ADJUSTABLE	FEC	FIRE EXTINGUISHER CABINET	PL	PLATE
ADTL	ADDITIONAL	FDN	FOUNDATION	PLAM	PLASTIC LAMINATE
AGG	AGGREGATE	FIN	FINISH	PLBG	PLUMBING
ALT	ALTERNATE	FLSHG	FLASHING	PLYWD	PLYWOOD
AL	ALUMINUM	FLR	FLOOR	PNT	PAINT
APPROX	APPROXIMATE(LY)	FRMG	FRAMING	PR	PAIR
ASPH	ASPHALT	FT	FOOT/FEET	PTD	PAINTED
AUTO	AUTOMATIC	FTG	FOOTING	PWR	POWER
B/O	BOTTOM OF	GC	GENERAL CONTRACTOR	RB	RUBBER BASE
BD	BOARD	GA	GAUGE	RD	ROOF DRAIN
BLDG	BUILDING	GALV	GALVANIZED	RO	ROUGH OPENING
BLKG	BLOCKING	GEN	GENERAL	RAD	RADIUS
BOT	BOTTOM	GYP	GYPSUM	REC	RECESSED
BRG	BEARING			REINF	REINFORCED
				REQD	REQUIRED
				REV	REVISED (REVISION)
				RM	ROOM
℄	CENTERLINE	HM	HOLLOW METAL	S	SOUTH
C/C	CENTER TO CENTER	HDWR	HARDWARE	SB	SPLASH BLOCK
CJ	CONTROL JOINT	HOL	HOLLOW	SF	SQUARE FEET
CLL	CONTRACT LIMIT LINE	HOR	HORIZONTAL	SS	STAINLESS STEEL
CEM	CEMENT(TIOUS)	HT	HEIGHT	SM	SIMILAR
CMU	CONCRETE MASONRY UNIT	HVAC	HEATING/VENTILATION/AIR	SPEC	SPECIFICATIONS
CLG	CEILING		CONDITIONING	SO	SQUARE
CLR	CLEAR	IDPH	ILLINOIS DEPARTMENT OF PUBLIC HEALTH	STD	STANDARD
COL	COLUMN	IN	INSIDE DIAMETER	STL	STEEL
CONC	CONCRETE	INCH	INCH	STOR	STORAGE
CONST	CONSTRUCTION	INCL	INCLUDING	STRUCT	STRUCTURAL
CONT	CONTINUOUS	INSUL	INSULATION	SUSP	SUSPENDED
CPT	CARPET	INT	INTERIOR		
CT	CERAMIC TILE	JAN	JANITOR		
CTR	CENTER(ED)	JT	JOINT		
DF	DRINKING FOUNTAIN	LAV	LAVATORY	T&G	TONGUE AND GROOVE
DS	DOWNSPOUT	LB(S)	POUND(S)	T/O	TOP OF
DBL	DOUBLE	L/S	LANDSCAPE	TELE	TELEPHONE
DEG	DEGREE	LT	LIGHT	TRTD	TREATED
DEMO	DEMOLITION			TS	TUBE STEEL
DET/DTL	DETAIL			TYP	TYPICAL
DIA	DIAMETER	MO	MASONRY OPENING		
DIM	DIMENSION	MAS	MASONRY	UNFIN	UNFINISHED
DN	DOWN	MATL	MATERIAL	UNO	UNLESS NOTED OTHERWISE
DWG(S)	DRAWING(S)	MAX	MAXIMUM		
		MECH	MECHANICAL		
		MFR	MANUFACTURER	VCT	VINYL COMPOSITION TILE
		MIN	MINIMUM	VIF	VERIFY IN FIELD
		MISC	MISCELLANEOUS	VERT	VERTICAL
		MTD	MOUNTED		
		MTL	METAL	W	WEST
		N	NORTH	W/	WITH
		NIC	NOT IN CONTRACT	W/O	WITHOUT
		NTS	NOT TO SCALE	WC	WATER CLOSET
		NOM	NOMINAL	WWF	WELODED WIRE FABRIC
				WD	WOOD
				WH	WATER HEATER
				WT	WEIGHT
E	EAST	OC	ON CENTER		
EC	ELECTRICAL CONTRACTOR	OD	OUTSIDE DIAMETER		
EHO	ELECTRICAL HOLD OPEN	O TO O	OUT TO OUT		
EJ	EXPANSION JOINT	OPNG	OPENING		
EW	EACH WAY	OPP	OPPOSITE		
EIFS	EXTERIOR INSULATION FINISH SYSTEM	OVHD	OVERHEAD		
EL	ELEVATION				
ELEC	ELECTRIC(AL)				
ELEV	ELEVATOR				
EMER	EMERGENCY				
EQ	EQUAL				
EQUIP	EQUIPMENT				
EXIST	EXISTING				
EXT	EXTERIOR				


DRAWING LIST

GENERAL	
G-001	COVER
G-002	GENERAL INFORMATION
CIVIL	
C-001	CIVIL GENERAL NOTES
C-002	DEMOLITION PLAN AND LAYOUT PLAN
C-003	GRADING AND UTILITY PLAN
C-004	DETAILS
LANDSCAPE	
L-101	PLANTING PLAN
STRUCTURAL	
S-001	GENERAL STRUCTURAL NOTES
S-002	SPECIAL INSPECTIONS
S-101	FOUNDATION PLAN OUTDOOR PAVILION
S-301	FOUNDATION DETAILS
ARCHITECTURAL	
A-101	PAVILION PLANS, ELEVATIONS, & SCHEDULES
A-102	PAVILION DETAILS
PLUMBING	
P-001	GENERAL INFORMATION
P-101	PAVILION PLUMBING PLAN
P-501	DIAGRAMS
P-601	SCHEDULES
MECHANICAL	
M-100	GENERAL INFORMATION
M-101	FIRST FLOOR MECHANICAL PLAN
M-102	DIAGRAMS
ELECTRICAL	
E-001	ELECTRICAL SYMBOLS
E-002	ELECTRICAL GENERAL NOTES AND ABBREVIATIONS
E-101	ELECTRICAL SITE PLAN
E-102	LIGHTING AND POWER PLAN - PAVILION
E-501	ELECTRICAL DETAILS

GENERAL SYMBOL LEGEND

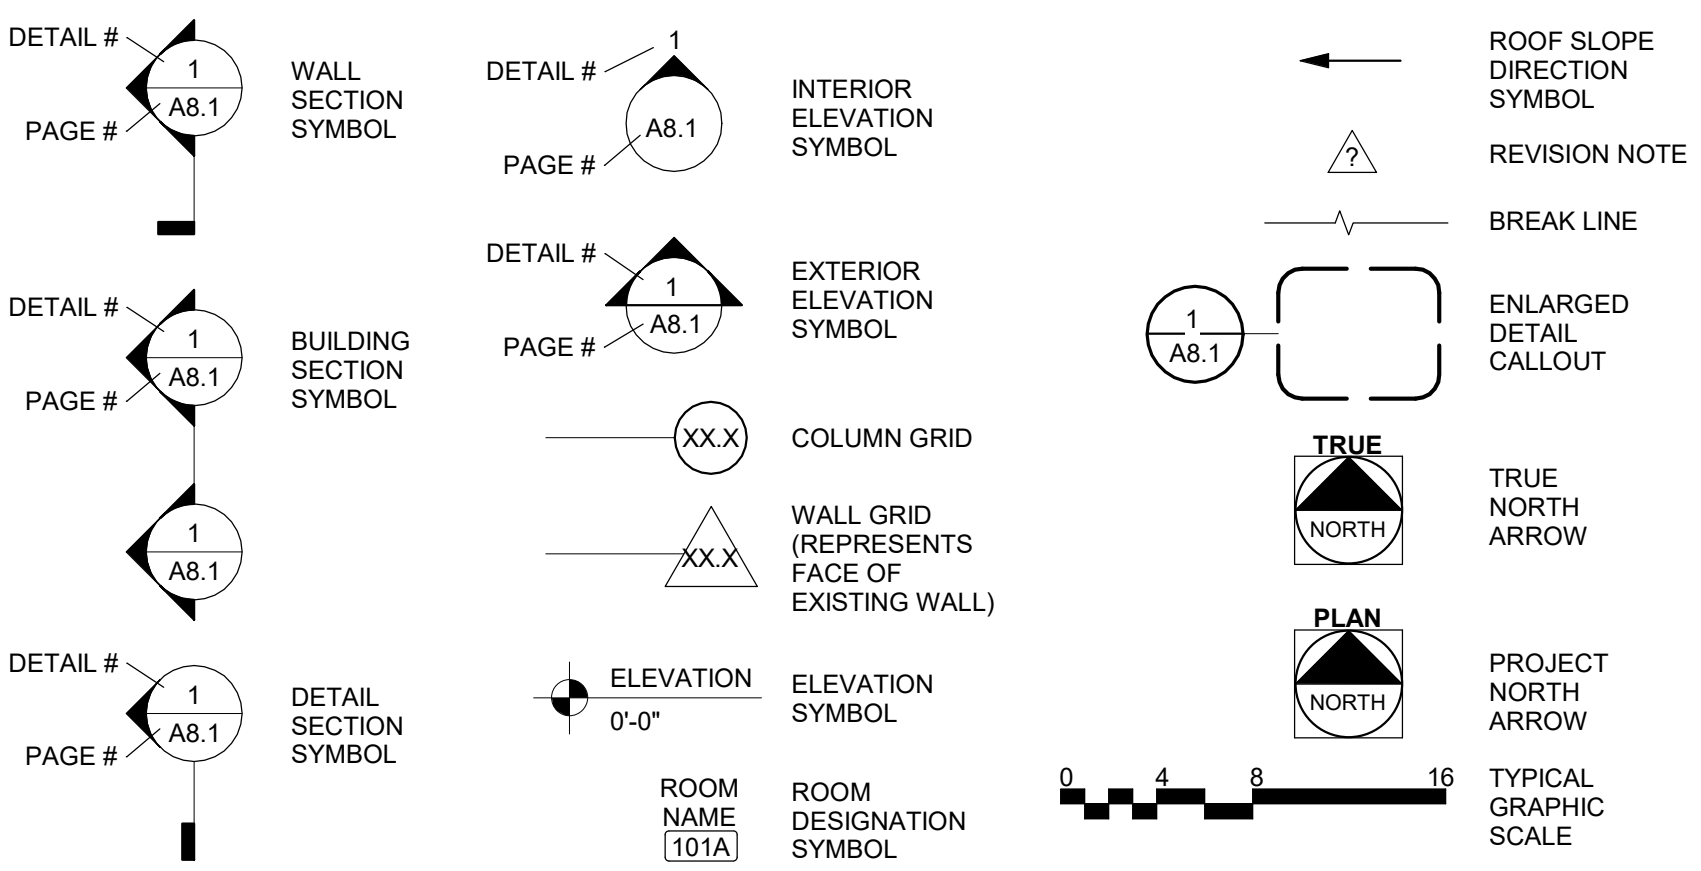

SYMBOL LEGEND

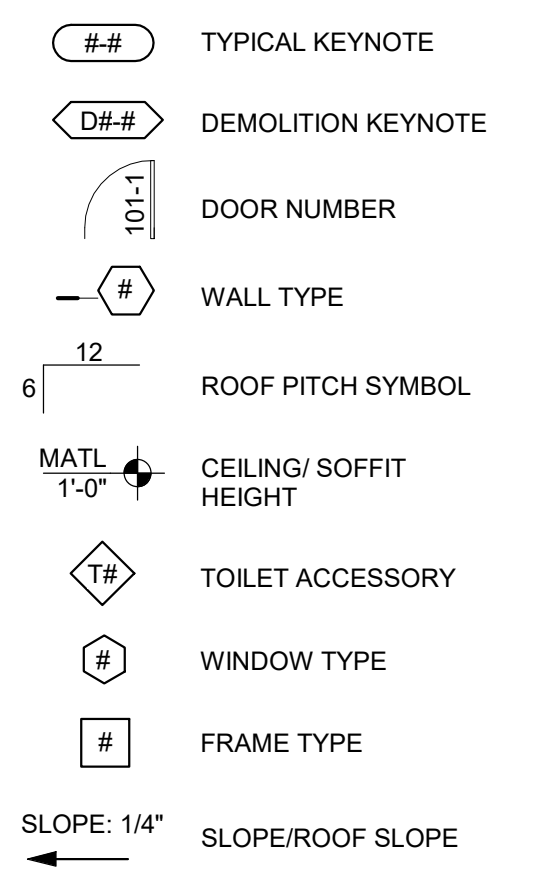


DEFERRED SUBMITTALS



THE FOLLOWING SYSTEMS ARE A DESIGN/BUILD RESPONSIBILITY OF THE CONTRACTOR OR PRODUCT MANUFACTURER AND WILL REQUIRE THE DEFERRED SUBMITTAL OF DESIGN WORK TO THE CITY OF ANYWHERE FOR PLAN REVIEW AND PERMITTING:

1. PRE-ENGINEERED HEAVY TIMBER FRAMING.
A. PAVILLION COLUMNS & FRAMING

STANDARD MOUNTING HEIGHTS

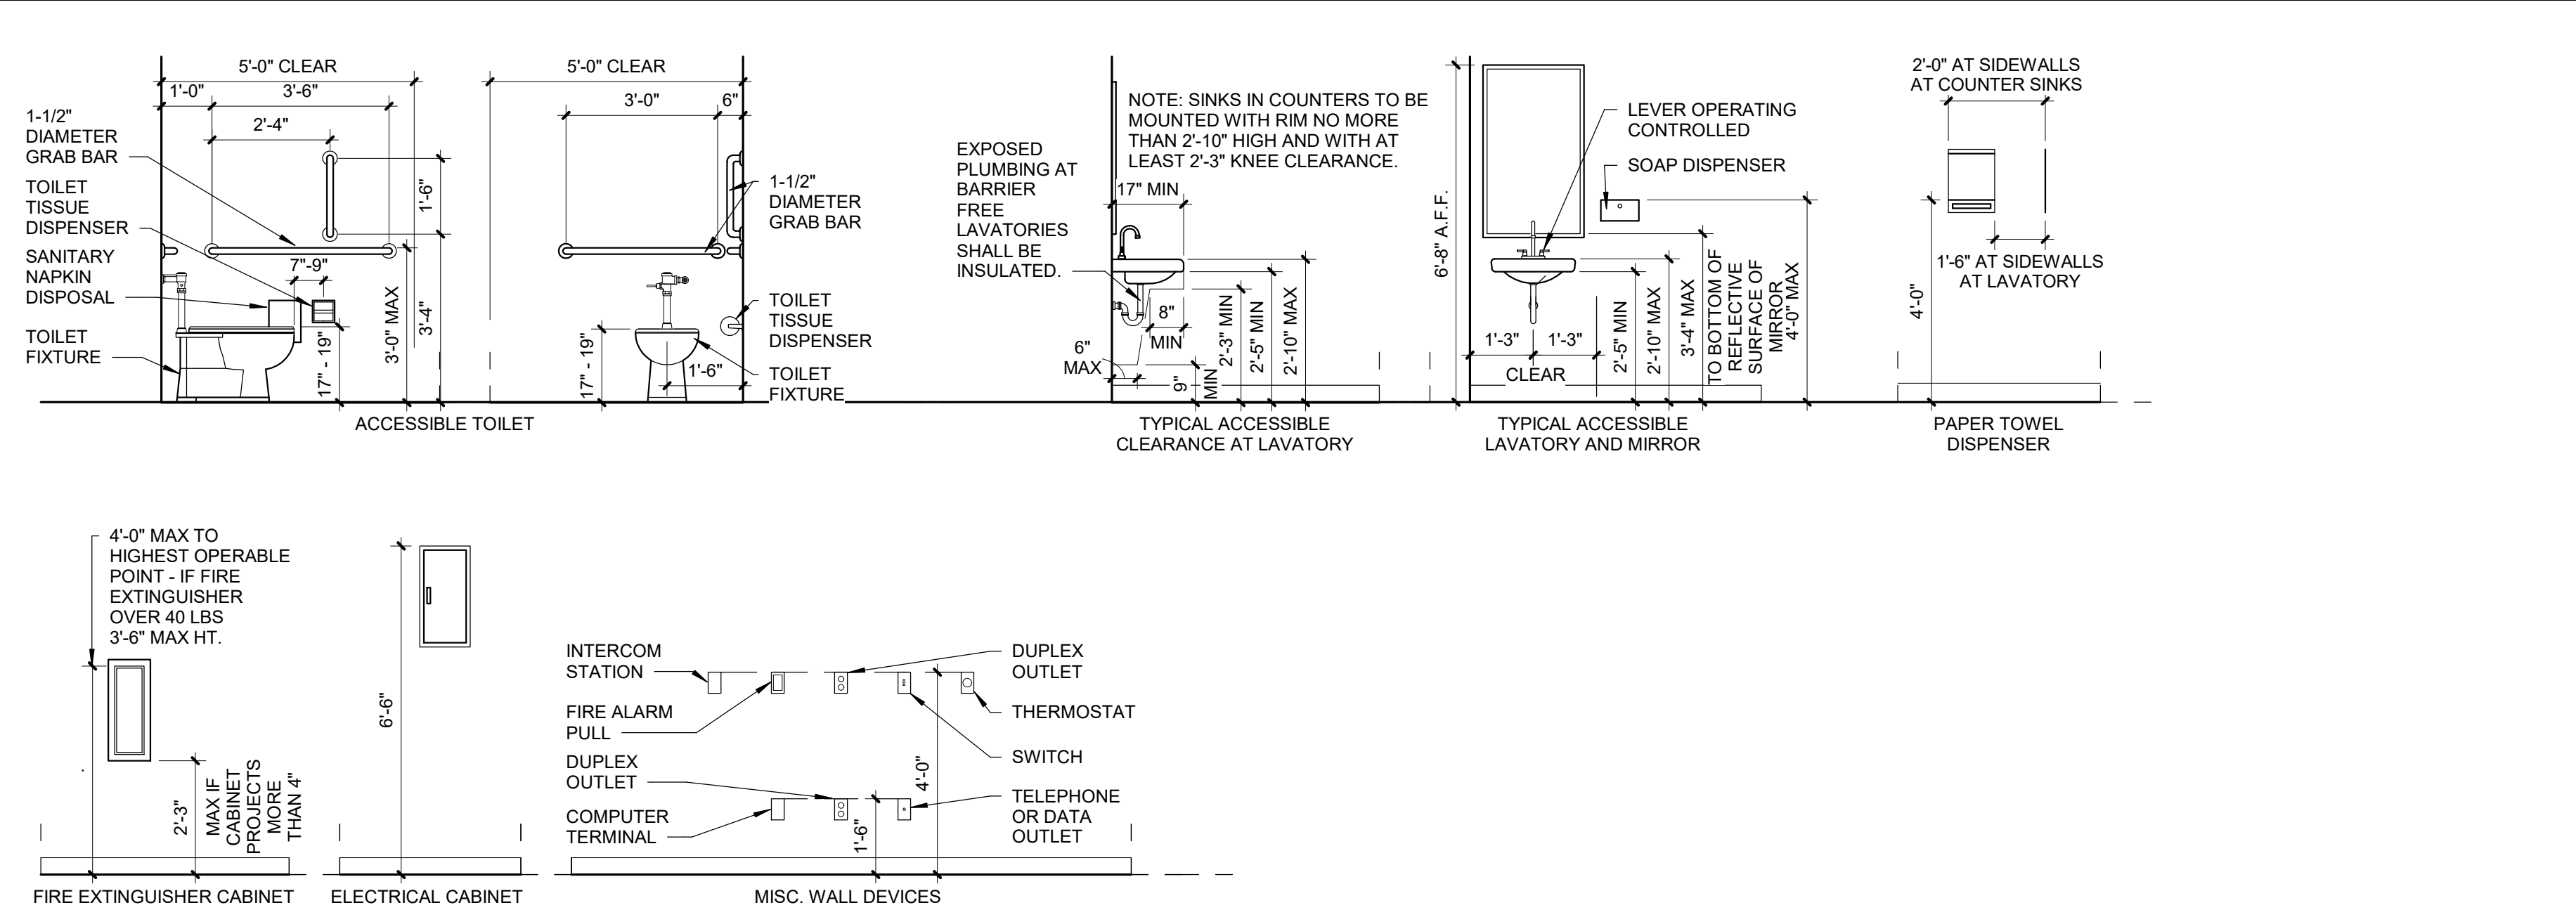

STATE OF MISSOURI
MICHAEL L. PARSON,
GOVERNOR

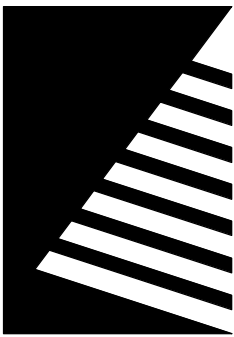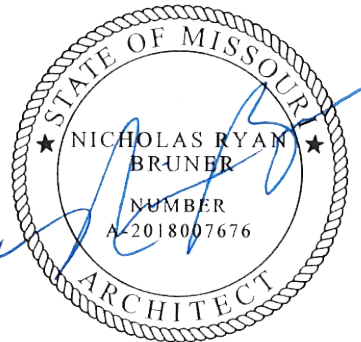

Farnsworth
GROUP

20 ALLEN AVENUE, SUITE 200
ST LOUIS, MISSOURI 63119
(314) 962-7900 / info@f-w.com

Farnsworth Group, Inc.
Missouri State Certificate of Authority #000744
www.f-w.com
Engineers | Architects | Surveyors | Scientists

100% BID SET

10/22/2024

OFFICE OF
ADMINISTRATION
DIVISION OF FACILITIES
MANAGEMENT, DESIGN
AND CONSTRUCTION

MISSOURI VETERANS
COMMISSION

**OUTDOOR PAVILION
CAPE GIRARDEAU
VETERANS HOME**

2400 Veterans Memorial Dr.
Cape Girardeau, MO 63701

PROJECT #.: U2415.01
SITE #.: 6803
ASSET #.: 8136803002
FAI #.: 29-043

DATE: DESCRIPTION:

DRAWN BY: AVR
CHECKED BY: NRB
DESIGNED BY: JUH

SHEET TITLE:
**GENERAL
INFORMATION**

SHEET NUMBER:

G-002

SHEET 2 OF 25
ISSUE DATE: 10/22/2024

SYMBOLS LEGEND

	EXISTING DECIDUOUS TREE
	EXISTING EVERGREEN TREE
	EXISTING EVERGREEN BUSH
	EXISTING BOLLARD
	EXISTING BORE HOLE
	EXISTING ELECTRIC LIGHT
	EXISTING AREA LIGHT
	EXISTING SPOT ELEVATION
	EXISTING FLAGPOLE
	EXISTING MAIL BOX
	EXISTING LANDSCAPE ROCK
	EXISTING SIGN
	EXISTING PARKING METER
	EXISTING TRAFFIC SIGNAL
	EXISTING PAY PHONE
	EXISTING COMMUNICATIONS MANHOLE
	EXISTING TV PEDESTAL
	EXISTING FIBER OPTIC CABLE MARKER
	EXISTING WATER METER
	EXISTING WATER VALVE
	EXISTING WATER MANHOLE
	EXISTING FIRE HYDRANT
	EXISTING GUY WIRE
	EXISTING POWER POLE
	EXISTING POWER POLE W/ TRANSFORMER
	EXISTING TRANSFORMER
	EXISTING ELECTRIC MANHOLE
	EXISTING GAS VALVE
	EXISTING GAS DRIP
	EXISTING CLEAN OUT
	EXISTING CURB INLET
	EXISTING GRATE INLET
	EXISTING SANITARY MANHOLE
	EXISTING FLARED END SECTION
	EXISTING STORM SEWER STRUCTURE DESIGNATOR
	EXISTING LIGHT
	NEW SANITARY SEWER MANHOLE
	NEW STORM SEWER MANHOLE
	NEW STORM SEWER STRUCTURE
	NEW CLEANOUT
	NEW FINISH SPOT ELEVATION
	NEW FINISH SPOT ELEVATION SET PER ARCHITECT
	PARKING COUNT DESIGNATOR
	NEW KEYED NOTE DESIGNATOR
	NEW PIPE FLOW DIRECTION INDICATOR
	NEW SWALE LINE
	NEW RIP RAP
	NEW FLARED END SECTION
	NEW STORM SEWER STRUCTURE DESIGNATOR
	NEW SANITARY MANHOLE DESIGNATOR
	NEW WATER METER
	NEW FIRE HYDRANT
	NEW GAS METER
	NEW TELEPHONE DISTRIBUTION BOX
	NEW ELECTRICAL MANHOLE
	NEW TRANSFORMER
	NEW PARKING LIGHT
	NEW FIRE DEPARTMENT CONNECTION
	NEW WATER VALVE

	NEW CONCRETE PAVEMENT AND BASE
--	--------------------------------

	EXISTING ASPHALT PAVEMENT TO BE REMOVED
--	---

	EXISTING CONCRETE WALK TO BE REMOVED
--	--------------------------------------

LINE LEGEND

EX 5' CONTOUR		505
EX 1' CONTOUR		504
EX STORM SEWER		ST
EX COMBINED SEWER		CS
EX SANITARY SEWER		SA
EX GAS LINE		G
EX UG TELEPHONE LINE		T
EX OVERHEAD ELECTRIC		OE
EXISTING UNDERGROUND ELECTRIC		E
EX WATER LINE WITH SIZE		W
EXISTING TREE MASS		
FINISH 5' CONTOUR		505
FINISH 1' CONTOUR		504
SAWCUT LINE		
NEW STORM SEWER		ST
NEW SANITARY SEWER		SA
NEW GAS MAIN		G
NEW TELEPHONE SERVICE		T
NEW OVERHEAD ELECTRIC		OE
NEW UNDERGROUND ELECTRICAL SERVICE		E
NEW WATER MAIN		W
EROSION CONTROL BARRIER		
DRAINAGE AREA LINE		

ABBREVIATIONS

EX	EXISTING	ELEV	ELEVATION
TYP	TYPICAL	MB	MAILBOX
TBR	TO BE REMOVED	FP	FLAG POLE
TREL	TO REMAIN	FO	FIBER OPTIC
TBR&REL	TO BE RELOCATED	DS	DOWNSPOUT
ME	MATCH EXISTING	CO	CLEANOUT
BM	BENCHMARK	MH	MANHOLE
COR	CORNER	SAN	SANITARY
PB	PLAT BOOK	ST	STORM
DB	DEED BOOK	FL	FLOW LINE
PG	PAGE	PVC	POLYVINYL CHLORIDE PIPE
(S)	SURVEYED	CMP	CORRUGATED METAL PIPE
(R)	RECORD	RCP	REINFORCED CONCRETE PIPE
N	NORTH		
S	SOUTH	UTIL	UTILITY
W	WEST	STM	STEAM
E	EAST	UG	UNDERGROUND
S.F.	SQUARE FEET	TBA	TO BE ABANDONED
BLDG	BUILDING		
CONC	CONCRETE		

GENERAL NOTES

- ALL EXISTING IMPROVEMENTS SHALL REMAIN UNLESS NOTED OTHERWISE
- THE CONTRACTOR SHALL KEEP ALL ACCESS ROADS FREE FROM MUD AND DEBRIS AT ALL TIMES.
- THE CONTRACTOR SHALL SAWCUT ALL EDGES OF EXISTING PAVEMENT THAT IS TO BE REMOVED. THE CONTRACTOR SHALL TAKE SPECIAL CARE TO CREATE A SMOOTH WORKING EDGE AND TO PLACE BACKFILL AND PAVEMENT SUCH THAT SETTLEMENT DOES NOT OCCUR.
- ALL MATERIALS AND WORKMANSHIP ASSOCIATED WITH THE STORM AND SANITARY SEWER CONSTRUCTION SHALL CONFORM TO THE LATEST STANDARDS SPECIFICATIONS FOR WATER AND SEWER CONSTRUCTION IN MISSOURI.
- ALL DISTURBED AREAS SHALL BE RESTORED WITH SEED. REFER TO TURF SPECIFICATIONS FOR SEEDING.
- THE EXISTING UTILITIES SHOWN HEREON ARE FROM INFORMATION PROVIDED BY THE OWNER AND UTILITY COMPANIES AND MUST BE CONSIDERED AS APPROXIMATE. THE CONTRACTOR SHALL BE RESPONSIBLE FOR DETERMINING THE EXACT LOCATIONS OF PUBLIC AND PRIVATE UTILITIES.
- THE CONTRACTOR SHALL ASSUME COMPLETE RESPONSIBILITY FOR CONTROLLING ALL SILTATION AND EROSION OF THE PROJECT AREA. THE CONTRACTOR SHALL USE WHATEVER MEANS NECESSARY TO CONTROL EROSION AND SILTATION INCLUDING BUT NOT LIMITED TO SILTATION FABRIC FENCES CONTROL SHALL COMMENCE WITH GRADING AND BE MAINTAINED THROUGHOUT THE PROJECT UNTIL ACCEPTANCE OF THE WORK BY THE OWNER AND/OR THE STATE OF MISSOURI. THE CONTRACTOR'S RESPONSIBILITIES INCLUDE ALL DESIGN AND IMPLEMENTATION AS REQUIRED TO PREVENT EROSION AND THE DEPOSITING OF SILT. THE OWNER AND/OR STATE MAY AT THEIR OPTION DIRECT THE CONTRACTOR IN HIS METHODS AS DEEMED FIT TO PROTECT PROPERTY AND IMPROVEMENTS. ANY DEPOSITING OF SILT OR MUD ON NEW OR EXISTING PAVEMENT OR IN NEW OR EXISTING STORM SEWERS OR SWALES SHALL BE REMOVED AFTER EACH RAIN AND AFFECTED AREAS CLEANED TO THE SATISFACTION OF THE OWNER AND/OR STATE.
- ALL EXISTING UNDERGROUND IMPROVEMENTS SHALL REMAIN UNLESS NOTED OTHERWISE.
- BACKFILL ALL UTILITY TRENCHES UNDER PAVEMENT WITH GRANULAR MATERIAL.
- THE CONTRACTOR SHALL BE RESPONSIBLE FOR VERIFYING TOPS AND FLOWLINES OF ALL EXISTING SEWERS PRIOR TO COMMENCING WORK.
- ABANDONMENT OF SEWERS SHALL CONFORM TO THE STATE OF MISSOURI DNR SPECIFICATIONS.
- EXISTING UTILITY POLES SHALL NOT BE DISTURBED. COORDINATE WITH AMEREN UE IF BRACING IS REQUIRED DURING EXCAVATION.
- THE CONTRACTOR SHALL MAINTAIN CONSTRUCTION FENCE AROUND ALL OPEN EXCAVATION AT ALL TIMES.
- THE CONTRACTOR SHALL BE RESPONSIBLE FOR ALL REQUIRED CONSTRUCTION STAKING AND LAYOUT.
- IT SHALL BE THE RESPONSIBILITY OF THE CONTRACTOR TO VERIFY THE LOCATIONS OF ALL EXISTING UTILITIES PRIOR TO THE START OF CONSTRUCTION WORK. ANY DAMAGE TO EXISTING STRUCTURES, UTILITIES, FENCES, AND/OR INCIDENTALS NOT DESIGNATED FOR REMOVAL SHALL BE REPAIRED AT THE CONTRACTOR'S EXPENSE

Utility Contacts


ELECTRIC AMEREN MISSOURI CAPE GIRARDEAU, MO 63703 800-552-7583	SANITARY & STORM SEWERS CAPE GIRARDEAU 2007 SOUTHERN EXPRESSWAY CAPE GIRARDEAU, MO 63703 973-339-6351	TELEPHONE AT&T-MISSOURI 800-499-7928
GAS AMEREN MISSOURI 24 MINNESOTA AVE. CAPE GIRARDEAU, MO 63703 800-552-7583	WATER CAPE GIRARDEAU 2007 SOUTHERN EXPRESSWAY CAPE GIRARDEAU, MO 63703 973-339-6351	 MISSOURI ONE CALL SYSTEM, INC.

Benchmark

BENCHMARK USED: SITE BENCHMARK: IRON ROD WITH A PLASTIC CAP, ROUGHLY 37 FEET EAST, AND 46 FEET SOUTH OF THE INTERSECTION OF VETERANS MEMORIAL DRIVE AND VETERANS DRIVE. LOCATED IN THE SOUTHEAST REGION OF A PARKING LOT ISLAND. ELEVATION= 577.92 ON THE NORTH AMERICAN VERTICAL DATUM OF 1988 (NAVD88). DERIVED BY REAL-TIME KINETIC (RTK) GPS OBSERVATIONS USING MISSOURI GEOGRAPHIC REFERENCE STATIONS: (GRS COORDINATES SHOWN IN METERS: 1 METER = 3.2808333 FEET) COR5_ID MOJK: NORTHING: 175,551.770, EASTING: 325,239.670.

CONTORL POINT TABLE					
Point Number	Easting	Northing	Point Elevation	Full Description	
200	1082708.60	551784.77	576.70	CP ~ 22	Rebar
201	1082211.50	551834.35	577.92	CP ~ 22	Rebar
202	1082179.31	551461.52	577.74	CP ~ 22	Rebar
203	1082463.47	551307.12	578.74	CP ~ 22	Rebar
204	1082794.16	551478.36	578.61	CP ~ 22	Rebar
210	1082207.44	551606.27	580.80	CP ~ 34	60D Nail
211	1082214.64	551673.93	580.36	CP ~ 34	60D Nail
212	1082451.70	551806.43	580.63	CP ~ 34	60D Nail
213	1082315.98	551656.98	581.00	CP ~ 34	60D Nail
214	1082204.79	551529.09	580.03	CP ~ 34	60D Nail
215	1082285.98	551432.28	579.73	CP ~ 34	60D Nail
216	1082317.91	551498.47	581.25	CP ~ 34	60D Nail
217	1082464.04	551407.89	580.92	CP ~ 34	60D Nail
218	1082590.56	551430.64	580.83	CP ~ 34	60D Nail
219	1082648.88	551475.56	580.87	CP ~ 34	60D Nail
220	1082702.34	551429.49	580.07	CP ~ 34	60D Nail
221	1082544.53	551470.14	581.48	CP ~ 34	60D Nail
222	1082712.59	551556.35	581.21	CP ~ 34	60D Nail
223	1082758.01	551599.27	580.28	CP ~ 34	60D Nail
224	1082721.41	551721.62	577.56	CP ~ 34	60D Nail
225	1082621.55	551605.74	580.78	CP ~ 34	60D Nail
226	1082498.97	551699.19	580.83	CP ~ 34	60D Nail
227	1082477.93	551671.28	581.34	CP ~ 34	60D Nail
228	1082421.29	551665.11	581.63	CP ~ 9	Ink Mark
229	1082397.35	551690.16	581.03	CP ~ 34	60D Nail
230	1082450.98	551444.64	581.37	CP ~ 34	60D Nail
300	1082708.58	551784.77	576.64	CP ~ 22	Rebar
302	1082179.32	551461.55	577.74	CP ~ 22	Rebar
303	1082463.48	551307.14	578.77	CP ~ 22	Rebar
304	1082794.13	551478.37	578.58	CP ~ 22	Rebar

STATE OF MISSOURI
MICHAEL L. PARSON,
GOVERNOR

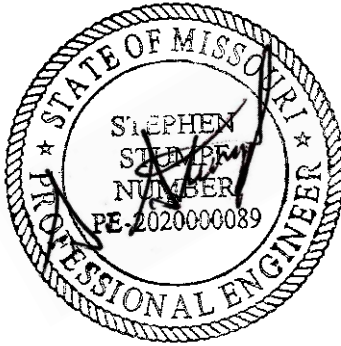

DATE: 10/22/2024



Farnsworth
GROUP

20 ALLEN AVENUE, SUITE 200
ST LOUIS, MISSOURI 63119
(314) 962-7900 / info@f-w.com
Farnsworth Group, Inc.
Missouri State Certificate of Authority #000744
www.f-w.com
Engineers | Architects | Surveyors | Scientists

100% BID SET

10/22/2024

OFFICE OF
ADMINISTRATION
DIVISION OF FACILITIES
MANAGEMENT, DESIGN
AND CONSTRUCTION

MISSOURI VETERANS
COMMISSION

OUTDOOR PAVILION
CAPE GIRARDEAU
VETERANS HOME

2400 Veterans Memorial Dr.
Cape Girardeau, MO 63701

PROJECT #.: U2415.01

SITE #.: 6803

ASSET #.: 8136803002

FAI#: 29-043

DATE: DESCRIPTION:

DRAWN BY: NJT

CHECKED BY: JSE

DESIGNED BY: NJT


SHEET TITLE:

CIVIL GENERAL NOTES


SHEET NUMBER:

C-001

SHEET 3 OF 25
ISSUE DATE: 10/22/2024

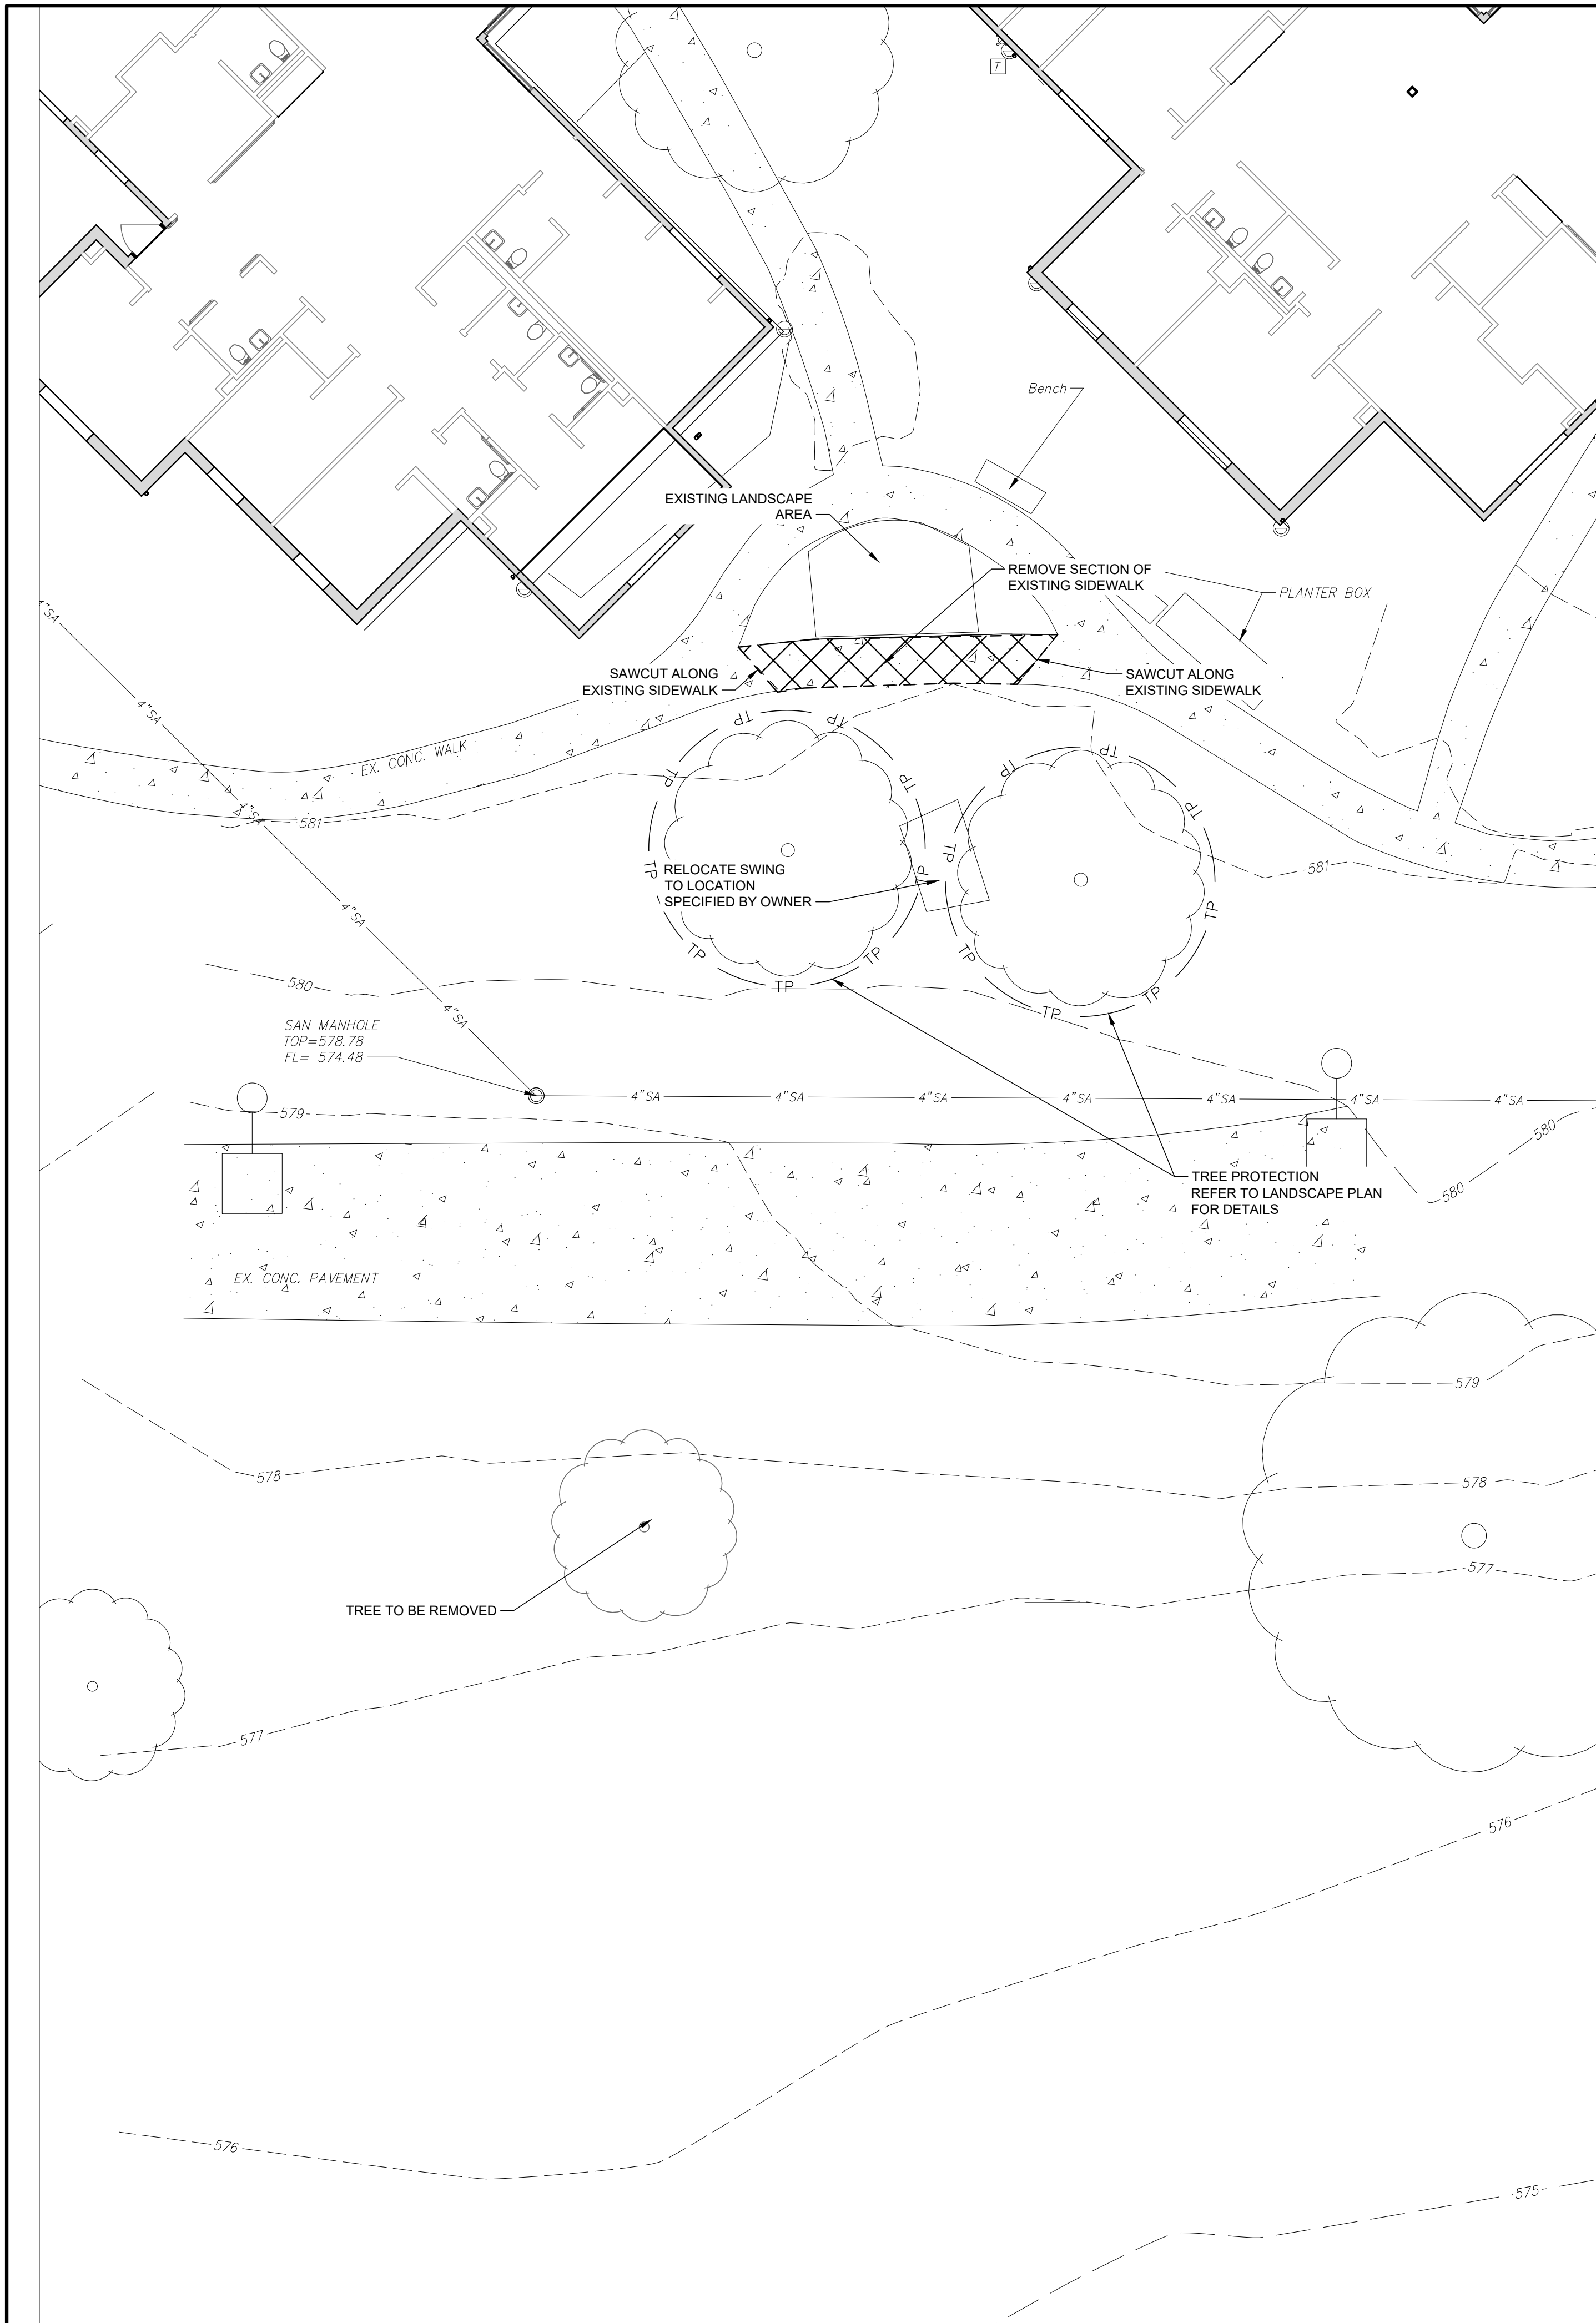


1 EXISTING CONDITIONS AND DEMO PLAN
Scale: 1"=10'

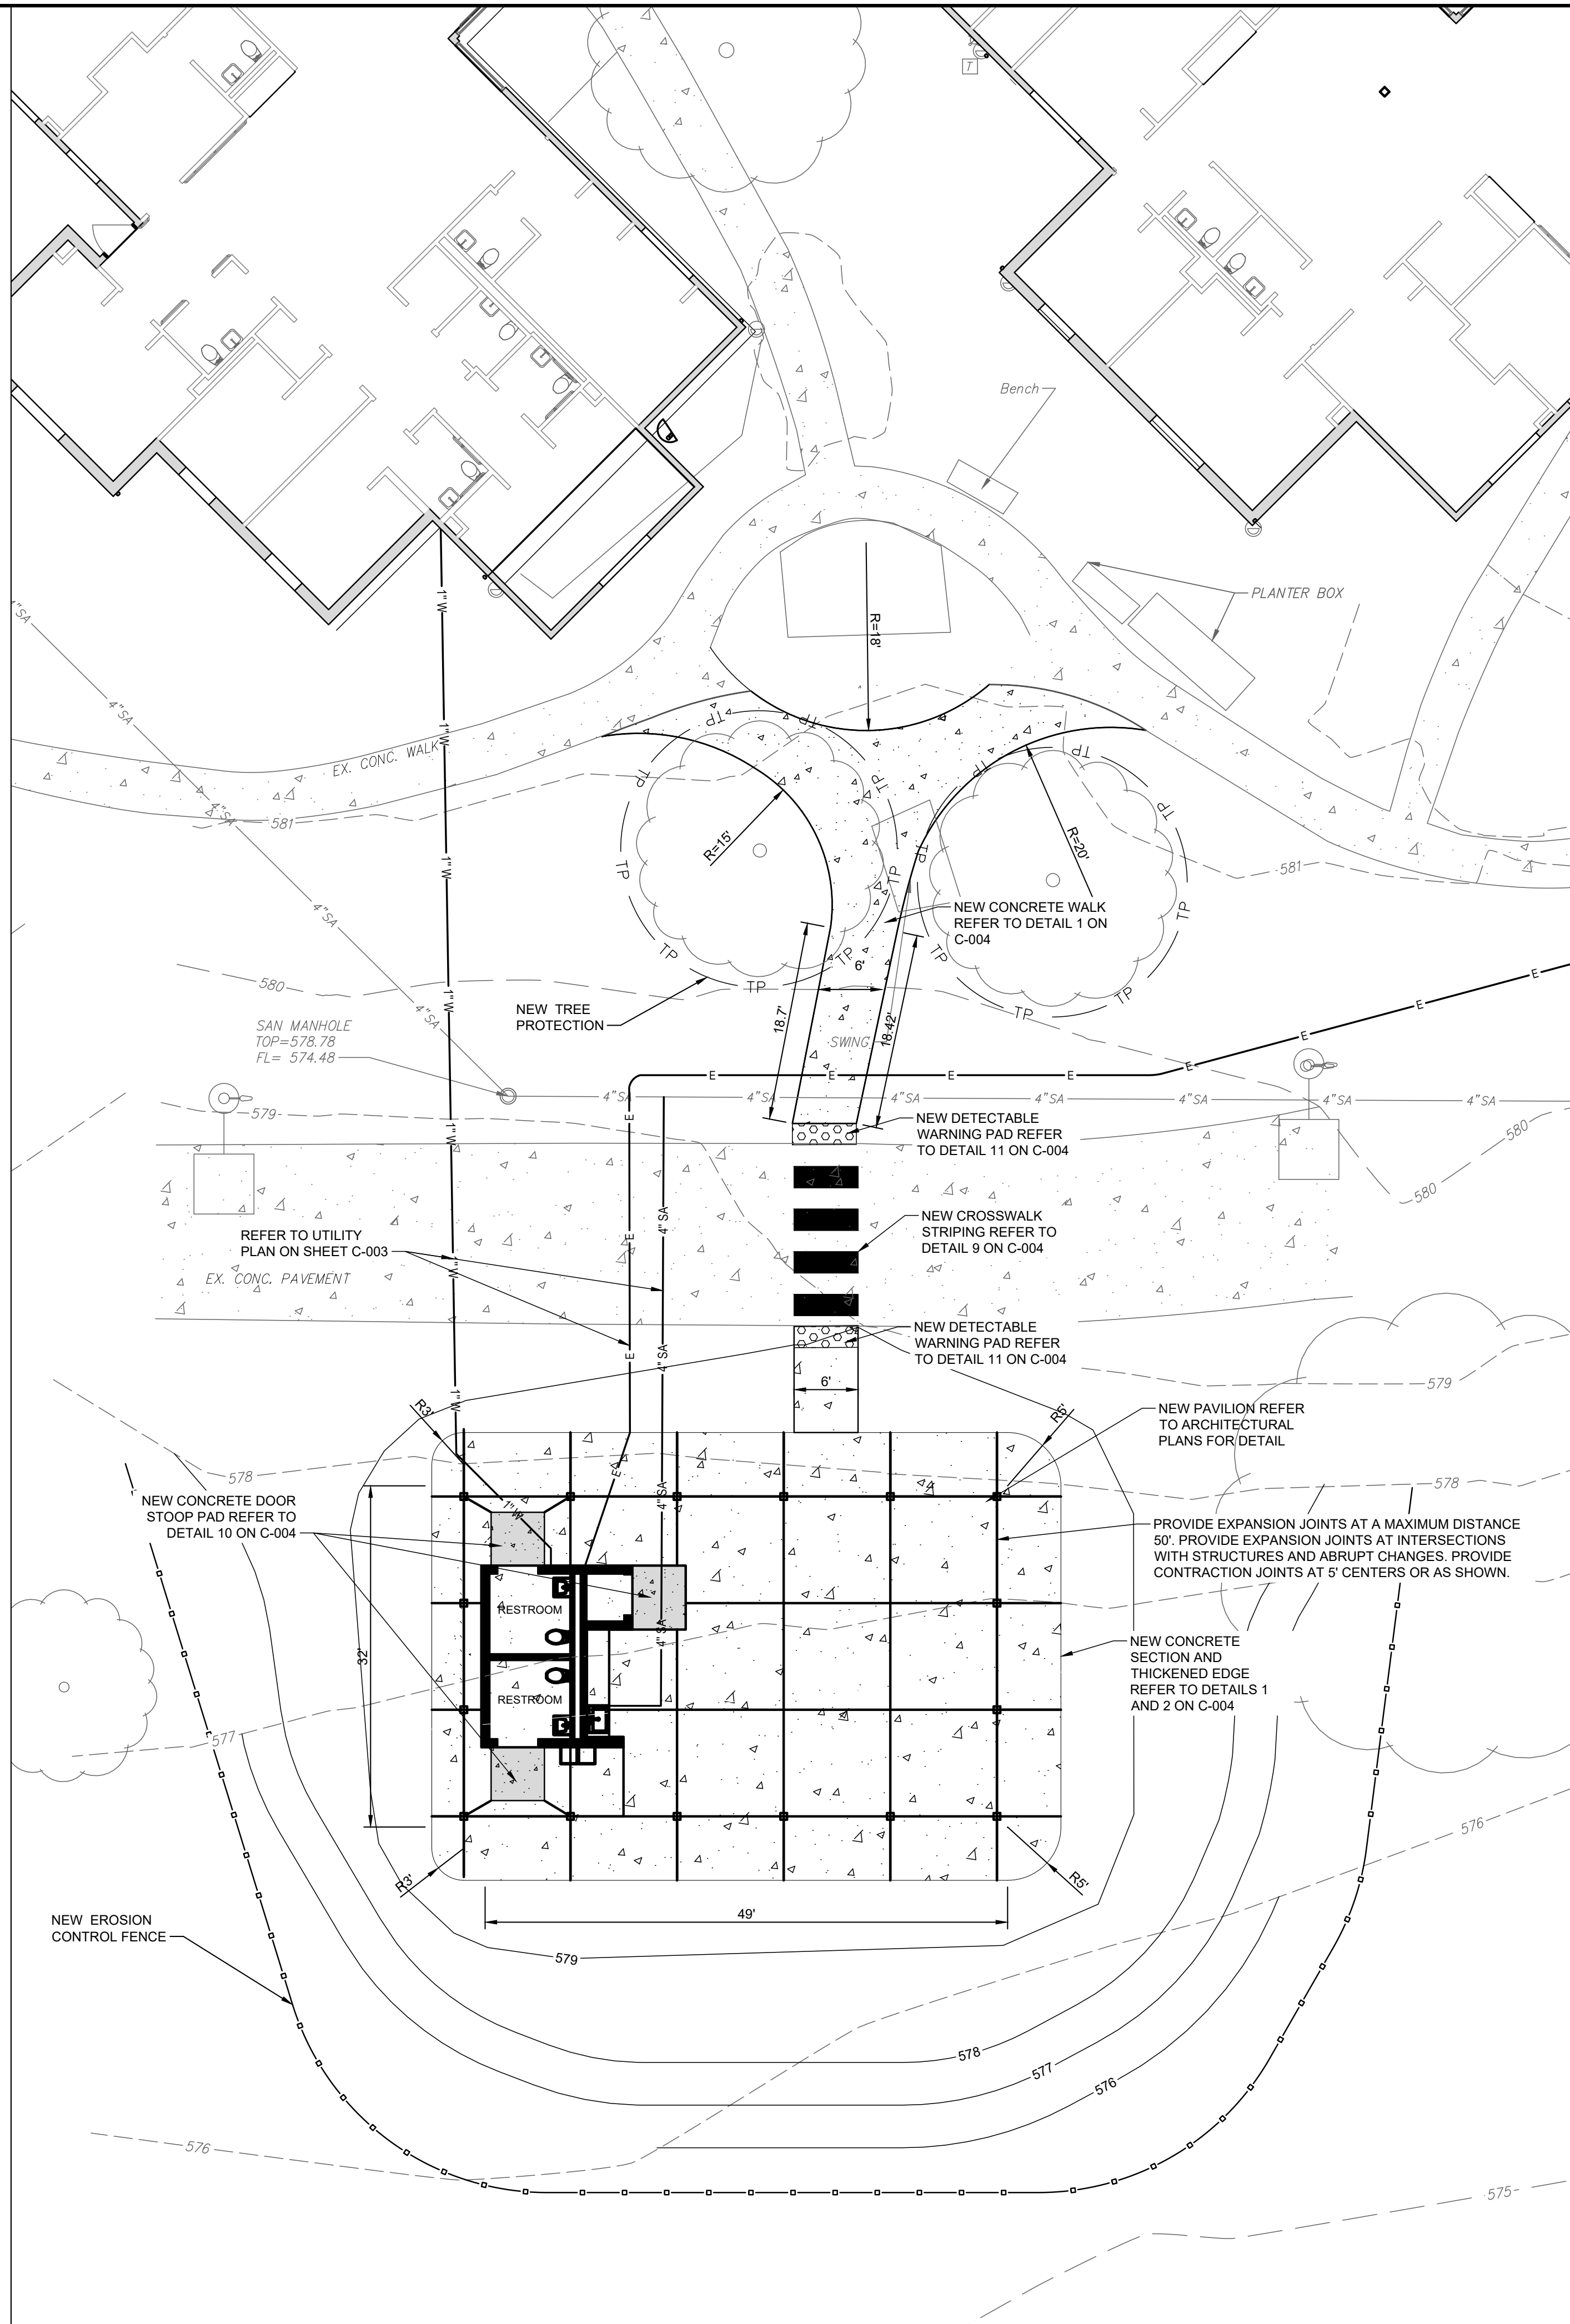


2 LAYOUT AND HARDSCAPE PLAN
Scale: 1"=10'

STATE OF MISSOURI
MICHAEL L. PARSON,
GOVERNOR

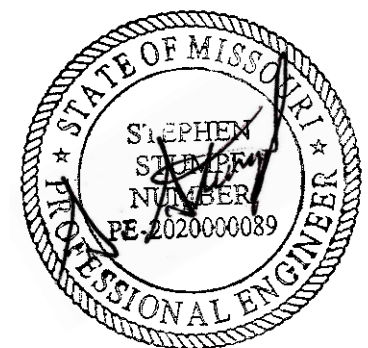

DATE: 10/22/2024

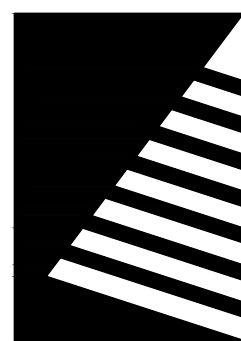

Farnsworth
GROUP

20 ALLEN AVENUE, SUITE 200
ST LOUIS, MISSOURI 63119
(314) 962-7900 / info@f-w.com
Farnsworth Group, Inc.
Missouri State Certificate of Authority #000744
www.f-w.com
Engineers | Architects | Surveyors | Scientists

100% BID SET
10/22/2024

OFFICE OF
ADMINISTRATION
DIVISION OF FACILITIES
MANAGEMENT, DESIGN
AND CONSTRUCTION

MISSOURI VETERANS
COMMISSION

**OUTDOOR PAVILION
CAPE GIRARDEAU
VETERANS HOME**

2400 Veterans Memorial Dr.
Cape Girardeau, MO 63701

PROJECT #:	U2415.01
SITE #:	6803
ASSET #:	8136803002
FAI #:	29-043
# DATE:	DESCRIPTION:


DRAWN BY: NJT
CHECKED BY: JSE
DESIGNED BY: NJT

SHEET TITLE:
**DEMOLITION PLAN AND
LAYOUT PLAN**


SHEET NUMBER:

C-002

SHEET 4 OF 25
ISSUE DATE: 10/22/2024

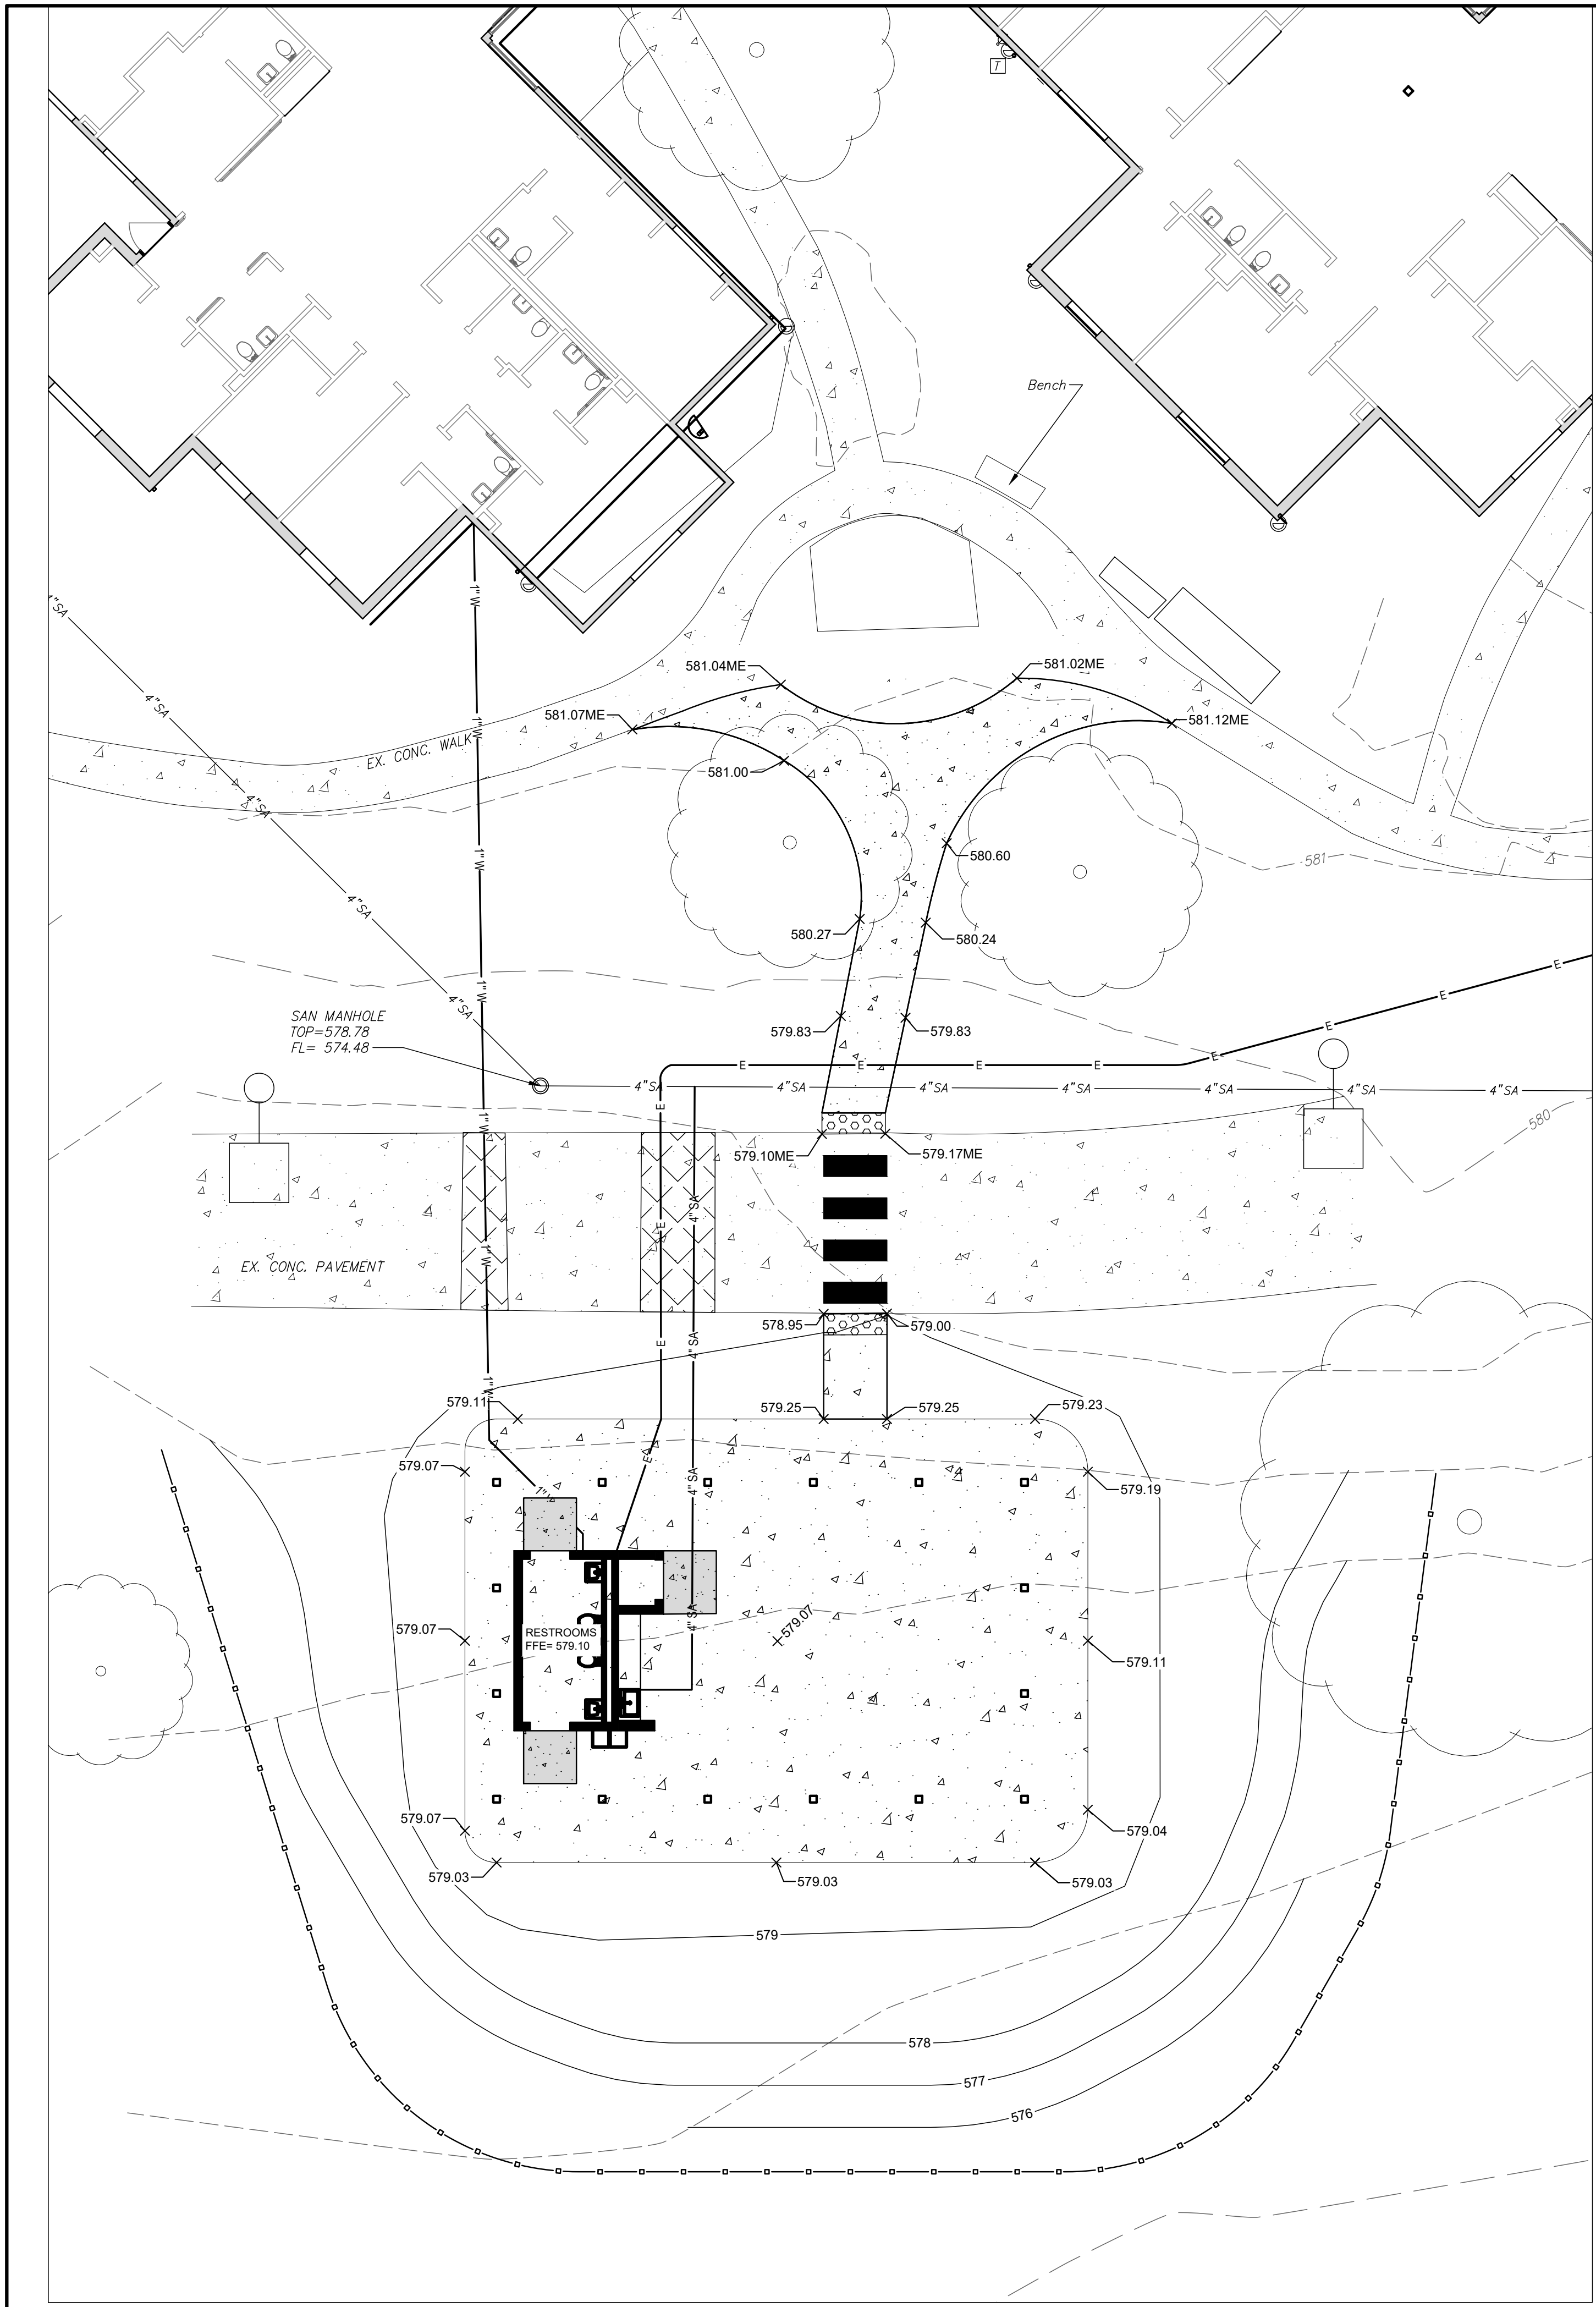

1 GRADING PLAN
Scale: 1"=10'

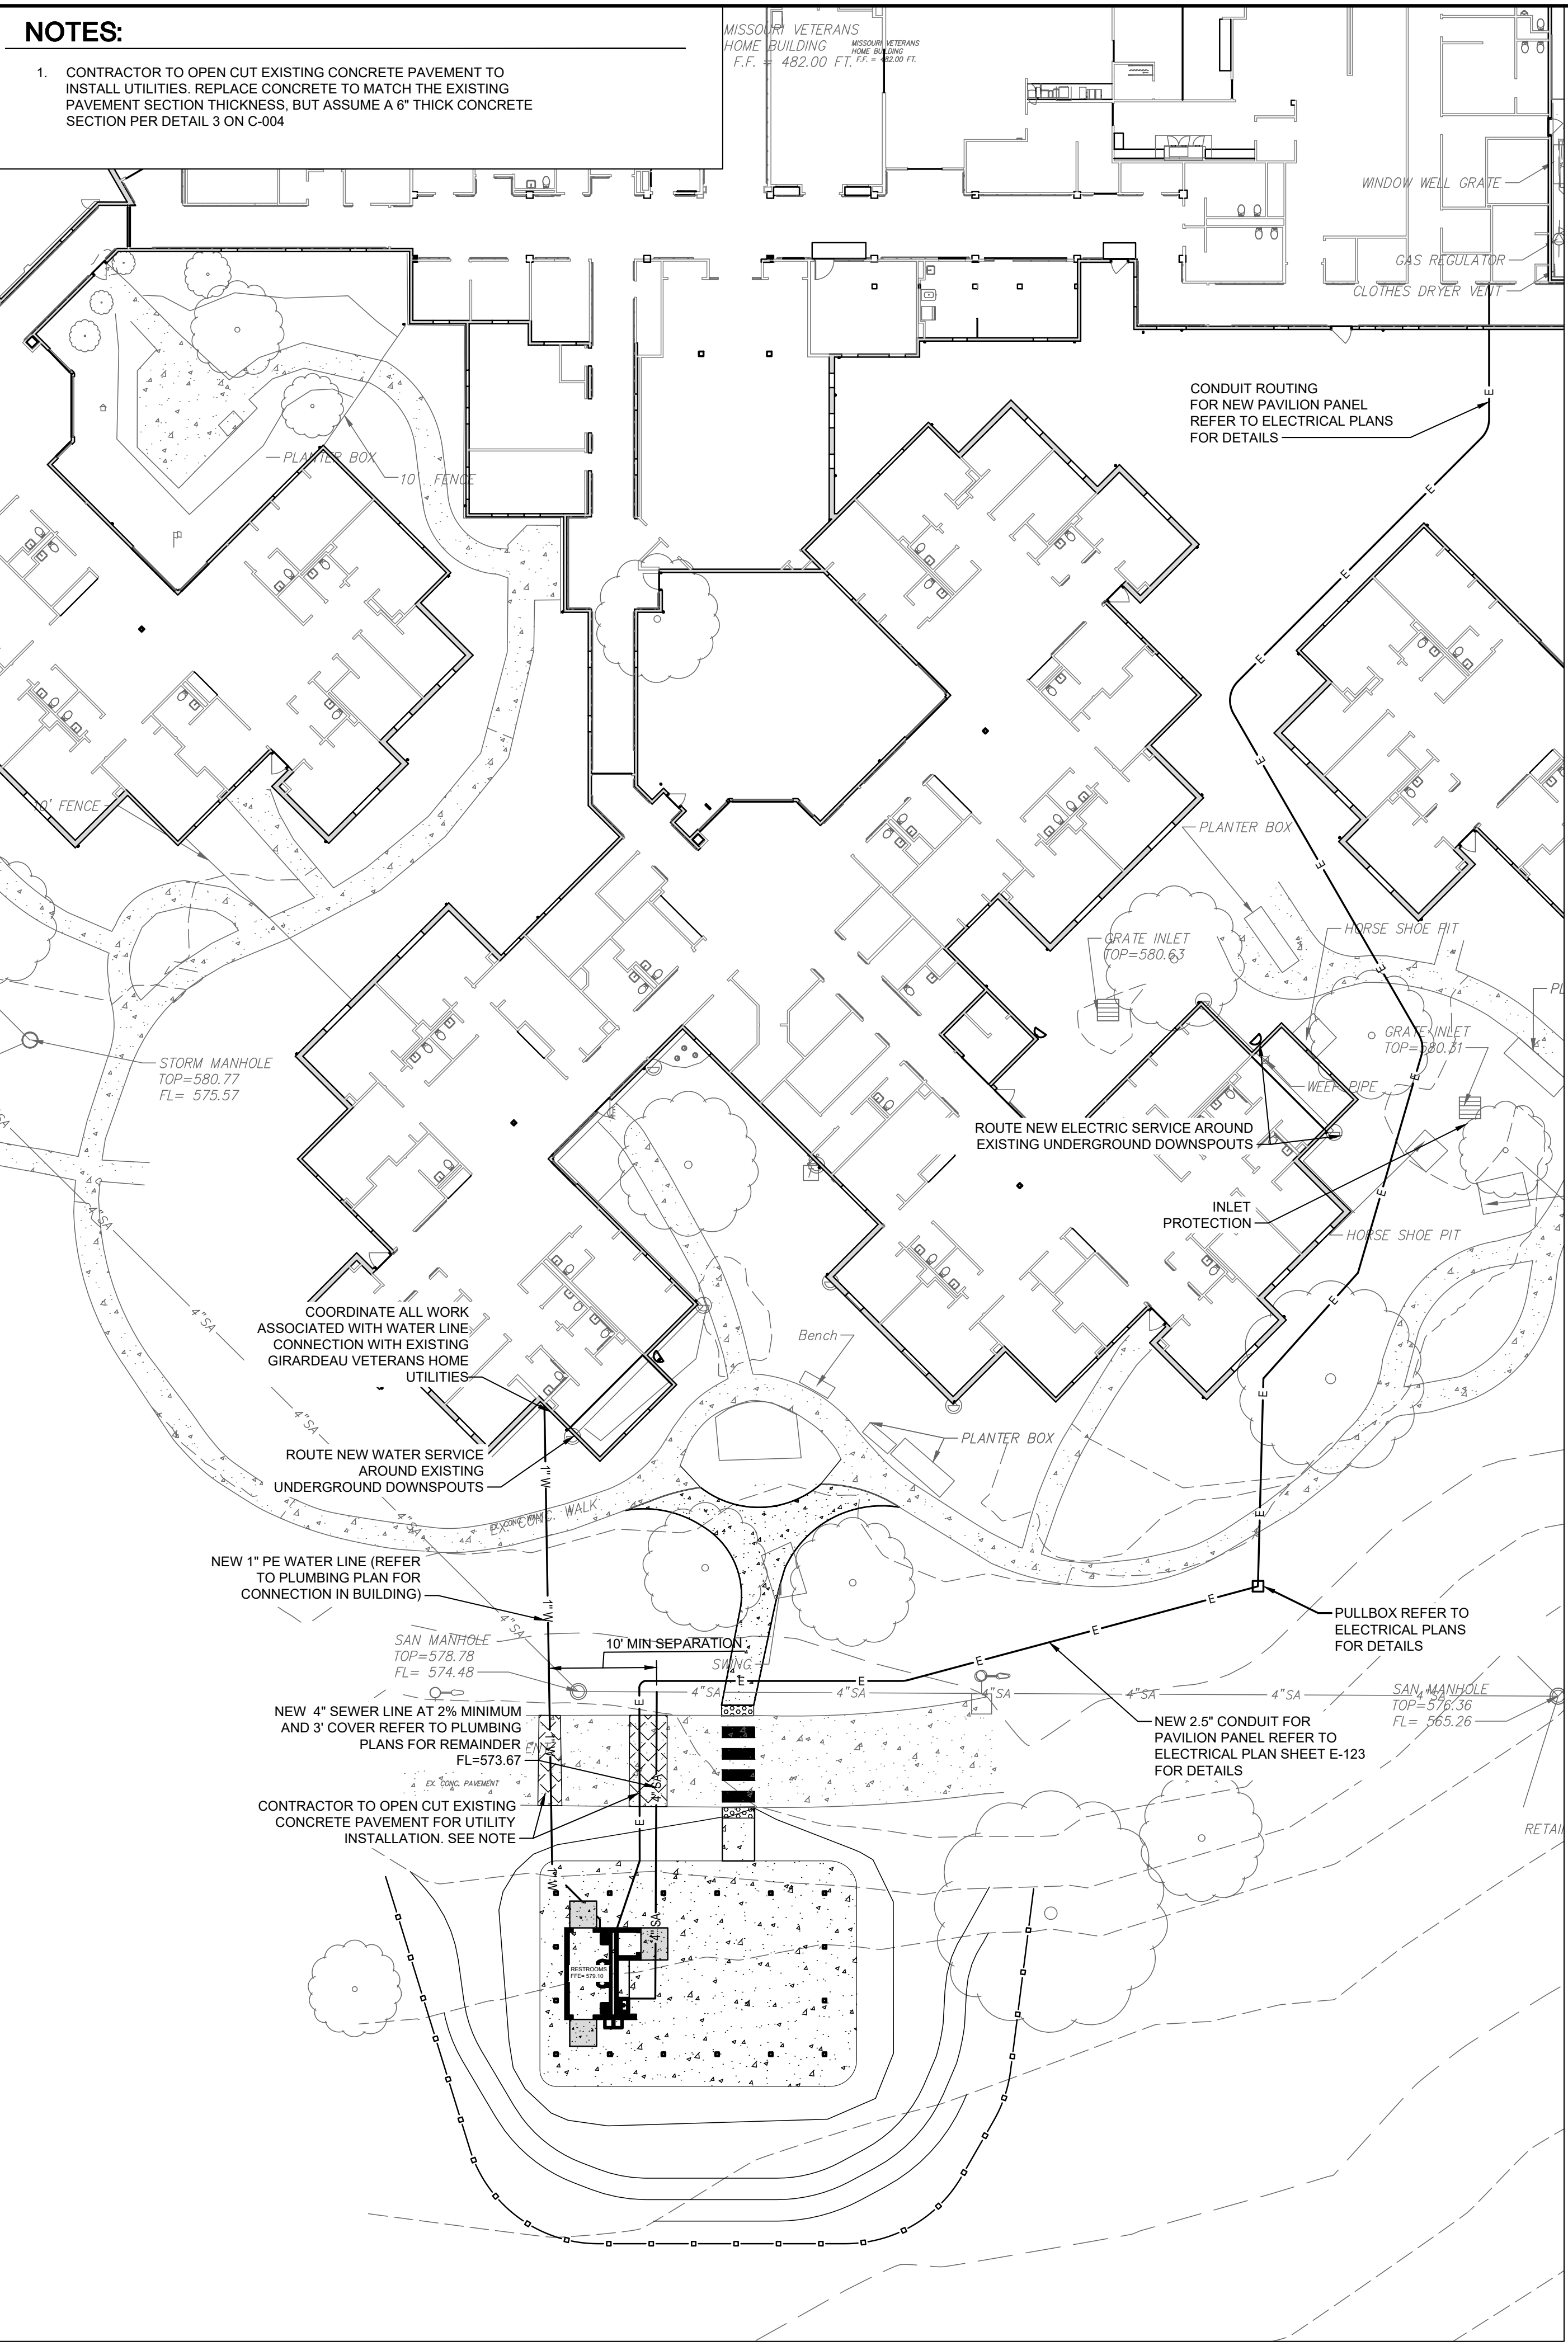

2 UTILITY PLAN
Scale: 1"=20'


NOTES:

1. CONTRACTOR TO OPEN CUT EXISTING CONCRETE PAVEMENT TO INSTALL UTILITIES. REPLACE CONCRETE TO MATCH THE EXISTING PAVEMENT SECTION THICKNESS, BUT ASSUME A 6" THICK CONCRETE SECTION PER DETAIL 3 ON C-004

STATE OF MISSOURI
MICHAEL L. PARSON,
GOVERNOR



DATE: 10/22/2024

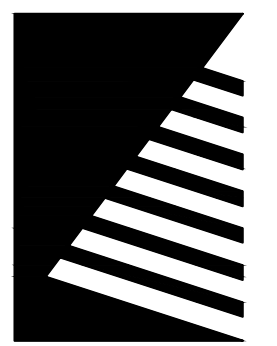

Farnsworth
GROUP

20 ALLEN AVENUE, SUITE 200
ST LOUIS, MISSOURI 63119
(314) 962-7900 / info@f-w.com
Farnsworth Group, Inc.
Missouri State Certificate of Authority #000744
www.f-w.com
Engineers | Architects | Surveyors | Scientists

100% BID SET
10/22/2024

OFFICE OF
ADMINISTRATION
DIVISION OF FACILITIES
MANAGEMENT, DESIGN
AND CONSTRUCTION

MISSOURI VETERANS
COMMISSION

**OUTDOOR PAVILION
CAPE GIRARDEAU
VETERANS HOME**

2400 Veterans Memorial Dr.
Cape Girardeau, MO 63701

PROJECT #:	U2415.01
SITE #:	6803
ASSET #:	8136803002
FAI #:	29-043
# DATE:	DESCRIPTION:

DRAWN BY: NJT
CHECKED BY: JSE
DESIGNED BY: NJT

SHEET TITLE:
**GRADING AND UTILITY
PLAN**

SHEET NUMBER:

C-003

SHEET 5 OF 25
ISSUE DATE: 10/22/2024



Farnsworth
GROUP

20 ALLEN AVENUE, SUITE 200
ST LOUIS, MISSOURI 63119
(314) 962-7900 / info@f-w.com

Farnsworth Group, Inc.
Missouri State Certificate of Authority #000744
www.f-w.com
Engineers | Architects | Surveyors | Scientists

00% BID SET

0/22/2024

OFFICE OF
ADMINISTRATION
DIVISION OF FACILITIES
MANAGEMENT, DESIGN
AND CONSTRUCTION

MISSOURI VETERANS
COMMISSION

**OUTDOOR PAVILION
CAPE GIRARDEAU
VETERANS HOME**

2400 Veterans Memorial Dr.
Cape Girardeau, MO 63701

PROJECT #.:	U2415.01
SITE #.:	6803
ASSET #.:	8136803002
FAI #.:	29-043

#	DATE:	DESCRIPTION:
---	-------	--------------


DRAWN BY: NJT
CHECKED BY: JSE
DESIGNED BY: NJT

SHEET TITLE:
DETAILS

SHEET NUMBER:


C-004

SHEET 6 OF 25
ISSUE DATE: 10/22/2024

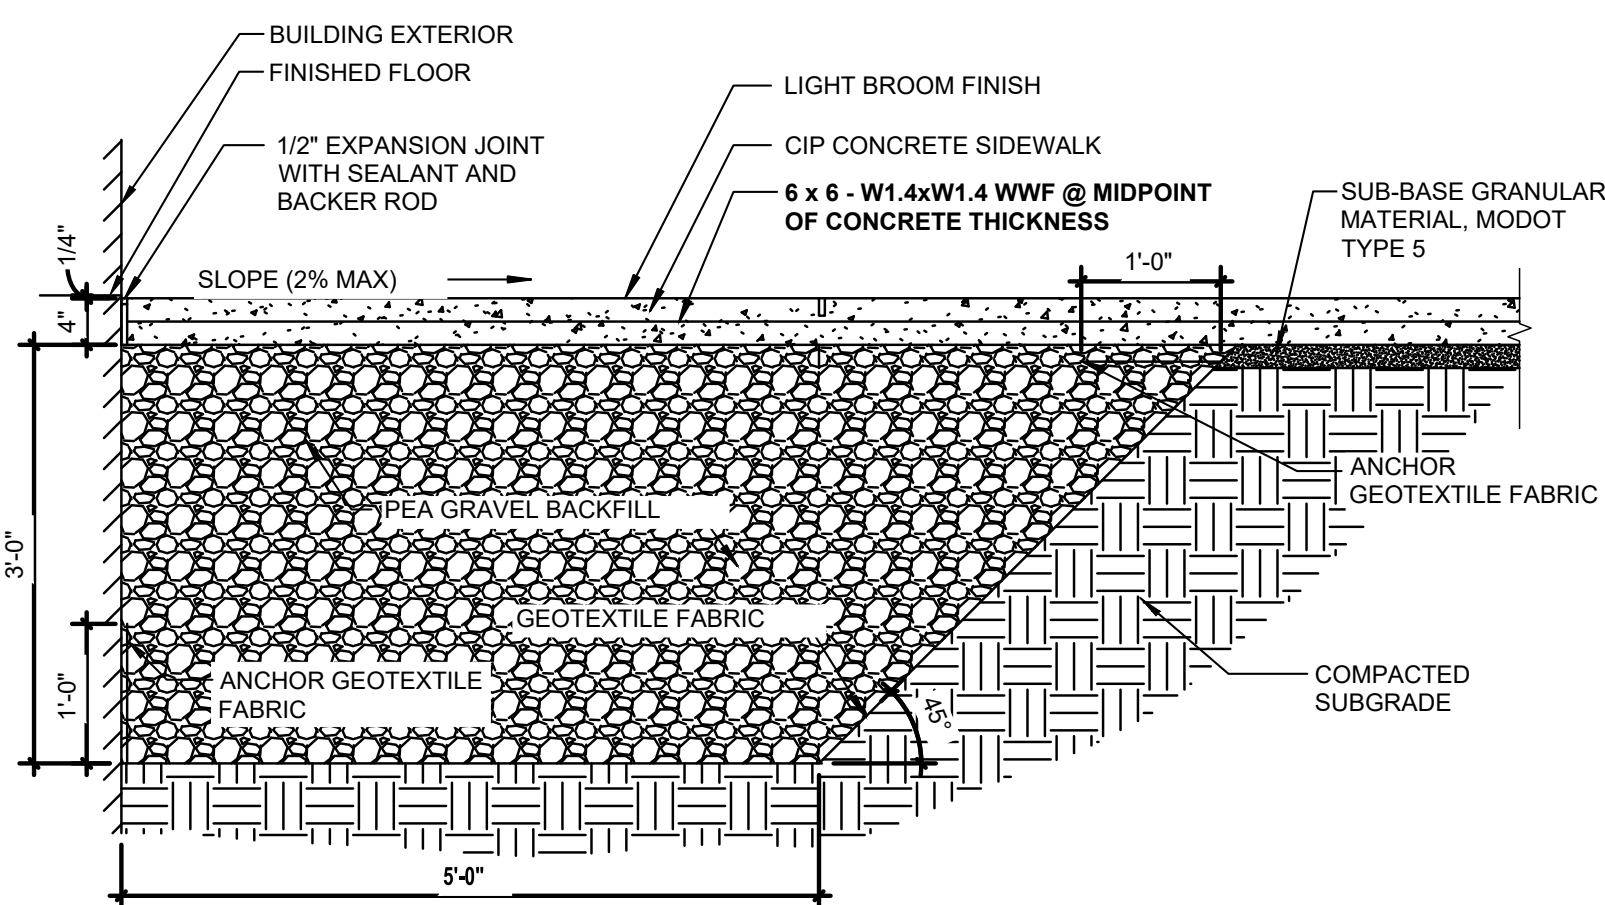


10 Concrete Door Stoop Pad Detail


Scale: Not To Scale

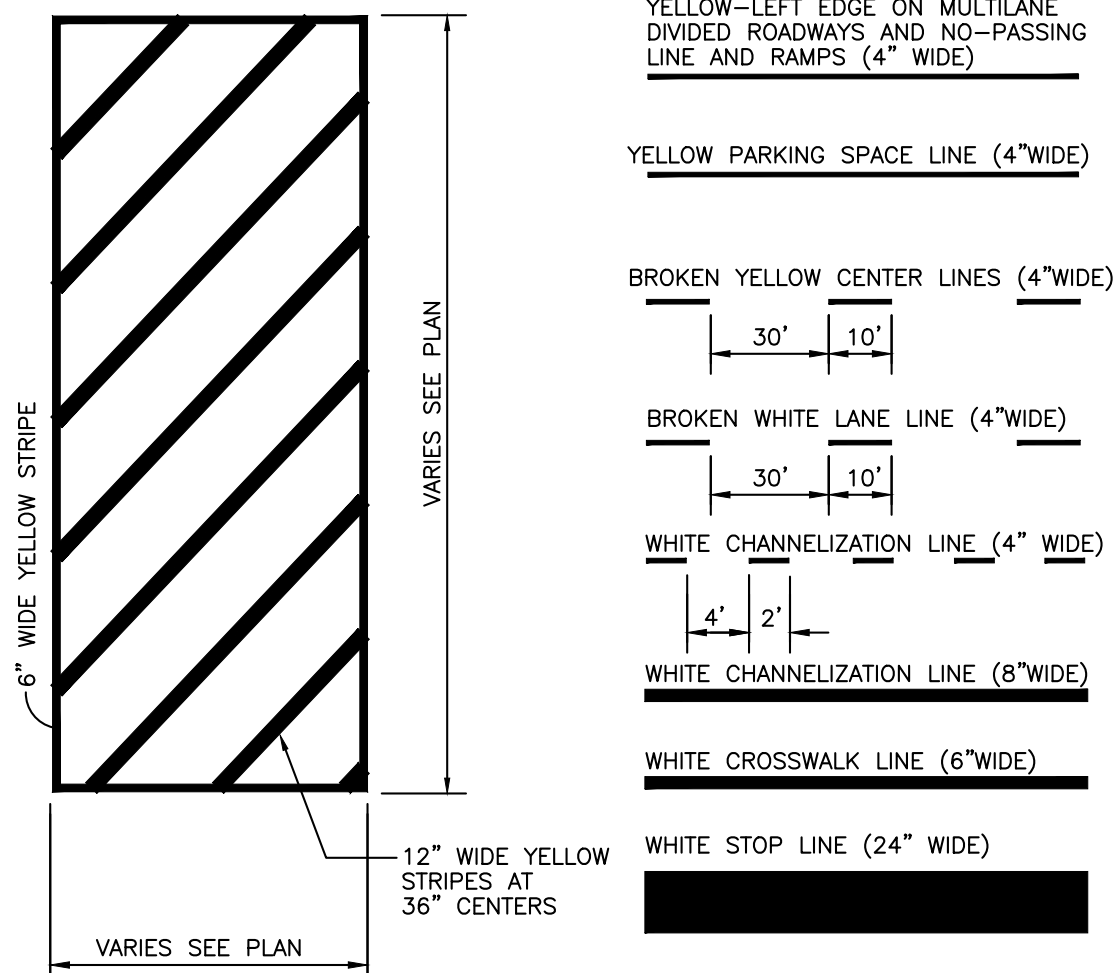


9 Painted Stripe Detail

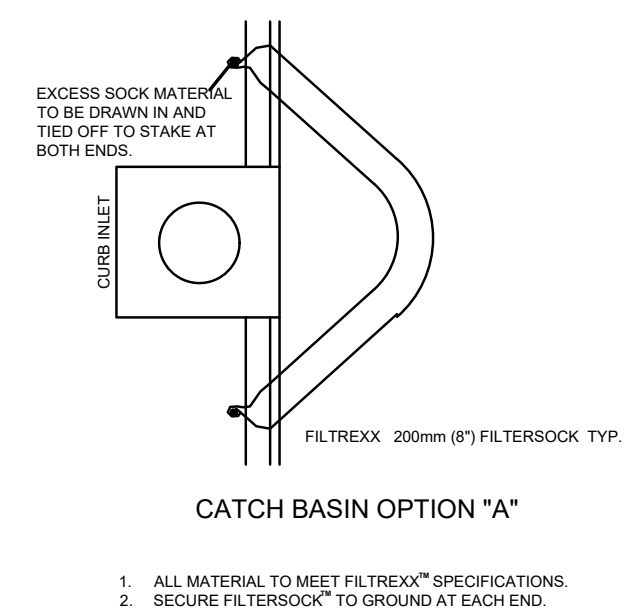


6 Curb Inlet Protection Detail
Scale: Not To Scale

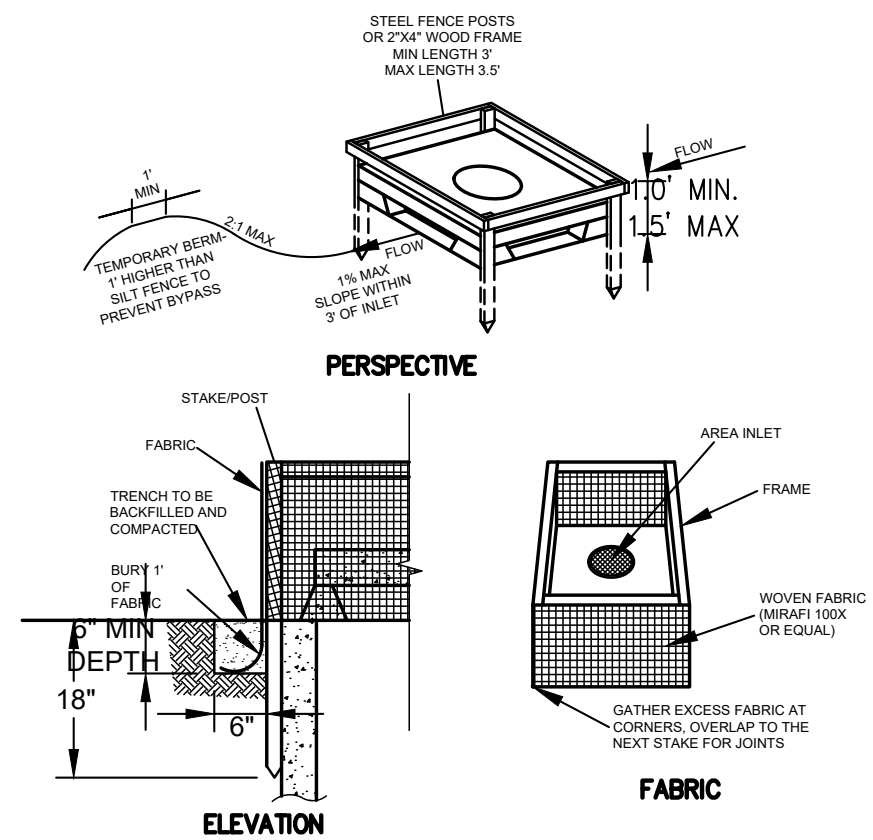


7 Inlet Protection Detail
Scale: Not To Scale

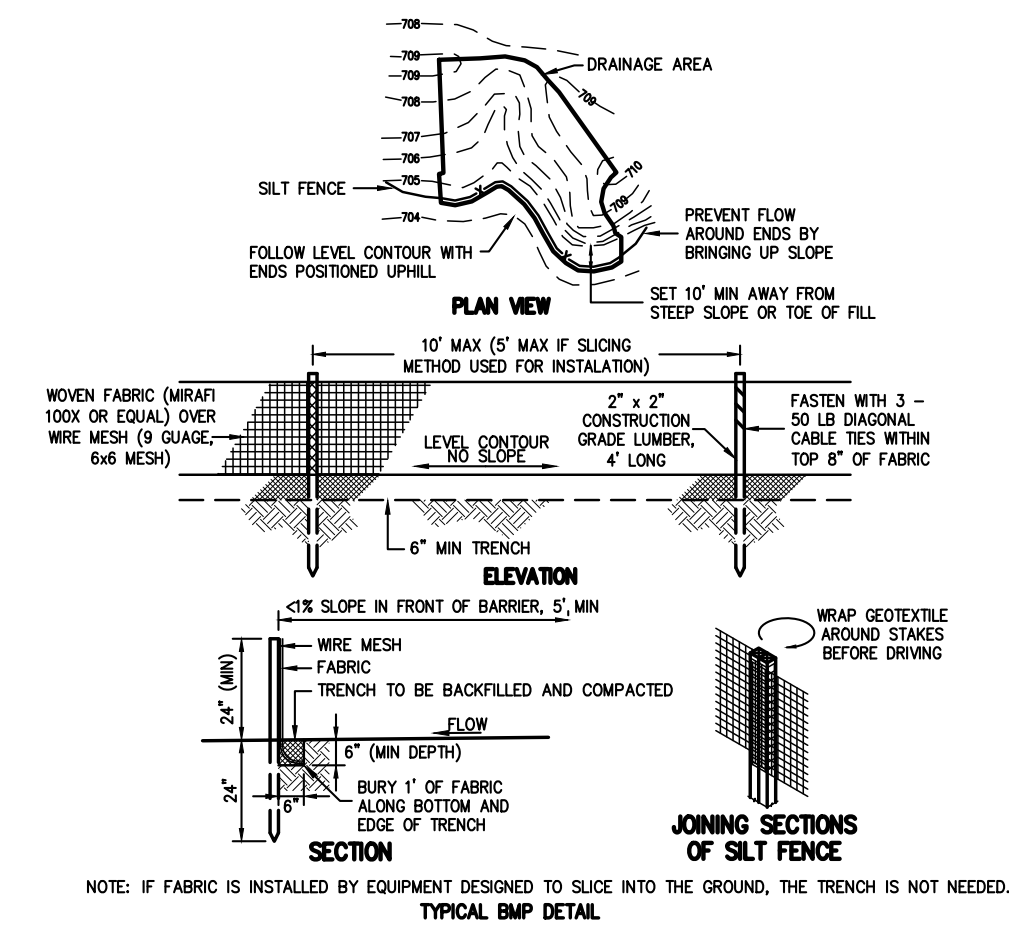


8 Silt Fence - SC-8
Scale: Not To Scale

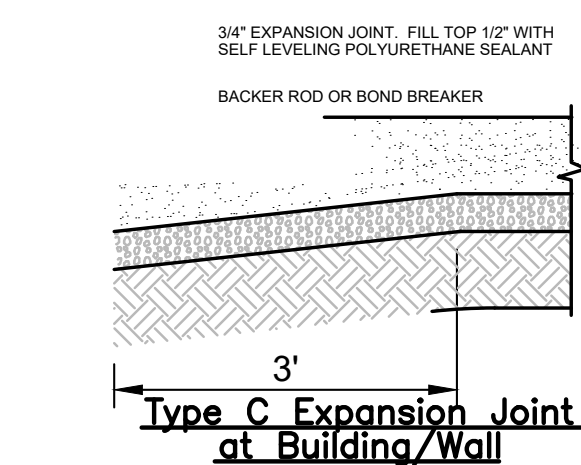


4 Typical Concrete Pavement Joint Details
Scale: Not To Scale

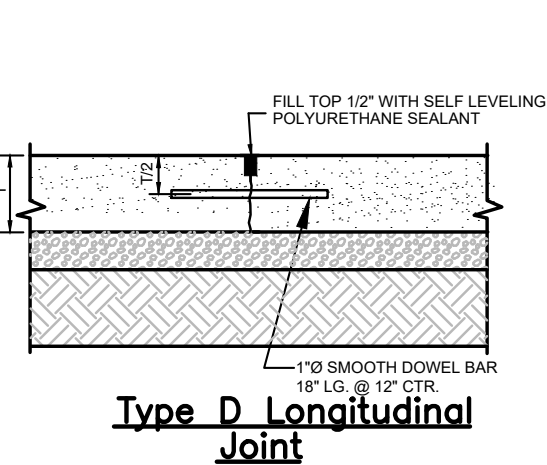


Type D Longitudinal Joint

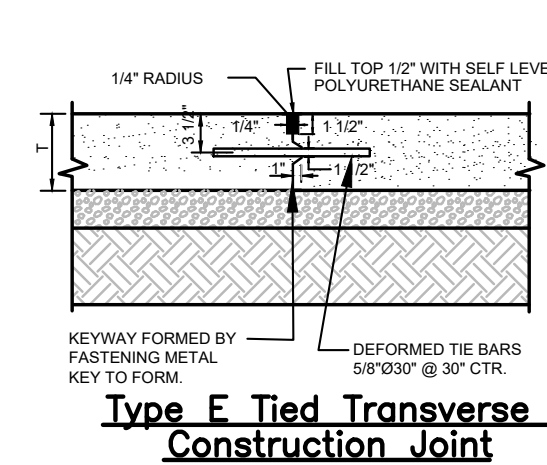


Type E Tied Transverse Construction Joint

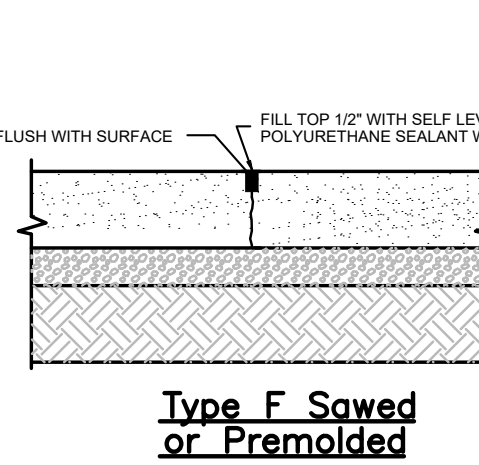


Type F Sawn
or Premolded

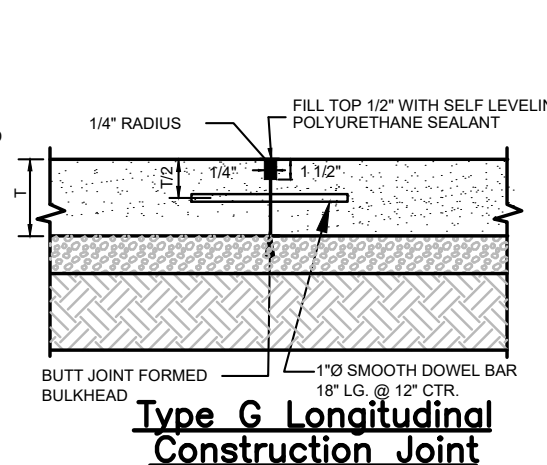


Type G Longitudinal Construction Joint

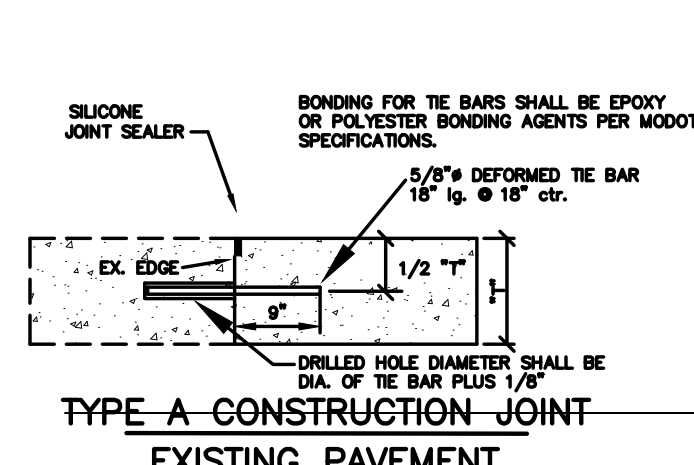


TYPE A CONSTRUCTION JOINT
EXISTING PAVEMENT

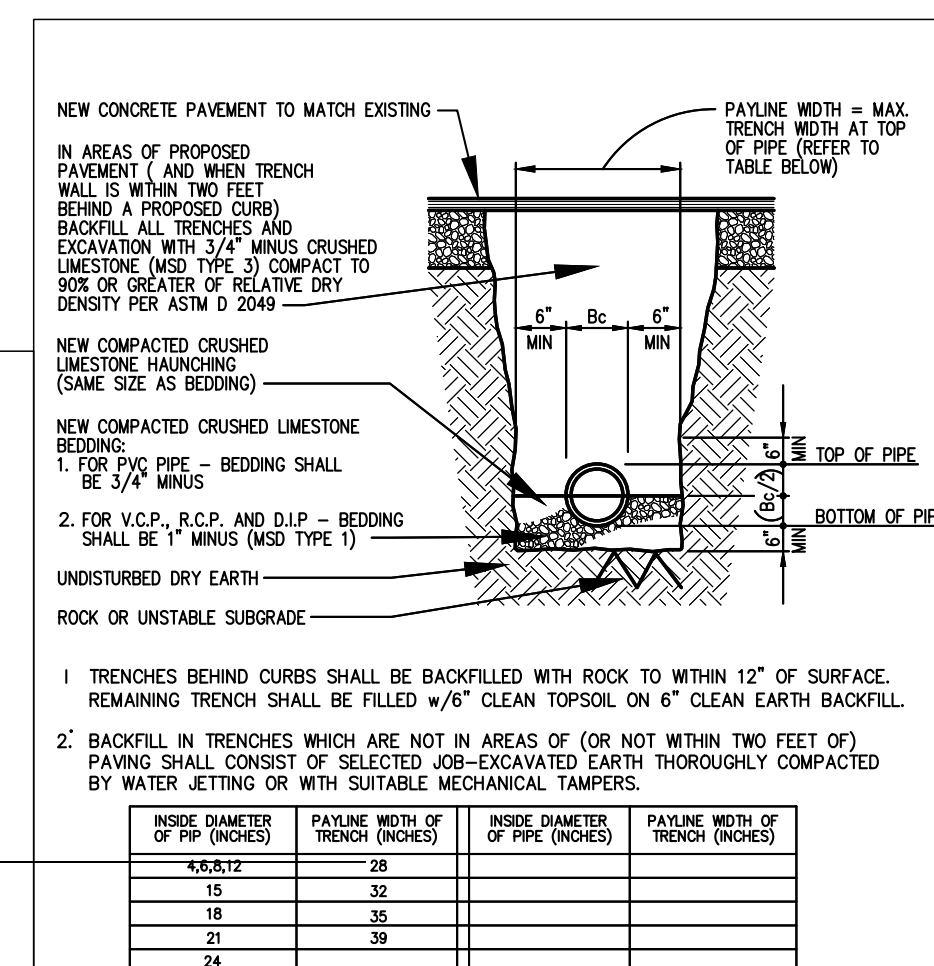


5 TRENCH DETAIL
Scale: Not To Scale

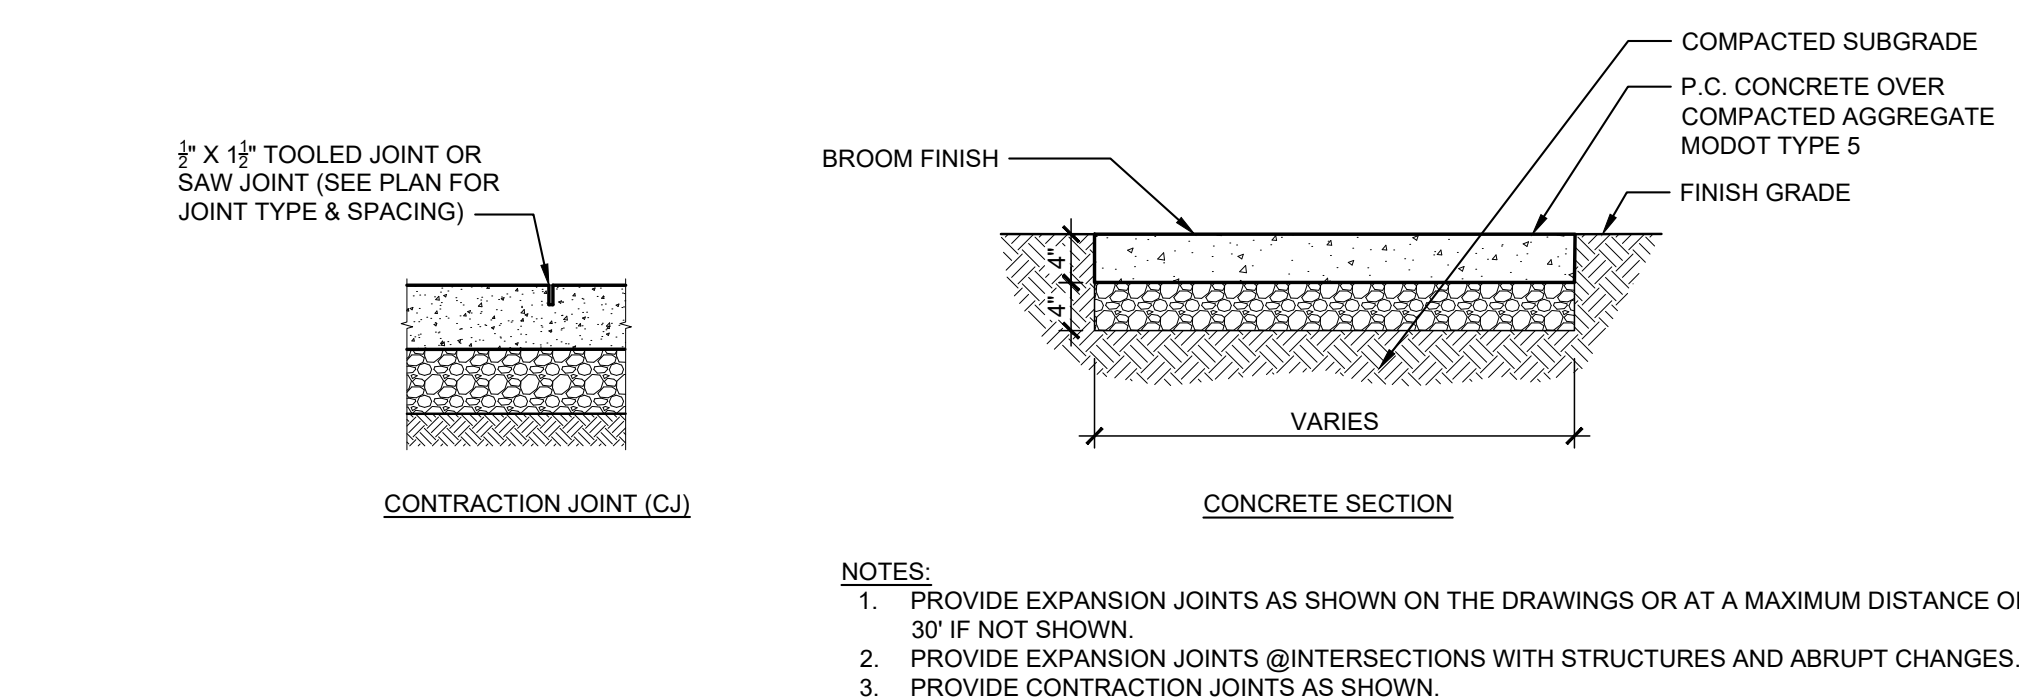

1 4" PC CONCRETE PAVEMENT
Scale: NOT TO SCALE

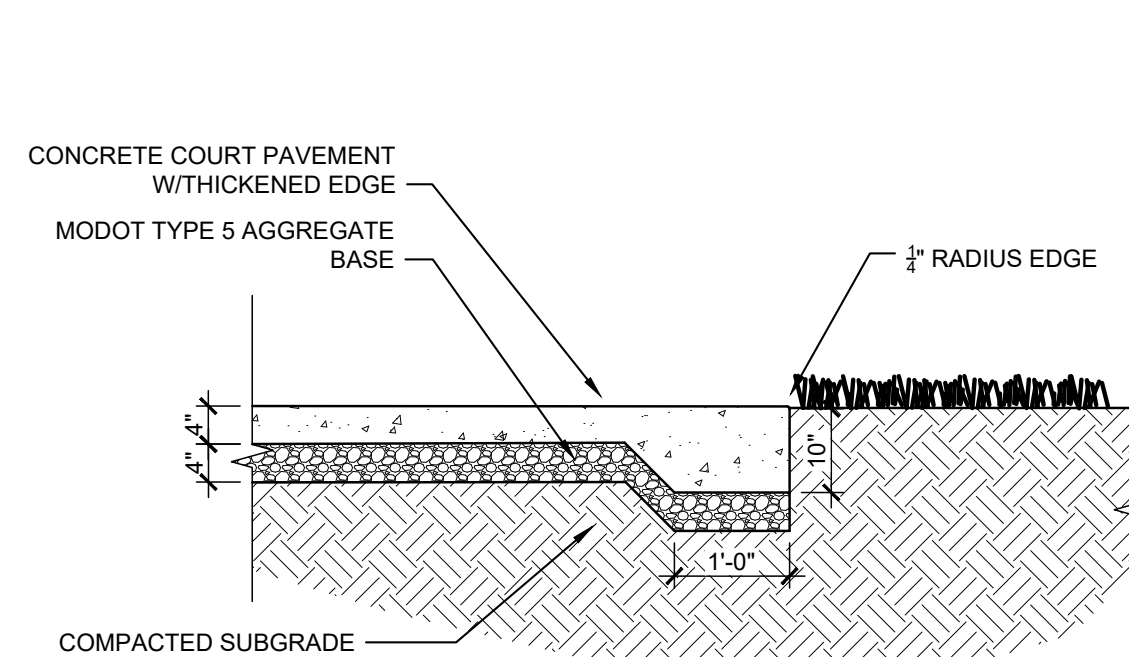

2 CONCRETE PAVEMENT THICKENED EDGE

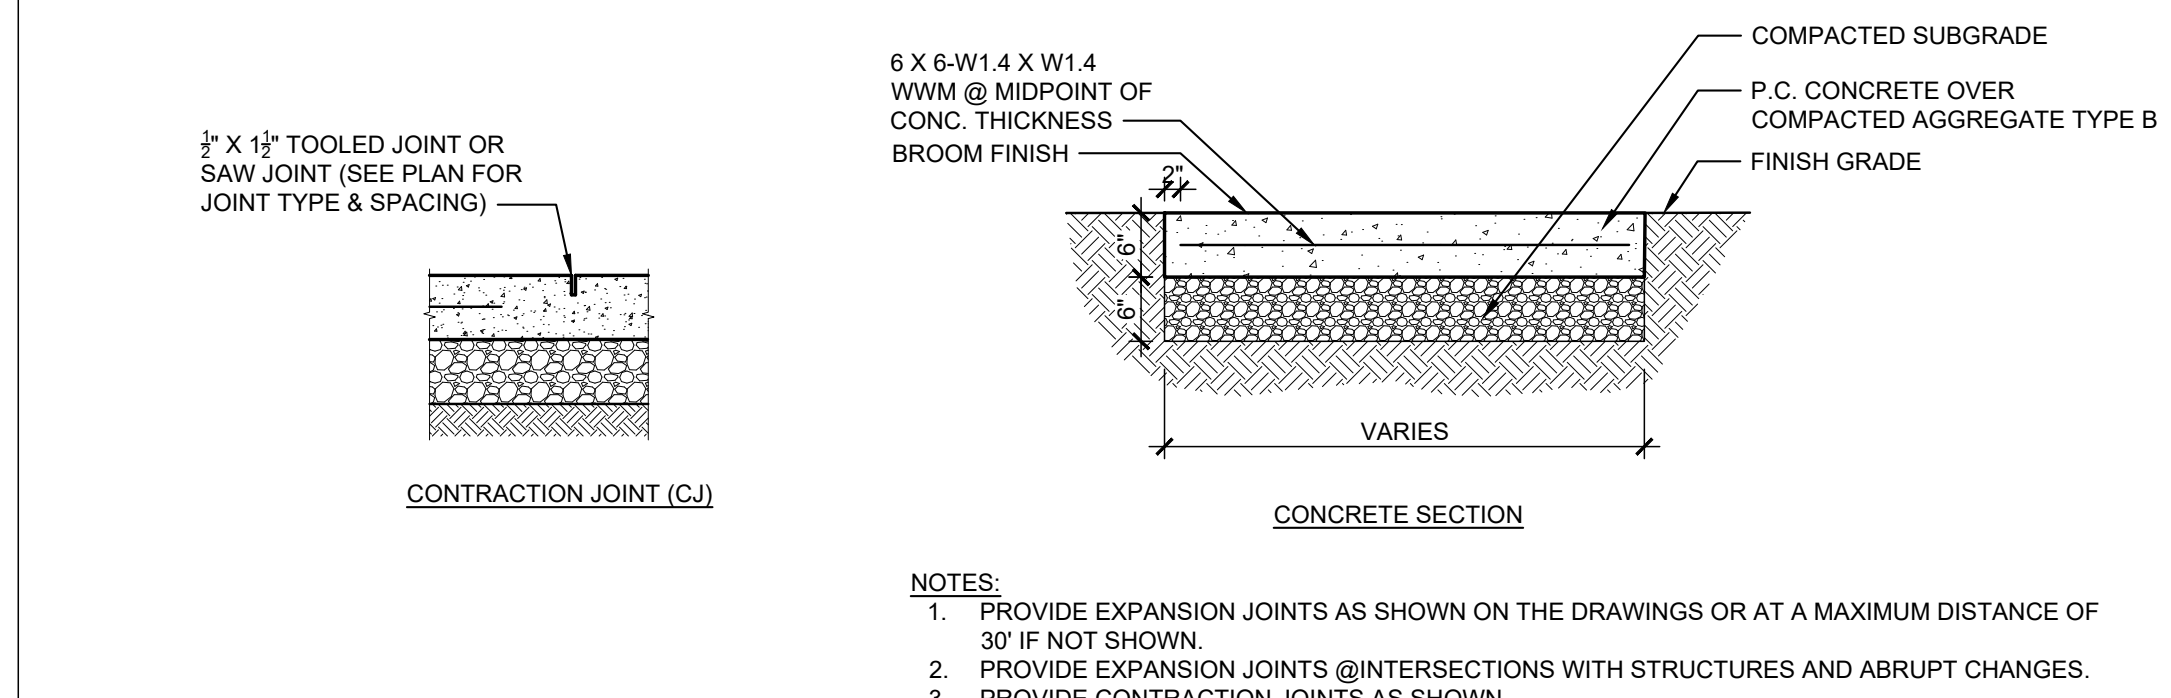

3 6" PC CONCRETE PAVEMENT
Scale: NOT TO SCALE

General Landscape Notes

- GENERAL
1. BASE SURVEY INFORMATION SUPPLIED BY OTHERS. ALL QUANTITIES AND DESIGN ARE BASED UPON THE PROVIDED SURVEY.
 2. PRIOR TO THE START OF ANY WORK, THE CONTRACTOR SHALL NOTIFY MISSOURI 811, OWNER AND GENERAL CONTRACTOR (IF ANY) FOR THE PROPER MARKING/LOCATION OF ALL EXISTING UTILITIES: PUBLIC AND PRIVATE.
 3. ANY DAMAGE TO EXISTING PROPERTIES SHALL BE REPAIRED AND OR REPLACED AT (SUB)CONTRACTOR'S EXPENSE. CONTRACTOR IS ENCOURAGED TO TAKE PERIODIC RECORD PHOTOGRAPHS (I.E. PRE-CONSTRUCTION, DURING AND POST-CONSTRUCTION) OF SITE CONDITIONS & DESIGN ELEMENTS; PAVEMENTS, HARDSCAPE, NEW & EXISTING PLANTS AND OTHER SITE ELEMENTS.
 4. WHEN APPLICABLE, CONSTRUCTION BARRIERS SHALL BE ERECTED TO PROTECT THE PROPOSED WORK AND THE PUBLIC AND TO PROVIDE SECURITY.
 5. ALL WORK AND OPERATIONS SHALL COMPLY WITH CURRENT SAFETY PRACTICES, CODES OR ORDINANCES AS DICTATED BY FEDERAL (O.S.H.A.), STATE, AND LOCAL (CITY OR COUNTY) SAFETY CODES AND ORDINANCES, AS WELL AS THOSE OF THE OWNER AND/OR GENERAL CONTRACTOR. IT IS THE (SUB) CONTRACTOR'S RESPONSIBILITY TO LEARN AND COMPLY WITH CODES, ORDINANCES AND JOB SITE RULES.
 6. ALL TRADES SHALL COORDINATE AND COLLABORATE WITH EACH OTHERS WORK SO THAT THE FLOW OF WORK IS MAINTAINED AND ONE CRAFTSMAN'S WORK IS NOT UNFAIRLY DELAYED. TIME IS OF THE ESSENCE. CONTRACTORS MUST START WORK UPON NOTICE TO PROCEED AND REMAIN ON-SITE FOR THE COMPLETION OF THEIR SCOPE OF WORK AS AND WHEN THE SITE IS AVAILABLE TO THEM.
 7. CONTRACTORS SHALL VISIT THE SITE PRIOR TO START OF WORK TO COMPLETELY FAMILIARIZE THEMSELVES WITH EXISTING AS WELL AS PROPOSED CONDITIONS.
 8. CONTRACTOR TO FOLLOW NORMAL CLIENT, CITY OR VILLAGE WORKDAY HOURS (TYPICALLY BETWEEN 7 AM AND 6 PM). WEEKEND WORK TO BE IN COMPLIANCE WITH LOCAL CODES (WHERE APPLICABLE) AND COORDINATED WITH THE CLIENT FOR SITE ACCESS. NOTIFY THE GENERAL CONTRACTOR (OR CLIENT) OF ALL NON-NORMAL BUSINESS HOURS OF WORK.
 9. ALL WORK SHALL COMPLY WITH CURRENT O.S.H.A. REQUIREMENTS AND THE AMERICAN WITH DISABILITIES ACT FOR PHYSICALLY HANDICAPPED PEOPLE.
 10. THE CONTRACTOR IS RESPONSIBLE FOR SECURING AND PAYING FOR ALL REQUIRED PERMITS UNLESS OTHERWISE NOTED IN THE DRAWINGS OR SPECIFICATIONS.
 11. CONTRACTOR IS RESPONSIBLE FOR PROVIDING SANITARY FACILITIES FOR THEIR CREWS IF NONE ARE PROVIDED.
 12. CONTRACTOR AND ALL SUB-CONTRACTORS ARE EXPECTED TO MAINTAIN THE CLIENT'S ACCESS TO ALL DRIVEWAYS, WALKS AND DOORWAYS.
 13. CONTRACTOR AND ALL SUB-CONTRACTORS WILL POLICE THE SITE AND THEIR RESPECTIVE WORK EFFORTS AT THE END OF EACH WORK DAY IN ORDER TO MAINTAIN A CLEAN, NEAT AND ORDERLY WORK SITE. SITE CLEAN-UP IS REQUIRED ON A DAILY BASIS AS WELL AS AT PROJECT CONCLUSION. THE CONTRACTOR SHALL PROTECT THE PROPERTY OF THE OWNER AND SAFETY AND WORK OF OTHER CONTRACTORS BY LEAVING THE PROJECT SITE AS FREE OF DEBRIS, CONSTRUCTION MATERIALS AND TOOLS AND OTHER ITEMS AS POSSIBLE FOR A NEAT AND ORDERLY APPEARANCE AT ALL TIMES. PLANT DEBRIS (LEAVES, TWIGS), DIRT AND DEBRIS SHALL BE SWEEPED FROM HARDSCAPES, DIRT CLODS, ROCKS, TWIGS/BRANCHES ETC. REMOVED FROM LAWN AREAS. THE CONTRACTOR SHALL ALSO BE DIRECTLY RESPONSIBLE FOR ALL DAMAGE CAUSED BY THE ACTIVITIES AND FOR THE DAILY REMOVAL OF ALL TRASH AND DEBRIS FROM HIS WORK AREA TO THE SATISFACTION OF THE LANDSCAPE ARCHITECT. THE OWNER MAY ELECT TO RETAIN PROGRESS AND/OR FINAL PAYMENT(S) UNTIL SITE CLEAN-UP CONDITIONS ARE MET.
 14. FIELD VERIFICATION: THE CONTRACTOR SHALL VERIFY ALL EXISTING CONDITIONS AND DIMENSIONS IN THE FIELD PRIOR TO BIDDING AND REPORT ANY DISCREPANCIES TO THE OWNER OR HIS REPRESENTATIVE.
 15. THE CONTRACTOR SHALL PROVIDE, AT THEIR OWN EXPENSE, TEMPORARY PROTECTION FOR LANDSCAPE CONSTRUCTION AREAS UNTIL ISSUANCE OF SUBSTANTIAL PROTECTION. THE CONTRACTOR SHALL MAKE EVERY EFFORT TO SECURE, PROTECT AND OTHERWISE MINIMIZE OPPORTUNITIES FOR ACCIDENTS, THEFT AND VANDALISM. CONTRACTOR SHALL PROVIDE BARRICADES, TEMPORARY FENCING, SIGNS, AND WRITTEN WARNING OR POLICING AS MAY BE REQUIRED TO PROTECT SUCH AREAS. THE CONTRACTOR SHALL ISSUE WRITTEN WARNINGS TO OWNER WHEN APPLICABLE. AFTER SUCH WARNINGS ARE ISSUED, THE CONTRACTOR SHALL NOT BE RESPONSIBLE FOR ANY DAMAGE CAUSED BY THE OWNER OR THE OWNER'S EMPLOYEES, GUESTS OR FACILITY USERS.
 16. IT SHALL BE THE CONTRACTOR'S RESPONSIBILITY TO LOCATE AND PROTECT ALL EXISTING ABOVE AND BELOW GROUND UTILITIES WITHIN THE LIMITS OF CONSTRUCTION. ANY DAMAGE TO UTILITIES AS A RESULT OF CONSTRUCTION SHALL BE REPAIRED AT THE CONTRACTOR'S EXPENSE WITHIN A REASONABLY SHORT PERIOD OF TIME, AND WITH AS LITTLE INCONVENIENCE TO THE OWNER AS POSSIBLE.
 17. THE CONTRACTOR SHALL BE RESPONSIBLE FOR THE PROTECTION OF CROWNS, TRUNKS AND ROOTS OF EXISTING TREES, SHRUBS, LAWNS, PAVED AREA AND OTHER EXISTING LANDSCAPED AREAS THAT ARE TO REMAIN. EXISTING TREES, WHICH MAY BE SUBJECT TO CONSTRUCTION DAMAGE, SHALL BE BOXED, FENCED, OR OTHERWISE PROTECTED BEFORE ANY WORK IS STARTED. BOXING OR OTHER PROTECTION WILL BE REMOVED AT THE END OF CONSTRUCTION. DO NOT LOCATE HEAVY EQUIPMENT OR STOCKPILES WITHIN THE DRIP-LINE OF EXISTING PLANTS OR ON LAWNS. ANY DAMAGE TO PLANTINGS OR LAWN AS A RESULT OF CONSTRUCTION SHALL BE REPAIRED AT THE CONTRACTOR'S EXPENSE WITHIN A REASONABLY SHORT PERIOD OF TIME, AND WITH AS LITTLE INCONVENIENCE TO THE OWNER AS POSSIBLE.
 18. NOTIFY THE LANDSCAPE ARCHITECT AT ANY TIME WITH CONCERNS OR SUGGESTIONS CONCERNING ANY OF THESE GENERAL NOTES.

SEQUENCE


31. PLACEMENT OF ALL SILT FENCE FILTERS AND PROTECTION DEVICES.
32. STRIPPING AND STOCKPILING AND/OR IMPORTING OF TOPSOIL AND ROUGH GRADING.
33. AMENDMENT AND FINE GRADING OF PLANTING SOILS.
34. FINAL GRADING AND CONSTRUCTION OR ESTABLISHMENT OF PERMANENT PAVEMENT AND VEGETATION IN ACCORDANCE WITH THE DESIGN DRAWINGS.

PLANTING

35. FOR ADDITIONAL INFORMATION REGARDING PLANTING REFER TO SPECIFICATION SECTION 32 9300 "PLANTS".

TURF

36. FOR ADDITIONAL INFORMATION REGARDING SEED/SOD REQUIREMENTS FOR ALL TURF AREAS REFER TO SPECIFICATION SECTION 32 9200 "TURF".

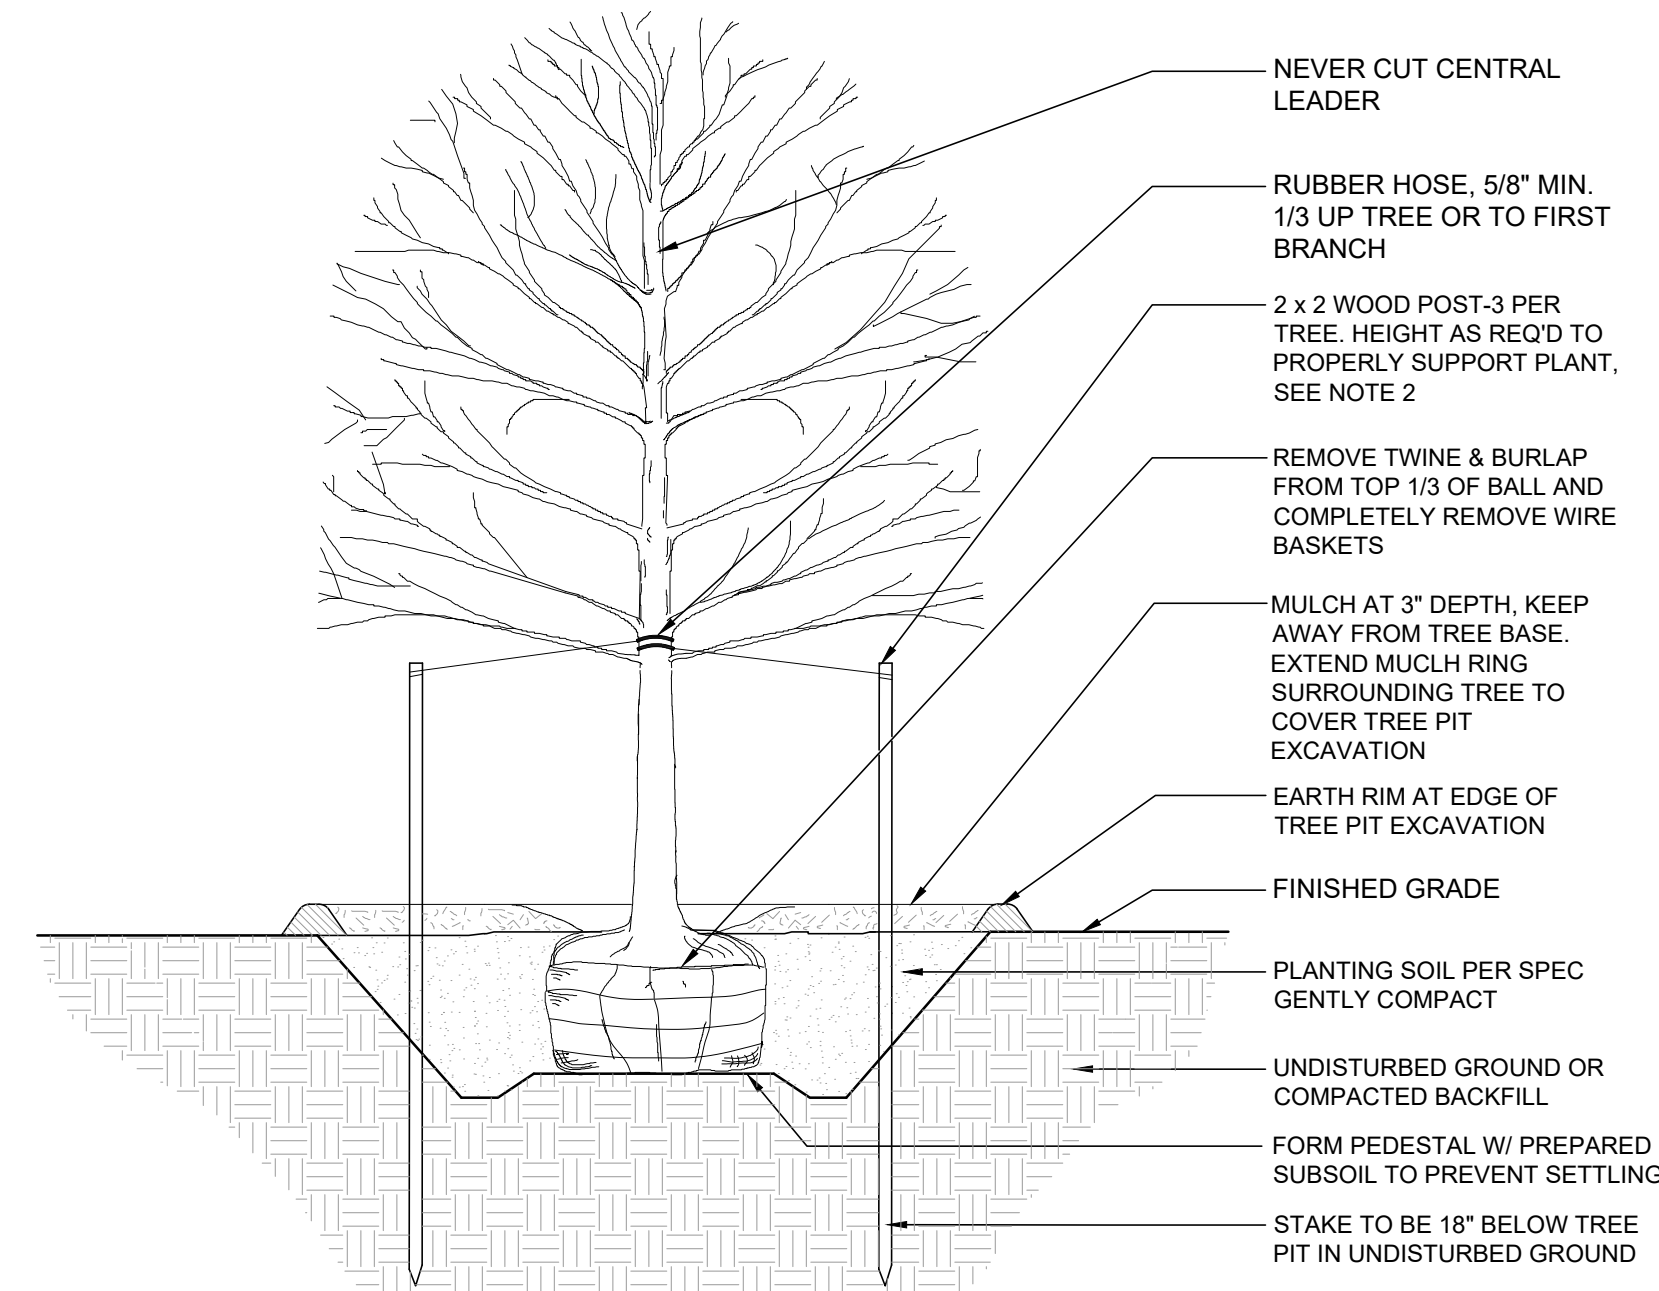

NOTES:


1. TREE SHALL BE PLANTED SO ROOT FLARE IS 2" ABOVE ADJACENT FINISHED GRADE.
2. STAKE TREES ONLY AS NEEDED AND/OR DIRECTED BY LANDSCAPE ARCHITECT OR OWNER.


2

DECIDUOUS TREE PLANTING


SCALE: NOT TO SCALE

PLANT SCHEDULE

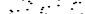	CODE	QTY	REMARKS	BOTANICAL NAME	COMMON NAME	SIZE	
TREES							
	ACE BAI	2		ACER SACCHARUM 'BALSTA'	FALL FIESTA® SUGAR MAPLE	2.5" CAL	
	NYS SYL	2		NYSSA SYLVATICA	TUPELO	2.5" CAL	
	QUE PAL	2		QUERCUS PALUSTRIS	PIN OAK	2.5" CAL	
SYMBOL	CODE	QTY	REMARKS	BOTANICAL NAME	COMMON NAME	VARIETY	SPACING
GROUND COVERS							
	TUR SEE	8,649 SF	REFER TO SPECIFICATIONS FOR SEED MIX	TURF SEED	DROUGHT TOLERANT FESCUE BLEND	SEED	

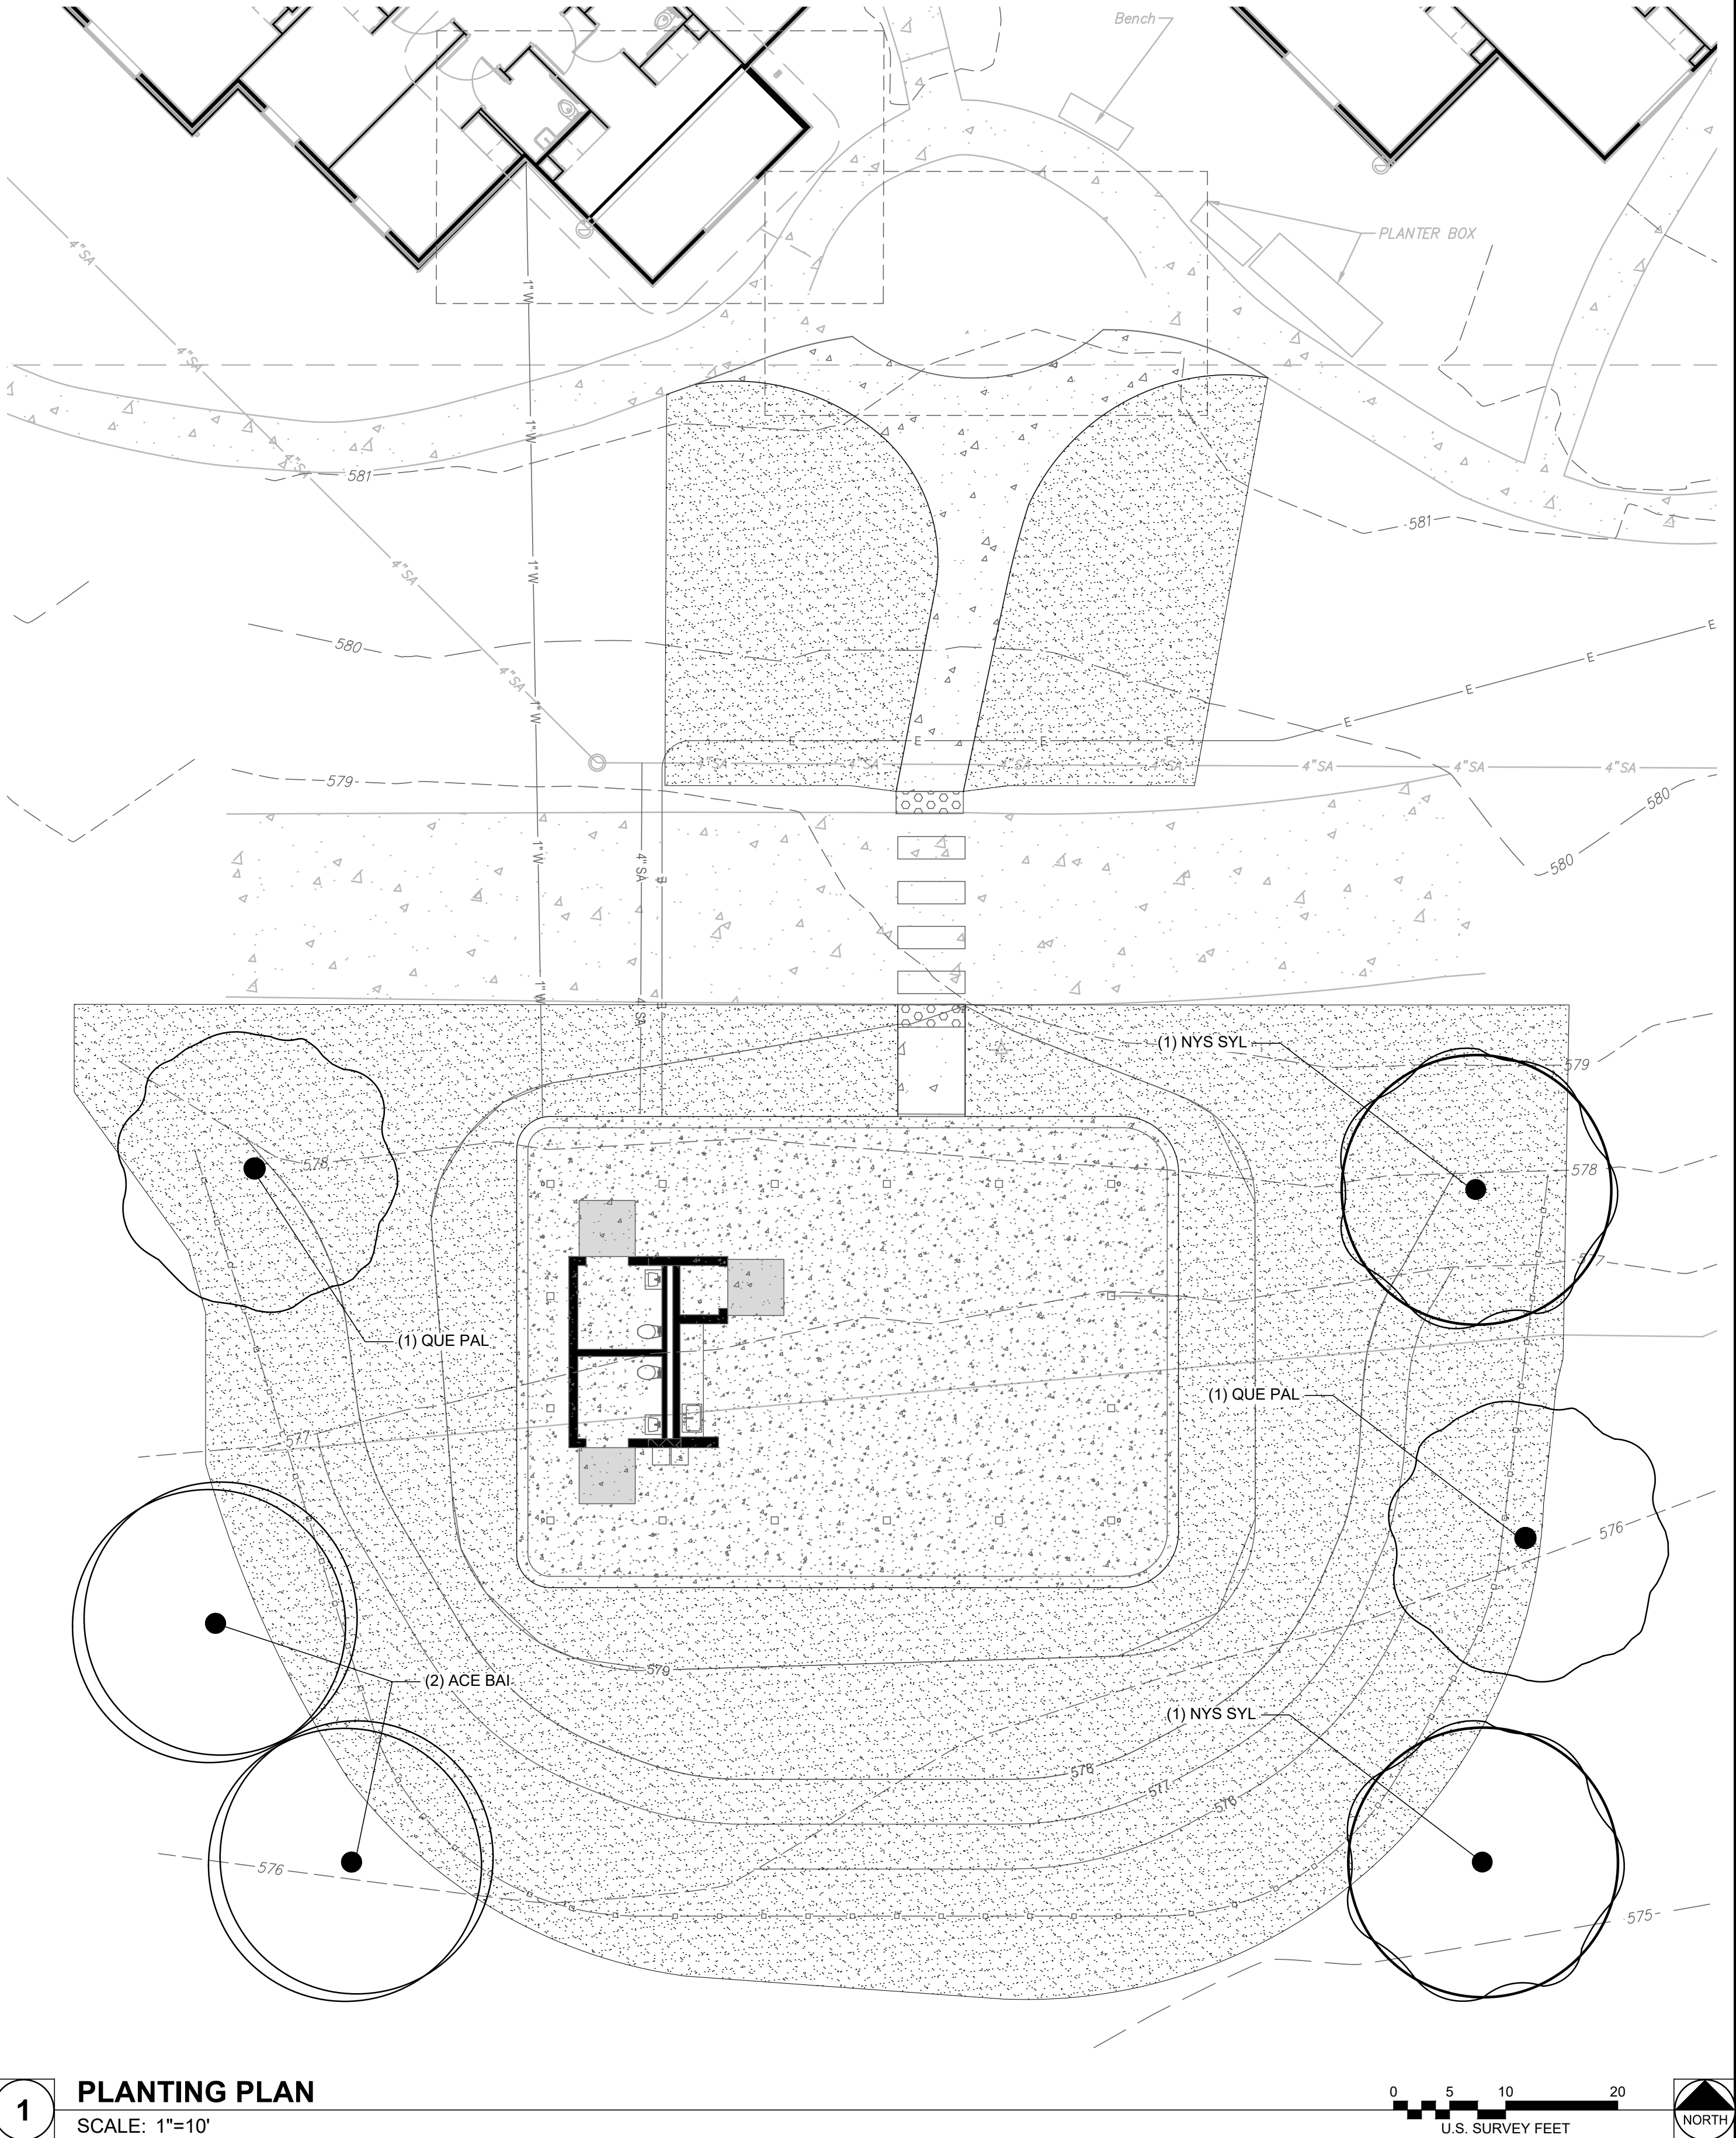

STATE OF MISSOURI
MICHAEL L. PARSON,
GOVERNOR

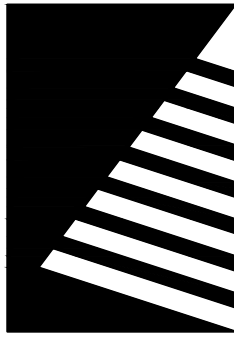

Farnsworth
GROUP

20 ALLEN AVENUE, SUITE 200
ST LOUIS, MISSOURI 63119
(314) 962-7900 / info@f-w.com
Farnsworth Group, Inc.
Missouri State Certificate of Authority #000744
www.f-w.com
Engineers | Architects | Surveyors | Scientists

100% BID SET

10/22/2024

OFFICE OF
ADMINISTRATION
DIVISION OF FACILITIES
MANAGEMENT, DESIGN
AND CONSTRUCTION

MISSOURI VETERANS
COMMISSION

OUTDOOR PAVILION
CAPE GIRARDEAU
VETERANS HOME

2400 Veterans Memorial Dr.
Cape Girardeau, MO 63701

PROJECT #.: U2415.01
SITE #.: 6803
ASSET #.: 8136803002
FAI #.: 29-043

DATE: DESCRIPTION:

DRAWN BY: LMS
CHECKED BY: JLH
DESIGNED BY: LMS

SHEET TITLE:

PLANTING PLAN

SHEET NUMBER:

L-101

SHEET 7 OF 25
ISSUE DATE: 10/22/2024

GENERAL CONSTRUCTION:	
1. ALL DETAILS AND SECTIONS SHOWN ON THE DRAWINGS ARE INTENDED TO BE TYPICAL AND SHALL BE CONSTRUED TO APPLY TO SIMILAR CONDITIONS ELSEWHERE.	
2. THESE NOTES SHALL BE READ IN CONJUNCTION WITH THE SPECIFICATIONS AND THE DRAWINGS. IN THE EVENT OF A CONFLICT, NOTIFY THE ENGINEER FOR CLARIFICATION.	
3. THE CONTRACTOR SHALL FIELD CHECK AND VERIFY ALL EXISTING CONDITIONS AND REPORT ANY DISCREPANCIES TO THE OWNER'S REPRESENTATIVE BEFORE PROCEEDING WITH THE WORK; SEE SPECIFICATIONS.	
4. THE CONTRACTOR SHALL HAVE SOLE RESPONSIBILITY FOR DETERMINING THE MEANS, METHODS, SEQUENCES, AND SAFETY PROCEDURES USED IN PERFORMING THE WORK. SHOULD THE ENGINEER VISIT THE SITE, IT IS IN THE CAPACITY AS ENGINEER AND NOT IN THE CAPACITY OF A CONTRACTOR.	
5. REQUESTS FOR INFORMATION SHALL BE SUBMITTED TO THE ENGINEER UNLESS OTHERWISE NOTED.	
6. THE CONTRACTOR IS TO ASSUME FULL RESPONSIBILITY, UNRELIEVED BY REVIEW OF SHOP DRAWINGS OR PERIODIC OBSERVATIONS, FOR COMPLIANCE WITH THE CONTRACT DOCUMENTS.	
7. THE EXISTING CONDITIONS INDICATED ON THE DRAWINGS ARE BASED ON MATERIAL PROVIDED BY THE OWNER AND NO CLAIM IS MADE AS TO ITS ABSOLUTE COMPLETENESS AND/OR ACCURACY PRIOR TO THE START OF CONSTRUCTION OPERATIONS.	
8. WHERE NEW CONSTRUCTION ABUTS OR INTEGRATES WITH EXISTING CONSTRUCTION, THE CONTRACTOR SHALL VERIFY THAT THE EXISTING CONDITIONS AND DIMENSIONS ARE CLOSE TO THOSE THAT HAVE BEEN ASSUMED. IF THERE ARE ANY VARIANCES THAT WILL PREVENT THE WORK FROM BEING COMPLETED IN ACCORDANCE WITH THE CONSTRUCTION DOCUMENTS, THEY SHALL BE REPORTED TO THE ENGINEER IMMEDIATELY UPON DISCOVERY. THE ENGINEER SHALL ADVISE THE CONTRACTOR AS TO THE NECESSARY MODIFICATIONS.	
9. THE CONTRACTOR SHALL FAMILIARIZE HIMSELF WITH THE SCOPE OF THE WORK AND SOIL AND WATER CONDITIONS BEFORE PROCEEDING WITH THE WORK. SOIL BORING LOCATIONS AND SOIL BORING LOGS ARE INCLUDED IN THE SPECIFICATIONS. SOIL INFORMATION RELEASED IN THE SPECIFICATIONS IS FOR GENERAL INFORMATION ONLY. THE ACTUAL CONDITIONS MAY VARY AT THE SITE.	
10. THE CONTRACTOR SHALL INVESTIGATE SITE DURING CLEARING AND EARTHWORK OPERATIONS FOR FILLED EXCAVATIONS OR BURIED STRUCTURES, SUCH AS CESSPOOLS, CISTERNS, FOUNDATIONS, ETC. IF ANY SUCH STRUCTURES ARE FOUND, THE STRUCTURAL ENGINEER AND GEOTECHNICAL ENGINEER SHALL BE NOTIFIED IMMEDIATELY.	
11. VERIFY SIZE AND LOCATIONS OF HOLES AND SLEEVES THROUGH MASONRY AND CONCRETE WALLS AND SLABS WITH MECHANICAL AND PLUMBING CONTRACTORS.	
12. ALL LATERAL LOAD RESISTANCE AND STABILITY OF THE BUILDING IN THE COMPLETED STRUCTURE IS PROVIDED BY WOOD SHEAR WALLS AND STEEL FRAMES (SEE PLAN SHEETS FOR LOCATIONS). THESE WALLS AND FRAMES PROVIDE ALL LATERAL LOAD RESISTANCE IN EACH ORTHOGONAL BUILDING DIRECTION. THE WOOD ROOF AND FLOOR DECKS SERVE AS HORIZONTAL DIAPHRAGMS THAT DISTRIBUTE THE LATERAL WIND AND SEISMIC FORCES HORIZONTALLY TO THE SHEAR WALLS AND FRAMES. THE SHEAR WALLS AND FRAMES CARRY THE APPLIED LATERAL LOADS TO THE BUILDING FOUNDATION.	
13. SEE ARCHITECTURAL DRAWINGS FOR: <ul style="list-style-type: none">• SIZE AND LOCATION OF DOOR AND WINDOW OPENINGS, EXCEPT AS SHOWN OR NOTED.• FLOOR AND ROOF FINISHES, DRAINAGE, AND WATERPROOFING• FIREPROOFING REQUIREMENTS• DIMENSIONS NOT SHOWN ON STRUCTURAL DRAWINGS.	
14. SEE MECHANICAL, ELECTRICAL, AND PLUMBING DRAWINGS FOR: <ul style="list-style-type: none">• PIPE RUNS, SLEEVES, TRENCHES, WALL AND SLAB OPENINGS, ETC., EXCEPT AS SHOWN OR NOTED.• ELECTRICAL CONDUIT RUNS, BOXES, OUTLETS IN WALLS AND SLABS• CONCRETE INSERTS FOR ELECTRICAL, MECHANICAL, OR PLUMBING FIXTURES.• DUCTWORK LOCATIONS FOR COORDINATION WITH TRUSS MEMBER LAYOUT.	
15. OPENINGS, POCKETS, ETC., LARGER THAN 6" SHALL NOT BE PLACED IN CONCRETE SLABS, AND WALLS, UNLESS SPECIALLY DETAILED ON THE STRUCTURAL DRAWINGS. NOTIFY THE STRUCTURAL ENGINEER WHEN DRAWINGS BY OTHERS SHOW OPENINGS, POCKETS, ETC., LARGER THAN 6" NOT SHOWN ON THE STRUCTURAL DRAWINGS, BUT WHICH ARE LOCATED IN STRUCTURAL MEMBERS.	
16. FOR PIPES EMBEDDED IN CONCRETE: <ul style="list-style-type: none">a. PIPES LARGER THAN 1-1/2" DIAMETER SHALL NOT BE EMBEDDED IN STRUCTURAL CONCRETE EXCEPT WHERE SPECIFICALLY APPROVED BY SEOR.b. PIPES SHALL NOT DISPLACE OR INTERRUPT REINFORCING BARS.c. DO NOT STACK CONDUITS. SPACE EMBEDDED PIPES AND CONDUITS AT A MINIMUM OF 3 DIAMETERS CLEAR FROM OTHER EMBEDDED PIPES/CONDUITS AND REBAR.	
17. CONSTRUCTION MATERIAL SHALL BE SPREAD OUT IF PLACED ON FRAMED FLOOR OR ROOF. LOAD SHALL NOT EXCEED THE DESIGN LIVE LOAD PER SQUARE FOOT. THE CONTRACTOR SHALL DESIGN AND PROVIDE ADEQUATE SHORING AND/OR BRACING WHERE STRUCTURE HAS NOT ATTAINED DESIGN STRENGTH.	
18. THE CONTRACT STRUCTURAL DRAWINGS AND SPECIFICATIONS REPRESENT THE DESIGN INTENT FOR THE FINISHED STRUCTURE. THEY DO NOT INDICATE MEANS OR METHODS OF CONSTRUCTION. THE CONTRACTOR SHALL PROVIDE ALL MEASURES NECESSARY TO PROTECT THE STRUCTURE DURING CONSTRUCTION. SUCH MEASURES SHALL INCLUDE, BUT ARE NOT LIMITED TO, BRACING, SHORING FOR LOADS DUE TO CONSTRUCTION EQUIPMENT, ETC. THE CONTRACTOR IS RESPONSIBLE FOR PROVISIONS OF TEMPORARY SHORING AND OTHER CONSTRUCTION AIDS, INCLUDING ALL ENGINEERING OF SUCH SYSTEMS, FOR TEMPORARY SUPPORT OF NEW AND/OR EXISTING STRUCTURAL ELEMENTS AS REQUIRED FOR ERECTION AND OTHER CONTRACTOR'S MEANS AND METHODS OF CONSTRUCTION, UNLESS NOTED OTHERWISE. OBSERVATION VISITS TO THE SITE BY THE STRUCTURAL ENGINEER SHALL NOT INCLUDE INSPECTION OF THE ABOVE ITEMS.	

FOUNDATIONS:	
1. GEOTECHNICAL INFORMATION AND FOUNDATION DESIGN IS BASED ON THE FOLLOWING GEOTECHNICAL REPORT(S): REPORTS OF SOIL EXPLORATION BY SCI ENGINEERING, INC REPORT NO. 2004-0063. 10, TASK 100 DATED SEPTEMBER 2018	
2. COPIES OF THE REPORT(S) AND ANY ADDENDUM/SUPPLEMENTAL LETTERS SHALL BE AVAILABLE AT THE JOBSITE AT ALL TIMES.	
3. FOOTING DESIGN CRITERIA: ALLOWABLE BEARING CAPACITY 2,000 PSF FOR WALL FOOTINGS 2,400 PSF FOR ISOLATED FOOTINGS PASSIVE LATERAL RESISTANCE 250 PSF COEFFICIENT OF FRICTION 0.3 FROST DEPTH 30 IN.	
4. COMPACTED FILL FOR THE PURPOSE OF UNDERLYING BUILDING OR SITE STRUCTURES SHALL BE PREPARED IN ACCORDANCE WITH THE PROJECT GEOTECHNICAL REPORT.	
5. REFER TO THE PROJECT GEOTECHNICAL REPORT FOR EXTENT AND DEPTH OF OVEREXCAVATION (SUB-EXCAVATION), AND FOR RECOMPACTION AND SOIL CONDITIONING REQUIREMENTS.	
6. BOTTOM DEPTHS OF EXCAVATION AS WELL AS ALL PLACEMENT AND COMPACTION OF FILL SHALL BE OBSERVED AND TESTED BY THE PROJECT GEOTECHNICAL ENGINEER.	
7. ALL PAD FOOTINGS SHALL BE CENTERED ON BUILDING COLUMN REFERENCE LINES UNLESS INDICATED BY AN OFFSET DIMENSION.	
8. ALL WALL FOOTINGS SHALL BE CENTERED ON WALL CENTERLINE UNLESS INDICATED BY AN OFFSET DIMENSION.	
9. ALL FOOTINGS SHALL REST ON UNDISTURBED SOIL OR COMPACTED FILL WHICH HAS A MINIMUM ALLOWABLE BEARING CAPACITY EQUAL TO OR GREATER THAN THAT NOTED ABOVE.	
10. BACKFILL SHALL BE PLACED EVENLY AGAINST EACH SIDE OF SUBGRADE STRUCTURAL ELEMENTS TO PRODUCE APPROXIMATELY EQUAL AND OPPOSITE LATERAL PRESSURES.	

DESIGN CRITERIA:

1. THE STRUCTURAL ENGINEERING DESIGN IS BASED ON AND IN ACCORDANCE WITH THE FOLLOWING CODE:

INTERNATIONAL BUILDING CODE - 2021

2. UNLESS OTHERWISE SHOWN OR NOTED ON THE DRAWINGS, THE STRUCTURAL DESIGN IS BASED ON THE FOLLOWING TYPICAL UNIFORM LOADS:

DEAD LOADS	ROOF TOP CHORD	=	12	PSF
	ROOF BOTTOM CHORD	=	11	PSF
	MEZZANINE	=	15	PSF
LIVE LOADS	ROOF	=	20	PSF
	MEZZANINE	=	80	PSF
SNOW LOADS	Pg	=	15	PSF
	Pf	=	22	PSF
	Ce	=	0.9	
	I	=	1.1	
	Ct	=	1.2	
WIND DESIGN DATA	V (ULT)	=	120	MPH
EXPOSURE CATEGORY		=	C	
	Gcpi	=	(+/-)0.18	

COMPONENTS AND CLADDING

ZONE	EFFECTIVE WIND AREA (SF)	ULTIMATE WIND PRESSURE (PSF)
1	10	= +31.4/-34.3
	20	= +30.5/-32.6
	50	= +29.4/-30.2
	100	= +28.5/-28.5
2	10	= +31.4/-40.1
	20	= +30.5/-38.4
	50	= +29.4/-36.1
	100	= +28.5/-34.3
3	10	= +31.4/-40.1
	20	= +30.5/-38.4
	50	= +29.4/-36.1
	100	= +28.5/-34.3
4	10	= +34.3/-37.2
	20	= +32.8/-35.7
	50	= +30.7/-33.6
	100	= +29.2/-32.1
	500	= +25.6/-28.5
5	10	= +34.3/-45.9
	20	= +32.8/-42.9
	50	= +30.7/-38.8
	100	= +29.2/-35.7
	500	= +25.6/-28.5


EARTHQUAKE DESIGN DATA

I	=	1.25
RISK CATEGORY	=	III
Ss	=	1.119
S1	=	0.392
SITE CLASS	=	D
SDS	=	0.79
SD1	=	0.418
SEISMIC DESIGN CATEGORY	=	D
BASIC SEISMIC-FORCE-RESISTING SYSTEM	=	LIGHT FRAME WALLS WITH WOOD SHEAR PANELS (NORTH-SOUTH DIRECTION)
R	=	6.5
Cs	=	0.151
V	=	0.151W
BASIC SEISMIC-FORCE-RESISTING SYSTEM	=	ORDINARY STEEL MOMENT FRAMES (EAST-WEST DIRECTION)
R	=	3.5
Cs	=	0.280
V	=	0.280W
BASIC SEISMIC-FORCE-RESISTING SYSTEM	=	ORDINARY STEEL CONCENTRICALLY BRACED FRAMES (EAST-WEST DIRECTION)
R	=	3.25
Cs	=	0.301
V	=	0.301W
ANALYSIS PROCEDURE	=	EQUIVALENT LATERAL FORCE ANALYSIS

WOOD:	
1. ENGINEERED TIMBER CONSTRUCTION DESIGNED IN ACCORDANCE WITH THE "NATIONAL DESIGN SPECIFICATION FOR WOOD CONSTRUCTION" BY THE NATIONAL FOREST PRODUCTS ASSOCIATION DATED 2015.	
A. WOOD BEAMS, HEADERS, RAFTERS, AND OTHER STRUCTURAL WOOD MEMBERS WHICH ARE 2" TO 4" THICK AND WIDER THAN 6" SHALL BE MIXED SOUTHERN PINE NO.2 AND HAVE THE FOLLOWING MINIMUM PROPERTIES: Fb (SINGLE MEMBER USE) 2100 PSI Fc (PARALLEL TO GRAIN) 1800 PSI Fc (PERPENDICULAR TO GRAIN) 565 PSI Fv 175 PSI E 1,800,000 PSI	
2. TIMBER CONNECTIONS SHALL BE AS SHOWN ON THE DRAWINGS, AND WHEN NOT DETAILED, SHALL CONFORM TO ACCEPTED INDUSTRY STANDARDS SUBJECT TO THE ENGINEER'S APPROVAL.	
3. LVL BEAMS WHERE SPECIFIED SHALL HAVE THE FOLLOWING MINIMUM PROPERTIES: Fb (SINGLE MEMBER USE) 2600 PSI Fc (PARALLEL TO GRAIN) 2510 PSI Fc (PERPENDICULAR TO GRAIN) 750 PSI Fv 285 PSI E 2,000,000 PSI	
4. ENGINEERED TIMBER CONSTRUCTION TO BE DESIGNED IN ACCORDANCE WITH THE "NATIONAL DESIGN SPECIFICATION FOR WOOD CONSTRUCTION" BY THE NATIONAL FOREST PRODUCTS ASSOCIATION DATED 2015.	
5. TIMBER CONNECTIONS SHALL BE AS SHOWN ON THE DRAWINGS, AND WHEN NOT DETAILED, SHALL CONFORM TO ACCEPTED INDUSTRY STANDARDS SUBJECT TO THE ENGINEER'S APPROVAL	

STRUCTURAL CONCRETE:	
1. REINFORCED CONCRETE DESIGNED IN ACCORDANCE WITH THE "BUILDING CODE REQUIREMENTS FOR REINFORCED CONCRETE" (ACI 318) BY THE AMERICAN CONCRETE INSTITUTE.	
2. REINFORCING BAR DETAILING, FABRICATING, AND PLACING SHALL CONFORM TO THE CONCRETE REINFORCING STEEL INSTITUTE'S "REINFORCING BAR DETAILING" AND "PLACING REINFORCING BARS".	
3. MINIMUM CONCRETE COMPRESSIVE STRENGTH (FC) AT 28 DAYS:	
FOOTINGS 4000 PSI FOUNDATION WALLS AND PEDESTALS 4000 PSI SLABS ON GRADE 4000 PSI	
4. PORTLAND CEMENT SHALL CONFORM TO ASTM C-150, TYPE III, UNLESS OTHERWISE NOTED.	
5. CONCRETE REINFORCEMENT: DEFORMED BARS - NEW BILLET STEEL COMPLYING WITH ASTM A615 AND HAVING A MINIMUM YIELD STRENGTH OF 60000 PSI. WELDED WIRE FABRIC - SMOOTH WIRE FABRIC COMPLYING WITH ASTM A185	
6. CONCRETE PROTECTION FOR REINFORCEMENT: UNLESS OTHERWISE SHOWN THE CLEAR DISTANCE FROM THE FACE OF CONCRETE TO THE REINFORCING STEEL SHALL BE:	
CONCRETE POURED AGAINST GROUND (NOTE A) 3" CONCRETE POURED AGAINST FORMS (NOTE A, B) #6 BARS OR LARGER 2" SMALLER THAN #6 BARS 1 1/2" SLABS POURED TO FORMS: FORMED SURFACE (NOTE B) 3/4" TROWELED SURFACE (NOTE B) 1" SCREEDED SURFACE FOR APPLIED TOPPING 3/4" SLABS POURED ON GRADE: FROM BOTTOM SURFACE 2" TROWELED SURFACE (NOTE B) 1" SCREEDED SURFACE FOR APPLIED TOPPING 3/4" (NOTE A) EXCLUDING SLABS POURED ON GRADE. (NOTE B) INCREASE BY 1/2" IF SURFACE IS TO BE IN PERMANENT CONTACT WITH GROUND OR WATER.	
7. UNLESS OTHERWISE SHOWN OR NOTED, SPLICING OF REINFORCING BARS OR WELDED WIRE FABRIC SHALL CONFORM TO THE REQUIREMENTS OF ACI 318.	
8. ARRANGE, SPACE, AND SECURELY TIE BARS AND BAR SUPPORTS TO HOLD REINFORCEMENT IN POSITION DURING CONCRETE PLACEMENT OPERATIONS. SET WIRE TIES SO ENDS ARE DIRECTED INTO CONCRETE.	
9. PROVIDE SUPPORT FOR REINFORCEMENT INCLUDING BOLSTERS, CHAIRS, AND SPACERS WITH SAND PLATES FOR SUPPORTING AND FASTENING REINFORCING BARS TO PROVIDE THE CONCRETE COVER INDICATED.	
10. ALTERNATE LOCATION OF LAP SPLICE IN WALLS AND SLABS.	
11. USE OF CONSTRUCTION JOINTS AT LOCATIONS OTHER THAN THOSE INDICATED ON THE DRAWINGS SHALL REQUIRE PRIOR APPROVAL OF THE ENGINEER.	
12. ALL KEYS FOR CONSTRUCTION JOINTS SHALL BE 2" X 4" (NOMINAL) UNLESS OTHERWISE SHOWN OR NOTED ON THE DRAWINGS.	
13. UNLESS OTHERWISE SHOWN OR NOTED, PROVIDE 2-#5 BARS (1-EACH FACE) AROUND UNFRAMED OPENINGS IN CONCRETE WALLS AND GRADE BEAMS. PLACE BARS PARALLEL TO SIDES OF OPENING AND EXTEND 24" BEYOND CORNERS.	
PREFABRICATED WOOD JOISTS/TRUSSES:	
1. METAL PLATE CONNECTED ROOF TRUSSES SHALL BE DESIGNED IN ACCORDANCE WITH ANSI/TPI "NATIONAL DESIGN STNADARD FOR METAL PLATE CONNECTED WOOD TRUSS CONSTRUCTION" TPI H18 COMMENTARY AND RECOMMENDATIONS FOR HANDLING, INSTALLING, AND BRACING METAL PLATE CONNECTED WOOD TRUSSES", AND TPI DSB "RECOMMENDED DESIGN SPECIFICATION FOR TEMPORARY BRACING OF METAL PLATE CONNECTED WOOD TRUSSES."	
2. THE CONTRACTOR SHALL PROVIDE CONTINUOUS LATERAL BRACING AS REQUIRED BY THE TRUSS MANUFACTURER'S TRUSS DESIGN DRAWINGS AND BC31-B3. ALL CONTINUOUS PERMANENT BRACING SHALL BE DIAGONALLY BRACED AT 20'-0" OC MAXIMUM, ONCE MINIMUM.	
3. SHOP DRAWINGS SHALL SHOW LOCATION, PITCH, SPAN, CAMBER, CONFIGURATION, AND SPACING FOR EACH TYPE OF TRUSS REQUIRED. INDICATE SIZES, STRESS GRADES, AND SPECIES OF LUMBER.	
4. TRUSSES, TRUSS BRACING, AND TRUSS TO TRUSS CONNECTIONS SHALL BE DELEGATED DESIGN. SUBMIT ANALYSIS DATA SIGNED AND SEALED BY THE QUALIFIED STRUCTURAL ENGINEER RESPONSIBLE FOR THEIR PREPARATION. DELEGATED DESIGN INCLUDES MEMBER SIZES OF TRUSS AS WELL AS PERMANENT BRACING REQUIRED TO PREVENT BUCKLING OF INDIVIDUAL TRUSS MEMBERS DUE TO DESIGN LOADS. A. MAXIMUM VERTICAL DEFLECTION: ROOF TRUSSES - L/240 FOR TOTAL LOAD AND L/360 FOR LIVE LOAD. FLOOR TRUSSES - L/360 FOR TOTAL LOAD AND L/480 FOR LIVE LOAD.	
5. LUMBER: DOC PS 20 AND APPLICABLE RULES-WRITING AGENCY CERTIFIED BY THE AMERICAN LUMBER STANDARD COMMITTEE (ALSC) BOARD OF REVIEW. PROVIDE LUMBER GRADED BY AN AGENCY CERTIFIED BY THE ALSC BOARD OF REVIEW TO INSPECT AND GRADE LUMBER UNDER THE RULES INDICATED. 1. PROVIDE DRY LUMBER WITH 19% MAXIMUM MOISTURE CONTENT AT TIME OF DRESSING.	
6. DELEGATED DESIGN TRUSSES SHALL BE DESIGNED FOR IN PLANE AXIAL LOADS AND SPECIAL CONNECTION REQUIREMENTS WHERE INDICATED ON PLANS.	

STATE OF MISSOURI
MICHAEL L. PARSON,
GOVERNOR

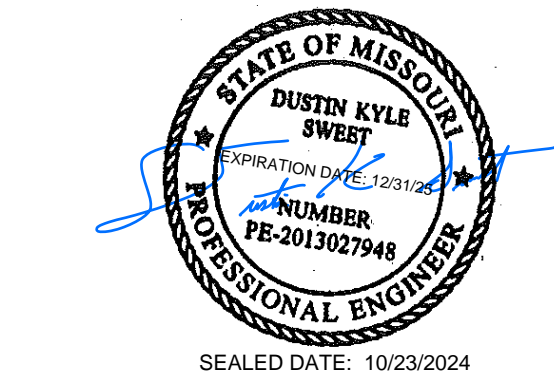



Farnsworth

GROUP

20 ALLEN AVENUE, SUITE 200
ST LOUIS, MISSOURI 63119
(314) 962-7900 / info@f-w.com

Farnsworth Group, Inc.
Missouri State Certificate of Authority #000744
www.f-w.com
Engineers | Architects | Surveyors | Scientists

OFFICE OF
ADMINISTRATION
DIVISION OF FACILITIES
MANAGEMENT, DESIGN
AND CONSTRUCTION

MISSOURI VETERANS
COMMISSION

OUTDOOR PAVILION
CAPE GIRARDEAU
VETERANS HOME

2400 Veterans Memorial Dr,
Cape Girardeau, MO 63701

PROJECT #.:	U2415.01
SITE #.:	6803
ASSET#.:	8136803002
FA#.:	29-043
# DATE:	DESCRIPTION:

DRAWN BY: AJC
CHECKED BY: DKS
DESIGNED BY: AMC

SHEET TITLE:
**GENERAL
STRUCTURAL NOTES**

SHEET NUMBER:
S-001

SHEET 8 OF 25
ISSUE DATE: 10/22/2024

SPECIAL INSPECTION:

1. INSPECTIONS AND TESTING SERVICES SHALL BE PERFORMED BY AN INDEPENDENT INSPECTION AND TESTING AGENCY (IES) PROVIDED BY THE OWNER IN CONFORMANCE WITH CHAPTER 17 OF THE IBC.
2. INSPECTIONS AND TESTING SHALL BE PERFORMED FOR, BUT NOT LIMITED TO, THE FOLLOWING:
3. PERIODIC INSPECTION OF STEEL FABRICATOR'S SHOP FOR QUALITY CONTROL AND FABRICATION PROCESSES THAT COMPLY WITH AISC CODE OF STANDARD PRACTICE.
4. PERIODIC INSPECTION OF BOLTED AND WELDED STEEL CONNECTIONS IN THE FIELD PER TABLE 1704.3 OF THE LATEST INTERNATIONAL BUILDING CODE
5. PERIODIC INSPECTION OF CONCRETE MATERIALS, REINFORCING AND PLACEMENT SHALL BE INSPECTED PER TABLE 1704.4 OF THE LATEST INTERNATIONAL BUILDING CODE.
6. PERIODIC INSPECTION OF MASONRY MATERIALS, REINFORCING & PLACEMENT SHALL BE INSPECTED PER TABLE 1704.5.3 OF THE LATEST INTERNATIONAL BUILDING CODE.
7. INSPECTION OF SITE SOILS, FILL PLACEMENT, AND BEARING CAPACITIES BY A LICENSED GEOTECHNICAL ENGINEER AS FOLLOWS:

A. OBSERVATION OF PROOF ROLLING FOR THE SITE PRIOR TO FILL PLACEMENT. COMPACTION TESTING OF STRUCTURAL FILL PLACEMENT. LIFTS SHALL NOT EXCEED 8"

B. COMPACT STRUCTURAL FILL TO 95% DRY DENSITY AS MEASURED BY THE STANDARD PROCTOR METHOD, ASTM D-698

C. PROVIDE BEARING TESTS AT EACH FOOTING LOCATION TO CONFIRM BEARING CAPACITY.
8. SPECIAL INSPECTION IS NOT A SUBSTITUTE FOR INSPECTION BY A CITY/COUNTY INSPECTOR.
9. SPECIAL INSPECTED WORK WHICH IS INSTALLED OR COVERED WITHOUT APPROVAL OF LOCAL AND SPECIAL INSPECTORS IS SUBJECT TO REMOVAL OR EXPOSURE.
10. SPECIAL INSPECTORS MUST BE CERTIFIED BY THE CITY/COUNTY TO PERFORM THE TYPES
11. IT IS THE RESPONSIBILITY OF THE CONTRACTOR TO INFORM THE SPECIAL INSPECTOR OR INSPECTION AGENCY AT LEAST ONE WORKING DAY PRIOR TO PERFORMING ANY WORK THAT REQUIRES SPECIAL INSPECTION. ANY WORK PERFORMED WITHOUT REQUIRED SPECIAL INSPECTION IS SUBJECT TO REMOVAL.
12. SUBMIT WRITTEN REPORTS WITHIN TWO DAYS OF TESTING TO ENGINEER OF RECORD.

VERIFICATION AND INSPECTION FOR SOILS					
SPECIAL INSPECTION REQUIRED	VERIFICATION, INSPECTION AND TESTING	INSPECTION FREQUENCY		REFERENCED STANDARD	IBC REFERENCE
		CONTINUOUS	PERIODICALLY		
YES	1. Verify materials below shallow foundations are adequate to achieve the design bearing capacity	-	X	-	TABLE 1705.6
YES	2. Verify excavations are extended to proper depth and have reached proper material	-	X		
YES	3. Perform classification and testing of compacted fill materials	-	X		
YES	4. Verify use of proper materials, densities and lift thicknesses during placement and compaction of compacted fill	X	-		
YES	5. Prior to placement of compacted fill, observe subgrade and verify that site has been prepared properly	-	X		
YES	6. Verify installation of drain tile (gravity, mechanical)	-	X		

Exception: Where IBC Section 1803 does not require reporting of materials and procedures for fill placement, the special inspector shall verify that the in-place dry density of the compacted fill is not less than 90 percent of the maximum dry density at optimum moisture content determined in accordance with ASTM D 1557.

Note: The approved geotechnical report, and the construction documents prepared by the registered design professionals shall be used to determine compliance. During fill placement, the special inspector shall determine that proper materials and procedures are used in accordance with the provisions of the approved geotechnical report.

VERIFICATION AND INSPECTION FOR WOOD CONSTRUCTION					
SPECIAL INSPECTION REQUIRED	VERIFICATION, INSPECTION AND TESTING	INSPECTION FREQUENCY		REFERENCED STANDARD	IBC REFERENCE
		CONTINUOUS	PERIODICALLY		
	1. High-Load Diaphragms			-	1705.5
YES	A) Inspect wood structural panel sheathing grade and thickness to agree with the approved construction documents	X	-		
YES	B) Verify the nominal size of framing members joining panel edges, the nail or staple diameter and length, the number of fastener lines and that the spacing between fasteners in each line and at edge margins agrees with the approved construction documents	X	-		
	2. Metal-Plate-Connected Wood Trusses				
YES	A) Verify installation of the permanent individual truss member restraint/bracing agrees with the approved truss submittal package where wood trusses have overall heights of 60 inches or greater	X	-		
YES	B) Verify that temporary installation of restraint/bracing is installed in accordance with the approved truss submittal package for wood trusses with a clear span of 60 feet or greater	X	-		

VERIFICATION AND INSPECTION FOR CONCRETE CONSTRUCTION					
SPECIAL INSPECTION REQUIRED	VERIFICATION, INSPECTION AND TESTING	INSPECTION FREQUENCY		REFERENCED STANDARD	IBC REFERENCE
		CONTINUOUS	PERIODICALLY		
YES	1. Inspection of reinforcing steel and verifying placement	-	X	ACI 318: Ch 20, 25.2, 25.3, 26.6.1-26.6.3; IBC: 1908.4	1705.3
	2. Inspection of reinforcing steel welding				
YES	A) Verification of weldability (determination of carbon equivalent) for reinforcing steel other than ASTM A 706	-	X	AWS D1.4; ACI 318: 26.6.4	
YES	B) Inspect single-pass fillet welds, maximum 5/16"	-	X		
YES	C) Inspect all other welds	X	-		
YES	3. Inspection of anchors cast in concrete	-	X	ACI 318: 17.8.2	
	4. Inspection of anchors post-installed in hardened concrete members				
YES	A) Adhesive anchors installed horizontally or in upwardly-inclined orientations to resist sustained tension loads	X	-	ACI 318: 26.12.3.2(c), 17.8.2.	
YES	B) Mechanical anchors and adhesive anchors not defined in 4.A	-	X		
YES	5. Verifying use of required design mix	-	X	ACI 318: Ch 19, 26.4; IBC: 1904.1, 1904.2, 1908.2, 1908.3	
YES	6. Prior to concrete placement, fabricate specimens for strength tests, perform slump and air content tests, and determine the temperature of the concrete	X	-	ASTM C 172, ASTM C31, ACI 318: 26.5, 26.12; IBC...	
YES	7. Inspection of concrete placement for proper application techniques	X	-	ACI 318: 26.5; IBC: 1908.6, 1908.7, 1908.8	
YES	8. Inspection/verification of maintenance of specified curing temperature and techniques	-	X	ACI 318: 26.5.3-26.5.5; IBC 1908.9	
YES	9. Verify in-situ concrete strength prior to removal of shores and forms from beams and structural slabs	-	X	ACI 318: 26.11.2	
YES	10. Inspect formwork for shape, location and dimensions of the concrete member being formed	-	X	ACI 318: 26.11.1.2(b)	



VERIFICATION AND SPECIAL INSPECTION FOR WIND RESISTANCE					
SPECIAL INSPECTION REQUIRED	VERIFICATION, INSPECTION AND TESTING	INSPECTION FREQUENCY		REFERENCED STANDARD	IBC REFERENCE
		CONTINUOUS	PERIODICAL...		
	1. Structural Wood			-	1705.11
YES	A) Field gluing operations of elements of the main windforce-resisting system(Special inspections are not required for wood shear walls, shear panels and diaphragms, including nailing, bolting, anchoring and other fastening to other element sof the main windforce-resisting system, where the specified fastener spacing at panel edges in more than 4 inches on center)	X	-		
YES	B) Nailing, bolting, anchoring and other fastening of elments of the main windforce-resisting system, including wood shear walls, wood diaphragms, drag struts, braces and hold-downs (Special inspections are not required for wood shear walls, shear panels and diaphragms, including nailing, bolting, anchoring and other fastening to other elements of the main windforce-resisting system, where the specified fastener spacing at panel edges in more than 4 inches on center)	-	X		
	2. Cold-Formed Steel Light-Frame Construction				
YES	A) Welding operations of elements of the main windforce-resisting system (Special inspections are not required if either of the following applies: a) the sheathing is gypsum board or fiberboard b) the sheathing is wood structural panel or steel sheets on only one side of the shear wall, shear panel or diaphragm assembly and the fastener spacing of the sheathign is more than 4 inches on center)	-	X		
YES	B) Screw attachment, bolting, anchoring and other fastening of elements of the main windforce-resisting system, including shear walls, braces, diaphragms, collectors (drag struts) and hold-downs (Special inspections are not required if either of the following applies: a) the sheathing is gypsum board or fiberboard b) the sheathing is wood structural panel or steel sheets on only one side of the shear wall, shear panel or diaphragm assembly and the fastener spacing of the sheathign is more than 4 inches on center)	-	X		
	3. Wind Resisting Components				
YES	A) Roof covering, roof deck and roof framing connections	-	X		
YES	B) Exterior wall covering and wall connections to roof and floor diaphragms and framing	-	X		

Exceptions: 1) Wind Exposure Category B, where Vasd as determined in accordance with Section 1609.3.1 is 120 miles per hour or greater 2) In wind Exposure Category C or D, where Vasd as determined in accordance with Section 1609.3.1 is 110 miles per hour or greater

VERIFICATION AND SPECIAL INSPECTION FOR SEISMIC RESISTANCE					
SPECIAL INSPECTION REQUIRED	VERIFICATION, INSPECTION AND TESTING	INSPECTION FREQUENCY		REFERENCE D STANDARD	IBC REFERENCE
		CONTINUOUS	PERIODICALLY		
	1. Structural Steel			AISC 341	1705.12.1
NO	A) Special inspections for structural steel in accordance with the quality assurance requirements of AISC 341, including nondestructive testing of structural steel elements in the seismic force-resisting system (Special Inspections of structural steel in Seismic Design Category B or C with R designated for "Steel systems not specifically detailed for siesmic resistnace, excluding cantilever column systems" and structural steel in Seismic Design Category D, E, or F where design and detailing in accordance with AISC 360 is exempt from special inspections in this section)	X	-		
	2. Structural Steel Elements			AISC 341	1705.12.1
NO	A) Special inspections of structural steel elements including struts, collectors, chords and foundation elements shall be performed in accordance with AISC 341, including nondestructive testing (Special Inspections of structural steel elements in Seismic Design Category B or C with R of 3 or less and structural steel elements in Seismic Design Category D, E, or F where design and detailing in accordance with AISC 360 is exempt from special inspection in thi...	X	-		
	3. Structural Wood			-	1705.12.2
YES	A) Field gluing operations of elements of the seismic force-resisting system (Special inspections of structural wood are not required for wood shear walls, shear panels and diaphragms, including nailing, bolting, anchoring, and other fastening to other elements of the seismic force-resisting system where the fastener spacing of the sheathing is more than 4 inches on center)	X	-		
YES	B) Nailing, bolting, anchoring and other fastening of elements of the seismic force-resisting system including wood shear walls, wood diaphragms, drag struts, braces, shear panels, and hold-downs (Special inspections of structural wood are not required for wood shear walls, shear panels and diaphragms, including nailing, bolting, anchoring, and other fastening to other elements of the seismic force-resisting system where the fastener spacing of the sheathing is more than 4 inches on center)	-	X		
	4. Cold-formed Steel Light-frame Construction			-	1705.12.3
YES	A) Welding operations of elements of seismic force-resisting system	-	X		
YES	B) Screw attachment, bolting, anchoring and other fastening of elements of the seismic force-resisting system, including shear walls, braces, diaphragms, collectors (drag struts) and hold-downs (Special inspections of cold-formed steel light-frame construction are not required where either the sheating is gypsum board or fiberboard or the sheathing is wood structural panel or sheets on only one side of the shear wall, shear panel or diaphragm assembly and the fastener spacing is more than 4 inches on center)	-	X		
	5. Designated Seismic Systems			-	1705.12.4
YES	A) Examine designated seismic systems requiring seismic qualification in accordance with Section 13.2.2 of ASCE 7 and verify the label, anchorage or mounting conforms to the certificate of compliance. (Structures assigned to Seismic Design Category C, ...	-	-		
YES	6. Architectural Components			-	1705.12.5
	A) During erection and fastening of exterior cladding, interior and exterior nonbearing walls and interior and exterior veneer for structures assigned to Seismic Design Category D, E or F (Special Inspection of architectural componenets are not required for exterior cladding, interior and exterior nonbearing walls and interior and exterior veneer 30 feet or less above grade or walking surface, exterior cladding and interior and exterior veneer weighing 5 psf or less, or interior nonbearing walls weighing 15 psf or less)	-	X		
	B) Anchorage of access floors in structures assigned to Seismic Design Category D, E or F	-	X		
	7. Plumbing, Mechanical and Electrical Components.				
YES	A) During anchorage of electrical equipment for emergency or standby power systems in structures assigned to Seismic Design Category C, D, E or F	-	X	-	1705.12.6
	B) During anchorage of other electrical equipment in structures assigned to Seismic Design Category E or F	-	X		
YES	C) During installation and anchorage of piping systems designed to carry hazardous materials and their associated mechanical units in structures assigned to Seismic Design Category C, D, E or F	-	X		
YES	D) During the installation and anchorage of ductwork designed to carry hazardous materials in structures assigned to Seismic Design Category C, D, E or F	-	X		
YES	E) During the installation and anchorage of vibration isolation systems in structures assigned to Seismic Design Category C, D, E or F where the construction documents require a nominal clearance of 1/4-inch or less between the equipment support frame and...	-	X		
YES	F) During installation of mechanical and electrical equipment, including duct work, piping systems, and their structural supports, where automatic fire sprinkler systems are installed in structures assigned to Seismic Design Category C,D,E or F to verify one of the following: a) Minimum clearances have been provided as required by Section 13.2.3 of ASCE 7 b) A nominal clearance of not less than 3 inches has been provided between fire protection sprinkler system drops and sprigs and: structural members are not used collectively or independently to support the sprinklers; equipment attached to the building structure; and other systems' piping (Where flexible sprinkler hose fittings are used, special inspection of minimum...	-	X		
	7. Storage Racks			-	1705.12.7
NO	A) During installation of required anchorage of storage racks that are 8 feet or greater in height in structures assigned to Seismic...	-	X		
	8. Seismic Isolation Systems			-	1705.12.8
NO	A) During fabrication and installation of isolator units and energy dissipation devices in seismically isolated structures assigned to Seismic Design Category B, C, D, E or F	-	X		
	9. Cold-formed Steel Special Bolted Moment Frames			-	1705.12.9
NO	A) During installation of cold-formed steel special bolted moment frames in seismic force-resisting systems of structures assigned to Seismic Design Category D, E or F	-	X		

Exceptions: 1) The structure consists of light-frame construction. Sds does not exceed 0.5, and the building height of the structure does not exceed 35 feet. 2) The seismic force-resisting system consists of reinforced masonry or reinforced concrete. Sds does not exceed 0.5, and the building height of the structure does not exceed 25 feet. 3) The structure is a detached one- or two-family dwelling not exceeding two stories above grade plane and does not have any of the following horizontal or vertical irregularities: a) Torsional or extreme torsional irregularity b) Nonparallel systems irregularity c) Stiffness-soft story or stiffness-extreme soft irregularity d)Discontinuity in lateral strength-weak story irregularity

STATE OF MISSOURI
MICHAEL L. PARSON,
GOVERNOR

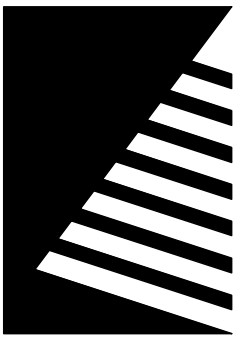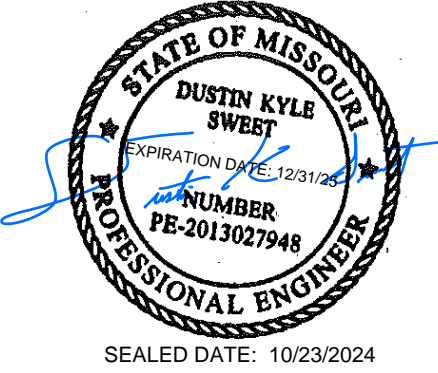

Farnsworth
GROUP

20 ALLEN AVENUE, SUITE 200
ST LOUIS, MISSOURI 63119
(314) 962-7900 / info@f-w.com

Farnsworth Group, Inc.
Missouri State Certificate of Authority #000744
www.f-w.com
Engineers | Architects | Surveyors | Scientists

OFFICE OF
ADMINISTRATION
DIVISION OF FACILITIES
MANAGEMENT, DESIGN
AND CONSTRUCTION

MISSOURI VETERANS
COMMISSION

OUTDOOR PAVILION
CAPE GIRARDEAU
VETERANS HOME

2400 Veterans Memorial Dr,
Cape Girardeau, MO 63701

PROJECT #.: U2415.01
SITE #.: 6803
ASSET #.: 8136803002
FAI #.: 29-043

DATE: DESCRIPTION:

DRAWN BY: AJC
CHECKED BY: DKS
DESIGNED BY: AMC

SHEET TITLE:

SPECIAL
INSPECTIONS

SHEET NUMBER:



S-002

SHEET 9 OF 25
ISSUE DATE: 10/22/2024

FOUNDATION NOTES

- A. SEE S-001 AND S-002 FOR GENERAL STRUCTURAL NOTES.
- B. SEE ARCHITECTURAL FOR DIMENSIONS NOT SHOWN.
- C. SEE ARCH FOR FLOOR SLAB SLOPE REQUIREMENTS.
- D. COORDINATE SIZES AND LOCATIONS OF OPENINGS THROUGH FLOOR DECK WITH MECHANICAL CONTRACTOR.
- E. SEE ARCH FOR TYPICAL BRACING AT T/CMU WALLS.
- F. T/ PAVILION COLUMN PEDESTAL ELEVATION = 580.11 TYP.

STATE OF MISSOURI
MICHAEL L. PARSON,
GOVERNOR

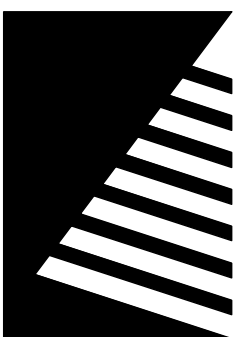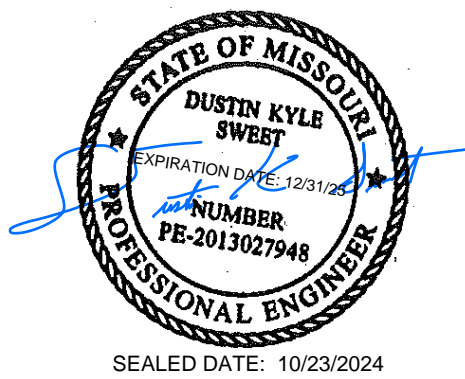

Farnsworth
GROUP

20 ALLEN AVENUE, SUITE 200
ST LOUIS, MISSOURI 63119
(314) 962-7900 / info@f-w.com

Farnsworth Group, Inc.
Missouri State Certificate of Authority #000744
www.f-w.com
Engineers | Architects | Surveyors | Scientists

OFFICE OF
ADMINISTRATION
DIVISION OF FACILITIES
MANAGEMENT, DESIGN
AND CONSTRUCTION

MISSOURI VETERANS
COMMISSION

OUTDOOR PAVILION
CAPE GIRARDEAU
VETERANS HOME

2400 Veterans Memorial Dr,
Cape Girardeau, MO 63701

PROJECT #.: U2415.01
SITE #.: 6803
ASSET #.: 8136803002
FAI #.: 29-043

DATE: DESCRIPTION:


DRAWN BY: AJC
CHECKED BY: DKS
DESIGNED BY: AMC

SHEET TITLE:
FOUNDATION PLAN
OUTDOOR PAVILION

SHEET NUMBER:

S-101

SHEET 10 OF 25
ISSUE DATE: 10/22/2024

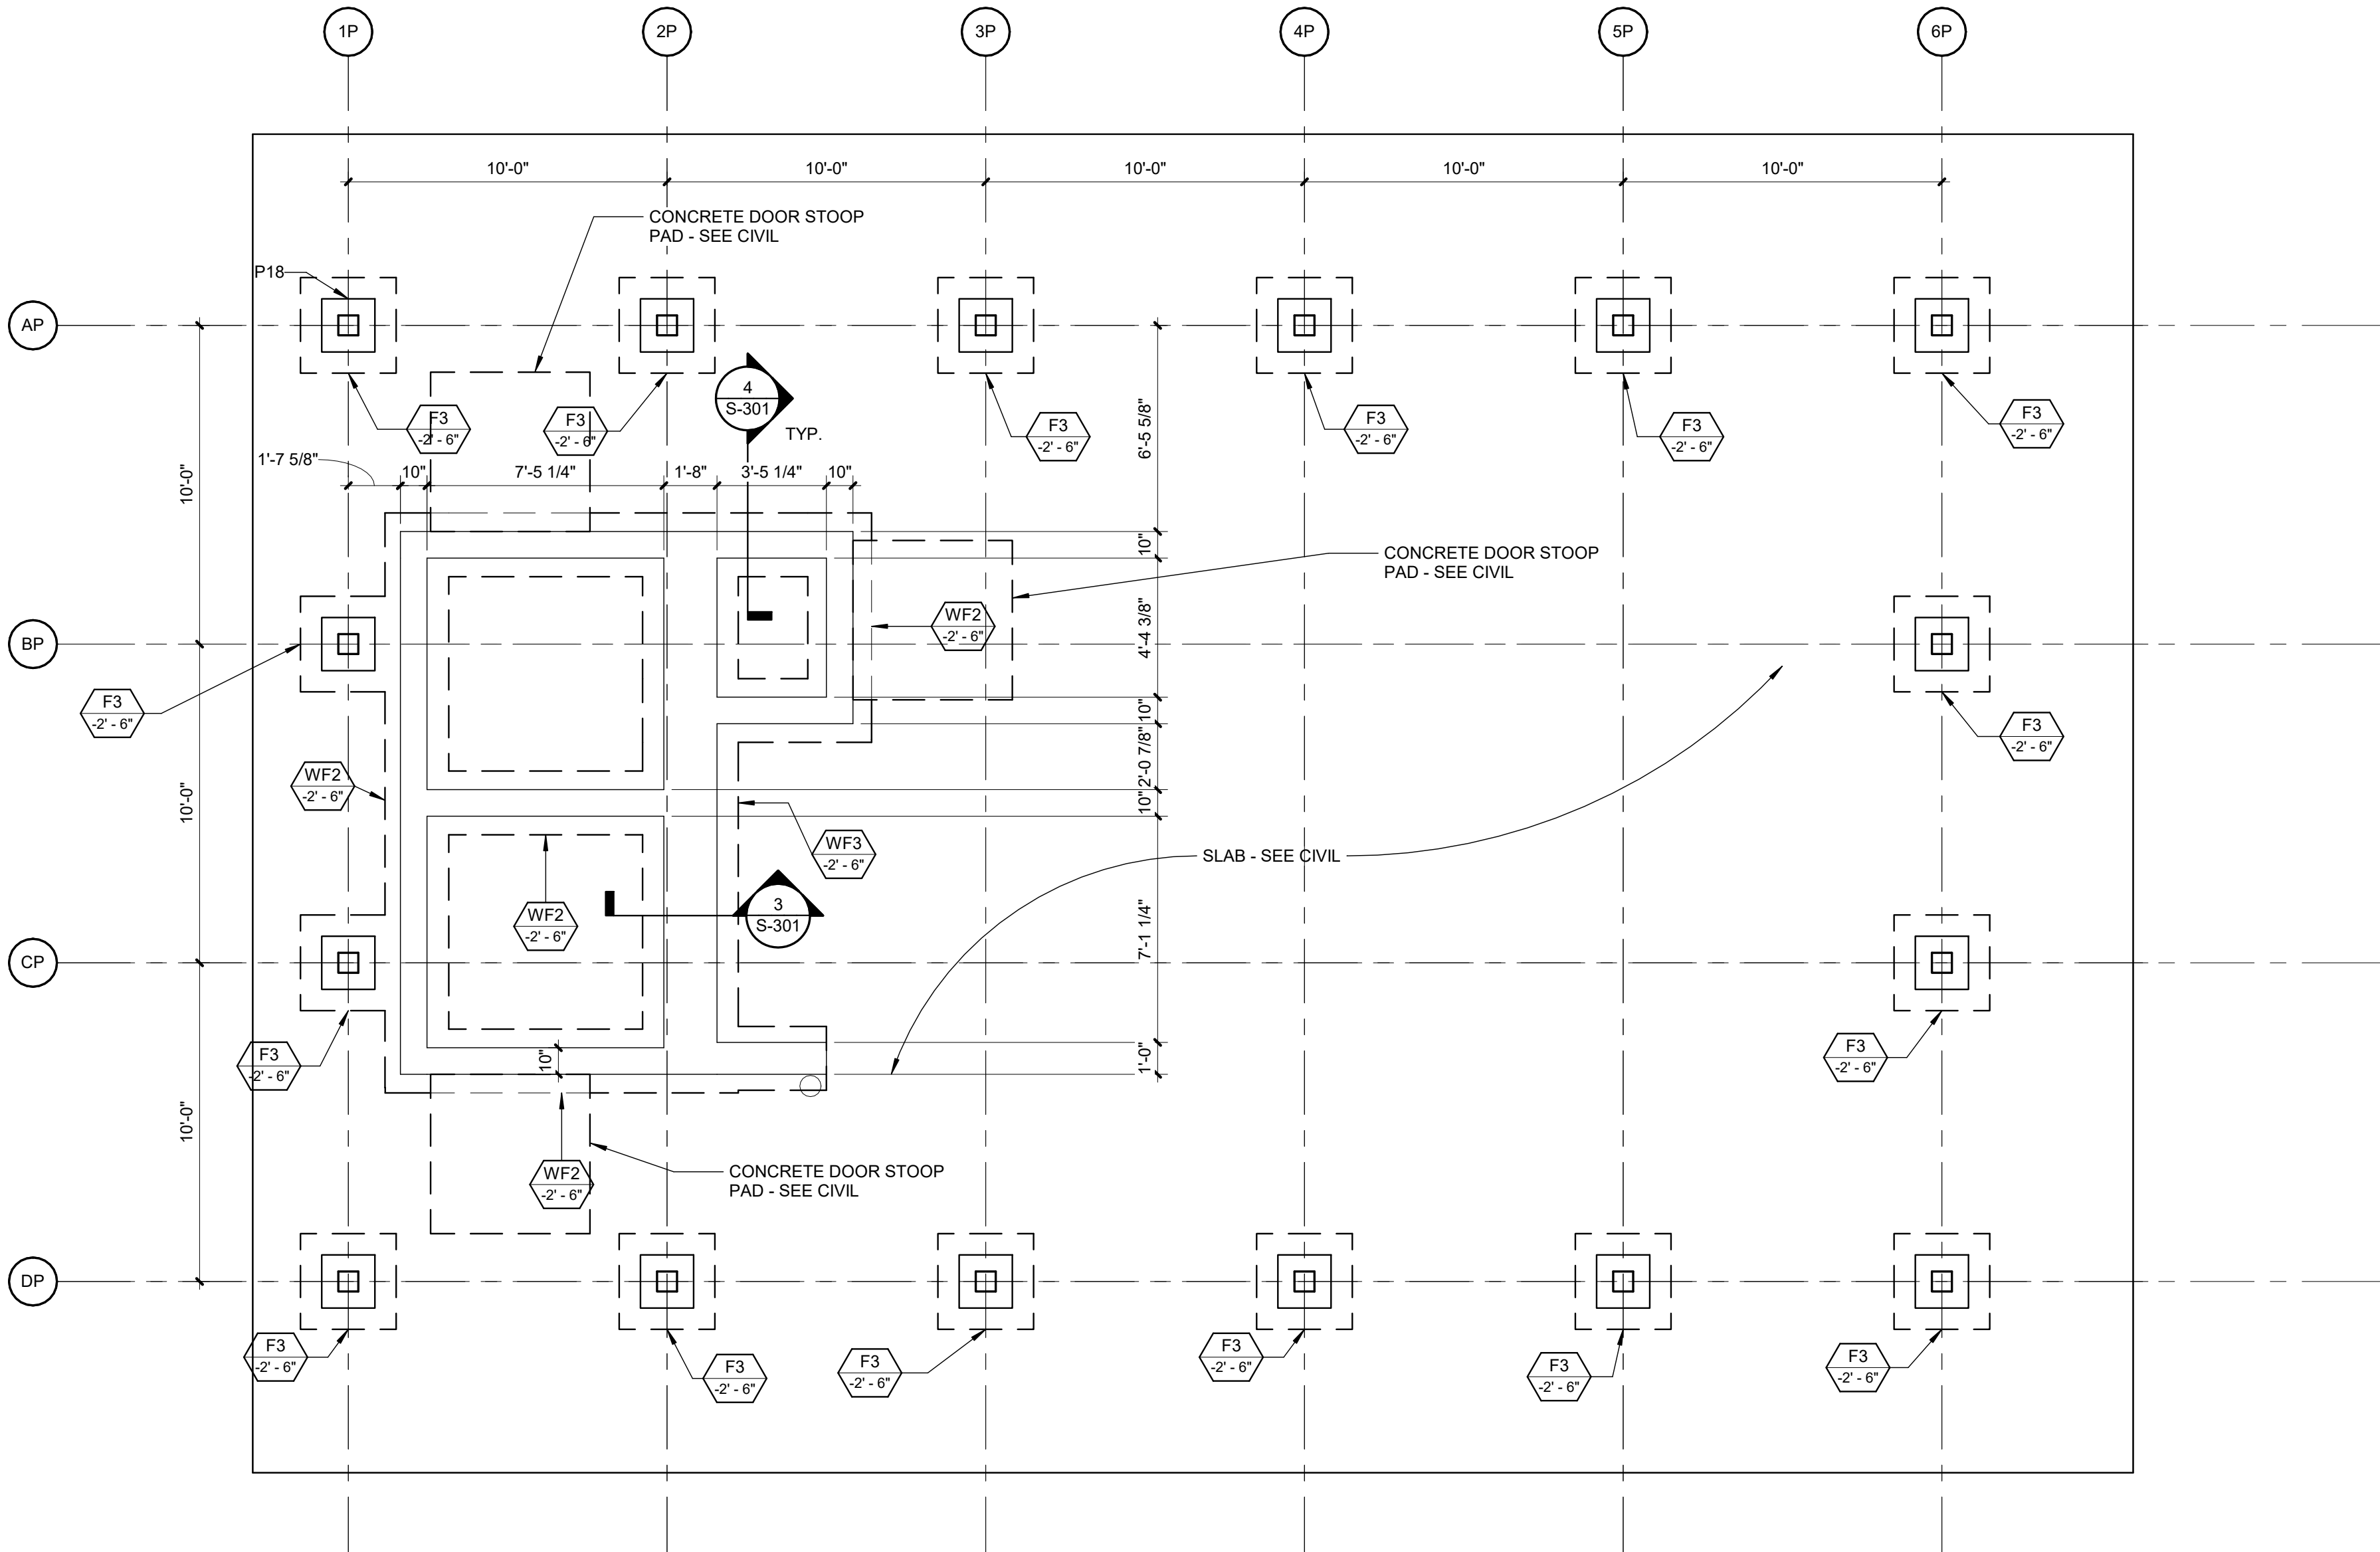

WALL FOOTING SCHEDULE


TYPE MARK	WIDTH	THICKNESS	LONG REINF	TRANS REINF
WF1.5	1' - 6"	1' - 0"	#5 AT 12" O.C.	#5 AT 12" O.C.
WF2	2' - 0"	1' - 0"	#5 AT 12" O.C.	#5 AT 12" O.C.
WF3	3' - 0"	1' - 0"	#5 AT 12" O.C.	#5 AT 12" O.C.
WF4	4' - 0"	1' - 0"	#5 AT 12" O.C.	#5 AT 12" O.C.

PEDESTAL SCHEDULE


TYPE MARK	WIDTH	DEPTH	VERTICAL REINF	HORIZONTAL REINF
P18	1' - 8"	1' - 8"	(16) #5	#4 TIES AT 10" O.C. TOP 12" AT 3" O.C.
P2	2' - 0"	2' - 0"	(22) #5	#4 TIES AT 10" O.C. TOP 12" AT 3" O.C.
P26	2' - 6"	2' - 6"	(24) #5	#4 TIES AT 10" O.C. TOP 12" AT 3" O.C.
P3	3' - 0"	3' - 0"	(26) #7	#4 TIES AT 10" O.C. TOP 12" AT 3" O.C.

PAD FOOTING SCHEDULE


TYPE MARK	WIDTH	LENGTH	DEPTH	LONG	TRANS	REMARKS
F3	3' - 0"	3' - 0"	1' - 0"	(4) #6 T&B	(4) #6 T&B	
F4	4' - 0"	4' - 0"	1' - 0"	(5) #6 T&B	(5) #6 T&B	
F5	5' - 0"	5' - 0"	1' - 6"	#6 AT 12" O.C. T&B	#6 AT 12" O.C. T&B	
F7	7' - 0"	7' - 0"	1' - 6"	#6 AT 12" O.C. T&B	#6 AT 12" O.C. T&B	
F10	10' - 0"	10' - 0"	1' - 6"	#6 AT 12" O.C. T&B	#6 AT 12" O.C. T&B	
F12	12' - 0"	12' - 0"	2' - 0"	#6 AT 12" O.C. T&B	#6 AT 12" O.C. T&B	

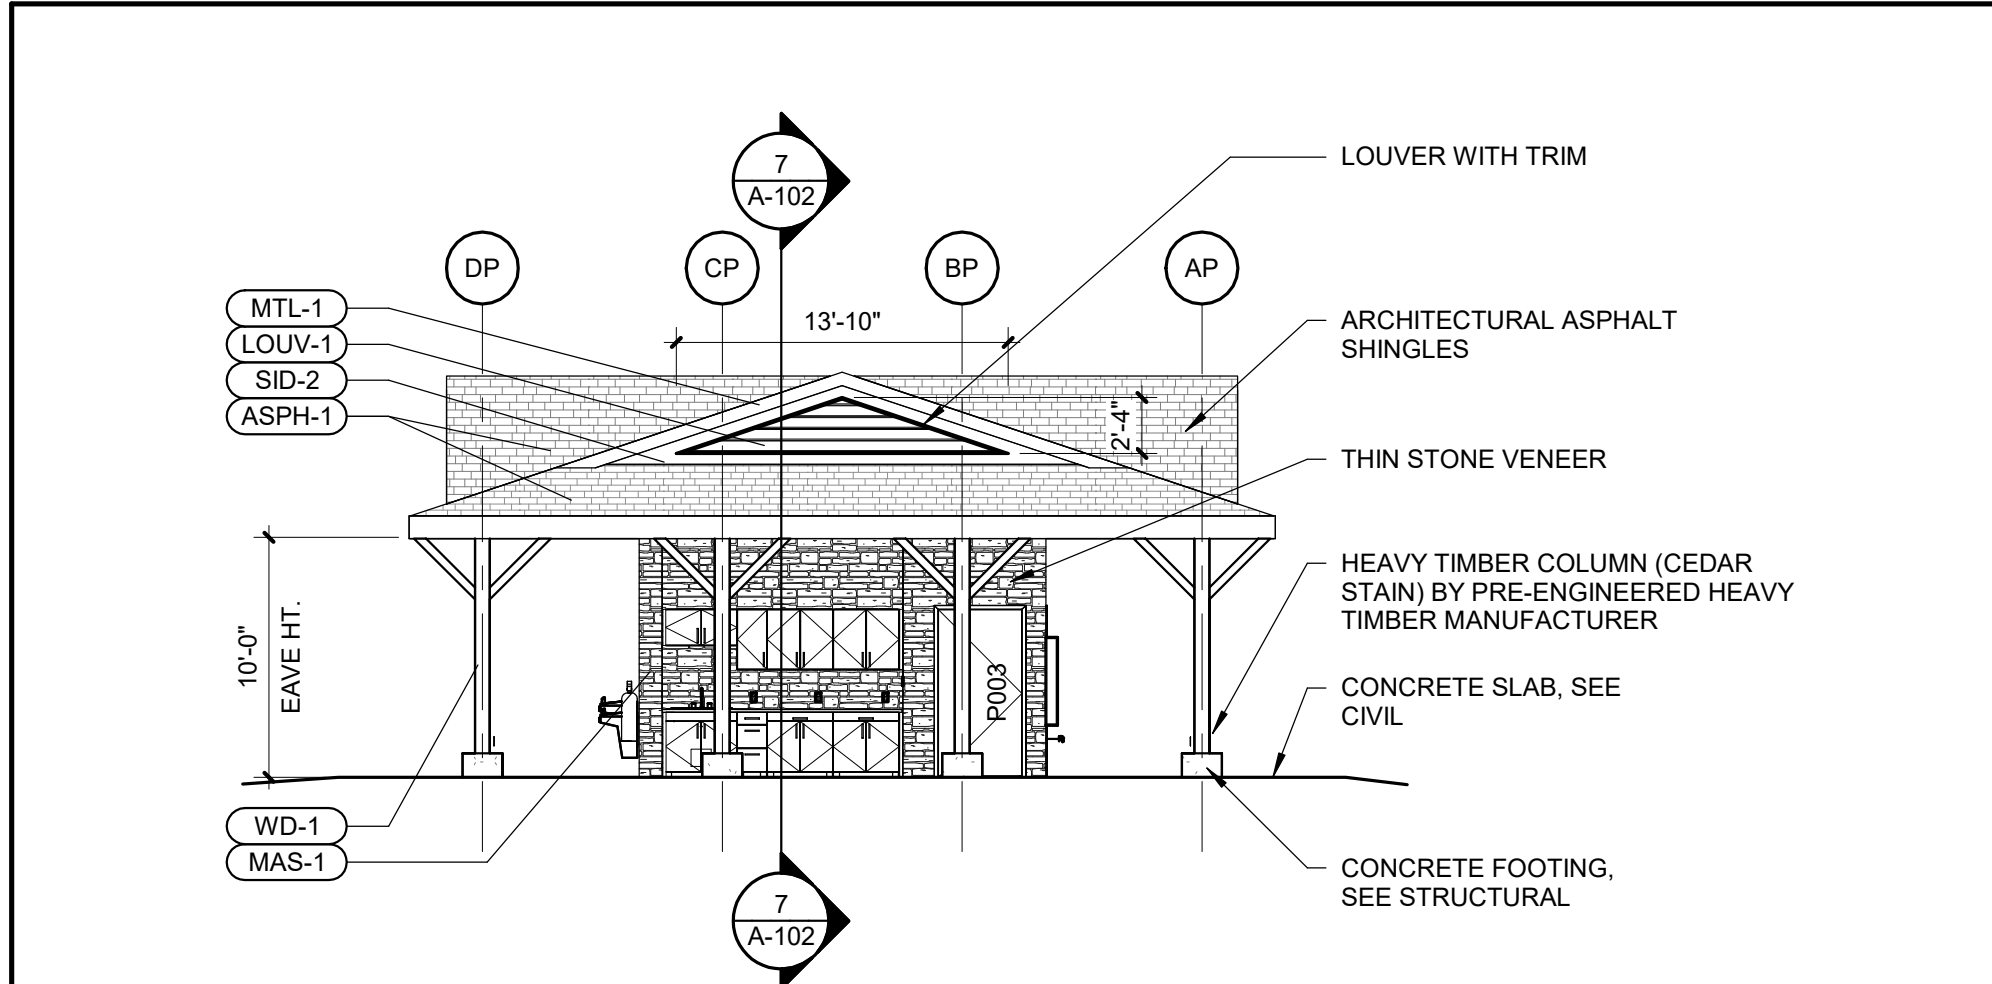


7 PAVILION EAST ELEVATION
Scale: 1/8" = 1'-0"

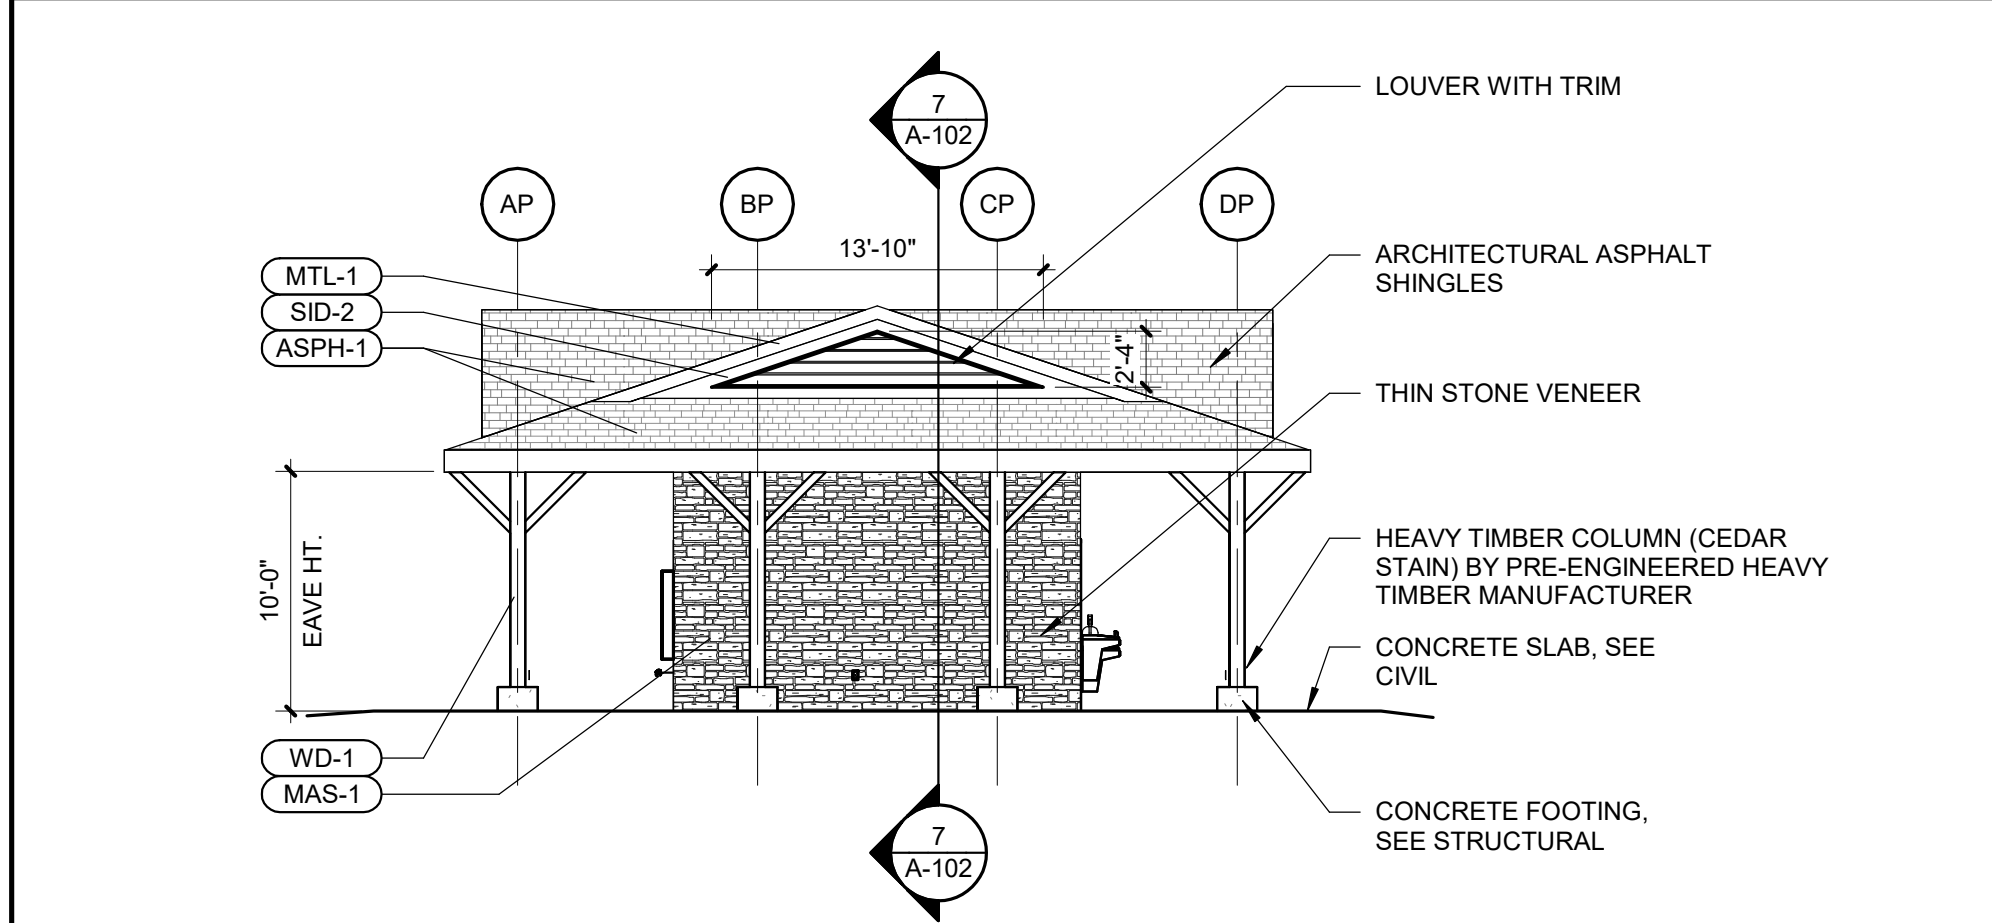


6 PAVILION WEST ELEVATION
Scale: 1/8" = 1'-0"

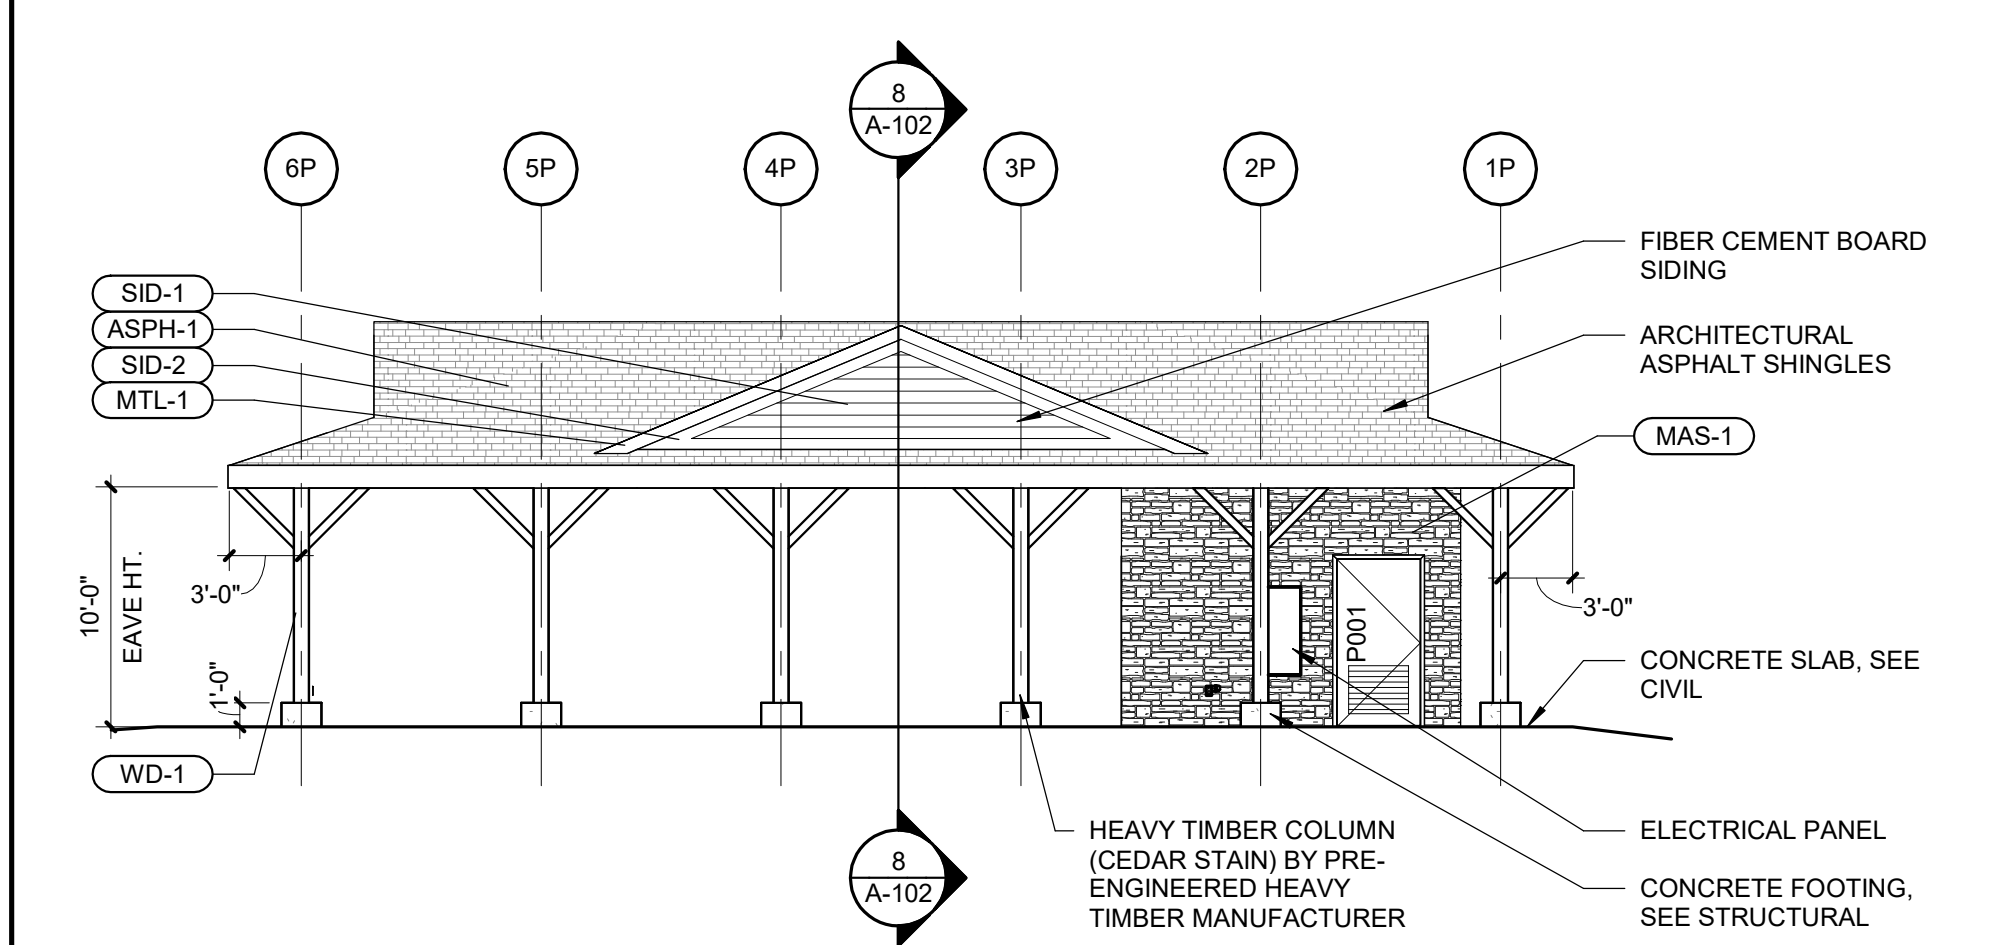


5 PAVILION NORTH ELEVATION
Scale: 1/8" = 1'-0"

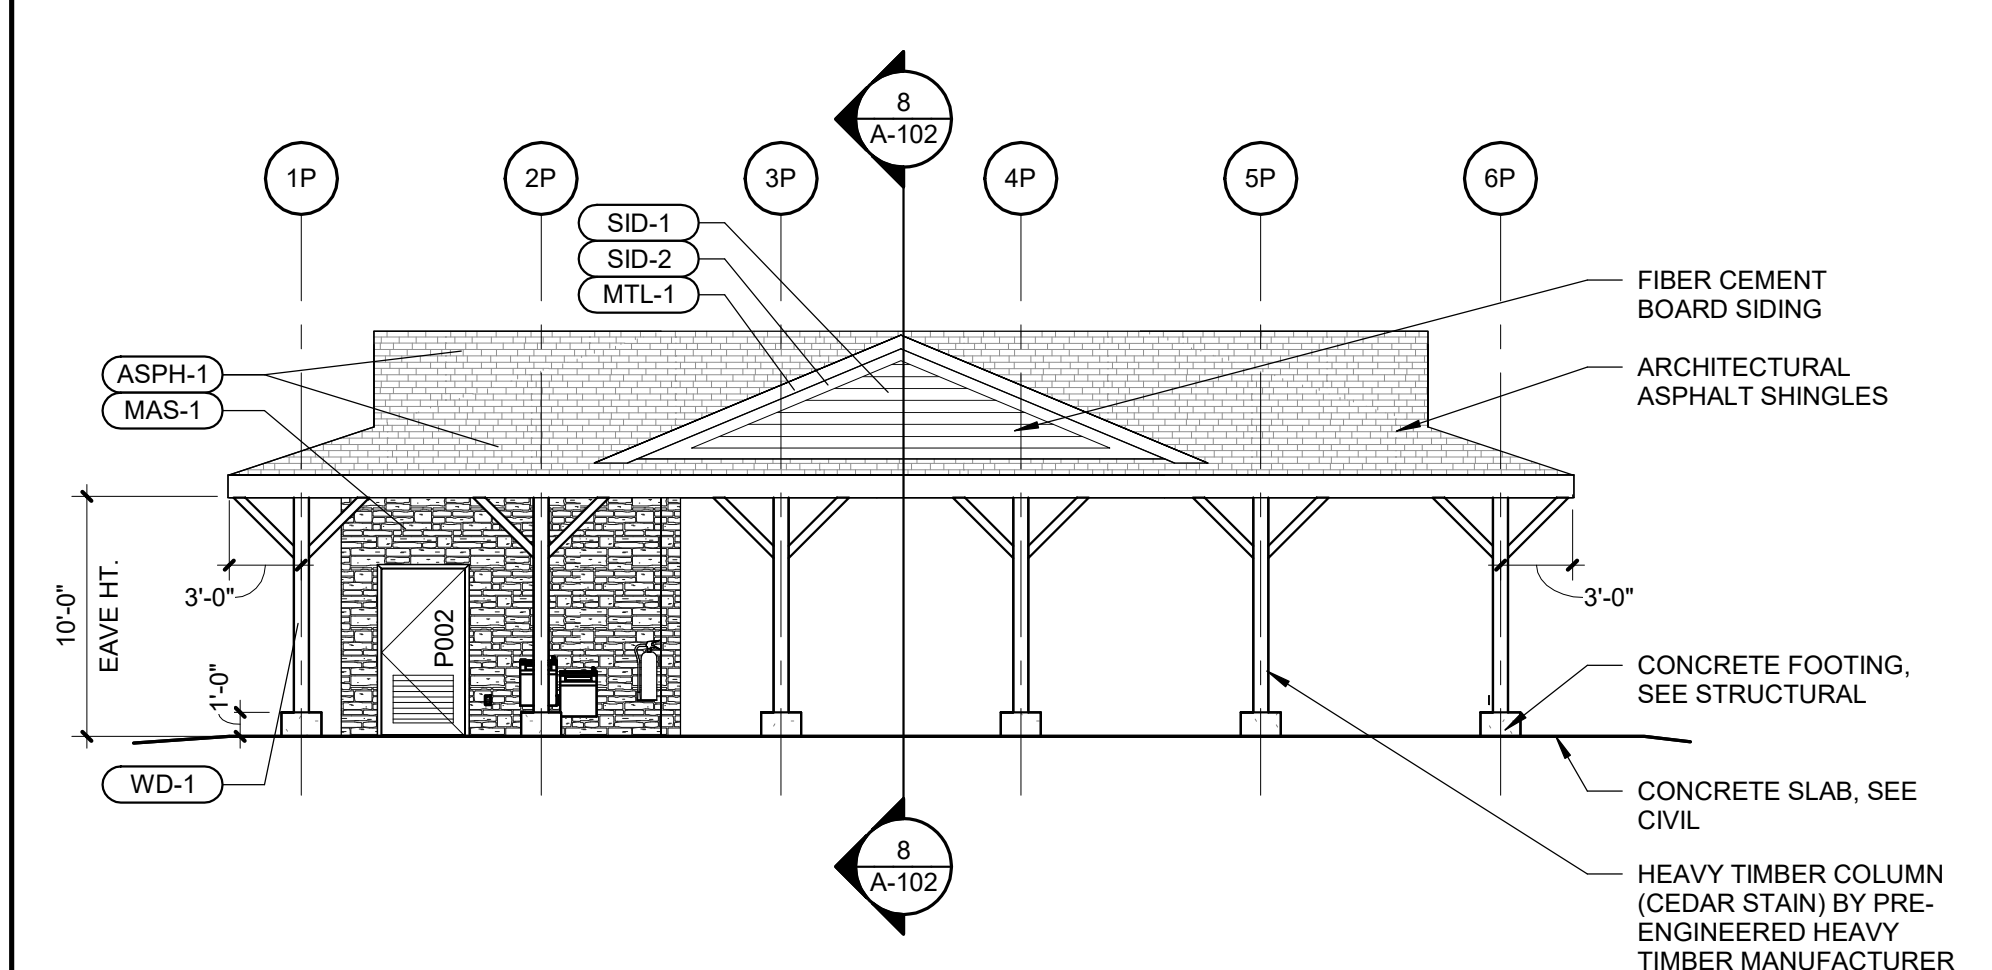


4 PAVILION SOUTH ELEVATION
Scale: 1/8" = 1'-0"

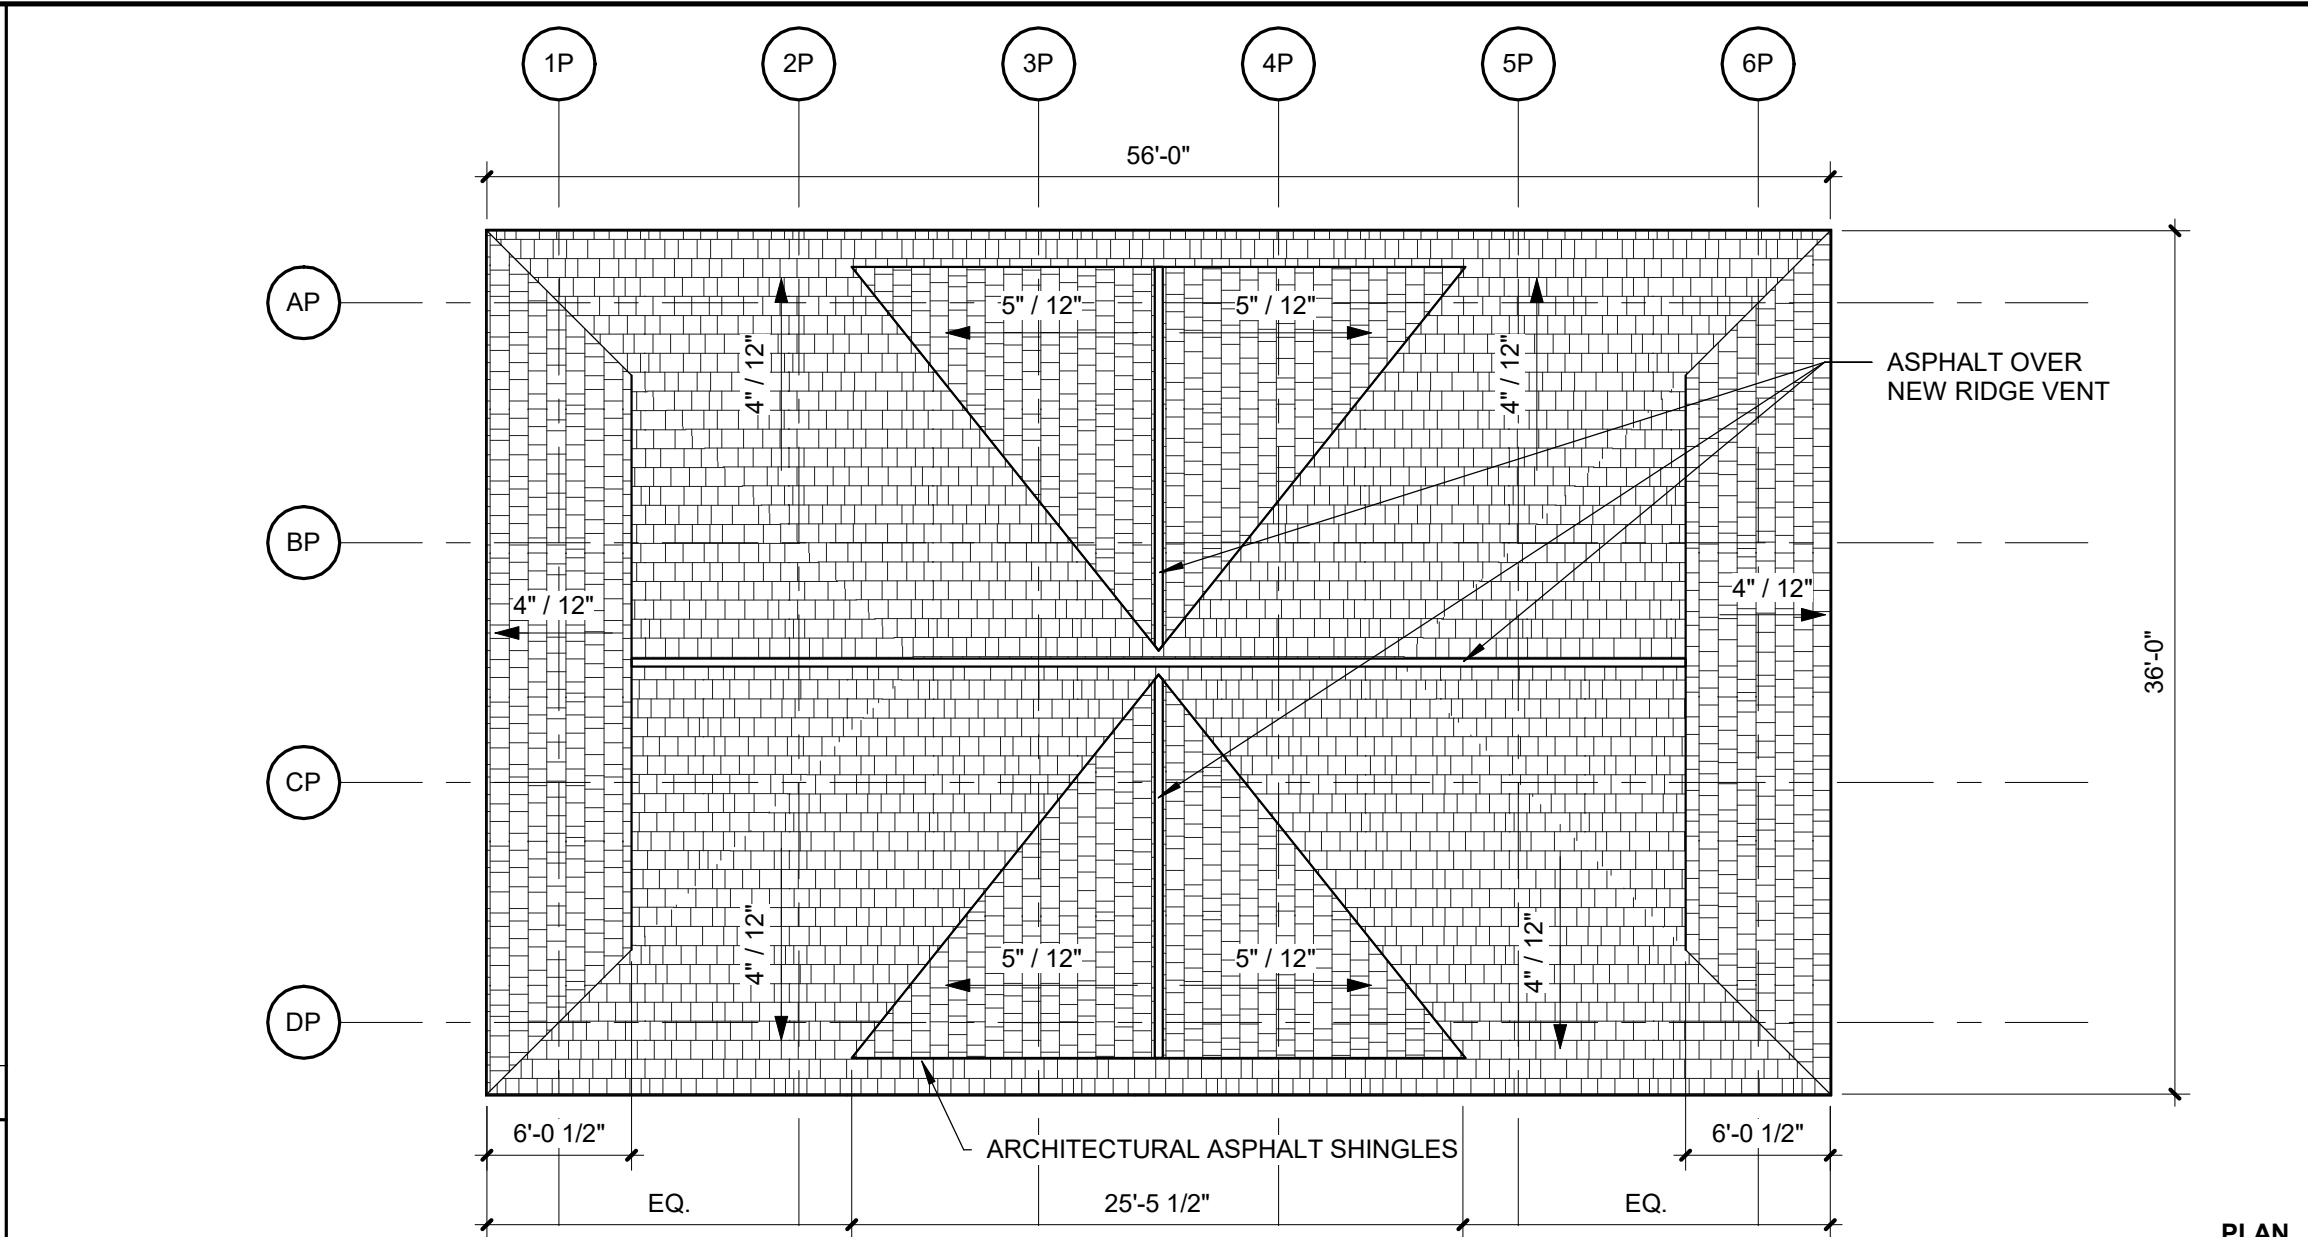

3 PAVILION ROOF PLAN
Scale: 1/8" = 1'-0"

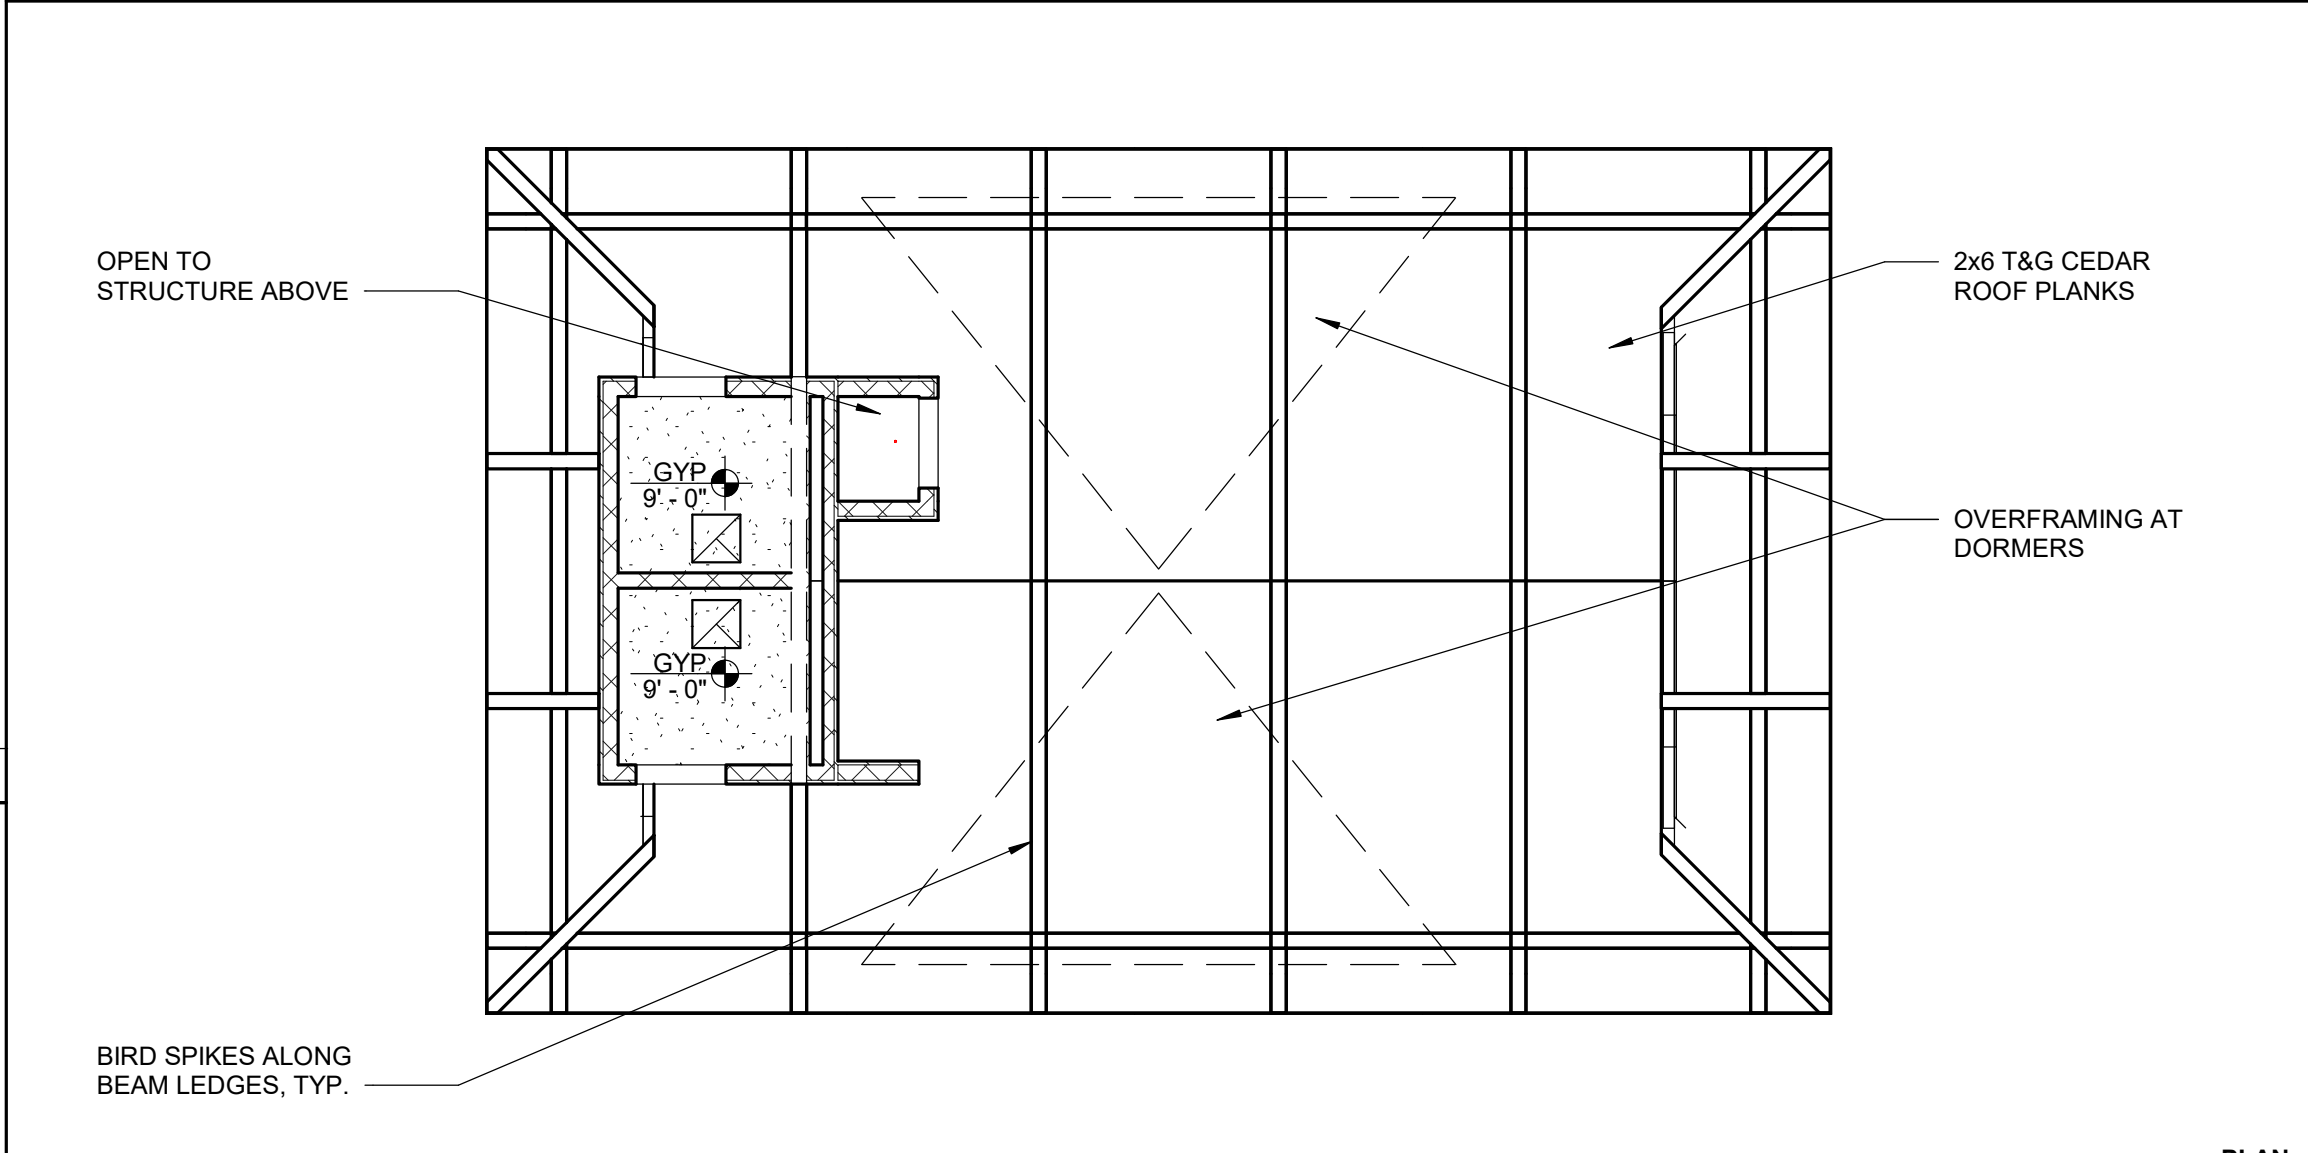

2 PAVILION REFLECTED CEILING PLAN
Scale: 1/8" = 1'-0"

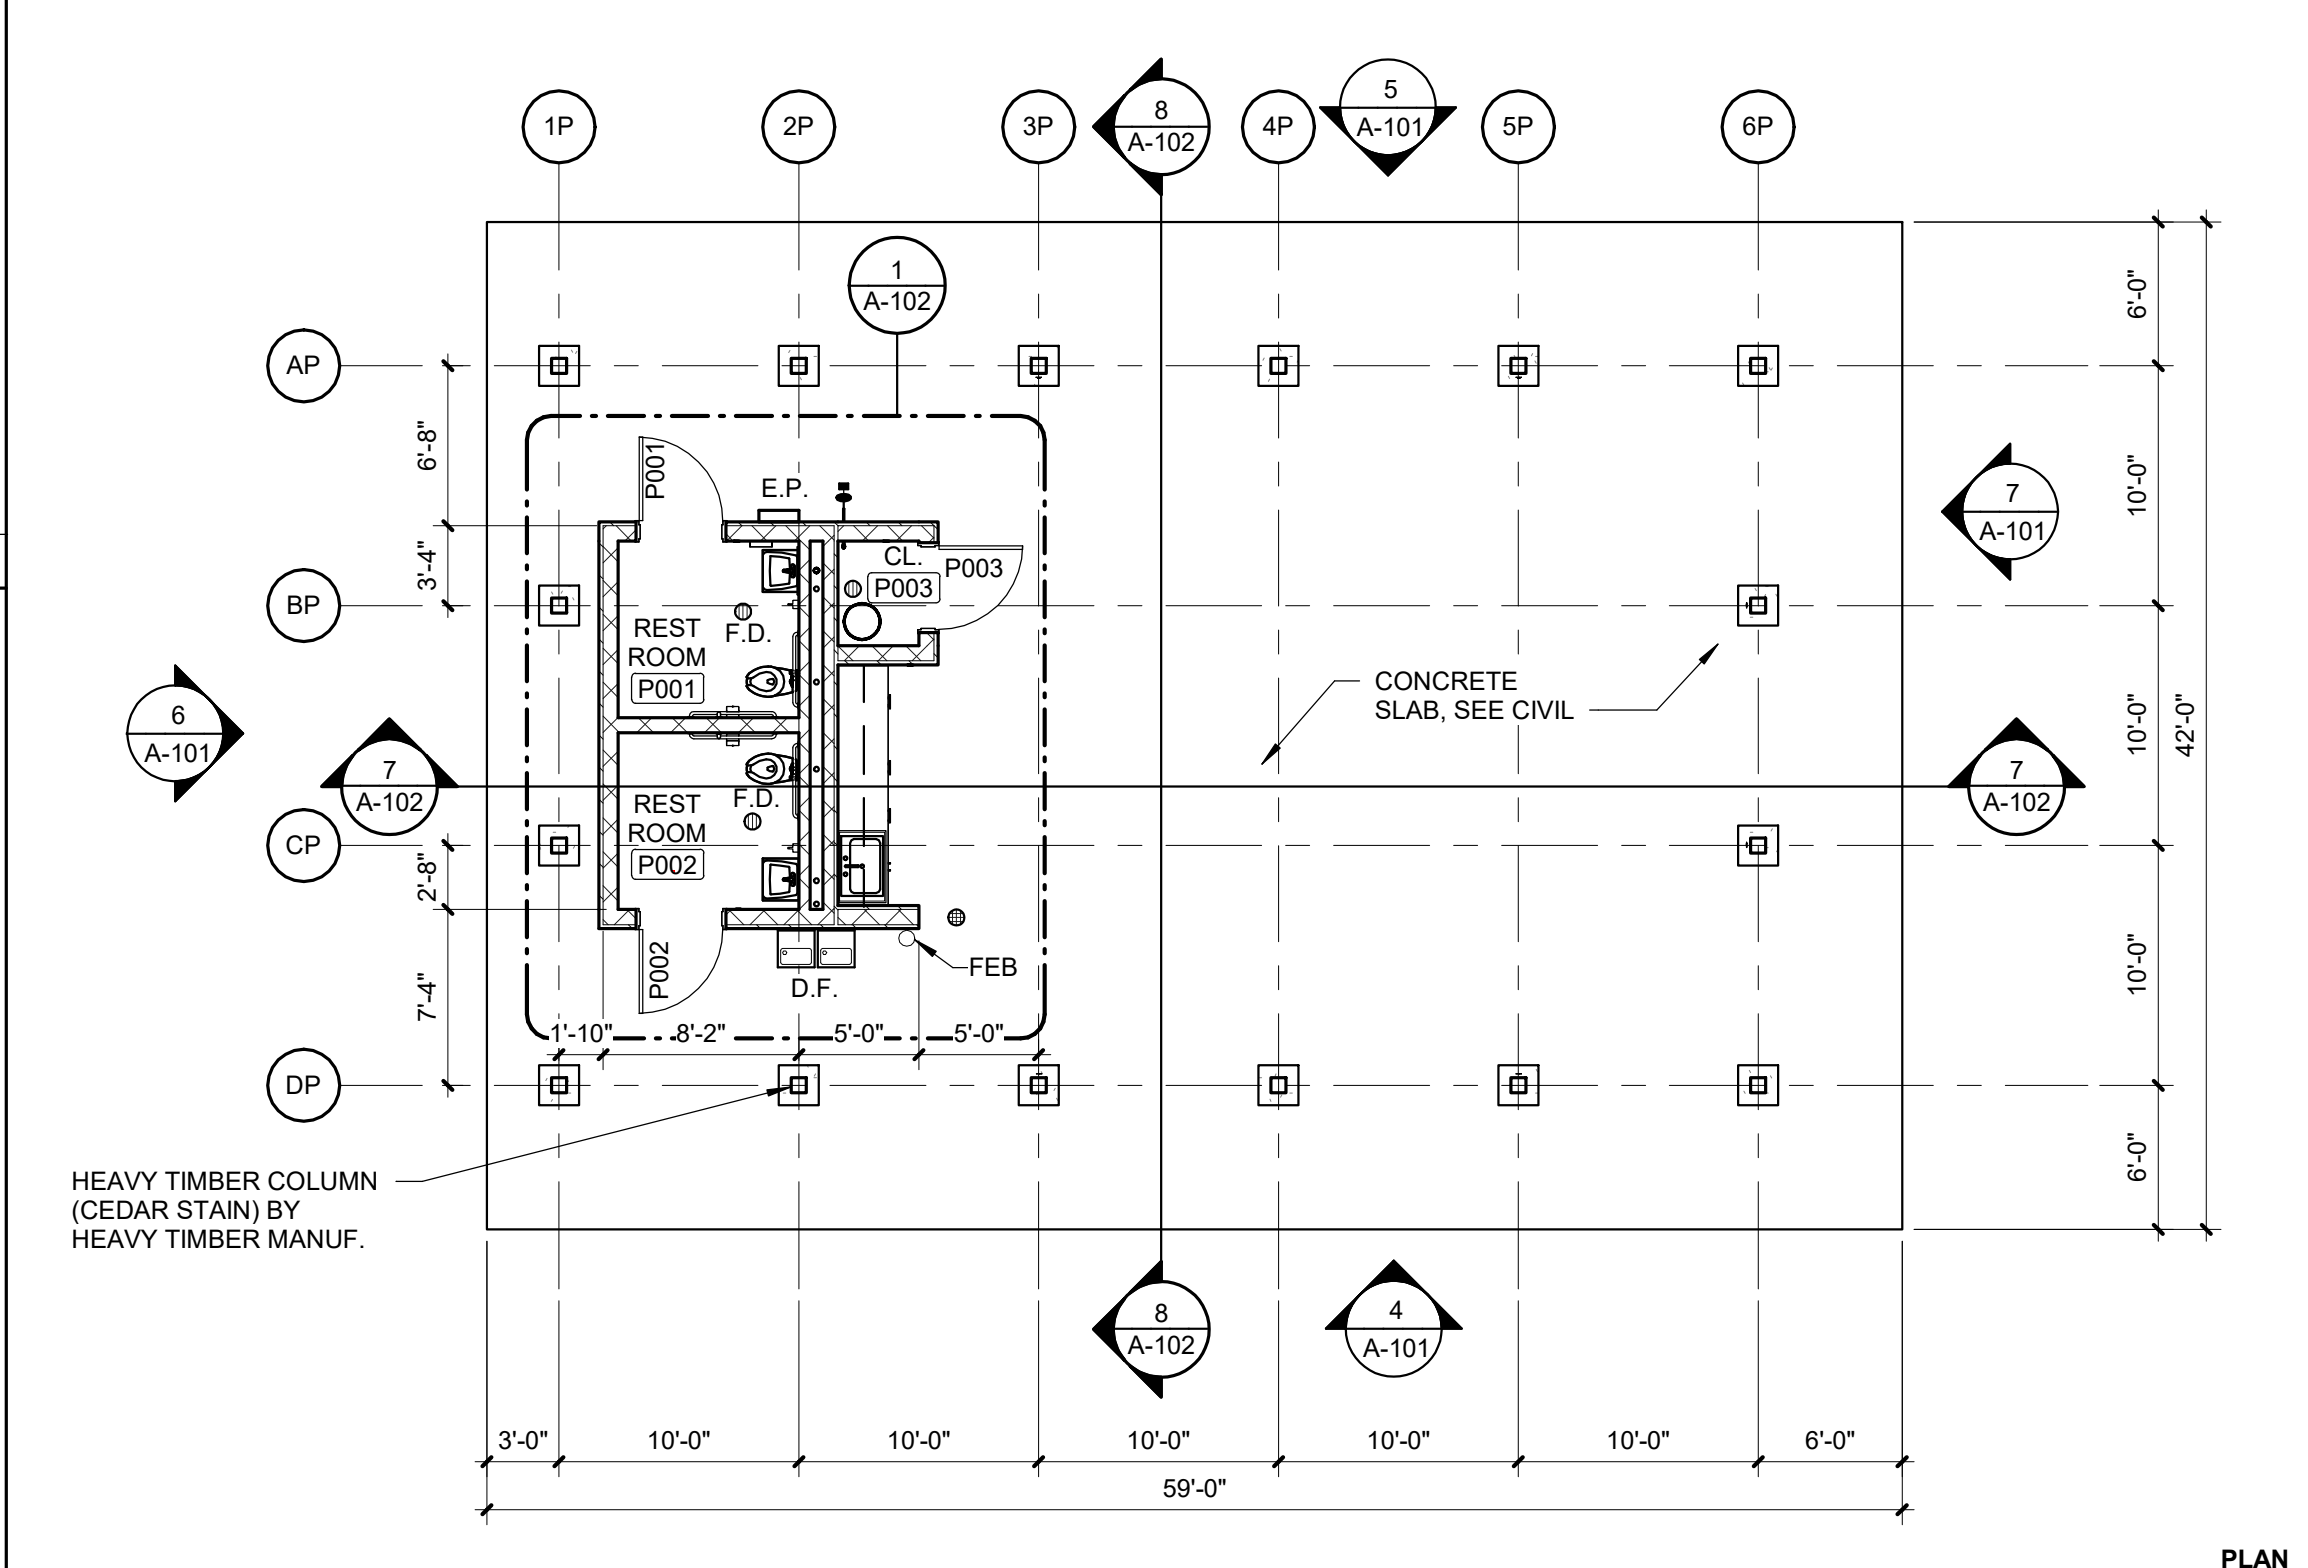

1 PAVILION FLOOR PLAN
Scale: 1/8" = 1'-0"


PLAN GENERAL NOTES

- A. SEE SCHEDULE FOR PARTITION TYPES.
- B. DIMENSIONS ARE SHOWN TO FACE OF STRUCTURE (WALL STUD, CMU AND/OR CONCRETE) UNLESS NOTED OTHERWISE. DIMENSIONS TO EXISTING CONSTRUCTION ARE SHOWN TO FINISH FACE OF WALL.
- C. ALL WOOD IN CONTACT WITH CONCRETE SHALL BE PRESSURE TREATED.
- D. HEAVY TIMBER FRAMING AND WOOD DECKING BY PAVILION DELEGATED DESIGNER AND FABRICATOR.
- E. INSTALL ALL DOORS WITH MINIMUM 18 INCHES CLEAR FROM INSIDE FACE OF LATCH SIDE OF JAMB TO FINISH FACE OF WALL ON PULL SIDE OF DOOR, AND MINIMUM 12" ON OPPOSITE SIDE.
- F. IT IS THE RESPONSIBILITY OF EACH CONTRACTOR TO PROVIDE COMPLETE WORKING SYSTEMS FOR ALL NEW ELEMENTS.
- G. ALL CONTRACTORS SHALL PROVIDE NEW, UNDAMAGED MATERIALS UNLESS OTHERWISE SPECIFIED.
- H. STORE MATERIALS IN SUCH A MANNER AS NOT TO OVERSTRESS, OVERLOAD, OR OTHERWISE PUT AN UNSAFE LOAD ON ANY STRUCTURE DURING CONSTRUCTION.
- I. INSTALL ALL WORK IN ACCORDANCE WITH CURRENT APPLICABLE CODES, PUBLISHED STANDARDS, AND ACCEPTABLE CONSTRUCTION STANDARDS.
- J. ALL NEW WORK SHALL BE PLUMB AND LEVEL UNLESS OTHERWISE NOTED.
- K. EACH CONTRACTOR SHALL COORDINATE THEIR WORK WITH ALL OTHER TRADES.
- L. DO NOT SCALE DRAWINGS TO DETERMINE DIMENSIONS. IF A REQUIRED DIMENSION IS NOT INDICATED, CONTACT THE ARCHITECT FOR DETERMINATION.
- M. DETAILS ARE GENERALLY TYPICAL AND ARE NOT TO BE CONSTRUED AS LIMITED TO THOSE AREAS SPECIFICALLY INDICATED. REVIEW ANY QUESTIONS OR CONFLICTING INFORMATION WITH THE ARCHITECT PRIOR TO INSTALLATION.
- N. HINGE SIDE OF DOOR JAMBS TO BE LOCATED 4" FROM NEAREST WALL INTERSECTION UNLESS OTHERWISE NOTED.
- O. PAINT ALL STEEL DOORS, DOOR FRAMES, INTERIOR BORROW LITE FRAMES, LINTELS AND OTHER EXPOSED METAL ITEMS UNLESS OTHERWISE NOTED OR SHOWN.
- P. PAINT ALL EXPOSED CMU BLOCK WALLS.

DOOR SCHEDULE

NO.	DOOR						DOOR FRAME			HEAD DETAIL	JAMB DETAIL	HJWR SET	REMARKS
	WIDTH	HEIGHT	THICK	MAT'L	FINISH	ELEV	MAT'L	FINISH	ELEV	NO.	NO.		
P001	3' - 6"	7' - 0"	1 3/4"	HM	PNT	L	HM	PNT	1	6/A-102	5/A-102	2.0	1, 2
P002	3' - 6"	7' - 0"	1 3/4"	HM	PNT	L	HM	PNT	1	6/A-102	5/A-102	2.0	1, 2
P003	3' - 6"	7' - 0"	1 3/4"	HM	PNT	F	HM	PNT	1	6/A-102	5/A-102	1.0	2

- REMARKS:
- DOOR WITH LOUVER
 - PAINT DOORS AND FRAMES

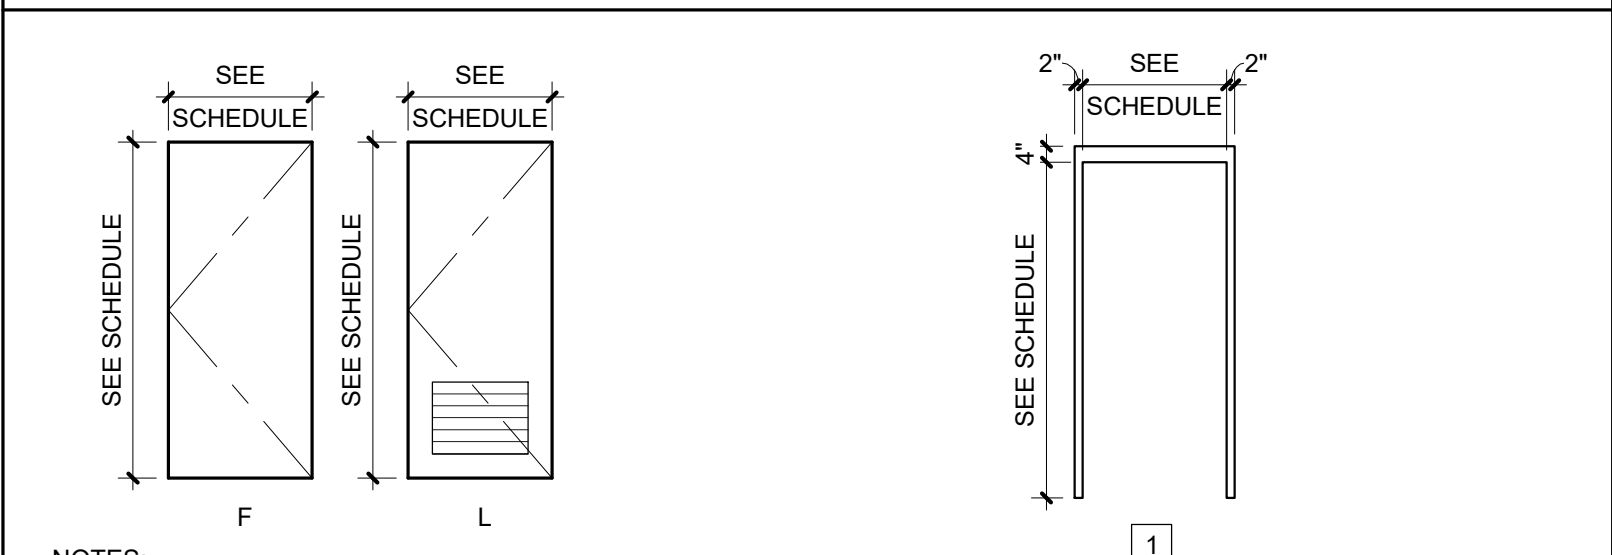

- NOTES:
- PROVIDE FIRE-RATED GLASS AT FIRE RATED CONDITIONS
 - ALL EXTERIOR GLASS SHALL BE INSULATED
 - ALL GLASS MUST BE TEMPERED


DOOR ELEVATIONS **FRAME ELEVATIONS**

EXTERIOR FINISH SCHEDULE **XX-#**

MARK	BASIS OF DESIGN MANUFACTURER	BASIS OF DESIGN PRODUCT LINE	SIZE	FINISH	NOTES
ASPH-1	CERTAINTED	ARCHITECTURAL SHINGLE - ALGAE RESISTANT	MATCH EXISTING	MATCH EXISTING / HARBOR GRAY 6105	
LOUV-1	RUSKIN	EXTRUDED ALUMINUM LOUVER	SEE DRAWINGS	PAINTED PVDF	CUSTOM COLOR TO MATCH APPROVED SAMPLE
MAS-1	EARTHWORKS	THIN ADHERED STONE - HARVEST MIX SNAPPED	3"-9" SNAPPED	SEE PRODUCT	THIN ADHERED
MTL-1	SHEET METAL TRIM	SEE SPECIFICATIONS	SEE DRAWINGS	WHITE	INCLUDES ALL FLASHINGS U.N.O.
SID-1	JAMES HARDIE	FIBER CEMENT BOARD; HARDIPLANK; LAP SIDING	7" EXPOSURE	EVENING BLUE; CEDARMILL	
SID-2	JAMES HARDIE	FIBER CEMENT BOARD; HARDI TRIM BOARDS; 4/4 NT3 SMOOTH	3-1/2" WIDTH x 3/4" THICK	ARCTIC WHITE	
WD-1	VERMONT TIMBER WORKS	DOUGLAS FIR WOOD SUPPORTS	BY DELEGATED DESIGNER, MIN. 6"x 6"	NATURAL CEDAR TONE SEMI TRANSPARENT - ARBORCOAT	COLUMNS TO BE PLANED AND CHAMFERED


LEGEND

ASPH	ASPHALT	SID	SIDING
LOUV	LOUVER	WD	WOOD
MAS	MASONRY		

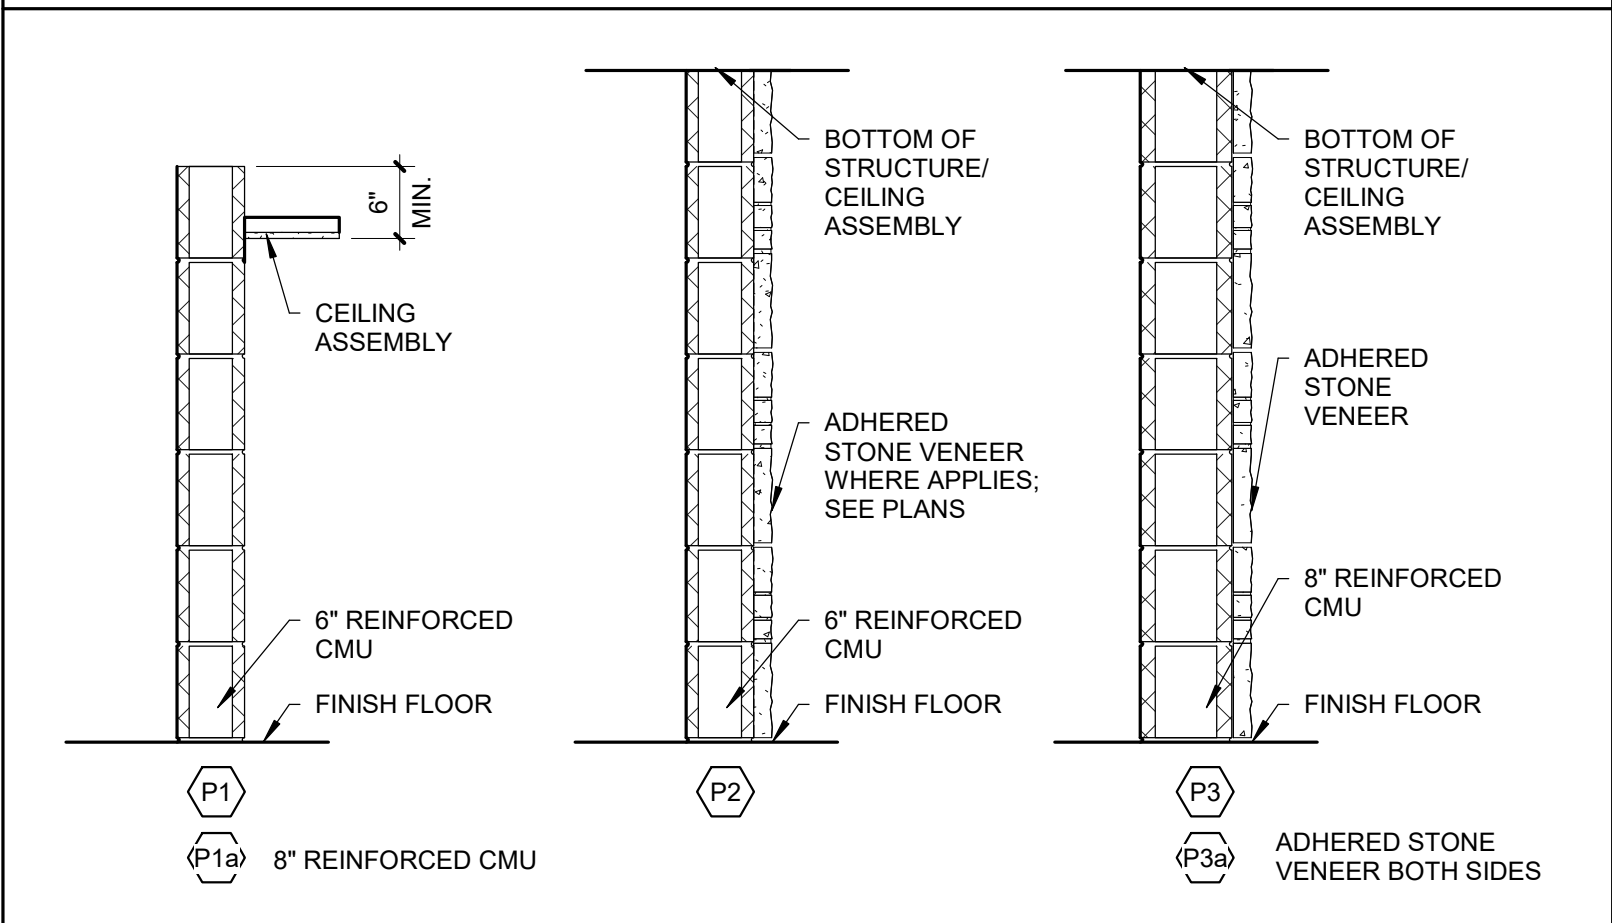

PARTITION TYPES

STATE OF MISSOURI
MICHAEL L. PARSON,
GOVERNOR

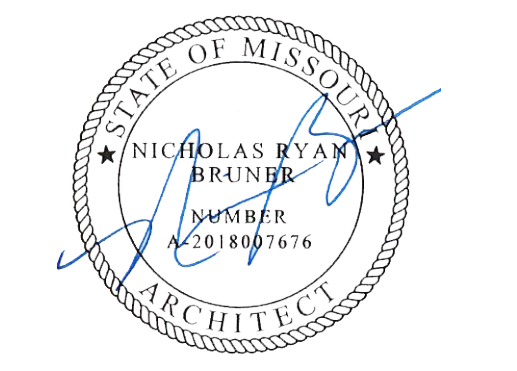

Farnsworth
GROUP

20 ALLEN AVENUE, SUITE 200
ST LOUIS, MISSOURI 63119
(314) 962-7900 / info@f-w.com
Farnsworth Group, Inc.
Missouri State Certificate of Authority #000744
www.f-w.com
Engineers | Architects | Surveyors | Scientists

100% BID SET

10/22/2024

OFFICE OF
ADMINISTRATION
DIVISION OF FACILITIES
MANAGEMENT, DESIGN
AND CONSTRUCTION

MISSOURI VETERANS
COMMISSION

**OUTDOOR PAVILION
CAPE GIRARDEAU
VETERANS HOME**

2400 Veterans Memorial Dr.
Cape Girardeau, MO 63701

PROJECT #: U2415.01
SITE #: 6803
ASSET #: 8136803002
FAI #: 29-043
DATE: DESCRIPTION:

DRAWN BY: KMM
CHECKED BY: SRJ
DESIGNED BY: SRJ

SHEET TITLE:
**PAVILION PLANS,
ELEVATIONS, &
SCHEDULES**



SHEET NUMBER:

A-101




SHEET 12 OF 25
ISSUE DATE: 10/22/2024

CASEWORK SCHEDULE						
NO.	WIDTH	HEIGHT	DEPTH	COUNT	DETAIL NO.	DESCRIPTION
BASE CABINETS						
B1	3'-0"	2'-8 1/2"	2'-0"	1		SINK CABINET, TWO HINGED DOORS, 6" FALSE FRONT ABOVE DOORS
B2	2'-9"	2'-8 1/2"	2'-0"	2		ONE LARGE 6" DRAWER, TWO HINGED DOORS, ONE ADJUSTABLE SHELF
B3	1'-3"	2'-8 1/2"	2'-0"	1		ONE 6" DRAWER, TWO EQUAL DRAWERS
WALL CABINETS						
W1	3'-0"	1'-6"	1'-1"	1		TWO HINGED DOORS, ONE ADJUSTABLE SHELF
W2	2'-9"	2'-6"	1'-1"	2		TWO HINGED DOORS, TWO ADJUSTABLE SHELVES
W3	1'-3"	2'-6"	1'-1"	1		ONE HINGED DOOR, TWO ADJUSTABLE SHELVES





TOILET ACCESSORY SCHEDULE		
MARK	DESCRIPTION	REMARKS
T1	GRAB BAR (42")	CFCI
T2	GRAB BAR (36")	CFCI
T3	GRAB BAR (18")	CFCI
T4	TOILET TISSUE DISPENSER	CFCI
T5	PAPER TOWEL DISPENSER	CFCI
T6	LIQUID SOAP DISPENSER	CFCI
T7	MIRROR UNIT	CFCI
T8	SANITARY NAPKIN DISPOSAL	CFCI
T9	UNDERLAVATORY GUARD	CFCI

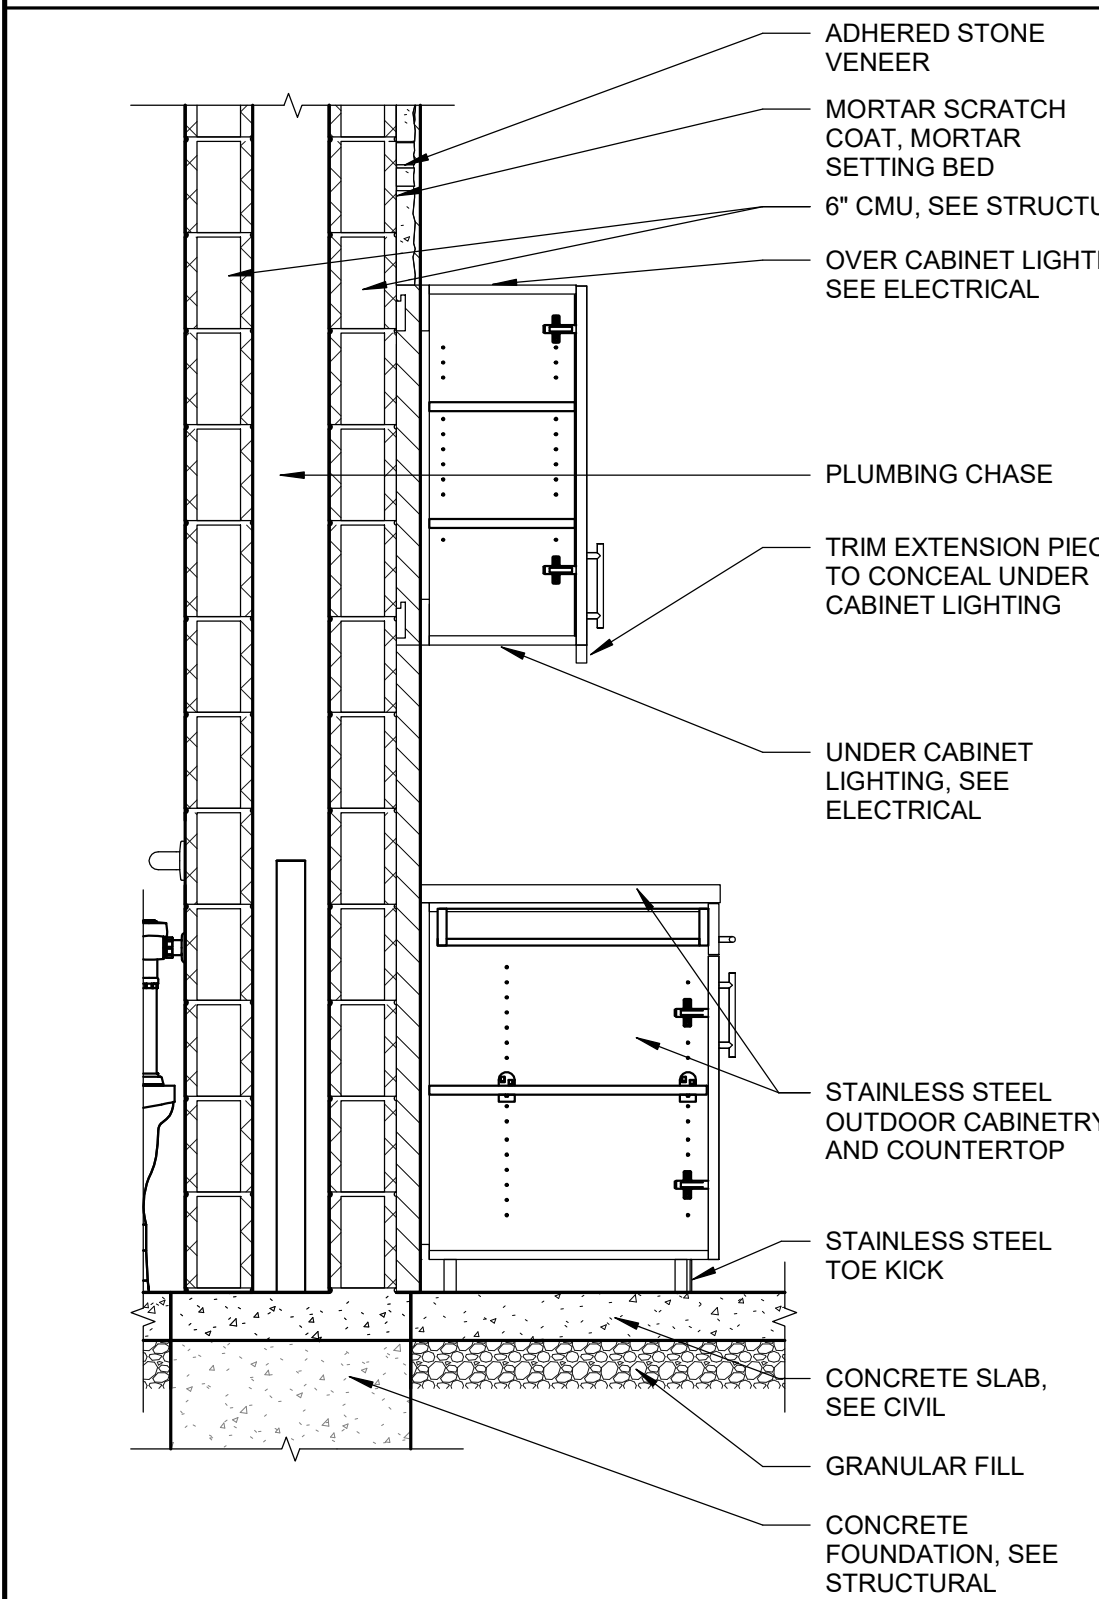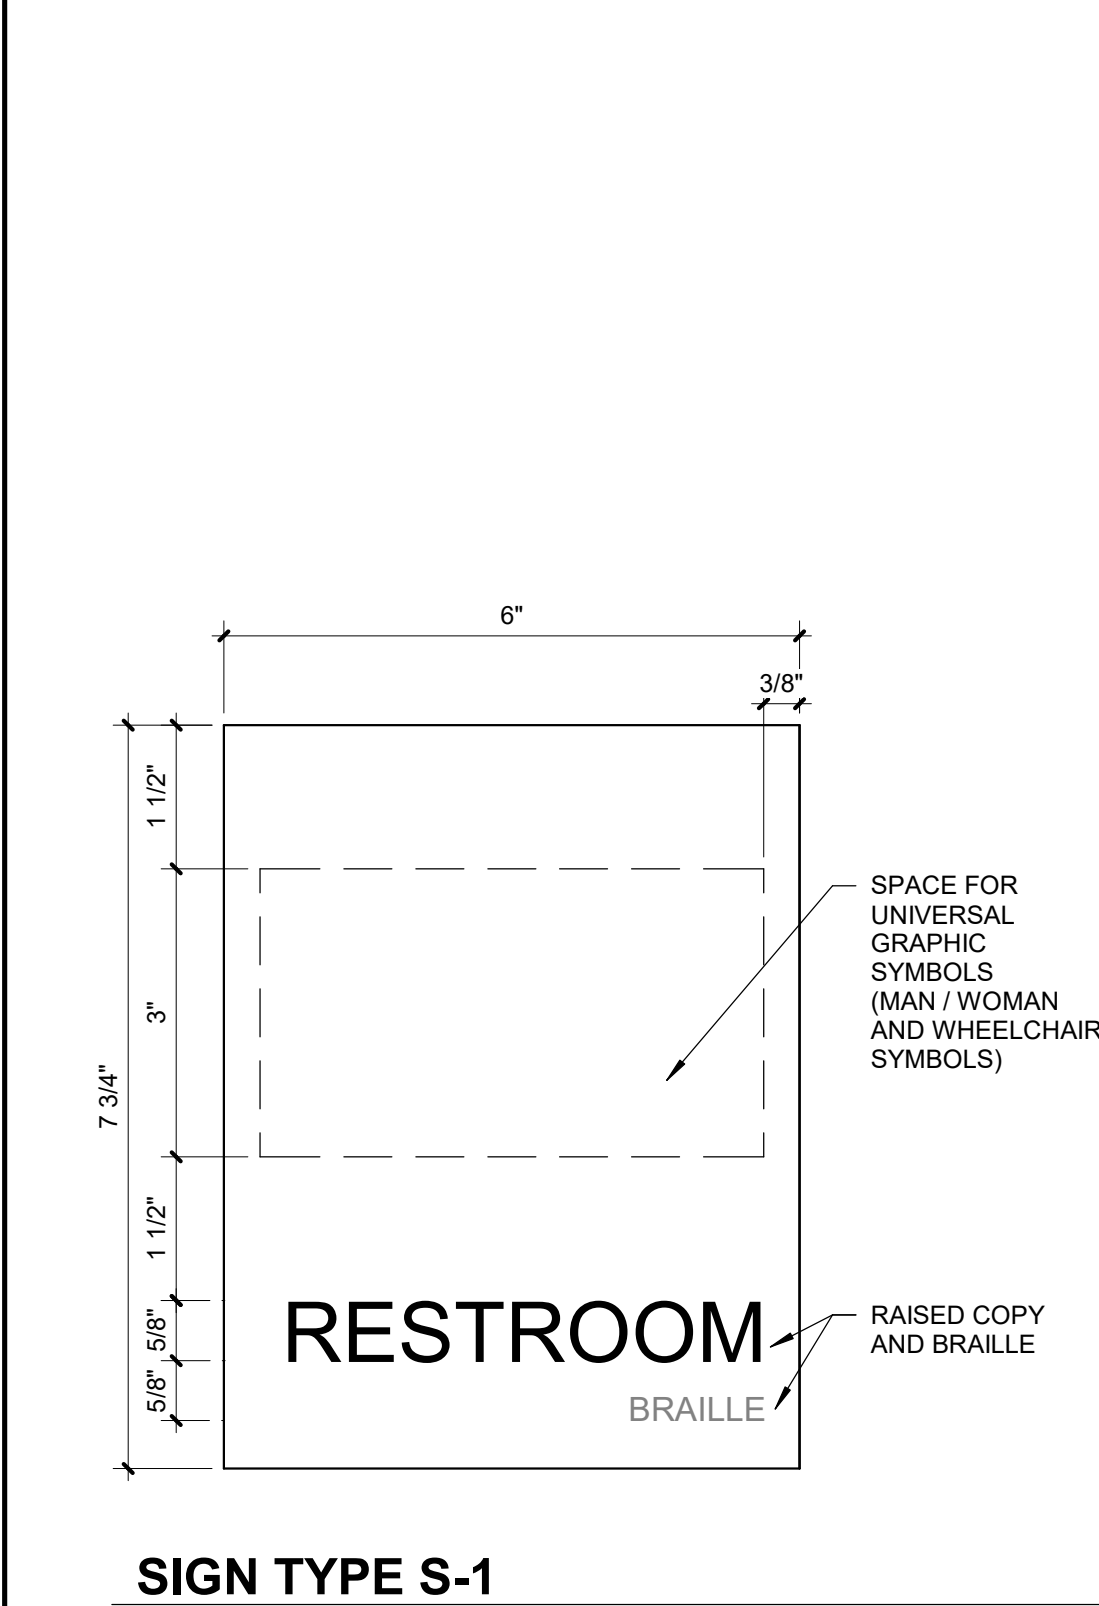

11 SECTION THROUGH CASEWORK
Scale: 3/4" = 1'-0"

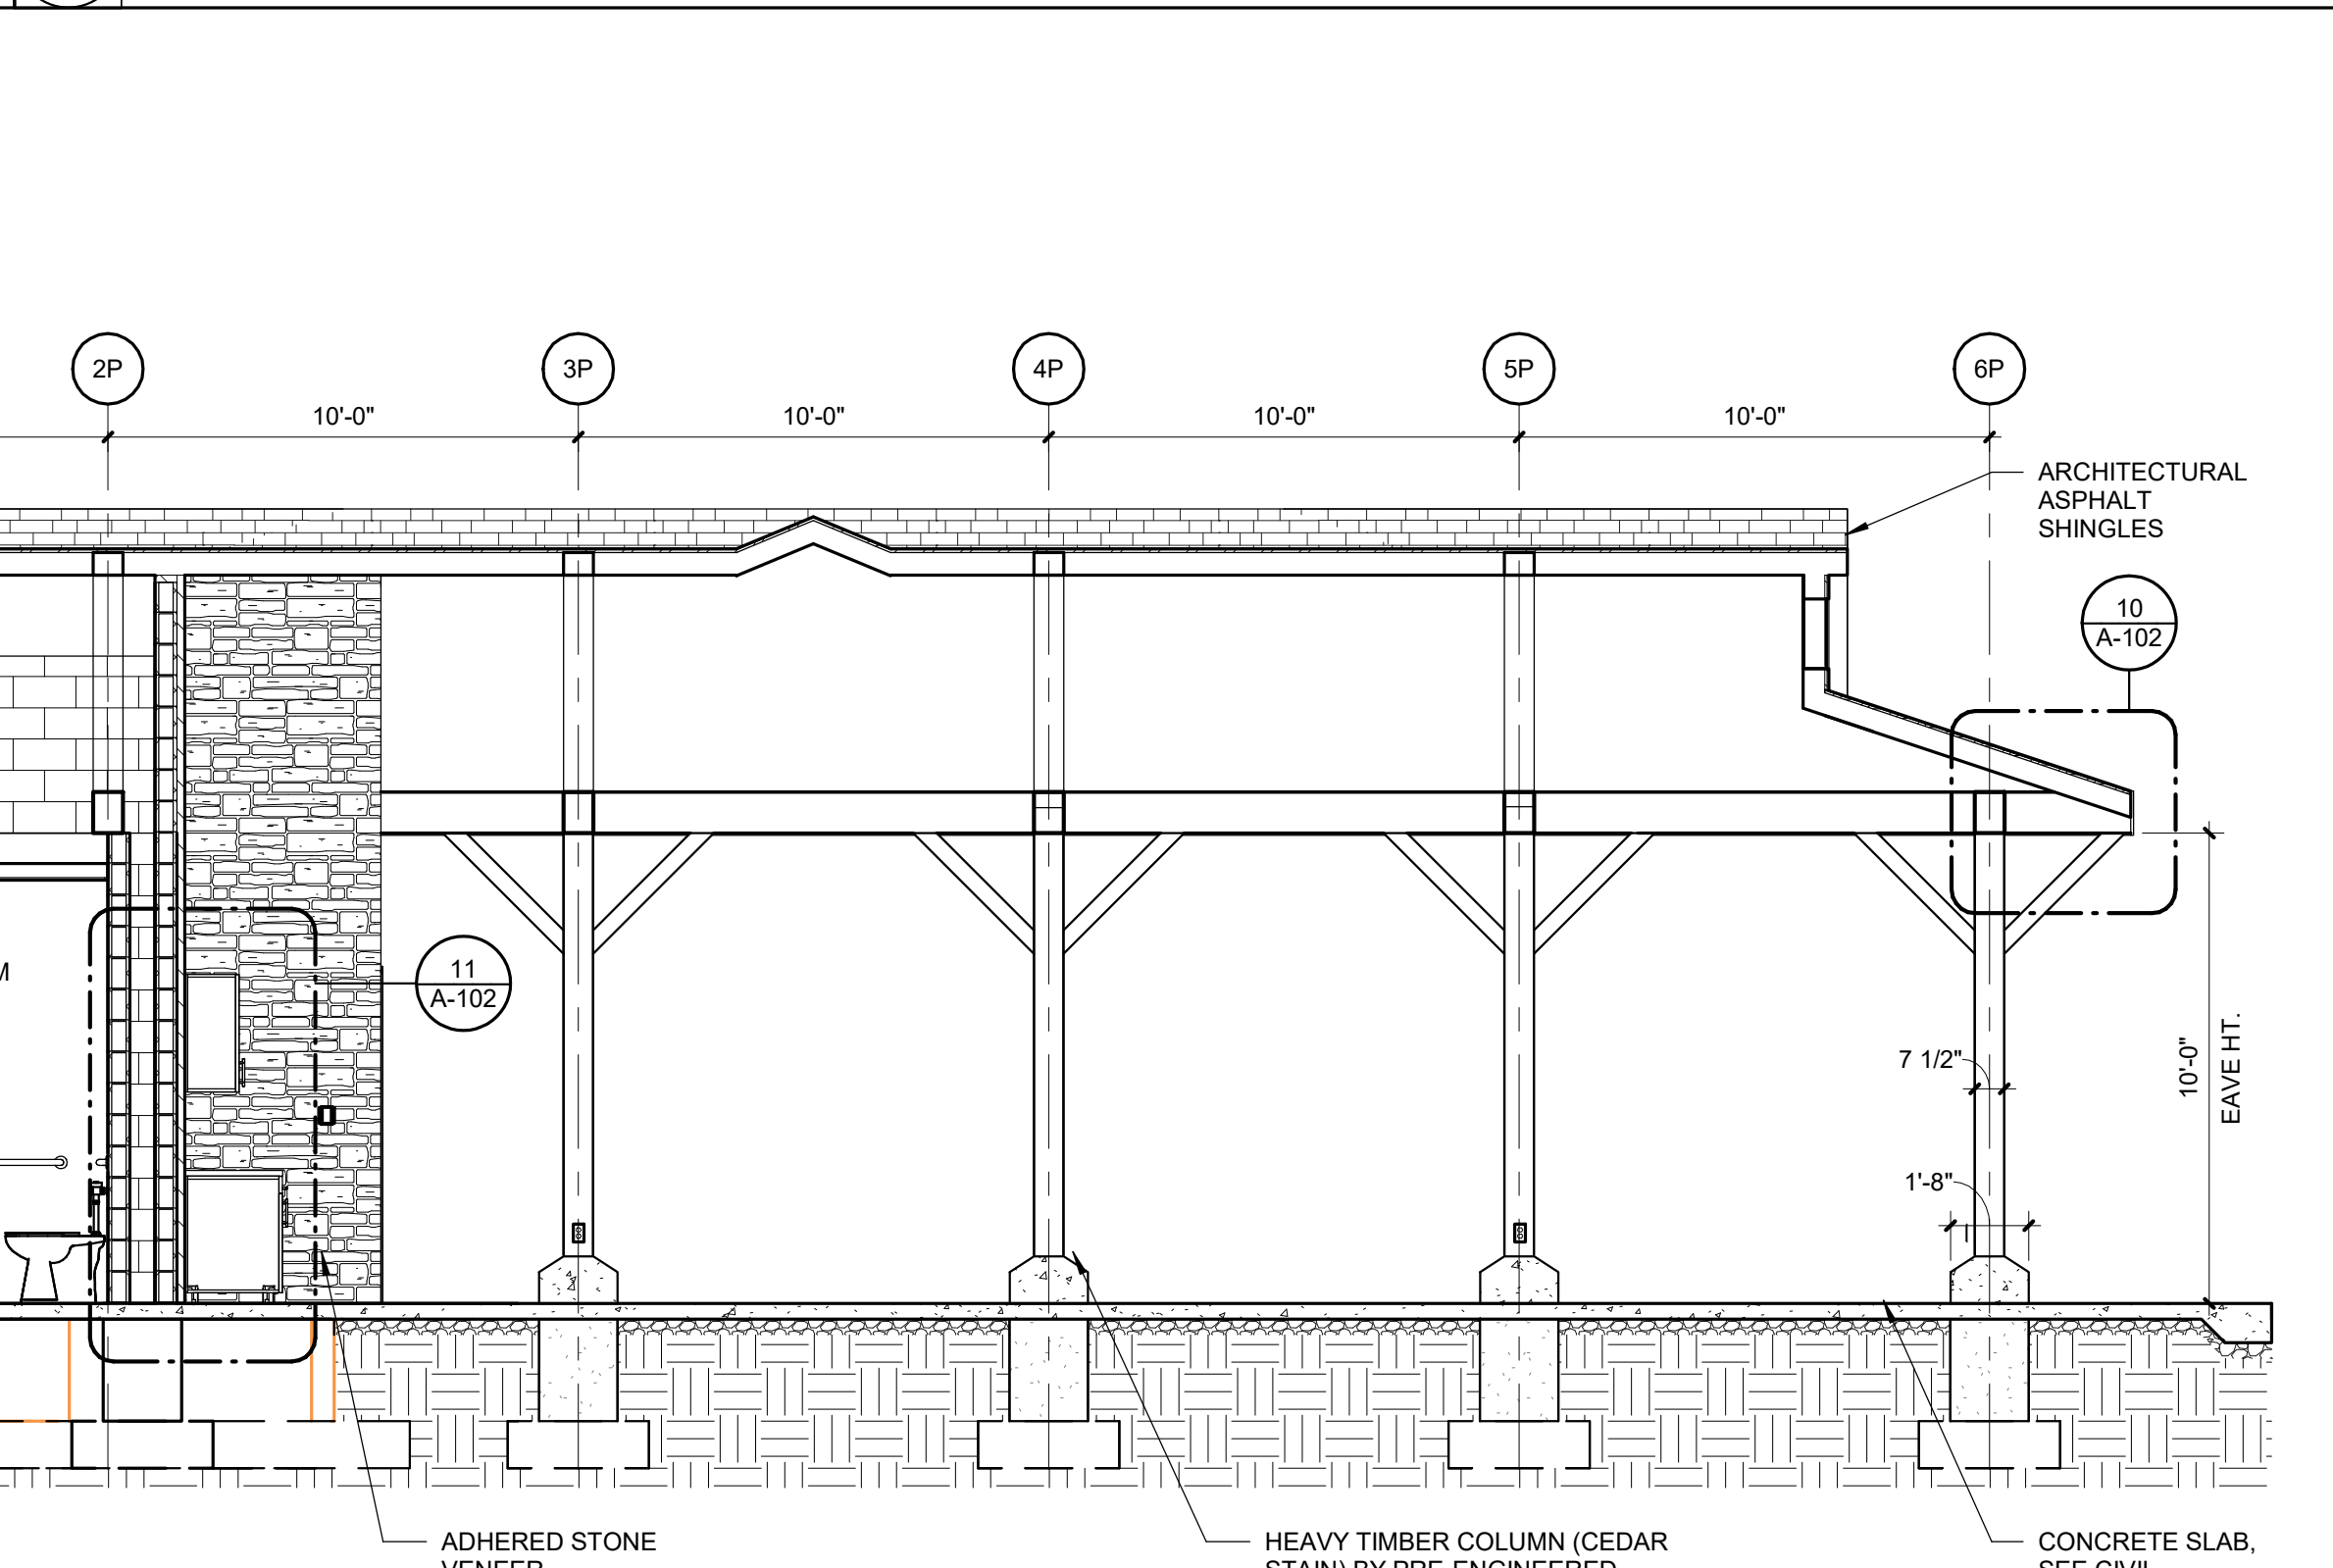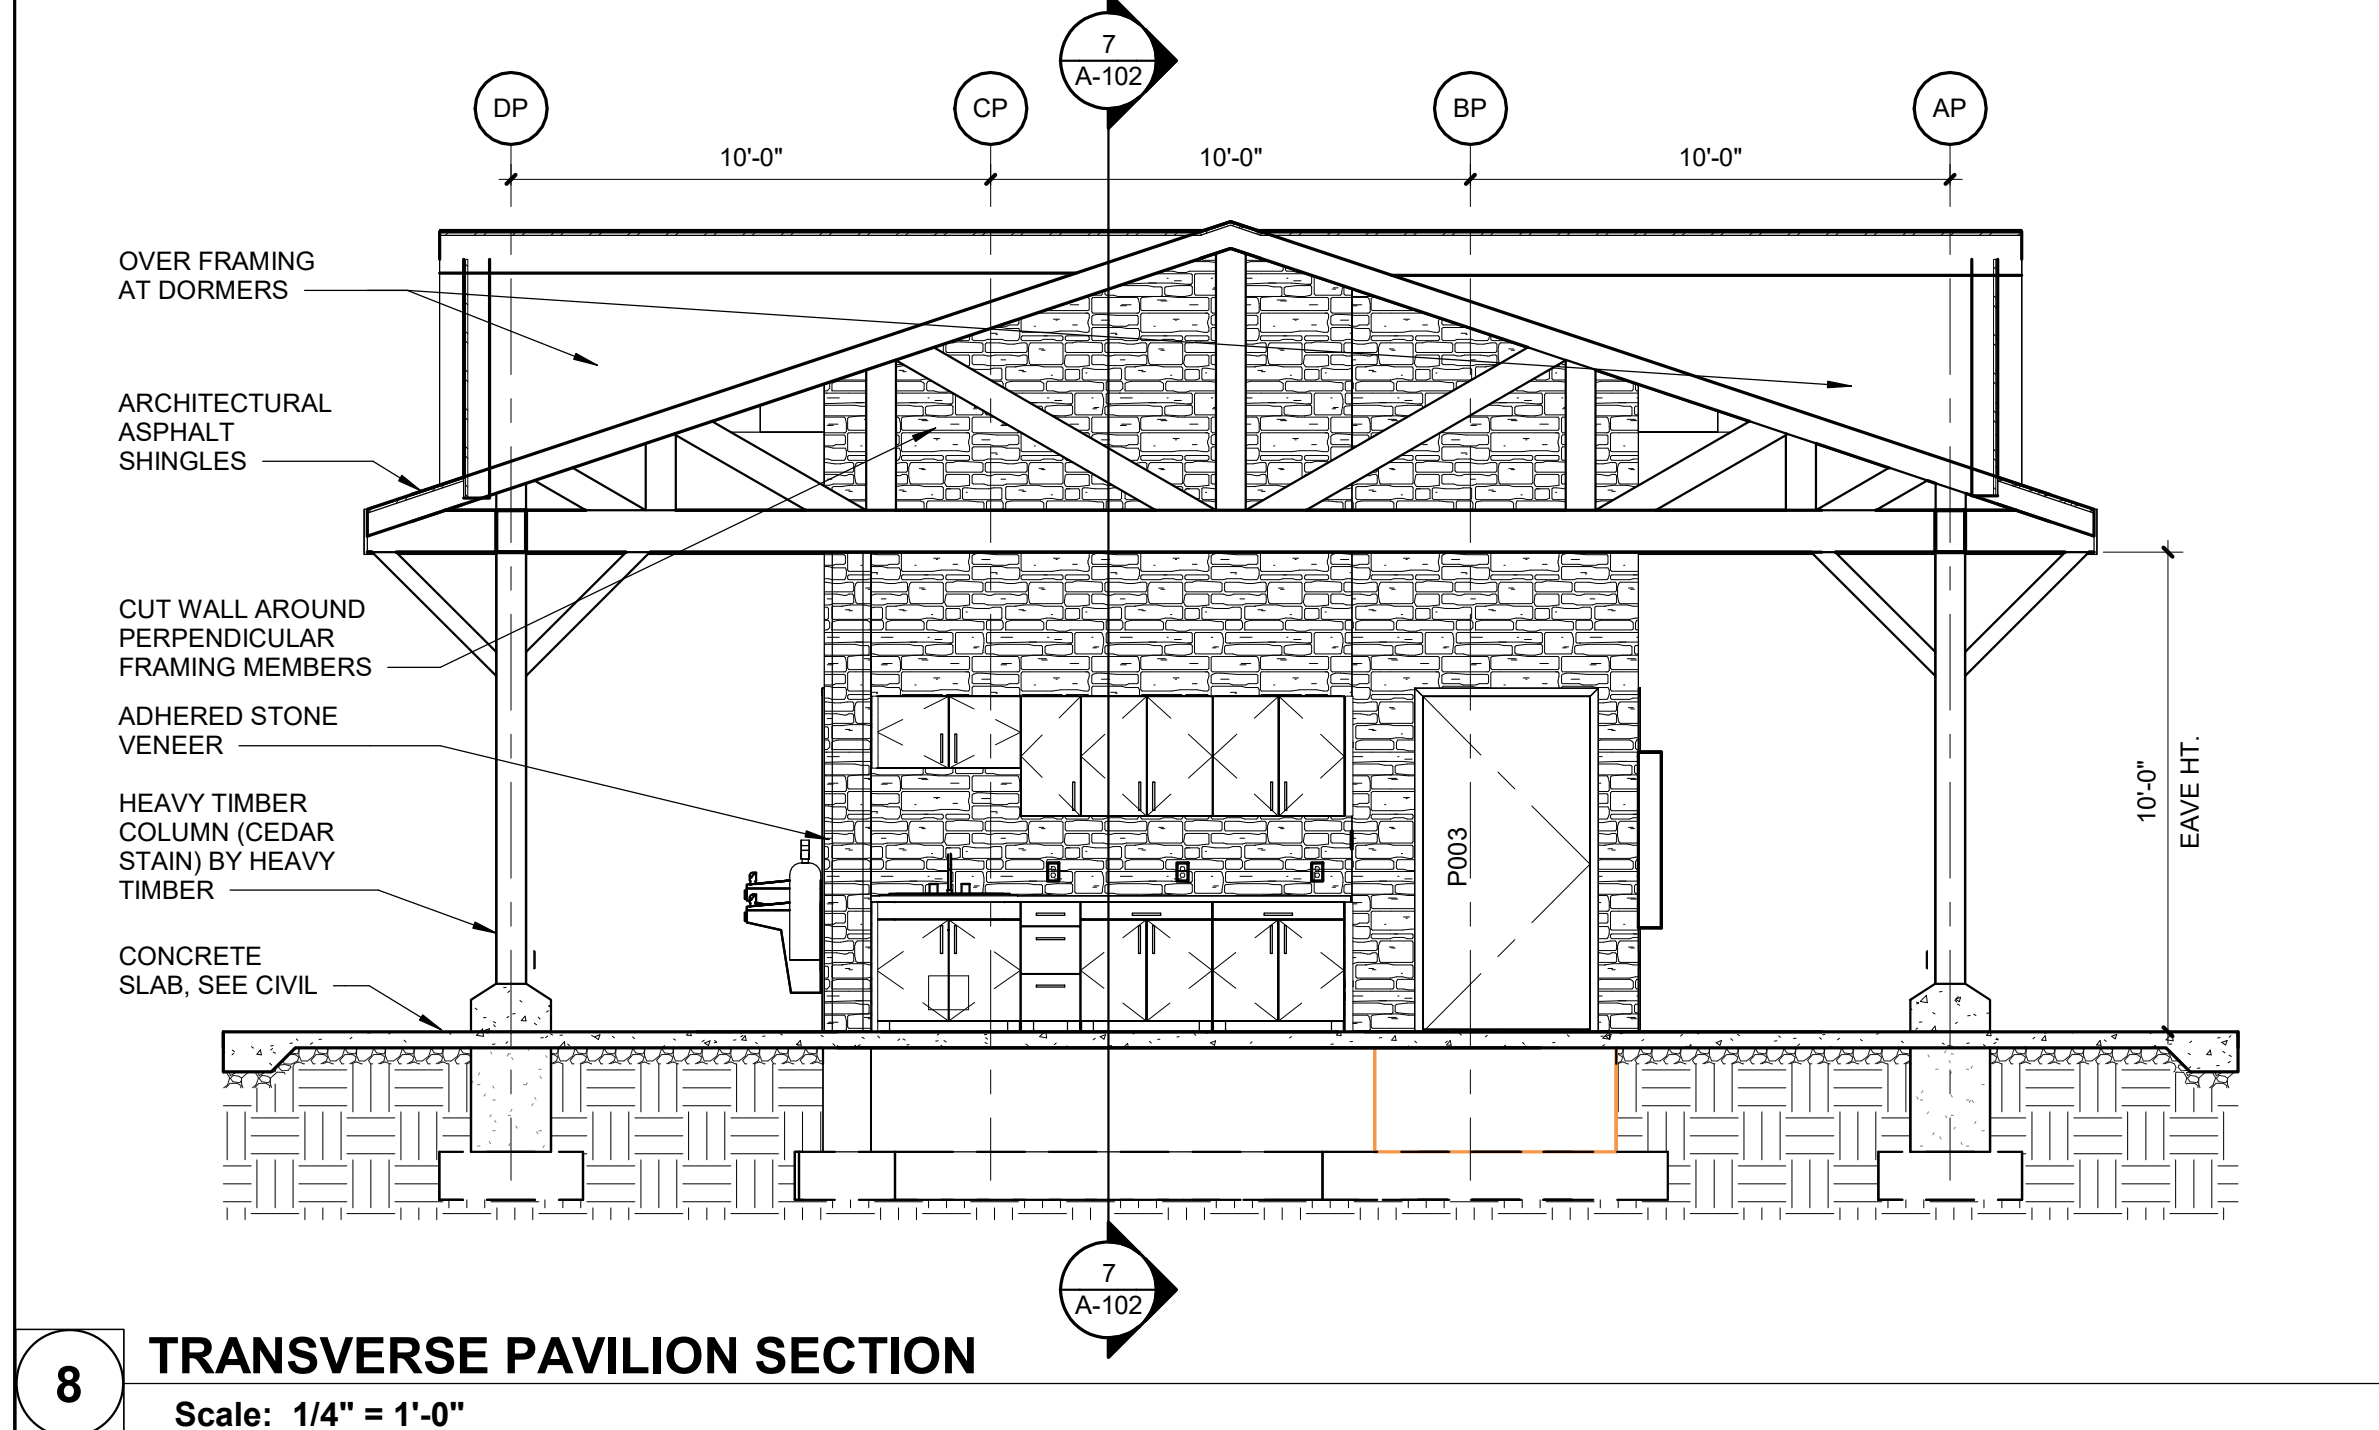
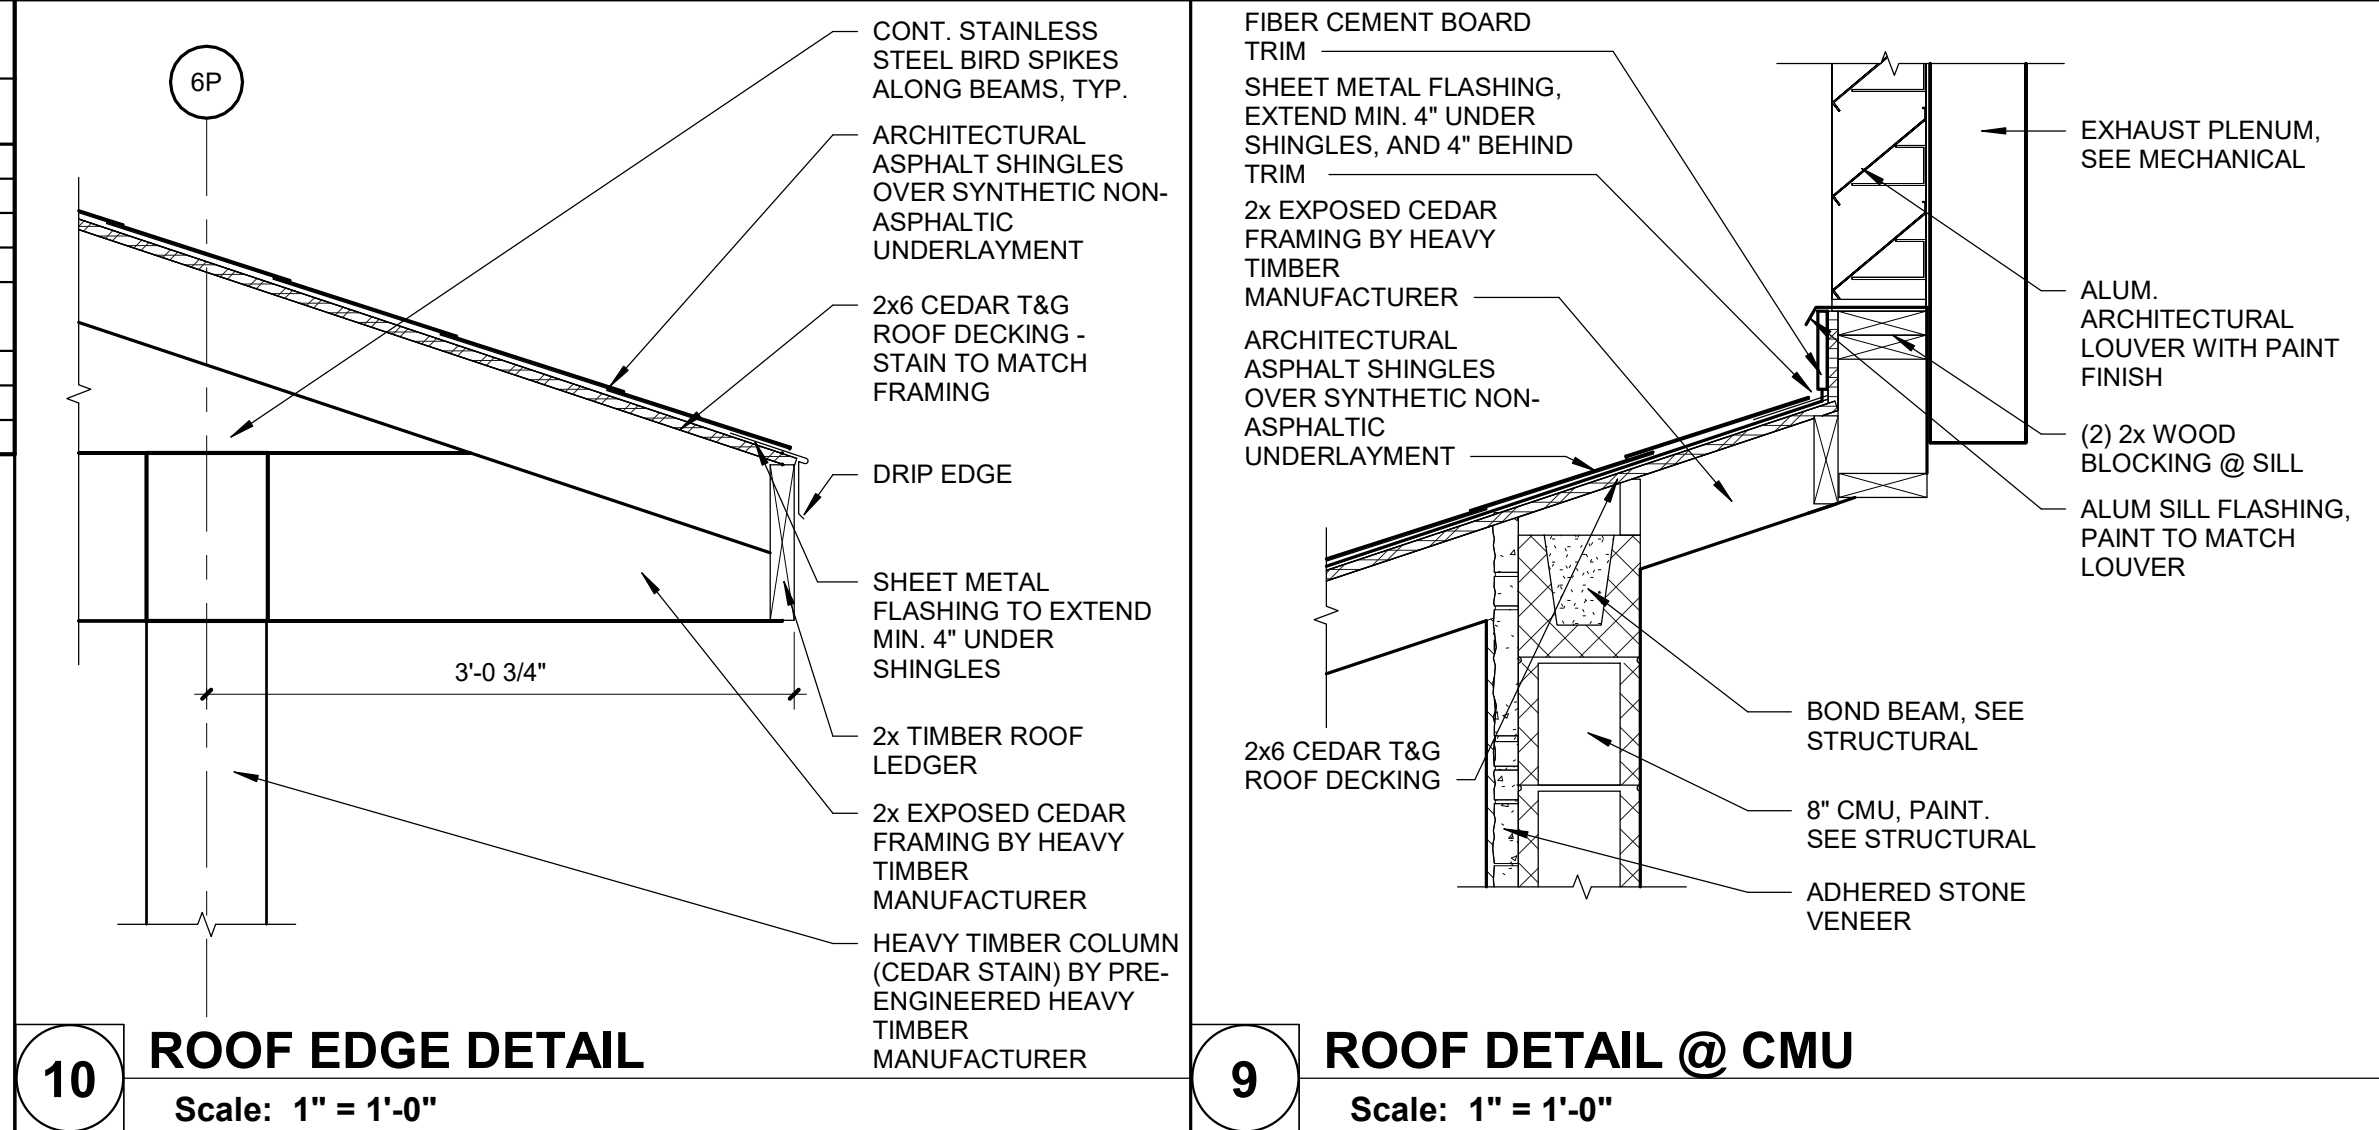


7 LONGITUDINAL PAVILION SECTION
Scale: 1/4" = 1'-0"

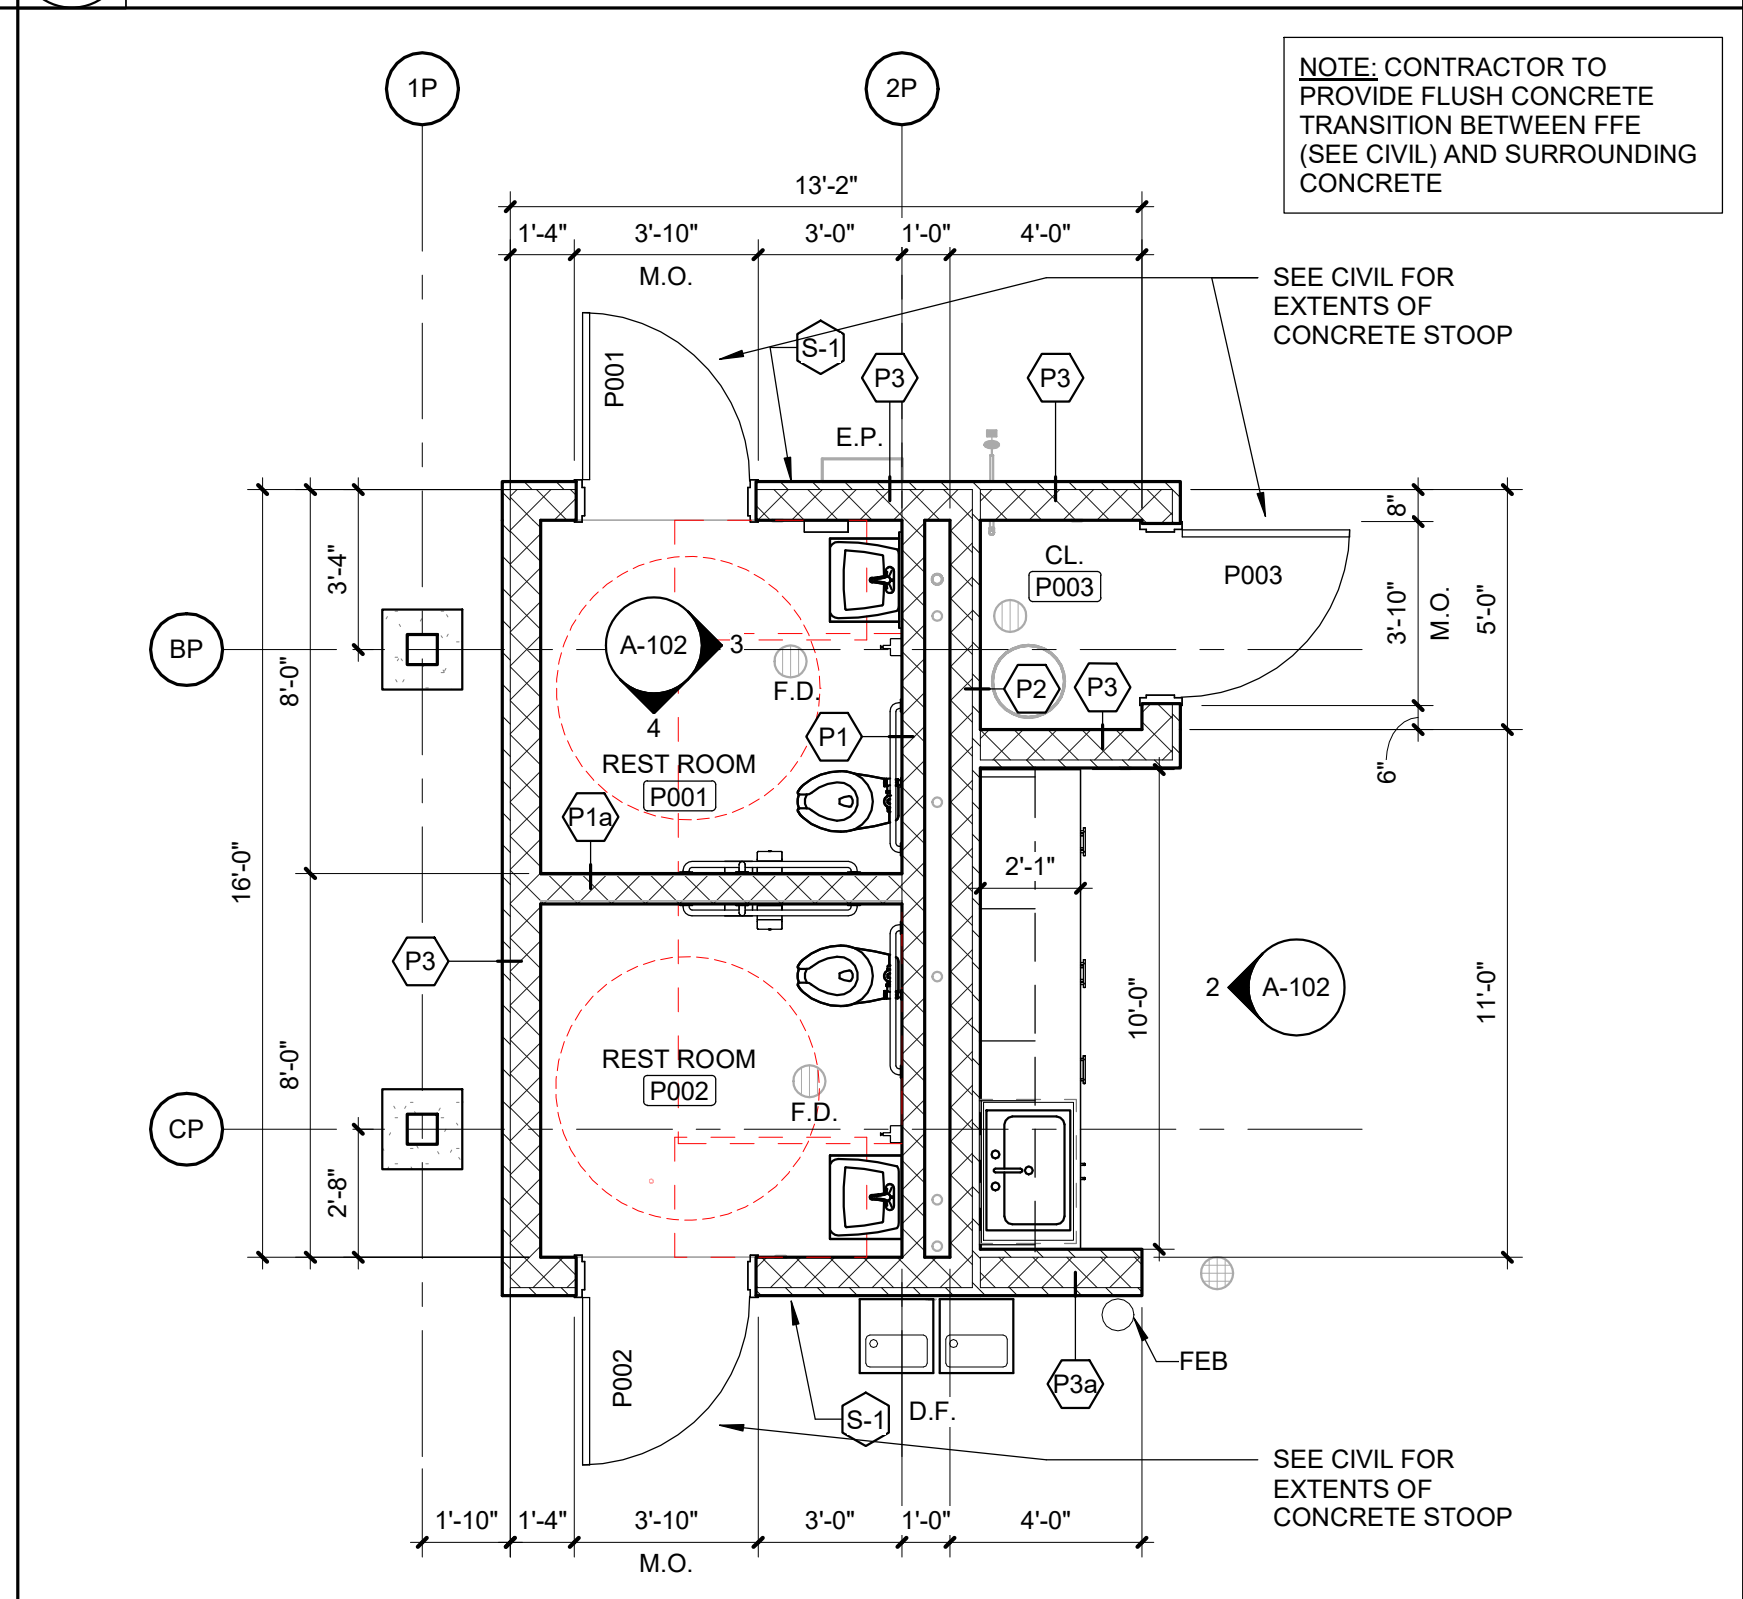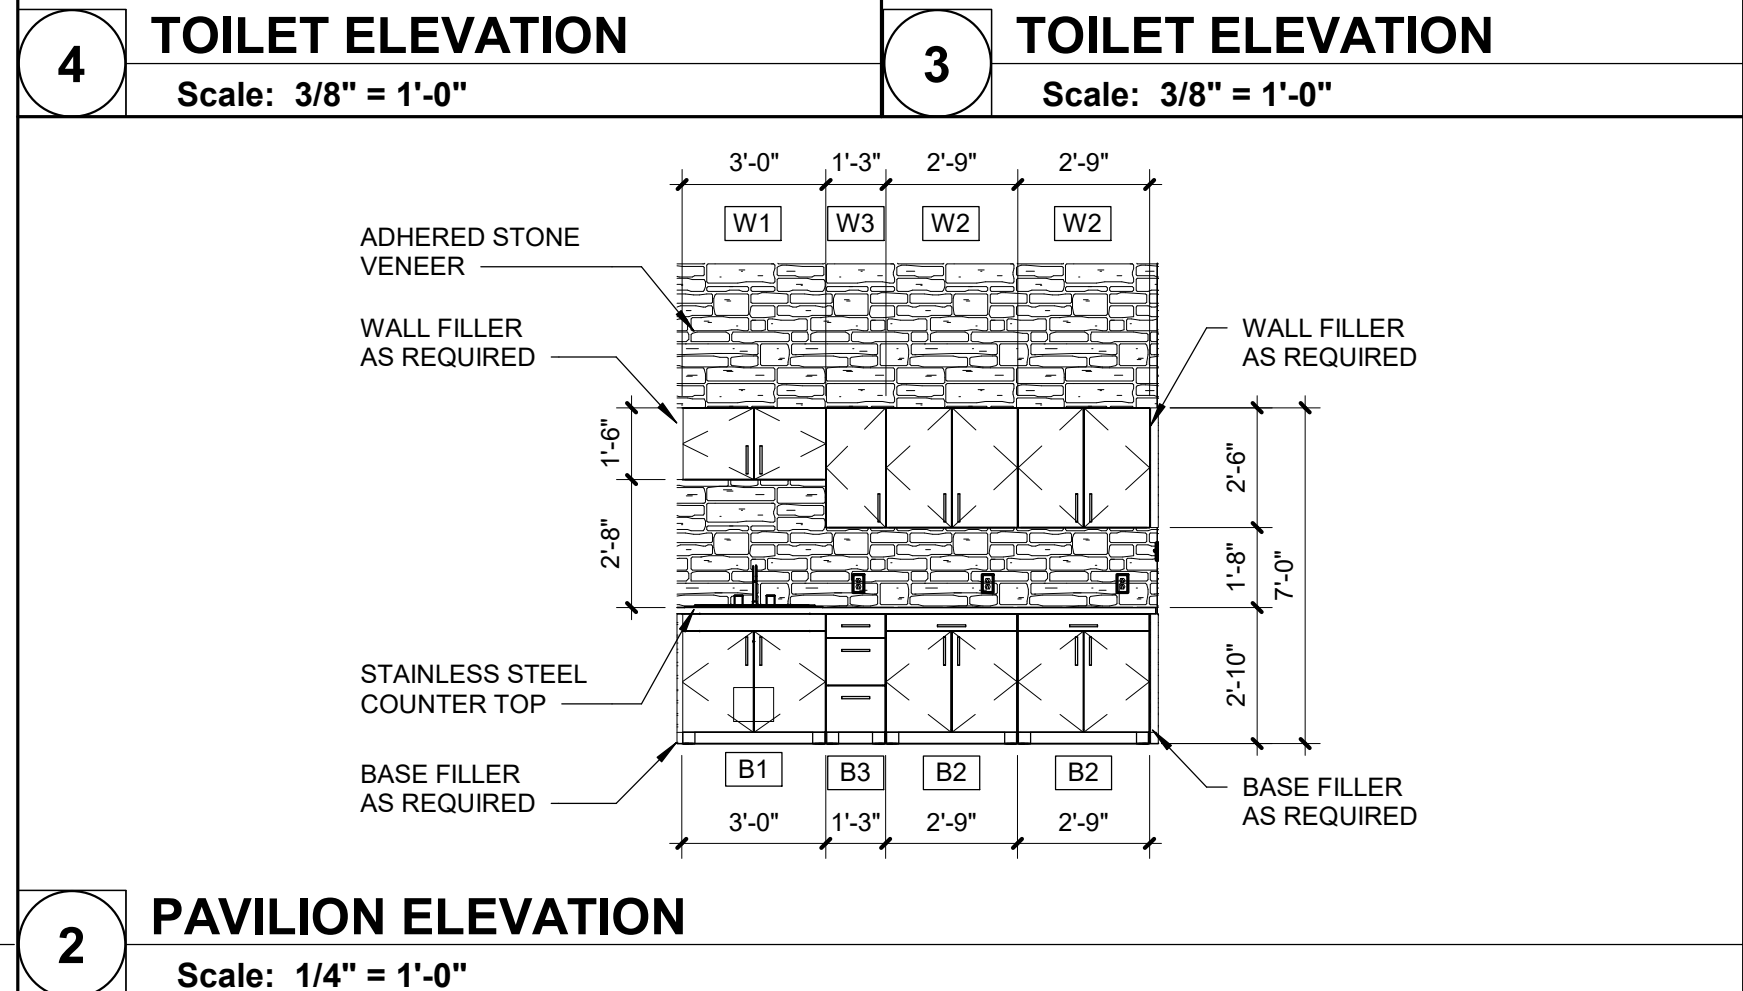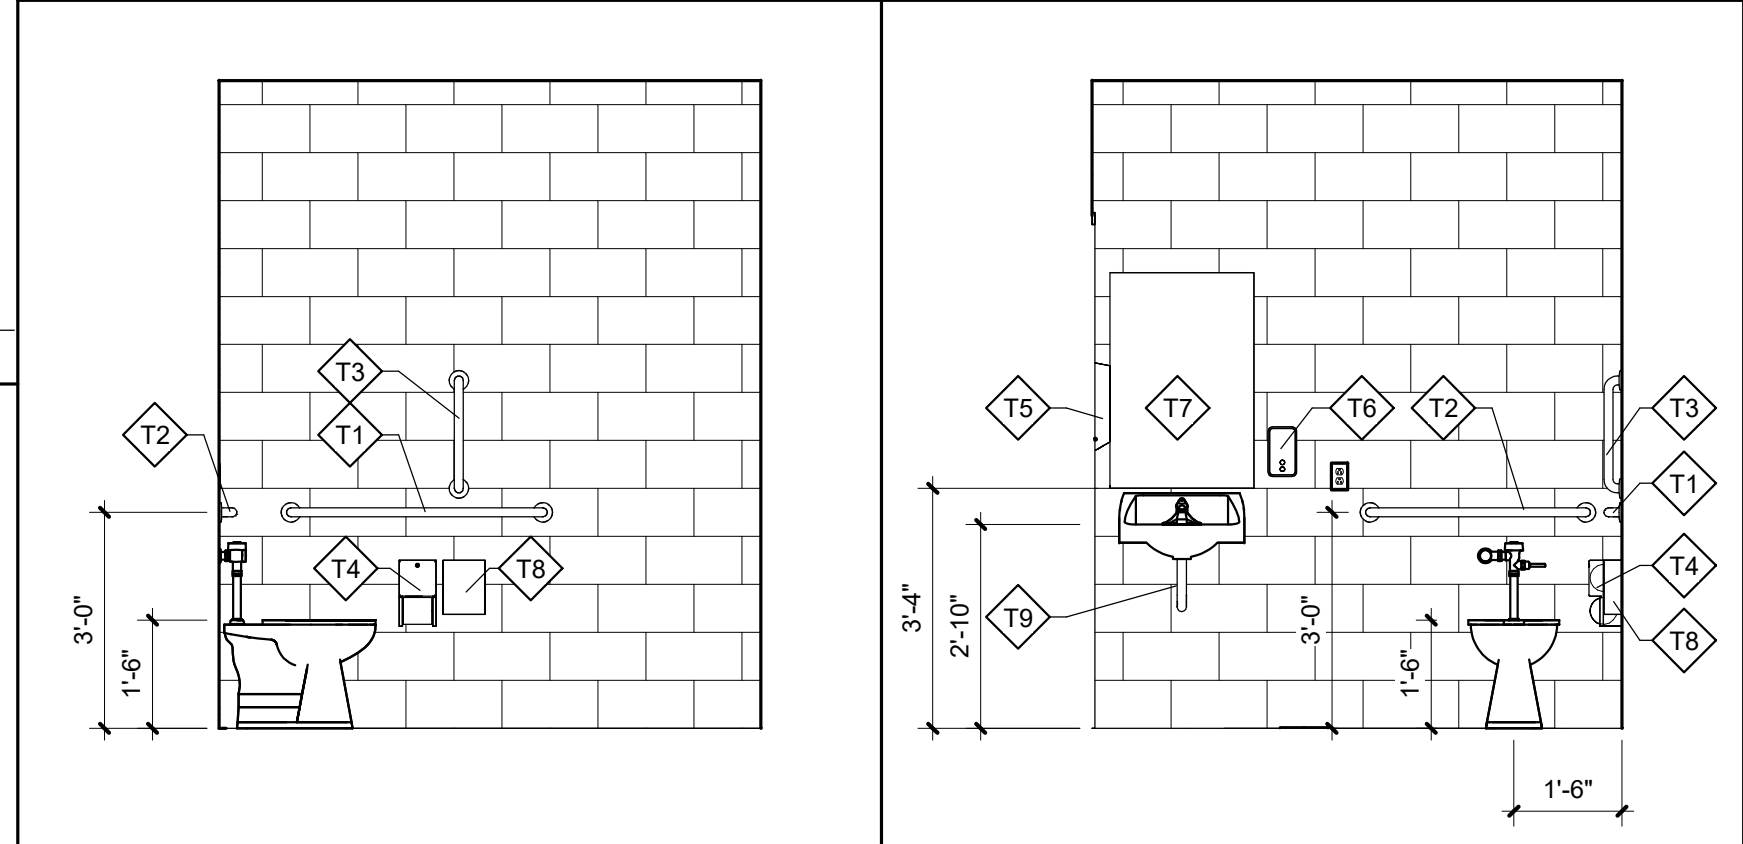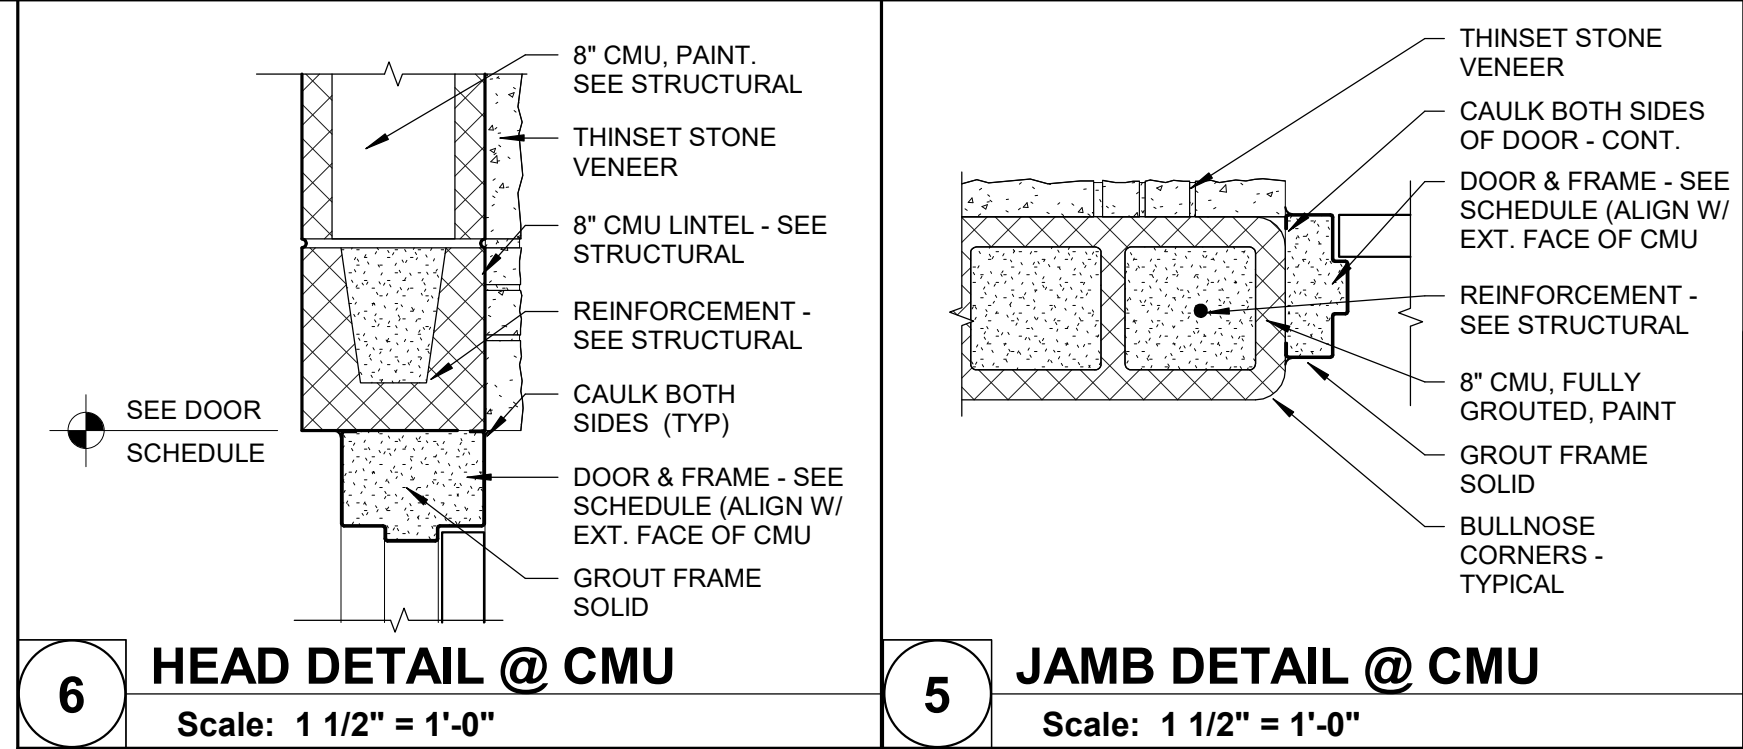

1 ENLARGED PAVILION FLOOR PLAN
Scale: 1/4" = 1'-0"

STATE OF MISSOURI
MICHAEL L. PARSON,
GOVERNOR

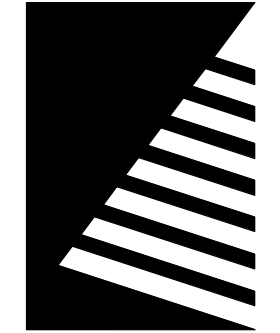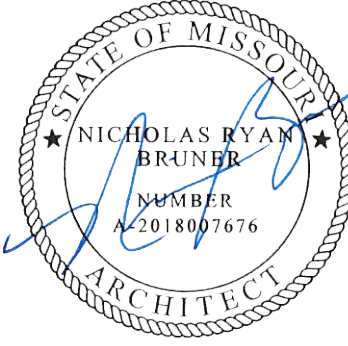

Farnsworth
GROUP
20 ALLEN AVENUE, SUITE 200
ST LOUIS, MISSOURI 63119
(314) 962-7900 / info@f-w.com
Farnsworth Group, Inc.
Missouri State Certificate of Authority #000744
www.f-w.com
Engineers | Architects | Surveyors | Scientists

100% BID SET

10/22/2024

OFFICE OF
ADMINISTRATION
DIVISION OF FACILITIES
MANAGEMENT, DESIGN
AND CONSTRUCTION

MISSOURI VETERANS
COMMISSION

**OUTDOOR PAVILION
CAPE GIRARDEAU
VETERANS HOME**

2400 Veterans Memorial Dr.
Cape Girardeau, MO 63701

PROJECT #.: U2415.01
SITE #.: 6803
ASSET #.: 8136803002
FAI #.: 29-043

DATE: DESCRIPTION:

DRAWN BY: KMM
CHECKED BY: SRJ
DESIGNED BY: SRJ

SHEET TITLE:

PAVILION DETAILS

SHEET NUMBER:

A-102

SHEET 13 OF 25
ISSUE DATE: 10/22/2024

PLUMBING SYMBOLS & ABBREVIATIONS

NOTE: NOT ALL MAY BE USED ON THIS PROJECT

ANNOTATION ABBREVIATIONS

AC	ABOVE CEILING
AD	AREA DRAIN
AFF	ABOVE FINISHED FLOOR
BAS	BUILDING AUTOMATION SYSTEM
BF	BELOW FLOOR
BG	BELOW GRADE
BH	BOOSTER HEATER
BFP	BACKFLOW PREVENTION DEVICE
BJ	BETWEEN JOISTS
BOP	BOTTOM OF PIPE
BTUH	BRITISH THERMAL UNITS PER HOUR
CF	COMBINATION FIXTURE
COND	CONDENSATE
CP	CONDENSATE PUMP
CSS	CLINICAL SERVICE SINK
CV	CONTROL VALVE
DF	DRINKING FOUNTAIN
DN	DOWN
DS	DOWNSPOUT NOZZLE
DW	DISHWASHER
EC	ELECTRICAL CONTRACTOR
EEW	EMERGENCY EYE WASH
EEWSH	COMB. EMERGENCY EYE WASH/SHOWER
ET	EXPANSION TANK
EWC	ELECTRIC WATER COOLER
EWB	ELECTRIC WATER HEATER
FA	FROM ABOVE
FB	FROM BELOW
FBO	FURNISHED BY OTHERS
FCO	FLOOR CLEANOUT
FD	FLOOR DRAIN
FFA	FROM FLOOR ABOVE
FFB	FROM FLOOR BELOW
FPC	FIRE PROTECTION SUBCONTRACTOR
FS	FLOOR SINK
FT	FILL TANK
GD	GARBAGE DISPOSAL
GPM	GALLONS PER MINUTE
GWH	GAS WATER HEATER
GC	GENERAL CONTRACTOR
HAP	HIGH AS POSSIBLE
HB	HOSE BIBB (INTERIOR)
HS	HOSE STATION
HWCP	HOT WATER RECIRCULATION PUMP
IM	ICE MAKER
L	LAVATORY
LT	LAUNDRY TUB
MBH	THOUSANDS OF BTU PER HOUR
MC	MECHANICAL CONTRACTOR
MSB	MOP SINK BASIN
NTS	NOT TO SCALE
ORD	OVERFLOW ROOF DRAIN
P	PUMP
PC	PLUMBING CONTRACTOR
PRV	PRESSURE RELIEF VALVE
RD	ROOF DRAIN
SC	SILLCOCK (EXTERIOR)
SE	SEWAGE EJECTOR
SF	SQUARE FOOT
SH	SHOWER
SK	SINK
SP	SUMP PUMP
SS	SERVICE SINK
TFA	TO FLOOR ABOVE
TB	TO BELOW
TFB	TO FLOOR BELOW
TMV	THERMOSTATIC MIXING VALVE
TOP	TOP OF PIPE
TYP	TYPICAL
UR	URINAL
VB	VACUUM BREAKER
VTR	VENT THRU ROOF
WB	WASHER BOX
WC	WATER CLOSET
WCO	WALL CLEANOUT
WF	WATER FILTER
WS	WATER SOFTENER
YCO	YARD CLEANOUT

ANNOTATION SYMOLOGY

	PLUMBING KEYNOTE
	KITCHEN EQUIPMENT DESIGNATION
NEW	BOLD TEXT INDICATES NEW ITEM
<i>(E)EXISTING</i>	ITALIC TEXT INDICATES EXISTING ITEM

PLUMBING SYMOLOGY


AW	ACID WASTE
CA	COMPRESSED AIR
CD	CONDENSATE DRAIN
CO2	CARBON DIOXIDE
G	NATURAL GAS
GW	GREASE WASTE
MA	MEDICAL AIR
N2	NITROGEN
N2O	NITROUS OXIDE
OST	OVERFLOW STORM
OW	OIL WASTE
O2	OXYGEN
PD	PUMP DISCHARGE
ST	STORM
VAC	VACUUM
WAGD	WASTE ANESTHETIC GAS DISPOSAL
W	SANITARY WASTE
AV	ACID VENT
OV	OIL VENT
V	SANITARY VENT
CW	DOMESTIC COLD WATER
DI	DE-IONIZED WATER
FCW	FILTERED COLD WATER
NPCW	NONPOTABLE COLD WATER
RO	REVERSE OSMOSIS WATER
HW	DOMESTIC HOT WATER
HW 140	DOMESTIC HOT WATER (OTHER TEMP)
HWC	DOMESTIC HW RECIRCULATION
	PIPE SLOPE ARROW
	FLOW ARROW
	CONCENTRIC REDUCER
	ECCENTRIC REDUCER
	3-WAY CONTROL VALVE
	ANGLE GATE VALVE
	ANGLE GLOBE VALVE
	BALANCING/SHUTOFF VALVE
	BALL VALVE
	BUTTERFLY VALVE
	CALIBRATED BALANCING VALVE
	CHECK VALVE
	CONTROL VALVE
	EXPANSION VALVE
	GAS COCK
	GATE VALVE
	GLOBE VALVE
	PLUG VALVE
	PRESSURE REDUCING VALVE (WATER)
	PRESSURE REGULATOR (GAS)
	QUICK OPEN VALVE
	SAFETY RELIEF VALVE
	SOLENOID VALVE
	VACUUM RELIEF VALVE
	BACKFLOW PREVENTER
	HOSE BIBB / SILLCOCK
	AUTOMATIC AIR VENT
	PRESSURE GAUGE
	THERMOMETER
	FLOW SWITCH
	PRESSURE SWITCH
	TEMPERATURE SWITCH
	PIPE UNION
	WYE STRAINER
	WYE STRAINER W/DRAIN VALVE
	PUMP
	FLOOR DRAIN - ROUND OR SQUARE
	FLOOR CLEANOUT - ROUND OR SQUARE
	SUSPENDED CLEANOUT
	WALL CLEANOUT
	PIPE CAP
	PIPE TURNING DOWN
	PIPE TURNING UP
	TEE UP
	TEE DOWN
	DROP AND RUN
	DROP AND TURN
	TEE OFF TOP
	TEE OFF BOTTOM
	CROSS AND RISER
	PLAN 90° ELBOW
	PIPE TEE
	FLEXIBLE PIPE CONNECTOR
	PIPE ANCHOR
	PIPE GUIDES
	WATER METER

	DETAIL MODULE NUMBER
	DETAIL OR SECTION MARK SHOWN ON DRAWING
	POINT OF NEW CONNECTION
	POINT OF TERMINATION/CAP
	PLUMBING EQUIPMENT DESIGNATION


PLUMBING GENERAL NOTES

- A. WORK SHALL BE PERFORMED BY A LICENSED PLUMBER OF THE STATE OF MISSOURI.
- B. MATERIALS, INSTALLATION, AND TESTING SHALL BE IN ACCORDANCE WITH THE LATEST ADOPTED EDITION OF STATE AND LOCAL CODE PROCEDURES, METHODS, AND REQUIREMENTS, INCLUDING THE MOST STRINGENT OF HEALTH AND SAFETY STANDARDS AS REQUIRED AND AS INTERPRETED BY THE AUTHORITY HAVING JURISDICTION. APPLICABLE CODES AND STANDARDS INCLUDE, BUT NOT LIMITED TO THE FOLLOWING: "INTERNATIONAL PLUMBING, BUILDING, ENERGY, MECHANICAL, AND FUEL GAS CODES" NFPA 99, STANDARD FOR HEALTHCARE FACILITIES
- C. **MEANING AND INTENT OF DRAWINGS:** DRAWINGS ARE DIAGRAMMATIC. PIPING IS SHOWN IN SCHEMATIC FORM. SCALES INDICATED ARE FOR ARCHITECTURAL REFERENCE ONLY. IT IS NOT INTENDED THAT THE DRAWINGS SHOW EVERY WASTE, VENT, WATER PIPE, FITTING, SUPPORTS, ETC., AND IT IS UNDERSTOOD THAT THE DRAWINGS MUST BE FOLLOWED AS CLOSELY AS CIRCUMSTANCES WILL PERMIT. THE PROPER INSTALLATION ACCORDING TO THE TRUE INTENT AND MEANING OF THE DRAWINGS, LOCAL CODES, AND STANDARD PRACTICES SHALL BE PROVIDED. PLUMBING CONTRACTOR SHALL FIELD VERIFY ALL EXISTING CONDITIONS PRIOR TO INSTALLATION. REPORT ANY PROBLEMS OR CONFLICTS TO THE ARCHITECT/ENGINEER. NOTED DIMENSIONS TAKE PRECEDENCE OVER SCALED DIMENSIONS. DO NOT SCALE DRAWINGS. ANY MINOR CHANGES IN LOCATION OF EQUIPMENT, WASTE VENT, WATER PIPE, ETC., FROM THOSE LOCATIONS SHOWN ON THE DRAWINGS, SHALL BE MADE WITHOUT EXTRA COST, IF SO DIRECTED BY THE ARCHITECT/ENGINEER BEFORE THE INSTALLATION IS MADE. A MINOR CHANGE IN LOCATION IS CONSIDERED TO BE WITHIN 5'-0" OF THE ORIGINAL INDICATED LOCATION. THE EQUIPMENT INDICATED ON THESE DRAWINGS INCLUDE ONLY THE MAJOR EQUIPMENT REQUIREMENTS. NOT WITHSTANDING, THE DETAILS PRESENTED IN THESE DRAWINGS VERIFY THE COMPLETENESS OF THE MATERIALS LISTS AND SUITABILITY OF DEVICES TO MEET THE INTENT OF THIS PROJECT. ANY ADDITIONAL EQUIPMENT OR MATERIAL REQUIRED, EVEN IF NOT SPECIFICALLY MENTIONED HEREIN, SHALL BE PROVIDED WITHOUT CLAIM FOR ADDITIONAL PAYMENT; IT BEING UNDERSTOOD THAT A COMPLETE AND OPERATIONAL PLUMBING SYSTEM, SATISFACTORY TO THE ARCHITECT/ENGINEER AND THE OWNER SHALL BE PROVIDED. USE ONLY THE MANUFACTURER'S TESTED ASSEMBLIES.
- D. COORDINATE ROUTING OF PIPING WITH ALL OTHER TRADES AND STRUCTURAL CONDITIONS TO AVOID ANY CONFLICTS.
- E. MAINTAIN A MINIMUM CLEARANCE OF 3'-0" IN FRONT OF ELECTRICAL PANELS AND 1'-0" EITHER SIDE WHEN INSTALLING PLUMBING SYSTEMS IN THE SAME AREA. PIPE SYSTEMS, EQUIPMENT, ETC., SHALL NOT BE ROUTED DIRECTLY OVER PANELS OR SWITCH GEAR, AND WHERE ABOVE MAY BE AS CLOSE AS 12 INCHES FROM PERIMETER. REFER TO ADOPTED ELECTRICAL CODES WHERE IN DOUBT.
- F. INCLUDE IN BID ALL LICENSE, PERMIT, INSPECTION, AND OTHER FEES REQUIRED BY UTILITY COMPANIES OR AUTHORITIES HAVING JURISDICTION REQUIRED FOR COMPLETION OF WORK SO THAT NO UNEXPECTED ADDITIONAL EXPENSES ARE INTRODUCED TO OWNER.
- G. PROVIDE ALL LABOR, MATERIALS, TOOLS, EQUIPMENT, ETC. REQUIRED TO ASSURE COMPLETE AND FUNCTIONAL PLUMBING SYSTEMS.
- H. ALL CLEANOUTS, VALVES, AIR CHAMBERS, ETC. ARE TO BE ACCESSIBLE. EXTEND PIPING AND PROVIDE ACCESS PANELS WHERE NECESSARY. PLUMBING CONTRACTOR WILL BE REQUIRED TO DEMONSTRATE ACCESSIBILITY IF IT IS QUESTIONABLE. ACCESS PANEL SIZES, LOCATIONS, AND FINAL COLOR SHALL BE COORDINATED WITH THE ARCHITECT AS WELL AS ALL OTHER TRADES TO AVOID ANY CONFLICTS. ACCESS PANELS PROVIDED BY PLUMBING CONTRACTOR FOR INSTALLATION BY GENERAL CONTRACTOR.
- I. PLUMBING CONTRACTOR SHALL CLEAN WORK AREA OF ALL DUST AND DEBRIS GENERATED BY THEIR WORK AT THE END OF EACH WORK DAY.
- J. ALL PLUMBING SYSTEM VALVES SHALL BE INSTALLED IN A LOCATION AND ORIENTATION THAT WILL PERMIT INTENDED USE.
- K. PROVIDE STOPS AND/OR ISOLATION VALVES TO EACH INDIVIDUAL FIXTURE OR PIECE OF EQUIPMENT TO ALLOW FOR INDIVIDUAL SERVICING UNLESS NOTED OTHERWISE ON PLANS.
- L. SANITARY WASTE PIPING SHALL BE SLOPED AT 1/8-INCH PER FOOT MINIMUM FOR ALL PIPING 4-INCH AND LARGER AND AT 1/4-INCH PER FOOT MINIMUM FOR ALL PIPING 3-INCH AND SMALLER.
- M. INDIRECT DRAIN PIPING FROM FIXTURES, SPECIALTIES, AND EQUIPMENT SHALL BE ROUTED TO FLOOR DRAIN OR OTHER APPROVED RECEPTACLES AND TERMINATED WITH AN AIR GAP 2 TIMES THE DIAMETER OF THE DRAIN PIPING BUT NOT LESS THAN A 1 INCH GAP. SUPPORT PIPING SO DRAIN PIPING CANNOT BE DEFLECTED FROM DRAIN SOURCE.
- N. WHEREVER POSSIBLE, HORIZONTAL SOIL OR WASTE PIPE SHALL COME OFF TOP OR AT 45 DEGREE VERTICALLY FROM CENTER OF PIPE BEFORE OFFSETTING HORIZONTALLY TO RISER.
- O. ALL VENT TERMINATIONS SHALL BE COORDINATED WITH BUILDING OPENINGS, AIR INTAKES, AND AIR EXHAUST OPENINGS. ADJUST VENT THROUGH ROOF LOCATIONS TO COMPLY WITH APPLICABLE CODE.
- P. PLUMBING CONTRACTOR SHALL BE RESPONSIBLE FOR ASSURING ALL HANGERS AND SUPPORTS ARE ANCHORED OR ATTACHED TO BUILDING ELEMENTS ADEQUATE FOR INTENDED PLUMBING SYSTEM OR EQUIPMENT.
- Q. PLUMBING CONTRACTOR TO PROVIDE AND INSTALL NAIL PLATES WHERE PIPING PASSES THROUGH STUD(S) WITHIN 2" OF NAILING SURFACE TO PROTECT PIPE FROM NAILS OR DRYWALL SCREWS.
- R. PLUMBING CONTRACTOR SHALL INSTALL AIR CHAMBERS ON VERTICAL DROP TO INDIVIDUAL SINKS WITH SPRAY FEATURE. INSTALL PISTON-TYPE WATER HAMMER ARRESTORS ON HORIZONTAL PIPING PRIOR TO DROP TO ALL INDIVIDUAL FLUSH VALVE FIXTURES. PISTON- OR DIAPHRAGM-TYPE WATER HAMMER ARRESTORS MAY BE UTILIZED FOR WATER HEADERS SERVING A GROUP OF FIXTURES WITHIN THE SAME CHASE AND SHALL BE LOCATED UPSTREAM THE LAST FIXTURE SERVED ON THE HEADER. LOCATE ARRESTORS IN ACCESSIBLE LOCATION, OR PROVIDE ACCESS PANEL. SIZE ARRESTORS PER MANUFACTURER'S RECOMMENDATION FOR RELATED FIXTURE LOAD.
- S. MINIMIZE DEVELOPED LENGTH OF BRANCH RUNOUTS FROM CIRCULATED DOMESTIC HOT WATER MAINS TO FIXTURES AND/OR MIXING VALVES WHENEVER POSSIBLE.
- T. ALL P-TRAPS FOR FLOOR DRAINS AND FLOOR SINKS SHALL BE DEEP SEAL TRAP FILLED WITH VEGETABLE OIL.
- U. PLUMBING CONTRACTOR TO INSTALL AND TEST EQUIPMENT PER MANUFACTURER'S WRITTEN INSTRUCTIONS AND RECOMMENDATIONS TO ASSURE PROPER OPERATION.
- V. PROJECT LOCATION IS SEISMIC CATEGORY D. REFER TO SHEET S-001 FOR SEISMIC DESIGN DATA.

STATE OF MISSOURI
MICHAEL L. PARSON,
GOVERNOR

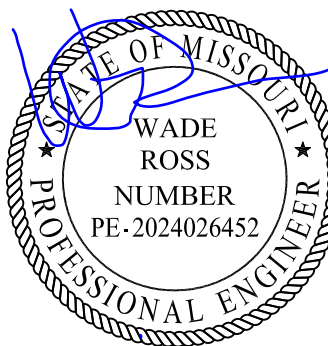

DATED: 10.22.2024
EXPIRATION: 12.31.2025

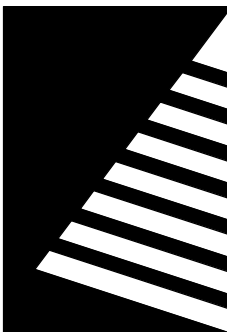

Farnsworth
GROUP

20 ALLEN AVENUE, SUITE 200
ST LOUIS, MISSOURI 63119
(314) 962-7900 / info@f-w.com

Farnsworth Group, Inc.
Missouri State Certificate of Authority #000744
www.f-w.com
Engineers | Architects | Surveyors | Scientists

100% BID SET

10/22/2024

OFFICE OF
ADMINISTRATION
DIVISION OF FACILITIES
MANAGEMENT, DESIGN
AND CONSTRUCTION

MISSOURI VETERANS
COMMISSION

OUTDOOR PAVILION
CAPE GIRARDEAU
VETERANS HOME

2400 Veterans Memorial Dr.
Cape Girardeau, MO 63701

PROJECT #.: U2415.01
SITE #.: 6803
ASSET #.: 8136803002
FAI #.: 29-043

DATE: DESCRIPTION:

DRAWN BY: RC

CHECKED BY: WR

DESIGNED BY: RC


SHEET TITLE:

GENERAL
INFORMATION

SHEET NUMBER:

P-001


SHEET 14 OF 25
ISSUE DATE: 10/22/2024

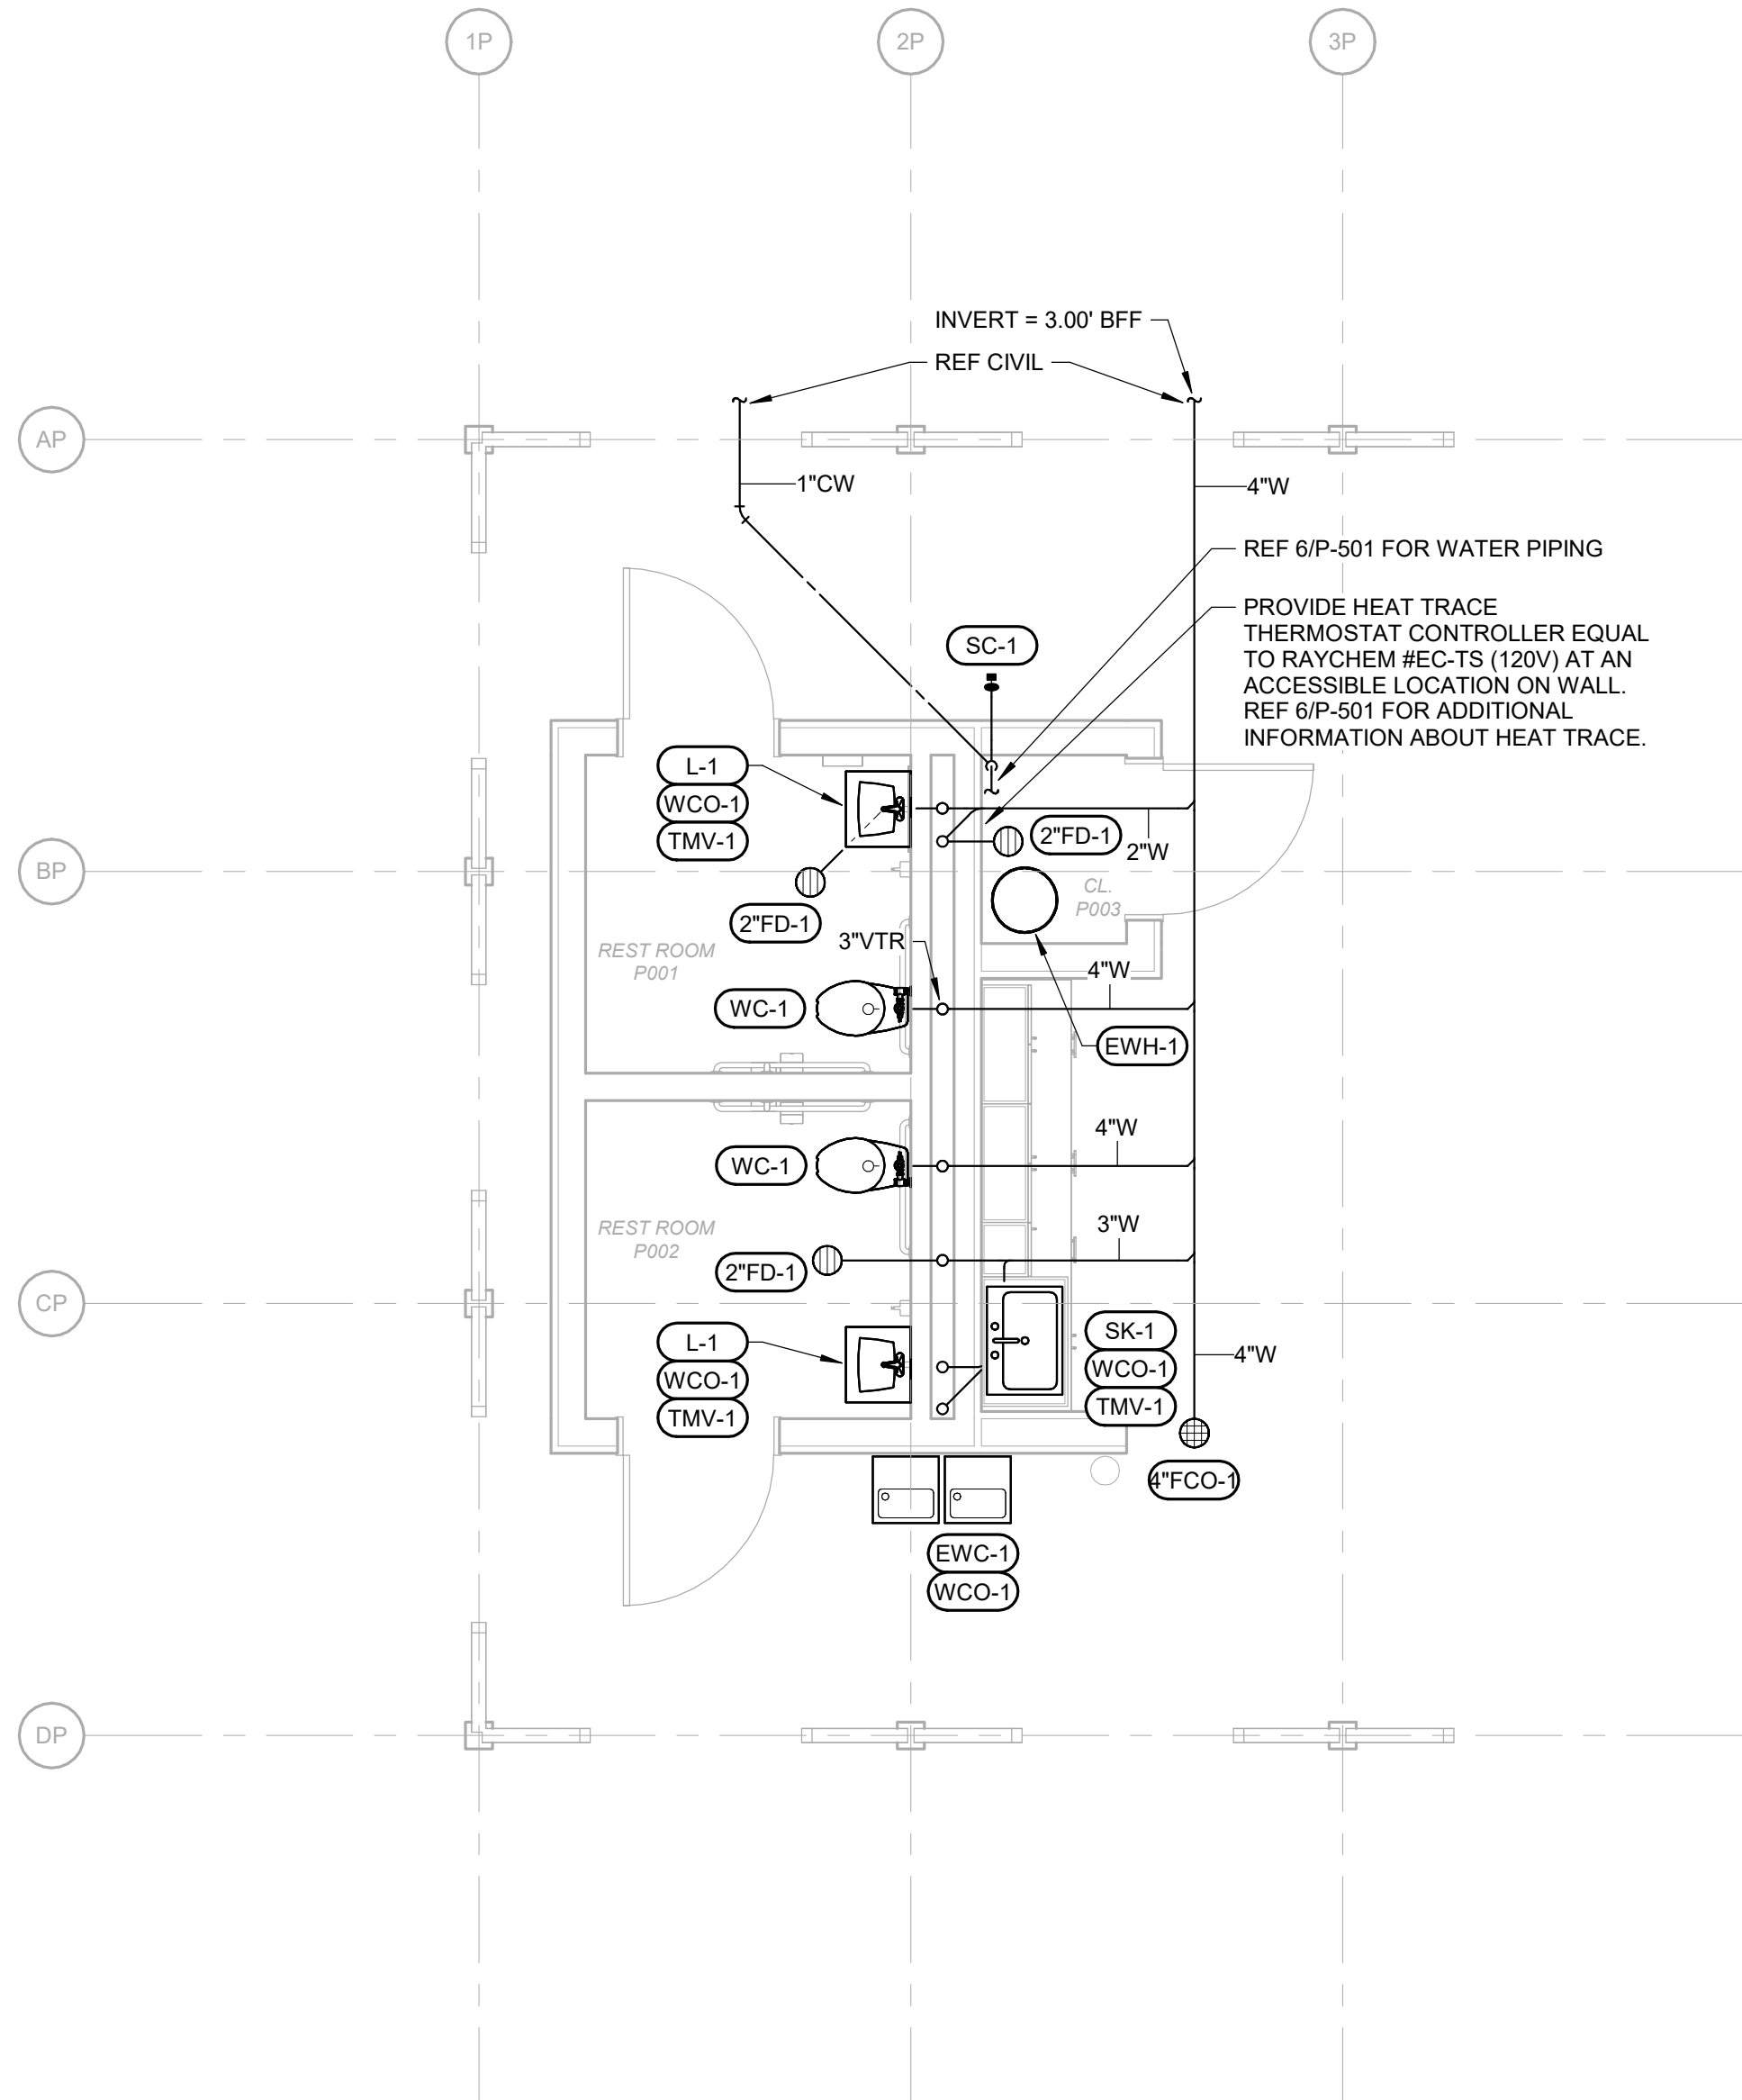


GENERAL NOTES

- A. REFER TO THE PLUMBING RISER DIAGRAMS ON SHEET P-501 FOR ADDITIONAL PIPE ROUTING, SIZING, AND NOTES.
- B. ALL SANITARY WASTE PIPING SHOWN ON THE PLUMBING PLAN IS BELOW GROUND UNLESS NOTED OTHERWISE.

STATE OF MISSOURI
MICHAEL L. PARSON,
GOVERNOR

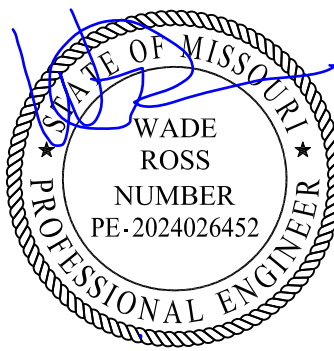

DATED: 10.22.2024
EXPIRATION: 12.31.2025

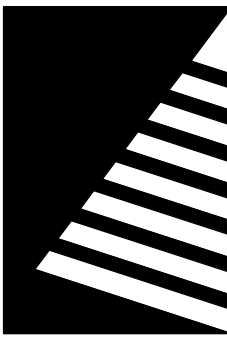

Farnsworth
GROUP

20 ALLEN AVENUE, SUITE 200
ST LOUIS, MISSOURI 63119
(314) 962-7900 / info@f-w.com

Farnsworth Group, Inc.
Missouri State Certificate of Authority #000744
www.f-w.com
Engineers | Architects | Surveyors | Scientists

100% BID SET

10/22/2024

OFFICE OF
ADMINISTRATION
DIVISION OF FACILITIES
MANAGEMENT, DESIGN
AND CONSTRUCTION

MISSOURI VETERANS
COMMISSION

OUTDOOR PAVILION
CAPE GIRARDEAU
VETERANS HOME

2400 Veterans Memorial Dr.
Cape Girardeau, MO 63701

PROJECT #: U2415.01
SITE #: 6803
ASSET#: 8136803002
FAI #: 29-043

#	DATE:	DESCRIPTION:
---	-------	--------------


DRAWN BY: RC
CHECKED BY: WR
DESIGNED BY: RC

SHEET TITLE:
PAVILION PLUMBING
PLAN


SHEET NUMBER:

P-101

SHEET 15 OF 25
ISSUE DATE: 10/22/2024

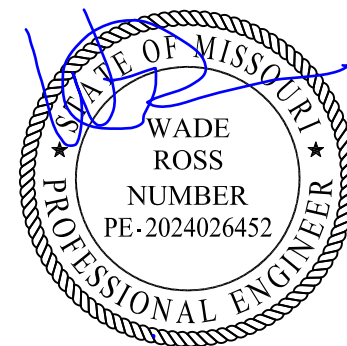

DATED: 10.22.2024
EXPIRATION: 12.31.2025

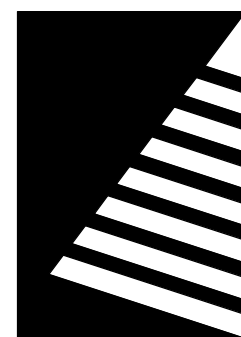

Farnsworth GROUP

20 ALLEN AVENUE, SUITE 200
ST LOUIS, MISSOURI 63119
(314) 962-7900 / info@f-w.com

Farnsworth Group, Inc.
Missouri State Certificate of Authority #000744
www.f-w.com
Engineers | Architects | Surveyors | Scientists

100% BID SET

10/22/2024

OFFICE OF
ADMINISTRATION
DIVISION OF FACILITIES
MANAGEMENT, DESIGN
AND CONSTRUCTION

MISSOURI VETERANS
COMMISSION

OUTDOOR PAVILION CAPE GIRARDEAU VETERANS HOME

2400 Veterans Memorial Dr.
Cape Girardeau, MO 63701

PROJECT #.: U2415.01

SITE #.: 6803

ASSET #.: 8136803002

FAI #.: 29-043

DATE: DESCRIPTION:

DRAWN BY: RC

CHECKED BY: WR

DESIGNED BY: RC


SHEET TITLE:

DIAGRAMS


SHEET NUMBER:

P-501


SHEET 16 OF 25
ISSUE DATE: 10/22/2024

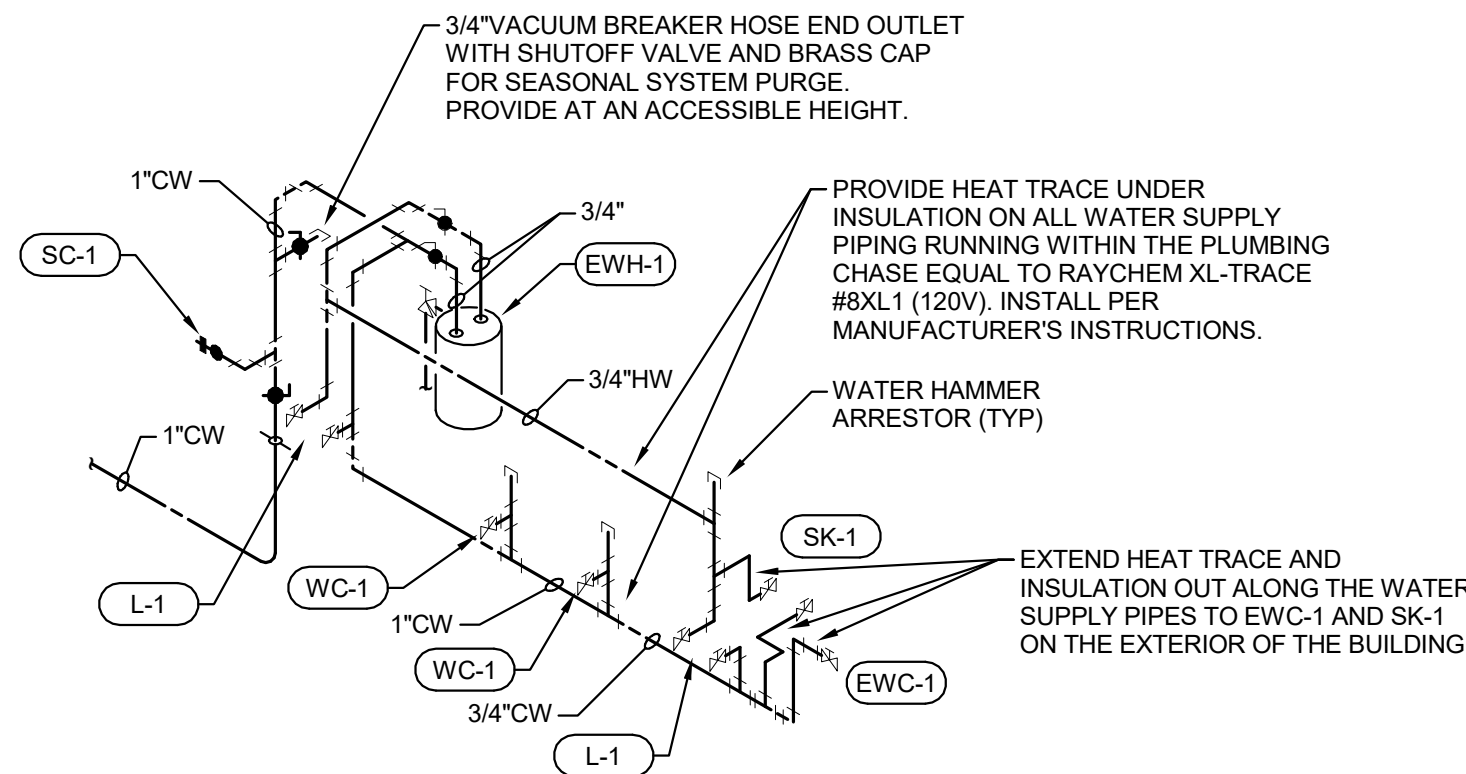

DOMESTIC WATER

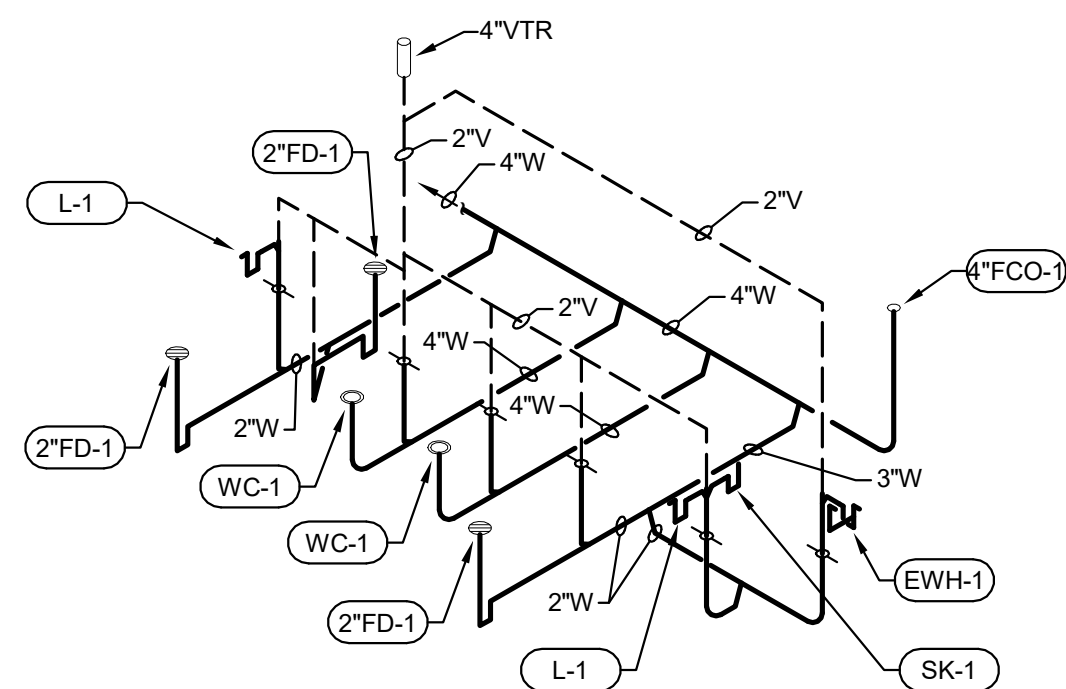


WASTE AND VENT

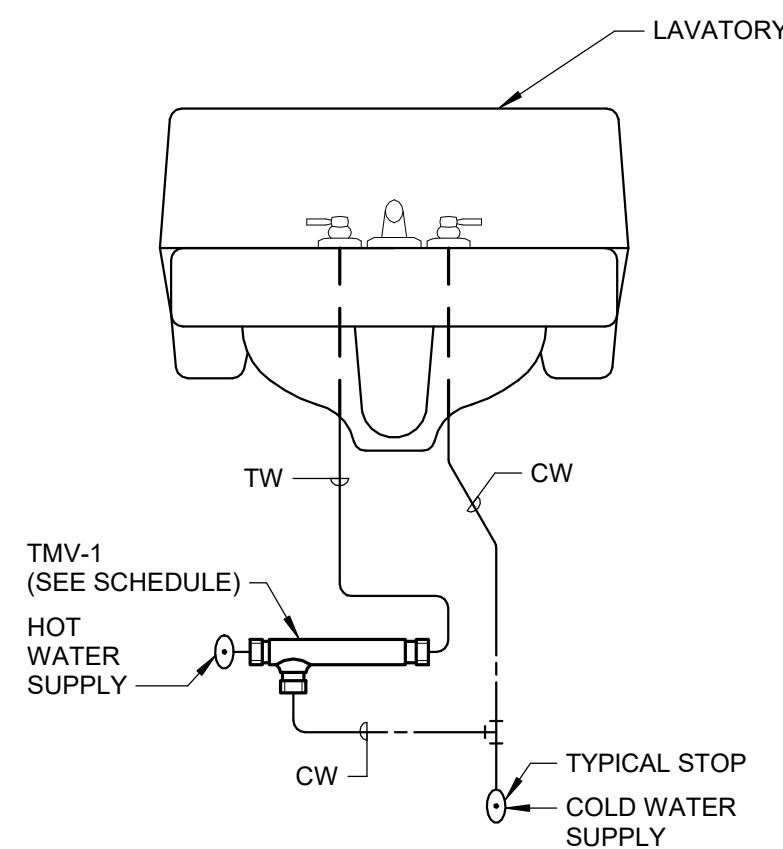


POINT-OF-USE MIXING VALVE

SCALE: NOT TO SCALE

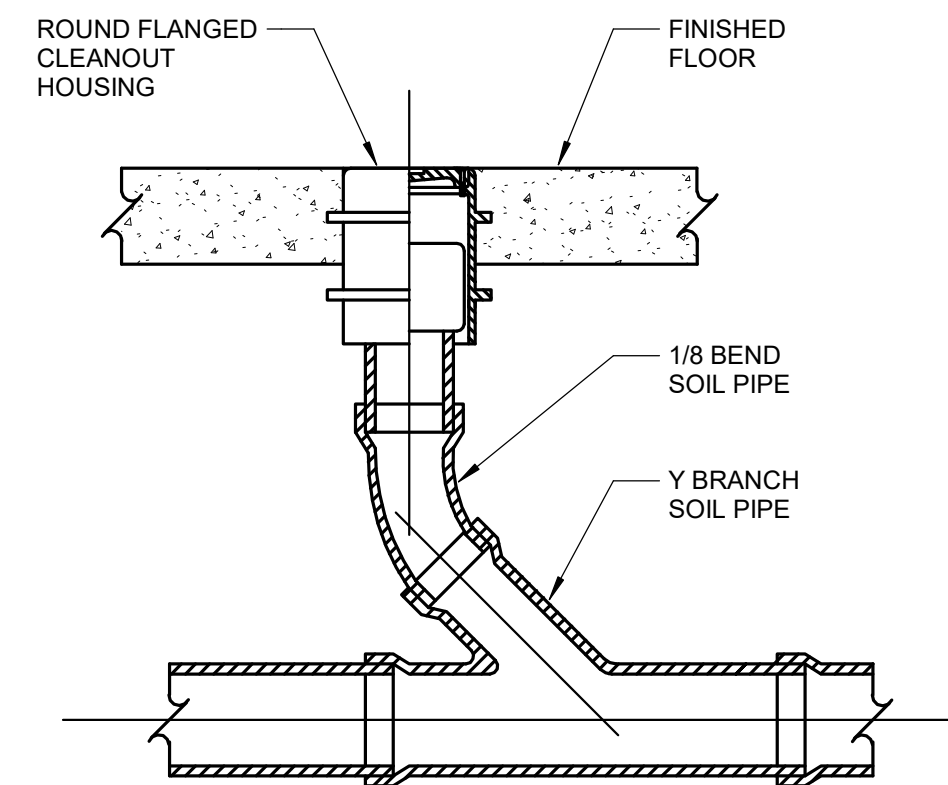


FLOOR CLEANOUT

SCALE: NOT TO SCALE

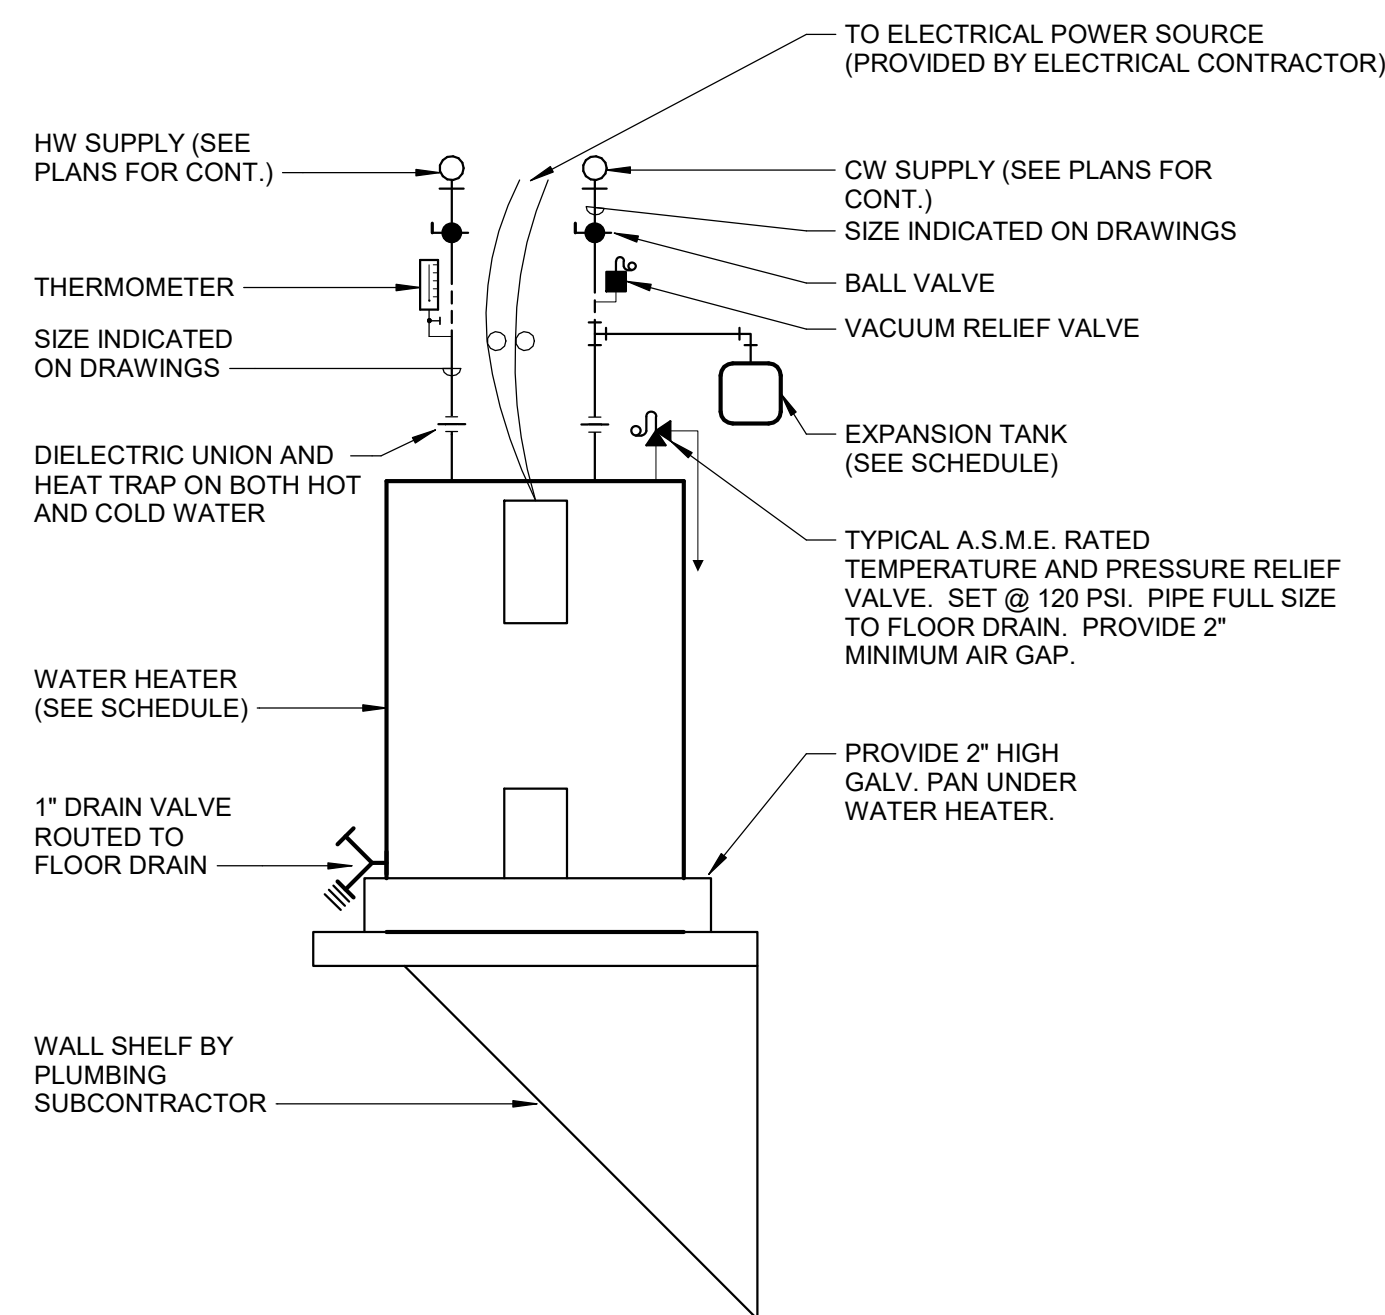


ELECTRIC WATER HEATER (SHELF MOUNTED)

SCALE: NOT TO SCALE

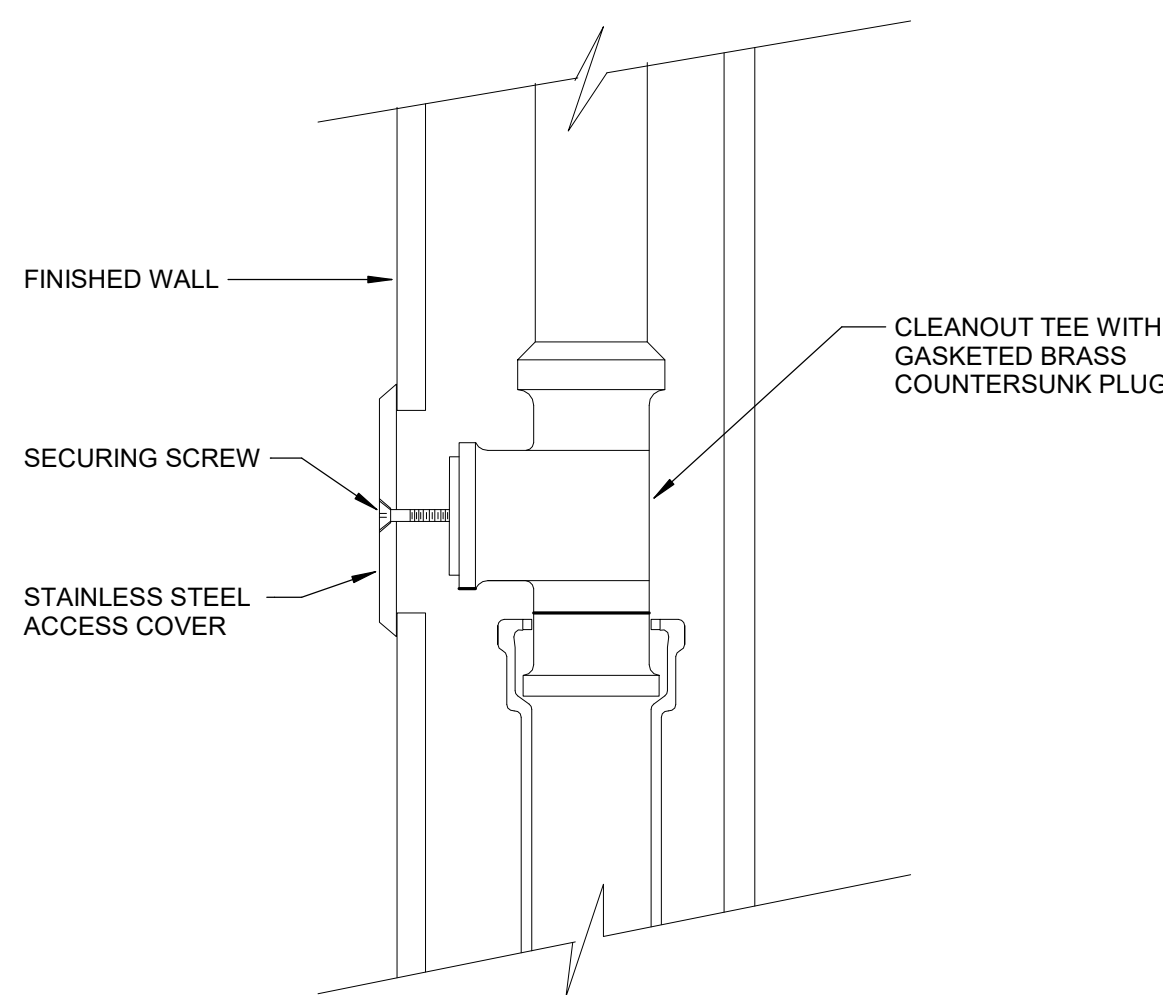

WALL CLEANOUT

SCALE: NOT TO SCALE

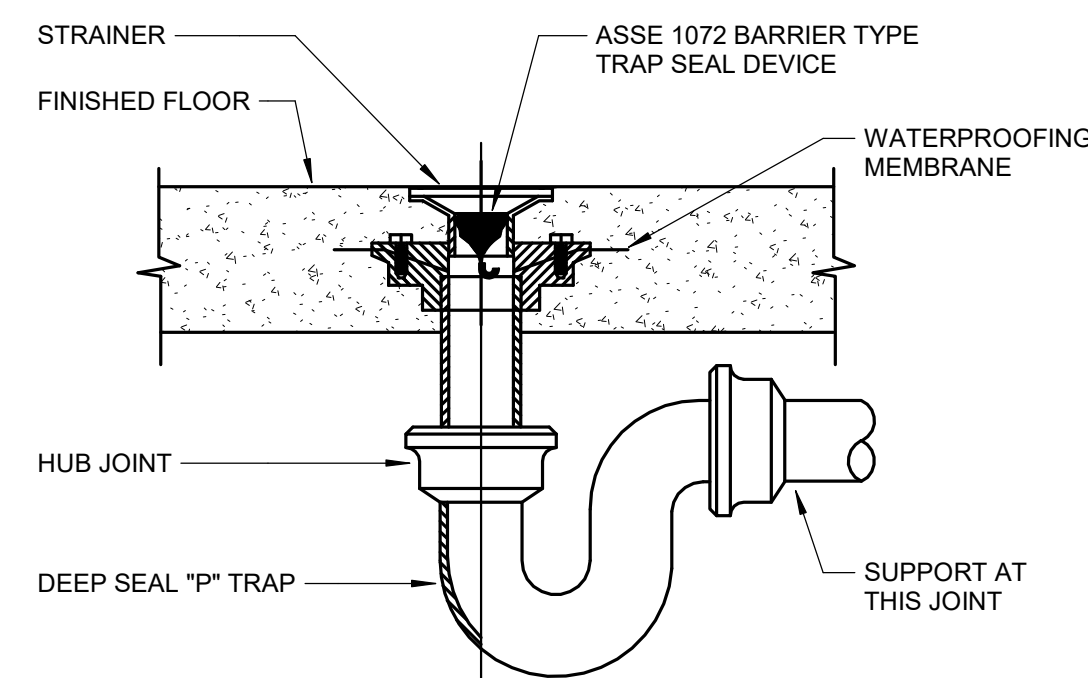

NOTES:
1. FLOOR SINK TRAP SEAL DEVICE INSTALLATION IS SIMILAR.
2. INSTALL TRAP SEAL DEVICE IN ACCORDANCE WITH
MANUFACTURER'S RECOMMENDATIONS.

FLOOR DRAIN

SCALE: NOT TO SCALE


ELECTRIC WATER HEATER SCHEDULE														
PLAN MARK	MANUFACTURER	MODEL	LOCATION	STORAGE IN GALLONS	RECOVERY GPH @ 100 DEG.	NUMBER OF ELEMENTS	ELECTRICAL DATA		PHYSICAL DATA					REMARKS
							KW INPUT	V/PH	D (IN.)	W (IN.)	H (IN.)	DIA. (IN.)	OPER. WT. (LB.)	
EW-H-1	A.O. SMITH	DEL-10	CLOSET	10	12	1	3	120/1	N/A	N/A	18.25	18	137	1, 2, 3, 4
NOTES:	1. SET TO 140 DEGREES. 2. PROVIDE WITH EXPANSION TANK EQUAL TO WATTS #DETA-5. 3. PROVIDE WITH SINGLE 3.0 KW ELEMENT. 4. REF 5/P-501.													

THERMOSTATIC MIXING VALVE SCHEDULE							
PLAN MARK	MANUFACTURER	MODEL	GPM	INLET	OUTLET	MOUNTING	REMARKS
TMV-1	WATTS	LFMMV	0.5-6	1/2"	1/2"	INLINE	LEAD FREE HIGH TEMP MIXING VALVE. PROVIDE WITH UNION ENDS INLET CHECK VALVES, SET TO 105°F. ASSE1017 (POINT-OF-USE, PROVIDE ON SINK AND LAVATORIES)
DESIGN FLOWS BASED ON 5 PSI PRESSURE DROP MAXIMUM.							
NOTE: OTHER ACCEPTABLE MANUFACTURER'S SHALL BE: BRADLEY, SYMMONS, POWERS, LEONARD, WILKINS, ZURN.							


DRAIN SCHEDULE		
PLAN MARK	MAKE/MODEL	DESCRIPTION REMARKS
FD-1	ZURN #Z415B WADE J.R. SMITH	COATED CAST IRON BODY FLOOR DRAIN WITH NO-HUB BOTTOM OUTLET, COMBINATION INVERTABLE MEMBRANE CLAMP AND ADJUSTABLE COLLAR WITH SEEPAGE SLOTS AND 6" DIAMETER POLISHED NICKEL BRONZE STRAINER. OUTLET SIZE AS INDICATED ON DRAWINGS. COORDINATE WITH GENERAL TRADE TO ASSURE DRAIN IS INSTALLED CENTERED IN MINIMUM 3 FOOT DIAMETER FLOOR SUMP AND LOWER THAN ADJACENT FLOOR LEVEL..

CLEANOUT SCHEDULE			
PLAN MARK	MAKE/MODEL	LOCATION	REMARKS
FCO-1	ZURN #Z1400-BZ WADE J.R. SMITH	FINISHED & CONCRETE FLOORS	ADJUSTABLE LEVELING COATED CAST IRON BODY FLOOR CLEANOUT WITH WATERTIGHT ABS TAPERED PLUG, NO-HUB BOTTOM OUTLET, AND 5" DIAMETER SCORIATED POLISHED NICKEL BRONZE TOP.
WCO-1	ZURN #Z1468 WADE J.R. SMITH	PROVIDE ON WASTE LINE OF EWC-1, L-1, AND SK-1	ROUND STAINLESS STEEL WALL ACCESS COVER COMPLETE WITH SECURING SCREW AND BROZE RAISED HEX HEAD PLUG COMPATIBLE WITH THREADED FEMALE COUPLING. EXCEPTION: THREADED PVC PLUG MAY BE UTILIZED WHERE CLEANOUT IS LOCATED ON RISER EXPOSED TO SITE.

PLAN MARK	FIXTURE DESCRIPTION AND REMARKS	MINIMUM INDIVIDUAL LINE SIZES				ELECTRICAL DATA	
		COLD WATER	HOT WATER	WASTE	VENT	V/PH	FLA
L-1 (ADA)	STANDARD/ADA WALL-MOUNTED LAVATORY WITH MANUAL FAUCET. MANUFACTURERS: KOHLER #K-2032 OR APPROVED COMMERCIAL GRADE EQUIVALENT BY AMERICAN STANDARD, BRIGGS, CRANE, GERBER, MANSFIELD, TOTO, OR ZURN. DESCRIPTION: ADA COMPLIANT RECTANGULAR 20.75"W x 18.25"D WHITE VITREOUS CHINA, WALL-MOUNT LAVATORY WITH: INTEGRAL BACKSPLASH (4" HIGH MIN.) AND RAISED PERIMETER; (3) 1.25"DIA. FAUCET HOLE DECK PUNCHINGS 2" ON CENTERS, AND CENTERED ON FIXTURE; 1.75" BOTTOM DRAIN HOLE; AND DRILLINGS FOR CONCEALED ARM CARRIER (SEE BELOW). MOUNT AT STANDARD, OR ADA COMPLIANT HEIGHT AS INDICATED ON PLANS. REFERENCE ARCHITECTURAL PLANS AND ELEVATIONS FOR DIMENSIONS. CARRIER: ASME A112.6.1M TYPE-II, CONCEALED ARM LAVATORY CARRIER WITH RECTANGULAR STEEL UPRIGHTS. MANUAL GOOSENECK SPOUT FAUCET WITH WRISTBLADE HANDLES. MANUFACTURERS: CHICAGO FAUCETS #895-317ABCP (0.5 GPM) OR APPROVED EQUIVALENT BY GROEHE, T&S BRASS, OR ZURN. DESCRIPTION: CENTERSET COMMERCIAL BRASS BODY; CHROME PLATED; PROVIDE WITH 0.5 GPM NON-AERATING SPRAY FLOW OUTLET; DECK/EXPOSED MOUNTING; 4-INCH INDEXED VANDAL-PROOF WRISTBLADE HANDLES; 9/625"H GOOSENECK/SWING SPOUT; COMPRESSION MANUAL OPERATION WITH CERAMIC CARTRIDGES. INCLUDE HOT AND COLD INDICATOR; COORDINATE FAUCET INLETS WITH SUPPLIES AND FIXTURE HOLE PUNCHINGS; COORDINATE OUTLET WITH SPOUT AND FIXTURE RECEPTOR. SUPPLY FITTINGS: CHROME PLATED SOFT COPPER TUBE, OR CORRUGATED STAINLESS STEEL; CHROME PLATED BRASS ESCUTCHEON; FLEXIBLE RISERS WITH COMPRESSION INLET AND OUTLET COMPONENTS COMPATIBLE WITH FAUCET AND STOPS, AND POINT-OF-USE TMV-1. COMMERCIAL GRADE CHROME PLATED BRASS QUARTER TURN BALL-TYPE, OR COMPRESSION ANGLE VALVE STOPS WITH INLET MATCHING SUPPLY PIPING AND LOOSE KEY HANDLES. WASTE FITTINGS: ASME 112.15.2 STANDARD; GRID DRAIN WITH 1.25" OFFSET (ADA), OR STRAIGHT TAILPIECE; 1.25" CHROME PLATED 17 GAUGE TWO-PIECE P-TRAP AND SWIVEL ELBOW WITH TUBULAR WASTE TO WALL. COORDINATE 1.5" x 1.25" TRAP ADAPTOR ROUGH-IN WITH CHROME PLATED BRASS WALL FLANGE.	1/2"	1/2"	1 1/4"	1 1/2"		
SK-1 (ADA)	ADA SINGLE BOWL STAINLESS STEEL DROP-IN SINK. MANUFACTURERS: ELKAY #LRAD3122 OR APPROVED COMMERCIAL GRADE EQUIVALENT BY AMERICAN STANDARD, JUST, OR KOHLER. FIXTURE: SINGLE BOWL 31" x 22" x 5-1/2" 18-GAUGE 304 STAINLESS STEEL DROP-IN SINK WITH: STAINLESS SATIN FINISH; SINGLE REAR CENTER 3.375" DRAIN; DECK HOLES FOR CENTER SET FAUCET AND RIGHT SIDE SPRAY 4 INCHES ON CENTERS; AND BOTTOM SOUND PADS. MANUAL GOOSENECK SPOUT FAUCET WITH WRISTBLADE HANDLES. MANUFACTURERS: CHICAGO FAUCETS #200-AGNBAE3-317AB OR APPROVED EQUIVALENT BY ADVANCE TABCO, T&S BRASS, OR ZURN. DESCRIPTION: CENTERSET, FIXED COMMERCIAL BRASS BODY (CONCEALED UNDER DECK); CHROME PLATED; 13.125"H x 8" (7.4" OUTLET TO DECK); GOOSENECK/SWING SPOUT WITH 2.2 GPM AERATOR; COMPRESSION MANUAL OPERATION WITH CERAMIC CARTRIDGES, DECK/EXPOSED MOUNTING 4-INCH WRISTBLADE HANDLES INCLUDING HOT AND COLD INDICATORS; SIDE SPRAY. COORDINATE 1/2" NPSM FAUCET INLETS WITH SUPPLIES AND FIXTURE HOLE PUNCHINGS; COORDINATE OUTLET WITH SPOUT AND FIXTURE RECEPTOR. SUPPLY FITTINGS: CHROME PLATED SOFT COPPER TUBE, OR BRAIDED STAINLESS STEEL FLEXIBLE RISERS WITH COMPRESSION INLET AND OUTLET COMPONENTS COMPATIBLE WITH FAUCET AND STOPS, AND POINT-OF-USE TMV-1. COMMERCIAL GRADE CHROME PLATED BRASS QUARTER TURN BALL-TYPE, OR COMPRESSION ANGLE VALVE STOPS WITH INLET MATCHING SUPPLY PIPING AND LOOSE KEY HANDLES. SUPPLY STOPS FOR SINK AND ONE EXTRA STOP COMPATIBLE WITH DISH MACHINE WHERE APPLICABLE. WASTE FITTINGS: 3.5" CHROME PLATED DRAIN AND CHRUMB CUP ASSEMBLY. ASME 112.15.2 STANDARD; GRID DRAIN WITH 1.5" OFFSET TAILPIECE; 1.5" CHROME PLATED 17 GAUGE TWO-PIECE P-TRAP AND SWIVEL ELBOW WITH TUBULAR WASTE TO WALL. COORDINATE 1.5" x 1.25" TRAP ADAPTOR ROUGH-IN WITH CHROME PLATED BRASS WALL FLANGE.	1/2"	1/2"	1 1/2"	1 1/2"		
WC-1 (ADA)	ADA COMPLIANT FLOOR-MOUNTED, BOTTOM OUTLET, GRAVITY TANK TYPE WATER CLOSET. MANUFACTURERS: KOHLER #K-3979 OR APPROVED COMMERCIAL GRADE EQUIVALENT BY AMERICAN STANDARD, BRIGGS, CRANE, GERBER, MANSFIELD, TOTO, OR ZURN. NOTE: REVIEW PLANS AND COORDINATE MODEL AT EACH LOCATION TO ASSURE TRIP LEVER IS TO WIDE SIDE OF STALL. FIXTURE: FLOOR MOUNTED, VITREOUS CHINA BOWL, TANK AND LID, SIPHON JET, CLOSE-COUPLED GRAVITY TANK TYPE, LEFT SIDE TRIP LEVER (IF OR MODEL INDICATED) 17" MINIMUM FLOOR TO RIM ADA COMPLIANT HEIGHT, ELONGATED, 1.6 GPF, WHITE COLOR, AND BOTTOM OUTLET (12" ROUGH-IN). INCLUDE ANSI Z124.5 ANTI-MICROBIAL COMMERCIAL ELONGATED WHITE TOILET SEAT WITHOUT COVER HAVING OPEN FRONT, SELF-SUSTAINING CHECK HINGE. SUPPLY FITTINGS: COMMERCIAL GRADE CHROME PLATED BRASS, QUARTER-TURN COMPRESSION STOP WITH WHEEL HANDLE AND INLET CONNECTION MATCHING WATER SUPPLY PIPING TYPE AND SIZE. 3/8", OR 1/2" BRAIDED STAINLESS STEEL FLEXIBLE HOSE CLOSET RISER.	1/2"	N/A	4"	2"		
EWC-1 (ADA)	ELECTRIC WATER COOLER - TWO STATION, B1 LEVEL, ADA COMPLIANT. DESCRIPTION: SELF-CONTAINED, DOUBLE WALL HUNG ELECTRIC REFRIGERATED, ADA COMPLIANT WATER COOLER HAVING: STAINLESS STEEL CONSTRUCTION TO WITHSTAND ABUSIVE ENVIRONMENTS; TAMPER RESISTANT, VANDAL-RESISTANT FASTENERS; VANDAL-RESISTANT BUBBLERS WITH CHROME PLATED INTEGRAL HOOD GUARD; GALVANIZED STRUCTURAL STEEL FRAME; 300 SERIES POLISHED STAINLESS STEEL TOP, CABINET/ENCLOSURE FOR FLUSH TO WALL MOUNTING AND BOTTOM COVER PLATE; AND WITHOUT FILTER. INCLUDE STAINLESS STEEL BOTTOM CANE APRON ACCESSORY FOR ALL EXTERIOR LOCATIONS. CAPACITY EQUAL TO 7.8. GPH OF 50°F WATER AT 90°F AMBIENT TEMPERATURE. COMPRESSOR: HERMETICALLY SEALED. MOTOR: THERMAL OVERLOAD PROTECTED ACCEPTABLE MANUFACTURERS: ELKAY #VRCTL8SC, HALSEY-TAYLOR, HAWS. ELECTRIC WATER COOLER TRIM: PROVIDE STAINLESS STEEL PERFORATED STRAINER WITH CONCEALED WASTE. ANGLE STOPS BY BRASSCRAFT OR MCGUIRE, 17 GAUGE 1 1/4" O.D. TAILPIECE, 17 GAUGE 1 1/4" P-TRAP BY BRASSCRAFT, MCGUIRE, DEARBORN. INSTALL DRINKING FOUNTAIN PER MANUFACTURER'S WRITTEN INSTRUCTIONS. PROVIDE WALL SUPPORT/BRACKET COMPATIBLE WITH APPROVED COOLER AND ASSOCIATED WALL MATERIALS.	1/2"	N/A	1 1/4"	1 1/2"	120V	6
SC-1	SILLCOOK - NON-FREEZE KEY OPERATED WITH 1 5/8 INCH BRASS CASTINGS, BRASS OPERATING MECHANISM, ADJUSTABLE LOCK NUT, REMOVABLE NYLON SEAT, NICKEL BRASS DEEP BOX WITH KEY HANDLE, INTEGRAL ANTI-SIPHON, NON-FREEZE VACUUM BREAKER AND WALL CLAMP. ACCEPTABLE MANUFACTURERS: WOODFORD #B67, WADE, JOSAM, ZURN. LENGTH OF WALL CLAMP AS REQUIRED BY WALL CONSTRUCTION AND ALL OTHER MOUNTING AS REQUIRED BY MANUFACTURER.	3/4"	N/A	N/A	N/A		

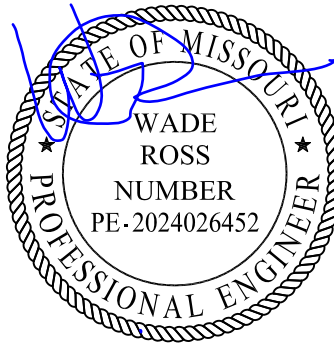

DATED: 10.22.2024
EXPIRATION: 12.31.2025

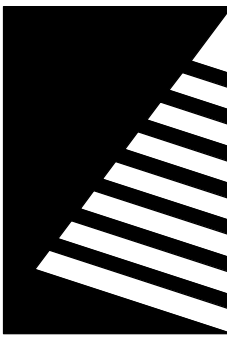

Farnsworth GROUP

20 ALLEN AVENUE, SUITE 200
ST LOUIS, MISSOURI 63119
(314) 962-7900 / info@f-w.com

Farnsworth Group, Inc.
Missouri State Certificate of Authority #000744
www.f-w.com
Engineers | Architects | Surveyors | Scientists

100% BID SET

10/22/2024

OFFICE OF
ADMINISTRATION
DIVISION OF FACILITIES
MANAGEMENT, DESIGN
AND CONSTRUCTION

MISSOURI VETERANS
COMMISSION

OUTDOOR PAVILION CAPE GIRARDEAU VETERANS HOME

2400 Veterans Memorial Dr.
Cape Girardeau, MO 63701

PROJECT #.: U2415.01
SITE #.: 6803
ASSET #.: 8136803002
FAI #.: 29-043

DATE: DESCRIPTION:

DRAWN BY: RC
CHECKED BY: WR
DESIGNED BY: RC

SHEET TITLE:
SCHEDULES

SHEET NUMBER:




P-601

SHEET 17 OF 25
ISSUE DATE: 10/22/2024


SYMBOLS LEGEND

NOTE: NOT ALL SYMBOLS ARE USED IN CONSTRUCTION DOCUMENTS


HYDRONIC

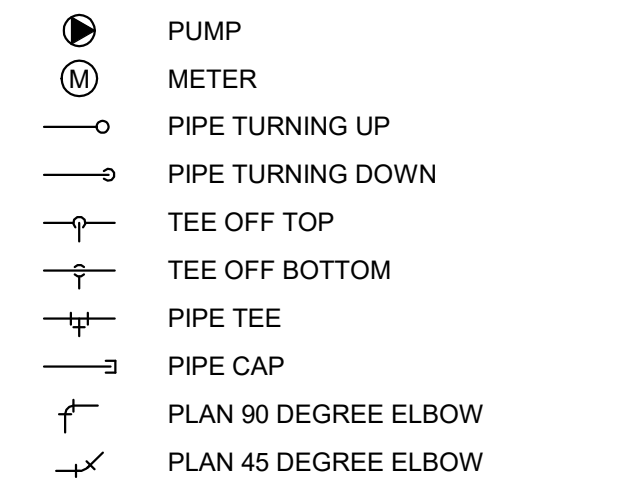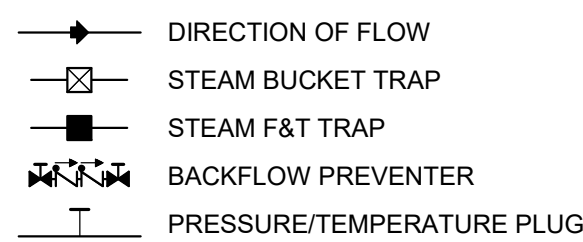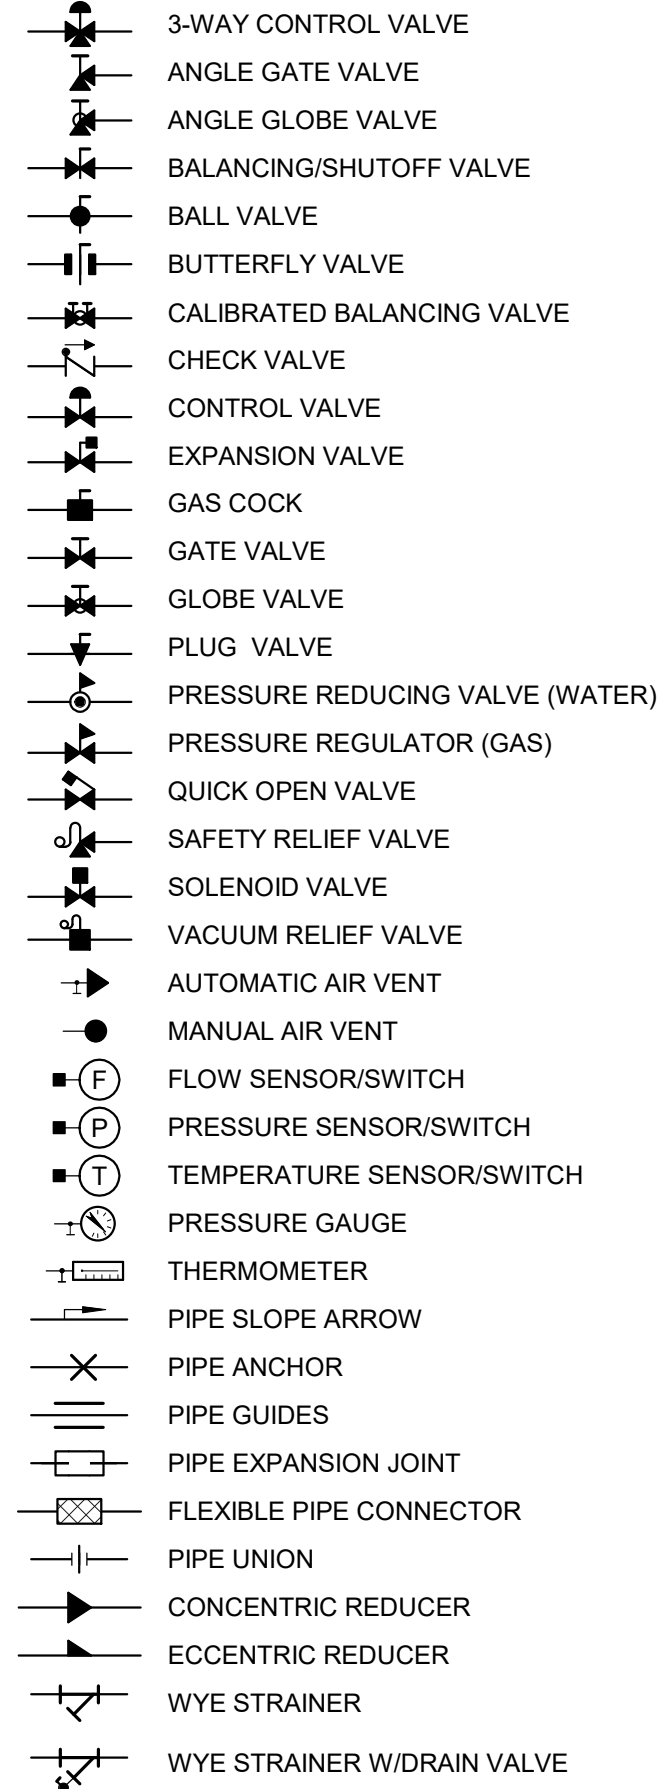


PIPING SYSTEM (SOLID LINE)

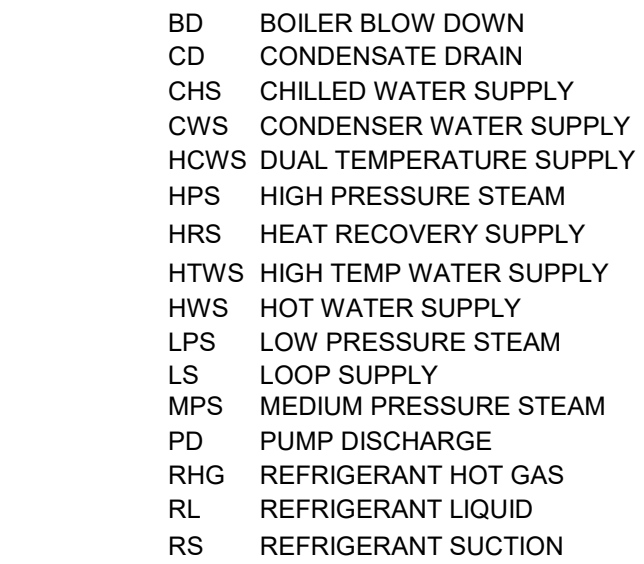


PIPING SYSTEM (DASHED LINE)

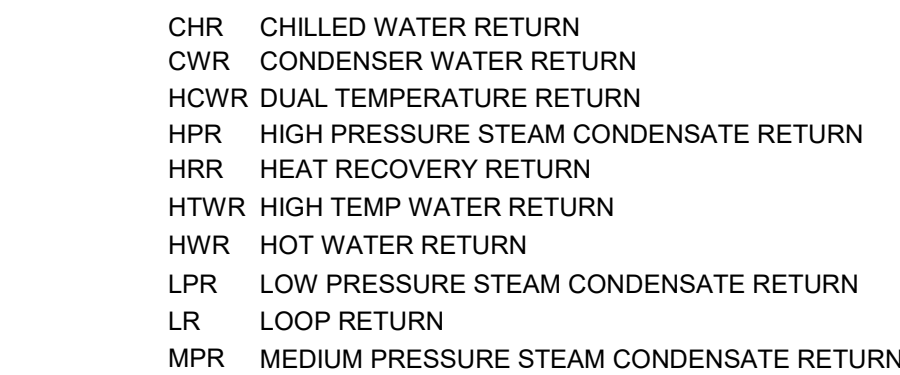

VENTILATION

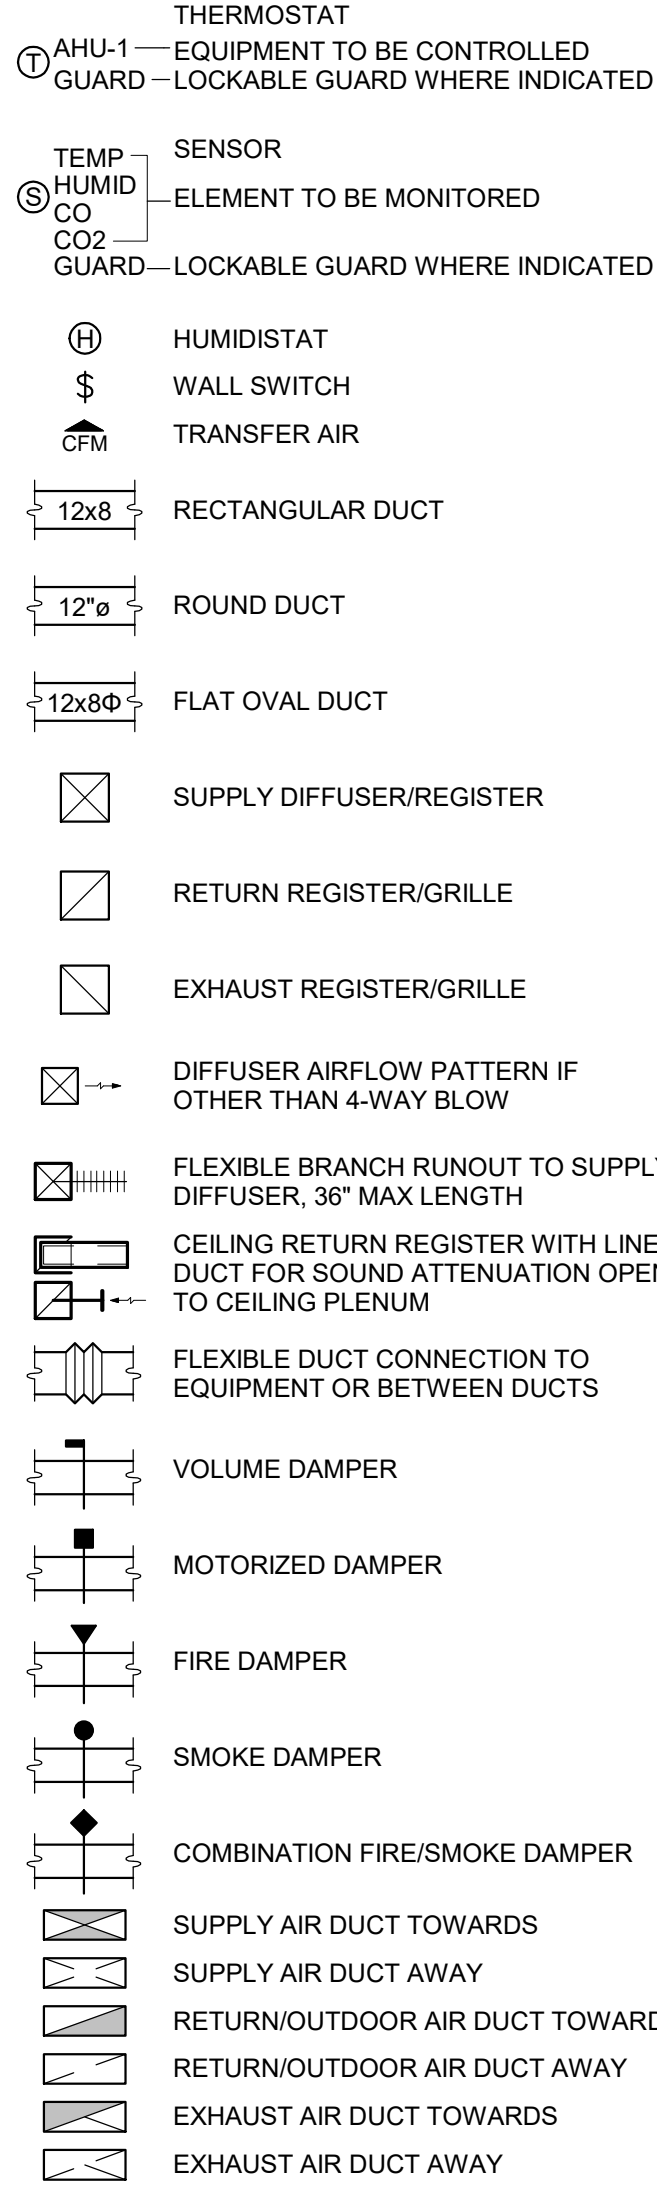

GENERAL

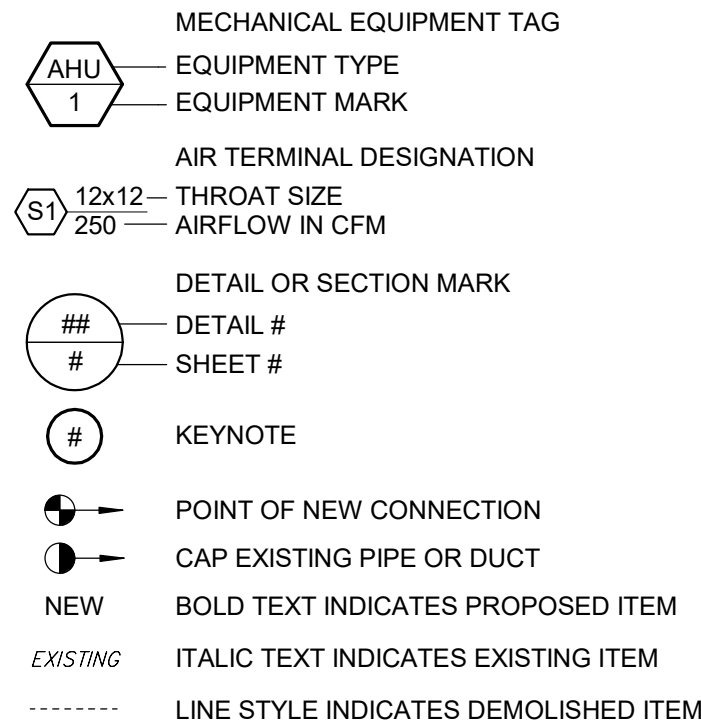

ABBREVIATIONS

AC	ABOVE CEILING/AIR CONDITIONER	GRH	GAS RADIANT HEATER
ACC	AIR COOLED CONDENSER	GS	GLYCOL SUPPLY
AF	AIR FILTER	GUH	GAS UNIT HEATER
AFF	ABOVE FINISHED FLOOR	HU	HUMIDIFIER
AHU	AIR HANDLING UNIT	HC	HEATING COIL
AL	ALUMINUM	HCWR	DUAL TEMPERATURE RETURN
AMS	AIR MEASURING STATION	HCWS	DUAL TEMPERATURE SUPPLY
AS	AIR SEPARATOR	HP	HEAT PUMP
AV	AUTOMATIC AIR VENT	HPR	HIGH PRESSURE STEAM RETURN
B	BOILER	HPS	HIGH PRESSURE STEAM SUPPLY
BAS	BUILDING AUTOMATION SYSTEM	HRC	HEAT RECOVERY COIL
BDD	BACKDRAFT DAMPER	HRV	HEAT RECOVERY VENTILATOR (SENSIBLE)
BFC	BELOW FINISHED CEILING	HS	HUMIDITY SENSOR
BFP	BACKFLOW PREVENTION DEVICE	HWP	HOT WATER PUMP
BJ	BETWEEN JOISTS	HWR	HOT WATER RETURN
BOD	BOTTOM OF DUCT	HWS	HOT WATER SUPPLY
BOP	BOTTOM OF PIPE	HX	HEAT EXCHANGER
BTUH	BRITISH THERMAL UNITS PER HOUR	ISP	INTERNAL STATIC PRESSURE
CA	COMPRESSED AIR	KH	KITCHEN HOOD - COMMERCIAL
CBS	COUNTER BALANCED SHUTTER	L	LOUVER
CC	COOLING COIL	LPR	LOW PRESSURE STEAM RETURN
CF	CEILING / CIRCULATING FAN	LPS	LOW PRESSURE STEAM SUPPLY
CFM	CUBIC FEET PER MINUTE	MA	MIXED AIR
CH	CHILLER	MAU	MAKEUP AIR UNIT
CHP	CHILLED WATER PUMP	MBH	THOUSANDS OF BTU PER HOUR
CHR	CHILLED WATER RETURN	MC	MECHANICAL CONTRACTOR
CHS	CHILLED WATER SUPPLY	MD	MOTORIZED DAMPER
CNV	CONVECTOR	MS	MOTORIZED SHUTTER
COND	CONDENSATE	NTS	NOT TO SCALE
CP	CONDENSATE PUMP	OA	OUTDOOR AIR
CRAC	COMPUTER ROOM AIR CONDITIONER	ODB	OPPOSED BLADE DAMPER
CT	COOLING TOWER	P	PUMP
CU	CONDENSING UNIT	PC	PLUMBING CONTRACTOR
CUH	CABINET UNIT HEATER	PBD	PARALLEL BLADE DAMPER
CV	CONTROL VALVE	PDH	POOL ROOM DEHUMIDIFIER
CW	DOMESTIC COLD WATER	PRV	PRESSURE RELIEF VALVE
CWP	CONDENSER WATER PUMP	PS	PRESSURE SWITCH
CWR	CONDENSER WATER RETURN	PSI	POUNDS PER SQUARE INCH
CWS	CONDENSER WATER SUPPLY	PTAC	PACKAGED TERMINAL AIR CONDITIONER
DAC	DOOR AIR CURTAIN	RA	RETURN AIR
DC	DRY COOLER	RF	RETURN AIR FAN
DH	DEHUMIDIFIER	RG	RETURN GRILLE (LESS DAMPER)
DN	DOWN	RH	ROOF HOOD
DOAS	DEDICATED OUTDOOR AIR SYSTEM	RHC	REHEAT COIL
DP	DIFFERENTIAL PRESSURE	RLFA	RELIEF AIR
DS	DUCT SILENCER	RP	RADIANT PANEL
DSU	DUCTLESS SPLIT UNIT	RPZ	REDUCED PRESSURE BFP
DX	DX COOLING COIL	RR	RETURN REGISTER (WITH DAMPER)
EA	EXHAUST AIR	RTU	ROOFTOP AIR HANDLING UNIT
EBB	ELECTRIC BASEBOARD HEATER	SA	SUPPLY AIR
EC	ELECTRICAL CONTRACTOR	SAS	SELF-ACTING SHUTTER
EF	EXHAUST FAN	SD	SUPPLY DIFFUSER/SMOKE DAMPER
EG	EXHAUST GRILLE (LESS DAMPER)	SF	SUPPLY FAN / SQUARE FOOT
EHC	ELECTRIC HEATING COIL	SFD	SMOKE/FIRE DAMPER
EL	ELEVATION	SG	SUPPLY GRILLE
ER	EXHAUST REGISTER	SR	SUPPLY REGISTER
ERP	ELECTRIC RADIANT PANEL	TCAC	TEMP. CONTROL AIR COMPRESSOR
ERV	ENERGY RECOVERY VENTILATOR	TCAD	TEMP. CONTROL AIR DRYER
ESP	EXTERNAL STATIC PRESSURE	TDV	TRIPLE DUTY VALVE
ET	EXPANSION TANK	TFA	TO FLOOR ABOVE
EUH	ELECTRIC UNIT HEATER	TFB	TO FLOOR BELOW
FA	FRESH AIR	TJ	THROUGH JOISTS
FCU	FAN COIL UNIT	TOD	TOP OF DUCT
FD	FIRE DAMPER	TOP	TOP OF PIPE
FDC	FLEXIBLE DUCT CONNECTION	TSP	TOTAL STATIC PRESSURE
FFA	FROM FLOOR ABOVE	UC	UNIT COOLER
FFB	FROM FLOOR BELOW	UFD	UNDERFLOOR DUCT
FFC	FLEXIBLE PIPE CONNECTION	UFT	UNDERFLOOR FAN TERMINAL
FPT	FAN POWERED AIR TERMINAL	UH	UNIT HEATER
FT	FINNED TUBE RADIATION	UV	UNIT VENTILATOR
GC	GENERAL CONTRACTOR	VAV	VARIABLE AIR VOLUME TERMINAL
GF	GAS FURNACE	VD	VOLUME DAMPER
GH	GRAVITY INTAKE HOOD	VFD	VARIABLE FREQUENCY DRIVE
GPM	GALLONS PER MINUTE	VRP	VERTICAL RADIANT PANEL
GR	GLYCOL RETURN	WAC	WINDOW / WALL AIR CONDITIONER

GENERAL NOTES

COMMON REQUIREMENTS

- A. THIS FACILITY HAS BEEN DESIGNATED A "SMOKE-FREE" ENVIRONMENT. NO MECHANICAL VENTILATION PROVISIONS HAVE BEEN MADE TO ACCOMMODATE TOBACCO USAGE BY THE BUILDING OCCUPANTS
- B. ALL MECHANICAL SYSTEMS SHALL BE INSTALLED TO THE SATISFACTION OF THE LOCAL CODE AUTHORITIES HAVING JURISDICTION
- C. EVERY ATTEMPT HAS BEEN MADE TO COORDINATE THE ROUTING OF DUCTWORK WITHIN THE WOOD TRUSSED ATTIC SPACE. ACTUAL LOCATION OF TRUSS WEBS HOWEVER CAN NOT BE DETERMINED UNTIL FABRICATION DRAWINGS ARE SUBMITTED FOR REVIEW. WHERE POSSIBLE, REFRAIN FROM PREFABRICATING DUCTWORK DESIGNATED FOR INSTALLATION WITHIN THE ATTIC UNTIL ROOF FRAMING IS IN PLACE AND ACTUAL STRUCTURAL CONDITIONS CAN BE FIELD VERIFIED.

MECHANICAL EQUIPMENT INSTALLATION

- A. INSTALL EQUIPMENT TO ALLOW MAXIMUM POSSIBLE HEADROOM UNLESS SPECIFIC MOUNTING HEIGHTS ARE INDICATED
- B. INSTALL EQUIPMENT LEVEL AND PLUMB, PARALLEL AND PERPENDICULAR TO OTHER BUILDING SYSTEMS AND COMPONENTS IN EXPOSED INTERIOR SPACES, UNLESS OTHERWISE INDICATED
- C. INSTALL HVAC EQUIPMENT TO FACILITATE SERVICE, MAINTENANCE, AND REPAIR OR REPLACEMENT OF COMPONENTS. CONNECT EQUIPMENT FOR EASE OF REMOVAL, WITH MINIMUM INTERFERENCE TO OTHER INSTALLATIONS
- D. ALL MECHANICAL EQUIPMENT WITH THE EXCEPTION OF AIR HANDLING UNITS, SUPPORTED FROM FLOOR STRUCTURE SHALL BE MOUNTED ON 4" THICK CONCRETE HOUSEKEEPING PADS UNLESS NOTED OTHERWISE. AIR-HANDLING UNITS SHALL BE MOUNTED ON 6" THICK CONCRETE HOUSEKEEPING PADS TO ACCOMMODATE PROPER TRAPPING OF THE CONDENSATE DRAIN
- E. AIR FILTERS SHALL BE REPLACED IN ALL AIR HANDLING EQUIPMENT EMPLOYING SUCH PRIOR TO FINAL COMPLETION AND OWNER OCCUPANCY
- F. THE INSTALLING CONTRACTOR ASSUMES FULL RESPONSIBILITY FOR ALL MECHANICAL EQUIPMENT PUT INTO OPERATION PRIOR TO THE INSTALLATION OF A WORKING CONTROL SYSTEM, TESTING, AND BALANCING, AND SUBSTANTIAL COMPLETION. ALL RETURN AND EXHAUST DUCT OPENINGS SHALL BE COVERED WITH ROLL TYPE FILTER MEDIA DURING SUCH TEMPORARY OPERATION. OPERATION OF THE MECHANICAL EQUIPMENT PRIOR TO FINAL COMPLETION SHALL NOT IMPACT THE EQUIPMENT WARRANTY. MINIMUM 1-YEAR FROM SUBSTANTIAL COMPLETION UNLESS SPECIFIED OTHERWISE
- G. PROVIDE FLEXIBLE DUCT CONNECTION BETWEEN MOTOR DRIVEN MECHANICAL UNITS AND SHEET METAL SUPPLY, OUTDOOR AIR, EXHAUST, AND/OR RETURN AIR DUCTWORK CONNECTIONS
- H. PROVIDE FLEXIBLE PIPE CONNECTION BETWEEN MOTOR DRIVEN MECHANICAL UNITS AND CONNECTING PIPING
- I. BASIS OF DESIGN MECHANICAL EQUIPMENT IS AS SCHEDULED ON THE DRAWINGS. INSTALLING CONTRACTOR ASSUMES RESPONSIBILITY FOR COORDINATING PHYSICAL SPACE REQUIREMENTS OF EQUIVALENT CAPACITY MECHANICAL EQUIPMENT DEEMED ACCEPTABLE BY THE ENGINEER
- J. MECHANICAL EQUIPMENT FACTORY FINISH DAMAGED DURING THE COURSE OF CONSTRUCTION SHALL BE RESTORED TO ORIGINAL CONDITION PRIOR TO FINAL ACCEPTANCE

DUCTWORK REQUIREMENTS

- A. DUCTWORK IS SHOWN IN SCHEMATIC FORM. ALL REQUIRED DUCT RISERS AND DROPS TO ALLOW GENERAL ROUTING DEPICTED MAY NOT BE SHOWN. PROVIDE OFFSETS AS REQUIRED TO MEET SPACE REQUIREMENTS AND TO AVOID INTERFERENCE WITH OTHER TRADES AND FIELD CONDITIONS. EXACT LOCATION OF THE DUCTWORK MAY VARY ACCORDING TO THE COORDINATED SPACE REQUIREMENTS. EACH TRADE SHALL BE TOTALLY RESPONSIBLE FOR COORDINATION WITH OTHER TRADES. NOTIFY ENGINEER OF CONDITIONS REPRESENTING SIGNIFICANT CHANGES TO THE DESIGNED ROUTING
- B. COMPLY WITH NFPA 90A, "INSTALLATION OF AIR CONDITIONING AND VENTILATING SYSTEMS," UNLESS OTHERWISE INDICATED
- C. COMPLY WITH NFPA 90B, "INSTALLATION OF WARM AIR HEATING AND AIR CONDITIONING SYSTEMS," UNLESS OTHERWISE INDICATED
- D. FABRICATE RECTANGULAR DUCTS, ELBOWS, TRANSITIONS, OFFSETS, BRANCH CONNECTIONS, AND OTHER CONSTRUCTION WITH GALVANIZED, SHEET STEEL, ACCORDING TO SMACNA'S "HVAC DUCT CONSTRUCTION STANDARDS--METAL AND FLEXIBLE." COMPLY WITH REQUIREMENTS FOR METAL THICKNESS, REINFORCING TYPES AND INTERVALS, TIE-ROD APPLICATIONS, AND JOINT TYPES AND INTERVALS
- E. COORDINATE SIZE, QUANTITY, AND LOCATION OF ALL OPENINGS REQUIRED FOR DUCT AND PIPE PENETRATIONS THROUGH WALLS, FLOORS, AND ROOFS, WITH CONTRACTOR RESPONSIBLE FOR ROUGH FRAMING. COORDINATE LOCATION OF AIR INTAKES WITH EXHAUST AND PLUMBING VENTS SO THAT INTAKES ARE A MINIMUM OF 10 FEET FROM EXHAUST OPENINGS OR PLUMBING VENTS
- F. INSTALL DUCTS IN LONGEST LENGTH POSSIBLE AND FEWEST POSSIBLE JOINTS. INSTALL FABRICATED FITTINGS FOR CHANGES IN DIRECTIONS, CHANGES IN SIZE AND SHAPE, AND CONNECTIONS
- G. INSTALL DUCTS, UNLESS OTHERWISE INDICATED, VERTICALLY AND HORIZONTALLY, PARALLEL AND PERPENDICULAR TO BUILDING LINES; AVOID DIAGONAL RUNS UNLESS SPECIFICALLY INDICATED ON DRAWINGS
- H. REFER TO ARCHITECTURAL REFLECTED CEILING PLAN FOR EXACT LOCATION OF CEILING MOUNTED DEVICES. COORDINATE MECHANICAL CEILING DEVICES SUCH AS DIFFUSERS AND REGISTERS WITH LIGHT FIXTURES, SPEAKERS, SPRINKLER HEADS, ETC.
- I. ELECTRICAL EQUIPMENT SPACES: ROUTE DUCTWORK TO AVOID PASSING THROUGH TRANSFORMER VAULTS AND ELECTRICAL EQUIPMENT SPACES AND ENCLOSURES. AVOID ROUTING DUCTWORK DIRECTLY ABOVE ELECTRICAL EQUIPMENT UNLESS SPECIFICALLY INDICATED ON THE MECHANICAL DRAWINGS
- J. NON-FIRE-RATED PARTITION PENETRATIONS: WHERE DUCTS PASS THROUGH INTERIOR PARTITIONS AND ARE EXPOSED TO VIEW IN MECHANICAL ROOMS, CONCEAL SPACE BETWEEN CONSTRUCTION OPENINGS AND DUCT OR DUCT INSULATION WITH SHEET METAL FLANGES OF SAME METAL THICKNESS AS DUCT. OVERLAP OPENING ON FOUR SIDES BY AT LEAST 1-1/2 INCHES UNLESS INDICATED OTHERWISE
- K. FIRE-RATED PARTITION PENETRATIONS: WHERE DUCTS PASS THROUGH INTERIOR PARTITIONS, INSTALL APPROPRIATELY RATED FIRE DAMPER. FIRE DAMPER INSTALLATION MUST STRICTLY ADHERE TO MANUFACTURER'S WRITTEN INSTRUCTIONS
- L. PROVIDE MANUAL VOLUME-CONTROL BALANCING DAMPER AT ALL BRANCH DUCTS AND AT ALL OTHER LOCATIONS REQUIRED FOR A COMPLETE AND BALANCEABLE AIR DISTRIBUTION SYSTEM
- M. BALANCE ENTIRE AIR DISTRIBUTION SYSTEM TO AIRFLOW QUANTITIES INDICATED ON MECHANICAL DRAWINGS
- N. FLEXIBLE DUCTWORK SHALL BE ALLOWED ONLY IN POSITIVE PRESSURE APPLICATIONS AT SUPPLY BRANCH RUNOUTS TO DIFFUSERS ABOVE ACCESSIBLE CEILINGS. FLEXIBLE DUCTWORK SHALL NOT EXCEED 36" IN LENGTH. 90 DEGREE TURNS SHALL ONLY BE ALLOWED IF RETAINING BANDS EQUAL TO THERMAFLEX "FLEX-FLOW" ARE EMPLOYED. UNDER NO CIRCUMSTANCES SHALL FLEXIBLE DUCTWORK BE ALLOWED IN NEGATIVE PRESSURE APPLICATIONS

DESIGN CONDITIONS

HVAC DESIGN LOAD CALCULATIONS ARE BASED ON THE FOLLOWING CLIMATE DATA:


CITY AND STATE: CAPE GIRARDEAU, MISSOURI

WINTER OUTDOOR AMBIENT DB: 7.4


SUMMER OUTDOOR AMBIENT DB/WB: 94.4/77

MECHANICAL SYSTEMS HAVE BEEN DESIGNED BASED UPON THE 2015 INTERNATIONAL MECHANICAL CODE, 2015 INTERNATIONAL ENERGY CONSERVATION CODE, NATIONAL FIRE PROTECTION (NFPA) STANDARDS, AND AMERICAN SOCIETY OF HEATING, REFRIGERATION, AND AIR-CONDITIONING ENGINEERS (ASHRAE) ACCEPTED STANDARDS AND PRACTICES

STATE OF MISSOURI
MICHAEL L. PARSON,
GOVERNOR

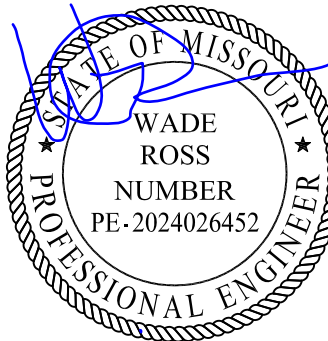

DATED: 10.22.2024
EXPIRATION: 12.31.2025

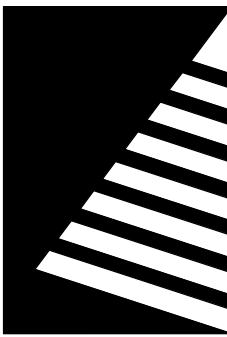

Farnsworth
GROUP

20 ALLEN AVENUE, SUITE 200
ST LOUIS, MISSOURI 63119
(314) 962-7900 / info@f-w.com

Farnsworth Group, Inc.
Missouri State Certificate of Authority #000744
www.f-w.com
Engineers | Architects | Surveyors | Scientists

100% BID SET

10/22/2024

OFFICE OF
ADMINISTRATION
DIVISION OF FACILITIES
MANAGEMENT, DESIGN
AND CONSTRUCTION

MISSOURI VETERANS
COMMISSION

OUTDOOR PAVILION
CAPE GIRARDEAU
VETERANS HOME

2400 Veterans Memorial Dr,
Cape Girardeau, MO 63701

PROJECT #.: U2415.01

SITE #.: 6803

ASSET #.: 8136803002

FAI #.: 29-043

DATE: DESCRIPTION:

DRAWN BY: SHR

CHECKED BY: WCR

DESIGNED BY: SHR/AK

SHEET TITLE:

GENERAL
INFORMATION

SHEET NUMBER:


M-100

SHEET 18 OF 25
ISSUE DATE: 10/22/2024

1

FIRST FLOOR MECHANICAL PLAN

SCALE: 1/4" = 1'-0"

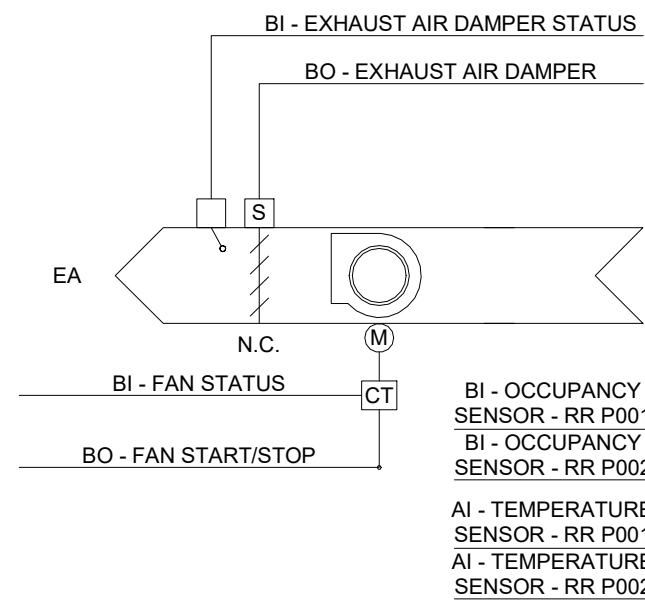

SEQUENCE OF OPERATION - EXHAUST FAN (TYPICAL OF 1)

- RUN CONDITIONS:
- THE UNIT SHALL BE ENABLED ACCORDING TO A USER DEFINABLE TIME SCHEDULE AND:
A. SPACE TEMPERATURE IN EITHER P001 OR P002 IS AT OR ABOVE 90 DEG. F (ADJ.) OR
B. P001 OR P002 STATUS IS OCCUPIED AS SENSED BY THE LOCAL OCCUPANCY SENSOR.
 - BUILDING AUTOMATION SYSTEM SHALL DISABLE THE OPERATION OF THE FAN WHEN:
A. NEITHER OF P001 AND P002 ARE OCCUPIED
B. SPACE TEMPERATURE IS AT OR BELOW 90 DEG. F. (ADJ.).
- SPACES TEMPERATURE:
BUILDING AUTOMATION SYSTEM SHALL MONITOR THE SPACE TEMPERATURES IN P001 AND P002.
- FAN:
THE FAN SHALL RUN ANYTIME THE ZONE TEMPERATURE RISES ABOVE COOLING SETPOINT, UNLESS SHUTDOWN ON SAFETIES.
- EXHAUST AIR DAMPER:
THE EXHAUST AIR DAMPER SHALL OPEN ANYTIME THE UNIT RUNS AND SHALL CLOSE ANYTIME THE UNIT STOPS. THE EXHAUST AIR DAMPER SHALL CLOSE 30 SEC (ADJ.) AFTER THE FAN STOPS.
- FAN STATUS:
THE CONTROLLER SHALL MONITOR THE FAN STATUS.
- ALARMS SHALL BE PROVIDED AS FOLLOWS:
- FAN FAILURE: COMMANDED ON, BUT THE STATUS IS OFF.
 - FAN IN HAND: COMMANDED OFF, BUT THE STATUS IS ON.
 - FAN RUNTIME EXCEEDED: FAN STATUS RUNTIME EXCEEDS A USER DEFINABLE LIMIT (ADJ.).

POINT NAME	HARDWARE POINTS				SOFTWARE POINTS						Show on Graphic
	AI	AO	BI	BO	AV	BV	Loop	Sched	Trend	Alarm	
Occupancy Sensor - P001			x						x		x
Occupancy Sensor - P002			x						x		x
Temperature Sensor - P001	x								x		x
Temperature Sensor - P002	x								x		x
Fan Status			x						x		x
Fan Start/Stop				x					x		x
Schedule								x			
Fan Failure										x	
Fan in Hand										x	
Fan Runtime Exceeded										x	

POINTS INDICATED ABOVE ARE MINIMUM POINTS REQUIRED. CONTRACTOR SHALL PROVIDE ADDITIONAL POINTS AS NEEDED TO COMPLY WITH THE DESIGN INTENT.

2


EXHAUST FAN - CONTROLS

SCALE: No Scale

3

ATTIC SPACE 3D VIEW

SCALE: NOT TO SCALE

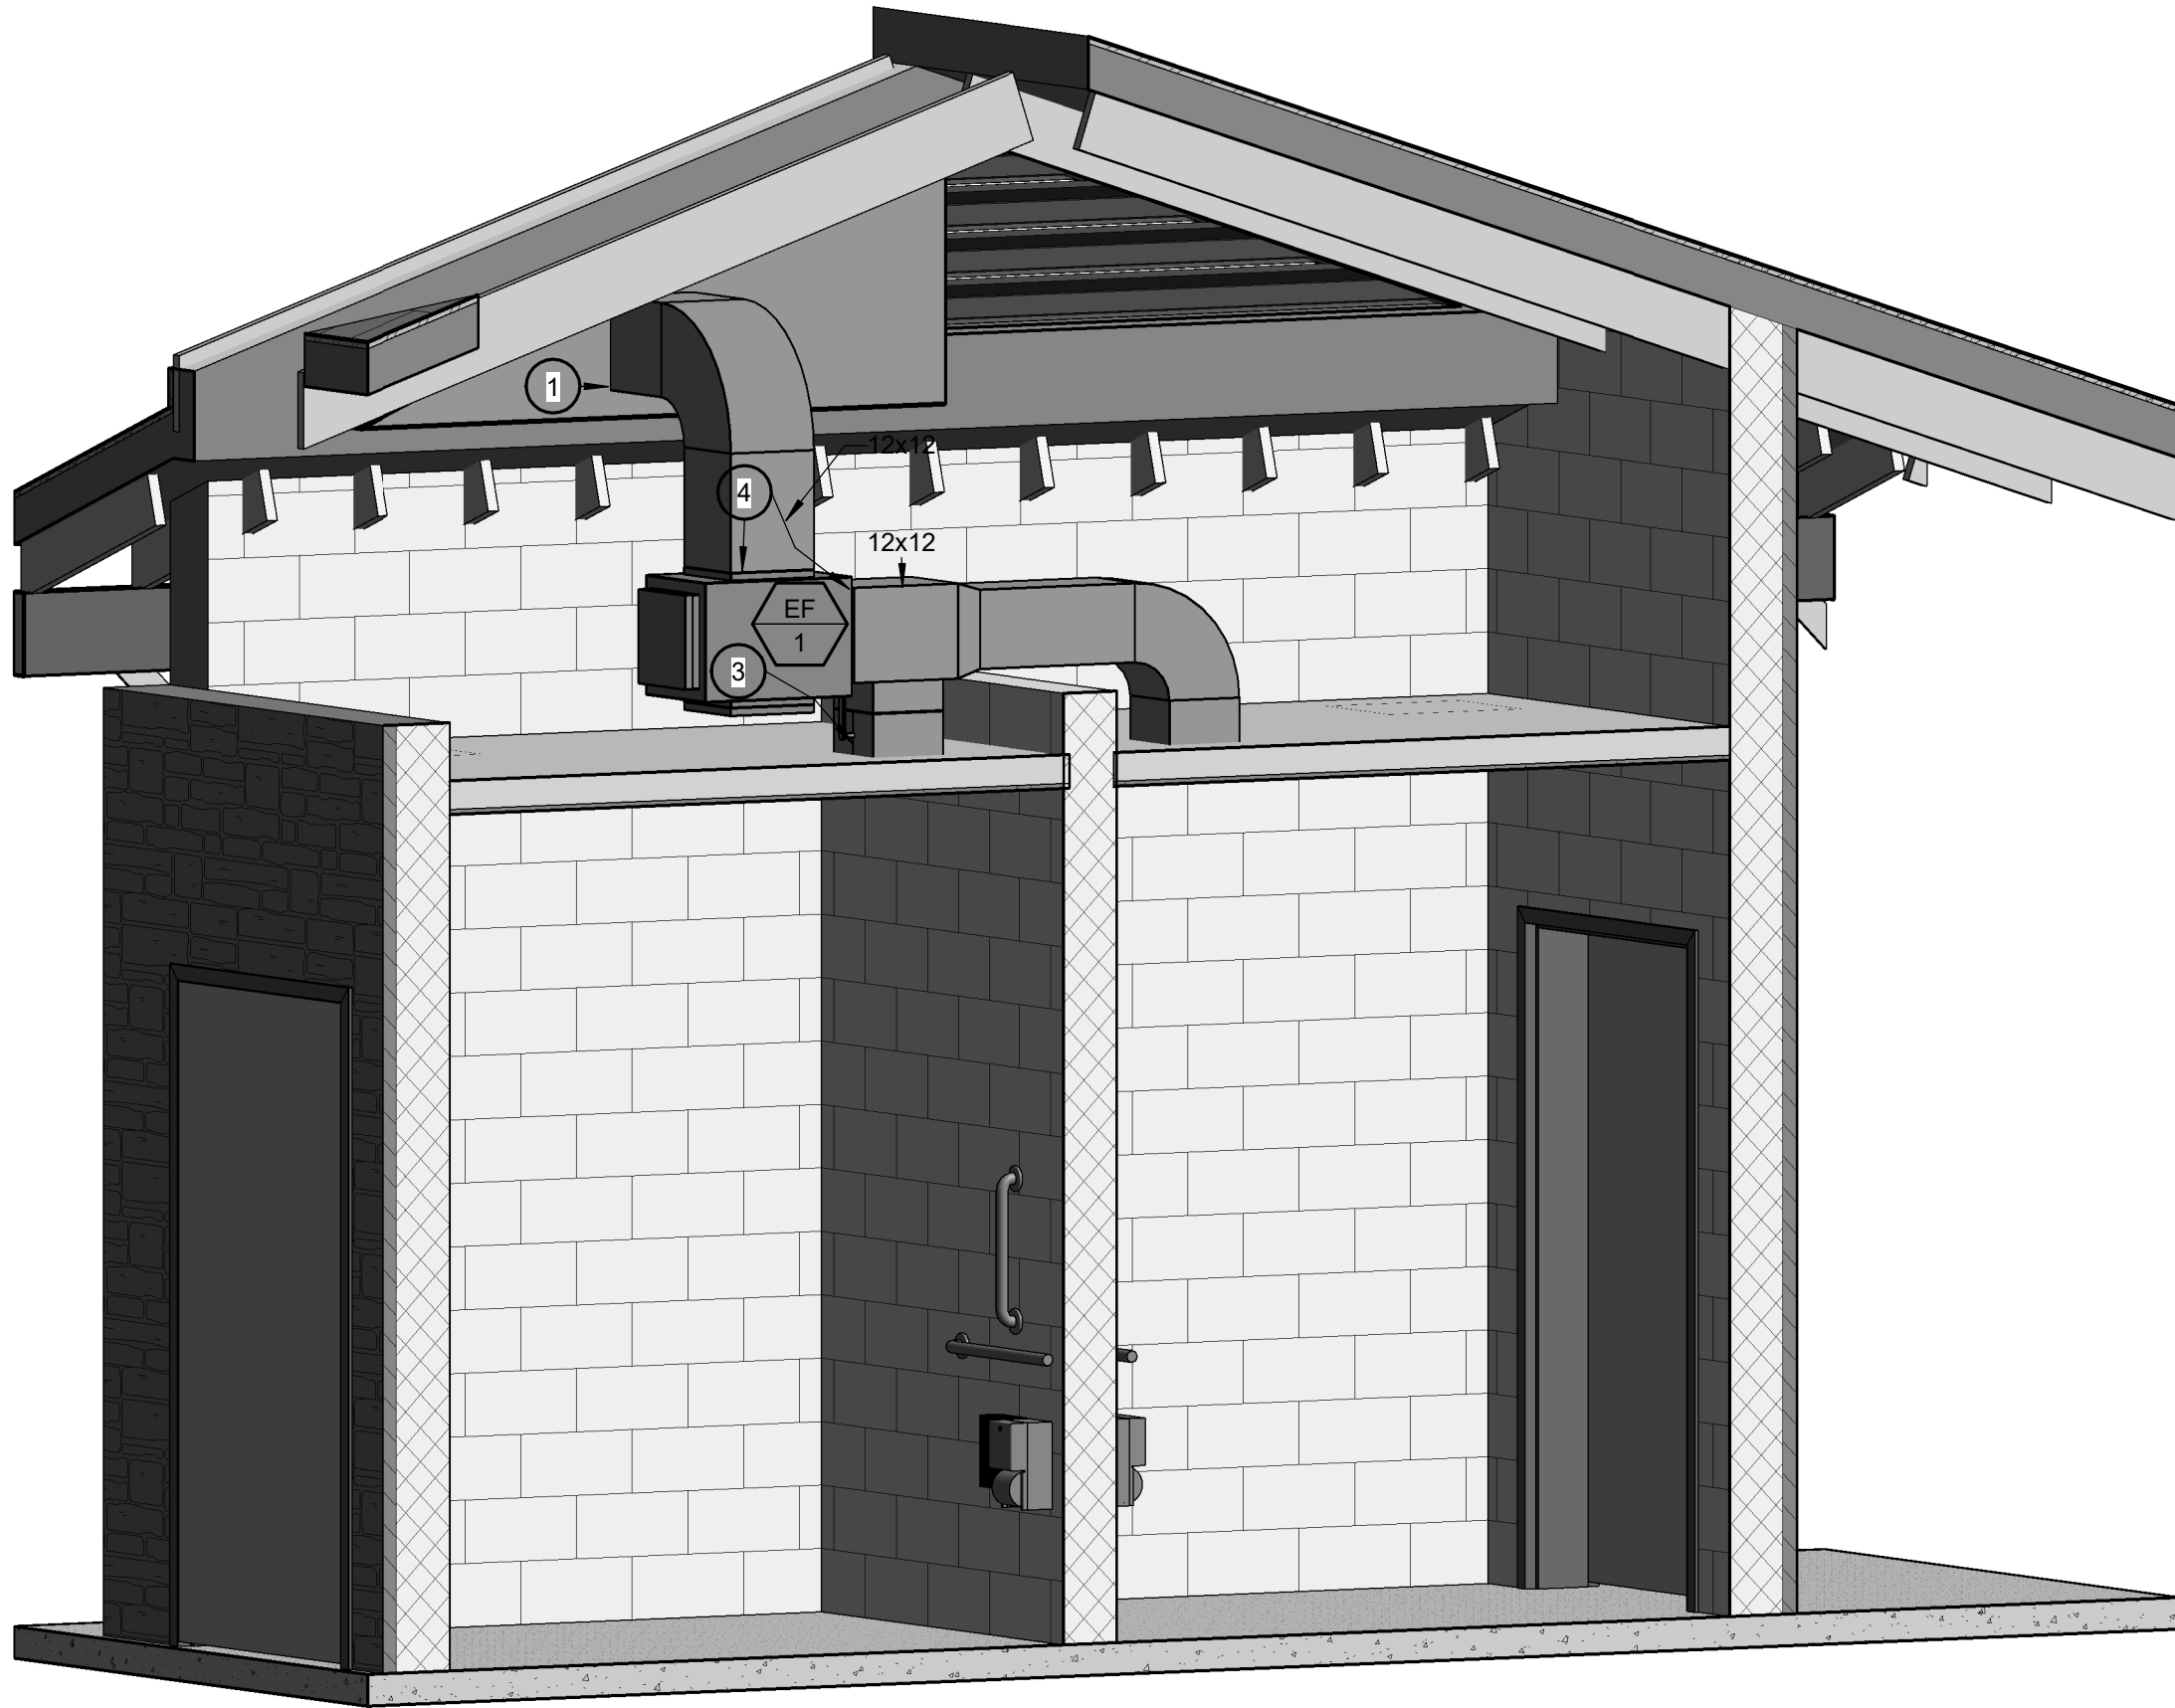

EXHAUST FAN SCHEDULE

MARK	MANUFACTURER	MODEL	TYPE	DRIVE	SERVICE	CFM	TSP (IN. W.C.)	FAN MOTOR BHP	SONES	DAMPER	ELECTRICAL DATA			PHYSICAL DATA				REMARKS
											V/PH	FLA	MCA	L (IN.)	W (IN.)	H (IN.)	WEIGHT (LBS.)	
EF1	GREENHECK	SQ-98-VG	INLINE	DIRECT	RESTROOMS	600	0.5	0.25	2.9	MOTORIZED	115/1	12	16.2	21	15	15	73	1-4

NOTES: 1.DISCONNECT SWITCH, FACTORY MOUNTED.
2.MOTORIZED BACKDRAFT DAMPER.
3.MOUNT FAN ROTATED 90 DEG TO ALLOW RIGHT-HANDED AIR DISCHARGE TO DISCHARGE VERTICALLY.
4.PROVIDE LATERAL BRACING AND SEISMIC RESTRAINTS.

ELECTRIC CEILING HEATER SCHEDULE

MARK	MANUFACTURER	MODEL	LOCATION	FAN		ELECTRICAL DATA			PHYSICAL DATA				REMARKS
				CFM	HP	KW	AMPS	V/PH	L (IN.)	W (IN.)	H (IN.)	WT. (LB.)	
ECH-1	MARLEY	QFF4004	RR P001	150	0.02	3	14.4	208/1	16	19	3.75	23	1,2
ECH-2	MARLEY	QFF4004	RR P002	150	0.02	3	14.5	208/1	16	19	3.75	23	1,2
ECH-3	MARLEY	QFF4004	CL2 P003	150	0.02	1.5	7.2	208/1	16	19	3.75	23	1,2

NOTES: 1. PROVIDE WITH INTEGRAL THERMOSTAT SET AT 45F AND TAMPER PROOF FRONT COVER.
2. FACTORY INTEGRATED DISCONNECT SWITCH BEHIND FACEPLATE

AIR DEVICE SCHEDULE

MARK	MANUFACTURER	MODEL	SERVICE	STYLE	FACE SIZE	FRAME	FINISH	MATERIAL	REMARKS
E1	TITUS	350RL	EXHAUST	GRILLE	24X24	SURFACE	WHITE	ALUMINUM	1,2,3

NOTES: 1. CONTRACTOR IS RESPONSIBLE FOR COORDINATING WITH REFLECTED CEILING PLAN.
2. PROVIDE TITUS "RAPID MOUNT" FRAMES AT GYPSUM CEILINGS.
3. INTEGRATED OPPOSED BLADE DAMPER


GENERAL NOTES

A. MAKE-UP AIR PROVIDED VIA DOOR LOUVERS, SEE ARCHITECTURAL DRAWINGS.


KEYNOTES #

- 12X12 EXHAUST DUCT UP TO ARCHITECTURAL LOUVER. PROVIDE AN INSULATED SHEET METAL EXHAUST AIR PLENUM 6" DEPTH TO CONNECT TO ARCHITECTURAL WALL LOUVER. 2" FIBERGLASS INSULATION AROUND EXHAUST PLENUM. SEAL CONNECTION WATER AND AIR TIGHT. PROVIDE AND INSTALL BACKDRAFT DAMPER WHERE DUCT CONNECTS TO EXHAUST PLENUM.
- LOW VOLTAGE CEILING OCCUPANCY SENSOR. FURNISHED AND INSTALLED BY ELECTRICAL CONTRACTOR. SEE ELECTRICAL DRAWINGS.
- 10" SQUARE VOLUME DAMPER.
- USE A FLEXIBLE DUCT CONNECTOR TO CONNECT DUCTWORK TO EXHAUST FAN EF-1.
- WALL MOUNTED TEMPERATURE SENSOR WITH VANDAL PROOF ENCLOSURE. FURNISH AND INSTALLED BY TEMPERATURE CONTROL CONTRACTOR.

STATE OF MISSOURI
MICHAEL L. PARSON,
GOVERNOR

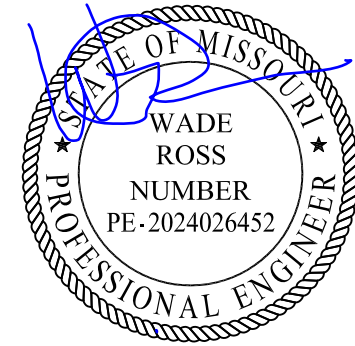

DATED: 10.22.2024
EXPIRATION: 12.31.2025

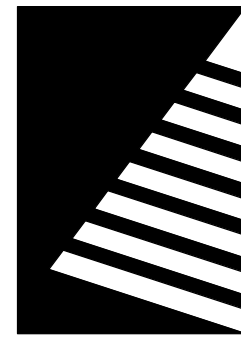

Farnsworth
GROUP

20 ALLEN AVENUE, SUITE 200
ST LOUIS, MISSOURI 63119
(314) 962-7900 / info@f-w.com

Farnsworth Group, Inc.
Missouri State Certificate of Authority #000744
www.f-w.com
Engineers | Architects | Surveyors | Scientists

100% BID SET

10/22/2024

OFFICE OF
ADMINISTRATION
DIVISION OF FACILITIES
MANAGEMENT, DESIGN
AND CONSTRUCTION

MISSOURI VETERANS
COMMISSION

OUTDOOR PAVILION
CAPE GIRARDEAU
VETERANS HOME

2400 Veterans Memorial Dr,
Cape Girardeau, MO 63701

PROJECT #.: U2415.01
SITE #.: 6803
ASSET #.: 8136803002
FAI #.: 29-043

DATE: DESCRIPTION:

DRAWN BY: SHR
CHECKED BY: WCR
DESIGNED BY: SHR/AK


SHEET TITLE:

FIRST FLOOR
MECHANICAL PLAN


SHEET NUMBER:

M-101

SHEET 19 OF 25
ISSUE DATE: 10/22/2024

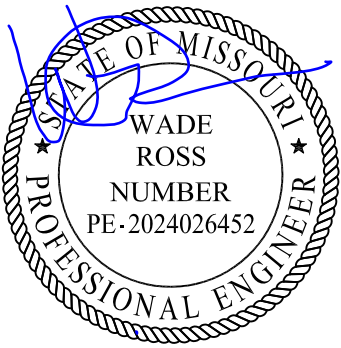

DATED: 10.22.2024
EXPIRATION: 12.31.2025

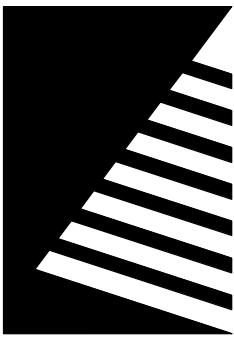

Farnsworth
GROUP

20 ALLEN AVENUE, SUITE 200
ST LOUIS, MISSOURI 63119
(314) 962-7900 / info@f-w.com

Farnsworth Group, Inc.
Missouri State Certificate of Authority #000744
www.f-w.com
Engineers | Architects | Surveyors | Scientists

100% BID SET

10/22/2024

OFFICE OF
ADMINISTRATION
DIVISION OF FACILITIES
MANAGEMENT, DESIGN
AND CONSTRUCTION

MISSOURI VETERANS
COMMISSION

OUTDOOR PAVILION
CAPE GIRARDEAU
VETERANS HOME

2400 Veterans Memorial Dr,
Cape Girardeau, MO 63701

PROJECT #.: U2415.01
SITE #.: 6803
ASSET#.: 8136803002
FAI #.: 29-043

DATE: DESCRIPTION:

DRAWN BY: SHR
CHECKED BY: WCR
DESIGNED BY: SHR/AK


SHEET TITLE:

DIAGRAMS


SHEET NUMBER:

M-102

SHEET 20 OF 25
ISSUE DATE: 10/22/2024

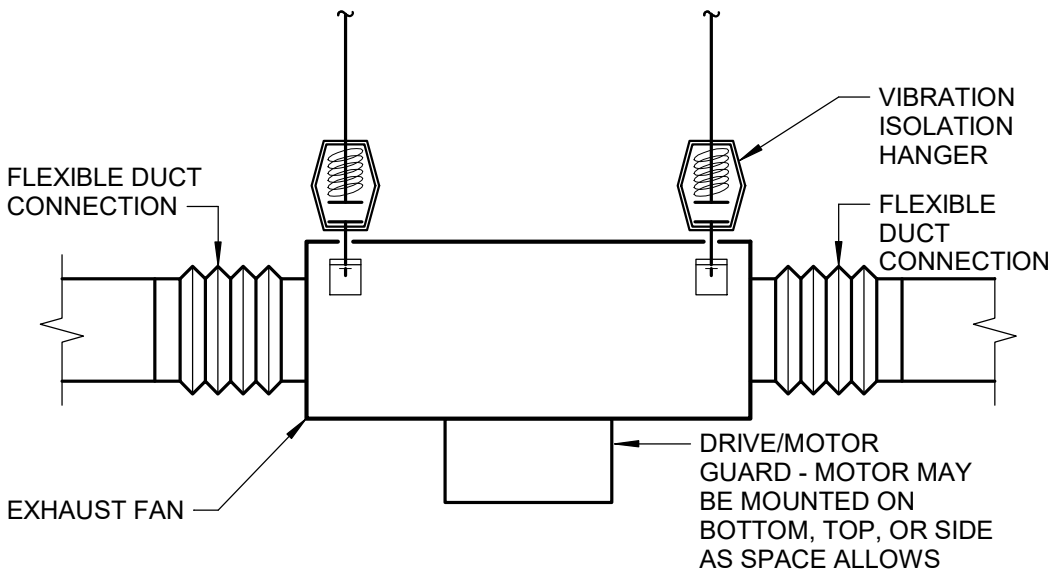

2 IN-LINE EXHAUST FAN
SCALE: No Scale

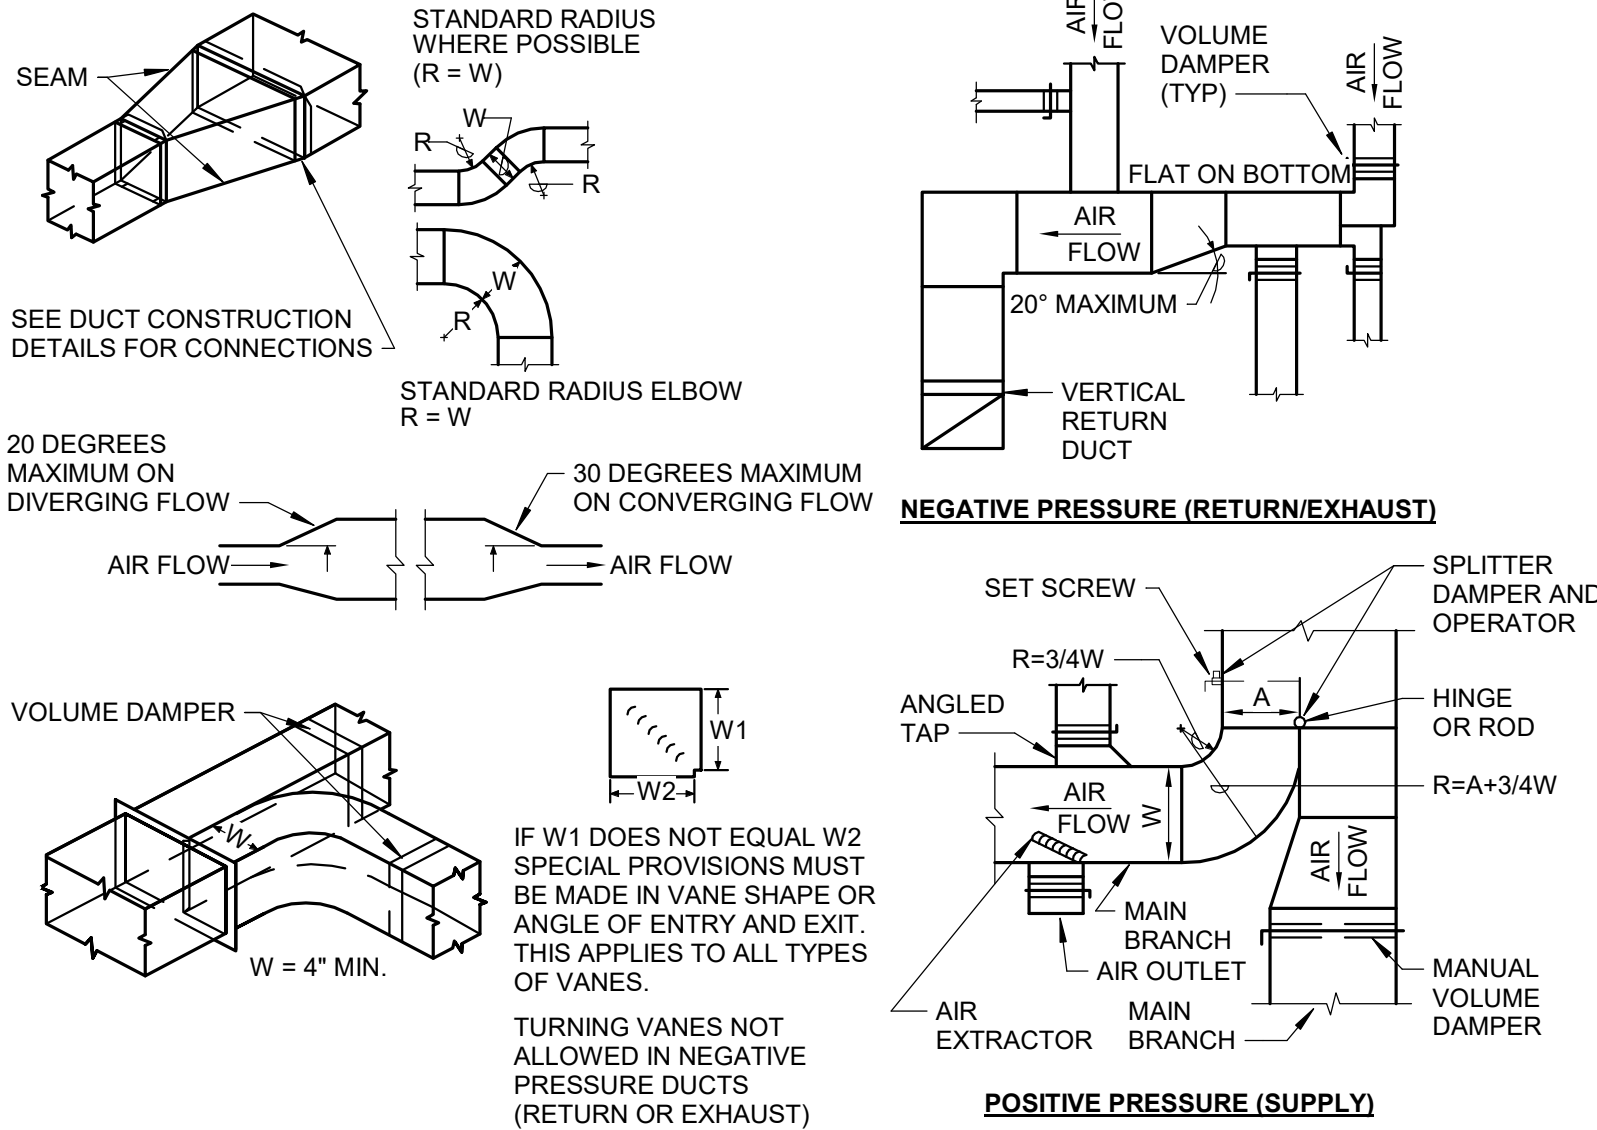

1 RECTANGULAR DUCT CONSTRUCTION
SCALE: No Scale

10/22/2024, 12:43:53 PM

ELECTRICAL FLOOR PLAN SYMBOLS (NOT ALL SYMBOLS ARE USED IN CONSTRUCTION DOCUMENTS)

Scale: No Scale

GENERAL SYMBOLS

	MECHANICAL EQUIPMENT CALL-OUT: REFER TO THE EQUIPMENT DATA SCHEDULE FOR DETAILS
	PLUMBING EQUIPMENT CALL-OUT: REFER TO THE EQUIPMENT DATA SCHEDULE FOR DETAILS
	KEYED NOTE
	FEEDER CALL-OUT
	FOOD SERVICE EQUIPMENT DESIGNATION
	ROOM NUMBER
	REVISION CALL-OUT
	NEW EQUIPMENT (TYPICAL)
	EXISTING EQUIPMENT (TYPICAL)
	DEMOLITION EQUIPMENT (TYPICAL)
	WALL MOUNT BRACKET (TYPICAL)

WIRING AND CONDUITS

	CONDUIT - CONCEALED IN SUSPENDED CEILING OR WALL
	CONDUIT - EXPOSED
	CONDUIT - CONCEALED BELOW SLAB OR GRADE
	CONDUIT - TURNING UP
	CONDUIT - TURNING DOWN
	CONDUIT - UP AND DOWN (CHANGE IN ELEVATION)
	CONDUIT - CONTINUED
	CONDUIT - FLEXIBLE
	CONDUIT - CAPPED
	JUNCTION BOX
	JUNCTION BOX - EMERGENCY POWER
	CONDUIT FITTING (CONDULET)
	EXPANSION FITTING
	SEALING FITTING
	CABLE TRAY

POWER SYMBOLS

	BRANCH CIRCUIT PANELBOARD - SURFACE MOUNTED
	BRANCH CIRCUIT PANELBOARD - FLUSH MOUNTED
	DISTRIBUTION PANELBOARD OR SWITCHBOARD
	TRANSFORMER
	POLE MOUNTED TRANSFORMER
	MOTOR CONTROL CENTER
	CONTROL PANEL
	GROUND BAR
	UTILITY KILOWATT-HOUR METER
	SAFETY SWITCH - NON-FUSIBLE
	SAFETY SWITCH - FUSIBLE
	MAGNETIC STARTER
	COMBINATION STARTER VFD VARIABLE FREQUENCY DRIVE
	EQUIPMENT - MOTOR
	DUPLEX RECEPTACLE (NEMA 5-20R) - MOUNTED 18" AFF GFH GROUND FAULT CIRCUIT INTERRUPTER SS SURGE SUPPRESSOR (ISOLATED GROUND TYPE) WP WEATHERPROOF H HOSPITAL GRADE TP TAMPER PROOF D DEDICATED USB STANDARD DUPLEX WITH 2 USB PORTS
	DUPLEX RECEPTACLE - MOUNTED 6" ABOVE COUNTER
	DUPLEX RECEPTACLE - SPLIT WIRED - MOUNTED 18" AFF
	DUPLEX RECEPTACLE - EMERGENCY POWER - MOUNTED 18" AFF
	DUPLEX RECEPTACLE - CEILING MOUNTED
	DUPLEX RECEPTACLE - FLUSH FLOOR MOUNTED
	QUADRUPLEX RECEPTACLE - MOUNTED 18" AFF
	QUADRUPLEX RECEPTACLE - MOUNTED 6" ABOVE COUNTER
	QUADRUPLEX RECEPTACLE - FLUSH FLOOR MOUNTED
	SINGLE RECEPTACLE - MOUNTED 18" AFF
	SPECIAL PURPOSE RECEPTACLE - MOUNTED 18" AFF
	SPECIAL PURPOSE RECEPTACLE - CEILING MOUNTED
	SPECIAL PURPOSE RECEPTACLE - FLUSH FLOOR MOUNTED
	FLOOR BOX - SEE SPECS OR KEYED NOTES ON PLAN FOR DETAILS
	POWER POLE
	CEILING FAN
	HAND DRYER
	PUSH BUTTON


LIGHTING SYMBOLS

	LUMINAIRE TYPE LUMINAIRE - RECESSED (REFER TO LUMINAIRE SCHEDULE) 1LP-1a NL CONNECTED FOR NIGHT LIGHT USE CIRCUIT NUMBER AND SWITCH LEG (LUMINAIRES ARE CONTROLLED BY LOCAL SWITCH UNLESS DESIGNATION GIVEN) PANEL NAME
	LUMINAIRE - SURFACE MOUNTED
	RECESSED LUMINAIRE CONNECTED TO THE EMERGENCY POWER SYSTEM OR BALLAST/DRIVER
	OPEN INDUSTRIAL LUMINAIRE OPEN INDUSTRIAL LUMINAIRE EMERGENCY POWER SYSTEM OR BALLAST/DRIVER
	WALL MOUNTED LUMINAIRE
	RECESSED DOWNLIGHT - CEILING MOUNTED
	RECESSED DOWNLIGHT w/ EMERGENCY BALLAST/DRIVER - CEILING MTD.
	SURFACE MOUNTED DOWNLIGHT
	RECESSED ADJUSTABLE/WALLWASH - CEILING MOUNTED
	POLE MOUNTED SITE LIGHTING - SINGLE HEAD
	POLE MOUNTED SITE LIGHTING - DUAL HEAD
	POLE MOUNTED SITE LIGHTING - TRIPLE HEAD
	POLE MOUNTED SITE LIGHTING - QUAD HEAD
	LINEAR PENDANT
	PENDANT
	TRACK LIGHTING
	EXIT SIGN - SINGLE FACE, CEILING MOUNTED ARROW INDICATES DIRECTION OF EXIT
	EXIT SIGN - SINGLE FACE, WALL MOUNTED
	EXIT SIGN - DUAL FACE, CEILING MOUNTED
	EXIT SIGN - DUAL FACE, WALL MOUNTED
	EXIT SIGN WITH EMERGENCY LIGHT ARROW INDICATES DIRECTION OF EXIT
	EMERGENCY LIGHT
	TOGGLE SWITCH - MOUNTED 48" AFF b LOWER CASE LETTER DENOTES LTG. SWITCH GROUP 2 DOUBLE-POLE SINGLE-THROW (DPST) 3 3-WAY 4 4-WAY B PUSHBUTTON D DIMMER (WALL BOX TYPE) K KEY OPERATED M MANUAL MOTOR STARTER P PILOT LIGHT T TIMER TT THERMAL TRIP SWITCH WP WEATHERPROOF OS WALL BOX OCCUPANCY SENSOR OS2 WALL BOX OCCUPANCY SENSOR FOR TWO LEVEL SWITCHING VS WALL BOX VACANCY SENSOR LV LOW VOLTAGE SWITCH TC TEACHER CONTROLS STATION TE TEACHER ENTRY STATION MC MOMENTARY CONTAT SWITCH
	CEILING MOUNTED DUAL TECHNOLOGY OCCUPANCY SENSOR a LOWER CASE LETTER DENOTES LTG. SWITCH GROUP
	CEILING MOUNTED DAYLIGHT SENSOR a LOWER CASE LETTER DENOTES LTG. SWITCH GROUP
	CEILING MOUNTED DUAL TECHNOLOGY VACANCY SENSOR a LOWER CASE LETTER DENOTES LTG. SWITCH GROUP
	PHOTOCELL
	ROOM CONTROLLER
	LIGHTING CONTACTOR
	LIGHTING RELAY PANEL
	INVERTER

STATE OF MISSOURI
MICHAEL L. PARSON,
GOVERNOR



10/22/2024
Expires 12/31/2024

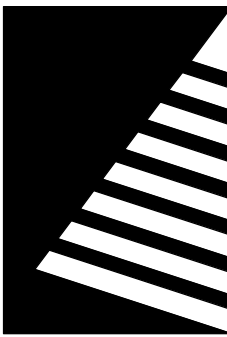

Farnsworth
GROUP

20 ALLEN AVENUE, SUITE 200
ST LOUIS, MISSOURI 63119
(314) 962-7900 / info@f-w.com

Farnsworth Group, Inc.
Missouri State Certificate of Authority #000744
www.f-w.com
Engineers | Architects | Surveyors | Scientists

100% BID SET

10/22/2024

OFFICE OF
ADMINISTRATION
DIVISION OF FACILITIES
MANAGEMENT, DESIGN
AND CONSTRUCTION

MISSOURI VETERANS
COMMISSION

OUTDOOR PAVILION
CAPE GIRARDEAU
VETERANS HOME

2400 Veterans Memorial Dr,
Cape Girardeau, MO 63701

PROJECT #.: U2415-01

SITE #.: 6803

ASSET #.: 8136803002

FAI #.: 29-043

DATE: DESCRIPTION:

DRAWN BY: KMA

CHECKED BY: WRK

DESIGNED BY: TLA

SHEET TITLE:

ELECTRICAL
SYMBOLS

SHEET NUMBER:

E-001

SHEET 21 OF 25
ISSUE DATE: 10/22/2024

GENERAL NOTES:

- A. SEE ARCHITECTURAL DRAWINGS FOR ALL DIMENSIONS, ELEVATIONS, AND BUILDING DETAILS. VERIFY LOCATION OF ALL WALL OUTLETS, SWITCHES, ETC., WITH ARCHITECTURAL DRAWINGS AND ACTUAL CONDITIONS.
- B. PRIOR TO ROUGH-IN AND FINAL CONNECTION, VERIFY ELECTRICAL CHARACTERISTICS AND EXACT LOCATION OF EQUIPMENT. THIS VERIFICATION SHALL BE DONE THROUGH THE ARCHITECT.
- C. SEE MECHANICAL/PLUMBING/KITCHEN DRAWINGS FOR ELECTRICAL REQUIREMENTS OF ALL MECHANICAL/PLUMBING/KITCHEN EQUIPMENT, FOR WIRING AND CONTROL DIAGRAMS, AND FOR EXACT LOCATION OF EQUIPMENT.
- D. COORDINATE SCHEDULE OF CONSTRUCTION WITH THE OWNER, OTHER TRADES AND UTILITIES INVOLVED BEFORE INSTALLATION OF UNDERGROUND FEEDERS, TRENCHING, ETC.
- E. USE EXTREME CAUTION DURING EXCAVATION TO LOCATE EXISTING UNDERGROUND PIPING, CONDUITS, ETC. LOCATE AND PROTECT ANY BURIED UTILITIES IN AREAS OF EXCAVATION.
- F. GROUT AND SEAL ALL CONDUIT PENETRATIONS OF WALLS AND FLOOR SLABS TO PRESERVE FIRE RATING AND WATERTIGHT INTEGRITY.
- G. DRAWINGS SHOW EXISTING CONDITIONS OF THE SITE. AN ATTEMPT HAS BEEN MADE TO SHOW EXISTING BUILDING, SITE DETAILS, ETC., BUT ACCURACY CANNOT BE GUARANTEED. VERIFY EXACT LOCATIONS OF ALL CIRCUITS, CONDUITS, PIPING, EQUIPMENT, ETC. VERIFY ALL SITE AND BUILDING DETAILS.
- H. PROVIDE DEDICATED, GREEN INSULATED, EQUIPMENT GROUND CONDUCTOR IN ALL CONDUIT AND WIRING RUNS. SIZE EQUIPMENT GROUND CONDUCTOR IN ACCORDANCE WITH CURRENT EDITION OF NATIONAL ELECTRICAL CODE IN FORCE IN JURISDICTION.
- I. THE ELECTRICAL CONTRACTOR SHALL BE RESPONSIBLE TO VERIFY, COORDINATE AND CONFIRM WITH THE MECHANICAL AND PLUMBING CONTRACTOR THE EXACT LOCATIONS AND FEED REQUIREMENTS OF ALL EQUIPMENT NEEDING AN ELECTRICAL CONNECTION.
- J. REFER TO ARCHITECTURAL REFLECTED CEILING PLANS FOR ACTUAL LAYOUT OF LIGHT FIXTURES AND CEILING TYPES. VERIFY CEILING TYPES PRIOR TO ORDERING FIXTURES.
- K. REFER TO ARCHITECTURAL PLANS TO CONFIRM ALL FIRE-RATED CEILINGS AND WALLS.
1. ALL PENETRATIONS OF FIRE-RESISTIVE FLOORS OR SHAFT WALLS SHALL BE PROTECTED BY MATERIALS AND INSTALLATION DETAILS THAT CONFORM TO UNDERWRITERS' LABORATORIES LISTINGS FOR THROUGH-PENETRATION FIRE STOP SYSTEMS. THE CONTRACTOR SHALL SUBMIT SHOP DRAWING DETAILS, FURNISHED BY THE MANUFACTURER OF THE FIRE STOP MATERIAL, WHICH SHOW COMPLETE CONFORMANCE TO THE UL LISTING AND SHALL BE SPECIFIC FOR EACH PENETRATION WITH ALL VARIABLES DEFINED. THESE FINAL AND APPROVED DRAWINGS SHALL BE READILY AVAILABLE TO THE LOCAL INSPECTORS AT ALL TIMES AT THE PROJECT SITE.
- L. ALL LIGHT FIXTURES SHALL BE EQUIPPED WITH A GREEN GROUND WIRE BONDED TO THE HOUSING.
- M. FINISH OF ALL LIGHTING FIXTURES IS SUBJECT TO ARCHITECT'S APPROVAL. SUBMIT SAMPLES IF REQUESTED.
- N. ALL SELF-CONTAINED EMERGENCY BATTERY PACK EXITS AND LIGHT FIXTURES SHALL BE CIRCUITED TO THE SAME BRANCH LIGHTING CIRCUIT SERVING THE NORMAL LIGHTING IN THE AREA. THE CIRCUIT SHALL BE UNSWITCHED SO THAT THE BATTERY CHARGER IS CONTINUOUSLY BEING ENERGIZED DURING NORMAL POWER CONDITIONS. IF THE LIGHT FIXTURE IS SHOWN OR INDICATED AS BEING SWITCHED, THE LAMPS ONLY SHALL BE CONTROLLED BY THE SWITCHED CONDUCTOR(S).
- O. THE ELECTRICAL CONTRACTOR SHALL BE HELD FINANCIALLY RESPONSIBLE FOR ANY AND ALL COSTS OF THE ENGINEERS TIME REQUIRED TO REVIEW AND RESEARCH NON-SPECIFIED EQUIPMENT SUBMITTED FOR SUBSTITUTION BY THE ELECTRICAL CONTRACTOR. THESE COSTS SHALL BE AUTOMATICALLY INVOICED TO THE CONTRACTOR UNLESS SUCH SUBSTITUTIONS FOLLOW THE GUIDELINES FOR SUBSTITUTION AND ARE WITHIN THE PROPER TIME FRAME AS OUTLINED IN OTHER SECTIONS OF THIS SPECIFICATION.
- P. PROVIDE AND INSTALL IN EACH PANEL, TYPEWRITTEN NEAT TWO-COLUMN CIRCUIT INDEX CARD SET UNDER PLASTIC COVERS ON INSIDE OF DOORS. EACH ODD-NUMBERED CIRCUIT SHALL BE IN SEQUENCE ON ONE COLUMN AND THE EVEN-NUMBERED CIRCUITS ON THE OTHER COLUMN (E.G. 1,3,5, 2,4,6,). EACH CIRCUIT SHALL BE IDENTIFIED AS TO THE USE AND ROOM NAME(S) OR AREA(S). THE CONTRACTOR SHALL CONFIRM ROOM NAMES AND/OR ROOM NUMBERS WITH THE ARCHITECT PRIOR TO PROJECT COMPLETION.
- Q. PRIOR TO SUBMITTING BID PROPOSAL, BIDDER SHALL EXAMINE ALL GENERAL CONSTRUCTION DRAWINGS AND VISIT CONSTRUCTION SITE TO BE FAMILIAR WITH EXISTING CONDITIONS UNDER WHICH HE WILL HAVE TO OPERATE AND WHICH WILL IN ANY WAY AFFECT THE WORK UNDER THIS CONTRACT. NO SUBSEQUENT ALLOWANCE WILL BE MADE IN THIS CONNECTION ON BEHALF OF THE CONTRACTOR FOR ANY ERROR OR NEGLIGENCE ON HIS PART.
- R. UNLESS INDICATED IN SOME MANNER THAT ELECTRICAL EQUIPMENT IS EXISTING ALL OTHER EQUIPMENT SHALL BE NEW.
- S. CONTRACTOR SHALL NOT SCALE DRAWING FOR QUANTITIES. CONTRACTOR IS RESPONSIBLE FOR FIELD VERIFYING ALL MEASUREMENTS.
- T. IF POSSIBLE, ALL NEWLY INSTALLED RECEPTACLES SHALL BE INSTALLED IN SEPARATE OR ADJACENT STUD SPACES, TO AVOID SOUND TRANSMISSION AND WALL INTEGRITY ISSUES. ALL NEWLY INSTALLED RECEPTACLES LOCATED IN COMMON STUD SPACES OF FIRE-RESISTANT WALLS SHALL BE EQUIPPED WITH FIRE-RESISTANT PUTTY PADS AT THE BACK OF EACH BOX IN ACCORDANCE WITH NEC 300.21.

GENERAL NOTES - CONDUIT AND WIRING:

- A. WHERE CONDUIT AND WIRING RUNS ARE NOT SHOWN ON FLOOR PLANS, THE CONTRACTOR SHALL DETERMINE AND PROVIDE THE REQUIRED CONDUIT AND WIRING FOR SPECIFIED CIRCUITING IN ACCORDANCE WITH NEC AND THE FOLLOWING MINIMUM REQUIREMENTS:
1. MINIMUM CONDUIT SIZE SHALL BE 3/4".
2. MINIMUM CONDUCTOR SIZE SHALL BE #12 AWG. #10 AWG SHALL BE USED FOR HOME RUNS OF 20 AMP BRANCH CIRCUITS OVER 100 FEET IN LENGTH.
3. EACH RACEWAY SHALL CONTAIN AN INSULATED EQUIPMENT GROUNDING CONDUCTOR PER NEC.
4. DERATING OF CONDUCTOR AMPACITY SHALL BE APPLIED PER NEC.
5. NO SHARING OF NEUTRALS ALLOWED. CIRCUIT SHALL HAVE DEDICATED NEUTRAL CONDUCTORS. ONE CIRCUIT, ONE NEUTRAL.
6. MAXIMUM SIX FOOT FLEXIBLE FIXTURE WHIP SHALL BE USED FOR FINAL CONNECTIONS TO LIGHT FIXTURES INSTALLED IN LAY-IN CEILINGS. MAXIMUM FOUR LIGHT FIXTURE WHIPS SHALL NOT BE CONNECTED FROM ONE JUNCTION BOX. FEED THRU BETWEEN LIGHT FIXTURES SHALL NOT BE ALLOWED.

REMODELING NOTES:

- A. PRIOR TO SUBMITTING PROPOSAL, BIDDER SHALL EXAMINE ALL GENERAL CONSTRUCTION DRAWINGS AND SHALL HAVE HAD VISITED THE CONSTRUCTION SITE. HE SHALL BE FAMILIAR WITH THE EXISTING CONDITIONS UNDER WHICH HE WILL HAVE TO OPERATE AND WHICH WILL IN ANY WAY AFFECT THE WORK UNDER THIS CONTRACT. NO SUBSEQUENT ALLOWANCE WILL BE MADE IN THIS CONNECTION IN BEHALF OF THE CONTRACTOR FOR ANY ERROR OR NEGLIGENCE ON HIS PART.
- B. CERTAIN REMODELING OF ELECTRICAL FACILITIES WILL BE REQUIRED IN THE EXISTING BUILDING. EXISTING CONDUIT RUNS ARE GENERALLY NOT SHOWN, ALTHOUGH A FULL ATTEMPT HAS BEEN MADE TO SHOW SOME EXISTING CONDITIONS, OF WHICH INFORMATION HAS BEEN TAKEN FROM EXISTING RECORD DRAWINGS OF THIS PROJECT. THE DRAWINGS SHOWING LOCATION OF EXISTING EQUIPMENT, OUTLETS, FIXTURES, ETC., IN EXISTING AREAS ARE APPROXIMATE ONLY (FIELD VERIFY).
- C. BRANCH CIRCUITS SHALL BE REUSED WHERE PRACTICAL AND SHALL, IN ADDITION, BE REMODELED AS REQUIRED. THE CONTRACTOR SHALL CONCEAL ALL WORK WHERE POSSIBLE. WHERE EXPOSED WORK IS REQUIRED IN FINISHED AREAS, THE CONTRACTOR SHALL USE WIREMOLD RACEWAY WITH #500 BEING THE MINIMUM SIZE ACCEPTABLE.
- D. EXISTING ELECTRICAL WIRING WHICH WILL NOT BE MADE OBSOLETE AND WHICH WILL BE DISTURBED DUE TO CONSTRUCTION CHANGES REQUIRED BY THIS CONTRACT SHALL BE RESTORED TO OPERATING CONDITION, AS REQUIRED AND/OR DIRECTED. WHERE REQUIRED, SHOWN AND/OR DIRECTED, OUTLETS AND CONDUIT RUNS SHALL BE RELOCATED. IN SOME CASES IT MAY BE NECESSARY TO EXTEND CONDUITS AND PULL IN NEW WIRING OR INSTALL JUNCTION BOXES AND SPLICER IN NEW WIRING OR REPLACE OLD WIRING WITH NEW.
- E. OUTLETS FROM WHICH FIXTURES, SWITCHES, RECEPTACLES, AND/OR OTHER ELECTRICAL DEVICES ARE MOVED AND WHICH ARE NOT REPLACED OR REUSED SHALL BE REMOVED OR, IF IT IS NOT POSSIBLE TO REMOVE, PLACE A BLANK COVER ON THE OUTLET BOX. WHERE OUTLETS, BOXES, ETC., ARE COMPLETELY REMOVED, THE CONTRACTOR SHALL CUT OFF CONDUITS AND REMOVE WIRING.
- F. WHERE EXISTING LIGHT FIXTURES ARE TO BE REUSED, THE ELECTRICAL CONTRACTOR SHALL CLEAN AND REPLACE LAMPS, REPAIR OR REPLACE DEFECTIVE PARTS, LENS, BALLAST, ETC. AS REQUIRED.
- G. WHERE EXISTING CONDUIT IS TO BE ABANDONED, THE CONDUIT SHALL BE REMOVED IF IT IS EXPOSED, IN A CRAWL SPACE OR IN AN ACCESSIBLE CEILING. WHERE IT IS IMPOSSIBLE TO REMOVE THE CONDUIT, IT SHALL BE CUT OFF AND CAPPED OR PLUGGED.
- H. THE CONTRACTOR SHALL BE HELD FULLY RESPONSIBLE FOR THE PROPER RESTORATION OF ALL EXISTING SURFACES REQUIRED PATCHING, PLASTERING, PAINTING AND/OR OTHER REPAIR DUE TO THE INSTALLATION OF ELECTRICAL WORK UNDER THE TERMS OF THIS SPECIFICATION. CLOSE ALL OPENINGS, REPAIR ALL SURFACED, ETC., AS REQUIRED. THE CONTRACTOR SHALL EMPLOY QUALIFIED AND EXPERIENCED WORKMEN FOR THIS WORK. ALL RESTORATION WORK SHALL BE SUBJECT TO THE APPROVAL OF THE ARCHITECT AND/OR THE OWNER.
- I. ALL TEMPORARY AND REMODELING WORK SHALL BE CONSIDERED A PART OF THIS CONTRACT AND NO EXTRA CHARGES WILL BE ALLOWED. THIS SHALL INCLUDE MINOR ITEMS OF MATERIAL OR EQUIPMENT NECESSARY TO MEET THE REQUIREMENTS AND INTENT OF THE PROJECT.
- J. EXAMINE ARCHITECTURAL, STRUCTURAL, AND MECHANICAL DRAWINGS AND SPECIFICATIONS TO DETERMINE THE SEQUENCE OF CONSTRUCTION THROUGHOUT THE PROJECT, INCLUDING EXISTING, TEMPORARY, REMODELED AND NEW AREAS.
- K. ALL ELECTRICAL CONNECTIONS REQUIRING AN OUTAGE SHALL BE MADE DURING AN APPROVED TIME LIMIT. CHANGEOVERS SHALL BE AS SHORT A DURATION AS POSSIBLE AND SHALL NOT INTERFERE WITH NORMAL OPERATION OF THE OWNER'S FACILITIES. NOTICE SHALL BE REQUIRED IN ADVANCE OF A SHUTDOWN OF ANY ELECTRICAL CIRCUIT FOR CHANGEOVER, AND SUCH A CHANGEOVER SHALL BE DONE DURING HOURS AS DIRECTED BY OWNER. WORK SHALL BE SCHEDULED SO THAT AT NO TIME WILL ANY EMERGENCY FEEDER, CIRCUIT, OR FIRE ALARM ZONE BE OUT OF SERVICE. PROVIDE NECESSARY TEMPORARY FEEDERS TO ACCOMPLISH THIS REQUIREMENT.
- L. EXISTING LOW VOLTAGE WIRING WHICH WILL NOT BE MADE OBSOLETE AND WHICH WILL BE DISTURBED DUE TO CONSTRUCTION CHANGES REQUIRED BY THIS CONTRACT SHALL BE RESTORED TO CONDITION, OR POSITION, AS REQUIRED. PROPERLY RE-SECURE CABLE IN CHASES, CRAWL SPACES, TUNNELS, AND CEILING SPACES AS REQUIRED BY NEC. IN SOME CASES IT MAY BE NECESSARY TO ADD SUPPORTING HARDWARE TO ACCOMPLISH THIS REQUIREMENT.
- M. IF POSSIBLE, ALL NEWLY INSTALLED RECEPTACLES SHALL BE INSTALLED IN SEPARATE OR ADJACENT STUD SPACES, TO AVOID SOUND TRANSMISSION AND WALL INTEGRITY ISSUES. ALL NEWLY INSTALLED RECEPTACLES LOCATED IN COMMON STUD SPACES OF FIRE-RESISTANT WALLS SHALL BE EQUIPPED WITH FIRE-RESISTANT PUTTY PADS AT THE BACK OF EACH BOX IN ACCORDANCE WITH NEC 300.21.

DEMOLITION GENERAL NOTES:

- A. RETURN REMOVED MATERIAL DEEMED SALVAGEABLE BY OWNER'S REPRESENTATIVE. MATERIALS DEEMED NOT SALVAGEABLE SHALL BE REMOVED FROM THE PREMISES.
- B. THE CONTRACTOR WILL BE HELD TO HAVE EXAMINED THE PREMISES AND SATISFIED HIMSELF AS TO EXISTING CONDITIONS UNDER WHICH HE WILL BE OBLIGED TO PERFORM HIS WORK. THE DRAWINGS ARE GENERALLY DIAGRAMMATIC AND THE CONTRACTOR SHALL HARMONIZE HIS WORK SO THAT EACH PIECE OF EQUIPMENT WILL BE INSTALLED AS TO FUNCTION PROPERLY. THE CONTRACTOR SHALL COOPERATE WITH OTHER TRADES.
- C. REMOVE ALL EXISTING WIRING DEVICES, LIGHT FIXTURES, WIRE, CONDUIT, ETC., AS NOTED OR INDICATED WITHIN DEMOLITION AREA. (ALL ITEMS MAY NOT BE SHOWN). REWORK AS NECESSARY CIRCUITING WHICH REQUIRES CONTINUATION THROUGH THE AREA.
- D. ELECTRICAL CONTRACTOR TO PROVIDE ALL NECESSARY LABOR, CONDUIT, WIRE, CONNECTIONS, ETC., FOR DEVICES, FIXTURES, ETC., NOTED AS "EXISTING TO REMAIN" SUCH THAT EXISTING CIRCUIT CONTINUITY IS MAINTAINED.
- E. ELECTRICAL CONTRACTOR SHALL BE RESPONSIBLE FOR ALL WORK REQUIRED TO REMOVE/RELOCATE ANY EXISTING ELECTRICAL EQUIPMENT SUCH THAT ELECTRIC SHOCK HAZARDS TO WORKMEN ARE ELIMINATED DURING DEMOLITION AND NEW CONSTRUCTION.
- F. ELECTRICAL CONTRACTOR SHALL BE RESPONSIBLE FOR ALL WORK IN REMOVING AND REPLACING "EXISTING TO REMAIN" FIXTURES, DEVICES, ETC., AS REQUIRED SO THAT THESE DEVICES ARE NOT DAMAGED DURING DEMOLITION. RELOCATED TO NEAREST APPROPRIATE LOCATION TO AVOID CONFLICTS WITH OTHER TRADES' WORK. REPLACE WITH NEW ANY "EXISTING TO REMAIN" FIXTURE, DEVICE, ETC., NOT DEEMED SALVAGEABLE BY OWNER'S REPRESENTATIVE.
- G. REMOVED OR DAMAGED CONDUIT, WIRE, AND FITTINGS SHALL NOT BE REUSED FOR RELOCATED OR NEW DEVICES.
- H. MAKE AS-BUILTS WITH NEW TYPED DIRECTORIES FOR ALL PANELBOARDS, INDICATING CIRCUIT DESCRIPTION (USED OR SPARE), CIRCUIT BREAKERS AND CIRCUIT LOAD.
- I. WORK REQUIRED FOR EXISTING EQUIPMENT NOTED AS "EXISTING TO BE REMOVED" SHALL INCLUDE:
1. REMOVAL OF FEEDER FROM EQUIPMENT TO POINT OF FEED.
2. REMOVAL OR RE-CIRCUITING OF ALL BRANCH CIRCUITING.
3. REMOVAL OF ALL FITTINGS, SUPPORTS, BRACKETS, ETC.
4. PATCHING OF WALLS, FLOORS AND CEILINGS PER ARCHITECT'S INSTRUCTIONS.
5. CAPPING OF FEEDER CONDUIT AT 6" ABOVE OR BELOW FLOOR/CEILING AS REQUIRED AND MARKING LOCATION OF POINT OF FEED WITH AN ENGRAVED BRASS TAG.
6. REMOVAL OF FEEDER CONDUIT IF FOUND TO BE UNSALVAGEABLE BY ARCHITECT, ENGINEER OR OWNER'S REPRESENTATIVE.
- J. EXISTING EQUIPMENT NOT IMPLICITLY SHOWN ON THE DRAWINGS IS INTENDED TO BE "EXISTING TO REMAIN UNCHANGED", UNLESS NOTED OTHERWISE.


ABBREVIATIONS

(E)	EXISTING (ALSO COVERED BT TEXT WEIGHT)
(F)	FUTURE
(PART)	PARTIAL CIRCUIT
(R)	RELOCATE
2S1W	TWO SPEED, SINGLE WINDING
2S2W	TWO SPEED, TWO WINDING
A	AMPERES
AC	6" ABOVE COUNTER
ADA	AMERICANS WITH DISABILITIES ACT
AF	AMPERES FRAME
AFCI	ARC FAULT CIRCUIT INTERRUPTER
AFF	ABOVE FINISHED FLOOR
AFG	ABOVE FINISHED GRADE
AHJ	AUTHORITY HAVING JURISDICTION
AIC	AMPERES INTERRUPTION CAPACITY
AL	ALUMINUM
AT	AMPERES TRIP
ATS	AUTOMATIC TRANSFER SWITCH
AWG	AMERICAN WIRE GAUGE
BMS	BUILDING MANAGEMENT SYSTEM
C	CONDUIT
CAM	CAMERA
CB	CIRCUIT BREAKER
CCTV	CLOSED CIRCUIT TELEVISION
CCW	COUNTER CLOCKWISE
CKT	CIRCUIT
CL	CENTER LINE
CLG	CEILING
CO	CONDUIT ONLY
CRI	COLOR RENDERING INDEX
CT	CURRENT TRANSFORMER
CU	COPPER
CW	CLOCKWISE
DIA	DIAMETER
DISC	DISCONNECT
DIST	DISTRIBUTION
DPDT	DOUBLE POLE DOUBLE THROW
DPST	DOUBLE POLE SINGLE THROW
DR	DUPLEX RECEPTACLE
DWG	DRAWING(S)
EC	ELECTRICAL CONTRACTOR
ELC	ELEVATOR CONTRACTOR
ELEC	ELECTRIC/ELECTRICAL
EM	EMERGENCY
EMT	ELECTRICAL METALLIC TUBING
EQUIP	EQUIPMENT
EWC	ELECTRIC WATER COOLER
EXP	EXPLOSION PROOF
F	FUSED
FA	FIRE ALARM
FAA	FIRE ALARM ANNUNCIATOR
FACP	FIRE ALARM CONTROL PANEL
FC	FOOTCANDLE
FLA	FULL LOAD AMPERES
FMC	FLEXIBLE METAL CONDUIT
FO	FIBER OPTIC
FPC	FIRE PROTECTION CONTRACTOR
FS	FUSED SWITCH
FSD	FIRE/SMOKE DAMPER
FT	FOOT/FEET
FVNR	FULL VOLTAGE, NON-REVERSING
FVR	FULL VOLTAGE, REVERSING
G	GROUND
GC	GENERAL CONTRACTOR
GEN	GENERATOR
GF	GROUND FAULT
GF/GFCI	GROUND FAULT INTERRUPTER
GND	GROUND/GROUNDING
H	HORIZONTALLY MOUNTED
HH	HANDHOLE
HID	HIGH INTENSITY DISCHARGE
HOA	HAND-OFF-AUTO
HP	HORSEPOWER
HPS	HIGH PRESSURE SODIUM
HZ	FREQUENCY
I/O	INPUT/OUTPUT
IC	INTERRUPTING CAPACITY
ID	INSIDE DIAMETER
IDF	INTERMEDIATE DISTRIBUTION FRAME
IG	ISOLATED GROUND
IMC	INTERMEDIATE METAL CONDUIT
ISC	SHORT CIRCUIT CURRENT
JB	JUNCTION BOX
K	KELVIN (COLOR TEMPERATURE)
KCMIL	1000 CIRCULAR MILS
KV	KILOVOLTS
KVA	KILVOLT-AMPERES
KW	KILOWATTS
KWH	KILOWATT-HOUR
LAN	LOCAL AREA NETWORK
LC	LIGHTING CONTRACTOR
LCP	LIGHTING CONTROL PANEL
LED	LIGHT EMITTING DIODE
LF	LINEAR FOOT
LFMC	LIQUID-TIGHT FLEXIBLE METAL CONDUIT
LFS	LIGHT FIXTURE SCHEDULE
LM	LUMEN
LTG	LIGHTING
LV	LOW VOLTAGE


ABBREVIATIONS

MAN	MANUAL MOTOR STARTER WITH OVERLOADS
MAX	MAXIMUM
MC	MECHANICAL CONTRACTOR
MCA	MINIMUM CIRCUIT AMPERES
MCB	MAIN CIRCUIT BREAKER
MCC	MOTOR CONTROL CENTER
MCP	MOTOR CIRCUIT PROTECTOR
MDF	MAIN DISTRIBUTION FRAME
MOP	MAIN DISTRIBUTION PANEL
MEFPF	MECHANICAL, ELECTRICAL, PLUMBING, FIRE PROTECTION
MGB	MASTER GROUND BAR
MH	MANHOLE
MH	METAL HALIDE
MIN	MINIMUM
MLO	MAIN LUG ONLY
MOCP	MAXIMUM OVERCURRENT PROTECTION
MSB	MAIN SWITCHBOARD
MTG	MOUNTING
MTS	MANUAL TRANSFER SWITCH
MVA	MEGAVOLT-AMPERES
MW	MEGAWATT
MWH	MEGAWATT-HOURS
N	NEUTRAL
N/A	NOT APPLICABLE
NC	NORMALLY CLOSED
NEC	NATIONAL ELECTRIC CODE
NEMA	NATIONAL ELECTRICAL MANUFACTURERS ASSOCIATION
NF	NONFUSED
NFPA	NATIONAL FIRE PROTECTION ASSOCIATION
NIC	NOT IN CONTRACT
NL	NIGHT LIGHT
NO	NORMALLY OPEN
NP	NAMEPLATE
NTS	NOT TO SCALE
OC	ON CENTER
OD	OUTSIDE DIAMETER
OH	OVERHEAD
OWN	OWNER
P	POLE
PA	PUBLIC ADDRESS
PB	PULL BOX
PC	PHOTOCELL
PC	PLUMBING CONTRACTOR
PDT	PASSIVE DUAL TECHNOLOGY
PF	POWER FACTOR
PH	PHASE
PIR	PASSIVE INFRARED
PLC	PROGRAMMABLE LOGIC CONTROLLER
PNL	PANEL
PR	PAIR
PRI	PRIMARY
PT	POTENTIAL TRANSFORMER
PV	PHOTOVOLTAIC
PVC	POLYVINYL CHLORIDE
PWC	PRE-WIRED CONTROLS
PWR	POWER
RCPT	RECEPTACLE
REQD	REQUIRED
RF	RADIO FREQUENCY
RM	ROOM
RMC	RIGID METAL CONDUIT
RNC	RIGID NON-METALLIC CONDUIT (SCH 40)
RVAT	REDUCED VOLTAGE - AUTOTRANSFORMER
SC	SHORT CIRCUIT
SCC	SHORT CIRCUIT CURRENT RATING
SDP	SUBDISTRIBUTION PANEL
SEC	SECONDARY
SHLD	SHIELD(ED) (AS IN CABLE)
SHT	SHEET
SPD	SURGE-PROTECTIVE DEVICE
SPDT	SINGLE POLE DOUBLE THROW
SPST	SINGLE POLE SINGLE THROW
SR	SINGLE RECEPTACLE
ST	SHUNT TRIP
SW	MOTOR RATED SWITCH
SWBD	SWITCHBOARD
SWGR	SWITCHGEAR
TBD	TO BE DETERMINED
TC	TIMECLOCK
TEMP	TEMPERATURE
TT	THERMAL TRIP SWITCH
TTB	TELEPHONE TERMINAL BOARD
TYP	TYPICAL
U	UTILITY
UG	UNDERGROUND
UL	UNDERWRITERS LABORATORY
UON	UNLESS OTHERWISE NOTED
UPS	UNINTERRUPTABLE POWER SUPPLY
V	VOLTS
VA	VOLT-AMPERES
VAC	VOLTS ALTERNATING CURRENT
VDC	VOLTS DIRECT CURRENT
VFD	VARIABLE FREQUENCY DRIVE
VND	VENDOR
W	WATTS
W	WIRE
WHM	WATT/ HOUR METER
WP	WEATHERPROOF
XFMR	TRANSFORMER
XP	EXPLOSION PROOF
Z	IMPEDANCE

STATE OF MISSOURI
MICHAEL L. PARSON,
GOVERNOR

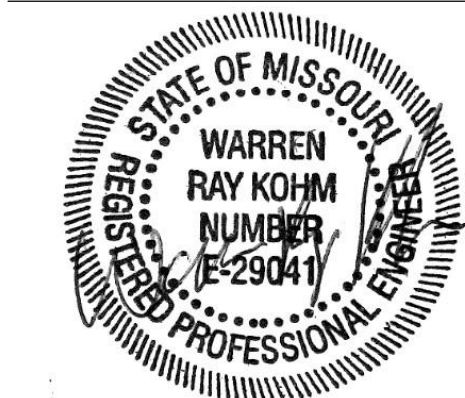

10/22/2024
Expires 12/31/2024

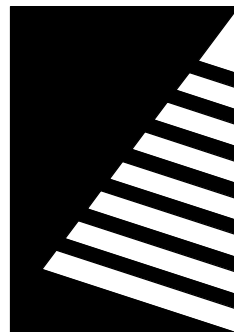

Farnsworth
GROUP

20 ALLEN AVENUE, SUITE 200
ST LOUIS, MISSOURI 63119
(314) 962-7900 / info@f-w.com

Farnsworth Group, Inc.
Missouri State Certificate of Authority #000744
www.f-w.com
Engineers | Architects | Surveyors | Scientists

100% BID SET

10/22/2024

OFFICE OF
ADMINISTRATION
DIVISION OF FACILITIES
MANAGEMENT, DESIGN
AND CONSTRUCTION

MISSOURI VETERANS
COMMISSION

OUTDOOR PAVILION
CAPE GIRARDEAU
VETERANS HOME

2400 Veterans Memorial Dr,
Cape Girardeau, MO 63701

PROJECT #.: U2415-01

SITE #.: 6803

ASSET #.: 8136803002

FAI #.: 29-043

DATE: DESCRIPTION:

DRAWN BY: KMA

CHECKED BY: WRK

DESIGNED BY: TLA

SHEET TITLE:

ELECTRICAL
GENERAL NOTES
AND ABBREVIATIONS

SHEET NUMBER:

E-002


SHEET 22 OF 25
ISSUE DATE: 10/22/2024

10/22/2024 12:44:58 PM

1

ELECTRICAL SITE PLAN

Scale: 1" = 30'-0"

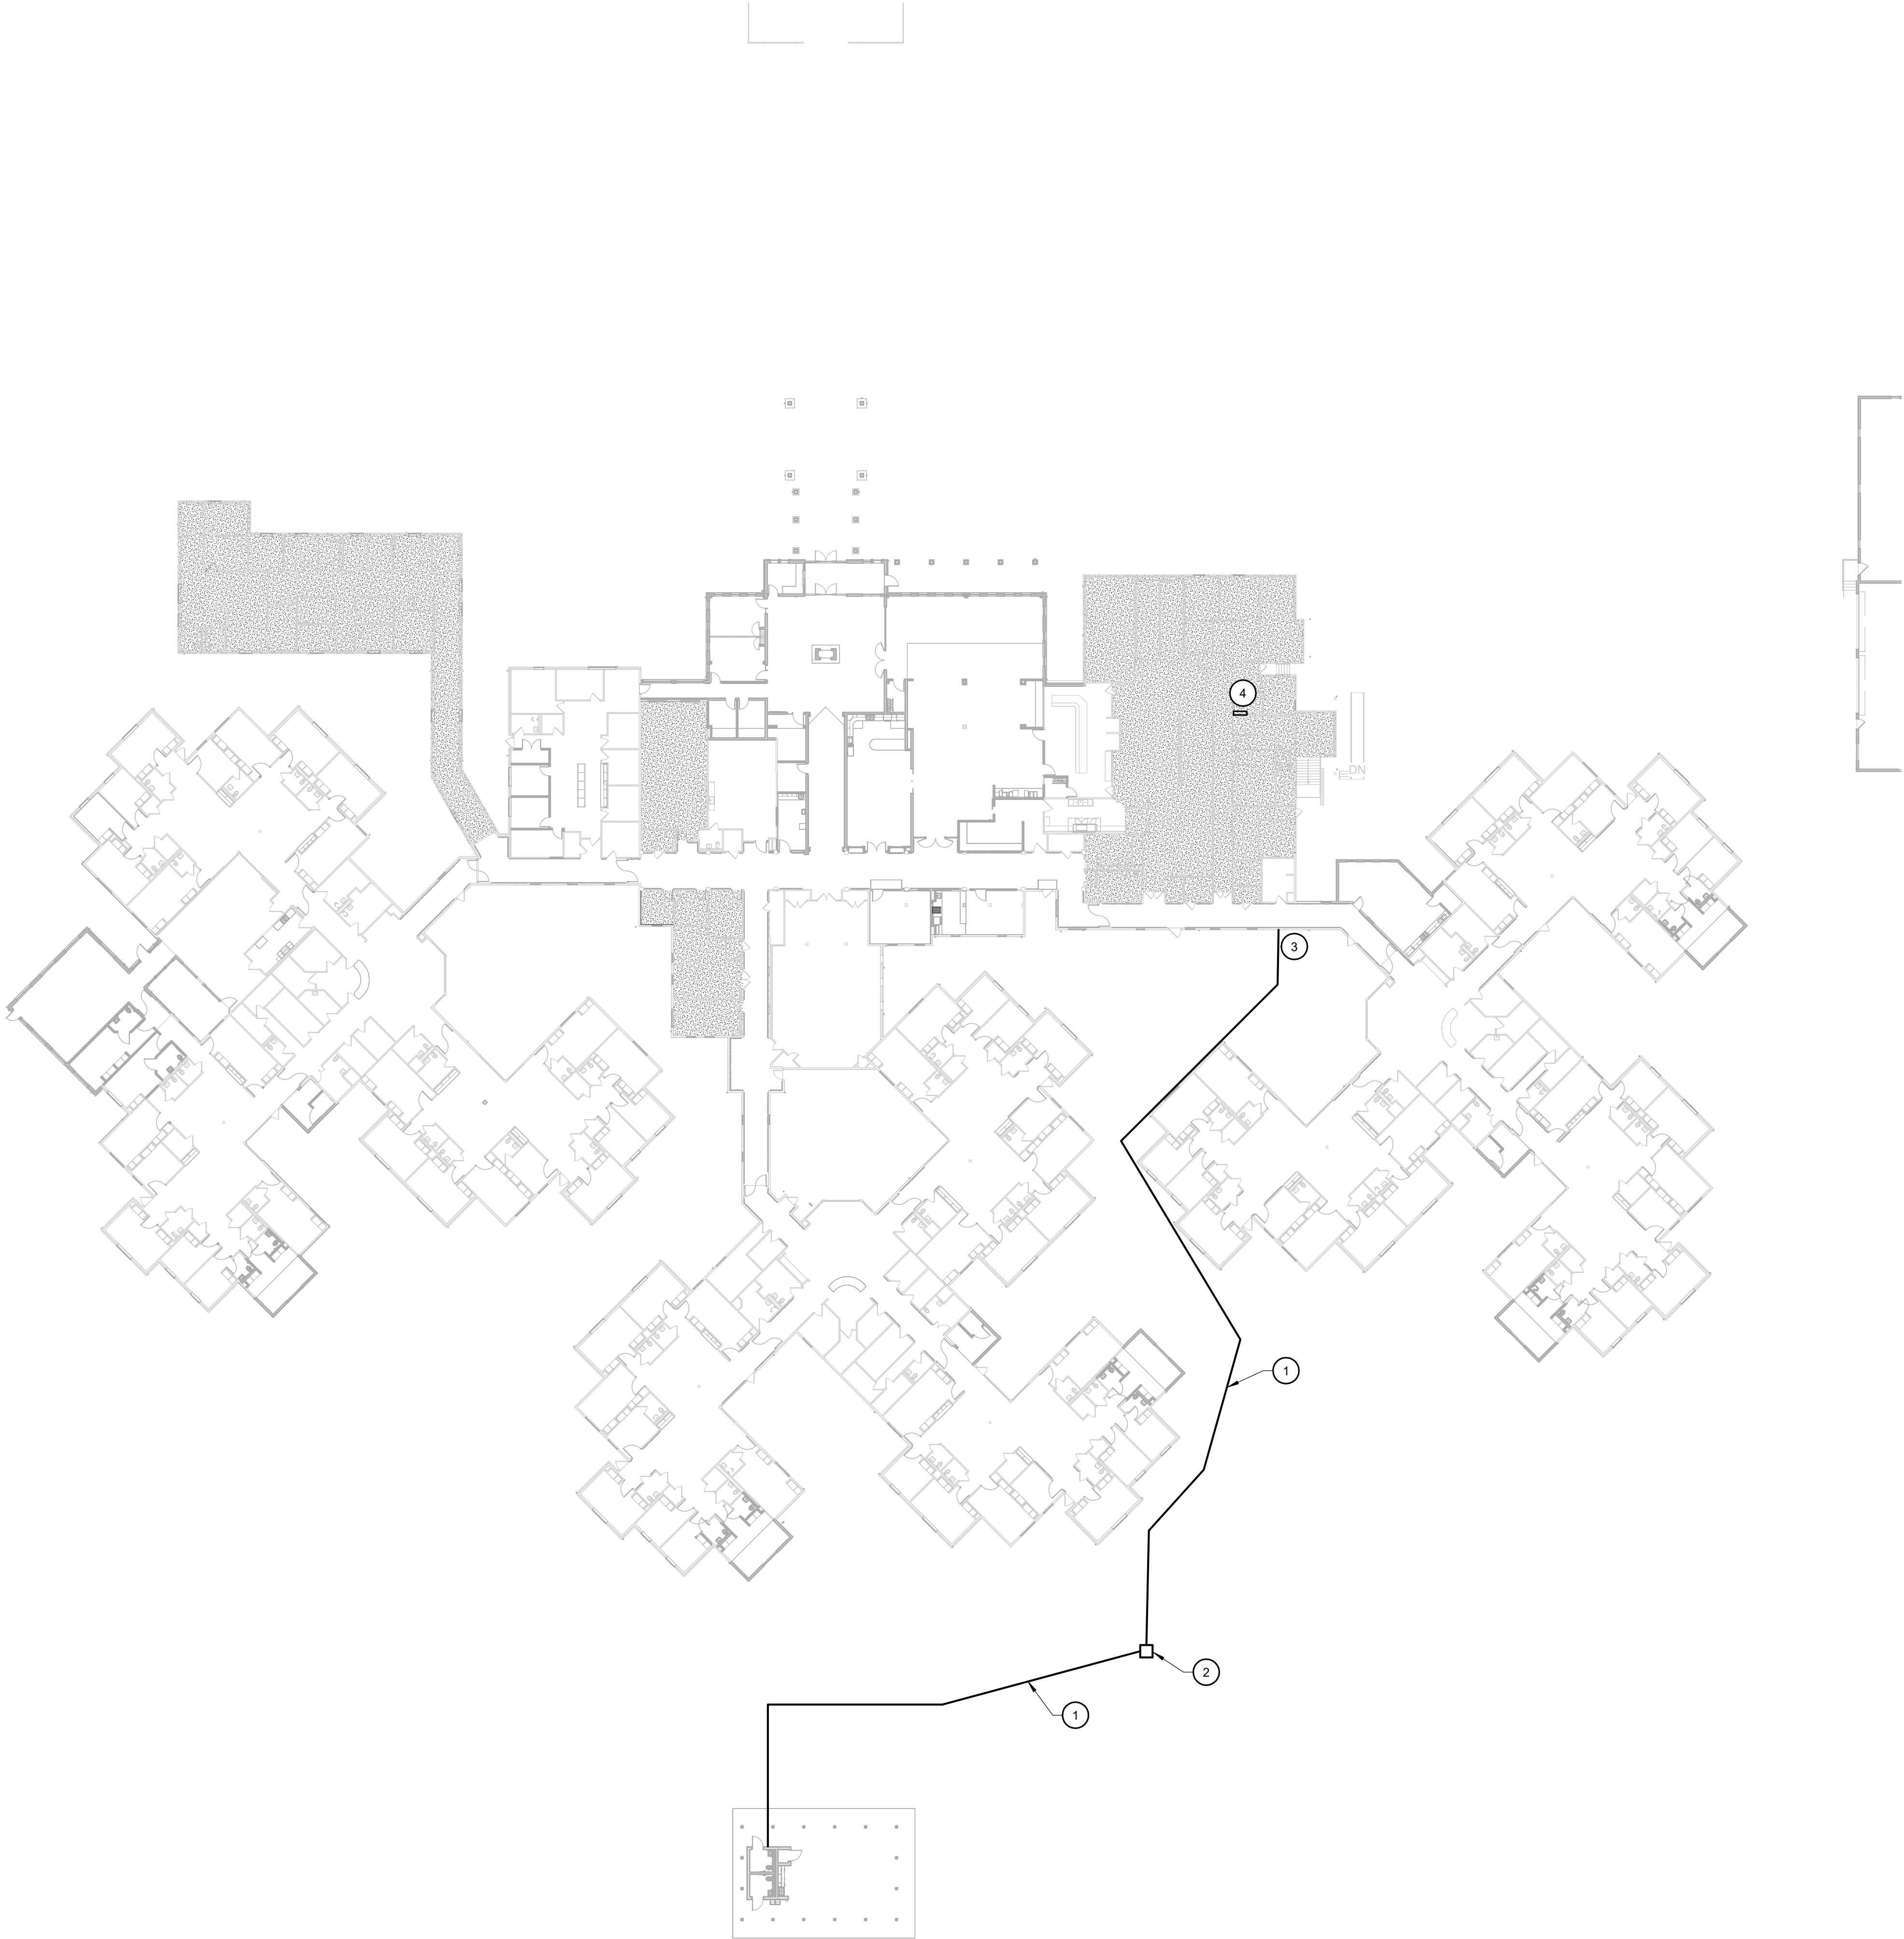

GENERAL NOTES

A. NOT USED.


KEYNOTES #

- 1 PROVIDE 4#3, 1#3G IN 1" FROM EXISTING 100A, 3 POLE FUSIBLE SWITCH IN PANEL DP1 IN EXISTING ELECTRICAL ROOM IN BASEMENT TO NEW PANEL PAV. CONDUCTOR MATERIAL SHALL BE COPPER
- 2 24"X24" BELOW GRADE PULL BOX.
- 3 COORDINATE PENETRATION INTO BASEMENT WITH EXISTING CONDITIONS IN BASEMENT.
- 4 APPROXIMATE LOCATION OF PANEL DP1.

STATE OF MISSOURI
MICHAEL L. PARSON,
GOVERNOR



10/22/2024
Expires 12/31/2024

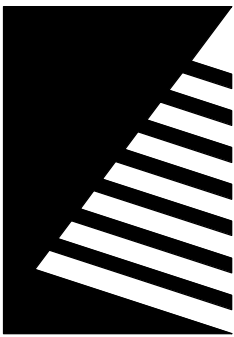

Farnsworth
GROUP

20 ALLEN AVENUE, SUITE 200
ST LOUIS, MISSOURI 63119
(314) 962-7900 / info@f-w.com

Farnsworth Group, Inc.
Missouri State Certificate of Authority #000744
www.f-w.com
Engineers | Architects | Surveyors | Scientists

100% BID SET

10/22/2024

OFFICE OF
ADMINISTRATION
DIVISION OF FACILITIES
MANAGEMENT, DESIGN
AND CONSTRUCTION

MISSOURI VETERANS
COMMISSION

OUTDOOR PAVILION
CAPE GIRARDEAU
VETERANS HOME

2400 Veterans Memorial Dr,
Cape Girardeau, MO 63701

PROJECT #: U2415-01
SITE #: 6803
ASSET #: 8136803002
FAI #: 29-043

DATE: DESCRIPTION:

DRAWN BY: KMA
CHECKED BY: WRK
DESIGNED BY: TLA


SHEET TITLE:

ELECTRICAL SITE
PLAN


SHEET NUMBER:

E-101

SHEET 23 OF 25
ISSUE DATE: 10/22/2024

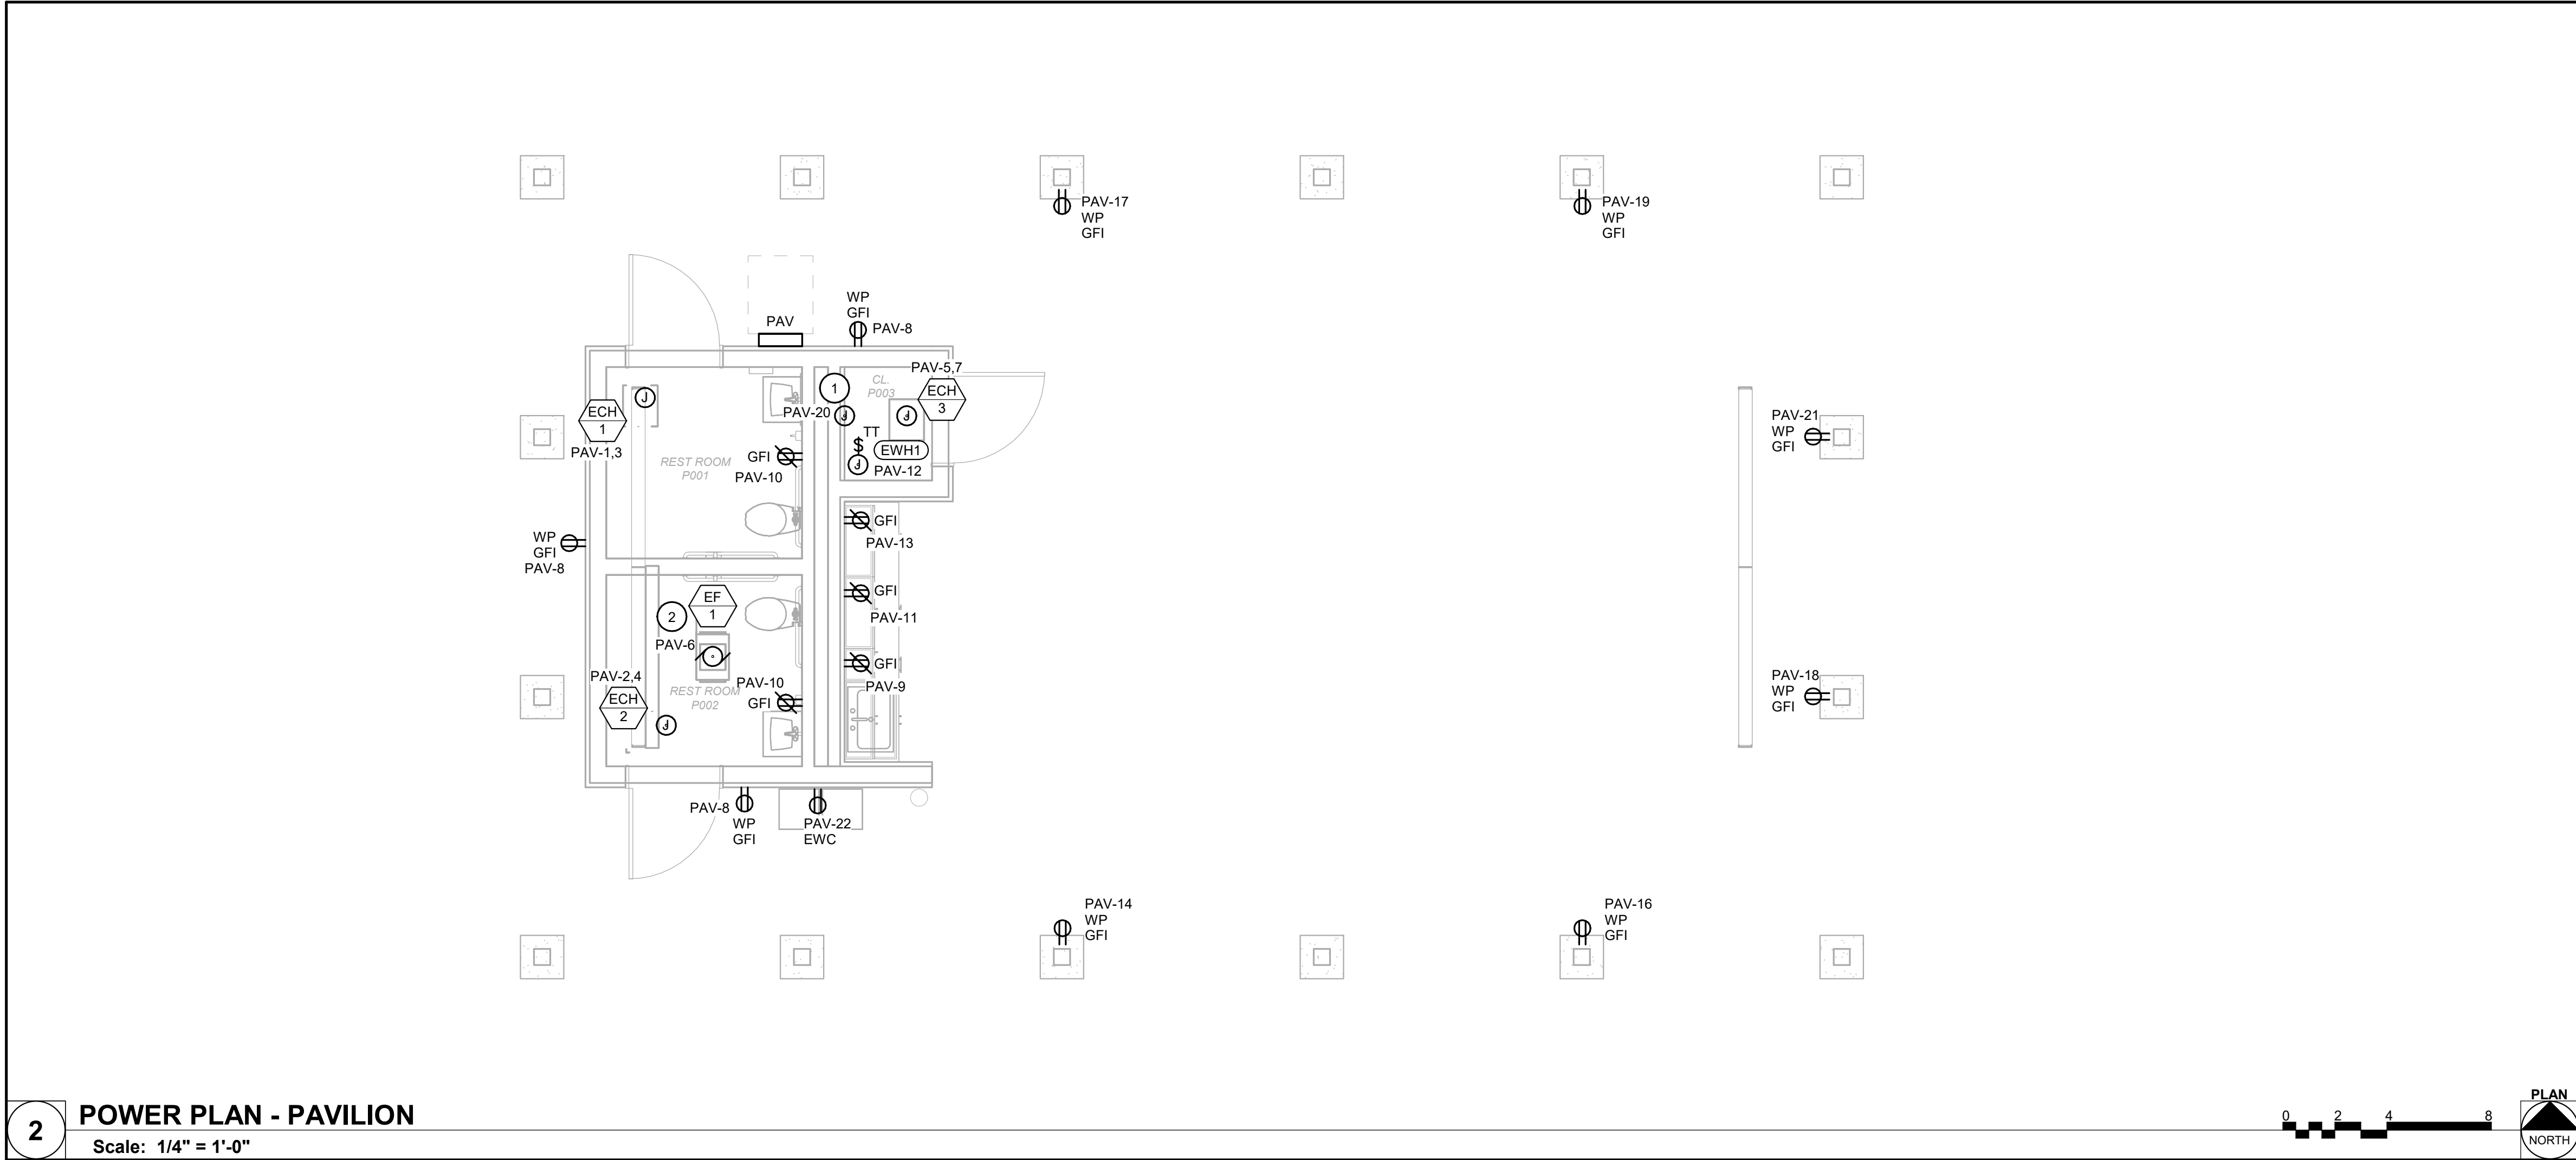

2 POWER PLAN - PAVILION
Scale: 1/4" = 1'-0"

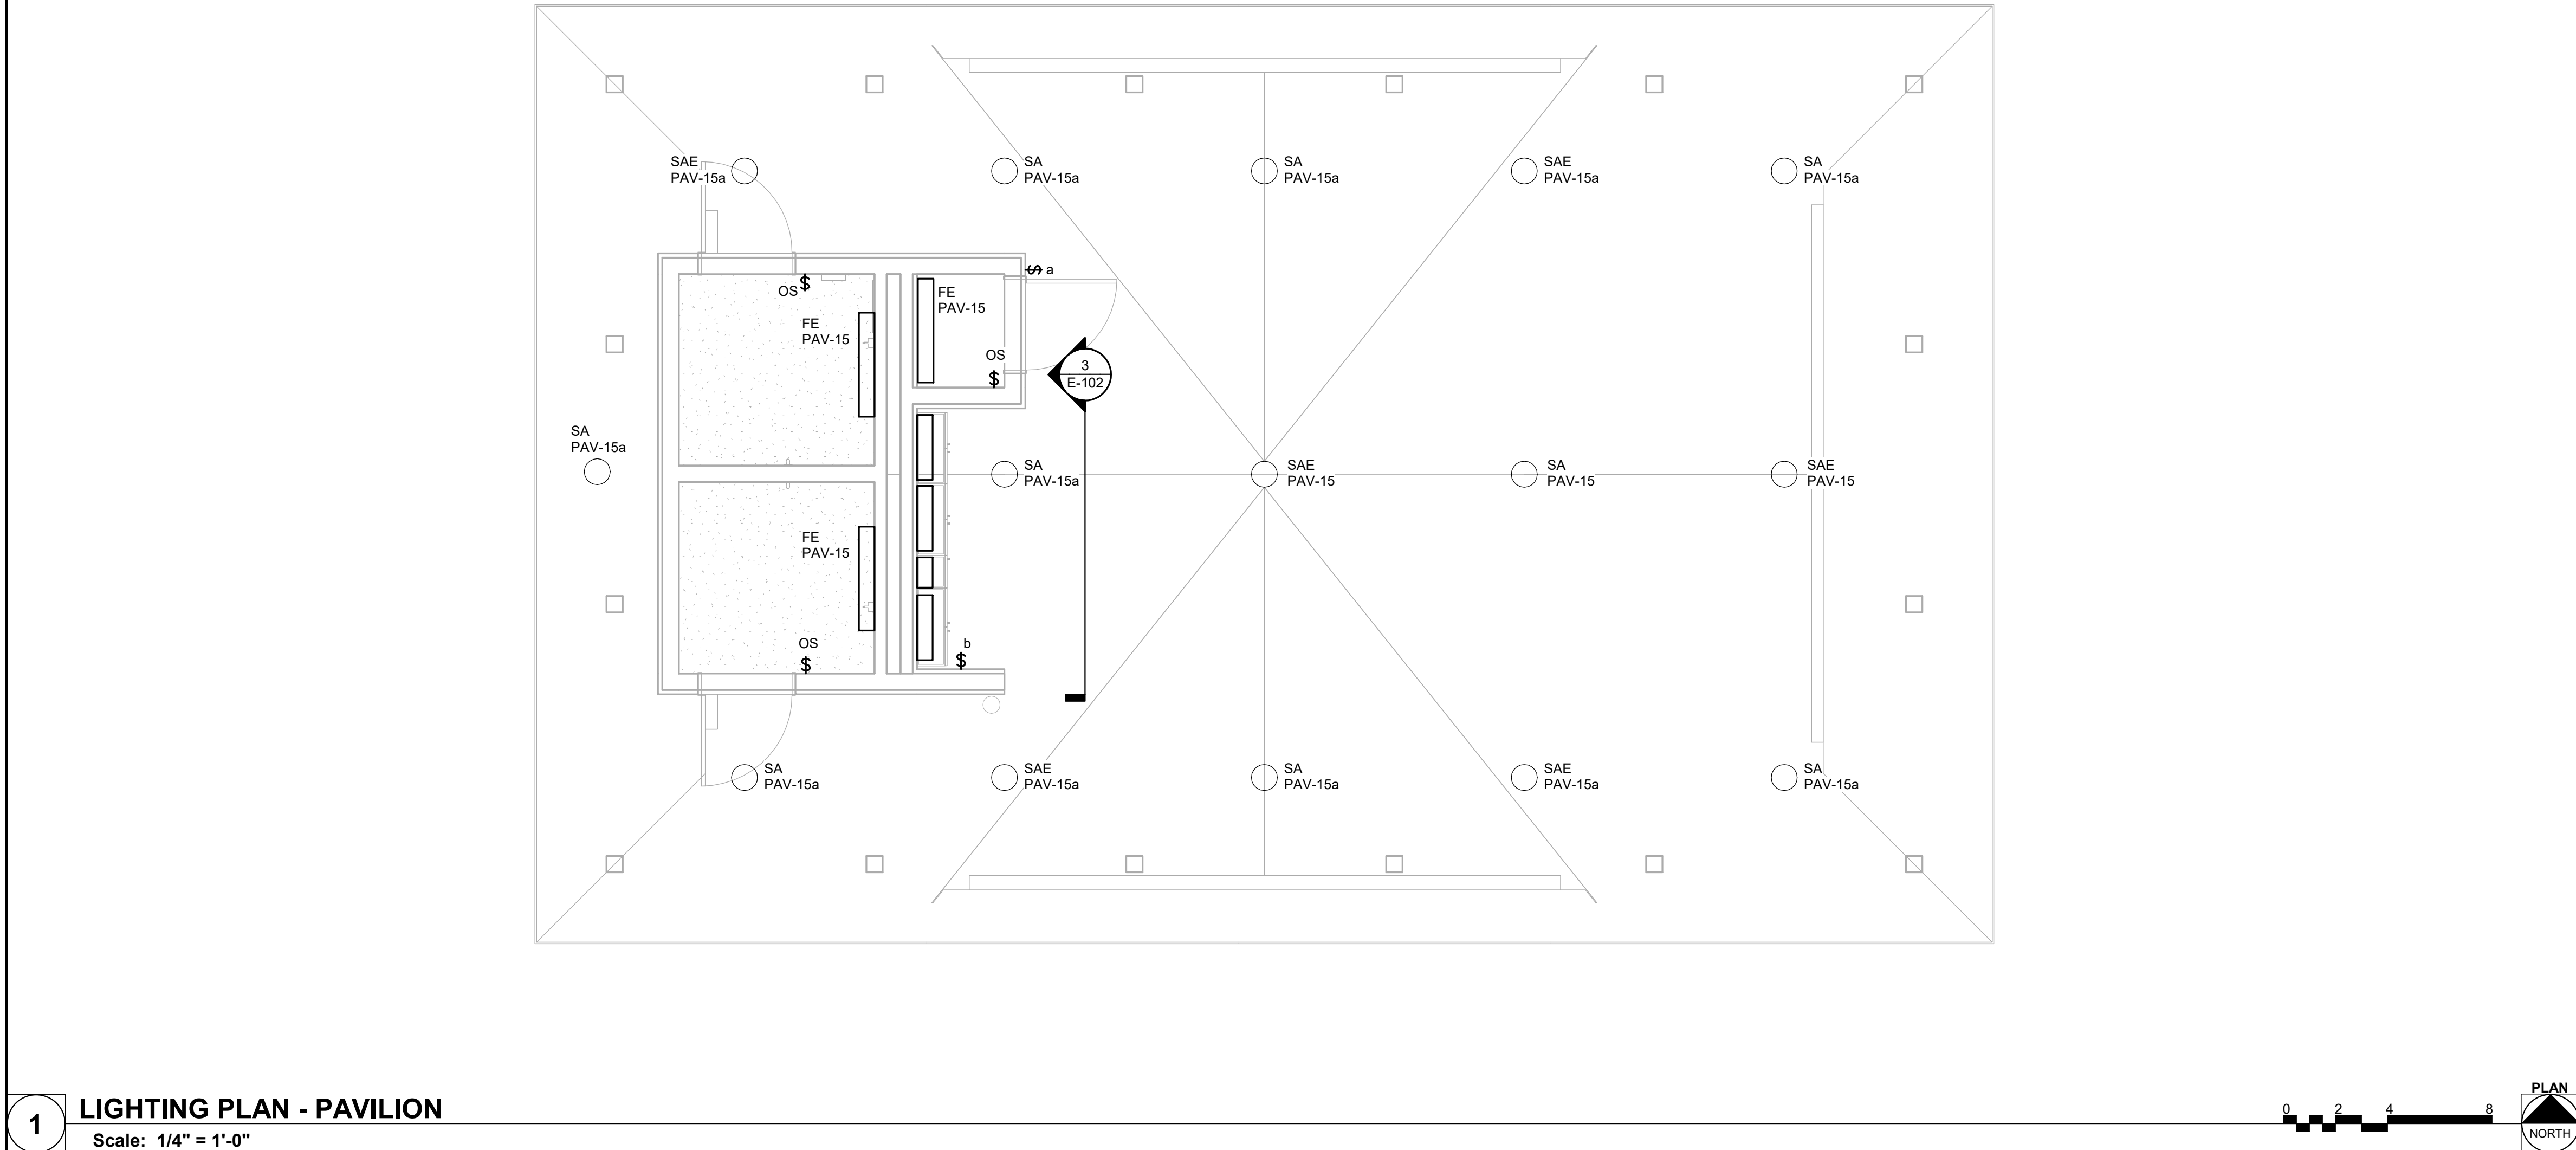

1 LIGHTING PLAN - PAVILION
Scale: 1/4" = 1'-0"

GENERAL NOTES


A. NOT USED

KEYNOTES


- 1 PROVIDE CONNECTION TO HEAT TRACE FOR PIPING. COORDINATE EXACT REQUIREMENTS WITH MECHANICAL/PLUMBING TRADE.
- 2 PROVIDE INTERCONNECTION OF EXHAUST FAN WITH LIGHTING CONTROLS IN BOTH RESTROOMS.
- 3 PROVIDE CONNECTION FOR ALL KITCHEN AREA LIGHTING FROM PANEL PAV CIRCUIT 15.

3 KITCHEN AREA LIGHTING ELEVATION

Scale: 1/4" = 1'-0"

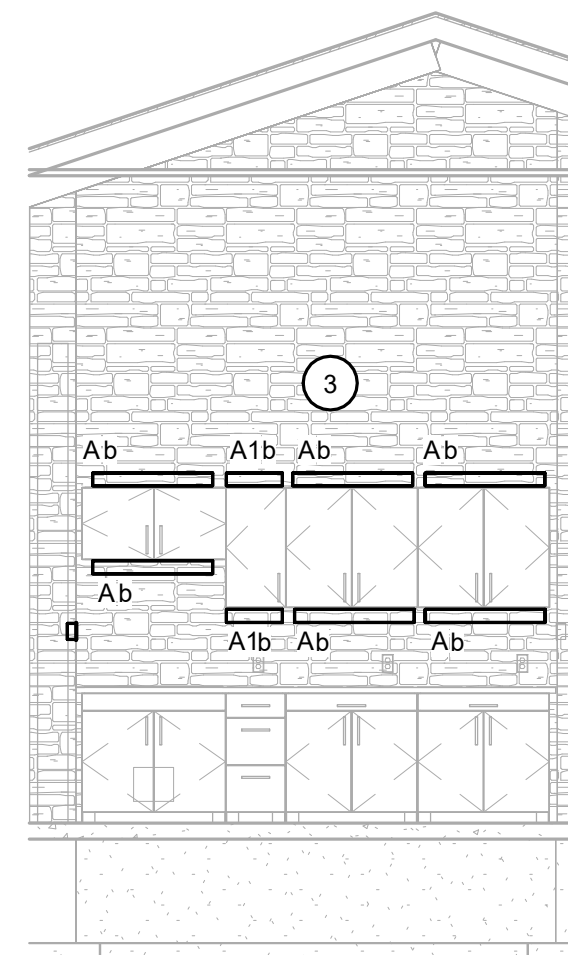

STATE OF MISSOURI
MICHAEL L. PARSON,
GOVERNOR

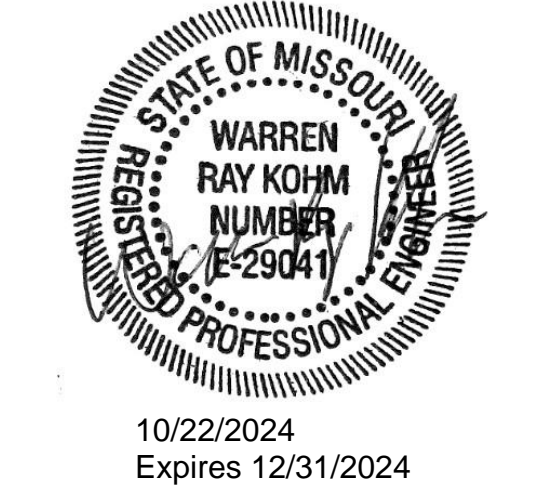

Farnsworth
GROUP
20 ALLEN AVENUE, SUITE 200
ST LOUIS, MISSOURI 63119
(314) 962-7900 / info@f-w.com
Farnsworth Group, Inc.
Missouri State Certificate of Authority #000744
www.f-w.com
Engineers | Architects | Surveyors | Scientists

100% BID SET
10/22/2024

OFFICE OF
ADMINISTRATION
DIVISION OF FACILITIES
MANAGEMENT, DESIGN
AND CONSTRUCTION

MISSOURI VETERANS
COMMISSION

**OUTDOOR PAVILION
CAPE GIRARDEAU
VETERANS HOME**

2400 Veterans Memorial Dr,
Cape Girardeau, MO 63701

PROJECT #: U2415-01
SITE #: 6803
ASSET#: 8136803002
FAI #: 29-043
DATE: DESCRIPTION:

DRAWN BY: KMA
CHECKED BY: WRK
DESIGNED BY: TLA

SHEET TITLE:
**LIGHTING AND
POWER PLAN -
PAVILION**


SHEET NUMBER:

E-102
SHEET 24 OF 25
ISSUE DATE: 10/22/2024

PANELBOARD PAV																
VOLTAGE: 208/120V			CONNECTED LOAD PER PHASE					ISOLATED GROUND BUS (Y/N):			N					
PHASE / WIRE: 3Ø / 4W								BUSSING: SEE SPEC								
RATED AMPERAGE: 100 A			A		B		C		MOUNTING: SURFACE							
MAIN: 100 A MCB			7500 VA		6315 VA		5736 VA		MCB GROUND FAULT PROTECTION (Y/N): N							
SCC RATING (SYM): 22,000 AIC			63 A		53 A		48 A		MCB SHUNT TRIP (Y/N): N							
									MCB 100% RATED (Y/N): N							
CKT	IDENTIFICATION	TYPE (*)	BKR SIZE	POLES	A		B		C		POLES	BKR SIZE	TYPE (*)	IDENTIFICATION	CKT	
1	EWH-1		20 A	2	1500	1500					2	20 A		EWH-2	2	
3							1500	1500							4	
5									1500	696	1	15 A			6	
7	EWH-3		20 A	2							1	20 A		RCPT	8	
9			20 A	1	1500	540					1	20 A			10	
11			20 A	1			180	360			1	35 A			12	
13	RCPT		20 A	1					180	3000	1	20 A		WATER HEATER EWH-1	14	
15			20 A	1	180	180					1	20 A			16	
17			20 A	1			1695	180			1	20 A			18	
19	RCPT		20 A	1					180	180	1	20 A		RCPT	20	
21			20 A	1	180	1920					1	20 A	3		HEAT TRACE	22
23			20 A	1			180	720			1	20 A			24	
25	SPARE		20 A	1					0	--	1	--		SPACE	26	
27			20 A	1	0	--					1	--			28	
29			20 A	1			0	--			1	--			30	
Load Classification					Connected Load		Demand Factor		Demand Load		PANEL TOTALS					
Motor					696 VA		125.00%		870 VA							
HVAC					13920 VA		100.00%		13920 VA		TOTAL CONNECTED LOAD:		19551 VA			
Lighting - Continuous					1695 VA		125.00%		2118 VA		TOTAL DEMAND:		20148 VA			
Receptacle					3240 VA		100.00%		3240 VA		TOTAL CONNECTED CURRENT:		54 A			
											TOTAL DEMAND CURRENT:		56 A			
NOTES:																
1. ALL BREAKERS ARE STANDARD UNLESS OTHERWISE NOTED																
2. (*) NUMBER INDICATES BREAKER TYPE: 1 = AFCI, 2 = CLASS A 5mA GFCI, 3 = 30mA GFPE, 4 = SHUNT TRIP ACTIVATED, 5 = PANELBOARD FEEDER SERVING UNIT SHALL BE LOCKABLE USING A PADLOCK, IN ACCORDANCE WITH OSHA LOCK-OUT-TAG RULES, 6 = LSI, 7 = LSIIG.																

TYPE	MANUFACTURER	CATALOG NUMBER	LAMP DESCRIPTION	VOLTAGE	LOAD (VA)	FINISH	MOUNTING	DESCRIPTION
A	ACUITY HUBBELL EATON	UPLD 30 SWW4 90CRI WH	LED	120 V	15	WHITE	SURFACE	30" UNDERCABINET LIGHTING
A1	ACUITY HUBBELL EATON	UPLD 14 SWW4 90CRI WH	LED	120 V	7	WHITE	SURFACE	14" UNDERCABINET LIGHTING
FE	ACUITY EATON HUBBELL	WL4 40L LP840 E10WLCP	LED	120 V	39.5	WHITE	WALL	4" WALL MOUNTED LENSED LED WITH EMERGENCY BATTERY
SA	ACUITY HUBBELL EATON	VCPG LED V4P4 40K T5W MVOLT PM BDS DBLXD	LED	120 V	56	BLACK	PENDANT	PAVILION LUMINAIRE WITH BIRD SHROUD
SAE	ACUITY HUBBELL EATON	VCPG LED V4P4 40K T5W MVOLT PM BDS DBLXD E10WLCP	LED	120 V	56	BLACK	PENDANT	PAVILION LUMINAIRE WITH BIRD SHROUD AND EMERGENCY BATTERY
NOTES:								
A. FOR CONTINUOUS FIXTURES, COORDINATE WITH SUPPLIER ON LENGTH AND REQUIRED FITTINGS, AND INSTALL WITH UNIFORM ILLUMINATION ALONG FIXTURE INCLUDING CORNERS.								
B. REMOVE ALL FINGER PRINTS FROM LENSES, REFLECTORS, AND LOUVERS FOLLOWING LIGHT FIXTURE INSTALLATION.								
C. FOR APPROVAL OF FIXTURES FROM MANUFACTURERS OTHER THAN THOSE LISTED, PROPOSED FIXTURES SHALL BE SUBMITTED TO THE ARCHITECT/ENGINEER TEN BUSINESS DAYS PRIOR TO BID FOR REVIEW. FINAL DETERMINATION OF 'EQUAL' STATUS FOR BIDDING SHALL BE THE SOLE DETERMINATION OF THE ARCHITECT/ENGINEER.								
D. PROVIDE ALL HOLLOW POLES WITH VIBRATION DAMPERS BY THE FACTORY.								

EQUIPMENT DATA SCHEDULE												
DESCRIPTION				LOAD DATA			DISCONNECT AT EQUIP.					REMARKS
MARK	EQUIPMENT	FURNISHED BY	INSTALLED BY	LOCATION	LOAD	VOLTAGE	PHASE	DISC. TYPE	DISC. SIZE	FURNISHED BY	INSTALLED BY	
ECH 1	ELECTRIC CEILING HEATER	MC	MC	PAVILION	3 KW	208	1	-	-	VND	VND	2#12, 1#12G, 3/4"C
ECH 2	ELECTRIC CEILING HEATER	MC	MC	PAVILION	3 KW	208	1	-	-	VND	VND	2#12, 1#12G, 3/4"C
ECH 3	ELECTRIC CEILING HEATER	MC	MC	PAVILION	3 KW	208	1	-	-	VND	VND	2#12, 1#12G, 3/4"C
EF 1	EXHAUST FAN	MC	MC	PAVILION	1/4 HP	120	1	-	-	VND	VND	2#12, 1#12G, 3/4"C
EWH 1	ELECTRIC WATER HEATER	PC	PC	PAVILION	3 KW	120	1	SW	60	EC	EC	2#10, 1#10G, 3/4"C
EQUIPMENT DATA NOTES:												
GENERAL NOTES:												
A.												
REMARKS:												
1. INSTALL DISCONNECT SWITCH ON THE SIDE OF THE EQUIPMENT HOUSING.												
2. PROVIDE DISCONNECT LOCKABLE IN ACCORDANCE WITH NEC 110.25.												

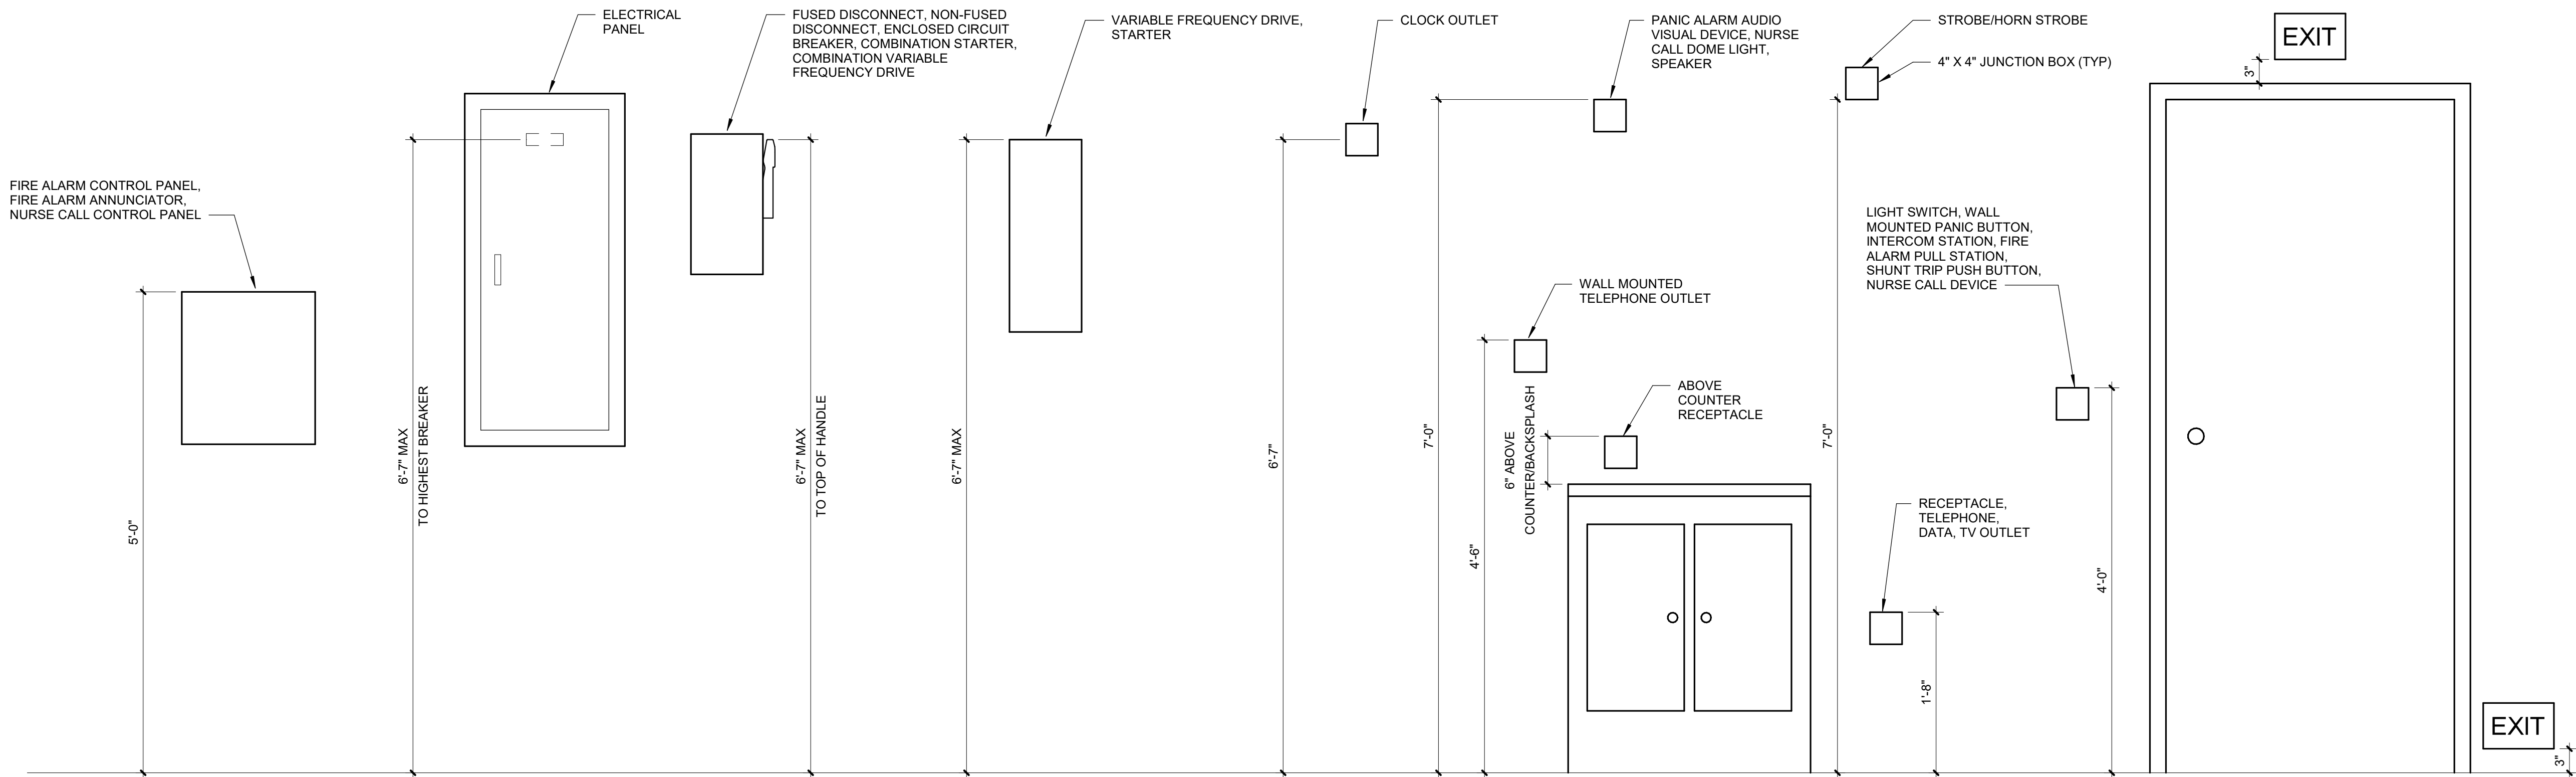


1 TYPICAL MOUNTING HEIGHT DETAIL
Scale: 1" = 1'-0"

STATE OF MISSOURI
MICHAEL L. PARSON,
GOVERNOR



10/22/2024
Expires 12/31/2024

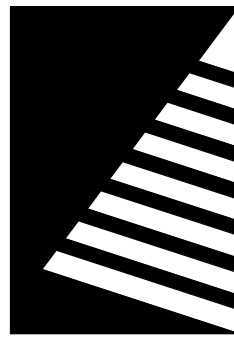

Farnsworth Group, Inc.
Missouri State Certificate of Authority #000744

100% BID SET

10/22/2024

OFFICE OF
ADMINISTRATION
DIVISION OF FACILITIES
MANAGEMENT, DESIGN
AND CONSTRUCTION

MISSOURI VETERANS
COMMISSION

OUTDOOR PAVILION
CAPE GIRARDEAU
VETERANS HOME

2400 Veterans Memorial Dr,
Cape Girardeau, MO 63701

PROJECT #.: U2415-01
SITE #.: 6803
ASSET #.: 8136803002
FAI #.: 29-043

DATE: DESCRIPTION:

DRAWN BY: KMA
CHECKED BY: WRK
DESIGNED BY: TLA

SHEET TITLE:

ELECTRICAL DETAILS

SHEET NUMBER:

E-501

SHEET 25 OF 25
ISSUE DATE: 10/22/2024