
Design & Construct New Pavilion for:

Missouri Veterans Home

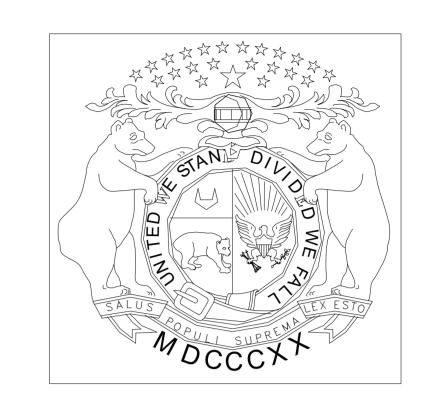



OWNER: STATE OF MISSOURI

MICHAEL L. KEHOE, GOVERNOR

MISSOURI VETERANS

COMMISSION

PROJECT OFFICE OF ADMINISTRATION MANAGEMENT:

DIVISION OF FACILITIES

MANAGEMENT DESIGN AND

CONSTRUCTION

DESIGNER: BUXTON KUBIK DODD, INC.


PINNACLE DESIGN CONSULTANTS, LLC.

CRAWFORD, MURPHY & TILLY, INC.

PROJECT NUMBER U2417-01

SITE NUMBER 6905

FACILITY NUMBER 8136905001

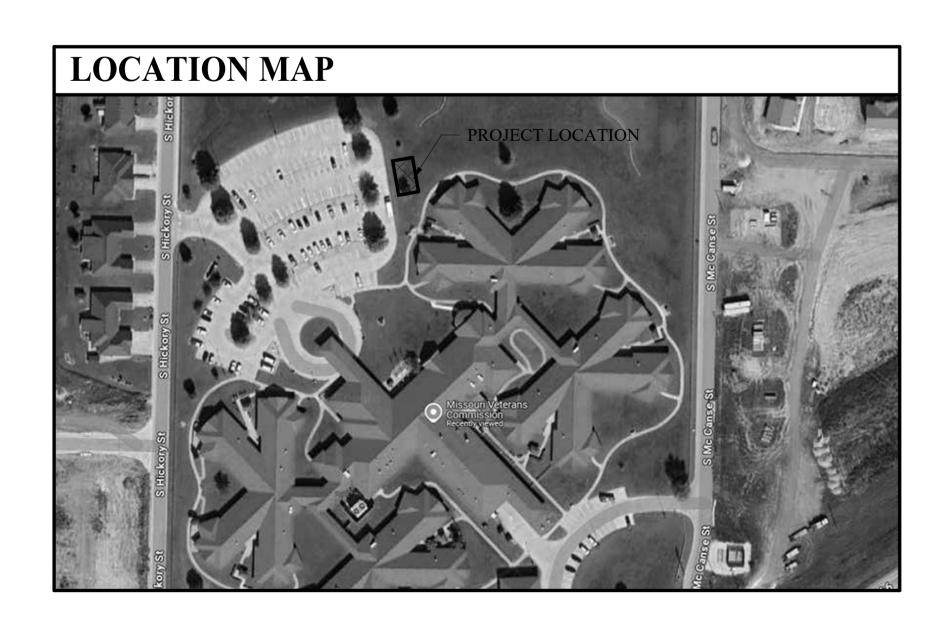

ARCHITECT OF RECORD: MECHANICAL/ELECTRICAL/PLUMBING **ENGINEER:**



STRUCTURAL ENGINEER:





CIVIL ENGINEER:




SHEET INDEX

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(4)	C-200	GRADING PLAN
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ARCHITECTURA	L	
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(10)	A-150	ROOF AND REFLECTED CEILING PLANS
(11)	A-200	ELEVATIONS AND SECTIONS
(12)	A-300	DETAILS AND SCHEDULES
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PLUMBING		
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MECHANICAL		
(16)	M-100	MECHANICAL PLAN

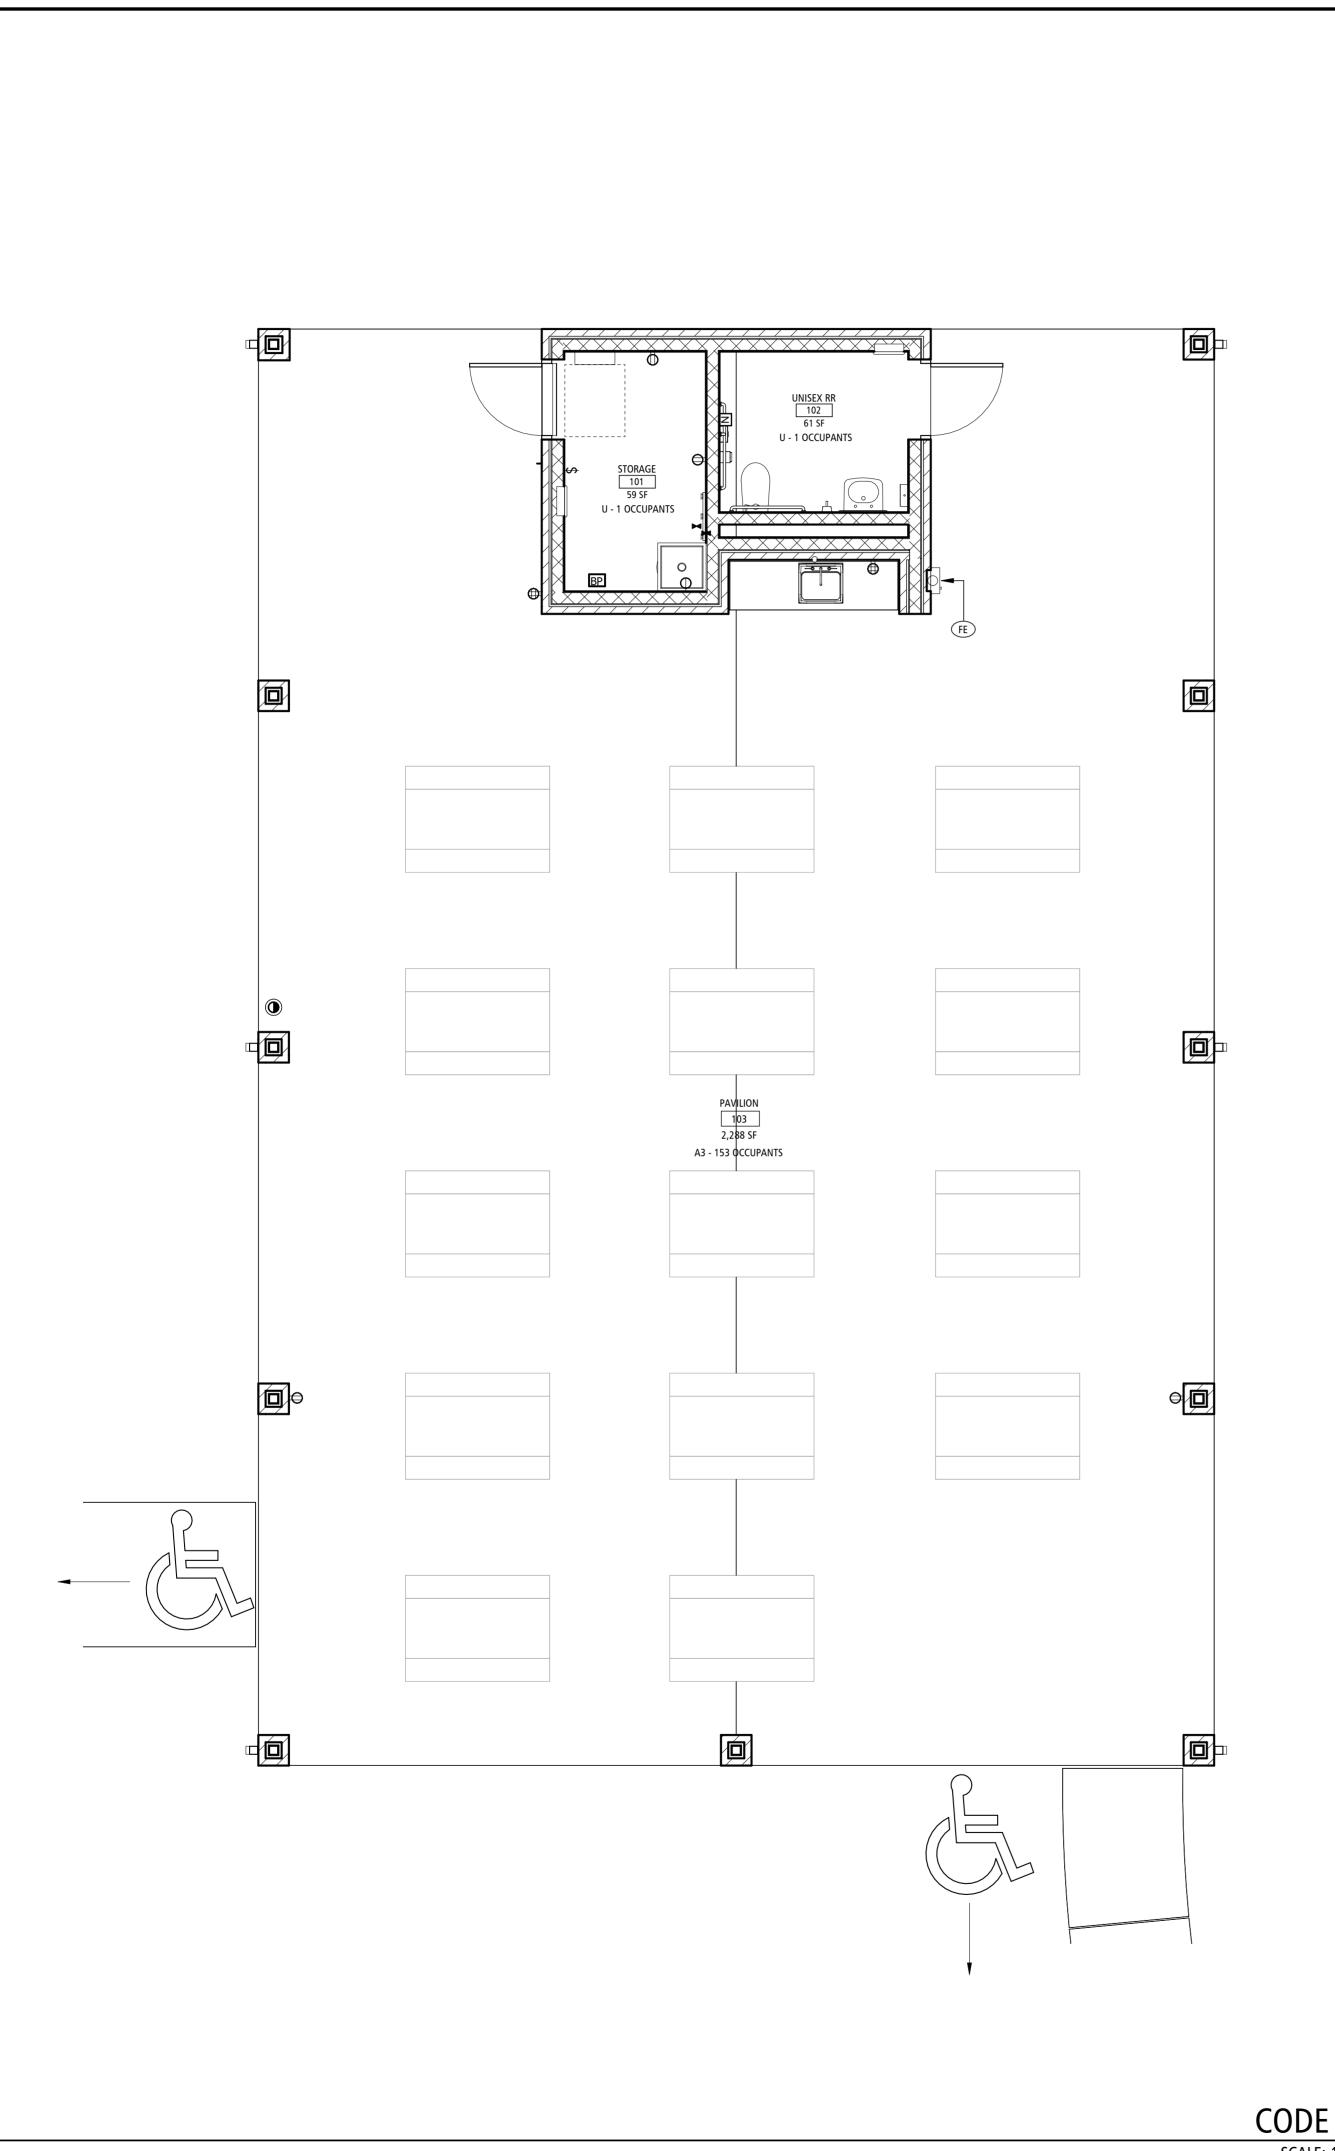

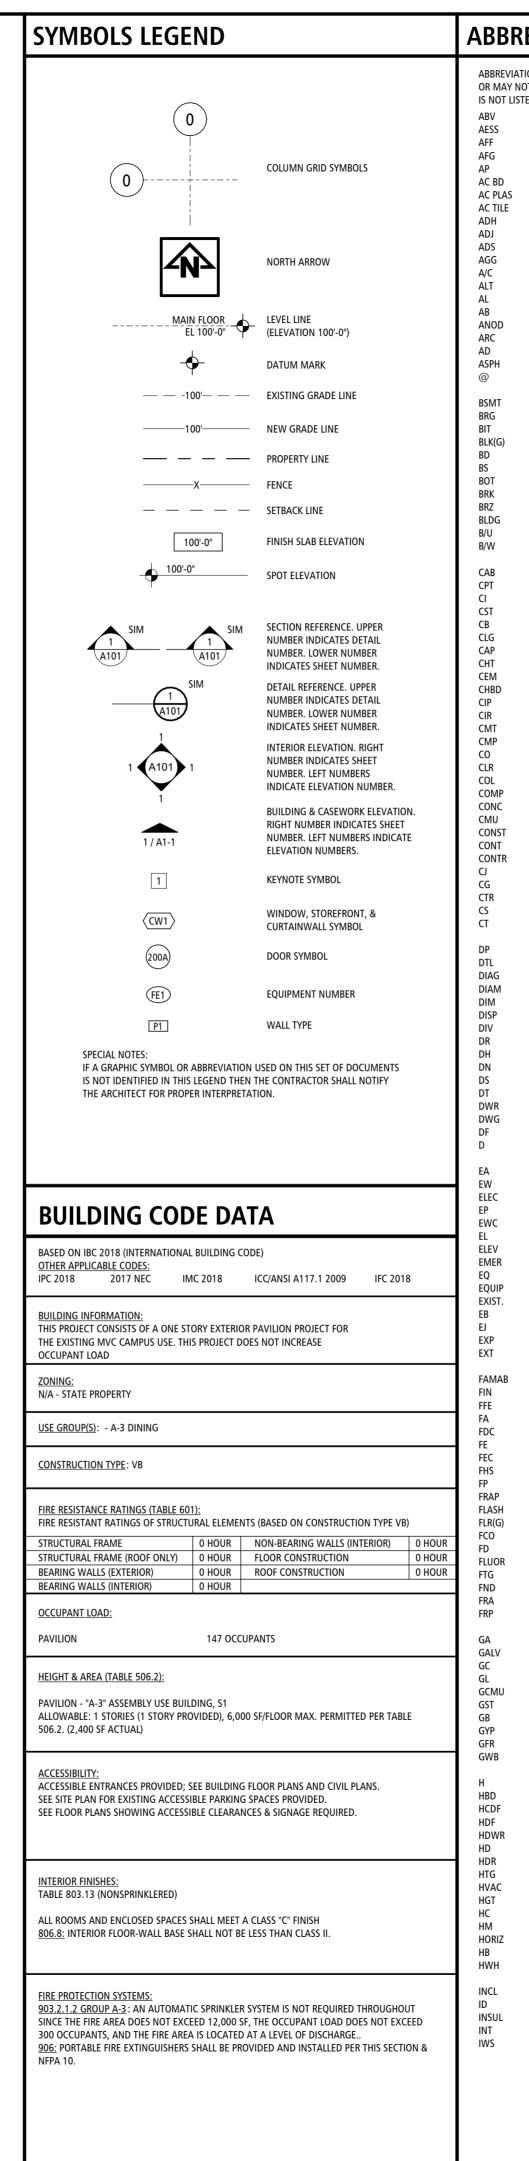

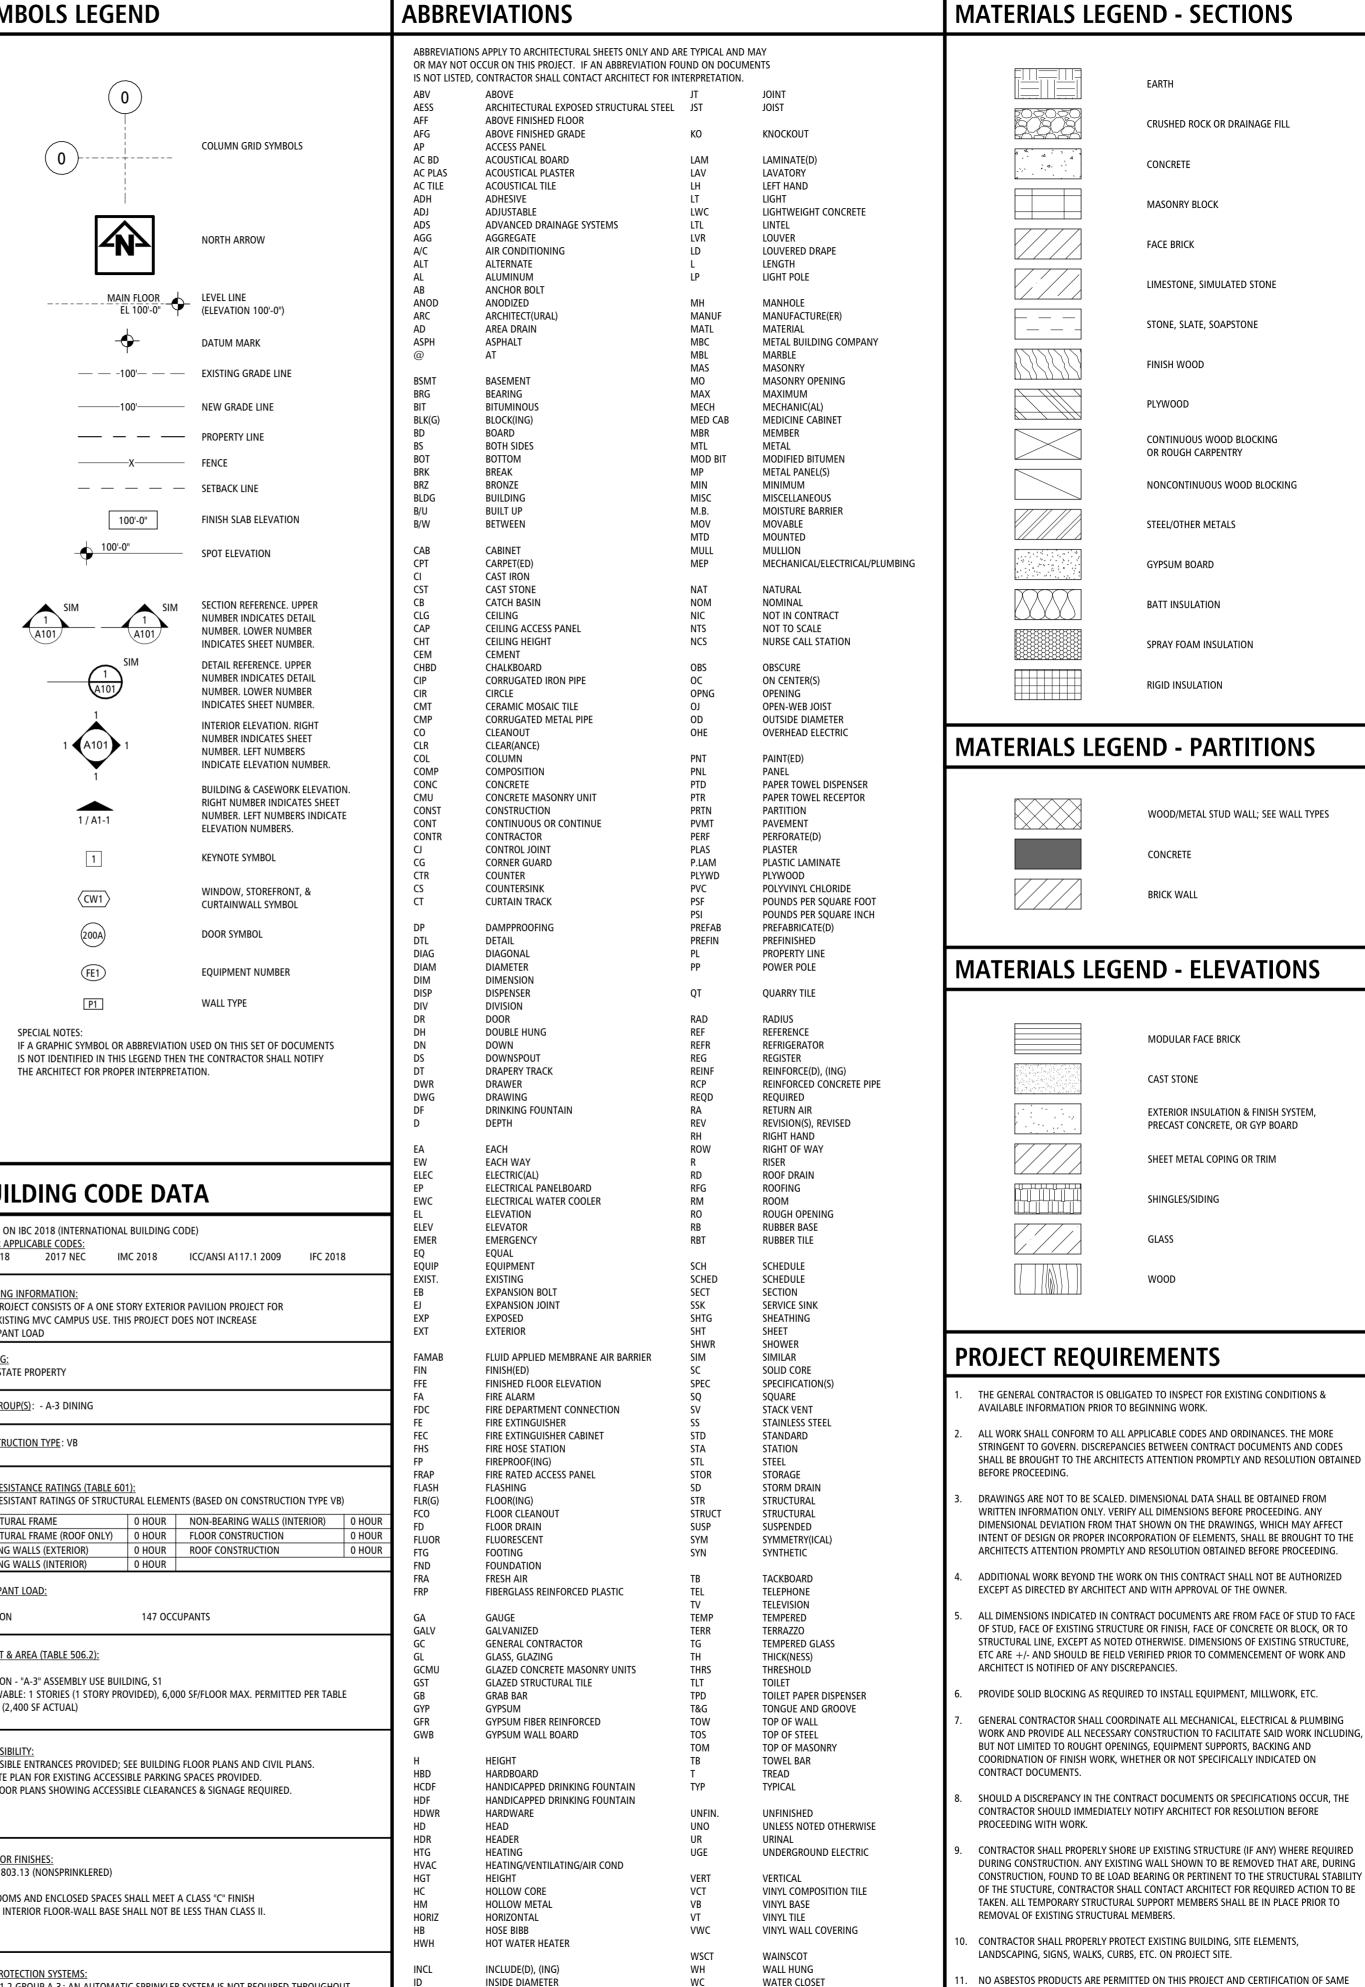

INSULATE(D)

ICE & WATER SHIELD (BITUTHENE)

INTERIOR

WATERPROOFING


WELDED WIRE FABRIC

WATERSTOP

WINDOW WITHOUT WOOD WIDTH WITH

WDW



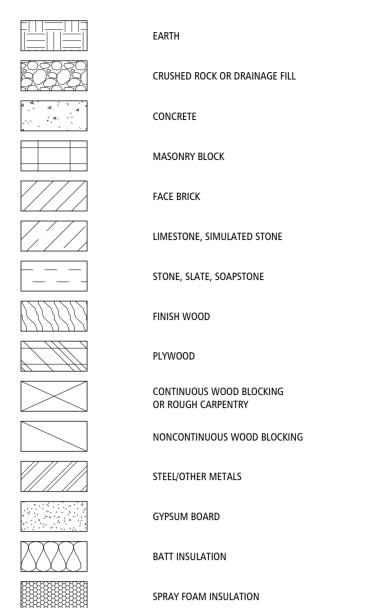

MICHAEL L. KEHOE, **GOVERNOR**

STATE OF MISSOURI





BUXTON KUBIK DODD DESIGN COLLECTIVE

3100 S. NATIONAL AVENUE, SUITE 300 S P R I N G F I E L D, M O 65807 PHONE: 417.890.5543 MISSOURI CERTIFICATE OF AUTHORITY NO. A-2006007284

MATERIALS LEGEND - PARTITIONS

RIGID INSULATION



MATERIALS LEGEND - ELEVATIONS

MODULAR FACE BRICK
CAST STONE
EXTERIOR INSULATION & FINISH SYSTEM, PRECAST CONCRETE, OR GYP BOARD
SHEET METAL COPING OR TRIM
SHINGLES/SIDING
GLASS

WOOD

MAY BE REQUIRED UPON REQUEST. PRIOR TO COMMENCEMENT OF WORK, THE

CERTIFICATES.

CONTRACTOR SHALL REQUEST FROM THE OWNER AN ASBESTOS SURVEY AND ABATEMENT

ADMINISTRATION DIVISION OF FACILITIES MANAGEMENT, **DESIGN AND** CONSTRUCTION

OFFICE OF

MO VETERANS **COMMISSION**

Design & Construct New Pavilion

Missouri Veterans Home

1600 S HICKORY ST. MT VERNON, MISSOURI 65712

PROJECT # U2417-01

FACILITY # 8136905001

REVISION REVISION:

ISSUE DATE: 06.04.2025

CAD DWG FILE: G0-DRAWN BY:


CHECKED BY: NS DESIGNED BY: NS

SHEET TITLE:

GENERAL INFORMATION

SHEET NUMBER

2 OF 18 SHEETS

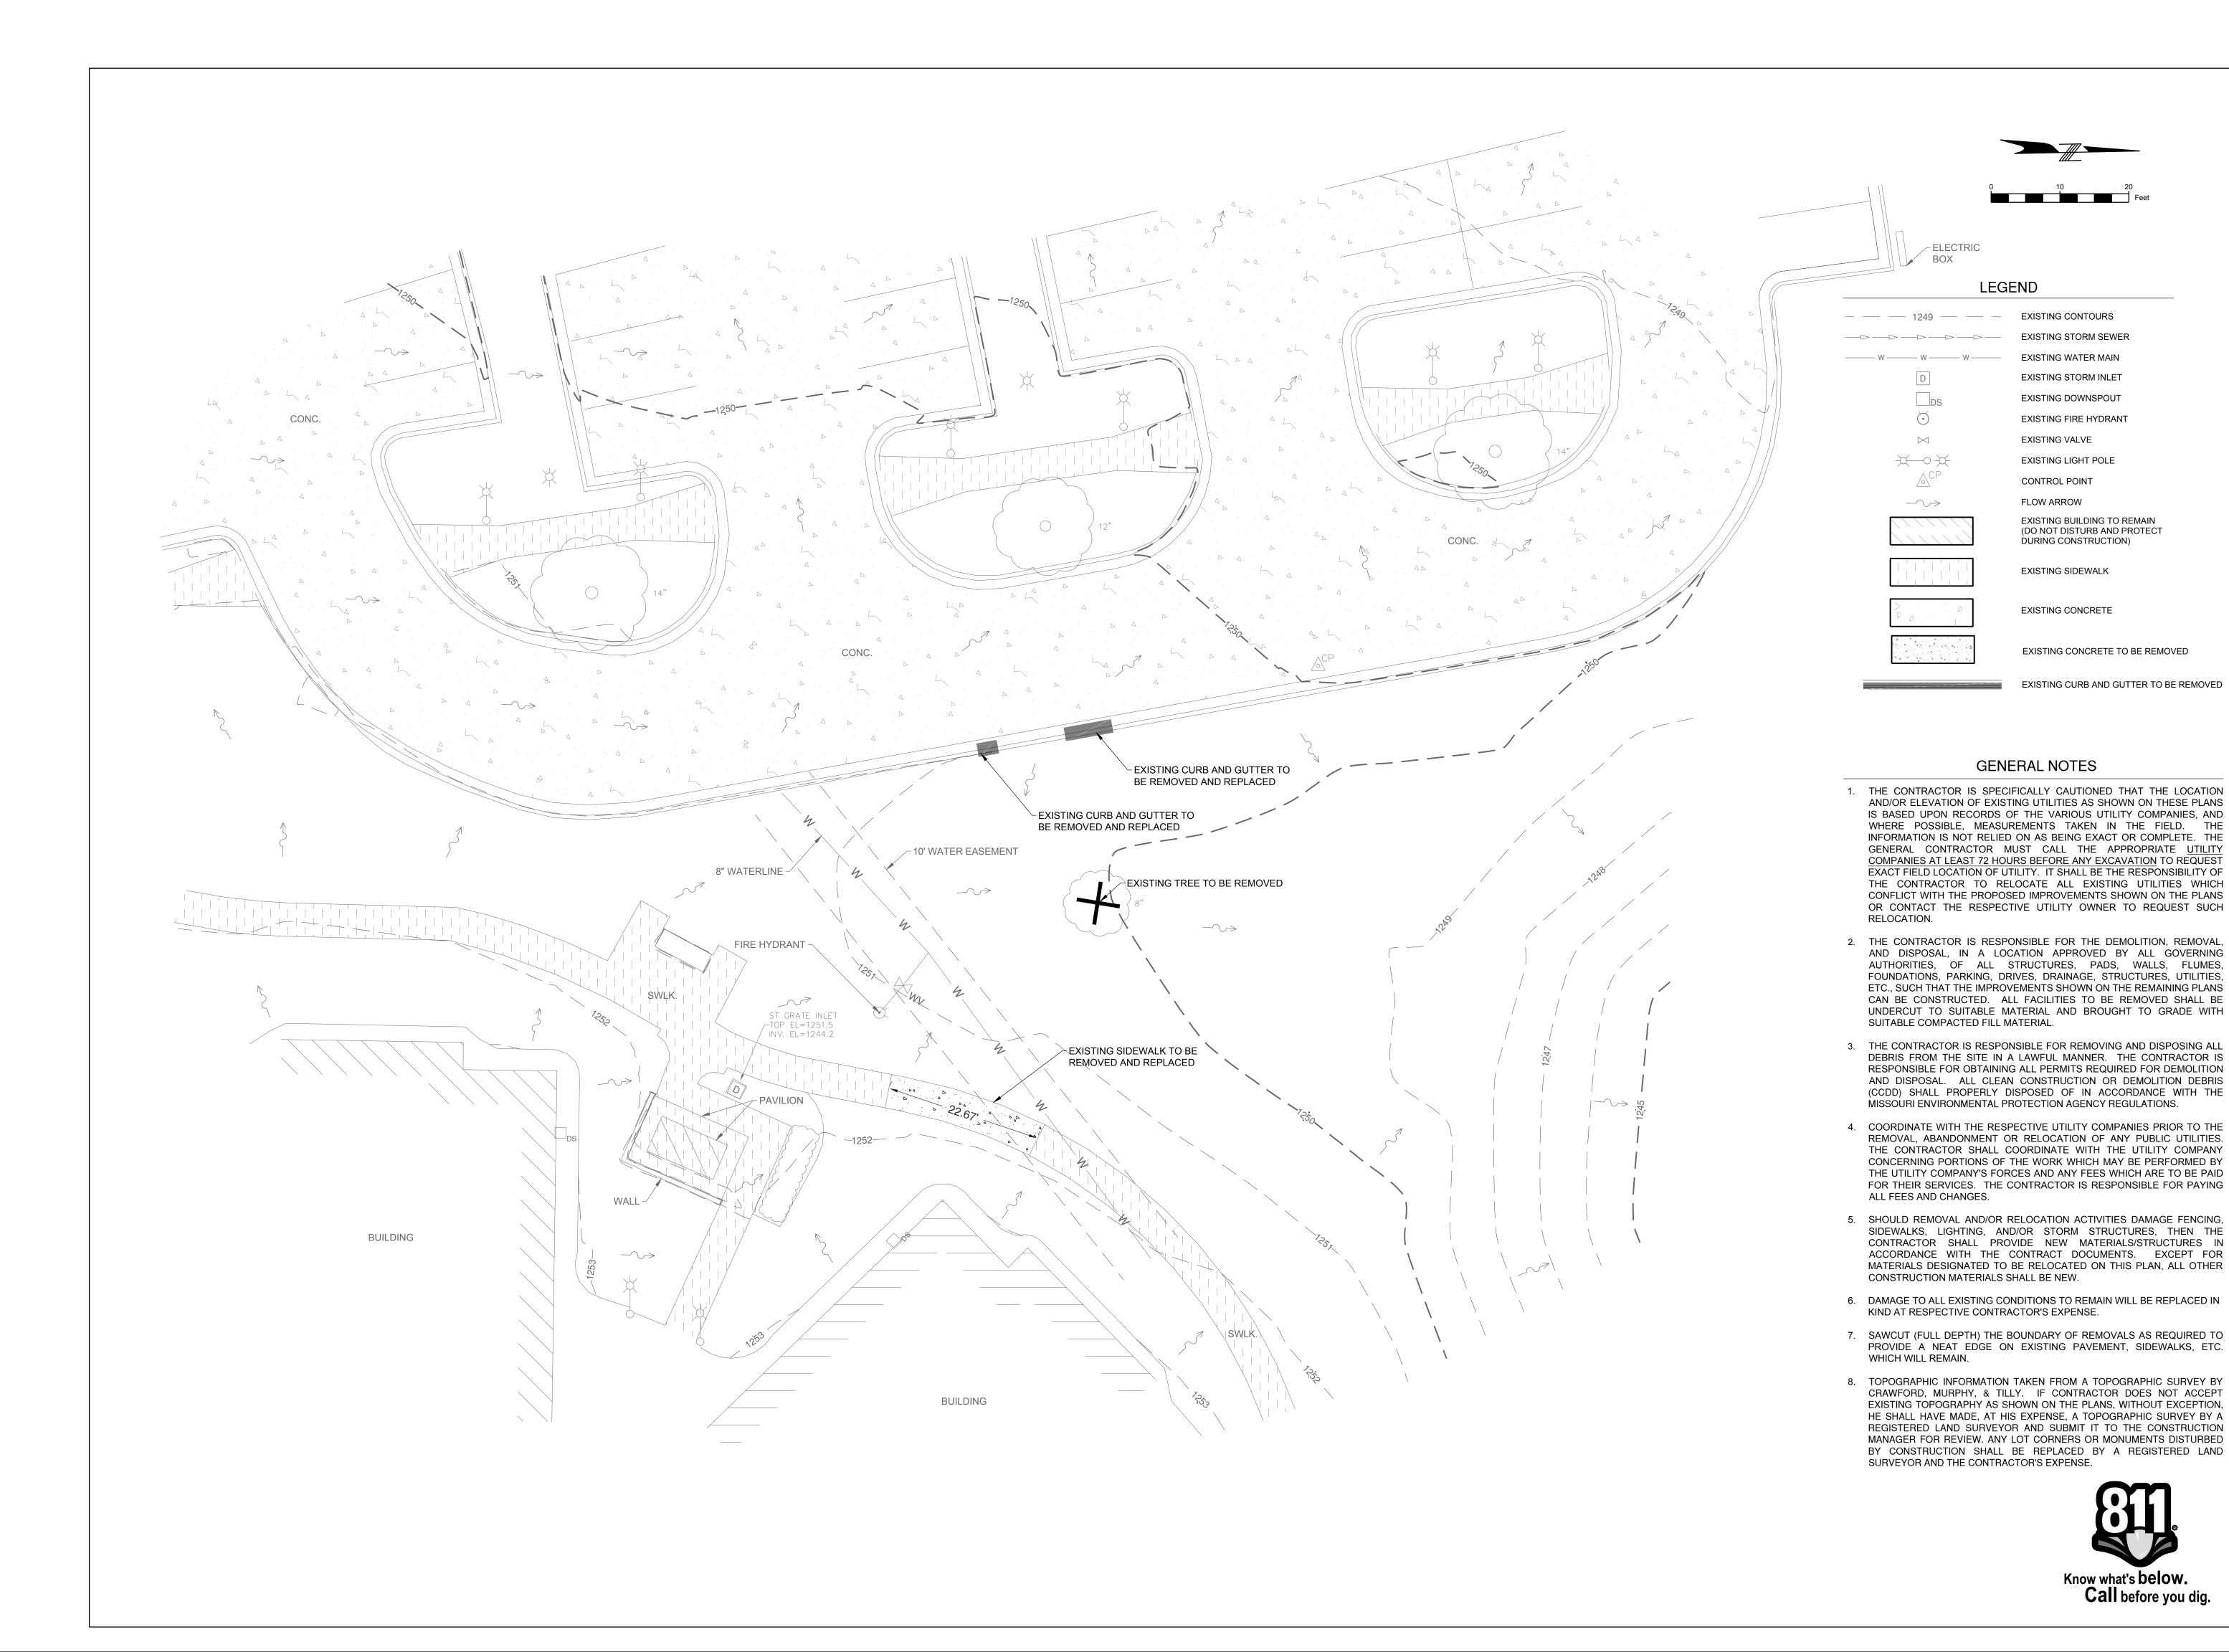

STATE OF MISSOURI MIKE KEHOE, **GOVERNOR**





EXISTING STORM SEWER

EXISTING WATER MAIN

EXISTING STORM INLET

EXISTING DOWNSPOUT

EXISTING FIRE HYDRANT

EXISTING LIGHT POLE

EXISTING SIDEWALK

EXISTING CONCRETE

EXISTING BUILDING TO REMAIN (DO NOT DISTURB AND PROTECT DURING CONSTRUCTION)

EXISTING CONCRETE TO BE REMOVED

EXISTING CURB AND GUTTER TO BE REMOVED

EXISTING VALVE

CONTROL POINT

FLOW ARROW

OFFICE OF ADMINISTRATION DIVISION OF FACILITIES MANAGEMENT, **DESIGN AND CONSTRUCTION**

MO VETERANS **COMMISSION**

DESIGN & CONSTRUCT NEW **PAVILION** MISSOURI VETERANS HOME

1600 S HICKORY ST. MT VERNON, MISSOURI 65712

PROJECT # U2417-01 6905 FACILITY # 8136905001

REVISION: REVISION: DATE **REVISION:** DATE:

ISSUE DATE: 06.04.2025 CAD DWG FILE: Survey.dwg DRAWN BY: <u>CMT</u>

CHECKED BY: <u>CMT</u> DESIGNED BY: <u>CMT</u>

SHEET TITLE:


EXISTING FEATURES & **DEMOLITION PLAN**

SHEET NUMBER:

Know what's below.

Call before you dig.

C-101

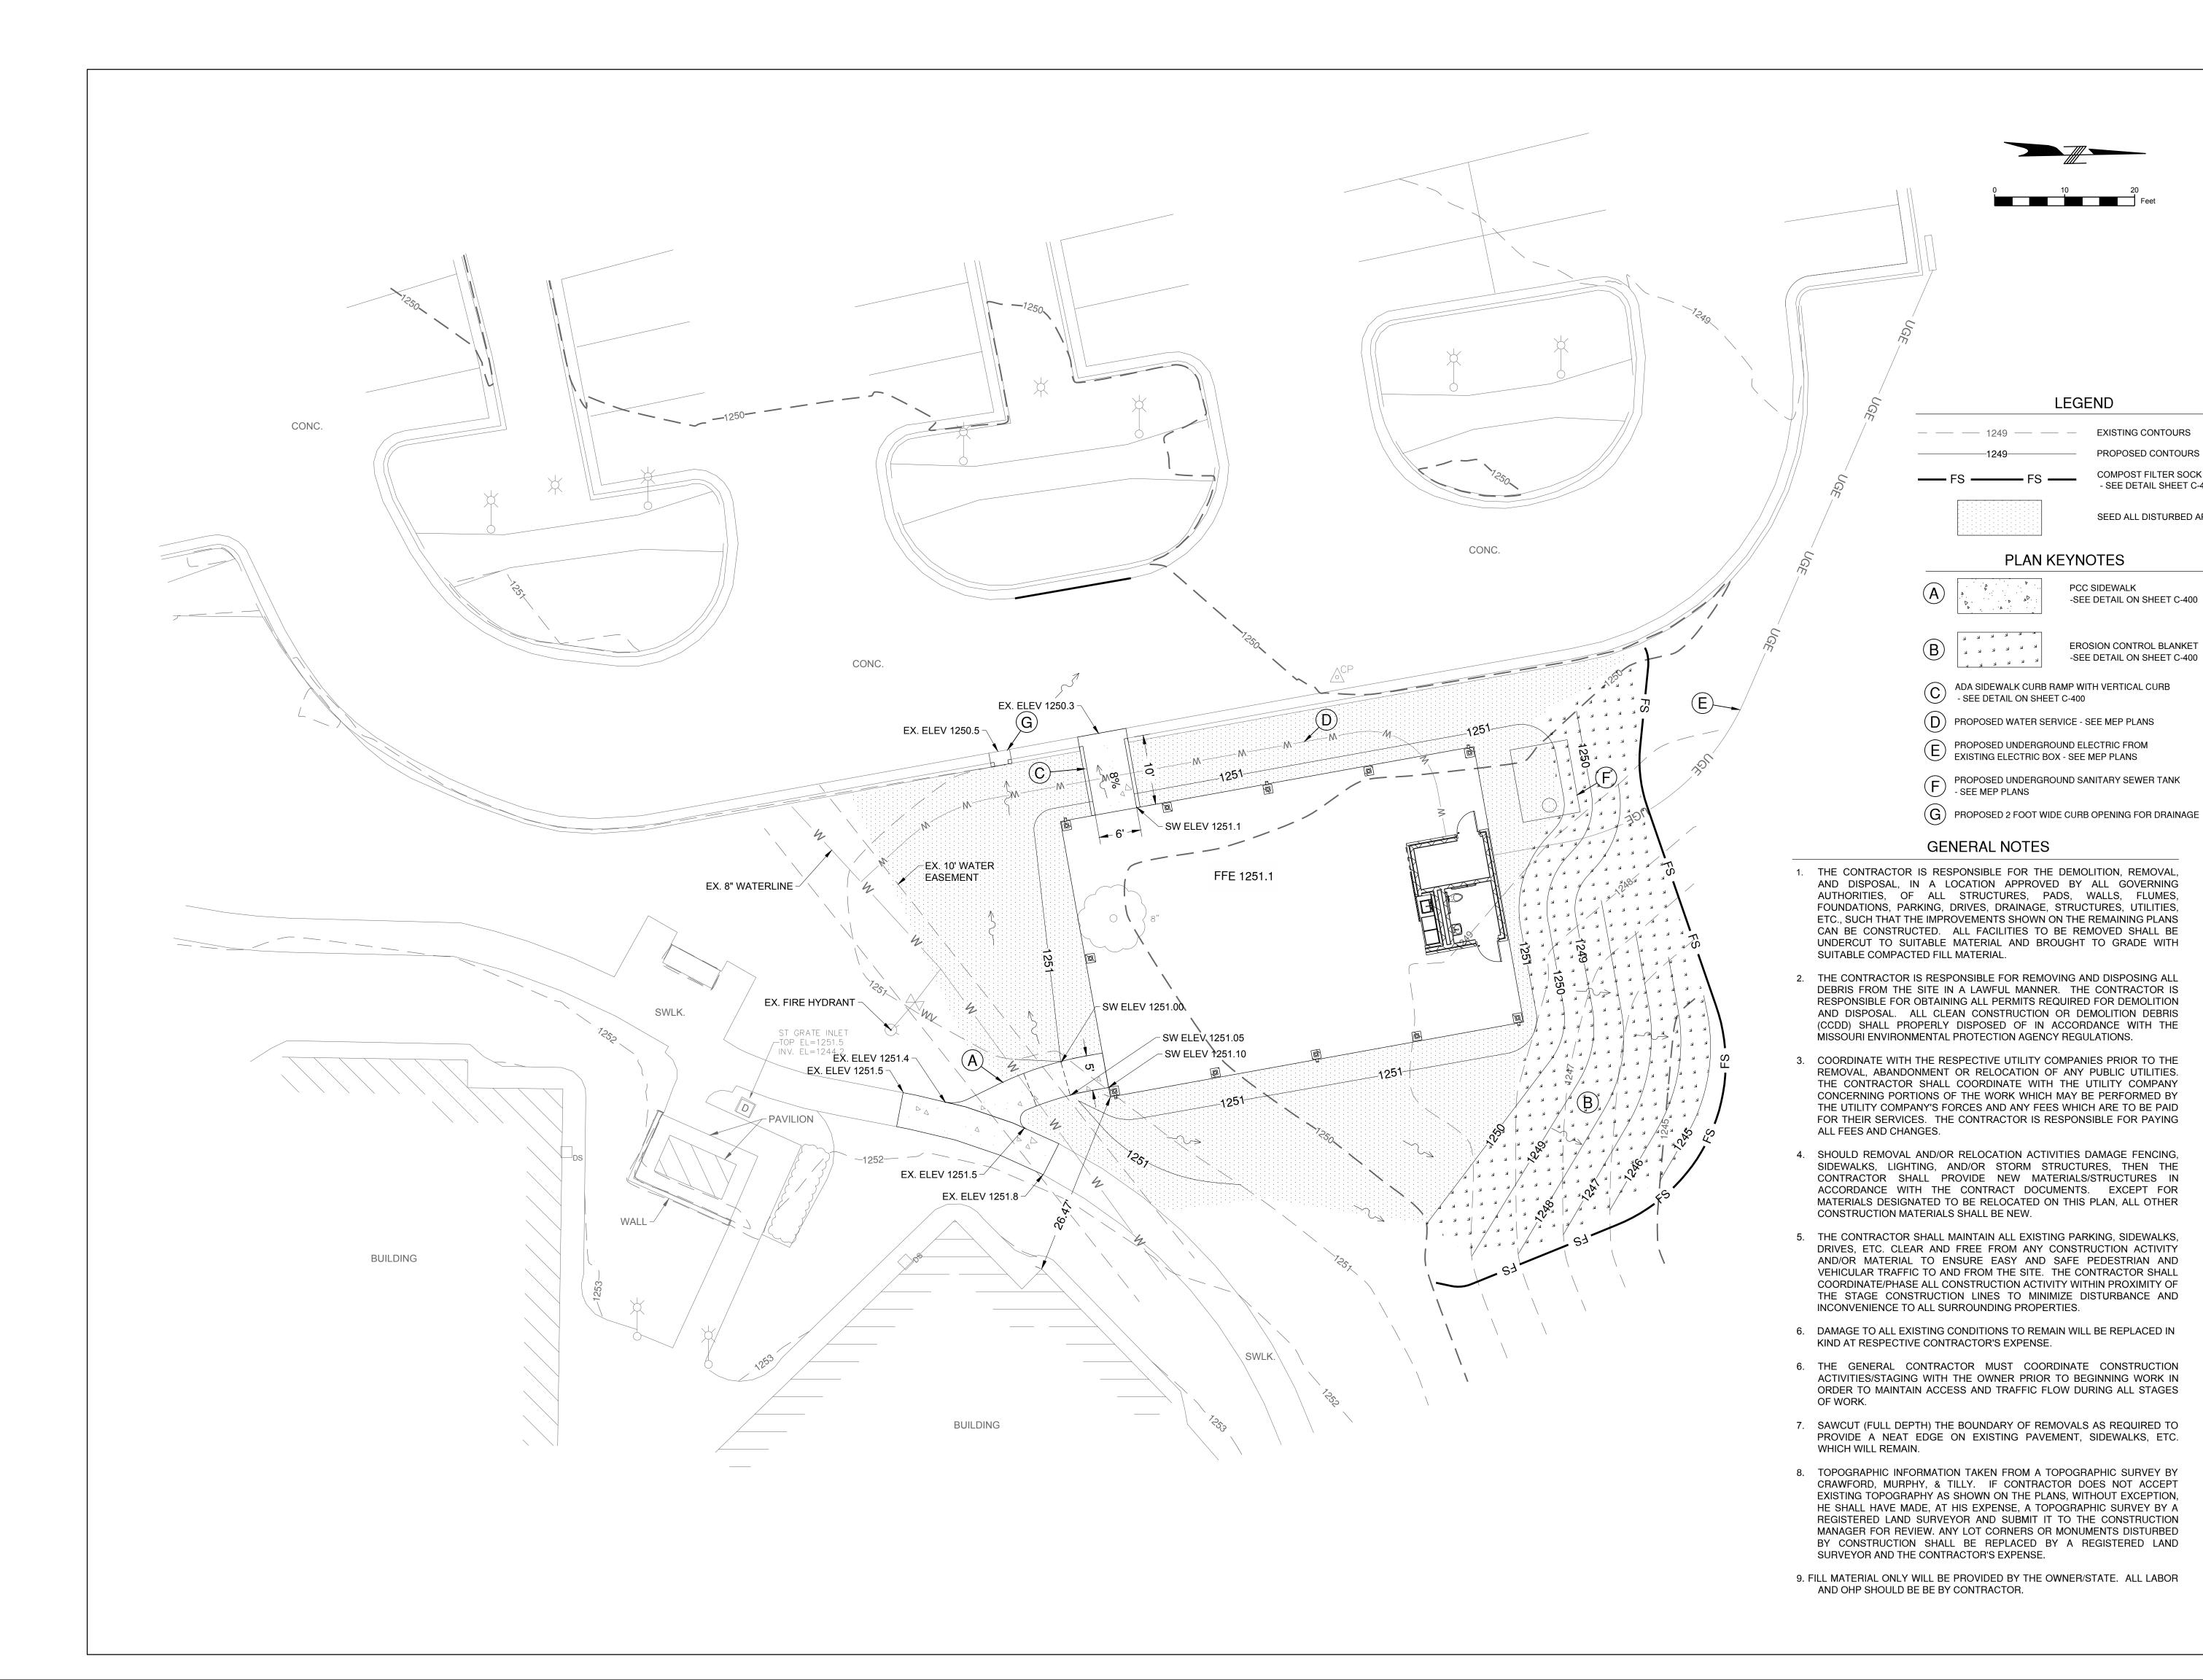

STATE OF MISSOURI MIKE KEHOE, **GOVERNOR**





EXISTING CONTOURS

PROPOSED CONTOURS

COMPOST FILTER SOCK - SEE DETAIL SHEET C-400

SEED ALL DISTURBED AREAS

OFFICE OF ADMINISTRATION DIVISION OF FACILITIES MANAGEMENT, **DESIGN AND CONSTRUCTION**

MO VETERANS **COMMISSION**

DESIGN & CONSTRUCT NEW **PAVILION** MISSOURI VETERANS HOME

1600 S HICKORY ST. MT VERNON, MISSOURI 65712

PROJECT # U2417-01 6905 FACILITY # 8136905001

REVISION: REVISION: DATE **REVISION:** DATE:_ ISSUE DATE: 06.04.2025

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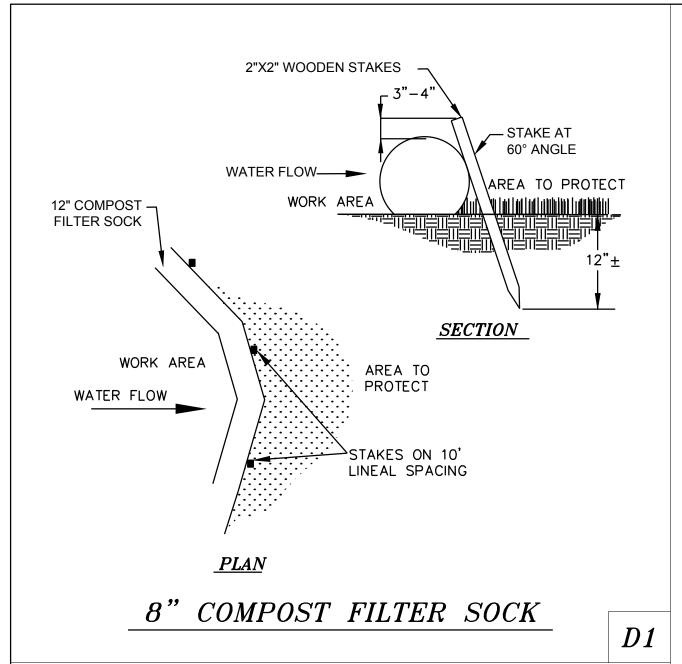
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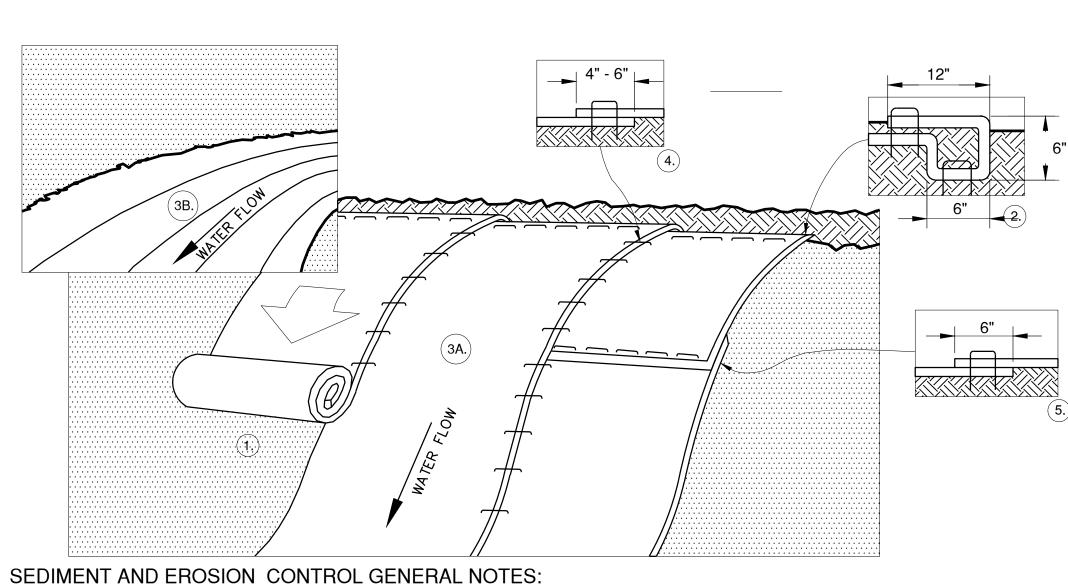
SHEET TITLE:

GRADING PLAN

SHEET NUMBER:

C-200





1. PREPARE SOIL BEFORE INSTALLING BLANKETS, INCLUDING ANY NECESSARY APPLICATION OF LIME, FERTILIZER, AND SEED.

2. BEGIN AT THE TOP OF THE SLOPE BY ANCHORING THE BLANKET IN A 6" DEEP X 6" WIDE TRENCH WITH APPROXIMATELY 12" OF BLANKET EXTENDED BEYOND THE UP-SLOPE PORTION OF THE TRENCH. ANCHOR THE BLANKET WITH A ROW OF STAPLES / STAKES APPROXIMATELY 12" APART IN THE BOTTOM OF THE TRENCH. BACKFILL AND COMPACT THE TRENCH AFTER STAPLING. APPLY SEED TO COMPACTED SOIL AND FOLD REMAINING 12" PORTION OF BLANKET BACK OVER SEED AND COMPACTED SOIL. SECURE BLANKET OVER COMPACTED SOIL WITH A ROW OF STAPLES / STAKES SPACED APPROXIMATELY 12" APART ACROSS THE WIDTH OF THE BLANKET.

3. ROLL THE BLANKETS (A.) DOWN OR (B.) HORIZONTALLY ACROSS THE SLOPE. BLANKETS WILL UNROLL WITH APPROPRIATE SIDE AGAINST THE SOIL SURFACE. ALL BLANKETS MUST BE SECURELY FASTENED TO SOIL SURFACE BY PLACING STAPLES / STAKES IN APPROPRIATE LOCATIONS PER MANUFACTURER'S RECOMMENDATION.

4. THE EDGES OF PARALLEL BLANKETS MUST BE STAPLED WITH MINIMUM 6" OVERLAP. TO ENSURE PROPER SEAM ALIGNMENT, PLACE THE EDGE OF THE OVERLAPPING BLANKET (BLANKET BEING INSTALLED ON TOP) EVEN WITH THE SEAM STITCH ON THE PREVIOUSLY INSTALLED BLANKET.

5. CONSECUTIVE BLANKETS SPLICED DOWN THE SLOPE MUST BE PLACED END OVER END (SHINGLE STYLE) WITH AN APPROXIMATELY 6" OVERLAP. STAPLE THROUGH OVERLAPPED AREA, APPROXIMATELY 12" APART ACROSS ENTIRE BLANKET WIDTH.

6. PLACE STAPLES / STAKES PER MANUFACTURER'S RECOMMENDATION FOR THE APPROPRIATE SLOPE BEING APPLIED.


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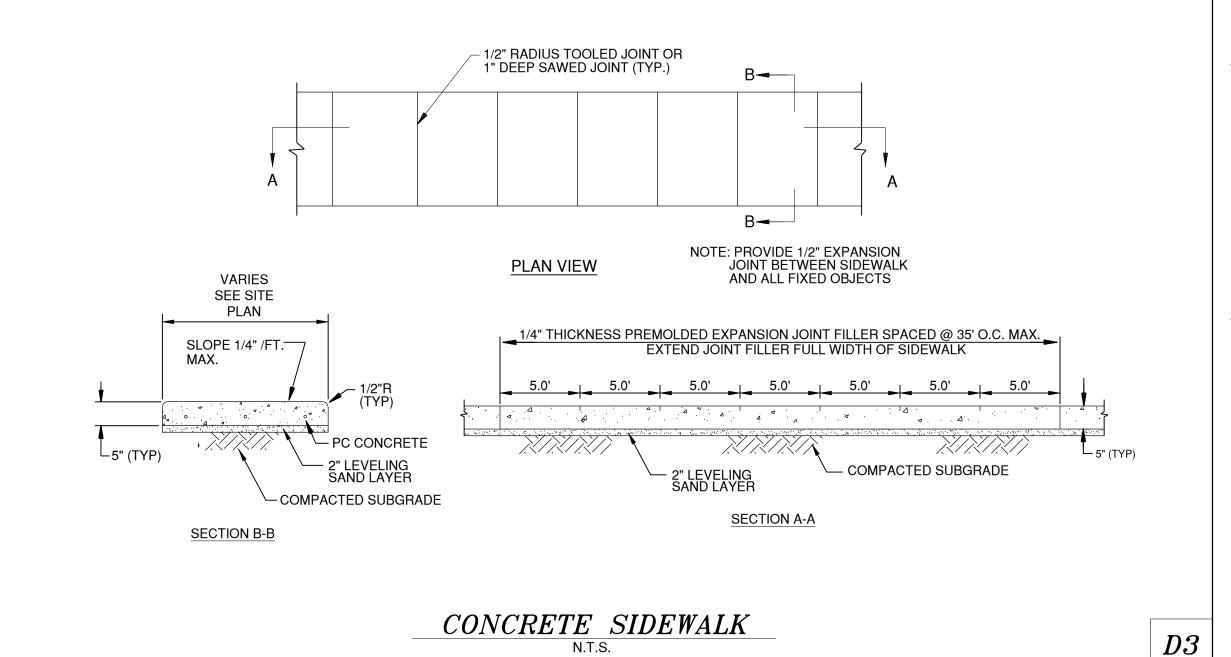
1. IN LOOSE SOIL CONDITIONS, THE USE OF STAPLE/STAKE LENGTHS GREATER THAN 6" MAY BE NECESSARY TO PROPERLY SECURE THE BLANKETS.

2. FOLLOW EROSION CONTROL TECHNOLOGY COUNCIL SPECIFICATIONS FOR PRODUCT SELECTION.

EROSION CONTROL BLANKET

 $\mid D_{\ell}$



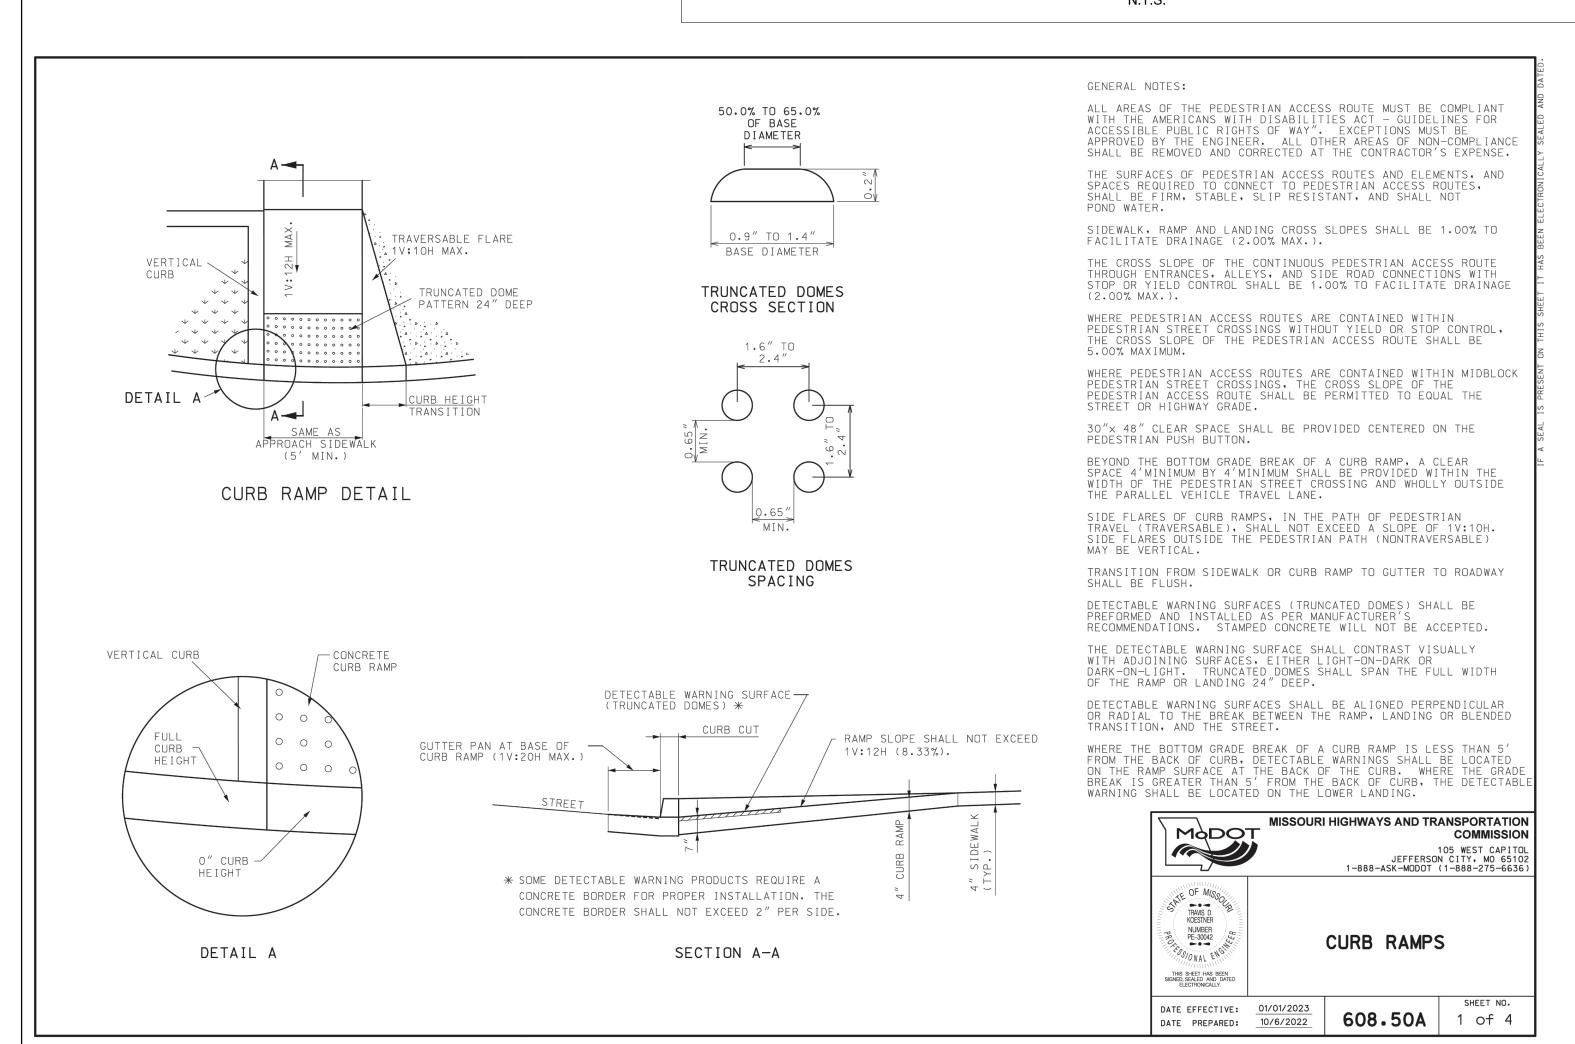

STATE OF MISSOURI MIKE KEHOE, GOVERNOR





OFFICE OF
ADMINISTRATION
DIVISION OF FACILITIES
MANAGEMENT,
DESIGN AND
CONSTRUCTION

MO VETERANS COMMISSION

DESIGN & CONSTRUCT NEW PAVILION
MISSOURI VETERANS HOME

1600 S HICKORY ST. MT VERNON, MISSOURI 65712

PROJECT # U2417-01 SITE # 6905 FACILITY # 8136905001

REVISION:	
DATE:	
REVISION:	
DATE:	
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DATE:	
ISSUE DATE: 06.04.2025	


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DRAWN BY: <u>CMT</u>
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DESIGNED BY: <u>CMT</u>

SHEET TITLE:


SITE DETAILS

SHEET NUMBER:

C-400

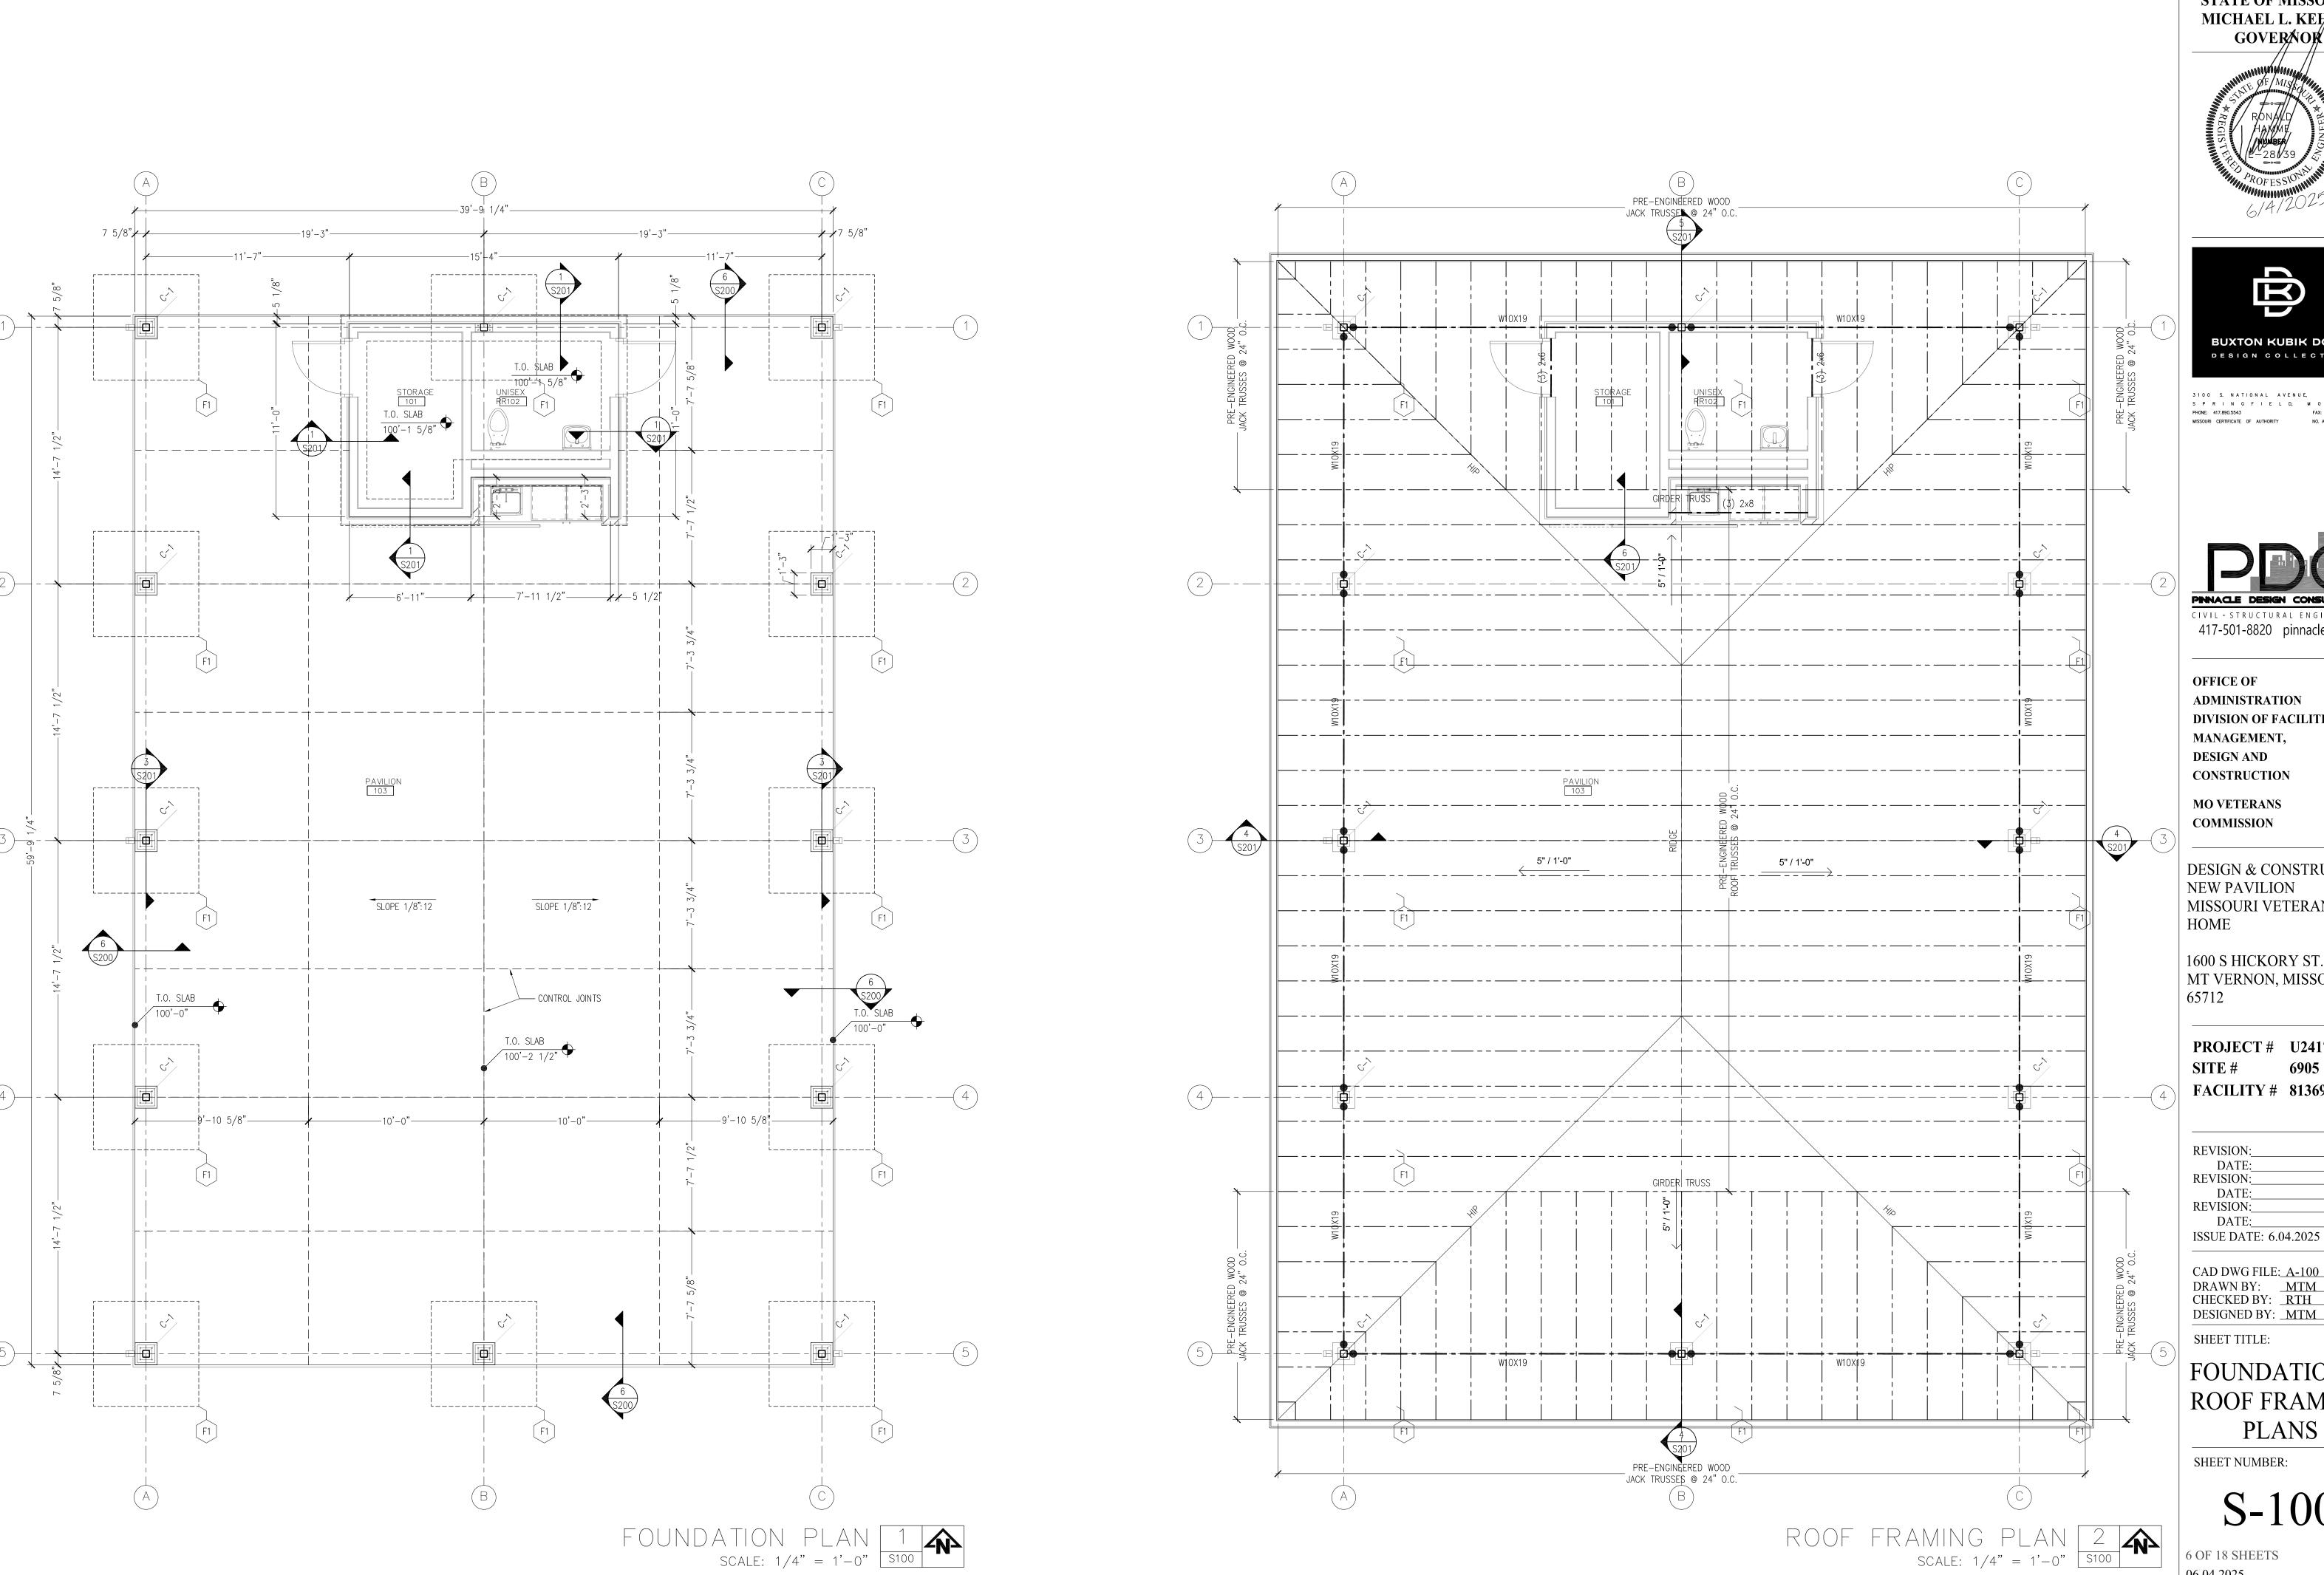

STATE OF MISSOURI MICHAEL L. КЕӉОЕ, GOVERNOR

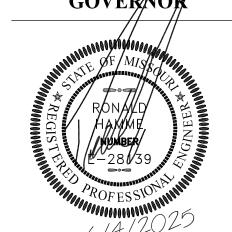



S P R I N G F I E L D, M O 65807 MISSOURI CERTIFICATE OF AUTHORITY NO. A-2006007284



417-501-8820 pinnacledc.com

OFFICE OF **ADMINISTRATION** DIVISION OF FACILITIES MANAGEMENT, **DESIGN AND** CONSTRUCTION

MO VETERANS COMMISSION

DESIGN & CONSTRUCT NEW PAVILION MISSOURI VETERANS

1600 S HICKORY ST. MT VERNON, MISSOURI

PROJECT # U2417-01 FACILITY # 8136905001

REVISION: REVISION: ISSUE DATE: 6.04.2025


DRAWN BY: MTM CHECKED BY: RTH DESIGNED BY: MTM

SHEET TITLE:

FOUNDATION & ROOF FRAMING **PLANS**

SHEET NUMBER:

6 OF 18 SHEETS PECIAL NOTICE: IN THE EVENT THE CLIENT CONSTRUCTION, USE OR RESULTS THEREOF ARE NOT THE RESPONSIBILITY OR FOR THE CONSTRUCTION, USE OR RESULT OF SUCH CHANGES. IN ADDITION, THE CLIENT AGREES TO RELEASE THE DESIGN PROFESSIONAL FROM ANY DIABRET OF THIS DRAWINGS MAY BE REPRODUCED BY PHOTOCOPY OR BY ANY OTHER MEANS, OR STORED, PROCESSED, OR TRANSMITTED IN OR BY ANY OTHER ACCHITECT.

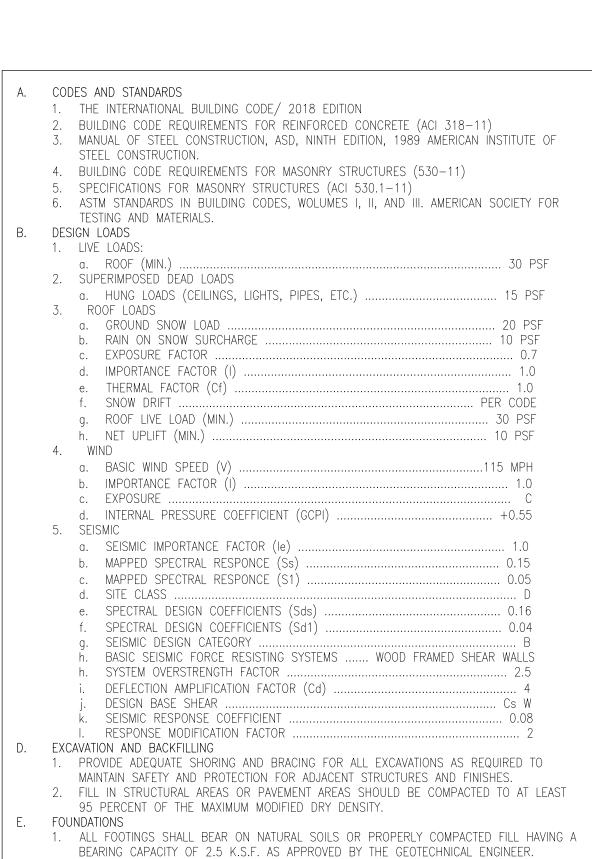

- 2. DEWATERING: PROVIDE PUMPING EQUIPMENT TO KEEP THE EXCAVATION FREE OF WATER BEFORE PLACING CONCRETE. 3. FOOTINGS SHALL NOT BE PLACED IN WATER OR ON FROZEN SOIL 4. FROST PROTECTION: 30" MINIMUM MEASURED FROM BOTTOM OF FOOTING
- 5. THE ARCHITECT AND ENGINEER ASSUME NO RESPONSIBILITY FOR THE VALIDITY OF
- SUBSURFACE CONDITIONS DESCRIBED ON THE DRAWINGS OR IN THE SPECIFICATIONS. THESE DATA ARE INCLUDED ONLY TO ASSIST THE CONTRACTOR DURING BIDDING AND SUBSEQUENT CONSTRUCTION AND REPRESENT CONDITIONS ONLY AT THESE SPECIFIC LOCATIONS AT THE PARTICULAR TIME THEY WERE MADE. CAST-IN-PLACE CONCRETE
- 1. CONCRETE WORK SHALL CONFORM TO THE INTERNATIONAL BUILDING CODE/2012 EDITION, THE ACI BUILDING CODE (ACI 318-11), AND TO THE SPECIFICATIONS. IN CASE OF CONFLICT. THE MOST STRINGENT REQUIREMENTS SHALL GOVERN. 2. ALL STRUCTURAL REINFORCED CONCRETE MEMBERS ARE DESIGNED USING "STRENGTH"
- DESIGN PROVISIONS. 3. CONCRETE WITH MINIMUM 28 DAY COMPRESSIVE STRENGTH SHALL BE USED IN THE
- FOLLOWING AREAS: a. 4,000 PSI NORMAL WIGHT CONCRETE; IN ALL AREAS
- 4. ALL CONSTRUCTION, CONTROL, AND EXPANSION JOINTS SHOWN ON THE DRAWINGS SHALL BE INCORPORATED INTO THE FINAL STRUCTURE UNLESS THE ELIMINATION IS APPROVED BY THE ARCHITECT.
- 5. IF NOT SHOWN ON DRAWING PROVIDE CONTROL JOINTS IN SLABS AT COLUMN LINES, AND MAXIMUM SPACING NOT TO EXCEED 12'-0" BETWEEN JOINTS. 6. ALL KEYS SHALL BE A NOMINAL 2 INCHES BY 4 INCHES UNLESS OTHERWISE NOTED ON
- THE DRAWINGS. 7. CONTRACTOR SHALL SUBMIT TO ARCHITECT, FOR APPROVAL, A SCHEDULE OF FLOOR POURS AT LEAST T20 WEEKS PRIOR TO INITIAL POUR.
- 8. ALL CONCRETE EXPOSED TO THE WEATHER SHALL BE AIR ENTRAINED WITH 5% MIN. AIR. 9. ADD 3" CHAMFER TO EDGES OF ALL CONCRETE EXPOSED TO VIEW. REINFORCING
- 1. ALL REINFORCING BAR DETAILS NOT OTHERWISE SHOWN OR SPECIFIED SHALL CONFORM TO THE LATEST ACI CODE AND DETAILING MANUAL. 2. NEW BILLET STEEL, ASTM A615, GRADE 60 SHALL BE USED FOR REINFORCING FOR ALL
- 3. ALL ACCESSORIES NECESSARY TO MAINTAIN EXACT BAR POSITIONS SHALL BE SHOWN ON REINFORCING SHOP DRAWINGS.
- 4. UNLESS OTHERWISE SPECIFIED IN THE DRAWINGS, THE CONCRETE COVER FOR THE REINFORCING SHALL BE AS FOLLOWS: a. UNIFORM SURFACES IN CONTACT WITH THE GROUND b. FORMED SURFACES IN CONTACT WITH THE GROUND
- 2" UNDER c. SLABS ON GRADE . d. INTERIOR SURFACES OTHER THAN SLABS ... e. IN ALL CASES CLEARANCE NOT LESS THAN THE DIAMETER OF THE BAR. f. MAXIMUM DEVIATION FROM THESE REQUIREMENTS SHALL BE +1/4" FOR SECTIONS 10
- INCHES OR LESS AND +1/2" FOR SECTIONS OVER 10 INCHES. q. LAP SPLICES SEE SCHEDULE ON THIS SHEET. WHERE REINFORCEMENT IS NOT SHOWN ON THE DRAWINGS PROVIDE THE MINIMUM
- REINFORCEMENT PERMITTED BY ACI CODES. WHEN CONSTRUCTION JOINTS, OTHER THAN THOSE SHOWN ON THE DRAWINGS, ARE REQUIRED BY THE CONTRACTOR, THE REINFORCEMENT SHALL RUN CONTINUOUSLY THROUGH THE JOINT AND ADEQUATE SHEAR TRANSFER REINFORCEMENT SHALL BE
- j. FOR SLAB ON METAL DECK, PROVIDE #4 BARS 5'-0" LONG AT 12" ON CENTERS OVER STEEL GIRDERS. (GIRDERS ARE DEFINED AS BEAMS PARALLEL TO DECK SPAN) k. PROVIDE THE EXTRA REINFORCING SHOWN IN TYPICAL DETAILS WHEREVER THE DETAIL CAN APPLY.
- STRUCTURAL STEEL
- 8. ALL STRUCTURAL STEEL ASTM A992, FOR WIDE FLANGE SHAPES, TEES, AND CHANNELS, 9. STRUCTURAL TUBES ASTM A500, TYPE B (Fy = 46 KSI).
- 10. STRUCTURAL PIPES ASTM A53, TYPE E OR S (Fy = 35 KSI). 11. STRUCTURAL STEEL CONNECTIONS SHALL BE COMPLETED BY THE STRUCTURAL STEEL CONTRACTOR. a) MOMENT CONNECTIONS (TYPE 1 RIGID FRAME) SHALL BE DESIGNED AND DETAILED
- SPECIFICALLY NOTED AND APPROVED. b) UNLESS SHOWN OTHERWISE, SHEAR CONNECTIONS SHALL BE A.I.S.C. FRAMED CONNECTIONS OF CAPACITY EQUAL TO ONE HALF OF THE TOTAL UNIFORM LOAD AS SHOWN IN "ALLOWABLE LOADS ON BEAMS" A.I.S.C. MANUAL OF STEEL

TO PROVIDE FULL MOMENT CAPACITY OF THE FRAMING MEMBERS UNLESS

- CONSTRUCTION, BUT NOT LESS THAN A TWO BOLT CONNECTION. CONNECTIONS FOR THE BRACING MEMBERS ETC. SHALL BE DESIGNED FOR 60% OF 2x STUDS @ 16" THE TENSILE CAPACITY OF THE MEMBERS BUT NOT LESS THAN A TWO BOLT
- CONNECTION. 5. ALL BOLTED CONNECTIONS OF STRUCTURAL STEEL TO BE $\frac{3}{4}$ " DIAMETER A325-N UNLESS OTHERWISE NOTED.
- 6. ANCHOR BOLTS SHALL CONFORM TO ASTM A325.
- 7. PAINTING: PRIMER PAINT FOR EXPOSED STRUCTURAL STEEL: SSPC-25. 8. STEEL JOISTS-K SERIES
- 9. STEEL JOIST SUPPLIER IS RESPONSIBLE FOR PROVIDING PROPER JOSTS SEATS FOR ALL JOISTS SHOWN IN THESE DRAWINGS. J. STRUCTURAL WOOD FRAMING

- 1. EXCEPT WHERE NOTED, OTHERWISE ALL 2" LUMBER SHALL BE #2 OR BETTER D.F. AND ALL SOLID TIMBER BEAMS AND POSTS SHALL BE #1 D.F.
- 2. STUDS SHALL BE #2 AND BETTER S.P.F. 3. TOP AND BOTTOM PLATES SHALL BE #2 OR BETTER D.F. PLATES IN CONTACT WITH CONCRETE SHALL BE ACQ. TREATED WOOD SHALL BE G185 CORROSION RESISTANT OR
- 4. EXCEPT AS NOTED, OTHERWISE MINIMUM NAILING SHALL BE PROVIDED AS SPECIFIED IN TABLE NO. 2304.9.1 FASTENING SCHEDULE OF THE CURRENT INTERNATIONAL BUILDING
- 5. 2x6 STUDS SHALL BE NAILED TO TOP PLATE WITH 3-16D END NAILS AND TO SOLE
- PLATE WITH 6-8D TOENAILS OR 3-16D END NAILS. 6. ALL PLYWOOD OR O.S.B. BD. SHEATHING SHALL BE APA RATED EXPOSURE 1. PANEL IDENTIFICATION INDEX AND/OR THICKNESS SHALL BE $\frac{32}{16}$, $\frac{1}{2}$ " MINIMUM, OR AS NOTED ON DRAWINGS
- 7. TRUSSED RAFTERS AND MANUFACTURED JOISTS, AS WELL AS ALL CONNECTIONS, SHALL BE DESIGNED BY A REGISTERED ENGINEER TO SUPPORT THE FULL DEAD AND LIVE LOADS OF THE ROOF, FLOOR, CEILING, AND ANY OTHER SUPERIMPOSED LOADS. WEB ARRANGEMENT AND MEMBER FORCES SHALL BE DETERMINED BY THE TRUSSED RAFTER/JOIST FABRICATOR, STRESSES SHALL NOT EXCEED THOSE ALLOWED BY THE CURRENT INTERNATIONAL BUILDING CODE. LOAD DURATION FACTOR MAY BE 1.15 FOR ROOF TRUSSES ONLY.CALCULATIONS AND SHOP DRAWINGS, INCLUDING MEMBER SIZES, LUMBER SPECIES AND GRADES, AND SUBSTANTIATING DATA FOR CONNECTOR CAPACITIES, SHALL BE SUBMITTED TO THE ARCHITECT FOR REVIEW AND APPROVAL PRIOR TO FABRICATION.
- 8. LEAD HOLES FOR LAG BOLTS SHALL BE DRILLED IN ACCORDANCE WITH TABLE 5.1 OF THE A.I.T.C. TIMBER CONSTRUCTION MANUAL. 9. TEMPORARY CONSTRUCTION LOADS WHICH EXCEED THE DESIGN CAPACITY OF ANY ELEMENT ARE PROHIBITED. ERECTION BRACING SHALL BE PROVIDED TO ASSURE ADEQUATE LATERAL SUPPORT FOR THE INDIVIDUAL ELEMENTS, AS WELL AS THE ENTIRE SYSTEM UNTIL
- SHEATHING IS INSTALLED. (SHEATHING CAN BE EITHER PLYWOOD, OSB, OR GYP-BOARD) WOOD DECKING
- 1. ROOF DECKING SHALL BE \$" PLYWOOD FASTENED WITH 10D NAILS AT 12" ON CENTER AND 6" ON CENTER OVER JOINTS. ROOF TRUSS LOADING
 - DL AT TOP CHORD DL AT BOTTOM CHORD TOTAL DEAD LOAD LIVE LOAD (MINIMUM) 30.0 PSF TOTAL DESIGN LOAD 50.0 PSF
- NET UPLIFT (DUE TO WIND) 10.0 PSF (30 @ 0.H.) O. HEADER SCHEDULE 1. FIRST FLOOR
 - a. SPAN • 3'-0" 4'-0" 5'-0" 6'-0" 7'-0" 8'-0" • (2) 2x6 (2) 2x8 (2) 2x10 (2) 2x12 (3) 2x12 (3) 2x12
- 2. ROOF a. SPAN • 3'-0" 4'-0" 5'-0" 6'-0" 7'-0" 8'-0"
- GROUTS FOR BASEPLATES AND ANCHORS 1. A NON-METALLIC SHRINKAGE RESISTANT GROUT UNDER BASEPLATES AND BEARING PLATES

• (2) 2x6 (2) 2x8 (2) 2x10 (2) 2x12 (2) 2x12 (2) 2x12

- SHALL BE "MASTERFLOW 713" BY MASTER BUILDERS. 2. EPOXY GROUT FOR GROUTING REBARS SHALL BE "SIKADUR 370" BY SIKA CHEMICAL COMPANY, OR APPROVED EQUAL. FOR SURFACE PREPARATION, PROPORTION, MIXING, AND
- APPLICATION, FOLLOW MANUFACTURER'S DIRECTIONS. MISCELLANEOUS CONSTRUCTION NOTES 17. THE CONTRACTOR SHALL VERIFY EXISTING CONDITIONS AND ALL DIMENSIONS IN THE FIELD, AND NOTIFY THE ARCHITECT IF CONDITIONS ENCOUNTERED ARE NOT AS SHOWN ON
- 18. CONSULT ARCHITECTURAL, MECHANICAL, AND ELECTRICAL DRAWINGS FOR VERIFICATION OF THE LOCATION AND DIMENSIONS OF THE CHASES, INSERTS, OPENINGS, SLEEVES, WASHES,
- DRIPS, REVEALS, DEPRESSIONS, AND OTHER PROJECT REQUIREMENTS NOT SHOWN ON THE STRUCTURAL DRAWINGS.
- 19. NO CHANGE IN SIZE OR DIMENSIONS OF MEMBERS SHALL BE MADE, NOR ANY OPENINGS OR SLEEVES SHALL BE PERMITTED THROUGH ANY STRUCTURAL MEMBERS WITHOUT THE APPROVAL OF THE ARCHITECT.
- 20. OPENINGS IN SLABS OR WALLS LESS THAN 12" IN DIAMETER ARE NOT GENERALLY SHOWN.
- 21. FURNISH AND INSTALL ALL SUPPORTS, TEMPORARY AND PERMANENT, NECESSARY TO BRACE WALLS, EXISTING ADJACENT STRUCTURES, AND GRADE SO THAT NO HORIZONTAL OR VERTICAL SETTLEMENT OCCURS TO THESE WALLS. STRUCTURES OR GRADES. BRACING SHALL BE LEFT IN PLACE UNTIL PERMANENT SUPPORTS ARE INSTALLED.
- 22. WHERE DETAIL IS NOT SHOWN ON THE DRAWINGS, FOR SUCH A SITUATION, THE DETAIL SHALL BE ASSUMED IN ACCORDANCE WITH APPLICABLE DETAILS OR SIMILAR TO THA SHOWN FOR MOST NEARLY SIMILAR SITUATIONS, AS DETERMINED BY THE ARCHITECT. CONTRACTOR SHALL PROVIDE A COMPLETE FUNCTIONAL SYSTEM WHETHER OR NOT A PARTICULAR ELEMENT IS SPECIFICALLY CALLED OUT
- 23. CONTRACTORS AND SUBCONTRACTORS SHALL THOROUGHLY REVIEW ALL CONDITIONS AND RESPONSIBILITIES STATED IN THESE NOTES, PLANS, SECTIONS, AND DETAILS, AND SHALL NOTIFY THE ENGINEER AND ARCHITECT IN WRITING PRIOR TO BIDDING OF ANY DISCREPANCIES, CONFLICTS, ERRORS, OR OMISSIONS FOUND ON THE PLANS. IF CONTRACTOR FAILS TO NOTIFY SAID REPRESENTATIVES, HE/SHE SHALL BE RESPONSIBLE FOR ALL COST OF LABOR AND MATERIALS NEEDED.

FIELD NAILING W/ 8d

NAILS REF. SHEARWALL

NOTES —

HEADER

LAP TOP PL 4'-0"

- (2)2x TOP PLATE

| PROVIDE STUDS @

| VERT. SHEATHING

STAGGERED, TYP


| JOINTS, TYP.

TREATED SILL PLATE


PROVIDE BLOCKING @

HEADER


SPLICE

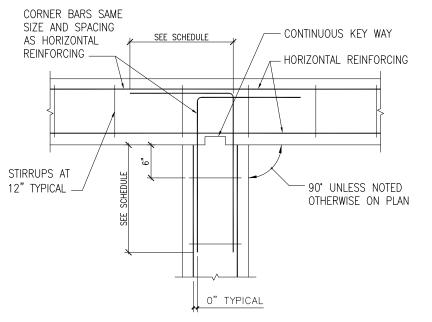


GRADE BEAM INTERSECTION REINFORCING

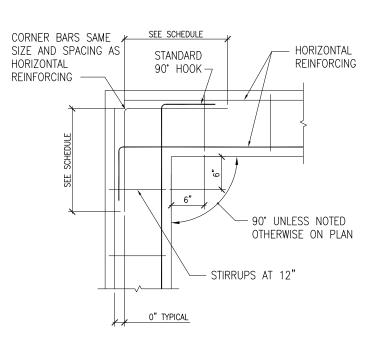

GRADE BEAM CORNER REINFORCING

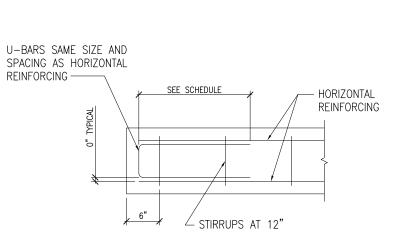

GRADE BEAM END REINFORCING

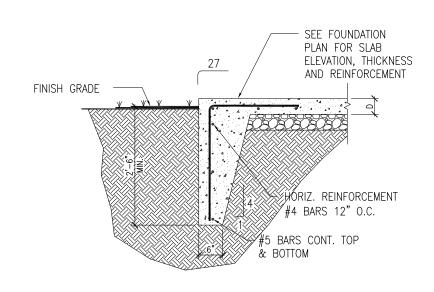


TYPICAL EDGE DETAIL (EXTERIOR SLAB ON GRADE)


	MICO LIN	TFL SCHEDUL	
	MISC. LIIV	TEL SCHEDULI	_
MAXIMUM MASONRY	W	ALL THICKNESS - NOM.	
OPENING	4" WALLS	6" WALLS	8" WALLS
3'-0"	L-3x2 1/2x1/4"	(2)L-3x2 1/2x1/4"	(2)L-3 1/2x3 1/2x1/4"
4'-0"	L-3x2 1/2x1/4"	(2)L- 3x2 1/2x1/4"	(2)(2) 2x10x3 1/2x1/4"
5'-0"	L-3 1/2x2 1/2x1/4"	(2)L-3 1/2x2 1/2x1/4"	(2)(2) 2x10x3 1/2x1/4"
6'-0"	L-3 1/2x2 1/2x1/4"	(2)L-3 1/2x2 1/2x1/4"	(2)L-5x3 1/2x1/4"
8'-0"	L-3 1/2x2 1/2x1/4"	(2)L- 3 1/2x2 1/2x1/4"	(2)L-6x3 1/2x1/4"

2. WHERE LINTELS OCCUR IN EXTERIOR WALLS, MINIMUM THICKNESS OF ANGLES SHALL BE 5/16". LINTELS SHALL BEAR AT LEAST 6" (8" FOR OPENINGS OVER 6'-0" WIDE) AT EACH SIDE OF THE MASONRY OPENING. WHERE SUCH BEARING CANNOT BE

SCHEDULE OF SPLICE AND EMBEDMENT LENG						, IH2				
f'c =3,000 PSI				ВА	R SI	ZE				
fy = 60,000 PSI	#3	#4	#5	#6	#7	#8	#9	#10	#11	
COMPRESSION SPLICE	CE	(L)	•	•						+ L
ALL BARS	12	15	19	23	26	30	34	38	42	- '' -
TENSION SPLICE (L)									
BEAM TOP BARS AND WALL HORIZONTAL BARS	28	38	47	56	81	93	105	118	131	_+
STRAIGHT BARS	22	29	36	43	63	72	81	91	101	
EMBEDMENT (E)										+ E
STRAIGHT TOP BARS	22	29	36	43	63	72	81	91	101	
STRAIGHT BARS	17	22	28	33	48	55	62	70	78	+ E
HOOKED BARS	6	8	10	12	14	16	18	20	22	ACI STANDARD H
	6	8			14	16	18		22	

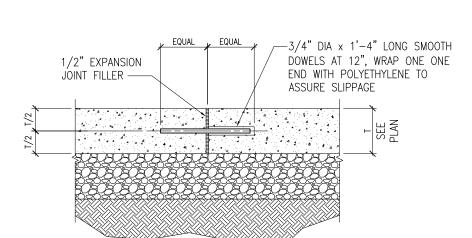

CONCRETE SLAB EXPANSION JOINT

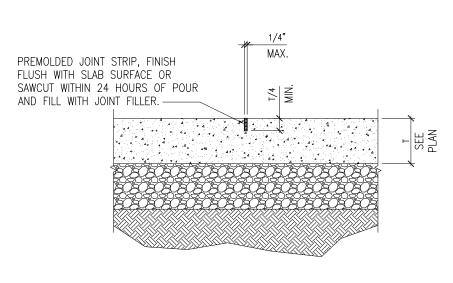

CONCRETE SLAB CONTROL JOINT

MISC. LINTEL SCHEDULE						
MAXIMUM MASONRY	W	ALL THICKNESS — NOM.				
OPENING	4" WALLS	6" WALLS	8" WALLS			
3'-0"	L-3x2 1/2x1/4"	(2)L-3x2 1/2x1/4"	(2)L-3 1/2x3 1/2x1/4"			
4'-0"	L-3x2 1/2x1/4"	(2)L- 3x2 1/2x1/4"	(2)(2) 2x10x3 1/2x1/4"			
5'-0"	L-3 1/2x2 1/2x1/4"	(2)L-3 1/2x2 1/2x1/4"	(2)(2) 2x10x3 1/2x1/4"			
6'-0"	L-3 1/2x2 1/2x1/4"	(2)L-3 1/2x2 1/2x1/4"	(2)L-5x3 1/2x1/4"			
8'-0"	L-3 1/2x2 1/2x1/4"	(2)L- 3 1/2x2 1/2x1/4"	(2)L-6x3 1/2x1/4"			

UNLESS OTHERWISE NOTED ON DRAWINGS, PROVIDE AND INSTALL LINTELS WITH LONG-LEGS VERTICALLY FOR MASONRY OPENINGS WHERE REQUIRED AND PER

PROVIDED, ATTACHED SECURELY TO ADJACENT STRUCTURAL MEMBERS OR PROVIDE

BEING FORMED.					
REQUIRE	TABL ED VERIFICATION	E 1704.7 I AND INSPECTI	ON OF SO	ILS	
VERIFICATION AND INSPECTION TASK	CONTINUOUS	DURING TASK L	ISTED	PERIODICALLY DUR	ING TASK LIST
VERIFY MATERIALS BELOW FOOTINGS ARE ADEQUATE TO ACHIEVE THE DESIGN BEARING CAPACITY.				х	
2. VERIFY EXCAVATIONS ARE EXTENDED TO PROPER DEPTH AND HAVE REACHED PROPER MATERIAL.				Х	
3. PERFORM CLASSIFICATION AND TESTING OF CONTROLLED FILL MATERIALS.				Х	
4. VERIFY USE OF PROPER MATERIALS, DENSITIES AND LIFT THICKNESSES DURING PLACEMENT AND COMPACTION OF CONTROLLED FILL.		X			
5. PRIOR TO PLACEMENT OF CONTROLLED FILL, OBSERVE SUBGRADE AND VERIFY THAT SITE HAS BEEN PREPARED PROPERLY.				X	

TABLE 1704.4

REQUIRED VERIFICATION AND INSPECTION OF CONCRETE CONSTRUCTION

CONTINUOUS | PERIODIC

REQUIRED VERIFICATION AND INSPECTION OF STEEL CONSTRUCTION

REFERENCED STANDARD

APPLICABLE ASTM MATERIAL

SPECIFICATIONS; AISC 360,

SECTION 3.3

AISC 360, SECTION M2.5

ASTM A 6 OR ASTM A 568

ASTM A 6 OR ASTM A 568

AISC 360, SECTION A3.5

AWS D1.1

AWS D1.3

AWS D1.4

ACI 318: 3.5.2

REFERENCED STANDARD

AWS D1.4

ACI 318:3.5.2

ACI 318: CH 4, 5.2-5.4

ASTM C 172

ACI 318: 5.6, 5.8

ACI 318: 5.9, 5.10

ACI 318: 5.11-5.13

ACI 318: 18.20

ACI 318: 18.18.4

ACI 318: CH. 16

ACI 318: 6.2

ACI 318: 6.1.1

ASTM C 31

1708.4

1704.3.1

1704.3.2

1911.5

1913.10

CONTINUOUS | PERIODIC

VERIFICATION AND INSPECTION

a. IDENTIFICATION OF MARKINGS TO

CONFORM TO ASTM STANDARDS

b. MANUFACTURER'S CERTIFICATE

a. BEARING-TYPE CONNECTIONS

b. SLIP-CRITICAL CONNECTIONS

a. IDENTIFICATION MARKINGS TO

b. MANUFACTURERS' CERTIFIED MILL

a. IDENTIFICATION MARKINGS TO

THE APPROVED CONSTRUCTION

CONFORM TO AWS SPECIFICATION IN

b. MANUFACTURER'S CERTIFICATE OF

1) COMPLETE AND PARTIAL

PENETRATION GROOVE WELDS.

3) SINGLE-PASS FILLET WELDS >

4) SINGLE-PASS FILLET WELDS ≤

5) FLOOR AND ROOF DECK WELDS.

1) VERIFICATION OF WELDABILITY

2) REINFORCING STEEL-RESISTING

MOMENT FRAMES, AND BOUNDARY

ELEMENTS OF SPECIAL REINFORCED

CONCRETE SHEAR WALLS AND SHEAR

FLEXURAL AND AXIAL FORCES IN

INTERMEDIATE AND SPECIAL

3) SHEAR REINFORCEMENT

a. DETAILS SUCH AS BRACING AND

c. APPLICATION OF JOINT DETAILS AT

VERIFICATION AND INSPECTION

4) OTHER REINFORCING STEEL

OF REINFORCING STEEL OTHER THAN

2) MULTIPASS FILLET WELDS.

CONFORM TO ASTM STANDARDS

SPECIFIED IN THE APPROVED

CONSTRUCTION DOCUMENTS.

4. MATERIAL VERIFICATION OF WELD

COMPLIANCE REQUIRED.

a. STRUCTURAL STEEL

b. REINFORCING STEEL

REINFORCEMENT.

6. INSPECTION OF STEEL FRAME

JOINT DETAILS FOR COMPLIANCE

WITH APPROVED CONSTRUCTION

b. MEMBER LOCATIONS.

EACH CONNECTION.

I. INSPECTION OF REINFORCING

TENDONS, AND PLACEMENT

TABLE 1704.3, ITEM 5b

DESIGN MIX

OF THE CONCRETE.

AND TECHNIQUES

2. INSPECTION OF REINFORCING

STEEL WELDING IN ACCORDANCE W/

3. INSPECT BOLTS TO BE INSTALLED IN

ALLOWABLE LOADS HAVE BEEN INCREASED

CONCRETE PRIOR TO AND DURING

PLACEMENT OF CONCRETE WHERE

4. VERIFYING USE OF REQUIRED

5. AT THE TIME FRESH CONCRETE IS

SAMPLED TO FABRICATE SPECIMENS

AND DETERMINE THE TEMPERATURE

SHOTCRETE PLACEMENT FOR PROPER

7. INSPECTION FOR MAINTENANCE OF

b. GROUTING OF BONDED

8. INSPECTION OF PRESTRESSED CONCRETE:

PRESTRESSING TENDONS IN THE

SEISMIC-FORCE-RESISTING SYSTEM

9. ERECTION OF PRECAST CONCRETE MEMBERS

IN POSTTENSIONED CONCRETE AND PRIOR TO

REMOVAL OF SHORES AND FORMS FROM BEAMS

11. INSPECT FORMWORK FOR SHAPE, LOCATION

AND DIMENSIONS OF THE CONCRETE MEMBER

10. VERIFICATION OF IN-SITU CONCRETE STRENGTH, PRIOR TO STRESSING OF TENDONS

a. APPLICATION OF PRESTRESSING FORCES.

SPECIFIED CURING TEMPERATURE

6. INSPECTION OF CONCRETE AND

APPLICATION TECHNIOUES

AND STRUCTURAL SLABS.

FOR STRENGTH TESTS, PERFORM

SLUMP AND AIR CONTENT TESTS,

DOCUMENTS:

ASTM A 706

SPECIFIED IN THE APPROVED

CONSTRUCTION DOCUMENTS

OF COMPLIANCE REQUIRED

. INSPECTION OF HIGH-STRENGTH

3. MATERIAL VERIFICATION OF

TEST REPORTS

FILLER MATERIALS.

DOCUMENTS

INSPECTION OF WELDING:

STRUCTURAL STEEL:

BOLTING:

1. MATERIAL VERIFICATION OF HIGH STRENGTH BOLTS, NUTS, AND

MICHAEL L. KEHOE, IBC REFERENCE GOVERNOR

STATE OF MISSOURI



3100 S. NATIONAL AVENUE, SUITE 300 SPRINGFIELD, MO 65807 MISSOURI CERTIFICATE OF AUTHORITY



OFFICE OF **ADMINISTRATION DIVISION OF FACILITIES** MANAGEMENT **DESIGN AND CONSTRUCTION**

MO VETERANS **COMMISSION**

DESIGN & CONSTRUCT NEW PAVILION MISSOURI VETERANS HOME

1600 S HICKORY ST. MT VERNON, MISSOURI 65712

PROJECT # U2417-01 FACILITY # 8136905001

REVISION: REVISION DATE **REVISION:** ISSUE DATE: 6.04.2025

> CAD DWG FILE: A-100 DRAWN BY: _MTM CHECKED BY: RTH DESIGNED BY: MTM

SHEET TITLE:

GENERAL

SHEET NUMBER

7 OF 18 SHEETS SPECIAL NOTICE: IN THE EVENT THE CLIENT CONSENST OF THE CLIENT CONSENST TO, ALLOWS, AUTHORIZES OR APPROVES OF CHANGES. TO ANY PLANS, SPECIFICATION, USE OR RESULTS THEREOF ARE NOT THE DESIGN PROFESSIONAL, THE CLIENT AGREES TO THE FULLEST EXTENT PERMITTED BY LAW, TO INDEMNIFY AND THE DESIGN PROFESSIONAL FROM ANY LIABILITY ARISING FROM THE CONSTRUCTION, USE OR RESULTS THEREOF ARE NOT THE DESIGN PROFESSIONAL, THE CLIENT AGREES TO THE FULLEST EXTENT PERMITTED BY LAW, TO INDEMNIFY AND THE MEANS, OR STORED, PROCESSED, OR TRANSMITTED IN OR BY ANY COMPUTER OR OTHER SYSTEMS WITHOUT THE PRIOR WRITTEN PERMISSION OF THE ARCHITECT.

HORIZ. SHEATHING JOINTS -FRAMING/SHEARWALL TYP. DETAIL

CORNERS -

(2)16d FA. STUD.

ADD 1-10d TOENAII

EA. SIDE FOR STUDS

OVER 12'-0" LONG

(4)16d @ CORNER

LAPS & CROSSWALL

16d @ 16" O.C.

EDGE NAILING W/ 8d

SHEARWALL NOTES. -

CRIPPLE STUDS PER

HEADER SCHEDULE AND

#2 TREATED SOUTHERN YELLOW

OPENINGS; 2 BOLTS/BOARD MIN.

PINE SILL PLATE W/ 5/8"

ANCHOR BOLT BETWEEN

(MAX. = 4' 0.C.)12" FROM

ONE KING STUD, TYP.

STAGGERED -

NAILS REF.

U.N.O. ____

O.C., MAX.

LAPS OF TOP PLATES

COMBINED PLAN NOTE

SLAB ON GRADE CONSTRUCTION = 4" NORMAL WEIGHT CONCRETE W/ 4x4 W2.9xW2.9 W.W.F. OVER 10 MIL VAPOR BARRIER OVER 4" MIN. COMPACTED GRANULAR FILL


- . T.O. SLAB IS 100' 0" U.N.O. REFERENCE CIVIL DRAWINGS FOR ACTUAL ELEVATION
- 3. BEARING ELEVATIONS:
- 3. ◆ T.O. CONCRETE SLAB = 100' 0" 3. ◆ 2ND FLOOR JOIST BRG = 110' - 0"
- . ROOF CONSTRUCTION: PRE-ENGINEERED WOOD GAMBREL TYPE ROOF TRUSSES @ 24"
- 5. FOR TYPICAL FOUNDATION AND FRAMING DETAILS REFER TO SHEETS \$2.2
- 6. FOR GENERAL NOTES, SPECIAL INSPECTIONS AND DETAILS REFER TO SHEETS S2.1
- 7. REFER TO ARCHITECTURAL DRAWINGS FOR DIMENSIONS NOT SHOWN.
- 3. COORDINATE WORK WITH OTHER TRADES, EQUIPMENT FURNISHED BY OTHERS, REQUIREMENTS OF THE TENANT AND LANDLORD/BUILDING OWNER, AND THE CONSTRAINTS OF THE EXISTING CONDITIONS OF THE PROJECT SITE. COORDINATE THE INSTALLATION WITH OTHER TRADES AS REQUIRED TO ENSURE A NEAT AND ORDERLY INSTALLATION. NOTIFY ARCHITECT/ENGINEER OF ANY DISCREPANCIES BEFORE STARTING WORK.
- O. GENERAL CONTRACTOR AND SUB-CONTRACTORS SHALL CAREFULLY REVIEW THE CONSTRUCTION DOCUMENTS. INFORMATION REGARDING THE COMPLETE WORK IS DISPERSED THROUGHOUT THE DOCUMENT SET AND CANNOT BE ACCURATELY DETERMINED WITHOUT REFERENCE TO THE COMPLETE DOCUMENT SET.
- 10. ALL ROOF TOP UNIT DIMENSIONS SHALL BE COORDINATED BY THE G.C. THE CURB MANUFACTURER IS TO PROVIDE HVAC AND ROOF TOP EQUIPMENT UPLIFT RESTRAINT BRACKET FOR APPLICABLE WIND SPEED.
- 11. ALL ROOF PENETRATIONS, DIMENSIONED AND NON—DIMENSIONED, ARE SUBJECT TO CHANGE DUE TO FIELD CONDITIONS. COORDINATE LOCATIONS WITH GENERAL CONTRACTOR AND OTHER TRADES PRIOR TO PENETRATING ROOF.
- 12. SHEAR WALLS: ALL EXTERIOR WALLS TO BE SHEAR WALLS. INTERIOR SHEAR WALLS AS LOCATED ON PLANS. PROVIDE BLOCKING AT ALL PANEL JOINTS.
- 13. FOR NEW LINTELS REFER TO SCHEDULE ON SHEET S200
- 14. PROVIDE 7/16" O.S.B. CEILING AT BOTTOM CHORD OF TRUSS. PROVIDE BLOCKING AT JOINTS. FASTEN W/ 10D NAILS @ 6" O.C. ALONG JOINTS & 12" O.C. ELSEWHERE
- DENOTES FULL-PENETRATION, FULL-PERIMETER MOMENT WELD.

	SPREAD FOOTING SCHEDULE						
FOOTING	WIDTH	LENGTH	DEPTH	REINFORCING			
F1	6' - 0"	6' - 0"	24"	(6) #5 BARS EACH WAY. TOP & BOTTOM			

	WALL FOOTING SCHEDULE						
FOOTING	WIDTH	DEPTH	REINFORCING				
WF1	18"	24"	(2) #5 LONGITUDINAL BARS. TOP & BOTTOM & #4 TRANSVERSE TIES @ 16" O.C.				


	COLUMN SCHEDULE							
COLUMN	SIZE	BASEPLATE (WxLxT)	ANCHOR ROD	EMBEDMENT				
C-1	5 x 5 x ¼ T.S.	12" x 12" x $\frac{3}{4}$ " OR 12" x $5\frac{1}{2}$ " x $\frac{3}{4}$ "	(4) <u>3</u> " DIA.	12"				

	HEADER / BEAM SCHEDULE						
ВЕАМ	BEAM TYPE	COMMENTS					
H-1	10 x 5 x ¼" TUBE STEEL	FULL-PERIMETER, FULL-PENETRATION MOMENT WELD TO COLUMN					
H-2	(3) 2x6						
H-3	(3) 2x8						

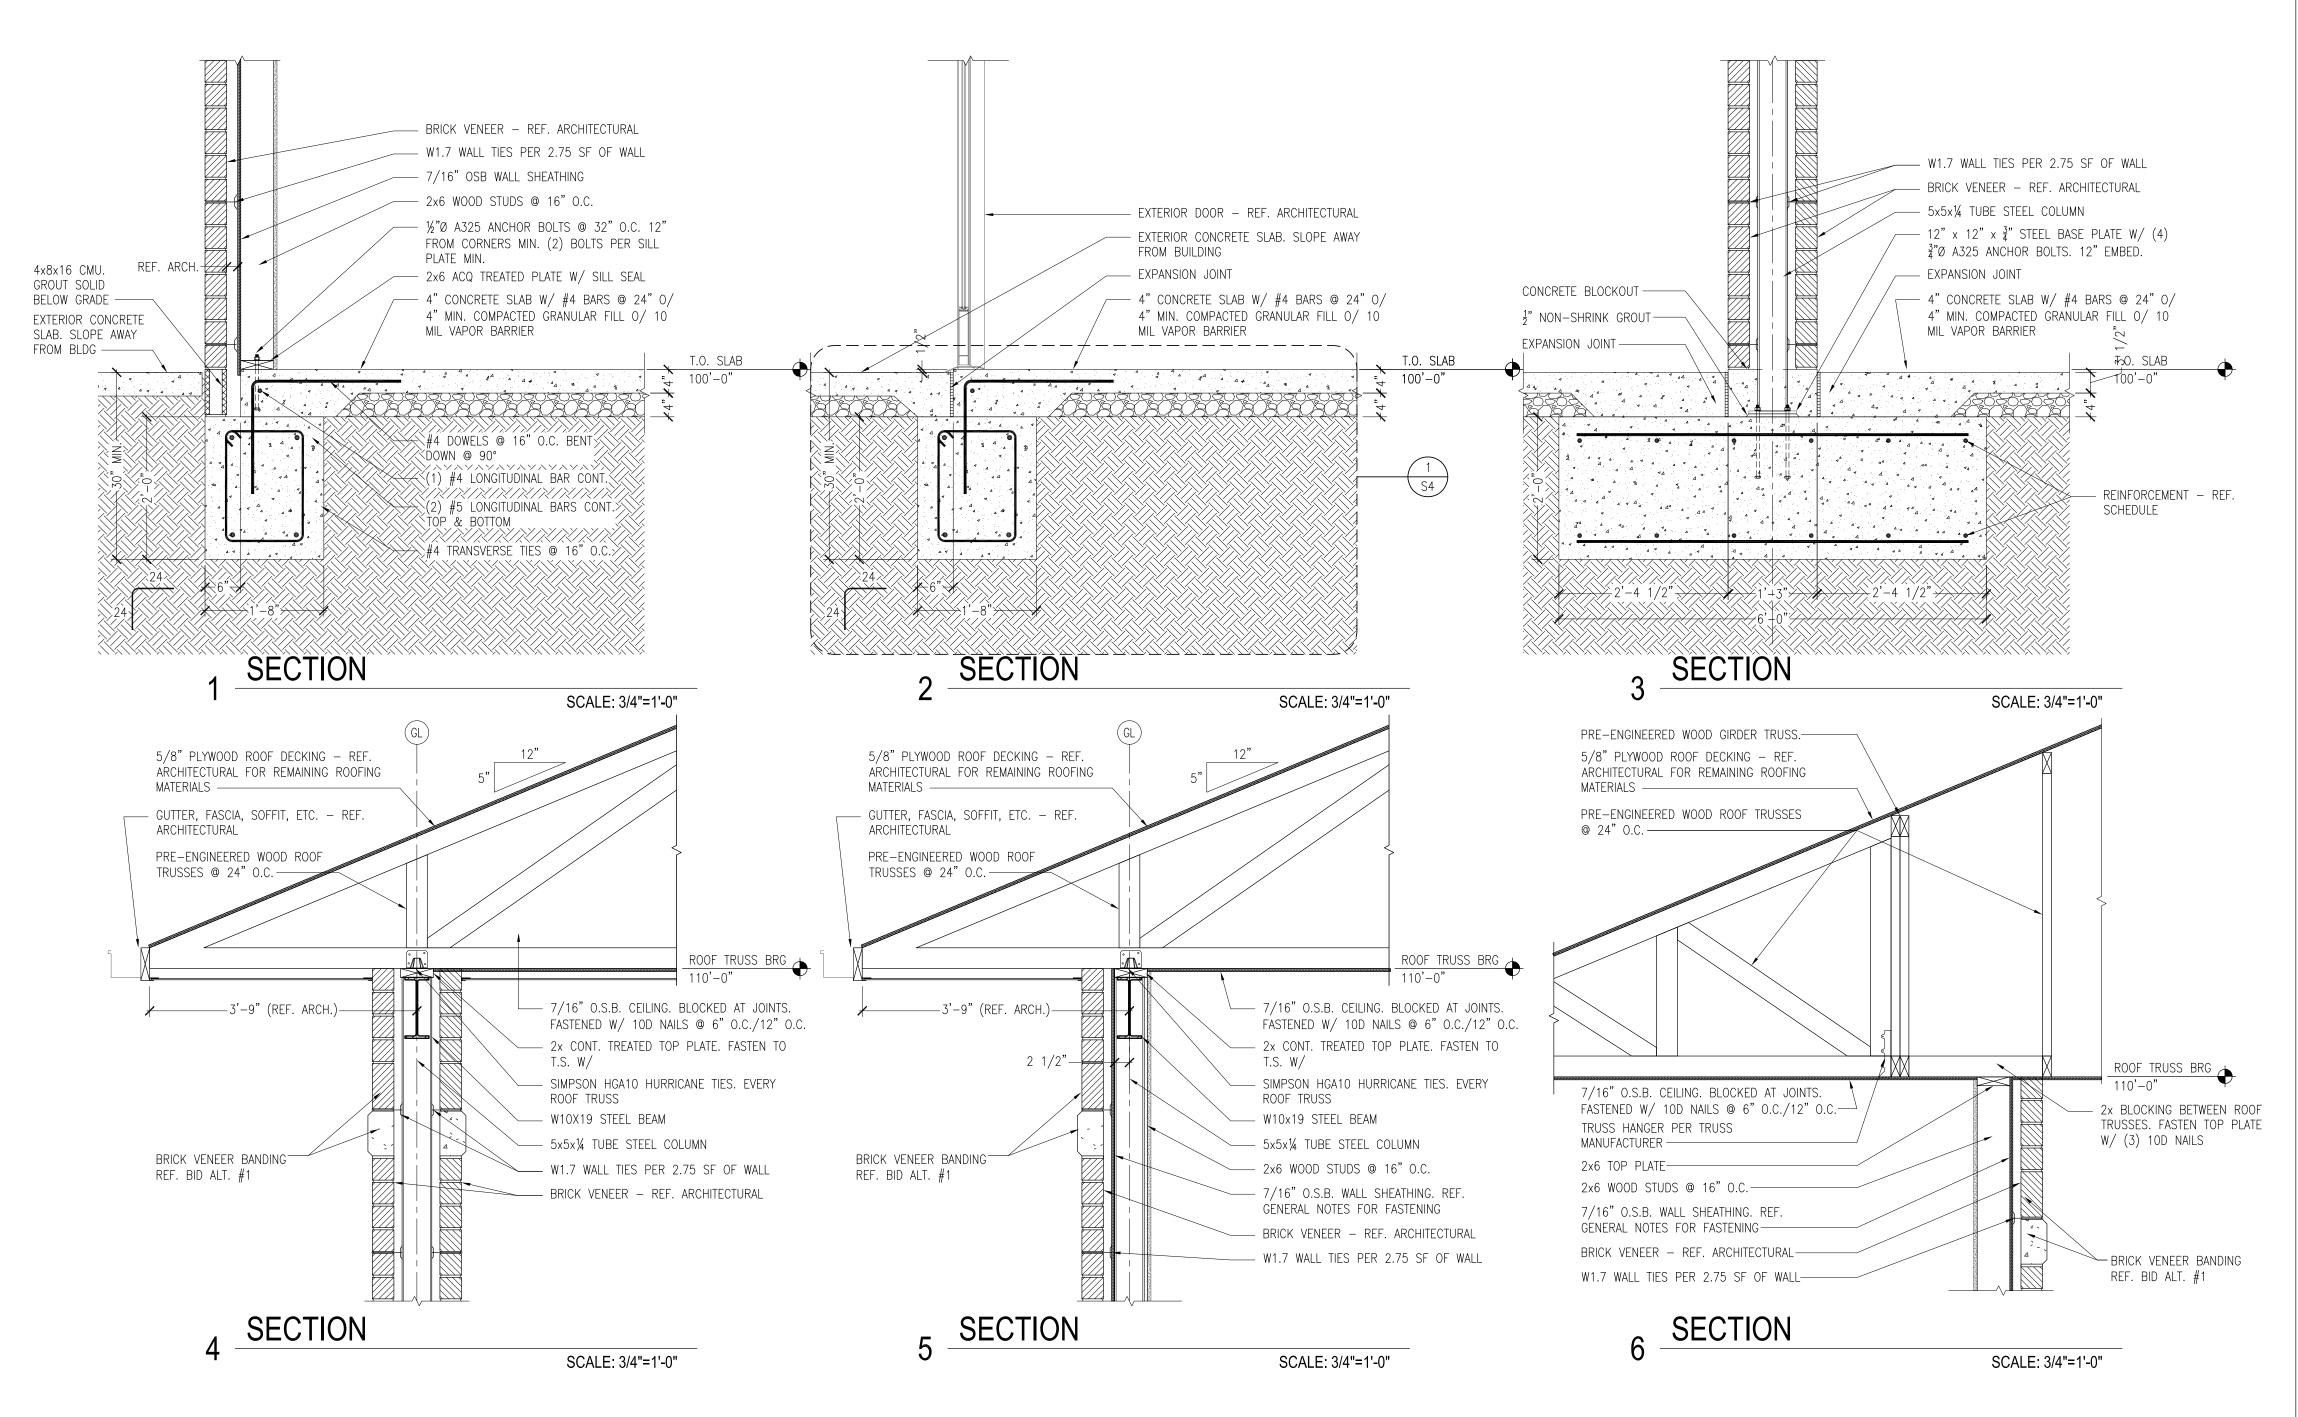

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 S.
 N A T I 0 N A L
 A V E N U E,
 S U I T E 3 0 0

 S P R I N G F I E L D,
 M 0 6 5 8 0 7

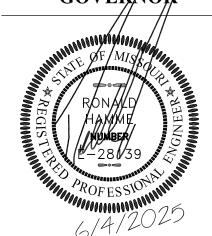 PHONE:
 417.890.5563

 MISSOURI
 CERTIFICATE OF AUTHORITY
 NO. A=2006007284



OFFICE OF
ADMINISTRATION
DIVISION OF FACILITIES
MANAGEMENT,
DESIGN AND
CONSTRUCTION

MO VETERANS COMMISSION

DESIGN & CONSTRUCT NEW PAVILION MISSOURI VETERANS HOME

1600 S HICKORY ST. MT VERNON, MISSOURI 65712

PROJECT # U2417-01 SITE # 6905 FACILITY # 8136905001

REVISION:
DATE:
REVISION:
DATE:
REVISION:
DATE:
REVISION:
DATE:
ISSUE DATE: 6.04.2025

CAD DWG FILE: A-100
DRAWN BY: MTM
CHECKED BY: RTH
DESIGNED BY: MTM


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DETAILS

SHEET NUMBER:

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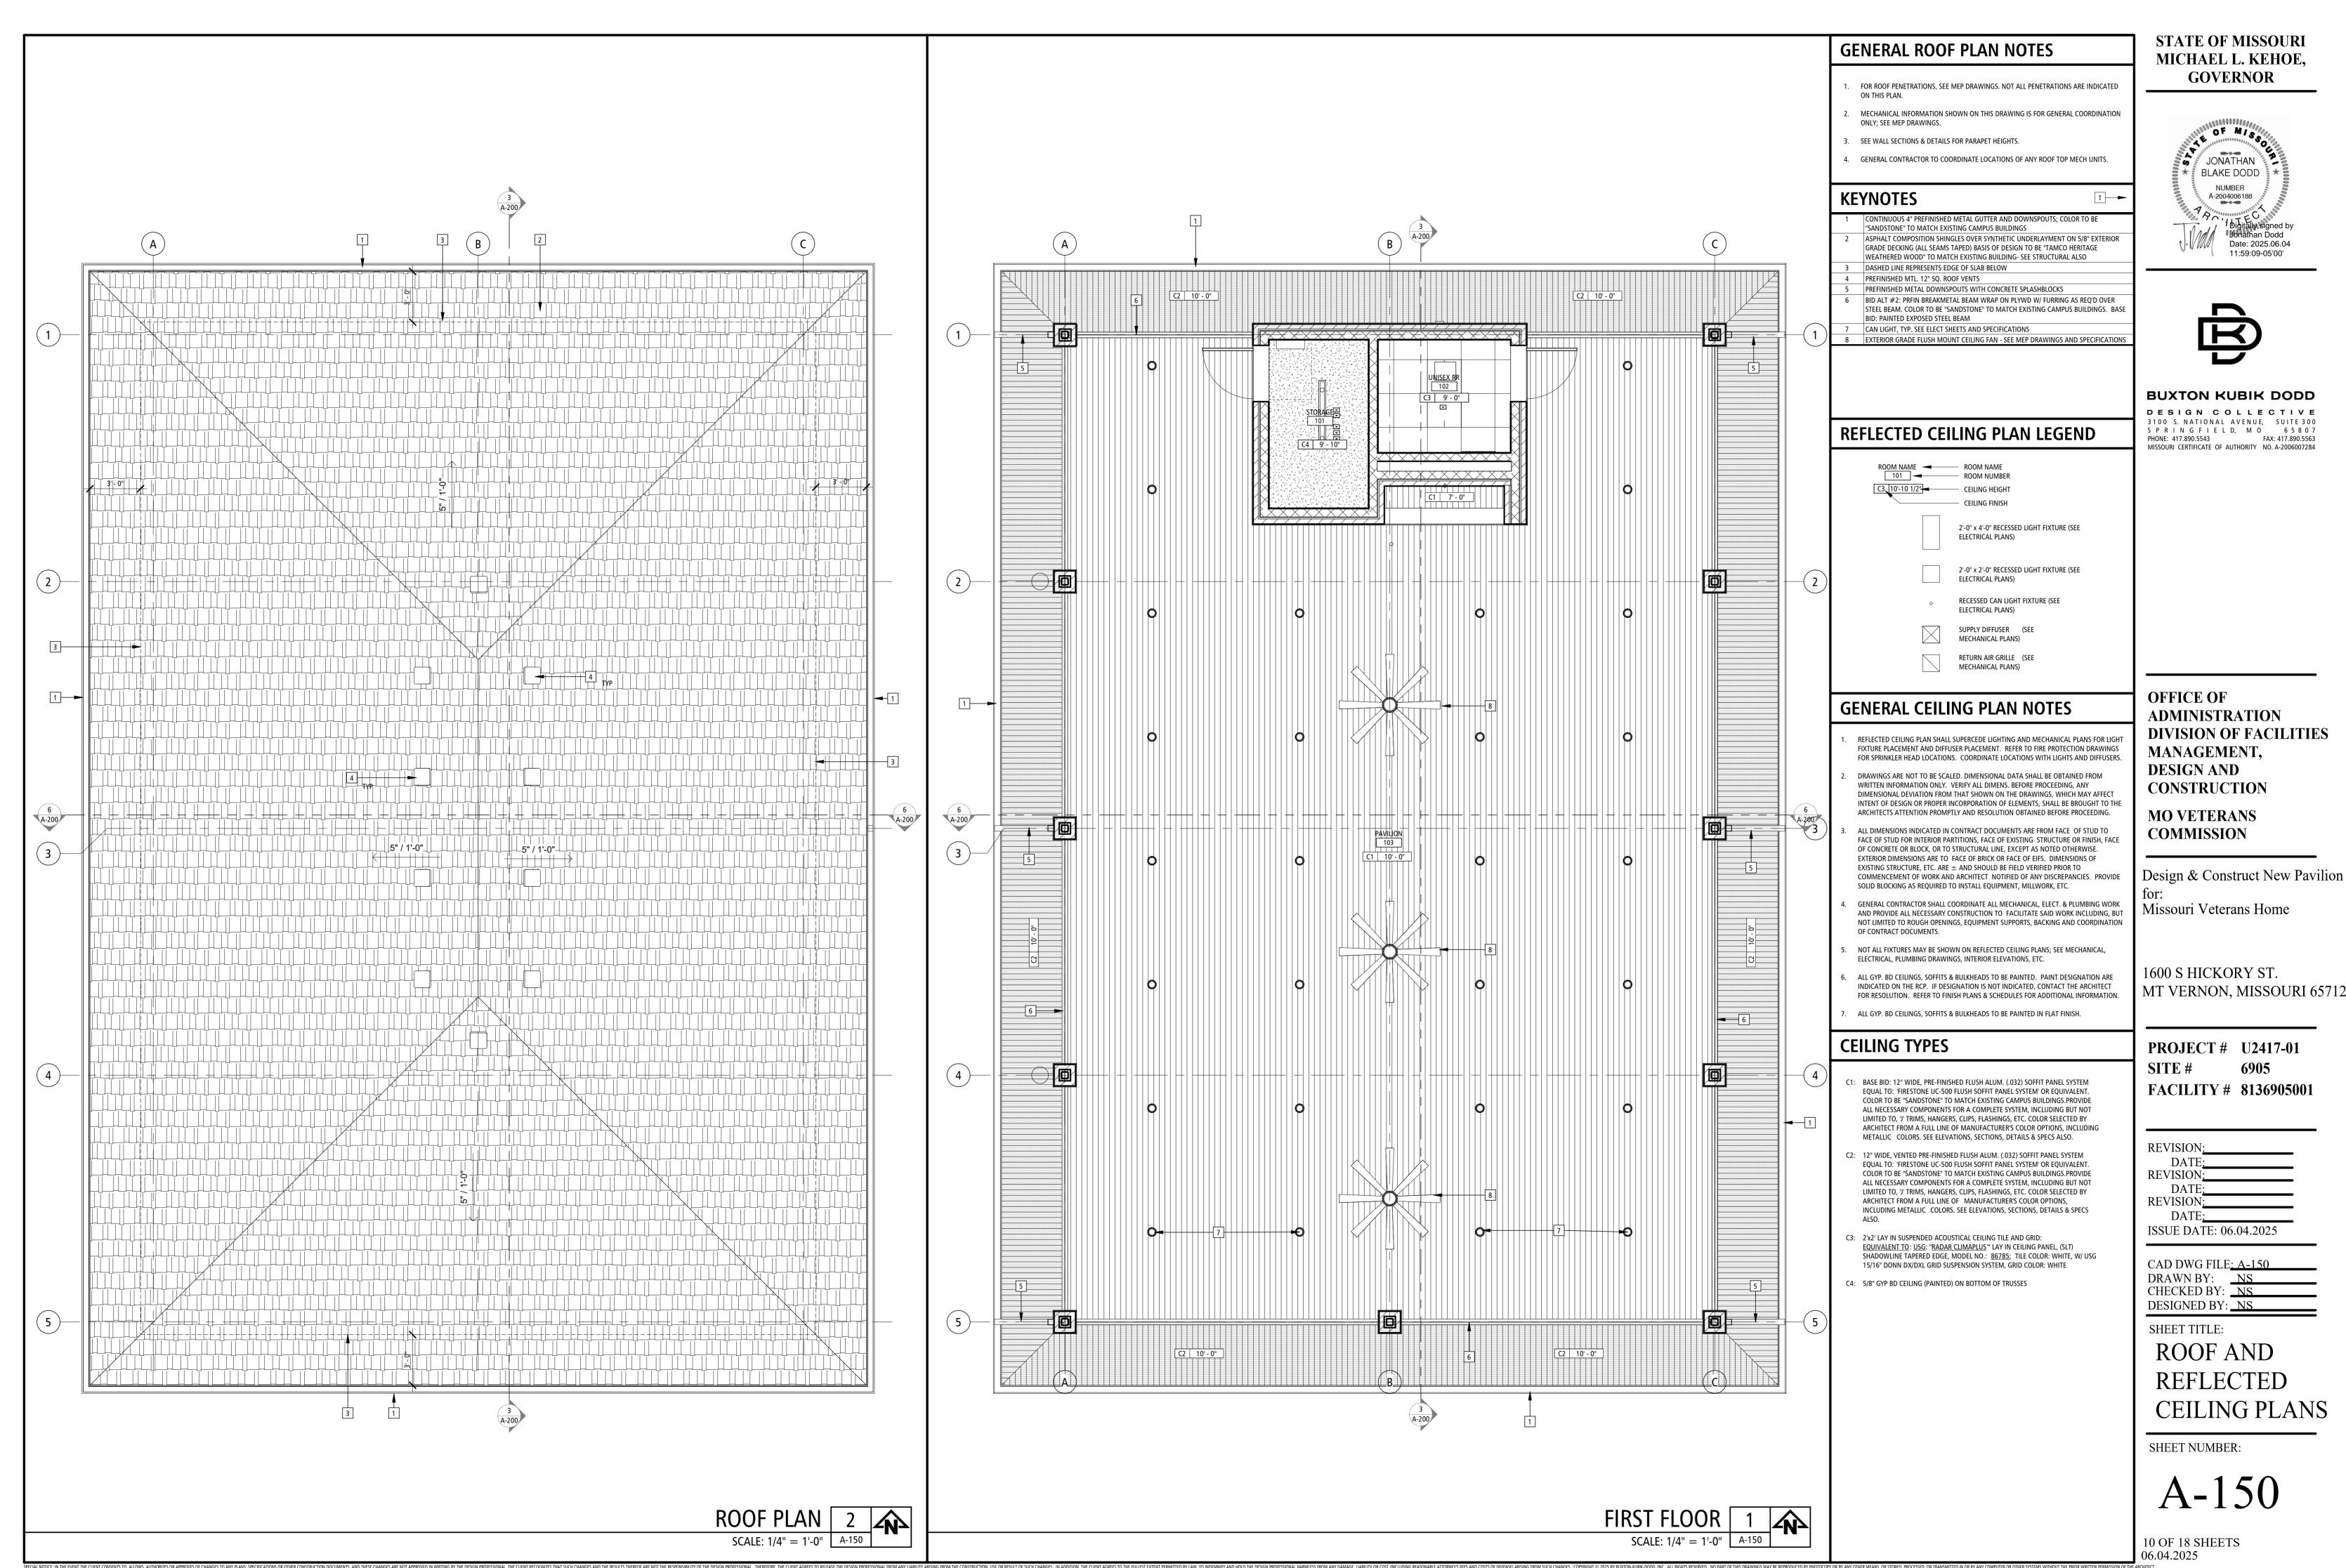
8 OF 18 SHEETS





STATE OF MISSOURI

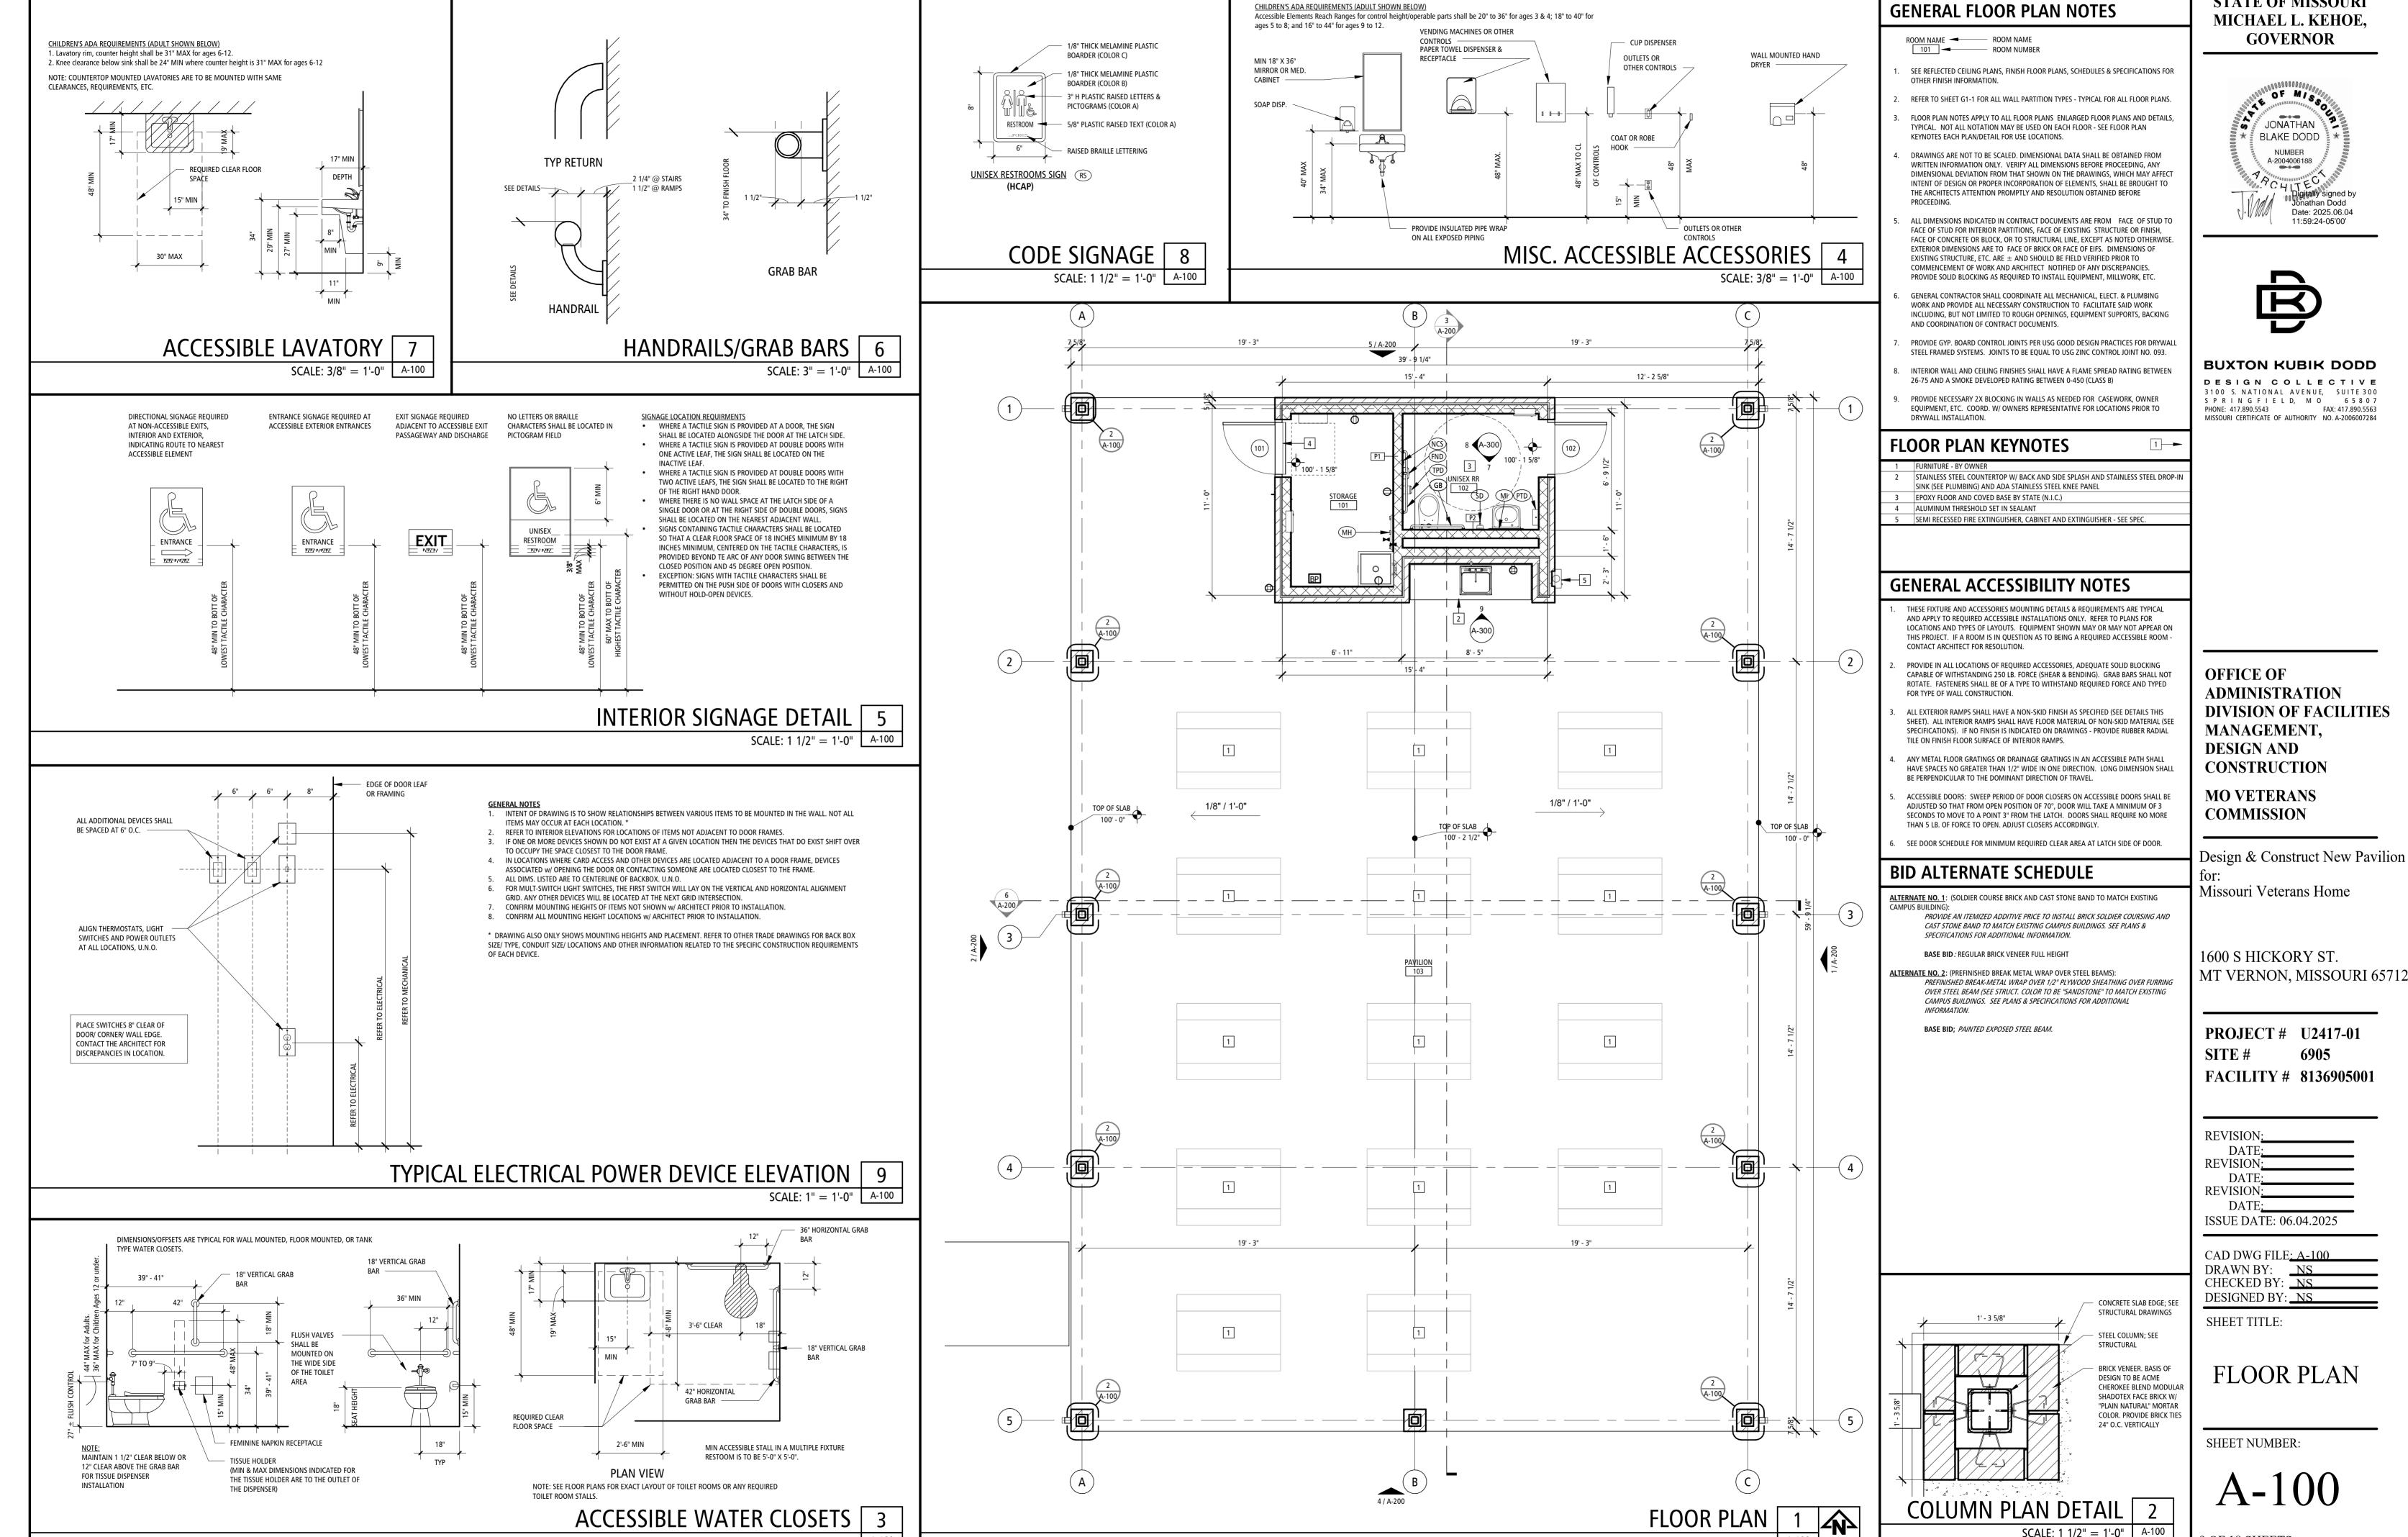DIVISION OF FACILITIES

9 OF 18 SHEETS




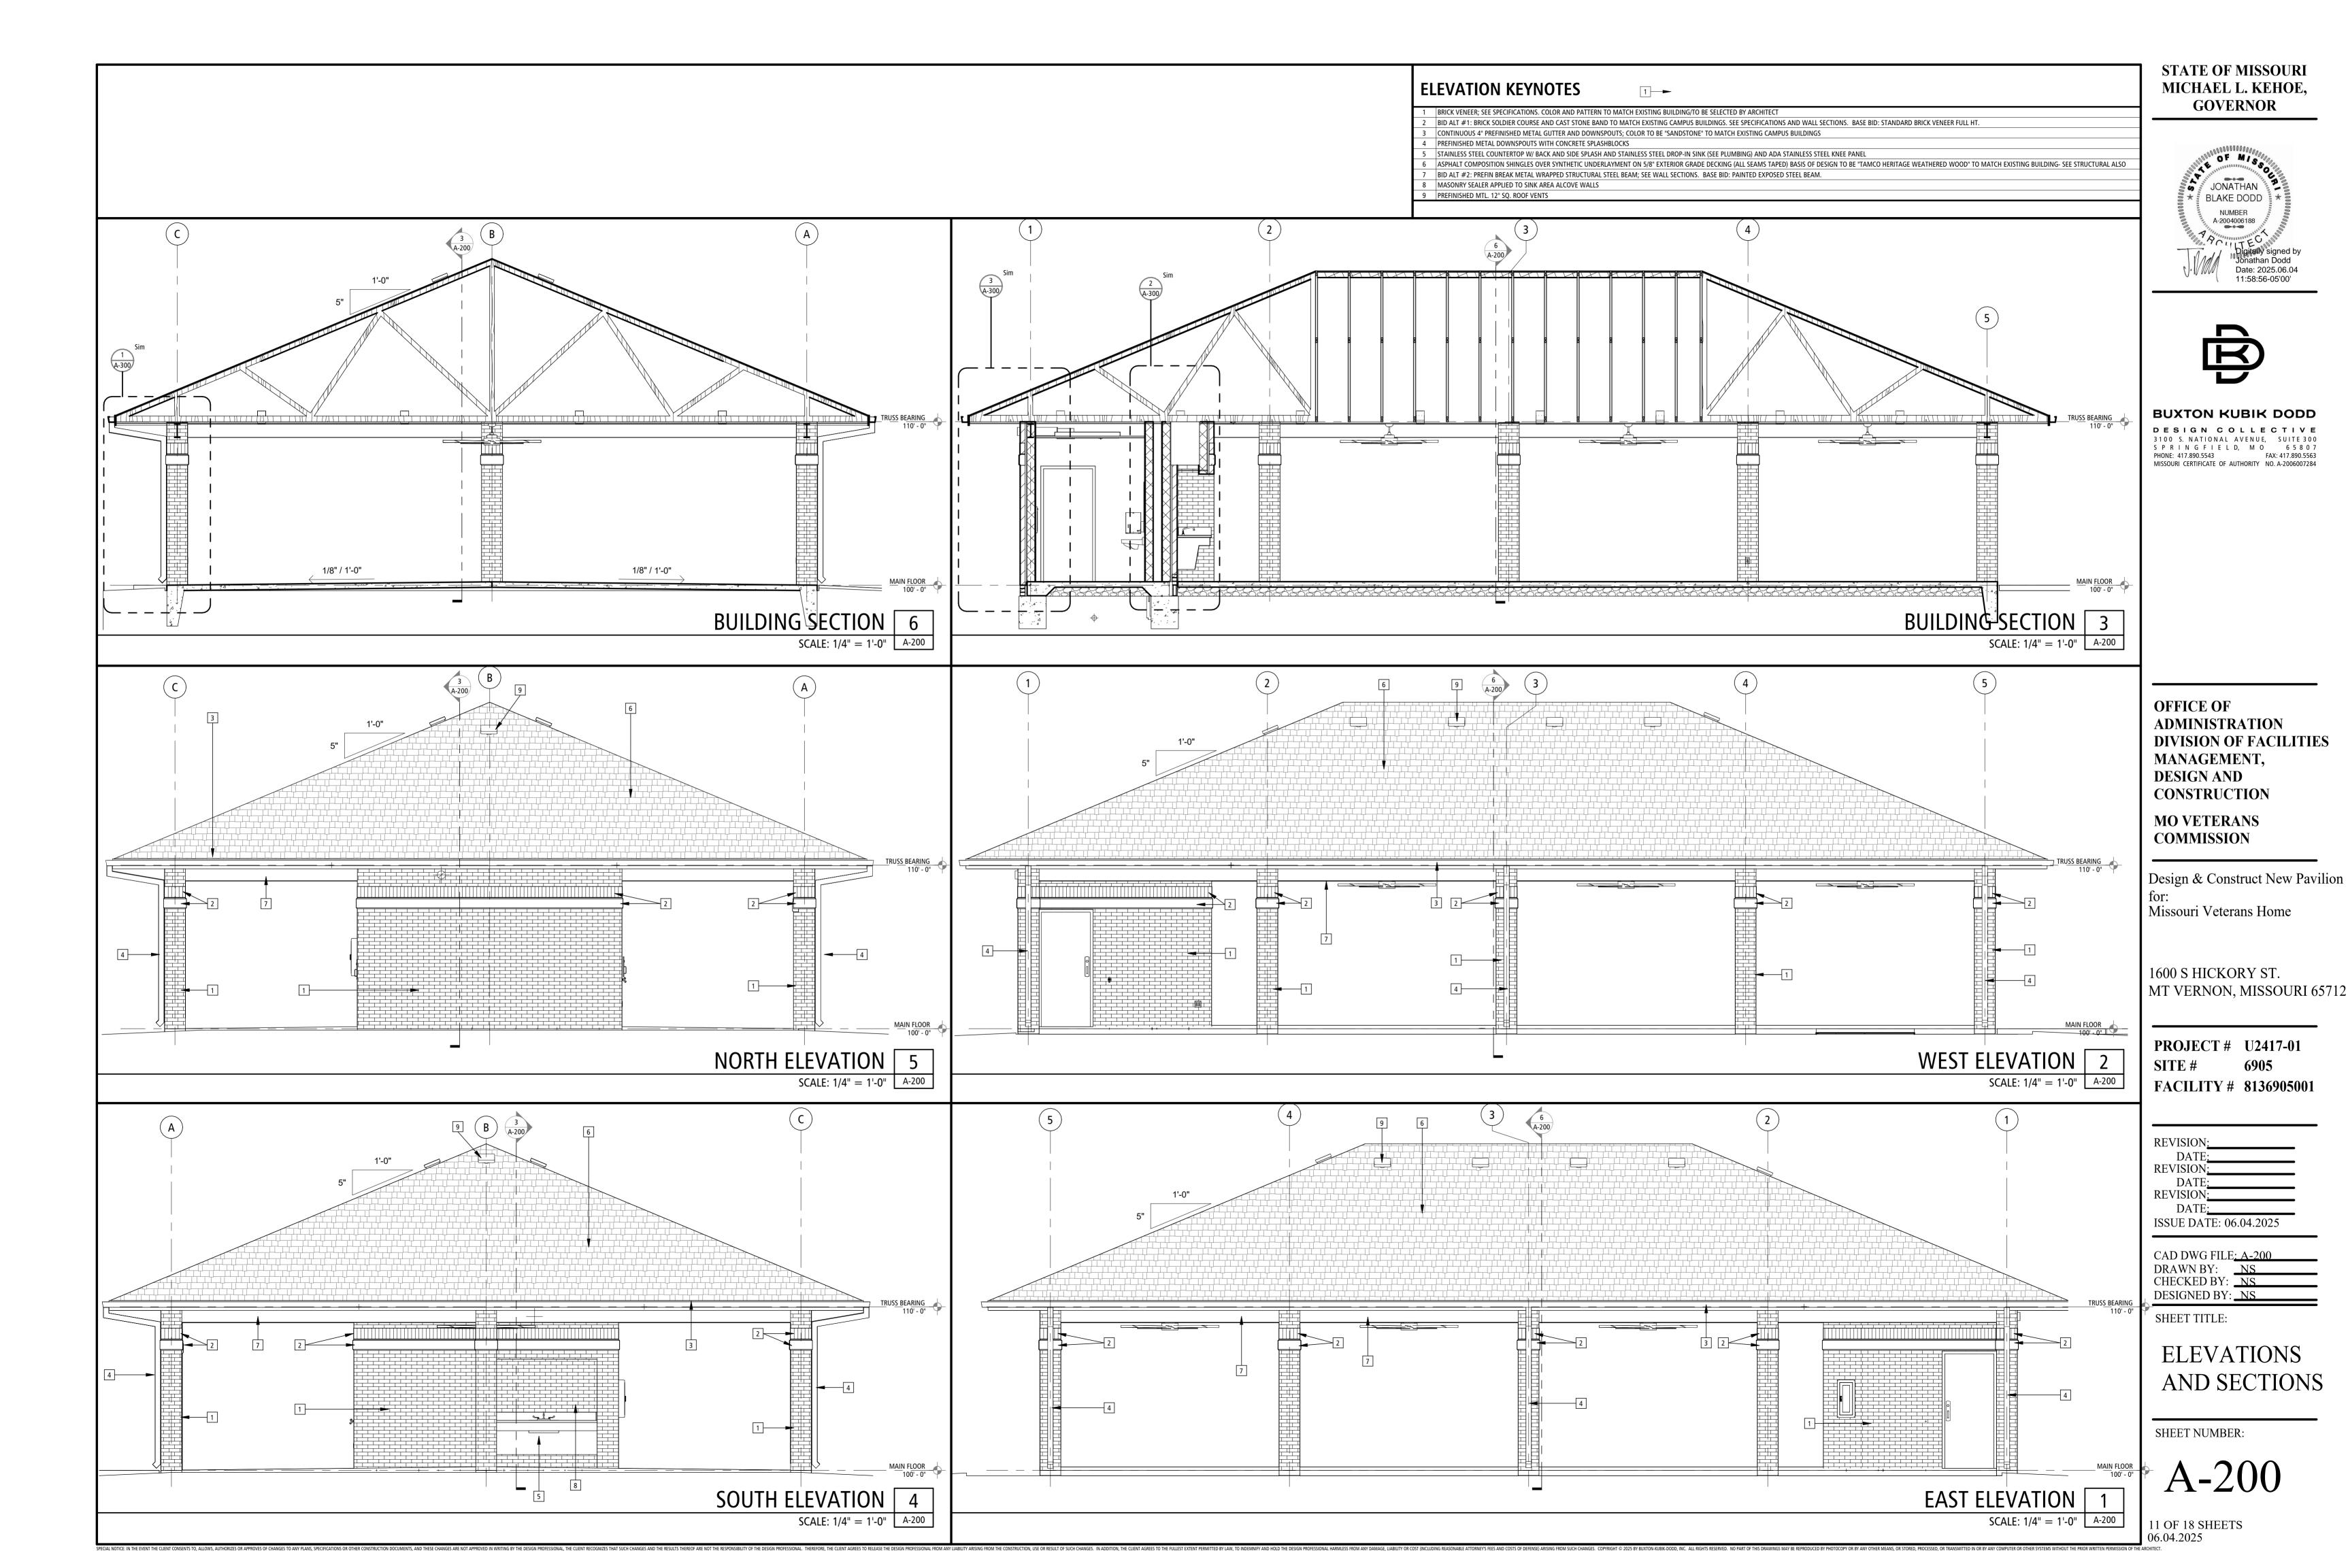

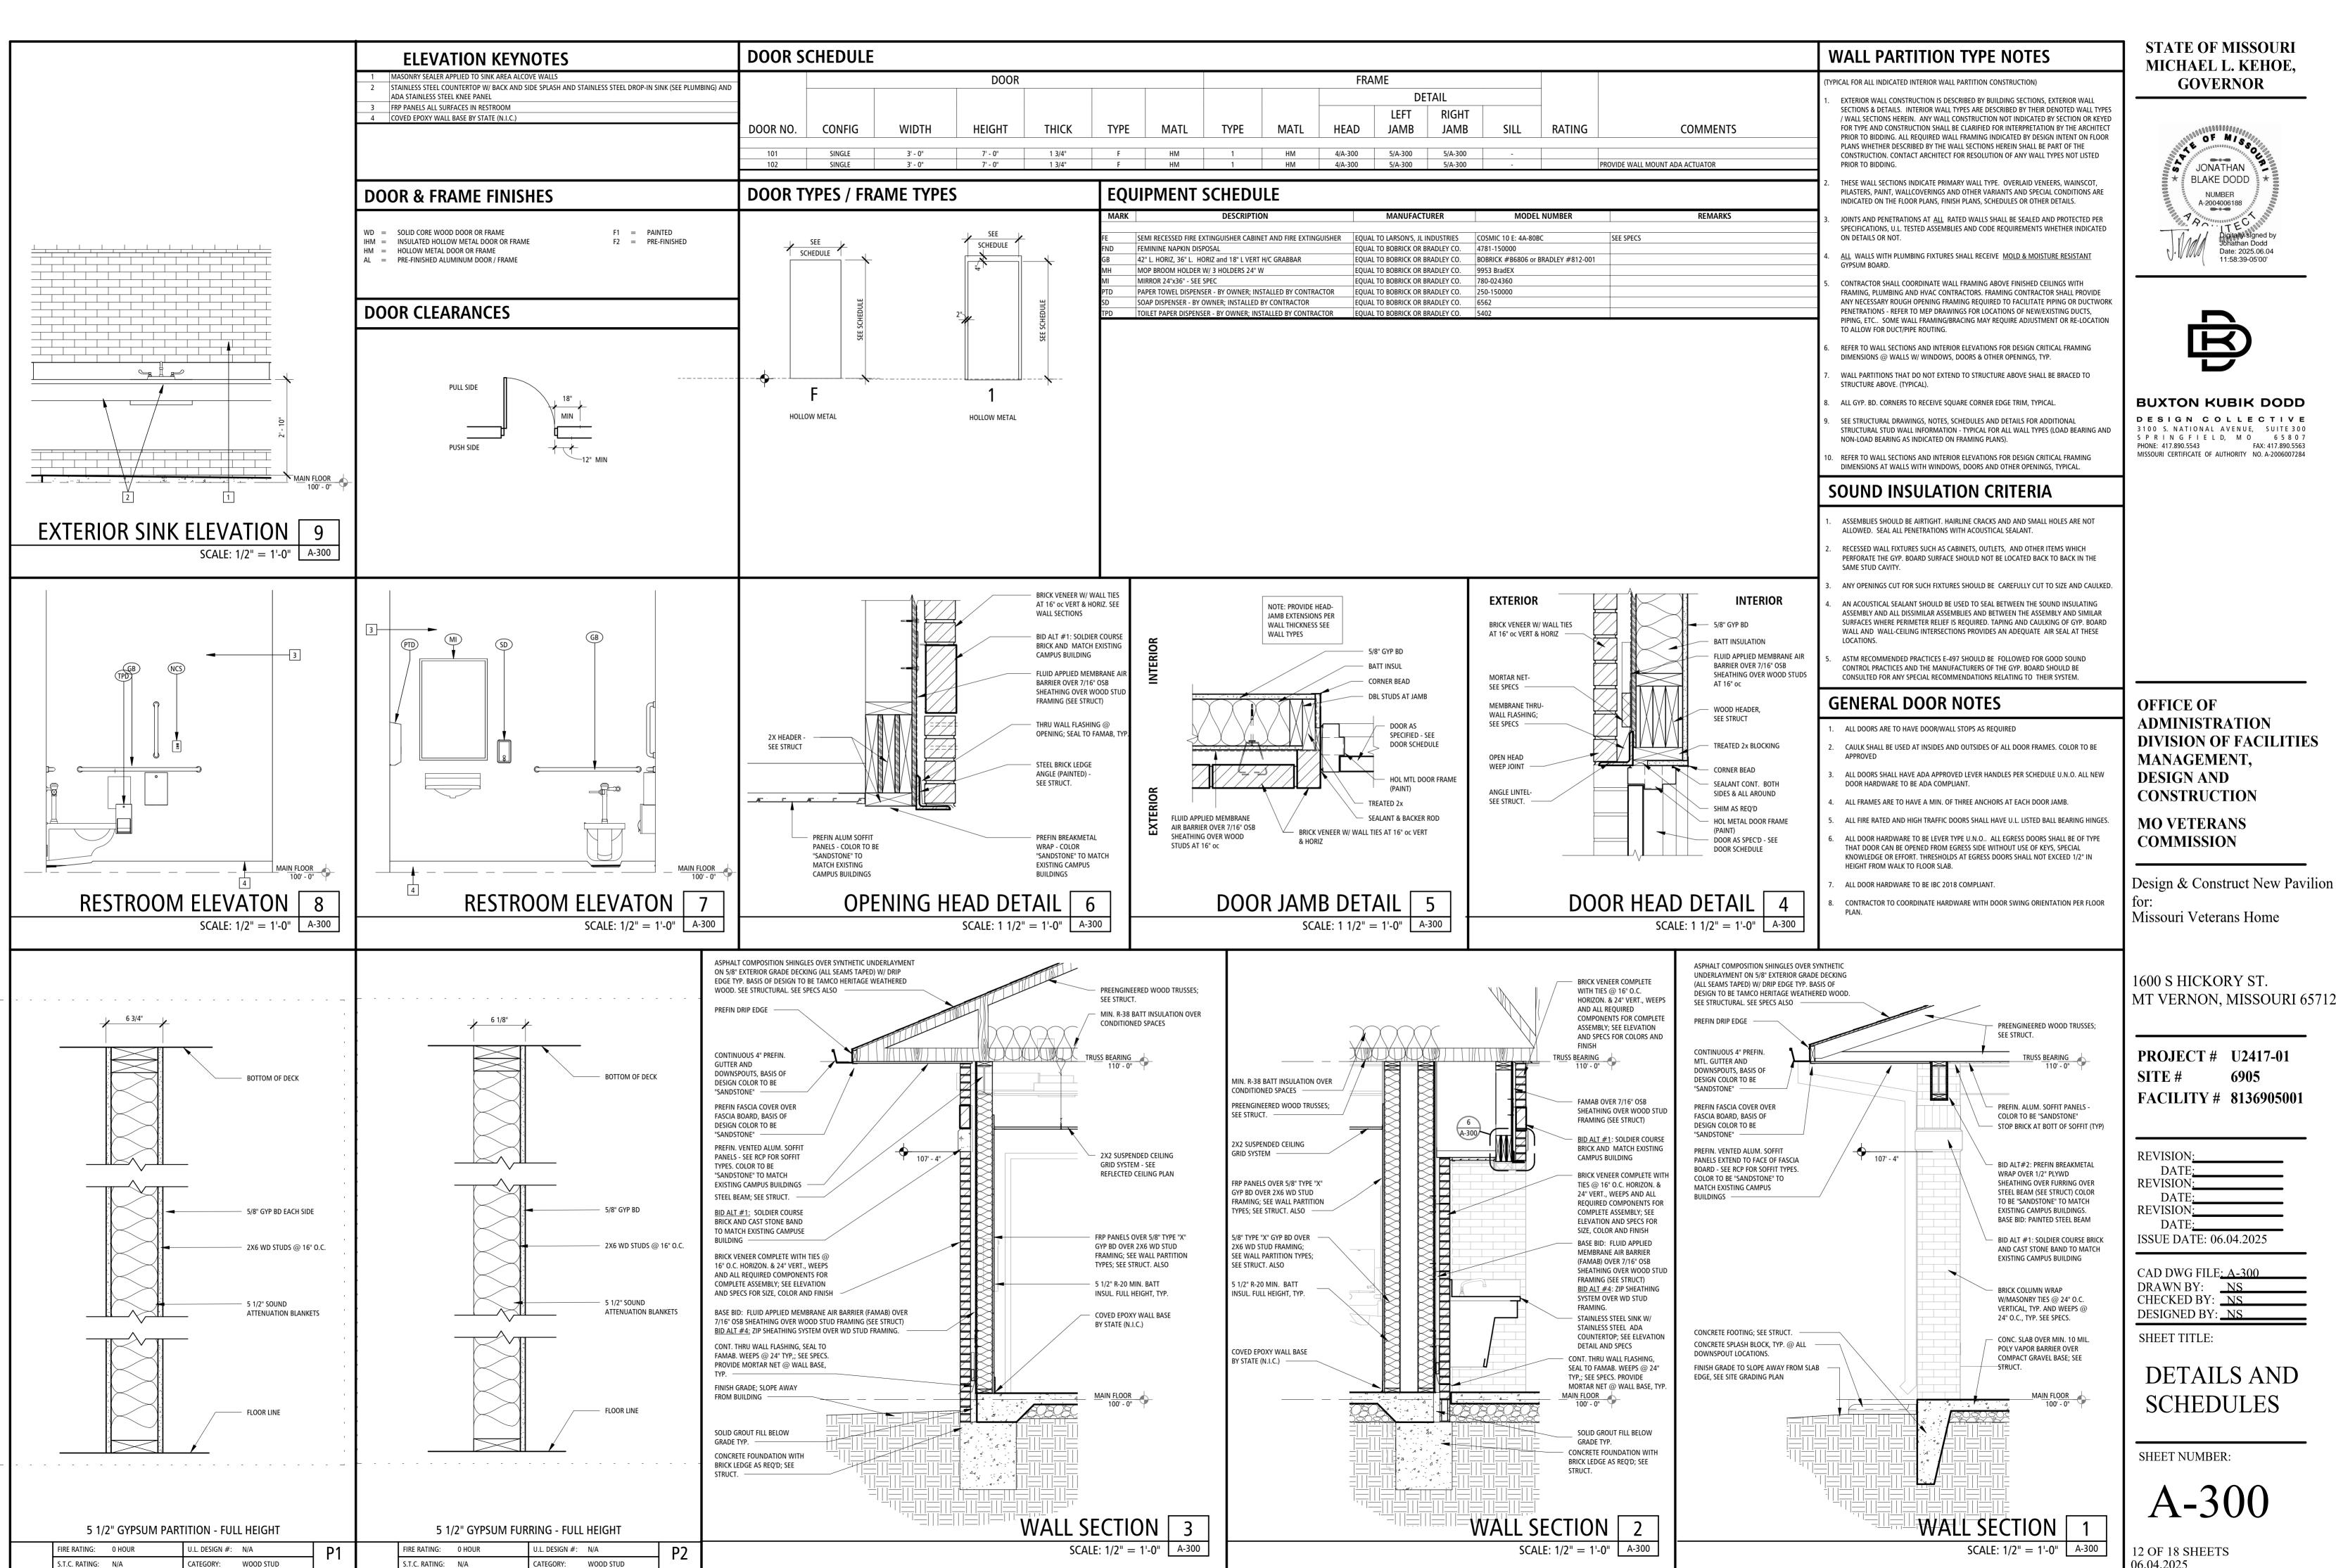

FAX: 417.890.5563

DIVISION OF FACILITIES

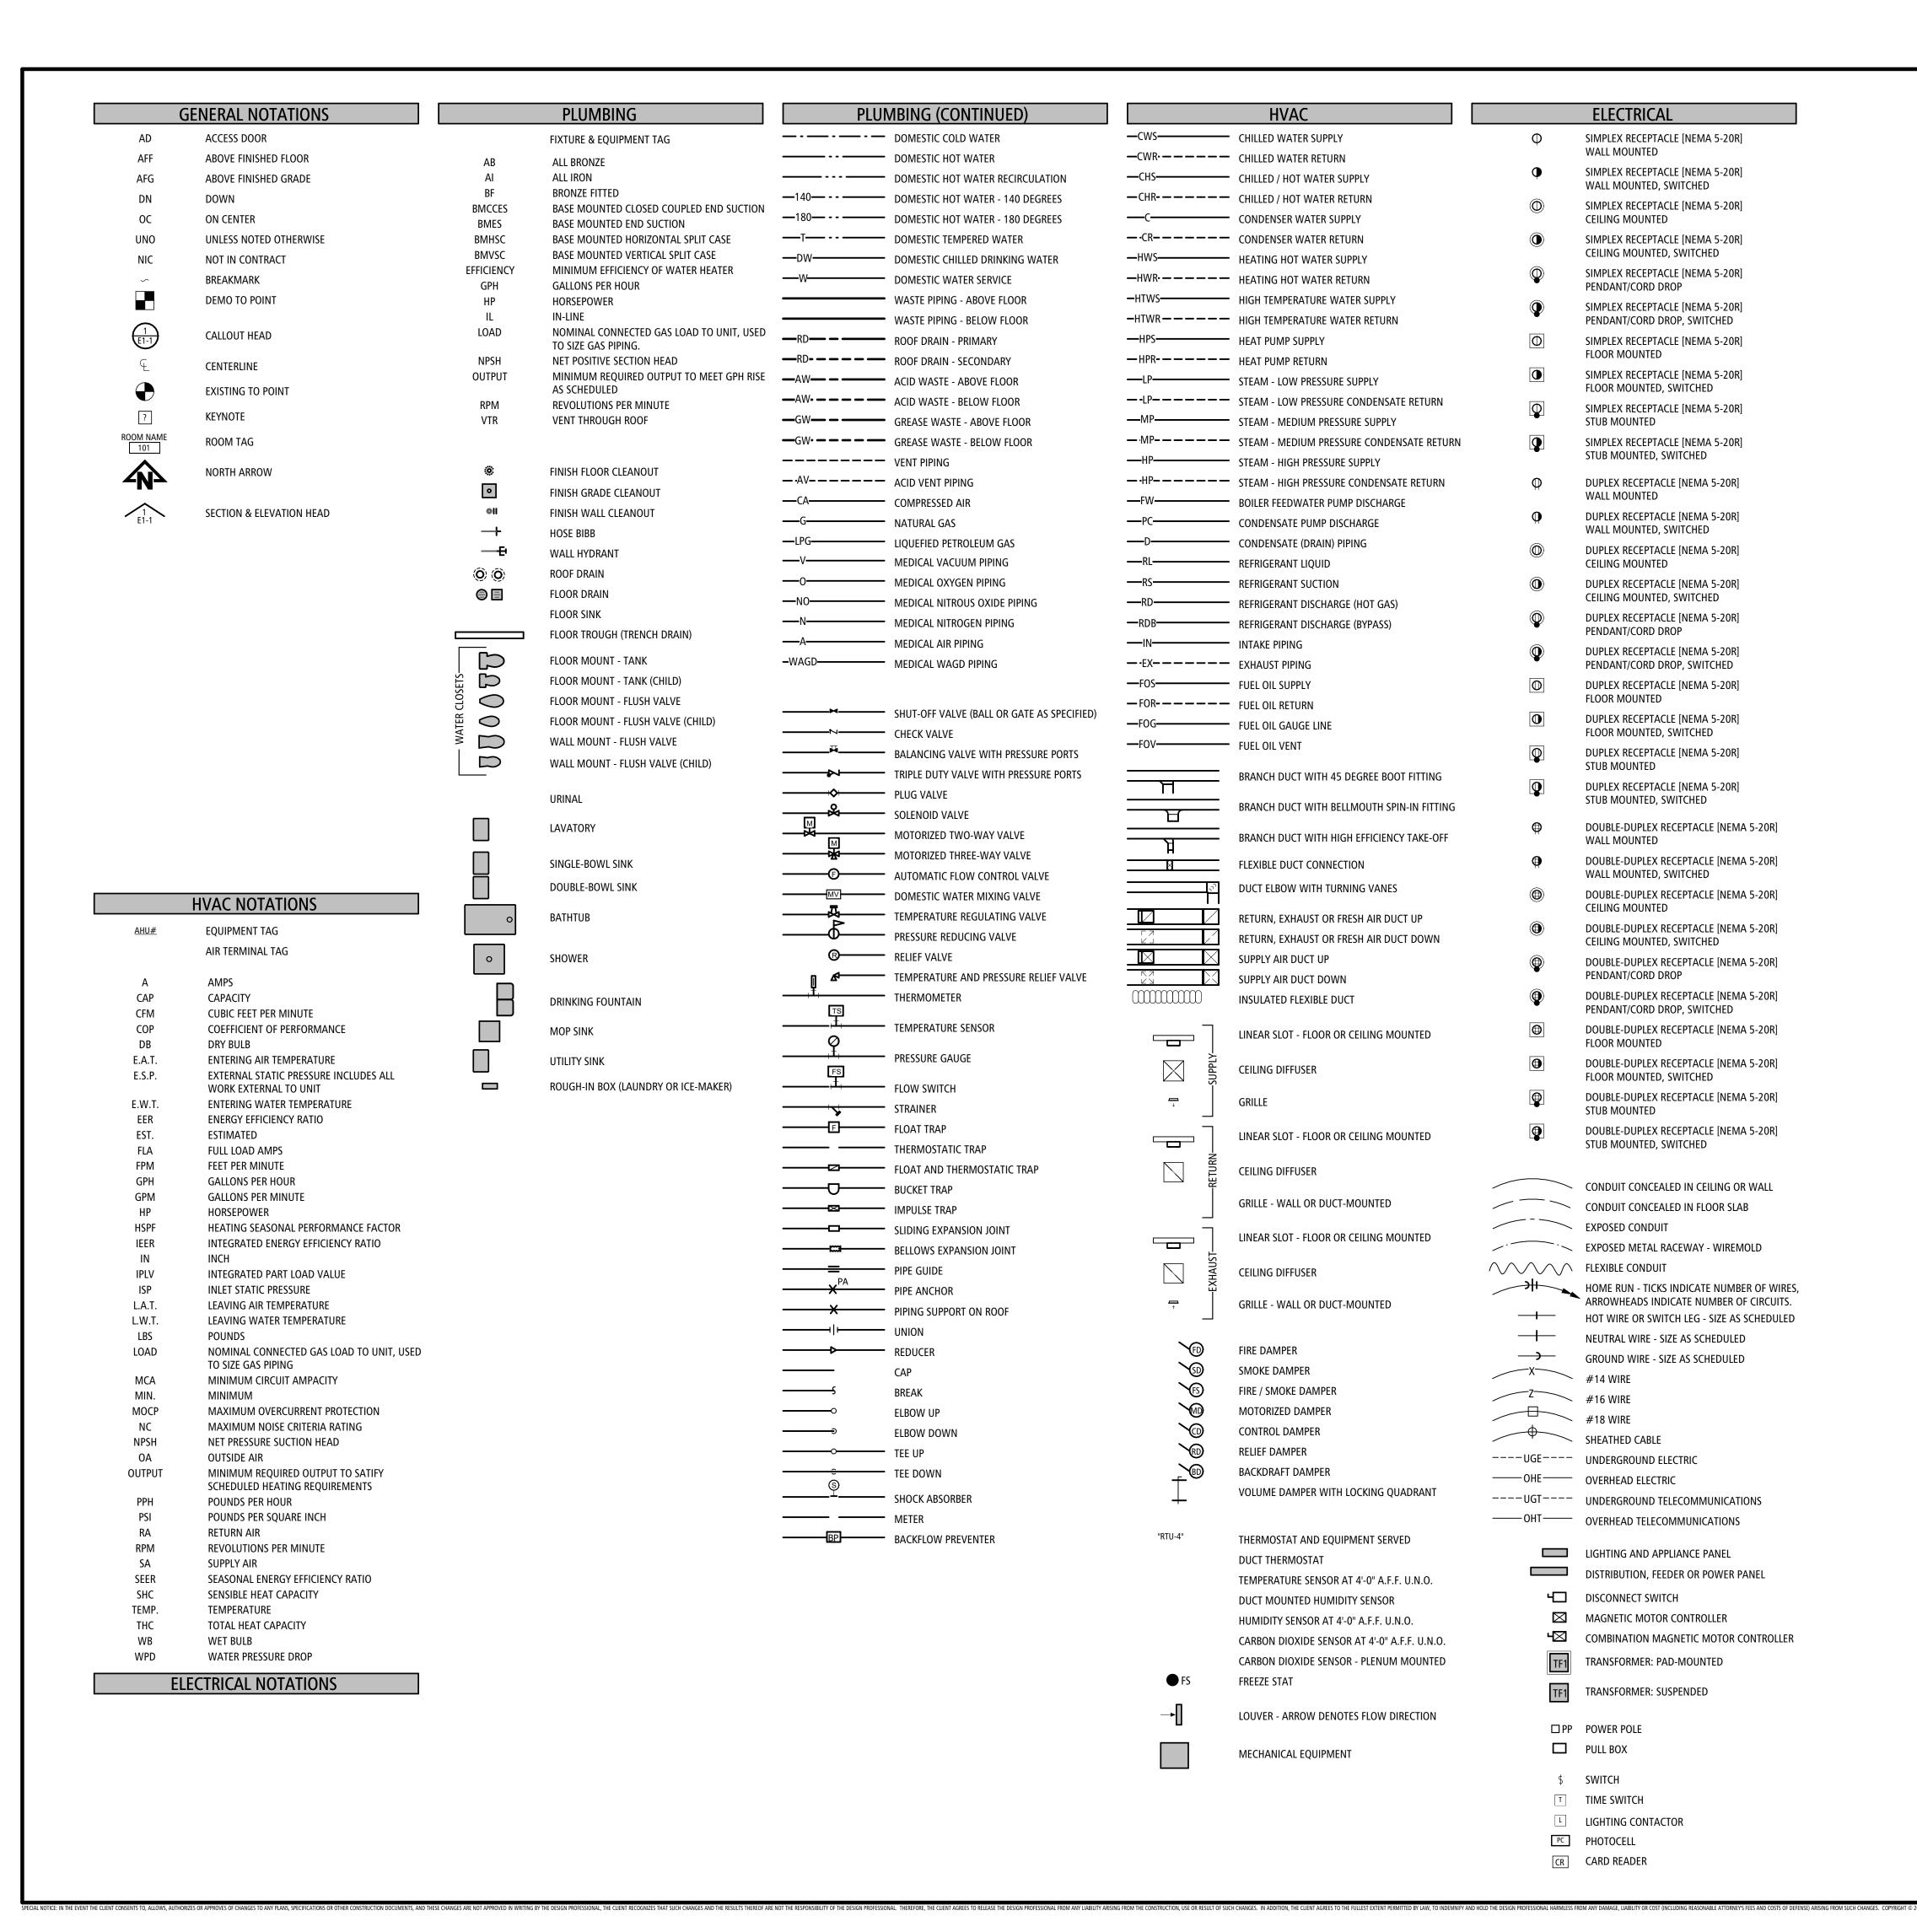

TELECOMMUNICATION SYSTEM

▼ TELECOMMUNICATIONS OUTLET - WALL

▼ TELECOMMUNICATIONS OUTLET - FLOOR

▼ TELECOMMUNICATIONS OUTLET - CEILING

TELECOMMUNICATIONS OUTLET - STUB

▼ TELECOMMUNICATIONS OUTLET - CORD DROP

FIRE ALARM SYSTEM FACP CONTROL PANEL ANNUNCIATOR PANEL ARCM AREA OF REFUGE COMMUNICATION MASTER AREA OF REFUGE COMMUNICATION REMOTE ARCR **ECM EMERGENCY COMMUNICATION MASTER ECR EMERGENCY COMMUNICATION REMOTE** BATT BATTERY CABINET FAC CABINET **EVAC VOICE EVACUATION** STROBE - WALL STROBE - CEILING STROBE & SPEAKER - WALL STROBE & SPEAKER - CEILING SPEAKER - WALL SPEAKER - CEILING STROBE & HORN - WALL STROBE & HORN - CEILING HORN - WALL HORN - CEILING BELL - WALL WATER FLOW SWITCH VALVE TAMPER SWITCH PANIC ALARM BUTTON MANUAL PULL STATION CARBON MONOXIDE SENSOR CARBON DIOXIDE SENSOR HEAT DETECTOR SMOKE DETECTOR - WALL SMOKE DETECTOR - CEILING

SMOKE DETECTOR - SIGNAL STATION

SMOKE DETECTOR - SOUNDER BASE

REMOTE EVACUATION MICROPHONE

SMOKE DETECTOR - IN DUCT

FAN SHUTDOWN RELAY


FIREMANS PHONE OUTLET

EVACUATION MICROPHONE

RELAY

DOOR HOLDER

STATE OF MISSOURI MICHAEL L. KEHOE, GOVERNOR

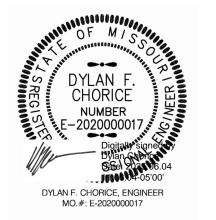



BUXTON KUBIK DODD

DESIGN COLLECTIVE

3 1 0 0 S. NATIONAL AVENUE, SUITE 3 0 0
S PRINGFIELD, M 0 6 5 8 0 7
PHONE: 417.890.5543

MISSOURI CERTIFICATE OF AUTHORITY NO. A-2006007284


OFFICE OF ADMINISTRATION DIVISION OF FACILITIES MANAGEMENT, DESIGN AND CONSTRUCTION

MO VETERANS COMMISSION

DESIGN AND CONSTRUCT NEW PAVILION FOR: MISSOURI VETERANS HOME

1600 S HICKORY ST. MT VERNON, MO 65712

PROJECT # U2417-01 SITE # 6905 FACILITY # 8136905001

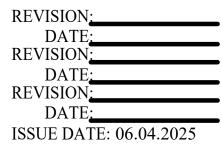

CAD DWG FILE: PME-100 DRAWN BY: XXX


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DESIGNED BY: XXX

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PME SYMBOLS LEGEND

SHEET NUMBER

PME-100

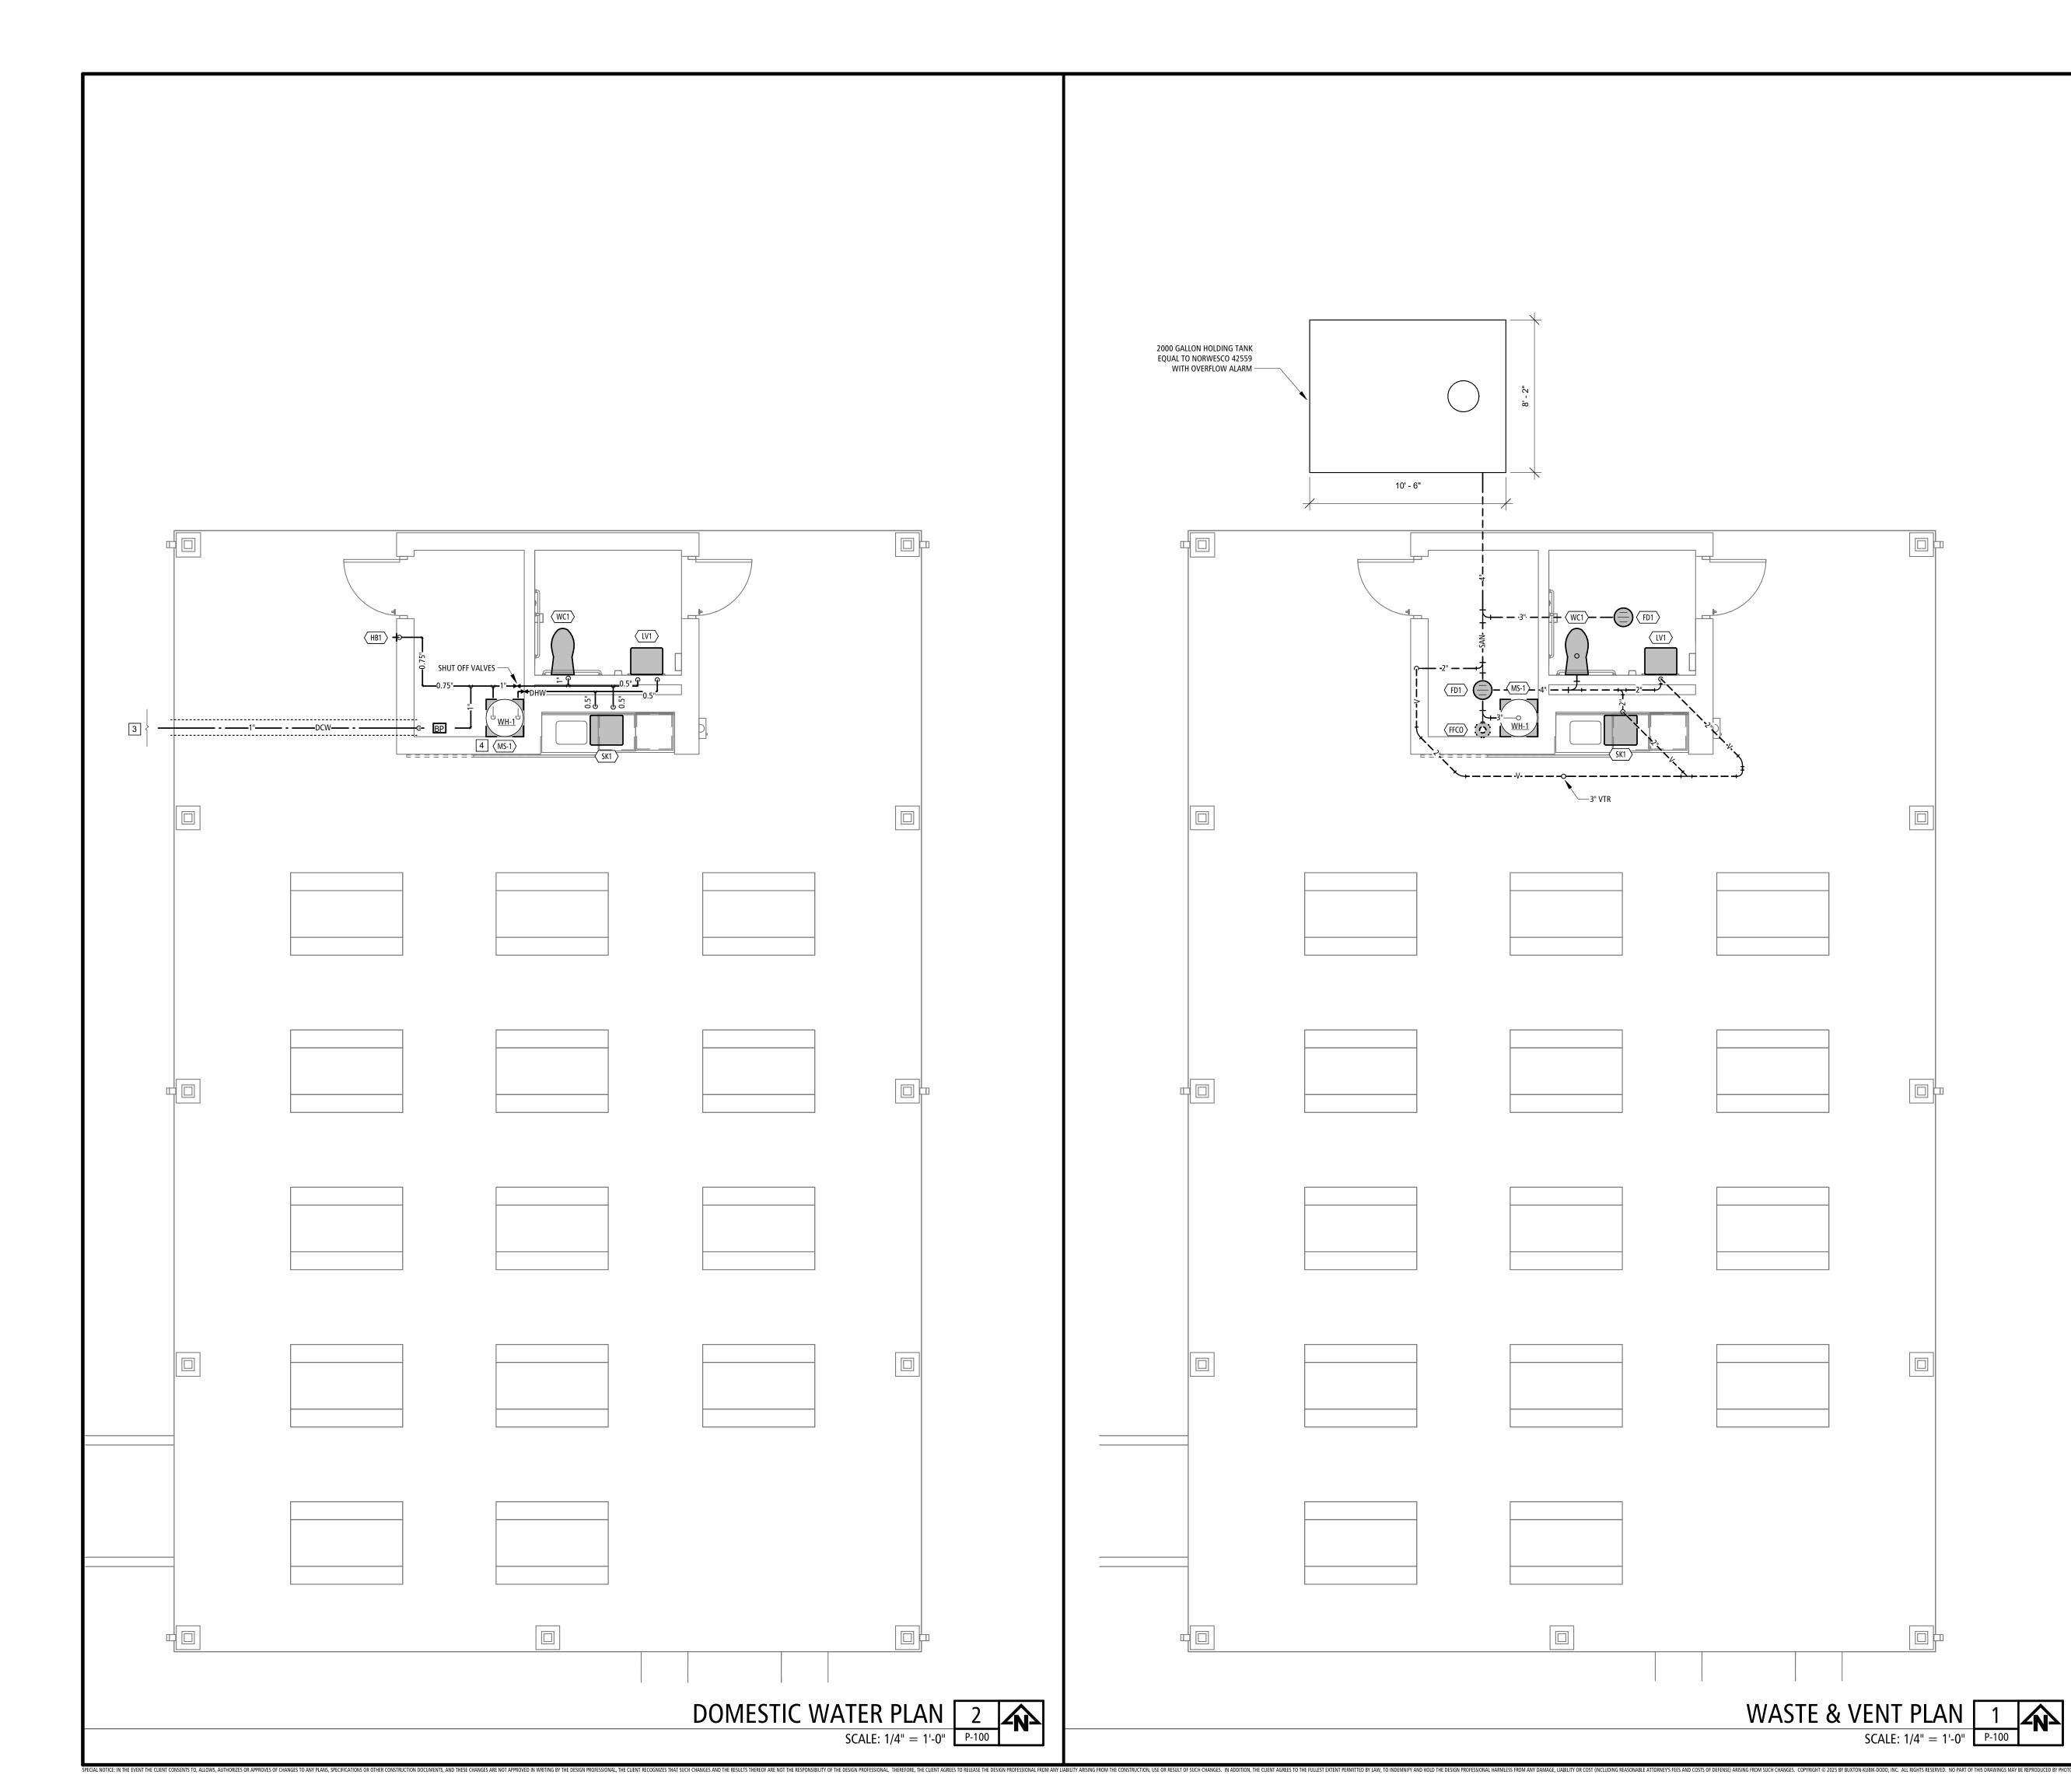

PLUMBING GENERAL NOTES:


FOR MT. VERNON, MO.

- A. THE GENERAL NOTES ON THIS SHEET SPACE SHALL APPLY TO ALL OTHER SHEET SPACES.
- B. ALL INSTALLATIONS SHALL CONFORM TO THE 2012 INTERNATIONAL PLUMBING CODE AND THE CURRENT ADOPTIVE ORDINANCES IN EFFECT
- . PLANS ARE DIAGRAMMATIC IN NATURE AND NOT TO BE SCALED. REFER TO ARCHITECTURAL DRAWINGS FOR FINISH DETAILS, ELEVATIONS, AND EXACT MOUNTING LOCATIONS OF AIR TERMINALS.
- D. ANY ADDITIONAL IMPACT COST, DESIGN MODIFICATIONS, ADDITIONAL ARCHITECTURAL AND/OR ENGINEERING SERVICES, MATERIALS, LABOR CHANGES, SCHEDULE CHANGES AND/OR OTHER UNANTICIPATED CONSEQUENCES RESULTING FROM SUBSTITUTIONS IN LIEU OF THE SPECIFIED ITEMS ON THE PLANS AND SPECIFICATIONS SHALL BE THE FULL RESPONSIBILITY OF THE CONTRACTOR, SUBCONTRACTOR, AND/OR SUPPLIER. NO ADDITIONAL COST SHALL BE INCURRED TO THE ARCHITECT, ENGINEER OR OWNER FOR THESE CHANGES.
- E. CLOSELY COORDINATE ALL WORK WITH ALL OTHER TRADES.
- SEAL ALL PENETRATIONS THROUGH FIRE-RATED ASSEMBLIES AS NECESSARY TO RESTORE FIRE-RESISTANCE RATING OF ASSEMBLY. REFER TO ARCHITECTURAL PLANS AND SPECIFICATIONS FOR RATED ASSEMBLIES, FIRE STOPPING MATERIALS, AND REQUIREMENTS.
- G. MAINTAIN MINIMUM 10'-0" CLEARANCE BETWEEN ALL VENTS AND OUTSIDE AIR INTAKES. REFER TO HVAC PLANS FOR LOCATIONS PRIOR TO VENT ROUGH-IN. ADJUST VENT LOCATIONS SHOWN AS NEEDED. KEEP ALL VENTS THROUGH ROOF OUT OF LINE OF SIGHT FROM GROUND VIEW.
- PREPARE ALL EXTERIOR GAS PIPING FOR PAINTING BY GENERAL CONTRACTOR. ALL VISIBLE AND EXPOSED GAS PIPING SHALL BE PAINTED TO MATCH EXTERIOR FINISH. ALL CONCEALED OR ROOF-MOUNTED GAS PIPING SHALL BE PAINTED YELLOW.
- PROVIDE SHUT-OFF VALVES FOR ALL PLUMBING FIXTURES WHETHER SHOWN ON PLANS OR NOT. INSTALL IN ACCESSIBLE LOCATION.
- REFER TO ARCHITECTURAL PLANS FOR ALL FIXTURE MOUNTING HEIGHTS.
- K. COORDINATE THE LOCATION OF ALL ROOF DRAIN LEADERS WITH ROOF CONSTRUCTION AND ROOF PLANS.

PLUMBING PLAN KEYNOTES

- 1. REFER TO DETAIL 7 ON P-200 FOR WATER HEATER CONNECTION.
- 2. PROVIDE SHUTOFF WITH DRAIN VALVE FOR WINTERIZATION DOWNSTREAM OF RPZ BACKFLOW PREVENTOR.
- 3. 1" DOMESTIC WATER LINE FROM LOOP. UTILITY TO PROVIDE METER AND METER VAULT. REFER TO CIVIL FOR CONTINUATION.
- 4. 1/2" HW/CW TO MOP SINK FROM WATER HEATER.

STATE OF MISSOURI MICHAEL L. KEHOE, **GOVERNOR**

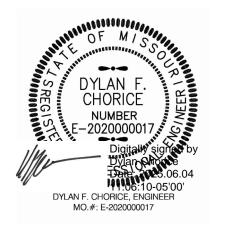



BUXTON KUBIK DODD

DESIGN COLLECTIVE 3100 S. NATIONAL AVENUE, SUITE 300 S P R I N G F I E L D, M O 6 5 8 0 7 PHONE: 417.890.5543 FAX: 417.890.5563 MISSOURI CERTIFICATE OF AUTHORITY NO. A-2006007284

OFFICE OF ADMINISTRATION DIVISION OF FACILITIES MANAGEMENT, **DESIGN AND CONSTRUCTION**

MO VETERANS **COMMISSION**

DESIGN AND CONSTRUCT NEW PAVILION FOR: MISSOURI VETERANS HOME

1600 S HICKORY ST. MT VERNON, MO 65712

PROJECT # U2417-01 SITE# 6905 FACILITY # 8136905001

ISSUE DATE: 06.04.2025


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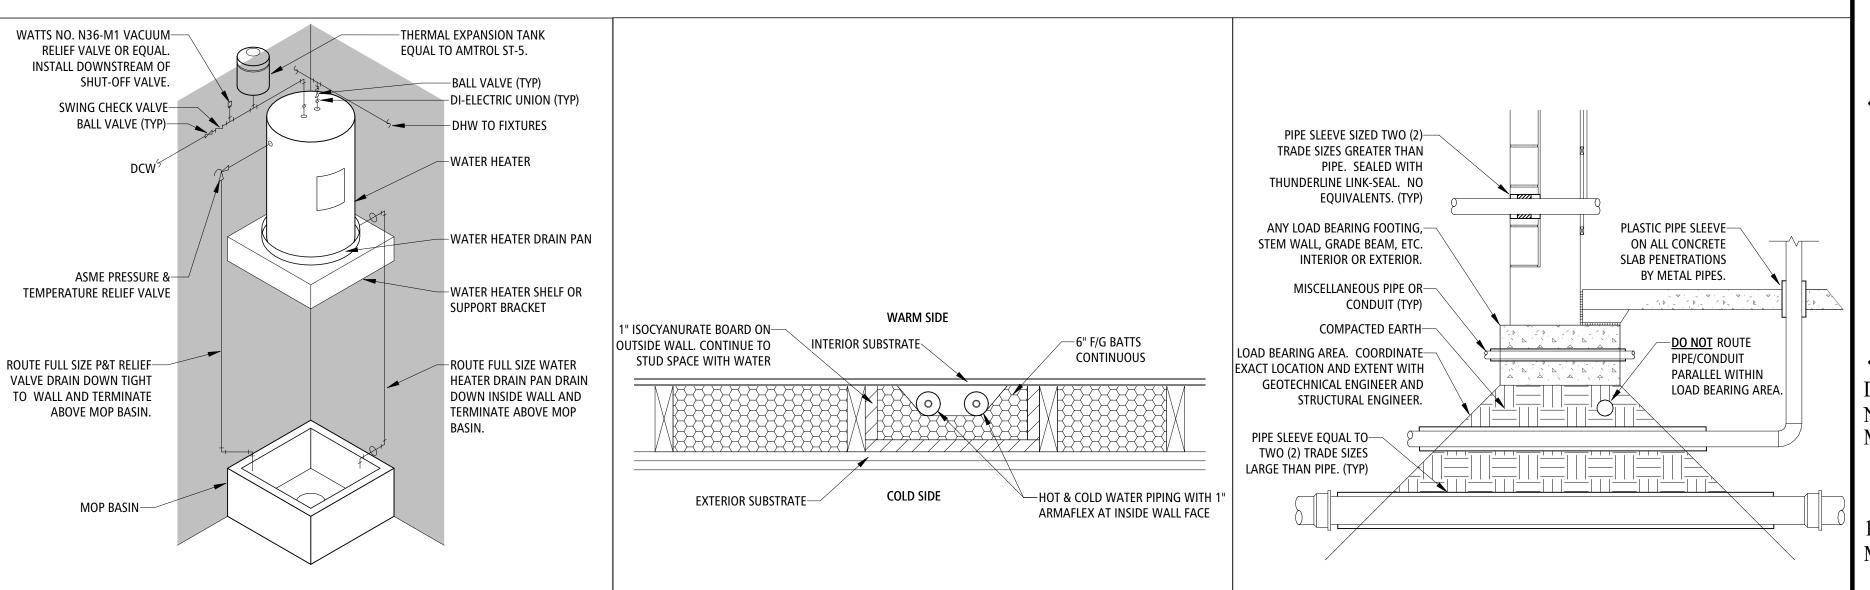
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SHEET NUMBER:

P-100




PLU	MBING FIXTURI	& EQUIP	MENT SC	HED	DUL	E		
				PIPE	CONNE	CTIONS		
PLAN					HW			
//ARK	DESCRIPTION	MANUFACTURER	MODEL	CW (IN)	(IN)	W (IN)	ACCESSORIES	NOTES
FD1	FLOOR DRAIN	ZURN	FD2210			SEE PLAN	PROSET TRAP GUARD.	
FCO	FINSISHED FLOOR CLEANOUT	ZURN	ZN1400			SEE PLAN	HARD FLOOR: ROUND CHROME PLATED SCORIATED COVER	VERIFY FLOOR MATERIALS USED FROM ARCHITECTURAL PLANS. CLAEANOUT TO BE FULL SIZE OF SOIL PIPE.
IB1	HOSE BIBB	WOODFORD	MODEL 17	3/4"			MODEL 34HF VACUUM BREAKER.	
V1	LAVATORY - WALL MOUNT	AMERICAN STANDARD	9024001EC.020	1/2"	1/2"	2"	FAUCET: AMERICAN STANDARD 6055.102. SHROUD: 0059.020EC. CARRIER, P-TRAP, GRID DRAIN, SUPPLY LINES, SHUT-OFF VALVES.	
IS-1	MOP SINK	FIAT	MSB-2424	3/4"	3/4"	3"	FAUCET: 830-AA, 832-AA HOSE AND HOSE BRACKET, 889-CC MOP HANGER, QDC-35N QUICK DRAIN CONNECTOR, 3" GRID DRAIN	MOLDED STONE, 3" DRAIN, SS STRAINER, SS WALL GUARD.
K1	SINK - DROP-IN SINGLE BOWL	ELKAY	DPC12020101	1/2"	1/2"	2"	FAUCET: DELTA 9113-DST IN STAINLESS P-TRAP, SUPPLY LINES, SHUT-OFF VALVES.	SINGLE HOLE DRILLING.
C1	WATER CLOSET - FLUSH VALVE	AMERICAN STANDARD	AFWALL - 3351.101	1"		4"		REFER TO ARCHITECTURAL DRAWINGS FOR ACTUAL MOUNTING HEIGHT. COORDINATE SPUD SIZE WITH FLUSH VALVE SUPPLIED. FLUSH CONTROLS SHALL BE LOCATED ON OPEN SIDE OF ACCESSIBLE WATER CLOSETS.

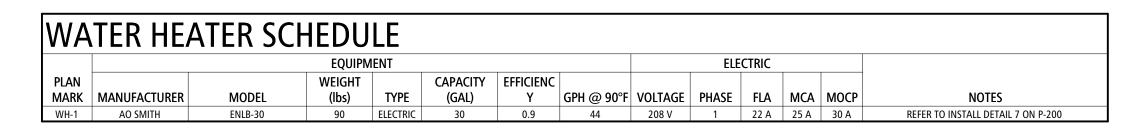


PIPING IN EXTERIOR WALL


SCALE:NOT TO SCALE

P-200

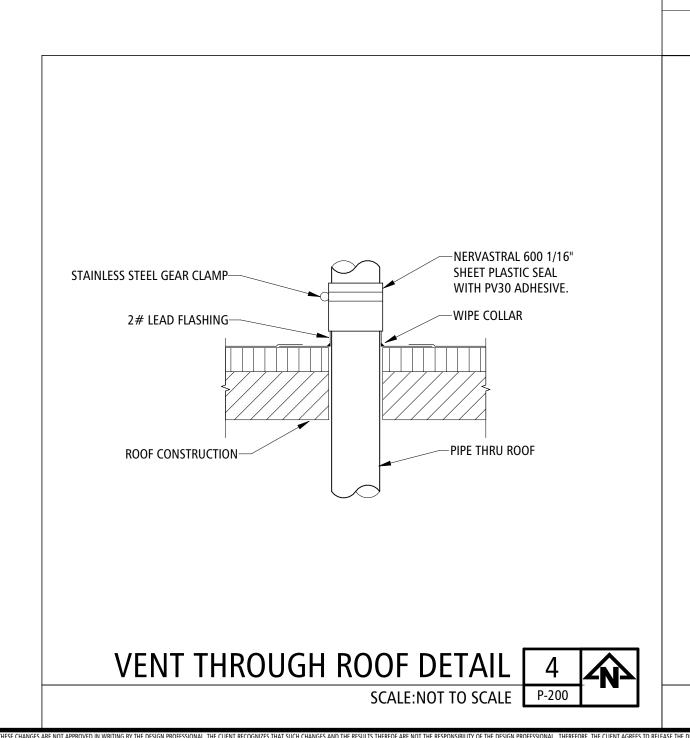


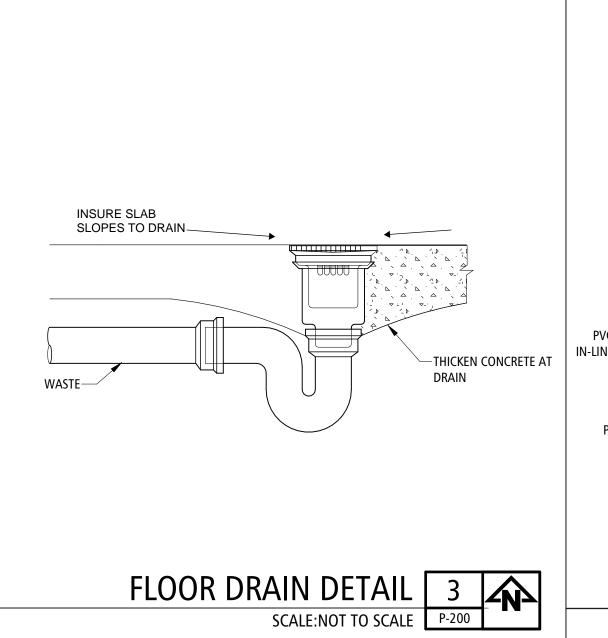

WATER HEATER & MOP SINK
SCALE:NOT TO SCALE
P-200

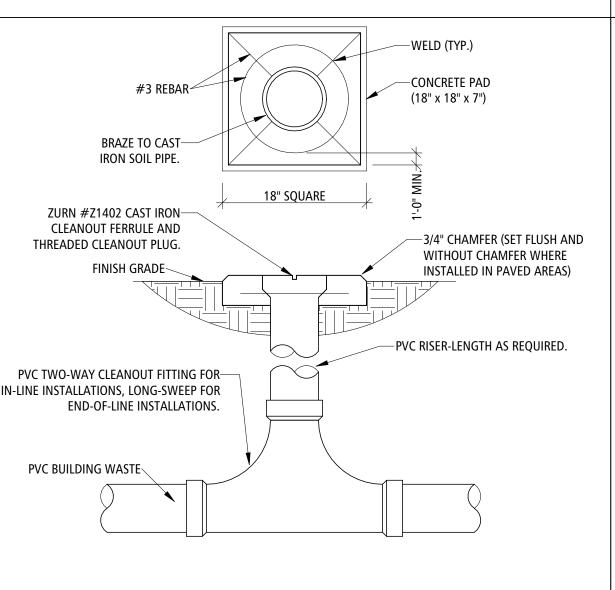



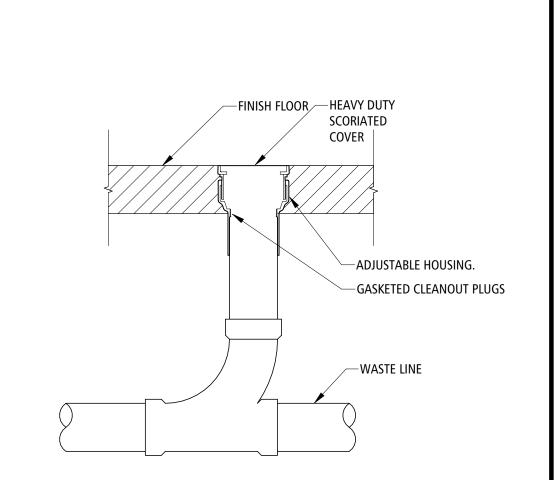

PENETRATION AND SLEEVING 5
SCALE:NOT TO SCALE P-200

FINISHED FLOOR CLEAN-OUT 1

SCALE:NOT TO SCALE P-200

STATE OF MISSOURI MICHAEL L. KEHOE, **GOVERNOR**





BUXTON KUBIK DODD DESIGN COLLECTIVE 3100 S. NATIONAL AVENUE, SUITE 300

S P R I N G F I E L D, M O 6 5 8 0 7 PHONE: 417.890.5543 FAX: 417.890.5563 MISSOURI CERTIFICATE OF AUTHORITY NO. A-2006007284


OFFICE OF ADMINISTRATION DIVISION OF FACILITIES MANAGEMENT, **DESIGN AND CONSTRUCTION**

MO VETERANS COMMISSION

DESIGN AND CONSTRUCT NEW PAVILION FOR: MISSOURI VETERANS HOME

1600 S HICKORY ST. MT VERNON, MO 65712

PROJECT # U2417-01 SITE# 6905 FACILITY # 8136905001

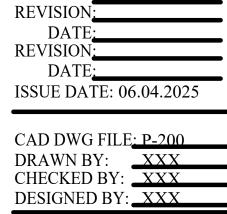

SHEET TITLE:


PLUMBING DETAILS & SCHEDULES

SHEET NUMBER:

P-200

PLAN EQUIPMENT ELECTRIC MARK MANUFACTURER MODEL VOLTAGE PHASE FLA MCA MOCP NOTES EH-1 QMARK LFK204F 208 V 1 7 A 8 A 20 A INTEGRAL THERMOSTAT AND CONTROL

EXHAUST FAN SCHEDULE PLAN EQUIPMENT ELECTRIC MARK MANUFACTURER MODEL VOLTAGE PHASE FLA MCA MOCP NOTES EF-1 COOK GC128 120 V 1 2.0 A 2 A 15 A INCLUDE FACTORY WALL CAP. OPERATE VIA LIGHTING CIRCUIT

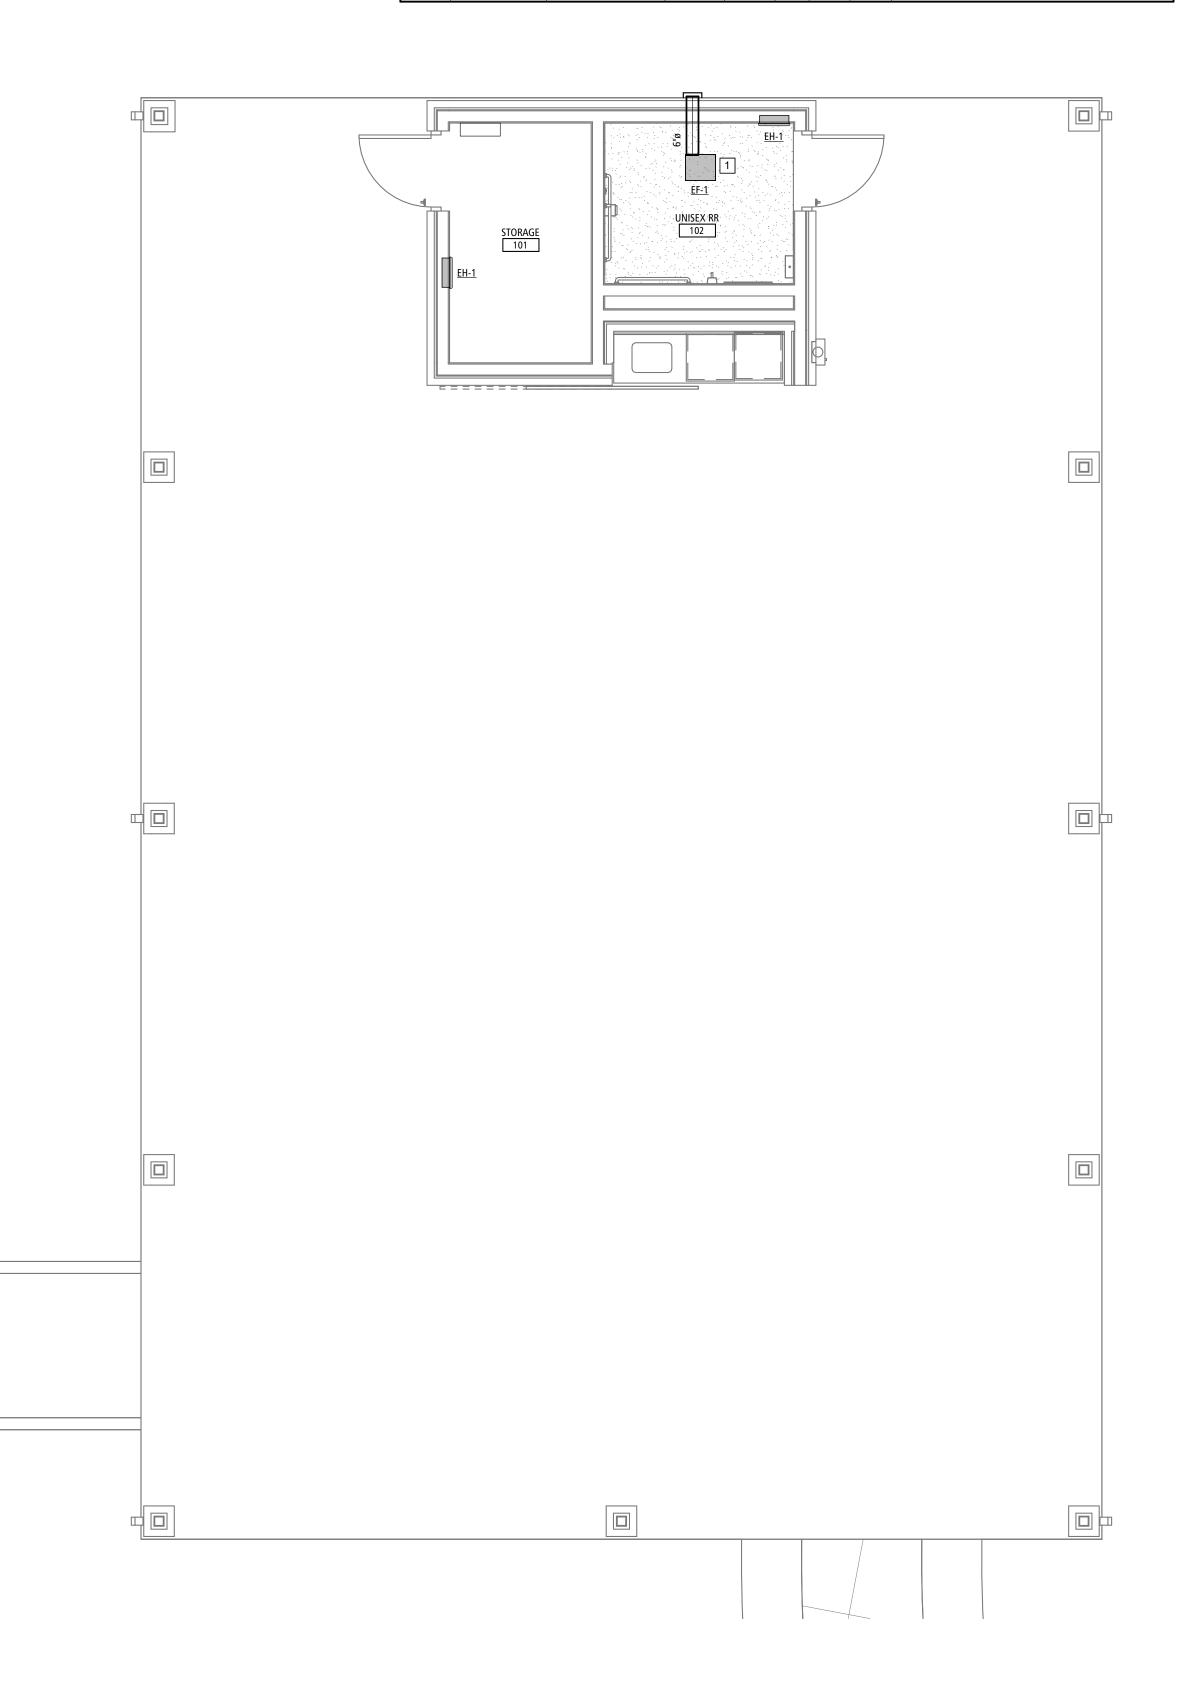

MECHANICAL GENERAL NOTES:

FOR MT. VERNON, MO.

- A. THE GENERAL NOTES ON THIS SHEET SPACE SHALL APPLY TO ALL OTHER SHEET SPACES.
- B. ALL INSTALLATIONS SHALL CONFORM TO THE 2012 INTERNATIONAL MECHANICAL CODE AND THE CURRENT ADOPTIVE ORDINANCES IN EFFECT
- C. PLANS ARE DIAGRAMMATIC IN NATURE AND NOT TO BE SCALED. REFER TO ARCHITECTURAL DRAWINGS FOR FINISH DETAILS, ELEVATIONS, AND EXACT MOUNTING LOCATIONS OF AIR TERMINALS.
 - ANY ADDITIONAL IMPACT COST, DESIGN MODIFICATIONS, ADDITIONAL ARCHITECTURAL AND/OR ENGINEERING SERVICES, MATERIALS, LABOR CHANGES, SCHEDULE CHANGES AND/OR OTHER UNANTICIPATED CONSEQUENCES RESULTING FROM SUBSTITUTIONS IN LIEU OF THE SPECIFIED ITEMS ON THE PLANS AND SPECIFICATIONS SHALL BE THE FULL RESPONSIBILITY OF THE CONTRACTOR, SUBCONTRACTOR, AND/OR SUPPLIER. NO ADDITIONAL COST SHALL BE INCURRED TO THE ARCHITECT, ENGINEER OR OWNER FOR THESE CHANGES.
- E. CLOSELY COORDINATE ALL WORK WITH ALL OTHER TRADES.
- F. SEAL ALL PENETRATIONS THROUGH FIRE-RATED ASSEMBLIES AS NECESSARY TO RESTORE FIRE-RESISTANCE RATING OF ASSEMBLY. REFER TO ARCHITECTURAL PLANS AND SPECIFICATIONS FOR RATED ASSEMBLIES, FIRE STOPPING MATERIALS, AND REQUIREMENTS.
- G. DIFFUSER NECK SHALL BE THE SAME SIZE AS BRANCH DUCT, UNLESS OTHERWISE NOTED.
- H. HVAC CONTRACTOR SHALL PROVIDE ALL HVAC CONTROL DEVICES AND MAKE ALL CONNECTIONS OF HVAC CONTROLS. ELECTRICIAN SHALL PROVIDE ALL NECESSARY CONDUIT, BOXES, AND WIRING.
- PROVIDE TURNING VEINS IN ALL ELBOWS.
- CONFIRM CEILING TYPES WITH ARCHITECTURAL DRAWINGS BEFORE ORDERING AIR TERMINALS.
- K. SUPPLY AND RETURN DUCT SHALL BE ATTACHED TO EQUIPMENT WITH 3" FABRIC DUCT CONNECTOR. PROVIDE 1" SLACK IN FABRIC TO ALLOW FOR VIBRATION ISOLATION.
- L. ALL MATERIALS IN RETURN AIR PLENUMS SHALL BE LISTED AND LABELED AS HAVING A FLAME SPREAD INDEX OF NOT MROE THAN 25 AND A SMOKE-DEVELOPED INDEX OF NOTE MORE THAN 50. PER SECTION 602 OI IMC 2012.
- M. ALL EXPOSED DUCTWORK SHALL BE PAINTED TO MATCH THE CEILING ABOVE.

MECHANICAL PLAN KEYNOTES

 PROVIDE FACTORY WALL CAP AT EXHAUST FAN EXIT. REFER TO LIGHTING PLAN E-200 FOR EF-1 WIRING AND OPERATION.

OFFICE OF
ADMINISTRATION
DIVISION OF FACILITIES
MANAGEMENT,
DESIGN AND
CONSTRUCTION

STATE OF MISSOURI

MICHAEL L. KEHOE,

GOVERNOR

DYLAN F. CHORICE

NUMBER

DYLAN F. CHORICE, ENGINEER

MO.#: E-2020000017

BUXTON KUBIK DODD
DESIGN COLLECTIVE

3 1 0 0 S. NATIONAL AVENUE, SUITE 3 0 0 S P R I N G F I E L D, M O 6 5 8 0 7 PHONE: 417.890.5563 FAX: 417.890.5563

MISSOURI CERTIFICATE OF AUTHORITY NO. A-2006007284

E-2020000017

MO VETERANS COMMISSION

DESIGN AND CONSTRUCT NEW PAVILION FOR: MISSOURI VETERANS HOME

1600 S HICKORY ST. MT VERNON, MO 65712

PROJECT # U2417-01 SITE # 6905 FACILITY # 8136905001

REVISION:
DATE:
REVISION:
DATE:
REVISION:
DATE:
REVISION:

ISSUE DATE: 06.04.2025

CAD DWG FILE: M-100

CAD DWG FILE: M-100
DRAWN BY: XXX
CHECKED BY: XXX
DESIGNED BY: XXX

SHEET TITLE:

MECHANICAL PLAN


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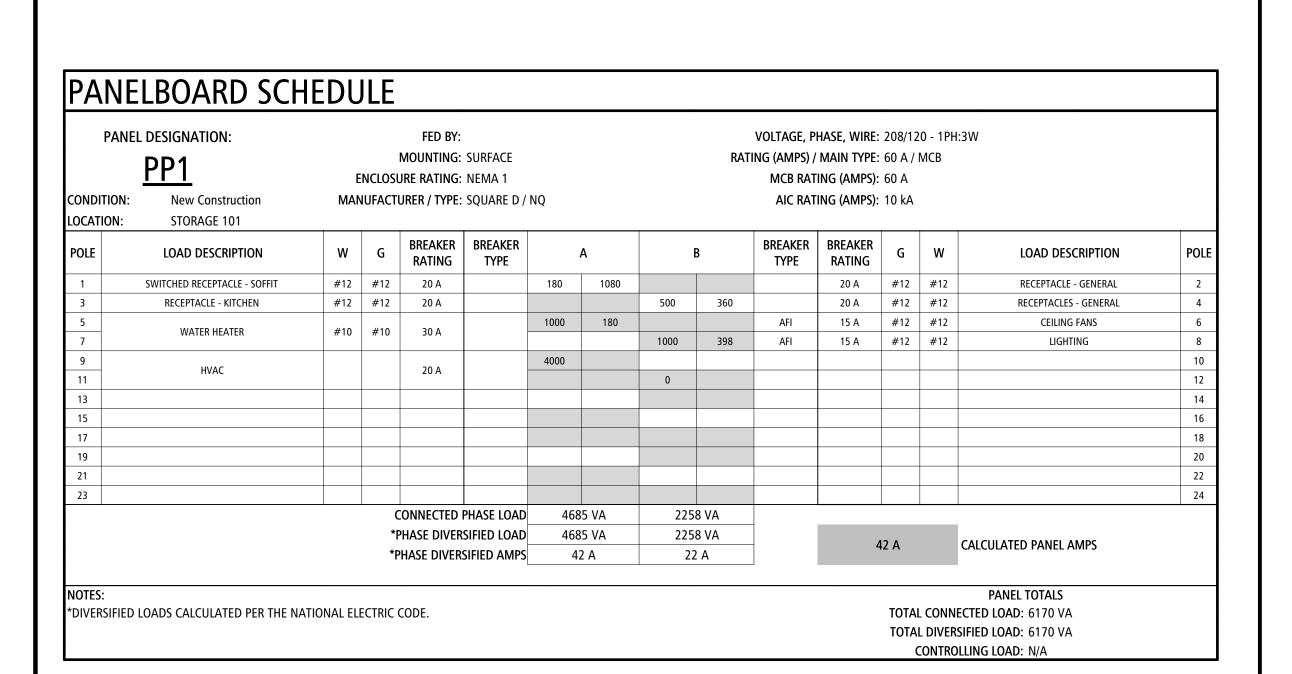
M-100


16 OF 18 SHEETS 06.04.2025

MECHANICAL PLAN 1

SCALE: 1/4" = 1'-0" M-100



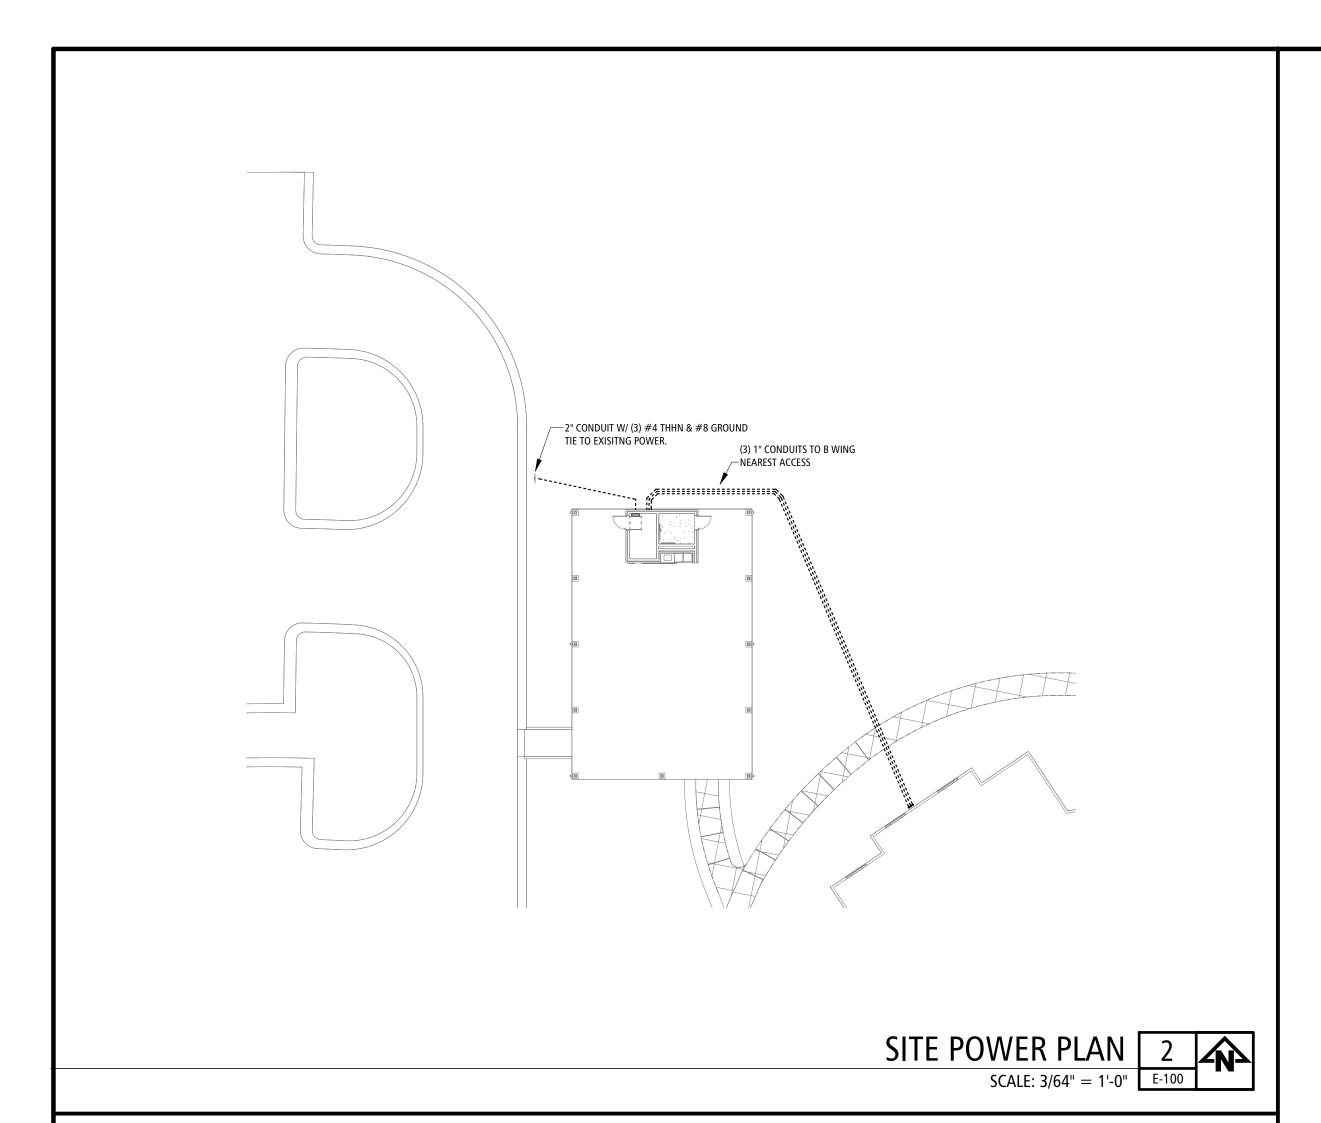

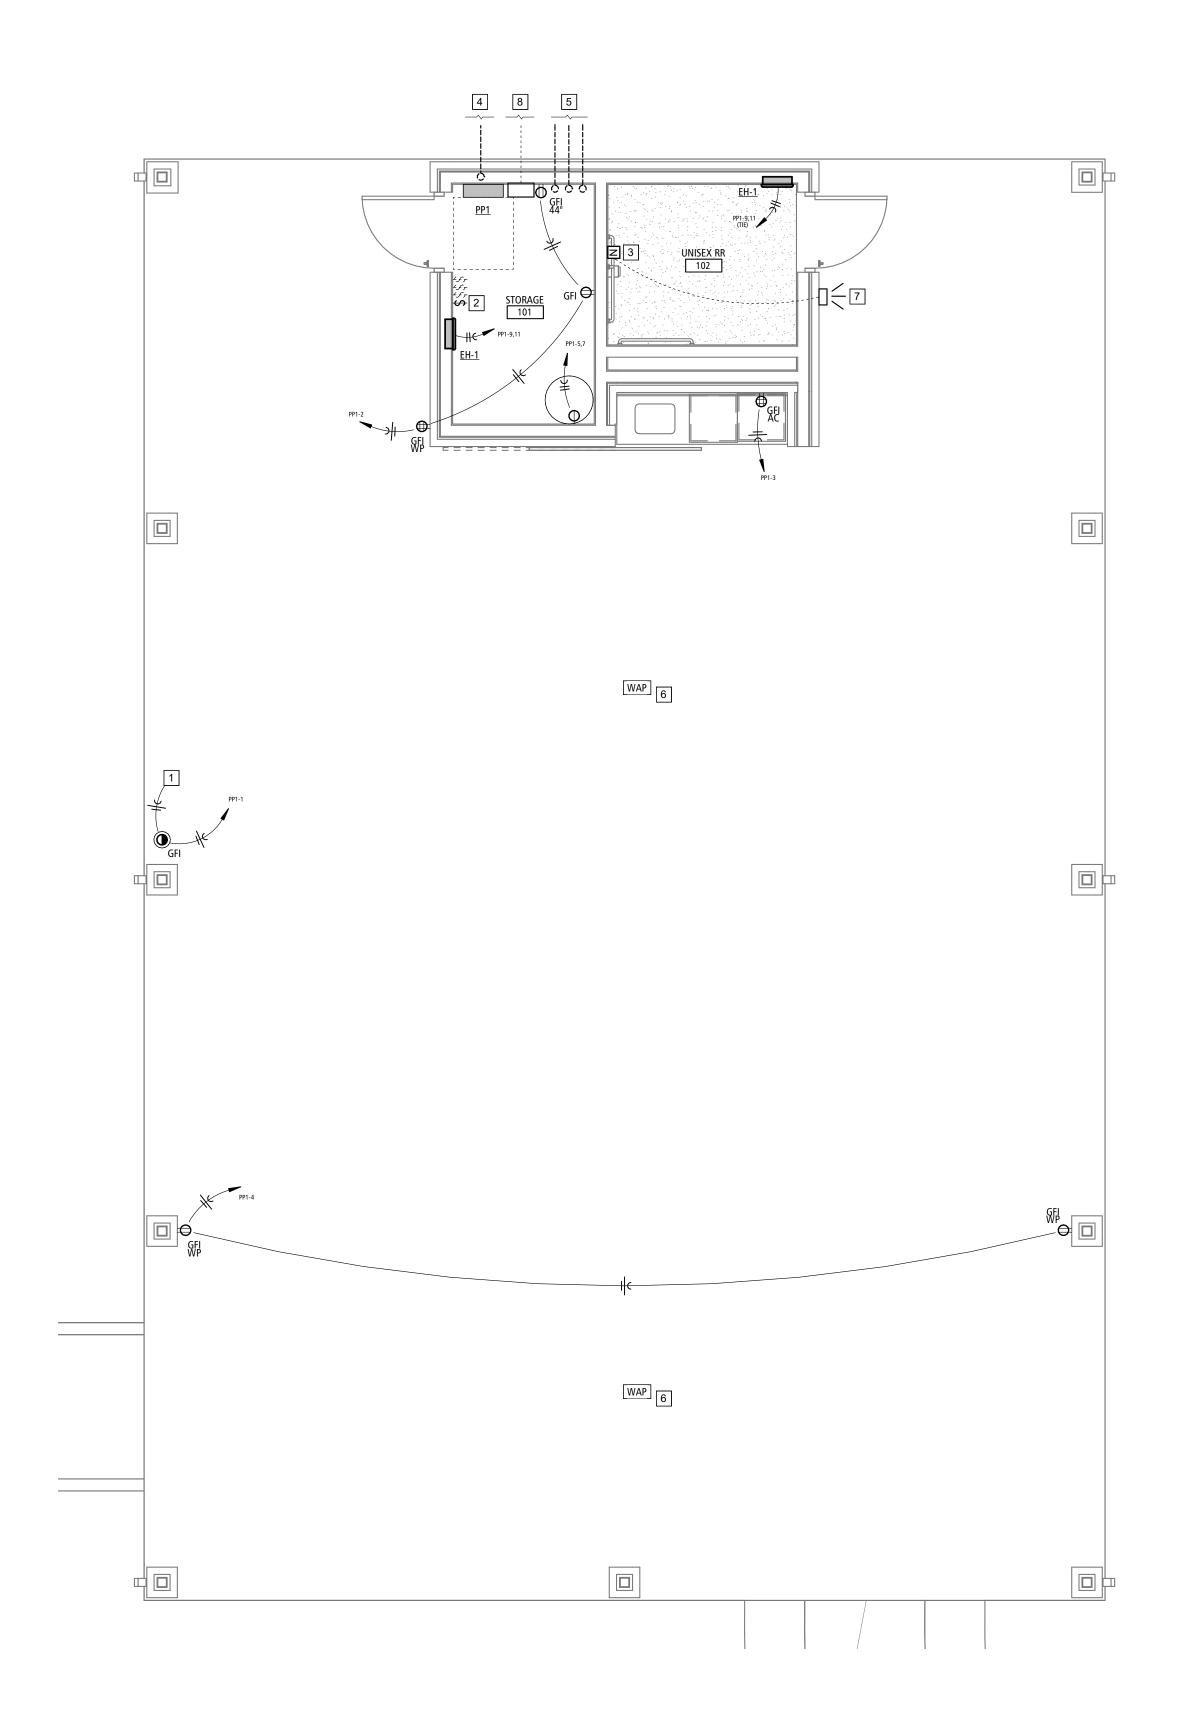

ELECTRICAL GENERAL NOTES:

- A. THE GENERAL NOTES ON THIS SHEET SPACE SHALL APPLY TO ALL OTHER SHEET SPACES.
- . ALL INSTALLATIONS SHALL CONFORM TO THE 2011 NATIONAL ELECTRIC CODE AND THE CURRENT ADOPTIVE ORDINANCES IN EFFECT FOR MT.
- PLANS ARE DIAGRAMMATIC IN NATURE AND NOT TO BE SCALED. REFER TO ARCHITECTURAL DRAWINGS FOR FINISH DETAILS, ELEVATIONS, AND EXACT MOUNTING LOCATIONS OF AIR TERMINALS.
- ANY ADDITIONAL IMPACT COST, DESIGN MODIFICATIONS, ADDITIONAL ARCHITECTURAL AND/OR ENGINEERING SERVICES, MATERIALS, LABOR CHANGES, SCHEDULE CHANGES AND/OR OTHER UNANTICIPATED CONSEQUENCES RESULTING FROM SUBSTITUTIONS IN LIEU OF THE SPECIFIED ITEMS ON THE PLANS AND SPECIFICATIONS SHALL BE THE FULL RESPONSIBILITY OF THE CONTRACTOR, SUBCONTRACTOR, AND/OR SUPPLIER. NO ADDITIONAL COST SHALL BE INCURRED TO THE ARCHITECT, ENGINEER OR OWNER FOR THESE CHANGES.
- CLOSELY COORDINATE ALL WORK WITH ALL OTHER TRADES.
- SEAL ALL PENETRATIONS THROUGH FIRE-RATED ASSEMBLIES AS NECESSARY TO RESTORE FIRE-RESISTANCE RATING OF ASSEMBLY. REFER TO ARCHITECTURAL PLANS AND SPECIFICATIONS FOR RATED ASSEMBLIES, FIRE STOPPING MATERIALS, AND REQUIREMENTS.
- ALL EXIT AND EMERGENCY LIGHT FIXTURES SHALL BE MOUNTED AT 9'-0" MAX ABOVE FINISHED FLOOR UNLESS NOTED OTHERWISE.
- . FIXTURE WITH THE "NL" (NIGHT LIGHT) SYMBOL SHALL NOT BE CONNECTED TO THE SWITCH LEG AND SHALL ALWAYS REMAIN ON.
- ELECTRICAL CONTRACTOR IS RESPONSIBLE FOR CONNECTIONS TO ALL EQUIPMENT, INCLUDING BUT NOT LIMITED TO HVAC EQUIPMENT. PROVIDE ALL CORD AND PLUG SETS AS NEEDED. COORDINATE ALL WORK AND ROUGH-INS WITH EQUIPMENT INSTALLATION.
- ELECTRICAL CONTRACTOR SHALL PROVIDE CONDUIT, WIRE, AND BOXES NECESSARY FOR HVAC CONTROLS. ALL CONTROL CONNECTIONS BY HVAC
- ELECTRICAL CONTRACTOR SHALL COORDINATE ALL DEVICE LOCATIONS
- COORDINATE ALL DEVICE HEIGHTS WITH ARCHITECTURAL ELEVATIONS, EQUIPMENT, CASEWORK INSTALLATION, AND FURNITURE INSTALLATION.
- M. TV ANNOTATION TO REPRESENT TELEVISION AUDIO/VISUAL BOX RECESSED IN WALL AND CONCEALED BEHIND TELEVISION IN AN ACCESSIBLE LOCATION. COORDINATE EXACT LOCATION AND HEIGHT WITH INTERIOR ELEVATIONS AND TELEVISION MOUNTING REQUIREMENTS. INSTALL NEARBY RECEPTACLE AND ROUGH-IN SINGLE GANG BOX WITH 1" CONDUIT LOW VOLTAGE WIRING AND DEVICES BY OWNER-SELECTED VENDOR.
- UNLESS OTHERWISE INDICATED BY UTILITY COMPANY, THE ELECTRICAL CONTRACTOR IS RESPONSILBE FOR PRIMARY TRENCHING, CONDUIT INSTALL, AND BACKFILLING. COORINDATE RESPONSIBILTY OF FEEDER PURCHASING AND INSTALL.
- ALL RECEPTACLES INSTALLED IN PUBLIC SPACES TO BE TAMPER RESISTANT.

ELECTRICAL PLAN KEYNOTES

. ROUTE TO SWITCH.

POWER PLAN

- SWITCH FOR 20A RECEPTACLE IN SOFFIT FOR LIGHTS OR MISC POWER. PROVIDE TAG ON SWITCH TO INDICATE "SWITCH FOR RECEPTACLE IN SOFFIT". COORDINATE LOCATION WITH OTHER LIGHT SWITCHES IN STORAGE ROOM.
- NURSE CALL STATION COMPATIBLE WITH EXISTING TELLIGENCE SYSTEM -CONFIRM SELECTION WITH OWNER. UTILIZE CONDUIT GOING TOWARDS MAIN BUILDING FOR OPERATION.
- 4. 2" CONDUIT TO EXISTING POWER. REFER TO SITE PLAN.
- 5. STUB UP (3) 1" CONDUITS TO ROUTE INTO B WING AND TERMINATE AT NEAREST ACCESSABLE POINT ABOVE CEILING FOR LOW VOLTAGE DATA AND COMMUNICATION WIRING. REFER TO SITE PLAN.
- 6. COORDIANTE WIRELESSS ACCESS POINT LOCAITONS WITH OWNER. ELECTRICIAN RESPONSIBLE FOR CONDUIT TO EACH LOCATION.
- 7. PROVIDE NURSE CALL LIGHT ON EXTERIOR WALL OF RESTROOM.
- 8. PROVIDE PATHWAY (IF REQUIRED) FOR HOLDING TANK OVERFLOW ALARM. TIE ALARM SYSTEM INTO CONVENIENCE RECEPTACLE. IF DIRECT BURIAL CALBE THEN PROVIDE SLEEVING THROUGH WALL AND UP TO ALARM CONTROL BOX. ENSURE ALARM PROVIES AUDIBLE AND VISUAL SIGNAL WITH 12V OUTPUT FOR INTEGRATION BY BUILDING MAINTENANCE IF REQUIRED.

STATE OF MISSOURI MICHAEL L. KEHOE, **GOVERNOR**





BUXTON KUBIK DODD

DESIGN COLLECTIVE 3100 S. NATIONAL AVENUE, SUITE 300 SPRINGFIELD, MO 65807 MISSOURI CERTIFICATE OF AUTHORITY NO. A-2006007284

OFFICE OF ADMINISTRATION DIVISION OF FACILITIES MANAGEMENT, **DESIGN AND** CONSTRUCTION

MO VETERANS COMMISSION

DESIGN AND CONSTRUCT NEW PAVILION FOR: MISSOURI VETERANS HOME

1600 S HICKORY ST. MT VERNON, MO 65712

PROJECT # U2417-01 6905 FACILITY # 8136905001

ISSUE DATE: 06.04.2025

CAD DWG FILE: E-100 DRAWN BY: CHECKED BY: XXX DESIGNED BY: XXX

SHEET TITLE:

POWER PLAN

SHEET NUMBER

E-100


17 OF 18 SHEETS

06.04.2025

LIG	LIGHT FIXTURE SCHEDULE														
					MOUNT				LAMPS			ELECTRICAL			
PLAN MARK	DESCRIPTION	MANUFACTURER	MODEL	RECESSED	SURFACE	SUSPENDED	WALL	POLE	TYPE	LUMENS	COLOR TEMP (K)	VOLTAGE	LOAD (VA)	NOTES	
Α	DOWNLIGHT - RECESSED	COOPER	RL4-LS-9FSD2W-1E-WH-DM						N/A	900	3500	120	10	2	
В	SUSPENDED STRIP	HE WILLIAMS	75S-4-L50-835-DIM-UNV						N/A	5000	3500	UNV	33		
С	WALL SCONCE	TBD	TO BE DETERMINED - MATCH EXISTING						N/A	1000	3500	UNV	30	3	
CF	CEILING FAN	MINKAAIRE	F896-65-CL						N/A	N/A		120	60	1	
TR1	RECESSED TROFFER	HE WILLIAMS	50G-S24-L33/835-S-AF12125-DIM-UNV						N/A	3300	3500	UNV	25		

LIGHTING PLAN KEYNOTES

- SWITCH SCHEDULE:
- A. STORAGE ROOM OCCUPANCY SWITCH
- B. OVERHEAD CAN LIGHTS ON/OFF
- C. COORDINATE MOUTNING LOCATION WITH SWITCH FOR SOFFIT POWER AS SHOWN ON E1-1.
- D. EACH FAN WILL HAVE AN INDIVIDUAL FAN LIGHT AND SPEED REMOTE. INSTALL REMOTE HOUSING IN LINE WITH SWITCHES AND INDICATE WHICH FAN IS LINKED TO EACH REMOTE. EXHAUST FAN WIRED INTO LIGHTING CIRCUIT

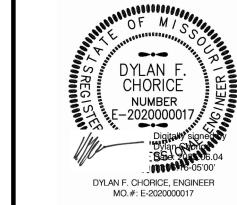

STATE OF MISSOURI

MICHAEL L. KEHOE, **GOVERNOR**



BUXTON KUBIK DODD

DESIGN COLLECTIVE 3 1 0 0 S. N A T I O N A L A V E N U E, S U I T E 3 0 0 S P R I N G F I E L D, M O 6 5 8 0 7 PHONE: 417.890.5563 MISSOURI CERTIFICATE OF AUTHORITY NO. A-2006007284


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CAD DWG FILE: E-200
DRAWN BY: XXX
CHECKED BY: XXX
DESIGNED BY: XXX

SHEET TITLE:

LIGHTING PLAN

SHEET NUMBER:

E-200

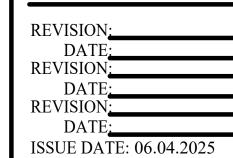