REPLACE FLOORING & RENOVATE FRONT ENTRANCE MISSOURI GEOLOGICAL SURVEY BUEHLER BUILDING ROLLA, MISSOURI

OWNER:

STATE OF MISSOURI

MIKE KEHOE, GOVERNOR

DEPARTMENT OF NATURAL RESOURCES

PROJECT

OFFICE OF ADMINISTRATION

MANAGEMENT: DIVISION OF FACILITIES MANAGEMENT,

DESIGN & CONSTRUCTION

DESIGNER:

STATE OF MISSOURI

OFFICE OF ADMINISTRATION

DIVISION OF FACILITIES MANAGEMENT,

DESIGN & CONSTRUCTION

301 W. HIGH STREET

JEFFERSON CITY, MISSOURI

PROJECT NUMBER:

W2303-01

ASSET NUMBER:

7815001007

05/09/2025



PHASE 1

RECEIVING

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PHASE 2

\ A103

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GENERAL NOTES:

DEMOLITION DRAWINGS AND PLANS ARE FROM FIELD TAKE-OFF AND ORIGINAL DRAWINGS. CONTRACTOR IS RESPONSIBLE FOR FIELD VERIFYING EXISTING CONDITIONS PRIOR TO BIDDING AND/OR CONSTRUCTION.

2. COVER ALL OPENINGS INTO THE BUILDING FROM THE WORK AREA. ENSURE DEBRIS IS REMOVED FROM THE CONSTRUCTION AND DEMOLITION AREA AND AIR BORN DEBRIS IS NOT ALLOWED TO TRAVEL TO THE REMAINDER OF THE BUILDING.

3. PROTECT ALL FIXED EQUIPMENT, FURNITURE, AND FINISHES DURING CONSTRUCTION.

CONTRACTOR IS RESPONSIBLE FOR REMOVAL AND DISPOSAL OF ALL DEMOLISHED MATERIAL, AS WELL AS REPAIRING ANY DAMAGE TO ANY SURFACE IN THE AREA OF CONSTRUCTION THAT IS A RESULT OF CONSTRUCTION ACTIVITY. SURFACE SHALL BE REPAIRED AND FINISHED TO MATCH EXISTING CONDITIONS.

5. RETURN ALL SALVAGED MATERIALS TO OWNER AS REQUESTED IN BID DOCUMENTS.

6. RECYCLE ALL APPLICABLE RECYCLABLE REFUSE OFF SITE.

 ITEMS TO BE REMOVED AND REPLACED BY THE AGENCY AND COORDINATED WITH THE CONSTRUCTION ADMINISTRATOR INCLUDE, BUT ARE NOT LIMITED TO, THE FOLLOWING: PERSONAL BELONGINGS, DIGITAL DISPLAYS AND MEDIA INSTALLATIONS.

BUILDING CODE NOTES:

NEW WORK INSTALLATION TO FOLLOW:
INTERNATIONAL BUILDING CODE 2024 EDITION (IBC)
INTERNATIONAL PLUMBING CODE 2021 EDITION (IPC)
NATIONAL ELECTRICAL CODE 2023 EDITION (NEC)
NFPA 101 LIFE SAFETY CODE 2024 EDITION (NFPA)
NFPA 13 STANDARD FOR THE INSTALLATION OF
SPRINKLER SYSTEMS 2025 EDITION

2010 STANDARDS FOR ACCESSIBLE DESIGN (ADA)

LEGEND:

- SHEET CALLOUT BOUNDARY

—— — PHASE BOUNDARY

A. Th. 1.

PROJECT PHASING NOTES:

A. THE WORK WILL BE CONDUCTED IN 3 PHASES.

1. PHASE 1: AREA OF WORK INCLUDES ROOMS LABELED 119 SHIPPING AND RECEIVING, 119A PUBLICATIONS, 119B STORAGE, 116 CORRIDOR, AND 118 CORRIDOR. WORK CONSISTS OF MOVING FURNITURE OUT OF THE AREAS OF WORK PRIOR TO CONSTRUCTION AND BACK IN AFTER CONSTRUCTION, AS DIRECTED BY OWNER; DEMOLITION OF FLOORING, WOOD CASEWORK AND COUNTERTOP, AND INTERIOR WINDOW, AND ASBESTOS ABATEMENT; INSTALLATION OF NEW CARPET TILES, CONCRETE FLOOR POLISH, VINYL WALL BASE, METAL STUD WALLS, GYPSUM BOARD, INTERIOR PAINT, AND OWNER FURNISHED SYSTEMS FURNITURE; SELECTIVE MODIFICATION OF CEILING GRID, FIRE PROTECTION, THERMOSTAT, AIR DIFFUSERS, RECEPTACLES, AND DATA ACCESS POINTS AS NEEDED. THIS PHASE SHALL BE SUBSTANTIALLY COMPLETE, READY FOR OCCUPANCY WITHIN 35 WORKING DAYS OF COMMENCEMENT OF CONSTRUCTION.

2. PHASE 2: AREA OF WORK INCLUDES ROOMS LABELED 121 GRAPHICS STUDIO AND 121A STORAGE. WORK CONSISTS OF MOVING FURNITURE OUT OF THE AREAS OF WORK PRIOR TO CONSTRUCTION AND BACK IN AFTER CONSTRUCTION, AS DIRECTED BY OWNER; DEMOLITION OF FLOORING, REMOVAL OF EXISTING ELECTRICAL FLOOR BOXES, AND ASBESTOS ABATEMENT; INSTALLATION OF NEW CARPET TILES, VINYL WALL BASE, INTERIOR PAINT, OWNER FURNISHED SYSTEMS FURNITURE, POWER AND DATA FOR SYSTEMS FURNITURE. PHASE 1 AND 2 MAY PROCEED SIMULTANEOUSLY AS NEEDED TO ACHIEVE THE MOST EFFICIENT CONSTRUCTION SCHEDULE TO ACCOMMODATE THE ASBESTOS ABATEMENT PHASING. THIS PHASE SHALL BE SUBSTANTIALLY COMPLETE, READY FOR OCCUPANCY WITHIN 70 WORKING DAYS OF COMMENCEMENT OF CONSTRUCTION.

3. PHASE 3: AREA OF WORK INCLUDES ROOMS LABELED 101 LOBBY, 101A GALLERY, 101B GALLERY, 102 CORRIDOR, AND 103 OFFICE. WORK CONSISTS OF MOVING FURNITURE OUT OF THE AREAS OF WORK PRIOR TO CONSTRUCTION AND BACK IN AFTER CONSTRUCTION, AS DIRECTED BY OWNER; DEMOLITION OF SYSTEMS FURNITURE, FLOORING, METAL STUD WALLS, WOOD DOORS, AND ACOUSTIC CEILING TILES; ASBESTOS ABATEMENT; INSTALLATION OF NEW LUXURY VINYL TILE, VINYL WALL BASE, INTERIOR PAINT, SERVICE WINDOW, ACOUSTIC CEILING TILE, AND SUSPENDED GRID T-BAR; RELOCATION OF FIRE PROTECTION, THERMOSTATS, RECEPTACLES, AND LIGHT FIXTURES AS NEEDED. WORK OF PHASE 3 SHALL NOT COMMENCE UNTIL PHASE 1 AND 2 ARE SUBSTANTIALLY COMPLETE. THIS PHASE SHALL BE SUBSTANTIALLY COMPLETE, READY FOR

OCCUPANCY WITHIN 150 WORKING DAYS OF COMMENCEMENT OF

CONSTRUCTION.

STATE OF MISSOURI MIKE KEHOE, GOVERNOR



Brad M. Schaefer - Architect MO# A-2009027294

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OFFICE OF ADMINISTRATION DIVISION OF FACILITIES MANAGEMENT, DESIGN & CONSTRUCTION

DEPARTMENT OF NATURAL RESOURCES

REPLACE FLOORING & RENOVATE FRONT ENTRANCE MISSOURI

GEOLOGICAL SURVEY -BUEHLER BUILDING 111 FAIRGROUNDS ROAD ROLLA, MISSOURI 65401

PROJECT # W2303-01 SITE # 5001 ASSET # 7815001007

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ISSUE DATE: 05/09/2025

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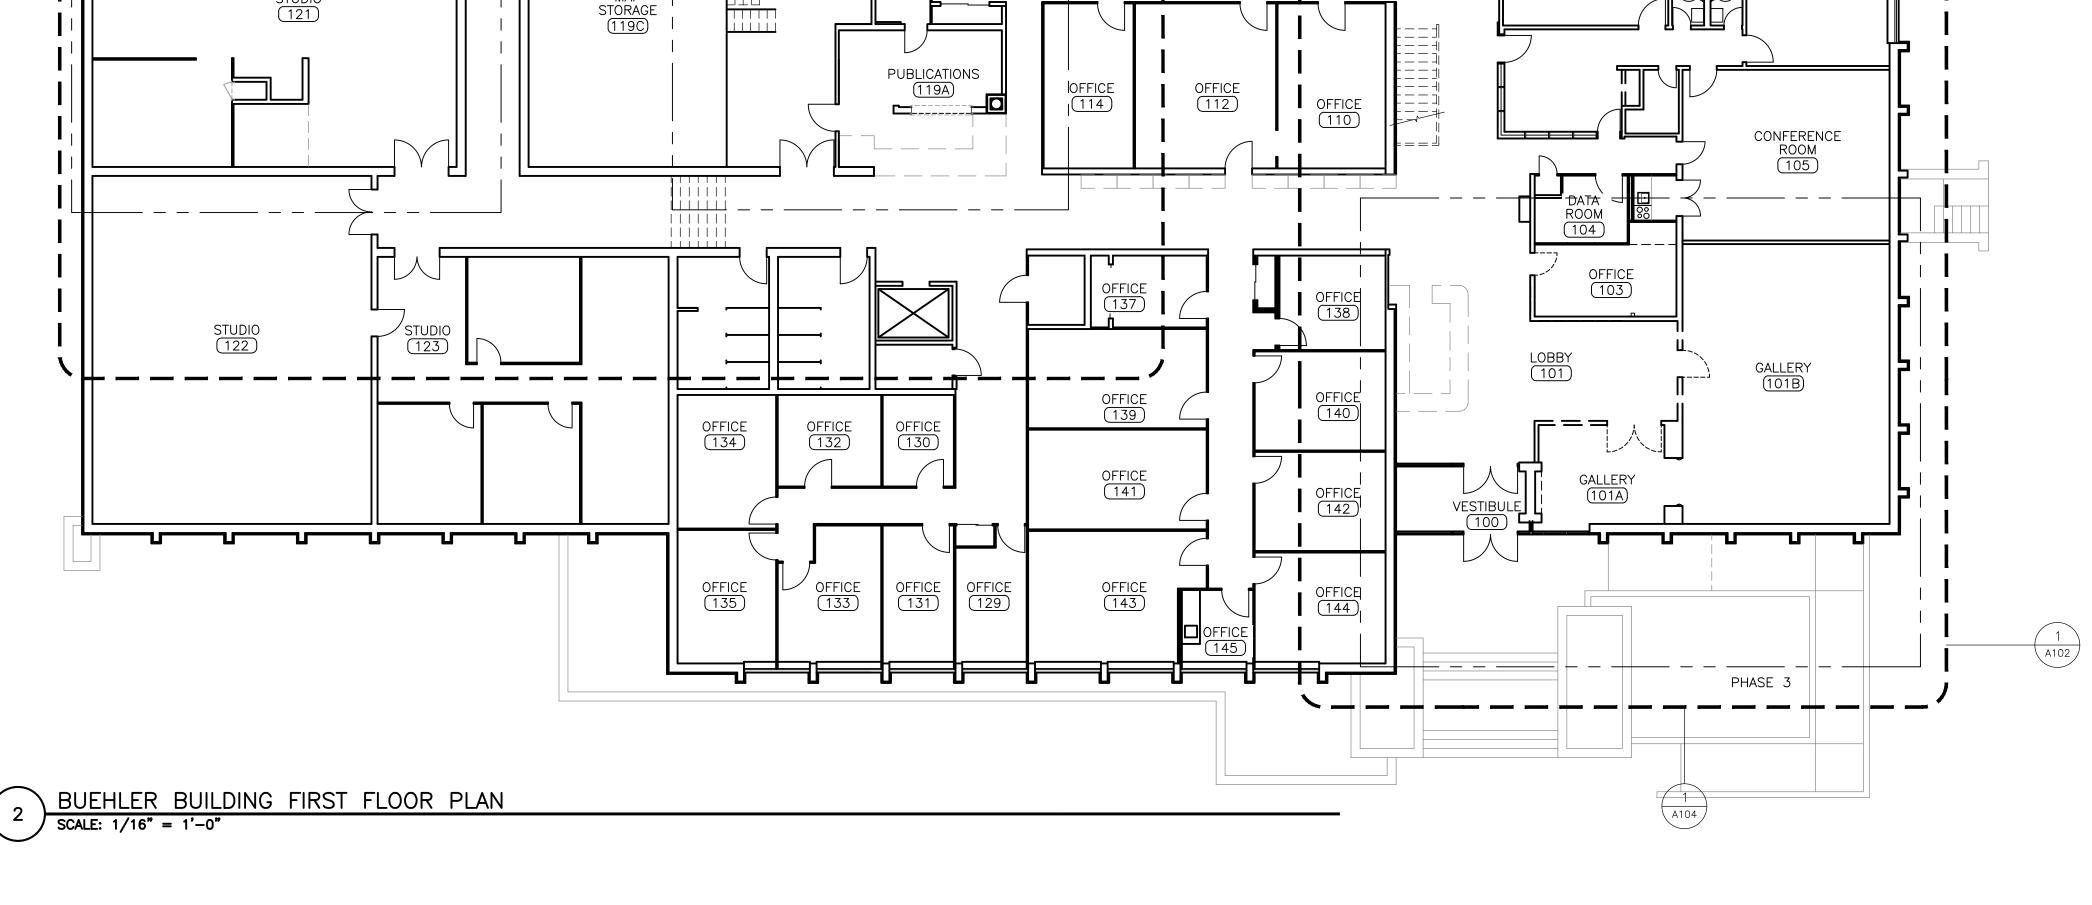
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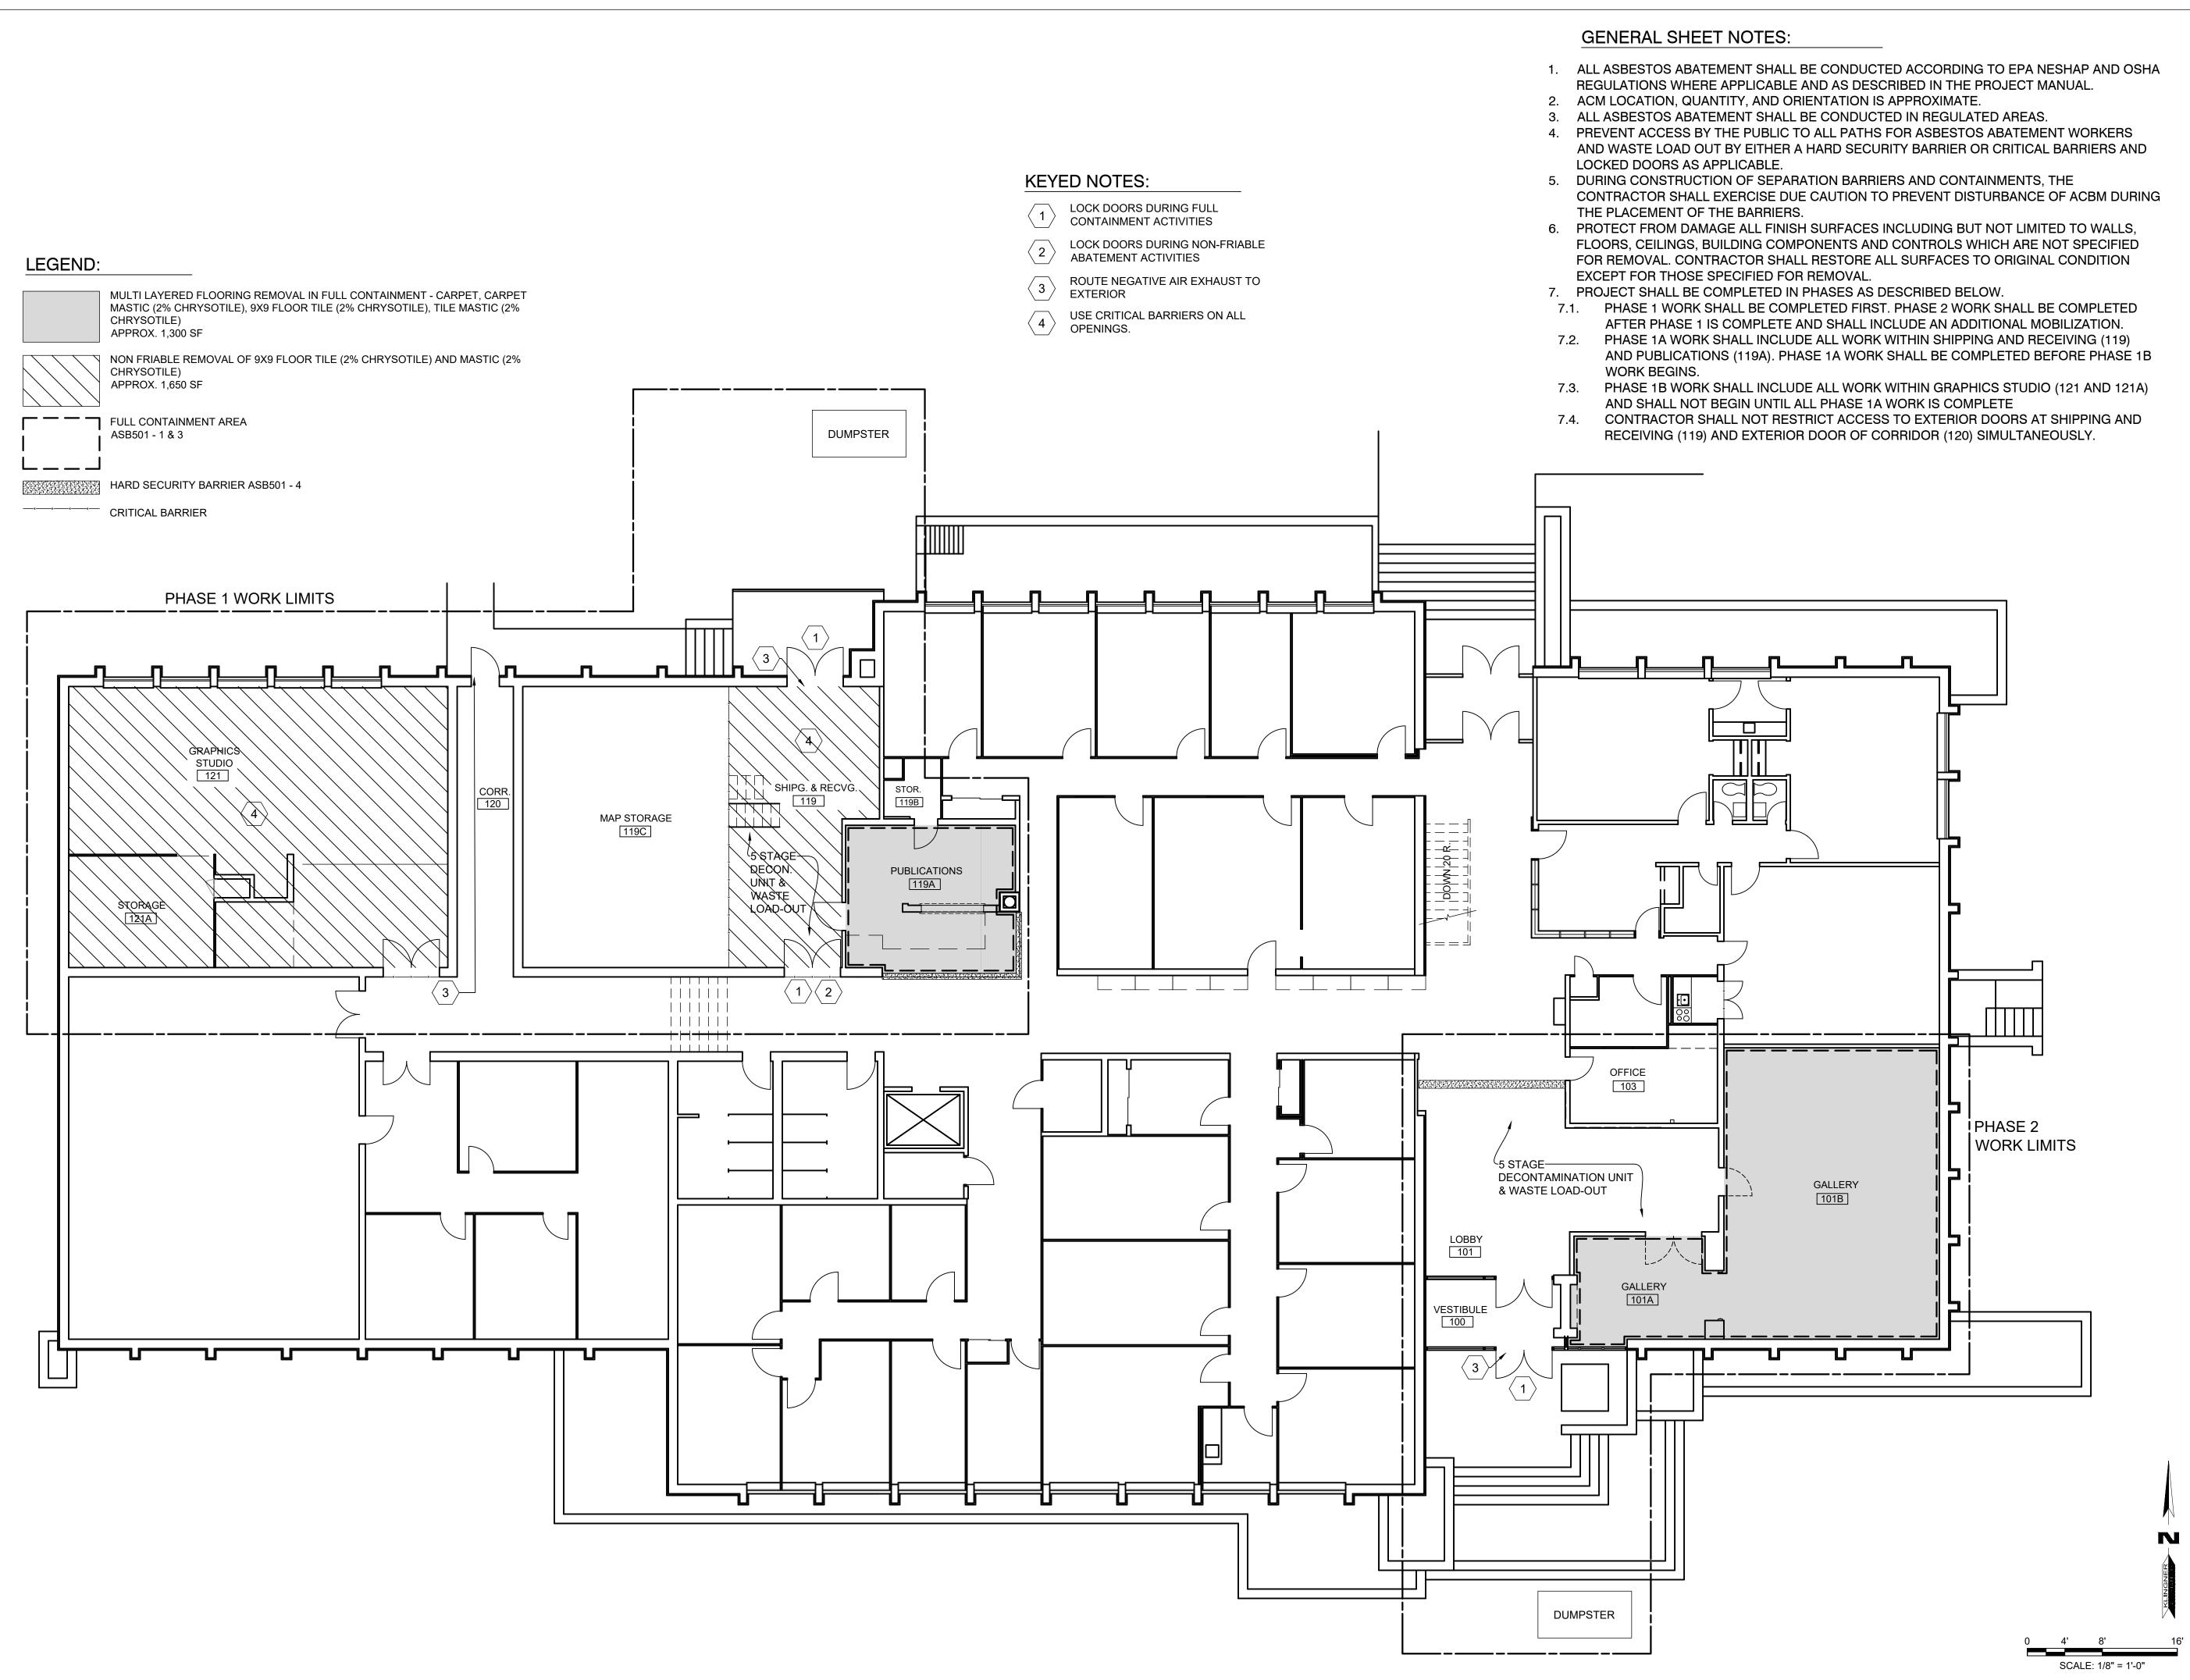
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SHEET INDEX & SITE MAPS

SHEET NUMBER:

G-002





STATE OF MISSOURI MIKE KEHOE,

GOVERNOR

JESSICA A NUMBER 5/5/2025

PE-2022005743

JESSICA COCA - ENGINEER PE MO # - 2022005743 MO ASBESTOS PROJECT DESIGNER #

7118092624MOPDR19727

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OFFICE OF ADMINISTRATION DIVISION OF FACILITIES MANAGEMENT, DESIGN AND CONSTRUCTION

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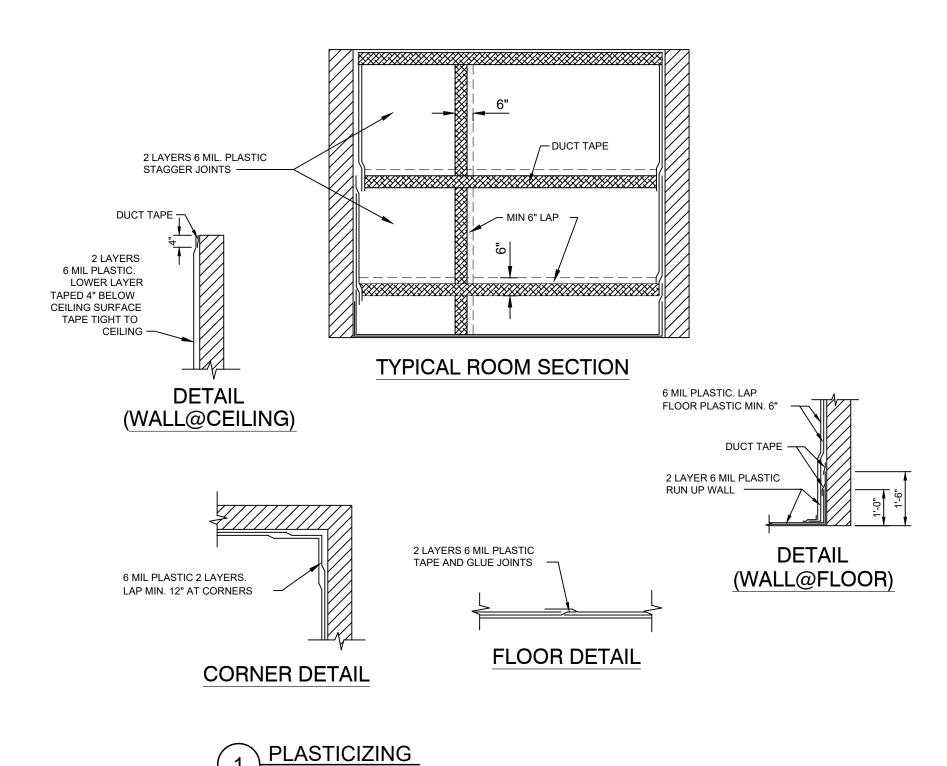
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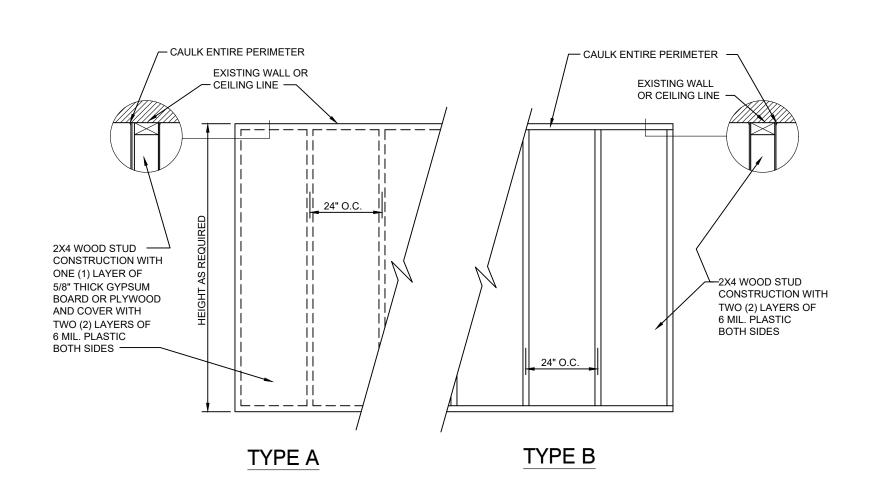
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ASBESTOS ABATEMENT PLAN


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3 TYPICAL WORK BARRIER
NO SCALE




WORKER DECONTAMINATION AND WASTE LOADOUT

UNITS SHALL CONFORM TO MDNR ASBESTOS ABATEMENT REGULATIONS FOUND IN CSR 10-6.240(8)(A)(1) E&F AS APPLICABLE

2 DECONTAMINATION UNIT AND WASTE LOADOUT NO SCALE

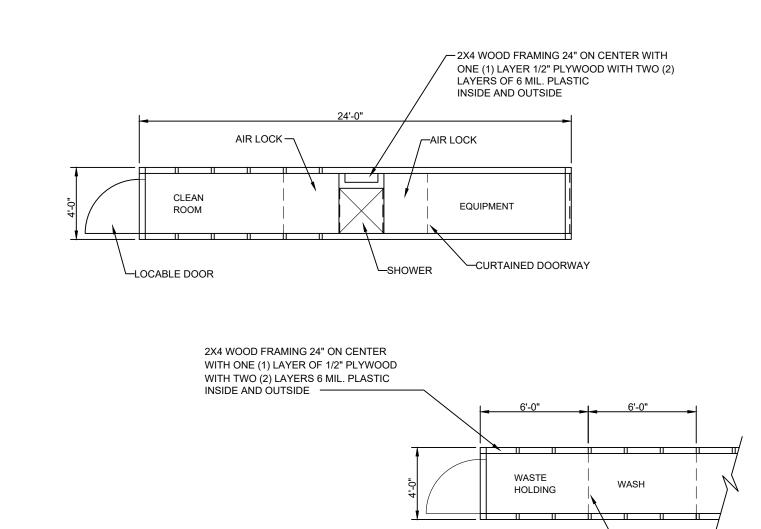CURTAINED DOORWAY

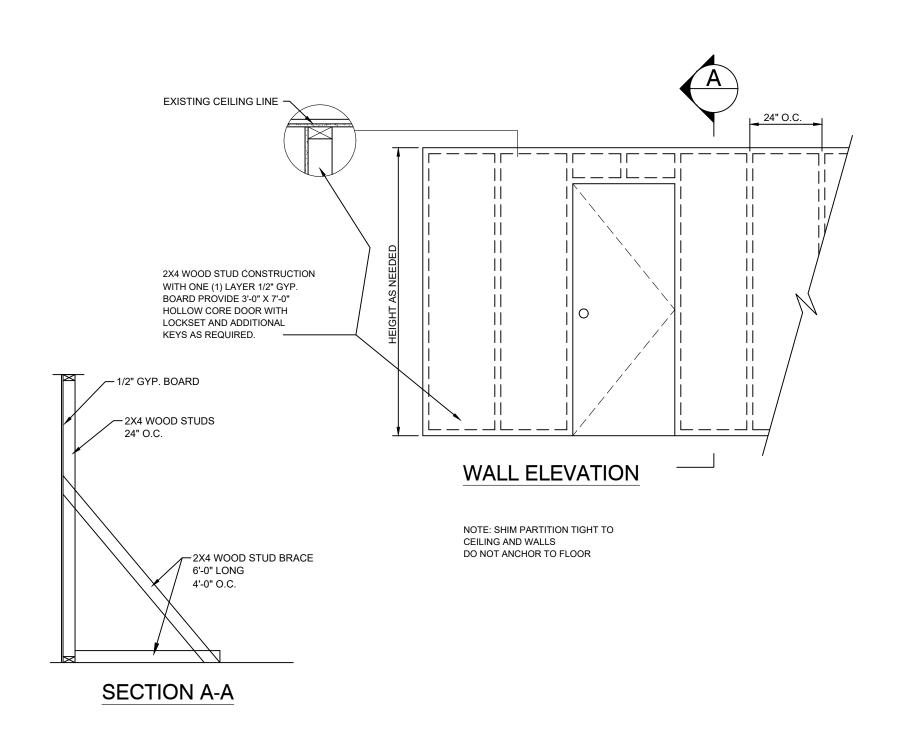

4 SECURITY BARRIER
NO SCALE

STATE OF MISSOURI MIKE KEHOE, GOVERNOR



JESSICA COCA - ENGINEER
PE MO # - 2022005743
MO ASBESTOS PROJECT
DESIGNER #
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111 FAIRGROUNDS ROAD
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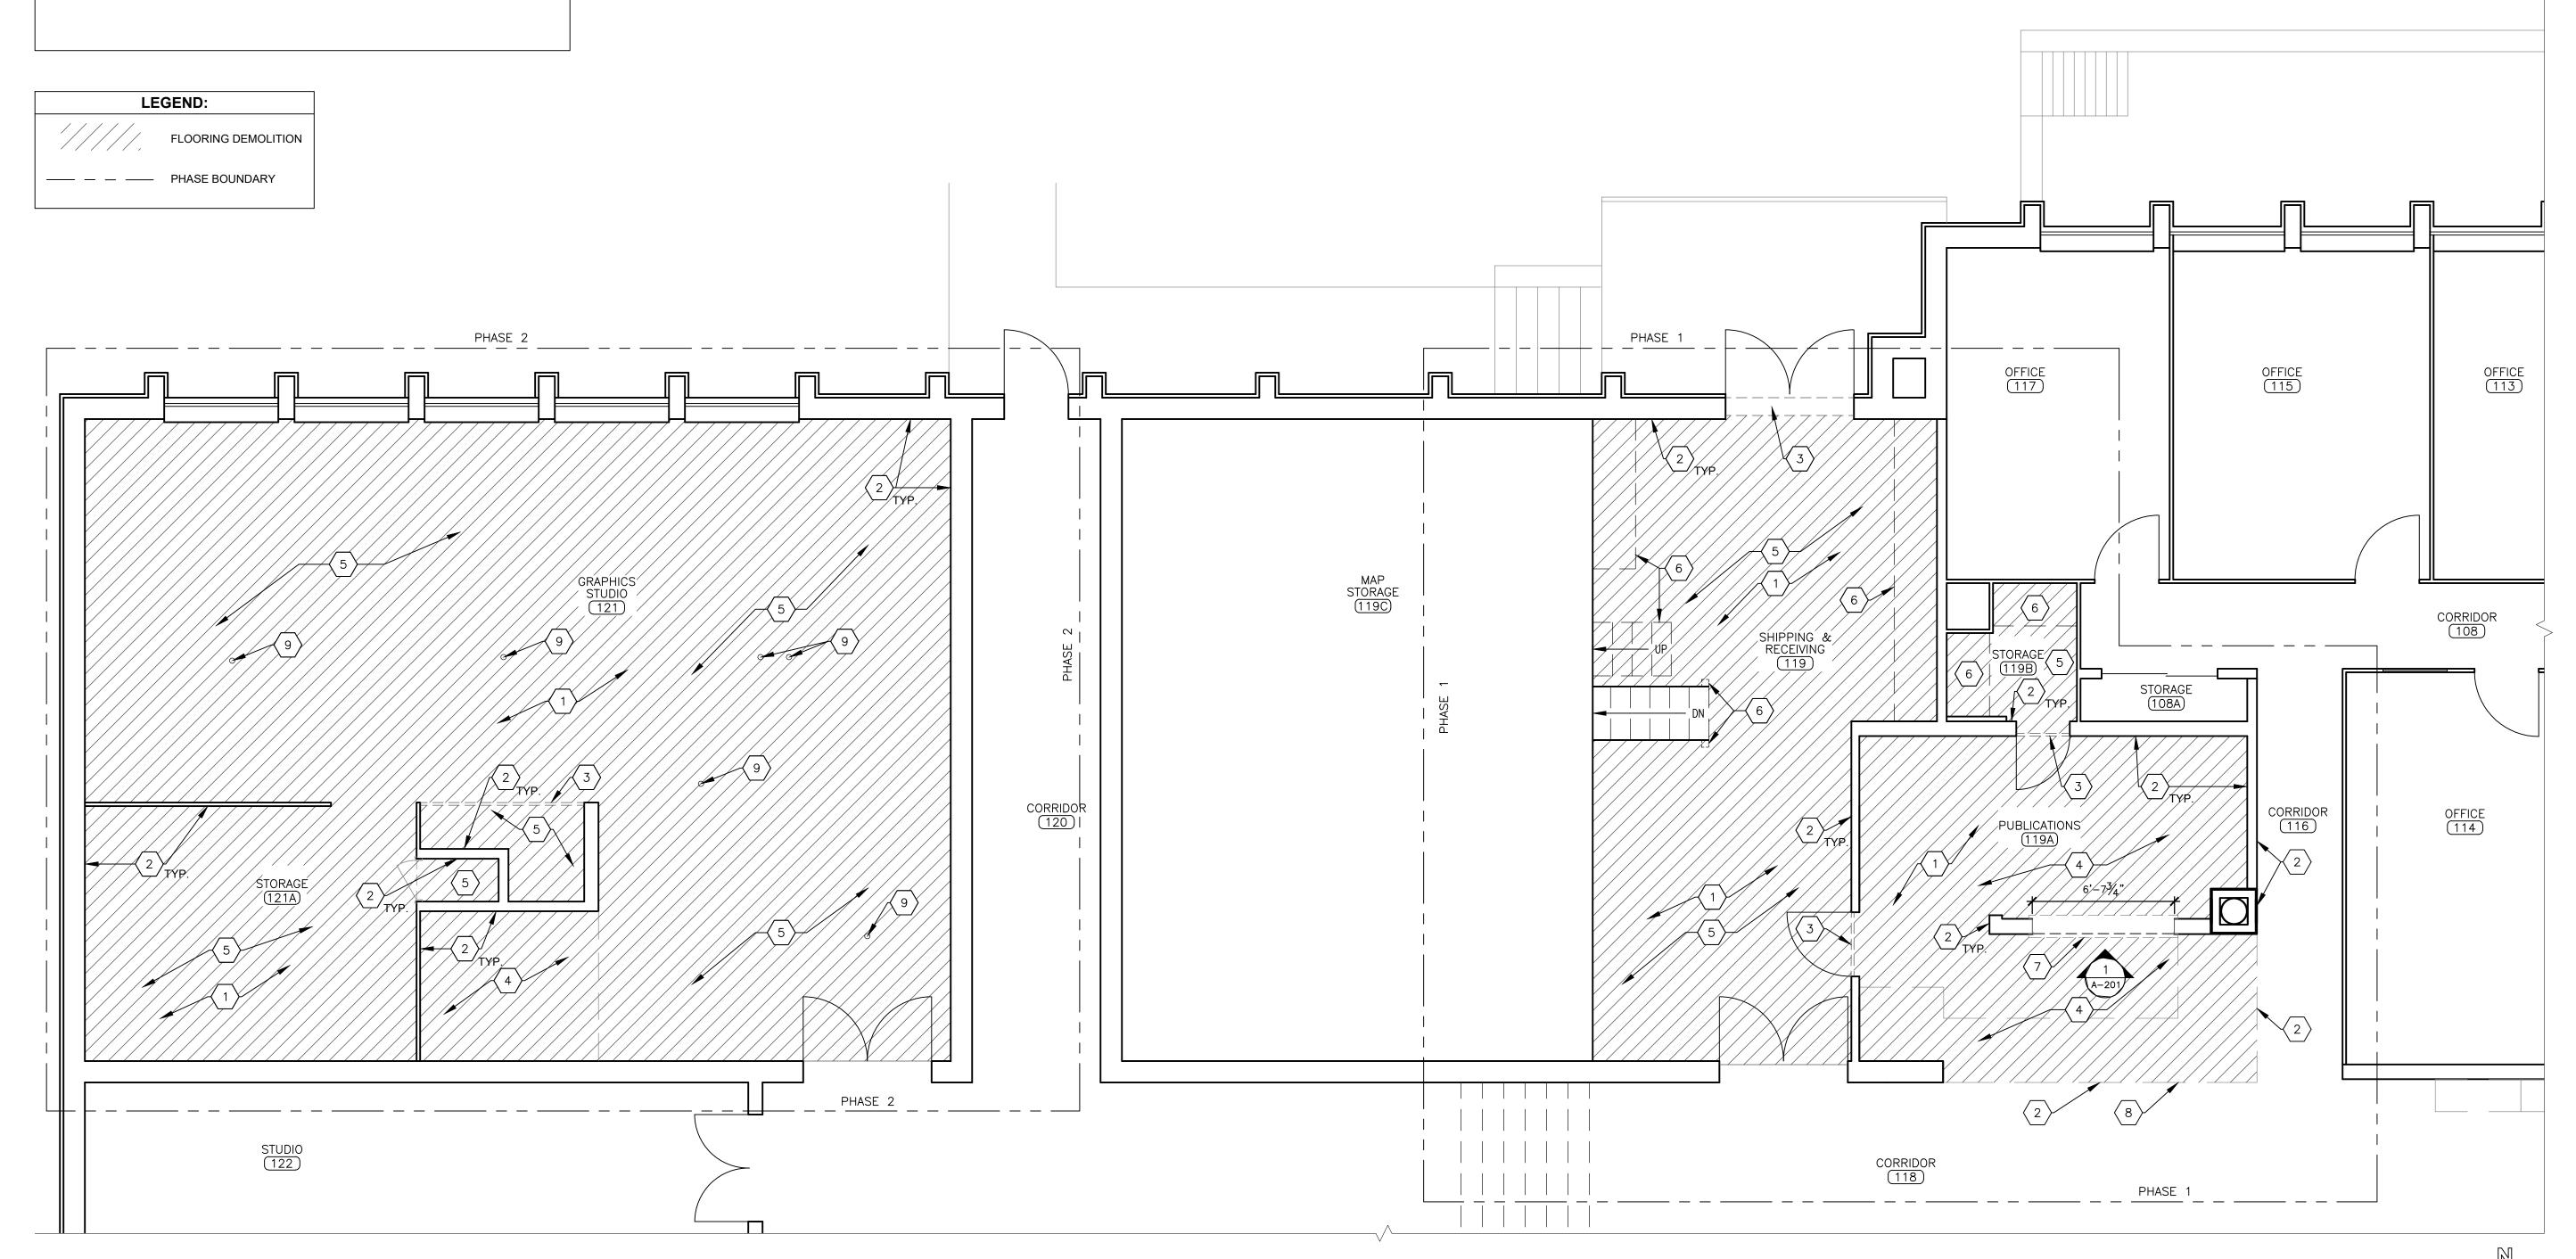
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DEMOLITION KEYNOTES:

- REMOVE ALL FREESTANDING FURNITURE WITHIN THE AREA OF WORK TO RECEIVE NEW FLOORING. PROTECT FURNITURE FROM DAMAGE. COORDINATE TEMPORARY STORAGE LOCATION WITH OWNER. COORDINATE WITH OWNER TO DETERMINE ITEMS TO BE DISPOSED OF, RELINQUISHED, OR MOVED BACK INTO THE AREAS OF WORK AFTER CONSTRUCTION IS COMPLETE.
- REMOVE AND DISPOSE OF EXISTING BASE TRIM WHERE EXISTING FLOOR IS REMOVED, AND WHERE INDICATED. REPAIR ANY DAMAGED WALLS TO A LEVEL 4 FINISH TO MATCH ADJACENT. ENSURE CLEAN AND MOUNTABLE SURFACE FOR NEW BASE APPLICATION.
- 3 REMOVE AND DISPOSE OF EXISTING THRESHOLD/TRANSITION STRIP.
- 4 REMOVE EXISTING FLOORING TO SUBFLOOR BELOW, INCLUDING CARPET TILE AND GLUE UNDERLAYMENT. CONTRACTOR TO REMOVE FLOORING IN ACCORDANCE WITH OWNER PHASING REQUEST. SUBFLOOR TO BE SMOOTHED AND PREPARED TO NEW FLOOR MANUFACTURER'S RECOMMENDATIONS FOR INSTALLATION. COORDINATE WITH ASBESTOS REMEDIATION FOR REMOVAL OF FLOORING.
- REMOVE EXISTING FLOORING TO SUBFLOOR BELOW, INCLUDING VINYL TILE AND GLUE UNDERLAYMENT. CONTRACTOR TO REMOVE FLOORING IN ACCORDANCE WITH OWNER PHASING REQUEST. SUBFLOOR TO BE SMOOTHED AND PREPARED TO NEW FLOOR MANUFACTURER'S RECOMMENDATIONS FOR INSTALLATION. COORDINATE WITH ASBESTOS REMEDIATION FOR REMOVAL OF FLOORING.
- REMOVE OBJECTS AFFIXED TO THE FLOOR AS NECESSARY FOR FLOORING
 DEMOLITION. COORDINATE WITH OWNER TO DETERMINE ITEMS TO BE DISPOSED OF,
 RELINQUISHED, OR SALVAGED FOR REUSE. AFFIXED OBJECTS MAY INCLUDE BUT ARE
 NOT LIMITED TO METAL STAIRS, RAILING, AND SHELVING UNITS.
- $\overline{7}$ REMOVE EXISTING SERVICE WINDOW, TRIM, AND SILL.
- $\binom{8}{8}$ REMOVE AND DISPOSE OF EXISTING WOOD CASEWORK AND COUNTERTOPS.
- PREFER TO ELECTRICAL DRAWINGS FOR FLOOR BOX DEMOLITION. REPAIR FLOOR AS NEEDED TO FLAT SURFACE FOR CARPET INSTALLATION.

GENERAL NOTES:

- CONTRACTOR TO VERIFY DIMENSIONS OF EXISTING SPACE PRIOR TO BID.
- CONTRACTOR TO REMOVE EXISTING TRANSITIONS AND TRIM
 AS REQUIRED AND TO PROTECT EXISTING TRIM TO REMAIN.
- CONTRACTOR TO TAKE MEASURES TO PROTECT EXISTING WALL FIXTURES AND MATERIAL FROM DAMAGE DURING DEMOLITION AND INSTALLATION.
- 4. CONTRACTOR TO COORDINATE PATHS THROUGH BUILDING FOR DELIVERY OF CONSTRUCTION MATERIAL AND WORKERS WITH FACILITY STAFF PRIOR TO COMMENCEMENT OF WORK.
- 5. CONTRACTOR TO COORDINATE WITH STAFF WHEN REMOVING FURNITURE TO DETERMINE EXACT LAYOUT FOR ACCURATE REPLACEMENT ALONG WITH STORAGE OF ITEMS.
- 6. CONTRACTOR TO FIELD VERIFY DIMENSIONS OF EXISTING SPACE AND NEW FLOORING LIMITS PRIOR TO MATERIAL PROCUREMENT AND INSTALLATION.
- 7. ALL ADJACENT STRUCTURES TO REMAIN IN PLACE.
 CONTRACTOR SHALL PROTECT ANY MATERIALS INSTALLATION
 ABUTS UP TO OR COULD POTENTIALLY BE DAMAGED DURING
 INSTALLATION TO ENSURE INTEGRITY AND FINISH ARE
 MAINTAINED.
- 8. COORDINATE SCHEDULE WITH FACILITY STAFF PRIOR TO START OF WORK.



STATE OF MISSOURI MIKE KEHOE, GOVERNOR



OCUMENTS

OFFICE OF ADMINISTRATION DIVISION OF FACILITIES MANAGEMENT, DESIGN & CONSTRUCTION

DEPARTMENT OF NATURAL RESOURCES

REPLACE FLOORING &
RENOVATE FRONT
ENTRANCE
MISSOURI
GEOLOGICAL SURVEY -

GEOLOGICAL SURVEY -BUEHLER BUILDING 111 FAIRGROUNDS ROAD ROLLA, MISSOURI 65401

PROJECT # W2303-01 SITE # 5001 ASSET # 7815001007

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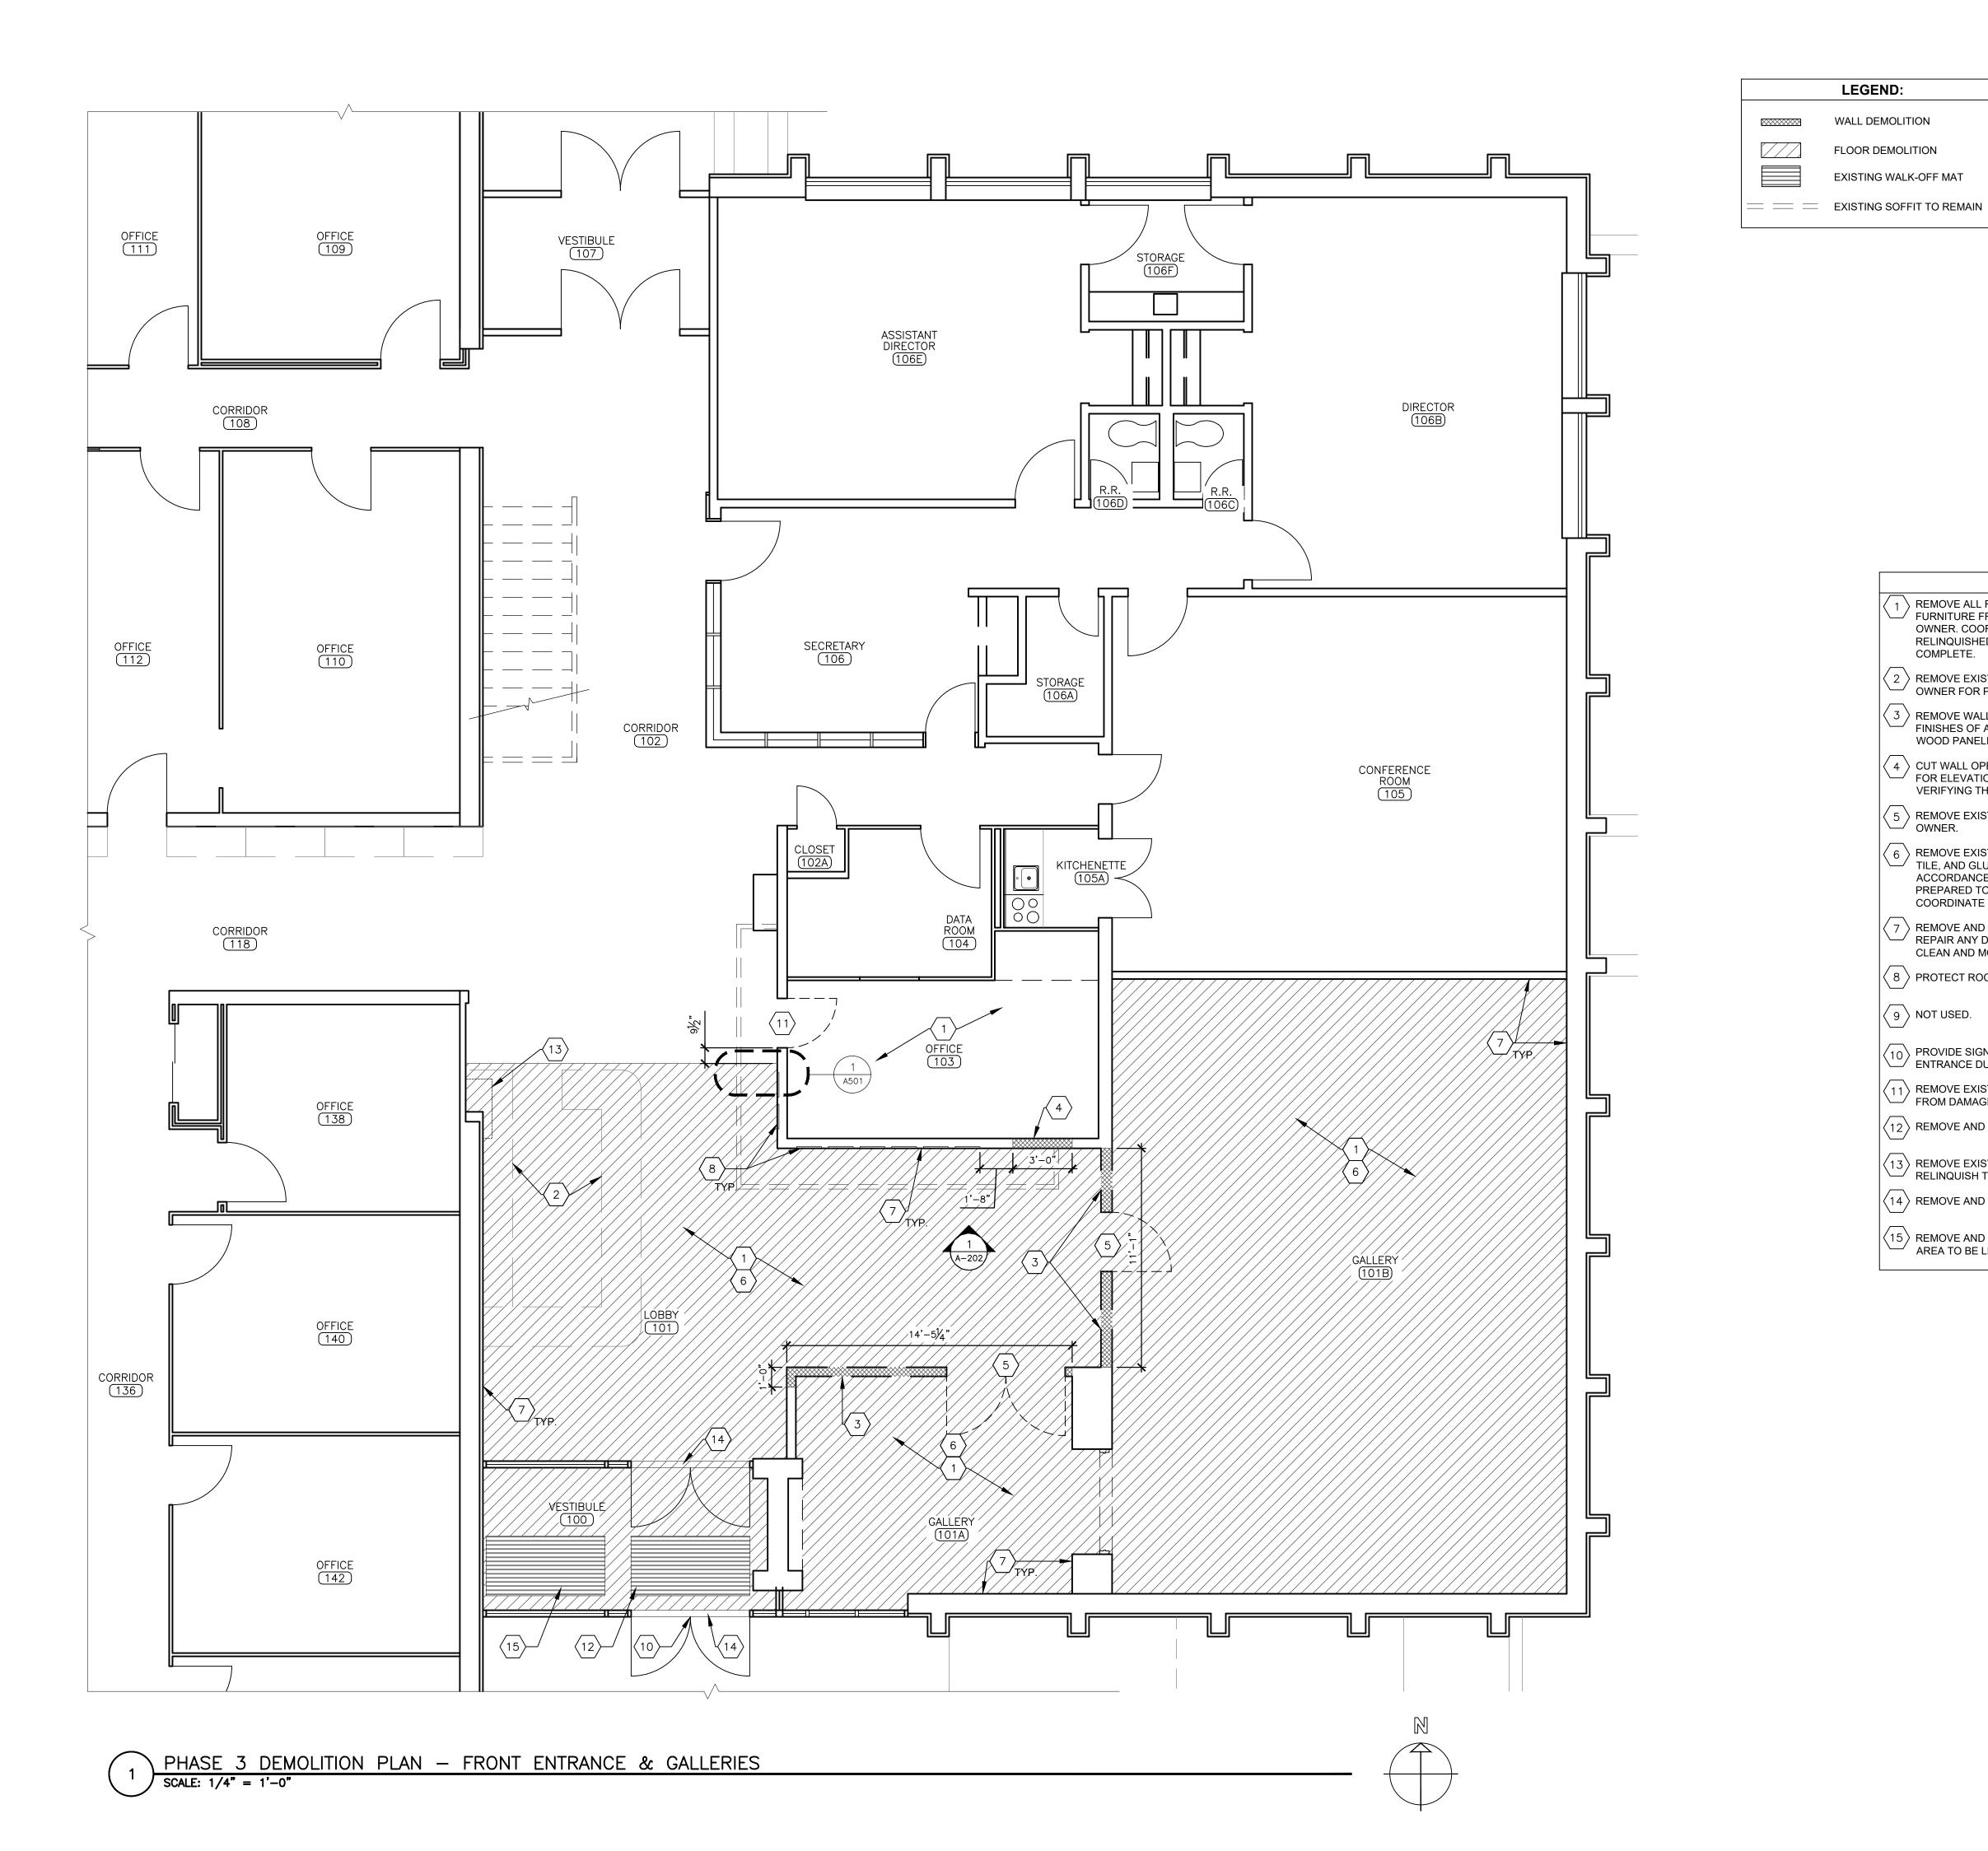
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DEMOLITION PLAN PUBLICATIONS &
GRAPHICS STUDIO

SHEET NUMBER:

A-10



LEGEND: WALL DEMOLITION FLOOR DEMOLITION

EXISTING WALK-OFF MAT

GENERAL NOTES:

- CONTRACTOR TO VERIFY DIMENSIONS OF EXISTING SPACE PRIOR TO BID.
- 2. CONTRACTOR TO REMOVE EXISTING TRANSITIONS AND TRIM AS REQUIRED AND TO PROTECT EXISTING TRIM TO REMAIN.
- WALL FIXTURES AND MATERIAL FROM DAMAGE DURING DEMOLITION AND INSTALLATION.
- FOR DELIVERY OF CONSTRUCTION MATERIAL AND WORKERS WITH FACILITY STAFF PRIOR TO COMMENCEMENT OF WORK.
- CONTRACTOR TO COORDINATE WITH STAFF WHEN REMOVING FURNITURE TO DETERMINE EXACT LAYOUT FOR ACCURATE REPLACEMENT ALONG WITH STORAGE OF ITEMS.
- 6. CONTRACTOR TO FIELD VERIFY DIMENSIONS OF EXISTING SPACE AND NEW FLOORING LIMITS PRIOR TO MATERIAL PROCUREMENT AND INSTALLATION.
- ALL ADJACENT STRUCTURES TO REMAIN IN PLACE. INSTALLATION TO ENSURE INTEGRITY AND FINISH ARE
- START OF WORK.

DEMOLITION KEYNOTES:

- \langle 4 \rangle CUT WALL OPENING TO EXTENTS SHOWN BY SOLID CROSS HATCH. REFER TO A-202 FOR ELEVATIONS. COORDINATE SILL DIMENSION NEEDED WITH OWNER AFTER VERIFYING THICKNESS OF WALL.
- \langle 5 \rangle REMOVE EXISTING DOOR, FRAME, AND TRANSITION STRIP, AND RELINQUISH TO
- 6 > REMOVE EXISTING FLOORING TO SUBFLOOR BELOW, INCLUDING CARPET TILE, VINYL TILE, AND GLUE UNDERLAYMENT. CONTRACTOR TO REMOVE FLOORING IN ACCORDANCE WITH OWNER PHASING REQUEST. SUBFLOOR TO BE SMOOTHED AND PREPARED TO NEW FLOOR MANUFACTURER'S RECOMMENDATIONS FOR INSTALLATION. COORDINATE WITH ASBESTOS REMEDIATION FOR REMOVAL OF FLOORING.
- angle REMOVE AND DISPOSE OF EXISTING BASE TRIM WHERE EXISTING FLOOR IS REMOVED. REPAIR ANY DAMAGED WALLS TO A LEVEL 4 FINISH TO MATCH ADJACENT. ENSURE CLEAN AND MOUNTABLE SURFACE FOR NEW BASE APPLICATION.
- 8 PROTECT ROCK WALL PANELS FROM DAMAGE DURING CONSTRUCTION.
- 9 NOT USED.
- 11 REMOVE EXISTING DOOR AND RELINQUISH TO OWNER. PROTECT EXISTING FRAME
- $\langle _{12}
 angle$ REMOVE AND DISPOSE OF RECESSED ENTRANCE MAT AND FRAME.
- REMOVE EXISTING WALL MOUNTED WOOD SHELF. PROTECT FROM DAMAGE AND RELINQUISH TO OWNER.
- $\langle 14 \rangle$ REMOVE AND DISPOSE OF EXISTING METAL THRESHOLD.
- AREA TO BE LEVEL WITH THE SURROUNDING CONCRETE SLAB.

- CONTRACTOR TO TAKE MEASURES TO PROTECT EXISTING
- CONTRACTOR TO COORDINATE PATHS THROUGH BUILDING

- CONTRACTOR SHALL PROTECT ANY MATERIALS INSTALLATION ABUTS UP TO OR COULD POTENTIALLY BE DAMAGED DURING
- 8. COORDINATE SCHEDULE WITH FACILITY STAFF PRIOR TO

- REMOVE ALL FREESTANDING FURNITURE WITHIN THE AREA OF WORK. PROTECT FURNITURE FROM DAMAGE. COORDINATE TEMPORARY STORAGE LOCATION WITH OWNER. COORDINATE WITH OWNER TO DETERMINE ITEMS TO BE DISPOSED OF, RELINQUISHED, OR MOVED BACK INTO THE AREAS OF WORK AFTER CONSTRUCTION IS COMPLETE.
- $\langle \; 2 \;
 angle$ REMOVE EXISTING RECEPTION DESK/ SYSTEMS FURNITURE. COORDINATE WITH OWNER FOR PARTS TO BE RELINQUISHED OR DISPOSED.
- $\langle \ 3 \ \rangle$ REMOVE WALL TO EXTENTS SHOWN BY SOLID CROSSHATCH. REPAIR AND TOUCH UP FINISHES OF ADJACENT SURFACES AFFECTED BY THE WALL REMOVAL. RELINQUISH WOOD PANELING TO OWNER.

- $\langle 10 \rangle$ PROVIDE SIGNAGE ON EXTERIOR DOOR DIRECTING PUBLIC TO ALTERNATIVE PINTRANCE DURING CONSTRUCTION OF THIS PHASE. COORDINATE WITH OWNER.

- $\langle 15 \rangle$ REMOVE AND DISPOSE OF RECESSED ENTRANCE MAT AND FRAME. INFILL RECESSED

STATE OF MISSOURI MIKE KEHOE, **GOVERNOR**



Brad M. Schaefer - Architect MO# A-2009027294

OFFICE OF ADMINISTRATION DIVISION OF FACILITIES MANAGEMENT, **DESIGN & CONSTRUCTION**

DEPARTMENT OF NATURAL RESOURCES

REPLACE FLOORING & RENOVATE FRONT **ENTRANCE MISSOURI** GEOLOGICAL SURVEY -

BUEHLER BUILDING 111 FAIRGROUNDS ROAD ROLLA, MISSOURI 65401

PROJECT # W2303-01 ASSET # 7815001007

REVISION: DATE: REVISION: DATE: **REVISION:**

ISSUE DATE: 05/09/2025


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DEMOLITION PLAN -FRONT ENTRANCE & GALLERIES

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STATE OF MISSOURI MIKE KEHOE, GOVERNOR



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OFFICE OF ADMINISTRATION DIVISION OF FACILITIES MANAGEMENT, DESIGN & CONSTRUCTION

DEPARTMENT OF NATURAL RESOURCES

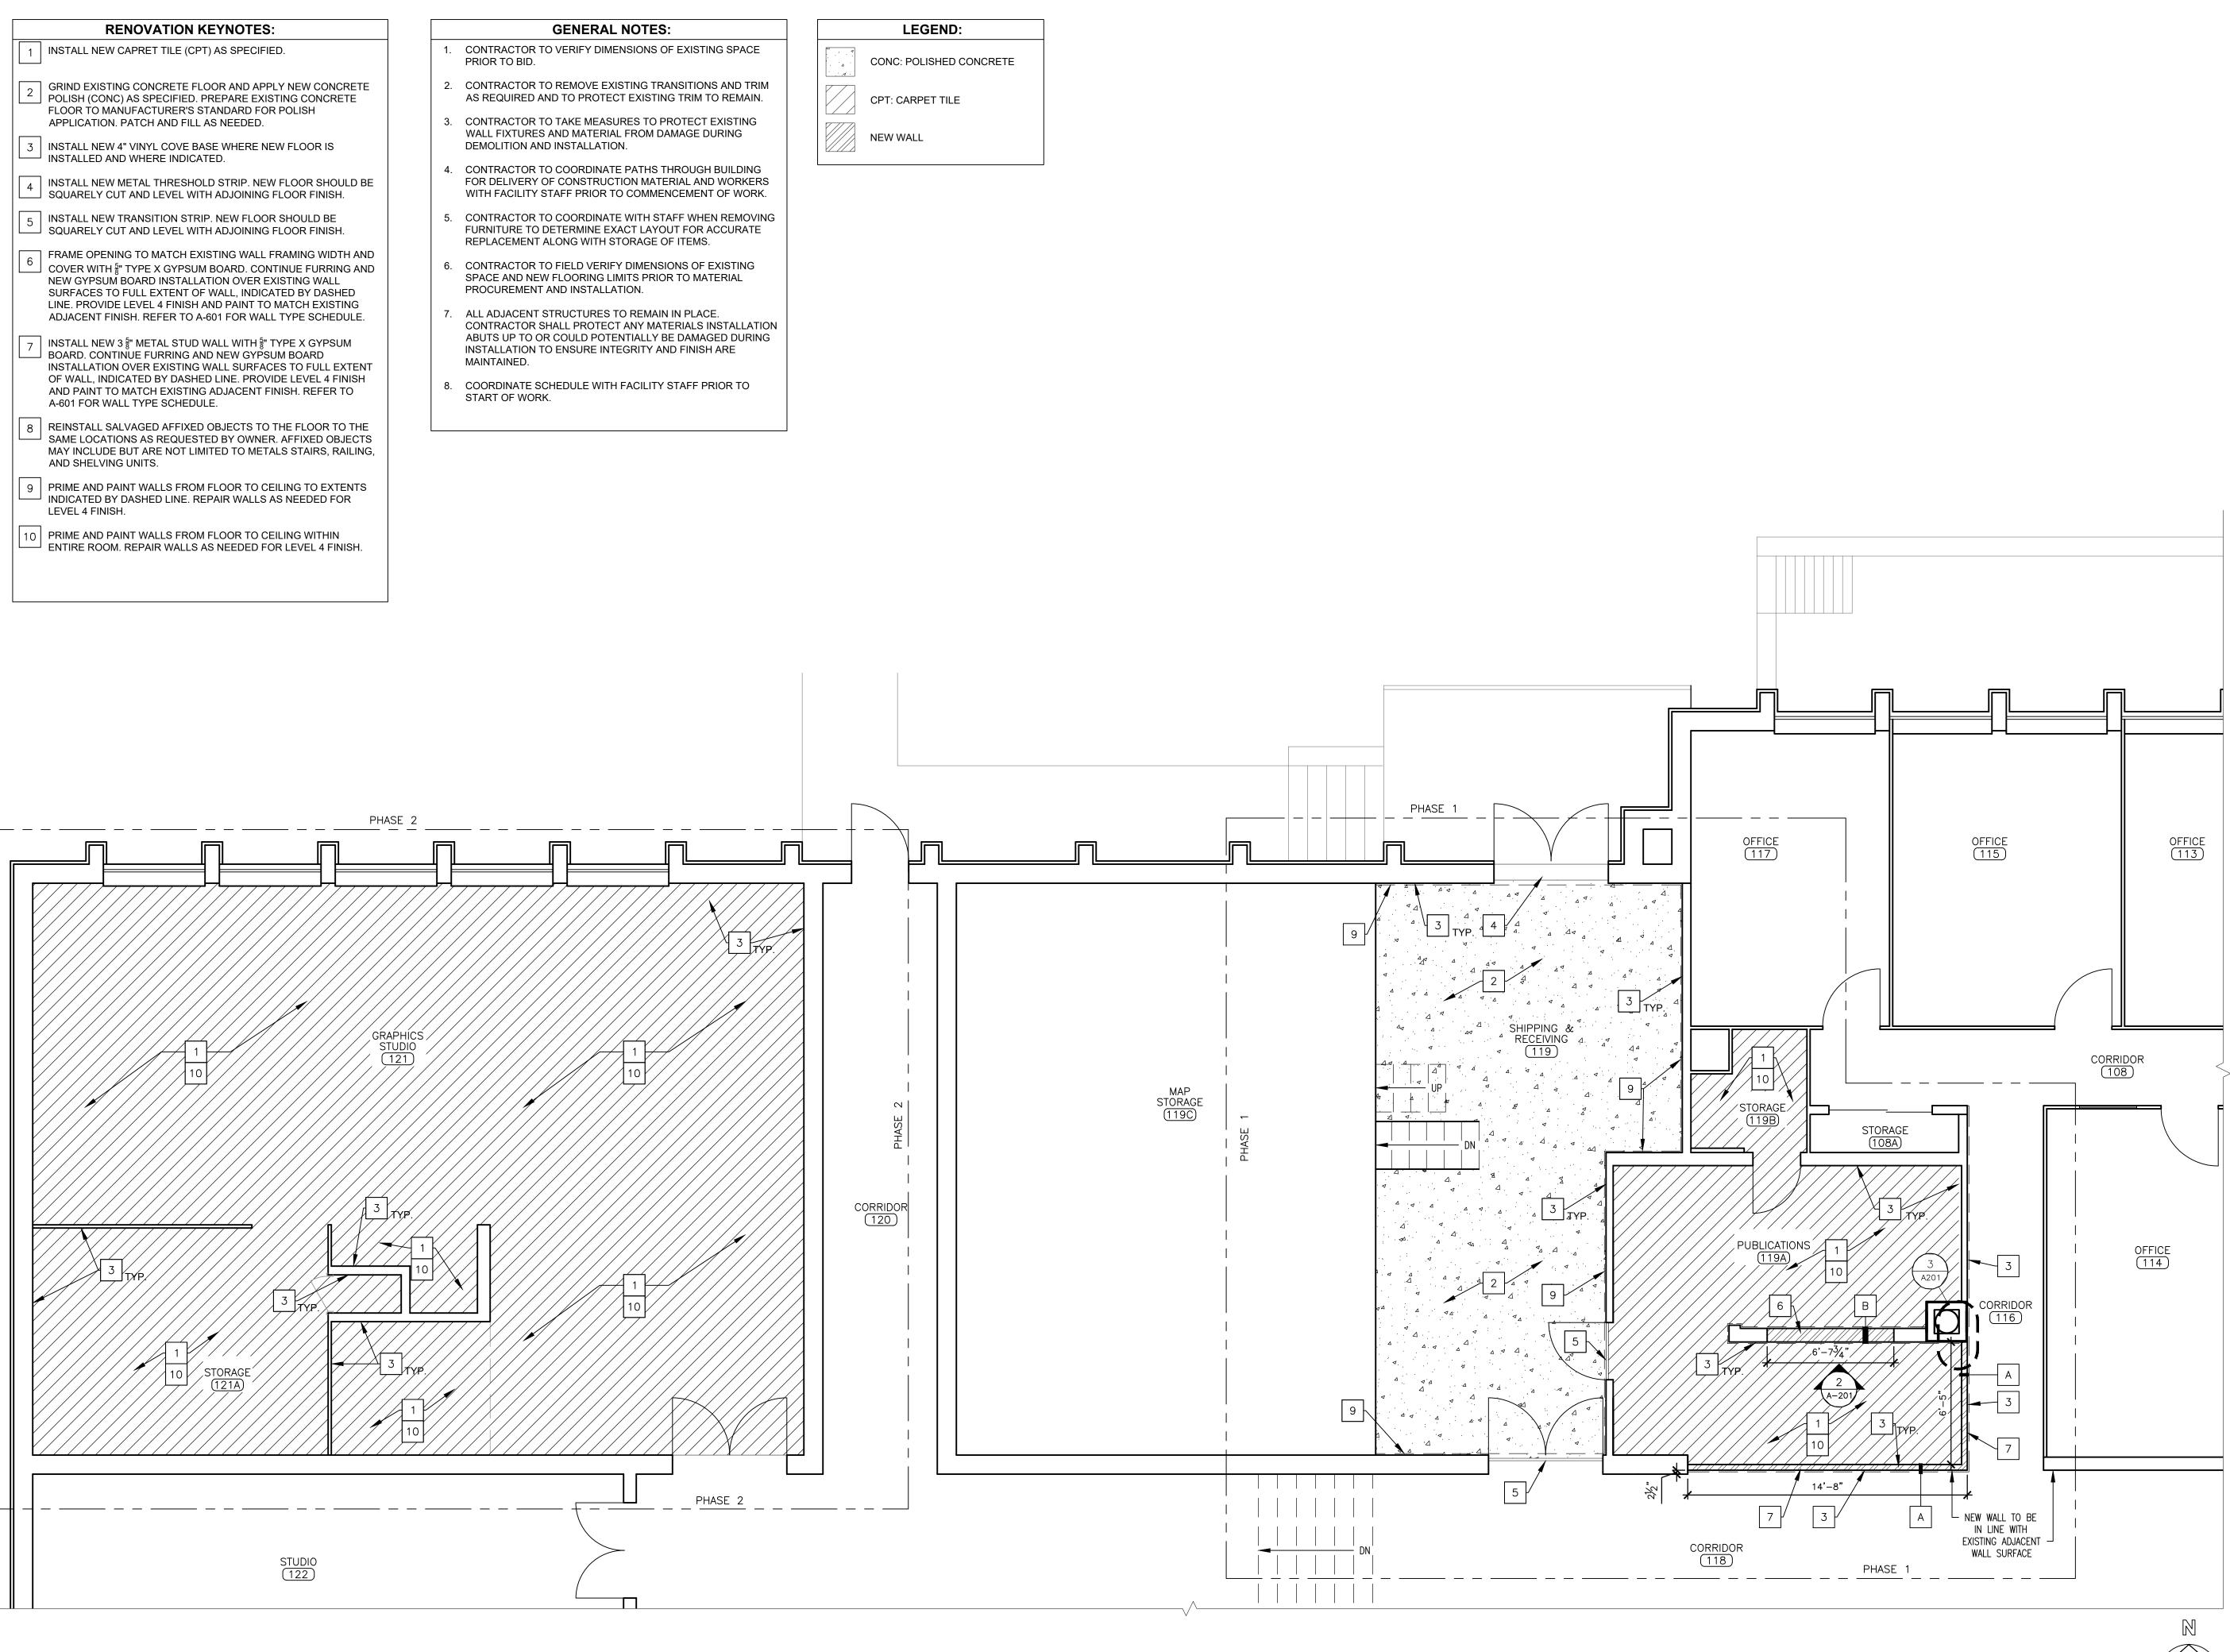REPLACE FLOORING & RENOVATE FRONT ENTRANCE MISSOURI

GEOLOGICAL SURVEY -BUEHLER BUILDING 111 FAIRGROUNDS ROAD ROLLA, MISSOURI 65401

PROJECT # W2303-01 SITE # 5001 ASSET # 7815001007

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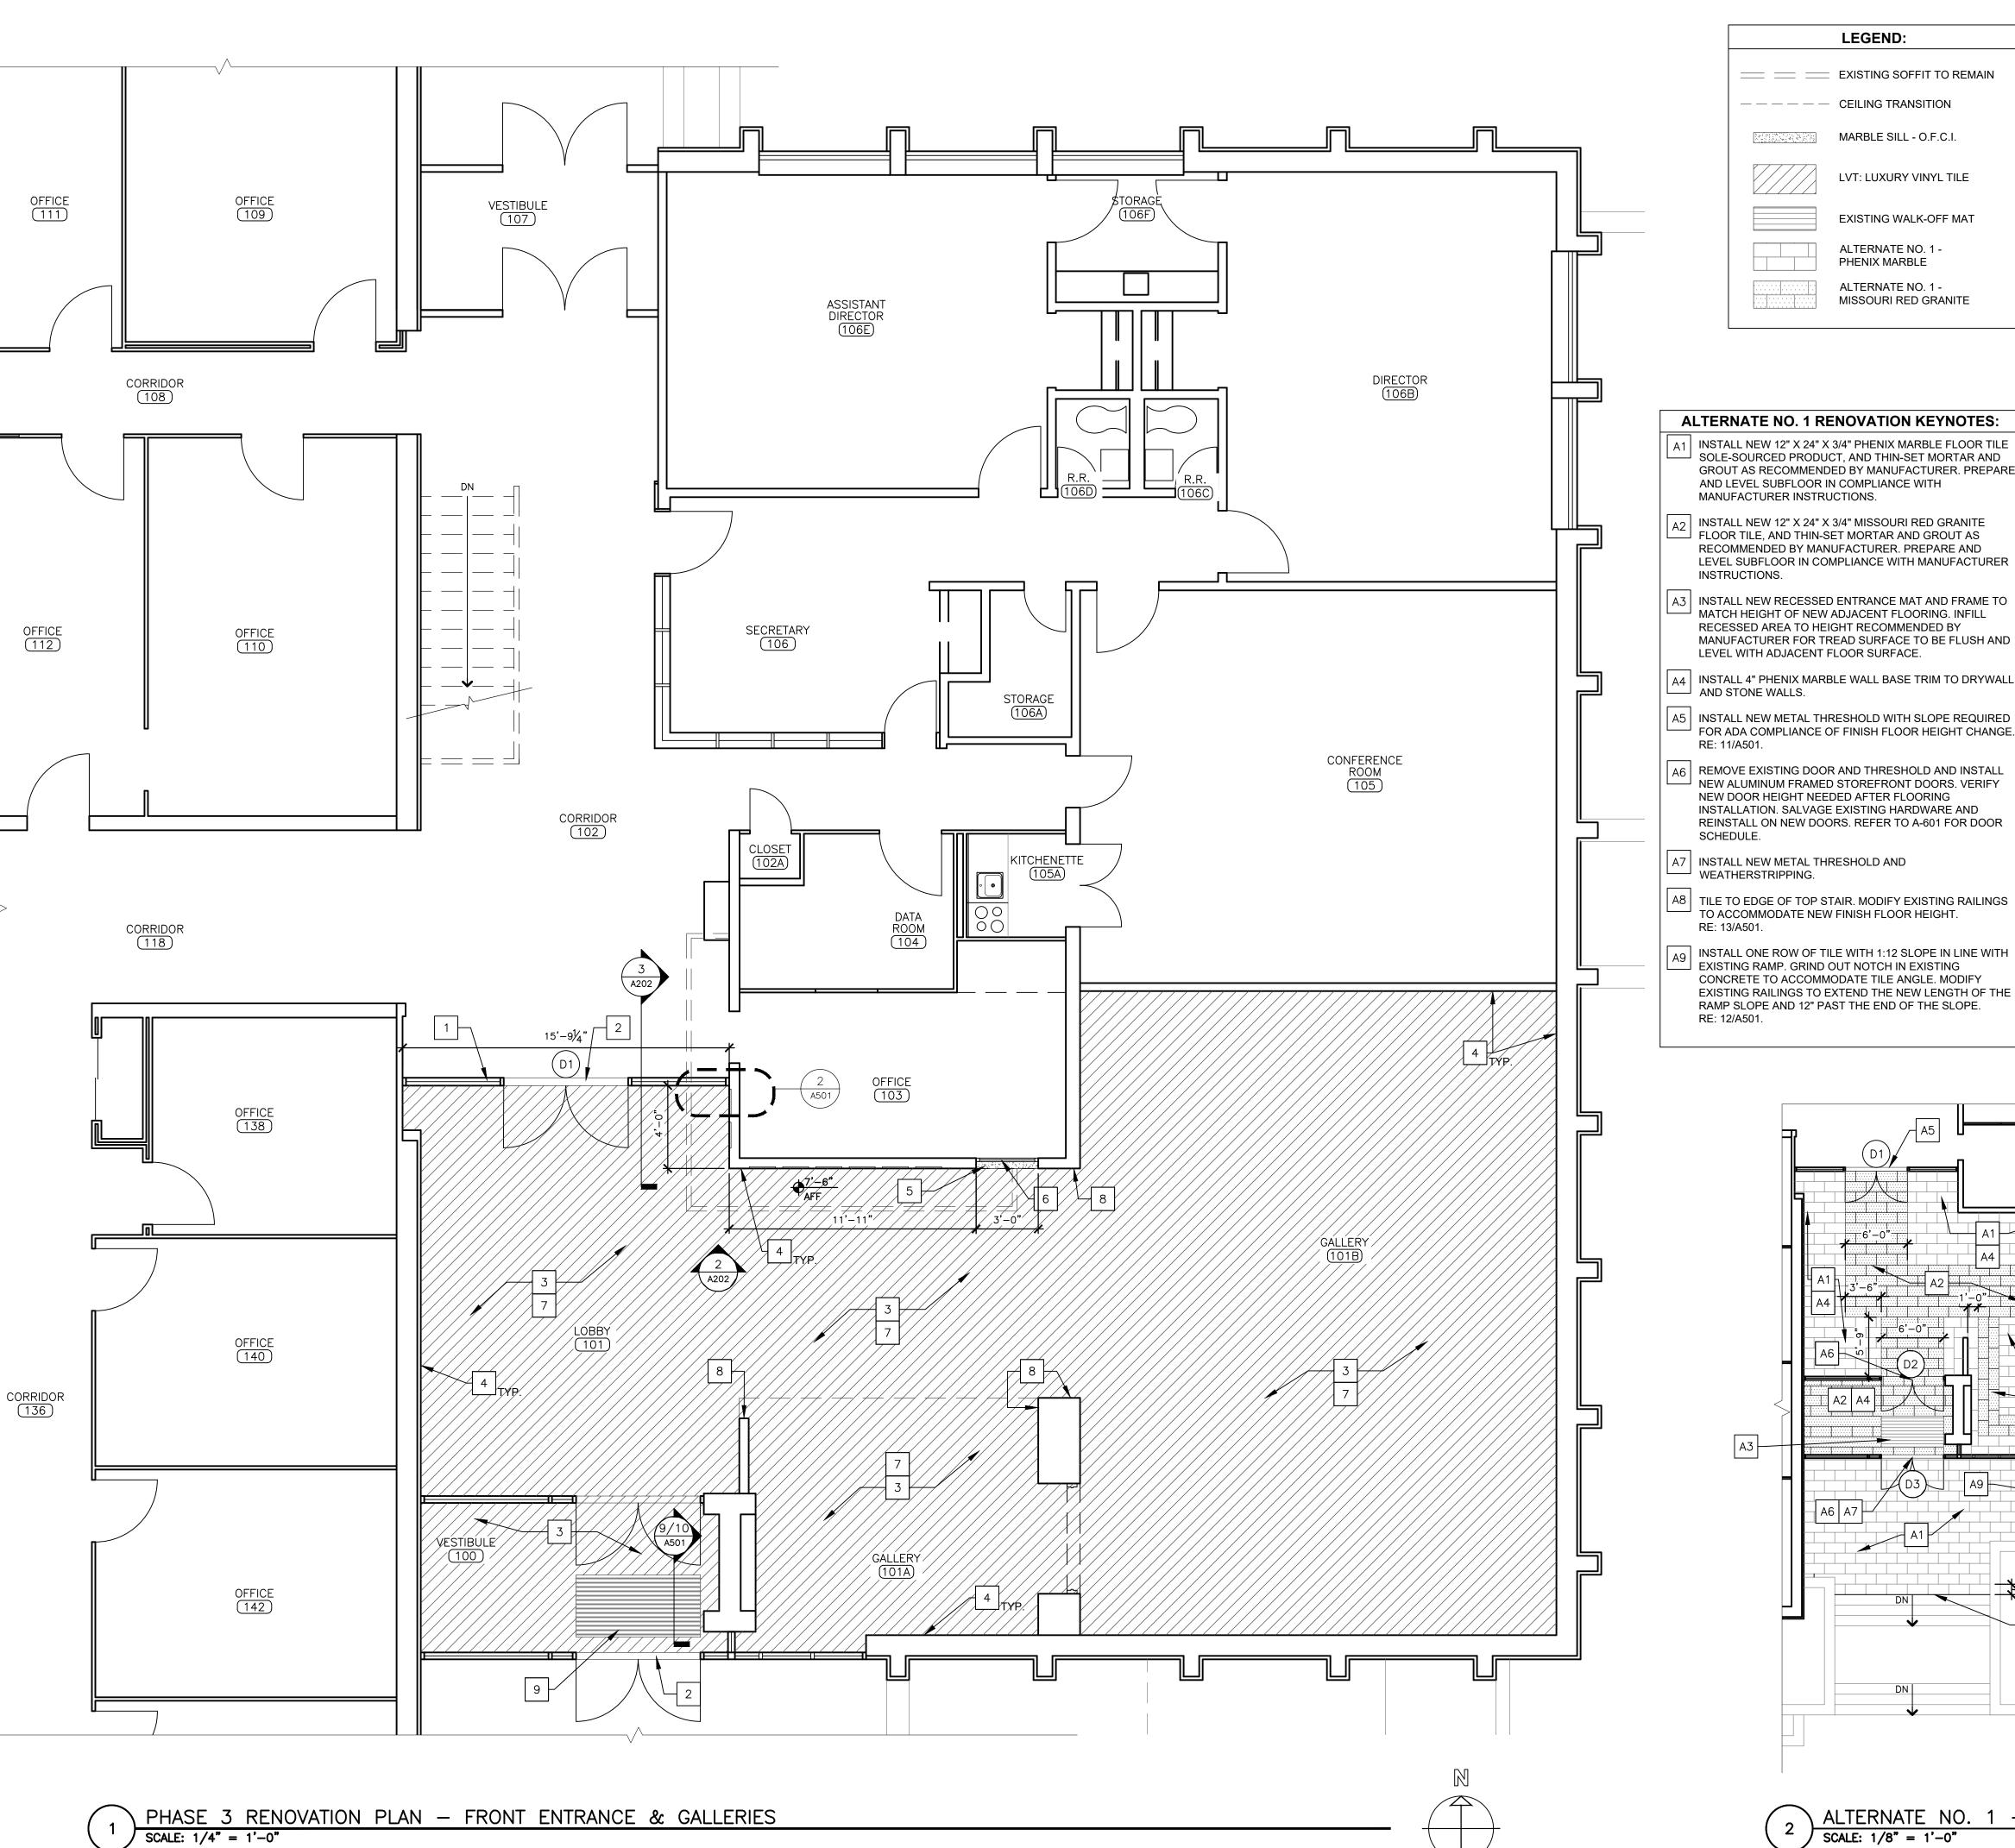
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RENOVATION PLAN PUBLICATIONS &
GRAPHICS STUDIO

SHEET NUMBER:

A-103



GENERAL NOTES:

MISSOURI RED GRANITE

ALTERNATE NO. 1 RENOVATION KEYNOTES:

- A1 INSTALL NEW 12" X 24" X 3/4" PHENIX MARBLE FLOOR TILE SOLE-SOURCED PRODUCT, AND THIN-SET MORTAR AND GROUT AS RECOMMENDED BY MANUFACTURER. PREPARE
- INSTALL NEW 12" X 24" X 3/4" MISSOURI RED GRANITE ☐ FLOOR TILE, AND THIN-SET MORTAR AND GROUT AS RECOMMENDED BY MANUFACTURER. PREPARE AND LEVEL SUBFLOOR IN COMPLIANCE WITH MANUFACTURER
- [」] MATCH HEIGHT OF NEW ADJACENT FLOORING. INFILL RECESSED AREA TO HEIGHT RECOMMENDED BY MANUFACTURER FOR TREAD SURFACE TO BE FLUSH AND
- $|\ |_{\mathsf{A4}}\ |\ \mathsf{INSTALL}$ 4" PHENIX MARBLE WALL BASE TRIM TO DRYWALL $|\ |$
- A5 | INSTALL NEW METAL THRESHOLD WITH SLOPE REQUIRED FOR ADA COMPLIANCE OF FINISH FLOOR HEIGHT CHANGE.
- NEW ALUMINUM FRAMED STOREFRONT DOORS. VERIFY INSTALLATION. SALVAGE EXISTING HARDWARE AND REINSTALL ON NEW DOORS. REFER TO A-601 FOR DOOR
- A8 TILE TO EDGE OF TOP STAIR. MODIFY EXISTING RAILINGS TO ACCOMMODATE NEW FINISH FLOOR HEIGHT.
- A9 INSTALL ONE ROW OF TILE WITH 1:12 SLOPE IN LINE WITH EXISTING RAMP. GRIND OUT NOTCH IN EXISTING CONCRETE TO ACCOMMODATE TILE ANGLE. MODIFY EXISTING RAILINGS TO EXTEND THE NEW LENGTH OF THE RAMP SLOPE AND 12" PAST THE END OF THE SLOPE.

- 1. HATCHING SHOWN INDICATES AREAS OF NEW FLOORING. CONTRACTOR TO VERIFY DIMENSIONS OF EXISTING SPACE PRIOR
- CONTRACTOR TO REMOVE EXISTING TRANSITIONS AND TRIM AS
- REQUIRED AND TO PROTECT EXISTING TRIM TO REMAIN. CONTRACTOR TO TAKE MEASURES TO PROTECT EXISTING WALL FIXTURES AND MATERIAL FROM DAMAGE DURING DEMOLITION AND
- CONTRACTOR TO COORDINATE PATHS THROUGH BUILDING FOR DELIVERY OF CONSTRUCTION MATERIAL AND WORKERS WITH FACILITY STAFF PRIOR TO COMMENCEMENT OF WORK.
- CONTRACTOR TO COORDINATE WITH STAFF WHEN REMOVING FURNITURE TO DETERMINE EXACT LAYOUT FOR ACCURATE

REPLACEMENT ALONG WITH STORAGE OF ITEMS.

- CONTRACTOR TO FIELD VERIFY DIMENSIONS OF EXISTING SPACE AND NEW FLOORING LIMITS PRIOR TO MATERIAL PROCUREMENT AND INSTALLATION.
- 8. ALL ADJACENT STRUCTURES TO REMAIN IN PLACE. CONTRACTOR SHALL PROTECT ANY MATERIALS INSTALLATION ABUTS UP TO OR COULD POTENTIALLY BE DAMAGED DURING INSTALLATION TO ENSURE INTEGRITY AND FINISH ARE MAINTAINED.
- 9. COORDINATE SCHEDULE WITH FACILITY STAFF PRIOR TO START OF WORK.

INSTALLATION.

- ALTERNATE NO. 1:


 10. PHENIX MARBLE AND MISSOURI RED GRANITE TO BE INSTALLED INSTEAD OF LUXURY VINYL TILE. PHENIX MARBLE WALL BASE TRIM TO BE INSTALLED INSTEAD OF VINYL BASE.
- 11. HATCH PATTERNS ON "ALTERNATE NO. 1- FLOOR PATTERN PLAN" INDICATE THE INTENDED SIZE AND RUN DIRECTION OF NEW STONE FLOORING.

RENOVATION KEYNOTES:

- INSTALL NEW STOREFRONT ASSEMBLY AS SPECIFIED, INCLUDING FRAME, GLAZING, AND DOUBLE DOORS. REFER TO A-202 FOR
- 2 | INSTALL NEW METAL THRESHOLD TO LOCATION SHOWN.
- 3 | INSTALL NEW LUXURY VINYL TILE (LVT) AS SPECIFIED.
- INSTALL NEW 4" VINYL COVE BASE WHERE NEW FLOOR IS
- INSTALLED.
- REFER TO A-501 FOR DETAILS.

INSTALL OWNER FURNISHED MARBLE SILL TO WINDOW OPENING.

- INSTALL SERVICE WINDOW TO LOCATION SHOWN. FRAME OPENING AS RECOMMENDED BY WINDOW MANUFACTURER. REFER TO A-202 FOR ELEVATIONS.
- PRIME AND PAINT DRYWALL SURFACES FROM FLOOR TO CEILING WITHIN ENTIRE ROOM. REPAIR WALLS AS NEEDED FOR LEVEL 4 FINISH. PROTECT STONE AND WOOD FEATURES FROM DAMAGE AND STAINING.
- PATCH AND REPAIR WALL SURFACE AS NEEDED FOR LEVEL 4 FINISH. MATCH ADJACENT WALL FINISH.
- 9 INSTALL NEW RECESSED ENTRANCE MAT AND FRAME TO MATCH HEIGHT OF NEW ADJACENT FLOORING.

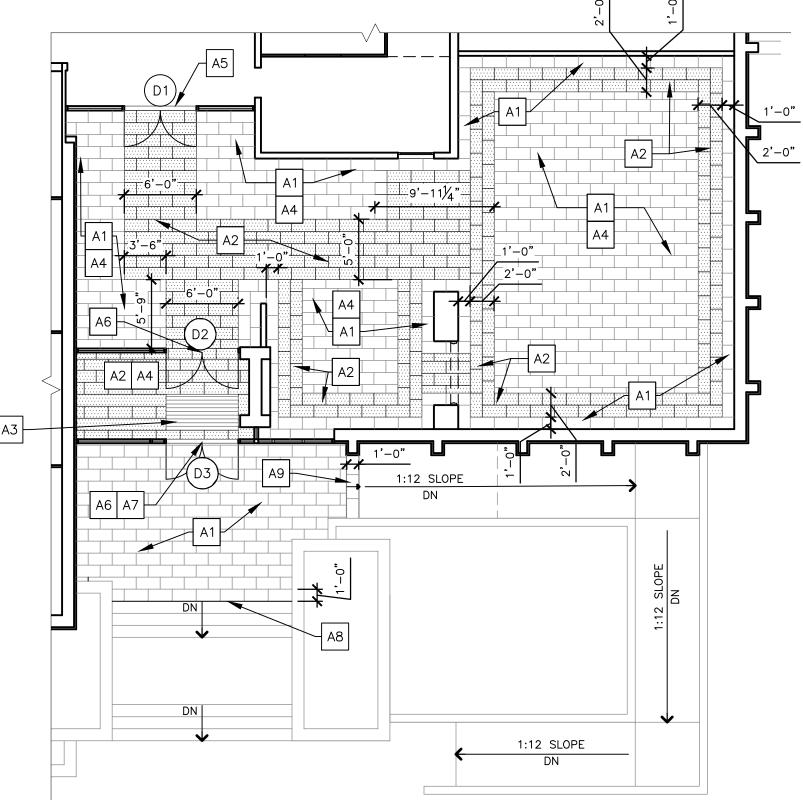

ALTERNATE NO. 1 — FLOOR PATTERN PLAN SCALE: 1/8" = 1'-0"

STATE OF MISSOURI MIKE KEHOE, **GOVERNOR**



Brad M. Schaefer - Architect MO# A-2009027294

OFFICE OF ADMINISTRATION DIVISION OF FACILITIES MANAGEMENT, **DESIGN & CONSTRUCTION**

DEPARTMENT OF NATURAL RESOURCES

REPLACE FLOORING & RENOVATE FRONT **ENTRANCE MISSOURI**

GEOLOGICAL SURVEY -BUEHLER BUILDING 111 FAIRGROUNDS ROAD ROLLA, MISSOURI 65401

PROJECT # W2303-01 ASSET # 7815001007

REVISION: DATE: REVISION: DATE: **REVISION:** DATE:


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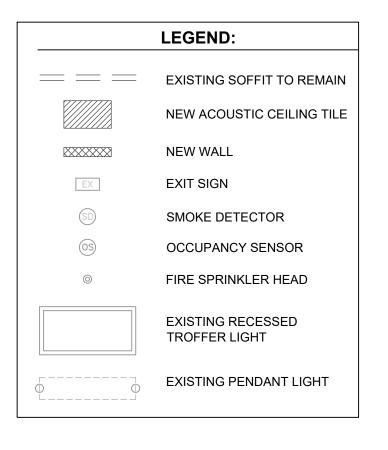
ISSUE DATE: 05/09/2025

SHEET TITLE:

RENOVATION PLAN -FRONT ENTRANCE & GALLERIES

SHEET NUMBER:



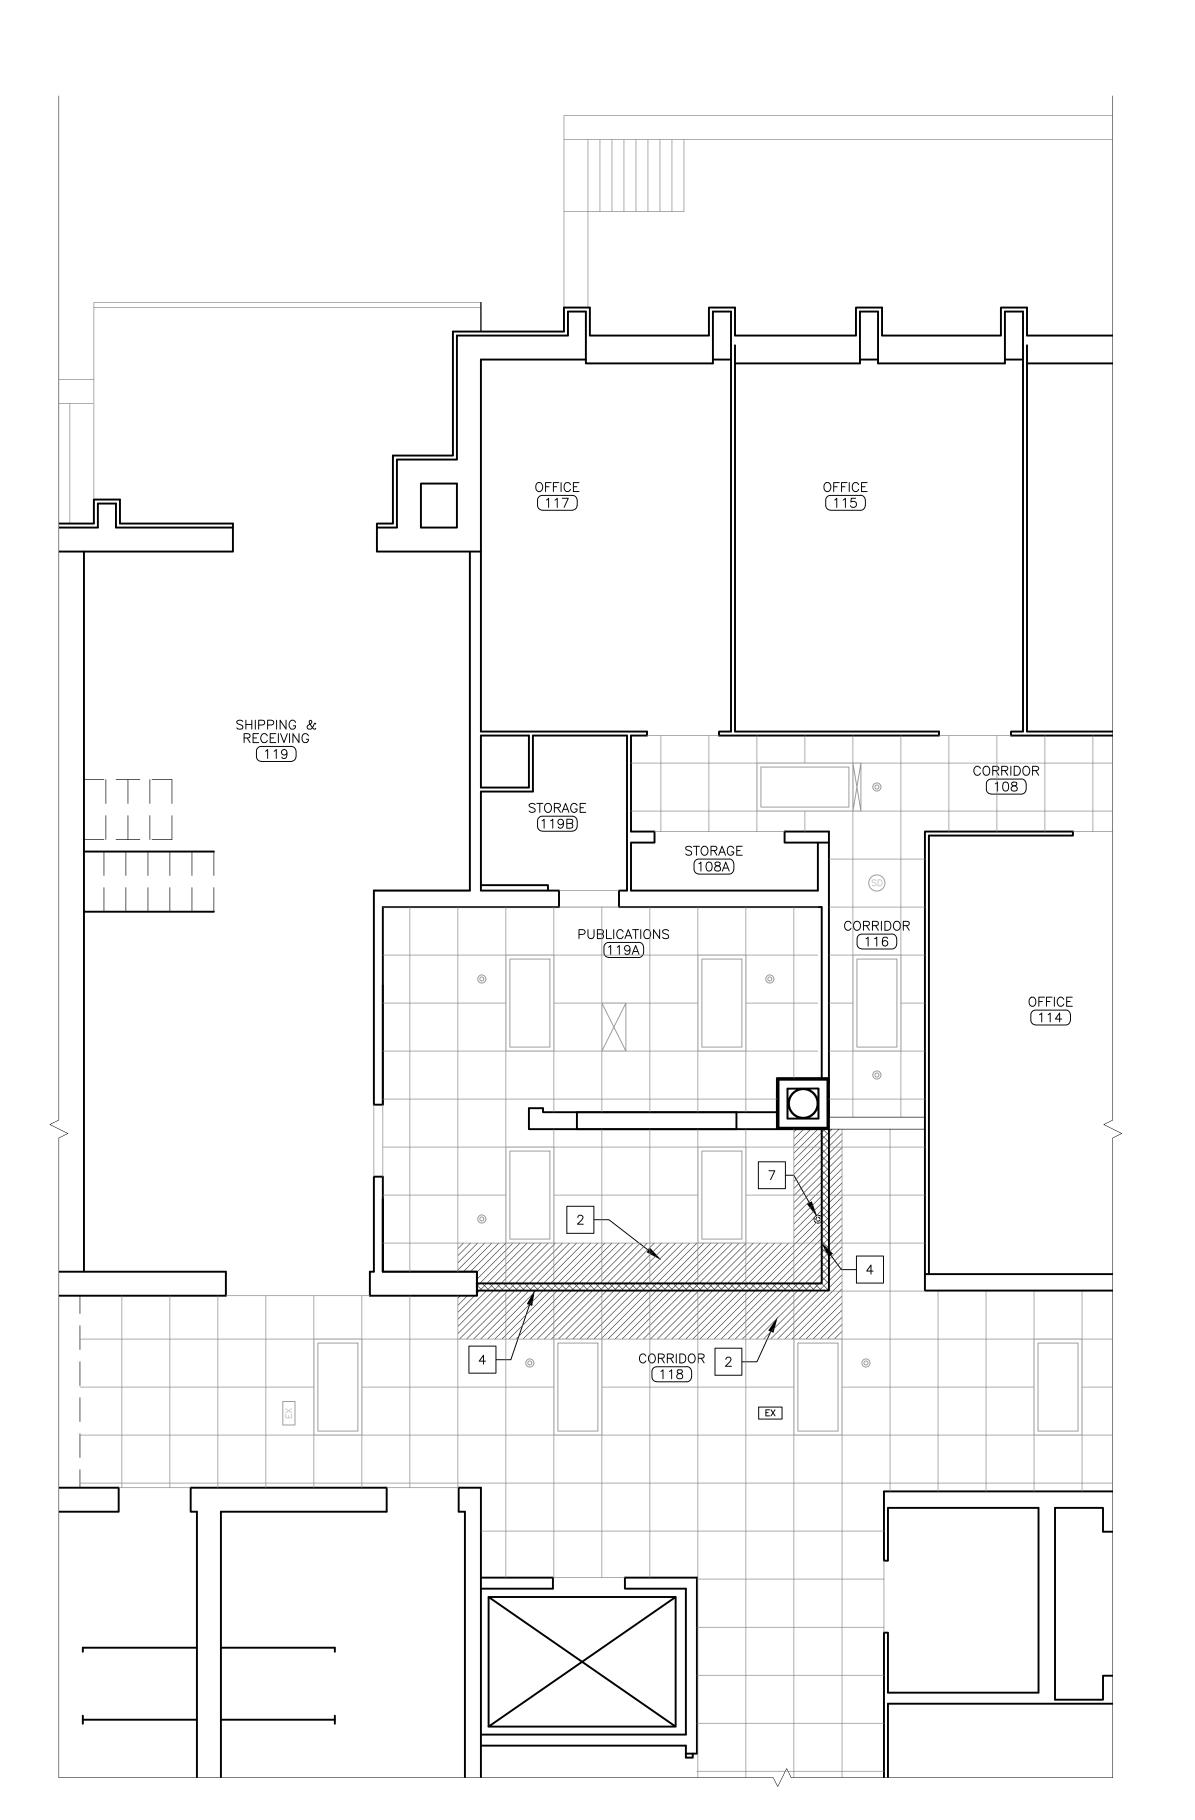

STORAGE (106A)

ASSISTANT

RENOVATION KEYNOTES: 1 INSTALL 12" CEILING TRANSITION TRIM AS SPECIFIED AND ADJUST CEILING GRID LAYOUT AS NEEDED. 2 INSTALL NEW ACOUSTIC CEILING TILES TO LOCATIONS INDICATED BY HATCH.

INSTALL NEW CEILING GRID T-BAR AND ADJUST GRID LAYOUT AS

4 ADJUST GRID LAYOUT TO ACCOMMODATE NEW WALL.

5 PROTECT EXISTING OCCUPANCY SENSOR FROM DAMAGE DURING CONSTRUCTION. REMOVE AND REINSTALL TO SAME LOCATION AS

6 PROTECT EXISTING SPRINKLER HEAD FROM DAMAGE DURING CONSTRUCTION.

7 REFER TO F-101 FOR SPRINKLER HEAD REMOVAL AND NEW SPRINKLER HEAD LOCATIONS.

CONFERENCE

STATE OF MISSOURI

MIKE KEHOE,

BRADMICHAEL

SCHAEFER

A-2009027294

Brad M. Schaefer - Architect

MO# A-2009027294

GOVERNOR

OFFICE OF ADMINISTRATION DIVISION OF FACILITIES MANAGEMENT, **DESIGN & CONSTRUCTION**

DEPARTMENT OF NATURAL RESOURCES

REPLACE FLOORING & RENOVATE FRONT ENTRANCE MISSOURI

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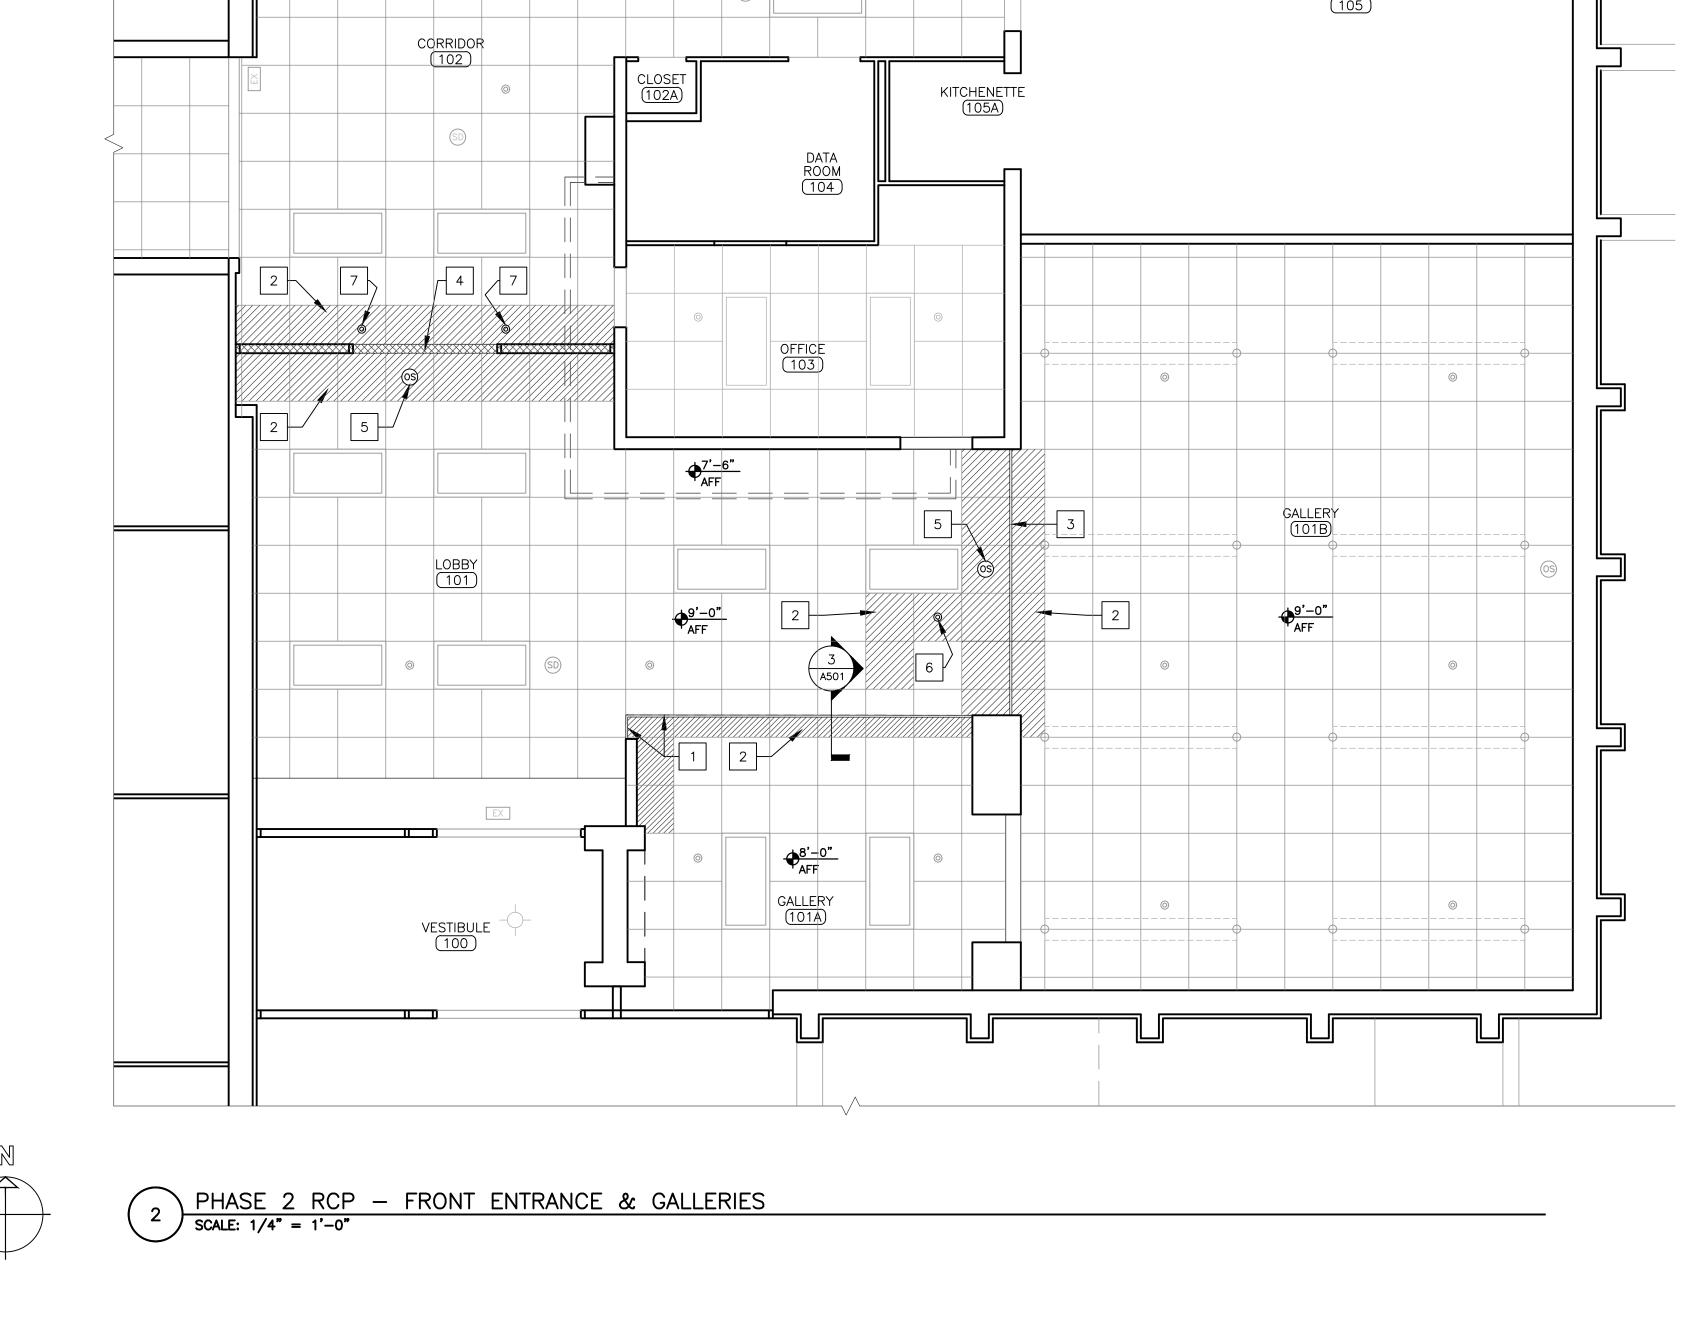
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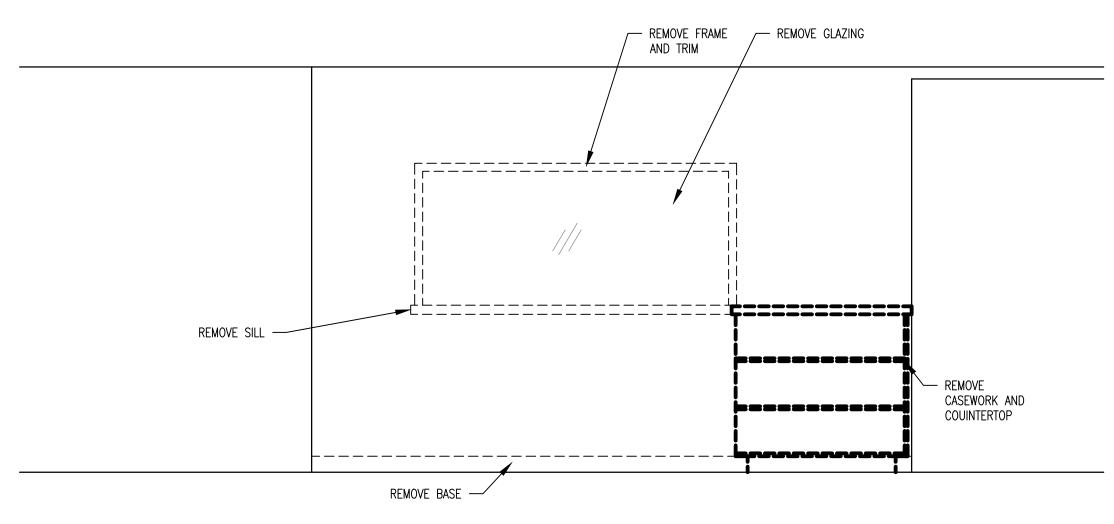
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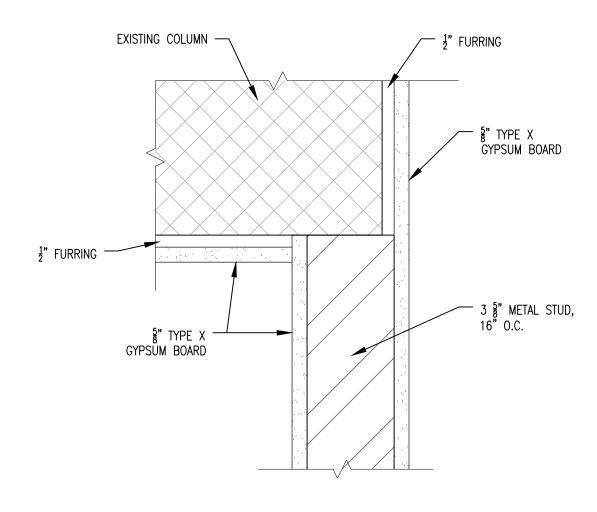
9 OF 18 SHEETS

05/09/2025






PUBLICATIONS ROOM ELEVATION — DEMO
SCALE: 1/2" = 1'-0"



WALL CONNECTION - NEW TO EXISTING

SCALE: 1/2" = 1'-0"

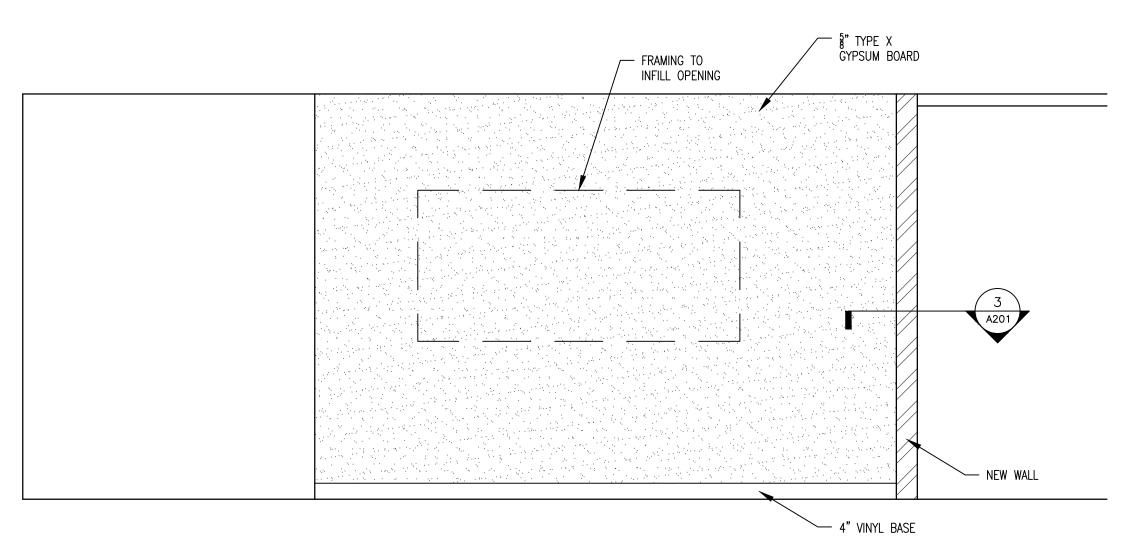

PUBLICATIONS ROOM ELEVATION - NEW SCALE: 1/2" = 1'-0"

STATE OF MISSOURI MIKE KEHOE, **GOVERNOR**



MO# A-2009027294

OFFICE OF ADMINISTRATION DIVISION OF FACILITIES MANAGEMENT, **DESIGN & CONSTRUCTION**

DEPARTMENT OF NATURAL RESOURCES

REPLACE FLOORING & RENOVATE FRONT ENTRANCE MISSOURI GEOLOGICAL SURVEY -BUEHLER BUILDING

111 FAIRGROUNDS ROAD ROLLA, MISSOURI 65401

PROJECT # W2303-01 ASSET # 7815001007


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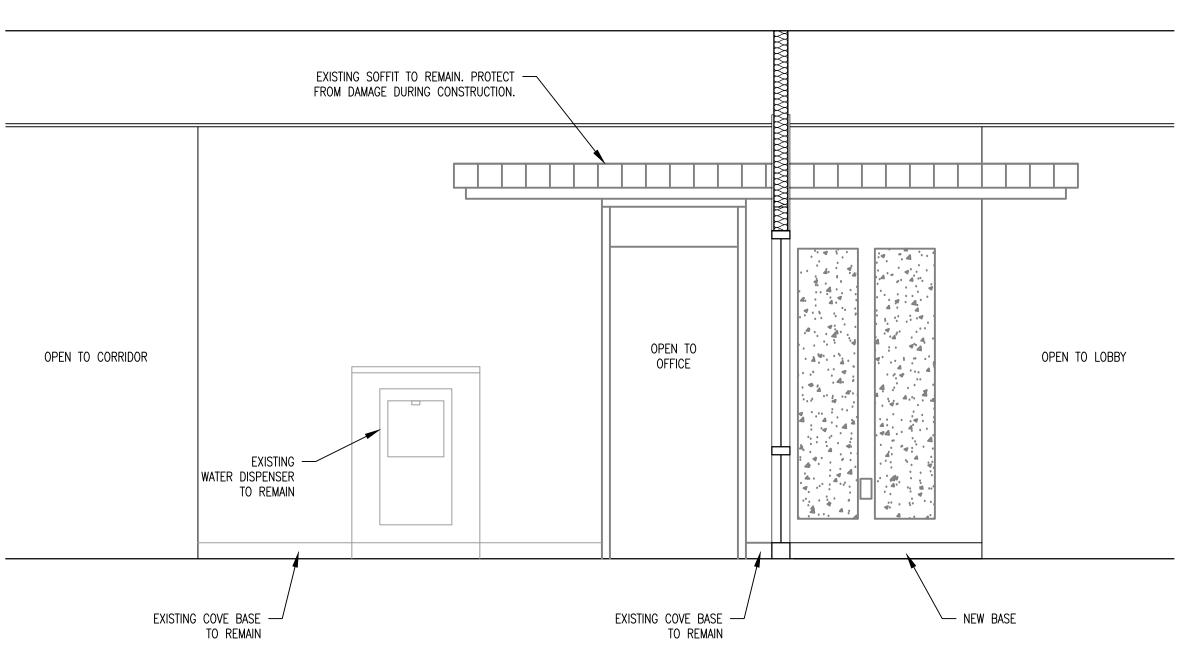
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DRAWN BY: CL
CHECKED BY: BMS

DESIGNED BY: <u>CL</u> SHEET TITLE:

PUBLICATIONS ROOM ELEVATIONS


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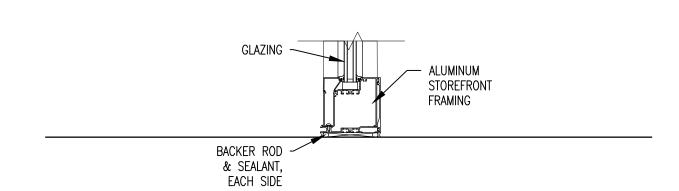


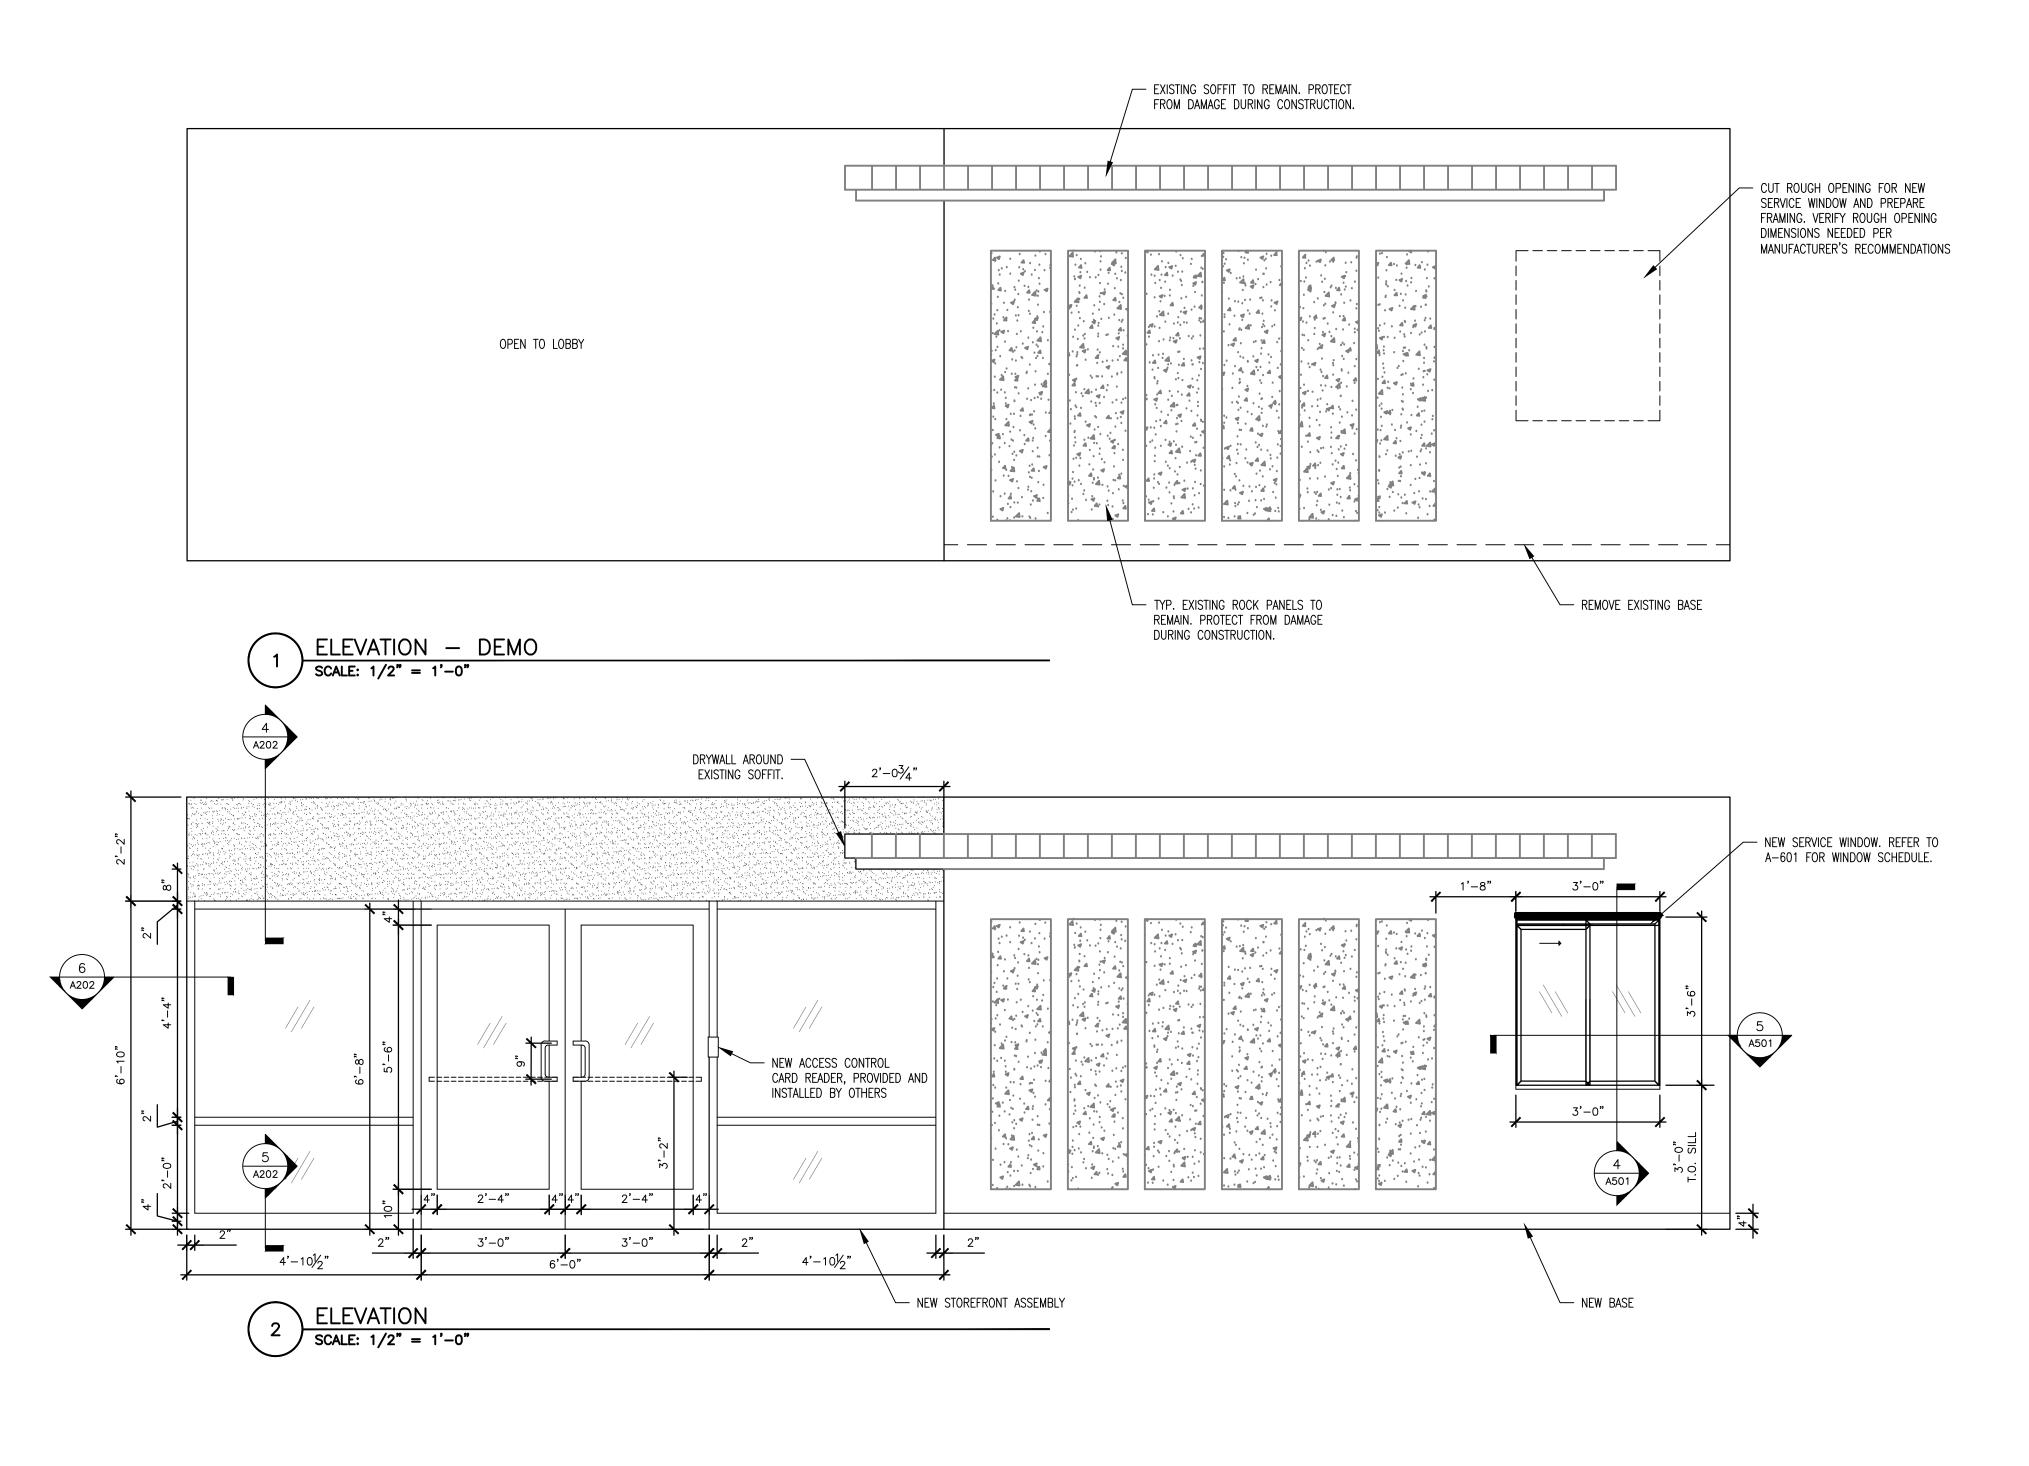


3 ELEVATION

SCALE: 1/2" = 1'-0"



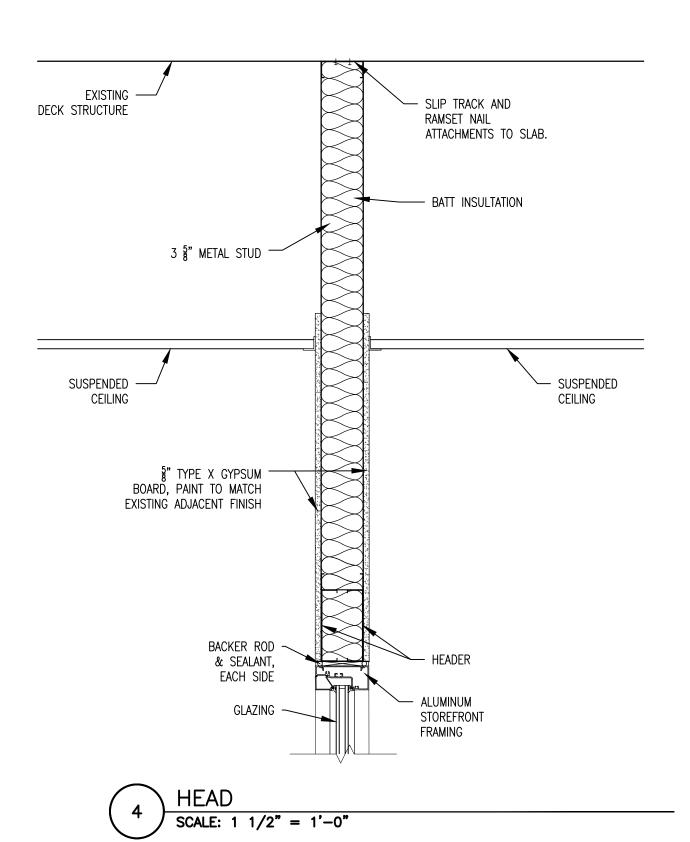

5 SILL SCALE: 1 1/2" = 1'-0"

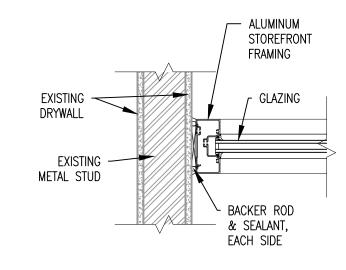

6 JAMB
SCALE: 1 1/2" = 1'-0"

STATE OF MISSOURI MIKE KEHOE, GOVERNOR



Brad M. Schaefer - Architect MO# A-2009027294

> BID DOCUMENTS

OFFICE OF ADMINISTRATION DIVISION OF FACILITIES MANAGEMENT, DESIGN & CONSTRUCTION

DEPARTMENT OF NATURAL RESOURCES

REPLACE FLOORING & RENOVATE FRONT ENTRANCE MISSOURI GEOLOGICAL SURVEY -

BUEHLER BUILDING 111 FAIRGROUNDS ROAD ROLLA, MISSOURI 65401

PROJECT # W2303-01 SITE # 5001 ASSET # 7815001007

REVISION:	
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REVISION:	
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REVISION:	
DATE:	
ISSUE DATE: 05/09/2025	


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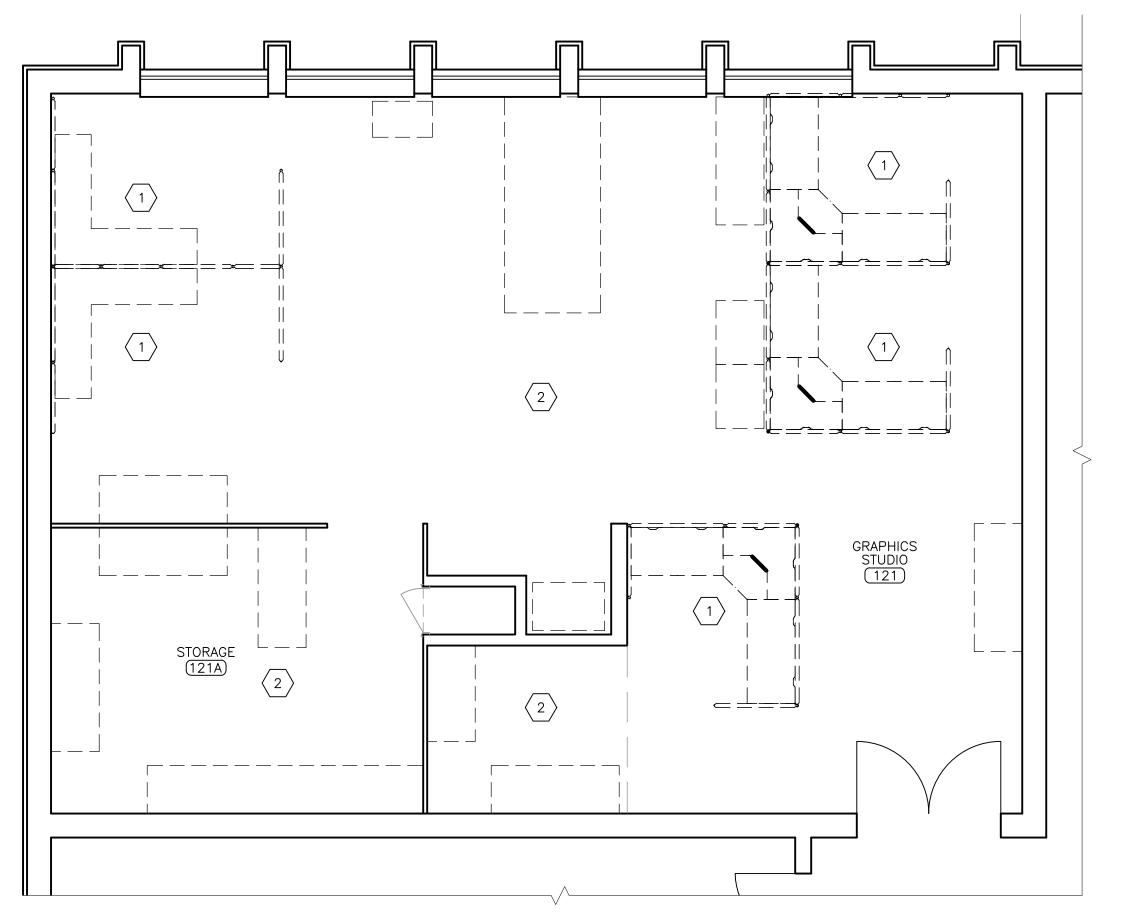
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FRONT ENTRANCE ELEVATIONS


SHEET NUMBER:

A-202



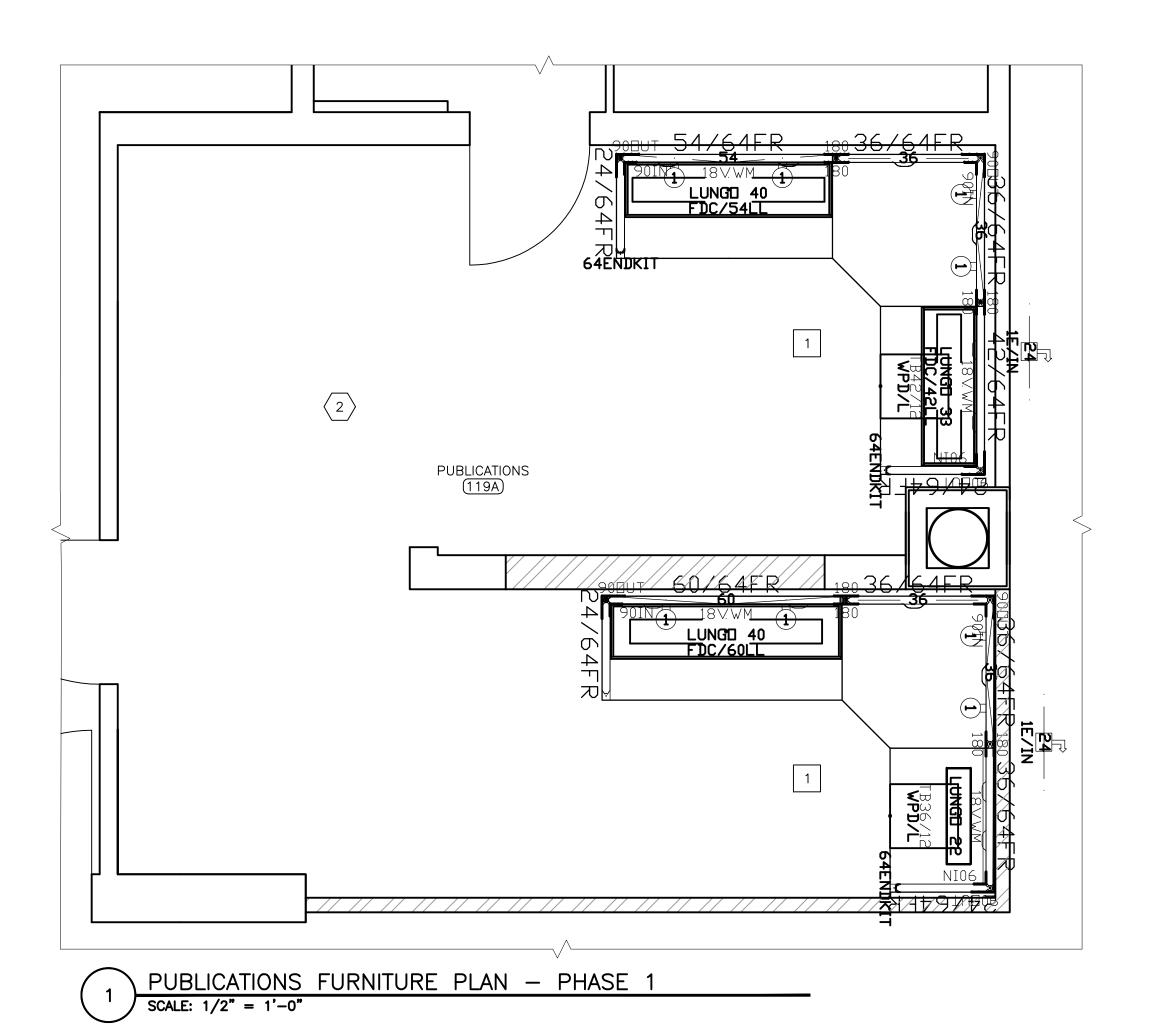

2 GRAPHICS STUDIO FURNITURE DEMOLITION PLAN - PHASE 2
SCALE: 1/4" = 1'-0"

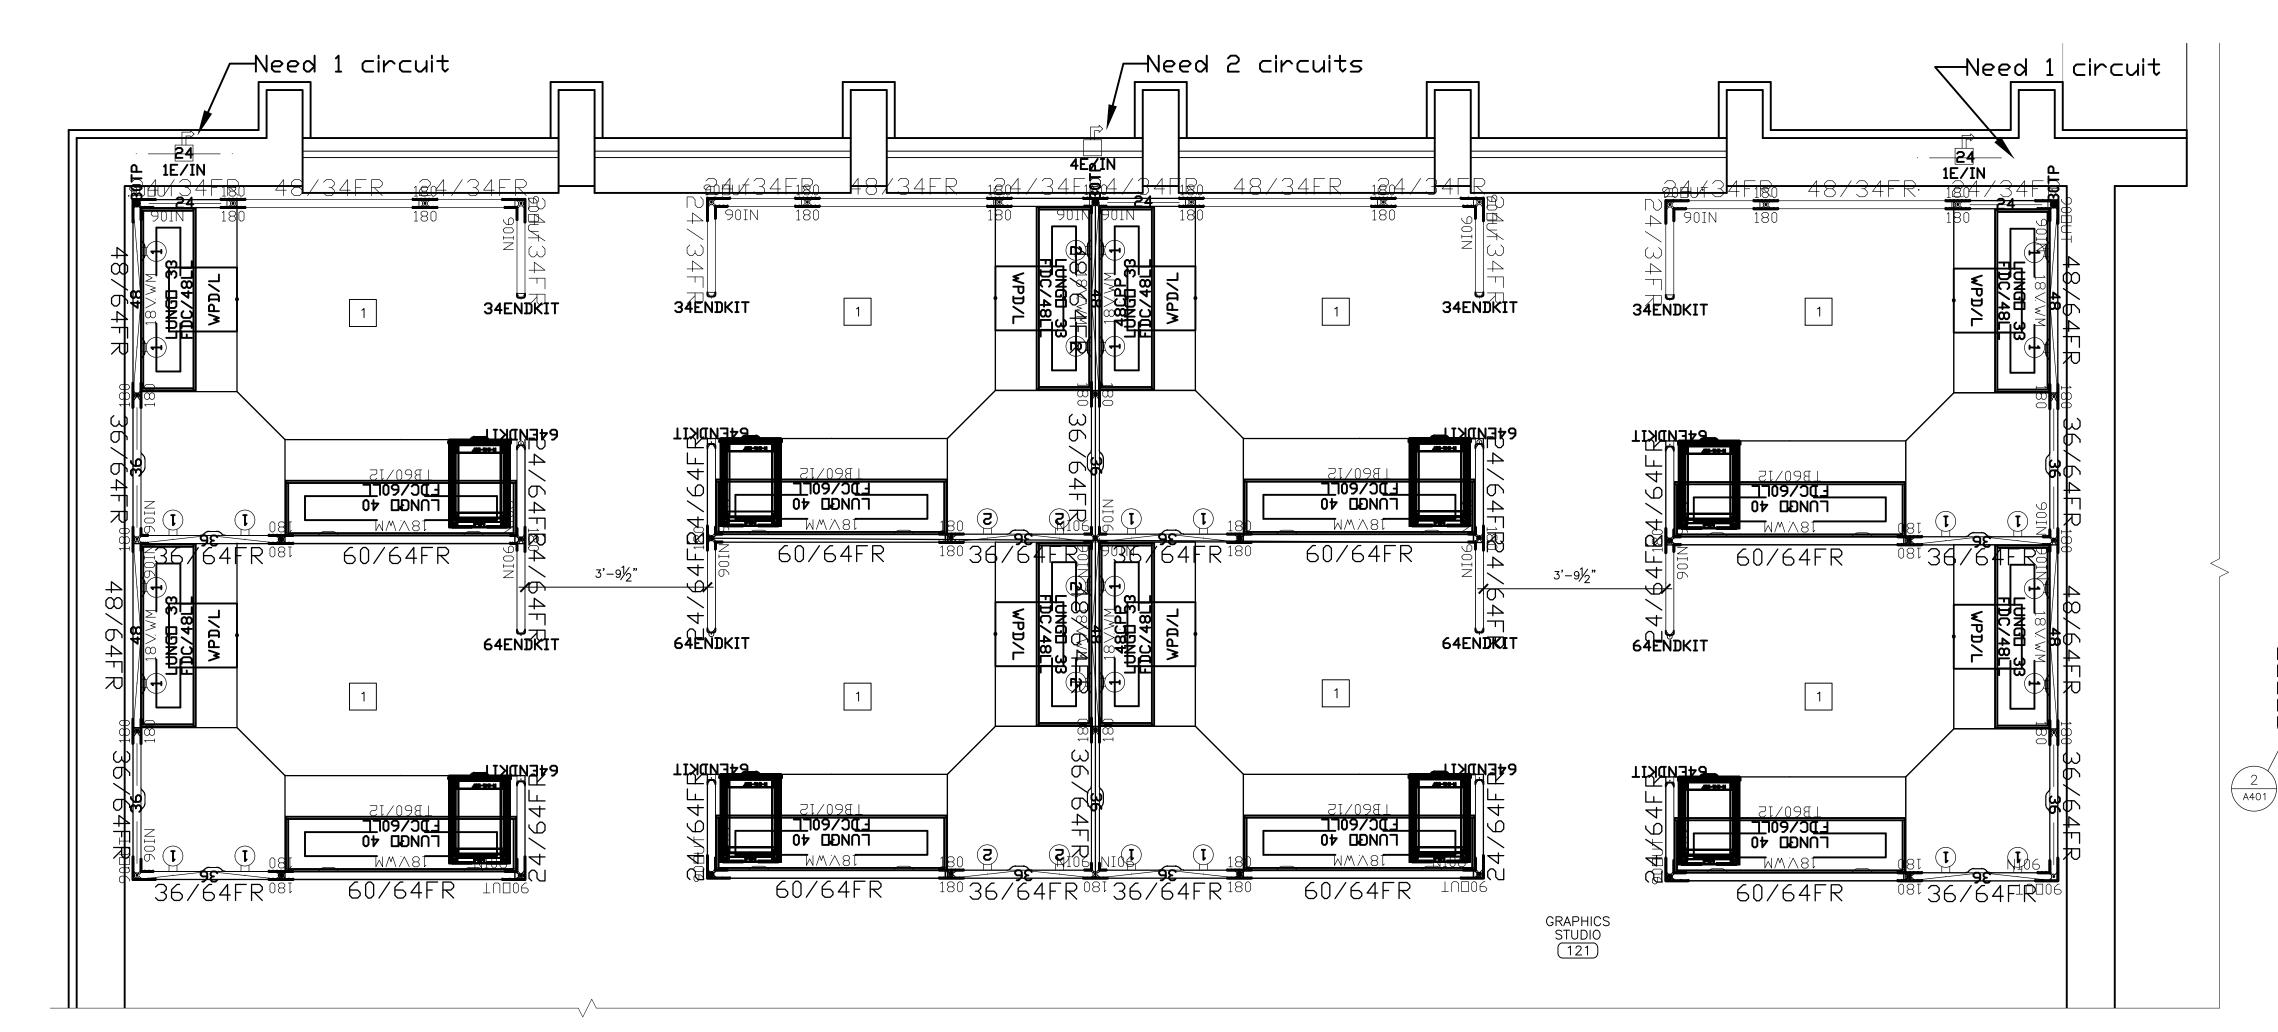

BUEHLER BUILDING KEY PLAN

SCALE: 1/32" = 1'-0"

3 A401

GENERAL NOTES:

- CONTRACTOR TO VERIFY DIMENSIONS OF EXISTING SPACE PRIOR TO BID.
- 2. CONTRACTOR TO TAKE MEASURES TO PROTECT EXISTING WALL FIXTURES AND MATERIAL FROM DAMAGE DURING DEMOLITION AND INSTALLATION.
- 3. CONTRACTOR TO COORDINATE PATHS THROUGH BUILDING FOR DELIVERY OF CONSTRUCTION MATERIAL AND WORKERS WITH FACILITY STAFF PRIOR TO COMMENCEMENT OF WORK.
- 4. CONTRACTOR TO COORDINATE WITH STAFF WHEN REMOVING FURNITURE TO DETERMINE EXACT LAYOUT FOR ACCURATE REPLACEMENT ALONG WITH STORAGE OF ITEMS.
- 5. ALL ADJACENT STRUCTURES TO REMAIN IN PLACE.
 CONTRACTOR SHALL PROTECT ANY MATERIALS INSTALLATION
 ABUTS UP TO OR COULD POTENTIALLY BE DAMAGED DURING
 INSTALLATION TO ENSURE INTEGRITY AND FINISH ARE
 MAINTAINED.
- 6. COORDINATE SCHEDULE WITH FACILITY STAFF PRIOR TO START OF WORK.

DEMOLITION KEYNOTES:

- REMOVE EXISTING SYSTEMS FURNITURE. COORDINATE WITH OWNER FOR DISPOSAL OR STORAGE OF FURNITURE PARTS.
- REMOVE ALL FREESTANDING FURNITURE WITHIN THE AREA O WORK TO RECEIVE NEW FLOORING. PROTECT FURNITURE FROM DAMAGE. COORDINATE TEMPORARY STORAGE LOCATION WITH OWNER. COORDINATE WITH OWNER TO DETERMINE ITEMS TO BE DISPOSED OF, RELINQUISHED, OR MOVED BACK INTO THE AREAS OF WORK AFTER CONSTRUCTION IS COMPLETE.

RENOVATION KEYNOTES:

NEW LAYOUT FOR SYSTEMS FURNITURE. PARTS TO BE OWNER PROVIDED NEW FROM M.V.E., AND INSTALLED BY CONTRACTOR.

STATE OF MISSOURI MIKE KEHOE, GOVERNOR



Brad M. Schaefer - Architect MO# A-2009027294

SOCUMENTS

OFFICE OF ADMINISTRATION DIVISION OF FACILITIES MANAGEMENT, DESIGN & CONSTRUCTION

DEPARTMENT OF NATURAL RESOURCES

REPLACE FLOORING & RENOVATE FRONT ENTRANCE

MISSOURI
GEOLOGICAL SURVEY BUEHLER BUILDING
111 FAIRGROUNDS ROAD
ROLLA, MISSOURI 65401

PROJECT # W2303-01 SITE # 5001 ASSET # 7815001007

REVISION:
DATE:
REVISION:
DATE:
REVISION:
DATE:
ISSUE DATE: 05/09/2025

CAD DWG FILE:W2303-01.DWG
DRAWN BY: EL
CHECKED BY: BMS
DESIGNED BY: M.V.E.

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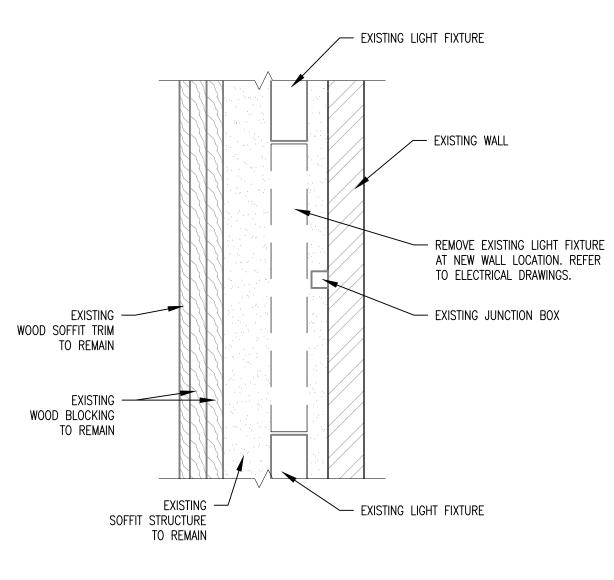
FURNITURE PLAN PUBLICATIONS &
GRAPHICS STUDIO


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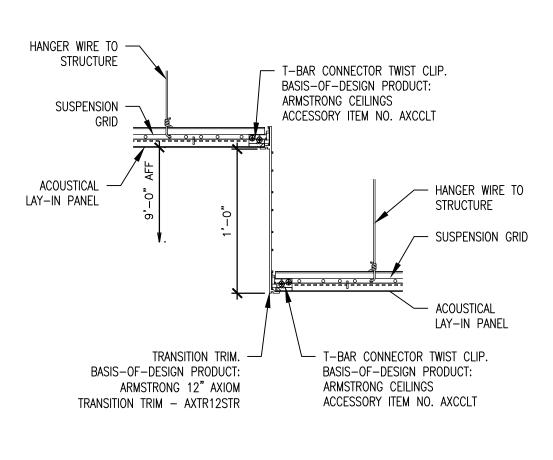
A-40

GRAPHICS STUDIO FURNITURE RENOVATION PLAN — PHASE 2

SCALE: 1/2" = 1'-0"





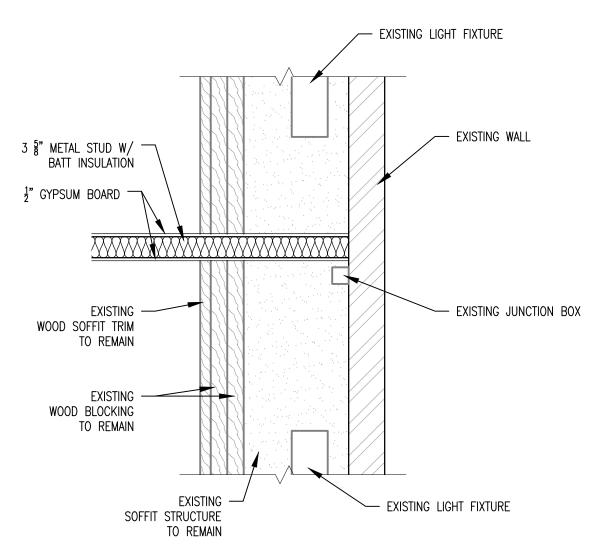



CEILING TRANISITION TRIM DETAIL


SCALE: 1 1/2" = 1'-0"






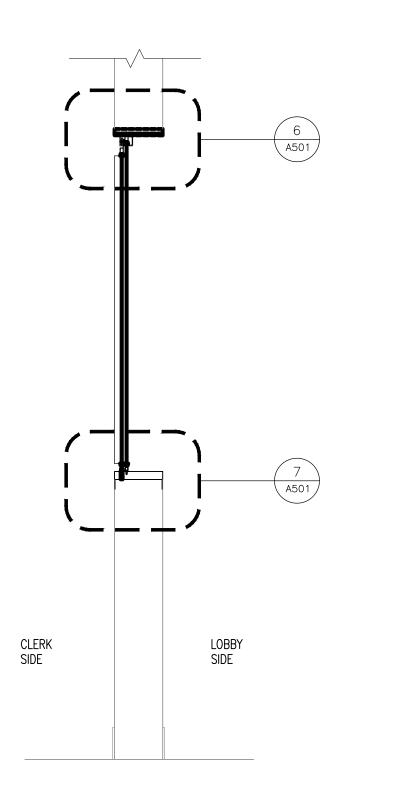


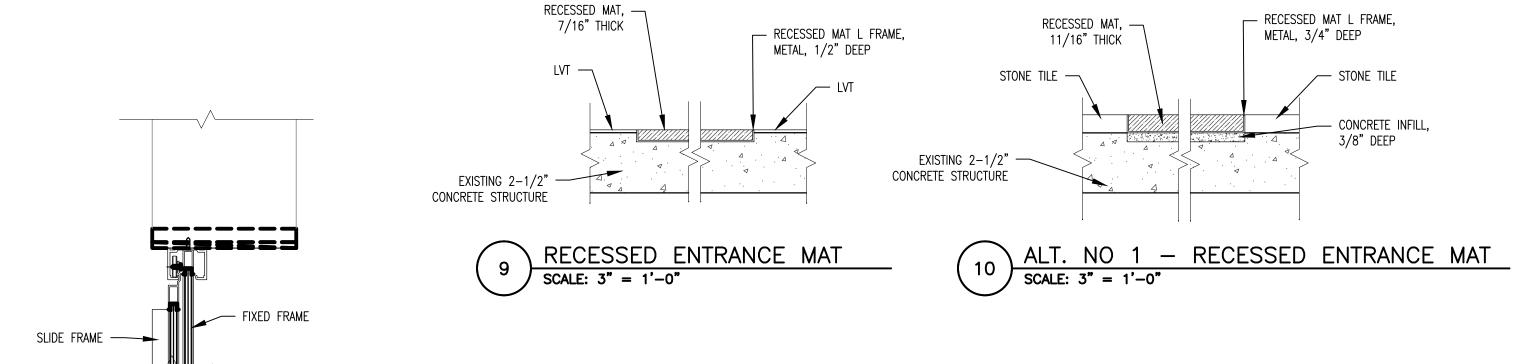


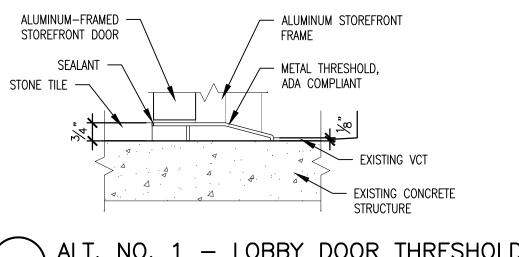


ALT. NO. 1 - LOBBY DOOR THRESHOLD SCALE: 3'' = 1'-0''

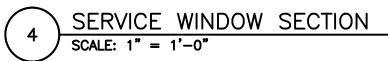

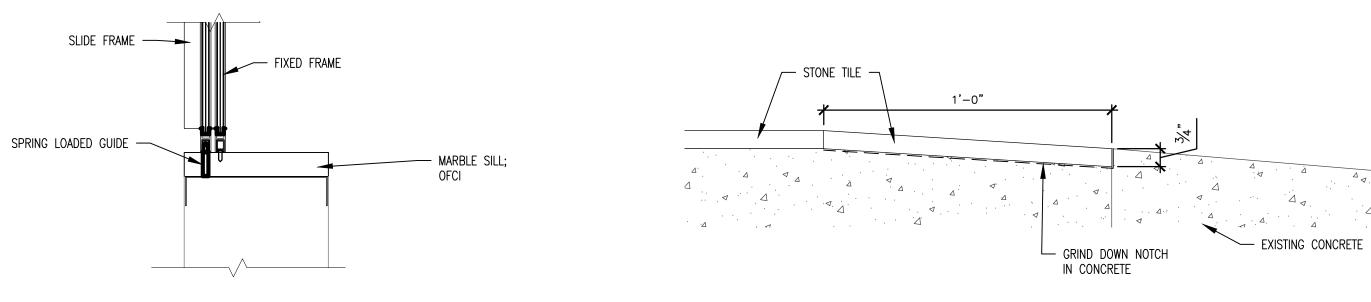

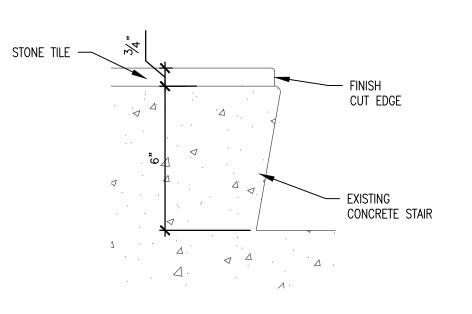

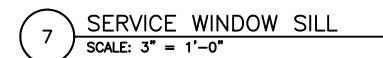


SERVICE WINDOW HEAD


SCALE: 3'' = 1'-0''

ALT. NO 1 - TILE AT RAMP SECTION


ALT. NO 1 — STAIR DETAIL


SCALE: 3" = 1'-0"

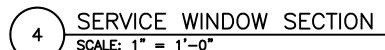

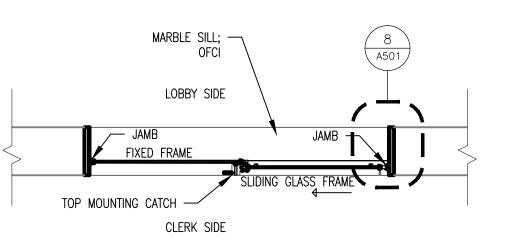



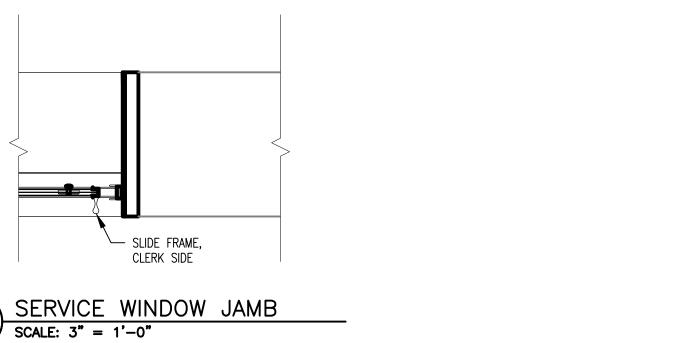

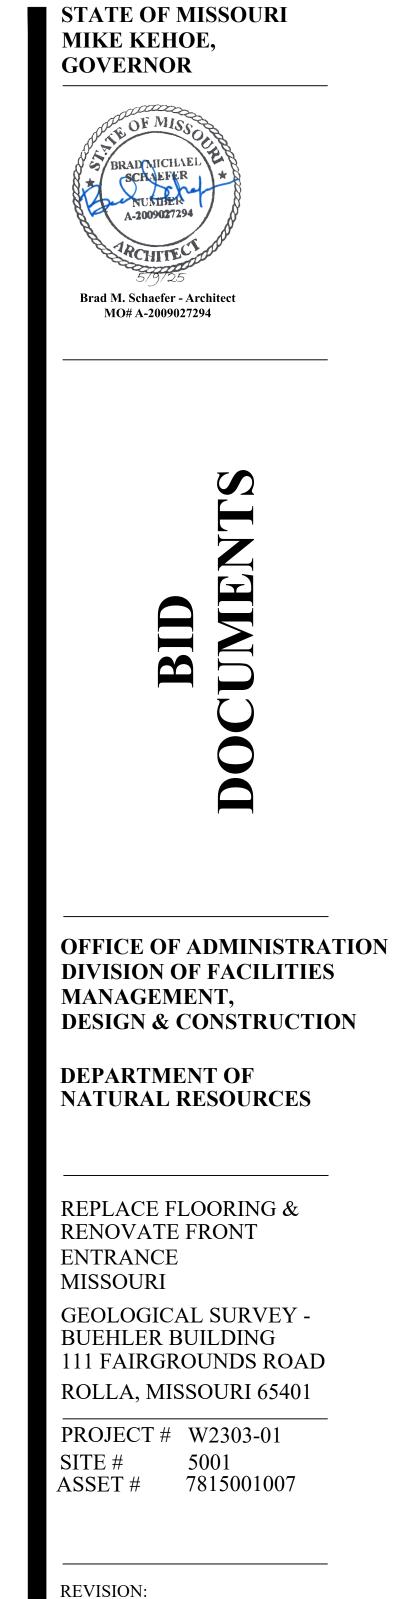

DATE:

ISSUE DATE: 05/09/2025

DESIGNED BY: CL

SHEET TITLE:

DETAILS


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13 OF 18 SHEETS

05/09/2025

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DRAWN BY: CL
CHECKED BY: BMS

REVISION: DATE: **REVISION:** DATE:

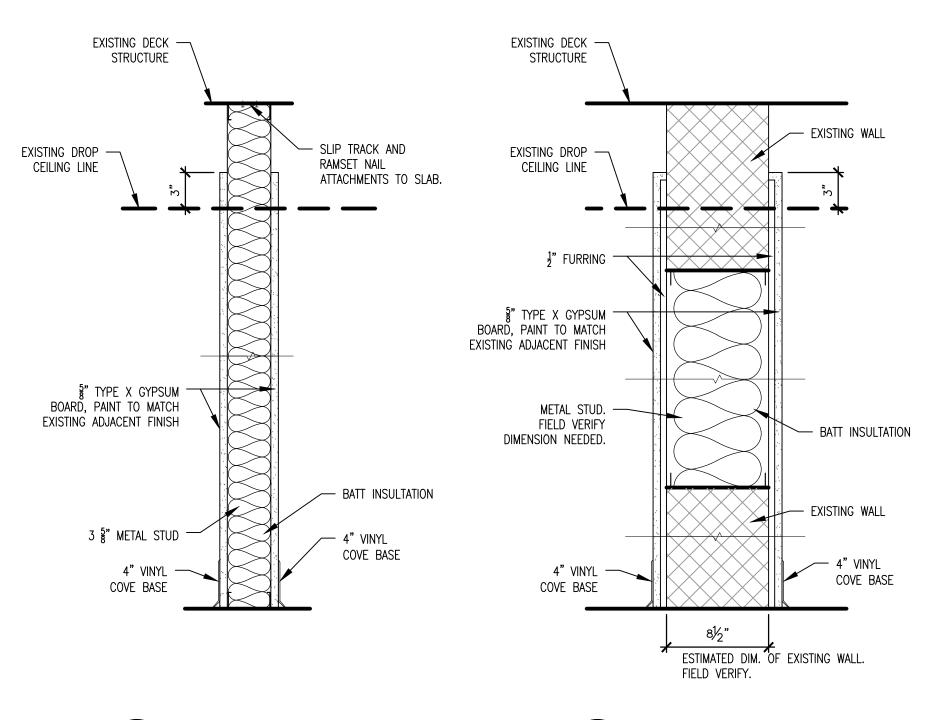


A WALL TYPE A

SCALE: 1 1/2" = 1'-0"

B WALL TYPE B
SCALE: 1 1/2" = 1'-0"

WALL TYPE SCHEDULE

SCALE: 1 1/2" = 1'-0"

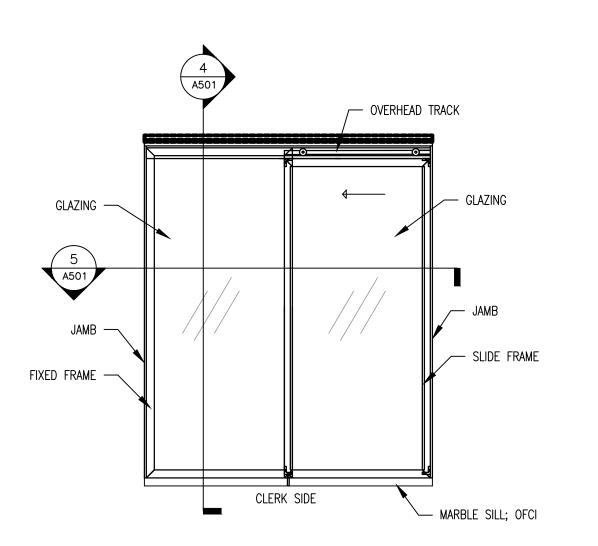


SERVICE WINDOW

SCALE: 1" = 1'-0"


WINDOW TYPE SCHDEULE

SCALE: 1" = 1'-0"

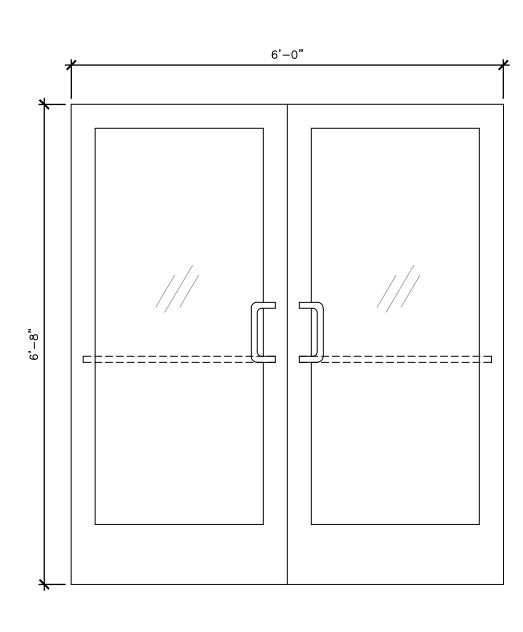


D1 INT. STOREFRONT DOOR

SCALE: 3/4" = 1'-0"

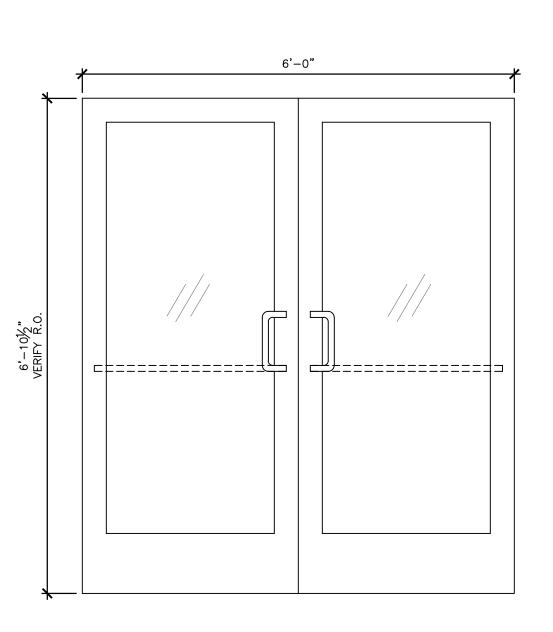

D2 ALT. NO. 1 - INT. STOREFRONT DOOR SCALE: 3/4" = 1'-0"

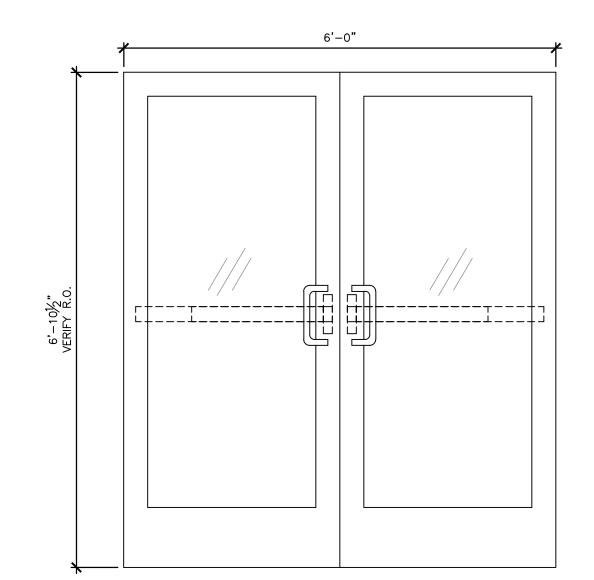

D3 ALT. NO.1 — EXT. STOREFRONT DOOR SCALE: 3/4" = 1'-0"

3 DOOR TYPE SCHDEULE

SCALE: 3/4" = 1'-0"

ROOM FINISH SCHEDULE NUMBER ROOM NAME FLOOR NORTH EAST SOUTH WEST GYP / PT WHERE WALL REMOVAL RESULTS IN EXPOSED LOBBY LVT UNFINISHED SURFACES. SEE A-104 FOR ALTERNATE NO. 1 FLOOR FINISH. SEE A-104 FOR ALTERNATE NO. 1 FLOOR FINISH. VINYL 101A LVT GALLERY PT PT SEE A-104 FOR ALTERNATE NO. 1 FLOOR FINISH. VINYL LVT 101B GALLERY 116 CORRIDOR VINYL GYP / PT 118 CORRIDOR VINYL GYP / PT 119 SHIPPING & RECEIVING ROOM CONC VINYL LOCATIONS OF NEW WALL FINISHES 119A CPT VINYL PT GYP / PT GYP / PT PUBLICATIONS ARE INDICATED ON A-103. 119B CPT VINYL STORAGE VINYL PT GRAPHICS STUDIO CPT 121A VINYL PT STORAGE

LEGEND

CPT: CARPET TILE
CONC: POLISHED CONCRETE
LVT: LUXURY VINYL TILE

NEW FLOOR IS INSTALLED AND NEW FINISH FLOOR HEIGHT IS

5. THIS DOOR IS NOT INCLUDED IN BASE BID. PROVIDE AND INSTALL IF

ALTERNATE NO. 1 IS ACCEPTED.

GYP: GYPSUM BOARD

PT: PAINT

			C	000R & F	RAME	SCHED	ULE				
				DOOR				FRAME		HRDWR	
MARK	LOCATION	SIZE	MATL	GLAZING	TYPE	FINISH	MATL	TYPE	FINISH	SET	NOTES
D1	LOBBY	6'-8" X 6'-0"	ALUM & GL	TEMP	STORE- FRONT	MATCH ADJ.	ALUM	STORE- FRONT	MATCH ADJ.	1	2, 4
D2	VEST. INT.	6'-10 1/2" X 6'-0"	ALUM & GL	TEMP	STORE- FRONT	MATCH EXIST.	EXIST.	EXIST.	EXIST.	EXIST.	1, 4, 5
D3	VEST. EXT.	6'-10 1/2" X 6'-0"	ALUM & GL	TEMP & INSUL.	STORE- FRONT	MATCH EXIST.	EXIST.	EXIST.	EXIST.	EXIST.	1, 2, 3, 4, 5
NC	OTES						LEGEN	ID			
1.		TING DOOR HARDV ARDWARE THAT IS				REUSE.		J: ADJAC JM: ALUN			
2.	PROVIDE NEV	N THRESHOLD.					EXI	ST: EXIS	TING		
3.	PROVIDE NEV	N WEATHERSTRIP	PING.				EXT	: EXTER	IOR		
4.	DOOR SIZES	ARE APPROXIMAT	E. VERIF	Y ROUGH O	PENING		GL:	GLAZING	3		
	REQUIREMEN	NTS PRIOR TO ORI	DERING D	OORS AND	FRAMES	AFTER	INS	UL: INSU	LATED		

INT: INTERIOR TEMP: TEMPERED

VEST: VESTIBULE

DOOR HARDWARE LEGEND

HARDWARE SET 1: DOUBLE STOREFRONT DOOR W/ ACCESS CONTROL.

- LOCATION: LOBBY.
 6 HINGES
- 1 ELECTRIFIED LOCKSET
- 2 PUSH/PULL HANDLES2 DOOR CLOSERS
- 1 CARD READER PROVIDED AND INSTALLED BY OTHERS

NOTES:

COORDINATE WITH OWNER FOR KEYING.
MOUNT OPERABLE PARTS BETWEEN 34" MINIMUM AND 48" MAXIMUM HEIGHT, FOR ADA COMPLIANCE.

DIVISION OF FACILITIES
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STATE OF MISSOURI

SCHAEFER

A-2009027294

Brad M. Schaefer - Architect

MO# A-2009027294

MIKE KEHOE,

GOVERNOR

BUEHLER BUILDING 111 FAIRGROUNDS ROAD ROLLA, MISSOURI 65401

OFFICE OF ADMINISTRATION

PROJECT # W2303-01 SITE # 5001 ASSET # 7815001007

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ISSUE DATE: 05/09/2025

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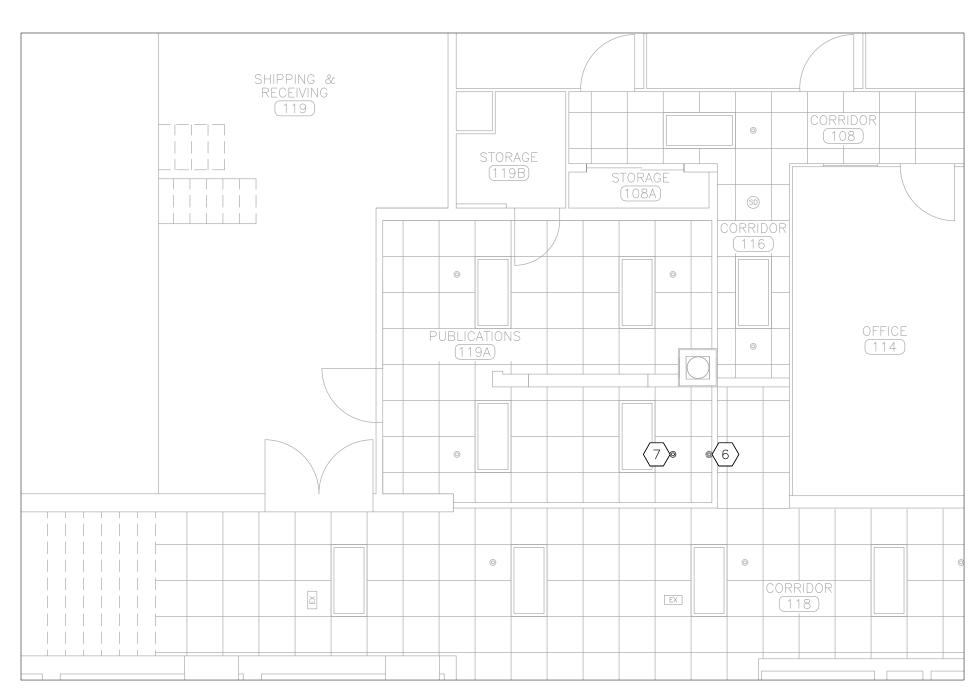
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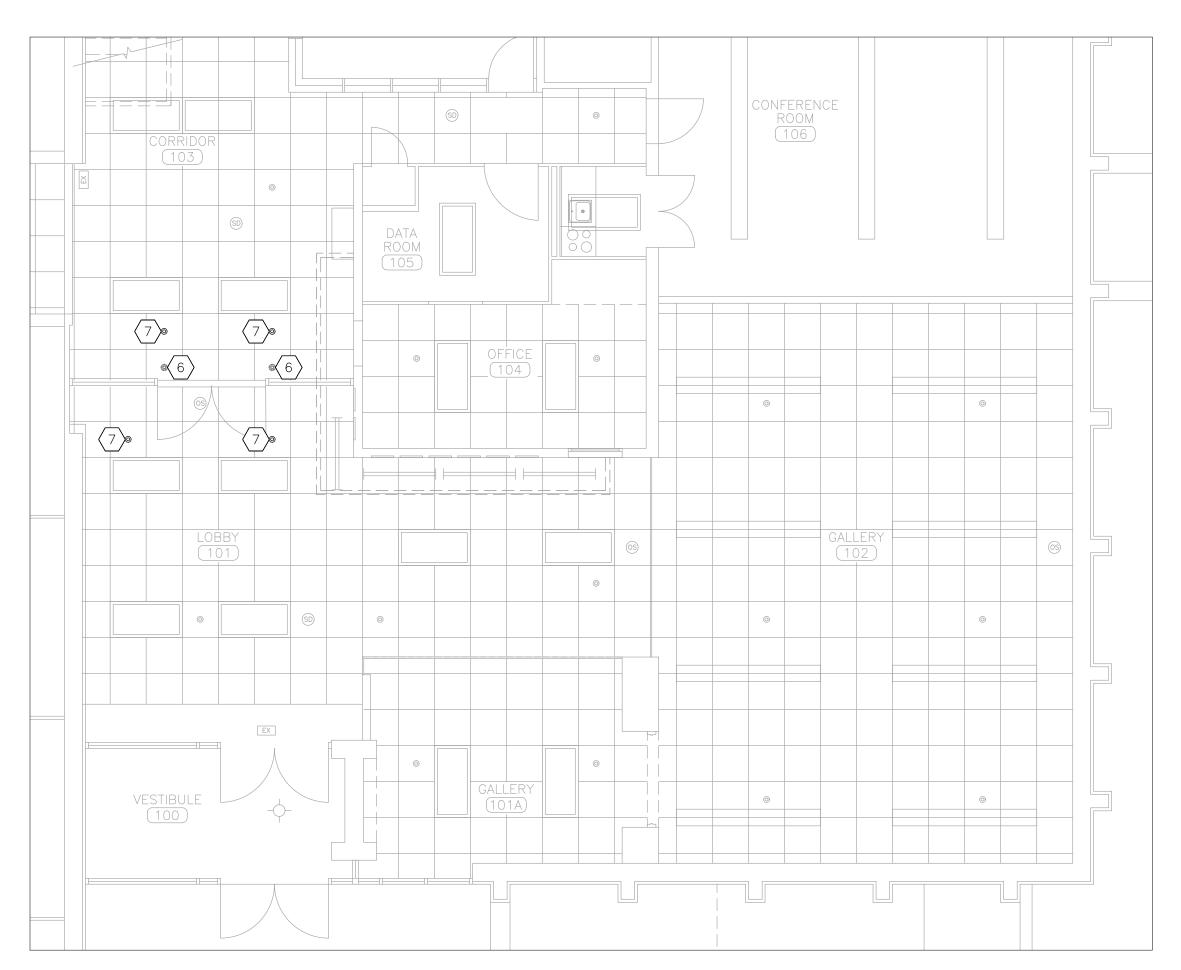
SCHEDULES

SHEET NUMBER:

A-60



FIRE PROTECTION PLAN - PUBLICATIONS (PHASE 1)



FIRE PROTECTION PLAN - FRONT ENTRANCE (PHASE 3) SCALE: 3/16" = 1'-0"

NOTES

 $\left\langle \#
ight
angle$ indicates keyed notes

- FABRICATION, INSTALLATION, AND TESTING OF ALL FIRE PROTECTION DEVICES SHALL BE DONE IN ACCORDANCE WITH THE LATEST VERSION OF THE NATIONAL FIRE PROTECTION ASSOCIATION'S STANDARD FOR THE INSTALLATION OF SPRINKLER SYSTEMS (NFPA 13), NATIONAL ELECTRIC CODE (NEC), AND ALL MANUFACTURER INSTALLATION GUIDELINES.
- 2 DRAWINGS AND PLANS ARE FROM FIELD TAKE-OFF AND ORIGINAL DRAWINGS. CONTRACTOR IS RESPONSIBLE FOR FIELD VERIFYING PRIOR TO BIDDING AND/OR CONSTRUCTION.
- ONTRACTOR IS RESPONSIBLE FOR REMOVAL AND DISPOSAL OF ALL DEMOLISHED MATERIAL, AS WELL AS REPAIRING ANY DAMAGE TO ANY SURFACE IN THE AREA OF CONSTRUCTION THAT IS A RESULT OF CONSTRUCTION ACTIVITY. SURFACE SHALL BE REPAIRED AND FINISHED TO MATCH EXISTING CONDITIONS.
- 4 COORDINATE WITH OWNER TO SHUT OFF FIRE ALARMS AND FIRE SUPPRESSION SYSTEM IN WORK AREA PRIOR TO BEGINNING CONSTRUCTION. CONSTRUCTION SHALL BE DONE SUCH THAT THE FIRE ALARM AND FIRE SUPPRESSION SYSTEMS ARE ACTIVE OVERNIGHT.
- 5 DELEGATED DESIGN: LOCATION OF NEW SPRINKLER HEADS ARE FOR REFERENCE ONLY. FIRE PROTECTION CONTRACTOR IS RESPONSIBLE FOR DESIGNING AND PROVIDING A COMPLETE, FUNCTIONAL, AND CODE COMPLIANT SYSTEM.
- DEMOLISH FIRE SPRINKLER HEAD. CAP PIPE WHERE HEAD IS REMOVED OR EXTEND PIPE TO NEW SPRINKLER HEAD LOCATION AS NEEDED. IF PIPE NO LONGER SERVES A SPRINKLER HEAD, REMOVE PIPE AND ALL ASSOCIATED HANGERS BACK TO MAIN AND CAP AT MAIN.
- PROVIDE AND INSTALL NEW FIRE SPRINKLER HEAD, ESCUTCHEON, AND ALL REQUIRED PIPE. ALL MATERIALS SHALL MATCH EXISTING FINISH AND PERFORMANCE.

STATE OF MISSOURI MIKE KEHOE, GOVERNOR



Tracie L. Siebeneck - Engineer MO# PE-2013019114

DOCUMENTS

OFFICE OF ADMINISTRATION DIVISION OF FACILITIES MANAGEMENT, DESIGN & CONSTRUCTION

DEPARTMENT OF NATURAL RESOURCES

REPLACE FLOORING & RENOVATE FRONT ENTRANCE

MISSOURI GEOLOGICAL SURVEY -BUEHLER BUILDING ROLLA, MISSOURI 65401

PROJECT # W2303-01 SITE # 5001 ASSET # 7815001007

REVISION:
DATE:
REVISION:
DATE:
REVISION:
DATE:

ISSUE DATE: 05/09/2025

CAD DWG FILE: W2303-0

CAD DWG FILE:W2303-01.DWG
DRAWN BY: TS/AH
CHECKED BY: TS
DESIGNED BY: TS/AH

SHEET TITLE:

FIRE PROTECTION
PLAN - MAIN FLOOR

SHEET NUMBER:

F-10

05/09/2025

AREA MAP

FIRE PROTECTION LEGEND


— — EXISTING MATERIALS TO BE REMOVED

FIRE SPRINKLER HEAD/ESCUTCHEON


MARK	MANUFACTURER	MODEL	NECK SIZE (INCHxINCH)	FACE SIZE (INCHxINCH)	TYPE	SPECIFICATION	NOTES
S1	PRICE	TBD3100	SEE PLANS	24	SUPPLY SLOT DIFFUSER ICE TONG PATTERN	MATERIAL: EXTRUDED ALUMINUM W/ INSULATED STEEL PLENUM; FINISH: WHITE; SLOT: THREE 1" SLOTS	1
R1	PRICE	535	SEE PLANS	24x12	RETURN LAY-IN MOUNT	MATERIAL: STEEL; FINISH: WHITE; BLADES: SINGLE 45° DEFLECTION W/ 1/2 INCH BLADE SPACING AND PARALLEL TO LONG DIMENSION	
BD-1	POTTORFF	CD-21R	MATCH DUCT	N/A	BALANCE DAMPER SINGLE BLADE ROUND	FRAME: 2"x16 GAUGE GALVANIZED STEEL; BLADES: 14 GAUGE GALVANIZED STEEL ROUND; AXLES: 1/2" DIAMETER PLATED STEEL; LINKAGE: CONCEALED IN FRAME; BEARINGS: SYNTHETIC; CONTROL SHAFT: 1/2"x3" DRIVE AXLE	

CORRIDOR	DATA ROOM 105	CONFERENCE ROOM (106)	
103 HPM-15 ©	7		
	(HPM-15)	GALLERY (102)	
LOBBY 101			
VESTIBULE 100	GALLERY (101A)		


MECHANICAL DEMOLITION PLAN — FRONT ENTRANCE (PHASE 3)

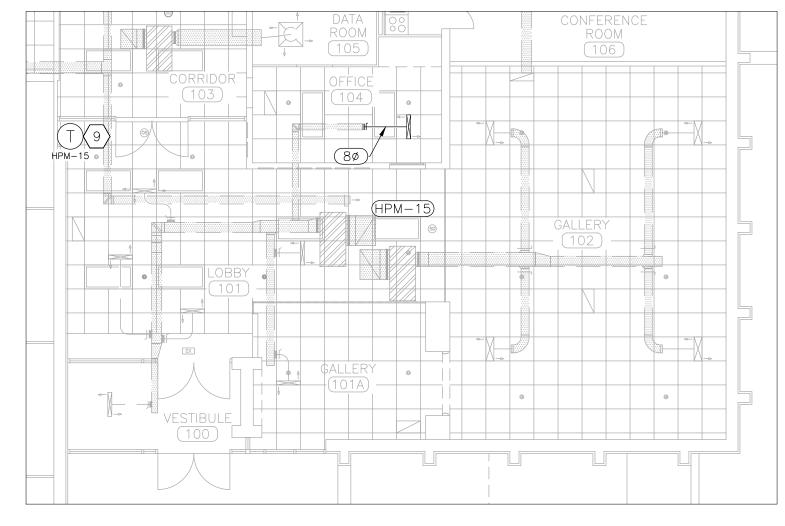

MECHANICAL RENOVATION PLAN — FRONT ENTRANCE (PHASE 3)

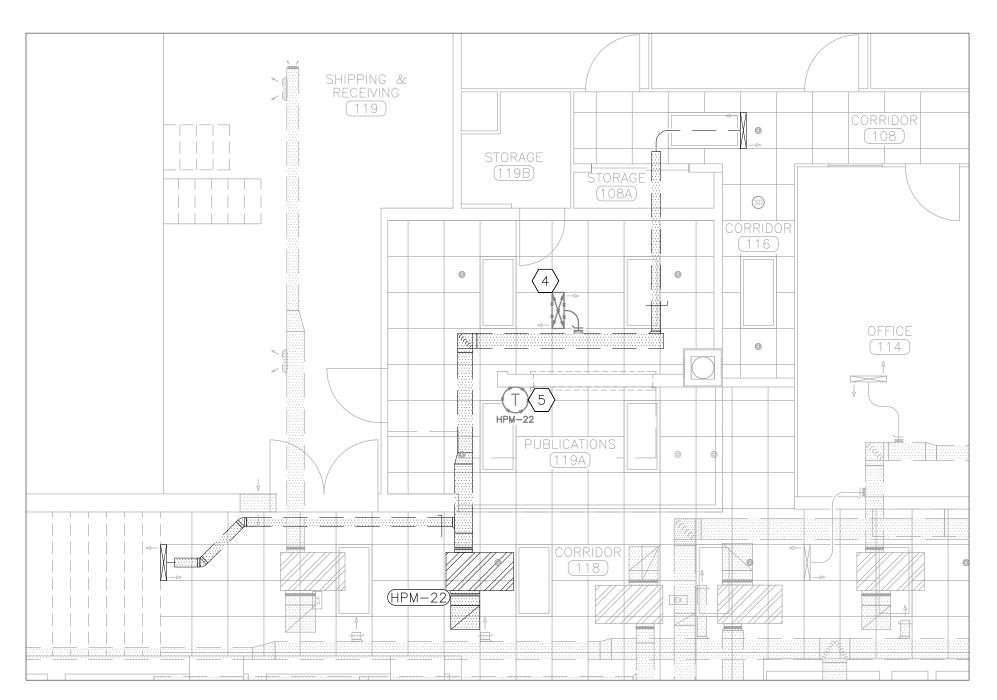

MECHANICAL DEMOLITION PLAN — PUBLICATIONS (PHASE 1)

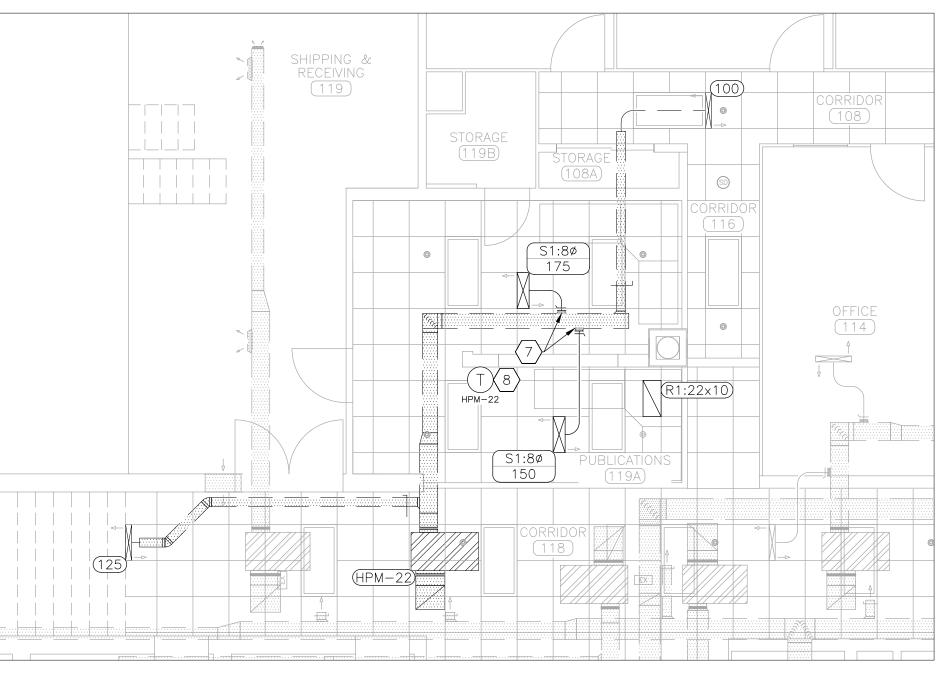

MECHANICAL RENOVATION PLAN — PUBLICATIONS (PHASE 1)

SCALE: 3/16" = 1'-0"

DEMOLITION NOTES - DETAILS 1 & 2


- ETAILS 1 & 2 # INDICATES KEYED NOTES
- 1 DEMOLITION DRAWINGS AND PLANS ARE FROM FIELD TAKE—OFF AND ORIGINAL DRAWINGS. CONTRACTOR IS RESPONSIBLE FOR FIELD VERIFYING PRIOR TO BIDDING AND/OR CONSTRUCTION.
- COVER ALL OPENINGS INTO THE BUILDING FROM THE WORK AREA. ENSURE DEBRIS IS REMOVED FROM THE CONSTRUCTION AND DEMOLITION AREA AND AIR BORN DEBRIS IS NOT ALLOWED TO TRAVEL TO THE REMAINDER OF THE BUILDING. CONTRACTOR IS RESPONSIBLE FOR REMOVAL AND DISPOSAL OF ALL DEMOLISHED MATERIAL.
- 3 CONTRACTOR IS RESPONSIBLE FOR REPAIRING ANY DAMAGE TO ANY SURFACE IN THE AREA OF CONSTRUCTION THAT IS A RESULT OF CONSTRUCTION ACTIVITY. SURFACE SHALL BE REPAIRED AND FINISHED TO MATCH EXISTING CONDITIONS.
- DEMOLISH SUPPLY AIR DEVICE. DEMOLISH ASSOCIATED TAKE—OFF AND PATCH DUCT TO REMAIN. PROVIDE AIR TIGHT SEAL AND INSULATE TO MATCH EXISTING.
- REMOVE AND RETAIN THERMOSTAT FOR USE IN NEW CONSTRUCTION. ASSOCIATED CONTROLS WIRING TO REMAIN.
- REMOVE AND RETAIN THERMOSTAT FOR USE IN NEW CONSTRUCTION. DEMOLISH ASSOCIATED CONTROLS WIRING TO ABOVE CEILING FOR USE IN NEW CONSTRUCTION.
- SUPPLY AIR DEVICE TO REMAIN. DEMOLISH DAMAGED DUCT BACK TO TAKE-OFF. TAKE-OFF TO REMAIN FOR USE IN NEW CONSTRUCTION.

RENOVATION NOTES - DETAILS 3 & 4 (#) INDICATES KEYED NOTES


- 1 FABRICATION, INSTALLATION, AND TESTING OF ALL HVAC SYSTEMS SHALL BE IN ACCORDANCE WITH THE LATEST VERSION OF THE INTERNATIONAL MECHANICAL CODE (IMC) AND ALL MANUFACTURER INSTALLATION GUIDELINES.
- 2 ALL METALLIC AND FLEXIBLE DUCTS SHALL BE CONSTRUCTED AND INSTALLED AS SPECIFIED IN THE IMC AND SMACNA HVAC DUCT CONSTRUCTION STANDARDS.
- TEST AND BALANCE HEAT PUMP HPM-22 AIRFLOW TO SPECIFIED VALUES AND PREPARE A BALANCE REPORT PER ASHRAE STANDARD 111 OR EQUAL. REPORT SHALL BE SENT TO THE ENGINEER FOR APPROVAL PRIOR TO FINAL COMPLETION. BALANCE DAMPERS ARE REQUIRED ON ALL SUPPLY AIR DEVICES. INSTALL BALANCE DAMPER (BD-1) ON ANY NEW TAKE-OFF. REFERENCE SPECIFICATIONS FOR ADDITIONAL INFORMATION.
- 4 ROUND DUCT SHALL MAINTAIN A CENTERLINE TURNING RADIUS OF 1.5 X DUCT DIAMETER. FLEXIBLE DUCT SHALL BE 5 FEET MAXIMUM LENGTH AND BE SUPPORTED TO MINIMIZE STATIC PRESSURE DROP.
- ALL INSULATION SHALL MEET THE ASTM E 84 FLAME/SMOKE SPREAD INDEX OF 25/50 MAXIMUM. DUCT SEAMS SHALL BE SEALED:

 SUPPLY DUCT LOCATED ABOVE THE CEILING: EXTERNAL INSULATION; INSTALLED R-VALUE: R-6.0; MINIMUM THERMAL CONDUCTIVITY OF 0.25 BTU-IN/HR/SF/°F WITH VAPOR BARRIER.
- 6 PROVIDE SUITABLE SUPPORTS FOR STABILITY OF ALL HVAC DEVICES AND DUCT.
- $\overline{\langle 7 \rangle}$ provide and install new take-off and route duct to supply air device.
- PROVIDE AND INSTALL EXTENSION RING. INSTALL RETAINED THERMOSTAT.
- 9) INSTALL RETAINED THERMOSTAT AS SHOWN. EXTEND CONTROLS WIRING AS NEEDED TO COMPLETE THE

HVAC	LEGEND
(HPM-##)	EXISTING EQUIPMENT LABEL
T HPM-#	THERMOSTAT WITH EQUIPMENT LABEL
S1:6ø 50	AIR DEVICE: NECK SIZE (INCHES)/CFM
(R1:18x30)	RETURN AIR DEVICE: NECK SIZE (INCHES)
(8ø)	DUCT SIZE-ROUND (INCHES DIAMETER)
350	AIR FLOW (CUBIC FEET PER MINUTE)
	HVAC EQUIPMENT — EXISTING
	SUPPLY AIR - NEW
	SUPPLY AIR — EXISTING
	RETURN AIR — EXISTING
	EXHAUST AIR — EXISTING
	EXISTING MATERIALS TO BE REMOVED

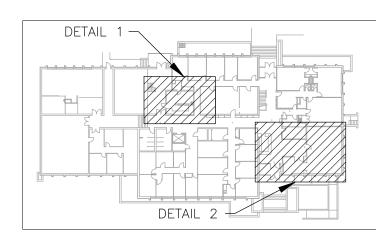



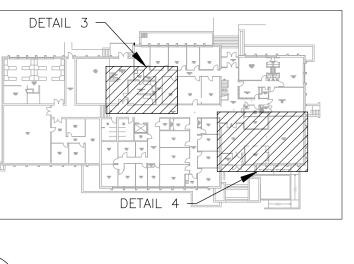

AREA MAP-RENOVATION

STATE OF MISSOURI MIKE KEHOE, GOVERNOR



DOCUMENTS

OFFICE OF ADMINISTRATION DIVISION OF FACILITIES MANAGEMENT, DESIGN & CONSTRUCTION

DEPARTMENT OF NATURAL RESOURCES

REPLACE FLOORING & RENOVATE FRONT ENTRANCE

MISSOURI GEOLOGICAL SURVEY -BUEHLER BUILDING ROLLA, MISSOURI 65401

PROJECT # W2303-01 SITE # 5001 ASSET # 7815001007

REVISION:	
DATE:	
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ISSUE DATE: 05/09/2025


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DRAWN BY: TS/AH
CHECKED BY: TS
DESIGNED BY: TS/AH

SHEET TITLE:

MECHANICAL PLAN MAIN FLOOR

SHEET NUMBER:

M-101

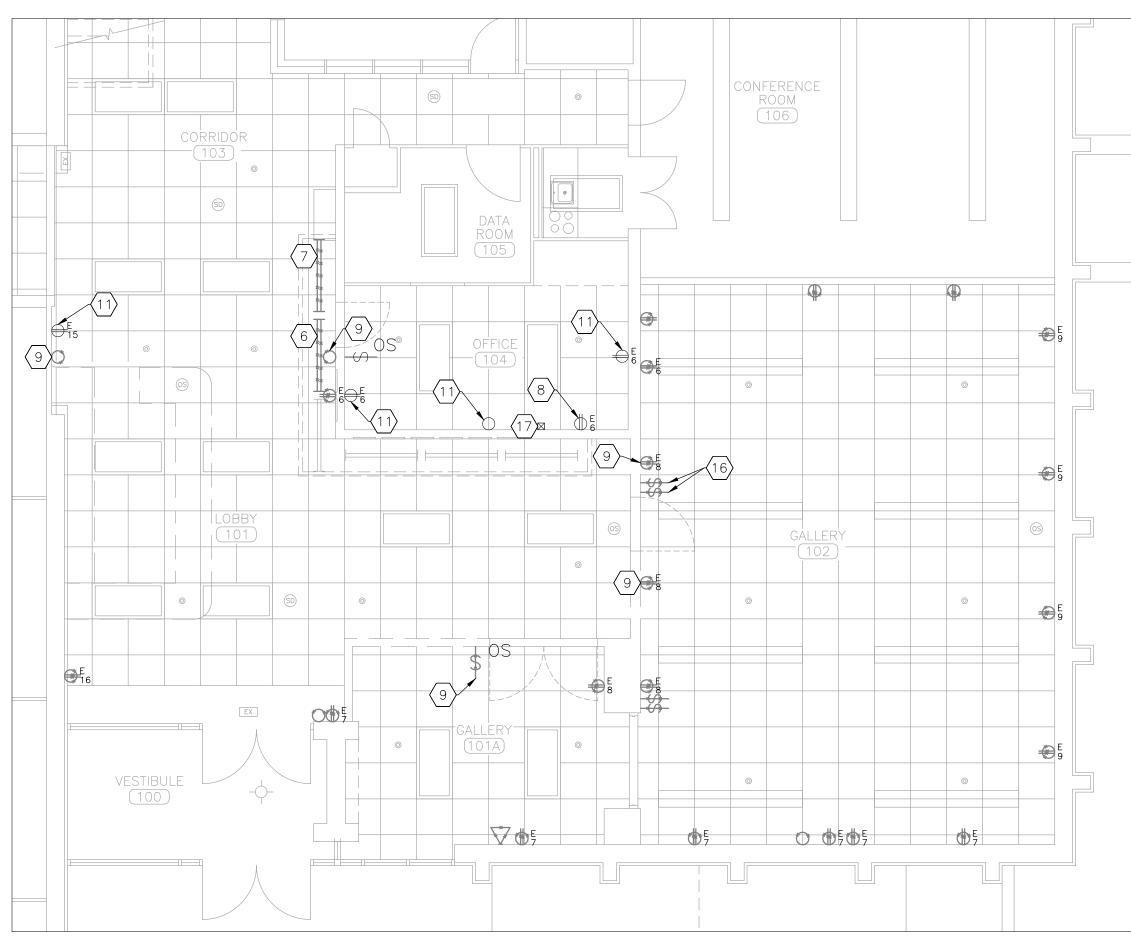

POWER AND LIGHTING DEMOLITION PLAN — FRONT ENTRANCE (PHASE 3)

SCALE: 3/16" = 1'-0"




DEMOLITION NOTES

CONDUCTORS.


- $\left\langle \#
 ight
 angle$ indicates keyed notes
- DEMOLITION DRAWINGS AND PLANS ARE FROM FIELD TAKE-OFF AND ORIGINAL DRAWINGS. CONTRACTOR IS RESPONSIBLE FOR FIELD VERIFYING PRIOR TO BIDDING AND/OR CONSTRUCTION.
- 2 CONTRACTOR IS RESPONSIBLE FOR REPAIRING ANY DAMAGE TO ANY SURFACE IN THE AREA OF CONSTRUCTION THAT IS A RESULT OF CONSTRUCTION ACTIVITY. SURFACE SHALL BE REPAIRED AND
- FINISHED TO MATCH EXISTING CONDITIONS.

 3 CONTRACTOR MAY REUSE EXISTING CONDUIT AND CONDUCTORS IF THEY ARE INSTALLED PER THE LATEST EDITION OF THE NEC. CONTRACTOR SHALL DISPOSE OF ANY UNUSED CONDUIT AND
- 4 UNLESS OTHERWISE NOTED, DEMOLISH ALL RECEPTACLES, WALL SWITCHES, AND WALL PLATES LOCATED WITHIN WALLS TO RECEIVE NEW SURFACE FINISH. DEVICE BOX, CONDUIT AND CONDUCTORS TO REMAIN FOR USE IN NEW CONSTRUCTION.
- DEMOLISH CONDUCTORS BACK TO PANEL AND DEMOLISH FLOOR BOX. COORDINATE WITH GENERAL CONTRACTOR TO REPAIR FLOOR.
- DEMOLISH SOFFIT LIGHT FIXTURE. DEMOLISH CONDUIT AND CONDUCTORS BACK TO NEAREST JUNCTION BOX. MAINTAIN EXISTING CIRCUIT AND SENSOR FOR LIGHTS TO REMAIN.
- REMOVE AND RETAIN SOFFIT LIGHT FIXTURE. CONDUIT AND CONDUCTORS TO REMAIN FOR USE IN NEW CONSTRUCTION.
- B GENERAL CONTRACTOR TO SELECTIVELY DEMOLISH EXISTING WALL TO INSTALL NEW WINDOW. DEMOLISH CONDUIT AND CONDUCTORS ASSOCIATED WITH RECEPTACLE TO REMAIN AS NEEDED TO COMPLETE THE WORK
- DEMOLISH OCCUPANCY SENSOR/RECEPTACLE/WALL PLATE AND ASSOCIATED DEVICE BOX. DEMOLISH CONDUIT AND CONDUCTORS TO NEAREST JUNCTION BOX. PERFORM WORK SUCH THAT CIRCUIT REMAINS INTACT FOR REMAINING ELECTRICAL DEVICES ON CIRCUIT.
- DEMOLISH RECEPTACLE AND WALL PLATE. DEVICE BOX AND CONDUIT TO REMAIN FOR USE IN NEW CONSTRUCTION. PULL CONDUCTORS TO NEAREST JUNCTION BOX AND PERFORM WORK SUCH THAT CIRCUIT REMAINS INTACT FOR REMAINING ELECTRICAL DEVICES ON CIRCUIT.
- $\langle 11 \rangle$ RECEPTACLE/WALL SWITCH AND WALL PLATE TO REMAIN.
- PULL EXPOSED DATA WIRE TO ABOVE SUSPENDED CEILING FOR USE IN NEW CONSTRUCTION.
- DEMOLISH SURFACE MOUNT CONDUIT AND PULL ASSOCIATED DATA CABLE TO DATA ACCESS POINT AS SHOWN. DEMOLISH DATA ACCESS POINT WALL PLATE. DATA CABLE TO REMAIN FOR USE IN NEW CONSTRUCTION.
- (14) DEMOLISH DATA ACCESS POINT. ASSOCIATED DATA CABLE TO REMAIN FOR USE IN NEW CONSTRUCTION.
- DEMOLISH DATA ACCESS POINT. PULL ASSOCIATED DATA CABLE TO ABOVE CEILING FOR USE IN NEW CONSTRUCTION.
- DEMOLISH WALL SWITCH, WALL PLATE, AND DEVICE BOX. DEMOLISH CONDUIT AND CONDUCTORS TO ABOVE CEILING FOR USE IN NEW CONSTRUCTION.
- (17) EXISTING COMMUNICATIONS WIRING DUCT TO REMAIN.

ELECT	TRICAL LEGEND
(OS)	OCCUPANCY SENSOR — CEILING MOUNTED
SD	SMOKE DETECTOR — CEILING MOUNTED
\$ OS	OCCUPANCY SENSOR — WALL MOUNTED
(\$)	WALL SWITCH
₩#	RECEPTACLE — TYPE: DUPLEX
₩ PANEL	RECEPTACLE — TYPE: QUAD
PANEL ##	FLOOR BOX -TYPE: DUPLEX
\triangleright	DATA ACCESS POINT -WALL MOUNT
	DATA ACCESS POINT — CEILING DROP
0	BLANK WALL PLATE
	WIRING DUCT — EXISTING
	LIGHT FIXTURE — EXISTING
	ELECTRICAL DEVICE - EXISTING
	EXISTING MATERIALS TO BE REMOVED

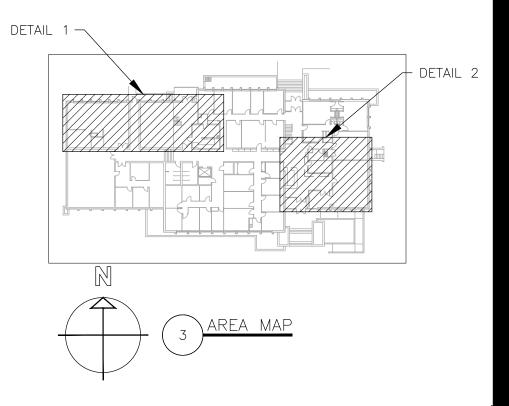

STATE OF MISSOURI MIKE KEHOE, GOVERNOR

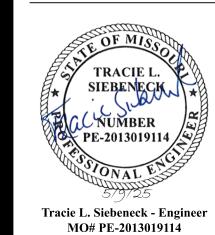

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DEPARTMENT OF NATURAL RESOURCES

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MISSOURI GEOLOGICAL SURVEY -BUEHLER BUILDING ROLLA, MISSOURI 65401

PROJECT # W2303-01 SITE # 5001 ASSET # 7815001007

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DRAWN BY: TS/AH
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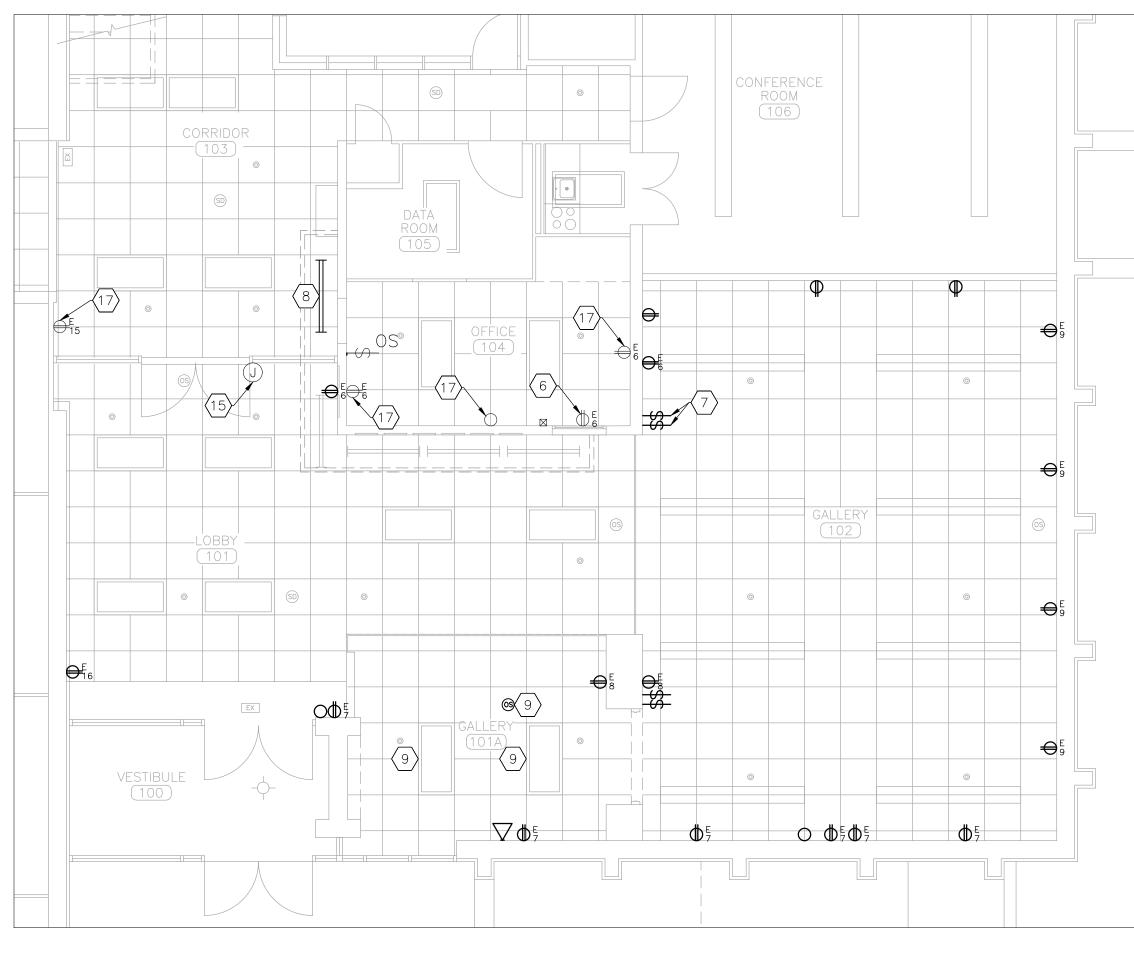
ISSUE DATE: 05/09/2025

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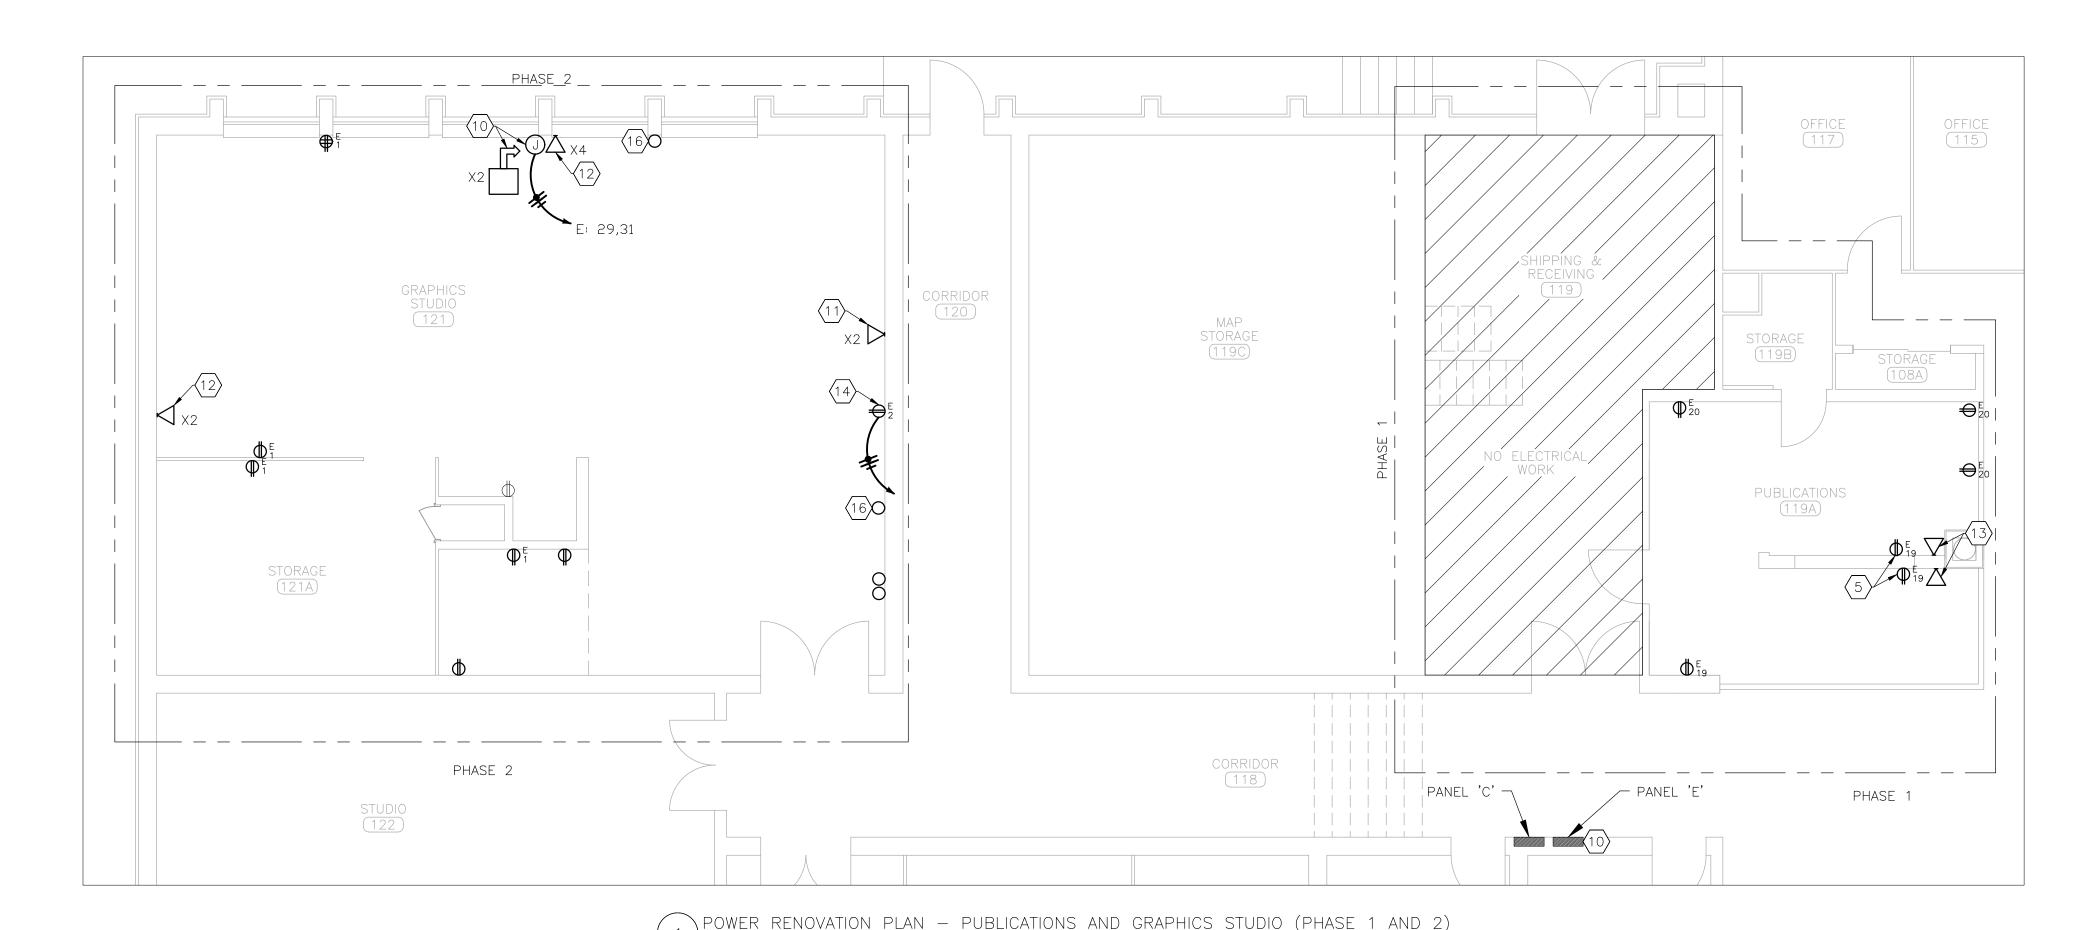
ELECTRICAL
DEMOLITION PLAN
MAIN FLOOR

SHEET NUMBER:

E-101




2 ELECTRICAL RENOVATION PLAN — FRONT ENTRANCE (PHASE 3)



RENOVATION NOTES

- # INDICATES KEYED NOTES
- 1 ALL ELECTRICAL WORK SHALL BE IN ACCORDANCE WITH THE LATEST EDITION OF THE NATIONAL ELECTRIC CODE (NEC) AND ALL MANUFACTURER INSTALLATION GUIDELINES.
- 2 ELECTRICAL CONTRACTOR SHALL BE RESPONSIBLE FOR PROVIDING ALL MATERIALS REQUIRED TO COMPLETE THE WORK. ALL EXPOSED LINE VOLTAGE WIRING SHALL BE PULLED IN PROPERLY SIZED CONDUIT (EMT) WITH APPROVED FITTINGS.
- 3 CONTRACTOR SHALL PROVIDE NEW, TYPE WRITTEN, PANEL SCHEDULES FOR ANY ELECTRICAL PANEL IMPACTED BY THE WORK.
- 4 UNLESS OTHERWISE NOTED, PROVIDE NEW RECEPTACLES, WALL SWITCHES, AND WALL PLATES LOCATED WITHIN WALLS TO RECEIVE NEW SURFACE FINISH. PROVIDE LABEL ON EACH RECEPTACLE PER SECTION 260533.
- PROVIDE AND INSTALL EXTENSION RING, RECEPTACLE, AND WALL PLATE. PERFORM WORK SUCH THAT RECEPTACLE IS FLUSH WITH NEW WALL THICKNESS.
- ROUTE CONDUIT AND CONDUCTORS AS NEEDED TO ACCOMMODATE NEW WINDOW AND MAINTAIN RECEPTACLE ON EXISTING CIRCUIT.
- PROVIDE AND INSTALL WALL SWITCH, WALL PLATE, AND DEVICE BOX. EXTEND CONDUIT AND CONDUCTORS TO NEW LOCATION. COORDINATE WITH GENERAL CONTRACTOR TO REPAIR WALL.
- 8 INSTALL RETAINED LIGHT FIXTURE IN NEW LOCATION. CENTER ON SOFFIT AS SHOWN. EXTEND CONDUIT AND CONDUCTORS AS NEEDED TO COMPLETE THE WORK.
- PROVIDE AND INSTALL OCCUPANCY SENSOR MODEL "UT-300-1" OR EQUAL WITH POWER PACK. EXTEND CONDUIT AND CONDUCTORS TO NEW CEILING OCCUPANCY SENSOR TO CONTROL LIGHT FIXTURES AS NOTED.
- PROVIDE AND INSTALL SURFACE MOUNT JUNCTION BOX AND SURFACE MOUNTED RACEWAY. EXTEND CIRCUITS TO JUNCTION BOX AND CONNECT SYSTEMS FURNITURE POWER WHIP. PROVIDE STAINLESS STEEL WALL PLATE WITH \$\frac{3}{4}\$ INCH KNOCKOUT. IN PANEL E, REPLACE 20 AMP, 2 POLE BREAKER WITH TWO 20 AMP, 1 POLE BREAKERS. OWNER TO PROVIDE FURNITURE POWER WHIP.
- PROVIDE NEW DATA ACCESS POINT ON EXISTING DEVICE BOX. ROUTE CAT—6 CABLE FROM DATA ACCESS POINT THROUGH SYSTEMS FURNITURE RACEWAY. PROVIDE AND INSTALL WALL BOX WITH ETHERNET WALL PLATE FOR EACH CUBICLE.
- PROVIDE AND INSTALL DATA ACCESS POINT AND SURFACE MOUNT DEVICE BOX. ROUTE 1 INCH SURFACE MOUNTED RACEWAY TO ABOVE SUSPENDED CEILING. ROUTE DATA CABLE RETAINED FROM DEMOLITION TO NEW LOCATION. ROUTE CAT-6 CABLE FROM DATA ACCESS POINT THROUGH SYSTEMS FURNITURE RACEWAY. PROVIDE AND INSTALL WALL BOX WITH ETHERNET WALL PLATE FOR EACH CUBICLE.
- PROVIDE AND INSTALL DATA ACCESS POINT. PERFORM WORK SUCH THAT DATA ACCESS POINT IS FLUSH WITH NEW WALL THICKNESS. ROUTE CAT—6 CABLE FROM DATA ACCESS POINT THROUGH SYSTEMS FURNITURE RACEWAY. PROVIDE AND INSTALL WALL BOX WITH ETHERNET WALL PLATE FOR EACH CUBICLE.
- RECEPTACLE TO SERVE AS DEDICATED CIRCUIT. EXTEND CONDUCTORS FROM BREAKER 2 IN ELECTRICAL PANEL E. PROVIDE AND INSTALL RECEPTACLE AND WALL PLATE IN EXISTING DEVICE BOX.
- PROVIDE AND INSTALL JUNCTION BOX IN NEW HOLLOW METAL FRAME. ROUTE CONDUIT TO ABOVE CEILING WITH BUSHING. SECURITY ACCESS CONTROLS PROVIDED BY OTHERS.
- 16) PROVIDE AND INSTALL BLANK WALL PLATE ON EXISTING DEVICE BOX.
- (17) RECEPTACLE/WALL SWITCH AND WALL PLATE TO REMAIN.

ELEC	TRICAL LEGEND
(S)	OCCUPANCY SENSOR — CEILING MOUNTED
(SD)	SMOKE DETECTOR — CEILING MOUNTED
\$ OS	OCCUPANCY SENSOR — WALL MOUNTED
\$	WALL SWITCH
₽ANEL ##	RECEPTACLE — TYPE: DUPLEX
₩ PANEL	RECEPTACLE — TYPE: QUAD
×#	SYSTEMS FURNITURE POWER WHIP - PROVIDED W/ FURNITURE PACKAGE - QUANTITY OF CIRCUITS
J	JUNCTION BOX
	DATA ACCESS POINT -QUANTITY OF PORTS
\circ	BLANK WALL PLATE
\boxtimes	WIRING DUCT — EXISTING
	ELECTRICAL DEVICE - NEW
	ELECTRICAL DEVICE - EXISTING
	WIRE/CONDUIT - NEW

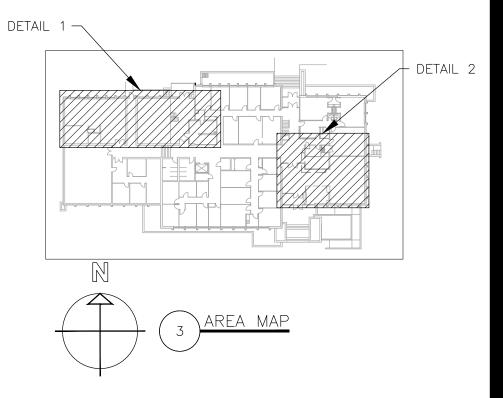

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CAD DWG FILE:W2303-01.DWG
DRAWN BY: TS/AH
CHECKED BY: TS
DESIGNED BY: TS/AH

SHEET TITLE:

ELECTRICAL RENOVATION PLAN MAIN FLOOR

SHEET NUMBER:

E-102