PLAYGROUND REPLACEMENT CONSTRUCTION DOCUMENTS MISSOURI STATE PARKS WEST REGION BOTHWELL LODGE STATE HISTORIC SITE, KNOB NOSTER STATE PARK & CONFEDERATE MEMORIAL STATE HISTORIC SITE

BOTHWELL LODGE STATE HISTORIC SITE 19349 Bothwell State Park Road Sedalia, MO 65301 SITE NUMBER: 5303 ASSET NUMBER: 9999



OWNER:


STATE OF MISSOURI MICHAEL L. PARSON, GOVERNOR

DEPARTMENT OF NATURAL RESOURCES, MISSOURI STATE PARKS

PROJECTOFFICE OF ADMINISTRATIONMANAGEMENT:DIVISION OF FACILITIESMANAGEMENT,DESIGN AND CONSTRUCTION

PROJECT NUMBER: X2109-01

KNOB NOSTER STATE PARK 873 SE 10th Knob Noster, MO 65336 SITE NUMBER: 5305 ASSET NUMBER: 9999

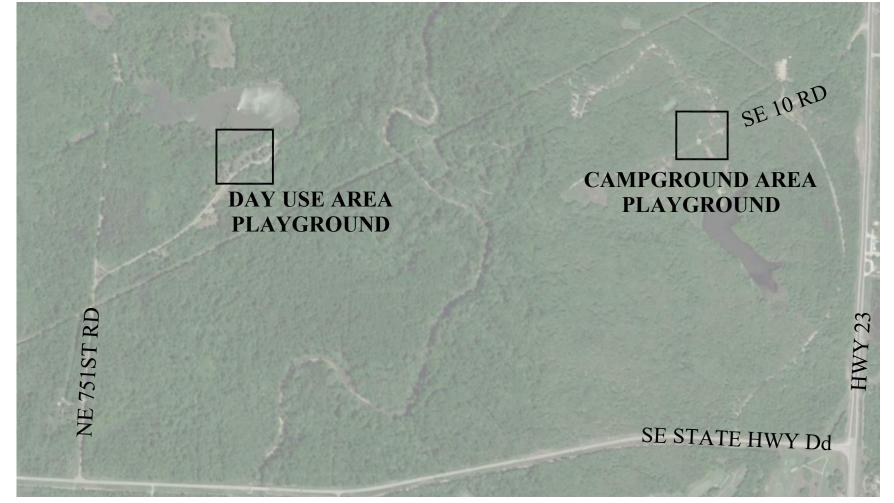







GEOTECHNICAL ENGINEER:
INTERTEK-PSI
1211 W. Cambridge Circle Drive
Kansas City, MO 64103
Phone: (913) 310-1600

CONFEDERATE MEMORIAL STATE HISTORIC SITE 211 West First Street Higginsville, MO 64037 SITE NUMBER: 5106 ASSET NUMBER: 9999



SHEET INDEX:

- DP-100 DEMOLITION & EROSION CONTROL PLAN
- SP-101 SITE PLAN
- SP-102 LAYOUT & GRADING PLAN
- C103 UTILITY PLAN & DETAILS
- DP-200 DEMOLITION & EROSION CONTROL PLAN
- SP-201 SITE PLAN
- SP-202 LAYOUT & GRADING PLAN
- C203 UTILITY PLAN & DETAILS
- DP-300 DEMOLITION & EROSION CONTROL PLAN SP-301 - SITE PLAN
- SP-302 LAYOUT & GRADING PLAN
- C303 UTILITY PLAN & DETAILS
- DP-400 ALT #1 DEMOLITION & EROSION CONTROL PLAN
- SP-401 ALT #1, #2, #3 SITE PLAN
- SP-402 ALT #1, #2, #3 LAYOUT & GRADING PLAN DT-500 - SITE DETAILS



SHEET NUMBER:


- 1. ALL UTILITIES SHALL BE FIELD LOCATED PRIOR TO LANDSCAPE AND PAVEMENT REMOVAL OPERATIONS.
- 2. ALL REMOVALS SHALL BE DISPOSED OF PER LOCAL REGULATIONS BY THE CONTRACTOR.
- 3. REFER TO CONSTRUCTION DOCUMENTS FOR GRADING AND RESTORATION OF SITE AFTER COMPLETION OF DEMOLITION WORK.
- 4. THE UNDERGROUND UTILITIES SHOWN HAVE BEEN LOCATED FROM FIELD SURVEY INFORMATION AND EXISTING DRAWINGS. THE ENGINEER MAKES NO GUARANTEES THAT THE UTILITIES SHOWN COMPRISE ALL SUCH UTILITIES IN THE AREA, EITHER IN SERVICE OR ABANDONED. THE ENGINEER HAS NOT PHYSICALLY LOCATED THE UNDERGROUND UTILITIES. THIS INCLUDES PRIVATE AND PUBLIC UTILITIES. IT IS THE CONTRACTOR'S RESPONSIBILITY TO CONTACT MISSOURI ONE CALL IN ADVANCE OF ANY EXCAVATION TO COORDINATE UTILITY LOCATIONS.
- 5. CONTRACTOR IS REQUIRED TO TAKE PRECAUTIONARY MEASURES TO PROTECT THE UTILITY LINES SHOWN AND ANY OTHER EXISTING LINES NOT OF RECORD OR SHOWN ON THESE PLANS.
- 6. DO NOT DISRUPT UTILITY SERVICE TO ADJACENT BUSINESSES OR RESIDENCES WITHOUT PRIOR WRITTEN APPROVAL BY THE ENGINEER.
- 7. DO NOT DISRUPT TRAFFIC ON ADJACENT STREETS WITHOUT PRIOR WRITTEN APPROVAL BY OWNER.
- 8. ALL SIDEWALK AND PAVEMENT TO REMAIN SHALL BE PROTECTED IN PLACE INCLUDING PROTECTION FROM DAMAGE CAUSED BY REMOVAL OF ABUTTING PAVEMENT. CONTRACTOR SHALL SAW CUT WHERE NECESSARY.
- 9. CONTRACTOR SHALL GIVE NOTICE TO ALL UTILITY COMPANIES REGARDING DISCONNECTION, DEMOLITION, AND REMOVAL OF SERVICE LINES. CAP ALL LINES BEFORE PROCEEDING WITH WORK ON THIS CONTRACT.
- 10. CONTRACTOR SHALL PROTECT THE PUBLIC AT ALL TIMES WITH FENCING, BARRICADES, ENCLOSURES, ETC. USING BEST PRACTICES AND AS APPROVED BY THE ENGINEER AND OWNER.
- 11. DAMAGE TO ALL EXISTING CONDITIONS TO REMAIN SHALL BE REPAIRED AT THE CONTRACTOR'S EXPENSE.

EROSION CONTROL NOTES


- 1. ALL EROSION AND SEDIMENT CONTROL SHALL COMPLY WITH KC METROPOLITAN APWA STANDARDS, VISIT http://kcmetro.apwa.net/PageDetails/439 FOR SPECIFICATIONS AND DETAILS. DEVICES SHOWN ON PLAN MAY NOT REPRESENT ALL DEVICES NECESSARY FOR EROSION CONTROL. UPON DISCOVERING UNFORESEEN CIRCUMSTANCES POSING THE POTENTIAL FOR ACCELERATED EROSION AND/OR SEDIMENT POLLUTION, THE CONTRACTOR SHALL ADJUST AND/OR IMPLEMENT ADDITIONAL DEVICES TO ELIMINATE POTENTIAL FOR ACCELERATED EROSION AND/OR SEDIMENT POLLUTION.
- THE CONTRACTOR SHALL HAVE AN EROSION CONTROL COORDINATOR AND SHALL COMPLY WITH PERMITS AS REQUIRED BY LAW.
- 3. THE CONTRACTOR SHALL STABILIZE THE SITE PRIOR TO AND DURING CONSTRUCTION. EROSION CONTROL DEVICES SHALL BE MAINTAINED AT ALL TIMES. ADDITIONAL DEVICES WILL BE INSTALLED IF DEEMED NECESSARY DURING ON SITE INSPECTION.
- 4. THE CONTRACTOR SHALL PRACTICE SEQUENTIAL STABILIZATION TO STABILIZE THE SITE AS IT'S BEING BUILT. USE SEED, SOD, EROSION BLANKETS, MULCH, HYDRO-MULCH, TURF REINFORCEMENT MATS (TRM), BONDED FIBER MATRIX AND/OR A COMBINATION OF THESE OR OTHER DEVICES.
- 5. ALL TOPSOIL SHALL BE REMOVED, STOCKPILED, AND REPLACED OVER DISTURBED AREAS AS SOON AS AREAS HAVE BEEN SHAPED TO FINAL GRADE.
- 6. THE CONTRACTOR SHALL STABILIZE ALL SWALES/DITCHES AS SOON AS POSSIBLE. USE DITCH CHECKS (I.E. WATTLES OR ROCK CHECKS), EROSION BLANKET, TRM, AND/OR OTHER DEVICES.
- 7. CONTRACTOR SHALL INSPECT AND EVALUATE EROSION CONTROL DEVICES REGULARLY AND FOLLOWING STORM EVENTS AND REPAIR DEFECTS IMMEDIATELY.
- 8. CONDUCT TEMPORARY SEEDING AND MULCHING OPERATIONS TO PROVIDE A TEMPORARY VEGETATIVE COVER FOR EROSION AND SEDIMENT CONTROL PER THE FOLLOWING:
- WHEN SEASONAL CONDITIONS DO NOT ALLOW FOR INSTALLATION OF THE PERMANENT VEGETATION SPECIFIED
 WHEN CONSTRUCTION ACTIVITY CEASES AND WILL NOT RESUME FOR A PERIOD EXCEEDING 14 CALENDAR DAYS
 WITHIN 7 DAYS OF COMPLETING GRADING OPERATIONS
- 11. STRAW WATTLE LENGTHS SHOWN ARE APPROXIMATE. CONTRACTOR SHALL ADJUST IN FIELD AS REQUIRED TO PROVIDE

EROSION AND SEDIMENT CONTROL AND ADDRESS ONSITE CONDITIONS.

- 12. THE OWNER WILL REMOVE ALL TEMPORARY EROSION AND SEDIMENT CONTROL DEVICES AFTER COMPLETION OF CONSTRUCTION OPERATIONS AND WHEN ALL DISTURBED AREAS ARE STABILIZED WITH AN ESTABLISHED STAND OF PERMANENT VEGETATION.
- 13. CONTRACTOR SHALL BE RESPONSIBLE FOR PREVENTING SEDIMENT MOVEMENT ON SITE TO KEEP MUD OFF OF ENTRY DRIVES AND OTHER AREAS BEING USED BY SITE USERS (STAFF AND GUESTS).

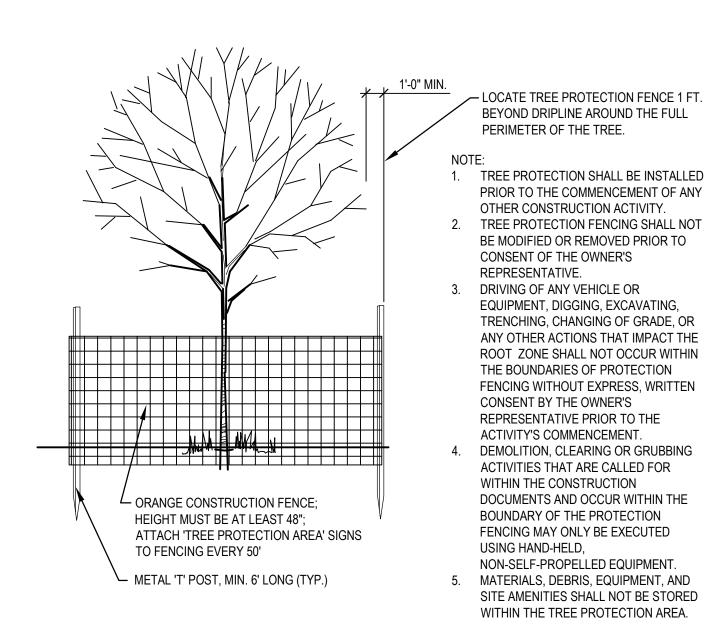

EXISTING TREE PROTECTION 01

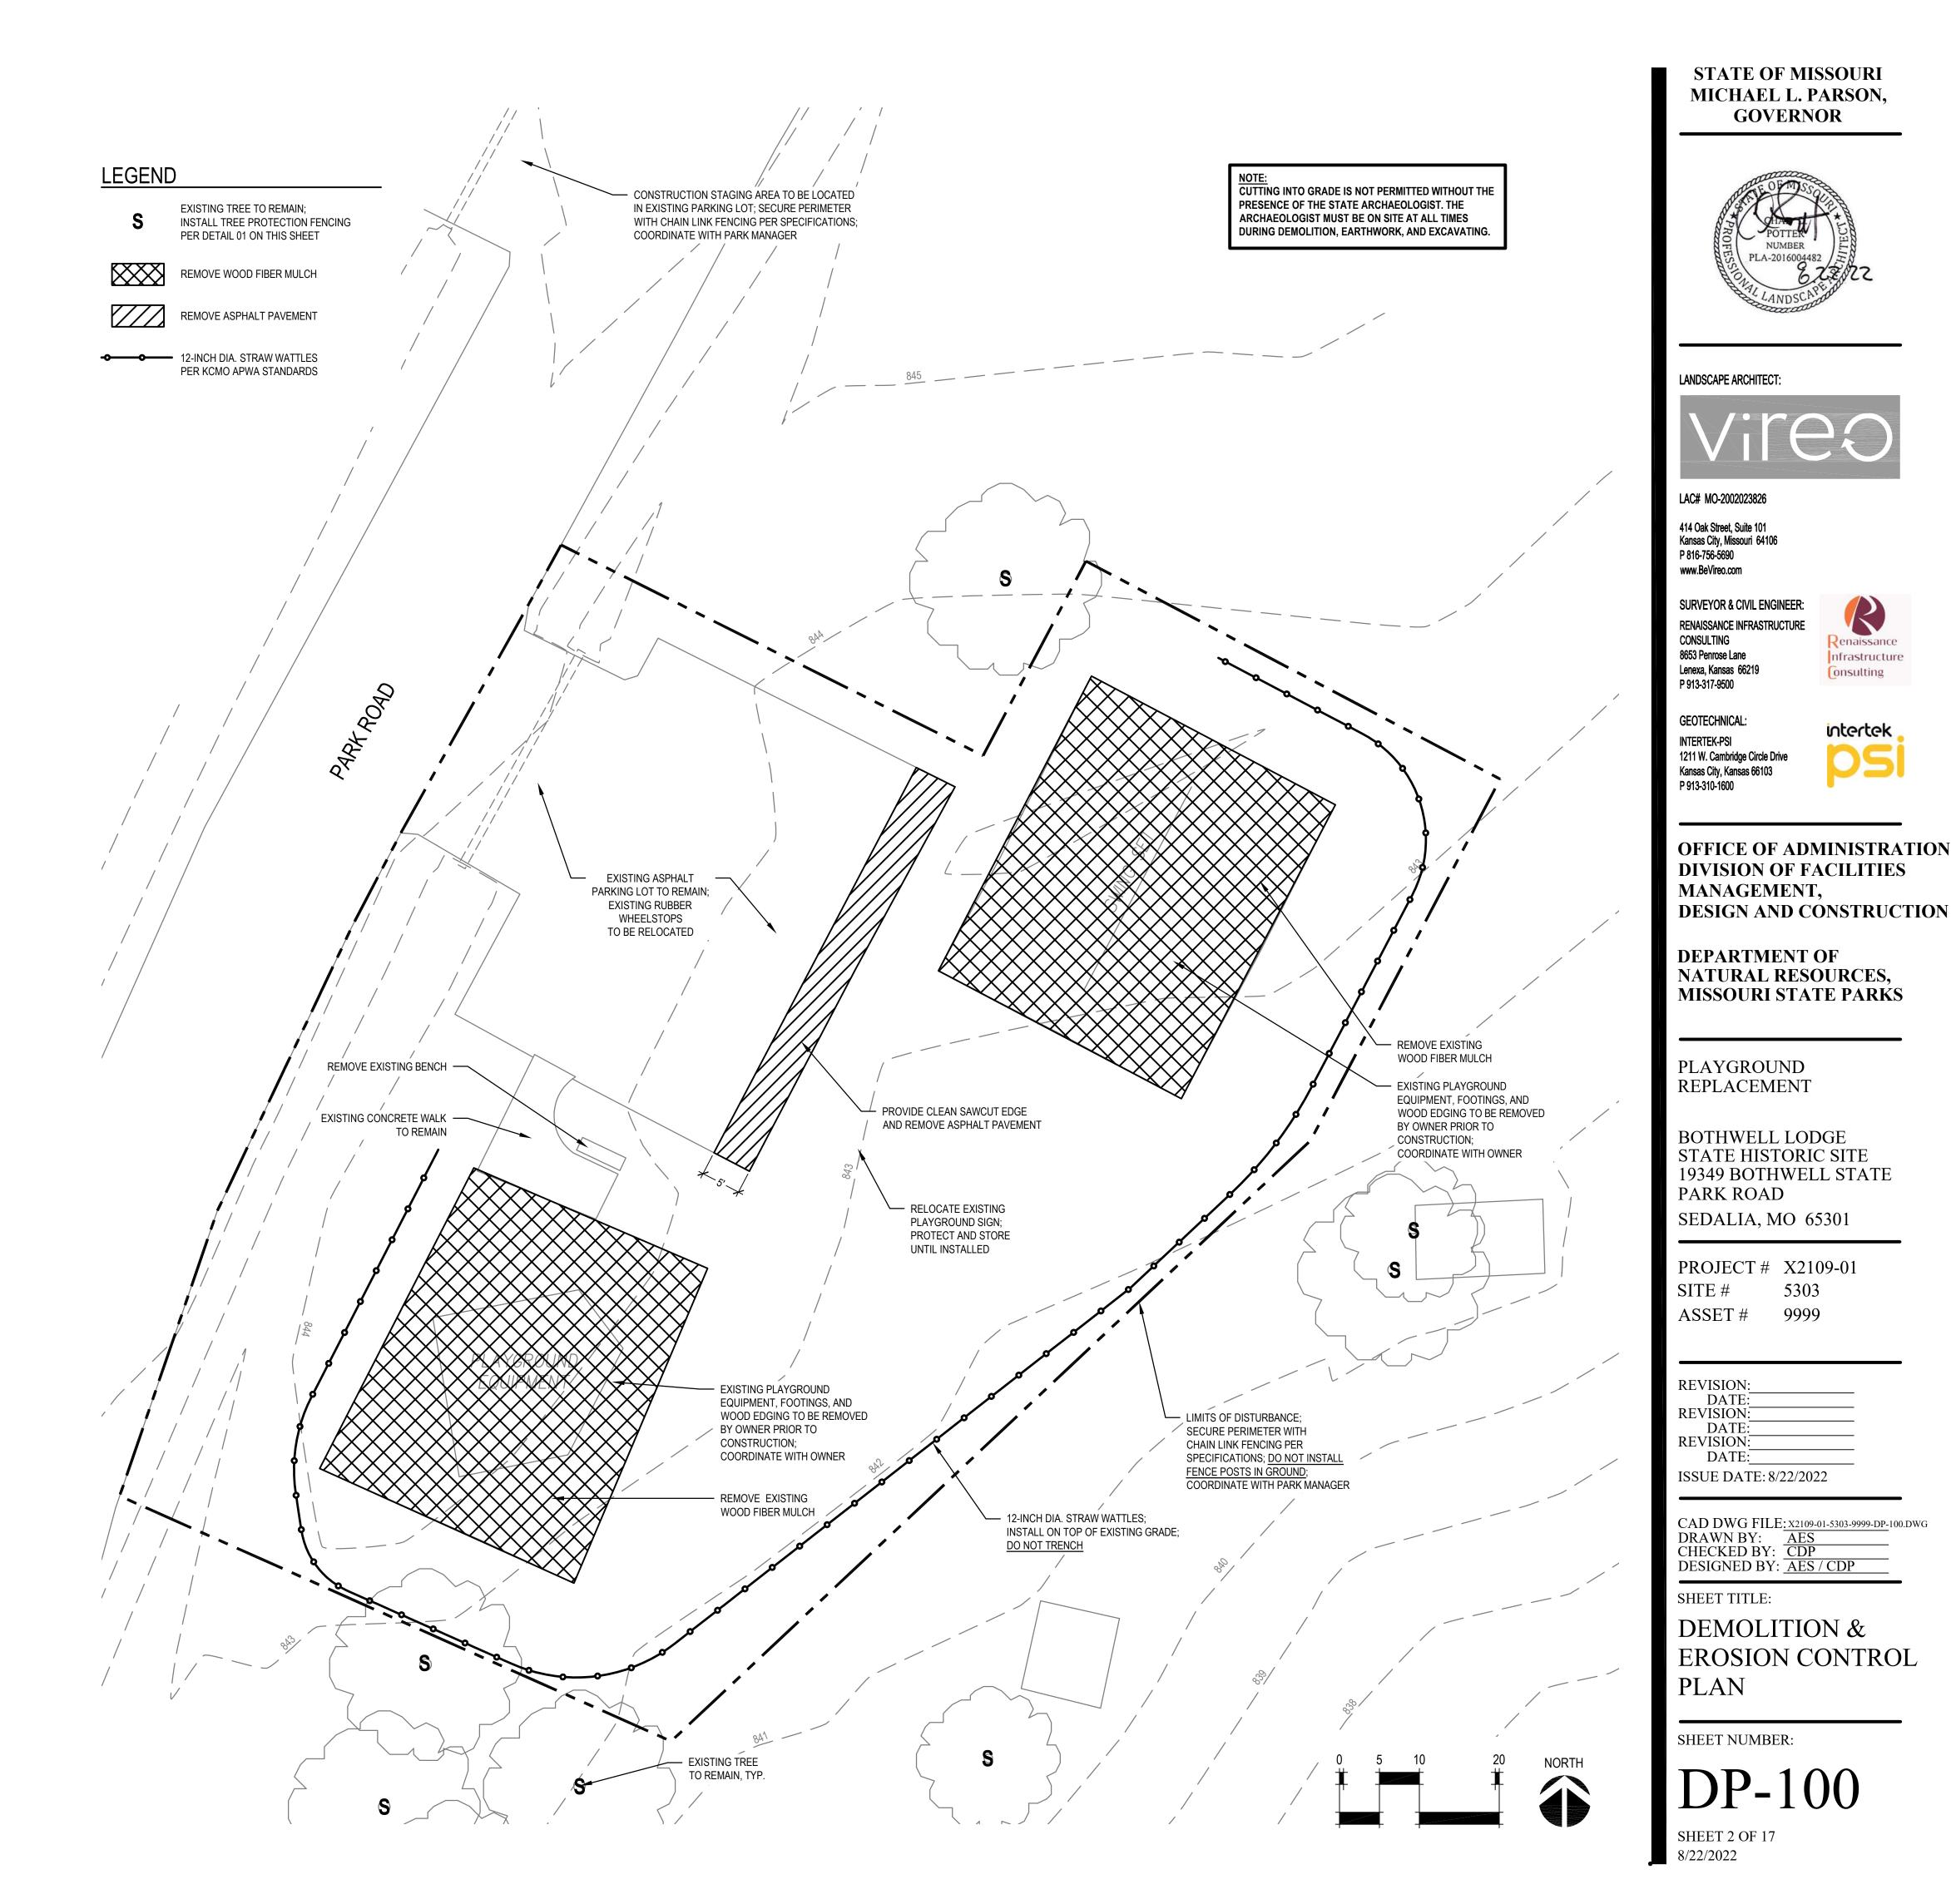

	ITEM	QTY MANUFACTURER		MODEL	REP.	
1	Tree House Themed Play Structure (see plan for individual play components)	1	Landscape Structures	see plan	ATHCO	
2	Music Instrument Play Equipment					
	Ditty Metallophone	1	Landscape Structures	228212	ATHCO	
	Goblet Junior Drum	1	Landscape Structures	228215	ATHCO	
	Kettle Junior Drum	1	Landscape Structures	228217	ATHCO	
3	Single Post Swing Frame with Additional Bay	1	Landscape Structures	177332 / 177333	ATHCO	
	Belt Seat with proguard chains	2	Landscape Structures	174018	ATHCO	
	Full Bucket Seat with chains	1	Landscape Structures	175038	ATHCO	
	Molded Seat with harness (ages 2-5) and proguard chains	1	Landscape Structures	218671	ATHCO	

*NOTE: INFORMATION SHOWN FOR BASIS OF DESIGN IS FOR BID PURPOSES ONLY. SUBJECT TO COMPLIANCE WITH REQUIREMENTS, AVAILABLE MANUFACTURERS OFFERING PRODUCTS THAT MAY BE INCORPORATED INTO THE WORK INCLUDE, BUT ARE NOT LIMITED TO THE FOLLOWING:

- LANDSCAPE STRUCTURES
 GAMETIME, A PLAYCORE
- COMPANY 3. BURKE
- ZEAGER BROS, INC.
 OR APPROVED EQUAL

CONTRACTOR SHALL SUBMIT SHOP DRAWINGS INCLUDING PLAY EQUIPMENT LAYOUT, SAFETY FALL ZONES, MATERIALS AND COLORS FOR ALL PLAY EQUIPMENT FOR REVIEW AND APPROVAL BY OWNER'S REPRESENTATIVE PRIOR TO FABRICATION AND/OR INSTALLATION.

TREEHOUSE THEMED PLAY STRUCTURE




METALLOPHONE & DRUMS







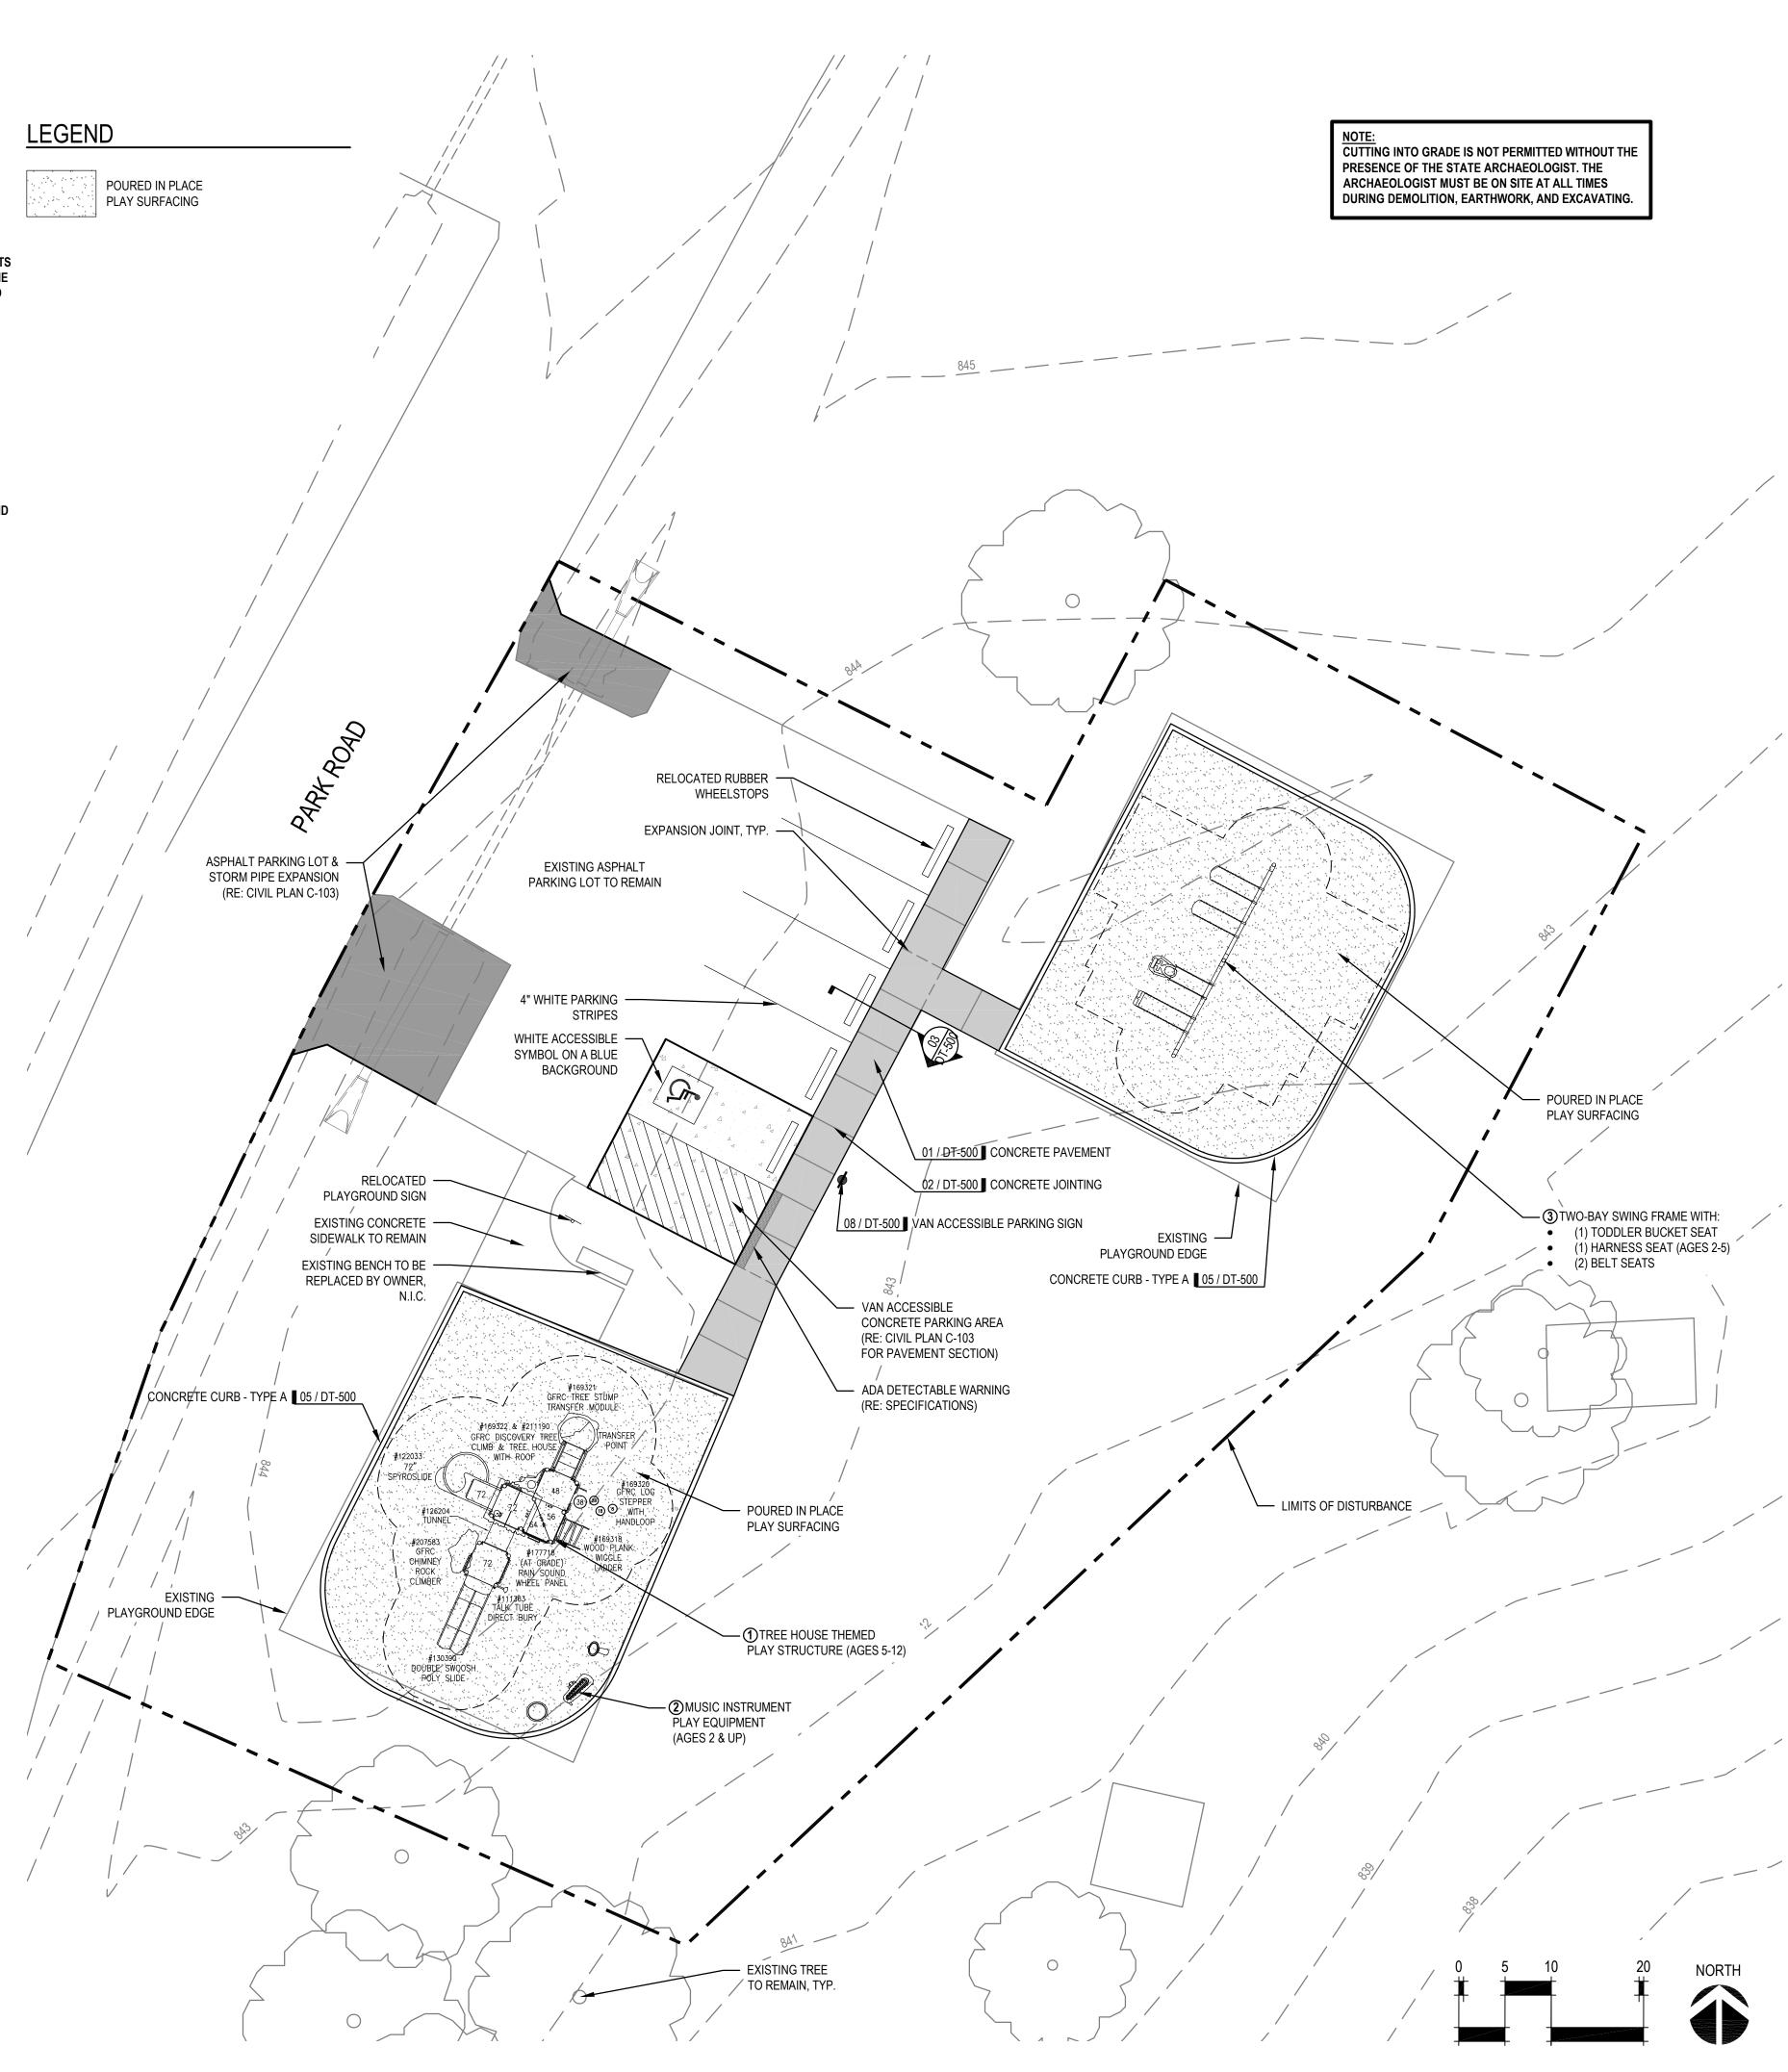

STATE OF MISSOURI MICHAEL L. PARSON, GOVERNOR
POTTER NUMBER PLA-2016004482 PLA-2016004482
ANDSCAPE ARCHITECT:
Vireo
AC# MO-2002023826 414 Oak Street, Suite 101 Kansas City, Missouri 64106 P 816-756-5690 www.BeVireo.com
SURVEYOR & CIVIL ENGINEER: RENAISSANCE INFRASTRUCTURE CONSULTING 8653 Penrose Lane Lenexa, Kansas 66219 P 913-317-9500
GEOTECHNICAL: NTERTEK-PSI 1211 W. Cambridge Circle Drive Kansas City, Kansas 66103 P 913-310-1600
OFFICE OF ADMINISTRATION DIVISION OF FACILITIES MANAGEMENT, DESIGN AND CONSTRUCTION DEPARTMENT OF NATURAL RESOURCES, MISSOURI STATE PARKS
PLAYGROUND REPLACEMENT
BOTHWELL LODGE STATE HISTORIC SITE 19349 BOTHWELL STATE PARK ROAD SEDALIA, MO 65301
PROJECT # X2109-01 SITE # 5303 ASSET # 9999
REVISION: DATE: REVISION: DATE: REVISION: DATE: DATE: SSUE DATE: 8/22/2022
CAD DWG FILE: $x_{2109-01-5303-9999-SP-101.DWG}$ DRAWN BY: <u>AES</u> CHECKED BY: <u>CDP</u> DESIGNED BY: <u>AES / CDP</u>
SHEET TITLE: SITE PLAN


SP-101 SHEET 3 OF 17 8/22/2022

- 1. SITE LAYOUT DATA, INCLUDING COORDINATE POINTS, IS BASED ON A SURVEY PROVIDED BY RENAISSANCE INFRASTRUCTURE CONSULTING (2021). REFER TO SURVEY FOR HORIZONTAL LAYOUT CONTROL POINTS. REPORT ANY DISCREPANCIES BETWEEN PLANS AND FIELD CONDITIONS TO OWNER'S REPRESENTATIVE IMMEDIATELY.
- IT SHALL BE THE RESPONSIBILITY OF THE CONTRACTOR TO CONTROL ON-SITE AND DOWNSTREAM EROSION AND SILTATION DURING ALL PHASES OF CONSTRUCTION. EROSION CONTROL SYSTEMS AND PROCEDURES SHALL BE IN PLACE PRIOR TO ANY GRADING OPERATIONS.
- 3. THE LOCATIONS OF EXISTING UTILITIES AS SHOWN ARE APPROXIMATE. THE CONTRACTOR SHALL HAVE ALL UTILITIES FLAGGED IN THE FIELD FOR INSPECTION PRIOR TO PROCEEDING WITH ANY GRADING OPERATIONS. THE CONTRACTOR SHALL VERIFY THE DEPTH AND LOCATION OF ALL EXISTING UTILITIES AND WILL BE HELD LIABLE FOR ANY DELAYS CAUSED BY DAMAGE TO UTILITIES OR FAILURE TO LOCATE UTILITIES.
- 4. ALL CONSTRUCTION DEBRIS SHALL BE DISPOSED OF BY THE CONTRACTOR AT A LOCATION PROVIDED BY THE CONTRACTOR AND IN ACCORDANCE WITH LOCAL REGULATIONS. THE CONTRACTOR SHALL SATISFY HIMSELF BY JOB-SITE INSPECTION AS TO THE EXTENT OF CLEARING REQUIRED PRIOR TO ENTERING INTO A CONSTRUCTION CONTRACT.
- 5. CONSTRUCTION STAKING SHALL BE PROVIDED BY THE CONTRACTOR. ALL CONSTRUCTION LAYOUT STAKING IS TO BE PERFORMED BY A LAND SURVEYOR OR PROFESSIONAL ENGINEER REGISTERED IN THE STATE OF MISSOURI. TO FACILITATE ACCURACY OF CONSTRUCTION STAKING, UPON WRITTEN REQUEST FROM CONTRACTOR, ELECTRONIC DATA COMPRISING THESE SITE DEVELOPMENT DRAWINGS WILL BE FORWARED TO THE LAND SURVEYOR OR PROFESSIONAL ENGINEER EMPLOYED TO PERFORM THE CONSTRUCTION STAKING.
- 6. IN ORDER TO MAINTAIN THE INTEGRITY OF HORIZONTAL AND VERTICAL CONTROL FOR THE SITE, THE SURVEYOR OR PROFESSIONAL ENGINEER EMPLOYED BY THE CONTRACTOR TO PERFORM CONSTRUCTION LAYOUT STAKING SHALL SET AND PROTECT ADDITIONAL TRAVERSE POINTS OUTSIDE THE AREAS OF CONSTRUCTION ACTIVITY.
- 7. ALL LAYOUTS SHALL BE SUBJECT OT FIELD APPROVAL BY THE OWNER'S REPRESENTATIVE.
- 8. SAWCUT EXISTING PAVEMENT FULL DEPTH WHERE IT MEETS NEW PAVEMENT.
- 9. UNLESS NOTED OTHERWISE, ALL DIMENSIONS ARE TO THE FOLLOWING: EDGE OF PAVEMENT, FACE OF WALL, AND EDGE OF CURB.
- 10. ALL EDGES OF PAVEMENTS ARE TO BE STRAIGHT (OR OF CONSISTENT RADIUS IN THE CASE OF CURVES) AS SHOWN HEREON. NO UNSPECIFIED TANGENTS OR KINKS WILL BE APPROVED.
- 11. THIS SITE HAS BEEN DESIGNED TO COMPLY WITH THE PROVISIONS OF THE AMERICANS WITH DISABILITIES ACT ACCESSIBILITY GUIDELINES (ADAAG). REPORT ANY COMPLIANCE DISCREPANCIES TO OWNER'S REPRESENTATIVE IMMEDIATELY.
- 12. ALL AREAS SHALL BE BROUGHT TO FINAL PLAN CONDITION (PAVED, SEEDED, OR MULCHED) AS SOON AS POSSIBLE TO MAINTAIN FINISH GRADE CONDITIONS AND PREVENT SOIL LOSS.
- 13. THE CONTRACTOR SHALL PROVIDE AND PAY FOR ALL INSPECTION SERVICES.

PLAYGROUND CURB ALIGNMENT

ALIGNMENT LINE DATA								
LINE #	LENGTH	BEARING	START POINT	END POINT				
L1	31.3527	N67° 55' 54.37"W	(3154051.7773, 958228.7803)	(3154022.7216, 958240.5599)				
L2	30.3287	S27° 00' 54.79"W	(3154022.7216, 958240.5599)	(3154008.9454, 958213.5404)				
L3	8.9368	S66° 01' 12.49"E	(3154014.8802, 958196.7834)	(3154023.0457, 958193.1514)				
L4	31.8006	N23° 07' 13.42"E	(3154039.2904, 958199.5339)	(3154051.7773, 958228.7803)				
L5	39.5000	S27° 45' 10.85"W	(3154099.5060, 958301.3413)	(3154081.1124, 958266.3852)				
L6	23.2500	S62° 14' 49.15"E	(3154081.1124, 958266.3852)	(3154101.6878, 958255.5586)				
L7	19.0000	N27° 45' 10.85"E	(3154115.5317, 958259.8565)	(3154124.3793, 958276.6708)				
L8	23.2500	N62° 14' 49.15"W	(3154120.0814, 958290.5147)	(3154099.5060, 958301.3413)				

ALIGNMENT CURVE DATA								
CURVE #	DELTA	RADIUS	LENGTH	TANGENT				
C1	90.86	12.25	19.43	12.44				
C2	93.04	12.25	19.89	12.92				
C3	90.00	10.25	16.10	10.25				
C4	90.00	10.25	16.10	10.25				

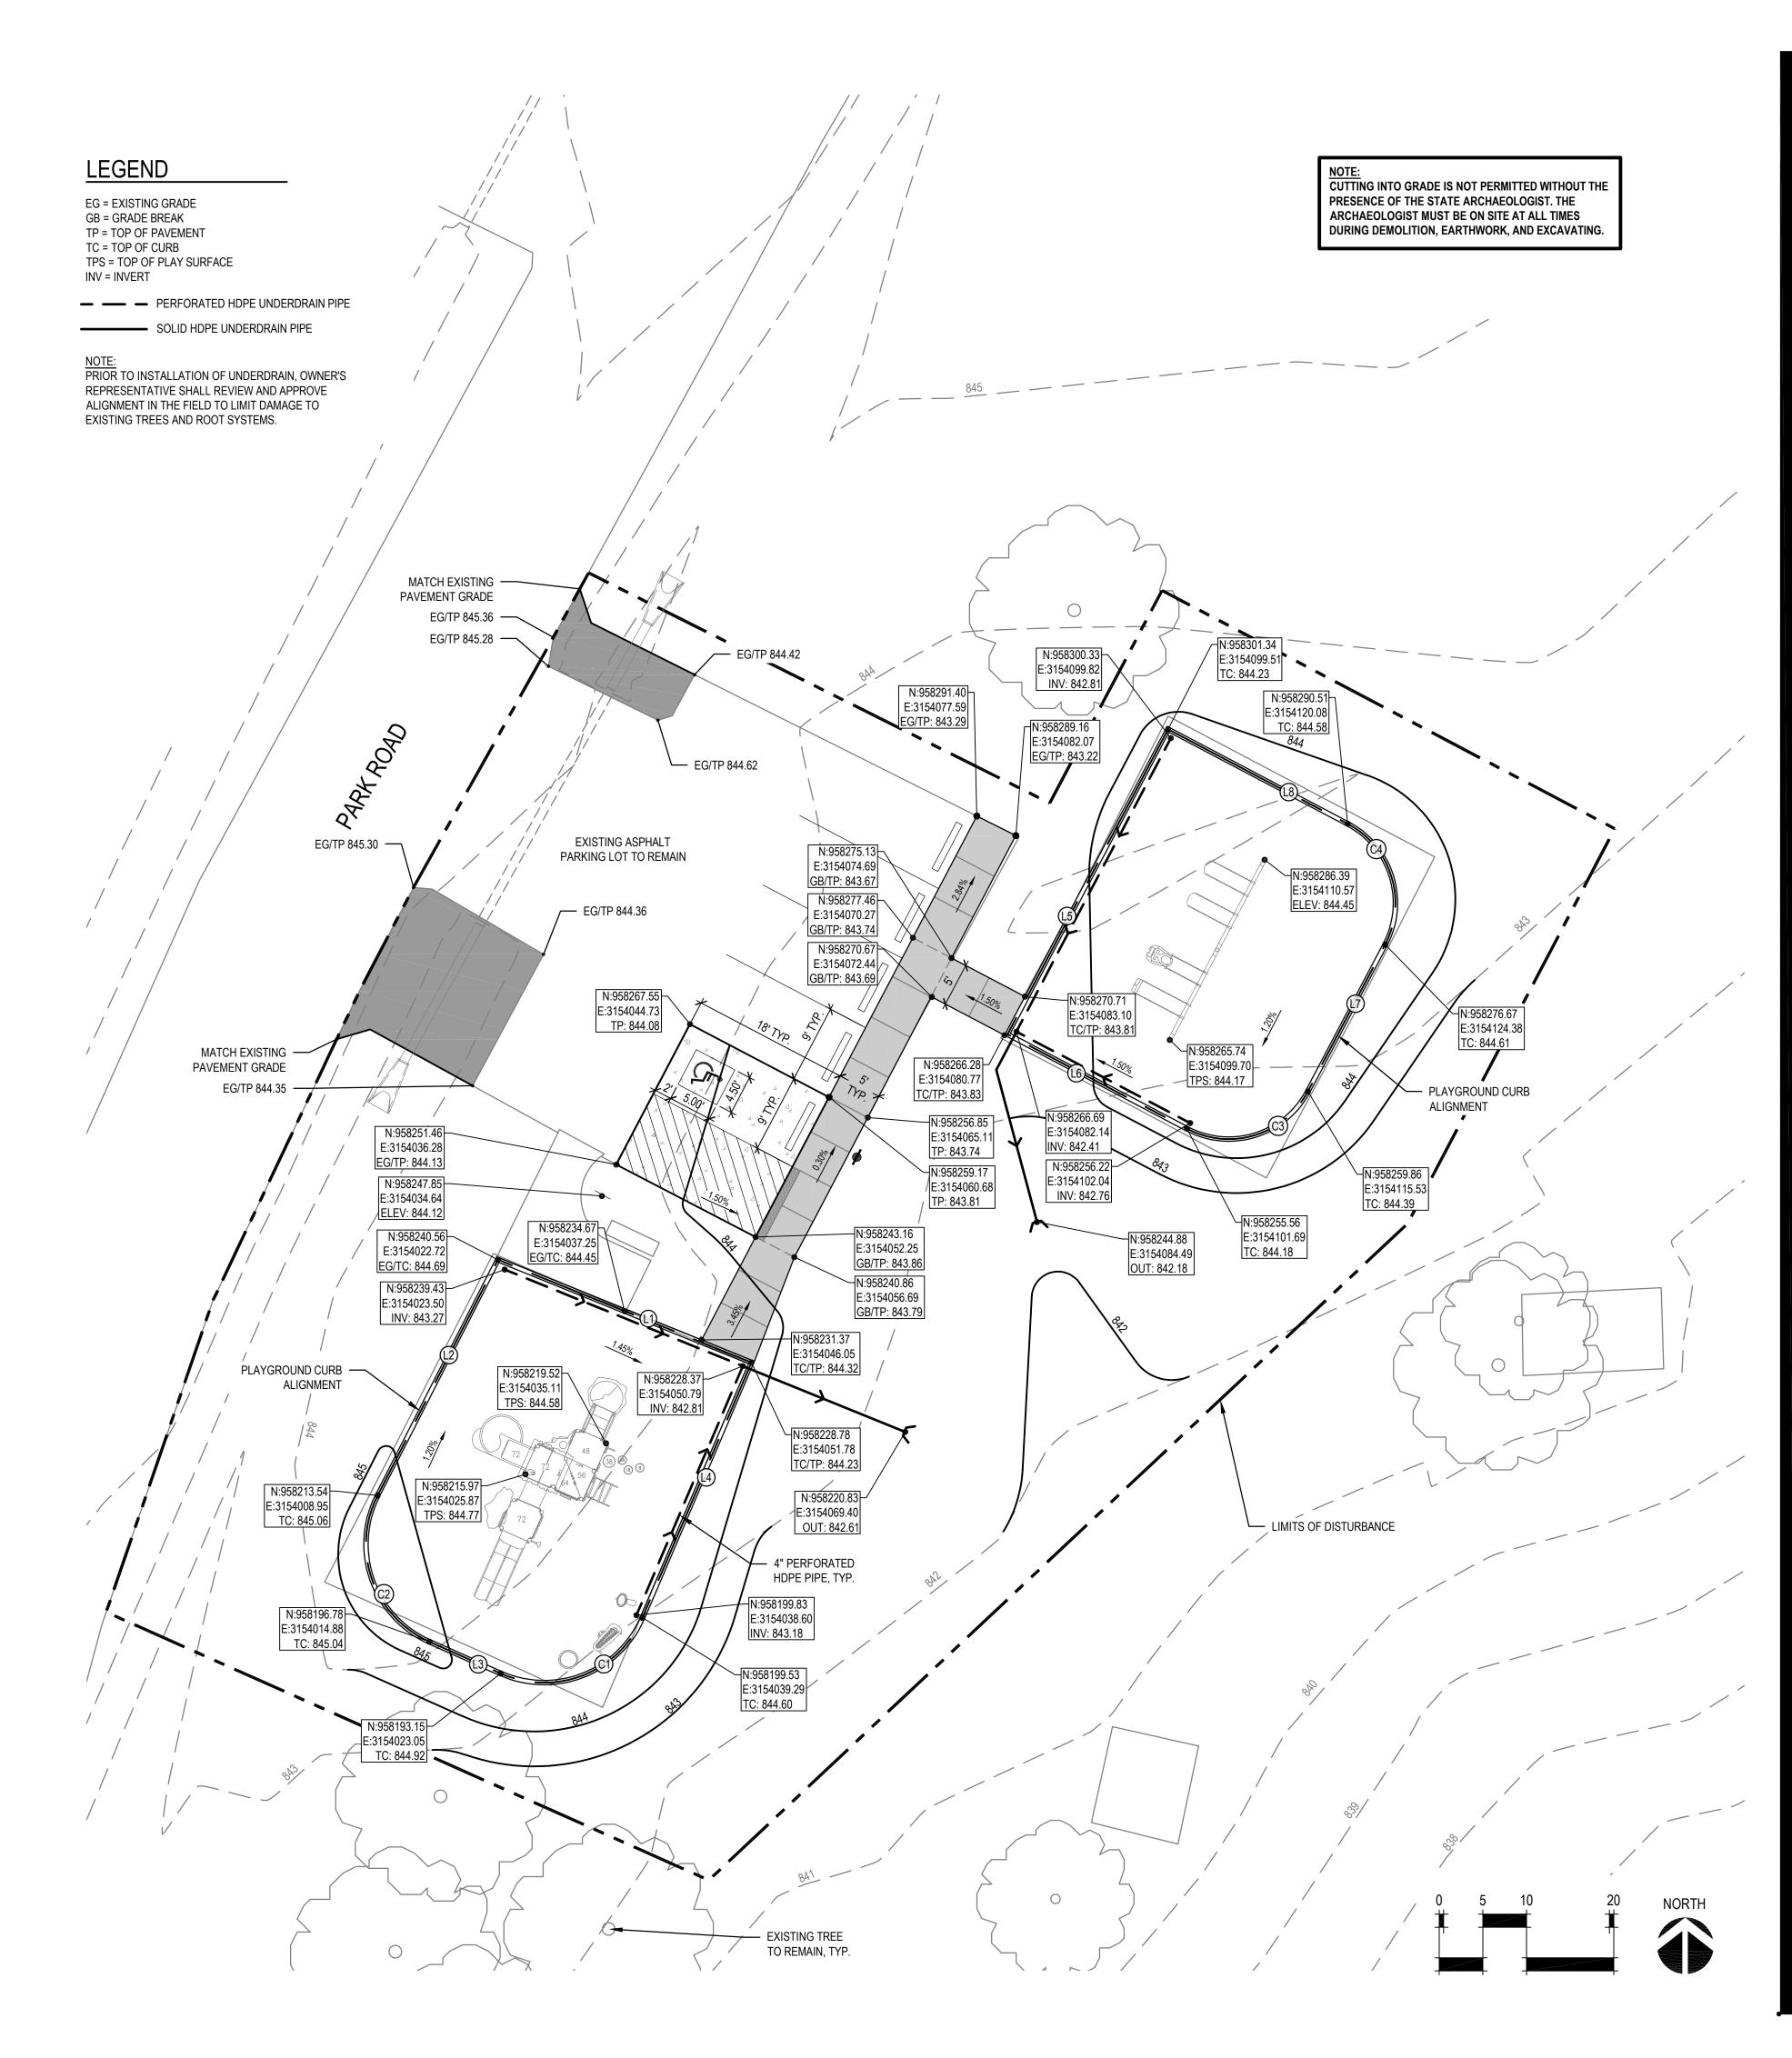


MICHAEL L. PARSON, GOVERNOR NUMBER PLA-2016004482 LANDSCAPE ARCHITECT: LAC# MO-2002023826 414 Oak Street, Suite 101 Kansas City, Missouri 64106 P 816-756-5690 www.BeVireo.com SURVEYOR & CIVIL ENGINEER: R RENAISSANCE INFRASTRUCTURE CONSULTING **R**enaissance 8653 Penrose Lane nfrastructure Lenexa, Kansas 66219 onsulting P 913-317-9500 GEOTECHNICAL: intertek INTERTEK-PSI 1211 W. Cambridge Circle Drive Kansas City, Kansas 66103 P 913-310-1600 **OFFICE OF ADMINISTRATION DIVISION OF FACILITIES** MANAGEMENT, **DESIGN AND CONSTRUCTION DEPARTMENT OF** NATURAL RESOURCES, **MISSOURI STATE PARKS** PLAYGROUND REPLACEMENT BOTHWELL LODGE STATE HISTORIC SITE 19349 BOTHWELL STATE PARK ROAD SEDALIA, MO 65301 PROJECT # X2109-01 5303 SITE # 9999 ASSET # **REVISION:** DATE: **REVISION:** DATE: **REVISION**: DATE: ISSUE DATE: 8/22/2022 CAD DWG FILE: x2109-01-5303-9999-SP-102.DWG DRAWN BY: <u>AES</u> CHECKED BY: <u>CDP</u> DESIGNED BY: AES / CDP SHEET TITLE: LAYOUT & **GRADING PLAN**

STATE OF MISSOURI

SHEET NUMBER:

SP-102 SHEET 4 OF 17 8/22/2022

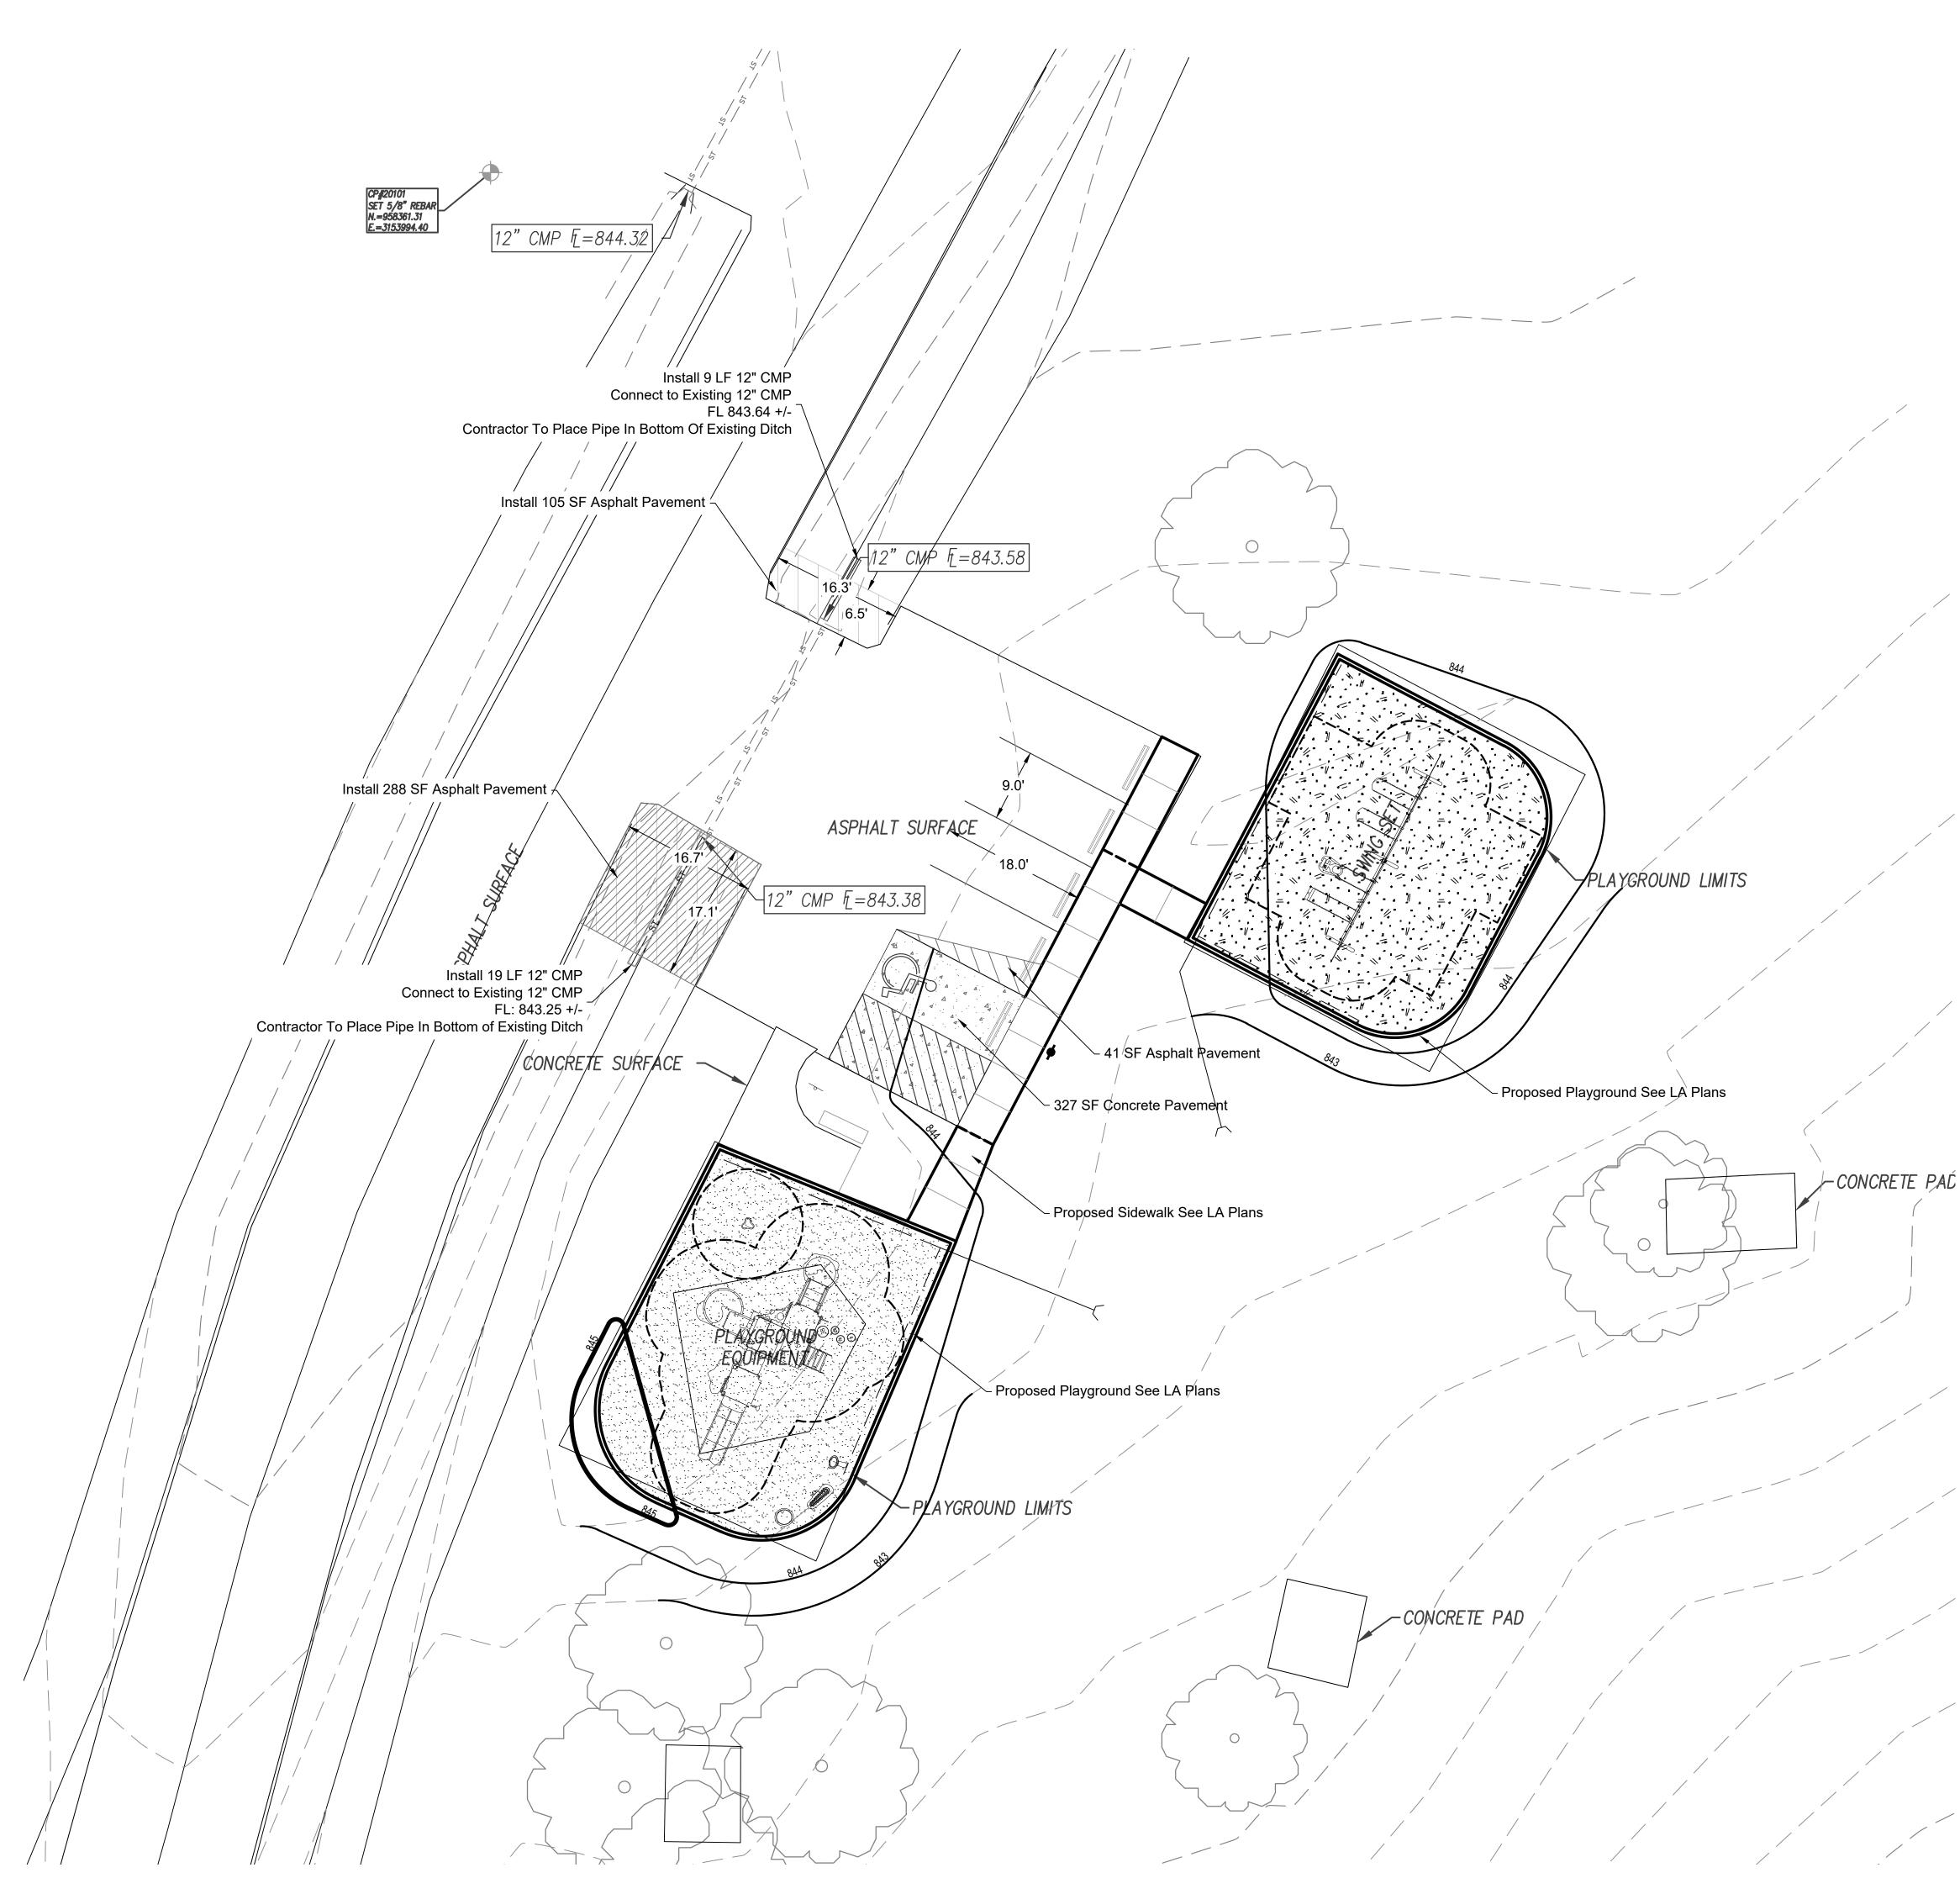

STATE OF MISSOURI MICHAEL L. PARSON, GOVERNOR



LANDSCAPE ARCHITECT:



LAC# MO-2002023826

929 Walnut Street, Ste. 700 Kansas City, Missouri 64106 P 816-756-5690 www.BeVireo.com

SURVEYOR & CIVIL ENGINEER: RENAISSANCE INFRASTRUCTURE CONSULTING 8653 Penrose Lane Lenexa, Kansas 66219 P 913-317-9500



GEOTECHNICAL: INTERTEK-PSI 1211 W. Cambridge Circle Drive Kansas City, Kansas 66103 P 913-310-1600



OFFICE OF ADMINISTRATION DIVISION OF FACILITIES MANAGEMENT, **DESIGN AND CONSTRUCTION**

DEPARTMENT OF NATURAL RESOURCES, **MISSOURI STATE PARKS**

PLAYGROUND REPLACEMENT

BOTHWELL LODGE STATE HISTORIC SITE 19349 BOTHWELL STATE PARK ROAD SEDALIA, MO 64037

PROJECT # X2109-01 SITE # 5303 FACILITY # 9999

REVISION:

DATE: REVISION DATE: **REVISION:** DATE: ISSUE DATE: 08/22/2022


CAD DWG FILE<u>:</u> DRAWN BY: <u>TCD</u> CHECKED BY: <u>MES</u> DESIGNED BY: <u>MES</u>

SHEET TITLE: UTILITY PLAN & DETAILS


SHEET NUMBER:

C103 SHEET 5 OF 17 08/22/2022

Asphalt Pavement

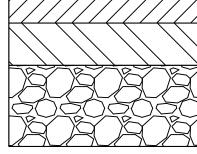

Concrete Pavement

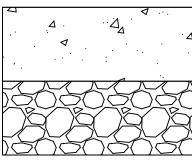

3" MoDOT BP-1 6" MoDOT Type 1 Aggregate

1" MoDOT BP-2


5" Concrete

4" MoDOT Type 1 Aggregate

VORT 1"=10' 0 5' 10'





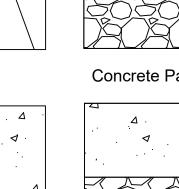

 \bigtriangleup

Δ

 \triangleleft

 \triangleleft


- 1. ALL UTILITIES SHALL BE FIELD LOCATED PRIOR TO LANDSCAPE AND PAVEMENT REMOVAL OPERATIONS.
- 2. ALL REMOVALS SHALL BE DISPOSED OF PER LOCAL REGULATIONS BY THE CONTRACTOR.
- 3. REFER TO CONSTRUCTION DOCUMENTS FOR GRADING AND RESTORATION OF SITE AFTER COMPLETION OF DEMOLITION WORK.
- 4. THE UNDERGROUND UTILITIES SHOWN HAVE BEEN LOCATED FROM FIELD SURVEY INFORMATION AND EXISTING DRAWINGS. THE ENGINEER MAKES NO GUARANTEES THAT THE UTILITIES SHOWN COMPRISE ALL SUCH UTILITIES IN THE AREA, EITHER IN SERVICE OR ABANDONED. THE ENGINEER HAS NOT PHYSICALLY LOCATED THE UNDERGROUND UTILITIES. THIS INCLUDES PRIVATE AND PUBLIC UTILITIES. IT IS THE CONTRACTOR'S RESPONSIBILITY TO CONTACT MISSOURI ONE CALL IN ADVANCE OF ANY EXCAVATION TO COORDINATE UTILITY LOCATIONS.
- 5. CONTRACTOR IS REQUIRED TO TAKE PRECAUTIONARY MEASURES TO PROTECT THE UTILITY LINES SHOWN AND ANY OTHER EXISTING LINES NOT OF RECORD OR SHOWN ON THESE PLANS.
- 6. DO NOT DISRUPT UTILITY SERVICE TO ADJACENT BUSINESSES OR RESIDENCES WITHOUT PRIOR WRITTEN APPROVAL BY THE ENGINEER.
- 7. DO NOT DISRUPT TRAFFIC ON ADJACENT STREETS WITHOUT PRIOR WRITTEN APPROVAL BY OWNER.
- 8. ALL SIDEWALK AND PAVEMENT TO REMAIN SHALL BE PROTECTED IN PLACE INCLUDING PROTECTION FROM DAMAGE CAUSED BY REMOVAL OF ABUTTING PAVEMENT. CONTRACTOR SHALL SAW CUT WHERE NECESSARY
- 9. CONTRACTOR SHALL GIVE NOTICE TO ALL UTILITY COMPANIES REGARDING DISCONNECTION, DEMOLITION, AND REMOVAL OF SERVICE LINES. CAP ALL LINES BEFORE PROCEEDING WITH WORK ON THIS CONTRACT.
- 10. CONTRACTOR SHALL PROTECT THE PUBLIC AT ALL TIMES WITH FENCING, BARRICADES, ENCLOSURES, ETC. USING BEST PRACTICES AND AS APPROVED BY THE ENGINEER AND OWNER.
- 11. DAMAGE TO ALL EXISTING CONDITIONS TO REMAIN SHALL BE REPAIRED AT THE CONTRACTOR'S EXPENSE.

EROSION CONTROL NOTES


- 1. ALL EROSION AND SEDIMENT CONTROL SHALL COMPLY WITH KC METROPOLITAN APWA STANDARDS, VISIT http://kcmetro.apwa.net/PageDetails/439 FOR SPECIFICATIONS AND DETAILS. DEVICES SHOWN ON PLAN MAY NOT REPRESENT ALL DEVICES NECESSARY FOR EROSION CONTROL. UPON DISCOVERING UNFORESEEN CIRCUMSTANCES POSING THE POTENTIAL FOR ACCELERATED EROSION AND/OR SEDIMENT POLLUTION, THE CONTRACTOR SHALL ADJUST AND/OR IMPLEMENT ADDITIONAL DEVICES TO ELIMINATE POTENTIAL FOR ACCELERATED EROSION AND/OR SEDIMENT POLLUTION.
- 2. THE CONTRACTOR SHALL HAVE AN EROSION CONTROL COORDINATOR AND SHALL COMPLY WITH PERMITS AS REQUIRED BY LAW.
- 3. THE CONTRACTOR SHALL STABILIZE THE SITE PRIOR TO AND DURING CONSTRUCTION. EROSION CONTROL DEVICES SHALL BE MAINTAINED AT ALL TIMES. ADDITIONAL DEVICES WILL BE INSTALLED IF DEEMED NECESSARY DURING ON SITE INSPECTION.
- 4. THE CONTRACTOR SHALL PRACTICE SEQUENTIAL STABILIZATION TO STABILIZE THE SITE AS IT'S BEING BUILT. USE SEED, SOD, EROSION BLANKETS, MULCH, HYDRO-MULCH, TURF REINFORCEMENT MATS (TRM), BONDED FIBER MATRIX AND/OR A COMBINATION OF THESE OR OTHER DEVICES.
- 5. ALL TOPSOIL SHALL BE REMOVED, STOCKPILED, AND REPLACED OVER DISTURBED AREAS AS SOON AS AREAS HAVE BEEN SHAPED TO FINAL GRADE.
- 6. THE CONTRACTOR SHALL STABILIZE ALL SWALES/DITCHES AS SOON AS POSSIBLE. USE DITCH CHECKS (I.E. WATTLES OR ROCK CHECKS), EROSION BLANKET, TRM, AND/OR OTHER DEVICES.
- 7. CONTRACTOR SHALL INSPECT AND EVALUATE EROSION CONTROL DEVICES REGULARLY AND FOLLOWING STORM EVENTS AND REPAIR DEFECTS IMMEDIATELY.
- 8. CONDUCT TEMPORARY SEEDING AND MULCHING OPERATIONS TO PROVIDE A TEMPORARY VEGETATIVE COVER FOR EROSION AND SEDIMENT CONTROL PER THE FOLLOWING:
- WHEN SEASONAL CONDITIONS DO NOT ALLOW FOR INSTALLATION OF THE PERMANENT VEGETATION SPECIFIED WHEN CONSTRUCTION ACTIVITY CEASES AND WILL NOT RESUME FOR A PERIOD EXCEEDING 14 CALENDAR DAYS WITHIN 7 DAYS OF COMPLETING GRADING OPERATIONS
- 11. STRAW WATTLE LENGTHS SHOWN ARE APPROXIMATE. CONTRACTOR SHALL ADJUST IN FIELD AS REQUIRED TO PROVIDE

EROSION AND SEDIMENT CONTROL AND ADDRESS ONSITE CONDITIONS.


- 12. THE OWNER WILL REMOVE ALL TEMPORARY EROSION AND SEDIMENT CONTROL DEVICES AFTER COMPLETION OF CONSTRUCTION OPERATIONS AND WHEN ALL DISTURBED AREAS ARE STABILIZED WITH AN ESTABLISHED STAND OF PERMANENT VEGETATION.
- 13. CONTRACTOR SHALL BE RESPONSIBLE FOR PREVENTING SEDIMENT MOVEMENT ON SITE TO KEEP MUD OFF OF ENTRY DRIVES AND OTHER AREAS BEING USED BY SITE USERS (STAFF AND GUESTS).

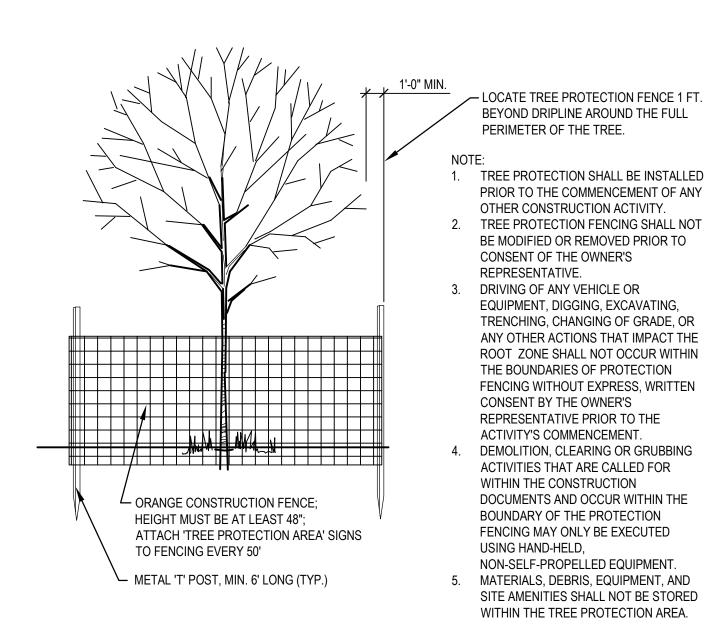

EXISTING TREE PROTECTION 01

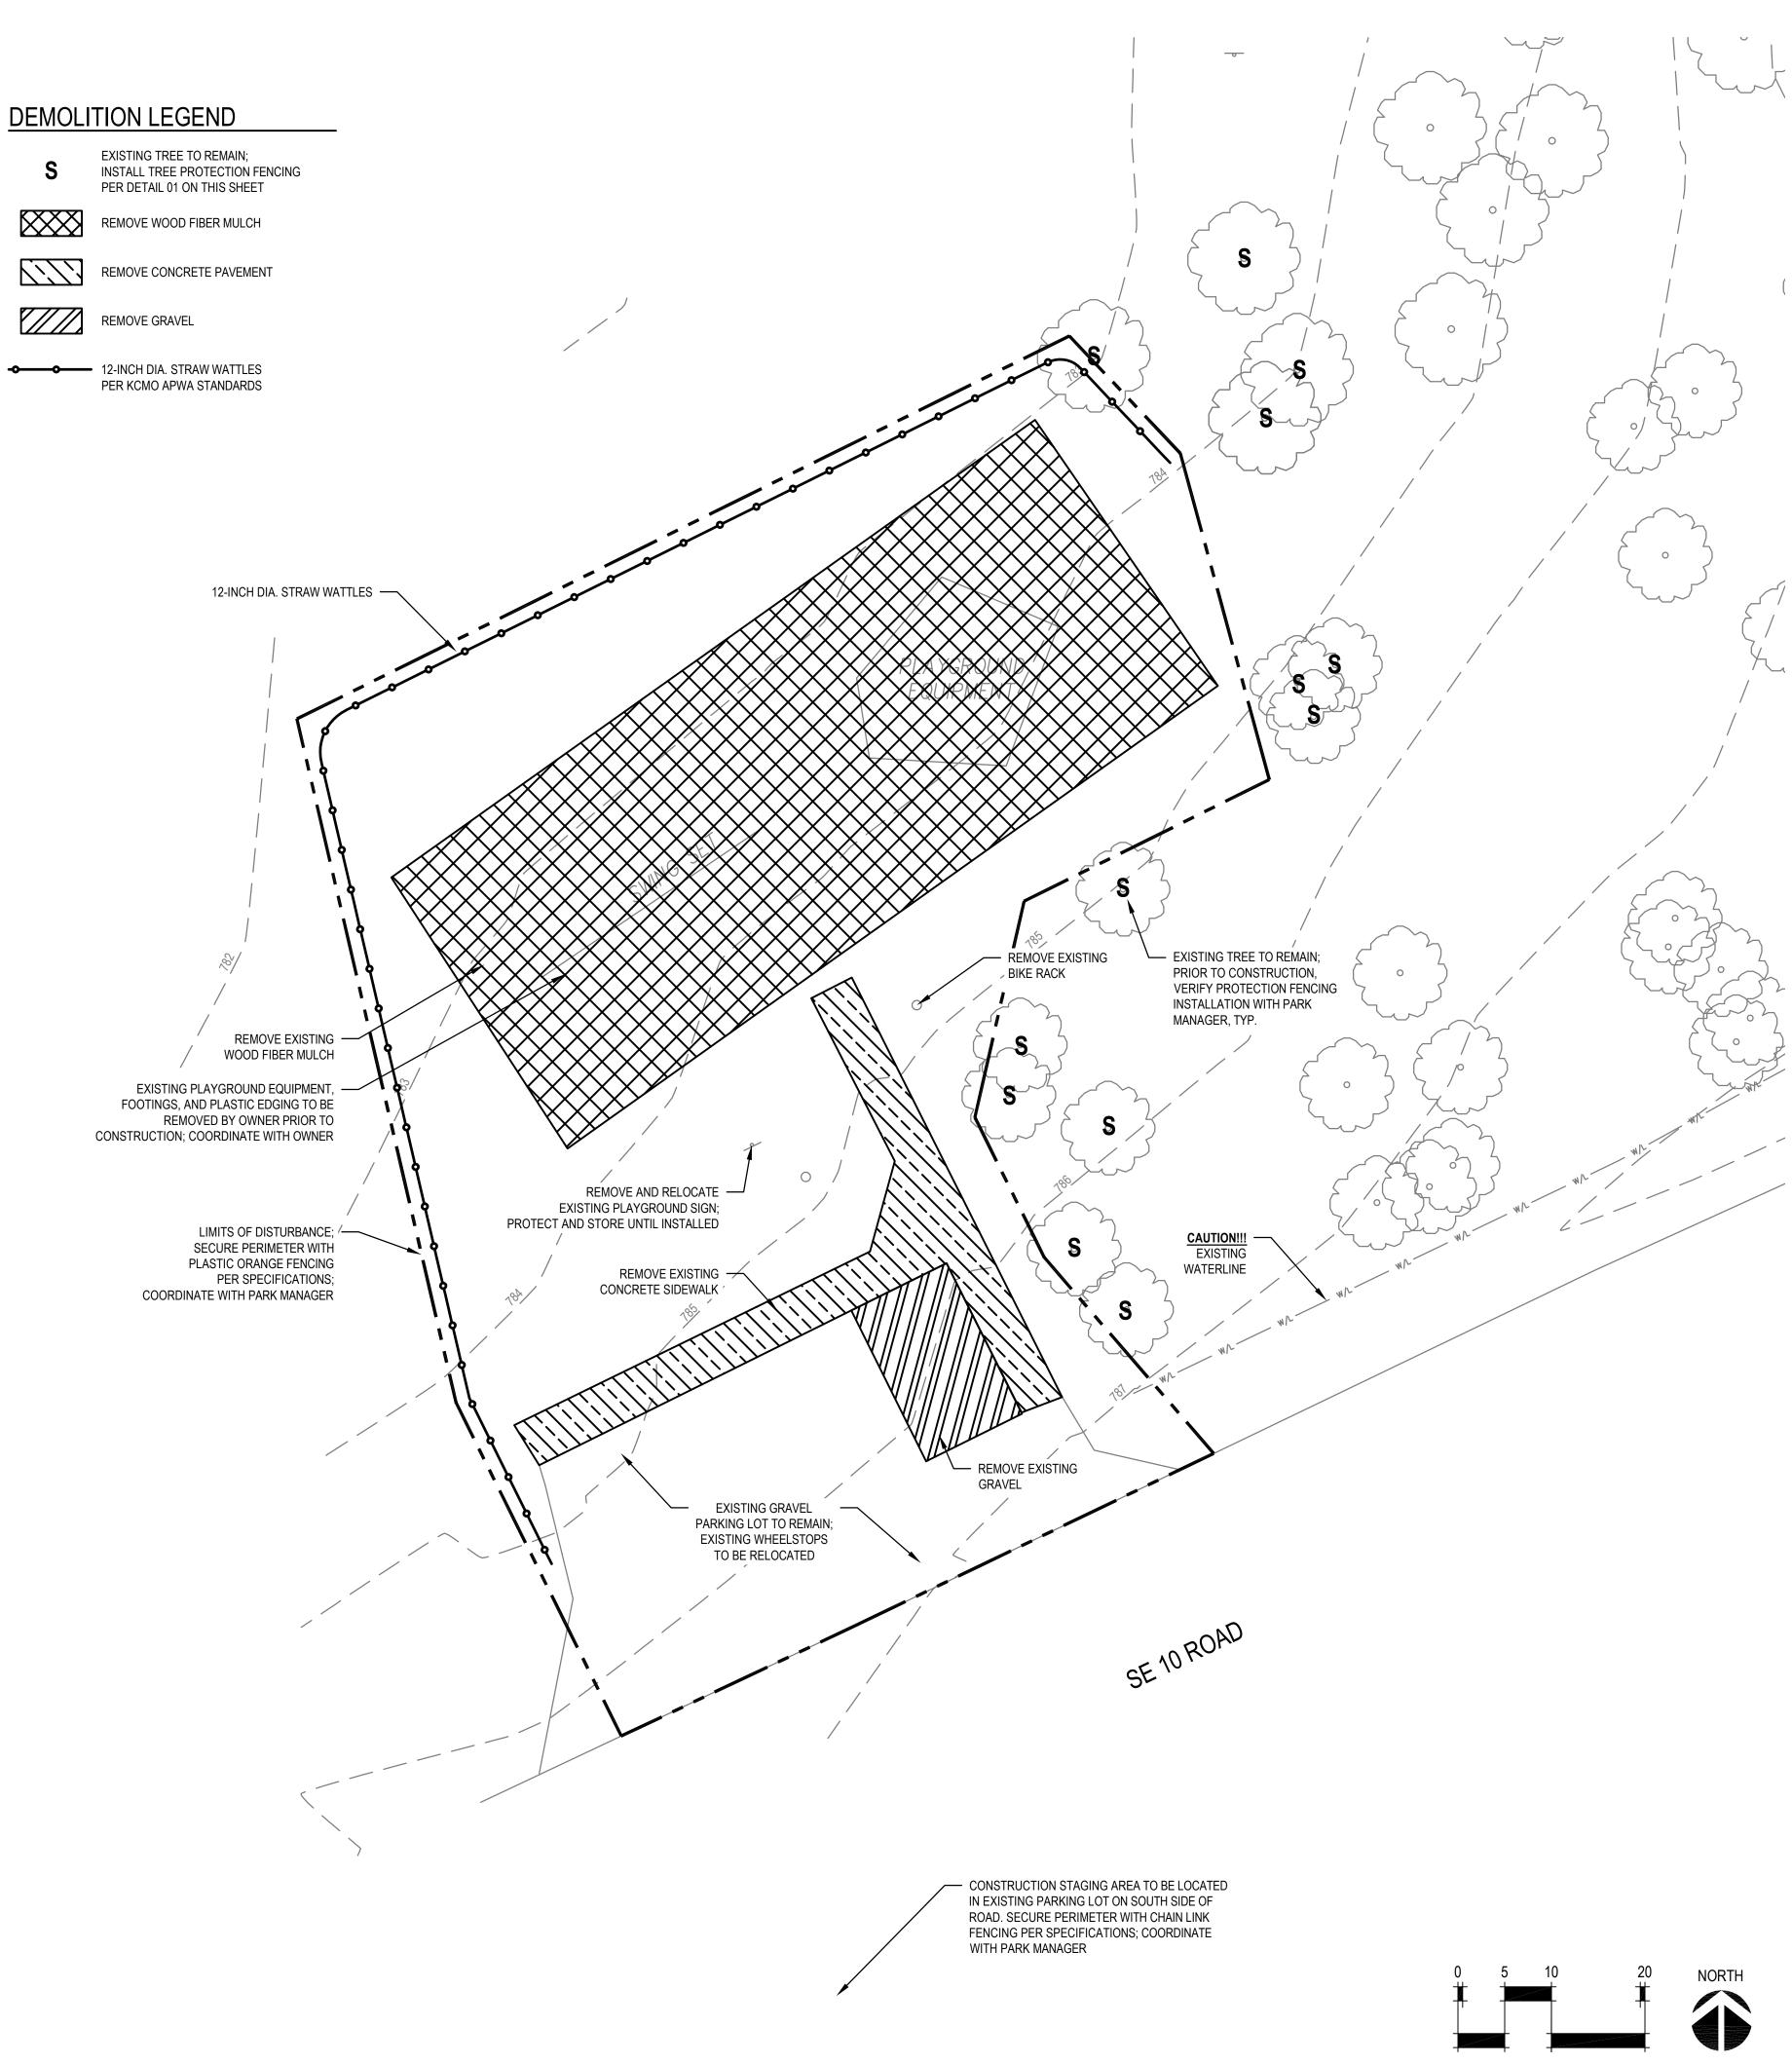

STATE OF MISSOURI MICHAEL L. PARSON, GOVERNOR

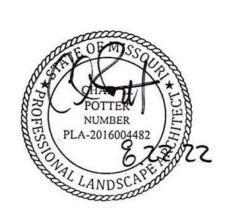

LANDSCAPE ARCHITECT:



LAC# MO-2002023826

414 Oak Street, Suite 101 Kansas City, Missouri 64106 P 816-756-5690 www.BeVireo.com

SURVEYOR & CIVIL ENGINEER: RENAISSANCE INFRASTRUCTURE CONSULTING 8653 Penrose Lane Lenexa, Kansas 66219 P 913-317-9500



GEOTECHNICAL: INTERTEK-PSI 1211 W. Cambridge Circle Drive Kansas City, Kansas 66103 P 913-310-1600



OFFICE OF ADMINISTRATION DIVISION OF FACILITIES MANAGEMENT, **DESIGN AND CONSTRUCTION**

DEPARTMENT OF NATURAL RESOURCES, **MISSOURI STATE PARKS**

CAMPGROUND PLAYGROUND REPLACEMENT

KNOB NOSTER STATE PARK 873 SE 10TH KNOB NOSTER, MO 65336

PROJECT # X2109-01 5305 SITE # FACILITY # 9999

REVISION:

DATE: **REVISION**: DATE: **REVISION**: DATE: ISSUE DATE: 8/22/2022

CAD DWG FILE: x2109-01-5305-9999-DP-200.DWG DRAWN BY: AES CHECKED BY: CDP DESIGNED BY: AES / CDP

SHEET TITLE:

DEMOLITION & EROSION CONTROL PLAN

SHEET NUMBER:

|DP-200 SHEET 6 OF 17 8/22/2022

	ITEM	QTY	MANUFACTURER	MODEL	REP.			
1 Tree House Themed Play Structure (see plan for individual play components)			1		1	Landscape Structures	see plan	ATHCO
	Log Balance Beam	1	Landscape Structures	173596	ATHCO			
3	Saddle Spinner	1	Landscape Structures	152179	ATHCO			
1	Single Post Swing Frame	1	Landscape Structures	177332	ATHCO			
	Belt Seat with proguard chains	1	Landscape Structures	174018	ATHCO			
	Molded Seat with harness (ages 5+) with proguard chains	1	Landscape Structures	177351	ATHCO			
5	72" x 90" Rubber Swing Mat	1	Zeager Bros, Inc.	TuffMat	Zeager			

INTO THE WORK INCLUDE, BUT ARE NOT LIMITED TO THE FOLLOWING: LANDSCAPE STRUCTURES GAMETIME, A PLAYCORE COMPANY

- BURKE
- 4. ZEAGER BROS, INC. 5. OR APPROVED EQUAL

CONTRACTOR SHALL SUBMIT SHOP DRAWINGS INCLUDING PLAY EQUIPMENT LAYOUT, SAFETY FALL ZONES, MATERIALS AND COLORS FOR ALL PLAY EQUIPMENT FOR REVIEW AND APPROVAL BY OWNER'S

DRINKING FOUNTAIN (OR APPROVED EQUAL)

ITEM	QTY	MANUFACTURER	MODEL	REP.
Accessible Drinking Fountain with Bottle Filler and Hose Bib; Color: Brown (RE: Specifications)	1	Most Dependable Fountains, Inc.	10145 SM	MDF

TREE HOUSE THEMED PLAY STRUCTURE





LOG BALANCE BEAM





SADDLE SPINNER




INFORMATION SHOWN FOR BASIS OF DESIGN IS FOR BID PURPOSES ONLY. SUBJECT TO COMPLIANCE WITH REQUIREMENTS, AVAILABLE MANUFACTURERS OFFERING PRODUCTS THAT MAY BE INCORPORATED

REPRESENTATIVE PRIOR TO FABRICATION AND/OR INSTALLATION.

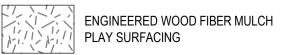

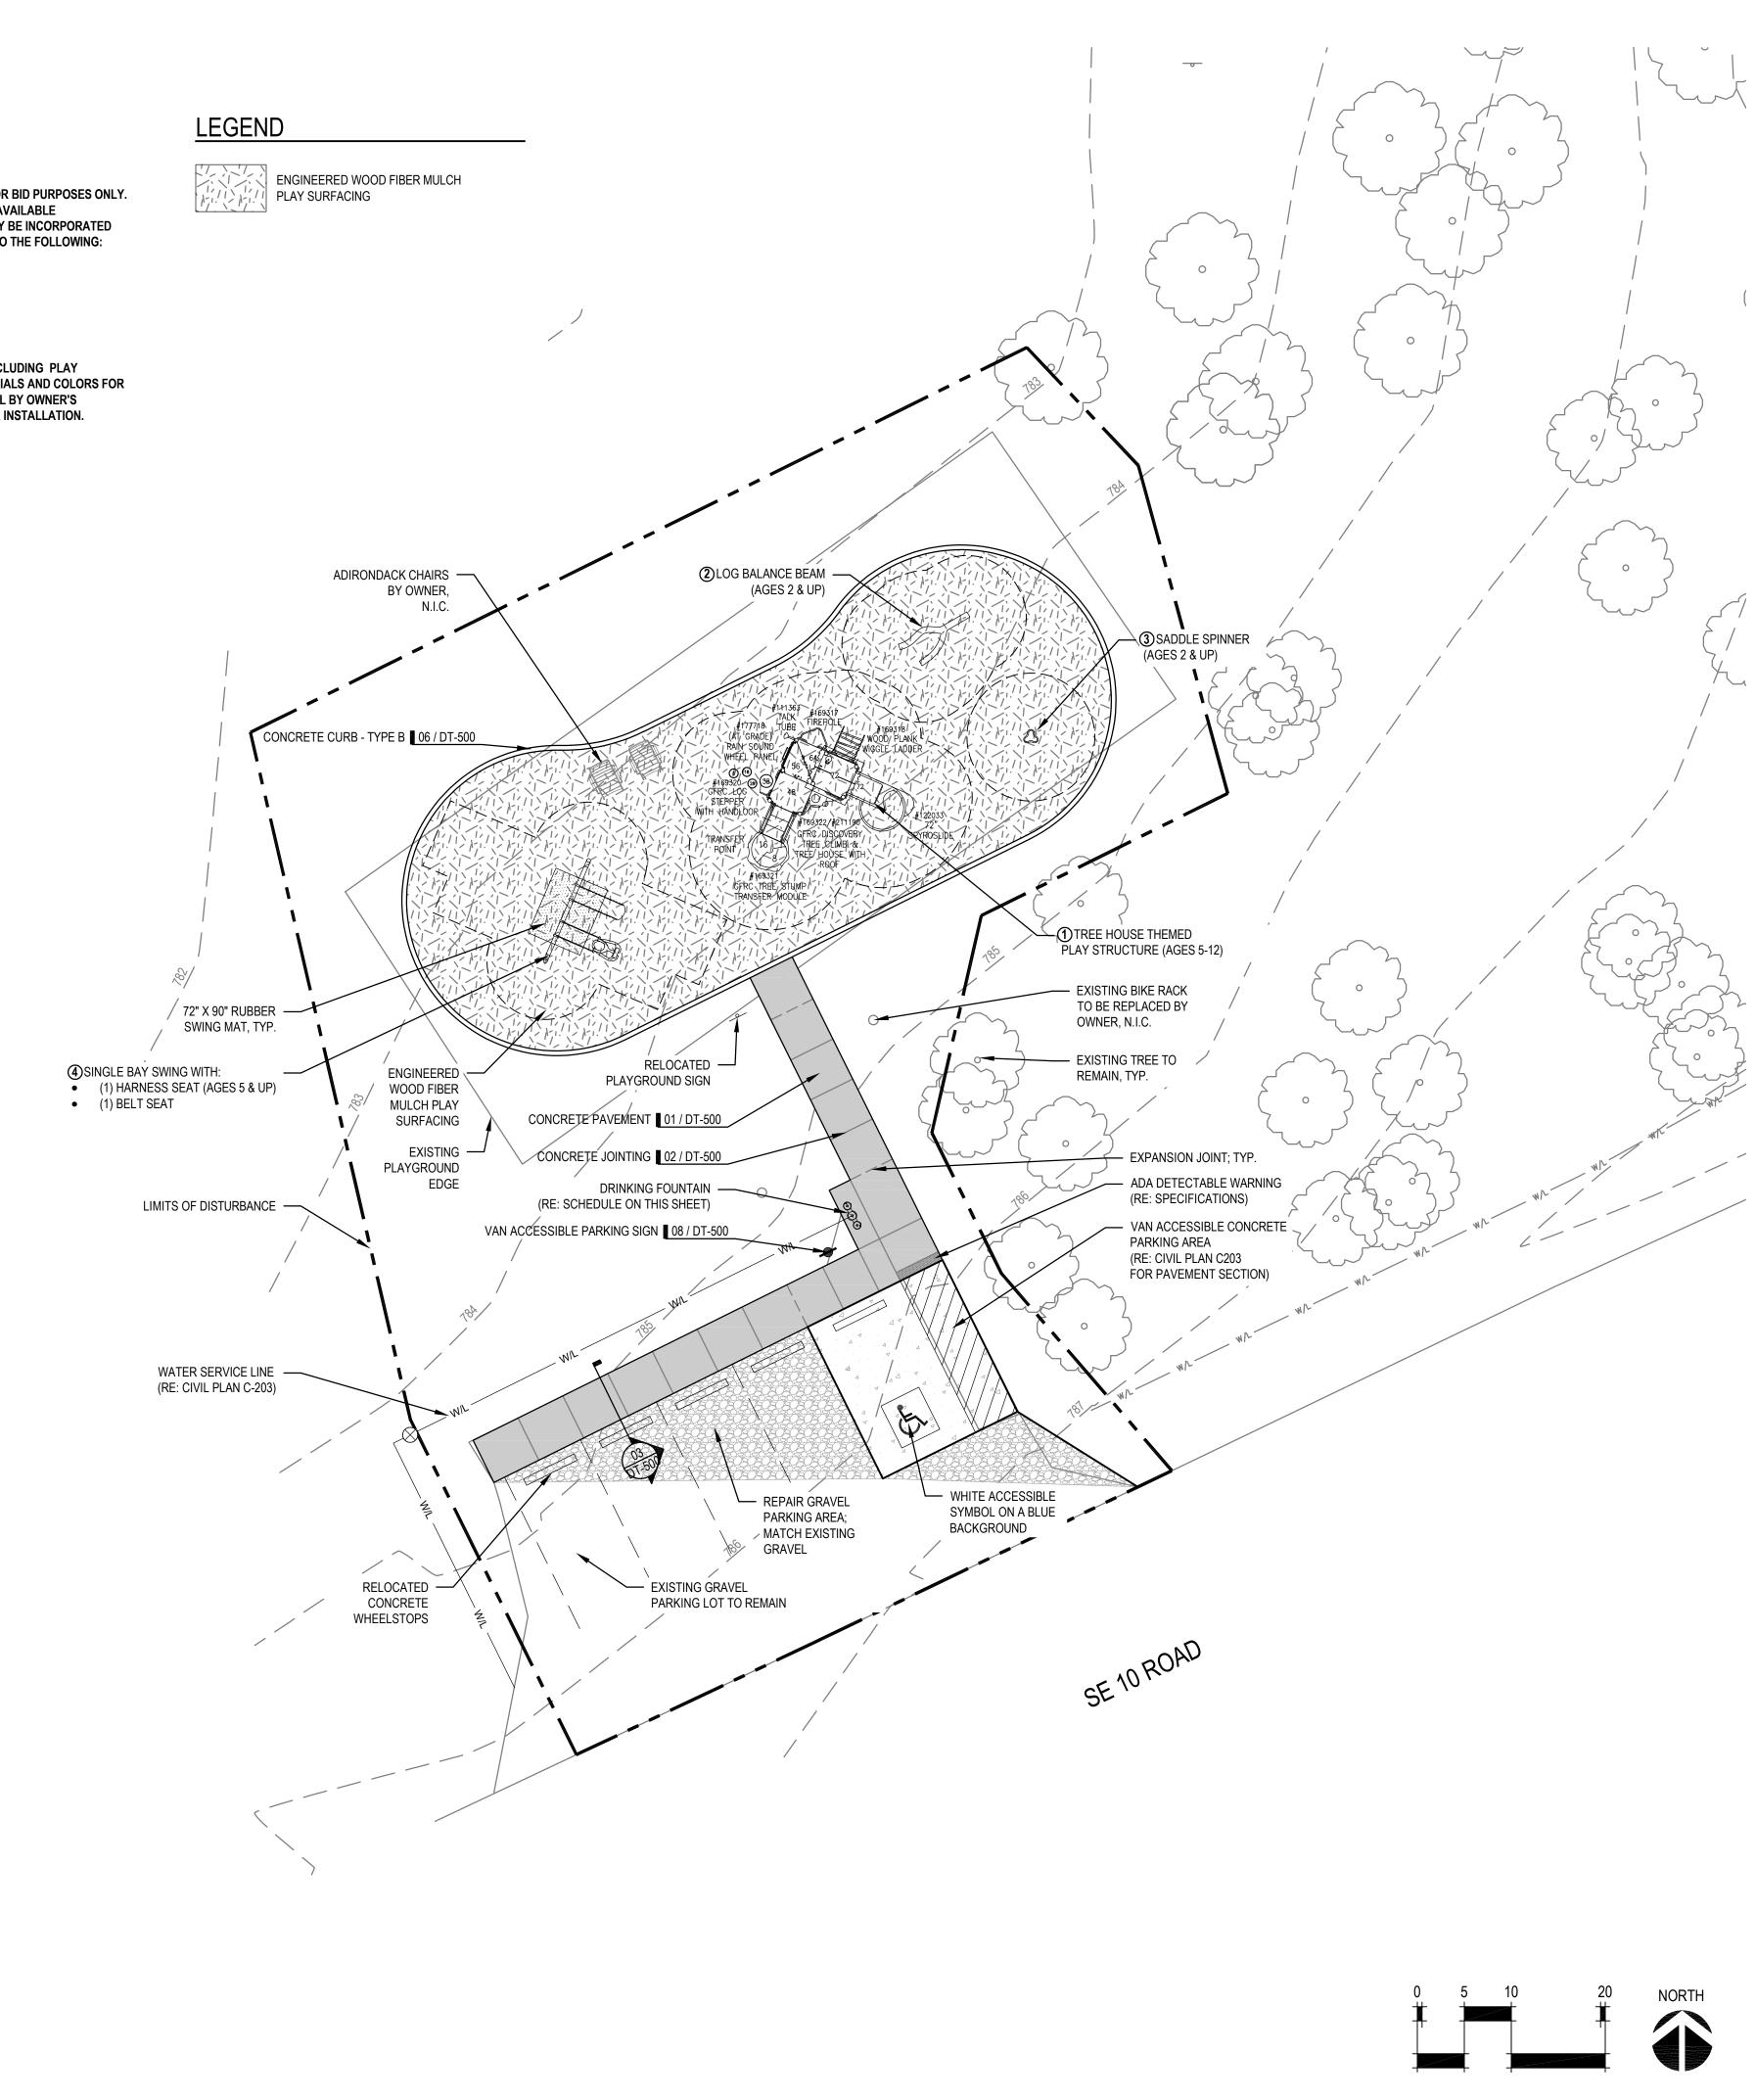

STATE OF MISSOURI MICHAEL L. PARSON, GOVERNOR

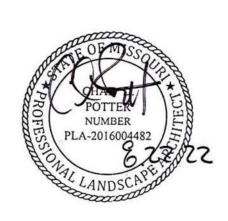

LANDSCAPE ARCHITECT:



LAC# MO-2002023826

414 Oak Street, Suite 101 Kansas City, Missouri 64106 P 816-756-5690 www.BeVireo.com

SURVEYOR & CIVIL ENGINEER: RENAISSANCE INFRASTRUCTURE CONSULTING 8653 Penrose Lane Lenexa, Kansas 66219 P 913-317-9500



GEOTECHNICAL: INTERTEK-PSI 1211 W. Cambridge Circle Drive Kansas City, Kansas 66103 P 913-310-1600



OFFICE OF ADMINISTRATION DIVISION OF FACILITIES MANAGEMENT, **DESIGN AND CONSTRUCTION**

DEPARTMENT OF NATURAL RESOURCES, MISSOURI STATE PARKS

CAMPGROUND PLAYGROUND REPLACEMENT

KNOB NOSTER STATE PARK 873 SE 10TH KNOB NOSTER, MO 65336

PROJECT # X2109-01 SITE # 5305 FACILITY # 9999

REVISION: DATE: **REVISION:** DATE: **REVISION:** DATE: ISSUE DATE: 8/22/2022

CAD DWG FILE: X2109-01-5305-9999-SP-201.DWG DRAWN BY: <u>AES</u> CHECKED BY: <u>CDP</u> DESIGNED BY: <u>AES / CDP</u>

SHEET TITLE:

SITE PLAN

SHEET NUMBER:

SP-201 SHEET 7 OF 17 8/22/2022

- 1. SITE LAYOUT DATA, INCLUDING COORDINATE POINTS, IS BASED ON A SURVEY PROVIDED BY RENAISSANCE INFRASTRUCTURE CONSULTING (2021). REFER TO SURVEY FOR HORIZONTAL LAYOUT CONTROL POINTS. REPORT ANY DISCREPANCIES BETWEEN PLANS AND FIELD CONDITIONS TO OWNER'S REPRESENTATIVE IMMEDIATELY.
- 2. IT SHALL BE THE RESPONSIBILITY OF THE CONTRACTOR TO CONTROL ON-SITE AND DOWNSTREAM EROSION AND SILTATION DURING ALL PHASES OF CONSTRUCTION. EROSION CONTROL SYSTEMS AND PROCEDURES SHALL BE IN PLACE PRIOR TO ANY GRADING OPERATIONS.
- 3. THE LOCATIONS OF EXISTING UTILITIES AS SHOWN ARE APPROXIMATE. THE CONTRACTOR SHALL HAVE ALL UTILITIES FLAGGED IN THE FIELD FOR INSPECTION PRIOR TO PROCEEDING WITH ANY GRADING OPERATIONS. THE CONTRACTOR SHALL VERIFY THE DEPTH AND LOCATION OF ALL EXISTING UTILITIES AND WILL BE HELD LIABLE FOR ANY DELAYS CAUSED BY DAMAGE TO UTILITIES OR FAILURE TO LOCATE UTILITIES.
- 4. ALL CONSTRUCTION DEBRIS SHALL BE DISPOSED OF BY THE CONTRACTOR AT A LOCATION PROVIDED BY THE CONTRACTOR AND IN ACCORDANCE WITH LOCAL REGULATIONS. THE CONTRACTOR SHALL SATISFY HIMSELF BY JOB-SITE INSPECTION AS TO THE EXTENT OF CLEARING REQUIRED PRIOR TO ENTERING INTO A CONSTRUCTION CONTRACT.
- CONSTRUCTION STAKING SHALL BE PROVIDED BY THE CONTRACTOR. ALL CONSTRUCTION LAYOUT STAKING IS TO BE PERFORMED BY A LAND SURVEYOR OR PROFESSIONAL ENGINEER REGISTERED IN THE STATE OF MISSOURI. TO FACILITATE ACCURACY OF CONSTRUCTION STAKING, UPON WRITTEN REQUEST FROM CONTRACTOR, ELECTRONIC DATA COMPRISING THESE SITE DEVELOPMENT DRAWINGS WILL BE FORWARED TO THE LAND SURVEYOR OR PROFESSIONAL ENGINEER EMPLOYED TO PERFORM THE CONSTRUCTION STAKING.
- IN ORDER TO MAINTAIN THE INTEGRITY OF HORIZONTAL AND VERTICAL CONTROL FOR THE SITE, THE SURVEYOR OR PROFESSIONAL ENGINEER EMPLOYED BY THE CONTRACTOR TO PERFORM CONSTRUCTION LAYOUT STAKING SHALL SET AND PROTECT ADDITIONAL TRAVERSE POINTS OUTSIDE THE AREAS OF CONSTRUCTION ACTIVITY.
- 7. ALL LAYOUTS SHALL BE SUBJECT OT FIELD APPROVAL BY THE OWNER'S REPRESENTATIVE.
- 8. SAWCUT EXISTING PAVEMENT FULL DEPTH WHERE IT MEETS NEW PAVEMENT.
- 9. UNLESS NOTED OTHERWISE, ALL DIMENSIONS ARE TO THE FOLLOWING: EDGE OF PAVEMENT, FACE OF WALL, AND EDGE OF CURB.
- 10. ALL EDGES OF PAVEMENTS ARE TO BE STRAIGHT (OR OF CONSISTENT RADIUS IN THE CASE OF CURVES) AS SHOWN HEREON. NO UNSPECIFIED TANGENTS OR KINKS WILL BE APPROVED.
- 11. THIS SITE HAS BEEN DESIGNED TO COMPLY WITH THE PROVISIONS OF THE AMERICANS WITH DISABILITIES ACT ACCESSIBILITY GUIDELINES (ADAAG). REPORT ANY COMPLIANCE DISCREPANCIES TO OWNER'S REPRESENTATIVE IMMEDIATELY.
- 12. ALL AREAS SHALL BE BROUGHT TO FINAL PLAN CONDITION (PAVED, SEEDED, OR MULCHED) AS SOON AS POSSIBLE TO MAINTAIN FINISH GRADE CONDITIONS AND PREVENT SOIL LOSS.
- 13. THE CONTRACTOR SHALL PROVIDE AND PAY FOR ALL INSPECTION SERVICES.

PLAYGROUND CURB ALIGNMENT

	ALIGNMENT LINE DATA									
LINE #	LENGTH	BEARING	START POINT	END POINT						
L1	15.5038	N63° 37' 34.49"E	(3050429.9495, 942419.0291)	(3050443.8397, 942425.9163)						
L2	48.0000	S63° 37' 34.49"W	(3050471.0570, 942407.6006)	(3050428.0530, 942386.2778)						


ALIGNMENT CURVE DATA									
CURVE #	DELTA	RADIUS	LENGTH	TANGENT					
C1	27.66	18.75	9.05	4.62					
C2	207.66	16.25	58.90	66.01					
C3	207.66	16.25	58.90	66.01					
C4	27.66	18.75	9.05	4.62					

LEGEND

EG = EXISTING GRADE GB = GRADE BREAK TP = TOP OF PAVEMENT TC = TOP OF CURB TPS = TOP OF PLAY SURFACE INV = INVERT

- - PERFORATED HDPE UNDERDRAIN PIPE

PRIOR TO INSTALLATION OF UNDERDRAIN, OWNER'S REPRESENTATIVE SHALL REVIEW AND APPROVE ALIGNMENT IN THE FIELD TO LIMIT DAMAGE TO EXISTING TREES AND ROOT SYSTEMS.

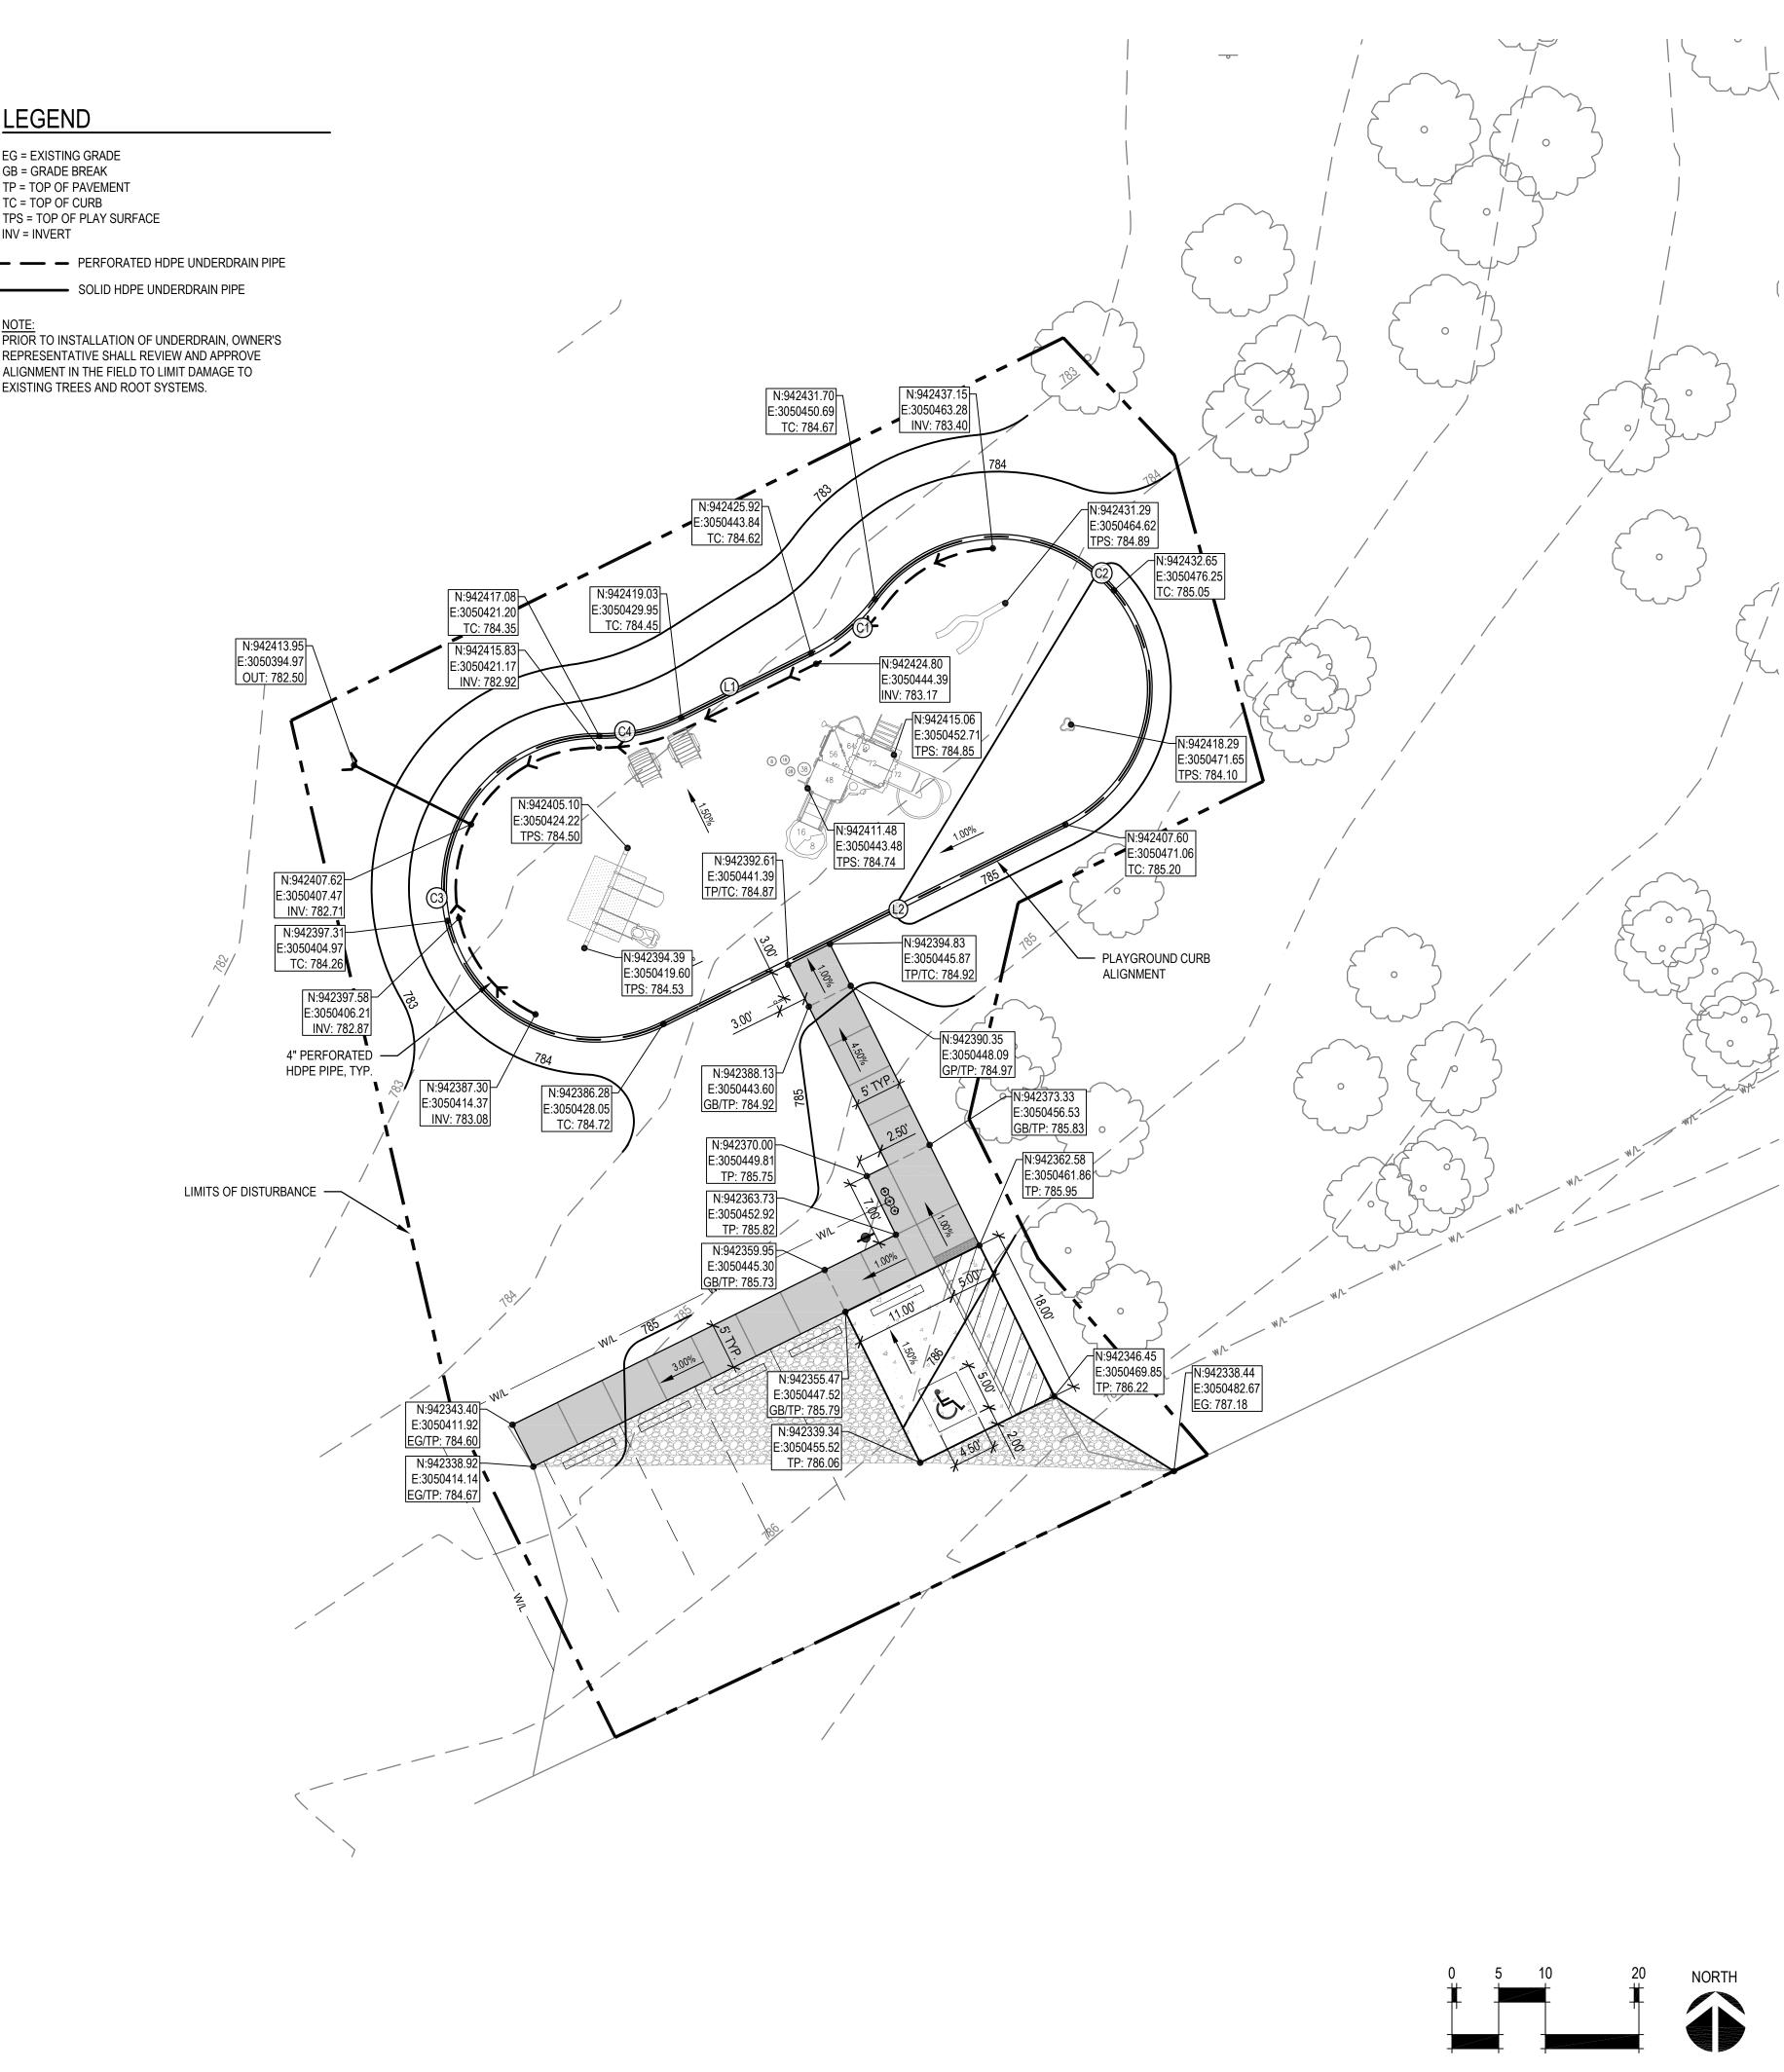

STATE OF MISSOURI MICHAEL L. PARSON, GOVERNOR



LANDSCAPE ARCHITECT:



LAC# MO-2002023826

414 Oak Street, Suite 101 Kansas City, Missouri 64106 P 816-756-5690 www.BeVireo.com

SURVEYOR & CIVIL ENGINEER: RENAISSANCE INFRASTRUCTURE CONSULTING 8653 Penrose Lane Lenexa, Kansas 66219 P 913-317-9500



GEOTECHNICAL: INTERTEK-PSI 1211 W. Cambridge Circle Drive Kansas City, Kansas 66103 P 913-310-1600

intertek

OFFICE OF ADMINISTRATION DIVISION OF FACILITIES MANAGEMENT, **DESIGN AND CONSTRUCTION**

DEPARTMENT OF NATURAL RESOURCES, **MISSOURI STATE PARKS**

CAMPGROUND PLAYGROUND REPLACEMENT

KNOB NOSTER STATE PARK 873 SE 10TH KNOB NOSTER, MO 65336

PROJECT # X2109-01 SITE # 5305 FACILITY # 9999

REVISION:


DATE: **REVISION:** DATE: **REVISION**: DATE: ISSUE DATE: 8/22/2022


CAD DWG FILE: x2109-01-5305-9999-SP-202.DWG DRAWN BY: <u>AES</u> CHECKED BY: <u>CDP</u> DESIGNED BY: AES / CDP

SHEET TITLE: LAYOUT & **GRADING PLAN**

SHEET NUMBER:

SP-202 SHEET 8 OF 17 8/22/2022

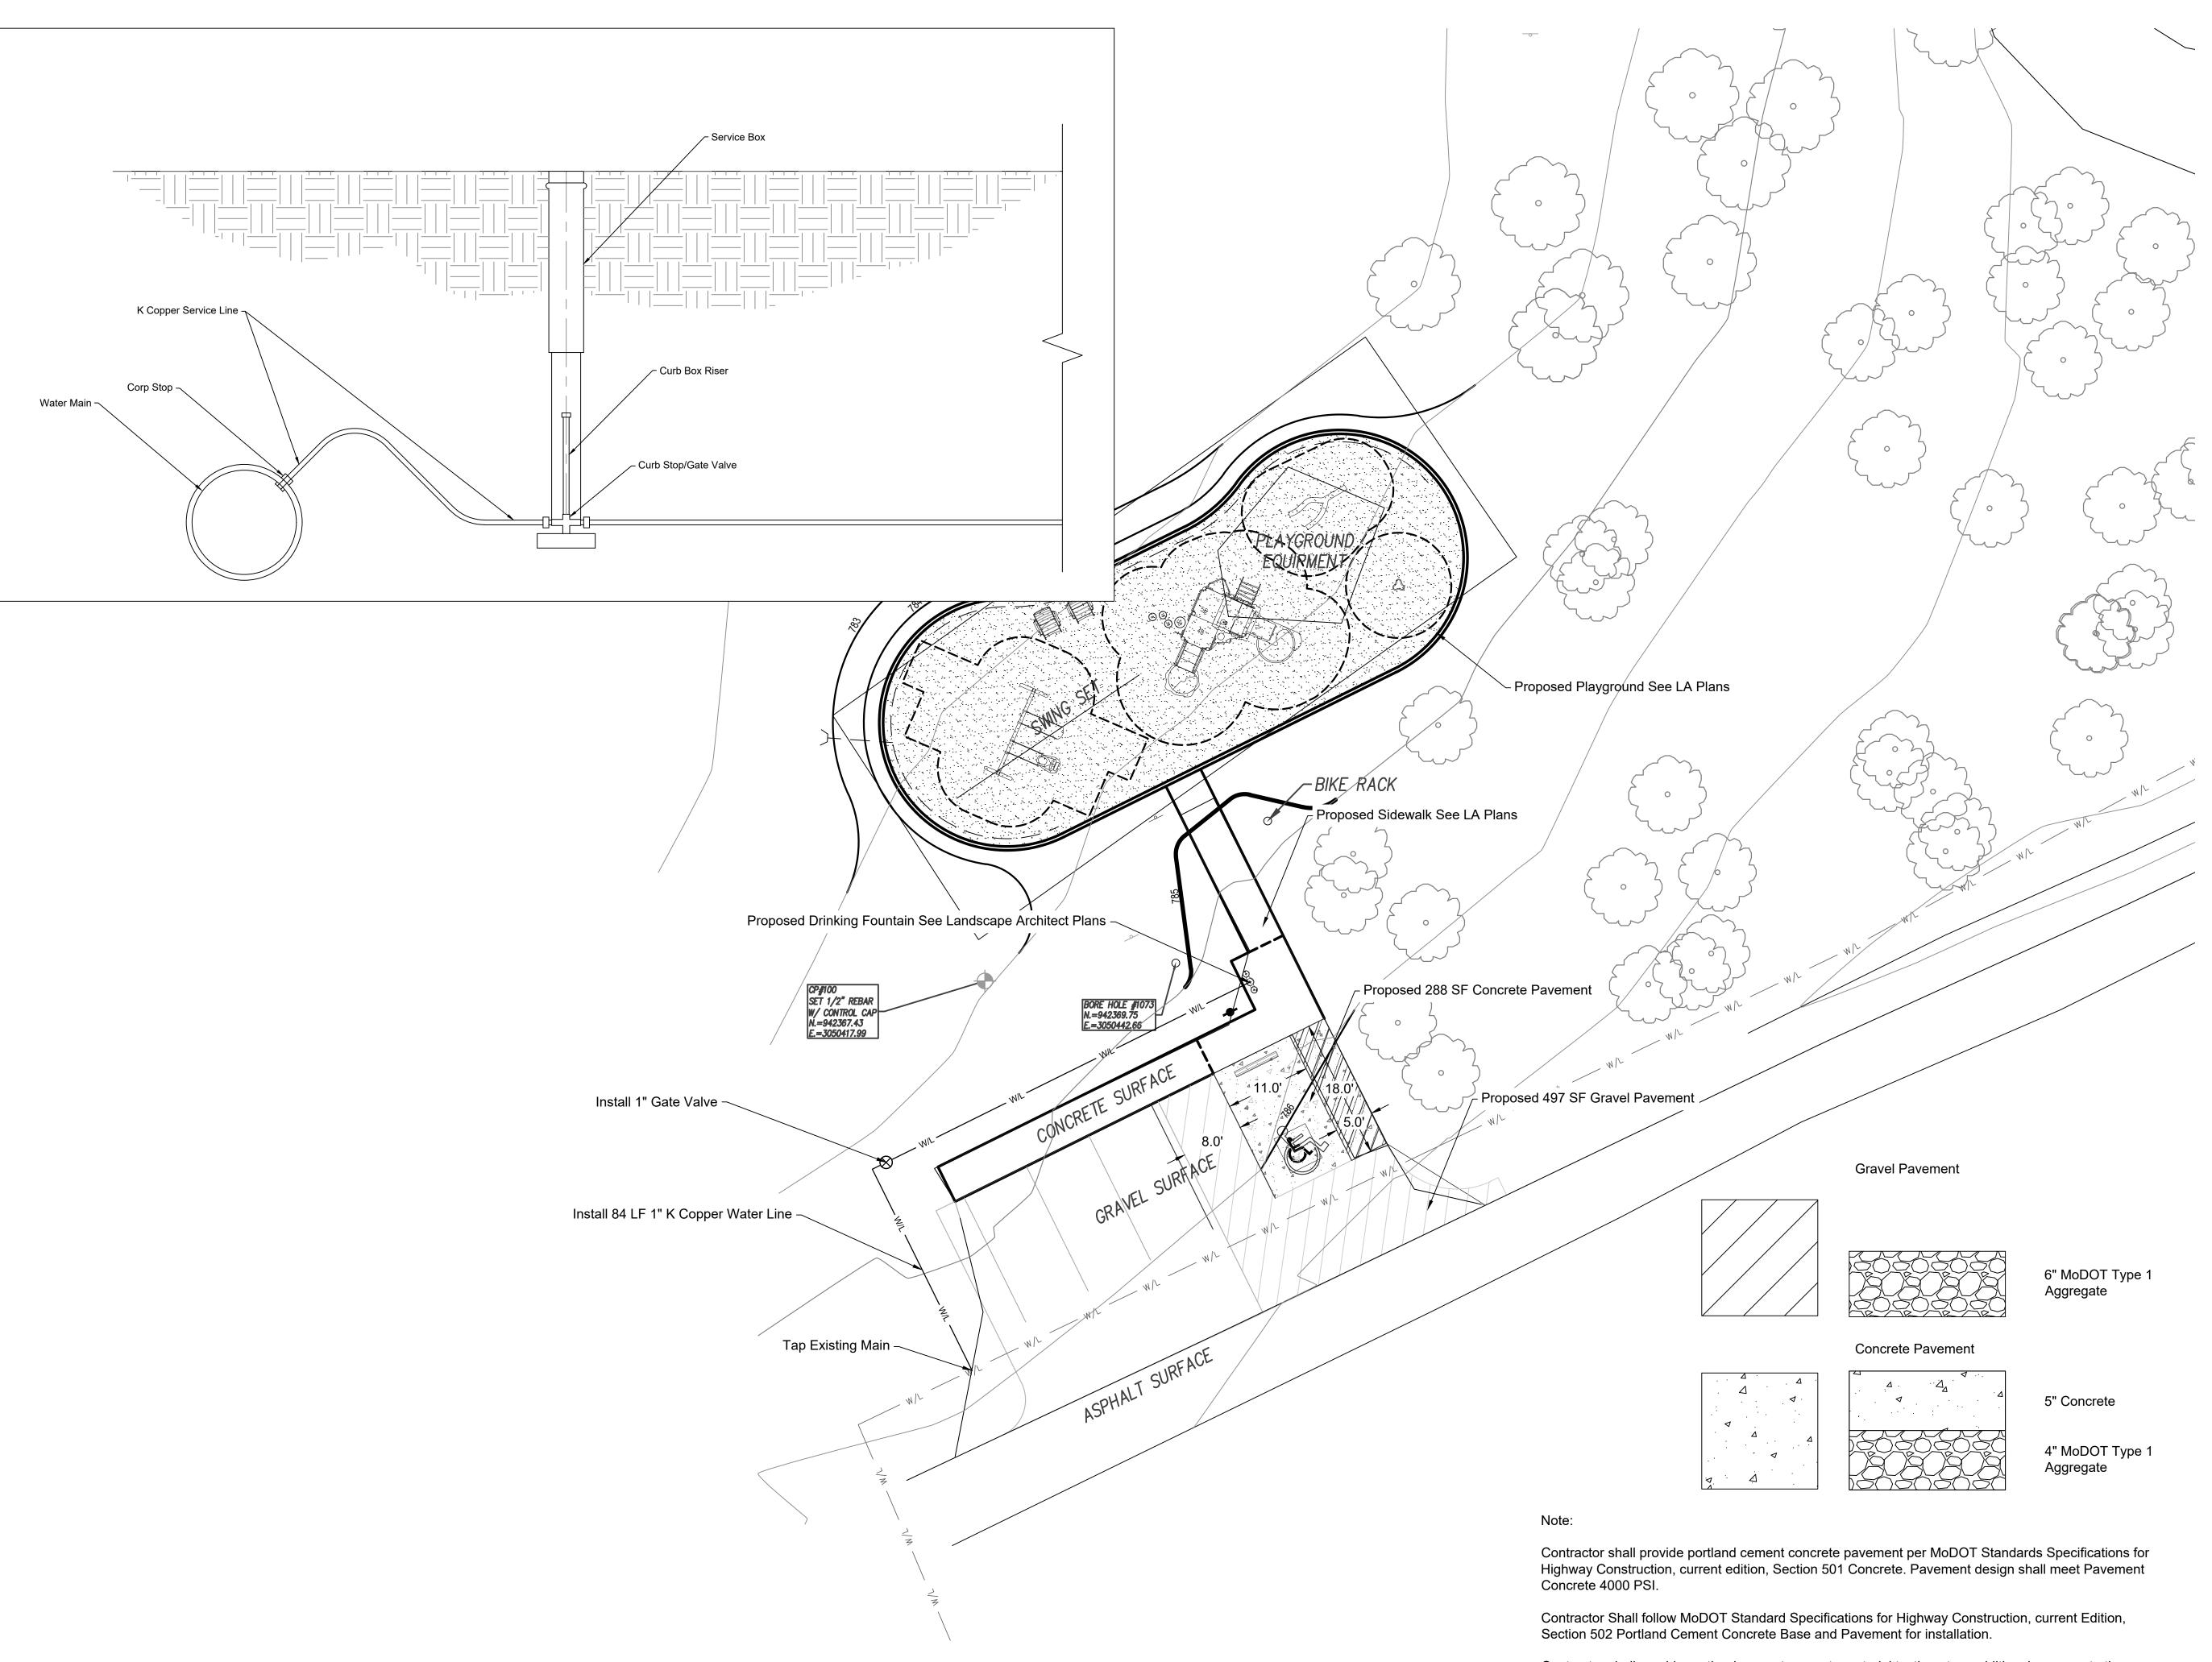

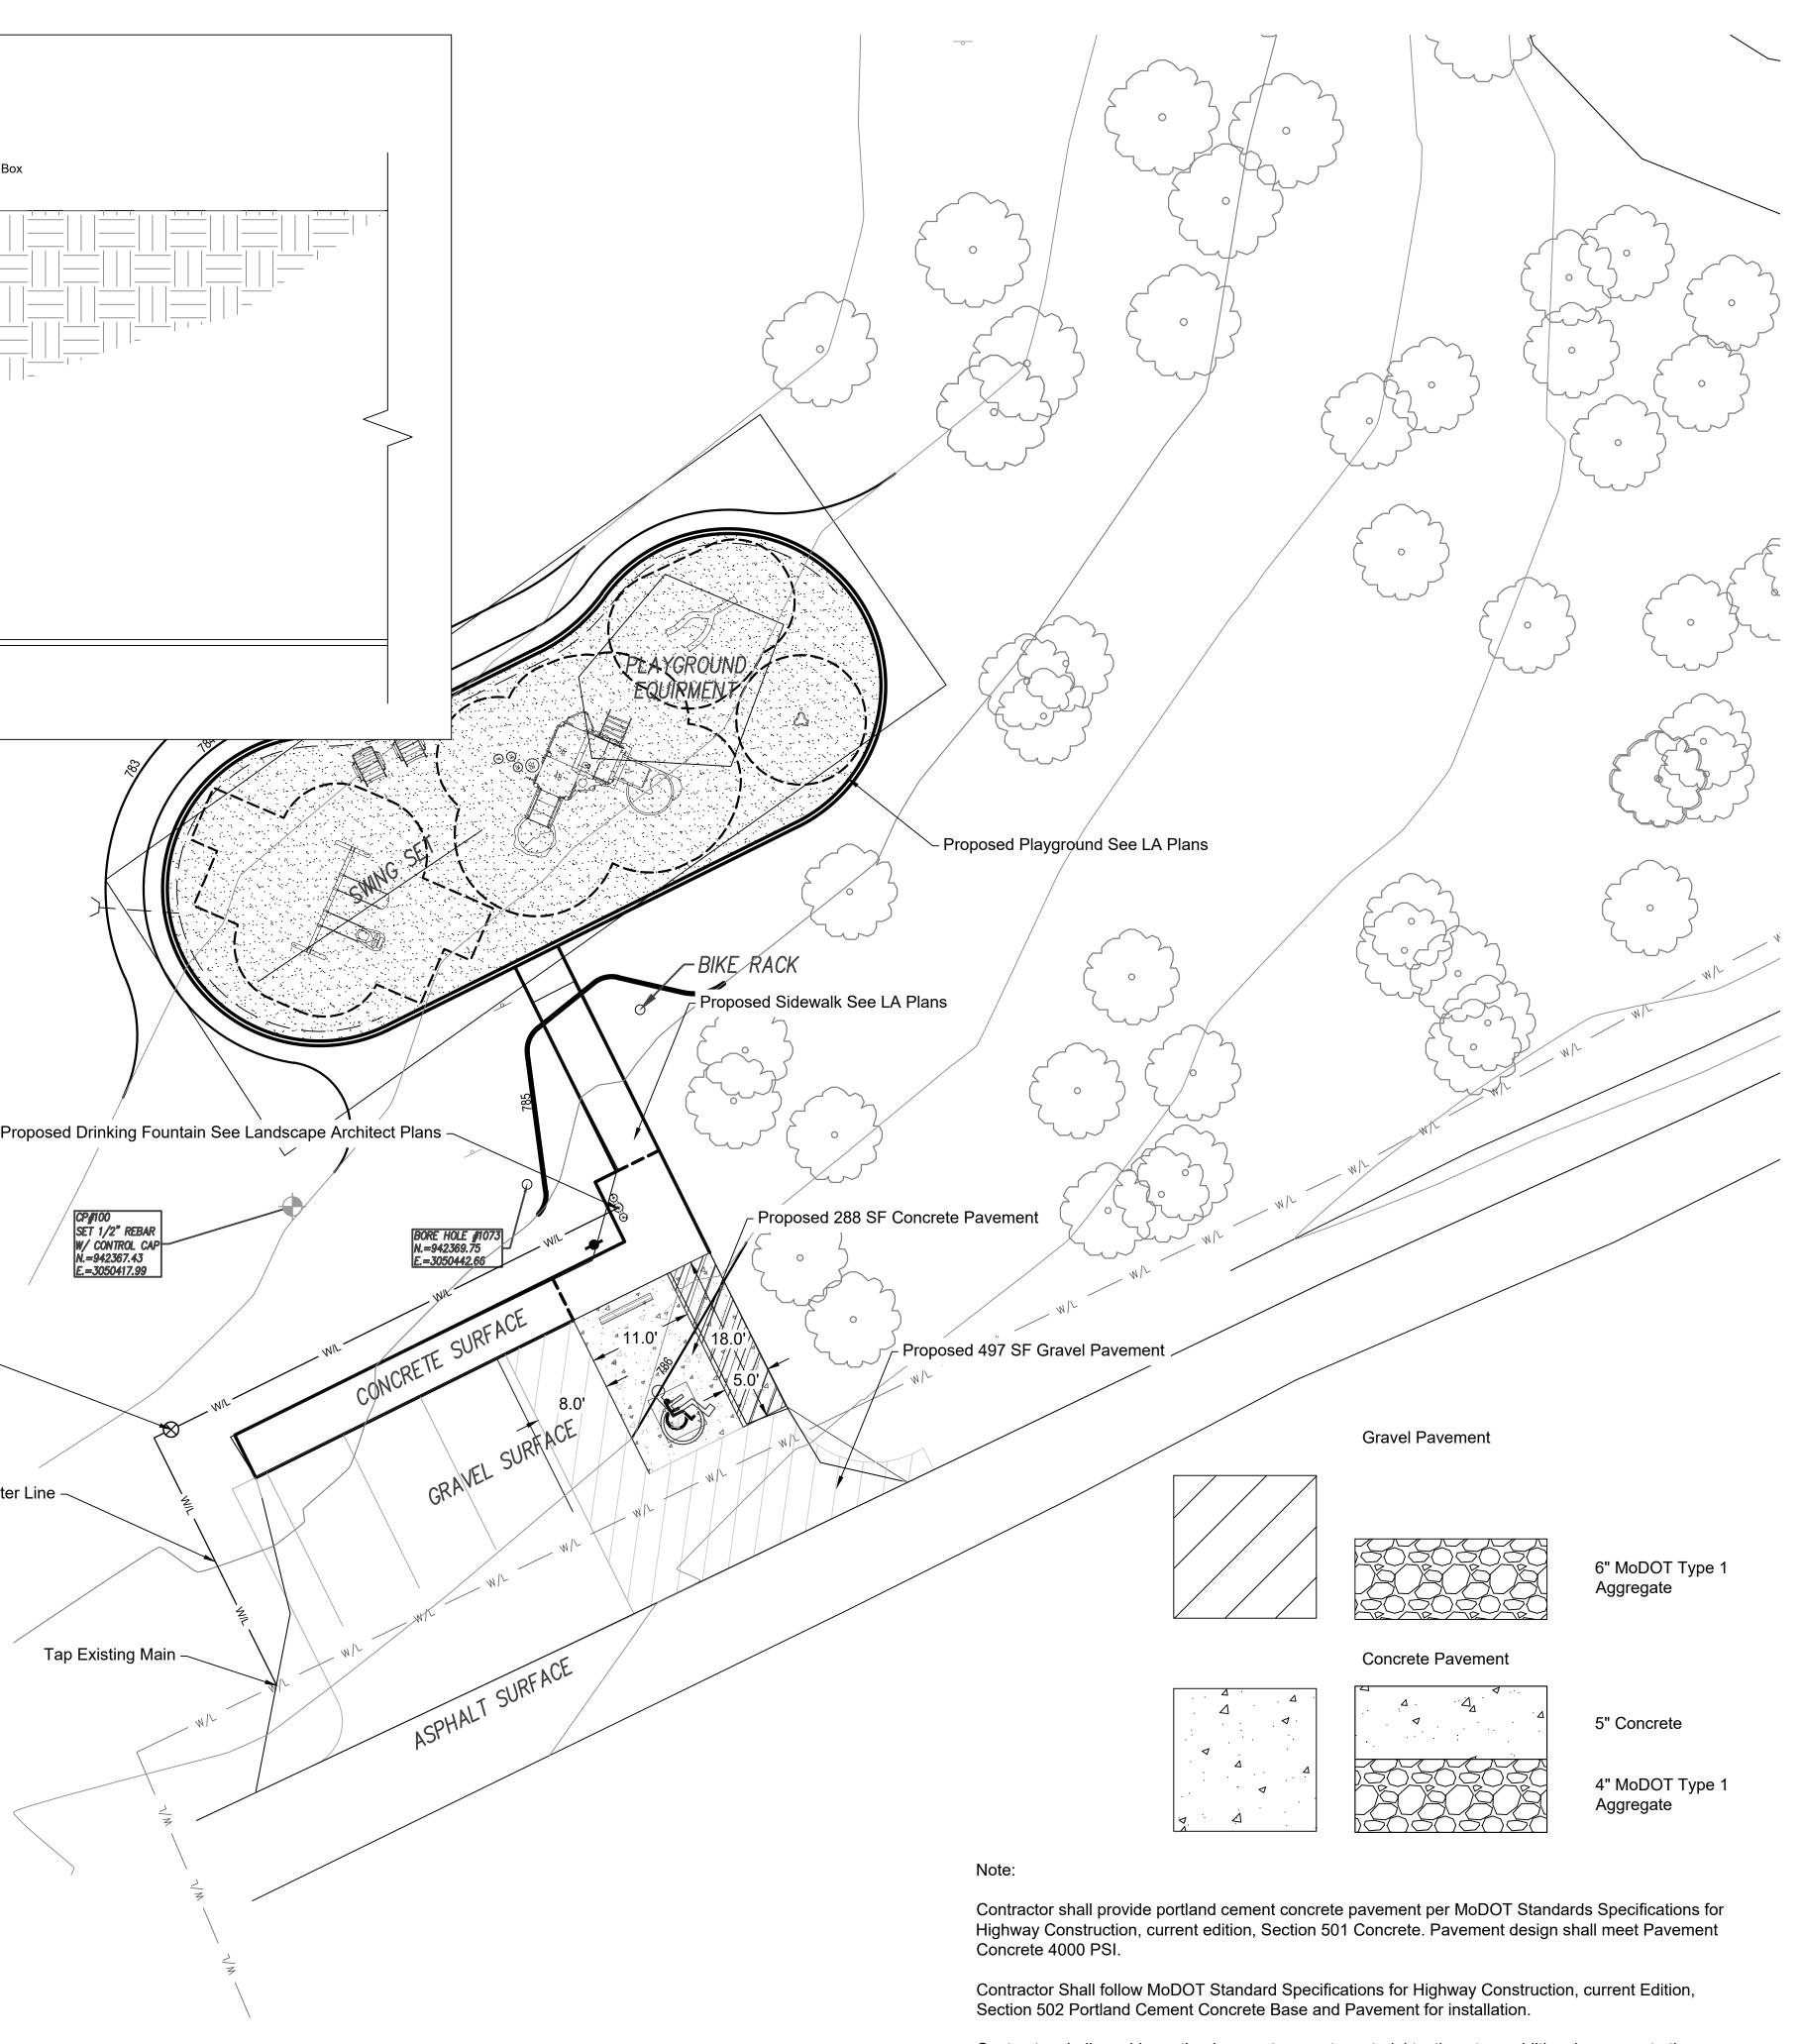

Contractor shall provide portland cement concrete material testing at no additional expense to the owner.



SHEET 9 OF 17


08/22/2022

STATE OF MISSOURI MICHAEL L. PARSON, GOVERNOR
NUMBER PE-2002003418 PE-2002003418 MITCHELL E. SLUTTER PE-2002003418
LANDSCAPE ARCHITECT:
LAC# MO-2002023826 929 Walnut Street, Ste. 700 Kansas City, Missouri 64106 P 816-756-5690 www.BeVireo.com
SURVEYOR & CIVIL ENGINEER: RENAISSANCE INFRASTRUCTURE CONSULTING 8653 Penrose Lane Lenexa, Kansas 66219 P 913-317-9500
GEOTECHNICAL: INTERTEK-PSI 1211 W. Cambridge Circle Drive Kansas City, Kansas 66103 P 913-310-1600
OFFICE OF ADMINISTRATION DIVISION OF FACILITIES MANAGEMENT, DESIGN AND CONSTRUCTION
DEPARTMENT OF NATURAL RESOURCES, MISSOURI STATE PARKS
CAMPGROUND PLAYGROUND REPLACEMENT
KNOB NOSTER STATE PARK 873 SE 10TH KNOB NOSTER, MO 65336
PROJECT # X2109-01 SITE # 5305 FACILITY # 9999
REVISION: DATE: REVISION: DATE: REVISION: DATE: ISSUE DATE: 08/22/2022
CAD DWG FILE: DRAWN BY: TCD CHECKED BY: MES DESIGNED BY: MES
SHEET TITLE: UTILITY PLAN & DETAILS
sheet number: $C203$
$\cup \angle UJ$

- 1. ALL UTILITIES SHALL BE FIELD LOCATED PRIOR TO LANDSCAPE AND PAVEMENT REMOVAL OPERATIONS.
- 2. ALL REMOVALS SHALL BE DISPOSED OF PER LOCAL REGULATIONS BY THE CONTRACTOR.
- 3. REFER TO CONSTRUCTION DOCUMENTS FOR GRADING AND RESTORATION OF SITE AFTER COMPLETION OF DEMOLITION WORK.
- 4. THE UNDERGROUND UTILITIES SHOWN HAVE BEEN LOCATED FROM FIELD SURVEY INFORMATION AND EXISTING DRAWINGS THE ENGINEER MAKES NO GUARANTEES THAT THE UTILITIES SHOWN COMPRISE ALL SUCH UTILITIES IN THE AREA, EITHER IN SERVICE OR ABANDONED. THE ENGINEER HAS NOT PHYSICALLY LOCATED THE UNDERGROUND UTILITIES. THIS INCLUDES PRIVATE AND PUBLIC UTILITIES. IT IS THE CONTRACTOR'S RESPONSIBILITY TO CONTACT MISSOURI ONE CALL IN ADVANCE OF ANY EXCAVATION TO COORDINATE UTILITY LOCATIONS.
- 5. CONTRACTOR IS REQUIRED TO TAKE PRECAUTIONARY MEASURES TO PROTECT THE UTILITY LINES SHOWN AND ANY OTHER EXISTING LINES NOT OF RECORD OR SHOWN ON THESE PLANS.
- 6. DO NOT DISRUPT UTILITY SERVICE TO ADJACENT BUSINESSES OR RESIDENCES WITHOUT PRIOR WRITTEN APPROVAL BY THE ENGINEER.
- 7. DO NOT DISRUPT TRAFFIC ON ADJACENT STREETS WITHOUT PRIOR WRITTEN APPROVAL BY OWNER.
- 8. ALL SIDEWALK AND PAVEMENT TO REMAIN SHALL BE PROTECTED IN PLACE INCLUDING PROTECTION FROM DAMAGE CAUSED BY REMOVAL OF ABUTTING PAVEMENT. CONTRACTOR SHALL SAW CUT WHERE NECESSARY
- 9. CONTRACTOR SHALL GIVE NOTICE TO ALL UTILITY COMPANIES REGARDING DISCONNECTION, DEMOLITION, AND REMOVAL OF SERVICE LINES. CAP ALL LINES BEFORE PROCEEDING WITH WORK ON THIS CONTRACT.
- 10. CONTRACTOR SHALL PROTECT THE PUBLIC AT ALL TIMES WITH FENCING, BARRICADES, ENCLOSURES, ETC. USING BEST PRACTICES AND AS APPROVED BY THE ENGINEER AND OWNER.
- 11. DAMAGE TO ALL EXISTING CONDITIONS TO REMAIN SHALL BE REPAIRED AT THE CONTRACTOR'S EXPENSE.

EROSION CONTROL NOTES

- 1. ALL EROSION AND SEDIMENT CONTROL SHALL COMPLY WITH KC METROPOLITAN APWA STANDARDS, VISIT http://kcmetro.apwa.net/PageDetails/439 FOR SPECIFICATIONS AND DETAILS. DEVICES SHOWN ON PLAN MAY NOT REPRESENT ALL DEVICES NECESSARY FOR EROSION CONTROL. UPON DISCOVERING UNFORESEEN CIRCUMSTANCES POSING THE POTENTIAL FOR ACCELERATED EROSION AND/OR SEDIMENT POLLUTION, THE CONTRACTOR SHALL ADJUST AND/OR IMPLEMENT ADDITIONAL DEVICES TO ELIMINATE POTENTIAL FOR ACCELERATED EROSION AND/OR SEDIMENT POLLUTION.
- 2. THE CONTRACTOR SHALL HAVE AN EROSION CONTROL COORDINATOR AND SHALL COMPLY WITH PERMITS AS REQUIRED BY LAW.
- 3. THE CONTRACTOR SHALL STABILIZE THE SITE PRIOR TO AND DURING CONSTRUCTION. EROSION CONTROL DEVICES SHALL BE MAINTAINED AT ALL TIMES. ADDITIONAL DEVICES WILL BE INSTALLED IF DEEMED NECESSARY DURING ON SITE INSPECTION.
- 4. THE CONTRACTOR SHALL PRACTICE SEQUENTIAL STABILIZATION TO STABILIZE THE SITE AS IT'S BEING BUILT. USE SEED, SOD, EROSION BLANKETS, MULCH, HYDRO-MULCH, TURF REINFORCEMENT MATS (TRM), BONDED FIBER MATRIX AND/OR A COMBINATION OF THESE OR OTHER DEVICES.
- 5. ALL TOPSOIL SHALL BE REMOVED, STOCKPILED, AND REPLACED OVER DISTURBED AREAS AS SOON AS AREAS HAVE BEEN SHAPED TO FINAL GRADE.
- 6. THE CONTRACTOR SHALL STABILIZE ALL SWALES/DITCHES AS SOON AS POSSIBLE. USE DITCH CHECKS (I.E. WATTLES OR ROCK CHECKS), EROSION BLANKET, TRM, AND/OR OTHER DEVICES.
- 7. CONTRACTOR SHALL INSPECT AND EVALUATE EROSION CONTROL DEVICES REGULARLY AND FOLLOWING STORM EVENTS AND REPAIR DEFECTS IMMEDIATELY.
- 8. CONDUCT TEMPORARY SEEDING AND MULCHING OPERATIONS TO PROVIDE A TEMPORARY VEGETATIVE COVER FOR EROSION AND SEDIMENT CONTROL PER THE FOLLOWING:
- WHEN SEASONAL CONDITIONS DO NOT ALLOW FOR INSTALLATION OF THE PERMANENT VEGETATION SPECIFIED WHEN CONSTRUCTION ACTIVITY CEASES AND WILL NOT RESUME FOR A PERIOD EXCEEDING 14 CALENDAR DAYS
- WITHIN 7 DAYS OF COMPLETING GRADING OPERATIONS
- 11. STRAW WATTLE LENGTHS SHOWN ARE APPROXIMATE. CONTRACTOR SHALL ADJUST IN FIELD AS REQUIRED TO PROVIDE EROSION AND SEDIMENT CONTROL AND ADDRESS ONSITE CONDITIONS.
- 12. THE OWNER WILL REMOVE ALL TEMPORARY EROSION AND SEDIMENT CONTROL DEVICES AFTER COMPLETION OF CONSTRUCTION OPERATIONS AND WHEN ALL DISTURBED AREAS ARE STABILIZED WITH AN ESTABLISHED STAND OF PERMANENT VEGETATION.
- 13. CONTRACTOR SHALL BE RESPONSIBLE FOR PREVENTING SEDIMENT MOVEMENT ON SITE TO KEEP MUD OFF OF ENTRY DRIVES AND OTHER AREAS BEING USED BY SITE USERS (STAFF AND GUESTS).

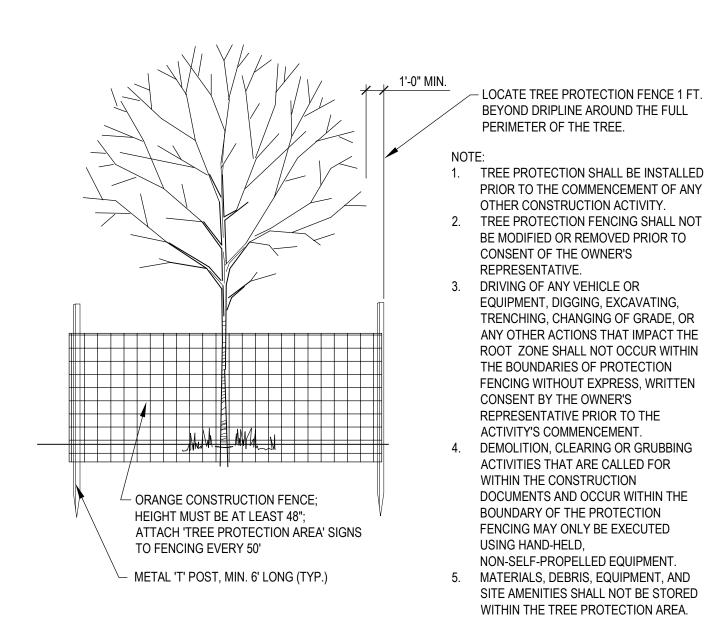

EXISTING TREE PROTECTION 01



(S)

S


EXISTING TREE TO REMAIN; INSTALL TREE PROTECTION FENCING PER DETAIL 01 ON THIS SHEET

----- 12-INCH DIA. STRAW WATTLES PER KCMO APWA STANDARDS

LIMITS OF DISTURBANC

SECURE PERIMETER OF PLAYGROUND AREA WITH PLASTIC ORANGE FENCING -PER SPECIFICATIONS COORDINATE WITH PARK MANAGER

12-INCH DIA. STRAW WATTLES

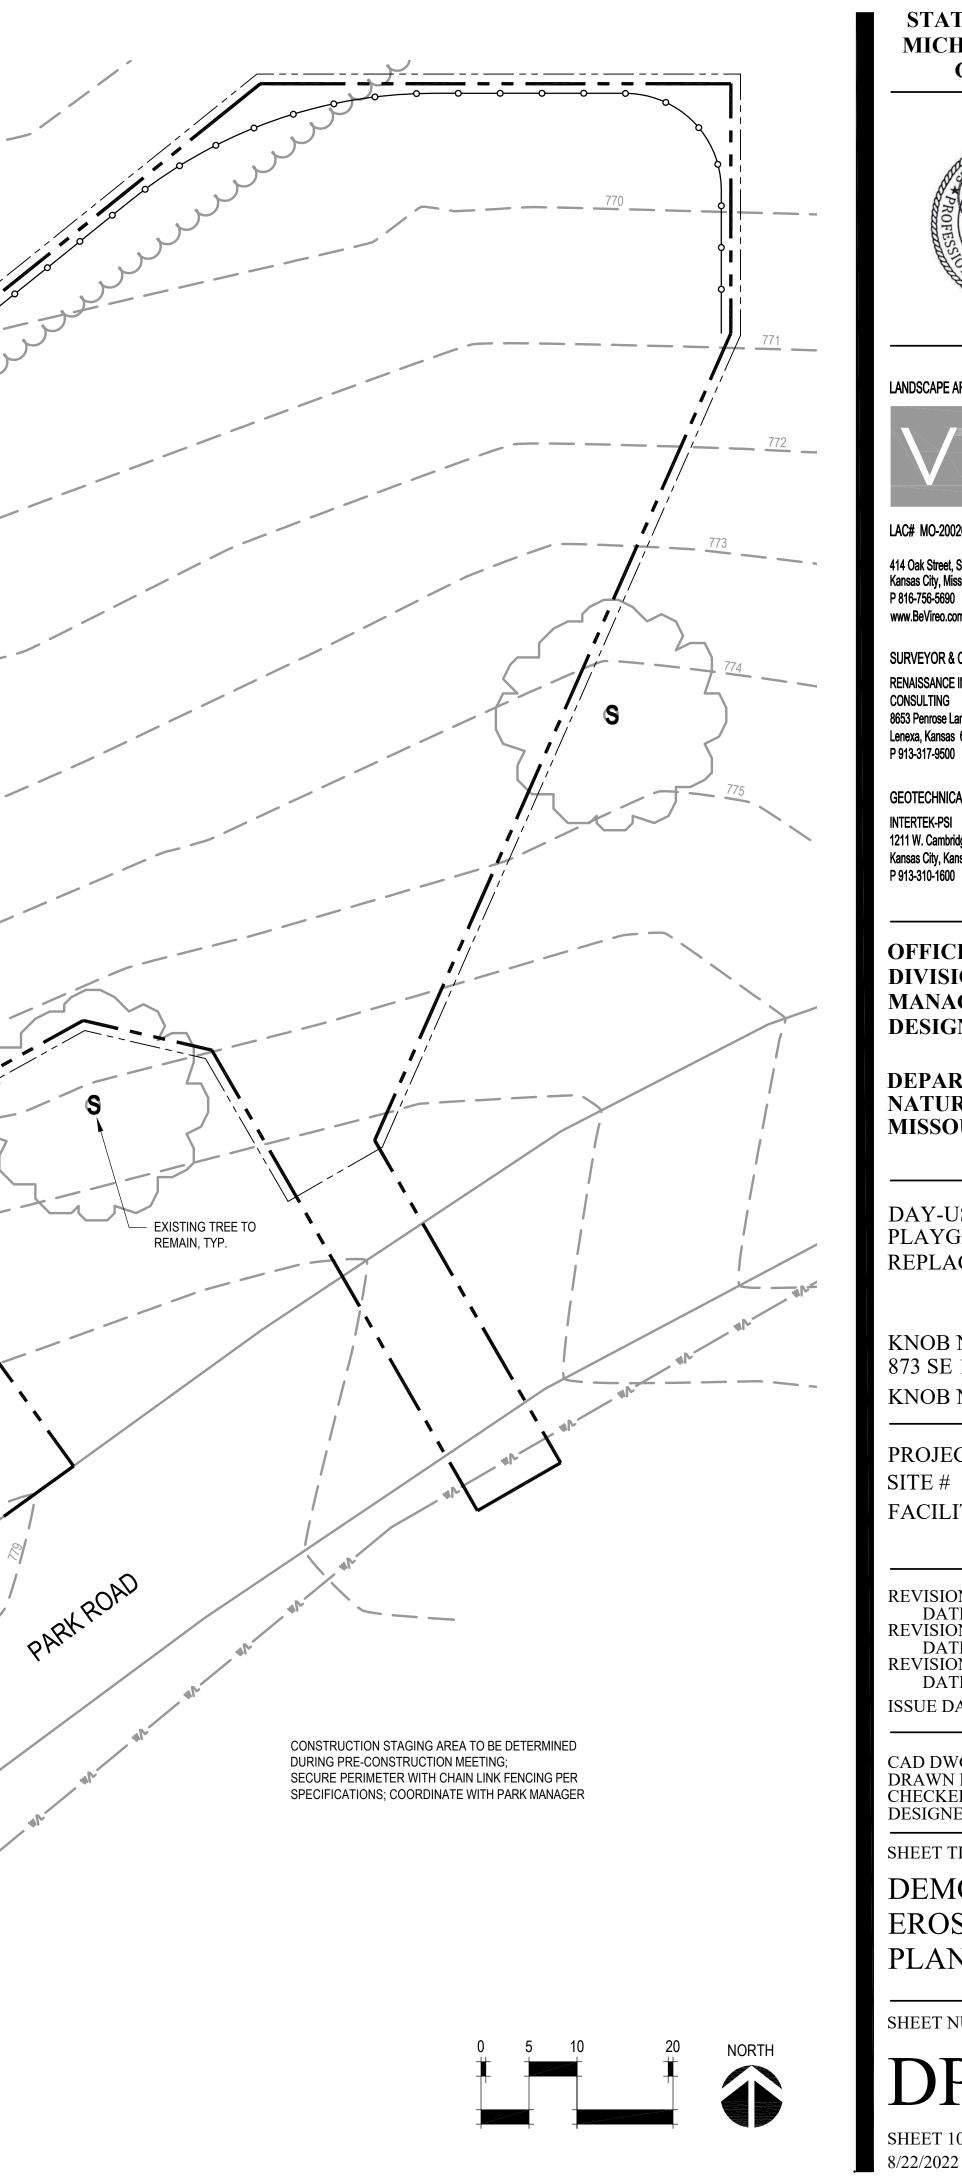

STATE OF MISSOURI MICHAEL L. PARSON, GOVERNOR



LANDSCAPE ARCHITECT:



LAC# MO-2002023826

414 Oak Street, Suite 101 Kansas City, Missouri 64106 P 816-756-5690 www.BeVireo.com

SURVEYOR & CIVIL ENGINEER: RENAISSANCE INFRASTRUCTURE CONSULTING 8653 Penrose Lane Lenexa, Kansas 66219 P 913-317-9500



GEOTECHNICAL: INTERTEK-PSI 1211 W. Cambridge Circle Drive Kansas City, Kansas 66103 P 913-310-1600

intertek

OFFICE OF ADMINISTRATION DIVISION OF FACILITIES MANAGEMENT, **DESIGN AND CONSTRUCTION**

DEPARTMENT OF NATURAL RESOURCES, **MISSOURI STATE PARKS**

DAY-USE AREA PLAYGROUND REPLACEMENT

KNOB NOSTER STATE PARK 873 SE 10TH KNOB NOSTER, MO 65336

PROJECT # X2109-01 5305 SITE # FACILITY # 9999

REVISION: DATE: **REVISION:** DATE: **REVISION:** DATE: ISSUE DATE: 8/22/2022

CAD DWG FILE: X2109-01-5305-9999-DP-300.DWG DRAWN BY: AES CHECKED BY: CDP DESIGNED BY: AES / CDP

SHEET TITLE:

DEMOLITION & EROSION CONTROL PLAN

SHEET NUMBER:

DP-300 SHEET 10 OF 17

	ITEM	QTY	MANUFACTURER	MODEL	REP.
1	1Challenge Course Themed Play Structure (see plan for individual play components)2Single Post Swing Frame with Additional Bay		Landscape Structures	see plan	ATHCO
2			Landscape Structures	177332 / 177333	ATHCO
	Belt Seat with proguard chains	2	Landscape Structures	174018	ATHCO
	Full Bucket Seat with chains		Landscape Structures	175038	ATHCO
	Molded Seat with harness (ages 2-5) and proguard chains	1	Landscape Structures	218671	ATHCO

*NOTE INFORMATION SHOWN FOR BASIS OF DESIGN IS FOR BID PURPOSES ONLY. BUT ARE NOT LIMITED TO THE FOLLOWING:

- LANDSCAPE STRUCTURES GAMETIME, A PLAYCORE COMPANY
- BURKE
- ZEAGER BROS, INC.
 OR APPROVED EQUAL

LAYOUT, SAFETY FALL ZONES, MATERIALS AND COLORS FOR ALL PLAY TO FABRICATION AND/OR INSTALLATION.


DRINKING FOUNTAIN (OR APPROVED EQUAL)

ITEM	QTY	MANUFACTURER	MODEL	REP.
Accessible Drinking Fountain with Bottle Filler and Hose Bib; Color: Brown (RE: Specifications)	1	Most Dependable Fountains, Inc.	10145 SM	MDF

CHALLENGE COURSE PLAY STRUCTURE





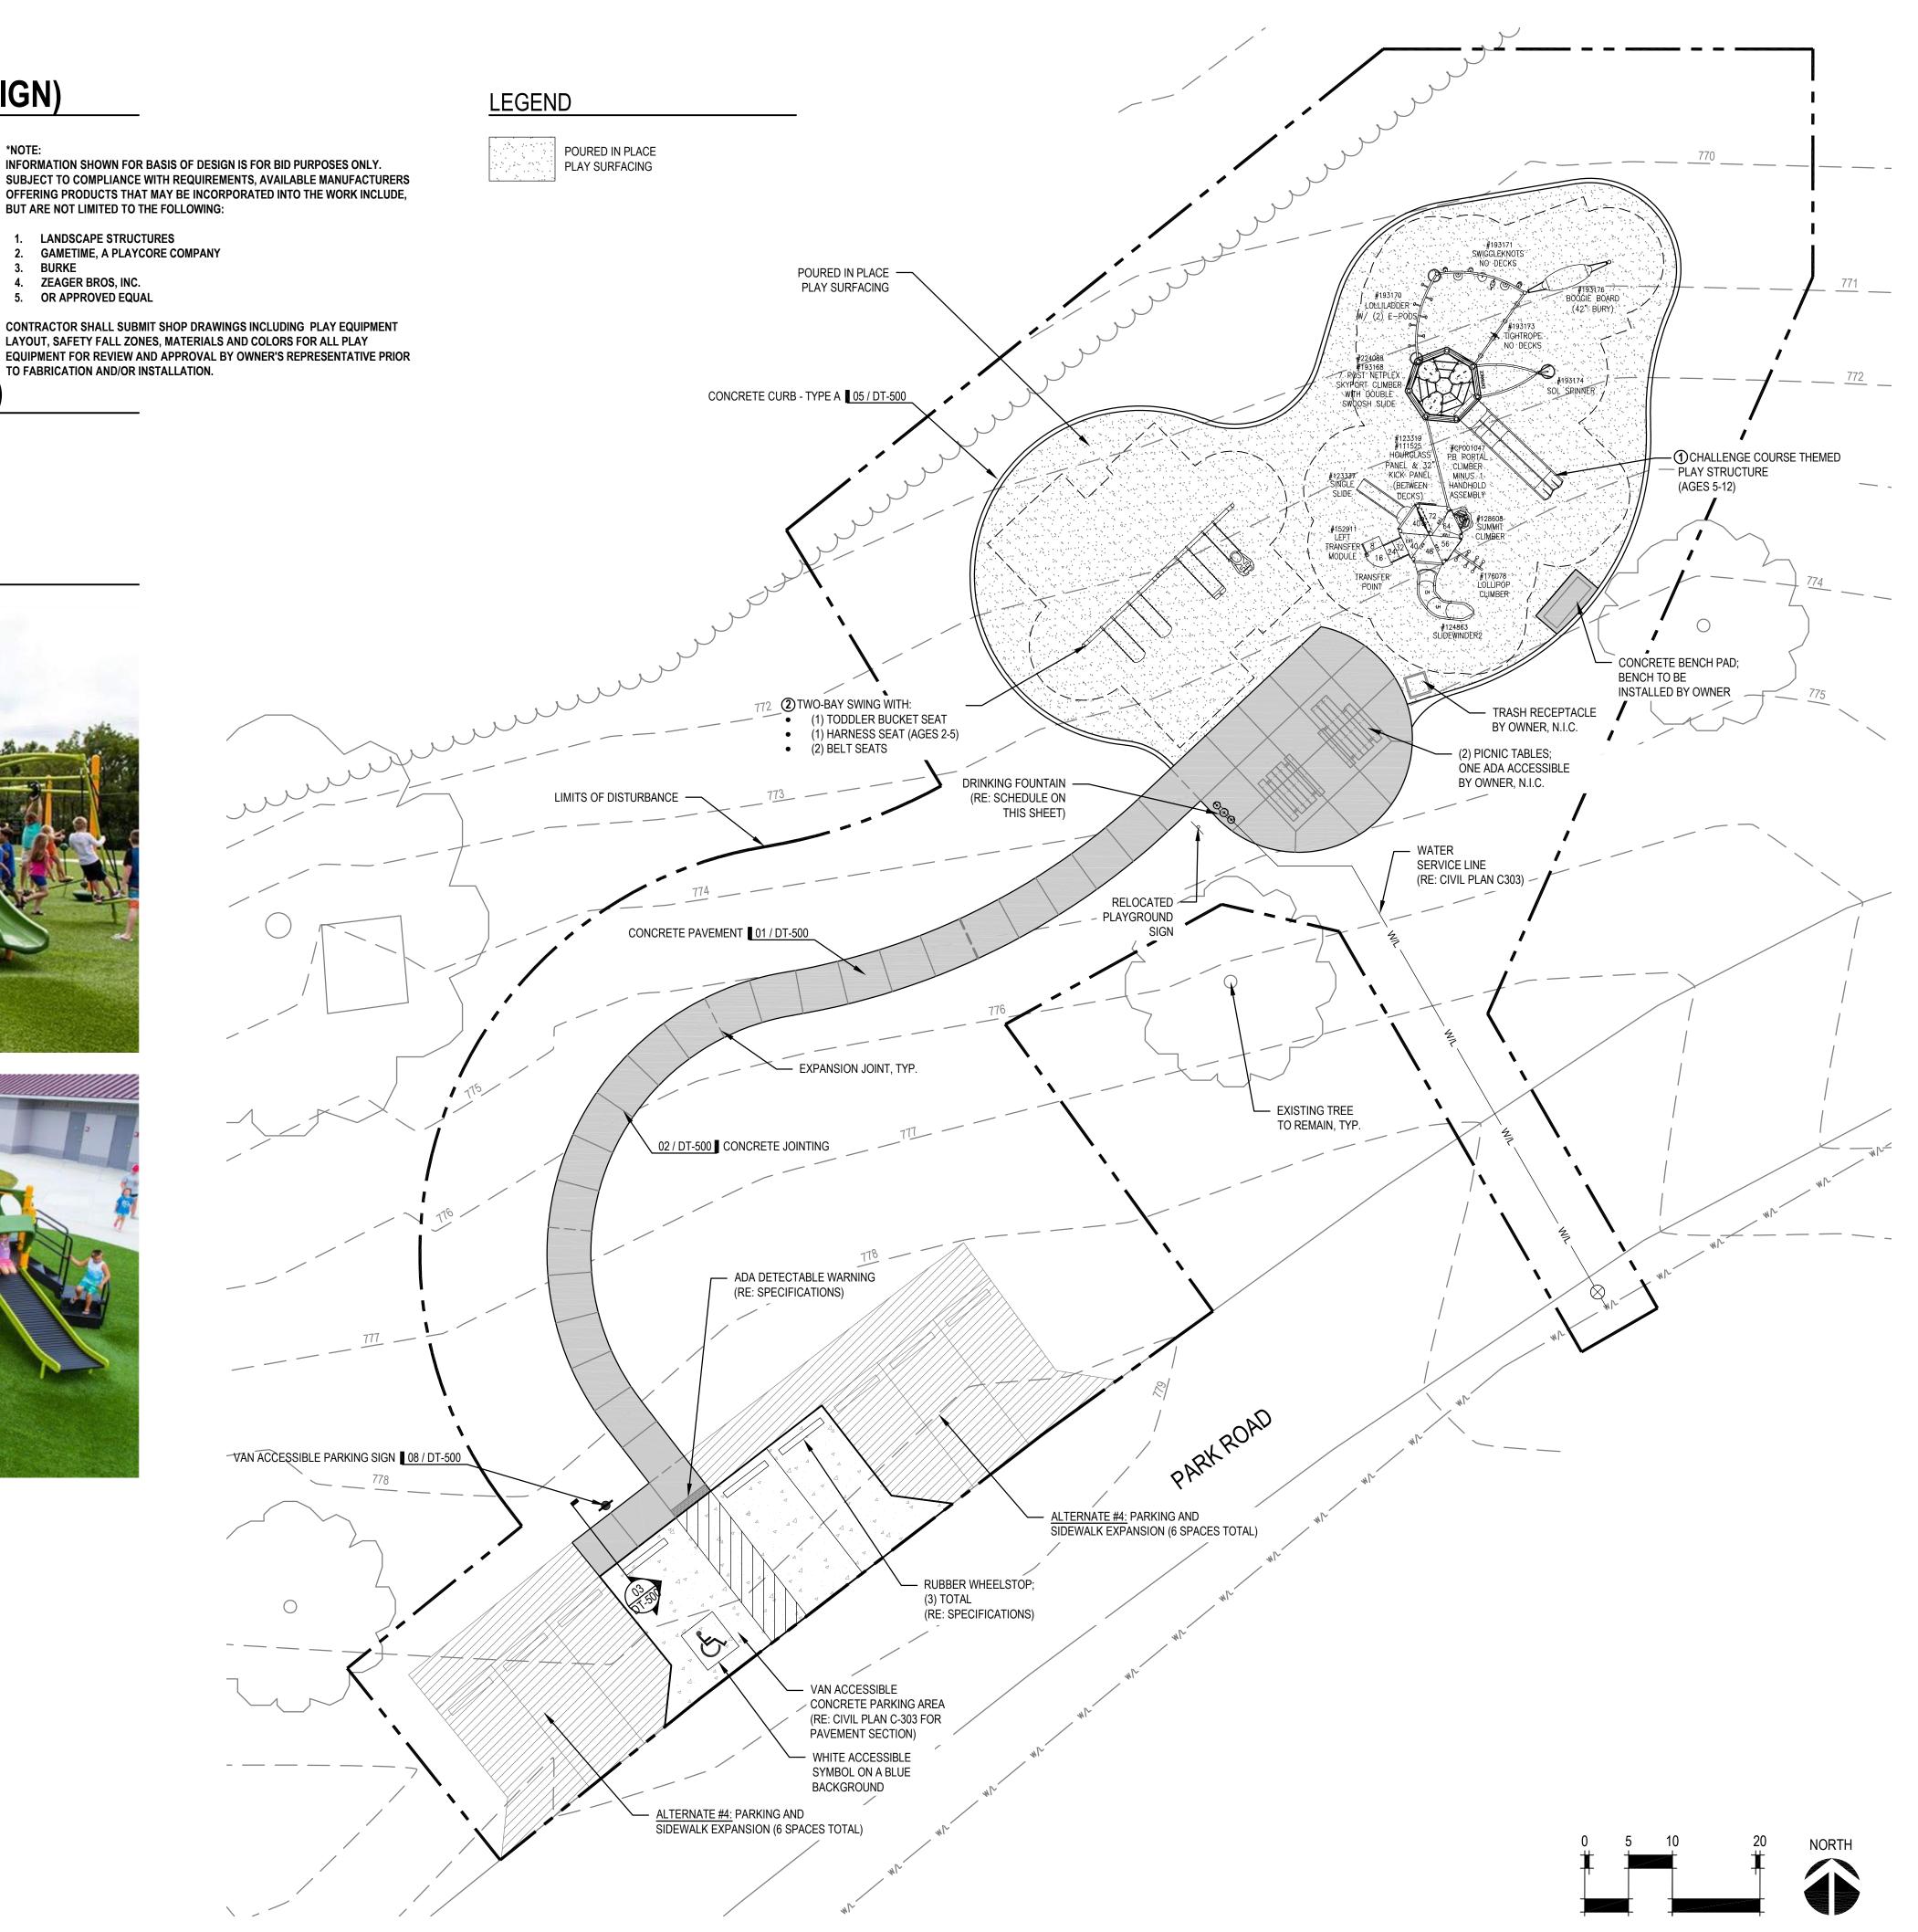

STATE OF MISSOURI MICHAEL L. PARSON, GOVERNOR



LANDSCAPE ARCHITECT:



LAC# MO-2002023826

414 Oak Street, Suite 101 Kansas City, Missouri 64106 P 816-756-5690 www.BeVireo.com

SURVEYOR & CIVIL ENGINEER: RENAISSANCE INFRASTRUCTURE CONSULTING 8653 Penrose Lane Lenexa, Kansas 66219 P 913-317-9500



GEOTECHNICAL: INTERTEK-PSI 1211 W. Cambridge Circle Drive Kansas City, Kansas 66103 P 913-310-1600



OFFICE OF ADMINISTRATION DIVISION OF FACILITIES MANAGEMENT, **DESIGN AND CONSTRUCTION**

DEPARTMENT OF NATURAL RESOURCES, MISSOURI STATE PARKS

DAY-USE AREA PLAYGROUND REPLACEMENT

KNOB NOSTER STATE PARK 873 SE 10TH KNOB NOSTER, MO 65336

PROJECT # X2109-01 SITE # 5305 FACILITY # 9999

DEVISION

REVISION:
DATE:
REVISION:
DATE:
REVISION:
DATE:
ISSUE DATE: 8/22/2022

CAD DWG FILE: X2109-01-5305-9999-SP-301.DWG DRAWN BY: <u>AES</u> CHECKED BY: <u>CDP</u> DESIGNED BY: <u>AES / CDP</u>

SHEET TITLE:

SITE PLAN

SHEET NUMBER:

SP-301 SHEET 11 OF 17 8/22/2022

- 1. SITE LAYOUT DATA, INCLUDING COORDINATE POINTS, IS BASED ON A SURVEY PROVIDED BY RENAISSANCE INFRASTRUCTURE CONSULTING (2021). REFER TO SURVEY FOR HORIZONTAL LAYOUT CONTROL POINTS. REPORT ANY DISCREPANCIES BETWEEN PLANS AND FIELD CONDITIONS TO OWNER'S REPRESENTATIVE IMMEDIATELY.
- 2. IT SHALL BE THE RESPONSIBILITY OF THE CONTRACTOR TO CONTROL ON-SITE AND DOWNSTREAM EROSION AND SILTATION DURING ALL PHASES OF CONSTRUCTION. EROSION CONTROL SYSTEMS AND PROCEDURES SHALL BE IN PLACE PRIOR TO ANY GRADING OPERATIONS.
- 3. THE LOCATIONS OF EXISTING UTILITIES AS SHOWN ARE APPROXIMATE. THE CONTRACTOR SHALL HAVE ALL UTILITIES FLAGGED IN THE FIELD FOR INSPECTION PRIOR TO PROCEEDING WITH ANY GRADING OPERATIONS. THE CONTRACTOR SHALL VERIFY THE DEPTH AND LOCATION OF ALL EXISTING UTILITIES AND WILL BE HELD LIABLE FOR ANY DELAYS CAUSED BY DAMAGE TO UTILITIES OR FAILURE TO LOCATE UTILITIES.
- 4. ALL CONSTRUCTION DEBRIS SHALL BE DISPOSED OF BY THE CONTRACTOR AT A LOCATION PROVIDED BY THE CONTRACTOR AND IN ACCORDANCE WITH LOCAL REGULATIONS. THE CONTRACTOR SHALL SATISFY HIMSELF BY JOB-SITE INSPECTION AS TO THE EXTENT OF CLEARING REQUIRED PRIOR TO ENTERING INTO A CONSTRUCTION CONTRACT.
- 5. CONSTRUCTION STAKING SHALL BE PROVIDED BY THE CONTRACTOR. ALL CONSTRUCTION LAYOUT STAKING IS TO BE PERFORMED BY A LAND SURVEYOR OR PROFESSIONAL ENGINEER REGISTERED IN THE STATE OF MISSOURI. TO FACILITATE ACCURACY OF CONSTRUCTION STAKING, UPON WRITTEN REQUEST FROM CONTRACTOR, ELECTRONIC DATA COMPRISING THESE SITE DEVELOPMENT DRAWINGS WILL BE FORWARED TO THE LAND SURVEYOR OR PROFESSIONAL ENGINEER EMPLOYED TO PERFORM THE CONSTRUCTION STAKING.
- 6. IN ORDER TO MAINTAIN THE INTEGRITY OF HORIZONTAL AND VERTICAL CONTROL FOR THE SITE, THE SURVEYOR OR PROFESSIONAL ENGINEER EMPLOYED BY THE CONTRACTOR TO PERFORM CONSTRUCTION LAYOUT STAKING SHALL SET AND PROTECT ADDITIONAL TRAVERSE POINTS OUTSIDE THE AREAS OF CONSTRUCTION ACTIVITY.
- 7. ALL LAYOUTS SHALL BE SUBJECT OT FIELD APPROVAL BY THE OWNER'S REPRESENTATIVE.
- 8. SAWCUT EXISTING PAVEMENT FULL DEPTH WHERE IT MEETS NEW PAVEMENT
- 9. UNLESS NOTED OTHERWISE, ALL DIMENSIONS ARE TO THE FOLLOWING: EDGE OF PAVEMENT, FACE OF WALL, AND EDGE OF CURB.
- 10. ALL EDGES OF PAVEMENTS ARE TO BE STRAIGHT (OR OF CONSISTENT RADIUS IN THE CASE OF CURVES) AS SHOWN HEREON. NO UNSPECIFIED TANGENTS OR KINKS WILL BE APPROVED.
- 11. THIS SITE HAS BEEN DESIGNED TO COMPLY WITH THE PROVISIONS OF THE AMERICANS WITH DISABILITIES ACT ACCESSIBILITY GUIDELINES (ADAAG). REPORT ANY COMPLIANCE DISCREPANCIES TO OWNER'S REPRESENTATIVE IMMEDIATELY.
- 12. ALL AREAS SHALL BE BROUGHT TO FINAL PLAN CONDITION (PAVED, SEEDED, OR MULCHED) AS SOON AS POSSIBLE TO MAINTAIN FINISH GRADE CONDITIONS AND PREVENT SOIL LOSS.
- 13. THE CONTRACTOR SHALL PROVIDE AND PAY FOR ALL INSPECTION SERVICES.

PLAYGROUND CURB ALIGNMENT

ALIGNMENT LINE DATA

		/ = •		
LINE #	LENGTH	BEARING	START POINT	END POINT
L1	0.4697	N43° 18' 22.54"W	(3045696.6548, 942075.9759)	(3045696.3327, 942076.3177)
L2	7.9552	N16° 23' 11.91"E	(3045713.2471, 942121.9365)	(3045715.4915, 942129.5686)
L3	15.3818	N80° 25' 08.55"E	(3045727.4847, 942140.2156)	(3045742.6519, 942142.7757)
L4	6.6572	S72° 35' 51.63"W	(3045729.9094, 942084.9039)	(3045723.5569, 942082.9129)


AL	IGNM	ENT CU	JRVE DA	TA
CURVE #	DELTA	RADIUS	LENGTH	TANGENT
C1	41.68	7.88	5.73	3.00
C2	196.87	19.12	65.72	128.94
C3	95.50	9.87	16.46	10.87
C4	64.03	15.13	16.90	9.46
C5	123.73	10.13	21.87	18.94
C6	26.80	29.88	13.98	7.12
C7	75.25	30.12	39.56	23.22

SIDEWALK ALIGNMENT

ALIGNMENT LINE DATA					
LINE #	LENGTH	BEARING	START POINT	END POINT	
L5	13.0447	N37° 37' 57.81"W	(3045642.0266, 941991.8755)	(3045634.0616, 942002.2061)	
L6	4.5648	N46° 41' 37.46"E	(3045694.8658, 942070.8542)	(3045698.1876, 942073.9852)	

ALIGNMENT CURVE DATA

CURVE #	DELTA	RADIUS	LENGTH	TANGENT
C8	118.31	30.00	61.95	50.23
C9	33.98	80.00	47.45	24.44

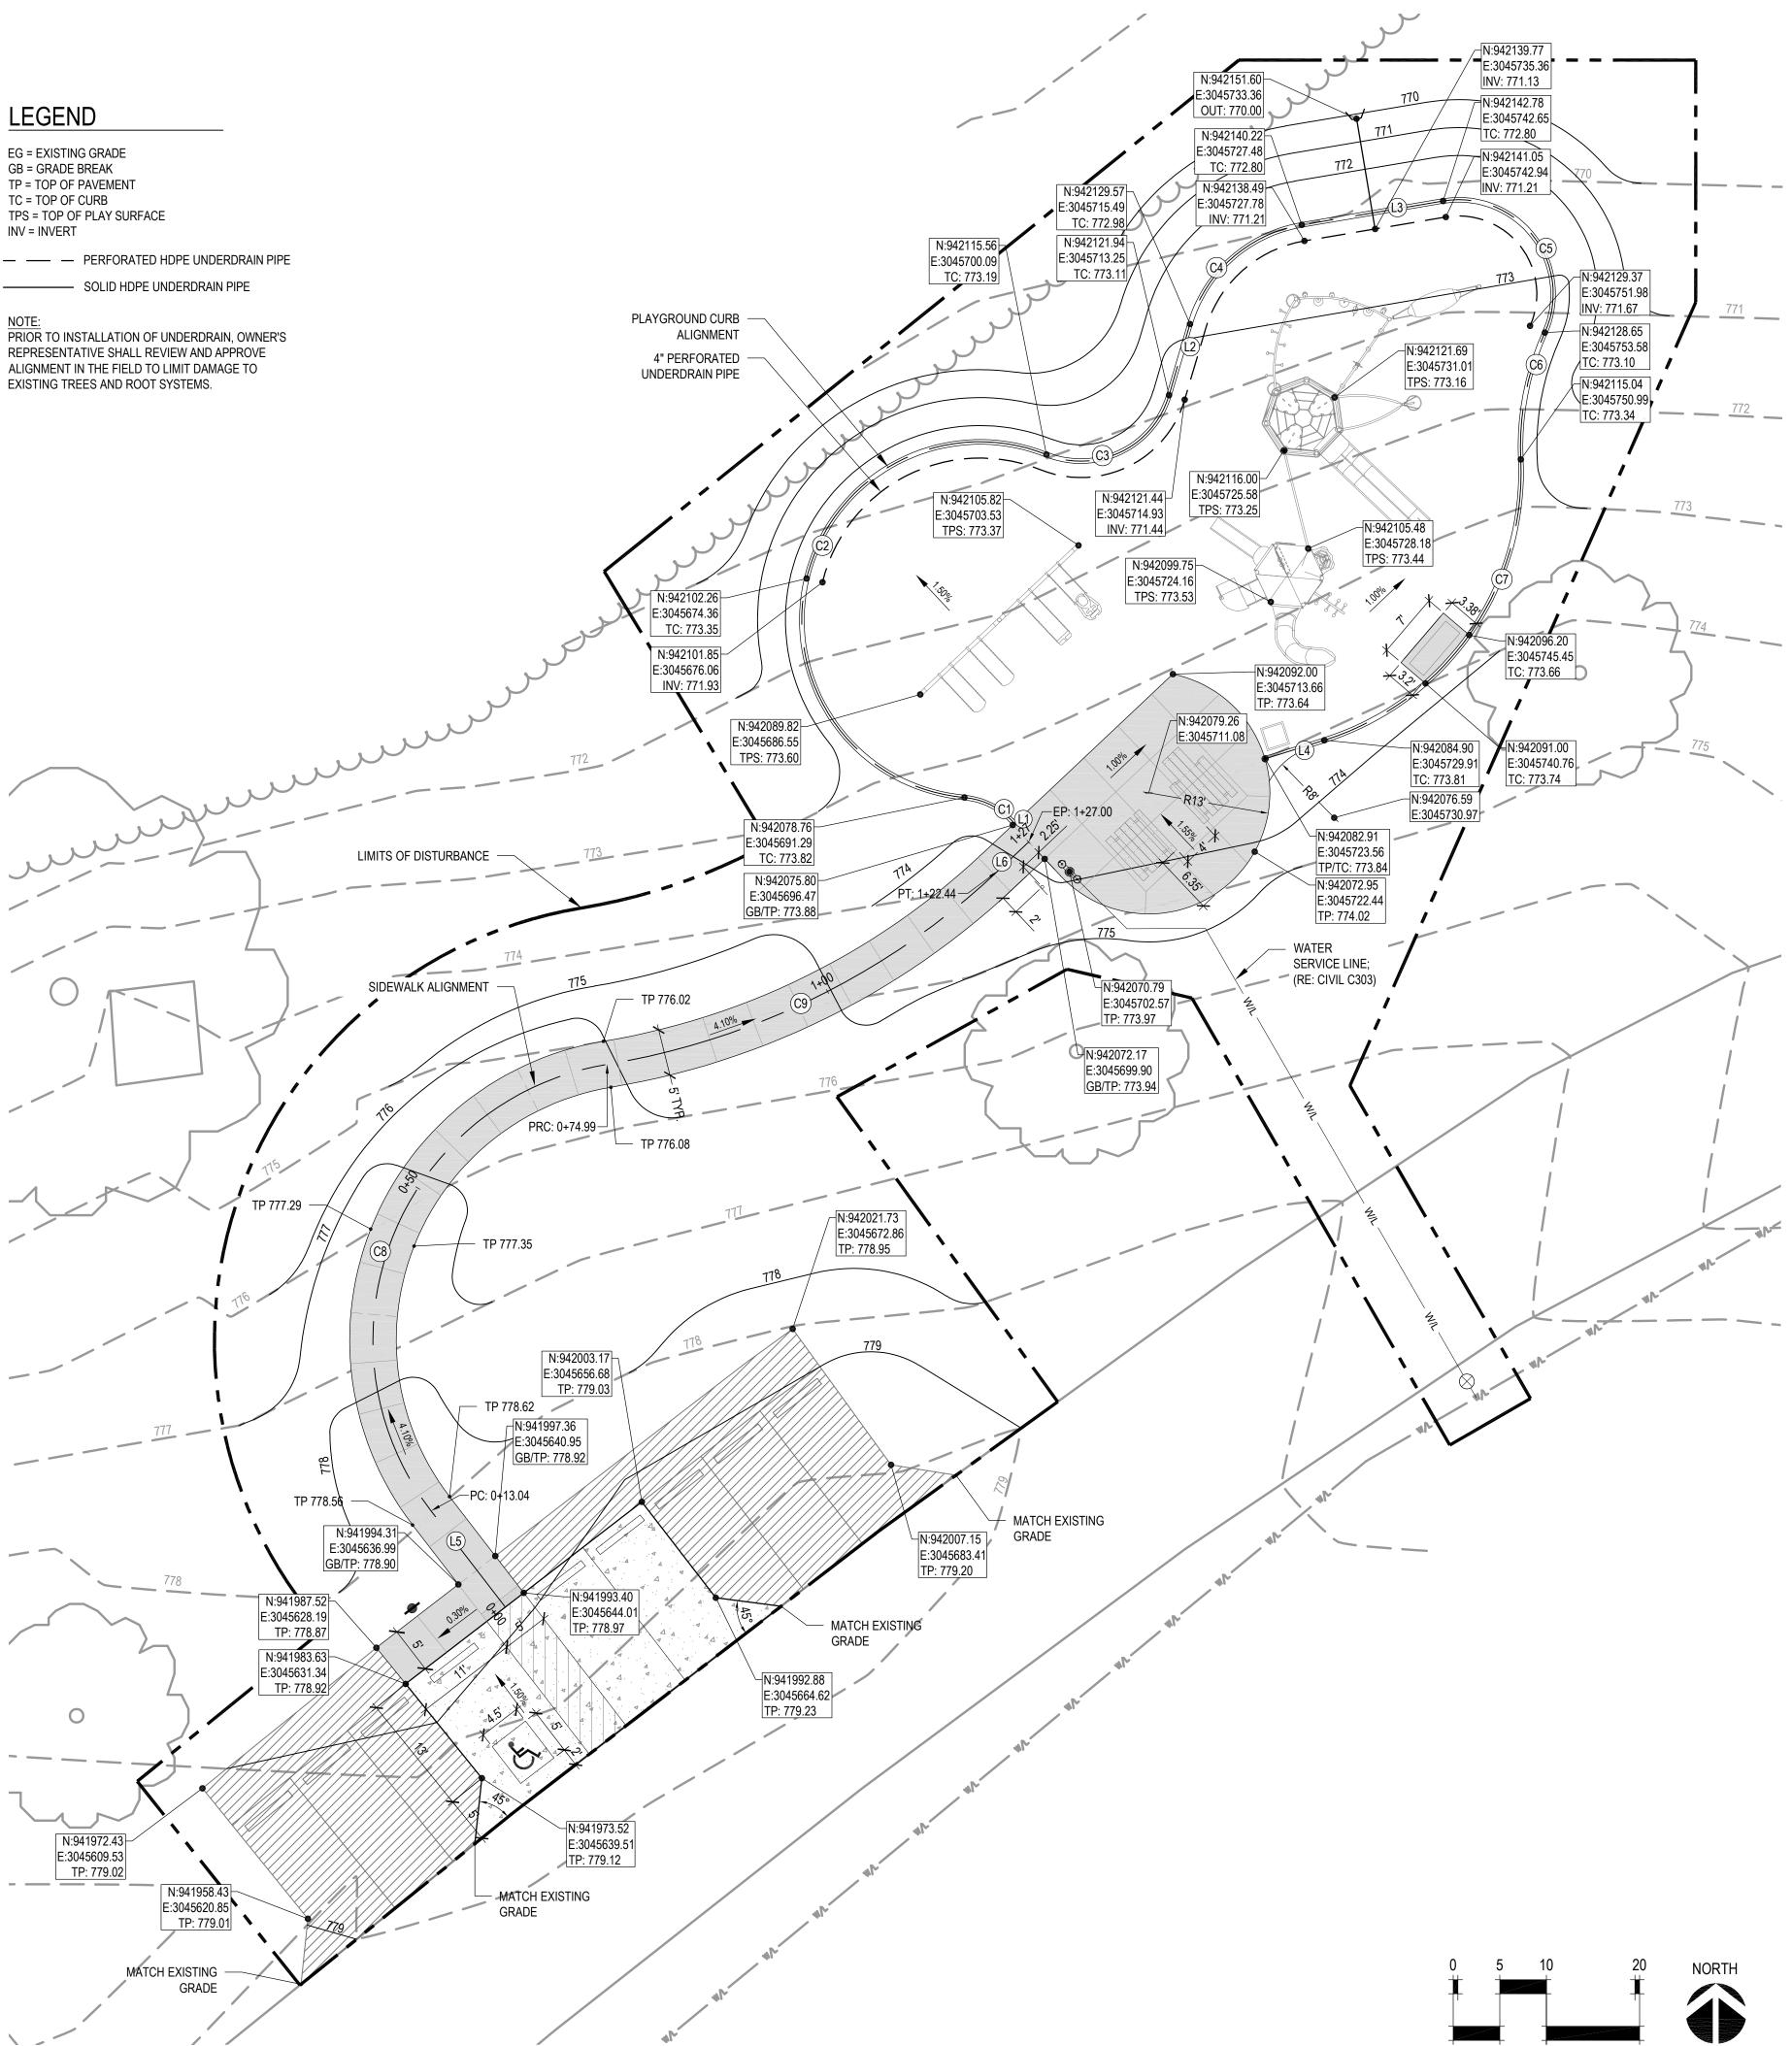

STATE OF MISSOURI MICHAEL L. PARSON, GOVERNOR



LANDSCAPE ARCHITECT:



LAC# MO-2002023826

414 Oak Street, Suite 101 Kansas City, Missouri 64106 P 816-756-5690 www.BeVireo.com

SURVEYOR & CIVIL ENGINEER: RENAISSANCE INFRASTRUCTURE CONSULTING 8653 Penrose Lane Lenexa, Kansas 66219 P 913-317-9500



GEOTECHNICAL: INTERTEK-PSI 1211 W. Cambridge Circle Drive Kansas City, Kansas 66103 P 913-310-1600

intertek

OFFICE OF ADMINISTRATION DIVISION OF FACILITIES MANAGEMENT, **DESIGN AND CONSTRUCTION**

DEPARTMENT OF NATURAL RESOURCES, **MISSOURI STATE PARKS**

DAY-USE AREA PLAYGROUND REPLACEMENT

KNOB NOSTER STATE PARK 873 SE 10TH KNOB NOSTER, MO 65336

PROJECT # X2109-01 5305 SITE # FACILITY # 9999

REVISION: DATE: **REVISION:** DATE: **REVISION:**

DATE: ISSUE DATE: 8/22/2022

CAD DWG FILE: X2109-01-5305-9999-SP-302.DWG DRAWN BY: <u>AES</u> CHECKED BY: <u>CDP</u>


DESIGNED BY: AES / CDP

SHEET TITLE:

LAYOUT & **GRADING PLAN**

SHEET NUMBER:

SP-302 SHEET 12 OF 17 08/22/2022

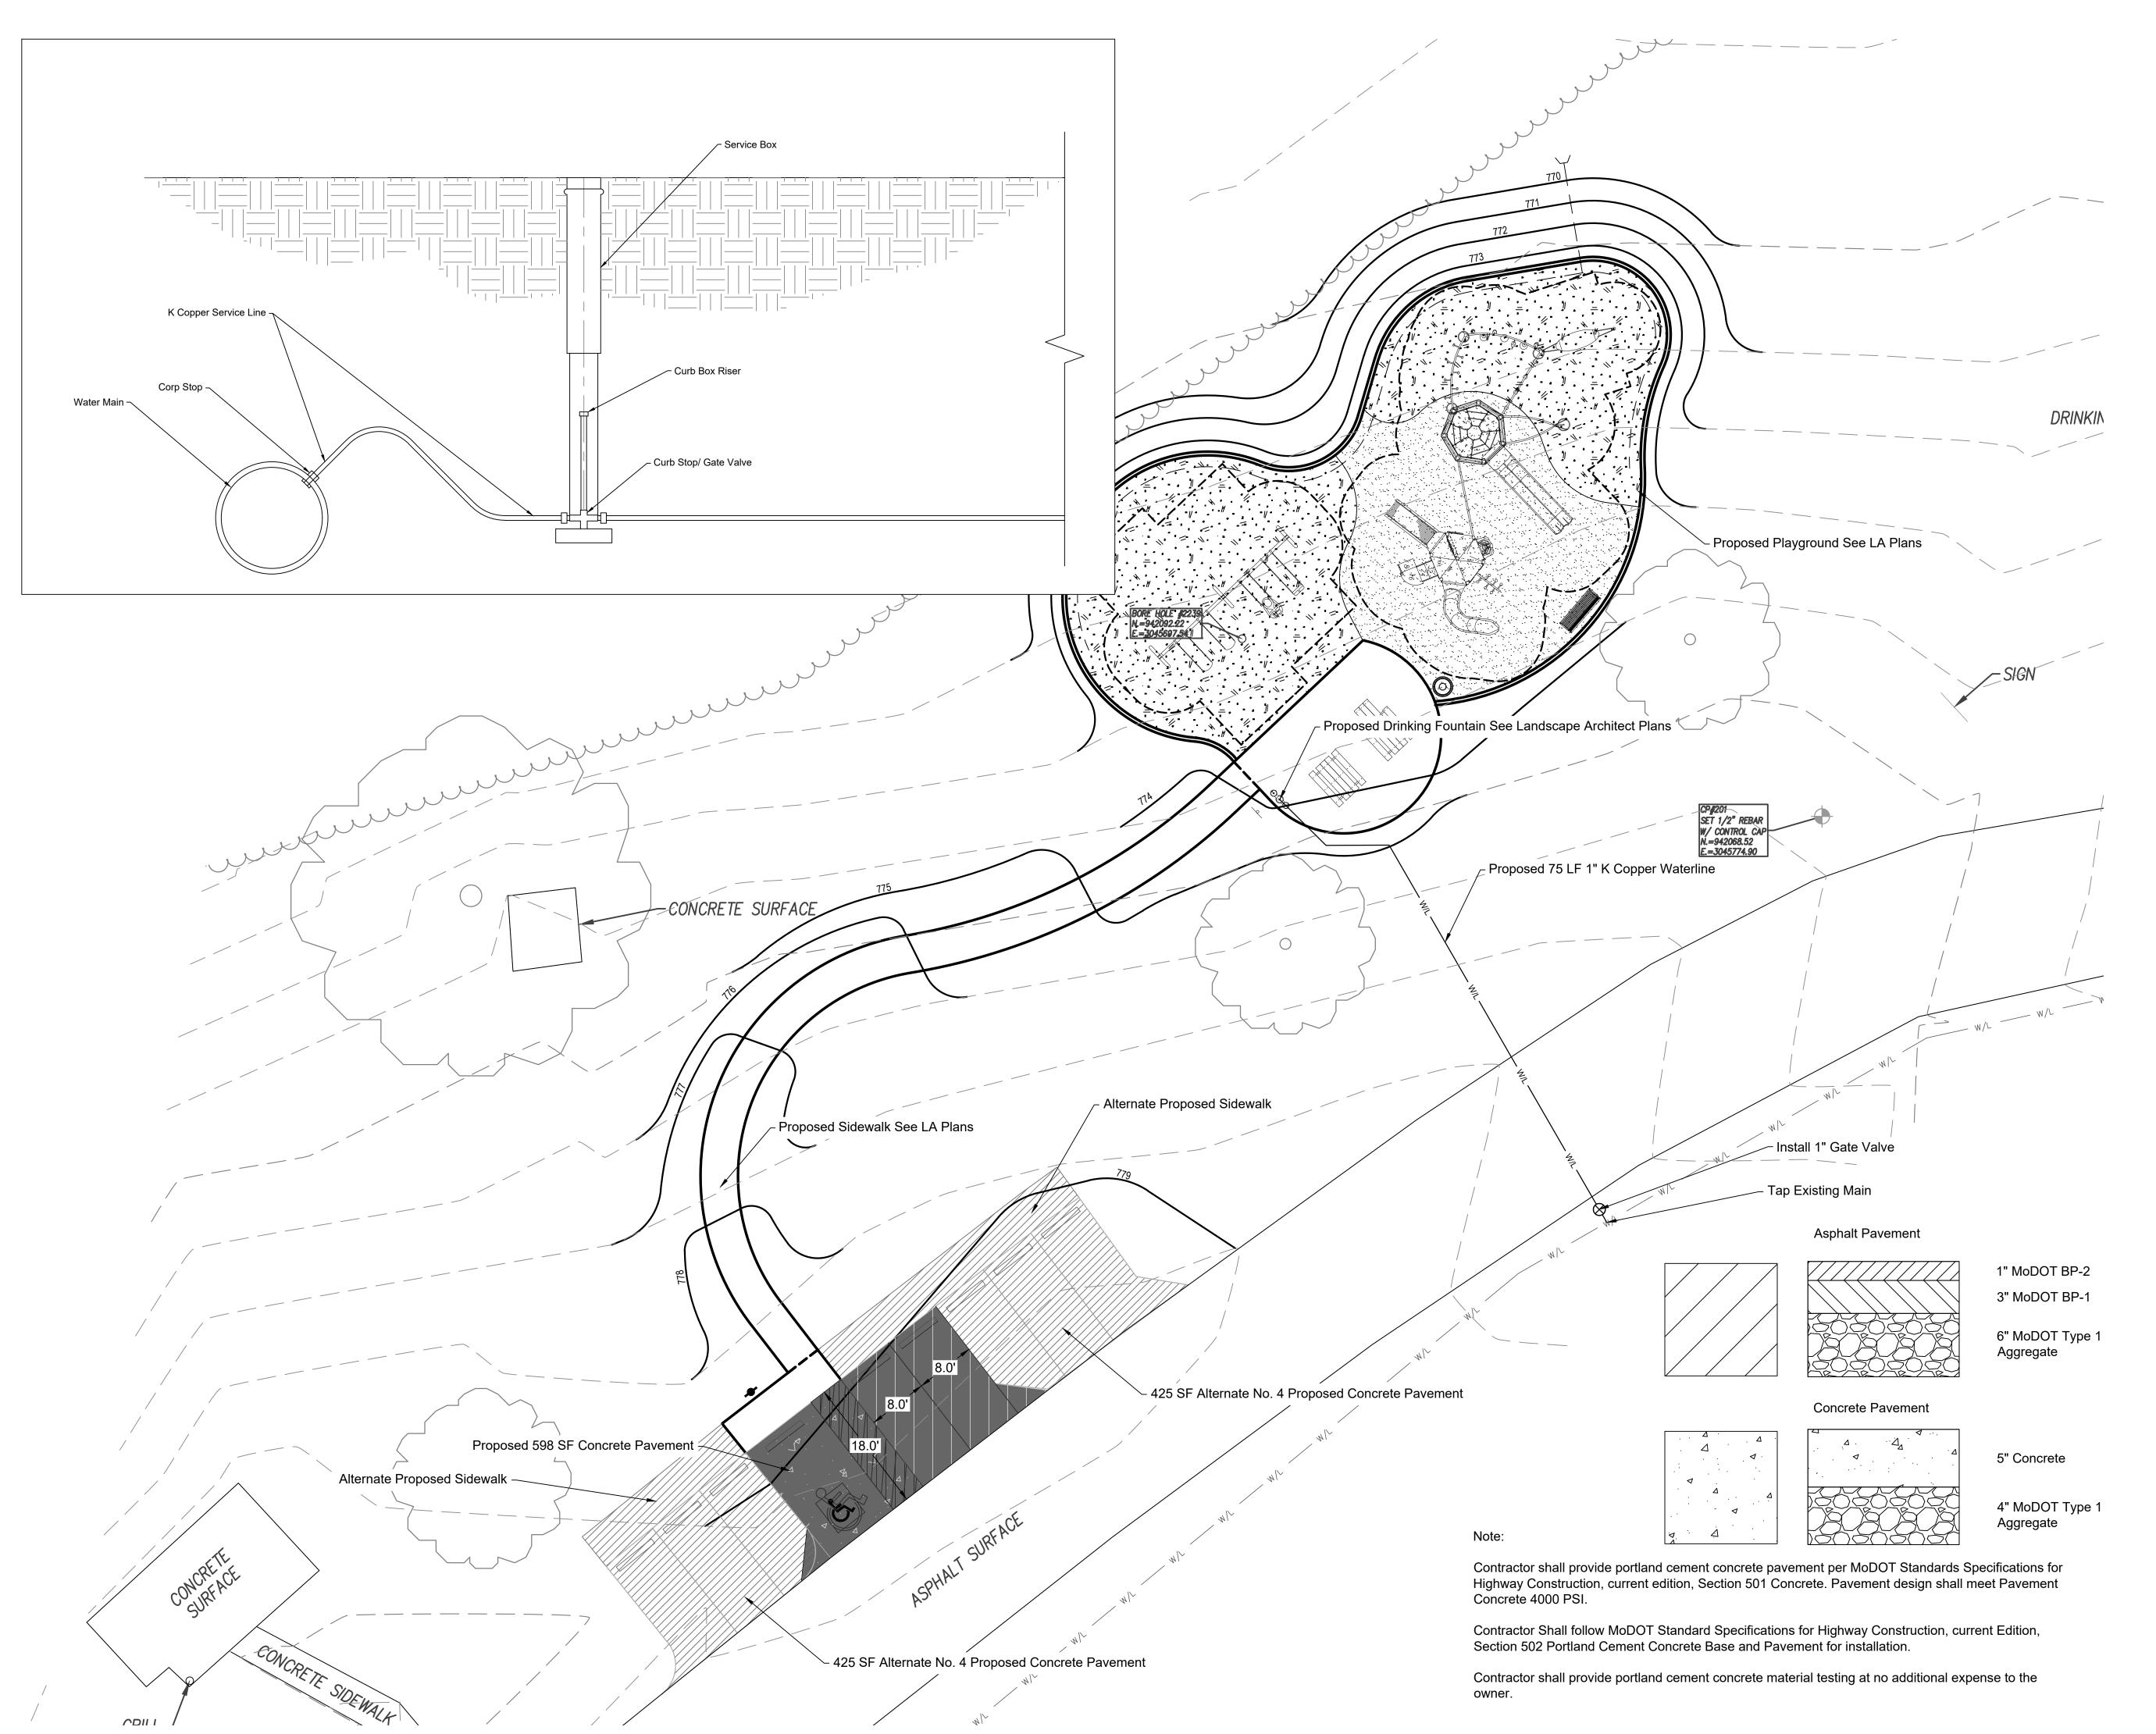



STATE OF MISSOURI MICHAEL L. PARSON, GOVERNOR



LANDSCAPE ARCHITECT:



LAC# MO-2002023826

929 Walnut Street, Ste. 700 Kansas City, Missouri 64106 P 816-756-5690 www.BeVireo.com

SURVEYOR & CIVIL ENGINEER: RENAISSANCE INFRASTRUCTURE CONSULTING 8653 Penrose Lane Lenexa, Kansas 66219 P 913-317-9500



GEOTECHNICAL: INTERTEK-PSI 1211 W. Cambridge Circle Drive Kansas City, Kansas 66103 P 913-310-1600



OFFICE OF ADMINISTRATION DIVISION OF FACILITIES MANAGEMENT, **DESIGN AND CONSTRUCTION**

DEPARTMENT OF NATURAL RESOURCES, MISSOURI STATE PARKS

DAY USE AREA PLAYGROUND REPLACEMENT

KNOB NOSTER STATE PARK 873 SE 10TH KNOB NOSTER, MO 65336

PROJECT # X2109-01 SITE # 5305 FACILITY # 9999

REVISION: DATE REVISION DATE REVISION DATE: ISSUE DATE: 08/22/2022

CAD DWG FILE<u>:</u> DRAWN BY: <u>TCD</u> CHECKED BY: <u>MES</u> DESIGNED BY: <u>MES</u>

SHEET TITLE: UTILITY PLAN & DETAILS


SHEET NUMBER:

C303 SHEET 13 OF 17 08/22/2022


- 1. ALL UTILITIES SHALL BE FIELD LOCATED PRIOR TO LANDSCAPE AND PAVEMENT REMOVAL OPERATIONS.
- 2. ALL REMOVALS SHALL BE DISPOSED OF PER LOCAL REGULATIONS BY THE CONTRACTOR.
- 3. REFER TO CONSTRUCTION DOCUMENTS FOR GRADING AND RESTORATION OF SITE AFTER COMPLETION OF DEMOLITION WORK.
- 4. THE UNDERGROUND UTILITIES SHOWN HAVE BEEN LOCATED FROM FIELD SURVEY INFORMATION AND EXISTING DRAWINGS. THE ENGINEER MAKES NO GUARANTEES THAT THE UTILITIES SHOWN COMPRISE ALL SUCH UTILITIES IN THE AREA, EITHER IN SERVICE OR ABANDONED. THE ENGINEER HAS NOT PHYSICALLY LOCATED THE UNDERGROUND UTILITIES. THIS INCLUDES PRIVATE AND PUBLIC UTILITIES. IT IS THE CONTRACTOR'S RESPONSIBILITY TO CONTACT MISSOURI ONE CALL IN ADVANCE OF ANY EXCAVATION TO COORDINATE UTILITY LOCATIONS.
- 5. CONTRACTOR IS REQUIRED TO TAKE PRECAUTIONARY MEASURES TO PROTECT THE UTILITY LINES SHOWN AND ANY OTHER EXISTING LINES NOT OF RECORD OR SHOWN ON THESE PLANS.
- 6. DO NOT DISRUPT UTILITY SERVICE TO ADJACENT BUSINESSES OR RESIDENCES WITHOUT PRIOR WRITTEN APPROVAL BY THE ENGINEER.
- 7. DO NOT DISRUPT TRAFFIC ON ADJACENT STREETS WITHOUT PRIOR WRITTEN APPROVAL BY OWNER.
- 8. ALL SIDEWALK AND PAVEMENT TO REMAIN SHALL BE PROTECTED IN PLACE INCLUDING PROTECTION FROM DAMAGE CAUSED BY REMOVAL OF ABUTTING PAVEMENT. CONTRACTOR SHALL SAW CUT WHERE NECESSARY.
- 9. CONTRACTOR SHALL GIVE NOTICE TO ALL UTILITY COMPANIES REGARDING DISCONNECTION, DEMOLITION, AND REMOVAL OF SERVICE LINES. CAP ALL LINES BEFORE PROCEEDING WITH WORK ON THIS CONTRACT.
- 10. CONTRACTOR SHALL PROTECT THE PUBLIC AT ALL TIMES WITH FENCING, BARRICADES, ENCLOSURES, ETC. USING BEST PRACTICES AND AS APPROVED BY THE ENGINEER AND OWNER.
- 11. DAMAGE TO ALL EXISTING CONDITIONS TO REMAIN SHALL BE REPAIRED AT THE CONTRACTOR'S EXPENSE.

EROSION CONTROL NOTES

- 1. ALL EROSION AND SEDIMENT CONTROL SHALL COMPLY WITH KC METROPOLITAN APWA STANDARDS, VISIT http://kcmetro.apwa.net/PageDetails/439 FOR SPECIFICATIONS AND DETAILS. DEVICES SHOWN ON PLAN MAY NOT REPRESENT ALL DEVICES NECESSARY FOR EROSION CONTROL. UPON DISCOVERING UNFORESEEN CIRCUMSTANCES POSING THE POTENTIAL FOR ACCELERATED EROSION AND/OR SEDIMENT POLLUTION, THE CONTRACTOR SHALL ADJUST AND/OR IMPLEMENT ADDITIONAL DEVICES TO ELIMINATE POTENTIAL FOR ACCELERATED EROSION AND/OR SEDIMENT POLLUTION.
- 2. THE CONTRACTOR SHALL HAVE AN EROSION CONTROL COORDINATOR AND SHALL COMPLY WITH PERMITS AS REQUIRED BY LAW.
- THE CONTRACTOR SHALL STABILIZE THE SITE PRIOR TO AND DURING CONSTRUCTION. EROSION CONTROL DEVICES SHALL BE MAINTAINED AT ALL TIMES. ADDITIONAL DEVICES WILL BE INSTALLED IF DEEMED NECESSARY DURING ON SITE INSPECTION.
- THE CONTRACTOR SHALL PRACTICE SEQUENTIAL STABILIZATION TO STABILIZE THE SITE AS IT'S BEING BUILT. USE SEED, SOD, EROSION BLANKETS, MULCH, HYDRO-MULCH, TURF REINFORCEMENT MATS (TRM), BONDED FIBER MATRIX AND/OR A COMBINATION OF THESE OR OTHER DEVICES.
- 5. ALL TOPSOIL SHALL BE REMOVED, STOCKPILED, AND REPLACED OVER DISTURBED AREAS AS SOON AS AREAS HAVE BEEN SHAPED TO FINAL GRADE.
- 6. THE CONTRACTOR SHALL STABILIZE ALL SWALES/DITCHES AS SOON AS POSSIBLE. USE DITCH CHECKS (I.E. WATTLES OR ROCK CHECKS), EROSION BLANKET, TRM, AND/OR OTHER DEVICES.
- CONTRACTOR SHALL INSPECT AND EVALUATE EROSION CONTROL DEVICES REGULARLY AND FOLLOWING STORM EVENTS AND REPAIR DEFECTS IMMEDIATELY.
- 8. CONDUCT TEMPORARY SEEDING AND MULCHING OPERATIONS TO PROVIDE A TEMPORARY VEGETATIVE COVER FOR EROSION AND SEDIMENT CONTROL PER THE FOLLOWING:
- WHEN SEASONAL CONDITIONS DO NOT ALLOW FOR INSTALLATION OF THE PERMANENT VEGETATION SPECIFIED
 WHEN CONSTRUCTION ACTIVITY CEASES AND WILL NOT RESUME FOR A PERIOD EXCEEDING 14 CALENDAR DAYS
- WITHIN 7 DAYS OF COMPLETING GRADING OPERATIONS
- 11. STRAW WATTLE LENGTHS SHOWN ARE APPROXIMATE. CONTRACTOR SHALL ADJUST IN FIELD AS REQUIRED TO PROVIDE EROSION AND SEDIMENT CONTROL AND ADDRESS ONSITE CONDITIONS.
- THE OWNER WILL REMOVE ALL TEMPORARY EROSION AND SEDIMENT CONTROL DEVICES AFTER COMPLETION OF CONSTRUCTION OPERATIONS AND WHEN ALL DISTURBED AREAS ARE STABILIZED WITH AN ESTABLISHED STAND OF PERMANENT VEGETATION.
- 13. CONTRACTOR SHALL BE RESPONSIBLE FOR PREVENTING SEDIMENT MOVEMENT ON SITE TO KEEP MUD OFF OF ENTRY DRIVES AND OTHER AREAS BEING USED BY SITE USERS (STAFF AND GUESTS).

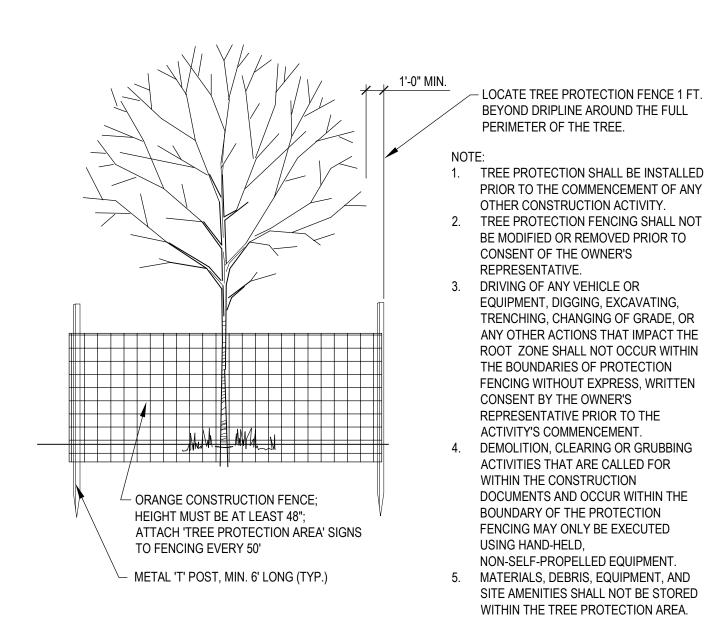

EXISTING TREE PROTECTION 01

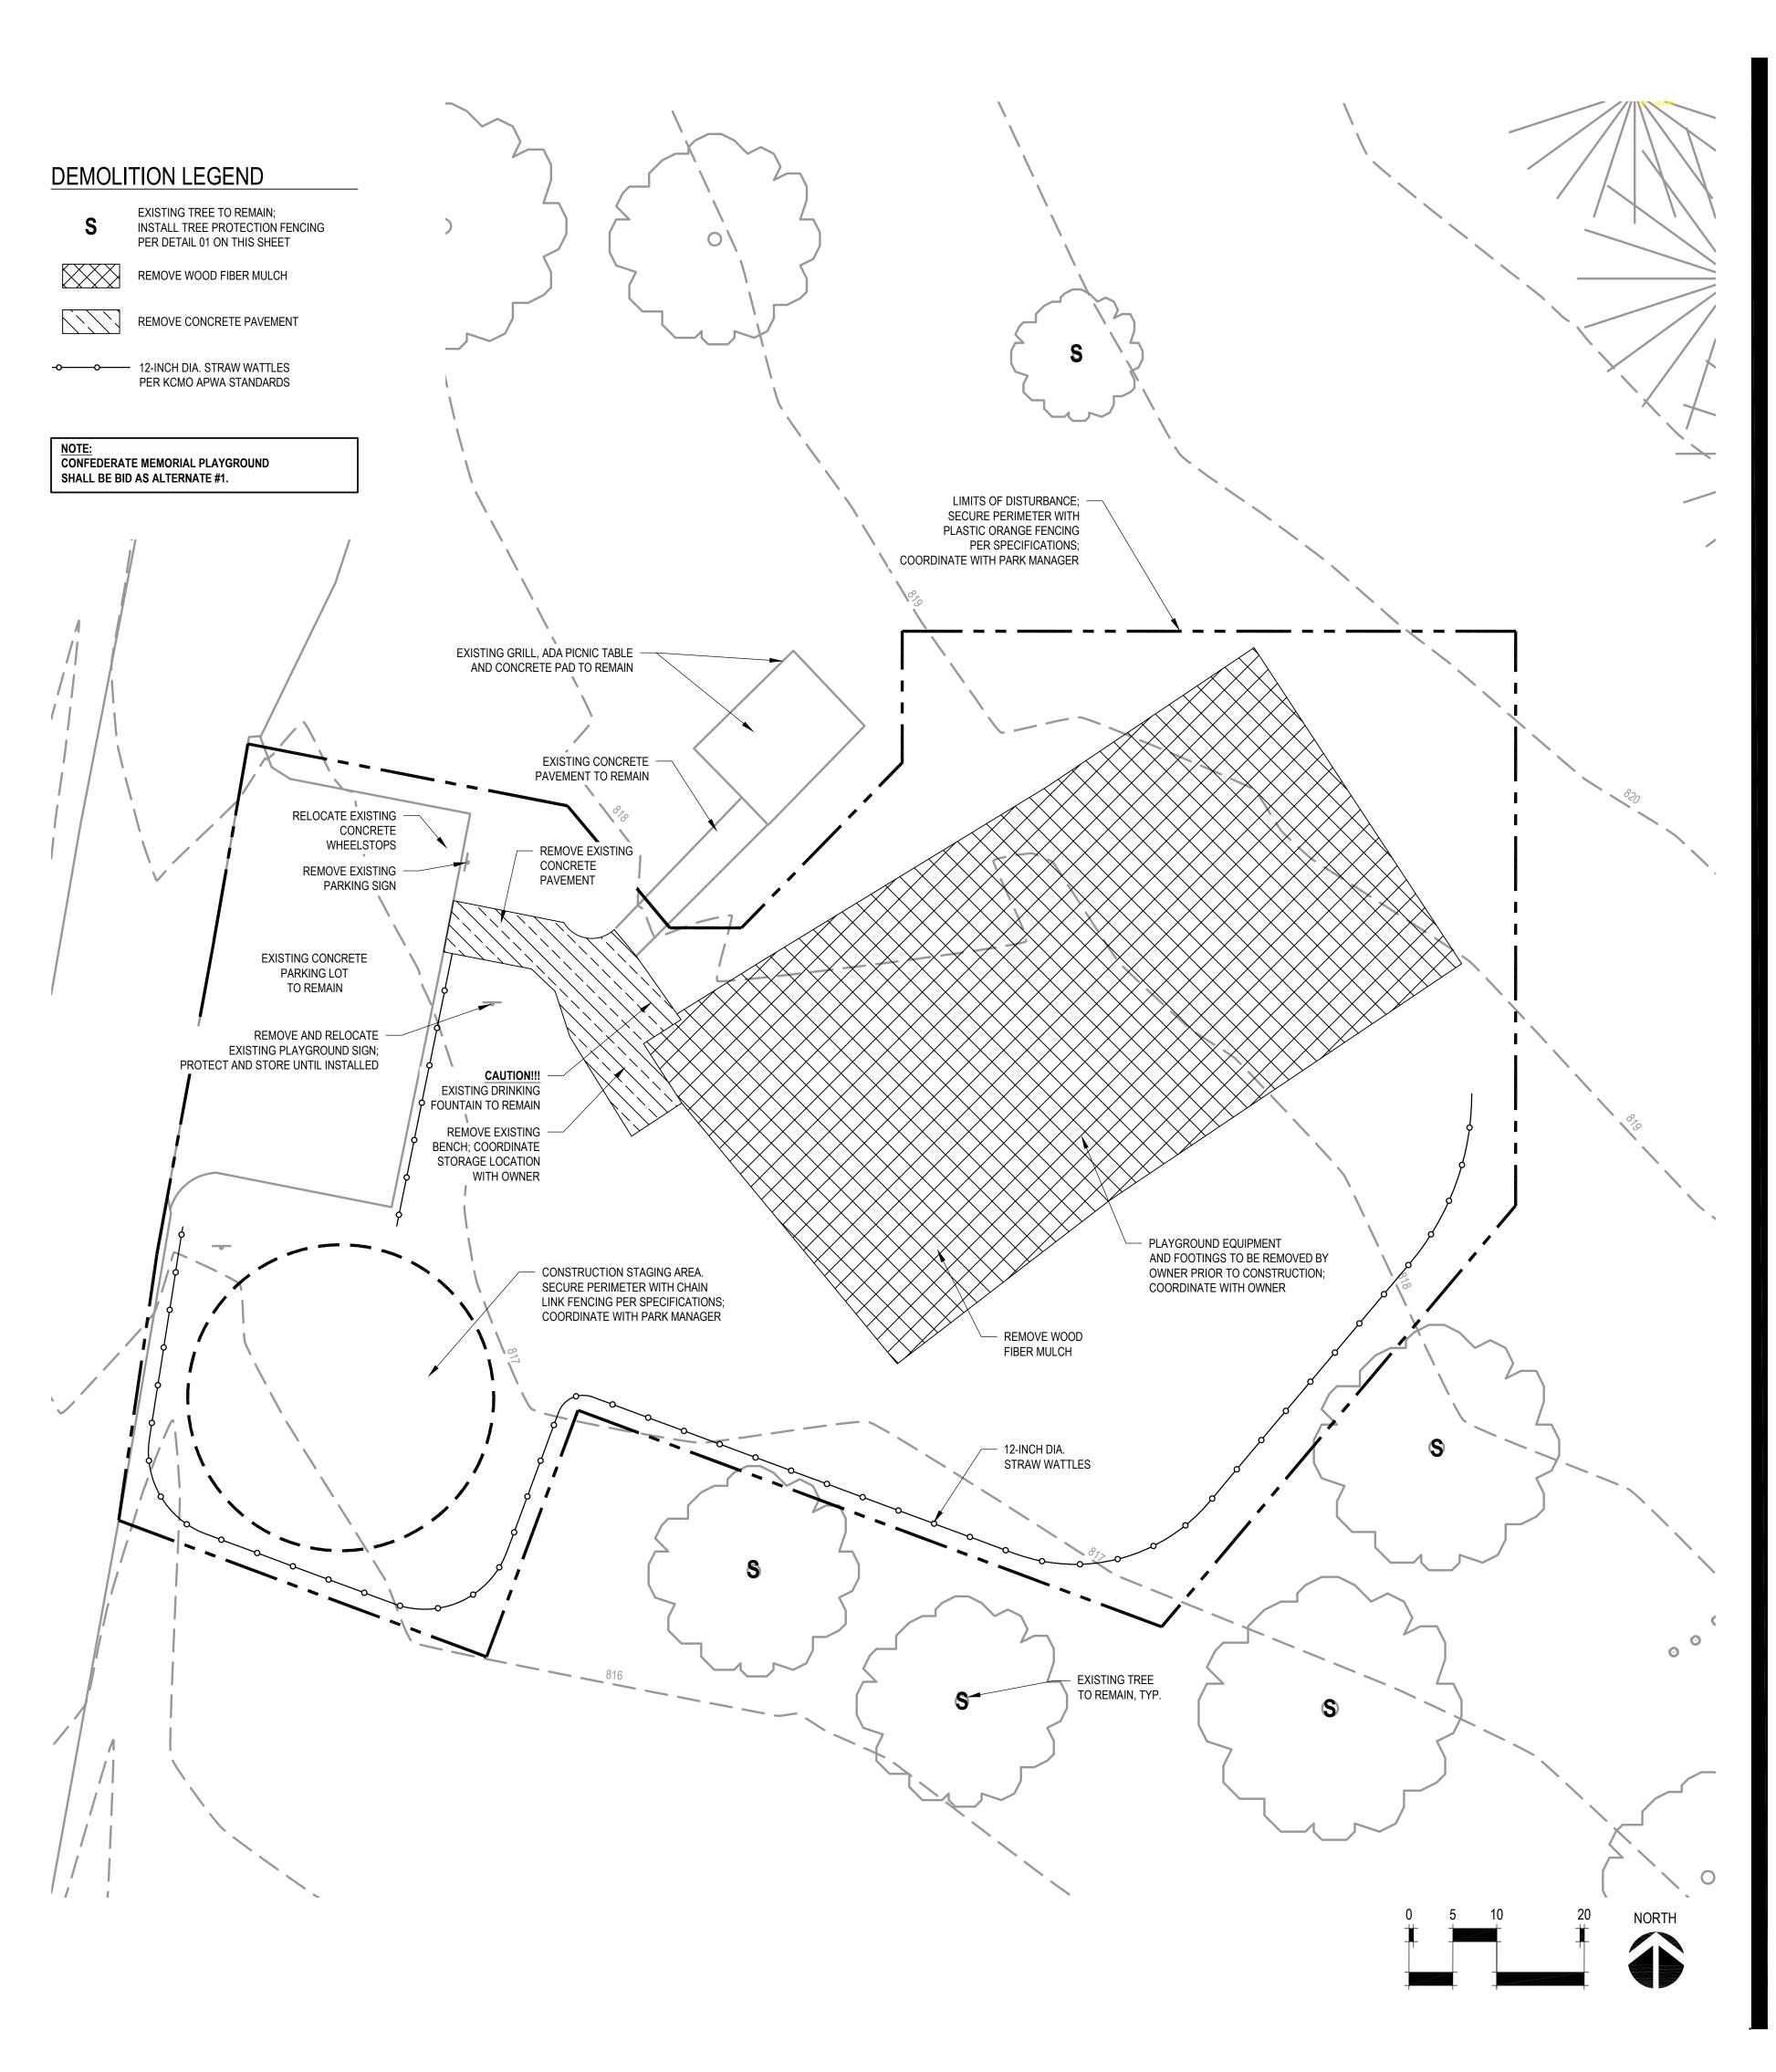

STATE OF MISSOURI MICHAEL L. PARSON, GOVERNOR



LANDSCAPE ARCHITECT:



LAC# MO-2002023826

414 Oak Street, Suite 101 Kansas City, Missouri 64106 P 816-756-5690 www.BeVireo.com

SURVEYOR & CIVIL ENGINEER: RENAISSANCE INFRASTRUCTURE CONSULTING 8653 Penrose Lane Lenexa, Kansas 66219 P 913-317-9500



GEOTECHNICAL: INTERTEK-PSI 1211 W. Cambridge Circle Drive Kansas City, Kansas 66103 P 913-310-1600



OFFICE OF ADMINISTRATION DIVISION OF FACILITIES MANAGEMENT, DESIGN AND CONSTRUCTION

DEPARTMENT OF NATURAL RESOURCES, MISSOURI STATE PARKS

PLAYGROUND REPLACEMENT

CONFEDERATE MEMORIAL STATE HISTORIC SITE 211 WEST FIRST STREET HIGGINSVILLE, MO 64037

PROJECT #X2109-01SITE #5106FACILITY #9999

REVISION: DATE: REVISION: DATE: REVISION: DATE: ISSUE DATE: 8/22/2022

CAD DWG FILE: X2109-01-5106-9999-DP-400.DWG DRAWN BY: <u>AES</u> CHECKED BY: <u>CDP</u> DESIGNED BY: <u>AES / CDP</u>

SHEET TITLE: ALT #1 -DEMOLITION & EROSION CONTROL PLAN

SHEET NUMBER:

DP-400 SHEET 14 OF 17

SHEET 14 OF 17 8/22/2022

	ITEM	QTY	MANUFACTURER	MODEL	REP.
1	Tree Tops Smart Play Structure (see plan for individual play components)	1	Landscape Structures	see plan	ATHCO
2	2 Music Instrument Play Equipment				
	Animato Metallophone	1	Landscape Structures	214438	ATHCO
	Grandioso Chimes		Landscape Structures	214442	ATHCO
3	Single Post Swing Frame with Additional Bay		Landscape Structures	177332 / 177333	ATHCO
	Belt Seat with proguard chains	2	Landscape Structures	174018	ATHCO
	Full Bucket Seat with chains	1	Landscape Structures	175038	ATHCO
	Molded Seat with harness (ages 2-5) and proguard chains	1	Landscape Structures	218671	ATHCO
4	Saddle Spinner	1	Landscape Structures	152179	ATHCO
5	72" x 90" Rubber Swing Mat		Zeager Bros, Inc.	TuffMat	Zeager
A2	Alternate #2 - OmniSpin Spinner		Landscape Structures	173591	ATHCO

TREE TOPS THEMED PLAY STRUCTURE



MUSIC INSTRUMENT PLAY EQUIPMENT




SADDLE SPINNER



*NOTE: INFORMATION SHOWN FOR BASIS OF DESIGN IS FOR BID PURPOSES ONLY. SUBJECT TO COMPLIANCE WITH REQUIREMENTS, AVAILABLE MANUFACTURERS OFFERING PRODUCTS THAT MAY BE INCORPORATED INTO THE WORK INCLUDE, BUT ARE NOT LIMITED TO THE FOLLOWING:

- LANDSCAPE STRUCTURES
 GAMETIME, A PLAYCORE COMPANY
- 3. BURKE
- ZEAGER BROS, INC.
 OR APPROVED EQUAL

CONTRACTOR SHALL SUBMIT SHOP DRAWINGS INCLUDING PLAY EQUIPMENT LAYOUT, SAFETY FALL ZONES, MATERIALS AND COLORS FOR ALL PLAY EQUIPMENT FOR REVIEW AND APPROVAL BY OWNER'S REPRESENTATIVE PRIOR TO FABRICATION AND/OR INSTALLATION.

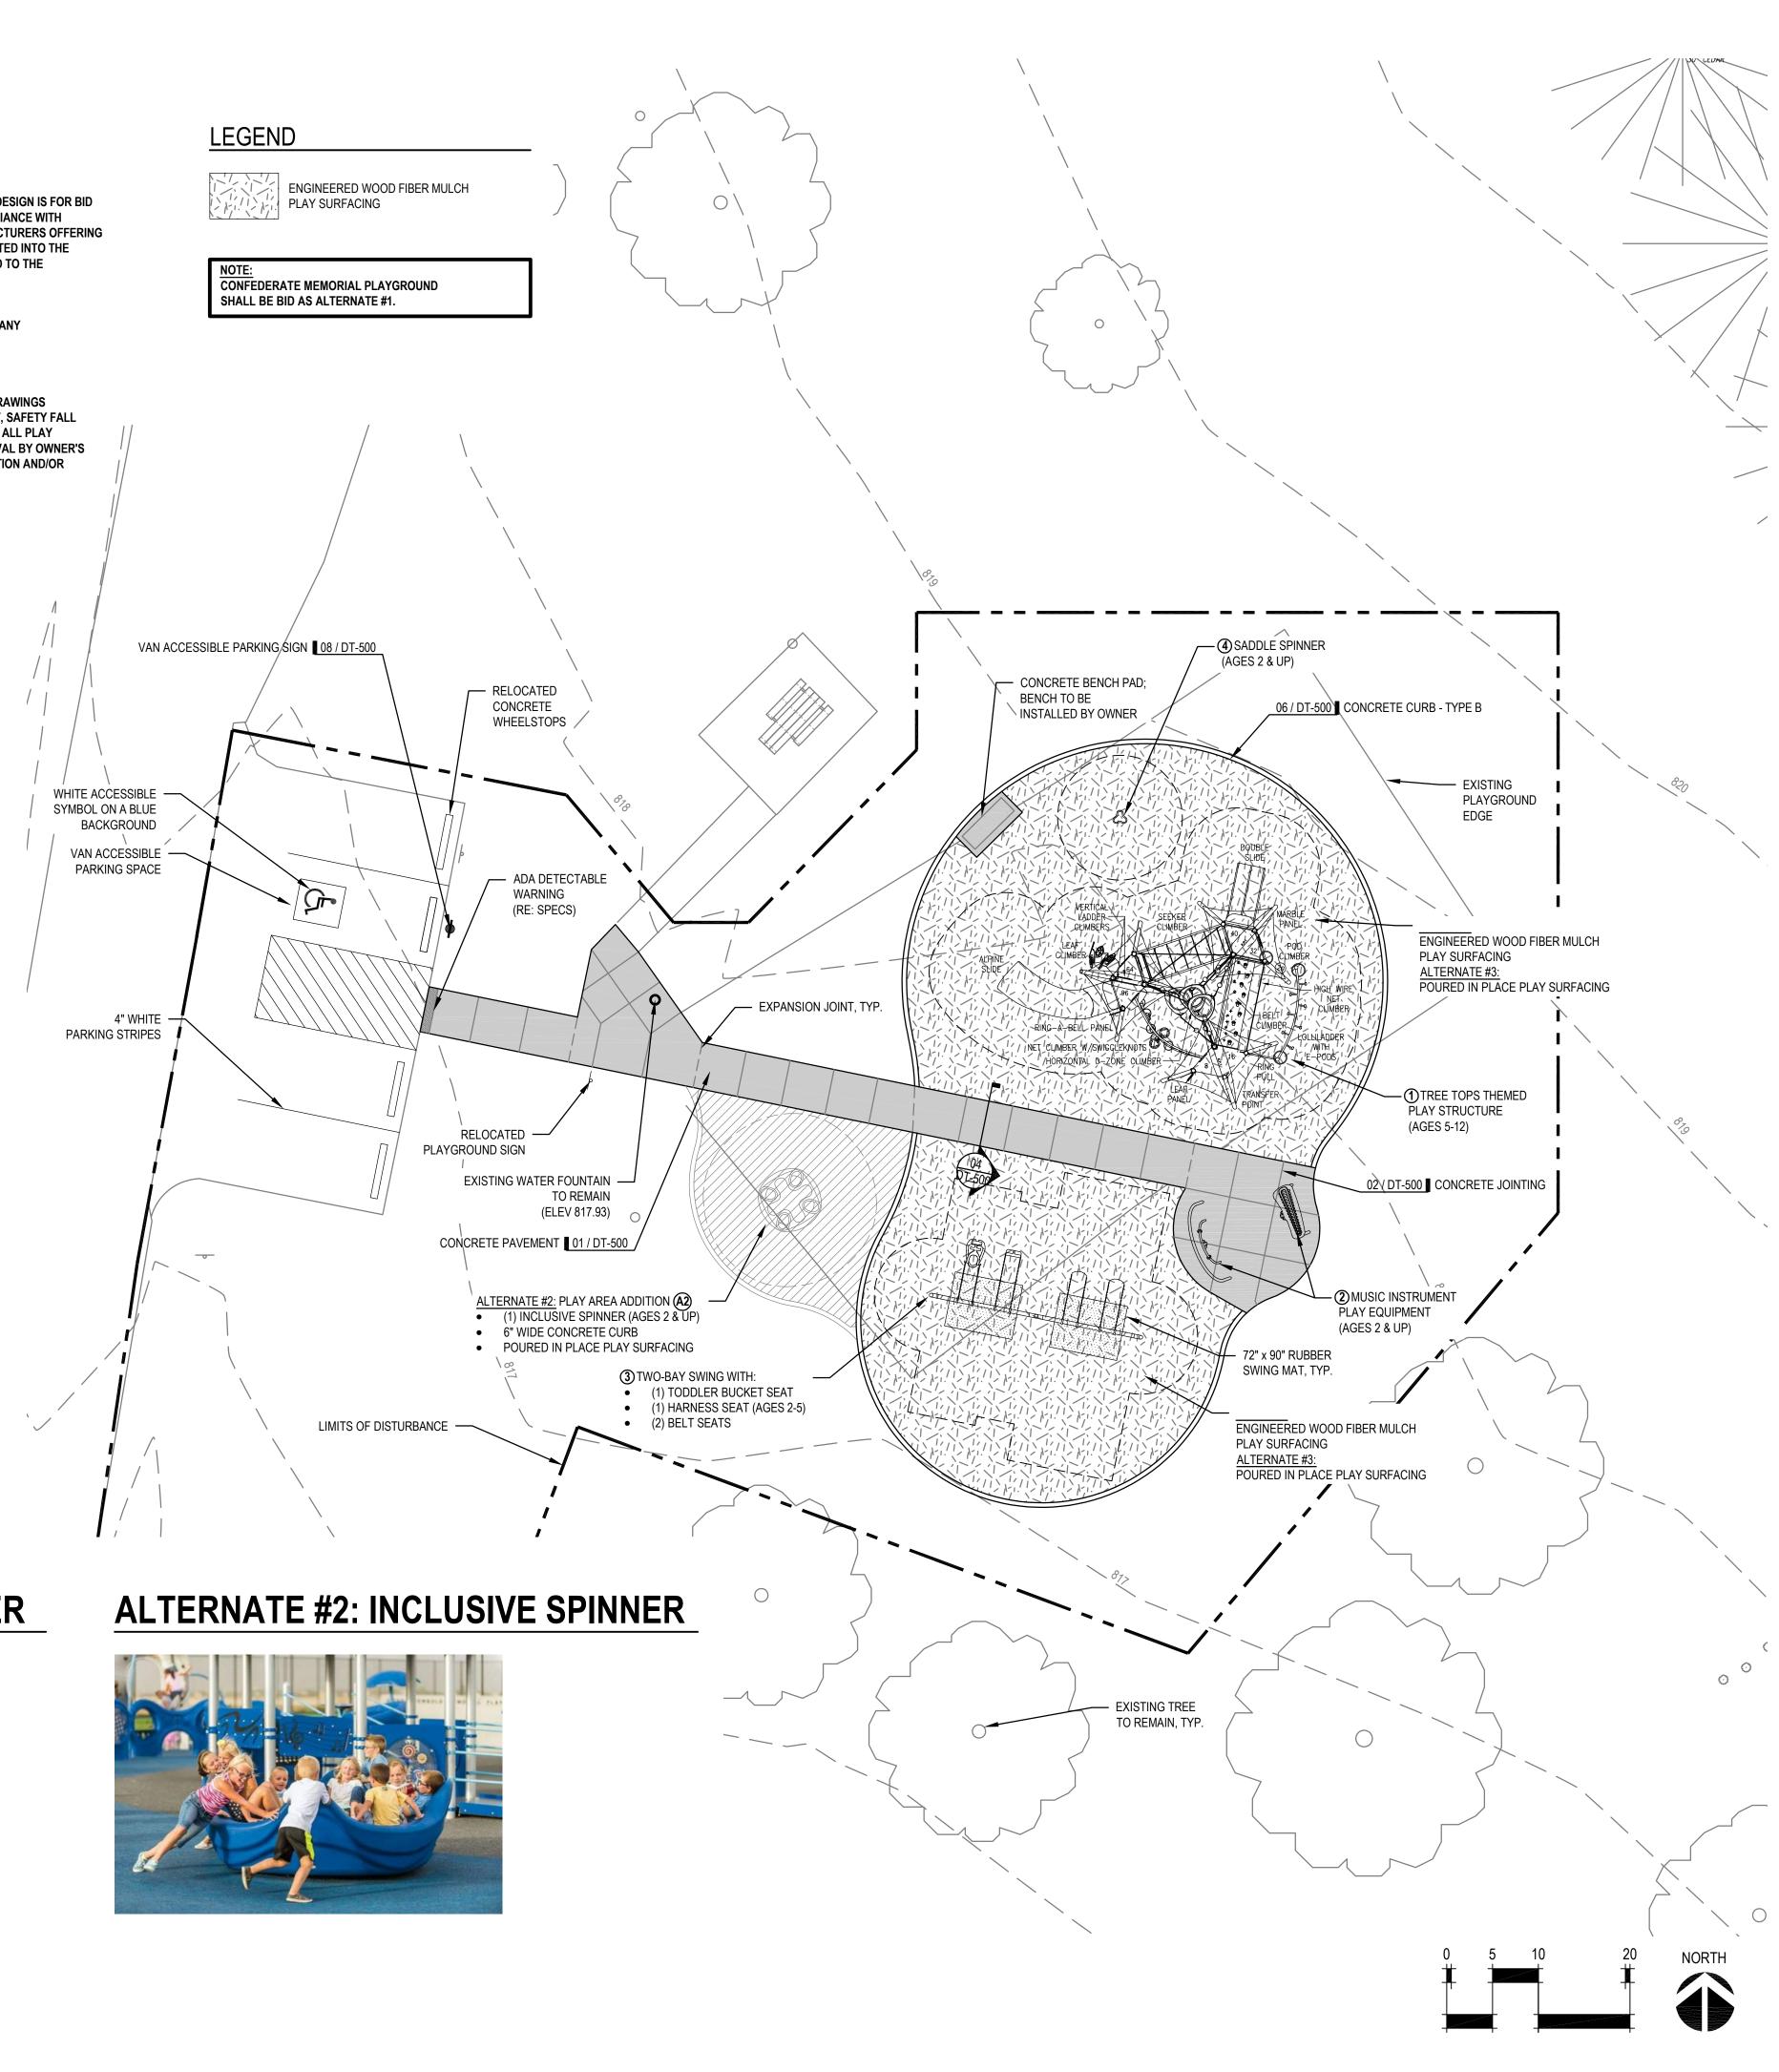

NUMBER PLA-2016004482 LANDSCAPE ARCHITECT: LAC# MO-2002023826 414 Oak Street, Suite 101 Kansas City, Missouri 64106 P 816-756-5690 www.BeVireo.com R SURVEYOR & CIVIL ENGINEER: RENAISSANCE INFRASTRUCTURE CONSULTING Renaissance 8653 Penrose Lane nfrastructure Lenexa, Kansas 66219 onsulting P 913-317-9500 GEOTECHNICAL: intertek INTERTEK-PSI 1211 W. Cambridge Circle Drive Kansas City, Kansas 66103 P 913-310-1600 **OFFICE OF ADMINISTRATION DIVISION OF FACILITIES** MANAGEMENT, **DESIGN AND CONSTRUCTION DEPARTMENT OF** NATURAL RESOURCES, **MISSOURI STATE PARKS** PLAYGROUND REPLACEMENT CONFEDERATE MEMORIAL STATE HISTORIC SITE 211 WEST FIRST STREET HIGGINSVILLE, MO 64037 PROJECT # X2109-01 SITE # 5106 FACILITY # 9999 **REVISION:** DATE: **REVISION:** DATE: **REVISION**: DATE: ISSUE DATE: 8/22/2022 CAD DWG FILE: X2109-01-5106-99999-SP-401.DWG DRAWN BY: <u>AES</u> CHECKED BY: <u>CDP</u> DESIGNED BY: <u>AES / CDP</u> SHEET TITLE: ALT #1, #2, #3 - SITE PLAN

STATE OF MISSOURI MICHAEL L. PARSON, GOVERNOR


SHEET NUMBER:

SP-401 SHEET 15 OF 17 8/22/2022

- 1. SITE LAYOUT DATA, INCLUDING COORDINATE POINTS, IS BASED ON A SURVEY PROVIDED BY RENAISSANCE INFRASTRUCTURE CONSULTING (2021). REFER TO SURVEY FOR HORIZONTAL LAYOUT CONTROL POINTS. REPORT ANY DISCREPANCIES BETWEEN PLANS AND FIELD CONDITIONS TO OWNER'S REPRESENTATIVE IMMEDIATELY.
- IT SHALL BE THE RESPONSIBILITY OF THE CONTRACTOR TO CONTROL ON-SITE AND DOWNSTREAM EROSION AND SILTATION DURING ALL PHASES OF CONSTRUCTION. EROSION CONTROL SYSTEMS AND PROCEDURES SHALL BE IN PLACE PRIOR TO ANY GRADING OPERATIONS.
- 3. THE LOCATIONS OF EXISTING UTILITIES AS SHOWN ARE APPROXIMATE. THE CONTRACTOR SHALL HAVE ALL UTILITIES FLAGGED IN THE FIELD FOR INSPECTION PRIOR TO PROCEEDING WITH ANY GRADING OPERATIONS. THE CONTRACTOR SHALL VERIFY THE DEPTH AND LOCATION OF ALL EXISTING UTILITIES AND WILL BE HELD LIABLE FOR ANY DELAYS CAUSED BY DAMAGE TO UTILITIES OR FAILURE TO LOCATE UTILITIES.
- 4. ALL CONSTRUCTION DEBRIS SHALL BE DISPOSED OF BY THE CONTRACTOR AT A LOCATION PROVIDED BY THE CONTRACTOR AND IN ACCORDANCE WITH LOCAL REGULATIONS. THE CONTRACTOR SHALL SATISFY HIMSELF BY JOB-SITE INSPECTION AS TO THE EXTENT OF CLEARING REQUIRED PRIOR TO ENTERING INTO A CONSTRUCTION CONTRACT.
- 5. CONSTRUCTION STAKING SHALL BE PROVIDED BY THE CONTRACTOR. ALL CONSTRUCTION LAYOUT STAKING IS TO BE PERFORMED BY A LAND SURVEYOR OR PROFESSIONAL ENGINEER REGISTERED IN THE STATE OF MISSOURI. TO FACILITATE ACCURACY OF CONSTRUCTION STAKING, UPON WRITTEN REQUEST FROM CONTRACTOR, ELECTRONIC DATA COMPRISING THESE SITE DEVELOPMENT DRAWINGS WILL BE FORWARED TO THE LAND SURVEYOR OR PROFESSIONAL ENGINEER EMPLOYED TO PERFORM THE CONSTRUCTION STAKING.
- 6. IN ORDER TO MAINTAIN THE INTEGRITY OF HORIZONTAL AND VERTICAL CONTROL FOR THE SITE, THE SURVEYOR OR PROFESSIONAL ENGINEER EMPLOYED BY THE CONTRACTOR TO PERFORM CONSTRUCTION LAYOUT STAKING SHALL SET AND PROTECT ADDITIONAL TRAVERSE POINTS OUTSIDE THE AREAS OF CONSTRUCTION ACTIVITY.
- 7. ALL LAYOUTS SHALL BE SUBJECT OT FIELD APPROVAL BY THE OWNER'S REPRESENTATIVE.
- 8. SAWCUT EXISTING PAVEMENT FULL DEPTH WHERE IT MEETS NEW PAVEMENT.
- 9. UNLESS NOTED OTHERWISE, ALL DIMENSIONS ARE TO THE FOLLOWING: EDGE OF PAVEMENT, FACE OF WALL, AND EDGE OF CURB.
- 10. ALL EDGES OF PAVEMENTS ARE TO BE STRAIGHT (OR OF CONSISTENT RADIUS IN THE CASE OF CURVES) AS SHOWN HEREON. NO UNSPECIFIED TANGENTS OR KINKS WILL BE APPROVED.
- 11. THIS SITE HAS BEEN DESIGNED TO COMPLY WITH THE PROVISIONS OF THE AMERICANS WITH DISABILITIES ACT ACCESSIBILITY GUIDELINES (ADAAG). REPORT ANY COMPLIANCE DISCREPANCIES TO OWNER'S REPRESENTATIVE IMMEDIATELY.
- 12. ALL AREAS SHALL BE BROUGHT TO FINAL PLAN CONDITION (PAVED, SEEDED, OR MULCHED) AS SOON AS POSSIBLE TO MAINTAIN FINISH GRADE CONDITIONS AND PREVENT SOIL LOSS.
- 13. THE CONTRACTOR SHALL PROVIDE AND PAY FOR ALL INSPECTION SERVICES.

PLAYGROUND CURB ALIGNMENT

AL	IGNM	ENT CU	JRVE DA	TA
CURVE #	DELTA	RADIUS	LENGTH	TANGENT
C1	10.56	30.25	5.58	2.80
C2	232.91	26.25	106.71	52.75
C3	26.32	8.25	3.79	1.93
C4	50.16	8.25	7.22	3.86
C5	199.32	20.00	69.58	117.49
C6	21.83	30.25	11.53	5.83
C7	48.87	8.25	7.04	3.75
C8	97.97	13.25	22.66	15.24
C9	36.82	12.25	7.87	4.08

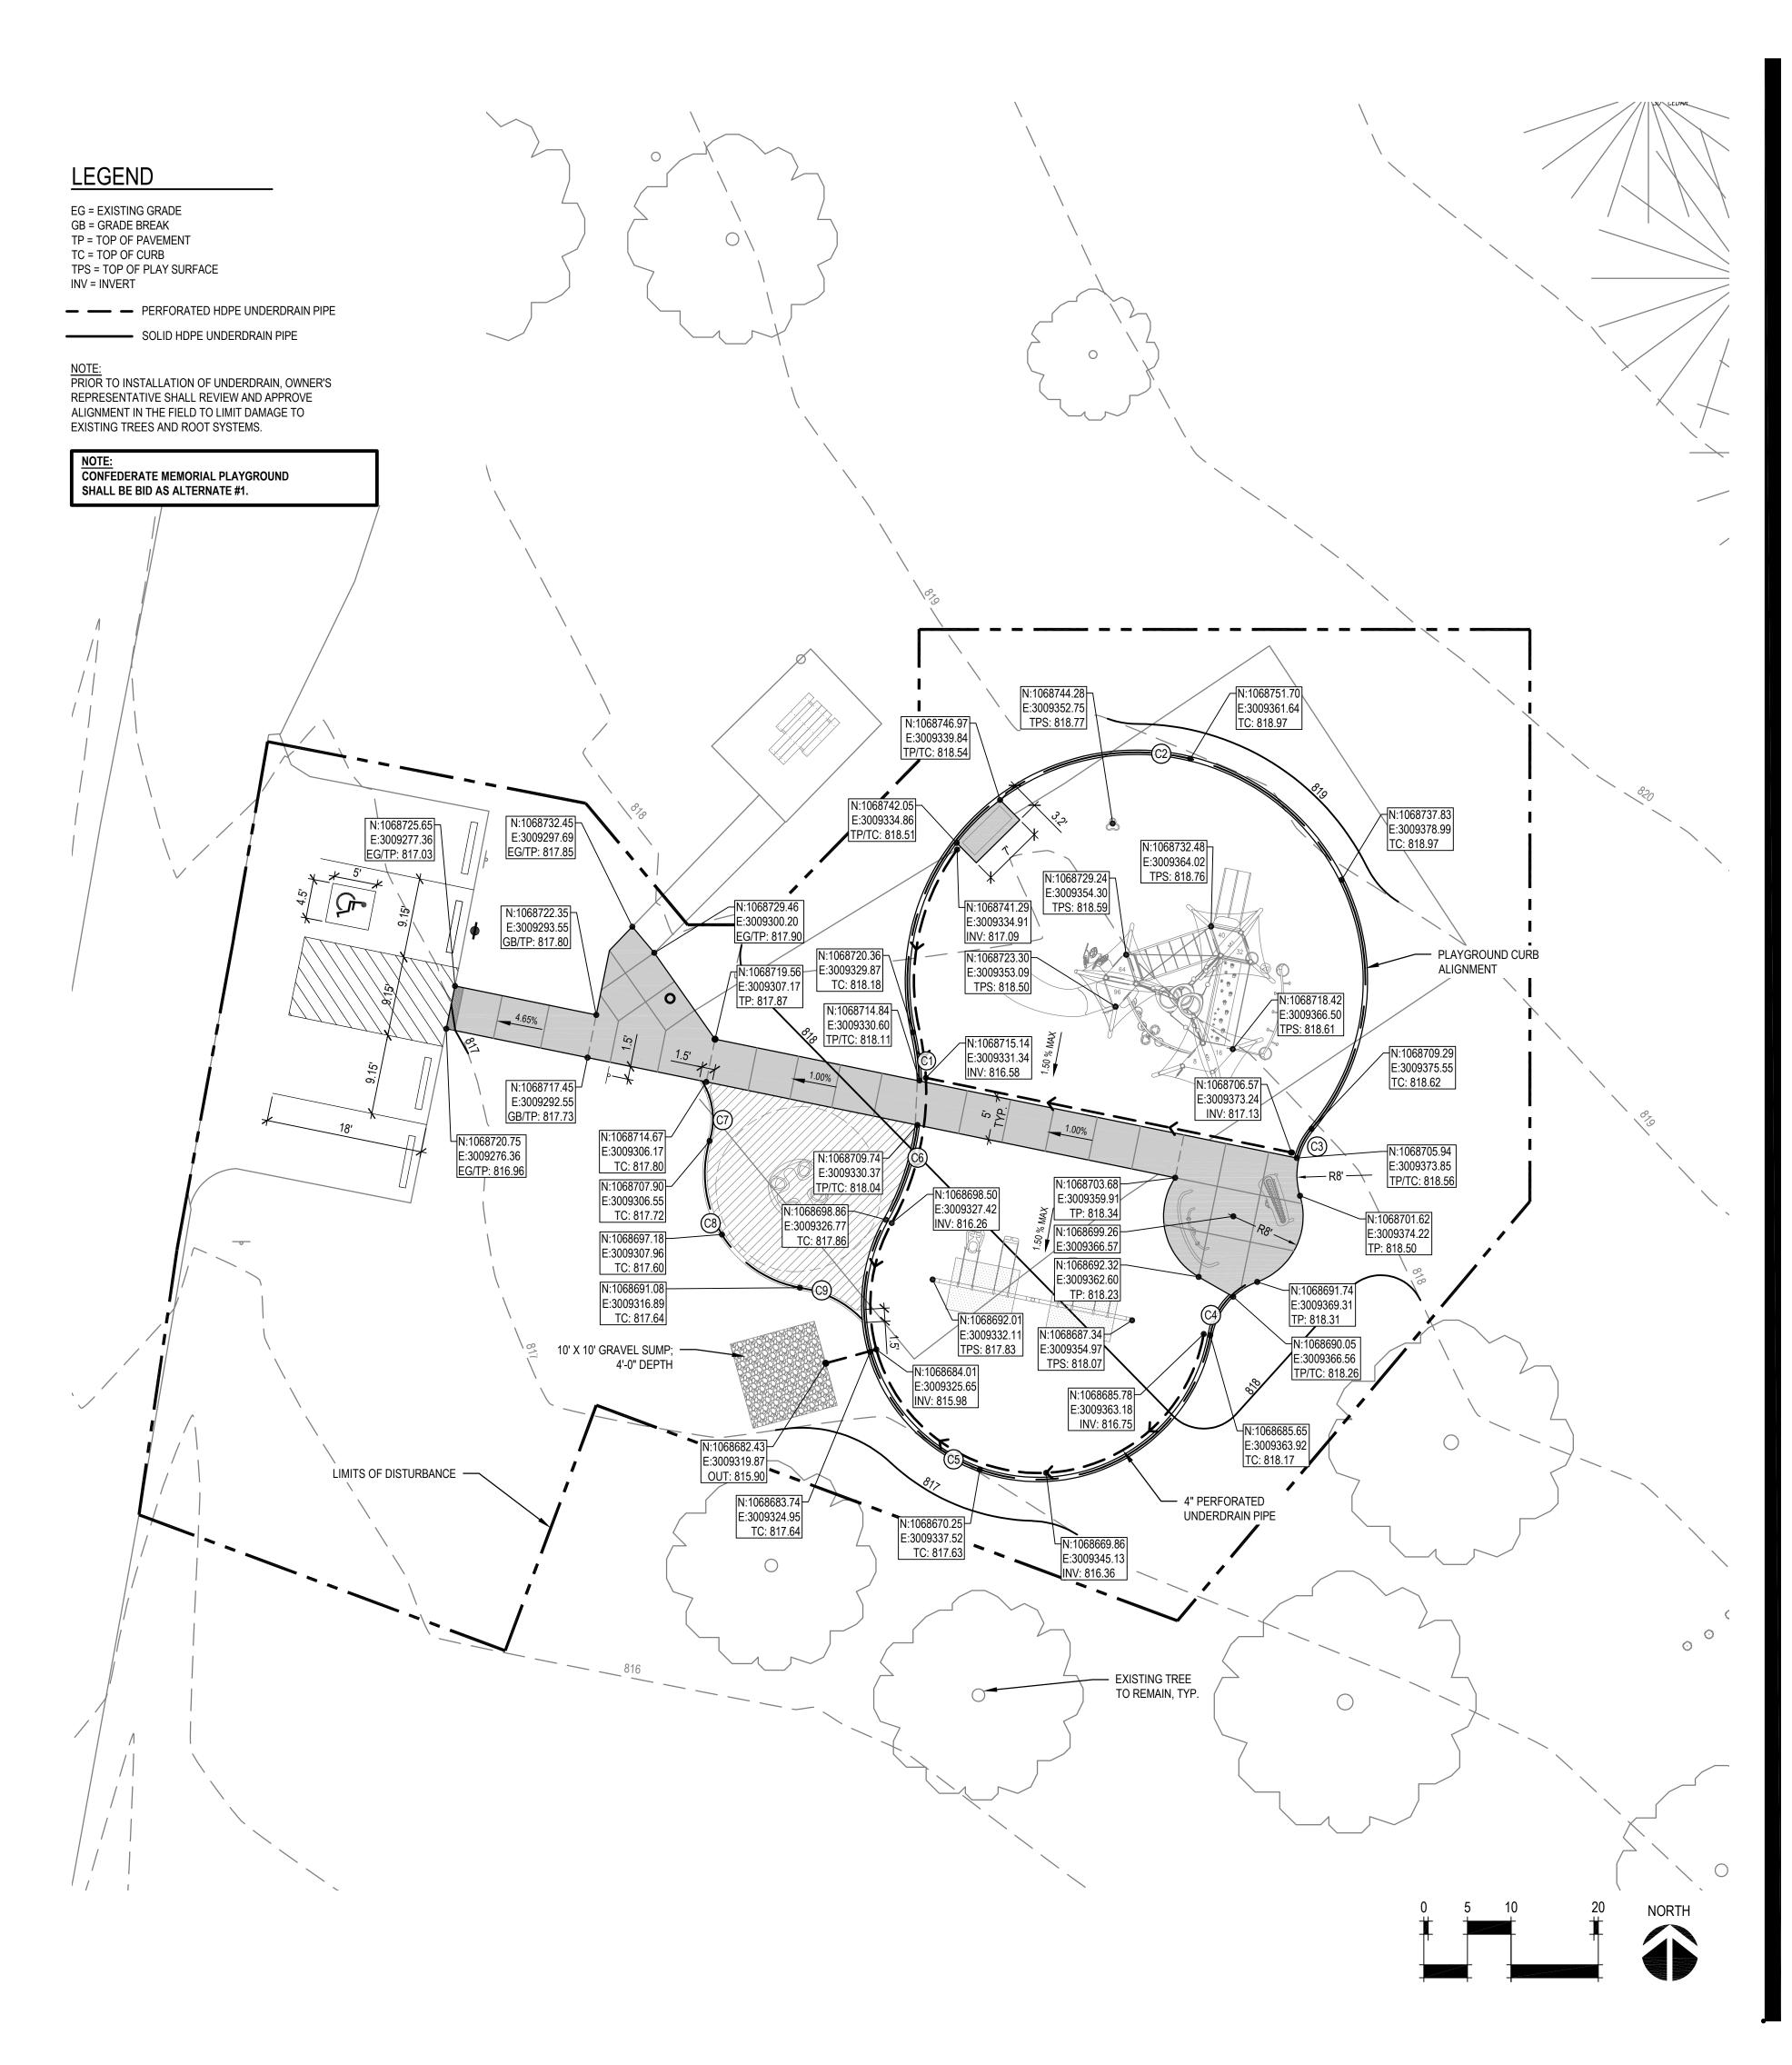

NUMBER PLA-2016004482 LANDSCAPE ARCHITECT: LAC# MO-2002023826 414 Oak Street, Suite 101 Kansas City, Missouri 64106 P 816-756-5690 www.BeVireo.com SURVEYOR & CIVIL ENGINEER: R RENAISSANCE INFRASTRUCTURE CONSULTING **R**enaissance 8653 Penrose Lane nfrastructure Lenexa, Kansas 66219 onsulting P 913-317-9500 GEOTECHNICAL: intertek INTERTEK-PSI 1211 W. Cambridge Circle Drive Kansas City, Kansas 66103 P 913-310-1600 **OFFICE OF ADMINISTRATION DIVISION OF FACILITIES** MANAGEMENT, **DESIGN AND CONSTRUCTION DEPARTMENT OF** NATURAL RESOURCES, **MISSOURI STATE PARKS** PLAYGROUND REPLACEMENT CONFEDERATE MEMORIAL STATE HISTORIC SITE 211 WEST FIRST STREET HIGGINSVILLE, MO 64037 PROJECT # X2109-01 SITE # 5106 FACILITY # 9999 **REVISION:** DATE: **REVISION:** DATE: **REVISION**: DATE: ISSUE DATE: 8/22/2022 CAD DWG FILE: x2109-01-5106-9999-SP-402.DWG DRAWN BY: <u>AES</u> CHECKED BY: <u>CDP</u> DESIGNED BY: AES / CDP


STATE OF MISSOURI MICHAEL L. PARSON, GOVERNOR

SHEET TITLE:

ALT #1, #2, #3 -LAYOUT & GRADING PLAN

SHEET NUMBER:

SP-402 SHEET 16 OF 17 8/22/2022

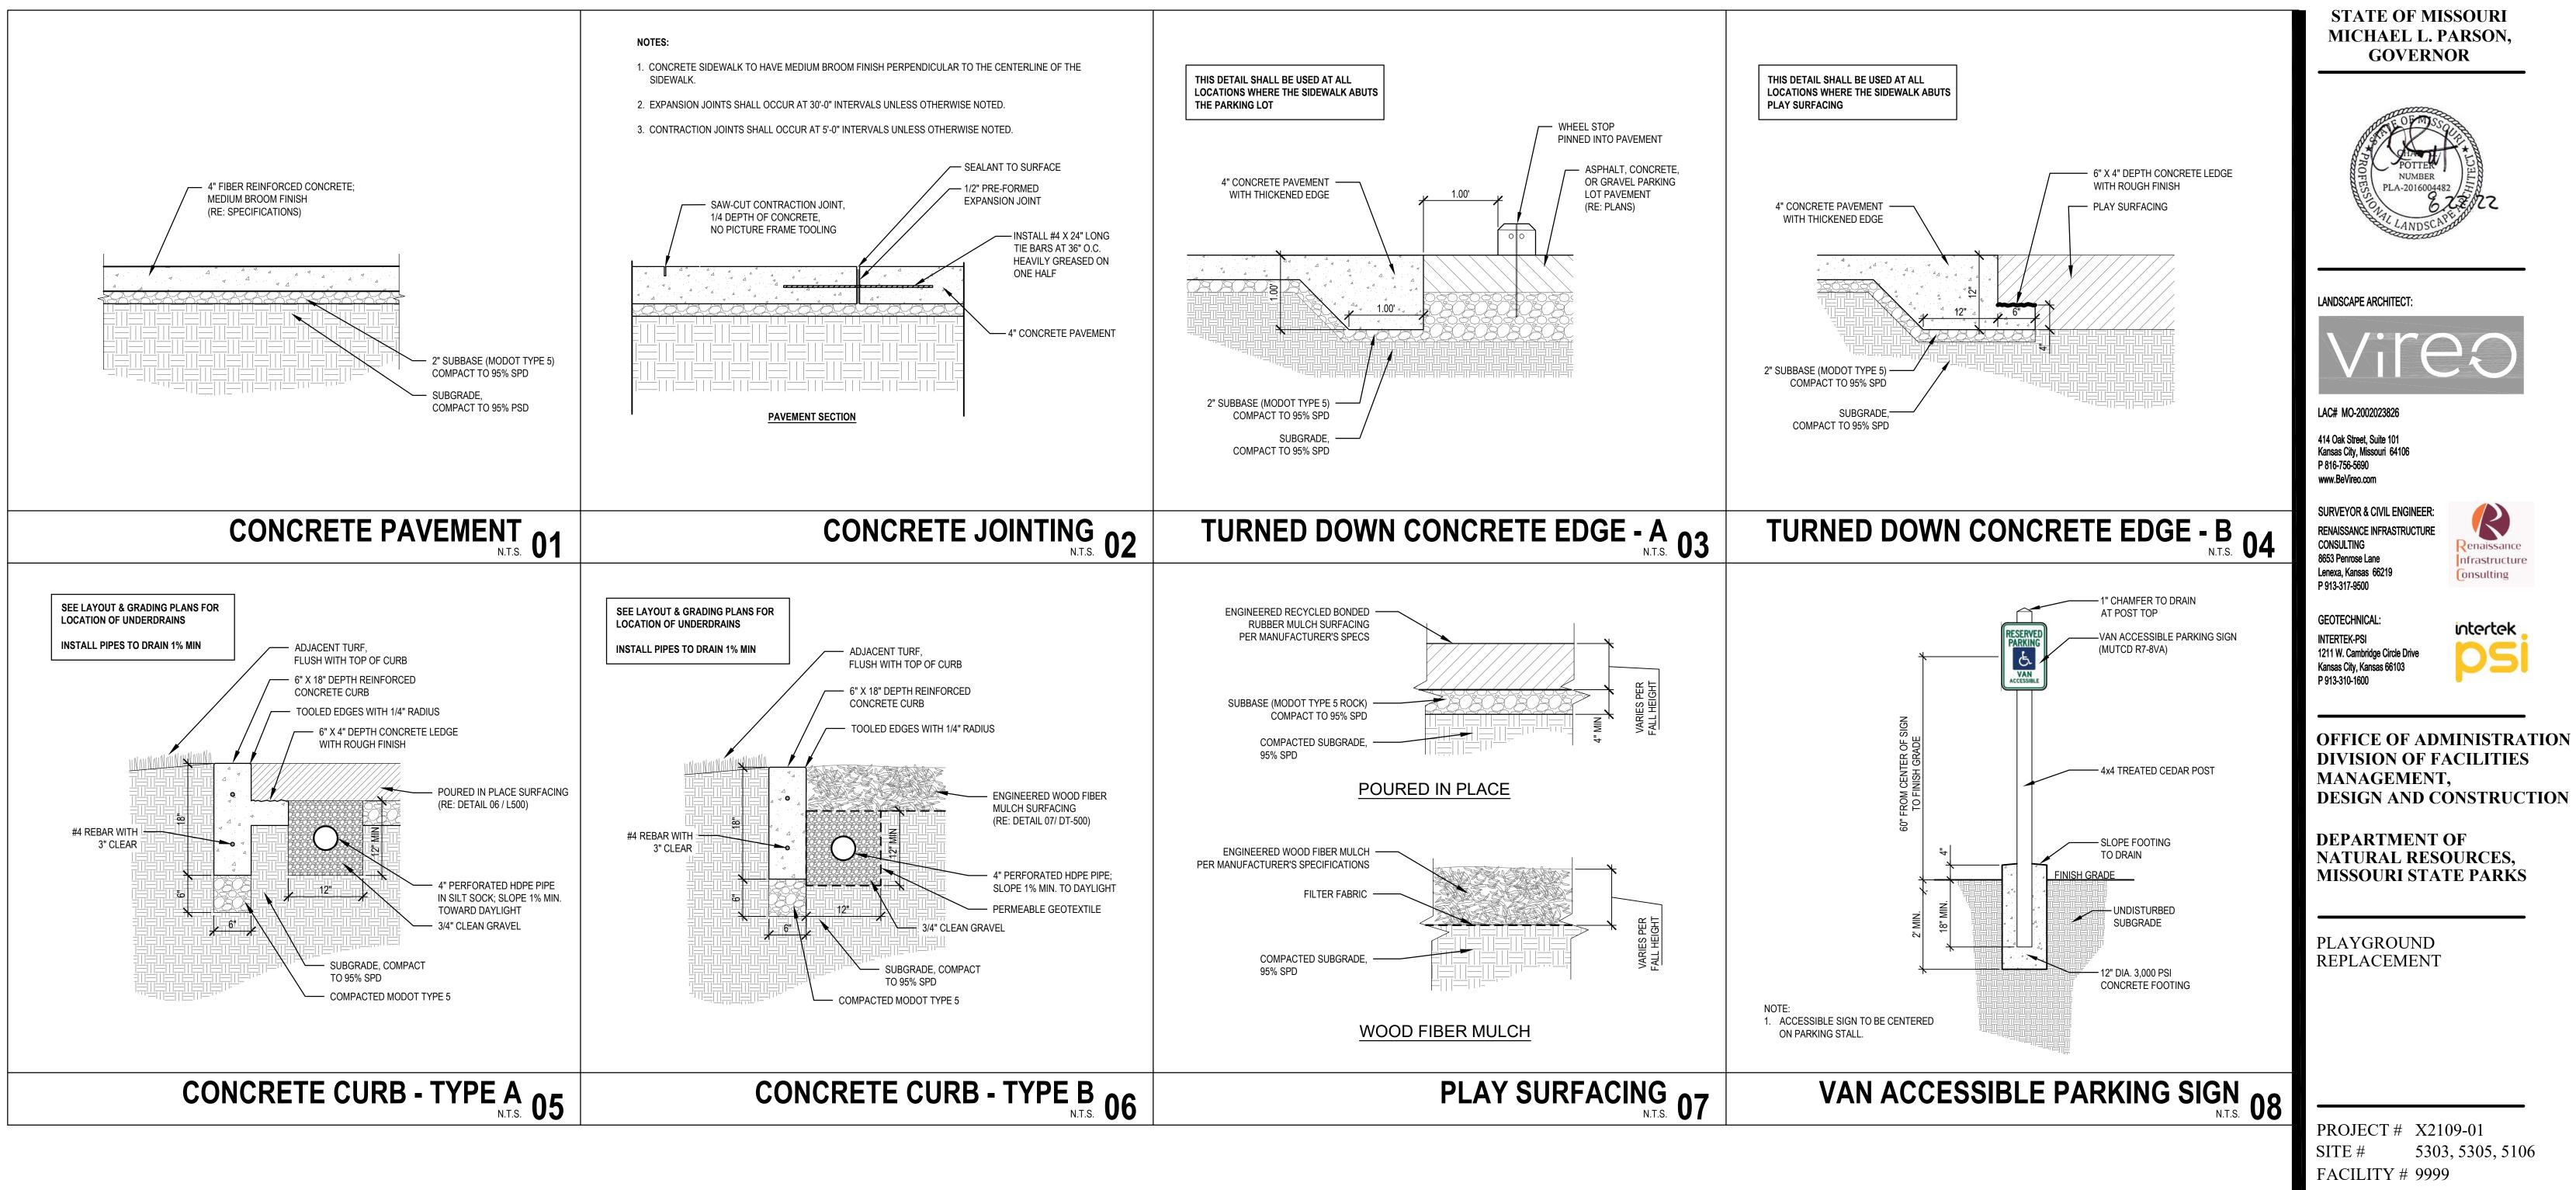

KOJECI #	A2109-01
SITE #	5303, 5305, 5106
FACILITY #	9999

REVISION:
DATE:
REVISION:
DATE:
REVISION:
DATE:
ISSUE DATE: 8/22/2022

CAD DWG FILE: X2109-01-DT-500.DWG DRAWN BY: <u>AES</u> CHECKED BY: <u>CDP</u> DESIGNED BY: AES / CDP

SHEET TITLE: SITE DETAILS

SHEET NUMBER:

DT-500 SHEET 17 OF 17 8/22/2022