
UPGRADE CAVE ELECTRIC ONONDAGA CAVE STATE PARK LEASBURG, MISSOURI

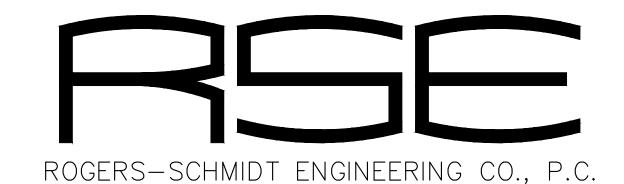

CONSULTING ENGINEERS
MISSOURI STATE CERTIFICATE
OF AUTHORITY #000408

BID ISSUE

OWNER: STATE OF MISSOURI

MICHAEL L. PARSON,

GOVERNOR

DEPARTMENT OF NATURAL RESOURCES

DIVISION OF STATE PARKS

PROJECT OFFICE OF ADMINISTRATION

MANAGEMENT: DIVISION OF FACILITIES MANAGEMENT,

DESIGN AND CONSTRUCTION

DESIGNER: ROGERS-SCHMIDT ENGINEERING CO., PC.

1736 WEST PARK CENTER DR.

SUITE 204


ST. LOUIS, MO 63026 PHONE: 636-600-1551

PROJECT NUMBER: X2212-01

SITE NUMBER: 5215

ASSET NUMBER: 7815215013



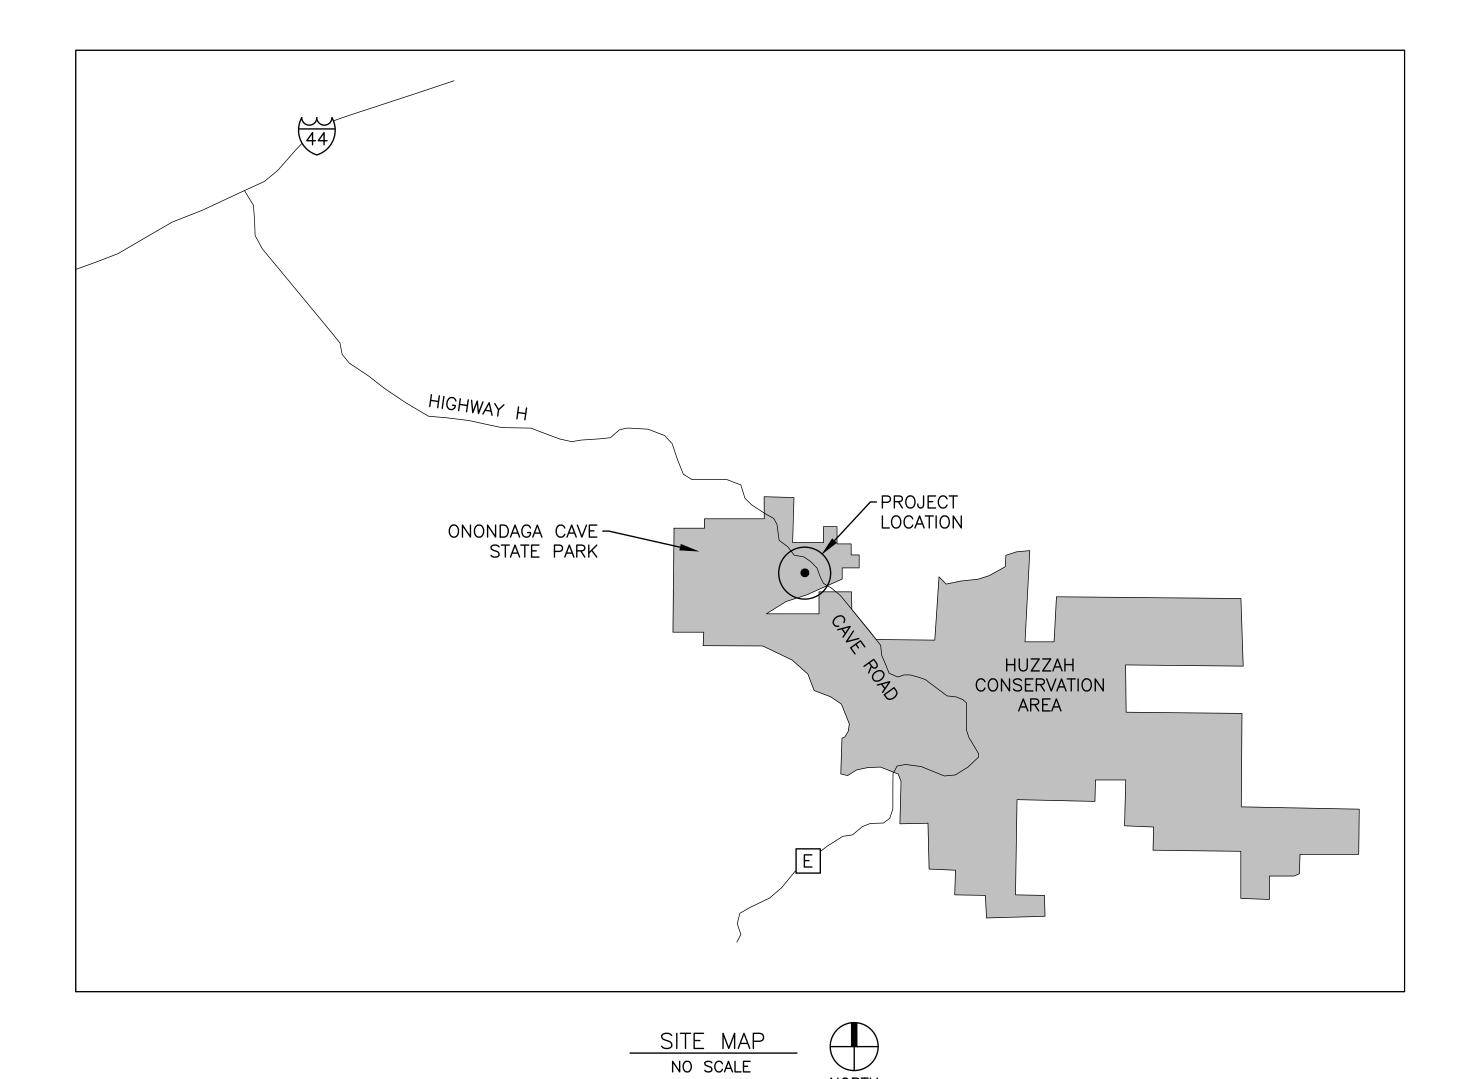

LOCATION MAP
NO SCALE

				D	RAWING INDEX			
SHEET	DRAWING NUMBER	DRAWING TITLE	SHEET	DRAWING NUMBER	DRAWING TITLE	SHEET	DRAWING NUMBER	DRAWING TITLE
01 OF 50	G-001	COVER SHEET	23 OF 50	ED-601	ONE-LINE DIAGRAMS (EXIST CONDITION)	47 OF 50	E-606	NEW LIGHTING POWER SUPPLY UNIT (PSU) SCHEDULE
02 OF 50	G-002	SITE MAPS AND DRAWING INDEX	24 OF 50	ED-602	ONE-LINE AIRLOCK SERVICE (EXIST CONDITION)	48 OF 50	E-607	NEW LIGHTING POWER SUPPLY UNIT (PSU) SCHEDULE
			25 OF 50	ED-603	ONE-LINE MO CAVERNS SERVICE (EXIST CONDITION)	49 OF 50	E-608	NEW LIGHTING CONTROL STATION CONFIGURATIONS
03 OF 50	C-101	CIVIL SITE PLAN	26 OF 50	ED-604	ONE-LINE SUBMARINE ROOM SERVICE (EXIST CONDITION)			
04 OF 50	C-501	CIVIL DETAILS				50 OF 50	T-601	ONE-LINE DIAGRAM - CAVE EMERGENCY TELEPHONES
			27 OF 50	E-101	CAVE ELECTRICAL PLAN - SECTION A			
5 OF 50	E-001	ELECTRICAL SYMBOLS, ABBREVIATIONS & GENERAL NOTES	28 OF 50	E-102	CAVE ELECTRICAL PLAN - SECTION B			
			29 OF 50	E-103	CAVE ELECTRICAL PLAN - SECTION C			
6 OF 50	ES-101	ABOVE GROUND SITE PLAN	30 OF 50	E-104	CAVE ELECTRICAL PLAN — SECTION D			
7 OF 50	ES-102	CAVE SITE PLAN	31 OF 50	E-105	CAVE ELECTRICAL PLAN — SECTION E			
			32 OF 50	E-106	CAVE ELECTRICAL PLAN — SECTION F			
8 OF 50	ES-401	ENLARGED SITE PLAN — DEMOLITION	33 OF 50	E-107	CAVE ELECTRICAL PLAN — SECTION G			
9 OF 50	ES-402	ENLARGED SITE PLAN - NEW WORK	34 OF 50	E-108	CAVE ELECTRICAL PLAN - SECTION H			
			35 OF 50	E-109	CAVE ELECTRICAL PLAN — SECTION I			
0 OF 50	ED-101	CAVE ELECTRICAL DEMOLITION PLAN — SECTION A	36 OF 50	E-110	CAVE ELECTRICAL PLAN — SECTION J			
1 OF 50	ED-102	CAVE ELECTRICAL DEMOLITION PLAN — SECTION B	37 OF 50	E-111	CAVE ELECTRICAL PLAN — SECTION K			
2 OF 50	ED-103	CAVE ELECTRICAL DEMOLITION PLAN — SECTION C	38 OF 50	E-112	CAVE ELECTRICAL PLAN — SECTION L			
3 OF 50	ED-104	CAVE ELECTRICAL DEMOLITION PLAN — SECTION D	39 OF 50	E-113	CAVE ELECTRICAL PLAN — SECTION M			
4 OF 50	ED-105	CAVE ELECTRICAL DEMOLITION PLAN — SECTION E						
		CAVE ELECTRICAL DEMOLITION PLAN - SECTION F	40 OF 50		ELECTRICAL DETAILS			
		CAVE ELECTRICAL DEMOLITION PLAN - SECTION G	41 OF 50	E-502	ELECTRICAL DETAILS			
		CAVE ELECTRICAL DEMOLITION PLAN - SECTION H						
8 OF 50	ED-109	CAVE ELECTRICAL DEMOLITION PLAN - SECTION I	42 OF 50	E-601	ONE-LINE DIAGRAM			
9 OF 50	ED-110	CAVE ELECTRICAL DEMOLITION PLAN - SECTION J	43 OF 50	E-602	ONE-LINE AIRLOCK FEEDER			
0 OF 50	ED-111	CAVE ELECTRICAL DEMOLITION PLAN - SECTION K	44 OF 50	E-603	ONE-LINE SUBMARINE ROOM FEEDER			
1 OF 50	ED-112	CAVE ELECTRICAL DEMOLITION PLAN - SECTION L	45 OF 50	E-604	NEW PANELBOARD SCHEDULES			
2 OF 50	ED-113	CAVE ELECTRICAL DEMOLITION PLAN - SECTION M	46 OF 50	E-605	NEW LIGHTING FIXTURE SCHEDULE			

STATE OF MISSOURI MICHAEL L. PARSON, GOVERNOR



BARRY D. FREINER Registered Professional Engineer MO # E-24220 Expires 12-31-2024

ROGERS-SCHMIDT

ENGINEERING CO., P.C. CONSULTING ENGINEERS 1736 WEST PARK CENTER DR. SUITE 204 ST. LOUIS, MO 63026 PHONE: 636-600-1551 MISSOURI STATE CERTIFICATE OF AUTHORITY #000408

OFFICE OF ADMINISTRATION DIVISION OF FACILITIES MANAGEMENT, DESIGN AND CONSTRUCTION

DEPARTMENT OF NATURAL RESOURCES DIVISION OF STATE PARKS

UPGRADE CAVE ELECTRIC

ONONDAGA CAVE STATE PARK 7556 HWY H LEASBURG, MO 65535

PROJECT # X2212-01 5215 SITE#

ASSET # 7815215013 REVISION: DATE: REVISION: DATE:

REVISION: DATE:

ISSUE DATE: <u>06-23-2023</u>

CAD DWG FILE: X2212-01-52157815215013-G-002.DWG

DRAWN BY: KET/MNS
CHECKED BY: BDF

DESIGNED BY: BDF

SHEET TITLE:
SITE MAPS AND DRAWING INDEX

SHEET NUMBER:



BARRY D. FREINER Registered Professional Engineer MO # E-24220 Expires 12-31-2024

ROGERS-SCHMIDT ENGINEERING CO., P.C. CONSULTING ENGINEERS

1736 WEST PARK CENTER DR. SUITE 204 ST. LOUIS, MO 63026 PHONE: 636-600-1551 MISSOURI STATE CERTIFICATE OF AUTHORITY #000408

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PROJECT # X2212-01 5215

7815215013 ASSET# **REVISION:**

REVISION: REVISION:

ISSUE DATE: <u>06-23-2023</u>

CAD DWG FILE: X2212-01-5215-7815215013-C-101.DWG

DRAWN BY: MNS/KET
CHECKED BY: BDF
DESIGNED BY: BDF

SHEET TITLE: CIVIL SITE PLAN

SHEET NUMBER:

03 OF 50 SHEETS

JUNE 23, 2023

C. ALL UG UTILITIES ARE PRIVATELY (STATE) OWNED. FIELD LOCATE ALL UTILTITIES PRIOR TO ANY EXCAVATING.

GENERATOR ABOVE

OKEY NOTES:

- 1. <u>DELEGATED DESIGN:</u> CONTRACTOR'S GEOTECHNICAL ENGINEER SHALL PROVIDE SOIL BORING(S) AND SUBSURFACE EXPLORATION REPORT FOR NEW FOUNDATION & ELECT EQUIP PAD DESIGNS PRIOR TO PROCEEDING. REPORT SHALL BE SEALED BY MISSOURI PROFESSIONAL ENGINEER.
- 2. <u>DELEGATED DESIGN:</u> GENERATOR FOUNDATION AND ELECT EQUIP PAD, INCLUDING ANCHORAGE AND REGRADING OF SLOPE, SHALL BE DESIGNED AND SEALED BY CONTRACTOR'S MISSOURI PROFESSIONAL ENGINEER AND PROVIDED AS A SHOP DWG SUBMITTAL. FOUNDATION AND ANCHORAGE DESIGN SHALL BE FULLY COORDINATED WITH DIESEL-ENGINE-DRIVEN GENERATOR SET MANUFACTURER'S INSTALLATION INSTRUCTIONS FOR SEISMICALLY CERTIFIED EQUIPMENT PROVIDED.

STATE OF MISSOURI MICHAEL L. PARSON, **GOVERNOR**



BARRY D. FREINER Registered Professional Engineer MO # E-24220 Expires 12-31-2024

ROGERS-SCHMIDT

ENGINEERING CO., P.C. CONSULTING ENGINEERS 1736 WEST PARK CENTER DR. SUITE 204 ST. LOUIS, MO 63026 PHONE: 636-600-1551 MISSOURI STATE CERTIFICATE OF AUTHORITY #000408

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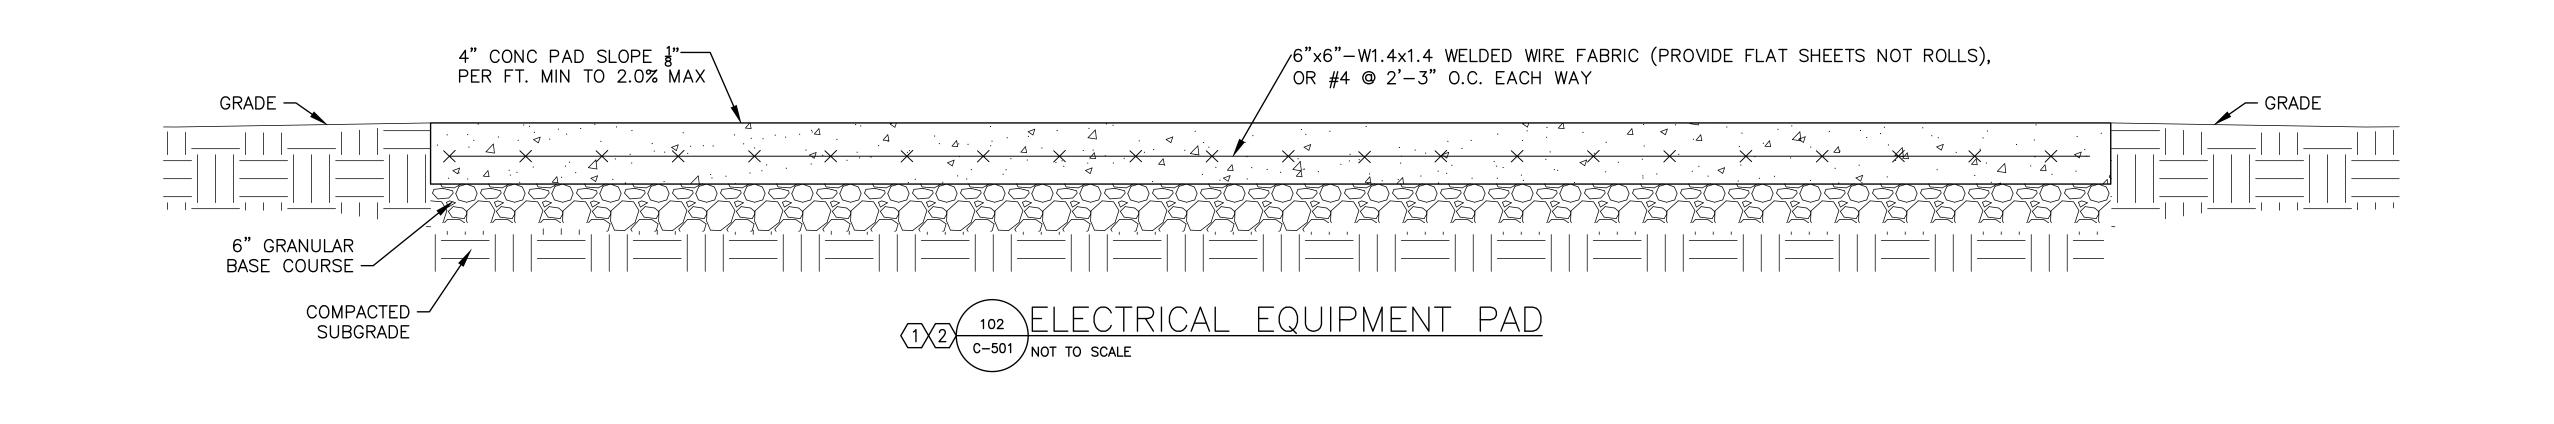
ISSUE DATE: <u>06-23-2023</u>

CAD DWG FILE: X2212-01-5215-7815215013-C-501.DWG DRAWN BY: MNS/KET
CHECKED BY: BDF
DESIGNED BY: B D F

SHEET TITLE:

CIVIL DETAILS

SHEET NUMBER:





BARRY D. FREINER Registered Professional Engineer MO # E-24220 Expires 12-31-2024

ROGERS-SCHMIDT ENGINEERING CO.. P.C. **CONSULTING ENGINEERS** 1736 WEST PARK CENTER DR SUITE 204 ST. LOUIS, MO 63026 PHONE: 636-600-1551 MISSOURI STATE CERTIFICATE

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SITE# 5215 7815215013 ASSET#

REVISION: DATE: **REVISION:**

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ISSUE DATE: 06-23-2023

CAD DWG FILE: X2212-01-5215-

7815215013-E-001.DWG

DRAWN BY: KET/MNS CHECKED BY: BDF DESIGNED BY: BDF

SHEET TITLE: ELECTRICAL

SYMBOLS, ABBREVIATIONS & GENERAL NOTES

SHEET NUMBER:


05 OF 50 SHEETS JUNE 23, 2023



CATWALK)

CEILING DOME

FLOOR LEDGE

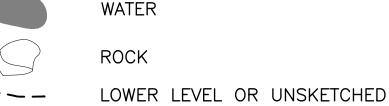

PASSAGE SLOPE (OPENS IN DIRECTION OF SLOPE)

APPROX CEILING HEIGHT

COLUMN, FLOWSTONE


STALAGMITE, STALACTITE

ELECTRICAL SYMBOLS

1	KEYNOTE; SPECIFICALLY REFERENCED TO AN ITEM ON THE FIELD OF THE DRAWING. DIGITS IDENTIFY NOTE NUMBER.	1116	HOME RUN TO PANEL — SHORT STROKES INDICATE PHASE OR SWITCHED WIRES, LONG STROKE DENOTES NEUTRAL,	NO OE	AUTOMATIC TRANSFER SWITCH (ATS)
Ŭ _x	EXISTING LANTERN LTG FIXTURE "x" INDICATES CIRCUIT EXISTING FEATURE LTG FIXTURE	- 1111	LONG STROKE WITH DOT DENOTES GROUND. #12 AWG WIRES IN \(\frac{3}{4} \) "GRC UNLESS NOTED OTHERWISE.		CIRCUIT BREAKER
E _x W _x	"x" INDICATES CIRCUIT EXISTING WALKWAY LTG FIXTURE "x" INDICATES CIRCUIT		CONDUIT EXPOSED		FUSIBLE DISCONNECT SWITCH
		——Э	CONDUIT OR CABLE TURNED DOWN		
	EXISTING LED ROPE LIGHT		CONDUIT OR CABLE TURNED UP	00	NON-FUSIBLE DISCONNECT SWITCH
	SURFACE MTD STRIP LIGHT		CONDUIT BELOW GRADE	M	ELECTRIC REVENUE METER
	NEW DIRECTIONAL FEATURE LTG FIXTURE NEW FEATURE LTG FIXTURE (AIMED	~~~	FLEXIBLE CONDUIT OR CABLE	—	TOGGLE SWITCH
\bigcup	VERTICALLY UPWARD)	I		-o оШо-	FUSED DISCONNECT SWITCH
	NEW TRAIL HANDRAIL STRIP LIGHT		WIRING CROSSING, CONNECTION		FUOF
MS	MOTION SENSOR	-	WIRING CROSSING, NO CONNECTION	- 	FUSE
\$	SINGLE POLE SWITCH	•	EQUIPMENT CONNECTION	<u>-010</u> -	OFF PUSHBUTTON
\$ ^{s#}	LTG CNTRL STATION		EXISTING CONTROL PANEL		ON PUSHBUTTON
Ψ	"#" INDICATES STATION NUMBER		NEW CONTROL PANEL	0-11-0	NORMALLY CLOSED CONTACT
	EXIST BATTERY OPERATED EMERGENCY LIGHT		EXISTING PANELBOARD	0—1—0	NORMALLY OPEN CONTACT
\triangle	EXIST EMERGENCY LIGHT REMOTE HEADS			m m	TRANSFORMER
1040	EXIT SIGN - SINGLE FACE WALL MTD		NEW PANELBOARD DISCONNECT SWITCH		CURRENT TRANSFORMER (SHOWN WITH POLARITY MARKS, RATIO & QUANTITY)
⊕ ^{GFCI/WP}	120V GFCI DUPLEX RECEPTACLE W/ WEATHERPROOF COVER	Χh	F = FUSIBLE N = NON-FUSIBLE	CPT E	CONTROL POWER TRANSFORMER
\triangle_{ET}	EXIST EMERGENCY TELEPHONE	J	JUNCTION BOX	\otimes	GROUNDING ROD
▲ ET	NEW EMERGENCY TELEPHONE	©	GENERATOR	<u></u>	EARTH GROUNDING CONNECTION
				\mathcal{A}	CHASSIS GROUNDING CONNECTION

GENERAL ELECTRICAL NOTES:

- A. THE CONTRACTOR SHALL PROVIDE ALL HOLES IN BLDG WALLS AS REQUIRED FOR CONDUIT ROUTING. SEAL PENETRATIONS IN ACCORDANCE WITH THE SPECIFICATIONS.
- B. COORDINATE EXACT LOCATIONS OF CONDUIT RUNS WITH EXISTING CONDITIONS AND WITH THE CONSTRUCTION REPRESENTATIVE. INDICATE FINAL ROUTING OF ALL CONDUITS ON "AS BUILT" DRAWINGS.
- C. ALL INFORMATION CONTAINED ON THIS DRAWING APPLIES TO ES, ED, E AND T SERIES DRAWINGS.
- D. THERE MAY BE SYMBOLS AND/OR ABBREVIATIONS SHOWN ON THIS SHEET THAT ARE NOT APPLICABLE TO THIS PROJECT.
- E. ALL ELECTRICAL WORK SHALL BE IN ACCORDANCE WITH THE 2020 NATIONAL ELECTRICAL CODE (NEC).
- F. CONTRACTOR SHALL REFERENCE SPECIFICATIONS FOR CONSTRUCTION MATERIALS AND INSTALLATION PROCEDURES. SPECIFICATIONS ARE A PART OF THE CONSTRUCTION DOCUMENTS. SHOULD ANY CONFLICT ARISE BETWEEN THE DRAWINGS AND SPECIFICATIONS, SUCH CONFLICT SHALL BE BROUGHT TO THE ATTENTION OF THE CONSTRUCTION REPRESENTATIVE FOR RESOLUTION.
- G. THESE DRAWINGS ARE DIAGRAMMATIC IN CHARACTER AND DO NOT NECESSARILY SHOW MATERIALS FOR A COMPLETE INSTALLATION. PLANS DO NOT INDICATE VERTICAL GRADE CHANGES.
- H. LOCATIONS AND INFORMATION FOR EXISTING ELECTRICAL DEVICES AND EQUIPMENT SHOWN ON THESE PLANS ARE APPROXIMATE. THIS INFORMATION IS DERIVED FROM FIELD OBSERVATIONS AND LIMITED DRAWINGS THAT WERE AVAILABLE AT THE TIME THESE DRAWINGS WERE ISSUED FOR BIDDING. THE CONTRACTOR IS TO VERIFY ACTUAL FIELD CONDITIONS PRIOR TO STARTING WORK.
- UP-TO-DATE AS-BUILT ELECTRICAL PLANS ARE NOT AVAILABLE FOR THIS SITE. INFORMATION FOR EXISTING CIRCUITRY IS BASED ON EXISTING PANEL DIRECTORIES, LIMITED AVAILABLE DRAWINGS, AND ASSUMPTIONS. IF SIGNIFICANT DISCREPANCIES ARE FOUND THAT CANNOT BE EASILY DEALT WITH. CONTACT THE DESIGNER.
- J. COORDINATE WITH CAVE NATURALIST FOR BEST MEANS OF ACCESS FOR DIFFICULT TO REACH LIGHTING FIXTURES.

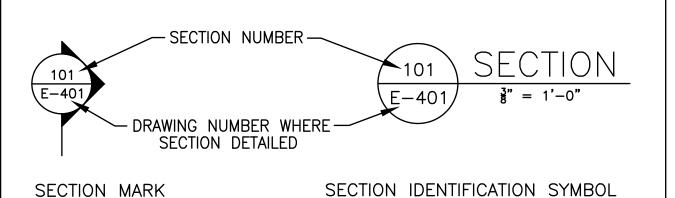

AMPERES ABAND ABANDONED AC ALTERNATING CURRENT ADJUST AMP FUSE OR AMP FRAME ABOVE FINISHED FLOOR ABOVE GRADE AMPERE INTERRUPTING CAPACITY (RMS SYMMETRICAL) ALUMINUM APPROX APPROXIMATELY OR APPROXIMATE ASSOC ASSOCIATED AT AMP TRIP AUTO AUTOMATIC AMERICAN WIRE GAUGE BELOW GRADE BREAKER BLDG BUILDING BSMT BASEMENT BYP BYPASS CONDUIT CIRCUIT BREAKER CKT CIRCUIT CEILING CONCRETE MASONRY UNIT CNTRL CONTROL COMB COMBINATION CONC CONCRETE CP CONTROL PANEL CONTROL POWER TRANSFORMER CURRENT TRANSFORMER CENTER CU COPPER DIRECT CURRENT DISCONNECT DN DOWN DEEP OR DISTRIBUTION PANEL DS DISCONNECT SWITCH DWG DRAWING EL ELEVATION ELEC ELECTRIC OR ELECTRICAL EMER EMERGENCY EMT ELECTRICAL METALLIC TUBING ENCL ENCLOSURE EPO EMERGENCY POWER OFF EXH EXHAUST EXIST EXISTING FUSE OR FUSIBLE FDR FEEDER FL FLOOR FO FIBER OPTIC FOR FORWARD FVNR FULL VOLTAGE NON REVERSING GALV GALVANIZED GENERATOR CONTROL PANEL GROUND FAULT CIRCUIT INTERRUPTER GRAP GENERATOR REMOTE ANNUNCIATOR PANEL GRC GALVANIZED RIGID STEEL CONDUIT GROUND HANDHOLE HPDE HIGH DENSITY POLYETHYLENE CONDUIT HORSEPOWER HTR HEATER FREQUENCY IN CYCLES PER SECOND INCL INCLUDING INS INSULATED

INSTR INSTRUMENT OR INSTRUMENTATION JUNCTION BOX J-BOX KA KILOAMPERE(S) KILOAMPERE INTERRUPTING CAPACITY (RMS SYMMETRICAL)

KVA KILOVOLT-AMPERE(S) KW KILOWATT(S) KWh KILOWATT-HOUR(S)

LIGHTNING ARRESTER LFMC LIQUIDTIGHT FLEXIBLE METAL CONDUIT LIGHTNING PROTECTION OR LIGHTING PANELBOARD LSI LONG TIME, SHORT TIME, INSTANTANEOUS LTG LIGHTING M METER mA MILLIAMPERE(S) MCB MAIN CIRCUIT BREAKER MCS MOLDED CASE SWITCH MDP MAIN DISTRIBUTION PANEL MLO MAIN LUG ONLY MTD MOUNTED NORMALLY CLOSED N.O. NORMALLY OPENED N/A NOT APPLICABLE NEC NATIONAL ELECTRICAL CODE NOM NOMINAL NF NON-FUSED NIGHT LIGHT NOT TO SCALE OR NON-AUTOMATIC TRANSFER SWITCH POLE(S) PNL PANEL PNLBD PANELBOARD PP POWER PANELBOARD PSU POWER SUPPLY UNIT PTT PUSH-TO-TEST SCHEDULE 40 POLYVINYLCHLORIDE CONDUIT RAC RIGID ALUMINUM CONDUIT RECPT RECEPTACLE REQD REQUIRED REQMTS REQUIREMENTS RM ROOM RMC RIGID METAL CONDUIT RMS ROOT MEAN SQUARE RSSC RIGID STAINLESS STEEL CONDUIT SCH SCHEDULE SHLD SHIELD OR SHIELDED SPD SURGE PROTECTIVE DEVICE SS SELECTOR SWITCH OR STAINLESS STEEL SHUNT TRIP STA STATION STL STEEL STRD STRANDED SW SWITCH SYM SYMMETRICAL TERMINAL BLOCK TOP OF CONCRETE TELE TELEPHONE TEMP TEMPORARY TCMB THERMAL MAGNETIC CIRCUIT BREAKER TS TIME SWITCH TYP TYPICAL UNDERGROUND ELECTRIC UG UNDERGROUND VOLT(S) VA VOLT-AMPERE(S) W WATT(S)WITH W/O WITHOUT WP WEATHERPROOF XFMR TRANSFORMER Z IMPEDANCE AND DELTA NUMBER % PERCENT THOUSAND CIRCULAR MIL(S) ø PHASE KV KILOVOLT(S)

A. FIELD VERIFY EXISTING CONDITIONS PRIOR TO BID.

○ KEY NOTES:

- 1. 3"GRC-3/0 AL TRIPLEX & (1) 3PR CABLE. REMOVE 3/0 AL TRIPLEX FROM SE DISC SW ON POLE TO DISC SW INSIDE CAVE. 3PR TELEPHONE CABLE TO REMAIN. SEE DWG ED-112.
- 2. REPLACE EXIST CONDUCTORS WITH NEW 3#2/0 & 1#2 GRD IN EXIST 2" PVC CÖNDUIT.
- 3. CONTRACTOR SHALL PUMP WATER OUT OF SUBMARINE RM, WHEN TEMP OUTSIDE CAVE IS ≥40°F, TO ALLOW ACCESS FOR REMOVAL OF EXIST CONDUCTORS AND INSTALLATION OF NEW TYPE MC CABLE. SEE DWGS ED-113 & E-113.
- 4. PROVIDE 8' HIGH TEMP PLYWOOD WALLS TO PROTECT BLDG WALLS AND DISPLAY
- 5. PROVIDE PLYWOOD ON FLOOR TO PROTECT FLOOR TILES.

STATE OF MISSOURI MICHAEL L. PARSON, GOVERNOR



BARRY D. FREINER Registered Professional Engineer MO # E-24220 Expires 12-31-2024

ROGERS-SCHMIDT

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OFFICE OF ADMINISTRATION DIVISION OF FACILITIES MANAGEMENT, DESIGN AND CONSTRUCTION

DEPARTMENT OF NATURAL RESOURCES DIVISION OF STATE PARKS

UPGRADE CAVE ELECTRIC

ONONDAGA CAVE STATE PARK 7556 HWY H LEASBURG, MO 65535

PROJECT # X2212-01 5215 SITE#

ASSET # 7815215013

REVISION: REVISION: DATE: **REVISION:**

ISSUE DATE: <u>06-23-2023</u>

CAD DWG FILE: X2212-01-5215-7815215013-ES-101.DWG

DRAWN BY: KET/MNS
CHECKED BY: BDF

DESIGNED BY: BDF SHEET TITLE:

ABOVE GROUND SITE PLAN

SHEET NUMBER:

ES-101

PROJECT GENERAL NOTES:

- A. FIELD VERIFY EXISTING CONDITIONS PRIOR TO BID.
- B. PROVIDE A PLAN INDICATING PHASING OF WORK FOR REVIEW AND APPROVAL OF CONSTRUCTION REPRESENTATIVE PRIOR TO COMMENCING WITH ANY WORK.
- C. ALL CABLE ROUTING AND CONNECTIONS MADE TO SURFACES IN THE CAVE SHALL BE COORDINATED WITH AND APPROVED BY THE PARK NATURALIST & CONSTRUCTION REPRESENTATIVE PRIOR TO ROUGH—IN.
- D. ALL METAL DEVICES IN THE CAVE INCLUDING, BUT NOT LIMITED TO, HINGES, LATCHES, SCREWS, MOUNTING PLATES, MOUNTING FRAMES, ETC., SHALL BE TYPE 304 OR 316 STAINLESS STEEL UNLESS OTHERWISE NOTED.
- E. DIMENSIONS INDICATED ARE APPROXIMATE. FIELD VERIFY EXACT DIMENSIONS AND DISTANCES WITH SLOPE OF CAVE AND CAVE FEATURES PRIOR TO INSTALLATION. SCALES INDICATED ON PLAN SHEETS ARE FOR GENERAL INFORMATION ONLY. ACTUAL DISTANCES IN CAVE WILL VARY DUE TO GRADE CHANGES, RESOURCE LAYOUT, AND LIMITATIONS OF CAVE MAP.
- F. PROVIDE NEW TRAIL CABLE CROSSINGS, PER DETAIL 204/E-502, IN ADDITION TO THOSE SHOWN ON DWGS E-101 THRU E-113, IF/AS REQUIRED. COORDINATE EXACT LOCATION OF ALL NEW TRAIL CROSSINGS WITH PARK NATURALIST & CONSTRUCTION REPRESENTATIVE PRIOR TO ROUGH-IN.
- G. BOND ALL METAL EQUIPMENT INCLUDING, BUT NOT LIMITED TO, TRANSFORMERS, PANELBOARDS, MOUNTING SUPPORTS, HANDRAILS, ETC. TO THE ELECTRICAL GROUNDING SYSTEM WITH #6 CU WIRE MINIMUM.
- H. "ABOVE GROUND" SHALL REFER TO INSTALLATIONS OR EQUIPMENT ABOVE THE SURFACE GROUND LEVEL OR IN THE OPEN AIR OF THE CAVE.
- I. PROVIDE COMPRESSION TYPE PIN ADAPTERS TO ACCOMMODATE LARGER WIRE SIZES FOR CONNECTION TO EQUIPMENT WHERE REQUIRED PER SPECIFICATION SECTION 260583.
- J. PROVIDE CABLE IDENTIFICATION FOR ALL CABLE TYPES AT BOTH SIDES OF ALL TRAIL CROSSINGS. CABLE IDENTIFICATION SHALL BE 304 STAINLESS STEEL LABEL CONNECTED WITH 304 STAINLESS STEEL CABLE TIE. PANDUIT MARKER TABS AND CABLE TIES OR APPROVED EQUAL. THE CABLE DESCRIPTION SHALL BE ENGRAVED ON THE LABEL. COORDINATE SIZE OF LABEL WITH PROVIDING MINIMUM OF 24 POINT TEXT HEIGHT.
- K. ALL PWR AND CNTRL CABLES INSTALLED INSIDE THE CAVE SHALL BE
- L. NEW WIRING SHALL NOT BE RUN IN WATER EXCEPT CABLES FOR LIGHTING FIXTURES LOCATED IN POOLS.
- M. ALL EQUIP, LTG FIXTURE AND PSU LOCATIONS SHALL BE APPROVED BY CAVE NATURALIST & CONSTRUCTION REPRESENTATIVE PRIOR TO ROUGH—IN.
- N. DEMOLITION WORK MAY BE COMPLETED AFTER NEW WORK IN EACH AREA IS COMPLETED OR AFTER ALL WORK IS COMPLETED. WHICHEVER IS MOST EFFICIENT. SEE SPECIFICATION SECTION 011000.

OKEY NOTES:

- 1. EXIST PNLBD A TO BE REPLACED WITH NEW PNLBD A IN NEW LOCATION. SEE DWGS ED-101 & E-101.
- 2. EXIST PNLBD B TO BE REMOVED. SEE DWG ED-104.
- 3. EXIST PNLBD C TO BE REPLACE WITH NEW PNLBD B IN EXIST LOCATION. SEE DWGS ED-105 & E-105.
- 4. EXIST PNLBD E TO BE REPLACED WITH NEW PNLBD C IN EXIST LOCATION. SEE DWGS ED-108 & E-108.
- 5. EXIST PNLBD G TO BE REPLACED WITH NEW PNLBD D IN NEW LOCATION. SEE DWGS ED-110 & E-110.
- 6. EXIST PNLBD F TO BE REPLACED WITH NEW PNLBD E IN EXIST LOCATION. SEE DWGS ED-111 & E-111.
- 7. EXIST PNLBD J TO BE REPLACED WITH NEW PNLBD F IN EXIST LOCATION. SEE DWGS ED-113 & E-113.
- 8. EXIST PNLBD I1 TO BE REMOVED. SEE DWG ED-106.
- 9. EXIST PNLBD I TO BE REPLACED WITH NEW PNLBD G IN NEW LOCATION. SEE DWGS ED-106 & E-106.
- 10. EXIST PNLBD H TO BE REPLACED WITH NEW PNLBD H IN NEW LOCATION. SEE DWGS ED-109 & E-109.
- 11. WORK ON DWGS ED-113 & E-113 SHALL BE COMPLETED LAST DUE TO WEATHER ISSUES WITH SUBMARINE ROOM. PROVIDE TEMP POWER CONNECTION FOR NEW PNLBD's G & H FROM NEW PNLBD C.

STATE OF MISSOURI MICHAEL L. PARSON, GOVERNOR



BARRY D. FREINER
Registered Professional Engineer
MO # E-24220
Expires 12-31-2024

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DATE:

ISSUE DATE: <u>06-23-2023</u>

CAD DWG FILE: X2212-01-5215-

7815215013-ES-102.DWG

DRAWN BY: KET/MNS

CHECKED BY: BDF

DESIGNED BY: BDF

SHEET TITLE:

CAVE SITE PLAN

SHEET NUMBER:

ES-102

- A. FIELD VERIFY EXISTING CONDITIONS PRIOR TO BID.
- B. PROVIDE TEMPORARY POWER TO VISITORS CENTER DURING SERVICE EQUIPMENT REPLACEMENT.
- C. CONTACT KURTIS REED, ENGINEERING MGR AT CRAWFORD ELECTRIC, AT 573-732-4415 X160 FOR DISCONNECTION OF EXIST ELECTRIC SERVICE TO THE VISITORS CENTER AND

○ KEY NOTES:

- 1. REMOVE CONDUCTORS FROM EXIST CONDUIT. CONDUIT TO REMAIN.
- 2. EXIST ITEM(S) TO BE REMOVED.
- 3. REMOVE METER BASE/SOCKET AFTER CRAWFORD ELECTRIC REMOVES THEIR REVENUE METER(S).
- 4. REMOVE EXIST CONC PAD.
- 5. REMOVE EXIST PRESSURE TREATED 6X6'S.

STATE OF MISSOURI MICHAEL L. PARSON, **GOVERNOR**



BARRY D. FREINER Registered Professional Engineer MO # E-24220 Expires 12-31-2024

ROGERS-SCHMIDT ENGINEERING CO., P.C.

CONSULTING ENGINEERS 1736 WEST PARK CENTER DR. SUITE 204 ST. LOUIS, MO 63026 PHONE: 636-600-1551 MISSOURI STATE CERTIFICATE OF AUTHORITY #000408

OFFICE OF ADMINISTRATION DIVISION OF FACILITIES MANAGEMENT, DESIGN AND CONSTRUCTION

DEPARTMENT OF NATURAL RESOURCES DIVISION OF STATE PARKS

UPGRADE CAVE ELECTRIC

ONONDAGA CAVE STATE PARK 7556 HWY H LEASBURG, MO 65535

PROJECT # X2212-01 5215 SITE#

7815215013 ASSET# **REVISION:**

DATE: **REVISION:** DATE: **REVISION:** DATE:

ISSUE DATE: <u>06-23-2023</u>

CAD DWG FILE: X2212-01-5215-7815215013-ES-401.DWG

DRAWN BY: KET/MNS
CHECKED BY: BDF
DESIGNED BY: BDF

SHEET TITLE:

ENLARGED SITE PLAN -DEMOLITION

SHEET NUMBER:

A. FIELD VERIFY EXISTING CONDITIONS PRIOR TO BID.

○ KEY NOTES:

- 1. CONNECT NEW 2"PVC TO EXIST UG 2"PVC.
- 2. 3#2/0 & 1#2 GRD IN EXIST 2" PVC
- 3. 2"PVC-3#2/0 & 1#2 GRD
- 4. PROVIDE TYPE 4X SS HINGED COVER J-BOX; 16"Hx14"Wx6"D.
- 5. PVC JACKETED TYPE MC CABLE (3#2/0 & 3#6 GRD) IN EXIST $2\frac{1}{2}$ "PVC.
- 6. NSTALL CT FURNISHED WITH LOAD BANK ON B-PHASE EMERG SOURCE CONDUCTOR IN ATS AND PROVIDE UG 1"C - 1 CABLE (2/C#14) & 2#12 CT LEADS TO CNTRL PNL ON LOAD BANK.
- 7. 1"C-2#12 & 1#12 GRD TO MDP
- 8. ARRANGE NEW PNLBD LOCATION TO ALLOW CONNECTION OF (2) EXIST 3"C-3#500KCM & 1#2 GRD FROM EXIST PNLBD MP1 & PNLBD MP2.
- 9. REQUEST CRAWFORD ELECTRIC TO MOVE XFMR SOUTH AS REQD TO PROVIDE 5'-0" MIN CLEARANCE BETWEEN XFMR & NEW ELECT EQUIP PER NEC 110.34(A).
- 10. 3"C-3#500KCM & 1#3/0 GRD
- 11. 1"C-2#8 & 1#10 GRD TO MDP
- 12. $1\frac{1}{4}$ "C-2#2 & 1#6 GRD
- 13. CONCRETE PAD. SEE DWGS C-101 & C-501.
- 14. 2"C-3#4/0 & 1#2 GRD

STATE OF MISSOURI MICHAEL L. PARSON, **GOVERNOR**



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OFFICE OF ADMINISTRATION DIVISION OF FACILITIES MANAGEMENT, DESIGN AND CONSTRUCTION

DEPARTMENT OF NATURAL RESOURCES DIVISION OF STATE PARKS

UPGRADE CAVE ELECTRIC

ONONDAGA CAVE STATE PARK 7556 HWY H LEASBURG, MO 65535

PROJECT # X2212-01 5215 SITE#

7815215013 ASSET# **REVISION: REVISION:**

DATE: **REVISION:**

ISSUE DATE: <u>06-23-2023</u>

CAD DWG FILE: X2212-01-5215-7815215013-ES-402.DWG

DRAWN BY: KET/MNS

CHECKED BY: BDF

DESIGNED BY: B D F

SHEET TITLE:

ENLARGED SITE PLAN - NEW WORK

SHEET NUMBER:

- A. FIELD VERIFY EXISTING CONDITIONS PRIOR TO BID.
- B. REMOVE ALL EXIST LTG FIXTURES, INCL ALL ASSOC WIRING & LTG SW STATIONS, UNLESS NOTED OTHERWISE. SEE DWG E-101 FOR NEW LTG FIXTURES.
- C. REMOVE ALL EXPOSED CONDUCTORS & CABLES FROM WITHIN THE CAVE INCLUDING THOSE LYING IN POOLS OF WATER AND THE LOST RIVER. BURIED WIRING SHALL BE CUT OFF 6" BG AND ABANDONED IN PLACE.
- D. REMOVE ALL EXIST LIGHT SHIELDS SUBJECT TO APPROVAL BY PARK NATURALIST.

○ KEY NOTES:

- 1. SERVED FROM AIRLOCK ELECTRICAL SERVICE. SEE DWG ES-101.
- 2. REMOVE EXIST PNLBD, RELAY PNL AND ALL ASSOC PWR, BRANCH CKT AND CNTRL CONDUITS AND CONDUCTORS. SEE DWG E-101 FOR NEW PNLBD LOCATION.
- REMOVE EXIST BATTERY POWERED EMER LTG UNIT, INCL ASSOC SUPPORT POST, CONDUIT, WIRING AND FUSED DISC SW AT SOURCE PNLBD.
- 4. EXIST ITEM(S) TO BE REMOVED.

CAVE KEY PLAN

STATE OF MISSOURI MICHAEL L. PARSON, **GOVERNOR**



BARRY D. FREINER Registered Professional Engineer MO # E-24220 Expires 12-31-2024

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OFFICE OF ADMINISTRATION DIVISION OF FACILITIES MANAGEMENT, DESIGN AND CONSTRUCTION

DEPARTMENT OF NATURAL RESOURCES DIVISION OF STATE PARKS

UPGRADE CAVE ELECTRIC

ONONDAGA CAVE STATE PARK 7556 HWY H LEASBURG, MO 65535

PROJECT # X2212-01 5215 SITE#

7815215013

REVISION: REVISION: REVISION:

ASSET#

ISSUE DATE: <u>06-23-2023</u>

CAD DWG FILE: X2212-01-5215-7815215013-ED-101.DWG

DRAWN BY: KET

CHECKED BY: B D F

DESIGNED BY: B D F

SHEET TITLE: CAVE ELECTRICAL **DEMOLITION PLAN** - SECTION A

SHEET NUMBER:

10 OF 50 SHEETS JUNE 23, 2023

NORTH $\frac{\text{CAVE E}}{\text{SCALE: }\frac{1}{8}\text{"=1'-0"}}$

- A. FIELD VERIFY EXISTING CONDITIONS PRIOR TO BID.
- B. REMOVE ALL EXIST LTG FIXTURES, INCL ALL ASSOC WIRING & LTG SW STATIONS, UNLESS NOTED OTHERWISE. SEE DWG E-102 FOR NEW LTG FIXTURES.
- C. REMOVE ALL EXPOSED CONDUCTORS & CABLES FROM WITHIN THE CAVE INCLUDING THOSE LYING IN POOLS OF WATER AND THE LOST RIVER. BURIED WIRING SHALL BE CUT OFF 6" BG AND ABANDONED IN PLACE.
- D. REMOVE ALL EXIST LIGHT SHIELDS SUBJECT TO APPROVAL BY PARK NATURALIST.

CAVE KEY PLAN

STATE OF MISSOURI MICHAEL L. PARSON, GOVERNOR



BARRY D. FREINER Registered Professional Engineer MO # E-24220 Expires 12-31-2024

ROGERS-SCHMIDT ENGINEERING CO., P.C.

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OFFICE OF ADMINISTRATION DIVISION OF FACILITIES MANAGEMENT, DESIGN AND CONSTRUCTION

DEPARTMENT OF NATURAL RESOURCES DIVISION OF STATE PARKS

UPGRADE CAVE ELECTRIC

ONONDAGA CAVE STATE PARK 7556 HWY H LEASBURG, MO 65535

PROJECT # X2212-01 5215 SITE#

ASSET # 7815215013

REVISION: DATE: REVISION: DATE: REVISION:

ISSUE DATE: <u>06-23-2023</u>

CAD DWG FILE: X2212-01-5215-7815215013-ED-102.DWG

DRAWN BY: KET

CHECKED BY: BDF

DESIGNED BY: BDF

SHEET TITLE: CAVE ELECTRICAL DEMOLITION PLAN - SECTION B

SHEET NUMBER:

ED-102



BARRY D. FREINER Registered Professional Engineer MO # E-24220 Expires 12-31-2024

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OFFICE OF ADMINISTRATION DIVISION OF FACILITIES MANAGEMENT, DESIGN AND CONSTRUCTION

DEPARTMENT OF NATURAL RESOURCES DIVISION OF STATE PARKS

UPGRADE CAVE ELECTRIC

ONONDAGA CAVE STATE PARK 7556 HWY H LEASBURG, MO 65535

PROJECT # X2212-01 5215

7815215013

REVISION: DATE: REVISION: DATE:

ASSET#

REVISION:

CAD DWG FILE: X2212-01-5215-7815215013-ED-103.DWG

DRAWN BY: KET/MNS
CHECKED BY: BDF
DESIGNED BY: BDF

SHEET TITLE: CAVE ELECTRICAL DEMOLITION PLAN

SHEET NUMBER:

ED-103

- SECTION C

ALL ASSOC PWR. BRANCH CKT AND CNTRL

STATE OF MISSOURI MICHAEL L. PARSON, **GOVERNOR**



BARRY D. FREINER Registered Professional Engineer MO # E-24220

Expires 12-31-2024 **ROGERS-SCHMIDT** ENGINEERING CO., P.C.

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DEPARTMENT OF NATURAL RESOURCES DIVISION OF STATE PARKS

UPGRADE CAVE ELECTRIC

ONONDAGA CAVE STATE PARK 7556 HWY H LEASBURG, MO 65535

PROJECT # X2212-01 5215

SITE# 7815215013 ASSET#

REVISION: REVISION: DATE: **REVISION:**

ISSUE DATE: <u>06-23-2023</u>

CAD DWG FILE: X2212-01-5215-7815215013-ED-104.DWG

DRAWN BY: KET

CHECKED BY: BDF

DESIGNED BY: BDF

SHEET TITLE: CAVE ELECTRICAL DEMOLITION PLAN - SECTION D

SHEET NUMBER:

- A. FIELD VERIFY EXISTING CONDITIONS PRIOR TO BID.
- B. REMOVE ALL EXIST LTG FIXTURES, INCL ALL ASSOC WIRING & LTG SW STATIONS, UNLESS NOTED OTHERWISE. SEE DWG E-105 FOR NEW LTG FIXTURES.
- C. REMOVE ALL EXPOSED CONDUCTORS & CABLES FROM WITHIN THE CAVE INCLUDING THOSE LYING IN POOLS OF WATER AND THE LOST RIVER. BURIED WIRING SHALL BE CUT OFF 6" BG AND ABANDONED IN PLACE.
- D. REMOVE ALL EXIST LIGHT SHIELDS SUBJECT TO APPROVAL BY PARK NATURALIST.

OKEY NOTES:

- 1. SERVED FROM AIRLOCK ELECTRICAL SERVICE. SEE DWG ES-101.
- 2. REMOVE EXIST PNLBD, RELAY PNL AND ALL ASSOC PWR, BRANCH CKT AND CNTRL CONDUITS AND CONDUCTORS. SEE DWG E-105 FOR NEW PNLBD LOCATION.
- 3. REMOVE EXIST BATTERY POWERED EMER LTG UNIT, INCL ASSOC SUPPORT POST, CONDUIT, WIRING AND FUSED DISC SW AT SOURCE PNLBD.
- 4. LOCATED UNDER BRIDGE.
- 5. REMOVE EXIST RADIO REPEATER/ANTENNA AND ASSOC COAX CABLE TO SOURCE/DESTINATION.
- 6. EXIST 2-WAY RADIO, 12VDC BATTERY AND ALL ASSOC CABLES TO SOURCE/DESTINATION ARE TO REMAIN.

CAVE KEY PLAN

STATE OF MISSOURI MICHAEL L. PARSON, **GOVERNOR**



BARRY D. FREINER Registered Professional Engineer MO # E-24220 Expires 12-31-2024

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DEPARTMENT OF NATURAL RESOURCES DIVISION OF STATE PARKS

UPGRADE CAVE ELECTRIC

ONONDAGA CAVE STATE PARK 7556 HWY H LEASBURG, MO 65535

PROJECT # X2212-01 5215

7815215013

REVISION: REVISION: DATE: **REVISION:**

ASSET#

ISSUE DATE: <u>06-23-2023</u>

CAD DWG FILE: X2212-01-5215-7815215013-ED-105.DWG

DRAWN BY: KET/MNS
CHECKED BY: BDF

DESIGNED BY: BDF

SHEET TITLE:

CAVE ELECTRICAL DEMOLITION PLAN - SECTION E

SHEET NUMBER:

ED-105



BARRY D. FREINER Registered Professional Engineer MO # E-24220 Expires 12-31-2024

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OFFICE OF ADMINISTRATION DIVISION OF FACILITIES MANAGEMENT, DESIGN AND CONSTRUCTION

DEPARTMENT OF NATURAL RESOURCES DIVISION OF STATE PARKS

UPGRADE CAVE ELECTRIC

ONONDAGA CAVE STATE PARK 7556 HWY H LEASBURG, MO 65535

PROJECT # X2212-01 5215

7815215013 ASSET#

REVISION: REVISION: REVISION:

CAD DWG FILE: X2212-01-5215-7815215013-ED-106.DWG

DRAWN BY: KET

CHECKED BY: B D F

DESIGNED BY: B D F

SHEET TITLE: CAVE ELECTRICAL **DEMOLITION PLAN**

- SECTION F

SHEET NUMBER:

- A. FIELD VERIFY EXISTING CONDITIONS PRIOR TO BID.
- B. REMOVE ALL EXIST LTG FIXTURES, INCL ALL ASSOC WIRING & LTG SW STATIONS, UNLESS NOTED OTHERWISE. SEE DWG E-107 FOR NEW LTG FIXTURES.
- C. REMOVE ALL EXPOSED CONDUCTORS & CABLES FROM WITHIN THE CAVE INCLUDING THOSE LYING IN POOLS OF WATER AND THE LOST RIVER. BURIED WIRING SHALL BE CUT OFF 6" BG AND ABANDONED IN PLACE.
- D. REMOVE ALL EXIST LIGHT SHIELDS SUBJECT TO APPROVAL BY PARK NATURALIST.

OKEY NOTES:

- 1. REMOVE EXIST BATTERY POWERED EMER LTG UNIT, INCL ASSOC SUPPORT POST, CONDUIT, WIRING AND FUSED DISC SW AT SOURCE PNLBD.
- 2. LOCATED UNDER BRIDGE.

CAVE KEY PLAN

STATE OF MISSOURI MICHAEL L. PARSON, **GOVERNOR**



BARRY D. FREINER Registered Professional Engineer MO # E-24220 Expires 12-31-2024

ROGERS-SCHMIDT ENGINEERING CO., P.C.

CONSULTING ENGINEERS 1736 WEST PARK CENTER DR. SUITE 204 ST. LOUIS, MO 63026 PHONE: 636-600-1551 MISSOURI STATE CERTIFICATE OF AUTHORITY #000408

OFFICE OF ADMINISTRATION DIVISION OF FACILITIES MANAGEMENT, DESIGN AND CONSTRUCTION

DEPARTMENT OF NATURAL RESOURCES DIVISION OF STATE PARKS

UPGRADE CAVE ELECTRIC

ONONDAGA CAVE STATE PARK 7556 HWY H LEASBURG, MO 65535

PROJECT # X2212-01 5215

7815215013

REVISION: REVISION: DATE: **REVISION:**

ASSET#

ISSUE DATE: <u>06-23-2023</u>

CAD DWG FILE: X2212-01-5215-7815215013-ED-107.DWG

DRAWN BY: KET


CHECKED BY: BDF

DESIGNED BY: B D F

SHEET TITLE: CAVE ELECTRICAL DEMOLITION PLAN - SECTION G

SHEET NUMBER:

ED-107

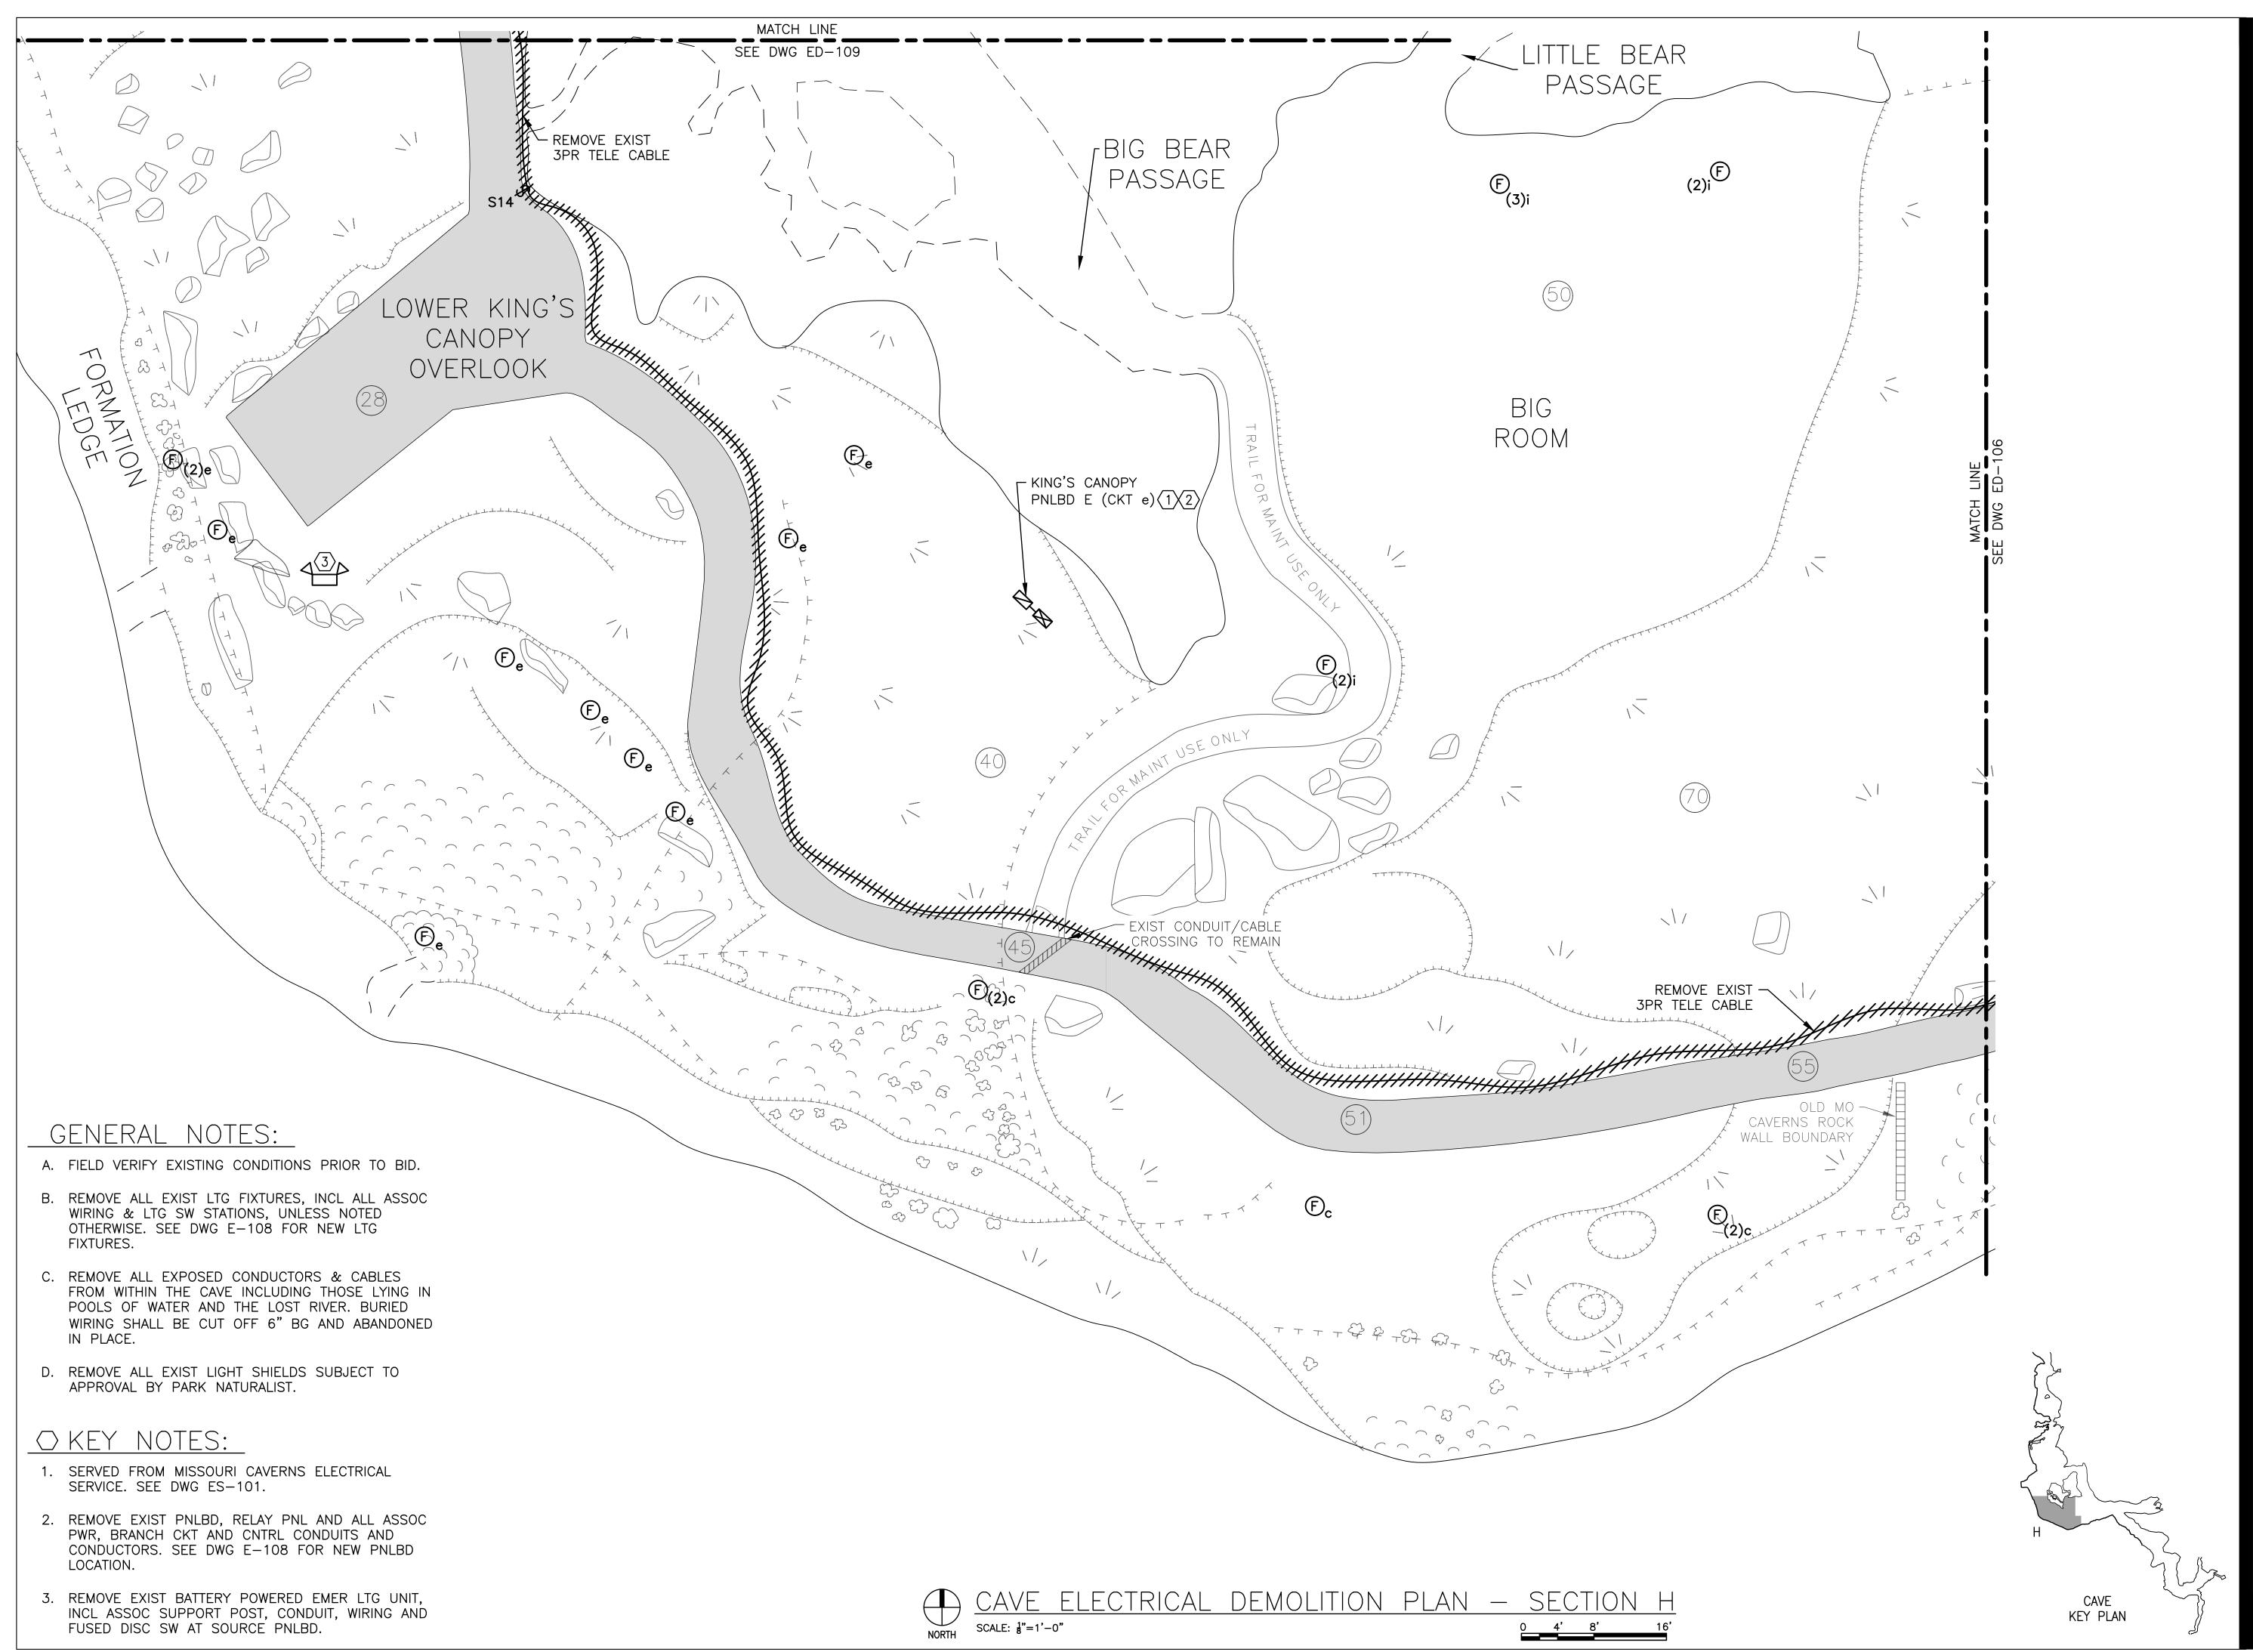



BARRY D. FREINER
Registered Professional Engineer
MO # E-24220
Expires 12-31-2024

ROGERS-SCHMIDT

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1736 WEST PARK CENTER DR.
SUITE 204
ST. LOUIS, MO 63026
PHONE: 636-600-1551
MISSOURI STATE CERTIFICATE
OF AUTHORITY #000408

OFFICE OF ADMINISTRATION
DIVISION OF FACILITIES
MANAGEMENT,
DESIGN AND CONSTRUCTION

DEPARTMENT OF NATURAL RESOURCES DIVISION OF STATE PARKS

UPGRADE CAVE ELECTRIC

ONONDAGA CAVE STATE PARK 7556 HWY H LEASBURG, MO 65535

PROJECT # X2212-01 SITE # 5215

ASSET#

7815215013

REVISION:
DATE:
REVISION:
DATE:
REVISION:

ISSUE DATE: <u>06-23-2023</u>

CAD DWG FILE: X2212-01-5215-

CAD DWG FILE: X2212-01 7815215013-ED-108.DWG DRAWN BY: <u>KET</u>

DRAWN BY: KET
CHECKED BY: BDF
DESIGNED BY: BDF

SHEET TITLE:

CAVE ELECTRICAL
DEMOLITION PLAN
- SECTION H

SHEET NUMBER:

ED-108



BARRY D. FREINER Registered Professional Engineer MO # E-24220 Expires 12-31-2024

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DEPARTMENT OF NATURAL RESOURCES DIVISION OF STATE PARKS

UPGRADE CAVE ELECTRIC

ONONDAGA CAVE STATE PARK 7556 HWY H LEASBURG, MO 65535

PROJECT # X2212-01 5215 SITE#

7815215013

REVISION: REVISION: DATE:

ASSET#

REVISION:

CAD DWG FILE: X2212-01-5215-7815215013-ED-109.DWG

DRAWN BY: KET

CHECKED BY: B D F

DESIGNED BY: B D F

SHEET TITLE: CAVE ELECTRICAL **DEMOLITION PLAN** - SECTION I

SHEET NUMBER:

ED-109



BARRY D. FREINER Registered Professional Engineer MO # E-24220 Expires 12-31-2024

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DEPARTMENT OF NATURAL RESOURCES DIVISION OF STATE PARKS

UPGRADE CAVE ELECTRIC

ONONDAGA CAVE STATE PARK 7556 HWY H LEASBURG, MO 65535

PROJECT # X2212-01 5215 SITE#

7815215013

REVISION: REVISION:

ASSET#

REVISION:

ISSUE DATE: <u>06-23-2023</u>

CAD DWG FILE: X2212-01-5215-7815215013-ED-110.DWG

DRAWN BY: KET

CHECKED BY: B D F

DESIGNED BY: B D F

SHEET TITLE: CAVE ELECTRICAL **DEMOLITION PLAN**

- SECTION J

SHEET NUMBER:

- A. FIELD VERIFY EXISTING CONDITIONS
- B. REMOVE ALL EXIST LTG FIXTURES, INCL ALL ASSOC WIRING & LTG SW STATIONS, UNLESS NOTED OTHERWISE. SEE DWG E-111 FOR NEW LTG FIXTURES.
- CABLES FROM WITHIN THE CAVE INCLUDING THOSE LYING IN POOLS OF WATER AND THE LOST RIVER. BURIED WIRING SHALL BE CUT OFF 6" BG AND
- SUBJECT TO APPROVAL BY PARK
- 1. SERVED FROM MISSOURI CAVERNS ELECTRICAL SERVICE. SEE DWG ES-101.
- 2. REMOVE EXIST PNLBD, RELAY PNL AND ALL ASSOC PWR, BRANCH CKT AND CNTRL CONDUITS AND CONDUCTORS. SEE DWG E-111 FOR NEW PNLBD LOCATION.
- LTG UNIT, INCL ASSOC SUPPORT POST, CONDUIT, WIRING AND FUSED DISC SW AT
- 5. REMOVE EXIST POTHEAD FITTING AND



BARRY D. FREINER Registered Professional Engineer MO # E-24220 Expires 12-31-2024

ROGERS-SCHMIDT ENGINEERING CO., P.C. CONSULTING ENGINEERS 1736 WEST PARK CENTER DR. SUITE 204 ST. LOUIS, MO 63026 PHONE: 636-600-1551 MISSOURI STATE CERTIFICATE

OF AUTHORITY #000408

OFFICE OF ADMINISTRATION DIVISION OF FACILITIES MANAGEMENT, DESIGN AND CONSTRUCTION

DEPARTMENT OF NATURAL RESOURCES DIVISION OF STATE PARKS

UPGRADE CAVE ELECTRIC

ONONDAGA CAVE STATE PARK 7556 HWY H LEASBURG, MO 65535

PROJECT # X2212-01 5215 SITE#

7815215013

REVISION: REVISION: REVISION:

ASSET#

CAD DWG FILE: X2212-01-5215-7815215013-ED-111.DWG

DRAWN BY: KET

CHECKED BY: BDF

DESIGNED BY: B D F SHEET TITLE:

CAVE ELECTRICAL **DEMOLITION PLAN** - SECTION K

SHEET NUMBER:

- A. FIELD VERIFY EXISTING CONDITIONS PRIOR TO BID.
- B. REMOVE ALL EXIST LTG FIXTURES, INCL ALL ASSOC WIRING & LTG SW STATIONS, UNLESS NOTED OTHERWISE. SEE DWG E-112 FOR NEW LTG FIXTURES.
- C. REMOVE ALL EXPOSED CONDUCTORS & CABLES FROM WITHIN THE CAVE INCLUDING THOSE LYING IN POOLS OF WATER AND THE LOST RIVER. BURIED WIRING SHALL BE CUT OFF 6" BG AND ABANDONED IN PLACE.
- D. REMOVE ALL EXIST LIGHT SHIELDS SUBJECT TO APPROVAL BY PARK NATURALIST.

○ KEY NOTES:

- 1. REMOVE ABAND DISC SW AND CONC PEDESTAL.
- 2. REMOVE 3/0 AL TRIPLEX UP TO SE DISC SW ON POLE ABOVE. (1) 3PR TELEPHONE CABLE TO REMAIN.
- 3. EXIST ITEM(S) TO BE REMOVED.

CAVE KEY PLAN

STATE OF MISSOURI MICHAEL L. PARSON, **GOVERNOR**



BARRY D. FREINER Registered Professional Engineer MO # E-24220 Expires 12-31-2024

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OFFICE OF ADMINISTRATION DIVISION OF FACILITIES MANAGEMENT, DESIGN AND CONSTRUCTION

NATURAL RESOURCES DIVISION OF STATE PARKS

UPGRADE CAVE ELECTRIC

ONONDAGA CAVE

PROJECT # X2212-01 5215

REVISION: DATE: REVISION: DATE: **REVISION:**

ISSUE DATE: <u>06-23-2023</u>

SHEET TITLE:

CAVE ELECTRICAL DEMOLITION PLAN - SECTION L

SHEET NUMBER:

21 OF 50 SHEETS JUNE 23, 2023

DEPARTMENT OF

STATE PARK	
7556 HWY H	
LEASBURG, MO	65535

7815215013 ASSET#

CAD DWG FILE: X2212-01-5215-7815215013-ED-112.DWG

DRAWN BY: KET

CHECKED BY: BDF

DESIGNED BY: B D F

CAVE ELECTRICAL DEMOLITION PLAN — SECTION M

SCALE: §"=1'-0"

O 4' 8' 16'

GENERAL NOTES:

- A. FIELD VERIFY EXISTING CONDITIONS PRIOR TO BID.
- B. REMOVE ALL EXIST LTG FIXTURES, INCL ALL ASSOC WIRING & LTG SW STATIONS, UNLESS NOTED OTHERWISE. SEE DWG E-113 FOR NEW LTG FIXTURES.
- C. REMOVE ALL EXPOSED CONDUCTORS & CABLES FROM WITHIN THE CAVE INCLUDING THOSE LYING IN POOLS OF WATER AND THE LOST RIVER. BURIED WIRING SHALL BE CUT OFF 6" BG AND ABANDONED IN PLACE.
- D. REMOVE ALL EXIST LIGHT SHIELDS, UNLESS OTHERWISE NOTED, AND SUBJECT TO APPROVAL BY PARK NATURALIST.

OKEY NOTES:

- 1. #2 THW CONDUCTORS SPLICED TO 1/0 TYPE RHH-RHW TO PANEL J AND CONTINUING ON TO PANEL I1 ON DWG ED-106. SEE DWG ES-101.
- 2. REMOVE EXIST PNLBD, RELAY PNL AND ALL ASSOC PWR, BRANCH CKT AND CNTRL CONDUITS AND CONDUCTORS. SEE DWG E-113 FOR NEW PNLBD LOCATION.
- 3. REMOVE EXIST BATTERY POWERED EMER LTG UNIT/REMOTE HEADS, INCL ASSOC SUPPORT POST, CONDUIT, WIRING AND FUSED DISC SW AT SOURCE PNLBD.
- 4. REMOVE 12"X6"X30"L LOOSE CONC BLOCK FROM UNDER ELEVATED WALKWAY.
- 5. CONTRACTOR SHALL PUMP WATER OUT OF SUBMARINE RM, WHEN TEMP OUTSIDE CAVE IS ≥40°F, TO ALLOW ACCESS TO EXIST CONDUCTORS FOR REMOVAL.
- 6. EXIST LIGHT SHIELD TO REMAIN.
- 7. COORDINATE WITH PARK NATURALIST FOR

CAVE KEY PLAN

STATE OF MISSOURI MICHAEL L. PARSON, **GOVERNOR**



BARRY D. FREINER Registered Professional Engineer MO # E-24220 Expires 12-31-2024

ROGERS-SCHMIDT ENGINEERING CO., P.C. CONSULTING ENGINEERS 1736 WEST PARK CENTER DR. SUITE 204 ST. LOUIS, MO 63026 PHONE: 636-600-1551

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DEPARTMENT OF NATURAL RESOURCES DIVISION OF STATE PARKS

UPGRADE CAVE ELECTRIC

ONONDAGA CAVE

ASSET# **REVISION: REVISION:**

SHEET TITLE:

CAVE ELECTRICAL **DEMOLITION PLAN** - SECTION M

SHEET NUMBER:

22 OF 50 SHEETS JUNE 23, 2023

DESIGN AND CONSTRUCTION

ONONDAIGH CALVE
STATE PARK
7556 HWY H
LEASBURG, MO 6553

PROJECT # X2212-01 5215 7815215013

REVISION:

ISSUE DATE: <u>06-23-2023</u>

CAD DWG FILE: X2212-01-5215-7815215013-ED-113.DWG

DRAWN BY: KET

CHECKED BY: BDF

DESIGNED BY: B D F



A. ALL CONDUCTORS ARE STRD CU UNLESS NOTED OTHERWISE.

○ KEY NOTES:

- 1. SEE DWG ED-602 FOR CONTINUATION.
- 2. SEE DWG ED-603 FOR CONTINUATION.
- 3. SEE DWG ED-604 FOR CONTINUATION.
- 4. EXIST ITEM(S) TO BE REMOVED.
- 5. REMOVE EXIST CONDUCTORS. CONDUIT TO REMAIN.
- 6. CRAWFORD ELECTRIC TO DISC SERVICE ON POLE, REMOVE METER AND INSTALL BLANK OFF AT METER OPENING.
- COORDINATE THIS WORK WITH KURTIS REED, CRAWFORD ELECTRIC ENGINEERING MGR, AT 573-732-4415 x160.

STATE OF MISSOURI MICHAEL L. PARSON, **GOVERNOR**



BARRY D. FREINER Registered Professional Engineer MO # E-24220 Expires 12-31-2024

ROGERS-SCHMIDT ENGINEERING CO., P.C.

CONSULTING ENGINEERS 1736 WEST PARK CENTER DR SUITE 204 ST. LOUIS, MO 63026 PHONE: 636-600-1551 MISSOURI STATE CERTIFICATE OF AUTHORITY #000408

OFFICE OF ADMINISTRATION DIVISION OF FACILITIES MANAGEMENT, DESIGN AND CONSTRUCTION

DEPARTMENT OF NATURAL RESOURCES DIVISION OF STATE PARKS

UPGRADE CAVE ELECTRIC

ONONDAGA CAVE STATE PARK 7556 HWY H LEASBURG, MO 65535

PROJECT # X2212-01

5215 SITE# ASSET # 7815215013

REVISION: DATE: **REVISION:** DATE: **REVISION:**

DATE: ISSUE DATE: <u>06-23-2023</u>

CAD DWG FILE: X2212-01-5215-7815215013-ED-601.DWG


DRAWN BY: KET/MNS CHECKED BY: BDF DESIGNED BY: BDF

SHEET TITLE:


ONE-LINE DIAGRAMS (EXIST CONDITION)

SHEET NUMBER:

23 OF 50 SHEETS JUNE 23, 2023

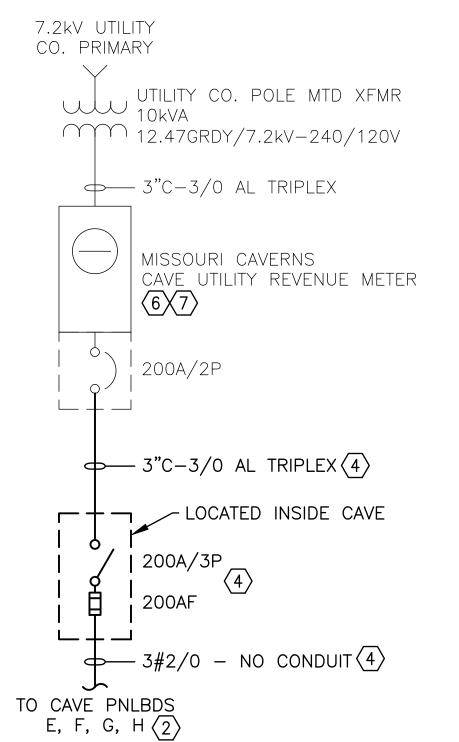

EXIST ONE-LINE DIAGRAM FOR MISSOURI CAVERNS CAVE SERVICE ENTRANCE

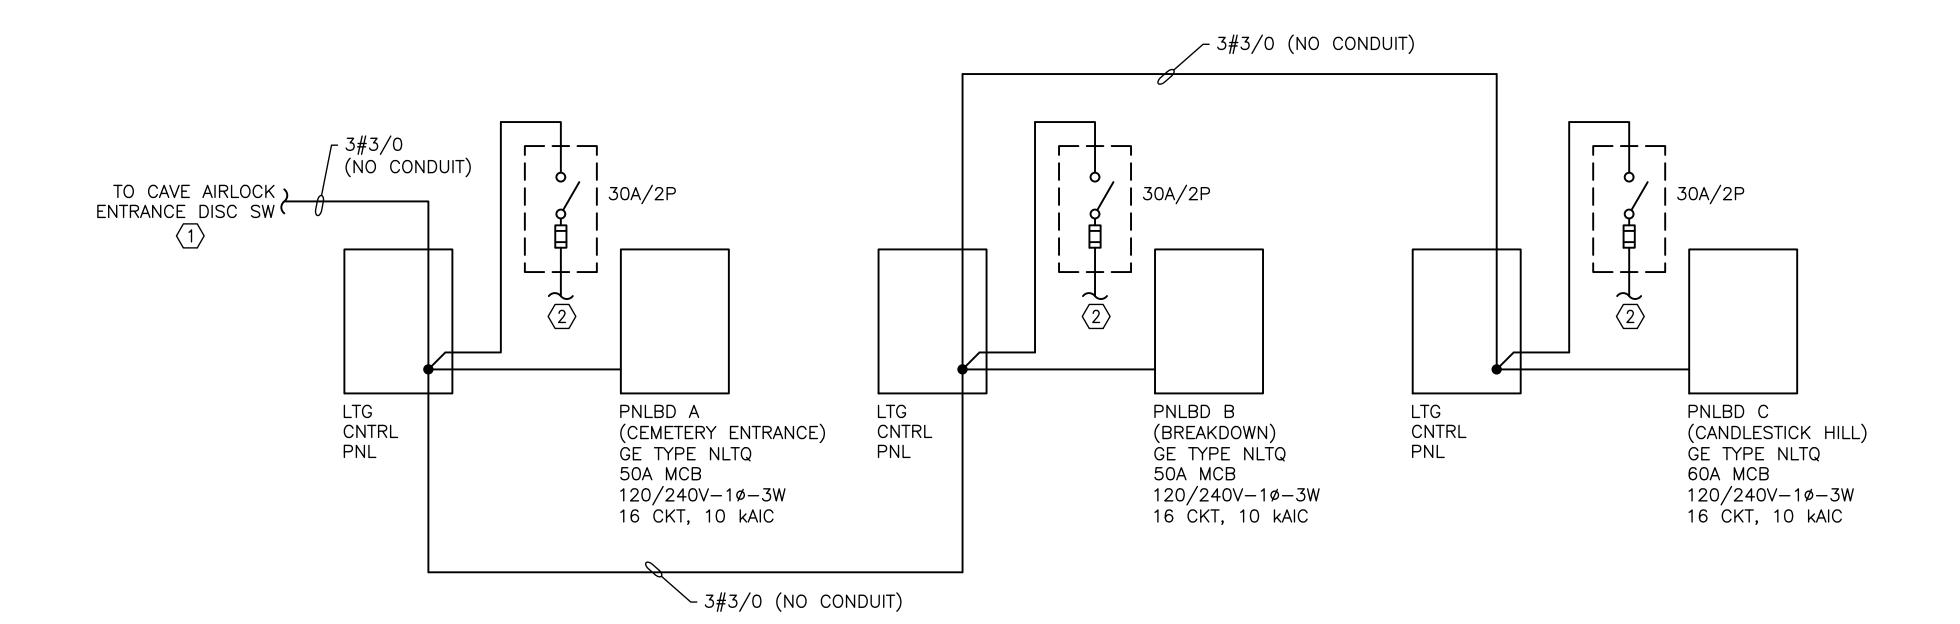

EXIST ONE-LINE DIAGRAM FOR CAVE AIRLOCK SERVICE

GENERAL NOTES:

- A. ALL CONDUCTORS ARE CU UNLESS NOTED OTHERWISE.
- B. ALL ITEMS SHOWN ON THIS DWG ARE TO BE REMOVED UNLESS NOTED OTHERWISE.

OKEY NOTES:

- 1. SEE DWG ED-601 FOR CONTINUATION.
- 2. 2#10 TO EMERG LTG FIXTURES.

STATE OF MISSOURI MICHAEL L. PARSON, **GOVERNOR**



BARRY D. FREINER Registered Professional Engineer MO # E-24220

Expires 12-31-2024 ROGERS-SCHMIDT

ENGINEERING CO., P.C. CONSULTING ENGINEERS 1736 WEST PARK CENTER DR. SUITE 204 ST. LOUIS, MO 63026 PHONE: 636-600-1551 MISSOURI STATE CERTIFICATE OF AUTHORITY #000408

OFFICE OF ADMINISTRATION DIVISION OF FACILITIES MANAGEMENT, DESIGN AND CONSTRUCTION

DEPARTMENT OF NATURAL RESOURCES DIVISION OF STATE PARKS

UPGRADE CAVE ELECTRIC

ONONDAGA CAVE STATE PARK 7556 HWY H LEASBURG, MO 65535

PROJECT # X2212-01 5215

ASSET # 7815215013

REVISION: REVISION: DATE: **REVISION:**

ISSUE DATE: <u>06-23-2023</u>

CAD DWG FILE: X2212-01-5215-7815215013- ED-602.DWG

DRAWN BY: KET

CHECKED BY: BDF

DESIGNED BY: BDF

SHEET TITLE:

ONE-LINE AIRLOCK SERVICE (EXIST CONDITION)

SHEET NUMBER:

-3#2/0 (NO CONDUIT)

EXIST ONE-LINE DIAGRAM FOR MISSOURI CAVERNS SERVICE

GENERAL NOTES:

- A. ALL CONDUCTORS ARE CU UNLESS NOTED OTHERWISE.
- B. ALL ITEMS SHOWN ON THIS DWG ARE TO BE REMOVED UNLESS NOTED OTHERWISE.

OKEY NOTES:

- 1. SEE DWG ED-601 FOR CONTINUATION.
- 2. 2#10 TO EMERG LTG FIXTURES.

STATE OF MISSOURI MICHAEL L. PARSON, **GOVERNOR**



BARRY D. FREINER Registered Professional Engineer MO # E-24220

Expires 12-31-2024 ROGERS-SCHMIDT

ENGINEERING CO., P.C. CONSULTING ENGINEERS 1736 WEST PARK CENTER DR. SUITE 204 ST. LOUIS, MO 63026 PHONE: 636-600-1551 MISSOURI STATE CERTIFICATE OF AUTHORITY #000408

OFFICE OF ADMINISTRATION DIVISION OF FACILITIES MANAGEMENT, DESIGN AND CONSTRUCTION

DEPARTMENT OF NATURAL RESOURCES DIVISION OF STATE PARKS

UPGRADE CAVE ELECTRIC

ONONDAGA CAVE STATE PARK 7556 HWY H LEASBURG, MO 65535

PROJECT # X2212-01 5215

ASSET # 7815215013

REVISION: REVISION: DATE: REVISION:

ISSUE DATE: <u>06-23-2023</u>

CAD DWG FILE: X2212-01-5215-7815215013- ED-603.DWG

DRAWN BY: KET

CHECKED BY: BDF

DESIGNED BY: BDF

SHEET TITLE: ONE-LINE MO

CAVERNS SERVICE (EXIST CONDITION)

SHEET NUMBER:

EXIST ONE-LINE DIAGRAM FOR SUBMARINE ROOM SERVICE

GENERAL NOTES:

- A. ALL CONDUCTORS ARE CU UNLESS NOTED OTHERWISE.
- B. ALL ITEMS SHOWN ON THIS DWG ARE TO BE REMOVED UNLESS NOTED OTHERWISE.

OKEY NOTES:

- 1. SEE DWG ED-601 FOR CONTINUATION.
- 2. 2#10 TO EMERG LTG FIXTURES.

STATE OF MISSOURI MICHAEL L. PARSON, GOVERNOR



BARRY D. FREINER Registered Professional Engineer MO # E-24220 Expires 12-31-2024

ROGERS-SCHMIDT

ENGINEERING CO., P.C. CONSULTING ENGINEERS 1736 WEST PARK CENTER DR. SUITE 204 ST. LOUIS, MO 63026 PHONE: 636-600-1551 MISSOURI STATE CERTIFICATE OF AUTHORITY #000408

OFFICE OF ADMINISTRATION DIVISION OF FACILITIES MANAGEMENT, DESIGN AND CONSTRUCTION

DEPARTMENT OF NATURAL RESOURCES DIVISION OF STATE PARKS

UPGRADE CAVE ELECTRIC

ONONDAGA CAVE STATE PARK 7556 HWY H LEASBURG, MO 65535

PROJECT # X2212-01 5215

ASSET # 7815215013

REVISION: REVISION: DATE: **REVISION:**

ISSUE DATE: <u>06-23-2023</u>

CAD DWG FILE: X2212-01-5215-7815215013- ED-604.DWG

DRAWN BY: KET

CHECKED BY: BDF

DESIGNED BY: BDF

SHEET TITLE:

ONE-LINE SUBMARINE ROOM SERVICE (EXIST CONDITION)


SHEET NUMBER:

- A. FIELD VERIFY EXISTING CONDITIONS PRIOR TO BID.
- B. PROVIDE NEW LTG FIXTURES PER THE NEW LIGHTING FIXTURE SCHEDULE ON DWG E-605 AND SPECIFICATION SECTIONS 265113 & 265613.
- C. PROVIDE NEW PSU's PER THE SCHEDULE ON DWGS E-606 & E-607 AND SPECIFICATION SECTION 265613.
- D. PROVIDE NEW LTG CNTRL STATIONS PER DETAIL 101/E-501, DWG E-608 AND SPECIFICATION SECTION 260943.23.
- E. PLACE PSU's AND LTG FIXTURES AS SHOWN BUT DO NOT REMOVE ANY EXCESS CABLE FROM LTG FIXTURES. CAVE LTG DESIGNER SHALL ESTABLISH FINAL PLACEMENTS AND FIXTURE AIMING PRIOR TO SUBSTANTIAL COMPLETION. ONCE FINAL LOCATION(S) HAVE BEEN APPROVED, ROUTE CABLES FROM FIXTURES TO PSU's IN AS CONCEALABLE A PATH AS POSSIBLE. COIL EXCESS CABLE IN AN INCONSPICUOUS LOCATION. DO NOT CUT FACTORY CABLE ON LTG FIXTURES.

○ KEY NOTES:


- 1. SERVED FROM AIRLOCK FEEDER. SEE DWGS ES-402 & E-602.
- 2. PROVIDE NEW PNLBD PER SPECIFICATION SECTION 262416 IN COMMON SS ENCL W/ LTG CNTRLS.
- 3. MOUNT TO WALL AT 3'-0" AFF.
- 4. $\frac{3}{4}$ "PVC-2#12 & 1#12 GRD
- 5. MOUNT LTG FIXTURE TO CONC PAVER PER DETAIL 105/E-501.
- 6. INSTALL ON UPPER LEVEL OF THE CAVE.
- 7. INSTALL NEW CABLE SLEEVE PER DETAIL 204/E-502.

TG FIXTURE NAMING:

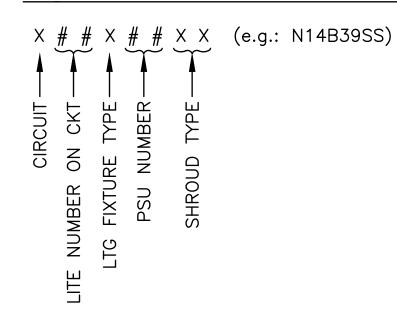

SHROUD TYPES:

S = SNOOTSS = SHORT SHROUDLS = LONG SHROUD

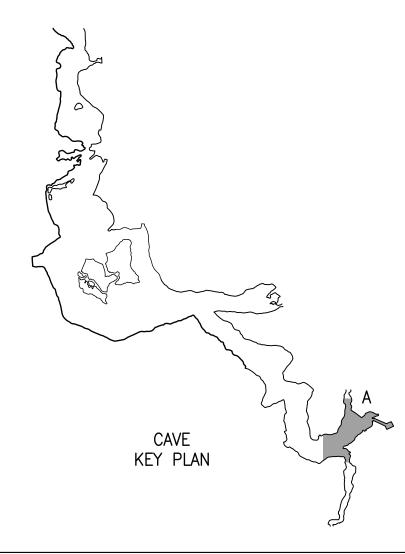

STATE OF MISSOURI MICHAEL L. PARSON, **GOVERNOR**



BARRY D. FREINER Registered Professional Engineer MO # E-24220

Expires 12-31-2024 **ROGERS-SCHMIDT** ENGINEERING CO., P.C.

CONSULTING ENGINEERS

1736 WEST PARK CENTER DR. SUITE 204 ST. LOUIS, MO 63026 PHONE: 636-600-1551 MISSOURI STATE CERTIFICATE OF AUTHORITY #000408

OFFICE OF ADMINISTRATION DIVISION OF FACILITIES MANAGEMENT, DESIGN AND CONSTRUCTION

DEPARTMENT OF NATURAL RESOURCES DIVISION OF STATE PARKS

UPGRADE CAVE ELECTRIC

ONONDAGA CAVE STATE PARK 7556 HWY H LEASBURG, MO 65535

PROJECT # X2212-01 5215 SITE#

7815215013 ASSET# **REVISION: REVISION:**

REVISION:

ISSUE DATE: <u>06-23-2023</u>

CAD DWG FILE: X2212-01-5215-7815215013-E-101.DWG

DRAWN BY: KET

CHECKED BY: BDF

DESIGNED BY: B D F

SHEET TITLE: CAVE ELECTRICAL PLAN - SECTION A

SHEET NUMBER:

JUNE 23, 2023

27 OF 50 SHEETS

- A. FIELD VERIFY EXISTING CONDITIONS PRIOR TO BID.
- B. PROVIDE NEW LTG FIXTURES PER THE NEW LIGHTING FIXTURE SCHEDULE ON DWG E-605 AND SPECIFICATION SECTION 265613.
- C. PLACE PSU's AND LTG FIXTURES AS SHOWN BUT DO NOT REMOVE ANY EXCESS CABLE FROM LTG FIXTURES. CAVE LTG DESIGNER SHALL ESTABLISH FINAL PLACEMENTS AND FIXTURE AIMING PRIOR TO SUBSTANTIAL COMPLETION. ONCE FINAL LOCATION(S) HAVE BEEN APPROVED, ROUTE CABLES FROM FIXTURES TO PSU's IN AS CONCEALABLE A PATH AS POSSIBLE. COIL EXCESS CABLE IN AN INCONSPICUOUS LOCATION. DO NOT CUT FACTORY CABLE ON LTG FIXTURES.

OKEY NOTE:

1. MOUNT LTG FIXTURE TO CONC PAVER PER DETAIL 105/E-501.

LTG FIXTURE NAMING:

X # # X # # X X (e.g.: N14B39SS)

SHROUD TYPES:

CAVE KEY PLAN

S = SNOOTSS = SHORT SHROUD LS = LONG SHROUD

OFFICE OF ADMINISTRATION DIVISION OF FACILITIES MANAGEMENT, DESIGN AND CONSTRUCTION

STATE OF MISSOURI

MICHAEL L. PARSON,

BARRY D. FREINER

Registered Professional Engineer

MO # E-24220

Expires 12-31-2024

ROGERS-SCHMIDT

ENGINEERING CO., P.C.

CONSULTING ENGINEERS

1736 WEST PARK CENTER DR.

SUITE 204 ST. LOUIS, MO 63026 PHONE: 636-600-1551 MISSOURI STATE CERTIFICATE

OF AUTHORITY #000408

GOVERNOR

DEPARTMENT OF NATURAL RESOURCES DIVISION OF STATE PARKS

UPGRADE CAVE ELECTRIC

ONONDAGA CAVE STATE PARK 7556 HWY H LEASBURG, MO 65535

PROJECT # X2212-01 5215 SITE# ASSET # 7815215013

REVISION: DATE: REVISION: DATE: **REVISION:**

ISSUE DATE: <u>06-23-2023</u>

CAD DWG FILE: X2212-01-5215-7815215013-E-102.DWG


DRAWN BY: KET

CHECKED BY: BDF

DESIGNED BY: BDF

SHEET TITLE: CAVE ELECTRICAL PLAN - SECTION B

SHEET NUMBER:

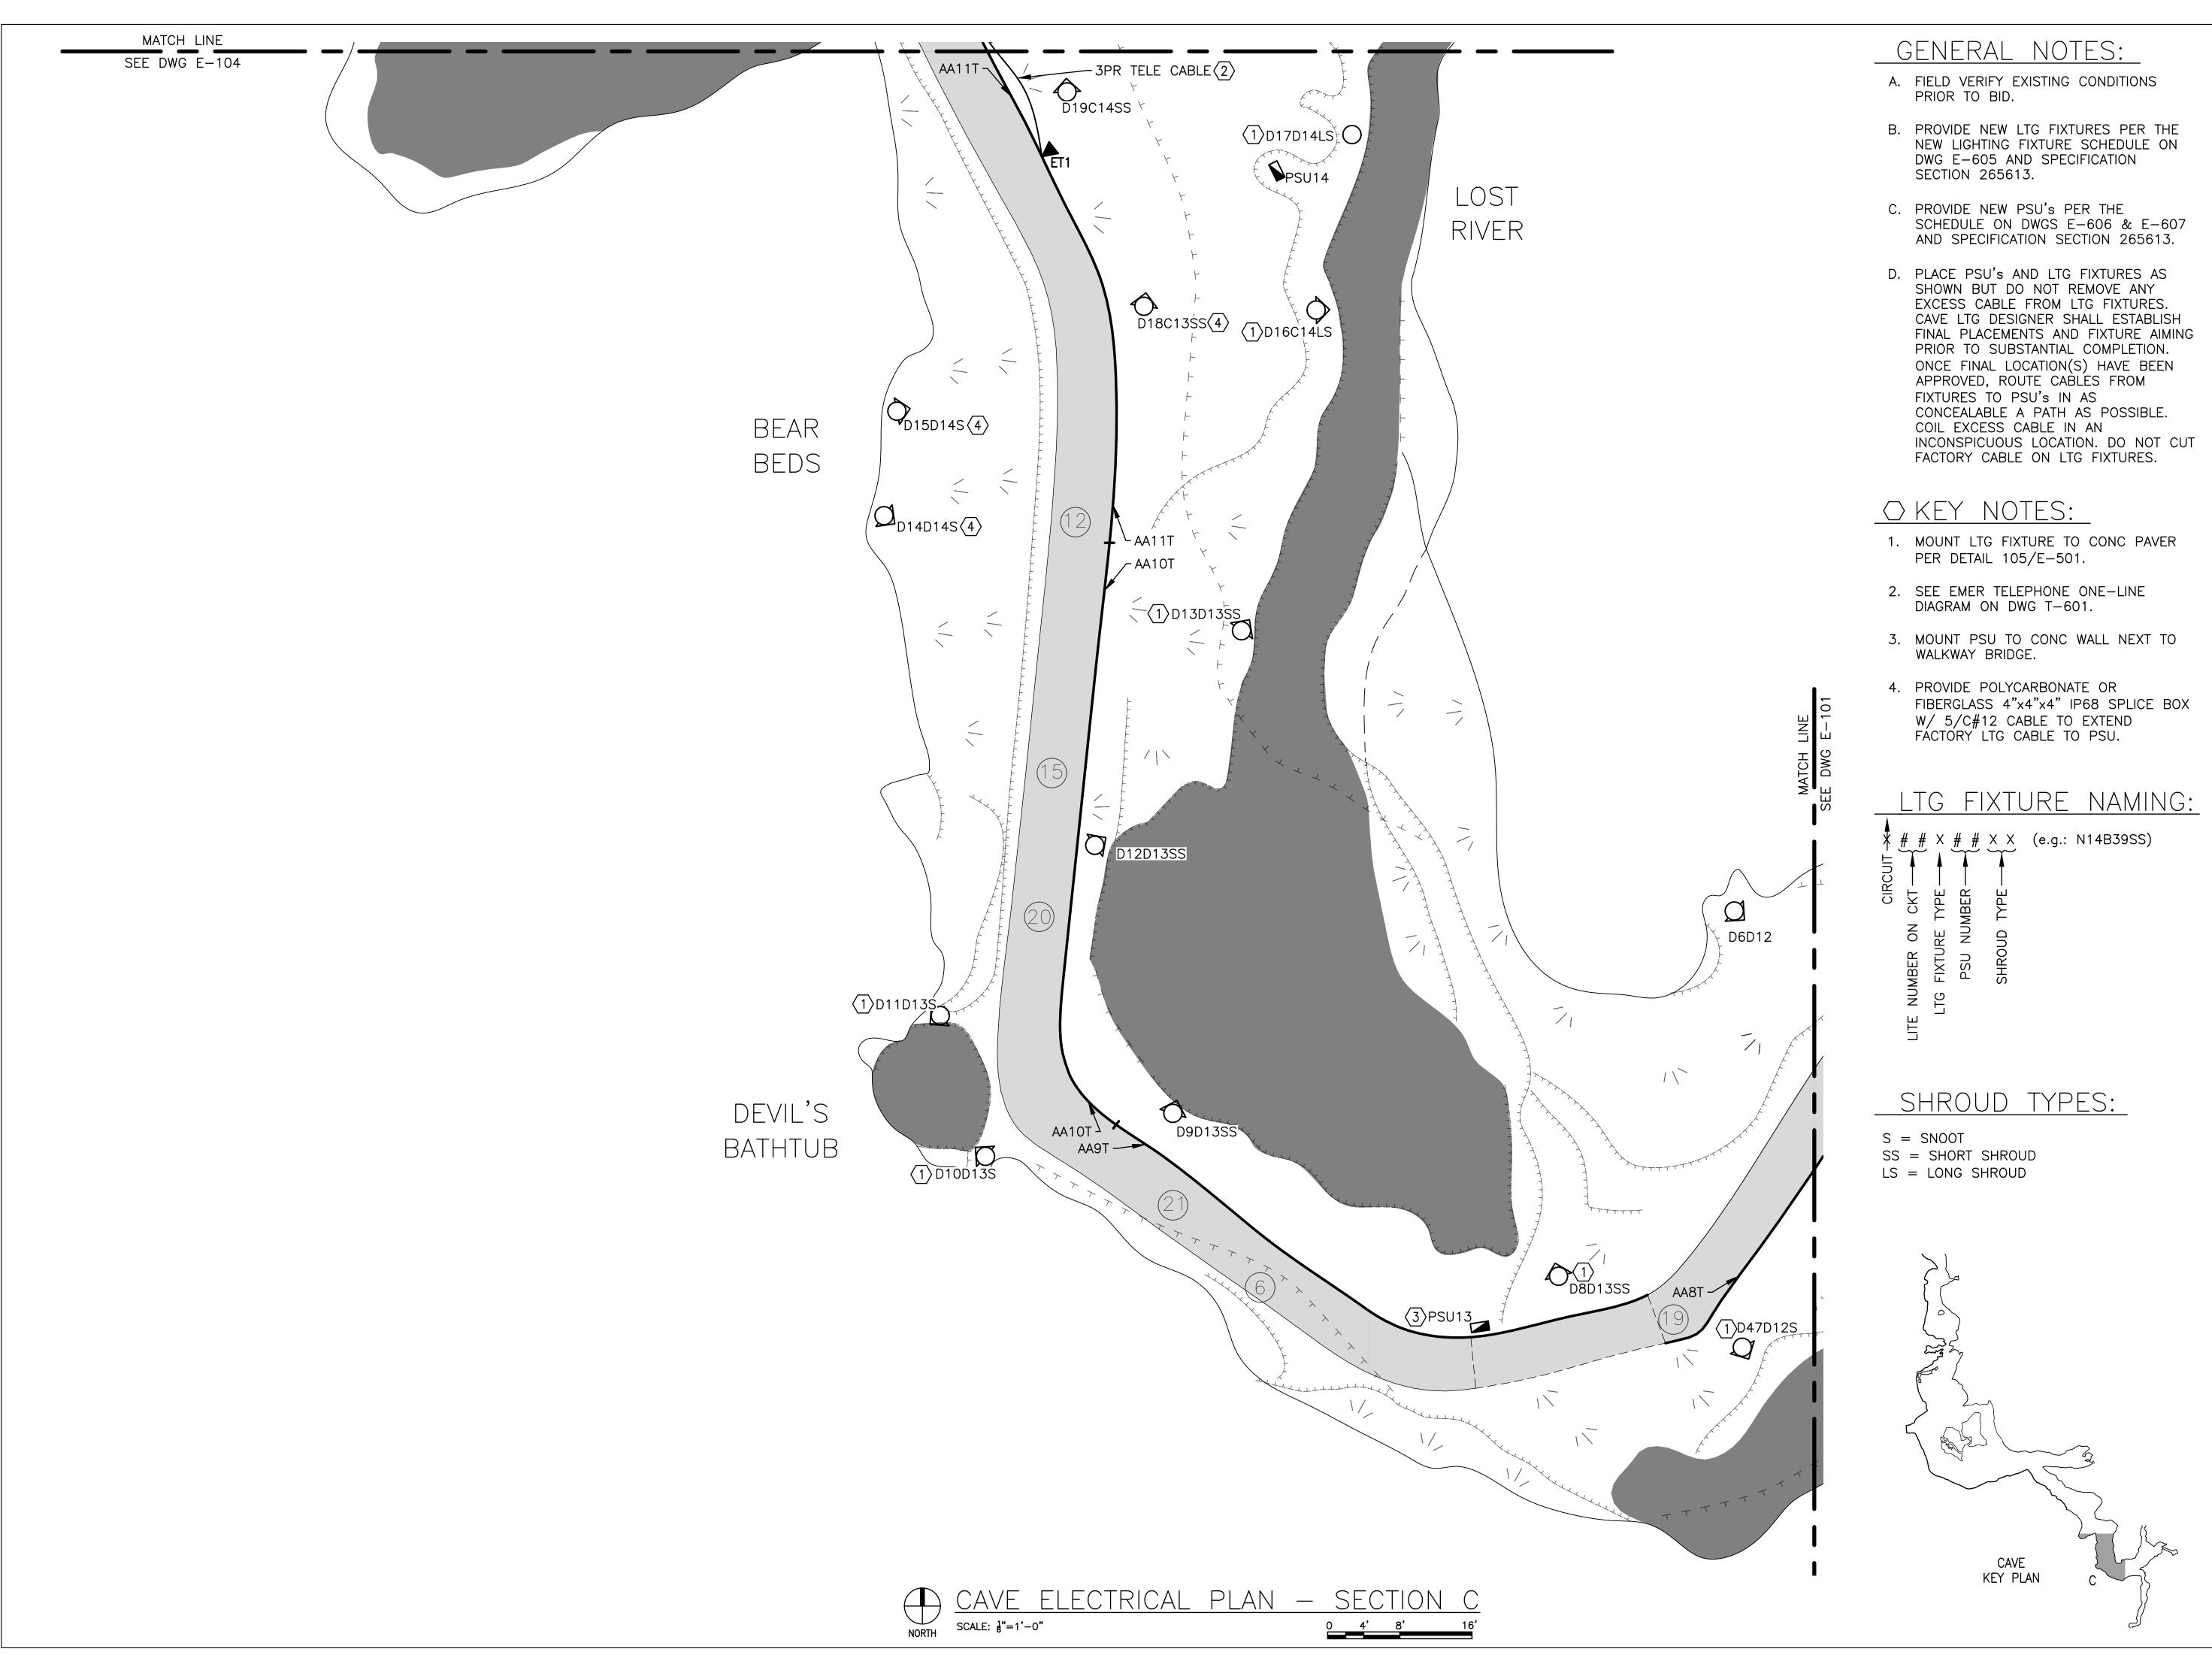

BARRY D. FREINER Registered Professional Engineer MO # E-24220 Expires 12-31-2024

ROGERS-SCHMIDT ENGINEERING CO., P.C.

CONSULTING ENGINEERS 1736 WEST PARK CENTER DR. SUITE 204 ST. LOUIS, MO 63026 PHONE: 636-600-1551 MISSOURI STATE CERTIFICATE OF AUTHORITY #000408

OFFICE OF ADMINISTRATION DIVISION OF FACILITIES MANAGEMENT, DESIGN AND CONSTRUCTION

DEPARTMENT OF NATURAL RESOURCES DIVISION OF STATE PARKS

UPGRADE CAVE ELECTRIC

ONONDAGA CAVE STATE PARK 7556 HWY H LEASBURG, MO 65535

PROJECT # X2212-01 5215 SITE#

7815215013 ASSET# **REVISION:**

REVISION: DATE: **REVISION:**

ISSUE DATE: <u>06-23-2023</u>

CAD DWG FILE: X2212-01-5215-7815215013-E-103.DWG

DRAWN BY: KET


CHECKED BY: BDF

DESIGNED BY: B D F

SHEET TITLE: CAVE ELECTRICAL

PLAN - SECTION C

SHEET NUMBER:

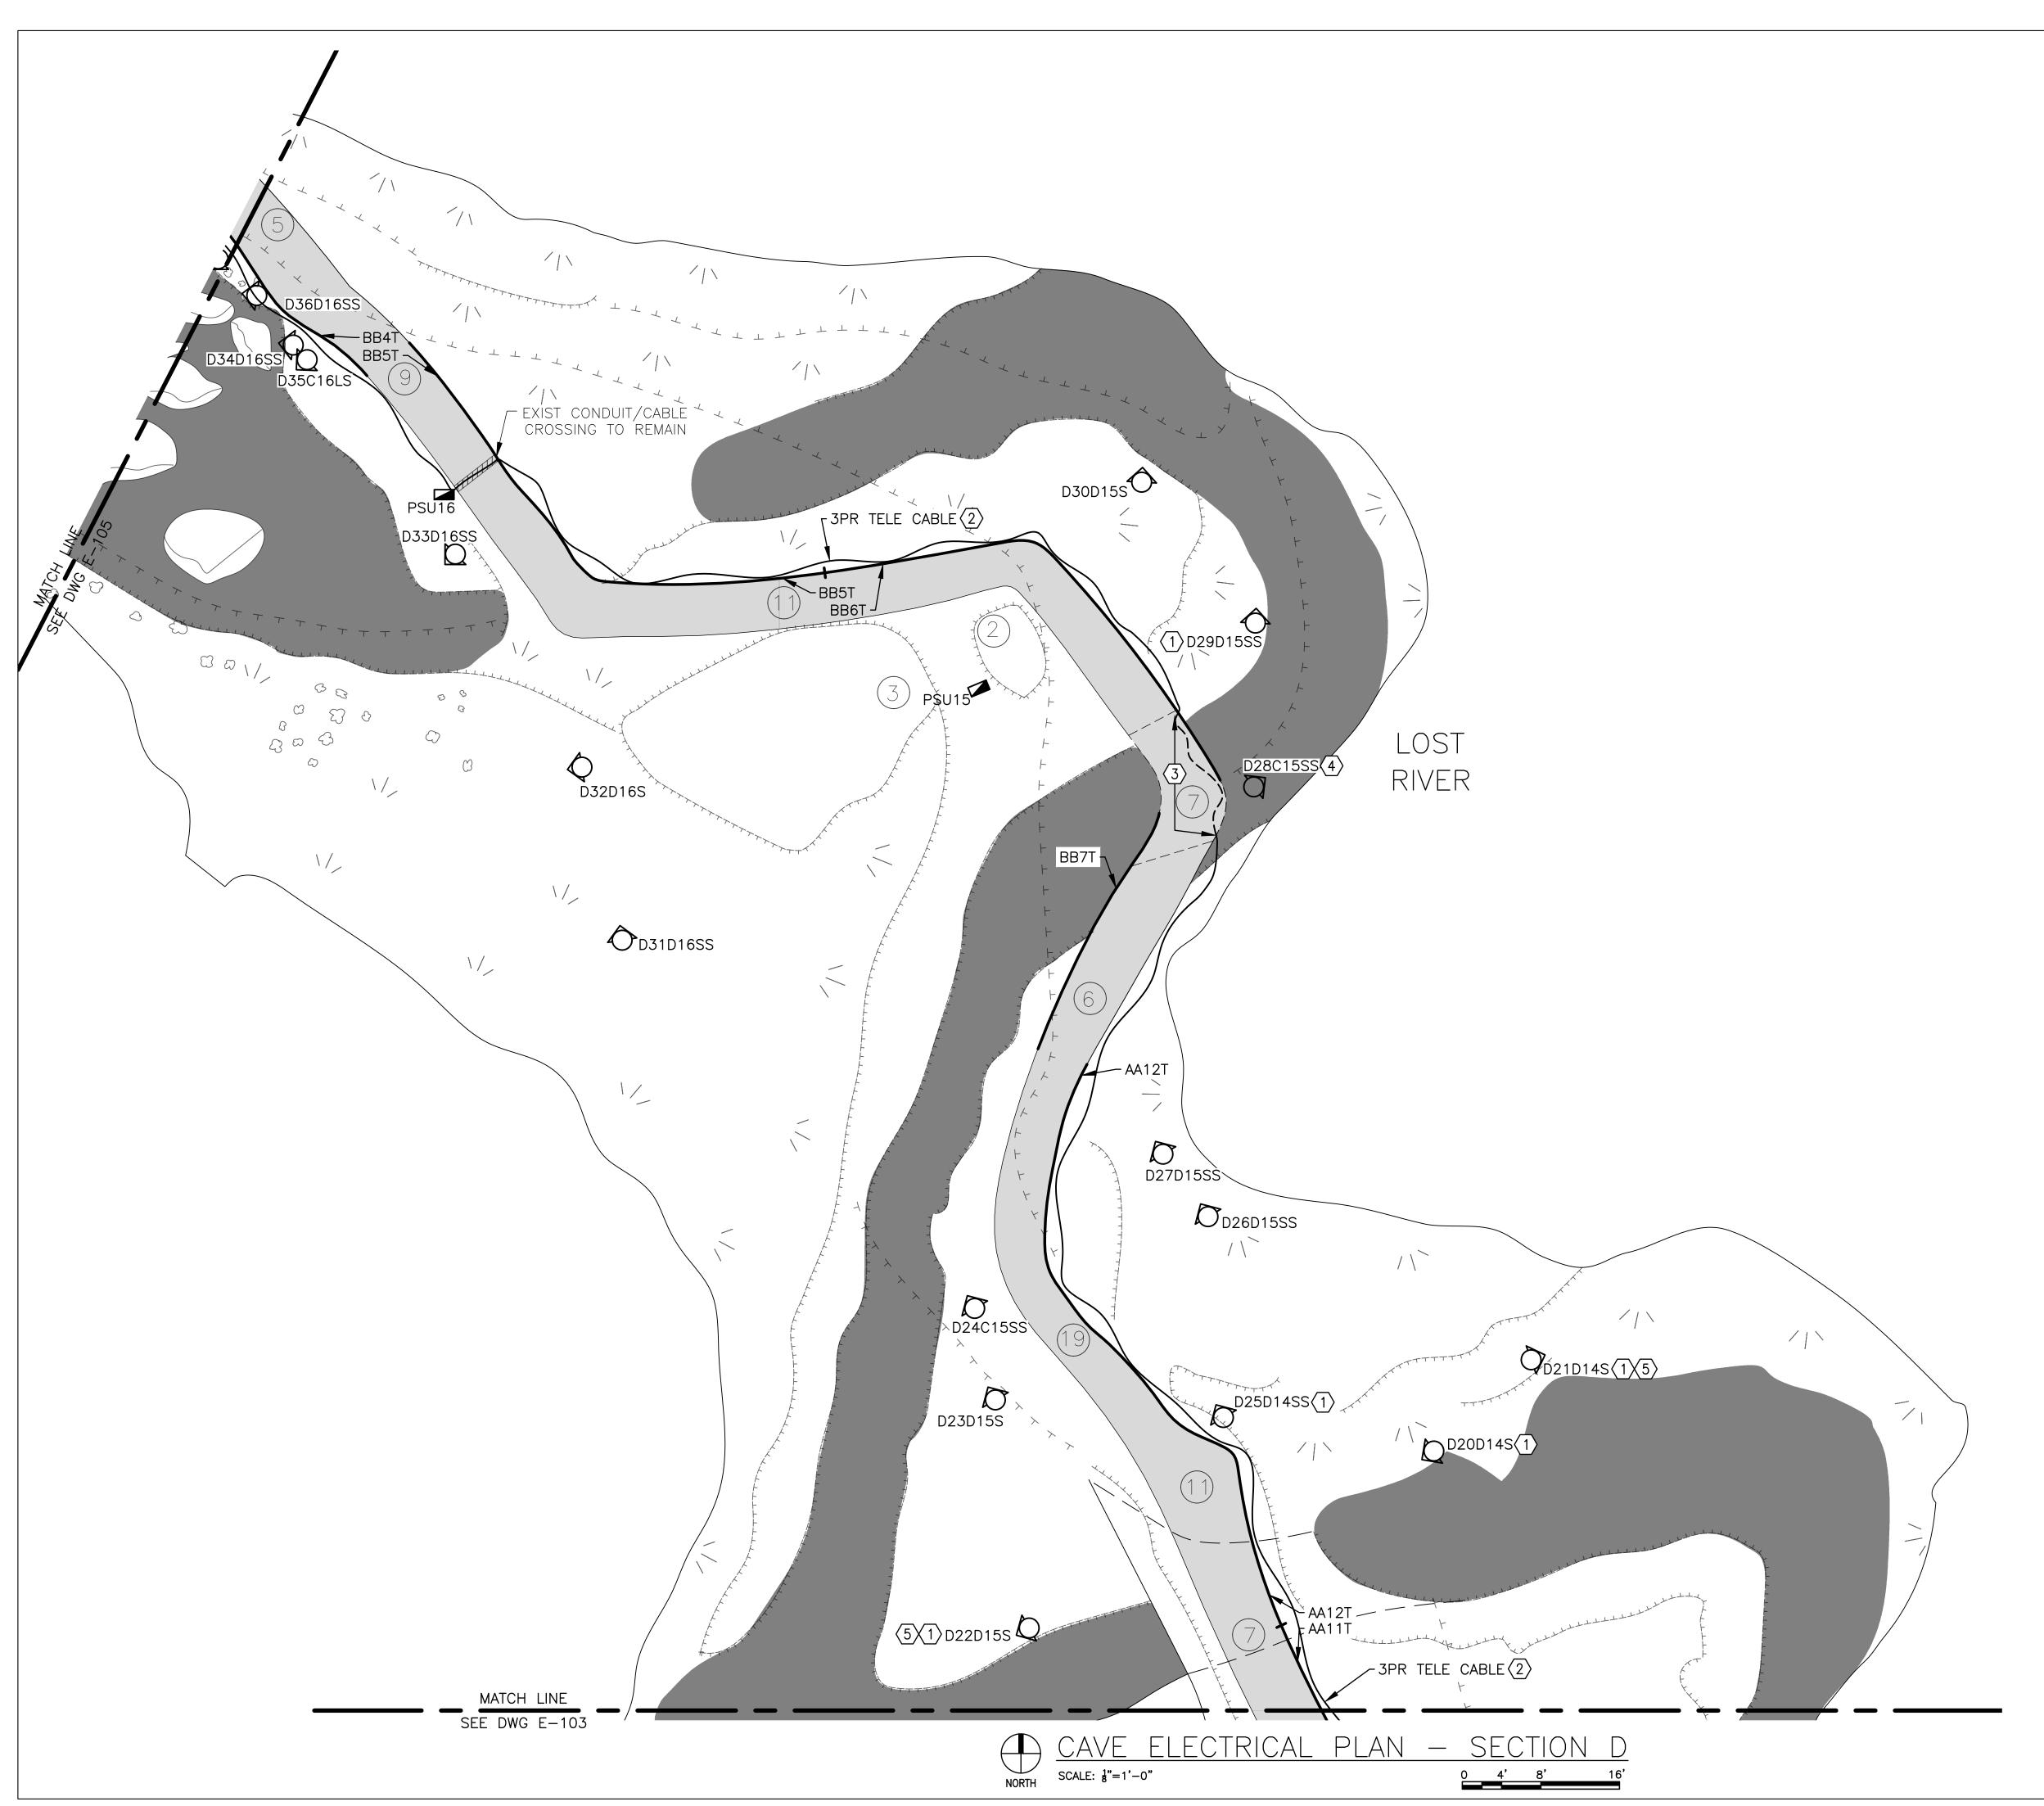

- A. FIELD VERIFY EXISTING CONDITIONS PRIOR TO BID.
- B. PROVIDE NEW LTG FIXTURES PER THE NEW LIGHTING FIXTURE SCHEDULE ON DWG E-605 AND SPECIFICATION SECTION 265613.
- C. PROVIDE NEW PSU's PER THE SCHEDULE ON DWGS E-606 & E-607 AND SPECIFICATION SECTION 265613.
- D. PLACE PSU's AND LTG FIXTURES AS SHOWN BUT DO NOT REMOVE ANY EXCESS CABLE FROM LTG FIXTURES. CAVE LTG DESIGNER SHALL ESTABLISH FINAL PLACEMENTS AND FIXTURE AIMING PRIOR TO SUBSTANTIAL COMPLETION. ONCE FINAL LOCATION(S) HAVE BEEN APPROVED, ROUTE CABLES FROM FIXTURES TO PSU's IN AS CONCEALABLE A PATH AS POSSIBLE. COIL EXCESS CABLE IN AN INCONSPICUOUS LOCATION. DO NOT CUT FACTORY CABLE ON LTG FIXTURES.

OKEY NOTES:


- 1. MOUNT LTG FIXTURE TO CONC PAVER PER DETAIL 105/E-501.
- 2. SEE EMER TELEPHONE ONE-LINE DIAGRAM ON DWG T-601.
- 3. SECURE TELEPHONE CABLE TO UNDERSIDE OF ELEVATED WALKWAY WITH SS BRIDLE RINGS.
- 4. MOUNT LTG FIXTURE ON LEDGE, NOT IN WATER.
- 5. PROVIDE POLYCARBONATE OR FIBERGLASS 4"x4"x4" IP68 SPLICE BOX W/ 5/C#12 CABLE TO EXTEND FÁCTÓRY" LTG CABLE TO PSU.

LTG FIXTURE NAMING:

X # # X # # X X (e.g.: N14B39SS)

SHROUD TYPES:

S = SNOOTSS = SHORT SHROUDLS = LONG SHROUD

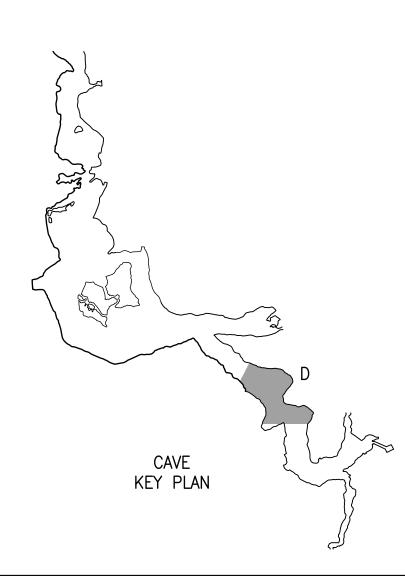

STATE OF MISSOURI MICHAEL L. PARSON, **GOVERNOR**



BARRY D. FREINER Registered Professional Engineer MO # E-24220 Expires 12-31-2024

ROGERS-SCHMIDT ENGINEERING CO., P.C.

CONSULTING ENGINEERS 1736 WEST PARK CENTER DR. SUITE 204 ST. LOUIS, MO 63026 PHONE: 636-600-1551 MISSOURI STATE CERTIFICATE OF AUTHORITY #000408

OFFICE OF ADMINISTRATION DIVISION OF FACILITIES MANAGEMENT, DESIGN AND CONSTRUCTION

DEPARTMENT OF NATURAL RESOURCES DIVISION OF STATE PARKS

UPGRADE CAVE ELECTRIC

ONONDAGA CAVE STATE PARK 7556 HWY H LEASBURG, MO 65535

PROJECT # X2212-01 5215 SITE#

7815215013

REVISION: DATE: REVISION: DATE: **REVISION:**

ASSET#

ISSUE DATE: <u>06-23-2023</u>

CAD DWG FILE: X2212-01-5215-7815215013-E-104.DWG

DRAWN BY: KET

CHECKED BY: BDF

DESIGNED BY: B D F

SHEET TITLE: CAVE ELECTRICAL PLAN - SECTION D

SHEET NUMBER:

- A. FIELD VERIFY EXISTING CONDITIONS PRIOR TO BID.
- B. PROVIDE NEW LTG FIXTURES PER THE NEW LIGHTING FIXTURE SCHEDULE ON DWG E-605 AND SPECIFICATION SECTION 265613.
- C. PROVIDE NEW PSU's PER THE SCHEDULE ON DWGS E-606 & E-607 AND SPECIFICATION SECTION
- D. PLACE PSU's AND LTG FIXTURES AS SHOWN BUT DO NOT REMOVE ANY EXCESS CABLE FROM LTG FIXTURES. CAVE LTG DESIGNER SHALL ESTABLISH FINAL PLACEMENTS AND FIXTURE AIMING PRIOR TO SUBSTANTIAL COMPLETION. ONCE FINAL LOCATION(S) HAVE BEEN APPROVED, ROUTE CABLES FROM FIXTURES TO PSU's IN AS CONCEALABLE A PATH AS POSSIBLE. COIL EXCESS CABLE IN AN INCONSPICUOUS LOCATION. DO NOT CUT FACTORY CABLE ON LTG FIXTURES.

○ KEY NOTES:


- 1. SERVED FROM AIRLOCK FEEDER. SEE DWGS ES-402
- 2. PROVIDE NEW PNLBD PER SPECIFICATION SECTION 262416 IN COMMON SS ENCL W/ LTG CNTRLS.
- 3. SEE EMER TELEPHONE ONE-LINE DIAGRAM ON DWG
- 4. HIGH WATER MARK DURING FLOODING IS 5'-6" ABOVE TRAIL AT HEAD KNOCKER ROCK. CONTRACTOR SHALL PLACE ALL PSU's THROUGHOUT CAVE ABOVE FLOOD LEVEL, UNLESS OTHERWISE NOTED, AND SHALL CONFIRM THAT ALL LTG FIXTURES BELOW FLOOD LEVEL ARE MTD PER DETAIL 105/E-501, UNLESS OTHERWISE NOTED.
- 5. MOUNT LTG FIXTURE TO CONC PAVER PER DETAIL
- 6. SECURE TELEPHONE CABLE TO UNDERSIDE OF ELEVATED WALKWAY WITH SS BRIDLE RINGS.
- 7. INSTALL NEW CABLE SLEEVE PER DETAIL
- 8. PROVIDE POLYCARBONATE OR FIBERGLASS 4"x4"x4" IP68 SPLICE BOX W/ 5/C#12 CABLE TO EXTEND FACTORY LTG CABLE TO PSU.

LTG FIXTURE NAMING:

X # # X # # X X (e.g.: N14B39SS)

SHROUD TYPES:

SS = SHORT SHROUDLS = LONG SHROUD

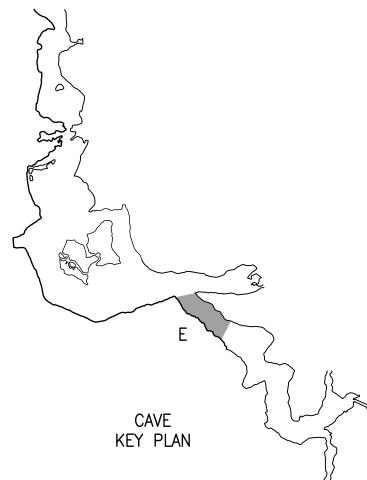

STATE OF MISSOURI MICHAEL L. PARSON, **GOVERNOR**



BARRY D. FREINER Registered Professional Engineer MO # E-24220 Expires 12-31-2024

ROGERS-SCHMIDT ENGINEERING CO., P.C.

CONSULTING ENGINEERS 1736 WEST PARK CENTER DR. SUITE 204 ST. LOUIS, MO 63026 PHONE: 636-600-1551 MISSOURI STATE CERTIFICATE OF AUTHORITY #000408

OFFICE OF ADMINISTRATION DIVISION OF FACILITIES MANAGEMENT, DESIGN AND CONSTRUCTION

DEPARTMENT OF NATURAL RESOURCES DIVISION OF STATE PARKS

UPGRADE CAVE ELECTRIC

ONONDAGA CAVE STATE PARK 7556 HWY H LEASBURG, MO 65535

PROJECT # X2212-01 5215 SITE#

ASSET#

7815215013

REVISION: REVISION: DATE: **REVISION:**

ISSUE DATE: <u>06-23-2023</u>

CAD DWG FILE: X2212-01-5215-7815215013-E-105.DWG

DRAWN BY: KET

CHECKED BY: BDF


DESIGNED BY: B D F

SHEET TITLE:

CAVE ELECTRICAL PLAN - SECTION E

SHEET NUMBER:

E-105 31 OF 50 SHEETS JUNE 23, 2023

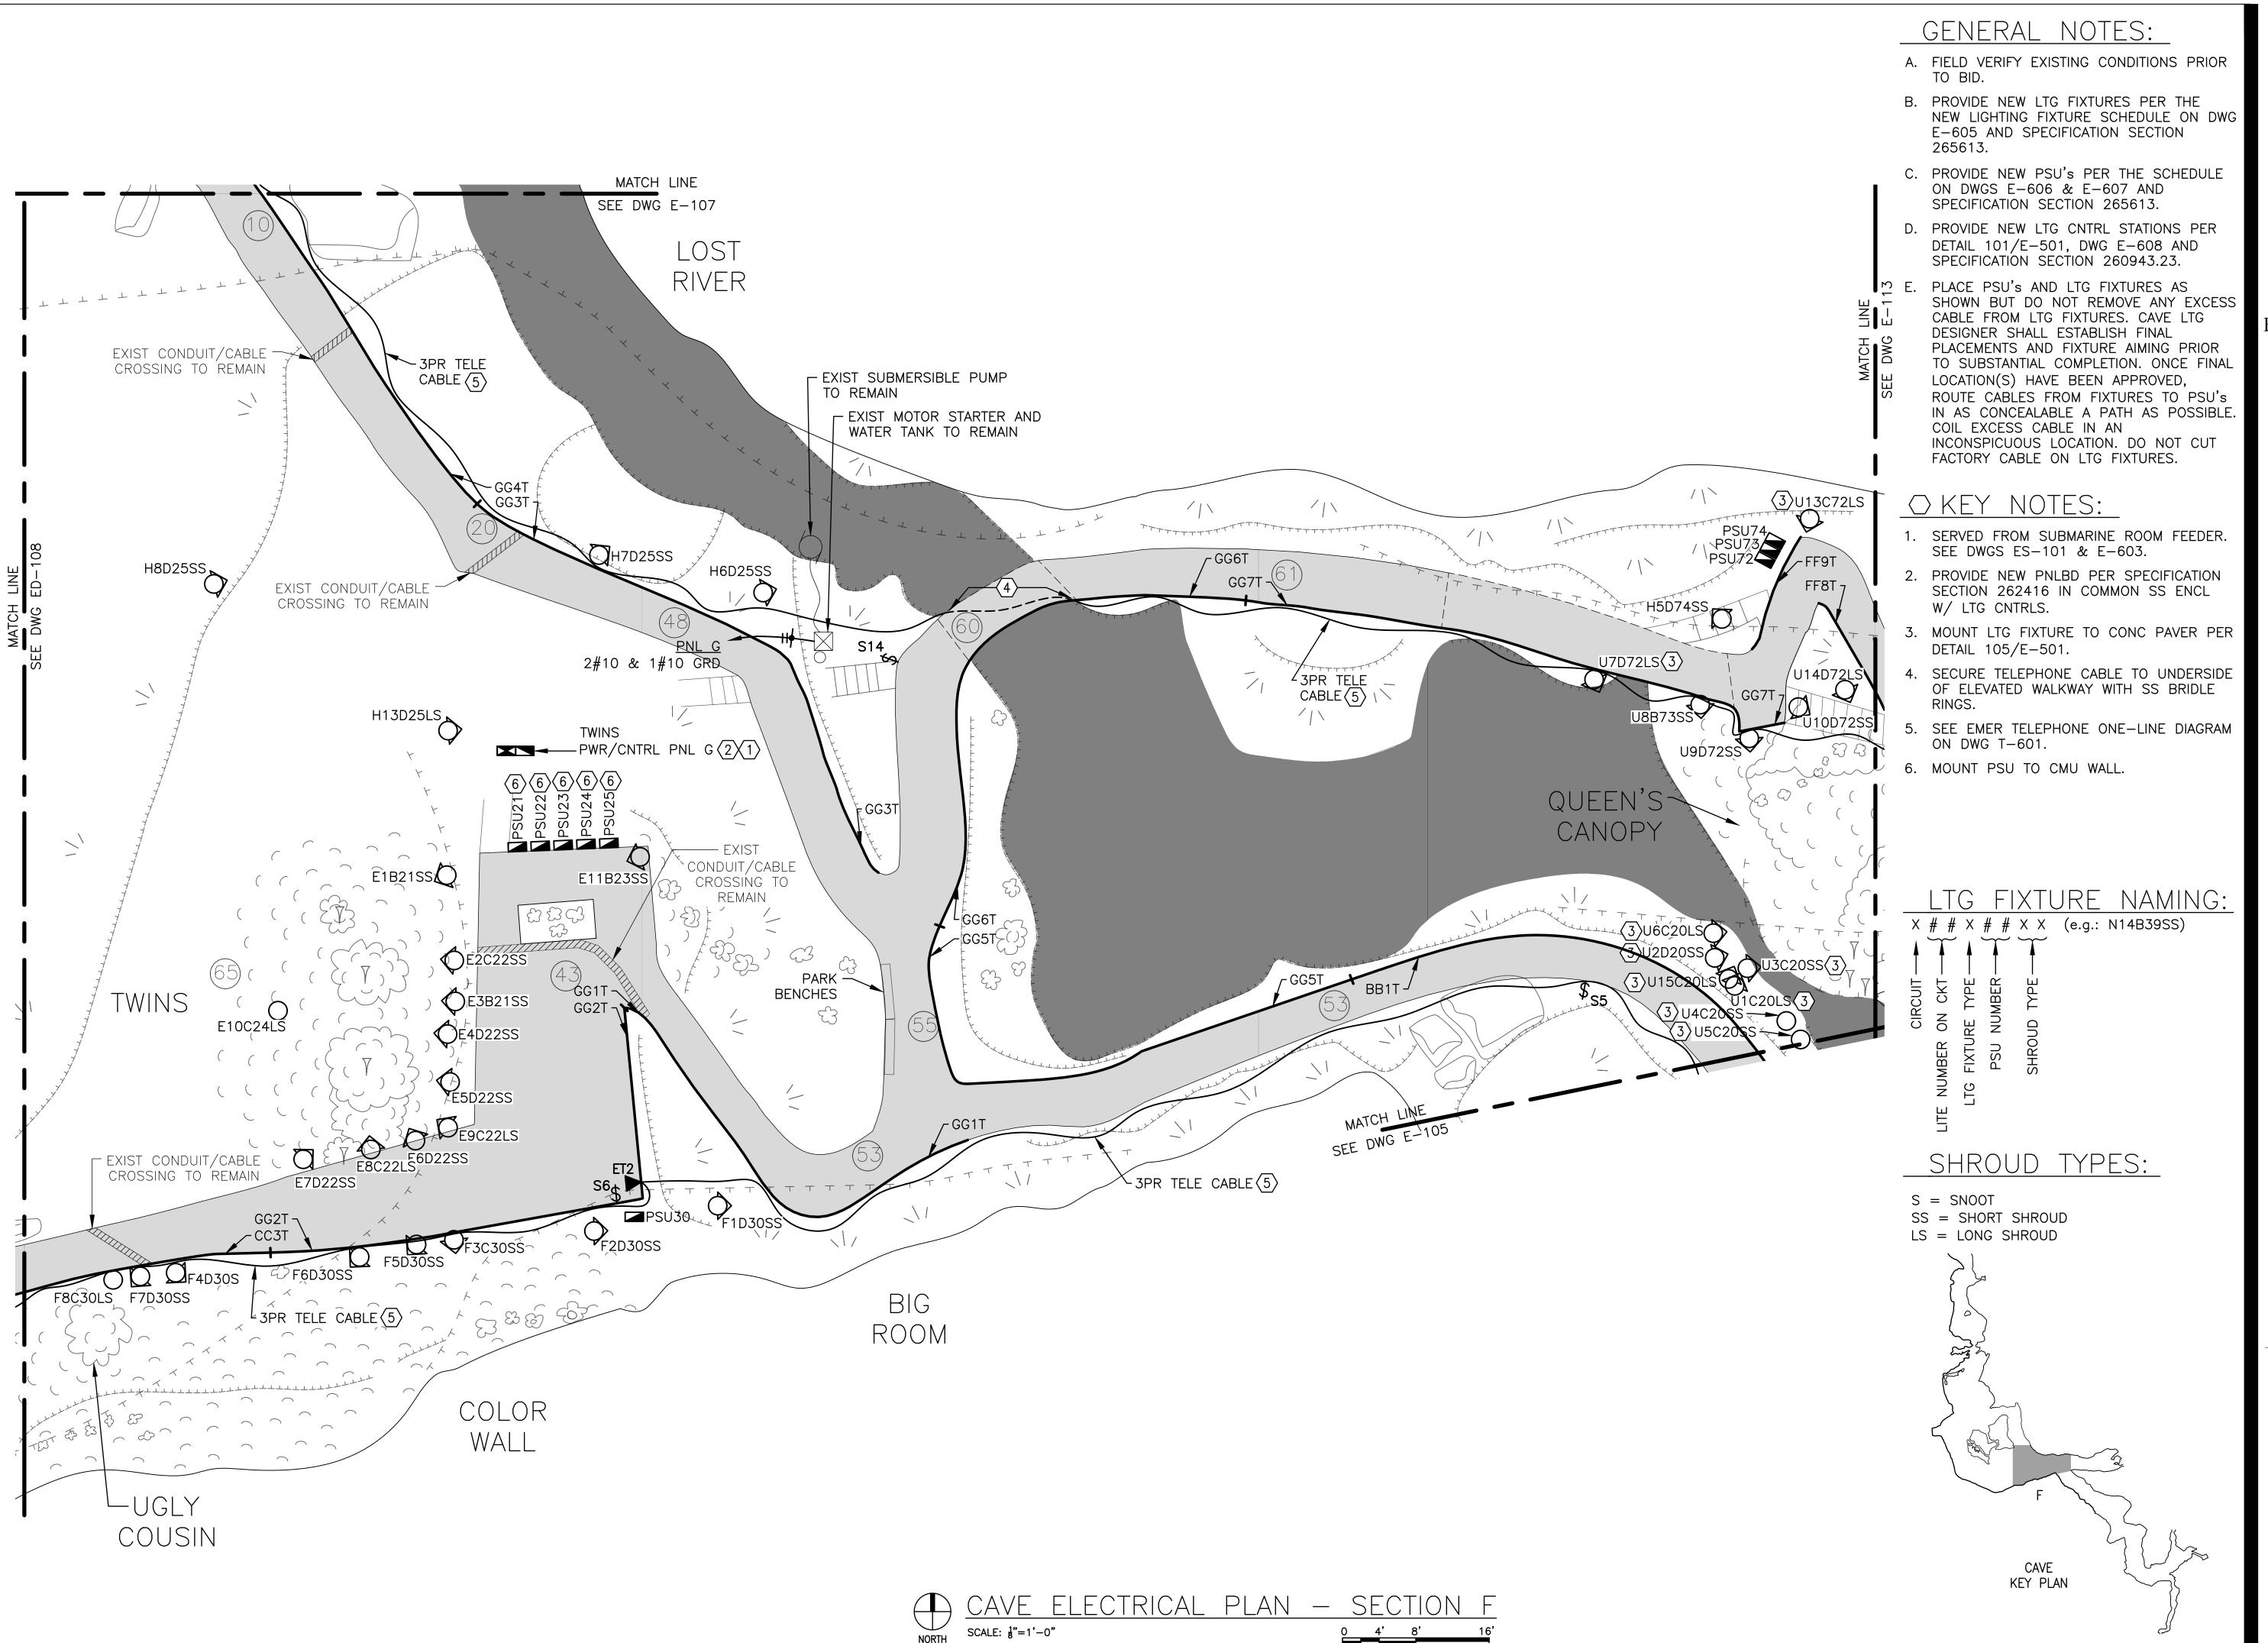



BARRY D. FREINER Registered Professional Engineer MO # E-24220 Expires 12-31-2024

ROGERS-SCHMIDT ENGINEERING CO., P.C. CONSULTING ENGINEERS 1736 WEST PARK CENTER DR.

SUITE 204 ST. LOUIS, MO 63026 PHONE: 636-600-1551 MISSOURI STATE CERTIFICATE OF AUTHORITY #000408

OFFICE OF ADMINISTRATION DIVISION OF FACILITIES MANAGEMENT, DESIGN AND CONSTRUCTION

DEPARTMENT OF NATURAL RESOURCES DIVISION OF STATE PARKS

UPGRADE CAVE ELECTRIC

ONONDAGA CAVE STATE PARK 7556 HWY H LEASBURG, MO 65535

PROJECT # X2212-01 5215 SITE# 7815215013 ASSET#

REVISION: REVISION:

REVISION:

ISSUE DATE: <u>06-23-2023</u>

CAD DWG FILE: X2212-01-5215-7815215013-E-106.DWG

DRAWN BY: KET

CHECKED BY: BDF

DESIGNED BY: B D F

SHEET TITLE: CAVE ELECTRICAL PLAN - SECTION F

SHEET NUMBER:

<u>CAVE ELECTRICAL PLAN — SECTION G</u>

SCALE: 1"=1'-0"

GENERAL NOTES:

- A. FIELD VERIFY EXISTING CONDITIONS PRIOR TO BID.
- B. PROVIDE NEW LTG FIXTURES PER THE NEW LIGHTING FIXTURE SCHEDULE ON DWG E-605 AND SPECIFICATION SECTION 265313.
- C. PROVIDE NEW PSU's PER THE SCHEDULE ON DWGS E-606 & E-607 AND SPECIFICATION SECTION 265613.
- D. PLACE PSU's AND LTG FIXTURES AS SHOWN BUT DO NOT REMOVE ANY EXCESS CABLE FROM LTG FIXTURES. CAVE LTG DESIGNER SHALL ESTABLISH FINAL PLACEMENTS AND FIXTURE AIMING PRIOR TO SUBSTANTIAL COMPLETION. ONCE FINAL LOCATION(S) HAVE BEEN APPROVED, ROUTE CABLES FROM FIXTURES TO PSU's IN AS CONCEALABLE A PATH AS POSSIBLE. COIL EXCESS CABLE IN AN INCONSPICUOUS LOCATION. DO NOT CUT FACTORY CABLE ON LTG FIXTURES.

○ KEY NOTES:


- 1. MOUNT LTG FIXTURE TO CONC PAVER PER DETAIL 105/E-501.
- 2. MOUNT LTG FIXTURE TO BRIDGE USING LUMINAIRE INSULATOR PER SPECIFICATION SECTION 265613.
- 3. SECURE TELEPHONE CABLE TO UNDERSIDE OF ELEVATED WALKWAY WITH SS BRIDLE RINGS.
- 4. SEE EMER TELEPHONE ONE-LINE DIAGRAM ON DWG T-601.
- 5. PROVIDE POLYCARBONATE OR FIBERGLASS 4"x4"x4" IP68 SPLICE BOX W/ 5/C#12 CABLE TO EXTEND FACTORY LTG CABLE TO PSÚ.

LTG FIXTURE NAMING:

X # # X # # X X (e.g.: N14B39SS)

SHROUD TYPES:

S = SNOOTSS = SHORT SHROUDLS = LONG SHROUD

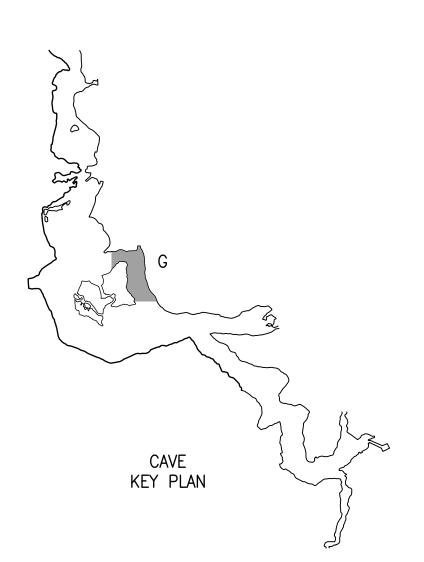

STATE OF MISSOURI MICHAEL L. PARSON, **GOVERNOR**



BARRY D. FREINER Registered Professional Engineer MO # E-24220 Expires 12-31-2024

ROGERS-SCHMIDT ENGINEERING CO., P.C.

CONSULTING ENGINEERS 1736 WEST PARK CENTER DR. SUITE 204 ST. LOUIS, MO 63026 PHONE: 636-600-1551 MISSOURI STATE CERTIFICATE OF AUTHORITY #000408

OFFICE OF ADMINISTRATION DIVISION OF FACILITIES MANAGEMENT, DESIGN AND CONSTRUCTION

DEPARTMENT OF NATURAL RESOURCES DIVISION OF STATE PARKS

UPGRADE CAVE ELECTRIC

ONONDAGA CAVE STATE PARK 7556 HWY H LEASBURG, MO 65535

PROJECT # X2212-01 5215 SITE#

7815215013

REVISION: REVISION: REVISION:

ASSET#

ISSUE DATE: <u>06-23-2023</u>

CAD DWG FILE: X2212-01-5215-7815215013-E-107.DWG

DRAWN BY: KET

CHECKED BY: BDF


DESIGNED BY: B D F

CAVE ELECTRICAL PLAN - SECTION G

SHEET NUMBER:

SHEET TITLE:

BEAR PASSAGE, UNDER EXISTING CATWALK.

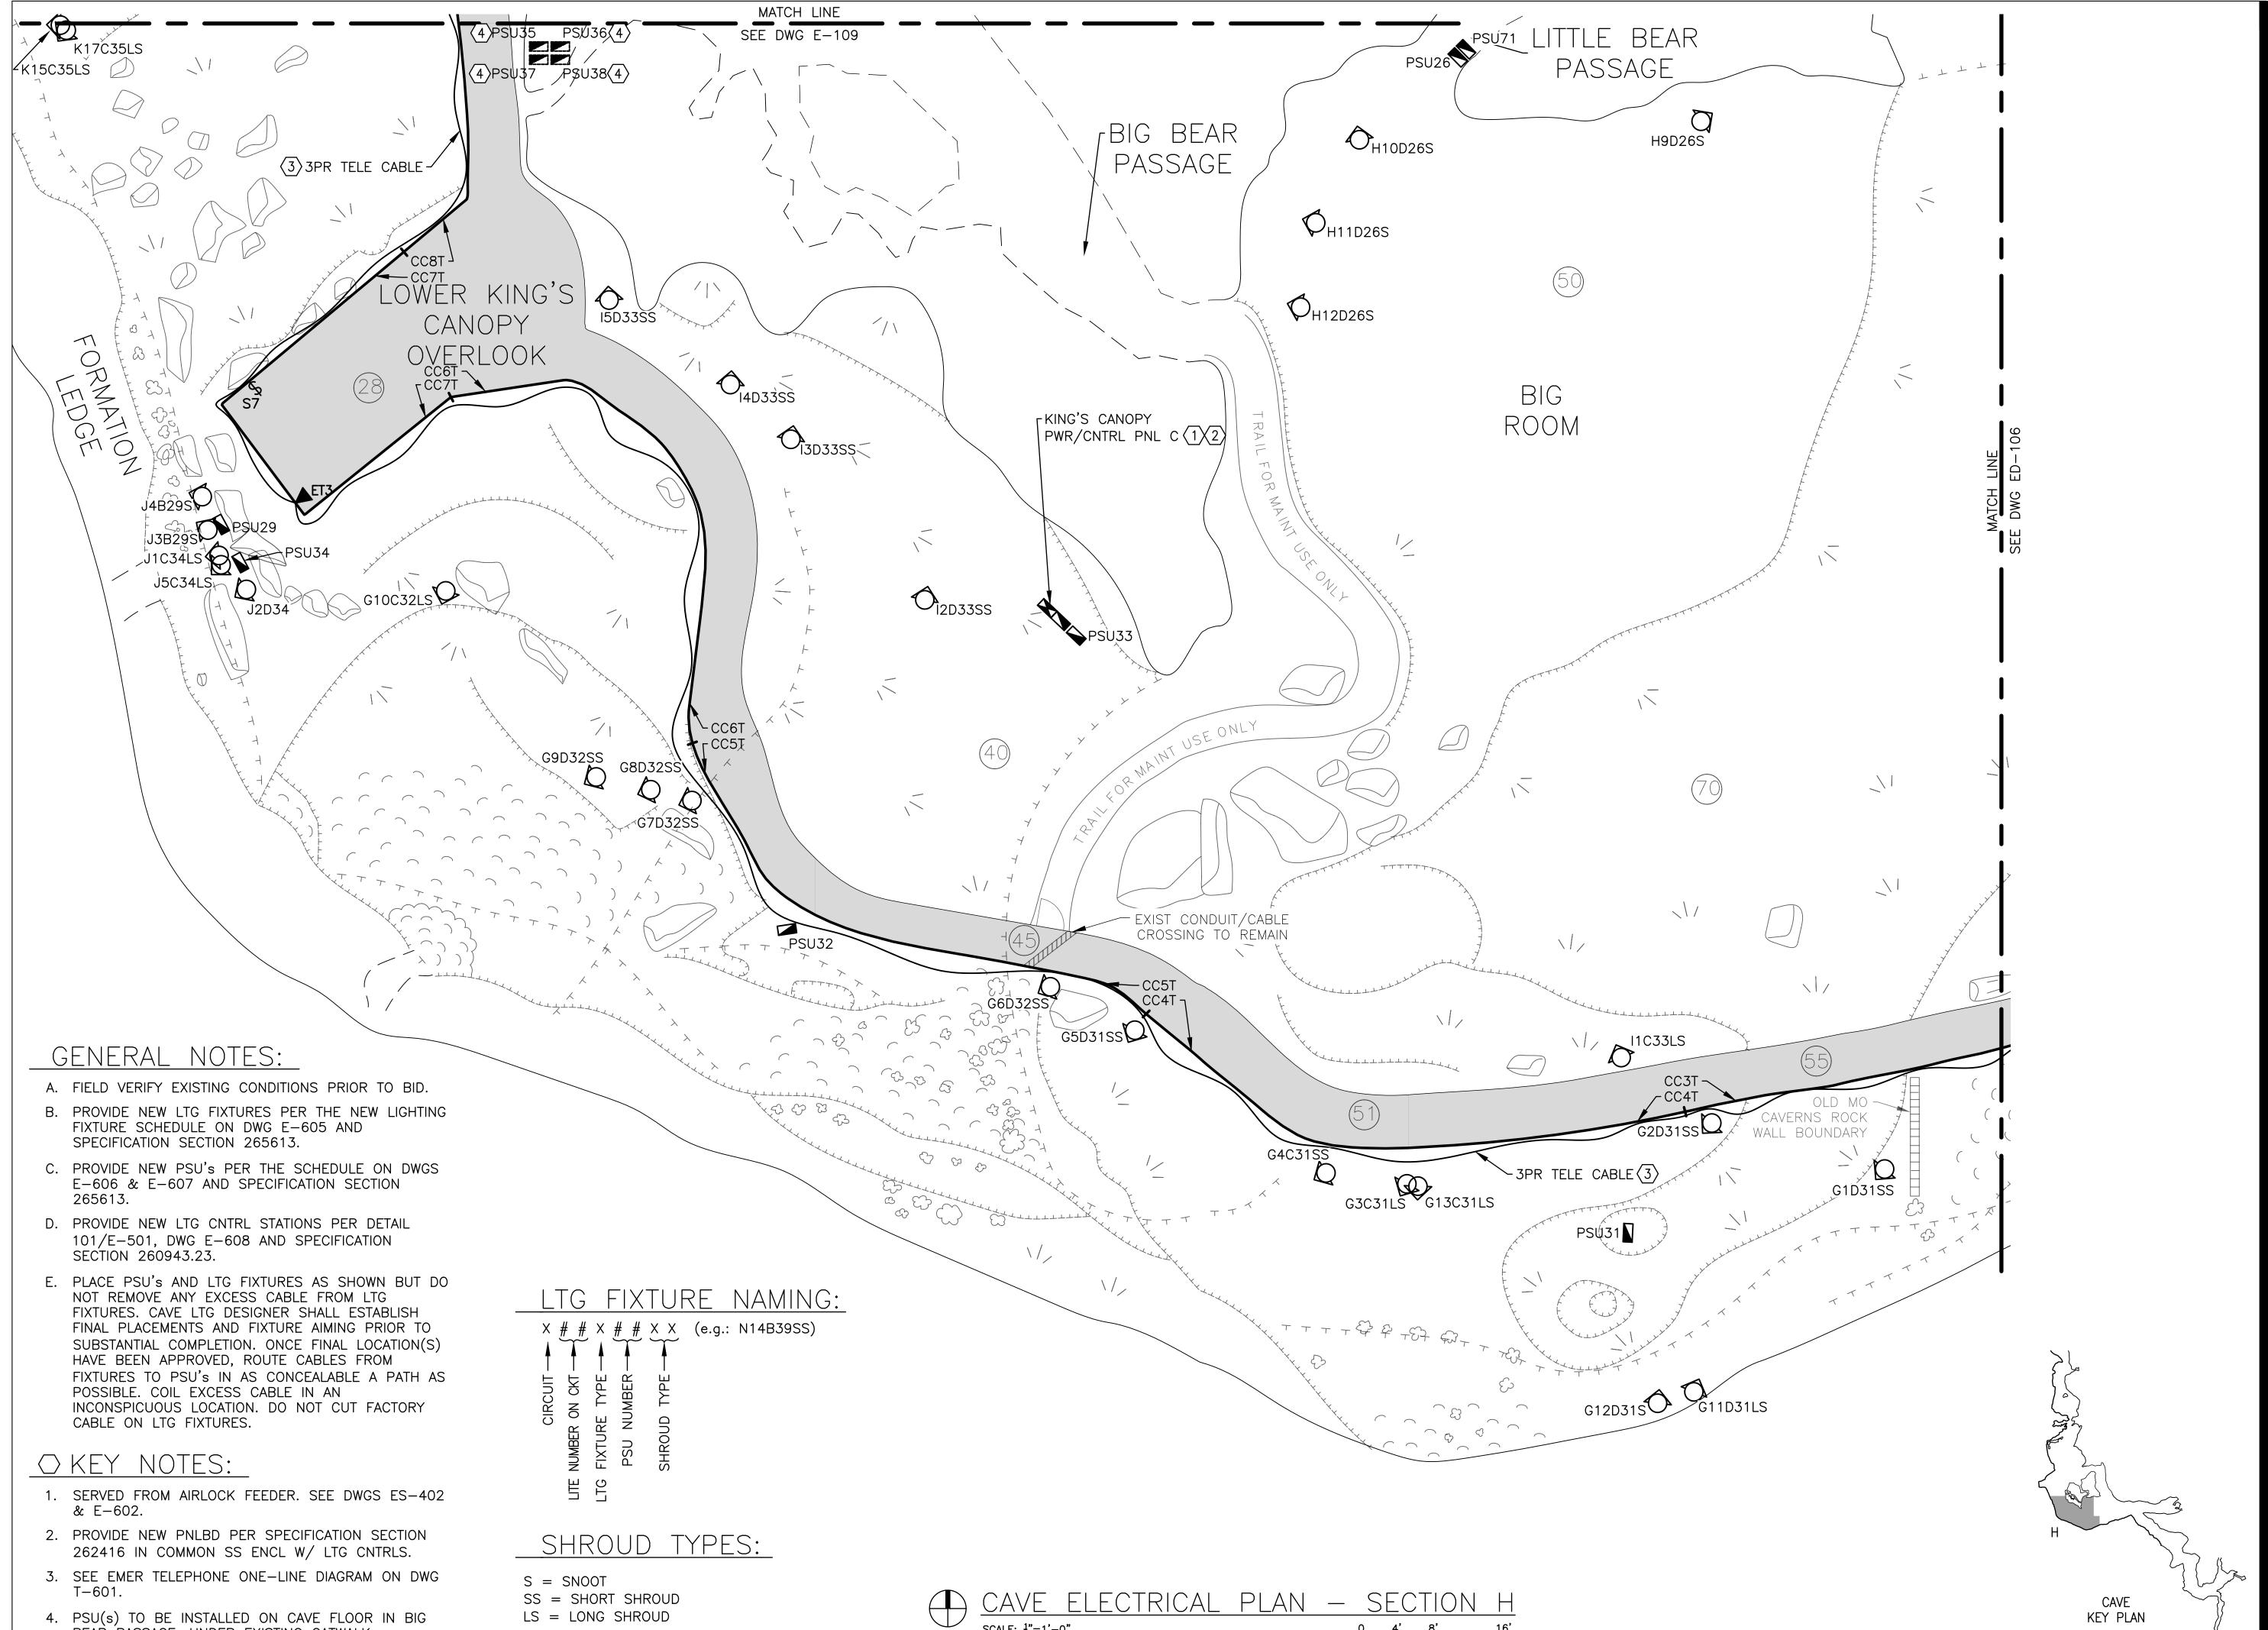

SCALE: 1"=1'-0"

STATE OF MISSOURI MICHAEL L. PARSON, **GOVERNOR**



BARRY D. FREINER Registered Professional Engineer MO # E-24220 Expires 12-31-2024

ROGERS-SCHMIDT ENGINEERING CO., P.C.

CONSULTING ENGINEERS 1736 WEST PARK CENTER DR. SUITE 204 ST. LOUIS, MO 63026 PHONE: 636-600-1551 MISSOURI STATE CERTIFICATE OF AUTHORITY #000408

OFFICE OF ADMINISTRATION DIVISION OF FACILITIES MANAGEMENT, DESIGN AND CONSTRUCTION

DEPARTMENT OF NATURAL RESOURCES DIVISION OF STATE PARKS

UPGRADE CAVE ELECTRIC

ONONDAGA CAVE STATE PARK 7556 HWY H LEASBURG, MO 65535

PROJECT # X2212-01 SITE# 5215 7815215013 ASSET#

REVISION: DATE: **REVISION:** DATE: **REVISION:**

DATE:

ISSUE DATE: 06-23-2023


CAD DWG FILE: X2212-01-5215-7815215013-E-108.DWG

DRAWN BY: KET
CHECKED BY: BDF
DESIGNED BY: BDF

CAVE ELECTRICAL PLAN - SECTION H

SHEET NUMBER:

SHEET TITLE:

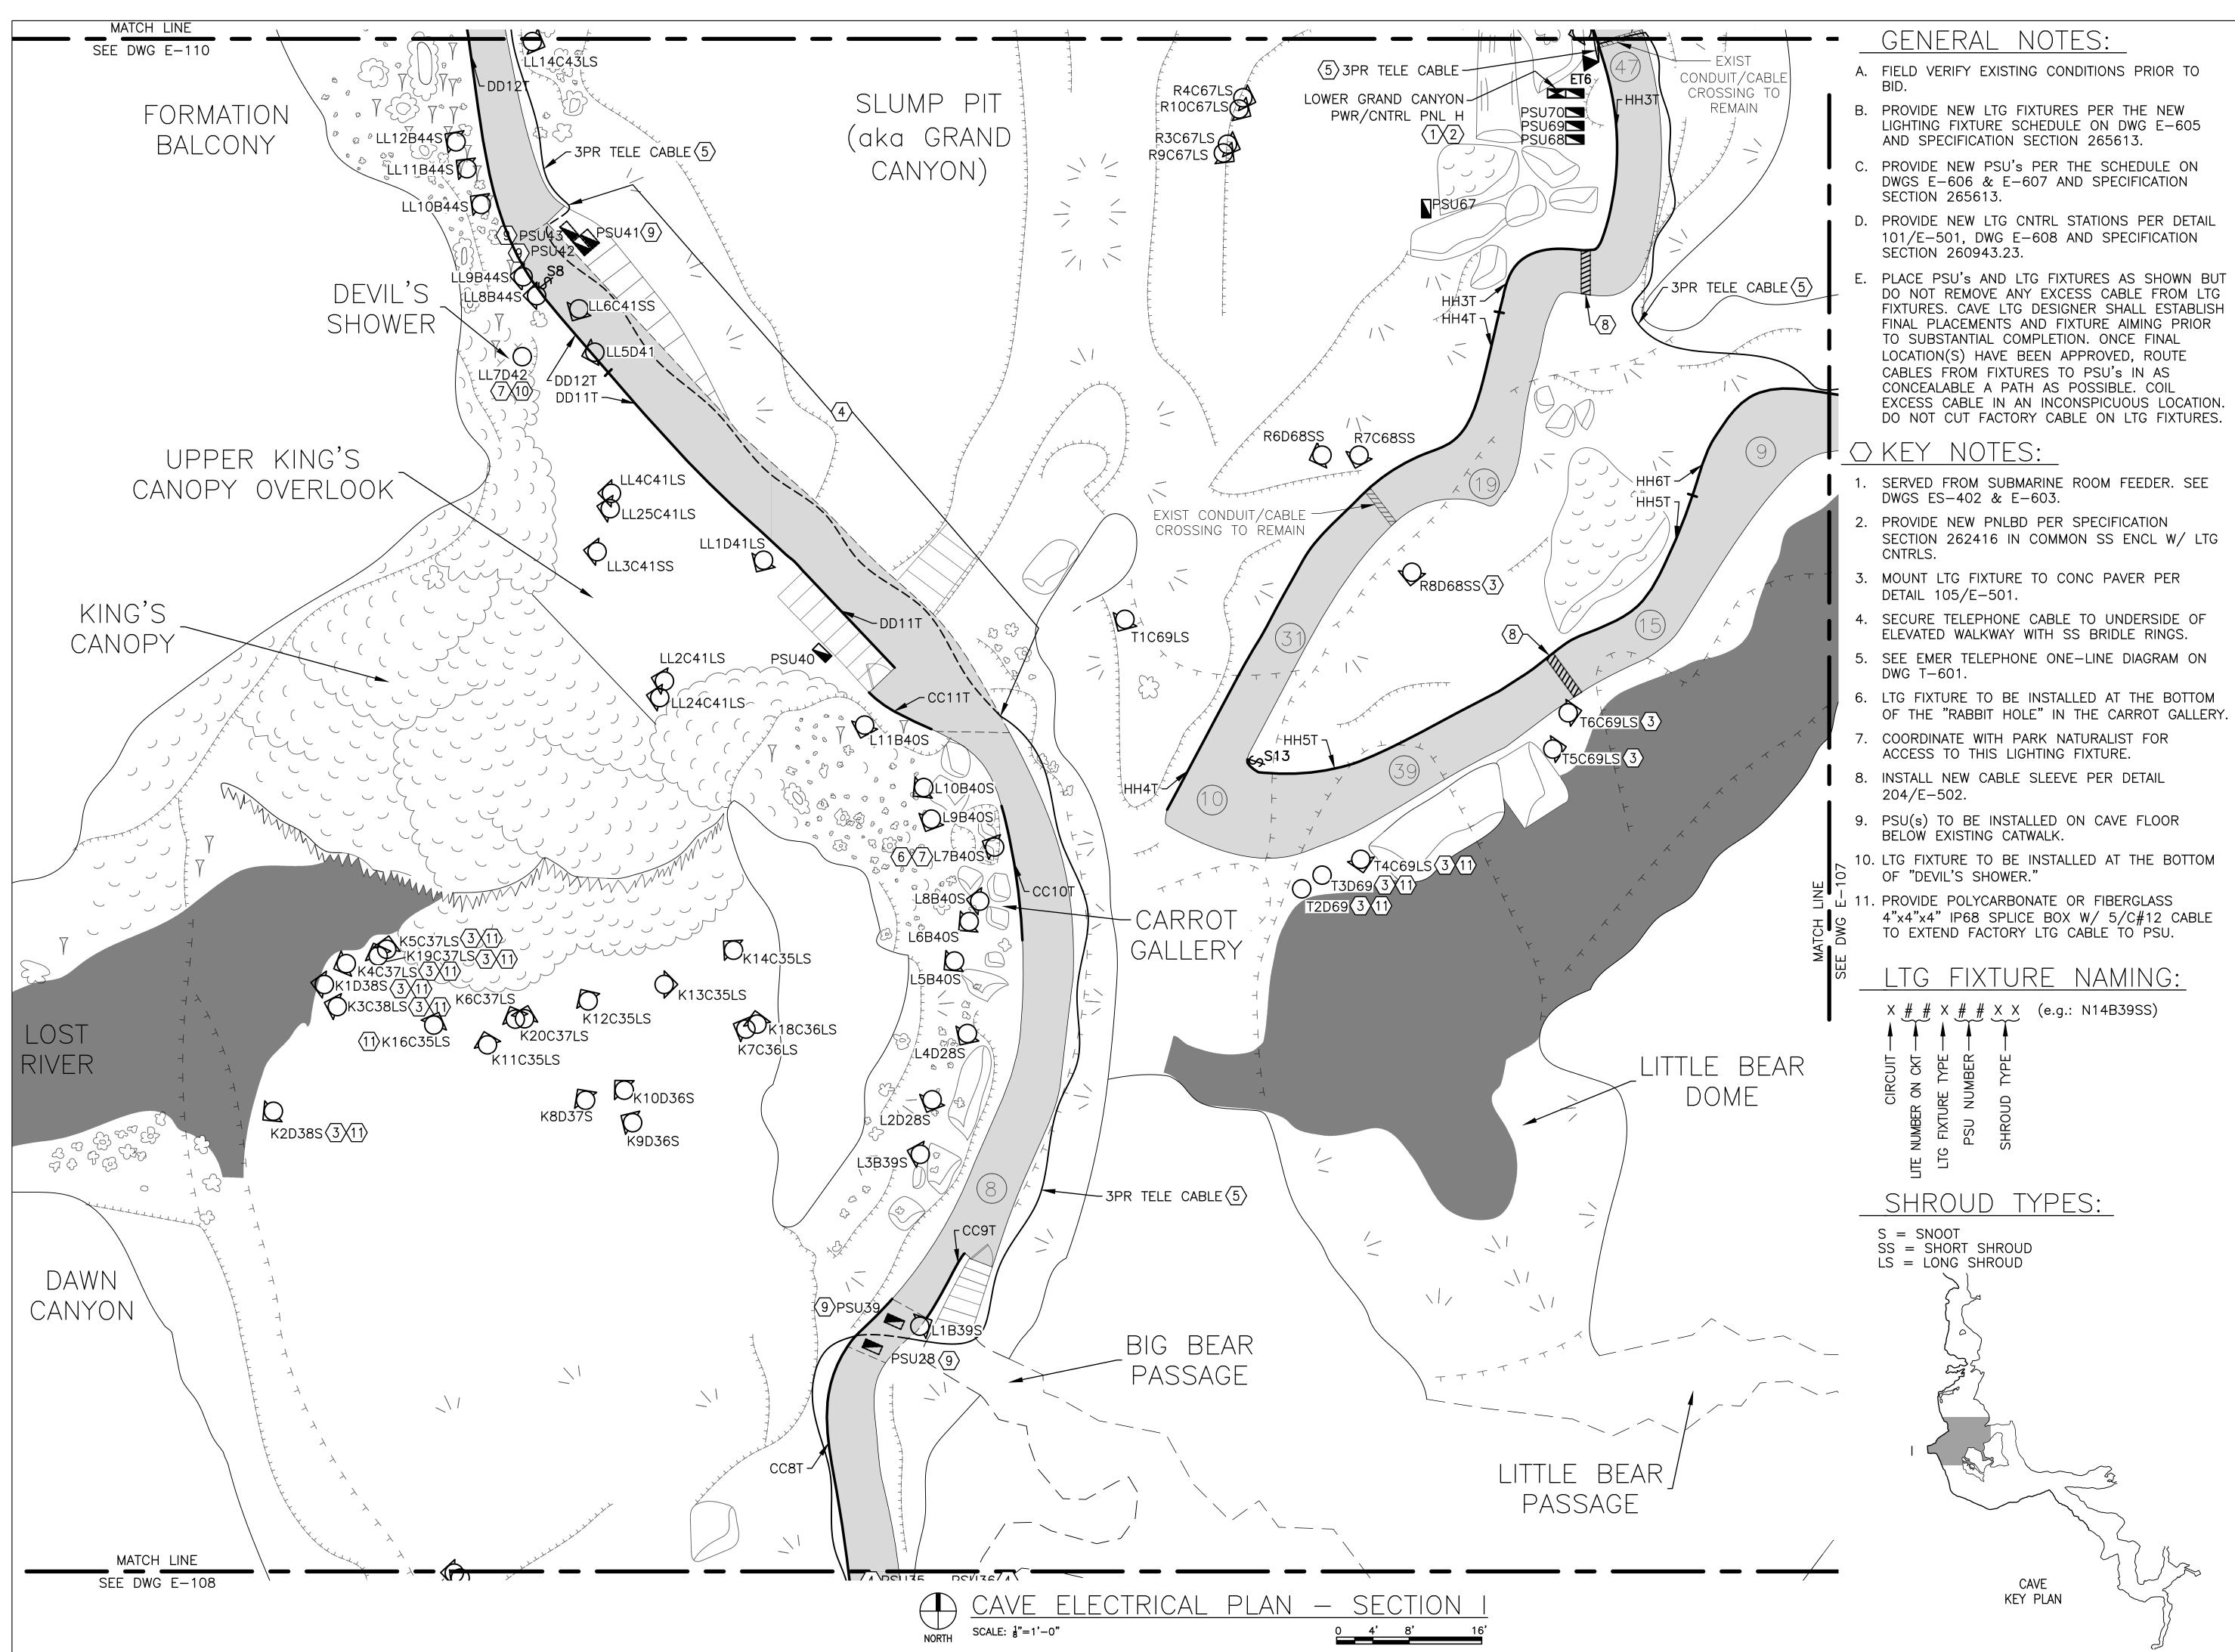



BARRY D. FREINER Registered Professional Engineer MO # E-24220 Expires 12-31-2024

ROGERS-SCHMIDT ENGINEERING CO., P.C. **CONSULTING ENGINEERS** 1736 WEST PARK CENTER DR

SUITE 204 ST. LOUIS, MO 63026 PHONE: 636-600-1551 MISSOURI STATE CERTIFICATE OF AUTHORITY #000408

OFFICE OF ADMINISTRATION **DIVISION OF FACILITIES** MANAGEMENT, DESIGN AND CONSTRUCTION

DEPARTMENT OF NATURAL RESOURCES DIVISION OF STATE PARKS

UPGRADE CAVE ELECTRIC

ONONDAGA CAVE STATE PARK 7556 HWY H LEASBURG, MO 65535

PROJECT # X2212-01 5215 SITE#

7815215013 ASSET# **REVISION: REVISION:**


REVISION:

ISSUE DATE: 06-23-2023

SHEET TITLE: CAVE ELECTRICAL PLAN - SECTION I

SHEET NUMBER:

E-109

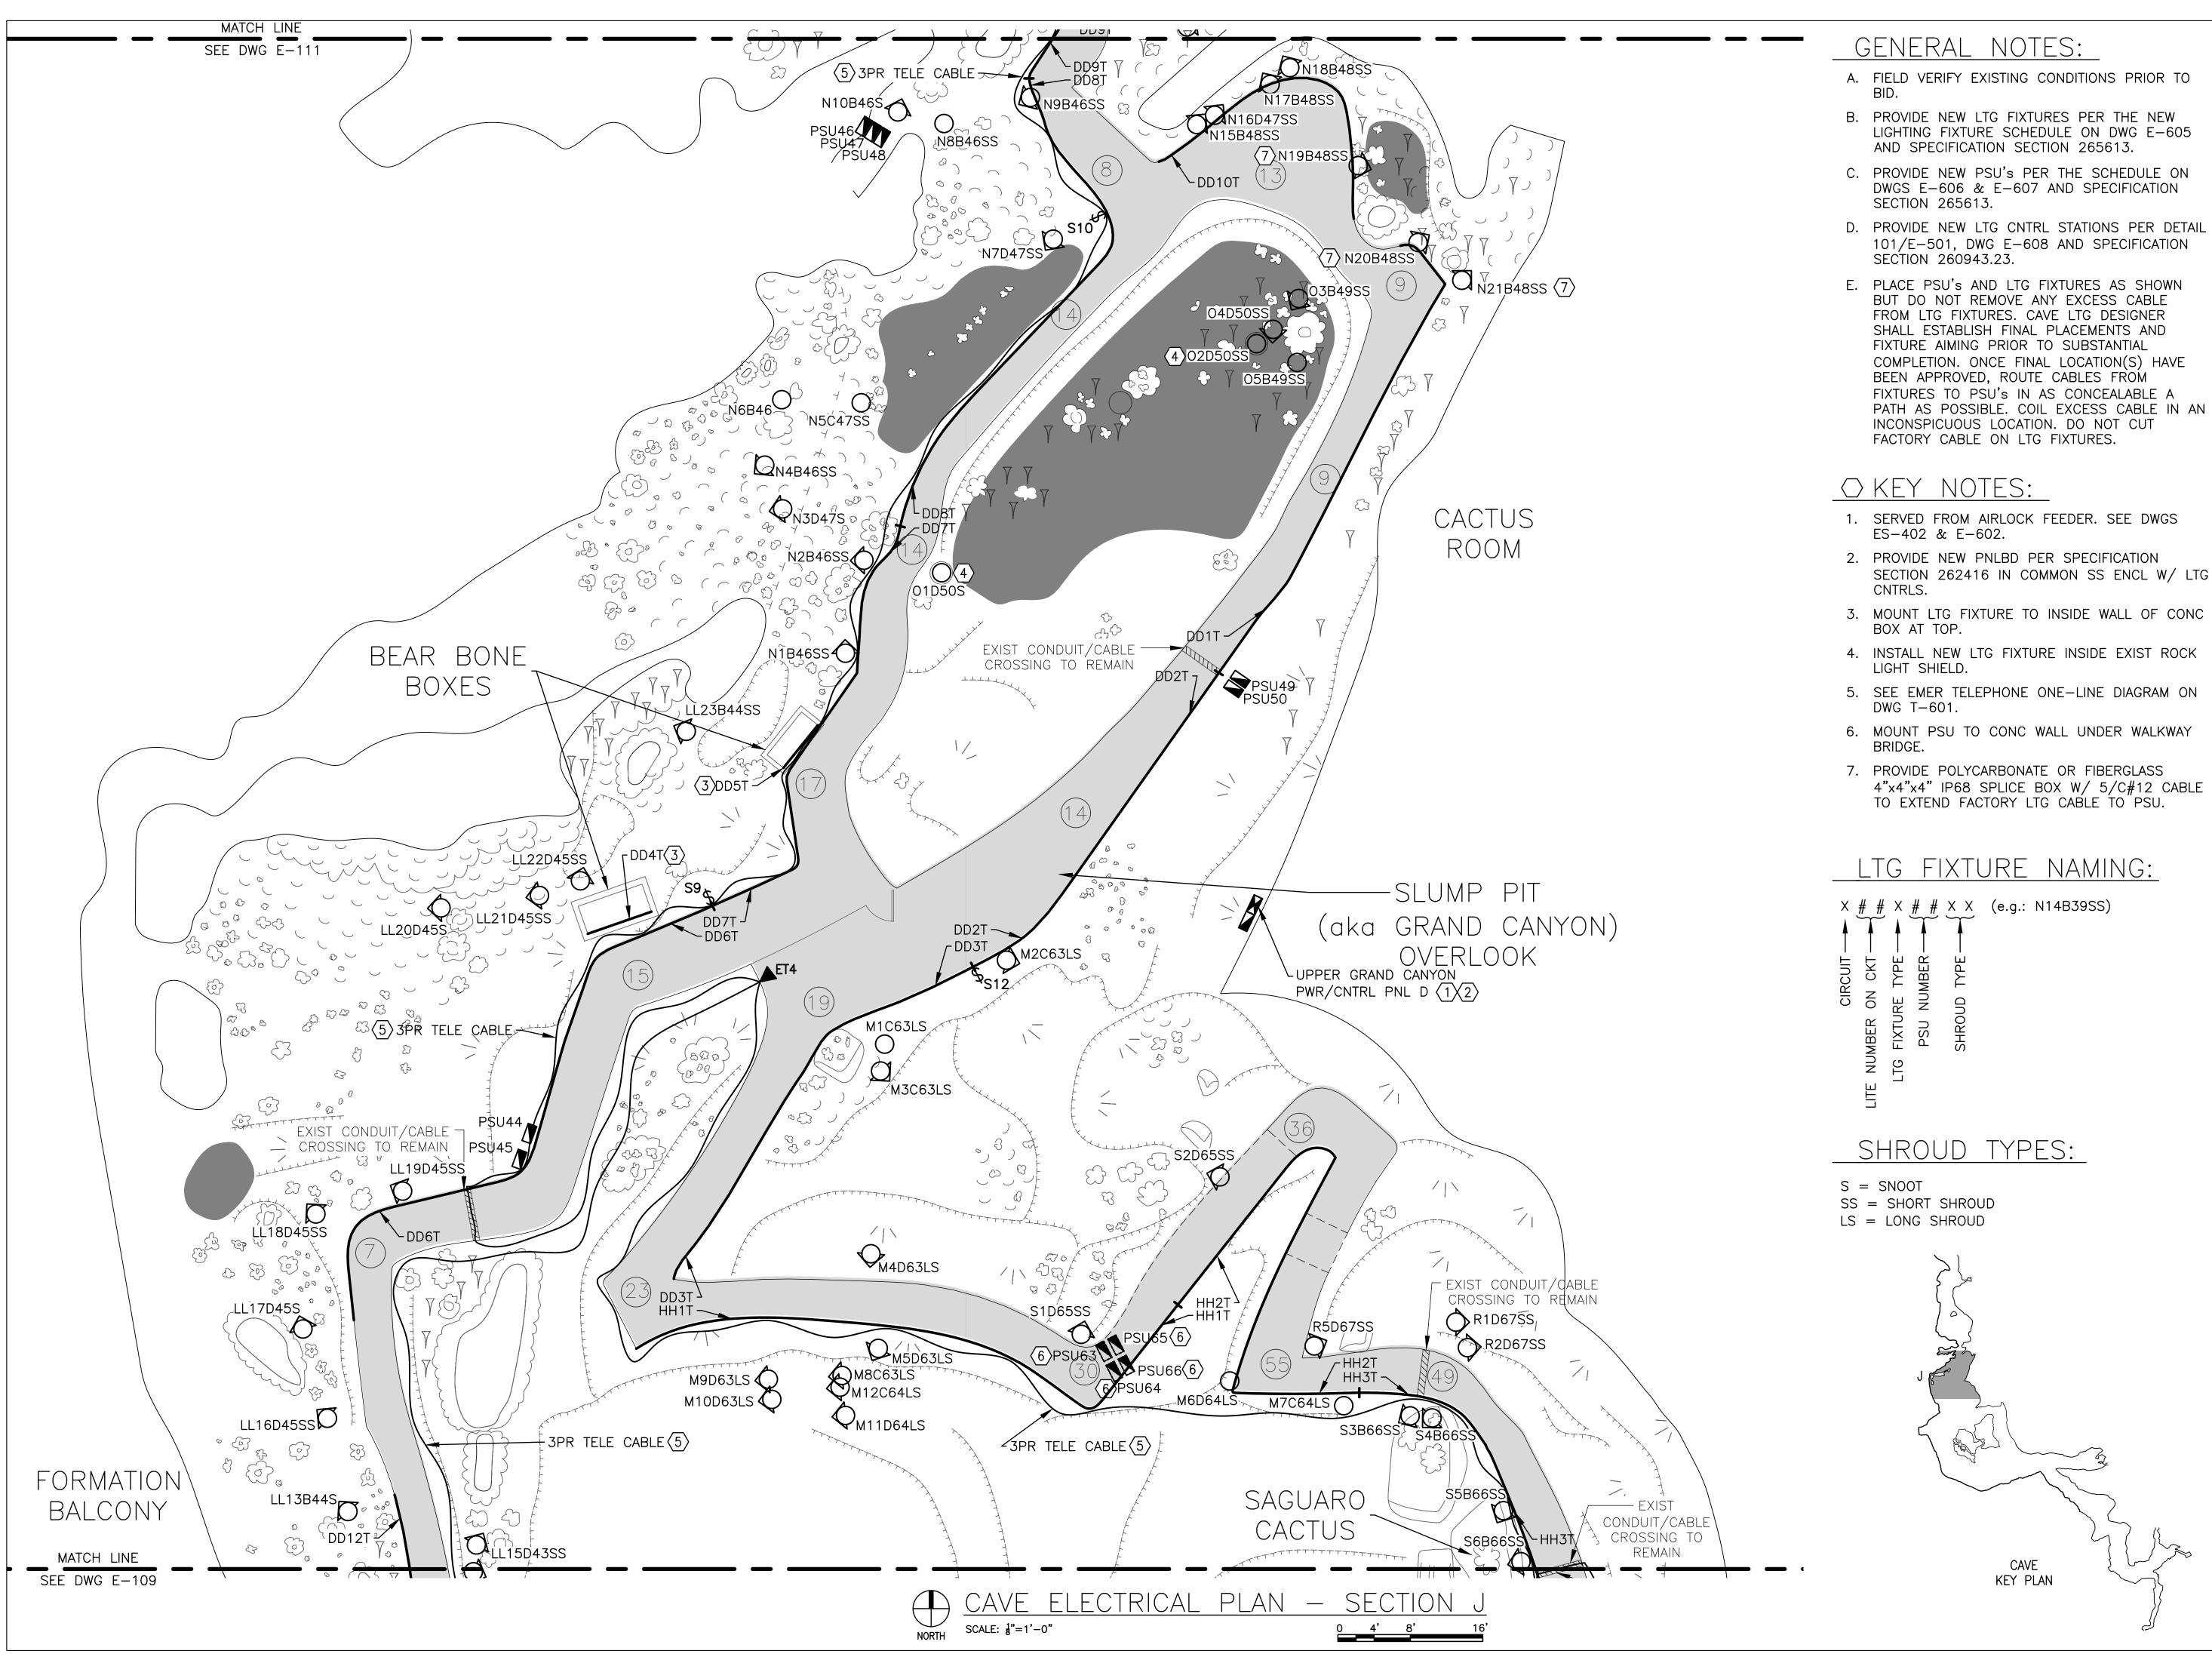

SECTION 262416 IN COMMON SS ENCL W/ LTG

STATE OF MISSOURI MICHAEL L. PARSON, **GOVERNOR**



BARRY D. FREINER Registered Professional Engineer MO # E-24220 Expires 12-31-2024

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UPGRADE CAVE ELECTRIC

ONONDAGA CAVE STATE PARK 7556 HWY H LEASBURG, MO 65535

PROJECT # X2212-01 5215

SITE# 7815215013 ASSET# **REVISION:**

REVISION: REVISION:

ISSUE DATE: <u>06-23-2023</u>

CAD DWG FILE: X2212-01-5215-7815215013-E-110.DWG

DRAWN BY: KET

CHECKED BY: BDF

DESIGNED BY: B D F


SHEET TITLE: CAVE ELECTRICAL PLAN - SECTION J

SHEET NUMBER:

JUNE 23, 2023

36 OF 50 SHEETS

- D. PROVIDE NEW LTG CNTRL STATIONS PER DETAIL
- PATH AS POSSIBLE. COIL EXCESS CABLE IN AN
- SECTION 262416 IN COMMON SS ENCL W/ LTG
- 3. SEE EMER TELEPHONE ONE-LINE DIAGRAM ON

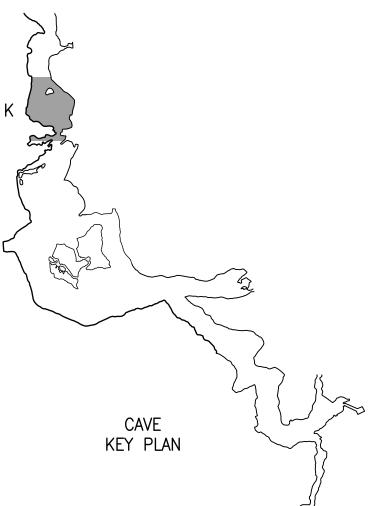

STATE OF MISSOURI MICHAEL L. PARSON, **GOVERNOR**



BARRY D. FREINER Registered Professional Engineer MO # E-24220 Expires 12-31-2024

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OFFICE OF ADMINISTRATION DIVISION OF FACILITIES MANAGEMENT, DESIGN AND CONSTRUCTION

DEPARTMENT OF NATURAL RESOURCES DIVISION OF STATE PARKS

UPGRADE CAVE ELECTRIC

ONONDAGA CAVE STATE PARK 7556 HWY H LEASBURG, MO 65535

PROJECT # X2212-01 5215 SITE#

ASSET#

7815215013

REVISION: REVISION: REVISION:

ISSUE DATE: <u>06-23-2023</u>

CAD DWG FILE: X2212-01-5215-7815215013-E-111.DWG

DRAWN BY: KET

CHECKED BY: BDF

DESIGNED BY: B D F SHEET TITLE:

CAVE ELECTRICAL PLAN - SECTION K

SHEET NUMBER:

37 OF 50 SHEETS

JUNE 23, 2023

GENERAL NOTES:

- A. FIELD VERIFY EXISTING CONDITIONS PRIOR TO BID.
- B. PROVIDE NEW LTG FIXTURES PER THE NEW LIGHTING FIXTURE SCHEDULE ON DWG E-605 AND SPECIFICATION SECTION 265613.
- C. PLACE PSU's AND LTG FIXTURES AS SHOWN BUT DO NOT REMOVE ANY EXCESS CABLE FROM LTG FIXTURES. CAVE LTG DESIGNER SHALL ESTABLISH FINAL PLACEMENTS AND FIXTURE AIMING PRIOR TO SUBSTANTIAL COMPLETION. ONCE FINAL LOCATION(S) HAVE BEEN APPROVED, ROUTE CABLES FROM FIXTURES TO PSU's IN AS CONCEALABLE A PATH AS POSSIBLE. COIL EXCESS CABLE IN AN INCONSPICUOUS LOCATION. DO NOT CUT FACTORY CABLE ON LTG FIXTURES.

OKEY NOTES:

- 1. SEE EMER TELEPHONE ONE-LINE DIAGRAM ON DWG T-601.
- 2. BURY CABLE 6" BG AT TRAIL CROSSING.

LTG FIXTURE NAMING:


X # # X # # X X (e.g.: N14B39SS)

SHROUD TYPES:

S = SNOOT

SS = SHORT SHROUD

LS = LONG SHROUD

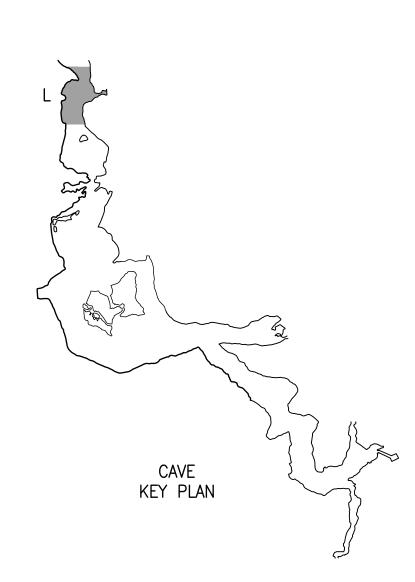

STATE OF MISSOURI MICHAEL L. PARSON, **GOVERNOR**



BARRY D. FREINER Registered Professional Engineer MO # E-24220 Expires 12-31-2024

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DEPARTMENT OF NATURAL RESOURCES DIVISION OF STATE PARKS

UPGRADE CAVE ELECTRIC

ONONDAGA CAVE STATE PARK 7556 HWY H LEASBURG, MO 65535

PROJECT # X2212-01 5215 SITE# 7815215013 ASSET#

REVISION: DATE: REVISION: DATE: **REVISION:**

ISSUE DATE: <u>06-23-2023</u>

CAD DWG FILE: X2212-01-5215-7815215013-E-112.DWG

DRAWN BY: KET

CHECKED BY: BDF

DESIGNED BY: B D F

CAVE ELECTRICAL PLAN - SECTION L

SHEET NUMBER:

SHEET TITLE:

GENERAL NOTES:

BARRY D.
FREINER
P-24220

BARRY D. FREINER
Registered Professional Engineer
MO # E-24220
Expires 12-31-2024

ROGERS-SCHMIDT
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PHONE: 636-600-1551

MISSOURI STATE CERTIFICATE

OF AUTHORITY #000408

STATE OF MISSOURI

GOVERNOR

MICHAEL L. PARSON,

OFFICE OF ADMINISTRATION DIVISION OF FACILITIES MANAGEMENT, DESIGN AND CONSTRUCTION

DEPARTMENT OF
NATURAL RESOURCES
DIVISION OF STATE PARKS

UPGRADE CAVE ELECTRIC

ONONDAGA CAVE STATE PARK 7556 HWY H LEASBURG, MO 65535

PROJECT # X2212-01 SITE # 5215 ASSET # 7815215013

REVISION: DATE: REVISION: DATE:

DATE: REVISION: DATE:

ISSUE DATE: <u>06-23-2023</u>

CAD DWG FILE: X2212-01-5215-7815215013-E-113.DWG

7815215013-E-113.DWG

DRAWN BY: KET


CHECKED BY: B D F


DESIGNED BY: B D F

SHEET TITLE:
CAVE ELECTRICAL
PLAN - SECTION M


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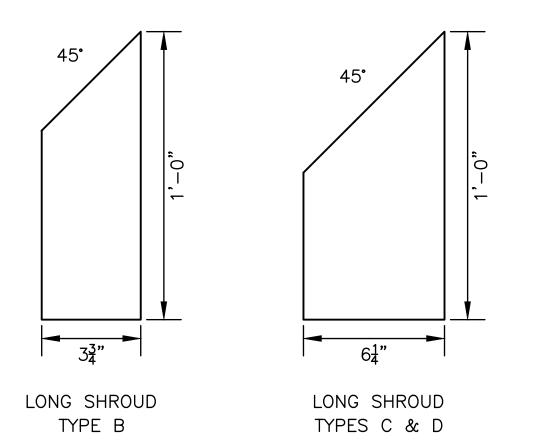
E-113



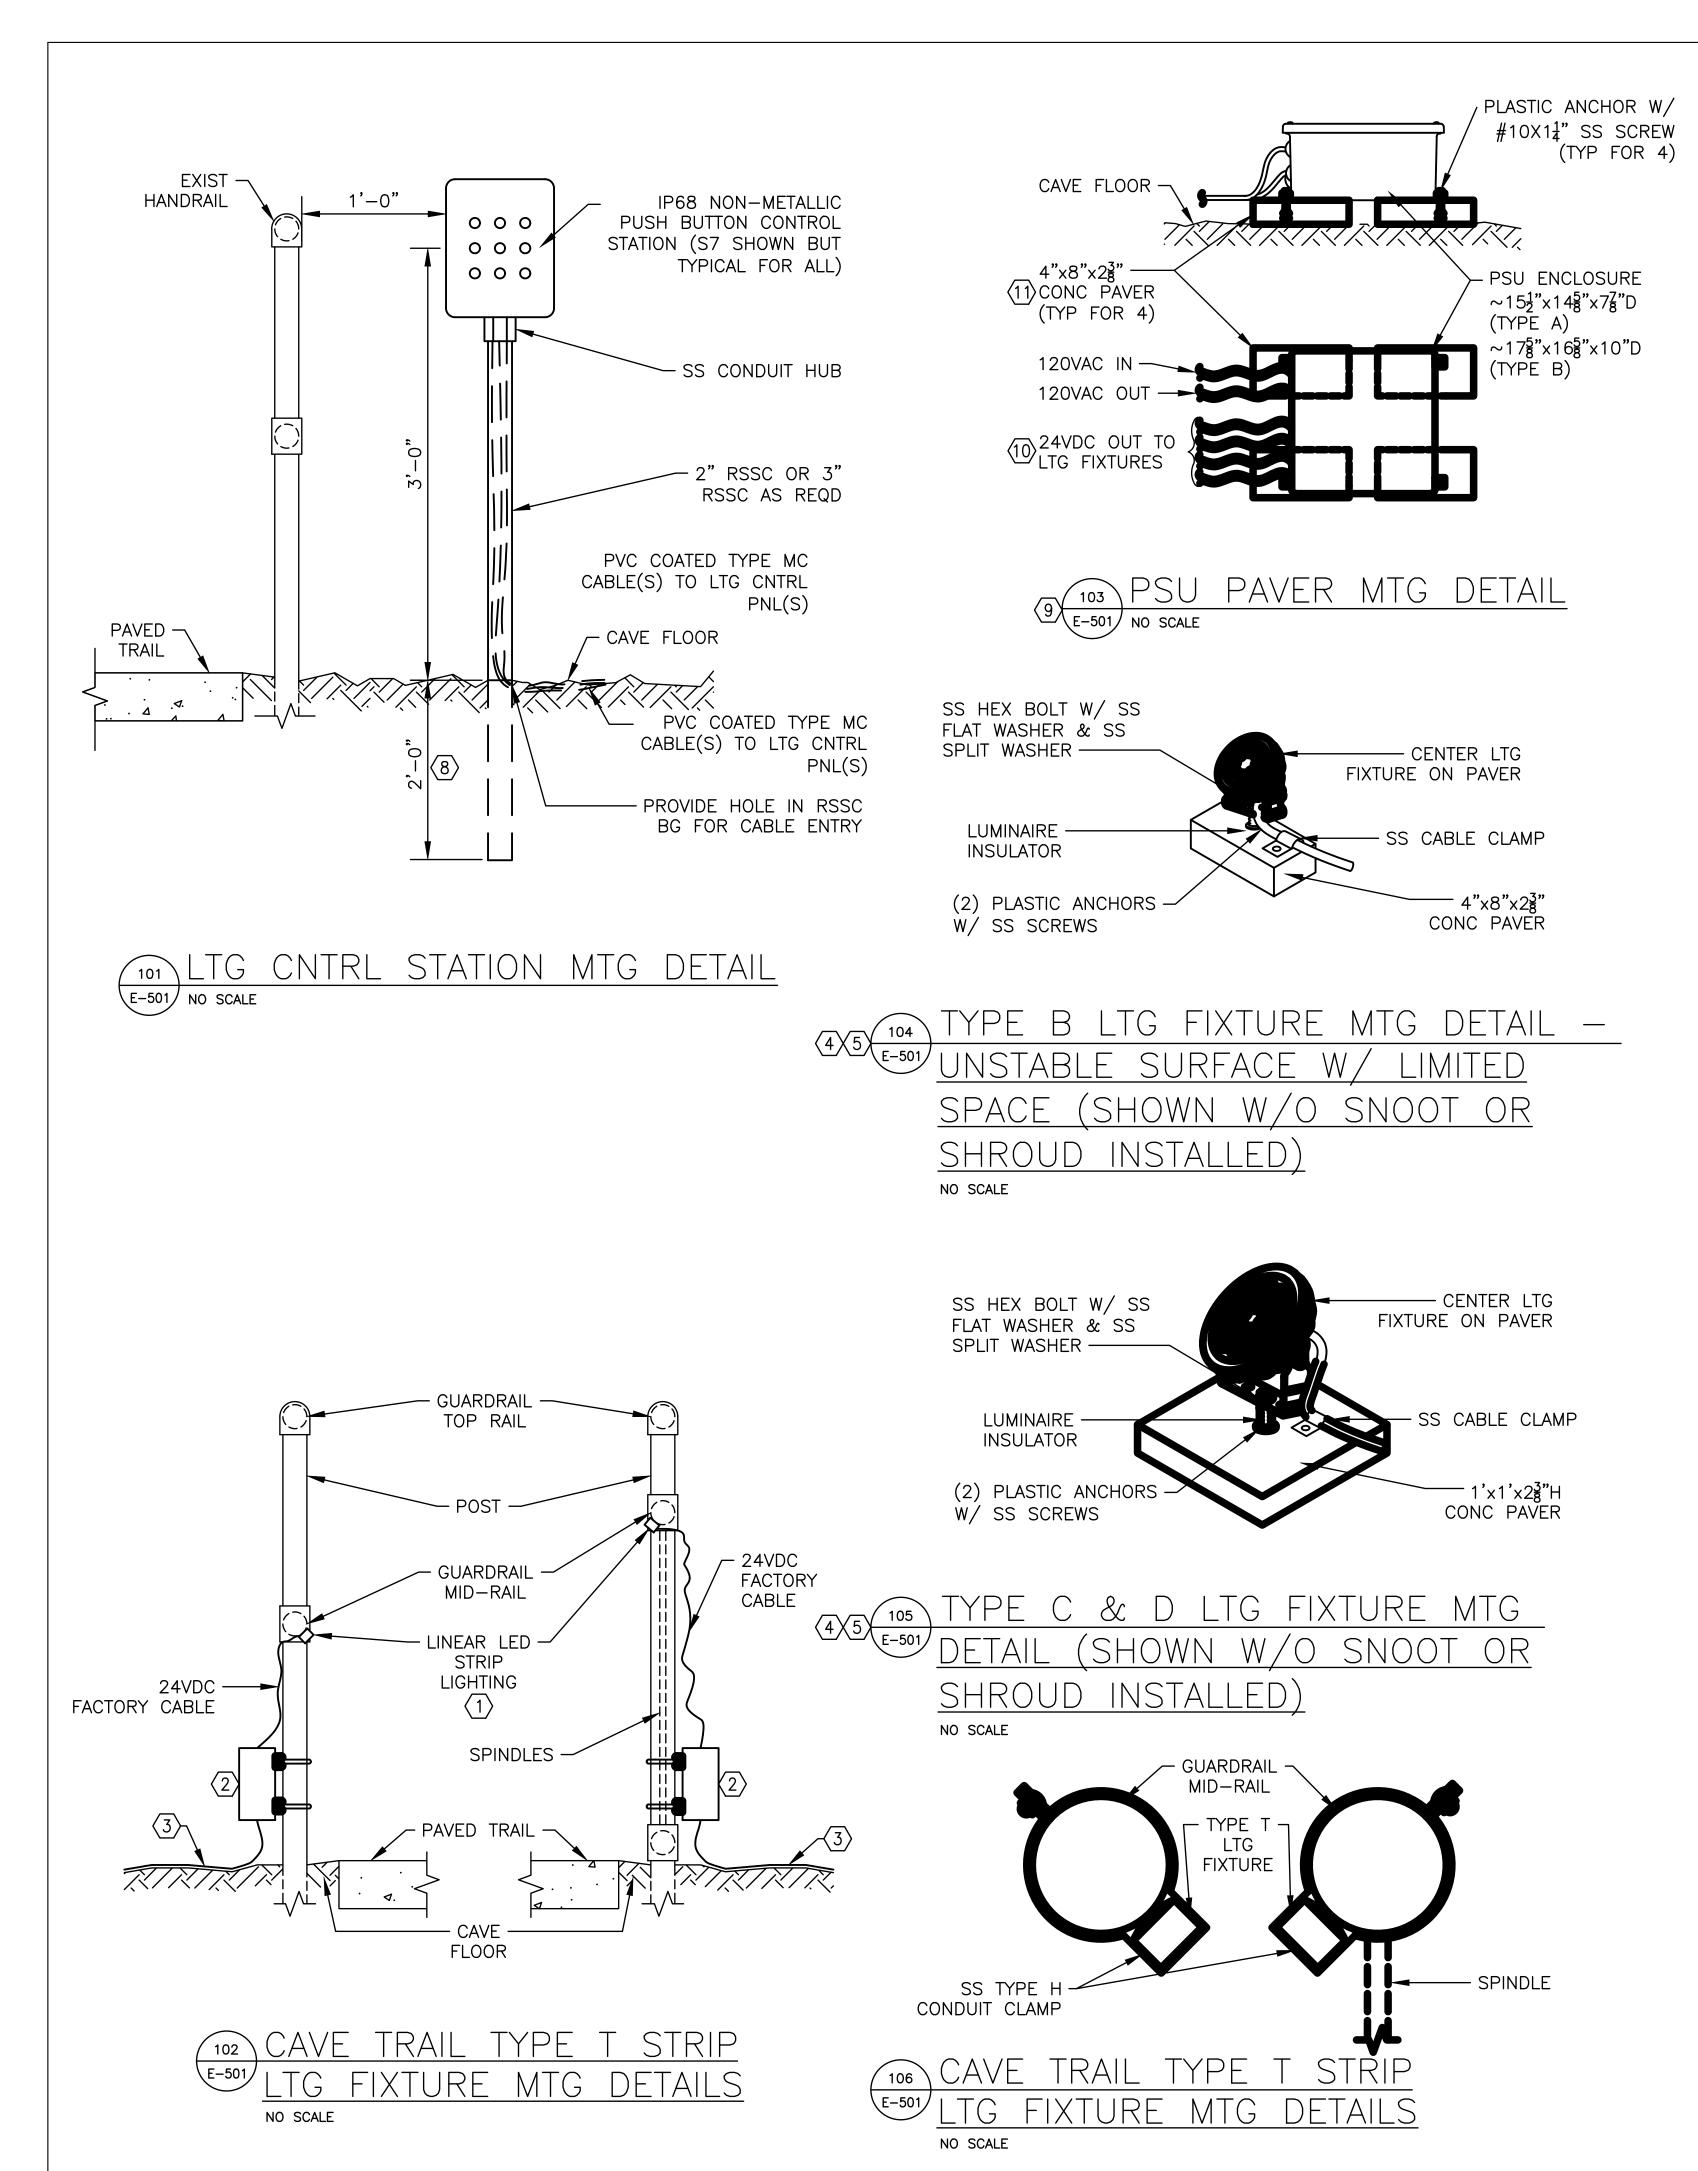

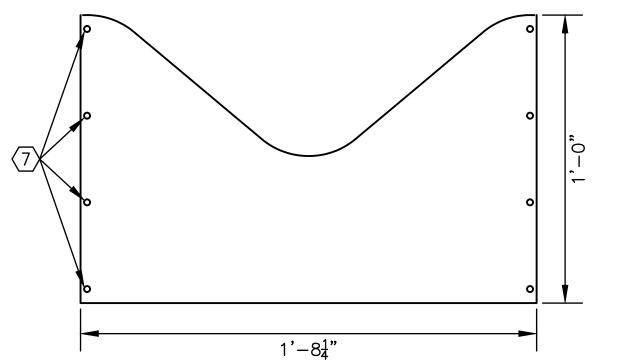LONG SHROUD TEMPLATE FOR LTG FIXTURE TYPES C & D (OTHER SHROUDS TO BE CONSTRUCTED SIMILARLY)



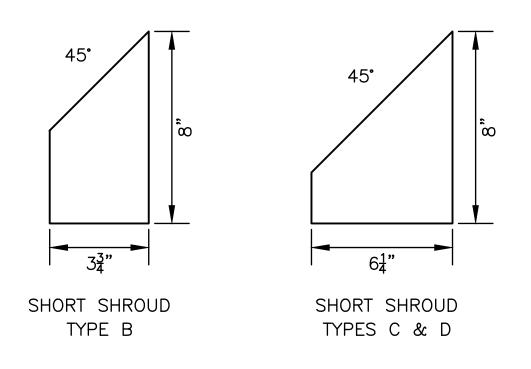

6 LIGHT SHROUD DETAIL

SCALE: 3"=1'-0"

OKEY NOTES:

- 1. INSTALL FIXTURES IN MANUFACTURER FURNISHED MTG CHANNEL, AIM LTG FIXTURES TO ILLUMINATE CENTER OF TRAIL AND CLAMP ASSEMBLY TO HORIZONTAL GUARDRAIL TUBE USING MANUFACTURER FURNISHED CLAMPS.
- 2. CONSTANT VOLTAGE DRIVER IN NEMA 6P/IP68 NON-METALLIC BOX. CLAMP DRIVER BOX EXTERNAL MTG FEET TO HANDRAIL POST USING 18" SS U-STRUT, SS U-BOLTS & SS MTG HARDWARE. DO NOT DRILL MTG HOLES IN BOX OR GUARDRAIL.
- 3. 120VAC, 12/2 WG PVC JACKETED TYPE MC CABLE.
- 4. USE FACTORY PROVIDED TRIPOD MOUNTS UNLESS DWGS SPECIFICALLY REFERENCE A MTD DETAIL ON THIS SHEET.
- 5. SS MTG HARDWARE TO BE SIZED AS REQD.
- 6. MATERIAL FOR LIGHT SHROUDS SHALL BE ABS16 OR KYDEX, 1/16" THICK. SHROUDS MOUNT INSIDE FACTORY PROVIDED SNOOT.
- 7. HOLES FOR BLACK PLASTIC POP RIVETS.
- 8. DRILL INTO ROCK & GROUT IN PLACE SO LTG CNTRL STATION CONDUIT IS PLUMB AND SOLID.
- 9. THIS DETAIL APPLIES UNLESS PSU IS SHOWN TO BE MTD OTHERWISE ON THE ELEC PLANS.
- 10. 1 TO 4 CABLES FOR TYPE A PSU. 5 TO 8 CABLES FOR TYPE B PSU.
- 11. A SINGLE PAVER THAT IS LARGE ENOUGH FOR MTG THE PSU IS ALSO ACCEPTABLE.

ELEVATED -

/- WATER POOL

-15g" SS U-STRUT

STOP U-STRUT 2" ABOVE BOTTOM OF POOL

TYPE DS LTG FIXTURE

WALKWAY

SECURE U-STRUT TO STRUCTURE -

PROVIDE SLACK IN CABLE TO ALLOW ADJ OF FIXTURE MTG

CAVE FLOOR

E-501 NO SCALE

V 108 MTG DETAIL

LOCATION ALONG U-STRUT

W/ (2) SS FASTENERS

STATE OF MISSOURI MICHAEL L. PARSON, GOVERNOR



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Registered Professional Engineer
MO # E-24220
Expires 12-31-2024

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MISSOURI STATE CERTIFICATE
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OFFICE OF ADMINISTRATION
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MANAGEMENT,
DESIGN AND CONSTRUCTION

DEPARTMENT OF NATURAL RESOURCES DIVISION OF STATE PARKS

UPGRADE CAVE ELECTRIC

ONONDAGA CAVE STATE PARK 7556 HWY H LEASBURG, MO 65535

PROJECT # X2212-01 SITE # 5215 ASSET # 7815215013

REVISION:
DATE:
REVISION:
DATE:
REVISION:
DATE:

EVISION:
DATE:

SSUE DATE: 06-23-20

ISSUE DATE: 06-23-2023

CAD DWG FILE: X2212-01-5215-7815215013-E-501.DWG

7815215013-E-501.DWG


DRAWN BY: KET/MNS
CHECKED BY: BDF
DESIGNED BY: BDF

SHEET TITLE:
ELECTRICAL
DETAILS


SHEET NUMBER:

E-50


CAVE POWER/CONTROL PANEL MTG DETAIL E-502 NO SCALE

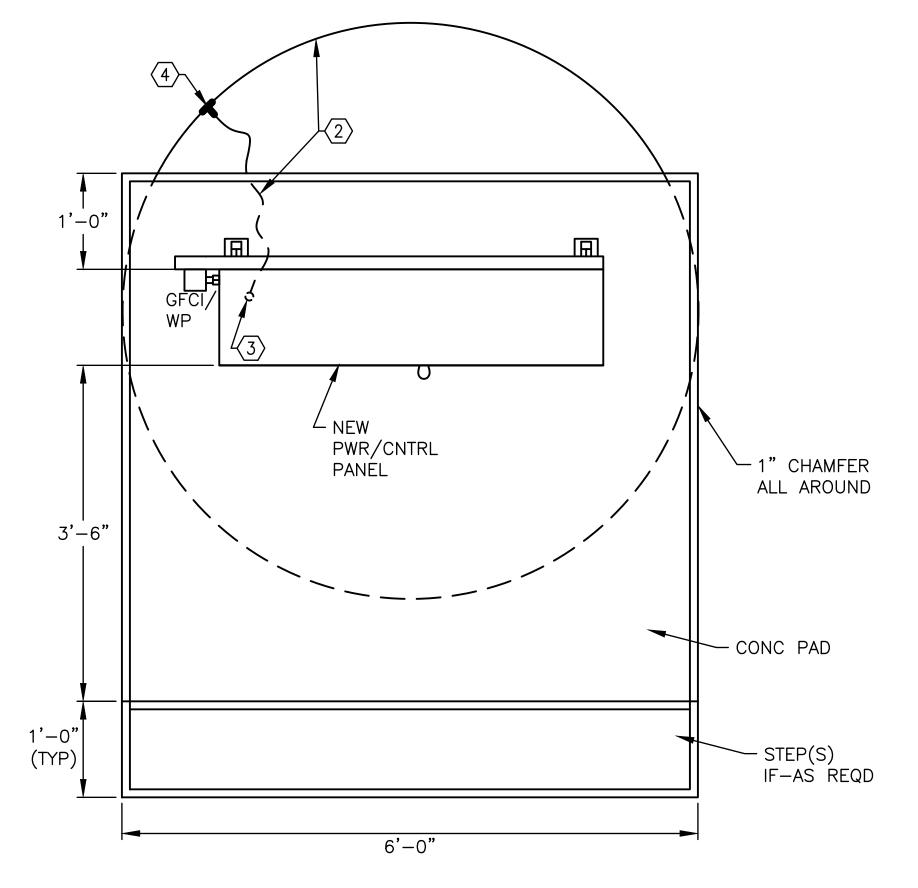

(202) CAVE PANELBOARD GROUNDING DETAIL E-502 NO SCALE

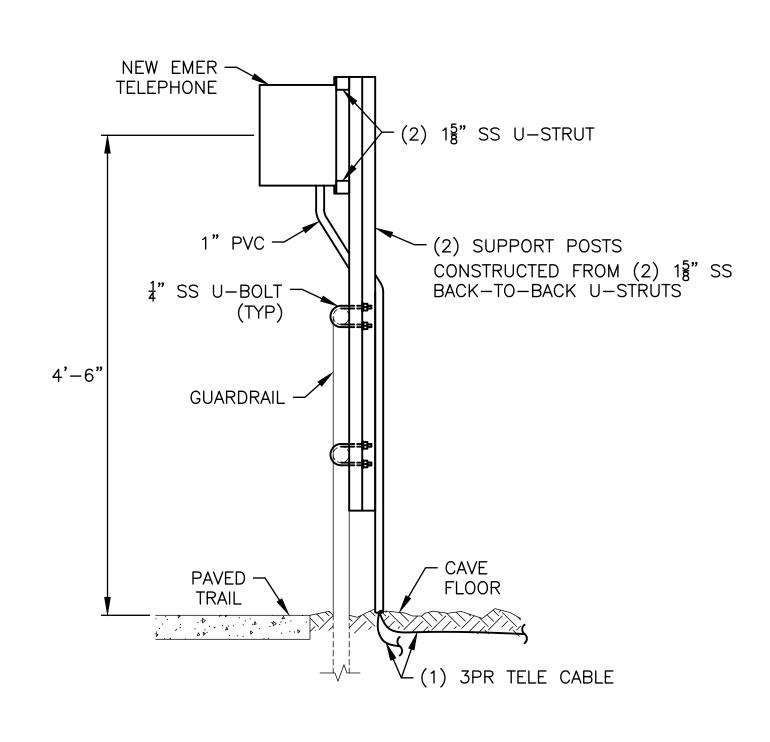

EMER TELEPHONE MTG DETAIL E-502 NO SCALE

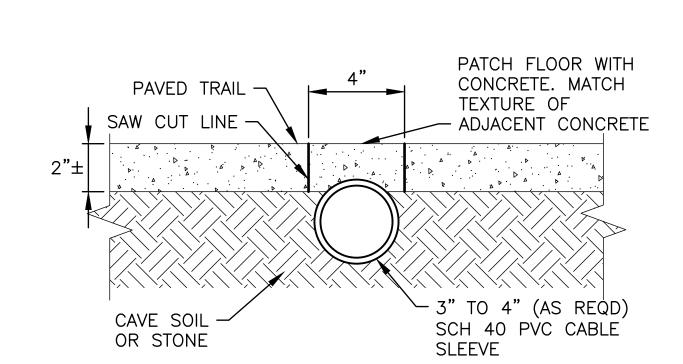

CABLE SLEEVE DETAIL

OKEY NOTES:

- 1. IF OVER 7", PROVIDE STEP(S) FOR ACCESS.
- 2. 4/0 BARE STRD CU GROUNDING CABLE IN 6' DIAMETER CIRCLE, 6" BG. WHERE BELOW CONC PAD, INSTALL UNDER THE BOND BREAKER SHEET.
- 3. TERMINATE GRD CABLE ON EQUIP GRD BUS INSIDE PNLBD. DO NOT BOND NEUT BUS TO GRD.
- 4. EXOTHERMICALLY WELDED CONNECTION.
- 5. OBTAIN APPROVAL OF PARK NATURALIST BEFORE ADDING ANY SLEEVES ACROSS
- 6. PROVIDE COLOR ADDITIVE PER SPECIFICATION SECTION 033000. BROOM FINISH WITH 1/8" SLOPE TO DRAIN.
- 7. PROVIDE GFCI DUPLEX RECPT IN SINGLE-GANG TYPE FDL CAST BOX WITH WHILE-IN-USE WEATHERPROOF COVER.

STATE OF MISSOURI MICHAEL L. PARSON, GOVERNOR



BARRY D. FREINER Registered Professional Engineer MO # E-24220

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OFFICE OF ADMINISTRATION DIVISION OF FACILITIES MANAGEMENT, DESIGN AND CONSTRUCTION

DEPARTMENT OF NATURAL RESOURCES DIVISION OF STATE PARKS

UPGRADE CAVE ELECTRIC

ONONDAGA CAVE STATE PARK 7556 HWY H LEASBURG, MO 65535

PROJECT # X2212-01 5215

7815215013

REVISION: DATE: **REVISION:** DATE:

ASSET#

REVISION:

ISSUE DATE: <u>06-23-2023</u>

CAD DWG FILE: X2212-01-5215-7815215013-E-502.DWG

DRAWN BY: KET

CHECKED BY: BDF

DESIGNED BY: B D F

SHEET TITLE: ELECTRICAL

DETAILS

SHEET NUMBER:

E-502

<u>One-line diagram</u>

GENERAL NOTE:

A. ALL CONDUCTORS ARE STRD CU UNLESS NOTED OTHERWISE.

- 1. SEE DWG E-602 FOR CONTINUATION.
- 2. SEE DWG E-603 FOR CONTINUATION.
- 3. FACTORY MTD ON GENERATOR SET.
- 4. SPLICE XHHW-2 SINGLE CONDUCTORS TO TYPE MC CABLE.
- 5. 1"C-2#8 & 1#10 GRD
- 6. $\frac{3}{4}$ "C-2#12 & 1#12 GRD
- 7. 1"C-2#12 & 1#12 GRD
- 8. DO NOT BOND NEUT TO GRD AT THE GENERATOR.
- 9. <u>ALT BID NO.1</u>: PROVIDE NEMA TYPE 4X SS FNCI.

STATE OF MISSOURI MICHAEL L. PARSON, GOVERNOR



BARRY D. FREINER
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MO # E-24220
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PROJECT # X2212-01 SITE # 5215

REVISION:
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REVISION:
DATE:
REVISION:

ASSET#

7815215013

ISSUE DATE: 06-23-2023

CAD DWG FILE: X2212-01-5

CAD DWG FILE: X2212-01-5215-7815215013-E-601.DWG

DRAWN BY: KET

CHECKED BY: B D F

DESIGNED BY: B D F

CHECKED BY: BDF
DESIGNED BY: BDF
SHEET TITLE:
ONE-LINE

DIAGRAM

ELECTRICAL

SHEET NUMBER:

STATE OF MISSOURI

MICHAEL L. PARSON,

GOVERNOR

BARRY D. FREINER Registered Professional Engineer MO # E-24220 Expires 12-31-2024

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ONONDAGA CAVE STATE PARK 7556 HWY H LEASBURG, MO 65535

PROJECT # X2212-01 5215

ASSET # 7815215013

REVISION: REVISION:

REVISION:

ISSUE DATE: <u>06-23-2023</u>

CAD DWG FILE: X2212-01-5215-7815215013-E-602.DWG

DRAWN BY: KET

CHECKED BY: BDF

DESIGNED BY: BDF

SHEET TITLE: ONE-LINE AIRLOCK FEEDER


SHEET NUMBER:

43 OF 50 SHEETS JUNE 23, 2023



1. SEE DWG E-601 FOR CONTINUATION.

2. SPLICE INSIDE PWR/CNTRL CABINET.

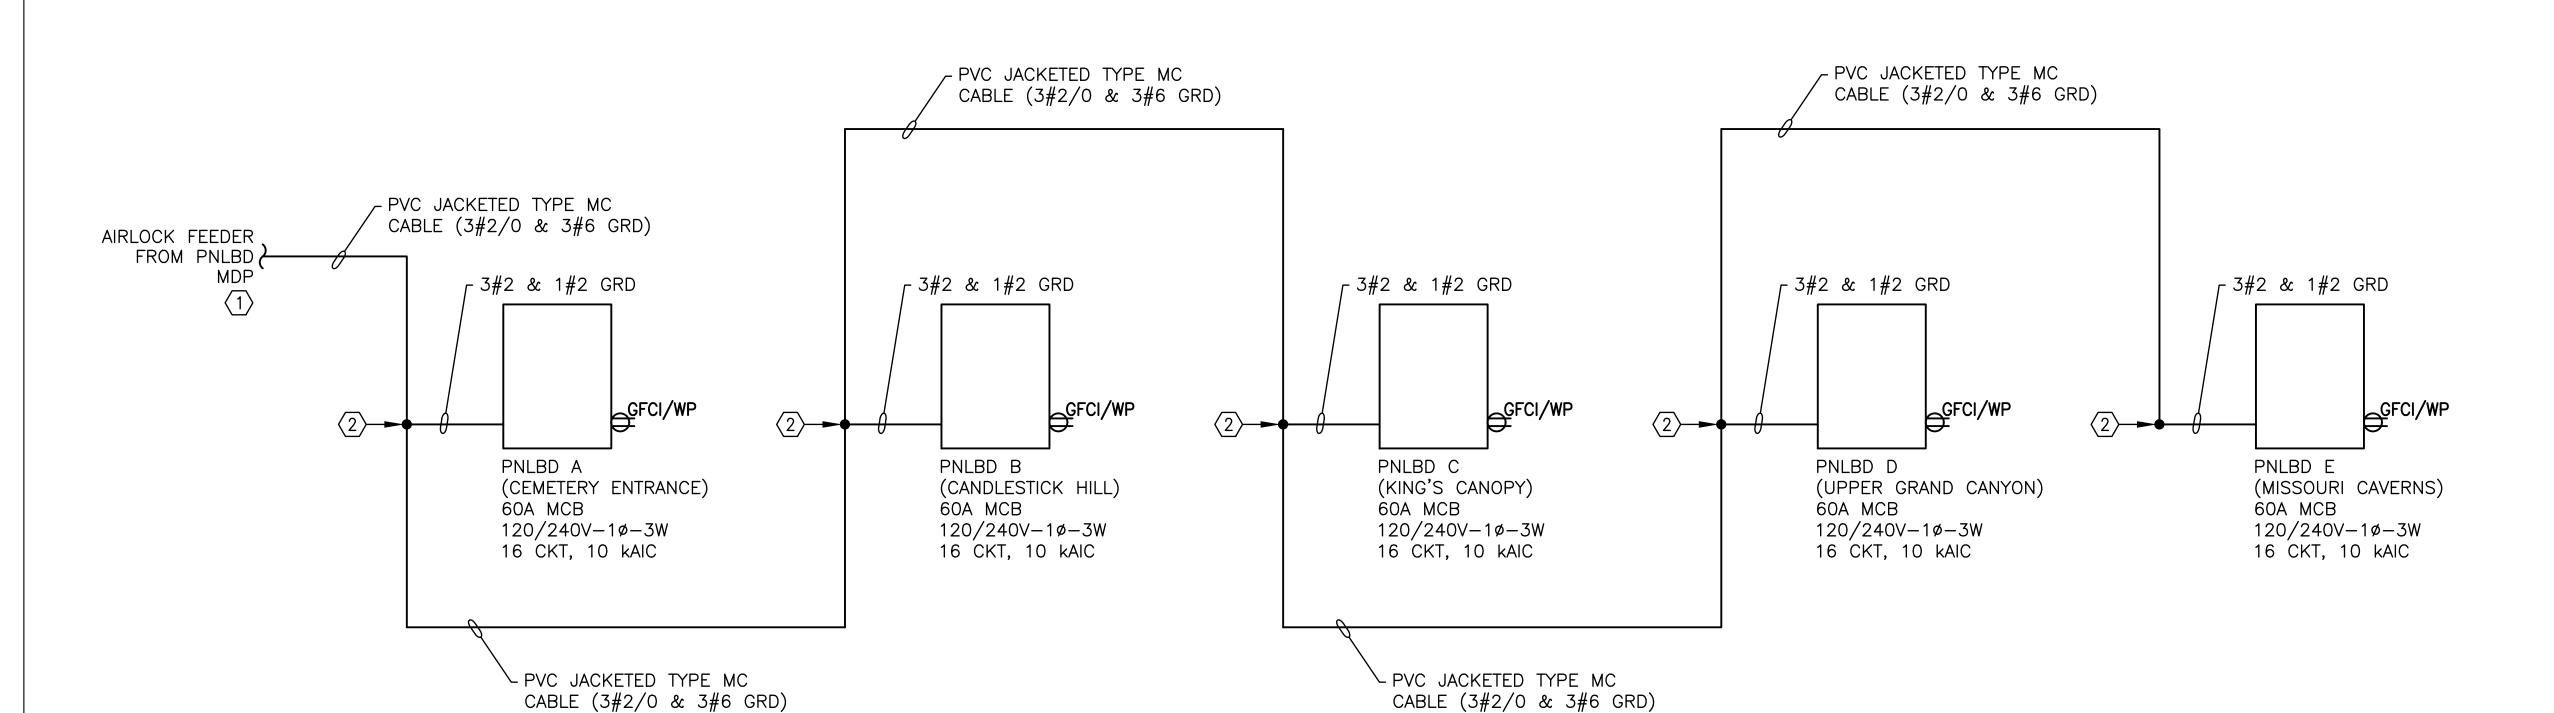


ONE-LINE DIAGRAM FOR CAVE AIRLOCK FEEDER

GENERAL NOTE:

A. ALL CONDUCTORS ARE CU UNLESS NOTED OTHERWISE.

OKEY NOTES:

- 1. SEE DWG E-601 FOR CONTINUATION.
- 2. SPLICE INSIDE PWR/CNTRL CABINET.

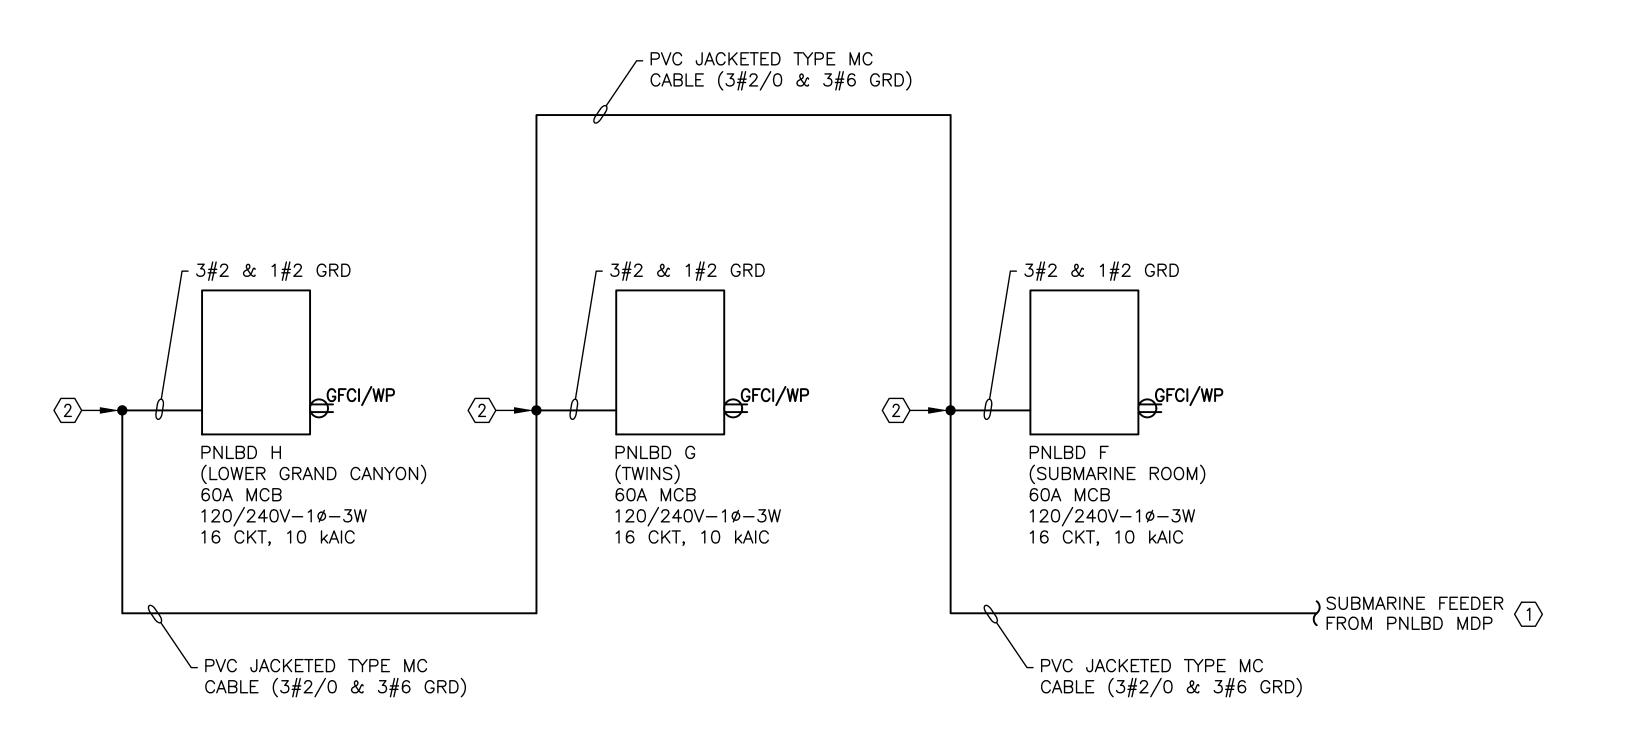

ONE-LINE DIAGRAM FOR SUBMARINE ROOM FEEDER

GOVERNOR

STATE OF MISSOURI

MICHAEL L. PARSON,



BARRY D. FREINER Registered Professional Engineer MO # E-24220 Expires 12-31-2024

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UPGRADE CAVE ELECTRIC

ONONDAGA CAVE STATE PARK 7556 HWY H LEASBURG, MO 65535

PROJECT # X2212-01 5215

ASSET # 7815215013

REVISION: REVISION: DATE: **REVISION:**

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CAD DWG FILE: X2212-01-5215-7815215013-E-603.DWG

DRAWN BY: KET

CHECKED BY: BDF

DESIGNED BY: BDF

SHEET TITLE: ONE-LINE

SUBMARINE ROOM FEEDER

SHEET NUMBER:

			NEW PAN	ELBOAF	RD A (0	CEME	TERY	ENTRANCE)			
CKT		ES		VOLT-A	MPERES	VOLT-A	MPERES		ES		СКТ
NO	AMPS	POLES	LOAD	ØA	ØB	ØA	ØB	LOAD	POLES	AMPS	NO
1	20	1	PSU 1, 2, 3, 4	158		650		TRAIL LIGHTS - AIR LOCK TO LOST RIVER	1	20	2
3	15	1	PSU 5, 6, 7		388		293	PSU 8, 9	1	15	4
5	20	1	SPARE	-		-		SPARE	1	20	6
7	20	1	SPARE		-		-	SPARE	1	20	8
9	20	1	SPARE	-		-		SPARE	1	20	10
11	20	1	SPARE		-		-	SPARE	1	20	12
13	20	1	ENCLOSURE MTD GFCI RECPT	180		-		SPARE	1	20	14
15	15	1	ENCLOSURE SPACE HEATER		120		120	CONTROL PANEL A	1	15	16
				-		-		MAIN BREAKER	2	60	
					-		-		1		
60 AMP	MCB, 120/	/240V-1	Ø-3W 16 CKT, 10KAIC	338	508	650	413	TOTAL VOLT AMPERES =		1909	

60 AMP MCB, 120/240V-1Ø-3W 16 CKT, 10KAIC W/ INTEGRAL, BUS MTD 160kA SPD IN TYPE 1 ENCL SERVED FROM AIR LOCK SERVICE ENTRANCE

			NEW P	ANELB	OARD	C (KII	NG'S (CANOPY)			
СКТ		ES		VOLT-A	MPERES	VOLT-A	MPERES		ES		CKT
NO	AMPS	POLES	LOAD	ØA	ØB	ØA	ØB	LOAD	POLES	AMPS	NO
1	15	1	PSU 22, 57, 58	388		630		TRAIL LIGHTS - BENCH JUNCTION TO UPPER KINGS CANOPY OVERLOOK	1	20	2
3	15	1	PSU 17, 23, 24		328		467	PSU 25, 26, 27, 28	1	20	4
5	20	1	SPARE	-		-		SPARE	1	20	6
7	20	1	SPARE		-		-	SPARE	1	20	8
9	20	1	SPARE	-		-		SPARE	1	20	10
11	20	1	SPARE		-		-	SPARE	1	20	12
13	20	1	ENCLOSURE MTD GFCI RECPT	180		-		SPARE	1	20	14
15	15	1	ENCLOSURE SPACE HEATER		120		120	CONTROL PANEL C	1	15	16
				-		-		MAIN BREAKER	2	60	
					-		-				
60 AMP	MCB, 120/	240V-19	Ø-3W 16 CKT, 10KAIC	568	448	630	587	TOTAL VOLT AMPERES =		2233	

			NEW PANE	ELBOA	ARD E	(MISS	OURI	CAVERNS)			
OLIT		SII		VOLT-A	MPERES	VOLT-A	MPERES		SII		01/7
CKT NO	AMPS	POLES	LOAD	ØA	ØB	ØA	ØB	LOAD	POLES	AMPS	CKT NO
1	15	1	PSU 43, 44	194		675		TRAIL LIGHTS - CATHEDRAL ROOM LOOP TO UPPER KINGS CANOPY OVERLOOK	1	20	2
3	20	1	PSU 45, 46, 47, 48		290		320	PSU 49, 50, 51, 52	1	20	4
5	20	1	SPARE	-		-		SPARE	1	20	6
7	20	1	SPARE		-		-	SPARE	1	20	8
9	20	1	SPARE	-		-		SPARE	1	20	10
11	20	1	SPARE		-		-	SPARE	1	20	12
13	20	1	ENCLOSURE MTD GFCI RECPT	180		-		SPARE	1	20	14
15	15	1	ENCLOSURE SPACE HEATER		120		120	CONTROL PANEL E	1	15	16
				-		-	_	MAIN BREAKER	2	60	
					-		-				

60 AMP MCB, 120/240V-1Ø-3W 16 CKT, 10KAIC W/ INTEGRAL, BUS MTD 160kA SPD IN TYPE 1 ENCL SERVED FROM AIR LOCK SERVICE ENTRANCE

W/ INTEGRAL, BUS MTD 160kA SPD IN TYPE 1 ENCL

SERVED FROM AIR LOCK SERVICE ENTRANCE

			N	IEW PAN	IELBO	ARD (G (TW	INS)			
CKT		ES		VOLT-AI	MPERES	VOLT-AI	MPERES		Si		CKT
NO	AMPS	POLES	LOAD	ØA	ØB	ØA	ØB	LOAD	POLES	AMPS	NO
1	15	1	PSU 14, 15, 21	287		460		TRAIL LIGHTS - BENCH JUNCTION TO LOWER NORTH RIVER	1	20	2
3	15	1	PSU 20, 60, 61		236		-	SPARE	1	20	4
5	15	1	PSU 62, 64	218		-		SPARE	1	20	6
7	20	1	SPARE		-		-	SPARE	1	20	8
9	20	1	SPARE	-		-		SPARE	1	20	10
11	20	1	SPARE		-		120	CONTROL PANEL G	1	15	12
13	20	1	ENCLOSURE MTD GFCI RECPT	180		1000		WATER PUMP	2	30	14
15	15	1	ENCLOSURE SPACE HEATER		120		1000				16
				-		-		MAIN BREAKER	2	60	
					-		-				
60 AMP	MCB, 120/	240V-1	Ø-3W 16 CKT, 10KAIC	685	356	1460	1120	TOTAL VOLT AMPERES =		3621	

W/ INTEGRAL, BUS MTD 160kA SPD IN TYPE 1 ENCL SERVED FROM SUBMARINE ROOM SERVICE ENTRANCE

			NEW PAN	IELBO	ARD B	(CAN	DLES	TICK HILL)			
CKT		ES.		VOLT-A	MPERES	VOLT-A	MPERES		ES.		СКТ
NO	AMPS	POLES	LOAD	ØA	ØB	ØA	ØB	LOAD	POLES	AMPS	NO
1	20	1	PSU 10, 11, 12	414		665		TRAIL LIGHTS - LOST RIVER TO BIG RM SWITCHBACKS	1	20	2
3	15	1	PSU 13, 59		292		-	SPARE	1	20	4
5	15	1	PSU 16, 18, 19	340		-		SPARE	1	20	6
7	20	1	SPARE		-		-	SPARE	1	20	8
9	20	1	SPARE	-		-		SPARE	1	20	10
11	20	1	SPARE		-		-	SPARE	1	20	12
13	20	1	ENCLOSURE MTD GFCI RECPT	180		-		SPARE	1	20	14
15	15	1	ENCLOSURE SPACE HEATER		120		120	CONTROL PANEL B	1	15	16
				-		-		MAIN BREAKER	2	60	
					-		-	7			
60 AMP	MCB, 120/	240V-19	Ø-3W 16 CKT, 10KAIC	934	412	665	120	TOTAL VOLT AMPERES =		2131	

W/ INTEGRAL, BUS MTD 160kA SPD IN TYPE 1 ENCL SERVED FROM AIR LOCK SERVICE ENTRANCE

			NEW PANE	ELBOAR	DD(L	JPPER	GRA	ND CANYON)			
CI/T		ES		VOLT-A	MPERES	VOLT-A	MPERES		ES		CIT
CKT NO	AMPS	POLES	LOAD	ØA	ØB	ØA	ØB	LOAD	POLES	AMPS	CKT NO
1	20	1	PSU 35, 36, 37, 41	334		285		TRAIL LIGHTS - CACTUS ROOM TO LOWER GRAND CANYON	1	20	2
3	20	1	PSU 38, 39, 40, 42		212		-	SPARE	1	20	4
5	20	1	SPARE	-		-		SPARE	1	20	6
7	20	1	SPARE		-		-	SPARE	1	20	8
9	20	1	SPARE	-		-		SPARE	1	20	10
11	20	1	SPARE		-		-	SPARE	1	20	12
13	20	1	ENCLOSURE MTD GFCI RECPT	180		-		SPARE	1	20	14
15	15	1	ENCLOSURE SPACE HEATER		120		120	CONTROL PANEL D	1	15	16
				-		-		MAIN BREAKER	2	60	
					-		-				
60 AMF	MCB, 120/	240V-10	Ø-3W 16 CKT, 10KAIC	514	332	285	120	TOTAL VOLT AMPERES =		1251	

W/ INTEGRAL, BUS MTD 160kA SPD IN TYPE 1 ENCL SERVED FROM AIR LOCK SERVICE ENTRANCE

			NEW PANEL	.BOAR	DF(S	SUBMA	RINE	ENTRANCE)			
CKT		ES		VOLT-A	MPERES	VOLT-AI	MPERES		ES		СКТ
NO	AMPS	POLES	LOAD	ØA	ØB	ØA	ØB	LOAD	POLES	AMPS	NO
1	20	1	PSU 65, 66, 67, 68	432		425		TRAIL LIGHTS - LILY PAD LOOP TO BIG RM SWITCHBACKS	1	20	2
3	20	1	PSU 63, 69, 70, 71		383		-	SPARE	1	20	4
5	20	1	SPARE	-		-		SPARE	1	20	6
7	20	1	SPARE		-		-	SPARE	1	20	8
9	20	1	SPARE	-		-		SPARE	1	20	10
11	20	1	SPARE		-		-	SPARE	1	20	12
13	20	1	ENCLOSURE MTD GFCI RECPT	180		-		SPARE	1	20	14
15	15	1	ENCLOSURE SPACE HEATER		120		120	CONTROL PANEL F	1	15	16
				-		-		MAIN BREAKER	2	60	
					-		-	1			

TOTAL VOLT AMPERES =

60 AMP MCB, 120/240V-1Ø-3W 16 CKT, 10KAIC W/ INTEGRAL, BUS MTD 160kA SPD IN TYPE 1 ENCL SERVED FROM SUBMARINE ROOM SERVICE ENTRANCE

TOTAL VOLT AMPERES =

			NEW PANE	LBOARI	DH(L	OWER	R GRA	ND CANYON)			
CKT		ËS		VOLT-A	MPERES	VOLT-A	MPERES		ES		CKT
NO	AMPS	POLES	LOAD	ØA	ØB	ØA	ØB	LOAD	POL	AMPS	NO
1	20	1	PSU 29, 30, 31, 32, 33	410		340		TRAIL LIGHTS - LOWER NORTH RIVER TO LOWER GRAND CANYON	1	20	2
3	15	1	PSU 34, 53, 54		366		291	PSU 55, 56, 72	1	15	4
5	20	1	SPARE	-		-		SPARE	1	20	6
7	20	1	SPARE		-		-	SPARE	1	20	8
9	20	1	SPARE	-		-		SPARE	1	20	10
11	20	1	SPARE		-		-	SPARE	1	20	12
13	20	1	ENCLOSURE MTD GFCI RECPT	180		-		SPARE	1	20	14
15	15	1	ENCLOSURE SPACE HEATER		120		120	CONTROL PANEL H	1	15	16
				-		-		MAIN BREAKER	2	60	
					-		-				
30 AMP	MCB, 120/2	240V-19	∂-3W 16 CKT, 10KAIC	590	486	340	411	TOTAL VOLT AMPERES =		1827	

W/ INTEGRAL, BUS MTD 160kA SPD IN TYPE 1 ENCL SERVED FROM SUBMARINE ROOM SERVICE ENTRANCE GENERAL NOTE:

A. PROVIDE PNLBD'S PER SPECIFICATION SECTION 262416.

STATE OF MISSOURI MICHAEL L. PARSON, GOVERNOR



BARRY D. FREINER Registered Professional Engineer MO # E-24220 Expires 12-31-2024

ROGERS-SCHMIDT ENGINEERING CO., P.C. CONSULTING ENGINEERS 1736 WEST PARK CENTER DR. SUITE 204 ST. LOUIS, MO 63026 PHONE: 636-600-1551 MISSOURI STATE CERTIFICATE OF AUTHORITY #000408

OFFICE OF ADMINISTRATION DIVISION OF FACILITIES MANAGEMENT, DESIGN AND CONSTRUCTION

DEPARTMENT OF NATURAL RESOURCES DIVISION OF STATE PARKS

UPGRADE CAVE ELECTRIC

ONONDAGA CAVE STATE PARK 7556 HWY H LEASBURG, MO 65535

PROJECT # X2212-01 SITE# 5215

ASSET # 7815215013

REVISION: DATE: **REVISION:** DATE:

REVISION:

ISSUE DATE: <u>06-23-2023</u>

CAD DWG FILE: X2212-01-5215-

7815215013-E-604.DWG DRAWN BY: KET BDF

DESIGNED BY: BDF SHEET TITLE:

NEW PANELBOARD SCHEDULES

SHEET NUMBER:

A. PROVIDE LTG FIXTURES PER SPECIFICATION SECTIONS 265113 & 265613.

STATE OF MISSOURI MICHAEL L. PARSON, GOVERNOR



BARRY D. FREINER Registered Professional Engineer MO # E-24220 Expires 12-31-2024

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PROJECT # X2212-01

5215 SITE# 7815215013 ASSET#

REVISION: DATE: **REVISION:** DATE: **REVISION:** DATE:

ISSUE DATE: <u>06-23-2023</u>

CAD DWG FILE: X2212-01-5215-7815215013-E-605.DWG

DRAWN BY: KET/MNS CHECKED BY: BDF DESIGNED BY: BDF SHEET TITLE:

NEW LIGHTING FIXTURE SCHEDULE

SHEET NUMBER:

46 OF 50 SHEETS JUNE 23, 2023

						LAMP DATA					
TYPE	DESCRIPTION	MANUFACTURER CATALOG NUMBER	TYPE	NO.	WATTS	SPECIFICATIONS	VOLTAGE	FIXTURE WATTAGE	MOUNTING	FINISH	REMARKS
Т	TRAIL GUARDRAIL LINEAR LIGHTING	DIODE LED DI-SO-24V-3D-AT-20-30-LENGTH(IN.) W/ SPCHSS OR MTCHSLVPVC-MTG CHANNEL NO APPROVED EQUAL	LED		0.5.\\\\\\\\\\\\\\\\\\\\\\\\\\\\\\\\\\\	20 LUMENS/FT, 3000K CCT, 90+ CRI 40 LM/W EFFICACY	24VDC	VARIES BASED ON LENGTH	GUARDRAIL HORIZONTAL TUBE	STAINLESS STEEL OR SILVER	IP69 CONTINUOUSLY SUBMERSIBLE PROVIDE W/ SS SPINE TYPE OR SILVER PVC MOUNTING CHANNEL AND W/ 24VDC CONSTANT VOLTAGE VLM DRIVER. FIXTURE LENGTHS AS REQD FOR EXIST GUARDRAIL CONFIGURATIONS.
В	SMALL FLOOD LIGHT 40° X 40° BEAM SPREAD	ACCLAIM AQP-211-AHCN NO APPROVED EQUAL	LED	8	1	3000K CCT, ≥ 80CRI	24VDC	8	YOKE ON ELECTRICALLY ISOLATED TRIPOD OR BOLTED TO PAVER	BLACK	IP68 CONTINUOUSLY SUBMERSIBLE TO 20 FEET PROVIDE W/ YOKE, TRIPOD & 3" SNOOT. PROVIDE W/ SHORT SHROUD WHERE INDICATED ON DWGS. ALL FIXTURE ACCESSORIES TO BE BLACK.
С	LARGE SPOT LIGHT 10° X 10° BEAM SPREAD	ACCLAIM AQP-211-CCCN NO APPROVED EQUAL	LED	36	1	3000K CCT, ≥ 80CRI	24VDC	36	YOKE ON ELECTRICALLY ISOLATED TRIPOD OR BOLTED TO PAVER	BLACK	IP68 CONTINUOUSLY SUBMERSIBLE TO 20 FEET PROVIDE W/ YOKE, TRIPOD & 3" SNOOT. PROVIDE W/ SHORT SHROUD WHERE INDICATED ON DWGS. ALL FIXTURE ACCESSORIES TO BE BLACK.
D	LARGE FLOOD LIGHT 40° X 40° BEAM SPREAD	ACCLAIM AQP-211-CHCN NO APPROVED EQUAL	LED	36	1	3000K CCT, ≥ 80CRI	24VDC	36	YOKE ON ELECTRICALLY ISOLATED TRIPOD OR BOLTED TO PAVER	BLACK	IP68 CONTINUOUSLY SUBMERSIBLE TO 20 FEET PROVIDE W/ YOKE, TRIPOD & 3" SNOOT. PROVIDE W/ SHORT SHROUD WHERE INDICATED ON DWGS. ALL FIXTURE ACCESSORIES TO BE BLACK.
DS	SUBMERGED LARGE FLOOD LIGHT 40° X 40° BEAM SPREAD	ACCLAIM AQP-211-CHCN NO APPROVED EQUAL	LED	36	1	3000K CCT, ≥ 80CRI	24VDC	36	YOKE BOLTED TO U-STRUT SUBMERGED IN WATER	BLACK	IP68 CONTINUOUSLY SUBMERSIBLE TO 20 FEET PROVIDE W/ YOKE, TRIPOD & 3" SNOOT. PROVIDE W/ SHORT SHROUD WHERE INDICATED ON DWGS. ALL FIXTURE ACCESSORIES TO BE BLACK. FIXTURE TO BE MOUNTED SUBMERGED IN A WATER FEATUR
F	ENCLOSED & GASKETED LED	LITHONIA FEM L48 3000LM IMAFL MD 120 GZ10 30K 80CRI SF STSL WITH WLFEND OR WLFEND2 AND WITH FEMSMB OR APPROVED EQUAL BY HE WILLIAMS OR COOPER	LED	1		2689 LUMENS, 3000K CCT, 80 CRI	120VAC	18	SURFACE CEILING	WHITE	FIBERGLASS HOUSING & ACRYLIC LINEAL FROSTED LENS WI GLR FUSING, SS LATCHES, (1) OR (2) 1/2" FACTORY WATERTIGHT HUBS, AND FEMSMB SS MTG BRACKETS
G	WET LOCATION CEILING MOUNT	AMERICAN SCIENTIFIC LIGHTING DREC W9 ND 30K W5 BBX OR APPROVED EQUAL	LED	1		1007 LUMENS, 3000K CCT, 80+ CRI	120VAC	9	SURFACE CEILING	BLACK	PROVIDE WITH OPAL WHITE LENS, BLACK BACK BOX WITH O 3/4" CONDUIT OPENING ON BOTH ENDS, GLR FUSING, AND SURGE PROTECTION
W	WET LOCATION WALL MOUNT	NEWPORT COASTAL 7974-01B OR APPROVED EQUAL BY FEISS OR PROGRESS LIGHTING	LED	1	4.5	EIKO - L4.5WA19/830GC/D/E26 3000K, E26, A19, 450 LUMENS, 80+	120VAC	4.5	SURFACE WALL	BLACK	PLASTIC HOUSING

NOTES:

1. CONFIGURATION CODE FOR FEATURE LIGHTING FIXTURES ON DRAWINGS: CIRCUIT NUMBER, NUMBER OF THE FIXTURE ON THE CIRCUIT, FIXTURE TYPE (B, C, D OR DS), PSU NUMBER FIXTURE IS CONNECTED TO, SNOOT/SHROUD SPEC (S=SNOOT, SS=SHORT SHROUD, LS=LONG SHROUD); E.G., A4B1S.

2. FIXTURE TYPES B, C, D & DS SHALL BE POWERED FROM ACCLAIM ADR157 OR ADR400 REMOTE DMX ADDRESSABLE POWER SUPPLY UNIT (PSU) MOUNTED IN A NON-METALLIC IP68 ENCLOSURE BY CONTRACTOR.

3. SHROUDS FOR FEATURE LIGHTING FIXTURES ARE TO BE FABRICATED PER THE DETAILS ON DWG E-501. ALL OTHER ITEMS ARE TO BE STANDARD ACCESSORIES PROVIDED BY THE LIGHTING FIXTURE MANUFACTURER. 4. ALL FEATURE LIGHTING FIXTURES CALLED OUT TO HAVE EITHER A SHORT OR LONG SHROUD SHALL ALSO BE PROVIDED WITH A FACTORY 3" SNOOT.

5. FIXTURE TYPES B, C, D & DS SHALL BE PROVIDED WITH A 98.5' FACTORY CABLE. LEAVE THE FACTORY CABLE FULL LENGTH ON ALL FIXTURES. DO NOT CUT THE FACTORY CABLES. 6. FIXTURE TYPE T SHALL BE POWERED FROM DIODELED TYPE VLM CONSTANT VOLTAGE (NON-DIMMABLE) DRIVER MOUNTED IN A NON-METALLIC IP68 ENCLOSURE BY THE FIXTURE MANUFACTURER.

EXTENT POSSIBLE.

		# OF LTG				=						TOTAL CONNECTED LOAD	
SU#	LTG CKT	FIXTURES		A 2 -			JMBER AND		A 2 =	A 15 -	LITE SWITCH # S1.1, S1.4, S2.1,	(WATTS)	LOCATION
1	A	8	A 1 B	A 2 B	A 3 B	A 6 B	A 7 B	A 8 B	A 9 B	A 10 B	S4.3	64	TUCKED BACK INTO THE ALCOVE JUST AFTER EXITING ENTRANCE TUNNEL ON THE RIGHT-HAND SIDE OF THE TRAIL
2	В	1	B 3 D								S2.5, S4.1	36	THE MOTI-HAND SIDE OF THE TIVALE
3	А	6	A 4 B	A 5 B	A 11 B	A 12 B	A 13 B	A 14 B			S1.1, S1.4, S2.1, S4.3	48	 -
4	В	1	B 4 D								S2.2, S4.1	36	
5	В	1	B 5 B								S2.3, S4.1	8	ON RIGHT-HAND SIDE OF THE TRAIL TUCKED UP AGAINST THE DROP-OFF AT THE
6	В	1	B 1 B								S2.4, S4.1	8	TRAIL EDGE
7	В	1	B 2 B								S2.5, S4.1	8	
8	В	1	B 6 B								S2.6, S4.1	8	
9	С	1	C 2 D								S3.1, S4.1	36	
0	С	1	C 1 C								S3.2, S4.1	36	
1	С	2	C 3 D	C 4 D							S3.3, S4.1	72	LOCATED ON TOP OF THE TOUCHSTONE BRIDGE
12	D	8	D 1 D	D 2 D	D 3 C	D 4 D	D 5 D	D 6 D	D 7 D	D 47 D	S4.2, S4.4, S5.1,	288	
3	D	7	D 8 D	D 9 D	D 10 D	D 11 D	D 12 D	D 13 D			\$5.2 \$4.2, \$4.4, \$5.1,	252	LOCATED NEXT TO THE BRIDGE OVER THE LOST RIVER AT TRAIL BEND BEFORE
14	D	,	D 14 D	D 15 D	D 16 C	D 17 D	D 19 C	D 20 D		D 25 D	\$5.2 \$4.2, \$4.4, \$5.1,	288	THE DEVIL'S BATHTUB. LOCATE AS HIGH AS POSSIBLE TO REDUCE FLOOD DEPTI LOCATED BEHIND THE NEW EMERGENCY TELEPHONE IN SLOT IN THE FLOOR
		0									S5.2 S4.2, S4.4, S5.1,		LEDGE 30' FROM THE RIGHT-HAND EDGE OF THE TRAIL LOCATED BETWEEN THE BOULDER-SHAPED LEDGES TO THE LEFT OF THE TRAIL
5	D	8	D 22 D	D 23 D	D 24 C	D 26 D	D 27 D	D 28 C	D 29 D	D 30 D	S5.2 S4.2, S4.4, S5.1,	288	BEFORE THE WOODEN BRIDGE LOCATED TO THE LEFT OF THE TRAIL AT THE CONDUIT CROSSING SOUTH OF TH
16	D	8	D 31 D	D 32 D	D 33 D	D 34 D	D 35 C	D 36 D	D 37 C	D 38 D	S5.2	288	BREAKDOWN ROOM
7	D	8	D 39 C	D 40 D	D 41 D	D 42 D	D 43 D	D 44 D	D 45 D	D 46 D	S4.2, S4.4, S5.1, S5.2	288	LOCATED BEHIND THE HEAD KNOCKER ROCK NEXT TO THE "CANDLESTICK HILL" PWR/CNTRL PNL B, NEXT TO PSU 20
18	Р	1	P 17 B								S11.5, S11.7, S11.8	8	LOCATED ALONG THE TRAIL TO MISSOURI CAVERNS ON THE RIGHT-HAND SIDE OF THE TRAIL AT THE TOP OF A CLAY BANK, NEXT TO PSU 58
9	V	7	V 31 C	V 32 D	V 33 D	V 34 C	V 36 D	V 37 D	V 38 D		S15.3, S15.4	252	LOCATED NEXT TO THE "SUBMARINE ROOM" PWR/CNTRL PNL F IN AN ALCOVE OF THE SUBMARINE PASSAGE
20	U	7	U 1 C	U 2 D	U 3 C	U 4 C	U 5 C	U 6 C	U 15 C		S14.2, S14.4, S15.4	252	LOCATED BEHIND THE HEAD KNOCKER ROCK NEXT TO THE "CANDLESTICK HILL" PWR/CNTRL PNL B, NEXT TO PSU 17
21	E	2	E 1 B	E 3 B							S6.1, S7.1	16	
22	E	7	E 2 C	E 4 D	E 5 D	E 6 D	E 7 D	E 8 C	E 9 C		S6.1, S7.1	252	
23	E	1	E 11 B								S6.3, S7.1	8	LOCATED ON NORTH EDGE OF THE PLATFORM AT THE TWINS SOUTH OF THE
24	E	1	E 10 C								S6.2, S7.1	36	TWINS" PWR/CNTRL PNL G
 25	H	1	H 6 D	H 7 D	H 8 D	H 13 D					S6.7, S7.1, S14.3,	144	
											S14.5, S15.1 S6.7, S7.1, S14.3,		
26	H	4		H 10 D	Н 11 D	H 12 D					S14.5, S15.1	144	LOCATED AT THE ENTRANCE TO LITTLE BEAR PASSAGE, NEXT TO PSU 71 LOCATED ALONG THE LEFT-HAND WALL IN THE LOW SIDE PASSAGE OFF OF THE
27	Q	1	Q 5 C								S11.2, S11.7, S11.8	36	ROCK OF AGES ROOM, NEXT TO PSUs 53 THRU 57
.8	L	2	L 2 D	L 4 D							S7.7, S8.5	72	LOCATED UNDER THE CATWALK AT THE ENTRANCE TO THE CARROT GALLERY, NEAR PSU 39
29	J	2	J 3 B	J 4 B							S7.2, S7.3	16	LOCATED BETWEEN THE ROCKS AT THE END OF THE KING'S CANOPY OVERLOOP AND THE FORMATION LEDGE, NEXT TO PSU 34
80	F	8	F 1 D	F 2 D	F 3 C	F 4 D	F 5 D	F 6 D	F 7 D	F 8 C	S6.4, S7.1	288	LOCATED AT THE CORNER OF THE TWINS PLATFORM AGAINST THE WALL NEXT THE EMERGENCY TELEPHONE.
31	G	8	G 1 D	G 2 D	G 3 C	G 4 C	G 5 D	G 11 D	G 12 D	G 13 C	S6.5, S7.1	288	LOCATED IN THE SHALLOW PIT NEXT TO THE NEW FOSSIL PASSAGE ON THE LEFT-HAND SIDE OF THE TRAIL
32	G	5	G 6 D	G 7 D	G 8 D	G 9 D	G 10 C				S6.5, S7.1	180	LOCATED ON THE FLOOR UNDER THE CEILING LEDGE 10' BELOW THE LEFT SIDE OF THE TRAIL
3	ı	5	I 1 C	I 2 D	I 3 D	I 4 D	I 5 D				S6.6, S7.1	180	LOCATED BY THE MAINTENANCE TRAIL NEXT TO THE NEW "KING'S CANOPY" PWR/CNTRL PNL C
34	J	3	J 1 C	J 2 D	J 5 C						\$7.2, \$7.3	108	LOCATED BETWEEN THE ROCKS AT THE END OF THE KING'S CANOPY OVERLOOK
 35	K	7	K 11 C	K 12 C	K 13 C	K 14 C	K 15 C	K 16 C	K 17 C		S7.6, S8.5	252	AND THE FORMATION LEDGE, NEXT TO PSU 30
		, ,					10 0	1. 10 0			\$7.0, \$8.5 \$7.5, \$8.5	144	-
36	K	4	K 7 C	K 9 D	K 10 D	K 18 C	1/ 10 0	I/ 00 5			,		LOCATED ON THE RIGHT-HAND SIDE OF THE TRAIL JUST NORTH OF THE KING'S CANOPY OVERLOOK VIEWING PLATFORM
37	K	6	K 4 C	K 5 C	K 6 C	K 8 D	K 19 C	K 20 C			S7.5, S8.5	216	_
8	K	3	K 1 D	K 2 D	K 3 C						S7.4, S8.5	108	LOCATED UNDER THE CATWALK AT THE ENTRANCE TO THE CARROT GALLERY,
39	L	2	L 1 B	L 3 B							S7.7, S8.5	16	NEAR PSU 28
.0	L	7	L 5 B	L 6 B	L 7 B	L 8 B	L 9 B	L 10 B	L 11 B		S7.7, S8.5	56	LOCATED AT THE BASE OF THE STAIRS AT THE EXIT OF THE CARROT GALLERY GOING DOWN TO THE KING'S CANOPY LANDING
11	LL	8	LL 1 D	LL 2 C	LL 3 C	LL 4 C	LL 5 D	LL 6 C	LL 24 C	LL 25 C	S8.4, S9.1	288	
12	LL	1	LL 7 D								S8.1, S9.1	36	LOCATED UNDER THE STAIRS AT THE ENTRANCE OF THE FORMATION BALCONY GOING DOWN TO THE KING'S CANOPY LANDING
13	LL	2	LL 14 C	LL 15 D							S8.4, S9.1	72	
14	LL	7	LL 8 B	LL 9 B	LL 10 B	LL 11 B	LL 12 B	LL 13 B	LL 23 B		S8.4, S9.1	252	LOCATED IN THE CORNER OF THE TRAIL SOUTH OF BEAR BONE BOXES ON THE
	+										+	1	LOCATED IN THE CORNER OF THE TRAIL SOUTH OF BEAR BONE BOXES ON THE LEFT-HAND SIDE OF THE TRAIL NEXT TO A FLOOR LEDGE

GENERAL NOTE:

A. PROVIDE PSU's PER SPECIFICATION SECTION 265613.

STATE OF MISSOURI MICHAEL L. PARSON, GOVERNOR



BARRY D. FREINER Registered Professional Engineer MO # E-24220 Expires 12-31-2024

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ONONDAGA CAVE STATE PARK 7556 HWY H LEASBURG, MO 65535

PROJECT # X2212-01 5215

ASSET # 7815215013

DATE: REVISION: DATE: REVISION: DATE:

REVISION:

ISSUE DATE: <u>06-23-2023</u>

CAD DWG FILE: X2212-01-5215-7815215013-E-606.DWG

DRAWN BY: KET

CHECKED BY: BDF

DESIGNED BY: BDF

SHEET TITLE: NEW LIGHTING

POWER SUPPLY UNIT (PSU) SCHEDULE

SHEET NUMBER:

												TOTAL CONNECTED	
SU#	LTG CKT	# OF LTG FIXTURES			LTG F	FIXTURE NU	IMBER AND	TYPE			LITE SWITCH#	LOAD (WATTS)	LOCATION
46	N	8	N 1 B	N 2 B	N 4 B	N 6 B	N 8 B	N 9 B	N 10 B	N 12 B	\$9.3, \$11.7, \$11.8, \$11.9, \$12.1	64	
47	N	5	N 3 D	N 5 C	N 7 D	N 11 D	N 16 D				S9.3, S11.7, S11.8, S11.9, S12.1	180	LOCATED BEHIND THE COLUMN TO THE LEFT OF THE TRAIL BEFORE THE ENTRANCE TO THE ROCK OF AGES ROOM
48	N	8	N 13 B	N 14 B	N 15 B	N 17 B	N 18 B	N 19 B	N 20 B	N 21 B	S9.3, S11.7, S11.8, S11.9, S12.1	64	
49	0	2	O 3 B	O 5 B							S10.2, S11.7, S11.8, S11.9, S12.1	16	LOCATED 4' TO THE LEFT OF THE TRAIL ON THE EAST SIDE OF THE CACTUS RO ON THE FLOOR, NEXT TO THE EXISTING CONDUIT CROSSING
50	0	3	O 1 D	O 2 D	O 4 D						\$10.2, \$11.7, \$11.8, \$11.9, \$12.1	108	LOCATED 4' TO THE LEFT OF THE TRAIL ON THE EAST SIDE OF THE CACTUS ROON THE FLOOR, NEXT TO THE EXISTING CONDUIT CROSSING
51	Р	8	P 1 B	P 3 B	P 5 B	P 8 B	P 9 B	P 10 B	P 37 B	P 38 B	\$10.3, \$11.7, \$11.8, \$11.9, \$12.1	64	
52	Р	8	P 2 D	P 4 D	P 6 D	P 7 D	P 11 C	P 12 C	P 13 D	P 36 D	\$10.3, \$11.7, \$11.8, \$11.9, \$12.1	288	LOCATED NEXT TO THE RIGHT-HAND SIDE OF THE TRAIL JUST AS YOU ENTER TROCK OF AGES ROOM
53	Q	5	Q 9 C	Q 10 C	Q 11 C	Q 13 C	Q 14 C				S11.4, S11.7, S11.8	180	
54	Q	1	Q 12 B								S11.4, S11.7, S11.8	8	
55	Q	1	Q 4 B								S11.2, S11.7, S11.8	8	LOCATED ALONG THE LEFT-HAND WALL IN THE LOW SIDE PASSAGE OFF OF TH ROCK OF AGES ROOM, NEXT TO PSU 27
56	Q	3	Q 6 C	Q 7 D	Q 8 C						S11.3, S11.7, S11.8	108	TROCK OF AGES ROOM, NEXT TO 1 30 27
57	Q	3	Q 1 C	Q 2 C	Q 3 C						S11.1, S11.7, S11.8	108	-
58	Р	5	P 18 C	P 19 C	P 39 D	P 40 C	P 41 C				S11.5, S11.7, S11.8	180	LOCATED ALONG THE TRAIL TO MISSOURI CAVERNS ON THE RIGHT-HAND SIDE THE TRAIL AT THE TOP OF A CLAY BANK, NEXT TO PSU 18
59	Р	1	P 20 B								S11.6, S11.7, S11.8	8	LOCATED IN A SMALL DEPRESSION, SO IT CAN'T BE SEEN FROM THE TRAIL, 16' FROM THE RIGHT-HAND SIDE OF THE TRAIL AND THE GATE FOR THE MISSOUR CAVERNS TRAIL
60	Р	8	P 14 D	P 16 D	P 21 C	P 22 C	P 23 C	P 25 D	P 42 C	P 43 C	S10.3, S11.7, S11.8, S11.9, S12.1	288	O TV EI TITULE
61	Р	6	P 15 B	P 26 B	P 27 B	P 28 B	P 30 B	P 31 B			\$10.3, \$11.7, \$11.8, \$11.9, \$12.1	48	LOCATED IN A SMALL DEPRESSION 14' FROM THE RIGHT-HAND SIDE OF THE TF JUST ABOVE THE MISSOURI CAVERNS STREAM, NEXT TO PSU 75
62	Р	2	P 24 D	P 29 D							\$10.3, \$11.7, \$11.8, \$11.9, \$12.1	72	JOST ABOVE THE IMISOCOTT CAVEILING STREAM, NEXT TO 1 30 73
63	М	8	M 1 C	M 2 C	M 3 C	M 4 D	M 5 D	M 8 C	M 9 D	M 10 D	S8.2, S8.3, S12.2, S13.1	288	
64	М	4	M 6 D	M 7 C	M 11 D	M 12 C					\$8.2, \$8.3, \$12.2, \$13.1	144	
65	S	2	S 1 D	S 2 D							\$13.1 \$12.3, \$13.1	72	LOCATED UNDER THE WALKWAY BRIDGE AT THE 2ND PLATFORM IN THE SLUM PIT
66	S	4	S 3 B	S 4 B	S 5 B	S 6 B					S12.3, S13.1	32	
67	R	7	R 1 D	R 2 D	R 3 C	R 4 C	R 5 D	R 9 C	R 10 C		S12.4, S13.1	252	LOCATED BEHIND THE BREAKDOWN BLOCK WITH THE SAGUARO STALAGMITE FROM THE RIGHT-HAND SIDE OF THE TRAIL
68	R	3	R 6 D	R 7 C	R 8 D						S12.4, S13.1	108	PROM THE RIGHT-HAND SIDE OF THE TRAIL
69	Т	8	T 1 C	T 2 D	T 3 D	T 4 C	T 5 C	T 6 C	T 7 D	T 9 D	S13.2, S14.1	288	LOCATED NEXT TO THE NEW "LOWER GRAND CANYON" PWR/CNTRL PNL H
70	Т	4	T 8 C	T 10 C	T 11 D	T 12 D					S13.2, S14.1	144	
71	Т	8	T 13 D	T 14 D	T 15 D	T 16 D	T 17 D	T 18 D	T 19 D	T 20 D	S13.2, S14.1	288	LOCATED AT THE ENTRANCE TO LITTLE BEAR PASSAGE, NEXT TO PSU 26
72	U	5	U 7 D	U 9 D	U 10 D	U 13 C	U 14 D				S14.2, S14.4, S15.2	180	
73	U	3	U 8 B	U 11 B	U 12 B						S14.2, S14.4, S15.2	24	LOCATED NEAR THE 2ND PLATFORM ON THE QUEENS CANOPY RAMP
74	Н	5	H 1 D	H 2 D	H 3 D	H 4 D	H 5 D				S6.7, S7.1, S14.3, S14.5, S15.1	180	
75	Р	4	P 32 B	P 33 B	P 34 B	P 35 B					S10.3, S11.7,	32	LOCATED IN A SMALL DEPRESSION 14' FROM THE RIGHT-HAND SIDE OF THE TE
76	V	8	V 1 D	V 2 D	V 9 D	V 10 C	V 11 D	V 44 D	V 45 D	V 47 D	S11.8, S11.9, S12.1 S15.3, S15.4	288	JUST ABOVE THE MISSOURI CAVERNS STREAM, NEXT TO PSUs 60 THRU 62 LOCATED UNDER THE CATWALK BEFORE THE LILY PAD LOOP TRAIL
77	V	8	V 3 C	V 4 D	V 5 D	V 6 D	V 12 D	V 13 D	V 41 D	V 42 D	S15.3, S15.4	288	LOCATED UNDER THE CATWALK BEFORE THE LILY PAD LOOP TRAIL
78	V	6	V 7 B	V 8 B	V 15 B	V 17 B	V 18 B	V 19 B			S15.3, S15.4	48	LOCATED AT THE END OF THE OLD TRAIL BEHIND THE CONE-SHAPED STALAGI
79	V	7	V 14 B	V 39 B	V 40 B	V 43 B	V 46 B	V 49 B	V 50 B		S15.3, S15.4	56	
80	V	7	V 16 D	V 48 D	V 52 C	V 53 D	V 54 D	V 55 D	V 56 D		S15.3, S15.4	180	LOCATED UNDER THE CATWALK BRIDGE AT THE BEGINNING OF THE LILY PAD LOOP TRAIL
81	V	5	V 28 B	V 29 B	V 30 B	V 35 B	V 51 B				S15.3, S15.4	40	
82	V	8	V 20 C	V 21 D	V 22 C	V 23 D		V 25 D	V 26 D	V 27 D	S15.3, S15.4	288	LOCATED IN A ALCOVE BETWEEN THE COLUMN ON THE RIGHT-HAND SIDE OF TRAIL
- <u>-</u> ГЕ:					-								

GENERAL NOTE:

A. PROVIDE PSU's PER SPECIFICATION SECTION 265613.

STATE OF MISSOURI MICHAEL L. PARSON, GOVERNOR



BARRY D. FREINER Registered Professional Engineer MO # E-24220 Expires 12-31-2024

ROGERS-SCHMIDT ENGINEERING CO., P.C. CONSULTING ENGINEERS 1736 WEST PARK CENTER DR. SUITE 204 ST. LOUIS, MO 63026 PHONE: 636-600-1551 MISSOURI STATE CERTIFICATE OF AUTHORITY #000408

OFFICE OF ADMINISTRATION DIVISION OF FACILITIES MANAGEMENT, DESIGN AND CONSTRUCTION

DEPARTMENT OF NATURAL RESOURCES DIVISION OF STATE PARKS

UPGRADE CAVE ELECTRIC

ONONDAGA CAVE STATE PARK 7556 HWY H LEASBURG, MO 65535

PROJECT # X2212-01 SITE# 5215

ASSET # 7815215013

REVISION: DATE: REVISION: DATE: REVISION: DATE:

ISSUE DATE: <u>06-23-2023</u>

CAD DWG FILE: X2212-01-5215-7815215013-E-607.DWG

DRAWN BY: KET

CHECKED BY: BDF

DESIGNED BY: BDF

SHEET TITLE: NEW LIGHTING POWER SUPPLY UNIT (PSU)

SCHEDULE SHEET NUMBER:

STATION S1


LOCATED ON NORTH WALL OF AIRLOCK ENTRANCE TUNNEL

S1.1: ALL TRAIL LIGHTS AND ENTRY LIGHTS AA1G, AA2T, AA3T, AA4W ON

S1.2: PSUs 1. 3 ON

S1.3: ALL TRAIL LIGHTS AND ENTRY LIGHTS AA1G, AA2T, AA3T, AA4W OFF

S1.4: PSUs 1, 3 OFF

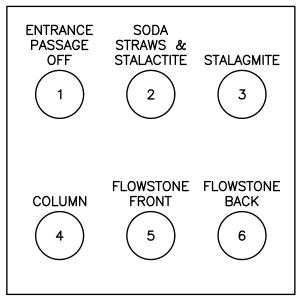


STATION S2

LOCATED AT NE CORNER OF THE SHOW ROOM PLATFORM

S2.1: PSUs 1, 3 OFF S2.2: PSU 4 ON

S2.3: PSU 5 ON S2.4: PSU 6 ON

S2.5: PSUs 2. 7 ON S2.6: PSU 8 ON

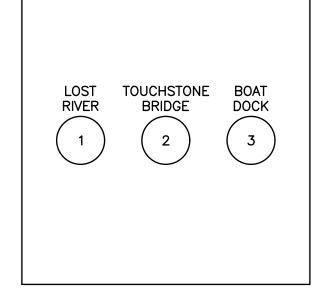


STATION S3

LOCATED AT WEST SIDE OF SHOW ROOM PLATFORM UNDER TOUCHSTONE BRIDGE

S3.1: PSU 9 ON S3.2: PSU 10 ON

S3.3: PSU 11 ON

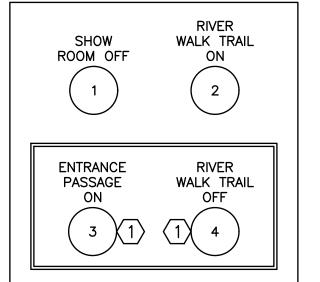


STATION S4

LOCATED AT NORTH SIDE OF TRAIL LEAVING SHOW ROOM

S4.1: PSUs 2, 4 - 11 OFF S4.2: PSUs 12 - 17 ON S4.3: PSUs 1. 3 ON


S4.4: PSUs 12 -17 OFF

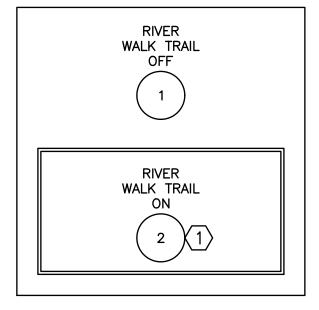

STATION S5

LOCATED ON THE TRAIL SOUTH OF QUEEN'S CANOPY

S5.1: PSUs 12 - 17 OFF S5.2: PSUs 12 - 17 ON

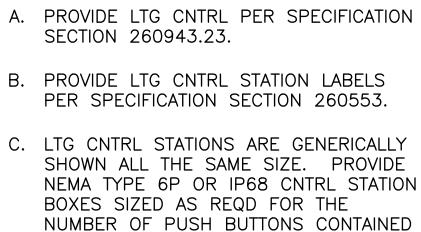

GENERAL NOTES:

COLOR OF ALL PUSH BUTTONS SHALL BE BLACK UNLESS OTHERWISE NOTED.

○ KEY NOTES:

1. YELLOW PUSH BUTTON

2. RED PUSH BUTTON.

MICHAEL L. PARSON, **GOVERNOR**

STATE OF MISSOURI




BARRY D. FREINER Registered Professional Engineer MO # E-24220

Expires 12-31-2024 **ROGERS-SCHMIDT**

ENGINEERING CO., P.C. **CONSULTING ENGINEERS** 1736 WEST PARK CENTER DR ST. LOUIS, MO 63026 PHONE: 636-600-1551

MISSOURI STATE CERTIFICATE

OF AUTHORITY #000408

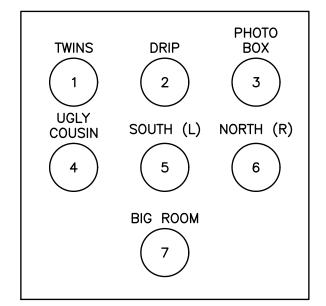

STATION S6

LOCATED AT SE CORNER OF THE TWINS PLATFORM

S6.1: PSUs 21, 22 ON S6.2: PSU 24 ON

S6.3: PSU 23 ON

S6.4: PSU 30 ON

S6.5: PSUs 31, 32 ON

S6.6: PSU 33 ON S6.7: PSUs 25, 26, 74 ON BIG ROOM FORMATION FORMATION LEDGE ON LEDGE OFF CANOPY DRAPERY CARROT GALLERY

STATION S7

LOCATED AT SW CORNER OF LOWER KING'S

S7.1: PSUs 21 - 26, 30 - 33, 74 OFF


S7.2: PSUs 29, 34 ON

S7.3: PSUs 29, 34 ON

S7.6: PSU 35 ON

S7.4: PSU 38 ON S7.5: PSUs 36, 37 ON

S7.7: PSUs 28, 39, 40 ON

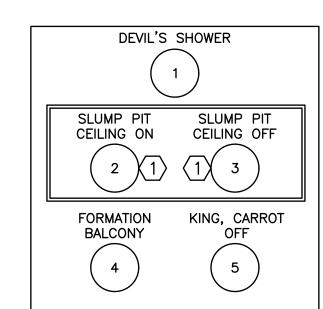


STATION S8

LOCATED NEXT TO THE DEVIL'S SHOWER ON THE UPPER KING'S CANOPY CATWALK

S8.1: PSU 42 ON

S8.2: PSUs 63, 64 ON S8.3: PSUs 63, 64 OFF

P8.4: PSUs 41, 43 - 45 ON S8.5: PSUs 28, 35 - 40 OFF

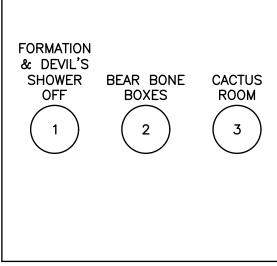


STATION S9

LOCATED BETWEEN THE TWO BEAR BONE

S9.1: PSUs 41 - 45 OFF

S9.2: LIGHTS EE4T & EE5T ON S9.3: PSUs 46 - 48 ON

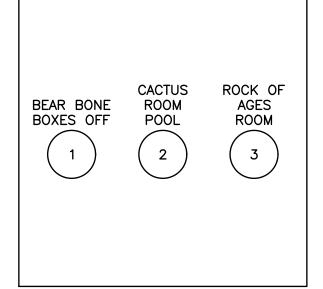

STATION S10

LOCATED AT THE NW CORNER OF THE

S10.3: PSUs 51, 52, 60 - 62, 75 ON


CANOPY

2

ROOM OFF

4

S10.1: LIGHTS EE4T & EE5T OFF S10.2: PSUs 49, 50 ON

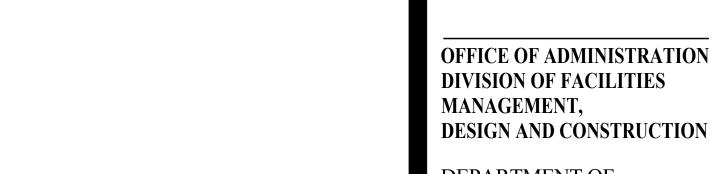

DEPARTMENT OF NATURAL RESOURCES DIVISION OF STATE PARKS

UPGRADE CAVE ELECTRIC

ONONDAGA CAVE STATE PARK 7556 HWY H LEASBURG, MO 65535

PROJECT # X2212-01 5215 SITE#

REVISION: REVISION: DATE: **REVISION:**

ASSET#

DATE:

ISSUE DATE: 06-23-2023

7815215013

CAD DWG FILE: X2212-01-5215-7815215013-E-608.DWG


DRAWN BY: KET CHECKED BY: BDF DESIGNED BY: BDF

SHEET TITLE: NEW LIGHTING

CONTROL STATION CONFIGURATIONS

SHEET NUMBER:

49 OF 50 SHEETS JUNE 23, 2023

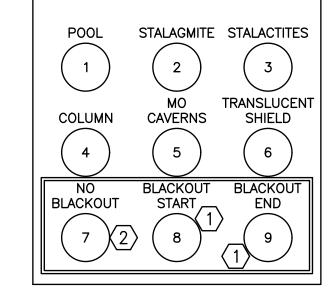

STATION S11

LOCATED ON THE NORTH SIDE OF THE ROCK OF AGES ROOM

S11.1: PSU 57 ON S11.2: PSUs 27, 55 ON


S11.3: PSU 56 ON S11.4: PSUs 53, 54 ON

S11.5: PSUs 18, 58 ON S11.6: PSU 59 ON

DD2T OFF

S11.7: PSUs 18, 27, 53 - 59 OFF S11.8: PSUs 18, 27, 46 - 62, 75 & TRAIL LIGHTS EE1T, EE2T, DD1T,

S11.9: PSUs 46 - 52, 60 - 62, 75 & TRAIL LIGHTS EE1T, EE2T, DD1T, DD2T ON

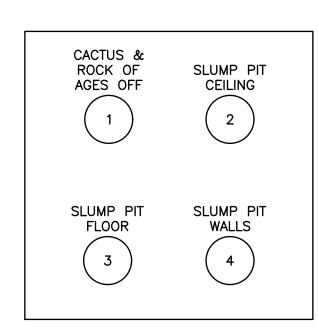


STATION S12

LOCATED AT THE SE CORNER OF THE CACTUS ROOM

S12.1: PSUs 46 - 52, 60 - 62, 75 OFF

S12.3: PSUs 65, 66 ON


S12.2: PSUs 63, 64 ON S12.4: PSUs 67, 68 ON

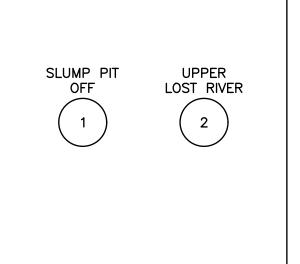


STATION S13

LOCATED AT THE SWITCHBACK SOUTH OF THE SLUMP PIT

S13.1: PSUs 63 - 68 OFF S13.2: PSUs 69 - 71 ON

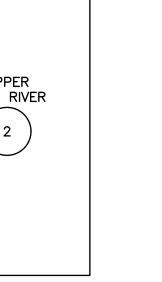


THE BIG ROOM

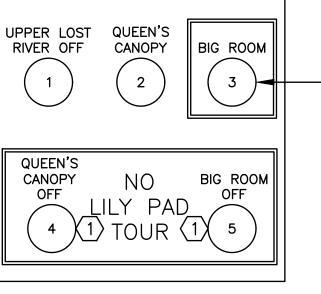

LOCATED NEXT TO THE WATER PUMP IN

S14.1: PSUs 69 - 71 ON S14.2: PSUs 20, 72, 73 ON

S14.3: PSUs 25, 26, 74 ON S14.4: PSUs 20, 72, 73 OFF S14.5: PSUs 25, 26, 74 OFF

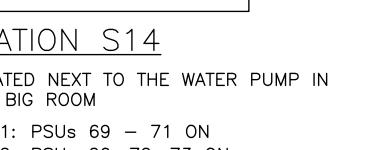

ROOM ON (3) STATION S14

STATION S15

BIG ROOM

LOCATED ON THE SWITCHBACK TRAIL NORTH OF QUEEN'S CANOPY

S15.1: PSUs 25, 26, 74 OFF S15.2: PSUs 20, 72, 73 OFF P15.3: PSUs 19, 76 - 82 ON S15.3: PSUs 19, 76 - 82 OFF

CAVE EMERGENCY TELEPHONE ONE-LINE DIAGRAM

►(1) 3PR CABLE

1"PVC-(2) 3PR CABLES

GENERAL NOTE:

A. SEE CAVE ELECTRICAL PLANS FOR EMER TELEPHONE LOCATIONS.

OKEY NOTES:

1"PVC-(1) 3PR CABLE

1"PVC-(2) 3PR CABLES

` (1) 3PR CABLE ✓

- 1. SEE MTG DETAIL ON DWG E-502.
- 2. PROVIDE SURGE SUPPRESSOR PER EMER TELEPHONE MANUFACTURER'S REQMTS IN TYPE 4X NON-METALLIC ENCLOSURE.

STATE OF MISSOURI MICHAEL L. PARSON, **GOVERNOR**



BARRY D. FREINER Registered Professional Engineer MO # E-24220

Expires 12-31-2024 **ROGERS-SCHMIDT**

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PROJECT # X2212-01 5215 SITE#

REVISION: REVISION: DATE: **REVISION:**

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7815215013

CAD DWG FILE: X2212-01-5215-7815215013-T-601.DWG

DRAWN BY: KET

CHECKED BY: BDF

DESIGNED BY: B D F

SHEET TITLE: ONE-LINE DIAGRAM - CAVE EMERGENCY

TELEPHONES

SHEET NUMBER:

T-601 50 OF 50 SHEETS JUNE 23, 2023