# REPLACE ROOF - LODGE BOTHWELL LODGE STATE HISTORIC SITE SEDALIA, MISSOURI

BID DOCUMENTS

OWNER:

STATE OF MISSOURI MICHAEL L. PARSON,

GOVERNOR

DEPARTMENT OF STATE PARKS

PROJECT
MANAGEMENT:

OFFICE OF ADMINISTRATION

T: DIVISION OF FACILITIES MANAGEMENT,

DESIGN AND CONSTRUCTION

DESIGNER:

STATE OF MISSOURI - OFFICE OF ADMINISTRATION DIVISION OF FACILITIES MANAGEMENT DESIGN

AND CONSTRUCTION: 301 W. HIGH STREET,


JEFFERSON CITY, MO. 65102

PROJECT NUMBER: X2214-01

ASSET NUMBER:

7815303002



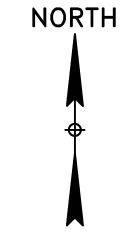

LOCATION MAP

### **DRAWING INDEX**

**G-001 COVER SHEET** G-002 DRAWING INDEX AND LOCATION MAP

### **ARCHITECTURAL**

A-101 ROOF PLAN - DEMOLITION AND NEW WORK A-201 BUILDING ELEVATIONS A-202 BUILDING ELEVATIONS A-301 EXISTING CONDITION IMAGES A-501 ROOFING DETAILS

STATE OF MISSOURI MICHAEL L. PARSON, GOVERNOR



Brad M. Schaefer - Architect MO# A-2009027294

OFFICE OF ADMINISTRATION DIVISION OF FACILITIES MANAGEMENT, DESIGN AND CONSTRUCTION

REPLACE ROOF - LODGE

BOTHWELL LODGE STATE HISTORIC SITE 19349 BOTHWELL STATE PARK SEDALIA, MISSOURI 65301

PROJECT # X2214-01 ASSET # 7815303002


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DESIGNED BY:

SHEET TITLE: DRAWING INDEX & LOCATION MAP

SHEET NUMBER:



STATE OF MISSOURI MICHAEL L. PARSON, GOVERNOR

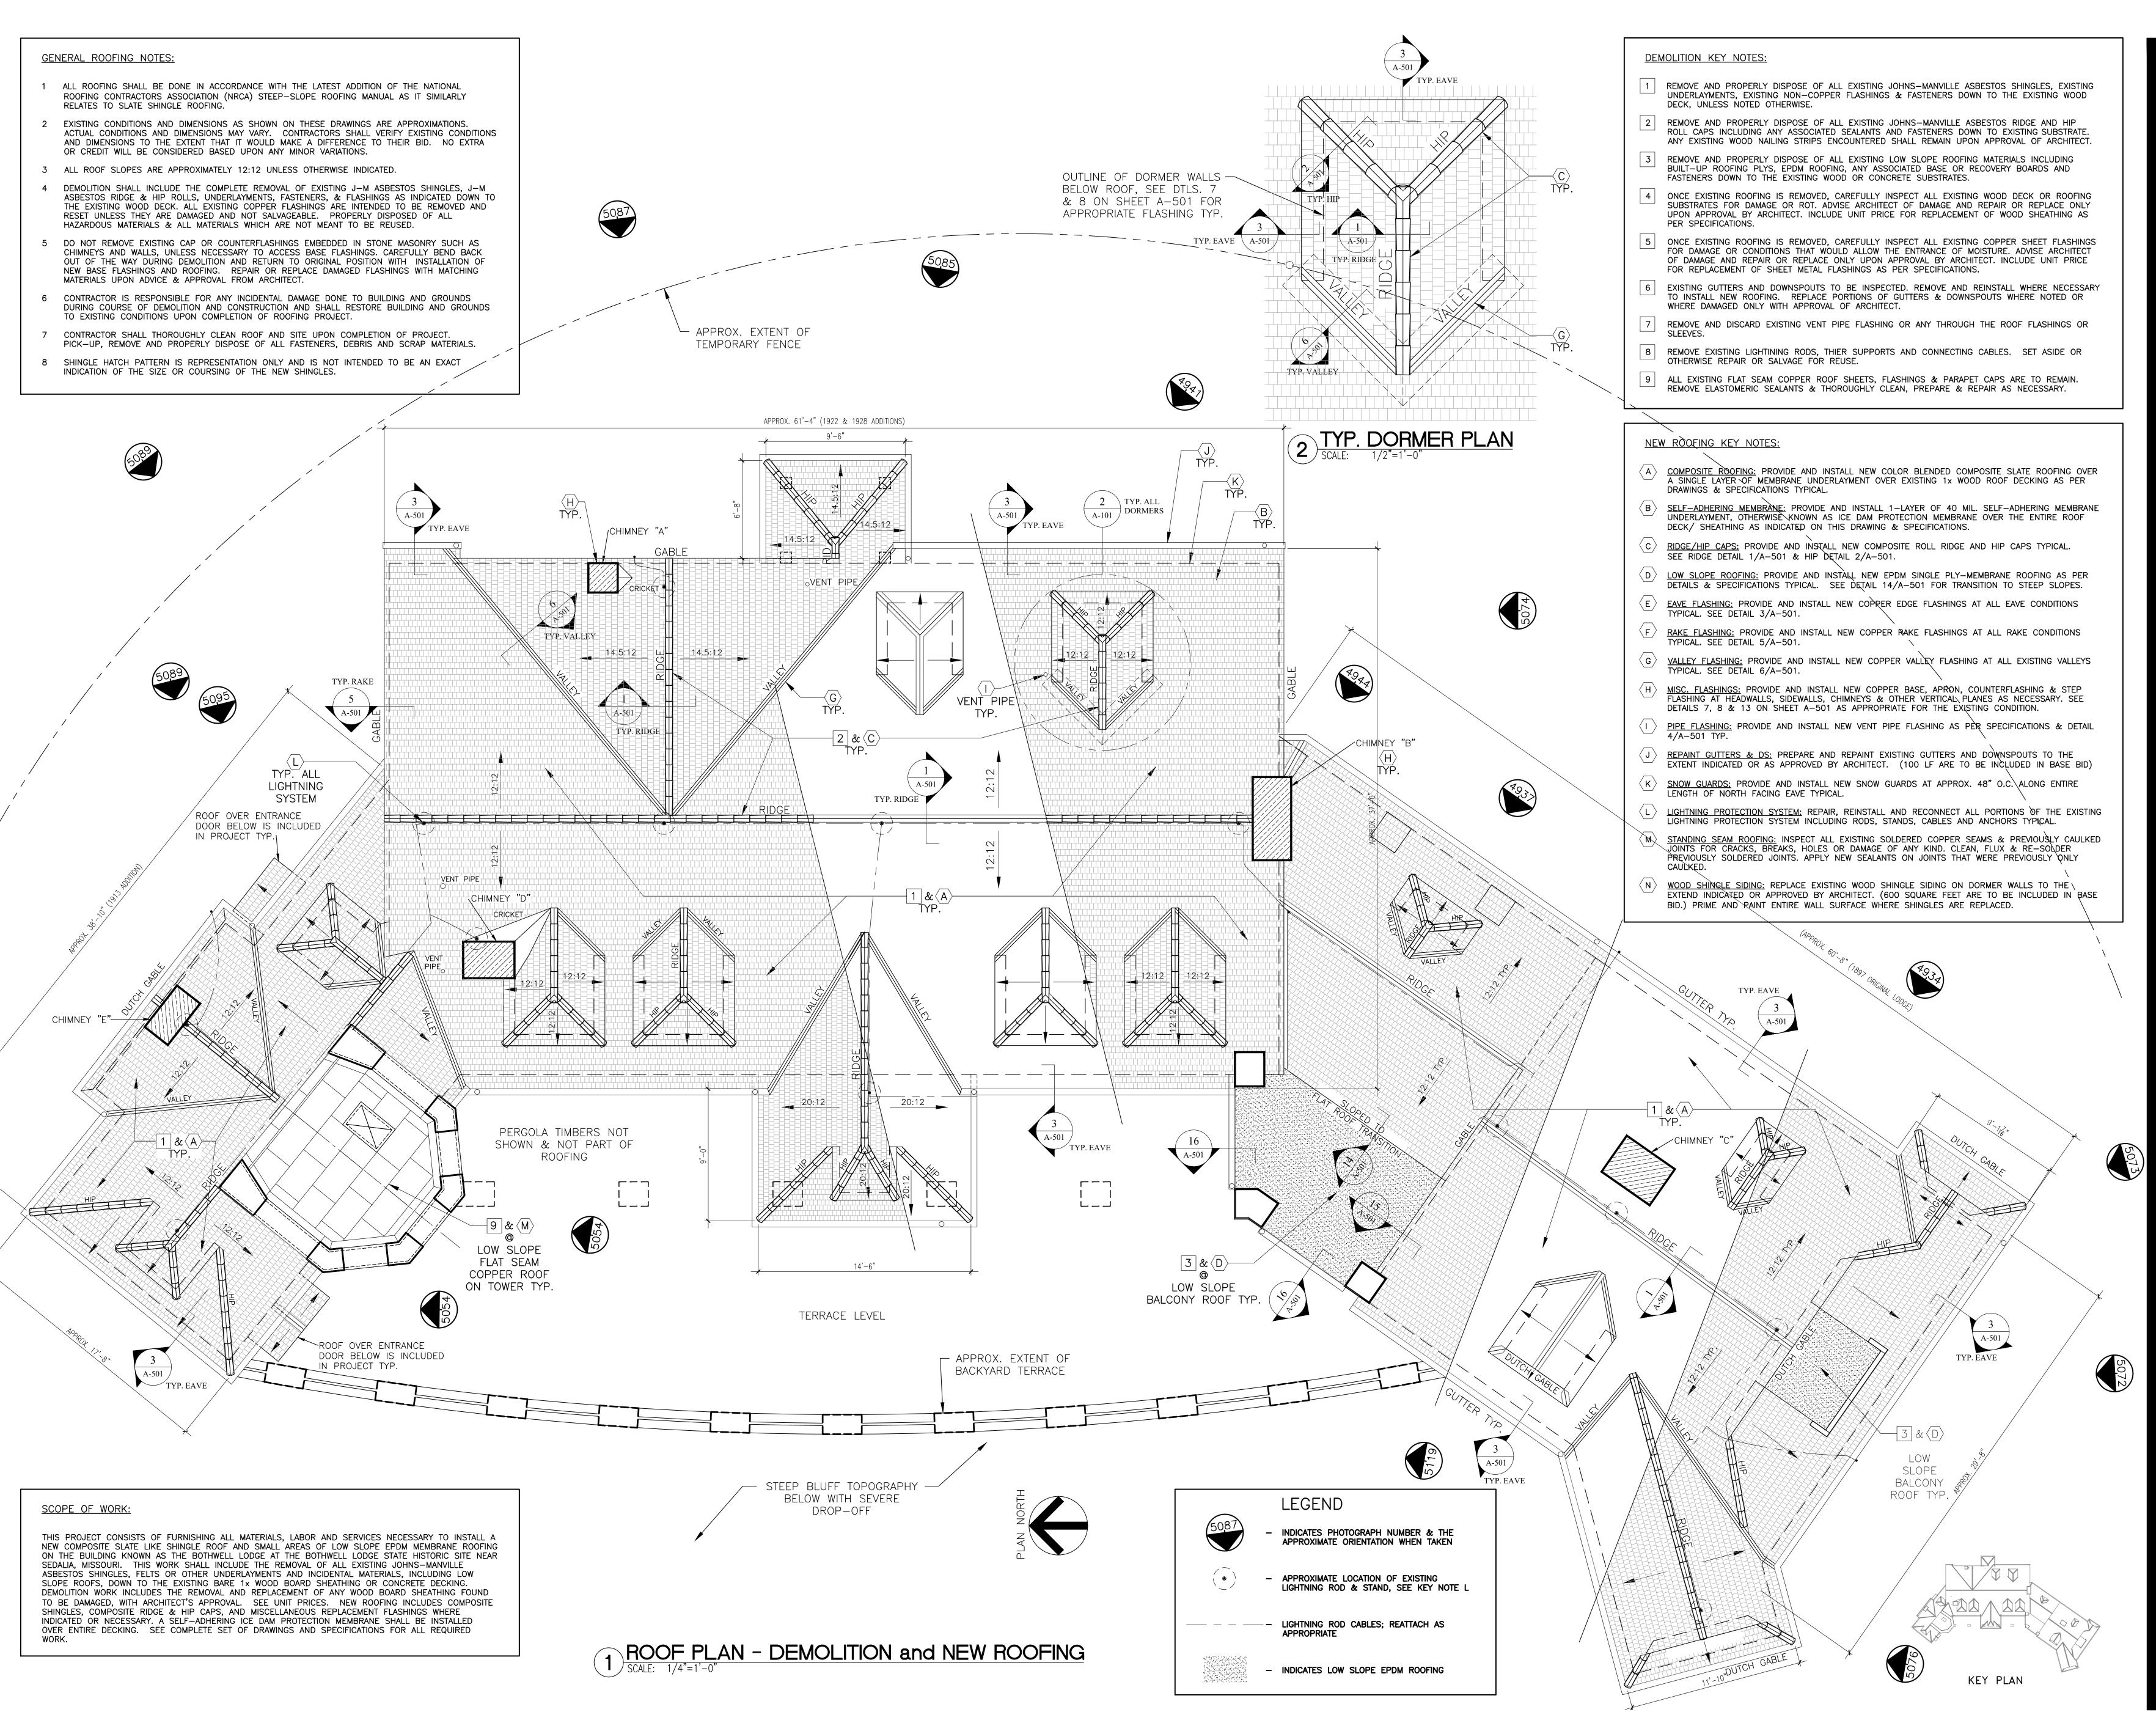

Brad M. Schaefer - Architect

MO# A-2009027294

DOCUMENTS

OFFICE OF ADMINISTRATION DIVISION OF FACILITIES MANAGEMENT, DESIGN AND CONSTRUCTION

REPLACE ROOF - LODGE

BOTHWELL LODGE STATE HISTORIC SITE 19349 BOTHWELL STATE PARK SEDALIA, MISSOURI 65301

PROJECT # X2214-01 SITE # 5303 ASSET # 7815303002

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CAD DWG FILE:
DRAWN BY: FML
CHECKED BY: BMS
DESIGNED BY: TEH
SHEET TITLE:

ROOF PLAN
DEMOLITION AND
NEW WORK

SHEET NUMBER:

A-101

3 OF 7 SHEETS 03/14/2024

STATE OF MISSOURI MICHAEL L. PARSON,


SCHAEFER

A-2009027294

Brad M. Schaefer - Architect

MO# A-2009027294

**GOVERNOR** 

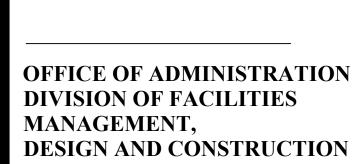

REPLACE ROOF - LODGE

BOTHWELL LODGE STATE HISTORIC SITE 19349 BOTHWELL STATE PARK SEDALIA, MISSOURI 65301

PROJECT # X2214-01 SITE # 5303 ASSET # 7815303002

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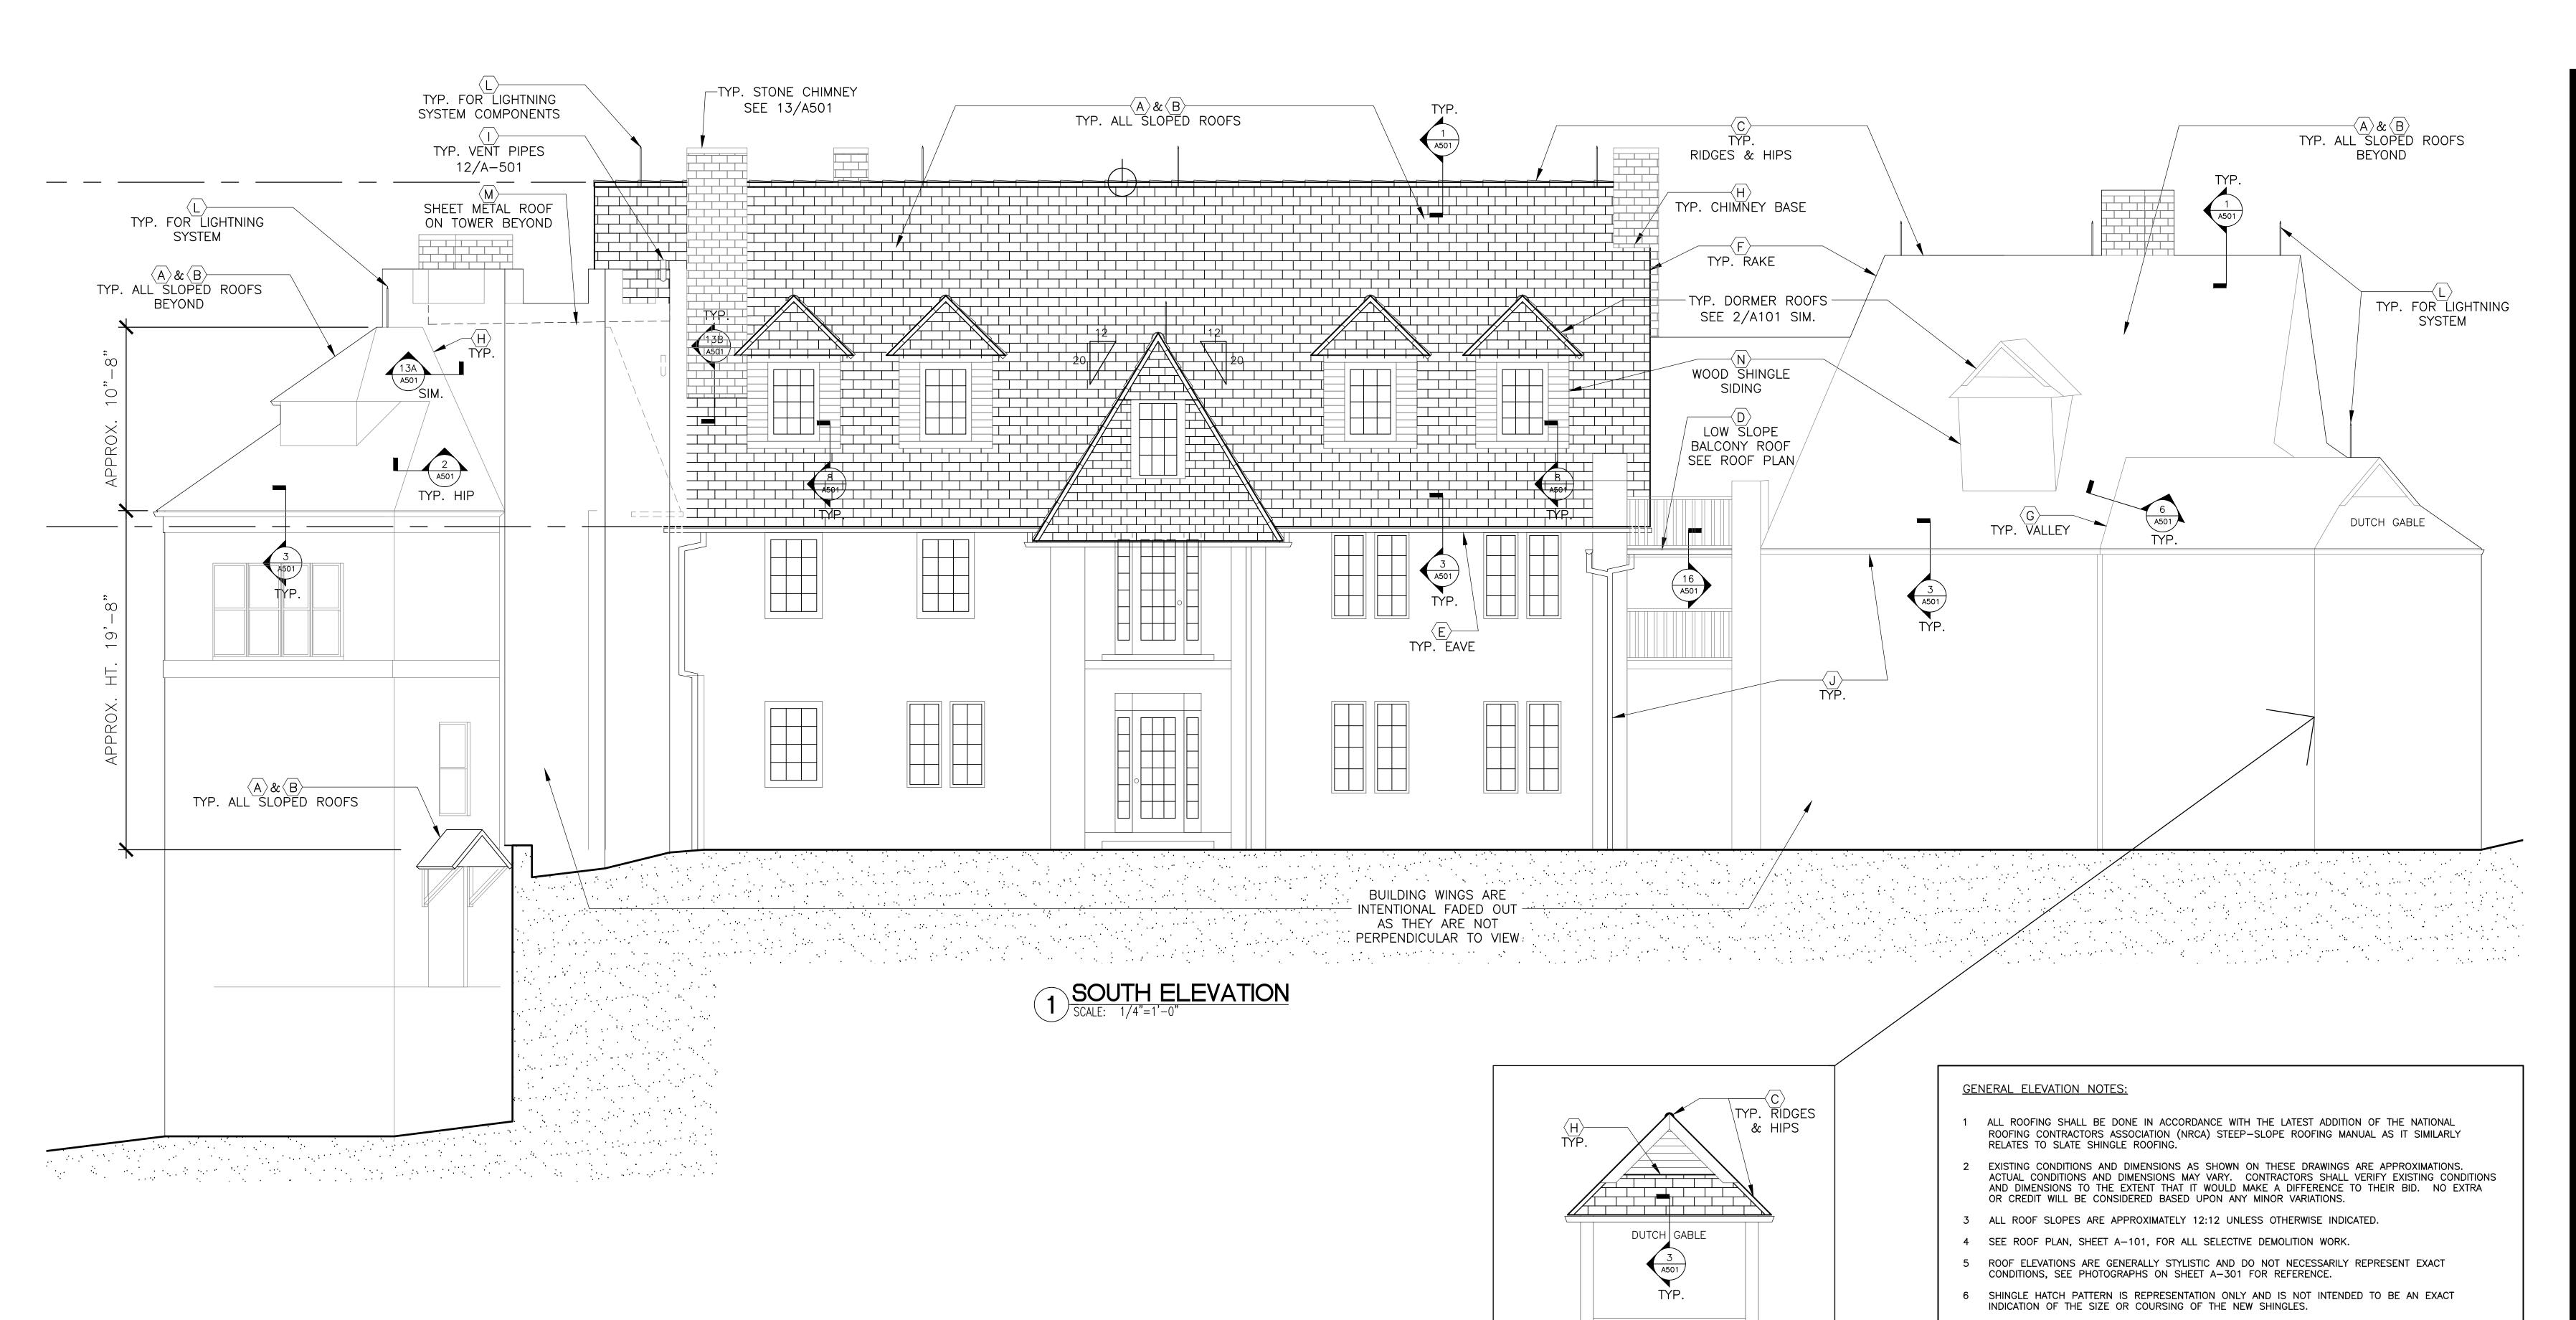
DATE: ISSUE DATE: 03/14/2024

CAD DWG FILE:
DRAWN BY: FML
CHECKED BY: BMS
DESIGNED BY: TEH

SHEET TITLE:
BUILDING
ELEVATIONS

SHEET NUMBER:

A-20



NEW ROOFING KEY NOTES:

SCALE: 1/4"=1'-0"

A COMPOSITE ROOFING: PROVIDE AND INSTALL NEW COLOR BLENDED COMPOSITE SLATE ROOFING OVER A SINGLE LAYER OF MEMBRANE UNDERLAYMENT OVER EXISTING 1x WOOD ROOF DECKING AS PER DRAWINGS & SPECIFICATIONS TYPICAL.

7 EXTERIOR WALL SURFACES AND CHIMNEYS ON THE LODGE ARE TYPICALLY ALL STONE MASONRY.

B SELF-ADHERING MEMBRANE: PROVIDE AND INSTALL 1-LAYER OF 40 MIL. SELF-ADHERING MEMBRANE UNDERLAYMENT, OTHERWISE KNOWN AS ICE DAM PROTECTION MEMBRANE OVER THE ENTIRE ROOF DECK/ SHEATHING AS INDICATED ON THIS DRAWING & SPECIFICATIONS.

LOW SLOPE ROOFING: PROVIDE AND INSTALL NEW EPDM SINGLE PLY-MEMBRANE ROOFING AS PER

DETAILS & SPECIFICATIONS TYPICAL. SEE DETAIL 14/A-501 FOR TRANSITION TO STEEP SLOPES.

- C RIDGE/HIP CAPS: PROVIDE AND INSTALL NEW COMPOSITE ROLL RIDGE AND HIP CAPS TYPICAL. SEE RIDGE DETAIL 1/A-501 & HIP DETAIL 2/A-501.
- E EAVE FLASHING: PROVIDE AND INSTALL NEW COPPER EDGE FLASHINGS AT ALL EAVE CONDITIONS TYPICAL. SEE DETAIL 3/A-501.
- RAKE FLASHING: PROVIDE AND INSTALL NEW COPPER RAKE FLASHINGS AT ALL RAKE CONDITIONS TYPICAL. SEE DETAIL 5/A-501.
- G VALLEY FLASHING: PROVIDE AND INSTALL NEW COPPER VALLEY FLASHING AT ALL EXISTING VALLEYS TYPICAL. SEE DETAIL 6/A-501.
- MISC. FLASHINGS: PROVIDE AND INSTALL NEW COPPER BASE, APRON, COUNTERFLASHING & STEP FLASHING AT HEADWALLS, SIDEWALLS, CHIMNEYS & OTHER VERTICAL PLANES AS NECESSARY. SEE DETAILS 7, 8 & 13 ON SHEET A-501 AS APPROPRIATE FOR THE EXISTING CONDITION.
- PIPE FLASHING: PROVIDE AND INSTALL NEW VENT PIPE FLASHING AS PER SPECIFICATIONS & DETAIL 4/A-501 TYP.
- A REPAINT GUTTERS & DS: PREPARE AND REPAINT EXISTING GUTTERS AND DOWNSPOUTS TO THE EXTENT INDICATED OR AS APPROVED BY ARCHITECT. (100 LF ARE TO BE INCLUDED IN BASE BID)
- EXTENT INDICATED OR AS APPROVED BY ARCHITECT. (100 LF ARE TO BE INCLUDED IN BASE BID)

  K

  SNOW GUARDS: PROVIDE AND INSTALL NEW SNOW GUARDS AT APPROX. 48" O.C. ALONG ENTIRE LENGTH OF NORTH FACING EAVE TYPICAL.
- LIGHTNING PROTECTION SYSTEM: REPAIR, REINSTALL AND RECONNECT ALL PORTIONS OF THE EXISTING LIGHTNING PROTECTION SYSTEM INCLUDING RODS, STANDS, CABLES AND ANCHORS TYPICAL.
- M STANDING SEAM ROOFING: INSPECT ALL EXISTING SOLDERED COPPER SEAMS & PREVIOUSLY CAULKED JOINTS FOR CRACKS, BREAKS, HOLES OR DAMAGE OF ANY KIND. CLEAN, FLUX & RE—SOLDER PREVIOUSLY SOLDERED JOINTS. APPLY NEW SEALANTS ON JOINTS THAT WERE PREVIOUSLY ONLY CAULKED.
- N WOOD SHINGLE SIDING: REPLACE EXISTING WOOD SHINGLE SIDING ON DORMER WALLS TO THE EXTEND INDICATED OR APPROVED BY ARCHITECT. (600 SQUARE FEET ARE TO BE INCLUDED IN BASE BID.) PRIME AND PAINT ENTIRE WALL SURFACE WHERE SHINGLES ARE REPLACED.

MICHAEL L. PARSON,

**GOVERNOR** 

OFFICE OF ADMINISTRATION DIVISION OF FACILITIES MANAGEMENT, **DESIGN AND CONSTRUCTION** 

REPLACE ROOF - LODGE

BOTHWELL LODGE STATE HISTORIC SITE 19349 BOTHWELL STATE PARK SEDALIA, MISSOURI 65301

PROJECT # X2214-01 ASSET # 7815303002


**REVISION:** DATE: **REVISION:** DATE: **REVISION:** 

DATE: ISSUE DATE: 03/14/2024

CAD DWG FILE DRAWN BY: CHECKED BY: BMS DESIGNED BY: TEH

SHEET TITLE: BUILDING **ELEVATIONS** 

SHEET NUMBER:

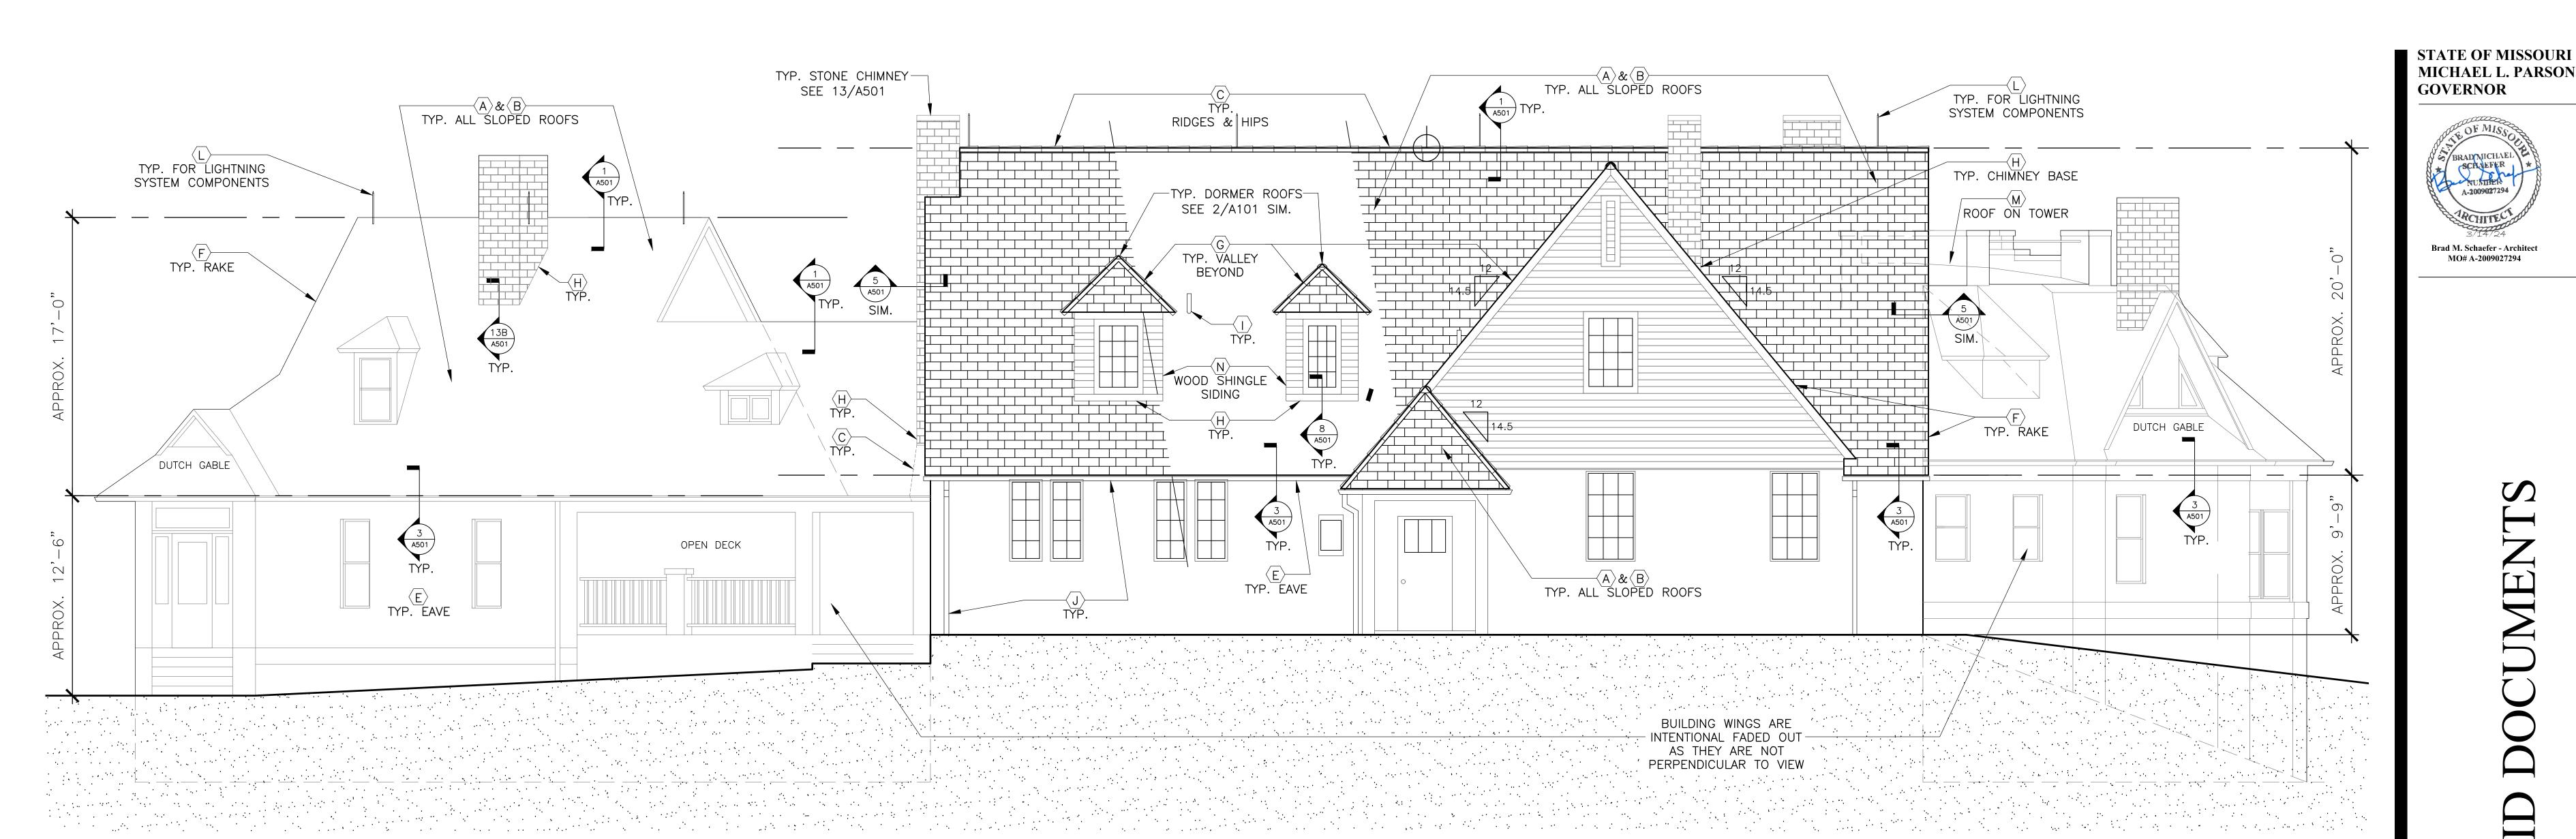

### NORTH ELEVATION SCALE: 1/4"=1'-0"

**GENERAL ELEVATION NOTES:** 

**NEW ROOFING KEY NOTES:** 

DRAWINGS & SPECIFICATIONS TYPICAL.

TYPICAL. SEE DETAIL 3/A-501.

TYPICAL. SEE DETAIL 6/A-501.

LENGTH OF NORTH FACING EAVE TYPICAL.

RELATES TO SLATE SHINGLE ROOFING.

ALL ROOFING SHALL BE DONE IN ACCORDANCE WITH THE LATEST ADDITION OF THE NATIONAL

ROOFING CONTRACTORS ASSOCIATION (NRCA) STEEP-SLOPE ROOFING MANUAL AS IT SIMILARLY

EXISTING CONDITIONS AND DIMENSIONS AS SHOWN ON THESE DRAWINGS ARE APPROXIMATIONS.

ROOF ELEVATIONS ARE GENERALLY STYLISTIC AND DO NOT NECESSARILY REPRESENT EXACT

SHINGLE HATCH PATTERN IS REPRESENTATION ONLY AND IS NOT INTENDED TO BE AN EXACT

7 EXTERIOR WALL SURFACES AND CHIMNEYS ON THE LODGE ARE TYPICALLY ALL STONE MASONRY.

COMPOSITE ROOFING: PROVIDE AND INSTALL NEW COLOR BLENDED COMPOSITE SLATE ROOFING OVER A SINGLE LAYER OF MEMBRANE UNDERLAYMENT OVER EXISTING 1x WOOD ROOF DECKING AS PER

<u>SELF-ADHERING MEMBRANE:</u> PROVIDE AND INSTALL 1-LAYER OF 40 MIL. SELF-ADHERING MEMBRANE UNDERLAYMENT, OTHERWISE KNOWN AS ICE DAM PROTECTION MEMBRANE OVER THE ENTIRE ROOF

RIDGE/HIP CAPS: PROVIDE AND INSTALL NEW COMPOSITE ROLL RIDGE AND HIP CAPS TYPICAL.

(E) EAVE FLASHING: PROVIDE AND INSTALL NEW COPPER EDGE FLASHINGS AT ALL EAVE CONDITIONS

LOW SLOPE ROOFING: PROVIDE AND INSTALL NEW EPDM SINGLE PLY-MEMBRANE ROOFING AS PER

DETAILS & SPECIFICATIONS TYPICAL. SEE DETAIL 14/A-501 FOR TRANSITION TO STEEP SLOPES.

RAKE FLASHING: PROVIDE AND INSTALL NEW COPPER RAKE FLASHINGS AT ALL RAKE CONDITIONS TYPICAL. SEE DETAIL 5/A-501.

MISC. FLASHINGS: PROVIDE AND INSTALL NEW COPPER BASE, APRON, COUNTERFLASHING & STEP FLASHING AT HEADWALLS, SIDEWALLS, CHIMNEYS & OTHER VERTICAL PLANES AS NECESSARY. SEE

PIPE FLASHING: PROVIDE AND INSTALL NEW VENT PIPE FLASHING AS PER SPECIFICATIONS & DETAIL

EXTENT INDICATED OR AS APPROVED BY ARCHITECT. (100 LF ARE TO BE INCLUDED IN BASE BID)

LIGHTNING PROTECTION SYSTEM: REPAIR, REINSTALL AND RECONNECT ALL PORTIONS OF THE EXISTING

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G VALLEY FLASHING: PROVIDE AND INSTALL NEW COPPER VALLEY FLASHING AT ALL EXISTING VALLEYS

DETAILS 7, 8 & 13 ON SHEET A-501 AS APPROPRIATE FOR THE EXISTING CONDITION.

APPROVED BY APPROV

K SNOW GUARDS: PROVIDE AND INSTALL NEW SNOW GUARDS AT APPROX. 48" O.C. ALONG ENTIRE

LIGHTNING PROTECTION SYSTEM INCLUDING RODS, STANDS, CABLES AND ANCHORS TYPICAL.

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(M) <u>STANDING SEAM ROOFING:</u> INSPECT ALL EXISTING SOLDERED COPPER SEAMS & PREVIOUSLY CAULKED JOINTS FOR CRACKS, BREAKS, HOLES OR DAMAGE OF ANY KIND. CLEAN, FLUX & RE-SOLDER PREVIOUSLY SOLDERED JOINTS. APPLY NEW SEALANTS ON JOINTS THAT WERE PREVIOUSLY ONLY

OR CREDIT WILL BE CONSIDERED BASED UPON ANY MINOR VARIATIONS.

3 ALL ROOF SLOPES ARE APPROXIMATELY 12:12 UNLESS OTHERWISE INDICATED.

4 SEE ROOF PLAN, SHEET A-101, FOR ALL SELECTIVE DEMOLITION WORK.


INDICATION OF THE SIZE OR COURSING OF THE NEW SHINGLES.


CONDITIONS, SEE PHOTOGRAPHS ON SHEET A-301 FOR REFERENCE.

DECK/ SHEATHING AS INDICATED ON THIS DRAWING & SPECIFICATIONS.

SEE RIDGE DETAIL 1/A-501 & HIP DETAIL 2/A-501.

ACTUAL CONDITIONS AND DIMENSIONS MAY VARY. CONTRACTORS SHALL VERIFY EXISTING CONDITIONS AND DIMENSIONS TO THE EXTENT THAT IT WOULD MAKE A DIFFERENCE TO THEIR BID. NO EXTRA

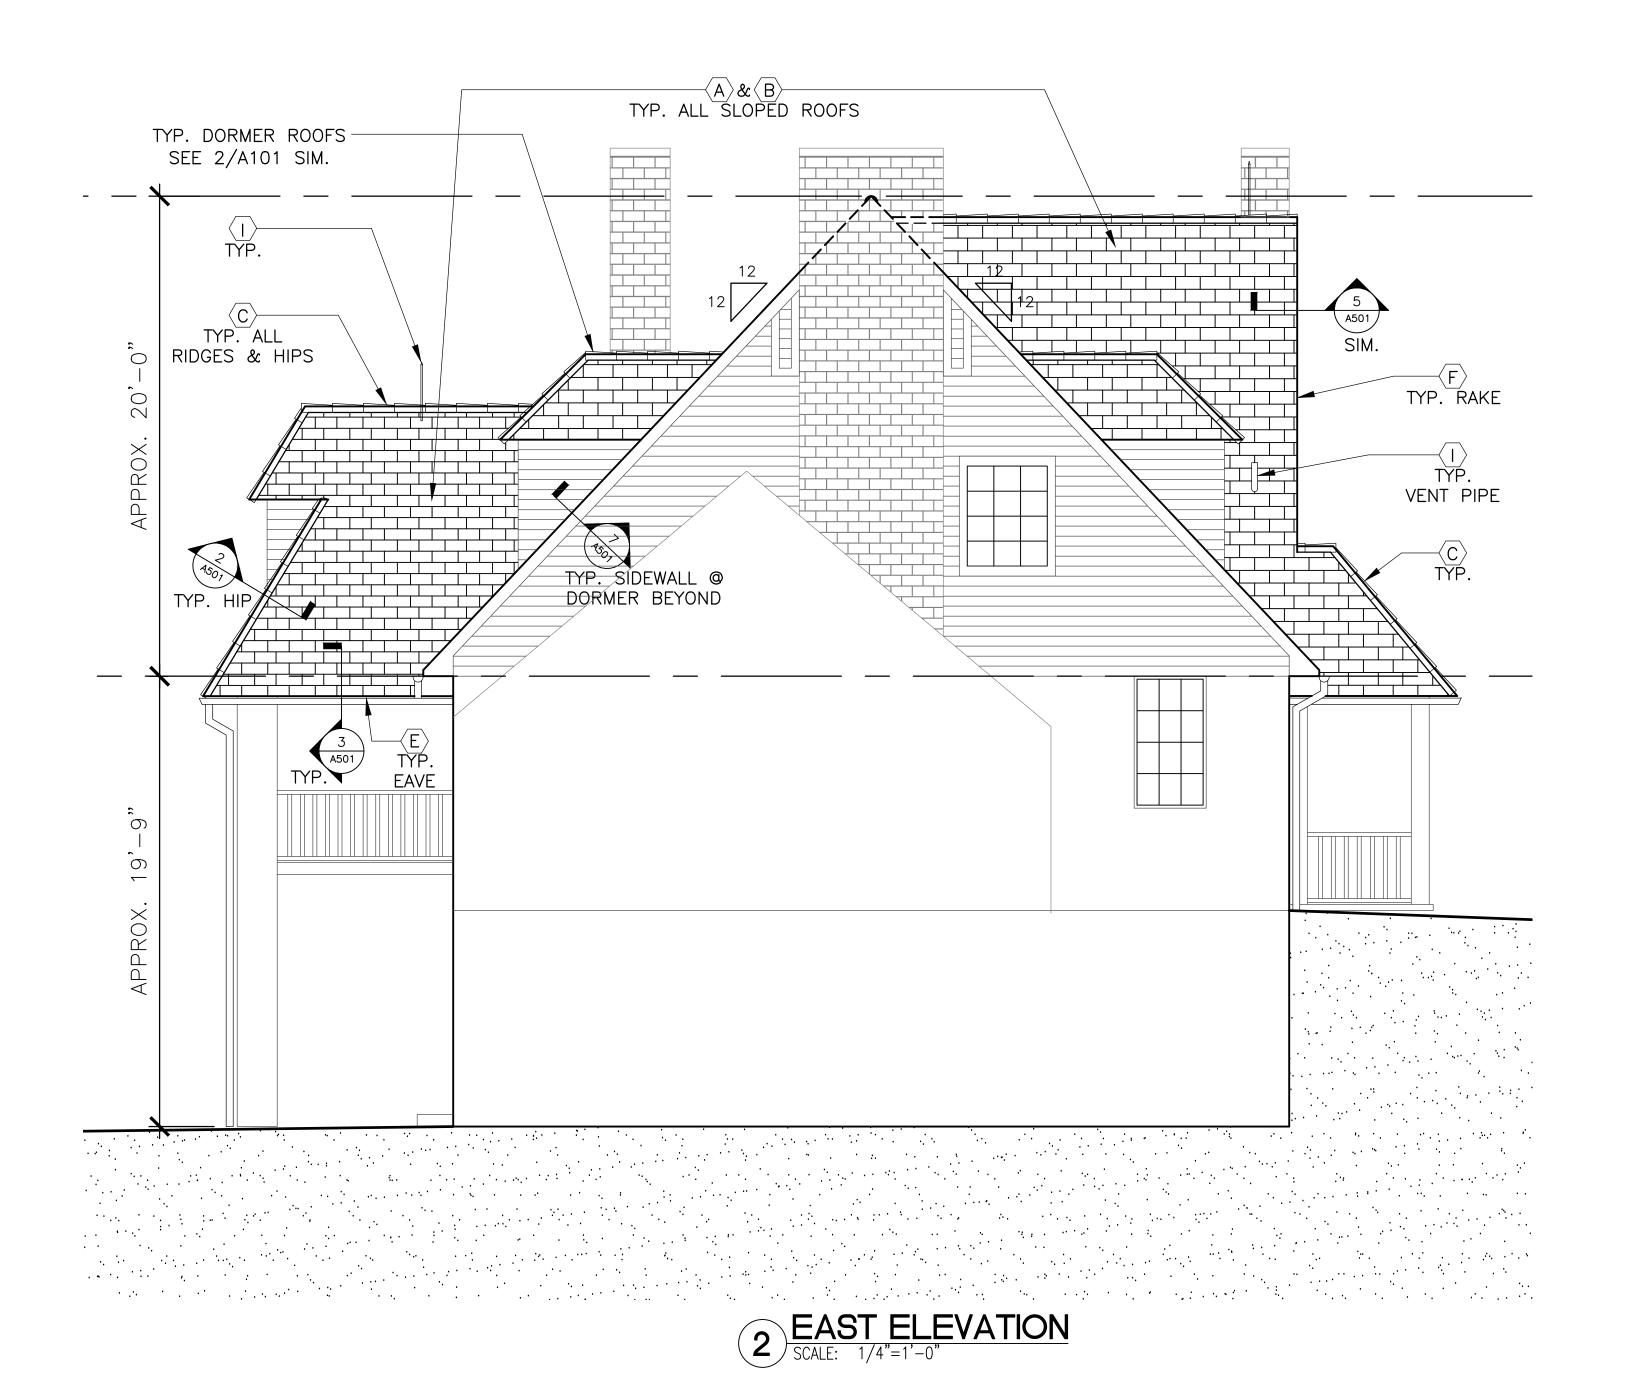


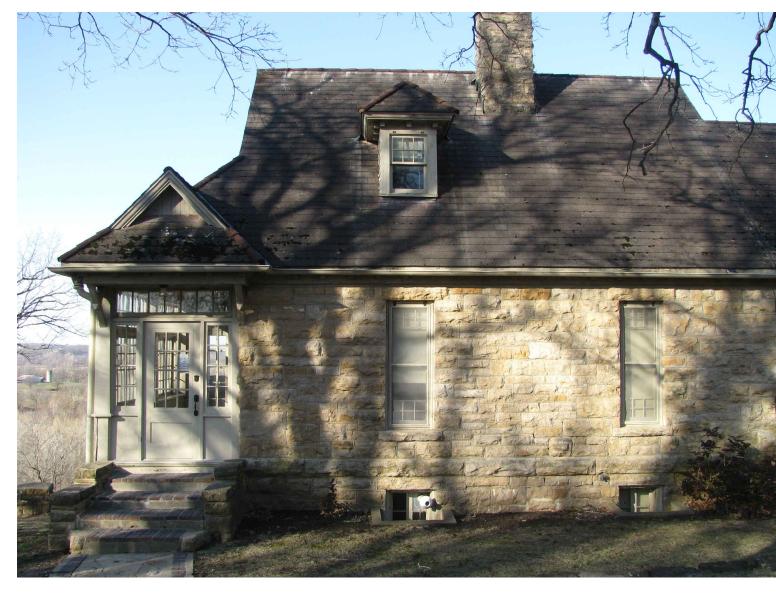

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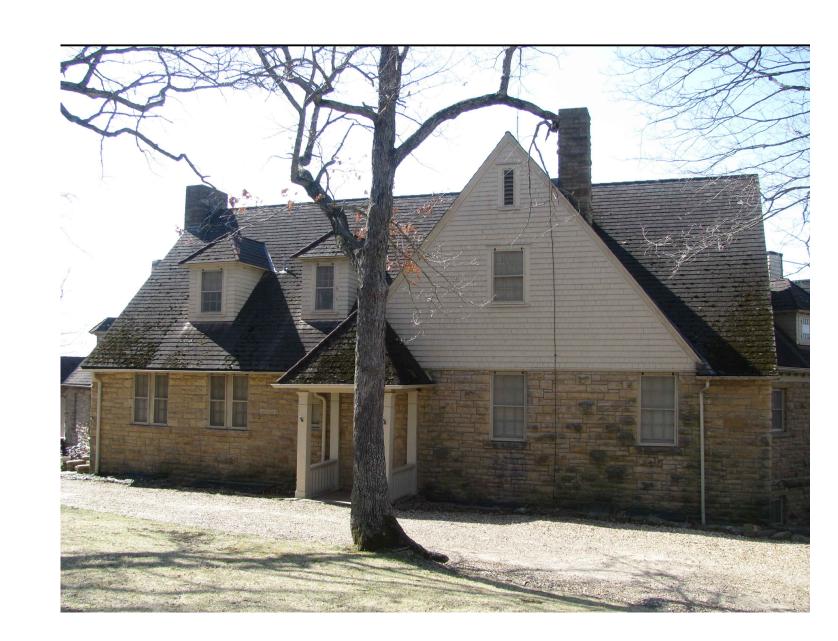






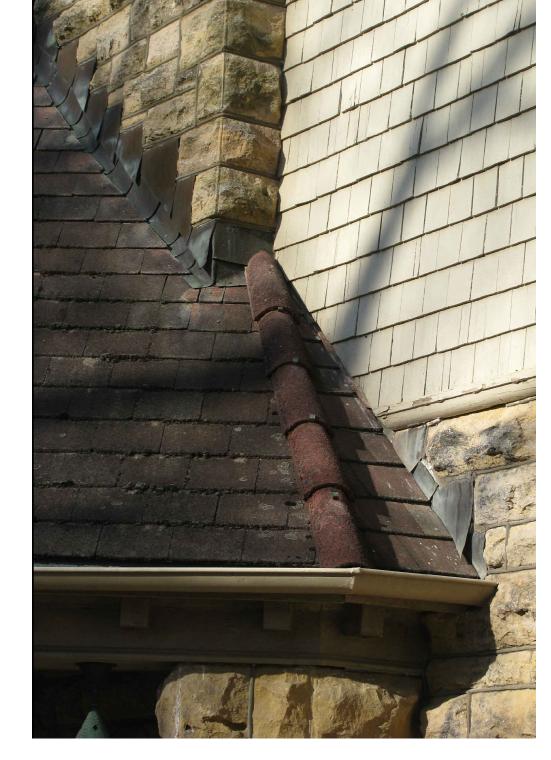

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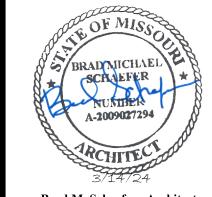








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Brad M. Schaefer - Architect MO# A-2009027294

OFFICE OF ADMINISTRATION DIVISION OF FACILITIES MANAGEMENT, DESIGN AND CONSTRUCTION

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PROJECT # X2214-01 ASSET # 7815303002

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CAD DWG FILE:
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CHECKED BY: BM
DESIGNED BY: TEE SHEET TITLE:

EXISTING CONDITION **IMAGES** 

SHEET NUMBER:

6 OF 7 SHEETS 03/14/2024

STATE OF MISSOURI

**GOVERNOR** 

MICHAEL L. PARSON,

**OFFICE OF ADMINISTRATION DIVISION OF FACILITIES** MANAGEMENT, **DESIGN AND CONSTRUCTION** 

REPLACE ROOF - LODGE

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ISSUE DATE: 03/14/2024

**CAD DWG FILE** DRAWN BY: CHECKED BY: DESIGNED BY: T

SHEET TITLE: **ROOFING DETAILS** 

SHEET NUMBER:

A-50

7 OF 7 SHEETS

SELF-ADHERING MEMBRANE -SEALANT UNDERLAYMENT TO BE INSTALLED AP UNDERLAYMENT — OVER THE ENTIRE ROOF DECK COMPOSITE SLATE SHINGLES -INSTALLED AS PER ROOF MFG. USING COLORS & BLEND AS PER THE SPECIFICATION TYP. SELF-ADHERING MEMBRANE -UNDERLAYMENT TO START AT EAVES & CONT. TO RIDGE, LAP SOFT-METAL FLASHING SLEEVE. ROLLED -OVER DRIP EDGE TYP. INTO TOP OF VENT PIPE AT LEAST 1" TYP. COMPOSITE SHINGLE STARTER — SHEET METAL FLANGE, PART OF PIPE -COURSE AS PER MFG. TYP. FLASHING ASSEMBLY TYP. #15 FELT STRIP UNDER DRIP EXISTING THRU-THE-ROOF VENT PIPE ËDGE & OVER GUTTER TYP. TO REMAIN TYP. <del>- APPROX. 1/2" TO 1" OF SHINGLE -</del> SELF-ADHERING MEMBRANE -

<u>OGEE</u>

WRAPPED OVER HIP EDGES FROM BOTH SIDES TYP. TREATED WOOD HIP NAILER: -2x4 OR SIZED AS REQD. TO ADEQUATELY SUPPORT & ANCHOR 24" WIDE SELF-ADHERING-MEMBRANE FLASHING STRIP WRAPPED OVER NAILERS TYP. COMPOSITE SLATE SHINGLES -CUT TO ANGLE OF THE HIP COMPOSITE SLATE SHINGLES ——— SPANISH STYLE RIDGE CAPS -WITH PRE-PUNCHED HOLES LAP & CAULK AS REQD. BY COMPOSITE ROOF MFG. HIP STARTER OR CLOSURE AT -BOTTOM OF HIPS AS REQD. BY COMPOSITE ROOF MFG.

SELF-ADHERING UNDERLAYMENT ---

## 1 TYPICAL RIDGE DETAIL SCALE: NTS

SPANISH STYLE RIDGE CAPS —

WITH PRE-PUNCHED HOLES

LAP & CAULK AS REQD. BY

COMPOSITE ROOF MFG. TYP.

FASTENERS COVERED BY -

SUCCEEDING RIDGE CAP

CONT. BED OF SEALANT —

ALONG RIDGE JOINTS AS

TREATED WOOD NAILER: -

SELF-ADHERING UNDERLAYMENT

WRAPPED OVER RIDGELINE

COMPOSITE SLATE SHINGLES

EXIST. 1x WOOD DECKING

SHEET-METAL -

APRON FLASHING

WITH HEMMED EDGE


REPAIR AS NECESSARY

FROM BOTH SIDES TYP.

THICKNESS TO MATCH


COMPOSITE SHINGLES


REQD. BY MFG. TYP.

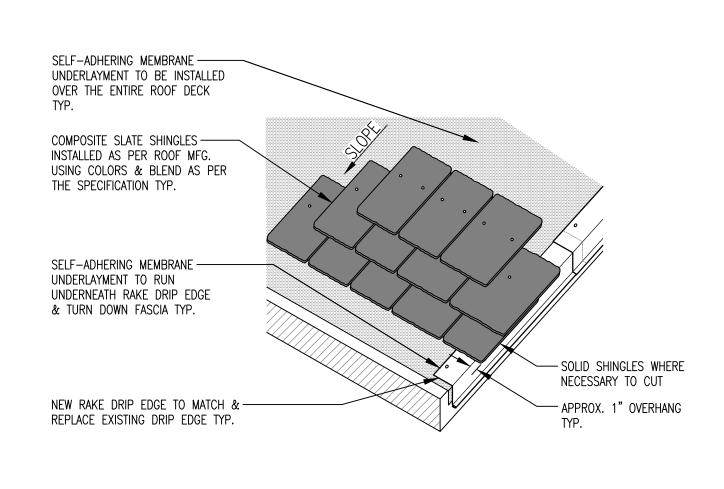

TYPICAL RAKE OR GABLE DETAIL

SCALE: NTS

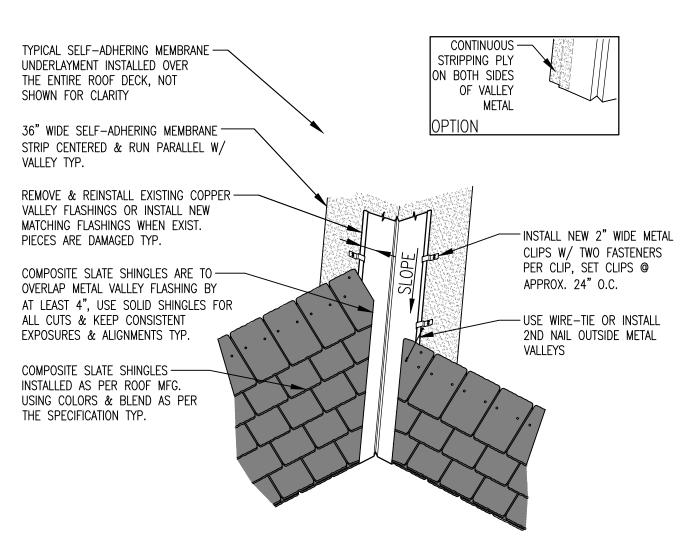

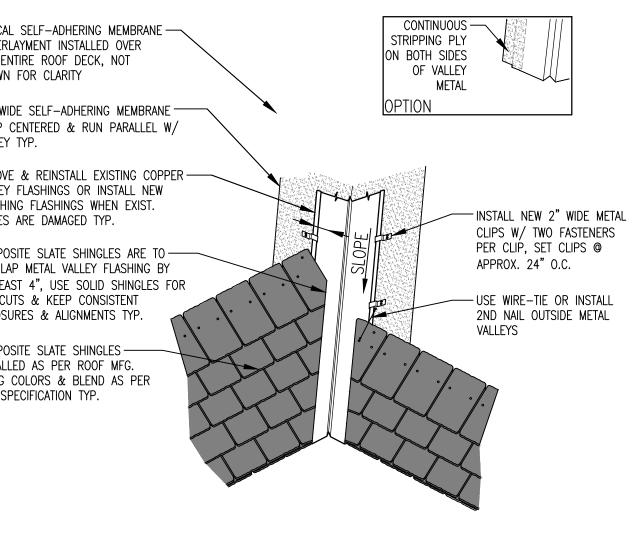


### TYPICAL EAVE DETAILS W/ GUTTERS

HALF ROUND

OVERHANG TYP.

COMPOSITE SHINGLES

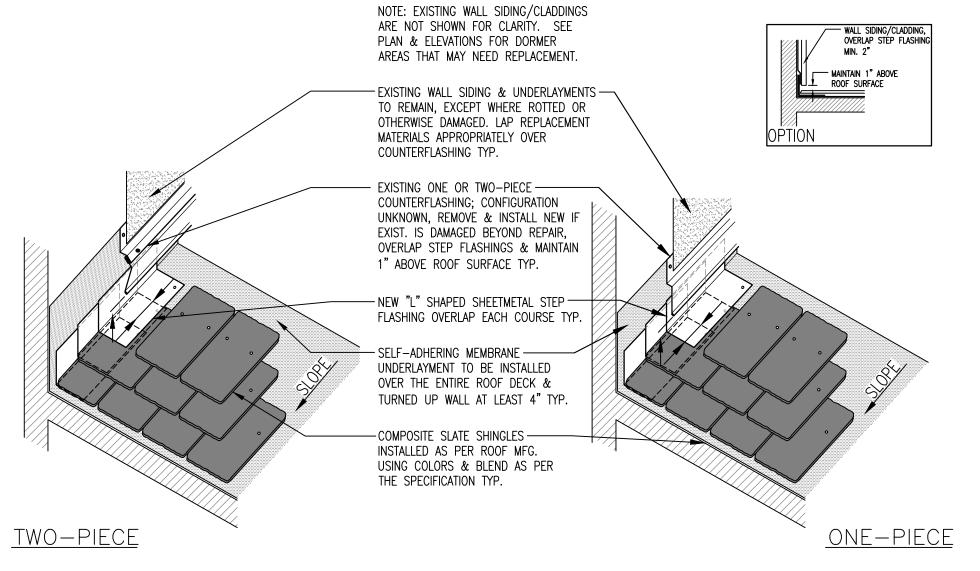


TREATED WOOD CANT STRIP W/

THICKNESS & ANGLE TO MATCH


NEW DRIP EDGE TO MATCH & -REPLACE EXISTING DRIP EDGE TYP.

UNLESS OTHERWISE NOTED TYP.

EXISTING GUTTERS TO REMAIN IN PLACE —

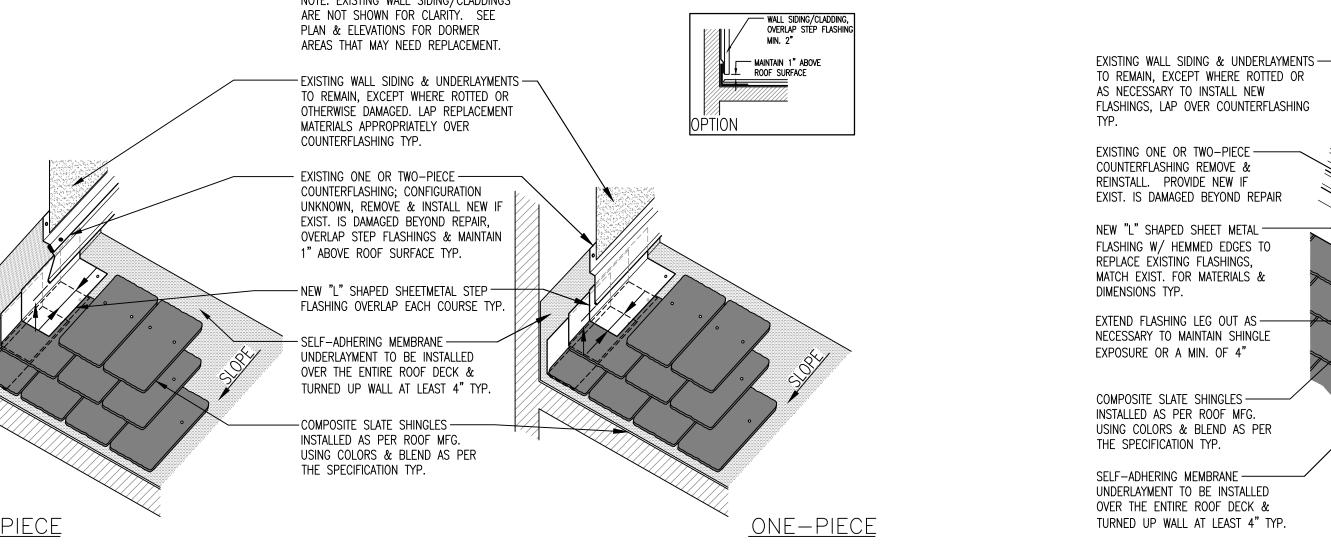

# 7 TYPICAL SIDEWALL FLASHING W/ COUNTERFLASHING

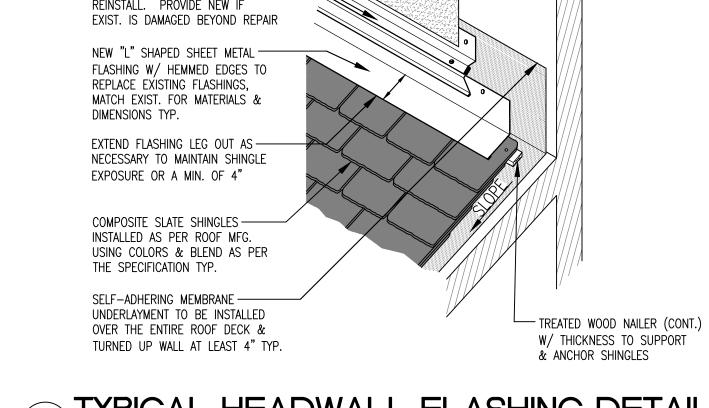

TYPICAL VENT PIPE PENETRATION

PENETRATION

⋒ FLASHING

UNDERLAYMENT IS NOT SHOWN FOR

COMPOSITE SLATE SHINGLES TO BE -

NEATLY CUT AROUND BASE OF PIPE,


APPLY A BEAD OF SEALANT BETWEEN -----SHINGLES & FLANGE AS SHOWN TYP.


CLARITY, OVERLAP TOP EDGE OF

FLANGE BY AT LEAST 4"

USE SOLID SHINGLES TYP.


# 8 TYPICAL HEADWALL FLASHING DETAIL SCALE: NTS

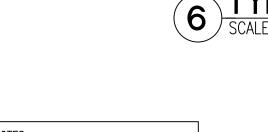

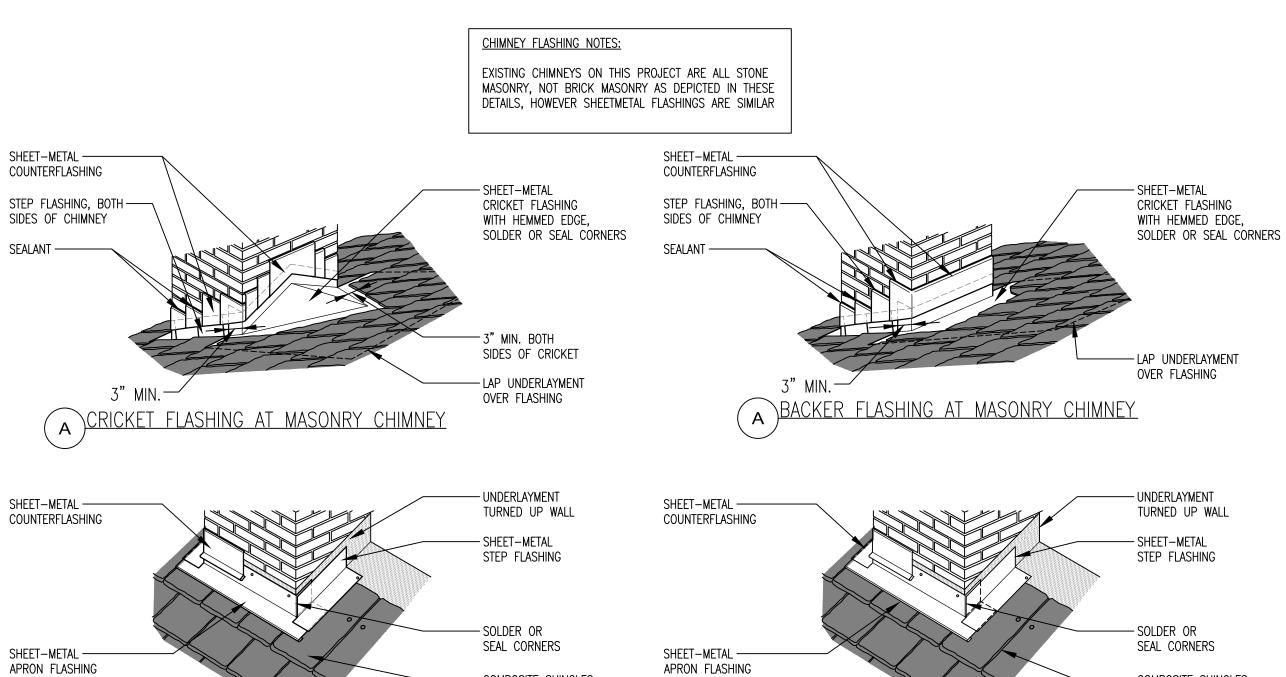

### 6 TYPICAL OPEN VALLEY DETAIL SCALE: NTS

- COMPOSITE SHINGLES

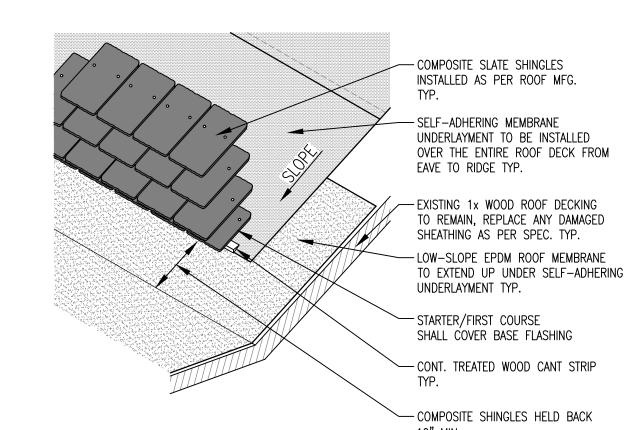


- 1 ALL ROOFING SHALL BE DONE IN ACCORDANCE WITH THE LATEST ADDITION OF THE NATIONAL ROOFING CONTRACTORS ASSOCIATION (NRCA) STEEP-SLOPE ROOFING MANUAL AS IT RELATES TO SLATE SHINGLE ROOFING OR THE LOW-SLOPE ROOFING MANUAL AS IT RELATES TO EPDM ROOFING.
- DETAILS SHOWN ON THIS SHEET ARE NOT TO SCALE AND GENERALLY REPRESENT A STYLISTIC ISOMETRIC VIEW OF THE CONDITIONS THAT WILL BE ENCOUNTERED IN THIS ROOFING PROJECT.
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- OR CREDIT WILL BE CONSIDERED BASED UPON ANY MINOR VARIATIONS. 4 ALL ROOF SLOPES ARE APPROXIMATELY 12:12 UNLESS OTHERWISE INDICATED.
- 5 SEE ROOF PLAN, SHEET A-101, FOR ALL SELECTIVE DEMOLITION WORK.

**GENERAL DETAIL NOTES:** 


# TYPICAL FLASHING AROUND CHIMNEYS or SIM. VERTICAL WALLS SCALE: NTS

WITH HEMMED EDGE

(B) APRON FLASHING AT MASONRY CHIMNEY

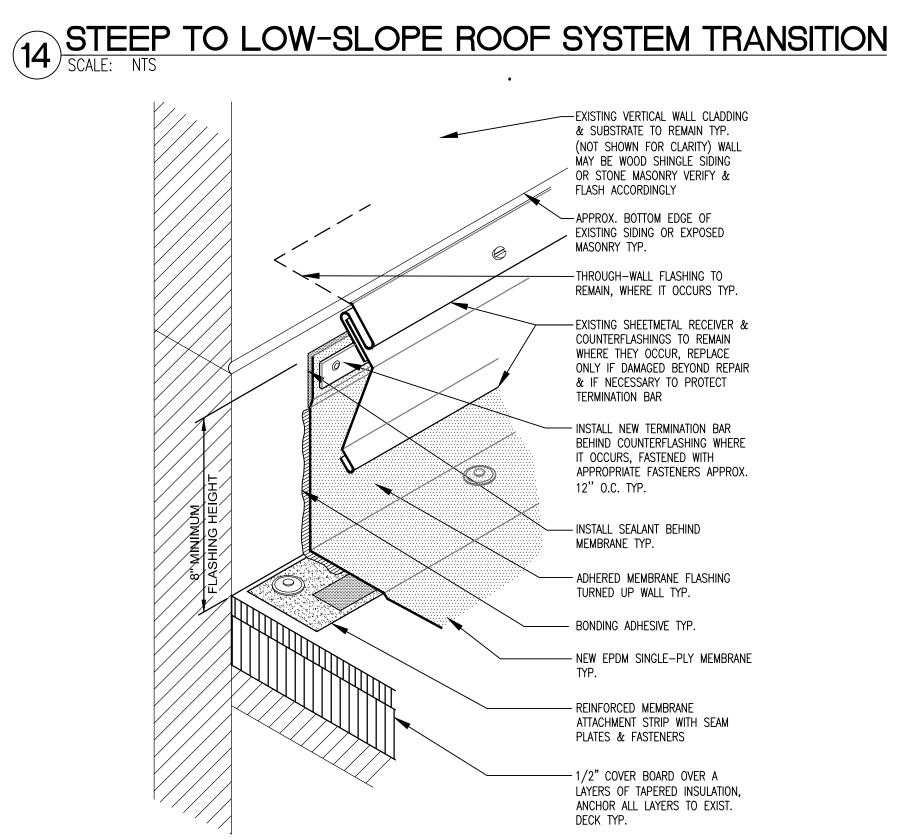

TYPICAL SINGLE-PLY ROOF @ VERT. WALLS
SCALE: NTS

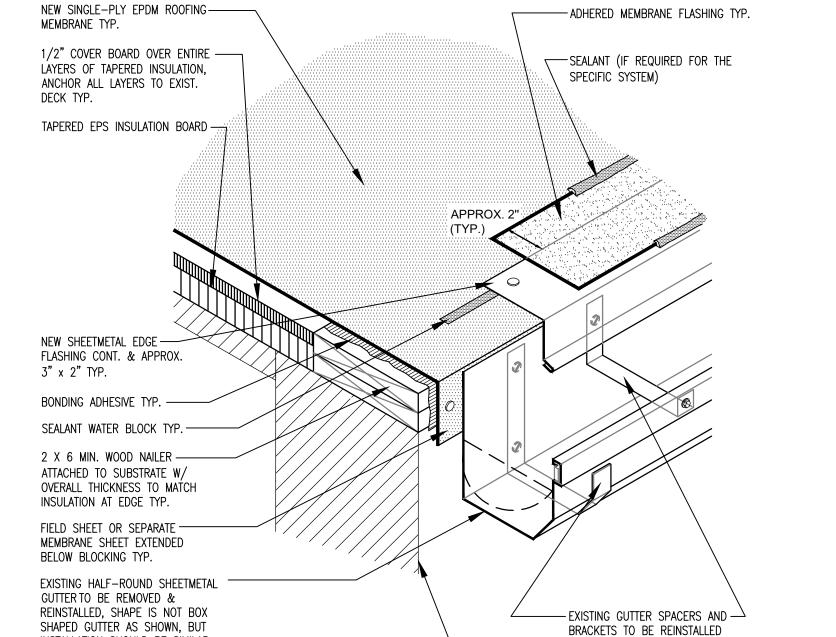

TYPICAL SINGLE-PLY ROOF EDGE @ GUTTER
SCALE: NTS

- EXISTING FASCIA, NO CHANGE

INSTALLATION SHOULD BE SIMILAR.

FRONT OF THE GUTTER SHOULD BE

A MIN. 1" LOWER THAN THE BACK

TO ALLOW OVERFLOW.