
Campground Renovation and Upgrade Big Lake State Park Craig, Missouri

BIG LAKE STATE PARK 204 LAKE SHORE DRIVE CRAIG, MO 64437

SITE NUMBER: 5105 ASSET NUMBER: 7815105008

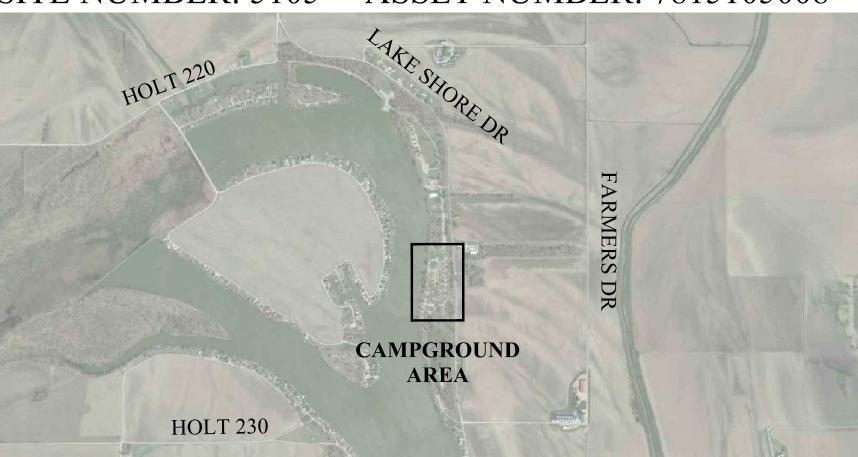

OWNER:

STATE OF MISSOURI MICHAEL L. PARSON,

GOVERNOR

DEPARTMENT OF NATURAL RESOURCES, MISSOURI STATE PARKS

PROJECT

OFFICE OF ADMINISTRATION MANAGEMENT: DIVISION OF FACILITIES

MANAGEMENT,

DESIGN AND CONSTRUCTION

PROJECT NUMBER: X2218-01



LANDSCAPE ARCHITECT:

VIREO

414 Oak Street, Suite 101 Kansas City, MO 64106

Phone: (816) 756-5690



CIVIL ENGINEER:

RENAISSANCE **INFRASTRUCTURE** CONSULTING 9653 Penrose Lane Lenexa, KS 66219

Phone: (913) 317-9500

LEIGH + O'KANE

Phone: (816) 444-3144

STRUCTURAL ENGINEER:

250 NE MULBERRY ST #201

LEE'S SUMMIT, MO 64086

ENGINEERS 1600 Genessee Street, Ste 260

Kansas City, Missouri 64102

intertek

GEOTECHNICAL ENGINEER:

INTERTEK-PSI

1211 W. Cambridge Circle Drive Kansas City, MO 64103 Phone: (913) 310-1600

MEP:

ANTELLA CONSULTING

Phone: (816) 421-0950

SHEET INDEX:

G-100 - COVER SHEET

L-100 - SITE PLAN

L-400 - ENLARGED SITE PLAN

L-401 - ENLARGED SITE PLAN

L-402 - ENLARGED SITE PLAN

L-403 - ENLARGED SITE PLAN L-500 - SITE DETAILS

L-501 - SITE DETAILS

L-502 - SITE DETAILS

C-001 - GENERAL NOTES

C-002 - EXISTING CONDITIONS

C-101 - DEMOLITION PLAN

C-102 - GENERAL LAYOUT

C-103 - PAVEMENT PLAN

C-104 - UTILITY PLAN

C-105 - WATER PLAN - NORTH

C-106 - WATER PLAN - SOUTH

C-201 - WATERLINE A - PLAN & PROFILE

C-202 - WATERLINE B - PLAN & PROFILE

C-203 - SANITARY LINE A PLAN & PROFILE

C-204 - SANITARY LINE B PLAN & PROFILE

C-501 - SANITARY STUBS & CALCS

C-502 - WATER DETAILS

C-503 - SANITARY DETAILS

C-504 - SANITARY DETAILS

C-505 - EROSION CONTROL DETAILS

C-601 - PHASE I OF CONSTRUCTION

C-602 - PHASE II OF CONSTRUCTION

C-603 - EROSION CONTROL PHASE I

C-604 - EROSION CONTROL PHASE II

C-605 - EROSION CONTROL PHASE III

S-001 - GENERAL NOTES

S-100 - PLANS

S-200 - ELEVATIONS

S-300 - FOUNDATION SECTIONS

S-301 - FRAMING SECTIONS

E-001 - ELECTRICAL SYMBOLS AND GENERAL NOTES

E-101 - ELECTRICAL SITE PLAN DEMOLITION


E-201 - ELECTRICAL SITE PLAN


E-501 - ELECTRICAL DETAILS

E-801 - ELECTRICAL RISER AND SCHEDULES

SHEET NUMBER:

1 of 41 SHEETS APRIL 7, 2023

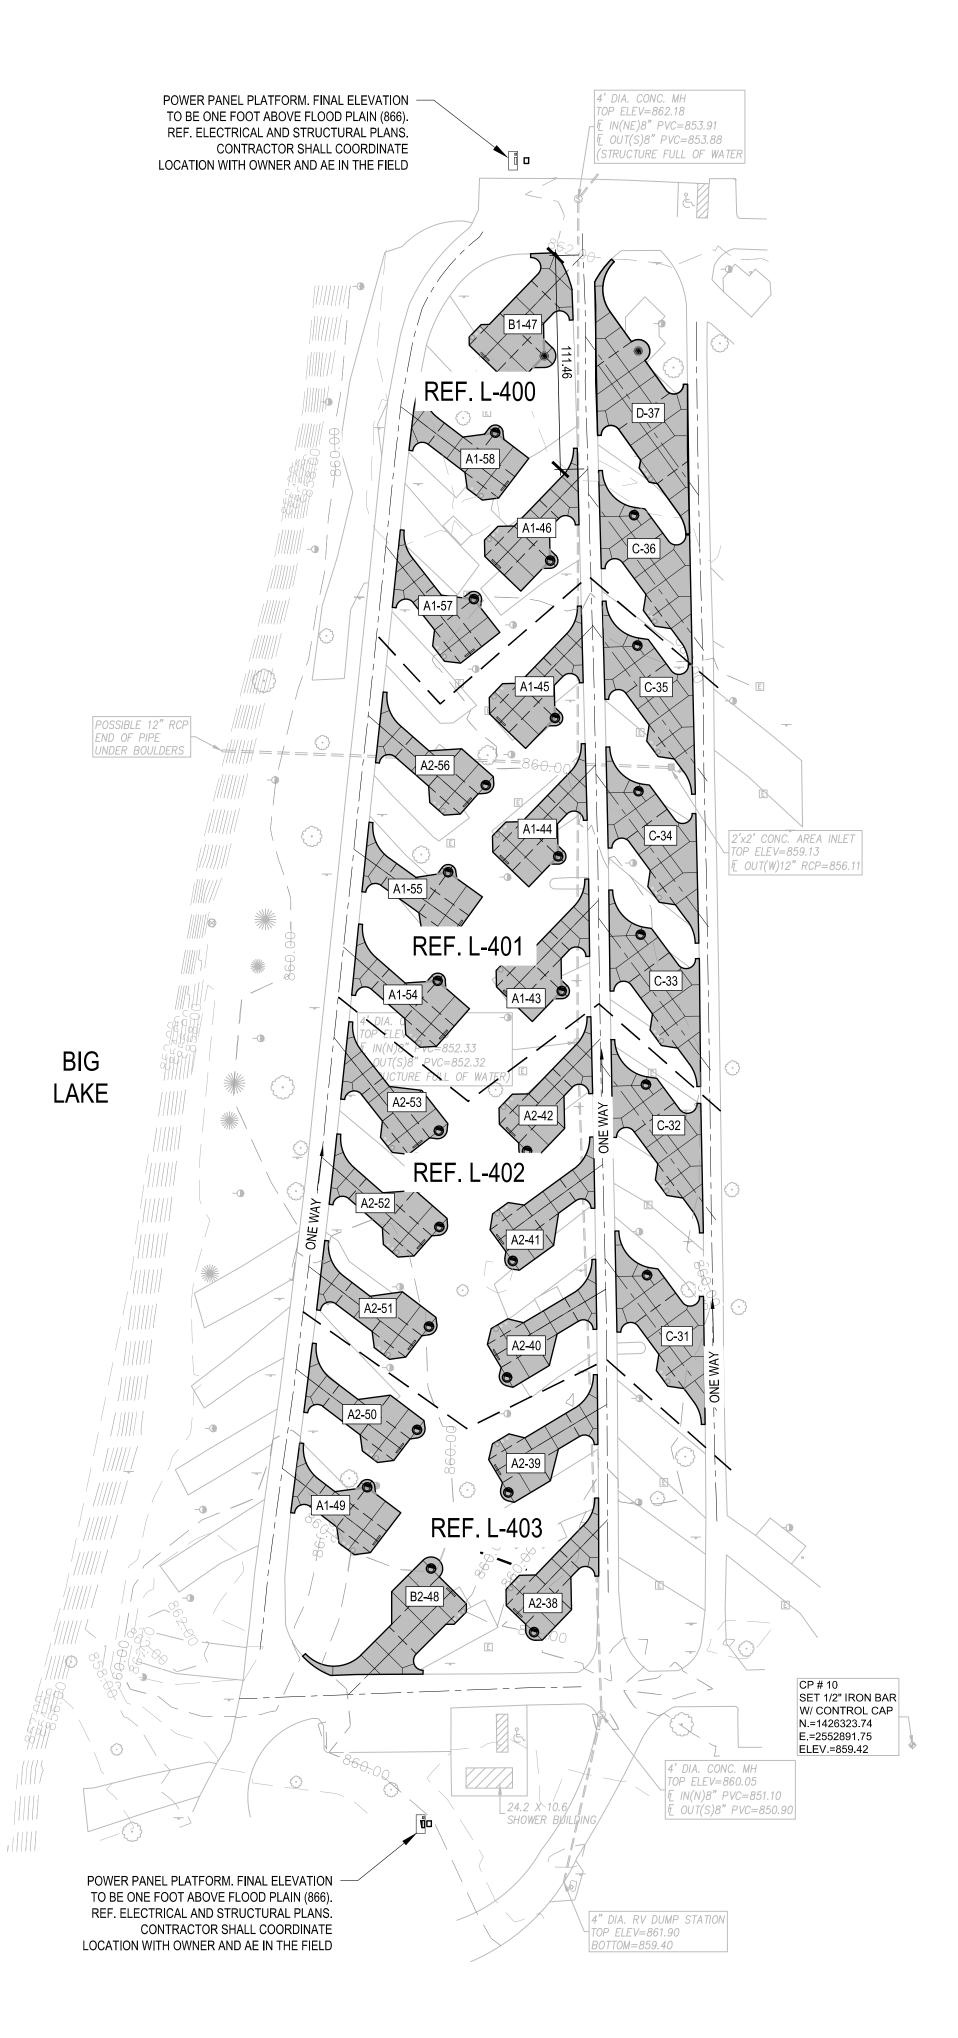

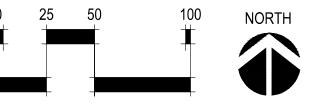

SITE LEGEND



PIP CONCRETE REF DETAIL 01/L-502 AND SPEC SECTION 321313



TYP. CENTERLINE OF EXISTING ROAD AND PROPOSED STALL ALIGNMENT

TYP. CONTROL JOINT. REF. SPEC



SECTION 321313

TYP. EXPANSION JOINT. REF. SPEC

SECTION 321313



A1-# 01 / L-500 STALL STYLE A1- BACK IN STANDARD

A2-# 02 / L-500 STALL STYLE A2- BACK IN STANDARD

B1-# 03 / L-500 ■ STALL STYLE B1- BACK-IN ADA STANDARD

B2-# 04 / L-500 ■ STALL STYLE B2- BACK IN STANDARD

C-# 01 / L-501 STALL STYLE C - STANDARD PULL-THROUGH

D-# 02 / L-501 STALL STYLE D - ADA PULL-THROUGH

STATE OF MISSOURI MICHAEL L. PARSON, GOVERNOR





LAC# MO-2002023826 929 Walnut Street, Ste. 700 Kansas City, Missouri 64106 P 816-756-5690

P 913-317-9500

P 913-310-1600

SURVEYOR & CIVIL ENGINEER:
RENAISSANCE INFRASTRUCTURE
CONSULTING
8653 Penrose Lane
Lenexa, Kansas 66219



ANTELLA CONSULTING ENGINEERS

1600 Genessee Street, Ste 260

Kansas City, Missouri 64102

P 816-421-0950

GEOTECHNICAL:
INTERTEK-PSI
1211 W. Cambridge Circle Drive
Kansas City, Kansas 66103



OFFICE OF ADMINISTRATION DIVISION OF FACILITIES MANAGEMENT, DESIGN AND CONSTRUCTION

DEPARTMENT OF NATURAL RESOURCES, MISSOURI STATE PARKS

CAMPGROUND RENOVATION AND UPGRADE

BIG LAKE STATE PARK 204 LAKE SHORE DRIVE CRAIG, MO 64437

PROJECT # X2218-01 SITE # 5105 FACILITY # 7815105008

REVISION:
DATE:
REVISION:
DATE:
REVISION:
DATE:
REVISION:
DATE:
ISSUE DATE:4/7/2023

CAD DWG FILE:
DRAWN BY: MJH
CHECKED BY: CDP
DESIGNED BY: MJH / CDP


SHEET TITLE:

SITE PLAN


SHEET NUMBER:

L-100

SHEET 2 OF 41 APRIL 7, 2023

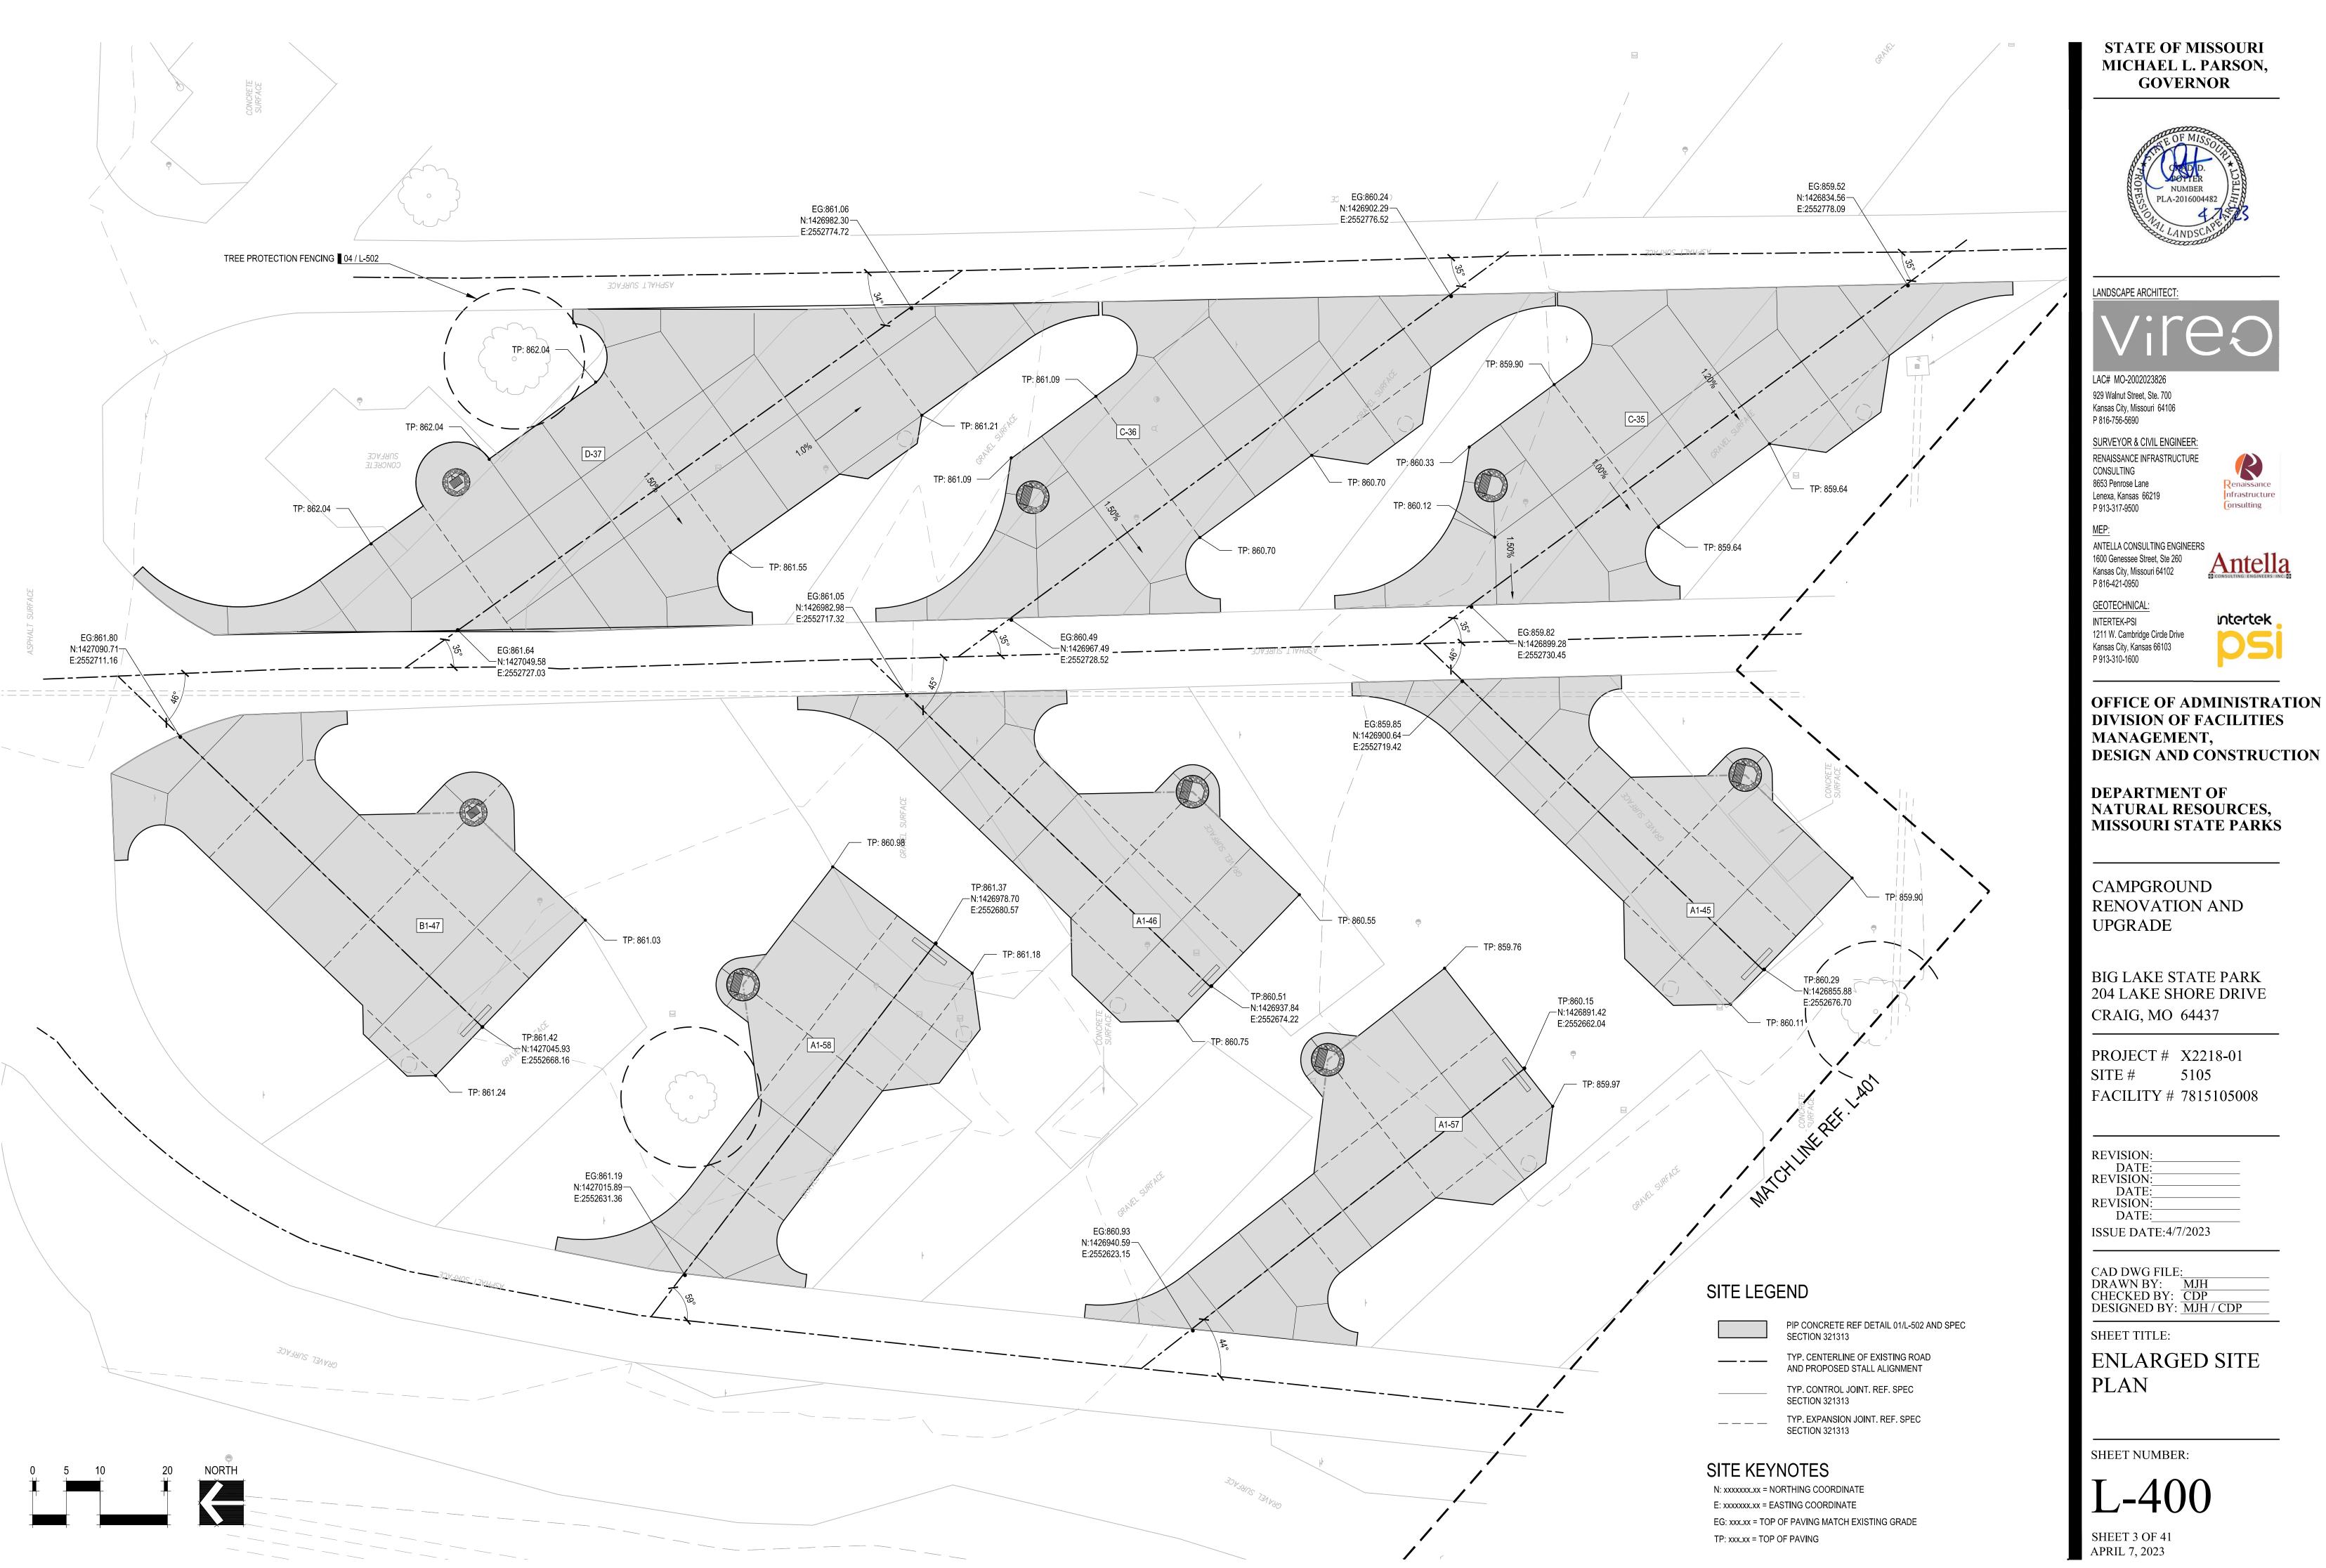

DESIGN AND CONSTRUCTION

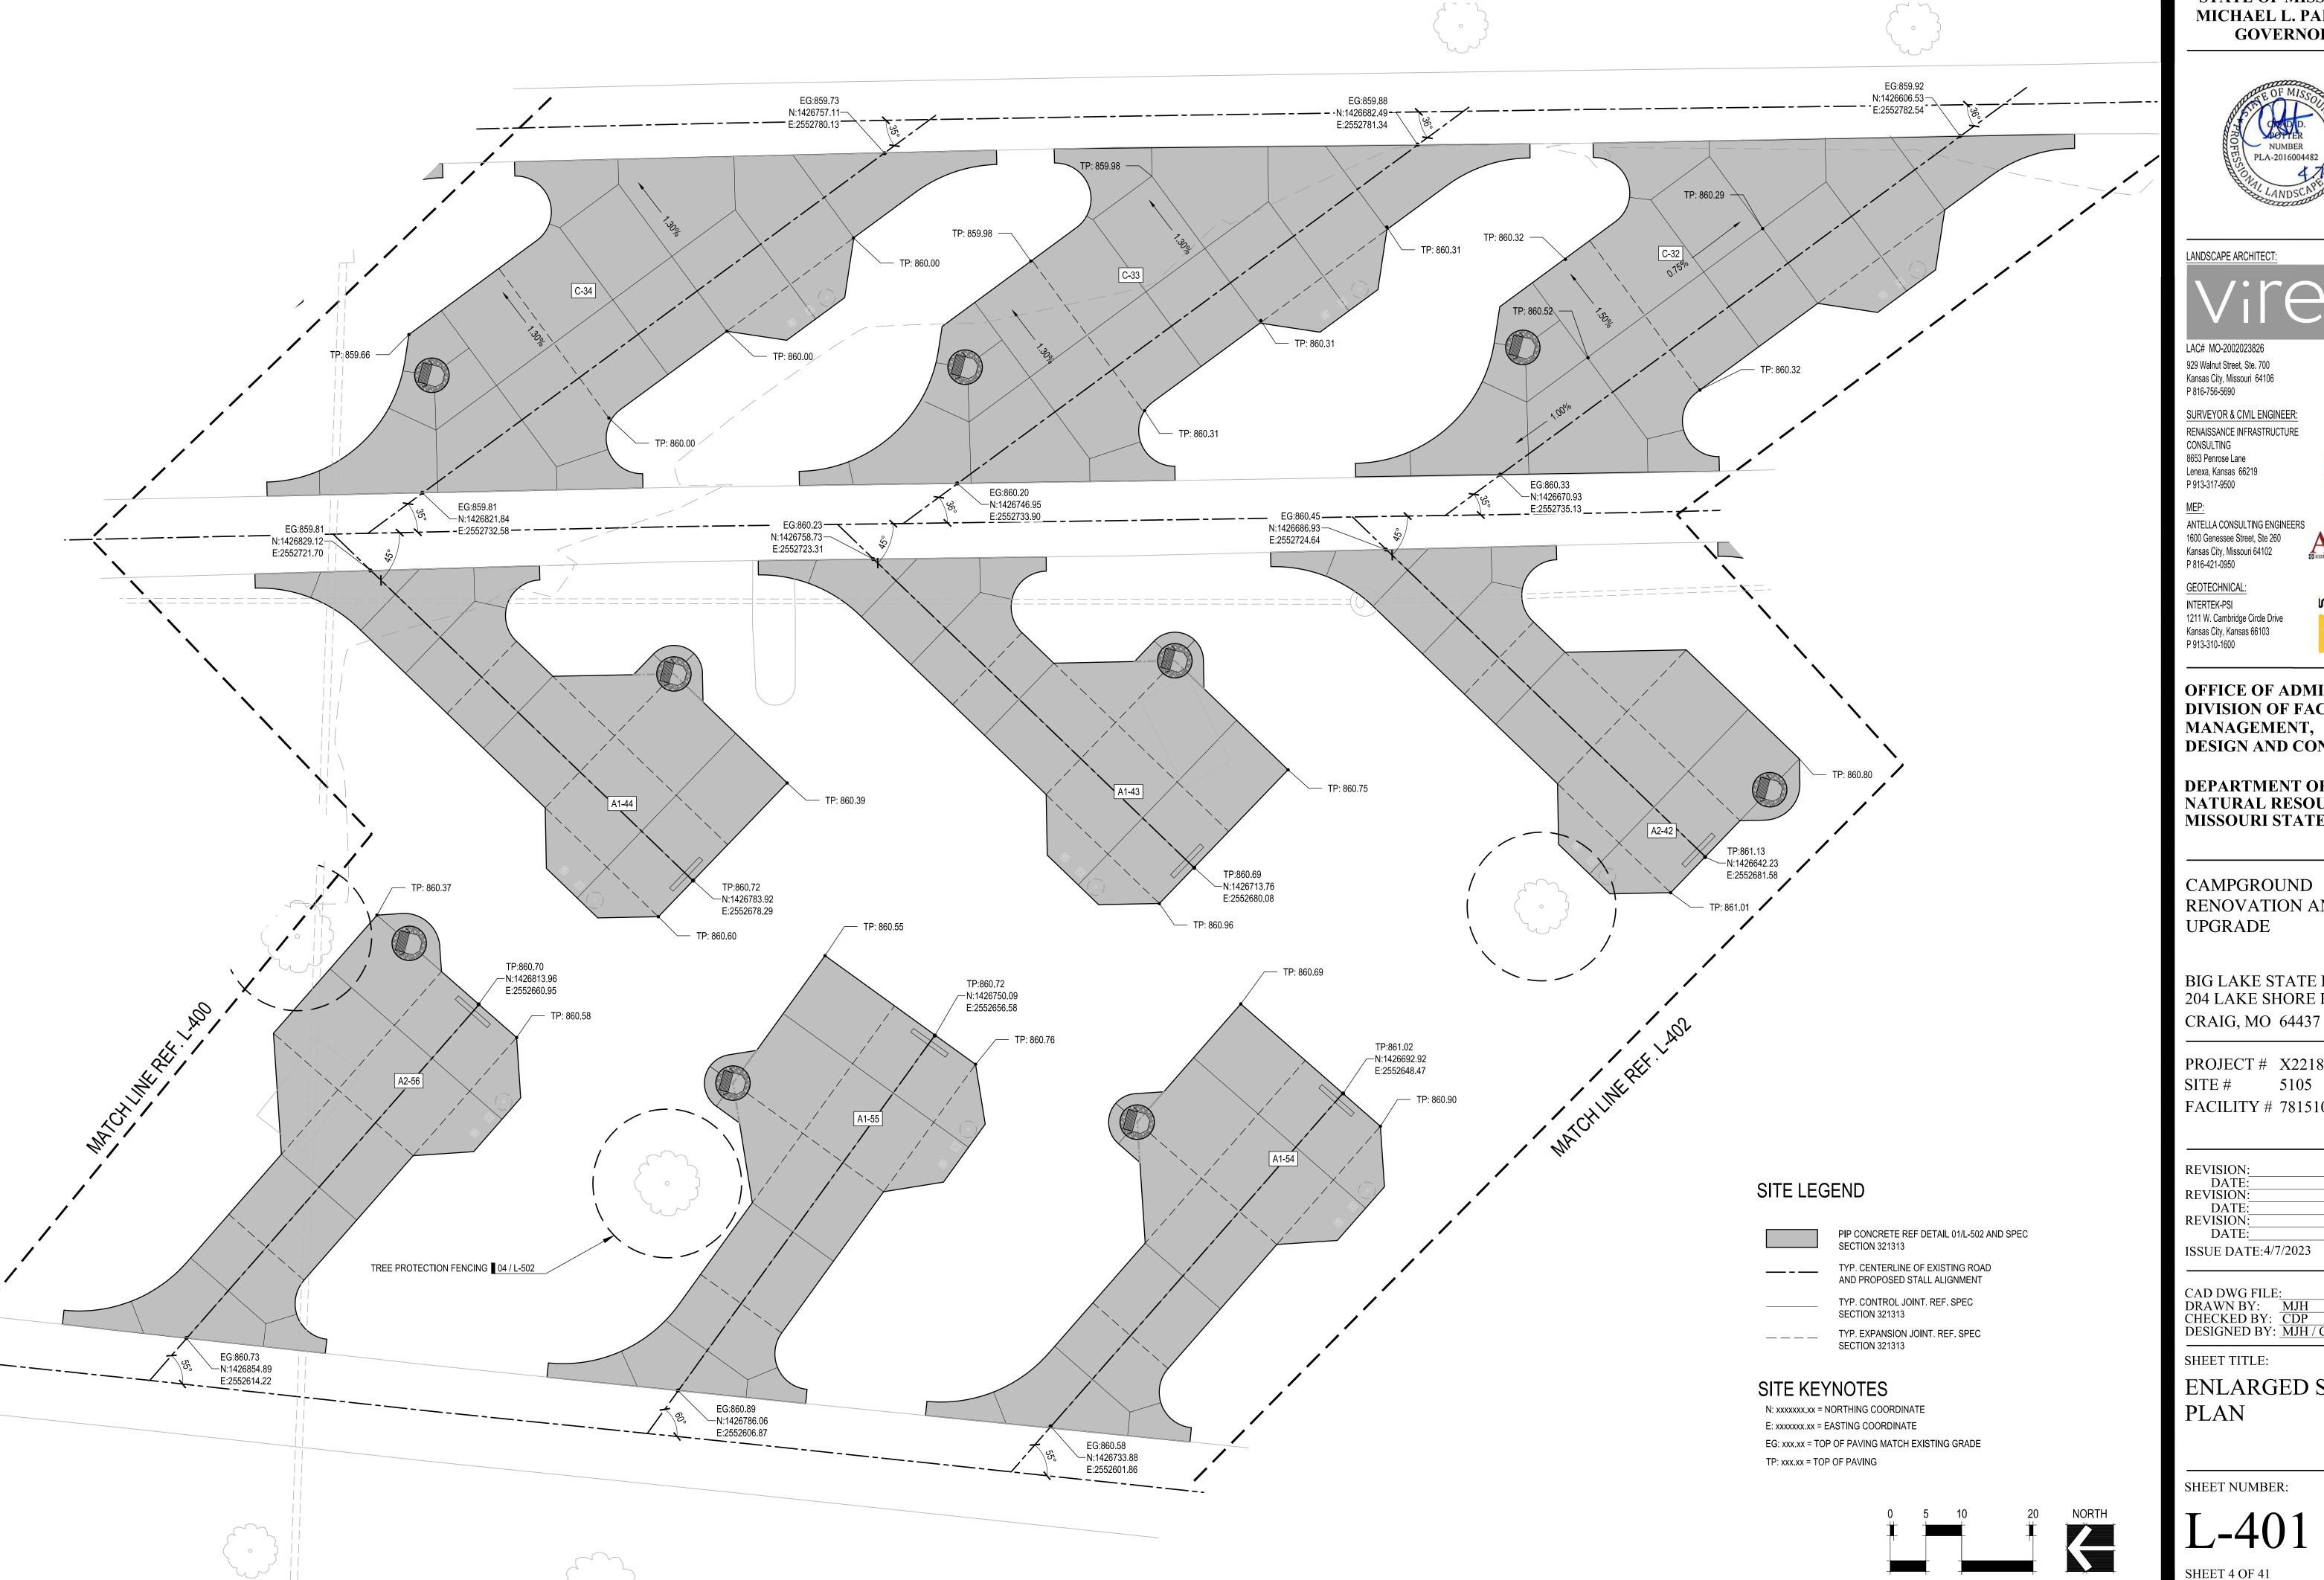



nfrastructure

OFFICE OF ADMINISTRATION DIVISION OF FACILITIES **DESIGN AND CONSTRUCTION**

DEPARTMENT OF NATURAL RESOURCES, MISSOURI STATE PARKS

RENOVATION AND

BIG LAKE STATE PARK 204 LAKE SHORE DRIVE

PROJECT # X2218-01 FACILITY # 7815105008

DESIGNED BY: MJH / CDP

ENLARGED SITE

SITE LEGEND


PIP CONCRETE REF DETAIL 01/L-502 AND SPEC **SECTION 321313** TYP. CENTERLINE OF EXISTING ROAD AND PROPOSED STALL ALIGNMENT TYP. CONTROL JOINT. REF. SPEC **SECTION 321313** TYP. EXPANSION JOINT. REF. SPEC

SECTION 321313

SITE KEYNOTES

N: xxxxxxx.xx = NORTHING COORDINATE E: xxxxxxx.xx = EASTING COORDINATE EG: xxx.xx = TOP OF PAVING MATCH EXISTING GRADE TP: xxx.xx = TOP OF PAVING

EG:860.47 N:1426684.52

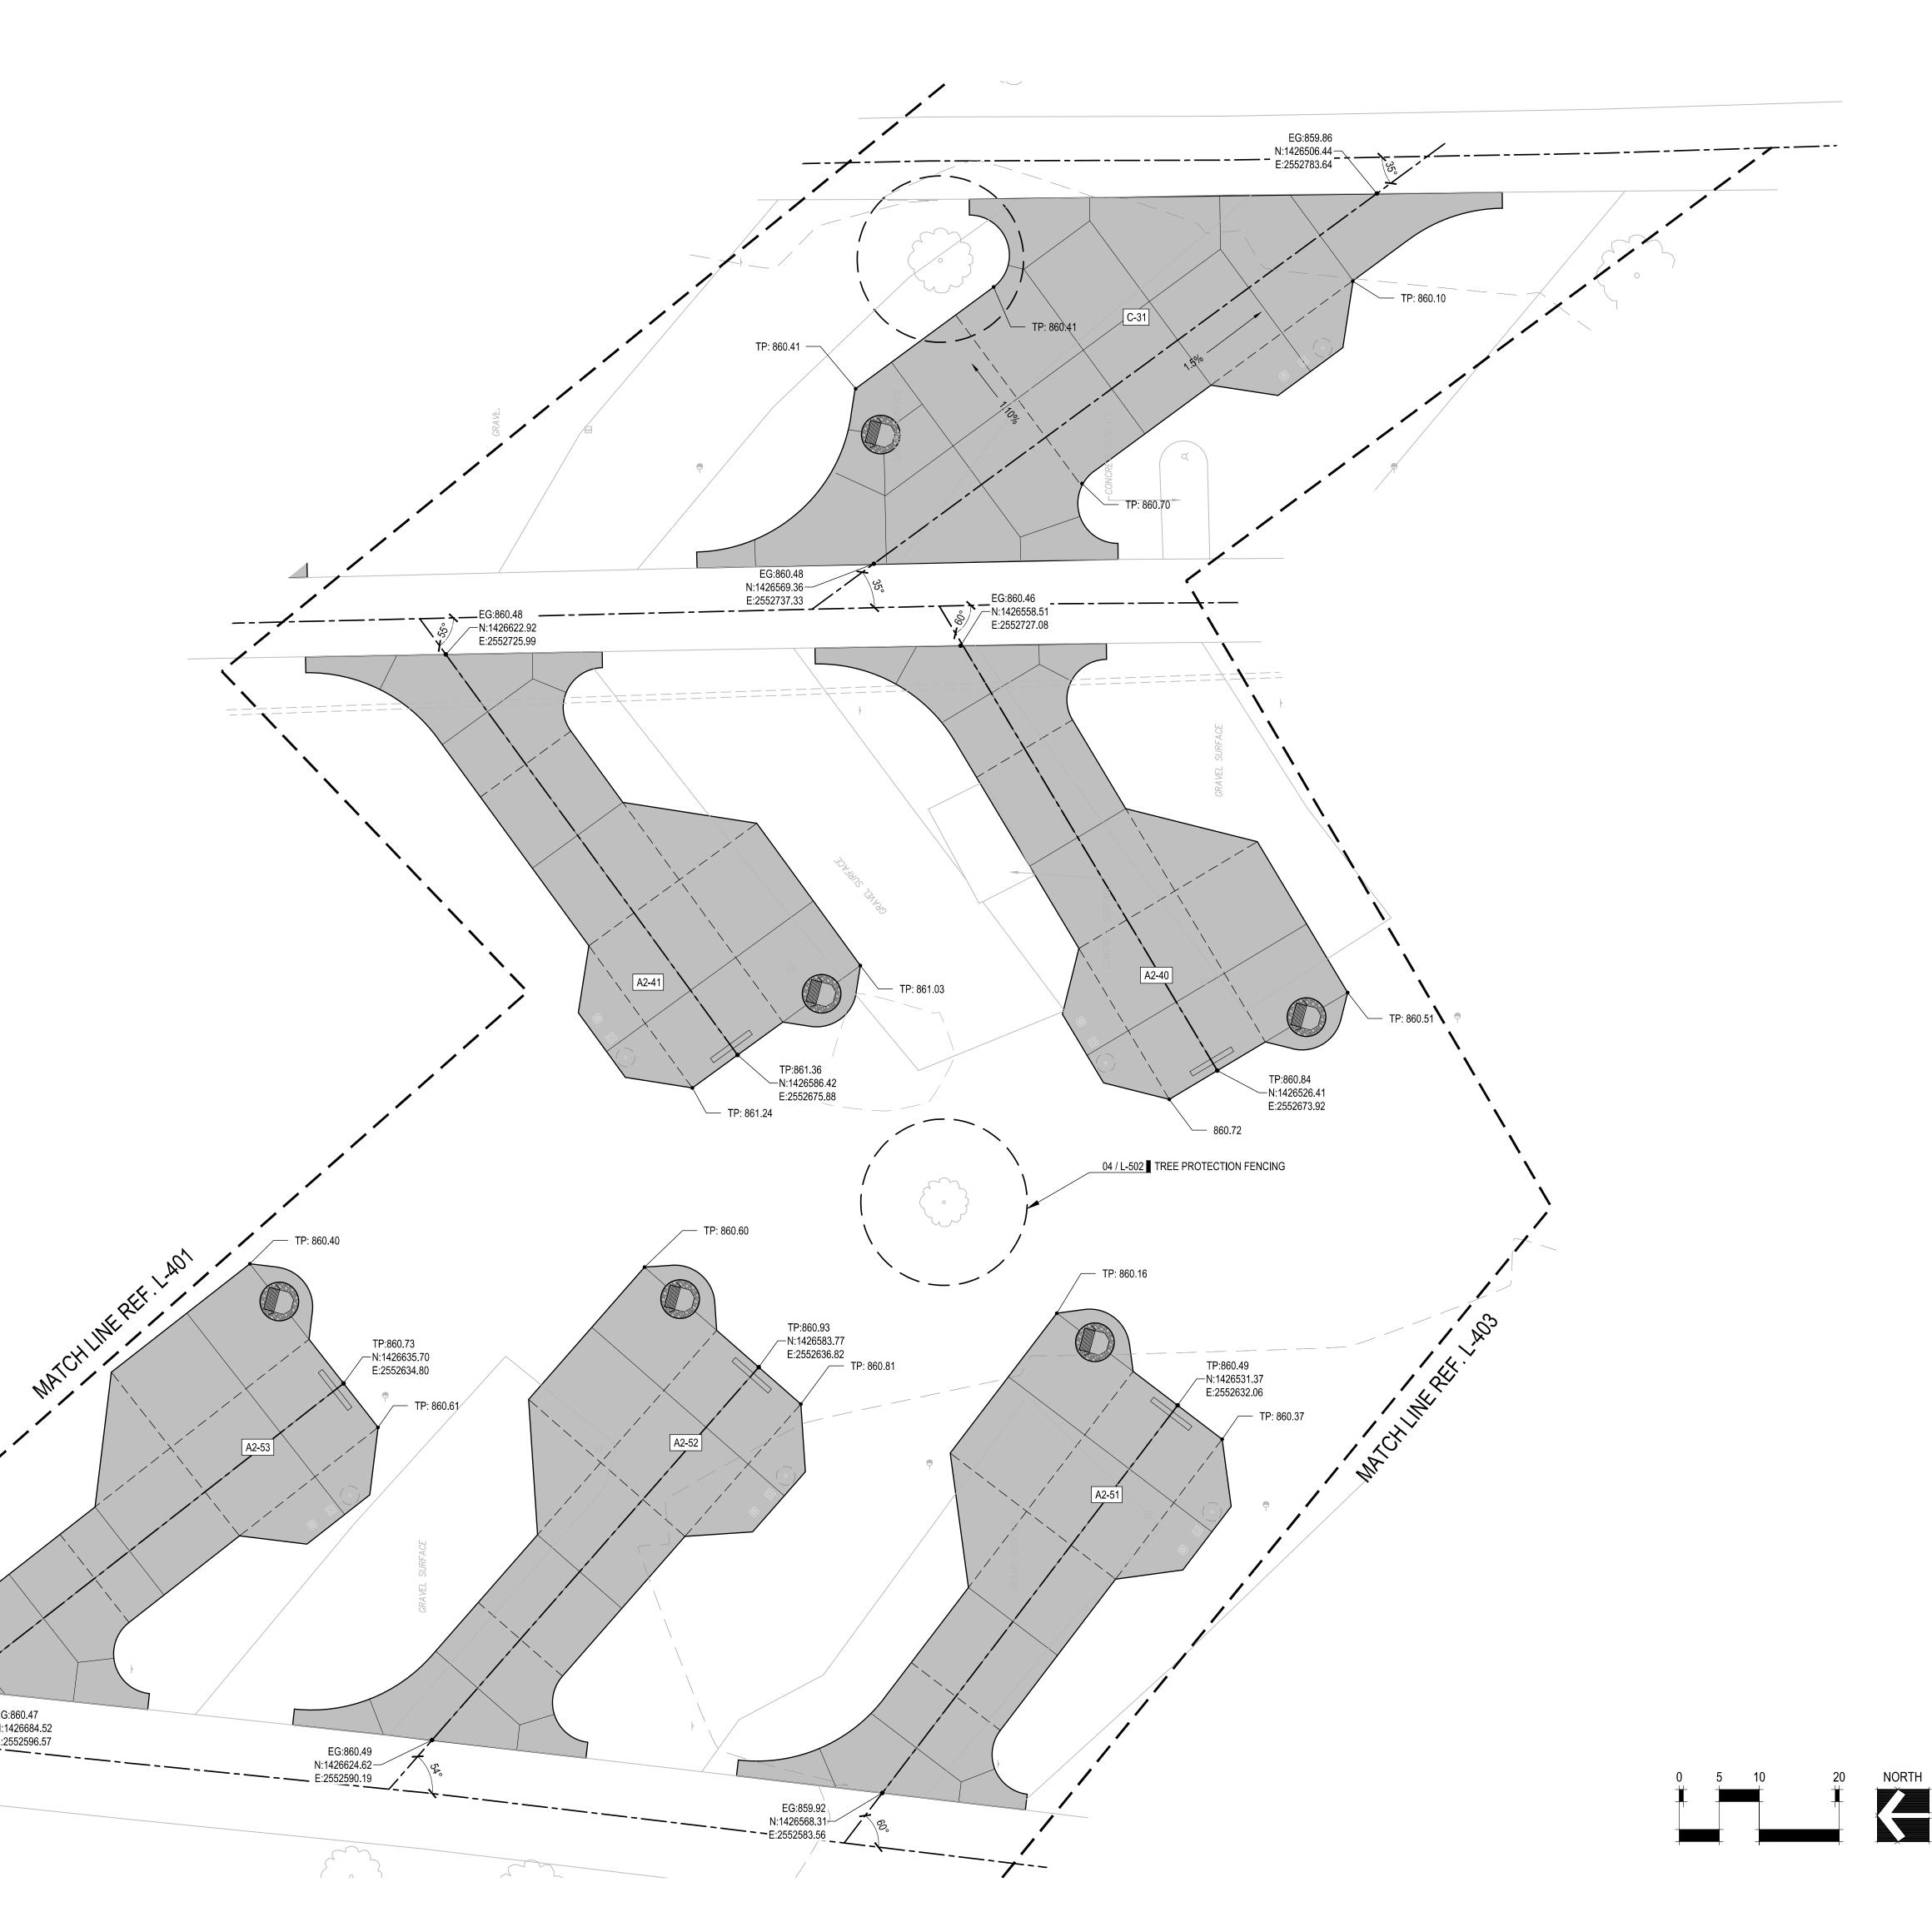

STATE OF MISSOURI MICHAEL L. PARSON, **GOVERNOR**



LANDSCAPE ARCHITECT:

LAC# MO-2002023826 929 Walnut Street, Ste. 700 Kansas City, Missouri 64106 P 816-756-5690

P 913-317-9500

SURVEYOR & CIVIL ENGINEER: RENAISSANCE INFRASTRUCTURE CONSULTING 8653 Penrose Lane Lenexa, Kansas 66219

nfrastructure

ANTELLA CONSULTING ENGINEERS 1600 Genessee Street, Ste 260 Kansas City, Missouri 64102 P 816-421-0950

GEOTECHNICAL: intertek

INTERTEK-PSI 1211 W. Cambridge Circle Drive Kansas City, Kansas 66103 P 913-310-1600

OFFICE OF ADMINISTRATION DIVISION OF FACILITIES MANAGEMENT,

DEPARTMENT OF NATURAL RESOURCES, MISSOURI STATE PARKS

DESIGN AND CONSTRUCTION

CAMPGROUND RENOVATION AND UPGRADE

BIG LAKE STATE PARK 204 LAKE SHORE DRIVE CRAIG, MO 64437

PROJECT # X2218-01 5105 SITE# FACILITY # 7815105008

REVISION: DATE: REVISION: DATE: REVISION: DATE: ISSUE DATE:4/7/2023

CAD DWG FILE:
DRAWN BY: MJH
CHECKED BY: CDP
DESIGNED BY: MJH / CDP

SHEET TITLE:

ENLARGED SITE PLAN

SHEET NUMBER:

SHEET 5 OF 41 APRIL 7, 2023

SITE LEGEND

PIP CONCRETE REF DETAIL 01/L-502 AND SPEC SECTION 321313

TYP. CENTERLINE OF EXISTING ROAD AND PROPOSED STALL ALIGNMENT


TYP. CONTROL JOINT. REF. SPEC


SECTION 321313

TYP. EXPANSION JOINT. REF. SPEC SECTION 321313

SITE KEYNOTES

N: xxxxxxx.xx = NORTHING COORDINATE
E: xxxxxxx.xx = EASTING COORDINATE
EG: xxx.xx = TOP OF PAVING MATCH EXISTING GRADE
TP: xxx.xx = TOP OF PAVING

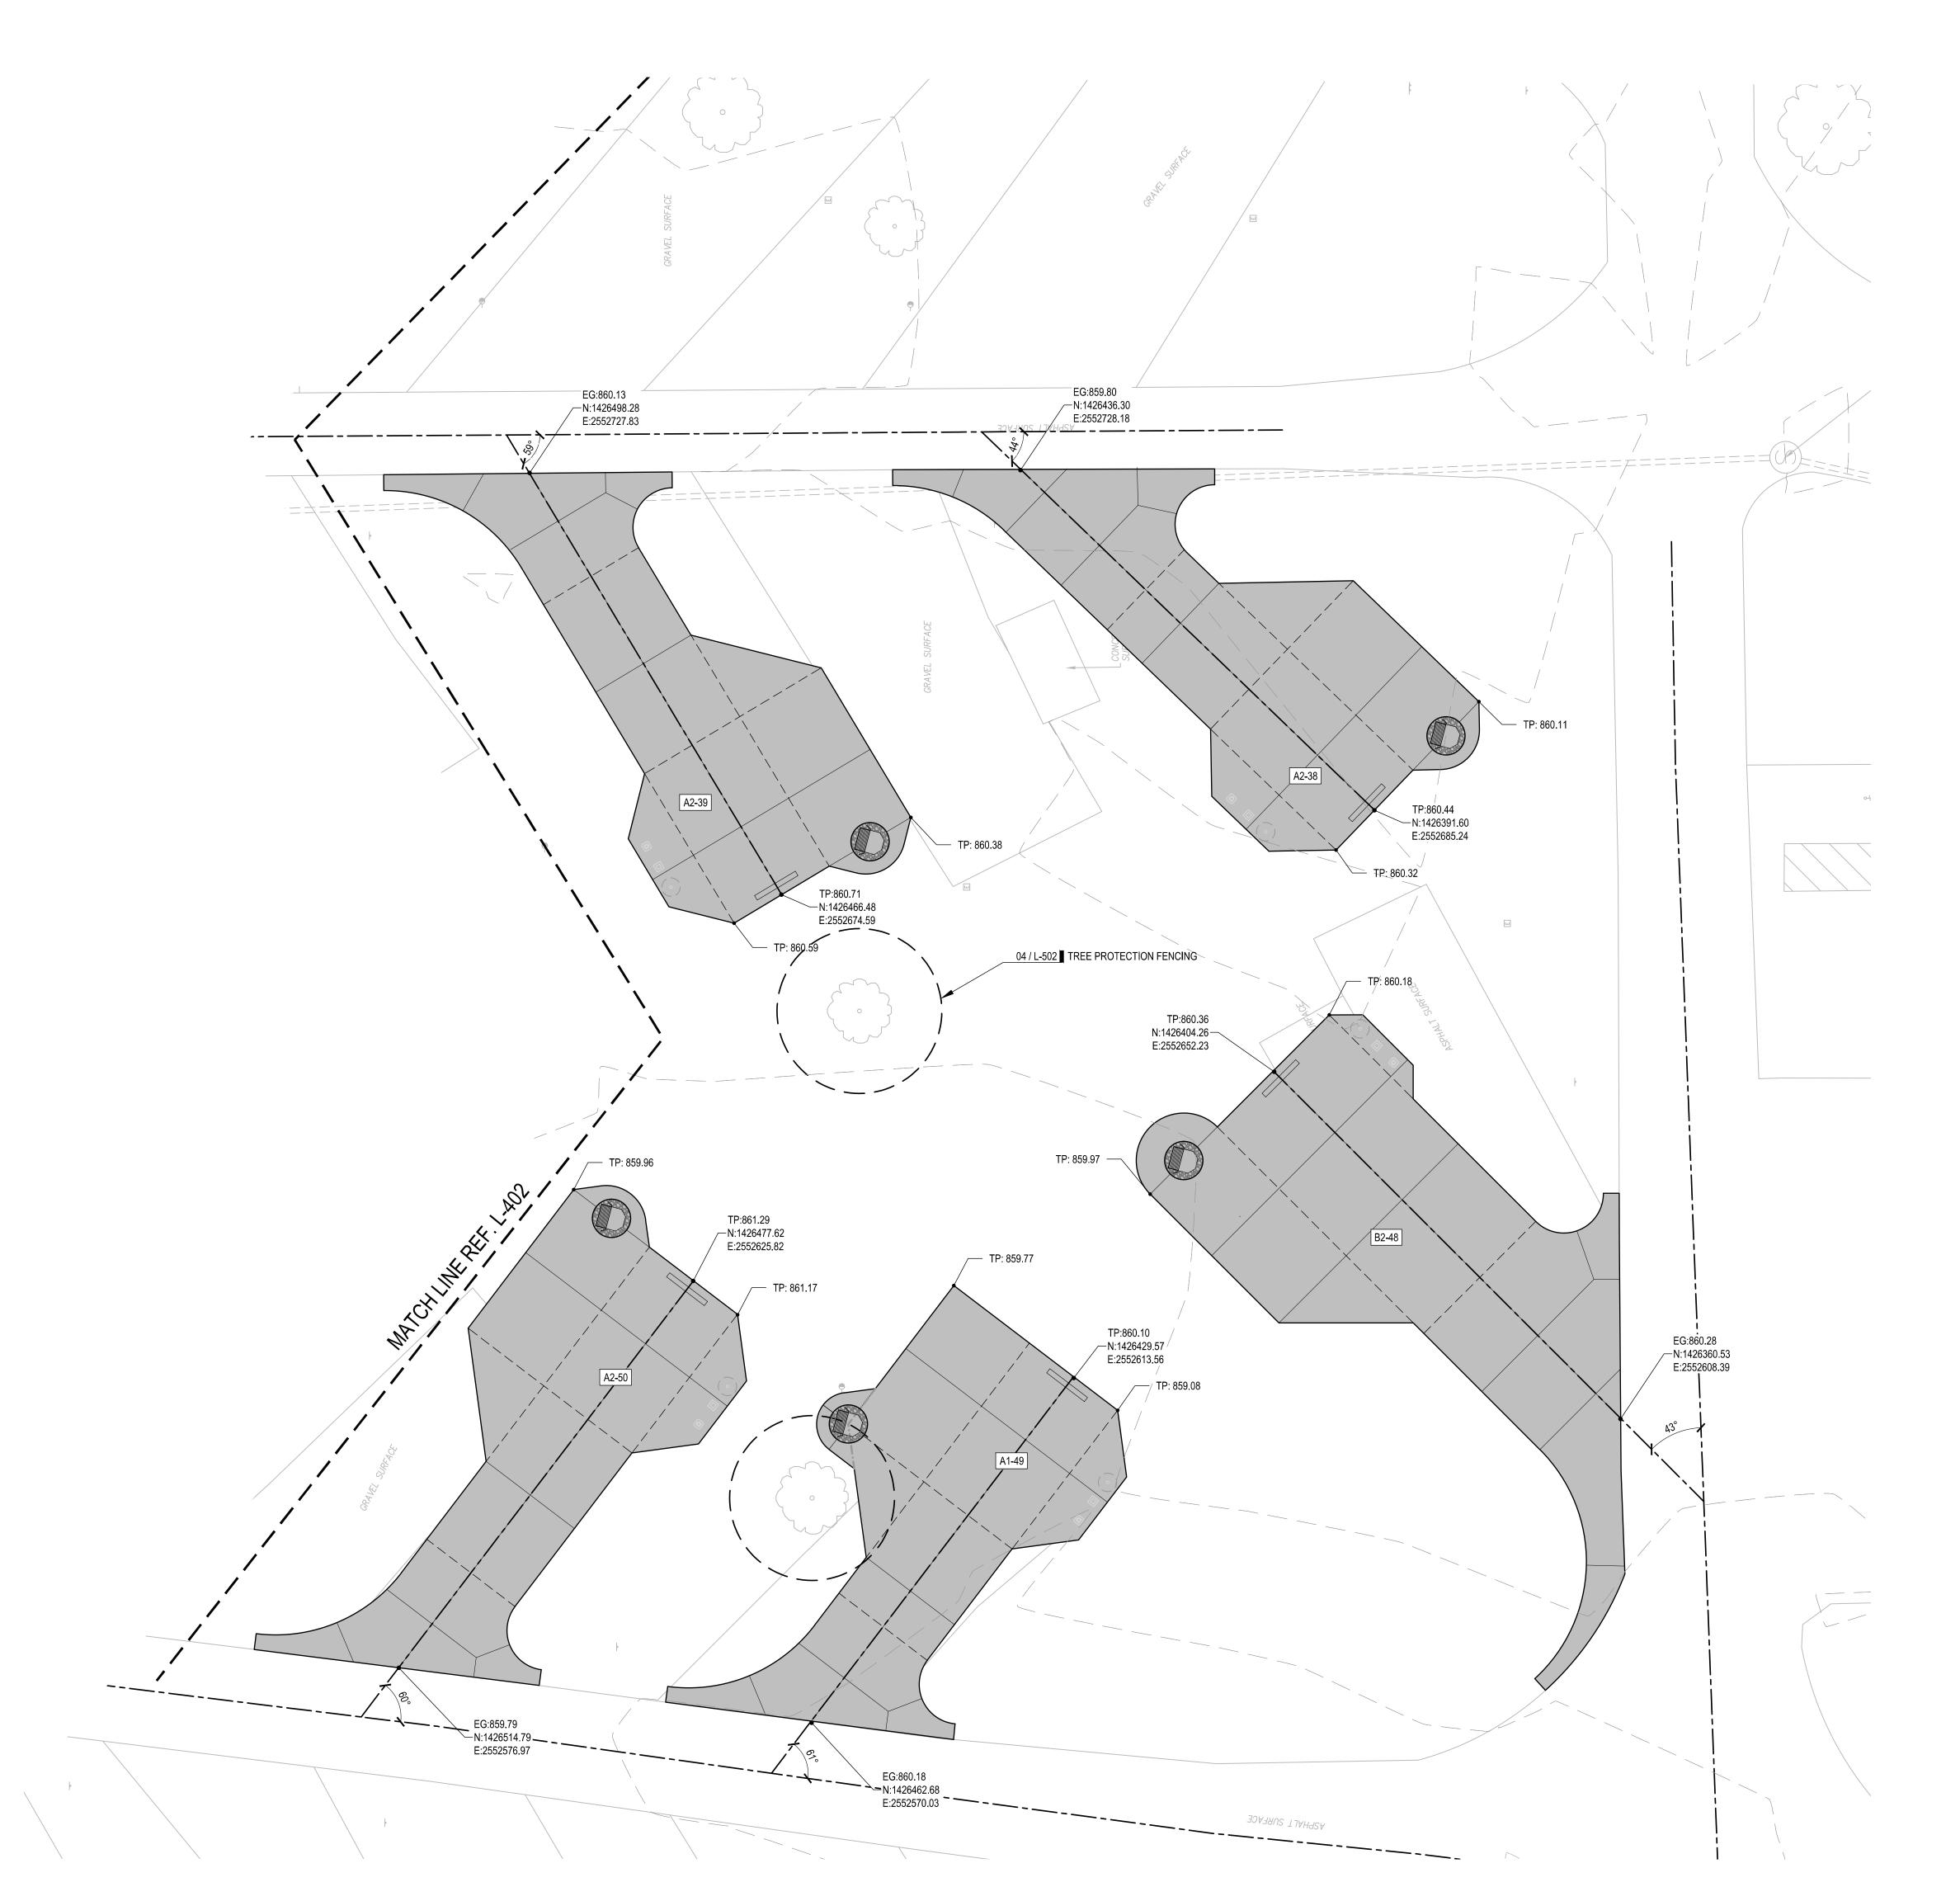

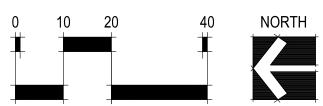

STATE OF MISSOURI MICHAEL L. PARSON, GOVERNOR



LANDSCAPE ARCHITECT:

LAC# MO-2002023826 929 Walnut Street, Ste. 700 Kansas City, Missouri 64106 P 816-756-5690

Lenexa, Kansas 66219

Kansas City, Kansas 66103

P 913-310-1600

P 913-317-9500

SURVEYOR & CIVIL ENGINEER:
RENAISSANCE INFRASTRUCTURE
CONSULTING
8653 Penrose Lane



MEP:
ANTELLA CONSULTING ENGINEERS
1600 Genessee Street, Ste 260
Kansas City, Missouri 64102

P 816-421-0950

GEOTECHNICAL:
INTERTEK-PSI
1211 W. Cambridge Circle Drive

intertek | DS

OFFICE OF ADMINISTRATION DIVISION OF FACILITIES MANAGEMENT, DESIGN AND CONSTRUCTION

DEPARTMENT OF NATURAL RESOURCES, MISSOURI STATE PARKS

CAMPGROUND RENOVATION AND UPGRADE

BIG LAKE STATE PARK 204 LAKE SHORE DRIVE CRAIG, MO 64437

PROJECT # X2218-01 SITE # 5105 FACILITY # 7815105008

REVISION:
DATE:
REVISION:
DATE:
REVISION:
DATE:
REVISION:
DATE:
ISSUE DATE:4/7/2023

CAD DWG FILE:
DRAWN BY: MJH
CHECKED BY: CDP
DESIGNED BY: MJH / CDP


SHEET TITLE:


ENLARGED SITE PLAN

SHEET NUMBER:

L-403

SHEET 6 OF 41 APRIL 7, 2023

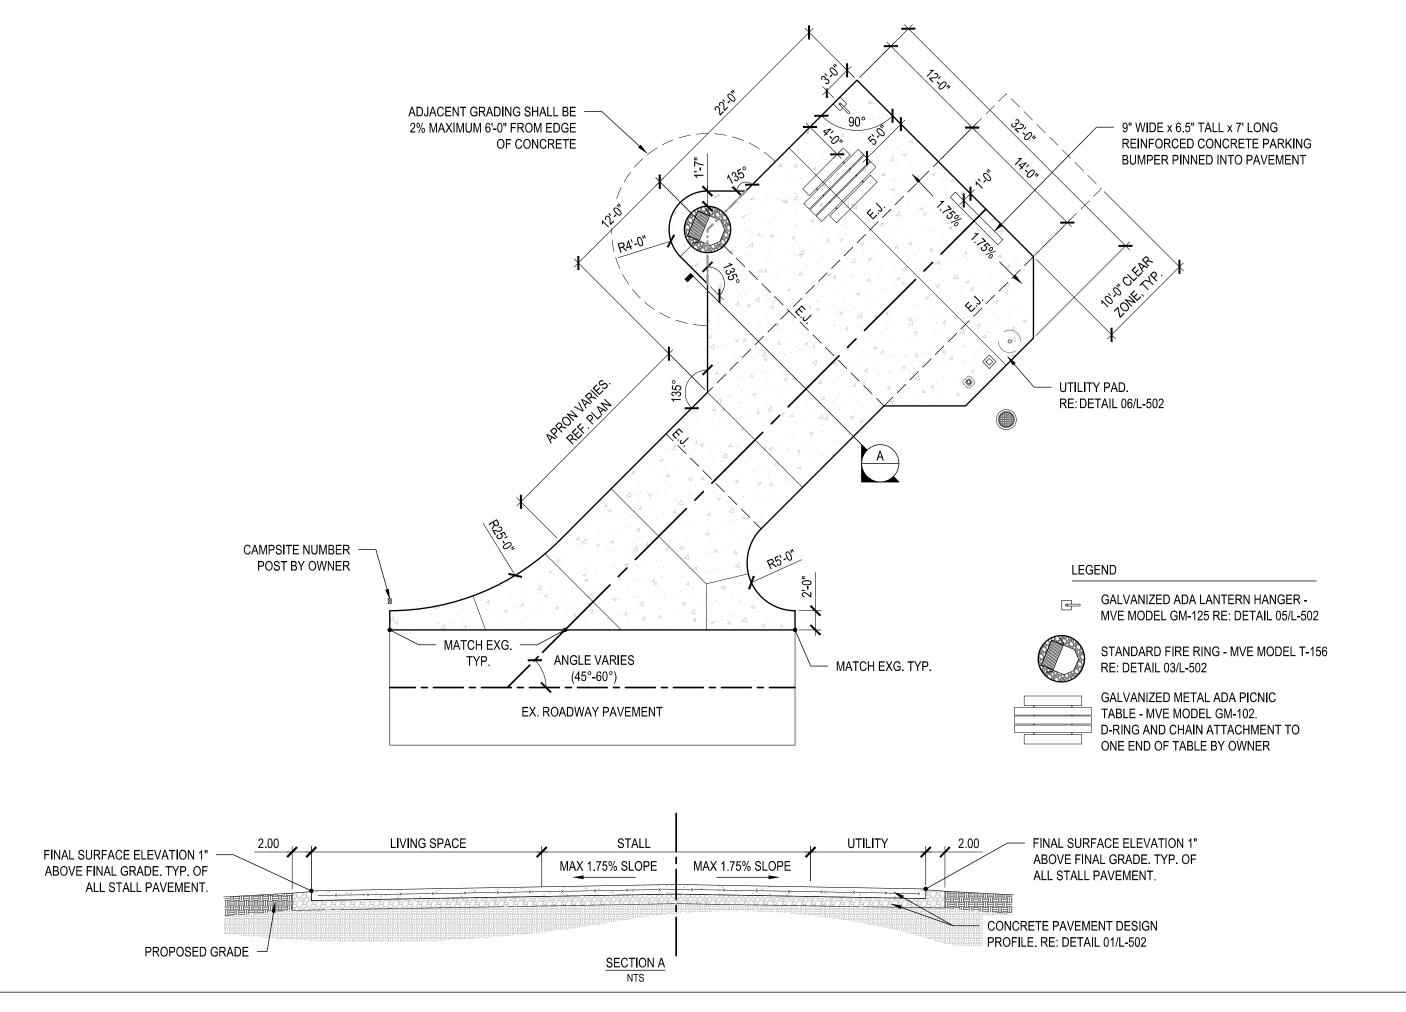

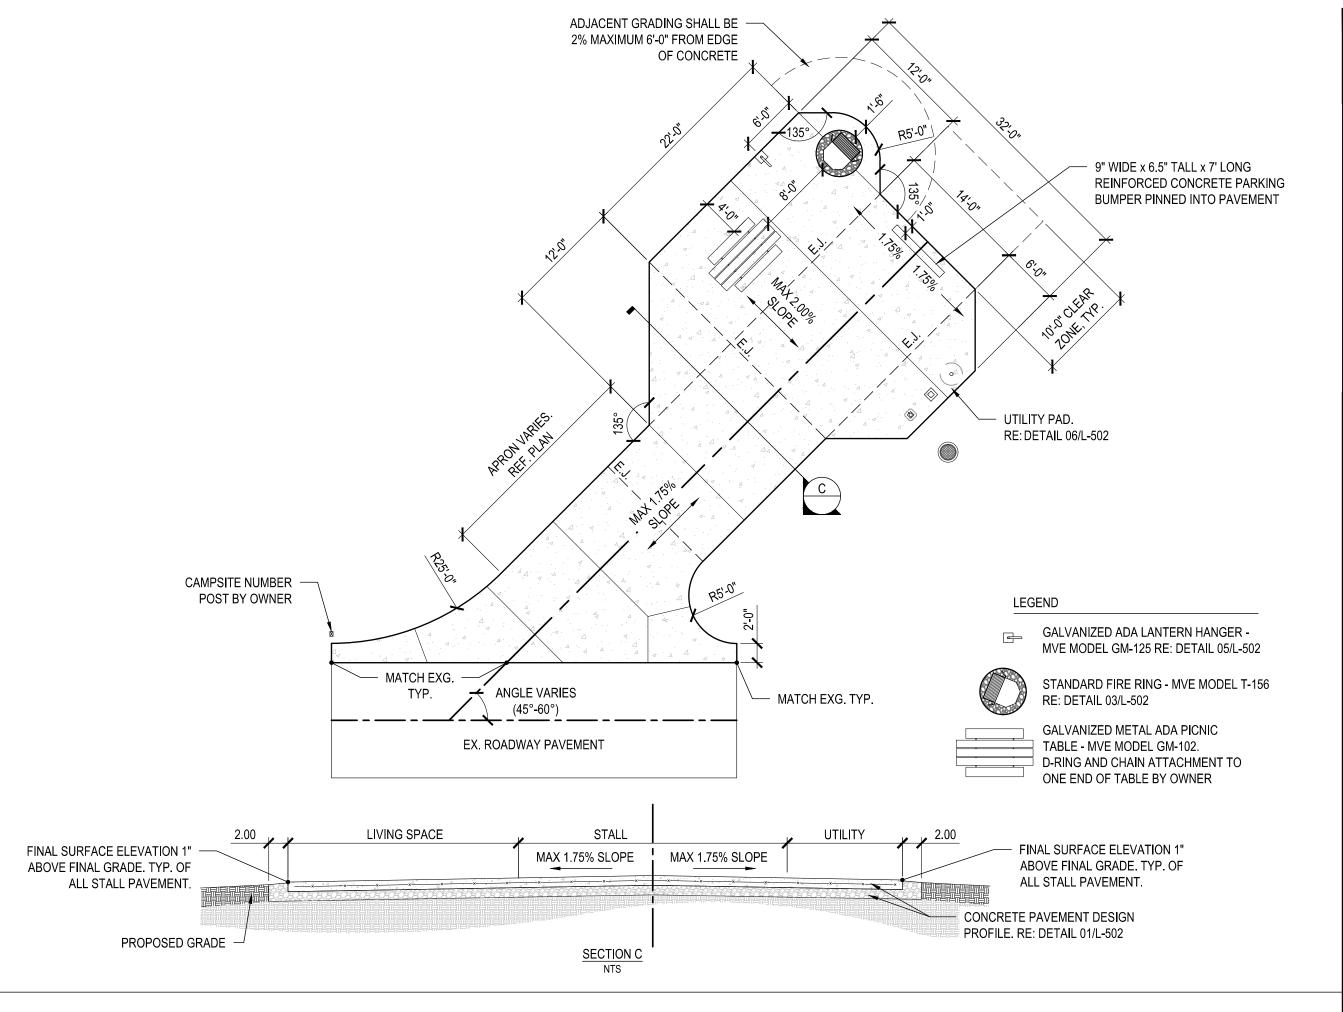

STALL STYLE A2- BACK IN STANDARD 02 ADJACENT GRADING SHALL BE — 2% MAXIMUM 6'-0" FROM EDGE OF CONCRETE 9" WIDE x 6.5" TALL x 7' LONG REINFORCED CONCRETE PARKING BUMPER PINNED INTO PAVEMENT UTILITY PAD. RE: DETAIL 07/L-502 LEGEND CAMPSITE NUMBER GALVANIZED ADA LANTERN HANGER -POST BY OWNER MVE MODEL GM-125 RE: DETAIL 05/L-502 ADA FIRE RING - MVE MODEL T-156 RE: DETAIL 03/L-502 - MATCH EXG. ANGLE VARIES GALVANIZED METAL ADA PICNIC MATCH EXG. TYP. TABLE - MVE MODEL GM-102. (45°-60°) D-RING AND CHAIN ATTACHMENT TO ONE END OF TABLE BY OWNER EX. ROADWAY PAVEMENT STALL LIVING SPACE MAX 1.75% SLOPE FINAL SURFACE ELEVATION 1" MAX 1.75% SLOPE FINAL SURFACE ELEVATION 1" ABOVE FINAL GRADE. TYP. OF ABOVE FINAL GRADE. TYP. OF ALL STALL PAVEMENT ALL STALL PAVEMENT.

SECTION D

PROPOSED GRADE

STALL STYLE A1- BACK IN STANDARD NT.S. 01

ADJACENT GRADING SHALL BE 2% MAXIMUM 6'-0" FROM EDGE OF CONCRETE 9" WIDE x 6.5" TALL x 7' LONG REINFORCED CONCRETE PARKING BUMPER PINNED INTO PAVEMENT UTILITY PAD. RE: DETAIL 07/L-502 CAMPSITE NUMBER GALVANIZED ADA LANTERN HANGER -POST BY OWNER MVE MODEL GM-125 RE: DETAIL 05/L-502 ADA FIRE RING - MVE MODEL T-156 RE: DETAIL 03/L-502 MATCH EXG. GALVANIZED METAL ADA PICNIC ANGLE VARIES MATCH EXG. TYP. TABLE - MVE MODEL GM-102. (45°-60°) D-RING AND CHAIN ATTACHMENT TO ONE END OF TABLE BY OWNER EX. ROADWAY PAVEMENT LIVING SPACE FINAL SURFACE ELEVATION 1" ABOVE FINAL GRADE. TYP. OF FINAL SURFACE ELEVATION 1" MAX 1.75% SLOPE ! MAX 1.75% SLOPE ABOVE FINAL GRADE. TYP. OF ALL STALL PAVEMENT. ALL STALL PAVEMENT. CONCRETE PAVEMENT DESIGN SECTION B NTS PROFILE. RE: DETAIL 01/L-502 PROPOSED GRADE -

STALL STYLE B1- BACK-IN ADA STANDARD NT.S. 03

STALL STYLE B2- BACK IN STANDARD N.T.S. 04 SHEET 7 OF 41 APRIL 7, 2023

CONCRETE PAVEMENT DESIGN

PROFILE. RE: DETAIL 01/L-502

STATE OF MISSOURI MICHAEL L. PARSON, **GOVERNOR**



LANDSCAPE ARCHITECT:

929 Walnut Street, Ste. 700 Kansas City, Missouri 64106 P 816-756-5690

Lenexa, Kansas 66219

P 913-317-9500

P 913-310-1600

SURVEYOR & CIVIL ENGINEER: RENAISSANCE INFRASTRUCTURE CONSULTING 8653 Penrose Lane

nfrastructure

ANTELLA CONSULTING ENGINEERS 1600 Genessee Street, Ste 260 Kansas City, Missouri 64102

P 816-421-0950 GEOTECHNICAL: INTERTEK-PSI 1211 W. Cambridge Circle Drive Kansas City, Kansas 66103

OFFICE OF ADMINISTRATION DIVISION OF FACILITIES MANAGEMENT, **DESIGN AND CONSTRUCTION**

DEPARTMENT OF NATURAL RESOURCES, MISSOURI STATE PARKS

CAMPGROUND RENOVATION AND **UPGRADE**

BIG LAKE STATE PARK 204 LAKE SHORE DRIVE CRAIG, MO 64437

PROJECT # X2218-01 5105 FACILITY # 7815105008

REVISION: DATE: **REVISION:** DATE: REVISION: DATE: ISSUE DATE:4/7/2023


CAD DWG FILE: DRAWN BY: MJ CHECKED BY: $\overline{\text{CDP}}$ DESIGNED BY: MJH / CDP


SHEET TITLE:

SITE DETAILS

SHEET NUMBER:

L-500

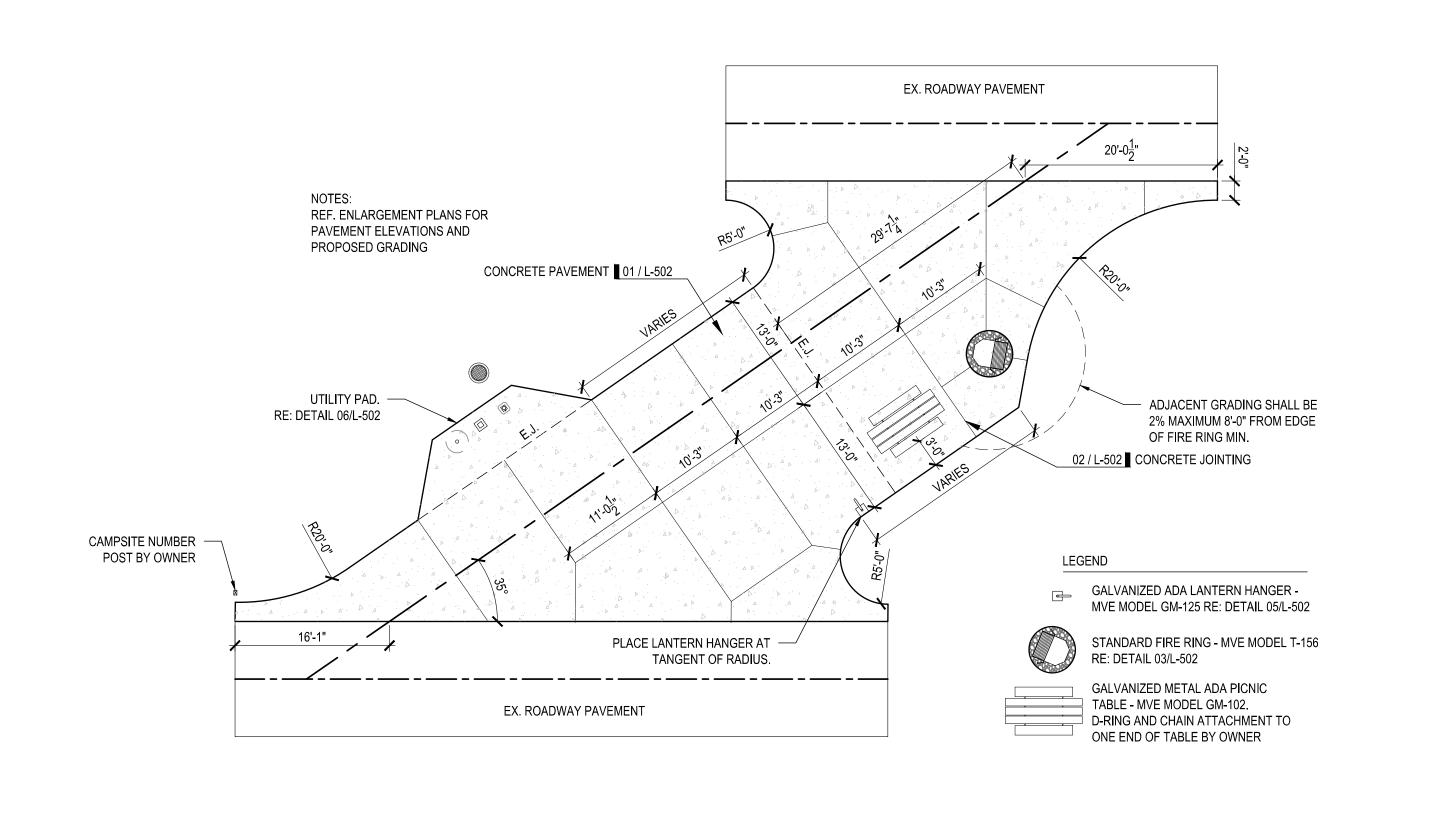

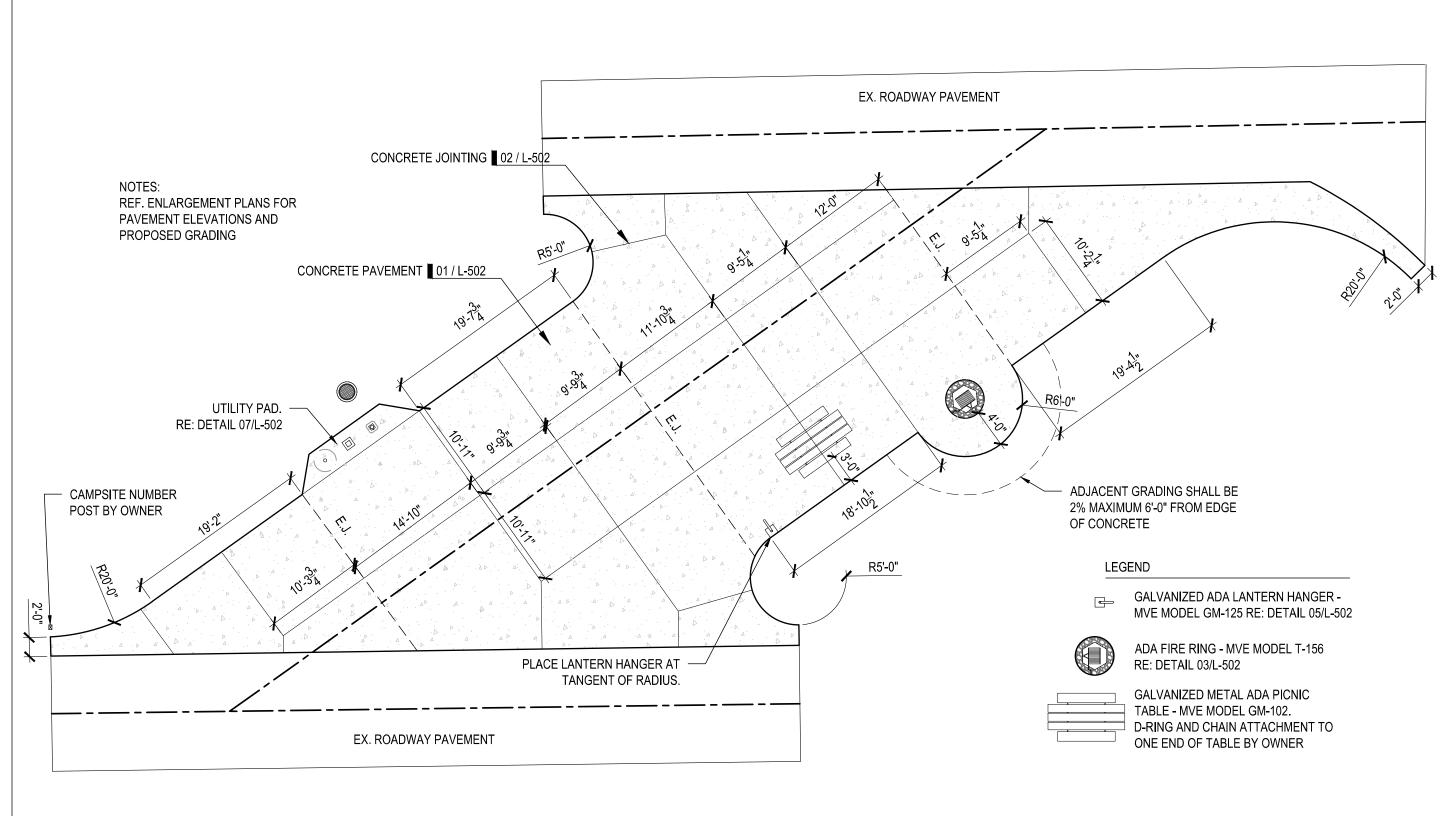

STALL STYLE C - STANDARD PULL-THROUGH 01

STALL STYLE D - ADA PULL-THROUGH N.T.S. 02

NATURAL RESOURCES, MISSOURI STATE PARKS

STATE OF MISSOURI MICHAEL L. PARSON, **GOVERNOR**



LANDSCAPE ARCHITECT:

LAC# MO-2002023826 929 Walnut Street, Ste. 700 Kansas City, Missouri 64106 P 816-756-5690

P 913-317-9500

P 913-310-1600

SURVEYOR & CIVIL ENGINEER: RENAISSANCE INFRASTRUCTURE CONSULTING 8653 Penrose Lane Lenexa, Kansas 66219

nfrastructure

ANTELLA CONSULTING ENGINEERS 1600 Genessee Street, Ste 260 Kansas City, Missouri 64102 P 816-421-0950

GEOTECHNICAL: INTERTEK-PSI 1211 W. Cambridge Circle Drive Kansas City, Kansas 66103



OFFICE OF ADMINISTRATION DIVISION OF FACILITIES MANAGEMENT, DESIGN AND CONSTRUCTION

DEPARTMENT OF

CAMPGROUND RENOVATION AND UPGRADE

BIG LAKE STATE PARK 204 LAKE SHORE DRIVE CRAIG, MO 64437

PROJECT # X2218-01 SITE # 5105 FACILITY # 7815105008

REVISION: DATE: REVISION: DATE: REVISION: DATE: ISSUE DATE:4/7/2023


CAD DWG FILE:
DRAWN BY: MJH
CHECKED BY: CDP
DESIGNED BY: MJH / CDP

SHEET TITLE:

SITE DETAILS

SHEET NUMBER:

SHEET 8 OF 41 APRIL 7, 2023

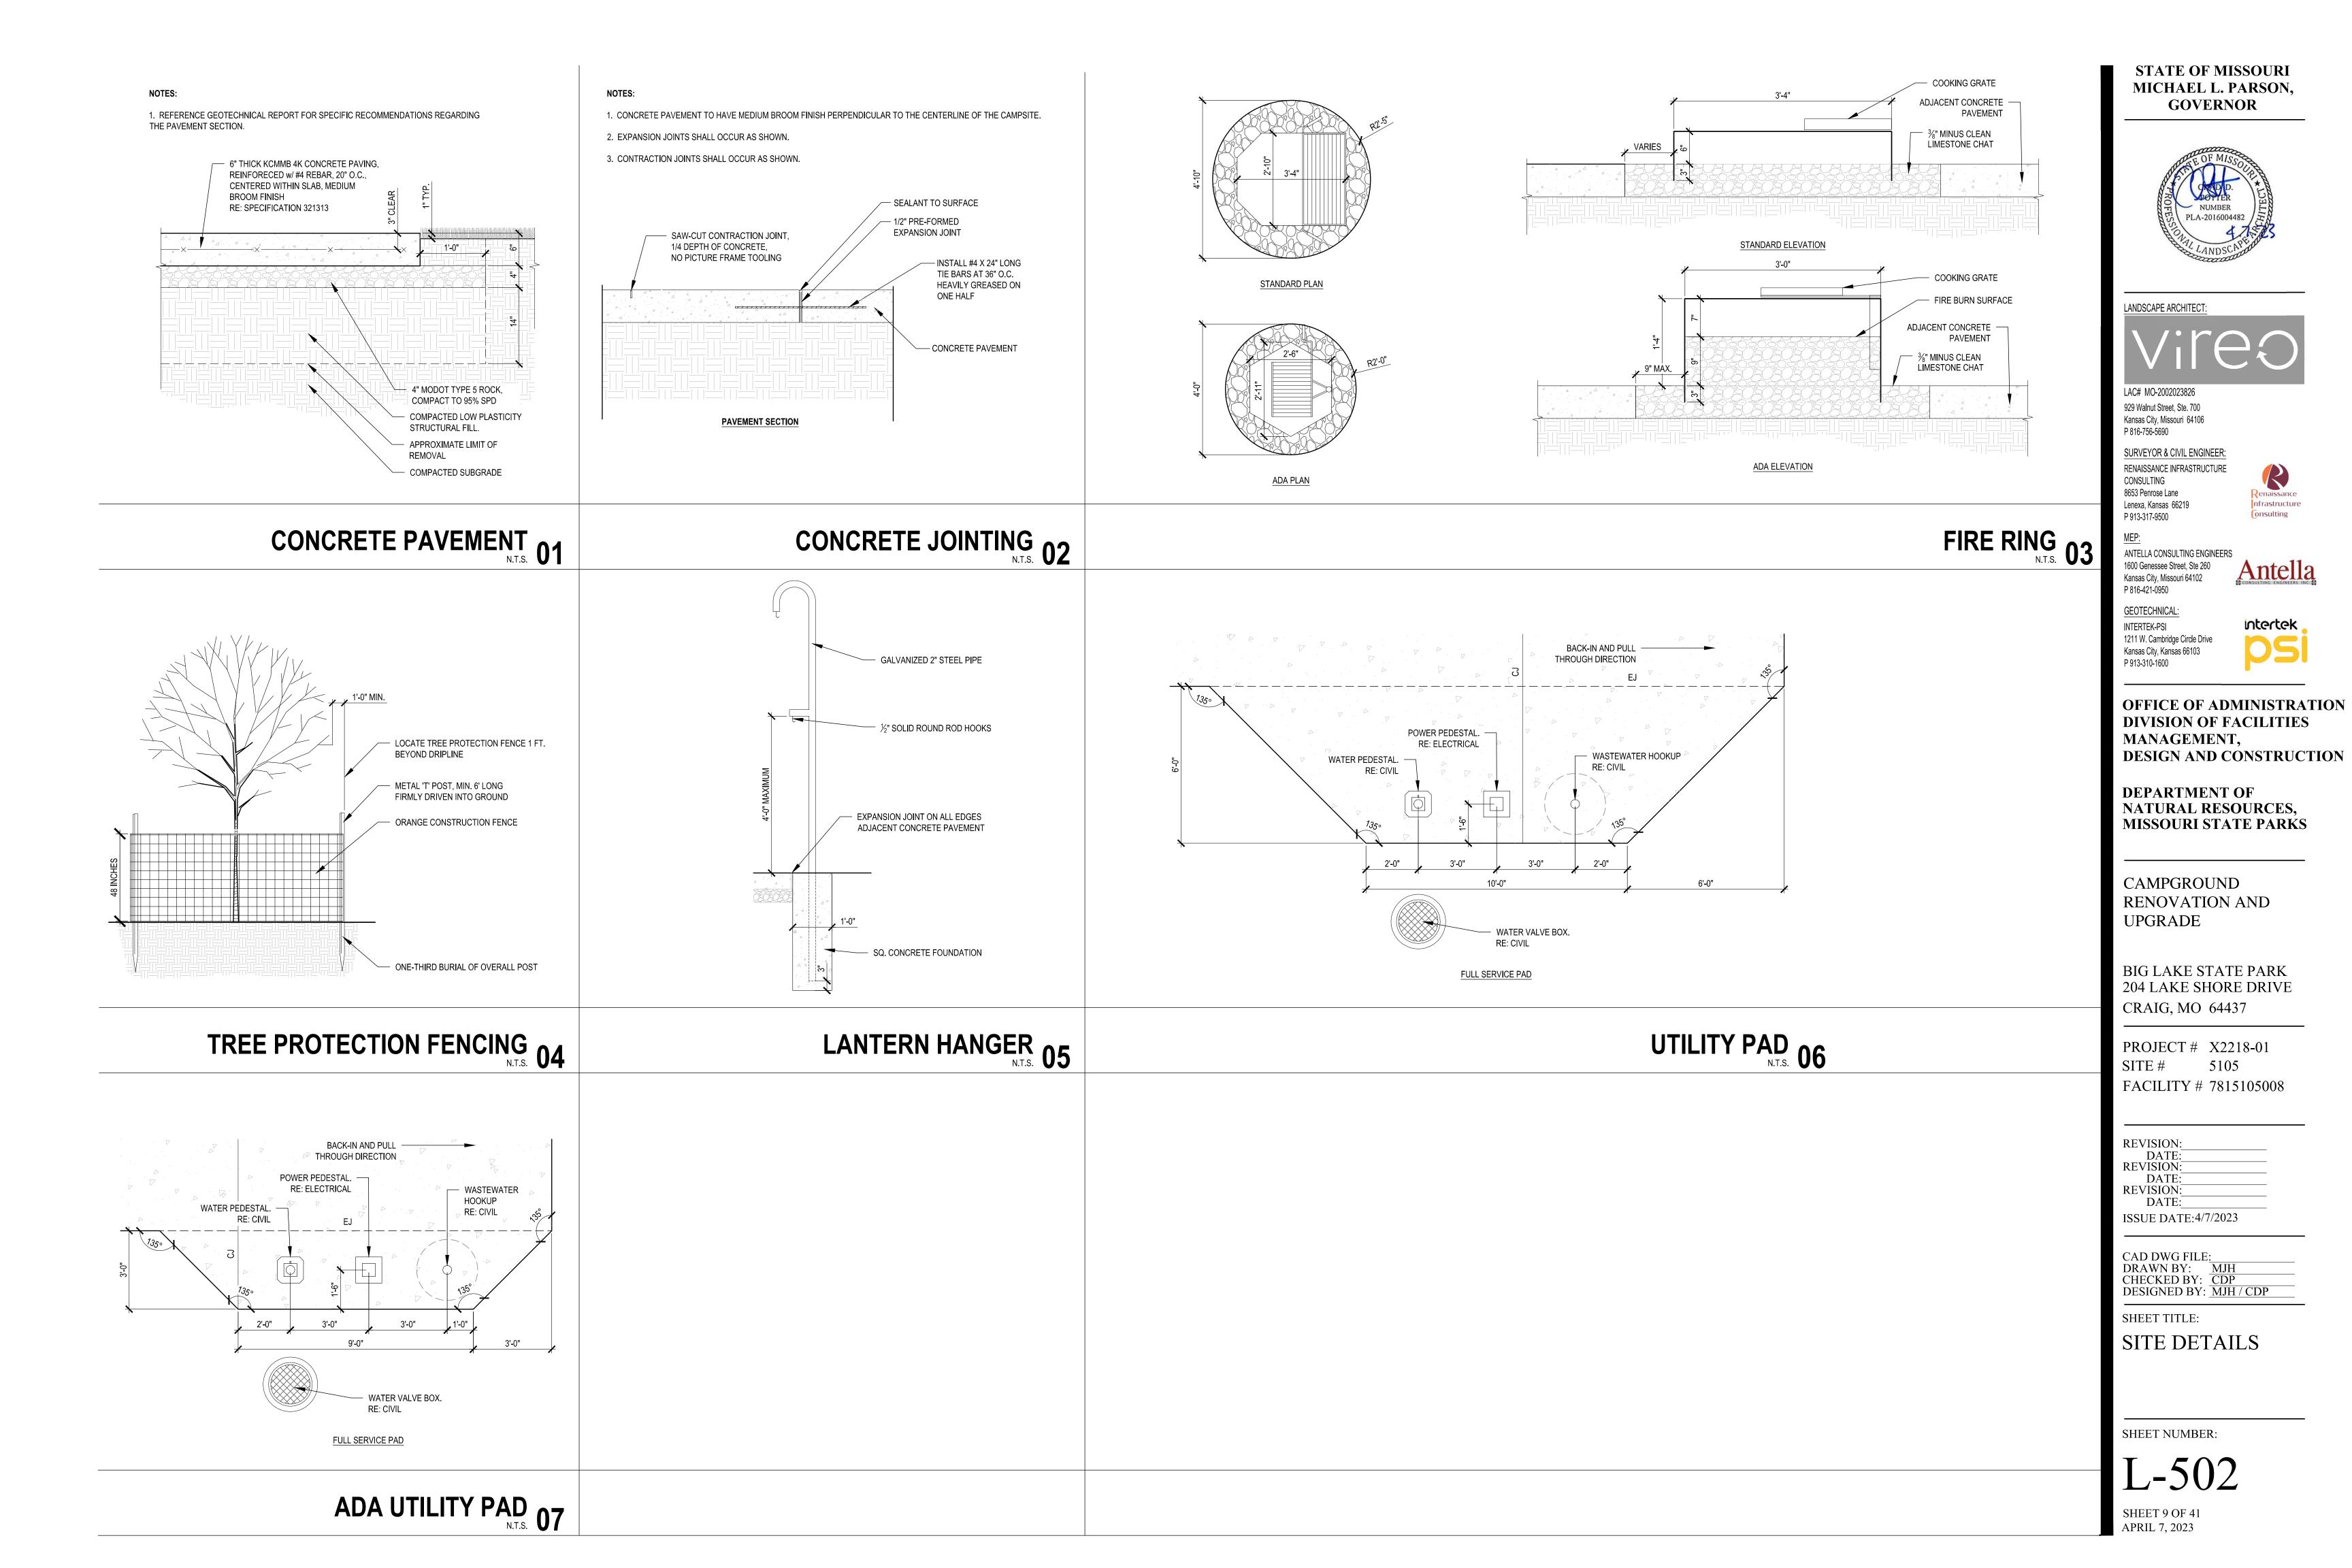

ADA ACCESSIBLE ROUTE NOTES

- All Accessible route construction shall conform to the latest version of the ADA Standards for Accessible Design published by the Department of Justice and the Proposed Accessibility Guidelines for Pedestrian Facilities in the Public Right-of-Way published by the United States Access Board.
- 2. Other than ramps and ramp runs, walking surfaces must have running slopes not steeper than 1:20.
- The cross slope of walking surfaces shall not be steeper than 2%.
- The minimum width for a linear segment of accessible route shall be 36 inches.
- Where the accessible route makes a 180 degree turn around an element which is less than 48 inches wide, clear width shall be 42 inches minimum approaching the turn, 48 inches minimum at the turn and 42 inches leaving the turn.
- An accessible route with a clear width less than 60 inches shall provide passing spaces at intervals of 200 feet maximum. Passing spaces shall be 60 inch by 60 inch minimum.
- Ramp runs shall have a running slope not steeper than 1:12.
- Ramp runs with a rise greater than 6 inches shall have handrails. Ramp landings with a maximum slope of 1:48 shall be provided before and after
- 10. The maximum rise of a ramp run shall be 30 inches.
- 11. The maximum counter slope between the pavement and the curb at a curb ramp shall be 1:20.
- 12. Curb ramp landings with a maximum slope of 1:48 shall be provided at the top of curb ramps with a clear width of 60 inches.
- 13. Detectable warning surfaces complying with the latest ADA Standards shall be
- provided at pedestrian street crossings and refuge islands. 14. Passenger loading zones shall be provided adjacent to any ADA Accessible stall
- and have a 2% maximum slope in all directions. 15. Contractor to field verify existing site conditions and contact the engineer if field conditions do not match plan prior to construction.

GRADING NOTES

Devices (MUTCD).

on the plans.

EARTHWORK NOTES:

- 1. All construction shall conform to the Missouri State Parks Dept minimum design
- Spot Grades shown herein shall govern over finished grades.
- The contractor shall provide evidence that his insurance meets the requirements of
- All traffic control shall be in conformance with the Manual of Uniform Traffic Control
- 5. The contractor is responsible for the protection of all property corners and section corners. Any property corners and/or section corners disturbed or damaged by construction activities shall be reset by a Registered Land Surveyor licensed in the State of Missouri, at the contractor's expense.
- The contractor is responsible for providing erosion and sediment control BMPs to prevent sediment from reaching paved areas, storm sewer systems, drainage courses and adjacent properties. In the event the prevention measures are not effective, the contractor shall remove any debris, silt, or mud and restore the right-of-way, or adjacent properties to original or better condition.
- All sidewalk ramps constructed will be required to comply with the Americans with Disabilities Act (ADA).
- All work shall be confined within easements and/or construction limits as shown on the plans.
- Curb stakes and hubs shall be provided at all high points, low points, ADA ramp
- openings, and on each side of all curb inlets when setting string line.
- 10. All National Pollution Discharge Elimination System (NPDES) standards shall be met. 11. Public and Private utility facilities shall be moved or adjusted as necessary by the owners to fit the new construction unless otherwise noted on the plans. The

Contractor is responsible for the cost of utility relocations unless otherwise indicated

CONTOURS AND ELEVATIONS: Existing and proposed contours are shown on

2. CLEARING AND GRUBBING: Prior to the start of grading and earthwork, the areas

to be graded shall be stripped of all vegetation, organic matter, and topsoil, to a

minimum depth of four inches (4") or as otherwise directed by the Geotechnical

Engineer. Stripping materials shall not be incorporated into structural fills. Topsoil

TOPSOIL: Prior to the start of grading, the contractor shall strip all topsoil from areas

to be graded and stockpile at a location on or adjacent to the site as directed by the

owner. At completion of grading operations and related construction, the contractor

construction activities. Topsoil shall be placed to a minimum depth of six inches (6")

subgrade shall be proof rolled and approved under the direction of the Geotechnical

Unsuitable areas identified by the proof rolling areas shall be undercut and replaced

A. GEOTECHNICAL: All earthwork shall conform to the recommendations of

B. SURFACE WATER: Surface water shall be intercepted and diverted during

C. FILLS: All fills shall be considered controlled or structural fill and shall be

shall be provided by the Contractor. Material Shall be pre-approved by the

D. EXISTING SLOPES: Where fill material is to be placed on existing slopes

providing a minimum vertical face of twelve inches (12"). Fill material shall be

placed and compacted in horizontal lifts not exceeding nine inched (9") (loose fit

compacted to a minimum density of ninety five percent (95%) of the material's

compaction). The moisture content at the time of placement and compaction

shall be within a range of -2% to 3% above the optimum moisture content as

shall be maintained within this range until completion of the work. Where

tests required by the specifications and to observe the placement of fills and other

SEEDING: All areas disturbed by earthwork operations in the right-of-way shall be

work performed on this project shall be provided by a commercial testing laboratory

7. TESTING AND INSPECTION: Testing and inspection services required to make

(Geotechnical Engineer) selected by the owner. The cost of testing will be the

shall be hand compacted with small vibrating rollers or mechanical tampers.

defined by the standard proctor compaction procedure. The moisture contents

compaction of earth fill by a large roller is impractical or undesirable, the earth fill

greater than 5:1 (horizontal to vertical), existing slope shall be benched

measurement), unless otherwise approved by the Geotechnical Engineer.

E. COMPACTION REQUIREMENTS: Earth fill material shall be placed and

maximum dry density as determined by ASTM D698 (standard proctor

free of vegetation, organic matter, topsoil, and debris. All fill required for project

with controlled structural fill or treated with fly ash per the Geotechnical report.

and in accordance with specifications for landscaping. Subgrade below turf areas

SUBGRADE PREPARATION: Prior to placement of new fill material, the existing

will be responsible for redistribution of topsoil over all areas disturbed by the

plans at one feet (1') contour intervals, unless otherwise noted. Proposed contours

and elevations shown represent approximate finish grade.

materials shall not be used in building and pavement areas.

shall have a minimum 6" depth of soil free of rock larger than 3".

Engineer or his representative.

the placement of fill.

owner's responsibility.

Engineer prior to placement

6. EARTHWORK:

LAYOUT & PAVING NOTES

- 1. All construction shall conform to the Missouri State Parks Dept minimum design
- 2. The contractor shall check existing grades, dimensions, and inverts in the field and report any discrepancies to the architect/engineer prior to beginning work.
- 3. The contractor shall verify the exact location of all existing utilities, take care to protect utilities that are to remain, and repair contractor caused damage according to current local standards and at the contractor's expense. Coordinate all construction with the appropriate utility company.
- 4. The contractor shall comply with all local codes, obtain all permits, and pay all fees prior
- 5. Provide a smooth transition between existing pavement and new pavement. Field adjustment of final grades may be necessary. Adjust all utilities prior to installation of
- 6. The contractor shall protect all trees to remain, in accordance with the specifications. Do not operate or store heavy equipment, nor handle, nor store materials within the drip lines of trees or outside the limit of grading.
- 7. Concrete walks and pads shall have a broom finish. All concrete shall be 4,000 p.s.i. unless otherwise noted. Curb ramps, sidewalk slopes, and driveway ramps shall be constructed in accordance with all current local requirements. If applicable, the contractor shall request inspection of sidewalk and ramp forms prior to placement of
- 8. All damage to existing asphalt pavement to remain which results from new construction shall be replaced with like materials at contractor's expense.
- Dimensions are to the back of curb, or edge of concrete, unless otherwise noted.
- 10. Maintain one set of as-built drawings on the job site for distribution to the engineer upon
- 11. For all asphalt pavement, the contractor shall have no more than 30% recycled material in the base course and no recycled material in the surface course.

PAVEMENT MARKING AND SIGNAGE NOTES

- Parking stall marking stripes shall be four inch (4") wide white stripes. Handicap stall marking shall be furnished at locations shown on plans.
- 2. Traffic control devices and pavement markings shall conform to the requirements of the "Manual of Uniform Traffic Control Devices."
- Traffic control and pavement markings shall be painted with a white Sherwin Williams TM2125 HOTLINE Fast Dry or approved equal. The pavement marking shall be applied in accordance with manufacturers recommendations. Apply on a clean, dry surface and at a surface temperature of not less than 70°f and the ambient air temperature shall not be less than 60°f and rising. Two coats shall be

WRITTEN SEQUENCING

Implement Pre-Construction Plan:

All temporary structural BMP's shown on the BMP plan must be in place before any site disturbance. Clearing necessary to place temporary structural BMP's is the minimum required for installation. Coordinate clearing necessary to place temporary structural BMP's with local weather forecast so that clearing and placement may be completed within a forecast dry period. Stabilize all erosion control measures after installation. Temporary Barrier Fence shall be in Place, around areas not to be disturbed, prior to any construction activities. This area includes Stream Corridor.

Clear and Stabilize Work Areas:

Grade contractor areas and place all-weather surface on contractor areas.

Clearing and Grubbing:

After Phase I BMP's are installed, contractor may clear, grub, and demo required areas as necessary.

SITE UTILITY NOTES

- The contractor is specifically cautioned that the location and/or elevation of existing utilities as Shown on these plans is based on records of the various utility Companies, und where possible, measurements taken in the field. The information is not to be relied on as being exact or complete. The contractor must call the appropriate utility companies at least 48 hours before any excavation to request exact field location of utilities. It shall be the responsibility of the contractor to coordinate with and relocate and/or remove all existing utilities which conflict with the proposed improvements shown on the plans.
- 2. The construction of storm sewers on this project shall conform to the requirements of Missouri State Parks Dept Technical Specifications and Design Criteria.
- The contractor shall field verify the exact location and elevation of the existing storm sewer locations and the existing elevations at locations where the proposed storm sewer collects or releases to existing ground. If discrepancies are encountered from the information shown on the plans. The contractor shall contact the design engineer. No pipes shall be laid until direction is received from the design engineer
- 4. It will be the contractors responsibility to field adjust the top of all manholes and boxes as necessary to match the grade of the adjacent area. Tops of existing manholes shall be raised as necessary to be flush with proposed pavement elevations, and to be 6-inches above finished ground elevations in non-paved areas. No separate or additional compensation will be made to the contractor for making final adjustments to the manholes and boxes.
- Inlet locations, horizontal pipe information and vertical pipe information is shown to the center of the structure. Deflection angles shown for storm sewer pipes are measured from the center of the curb inlets and manholes. The contractor shall adjust the horizontal location of the pipes to go to the face of the boxes.
- The contractor shall be responsible for furnishing and installing all domestic water lines, meters, back flow devices, pits, valves and all other incidentals required for a complete operable domestic water system. Coordinate with the local water department as necessary. All costs associated with the complete water system for the campgrounds shall be the responsibility of the contractor. All work shall conform to the requirements of Missouri State Parks Dept.
- 7. The contractor shall be responsible for furnishing and installing all sanitary sewer service lines from the campground to the main line. All work shall conform to the requirements of Missouri State Parks Dept.
 - The contractor is responsible for securing all permits, bonds and insurance required by the contract documents, Missouri State Parks Dept, and all other governing agencies (including local, county, state and federal authorities) having jurisdiction over the work proposed by the construction documents. The cost for all permit bonds and insurance shall be the contractors responsibility and shall be included in the bid for the work.
- By the use of these construction documents the contractor hereby agrees that he/she shall be solely responsible for the safety of the construction workers and the public. The contractor agrees to hold the engineer and owner harmless for any and all injuries, claims, losses or damages related to the project.
- 10. All fill material is to be in place, compacted, and consolidated before installation of proposed utilities. On-site geotechnical engineer shall provide written confirmation that this requirement has been met and that utilities may proceed in the fill areas. All utilities are to be placed in trench conditions.
- 11. Minimum trench width shall be 2 feet.
- 12. Contractor shall maintain a minimum of 42" of cover on all waterlines. All water line joints are to be mechanical joints with thrust blocking as called out in specifications and construction plans. Water mains and service lines shall be constructed in accordance to 5. proof rolling: Prior to the placement of new fill material, the existing subgrade shall be

 All waterlines shall be kept ten feet (10') apart (parallel) from sanitary sewer lines or
 - manholes. Or when crossing, an 18" vertical clearance (outside edge of pipe to outside edge of pipe) of the waterline above the sewer line is required.
 - 14. In the event of a vertical conflict between waterlines, sanitary lines, storm lines and gas lines (existing and proposed), the sanitary line shall be ductile iron pipe with mechanical joints at least 10 feet on both sides of the crossing (or encased in concrete the same distance), the waterline shall have mechanical joints with appropriate thrust blocking as required to provide a minimum of 18" clearance. Meeting requirements ANSI A21.10 or ANSI 21.11 (AWWA C151)(Class 50).
 - All necessary inspections and/or certifications required by codes and/or utility service companies shall be performed prior to announced building possession and the final connection of service. Contractor shall coordinate with all utility companies for installation requirements and specifications.
 - When a building utility Connection from site utilities leading up to the building cannot be made immediately, temporarily mark all such utility terminations.

GENERAL NOTES

- 1. The contractor shall provide evidence that his insurance meets the requirements of Missouri
- 2. All traffic control shall be in conformance with the Manual of Uniform Traffic Control Devices
- The contractor is responsible for the protection of all property corners and section corners. Any property corners and/or section corners disturbed or damaged by construction activities shall be reset by a Registered Land Surveyor licensed in the State of Missouri, at the contractor's expense.
- The contractor shall be responsible for the restoration of the right-of-way and for damaged improvements such as curbs, driveways, sidewalks, street light and traffic signal junction boxes, traffic signal loop lead ins, signal poles, irrigation systems, etc. Damaged improvements shall be repaired in conformance with the latest City and State standards and to the City's and/or State's satisfaction.
- The contractor is responsible for providing erosion and sediment control BMPs to prevent sediment from reaching paved areas, storm sewer systems, drainage courses and adjacent properties. In the event the prevention measures are not effective, the contractor shall remove any debris, silt, or mud and restore the right-of-way, or adjacent properties to original or better
- 6. Excavation for utility work in public street right-of-way requires a Right-of-Way Work Permit from the Public Works Department, in addition to all other permits.
- All work shall be confined within easements and/or construction limits as shown on the plans. 8. All existing utilities indicated on the drawings are according to the best information available to the engineer; however, all utilities actually existing may not be shown. The contractor shall be responsible for contacting all utility companies for an exact field location of each utility prior to any construction. All utilities, shown and un-shown, damaged through the negligence of the
- The contractor will be responsible for all damages to existing utilities, pavement, fences, structures, and other features not designated for removal. The contractor shall repair all damages at his expense.

contractor shall be repaired or replaced by the contractor at his expense.

- 10. By use of these construction documents the contractor hereby agrees that he shall be solely responsible for the safety of the construction workers and the public. The contractor agrees to hold the engineer and owner harmless for any and all injuries, claims, losses, or damages related to the project.
- 11. The contractor will be responsible for providing all signage, barricades, lighting, etc., as required for temporary traffic control during the construction of this project. Maintenance of the temporary traffic control devices will be the contractor's responsibility.
- 12. Geogrid, footings, or other elements of the retaining wall(s) cannot encroach into the right of way, public easements, or adjacent private property. 13. Contractor shall be responsible for obtaining all permits including land disturbance, right-of-way,
- hauling, etc., prior to construction. 14. Contractor shall restore all disturbed right-of-way upon project completion.
- 15. Prior to construction, contractor shall install pre-construction erosion control measures.

EROSION CONTROL NOTES

- 1. The contractor shall provide all materials, tools, equipment, and labor as necessary to install and maintain adequate erosion control, keep the streets clean of mud and debris, and prevent soil from leaving the project site. The contractor's erosion control measures shall conform to Missouri State Parks Dept Technical Provisions and Specifications.
- 2. Erosion control plan modifications shall be required if the plan fails to substantially control erosion and offsite sedimentation.
- 3. The contractor shall be responsible for maintaining erosion control devices and removing sediment until a minimum of 70% of permanent vegetation has become stabilized and established. Erosion control devices shall remain in place until the 70% established vegetation is met, or the duration of the project, whichever is the later date.
- 4. The contractor shall temporarily seed and mulch all disturbed areas if there has been no construction activity on them for a period of fourteen (14) calendar days.
- 5. Contractor to install all Phase I erosion control devices prior to construction.
- 6. Contractor shall replace disturbed area with seed or sod, as indicated on the plans, and shall be installed within 14 days after paving completion and final topsoil grading.
- Topsoil replacement shall be 6" thick.
- 8. Straw wattles to be installed in accordance with Missouri State Parks Dept Standard Details.
- Refer to Specifications for good housekeeping and spill measures.
- 10. The Contractor shall inspect erosion control devices every 7 days and within 24 hours of a storm of 0.5 inches or more. The Contractor shall repair damage, clean out sediment, and add additional erosion control devices as needed, as soon as practicable, after inspection. The Contractor shall also inspect and assure that all sediment control devices are in working condition prior to any forecasted rainfall.

STATE OF MISSOURI MICHAEL L. PARSON, **GOVERNOR**



ANDSCAPE ARCHITECT

LAC# MO-2002023826 929 Walnut Street, Ste. 700 Kansas City, Missouri 64106 P 816-756-5690

INTERTEK-PSI

P 913-310-1600

SURVEYOR & CIVIL ENGINEER: RENAISSANCE INFRASTRUCTURE CONSULTING 8653 Penrose Lane Lenexa, Kansas 66219 P 913-317-9500



ANTELLA CONSULTING ENGINEERS 1600 Genessee Street, Ste 260 Kansas City, Missouri 64102 P 816-421-0950 **GEOTECHNICAL**

intertek 1211 W. Cambridge Circle Drive Kansas City, Kansas 66103

OFFICE OF ADMINISTRATION DIVISION OF FACILITIES MANAGEMENT, **DESIGN AND CONSTRUCTION**

DEPARTMENT OF NATURAL RESOURCES, MISSOURI STATE PARKS

CAMPGROUND RENOVATION AND **UPGRADE**

BIG LAKE STATE PARK 204 LAKE SHORE DRIVE CRAIG, MO 64437

PROJECT # X2218-01 5105 FACILITY # 7815105008

REVISION:
DATE:
REVISION:
DATE:
REVISION:
DATE:
ISSUE DATE:4/7/2023

CAD DWG FILE DRAWN BY: CHECKED BY: MES DESIGNED BY: ZMM

SHEET TITLE: GENERAL NOTES

SHEET NUMBER:

APRIL 7, 2023





Vile C

P 816-756-5690

SURVEYOR & CIVIL ENGINEER:

RENAISSANCE INFRASTRUCTURE CONSULTING 8653 Penrose Lane Lenexa, Kansas 66219 P 913-317-9500

Renaissance Infrastructure Consulting

MEP:
ANTELLA CONSULTING ENGINEERS
1600 Genessee Street, Ste 260
Kansas City, Missouri 64102
P 816-421-0950

GEOTECHNICAL:
INTERTEK-PSI
1211 W. Cambridge Circle Drive

Kansas City, Kansas 66103

P 913-310-1600



OFFICE OF ADMINISTRATION DIVISION OF FACILITIES MANAGEMENT, DESIGN AND CONSTRUCTION

DEPARTMENT OF NATURAL RESOURCES, MISSOURI STATE PARKS

CAMPGROUND RENOVATION AND UPGRADE

BIG LAKE STATE PARK 204 LAKE SHORE DRIVE CRAIG, MO 64437

PROJECT # X2218-01 SITE # 5105 FACILITY # 7815105008

REVISION:
DATE:
REVISION:
DATE:
REVISION:
DATE:
ISSUE DATE:4/7/2023

CAD DWG FILE:
DRAWN BY: TCD
CHECKED BY: MES
DESIGNED BY: ZMM

SHEET TITLE:

EXISTING CONDITIONS



SHEET NUMBER:

C-002

SHEET 11 OF 41
APRIL 7, 2023



LANDSCAPE ARCHITEC



929 Walnut Street, Ste. 700 Kansas City, Missouri 64106 P 816-756-5690

SURVEYOR & CIVIL ENGINEER:

RENAISSANCE INFRASTRUCTURE CONSULTING 8653 Penrose Lane Lenexa, Kansas 66219 P 913-317-9500

MEP:
ANTELLA CONSULTING ENGINEERS
1600 Genessee Street, Ste 260

1600 Genessee Street, Ste 260
Kansas City, Missouri 64102
P 816-421-0950

GEOTECHNICAL:
INTERTEK-PSI
1211 W. Combridge Circle

1211 W. Cambridge Circle Drive Kansas City, Kansas 66103 P 913-310-1600

OFFICE OF ADMINISTRATION DIVISION OF FACILITIES MANAGEMENT, DESIGN AND CONSTRUCTION

DEPARTMENT OF NATURAL RESOURCES, MISSOURI STATE PARKS

CAMPGROUND RENOVATION AND UPGRADE

BIG LAKE STATE PARK 204 LAKE SHORE DRIVE CRAIG, MO 64437

PROJECT # X2218-01 SITE # 5105 FACILITY # 7815105008

REVISION:
DATE:
REVISION:
DATE:
REVISION:
DATE:
ISSUE DATE:4/7/2023

CAD DWG FILE:

CAD DWG FILE:
DRAWN BY: TCD
CHECKED BY: MES
DESIGNED BY: ZMM

SHEET TITLE:

DEMOLITION PLAN

SHEET NUMBER:

C-10]

SHEET 12 OF 41
APRIL 7, 2023







LANDSCAPE ARCHITECT:

LAC# MO-2002023826 929 Walnut Street, Ste. 700 Kansas City, Missouri 64106 P 816-756-5690


8653 Penrose Lane Lenexa, Kansas 66219

P 913-317-9500

SURVEYOR & CIVIL ENGINEER:
RENAISSANCE INFRASTRUCTURE
CONSULTING



MEP:
ANTELLA CONSULTING ENGINEERS
1600 Genessee Street, Ste 260

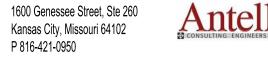

GEOTECHNICAL:
INTERTEK-PSI

INTERTEK-PSI 1211 W. Cambridge Circle Drive Kansas City, Kansas 66103 P 913-310-1600



OFFICE OF ADMINISTRATION DIVISION OF FACILITIES MANAGEMENT, DESIGN AND CONSTRUCTION

DEPARTMENT OF NATURAL RESOURCES, MISSOURI STATE PARKS

CAMPGROUND RENOVATION AND UPGRADE

BIG LAKE STATE PARK 204 LAKE SHORE DRIVE CRAIG, MO 64437

PROJECT # X2218-01 SITE # 5105 FACILITY # 7815105008

REVISION:
DATE:
REVISION:
DATE:
REVISION:
DATE:
ISSUE DATE:4/7/2023

CAD DWG FILE:
DRAWN BY: TCD
CHECKED BY: MES
DESIGNED BY: ZMM

SHEET TITLE:


GENERAL LAYOUT




SHEET NUMBER:

C-102


SHEET 13 OF 41 APRIL 7, 2023

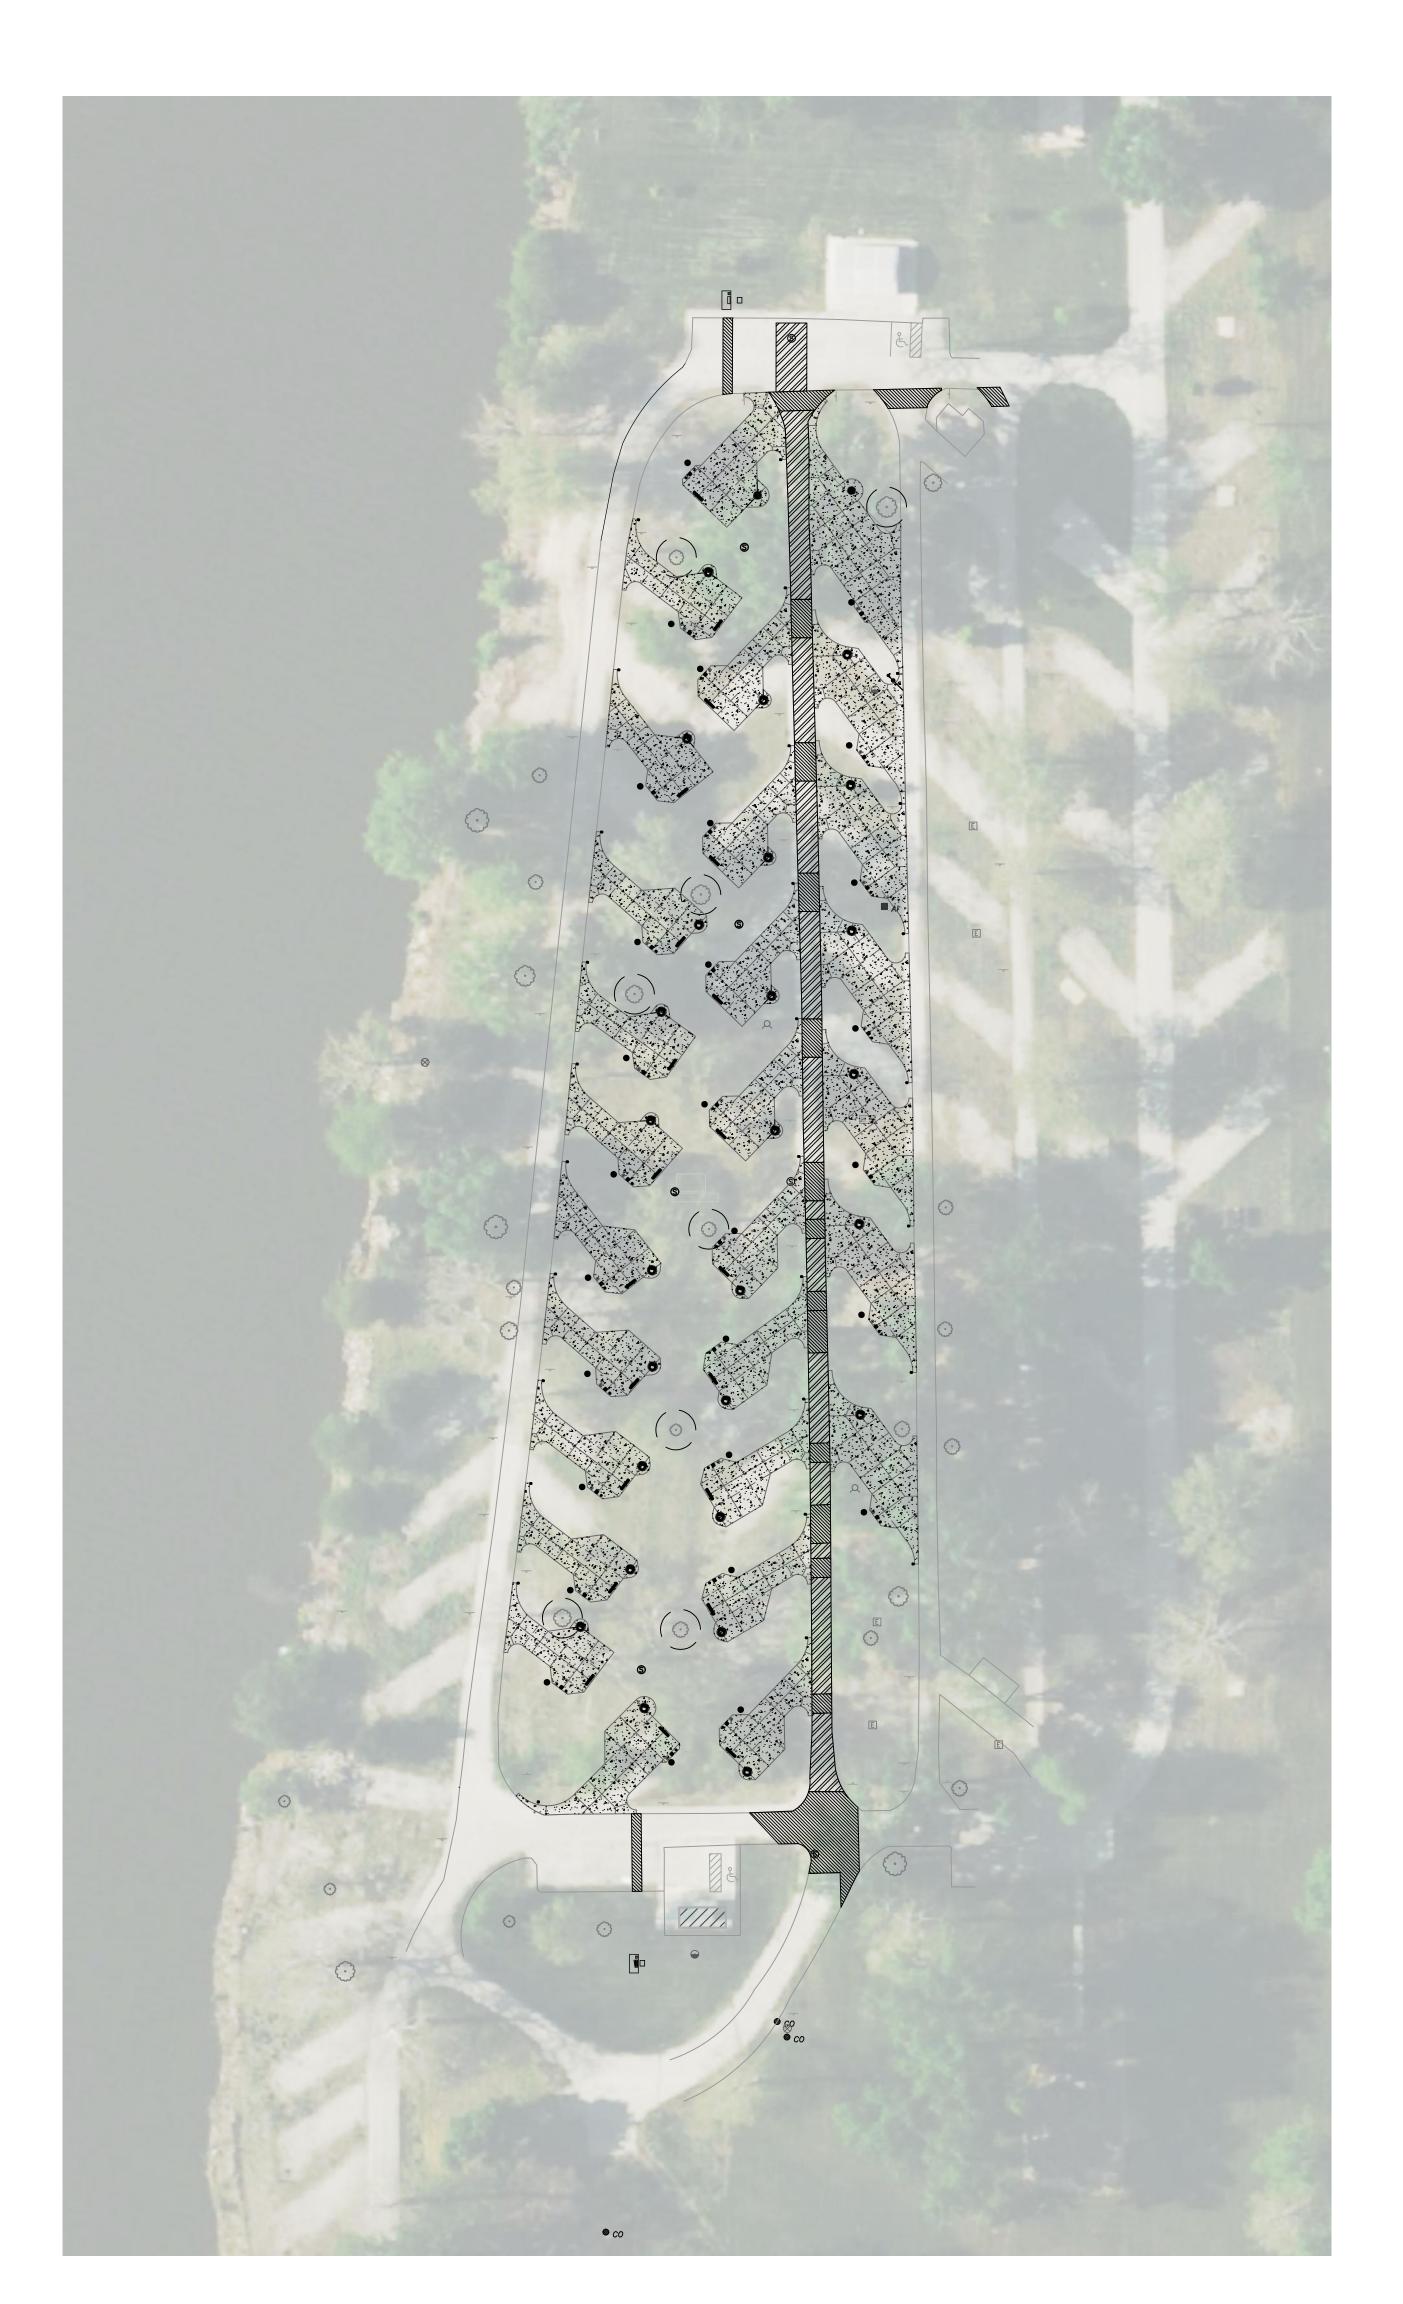

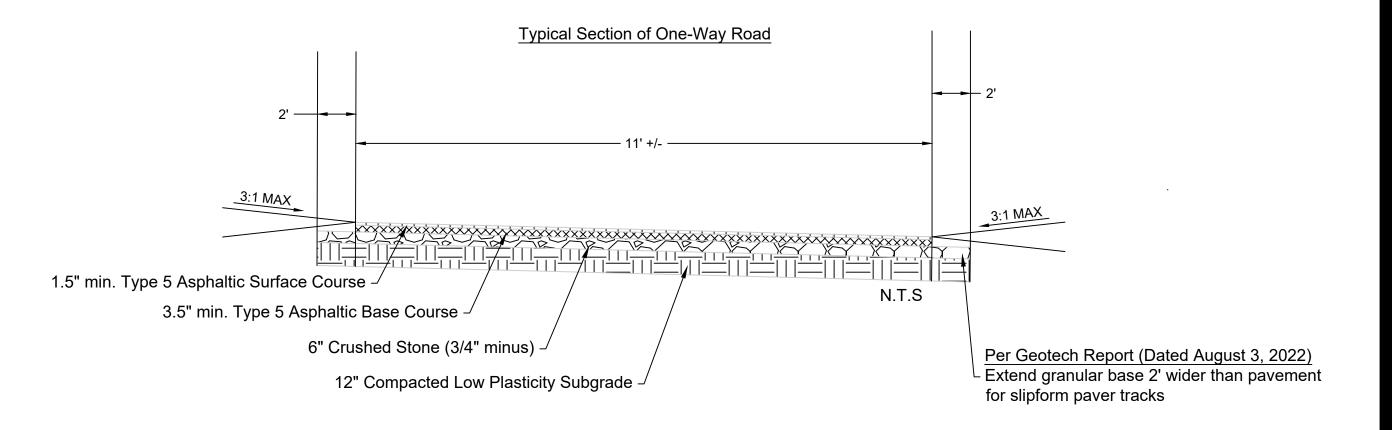


Pavement Alternates

Alternate #1 - Sanitary Main Replacement: Full depth pavement to be replaced above the existing sanitary pipe to be removed.

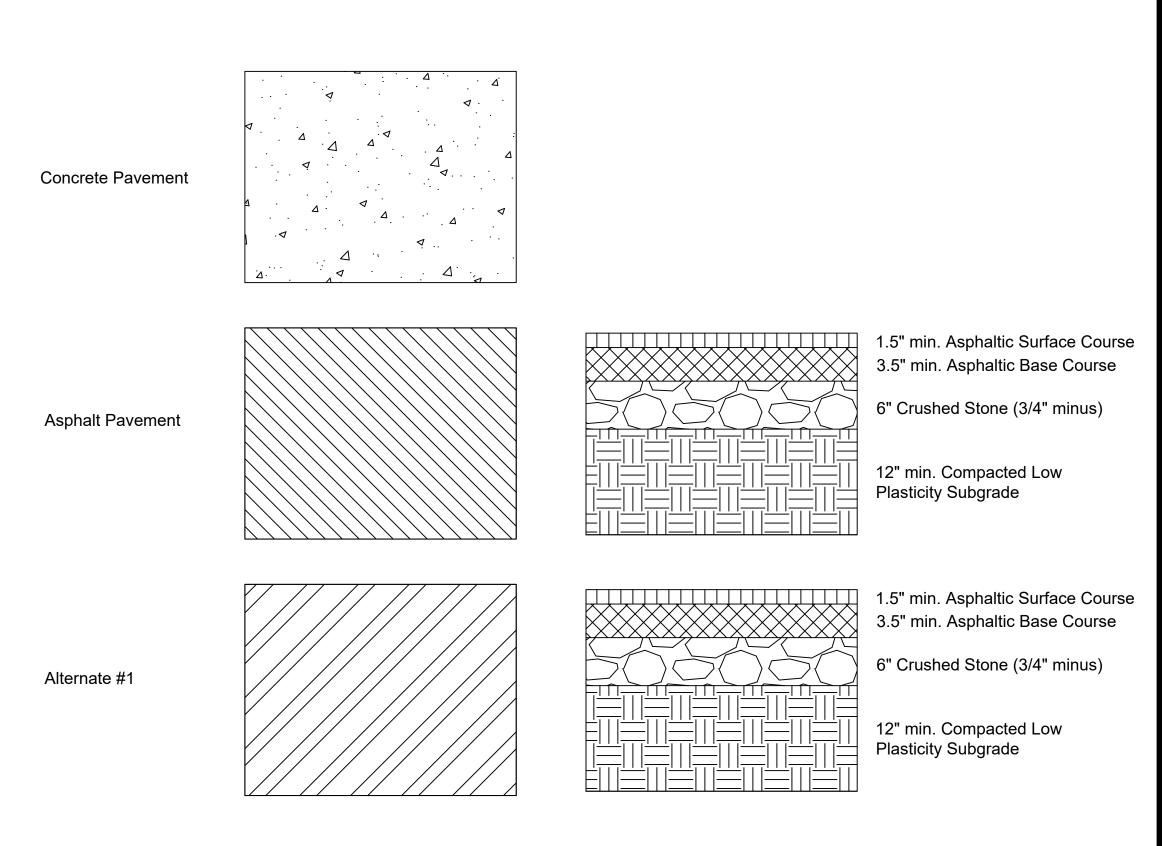

See Intertek Geotech Report Dated August 3, 2022
Pavement Sections are provided for information only, Contractor Shall refer to Intertek PSI Geotech Report Dated August 3, 2022

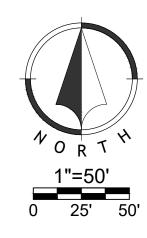

STATE OF MISSOURI MICHAEL L. PARSON, **GOVERNOR**



929 Walnut Street, Ste. 700 Kansas City, Missouri 64106 P 816-756-5690

LAC# MO-2002023826

SURVEYOR & CIVIL ENGINEER: RENAISSANCE INFRASTRUCTURE CONSULTING 8653 Penrose Lane

Lenexa, Kansas 66219 P 913-317-9500

MEP:
ANTELLA CONSULTING ENGINEERS 1600 Genessee Street, Ste 260 Kansas City, Missouri 64102

P 816-421-0950 GEOTECHNICAL: INTERTEK-PSI

1211 W. Cambridge Circle Drive Kansas City, Kansas 66103 P 913-310-1600

OFFICE OF ADMINISTRATION DIVISION OF FACILITIES MANAGEMENT, **DESIGN AND CONSTRUCTION**

DEPARTMENT OF NATURAL RESOURCES, MISSOURI STATE PARKS

CAMPSITE RENOVATION & UPDATES

BIG LAKE STATE PARK 204 LAKE SHORE DRIVE CRAIG, MO 64437

PROJECT # X2218-01 SITE# 5105 FACILITY # 7815105008

REVISION:
DATE:
REVISION:
DATE:
REVISION:
DATE:
ISSUE DATE:4/7/2023

CAD DWG FILE:
DRAWN BY: TCD
CHECKED BY: MES
DESIGNED BY: ZMM


SHEET TITLE:

PAVEMENT PLAN

SHEET NUMBER:

C-103

SHEET 14 OF 41 APRIL 7, 2023

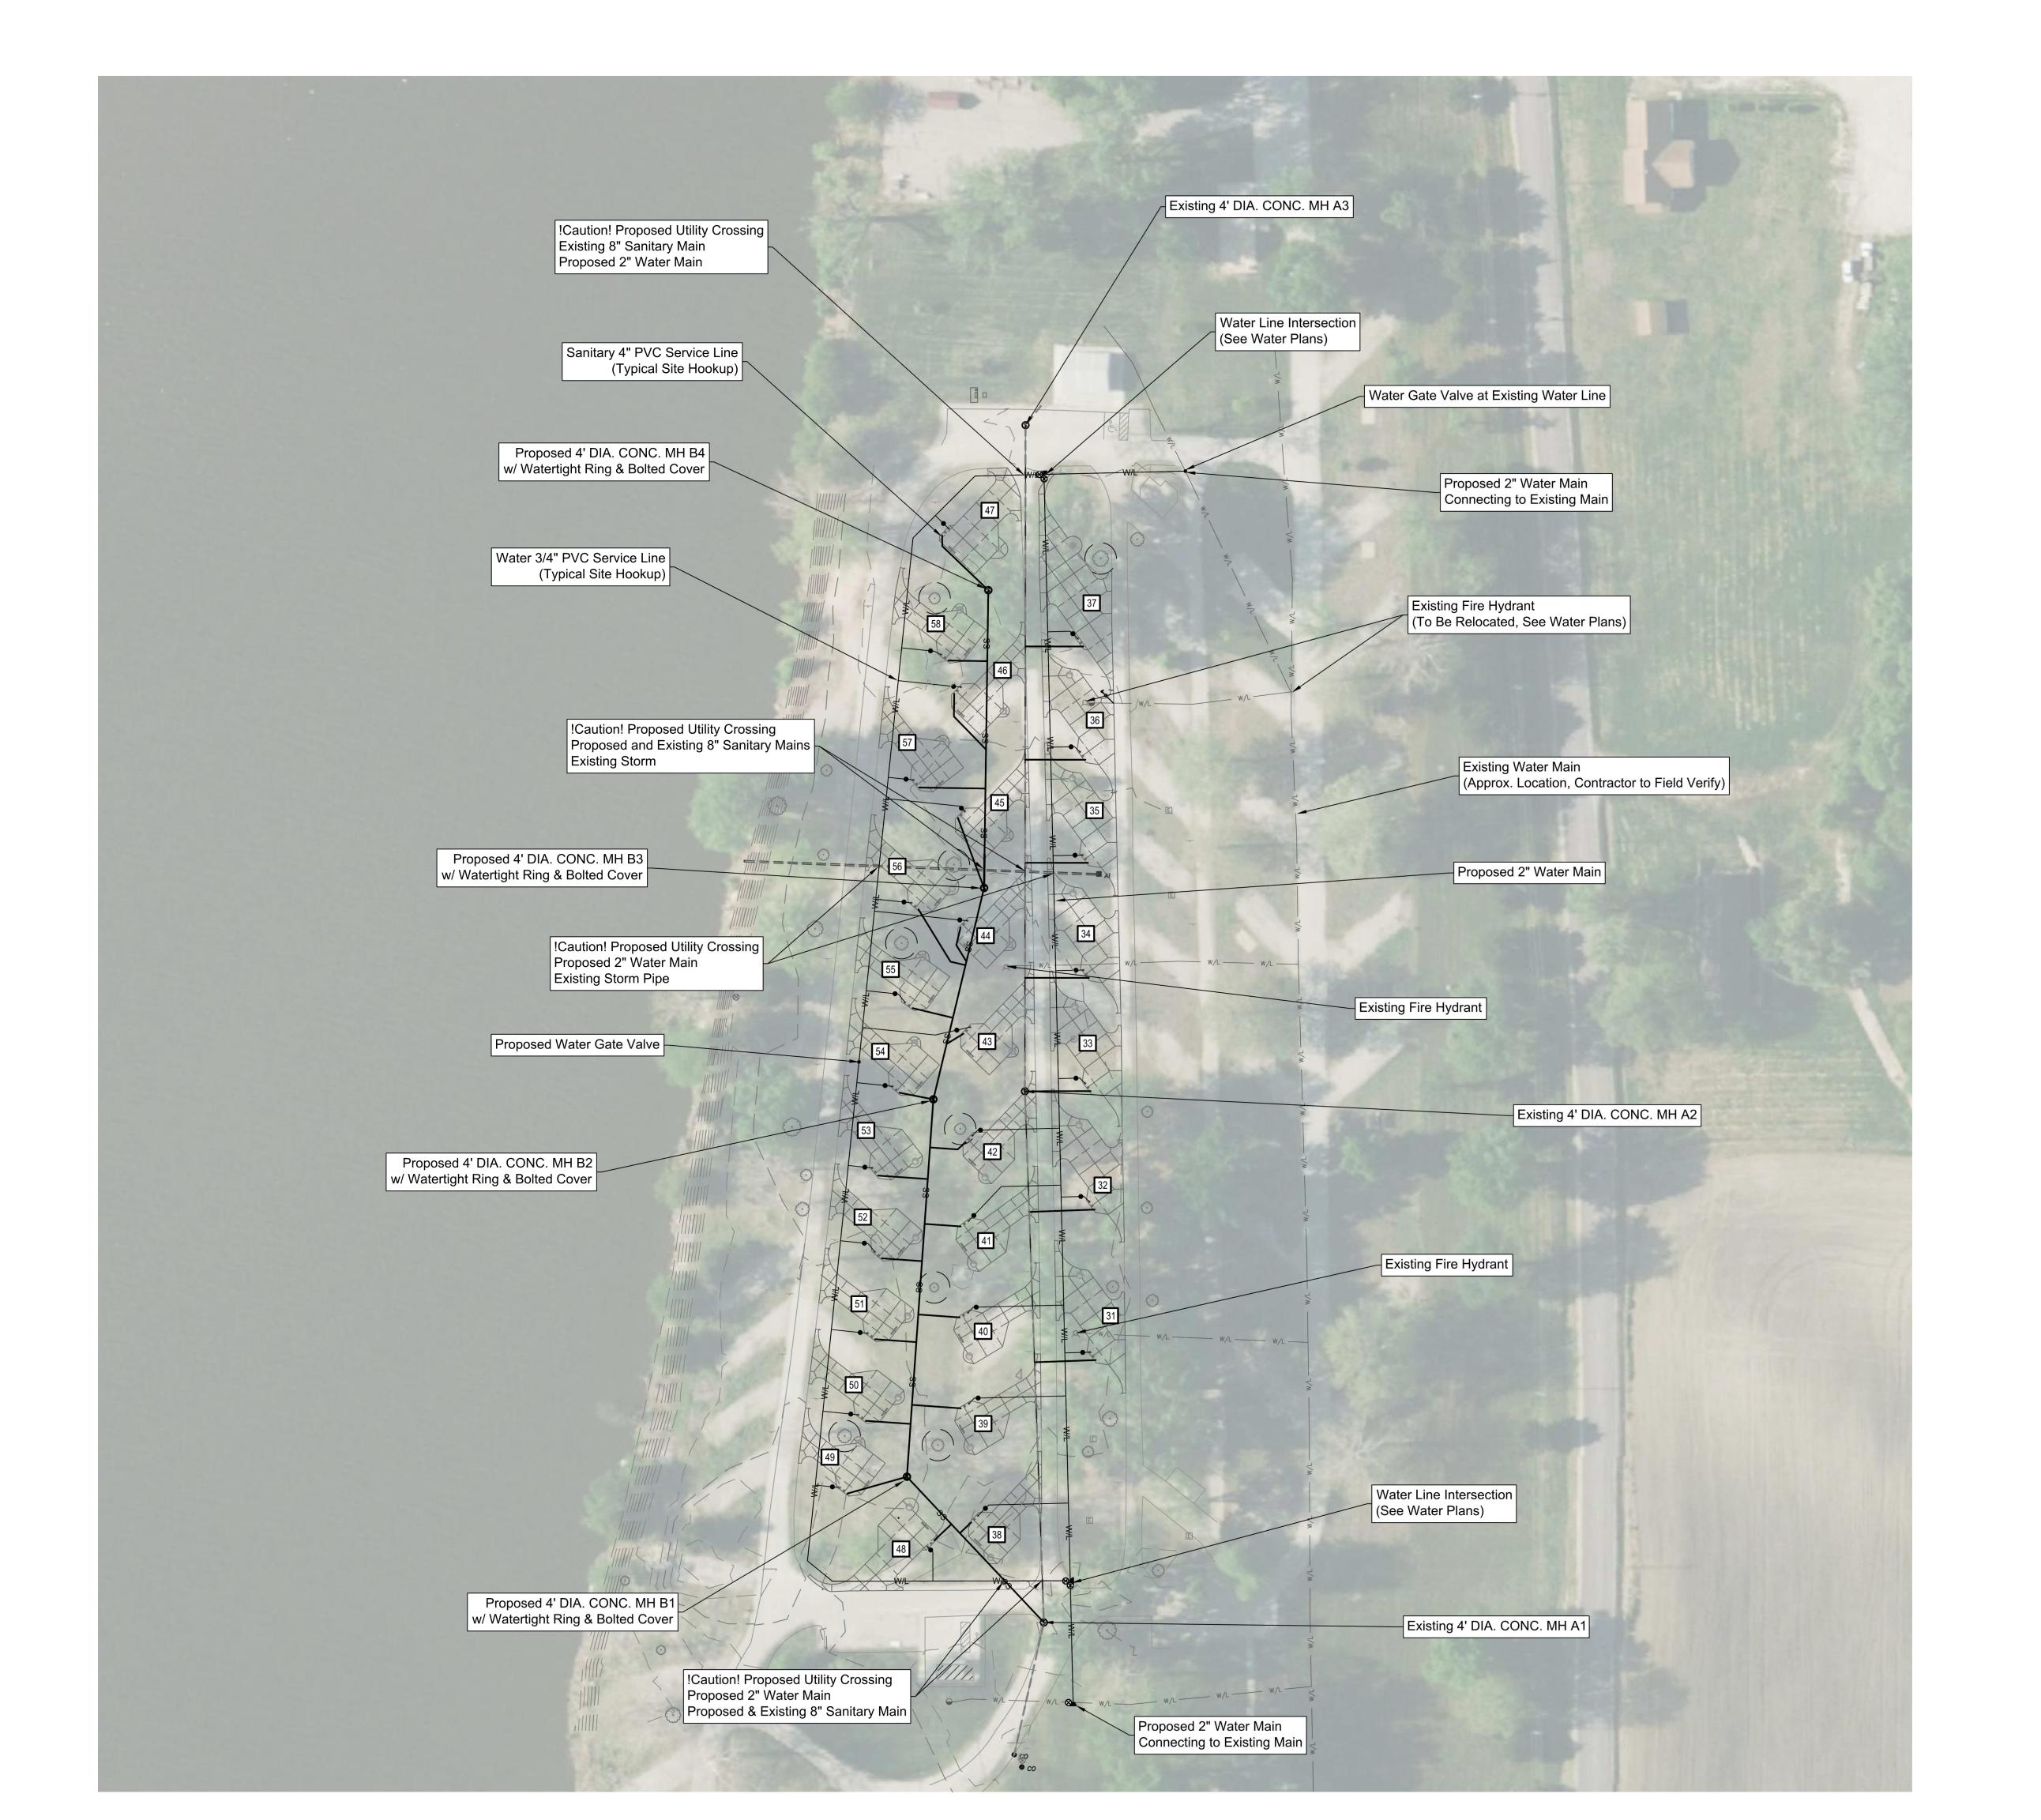



Vileo

929 Walnut Street, Ste. 700 Kansas City, Missouri 64106 P 816-756-5690

Lenexa, Kansas 66219 P 913-317-9500


P 913-310-1600

SURVEYOR & CIVIL ENGINEER:
RENAISSANCE INFRASTRUCTURE
CONSULTING
8653 Penrose Lane



MEP:

ANTELLA CONSULTING ENGINEERS
1600 Genessee Street, Ste 260
Kansas City, Missouri 64102

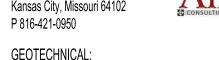

GEOTECHNICAL:
INTERTEK-PSI
1211 W. Cambridge Circle Drive
Kansas City, Kansas 66103



OFFICE OF ADMINISTRATION DIVISION OF FACILITIES MANAGEMENT, DESIGN AND CONSTRUCTION

DEPARTMENT OF NATURAL RESOURCES, MISSOURI STATE PARKS

CAMPGROUND RENOVATION AND UPGRADE

BIG LAKE STATE PARK 204 LAKE SHORE DRIVE CRAIG, MO 64437

PROJECT # X2218-01 SITE # 5105 FACILITY # 7815105008

REVISION:
DATE:
REVISION:
DATE:
REVISION:
DATE:
ISSUE DATE:4/7/2023

CAD DWG FILE:
DRAWN BY: TCD
CHECKED BY: MES
DESIGNED BY: ZMM

SHEET TITLE:

UTILITY PLAN



SHEET NUMBER:

C-104

SHEET 15 OF 41 APRIL 7, 2023





929 Walnut Street, Ste. 700 Kansas City, Missouri 64106 P 816-756-5690

SURVEYOR & CIVIL ENGINEER: RENAISSANCE INFRASTRUCTURE CONSULTING 8653 Penrose Lane

Lenexa, Kansas 66219 P 913-317-9500

MEP: ANTELLA CONSULTING ENGINEERS 1600 Genessee Street, Ste 260 Kansas City, Missouri 64102 P 816-421-0950

GEOTECHNICAL: INTERTEK-PSI 1211 W. Cambridge Circle Drive Kansas City, Kansas 66103

intertek

nfrastructure

OFFICE OF ADMINISTRATION DIVISION OF FACILITIES MANAGEMENT, **DESIGN AND CONSTRUCTION**

DEPARTMENT OF NATURAL RESOURCES, MISSOURI STATE PARKS

CAMPGROUND RENOVATION AND **UPGRADE**

BIG LAKE STATE PARK 204 LAKE SHORE DRIVE CRAIG, MO 64437

PROJECT # X2218-01 SITE# 5105 FACILITY # 7815105008

REVISION: REVISION: **REVISION**: DATE: ISSUE DATE:4/7/2023

CAD DWG FILE:
DRAWN BY: TCD
CHECKED BY: MES
DESIGNED BY: ZMM


SHEET TITLE:

WATER PLAN -NORTH

SHEET NUMBER:

C-105

SHEET 16 OF 41 APRIL 7, 2023

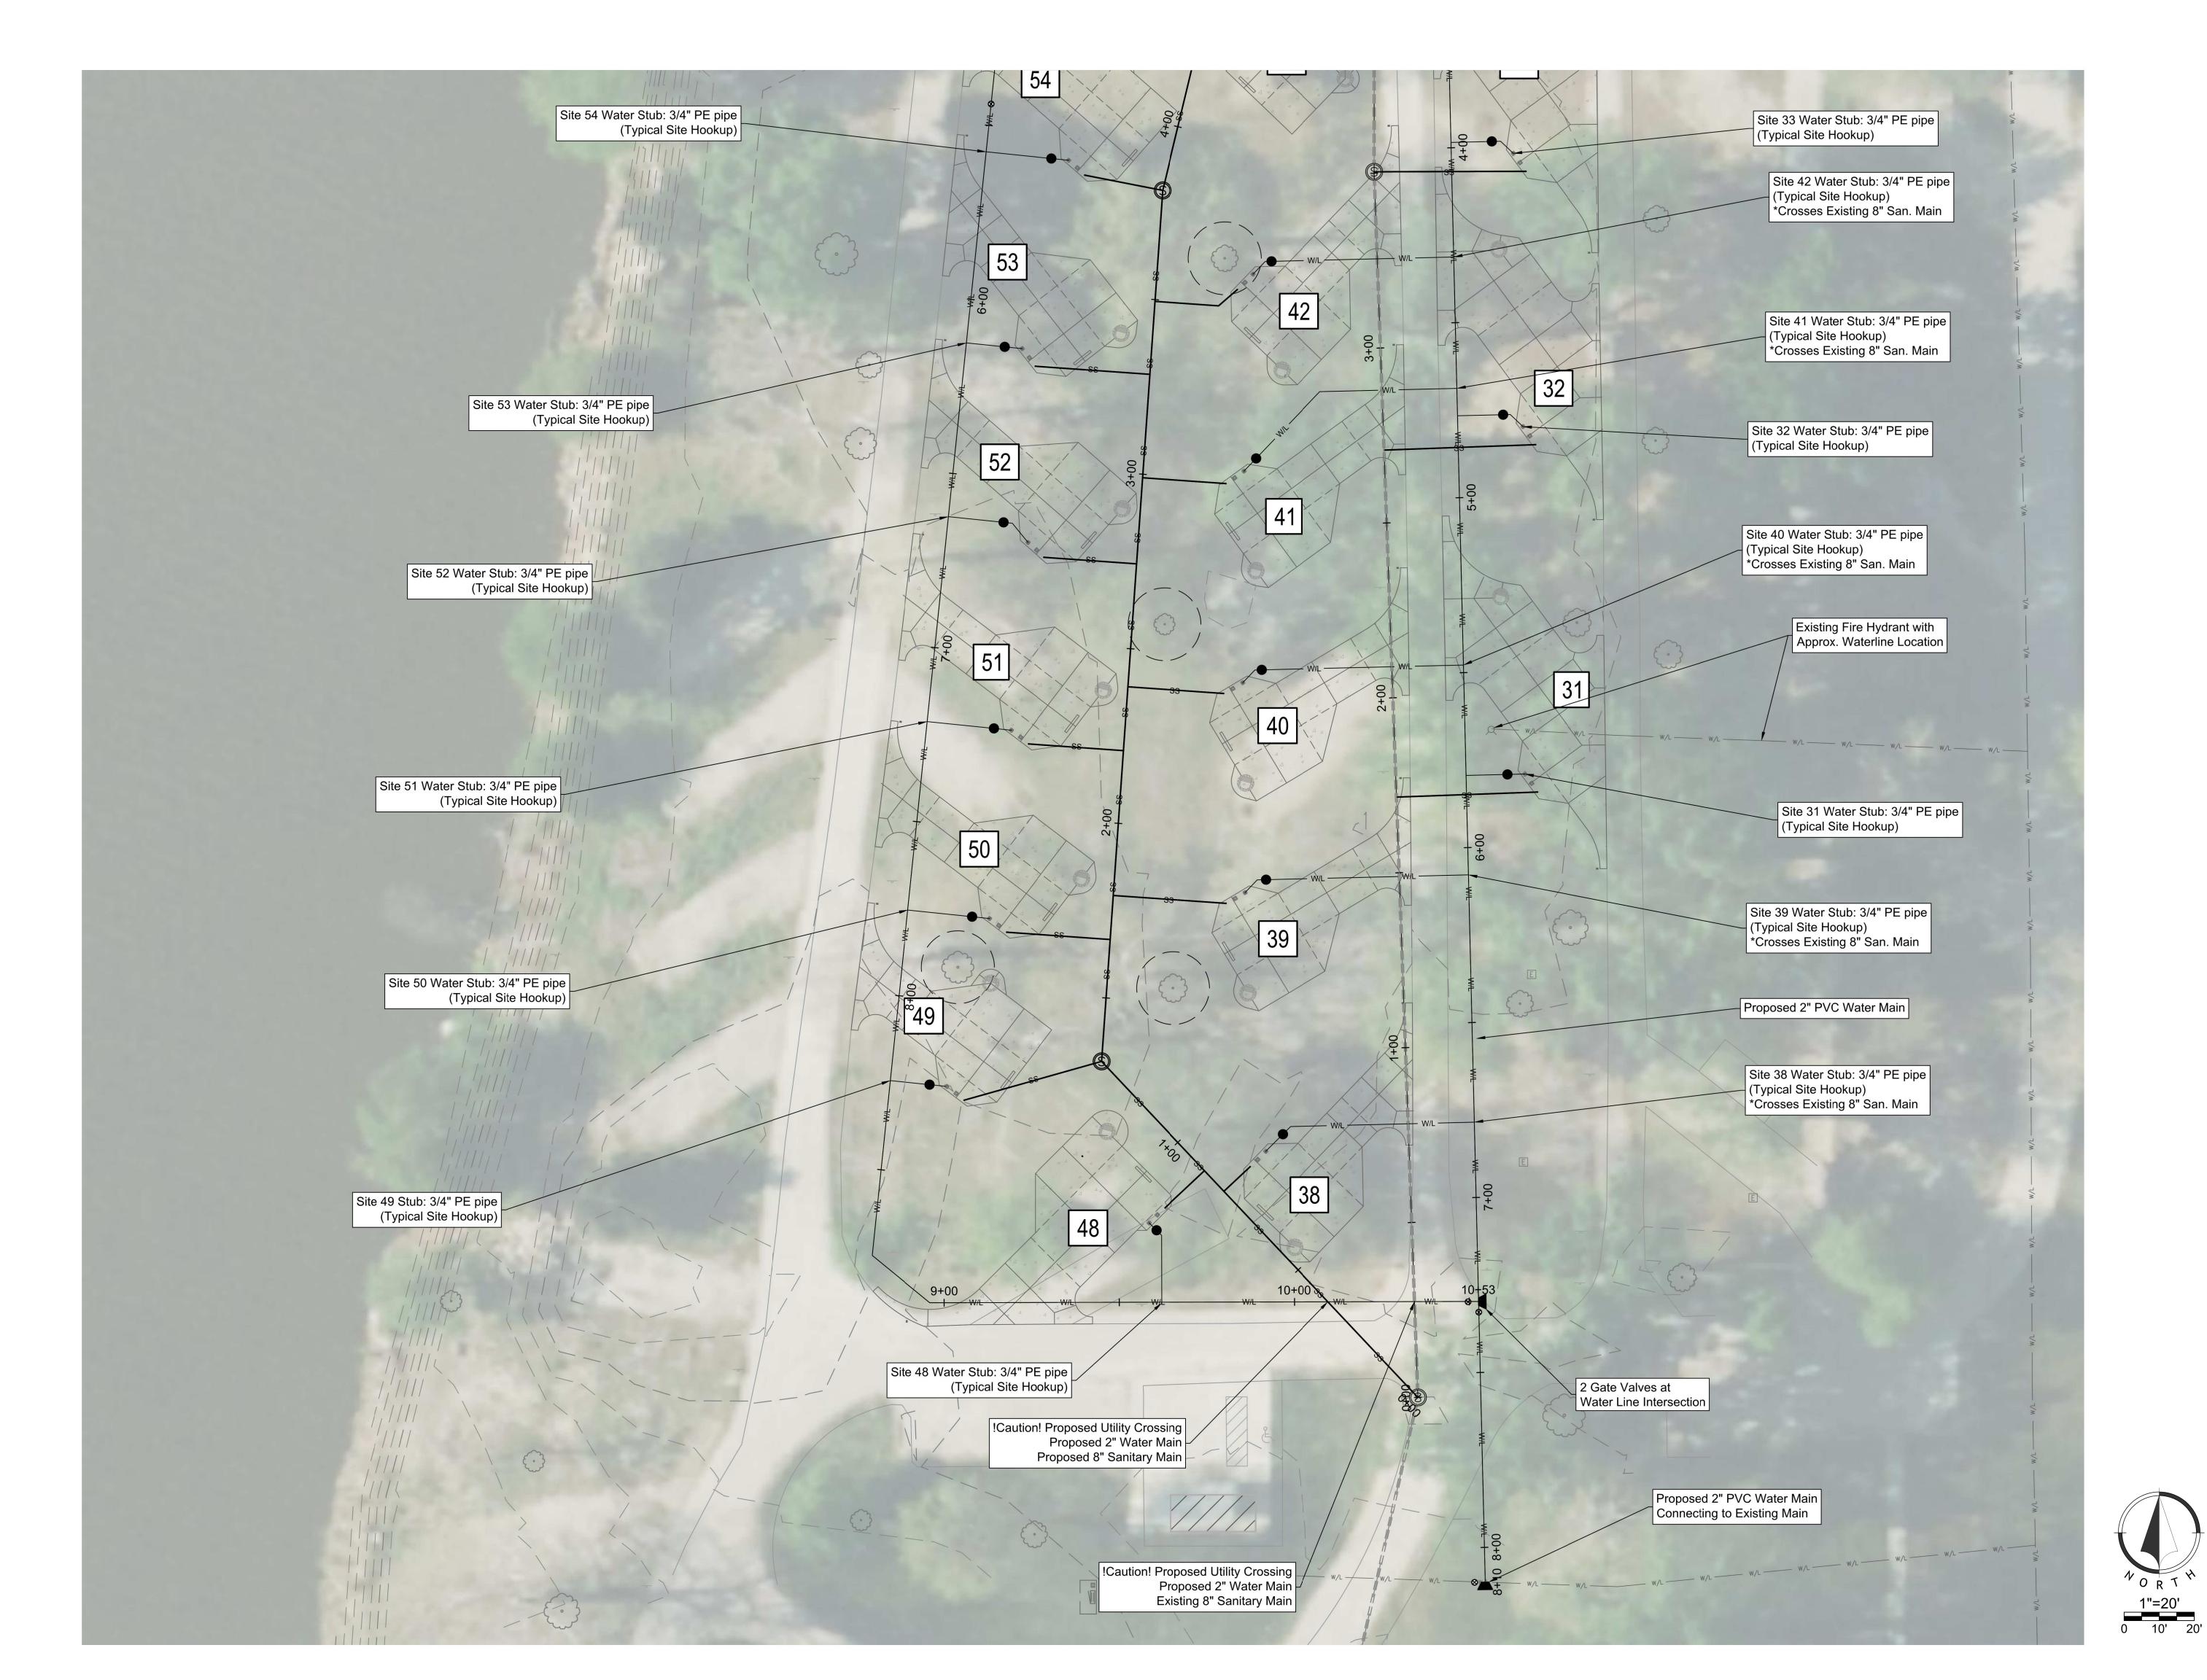



LANDSCAPE ARCHITECT:

LAC# MO-2002023826 929 Walnut Street, Ste. 700 Kansas City, Missouri 64106 P 816-756-5690

SURVEYOR & CIVIL ENGINEER:
RENAISSANCE INFRASTRUCTURE
CONSULTING
8653 Penrose Lane

CONSULTING

8653 Penrose Lane
Lenexa, Kansas 66219
P 913-317-9500

MFP

MEP:

ANTELLA CONSULTING ENGINEERS
1600 Genessee Street, Ste 260
Kansas City, Missouri 64102
P 816-421-0950

GEOTECHNICAL:
INTERTEK-PSI

INTERTEK-PSI 1211 W. Cambridge Circle Drive Kansas City, Kansas 66103 P 913-310-1600



DIVISION OF FACILITIES MANAGEMENT, DESIGN AND CONSTRUCTION

OFFICE OF ADMINISTRATION

DEPARTMENT OF NATURAL RESOURCES, MISSOURI STATE PARKS

CAMPGROUND RENOVATION AND UPGRADE

BIG LAKE STATE PARK 204 LAKE SHORE DRIVE CRAIG, MO 64437

PROJECT # X2218-01 SITE # 5105 FACILITY # 7815105008

REVISION:
DATE:
REVISION:
DATE:
REVISION:
DATE:
ISSUE DATE:4/7/2023

CAD DWG FILE:
DRAWN BY: TCD
CHECKED BY: MES
DESIGNED BY: ZMM

SHEET TITLE:


WATER PLAN -SOUTH

SHEET NUMBER:

C-106

SHEET 17 OF 41 APRIL 7, 2023



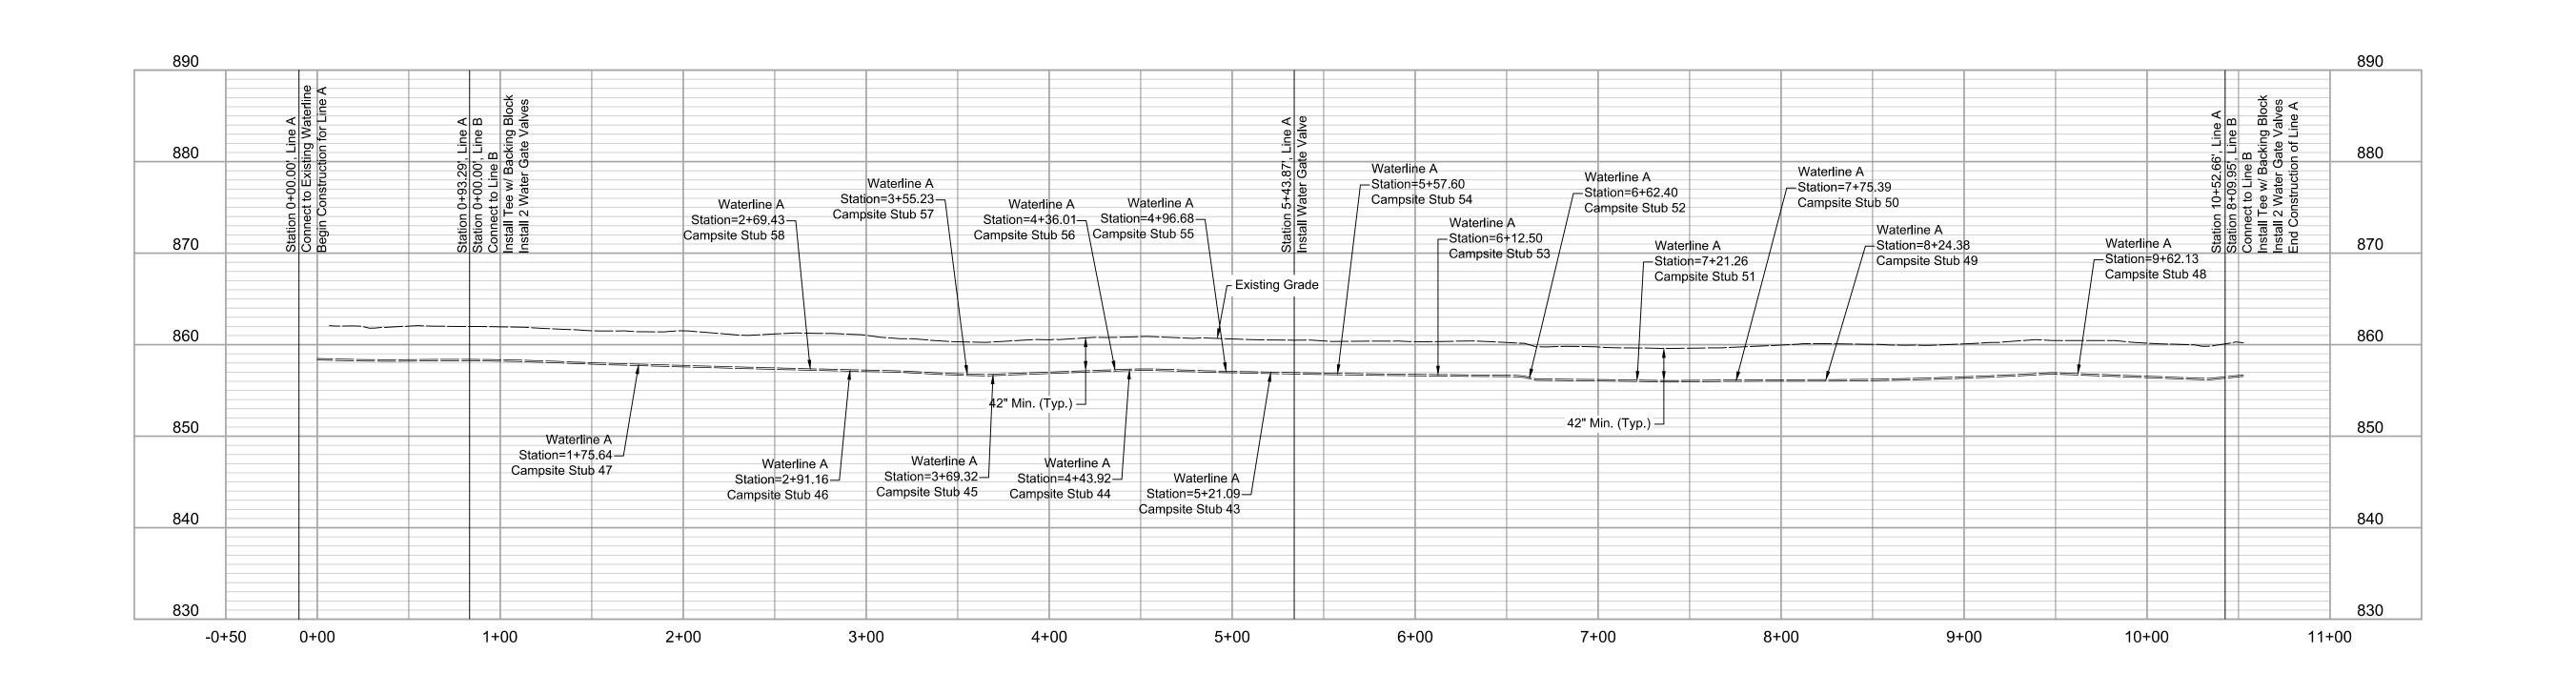



929 Walnut Street, Ste. 700 Kansas City, Missouri 64106 P 816-756-5690

SURVEYOR & CIVIL ENGINEER: RENAISSANCE INFRASTRUCTURE CONSULTING

Renaissance Infrastructure

MEP: ANTELLA CONSULTING ENGINEERS 1600 Genessee Street, Ste 260 Kansas City, Missouri 64102 P 816-421-0950

intertek 1211 W. Cambridge Circle Drive Kansas City, Kansas 66103

OFFICE OF ADMINISTRATION DIVISION OF FACILITIES MANAGEMENT, **DESIGN AND CONSTRUCTION**

DEPARTMENT OF NATURAL RESOURCES, MISSOURI STATE PARKS

CAMPGROUND RENOVATION AND UPGRADE

BIG LAKE STATE PARK 204 LAKE SHORE DRIVE CRAIG, MO 64437

PROJECT # X2218-01 SITE# 5105 FACILITY # 7815105008


REVISION: REVISION: **REVISION** ISSUE DATE:4/7/2023


CAD DWG FILE:
DRAWN BY: TCD
CHECKED BY: MES
DESIGNED BY: ZMM

SHEET TITLE:

WATERLINE A PLAN & PROFILE

SHEET NUMBER:

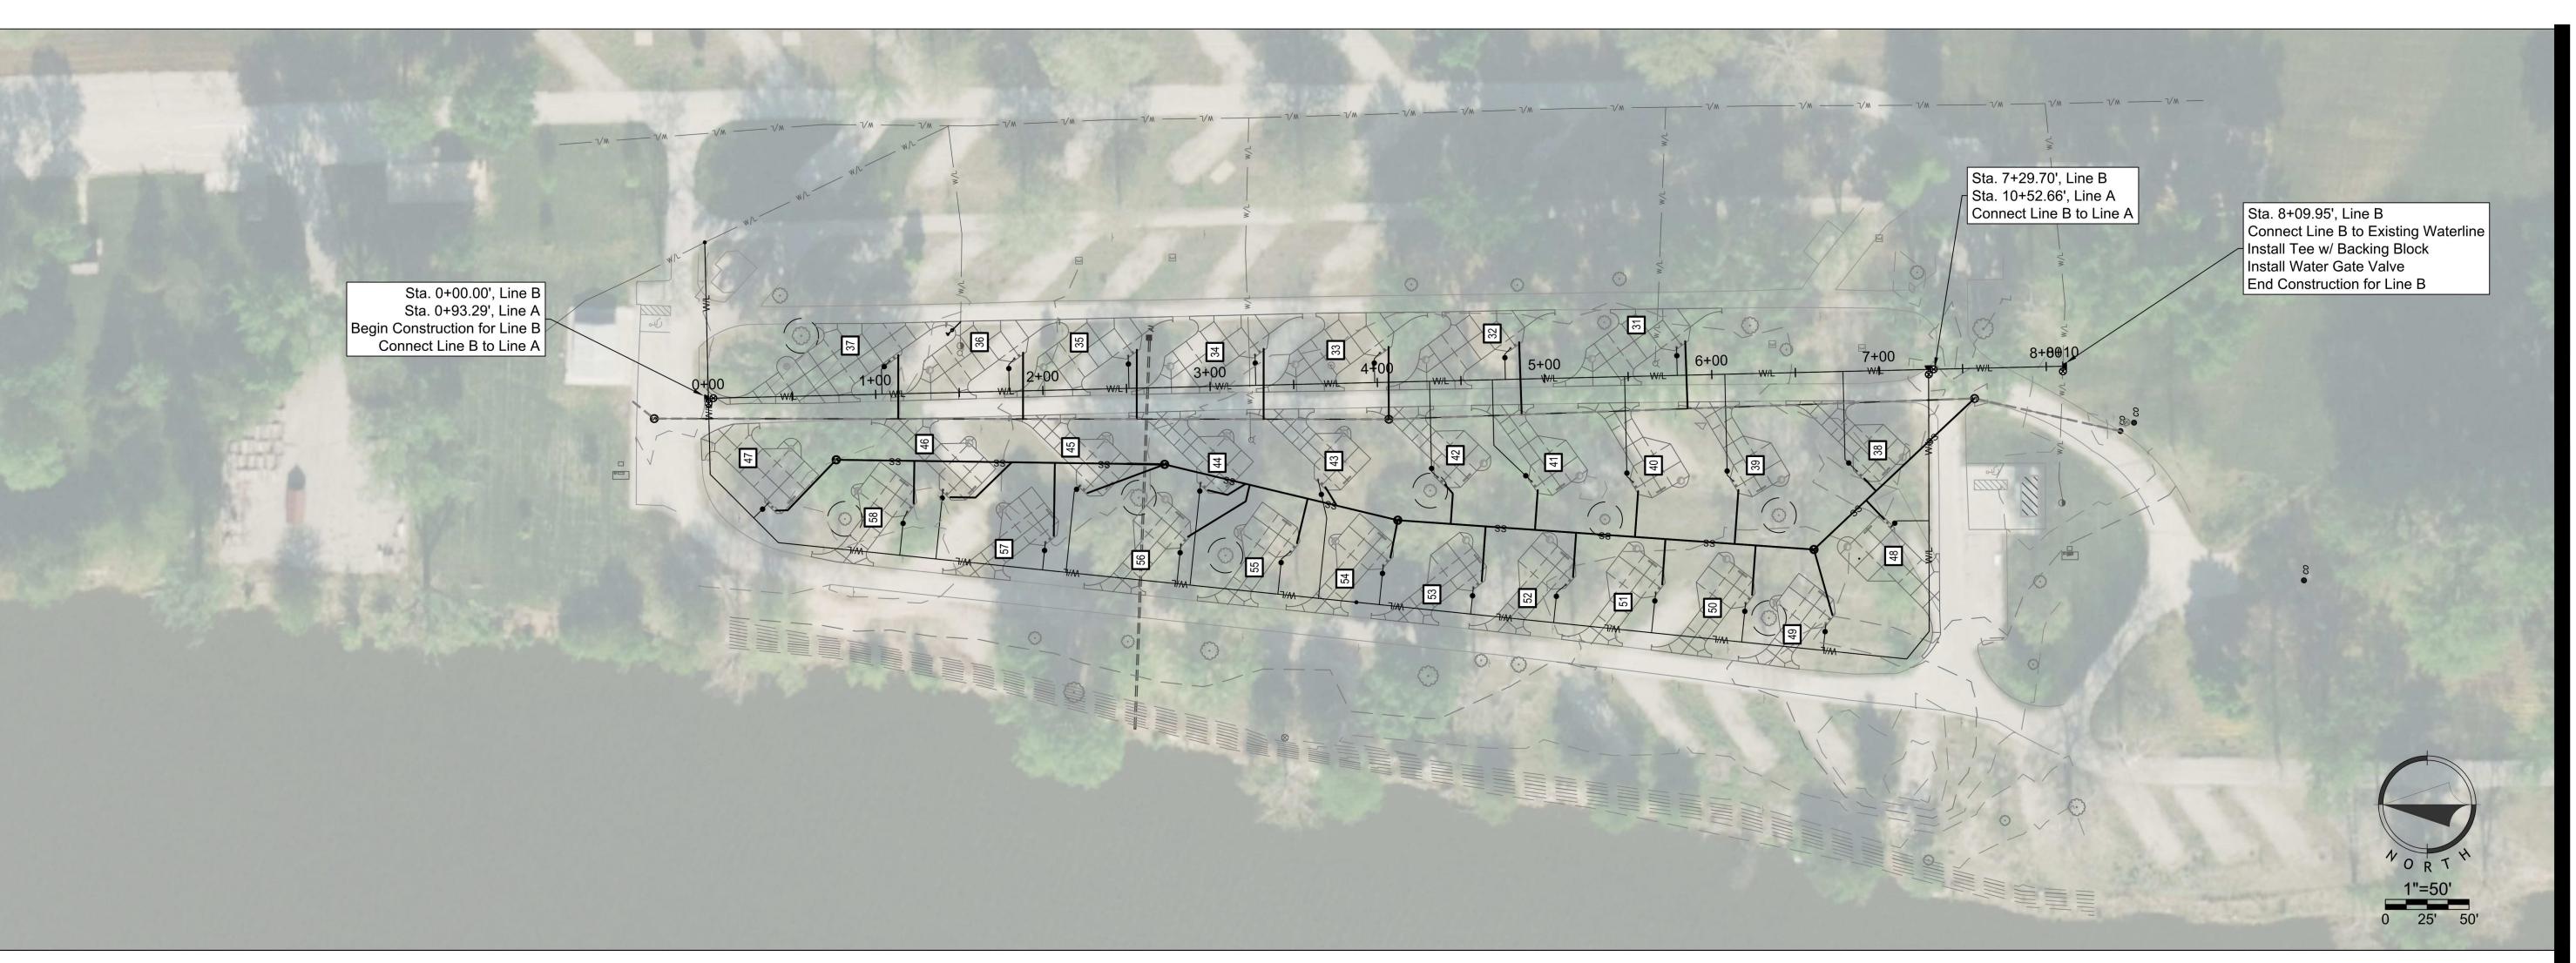

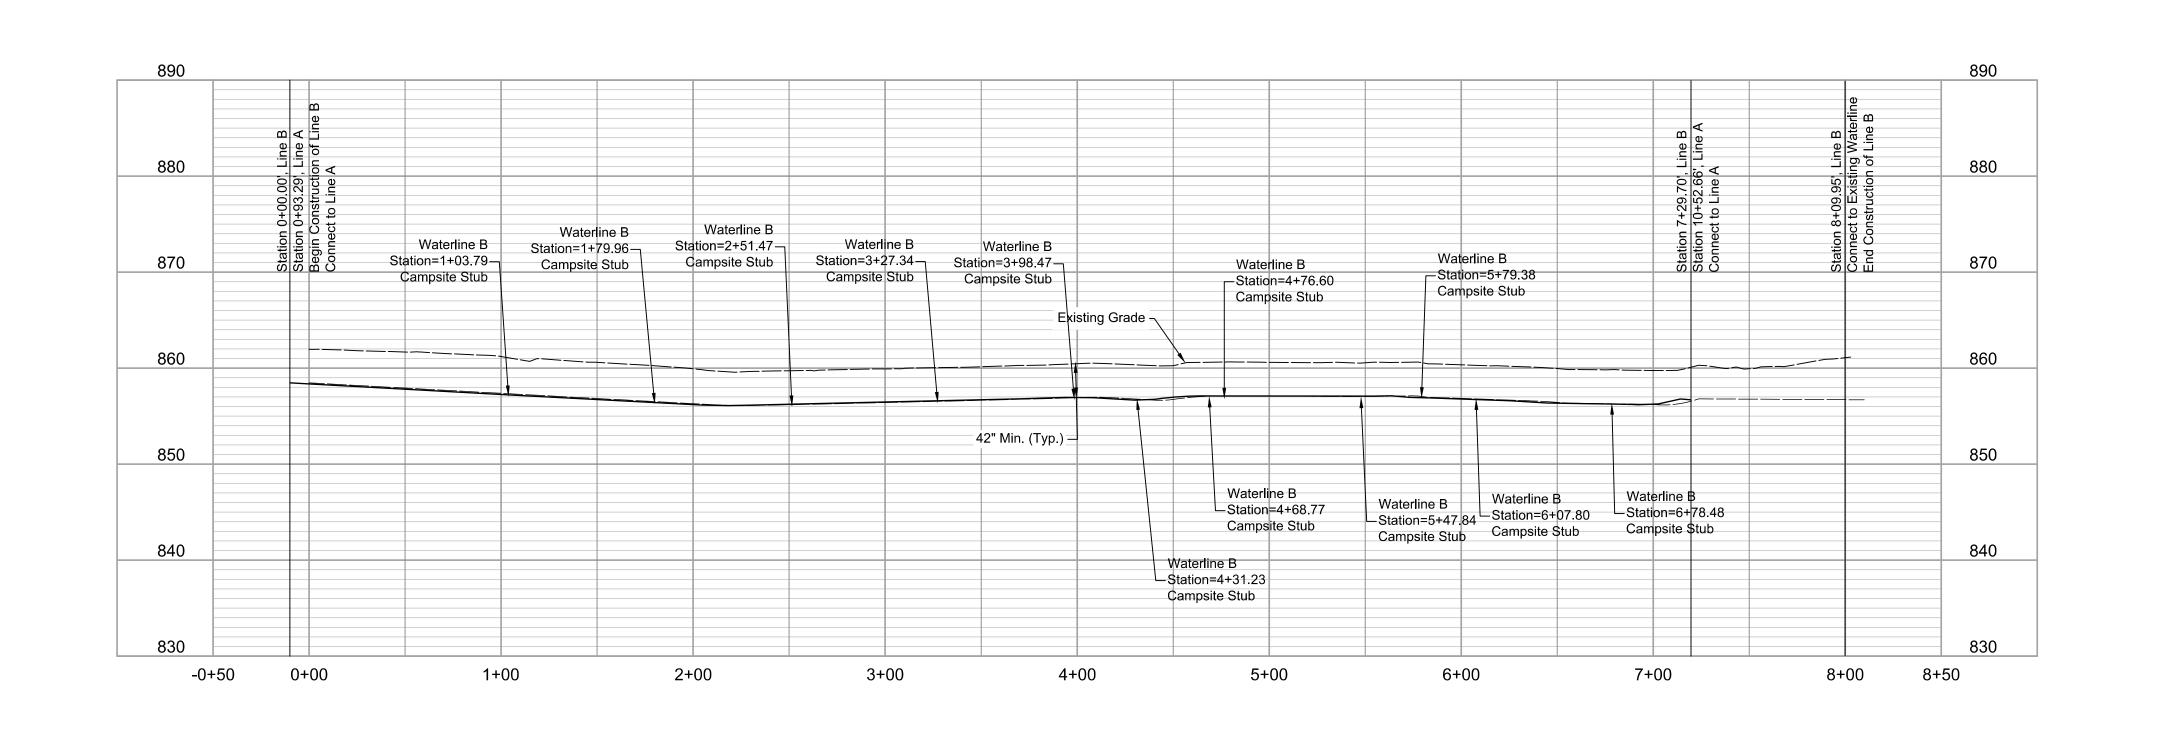



LAC# MO-2002023826 929 Walnut Street, Ste. 700

Kansas City, Missouri 64106 P 816-756-5690 SURVEYOR & CIVIL ENGINEER: RENAISSANCE INFRASTRUCTURE CONSULTING

8653 Penrose Lane Renaissance Infrastructure Lenexa, Kansas 66219 P 913-317-9500

MEP: ANTELLA CONSULTING ENGINEERS 1600 Genessee Street, Ste 260

Kansas City, Missouri 64102 P 816-421-0950

GEOTECHNICAL: INTERTEK-PSI

1211 W. Cambridge Circle Drive Kansas City, Kansas 66103 P 913-310-1600



OFFICE OF ADMINISTRATION DIVISION OF FACILITIES MANAGEMENT, **DESIGN AND CONSTRUCTION**

DEPARTMENT OF NATURAL RESOURCES, MISSOURI STATE PARKS

CAMPGROUND RENOVATION AND UPGRADE

BIG LAKE STATE PARK 204 LAKE SHORE DRIVE CRAIG, MO 64437

PROJECT # X2218-01 5105 FACILITY # 7815105008

REVISION: REVISION: **REVISION** ISSUE DATE:4/7/2023

CAD DWG FILE:
DRAWN BY: TCD
CHECKED BY: MES
DESIGNED BY: ZMM

SHEET TITLE:

WATERLINE B PLAN & PROFILE

SHEET NUMBER:

*See Sheet C-501 for Stub Details

890 Sanitary Existing Line ___ Station=4+25.21— 890 Sanitary Existing Line Campsite Stub 34 __Station=3+50.39 Sanitary Existing Line Campsite Stub 33 Station=5+01.08 ─ Campsite Stub 35 Sanitary Existing Line
Station=2+70.83 880 880 Sanitary Existing Line
Station=5+69.03
Campsite Stub 36 Campsite Stub 32 Sanitary Existing Line Station=1+71.62 870 870 Sanitary Existing Line ___ Station=6+42.86 Campsite Stub 31 Campsite Stub 37 860 860 850 850 439.16 LF 350.39 LF 8" Ex. VCP Pipe 8" Ex. VCP Pipe @ 0.35% Slope 840 840 @ 0.35% Slope 830 830 820 820 810 810 800

4+00

3+00

2+00

1+00

0+00

7+00

9+00

6+00

5+00

STATE OF MISSOURI MICHAEL L. PARSON, **GOVERNOR**

LAC# MO-2002023826

929 Walnut Street, Ste. 700 Kansas City, Missouri 64106 P 816-756-5690

SURVEYOR & CIVIL ENGINEER:

RENAISSANCE INFRASTRUCTURE CONSULTING 8653 Penrose Lane Lenexa, Kansas 66219

P 913-317-9500 MEP:
ANTELLA CONSULTING ENGINEERS 1600 Genessee Street, Ste 260

Kansas City, Missouri 64102

GEOTECHNICAL: INTERTEK-PSI 1211 W. Cambridge Circle Drive



nfrastructure

OFFICE OF ADMINISTRATION DIVISION OF FACILITIES MANAGEMENT, **DESIGN AND CONSTRUCTION**

DEPARTMENT OF NATURAL RESOURCES, MISSOURI STATE PARKS

CAMPSITE RENOVATION & UPDATES

BIG LAKE STATE PARK 204 LAKE SHORE DRIVE CRAIG, MO 64437

PROJECT # X2218-01 SITE# 5105 FACILITY # 7815105008

REVISION: REVISION: REVISION: ISSUE DATE:4/7/2023

CAD DWG FILE:
DRAWN BY: TCD
CHECKED BY: MES DESIGNED BY: ZMM


SHEET TITLE:

SANITARY LINE A PLAN & PROFILE

SHEET NUMBER:

APRIL 7, 2023

-1+00

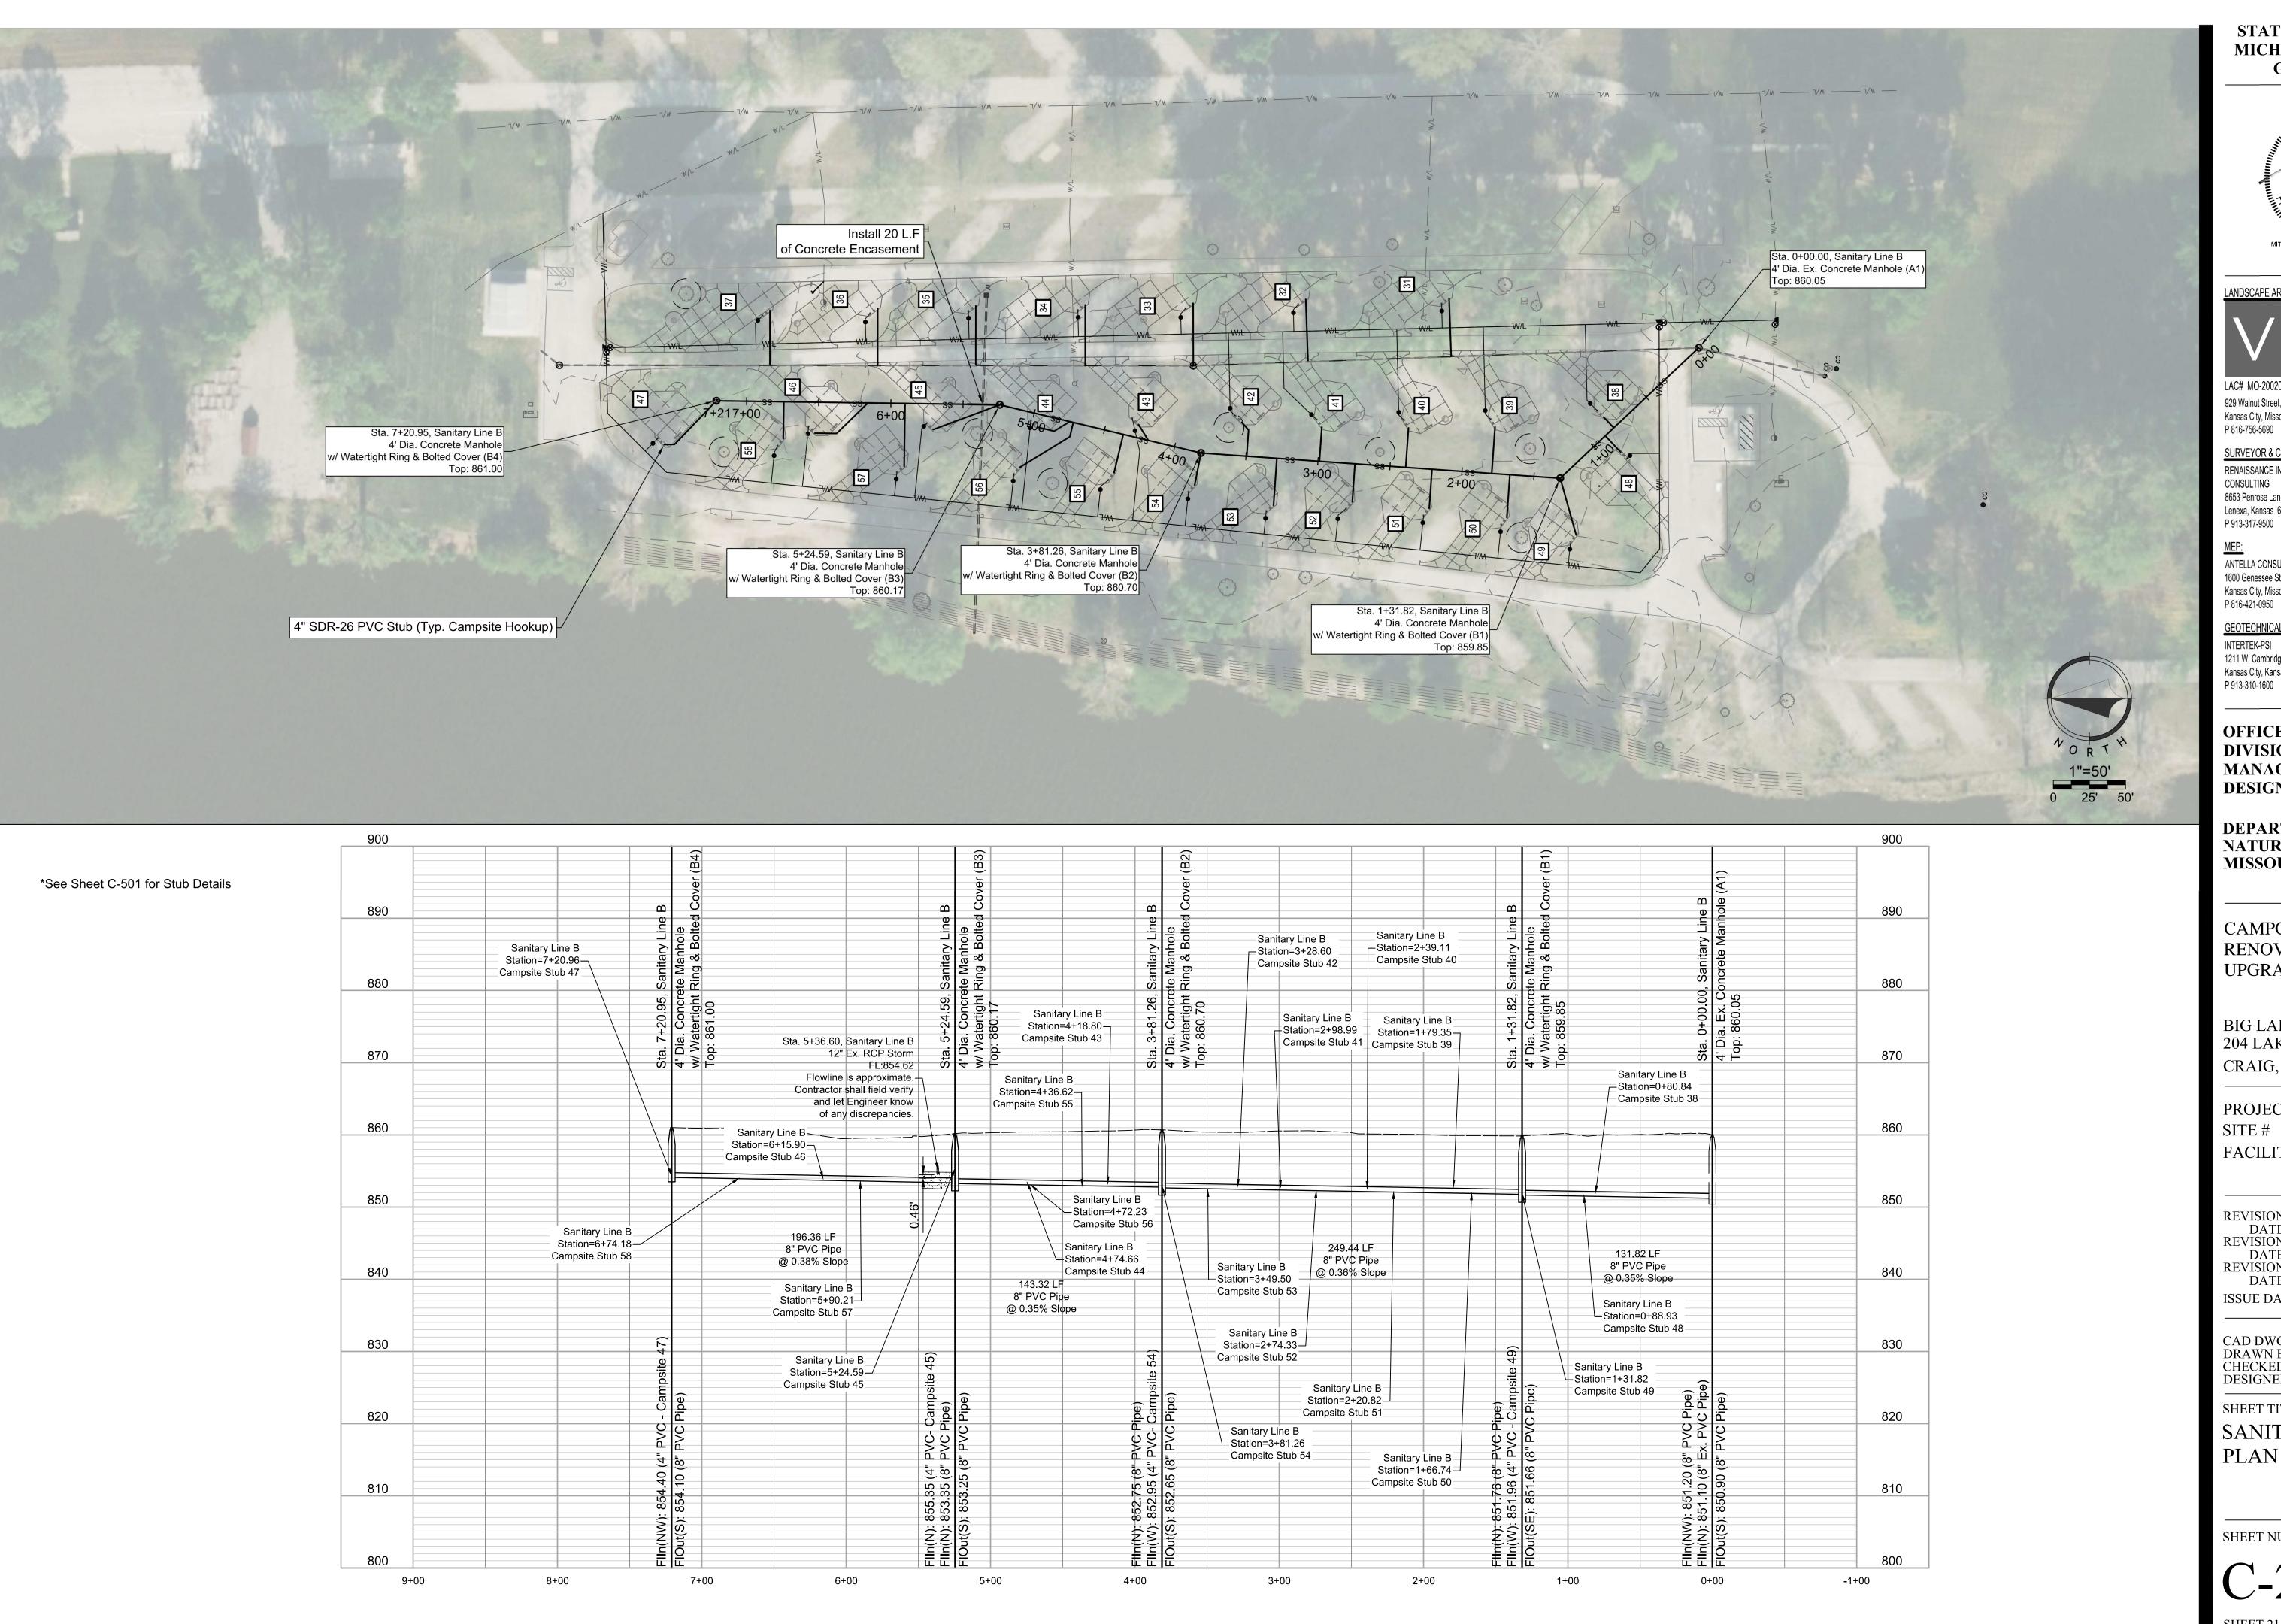



LAC# MO-2002023826 929 Walnut Street, Ste. 700 Kansas City, Missouri 64106 P 816-756-5690

SURVEYOR & CIVIL ENGINEER: RENAISSANCE INFRASTRUCTURE CONSULTING 8653 Penrose Lane Lenexa, Kansas 66219

MEP: ANTELLA CONSULTING ENGINEERS 1600 Genessee Street, Ste 260 Kansas City, Missouri 64102 P 816-421-0950

GEOTECHNICAL: INTERTEK-PSI

1211 W. Cambridge Circle Drive Kansas City, Kansas 66103



OFFICE OF ADMINISTRATION DIVISION OF FACILITIES MANAGEMENT, **DESIGN AND CONSTRUCTION**

DEPARTMENT OF NATURAL RESOURCES, MISSOURI STATE PARKS

CAMPGROUND RENOVATION AND **UPGRADE**

BIG LAKE STATE PARK 204 LAKE SHORE DRIVE CRAIG, MO 64437

PROJECT # X2218-01 SITE# 5105 FACILITY # 7815105008

REVISION: REVISION: **REVISION** ISSUE DATE:4/7/2023

CAD DWG FILE: DRAWN BY: CHECKED BY: MES DESIGNED BY: ZMM

SHEET TITLE:

SANITARY LINE B PLAN & PROFILE

SHEET NUMBER:

APRIL 7, 2023

Note: Minimum Cleansing Velocity = 2 fps per MDNR Minimum Design Standards for Gravity Sewers

STATE OF MISSOURI MICHAEL L. PARSON, **GOVERNOR**





929 Walnut Street, Ste. 700 Kansas City, Missouri 64106 P 816-756-5690

Lenexa, Kansas 66219 P 913-317-9500

SURVEYOR & CIVIL ENGINEER: RENAISSANCE INFRASTRUCTURE CONSULTING 8653 Penrose Lane



MEP:
ANTELLA CONSULTING ENGINEERS 1600 Genessee Street, Ste 260



GEOTECHNICAL: INTERTEK-PSI

P 816-421-0950

1211 W. Cambridge Circle Drive Kansas City, Kansas 66103 P 913-310-1600



intertek

DIVISION OF FACILITIES MANAGEMENT, DESIGN AND CONSTRUCTION

DEPARTMENT OF NATURAL RESOURCES, MISSOURI STATE PARKS

CAMPGROUND RENOVATION AND UPGRADE

BIG LAKE STATE PARK 204 LAKE SHORE DRIVE CRAIG, MO 64437

PROJECT # X2218-01 SITE # 5105 FACILITY # 7815105008


REVISION:
DATE:
REVISION:
DATE:
REVISION:
DATE:
ISSUE DATE:4/7/2023


· ·
TCD
MES
ZMM

SHEET TITLE: SANITARY STUBS & CALCS

SHEET NUMBER:

SHEET 22 OF 41 APRIL 7, 2023

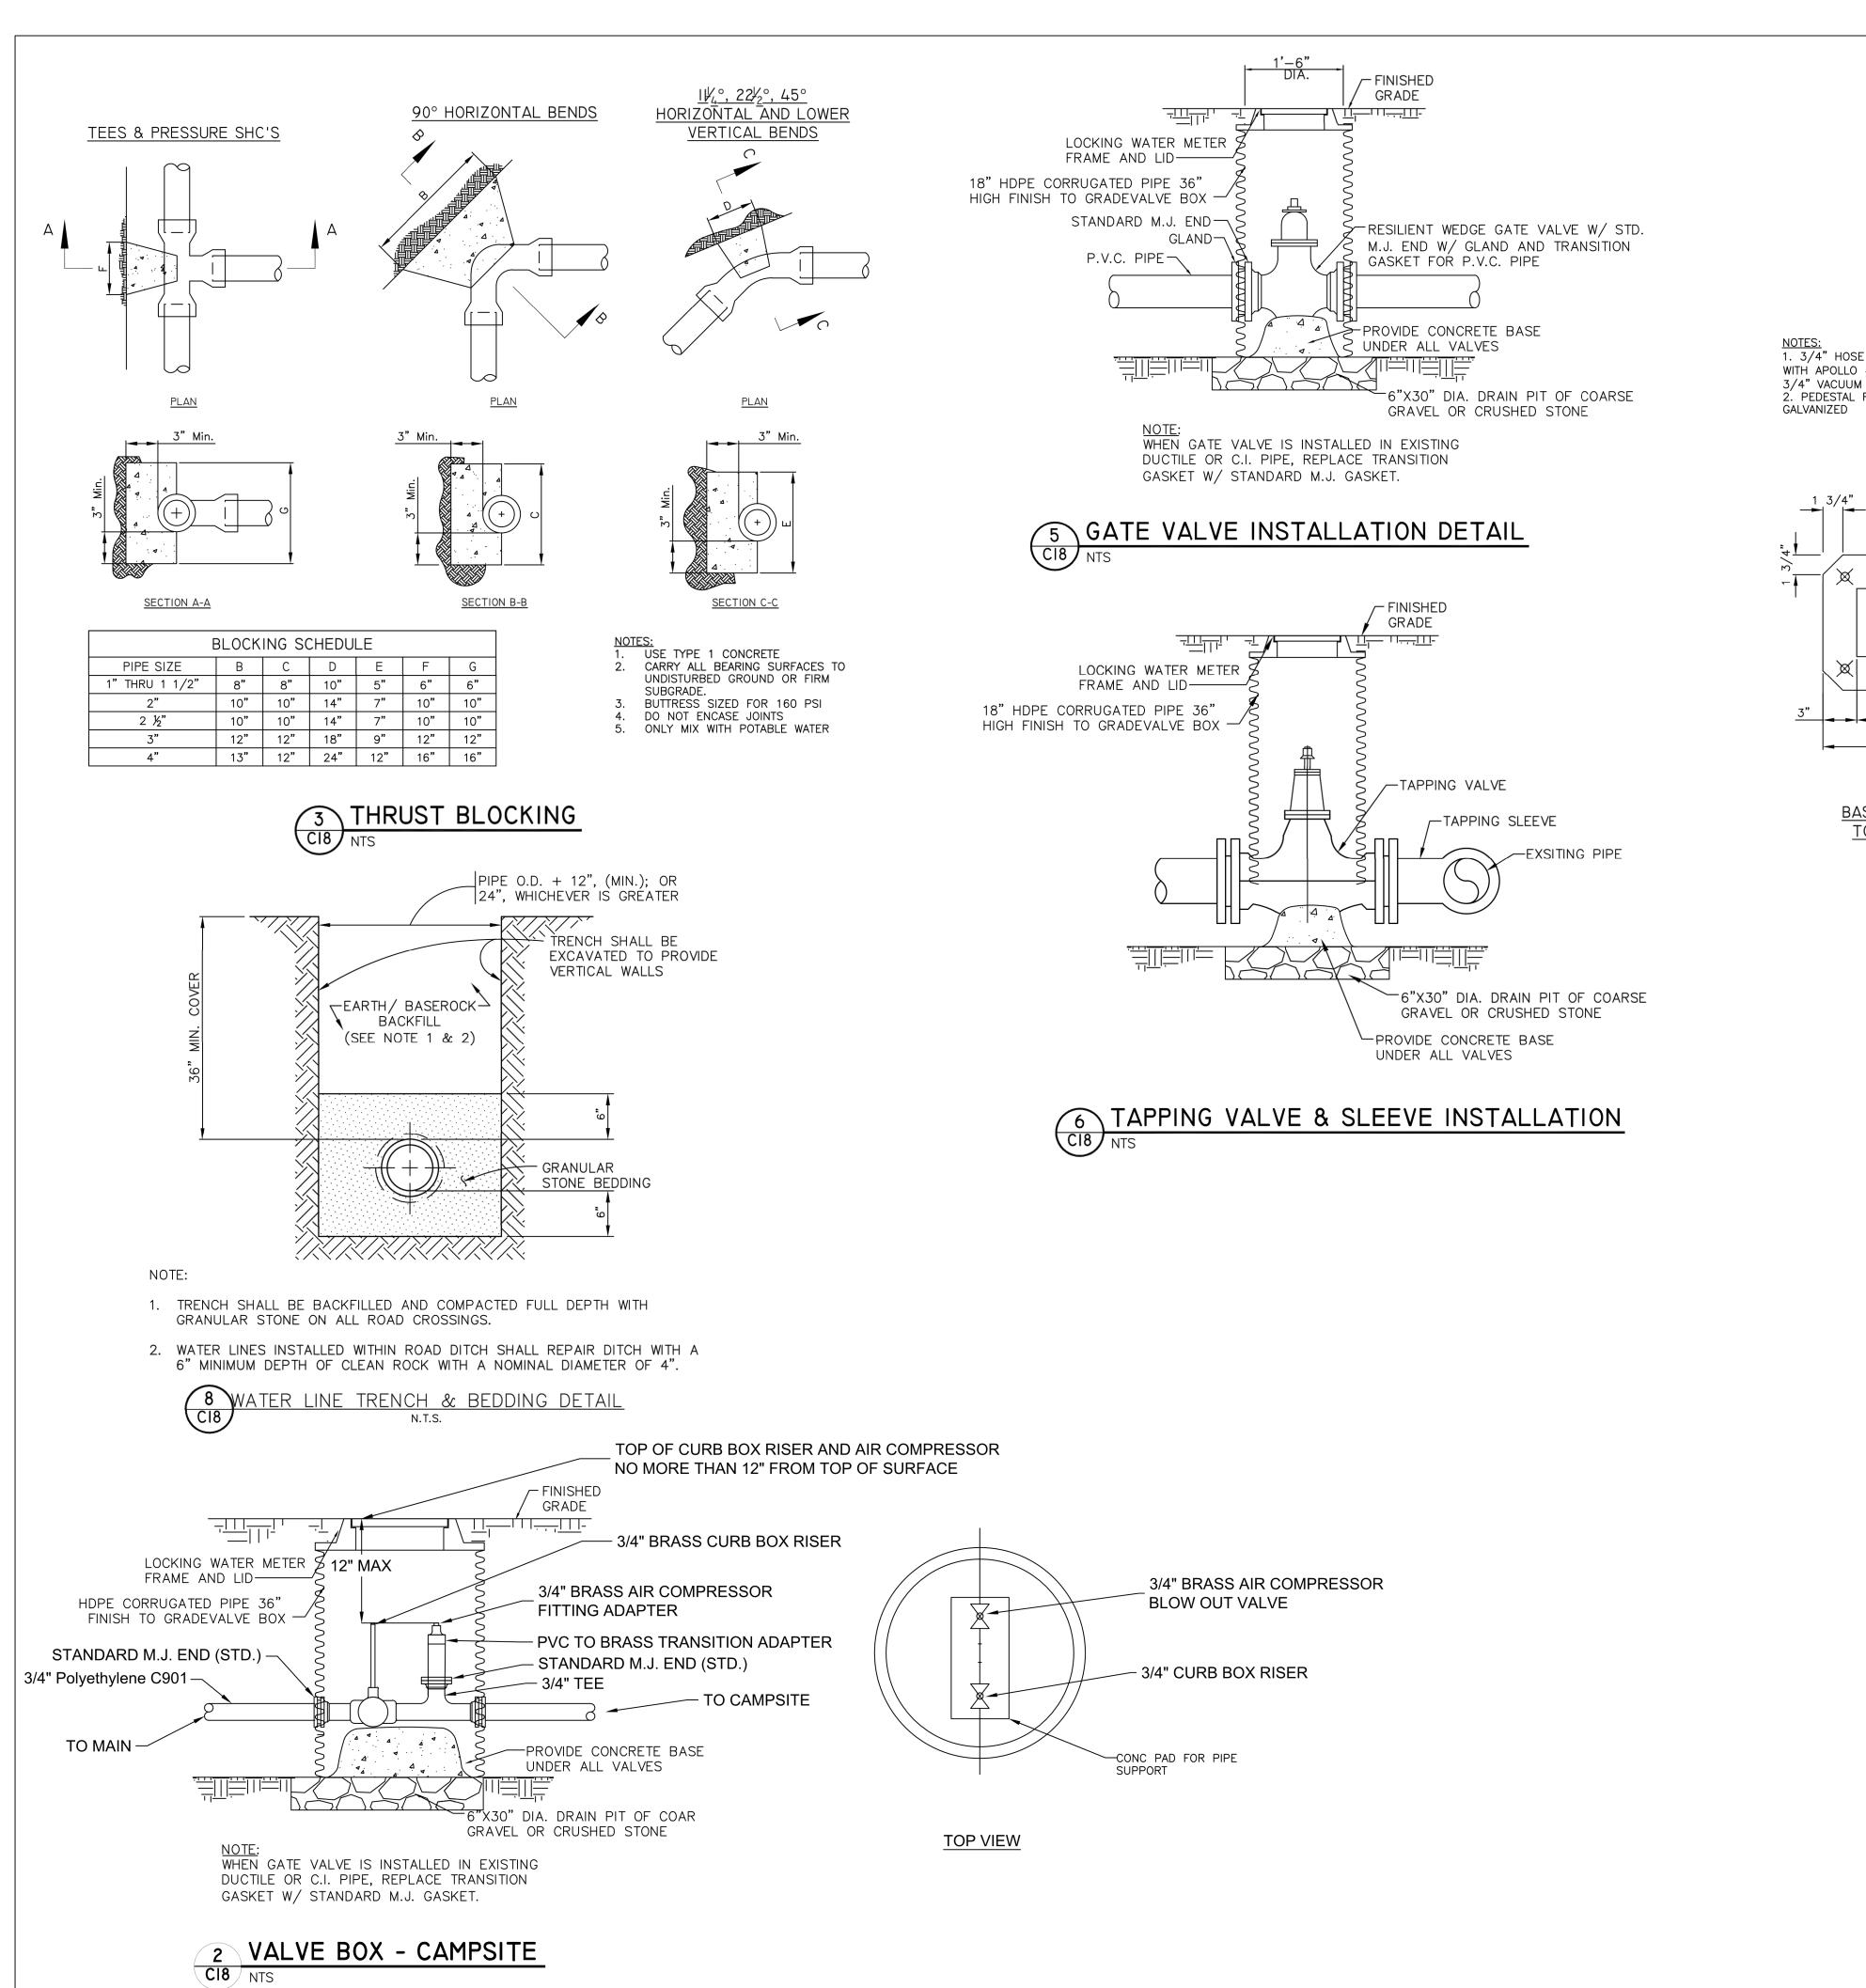

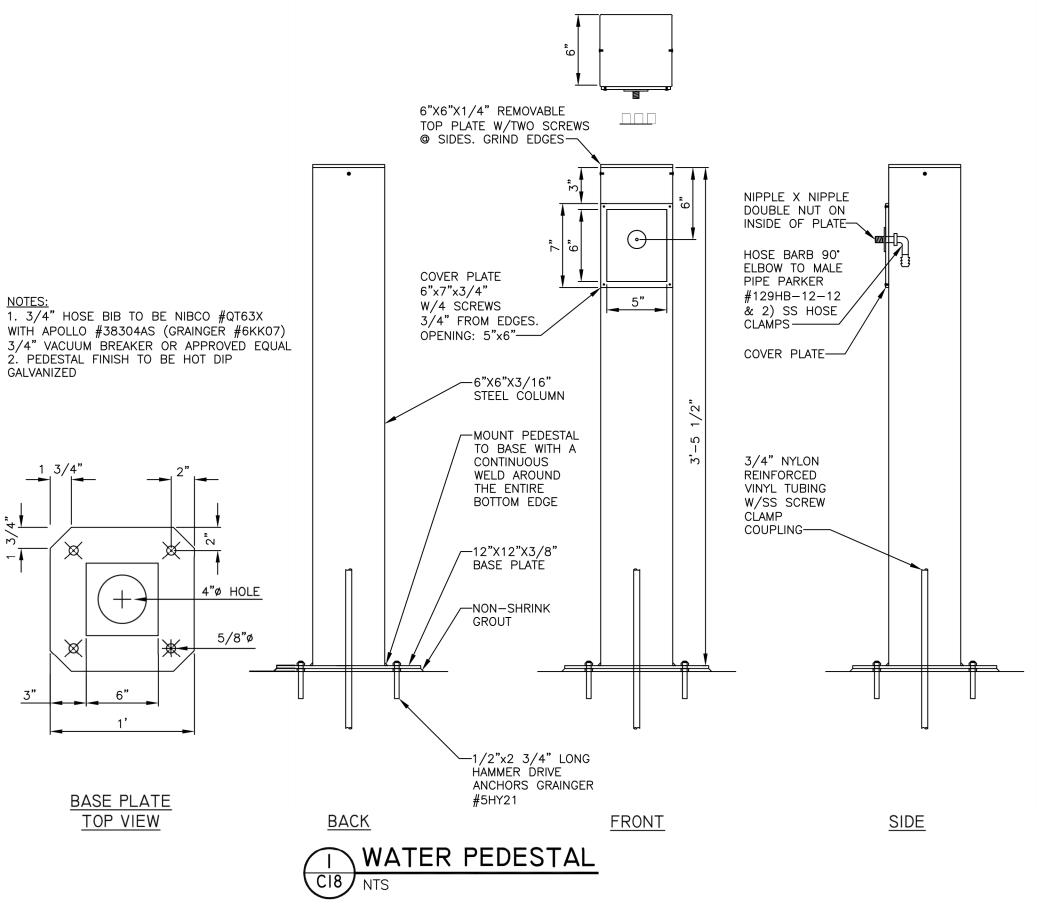



929 Walnut Street, Ste. 700 Kansas City, Missouri 64106 P 816-756-5690

SURVEYOR & CIVIL ENGINEER: RENAISSANCE INFRASTRUCTURE CONSULTING

8653 Penrose Lane Lenexa, Kansas 66219 P 913-317-9500

ANTELLA CONSULTING ENGINEERS

1600 Genessee Street, Ste 260 Kansas City, Missouri 64102 P 816-421-0950

INTERTEK-PSI

TYPE "K" COPPER TUBING UNLESS

OTHERWISE NOTED. MIN. 24" BELOW FINISHED GRADE

-CORPORATION STOP, MUELLER

OR APPROVED EQUAL.

APPROVED EQUAL.

SERVICE TAP DETAIL

OLD MAIN WATE.

A SERVICE TAP DETAIL

OLD MAIN WATE.

TWIN SEAL TAPPING SERVICE

SADDLE, CLOW F-6350 OR

-PROPOSED MAIN WATER LINE

1211 W. Cambridge Circle Drive Kansas City, Kansas 66103 P 913-310-1600

intertek

nfrastructure

OFFICE OF ADMINISTRATION DIVISION OF FACILITIES MANAGEMENT, **DESIGN AND CONSTRUCTION**

DEPARTMENT OF NATURAL RESOURCES, MISSOURI STATE PARKS

CAMPGROUND RENOVATION AND **UPGRADE**

BIG LAKE STATE PARK 204 LAKE SHORE DRIVE CRAIG, MO 64437

PROJECT # X2218-01 5105

FACILITY # 7815105008

REVISION REVISION REVISION ISSUE DATE:4/7/2023


CAD DWG FILE DRAWN BY: CHECKED BY: MES DESIGNED BY: ZMM

SHEET TITLE:

WATER DETAILS

SHEET NUMBER:


SHEET 23 OF 41 APRIL 7, 2023

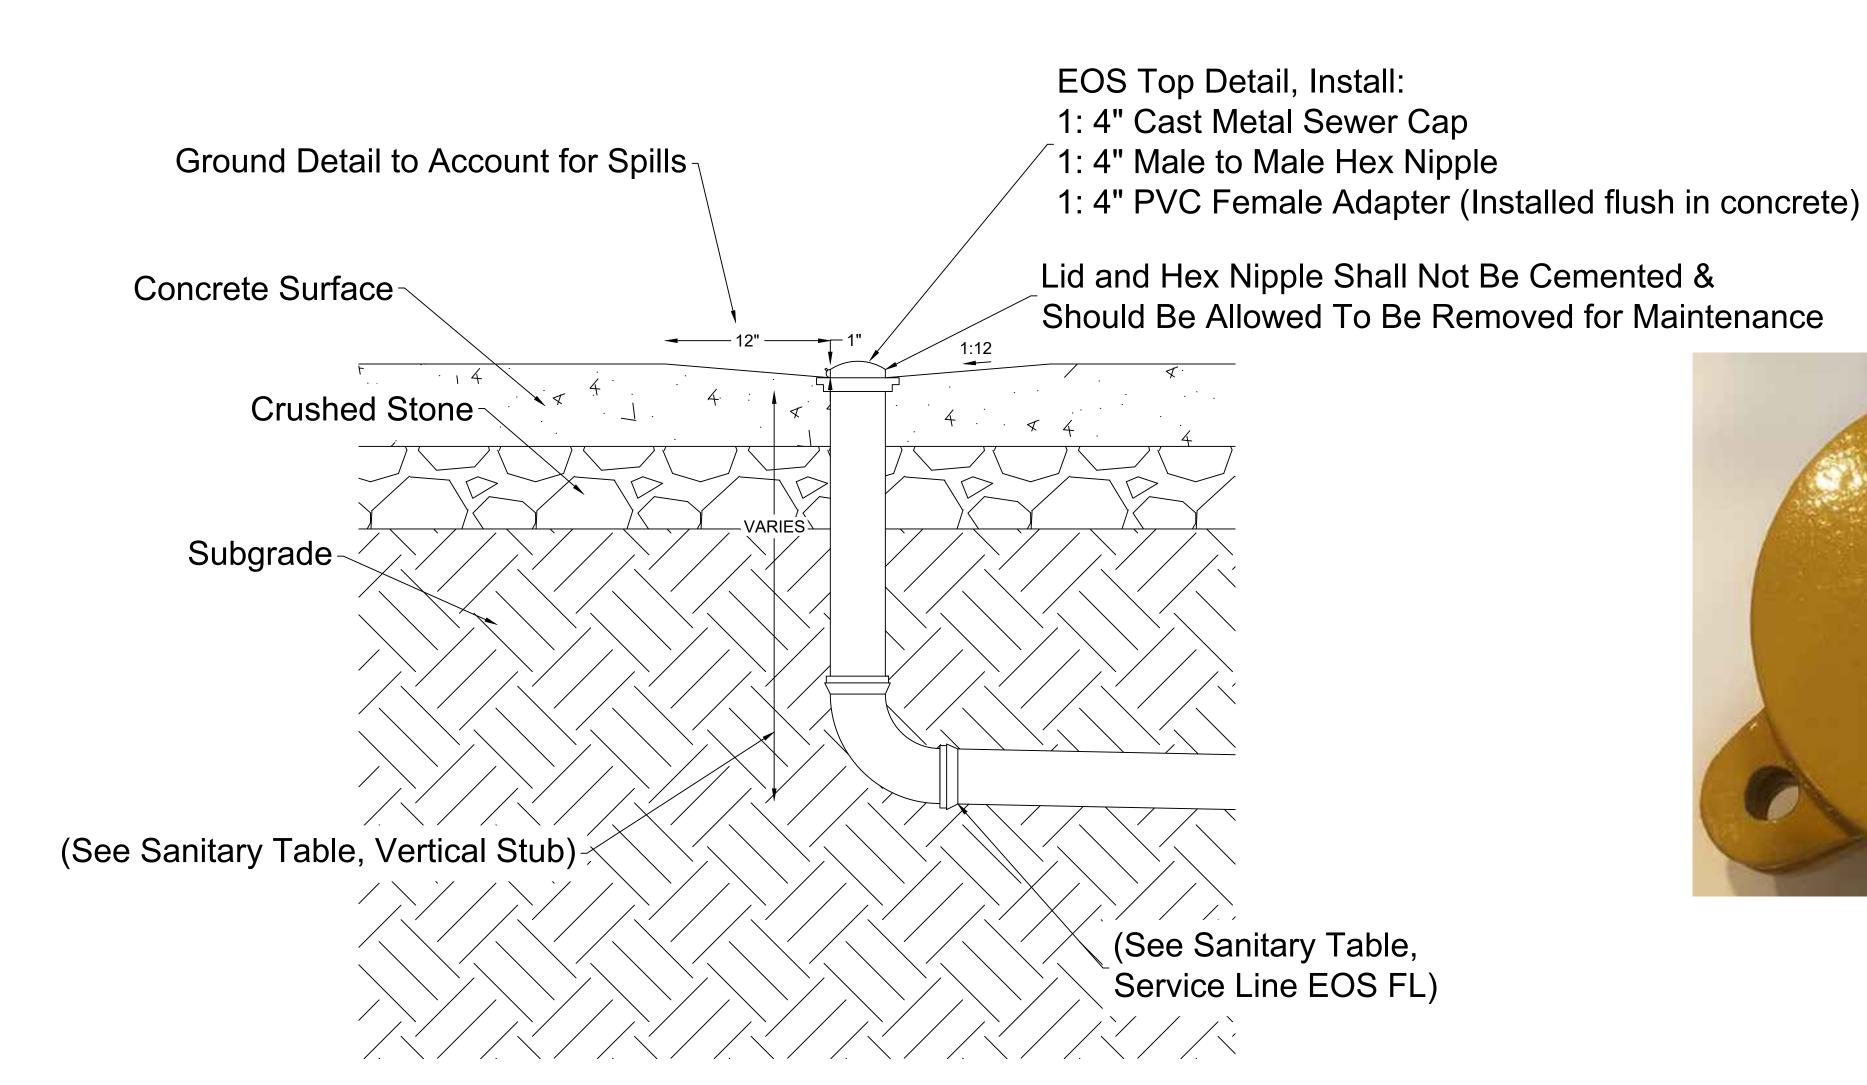


The Tower Company, Inc. 4" RV Site Sewer Cap, Cast Metal (Or approved equal)






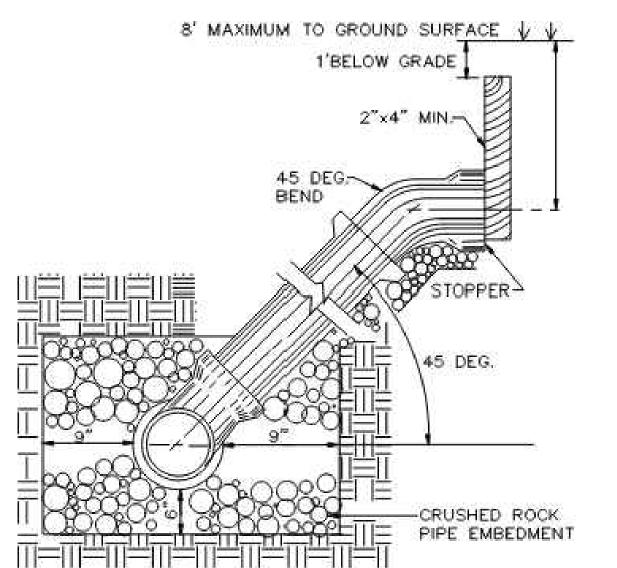

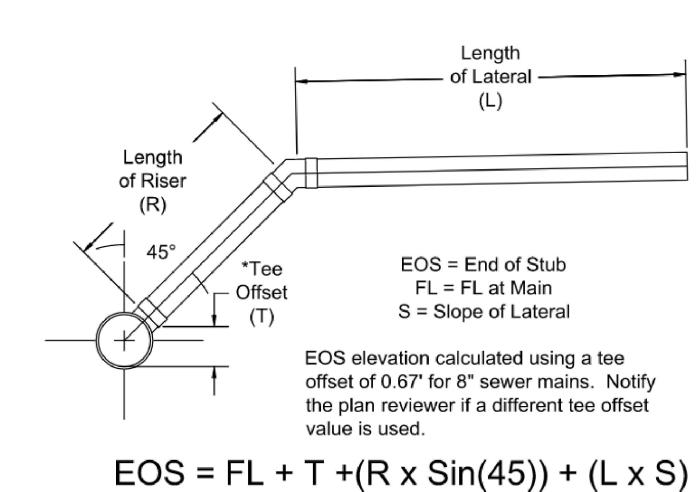

STANDARD DEEP TRENCH SERVICE RISER NOT TO SCALE

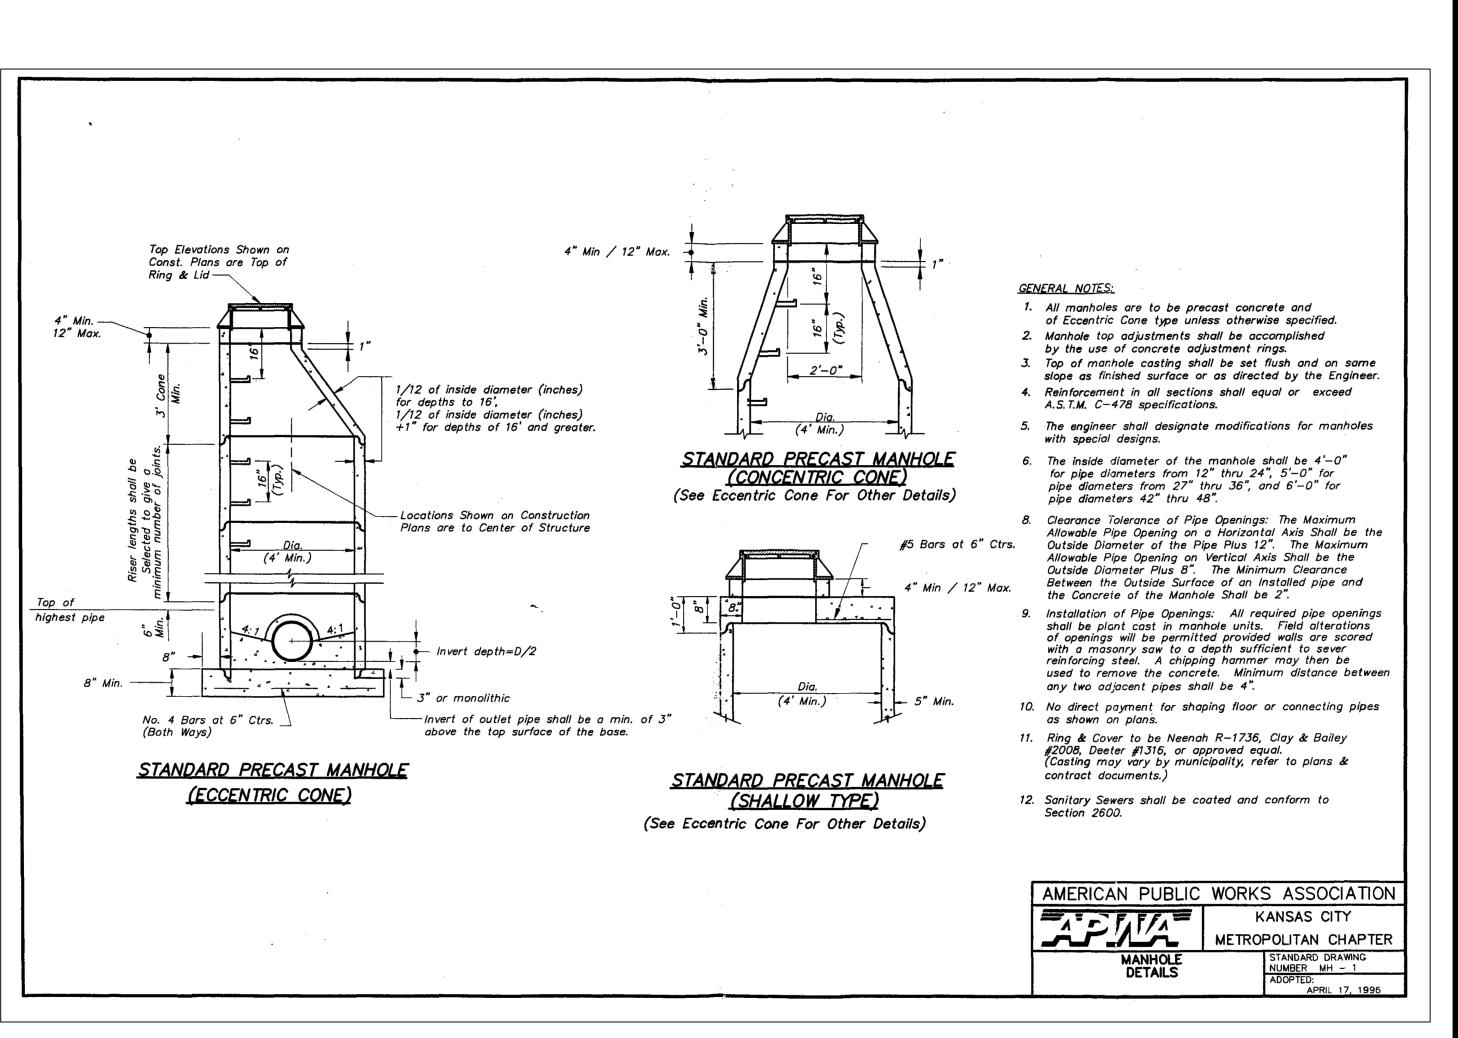

STATE OF MISSOURI MICHAEL L. PARSON, **GOVERNOR**



929 Walnut Street, Ste. 700 Kansas City, Missouri 64106

RENAISSANCE INFRASTRUCTURE

MEP: ANTELLA CONSULTING ENGINEERS

Antella

GEOTECHNICAL INTERTEK-PSI

1211 W. Cambridge Circle Drive Kansas City, Kansas 66103



OFFICE OF ADMINISTRATION DIVISION OF FACILITIES MANAGEMENT, **DESIGN AND CONSTRUCTION**

DEPARTMENT OF NATURAL RESOURCES, MISSOURI STATE PARKS

CAMPSITE RENOVATION & UPDATES

BIG LAKE STATE PARK 204 LAKE SHORE DRIVE CRAIG, MO 64437

PROJECT # X2218-01 FACILITY # 7815105008

REVISION REVISION ISSUE DATE:4/7/2023

DRAWN BY: CHECKED BY: MES

DESIGNED BY: ZMM

SHEET TITLE:

SANITARY DETAILS

SHEET NUMBER:

C-503

APRIL 7, 2023

LANDSCAPE ARCHITECT: LAC# MO-2002023826 929 Walnut Street, Ste. 700 Kansas City, Missouri 64106 P 816-756-5690 SURVEYOR & CIVIL ENGINEER: RENAISSANCE INFRASTRUCTURE CONSULTING 8653 Penrose Lane Lenexa, Kansas 66219 P 913-317-9500 MEP: ANTELLA CONSULTING ENGINEERS 1600 Genessee Street, Ste 260 Kansas City, Missouri 64102 P 816-421-0950 GEOTECHNICAL: INTERTEK-PSI 1211 W. Cambridge Circle Drive Kansas City, Kansas 66103 P 913-310-1600 MANAGEMENT, CAMPGROUND RENOVATION AND UPGRADE CRAIG, MO 64437 SITE # 5105 FACILITY # 7815105008 CAD DWG FILE: DRAWN BY: TCD CHECKED BY: MES DESIGNED BY: ZMM SHEET TITLE: SANITARY DETAILS SHEET NUMBER: SHEET 25 OF 41 APRIL 7, 2023

STATE OF MISSOURI MICHAEL L. PARSON, **GOVERNOR**












OFFICE OF ADMINISTRATION DIVISION OF FACILITIES DESIGN AND CONSTRUCTION


DEPARTMENT OF NATURAL RESOURCES, MISSOURI STATE PARKS


BIG LAKE STATE PARK 204 LAKE SHORE DRIVE

PROJECT # X2218-01

REVISION:
DATE:
REVISION:
DATE:
REVISION:
DATE:
ISSUE DATE: 4/7/2023

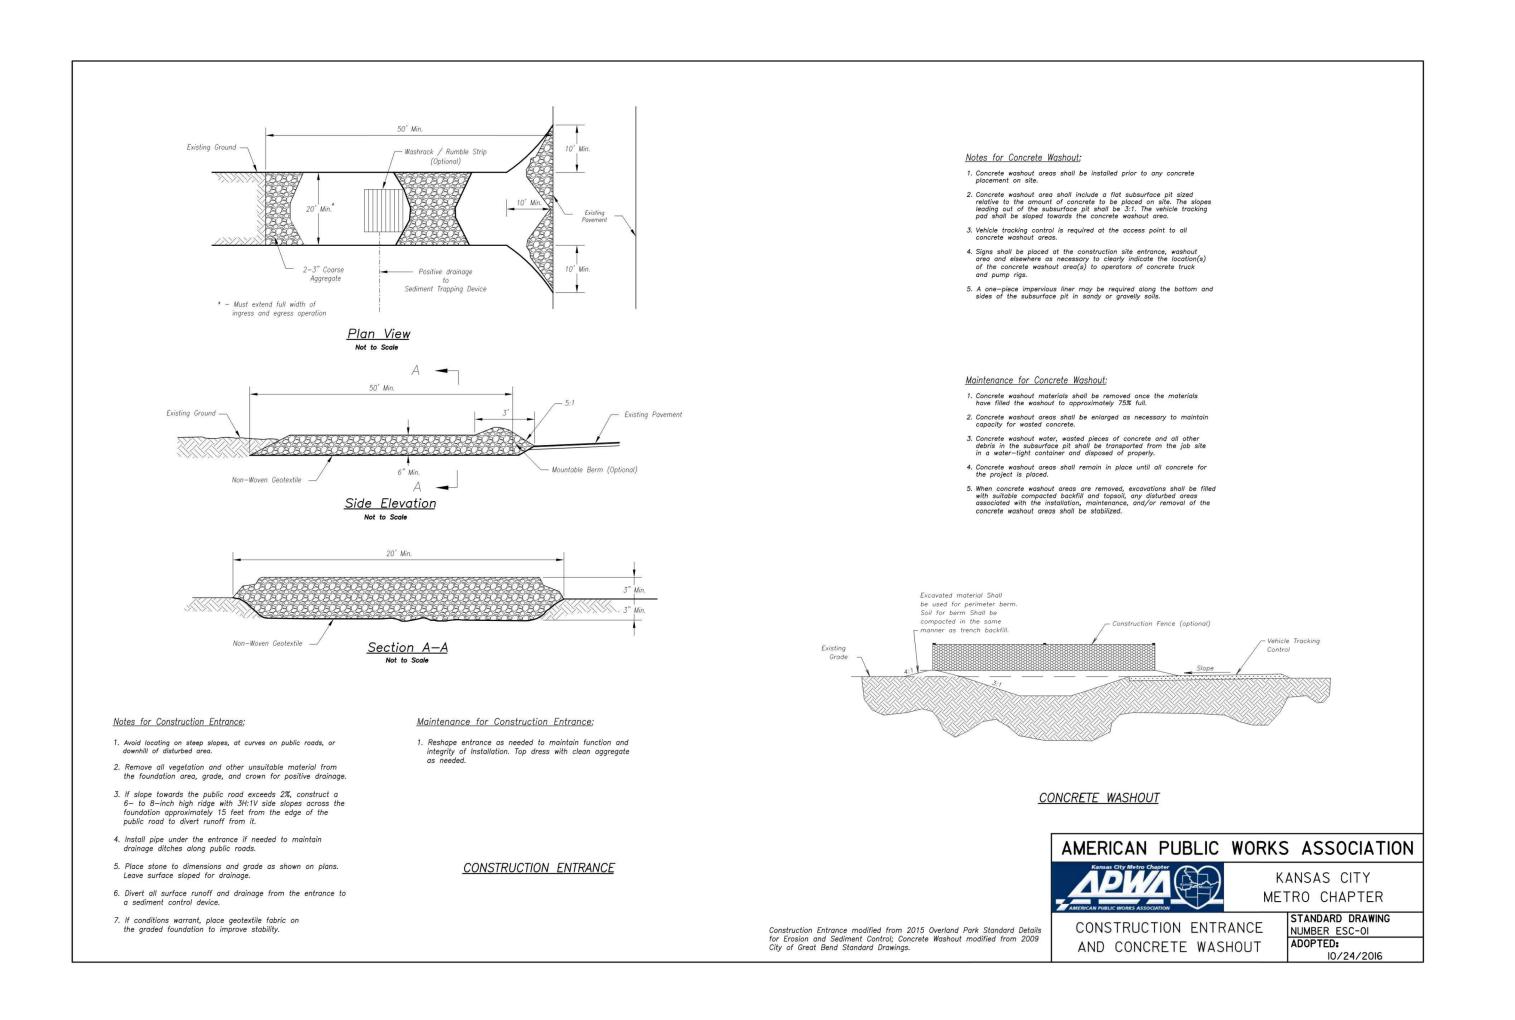

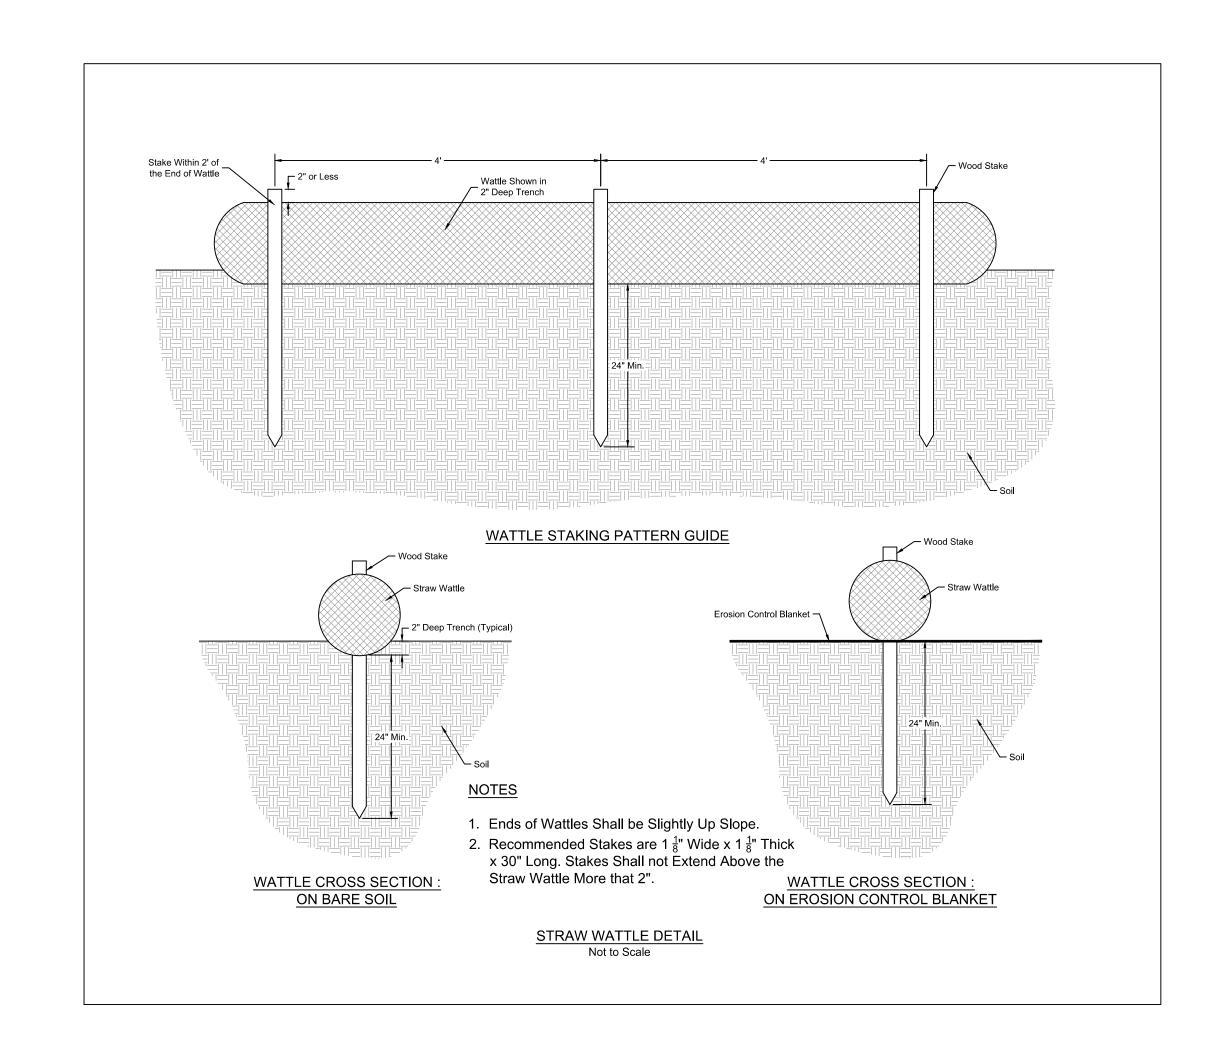

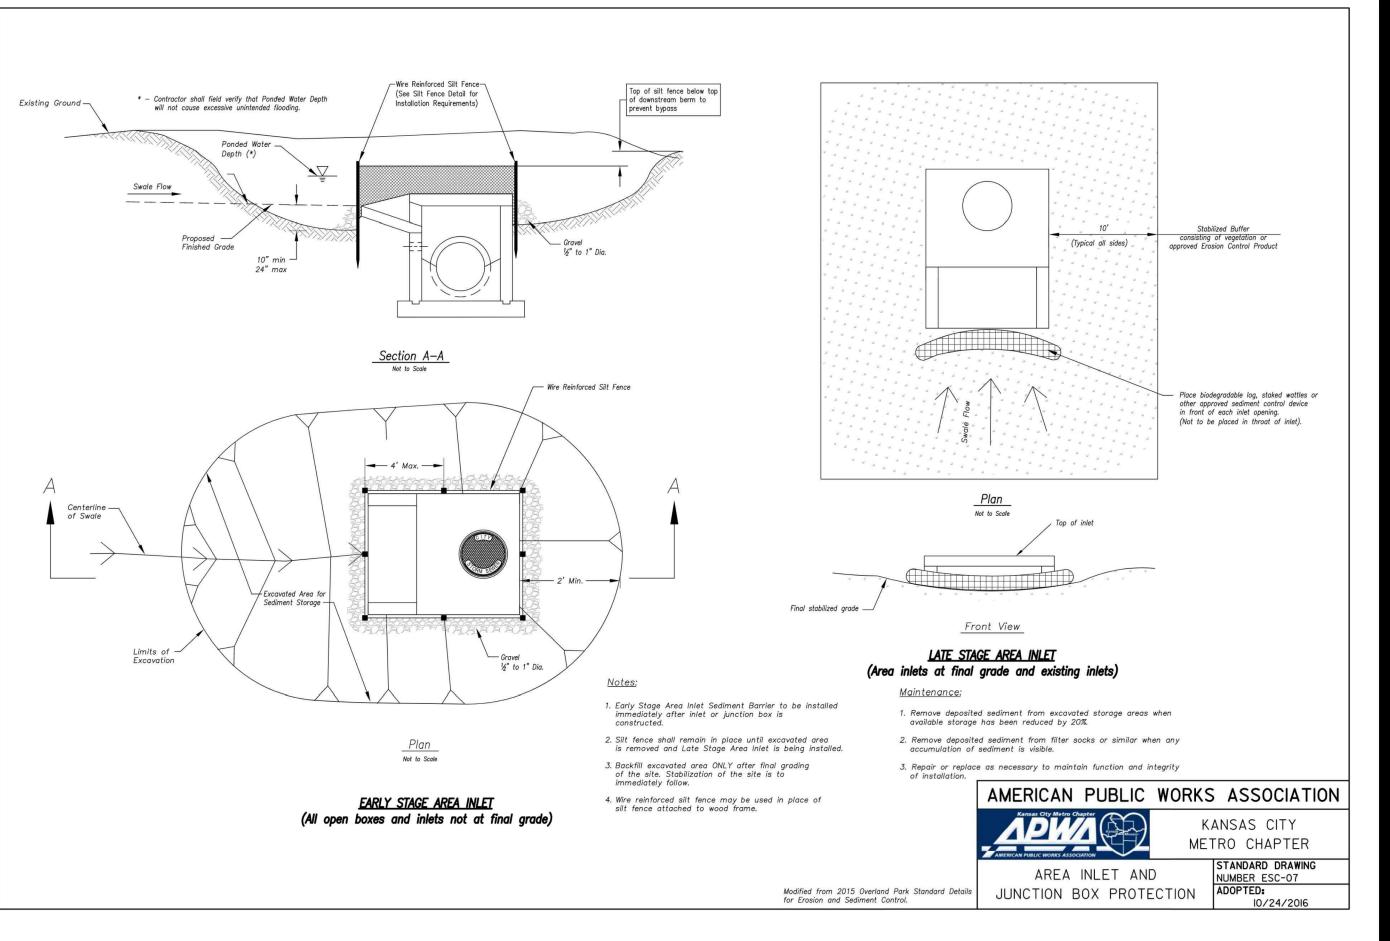





LAC# MO-2002023826
929 Walnut Street, Ste. 700
Kansas City, Missouri 64106

P 816-756-5690 SURVEYOR & CIVIL ENGINEER:

RENAISSANCE INFRASTRUCTURE CONSULTING 8653 Penrose Lane

8653 Penrose Lane
Lenexa, Kansas 66219
P 913-317-9500

MEP:

ANTELLA CONSULTING ENGINEERS

1600 Genessee Street, Ste 260

Kansas City, Missouri 64102

P 816-421-0950

GEOTECHNICAL:

INTERTEK-PSI 1211 W. Cambridge Circle Drive Kansas City, Kansas 66103 P 913-310-1600

intertek 05

OFFICE OF ADMINISTRATION DIVISION OF FACILITIES MANAGEMENT, DESIGN AND CONSTRUCTION

DEPARTMENT OF NATURAL RESOURCES, MISSOURI STATE PARKS

CAMPGROUND RENOVATION AND UPGRADE

BIG LAKE STATE PARK 204 LAKE SHORE DRIVE CRAIG, MO 64437

PROJECT # X2218-01 SITE # 5105 FACILITY # 7815105008

REVISION:
DATE:
REVISION:
DATE:
REVISION:
DATE:
ISSUE DATE:4/7/2023

CAD DWG FILE:
DRAWN BY: TCD
CHECKED BY: MES
DESIGNED BY: ZMM

SHEET TITLE:

EROSION CONTROL DETAILS


SHEET NUMBER:

C-505

SHEET 26 OF 41 APRIL 7, 2023

*Contractor to coordinate with Missouri State Parks staff to schedule work around park availability.

*Contractor to provide temporary signage for public use of park during each phase.

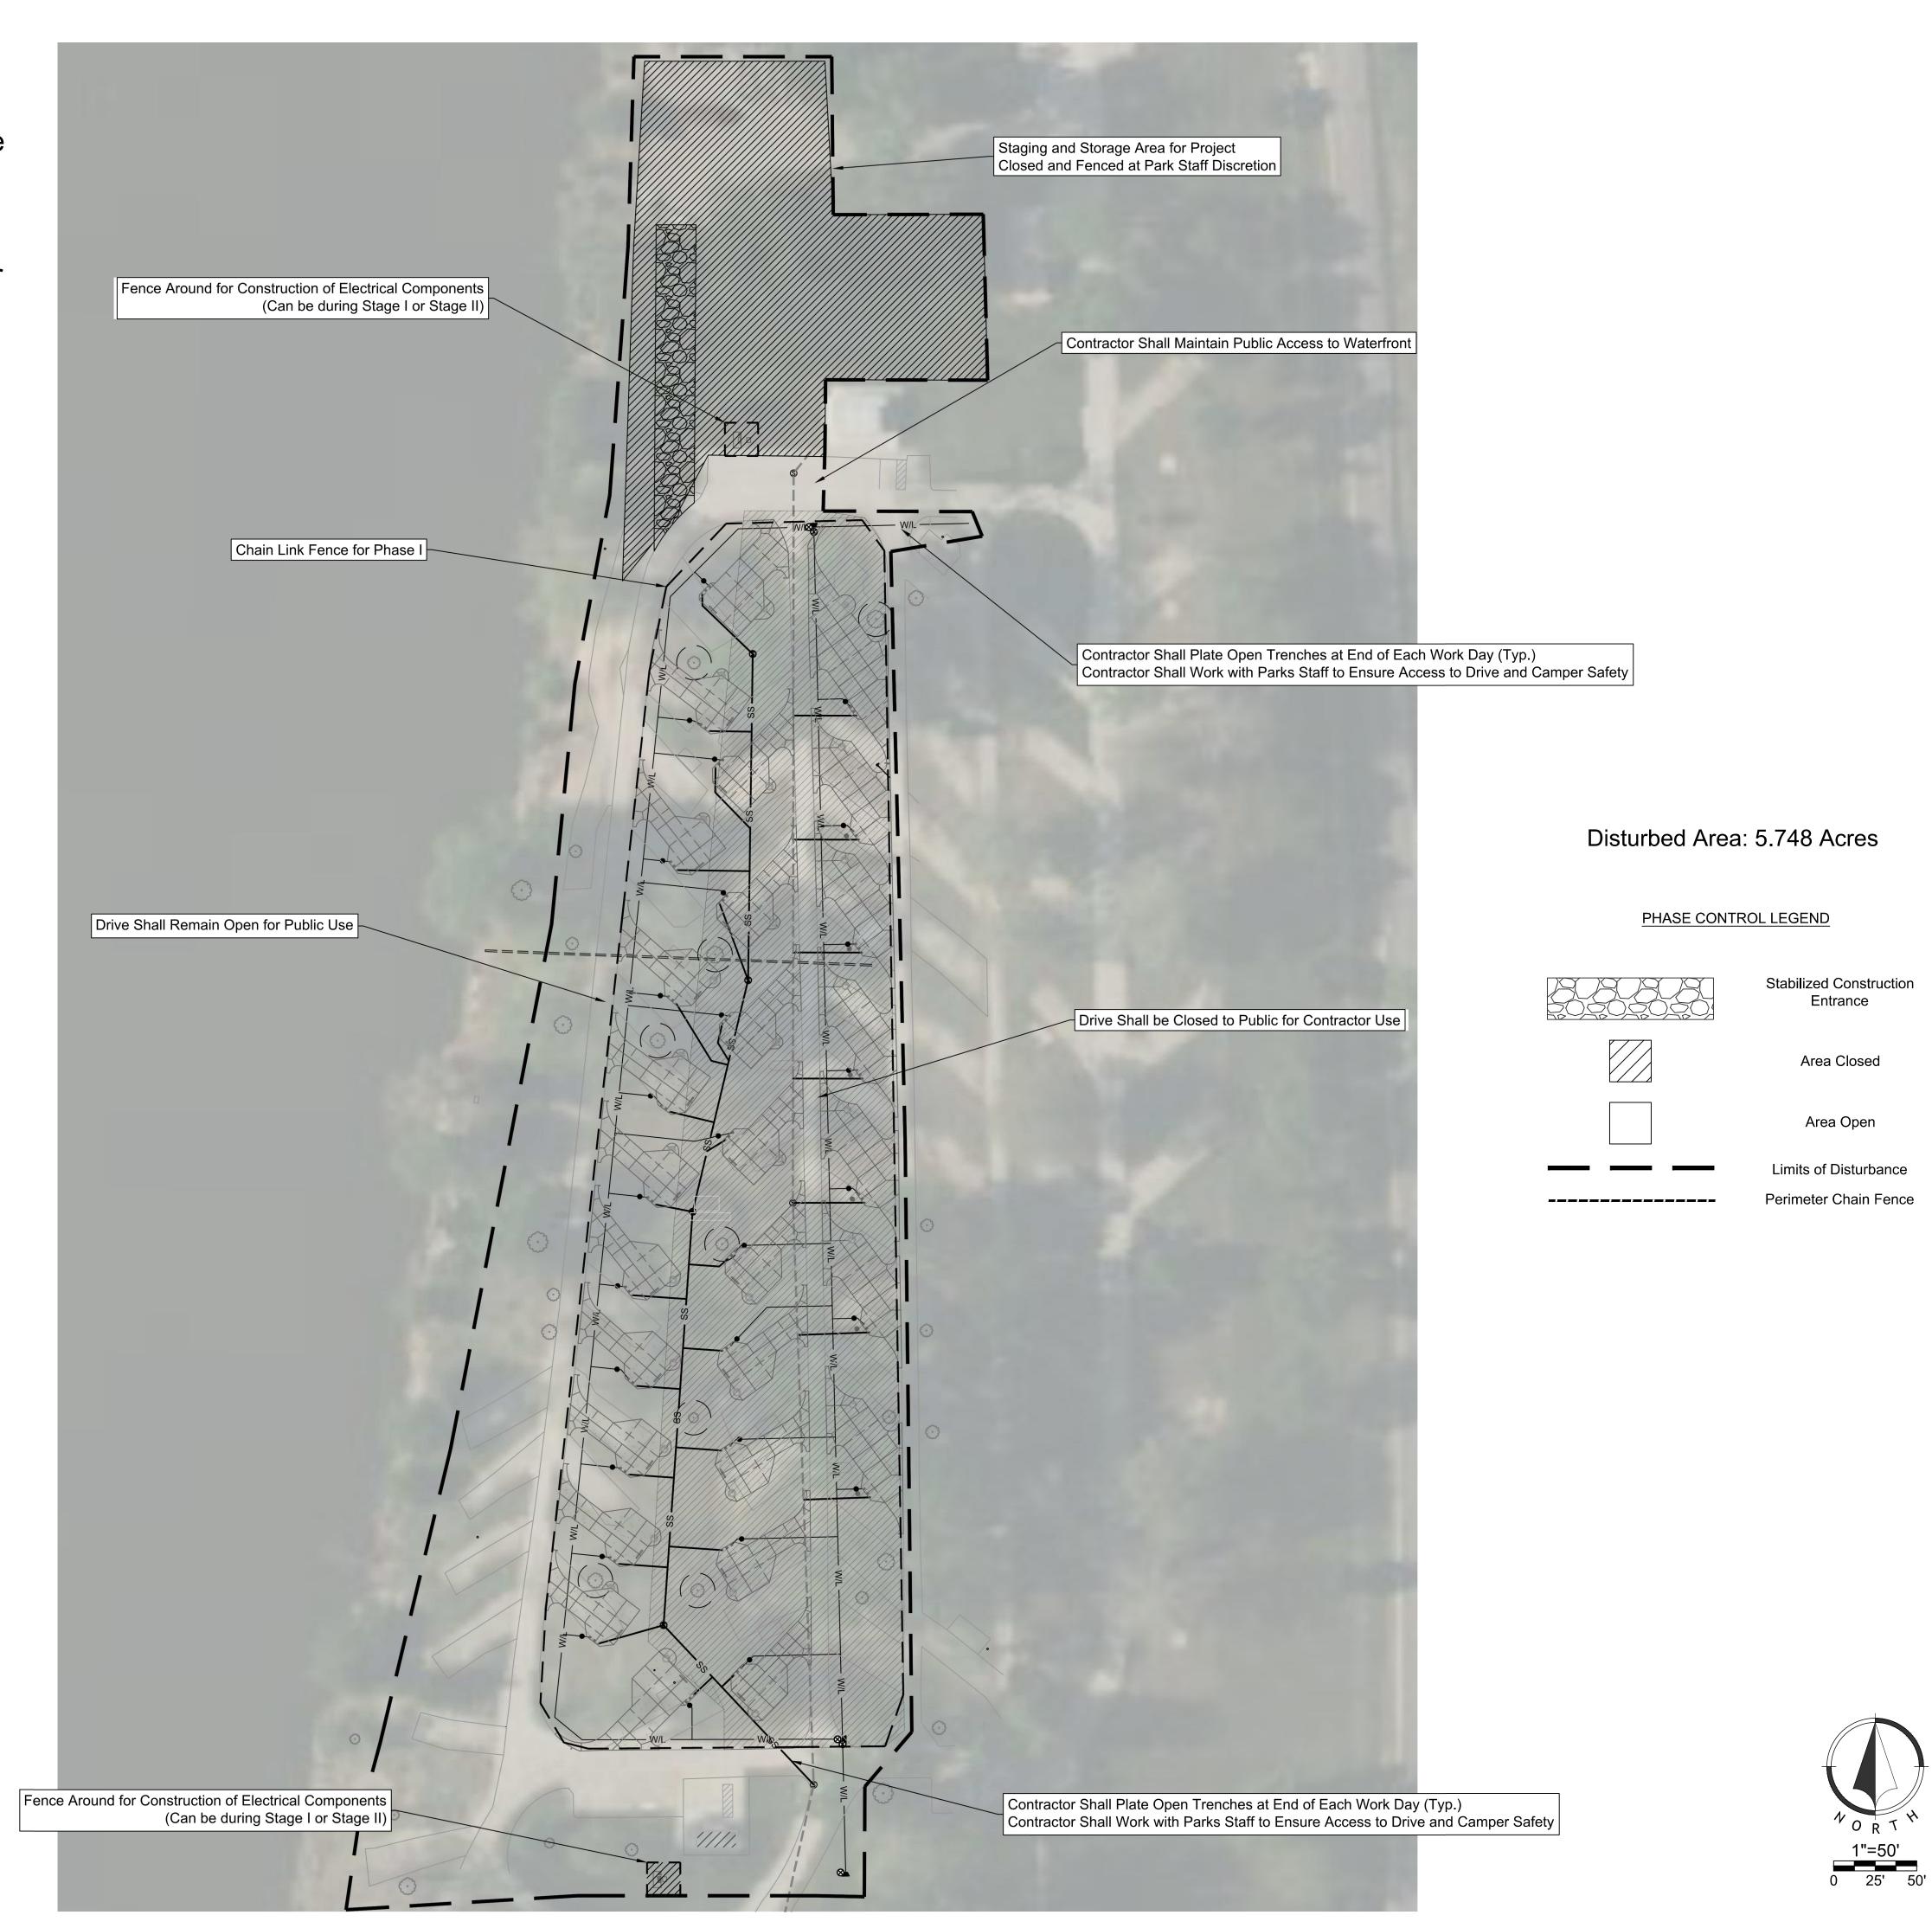

STATE OF MISSOURI MICHAEL L. PARSON, **GOVERNOR**



929 Walnut Street, Ste. 700 Kansas City, Missouri 64106

SURVEYOR & CIVIL ENGINEER: RENAISSANCE INFRASTRUCTURE

8653 Penrose Lane Lenexa, Kansas 66219 P 913-317-9500

MEP: ANTELLA CONSULTING ENGINEERS 1600 Genessee Street, Ste 260 Kansas City, Missouri 64102

Antella P 816-421-0950 GEOTECHNICAL: INTERTEK-PSI

1211 W. Cambridge Circle Drive Kansas City, Kansas 66103

P 913-310-1600 OFFICE OF ADMINISTRATION

MANAGEMENT, **DESIGN AND CONSTRUCTION**

DIVISION OF FACILITIES

DEPARTMENT OF NATURAL RESOURCES, MISSOURI STATE PARKS

CAMPGROUND RENOVATION AND **UPGRADE**

BIG LAKE STATE PARK 204 LAKE SHORE DRIVE CRAIG, MO 64437

PROJECT # X2218-01 SITE# 5105 FACILITY # 7815105008

REVISION: **REVISION** ISSUE DATE:4/7/2023

CAD DWG FILE:
DRAWN BY: TCD
CHECKED BY: MES
DESIGNED BY: ZMM


SHEET TITLE: PHASE I OF CONSTRUCTION

SHEET NUMBER:

SHEET 27 OF 41 APRIL 7, 2023

*Contractor to coordinate with Missouri State Parks staff to schedule work around park availability.

*Contractor to provide temporary signage for public use of park during each phase.

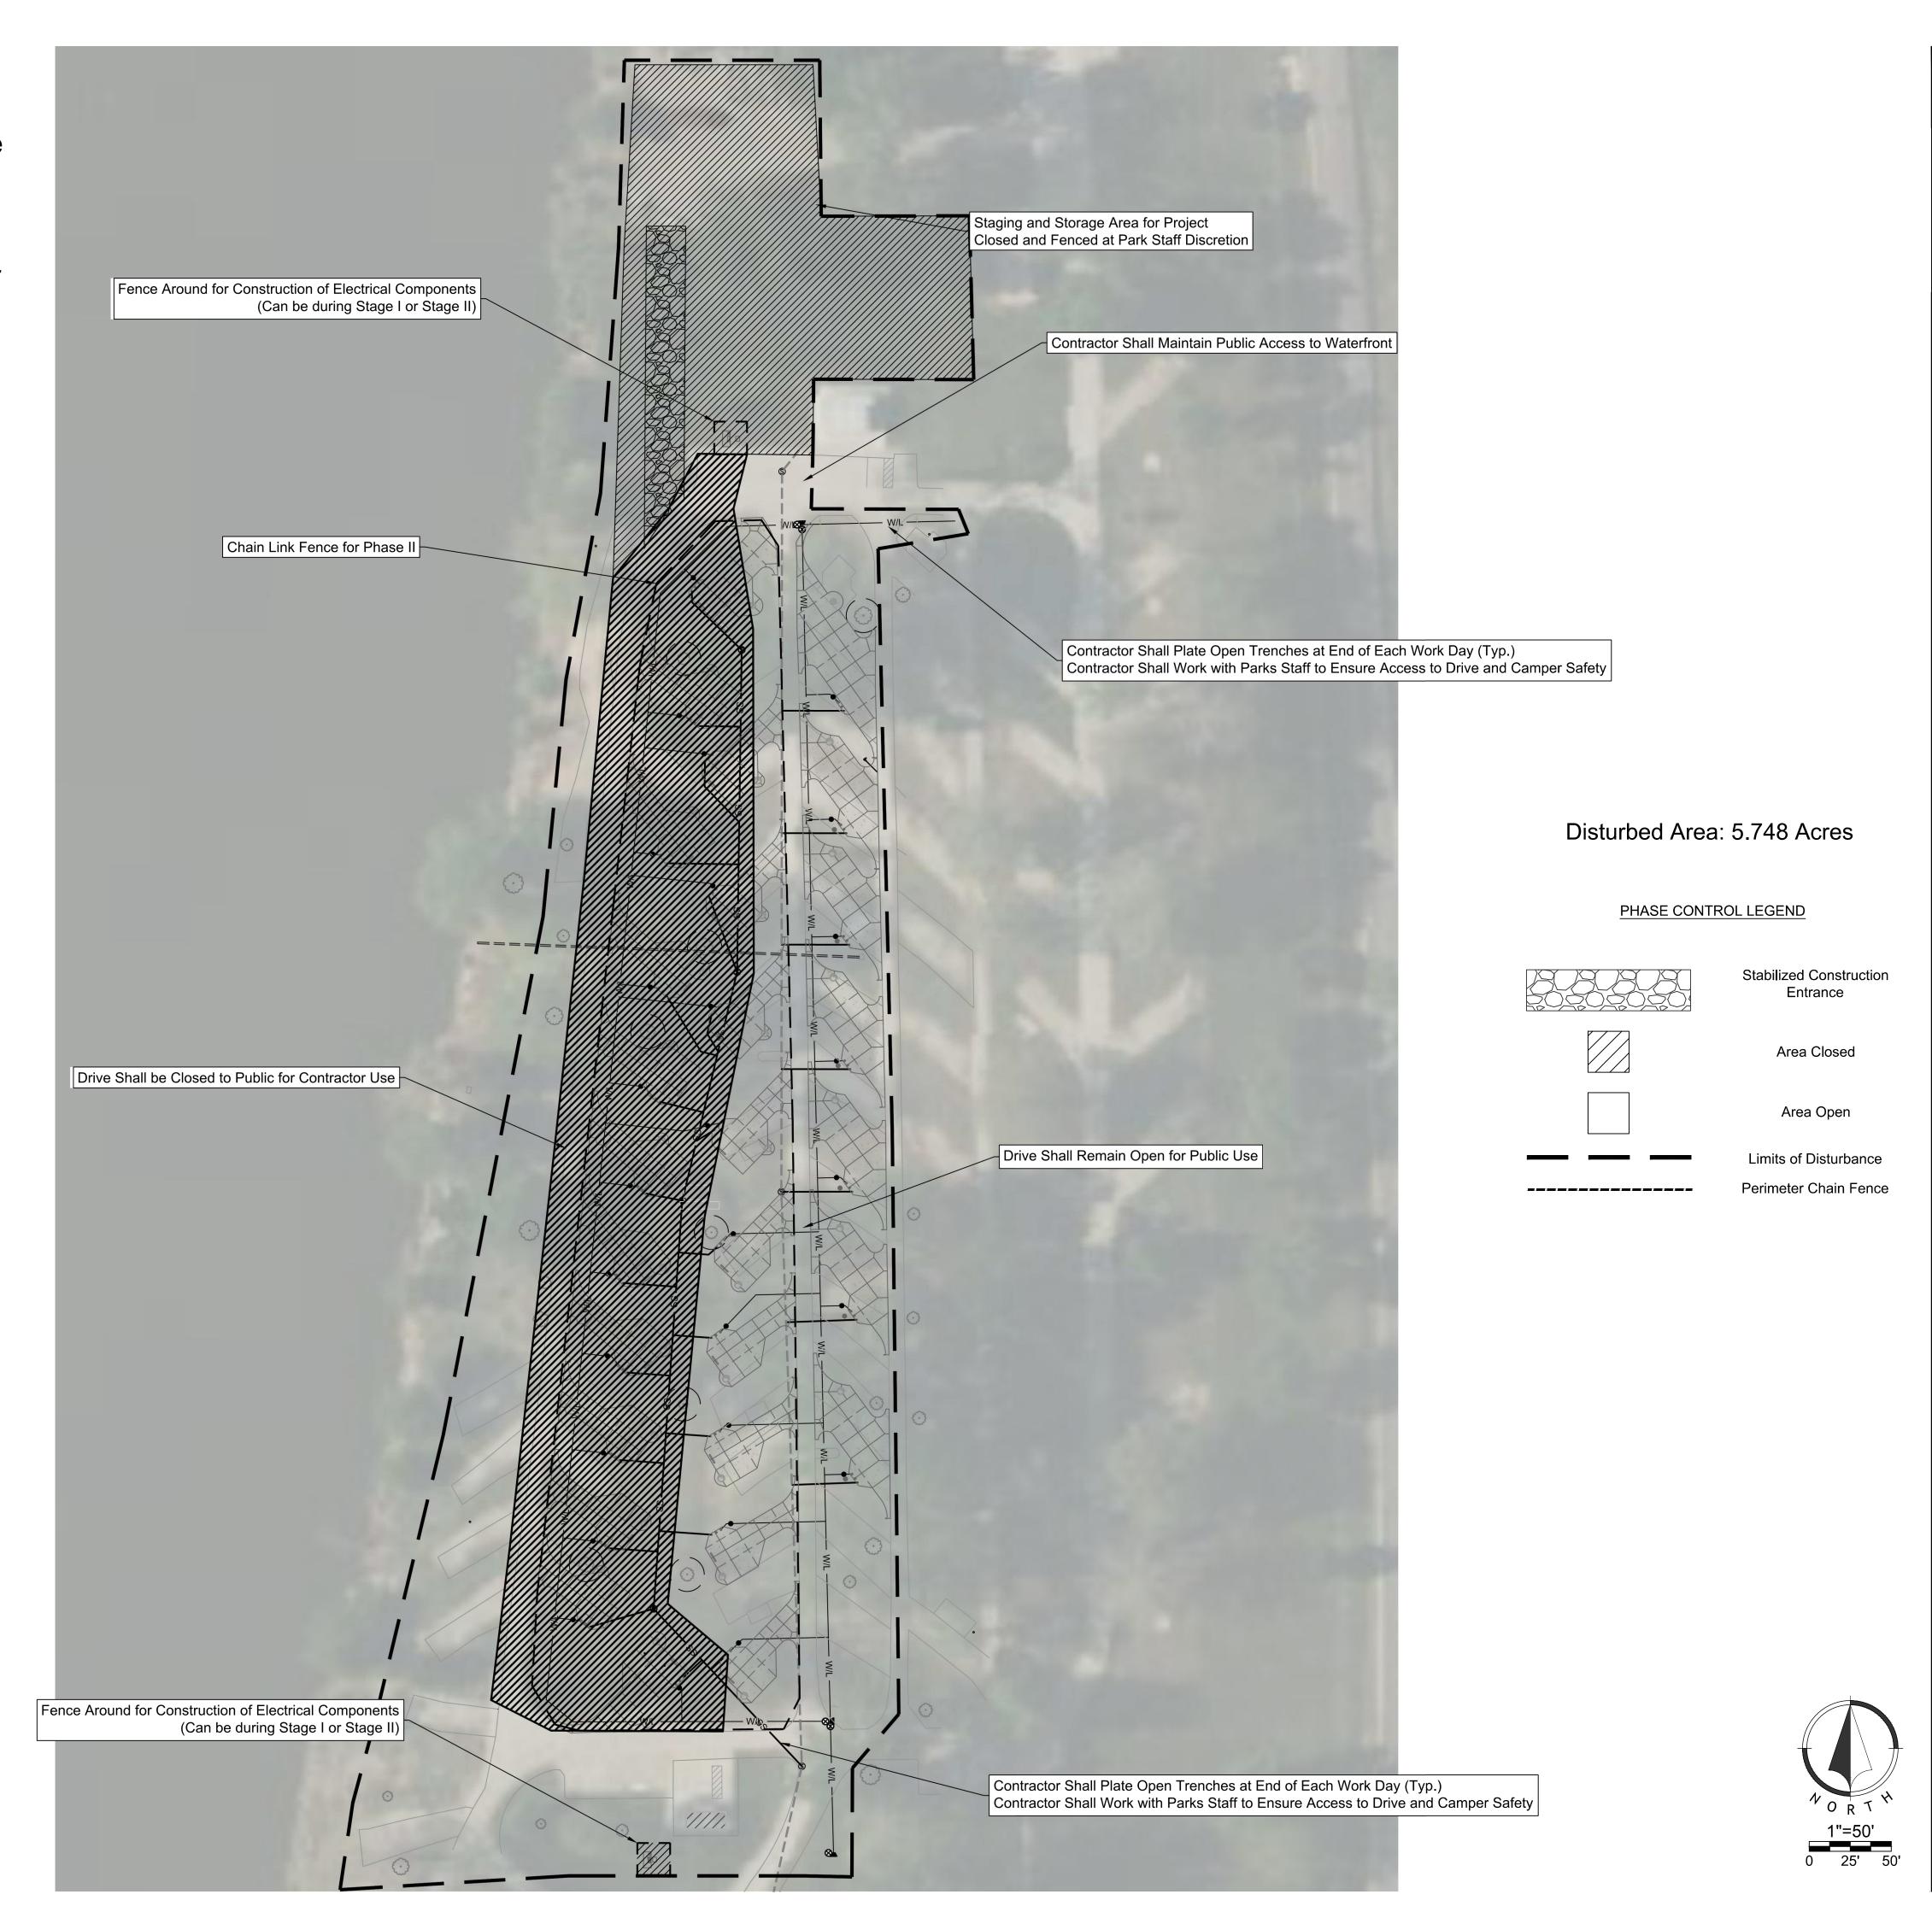





929 Walnut Street, Ste. 700 Kansas City, Missouri 64106

SURVEYOR & CIVIL ENGINEER: RENAISSANCE INFRASTRUCTURE 8653 Penrose Lane

Lenexa, Kansas 66219 P 913-317-9500

MEP: ANTELLA CONSULTING ENGINEERS 1600 Genessee Street, Ste 260 Kansas City, Missouri 64102

P 816-421-0950

GEOTECHNICAL: INTERTEK-PSI 1211 W. Cambridge Circle Drive Kansas City, Kansas 66103 P 913-310-1600



DIVISION OF FACILITIES MANAGEMENT, **DESIGN AND CONSTRUCTION**

OFFICE OF ADMINISTRATION

DEPARTMENT OF NATURAL RESOURCES, MISSOURI STATE PARKS

CAMPGROUND RENOVATION AND **UPGRADE**

BIG LAKE STATE PARK 204 LAKE SHORE DRIVE CRAIG, MO 64437

PROJECT # X2218-01 SITE# 5105 FACILITY # 7815105008


REVISION: **REVISION** ISSUE DATE:4/7/2023

CAD DWG FILE:
DRAWN BY: TCD
CHECKED BY: MES
DESIGNED BY: ZMM

SHEET TITLE: PHASE II OF CONSTRUCTION

SHEET NUMBER:


SHEET 28 OF 41 APRIL 7, 2023

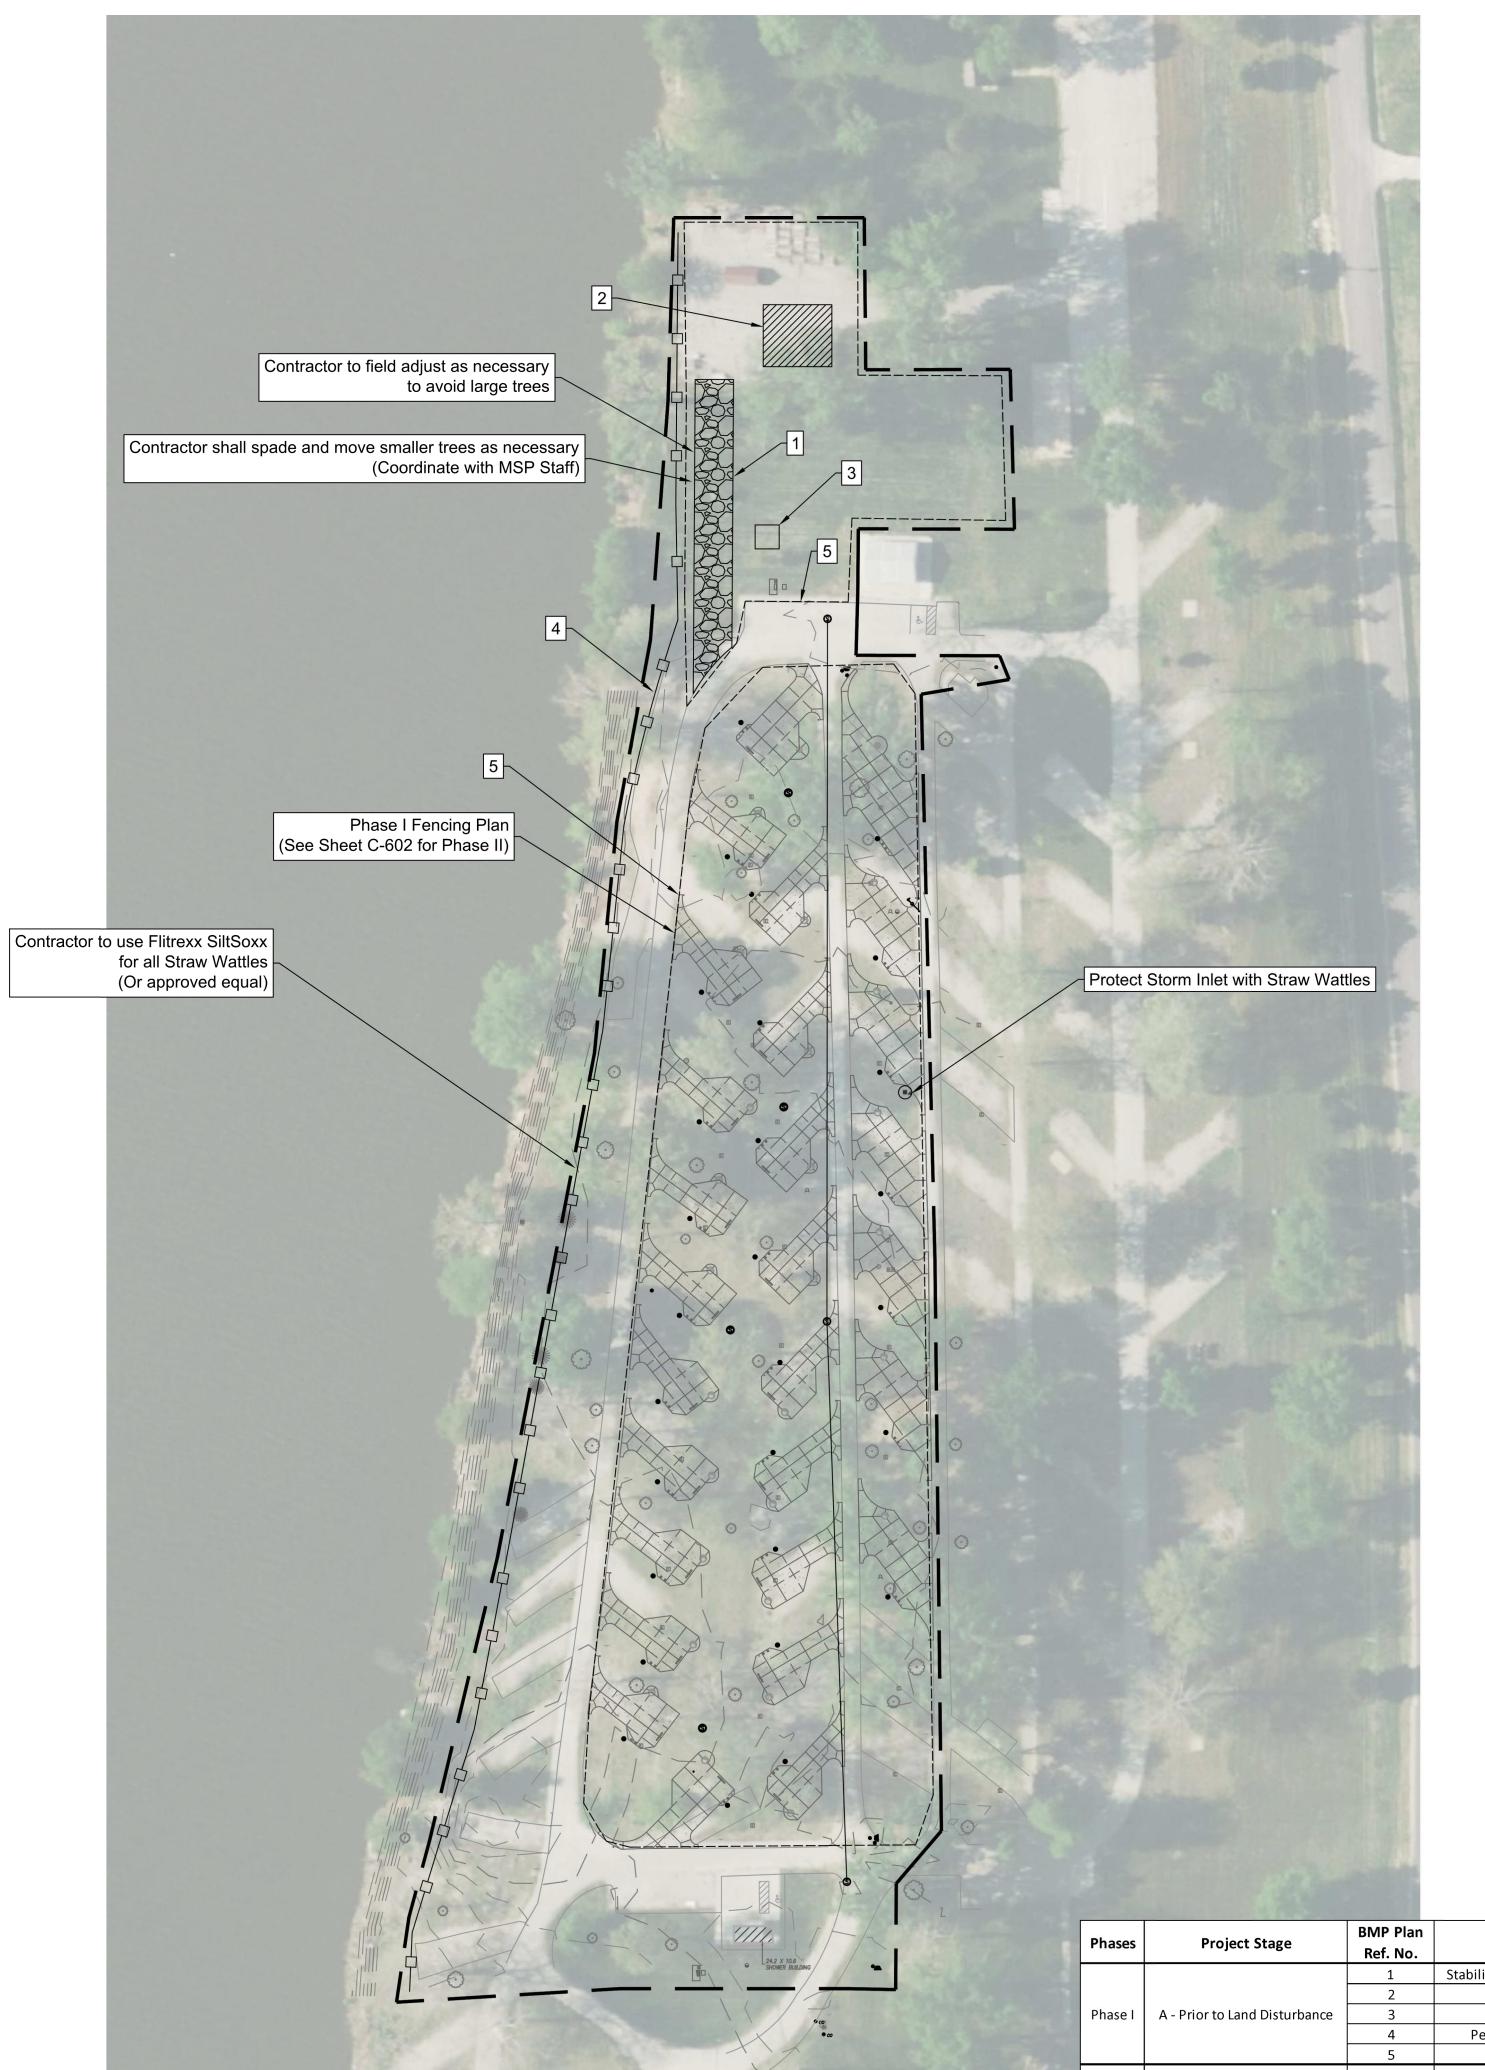

Phase I

Disturbed Area: 5.748 Acres

EROSION CONTROL LEGEND

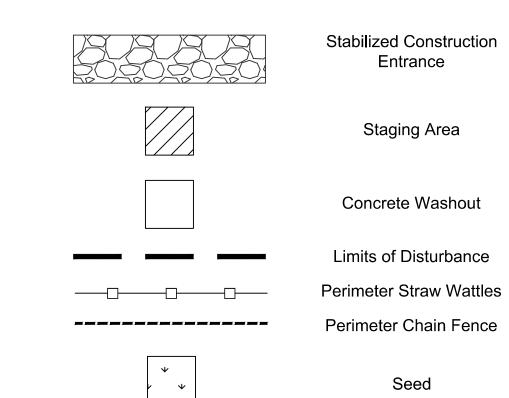



BMP Description Remove After Stage Stabilized Construction Entrance Install Construction Vehical Entry per APWA Standards (see Standard Details). Staging Area Install Staging Area. Concrete Washout Install Concrete Washout as shown on plans prior to pouring any concrete. Install Perimeter Straw Wattles. As Shown on the Plans. Perimeter Straw Wattles Perimeter Fencing Install Chain Link Fence around the perimeter of the working area. B - Mass Grading Stockpile Topsoil Install Silt Fence a Minimum of 5' Beyond Toe of Slope. Redistribute Topsoil and Seed all Disturbed Areas. Stabilization Complete when 100% Disturbed Area is Established with Perennial Vegetation with a Density of 70% per MDNR Phase III C - Final Stabilization Establish Perennial Vegetation N/A

STATE OF MISSOURI MICHAEL L. PARSON, **GOVERNOR**



929 Walnut Street, Ste. 700 Kansas City, Missouri 64106 P 816-756-5690

P 913-310-1600

SURVEYOR & CIVIL ENGINEER: RENAISSANCE INFRASTRUCTURE CONSULTING 8653 Penrose Lane

Lenexa, Kansas 66219 nfrastructure P 913-317-9500

MEP:
ANTELLA CONSULTING ENGINEERS 1600 Genessee Street, Ste 260 Kansas City, Missouri 64102 P 816-421-0950

GEOTECHNICAL: INTERTEK-PSI 1211 W. Cambridge Circle Drive

Kansas City, Kansas 66103

OFFICE OF ADMINISTRATION DIVISION OF FACILITIES MANAGEMENT, **DESIGN AND CONSTRUCTION**

DEPARTMENT OF NATURAL RESOURCES, MISSOURI STATE PARKS

CAMPGROUND RENOVATION AND UPGRADE

BIG LAKE STATE PARK 204 LAKE SHORE DRIVE CRAIG, MO 64437

PROJECT # X2218-01 5105 FACILITY # 7815105008

REVISION: REVISION: REVISION ISSUE DATE:4/7/2023

CAD DWG FILE:
DRAWN BY: TCD
CHECKED BY: MES
DESIGNED BY: ZMM

SHEET TITLE: **EROSION CONTROL** PHASE I


SHEET NUMBER:

SHEET 29 OF 41 APRIL 7, 2023



Disturbed Area: 5.748 Acres

EROSION CONTROL LEGEND

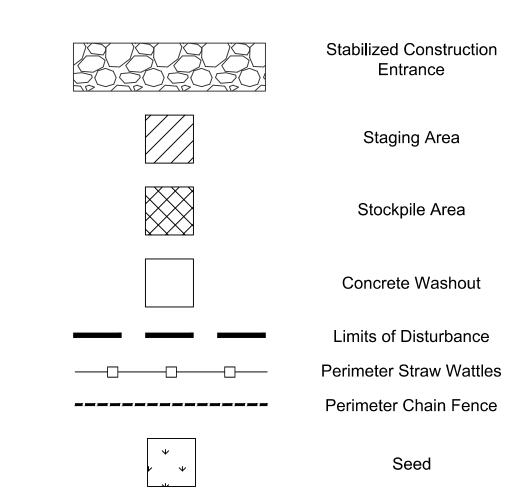

Remove After Stage

С

N/A

Install Staging Area.

Land Disturbance Permit.

Install Silt Fence a Minimum of 5' Beyond Toe of Slope.



Install Construction Vehical Entry per APWA Standards (see Standard Details). Install Concrete Washout as shown on plans prior to pouring any concrete. Install Perimeter Straw Wattles. As Shown on the Plans. Install Chain Link Fence around the perimeter of the working area. Redistribute Topsoil and Seed all Disturbed Areas. Stabilization Complete when 100% Disturbed Area is Established with Perennial Vegetation with a Density of 70% per MDNR

STATE OF MISSOURI MICHAEL L. PARSON, **GOVERNOR**



929 Walnut Street, Ste. 700 Kansas City, Missouri 64106 P 816-756-5690

Lenexa, Kansas 66219

SURVEYOR & CIVIL ENGINEER: RENAISSANCE INFRASTRUCTURE CONSULTING 8653 Penrose Lane

P 913-317-9500 MEP: ANTELLA CONSULTING ENGINEERS

1600 Genessee Street, Ste 260 Kansas City, Missouri 64102

nfrastructure

P 816-421-0950 GEOTECHNICAL: INTERTEK-PSI

intertek 1211 W. Cambridge Circle Drive Kansas City, Kansas 66103 P 913-310-1600

OFFICE OF ADMINISTRATION DIVISION OF FACILITIES MANAGEMENT, **DESIGN AND CONSTRUCTION**

DEPARTMENT OF NATURAL RESOURCES, MISSOURI STATE PARKS

CAMPGROUND RENOVATION AND UPGRADE

BIG LAKE STATE PARK 204 LAKE SHORE DRIVE CRAIG, MO 64437

PROJECT # X2218-01 SITE# 5105 FACILITY # 7815105008

REVISION: REVISION: REVISION ISSUE DATE:4/7/2023

CAD DWG FILE:
DRAWN BY: TCD
CHECKED BY: MES
DESIGNED BY: ZMM

SHEET TITLE: **EROSION CONTROL** PHASE II

SHEET NUMBER:

SHEET 30 OF 41 APRIL 7, 2023





929 Walnut Street, Ste. 700 Kansas City, Missouri 64106 P 816-756-5690

SURVEYOR & CIVIL ENGINEER: RENAISSANCE INFRASTRUCTURE CONSULTING

8653 Penrose Lane Lenexa, Kansas 66219 P 913-317-9500

MEP: ANTELLA CONSULTING ENGINEERS 1600 Genessee Street, Ste 260 Kansas City, Missouri 64102

1211 W. Cambridge Circle Drive Kansas City, Kansas 66103

OFFICE OF ADMINISTRATION DIVISION OF FACILITIES MANAGEMENT, **DESIGN AND CONSTRUCTION**

DEPARTMENT OF NATURAL RESOURCES, MISSOURI STATE PARKS

CAMPGROUND RENOVATION AND **UPGRADE**

BIG LAKE STATE PARK 204 LAKE SHORE DRIVE CRAIG, MO 64437

PROJECT # X2218-01 5105 FACILITY # 7815105008


REVISION: REVISION ISSUE DATE:4/7/2023

CAD DWG FILE:
DRAWN BY: TCD
CHECKED BY: MES
DESIGNED BY: ZMM

SHEET TITLE: **EROSION CONTROL** PHASE III

SHEET NUMBER:

SHEET 31 OF 41 APRIL 7, 2023

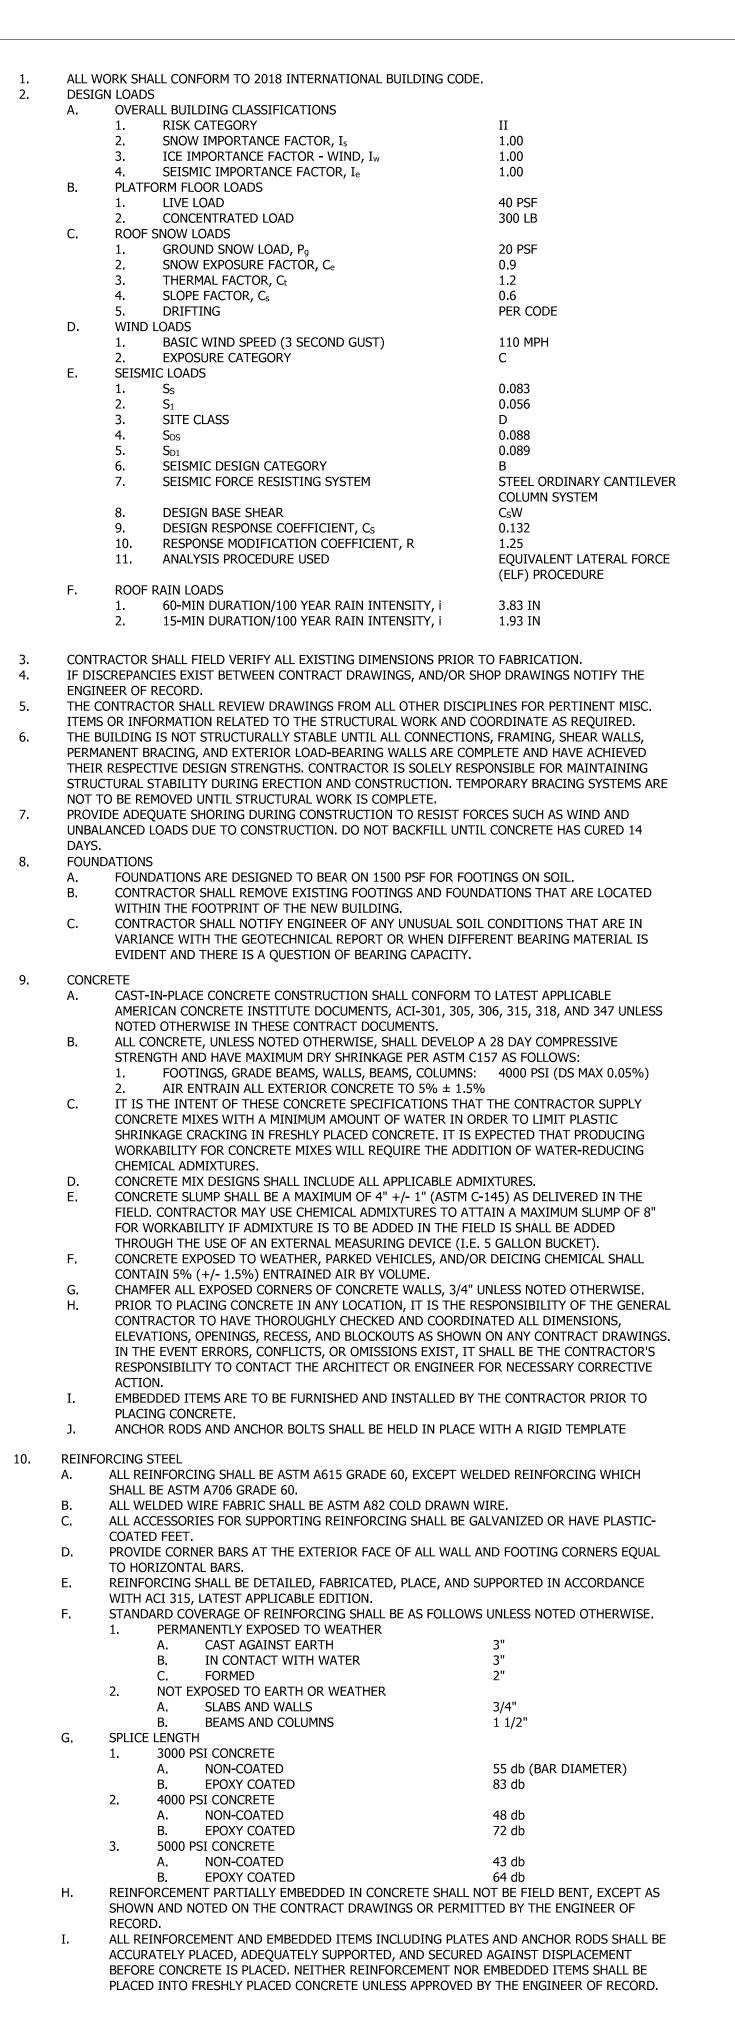

16.	STRUCTURAL STEEL
10.	A. ALL STRUCTURAL STEEL SHALL BE DETAILED, FABRICATED, AND ERECTED IN ACCORDANCE
	WITH AISC SPECIFICATION FOR STRUCTURAL STEEL BUILDINGS, LATEST APPLICABLE EDITION
	,
	AND AISC CODE OF STANDARD PRACTICE.
	B. ALL STRUCTURAL STEEL FOR WIDE FLANGE SHALL BE A992 GRADE 50 UNLESS NOTED
	OTHERWISE. ALL ANGLES, PLATES AND CHANNELS SHALL BE ASTM A36 UNLESS NOTED
	OTHERWISE. ALL RECTANGULAR AND ROUND HSS SHAPES SHALL BE ASTM A500, GRADE B.
	C. ALL BOLTS SHALL BE 3/4" Ø A-325 BOLTS WITH HEAVY HEX HEADS UNLESS NOTED OTHERWIS
	ALL CONNECTIONS SHALL HAVE A MINIMUM OF (2) 3/4" Ø BOLTS, BEARING TYPE CONNECTION
	ONLY.
	D. ALL STRUCTURAL STEEL WELDS IN THE SHOP OR IN THE FIELD SHALL BE PERFORMED BY A
	QUALIFIED WELDER AND SHALL CONFORM TO THE CURRENT REQUIREMENTS OF A.W.S.
	E. SHOP WELDED AND FIELD BOLTED CONNECTIONS ARE PREFERRED UNLESS NOTED
	OTHERWISE.
	F. ALL STEEL EXPOSED TO THE EXTERIOR, EXHIBITS, POOLS, AND LSS AREAS SHALL BE HOT-DIP
	GALVANIZED AND PAINTED PER ARCHITECT UNLESS NOTED OTHERWISE.
	G. THE CONTRACTOR SHALL PROVIDE SHELF ANGLES, GLASS SUPPORTS, LINTELS, AND OTHER
	MISC. STEEL AS SHOWN ON THESE DRAWINGS AS REQUIRED TO PROVIDE SUPPORT
	(STABILIZATION) AROUND AND THROUGHOUT THE BUILDING. SEE ARCHITECTURAL DRAWING
	FOR ADDITIONAL MISC. STEEL DETAILS.
14.	STRUCTURAL ENGINEER SITE OBSERVATIONS
	A. THE CONTRACT STRUCTURAL DRAWINGS REPRESENT THE FINISHED STRUCTURE AND,
	EXCEPT WHERE SPECIFICALLY SHOWN, DO NOT INDICATE THE METHOD OR MEANS OF
	CONSTRUCTION. THE CONTRACTOR SHALL SUPERVISE AND DIRECT THE WORK AND SHALL
	BE SOLELY RESPONSIBLE FOR ALL CONSTRUCTION MEANS, METHODS, PROCEDURES,
	TECHNIQUES, AND SEQUENCES.
	B. THE ENGINEER SHALL NOT HAVE CONTROL NOR CHARGE OF, AND SHALL NOT BE
	RESPONSIBLE FOR, CONSTRUCTION MEANS, METHODS, PROCEDURES, TECHNIQUES, OR
	SEQUENCES, FOR SAFETY PRECAUTIONS AND PROGRAMS IN CONNECTION WITH THE
	WORK, FOR THE ACTS OR OMISSION OF THE CONTRACTOR, SUBCONTRACTOR, OR AN
	OTHER PERSONS PERFORMING ANY OF THE WORK, OR THE FAILURE OF ANY OF THEM TO
	CARRY OUT THE WORK IN ACCORDANCE WITH THE CONTRACT DOCUMENTS.
	C. PERIODIC SITE OBSERVATION BY FIELD REPRESENTATIVES OF LEIGH & O'KANE L.L.C. IS
	SOLELY FOR THE PURPOSE OF DETERMINING IF THE WORK OF THE CONTRACTOR IS
	PROCEEDING IN ACCORDANCE WITH THE STRUCTURAL CONTRACT DOCUMENTS, THIS
	LIMITED SITE OBSERVATION SHOULD NOT BE CONSTRUED AS EXHAUSTIVE OR
	CONTINUOUS TO CHECK THE QUALITY OR QUANTITY OF WORK, BUT RATHER PERIODIC IN
	AN EFFORT TO GUARD THE OWNER AGAINST DEFECTS AND DEFICIENCIES IN THE WORK OF
	THE CONTRACTOR.
	THE CONTRACTOR.
15.	SUBMITTALS
	A. ALL SHOP DRAWINGS AND SUBMITTALS MUST BE REVIEWED AND APPROVED BY THE
	CONTRACTOR PRIOR TO SUBMITTAL. ENGINEER'S REVIEW OF SHOP DRAWINGS IS LIMITED TO
	CHECKING FOR GENERAL CONFORMANCE WITH DESIGN DRAWINGS AND STRENGTH OF
	COMPONENTS AND MATERIALS. CONTRACTOR IS RESPONSIBLE FOR ANY CHANGES FROM THE
	DESIGN DRAWINGS, QUANTITIES, DIMENSIONAL ERRORS, OR OMISSIONS IN THE SHOP
	DRAWINGS.
	B. ALL SHOP DRAWINGS MUST BE ORIGINAL DOCUMENTS AND SHALL NOT BE REPRODUCTIONS (
	THESE CONTRACT DOCUMENTS.
	C. CONTRACT DOCUMENTS. C. CONTRACTOR SHALL SUBMIT STRUCTURAL SHOP DRAWINGS FOR THE FOLLOWING ITEMS.
	1. CONCRETE MIX DESIGN AND MATERIALS
	2. CONCRETE REINFORCING STEEL
	3. STRUCTURAL STEEL FRAMING
	D. PROVIDE A FINAL, "FOR CONSTRUCTION" SET OF ALL SHOP DRAWINGS TO THE ENGINEER OF RECORD PRIOR TO FABRICATION OR CONSTRUCTION OF THOSE ITEMS.
	RECORD FRIOR TO FABRICATION OR CONSTRUCTION OF THOSE ITEMS.
16.	SPECIAL INSPECTIONS
-01	A. THE FOLLOWING MINIMUM ITEMS REQUIRE SPECIAL INSPECTION IN ACCORDANCE WITH THE
	BUILDING CODE.
	1. CONCRETE PLACING
	2. CONCRETE PLACING
	BOLTS EMBEDDED IN CONCRETE / POST-INSTALLED ANCHORS
	,
	4. ANCHOR RODS

THE CONTRACTOR SHALL REQUEST SPECIAL INSPECTION OF THE ITEMS LISTED ABOVE PRIOR


TO THOSE ITEMS BECOMING INACCESSIBLE AND UNOBSERVABLE DUE TO PROGRESSION OF

THE WORK.

PLAN SYMBOL KEY F? = FOOTING TYPE (REFER TO FOOTING SCHEDULE) (C?) = COLUMN TYPE (REFER TO COLUMN SCHEDULE) (W?) = WOOD WALL TYPE (REFER TO WOOD WALL SCHEDULE) (\$W?) = SHEAR WALL TYPE (REFER TO WOOD WALL SCHEDULE) (W?) = CONCRETE WALL TYPE (REFER TO CONCRETE WALL SCHEDULE) (MW) = MASONRY WALL TYPE (REFER TO MASONRY WALL SCHEDULE) = SHEAR WALL HOLDOWN = MOMENT FRAME CONNECTION **WALL TYPE KEY**

= LOAD BEARING WALL

= SHEAR WALL

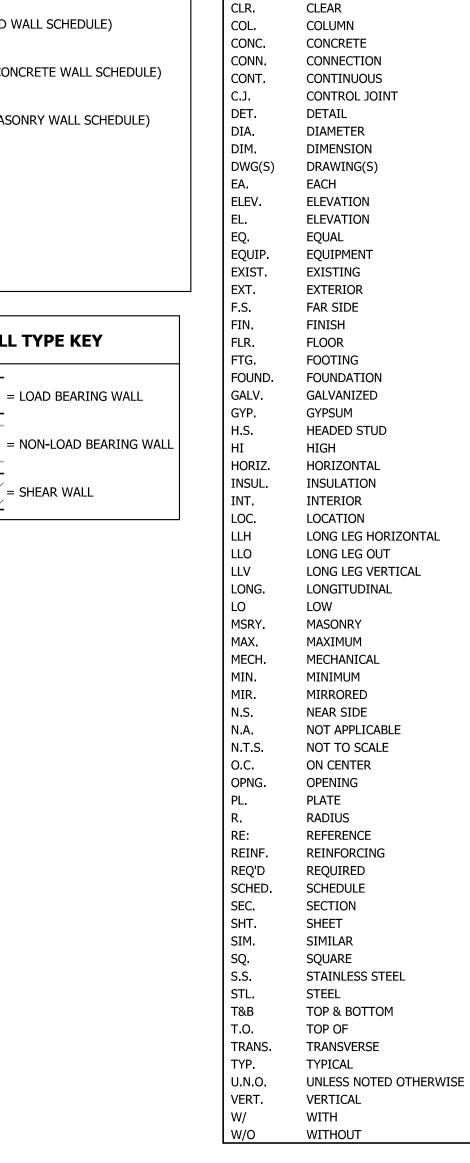

STANDARD ABBREVIATIONS

ALTERNATE

ARCHITECT

BEAM

BOTTOM

BOTTOM OF

CENTER LINE


BUILDING

ARCH.

вот.

BLDG.

ANCHOR BOLT

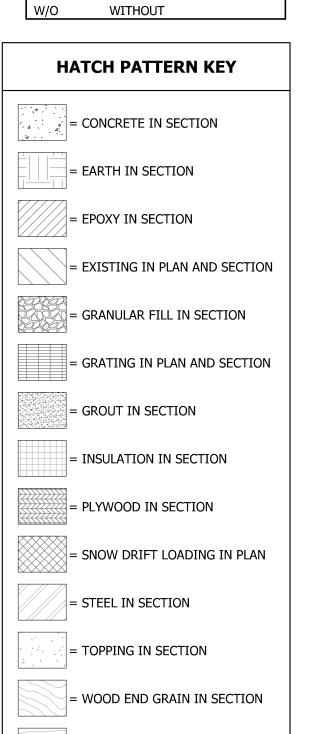

= WOOD FACE GRAIN IN SECTION

STATE OF MISSOURI MICHAEL L. PARSON, **GOVERNOR**



ANDSCAPE ARCHITECT

LAC# MO-2002023826

Kansas City, Missouri 64106 P 816-756-5690 SURVEYOR & CIVIL ENGINEER:

929 Walnut Street, Ste. 700

RENAISSANCE INFRASTRUCTURE CONSULTING 8653 Penrose Lane Lenexa, Kansas 66219 P 913-317-9500

nfrastructure

ANTELLA CONSULTING ENGINEERS 1600 Genessee Street, Ste 260 Kansas City, Missouri 64102 P 816-421-0950

GEOTECHNICAL: intertek INTERTEK-PSI 1211 W. Cambridge Circle Drive Kansas City, Kansas 66103 P 913-310-1600

OFFICE OF ADMINISTRATION

DIVISION OF FACILITIES MANAGEMENT, DESIGN AND CONSTRUCTION

DEPARTMENT OF NATURAL RESOURCES, MISSOURI STATE PARKS

CAMPGROUND RENOVATION AND **UPGRADE**

BIG LAKE STATE PARK 204 LAKE SHORE DRIVE

PROJECT # X2218-01 5105 FACILITY # 7815105008

CRAIG, MO 64437

REVISION: DATE: **REVISION:** DATE: **REVISION:** DATE: ISSUE DATE:4/7/2023

CAD DWG FILE: DRAWN BY: WNH

CHECKED BY: WNH DESIGNED BY: WNH

SHEET TITLE:

GENERAL NOTES

SHEET NUMBER:

SHEET 32 OF 41 APRIL 7, 2023


FRAMING PLAN NOTES

1. ALL STEEL TO BE HOT DIPPED GALVANIZED.

ALL BOLTS TO BE A325N.
FLOOR GRATING TO BE 1 1/4" X 3/16" GALVANIZED WELDED BAR GRATING

COORDINATE ALL OPENINGS IN FLOOR GRATING WITH OTHER DISCIPLINES.

CONTRACTOR IS RESPONSIBLE FOR THE DESIGN OF MEMBERS DIRECTLY SUPPORTING THE ELECTICAL PANEL AND ATTACHED TO SUPPORTS.

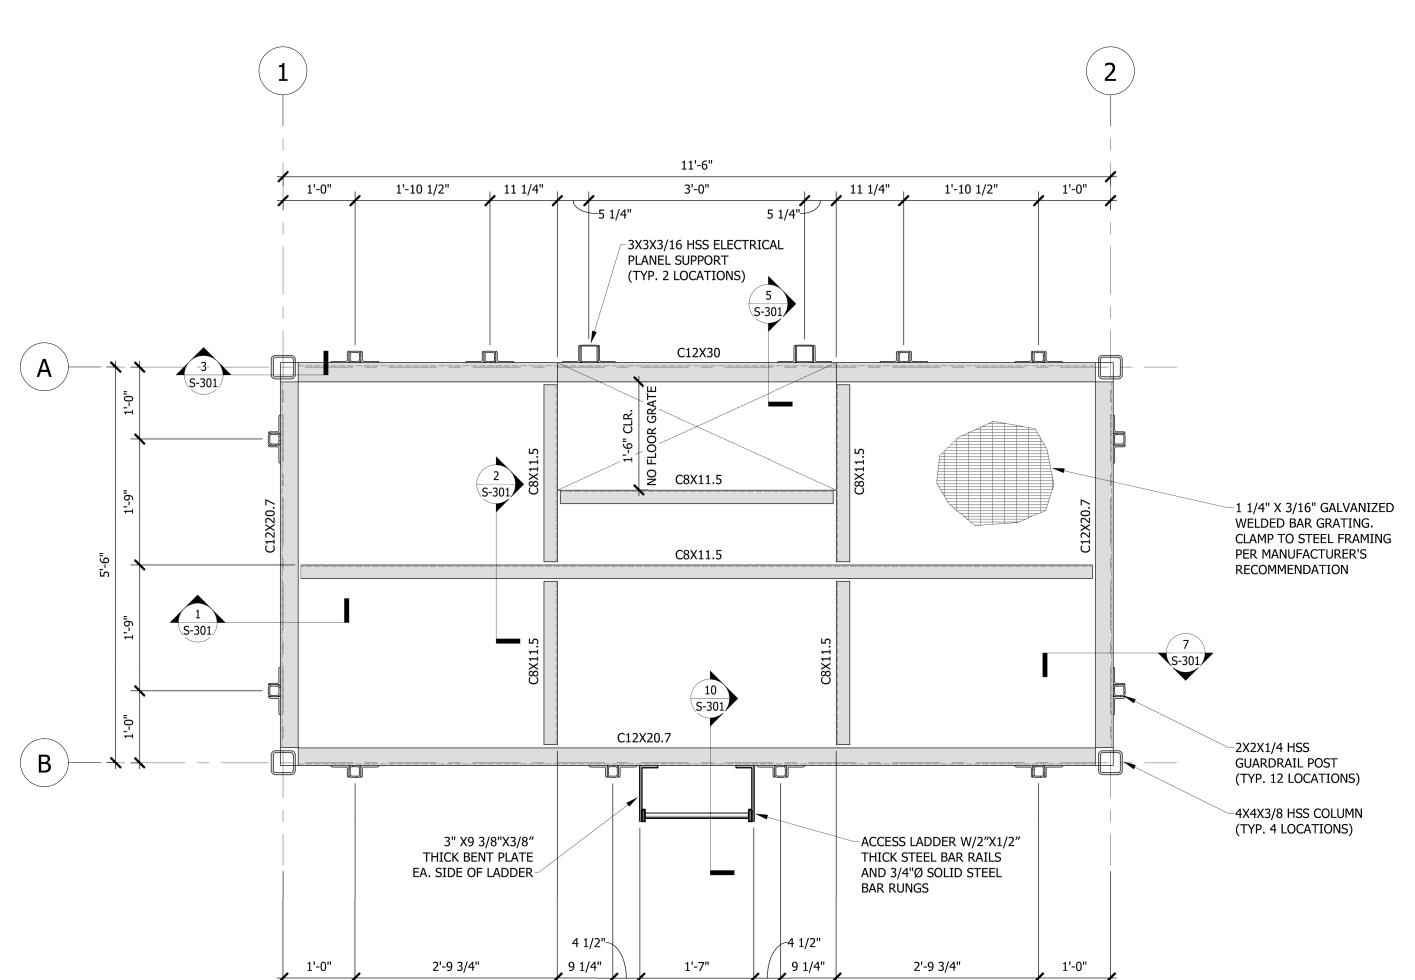


FOUNDATION PLAN NOTES

ALL CONCRETE TO HAVE 4000 PSI COMPRESSIVE STRENGTH.
BASE ELEVATIONS VARY BETWEEN THE NORTH AND SOUTH PLATFORM LOCATION.
REFER TO OTHER DISCIPLINES DRAWINGS FOR ELECTRICAL PLATFORM LOCATIONS.

ALL ANCHOR RODS TO BE F1554 GRADE 36.

. ANCHOR RODS TO BE CAST-IN-PLACE AND HELD IN PLACE USING A RIGID TEMPLATE.

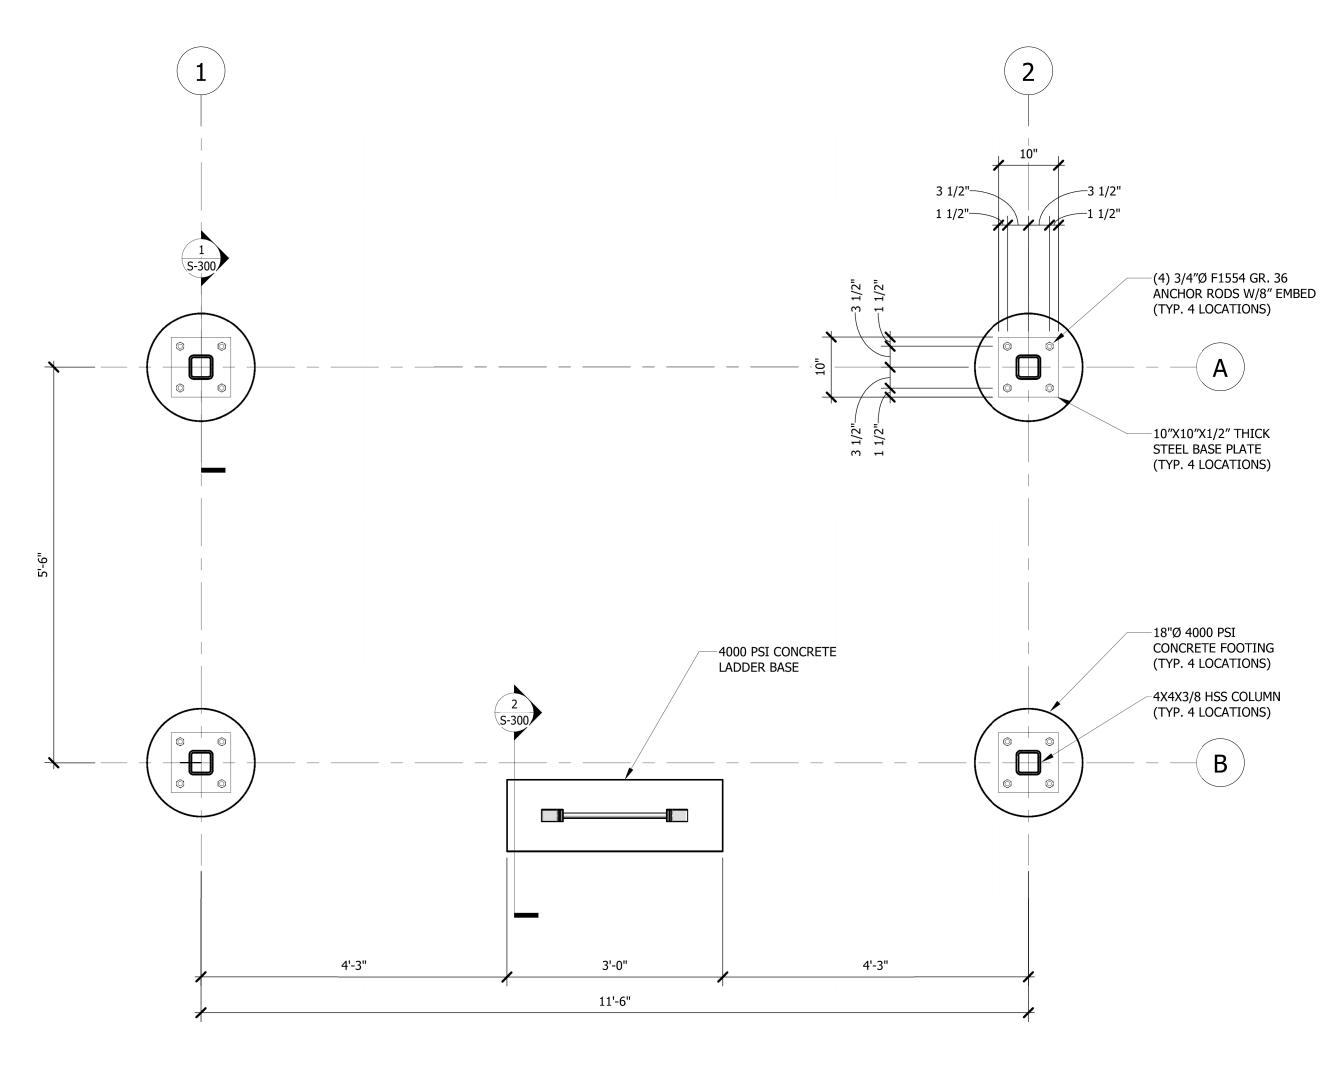

STATE OF MISSOURI MICHAEL L. PARSON, GOVERNOR



LANDSCAPE ARCHITECT:

LAC# MO-2002023826 929 Walnut Street, Ste. 700 Kansas City, Missouri 64106

P 913-317-9500

P 816-756-5690

SURVEYOR & CIVIL ENGINEER:
RENAISSANCE INFRASTRUCTURE
CONSULTING
8653 Penrose Lane
Lenexa, Kansas 66219

Renaissance Infrastructure Consulting

MEP:
ANTELLA CONSULTING ENGINEERS
1600 Genessee Street, Ste 260
Kansas City, Missouri 64102
P 816-421-0950

GEOTECHNICAL:
INTERTEK-PSI
1211 W. Cambridge Circle Drive
Kansas City, Kansas 66103
P 913-310-1600



OFFICE OF ADMINISTRATION DIVISION OF FACILITIES MANAGEMENT, DESIGN AND CONSTRUCTION

DEPARTMENT OF NATURAL RESOURCES, MISSOURI STATE PARKS

CAMPGROUND RENOVATION AND UPGRADE

BIG LAKE STATE PARK 204 LAKE SHORE DRIVE CRAIG, MO 64437

PROJECT # X2218-01 SITE # 5105 FACILITY # 7815105008

REVISION:
DATE:
REVISION:
DATE:
REVISION:
DATE:
REVISION:
DATE:
ISSUE DATE:4/7/2023

CAD DWG FILE:
DRAWN BY: WNH
CHECKED BY: WNH
DESIGNED BY: WNH

SHEET TITLE:

PLANS

SHEET NUMBER:


S-100


SHEET 33 OF 41 APRIL 7, 2023


-CAUTION SIGN TO BE ATTACHED TO PLATFORM STRUCTURE COORDINATE SIZE, QUANTITY, TYPE, AND LOCATIONS WITH OWNER. CONTRACTOR TO INSTALL SIGNS IN LOCATIONS PROVIDED BY OWNER.

CAUTION!!! DO NOT CLIMB DO NOT ENTER

4 CAUTION SIGN 3" = 1'-0"

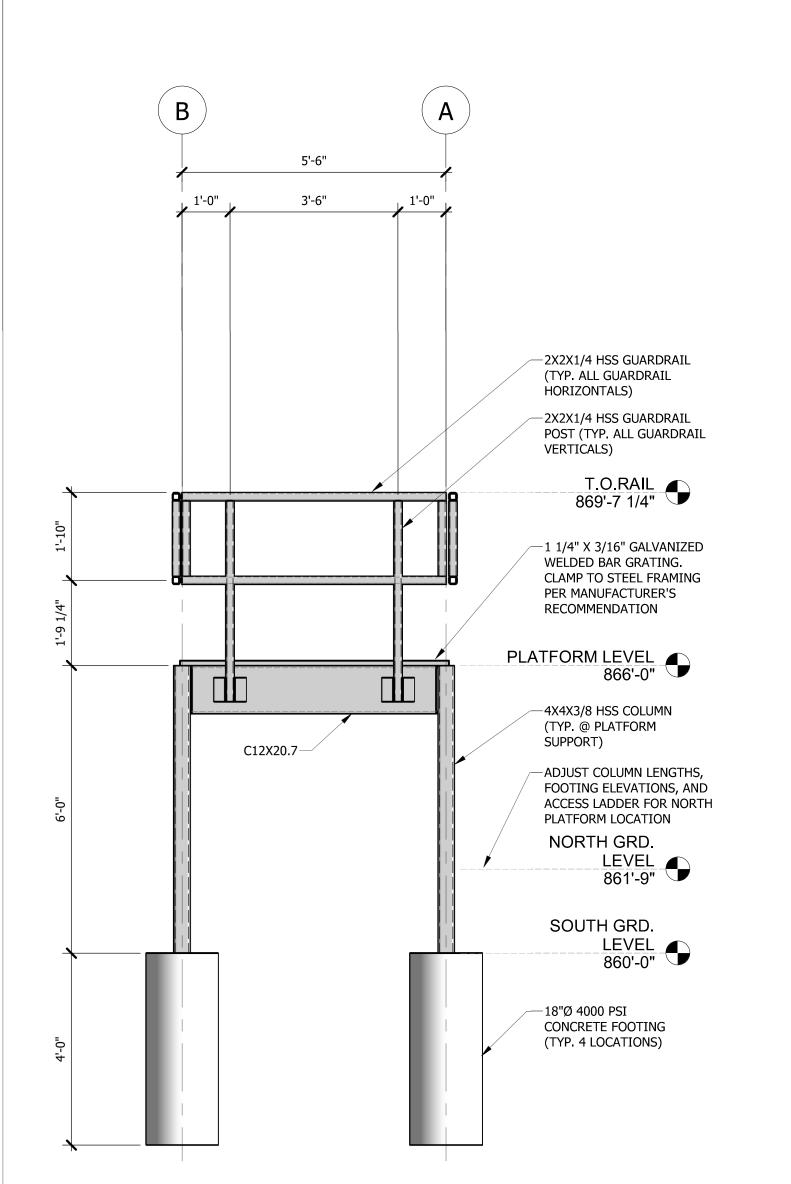

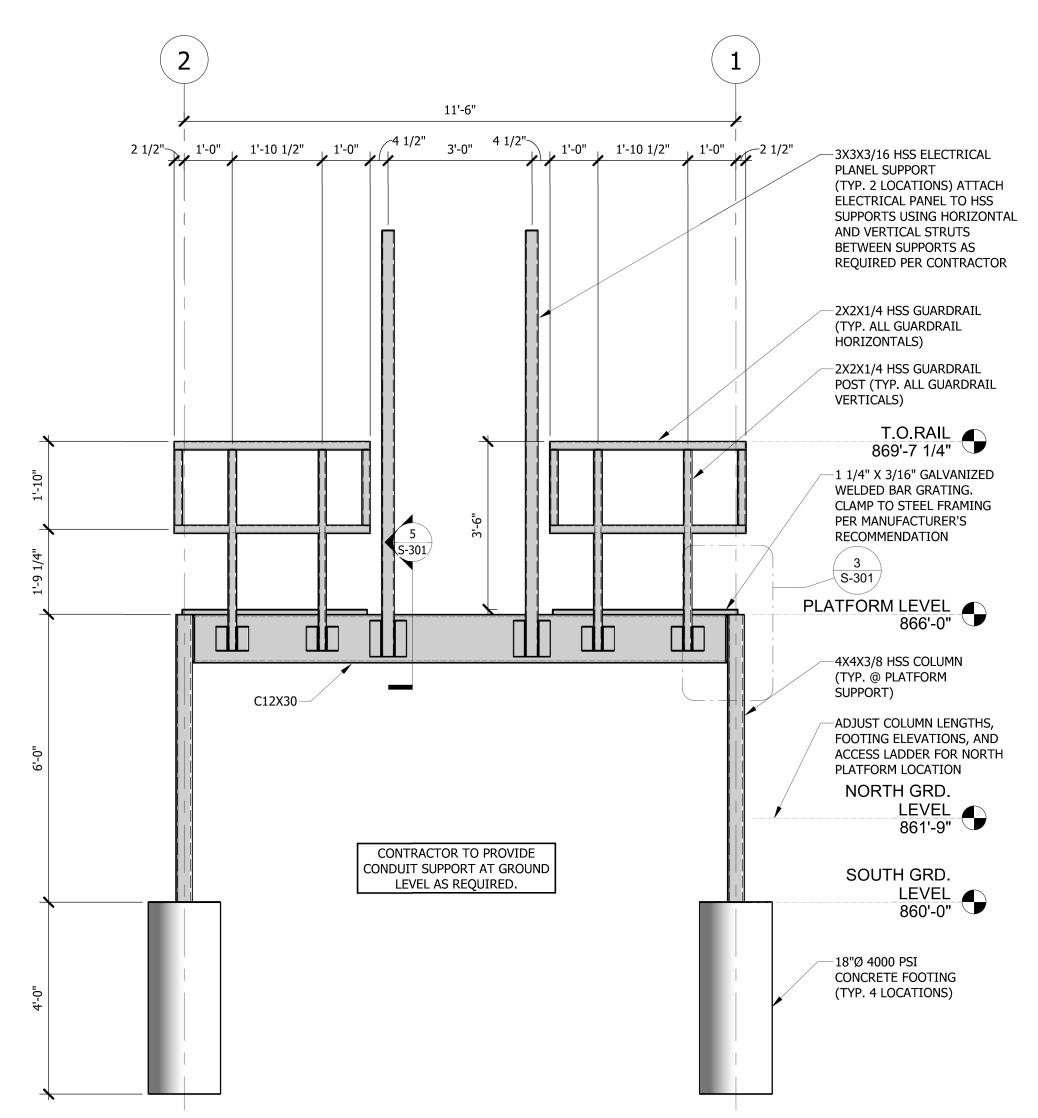

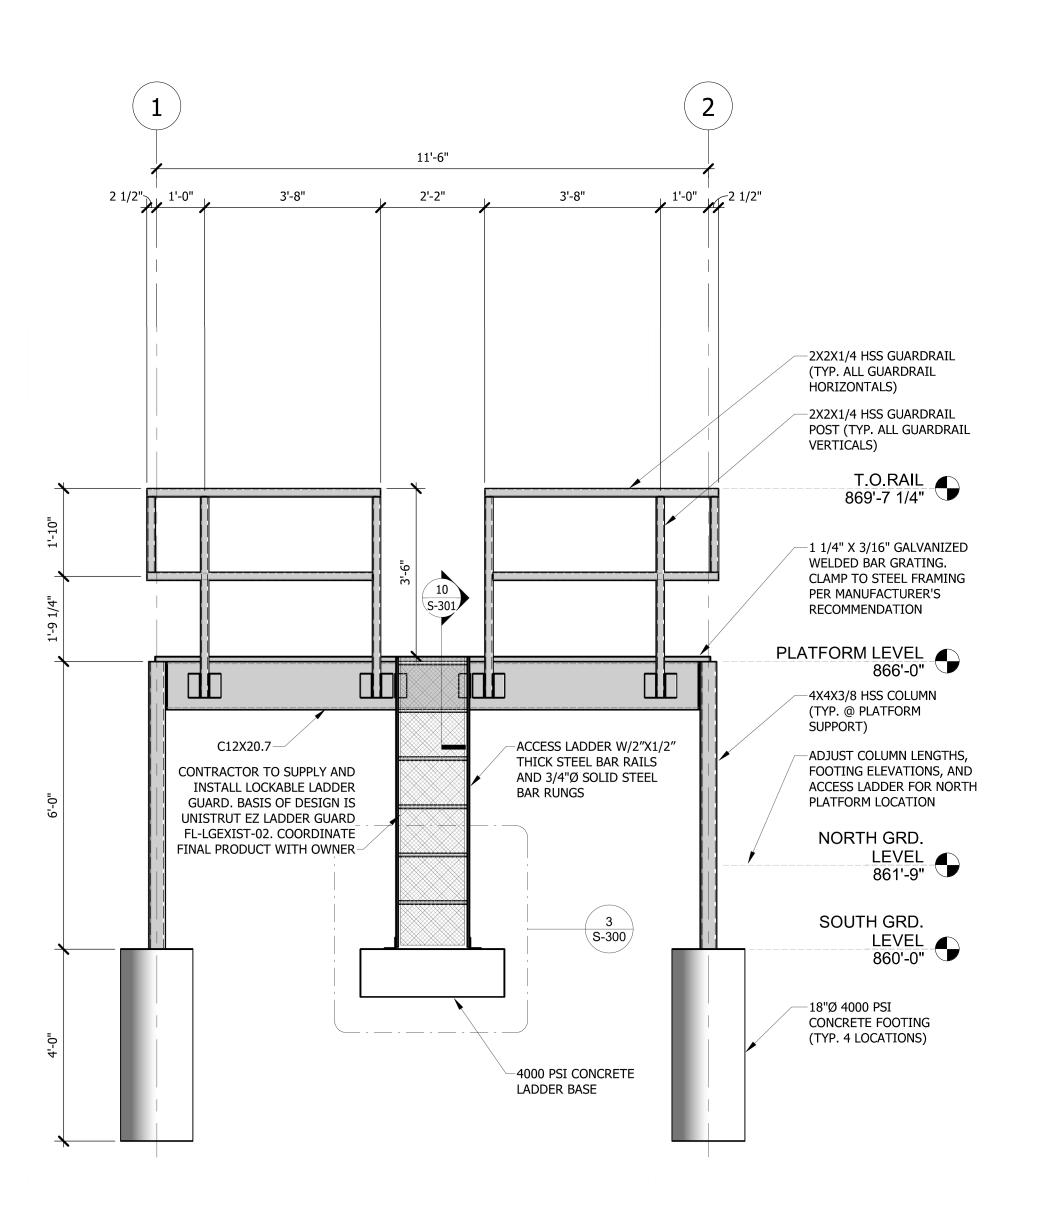

MICHAEL L. PARSON, **GOVERNOR**

STATE OF MISSOURI



ANDSCAPE ARCHITECT:

929 Walnut Street, Ste. 700 Kansas City, Missouri 64106 P 816-756-5690

P 913-317-9500

INTERTEK-PSI

P 913-310-1600

SURVEYOR & CIVIL ENGINEER: RENAISSANCE INFRASTRUCTURE CONSULTING 8653 Penrose Lane Lenexa, Kansas 66219

nfrastructure

ANTELLA CONSULTING ENGINEERS 1600 Genessee Street, Ste 260 Kansas City, Missouri 64102 P 816-421-0950

GEOTECHNICAL: 1211 W. Cambridge Circle Drive Kansas City, Kansas 66103



OFFICE OF ADMINISTRATION **DIVISION OF FACILITIES** MANAGEMENT, **DESIGN AND CONSTRUCTION**

DEPARTMENT OF NATURAL RESOURCES, MISSOURI STATE PARKS

CAMPGROUND RENOVATION AND **UPGRADE**

BIG LAKE STATE PARK 204 LAKE SHORE DRIVE CRAIG, MO 64437

PROJECT # X2218-01 5105 FACILITY # 7815105008

REVISION: REVISION: DATE: **REVISION:** DATE: ISSUE DATE:4/7/2023


CAD DWG FILE: DRAWN BY: WNH CHECKED BY: WNH DESIGNED BY: WNH

SHEET TITLE:


ELEVATIONS

SHEET NUMBER:


SHEET 34 OF 41 APRIL 7, 2023

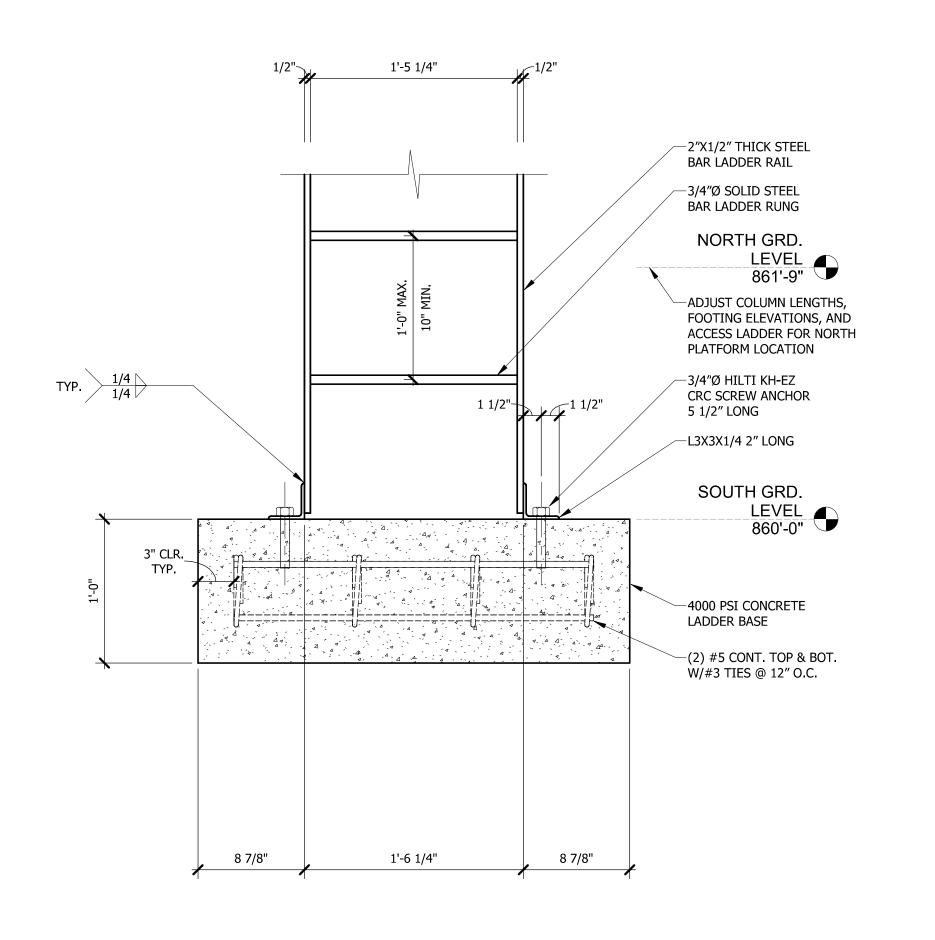

3 LADDER BASE SECTION - LONGITUDINAL 1 1/2" = 1'-0"

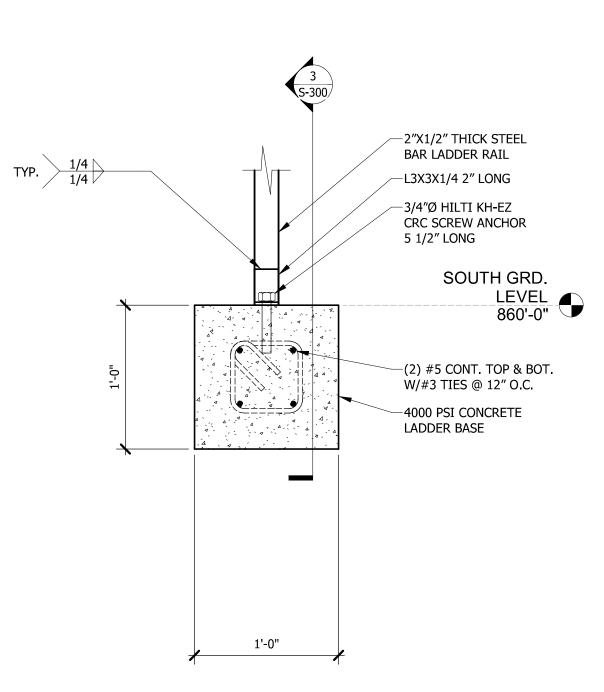

2 LADDER BASE SECTION
1 1/2" = 1'-0"

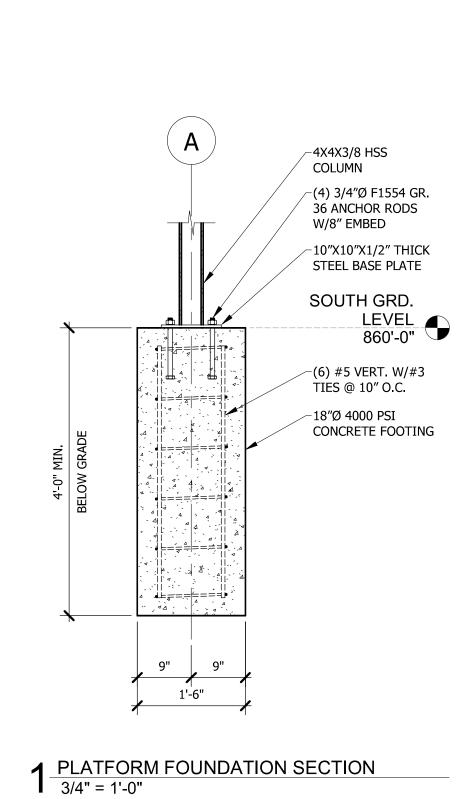

STATE OF MISSOURI MICHAEL L. PARSON, **GOVERNOR**



LANDSCAPE ARCHITECT:

929 Walnut Street, Ste. 700 Kansas City, Missouri 64106 P 816-756-5690

LAC# MO-2002023826

SURVEYOR & CIVIL ENGINEER: RENAISSANCE INFRASTRUCTURE CONSULTING 8653 Penrose Lane Lenexa, Kansas 66219 P 913-317-9500

nfrastructure

ANTELLA CONSULTING ENGINEERS 1600 Genessee Street, Ste 260 Kansas City, Missouri 64102 P 816-421-0950

GEOTECHNICAL: INTERTEK-PSI 1211 W. Cambridge Circle Drive

P 913-310-1600

intertek Kansas City, Kansas 66103

OFFICE OF ADMINISTRATION DIVISION OF FACILITIES MANAGEMENT, **DESIGN AND CONSTRUCTION**

DEPARTMENT OF NATURAL RESOURCES, MISSOURI STATE PARKS

CAMPGROUND RENOVATION AND UPGRADE

BIG LAKE STATE PARK 204 LAKE SHORE DRIVE CRAIG, MO 64437

PROJECT # X2218-01 5105 FACILITY # 7815105008

REVISION: DATE: **REVISION:** DATE: REVISION: DATE: ISSUE DATE:4/7/2023


CAD DWG FILE:
DRAWN BY: WNH
CHECKED BY: WNH DESIGNED BY: WNH

SHEET TITLE:

FOUNDATION SECTIONS

SHEET NUMBER:

SHEET 35 OF 41 APRIL 7, 2023

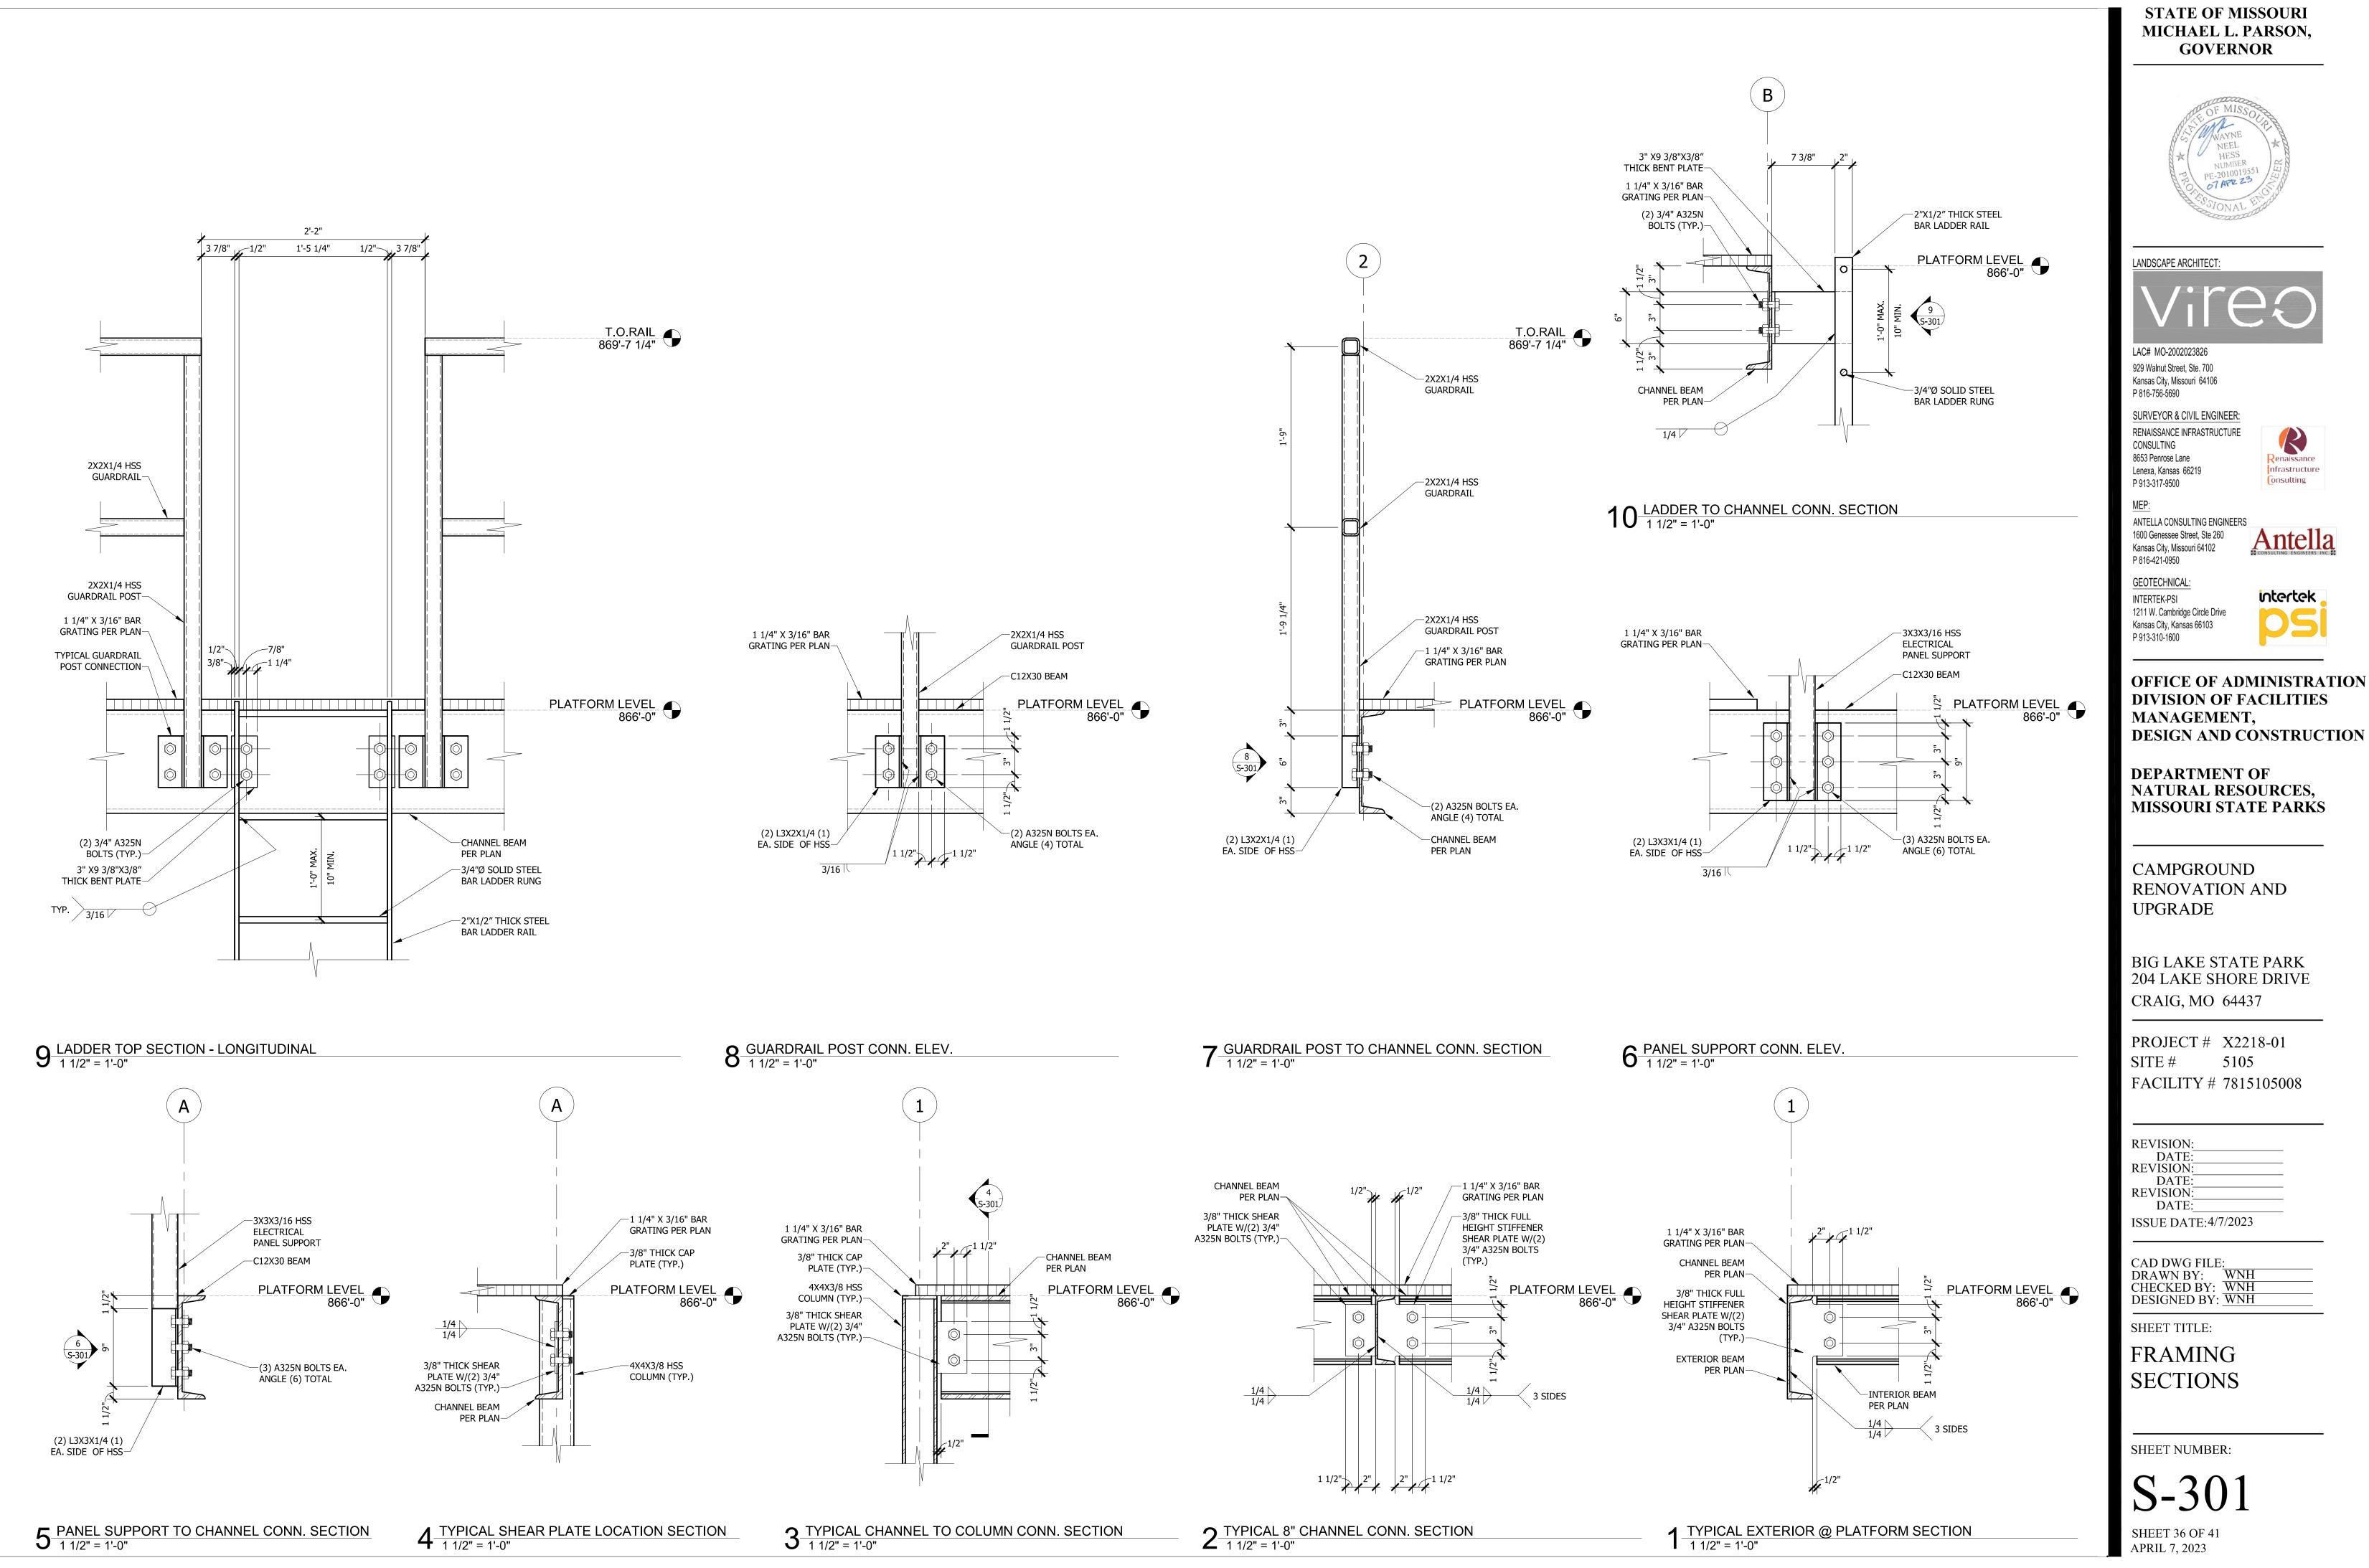



LANDSCAPE ARCHITECT:

LAC# MO-2002023826 929 Walnut Street, Ste. 700 Kansas City, Missouri 64106 P 816-756-5690

SURVEYOR & CIVIL ENGINEER: RENAISSANCE INFRASTRUCTURE nfrastructure

ANTELLA CONSULTING ENGINEERS 1600 Genessee Street, Ste 260 Kansas City, Missouri 64102

intertek 1211 W. Cambridge Circle Drive Kansas City, Kansas 66103

OFFICE OF ADMINISTRATION **DIVISION OF FACILITIES** MANAGEMENT,

DEPARTMENT OF NATURAL RESOURCES, MISSOURI STATE PARKS

CAMPGROUND RENOVATION AND **UPGRADE**

BIG LAKE STATE PARK 204 LAKE SHORE DRIVE CRAIG, MO 64437

PROJECT # X2218-01 5105 FACILITY # 7815105008

REVISION: DATE: **REVISION:** DATE: **REVISION:** DATE: ISSUE DATE: 4/7/2023

CAD DWG FILE:
DRAWN BY: WNH
CHECKED BY: WNH
DESIGNED BY: WNH

SHEET TITLE:

FRAMING SECTIONS

SHEET NUMBER:

SHEET 36 OF 41 APRIL 7, 2023

GENERAL NOTES: (TYPICAL ALL SHEETS)


- A) ALL WORK SHALL CONFORM TO THE APPLICABLE PROVISIONS OF THE LATEST NATIONAL ELECTRICAL CODE, UNDERWRITER'S LABORATORIES, INC., OCCUPATIONAL SAFETY AND HEALTH ACT, AND ALL STATE, LOCAL, MUNICIPAL, AND STATUTORY REQUIREMENTS.
- B) PEDESTAL FEEDER WIRING TO BE COPPER: XLPE, RHW-2 OR USE-2 TYPE, DIRECT
- C) ALL SINGLE PHASE, SINGLE POLE LOADS TO HAVE DEDICATED NEUTRALS. LABEL NEUTRAL CONDUCTORS WITH CORRESPONDING CIRCUIT NUMBER AT EACH PULL BOX, JUNCTION BOX, HANDHOLE AND OTHER SPLICE POINTS. USE OF BREAKER TIES IS NOT PERMITTED. SHARING OF NEUTRALS IS NOT PERMITTED.
- D) WHERE ELECTRICAL SITE WORK IS REQUIRED, CONTRACTOR SHALL RESTORE EXISTING SITE TO IT'S ORIGINAL CONDITION. INCLUDING BUT NOT LIMITED TO REPLACING VEGETATION, SOFTSCAPE AND HARDSCAPE REQUIRED TO BE DISTURBED DURING INSTALLATION OF ELECTRICAL COMPONENTS.
- E) USE OF 3M SCOTCHLOK CONNECTORS OR PUSH-IN WIRE CONNECTORS (SIMILAR TO WAGO PUSH-IN CONNECTORS) ARE NOT PERMITTED. ALL WIRING CONNECTIONS TO BE DONE WITH WIRE NUT CONNECTORS.
- F) IF CONTRACTOR CHOOSES TO GROUP CIRCUITS FOR HOMERUNS, CONTRACTOR SHALL APPLY ADJUSTMENT FACTORS FOR MORE THAN THREE CURRENT CARRYING CONDUCTORS IN A RACEWAY PER NEC TABLE 310.15(B)(3)(a). CONDUCTORS SHALL BE UPSIZED AS REQUIRED TO MAINTAIN FÙLL AMPACITY
- G) ALL EMPTY CONDUITS SHALL BE PROVIDED WITH A PULL WIRE.
- H) ALL PANELBOARDS, SWITCHBOARDS AND LINE VOLTAGE CONTROL EQUIPMENT SHALL BE FIELD MARKED TO WARN QUALIFIED PERSONS OF POTENTIAL ELECTRIC ARC FLASH HAZARDS. MARKING SHALL BE LOCATED SO AS TO BE CLEARLY VISIBLE TO QUALIFIED PERSONS BEFORE EXAMINATINON, ADJUSTING, SERVICING OR MAINTENANCE OF EQUIPMENT. MARKING SHALL BE SELF ADHESIVE, COMMERCIAL LABEL CONFORMING TO NEC AND ANSI REQUIREMENTS.
- ANY MATERIAL REMOVED THAT OWNER DOES NOT WISH TO RETAIN SHALL BE REMOVED FROM PROJECT SITE AND DISPOSED OF BY THE CONTRACTOR.
- UPDATED, TYPEWRITTEN PANELBOARD DIRECTORY SHALL BE PROVIDED FOR EACH PANELBOARD THAT CIRCUITS HAVE BEEN ADDED TO OR MODIFIED.

GENERAL DEMO NOTES:

- A) REMOVE ALL WIRING (CONDUIT, CONDUCTORS, BOXES, ETC.) ABANDONED AS PART OF THIS PROJECT.
- C) ANY EXISTING DEVICE AND/OR CIRCUIT SHOWN ARE INDICATED ONLY FOR INFORMATION PURPOSES. THE CONTRACTOR SHALL VISIT THE SITE AND VERIFY ALL CONDITIONS AS THEY EXIST AND SHALL REMOVE, RELOCATE AND/OR REWORK ANY ELECTRICAL EQUIPMENT OR CIRCUITS NECESSARY FOR A COMPLETE REWIRING SYSTEM.
- D) UNLESS NOTED OTHERWISE, THE CONTRACTOR SHALL FAMILIARIZE THEMSELVES WITH ALL WORK TO BE DONE BY OBSERVATION OF THE SITE. FAILURE TO DO SO WILL NOT RELIEVE THE CONTRACTOR OF THE RESPONSIBILITY FOR PERFORMING ALL WORK NECESSARY TO PROVIDE A WORKMANLIKE INSTALLATION.
- E) THE CONTRACTOR SHALL MAINTAIN ACCURATE RECORDS OF ANY MODIFICATIONS TO THE EXISTING SYSTEMS WHICH ARE TO REMAIN AND SHALL. UPON COMPLETION OF THIS PROJECT, DELIVER "RECORD" DRAWINGS TO THE ARCHITECT INDICATING ALL SUCH CHANGES. THE CONTRACTOR SHALL MAINTAIN IN THE PROJECT OFFICE, AS WORK PROGRESSES, AN UP-TO-DATE NEATLY MARKED COPY OF THESE DRAWINGS FOR REVIEW BY THE APPROPRIATE PARTIES.
- F) WHERE NEW WORK INTERFERES WITH CIRCUITS OTHERWISE UNDISTURBED. EXISTING CIRCUITS SHALL BE REWORKED AS REQUIRED TO MAINTAIN SERVICE.
- G) THE CONTRACTOR SHALL FIELD VERIFY THE LOCATION OF ALL EXISTING UTILITIES, THE CONDITION OF EXISTING DEVICES AND MATERIALS, AND SHALL BE RESPONSIBLE FOR THE PROTECTION OF THE SAME DURING THE COURSE OF THIS WORK. EXISTING UTILITIES, EXISTING BUILDING, AND/OR MATERIALS WHICH ARE DAMAGED BY NEGLIGENCE ON THIS CONTRACTOR'S PART OR ANY PARTIES ASSOCIATED WITH THIS CONTRACTOR, SHALL BE REPAIRED OR REPLACED AT THIS CONTRACTOR'S EXPENSE, IN A TIMELY MANNER, AND TO THE ARCHITECT'S AND OWNER'S WRITTEN ACCEPTANCE.
- H) CIRCUIT ROUTINGS SHOWN MAY BE MODIFIED TO SUIT FIELD CONDITIONS, HOWEVER, KEEP CIRCUITS AS INDICATED TO AVOID OVERLOADING OF THE
- WHERE EXISTING ELECTRICAL DISTRIBUTION PANELBOARDS ARE TO BE REMOVED, THE CONTRACTOR SHALL PROVIDE TEMPORARY CONNECTIONS TO MAINTAIN POWER TO FEEDER CIRCUITS UNTIL A PERMANENT PANEL IS INSTALLED TO RECONNECT THE EXISTING REMAINING CIRCUITS.
- MAINTAIN CONTINUITY OF EXISTING CIRCUITS SERVING DEVICES, FIXTURES OR EQUIPMENT TO REMAIN.

CODE SUMMARY: INTERNATIONAL BUILDING CODE 2018 NFPA 70 NATIONAL ELECTRICAL CODE 2020


ELECTRICAL SYMBOLS:

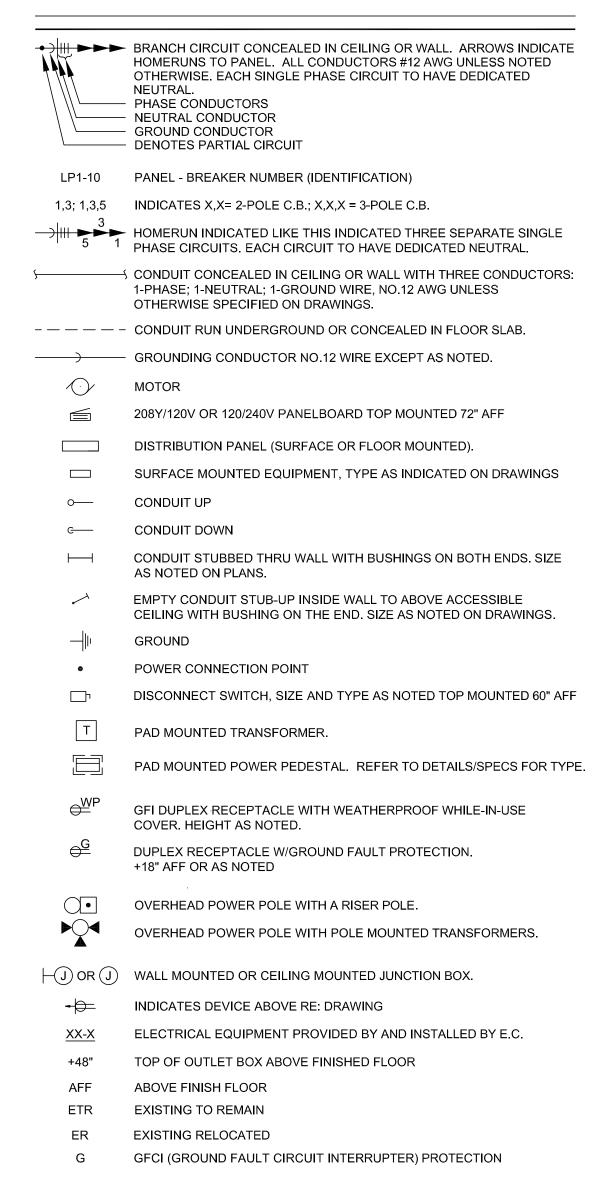

	LAN NOTE LEGEND
TAG VALUE	PLAN NOTE TEXT
ED000	ELECTRICAL DEMOLITION
EP000	POWER

DISTANCE	CONDUCTOR SIZE
120V-20A BR/	ANCH CIRCUIT
UP TO 100'	#12
100'-150'	#10
150'-250'	#8
250'-OVER	#6
277V-20A BRA	ANCH CIRCUIT
UP TO 200'	#12
200'-375'	#10
375'-OVER	#8
NOTE: FOR ALL CIRCUITS WITH #6 6 #8 CONDUCTORS AT PANEL CIRCUIT BREAKER.	*

STATE OF MISSOURI MICHAEL L. PARSON, **GOVERNOR**

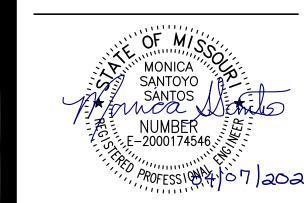

Monica S Santos - Electrical MO # E-2000174546



929 Walnut Street, Ste. 700 Kansas City, Missouri 64106 P 816-756-5690

CONSULTING

P 913-317-9500

P 913-310-1600

SURVEYOR & CIVIL ENGINEER:

RENAISSANCE INFRASTRUCTURE 8653 Penrose Lane Lenexa, Kansas 66219

nfrastructure

ANTELLA CONSULTING ENGINEERS 1600 Genessee Street, Ste 260 Kansas City, Missouri 64102 P 816-421-0950

GEOTECHNICAL: INTERTEK-PSI 1211 W. Cambridge Circle Drive

intertek Kansas City, Kansas 66103

OFFICE OF ADMINISTRATION DIVISION OF FACILITIES MANAGEMENT, **DESIGN AND CONSTRUCTION**

DEPARTMENT OF NATURAL RESOURCES, MISSOURI STATE PARKS

CAMPGROUND RENOVATION AND **UPGRADE**

BIG LAKE STATE PARK 204 LAKE SHORE DRIVE CRAIG, MO 64437

PROJECT # X2218-01 SITE# 5105 FACILITY # 7815105008

REVISION: DATE: **REVISION:** DATE: **REVISION:** DATE: ISSUE DATE: 4/7/2023


CAD DWG FILE: DRAWN BY: MSS CHECKED BY: MSS DESIGNED BY: MSS

SHEET TITLE:

ELECTRICAL SYMBOLS AND GENERAL NOTES


SHEET NUMBER:

SHEET 37 OF 41 APRIL 7, 2023

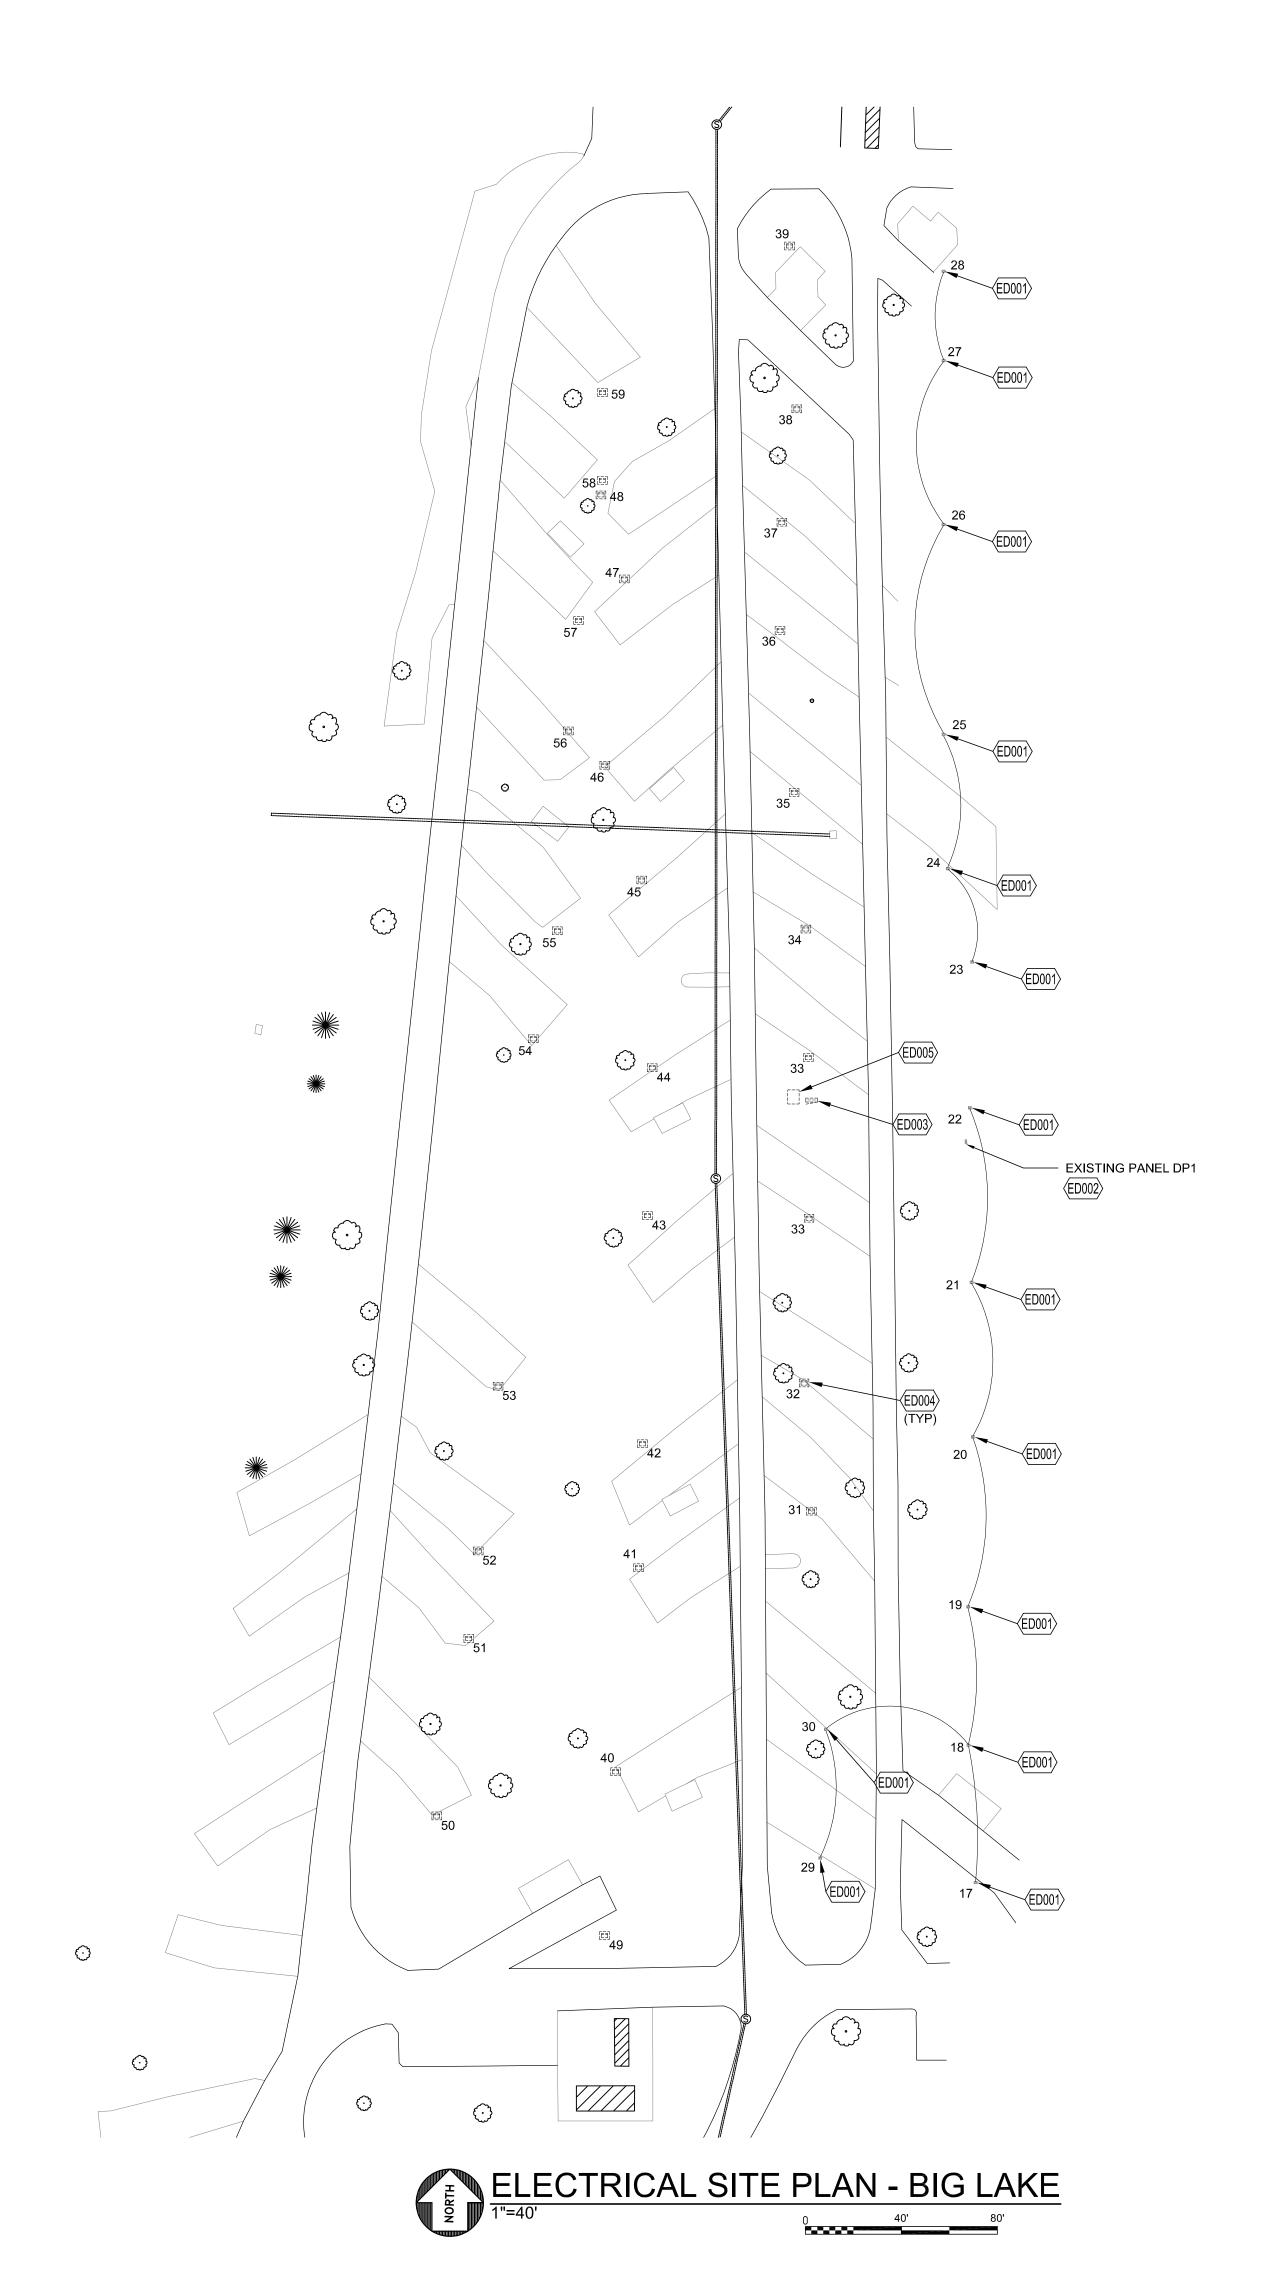

	GENERAL NOTES
1	CIRCUIT ROUTING SHOWN IS DIAGRAMMATIC ONLY.
2	CONTRACTOR TO FIELD LOCATE, MAINTAIN AND PROTECT ALL EXISTING UTILITIES UNLESS OTHERWISE NOTED.
3	ATCHISON-HOLT ELECTRIC COOP (AHEC) CONTACT IS: MIKE DAUGHERTY. EMAIL: MDAUGHERTY@AHEC.COOP. CELL (660) 744-4599

	DEMOLITION PLAN NOTES
ED001	EXISTING POWER PEDESTAL TO REMAIN. MAINTAIN CONTINUITY OF CIRCUIT FEEDIN PEDESTAL. WIRING SHOWN TO SHOW GROUPING OF PEDESTALS AND FOR REFEREI ONLY.
ED002	EXISTING PANEL TO REMAIN. PROTECT DURING NEW WORK. RE-FEED FROM RELOCATED TRANSFORMER AS PER NEW WORK PLANS.
ED003	EXISTING PANEL TO BE DISCONNECTED AND REMOVED. REMOVE ALL ASSOCIATED
ED003	WIRING AND CONDUIT BACK TO UTILITY TRANSFORMER.
ED004	EXISTING PEDESTAL TO BE SALVAGED. DISCONNECT AND REMOVE ALL ASSOCIATE WIRING AND CONDUIT BACK TO PANEL. OWNER HAS THE RIGHT OF FIRST REFUSAL POWER PEDESTAL. IF THEY DO NOT WANT IT, THEN PROPERLY DISPOSE OF PEDES
ED005	EXISTING UTILITY TRANSFORMER TO BE RELOCATED. COORDINATE WITH ATCHISON-HOLT ELECTRIC COOP (AHEC) FOR REMOVAL AND RE-INSTALL PER NEW WORK PLANS. EXISTING METER ASSOCIATED WITH TRANSORMER TO BE RELOCATE ADJACENT TO EXISTING PANEL TO REMAIN.

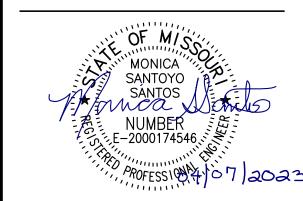

Monica S Santos - Electrical MO # E-2000174546



LAC# MO-2002023826 929 Walnut Street, Ste. 700 Kansas City, Missouri 64106

Lenexa, Kansas 66219

P 913-317-9500

INTERTEK-PSI

P 816-756-5690 SURVEYOR & CIVIL ENGINEER: RENAISSANCE INFRASTRUCTURE CONSULTING 8653 Penrose Lane



ANTELLA CONSULTING ENGINEERS 1600 Genessee Street, Ste 260 Kansas City, Missouri 64102

P 816-421-0950 GEOTECHNICAL:

intertek 1211 W. Cambridge Circle Drive Kansas City, Kansas 66103



DESIGN AND CONSTRUCTION DEPARTMENT OF NATURAL RESOURCES,

MISSOURI STATE PARKS

CAMPGROUND RENOVATION AND UPGRADE

MANAGEMENT,

BIG LAKE STATE PARK 204 LAKE SHORE DRIVE CRAIG, MO 64437

PROJECT # X2218-01 5105 FACILITY # 7815105008

REVISION: REVISION: DATE: **REVISION:** DATE: ISSUE DATE: 4/7/2023


CAD DWG FILE:
DRAWN BY: MSS
CHECKED BY: MSS
DESIGNED BY: MSS

SHEET TITLE:

ELECTRICAL SITE PLAN DEMOLITION

SHEET NUMBER:

SHEET 38 OF 41 APRIL 7, 2023

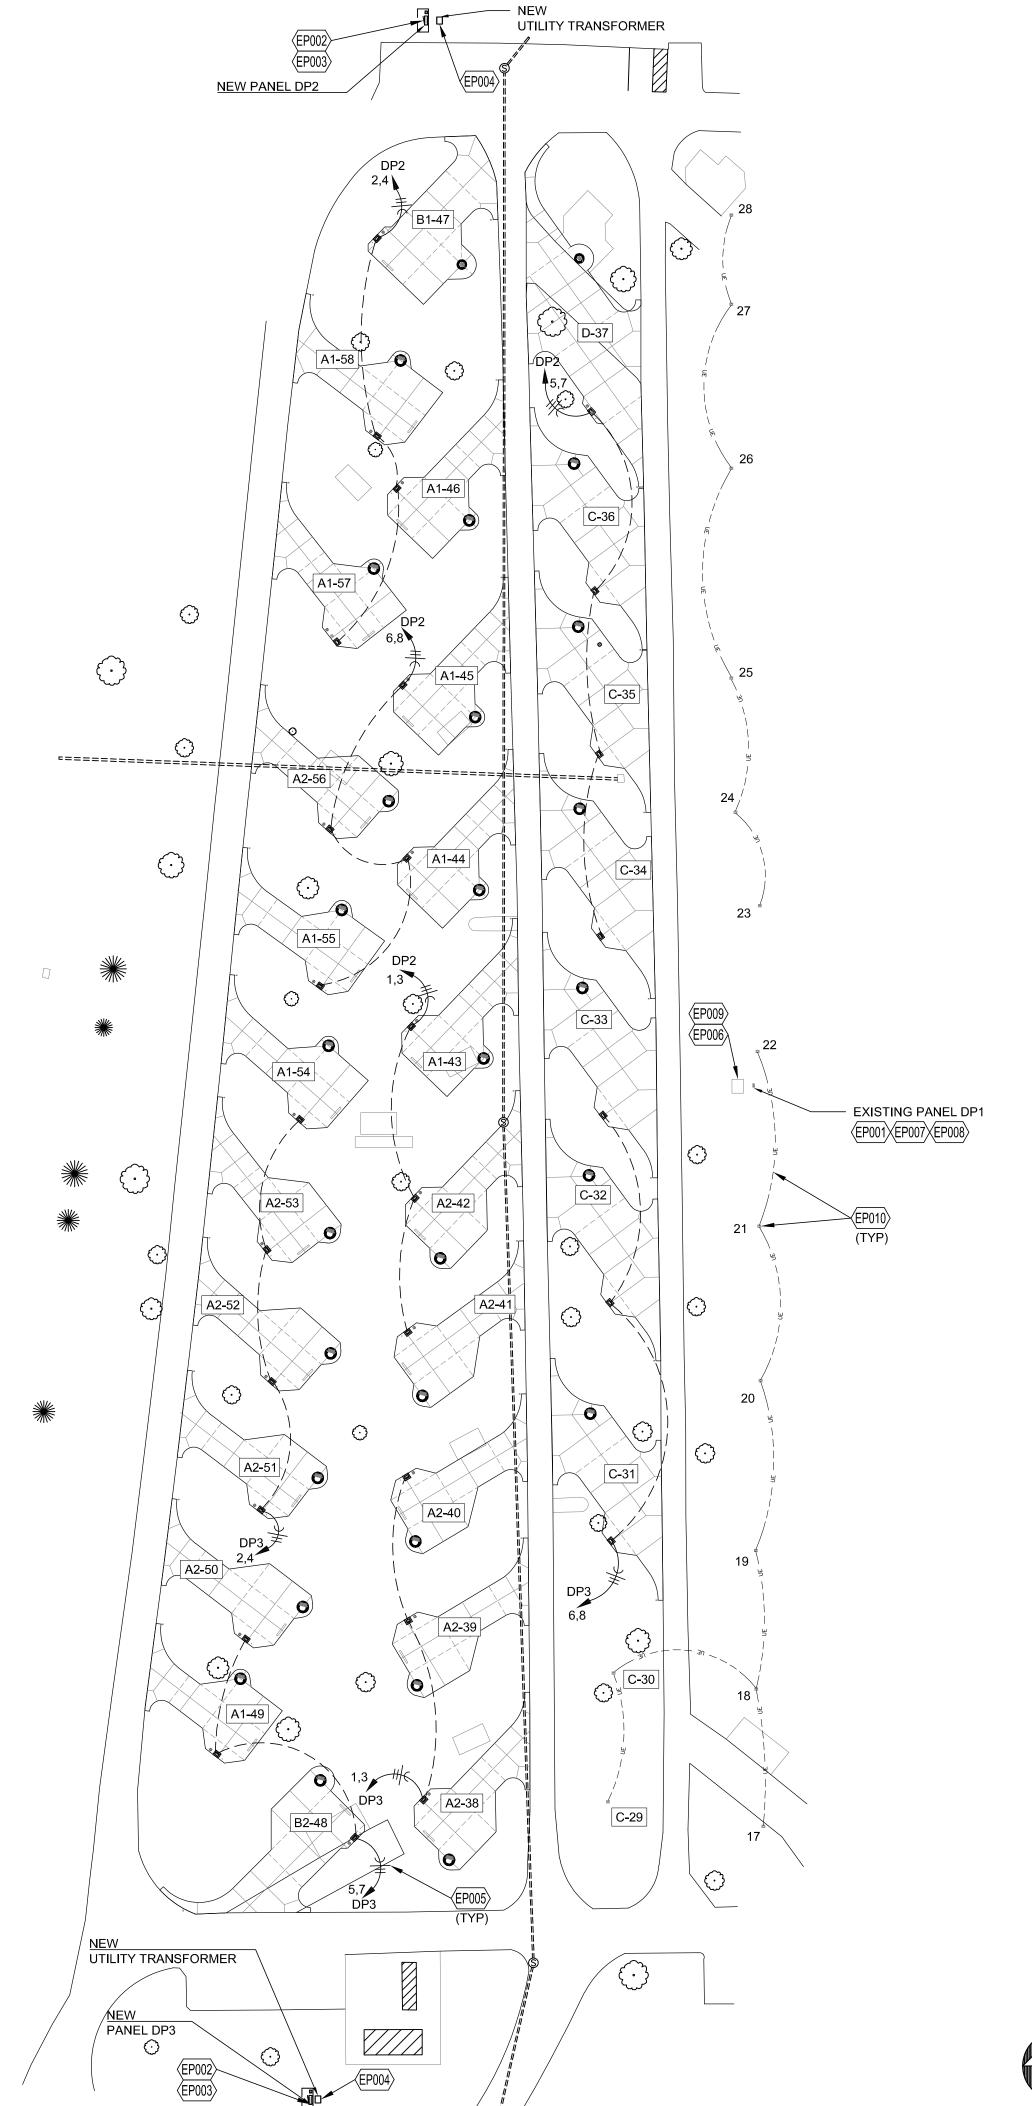


 \odot

 \odot

	GENERAL NOTES
1	CIRCUIT ROUTING SHOWN IS DIAGRAMMATIC ONLY.
2	CONTRACTOR TO FIELD LOCATE, MAINTAIN AND PROTECT ALL EXISTING UTILITIES UNLESS OTHERWISE NOTED.
3	ATCHISON-HOLT ELECTRIC COOP (AHEC) CONTACT IS: MIKE DAUGHERTY, EMAIL: MDAUGHERTY@AHEC.COOP. CELL: (660) 744-4599.

EP001	EXISTING PANEL TO REMAIN. RE-CONNECT TO RELOCATED TRANSFORMER. COORDINATE WITH AHEC.
FROOD	PROVIDE NEW ONIOLE BUAGE, GAGAGOV BANEL BOARD IN NEWA OR ENGLOOUSE, GET
EP002	PROVIDE NEW SINGLE PHASE, 240/120V PANELBOARD IN NEMA 3R ENCLOSURE. SEE ASSOCIATED PANEL SCHEDULE AND RISER DIAGRAM FOR ADDITIONAL INFORMATION AND REQUIREMENTS.
EP003	PANELBOARD TO BE MOUNTED SO THAT BOTTOM OF PANEL IS A MINIMUM OF ONE (1)
2. 000	FOOT ABOVE THE 100 YEAR FLOOD PLAIN (866): PANELBOARD TO BE MOUNTED ON
	ELEVATED GALVANIZED STEEL PLATFORM. PROVIDE ALL THE REQUIRED UNI-STRUT
	SUPPORT FRAMING TO PROPERLY SUPPORT THE CONDUIT RISERS FROM THE GROUND
	AND TO PROPERLY SUPPORT THE PANELBOARD AND METER FROM THE ELEVATED
	PLATFORM. REFER TO S-100 & S-200 FOR PLATFORM DETAILS.
EP004	NEW TRANSFORMER TO BE LOCATED CLOSE TO THE ELEVATED PLATFORM MAINTAINING PROPER CLEARANCES AS REQUIRED BY ATCHISON-HOLT ELECTRIC.
EP005	PROVIDE 3#250 KCMIL AND 1 #4 GROUND (TYPE CU USE-2/RHW-2/XLPE CABLE) DIRECT BURIED A MINIMUM OF 24" INCHES THROUGHOUT FULL LENGTH OF CIRCUIT.
EP006	COORDINATE WITH ATCHISON-HOLT ELECTRIC COOP (AHEC) FOR THE RELOCATION OF
EPUUU	THE EXISTING TRANSFORMER AND TERMINATION OF SECONDARY CONDUCTORS AT THE TRANSFORMER.
EP007	CONTRACTOR TO REFEED EXISTING PANEL FROM NEW TRANSFORMER LOCATION. MATCH EXISTING FEEDER CONDUCTOR SIZES AND TYPE. DO NOT SPLICE EXISTING FEEDERS. PROVIDE NEW RUN TO NEW TRANSFORMER LOCATION. AT MINIMUM FEEDER
	TO BE: TWO SETS OF: 3 # 500 KCMIL CU XLP IN 4" SCHEDULE 40 PVC CONDUIT EACH.
EP008	RE-LABEL EXISTING PANEL AS NOTED. PROVIDE A NEW PANEL ID ON INSIDE FACE OF
	CABINET.
EP009	UTILITY TO RE-LOCATE METER NEXT TO RE-LOCATED TRANSFORMER.
	The state of the s
EP010	EXISTING WIRING SHOWN ONLY TO REPRESENT GROUPING OF CIRCUITS. INFORMATION
	TAKEN FROM EXISTING DRAWINGS. CONTRACTOR SHALL PROTECT FEEDERS TO PEDESTALS TO REMAIN. FIELD VERIFY AS REQUIRED TO PROTECT EXISTING PEDESTALS
	AND WIRING TO REMAIN.

STATE OF MISSOURI MICHAEL L. PARSON, **GOVERNOR**

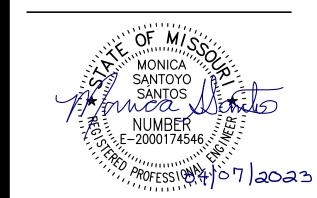

Monica S Santos - Electrical MO # E-2000174546



LAC# MO-2002023826

929 Walnut Street, Ste. 700 Kansas City, Missouri 64106 P 816-756-5690 SURVEYOR & CIVIL ENGINEER:

CONSULTING 8653 Penrose Lane

P 913-317-9500

P 913-310-1600

RENAISSANCE INFRASTRUCTURE nfrastructure

Lenexa, Kansas 66219

ANTELLA CONSULTING ENGINEERS

1600 Genessee Street, Ste 260 Kansas City, Missouri 64102 P 816-421-0950

GEOTECHNICAL: INTERTEK-PSI 1211 W. Cambridge Circle Drive Kansas City, Kansas 66103

intertek

OFFICE OF ADMINISTRATION DIVISION OF FACILITIES MANAGEMENT, **DESIGN AND CONSTRUCTION**

DEPARTMENT OF NATURAL RESOURCES, MISSOURI STATE PARKS

CAMPGROUND RENOVATION AND UPGRADE

BIG LAKE STATE PARK 204 LAKE SHORE DRIVE CRAIG, MO 64437

PROJECT # X2218-01 5105 FACILITY # 7815105008

REVISION: REVISION: DATE: **REVISION:** DATE: ISSUE DATE: 4/7/2023


CAD DWG FILE:
DRAWN BY: MSS
CHECKED BY: MSS
DESIGNED BY: MSS


SHEET TITLE: ELECTRICAL SITE PLAN

SHEET NUMBER:

SHEET 39 OF 41 APRIL 7, 2023



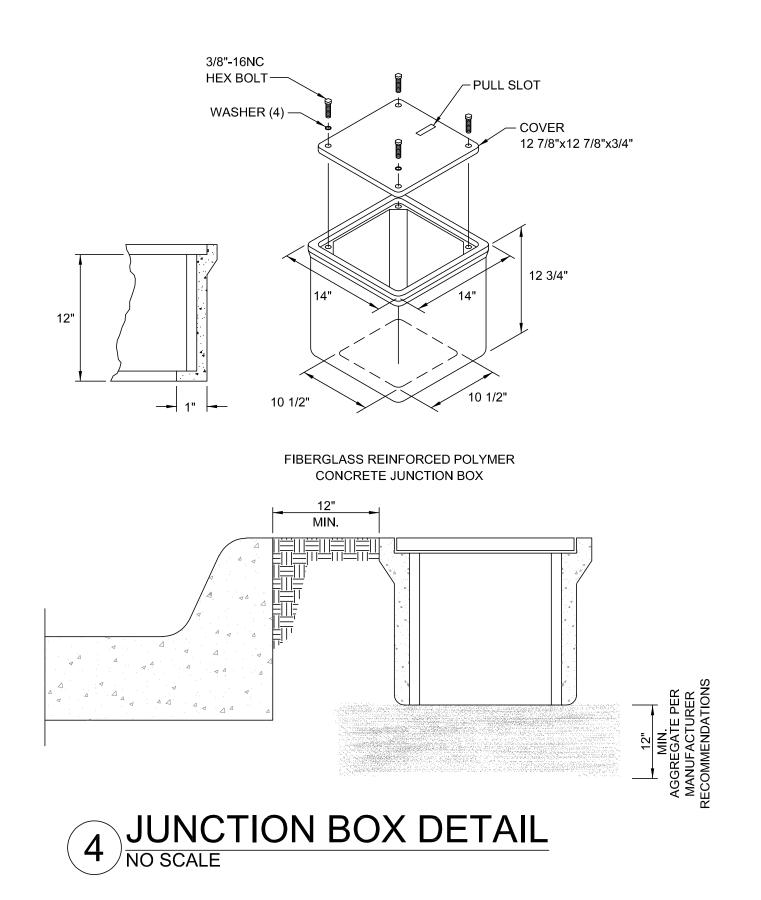


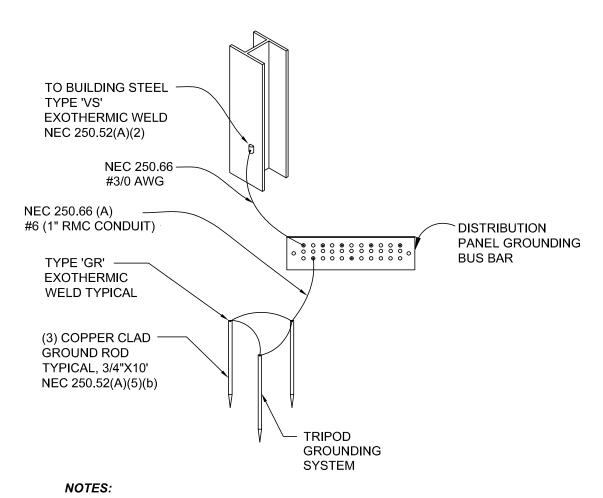



- EXOTHERMIC WELD DESIGNATION INDICATED ABOVE ARE ERICO 'CADWELD'.
- 2. ALL GROUND BUS CONNECTIONS TO BE MADE WITH COPRESSION TYPE CONNECTORS.
- 3. ALL WIRING TO BE TYPE THHN/THWN-2.
- 4. MAIN GROUP OF RODS ARE TO BE LOCATED AT SERVICE ENTRANCE WITH SIZE AND QUANTITY PER SPECIFICATIONS.
- 5. EACH CABLE TIED TO THE MAIN PANEL GROUNDING BUS TO BE LABELED.


3 MAIN SERVICE GROUNDING
NO SCALE


6. SIZING AND CODE REFERENCES ARE BASED ON NEC 2020.

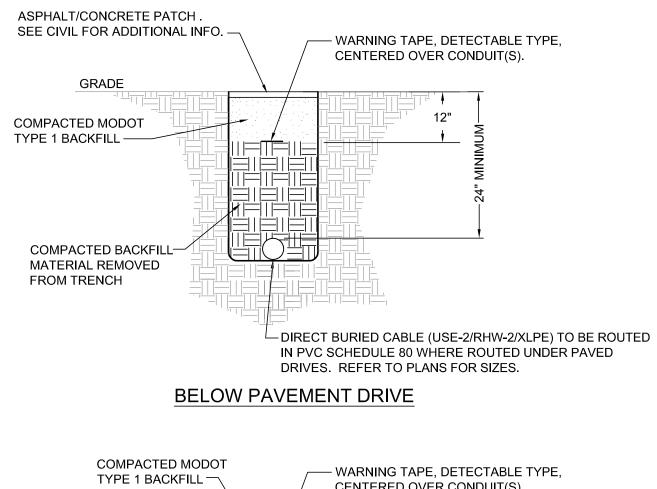

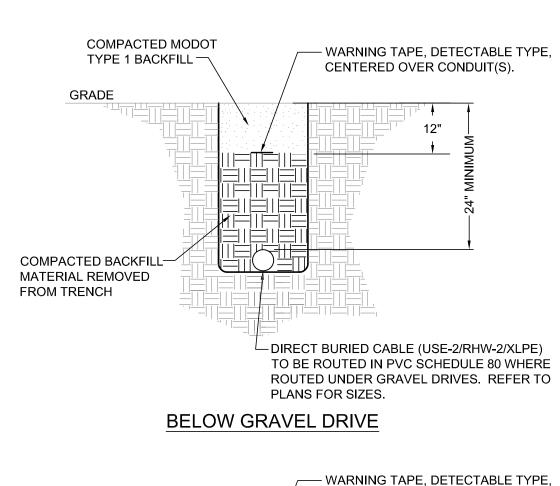


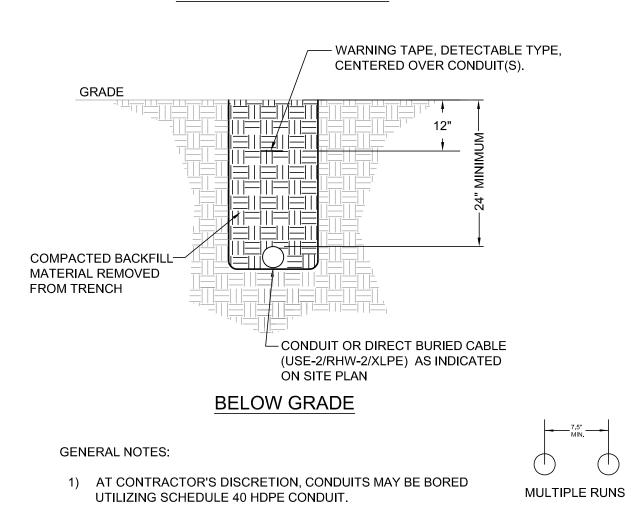

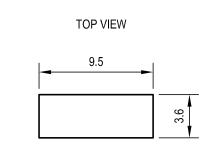

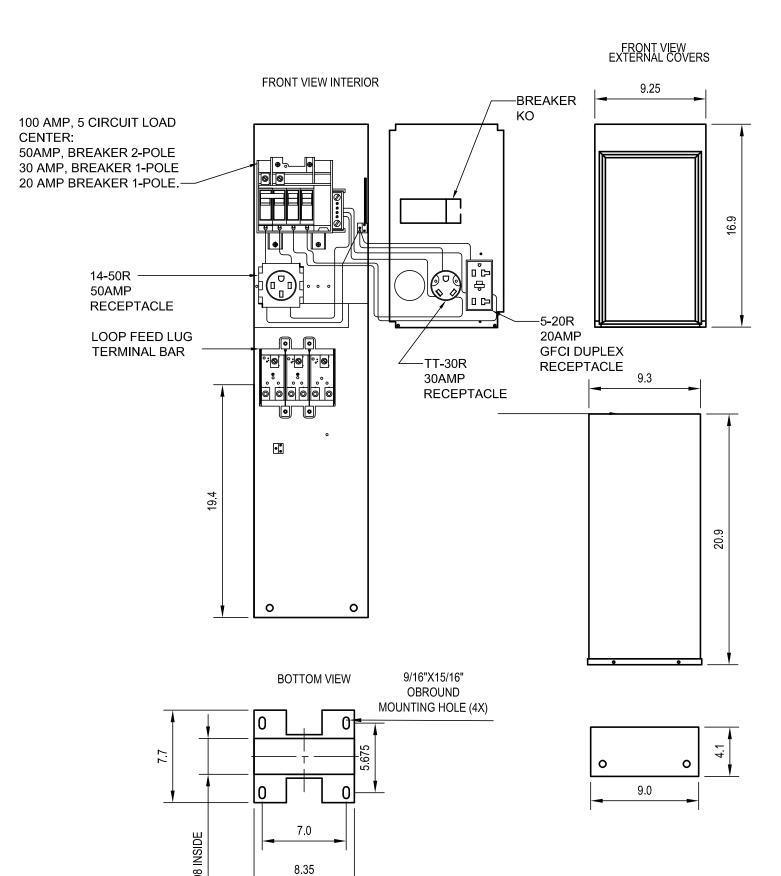

INSIDE

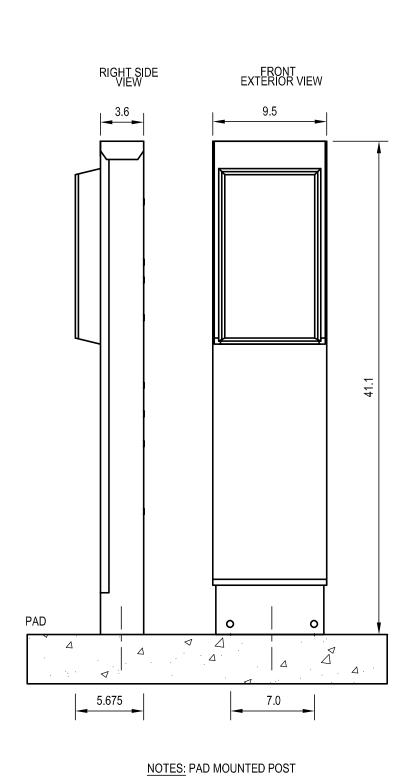


WIRE RANGE SIZE

WITTE TO 1140E 012E											
	COPF	PER									
CONNECTOR	SOILD	STRAND									
LINE	14-8	14-8									
LOAD	14-10	14-10									
NEUTRAL	14-4	14-4									
POST LINE CONNECTORS SUITABLE FOR LOOP FEED	#6-350 KCMIL										
EQUIP, GRND POST	14-2/0	14-2/0									

2 UP TO 600V CONDUIT TRENCH DETAILS

1 POWER PEDESTAL DETAIL
NO SCALE

STATE OF MISSOURI MICHAEL L. PARSON, GOVERNOR

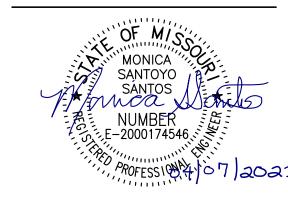

Monica S Santos - Electrical MO # E-2000174546

LANDSCAPE ARCHITECT:

LAC# MO-2002023826 929 Walnut Street, Ste. 700 Kansas City, Missouri 64106 P 816-756-5690

Lenexa, Kansas 66219 P 913-317-9500

Kansas City, Kansas 66103

P 913-310-1600

SURVEYOR & CIVIL ENGINEER:
RENAISSANCE INFRASTRUCTURE
CONSULTING
8653 Penrose Lane

Renaissance Infrastructure Consulting

MEP:
ANTELLA CONSULTING ENGINEERS
1600 Genessee Street, Ste 260
Kansas City, Missouri 64102

P 816-421-0950

GEOTECHNICAL:
INTERTEK-PSI
1211 W. Cambridge Circle Drive

intertek 05

OFFICE OF ADMINISTRATION DIVISION OF FACILITIES MANAGEMENT,

DESIGN AND CONSTRUCTION

DEPARTMENT OF NATURAL RESOURCES, MISSOURI STATE PARKS

CAMPGROUND RENOVATION AND UPGRADE

BIG LAKE STATE PARK 204 LAKE SHORE DRIVE CRAIG, MO 64437

PROJECT # X2218-01 SITE # 5105 FACILITY # 7815105008

REVISION:______
DATE:
REVISION:_____
DATE:
REVISION:_____
REVISION:_____
DATE:____

CAD DWG FILE:
DRAWN BY: MSS
CHECKED BY: MSS
DESIGNED BY: MSS

ISSUE DATE: 4/7/2023

SHEET TITLE:

ELECTRICAL DETAILS


SHEET NUMBER:

E-501

SHEET 40 OF 41 APRIL 7, 2023


SERVICE: 240/120 VOLT, 1 - PHASE, 3 - WIRE AMP: 1200 AMP										RATING: 42000 A.I.C.						
											1	LOCATION:	BIG LAKE			
		MAINS	: MCB / 1000 AMP MAIN BREAKER				MOUNTING:	SURFACE						NEMA 3R		
			PANEL SERVICE ENTRANCE RATED													
ПОИ	<u> </u>		LOAD	BRKR		LOA	D KVA		LOAD		BRKR		LOA	KVA	NOTE	REV
NO.		CRT#	DESCRIPTION	Р	AMP	Α	В	CRT#	DESCRIPTION		Р	AMP	Α	В	NO.	NO.
		1	SITES A2-41, A2-42, A1-43	2	250	18		2	SITES B1-47, A1-58, A1-47, A1-57		2	250	18			
		3					18	4						18		
		5	SITES C-34, C-35, C-36, D-37	2	250	24		6	SITES A1-55, A1-44, A2-56, A1-45		2	250	24			
		7	1				24	8						24		
		9	SPARE	2	125			10	SPARE		2	125				
		11						12								
		13	SPARE	2	125			14	SPARE		2	125				
		15						16								
		17	SPACE ONLY	1	20			18	SPACE ONLY		1	20				
		19	SPACE ONLY	1	20			20	SPACE ONLY		1	20				
		21	SPACE ONLY	1	20			22	SPACE ONLY		1	20				
		23	SPACE ONLY	1	20			24	SPACE ONLY		1	20				
		25	SPACE ONLY	1	20			26	SPACE ONLY		1	20				
		27	SPACE ONLY	1	20			28	SPACE ONLY		1	20				
		29	SPACE ONLY	1	20			30	SPACE ONLY		1	20				L
					TOTAL:	42	42					TOTAL:	42	42		
								J					42	42	1	
NOTI	≣S:									KV	A / PHAS	E TOTAL:	84	84	-	
		AIN BREA	AKER TO BE 100% RATED. IF ADJUSTABLE TO 1200	AMP								E TOTAL:	700	700	-	
			VIDE WITH ARC REDUCING MAINTENANCE SWITCH, (AMPERAG	E AS SHO	WN.			7.111		[. 30	1	1	
										TOTAL CONNECTED LOAD:			168.00			
										TOTAL CONN	TOTAL CONNECTED CURRENT: TOTAL DEMAND CURRENT:			700.00	AMPS	

		SERVICE	: 240/120 VOLT , 1 - PHASE , 3 - WIRE						SCHEDULE S/N ,GND BUS			RATING:	42000 A.I.C	•	
		AMP	: 1200 AMP									LOCATION:	BIG LAKE		
		MAINS	: MCB / 1000 AMP MAIN BREAKER			N	MOUNTING:	SURFACE					NEMA 3R E	NCLOSURE	
		1	PANEL SERVICE ENTRANCE RATED							,		Γ		T	
V	NOTE	LOAD		BRKR		LOAD KVA			LOAD	BRKR		LOAD KVA		NOTE	REV
Э.	NO.	CRT#	DESCRIPTION	P	AMP	А	В	CRT#	DESCRIPTION	P	AMP	A	В	NO.	NO.
		1	SITES A2-38, A2-39, A2-40	2	250	24		2	SITES A2-51, A2-52, A2-53, A1-54	2	250	24			
		3					12	4					24		
		5	SITES B2-48, A1-49, A2-50	2	250	12		6	SITES C-31, C-32, C-33	2	250	12			
		7					24	8					24		
		9	SPACE ONLY	2				10	SPACE ONLY	2					
		11						12							
		13	SPACE ONLY	2				14	SPACE ONLY	2					
		15						16							
		17	SPACE ONLY	1	20			18	SPACE ONLY	1	20				
		19	SPACE ONLY	1	20			20	SPACE ONLY	1	20				
		21	SPACE ONLY	1	20			22	SPACE ONLY	1	20				
		23	SPACE ONLY	1	20			24	SPACE ONLY	1	20				
		25	SPACE ONLY	1	20			26	SPACE ONLY	1	20				
		27	SPACE ONLY	1	20			28	SPACE ONLY	1	20				
		29	SPACE ONLY	1	20			30	SPACE ONLY	1	20				
					TOTAL:	36	36				TOTAL:	36	48		
					101/12.	00		_			TO TAL.	36	36	_	
	NOTES:									KVA / PHA	SE TOTAL		84	-	
	NO ILO.	MAIN BRE	AKER TO BE 100% RATED. IF ADJUSTABLE TO 1200 AMP							AMP / PHA			700	-	
			OVIE WITH ARC REDUCING MAINTENANCE SWITCH, OTHERWIS	SE LIMIT TO A	MPERAGE	AS SHOWN	I .			CHAIL T. L. LICA	OI TOTAL		1 ,00	J	
			,							TOTAL CONNEC	TED LOAD:		156.00	KVA	
										TOTAL CONNECTED				AMPS	

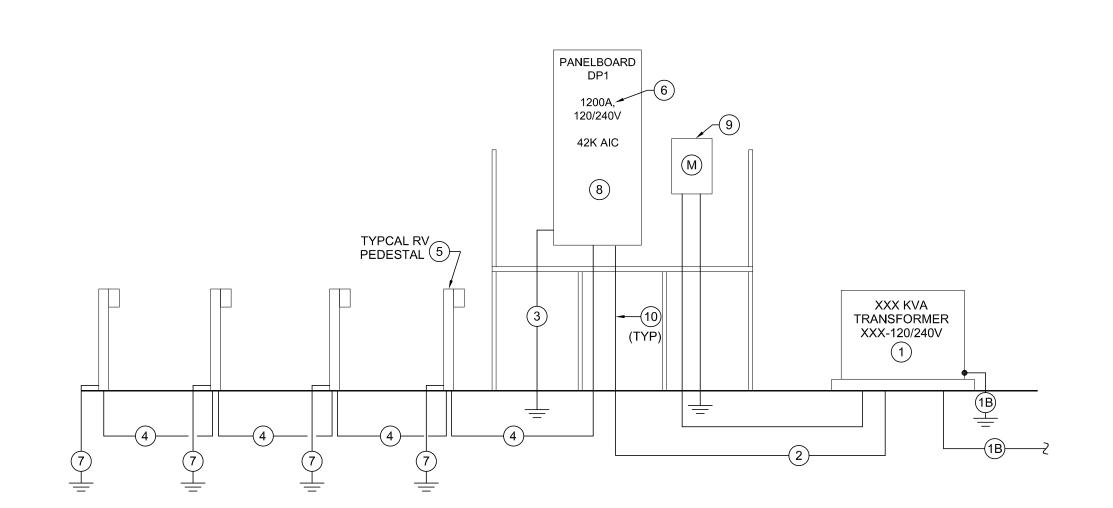

120/240V	TYPICAL ELEC	CTRICAL RIS	ER DIAGRAM
NO SCALE			

120/240V FEEDER SCHEDULE								
SYMBOL NUMBER	AMPACITY	NUMBER OF RUNS		TEMP RATING				
1			UTILITY TRANSFORMER AND PAD TO BE PROVIDED AND INSTALLED BY ATCHISON-HOLT ELECTRIC COOP (AHEC). CONTRACTOR TO COORDINATE EXACT PLACEMENT PRIOR TO ROUGH-IN OF PANELBOARD FEEDERS.					
1B			AHEC TO PROVIDE AND INSTALL PRIMARY FEEDER.					
2	1000	3	(3) #400 KCMIL IN 3" SCHEDULE 40 PVC CONDUIT.	90 DEG				
3			#3/0 COPPER GROUNDING CONDUCTOR TO 3/4" X 10' GROUND ROD.					
4	250	1	(3) #250 KCMIL & (1) # 4 GROUND DIRECT BURIED CU TYPE USE-2/RHW-2/XLPE CABLE.	90 DEG				
5			PROVIDE NEW NEMA 3R, SURFACE MOUNTED, 125A, 120/240V, 1 PH, 3 WIRE SINGLE SIDED PEDESTAL (MILLBANK XXXX OR APPROVED EQUAL) WITH FULLY RATED LOOP-FEED LUG ASSEMBLY (MIN. #250 KCMIL). TO INCLUDE ONE (1) 20A, 1P, GFCI; ONE (1) 30A, 1P AND ONE (1) 50A, 2P BREAKER TO SERVE THE FOLLOWING RECEPTACLES: 20A NEMA 5-20 (WEATHER RESISTANT TYPE); 30A NEMA TT-30 AND 50A, NEMA 14-50R.					
6			PANELBOARD TO BE RATED AS NOTED ON SCHEDULE.					
7			#6 COPPER GROUNDING CONDUCTOR TO 3/4" X 10' GROUND ROD.					
8			PANELBOARD TO BE MOUNTED ON ELEVATED PLATFORM. REFER TO PLANS AND STRUCTURAL DETAILS FOR PLATFORM DETAILS. CONTRACTOR TO PROVIDE HORIZONTAL UNITSTRUT SUPPORT AS REQUIRED TO MOUNT OFF PLATFORM VERTICAL SUPPORTS FOR PANELBOARD AND METER.					
9			METER TO BE INSTALLED ADJACENT TO PANEL ON ELEVATED PLATFORM. COORDINATE EXACT PLACEMENT WITH AHEC. AHEC TO INSTALL. CONTRACTOR TO COORDINATE WORK WITH AHEC.					
10			CONTRACTOR TO PROVIDE UNI-STRUT SUPPORT AS REQUIRED TO PROPERLY SUPPORT VERTICAL RUNS OF CONDUIT.					

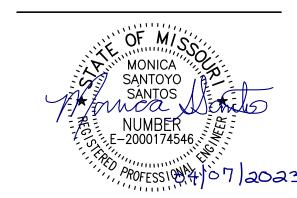

Monica S Santos - Electrical MO # E-2000174546



LAC# MO-2002023826 929 Walnut Street, Ste. 700 Kansas City, Missouri 64106 P 816-756-5690

8653 Penrose Lane Lenexa, Kansas 66219

P 913-317-9500

P 816-421-0950

P 913-310-1600

SURVEYOR & CIVIL ENGINEER:
RENAISSANCE INFRASTRUCTURE
CONSULTING



MEP:
ANTELLA CONSULTING ENGINEERS
1600 Genessee Street, Ste 260
Kansas City, Missouri 64102

GEOTECHNICAL:
INTERTEK-PSI
1211 W. Cambridge Circle Drive
Kansas City, Kansas 66103



OFFICE OF ADMINISTRATION DIVISION OF FACILITIES MANAGEMENT, DESIGN AND CONSTRUCTION

DEPARTMENT OF NATURAL RESOURCES, MISSOURI STATE PARKS

CAMPGROUND RENOVATION AND UPGRADE

BIG LAKE STATE PARK 204 LAKE SHORE DRIVE CRAIG, MO 64437

PROJECT # X2218-01 SITE # 5105 FACILITY # 7815105008

REVISION:
DATE:
REVISION:
DATE:
REVISION:
DATE:
REVISION:
DATE:
ISSUE DATE: 4/7/2023

CAD DWG FILE:
DRAWN BY: MSS
CHECKED BY: MSS
DESIGNED BY: MSS

SHEET TITLE:

ELECTRICAL RISER AND SCHEDULES

SHEET NUMBER:

E-801

SHEET 41 OF 41 APRIL 7, 2023