NEW PREMIUM CAMPSITES WESTON BEND STATE PARK

WESTON, MISSOURI

BID DOCUMENTS

WESTON BEND STATE PARK

16600 MO-45 Weston, MO 64098

SITE NUMBER: 5118 ASSET NUMBER: 7815118006

STATE OF MISSOURI MICHAEL L. PARSON,

GOVERNOR

DEPARTMENT OF NATURAL RESOURCES, MISSOURI STATE PARKS


PROJECT OFFICE OF ADMINISTRATION

MANAGEMENT: DIVISION OF FACILITIES MANAGEMENT,

DESIGN AND CONSTRUCTION

PROJECT NUMBER: X2221-01

OWNER:

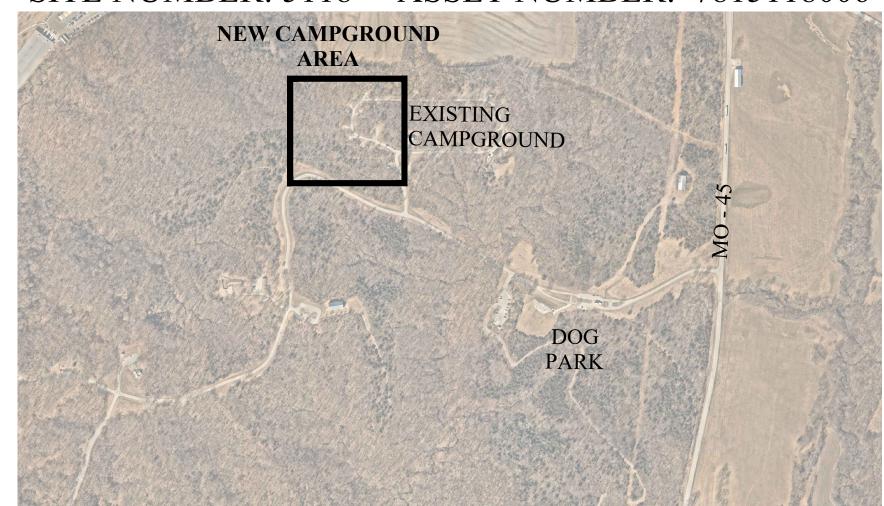



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ELECTRICAL ENGINEER:

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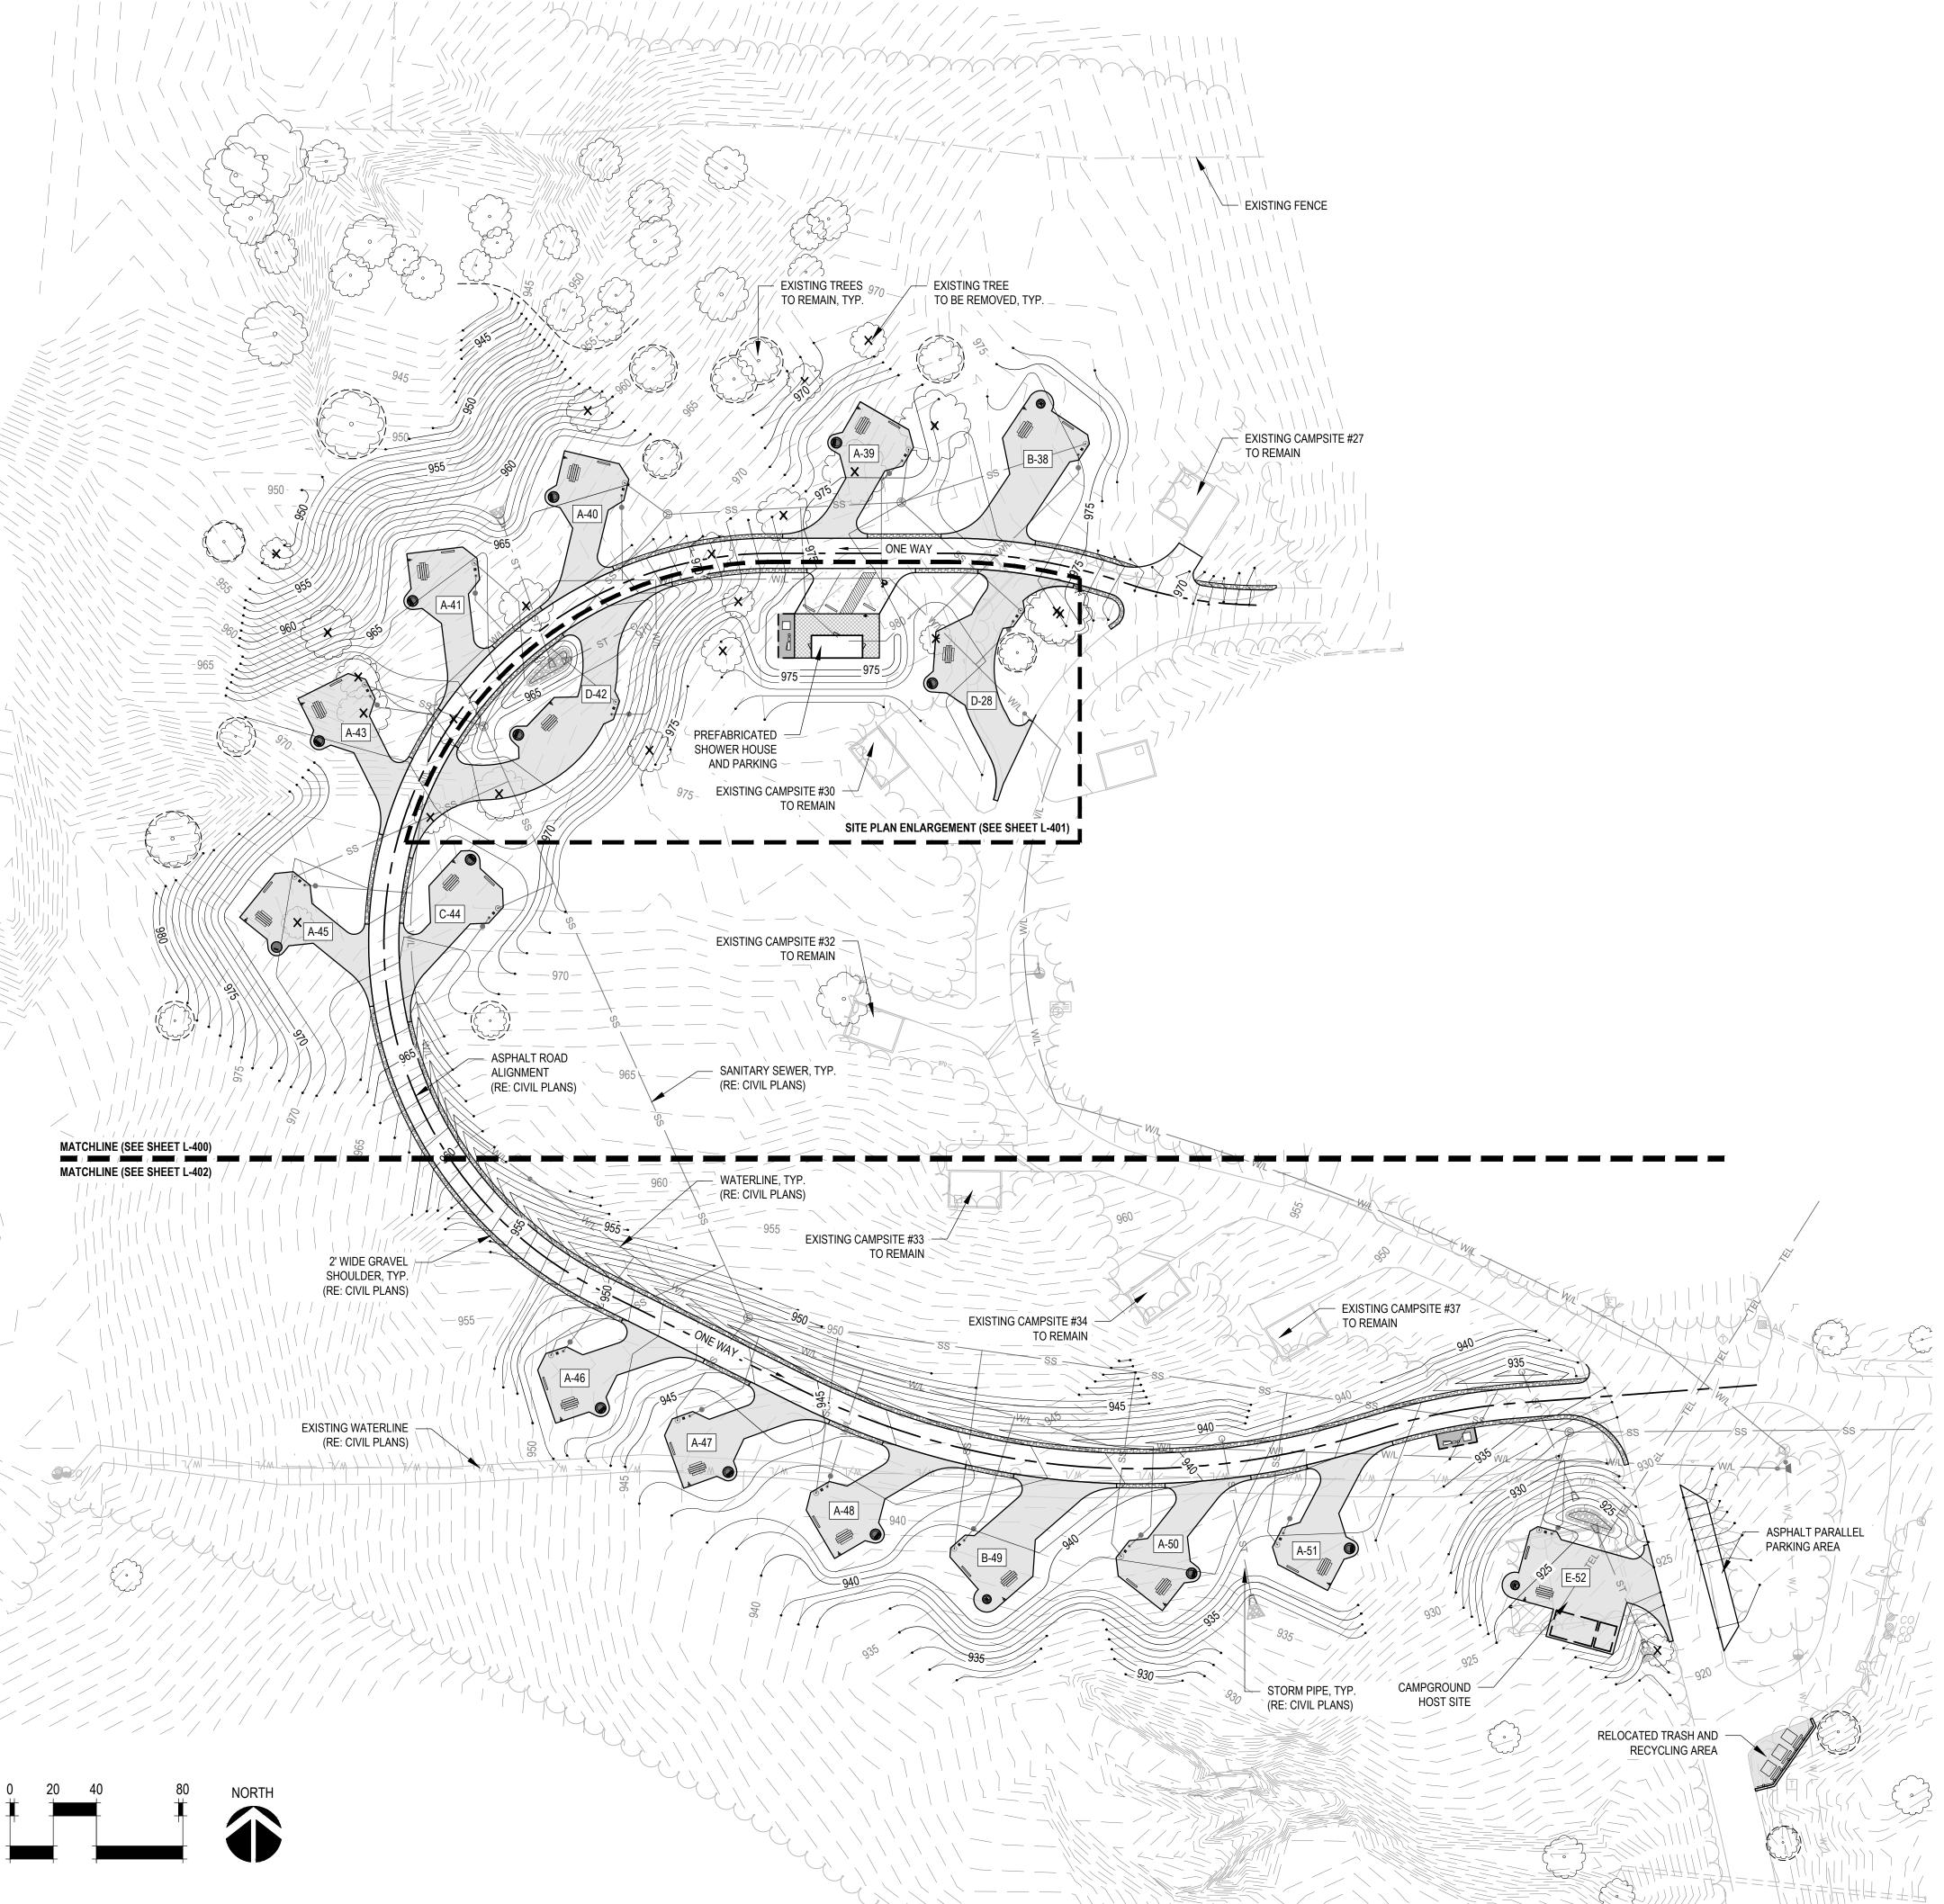
SHEET NUMBER:

E-201 - ELECTRICAL SITE PLAN

E-501 - ELECTRICAL DETAILS

G-0011 OF 36 SHEETS December 12, 2023

E-801 - ELECTRICAL RISER AND SCHEDULES



SITE LEGEND

POURED-IN-PLACE CONCRETE PAVEMENT - 6" THICK RE: DETAIL 01 / L-502 AND SPECIFICATION 321313



POURED-IN-PLACE CONCRETE PAVEMENT - 4" THICK RE: DETAIL 06 / L-502 AND SPECIFICATION 321313




CAMPSITE LEGEND

BACK-IN ADA STANDARD CAMPSITE

RE: 02 / L-501 FOR LAYOUT AND AMENITIES

- 2. THE CONTRACTOR IS RESPONSIBLE FOR ALL PERMITS AND FEES.
- 4. THE CONTRACTOR SHALL BE RESPONSIBLE FOR INSTALLING EROSION CONTROL DEVICES NECESSARY TO CONTROL SOIL LOSS FROM THE SITE.
- 5. ALL AREAS SHALL BE BROUGHT TO FINAL PLAN CONDITION (PAVED, SODDED, SEEDED OR MULCHED) AS
- 6. ALL CONSTRUCTION DEBRIS SHALL BE DISPOSED BY THE CONTRACTOR OFF SITE AT A LOCATION PROVIDED BY THE CONTRACTOR AND IN ACCORDANCE WITH MISSOURI REGULATIONS. THE CONTRACTOR SHALL SATISFY HIMSELF BY JOB-SITE INSPECTION AS TO THE EXTENT OF CLEARING REQUIRED PRIOR TO SUBMITTING A BID.
- 7. CONTRACTOR IS FULLY RESPONSIBLE FOR NOTIFYING ALL UTILITY COMPANIES ENCOUNTERED DURING THESE UTILITIES ARE NOT REPRESENTED AS ALL INCLUSIVE AS OTHER UTILITIES MAY BE PRESENT. THE CONTRACTOR SHALL HAVE ALL UTILITIES FLAGGED IN THE FIELD FOR INSPECTION PRIOR TO PRECEDING WITH ANY GRADING OPERATIONS. THE CONTRACTOR SHALL VERIFY THE DEPTH AND LOCATION OF ALL EXISTING UTILITIES AND WILL BE HELD LIABLE FOR ANY DELAYS CAUSED BY DAMAGE TO UTILITIES OR FAILURE TO LOCATE UTILITIES.
- 9. ALL EXISTING UTILITIES AND UTILITY POLES TO REMAIN UNLESS OTHERWISE NOTED. REFER TO CIVIL.
- 10. THE CONTRACTOR SHALL PROVIDE AND PAY FOR ALL INSPECTION SERVICES.
- 12. ALL AREAS DISTURBED DURING CONSTRUCTION AND NOT DESIGNATED FOR OTHER PLANTINGS SHALL
- 13. CONTRACTOR SHALL VERIFY TREES TO BE REMOVED WITH OWNER PRIOR TO REMOVAL. OWNER MAY
- 14. ONLY EXISTING TREES 18-INCH DIAMETER AND LARGER WERE SURVEYED. EXISTING TREES SHOWN ON PLAN DO NOT CONSTITUTE ALL TREES TO BE REMOVED OR SAVED. NO ADDITIONAL PAYMENTS WILL BE MADE FOR EXISTING TREE REMOVALS UNDER 18-INCH DIAMETER. REFER TO SPECIFICATION SECTION 311000 SITE CLEARING.

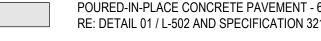

TREE PROTECTION FENCING RE: DETAIL 04 / L-502





EXISTING TREE AND STUMP (18-INCH DIA. AND LARGER) TO BE REMOVED (RE: SPECIFICATIONS)

BACK-IN STANDARD CAMPSITE (RIGHT SIDE) RE: 01 / L-500 FOR LAYOUT AND AMENITIES

RE: 01 / L-501 FOR LAYOUT AND AMENITIES

BACK-IN STANDARD CAMPSITE (LEFT SIDE) RE: 02 / L-500 FOR LAYOUT AND AMENITIES

PULL-THROUGH CAMPSITE

BACK-IN ADA CAMPGROUND HOST CAMPSITE

GENERAL NOTES

- 1. LANDSCAPE ARCHITECT WILL NOT BE HELD LIABLE FOR DISCREPANCIES BETWEEN SURVEY AND FIELD CONDITIONS. CONTRACTOR SHALL VISIT SITE IN ORDER TO VERIFY EXISTING SITE CONDITIONS FOR ACCURACY OF BID.
- 3. CONTRACTOR SHALL MAINTAIN DRAINAGE AND EROSION CONTROL DURING CONSTRUCTION AND IS RESPONSIBLE FOR ALL DE-WATERING NECESSARY DURING CONSTRUCTION. THE CONTRACTOR SHALL BE RESPONSIBLE FOR ALL PERMITTING, FOLLOWING LOCAL, STATE AND FEDERAL EROSION AND SEDIMENTATION CONTROL REQUIREMENTS.
- SOON AS POSSIBLE TO MAINTAIN FINISH GRADE CONDITIONS AND PREVENT SOIL LOSS.
- 8. THE CONTRACTOR IS RESPONSIBLE FOR ALL CONSTRUCTION STAKING.
- 11. DRAWINGS AND SPECIFICATIONS DO NOT INDICATE OR DESCRIBE TOTAL WORK REQUIRED FOR COMPLETION OF WORK AND MAY NOT COVER SOME CONDITIONS WHICH MAY BE REQUIRED.
- BE SEEDED WITH DROUGHT TOLERANT TURF-TYPE TALL FESCUE, RE: SPECIFICATIONS.
- DESIRE TO TRANSPLANT SMALL TREE SPECIES.

STATE OF MISSOURI MICHAEL L. PARSON, **GOVERNOR**





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OFFICE OF ADMINISTRATION DIVISION OF FACILITIES MANAGEMENT, **DESIGN AND CONSTRUCTION**

DEPARTMENT OF NATURAL RESOURCES, MISSOURI STATE PARKS

NEW PREMIUM CAMPSITES

WESTON BEND STATE PARK 16600 MO-45 HWY WESTON, MO 64098

PROJECT # X2221-01 5118

FACILITY # 7815118006

REVISION: DATE: REVISION: DATE: **REVISION:** DATE:

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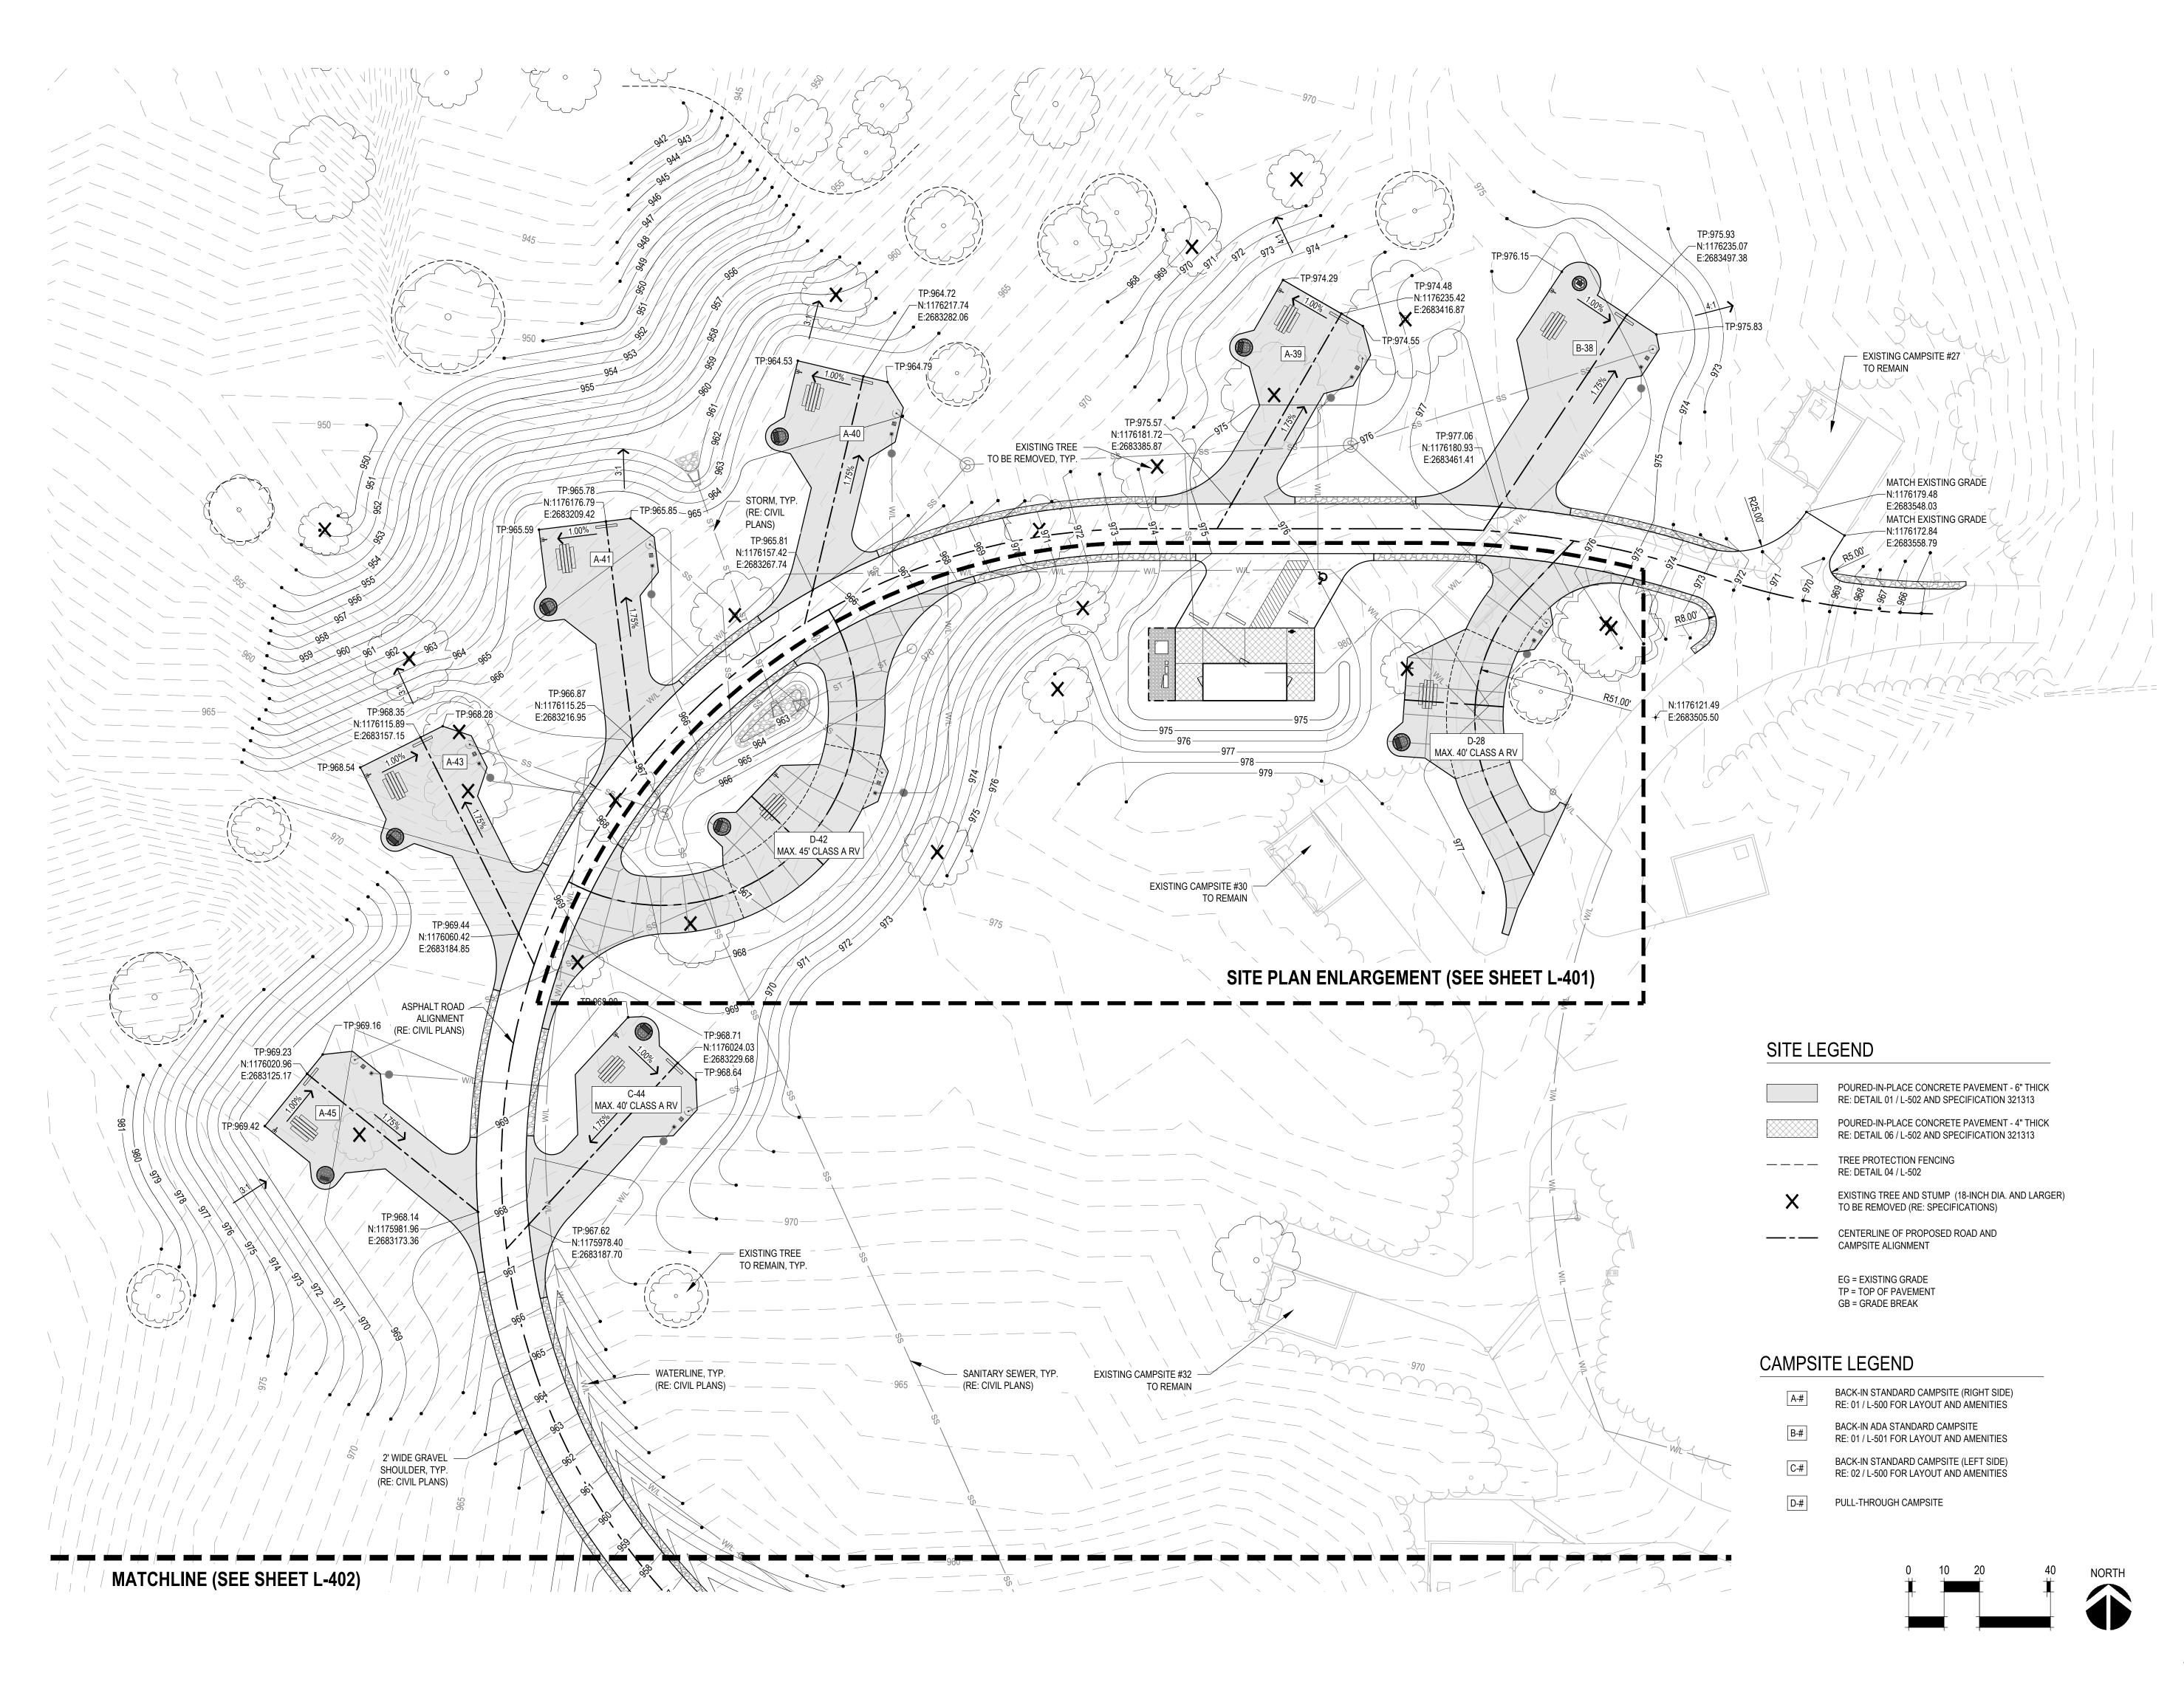
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SHEET TITLE:

SITE PLAN

SHEET NUMBER:

SHEET 2 OF 36 12/12/2023





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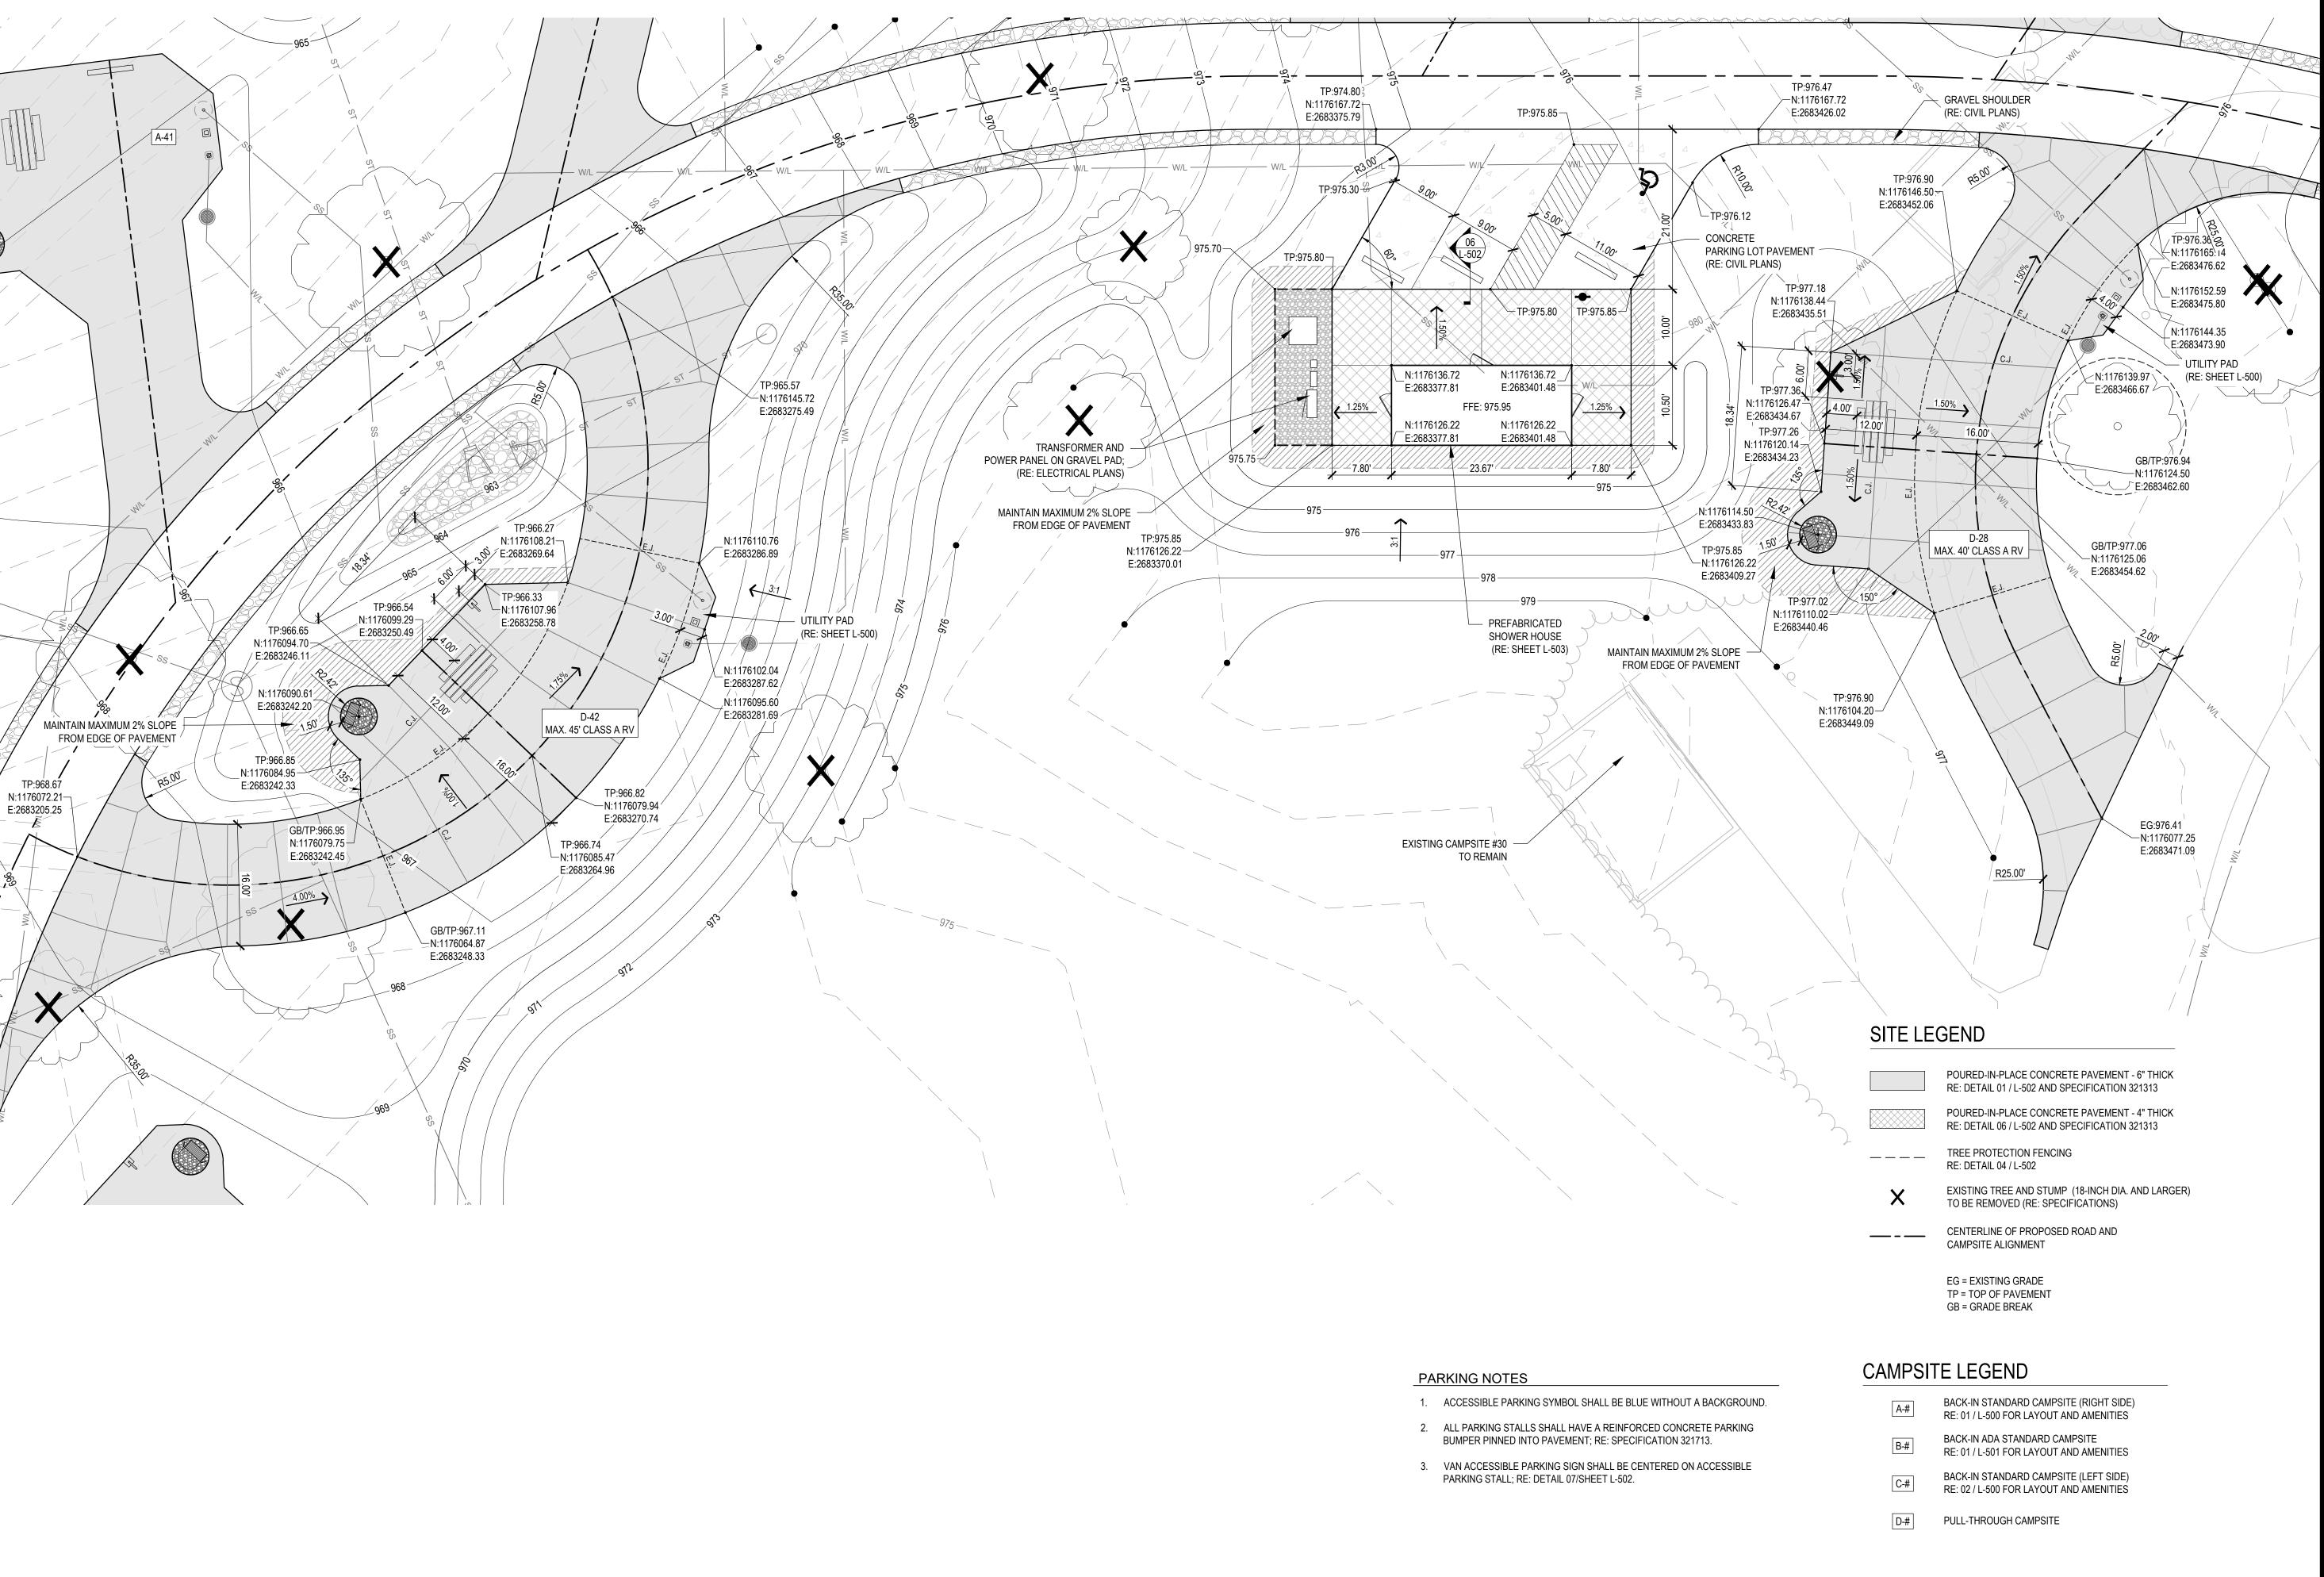
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SHEET TITLE:

SITE PLAN ENLARGEMENT

SHEET NUMBER:

SHEET 3 OF 36 12/12/2023







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DEPARTMENT OF NATURAL RESOURCES, MISSOURI STATE PARKS

DESIGN AND CONSTRUCTION

NEW PREMIUM CAMPSITES

WESTON BEND STATE PARK 16600 MO-45 HWY WESTON, MO 64098

PROJECT # X2221-01 SITE # 5118 FACILITY # 7815118006

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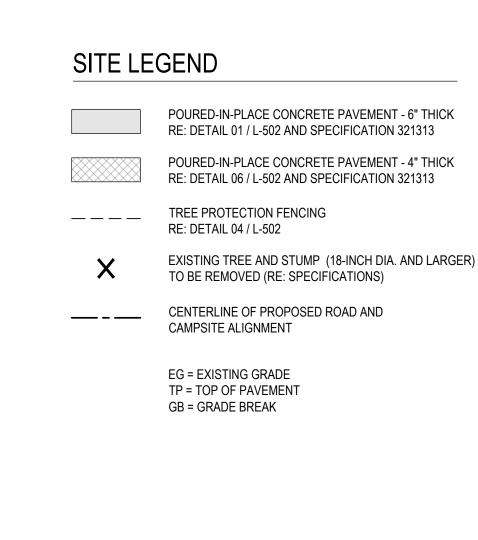
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SITE PLAN ENLARGEMENT

SHEET NUMBER:


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CAMPSITE LEGEND

- BACK-IN STANDARD CAMPSITE (RIGHT SIDE) RE: 01 / L-500 FOR LAYOUT AND AMENITIES
- BACK-IN ADA STANDARD CAMPSITE RE: 01 / L-501 FOR LAYOUT AND AMENITIES
- BACK-IN STANDARD CAMPSITE (LEFT SIDE) RE: 02 / L-500 FOR LAYOUT AND AMENITIES
- PULL-THROUGH CAMPSITE
- BACK-IN ADA CAMPGROUND HOST CAMPSITE RE: 02 / L-501 FOR LAYOUT AND AMENITIES



STATE OF MISSOURI MICHAEL L. PARSON, **GOVERNOR**



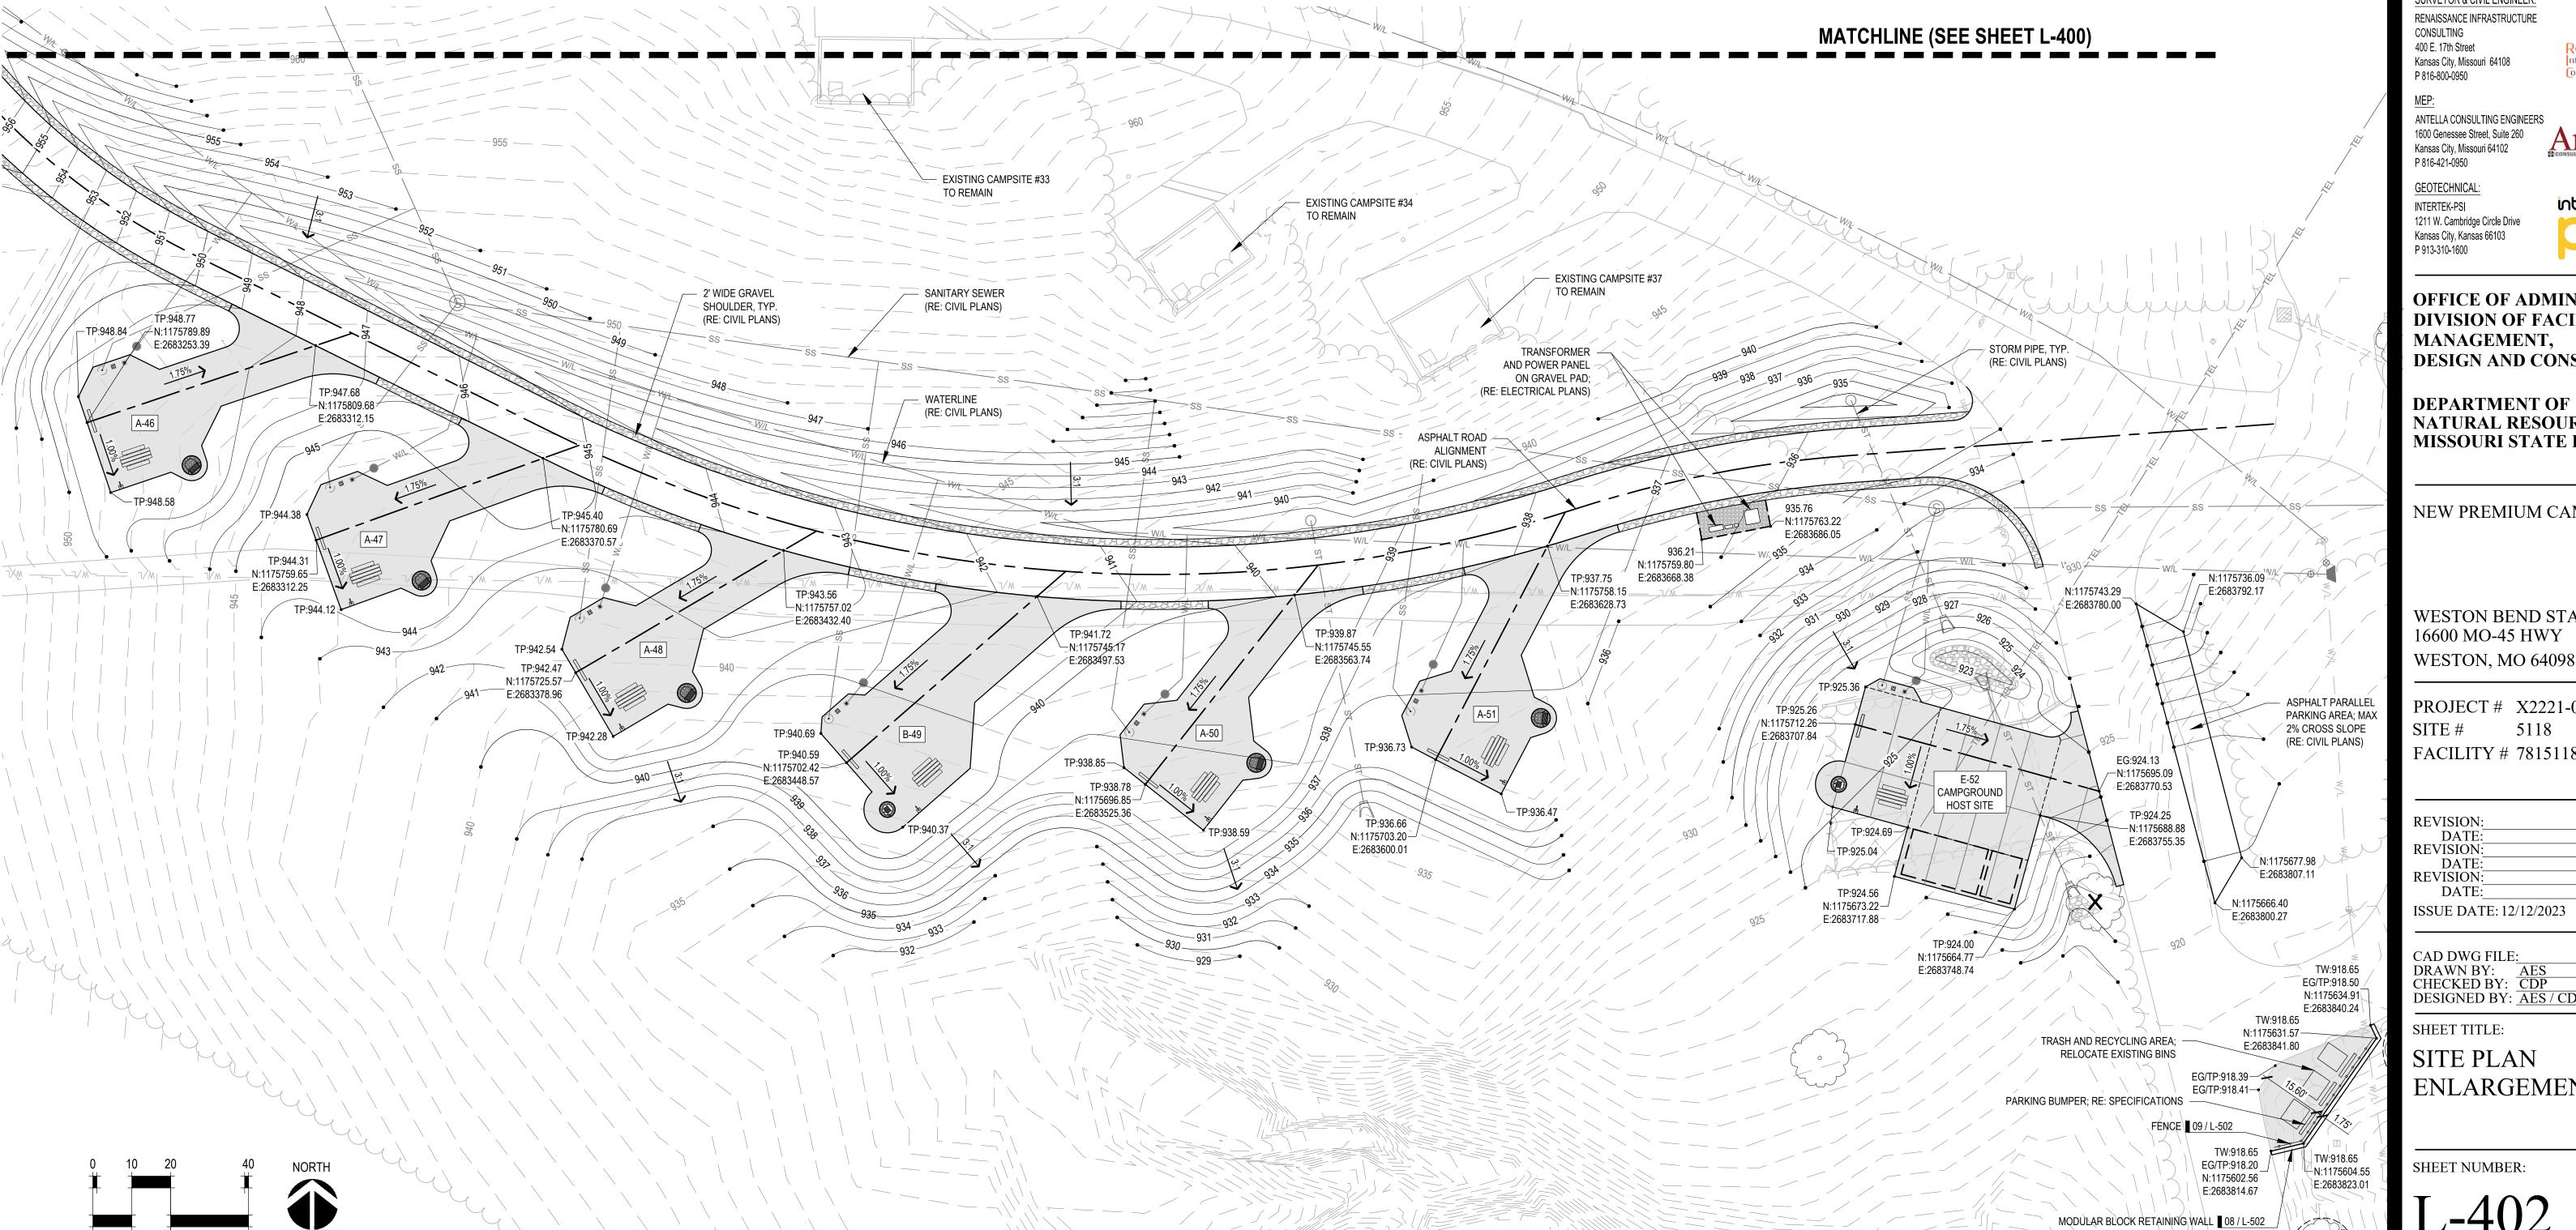

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NATURAL RESOURCES, MISSOURI STATE PARKS

NEW PREMIUM CAMPSITES

WESTON BEND STATE PARK 16600 MO-45 HWY WESTON, MO 64098

PROJECT # X2221-01 5118 FACILITY # 7815118006


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SITE PLAN ENLARGEMENT

SHEET NUMBER:



BACK-IN AND PULL THROUGH DIRECTION POWER PEDESTAL RE: ELECTRICAL WATER PEDESTAL RE: CIVIL 2'-0" 2'-0" WATER VALVE BOX RE: CIVIL FULL SERVICE PAD UTILITY PAD N.T.S. 03 STALL STYLE C - BACK-IN STANDARD (LEFT SIDE) 02 NATURAL RESOURCES, MISSOURI STATE PARKS

STATE OF MISSOURI MICHAEL L. PARSON, **GOVERNOR**

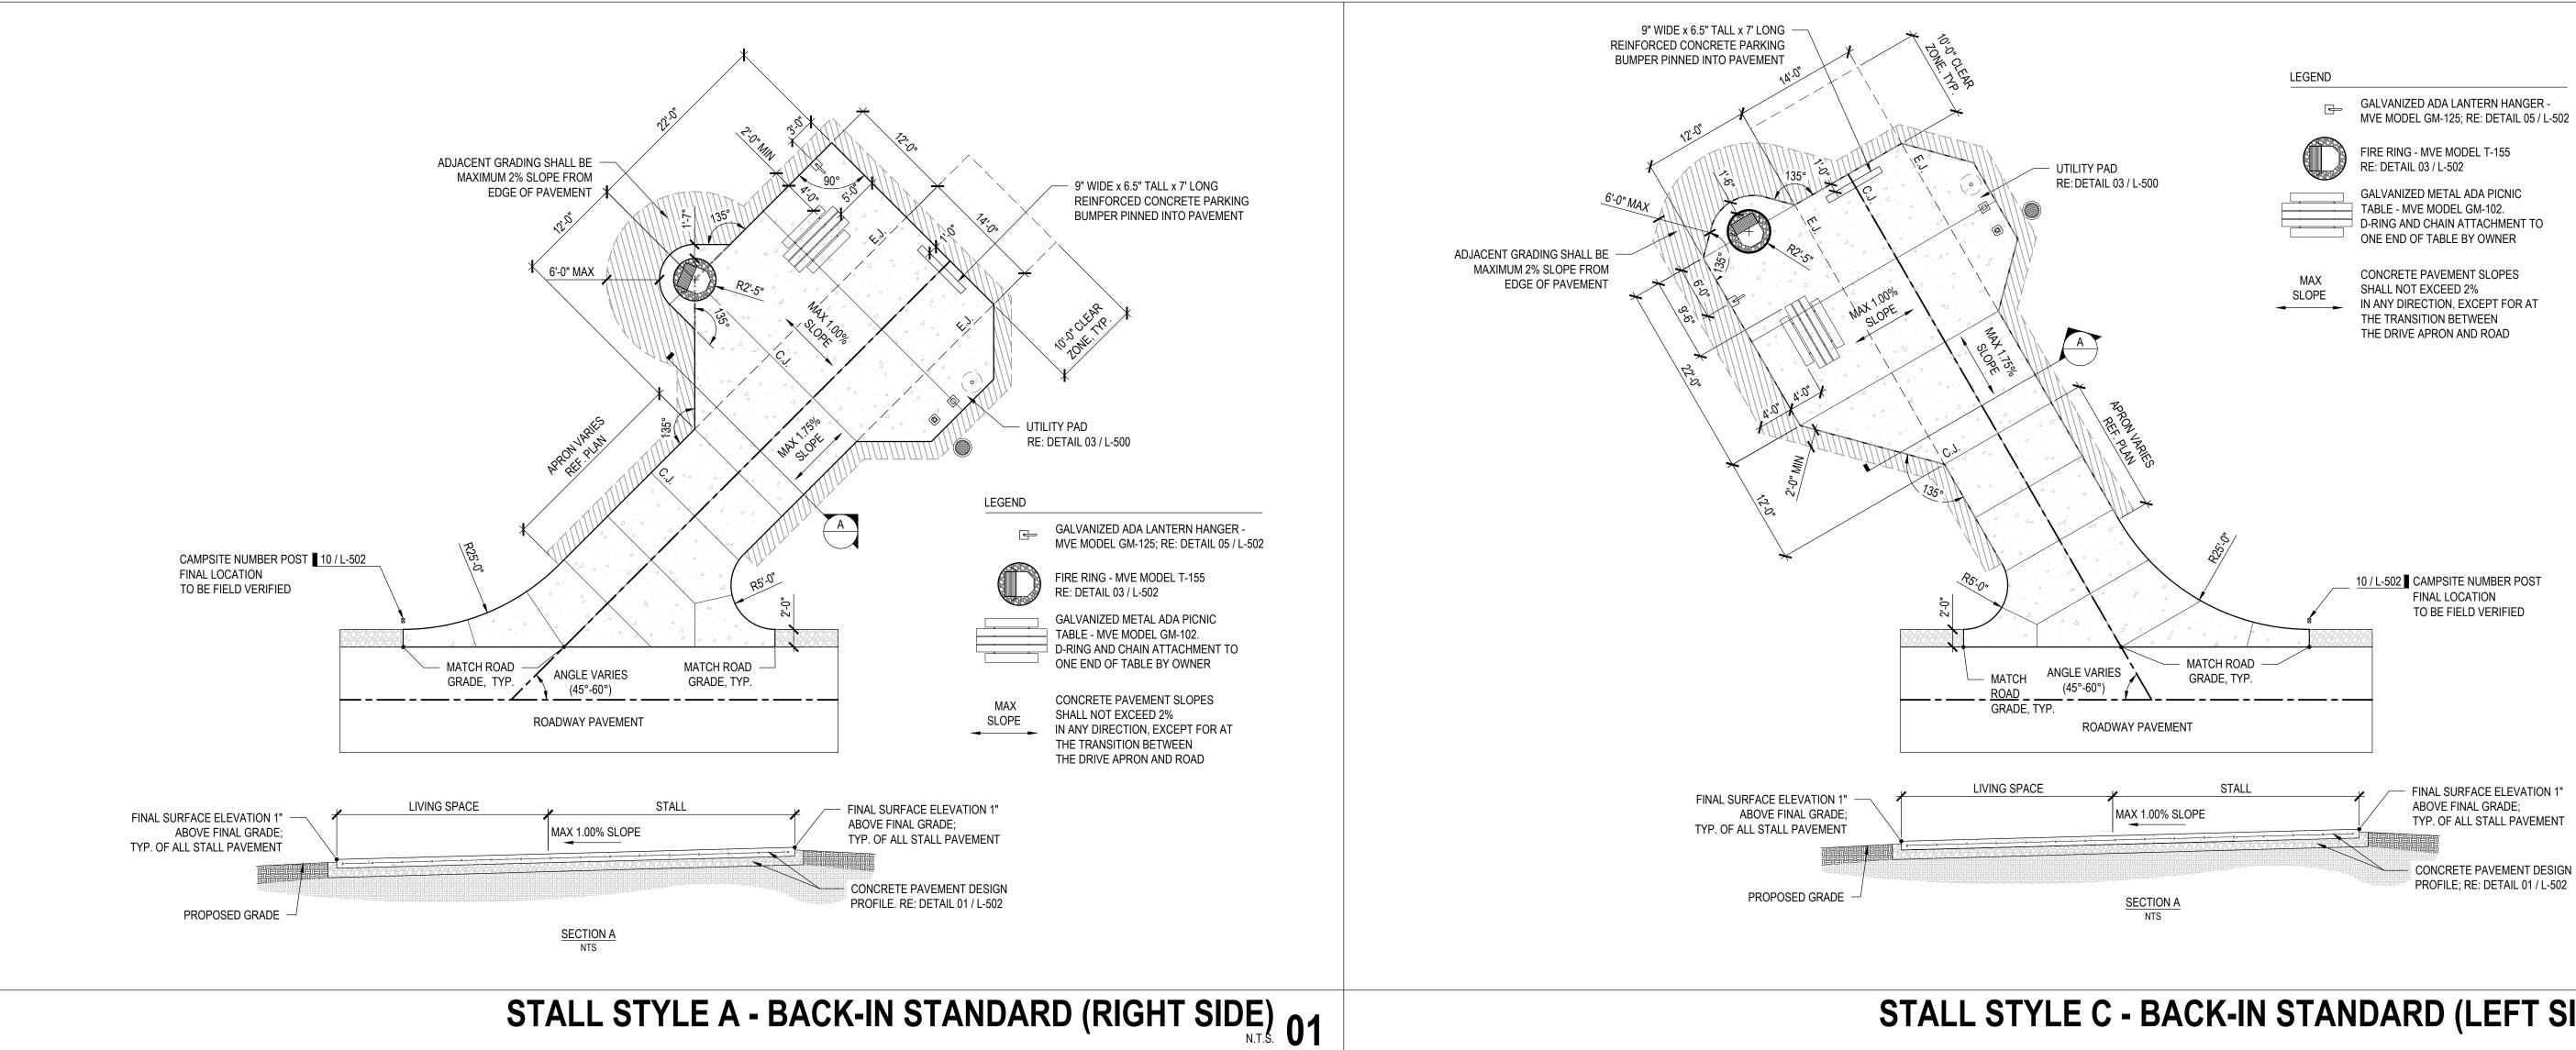

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OFFICE OF ADMINISTRATION DIVISION OF FACILITIES MANAGEMENT, **DESIGN AND CONSTRUCTION**

DEPARTMENT OF

NEW PREMIUM CAMPSITES

WESTON BEND STATE PARK 16600 MO-45 HWY WESTON, MO 64098

PROJECT # X2221-01 5118 FACILITY # 7815118006

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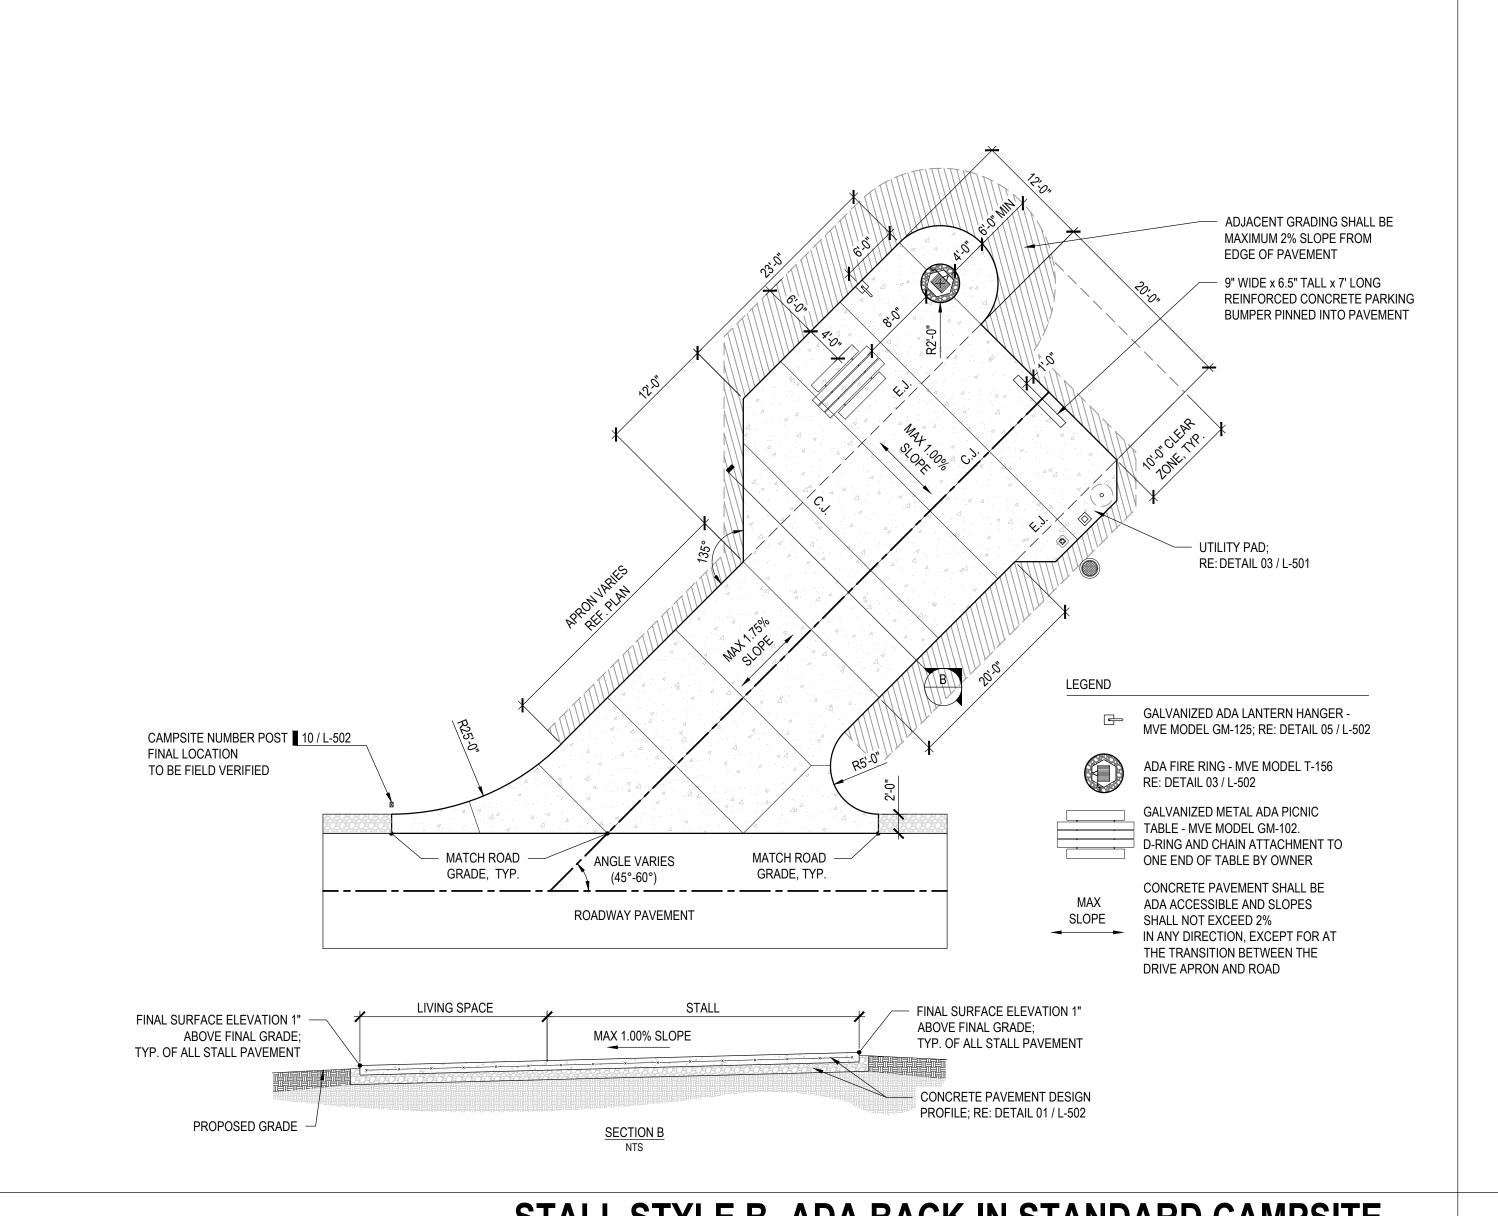
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SITE DETAILS

SHEET NUMBER:

L-500


SHEET 6 OF 36 12/12/2023



ADJACENT GRADING SHALL BE MAXIMUM 2% SLOPE FROM EDGE OF PAVEMENT 9" WIDE x 6.5" TALL x 7' LONG REINFORCED CONCRETE PARKING BUMPER PINNED INTO PAVEMENT 20' X 12' WOOD STORAGE SHED LOCATION -(PROVIDED AND INSTALLED 8' X 12' OFFICE SHED LOCATION -(PROVIDED AND INSTALLED UTILITY PAD; BY OWNER) RE: DETAIL 03 / L-501 LEGEND GALVANIZED ADA LANTERN HANGER -MVE MODEL GM-125; RE: DETAIL 05 / L-502 CAMPSITE NUMBER POST 10 / L-502 FINAL LOCATION TO BE FIELD VERIFIED ADA FIRE RING - MVE MODEL T-156 RE: DETAIL 03 / L-502 GALVANIZED METAL ADA PICNIC TABLE - MVE MODEL GM-102. D-RING AND CHAIN ATTACHMENT TO ONE END OF TABLE BY OWNER MATCH EXISTING MATCH EXISTING ROAD GRADE, TYP. ROAD GRADE, TYP. CONCRETE PAVEMENT SHALL BE ADA ACCESSIBLE AND SLOPES EXISTING ROADWAY PAVEMENT SHALL NOT EXCEED 2% IN ANY DIRECTION, EXCEPT FOR AT THE TRANSITION BETWEEN THE DRIVE APRON AND ROAD LIVING SPACE FINAL SURFACE ELEVATION 1" FINAL SURFACE ELEVATION 1" -ABOVE FINAL GRADE; ABOVE FINAL GRADE; MAX 1.00% SLOPE TYP. OF ALL STALL PAVEMENT TYP. OF ALL STALL PAVEMENT CONCRETE PAVEMENT DESIGN PROPOSED GRADE SECTION B NTS

STALL STYLE E - ADA CAMPGROUND HOST SITE 02

STALL STYLE B- ADA BACK-IN STANDARD CAMPSITE 01

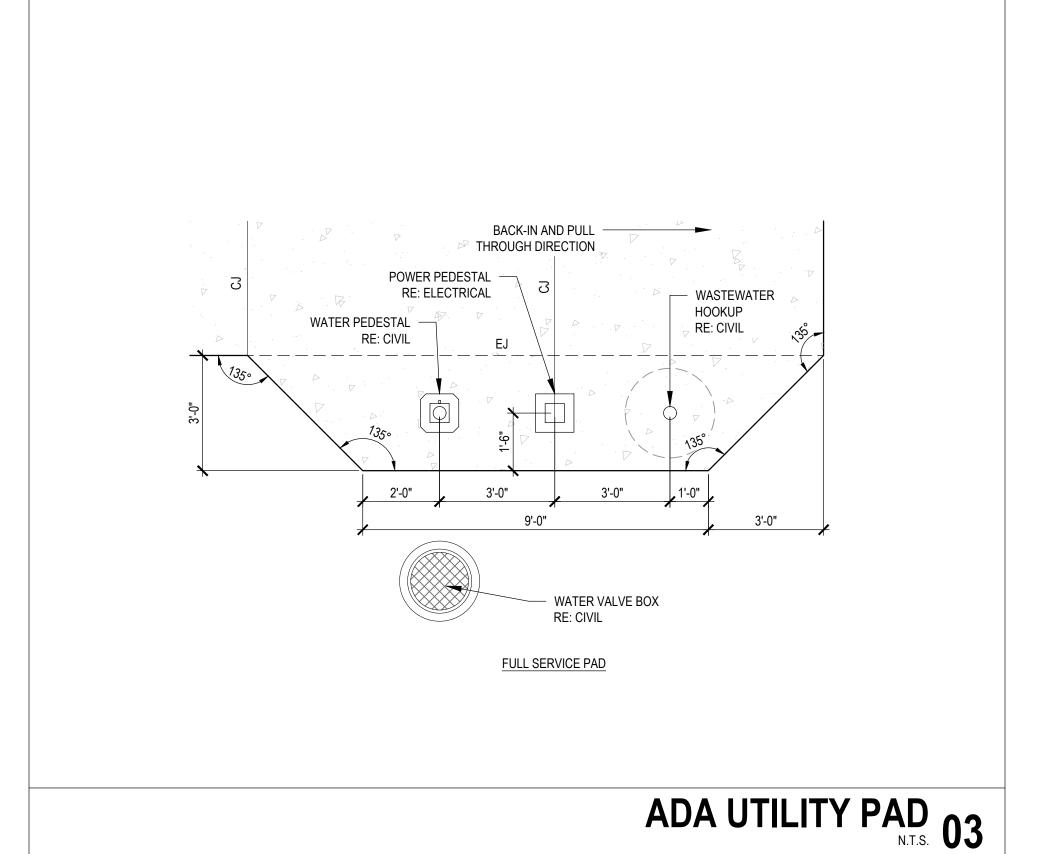

WESTON BEND STATE PARK
16600 MO-45 HWY
WESTON, MO 64098

PROJECT # X2221-01
SITE # 5118
FACILITY # 7815118006

REVISION:
DATE:

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DESIGNED BY: AES / CDP

SITE DETAILS

STATE OF MISSOURI MICHAEL L. PARSON, GOVERNOR

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DEPARTMENT OF

NATURAL RESOURCES, MISSOURI STATE PARKS

NEW PREMIUM CAMPSITES

Kansas City, Kansas 66103

SURVEYOR & CIVIL ENGINEER:
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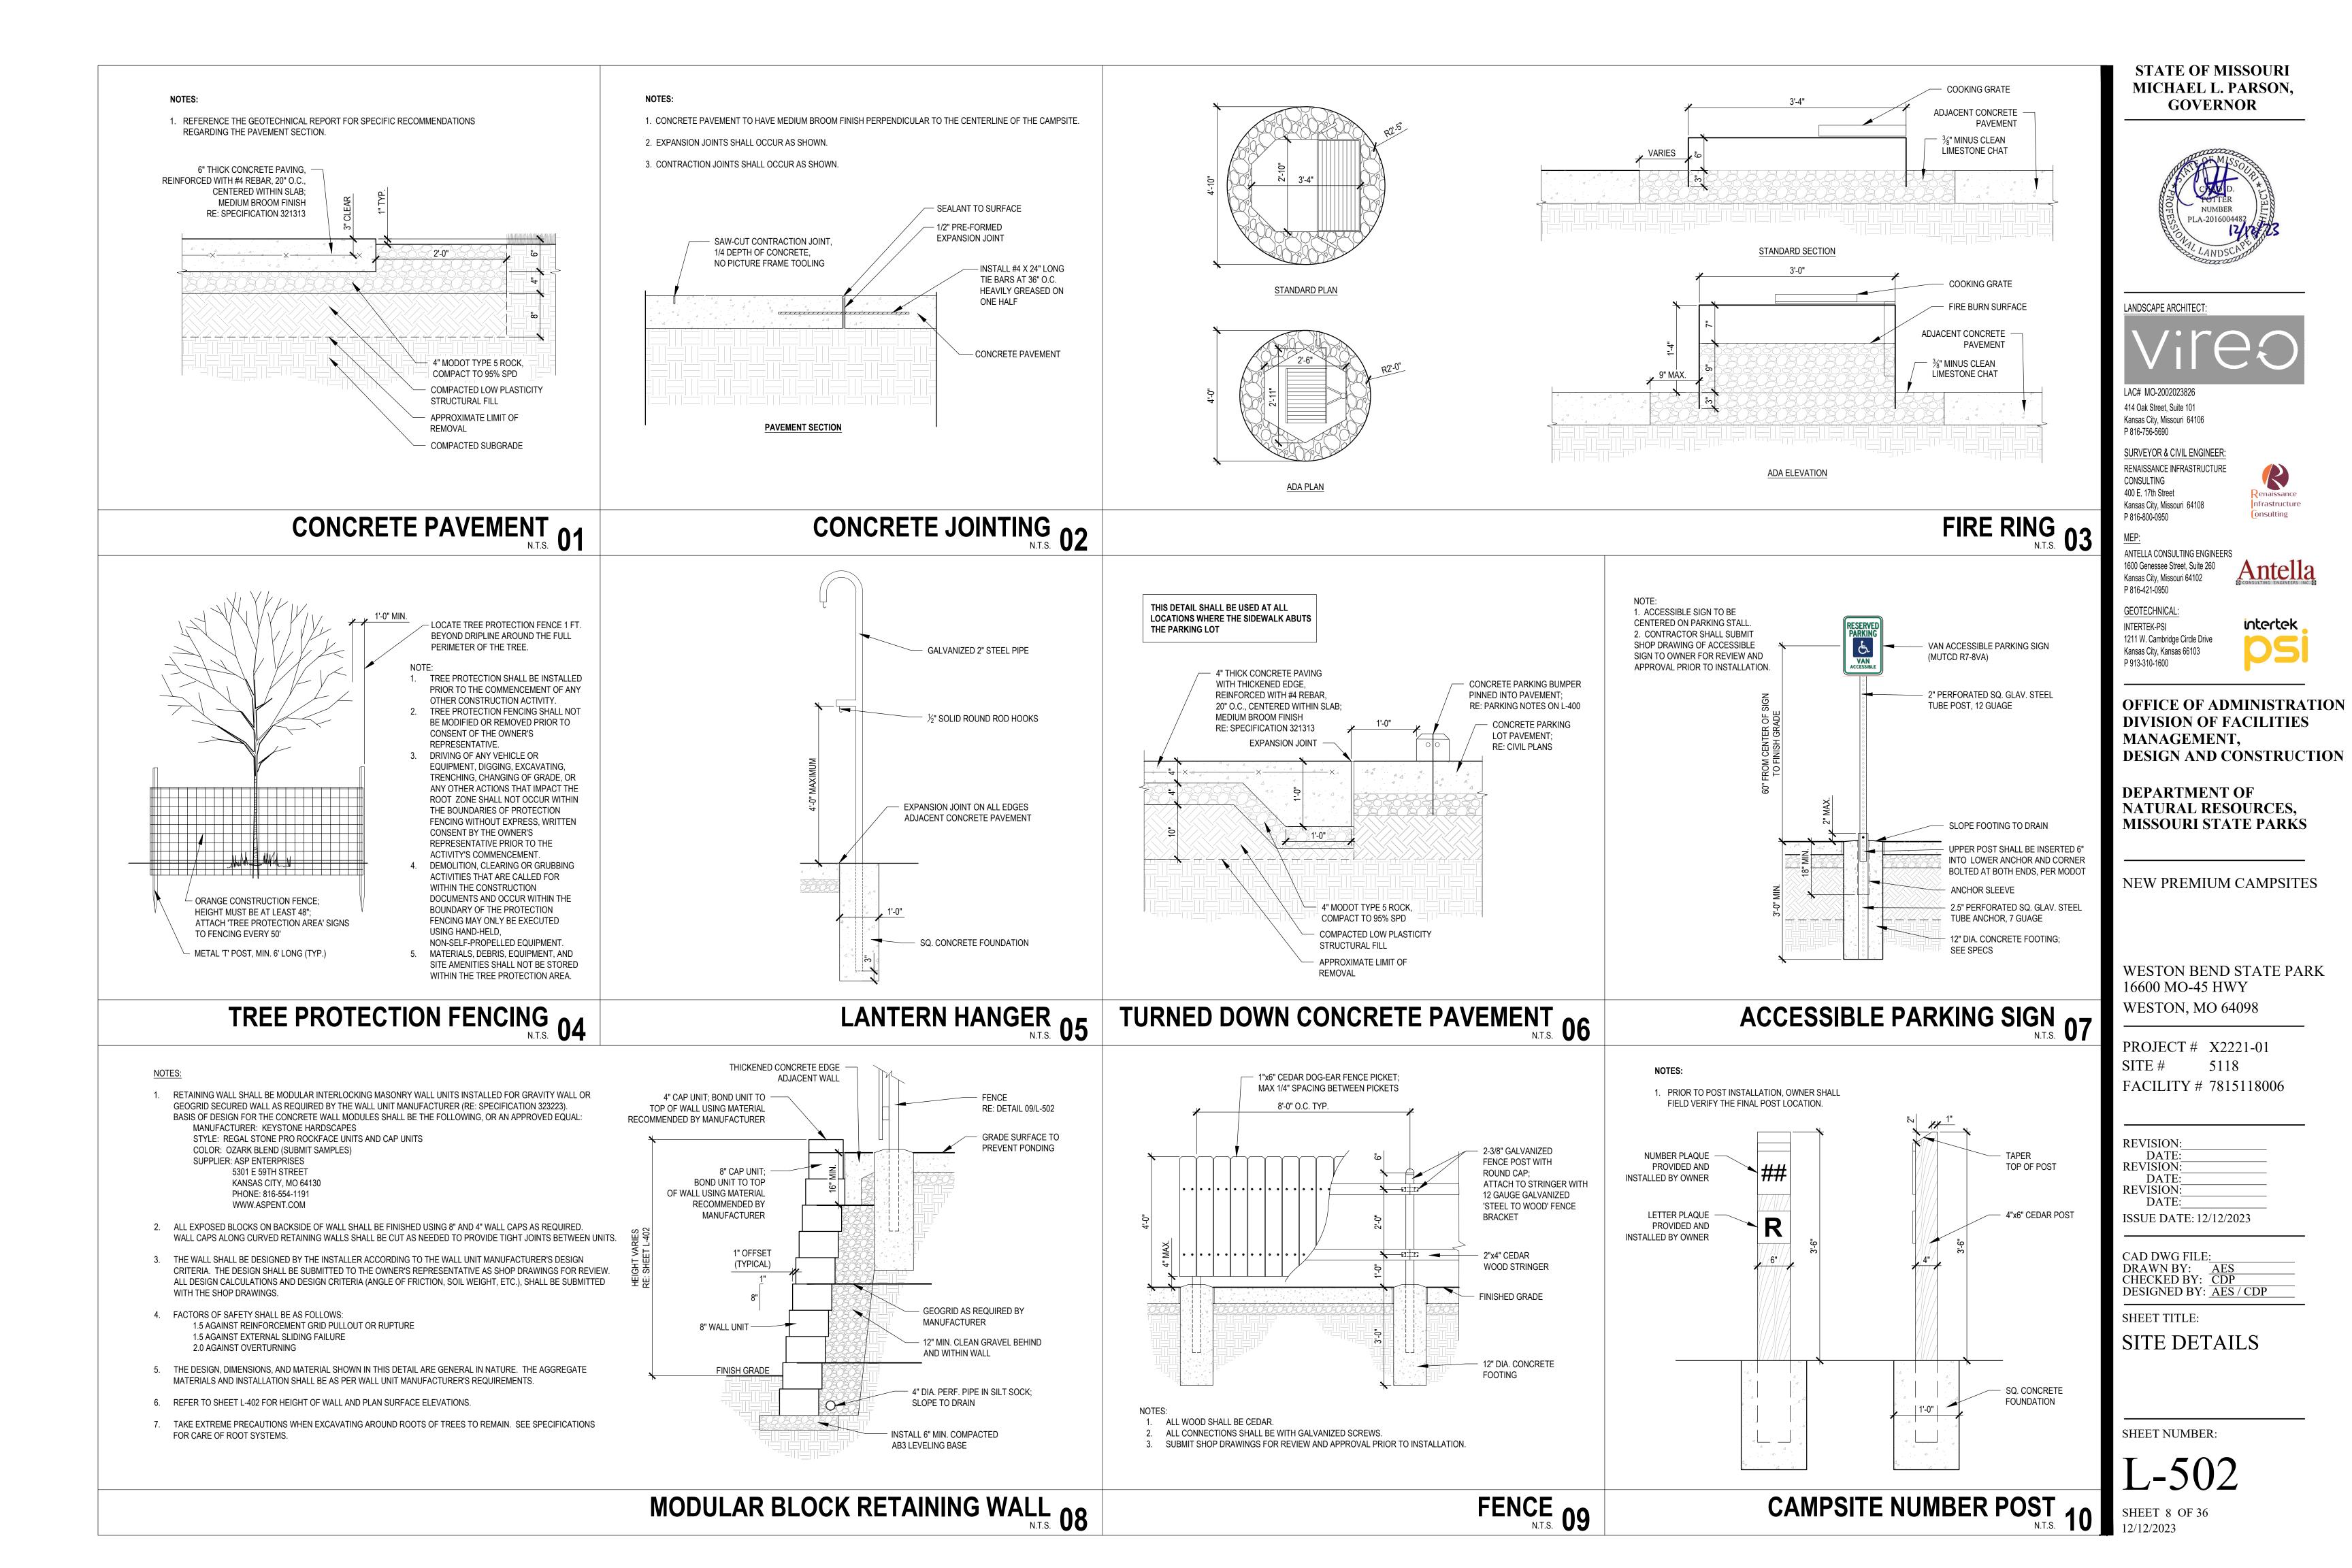
OFFICE OF ADMINISTRATION


DESIGN AND CONSTRUCTION

DIVISION OF FACILITIES

L-50

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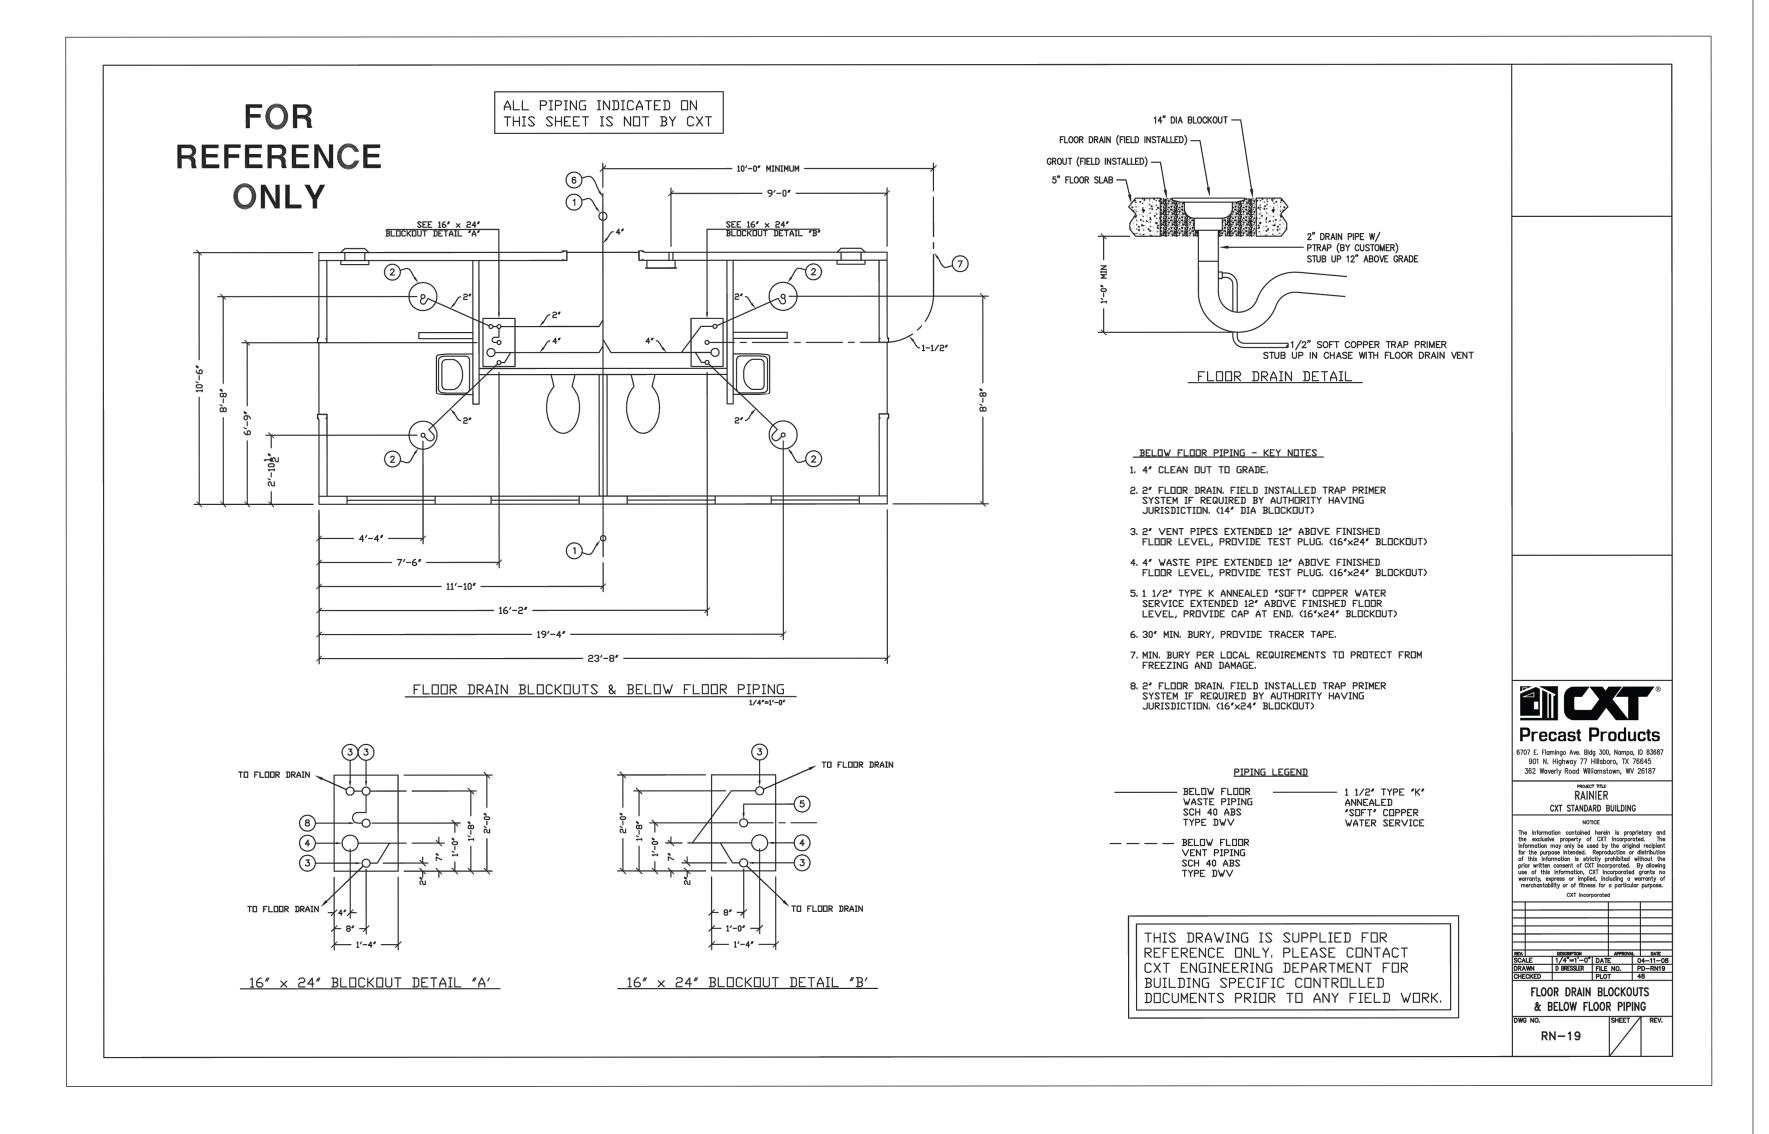
NOTE: 1. SHOWER HOUSE TO BE PURCHASED BY OWNER.

- 2. PROVIDED BY RESTROOM MANUFACTURER: A. FABRICATION OF RESTROOM
- B. DELIVERY TO SITE C. PLACEMENT ON PREPARED PAD

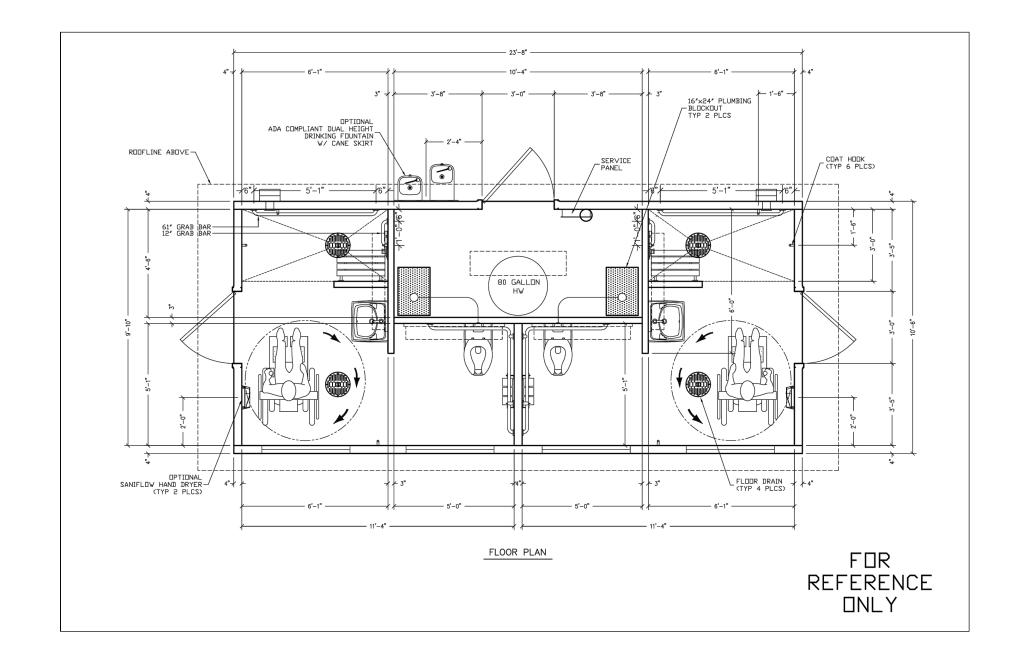3. PROVIDED BY CONTRACTOR:

MANUFACTURER.


- A. PREPARE SHOWER HOUSE FOUNDATION PER DETAIL 02 ON THIS SHEET. B. INSTALLATION OF ALL NECESSARY SITE UTILITIES AND UTILITIES UNDER RESTROOM PAD. CONTRACTOR SHALL COORDINATE ALL BLOCKOUT LOCATIONS AND REQUIRED UTILITIES WITH SHOWER HOUSE
- C. CONTRACTOR SHALL COORDINATE WITH SHOWER HOUSE MANUFACTURER AND MEP PROFESSIONAL LICENSED IN THE STATE OF MISSOURI FOR ALL REQUIRED BELOW FLOOR PIPING INCLUDING, BUT NOT LIMITED TO, FLOOR DRAINS, VENT PIPES, WASTE PIPES, WATER SERVICE AND ELECTRICAL STUBS.
- D. AFTER SHOWER HOUSE IS PLACED, CONTRACTOR SHALL PROVIDE CONNECTIONS BY A LICENSED PLUMBER AND ELECTRICIAN.
- E. MINIMUM BURY 42-INCHES, OR PER LOCAL REQUIREMENTS, TO PROTECT AGAINST FREEZING AND DAMAGE.



1. PRIOR TO PLACEMENT OF THE BUILDING, A PROPERLY PREPARED SUB-BASE SHALL BE PROVIDED AND APPROVED BY OWNER'S REPRESENTATIVE. REFERENCE THE GEOTECHNICAL REPORT AND MANUFACTURER'S RECOMMENDATIONS FOR SPECIFIC RECOMMENDATIONS REGARDING SOIL PREPARATION FOR THE SLAB ON GRADE FOUNDATION.

2. SUB-BASE SHALL BE A MINIMUM OF 6" THICK AND CONSIST OF 3/4" MINUS CRUSHED ROCK COMPACTED TO 95% OF OPTIMUM DENSITY IN ACCORDANCE WITH ASTM D1557

- 3. FINISHED SURFACE OF SUB-BASE SHALL BE UNIFORMLY LEVEL, NOT VARYING MORE THAN 1/2" FROM A TRUE HORIZONTAL PLANE.
- 4. THE EDGES OF COMPACTED FILL SHOULD EXTEND A MINIMUM OF FIVE (5) FEET BEYOND THE BUILDING FOOTPRINT. THE MEASUREMENT SHOULD BE TAKEN FROM THE OUTSIDE EDGE OF THE FOOTING TO THE TOE OF THE EXCAVATION PRIOR TO SLOPING.

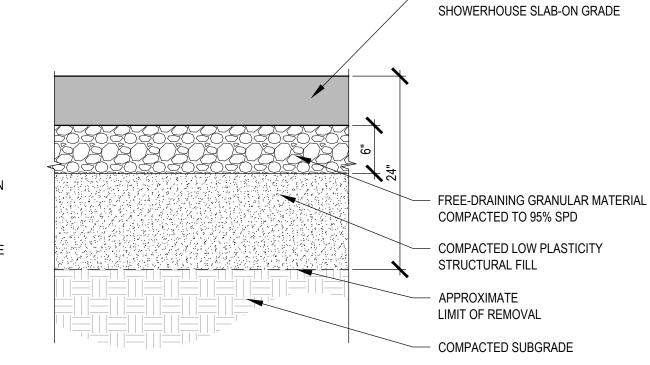

STATE OF MISSOURI MICHAEL L. PARSON, **GOVERNOR**



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OFFICE OF ADMINISTRATION DIVISION OF FACILITIES MANAGEMENT, **DESIGN AND CONSTRUCTION**

DEPARTMENT OF NATURAL RESOURCES, MISSOURI STATE PARKS

NEW PREMIUM CAMPSITES

WESTON BEND STATE PARK 16600 MO-45 HWY **WESTON, MO 64098**

PROJECT # X2221-01 FACILITY # 7815118006

REVISION: REVISION: REVISION: DATE: ISSUE DATE: 12/12/2023

DRAWN BY: CHECKED BY: CDP DESIGNED BY: AES / CDP

SHEET TITLE:

SHOWER HOUSE **DETAILS**

SHEET NUMBER:

ADA ACCESSIBLE ROUTE NOTES

LAYOUT & PAVING NOTES

appropriate utility company.

- All Accessible route construction shall conform to the latest version of the ADA Standards for Accessible Design published by the Department of Justice and the Proposed Accessibility Guidelines for Pedestrian Facilities in the Public Right-of-Way published by the United States Access Board.
- 2. Other than ramps and ramp runs, walking surfaces must have running slopes not steeper than 1:20.
- The cross slope of walking surfaces shall not be steeper than 2%.
- The minimum width for a linear segment of accessible route shall be 36 inches.
- Where the accessible route makes a 180 degree turn around an element which is less than 48 inches wide, clear width shall be 42 inches minimum approaching the turn, 48 inches minimum at the turn and 42 inches leaving the turn.
- An accessible route with a clear width less than 60 inches shall provide passing spaces at intervals of 200 feet maximum. Passing spaces shall be 60 inch by 60 inch minimum.
- Ramp runs shall have a running slope not steeper than 1:12.
- Ramp runs with a rise greater than 6 inches shall have handrails. Ramp landings with a maximum slope of 1:48 shall be provided before and after
- 10. The maximum rise of a ramp run shall be 30 inches.
- 11. The maximum counter slope between the pavement and the curb at a curb ramp shall be 1:20.
- 12. Curb ramp landings with a maximum slope of 1:48 shall be provided at the top of curb ramps with a clear width of 60 inches.
- 13. Detectable warning surfaces complying with the latest ADA Standards shall be
- provided at pedestrian street crossings and refuge islands. 14. Passenger loading zones shall be provided adjacent to any ADA Accessible stall
- and have a 2% maximum slope in all directions. 15. Contractor to field verify existing site conditions and contact the engineer if field conditions do not match plan prior to construction.

1. All construction shall conform to the Missouri State Parks Dept minimum design

report any discrepancies to the architect/engineer prior to beginning work.

2. The contractor shall check existing grades, dimensions, and inverts in the field and

3. The contractor shall verify the exact location of all existing utilities, take care to protect

utilities that are to remain, and repair contractor caused damage according to current

local standards and at the contractor's expense. Coordinate all construction with the

4. The contractor shall comply with all local codes, obtain all permits, and pay all fees prior

adjustment of final grades may be necessary. Adjust all utilities prior to installation of

Do not operate or store heavy equipment, nor handle, nor store materials within the drip

5. Provide a smooth transition between existing pavement and new pavement. Field

6. The contractor shall protect all trees to remain, in accordance with the specifications.

7. Concrete walks and pads shall have a broom finish. All concrete shall be 4,000 p.s.i.

unless otherwise noted. Curb ramps, sidewalk slopes, and driveway ramps shall be constructed in accordance with all current local requirements. If applicable, the

contractor shall request inspection of sidewalk and ramp forms prior to placement of

8. All damage to existing asphalt pavement to remain which results from new construction

10. Maintain one set of as-built drawings on the job site for distribution to the engineer upon

11. For all asphalt pavement, the contractor shall have no more than 30% recycled material

Dimensions are to the back of curb, or edge of concrete, unless otherwise noted.

shall be replaced with like materials at contractor's expense.

in the base course and no recycled material in the surface course.

GRADING NOTES

- 1. All construction shall conform to the Missouri State Parks Dept minimum design
- Spot Grades shown herein shall govern over finished grades.
- The contractor shall provide evidence that his insurance meets the requirements of
- All traffic control shall be in conformance with the Manual of Uniform Traffic Control
- 5. The contractor is responsible for the protection of all property corners and section corners. Any property corners and/or section corners disturbed or damaged by construction activities shall be reset by a Registered Land Surveyor licensed in the State of Missouri, at the contractor's expense.
- The contractor is responsible for providing erosion and sediment control BMPs to prevent sediment from reaching paved areas, storm sewer systems, drainage courses and adjacent properties. In the event the prevention measures are not effective, the contractor shall remove any debris, silt, or mud and restore the right-of-way, or adjacent properties to original or better condition.
- All sidewalk ramps constructed will be required to comply with the Americans with Disabilities Act (ADA).
- All work shall be confined within easements and/or construction limits as shown on
- Curb stakes and hubs shall be provided at all high points, low points, ADA ramp
- 10. All National Pollution Discharge Elimination System (NPDES) standards shall be met. 11. Public and Private utility facilities shall be moved or adjusted as necessary by the

EARTHWORK NOTES:

on the plans.

- CONTOURS AND ELEVATIONS: Existing and proposed contours are shown on plans at one feet (1') contour intervals, unless otherwise noted. Proposed contours and elevations shown represent approximate finish grade.
- 2. CLEARING AND GRUBBING: Prior to the start of grading and earthwork, the areas to be graded shall be stripped of all vegetation, organic matter, and topsoil, to a minimum depth of four inches (4") or as otherwise directed by the Geotechnical Engineer. Stripping materials shall not be incorporated into structural fills. Topsoil
- materials shall not be used in building and pavement areas. TOPSOIL: Prior to the start of grading, the contractor shall strip all topsoil from areas to be graded and stockpile at a location on or adjacent to the site as directed by the owner. At completion of grading operations and related construction, the contractor will be responsible for redistribution of topsoil over all areas disturbed by the construction activities. Topsoil shall be placed to a minimum depth of six inches (6") and in accordance with specifications for landscaping. Subgrade below turf areas shall have a minimum 6" depth of soil free of rock larger than 3".
- SUBGRADE PREPARATION: Prior to placement of new fill material, the existing subgrade shall be proof rolled and approved under the direction of the Geotechnical Engineer or his representative.
- Unsuitable areas identified by the proof rolling areas shall be undercut and replaced with controlled structural fill or treated with fly ash per the Geotechnical report.
- 6. EARTHWORK: A. GEOTECHNICAL: All earthwork shall conform to the recommendations of

 - B. SURFACE WATER: Surface water shall be intercepted and diverted during
 - C. FILLS: All fills shall be considered controlled or structural fill and shall be free of vegetation, organic matter, topsoil, and debris. All fill required for project shall be provided by the Contractor. Material Shall be pre-approved by the Engineer prior to placement
 - D. EXISTING SLOPES: Where fill material is to be placed on existing slopes greater than 5:1 (horizontal to vertical), existing slope shall be benched providing a minimum vertical face of twelve inches (12"). Fill material shall be placed and compacted in horizontal lifts not exceeding nine inched (9") (loose fit measurement), unless otherwise approved by the Geotechnical Engineer.
- E. COMPACTION REQUIREMENTS: Earth fill material shall be placed and compacted to a minimum density of ninety five percent (95%) of the material's maximum dry density as determined by ASTM D698 (standard proctor compaction). The moisture content at the time of placement and compaction shall be within a range of -2% to 3% above the optimum moisture content as defined by the standard proctor compaction procedure. The moisture contents shall be maintained within this range until completion of the work. Where compaction of earth fill by a large roller is impractical or undesirable, the earth fill shall be hand compacted with small vibrating rollers or mechanical tampers.
- TESTING AND INSPECTION: Testing and inspection services required to make tests required by the specifications and to observe the placement of fills and other work performed on this project shall be provided by a commercial testing laboratory (Geotechnical Engineer) selected by the owner. The cost of testing will be the owner's responsibility.
- SEEDING: All areas disturbed by earthwork operations in the right-of-way shall be

SITE UTILITY NOTES

- The contractor is specifically cautioned that the location and/or elevation of existing utilities as Shown on these plans is based on records of the various utility Companies, und where possible, measurements taken in the field. The information is not to be relied on as being exact or complete. The contractor must call the appropriate utility companies at least 48 hours before any excavation to request exact field location of utilities. It shall be the responsibility of the contractor to coordinate with and relocate and/or remove all existing utilities which conflict with the proposed improvements shown on the plans.
- 2. The construction of storm sewers on this project shall conform to the requirements of Missouri State Parks Dept Technical Specifications and Design Criteria. The contractor shall field verify the exact location and elevation of the existing storm sewer
- locations and the existing elevations at locations where the proposed storm sewer collects or releases to existing ground. If discrepancies are encountered from the information shown on the plans. The contractor shall contact the design engineer. No pipes shall be laid until direction is received from the design engineer.
- 4. It will be the contractors responsibility to field adjust the top of all manholes and boxes as necessary to match the grade of the adjacent area. Tops of existing manholes shall be raised as necessary to be flush with proposed pavement elevations, and to be 6-inches above finished ground elevations in non-paved areas. No separate or additional compensation will be made to the contractor for making final adjustments to the manholes and boxes.
- Inlet locations, horizontal pipe information and vertical pipe information is shown to the center of the structure. Deflection angles shown for storm sewer pipes are measured from the center of the curb inlets and manholes. The contractor shall adjust the horizontal location of the pipes to go to the face of the boxes.
- The contractor shall be responsible for furnishing and installing all domestic water lines, meters, back flow devices, pits, valves and all other incidentals required for a complete operable domestic water system. Coordinate with the local water department as necessary. All costs associated with the complete water system for the campgrounds shall be the responsibility of the contractor. All work shall conform to the requirements of Missouri State Parks Dept.
- 7. The contractor shall be responsible for furnishing and installing all sanitary sewer service lines from the campground to the main line. All work shall conform to the requirements of Missouri State Parks Dept.
 - The contractor is responsible for securing all permits, bonds and insurance required by the contract documents, Missouri State Parks Dept, and all other governing agencies (including local, county, state and federal authorities) having jurisdiction over the work proposed by the construction documents. The cost for all permit bonds and insurance shall be the contractors responsibility and shall be included in the bid for the work.
- By the use of these construction documents the contractor hereby agrees that he/she shall be solely responsible for the safety of the construction workers and the public. The contractor agrees to hold the engineer and owner harmless for any and all injuries, claims, losses or damages related to the project.
- 10. All fill material is to be in place, compacted, and consolidated before installation of proposed utilities. On-site geotechnical engineer shall provide written confirmation that this requirement has been met and that utilities may proceed in the fill areas. All utilities are to be placed in trench conditions.
- 11. Minimum trench width shall be 2 feet.
- 12. Contractor shall maintain a minimum of 42" of cover on all waterlines. All water line joints are to be mechanical joints with thrust blocking as called out in specifications and construction plans. Water mains and service lines shall be constructed in accordance to proof rolling: Prior to the placement of new fill material, the existing subgrade shall be

 13. All waterlines shall be kept ten feet (10') apart (parallel) from sanitary sewer lines or manholes. Or when crossing, an 18" vertical clearance (outside edge of pipe to outside
 - 14. In the event of a vertical conflict between waterlines, sanitary lines, storm lines and gas lines (existing and proposed), the sanitary line shall be ductile iron pipe with mechanical joints at least 10 feet on both sides of the crossing (or encased in concrete the same distance), the waterline shall have mechanical joints with appropriate thrust blocking as required to provide a minimum of 18" clearance. Meeting requirements ANSI A21.10 or ANSI 21.11 (AWWA C151)(Class 50).

edge of pipe) of the waterline above the sewer line is required.

- All necessary inspections and/or certifications required by codes and/or utility service companies shall be performed prior to announced building possession and the final connection of service. Contractor shall coordinate with all utility companies for installation requirements and specifications.
- When a building utility Connection from site utilities leading up to the building cannot be made immediately, temporarily mark all such utility terminations.

GENERAL NOTES

EROSION CONTROL NOTES

erosion and offsite sedimentation.

Topsoil replacement shall be 6" thick.

condition prior to any forecasted rainfall.

- 1. The contractor shall provide evidence that his insurance meets the requirements of Missouri
- 2. All traffic control shall be in conformance with the Manual of Uniform Traffic Control Devices
- The contractor is responsible for the protection of all property corners and section corners. Any property corners and/or section corners disturbed or damaged by construction activities shall be reset by a Registered Land Surveyor licensed in the State of Missouri, at the contractor's expense.
- The contractor shall be responsible for the restoration of the right-of-way and for damaged improvements such as curbs, driveways, sidewalks, street light and traffic signal junction boxes, traffic signal loop lead ins, signal poles, irrigation systems, etc. Damaged improvements shall be repaired in conformance with the latest City and State standards and to the City's and/or State's satisfaction.
- The contractor is responsible for providing erosion and sediment control BMPs to prevent sediment from reaching paved areas, storm sewer systems, drainage courses and adjacent properties. In the event the prevention measures are not effective, the contractor shall remove any debris, silt, or mud and restore the right-of-way, or adjacent properties to original or better
- 6. Excavation for utility work in public street right-of-way requires a Right-of-Way Work Permit from the Public Works Department, in addition to all other permits.
- All work shall be confined within easements and/or construction limits as shown on the plans. All existing utilities indicated on the drawings are according to the best information available to the engineer; however, all utilities actually existing may not be shown. The contractor shall be responsible for contacting all utility companies for an exact field location of each utility prior to any construction. All utilities, shown and un-shown, damaged through the negligence of the
- The contractor will be responsible for all damages to existing utilities, pavement, fences, structures, and other features not designated for removal. The contractor shall repair all damages at his expense.

contractor shall be repaired or replaced by the contractor at his expense.

- 10. By use of these construction documents the contractor hereby agrees that he shall be solely responsible for the safety of the construction workers and the public. The contractor agrees to hold the engineer and owner harmless for any and all injuries, claims, losses, or damages related to the project.
- 11. The contractor will be responsible for providing all signage, barricades, lighting, etc., as required for temporary traffic control during the construction of this project. Maintenance of the temporary traffic control devices will be the contractor's responsibility.
- 12. Geogrid, footings, or other elements of the retaining wall(s) cannot encroach into the right of way, public easements, or adjacent private property.
- 13. Contractor shall be responsible for obtaining all permits including land disturbance, right-of-way, hauling, etc., prior to construction.
- 14. Contractor shall restore all disturbed right-of-way upon project completion.

15. Prior to construction, contractor shall install pre-construction erosion control measures.

1. The contractor shall provide all materials, tools, equipment, and labor as necessary to install and

2. Erosion control plan modifications shall be required if the plan fails to substantially control

3. The contractor shall be responsible for maintaining erosion control devices and removing

4. The contractor shall temporarily seed and mulch all disturbed areas if there has been no

construction activity on them for a period of fourteen (14) calendar days.

installed within 14 days after paving completion and final topsoil grading.

Refer to Specifications for good housekeeping and spill measures.

Contractor to install all Phase I erosion control devices prior to construction.

sediment until a minimum of 70% of permanent vegetation has become stabilized and

State Parks Dept Technical Provisions and Specifications.

met, or the duration of the project, whichever is the later date.

maintain adequate erosion control, keep the streets clean of mud and debris, and prevent soil

from leaving the project site. The contractor's erosion control measures shall conform to Missouri

established. Erosion control devices shall remain in place until the 70% established vegetation is

6. Contractor shall replace disturbed area with seed or sod, as indicated on the plans, and shall be

10. The Contractor shall inspect erosion control devices every 7 days and within 24 hours of a storm

8. Straw wattles to be installed in accordance with Missouri State Parks Dept Standard Details.

of 0.5 inches or more. The Contractor shall repair damage, clean out sediment, and add

Contractor shall also inspect and assure that all sediment control devices are in working

additional erosion control devices as needed, as soon as practicable, after inspection. The

NATURAL RESOURCES,

MISSOURI STATE PARKS

STATE OF MISSOURI MICHAEL L. PARSON,

GOVERNOR

NUMBER

PE-2002003418

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OFFICE OF ADMINISTRATION

DESIGN AND CONSTRUCTION

DIVISION OF FACILITIES

NEW PREMIUM CAMPSITES

WESTON BEND STATE PARK 16600 MO-45 HWY **WESTON, MO 64098**

PROJECT # X2221-01 5118 FACILITY # 7815118006

REVISION: DATE: **REVISION**: **REVISION**: ISSUE DATE: 12/12/2023

CAD DWG FILE DRAWN BY: CHECKED BY: MES DESIGNED BY: ZMM

SHEET TITLE:

GENERAL NOTES

SHEET NUMBER:

PAVEMENT MARKING AND SIGNAGE NOTES

lines of trees or outside the limit of grading.

- Parking stall marking stripes shall be four inch (4") wide white stripes. Handicap stall marking shall be furnished at locations shown on plans.
- 2. Traffic control devices and pavement markings shall conform to the requirements of the "Manual of Uniform Traffic Control Devices."
- Traffic control and pavement markings shall be painted with a white Sherwin Williams TM2125 HOTLINE Fast Dry or approved equal. The pavement marking shall be applied in accordance with manufacturers recommendations. Apply on a clean, dry surface and at a surface temperature of not less than 70°f and the ambient air temperature shall not be less than 60°f and rising. Two coats shall be

WRITTEN SEQUENCING

Implement Pre-Construction Plan:

All temporary structural BMP's shown on the BMP plan must be in place before any site disturbance. Clearing necessary to place temporary structural BMP's is the minimum required for installation. Coordinate clearing necessary to place temporary structural BMP's with local weather forecast so that clearing and placement may be completed within a forecast dry period. Stabilize all erosion control measures after installation. Temporary Barrier Fence shall be in Place, around areas not to be disturbed, prior to any construction activities. This area includes Stream Corridor.

Clear and Stabilize Work Areas:

Grade contractor areas and place all-weather surface on contractor areas.

Clearing and Grubbing:

After Phase I BMP's are installed, contractor may clear, grub, and demo required areas as necessary.

Devices (MUTCD).

- the plans. openings, and on each side of all curb inlets when setting string line.
- owners to fit the new construction unless otherwise noted on the plans. The Contractor is responsible for the cost of utility relocations unless otherwise indicated







MICHAEL L. PARSON,








DIVISION OF FACILITIES **DESIGN AND CONSTRUCTION**

MISSOURI STATE PARKS

NEW PREMIUM CAMPSITES

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OFFICE OF ADMINISTRATION

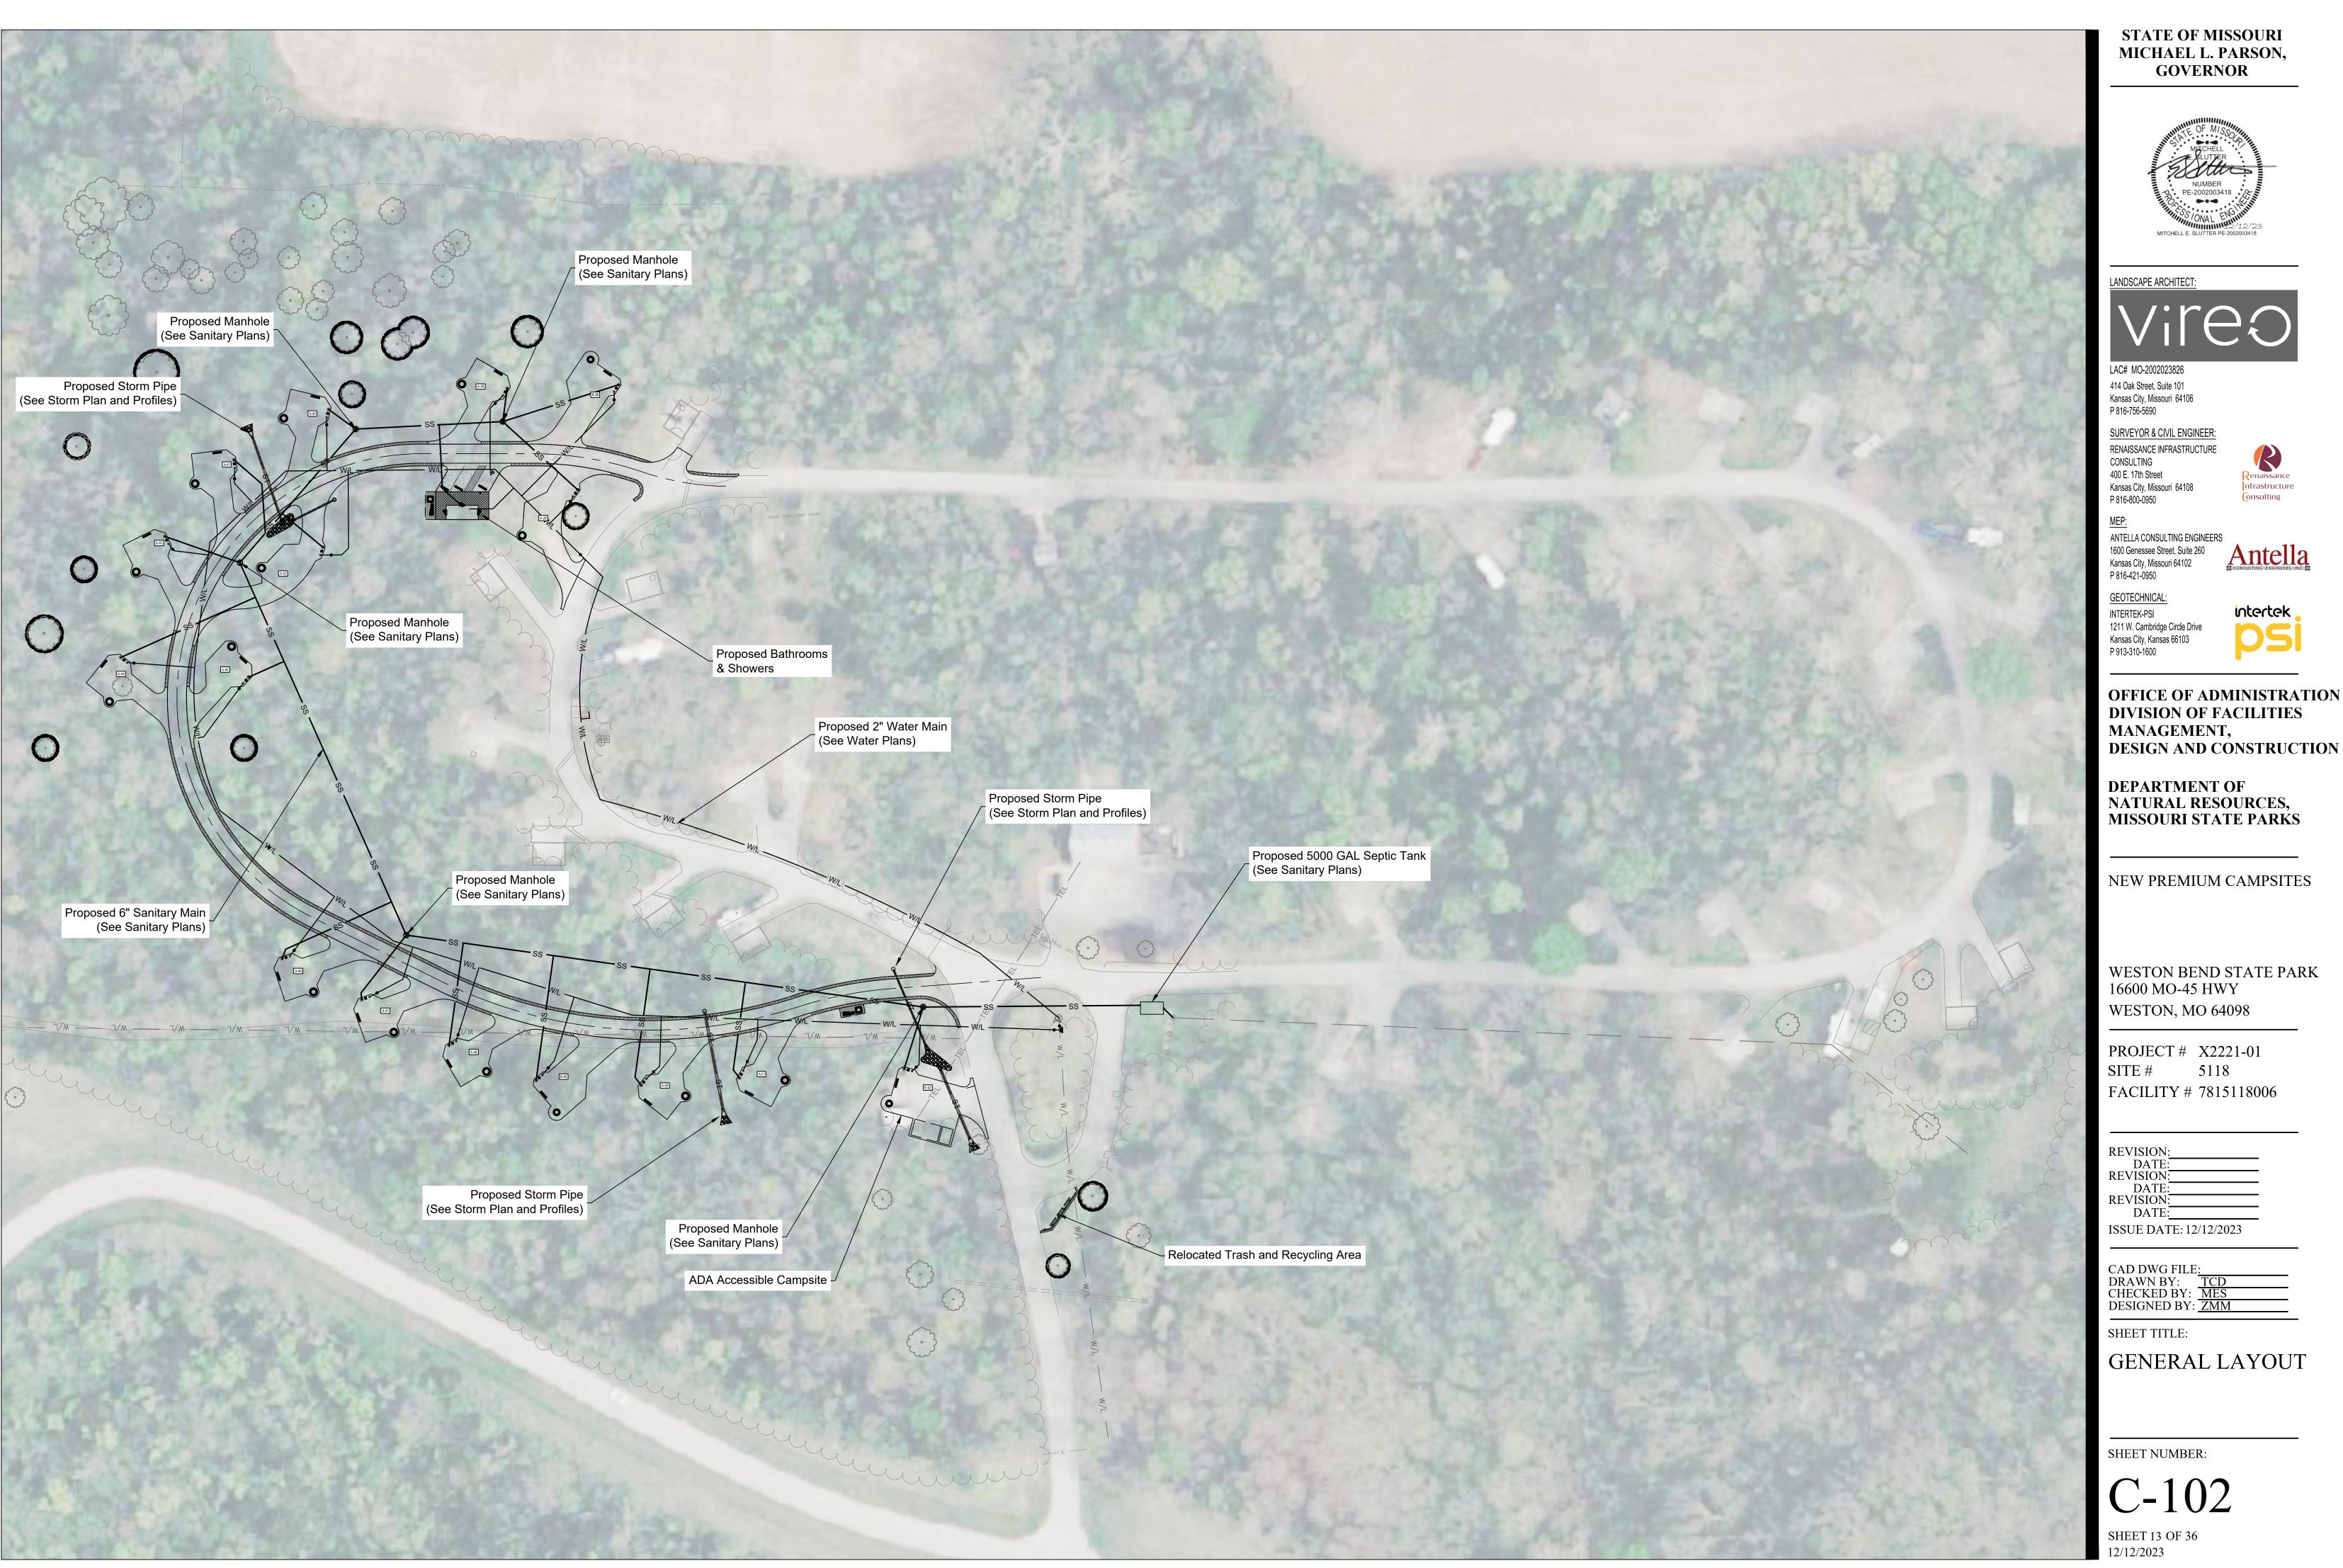



LANDSCAPE ARCHITECT:



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PROJECT # X2221-01 SITE # 5118 FACILITY # 7815118006

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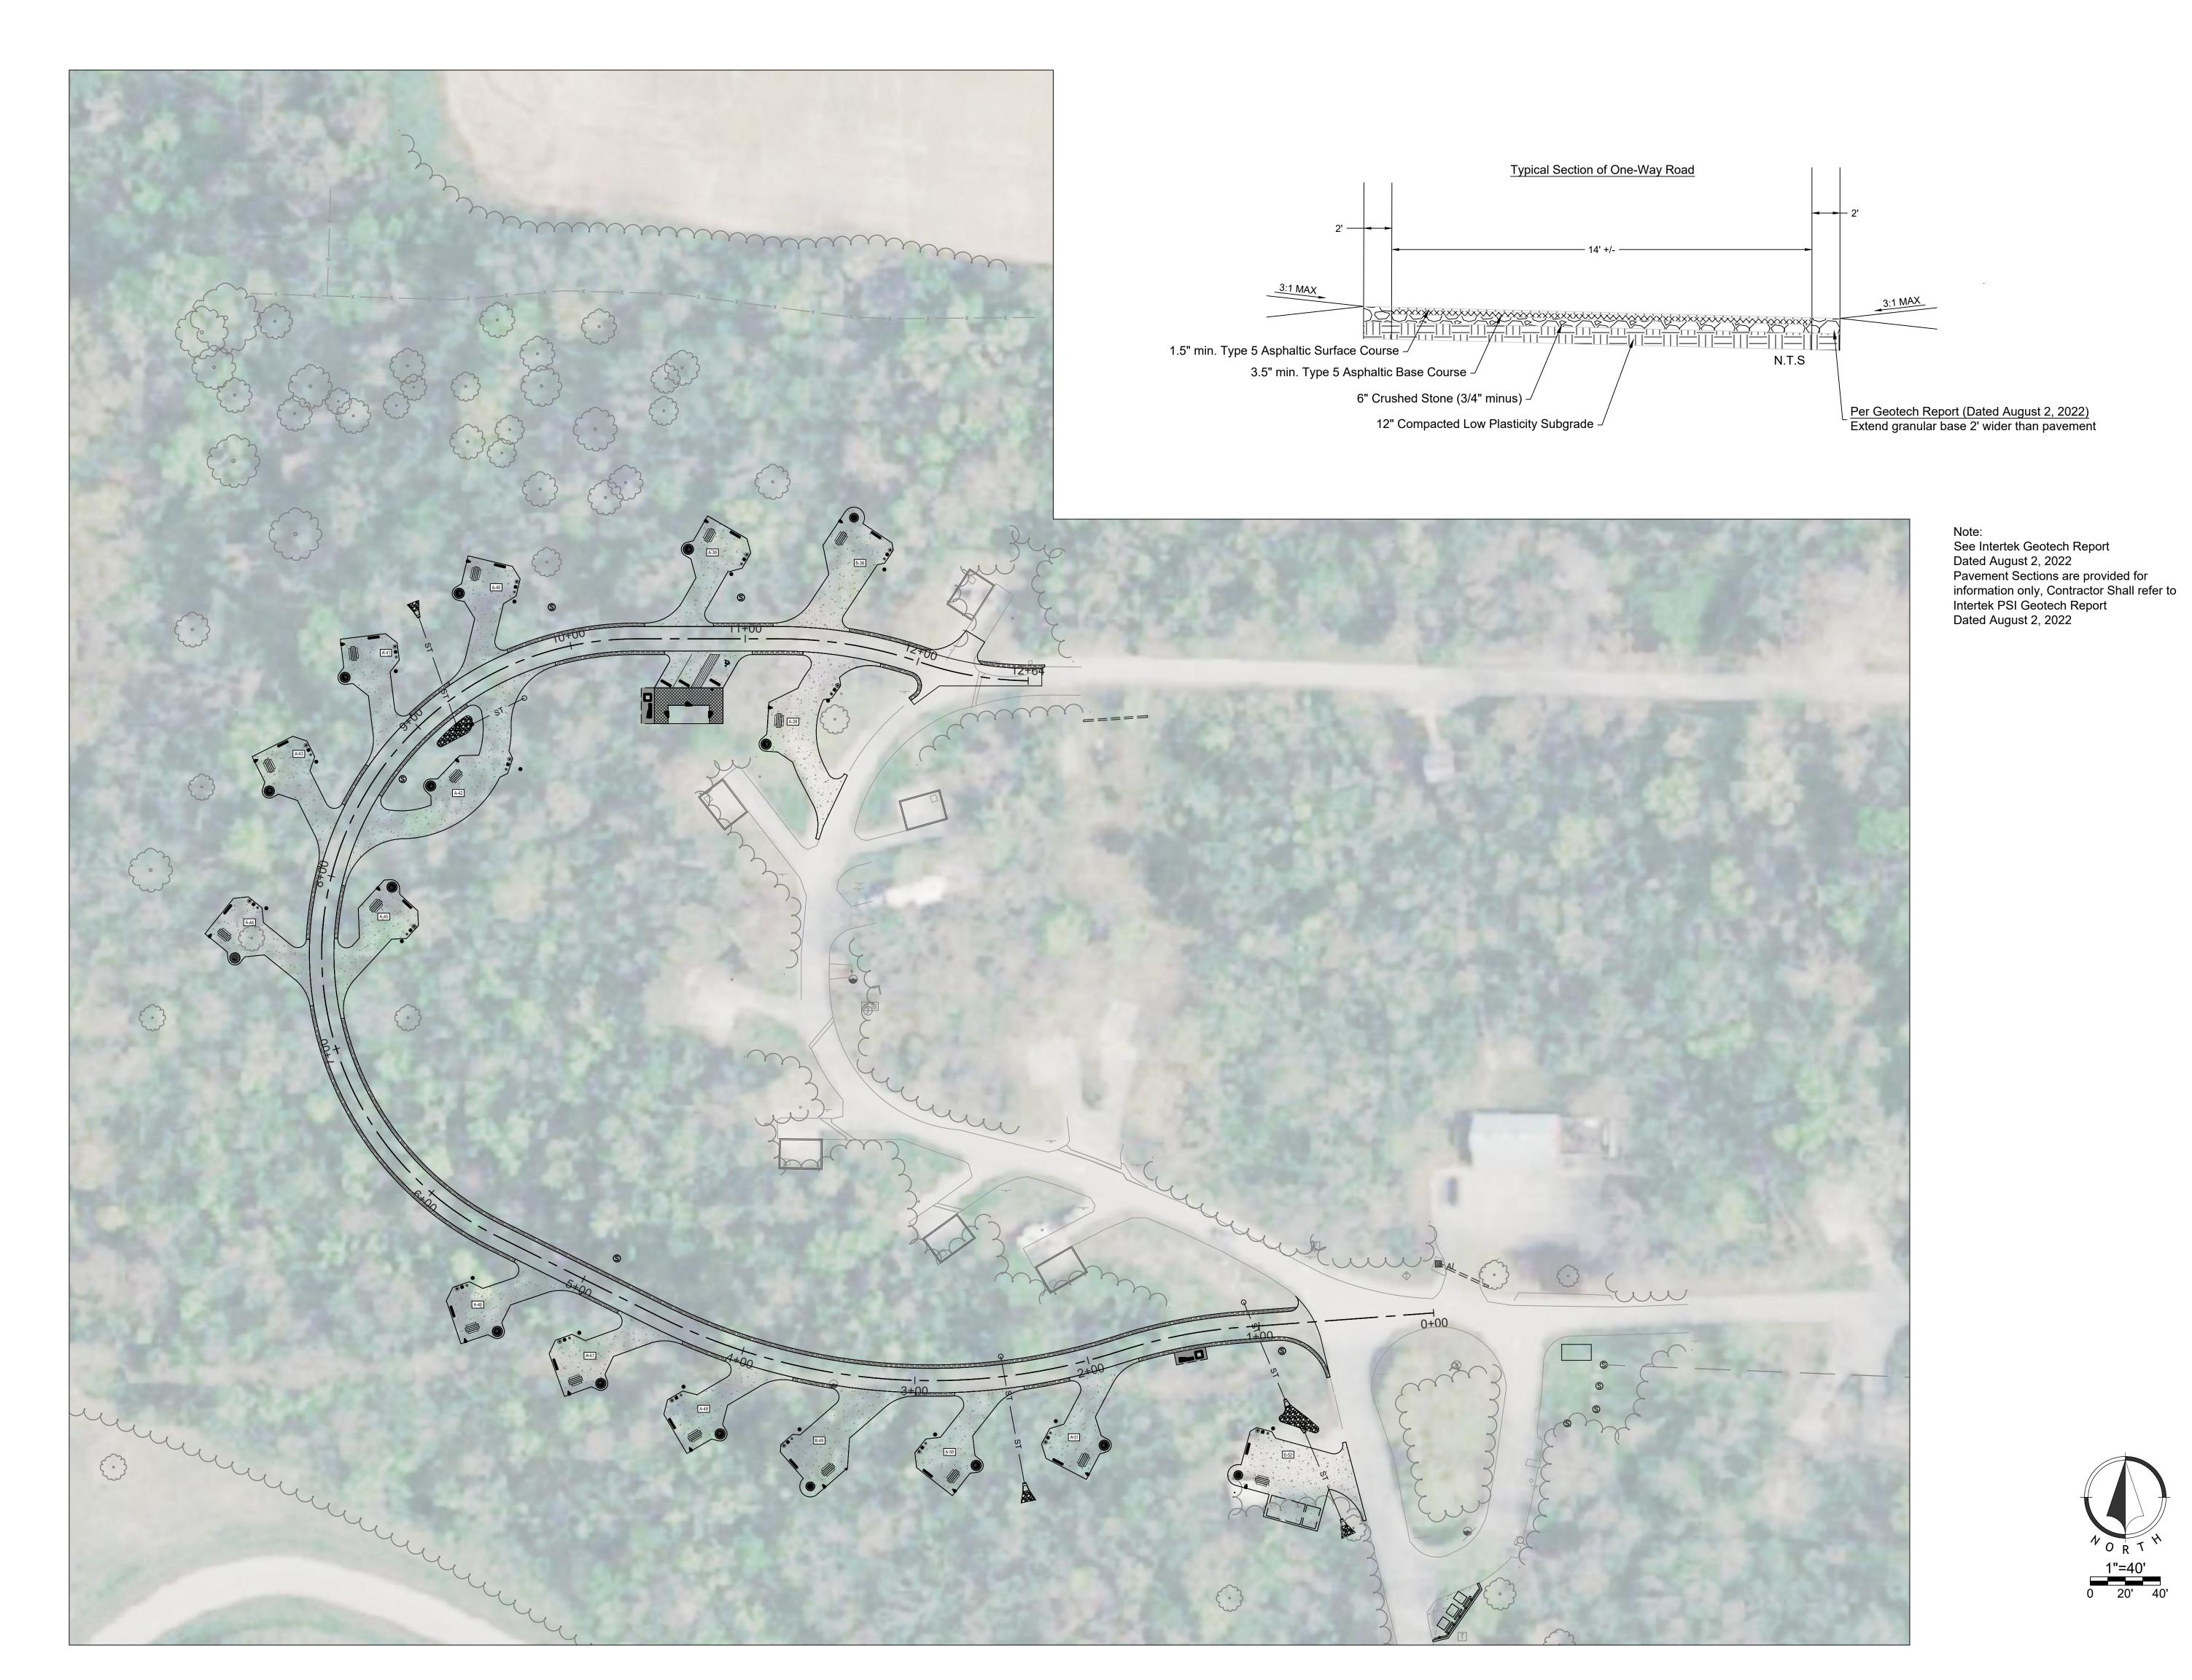
SHEET TITLE:

PAVEMENT PLAN

SHEET NUMBER:

C-103

SHEET 14 OF 36 12/12/2023







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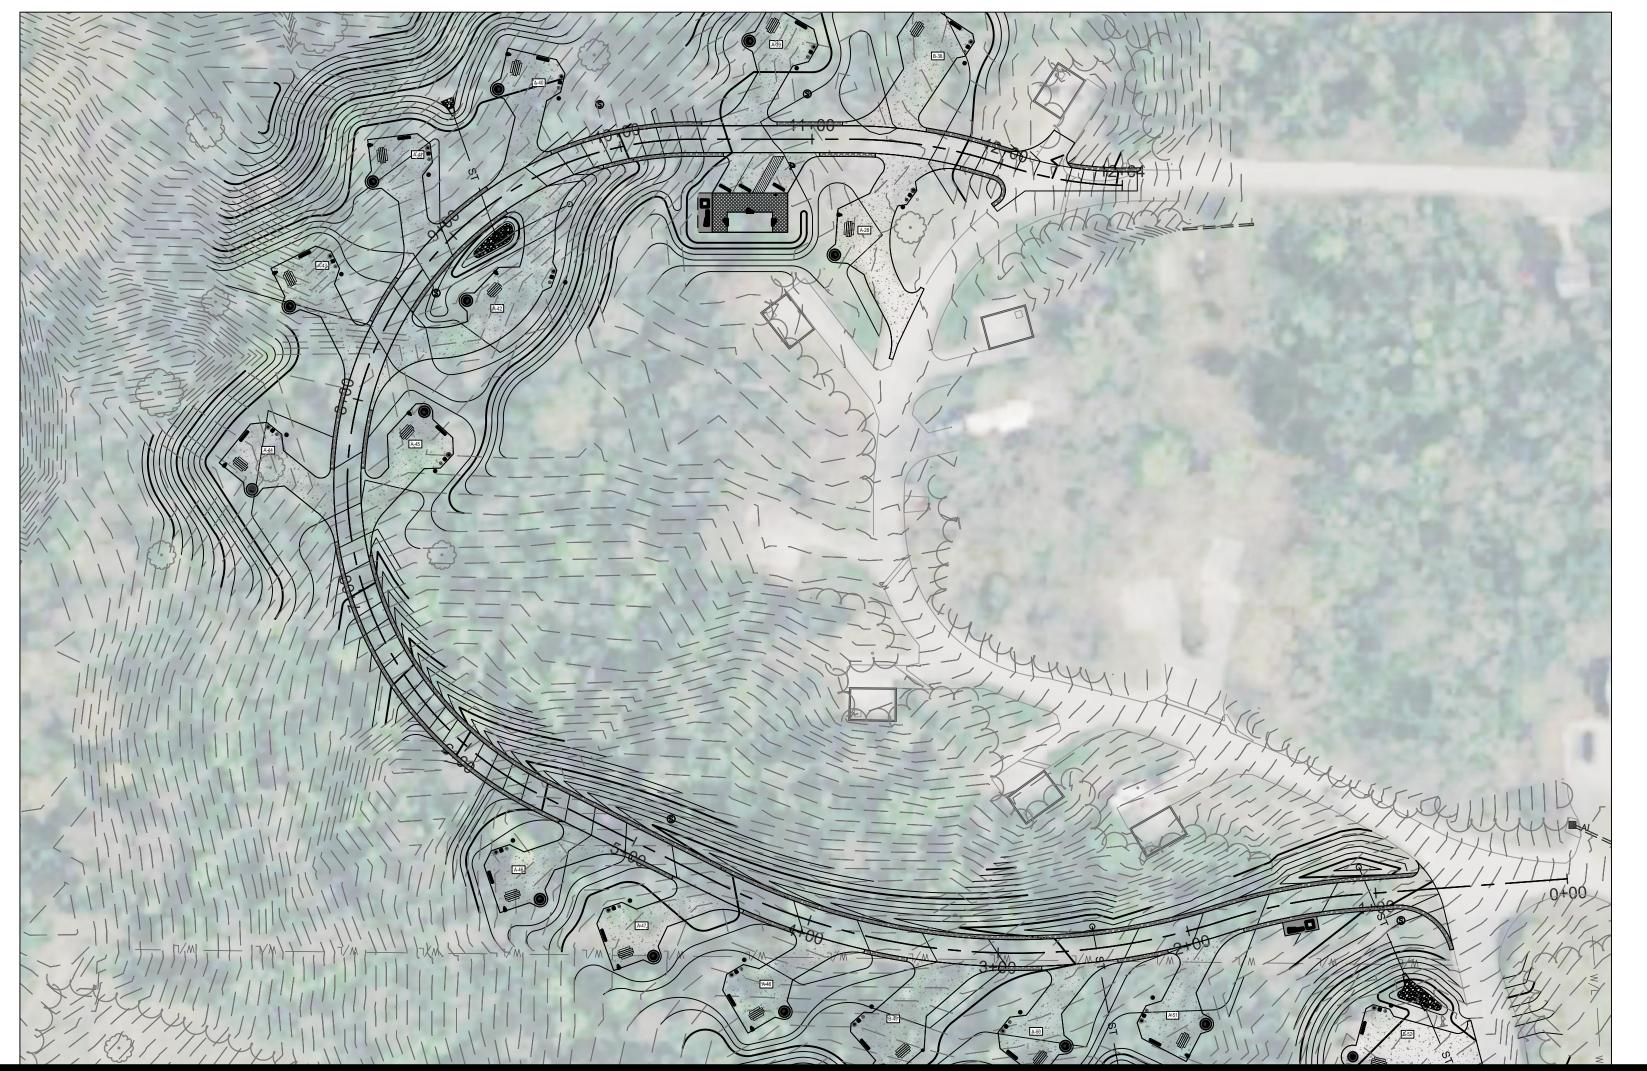
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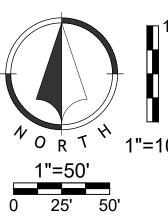
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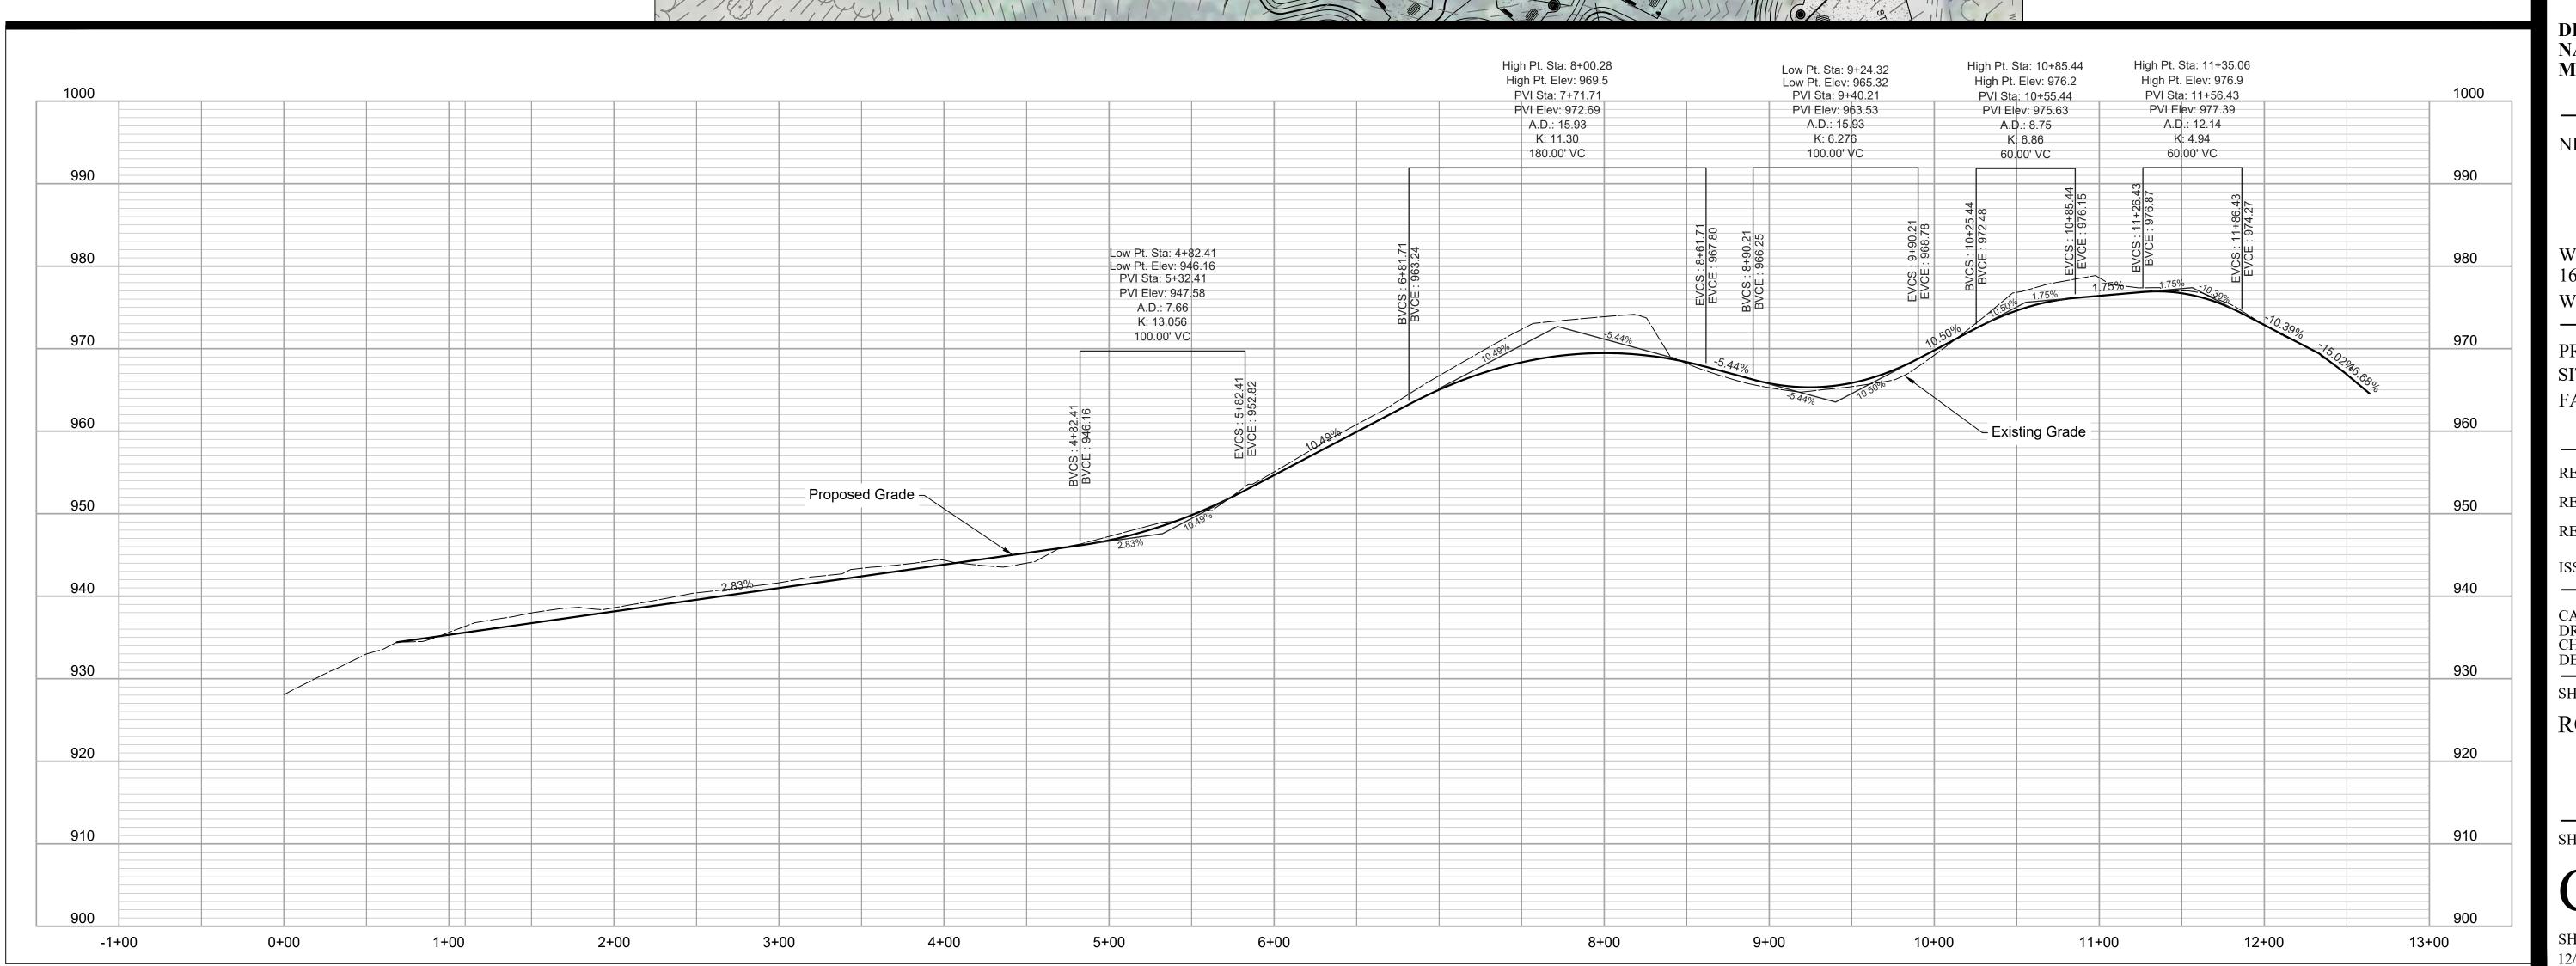
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C-104

SHEET 15 OF 36 12/12/2023









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WESTON BEND STATE PARK 16600 MO-45 HWY WESTON, MO 64098

PROJECT # X2221-01 SITE # 5118 FACILITY # 7815118006

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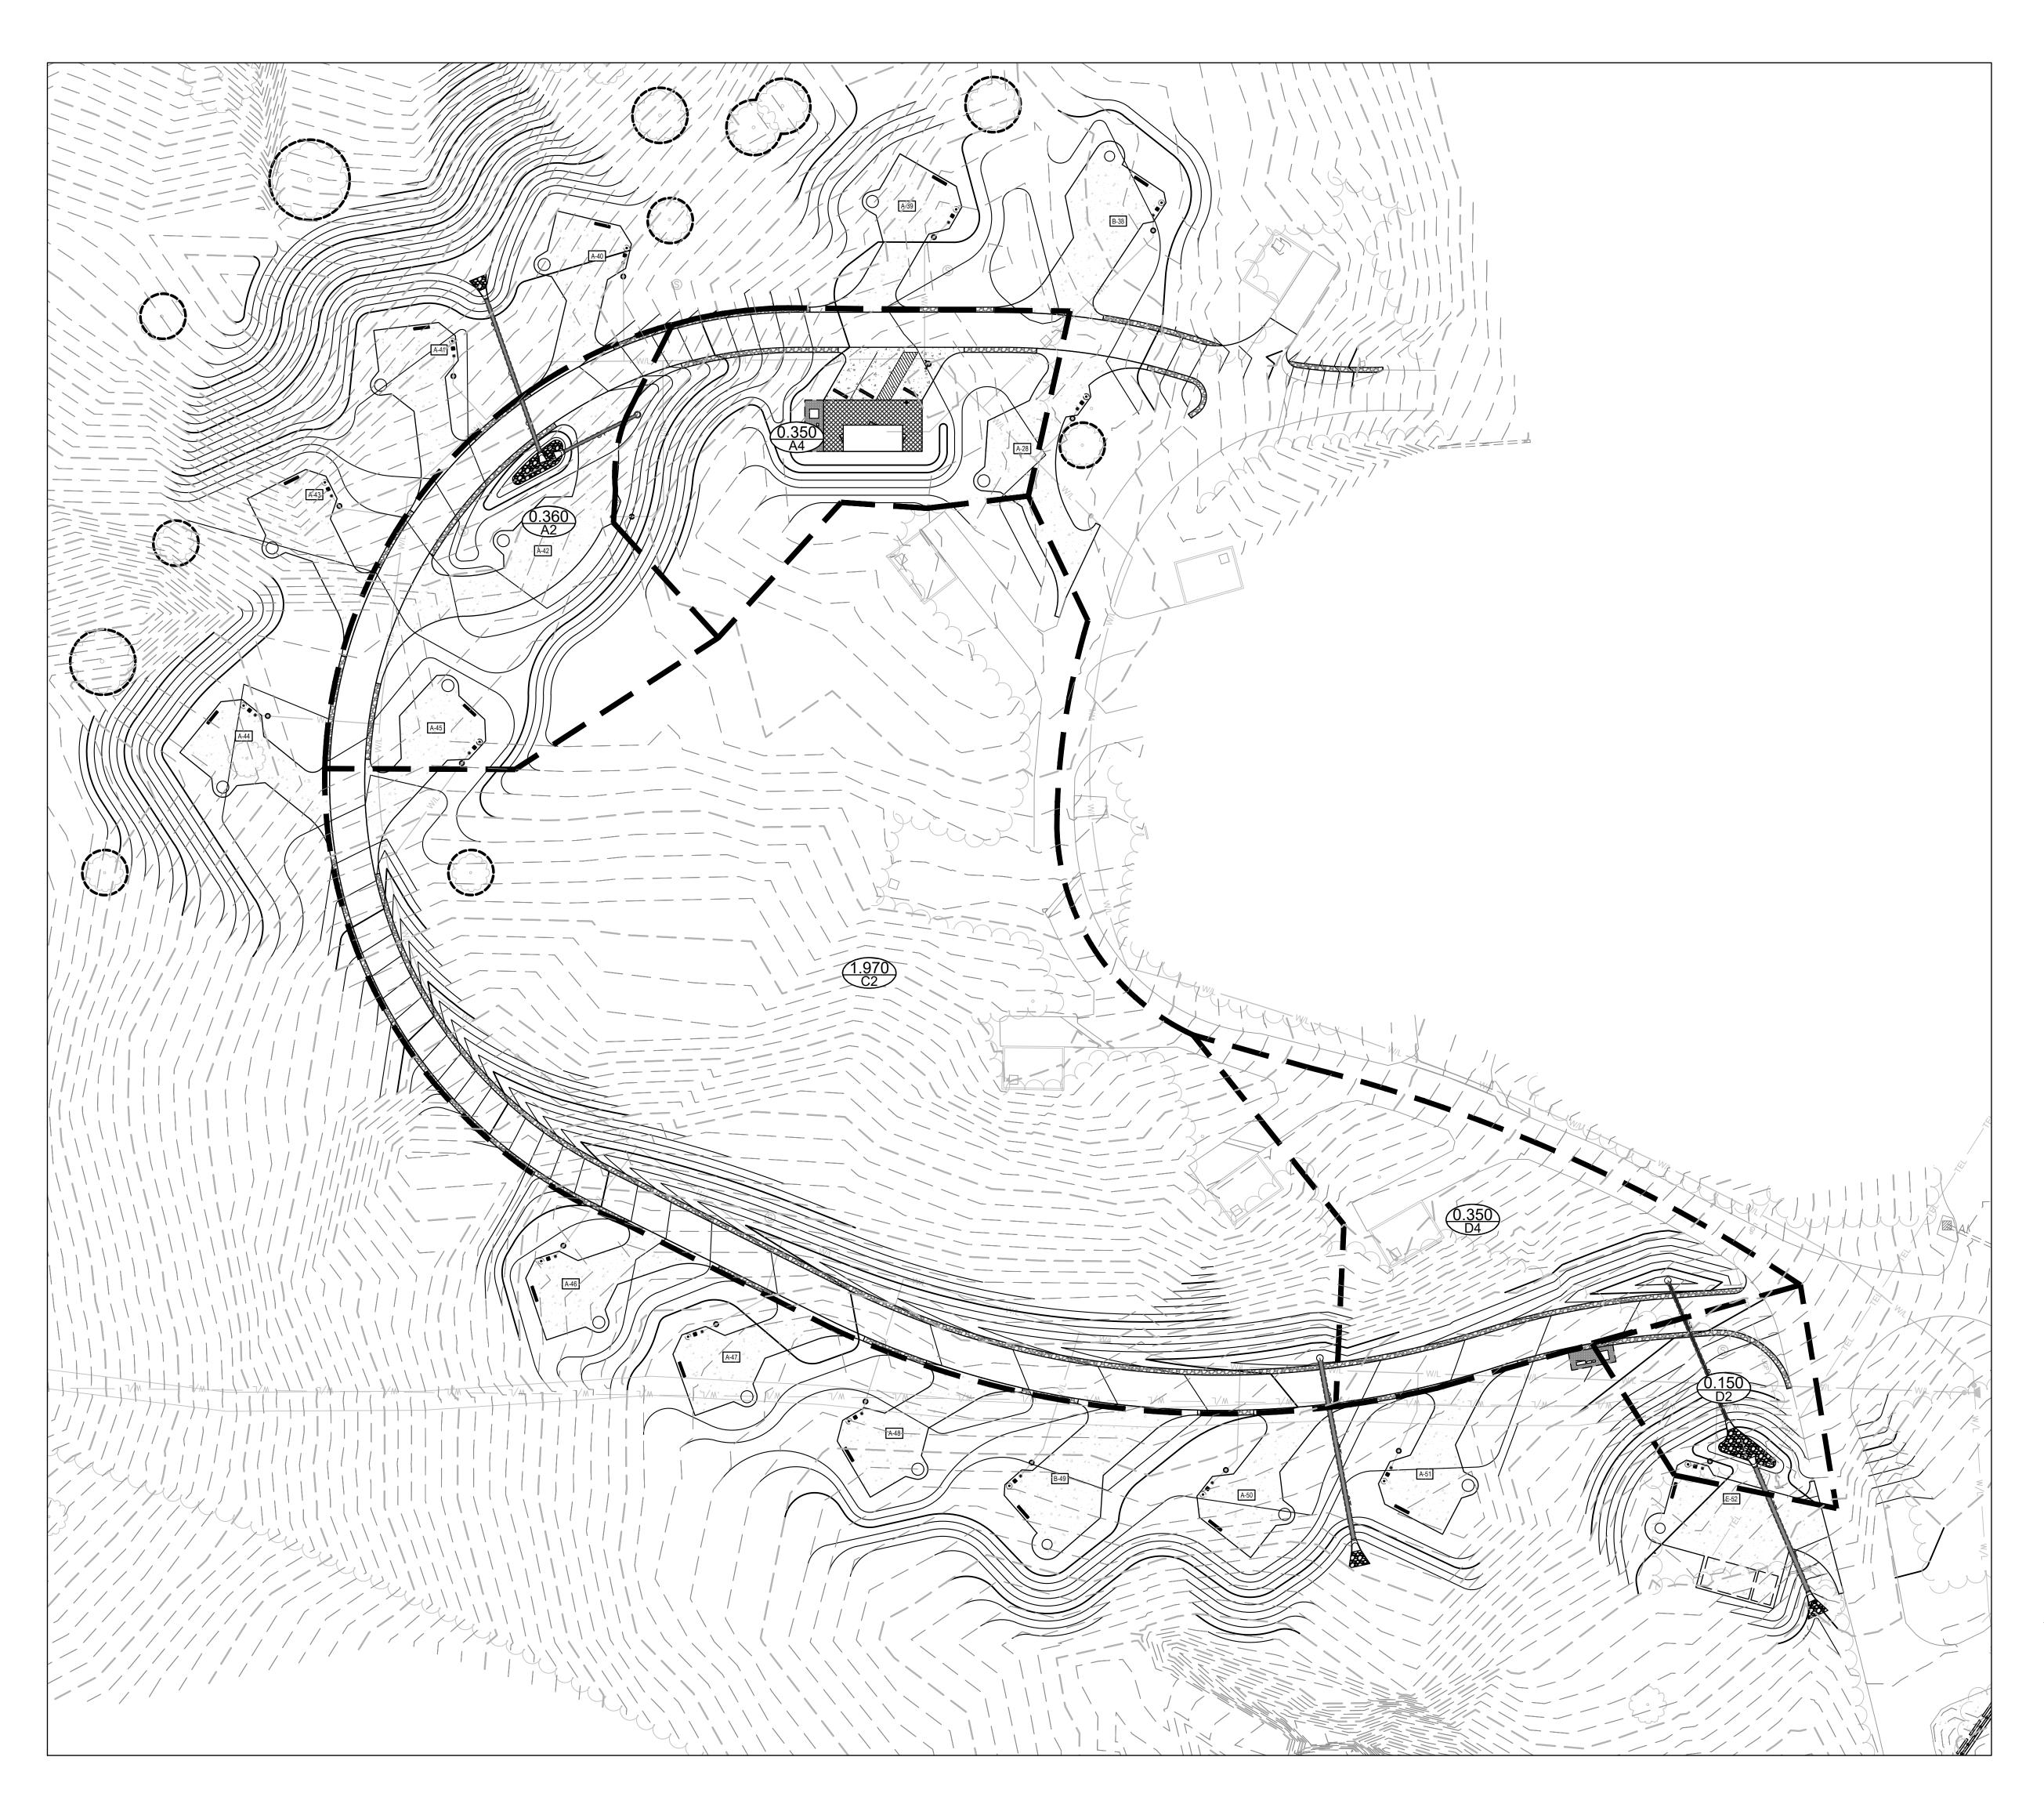
SHEET TITLE:

ROAD PLAN & PROFILE

SHEET NUMBER:

C-201

SHEET 16 OF 36 12/12/2023





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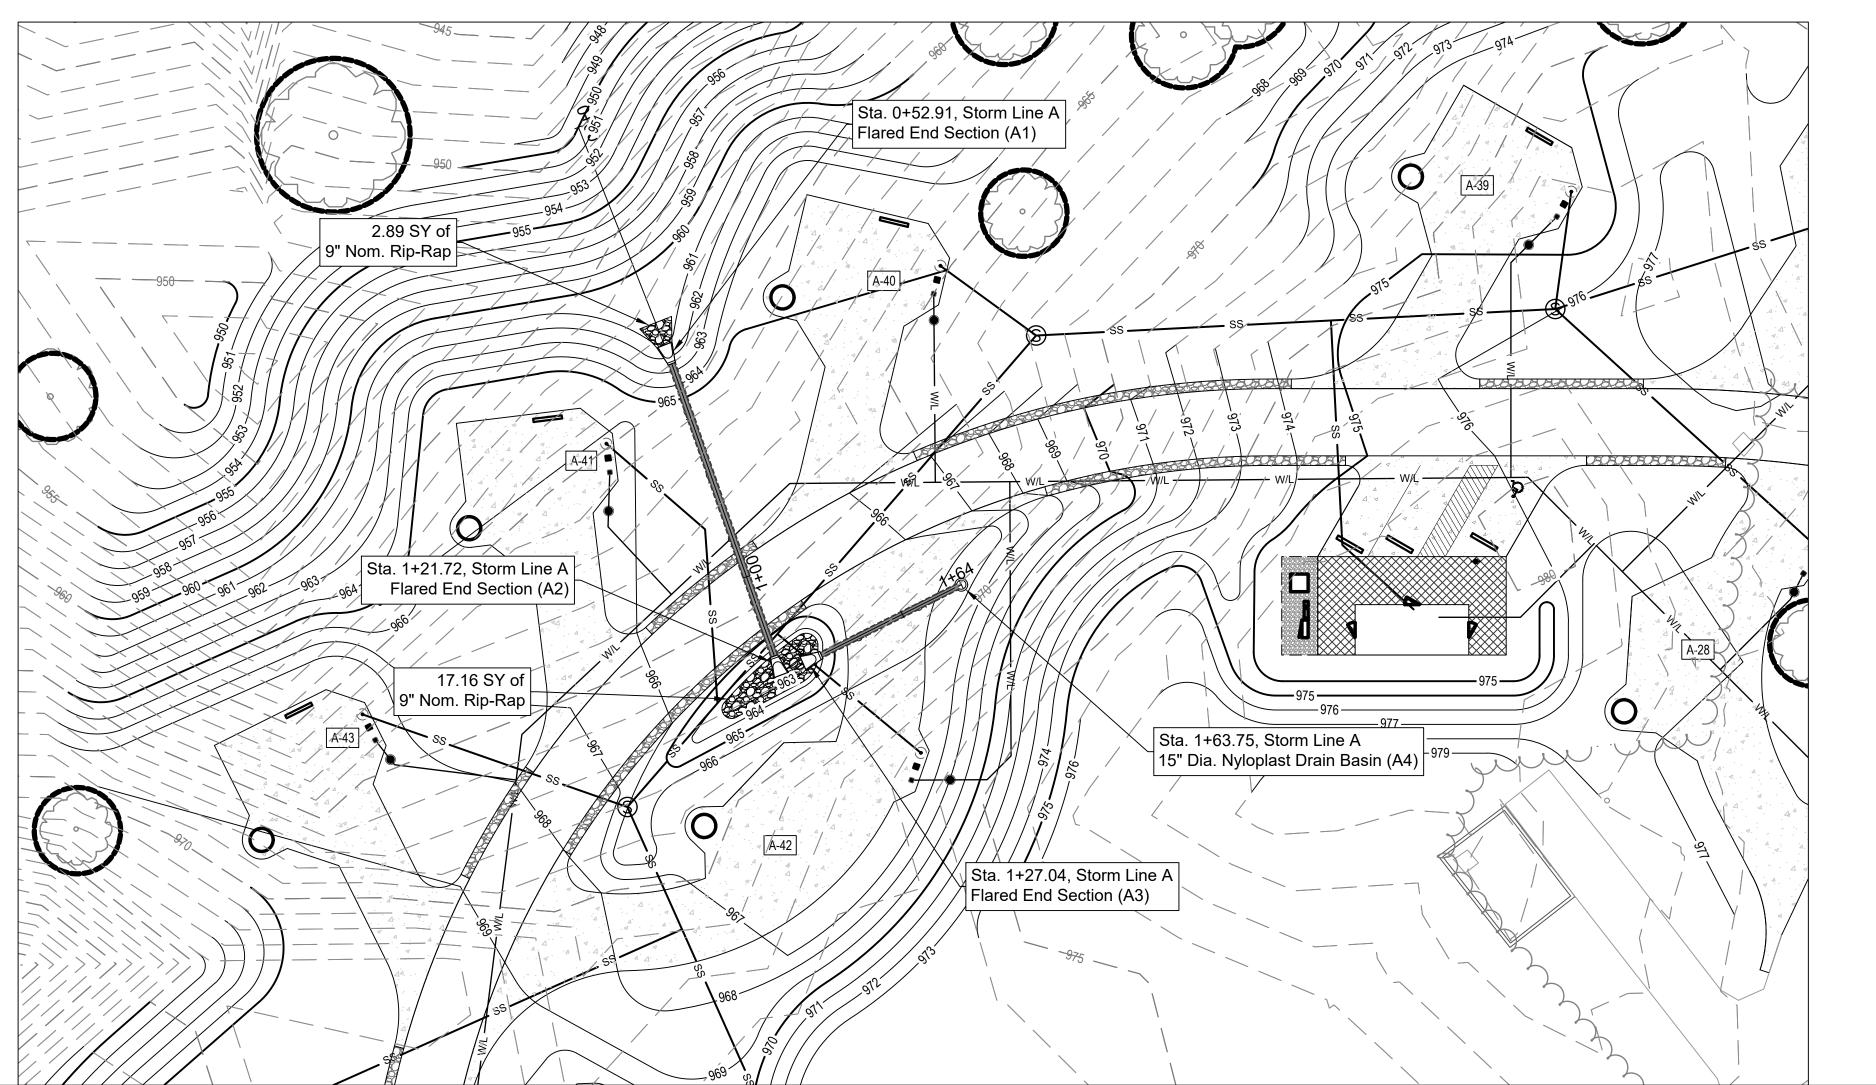
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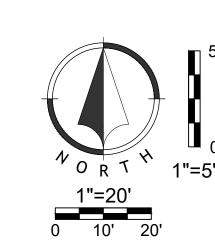
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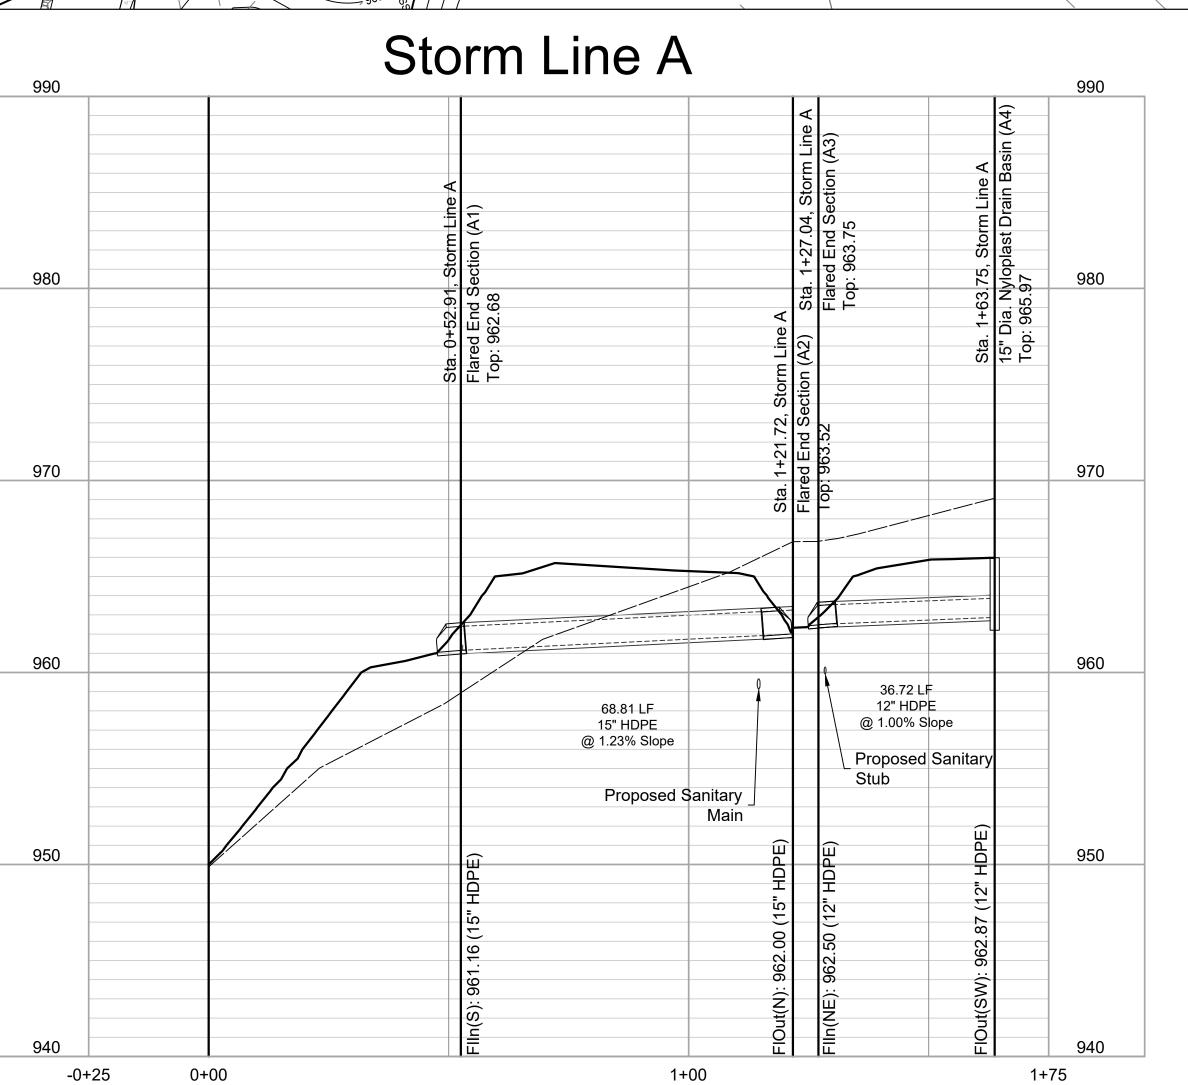
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SHEET 17 OF 36 12/12/2023











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DEPARTMENT OF NATURAL RESOURCES, MISSOURI STATE PARKS

NEW PREMIUM CAMPSITES

WESTON BEND STATE PARK 16600 MO-45 HWY WESTON, MO 64098

PROJECT # X2221-01 SITE # 5118 FACILITY # 7815118006

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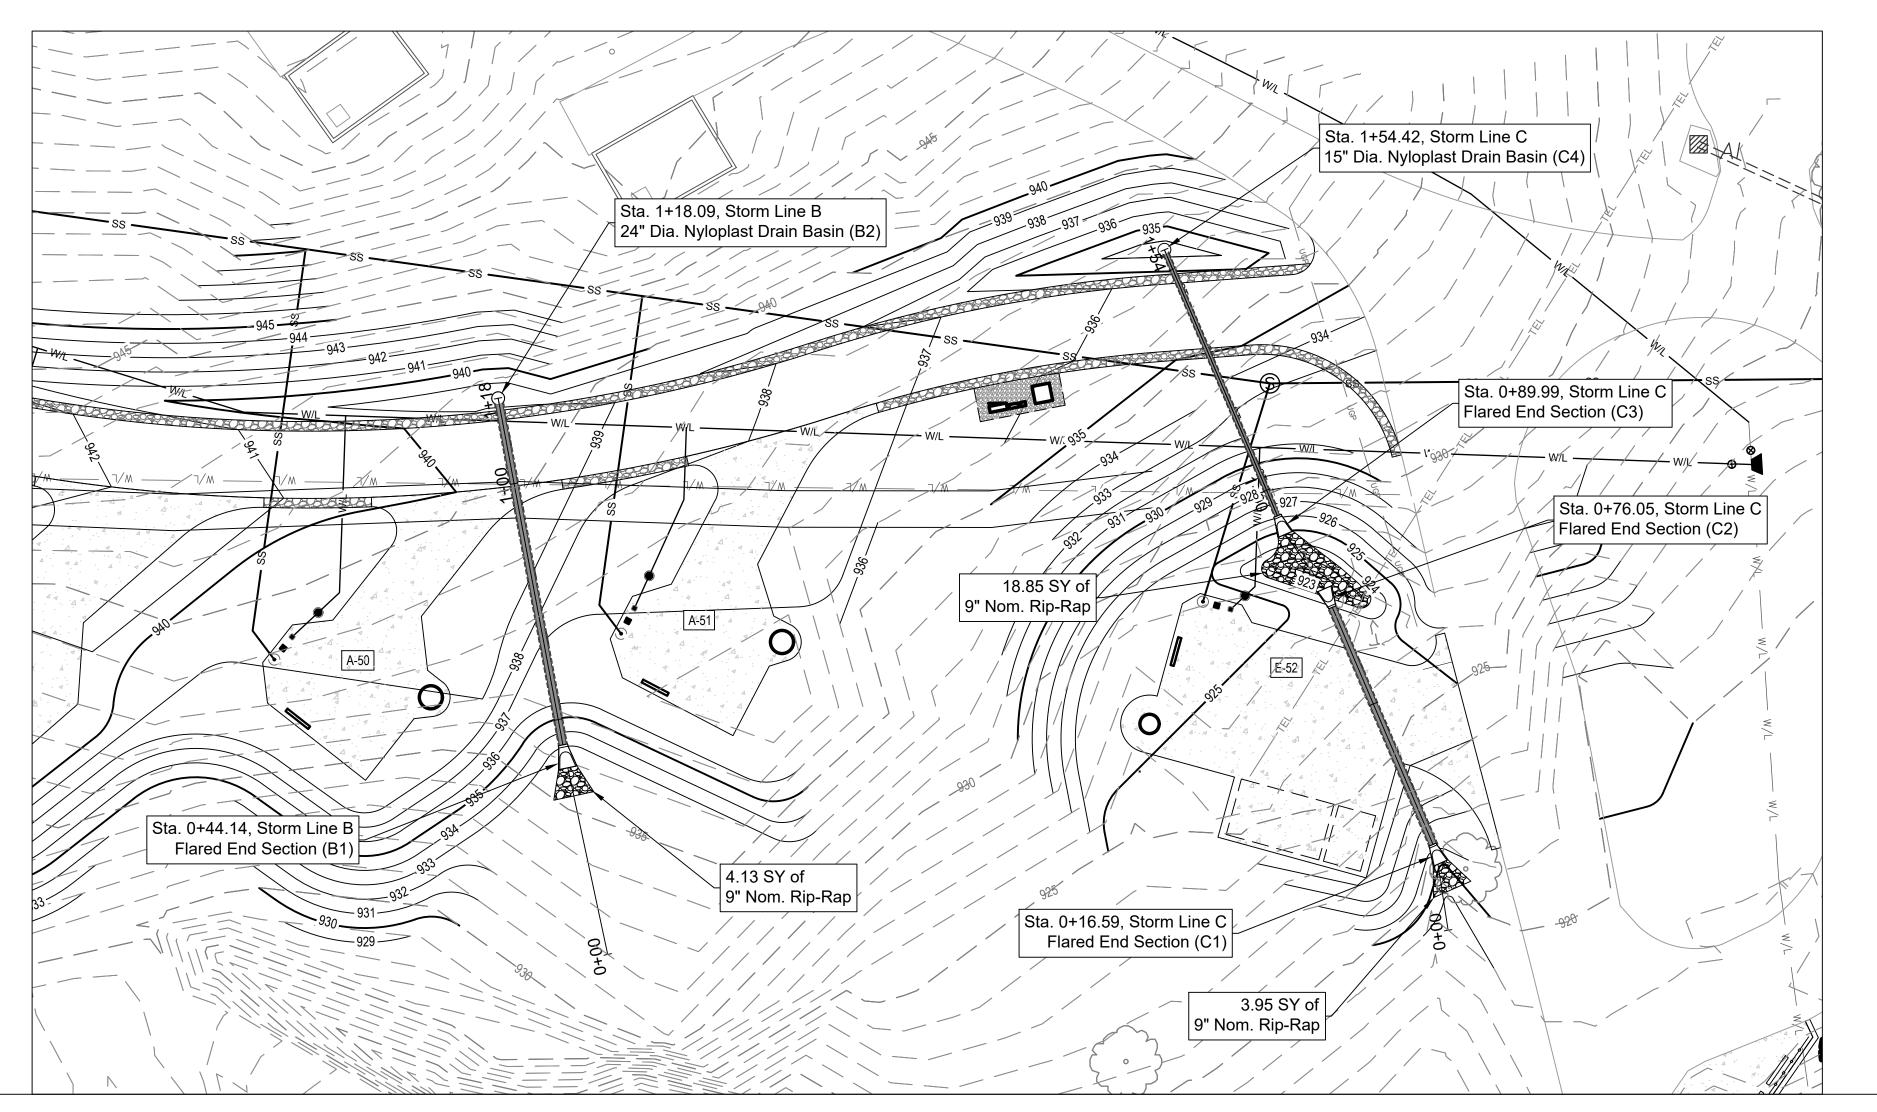
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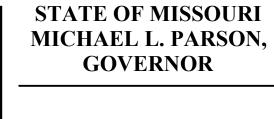
SHEET TITLE:
STORM LINES A
PLAN & PROFILE

SHEET NUMBER:

C-402

SHEET 18 OF 36 12/12/2023







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DEPARTMENT OF NATURAL RESOURCES, MISSOURI STATE PARKS

NEW PREMIUM CAMPSITES

WESTON BEND STATE PARK 16600 MO-45 HWY WESTON, MO 64098

PROJECT # X2221-01 SITE # 5118 FACILITY # 7815118006

REVISION: REVISION:

ISSUE DATE: 12/12/2023


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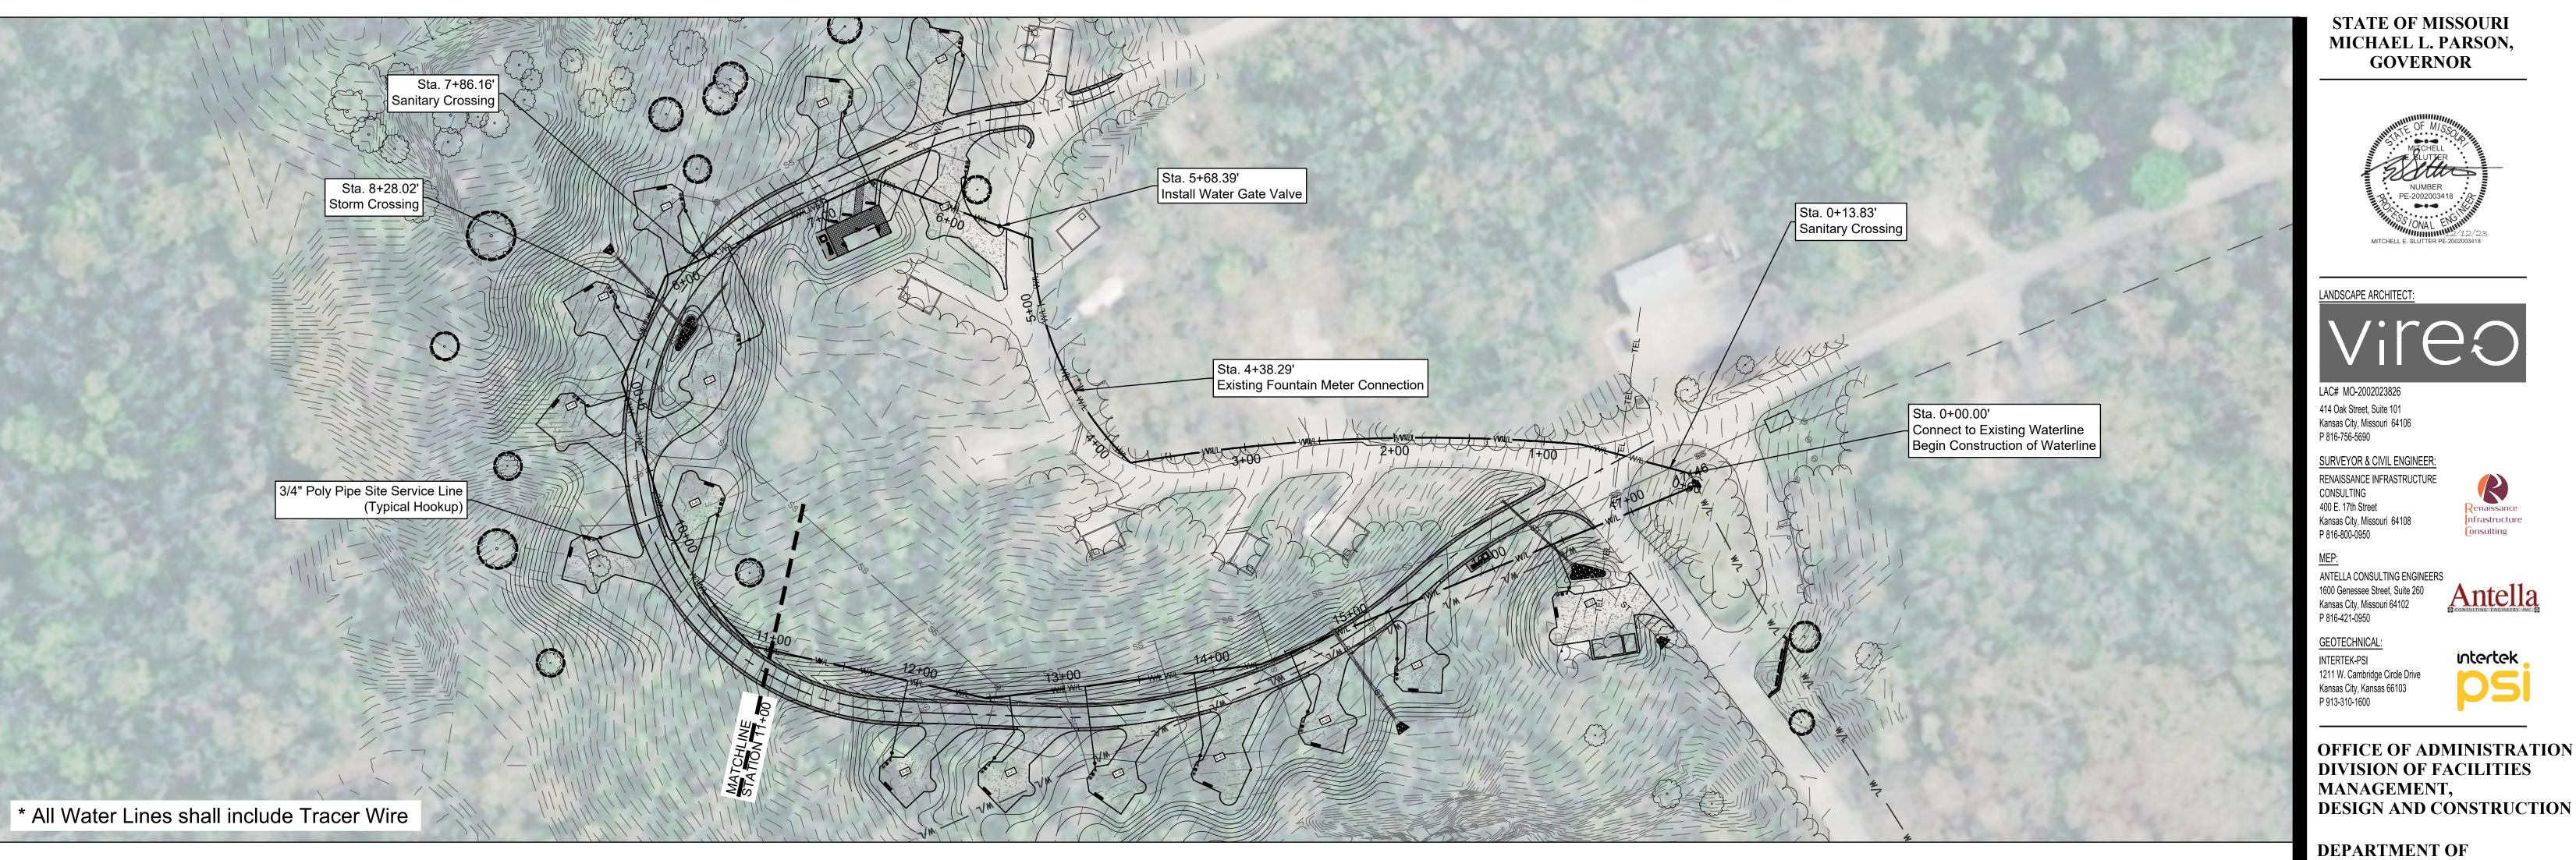
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STORM LINES B & C PLAN & PROFILE


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SHEET 19 OF 36





Waterline Profile

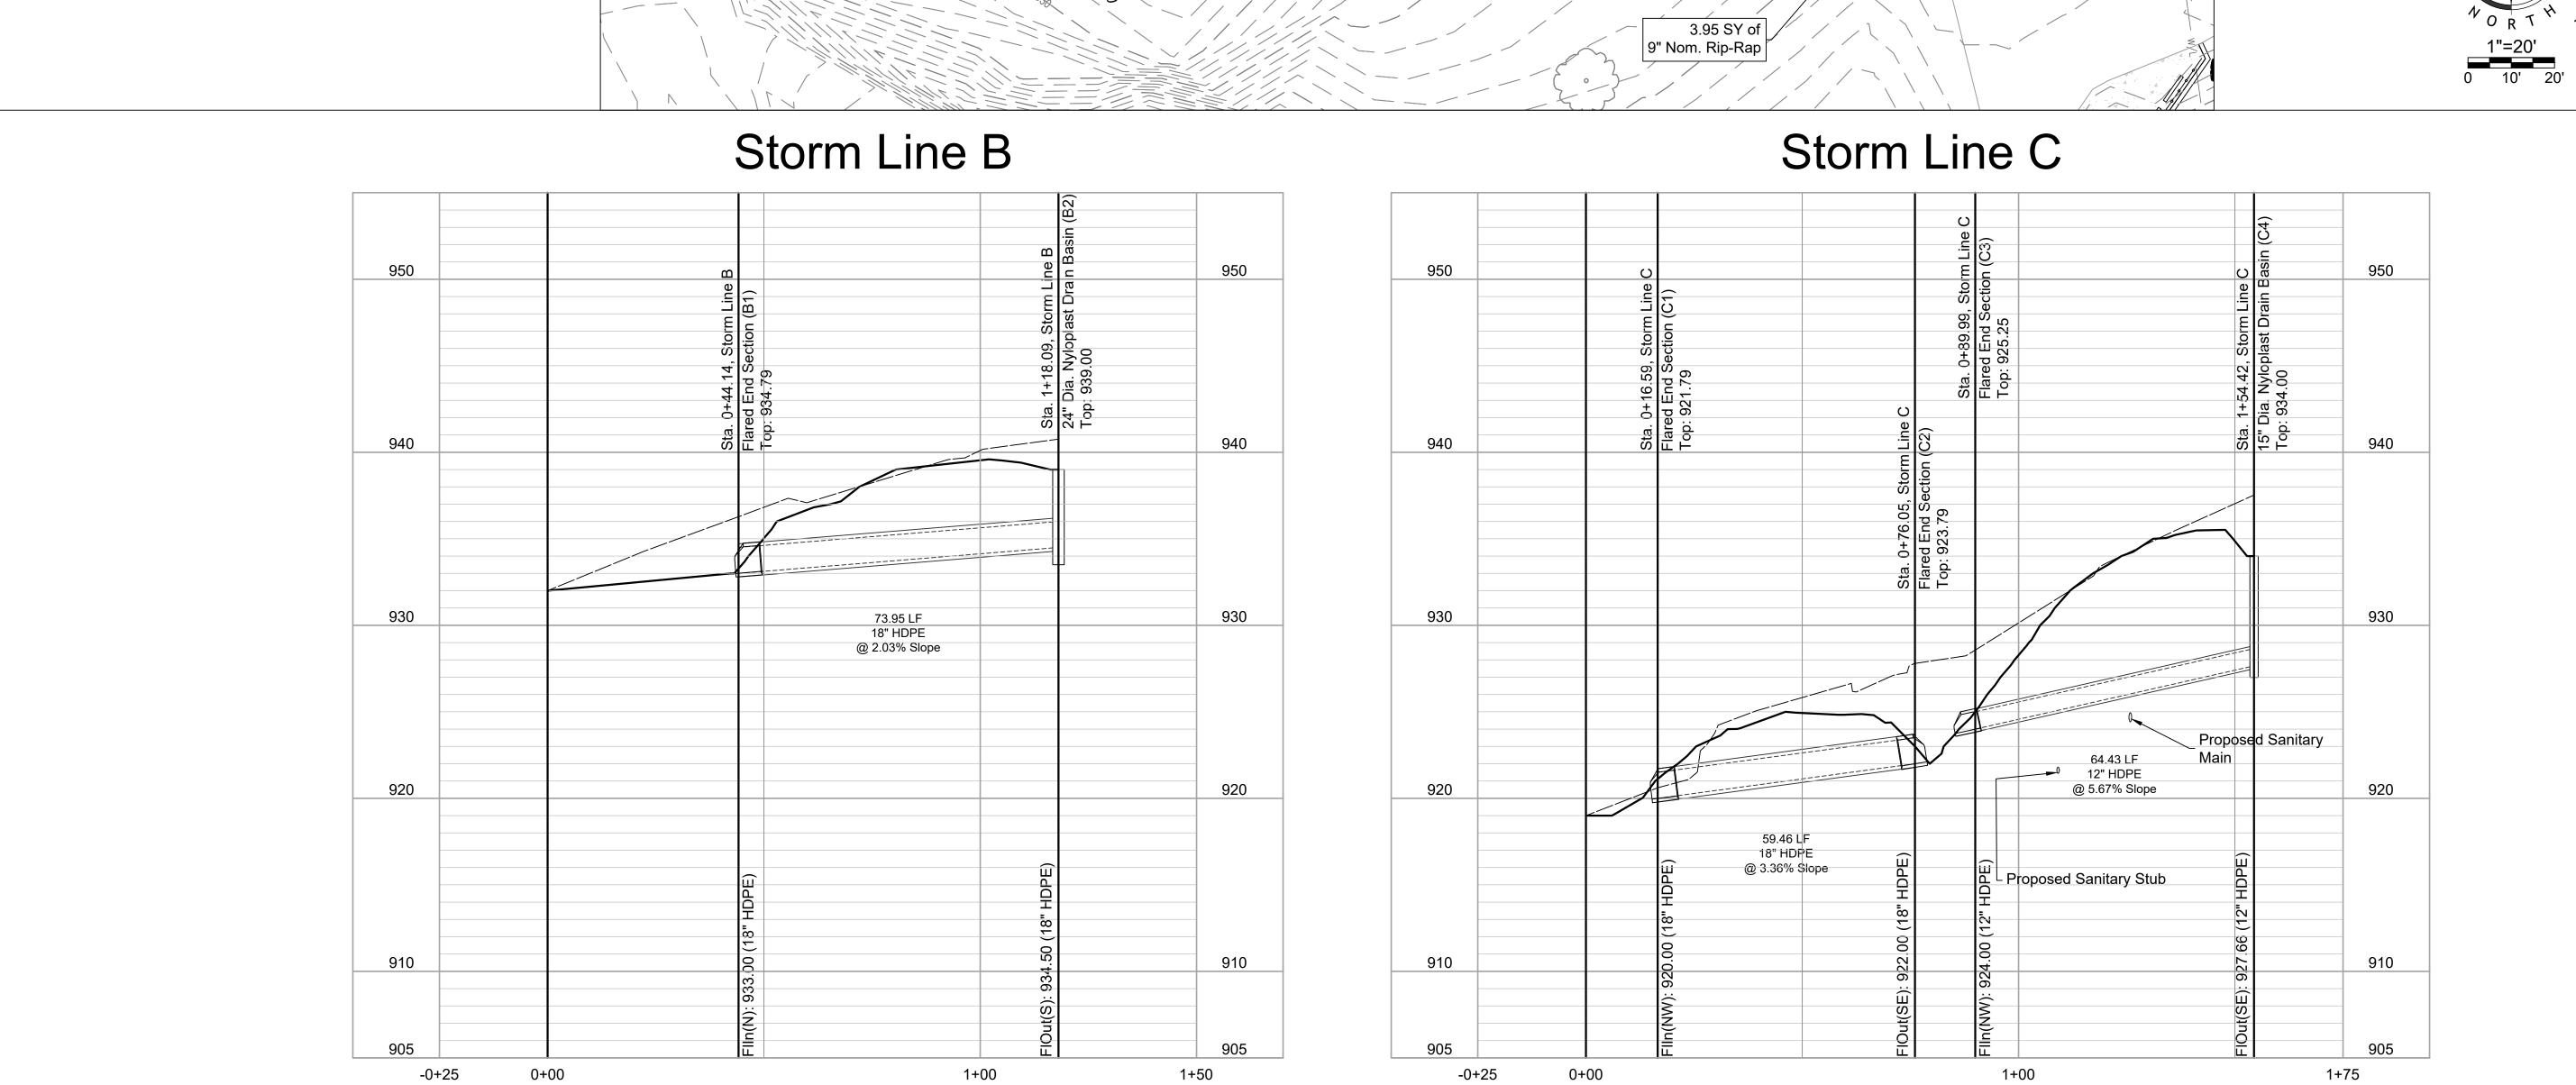

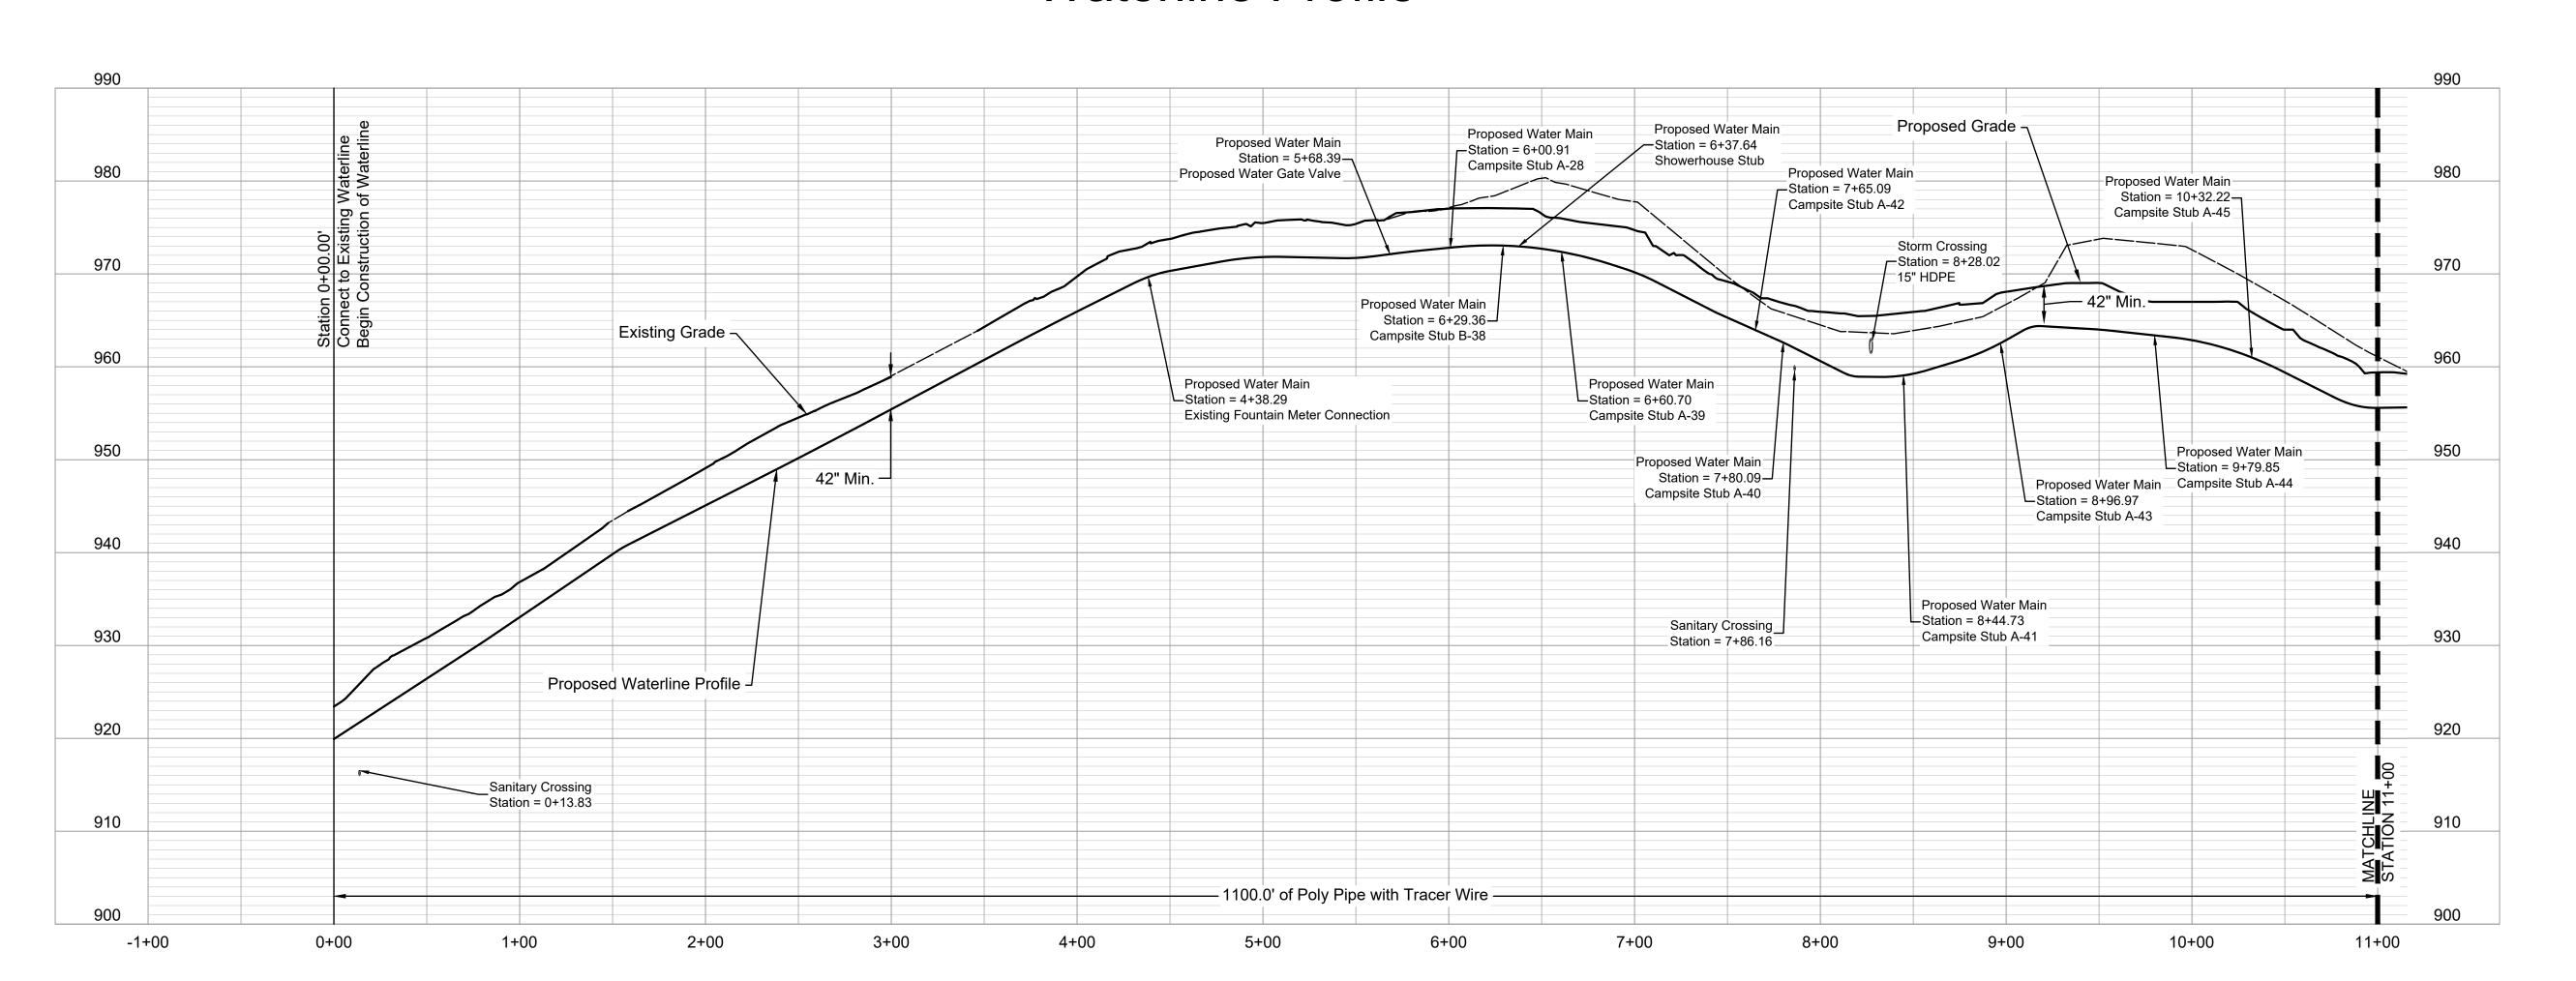STATE OF MISSOURI MICHAEL L. PARSON, **GOVERNOR**



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OFFICE OF ADMINISTRATION DIVISION OF FACILITIES

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DEPARTMENT OF NATURAL RESOURCES,

NEW PREMIUM CAMPSITES

MISSOURI STATE PARKS

WESTON BEND STATE PARK 16600 MO-45 HWY WESTON, MO 64098

PROJECT # X2221-01 SITE# 5118 FACILITY # 7815118006


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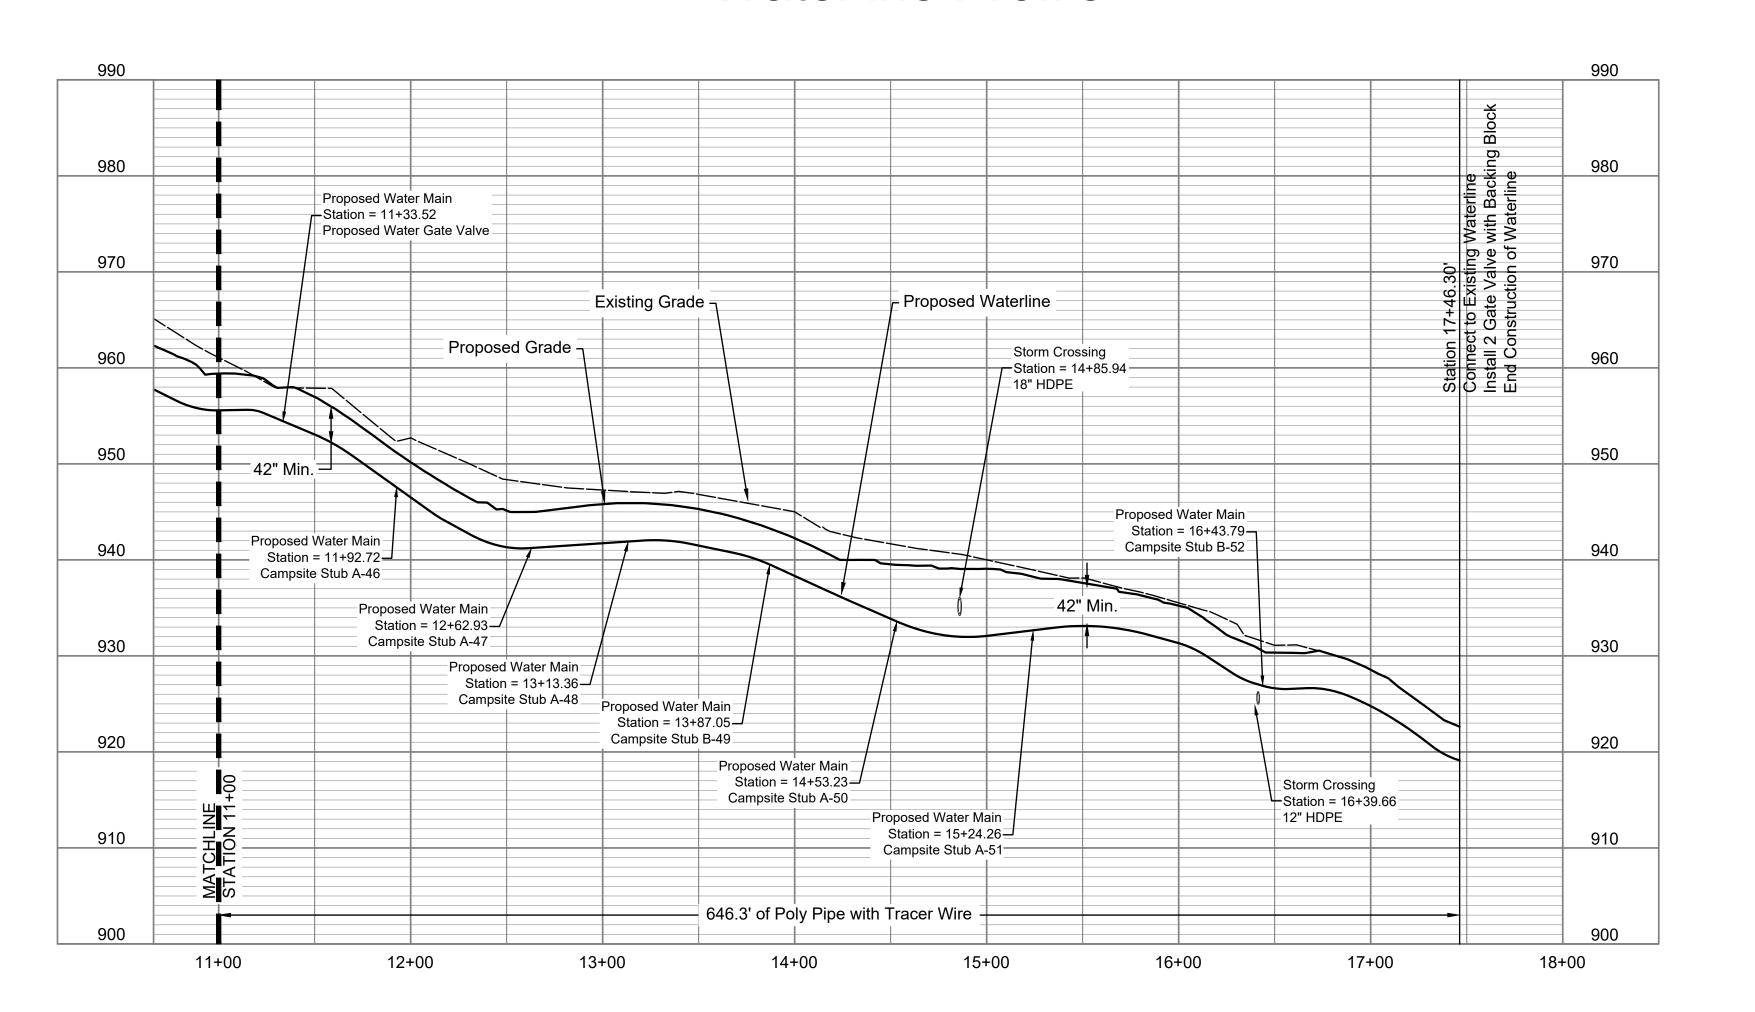
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WATERLINE PLAN & PROFILE I

SHEET NUMBER:



Waterline Profile

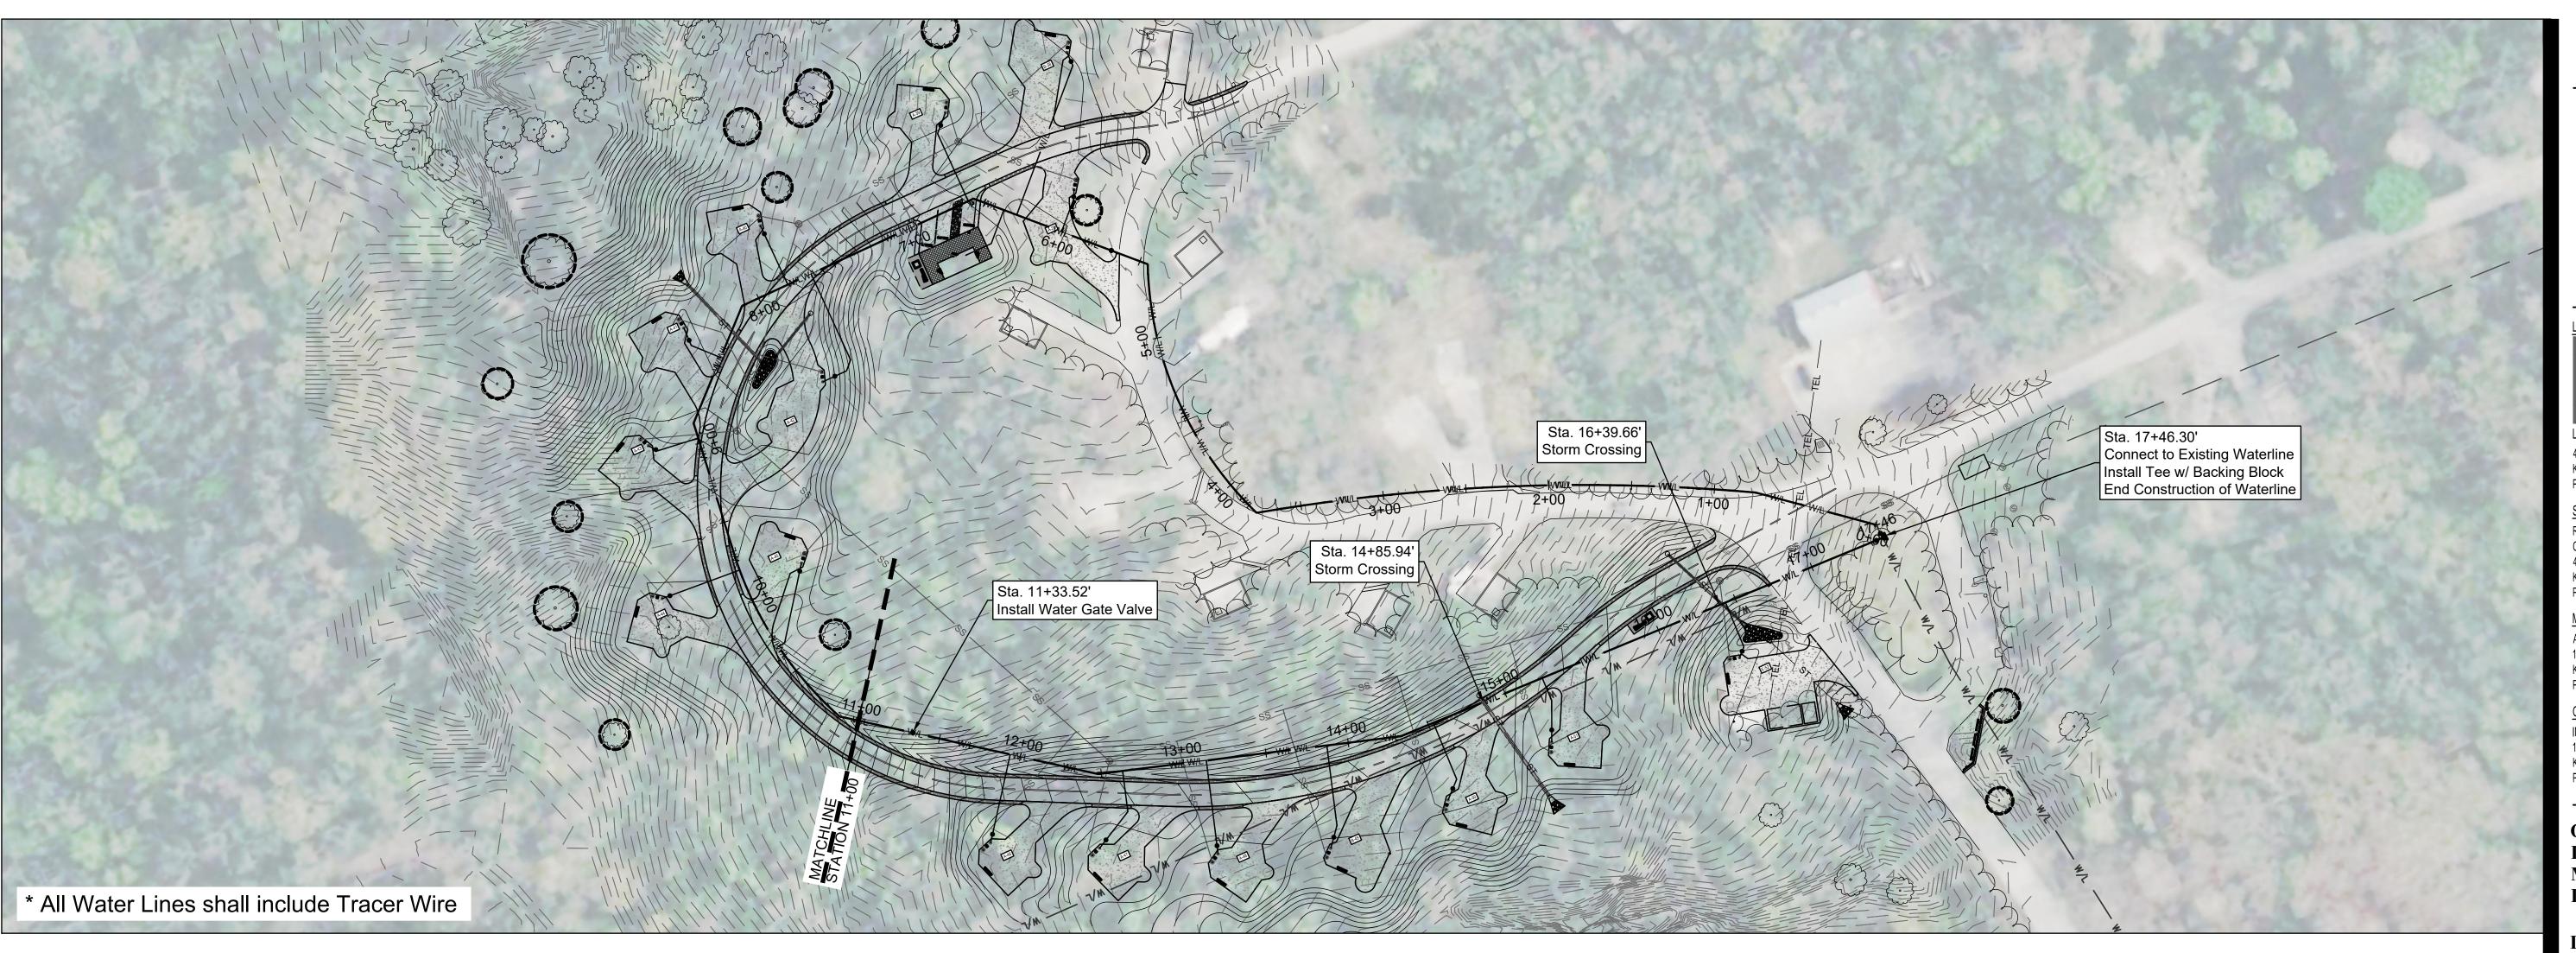

STATE OF MISSOURI MICHAEL L. PARSON, GOVERNOR



LANDSCAPE ARCHITECT:

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P 913-310-1600



nfrastructure

OFFICE OF ADMINISTRATION DIVISION OF FACILITIES MANAGEMENT, DESIGN AND CONSTRUCTION

DEPARTMENT OF NATURAL RESOURCES, MISSOURI STATE PARKS

NEW PREMIUM CAMPSITES

WESTON BEND STATE PARK 16600 MO-45 HWY WESTON, MO 64098

PROJECT # X2221-01 SITE # 5118 FACILITY # 7815118006

REVISION:
DATE:
REVISION:
DATE:
REVISION:
DATE:
ISSUE DATE: 12/12/2023

CAD DWG FILE:
DRAWN BY: TCD
CHECKED BY: MES

DESIGNED BY: MES ZMM


SHEET TITLE:
WATERLINE PLAN &

PROFILE II

SHEET NUMBER:


C-405

SHEET 21 OF 3 12/12/2023

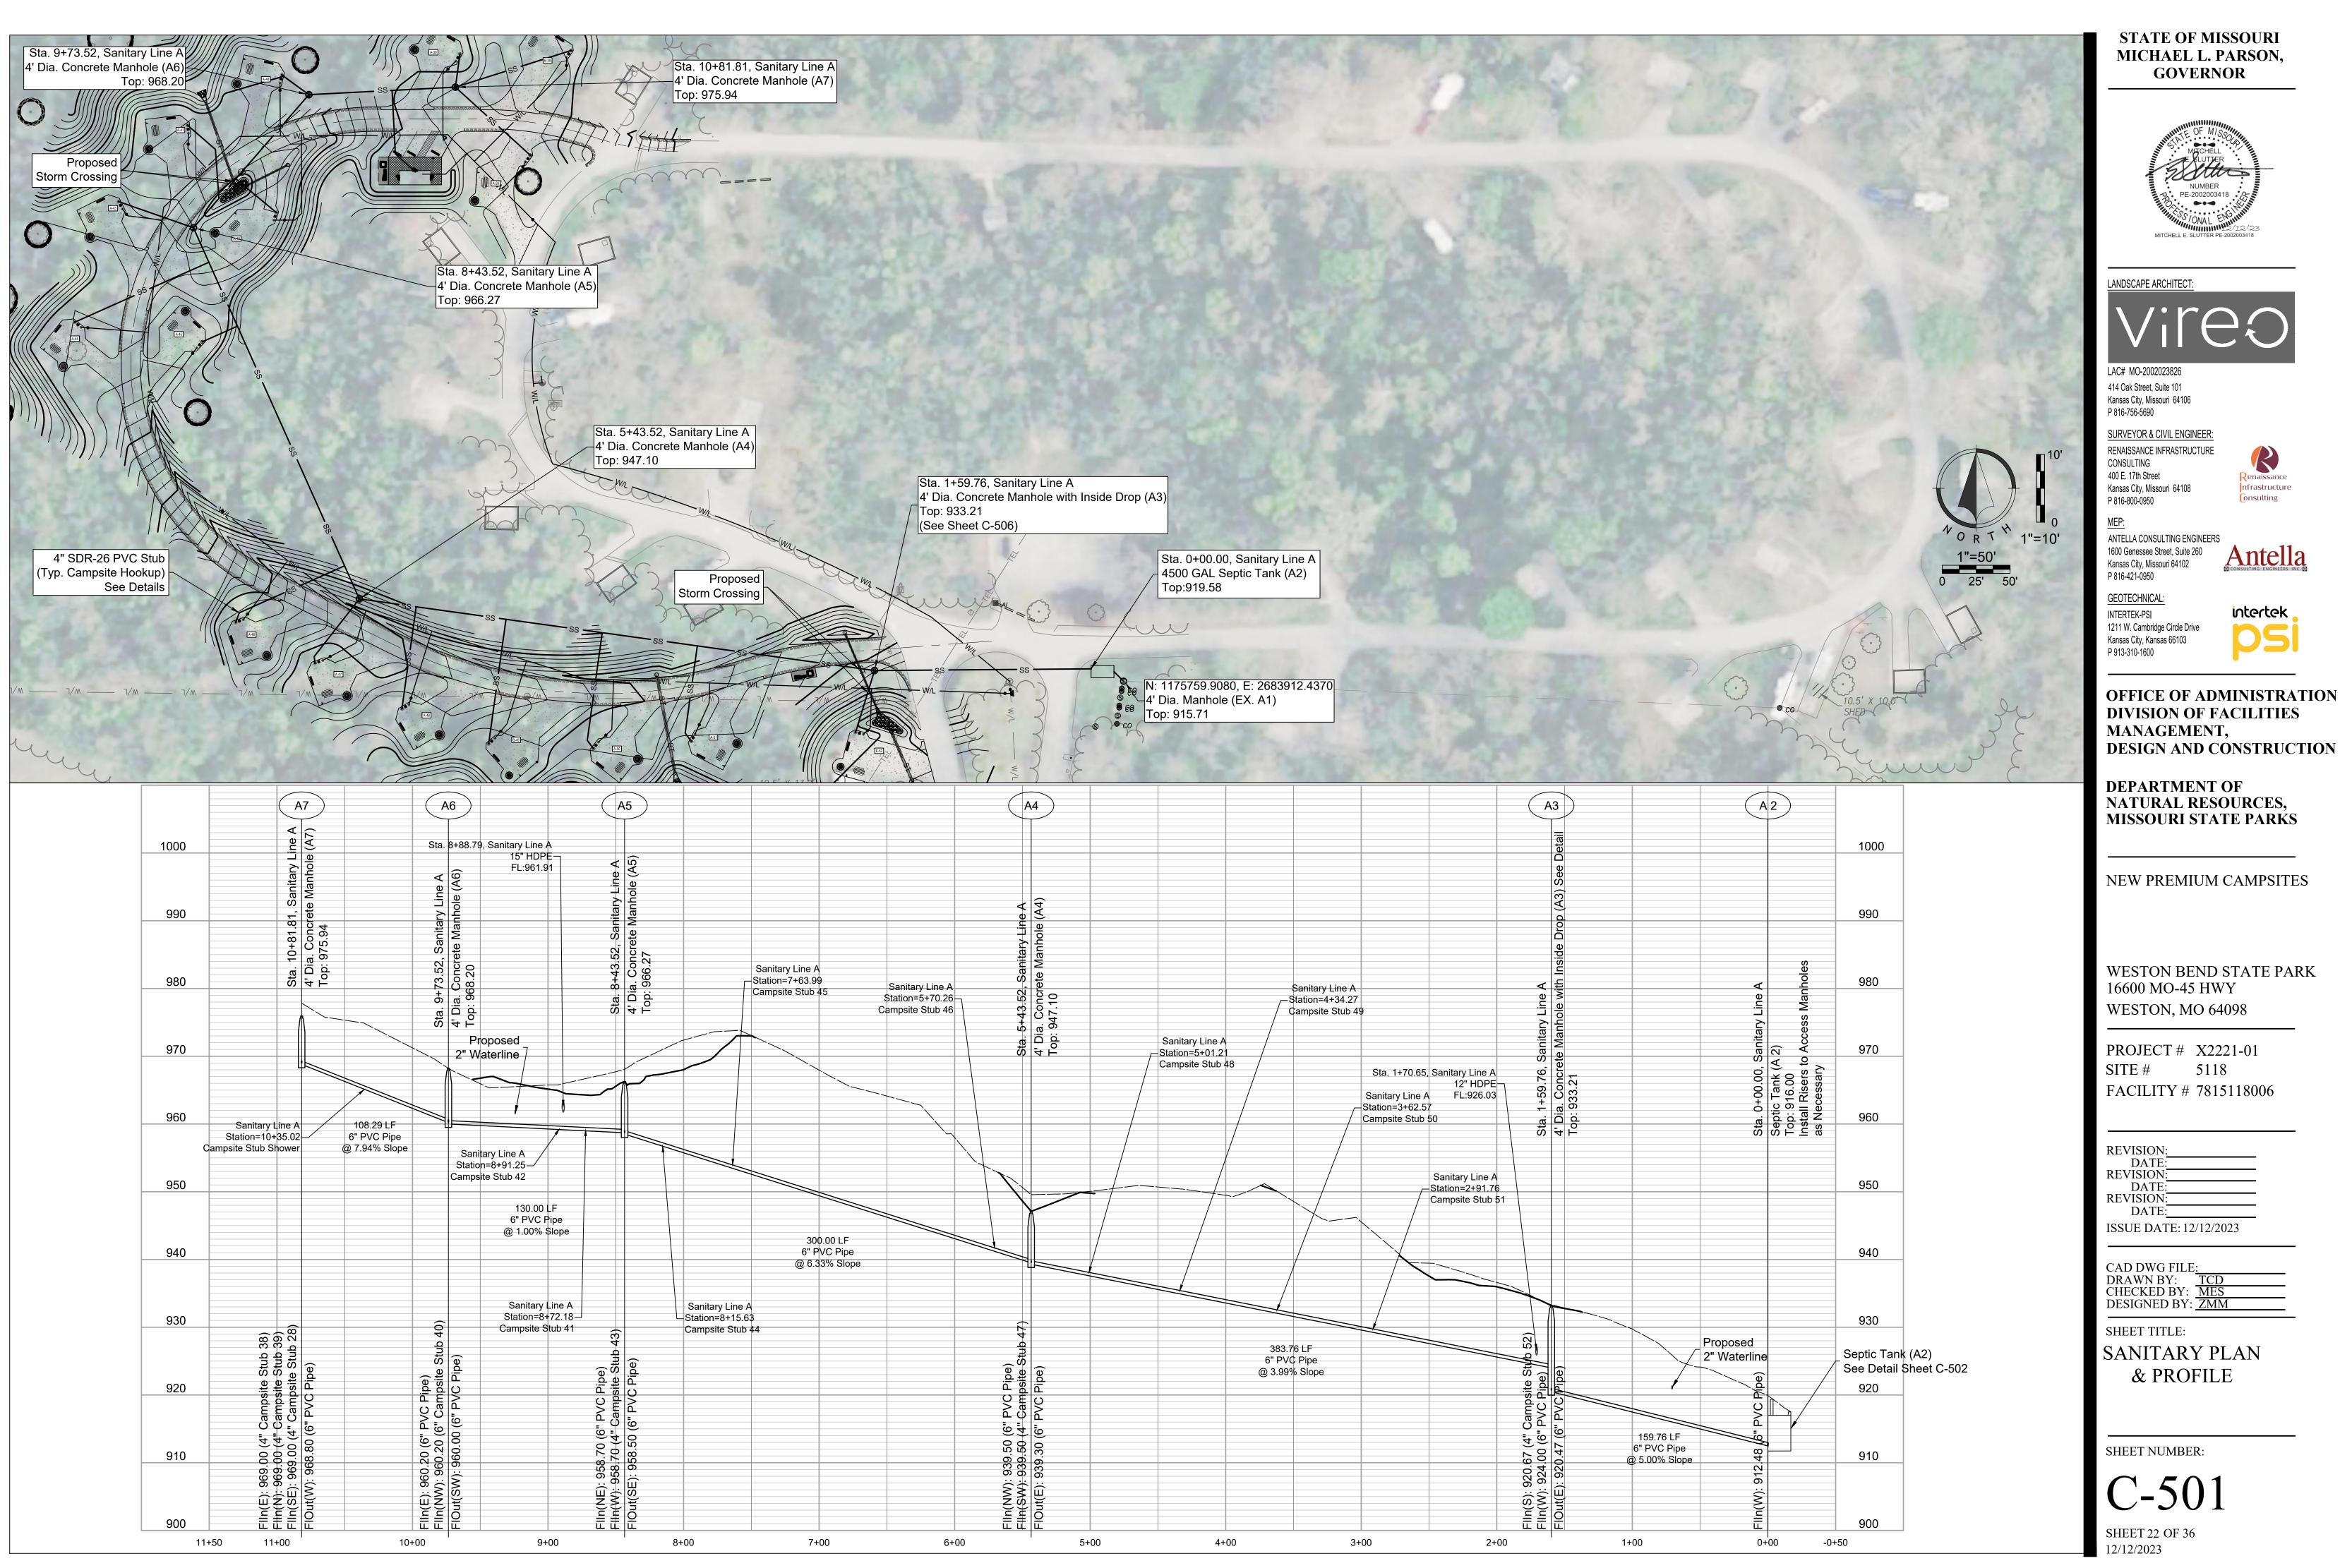

OFFICE OF ADMINISTRATION



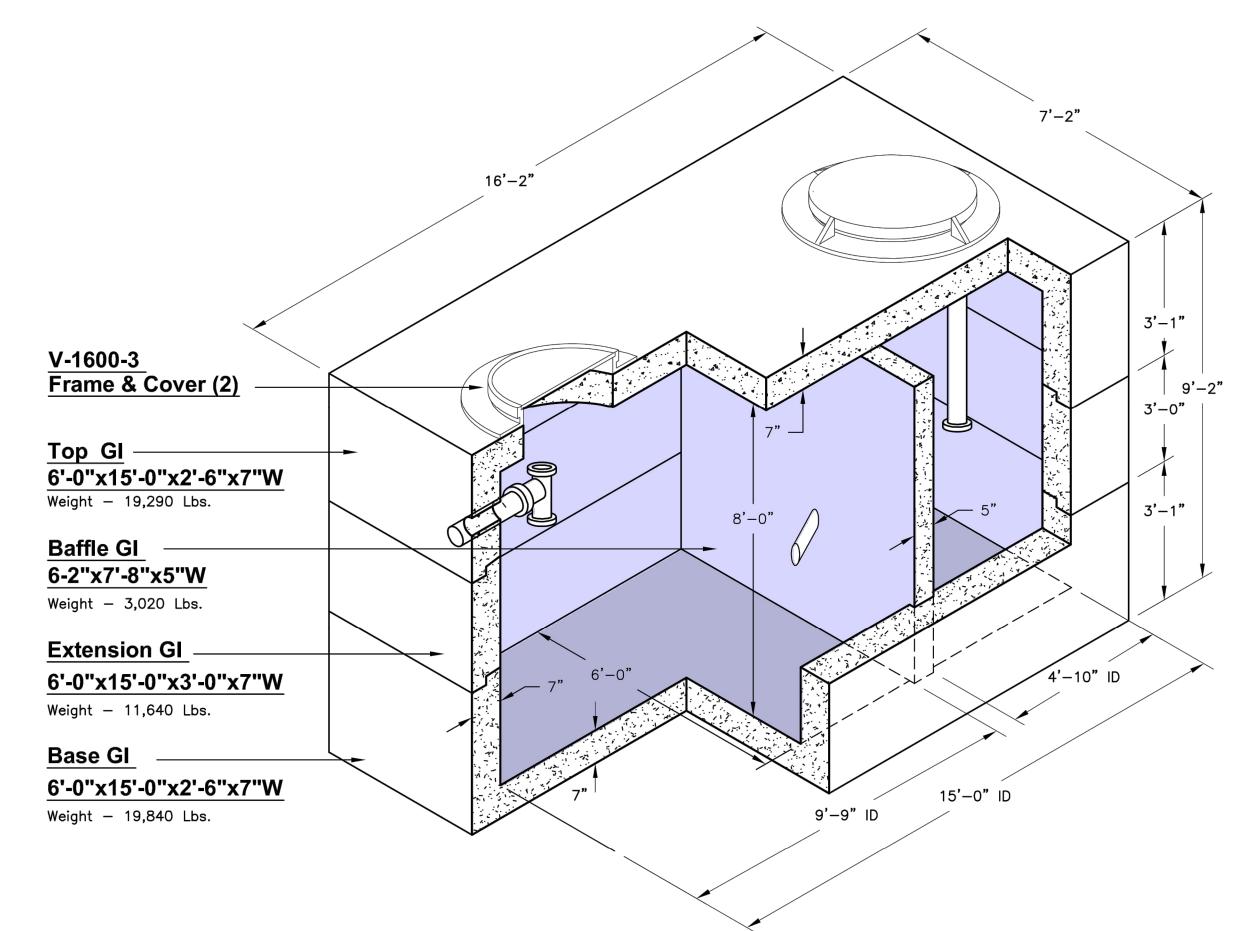

4.500 Gallon Septic Tank Detail

SPECIFICATIONS:

- Concrete: Design Strength of 5500 PSI at 28 Days.
 Steel Reinforcement: ASTM A-615 Grade 60.
 Loading: Designed for HS-20 Loading.
 C.I. Castings: ASTM A-48 Class 30/35.


- GENERAL NOTES:

 1. Interceptor is Structurally and Hydraulically Engineered Conforming to Uniform Plumbing Code.

 2.Liquid Capacity is 4,588 Gallons with Solids Retention Capacity of Approx. 17,200 Pounds.

 3.Recommended for Flow Rate up to 70 GAL Per Minute.

STATE OF MISSOURI MICHAEL L. PARSON, **GOVERNOR**

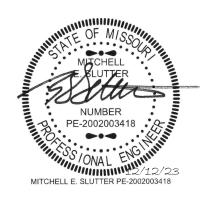

LANDSCAPE ARCHITECT:

414 Oak Street, Suite 101 Kansas City, Missouri 64106 P 816-756-5690

P 816-800-0950

P 913-310-1600

SURVEYOR & CIVIL ENGINEER: RENAISSANCE INFRASTRUCTURE CONSULTING 400 E. 17th Street

Kansas City, Missouri 64108 nfrastructure

ANTELLA CONSULTING ENGINEERS 1600 Genessee Street, Suite 260 Kansas City, Missouri 64102 P 816-421-0950

INTERTEK-PSI 1211 W. Cambridge Circle Drive Kansas City, Kansas 66103



OFFICE OF ADMINISTRATION DIVISION OF FACILITIES MANAGEMENT, **DESIGN AND CONSTRUCTION**

DEPARTMENT OF NATURAL RESOURCES, MISSOURI STATE PARKS

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PROJECT # X2221-01 5118 SITE# FACILITY # 7815118006

REVISION: REVISION ISSUE DATE: 12/12/2023

CAD DWG FILE:
DRAWN BY: TCD
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DESIGNED BY: ZMM

SHEET TITLE:
SANITARY SEPTIC TANK PLAN

SHEET NUMBER:

C-502

SHEET 23 OF 36 12/12/2023

SANITARY STUBS

							LINE	A					
Campsite Number	Downstream Manhole	Distance Down Stream (LF)	Connection Type	Length of Service Line (LF)	Type of Service Line	Slope of Service Line	FL @ Connection	Tee Offset (T)	Length of Riser (R)	Length of Lateral (L)	Proposed Grade @ EOS +/- (LLC)	Service Line EOS FL Elevation	Vertical Stub (LF)
52	A2	159.76	6"x4" TEE	47.57	4" PVC (SDR-26)	2.00%	920.67	0.50	0.00	47.57	925.37	922.12	3.25
51	A3	131.91	6"x4" TEE	72.48	4" PVC (SDR-26)	2.00%	929.26	0.50	3.00	70.90	937.00	933.73	3.27
50	A3	202.81	6"x4" TEE	87.75	4" PVC (SDR-26)	2.00%	932.09	0.50	2.00	86.70	939.10	936.03	3.07
49	A3	274.51	6"x4" TEE	92.78	4" PVC (SDR-26)	2.00%	934.95	0.50	0.00	92.78	940.80	937.31	3.49
48	A3	341.45	6"x4" TEE	76.02	4" PVC (SDR-26)	2.00%	937.62	0.50	0.00	76.02	942.80	939.64	3.16
47	A3	383.76	6"x4" TEE	59.00	4" PVC (SDR-26)	2.00%	939.51	0.50	0.00	59.00	944.60	941.19	3.41
46	A4	26.74	6"x4" TEE	92.61	4" PVC (SDR-26)	2.00%	941.19	0.50	2.50	91.30	948.80	945.65	3.15
45	A4	220.47	6"x4" TEE	28.39	4" PVC (SDR-26)	2.00%	953.46	0.50	13.00	21.56	968.40	965.45	2.95
44	A4	266.8	6"x4" TEE	110.58	4" PVC (SDR-26)	2.00%	956.39	0.50	8.00	106.38	968.90	965.82	3.08
43	A4	300	6"x4" TEE	58.47	4" PVC (SDR-26)	2.00%	958.69	0.50	5.75	55.45	968.25	965.19	3.06
42	A5	47.73	6"x4" TEE	38.82	4" PVC (SDR-26)	2.00%	959.18	0.50	0.00	38.82	966.35	960.45	5.90
41	A5	28.66	6"x4" TEE	63.52	4" PVC (SDR-26)	2.00%	958.99	0.50	2.50	63.52	966.10	962.88	3.22
40	A5	130	6"x4" TEE	24.67	4" PVC (SDR-26)	2.00%	960.20	0.50	1.00	24.14	965.10	962.03	3.07
SHWR	A6	61.5	6"x4" TEE	66.85	4" PVC (SDR-26)	2.00%	965.08	0.50	5.00	64.22	975.75	971.12	4.63
39	A7	0	6"x4" TEE	24.66	4" PVC (SDR-26)	2.00%	969.00	0.50	2.00	23.61	974.79	971.67	3.12
38	A7	0	6"x4" TEE	89.45	4" PVC (SDR-26)	2.00%	969.00	0.50	1.50	88.66	975.80	972.55	3.25
28	A7	0	6"x4" TEE	74.67	4" PVC (SDR-26)	2.00%	969.00	0.50	3.00	73.09	976.70	973.51	3.19

SANITARY CAPACITY CALCS

Downstream Manhole	Users	Sewer Demand (GPD)	Contributing Flow (GPD)	Total Average Flow (GPD)	Total Average Flow (cfs)	Peak Factor	Total Peak Flow (cfs)	Pipe Size (inches)	Slope %	Full Flow Velocity (fps)	67% Capacity (cfs)	Q	А	n	R	Р
Shower House	40	15	600	600	0.0009	3	0.0028	6	7.94%	8.1	1.1	1.58	0.20	0.013	0.13	1.57
A6	3	120	360	960	0.0015	3	0.0045	6	7.94%	8.1	1.1	1.58	0.20	0.013	0.13	1.57
A5	3	120	360	1320	0.0020	3	0.0061	6	1.00%	2.9	0.4	0.56	0.20	0.013	0.13	1.57
A4	4	120	480	1800	0.0028	4	0.0111	6	6.33%	7.2	0.9	1.41	0.20	0.013	0.13	1.57
А3	5	120	600	2400	0.0037	5	0.0186	6	3.99%	5.7	0.8	1.12	0.20	0.013	0.13	1.57
A2	1	120	120	2520	0.0039	6	0.0234	6	5.00%	6.4	0.8	1.25	0.20	0.013	0.13	1.57

Note: Minimum Cleansing Velocity = 2 fps per MDNR Minimum Design Standards for Gravity Sewers

SEPTIC TANK AND LATERAL FIELD CALCS

	Peaking Factor	Daily Sewage Flow (GPD)	Calculated Required Tank Size (GPD)	Tank Size Used (Gallons)
Septic Tank Size:	1.5	2520	4280	4500

STATE OF MISSOURI MICHAEL L. PARSON, GOVERNOR



LANDSCAPE ARCHITECT:

LAC# MO-2002023826 414 Oak Street, Suite 101 Kansas City, Missouri 64106 P 816-756-5690

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RENAISSANCE INFRASTRUCTURE
CONSULTING
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Kansas City, Missouri 64108

P 816-800-0950

P 913-310-1600

Renaissance Infrastructure Consulting

MEP:

ANTELLA CONSULTING ENGINEERS
1600 Genessee Street, Suite 260
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GEOTECHNICAL:
INTERTEK-PSI
1211 W. Cambridge Circle Drive
Kansas City, Kansas 66103



OFFICE OF ADMINISTRATION DIVISION OF FACILITIES MANAGEMENT, DESIGN AND CONSTRUCTION

DEPARTMENT OF NATURAL RESOURCES, MISSOURI STATE PARKS

NEW PREMIUM CAMPSITES

WESTON BEND STATE PARK 16600 MO-45 HWY WESTON, MO 64098

PROJECT # X2221-01 SITE # 5118 FACILITY # 7815118006

REVISION:
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DESIGNED BY: ZMM


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SANITARY STUI

SANITARY STUBS & CALCS

SHEET NUMBER:

C-503


SHEET 24 OF 36 12/12/2023

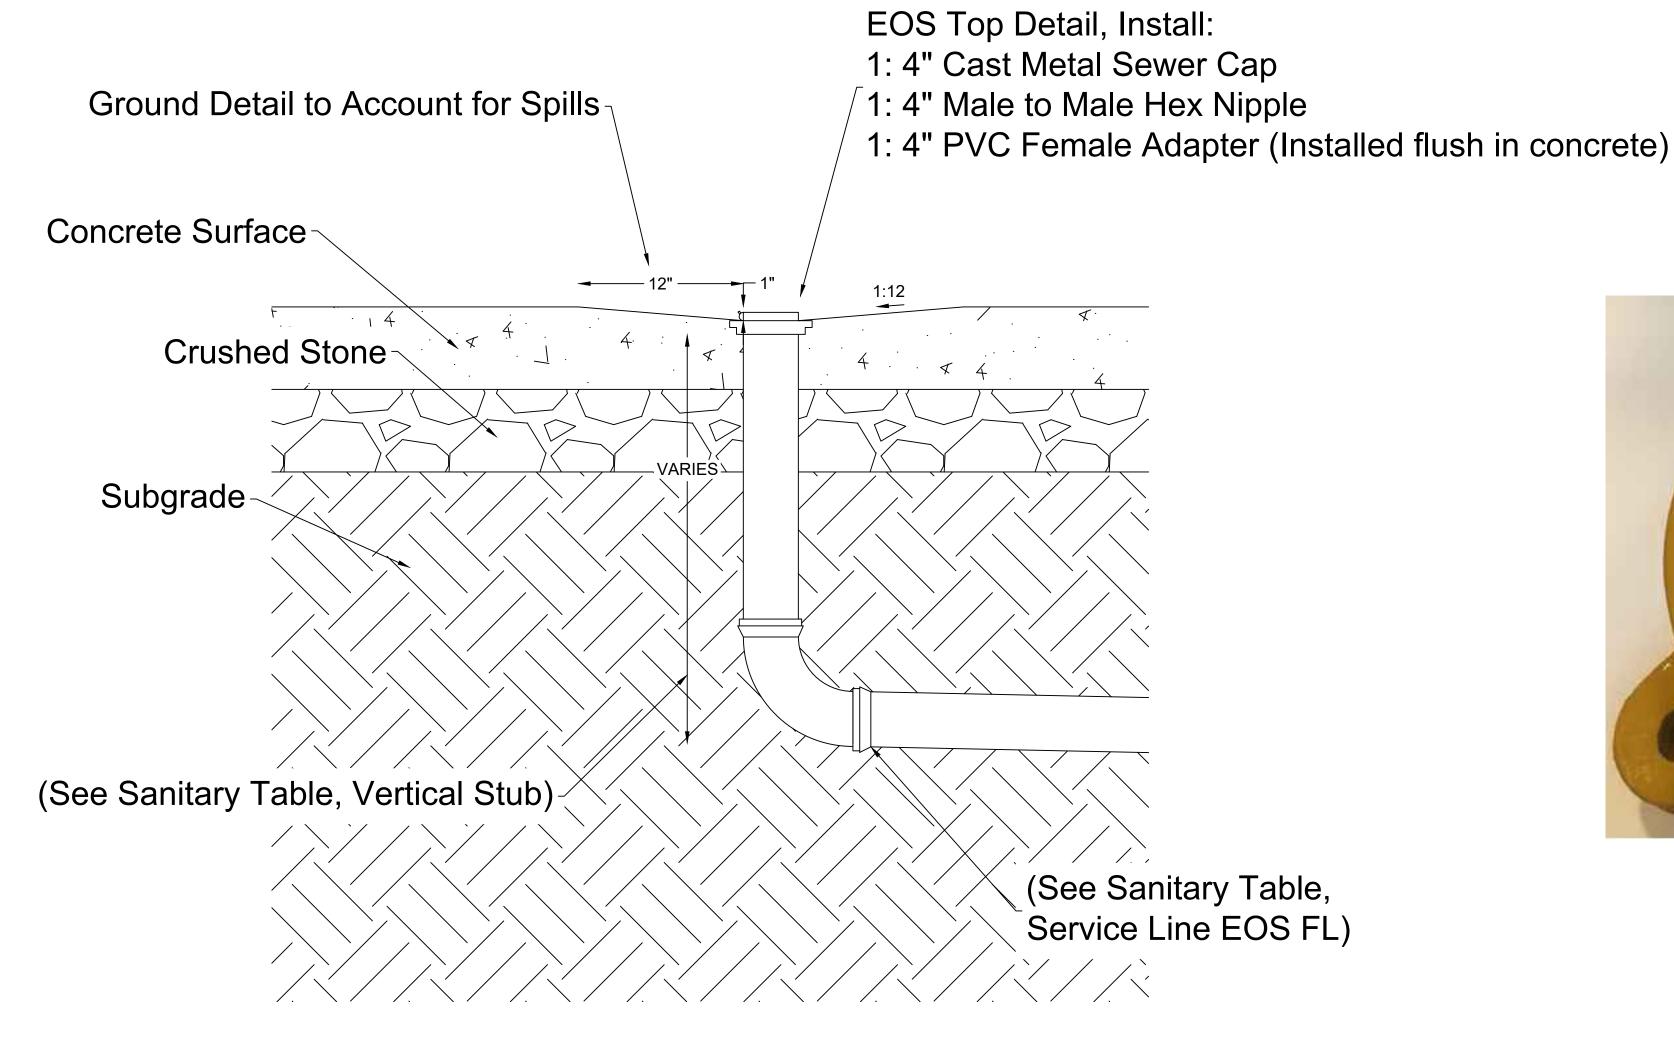


The Tower Company, Inc. 4" RV Site Sewer Cap, Cast Metal (Or approved equal)






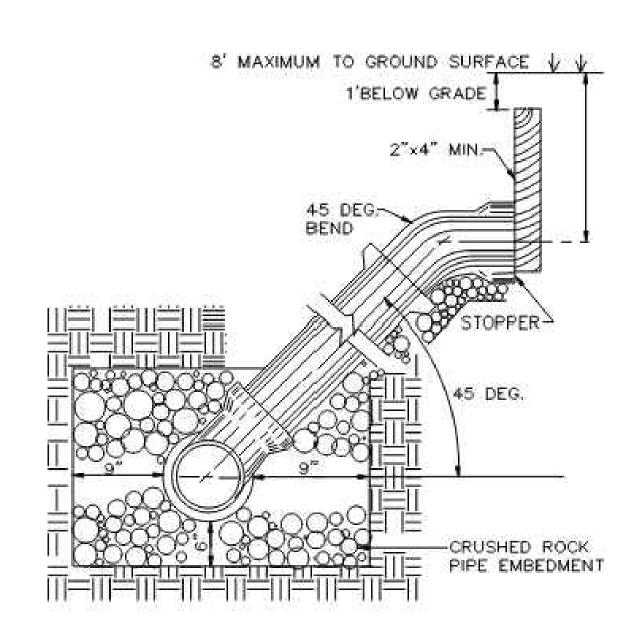

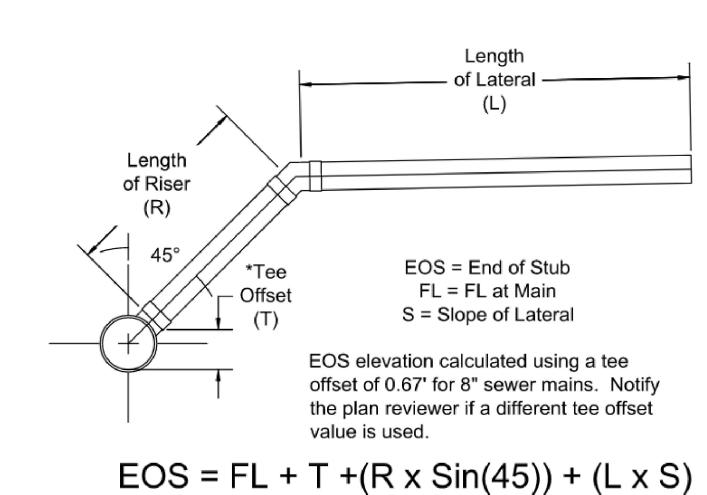

STANDARD DEEP TRENCH SERVICE RISER NOT TO SCALE

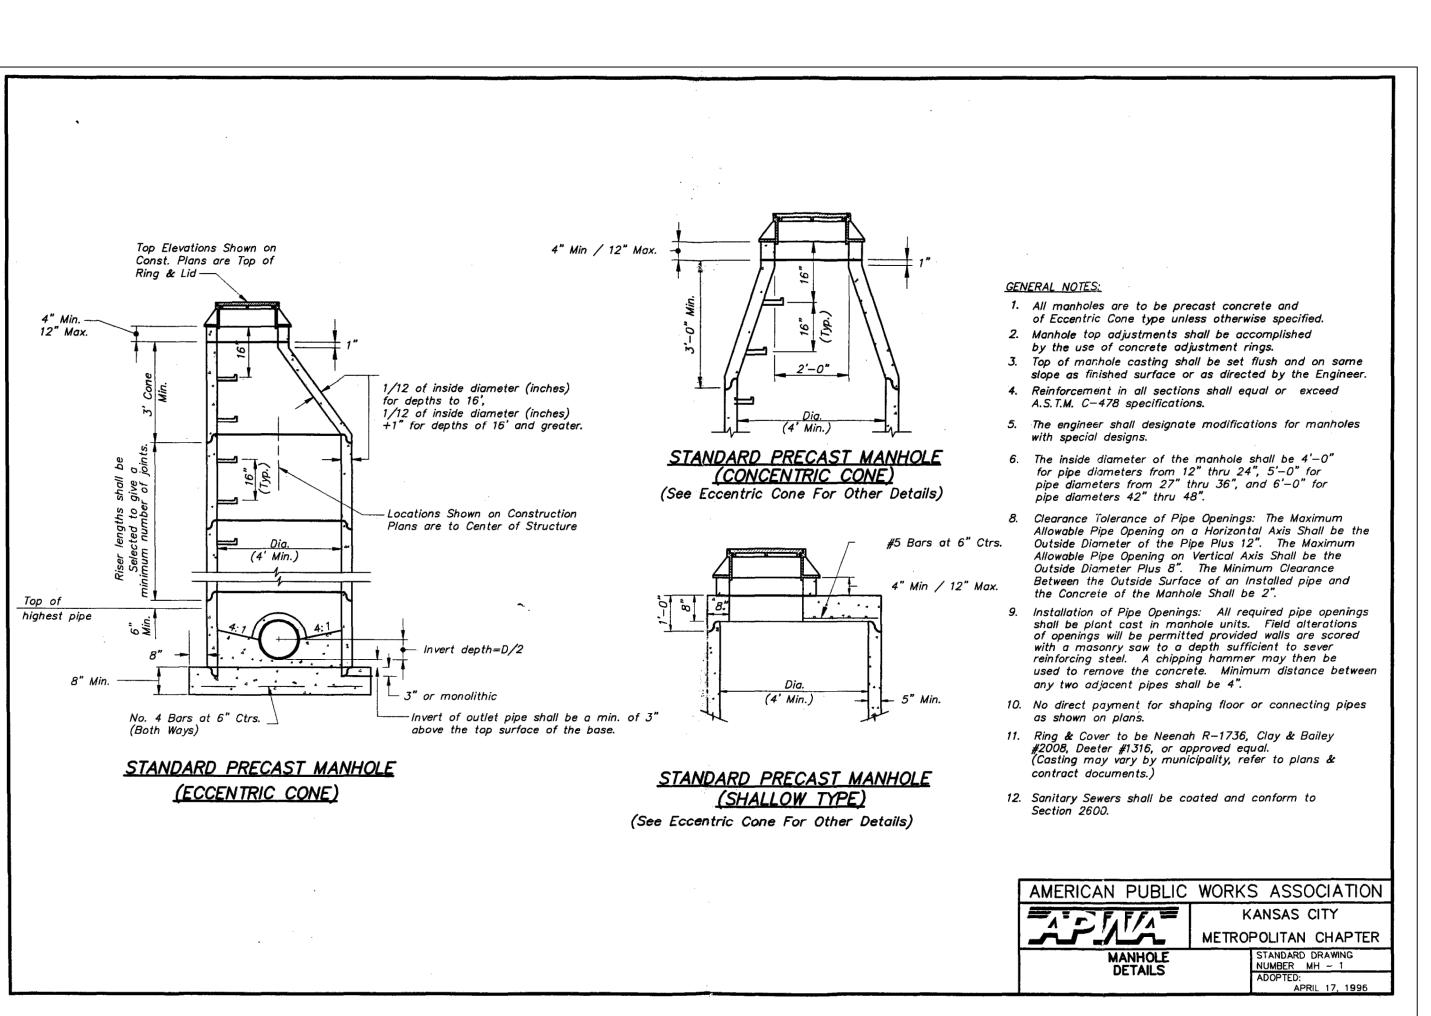

STATE OF MISSOURI MICHAEL L. PARSON, **GOVERNOR**



LANDSCAPE ARCHITECT:

414 Oak Street, Suite 101 Kansas City, Missouri 64106

SURVEYOR & CIVIL ENGINEER:

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DIVISION OF FACILITIES MANAGEMENT, **DESIGN AND CONSTRUCTION**

DEPARTMENT OF NATURAL RESOURCES, MISSOURI STATE PARKS

NEW PREMIUM CAMPSITES

WESTON BEND STATE PARK 16600 MO-45 HWY **WESTON, MO 64098**

PROJECT # X2221-01 FACILITY # 7815118006

REVISION: REVISION: DATE REVISION

ISSUE DATE: 12/12/2023

DRAWN BY: CHECKED BY: MES DESIGNED BY: ZMM


SHEET TITLE:

SANITARY DETAILS I

SHEET NUMBER:

C-504

12/12/2023

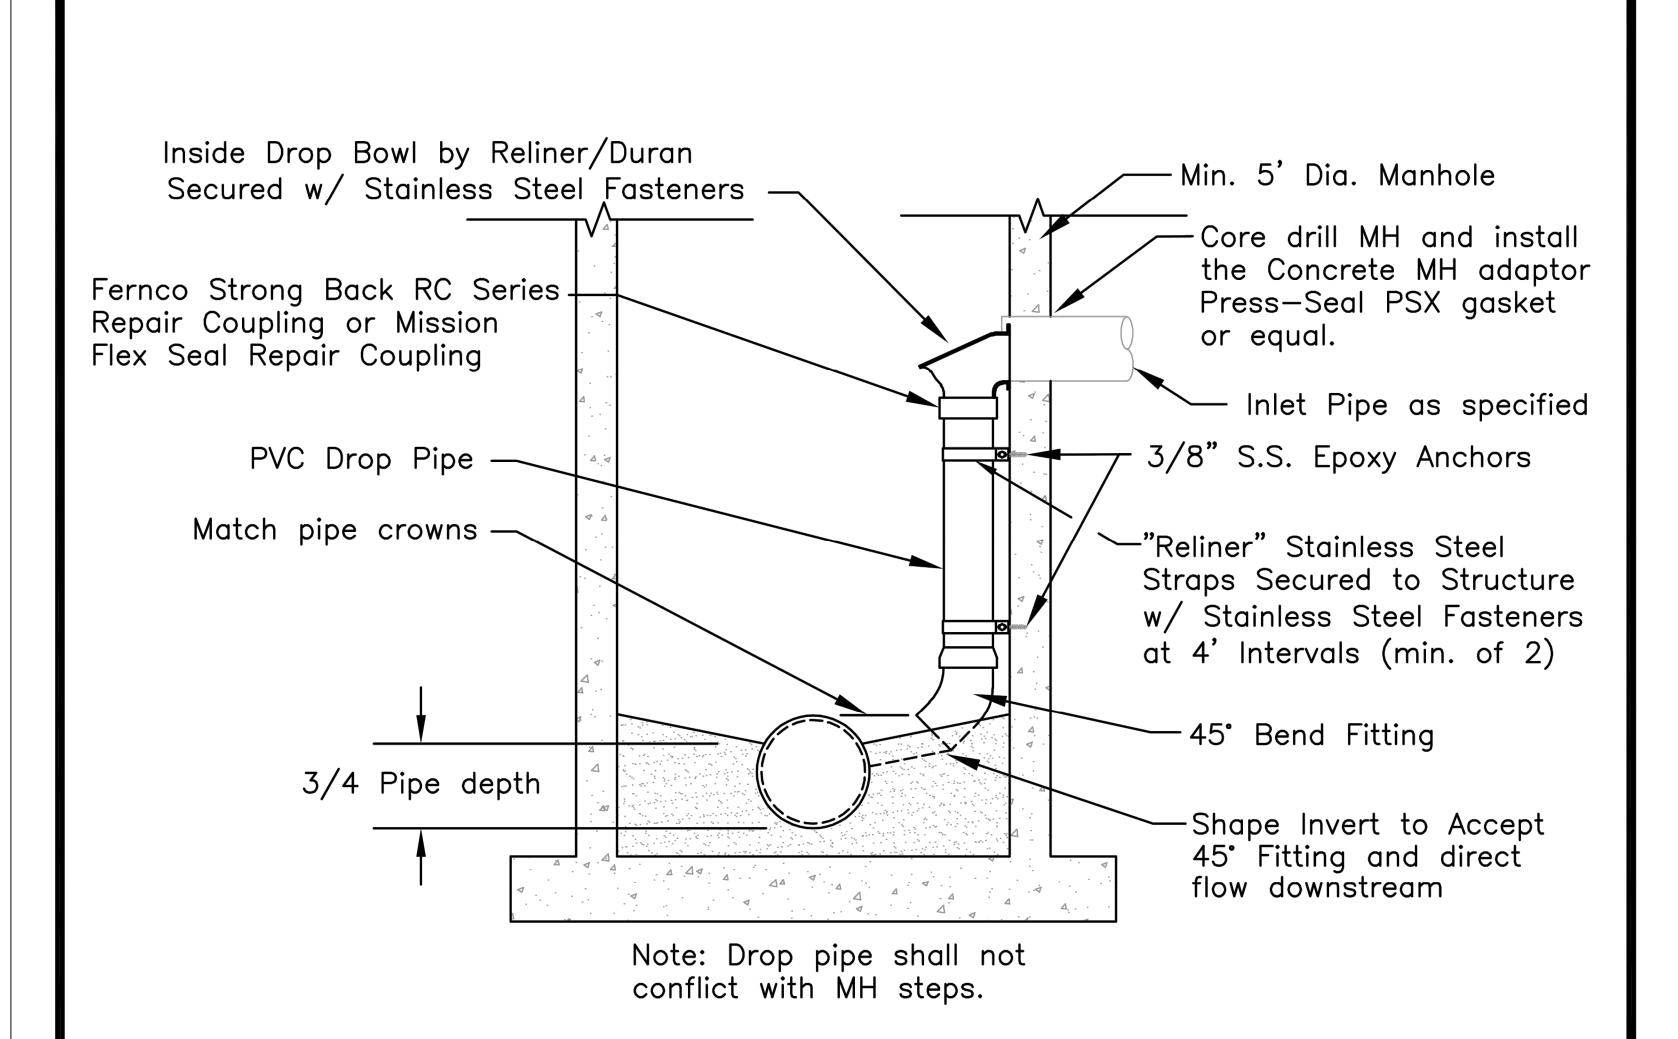

* Schedule 40 PVC with solvent sealed joints. Solvent shall be the type recommended by manufacture.

INSIDE DROP	SELECTION BO	WL TABLE			
Inlet Pipe Dia.	Reliner Size	Drop Pipe Dia.			
8-INCH	B-8	8-INCH			
10-INCH	B-10	10-INCH			
12-INCH	24" BOWL	12-INCH			
15 to 18-INCH	30" BOWL	18-INCH			

INSIDE DROP BOWL DETAIL

STATE OF MISSOURI MICHAEL L. PARSON, GOVERNOR



LANDSCAPE ARCHITECT:
\ / ! ! 6 0 0

LAC# MO-2002023826 414 Oak Street, Suite 101 Kansas City, Missouri 64106 P 816-756-5690

SURVEYOR & CIVIL ENGINEER:
RENAISSANCE INFRASTRUCTURE
CONSULTING
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MEP:
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DEPARTMENT OF NATURAL RESOURCES, MISSOURI STATE PARKS

NEW PREMIUM CAMPSITES

WESTON BEND STATE PARK 16600 MO-45 HWY WESTON, MO 64098

PROJECT # X2221-01 SITE # 5118 FACILITY # 7815118006

REVISION:
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ISSUE DATE: 12/12/2023

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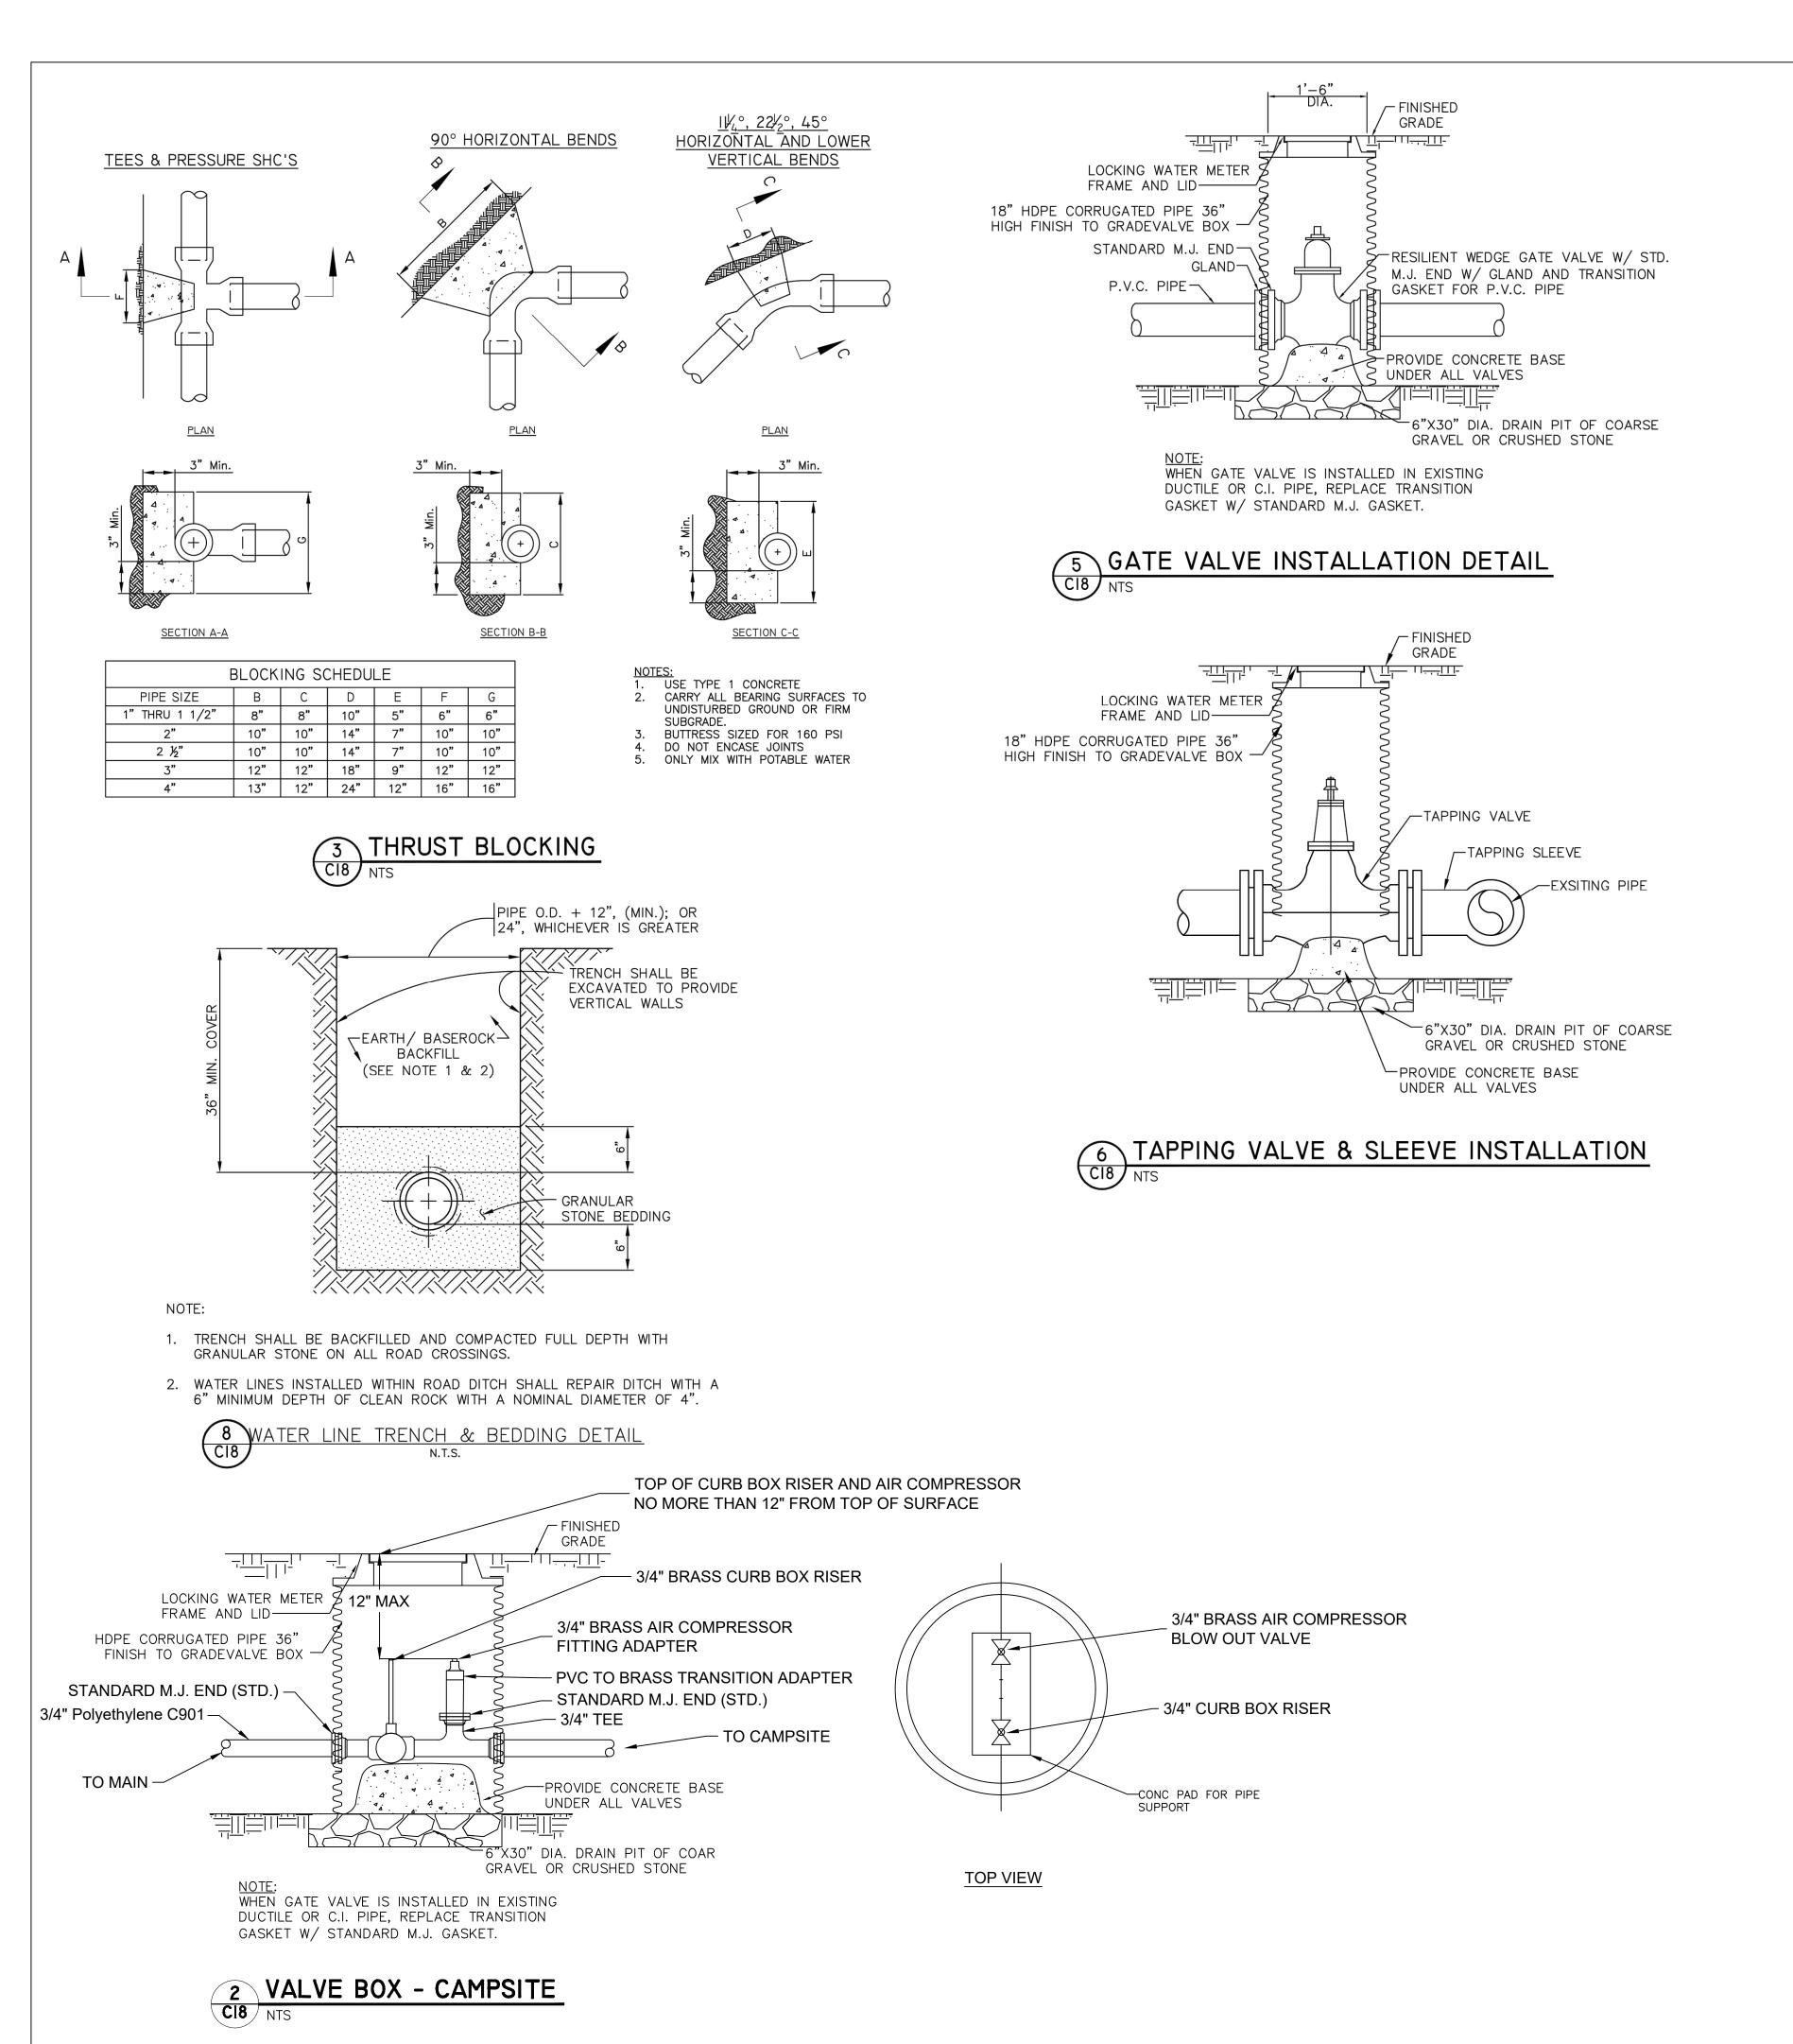
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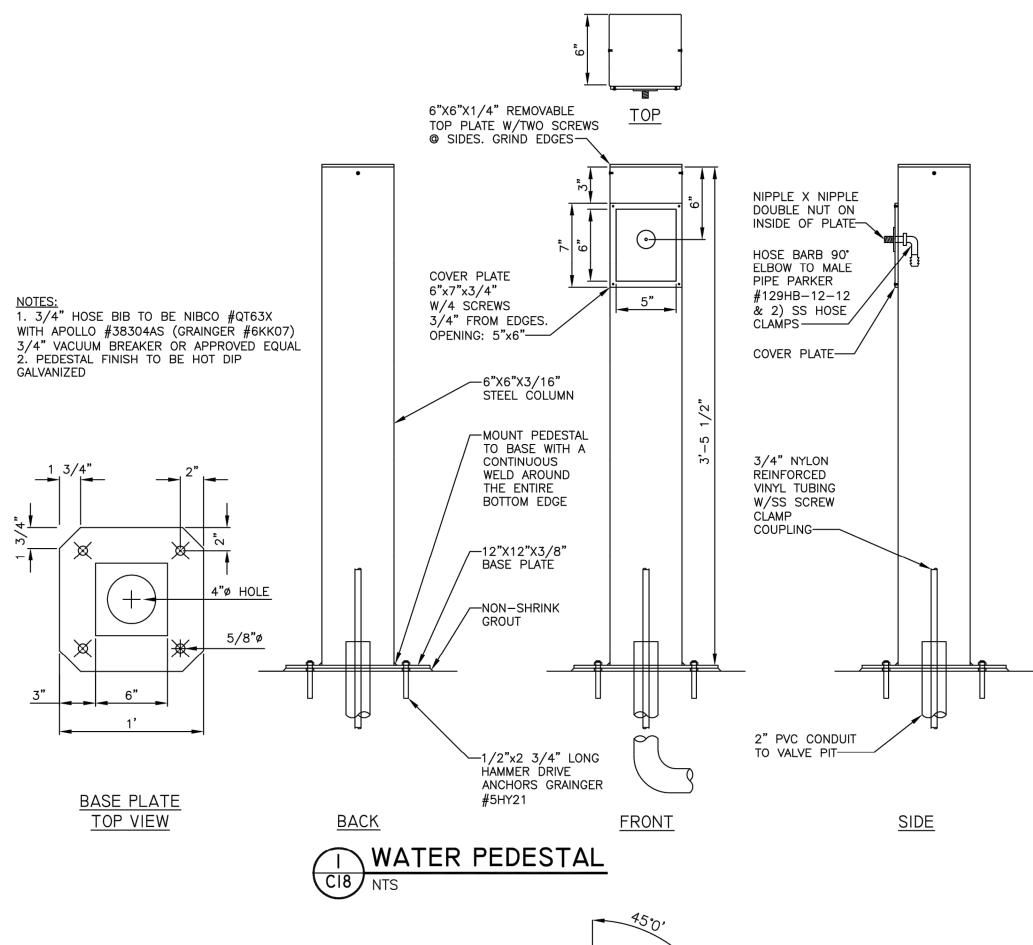
SANITARY DETAILS II

SHEET NUMBER:

C-505

SHEET 26 OF 3 12/12/2023







ANDSCAPE ARCHITECT:

LAC# MO-2002023826 414 Oak Street, Suite 101 Kansas City, Missouri 64106

P 816-756-5690 SURVEYOR & CIVIL ENGINEER: RENAISSANCE INFRASTRUCTURE

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P 816-800-0950 ANTELLA CONSULTING ENGINEERS

1600 Genessee Street, Suite 260 Kansas City, Missouri 64102 P 816-421-0950

INTERTEK-PSI 1211 W. Cambridge Circle Drive

P 913-310-1600

TYPE "K" COPPER TUBING UNLESS

OTHERWISE NOTED. MIN. 24" BELOW FINISHED GRADE

-CORPORATION STOP, MUELLER

TWIN SEAL TAPPING SERVICE

-PROPOSED MAIN WATER LINE

SADDLE, CLOW F-6350 OR

OR APPROVED EQUAL.

APPROVED EQUAL.

SERVICE TAP DETAIL

OSED MAIN WATE.

OSED MAIN WATE.

intertek Kansas City, Kansas 66103

nfrastructure

OFFICE OF ADMINISTRATION DIVISION OF FACILITIES MANAGEMENT,

DEPARTMENT OF NATURAL RESOURCES, MISSOURI STATE PARKS

DESIGN AND CONSTRUCTION

NEW PREMIUM CAMPSITES

WESTON BEND STATE PARK 16600 MO-45 HWY **WESTON, MO 64098**

PROJECT # X2221-01 5118

FACILITY # 7815118006

REVISION: REVISION: DATE REVISION:

ISSUE DATE: 12/12/2023


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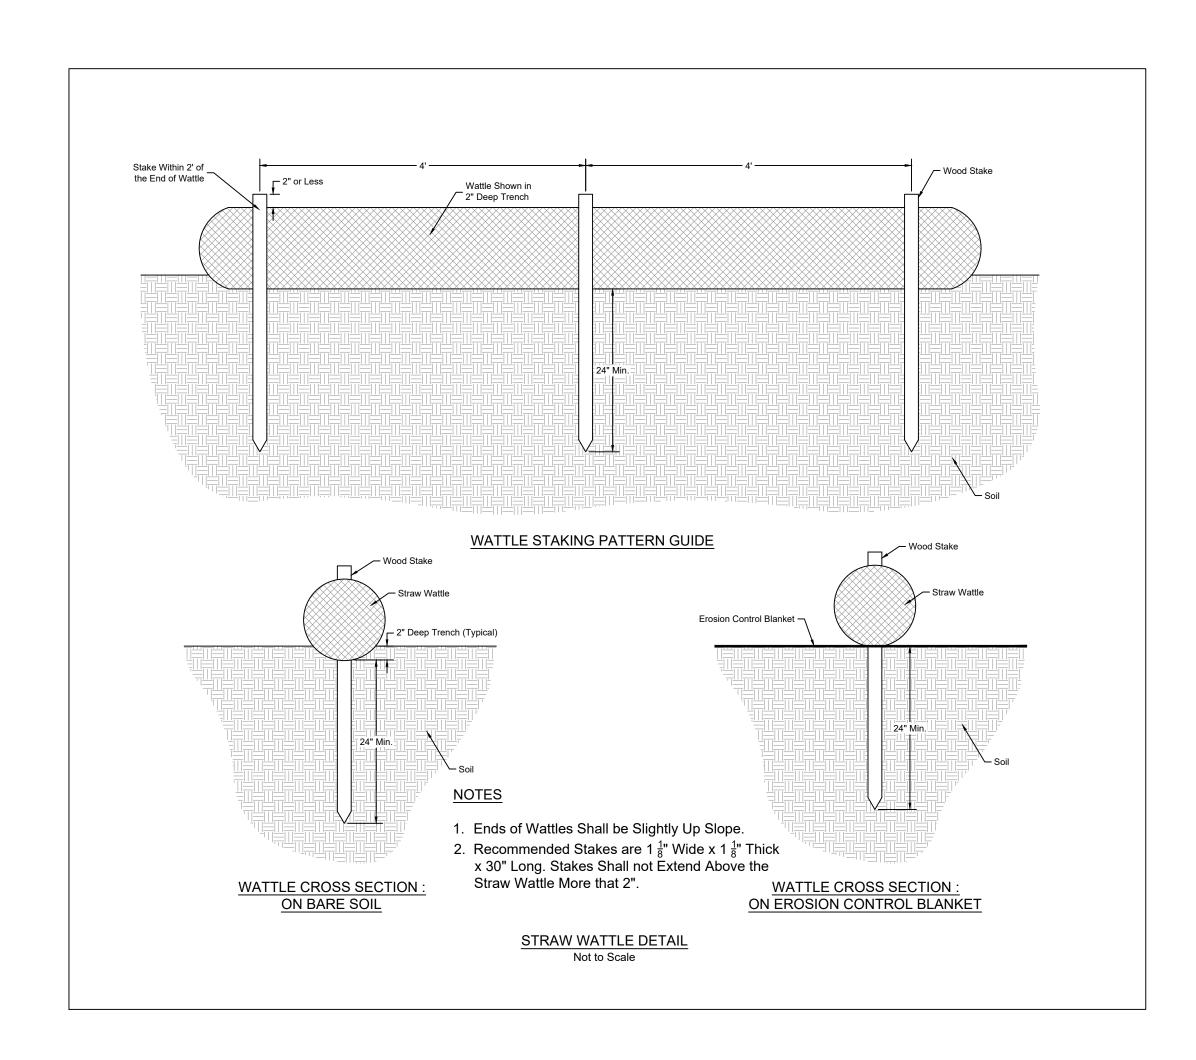
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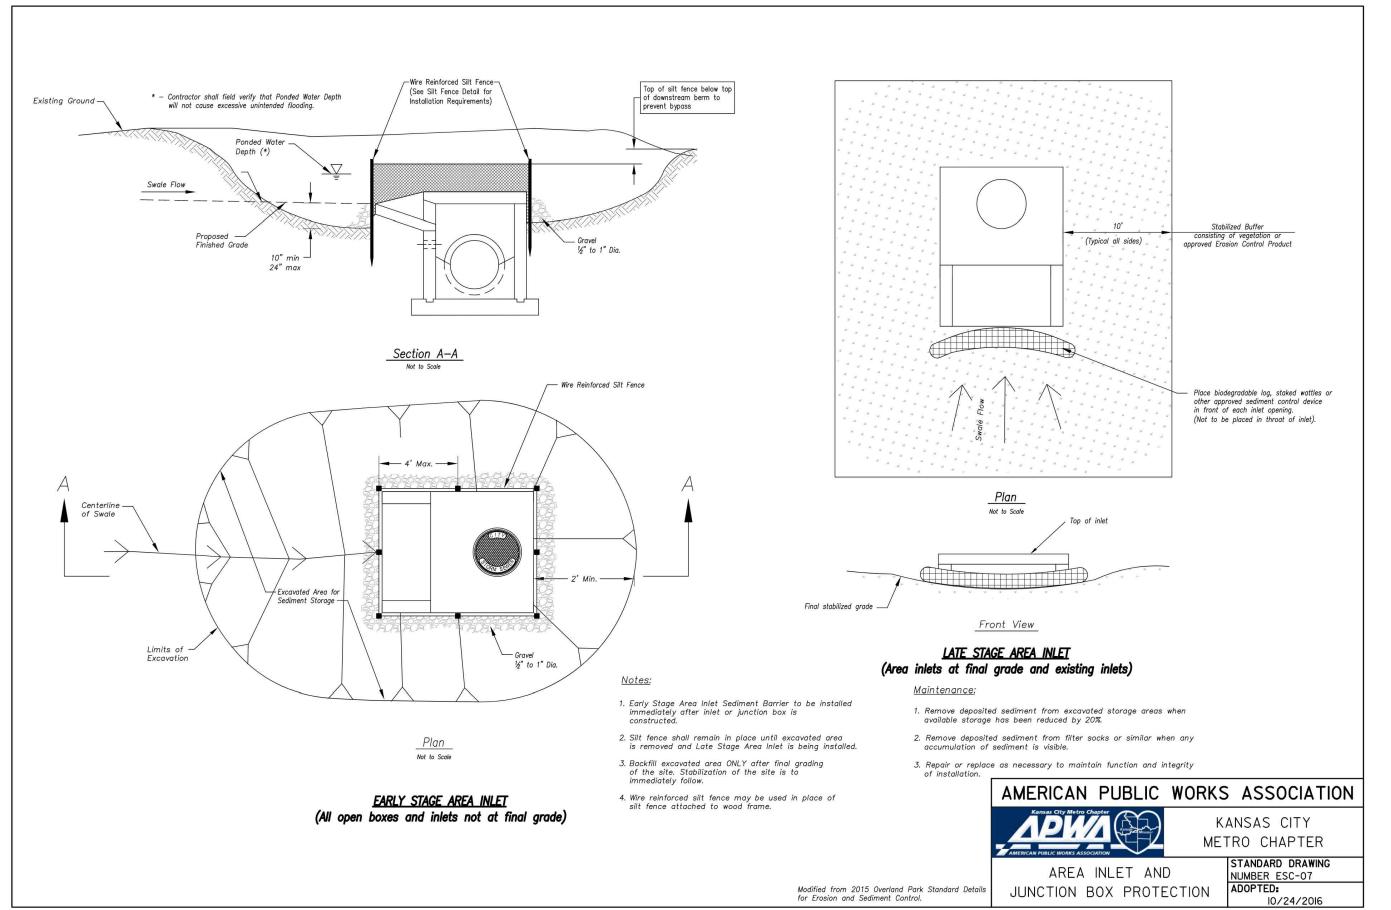
WATER DETAILS


SHEET NUMBER:

SHEET 27 OF 36 12/12/2023





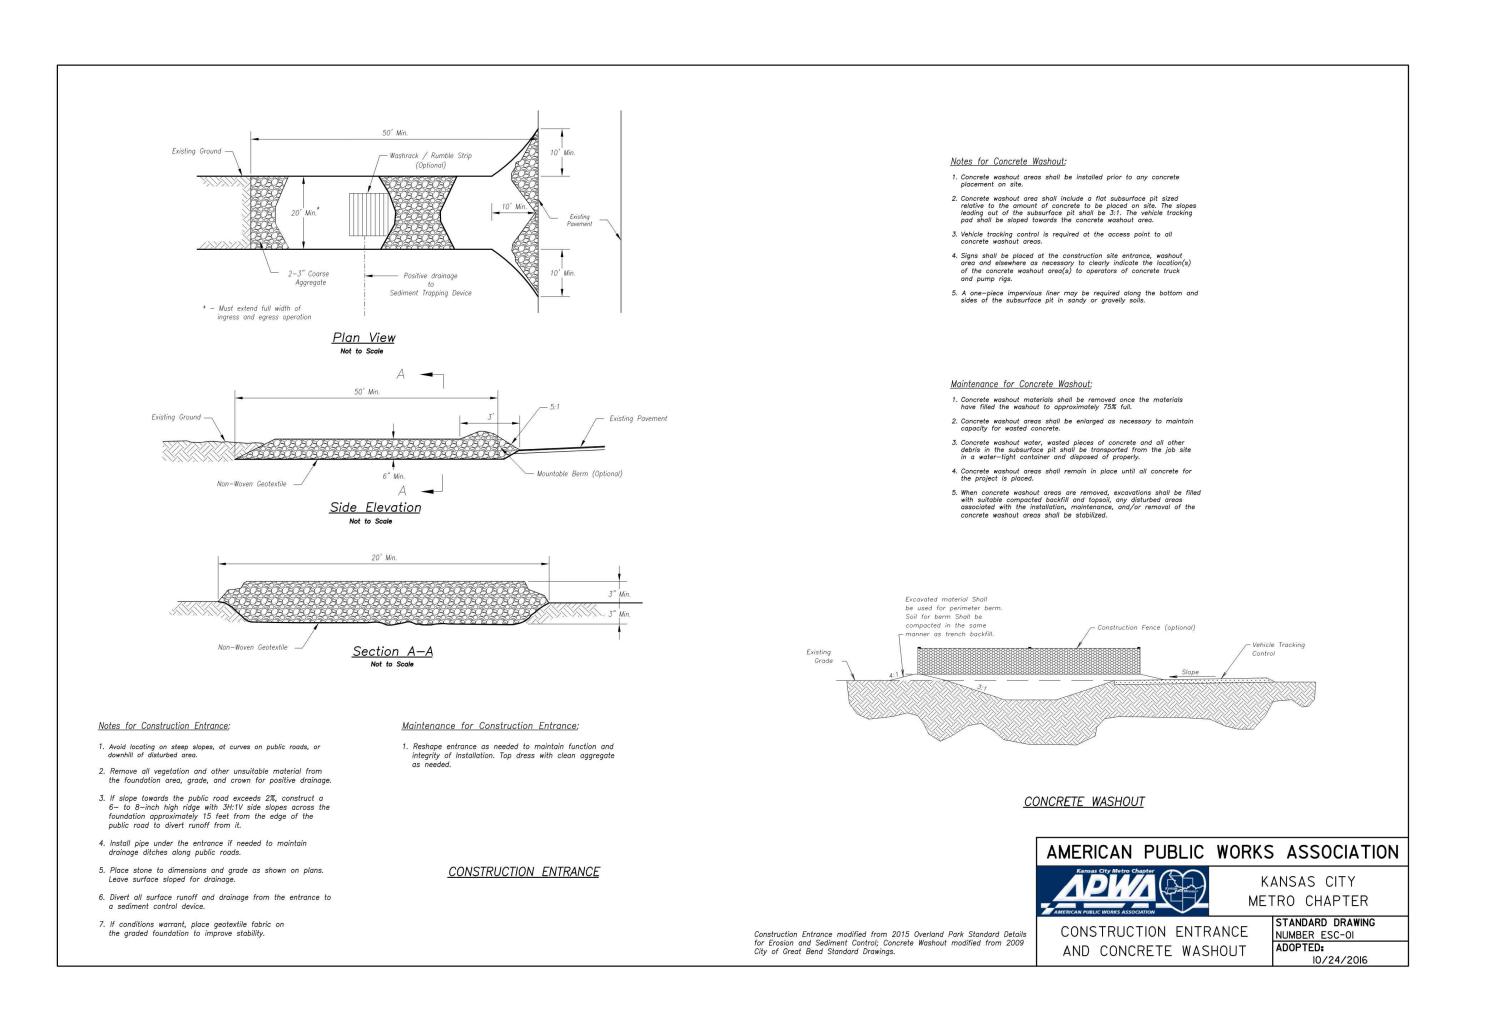

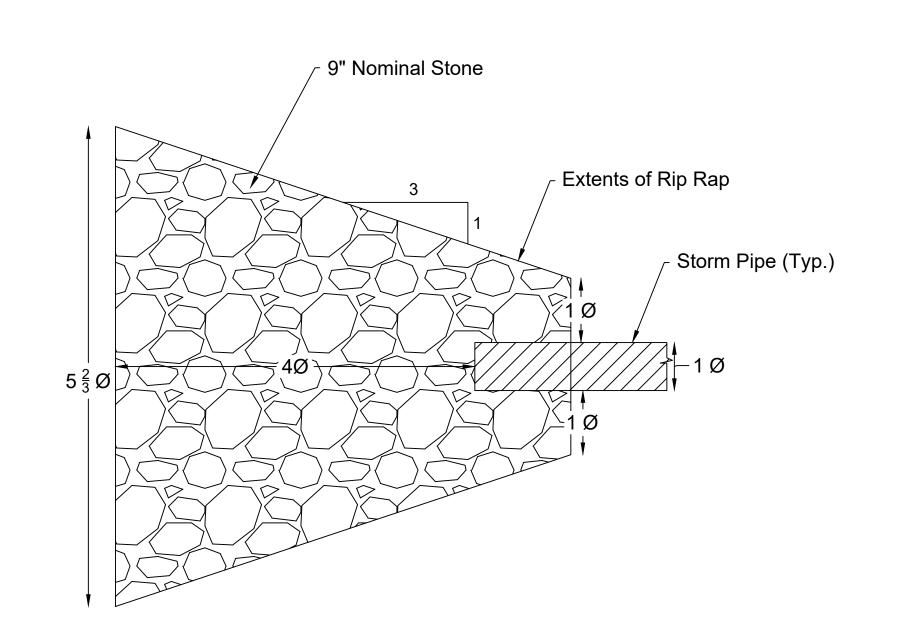

RIP RAP DETAIL (FLARED END SECTION) SCALE: NOT TO SCALE





LAC# MO-2002023826 414 Oak Street, Suite 101 Kansas City, Missouri 64106

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intertek

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OFFICE OF ADMINISTRATION DIVISION OF FACILITIES MANAGEMENT, **DESIGN AND CONSTRUCTION**

DEPARTMENT OF NATURAL RESOURCES, MISSOURI STATE PARKS

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PROJECT # X2221-01 5118 FACILITY # 7815118006

REVISION: REVISION: **REVISION**: DATE: ISSUE DATE: 12/12/2023


CAD DWG FILE:
DRAWN BY: TCD
CHECKED BY: MES DESIGNED BY: ZMM

SHEET TITLE:

EROSION CONTROL DETAILS

SHEET NUMBER:

SHEET 28 OF 36 12/12/2023

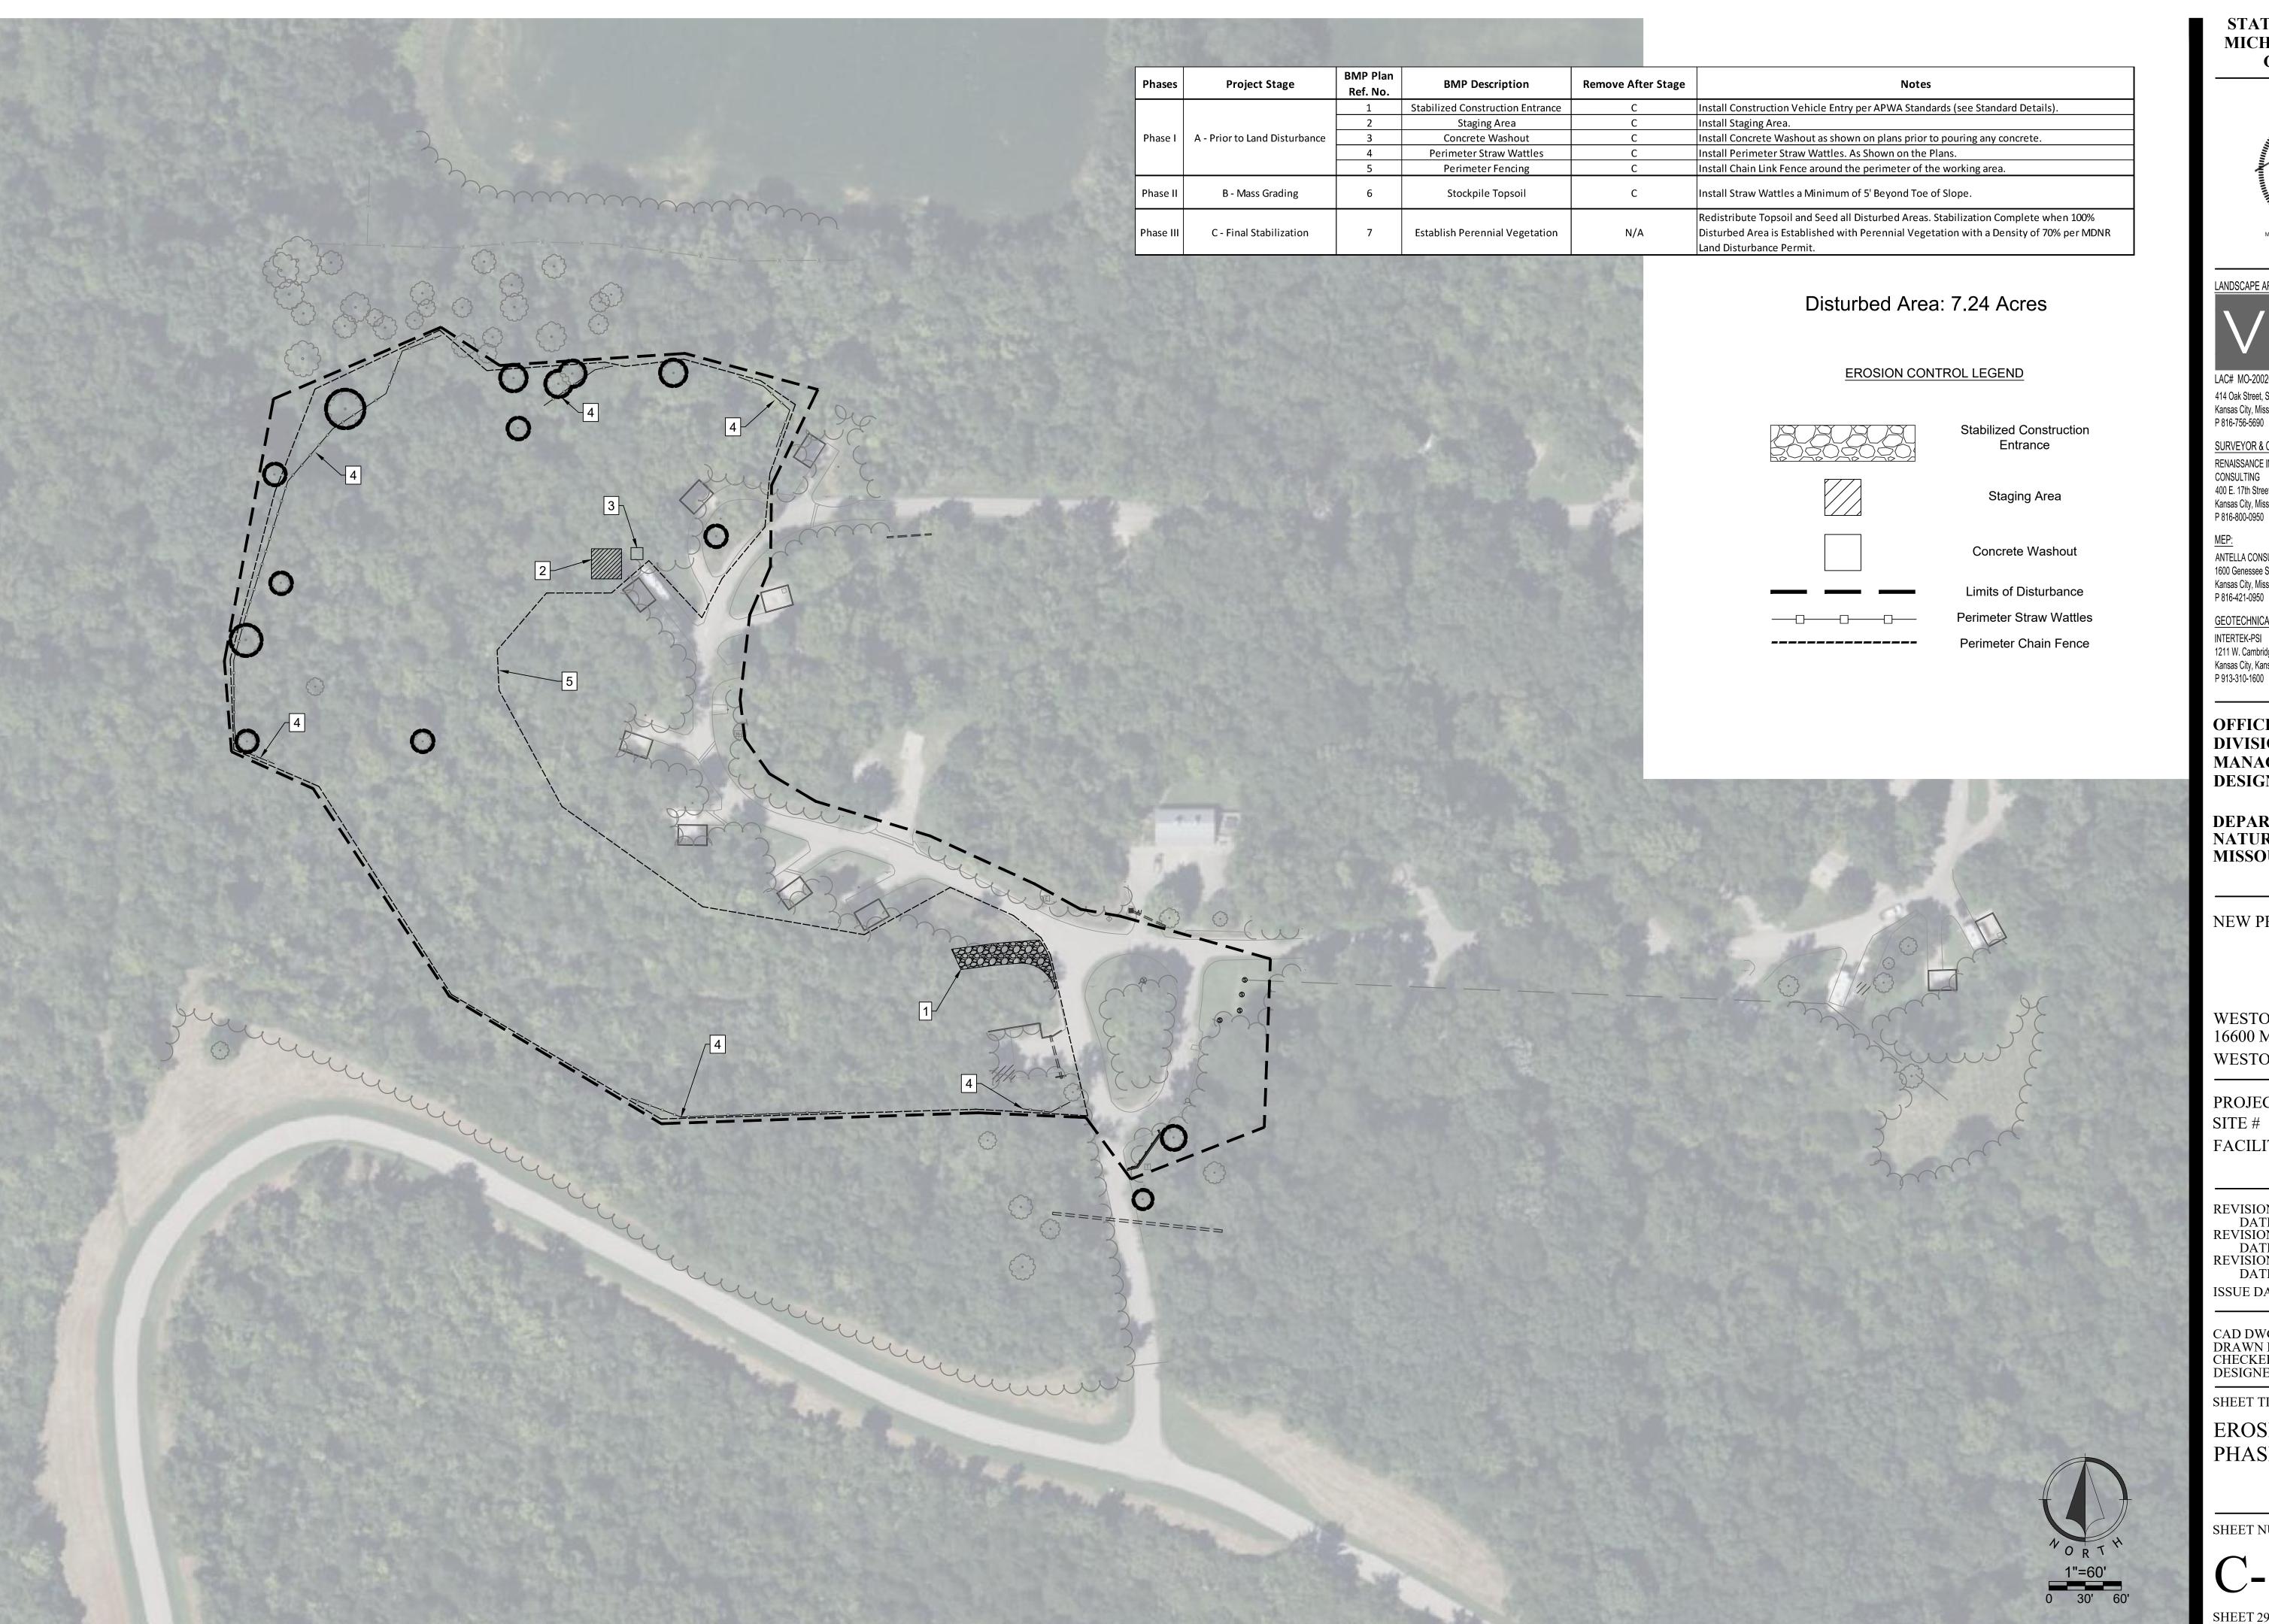



LANDSCAPE ARCHITECT:

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GEOTECHNICAL:

INTERTEK-PSI 1211 W. Cambridge Circle Drive Kansas City, Kansas 66103 P 913-310-1600

OFFICE OF ADMINISTRATION DIVISION OF FACILITIES MANAGEMENT, **DESIGN AND CONSTRUCTION**

DEPARTMENT OF NATURAL RESOURCES, MISSOURI STATE PARKS

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PROJECT # X2221-01 SITE # 5118 FACILITY # 7815118006

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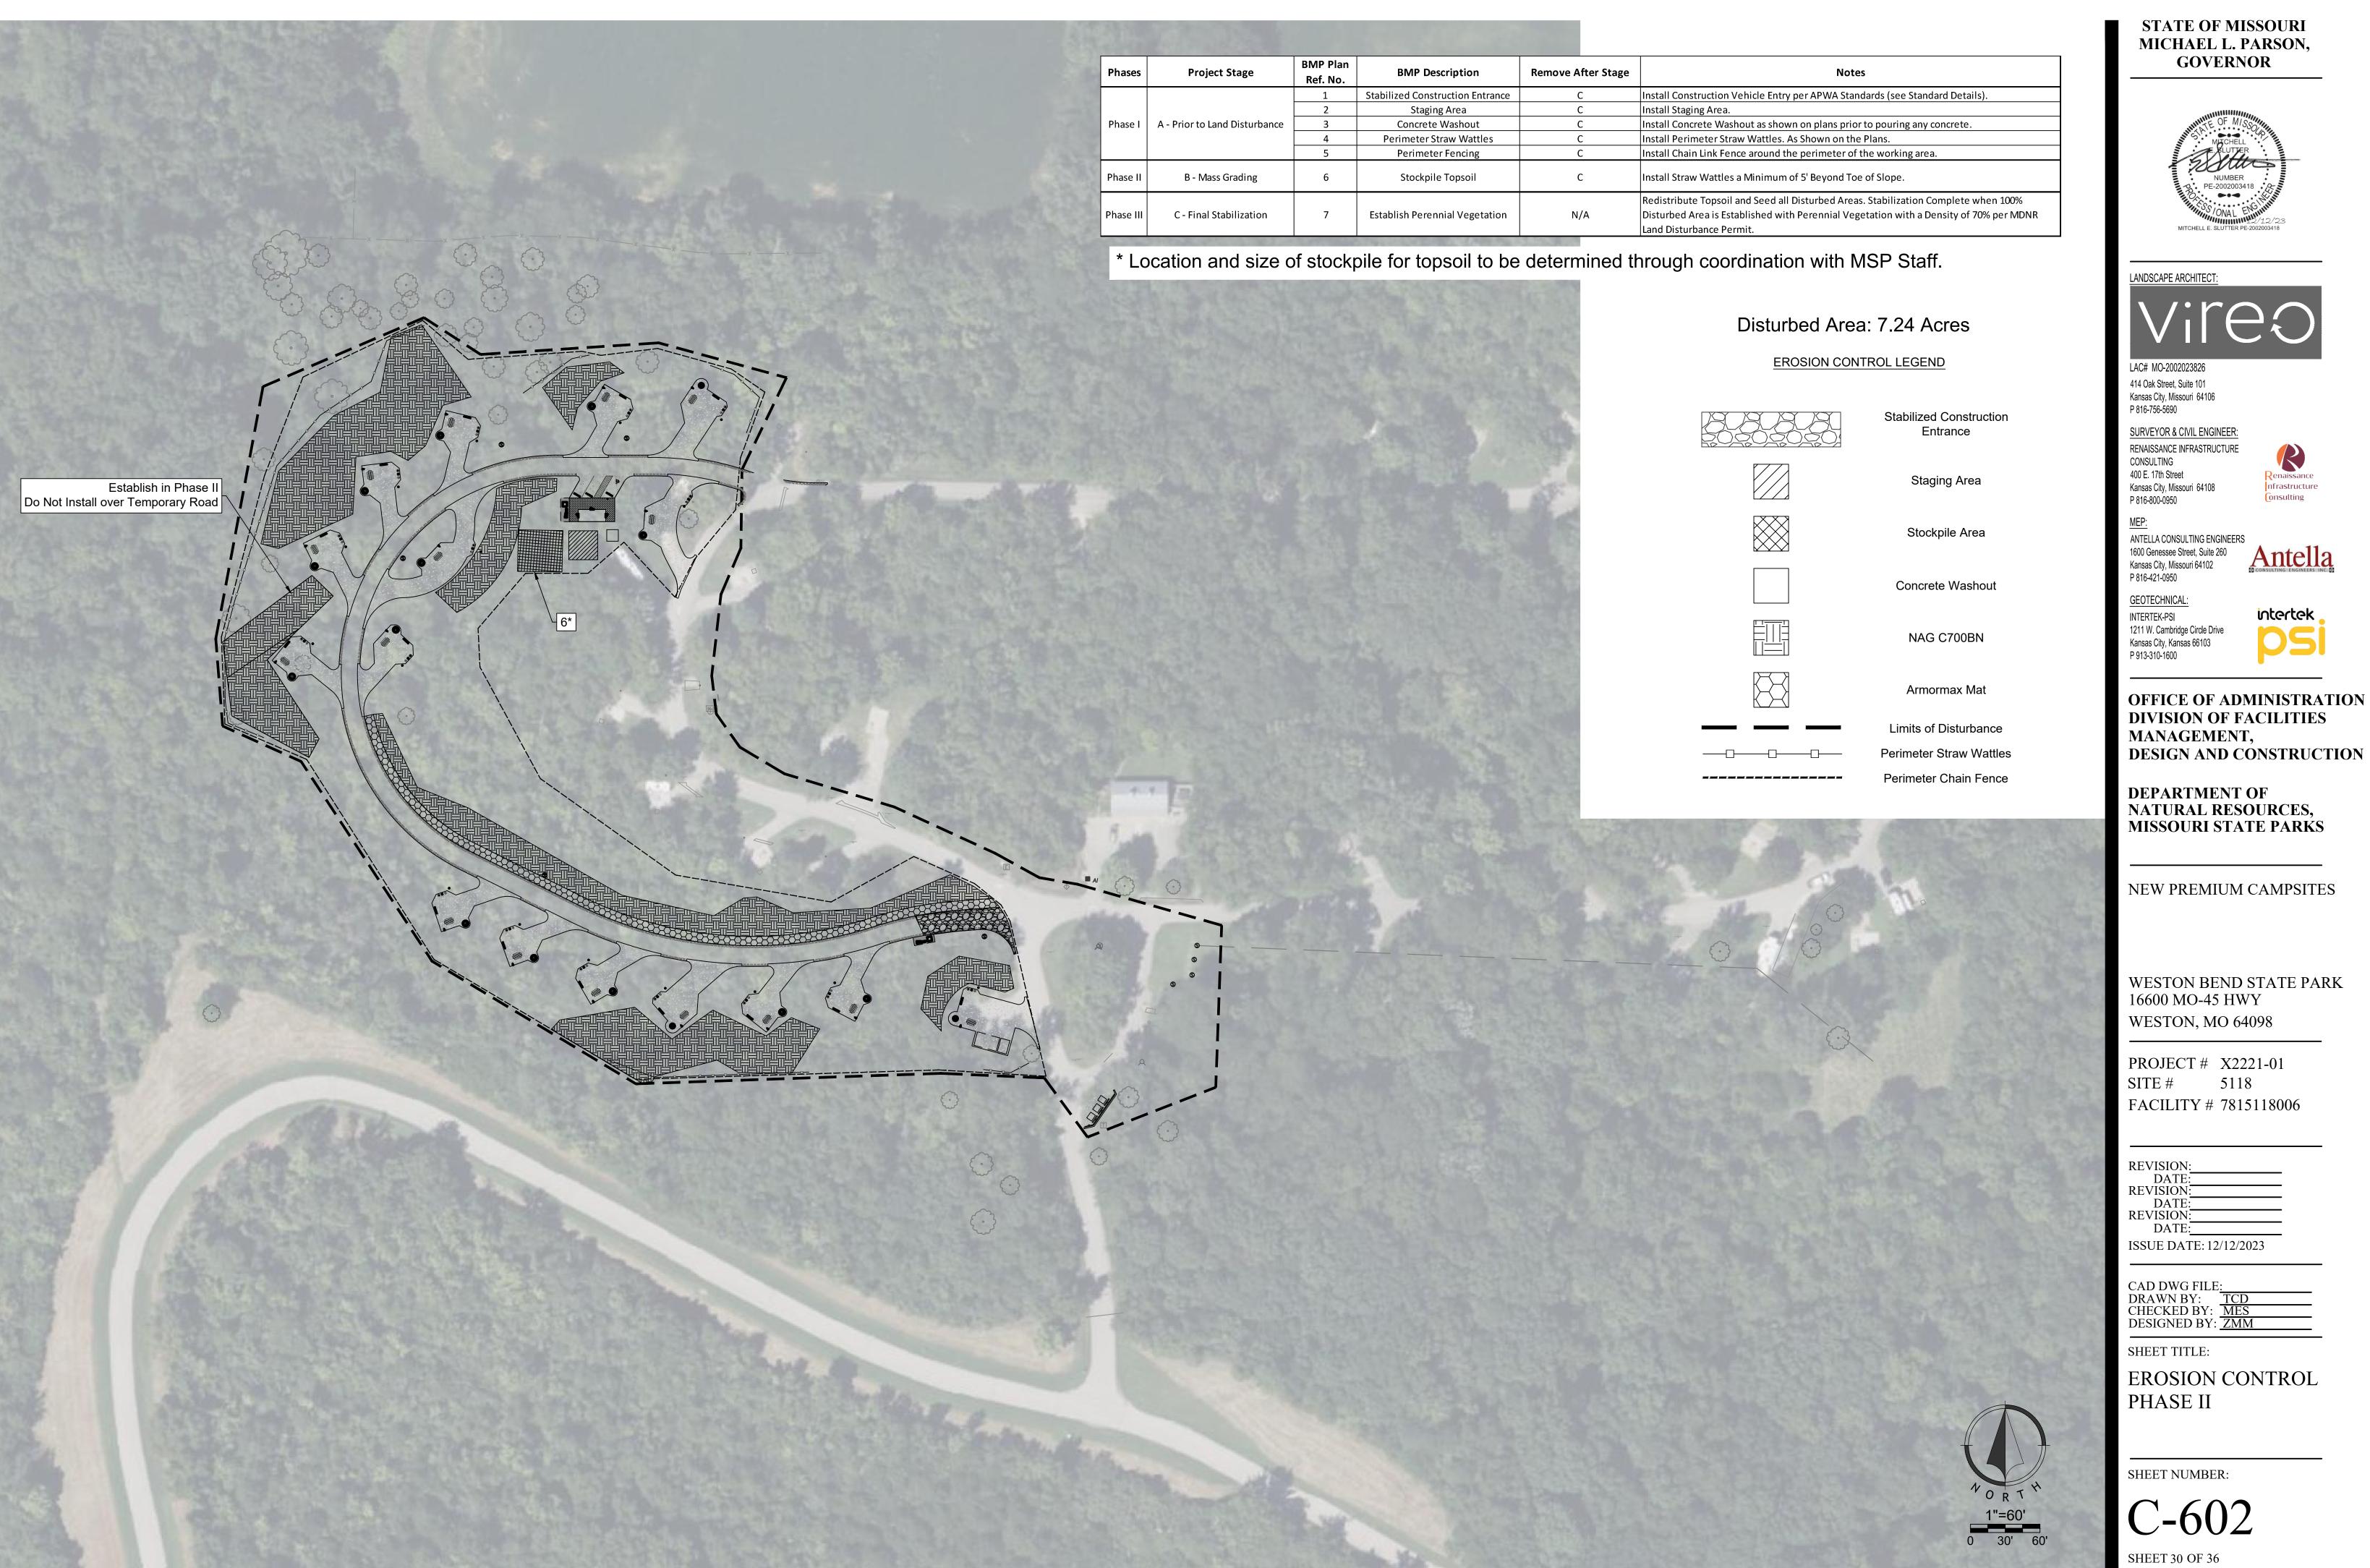
SHEET TITLE:

EROSION CONTROL PHASE I

SHEET NUMBER:

C-601

SHEET 29 OF 36





LANDSCAPE ARCHITECT:

414 Oak Street, Suite 101 Kansas City, Missouri 64106 P 816-756-5690

SURVEYOR & CIVIL ENGINEER: RENAISSANCE INFRASTRUCTURE CONSULTING 400 E. 17th Street

Kansas City, Missouri 64108 nfrastructure P 816-800-0950

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P 816-421-0950 GEOTECHNICAL:

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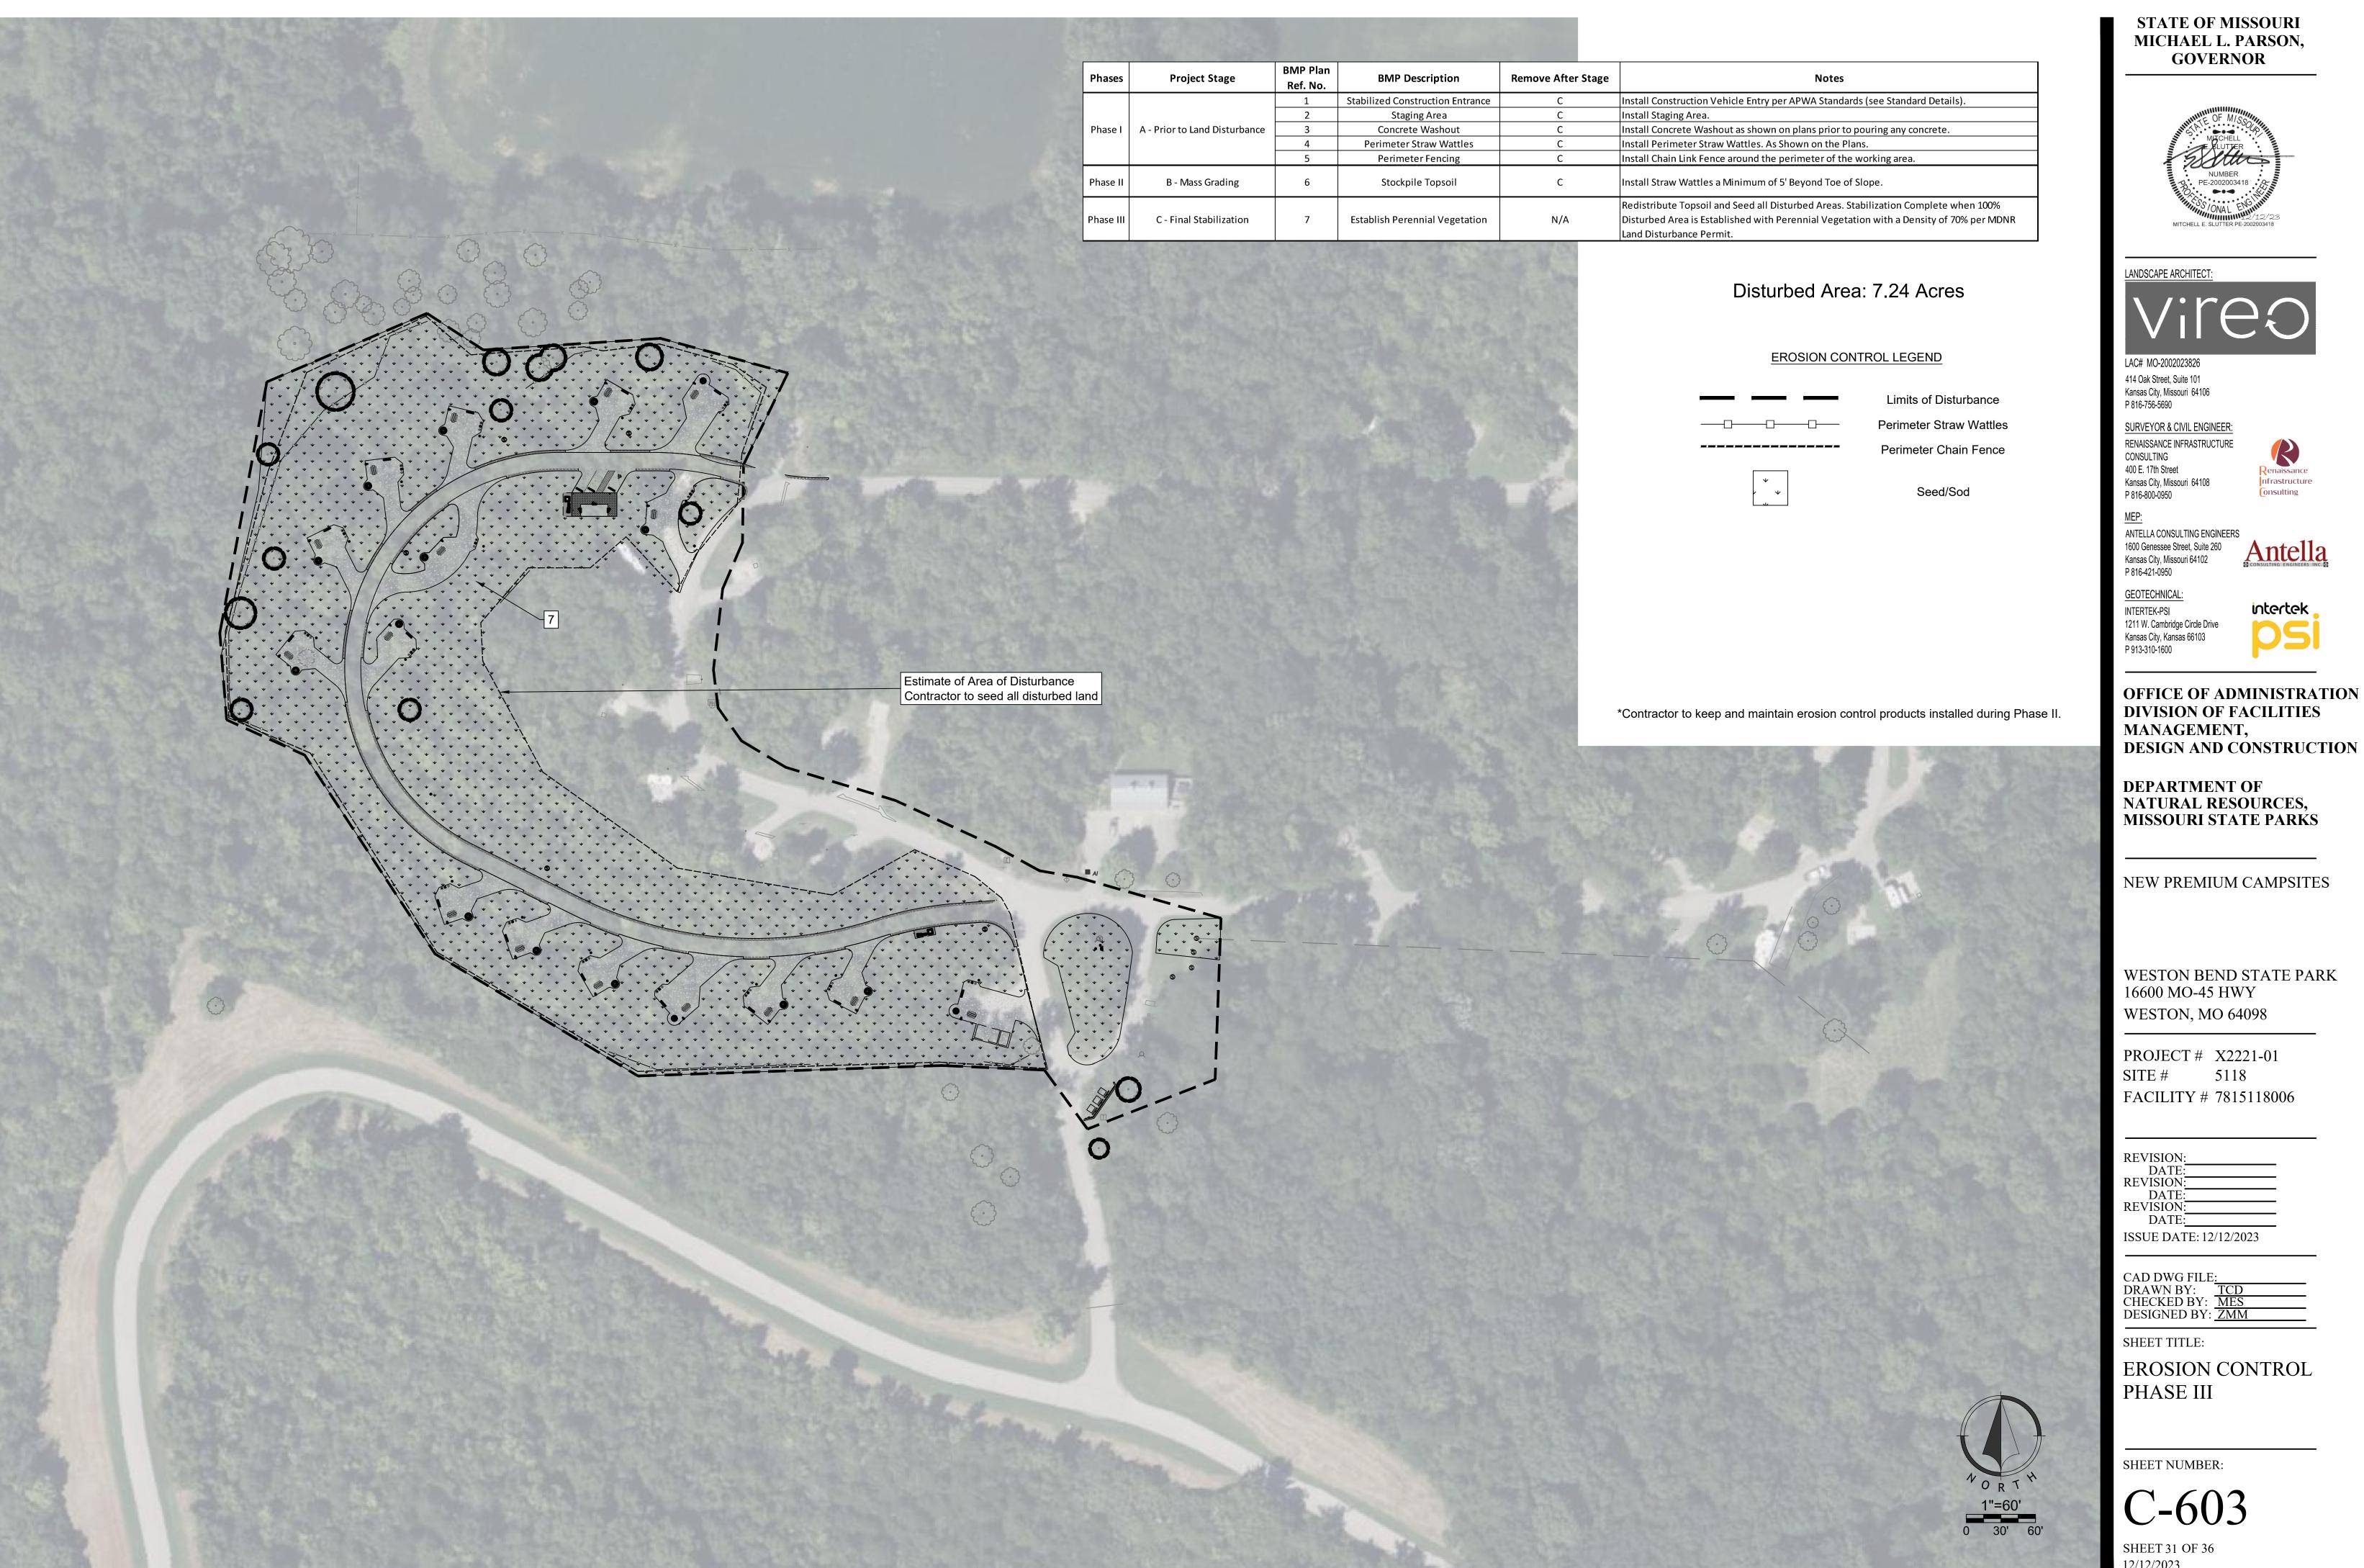
SHEET TITLE:

EROSION CONTROL PHASE II

SHEET NUMBER:

C-602

SHEET 30 OF 36





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DIVISION OF FACILITIES MANAGEMENT, **DESIGN AND CONSTRUCTION**

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EROSION CONTROL

C-603


GENERAL NOTES: (TYPICAL ALL SHEETS)

- A) ALL WORK SHALL CONFORM TO THE APPLICABLE PROVISIONS OF THE LATEST NATIONAL ELECTRICAL CODE, UNDERWRITER'S LABORATORIES, INC., OCCUPATIONAL SAFETY AND HEALTH ACT, AND ALL STATE, LOCAL, MUNICIPAL, AND STATUTORY REQUIREMENTS.
- B) PEDESTAL FEEDER WIRING TO BE COPPER: XLPE, RHW-2 OR USE-2 TYPE, DIRECT BURIED MINIMUM OF 24 INCHES. ROUTE IN CONDUIT WHERE RUN UNDER GRAVEL OR PAVING AS NOTED IN DETAILS.
- C) ALL SINGLE PHASE, SINGLE POLE LOADS TO HAVE DEDICATED NEUTRALS. LABEL NEUTRAL CONDUCTORS WITH CORRESPONDING CIRCUIT NUMBER AT EACH PULL BOX, JUNCTION BOX, HANDHOLE AND OTHER SPLICE POINTS. USE OF BREAKER TIES IS NOT PERMITTED. SHARING OF NEUTRALS IS NOT PERMITTED.
- D) WHERE ELECTRICAL SITE WORK IS REQUIRED, CONTRACTOR SHALL RESTORE EXISTING SITE TO IT'S ORIGINAL CONDITION. INCLUDING BUT NOT LIMITED TO REPLACING VEGETATION, SOFTSCAPE AND HARDSCAPE REQUIRED TO BE DISTURBED DURING INSTALLATION OF ELECTRICAL COMPONENTS.
- E) USE OF 3M SCOTCHLOK CONNECTORS OR PUSH-IN WIRE CONNECTORS (SIMILAR TO WAGO PUSH-IN CONNECTORS) ARE NOT PERMITTED. ALL WIRING CONNECTIONS TO BE DONE WITH WIRE NUT CONNECTORS.
- F) IF CONTRACTOR CHOOSES TO GROUP CIRCUITS FOR HOMERUNS, CONTRACTOR SHALL APPLY ADJUSTMENT FACTORS FOR MORE THAN THREE CURRENT CARRYING CONDUCTORS IN A RACEWAY PER NEC TABLE 310.15(B)(3)(a). CONDUCTORS SHALL BE UPSIZED AS REQUIRED TO MAINTAIN FULL AMPACITY
- G) ALL EMPTY CONDUITS SHALL BE PROVIDED WITH A PULL WIRE.
- H) ALL PANELBOARDS, SWITCHBOARDS AND LINE VOLTAGE CONTROL EQUIPMENT SHALL BE FIELD MARKED TO WARN QUALIFIED PERSONS OF POTENTIAL ELECTRIC ARC FLASH HAZARDS. MARKING SHALL BE LOCATED SO AS TO BE CLEARLY VISIBLE TO QUALIFIED PERSONS BEFORE EXAMINATINON, ADJUSTING, SERVICING OR MAINTENANCE OF EQUIPMENT. MARKING SHALL BE SELF ADHESIVE, COMMERCIAL LABEL CONFORMING TO NEC AND ANSI REQUIREMENTS.
- ANY MATERIAL REMOVED THAT OWNER DOES NOT WISH TO RETAIN SHALL BE REMOVED FROM PROJECT SITE AND DISPOSED OF BY THE CONTRACTOR.
- J) UPDATED, TYPEWRITTEN PANELBOARD DIRECTORY SHALL BE PROVIDED FOR EACH PANELBOARD THAT CIRCUITS HAVE BEEN ADDED TO OR MODIFIED.

GENERAL DEMO NOTES:

- A) REMOVE ALL WIRING (CONDUIT, CONDUCTORS, BOXES, ETC.) ABANDONED AS PART OF THIS PROJECT.
- C) ANY EXISTING DEVICE AND/OR CIRCUIT SHOWN ARE INDICATED ONLY FOR INFORMATION PURPOSES. THE CONTRACTOR SHALL VISIT THE SITE AND VERIFY ALL CONDITIONS AS THEY EXIST AND SHALL REMOVE, RELOCATE AND/OR REWORK ANY ELECTRICAL EQUIPMENT OR CIRCUITS NECESSARY FOR A COMPLETE REWIRING SYSTEM.
- D) UNLESS NOTED OTHERWISE, THE CONTRACTOR SHALL FAMILIARIZE THEMSELVES WITH ALL WORK TO BE DONE BY OBSERVATION OF THE SITE. FAILURE TO DO SO WILL NOT RELIEVE THE CONTRACTOR OF THE RESPONSIBILITY FOR PERFORMING ALL WORK NECESSARY TO PROVIDE A WORKMANLIKE INSTALLATION.
- E) THE CONTRACTOR SHALL MAINTAIN ACCURATE RECORDS OF ANY MODIFICATIONS TO THE EXISTING SYSTEMS WHICH ARE TO REMAIN AND SHALL, UPON COMPLETION OF THIS PROJECT, DELIVER "RECORD" DRAWINGS TO THE ARCHITECT INDICATING ALL SUCH CHANGES. THE CONTRACTOR SHALL MAINTAIN IN THE PROJECT OFFICE, AS WORK PROGRESSES, AN UP-TO-DATE NEATLY MARKED COPY OF THESE DRAWINGS FOR REVIEW BY THE APPROPRIATE PARTIES.
- F) WHERE NEW WORK INTERFERES WITH CIRCUITS OTHERWISE UNDISTURBED, EXISTING CIRCUITS SHALL BE REWORKED AS REQUIRED TO MAINTAIN SERVICE.
- G) THE CONTRACTOR SHALL FIELD VERIFY THE LOCATION OF ALL EXISTING UTILITIES. THE CONDITION OF EXISTING DEVICES AND MATERIALS, AND SHALL BE RESPONSIBLE FOR THE PROTECTION OF THE SAME DURING THE COURSE OF THIS WORK. EXISTING UTILITIES, EXISTING BUILDING, AND/OR MATERIALS WHICH ARE DAMAGED BY NEGLIGENCE ON THIS CONTRACTOR'S PART OR ANY PARTIES ASSOCIATED WITH THIS CONTRACTOR, SHALL BE REPAIRED OR REPLACED AT THIS CONTRACTOR'S EXPENSE. IN A TIMELY MANNER, AND TO THE ARCHITECT'S AND OWNER'S WRITTEN ACCEPTANCE.
- H) CIRCUIT ROUTINGS SHOWN MAY BE MODIFIED TO SUIT FIELD CONDITIONS, HOWEVER, KEEP CIRCUITS AS INDICATED TO AVOID OVERLOADING OF THE
- WHERE EXISTING ELECTRICAL DISTRIBUTION PANELBOARDS ARE TO BE REMOVED, THE CONTRACTOR SHALL PROVIDE TEMPORARY CONNECTIONS TO MAINTAIN POWER TO FEEDER CIRCUITS UNTIL A PERMANENT PANEL IS INSTALLED TO RECONNECT THE EXISTING REMAINING CIRCUITS.
- MAINTAIN CONTINUITY OF EXISTING CIRCUITS SERVING DEVICES, FIXTURES OR EQUIPMENT TO REMAIN.

CODE SUMMARY: INTERNATIONAL BUILDING CODE 2018 NFPA 70 NATIONAL ELECTRICAL CODE 2020

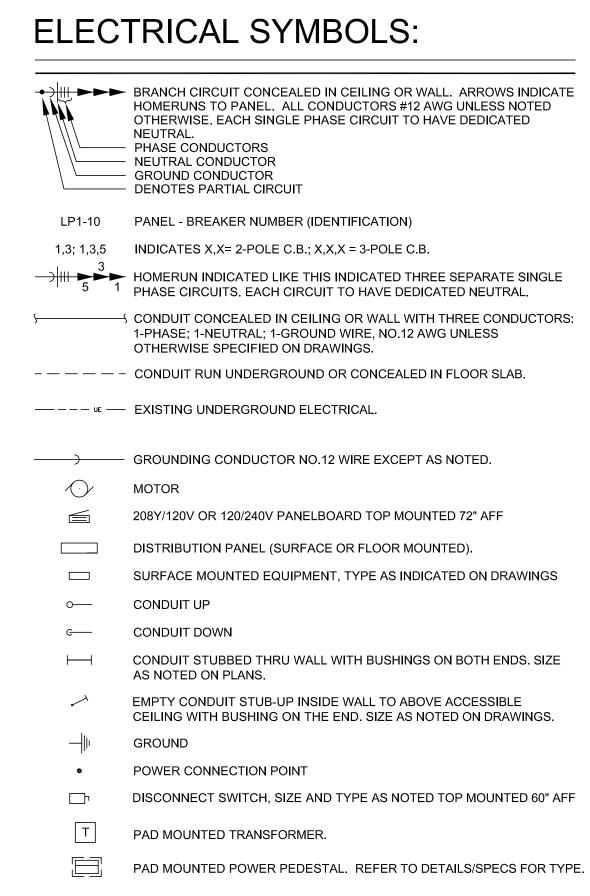

GFI DUPLEX RECEPTACLE WITH WEATHERPROOF WHILE-IN-USE COVER. HEIGHT AS NOTED. DUPLEX RECEPTACLE W/GROUND FAULT PROTECTION.

+18" AFF OR AS NOTED OVERHEAD POWER POLE WITH A RISER POLE. OVERHEAD POWER POLE WITH POLE MOUNTED TRANSFORMERS.

 $\biguplus \mathsf{J} \ \mathsf{OR} \ \mathsf{J} \quad \mathsf{WALL} \ \mathsf{MOUNTED} \ \mathsf{OR} \ \mathsf{CEILING} \ \mathsf{MOUNTED} \ \mathsf{JUNCTION} \ \mathsf{BOX}.$

INDICATES DEVICE ABOVE RE: DRAWING ELECTRICAL EQUIPMENT PROVIDED BY AND INSTALLED BY E.C. TOP OF OUTLET BOX ABOVE FINISHED FLOOR

ABOVE FINISH FLOOR EXISTING TO REMAIN

EXISTING RELOCATED

EP000

GFCI (GROUND FAULT CIRCUIT INTERRUPTER) PROTECTION

PLAN NOTE LEGEND TAG VALUE PLAN NOTE TEXT ELECTRICAL DEMOLITION

DISTANCE	CONDUCTOR SIZE
120V-20A BRA	ANCH CIRCUIT
UP TO 100'	#12
100'-150'	#10
150'-250'	#8
250'-OVER	#6
277V-20A BRA	ANCH CIRCUIT
UP TO 200'	#12
200'-375'	#10
375'-OVER	#8
NOTE: FOR ALL CIRCUITS WITH #6 (#8 CONDUCTORS AT PANEL CIRCUIT BREAKER.	

POWER

STATE OF MISSOURI MICHAEL L. PARSON, **GOVERNOR**

MO STATE CERTIFICATE OF AUTHORITY #2005013590



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CONSULTING 400 E. 17th Street nfrastructure Kansas City, Missouri 64108 P 816-800-0950

ANTELLA CONSULTING ENGINEERS

1600 Genessee Street, Suite 260 Kansas City, Missouri 64102 P 816-421-0950 GEOTECHNICAL:

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OFFICE OF ADMINISTRATION **DIVISION OF FACILITIES** MANAGEMENT, **DESIGN AND CONSTRUCTION**

DEPARTMENT OF NATURAL RESOURCES, MISSOURI STATE PARKS

NEW PREMIUM CAMPSITES

WESTON BEND STATE PARK 16600 MO-45 HWY WESTON, MO 64098

PROJECT # X2221-01 SITE# 5118 FACILITY # 7815118006

REVISION: DATE: **REVISION:** DATE: **REVISION:** DATE: ISSUE DATE: 12/12/2023

CAD DWG FILE: DRAWN BY: MSS CHECKED BY: MSS DESIGNED BY: MSS

SHEET TITLE:

ELECTRICAL SYMBOLS AND GENERAL NOTES

SHEET NUMBER:

SHEET 32 OF 36 12/12/2023





CIRCUIT ROUTING SHOWN IS DIAGRAMMATIC ONLY.

CONTRACTOR TO FIELD LOCATE, MAINTAIN AND PROTECT ALL EXISTING UTILITIES UNLESS OTHERWISE NOTED.

□ DEMOLITION PLAN NOTES

BREAKER DESCRIPTIONS TO CAPTURE SITES REMOVED.

PEDESTALS TO REMAIN.

ED004 EXISTING UTILITY TRANSFORMER TO REMAIN.

EXISTING POWER PEDESTAL TO REMAIN. MAINTAIN CONTINUITY OF CIRCUIT FEEDING

ONLY. CONTRACTOR TO PROTECT FEEDS TO EXISTING PEDESTALS TO REMAIN.

EXISTING PANEL TO REMAIN. MAINTAIN POWER TO CAMPSITES TO REMAIN. UPDATE

EXISTING PEDESTAL TO BE REMOVED. REMOVE ALL ASSOCIATED WIRING BACK TO SOURCE. CONTRACTOR SHALL ENSURE CONTINUITY OF CIRCUIT FEEDING ANY

PEDESTAL. WIRING SHOWN TO SHOW GROUPING OF PEDESTALS AND FOR REFERENCE

LANDSCAPE ARCHITECT:

MONICA S SANTOS - ENGINEER - MO# 2000174546

STATE OF MISSOURI

MICHAEL L. PARSON, **GOVERNOR**

MO STATE CERTIFICATE OF AUTHORITY #2005013590

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OFFICE OF ADMINISTRATION DIVISION OF FACILITIES MANAGEMENT, **DESIGN AND CONSTRUCTION**

DEPARTMENT OF NATURAL RESOURCES, MISSOURI STATE PARKS

NEW PREMIUM CAMPSITES

WESTON BEND STATE PARK 16600 MO-45 HWY WESTON, MO 64098

PROJECT # X2221-01 5118 FACILITY # 7815118006

REVISION: REVISION: DATE: REVISION: DATE:

ISSUE DATE: 12/12/2023


CAD DWG FILE:
DRAWN BY: MSS
CHECKED BY: MSS
DESIGNED BY: MSS

SHEET TITLE:

ELECTRICAL SITE PLAN DEMOLITION

SHEET NUMBER:

SHEET 33 OF 36 12/12/2023

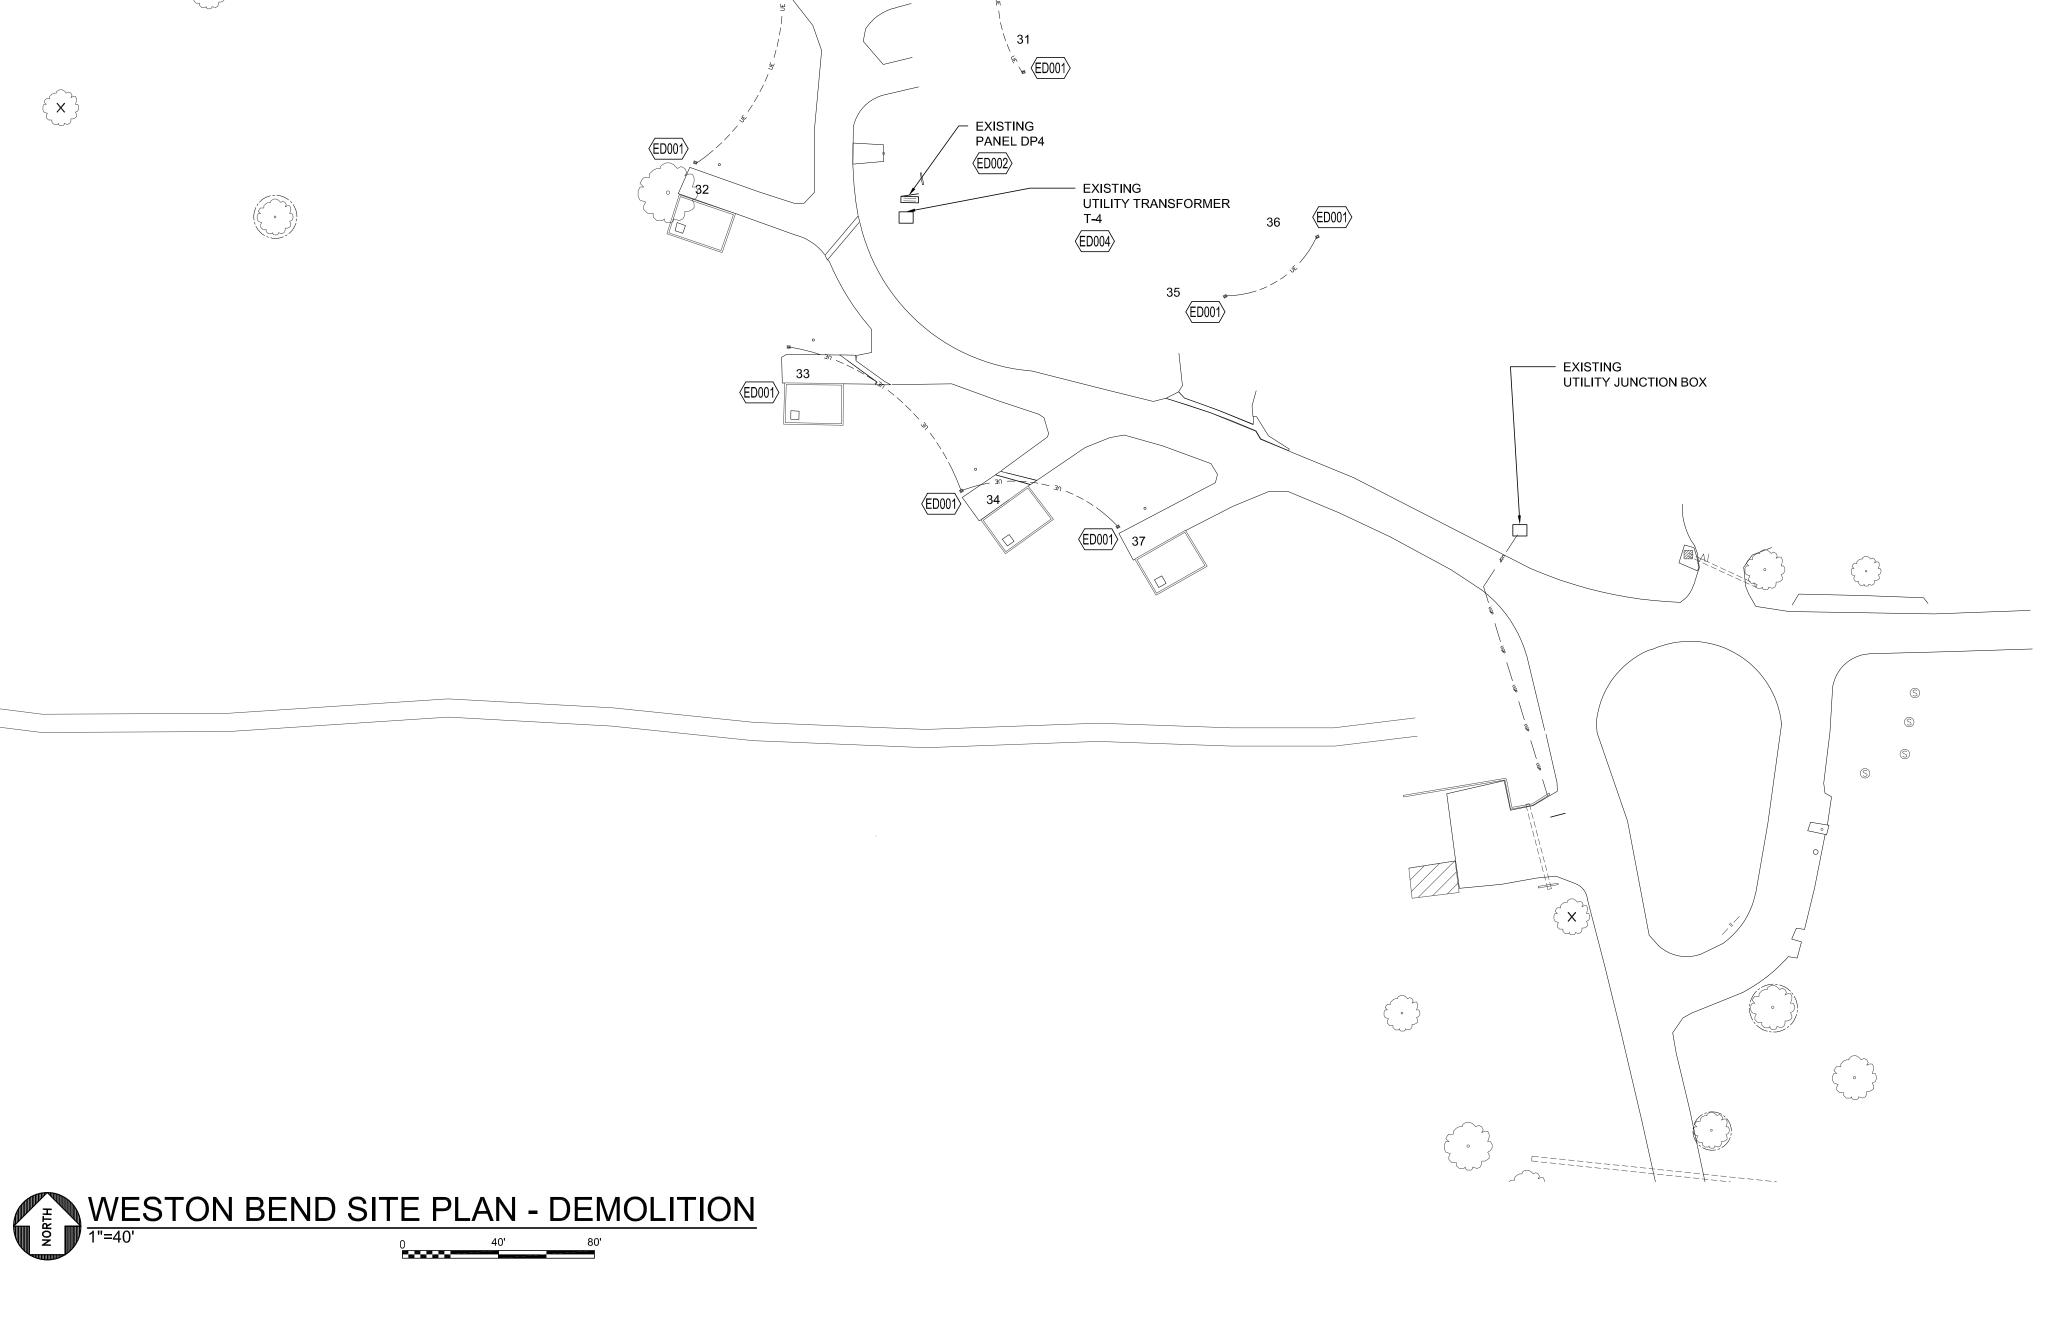



	GENERAL NOTES
1	CIRCUIT ROUTING SHOWN IS DIAGRAMMATIC ONLY.
2	CONTRACTOR TO FIELD LOCATE, MAINTAIN AND PROTECT ALL EXISTING UTILITIES UNLESS OTHERWISE NOTED.
3	COORDINATE UTILITY POWER WITH EVERGY. CALL CUSTOMER SERVICE NUMBER 1-888-471-5275 FOR A SERVICE REQUEST. EVERGY MISSOURI WEST REGION. PENDING ASSIGNMENT OF DESIGNER CONTACT.
4	REFER TO SHEEET E-501 FOR TRENCH DETAILS AND WHERE CONDUIT SLEEVES ARE REQUIRED.

	NEW WORK PLAN NOTES
EP001	EXISTING PANEL TO REMAIN. MAINTAIN POWER TO CAMPSITE PEDESTAL AFTER DEMOLITON OF ADJACENT SITES.
EP002	MAKE FINAL CONNECTIONS TO SHOWER HOUSE PANEL. SHOWER HOUSE PANEL TO HAVE MAIN BREAKER. CONFIRM SIZE OF MAIN SUPPLIED PRIOR TO ROUGH-IN.
EP003	PROVIDE NEW SINGLE PHASE, 240/120V PANELBOARD IN NEMA 3R ENCLOSURE. SEE ASSOCIATED PANEL SCHEDULE AND RISER DIAGRAM FOR ADDITIONAL INFORMATION AND REQUIREMENTS.
EP004	NEW TRANSFORMER. MAINTAIN PROPER CLEARANCES AS REQUIRED BY EVERGY.
EP005	PROVIDE 3 #250 KCMIL AND 1 #4 GROUND (TYPE CU USE-2/RHW-2/XLPE CABLE) THROUGHOUT FULL LENGTH OF CIRCUIT. DIRECT BURIED A MINIMUM OF 24 INCHES.
EP006	PROVIDE 3 #4 KCMIL AND 1 #8 GROUND (TYPE CU USE-2/RHW-2/XLPE CABLE) THROUGHOUT FULL LENGTH OF CIRCUIT. DIRECT BURIED A MINIMUM OF 24 INCHES. (UPSIZED DUE TO VOLTAGE DROP). TRANSITION TO RIGID CONDUIT ABOVE GROUND.
EP007	PROVIDE 3 #300 KCMIL AND 1 #3 GROUND (TYPE CU USE-2/RHW-2/XLPE CABLE) THROUGHOUT FULL LENGTH OF CIRCUIT. DIRECT BURIED A MINIMUM OF 24 INCHES. (UPSIZED DUE TO VOLTAGE DROP)
EP008	PROVIDE NEW NEMA 3R RATED 100AMP, SINGLE PHASE PANEL, 3 WIRE, WITH 12 POLES TO POWER THE FOLLOWING LOADS: LIGHTING, GENERAL RECEPTACLES AND WINDOW AC UNIT. PROVIDE PANEL WITH 50 AMP MAIN BREAKER. REFER TO PANELBOARD SCHEDULE FOR ADDITIONAL INFORMATION.
EP009	COORDINATE EXACT PLACEMENT OF PANEL WITH OWNER PRIOR TO ROUGH-IN. PROV UNISTRUT SUPPORT OF PANEL AS REQUIRED FOR MOUNTING OFFSET OFF THE CONCRETE PAD. FEEDER TO PANEL NOT TO COME THROUGH THE PAD.
EP010	PROVIDE 3 #1 AWG AND 1 #6 GROUND (TYPE CU USE-2/RHW-2/XLPE CABLE) DIRECT BURIED A MINIMUM OF 24 INCHES. TRANSITION TO RIGID CONDUIT ABOVE GROUND.

MO STATE CERTIFICATE OF AUTHORITY #2005013590



MONICA S SANTOS - ENGINEER - MO# 2000174546



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intertek 1211 W. Cambridge Circle Drive Kansas City, Kansas 66103

OFFICE OF ADMINISTRATION DIVISION OF FACILITIES MANAGEMENT,

DEPARTMENT OF NATURAL RESOURCES, MISSOURI STATE PARKS

DESIGN AND CONSTRUCTION

NEW PREMIUM CAMPSITES

WESTON BEND STATE PARK 16600 MO-45 HWY WESTON, MO 64098

PROJECT # X2221-01 5118 FACILITY # 7815118006

REVISION: REVISION:

ISSUE DATE: 12/12/2023


CAD DWG FILE:
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DESIGNED BY: MSS

SHEET TITLE:


ELECTRICAL SITE PLAN

SHEET NUMBER:

SHEET 34 OF 36 12/12/2023

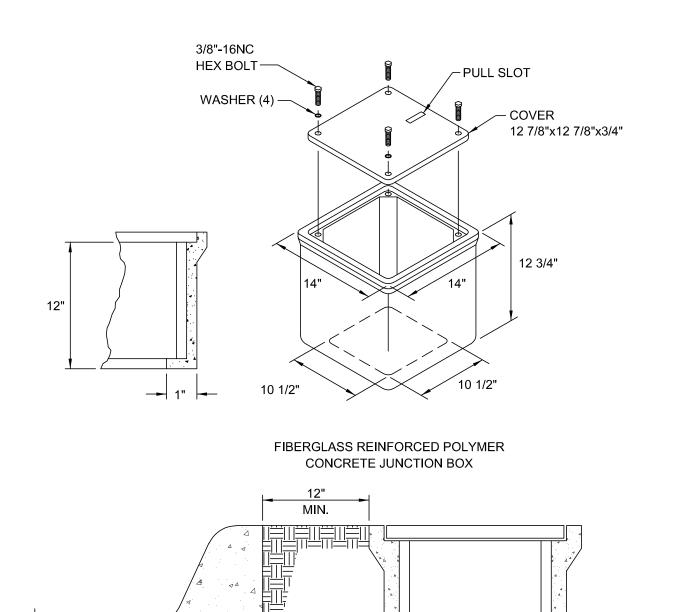


5 JUNCTION BOX DETAIL NO SCALE

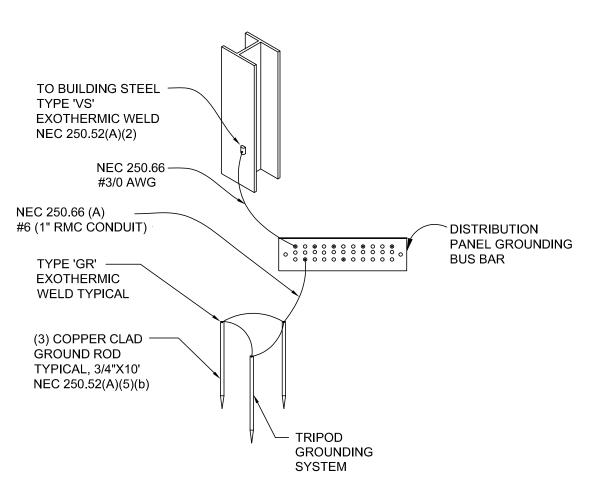


NOTES:

- 1. EXOTHERMIC WELD DESIGNATION INDICATED ABOVE ARE ERICO 'CADWELD'.
- 2. ALL GROUND BUS CONNECTIONS TO BE MADE WITH COPRESSION TYPE
- 3. ALL WIRING TO BE TYPE THHN/THWN-2.
- 4. MAIN GROUP OF RODS ARE TO BE LOCATED AT SERVICE ENTRANCE WITH SIZE AND QUANTITY PER SPECIFICATIONS.
- 5. EACH CABLE TIED TO THE MAIN PANEL GROUNDING BUS TO BE LABELED.
- 6. SIZING AND CODE REFERENCES ARE BASED ON NEC 2020.


3 MAIN SERVICE GROUNDING NO SCALE

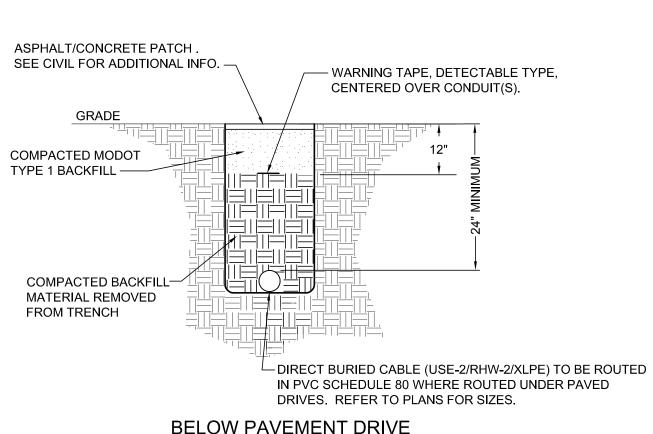

BELOW PAVEMENT DRIVE

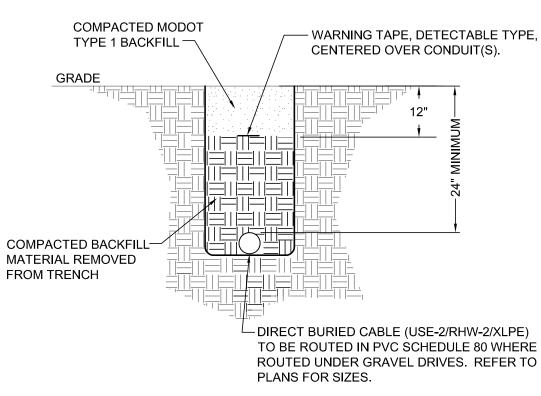

BELOW GRAVEL DRIVE

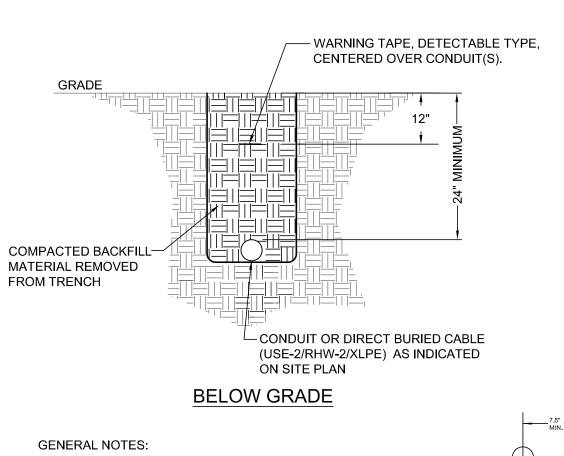


1) AT CONTRACTOR'S DISCRETION, CONDUITS MAY BE BORED

UTILIZING SCHEDULE 40 HDPE CONDUIT.

MULTIPLE RUNS

2 UP TO 600V CONDUIT TRENCH DETAILS NO SCALE

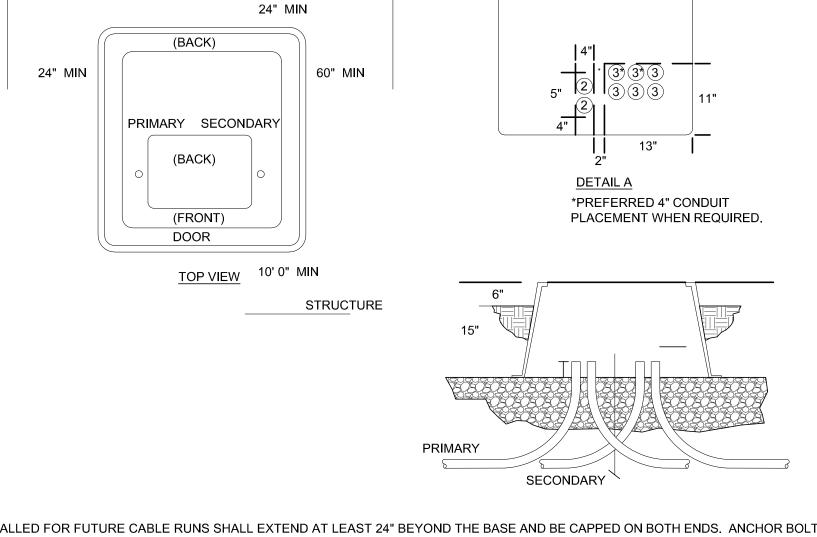


- 1. CONDUIT INSTALLED FOR FUTURE CABLE RUNS SHALL EXTEND AT LEAST 24" BEYOND THE BASE AND BE CAPPED ON BOTH ENDS. ANCHOR BOLT INSERTS ARE POSITIONED FOR TRANSFORMERS.
- A MINIMUM WIDTH OF 10'4" WORKING SPACE BETWEEN STRUCTURES WILL BE REQUIRED FOR TRANSFORMER INSTALLATION AND MAINTENANCE.
- ANY FENCE OR WALL INFRONT OF TRANSFORMER DOOR LESS THAN 10' AWAY MUST BE REMOVABLE OR OPENABLE. COORDINATE WITH EVERGY. SINGLE PHASE TRANSFORMER "BOX" PAD CONSTRUCTED OF POLYETHYLENE FIBERGLASS, SUPPLIED BY THE COMPANY.
- EXCAVATE 12" DOWN AND 6" WIDER THAN THE FLANGE OF THE BOX PAD BASE. PAD SHALL SIT 3" - 6" ABOVE GRADE.


ADJACENT STRUCTURE

- PAD SHALL BE SET ON FIRM LEVEL UNDISTURBED EARTH OR FIRMLY COMPACTED LEVEL BACKFILL. (THE COMPANY DEFINES THE FIRM LEVEL AND/OR FIRMLY COMPACTED LEVEL BACKFILL AS A PAD SITE TOPPED WITH A MINIMUM OF 6" CRUSHED ROCK). COMPACTION SHALL BE TO 95% OF MAXIMUM DENSITY (PROCTOR - ASTM D698)
- 8. FOR STREET SIDE INSTALLATIONS, PAD AND PRIMARY/SECONDARY CONDUITS SHALL BE ORIENTED SO THAT THE FRONT OF THE PAD, AND THE FRONT OF THE TRANSFORMER AFTER IT IS INSTALLED, FACES THE STREET.



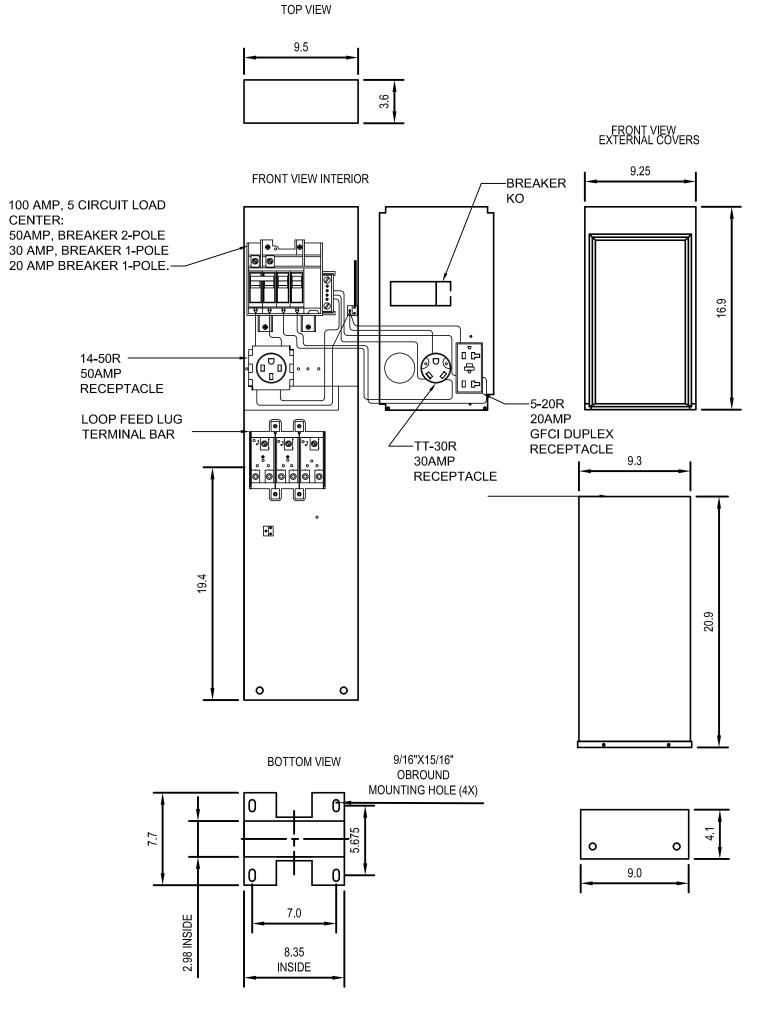



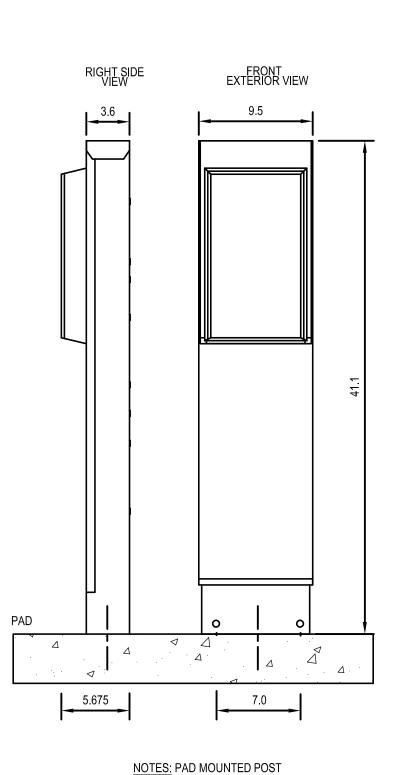

WIRE RANGE SIZE

	COPF	ER
CONNECTOR	SOILD	STRAND
LINE	14-8	14-8
LOAD	14-10	14-10
NEUTRAL	14-4	14-4
POST LINE CONNECTORS SUITABLE FOR LOOP FEED	#6-350 KCMIL	
EQUIP, GRND POST	14-2/0	14-2/0

STATE OF MISSOURI MICHAEL L. PARSON, **GOVERNOR**

MO STATE CERTIFICATE OF AUTHORITY #2005013590



P 816-756-5690 SURVEYOR & CIVIL ENGINEER: RENAISSANCE INFRASTRUCTURE CONSULTING

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Kansas City, Kansas 66103

P 913-310-1600

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ANTELLA CONSULTING ENGINEERS 1600 Genessee Street, Suite 260 Kansas City, Missouri 64102 P 816-421-0950

GEOTECHNICAL: INTERTEK-PSI 1211 W. Cambridge Circle Drive

OFFICE OF ADMINISTRATION **DIVISION OF FACILITIES** MANAGEMENT, **DESIGN AND CONSTRUCTION**

DEPARTMENT OF NATURAL RESOURCES, MISSOURI STATE PARKS

NEW PREMIUM CAMPSITES

WESTON BEND STATE PARK 16600 MO-45 HWY

PROJECT # X2221-01 5118 FACILITY # 7815118006

WESTON, MO 64098

REVISION: REVISION: DATE: **REVISION:** DATE: ISSUE DATE: 12/12/2023

CAD DWG FILE: DRAWN BY: CHECKED BY: MSS DESIGNED BY: MSS

SHEET TITLE:

ELECTRICAL **DETAILS**


SHEET NUMBER:

12/12/2023

		AMP	2: 240/120 VOLT , 1 - PHASE , 3 - WIRE 2: 800 AMP 3: MCB / 800 AMP MAIN BREAKER PANEL TO BE SERVICE ENTRANCE RATED				BUS: MOUNTING:		S/N ,GND BUS		LOCATION:	42000 A.I.C. WESTON BE NEMA 3R	ND	
N	IOTE		LOAD	BRKR		LOA	D KVA		LOAD	BRKR	LOAD	KVA	NOTE	REV
N	10.	CRT#	DESCRIPTION	Р	AMP	Α	В	CRT#	DESCRIPTION	P AMP	А	В	NO.	NO.
		1	SITES A-50, A-51, E-52 (HOST)	2	250	24		2	SITES A-46, A-47, A-48, B-49	2 250	24			
		3	7				12	4				24		
		5	PANEL PP1	2	50	4		6	SPARE	2 250	24			
		7	1				4	8				24		
		9	SPACE ONLY	2				10	SPACE ONLY	2				
		11	1					12						
		13	SPACE ONLY	1				14	SPACE ONLY	1				
		15	SPACE ONLY	1				16	SPACE ONLY	1				
		17	SPACE ONLY	1				18	SPACE ONLY	1				
		19	SPACE ONLY	1				20	SPACE ONLY	1				
		21	SPACE ONLY	1				22	SPACE ONLY	1				
		23	SPACE ONLY	1				24	SPACE ONLY	1				
		25	SPACE ONLY	1				26	SPACE ONLY	1				
		27	SPACE ONLY	1				28	SPACE ONLY	1				
		29	SPACE ONLY	1				30	SPACE ONLY	1				
					TOTAL:	28	16			TOTAL:	48	48		
					IOI/IL.	20	1 10	_		TOTAL.	28	16		
N	IOTES:									KVA / PHASE TOTAL:	76	64		
,		MAIN RRF	AKER TO BE 100% RATED.							AMP / PHASE TOTAL:		533		
		5112								. iiii / i i iii c i i iii ii ii ii ii ii ii ii				
										TOTAL CONNECTED LOAD:		140.00	KVA	
										TOTAL CONNECTED CURRENT:			AMPS	

		SERVICE	E: 240/120 VOLT, 1 - PHASE, 3 - WIRE	PAN	ELBO	DARD			STON) SCHEDULE S/N ,GND BUS	Ē		RATING:	42000 A.I.O	C .	
		AMF	P: 800 AMP									LOCATION:	WESTON E	BEND	
		MAINS	S: MCB / 800 AMP MAIN BREAKER				MOUNTING:	SURFACE					NEMA 3R		
	1		PANEL TO BE SERVICE ENTRANCE RATED												
ΕV	NOTE		LOAD	BRKR	Γ	LOA	D KVA		LOAD	BRKR		LOAI	D KVA	NOTE	REV
D	NO.	CRT#	DESCRIPTION	Р	AMP	А	В	CRT#	DESCRIPTION	P	AMP	A	В	NO.	NO.
		1	SITES A-40, A-41, A-43, A-45	2	250	24		2	SITES D-28, B-38, A-39	2	250	12			
		3					24	4					24		
		5	SITES D-42, C-44	2	125	12		6	SPARE	2	250	24			
		7					12	8					12		
		9	SHOWER HOUSE	2	100	12		10	SPACE ONLY	2					
		11					12	12							
		13	SPACE ONLY	1				14	SPACE ONLY	1					
		15	SPACE ONLY	1				16	SPACE ONLY	1					
		17	SPACE ONLY	1				18	SPACE ONLY	1					
		19	SPACE ONLY	1				20	SPACE ONLY	1					
		21	SPACE ONLY	1				22	SPACE ONLY	1					
		23	SPACE ONLY	1				24	SPACE ONLY	1					
		25	SPACE ONLY	1				26	SPACE ONLY	1					
		27	SPACE ONLY	1				28	SPACE ONLY	1					
		29	SPACE ONLY	1				30	SPACE ONLY	1					<u> </u>
					TOTAL:	48	48				TOTAL:	36	36		
							1	_				48	48	1	
	NOTES:									KVA / PHA	SE TOTAL:		84	1	
		MAIN BRE	EAKER TO BE 100% RATED.							AMP / PHA			700		
										TOTAL CONNEC TOTAL CONNECTED TOTAL DEMAND	CURRENT:		168.0 700.0 700.0		


		SERVICE	E: 240/120 VOLT, 1 - PHASE, 3 - WIRE						STON) SCHEDULE S/N . GND BUS				RATING:	42000 A.I.C.		
			P: 100 AMP									1		WESTON BE	ND.	
			S: MCB / 50 AMP MAIN BREAKER			N.	AOLINTING:	SURFACE				į		NEMA 3R	.IND	
		IVIAINO	PANEL TO BE SERVICE ENTRANCE RATED			IV	NOONTING.	SOIN AGE						NEMA SIX		
V	NOTE		LOAD	BRKR		LOAD	KVA		LOAD		BRKR		LOAD	KVA	NOTE	REV
).	NO.	CRT#	DESCRIPTION	Р	AMP	А	В	CRT#	DESCRIPTION		Р	AMP	A	В	NO.	NO.
		1	LTG - SHED	1	20	1		2	WINDOW AC UNIT		1	20	1.2			
		3	REC - SHED	1	20		0.72	4	SPARE		1	20				
		5	SPARE	1	20			6	SPARE		1	20				
		7	SPACE ONLY	1	20			8	SPACE ONLY		1	20				
		9	SPACE ONLY	1	20			10	SPACE ONLY		1	20				
		11	SPACE ONLY	1	20			12	SPACE ONLY		1	20				
					TOTAL:	1	0.72					TOTAL:	1.2	0		
													1	0.72		
	NOTES:									K	VA / PHA	SE TOTAL:	2.2	0.72		
										AI	MP / PHA:	SE TOTAL:	18	6		
										TOTAL	CONNECT	TED LOAD:		2.02	KVA	
										TOTAL CON		-			AMPS	
												CURRENT:		13.21		

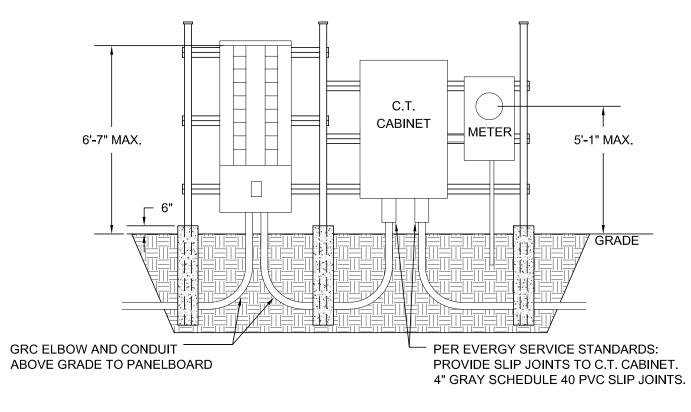

SUPPORT DETAIL NOTE:

 PROVIDE 10'-0" SCHEDULE 40 GALVANIZED RIGID STEEL CONDUIT WITH PIPE CAP FOR VERTICAL SUPPORTS AND 12 GAUGE GALVANIZED, SOLID DOUBLE STRUT FOR EACH HORIZONTAL SUPPORT MEMBER.

PROVIDE CONCRETE BASE IN 3'-0"X10" SONATUBE. TOP OF CONCRETE BASE TO BE 6" ABOVE FINISHED GRADE.

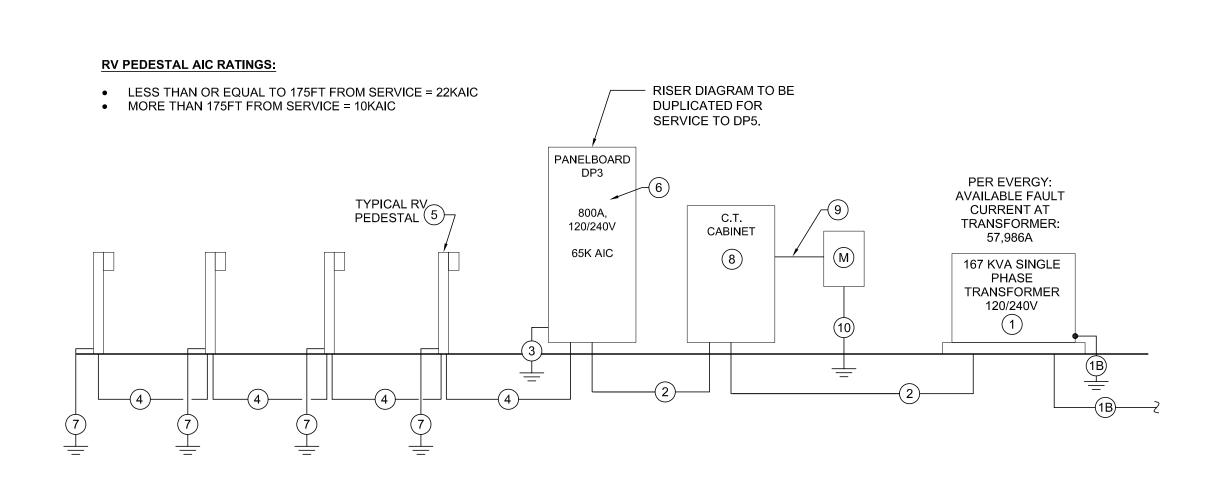

1 120/240V TYPICAL ELECTRICAL RISER DIAGRAM NO SCALE

	120/240V FEEDER SCHEDULE									
SYMBOL NUMBER	AMPACITY	FEEDER SIZE/NOTE	TEMP RATING							
1			PROVIDE TRANSFORMER PAD PER EVERGY DESIGN GUIDELINES. COORDINATE WITH EVERGY FOR INSTALLATION OF TRANSFORMER.							
1B			PROVIDE 3" CONDUIT FOR PRIMARY WIRING BY EVERGY. COORDINATE EXACT ROUTING WITH EVERGY PRIOR TO INSTALLATION							
2	800	3	(3) #350 KCMIL IN 3" CONDUIT.	90 DEG						
3			#3/0 COPPER GROUNDING CONDUCTOR TO 3/4" X 10' GROUND ROD.							
4	250	1	(3) #250 KCMIL & (1) #4 GROUND IN 2-1/2" CONDUIT. (UNLESS NOTED OTHERWISE IN ON PLANS.	90 DEG						
5			PROVIDE NEW NEMA 3R, SURFACE MOUNTED, 125A, 120/240V, 1 PH, 3 WIRE SINGLE SIDED PEDESTAL (MILLBANK U5200-XL-75 SERIES OR APPROVED EQUAL) WITH FULLY RATED LOOP-FEED LUG ASSEMBLY (MIN. #250 KCMIL). TO INCLUDE ONE (1) 20A, 1P, GFCI; ONE (1) 30A, 1P AND ONE (1) 50A, 2P BREAKER TO SERVE THE FOLLOWING RECEPTACLES: 20A NEMA 5-20 (WEATHER RESISTANT TYPE); 30A NEMA TT-30 AND 50A, NEMA 14-50R. PEDESTAL TO BE PROVIDED WITH PAD MOUNT KIT.							
6			PANELBOARD TO BE RATED AS NOTED ON SCHEDULE.							
7			#6 COPPER GROUNDING CONDUCTOR TO 3/4" X 10' GROUND ROD.							
8			PROVIDE EVERGY APPROVED C.T. CABINET SIZED FOR 800 AMP SERVICE: KCPLM-813UBGX (24W"X48"HX9"D) OR APPROVED EQUAL. INSTALL C.T.S AS PROVIDED BY EVERGY PER EVERGY STANDARDS.							
9			EXTEND 1-1/4" GRC TO METER SOCKET.							
10			1" GRAY SCHEDULE 40 PVC CONDUIT TO GROUND. PROVIDE MINIMUM OF 6 AWG SOLID BARE COPPER GROUND WIRE AND ATTCHED TO 5/8" X 8FT COPER CLAD STEEL GROUND ROD. PER EVERGY DESIGN GUIDELINES.							

STATE OF MISSOURI MICHAEL L. PARSON, GOVERNOR

> OF M/SS MONICA SANTOYO SANTOS NUMBER E-2000174546

MO STATE CERTIFICATE OF AUTHORITY #2005013590

MONICA S SANTOS - ENGINEER - MO# 2000174546

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CONSULTING
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Renaissance Infrastructure Consulting

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OFFICE OF ADMINISTRATION DIVISION OF FACILITIES MANAGEMENT, DESIGN AND CONSTRUCTION

DEPARTMENT OF NATURAL RESOURCES, MISSOURI STATE PARKS

NEW PREMIUM CAMPSITES

WESTON BEND STATE PARK 16600 MO-45 HWY WESTON, MO 64098

PROJECT # X2221-01 SITE # 5118

FACILITY # 7815118006

REVISION:
DATE:
REVISION:
DATE:
REVISION:

CAD DWG FILE:
DRAWN BY: MSS
CHECKED BY: MSS
DESIGNED BY: MSS

SHEET TITLE:

ELECTRICAL RISER AND SCHEDULES

SHEET NUMBER:

E-801

SHEET 36 OF 36 12/12/2023

