REPLACE LAGOON

LONG BRANCH STATE PARK MACON, MISSOURI

OWNER: STATE OF MISSOURI

MICHAEL L. PARSON,

GOVERNOR

PROJECT OFFICE OF ADMINISTRATION

MANAGEMENT: DIVISION OF FACILITIES MANAGEMENT,


DESIGN AND CONSTRUCTION

DESIGNER: Klingner & Associates, PC

PROJECT NUMBER: X2302-02

SITE NUMBER: 5601

ASSET NUMBER: 7815601020

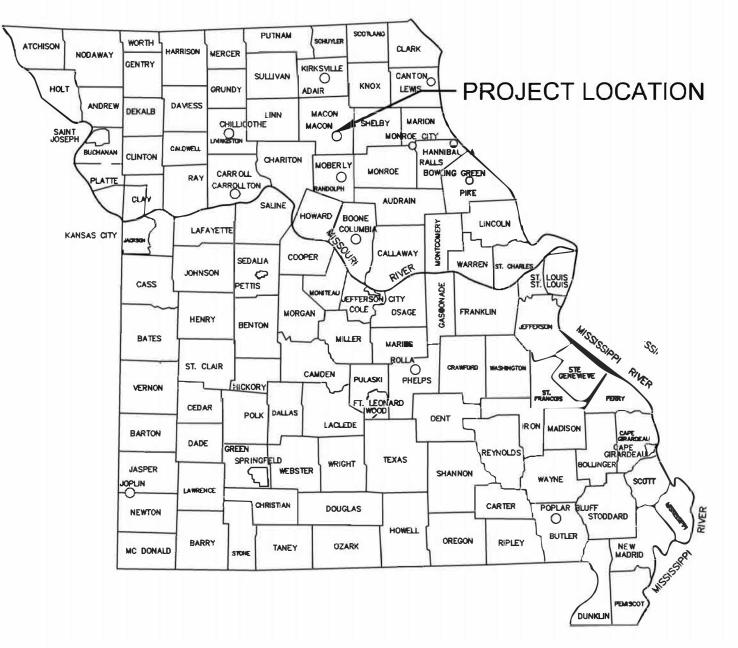



PROJECT LOCATION MAP

SHEET NUMBER	SHEET NAME	CURRENT REVISION DATE	
G001	COVER SHEET	2/12/2024	
G002	GENERAL NOTES AND LEGENDS	2/12/2024	
C100	GENERAL SITE LAYOUT	2/12/2024	
C101	LIFT STATION DETAILS AND FORCEMAIN RUN 1	2/12/2024	
C102	FORCEMAIN RUNS 2 & 3	2/12/2024	
C103	FORCEMAIN RUNS 4 & 5	2/12/2024	
C104	FORCEMAIN RUNS 6 & 7	2/12/2024	
C105	FORCEMAIN RUNS 8	2/12/2024	
C200	LPP DETAILS - 1	2/12/2024	
C201	LPP DETAILS - 2	2/12/2024	
C500	MISCELLANEOUS DETAILS	2/12/2024	
E501	ELECTRICAL DETAILS	2/12/2024	
E502	ELECTRICAL DETAILS AND SCHEDULES	2/12/2024	
E801	CTRL DIAGRAM - LIFT STATION	2/12/2024	
E802	CTRL DIAGRAM - DOSING TANK	2/12/2024	

THE CONTRACTOR(S) SHALL COMPLY WITH THE LATEST EDITION OF APPLICABLE CODES AND STANDARDS INCLUDING BUT NOT LIMITED TO:

- THE AMERICANS WITH DISABILITIES ACT (ADAAG)
- INTERNATIONAL BUILDING CODE (IBC)
- NATIONAL ELECTRIC CODE (NEC)
- INTERNATIONAL PLUMBING CODE (IPC)
- LIFE SAFETY CODE (NFPA 101)
- AMERICAN SOCIETY OF MECHANICAL ENGINEERS (ASME)
- AMERICAN NATIONAL STANDARDS INSTITUTE (ANSI) - AMERICAN CONCRETE INSTITUTE (ACI)

- MISSOURI DEPARTMENT OF TRANSPORTATION (MODOT) - MISSOURI DEPARTMENT OF NATURAL RESOURCES (MODNR)

GENERAL NOTES

- 1. ALL DIMENSIONS SHALL BE FIELD VERIFIED BY THE CONTRACTOR.
- 2. ANY DISCREPANCIES BETWEEN SPECIFICATIONS, DRAWINGS, AND/OR SITE CONDITIONS SHALL BE REPORTED TO THE ENGINEER IMMEDIATELY.
- 3. ALL AREAS DESIGNATED TO REMAIN UNDISTURBED SHALL BE PROTECTED BY THE CONTRACTOR THROUGHOUT CONSTRUCTION.
- 4. THE CONTRACTOR SHALL BE RESPONSIBLE FOR STAKING THE LOCATION OF ALL PROPOSED IMPROVEMENTS, INCLUDING ROUGH AND FINISHED ELEVATIONS AND ALL OTHER PROPOSED IMPROVEMENTS INDICATED ON THE DRAWINGS.
- 5. THE CONTRACTOR SHALL VERIFY THAT ALL APPLICABLE LOCAL, STATE, & FEDERAL CODES ARE FOLLOWED. ALL APPLICABLE LOCAL AND STATE NOTIFICATIONS AND PERMITS SHALL BE ACQUIRED PRIOR TO CONSTRUCTION, INCLUDING ALL NECESSARY UTILITY CONNECTION PERMITS FROM THE RESPECTIVE UTILITIES.
- 6. THE CONTRACTOR SHALL BE RESPONSIBLE FOR ALL TEMPORARY UTILITIES AND SERVICES REQUIRED DURING CONSTRUCTION.
- 7. THE CONTRACTOR SHALL BE RESPONSIBLE FOR MAINTAINING ALL REFERENCE POINTS, BENCHMARKS, MONUMENTS, STAKES, AND PROPERTY CORNERS DURING CONSTRUCTION. REPLACEMENT OF LOST REFERENCE POINTS SHALL BE AT THE CONTRACTORS EXPENSE.
- 8. REMOVE ALL STRUCTURES, FOUNDATIONS, WALLS, PAVEMENTS, AND ALL OTHER ITEMS IN CONFLICT WITH PROPOSED IMPROVEMENTS IN ACCORDANCE WITH THE SPECIFICATIONS.
- 9. REFERENCES TO "STANDARD SPECIFICATIONS" SHALL MEAN THE MISSOURI DEPARTMENT OF TRANSPORTATION, "STANDARD SPECIFICATIONS FOR HIGHWAY CONSTRUCTION", LATEST ADDITION.
- 10. THE MEANS OF THE WORK AND THE SAFETY OF THE CONTRACTOR'S EMPLOYEES SHALL BE THE RESPONSIBILITY OF THE CONTRACTOR.
- 11. NO WORK SHALL BE PERFORMED BEYOND THE LIMITS OF CONSTRUCTION WITHOUT OWNER APPROVAL.
- 12. SITE CLEAN-UP SHALL BE PERFORMED ON A DAILY BASIS. SIDEWALKS, PARKING LOTS. ROADWAYS, AND THE PROJECT SITE SHALL BE KEPT CLEAN AT ALL TIMES. CONTROL DUST IN AND AROUND ALL WORK AND STAGING AREAS.
- 13. ALL OPEN EXCAVATIONS SHALL BE PROTECTED.
- 14. MAINTAIN POSITIVE DRAINAGE ON THE SITE THROUGHOUT THE PROJECT DURATION.

15. OWNER TO REMOVE BRUSH PILES.

- 16. IF A DISCREPANCY IN THE SPOT ELEVATIONS IS NOTED, THE CONTRACTOR SHALL NOTIFY THE ENGINEER PRIOR TO CONSTRUCTING. IF THERE IS A DISCREPANCY BETWEEN THE SPOT ELEVATIONS AND CONTOURS, THE CONTOURS SHALL GOVERN.
- 17. IF SOIL OR GROUNDWATER IS ENCOUNTERED WHICH EMITS A PETROLEUM ODOR OR IS DISCOLORED THE CONTRACTOR SHALL STOP EXCAVATION AND NOTIFY THE OWNER IMMEDIATELY. THE OWNER WILL COORDINATE ENVIRONMENTAL EFFORTS TO HANDLE THE IMPACTED SOIL OR GROUNDWATER IN ACCORDANCE WITH FEDERAL, STATE, AND LOCAL REQUIREMENTS, THE CONTRACTOR SHALL TAKE APPROPRIATE ACTION TO ENSURE PUBLIC AND EMPLOYEE SAFETY.

UTILITY NOTES

- 1. THE LOCATION OF EXISTING UTILITIES IN CONSTRUCTION AREAS SHALL BE FIELD VERIFIED BY THE CONTRACTOR BY CONTACTING THE MISSOURI ONE CALL SYSTEM, INC. OR THE INDIVIDUAL UTILITIES NOT PARTICIPATING IN THIS SYSTEM. EXISTING UTILITIES TO REMAIN SHALL BE PROTECTED. ANY REPAIR OR RELOCATION REQUIRED, AS A RESULT OF DAMAGE BY CONSTRUCTION ACTIVITIES SHALL BE AT THE CONTRACTOR'S EXPENSE. THE CONTRACTOR SHALL PAY UTILITY PERMIT AND/OR INSPECTION FEES.
- 2. UTILITY TRENCHES WITHIN PAVEMENT AREAS SHALL BE BACKFILLED WITH APPROVED COMPACTED GRANULAR BACKFILL.
- 3. ALL ELECTRIC SHALL BE IN ACCORDANCE WITH THE NATIONAL ELECTRIC CODE, CURRENT VERSION.
- 4. ADJUST ALL VALVES, MANHOLES, CASTINGS, GAS VENTS, ETC., TO MATCH THE NEW SURFACE. ADJUSTMENT SHALL BE COORDINATED WITH THE UTILITY COMPANIES AND THE COST FOR ALL ADJUSTMENTS SHALL BE INCIDENTAL TO THE CONSTRUCTION AT NO ADDITIONAL COST TO THE OWNER. REPAIR ANY DAMAGE TO SAID STRUCTURES AND APPURTENANCES THAT OCCUR DURING
- 5. THE DRAWINGS INDICATE THE BEST KNOWLEDGE OF THE OWNER AND ENGINEER/ARCHITECT ON THE GENERAL LOCATION AND NATURE OF THE EXISTING AND OR PROPOSED UNDERGROUND UTILITIES IN THE AREA OF CONSTRUCTION. EXPLORATORY EXCAVATIONS AT THE SITE TO DETERMINE INSITU LOCATIONS WERE NOT CONDUCTED. QUALITY LEVEL D IN ACCORDANCE WITH CI/ASCE 38-02, STANDARD GUIDELINE FOR THE COLLECTION AND DEPICTION OF EXISTING SUBSURFACE UTILITY DATA, WAS UTILIZED. REGARDLESS OF THE LEVEL OF INVESTIGATION, THE UTILITIES SHOWN SHOULD NOT BE CONSIDERED A WARRANTY OR GUARANTEE OF ACTUAL PRESENCE OR LOCATION AND THE CONTRACTOR REMAINS RESPONSIBLE FOR THE LOCATION, VERIFICATION, AND PROPER NOTIFICATION OF POTENTIAL UTILITIES.

QUALITY LEVELS: B

QUALITY LEVEL A - PROVIDES THE HIGHEST LEVEL OF ACCURACY. BY LOCATING OR POTHOLING UTILITIES IN ADDITION TO QUALITY LEVELS B, C, AND D TASKS. THE LOCATED UTILITY INFRASTRUCTURE IS SURVEYED AND MAPPED TO DEVELOP PLAN AND PROFILE INFORMATION.

QUALITY LEVEL B - INVOLVES DESIGNATING THE HORIZONTAL POSITION OF SUBSURFACE UTILITIES THROUGH SURFACE DETECTION METHODS AND RECORDING THE INFORMATION THROUGH A SURVEY METHOD. IN ADDITION TO QUALITY LEVEL C AND D TASKS.

QUALITY LEVEL C - INVOLVES SURVEYING VISIBLE SUBSURFACE UTILITY STRUCTURES SUCH AS MANHOLES, HAND-HOLES, UTILITY VALVES AND METERS, FIRE HYDRANTS, PEDESTALS AND UTILITY MARKERS, AND THEN CORRELATING THE INFORMATION WITH EXISTING UTILITY RECORDS TO CREATE COMPOSITE DRAWINGS. IN ADDITION TO QUALITY LEVEL D TASKS

QUALITY LEVEL D - INVOLVES COLLECTING DATA FROM EXISTING UTILITY RECORDS, THAT MAY INCLUDE AS-BUILT DRAWINGS, DISTRIBUTION AND SERVICE MAPS, EXISTING GEOGRAPHIC INFORMATION SYSTEM DATABASE, CONSTRUCTION PLANS, ETC. DATABASES, CONSTRUCTION PLANS,

EROSION CONTROL NOTES

- 1. EROSION CONTROL SHALL BE INSTALLED IN ACCORDANCE WITH MANUFACTURER'S RECOMMENDATIONS, THE DETAILS IN THESE PLANS, AND THE MISSOURI DEPARTMENT OF NATURAL RESOURCES STANDARDS AND REQUIREMENTS FOR EROSION AND SEDIMENT
- 2. THE EROSION CONTROL SHOWN ON THIS SET OF PLANS SHALL BE CONSIDERED THE MINIMUM ACCEPTABLE FOR THIS PROJECT. THERE MAY BE ADDITIONAL EROSION CONTROL REQUIRED DUE TO THE VARIOUS CONSTRUCTION TECHNIQUES, WHICH MAY BE USED. THE CONTRACTOR IS RESPONSIBLE FOR CONTROLLING AND MAINTAINING ALL THE RUNOFF FROM THE SITE, IN A MANNER WHICH KEEPS ALL SILT ON SITE.
- 3. A LAND DISTURBANCE PERMIT WILL NOT BE REQUIRED SINCE LESS THAN 1 ACRE OF LAND WILL BE DISTURBED BY GRADING OPERATIONS.
- 4. ALL INLET PROTECTION AND TEMPORARY EROSION CONTROL MEASURES SHALL BE REMOVED UPON COMPLETION OF PAVING OPERATIONS AND FINAL STABILIZATION OF LANDSCAPED AND SEED AREAS.

ABBREVIATIONS

FL	FLOWLINE ELEVATION
TC	TOP OF CURB ELEVATION
GL	GUTTER LINE ELEVATION
TG	TOP OF GRATE ELEVATION
STA	STATION
FES	FLARED END SECTION
SWI	STORM WATER INLET
FFE	FINISH FLOOR ELEVATION
HP	HIGH POINT
LP	LOW POINT
TW	TOP OF WALL ELEVATION
BW	BOTTOM OF WALL ELEVATION
DS	DOWNSPOUT
EP	EDGE OF PAVEMENT

NOT IN CONTRACT

(M) MATCH EXISTING

Know what's below. Call before you dig.

— NOTE — UTILITY INFORMATION IS FOR THE CONVENIENCE OF THE CONTRACTOR. BEFORE CONSTRUCTION BEGINS THE CONTRACTOR SHALL CONTACT MISSOURI ONE CALL SYSTEM, INC. AT 811 OR 1-800-344-7483 AND THE INDIVIDUAL UTILITIES NOT INCLUDED IN THIS SYSTEM FOR THE LOCATION OF ALL EXISTING UTILITIES.

EXISTING	PROPOSED	
	Y	PROPERTY LINE
	-	LOT LINE
	·	RIGHT OF WAY LINE
	· · · · · · · · · · · · · · · · · · ·	CENTERLINE
		EASEMENT
		BUILDING SETBACK
		CONSTRUCTION LIMITS
X	x	FENCE LINE
0		CHAIN LINK FENCE
		FENCE W/ SQUARE POSTS STREAM
		STRUCTURE
		PAVEMENT MARKINGS
		EDGE OF PAVEMENT
=======		CURB AND GUTTER
		RAILROAD TRACKS
	—— w ——— w ———	WATER LINE
FP FP	—— FP ——— FP ———	FIRE PROTECTION
G G	G G	GAS LINE
	—— 0E——— 0E———	OVERHEAD ELECTRIC
UEUE	UE	UNDERGROUND ELECTRIC
OT	—— от ——— от ———	OVERHEAD TELEPHONE
UT	——	
CATV —— CATV——	CATV	
F0 — F0 —	F0F0	FIBER OPTIC
COM	COM COM	COMMUNICATION LINE
) ST)		
FMFM	FMFM	
ST-SAN		COMBINED SEWER
IR		IRRIGATION SYSTEM
<u>\$</u> \$ \$	<u> </u>	MAST ARM SIGNAL (3 SIGNALS)
44	<u> </u>	MAST ARM SIGNALS (2 SIGNALS
Ф	•	UTILITY TRAFFIC SIGN
σ	T	SIGN
0		MANHOLE
		STORM WATER INLET
⊕ ⊞	#	CATCH BASIN
c/0 ₀	c/0•	CLEANOUT
		CULVERT BOX CULVERT
	IBI I	WATER VALVE
A	~	FIRE HYDRANT
PIV	PN	POST INDICATOR VALVE
W	W	WATER METER
\otimes	⊗	GAS VALVE
G	G	GAS METER
T	T	TELEPHONE PEDESTAL
\square	M	CABLE TV PEDESTAL
E	Ε	ELECTRIC METER
Ø	ø	UTILITY POLE
₩	*	LIGHT STANDARD
0-0	•••	LIGHT POLE
2		GUY WIRE
004		SUMMIT / HIGH POINT
	600	CONTOURS INDEX CONTOURS
000	~~	DIRECTION OF DRAINAGE
	~ 600.00	
63	Z 000.00	SPOT ELEVATION DECIDUOUS SHRUB
Sand Sand	+	DECIDUOUS TREE
		CONIFEROUS SHRUB
Z		CONIFEROUS TREE

STATE OF MISSOURI MICHAEL L. PARSON, **GOVERNOR**

BIDDING DOCUMENTS



OFFICE OF ADMINISTRATION DIVISION OF FACILITIES MANAGEMENT, **DESIGN AND CONSTRUCTION**

DEPARTMENT OF NATURAL RESOURCES DIVISION OF STATE PARKS

REPLACE LAGOON

LONG BRANCH STATE PARK 28615 VISITOR CENTER RD MACON, MO 63552

PROJECT # X2302-02 SITE# 5601 7815601020 ASSET#

REVISION: DATE REVISION: DATE REVISION: DATE ISSUE DATE: 02-12-2024


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SHEET TITLE:

GENERAL NOTES AND

LEGENDS

SHEET NUMBER:

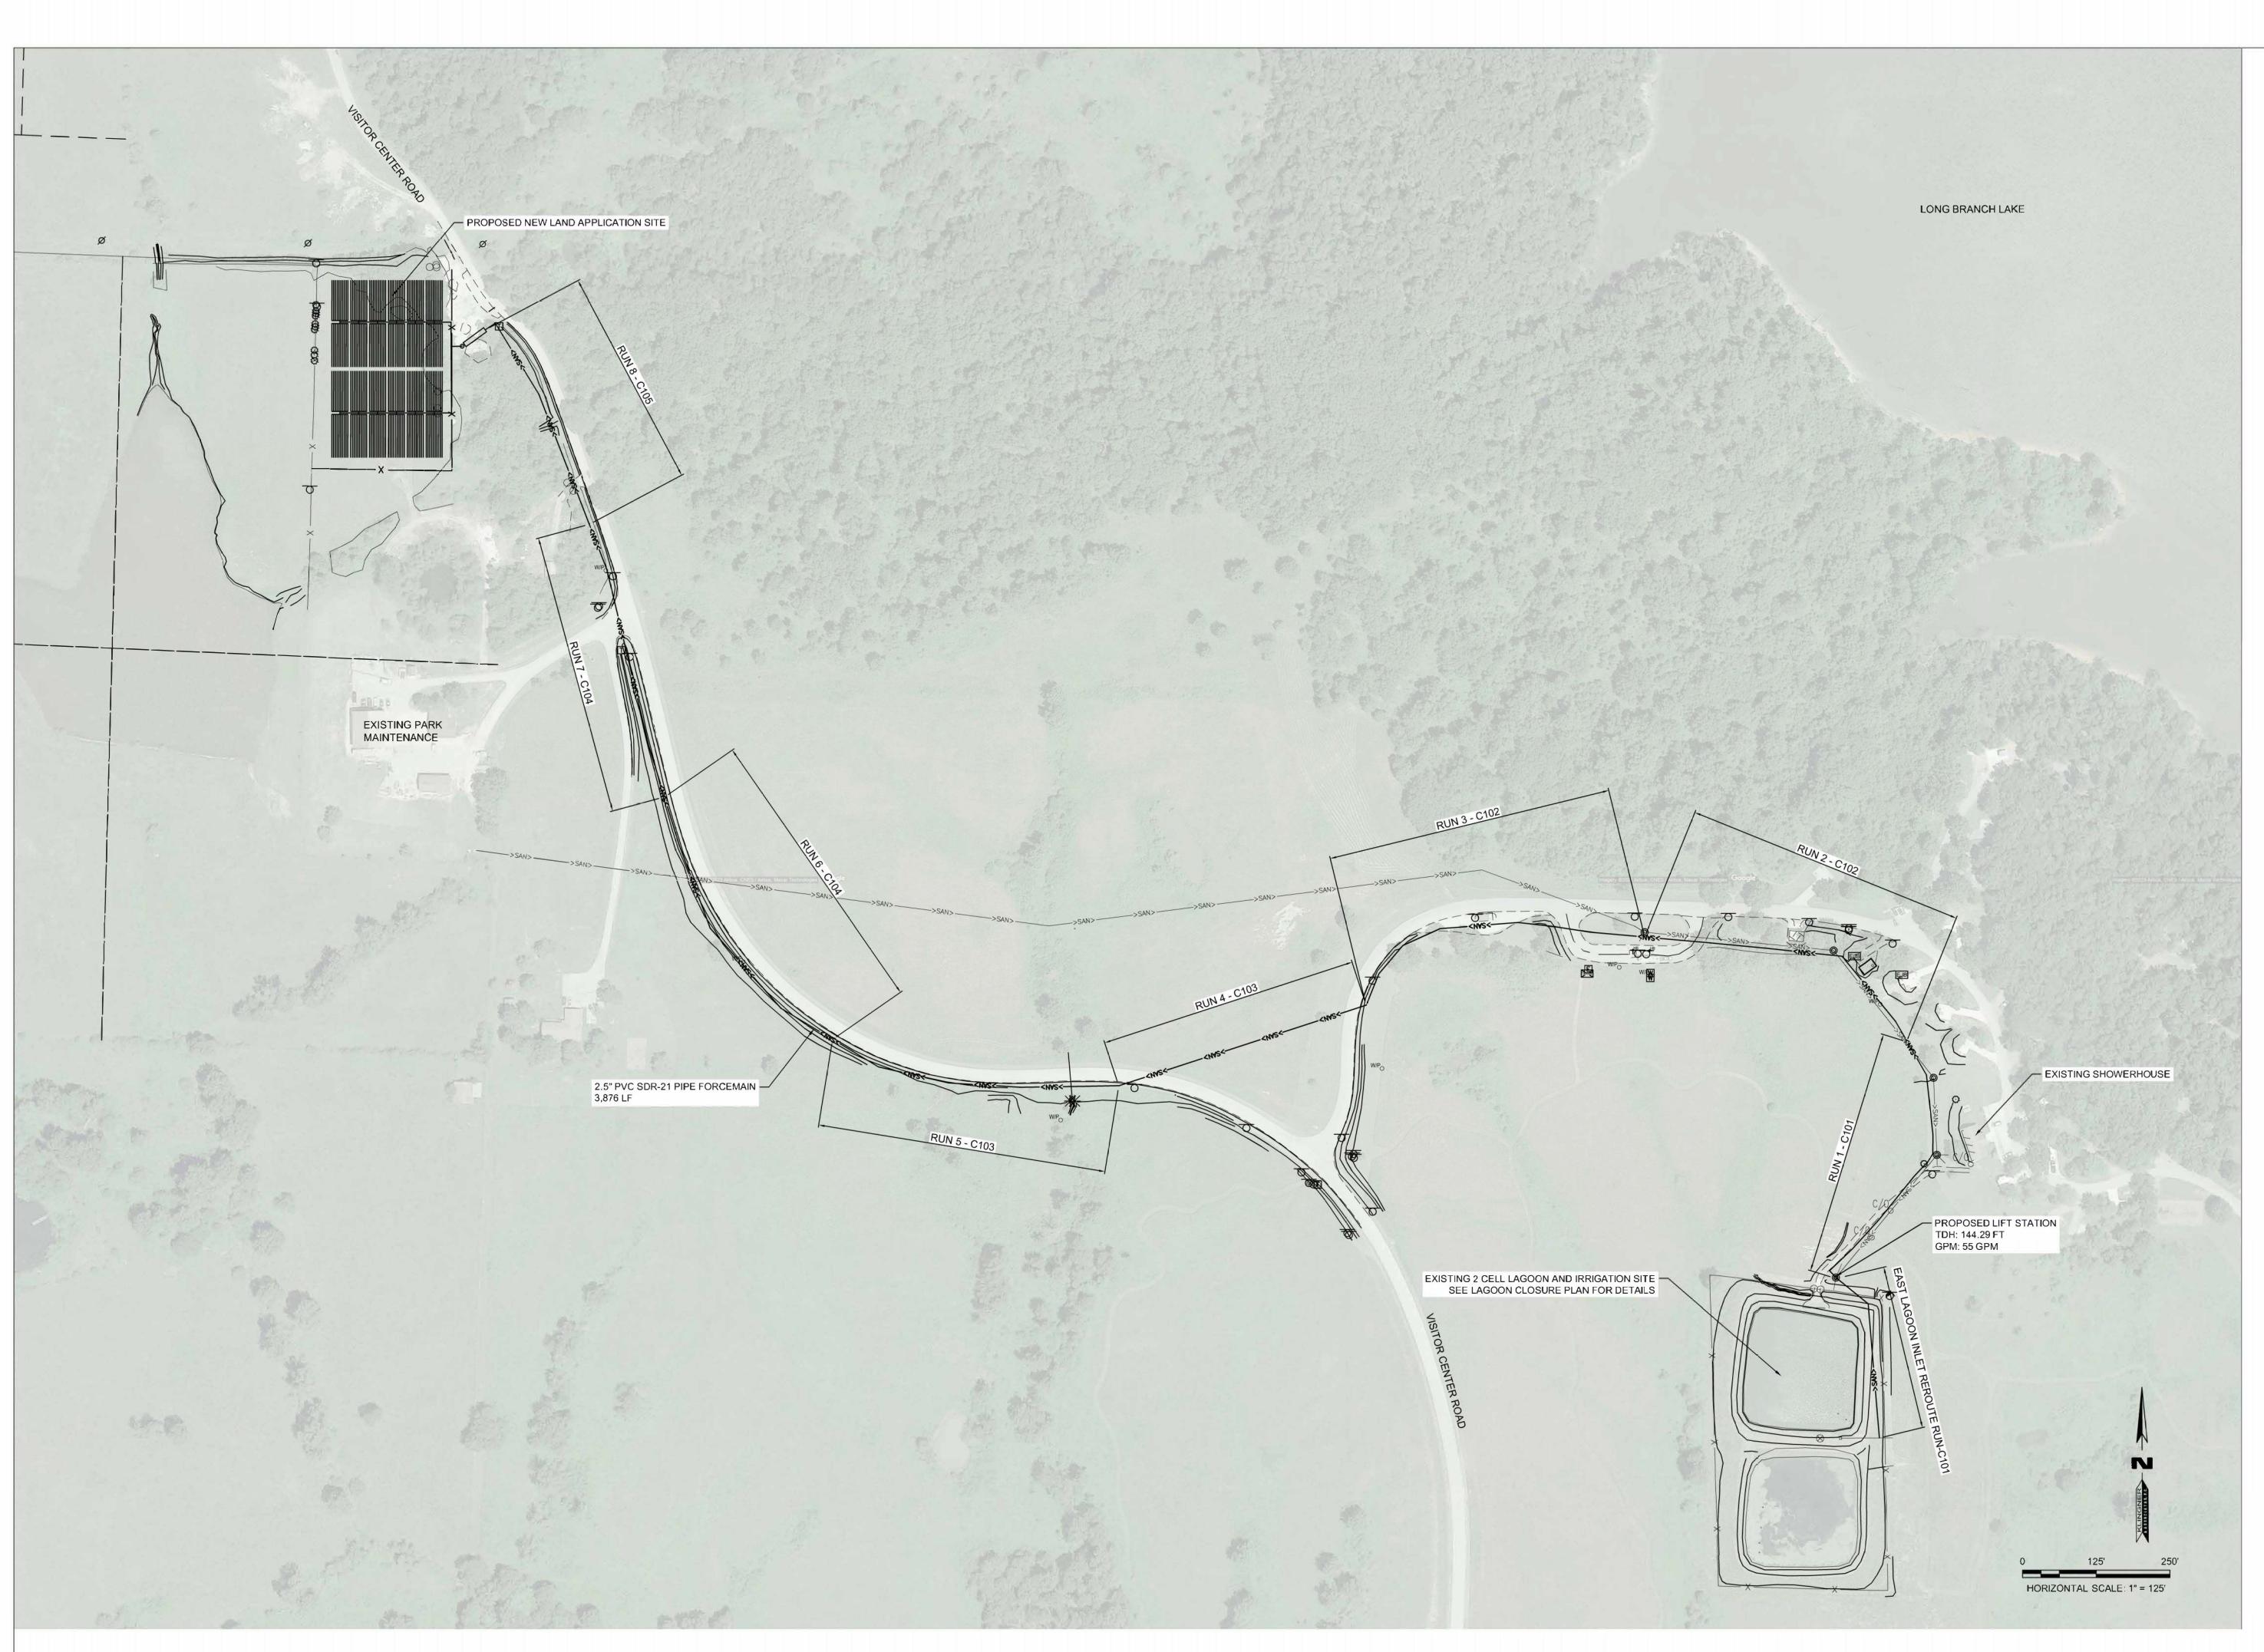

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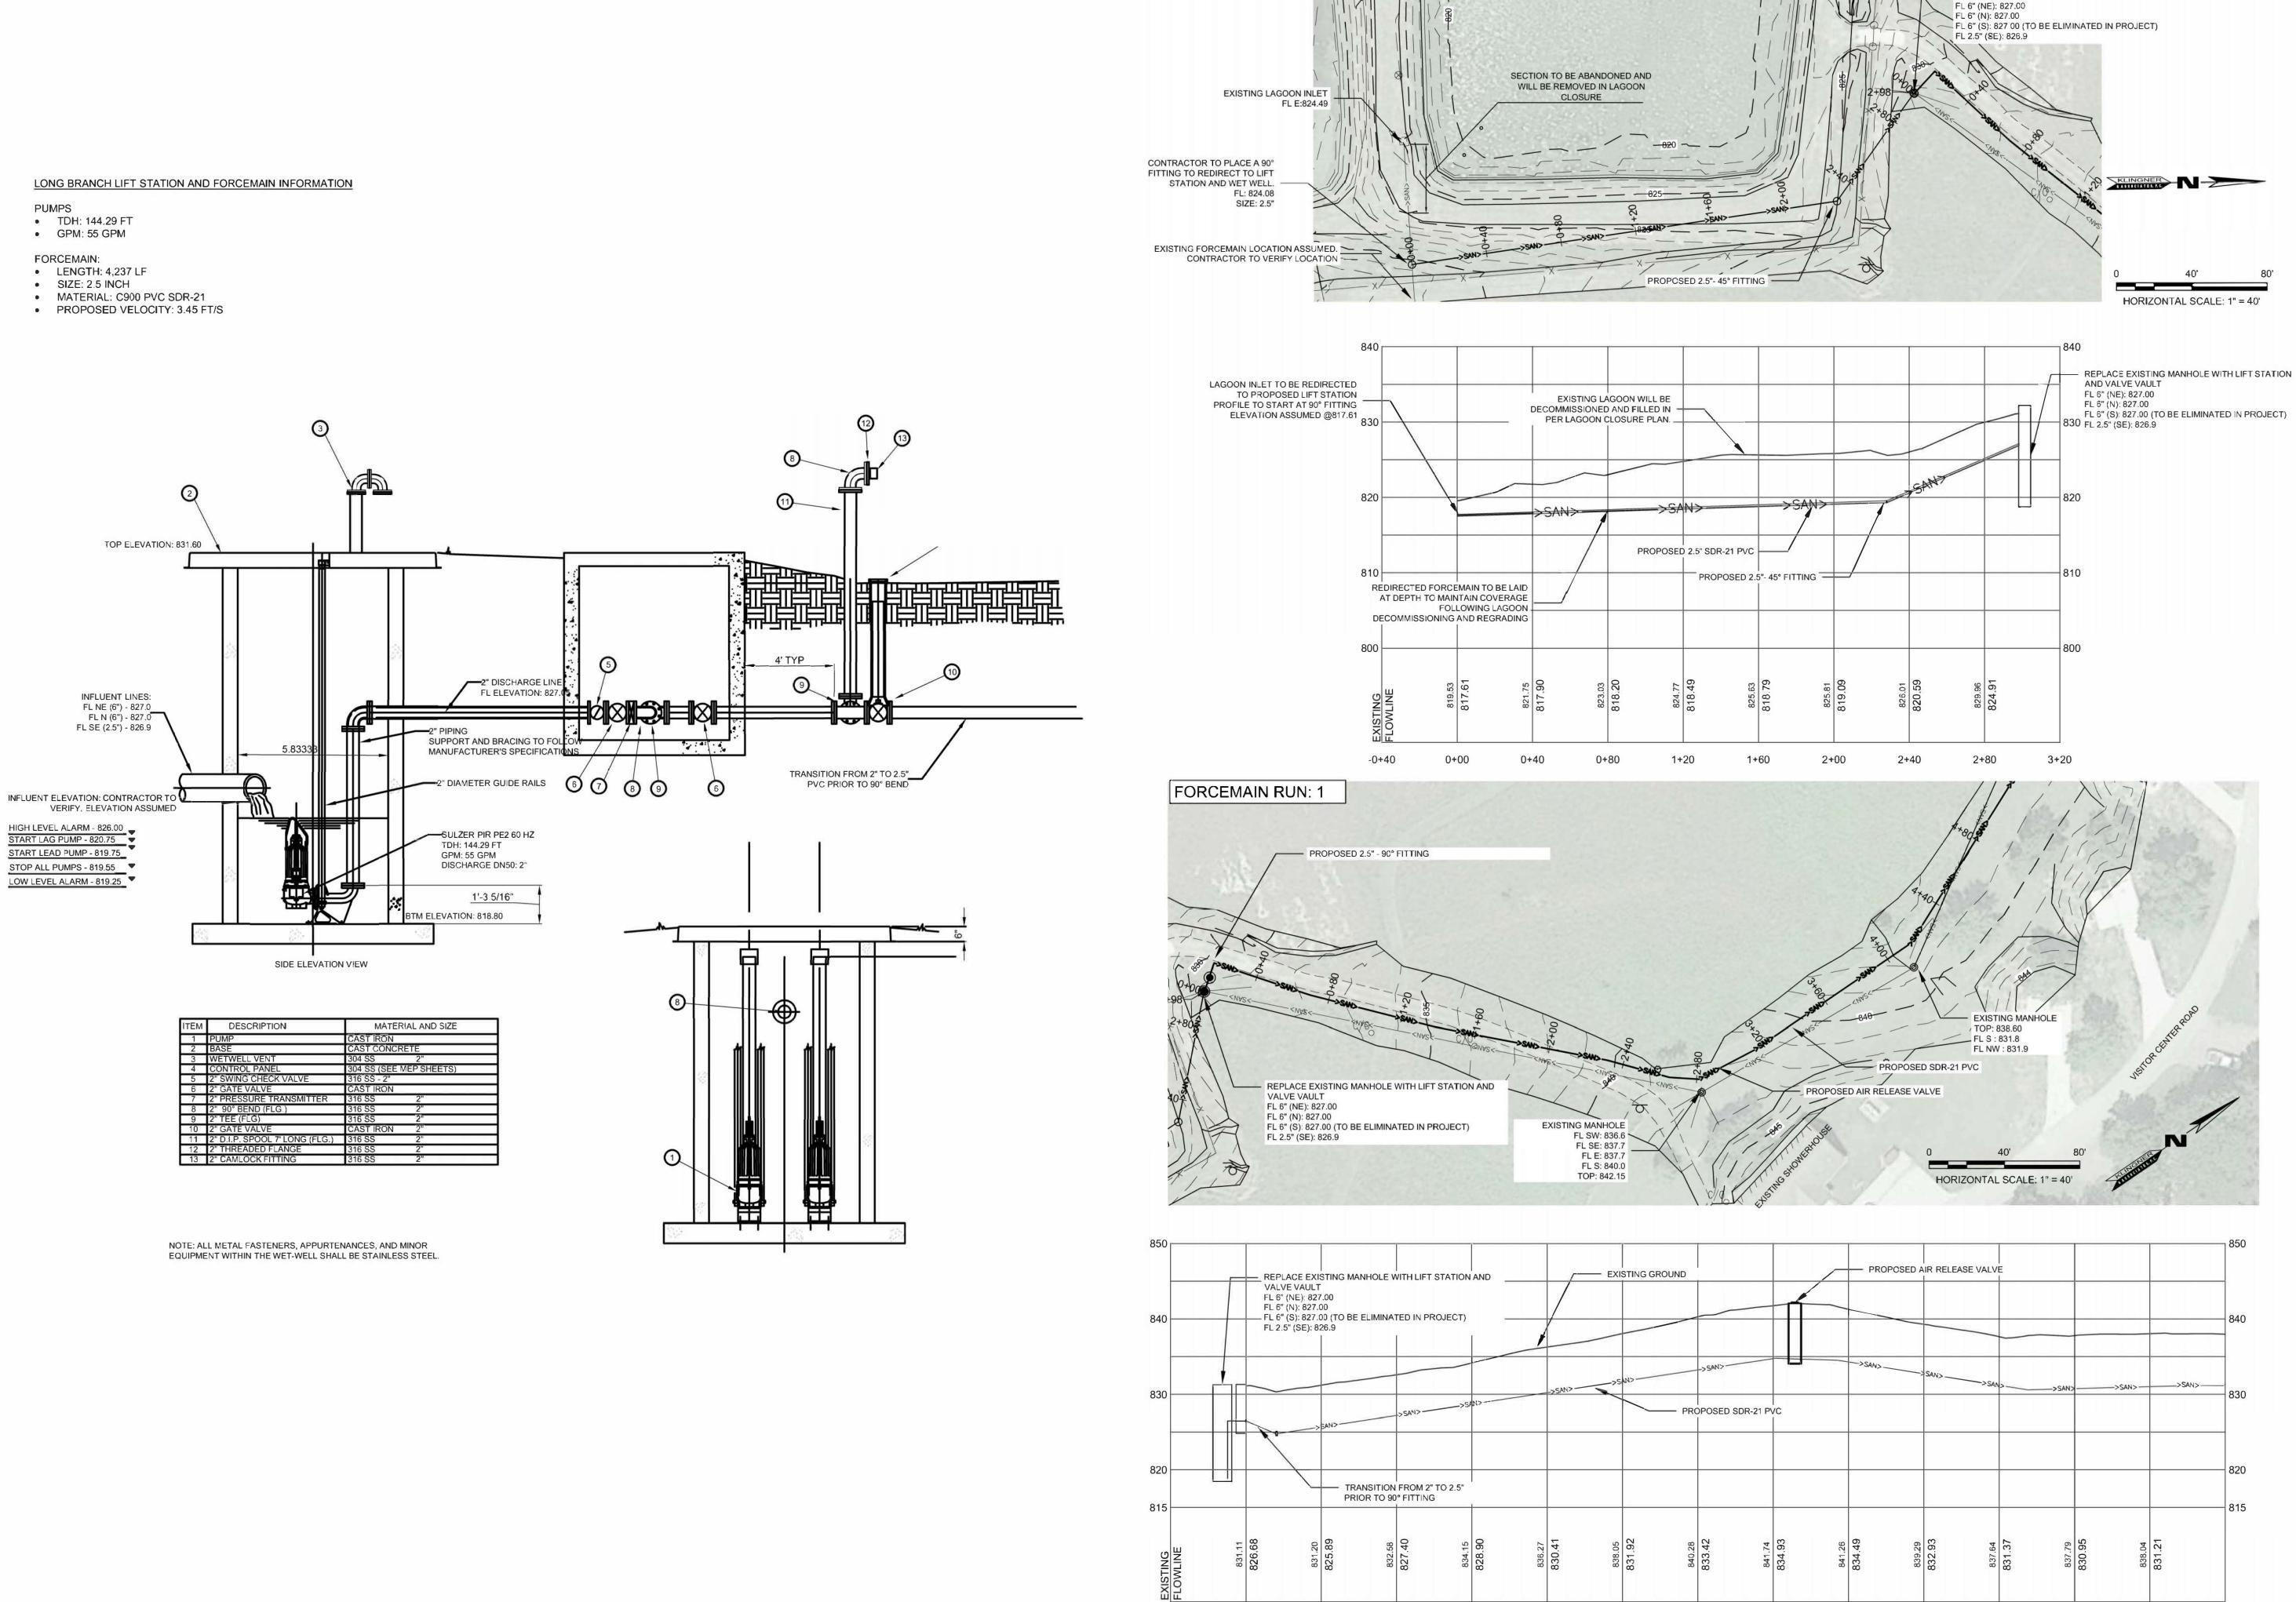
CAD DWG FILE:
DRAWING BY: JDH
CHECKED BY: JDH
DESIGNED BY: JDH

SHEET TITLE:

GENERAL SITE LAYOUT

SHEET NUMBER:

C100



0+80

1+20

1+60

2+00

2+40

2+80

3+20

3+60

EAST LAGOON INLET REROUTE

STATE OF MISSOURI MICHAEL L. PARSON, **GOVERNOR**

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- REPLACE EXISTING MANHOLE WITH LIFT STATION AND

VALVE VAULT





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> CAD DWG FILE: DRAWING BY: JDH CHECKED BY: JDH DESIGNED BY: JDH

SHEET TITLE:

LIFT STATION DETAILS AND FORCEMAIN RUN 1

SHEET NUMBER:

FORCEMAIN RUN: 2 PROPOSED 2.5" - 45° FITTING 36 LF CONCRETE DRIVE CROSSING TO BE REPLACED EXISTING MANHOLE TOP 845.99 FL E: 837.50 TOP OF SW: 839.3 FL NW: 841.2 HORIZONTAL SCALE: 1" = 40' 36 LF CONCRETE DRIVE CROSSING TO BE REPLACED ----- SANITARY SEWER CROSSING PROPOSED SDR-21 PVC PF OPOSED 2.5" - 45° FITTING FORCEMAIN RUN: 3 START OF BORE -PROPOSED 2.5" -45° FITTING — 150 LF CONCRETE DRIVEWAY CROSSING (TO BE REPLACED) PROPOSED AIR RELEASE VALVE 30 LF OPEN CUT ROAD TROSSING TO BE REPLACED PROPOSED SDR-21 PVC HORIZONTAL SCALE: 1" = 40' PROPOSED AIR RELEASE VALVE

PROPOSED 2.5" - 45° FITT NG ----

14+80

14+40

PROPOSED SDR-21 FVC

150 LF CONCRETE DRIVEWAY CROSSING (TO BE REPLACED)

13+20

13+60

14+00

12+40

30 LF OPEN CUT ROAD CROSSING TO BE REPLACED STATE OF MISSOURI MICHAEL L. PARSON, GOVERNOR BIDDING DOCUMENTS





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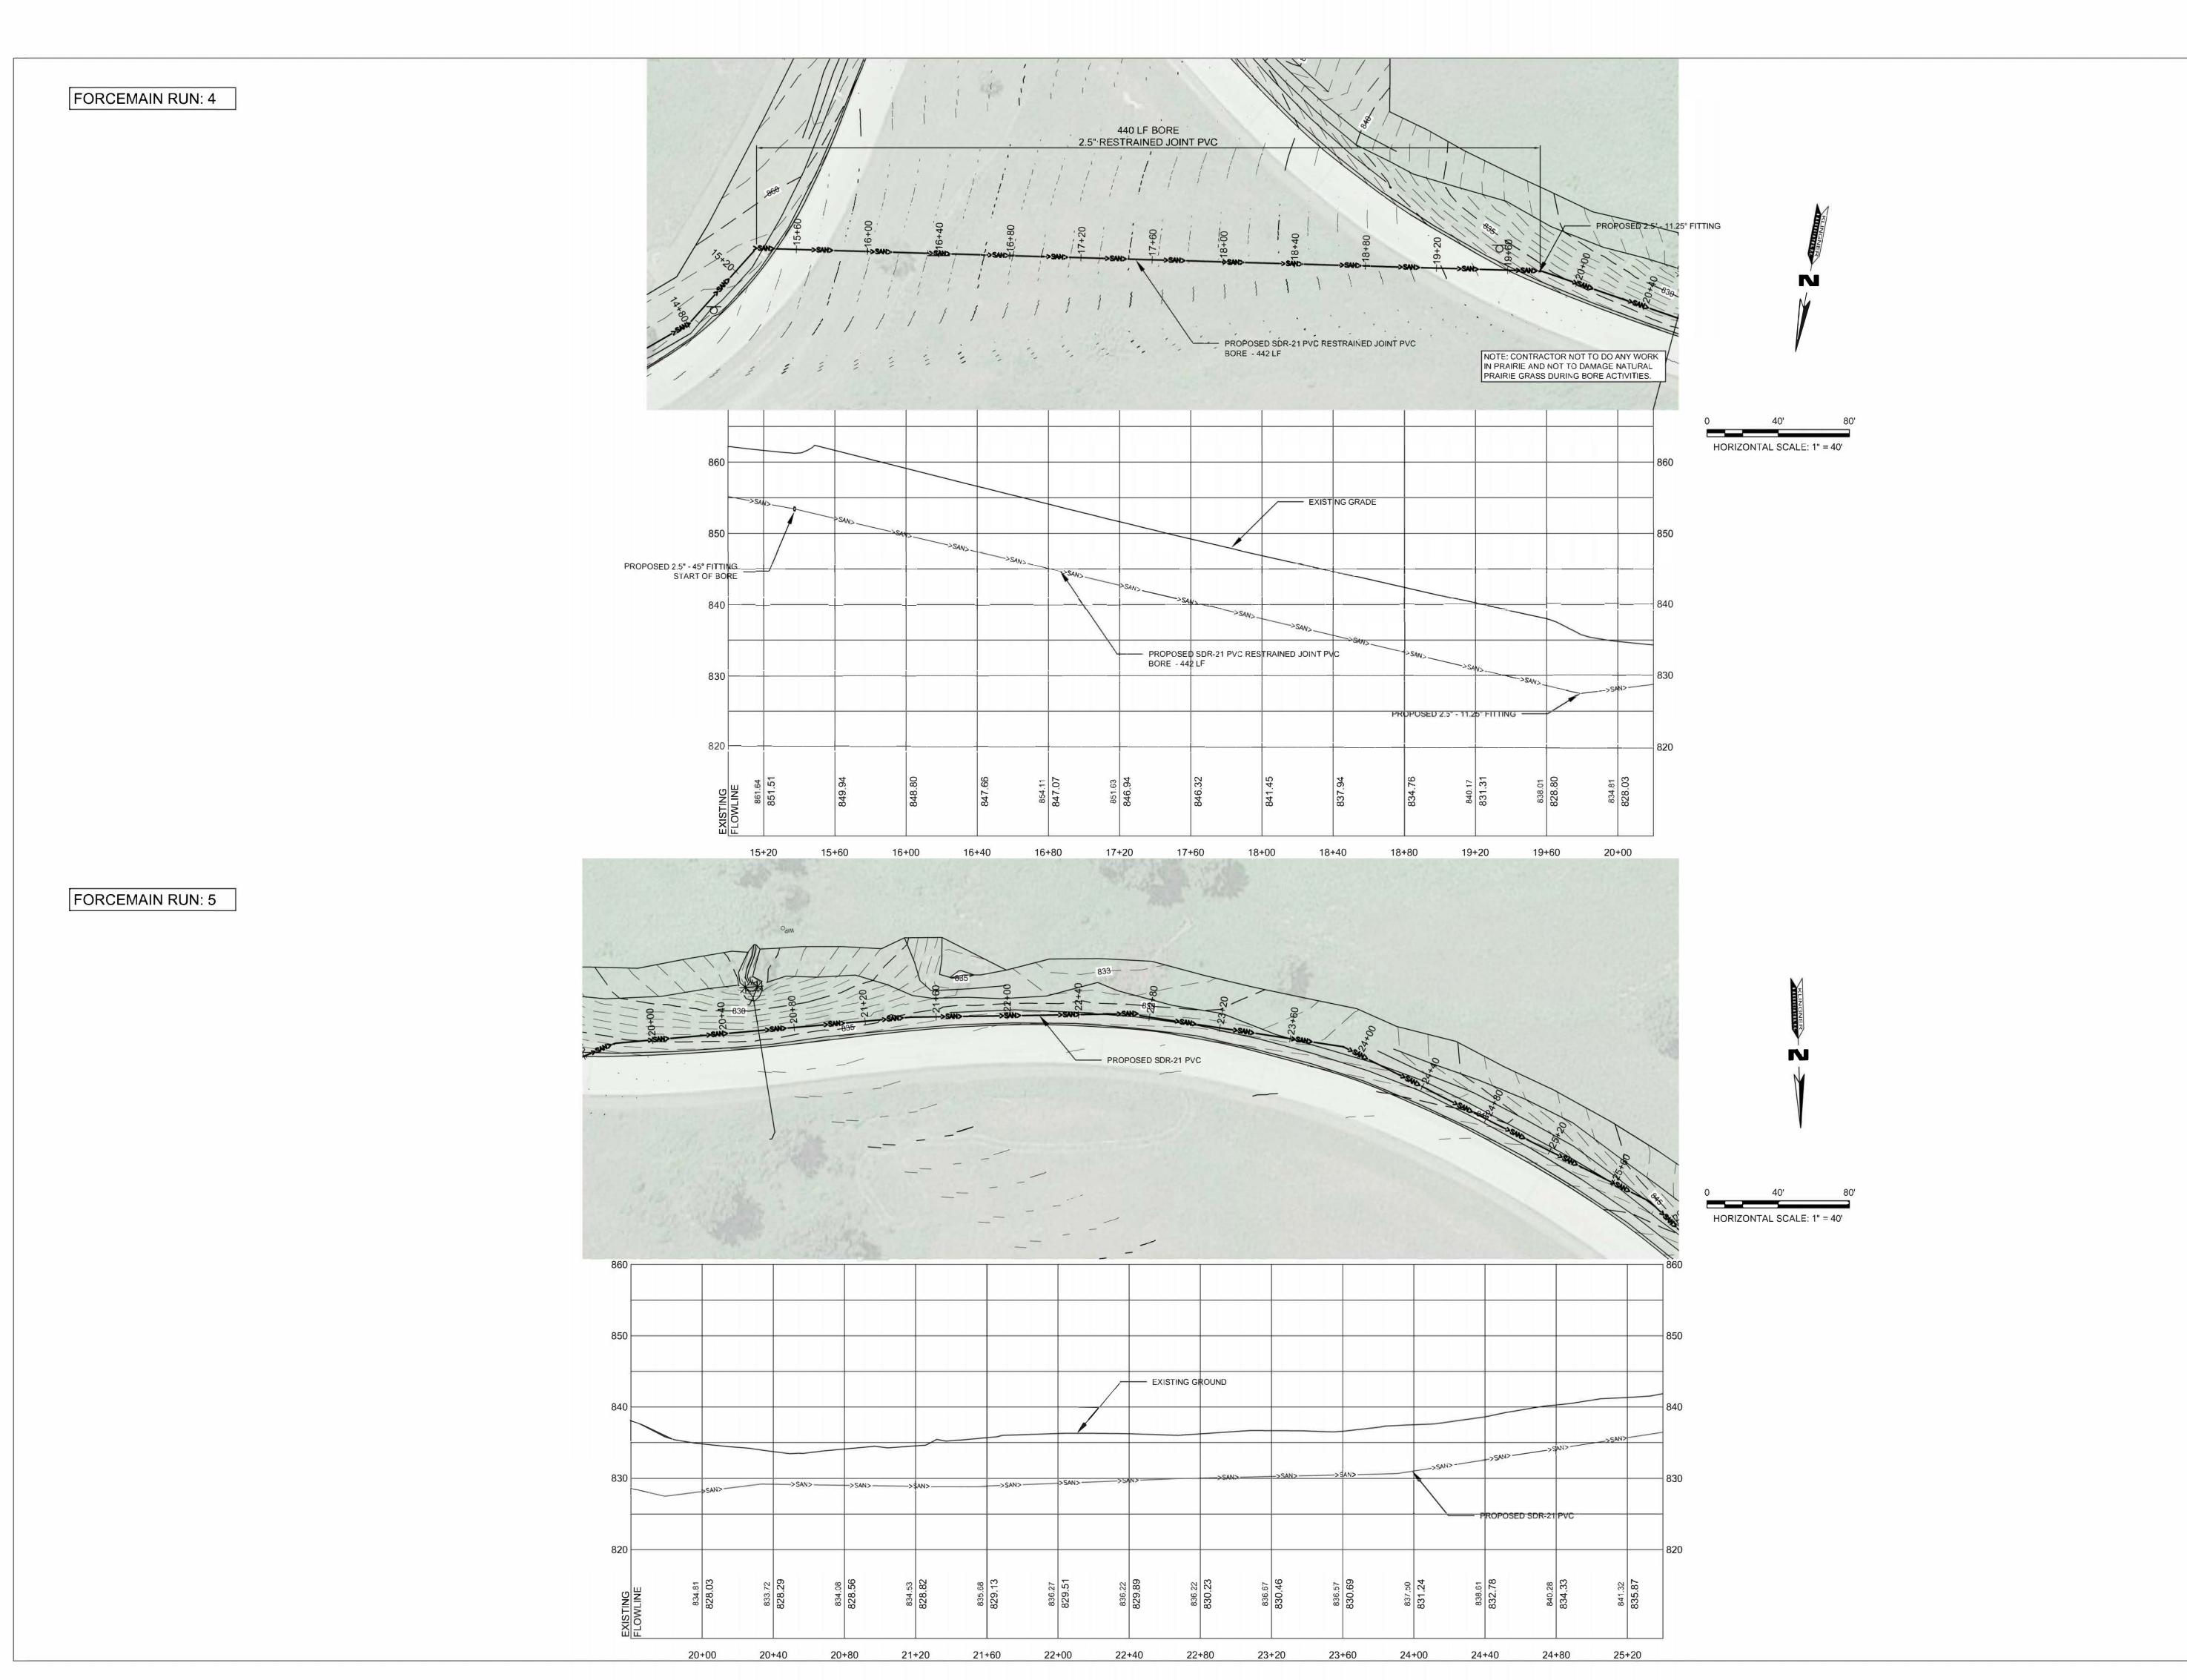
CAD DWG FILE:
DRAWING BY: JDH
CHECKED BY: JDH
DESIGNED BY: JDH

SHEET TITLE:

FORCEMAIN RUNS 2 & 3

SHEET NUMBER:

C102



BIDDING DOCUMENTS





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DATE:
ISSUE DATE: 02-12-2024

CAD DWG FILE:
DRAWING BY: JDH
CHECKED BY: JDH
DESIGNED BY: JDH

SHEET TITLE:

FORCEMAIN RUNS 4 & 5

SHEET NUMBER:

C103

EXISTING MAINTENANCE SHOP FORCEMAIN DEPTH AND LOCATION ASSUMED — STA 28+52 FORCEMAIN RUN: 6 EXISTING MAINTENANCE SHOP FORCEMAIN
DEPTH AND LOCATION ASSUMED
STA 28+52 HORIZONTAL SCALE: 1" = 40' EXISTING GRADE -PROPOSED 2.5" -SDR-21.P\ 29+60 FORCEMAIN RUN: 7 EXISTING TELEPHONE JUNCTION BOX PROPOSED AIR RELEASE VALVE EXISTING UTILITY POLE 60 LF OPEN CUT DRIVEWAY CROSSING TO BE REPLACED - EXISTING UTILITY POLE HORIZONTAL SCALE: 1" = 40' PROPCISED AIR RELEASE VALVE 60 LF OPEN CUT DRIVEWAY CROSSING TO BE REPLACED PROPOSED 2.5" - PVC SDR-21 -

31+20

31+60

32+00

32+40

32+80

33+20

33+60

34+40

STATE OF MISSOURI MICHAEL L. PARSON, **GOVERNOR**

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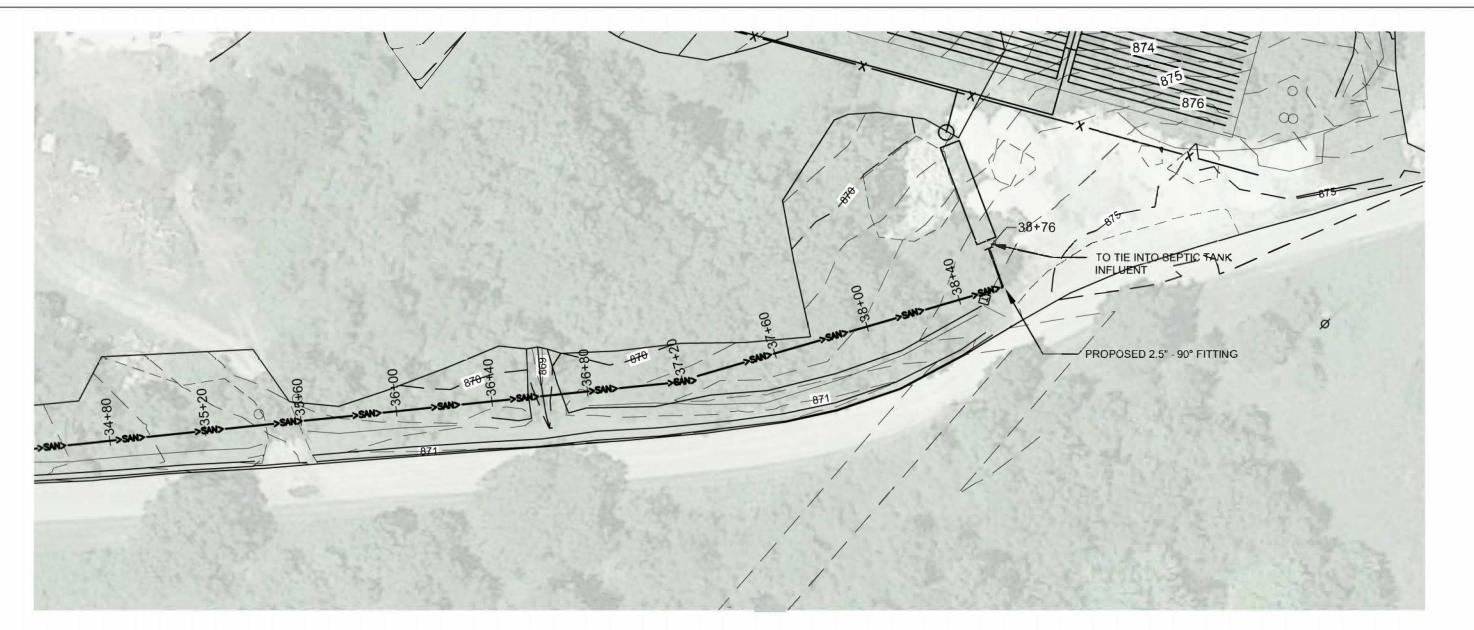
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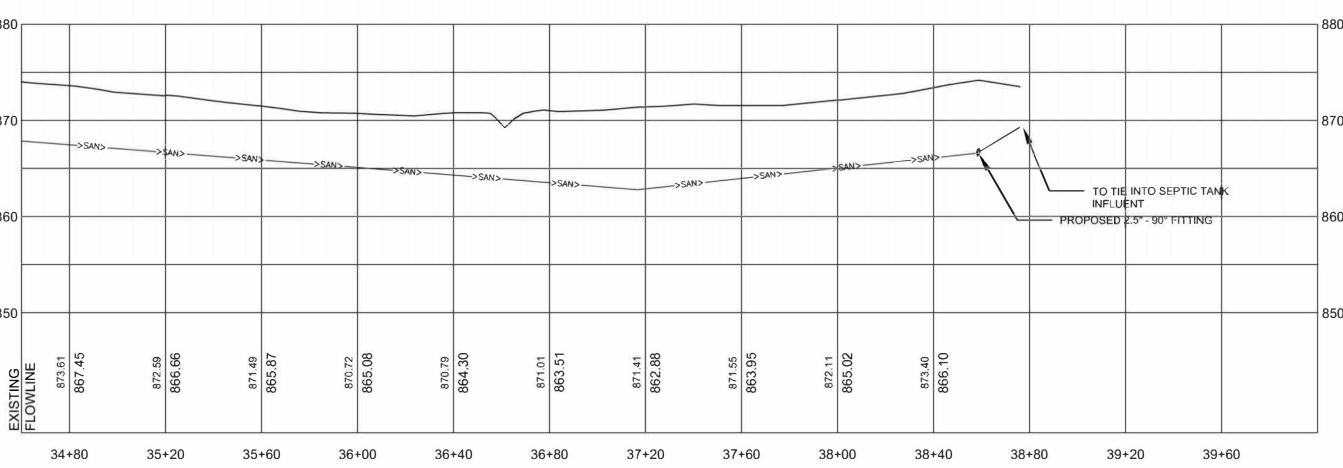
FORCEMAIN RUNS 6 & 7

SHEET NUMBER:

C104

FORCEMAIN RUN: 8





STATE OF MISSOURI MICHAEL L. PARSON, GOVERNOR

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HORIZONTAL SCALE: 1" = 40"

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DATE:
ISSUE DATE: 02-12-2024

ISSUE DATE: 02-12-202

CAD DWG FILE:
DRAWING BY: JDH
CHECKED BY: JDH
DESIGNED BY: JDH

SHEET TITLE:

FORCEMAIN RUN 8

SHEET NUMBER:

C105



FLOATS TO BE SET AT THE FOLLOWING: HIGH LEVEL ALARM- 2" BELOW INLET
 PUMP ON: 4" BELOW INLET

FILTER CARTRIDGE

3. PUMP OFF: 6.5 INCHES BELOW INLET AND MIN 5" ABOVE TOP OF BIOTUBE


FLEXIBLE CONNECTOR -

3 1,000 GALLON DOSING TANK

Table 1-Minimum Set-Back Distances

Minimum Distance From	Sewage Tank ¹	Disposal Area ²	Lagoons	
Private water supply well ³	(feet)	(feet)	(feet)	
	50	100	100	
Public water supply well	300	300	300	
Cistern	25	25	25	
Spring	50	100	100	
Classified stream, lake or impoundment*	50	50	50	
Stream or open ditch ⁴	25	25	25	
Property lines	10	10**	75	
Building foundation	5	15	15	
Basement	15	25	25	
Swimming pool	15	15	15	
Water line under pressure	10	10	10	
Suction water line	50	100	100	
Upslope interceptor drains		10	10	
Downslope interceptor drains		25	25	
Top of slope of embankments or cuts of two				
feet (2') or more vertical height	_	20	20	
Edge of surficial sink holes	50	100	500	
Other soil absorption system except repair area	-	20	20	

^{*}A classified stream is any stream that maintains permanent flow or permanent pools during drought periods and

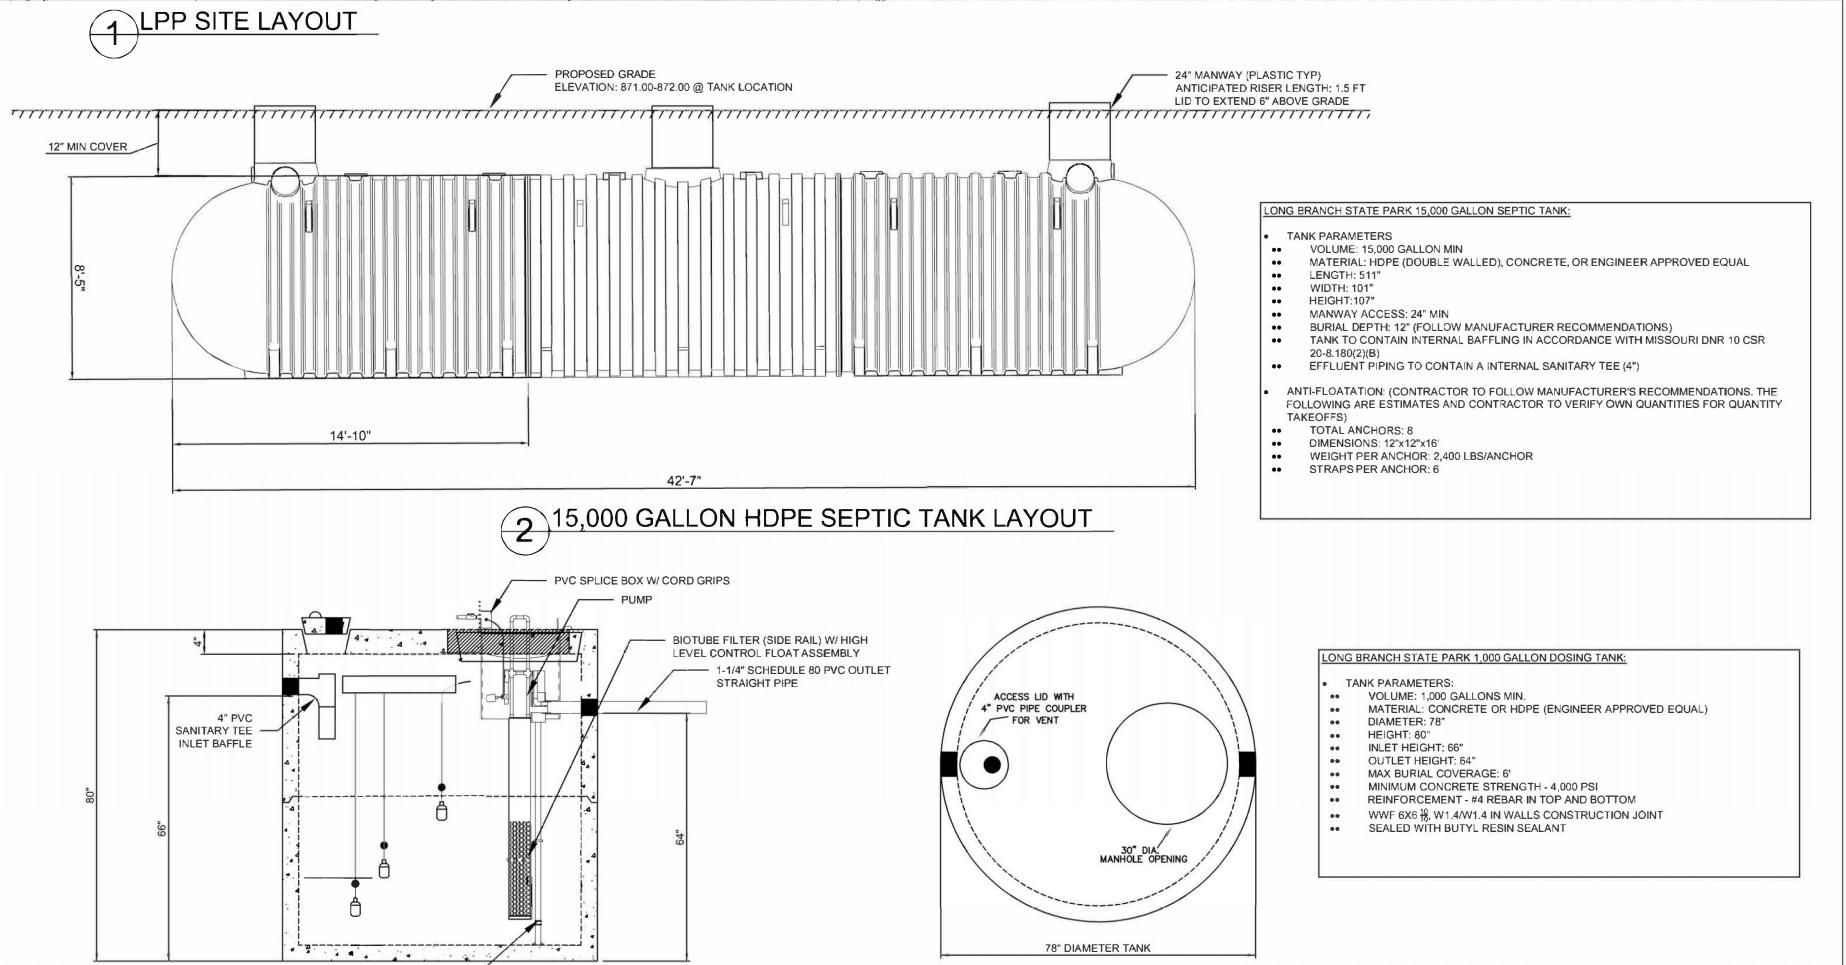

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PROJECT # X2302-02 5601 SITE# 7815601020 ASSET#

REVISION: DATE **REVISION:** DATE REVISION: DATE:

ISSUE DATE: 02-12-2024

CAD DWG FILE: DRAWING BY: JD CHECKED BY: JDH DESIGNED BY: JD.H

SHEET TITLE:

LPP DETAILS - 1

SHEET NUMBER:

9 OF 15 SHEETS

FEBRUARY 12, 2024


^{**}Recommend twenty-five feet (25') of downslope property line initially, but repair may be allowed to ten feet (10') of downslope property line.

Includes sewage tanks, intermittent sand filters and dosing chambers.

² Includes all systems (sand filter, wetland and the like) except wastewater stabilization ponds.


³ Unplugged abandoned wells or wells with less than eighty feet (< 80') of casing depth shall have one-hundred-fifty feet (150') minimum distance from all above.

⁴ Sewage tanks and soil absorption systems should never be located in the drainage area of a sinkhole.

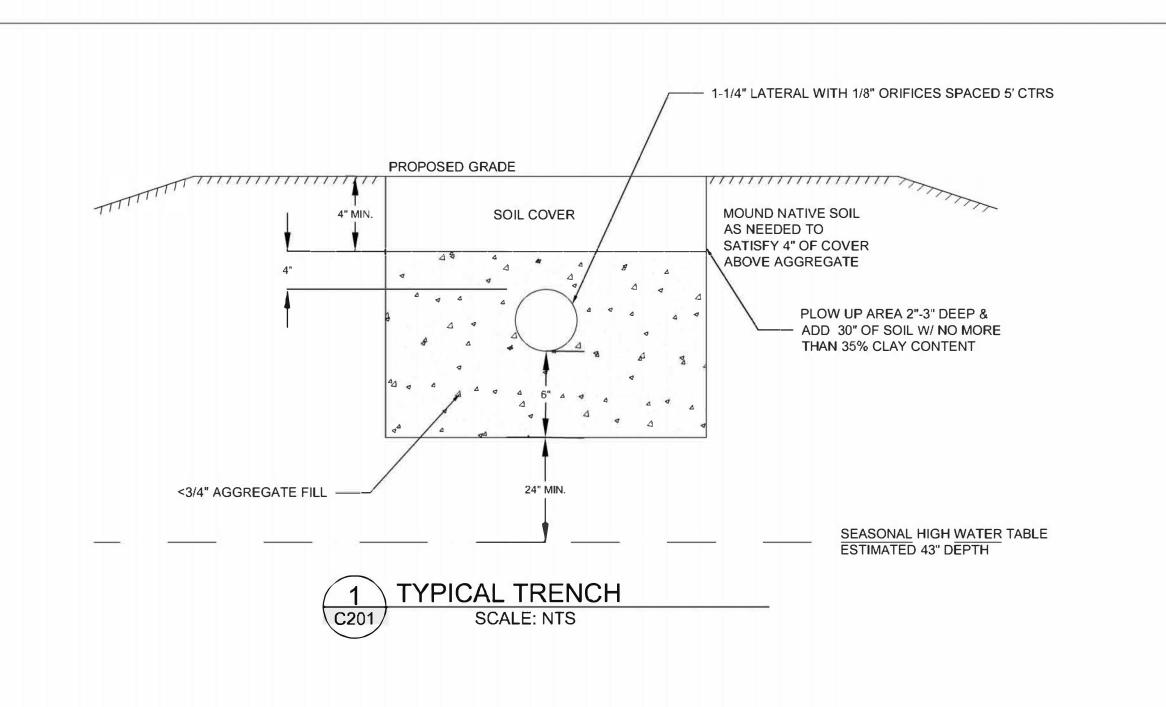


HORIZONTAL SCALE: 1" = 40' EXISTING GRADING
CONTOUR ELEVATION T PROPOSED GATE LOCATION SEE SHEET C500 FOR DETAILS EDGE OF LPP FIELD (5 FT FROM EDGE OF LAST LATERAL) GRADING TO BLEND TO EXISTING GRADE PROPOSED GRADING CONTOUR ELEVATION FIELD TO BE RAISED 2.5 FT AND COMPACTED WITHIN BORDER AND BLEND GRADING TO EXISTING AT A 4:1 SLOPE FILL TO BE 30" OF SOIL W/ NO - MORE THAN 35% CLAY CONTENT LPP FIELD FENCE OUTLINE 570 LF TO BE TIED INTO THE EXISTING FENCELINE GRADING NOTE: GRADING TO BE COMPACTED AND RESEEDED PER SPECIFICATIONS. GRADING TO BLEND OUTSIDE LPP FIELD BOUNDARY TO THE EXISTING GRADE AT A MINIMUM 4:1 SLOPE. SEEDING NOTE: ANNUAL GRASS COVER: VIRGINIA OR CANADA WILD RYE (QUICK PERENNIAL COVER RESPONSE) 2. FALL FOLLOW UP: NATIVE WARM SEASON GRASSES (COLLECTED BY PARK)

LPP FIELD GRADING PLAN

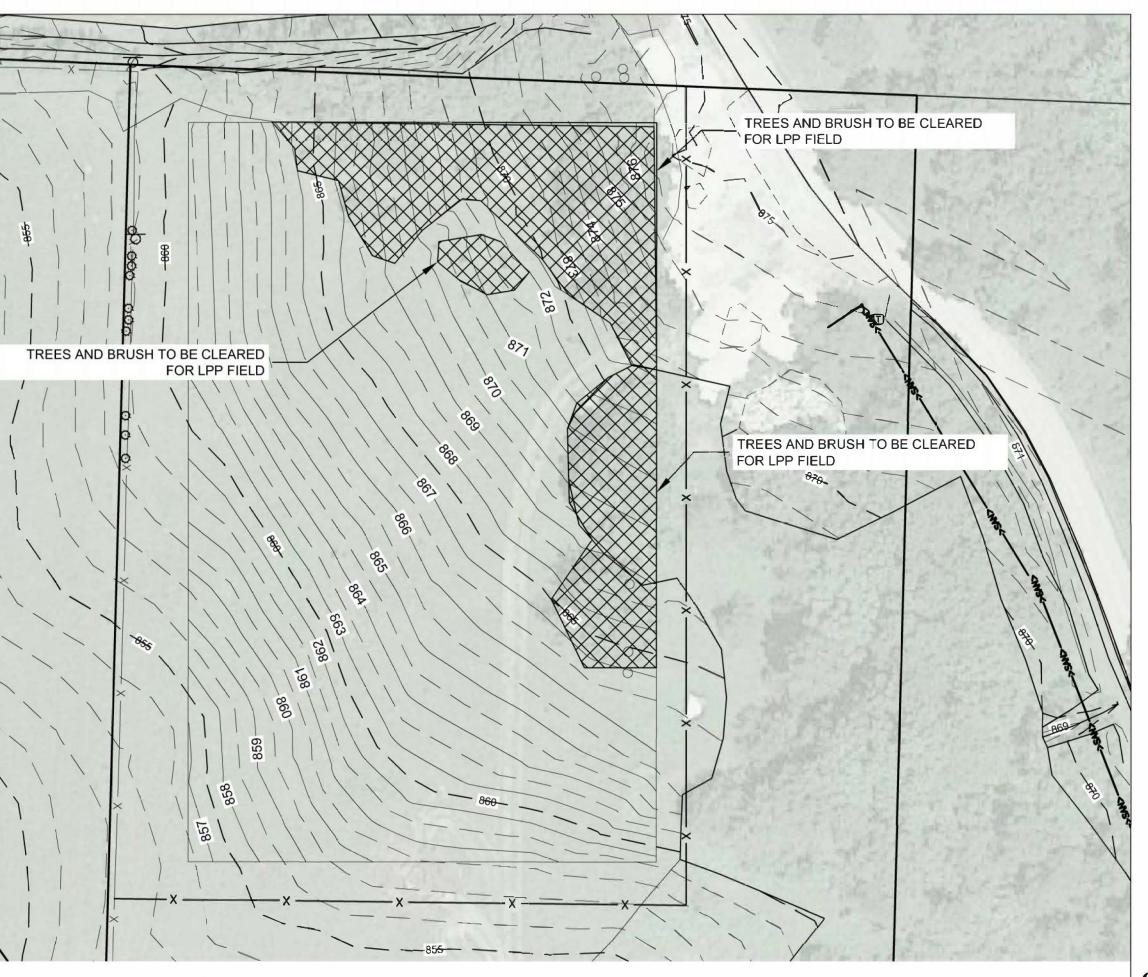

2 SITE CLEARING PLAN FOR LPP FIELD SCALE: 1"=40'

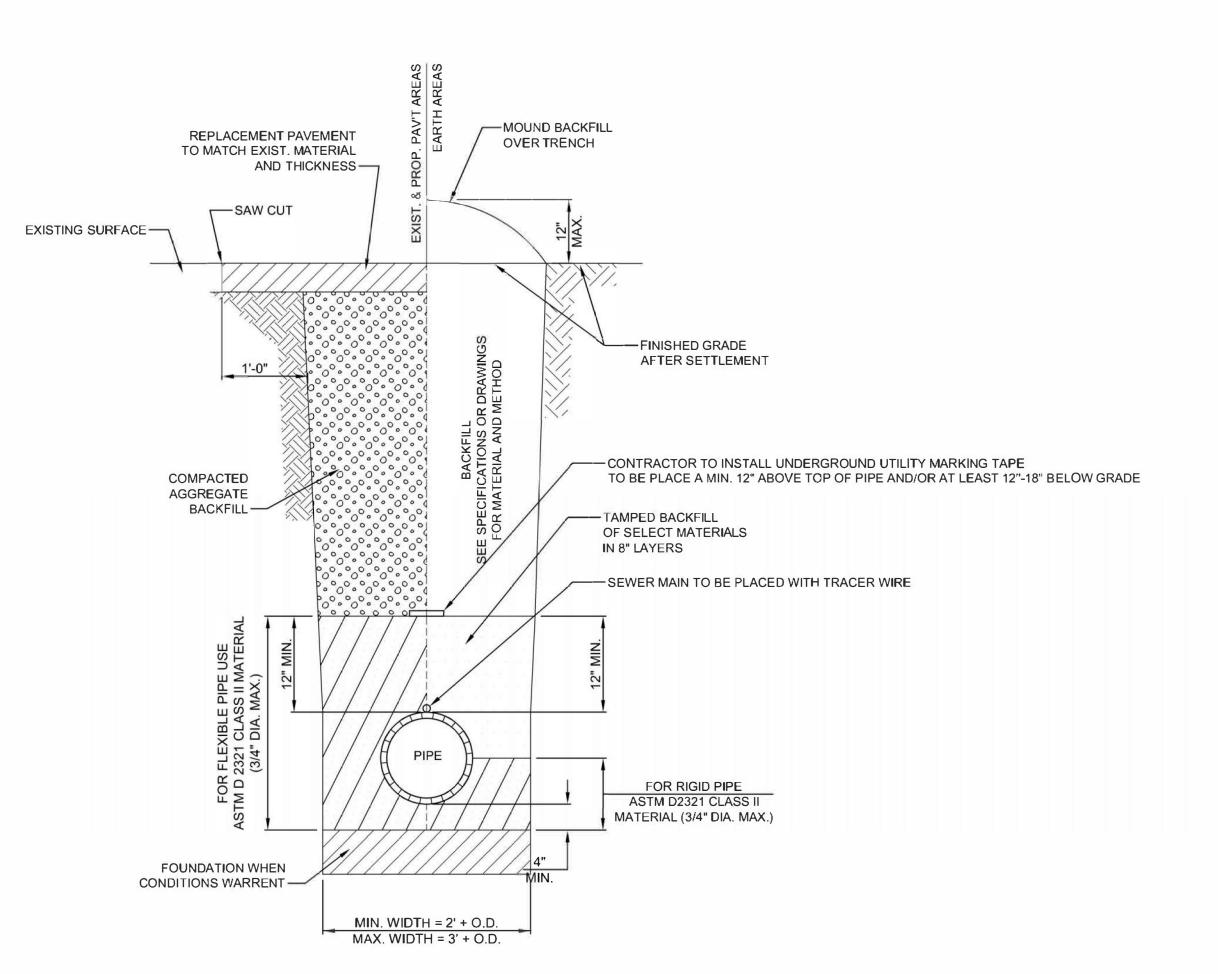

4 SANITARY SEWER TRENCH DETAIL
N.T.S.

STATE OF MISSOURI MICHAEL L. PARSON, **GOVERNOR**

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LONG BRANCH STATE PARK 28615 VISITOR CENTER RD MACON, MO 63552

PROJECT # X2302-02 5601 ASSET # 7815601020


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ISSUE DATE: 02-12-2024	


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DESIGNED BY: JD SHEET TITLE:

LPP DETAILS - 2


SHEET NUMBER:



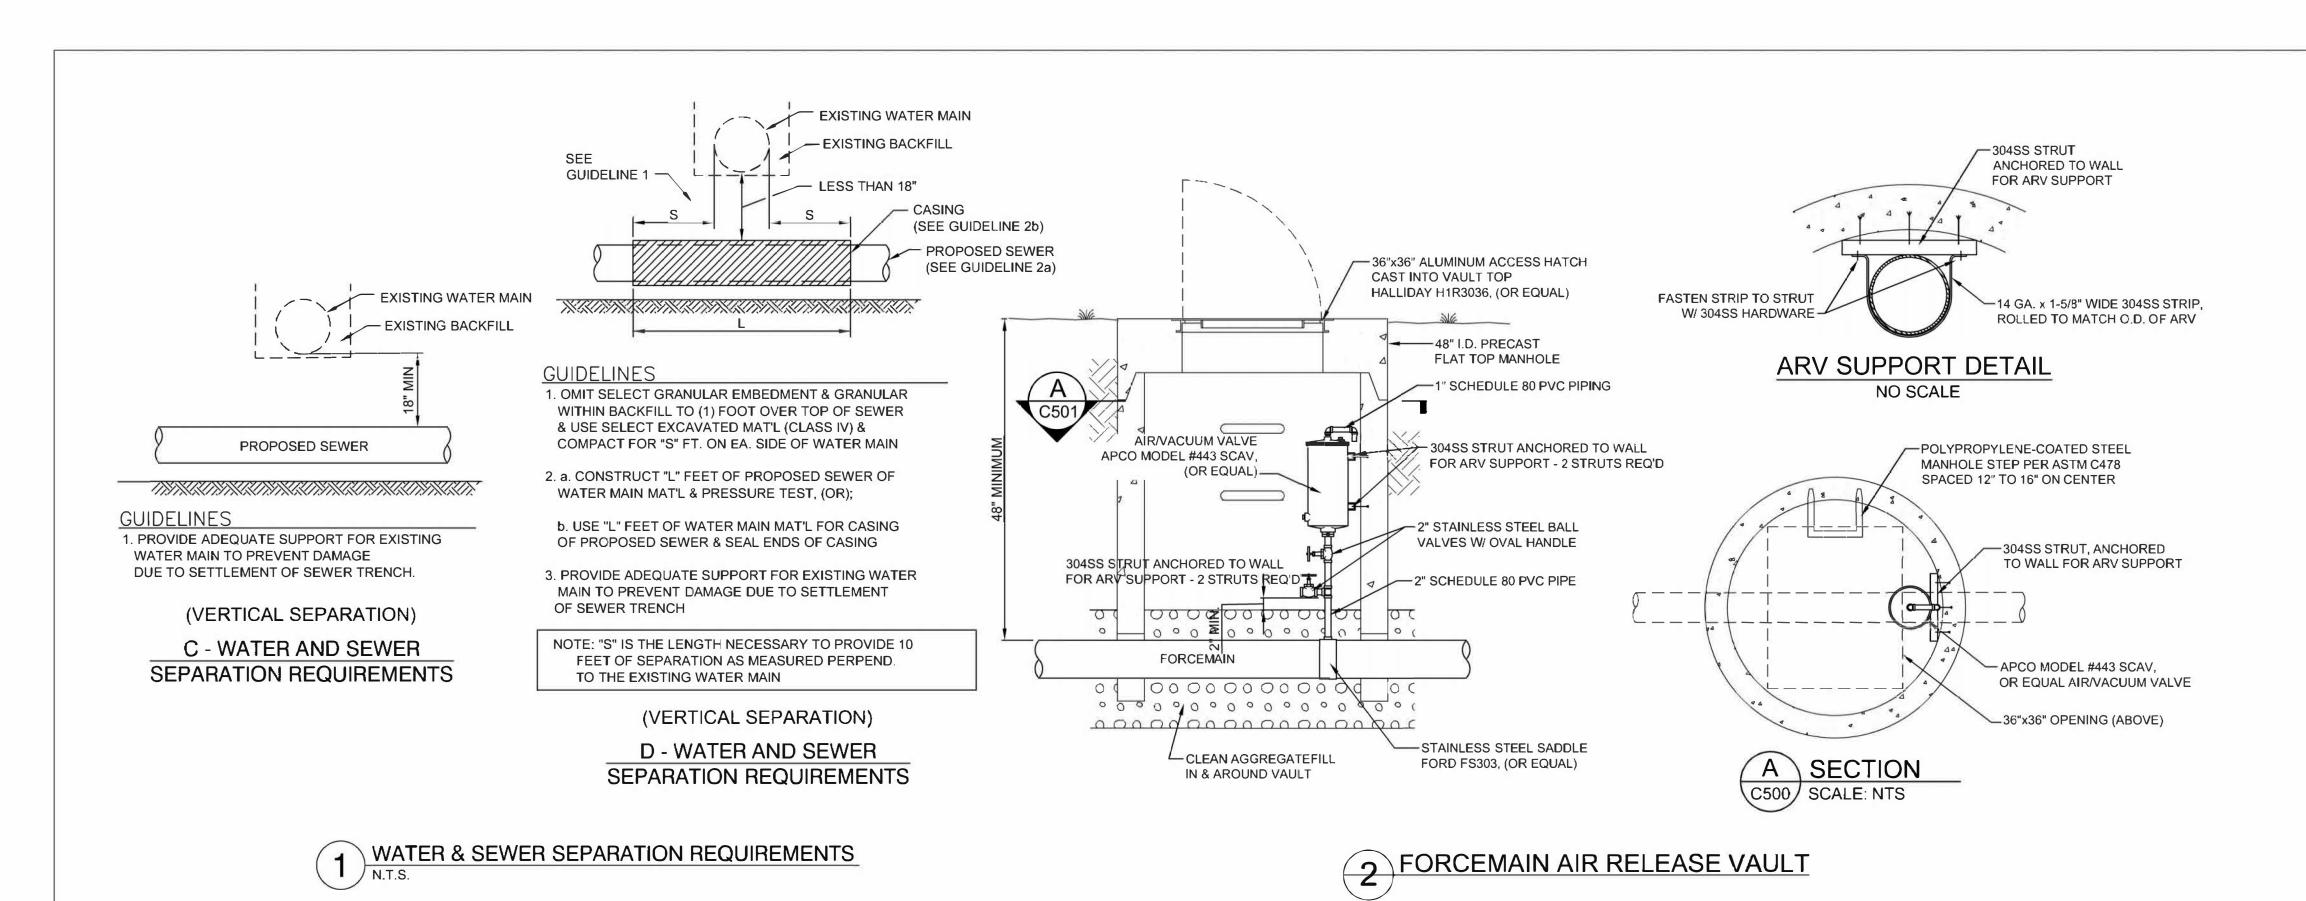

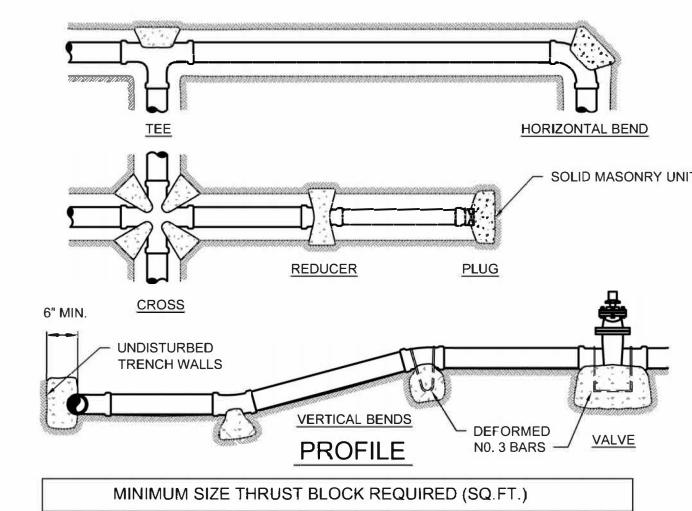MINIMUM SIZE THRUST BLOCK REQUIRED (SQ.FT.)								
PIPE DIA.	BENDS 11 1/4° & 22 1/2°	45°	90°	REDUCER	CROSS, TEE, PLUG AND VALVE			
2"	0.25	0.5	1	-	0.25			
2.5"	0.3125	0.625	1.25	0.47	0.3125			
4"	0.5	1	2	0.75	1			
6"	1	2	4	1.75	2.25			
8"	2	4	7	2.75	4			
10"	3	6	11.5	3.75	6.25			
12"	4.5	9	16	4.75	9			

- 1. MINIMUM COMPRESSIVE STRENGTH OF CONCRETE = 3000 PSI.
- 2. DESIGN TEST PRESSURE = 100 PSI + 50% FOR IMPACT. 3. DESIGN SOIL BEARING CAPACITY = 2000 PSF.
- 4. CONCRETE FOR THRUST BLOCKS BASED ON SOIL HAVING A SAFE LOAD BEARING OF 2000 PSF. FOR SOFT SOIL, INCREASE BEARING AREA AND VOLUME OF THRUST BLOCK.

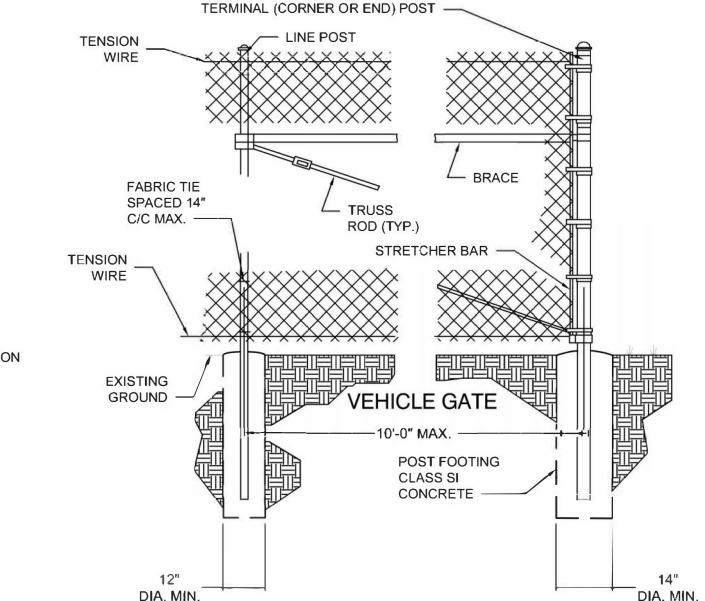

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STATE OF MISSOURI

GOVERNOR

MICHAEL L. PARSON,

BIDDING DOCUMENTS

OFFICE OF ADMINISTRATION **DIVISION OF FACILITIES** MANAGEMENT, **DESIGN AND CONSTRUCTION**

DEPARTMENT OF NATURAL RESOURCES DIVISION OF STATE PARKS

REPLACE LAGOON

LONG BRANCH STATE PARK 28615 VISITOR CENTER RD MACON, MO 63552

PROJECT #	X2302-02
SITE#	5601
ASSET#	7815601020

REVISION: DATE **REVISION** DATE REVISION: DATE: ISSUE DATE: 02-12-2024

CAD DWG FILE: DRAWING BY: JE


CHECKED BY: DESIGNED BY: JDH


SHEET TITLE:

MISCELLANEOUS DETAILS

SHEET NUMBER:


C500

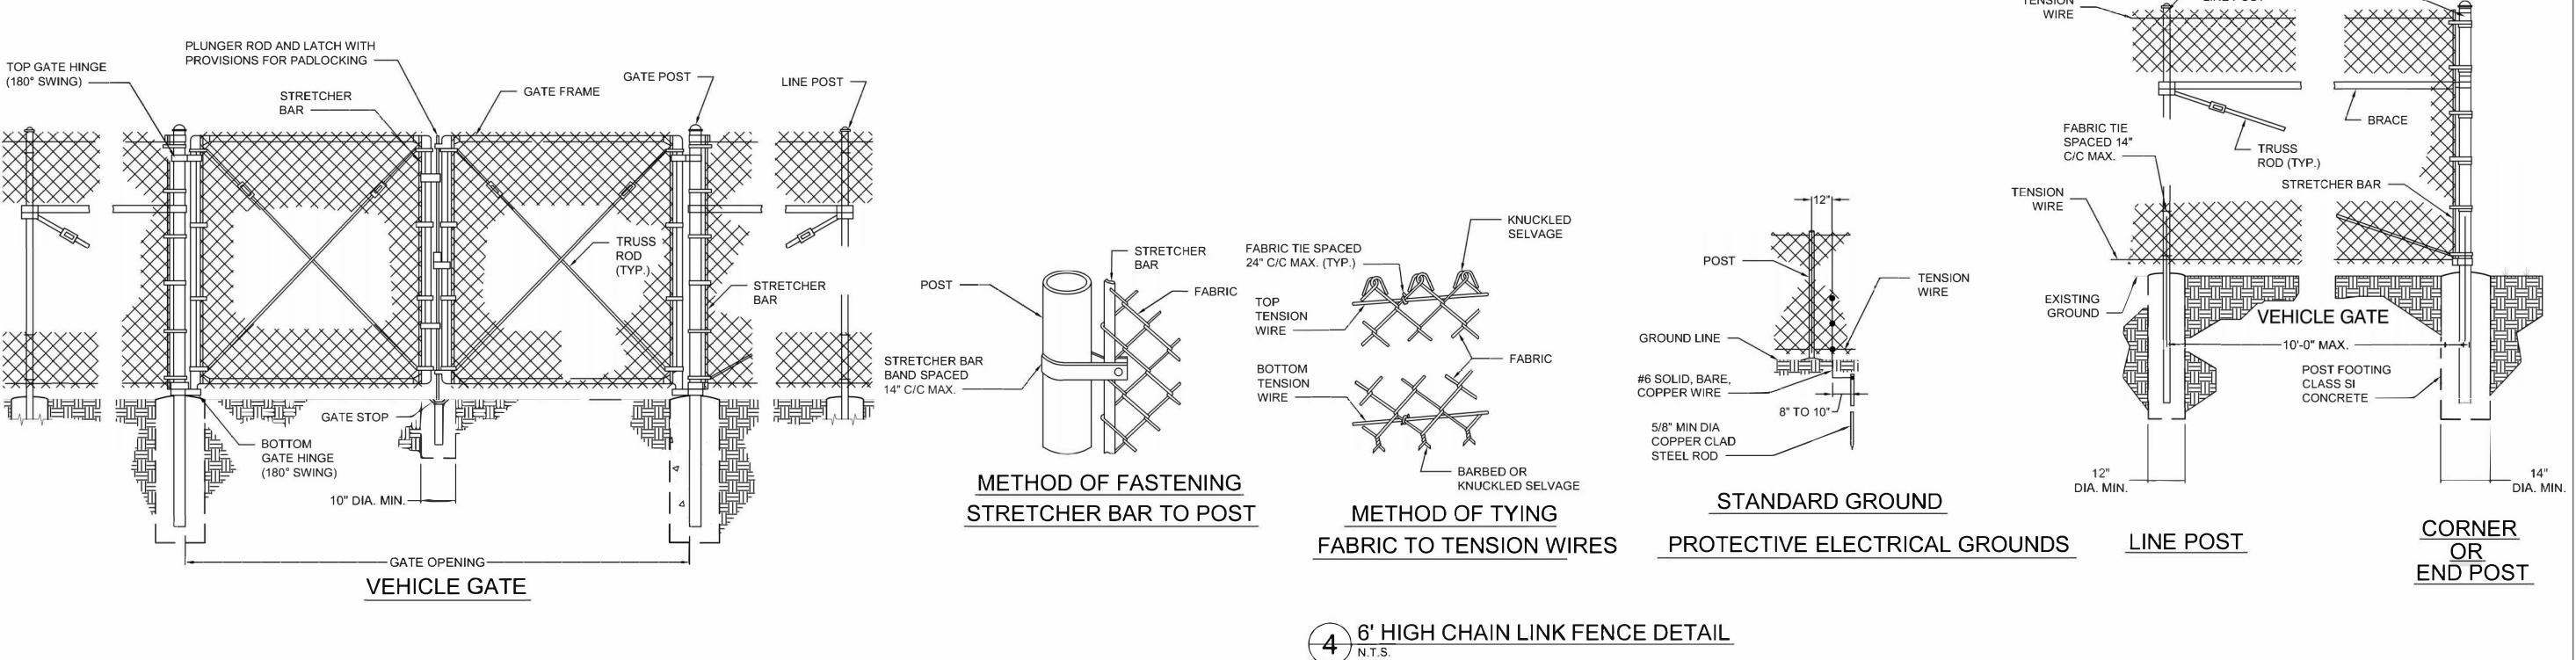

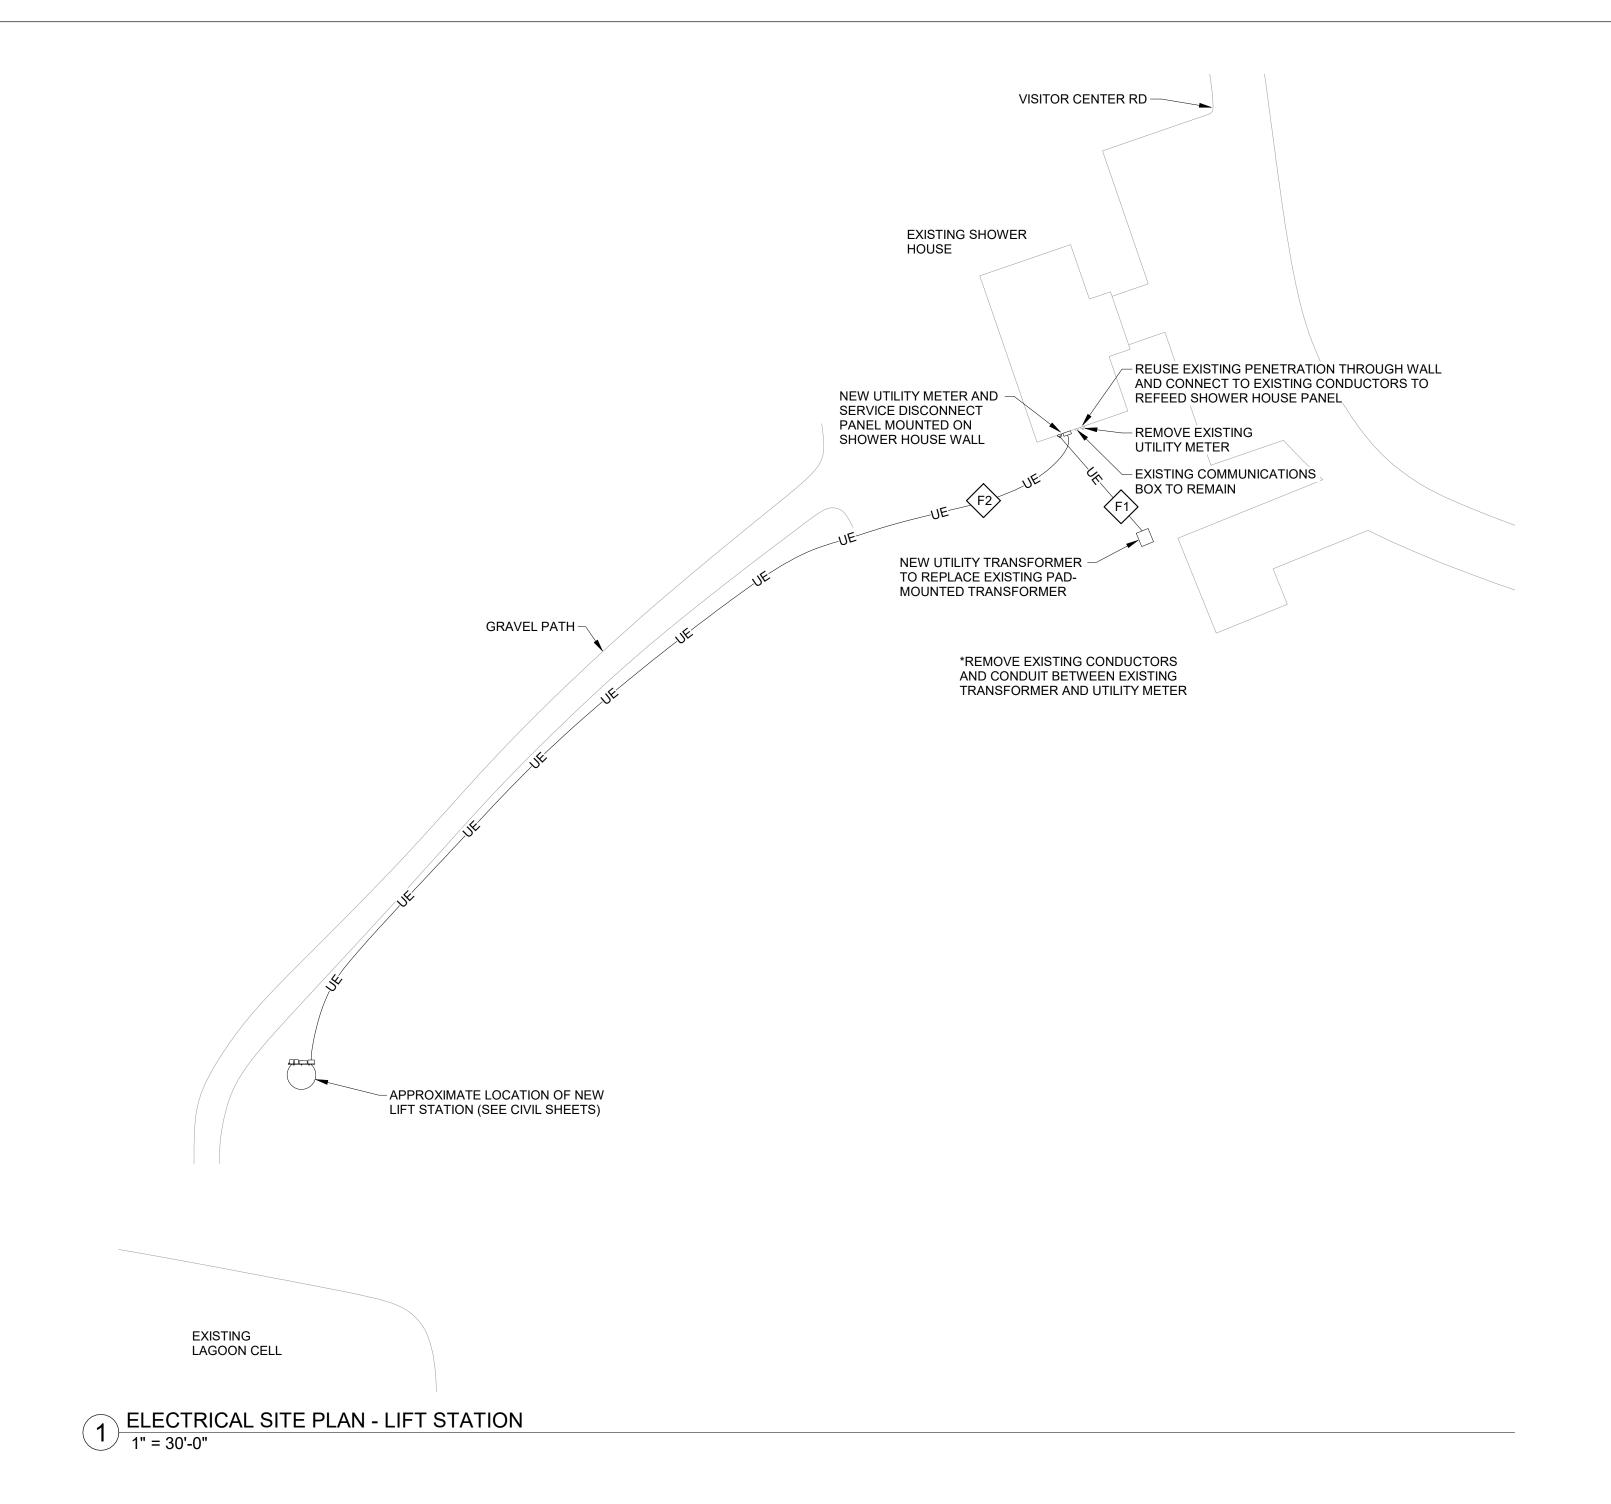



GENERAL ELECTRICAL NOTES:

- 1. APPLICABLE STANDARDS: NFPA-70 AND THE OCCUPATIONAL SAFETY AND HEALTH ACT (OSHA) OF 1971 AND ALL AMENDMENTS THERETO; EQUIPMENT, DEVICES, APPARATUS, SYSTEMS, AND INSTALLATIONS SHALL BE ENTIRELY SUITABLE AND SAFE FOR EACH INTENDED APPLICATION AND BE IN FULL COMPLIANCE WITH APPLICABLE STANDARDS, REQUIREMENTS, RULES, REGULATIONS, CODES, STATUTES, ORDINANCES, ETC., OF MUNICIPAL, COUNTY, AND STATE GOVERNMENTS, OWNER'S INSURANCE COMPANY, LOCAL UTILITIES, AND LABOR REGULATIONS. NOTHING CONTAINED IN THESE PLANS AND SPECIFICATIONS SHALL BE CONSTRUED TO CONFLICT WITH THESE LAWS, CODES,
- AND ORDINANCES. 2. DRAWING PLANS, SCHEMATICS, AND DIAGRAMS INDICATE GENERAL LOCATION AND ARRANGEMENT OF SYSTEMS. INSTALL SYSTEMS AS INDICATED UNLESS DEVIATIONS TO
- LAYOUT ARE APPROVED ON COORDINATION DRAWINGS.
- 3. CONTRACTOR SHALL OBTAIN ALL NECESSARY PERMITS AND ARRANGE FOR ALL INSPECTIONS REQUIRED BY LOCAL AUTHORITIES. 4. CONTRACTOR SHALL FURNISH AND INSTALL ALL MATERIALS, ACCESSORIES, TOOLS, EQUIPMENT, TRANSPORTATION, LABOR, SERVICES, AND OPERATIONS NECESSARY FOR
- A COMPLETE ELECTRICAL SYSTEM. 5. CONTRACTOR SHALL PERFORM EXCAVATION REQUIRED TO INSTALL HIS WORK.
- 6. COORDINATE INSTALLATION OF ELECTRICAL EQUIPMENT ON TOP OF WET WELL AND DOSING TANK CONCRETE CAPS WITH LOCATION OF ACCESS HATCHES. DO NOT INSTALL
- ELECTRICAL EQUIPMENT DIRECTLY ABOVE ACCESS HATCHES. 7. ELECTRICAL UTILITY PROVIDER: MACON ELECTRIC.

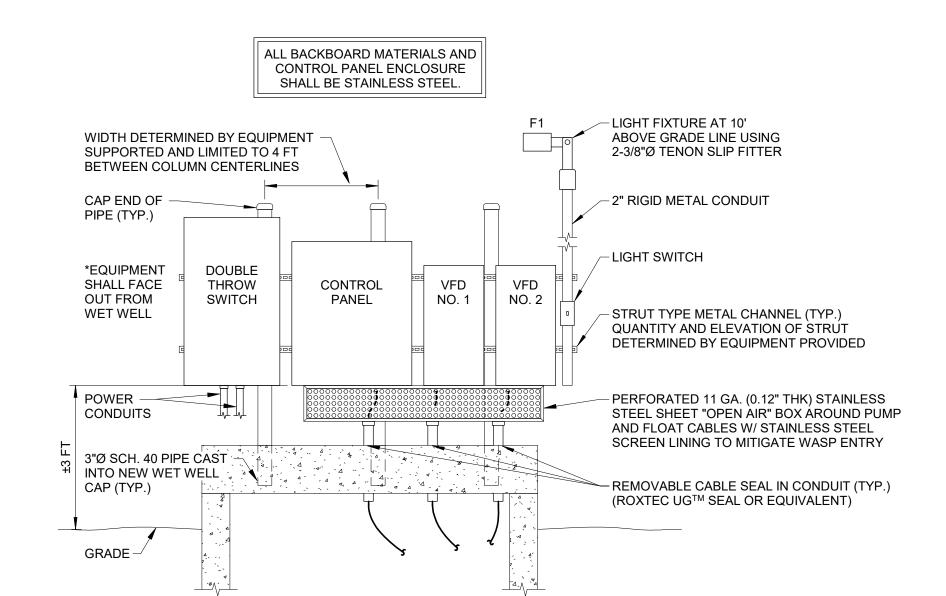


2 PUMP CONTROL PANEL ELEVATION - LIFT STATION NTS

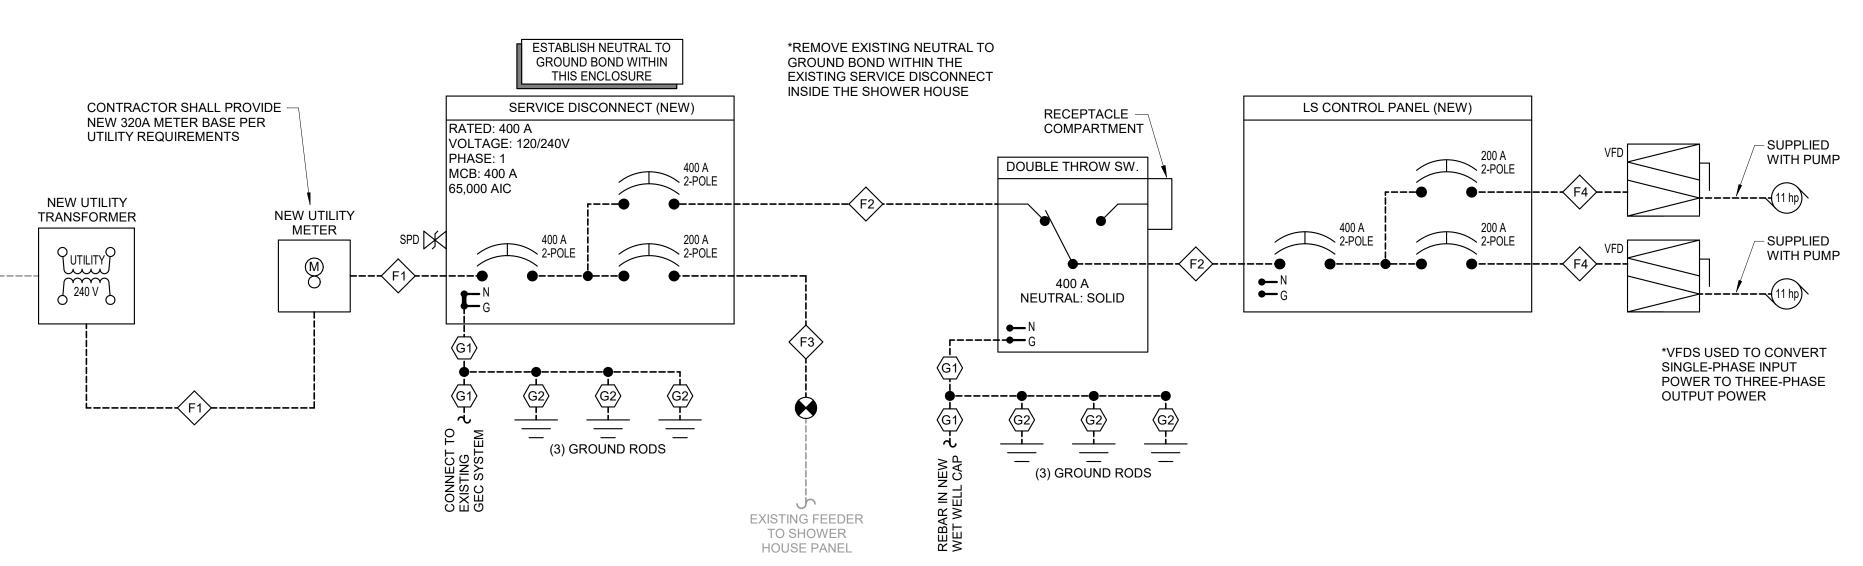

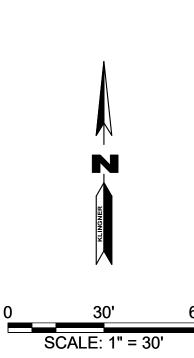

STATE OF MISSOURI MICHAEL L. PARSON, **GOVERNOR**

BIDDING DOCUMENTS

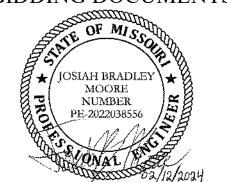

JOSIAH B. MOORE - ENGINEER MO # PE-2022038556



OFFICE OF ADMINISTRATION **DIVISION OF FACILITIES** MANAGEMENT, **DESIGN AND CONSTRUCTION**

REPLACE LAGOON

LONG BRANCH STATE PARK, 28615 VISITOR CENTER RD **MACON, MO 63552**

7815601020

PROJECT # X2302-02 5601

REVISION: DATE REVISION: DATE **REVISION:** DATE: ISSUE DATE: 02/12/2024

ASSET#

CAD DWG FILE: E501 DRAWING BY: JBM


CHECKED BY: JJN DESIGNED BY: JBM

SHEET TITLE:

ELECTRICAL DETAILS

SHEET NUMBER:


E501

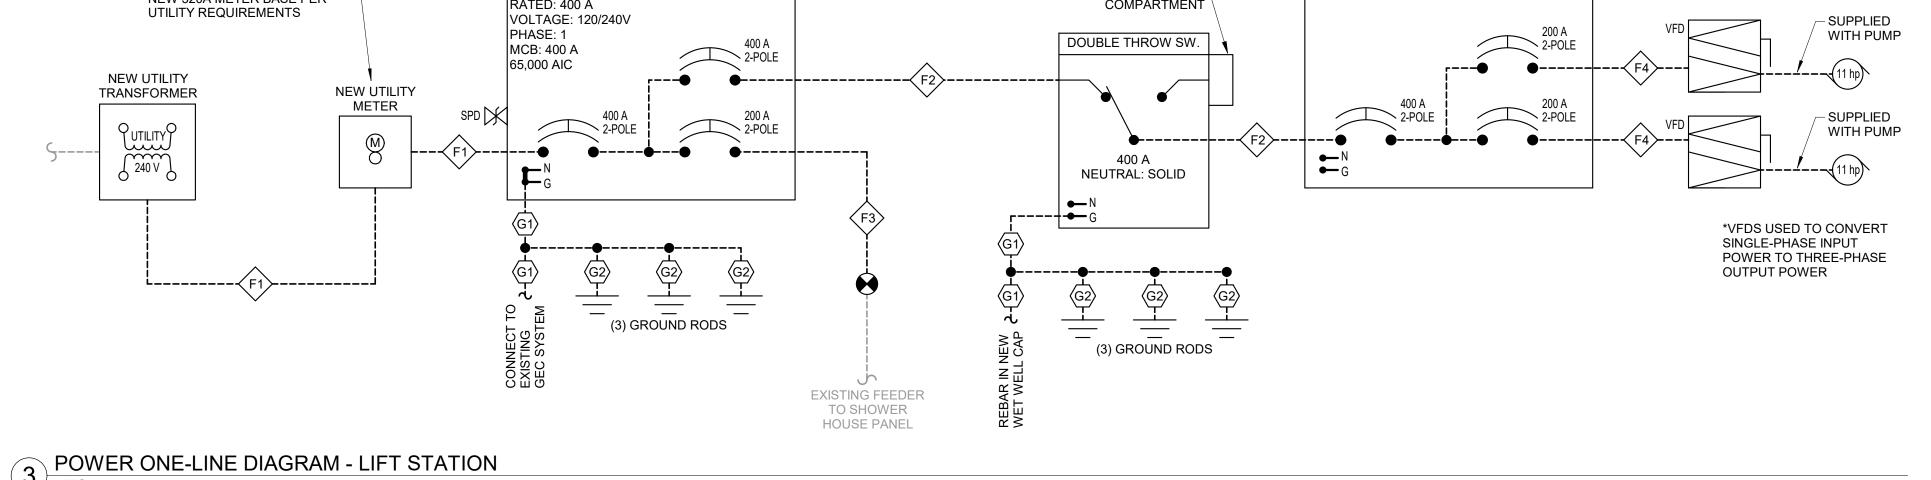



	LIGHTING FIXTURE SCHEDULE																					
TAG DESCRIPTION MOUNT LENS LAMP OUTPUT DRIVER VOLT LOAD			BASIS OF DESIGN		REMARKS																	
IAG	DESCRIPTION	MOONI	LENS	TYPE	COLOR TEMP.	OUIPUI	CONTROL VOLT	CONTROL	CONTROL	CONTROL	CONTROL	CONTROL	ONTROL VOLI (V	ONTROL VOLI	VOLI (W)	(W)	(W)	(W) MAKE	MAKE	MODEL	ACCESSORIES	REWARKS
		TENON				12,054			93	LITHONIA	DSXF2-LED-P3-30K-70CRI-WFL-MVOLT-IS-PE-DDBXD		SEE DRAWINGS FOR									
F1	EXTERIOR FLOOD LIGHT	SLIP-	GLASS, IP66	LED	3,000 K	10,122	INTEGRAL PHOTOCELL	120	85	LUMARK	NFFLD-C25-E-UNV-66-S-CB-PER	SLIPFITTER FOR 2-3/8" O.D. TENON	INSTALLATION									
		FITTER									ENGINEER-APPROVED EQUAL		DETAILS.									


FEEDER SCHEDULE (LONG BRANCH)								
FEEDER	PARALLEL	PHASE CO	ONDUCTORS	NEUTRAL		CONDUIT		
TAG	SETS	QUANTITY	SIZE	SIZE	EGC SIZE	SIZE		
F1	2	2	3/0 AWG Cu	3/0 AWG Cu	N/A	2"		
F2	2	2	3/0 AWG Cu	3/0 AWG Cu	#3 AWG Cu	2"		
F3	1	2	3/0 AWG Cu	3/0 AWG Cu	#6 AWG Cu	2"		
F4	1	2	3/0 AWG Cu	N/A	#6 AWG Cu	2"		
F5	1	2	#4 AWG Cu	#4 AWG Cu	#4 AWG Cu	1.25"		

GEC SCHEDULE						
GEC TAG	GEC SIZE					
G1	#4 AWG Cu					
G2	#6 AWG Cu					

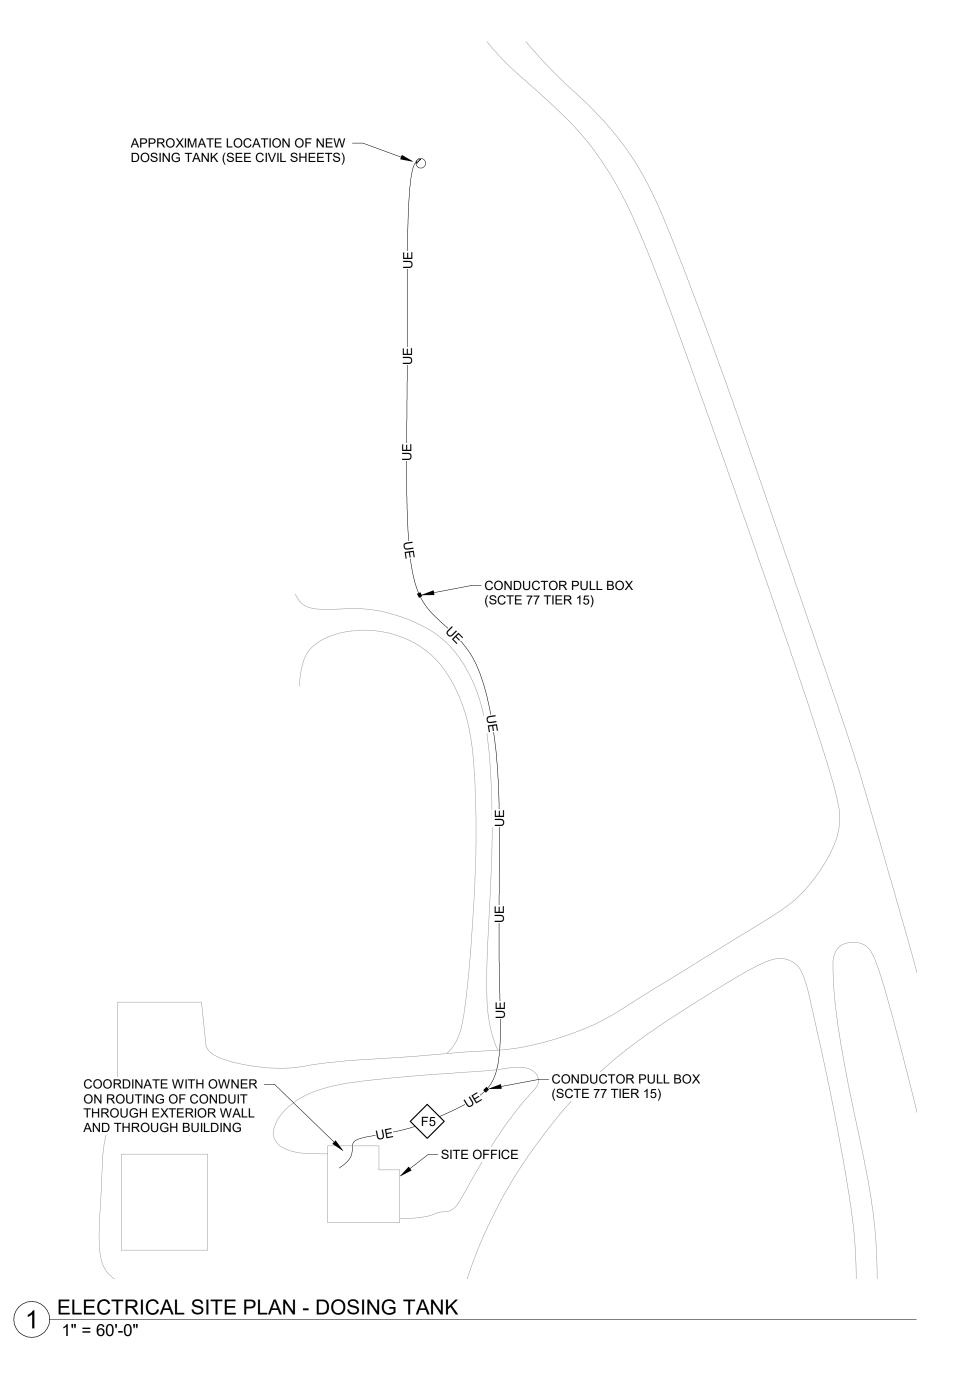

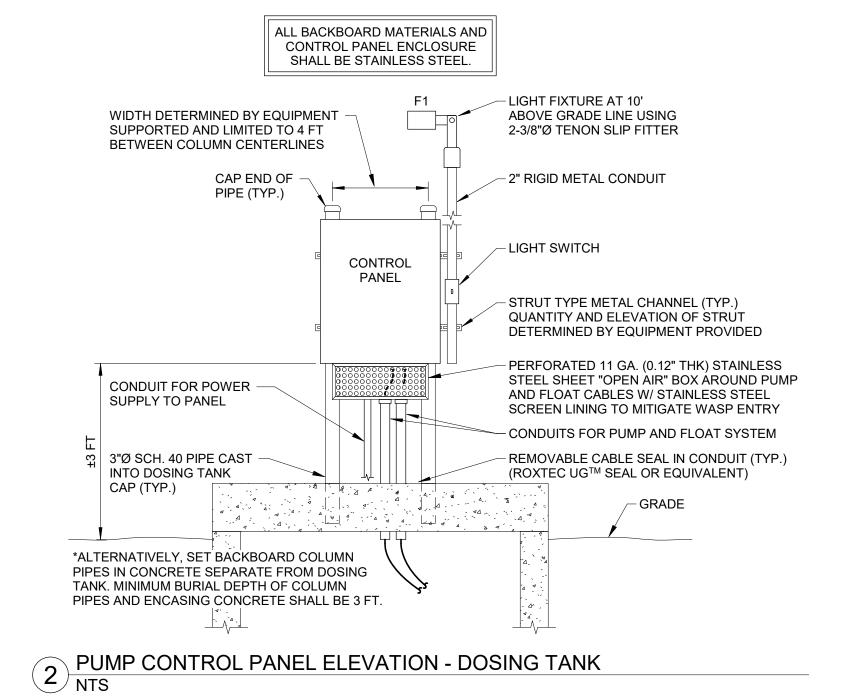

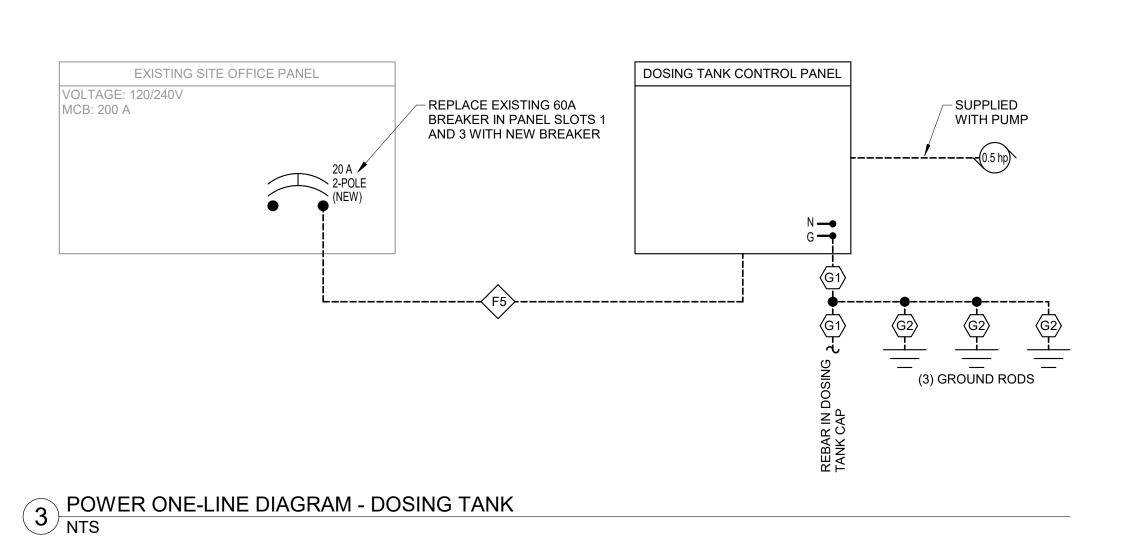

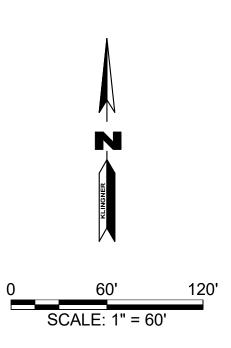

BIDDING DOCUMENTS

OF MISSON

MOORE
NUMBER
PE-2022038556

JOSIAH B. MOORE - ENGINEER

MO # PE-2022038556

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SSOCIATES, P. Conservation of the service of the se

OFFICE OF ADMINISTRATION DIVISION OF FACILITIES MANAGEMENT, DESIGN AND CONSTRUCTION

REPLACE LAGOON

LONG BRANCH STATE PARK, 28615 VISITOR CENTER RD MACON, MO 63552

PROJECT # X2302-02 SITE # 5601

ASSET # 7815601020

REVISION:
DATE:
REVISION:
DATE:
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DATE:
REVISION:

CAD DWG FILE: E502 DRAWING BY: JBM CHECKED BY: JJN DESIGNED BY: JBM


ISSUE DATE: 02/12/2024

SHEET TITLE:


ELECTRICAL DETAILS & SCHEDULES

SHEET NUMBER:

E502

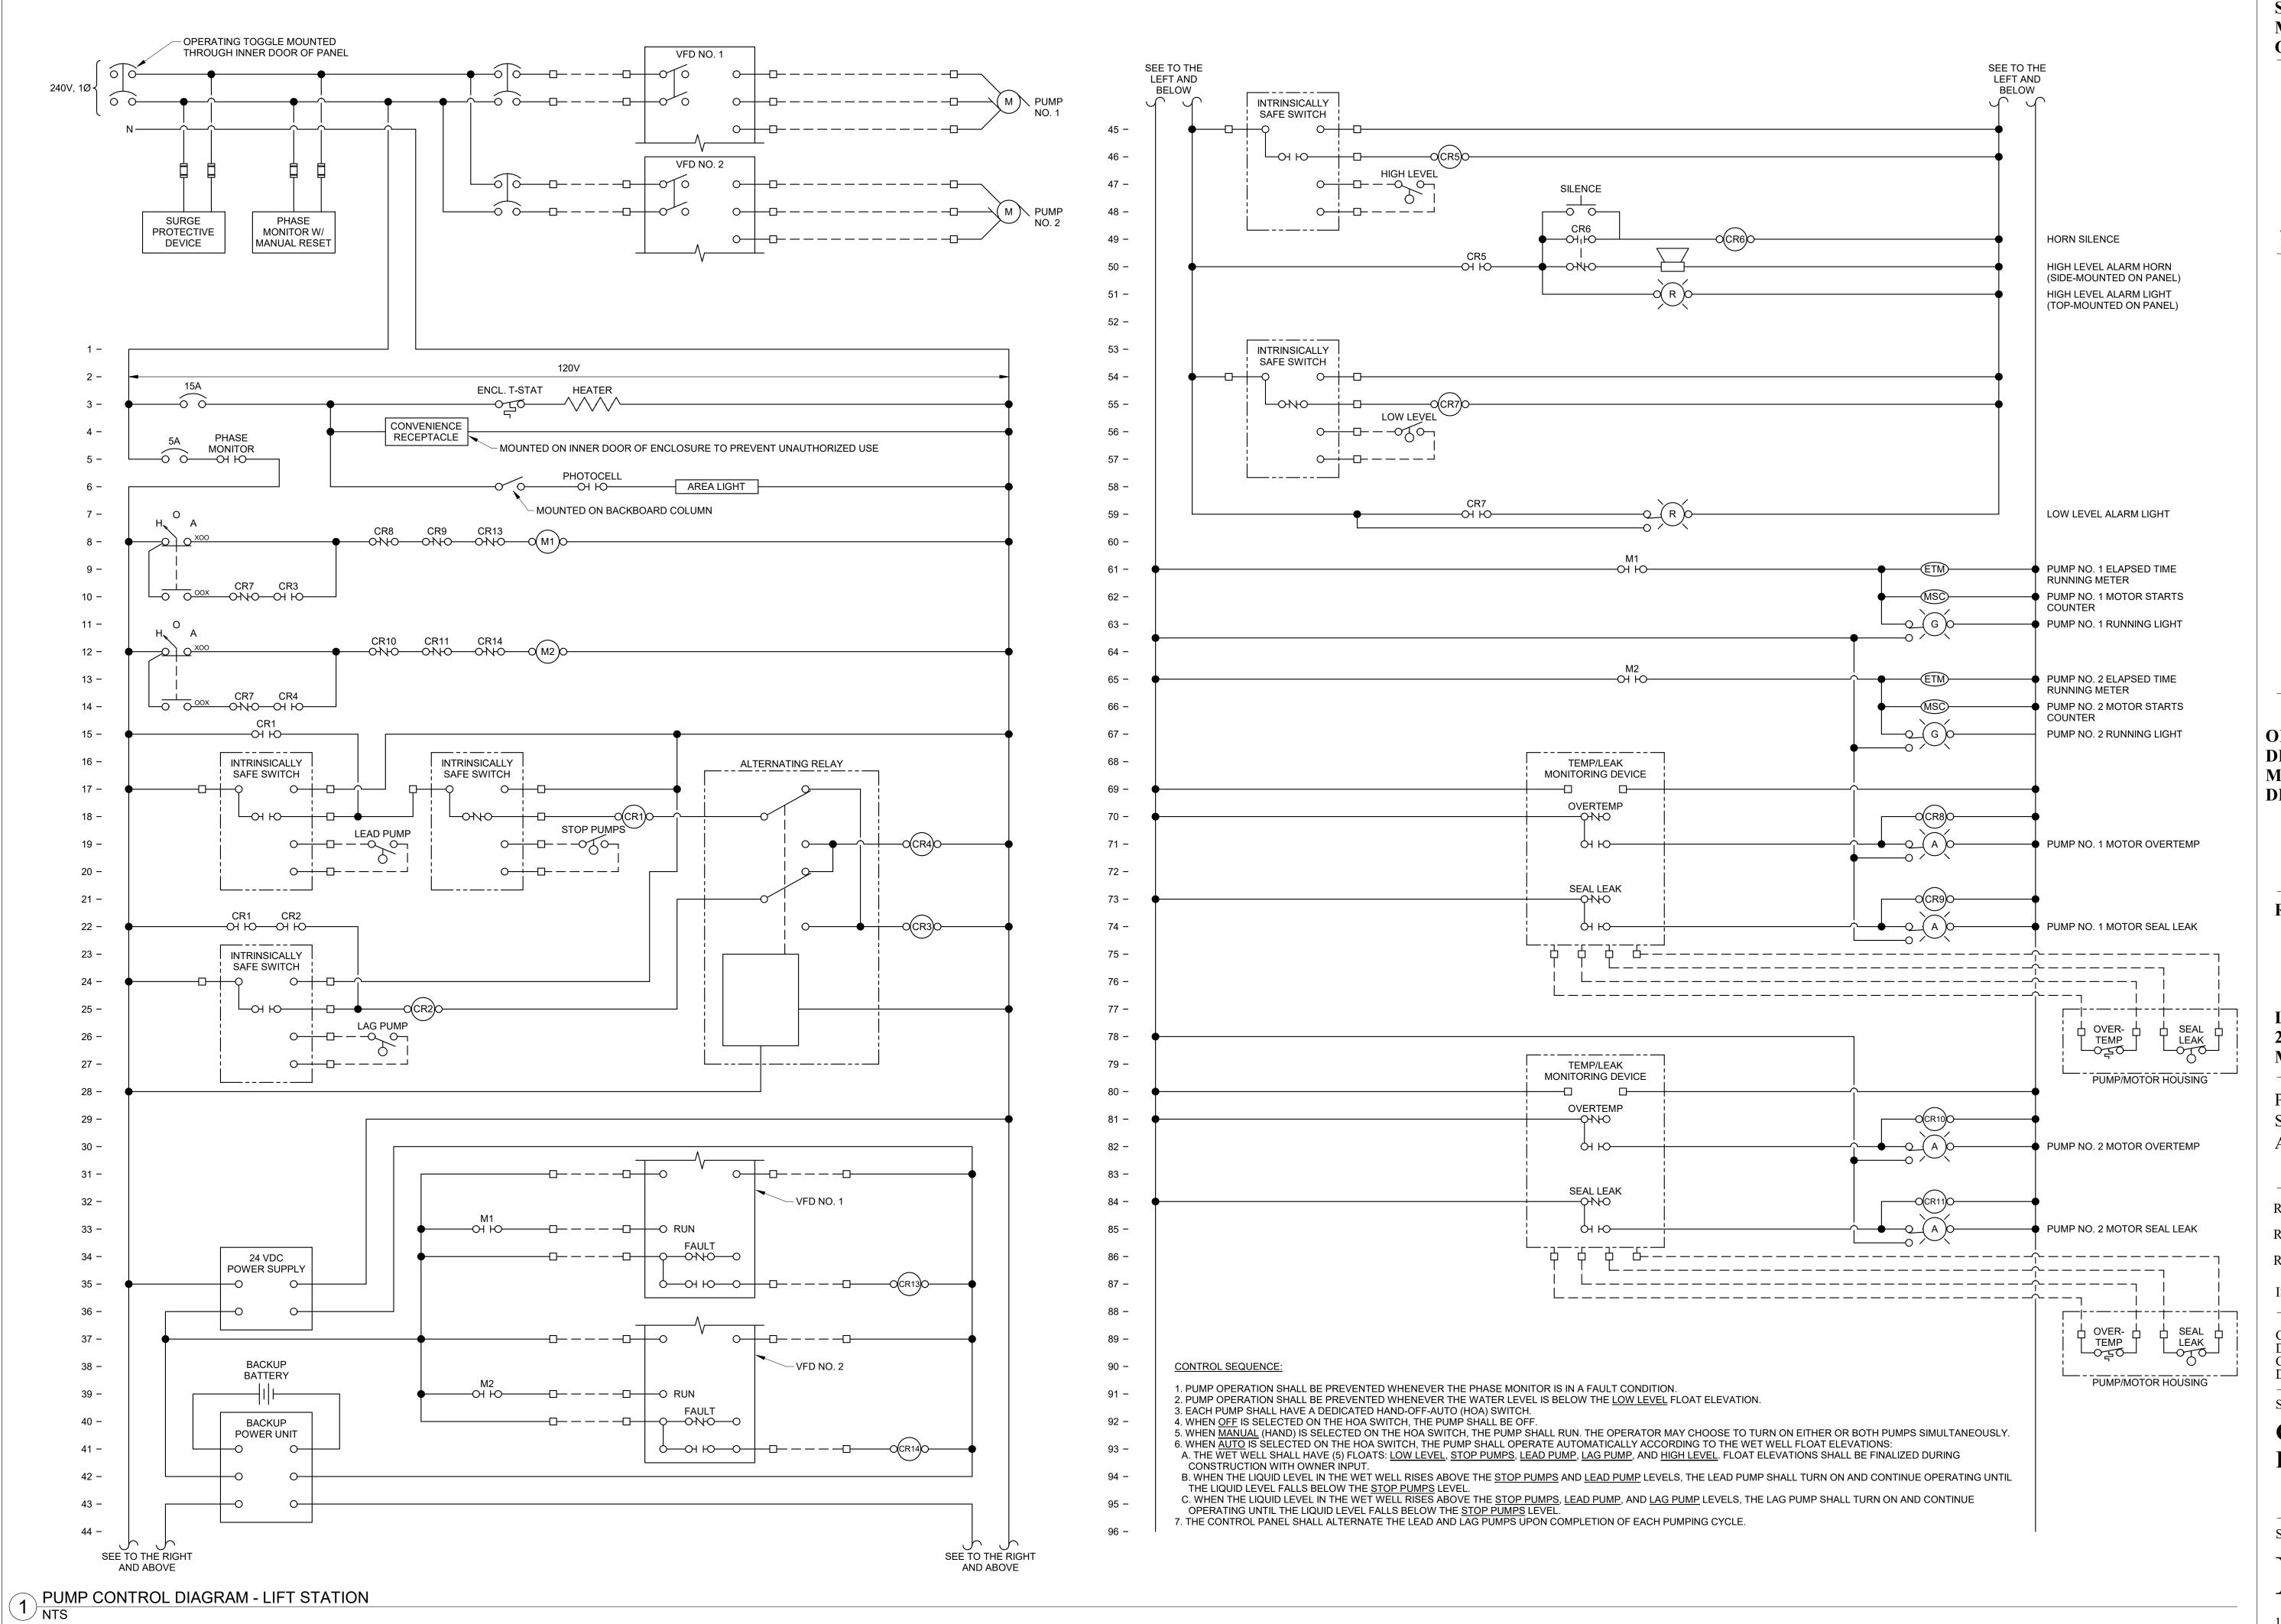

BIDDING DOCUMENTS

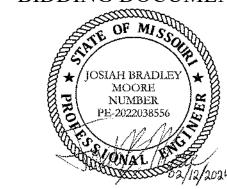

JOSIAH B. MOORE - ENGINEER MO # PE-2022038556



OFFICE OF ADMINISTRATION **DIVISION OF FACILITIES** MANAGEMENT, **DESIGN AND CONSTRUCTION**

REPLACE LAGOON

LONG BRANCH STATE PARK, 28615 VISITOR CENTER RD **MACON, MO 63552**

PROJECT # X2302-02 5601 7815601020 ASSET #

REVISION:	
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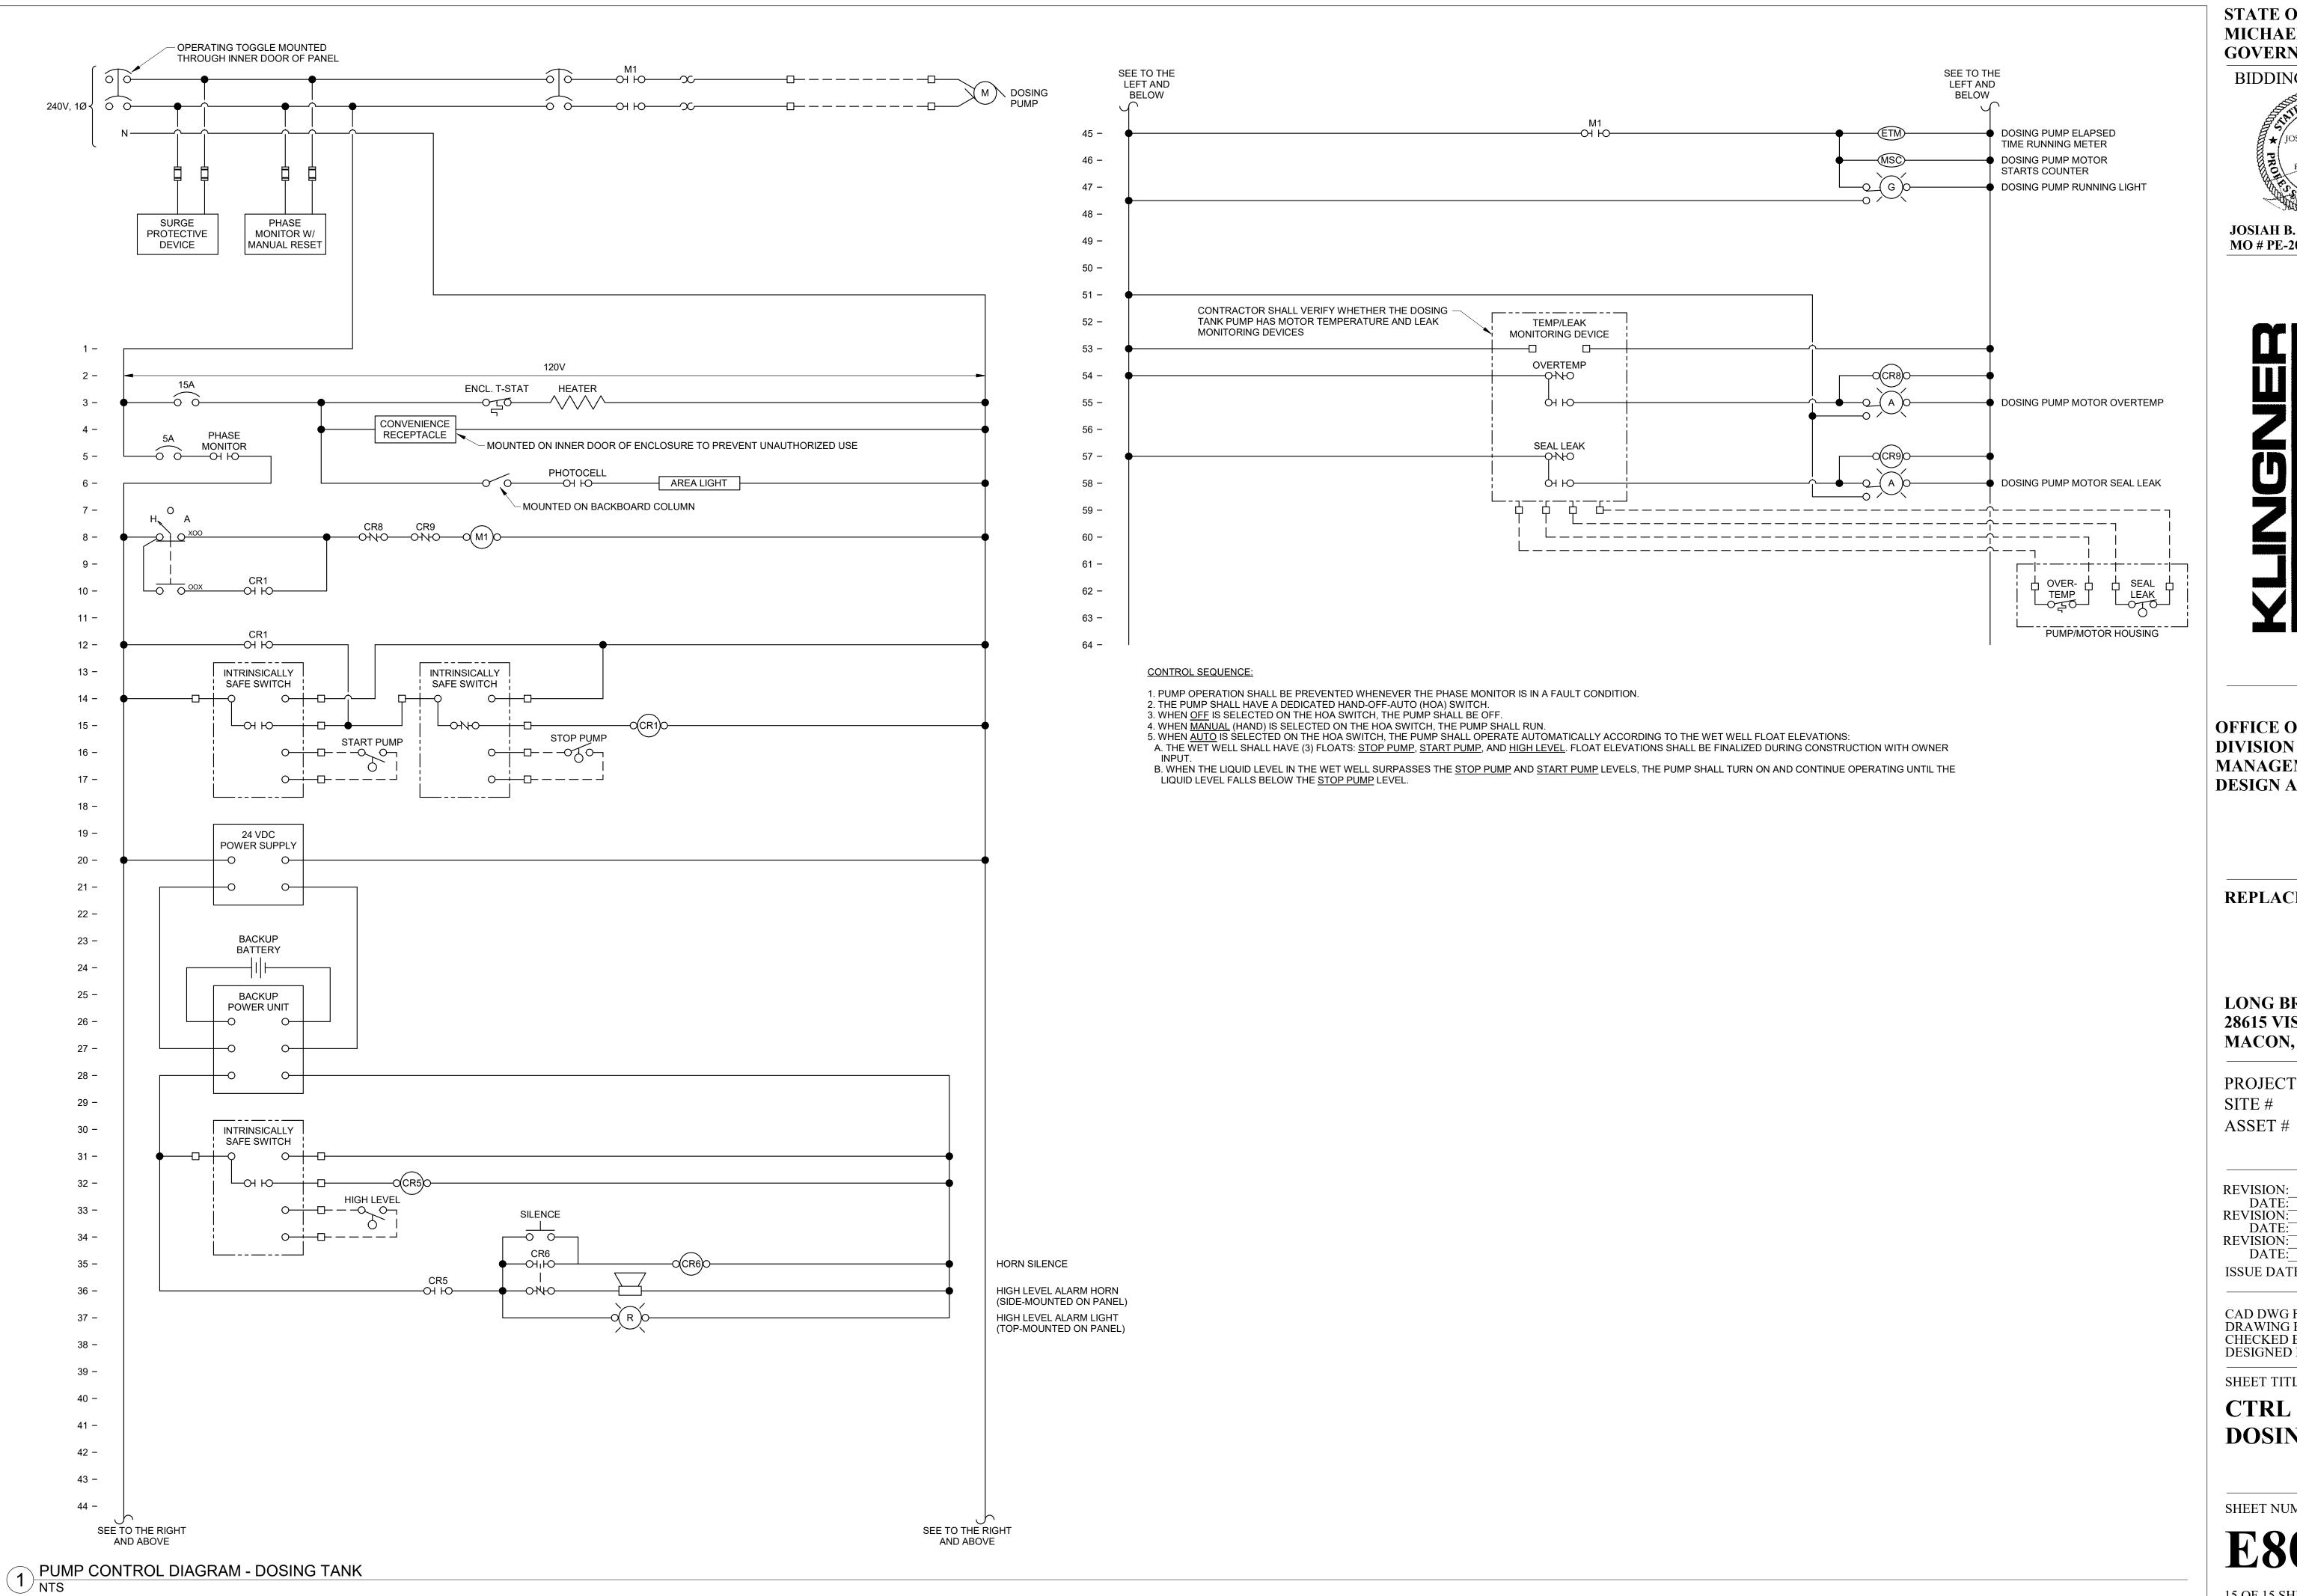
ISSUE DATE: 02/12/2024

CAD DWG FILE: E801 DRAWING BY: JBM CHECKED BY: JJN DESIGNED BY: JBM

SHEET TITLE:

CTRL DIAGRAM -**LIFT STATION**

SHEET NUMBER:



BIDDING DOCUMENTS ★/JOSIAH BRADLEY \★ NUMBER PE-2022038556

JOSIAH B. MOORE - ENGINEER MO # PE-2022038556

OFFICE OF ADMINISTRATION **DIVISION OF FACILITIES** MANAGEMENT, **DESIGN AND CONSTRUCTION**

REPLACE LAGOON

LONG BRANCH STATE PARK, 28615 VISITOR CENTER RD **MACON, MO 63552**

PROJECT # X2302-02 5601 SITE# 7815601020

REVISION: DATE: **REVISION:** DATE REVISION: DATE: ISSUE DATE: 02/12/2024

CAD DWG FILE: E802 DRAWING BY: JBM CHECKED BY: \overline{JJN} DESIGNED BY: JBM

SHEET TITLE:

CTRL DIAGRAM -**DOSING TANK**

SHEET NUMBER: