SEWAGE LIFT STATIONS THOUSAND HILLS STATE PARK KIRKSVILLE, MISSOURI

OWNER:

STATE OF MISSOURI MICHAEL L. PARSON, GOVERNOR


DEPARTMENT OF NATURAL RESOURCES DIVISION OF STATE PARKS


PROJECTOFFICE OF ADMINISTRATIONMANAGEMENT:DIVISION OF FACILITIES MANAGEMENT,DESIGN AND CONSTRUCTION

DESIGNER: Klingner & Associates, PC

PROJECT NUMBER: X2302-03

SITE NUMBER:5114ASSET NUMBER:7815114035

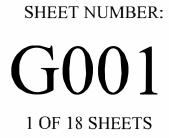

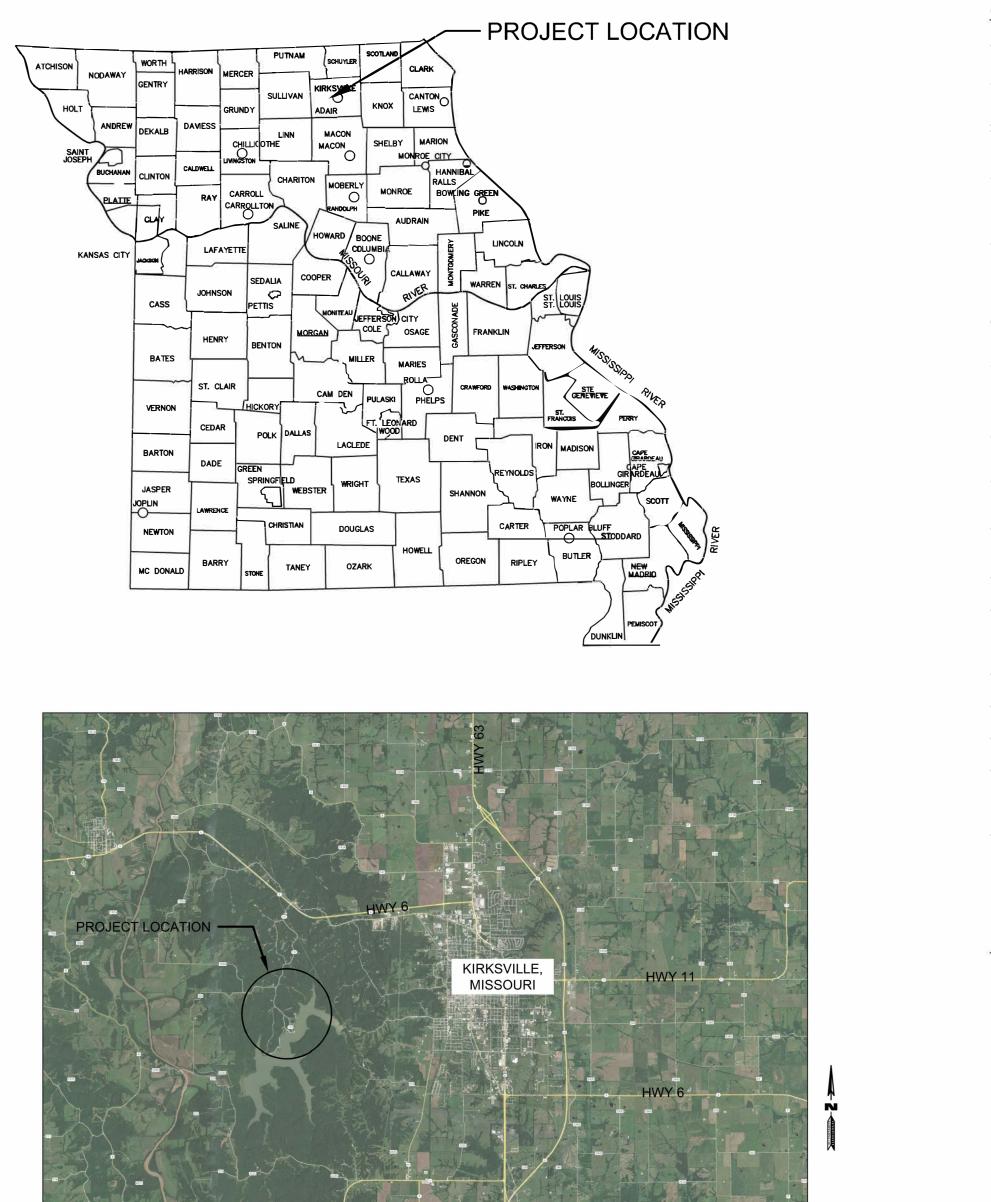

PROJECT LOCATION MAP

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SHEET	SHEET NAME	CURRENT REVISION
		DATE
G001	COVER SHEET	2/12/2024
G002	GENERAL NOTES AND LEGENDS	2/12/2024
C001	OVERALL SITE PLAN	2/12/2024
C100	LIFT STATION 1 DETAILS	2/12/2024
C101	LIFT STATION 2 DETAILS	2/12/2024
C102	LIFT STATION 3 REHAB AND LIFT STATION 4 BYPASS	2/12/2024
C103	LIFT STATION 5 DETAILS	2/12/2024
C104	LIFT STATION 6 DETAILS	2/12/2024
C500	MISCELLANEOUS CIVIL DETAILS	2/12/2024
E501	ELECTRICAL DETAILS - LIFT STATIONS 1&2	2/12/2024
E502	ELECTRICAL DETAILS - LIFT STATION 3	2/12/2024
E503	ELECTRICAL DETAILS LIFT STATIONS 5 & 6	2/12/2024
E701	ELECTRICAL SCHEDULES	2/12/2024
E801	CTRL DIAGRAM - LIFT STATION 1	2/12/2024
E802	CTRL DIAGRAM - LIFT STATION 2	2/12/2024
E803	CTRL DIAGRAM - LIFT STATION 3	2/12/2024
E804	CTRL DIAGRAM - LIFT STATION 5	2/12/2024
E805	CTRL DIAGRAM - LIFT STATION 6	2/12/2024

THE CONTRACTOR(S) SHALL COMPLY WITH THE LATEST EDITION OF APPLICABLE CODES AND STANDARDS INCLUDING BUT NOT LIMITED TO:

- THE AMERICANS WITH DISABILITIES ACT (ADAAG) - INTERNATIONAL BUILDING CODE (IBC)

- NATIONAL ELECTRIC CODE (NEC)

- INTERNATIONAL PLUMBING CODE (IPC)

- LIFE SAFETY CODE (NFPA 101)

- AMERICAN SOCIETY OF MECHANICAL ENGINEERS (ASME)

- AMERICAN NATIONAL STANDARDS INSTITUTE (ANSI) - AMERICAN CONCRETE INSTITUTE (ACI)

- MISSOURI DEPARTMENT OF TRANSPORTATION (MODOT) - MISSOURI DEPARTMENT OF NATURAL RESOURCES (MODNR) 2. THE EROSION CONTROL SHOWN ON THIS SET OF PLANS SHALL BE CONSIDERED THE MINIMUM ACCEPTABLE FOR THIS PROJECT. THERE MAY BE ADDITIONAL EROSION CONTROL REQUIRED DUE TO THE VARIOUS CONSTRUCTION TECHNIQUES, WHICH MAY BE USED. THE CONTRACTOR IS RESPONSIBLE FOR CONTROLLING AND MAINTAINING ALL THE RUNOFF FROM THE SITE, IN A MANNER WHICH KEEPS ALL SILT ON SITE.

4. ADJUST ALL VALVES, MANHOLES, CASTINGS, GAS VENTS, ETC., TO MATCH THE NEW SURFACE. ADJUSTMENT SHALL BE COORDINATED WITH THE UTILITY COMPANIES AND THE COST FOR ALL ADJUSTMENTS SHALL BE INCIDENTAL TO THE CONSTRUCTION AT NO ADDITIONAL COST TO THE OWNER. REPAIR ANY DAMAGE TO SAID STRUCTURES AND APPURTENANCES THAT OCCUR DURING CONSTRUCTION.

5. THE DRAWINGS INDICATE THE BEST KNOWLEDGE OF THE OWNER AND ENGINEER/ARCHITECT ON THE GENERAL LOCATION AND NATURE OF THE EXISTING AND OR PROPOSED UNDERGROUND UTILITIES IN THE AREA OF CONSTRUCTION. EXPLORATORY EXCAVATIONS AT THE SITE TO DETERMINE INSITU LOCATIONS WERE NOT CONDUCTED. QUALITY LEVEL D IN ACCORDANCE WITH CI/ASCE 38-02, STANDARD GUIDELINE FOR THE COLLECTION AND DEPICTION OF EXISTING SUBSURFACE UTILITY DATA, WAS UTILIZED. REGARDLESS OF THE LEVEL OF INVESTIGATION, THE UTILITIES SHOWN SHOULD NOT BE CONSIDERED A WARRANTY OR GUARANTEE OF ACTUAL PRESENCE OR LOCATION AND THE CONTRACTOR REMAINS RESPONSIBLE FOR THE LOCATION, VERIFICATION, AND PROPER NOTIFICATION OF POTENTIAL UTILITIES.

QUALITY LEVELS: B

QUALITY LEVEL A - PROVIDES THE HIGHEST LEVEL OF ACCURACY. BY LOCATING OR POTHOLING UTILITIES IN ADDITION TO QUALITY LEVELS B, C, AND D TASKS. THE LOCATED UTILITY INFRASTRUCTURE IS SURVEYED AND MAPPED TO DEVELOP PLAN AND PROFILE INFORMATION.

QUALITY LEVEL B - INVOLVES DESIGNATING THE HORIZONTAL POSITION OF SUBSURFACE UTILITIES THROUGH SURFACE DETECTION METHODS AND RECORDING THE INFORMATION THROUGH A SURVEY METHOD. IN ADDITION TO QUALITY LEVEL C AND D TASKS.

QUALITY LEVEL C - INVOLVES SURVEYING VISIBLE SUBSURFACE UTILITY STRUCTURES SUCH AS MANHOLES, HAND-HOLES, UTILITY VALVES AND METERS, FIRE HYDRANTS, PEDESTALS AND UTILITY MARKERS, AND THEN CORRELATING THE INFORMATION WITH EXISTING UTILITY RECORDS TO CREATE COMPOSITE DRAWINGS. IN ADDITION TO QUALITY LEVEL D TASKS

ETC.

1. EROSION CONTROL SHALL BE INSTALLED IN ACCORDANCE WITH MANUFACTURER'S RECOMMENDATIONS, THE DETAILS IN THESE PLANS, AND THE MISSOURI DEPARTMENT OF NATURAL RESOURCES STANDARDS AND REQUIREMENTS FOR EROSION AND SEDIMENT CONTROL.

GENERAL NOTES

1. ALL DIMENSIONS SHALL BE FIELD VERIFIED BY THE CONTRACTOR.

2. ANY DISCREPANCIES BETWEEN SPECIFICATIONS, DRAWINGS, AND/OR SITE CONDITIONS SHALL BE REPORTED TO THE ENGINEER IMMEDIATELY.

3. ALL AREAS DESIGNATED TO REMAIN UNDISTURBED SHALL BE PROTECTED BY THE CONTRACTOR THROUGHOUT CONSTRUCTION.

4. THE CONTRACTOR SHALL BE RESPONSIBLE FOR STAKING THE LOCATION OF ALL PROPOSED IMPROVEMENTS, INCLUDING ROUGH AND FINISHED ELEVATIONS AND ALL OTHER PROPOSED IMPROVEMENTS INDICATED ON THE DRAWINGS.

5. THE CONTRACTOR SHALL VERIFY THAT ALL APPLICABLE LOCAL, STATE, & FEDERAL CODES ARE FOLLOWED. ALL APPLICABLE LOCAL AND STATE NOTIFICATIONS AND PERMITS SHALL BE ACQUIRED PRIOR TO CONSTRUCTION, INCLUDING ALL NECESSARY UTILITY CONNECTION PERMITS FROM THE RESPECTIVE UTILITIES.

6. THE CONTRACTOR SHALL BE RESPONSIBLE FOR ALL TEMPORARY UTILITIES AND SERVICES REQUIRED DURING CONSTRUCTION.

7. THE CONTRACTOR SHALL BE RESPONSIBLE FOR MAINTAINING ALL REFERENCE POINTS, BENCHMARKS, MONUMENTS, STAKES, AND PROPERTY CORNERS DURING CONSTRUCTION. REPLACEMENT OF LOST REFERENCE POINTS SHALL BE AT THE CONTRACTORS EXPENSE.

8. REMOVE ALL STRUCTURES, FOUNDATIONS, WALLS, PAVEMENTS, AND ALL OTHER ITEMS IN CONFLICT WITH PROPOSED IMPROVEMENTS IN ACCORDANCE WITH THE SPECIFICATIONS.

9. REFERENCES TO "STANDARD SPECIFICATIONS" SHALL MEAN THE MISSOURI DEPARTMENT OF TRANSPORTATION, "STANDARD SPECIFICATIONS FOR HIGHWAY CONSTRUCTION", LATEST ADDITION.

10. THE MEANS OF THE WORK AND THE SAFETY OF THE CONTRACTOR'S EMPLOYEES SHALL BE THE RESPONSIBILITY OF THE CONTRACTOR.

11. NO WORK SHALL BE PERFORMED BEYOND THE LIMITS OF CONSTRUCTION WITHOUT OWNER APPROVAL.

12. SITE CLEAN-UP SHALL BE PERFORMED ON A DAILY BASIS. SIDEWALKS, PARKING LOTS. ROADWAYS, AND THE PROJECT SITE SHALL BE KEPT CLEAN AT ALL TIMES. CONTROL DUST IN AND AROUND ALL WORK AND STAGING AREAS.

13. ALL OPEN EXCAVATIONS SHALL BE PROTECTED.

14. MAINTAIN POSITIVE DRAINAGE ON THE SITE THROUGHOUT THE PROJECT DURATION.

15. OWNER TO REMOVE BRUSH PILES.

16. IF A DISCREPANCY IN THE SPOT ELEVATIONS IS NOTED, THE CONTRACTOR SHALL NOTIFY THE ENGINEER PRIOR TO CONSTRUCTING. IF THERE IS A DISCREPANCY BETWEEN THE SPOT ELEVATIONS AND CONTOURS, THE CONTOURS SHALL GOVERN.

17. IF SOIL OR GROUNDWATER IS ENCOUNTERED WHICH EMITS A PETROLEUM ODOR OR IS DISCOLORED THE CONTRACTOR SHALL STOP EXCAVATION AND NOTIFY THE OWNER IMMEDIATELY. THE OWNER WILL COORDINATE ENVIRONMENTAL EFFORTS TO HANDLE THE IMPACTED SOIL OR GROUNDWATER IN ACCORDANCE WITH FEDERAL, STATE, AND LOCAL REQUIREMENTS. THE CONTRACTOR SHALL TAKE APPROPRIATE ACTION TO ENSURE PUBLIC AND EMPLOYEE SAFETY.

UTILITY NOTES

1. THE LOCATION OF EXISTING UTILITIES IN CONSTRUCTION AREAS SHALL BE FIELD VERIFIED BY THE CONTRACTOR BY CONTACTING THE MISSOURI ONE CALL SYSTEM, INC. OR THE INDIVIDUAL UTILITIES NOT PARTICIPATING IN THIS SYSTEM. EXISTING UTILITIES TO REMAIN SHALL BE PROTECTED. ANY REPAIR OR RELOCATION REQUIRED, AS A RESULT OF DAMAGE BY CONSTRUCTION ACTIVITIES SHALL BE AT THE CONTRACTOR'S EXPENSE. THE CONTRACTOR SHALL PAY UTILITY PERMIT AND/OR INSPECTION FEES.

2. UTILITY TRENCHES WITHIN PAVEMENT AREAS SHALL BE BACKFILLED WITH APPROVED COMPACTED GRANULAR BACKFILL.

3. ALL ELECTRIC SHALL BE IN ACCORDANCE WITH THE NATIONAL ELECTRIC CODE, CURRENT VERSION.

QUALITY LEVEL D - INVOLVES COLLECTING DATA FROM EXISTING UTILITY RECORDS, THAT MAY INCLUDE AS-BUILT DRAWINGS, DISTRIBUTION AND SERVICE MAPS, EXISTING GEOGRAPHIC INFORMATION SYSTEM DATABASE, CONSTRUCTION PLANS, ETC. DATABASES, CONSTRUCTION PLANS,

EROSION CONTROL NOTES

3. A LAND DISTURBANCE PERMIT WILL NOT BE REQUIRED SINCE LESS THAN 1 ACRE OF LAND WILL BE DISTURBED BY GRADING OPERATIONS.

4. ALL INLET PROTECTION AND TEMPORARY EROSION CONTROL MEASURES SHALL BE REMOVED UPON COMPLETION OF PAVING OPERATIONS AND FINAL STABILIZATION OF LANDSCAPED AND SEED AREAS.

ABBREVIATIONS

FL	FLOWLINE ELEVATION
тс	TOP OF CURB ELEVATION
GL	GUTTER LINE ELEVATION
TG	TOP OF GRATE ELEVATION
STA	STATION
FES	FLARED END SECTION
SWI	STORM WATER INLET
FFE	FINISH FLOOR ELEVATION
HP	HIGH POINT
LP	LOW POINT
TW	TOP OF WALL ELEVATION
BW	BOTTOM OF WALL ELEVATION
DS	DOWNSPOUT
EP	EDGE OF PAVEMENT
(NIC)	NOT IN CONTRACT
(M)	MATCH EXISTING

NOTE: SEE SHEET E501 FOR PUMP CONTROL DIAGRAM AND CONTROL PANEL INSTALLATION




Know what's **below**. Call before you dig.


— NOTE —

UTILITY INFORMATION IS FOR THE CONVENIENCE OF THE CONTRACTOR. BEFORE CONSTRUCTION BEGINS THE CONTRACTOR SHALL CONTACT MISSOURI ONE CALL SYSTEM, INC. AT 811 OR 1-800-344-7483 AND THE INDIVIDUAL UTILITIES NOT INCLUDED IN THIS SYSTEM FOR THE LOCATION OF ALL EXISTING UTILITIES.

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PROPERTY LINE LOT LINE RIGHT OF WAY LINE CENTERLINE BUILDING SETBACK ---- --- CONSTRUCTION LIMITS —— FENCE LINE —— CHAIN LINK FENCE FENCE W/ SQUARE POSTS STREAM STRUCTURE PAVEMENT MARKINGS EDGE OF PAVEMENT CURB AND GUTTER RAILROAD TRACKS WATER LINE - FP ----- FIRE PROTECTION -OE ----- OVERHEAD ELECTRIC UNDERGROUND ELECTRIC — σ — OVERHEAD TELEPHONE ______UNDERGROUND TELEPHONE -FO ------ FIBER OPTIC -FM FORCE MAIN ----------------------COMBINED SEWER -IR ----- IRRIGATION SYSTEM MAST ARM SIGNAL (3 SIGNALS) MAST ARM SIGNALS (2 SIGNALS) UTILITY TRAFFIC SIGN SIGN MANHOLE STORM WATER INLET CATCH BASIN CLEANOUT CULVERT BOX CULVERT WATER VALVE FIRE HYDRANT POST INDICATOR VALVE WATER METER GAS VALVE GAS METER TELEPHONE PEDESTAL CABLE TV PEDESTAL ELECTRIC METER UTILITY POLE LIGHT STANDARD LIGHT POLE GUY WIRE SUMMIT / HIGH POINT CONTOURS INDEX CONTOURS DIRECTION OF DRAINAGE SPOT ELEVATION DECIDUOUS SHRUB DECIDUOUS TREE CONIFEROUS SHRUB

CONIFEROUS TREE

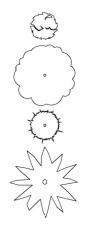STATE OF MISSOURI MICHAEL L. PARSON, GOVERNOR **BIDDING DOCUMENTS**

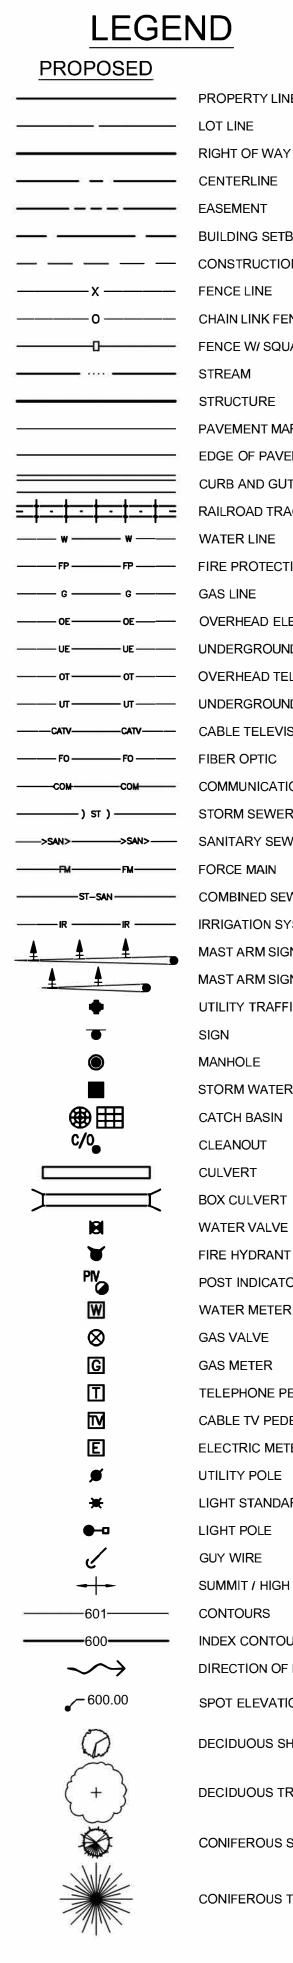



OFFICE OF ADMINISTRATION DIVISION OF FACILITIES MANAGEMENT, **DESIGN AND CONSTRUCTION**

DEPARTMENT OF NATURAL RESOURCES DIVISION OF STATE PARKS

SEWAGE LIFT STATIONS

20431 STATE HWY 157 **KIRKSVILLE, MO 63501-7069**

PROJECT #	X2302-03
SITE #	5114
ASSET #	78151140

DEVISION

REVISION:	
DATE:	
REVISION:	
DATE:	53
REVISION:	
DATE:	
	0004

ISSUE DATE: 02-12-2024


CAD DWG FILE: G002 DRAWING BY: JDH CHECKED BY: MCB/JJN

DESIGNED BY: JDH/MCB/JJN SHEET TITLE:

GENERAL NOTES AND LEGENDS

SHEET NUMBER:



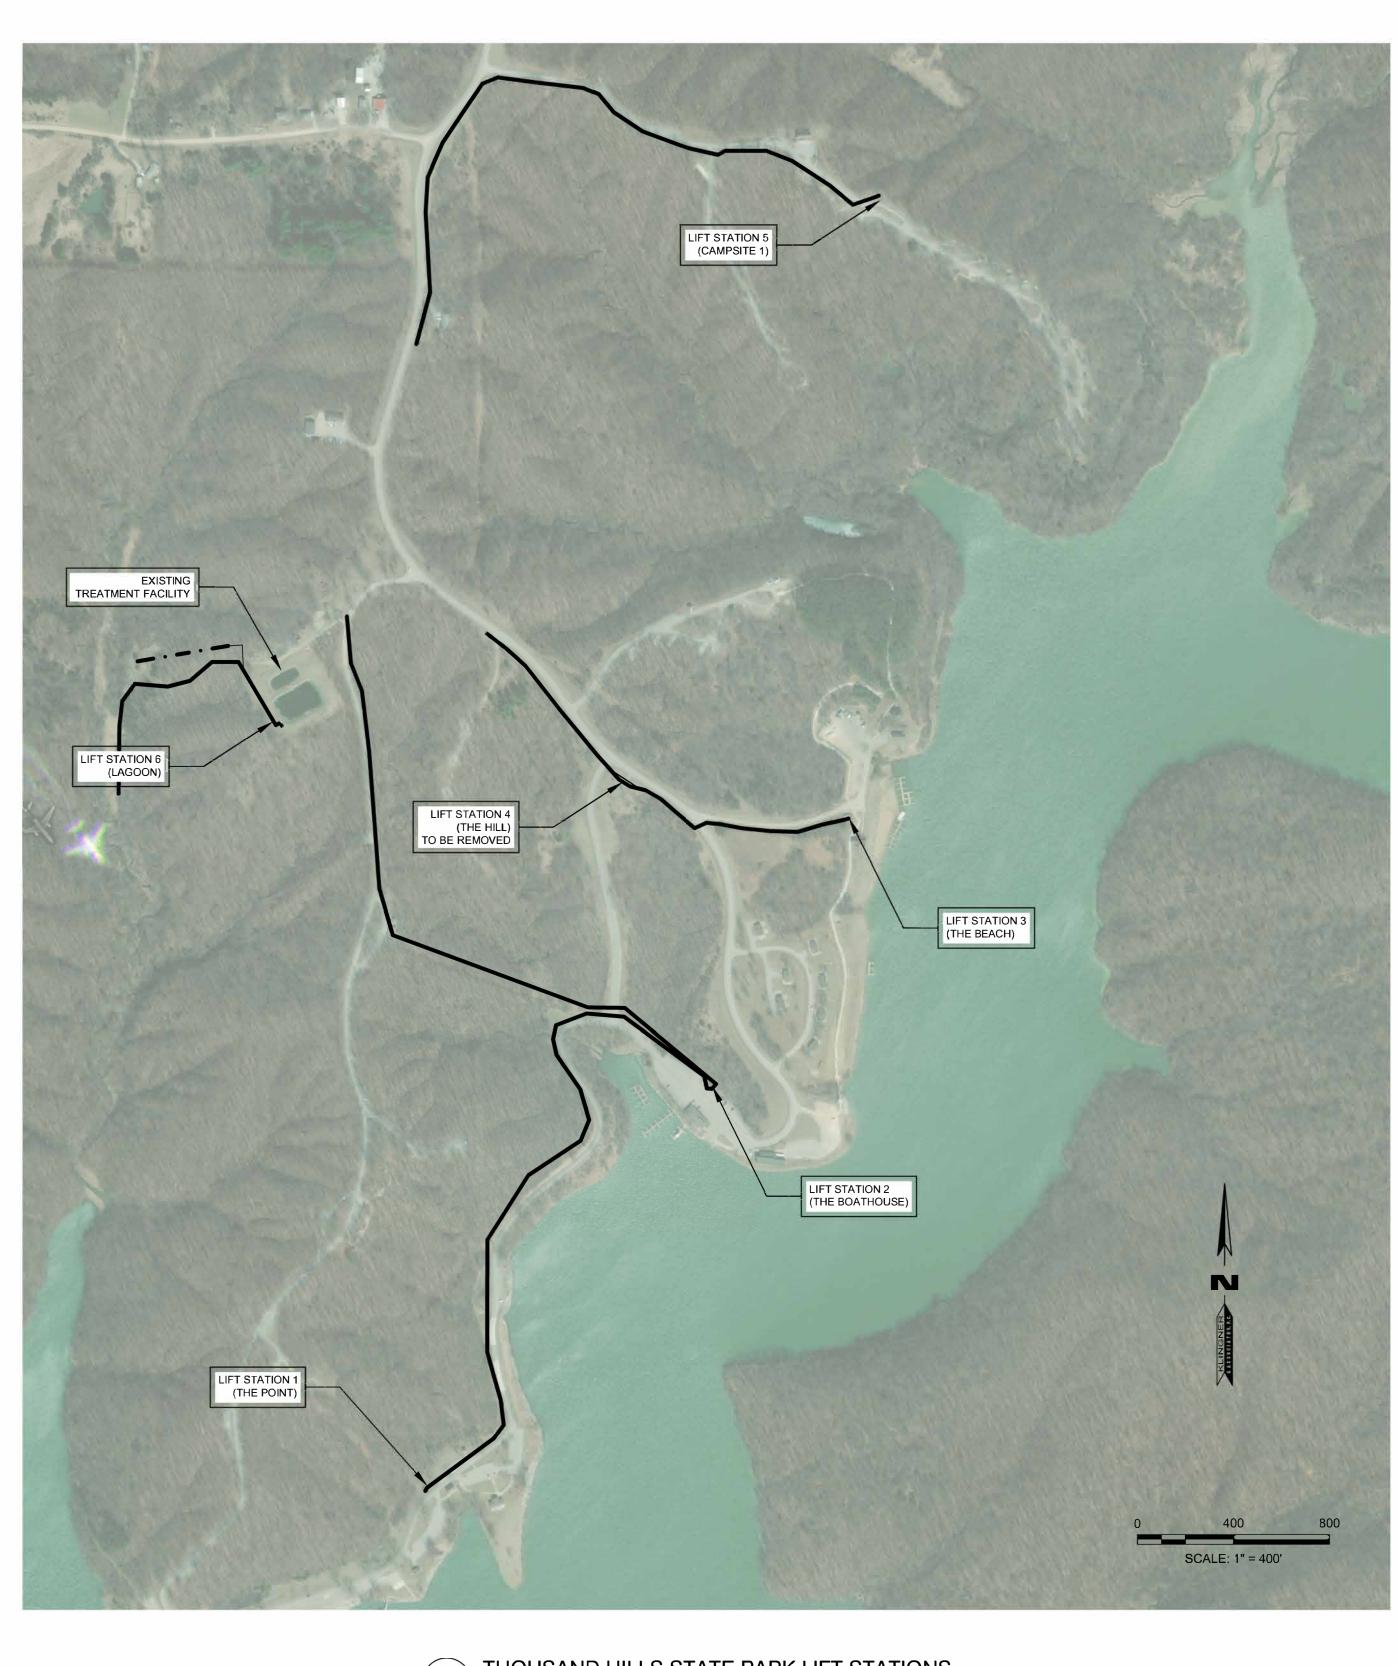

1 IHOUSANL SCALE: 1" = 400'

THOUSAND HILLS STATE PARK LIFT STATIONS

LIFT STATION IDENTIFICATION	LIFT STATION 1	LIFT STATION 2	LIFT STATION 3	LIFT STATION 4	LIFT STATION 5	LIFT STATION 6
DESCRIPTOR	THE POINT	THE BOATHOUSE	THE BEACH	THE HILL	CAMPSITE 1	THE LAGOON
GROUT SEAMS	YES	YES	YES	TO BE REMOVED	YES	YES
PRECAST WET WELL CAP REPLACEMENT WITH 4" VENT	YES	YES	YES	TO BE REMOVED	YES	YES
WET WELL PUMP AND FLOAT EQUIPMENT REPLACEMENT	YES	YES	YES	TO BE REMOVED	YES	YES
WET WELL MOUNTING EQUIPMENT REPLACEMENT	YES	YES	YES	TO BE REMOVED	YES	YES
VALVE VAULT INTERNAL PIPING AND FITTING REPLACEMENT	YES	YES	YES	TO BE REMOVED	YES	YES
CONTROL PANEL REPLACEMENT	YES	YES	YES	TO BE REMOVED	YES	YES
CONTROL PANEL ELECTRICAL REPLACEMENT	YES	YES	YES	TO BE REMOVED	YES	YES
PUMP MANUFACTURER	SULZER	SULZER	SULZER	TO BE REMOVED	SULZER	SULZER
PUMP MODEL	PE45/2W-C-60 HZ	PE80/2-E-60HZ	PE300/2-G-60HZ	TO BE REMOVED	PE100/2-E-60HZ	PE185/2-G-60HZ
SHEET	C100	C101	C102	TO BE REMOVED	C103	C104



STATE OF MISSOURI	
MICHAEL L. PARSON,	
GOVERNOR	
BIDDING DOCUMENT	S



& A S S O C I A T E S, P.C.	Engineers • Architects • Surveyors	Columbia, Missouri 907 East Ash Street Quincy, IL Galesburg, IL Hannibal, MO 573.355.5988 Burlington, IA Pella, IA Davenport, IA	KLINGNER & ASSOCIATES, P.C ENGINEERING MISSOURI STATE CERTIFICATE OF AUTHORITY #00086
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OFFICE OF ADMINISTRATION DIVISION OF FACILITIES MANAGEMENT, **DESIGN AND CONSTRUCTION**

DEPARTMENT OF NATURAL **RESOURCES DIVISION OF STATE PARKS**

SEWAGE LIFT STATIONS

20431 STATE HWY 157 **KIRKSVILLE, MO 63501-7069**

PROJECT #	X2302-03
SITE #	5114
ASSET #	78151140

DEVISION

REVISION:	
DATE:	
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REVISION:	_
DATE:	

ISSUE DATE: 02-12-2024

CAD DWG <u>FILE: C001</u> DRAWING <u>BY</u>: <u>JDH</u> CHECKED BY: <u>MCB/JJN</u> DESIGNED BY: <u>JDH/MCB/JJN</u>

SHEET TITLE: **OVERALL SITE** PLAN


SHEET NUMBER:



3 OF 18 SHEETS	
FEBRUARY 12, 2024	

NOTE:

- 1. ALL PUMPS TO BE REPLACED ARE TO BE SULZER PUMPS AND EXISTING PUMPS TO BE REMOVED AND PROVIDED TO THE PARK FOR USE IN EMERGENCY SITUATIONS
- 2. WET WELL CAP TO BE REPLACED WITH PRECAST CONCRETE. CONTRACTOR TO SUBMIT SHOP DRAWINGS WITH REINFORCING DETAILS FOR APPROVAL PRIOR TO FABRICATION. 3. LIFT STATION WET WELL AND VALVE VAULT
- REPLACEMENT MATERIAL AND PRODUCTS TO MATCH EXISTING UNLESS OTHERWISE NOTED.

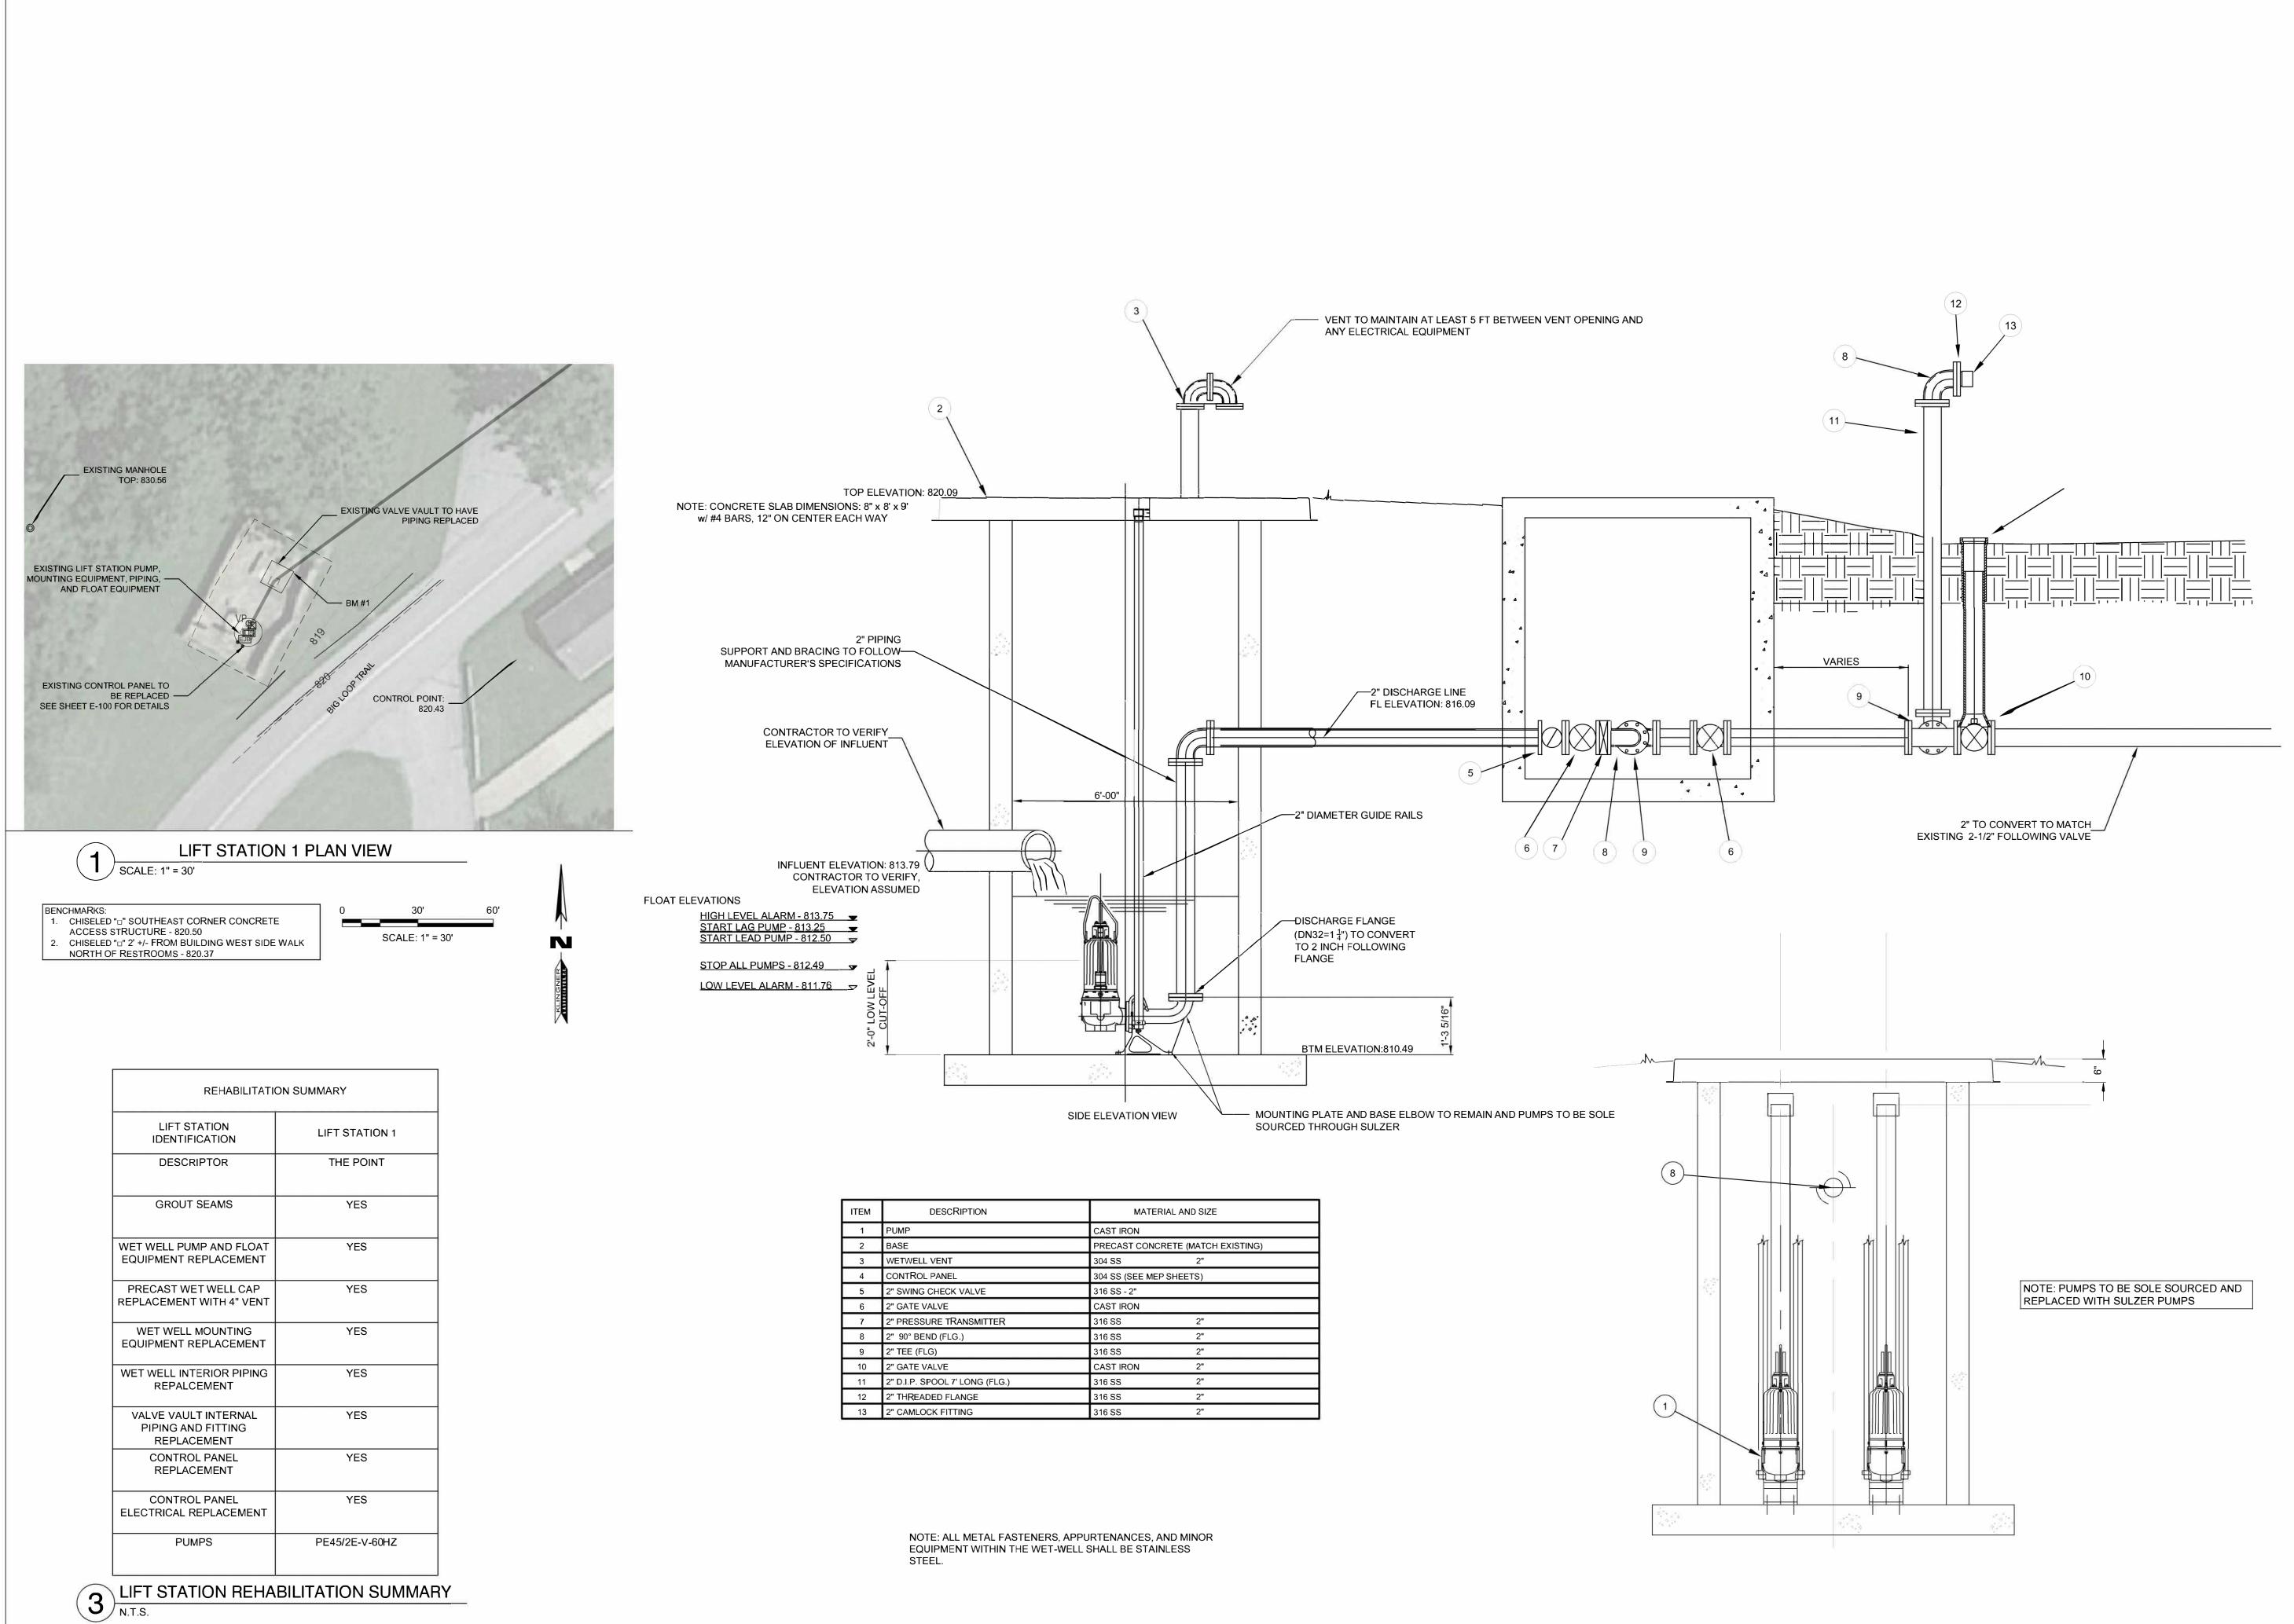

2 LIFT STATION 1 (THE POINT) REHABILITATION NOTES

STATE OF MISSOURI MICHAEL L. PARSON, GOVERNOR **BIDDING DOCUMENTS**





OFFICE OF ADMINISTRATION DIVISION OF FACILITIES MANAGEMENT, **DESIGN AND CONSTRUCTION**

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ISSUE DATE: 02 12 2024

ISSUE DATE: 02-12-2024 _____

CAD DWG FILE: C100 DRAWING BY: JDH____ CHECKED BY: MCB/JJN DESIGNED BY: JDH/MCB/JJN

SHEET TITLE: **LIFT STATION 1** DETAILS

SHEET NUMBER:




3 LIFT STATION REHABILITATION SUMMARY

REHABILITATION SUMMARY		
LIFT STATION IDENTIFICATION	LIFT STATION 2	
DESCRIPTOR	THE BOATHOUSE	
GROUT SEAMS	YES	
WET WELL PUMP AND FLOAT EQUIPMENT REPLACEMENT	YES	
PRECAST WET WELL CAP REPLACEMENT WITH 4" VENT	YES	
WET WELL MOUNTING EQUIPMENT REPLACEMENT	YES	
WET WELL INTERIOR PIPING REPLACEMENT	YES	
VALVE VAULT INTERNAL PIPING AND FITTING REPLACEMENT	YES	
CONTROL PANEL REPLACEMENT	YES	
CONTROL PANEL ELECTRICAL REPLACEMENT	YES	
PUMPS	PE80/2-E-60HZ	

BENCHMARKS: 1. CHISELED "D" NORTHWEST CORNER CONCRETE ACCESS STRUCTURE - 809.60 2. 8" SPIKE IN EAST SIDE POWER POLE EAST OF BOAT RENTAL BUILDING - 807.80


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60' 30' SCALE: 1" = 30'

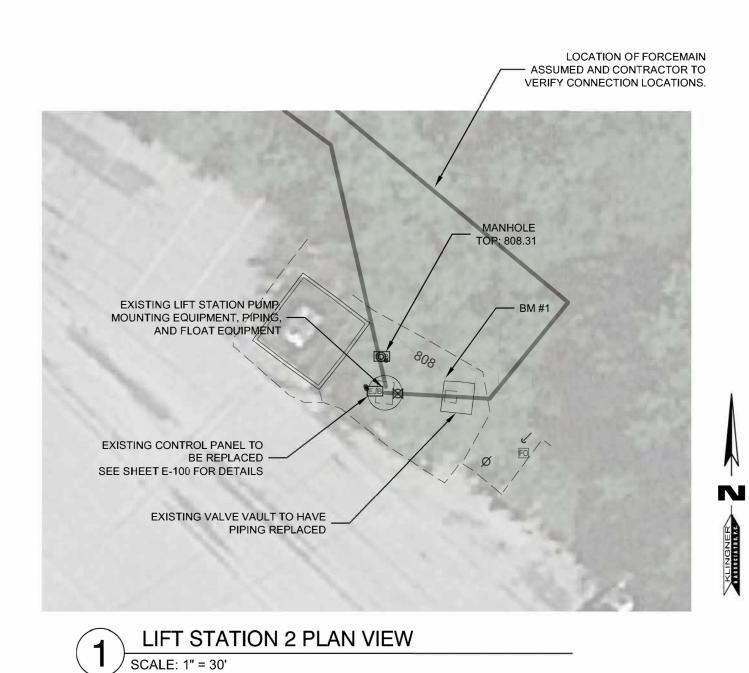


FLOAT ELEVATIONS

CONTRACTOR TO VERIFY_

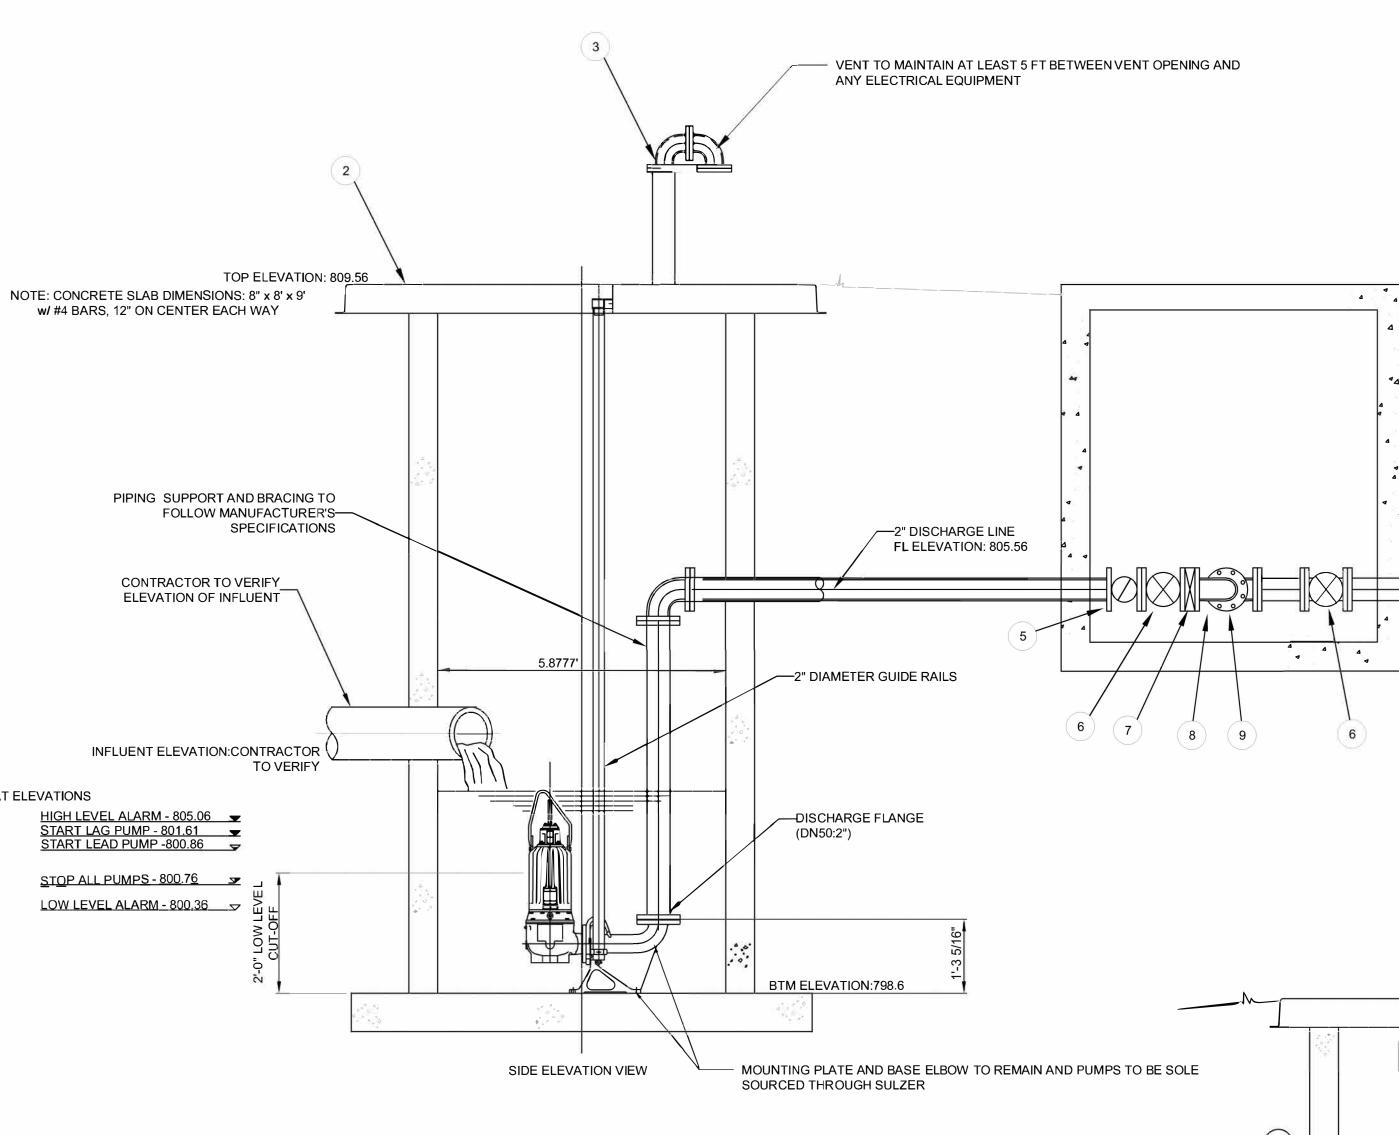

ITEM	DESCRIPTION	MATERIAL AND SIZE	
1	PUMP	CAST IRON	
2	BASE	PRECAST CONCRETE (MATCH EXISTING)	
3	WETWELL VENT	304 SS 2"	
4	CONTROL PANEL	304 SS (SEE MEP SHEETS)	
5	2" SWING CHECK VALVE	316 SS - 2"	
6	2" GATE VALVE	CAST IRON	
7	2" PRESSURE TRANSMITTER	316 SS 2"	
8	2" 90° BEND (FLG.)	316 SS 2"	
9	2" TEE (FLG)	316 SS 2"	
10	2" GATE VALVE	CAST IRON 2"	
11	2" D.I.P. SPOOL 7' LONG (FLG.)	316 SS 2"	
12	2" THREADED FLANGE	316 SS 2"	
13	2" CAMLOCK FITTING	316 SS 2"	

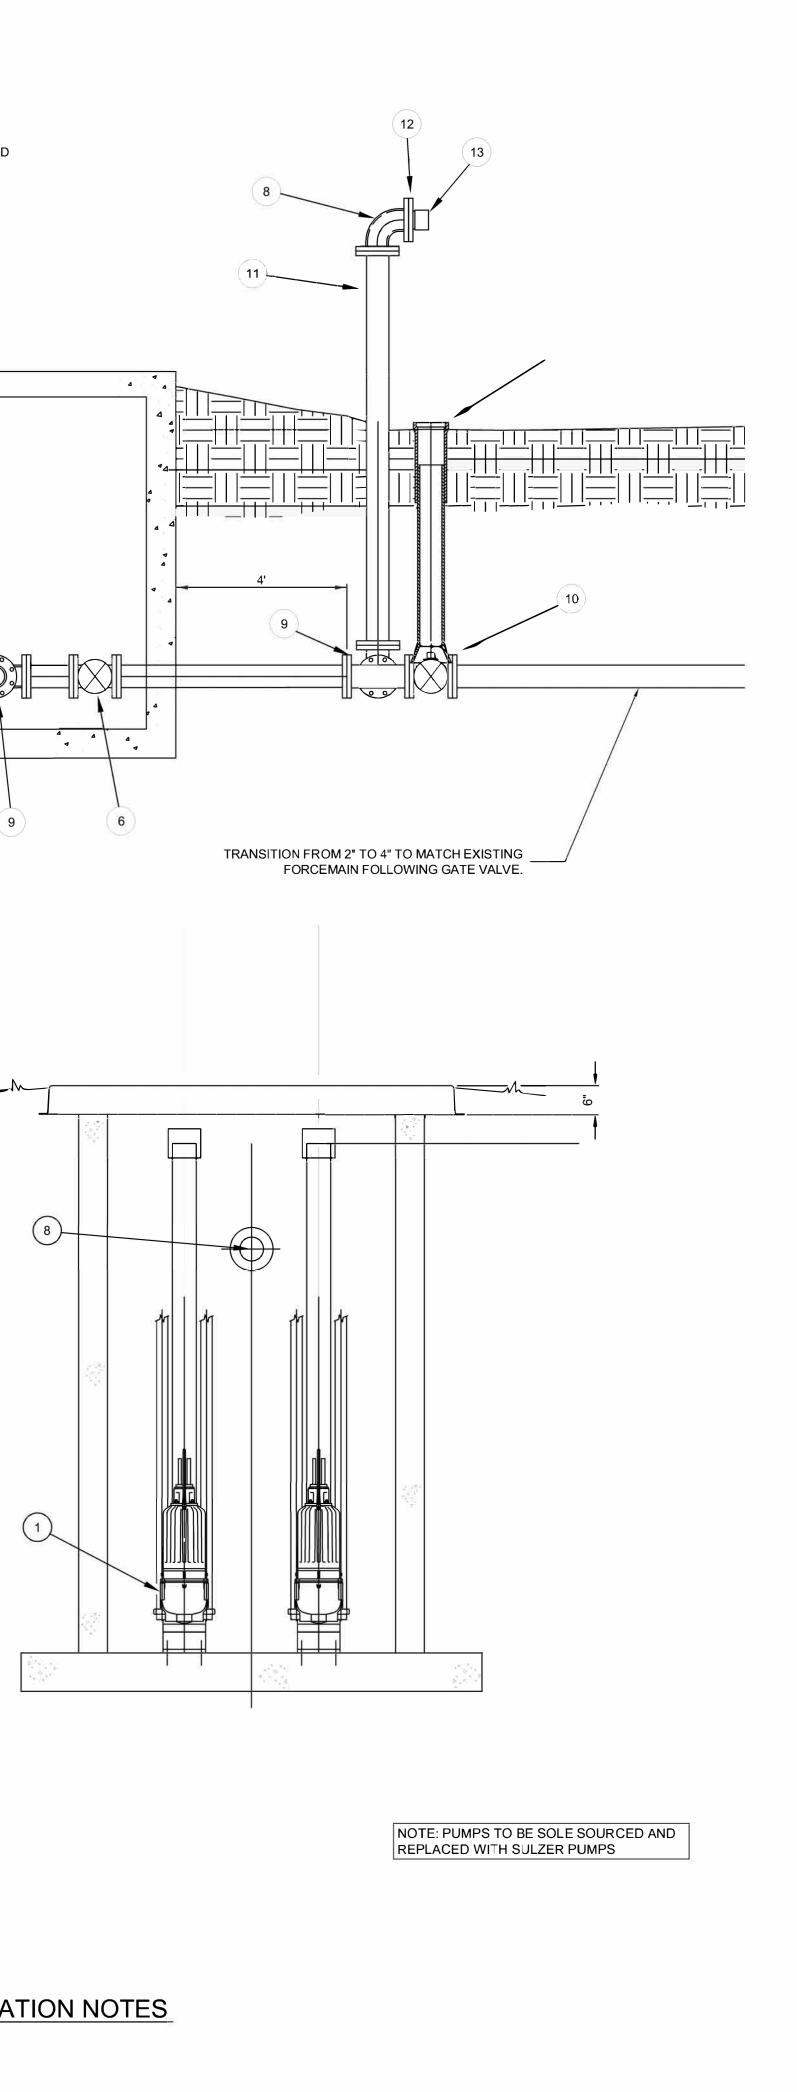

NOTE: ALL METAL FASTENERS, APPURTENANCES, AND MINOR EQUIPMENT WITHIN THE WET-WELL SHALL BE STAINLESS STEEL.

2 LIFT STATION 2 (THE BOATHOUSE) REHABILITATION NOTES

STATE OF MISSOURI MICHAEL L. PARSON, GOVERNOR **BIDDING DOCUMENTS**





OFFICE OF ADMINISTRATION DIVISION OF FACILITIES MANAGEMENT, **DESIGN AND CONSTRUCTION**

DEPARTMENT OF NATURAL **RESOURCES DIVISION OF** STATE PARKS

SEWAGE LIFT STATIONS

20431 STATE HWY 157 **KIRKSVILLE, MO 63501-7069**

X2302-03
5114
78151140

EVISION:	
DATE:	
EVISION:	
DATE:	53
EVISION:	
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DATE: ISSUE DATE: 02-12-2024

CAD DWG FILE: C101 DRAWING BY: JDH____ CHECKED BY: MCB/JJN DESIGNED BY: JDH/MCB/JJN

SHEET TITLE:


LIFT STATION 2 DETAILS


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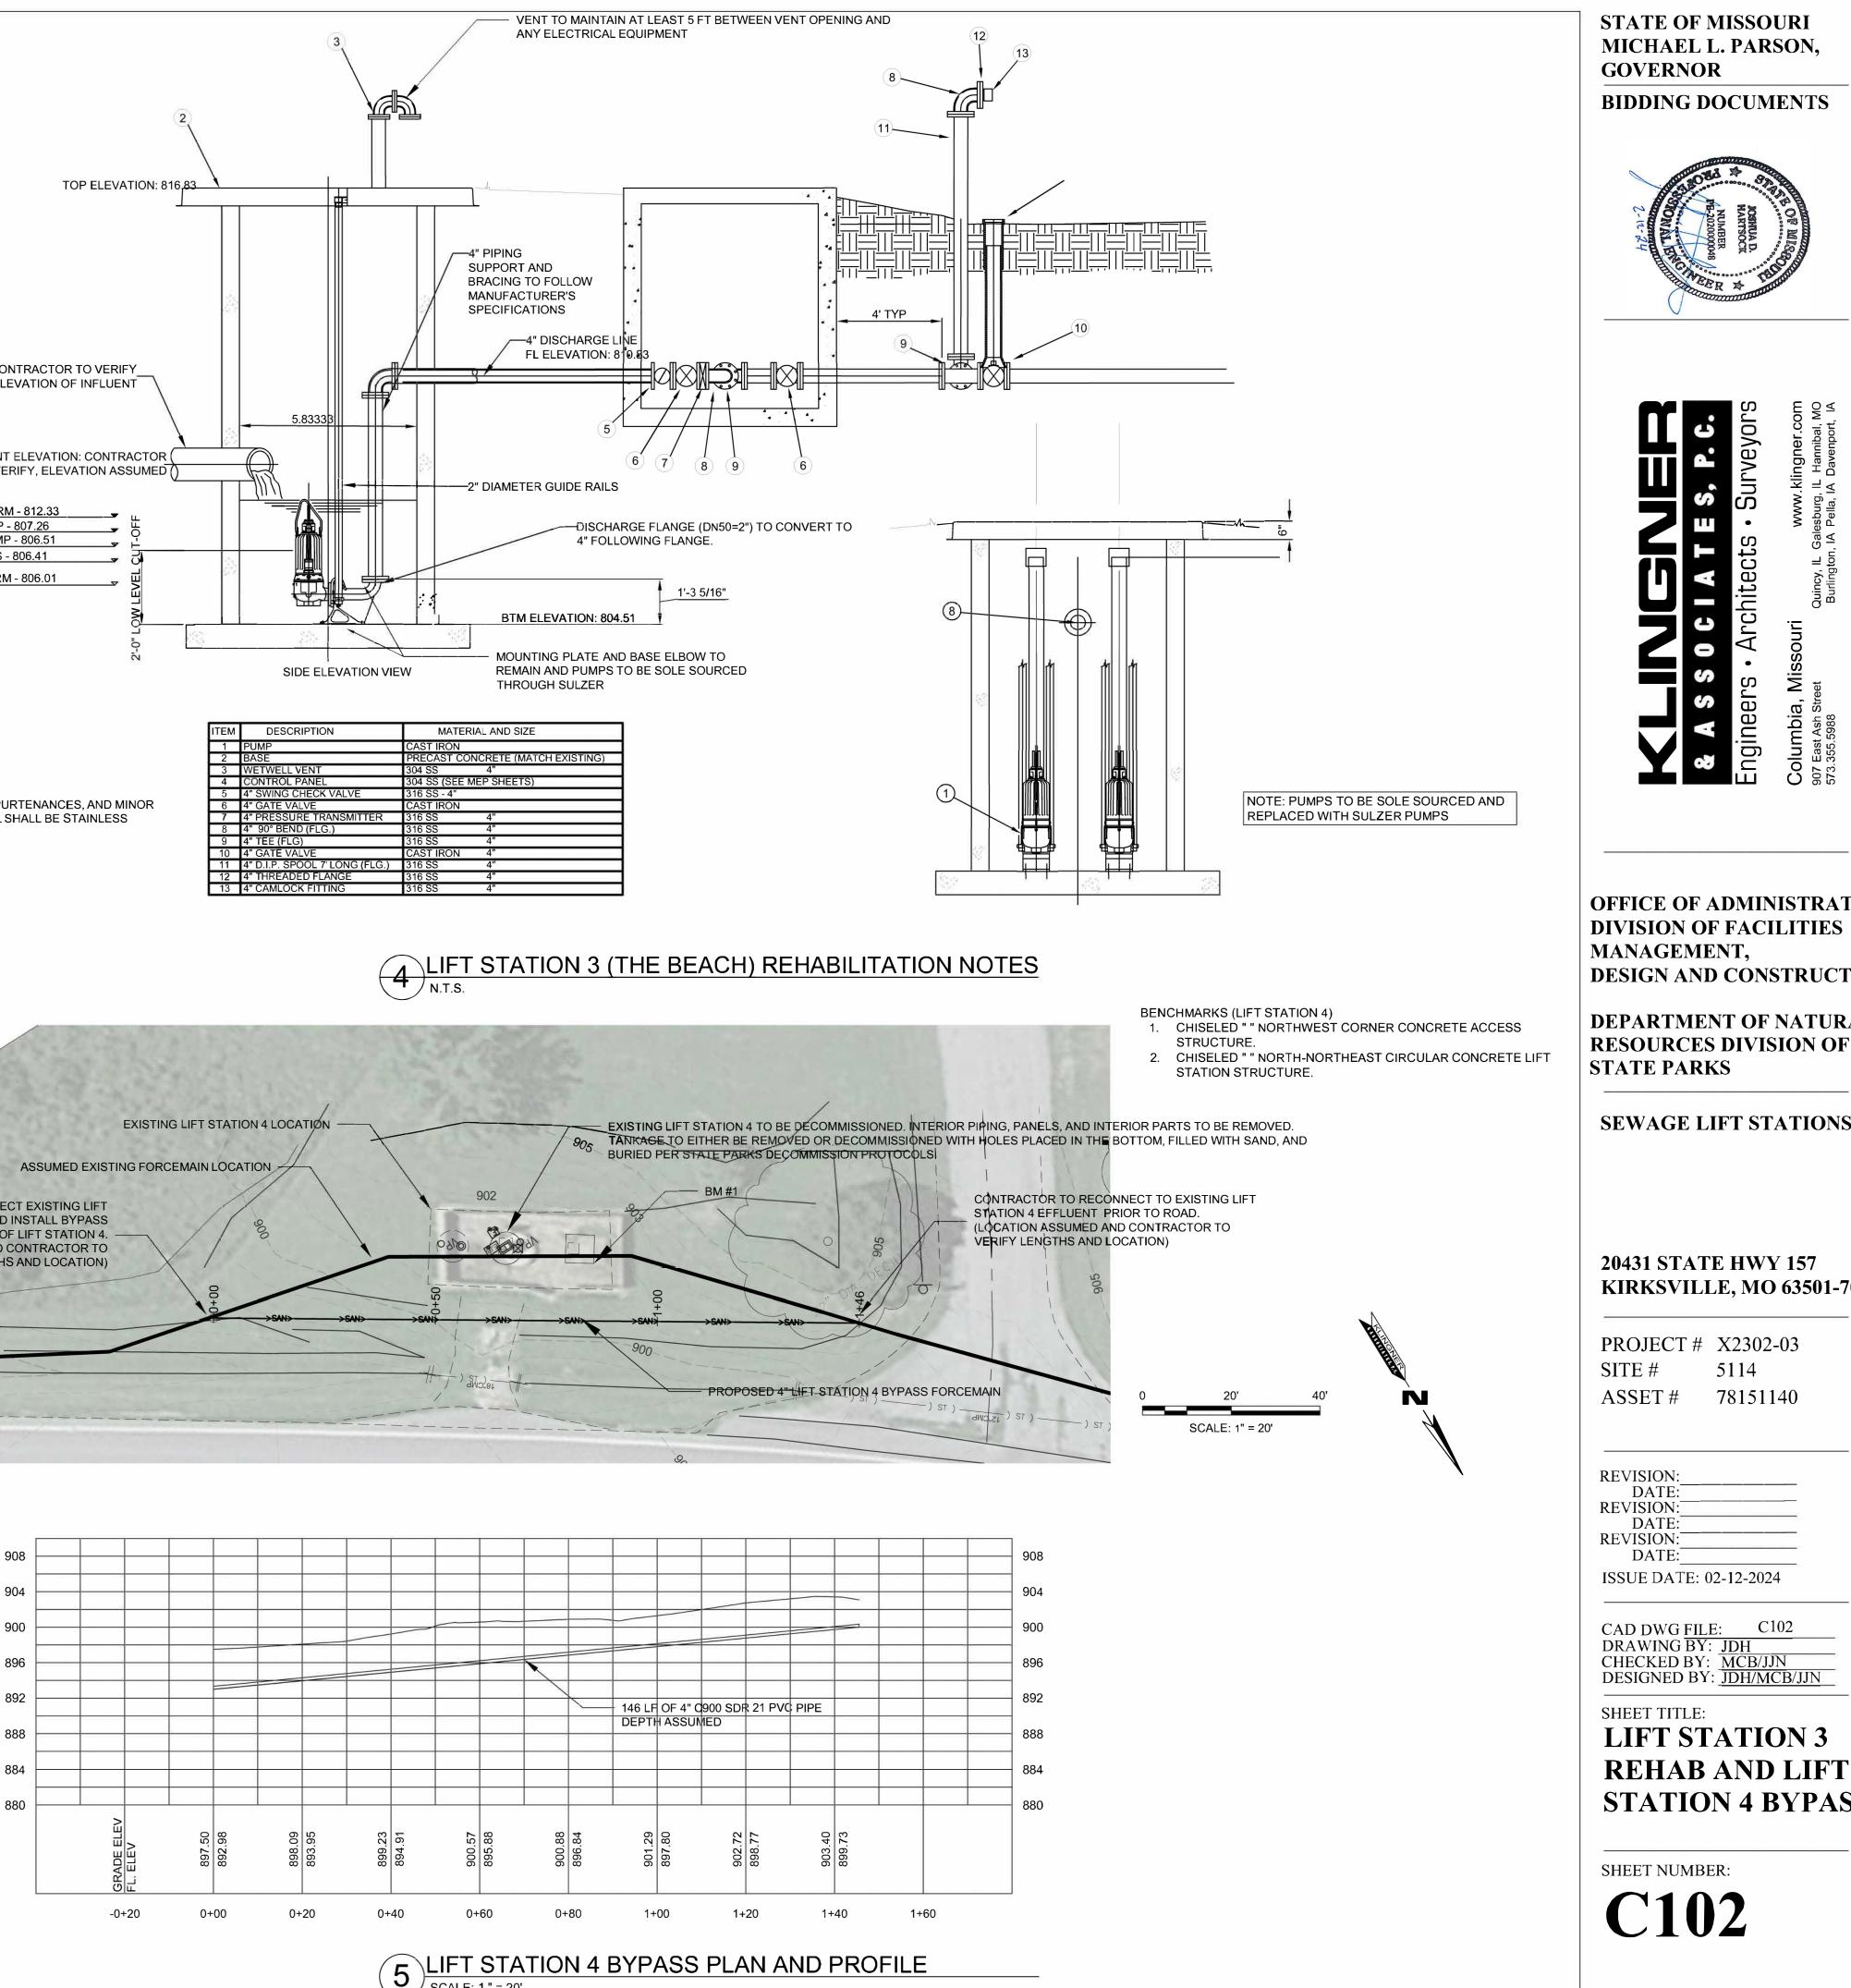
825	ANG LIFT STATION PUMP, NGEQUIPMENT, PIPING, ANDFLOAT EQUIPMENT REPLACEMENT BM #1	/ BE	ISTING CONTROL PANEL TO REPLACED E SHEET E-100 FOR DETAILS MANHOL TOP 814.	E: 61	
INTERNAL	PIPING REPLACED	817 MANH TOP 8	MANHOLE: TOP 816.70		FLC
BENCHMARKS: 1. CHISELED "□" NORTHWEST CO STRUCTURE 816.78 2. CHISELED "□" SOUTH END CUR LOT NORTH OF SITE - 814.55		0 20' SCALE: 1" =	40' = 20'	KLINGNER	NOTE: ALL EQUIPMEN STEEL.
The number of the second	PROPOSED	BYPASS OF LIFT STAT	D ELECTRICAL BE UPGRADED	N TO BE USED EXCEPT F	
2 LIFT STA SCALE: 1" = 200"	TION 3 (THE BEACH) FORCEMA	AIN ROUTE		
	LIFT STATION IDENTIFICATION DESCRIPTOR GROUT SEAMS	LIFT STATION 3 THE BEACH YES			
	WET WELL PUMP AND FLOAT EQUIPMENT REPLACEMENT PRECAST WET WELL CAP REPLACEMENT WITH 4" VENT	YES			
	WET WELL MOUNTING EQUIPMENT REPLACEMENT WET WELL INTERIOR PIPING REPLACEMENT	YES			
	VALVE VAULT INTERNAL PIPING AND FITTING REPLACEMENT	YES			
		YES			
	CONTROL PANEL ELECTRICAL REPLACEMENT	YES			
	PUMPS	PE300/2-G-60HZ			
	ΙΕΤ STATION BEHABILIT				

3 LIFT STATION REHABILITATION SUMMARY




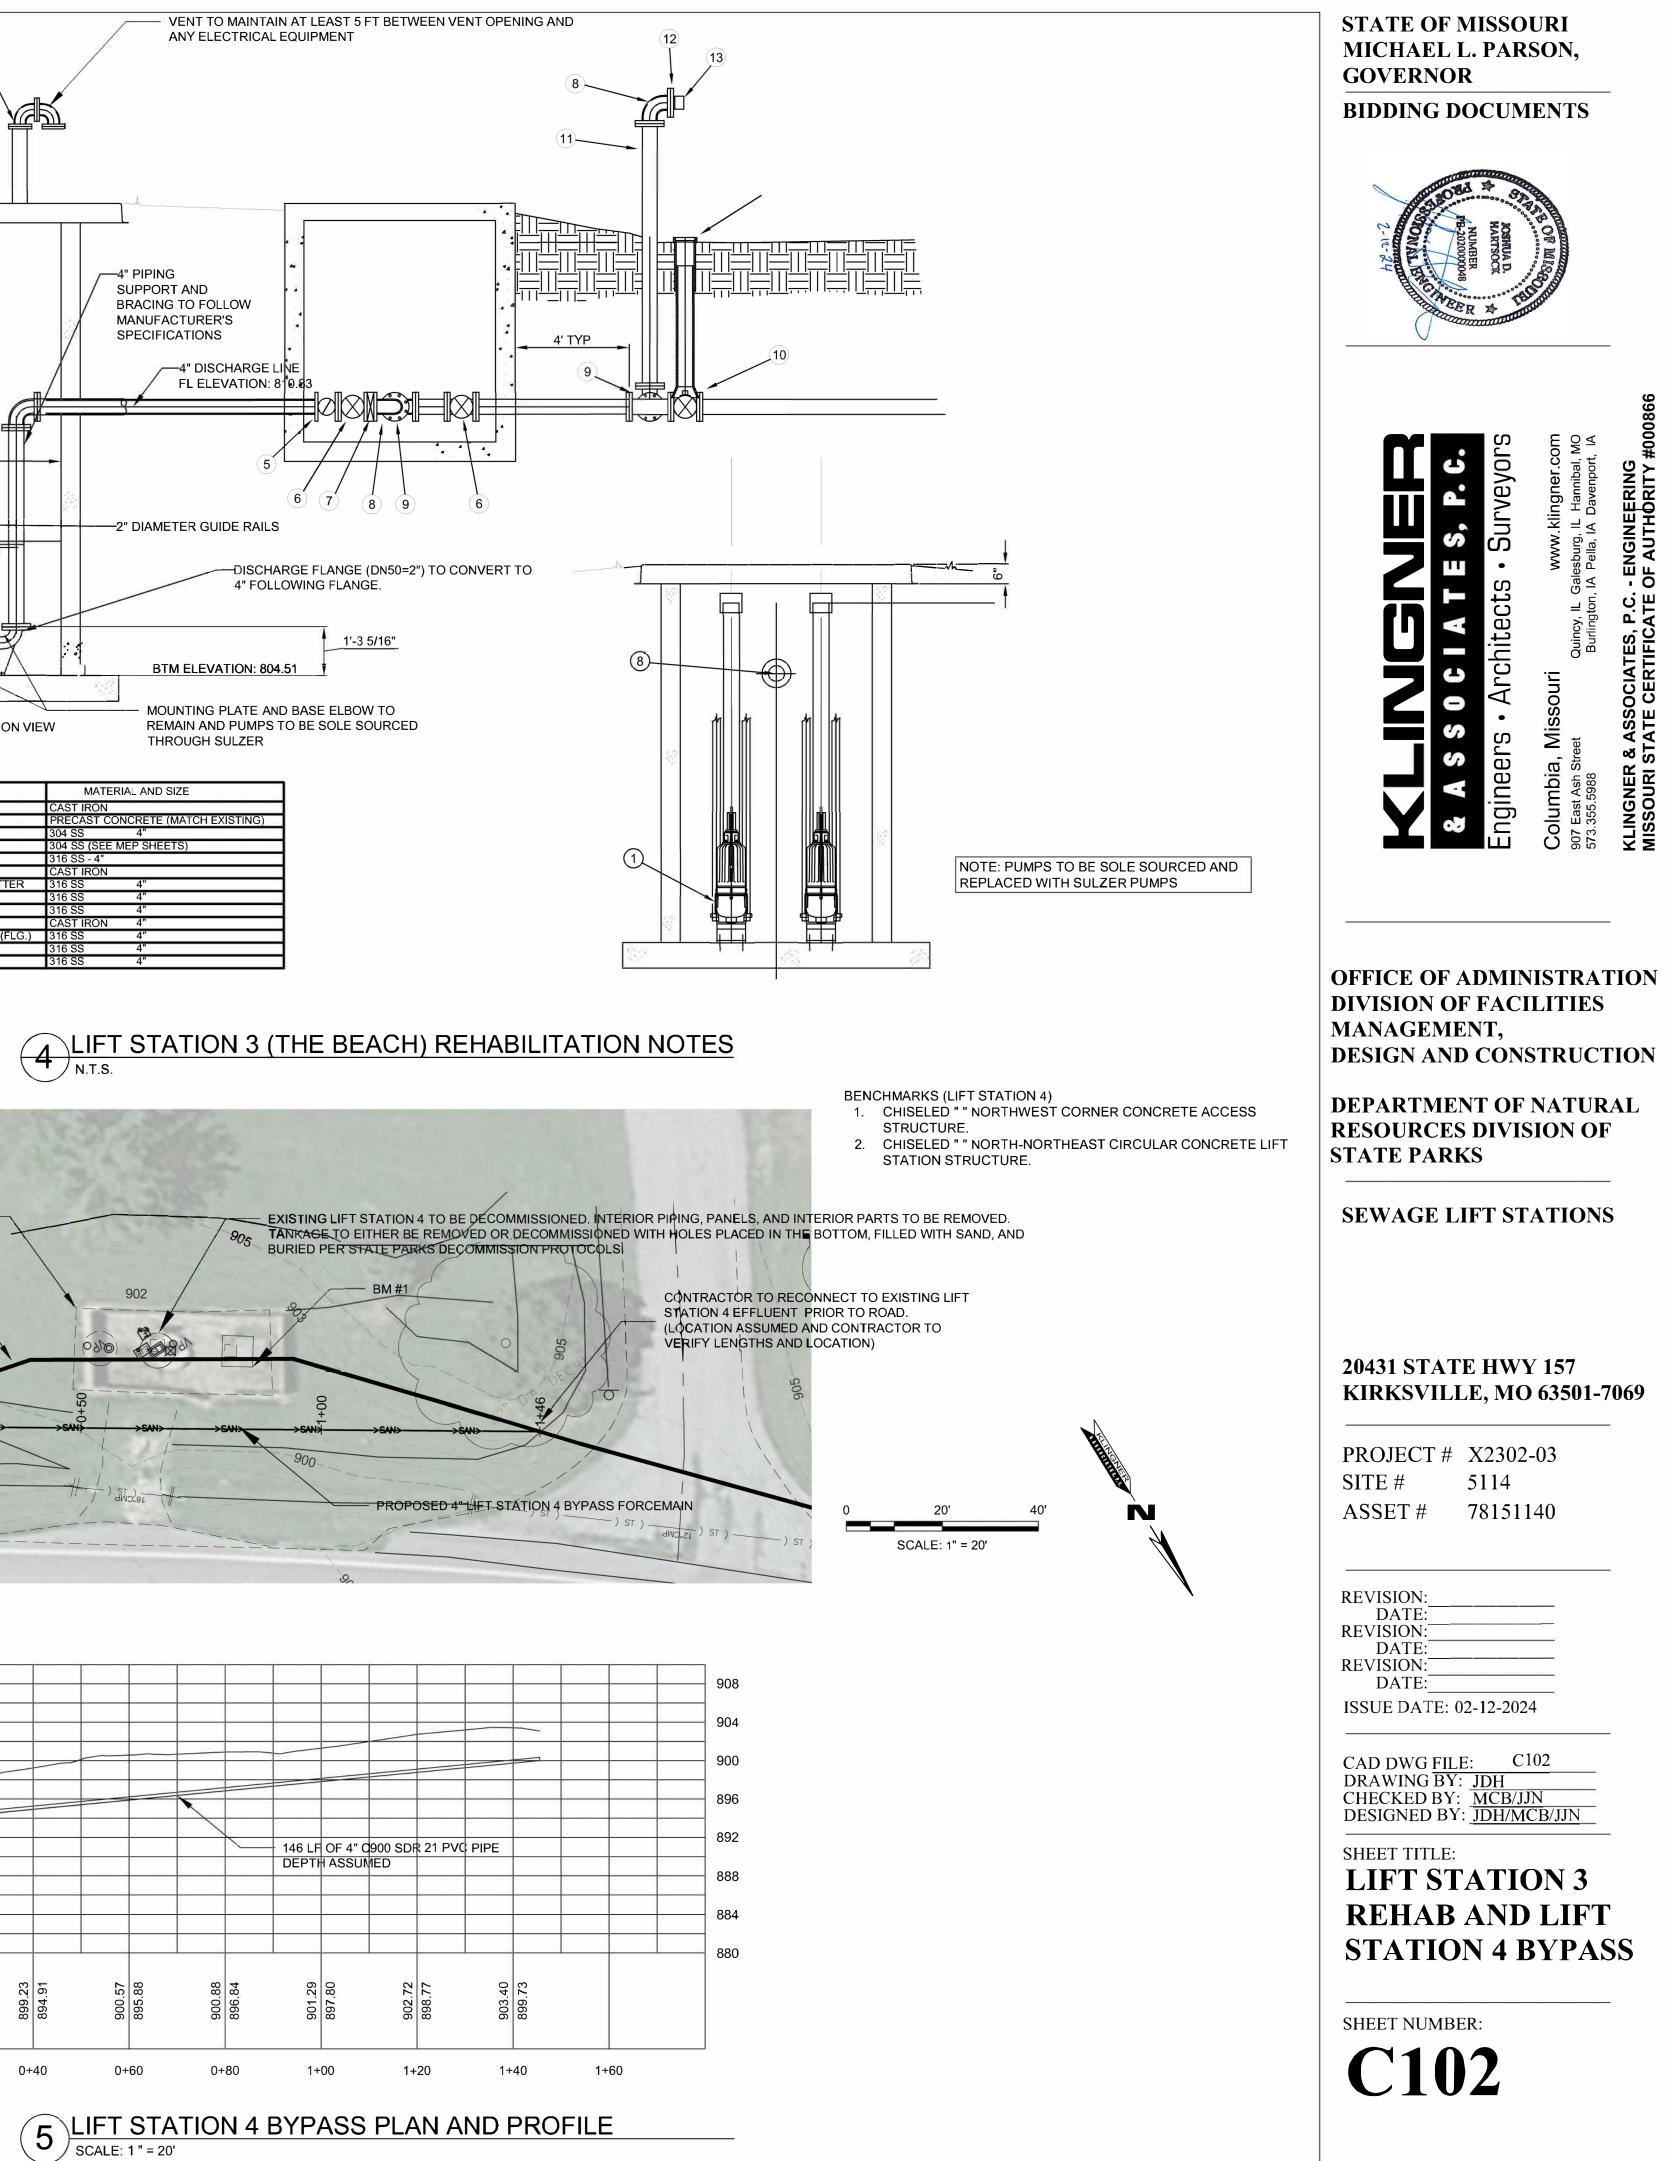

CONTRACTOR TO DISCONNECT EXISTING LIFT STATION 4 INFLUENT PIPING AND INSTALL BYPASS

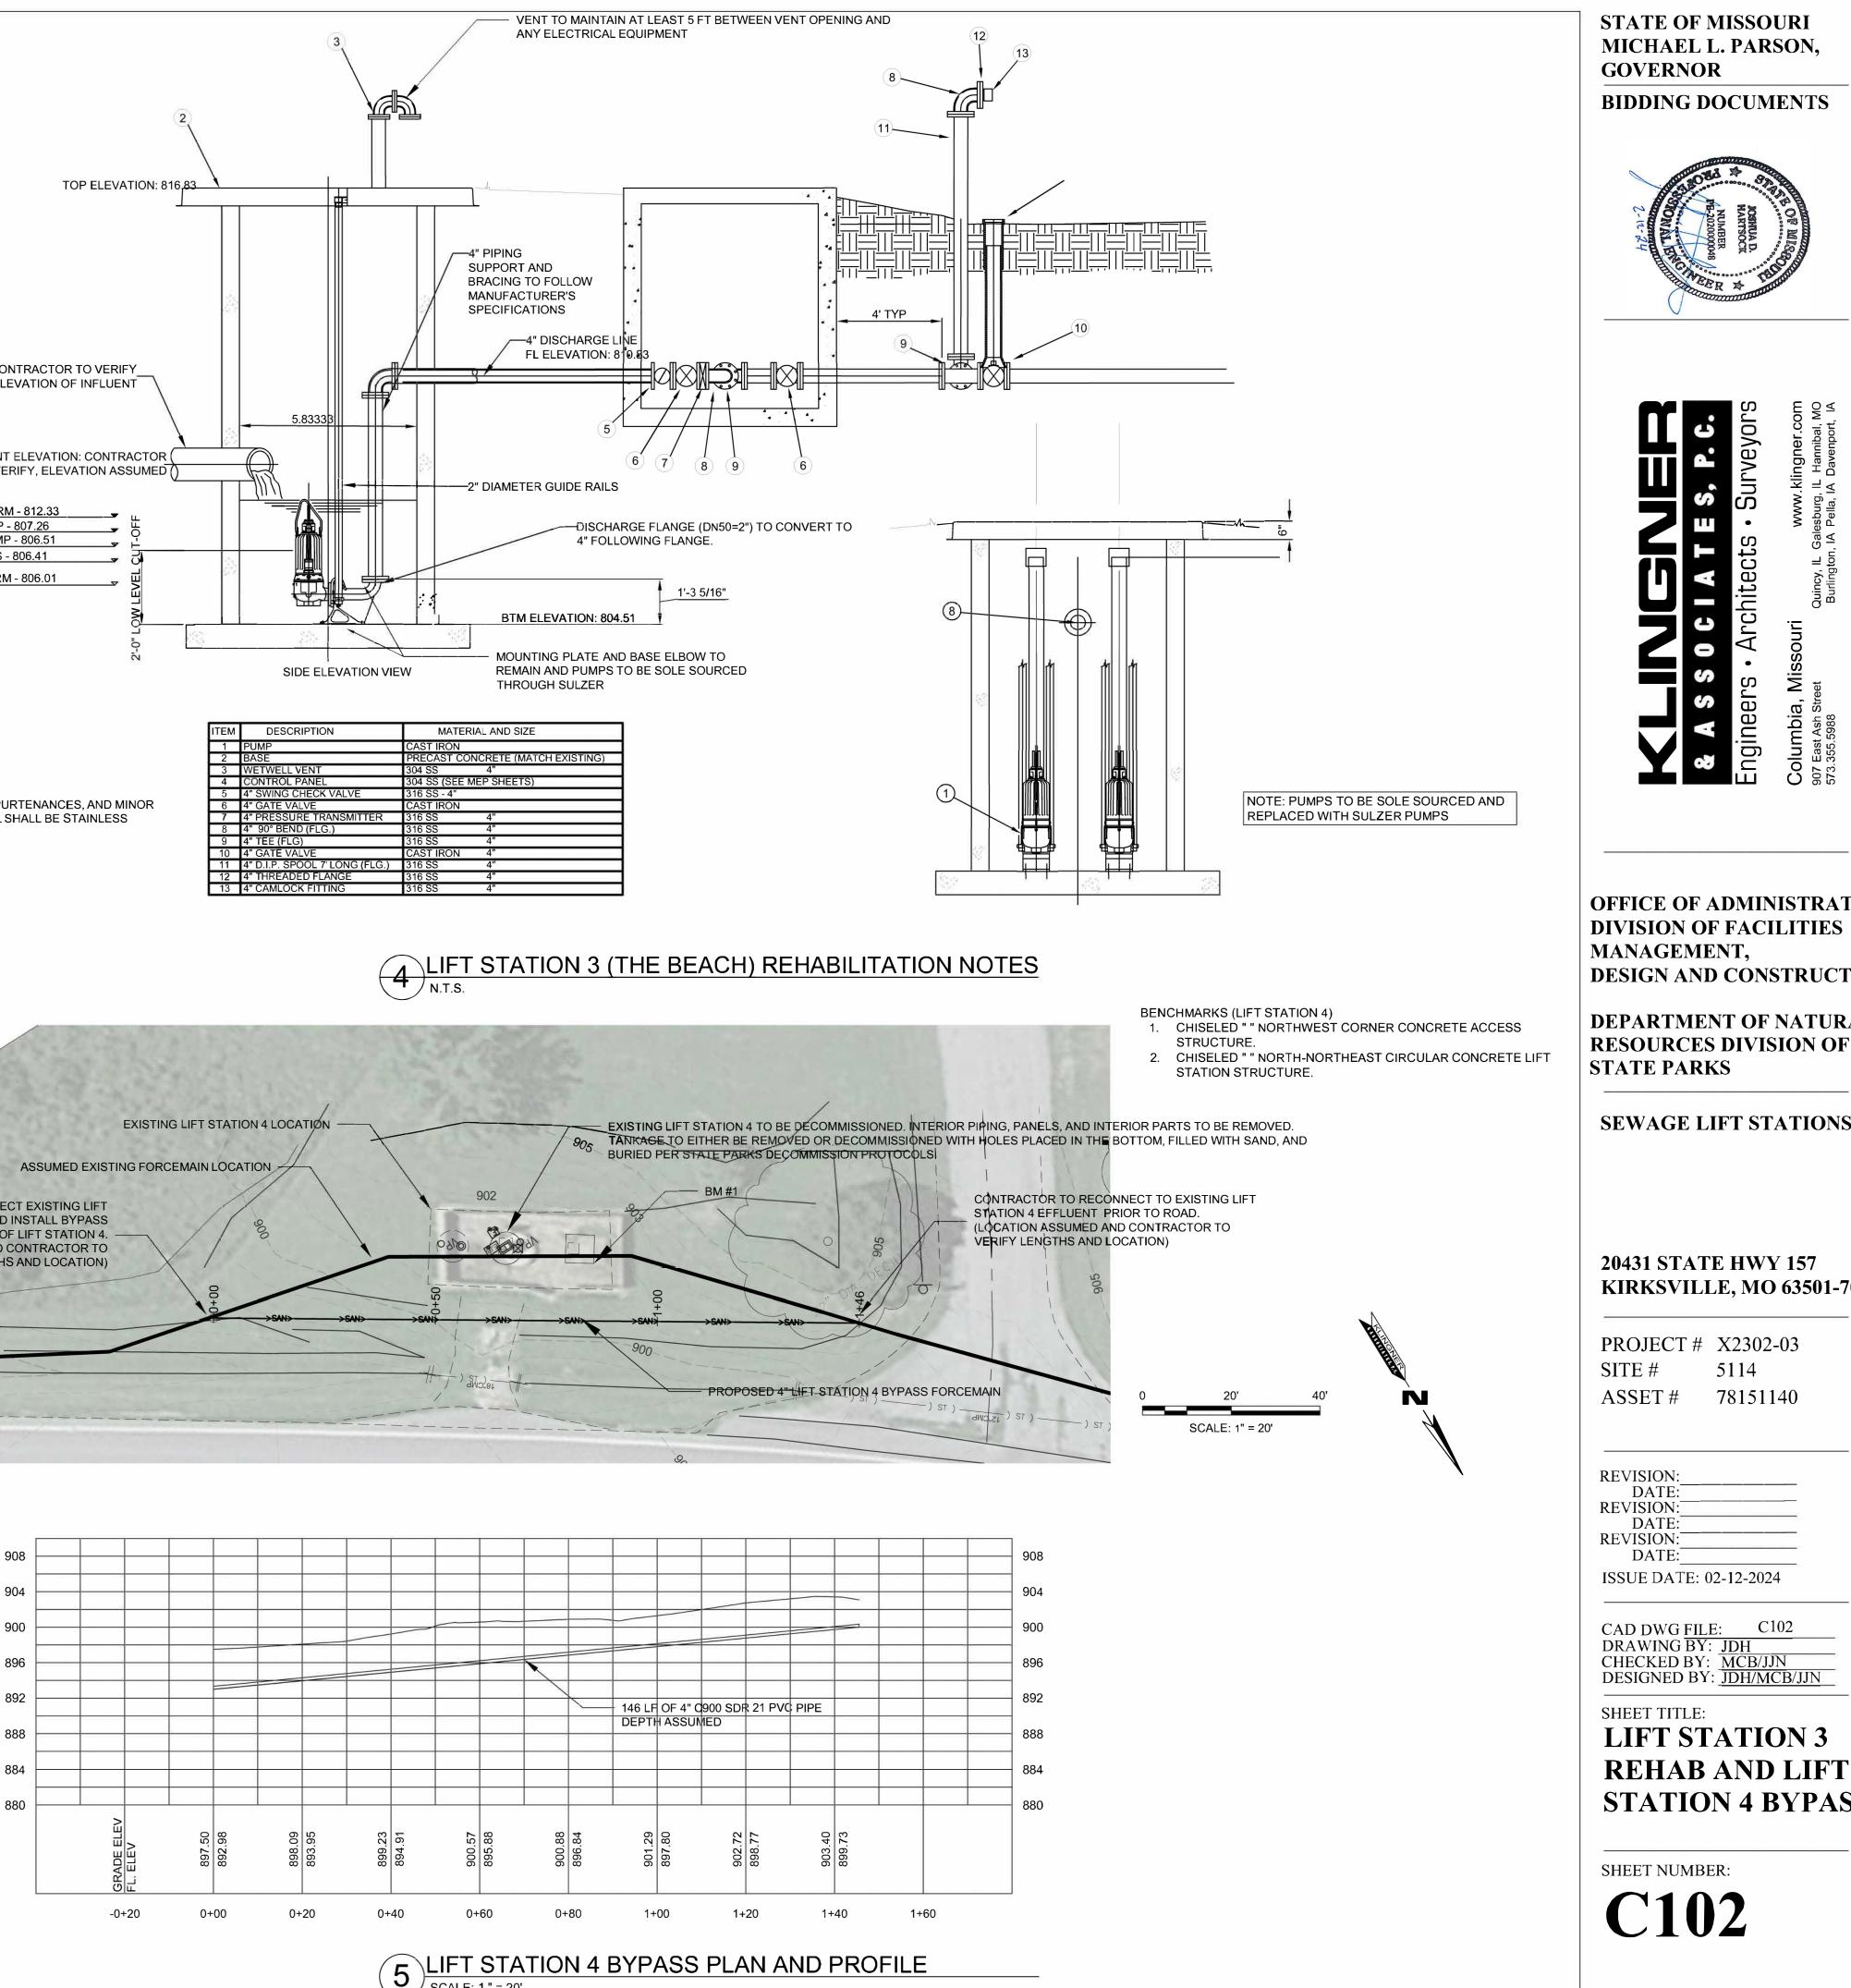


EQUIPMENT WITHIN THE WET-WELL SHALL BE STAINLESS STEEL.

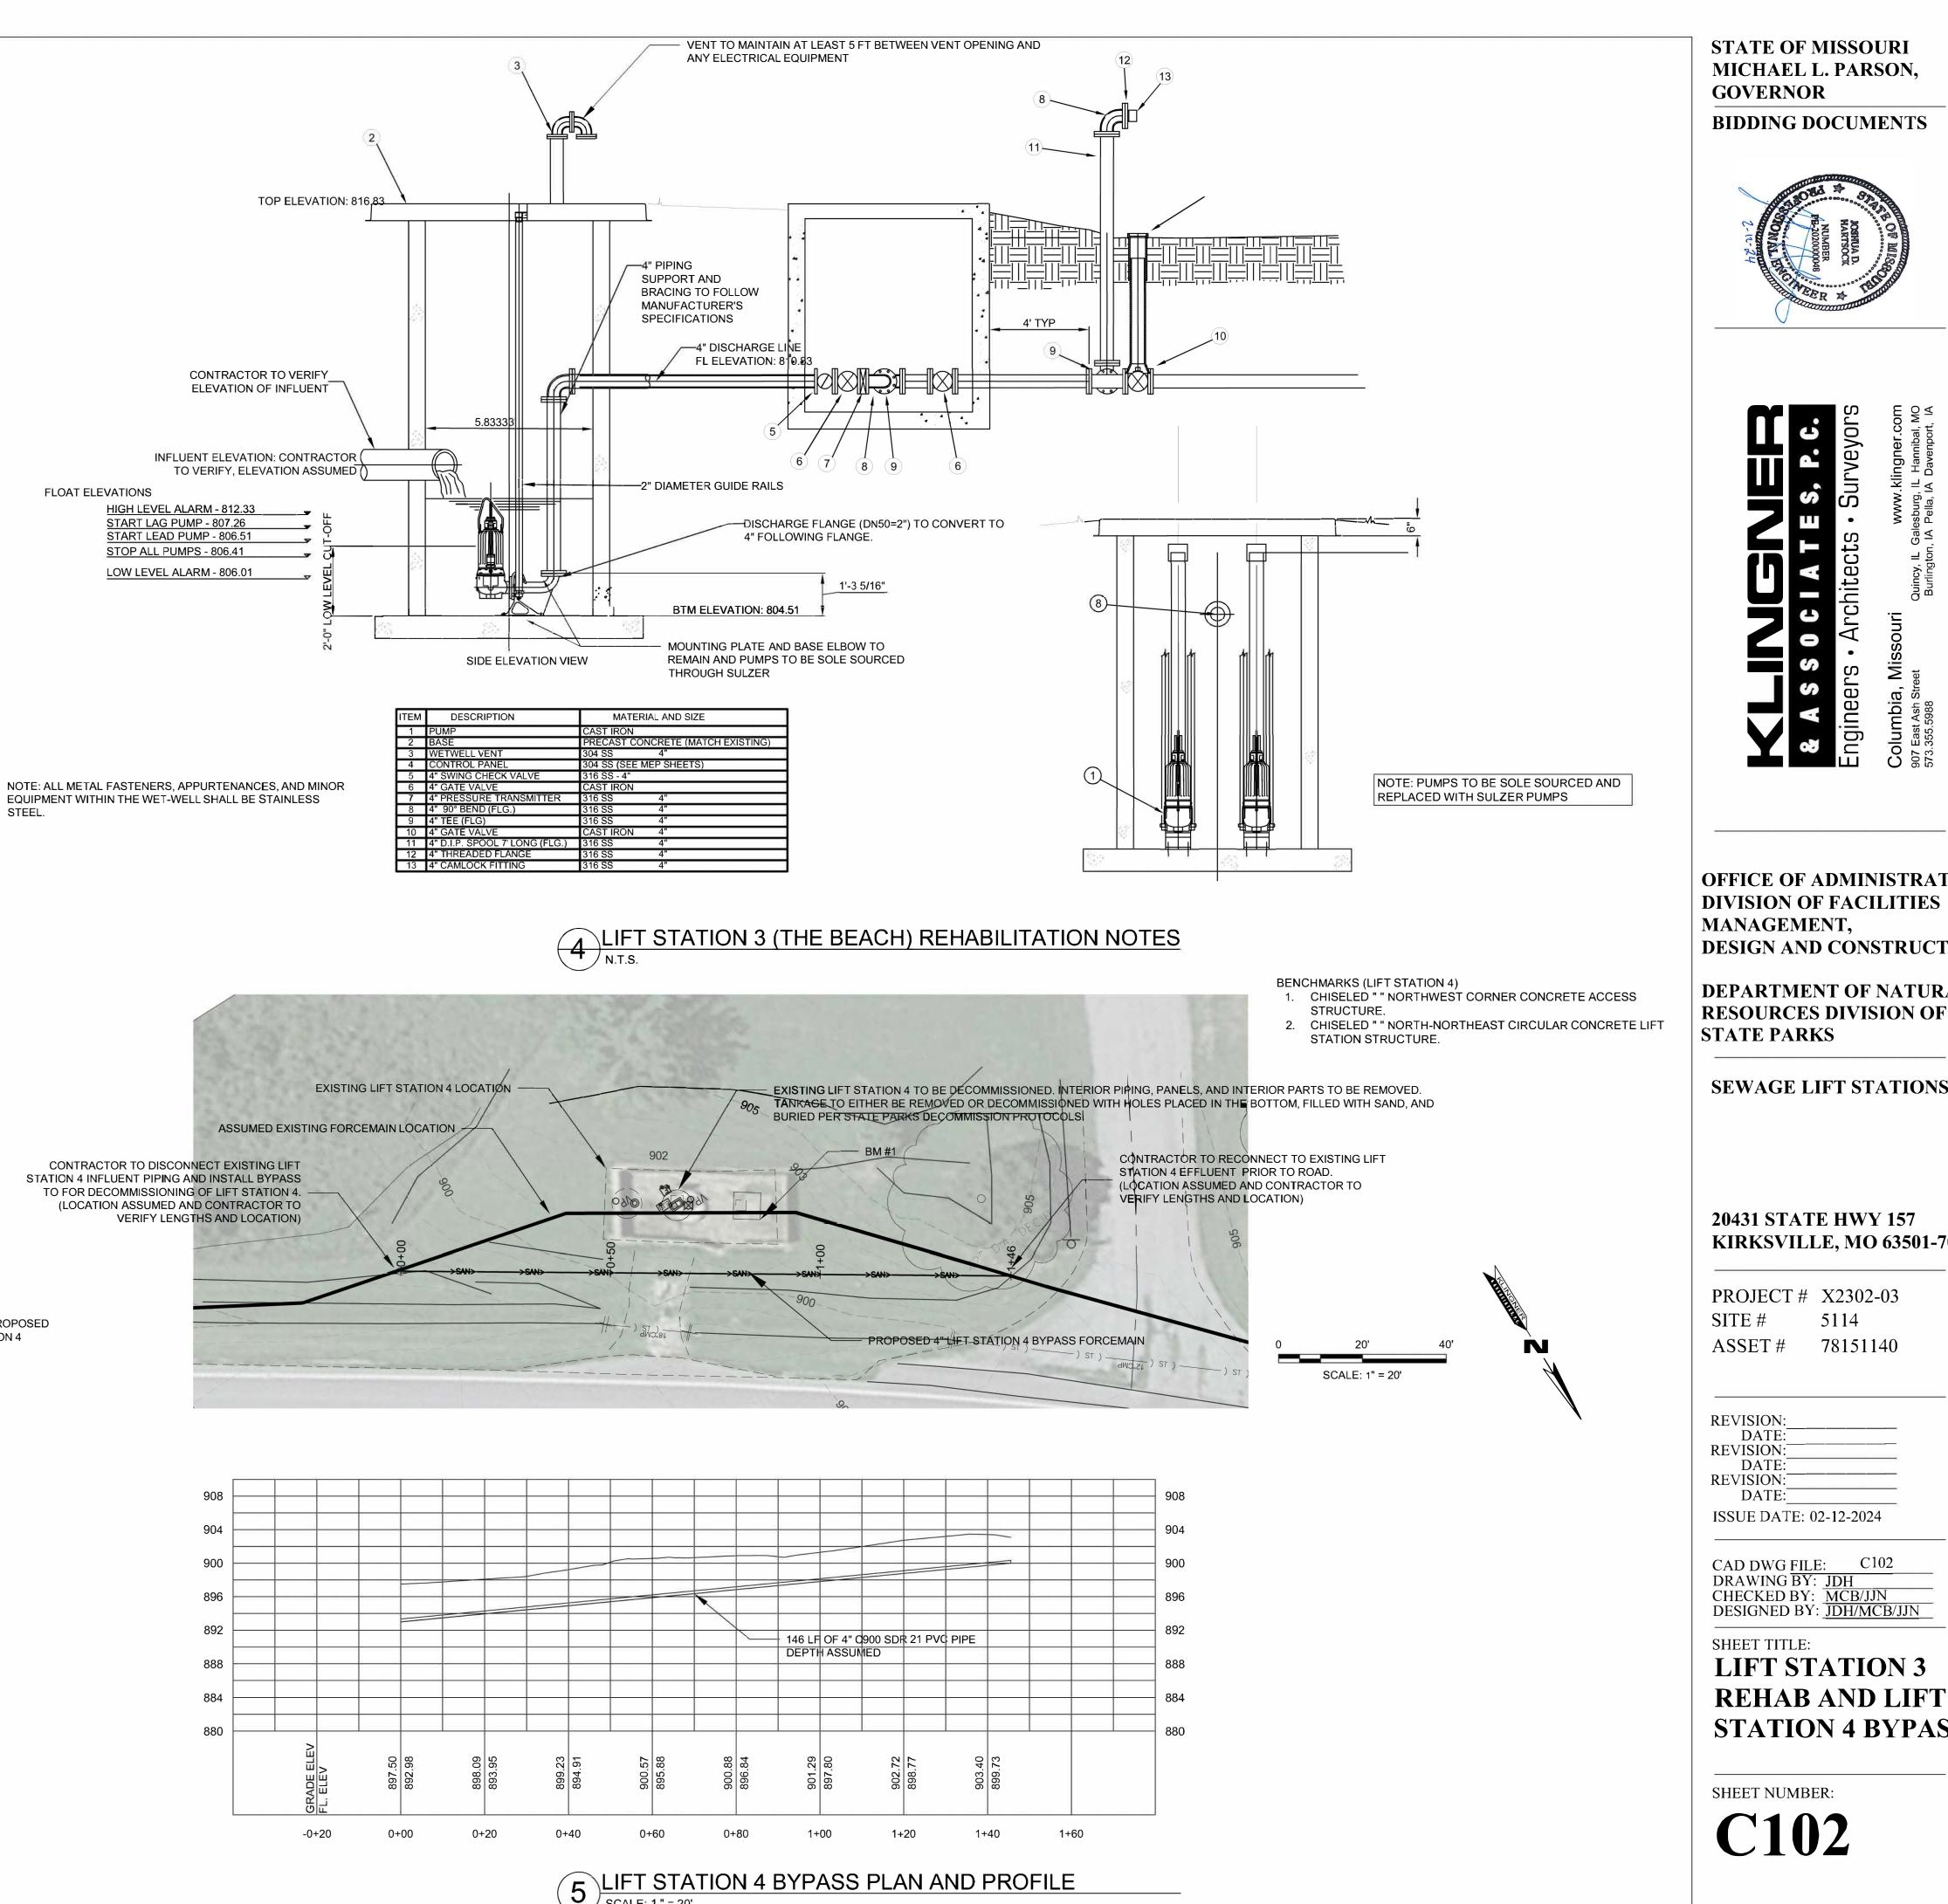

	NSFORMER ON NCRETE BASE	X	
EXISTING VA	VE VAULT TO HAVE PIPING REPLACED	905	EXISTING LIFT STATION PUMP, MOUNTING EQUIPMENT, PIPING, AND FLOAT EQUIPMENT
	EE 4" VALVE VAULT		XISTING METER BOXES
RECON	ENT TO 2-1/2" AND NECT TO EXISTING LOWING VALVING		The second
			and the
BENCHMA	RKS:	0	30' 60'
1. CHIS SOL 2. CHIS	ELED "□" ON CONCRETE PAD AT WATER STAT THEAST OF SITE - 906.71 SELED "□" WEST SIDE CIRCULAR CONCRETE L TION STRUCTURE - 906.56		CALE: 1" = 30'
		N 5 LAYOU	
	SCALE: 1" = 30'		
			KLINGNER
	LIFT STATION REHABILIT	TATION SUMMARY	
	LIFT STATION REHABILIT	TATION SUMMARY	
	Ţ		
	LIFT STATION IDENTIFICATION	LIFT STATION 5	
	LIFT STATION IDENTIFICATION DESCRIPTOR	LIFT STATION 5	
	LIFT STATION IDENTIFICATION DESCRIPTOR GROUT SEAMS WET WELL PUMP AND FLOAT	LIFT STATION 5 CAMPSITE 1 YES	
	LIFT STATION IDENTIFICATION DESCRIPTOR GROUT SEAMS WET WELL PUMP AND FLOAT EQUIPMENT REPLACEMENT PRECAST WET WELL CAP	LIFT STATION 5 CAMPSITE 1 YES YES	
	LIFT STATION IDENTIFICATION DESCRIPTOR GROUT SEAMS WET WELL PUMP AND FLOAT EQUIPMENT REPLACEMENT PRECAST WET WELL CAP REPLACEMENT WITH 4" VENT WET WELL MOUNTING	LIFT STATION 5 CAMPSITE 1 YES YES YES	
	LIFT STATION IDENTIFICATION DESCRIPTOR GROUT SEAMS WET WELL PUMP AND FLOAT EQUIPMENT REPLACEMENT PRECAST WET WELL CAP REPLACEMENT WITH 4" VENT WET WELL INTERIOR PIPING WET WELL INTERIOR PIPING VALVE VAULT INTERNAL PIPING AND FITTING	LIFT STATION S CAMPSITE 1 YES YES YES	
	LIFT STATION IDENTIFICATION DESCRIPTOR GROUT SEAMS WET WELL PUMP AND FLOAT EQUIPMENT REPLACEMENT PRECAST WET WELL CAP REPLACEMENT WITH 4" VENT WET WELL MOUNTING EQUIPMENT REPLACEMENT WET WELL INTERIOR PIPING REPLACEMENT VALVE VAULT INTERNAL	LIFT STATION S CAMPSITE 1 YES YES YES YES	
	LIFT STATION IDENTIFICATION DESCRIPTOR GROUT SEAMS WET WELL PUMP AND FLOAT EQUIPMENT REPLACEMENT PRECAST WET WELL CAP REPLACEMENT WITH 4" VENT WET WELL MOUNTING EQUIPMENT REPLACEMENT WET WELL INTERIOR PIPING REPLACEMENT VALVE VAULT INTERNAL PIPING AND FITTING REPLACEMENT CONTROL PANEL	LIFT STATION S CAMPSITE 1 YES YES YES YES YES	
	LIFT STATION IDENTIFICATIONDESCRIPTORGROUT SEAMSGROUT SEAMSWET WELL PUMP AND FLOAT EQUIPMENT REPLACEMENTPRECAST WET WELL CAP REPLACEMENT WITH 4" VENTWET WELL MOUNTING EQUIPMENT REPLACEMENTWET WELL INTERIOR PIPING REPLACEMENTVALVE VAULT INTERNAL PIPING AND FITTING REPLACEMENTVALVE VAULT INTERNAL PIPING AND FITTING REPLACEMENTCONTROL PANEL ELECTRICAL	LIFT STATION S CAMPSITE 1 YES YES YES YES YES	

FLOAT ELEVATIONS

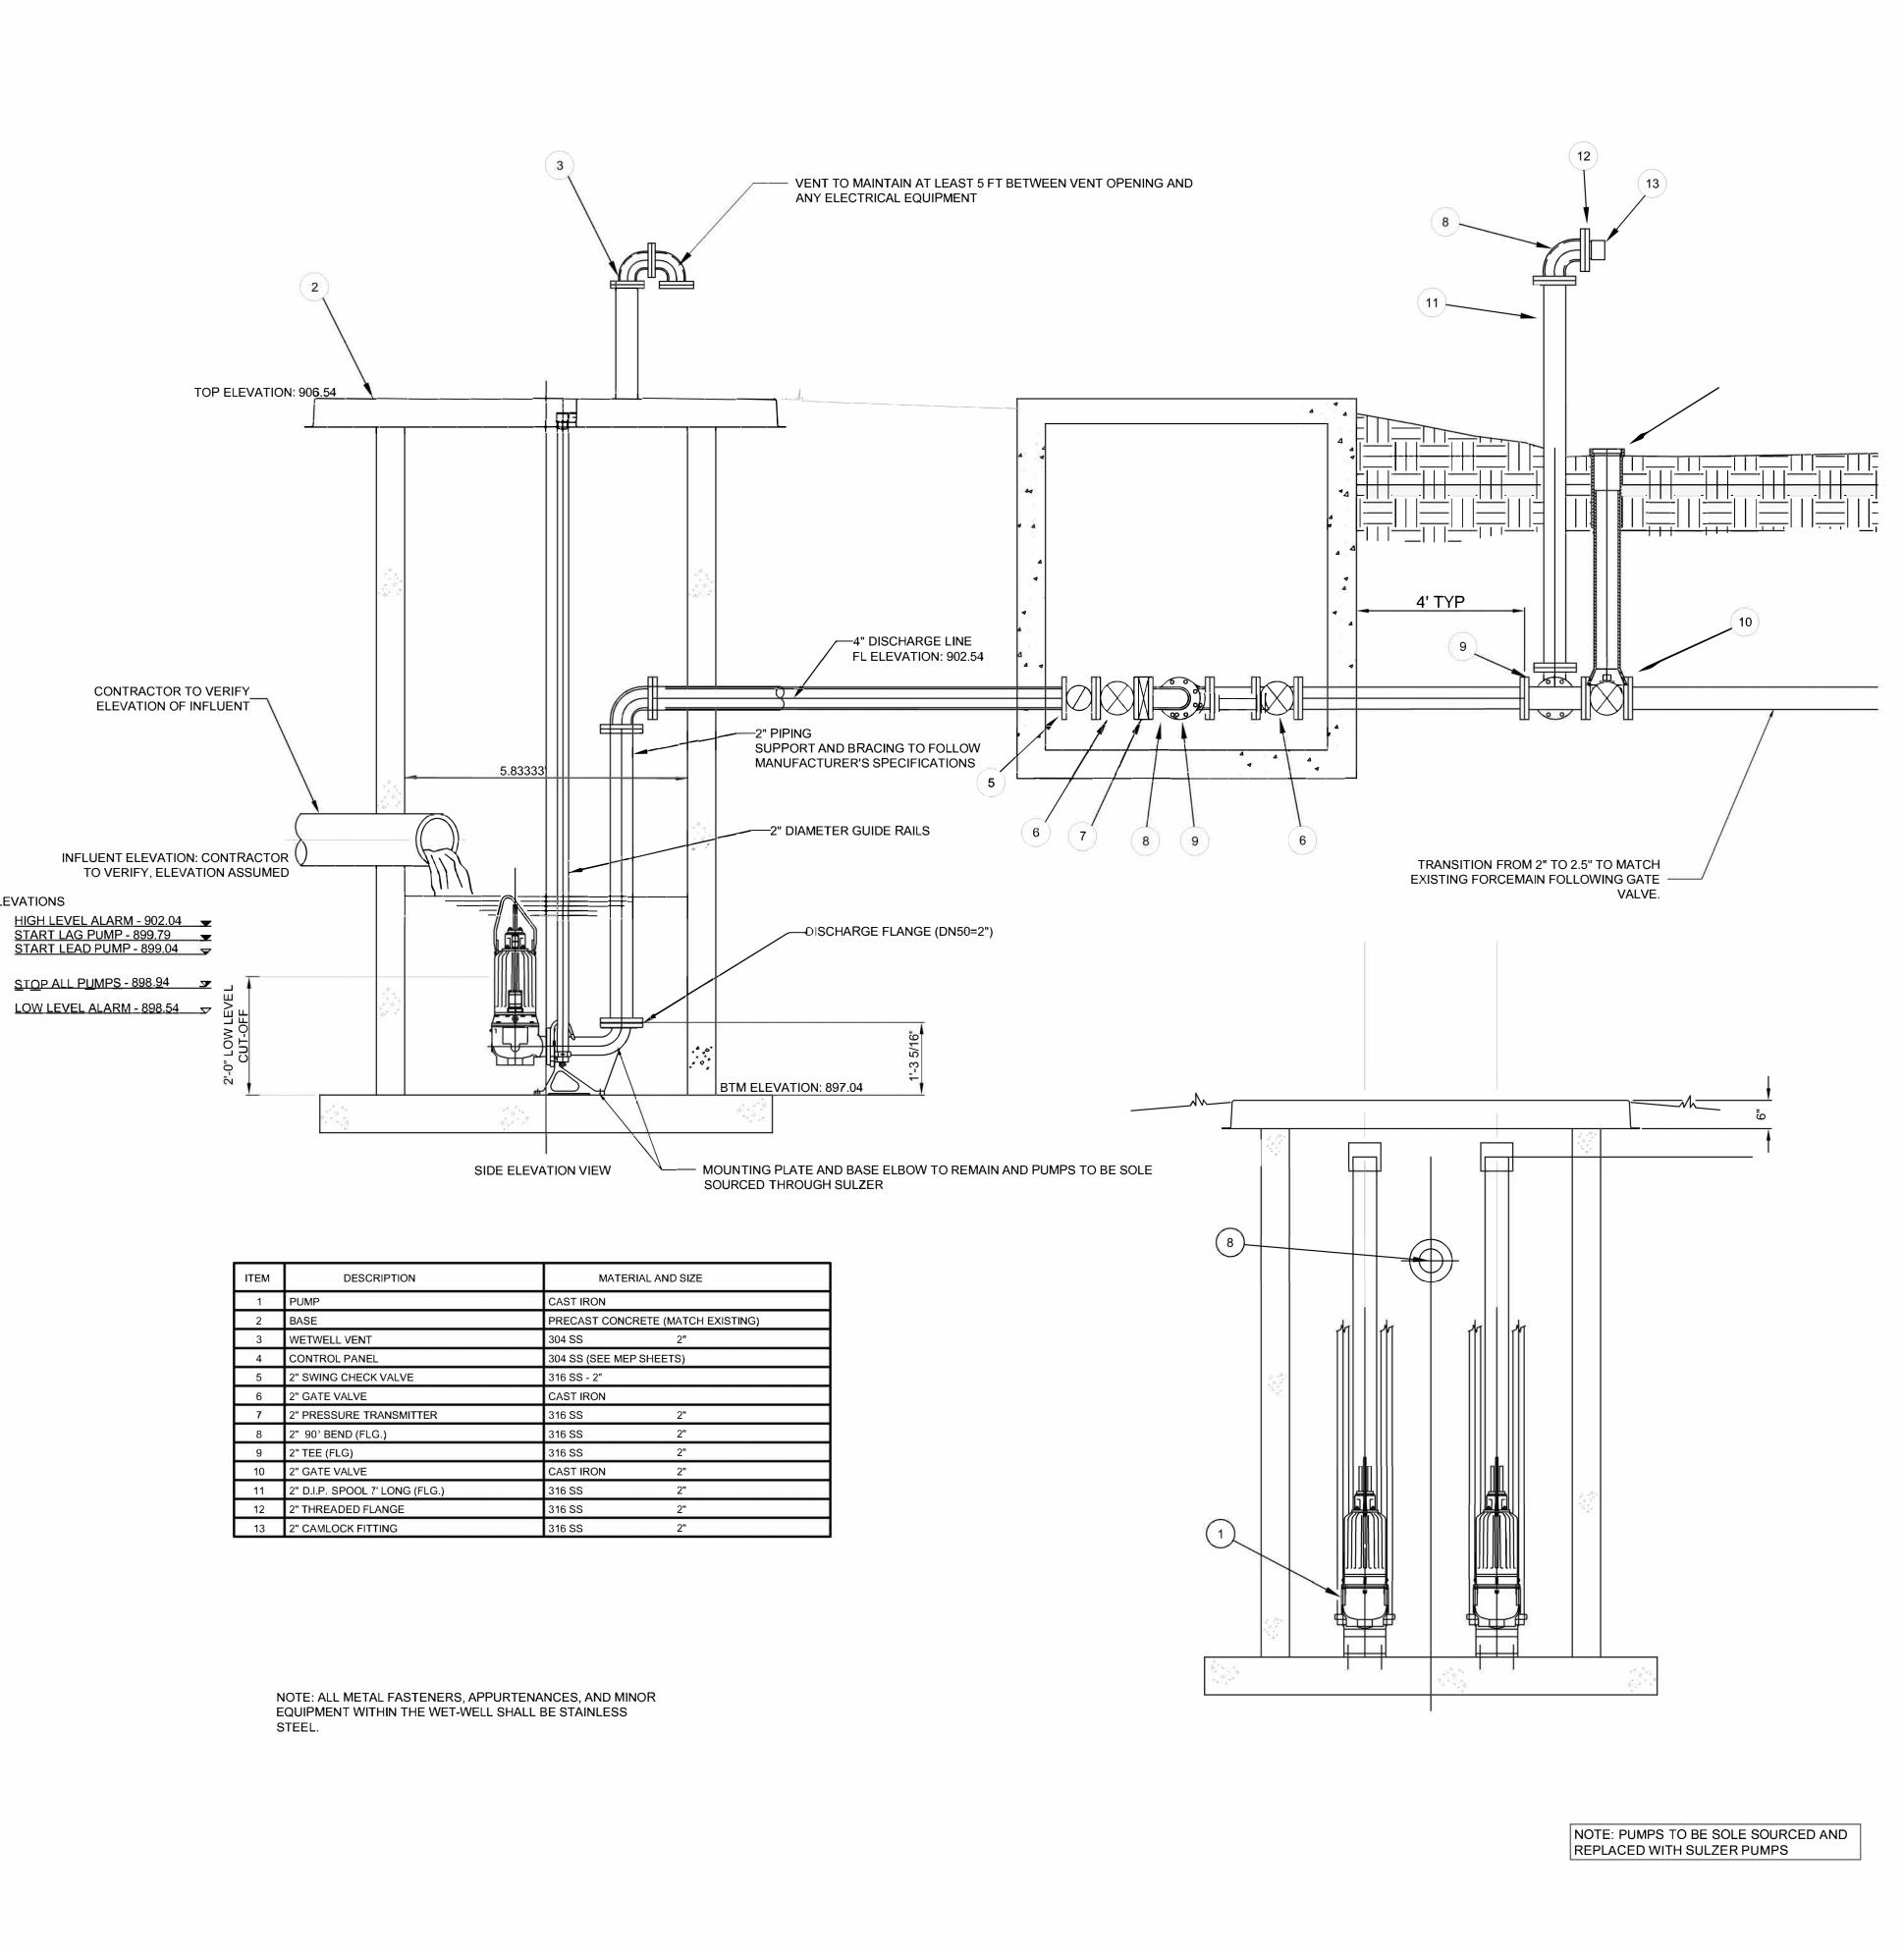

ITEM	DESCRIPTION	MATERIAL AND SIZE	
1	PUMP	CAST IRON	
2	BASE	PRECAST CONCRETE (MATCH EXISTING)	
3	WETWELL VENT	304 SS 2"	
4	CONTROL PANEL	304 SS (SEE MEP SHEETS)	
5	2" SWING CHECK VALVE	316 SS - 2"	
6	2" GATE VALVE	CAST IRON	
7	2" PRESSURE TRANSMITTER	316 SS 2"	
8	2" 90° BEND (FLG.)	316 SS 2"	
9	2" TEE (FLG)	316 SS 2"	
10	2" GATE VALVE	CAST IRON 2"	
11	2" D.I.P. SPOOL 7' LONG (FLG.)	316 SS 2"	
12	2" THREADED FLANGE	316 SS 2"	
13	2" CAMLOCK FITTING	316 SS 2"	



STATE OF MISSOURI MICHAEL L. PARSON, GOVERNOR **BIDDING DOCUMENTS**





OFFICE OF ADMINISTRATION DIVISION OF FACILITIES MANAGEMENT, **DESIGN AND CONSTRUCTION**

DEPARTMENT OF NATURAL RESOURCES DIVISION OF STATE PARKS

SEWAGE LIFT STATIONS

20431 STATE HWY 157 **KIRKSVILLE, MO 63501-7069**

	370000 00
PROJECT #	X2302-03
SITE #	5114
ASSET #	78151140

REVISION:
DATE:
REVISION:
DATE:
REVISION:
DATE:

ISSUE DATE: 02-12-2024

CAD DWG <u>FILE: C103</u> DRAWING <u>BY</u>: <u>JDH</u> CHECKED BY: <u>MCB/JJN</u> DESIGNED BY: <u>JDH/MCB/JJN</u>


SHEET TITLE: **LIFT STATION 5** DETAILS

SHEET NUMBER:


C103

	CONTROL PANEL	YES	
	ELECTRICAL		
	REPLACEMENT		
	PUMP	PE85/2-G-60HZ	
\frown	IFT STATION RE	HABILITATION S	
(∠) N	.T.S.		
\smile			

LIFT STATION REHABILI	TATION SUMMARY
LIFT STATION IDENTIFICATION	LIFT STATION 6
DESCRIPTOR	THE LAGOON
GROUT SEAMS	YES
WET WELL PUMP AND FLOAT EQUIPMENT REPLACEMENT	YES
PRECAST WET WELL CAP REPLACEMENT WITH 4" VENT	YES
WET WELL MOUNTING EQUIPMENT REPLACEMENT	YES
WET WELL INTERIOR PIPING REPLACEMENT	YES
VALVE VAULT INTERNAL PIPING AND FITTING REPLACEMENT	YES
CONTROL PANEL REPLACEMENT	YES
CONTROL PANEL ELECTRICAL REPLACEMENT	YES
PUMP	PE85/2-G-60HZ

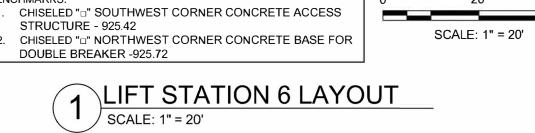


BENCHMARKS:

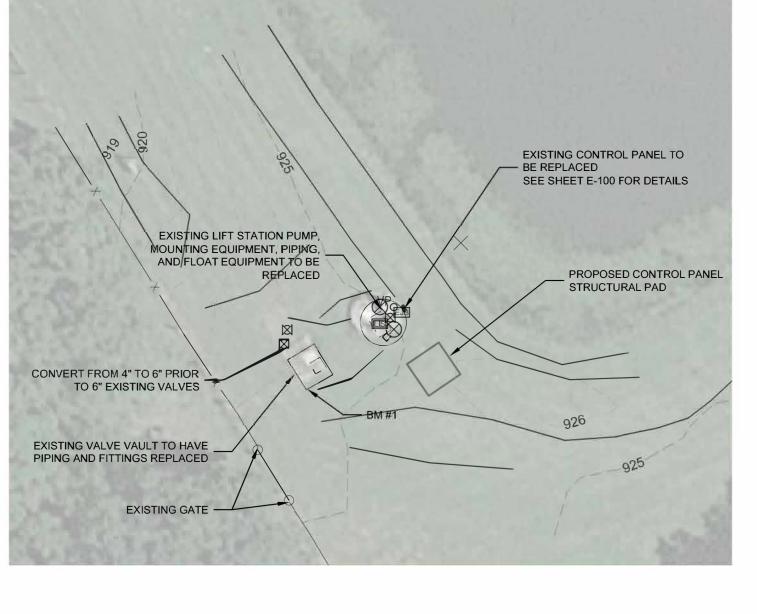

FLOAT ELEVATIONS

N

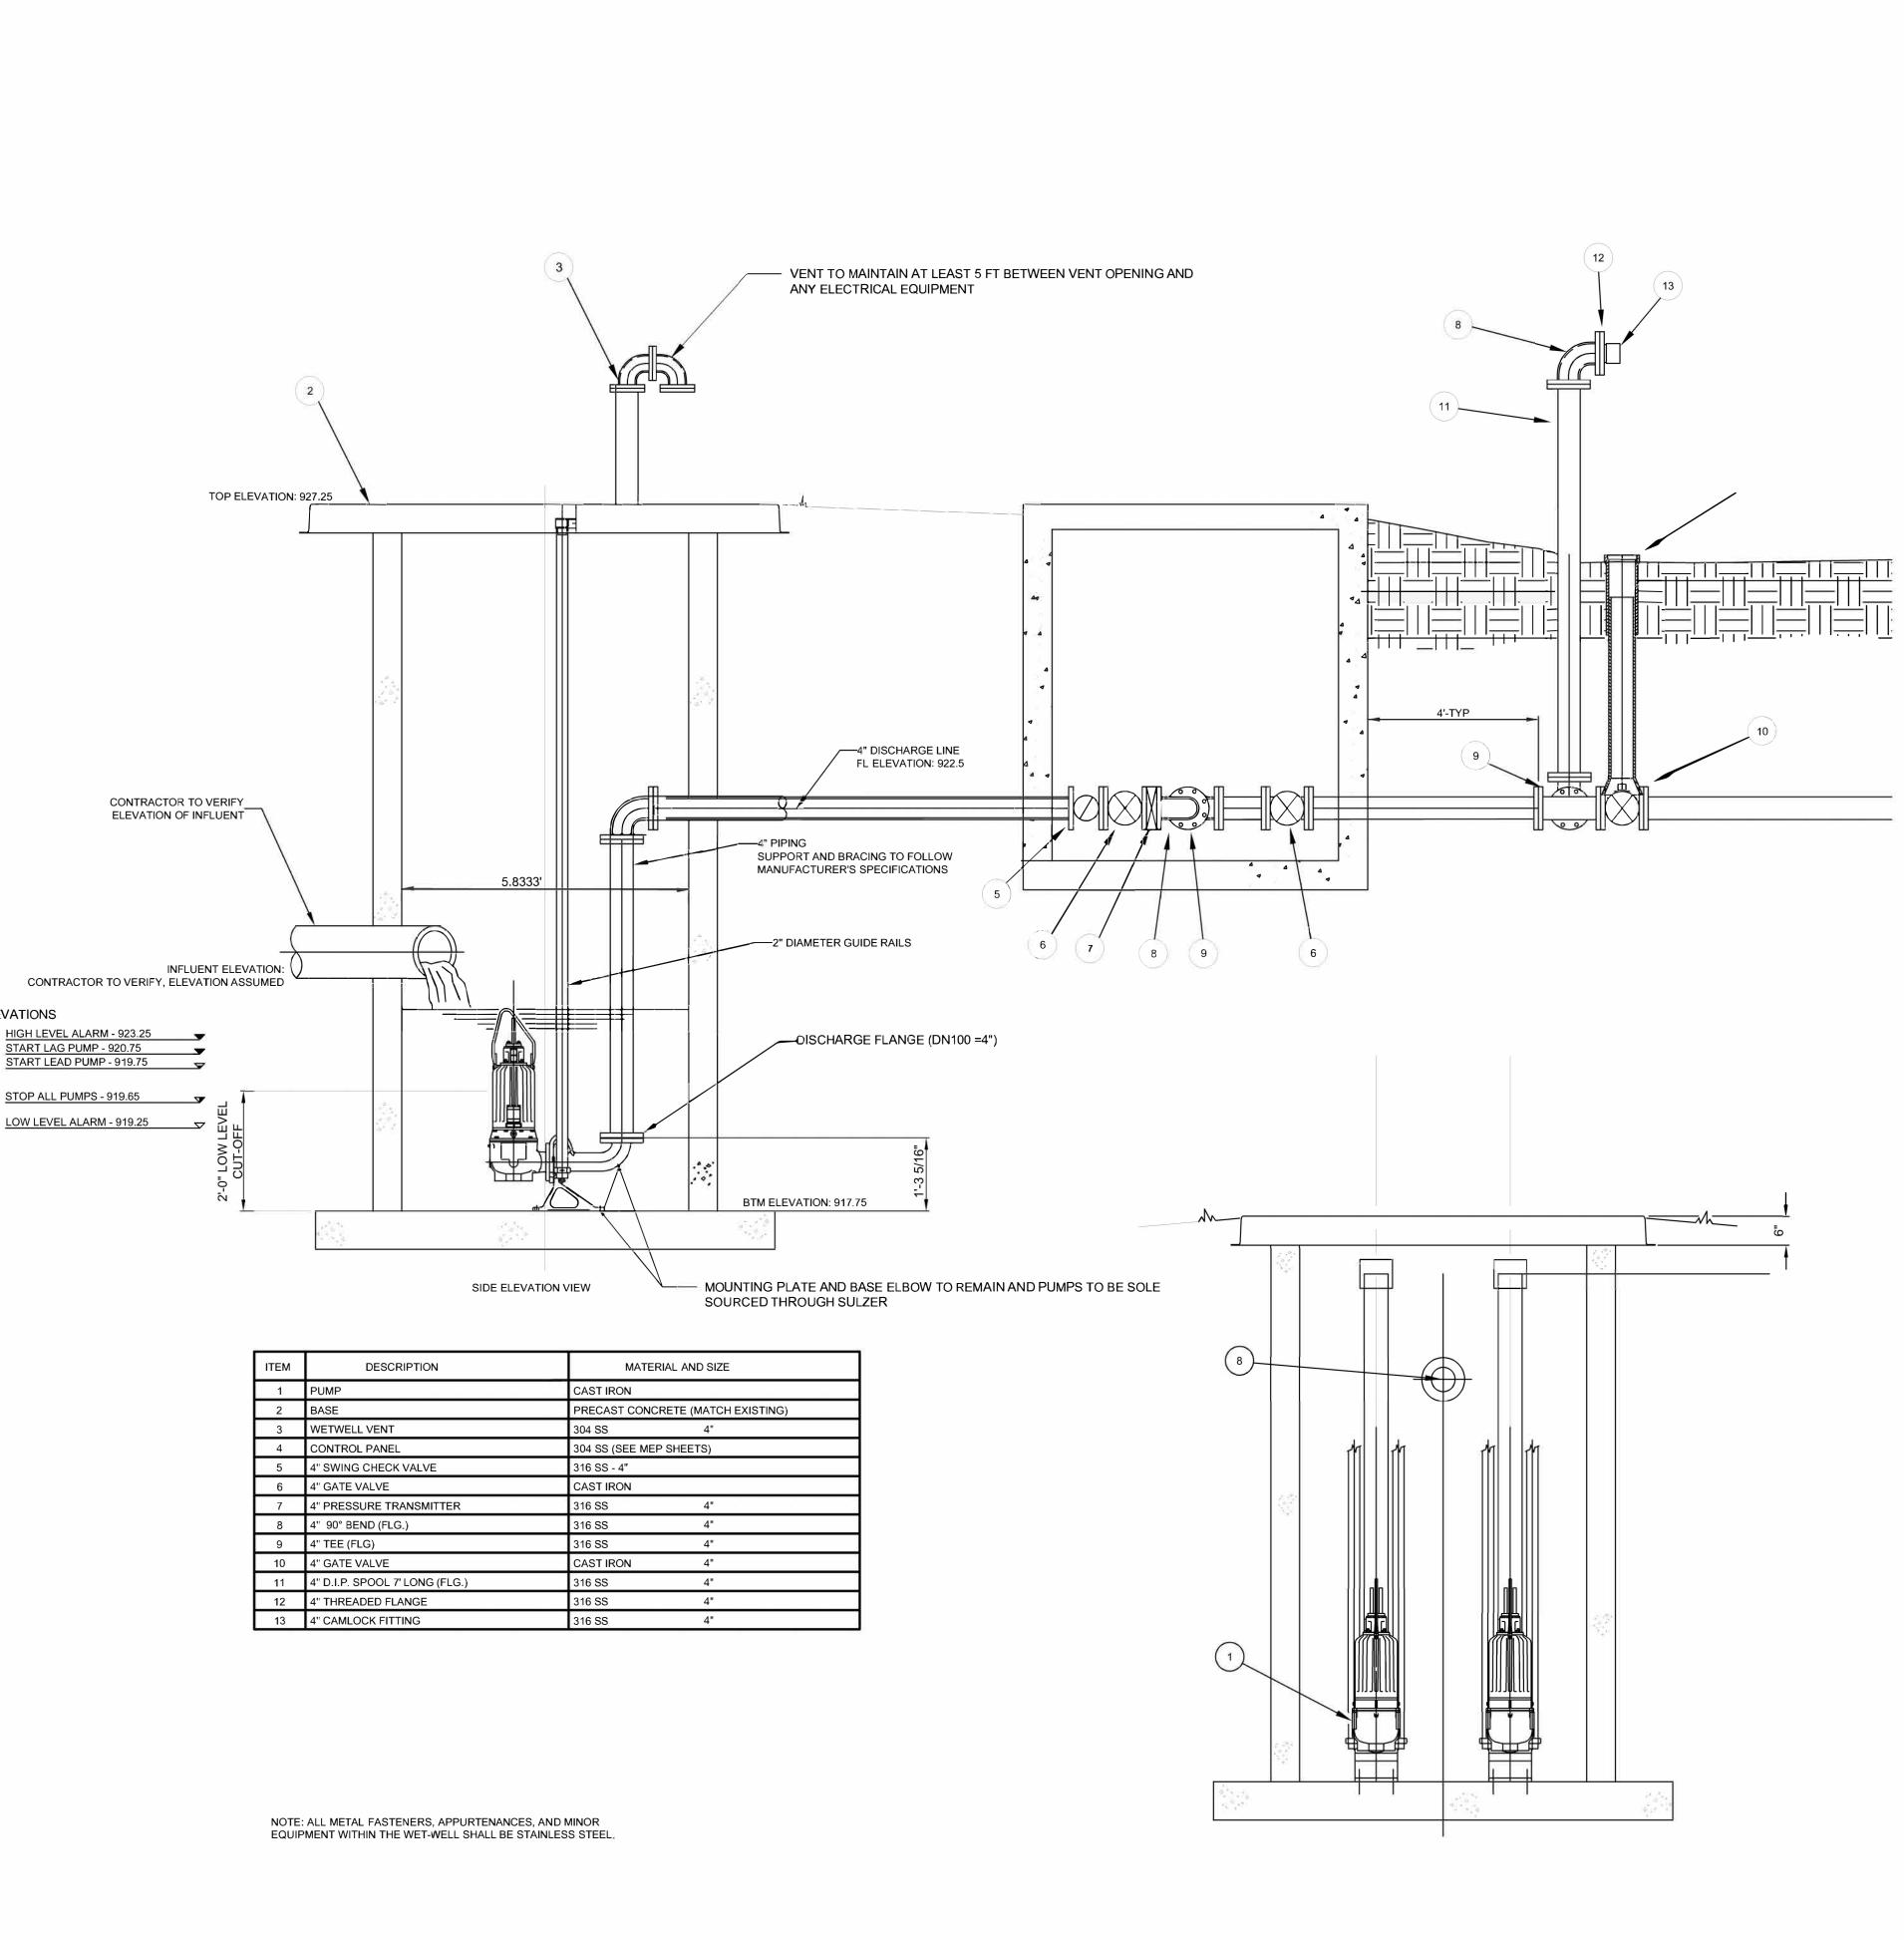

ITEM	DESCRIPTION	MATERIAL AND SIZE				
1	PUMP	CAST IRON				
2	BASE	PRECAST CONCRETE (MATCH EXISTING)				
3	WETWELL VENT	304 SS 4"				
4	CONTROL PANEL	304 SS (SEE MEP SHEETS)				
5	4" SWING CHECK VALVE	316 SS - 4"				
6	4" GATE VALVE	CAST IRON				
7	4" PRESSURE TRANSMITTER	316 SS 4"				
8	4" 90° BEND (FLG.)	316 SS 4"				
9	4" TEE (FLG)	316 SS 4"				
10	4" GATE VALVE	CAST IRON 4"				
11	4" D.I.P. SPOOL 7' LONG (FLG.)	316 SS 4"				
12	4" THREADED FLANGE	316 SS 4"				
13	4" CAMLOCK FITTING	316 55 4"				

NOTE: PUMPS TO BE SOLE SOURCED AND REPLACED WITH SULZER PUMPS

STATE OF MISSOURI MICHAEL L. PARSON, GOVERNOR **BIDDING DOCUMENTS**





OFFICE OF ADMINISTRATION DIVISION OF FACILITIES MANAGEMENT, **DESIGN AND CONSTRUCTION**

DEPARTMENT OF NATURAL RESOURCES DIVISION OF STATE PARKS

SEWAGE LIFT STATIONS

20431 STATE HWY 157 **KIRKSVILLE, MO 63501-7069**

X2302-03
5114
78151140

DEVISION

REVISION:
DATE:
REVISION:
DATE:
REVISION:
DATE:
ICCLIE DATE. 02 12 2024

ISSUE DATE: 02-12-2024


CAD DWG <u>FILE: C104</u> DRAWING <u>BY</u>: JDH CHECKED BY: <u>MCB/JJN</u> DESIGNED BY: <u>JDH/MCB/JJN</u>


SHEET TITLE:

LIFT STATION 6 DETAILS

SHEET NUMBER:



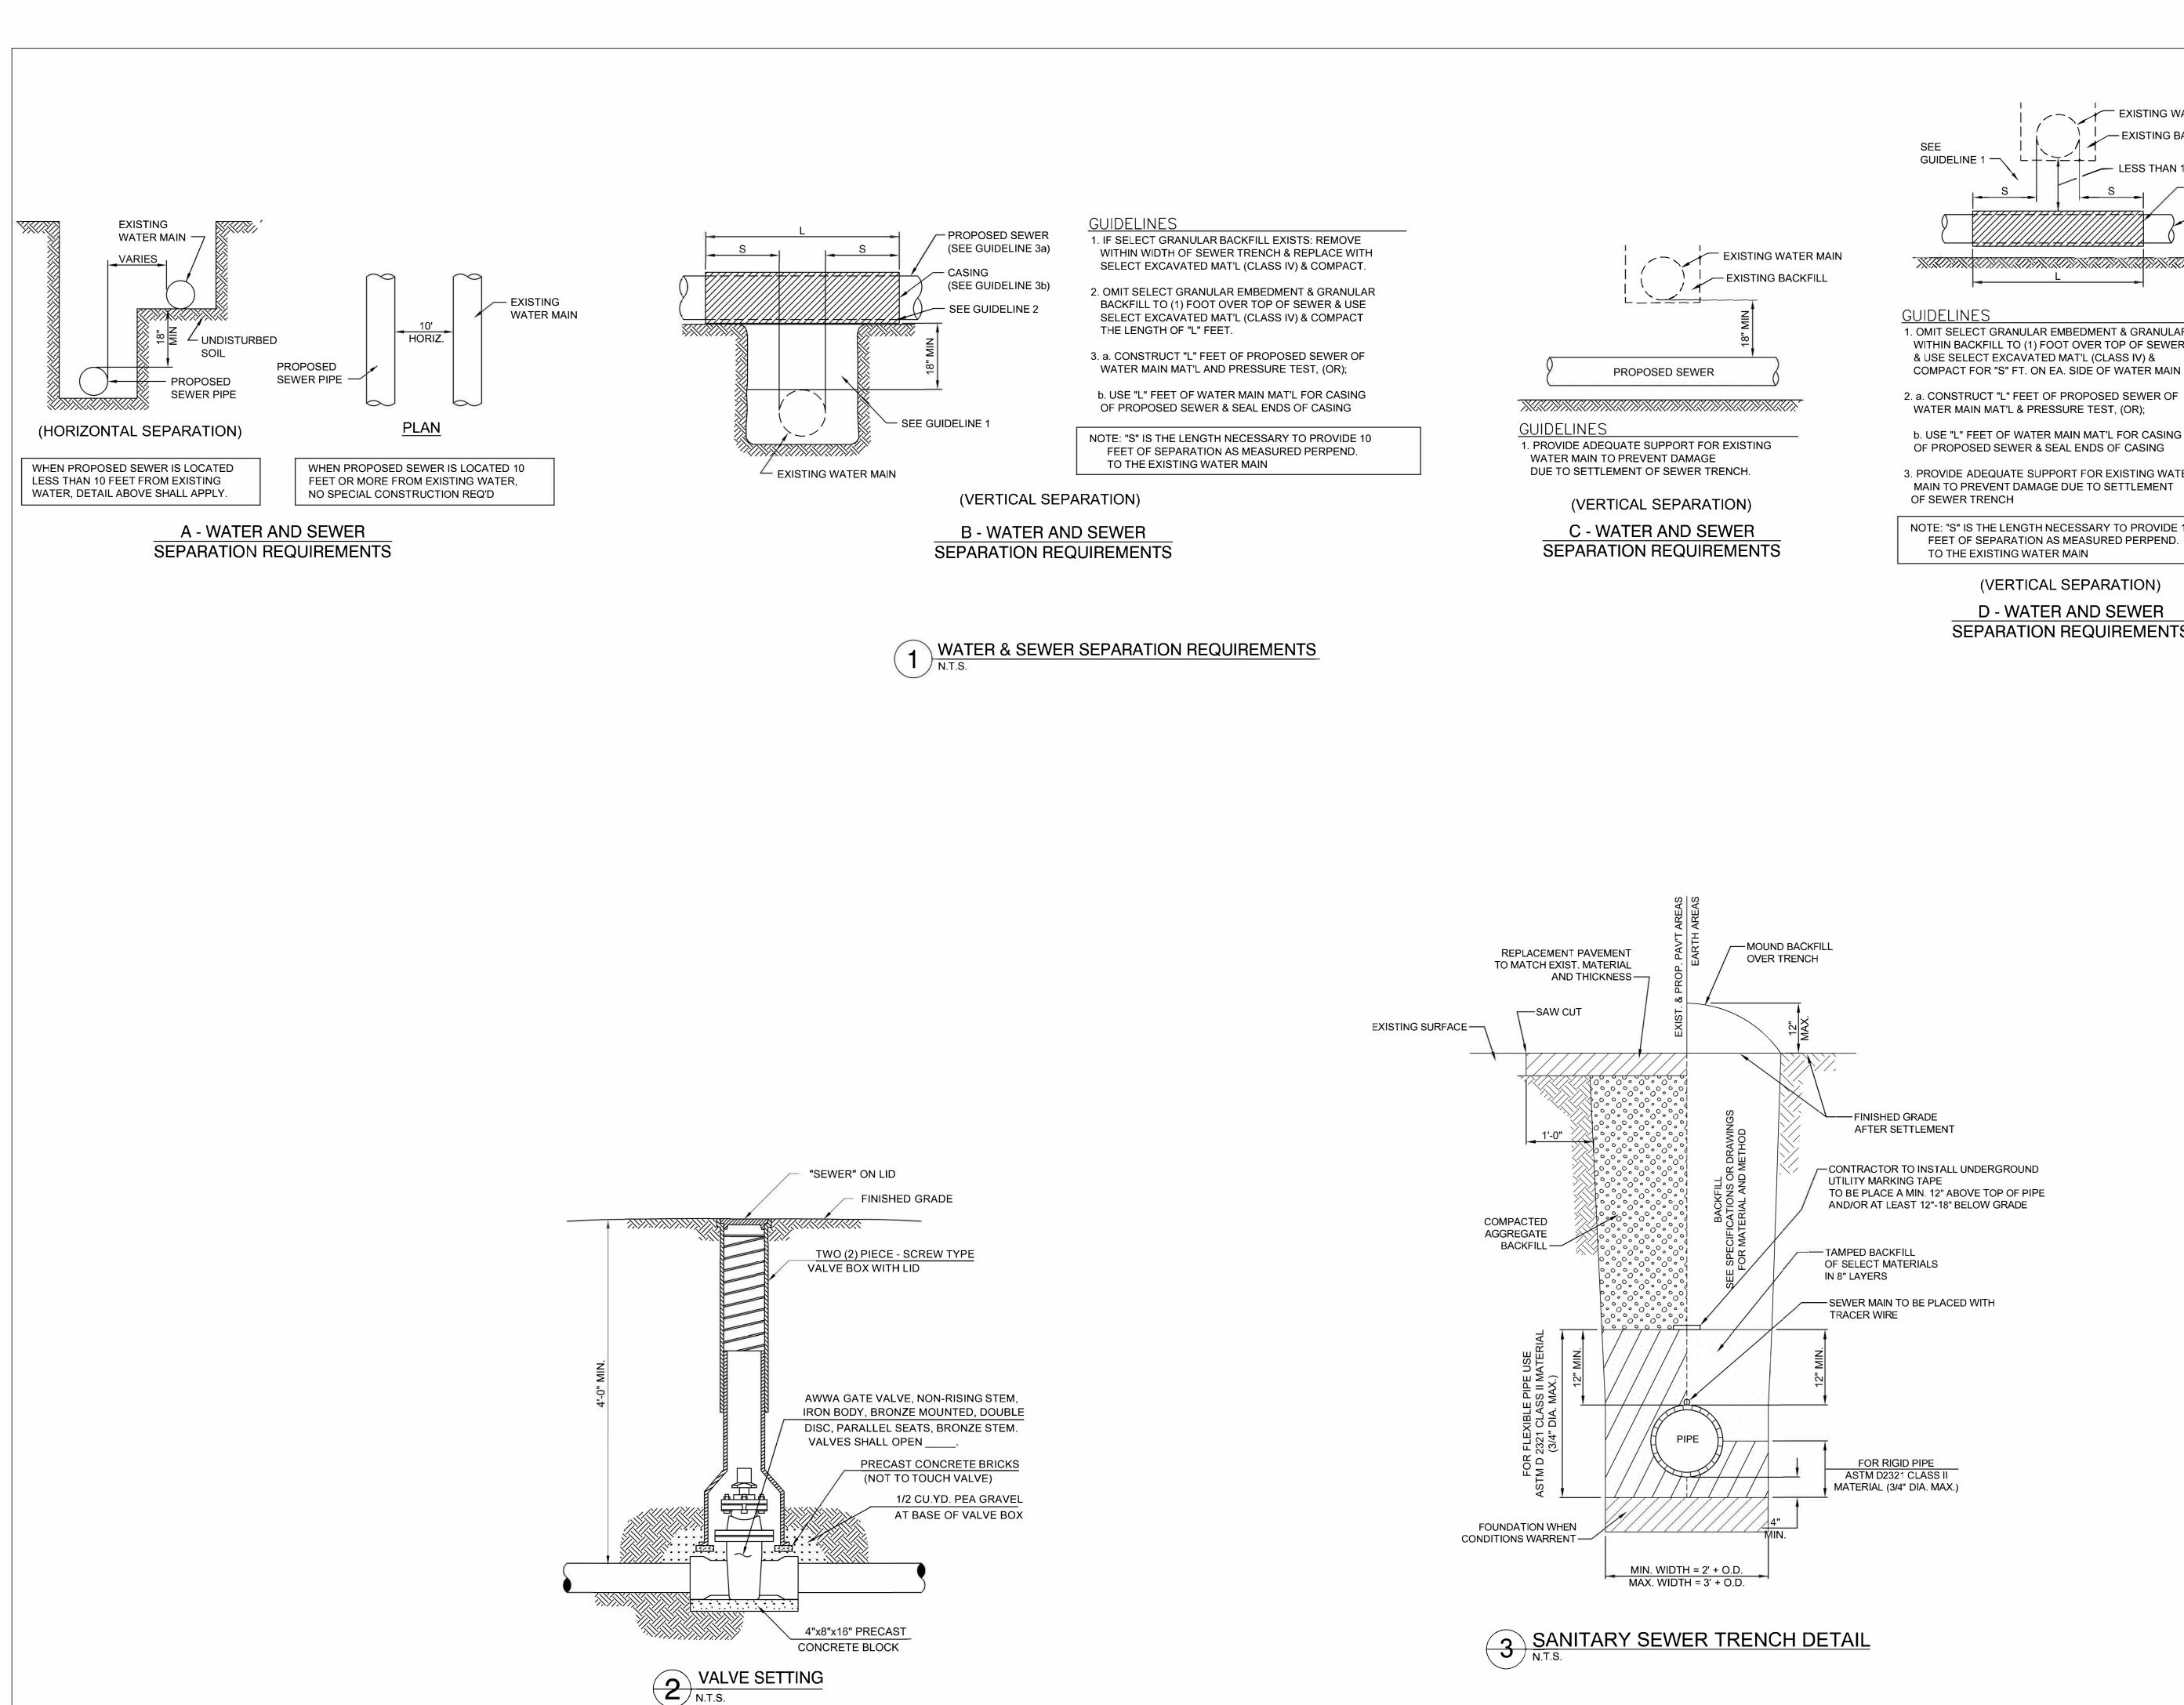

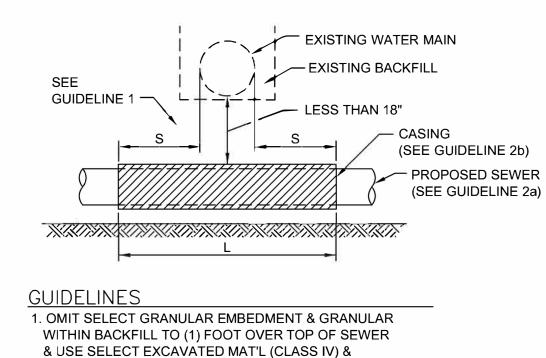

b. USE "L" FEET OF WATER MAIN MAT'L FOR CASING OF PROPOSED SEWER & SEAL ENDS OF CASING

3. PROVIDE ADEQUATE SUPPORT FOR EXISTING WATER MAIN TO PREVENT DAMAGE DUE TO SETTLEMENT

NOTE: "S" IS THE LENGTH NECESSARY TO PROVIDE 10 FEET OF SEPARATION AS MEASURED PERPEND. TO THE EXISTING WATER MAIN

(VERTICAL SEPARATION) D - WATER AND SEWER SEPARATION REQUIREMENTS

STATE OF MISSOURI MICHAEL L. PARSON, GOVERNOR **BIDDING DOCUMENTS**





OFFICE OF ADMINISTRATION DIVISION OF FACILITIES MANAGEMENT, **DESIGN AND CONSTRUCTION**

DEPARTMENT OF NATURAL RESOURCES DIVISION OF STATE PARKS

SEWAGE LIFT STATIONS

20431 STATE HWY 157 **KIRKSVILLE, MO 63501-7069**

PROJECT # X2302-03 5114 SITE # 78151140 ASSET #

REVISION:

DATE **REVISION:** DATE **REVISION:** DATE:


ISSUE DATE: 02-12-2024

CAD DWG FILE: C500 DRAWING BY: JDH CHECKED BY: <u>MCB/JJN</u> DESIGNED BY: <u>JDH/MCB/JJN</u>

SHEET TITLE: MISCELLANEOUS DETAILS

SHEET NUMBER:



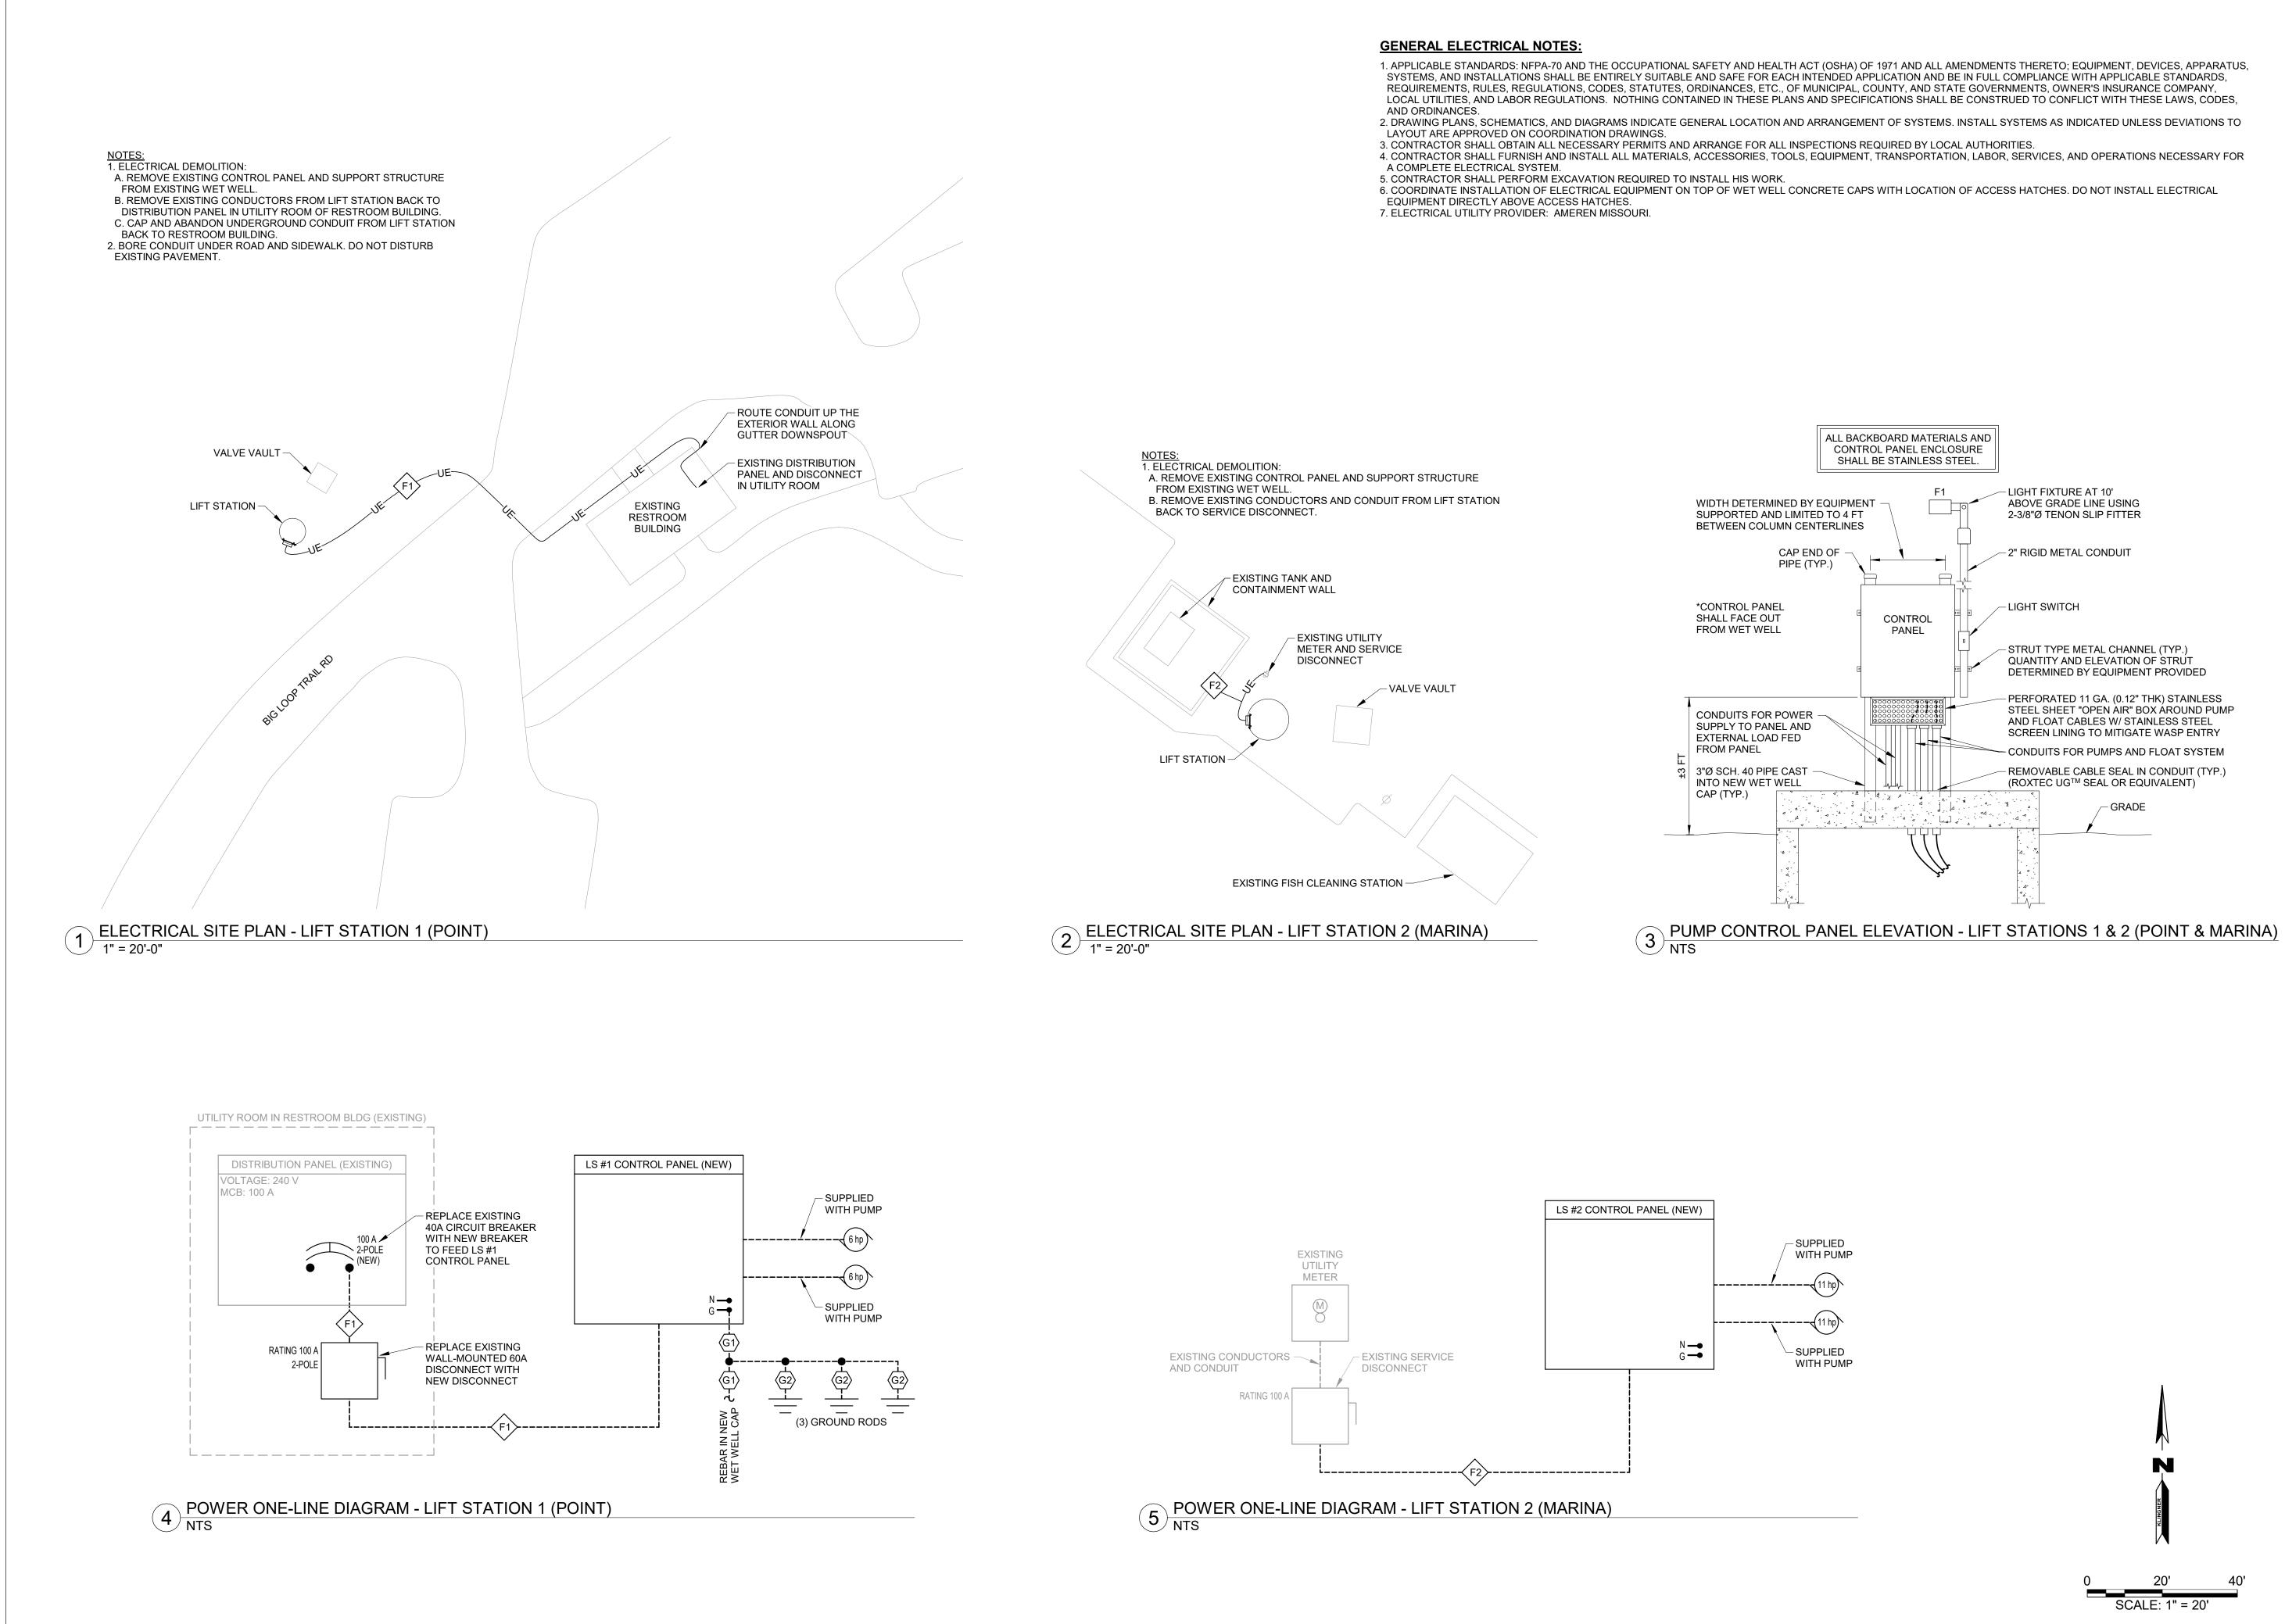



STATE OF MISSOURI

OFFICE OF ADMINISTRATION DIVISION OF FACILITIES MANAGEMENT, **DESIGN AND CONSTRUCTION**

SEWAGE LIFT STATIONS

THOUSAND HILLS STATE PARK, 20431 STATE HWY 157 KIRKSVILLE, MO 63501-7069

PROJECT # X2302-03 5114 SITE # ASSET # 7815114035

REVISION: DATE **REVISION:** DATE **REVISION**: DATE: ISSUE DATE: 02/12/2024


CAD DWG FILE: E501 DRAWING BY: JBM CHECKED BY: JJN DESIGNED BY: JBM


SHEET TITLE:


ELECTRICAL DETAILS – LIFT STATIONS 1 & 2


SHEET NUMBER:

E501 10 OF 18 SHEETS February 12, 2024

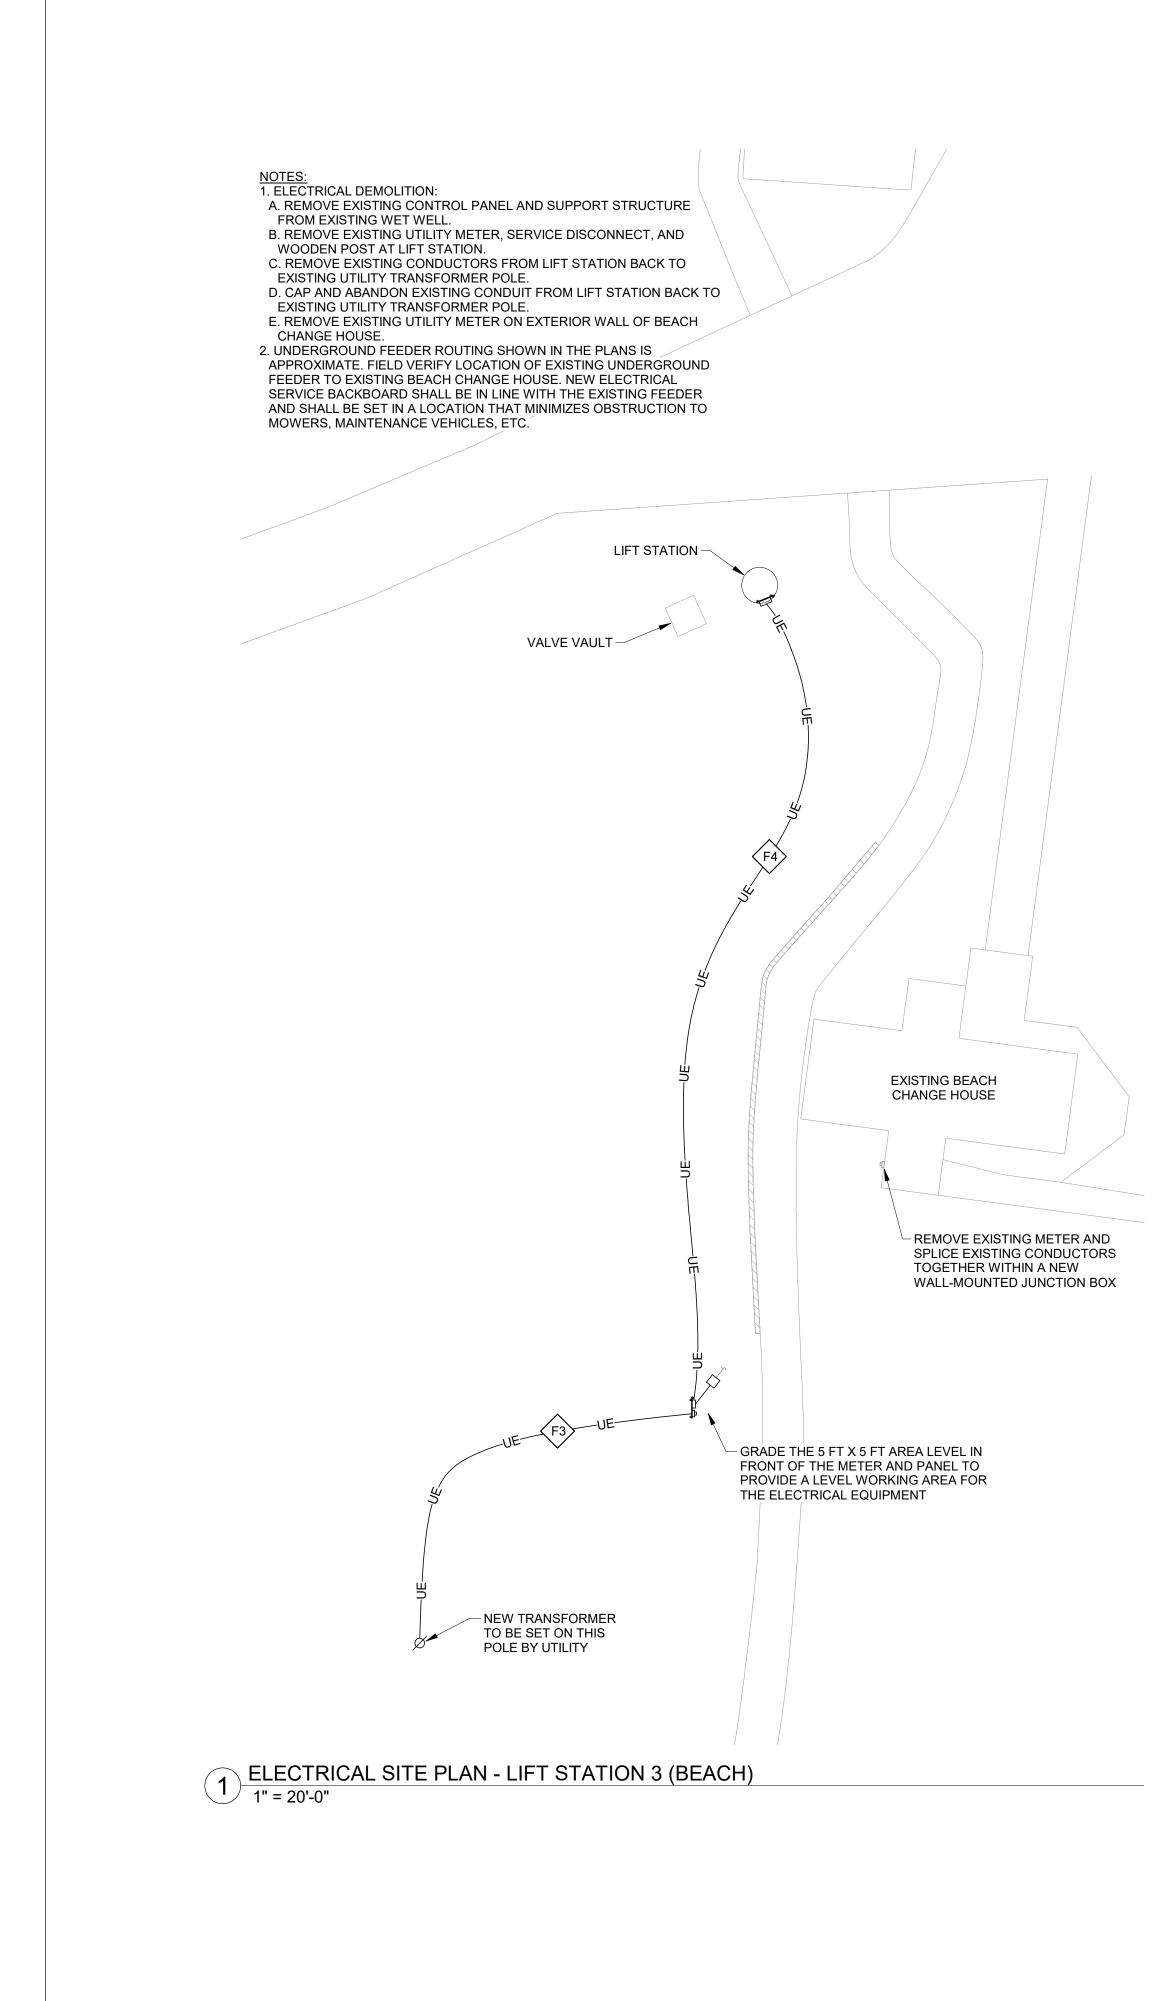

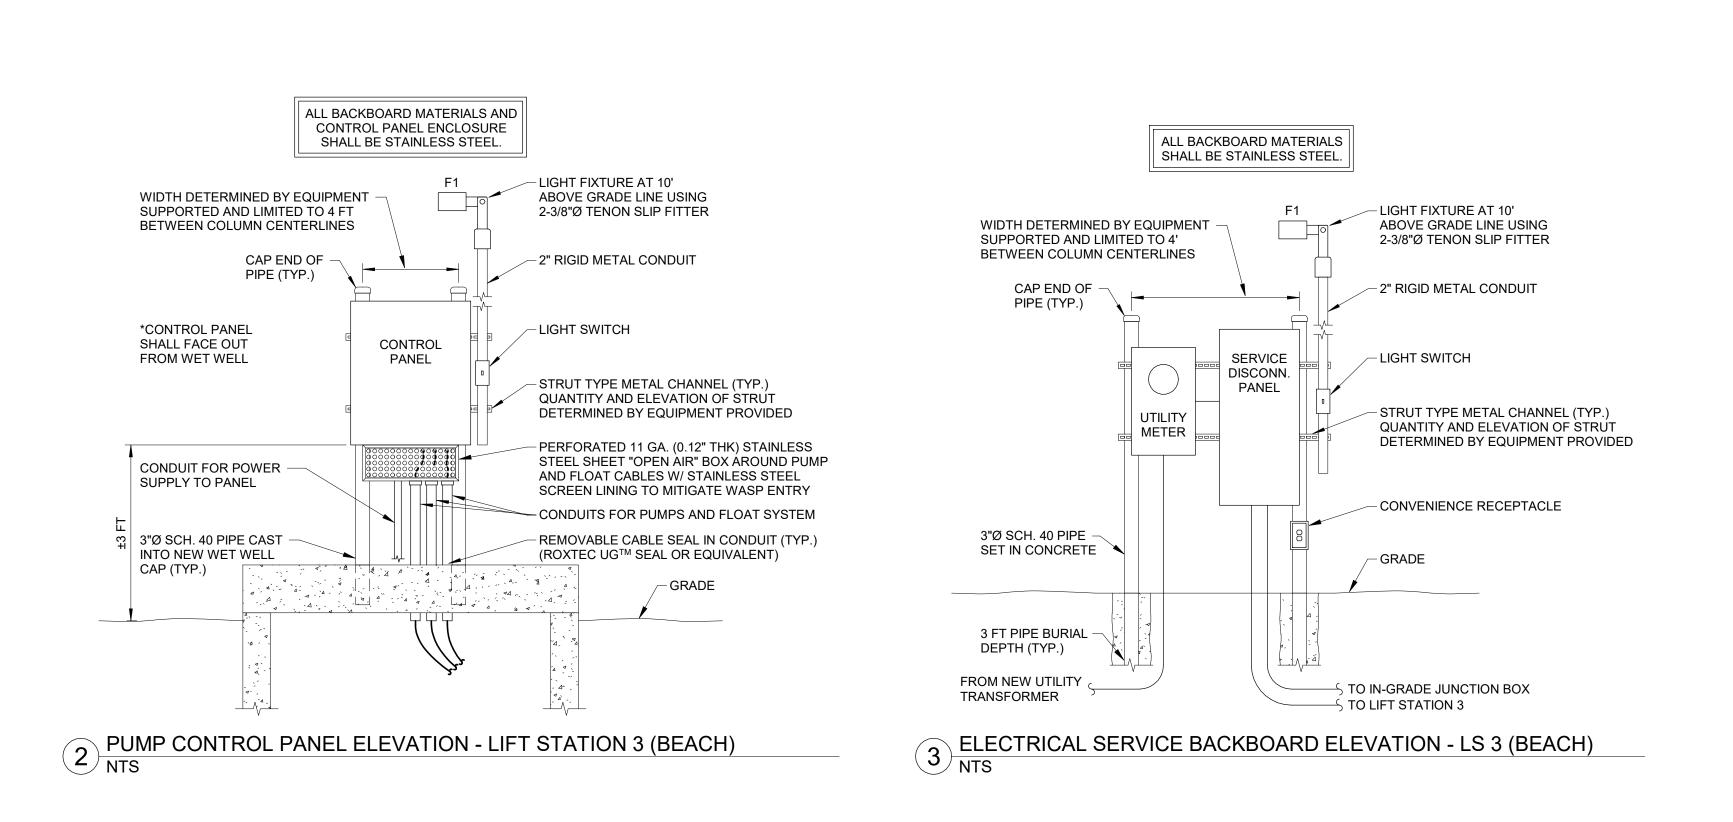


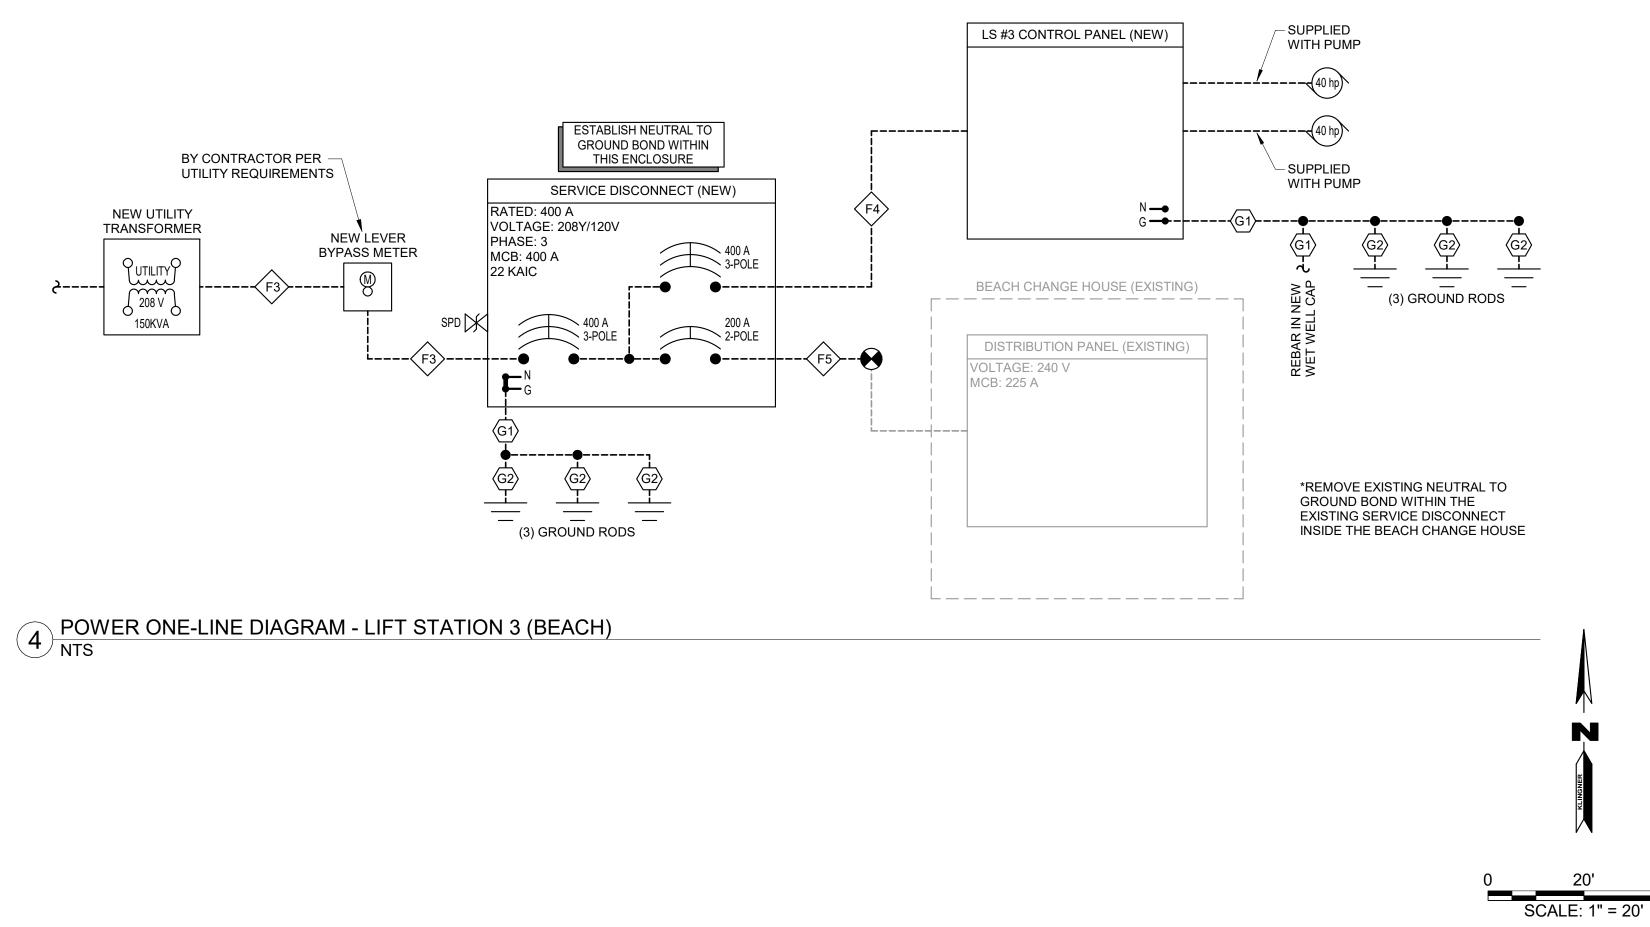


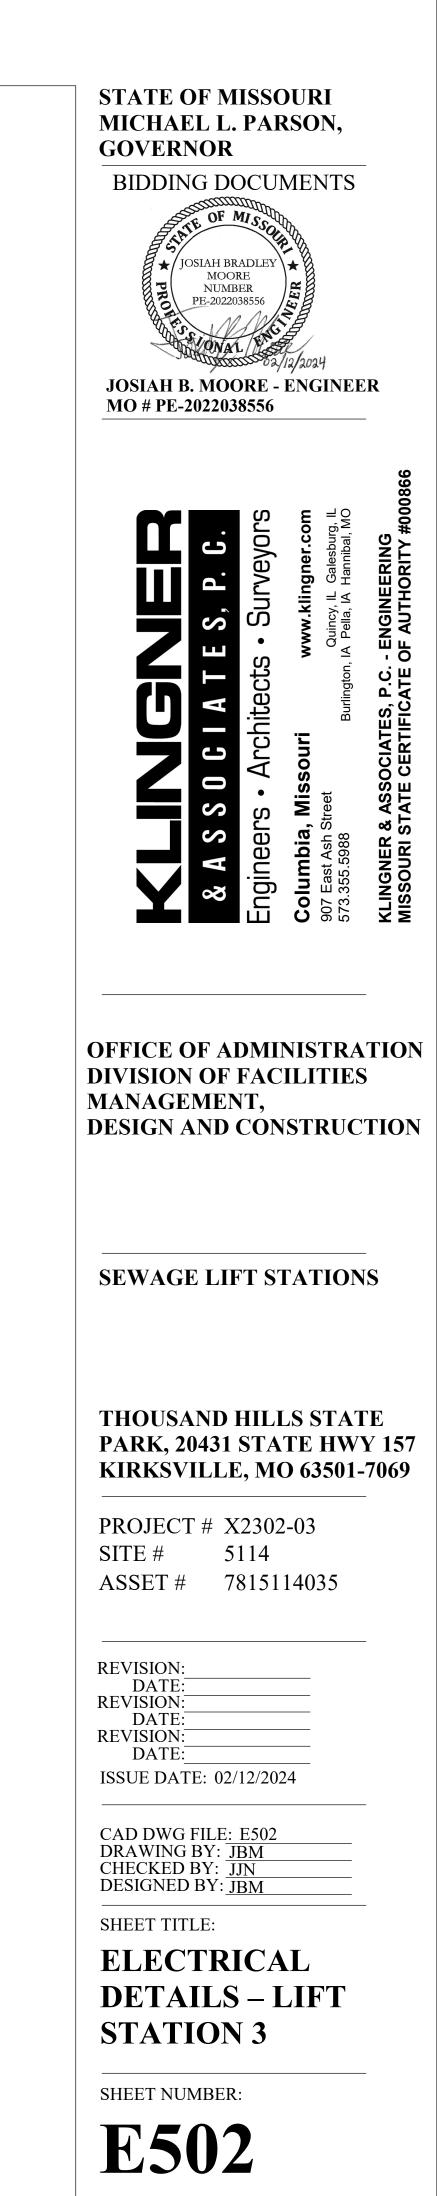

11 OF 18 SHEETS February 12, 2024

40'

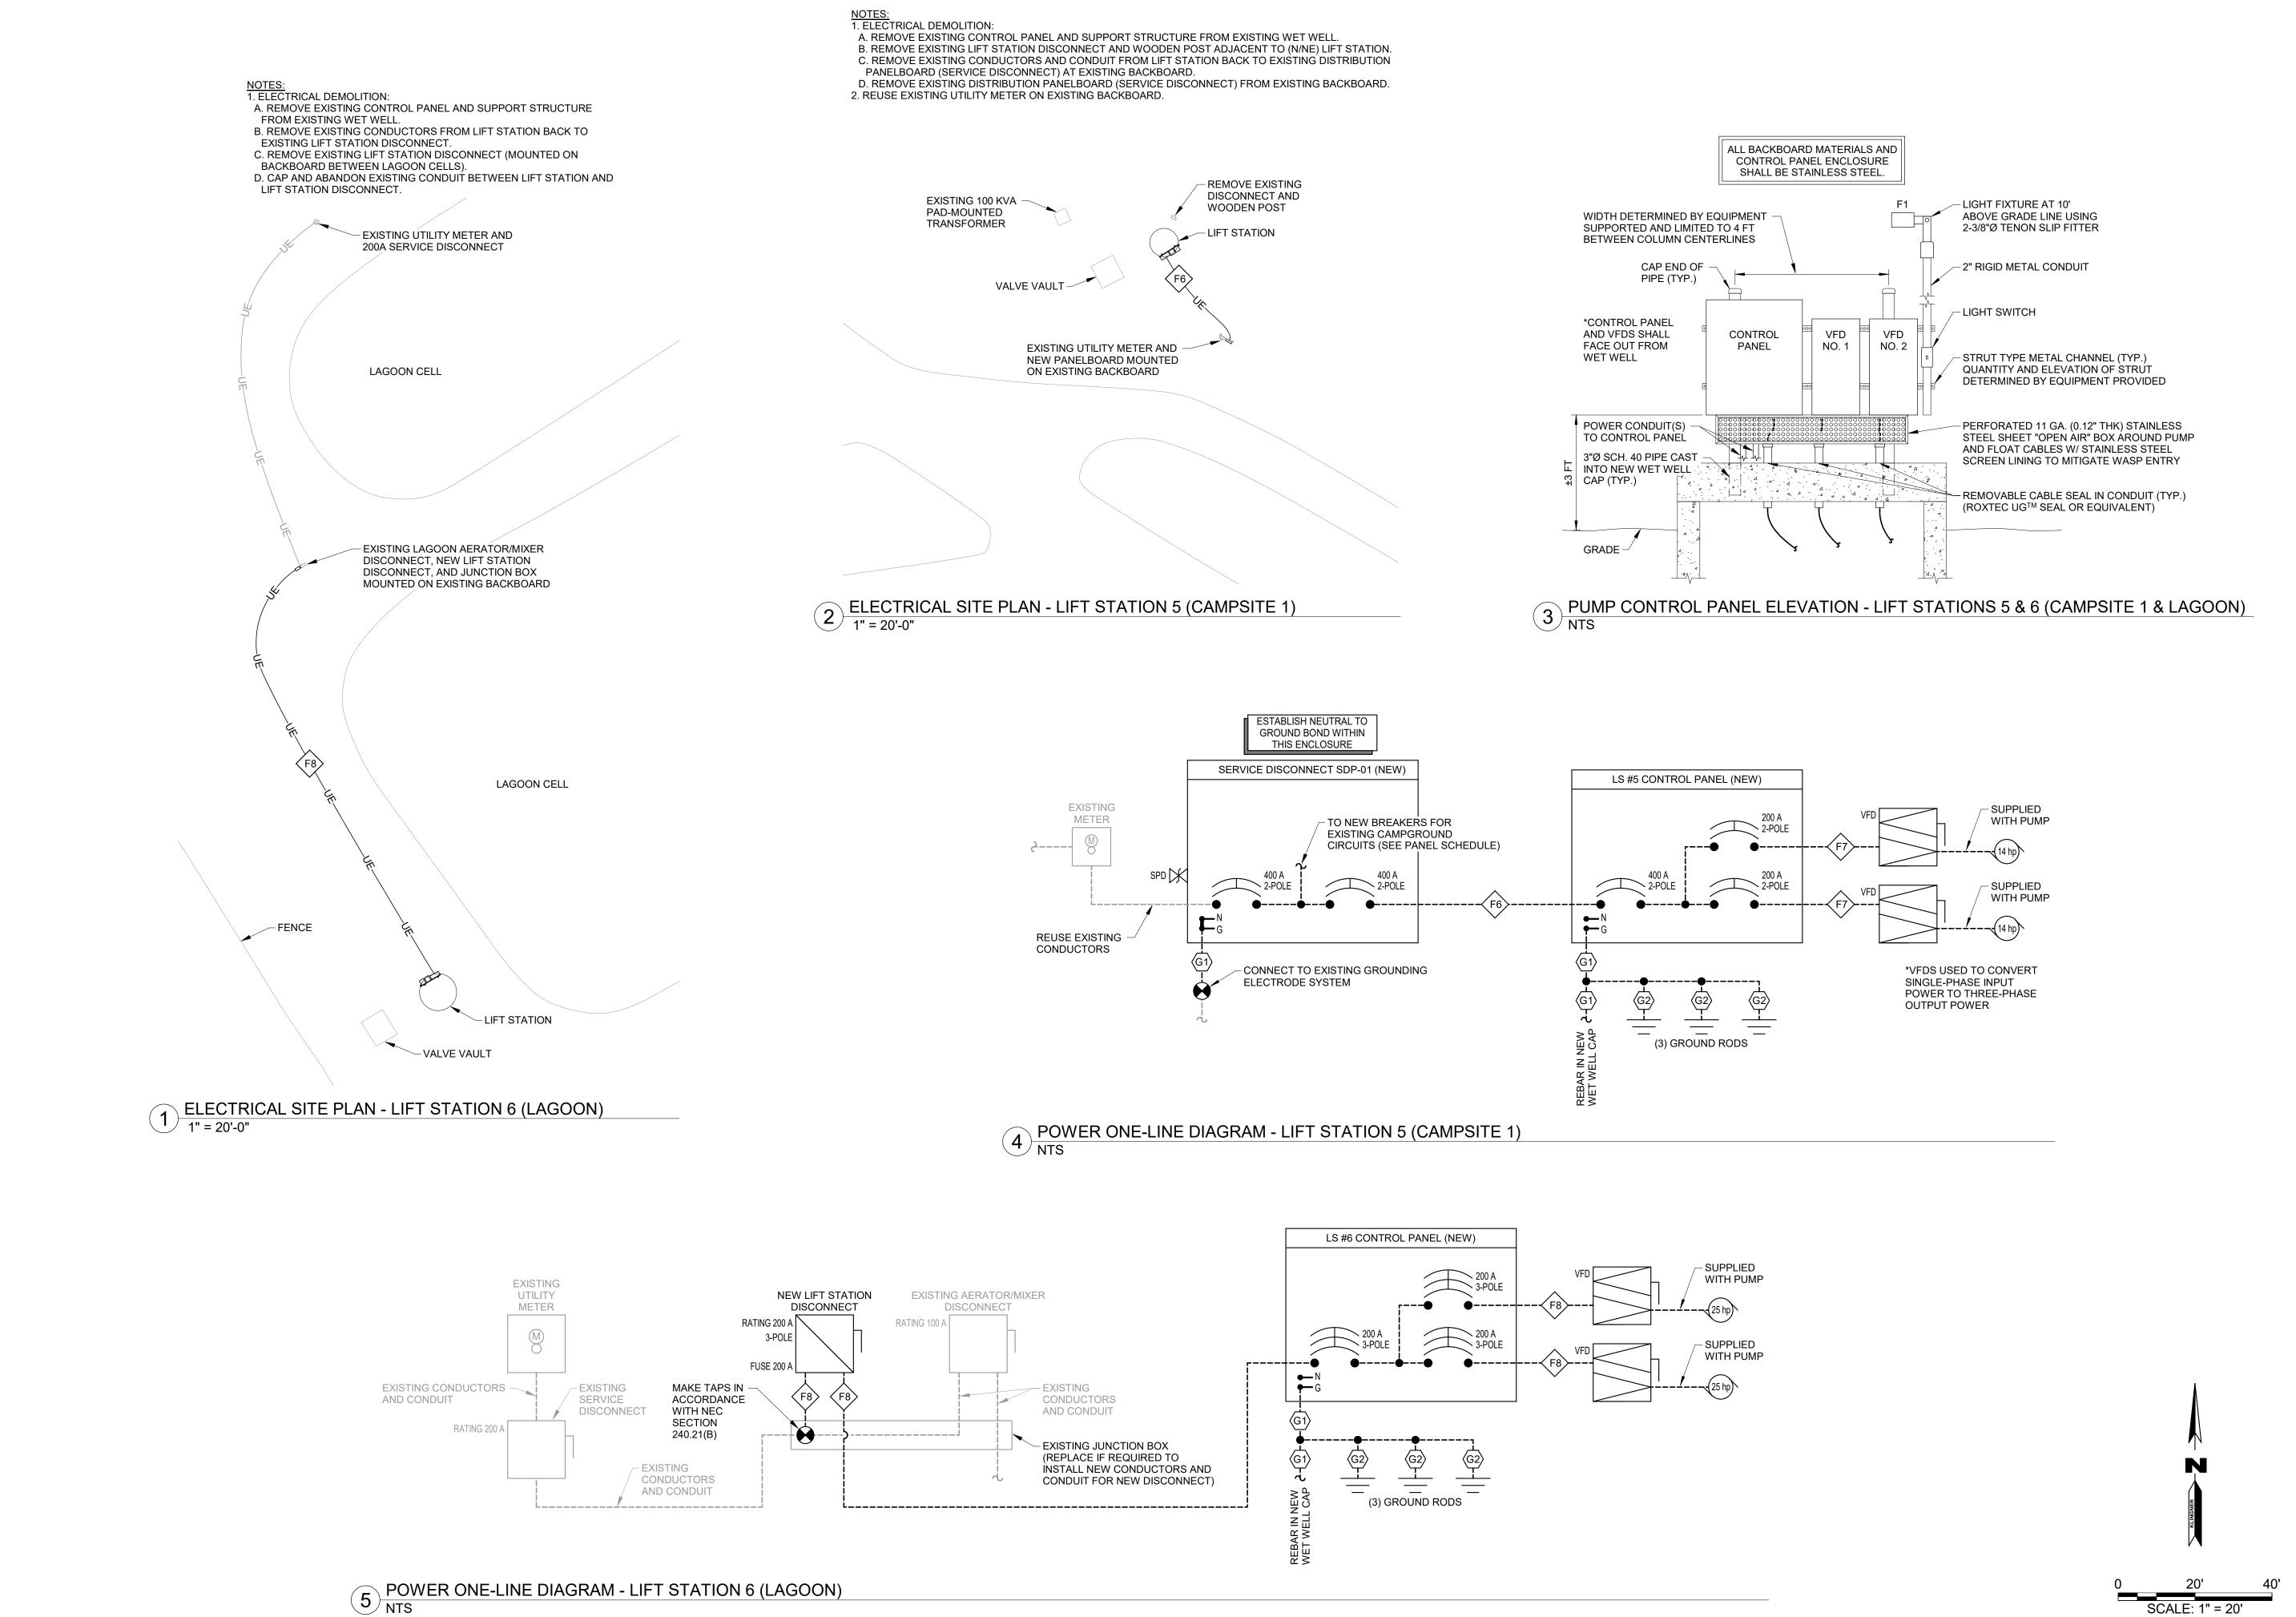

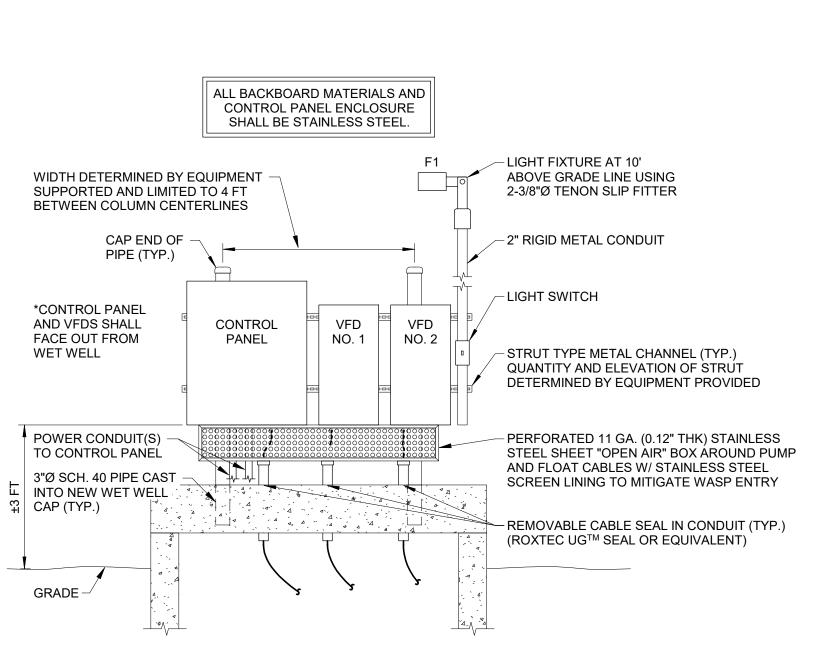



DESIGN AND CONSTRUCTION

SEWAGE LIFT STATIONS

THOUSAND HILLS STATE PARK, 20431 STATE HWY 157 KIRKSVILLE, MO 63501-7069

PROJECT # X2302-03 5114 SITE # ASSET # 7815114035

REVISION: DATE **REVISION:** DATE **REVISION**: DATE: ISSUE DATE: 02/12/2024

CAD DWG FILE: E503 DRAWING BY: JBM CHECKED BY: JJN

DESIGNED BY: JBM SHEET TITLE:

ELECTRICAL DETAILS – LIFT STATIONS 5 & 6

SHEET NUMBER:

E503 12 OF 18 SHEETS February 12, 2024

	BRANCH PANEL:						
	LOCATION: SUPPLY FROM: MOUNTING: ENCLOSURE:						
СКТ	CIRCUIT DESCRIPTIC						
1	LIFT STATION #5						
3							
5	CAMPGROUND FEEDER						
7							
9	CAMPGROUND FEEDER						
11							
13							
15							
17							
19							
21							
23							
* LIFT ST	ATION #5 BREAKER MAY BE						
** COOR	DINATE CIRCUIT DESCRIPTIO						


	LIGHTING FIXTURE SCHEDULE												
TAG	TAG DESCRIPTION MOUNT LENS		LAMP	OUTPUT					REMARKS				
TAG	DESCRIPTION		LENS	TYPE	COLOR TEMP.	OUIFUI	CONTROL	VOLT (W)		MAKE	MODEL	ACCESSORIES	
		TENON				12,054			93	LITHONIA	DSXF2-LED-P3-30K-70CRI-WFL-MVOLT-IS-PE-DDBXD		SEE DRAWINGS FOR
F1	F1 ELOOD LICHT	SLIP-	GLASS, IP66	LED	3,000 K	10,122	INTEGRAL PHOTOCELL	120	85	LUMARK	NFFLD-C25-E-UNV-66-S-CB-PER	SLIPFITTER FOR 2-3/8" O.D. TENON	INSTALLATION
		FITTER									ENGINEER-APPROVED EQUAL		DETAILS.

01									
TATION #5 AF	REA		VOLTS:	120/240			A.I.C.	RATING: 65,000 AMPS SYMMETRICA	AL.
Y METER			PHASES:	1			PAN	EL TYPE: MAIN CB	
CE			WIRES:	3			MAINS	RATING: 400 A	
ROJECT MAN	IUAL	ACC	ESSORIES:	1		1	MAIN B	REAKER: 400 A	
TRIP	POLES		4	E	3	POLES	TRIP	CIRCUIT DESCRIPTION	СКТ
400 A	2 18823 VA 3456 VA 2 100 A CAMPGROUND FEEDER		2						
400 A	2			18823 VA	3456 VA	2	100 A	CAMPGROUND FEEDER	4
100 4	A 2 3456 VA 3456 VA		2	100 A		6			
100 A	2			3456 VA	3456 VA	2	100 A	CAMPGROUND FEEDER	8
100 A	2	3456 VA	3456 VA			2	100 A		10
100 A	2			3456 VA	3456 VA		100 A	CAMPGROUNDTELDER	12
									14
									16
									18
									20
									22
									24
PHA	ASE LOAD:	36,10)3 VA	36,10)3 VA	**TO	TAL LOAD:	72,206 VA	
PHA	ASE AMPS:	30	1 A	30	1 A	**TO	TAL AMPS:	301 A	
ED BREAKE	R IF REQUIE	RED.							
	TATION #5 AF Y METER CE ROJECT MAN 400 A 100 A 100 A 100 A PH/ PH/	TATION #5 AREA Y METER CCE ROJECT MANUAL TRIP POLES 400 A 2 100 A 2 100 A 2 100 A 2 100 A 2 PHASE LOAD: PHASE AMPS:	TATION #5 AREA Y METER ACECE ROJECT MANUALACCTRIPPOLES400 A2400 A218823 VA100 A2100 A2100 A2100 A2100 A2100 A2100 A2100 A2100 A3456 VA100 A2100 A3456 VA100 A <td>TATION #5 AREAVOLTS:Y METERPHASES:PHASES:CEWIRES:WIRES:ROJECT MANUALACCESSORIES:TRIPPOLESA400 A218823 VA400 A218823 VA400 A23456 VA100 A36,103 VAPHASE LOAD:36,103 VA</td> <td>TATION #5 AREAVOLTS: 120/240Y METERPHASES: 1ACEPHASES: 3ROJECT MANUALACCESSORIES:TRIPPOLES$ACCESSORIES:$400 A218823 VA400 A218823 VA100 A23456 VA100 A33456 VA100 A33456 VA100 A33456 VA100 A33456 VA100 A23456 VA100 A33456 VA100 A33100 A33100 A33100 A3100 A3100 A3100 A3100 A3<td>TATION #5 AREA VOLTS: $120/240$ Y METER PHASES: 1 CC WIRES: 3 ROJECT MANUAL ACCESSORIES: TRIP POLES 18823 VA 3456 VA 400 A 2 18823 VA 3456 VA 18823 VA 100 A 2 3456 VA 3456 VA 3456 VA 100 A 2 3456 VA 3456 VA 3456 VA 100 A 2 3456 VA 3456 VA 3456 VA 100 A 2 3456 VA 3456 VA 3456 VA 100 A 2 3456 VA 3456 VA 3456 VA 100 A 2 3456 VA 3456 VA 3456 VA 100 A 2 3456 VA 3456 VA 3456 VA 100 A 2 3456 VA 3456 VA 3456 VA 100 A 2 3456 VA 3456 VA 3456 VA 100 A 2 3456 VA 3456 VA 3456 VA 100 A 2 3456 VA 3456 VA 3456 VA 100 A 2 3456 VA 3456 VA 3456 VA</td><td>TATION #5 AREA VOLTS: $120/240$ Y METER PHASES: 1 CE WIRES: 3 ROJECT MANUAL ACCESSORIES: ACCESSORIES: POLES 400 A 2 18823 VA 3456 VA POLES 2 400 A 2 18823 VA 3456 VA 3456 VA 3456 VA 2 100 A 2 3456 VA 3456 VA 3456 VA 3456 VA 2 100 A 2 3456 VA 3456 VA 3456 VA 3456 VA 2 100 A 2 3456 VA 3456 VA 3456 VA 3456 VA 2 100 A 2 3456 VA 3456 VA 3456 VA 3456 VA 2 100 A 2 3456 VA 3456 VA 3456 VA 3456 VA 2 100 A 2 3456 VA 3456 VA 3456 VA 3456 VA 2 100 A 2 3456 VA 3456 VA 3456 VA 3456 VA 2 100 A 2 3456 VA 3456 VA 3456 VA 3456 VA 3456 VA 2 <!--</td--><td>TATION #5 AREA VOLTS: 120/240 A.I.C. Y METER PHASES: 1 PAN CE WIRES: 3 MAINS ROJECT MANUAL ACCESSORIES: MAINS ROJECT MANUAL ACCESSORIES: POLES TRIP 400 A 2 18823 VA 3456 VA 18823 VA 3456 VA 2 100 A 400 A 2 18823 VA 3456 VA 3456 VA 3456 VA 3456 VA 2 100 A 100 A 2 18823 VA 3456 VA</td><td>ATION #5 AREA VOLTS: 120/240 ALC. RATING: 65,000 AMPS SYMMETRIC/ PANEL TYPE: MAIN CB YMETER PHASES: 1 PANEL TYPE: MAIN CB CC WIRES: 3 MAINS RATING: 400 A ROJECT MANUAL ACCESSORIES: POLES TRIP CIRCUIT DESCRIPTION 400 A 2 18823 VA 3456 VA 4056 VA 2 100 A 2 CAMPGROUND FEEDER 400 A 2 3456 VA 3456 VA 3456 VA 2 100 A 2 CAMPGROUND FEEDER 100 A 2 3456 VA 3456 VA 3456 VA 2 100 A 2 CAMPGROUND FEEDER 100 A 2 3456 VA 3456 VA 3456 VA 2 100 A CAMPGROUND FEEDER 100 A 2 3456 VA 3456 VA 3456 VA 2 100 A CAMPGROUND FEEDER 100 A 2 3456 VA 3456 VA 3456 VA 2 100 A CAMPGROUND FEEDER 100 A 2 3456 VA 3456 VA 3456 VA 2 100 A CAMPGROUND FEEDER 100 A 100 A 100 A 100 A <</td></td></td>	TATION #5 AREAVOLTS:Y METERPHASES:PHASES:CEWIRES:WIRES:ROJECT MANUALACCESSORIES:TRIPPOLESA400 A218823 VA400 A218823 VA400 A23456 VA100 A36,103 VAPHASE LOAD:36,103 VA	TATION #5 AREAVOLTS: 120/240Y METERPHASES: 1ACEPHASES: 3ROJECT MANUALACCESSORIES:TRIPPOLES $ACCESSORIES:$ 400 A218823 VA400 A218823 VA100 A23456 VA100 A33456 VA100 A33456 VA100 A33456 VA100 A33456 VA100 A23456 VA100 A33456 VA100 A33100 A33100 A33100 A3100 A3100 A3100 A3100 A3 <td>TATION #5 AREA VOLTS: $120/240$ Y METER PHASES: 1 CC WIRES: 3 ROJECT MANUAL ACCESSORIES: TRIP POLES 18823 VA 3456 VA 400 A 2 18823 VA 3456 VA 18823 VA 100 A 2 3456 VA 3456 VA 3456 VA 100 A 2 3456 VA 3456 VA 3456 VA 100 A 2 3456 VA 3456 VA 3456 VA 100 A 2 3456 VA 3456 VA 3456 VA 100 A 2 3456 VA 3456 VA 3456 VA 100 A 2 3456 VA 3456 VA 3456 VA 100 A 2 3456 VA 3456 VA 3456 VA 100 A 2 3456 VA 3456 VA 3456 VA 100 A 2 3456 VA 3456 VA 3456 VA 100 A 2 3456 VA 3456 VA 3456 VA 100 A 2 3456 VA 3456 VA 3456 VA 100 A 2 3456 VA 3456 VA 3456 VA</td> <td>TATION #5 AREA VOLTS: $120/240$ Y METER PHASES: 1 CE WIRES: 3 ROJECT MANUAL ACCESSORIES: ACCESSORIES: POLES 400 A 2 18823 VA 3456 VA POLES 2 400 A 2 18823 VA 3456 VA 3456 VA 3456 VA 2 100 A 2 3456 VA 3456 VA 3456 VA 3456 VA 2 100 A 2 3456 VA 3456 VA 3456 VA 3456 VA 2 100 A 2 3456 VA 3456 VA 3456 VA 3456 VA 2 100 A 2 3456 VA 3456 VA 3456 VA 3456 VA 2 100 A 2 3456 VA 3456 VA 3456 VA 3456 VA 2 100 A 2 3456 VA 3456 VA 3456 VA 3456 VA 2 100 A 2 3456 VA 3456 VA 3456 VA 3456 VA 2 100 A 2 3456 VA 3456 VA 3456 VA 3456 VA 3456 VA 2 <!--</td--><td>TATION #5 AREA VOLTS: 120/240 A.I.C. Y METER PHASES: 1 PAN CE WIRES: 3 MAINS ROJECT MANUAL ACCESSORIES: MAINS ROJECT MANUAL ACCESSORIES: POLES TRIP 400 A 2 18823 VA 3456 VA 18823 VA 3456 VA 2 100 A 400 A 2 18823 VA 3456 VA 3456 VA 3456 VA 3456 VA 2 100 A 100 A 2 18823 VA 3456 VA</td><td>ATION #5 AREA VOLTS: 120/240 ALC. RATING: 65,000 AMPS SYMMETRIC/ PANEL TYPE: MAIN CB YMETER PHASES: 1 PANEL TYPE: MAIN CB CC WIRES: 3 MAINS RATING: 400 A ROJECT MANUAL ACCESSORIES: POLES TRIP CIRCUIT DESCRIPTION 400 A 2 18823 VA 3456 VA 4056 VA 2 100 A 2 CAMPGROUND FEEDER 400 A 2 3456 VA 3456 VA 3456 VA 2 100 A 2 CAMPGROUND FEEDER 100 A 2 3456 VA 3456 VA 3456 VA 2 100 A 2 CAMPGROUND FEEDER 100 A 2 3456 VA 3456 VA 3456 VA 2 100 A CAMPGROUND FEEDER 100 A 2 3456 VA 3456 VA 3456 VA 2 100 A CAMPGROUND FEEDER 100 A 2 3456 VA 3456 VA 3456 VA 2 100 A CAMPGROUND FEEDER 100 A 2 3456 VA 3456 VA 3456 VA 2 100 A CAMPGROUND FEEDER 100 A 100 A 100 A 100 A <</td></td>	TATION #5 AREA VOLTS: $120/240$ Y METER PHASES: 1 CC WIRES: 3 ROJECT MANUAL ACCESSORIES: TRIP POLES 18823 VA 3456 VA 400 A 2 18823 VA 3456 VA 18823 VA 100 A 2 3456 VA 3456 VA 3456 VA 100 A 2 3456 VA 3456 VA 3456 VA 100 A 2 3456 VA 3456 VA 3456 VA 100 A 2 3456 VA 3456 VA 3456 VA 100 A 2 3456 VA 3456 VA 3456 VA 100 A 2 3456 VA 3456 VA 3456 VA 100 A 2 3456 VA 3456 VA 3456 VA 100 A 2 3456 VA 3456 VA 3456 VA 100 A 2 3456 VA 3456 VA 3456 VA 100 A 2 3456 VA 3456 VA 3456 VA 100 A 2 3456 VA 3456 VA 3456 VA 100 A 2 3456 VA 3456 VA 3456 VA	TATION #5 AREA VOLTS: $120/240$ Y METER PHASES: 1 CE WIRES: 3 ROJECT MANUAL ACCESSORIES: ACCESSORIES: POLES 400 A 2 18823 VA 3456 VA POLES 2 400 A 2 18823 VA 3456 VA 3456 VA 3456 VA 2 100 A 2 3456 VA 3456 VA 3456 VA 3456 VA 2 100 A 2 3456 VA 3456 VA 3456 VA 3456 VA 2 100 A 2 3456 VA 3456 VA 3456 VA 3456 VA 2 100 A 2 3456 VA 3456 VA 3456 VA 3456 VA 2 100 A 2 3456 VA 3456 VA 3456 VA 3456 VA 2 100 A 2 3456 VA 3456 VA 3456 VA 3456 VA 2 100 A 2 3456 VA 3456 VA 3456 VA 3456 VA 2 100 A 2 3456 VA 3456 VA 3456 VA 3456 VA 3456 VA 2 </td <td>TATION #5 AREA VOLTS: 120/240 A.I.C. Y METER PHASES: 1 PAN CE WIRES: 3 MAINS ROJECT MANUAL ACCESSORIES: MAINS ROJECT MANUAL ACCESSORIES: POLES TRIP 400 A 2 18823 VA 3456 VA 18823 VA 3456 VA 2 100 A 400 A 2 18823 VA 3456 VA 3456 VA 3456 VA 3456 VA 2 100 A 100 A 2 18823 VA 3456 VA</td> <td>ATION #5 AREA VOLTS: 120/240 ALC. RATING: 65,000 AMPS SYMMETRIC/ PANEL TYPE: MAIN CB YMETER PHASES: 1 PANEL TYPE: MAIN CB CC WIRES: 3 MAINS RATING: 400 A ROJECT MANUAL ACCESSORIES: POLES TRIP CIRCUIT DESCRIPTION 400 A 2 18823 VA 3456 VA 4056 VA 2 100 A 2 CAMPGROUND FEEDER 400 A 2 3456 VA 3456 VA 3456 VA 2 100 A 2 CAMPGROUND FEEDER 100 A 2 3456 VA 3456 VA 3456 VA 2 100 A 2 CAMPGROUND FEEDER 100 A 2 3456 VA 3456 VA 3456 VA 2 100 A CAMPGROUND FEEDER 100 A 2 3456 VA 3456 VA 3456 VA 2 100 A CAMPGROUND FEEDER 100 A 2 3456 VA 3456 VA 3456 VA 2 100 A CAMPGROUND FEEDER 100 A 2 3456 VA 3456 VA 3456 VA 2 100 A CAMPGROUND FEEDER 100 A 100 A 100 A 100 A <</td>	TATION #5 AREA VOLTS: 120/240 A.I.C. Y METER PHASES: 1 PAN CE WIRES: 3 MAINS ROJECT MANUAL ACCESSORIES: MAINS ROJECT MANUAL ACCESSORIES: POLES TRIP 400 A 2 18823 VA 3456 VA 18823 VA 3456 VA 2 100 A 400 A 2 18823 VA 3456 VA 3456 VA 3456 VA 3456 VA 2 100 A 100 A 2 18823 VA 3456 VA	ATION #5 AREA VOLTS: 120/240 ALC. RATING: 65,000 AMPS SYMMETRIC/ PANEL TYPE: MAIN CB YMETER PHASES: 1 PANEL TYPE: MAIN CB CC WIRES: 3 MAINS RATING: 400 A ROJECT MANUAL ACCESSORIES: POLES TRIP CIRCUIT DESCRIPTION 400 A 2 18823 VA 3456 VA 4056 VA 2 100 A 2 CAMPGROUND FEEDER 400 A 2 3456 VA 3456 VA 3456 VA 2 100 A 2 CAMPGROUND FEEDER 100 A 2 3456 VA 3456 VA 3456 VA 2 100 A 2 CAMPGROUND FEEDER 100 A 2 3456 VA 3456 VA 3456 VA 2 100 A CAMPGROUND FEEDER 100 A 2 3456 VA 3456 VA 3456 VA 2 100 A CAMPGROUND FEEDER 100 A 2 3456 VA 3456 VA 3456 VA 2 100 A CAMPGROUND FEEDER 100 A 2 3456 VA 3456 VA 3456 VA 2 100 A CAMPGROUND FEEDER 100 A 100 A 100 A 100 A <

SOD-I LLD BRLAREN II REGOIRED.
N FOR CAMPGROUND FEEDER CIRCUITS INSIDE THE PANEL DOOR WITH THE OWNER.

FEEDER SCHEDULE (THOUSAND HILLS)									
FEEDER	PARALLEL	PHASE CO	ONDUCTORS	NEUTRAL	EGC SIZE	CONDUIT			
TAG	SETS	QUANTITY	SIZE	SIZE		SIZE			
F1	1	2	#3 AWG Cu	#3 AWG Cu	#8 AWG Cu	1.25"			
F2	1	3	#3 AWG Cu	#3 AWG Cu	#8 AWG Cu	1.25"			
F3	2	3	3/0 AWG Cu	3/0 AWG Cu	N/A	2"			
F4	2	3	3/0 AWG Cu	3/0 AWG Cu	#3 AWG Cu	2"			
F5	1	2	3/0 AWG Cu	3/0 AWG Cu	#6 AWG Cu	2"			
F6	2	2	3/0 AWG Cu	3/0 AWG Cu	#3 AWG Cu	2"			
F7	1	2	3/0 AWG Cu	N/A	#6 AWG Cu	2"			
F8	1	3	3/0 AWG Cu	N/A	#6 AWG Cu	2"			

GEC SCHEDULE						
GEC TAG	GEC SIZE					
G1	#4 AWG Cu					
G2	#6 AWG Cu					

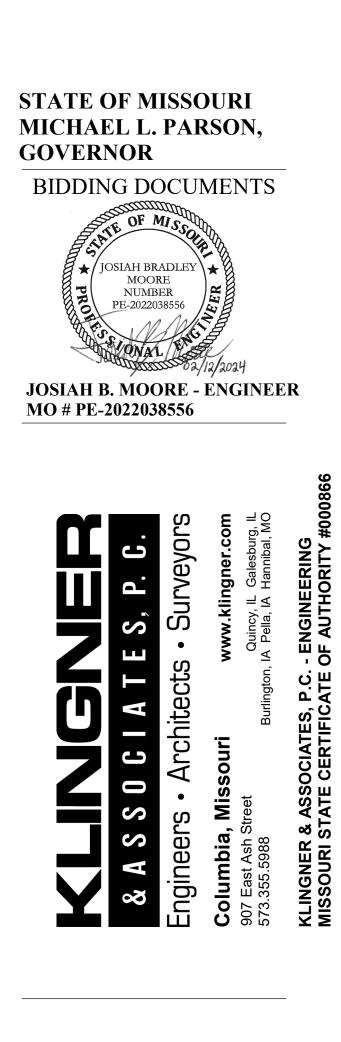

OFFICE OF ADMINISTRATION DIVISION OF FACILITIES MANAGEMENT, DESIGN AND CONSTRUCTION

SEWAGE LIFT STATIONS

THOUSAND HILLS STATE PARK, 20431 STATE HWY 157 KIRKSVILLE, MO 63501-7069

PROJECT #X2302-03SITE #5114ASSET #7815114035

REVISION: DATE: REVISION: DATE: REVISION: DATE: ISSUE DATE: 02/12/2024


CAD DWG FILE: E701 DRAWING BY: JBM CHECKED BY: JJN DESIGNED BY: JBM


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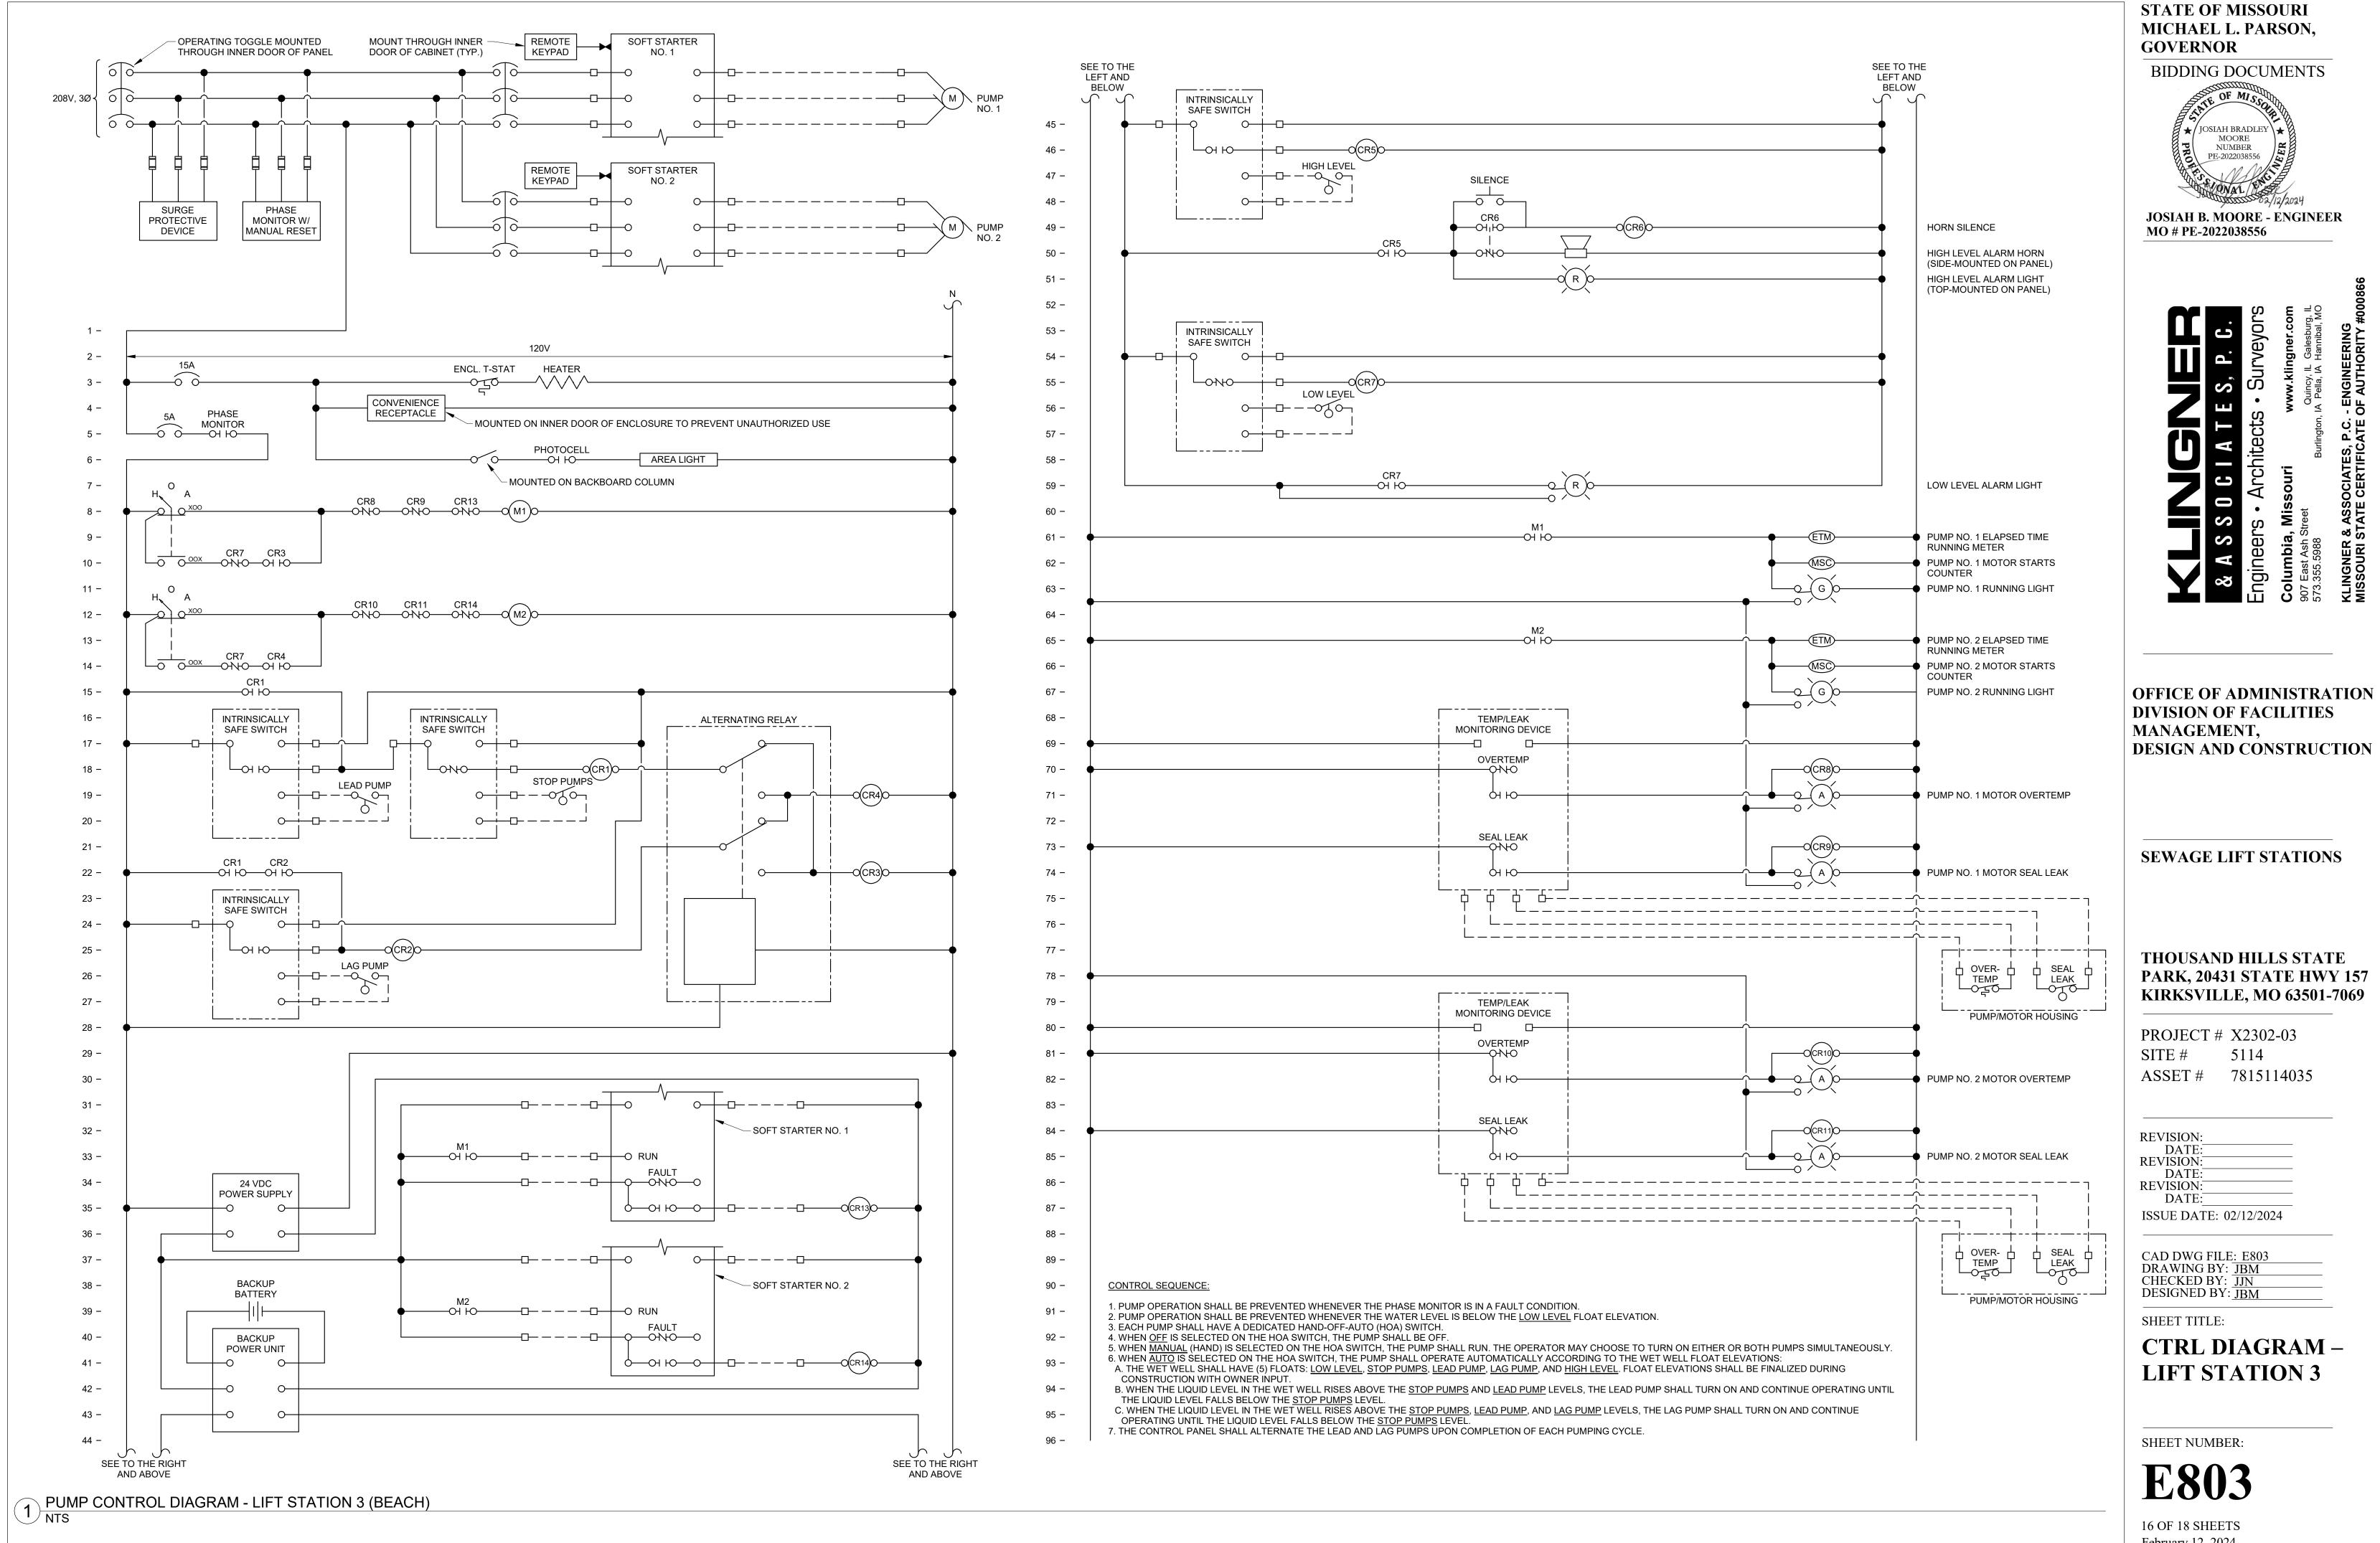
ELECTRICAL SCHEDULES

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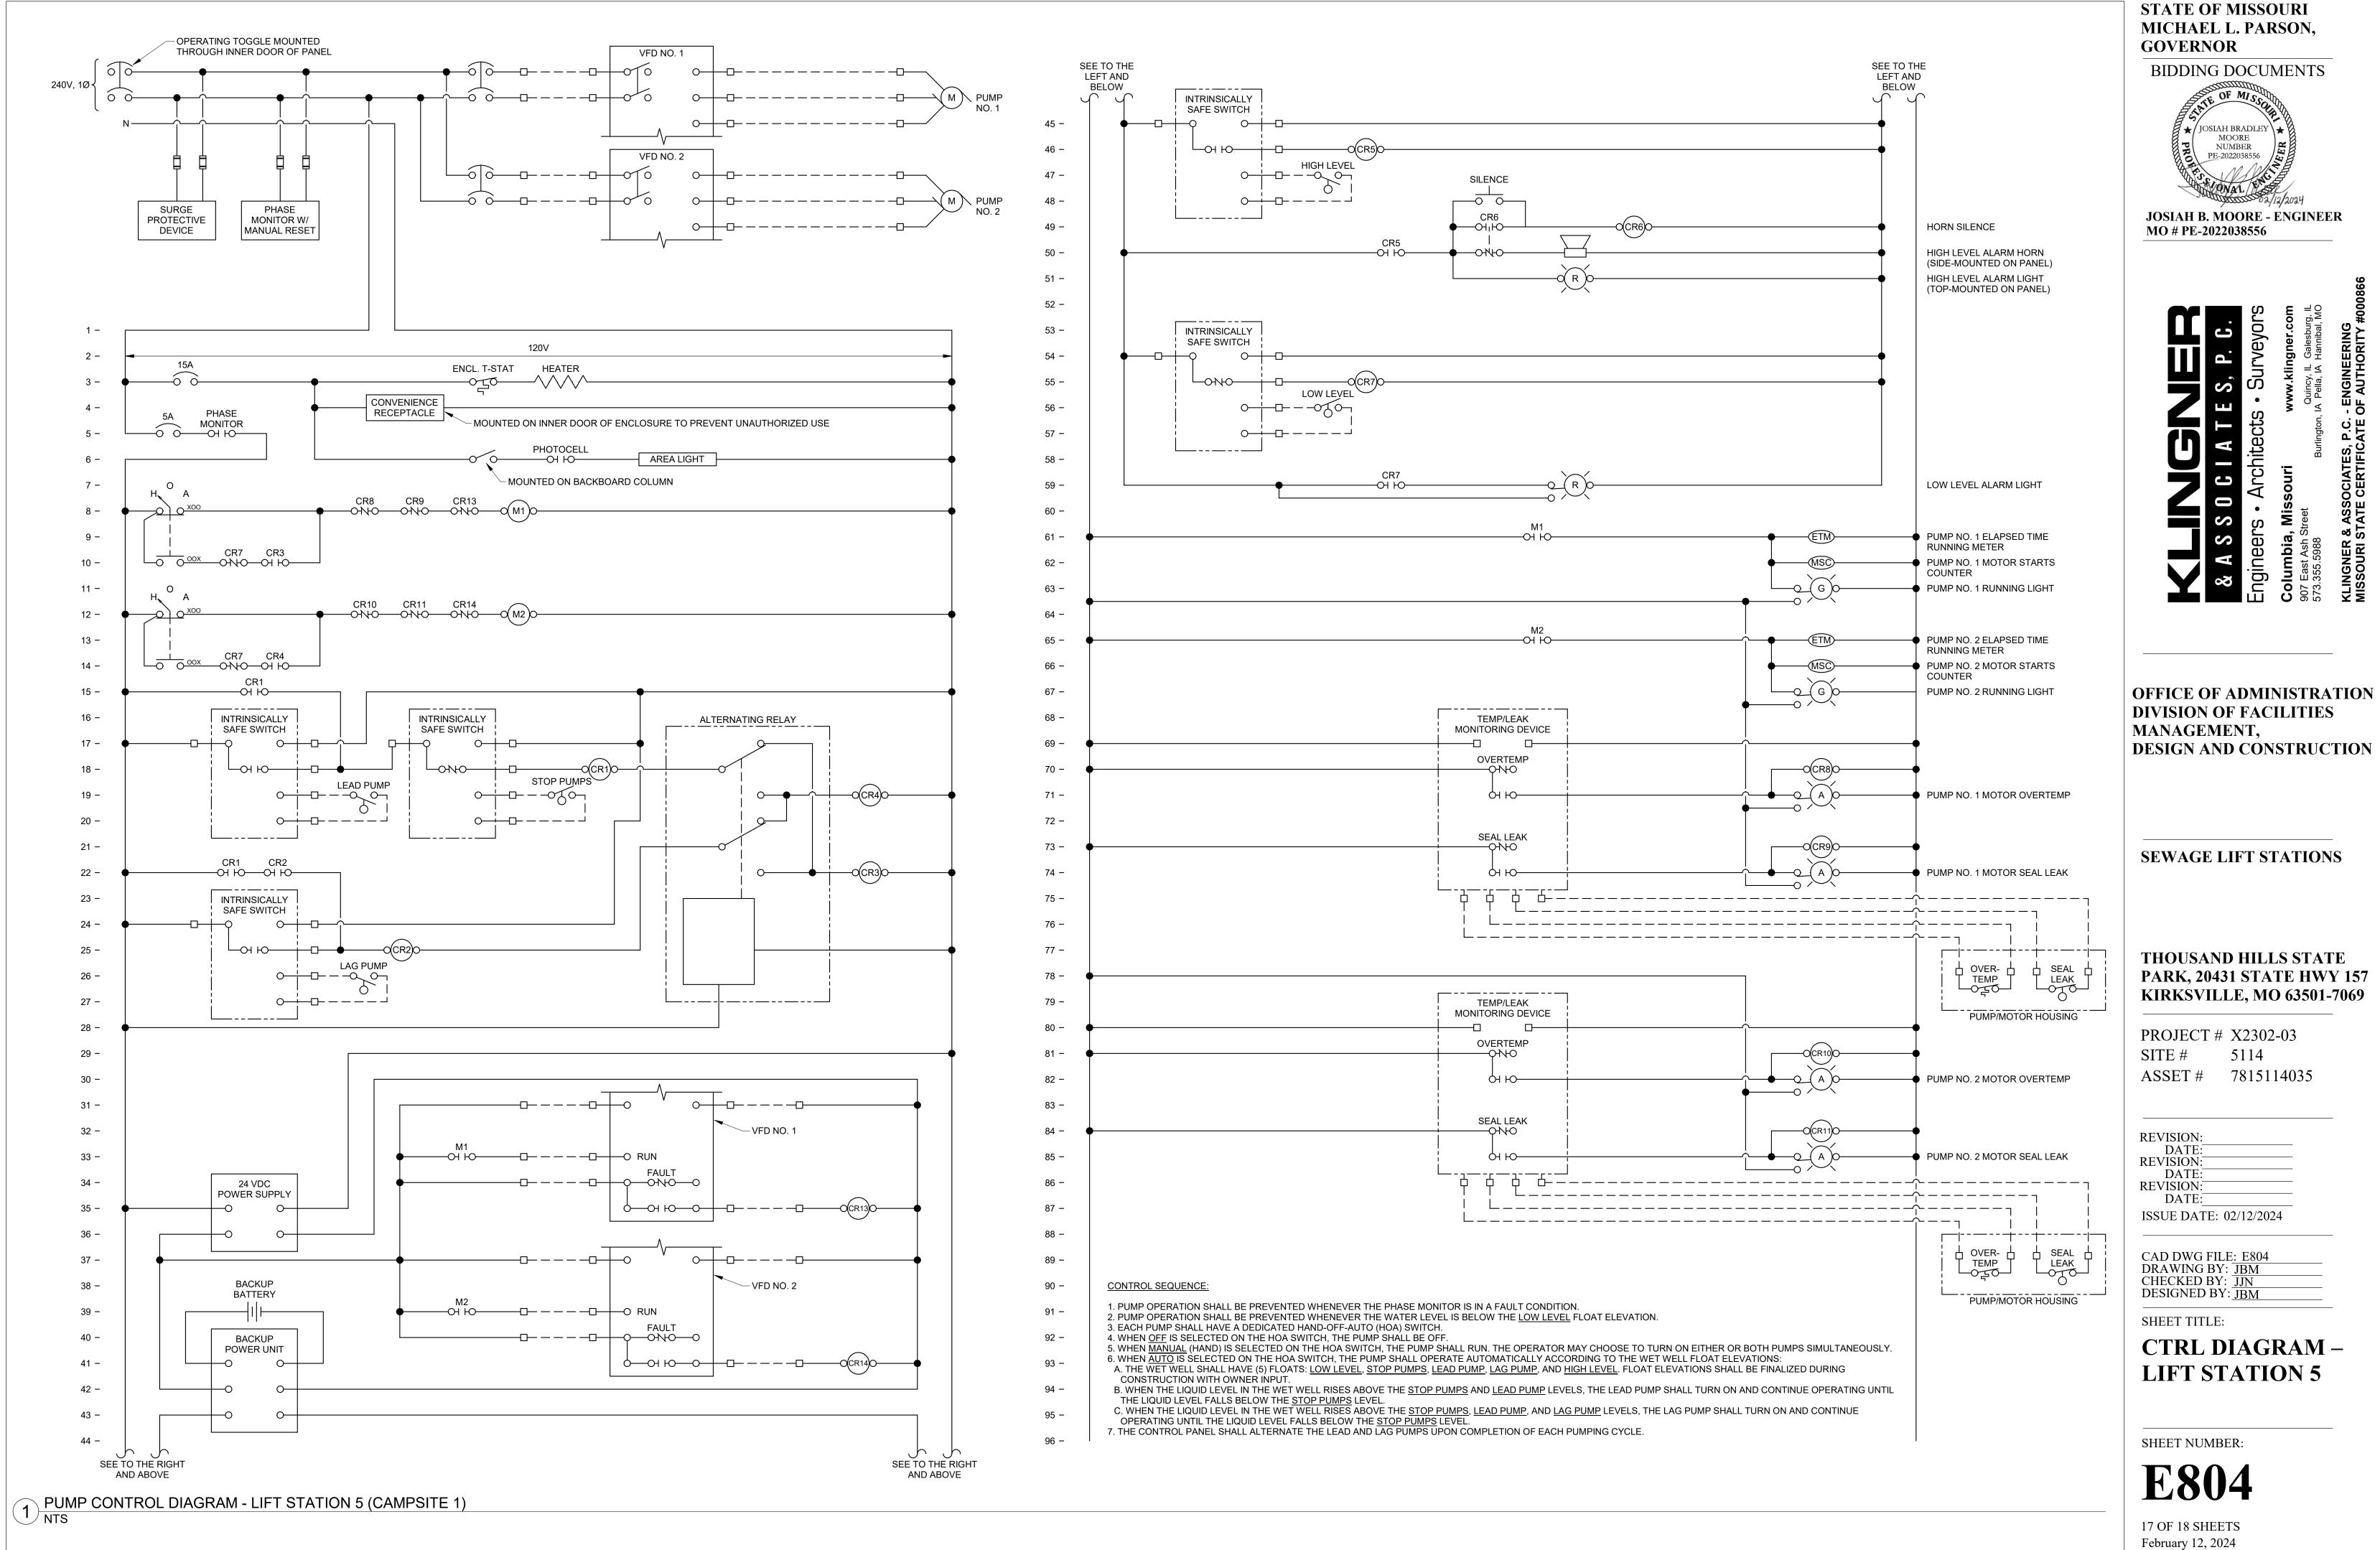
E701 13 OF 18 SHEETS February 12, 2024






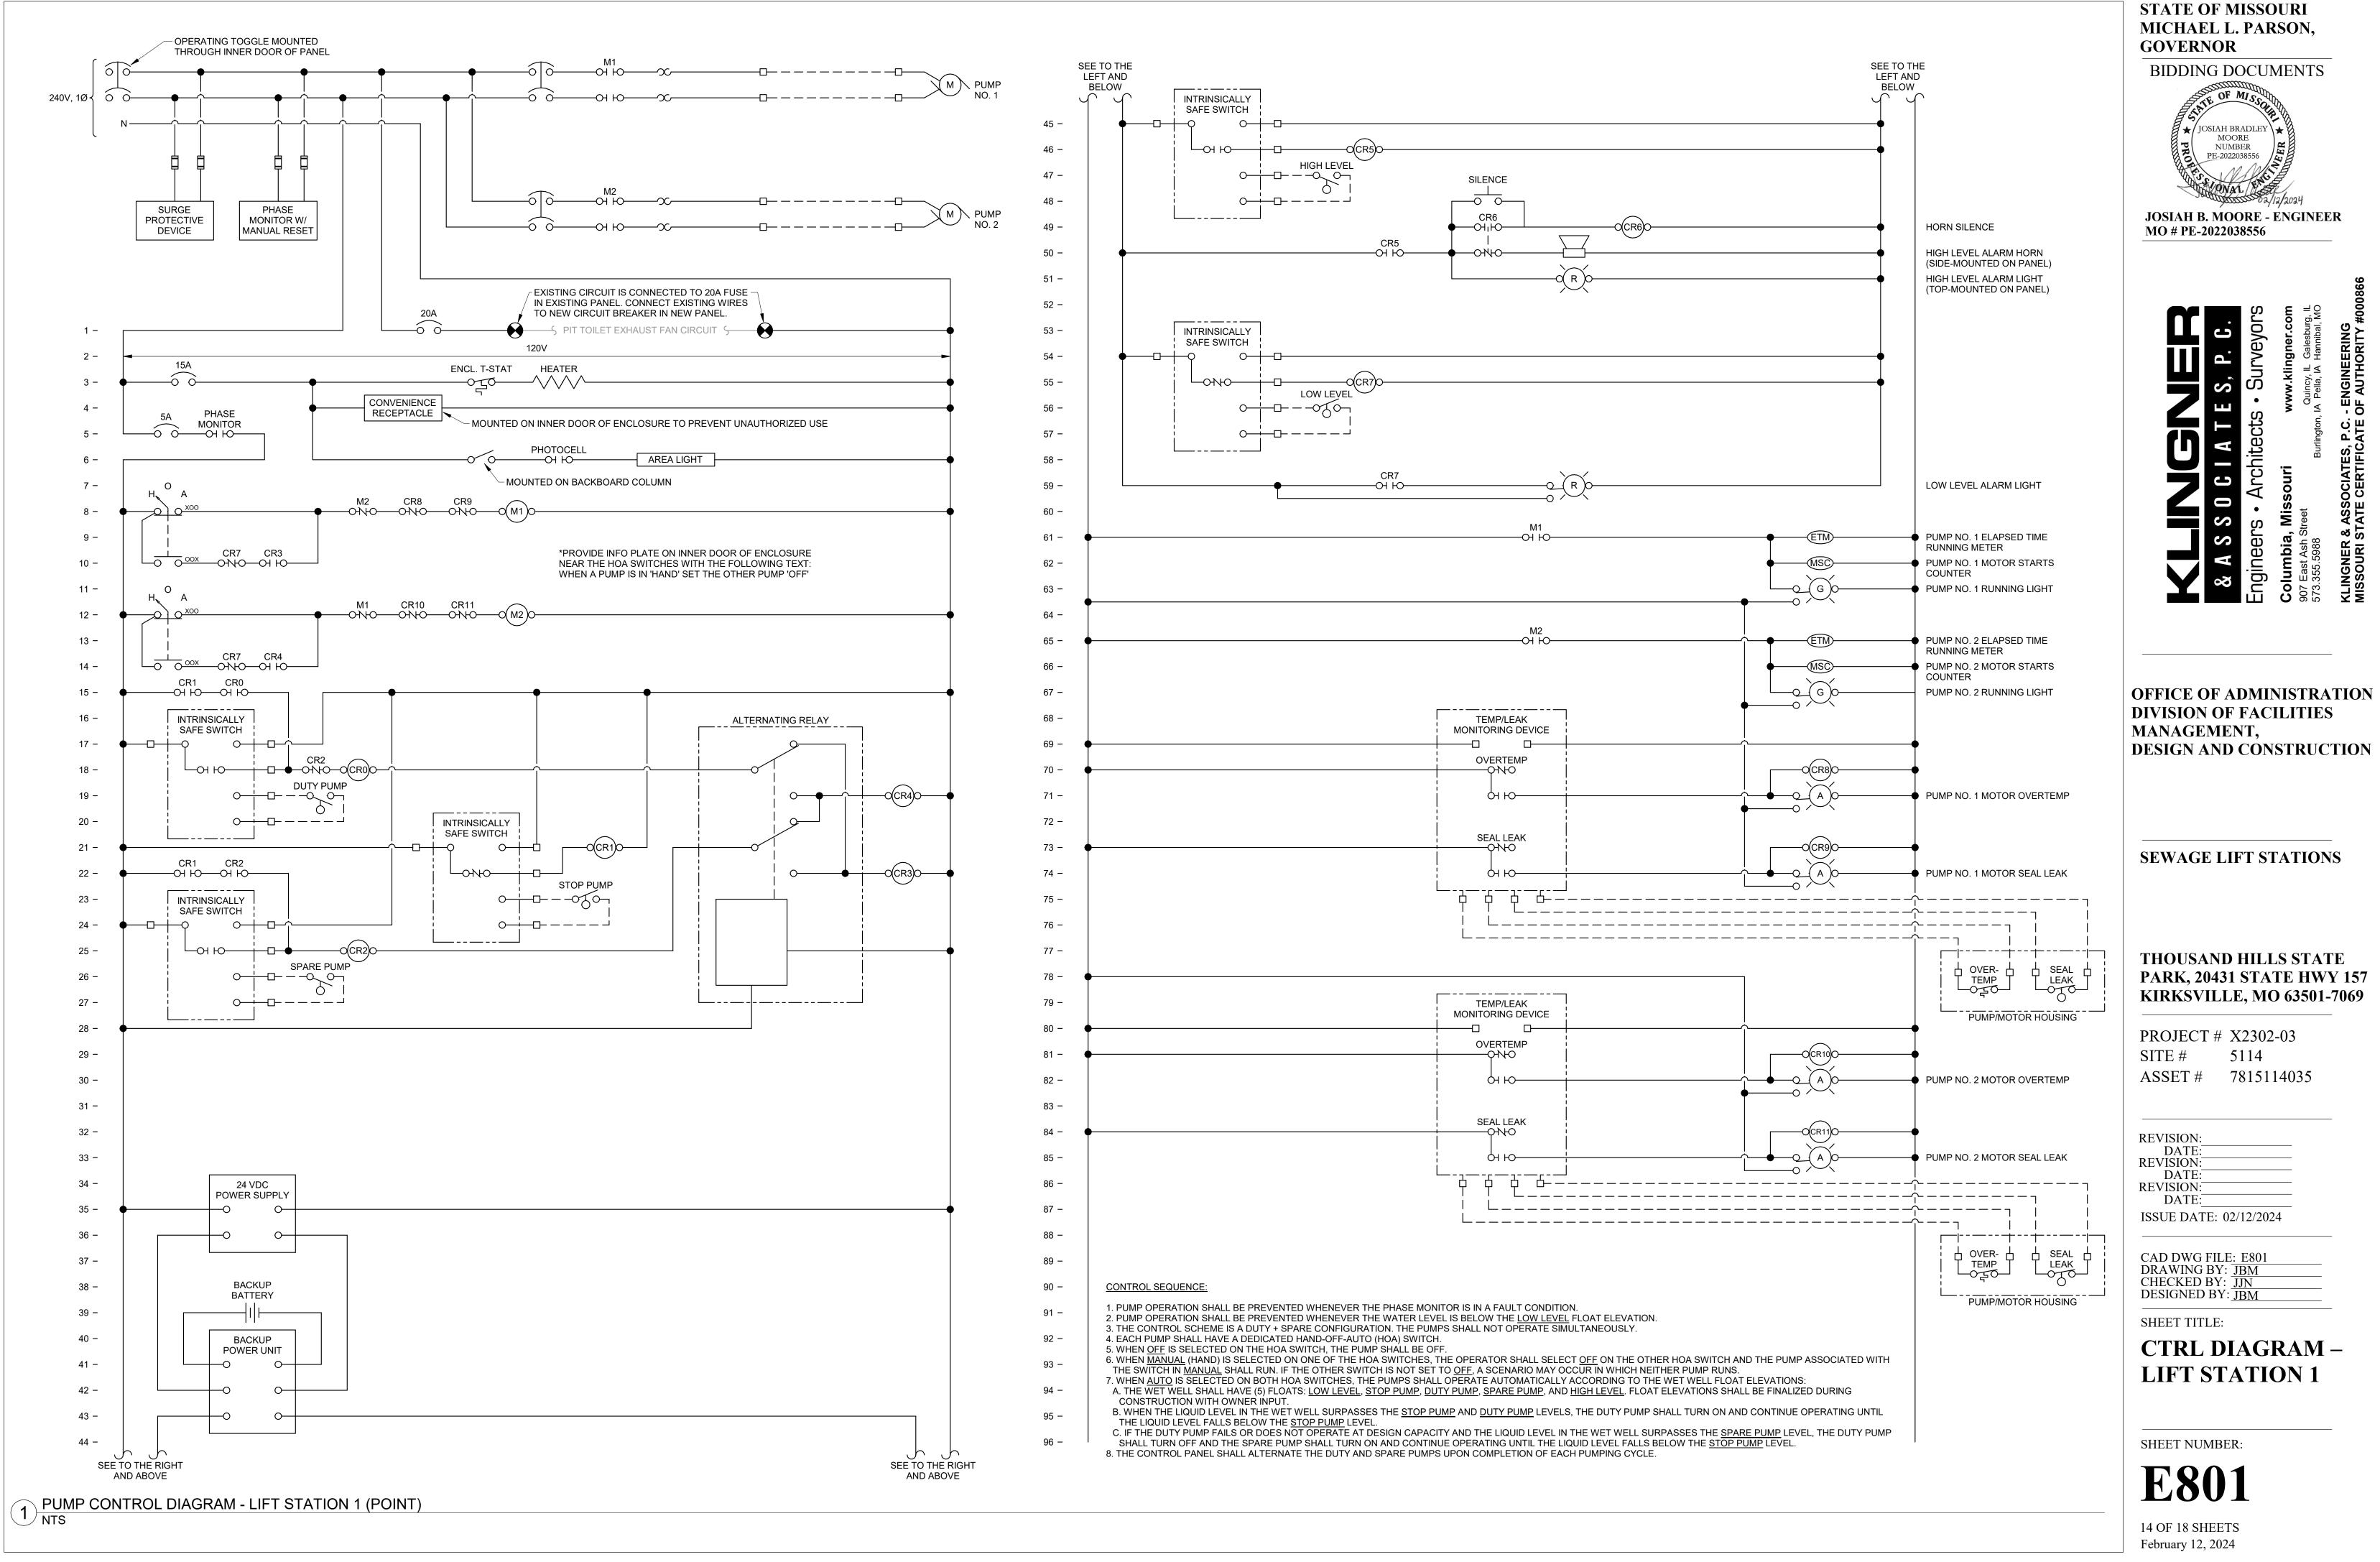

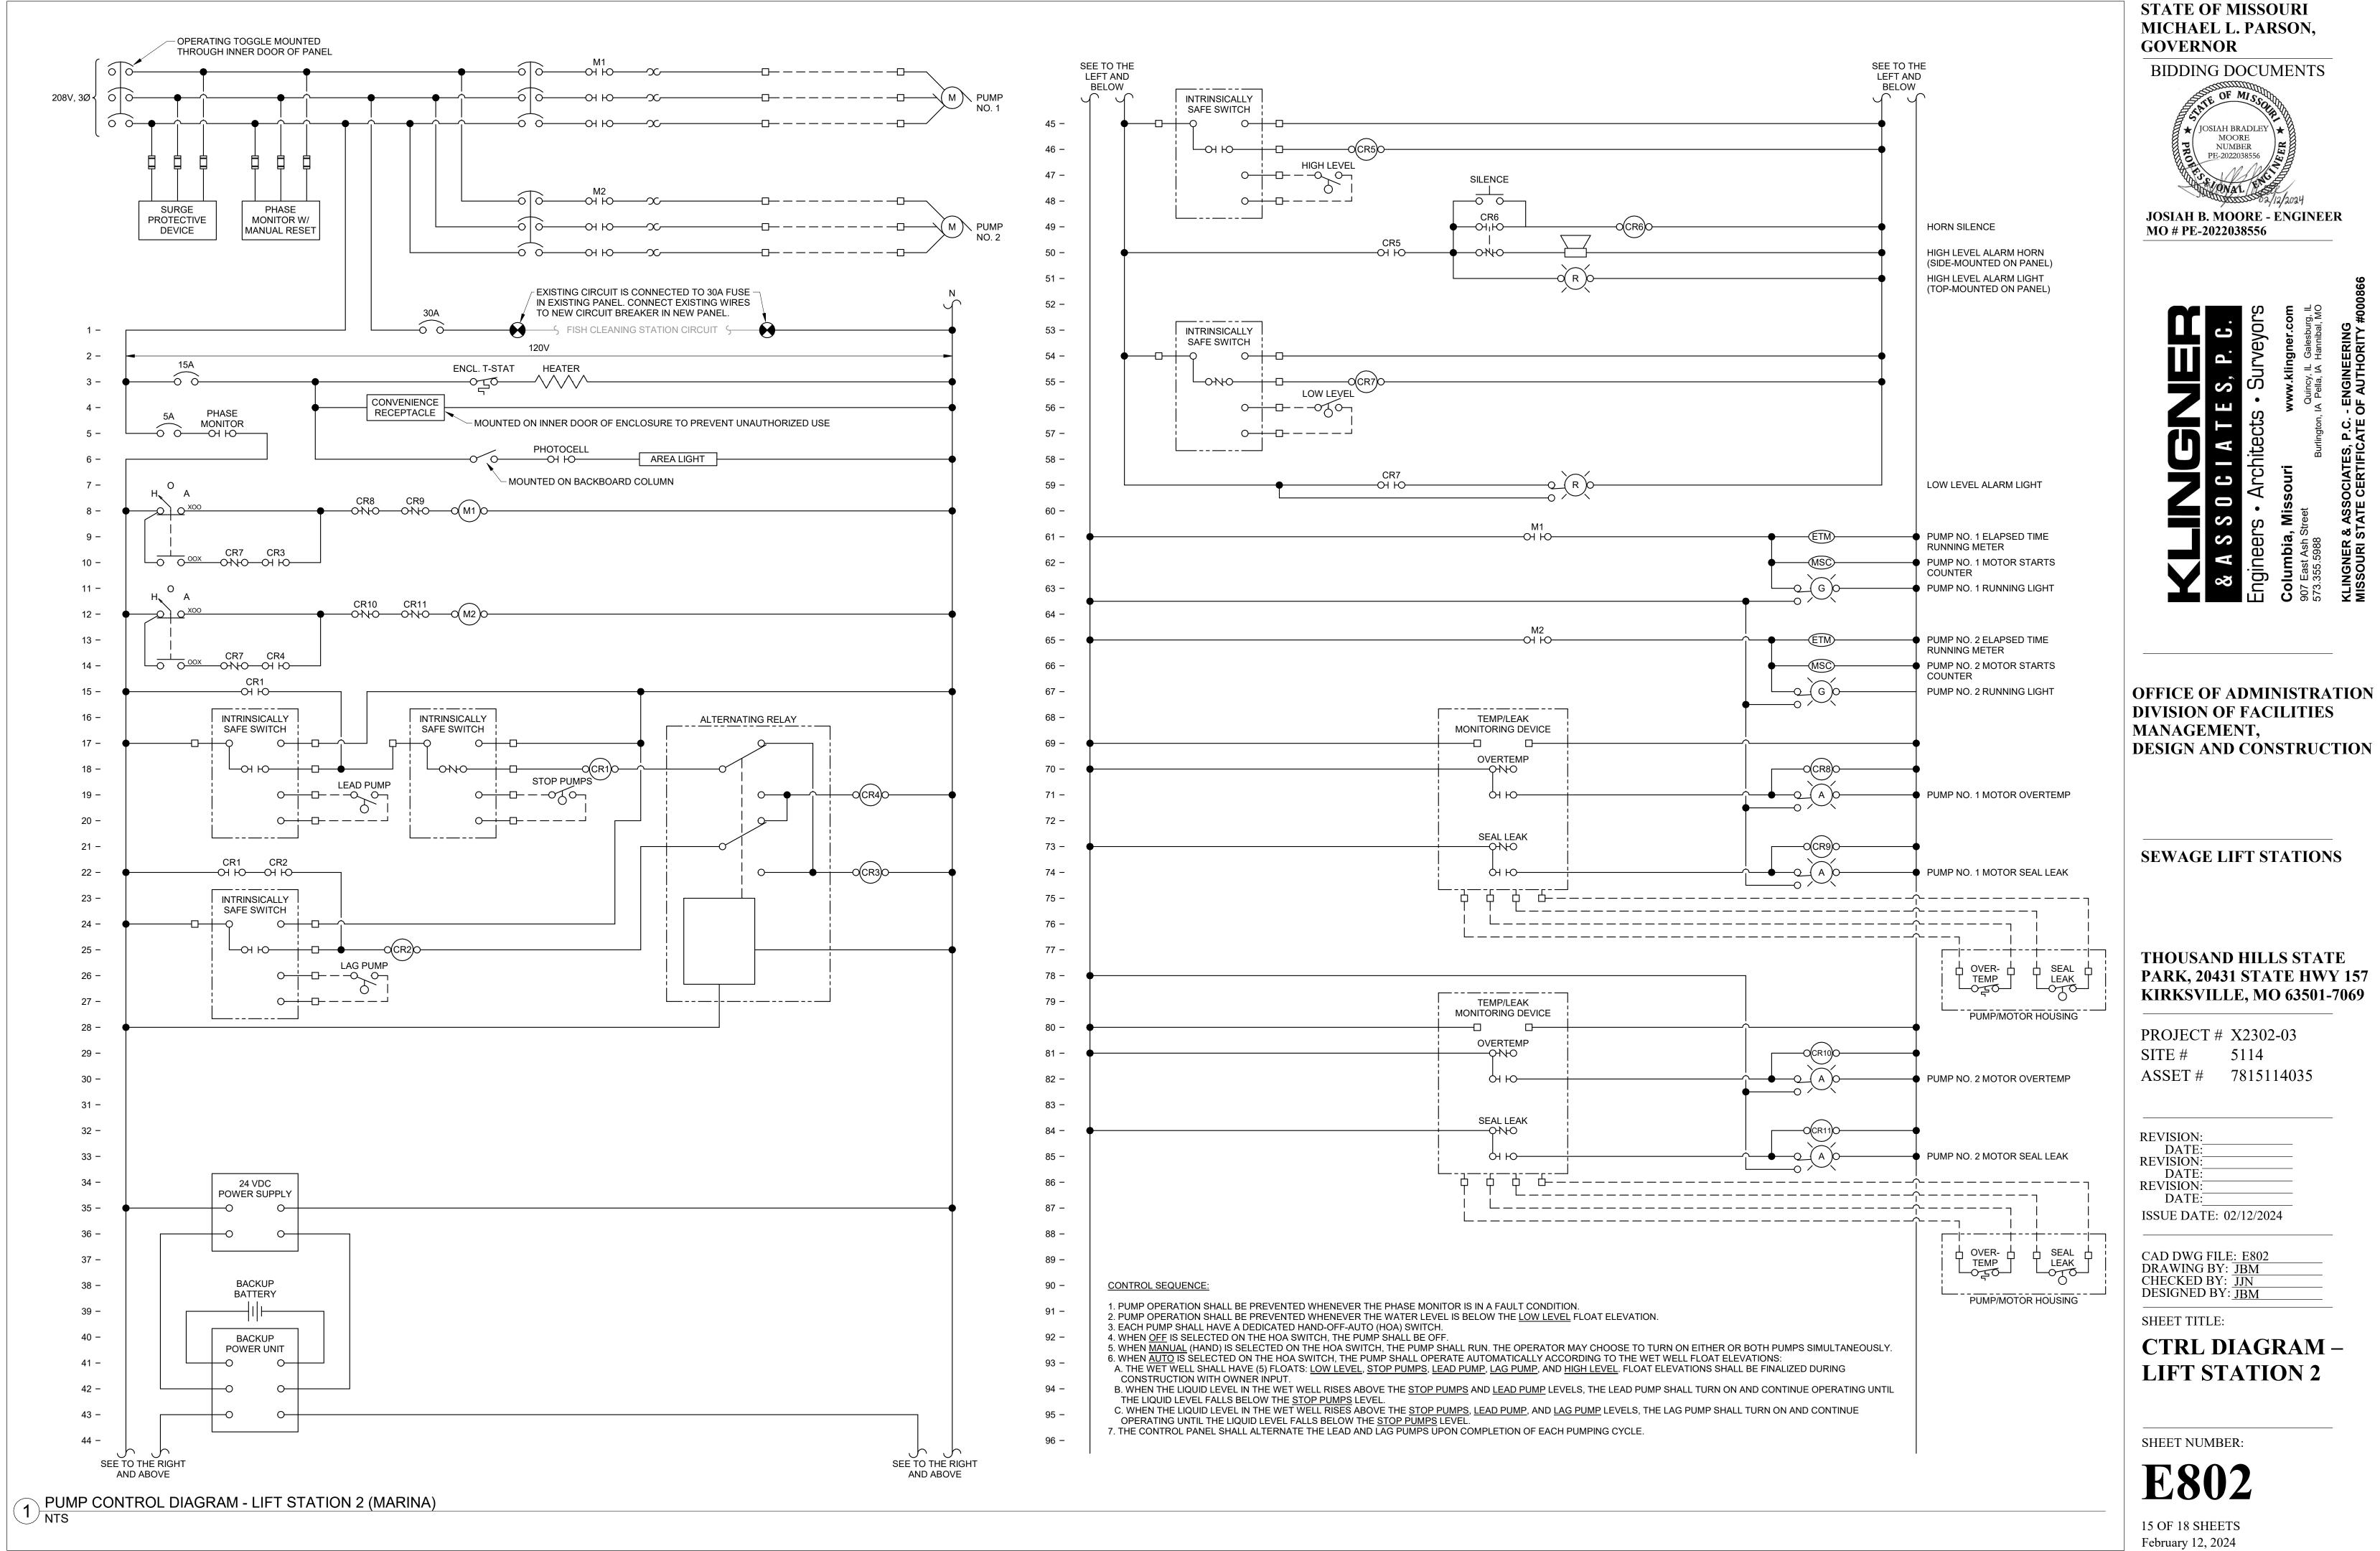February 12, 2024



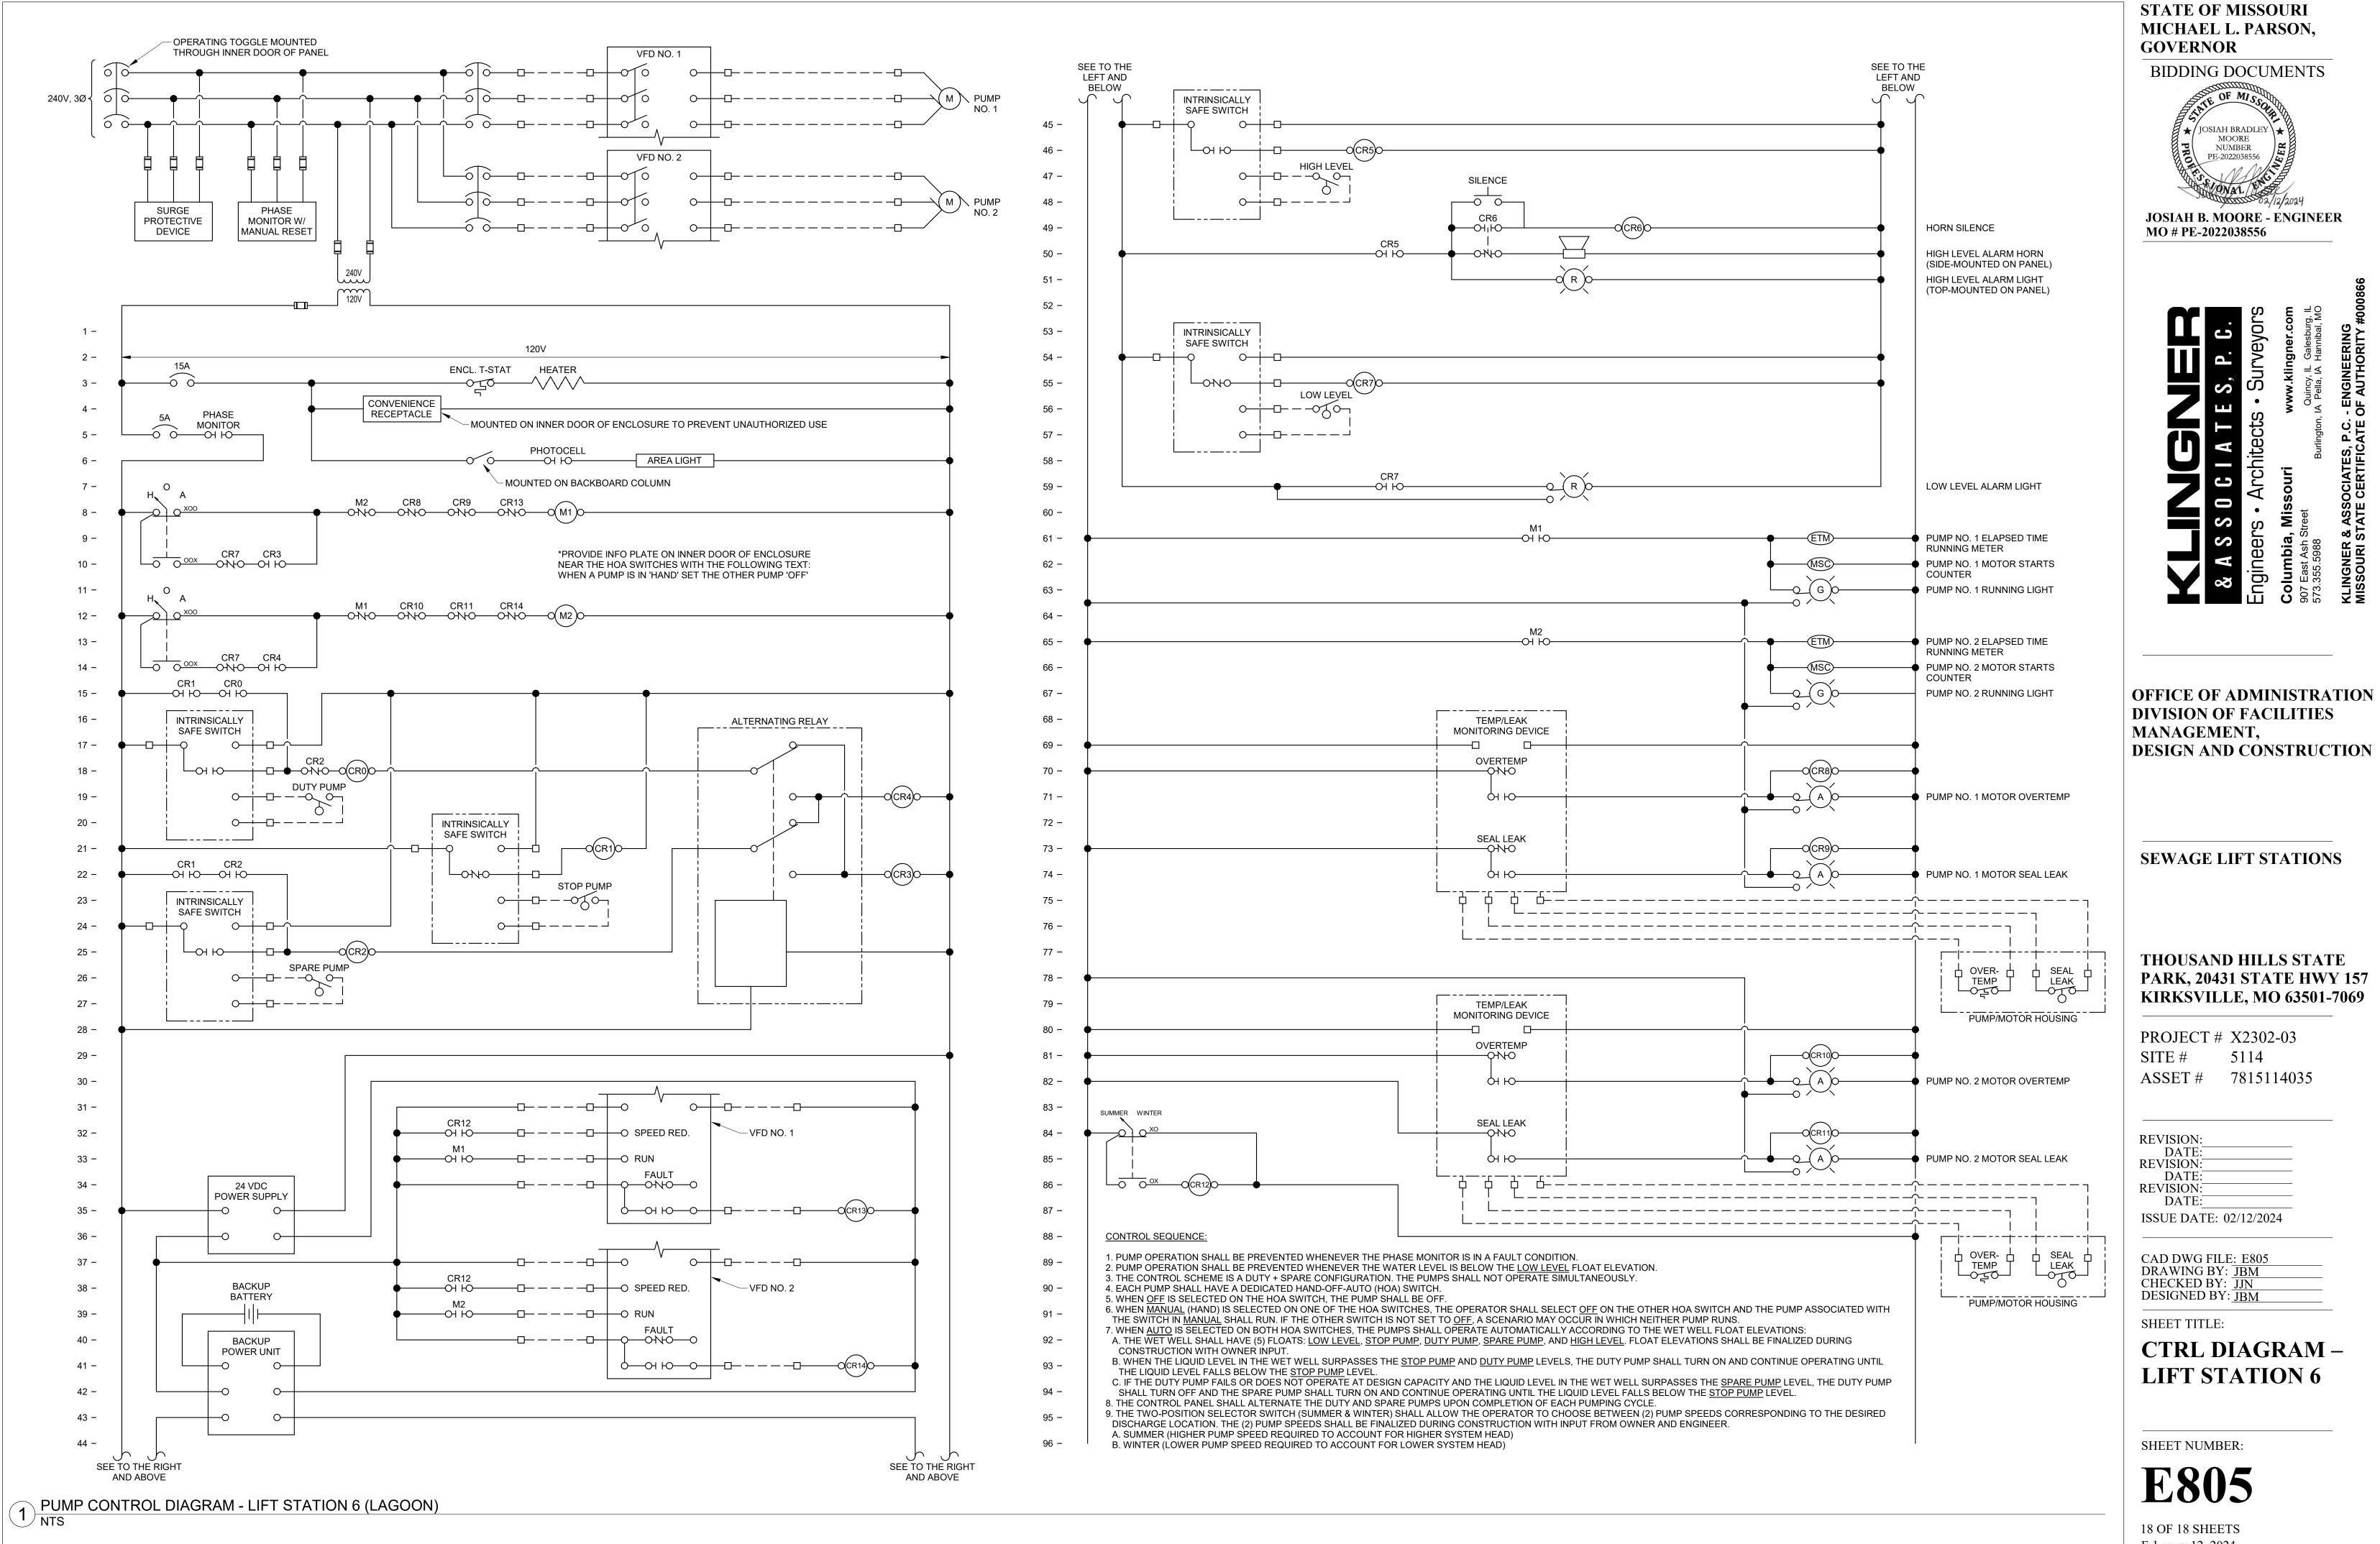

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