WATER & WASTEWATER IMPROVEMENTS GRAHAM CAVE STATE PARK DANVILLE, MISSOURI

OWNER: STATE OF MISSOURI

MICHAEL L. PARSON,

GOVERNOR

DEPARTMENT OF
NATURAL RESOURCES
MISSOURI STATE PARKS

PROJECT

OFFICE OF ADMINISTRATION

MANAGEMENT: DIVISION OF FACILITIES MANAGEMENT,

DESIGN AND CONSTRUCTION

PROJECT NUMBER: X2321-01

SITE NUMBER: 5210

ASSET NUMBER: 7815210016 - PUMP HOUSE WELL #1

7815210017 - PUMP HOUSE WELL #2 7815210025 - LAGOON SERVICE AREA

JESSE RAY

* STEPHENS *

NUMBER

* PE-2010000868 *

STONAL

JESSE RAY STEPHENS MO LICENSE - 2010000868


SITE/CIVIL ENGINEER:

ENGINEERING CONSULTANTS
1000 West Nifong, Building 1
Columbia, Missouri 65203
(573) 447-0202

www.crockettengineering.com

Crockett Engineering Consultants, LLC
Missouri Certificate of Authority
#2000151301

LOCATION MAP

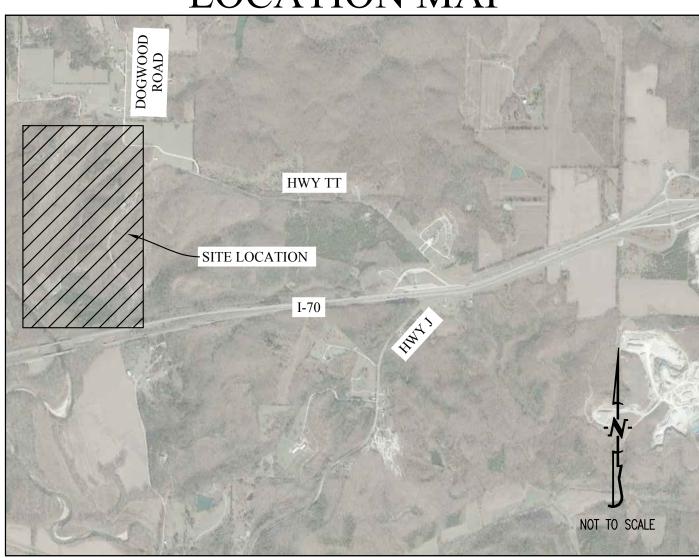

DESIGNER:

Crockett Engineering 1000 W. Nifong Building 1 Columbia, MO 65203 573-447-0292

SHEET INDEX

G001 - COVER SHEET

G002 - SITE LOCATION AND CONTROL PLAN

D101 - SEWER DEMOLITION PLAN - CAMPGROUND

D102 - WELE HOUSE DEMOLITION TEAN - CAMINGRO D103 - SEWER DEMOLITION PLAN - PARK OFFICE

D104 - WELL HOUSE DEMOLITION PLAN - PARK OFFICE

D105 - PAVILLION/PLAYGROUND DEMOLITION PLAN

C101 - SEWER GRADING PLAN - CAMPGROUND C102 - SEWER GRADING PLAN - PARK OFFICE

C201 - SEWER DRIP IRRIGATION PLAN - CAMPGROUND C202 - WELL HOUSE SITE PLAN - CAMPGROUND

C203 - SEWER DRIP IRRIGATION PLAN - PARK OFFICE

C204 - WELL HOUSE SITE PLAN - PARK OFFICE

C205 - PAVILLION/PLAYGROUND WATER PLAN

C301 - DRIP IRRIGATION DETAILS

C302 - SITE CONSTRUCTION DETAILS

S-101 - WELL HOUSE BUILDING CODE CRITERIA

S-102 - WELL HOUSE BUILDING PLAN AND ELEVATIONS

S-103 - WELL HOUSE STRUCTURAL DETAILS

E-101 - WELL HOUSE EQUIPMENT PLAN

E-102 - ELECTRICAL PLAN






TELEPHONE:

573-581-3630

AT&T 2210 HIGHWAY K O'FALLON, MO 63368 314-420-1973



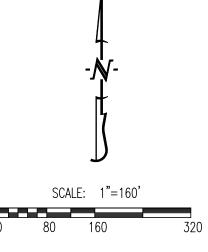

CONTROL POINTS:

CP 1241 - PK NAIL IN ASPHALT NEAR PARK OFFICE

- NORTHING = 1120782.21
- EASTING = 1903066.32ELEVATION = 758.39

CP 2582 - PK NAIL IN ASPHALT NEAR CAMPGROUND - NORTHING = 1121694.31

- EASTING = 1901803.51ELEVATION = 755.47
- CP 3260 PK NAIL IN ASPHALT NEAR PAVILLION/PLAYGROUND
- NORTHING = 1119025.31EASTING = 1903197.92
- EASTING = 1903197.9 - ELEVATION = 580.48

LEGEND OF SYMBOLS:

LEGEND OF	SYMBOLS:
	EXISTING CURB
	PROPOSED CURB
	RIP RAP
	EXISTING STRUCTURE
~~~~	EXISTING TREELINE
~~~~	PROPOSED TREELINE
000	EDGE OF WATERWAY
— w — —	EXISTING WATERLINE
w	PROPOSED WATERLINE
—— G ——	EXISTING GAS LINE
G	PROPOSED GAS LINE
UT	EXISTING UNDERGROUND TELEPHONE
— — —UTV — — —	EXISTING UNDERGROUND CABLE TELEVISIO
— — – HVE— — —	EXISTING HIGH VOLTAGE ELECTRIC
—— OE ——	EXISTING OVERHEAD ELECTRIC
— — —UE — — —	EXISTING UNDERGROUND ELECTRIC
—— OETV ——	EXISTING OVERHEAD ELEC. & TV
— — OETVT — —	EXISTING OVERHEAD ELEC., TV & TELE.
—— s ——	EXISTING SANITARY SEWER
—— s ——	PROPOSED SANITARY SEWER
XXX	EXISTING MINOR CONTOUR
XXX	EXISTING MAJOR CONTOUR
XXX	PROPOSED MINOR CONTOUR
XXX	PROPOSED MAJOR CONTOUR
	100 YEAR FLOOD PLAIN
111111111	
· · ·	ORDINARY HIGH WATER MARK
·	STREAM SIDE BUFFER
	OUTER STREAM BUFFER


EXISTING GAS VALVE
EXISTING WATER VALVE
EXISTING GAS METER
EXISTING WATER METER
EXISTING FIRE HYDRANT
MANHOLE
EXISTING SANITARY SEWER LATERAL
PROPOSED SANITARY SEWER LATERAL
PROPOSED TRACER WIRE TEST STATION BOX
EXISTING AIR CONDITIONER
EXISTING TELEPHONE PEDESTAL
EXISTING ELECTRICAL TRANSFORMER
EXISTING ELECTRIC METER

EXISTING SIGNS

EXISTING POWER POLE

EXISTING LIGHT POLE

EXISTING GUY WIRE

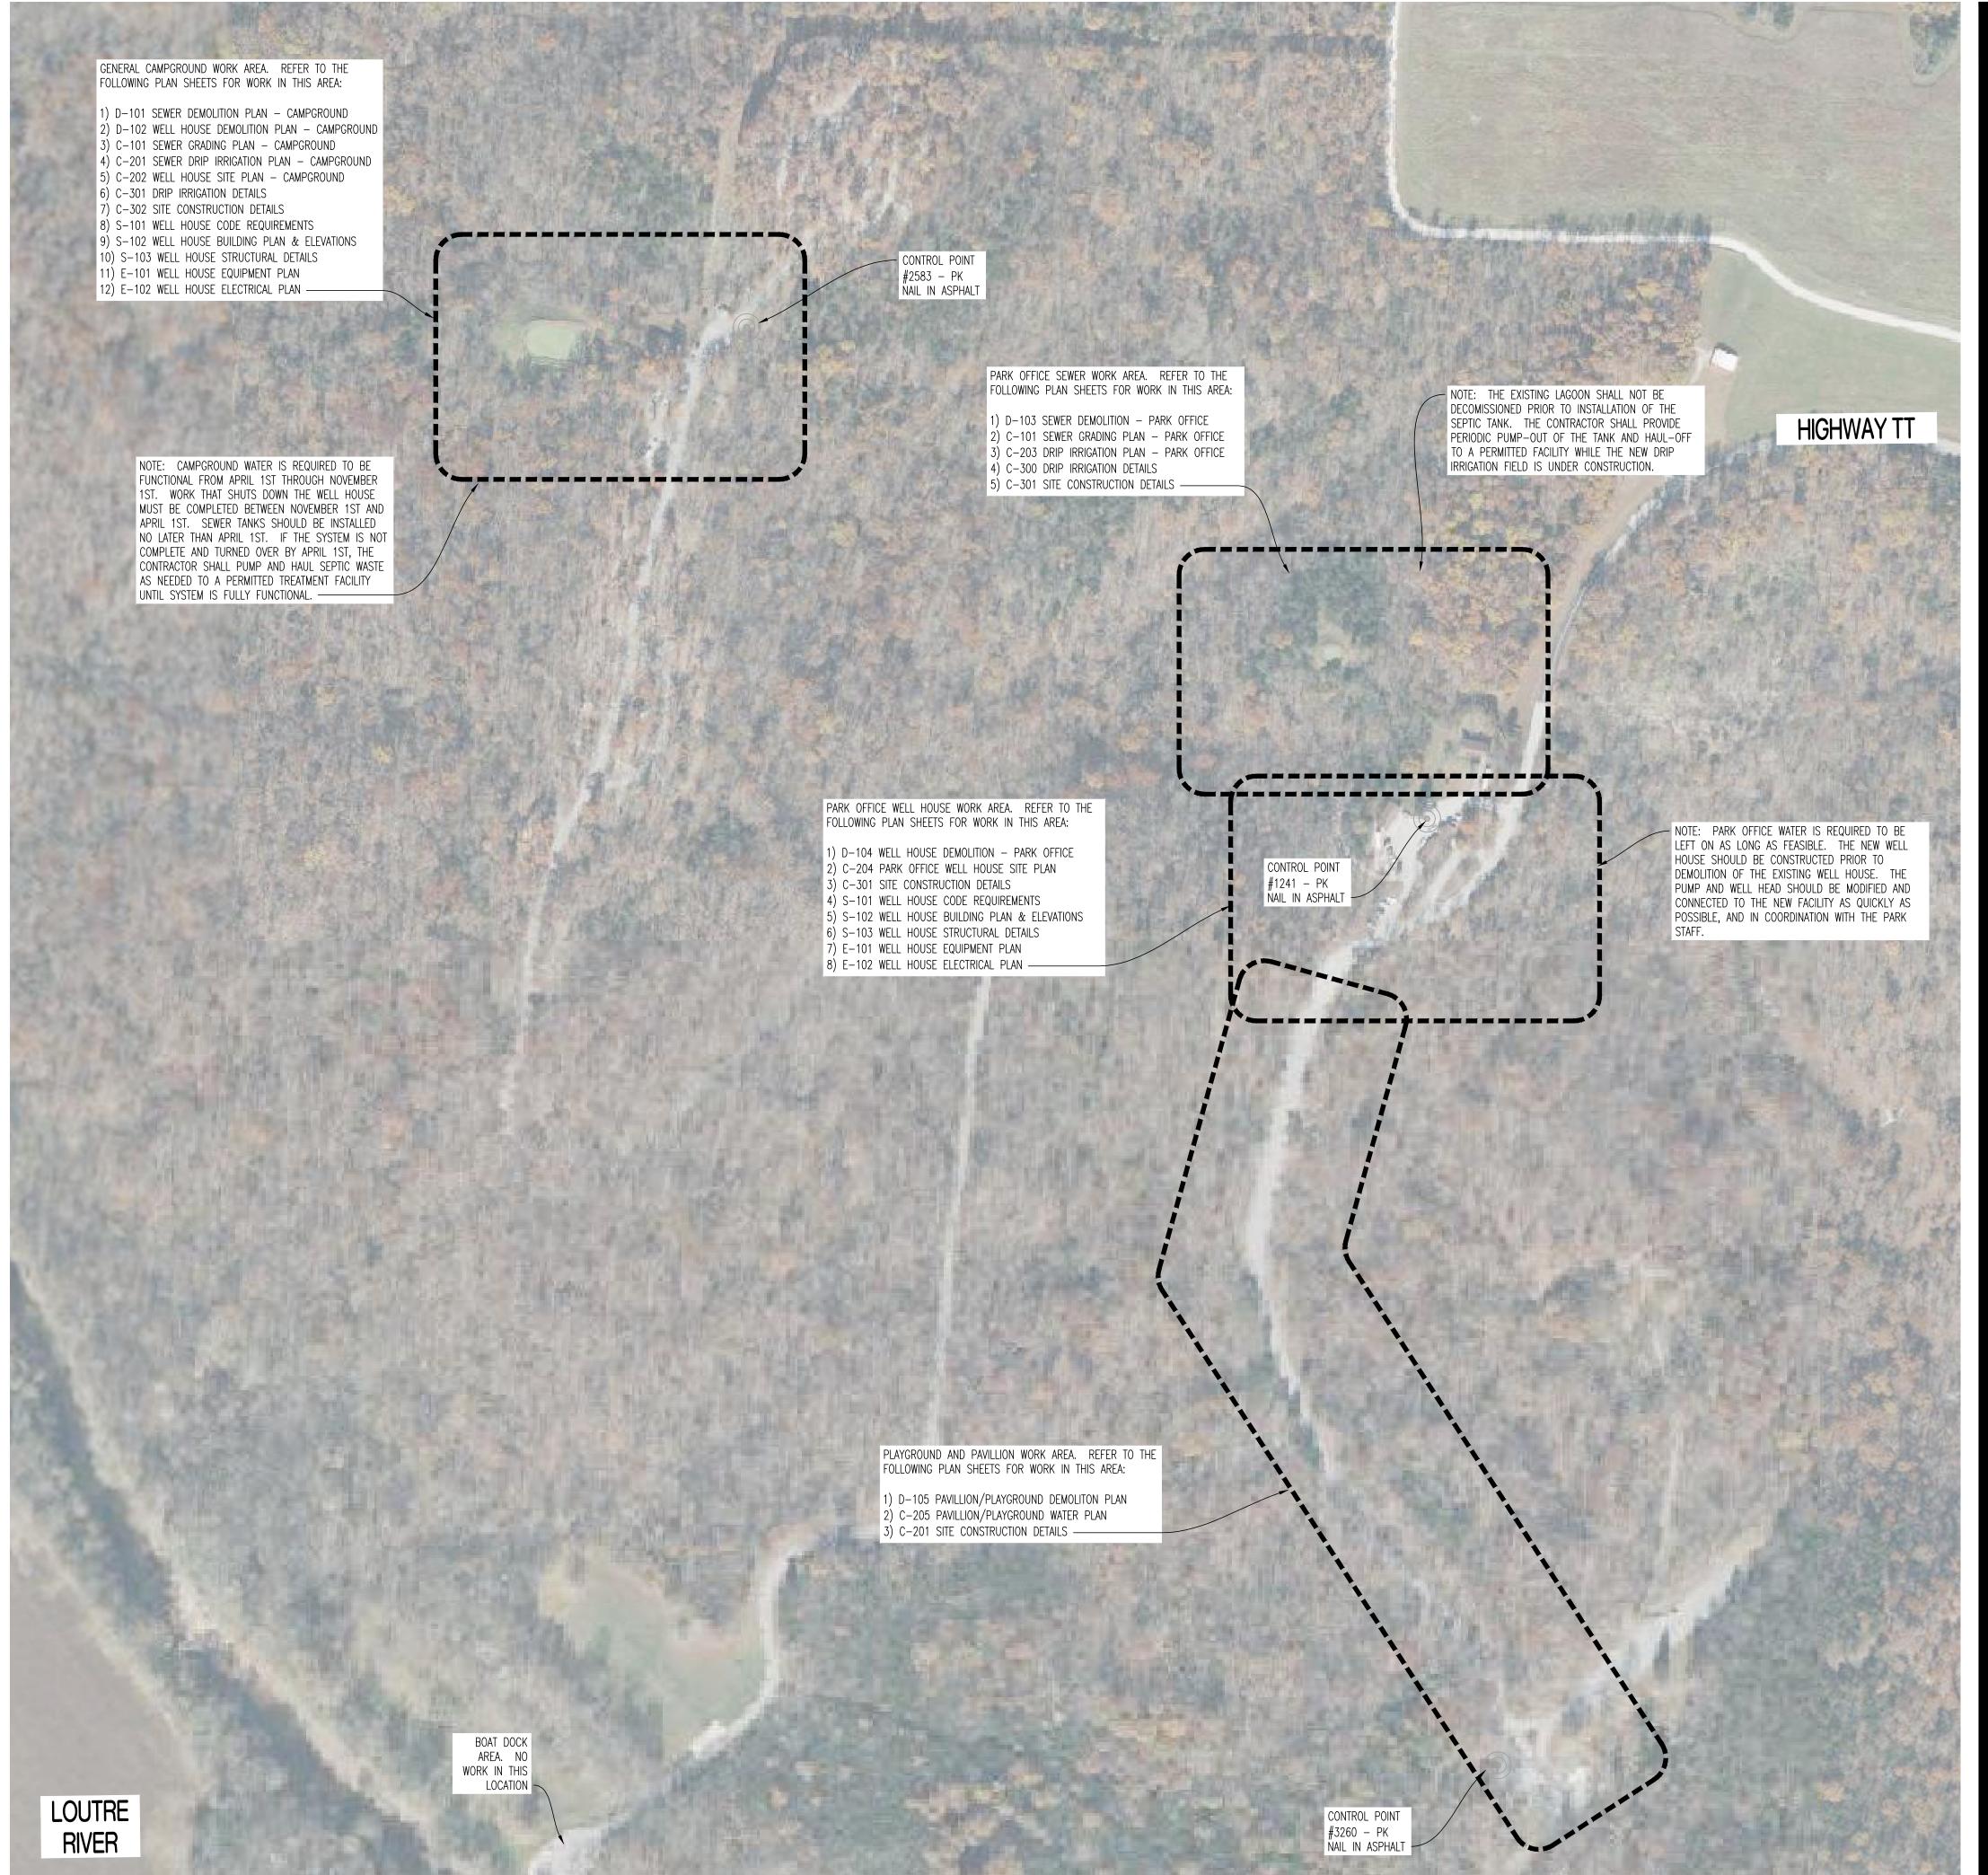

STATE OF MISSOURI MICHAEL L. PARSON, GOVERNOR



JESSE RAY STEPHENS MO LICENSE - 2010000868

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OFFICE OF ADMINISTRATION DIVISION OF FACILITIES MANAGEMENT, DESIGN AND CONSTRUCTION

730 TRUMAN BUILDING 301 WEST HIGH STREET POST OFFICE BOX 809 JEFFERSON CITY, MO 65102

IMPROVEMENTS TO WATER AND WASTEWATER SYSTEM MULTIPLE ASSETS

GRAHAM CAVE STATE PARK 217 HIGHWAY TT DANVILLE, MO 63361

PROJECT # X2321-01 SITE NUMBER: 5210 ASSET NUMBER: 7815210016 - PUMP HOUSE WELL #1 7815210017 - PUMP HOUSE WELL #2 7815210025 - LAGOON SERVICE AREA

REVISION:
DATE:
REVISION:
DATE:
REVISION:
DATE:
ISSUE DATE: 09/09/2024

CAD DWG FILE: 230188_GRAHAM CIVIL DRAWN BY: JRS CHECKED BY: ATG DESIGNED BY: JRS

SHEET TITLE:


SITE LOCATION & CONTROL PLAN

SHEET NUMBER:


CROCKETT PROJECT #230188

G-002


SHEET 2 OF 21

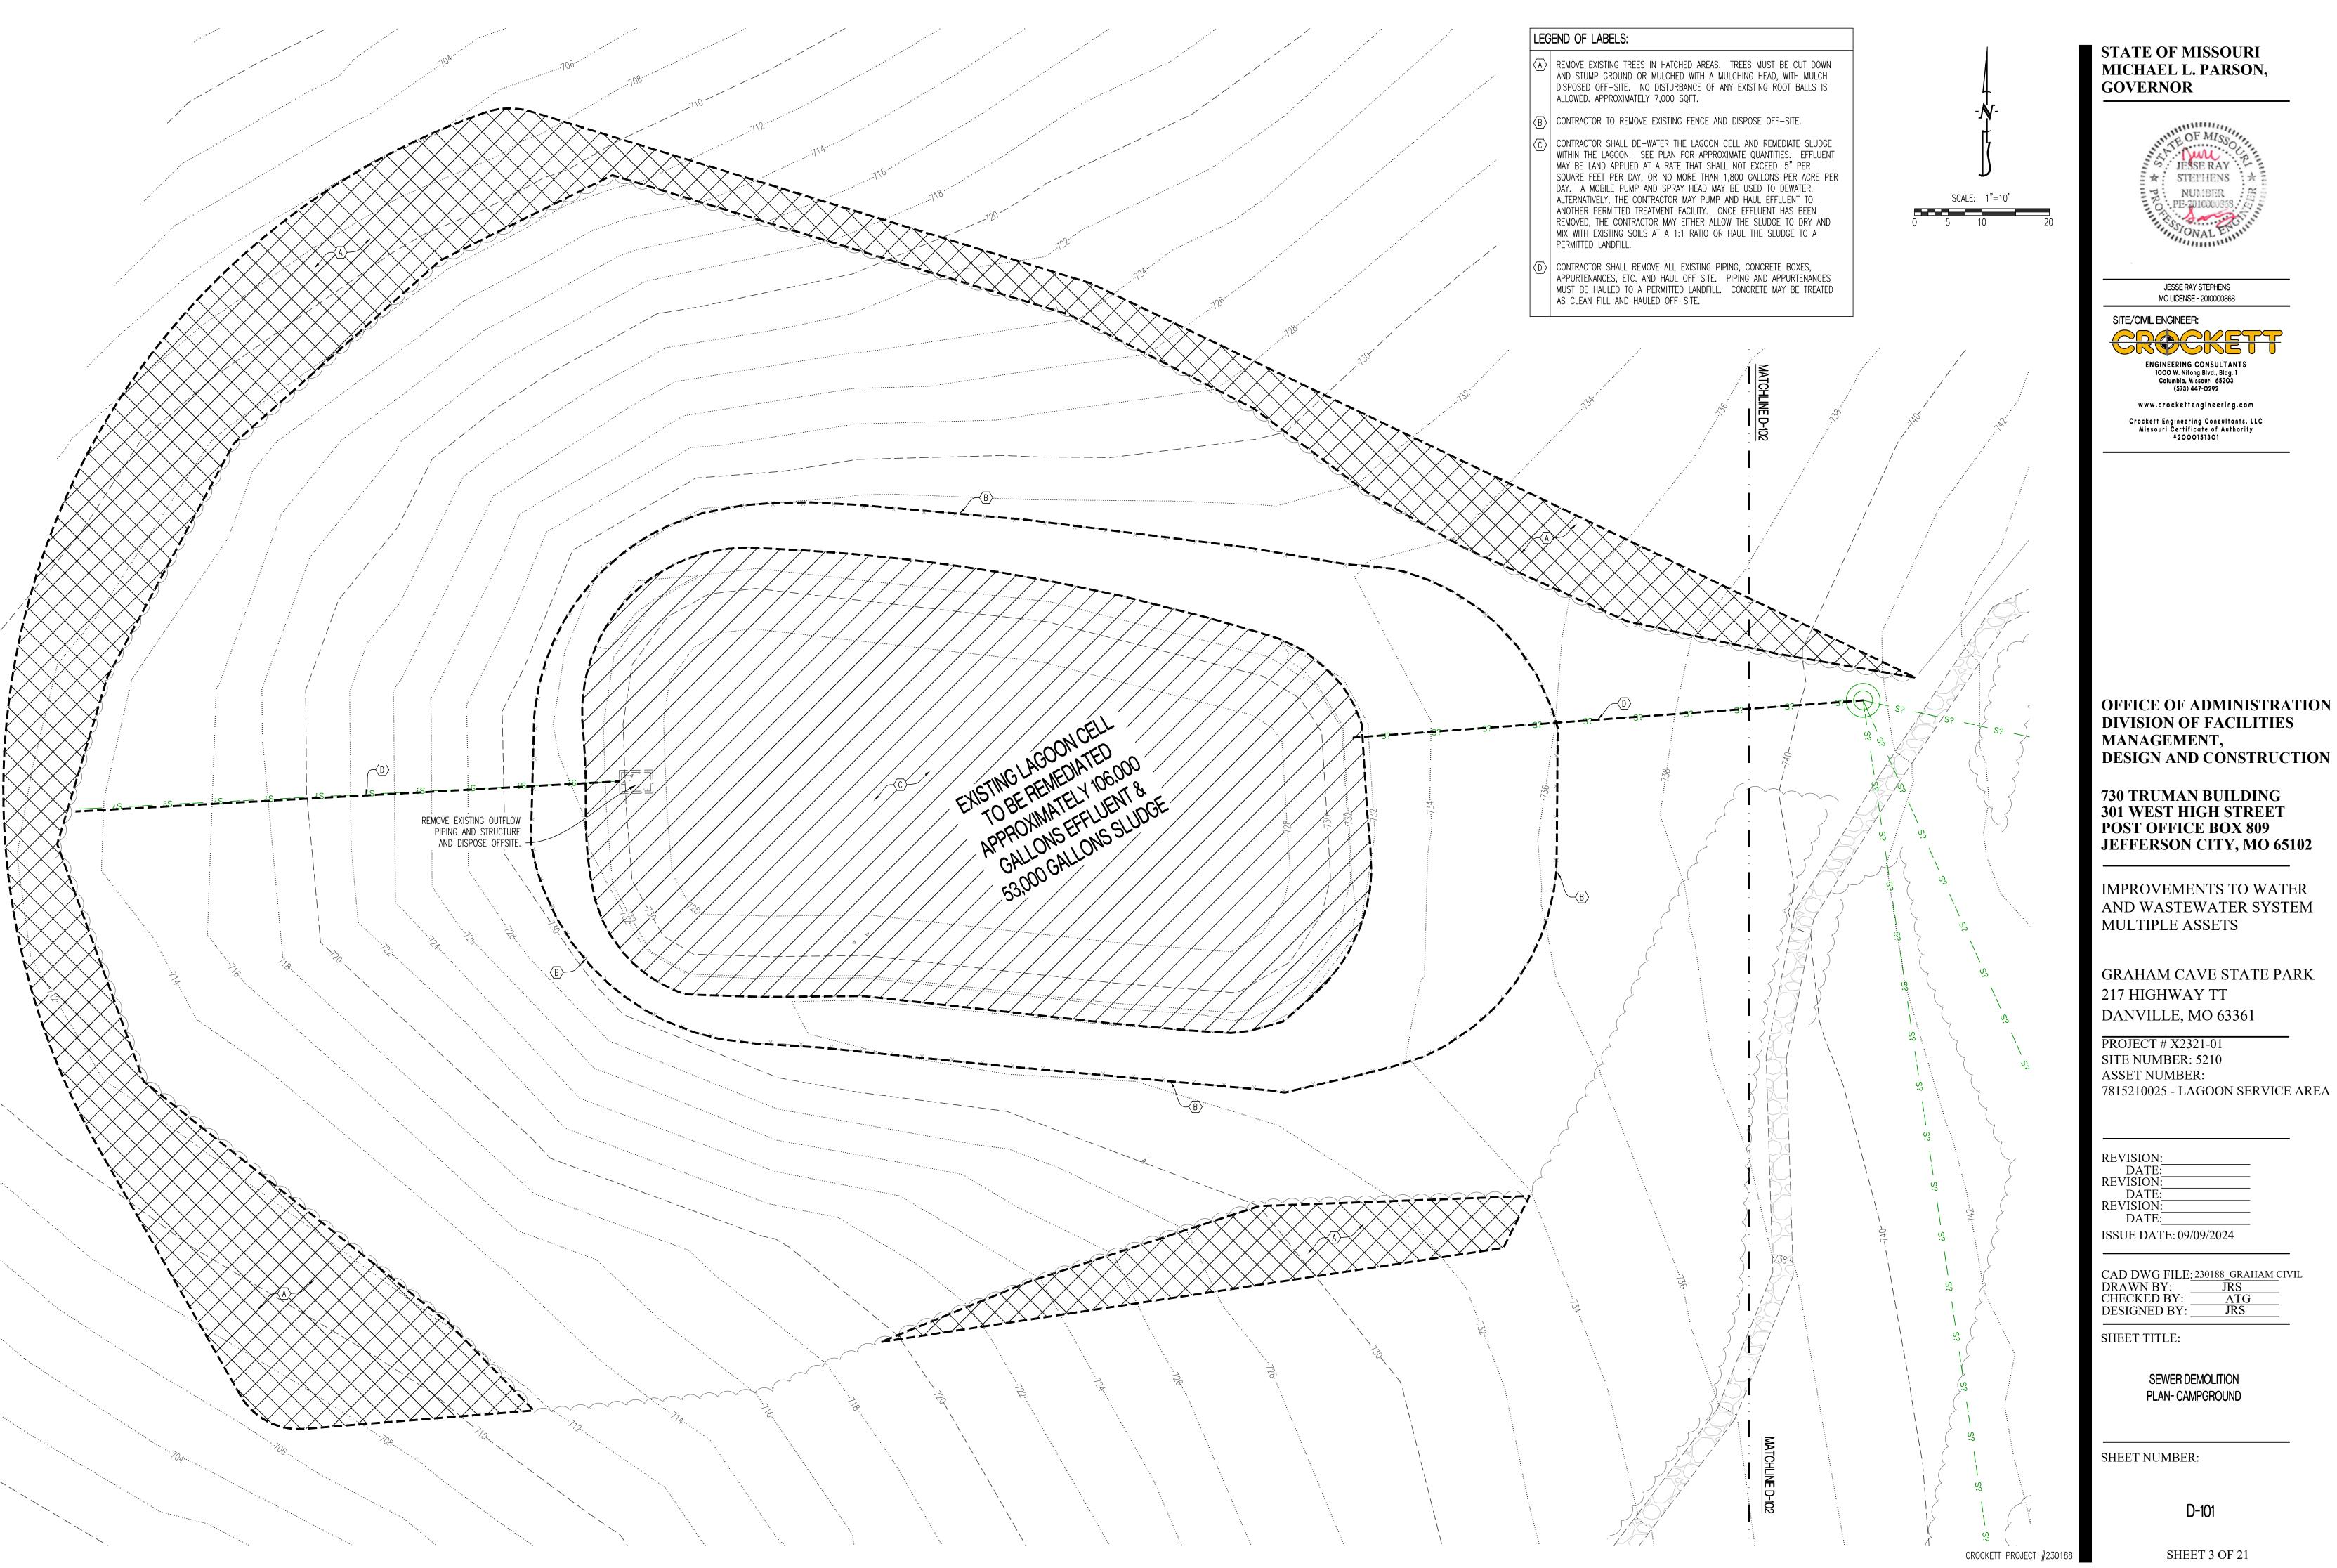

OFFICE OF ADMINISTRATION

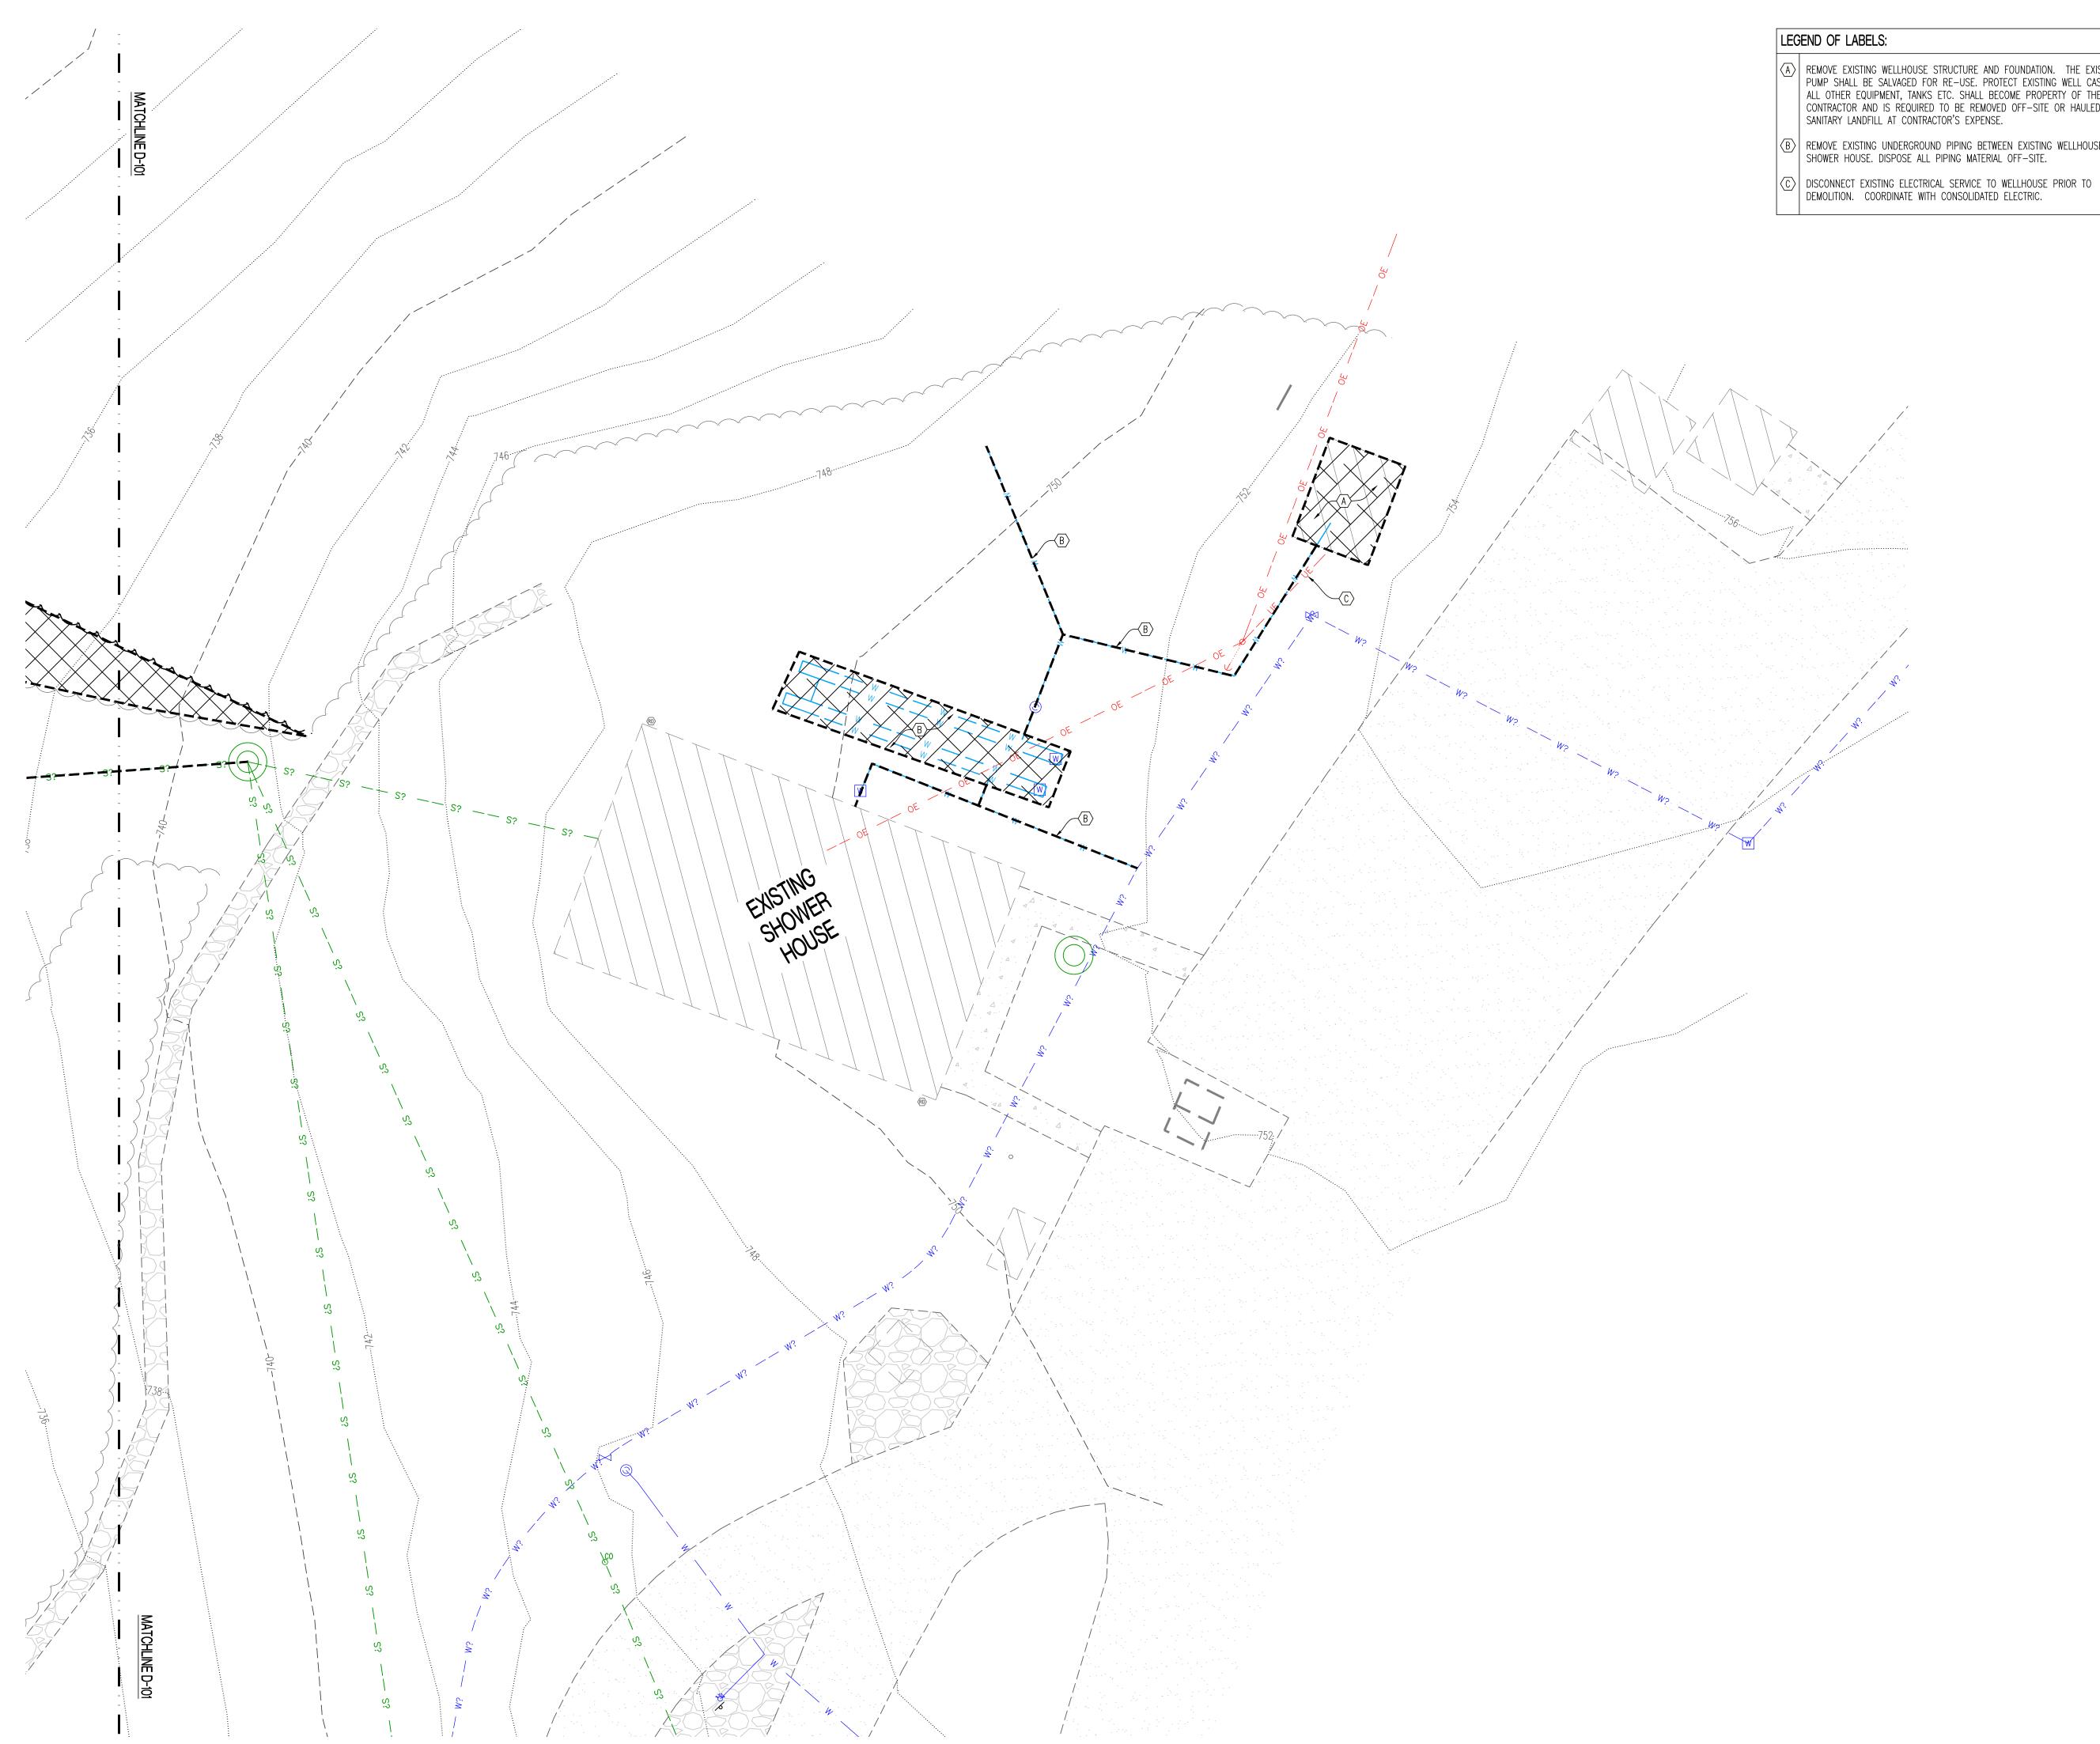

- REMOVE EXISTING WELLHOUSE STRUCTURE AND FOUNDATION. THE EXISTING PUMP SHALL BE SALVAGED FOR RE-USE. PROTECT EXISTING WELL CASING. ALL OTHER EQUIPMENT, TANKS ETC. SHALL BECOME PROPERTY OF THE CONTRACTOR AND IS REQUIRED TO BE REMOVED OFF-SITE OR HAULED TO A SANITARY LANDFILL AT CONTRACTOR'S EXPENSE.
- (B) REMOVE EXISTING UNDERGROUND PIPING BETWEEN EXISTING WELLHOUSE AND SHOWER HOUSE. DISPOSE ALL PIPING MATERIAL OFF—SITE.

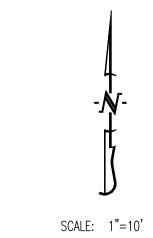



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IMPROVEMENTS TO WATER AND WASTEWATER SYSTEM MULTIPLE ASSETS

GRAHAM CAVE STATE PARK 217 HIGHWAY TT DANVILLE, MO 63361

PROJECT # X2321-01 SITE NUMBER: 5210 ASSET NUMBER: 7815210016 - PUMP HOUSE WELL #1 7815210017 - PUMP HOUSE WELL #3

REVISION:
DATE:
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REVISION:
DATE:
ISSUE DATE: 09/09/2024

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DRAWN BY: JRS
CHECKED BY: ATG
DESIGNED BY: JRS


SHEET TITLE:

WELL HOUSE DEMOLITION PLAN -CAMPGROUND

SHEET NUMBER:

D-102

SHEET 4 OF 21

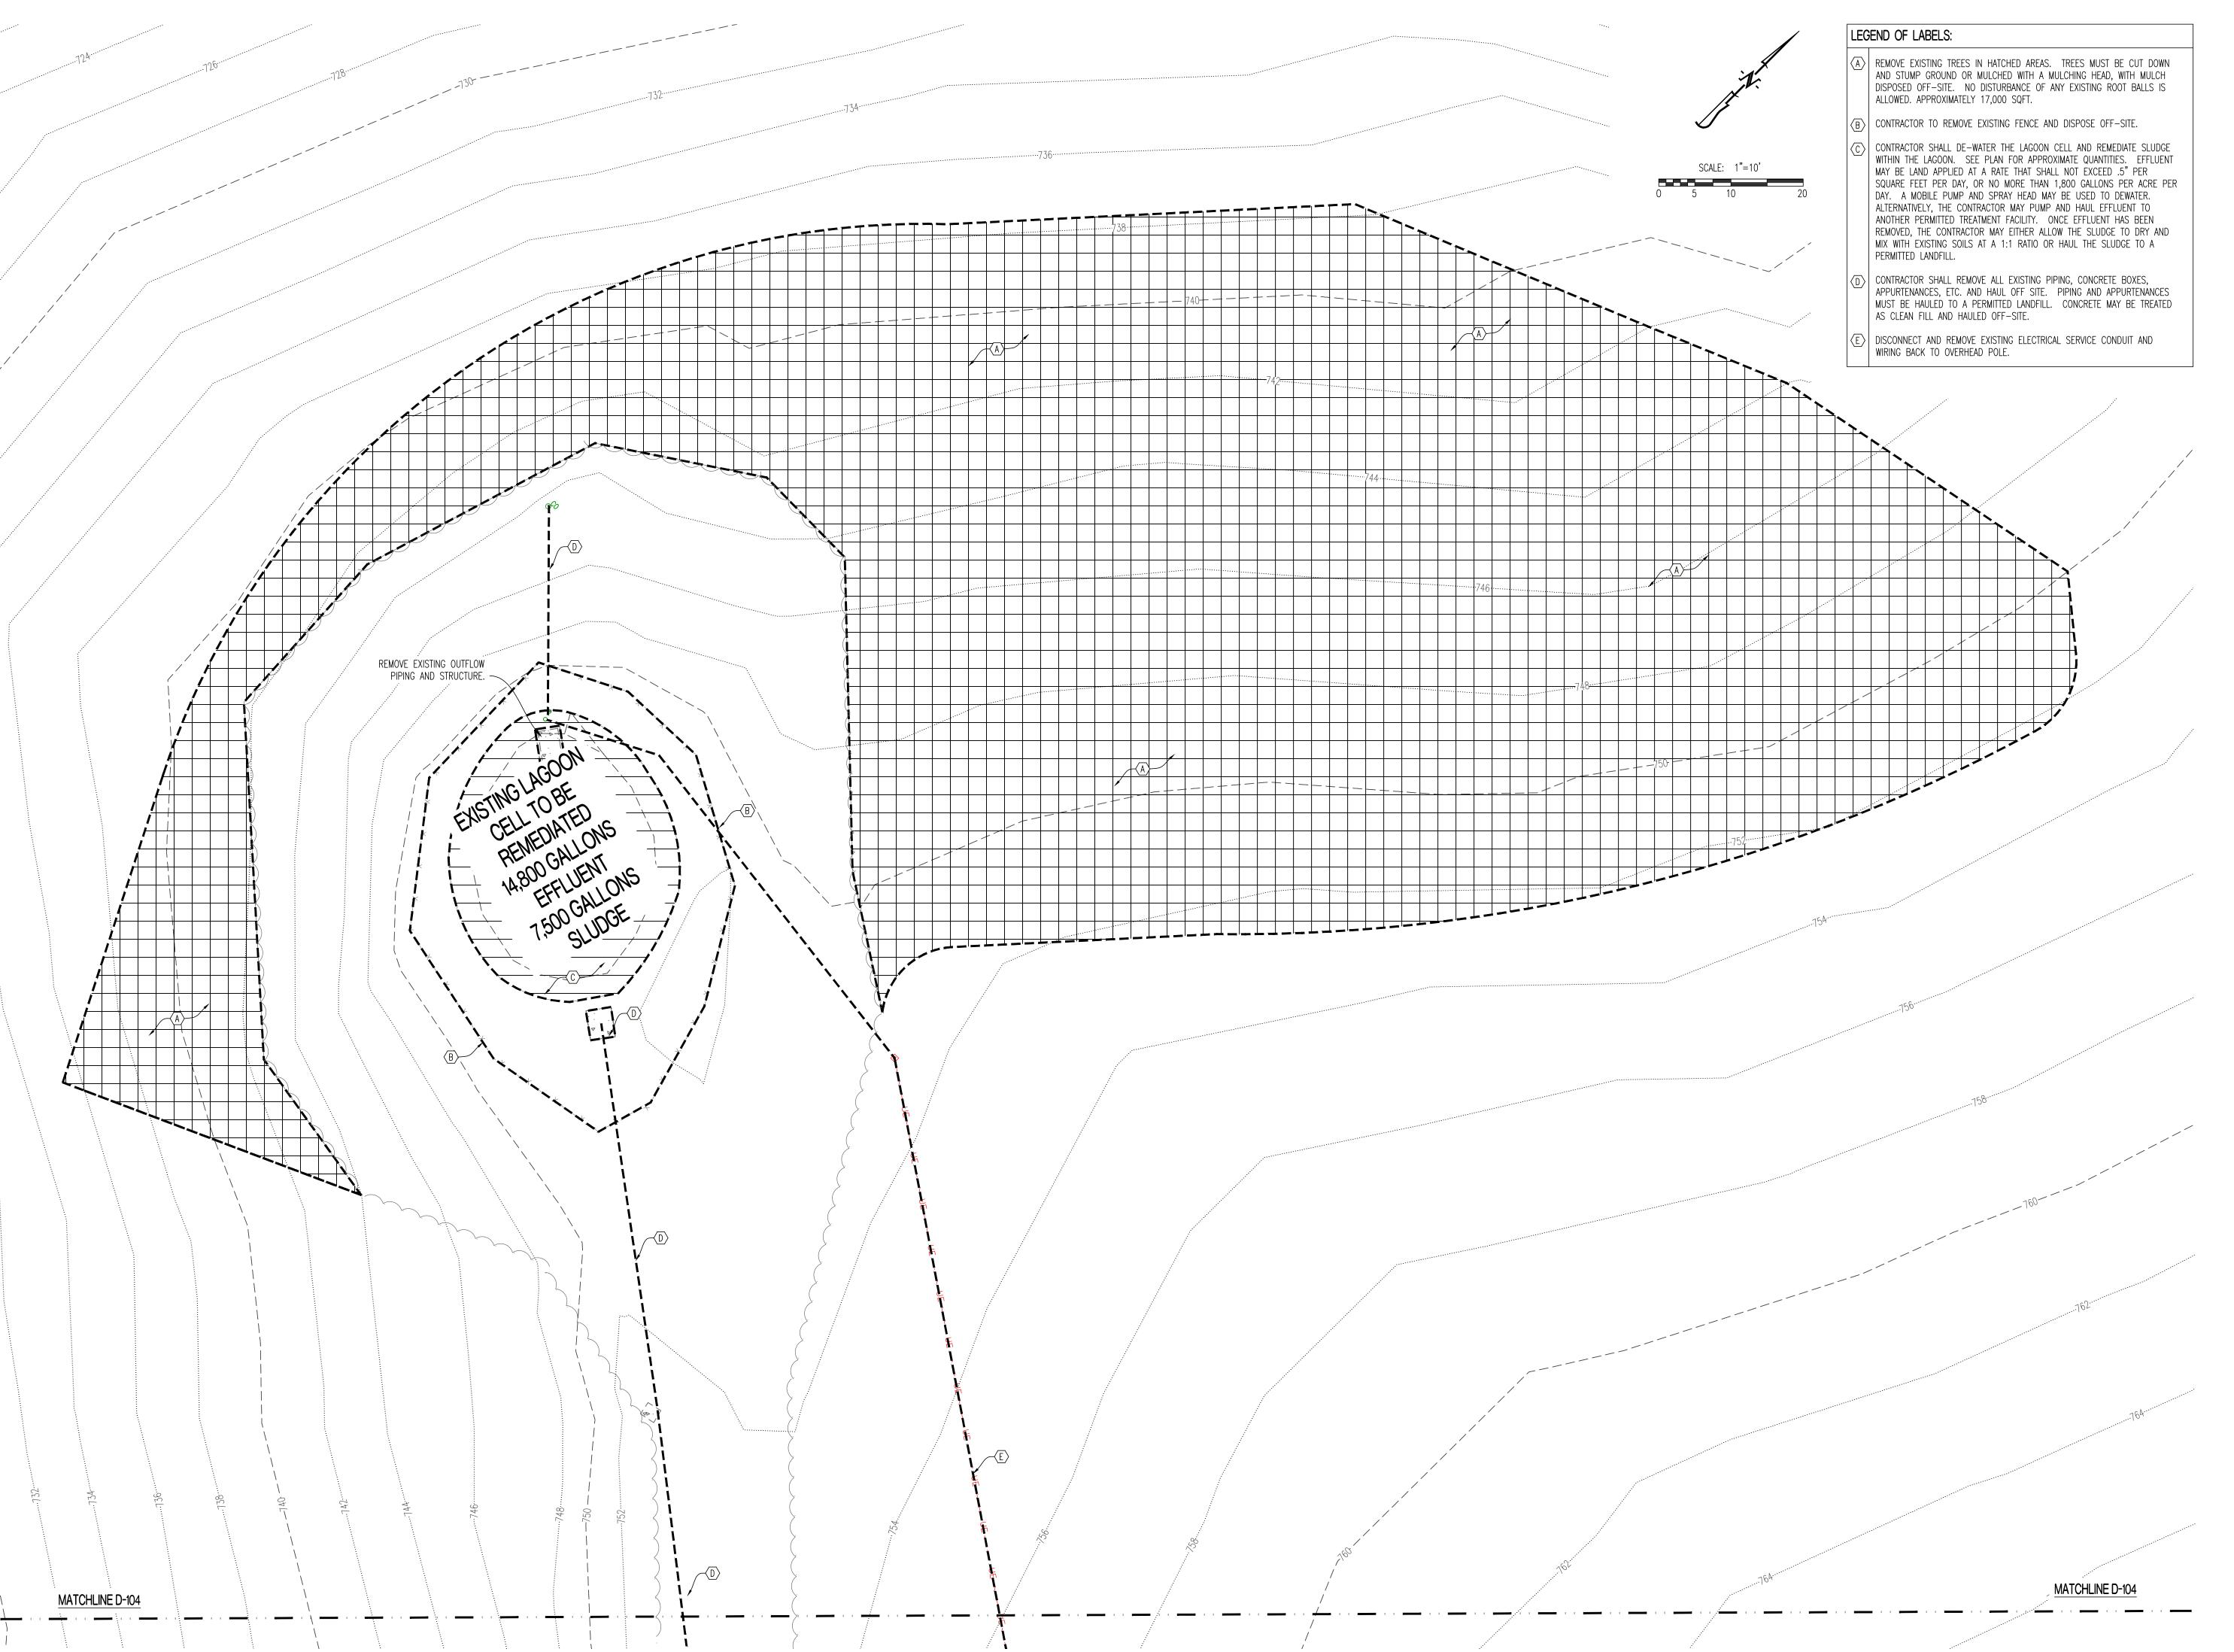



JESSE RAY STEPHENS MO LICENSE - 2010000868

SITE/CIVIL ENGINEER:

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730 TRUMAN BUILDING 301 WEST HIGH STREET POST OFFICE BOX 809 JEFFERSON CITY, MO 65102

IMPROVEMENTS TO WATER AND WASTEWATER SYSTEM MULTIPLE ASSETS

GRAHAM CAVE STATE PARK 217 HIGHWAY TT DANVILLE, MO 63361

PROJECT # X2321-01 SITE NUMBER: 5210 ASSET NUMBER: 7815210025 - LAGOON SERVICE AREA

REVISION:	
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REVISION:	
DATE.	

ISSUE DATE: 09/09/2024

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CHECKED BY:	ATG
DESIGNED BY:	JRS


SHEET TITLE:

SEWER DEMOLITION PLAN - PARK OFFICE

SHEET NUMBER:

D-103

SHEET 5 OF 21

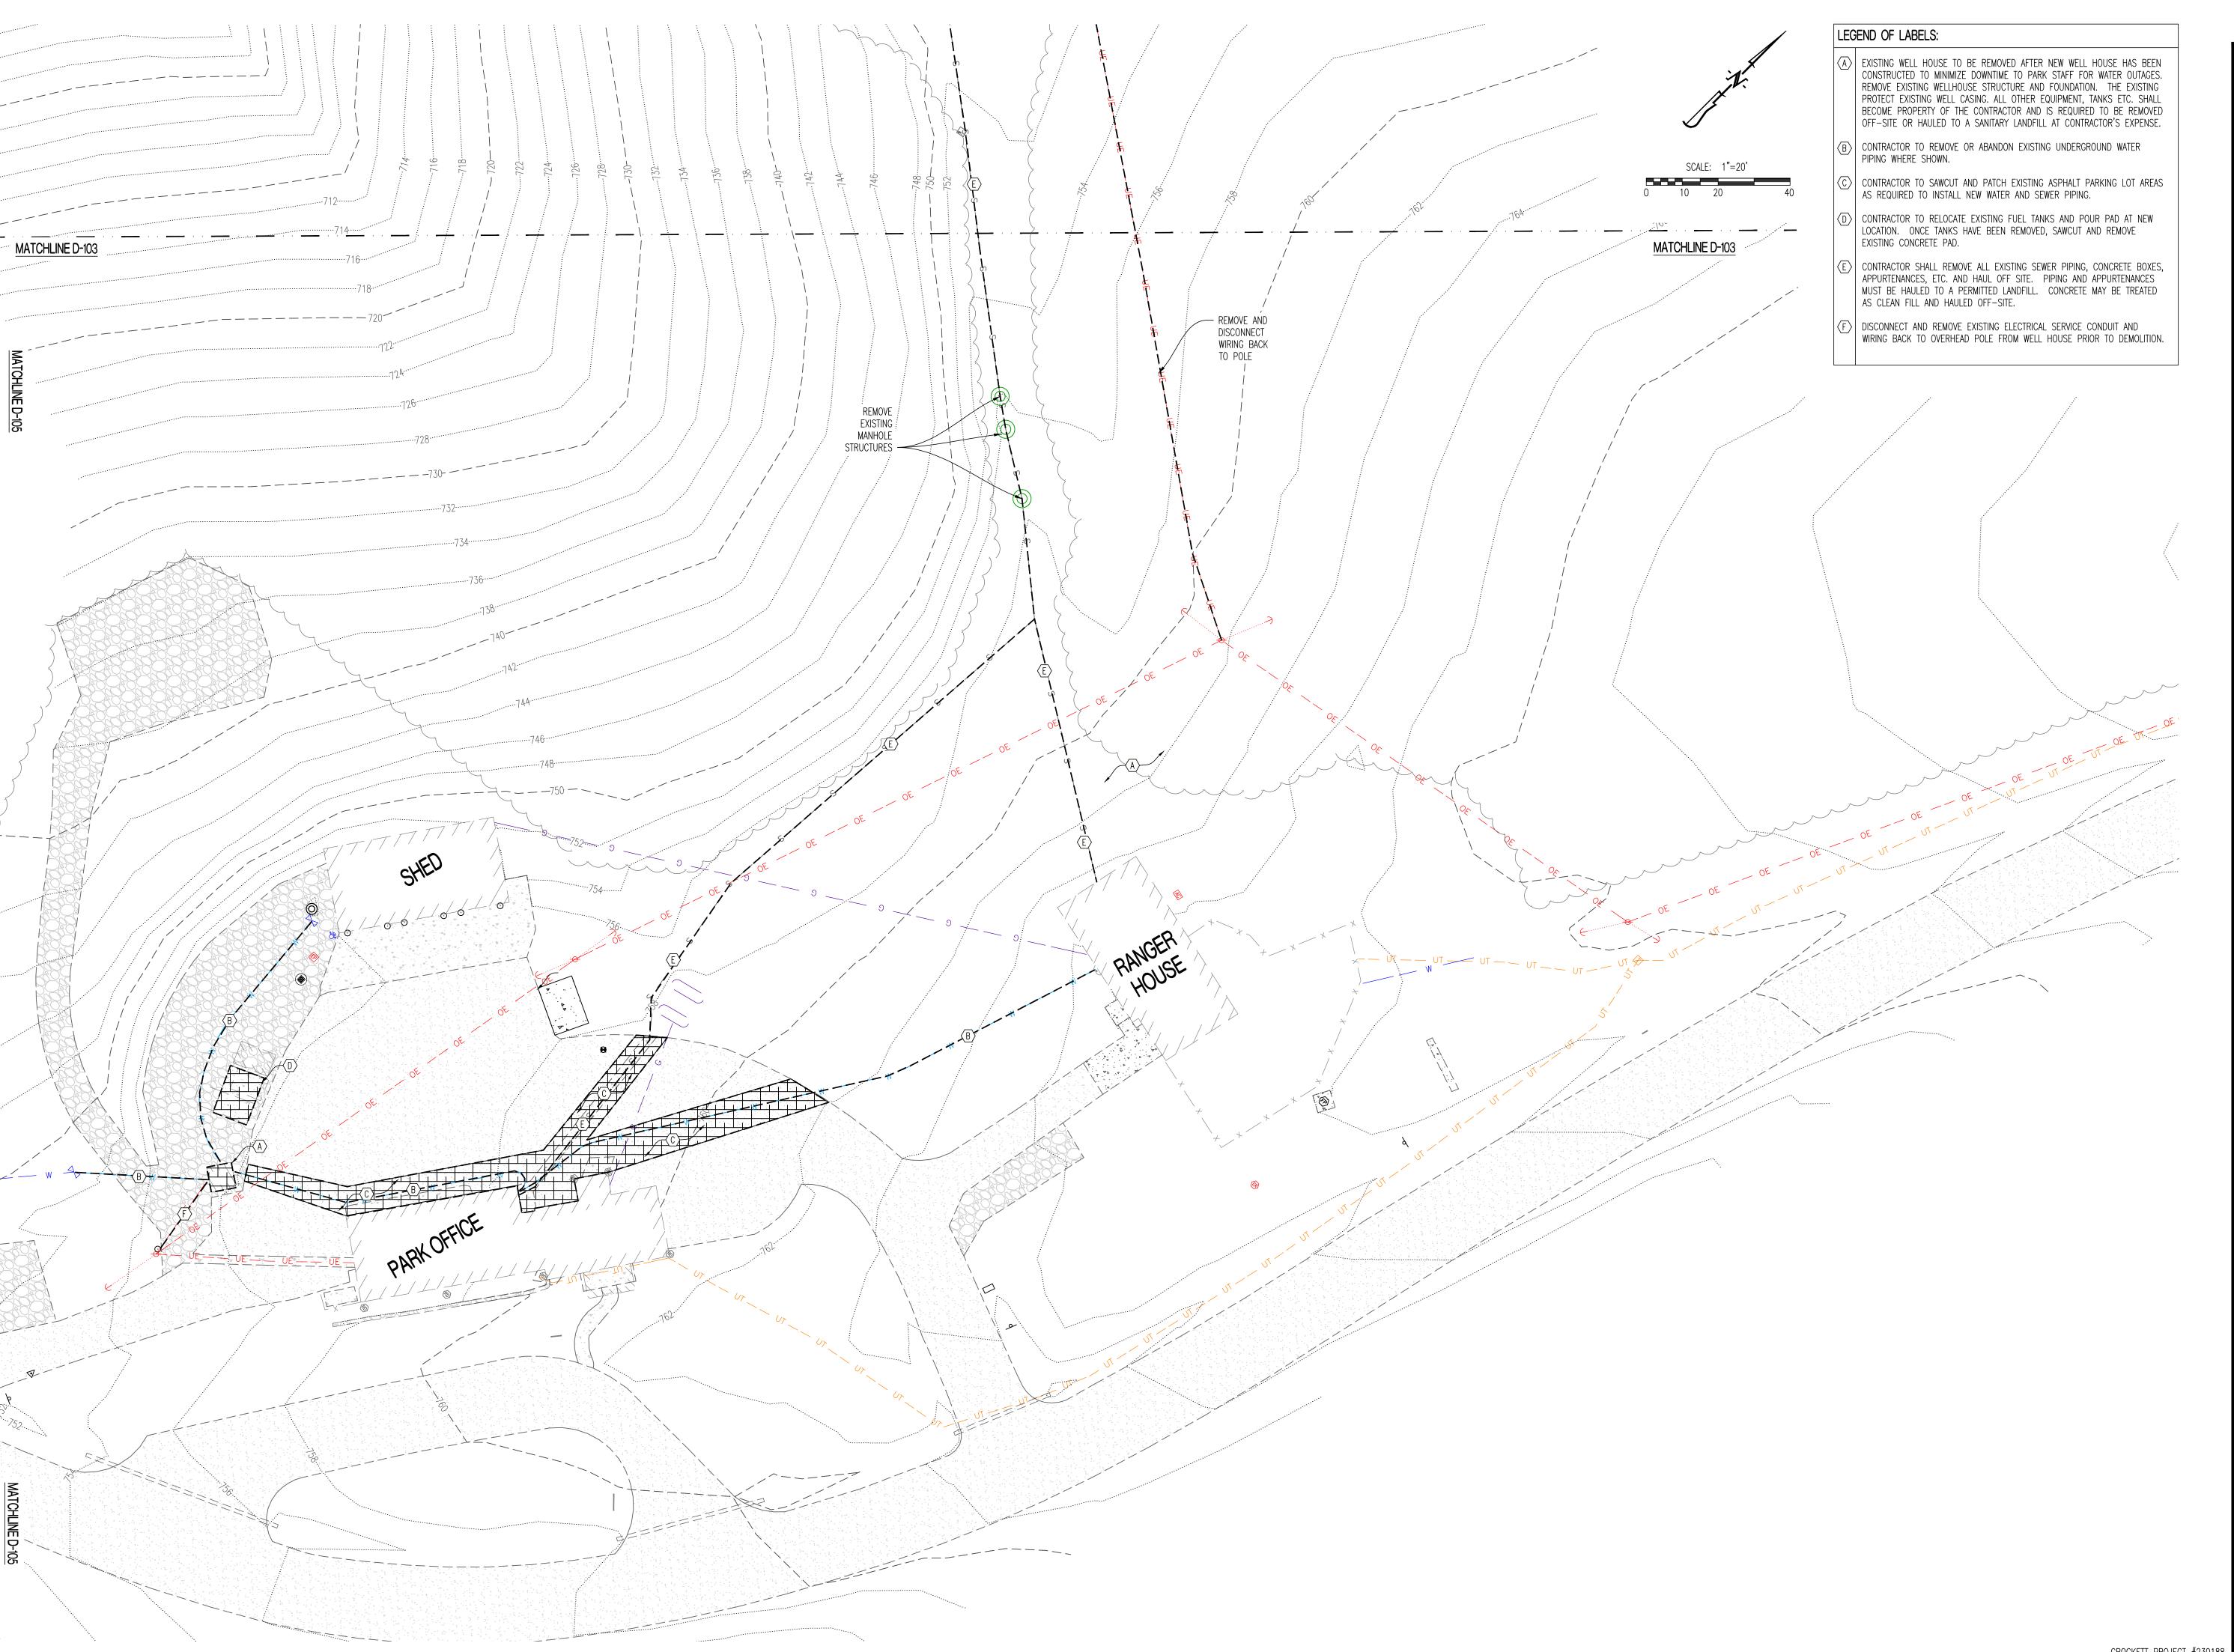



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301 WEST HIGH STREET POST OFFICE BOX 809 JEFFERSON CITY, MO 65102

730 TRUMAN BUILDING

IMPROVEMENTS TO WATER AND WASTEWATER SYSTEM MULTIPLE ASSETS

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PROJECT # X2321-01 SITE NUMBER: 5210 ASSET NUMBER: 7815210016 - PUMP HOUSE WELL #1 7815210017 - PUMP HOUSE WELL #2

REVISION:
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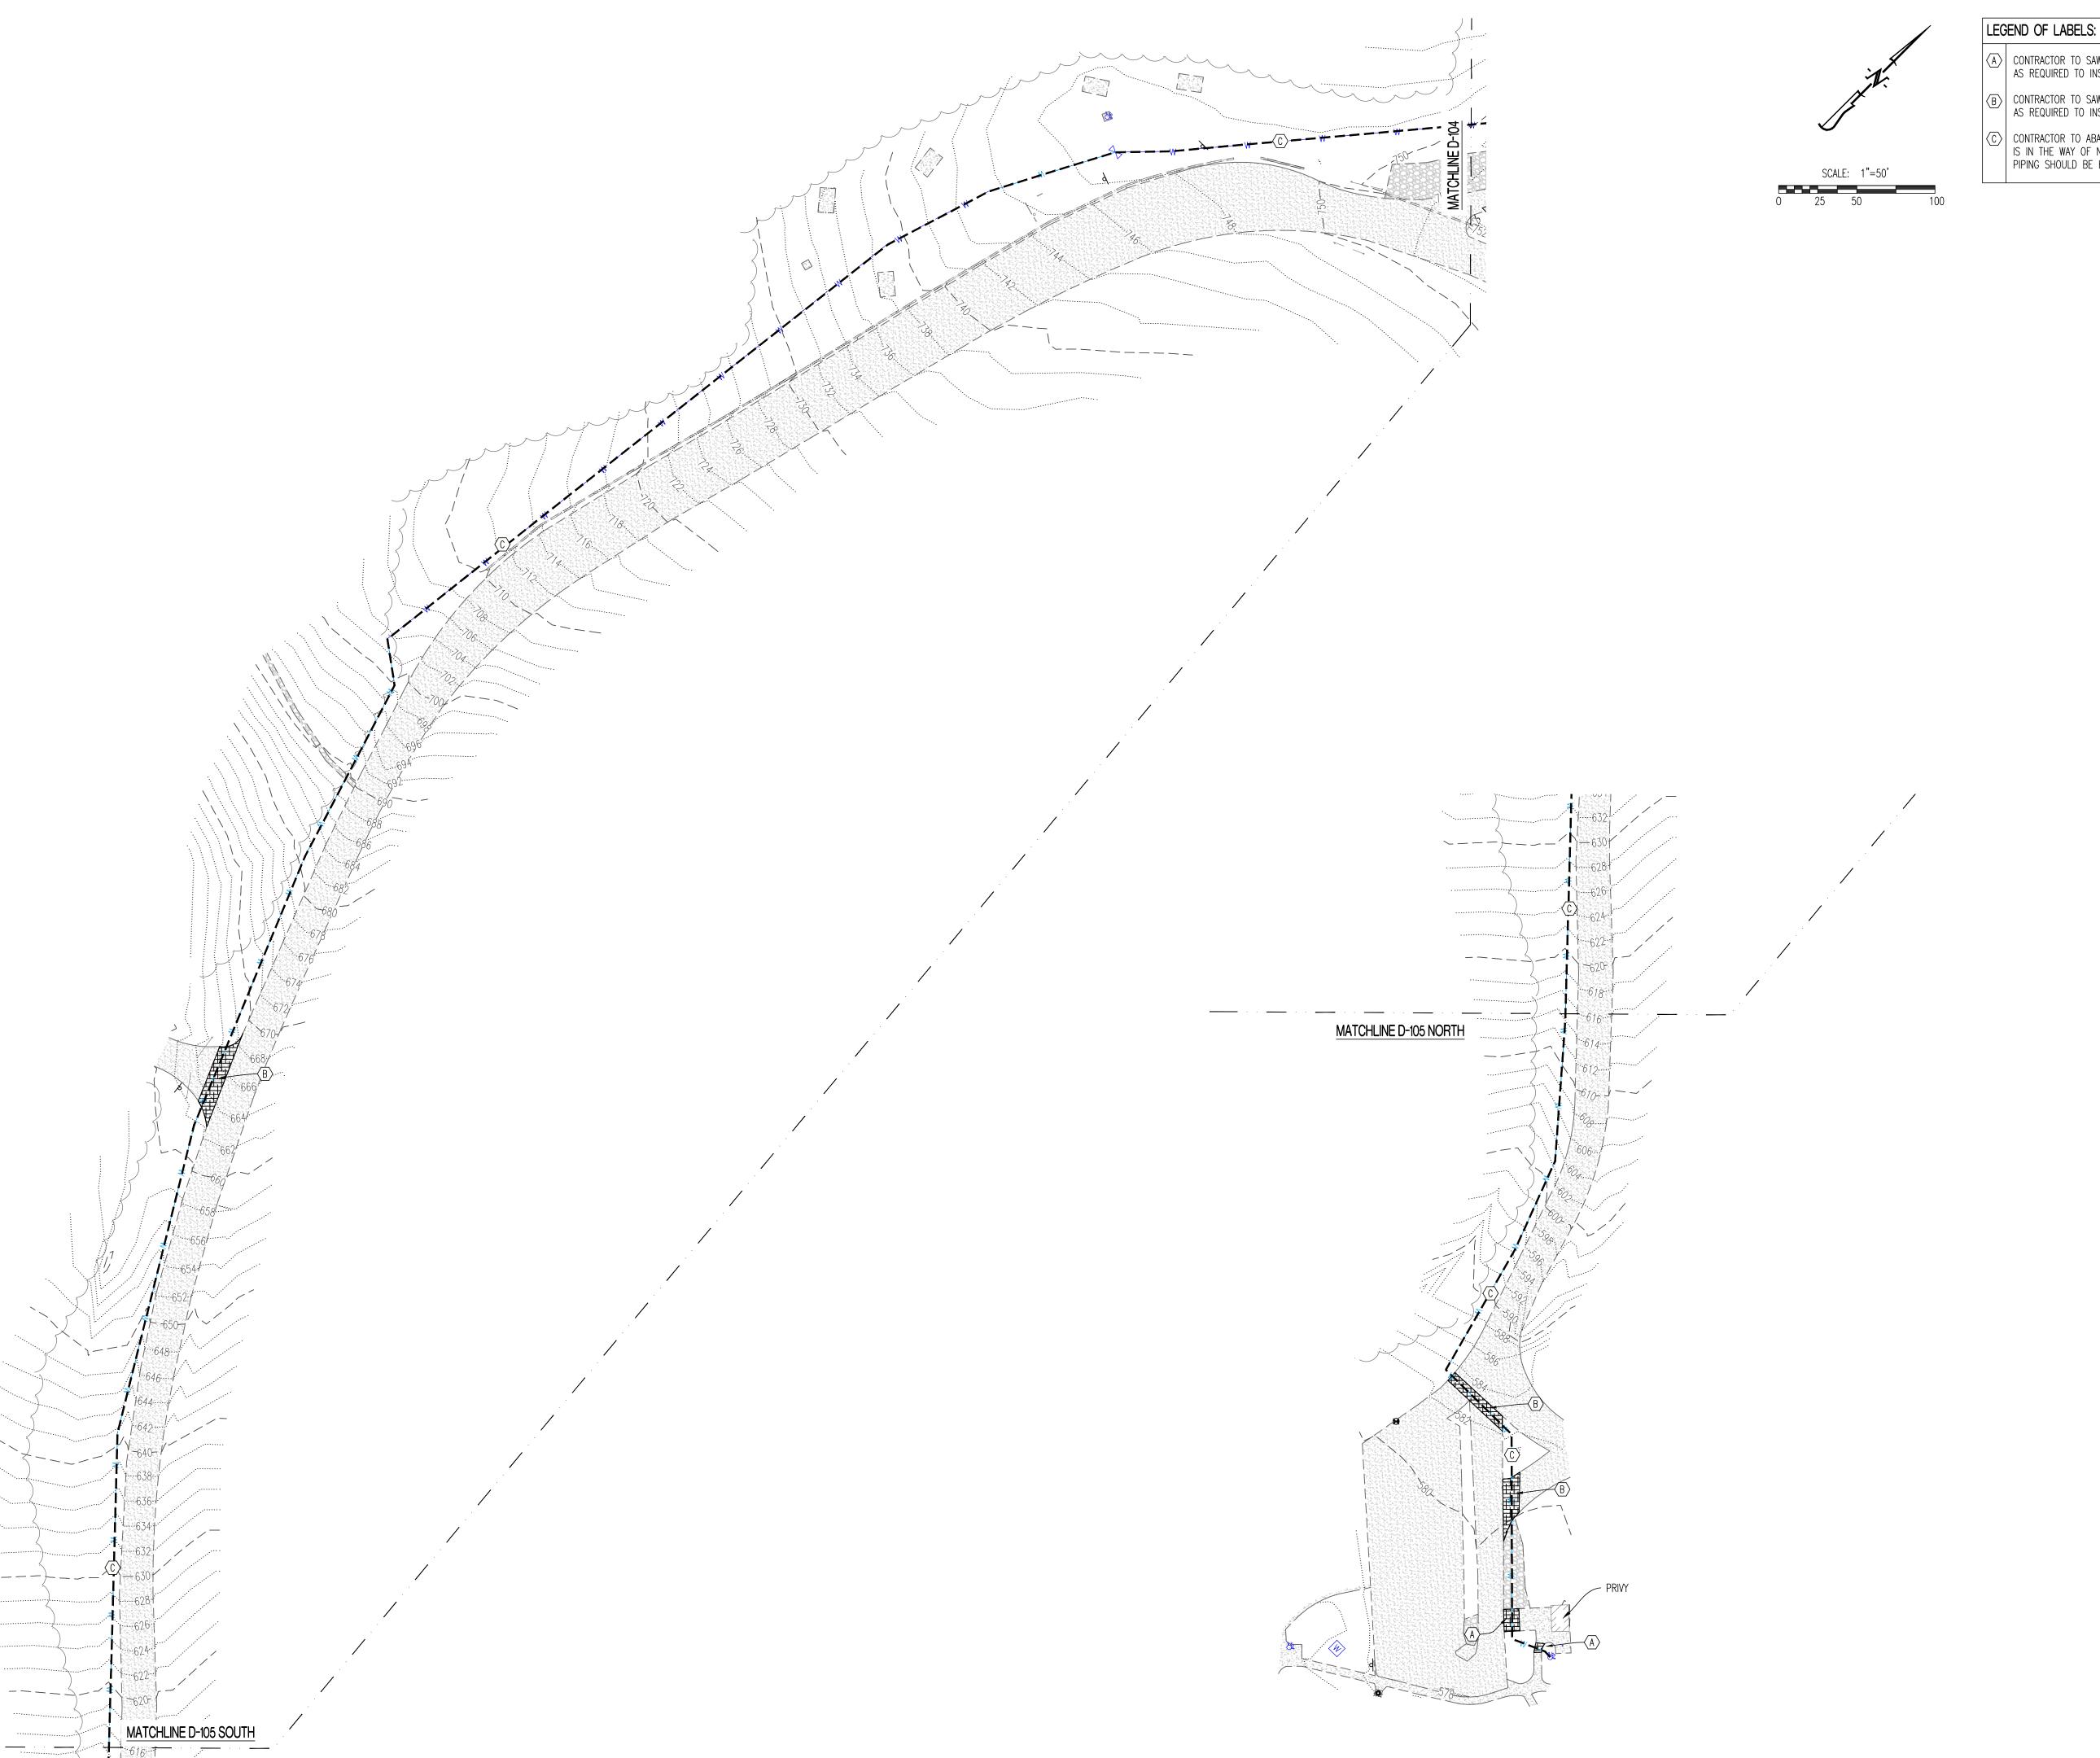
: 230188_GRAHAM CIV
JRS
ATG
JRS

SHEET TITLE:

WELL HOUSE DEMOLITION PLAN PARK OFFICE

SHEET NUMBER:

D-104



- CONTRACTOR TO SAWCUT AND PATCH EXISTING CONCRETE SIDEWALK AREAS AS REQUIRED TO INSTALL NEW WATER PIPING.
- CONTRACTOR TO SAWCUT AND PATCH EXISTING ASPHALT PARKING LOT AREAS AS REQUIRED TO INSTALL NEW WATER PIPING.
- CONTRACTOR TO ABANDON OR REMOVE EXISTING METAL WATER PIPING IF IT IS IN THE WAY OF NEW POLY WATERLINE INSTALLATION. ANY REMOVED PIPING SHOULD BE HAULED OFF—SITE.



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CHECKED BY: ATG
DESIGNED BY: JRS


SHEET TITLE:

PAVILLION/PLAYGROUND **DEMOLITION PLAN**

SHEET NUMBER:

D-105

SHEET 7 OF 21

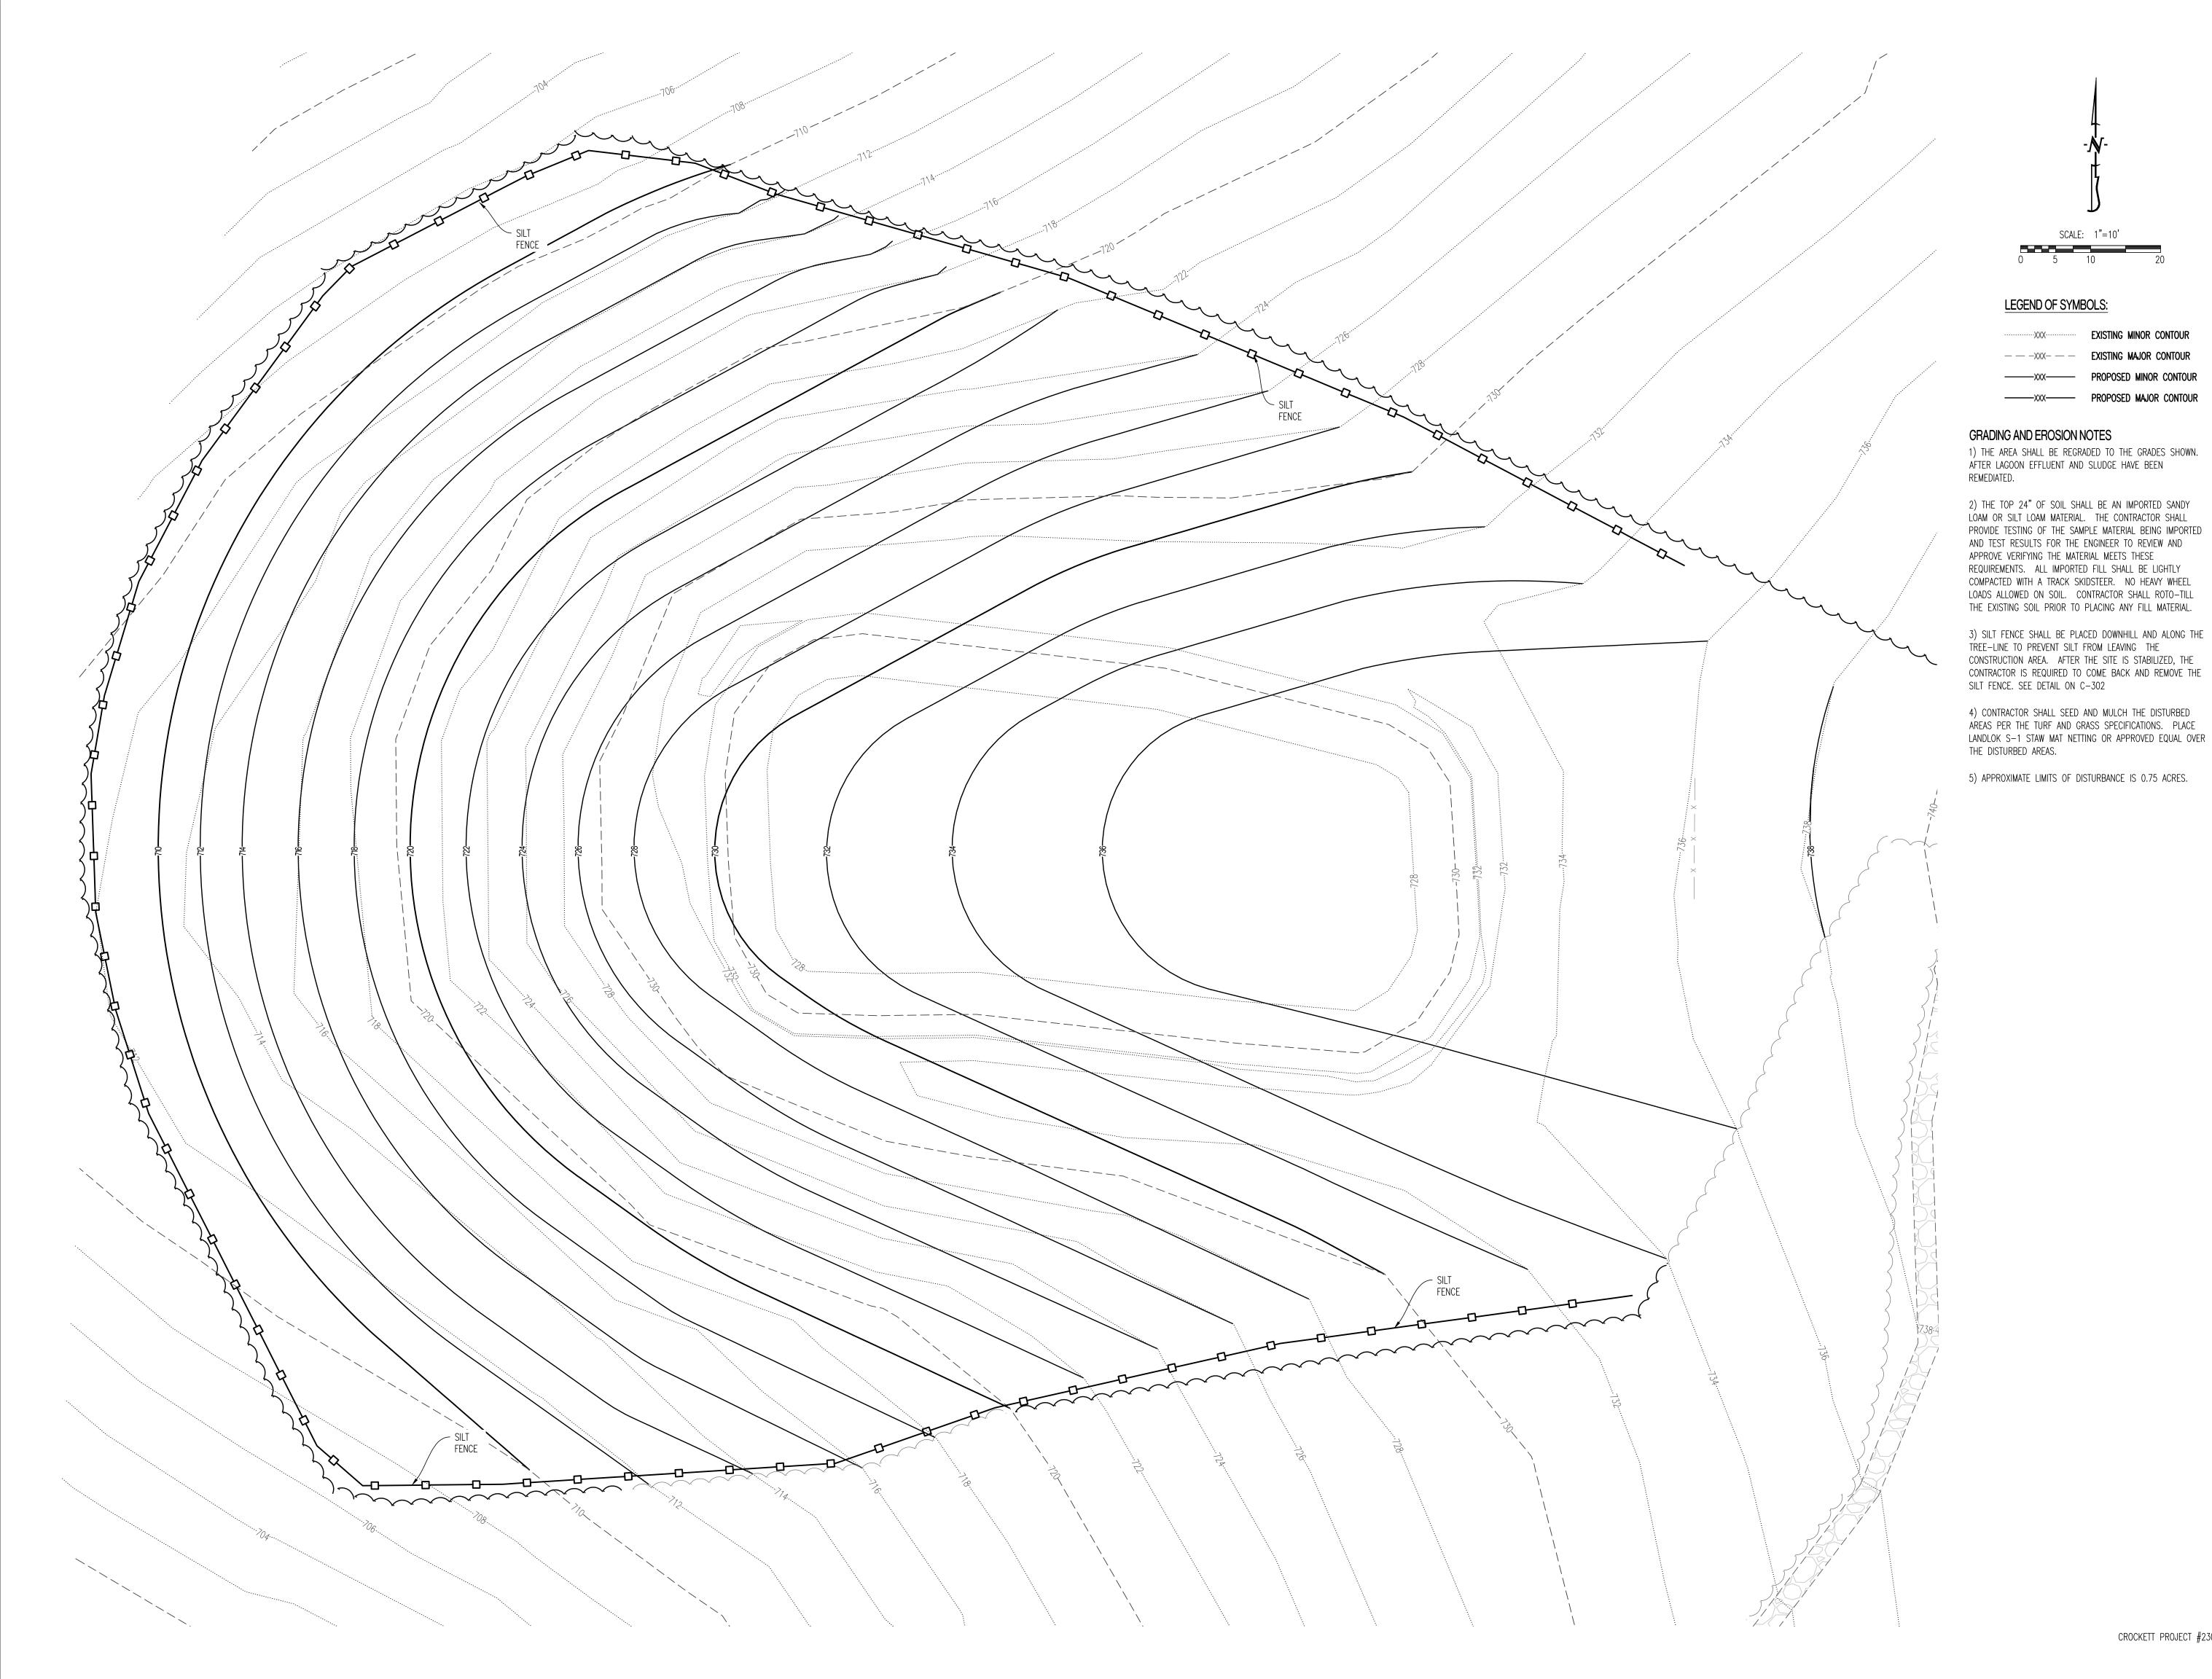



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730 TRUMAN BUILDING 301 WEST HIGH STREET POST OFFICE BOX 809 **JEFFERSON CITY, MO 65102**

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GRAHAM CAVE STATE PARK 217 HIGHWAY TT DANVILLE, MO 63361

PROJECT # X2321-01 SITE NUMBER: 5210 ASSET NUMBER: 7815210025 - LAGOON SERVICE AREA

REVISION: REVISION: DATE: REVISION: DATE:

ISSUE DATE: 09/09/2024


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SHEET TITLE:

SEWER GRADING PLAN - CAMPGROUND

SHEET NUMBER:

SHEET 8 OF 21



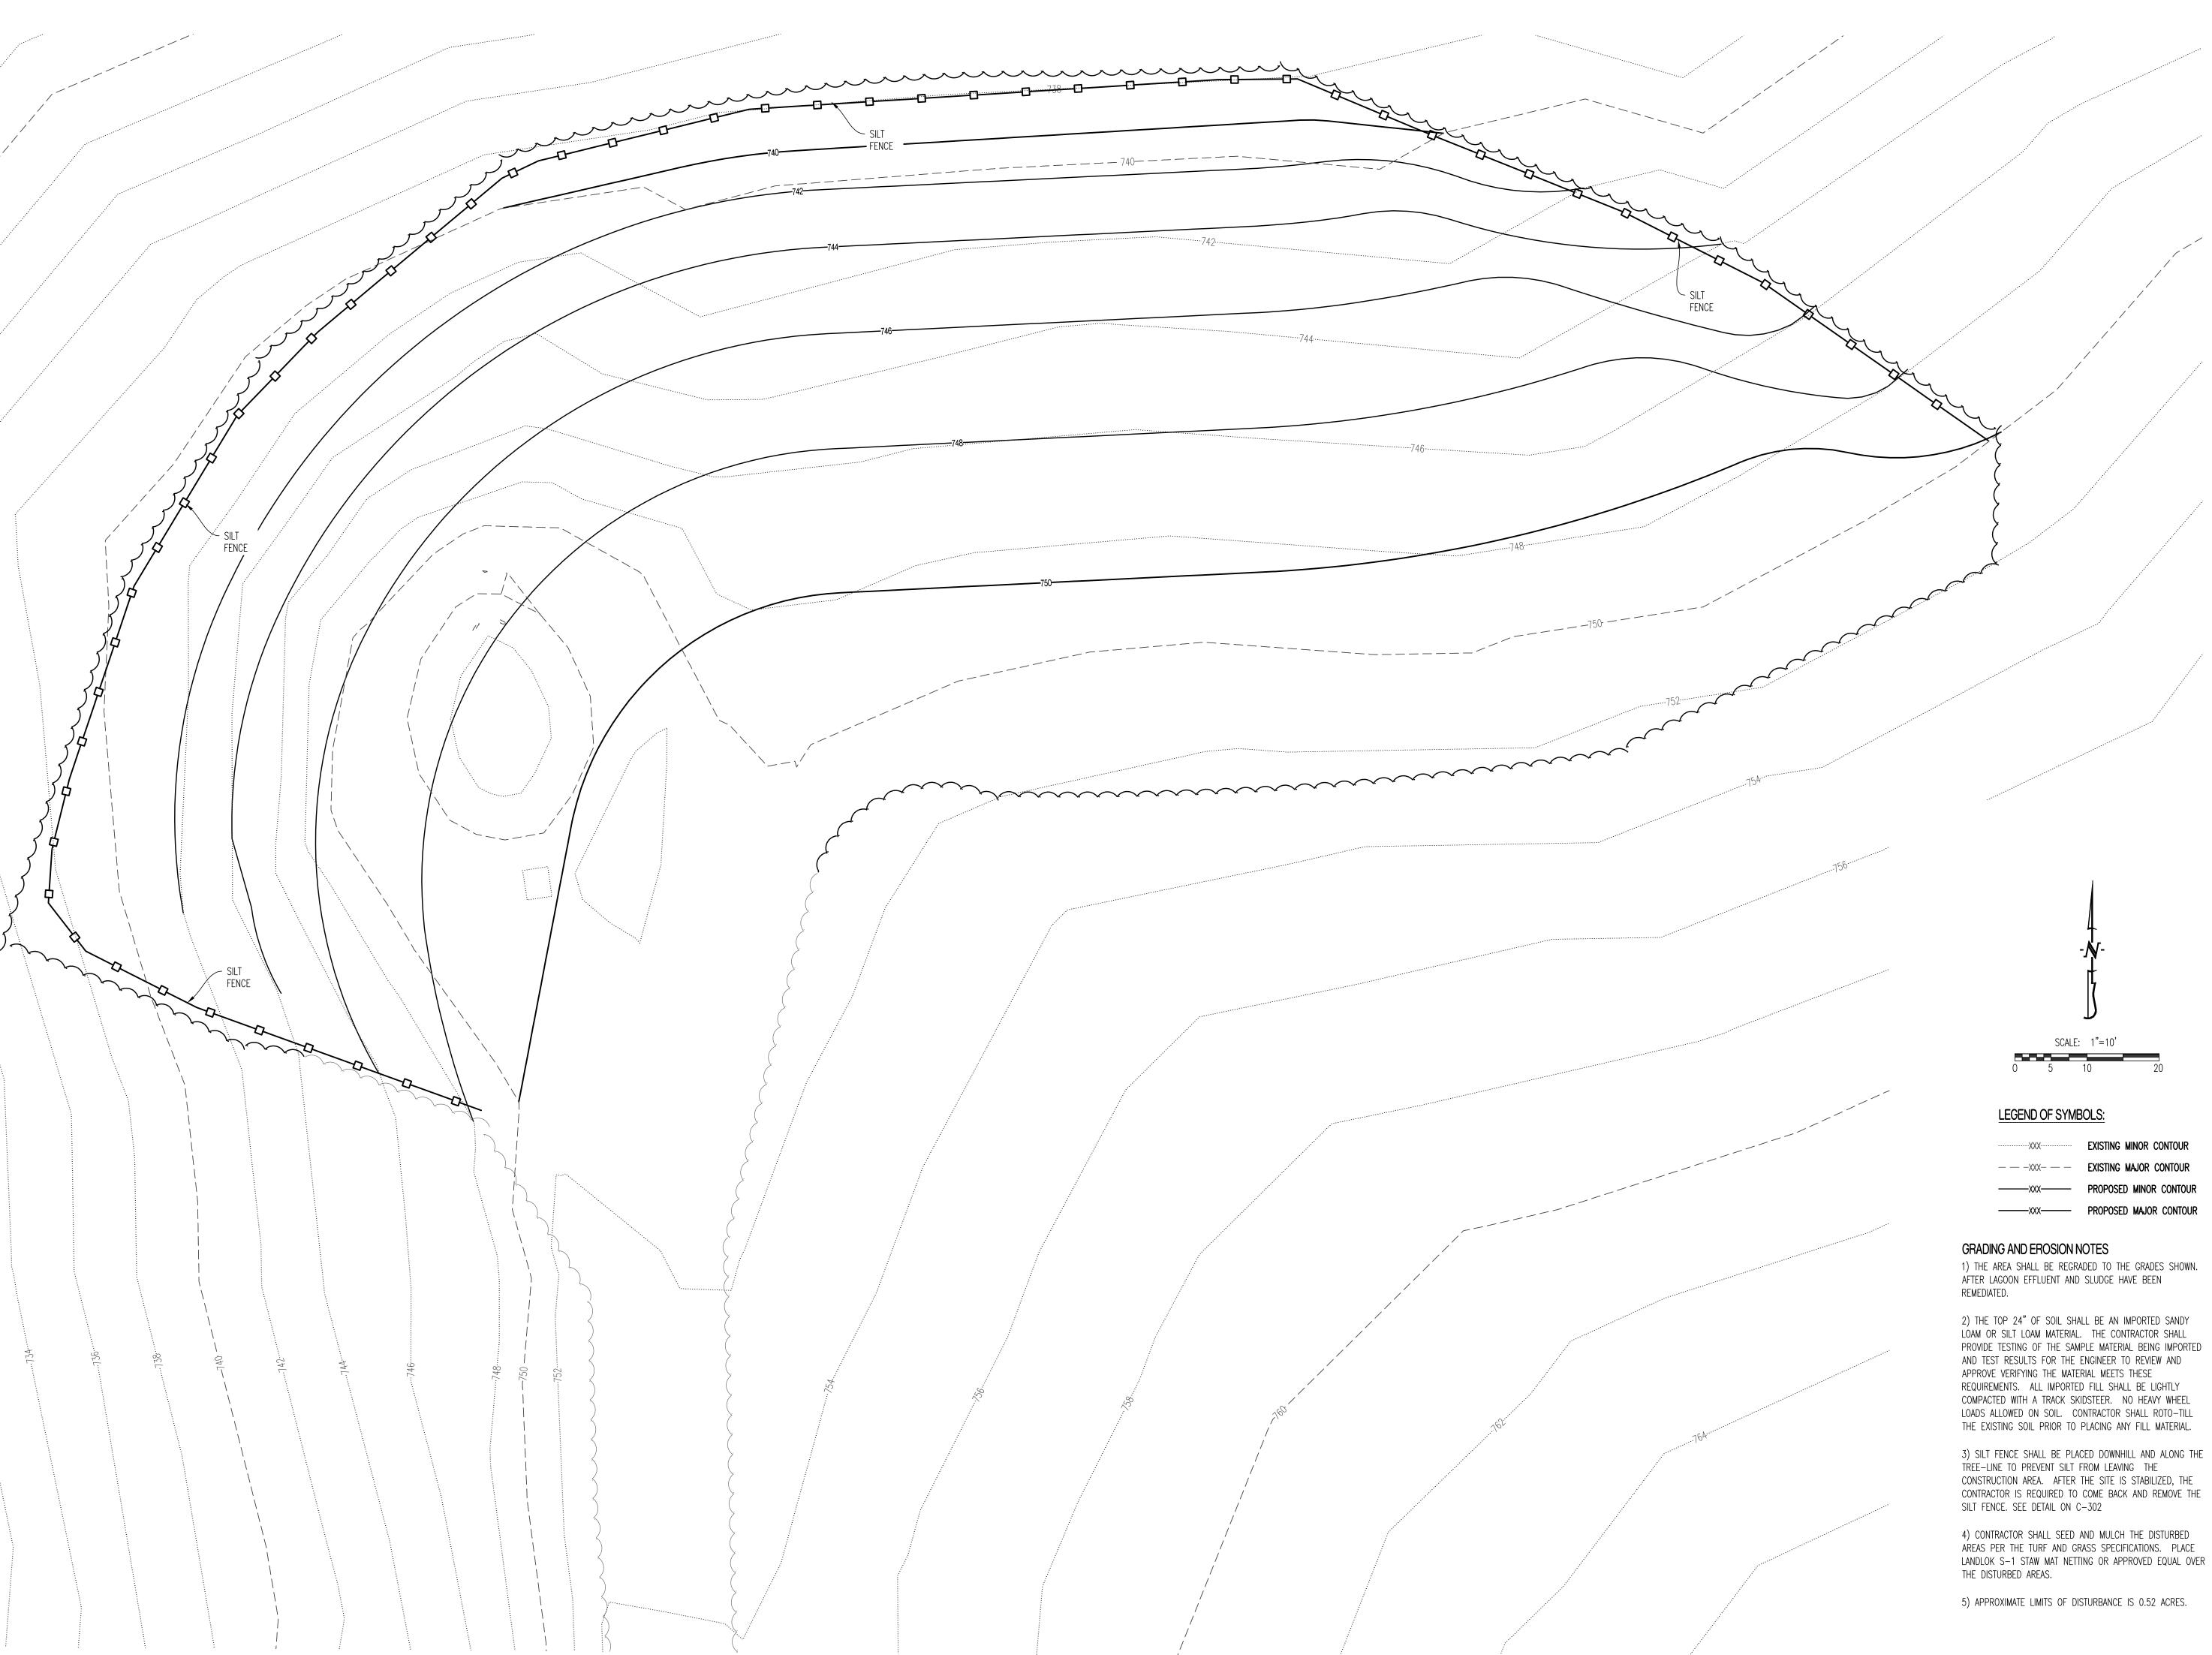

JESSE RAY STEPHENS MO LICENSE - 2010000868

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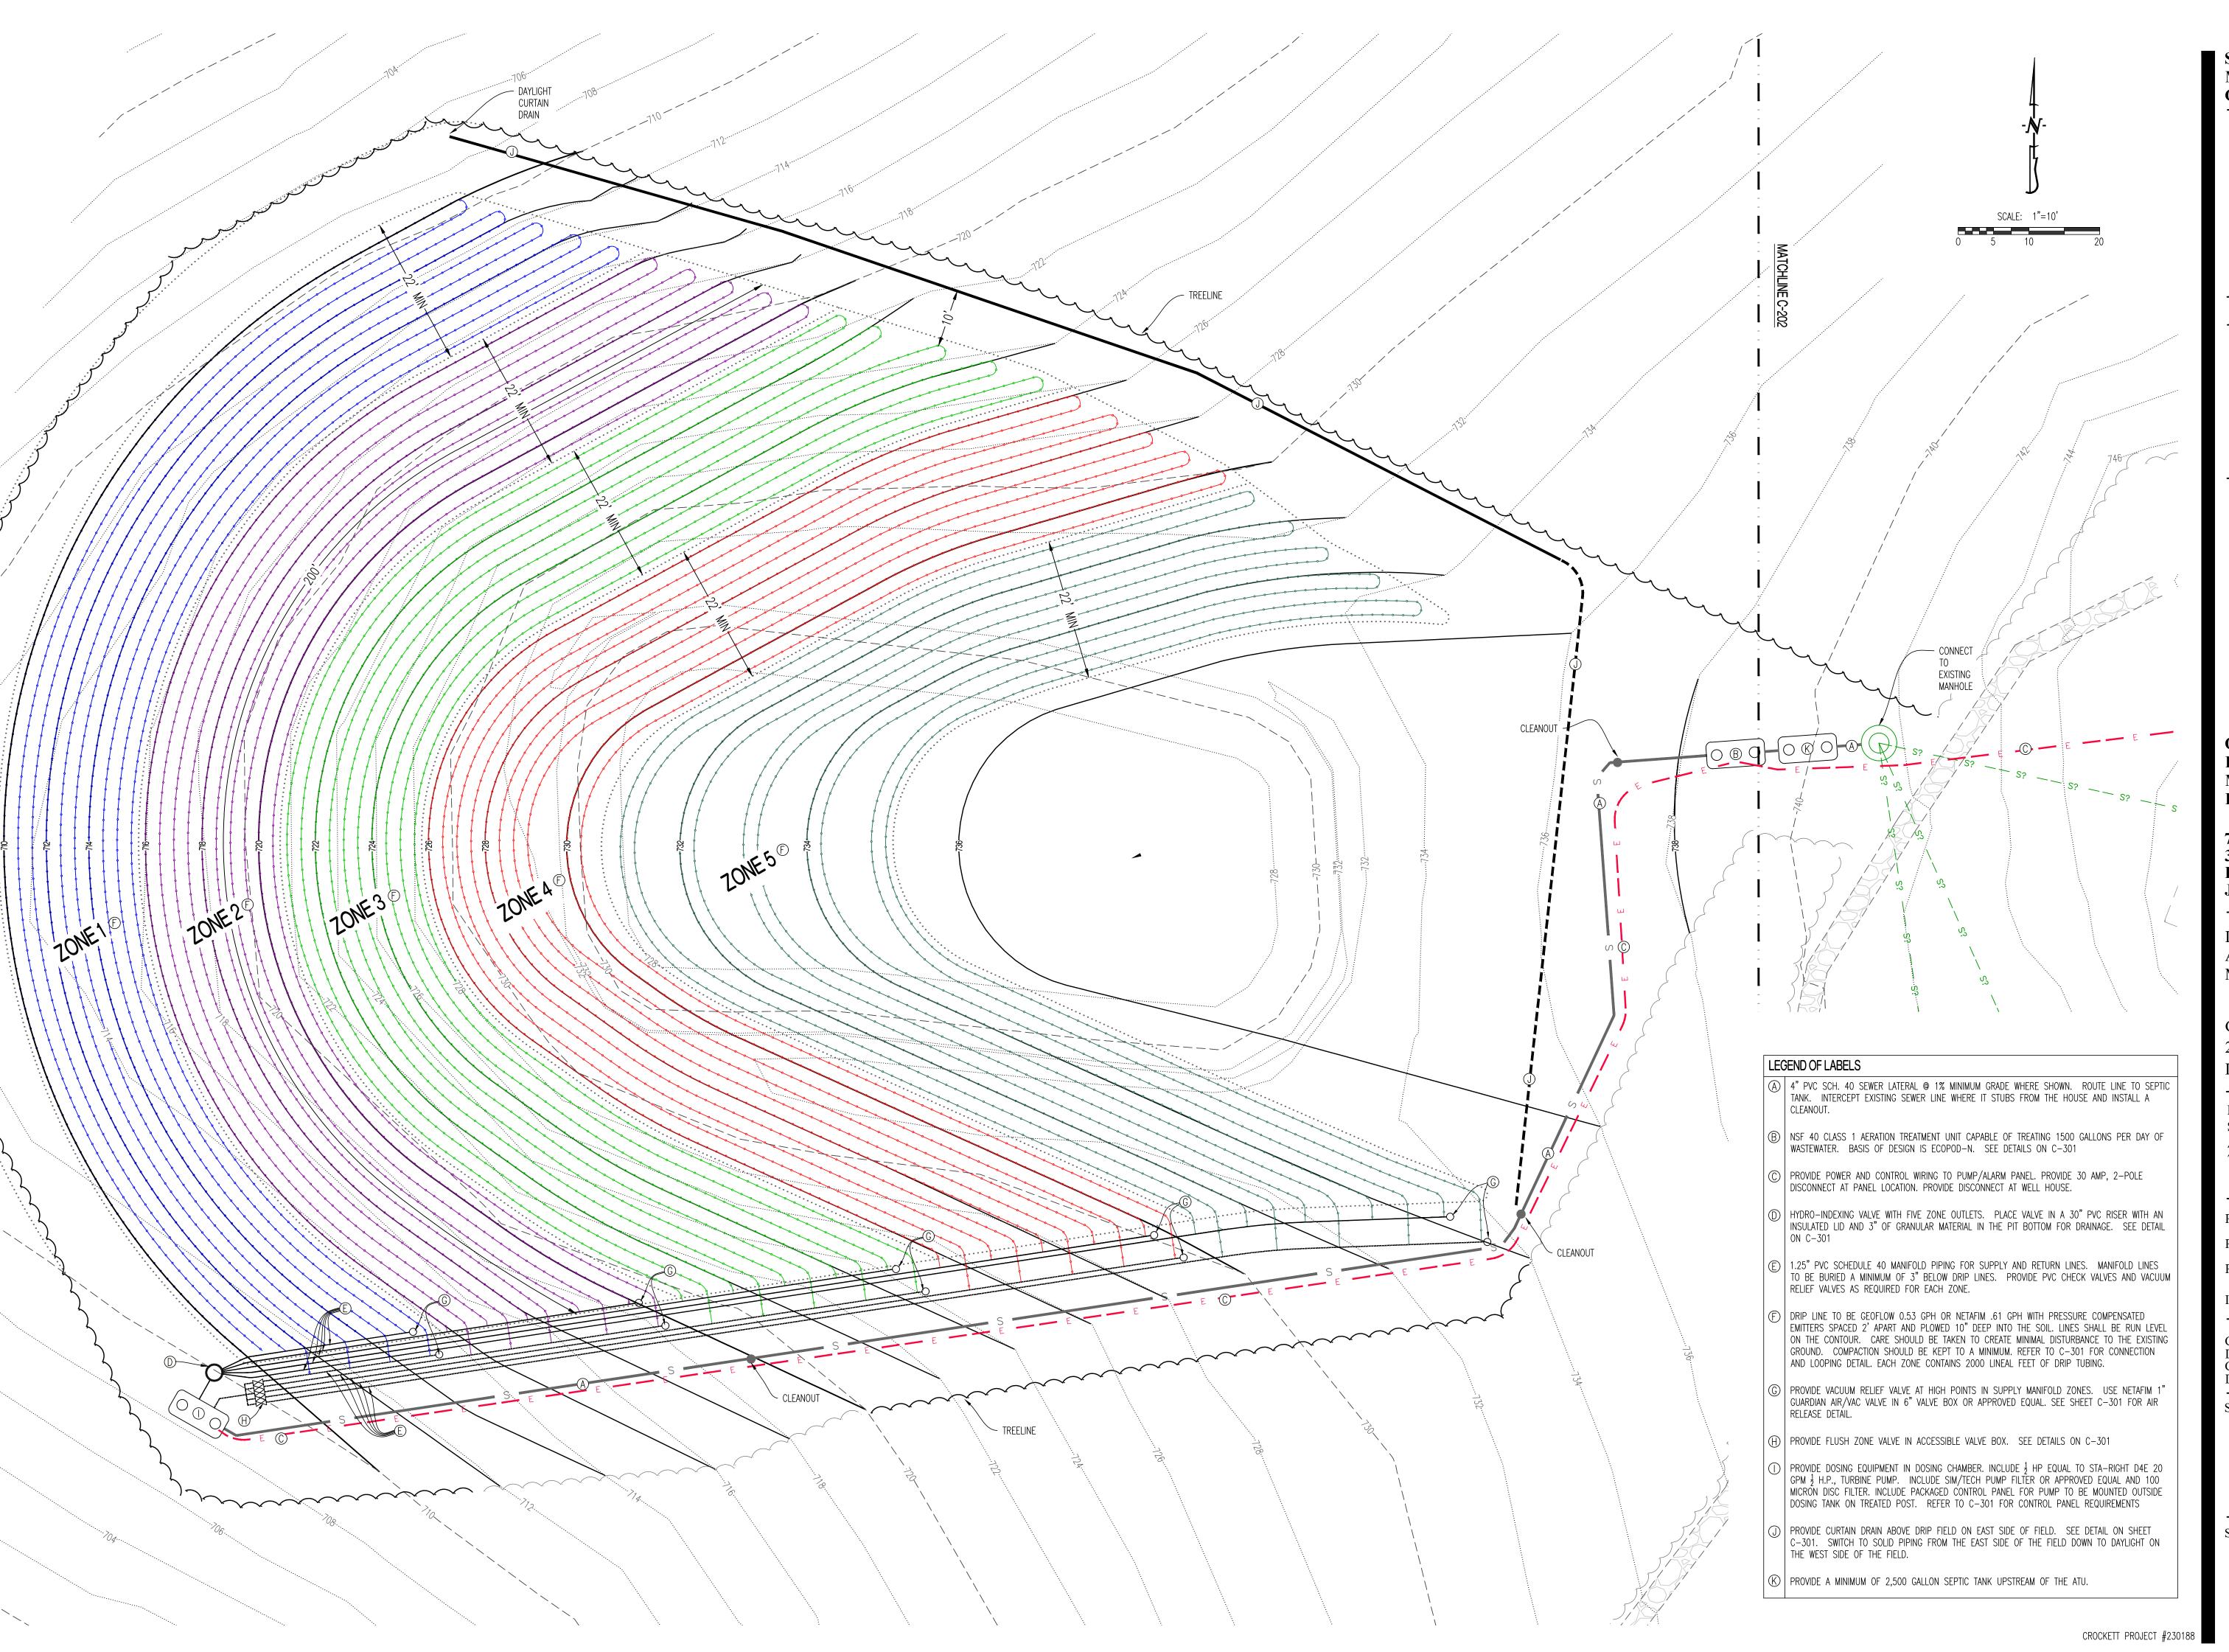
SHEET TITLE:

SEWER GRADING PLAN - PARK OFFICE

SHEET NUMBER:

C-10

SHEET 9 OF 21





JESSE RAY STEPHENS MO LICENSE - 2010000868

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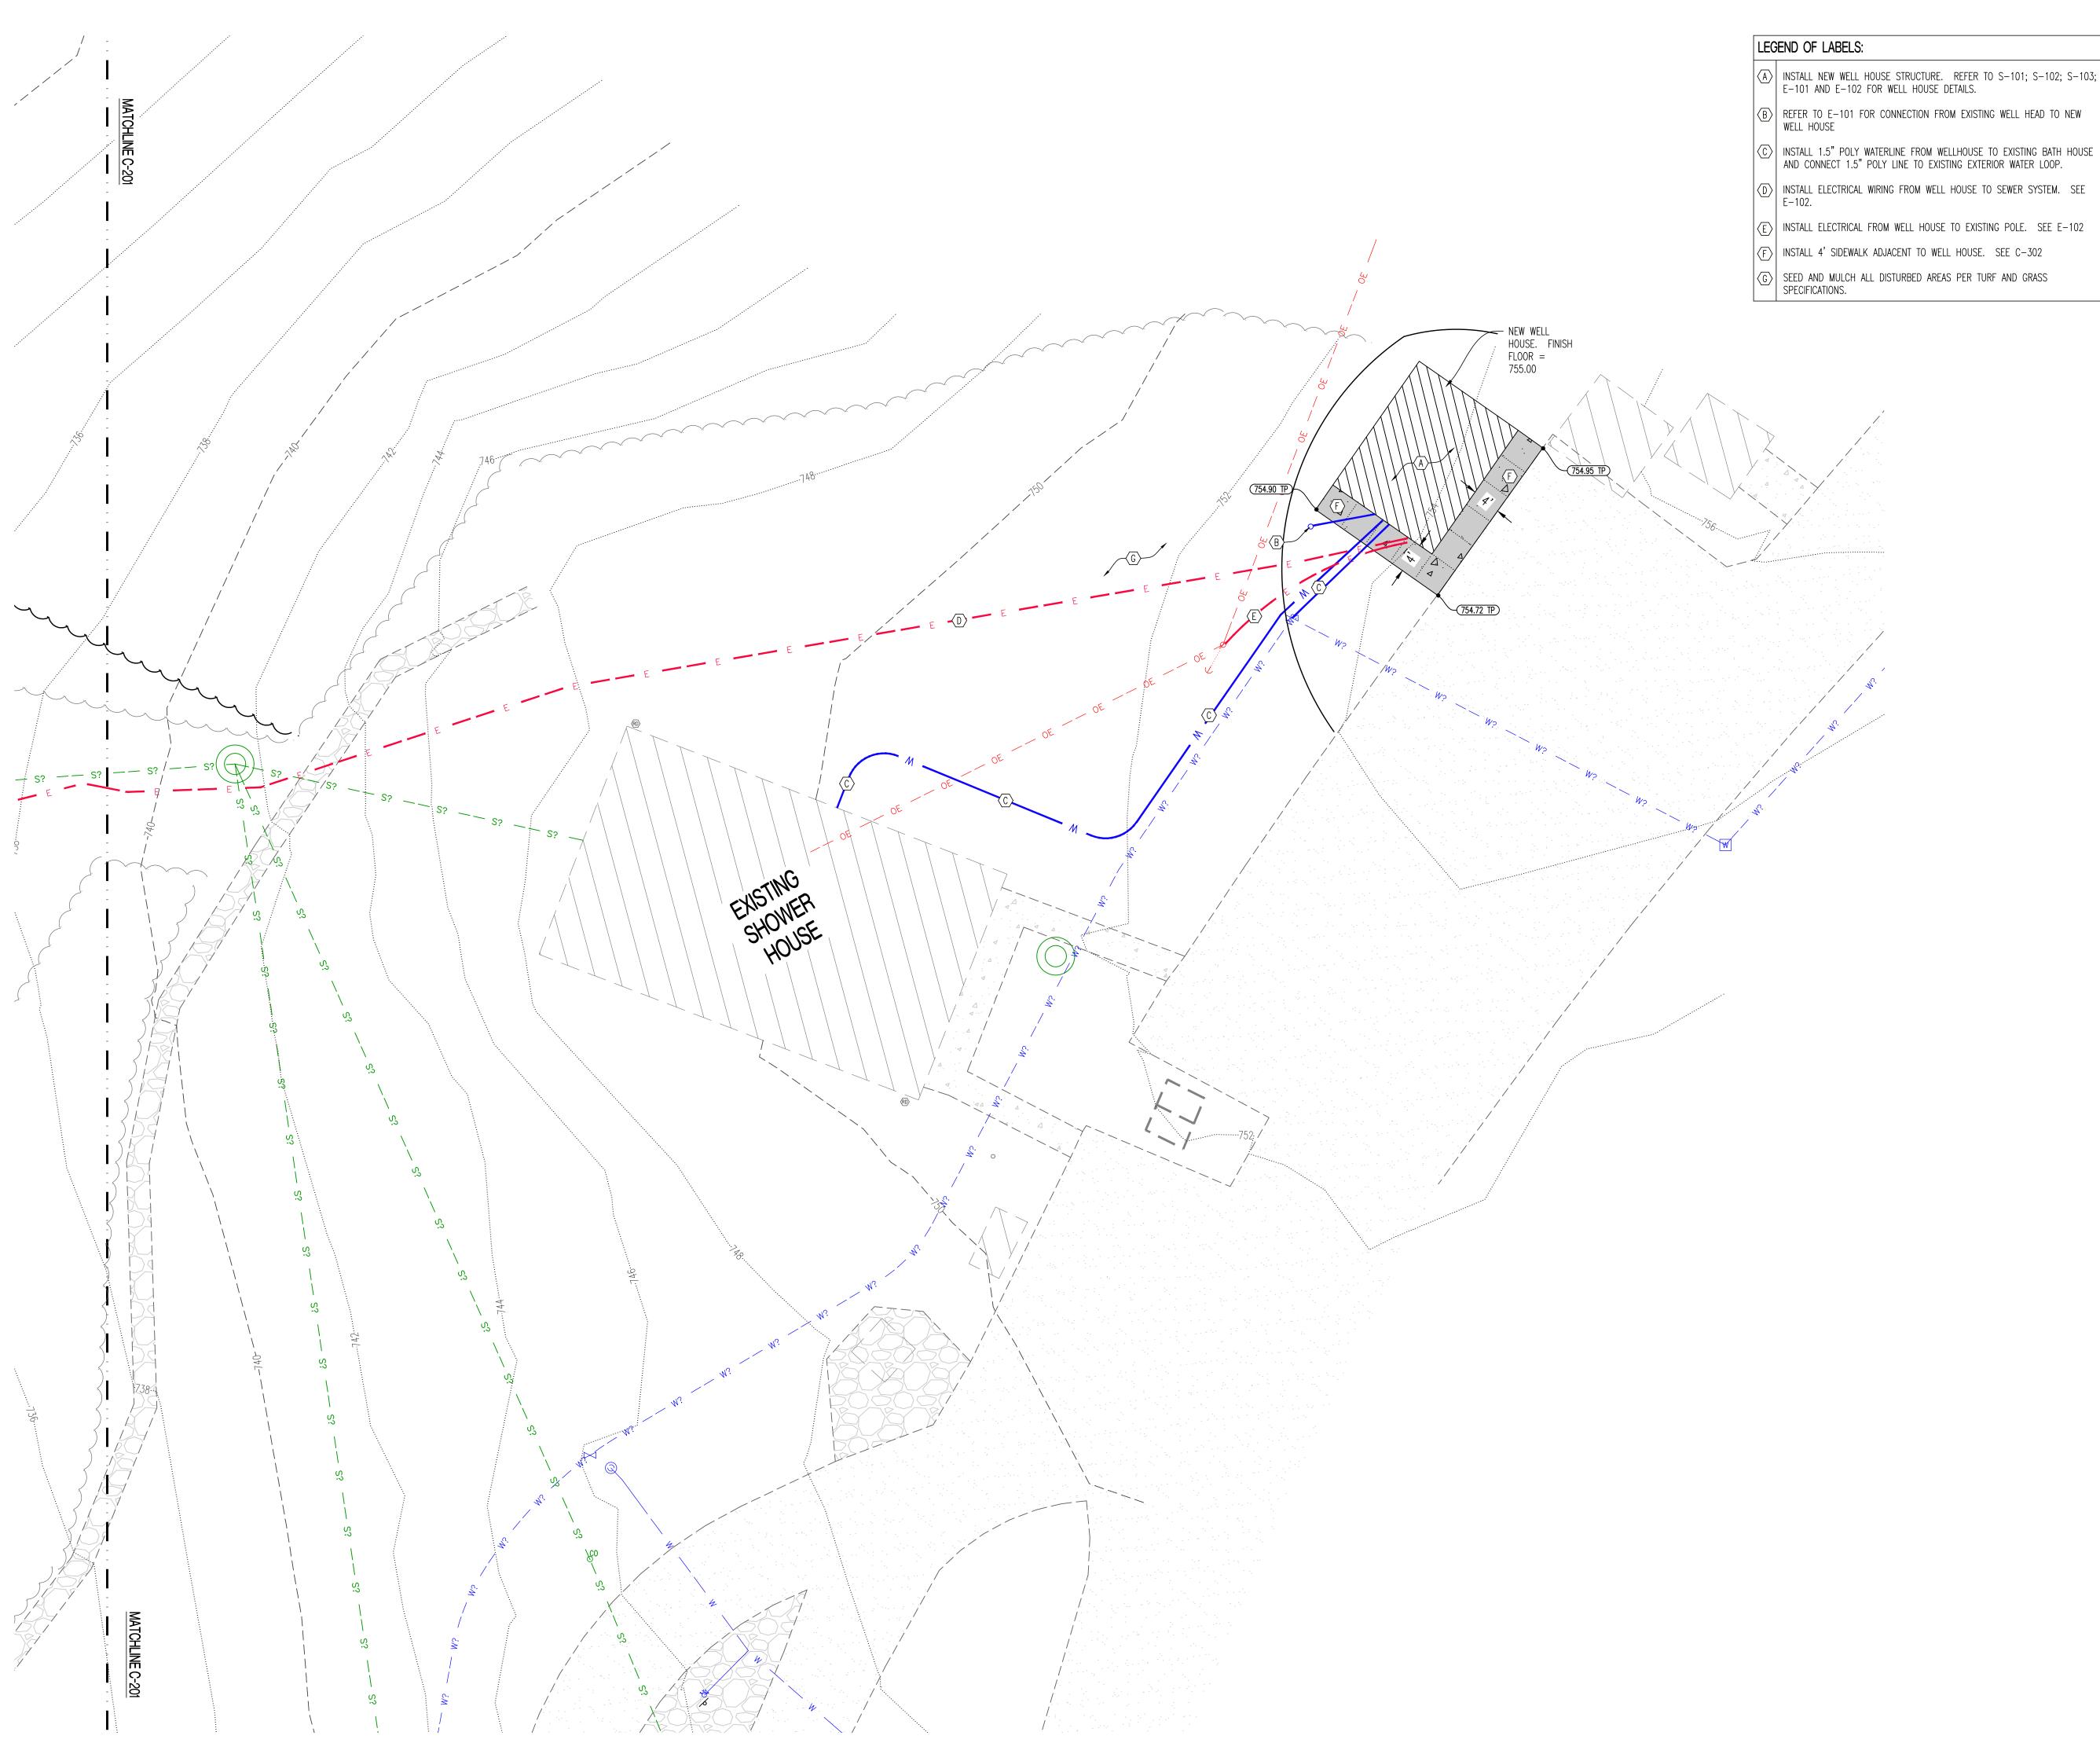
SEWER DRIP IRRIGATION PLAN -

CAMPGROUND

SHEET NUMBER:

C-2


SHEET 10 OF 21



- INSTALL NEW WELL HOUSE STRUCTURE. REFER TO S-101; S-102; S-103; E-101 AND E-102 FOR WELL HOUSE DETAILS.
- REFER TO E-101 FOR CONNECTION FROM EXISTING WELL HEAD TO NEW WELL HOUSE

- (F) INSTALL 4' SIDEWALK ADJACENT TO WELL HOUSE. SEE C-302



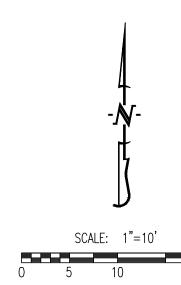



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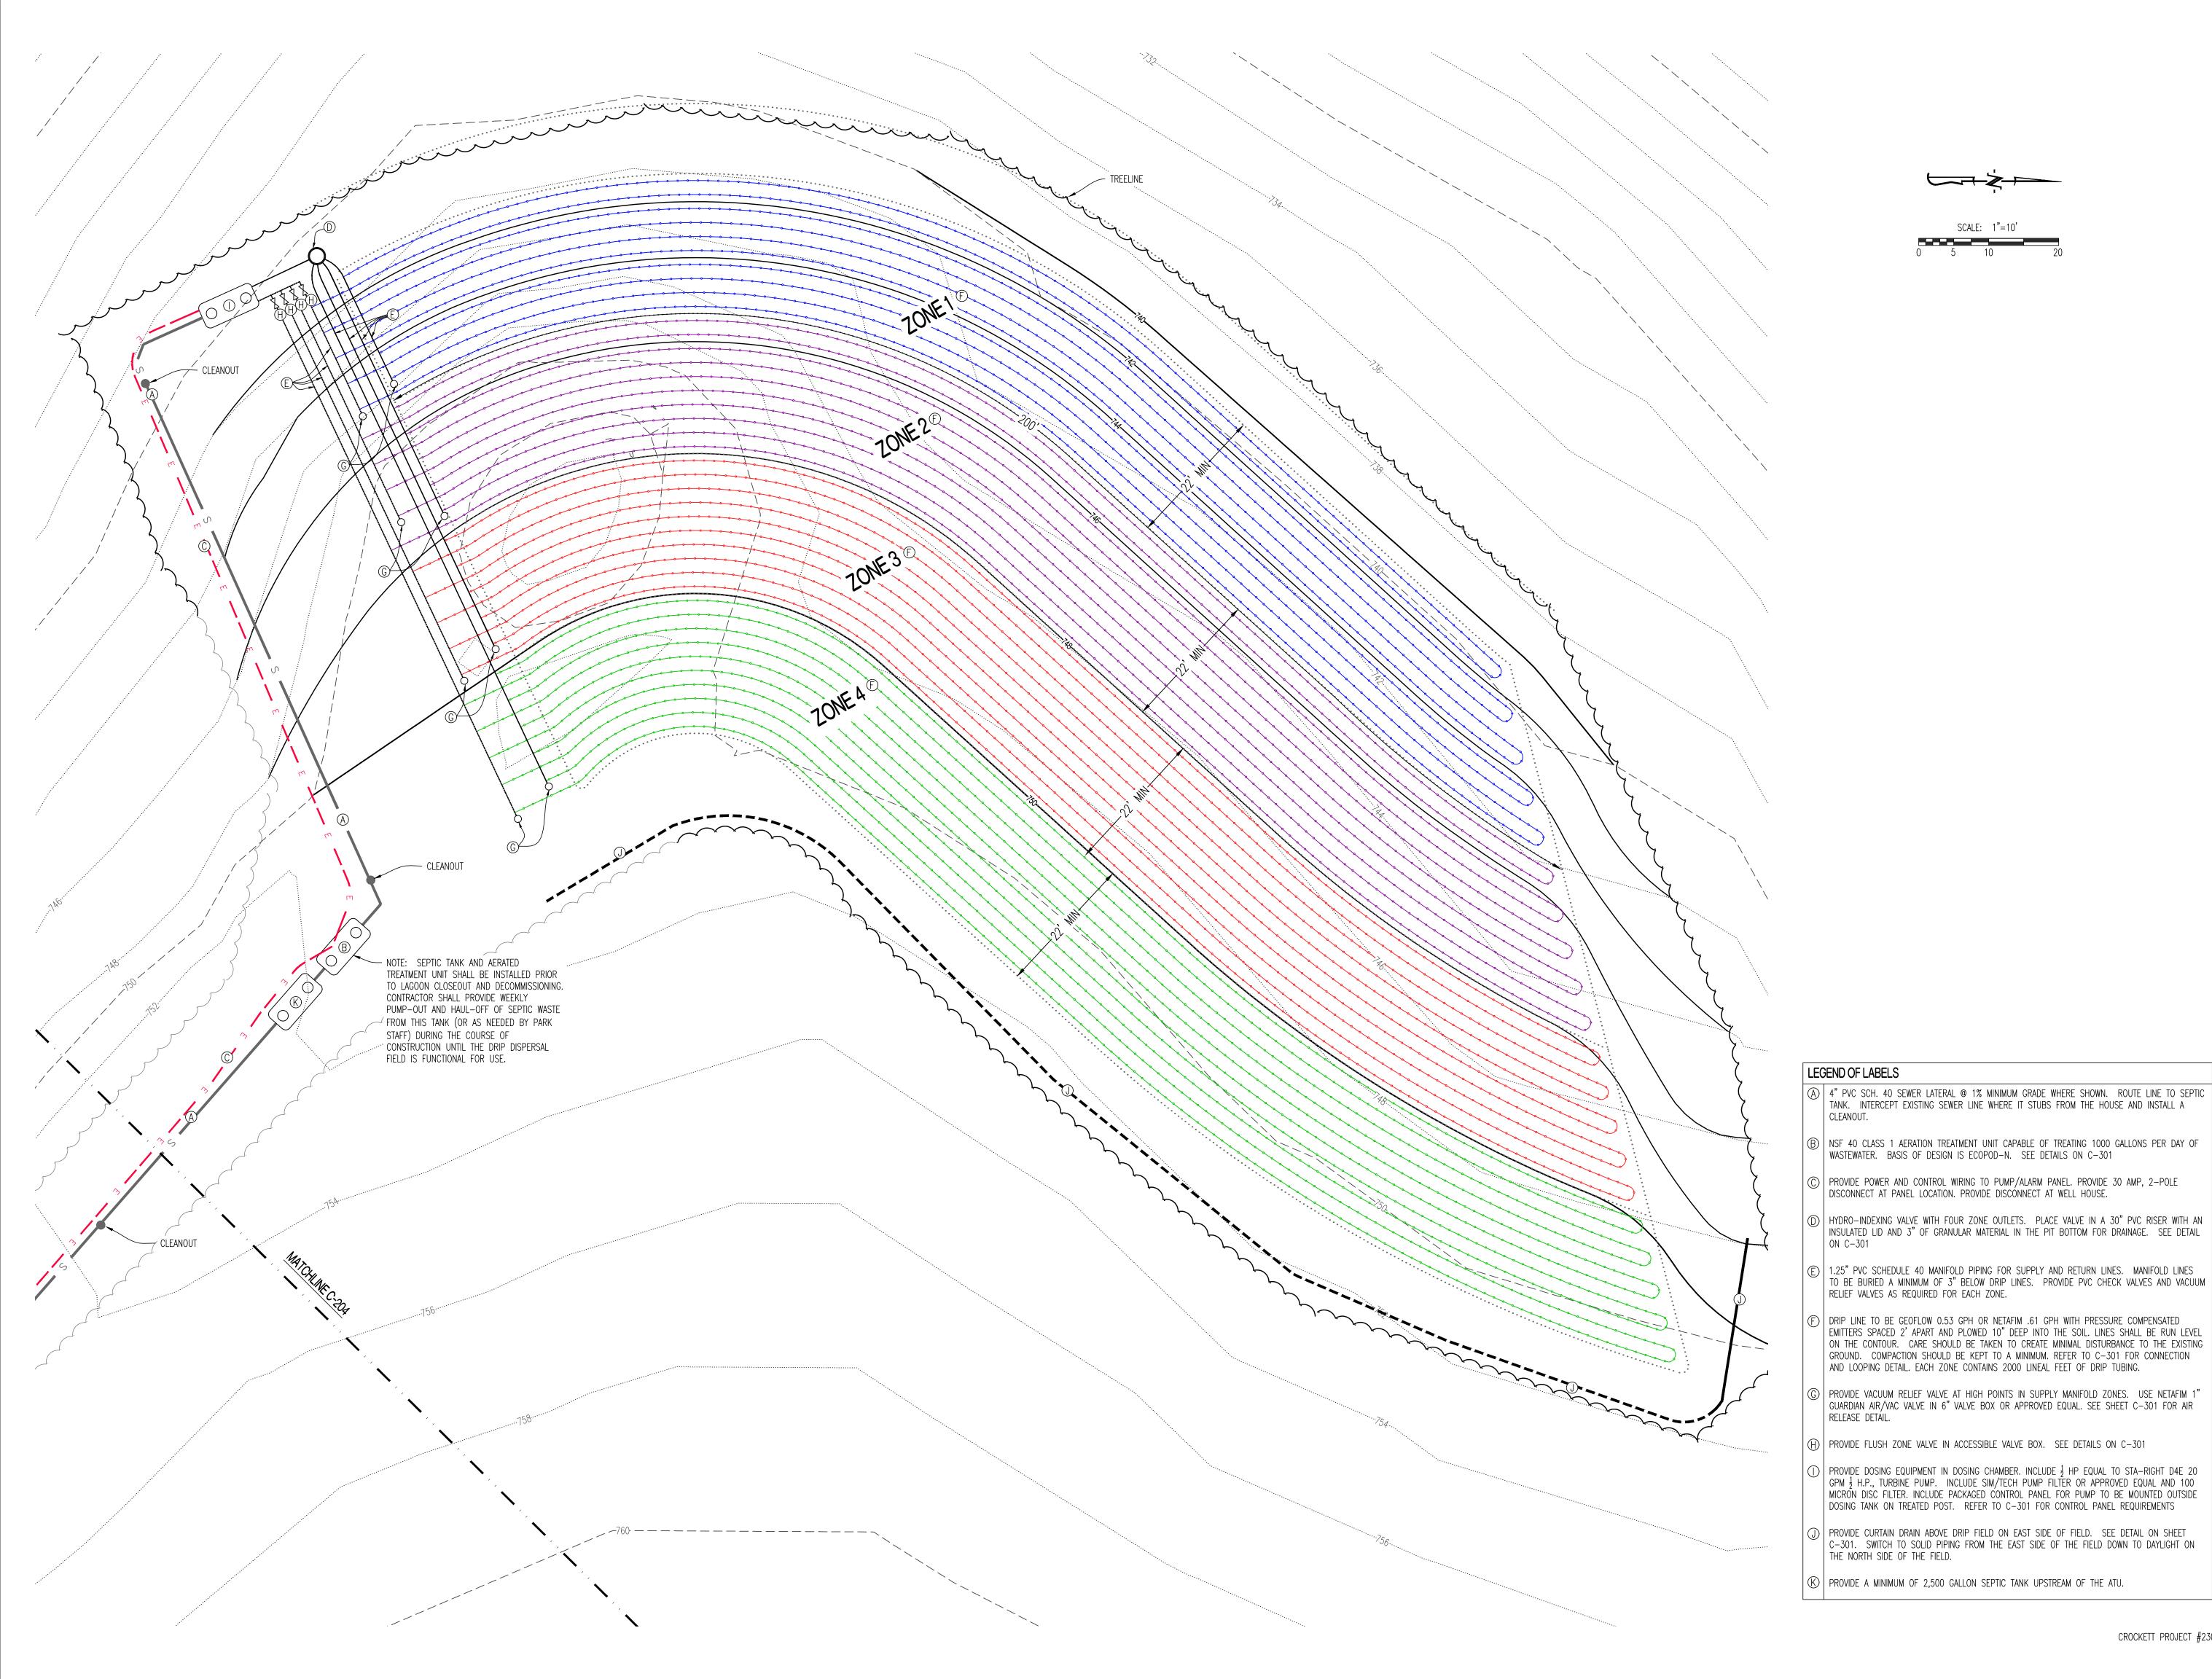
SHEET TITLE:

WELL HOUSE SITE PLAN - CAMPGROUND

SHEET NUMBER:

C-202

SHEET 11 OF 21







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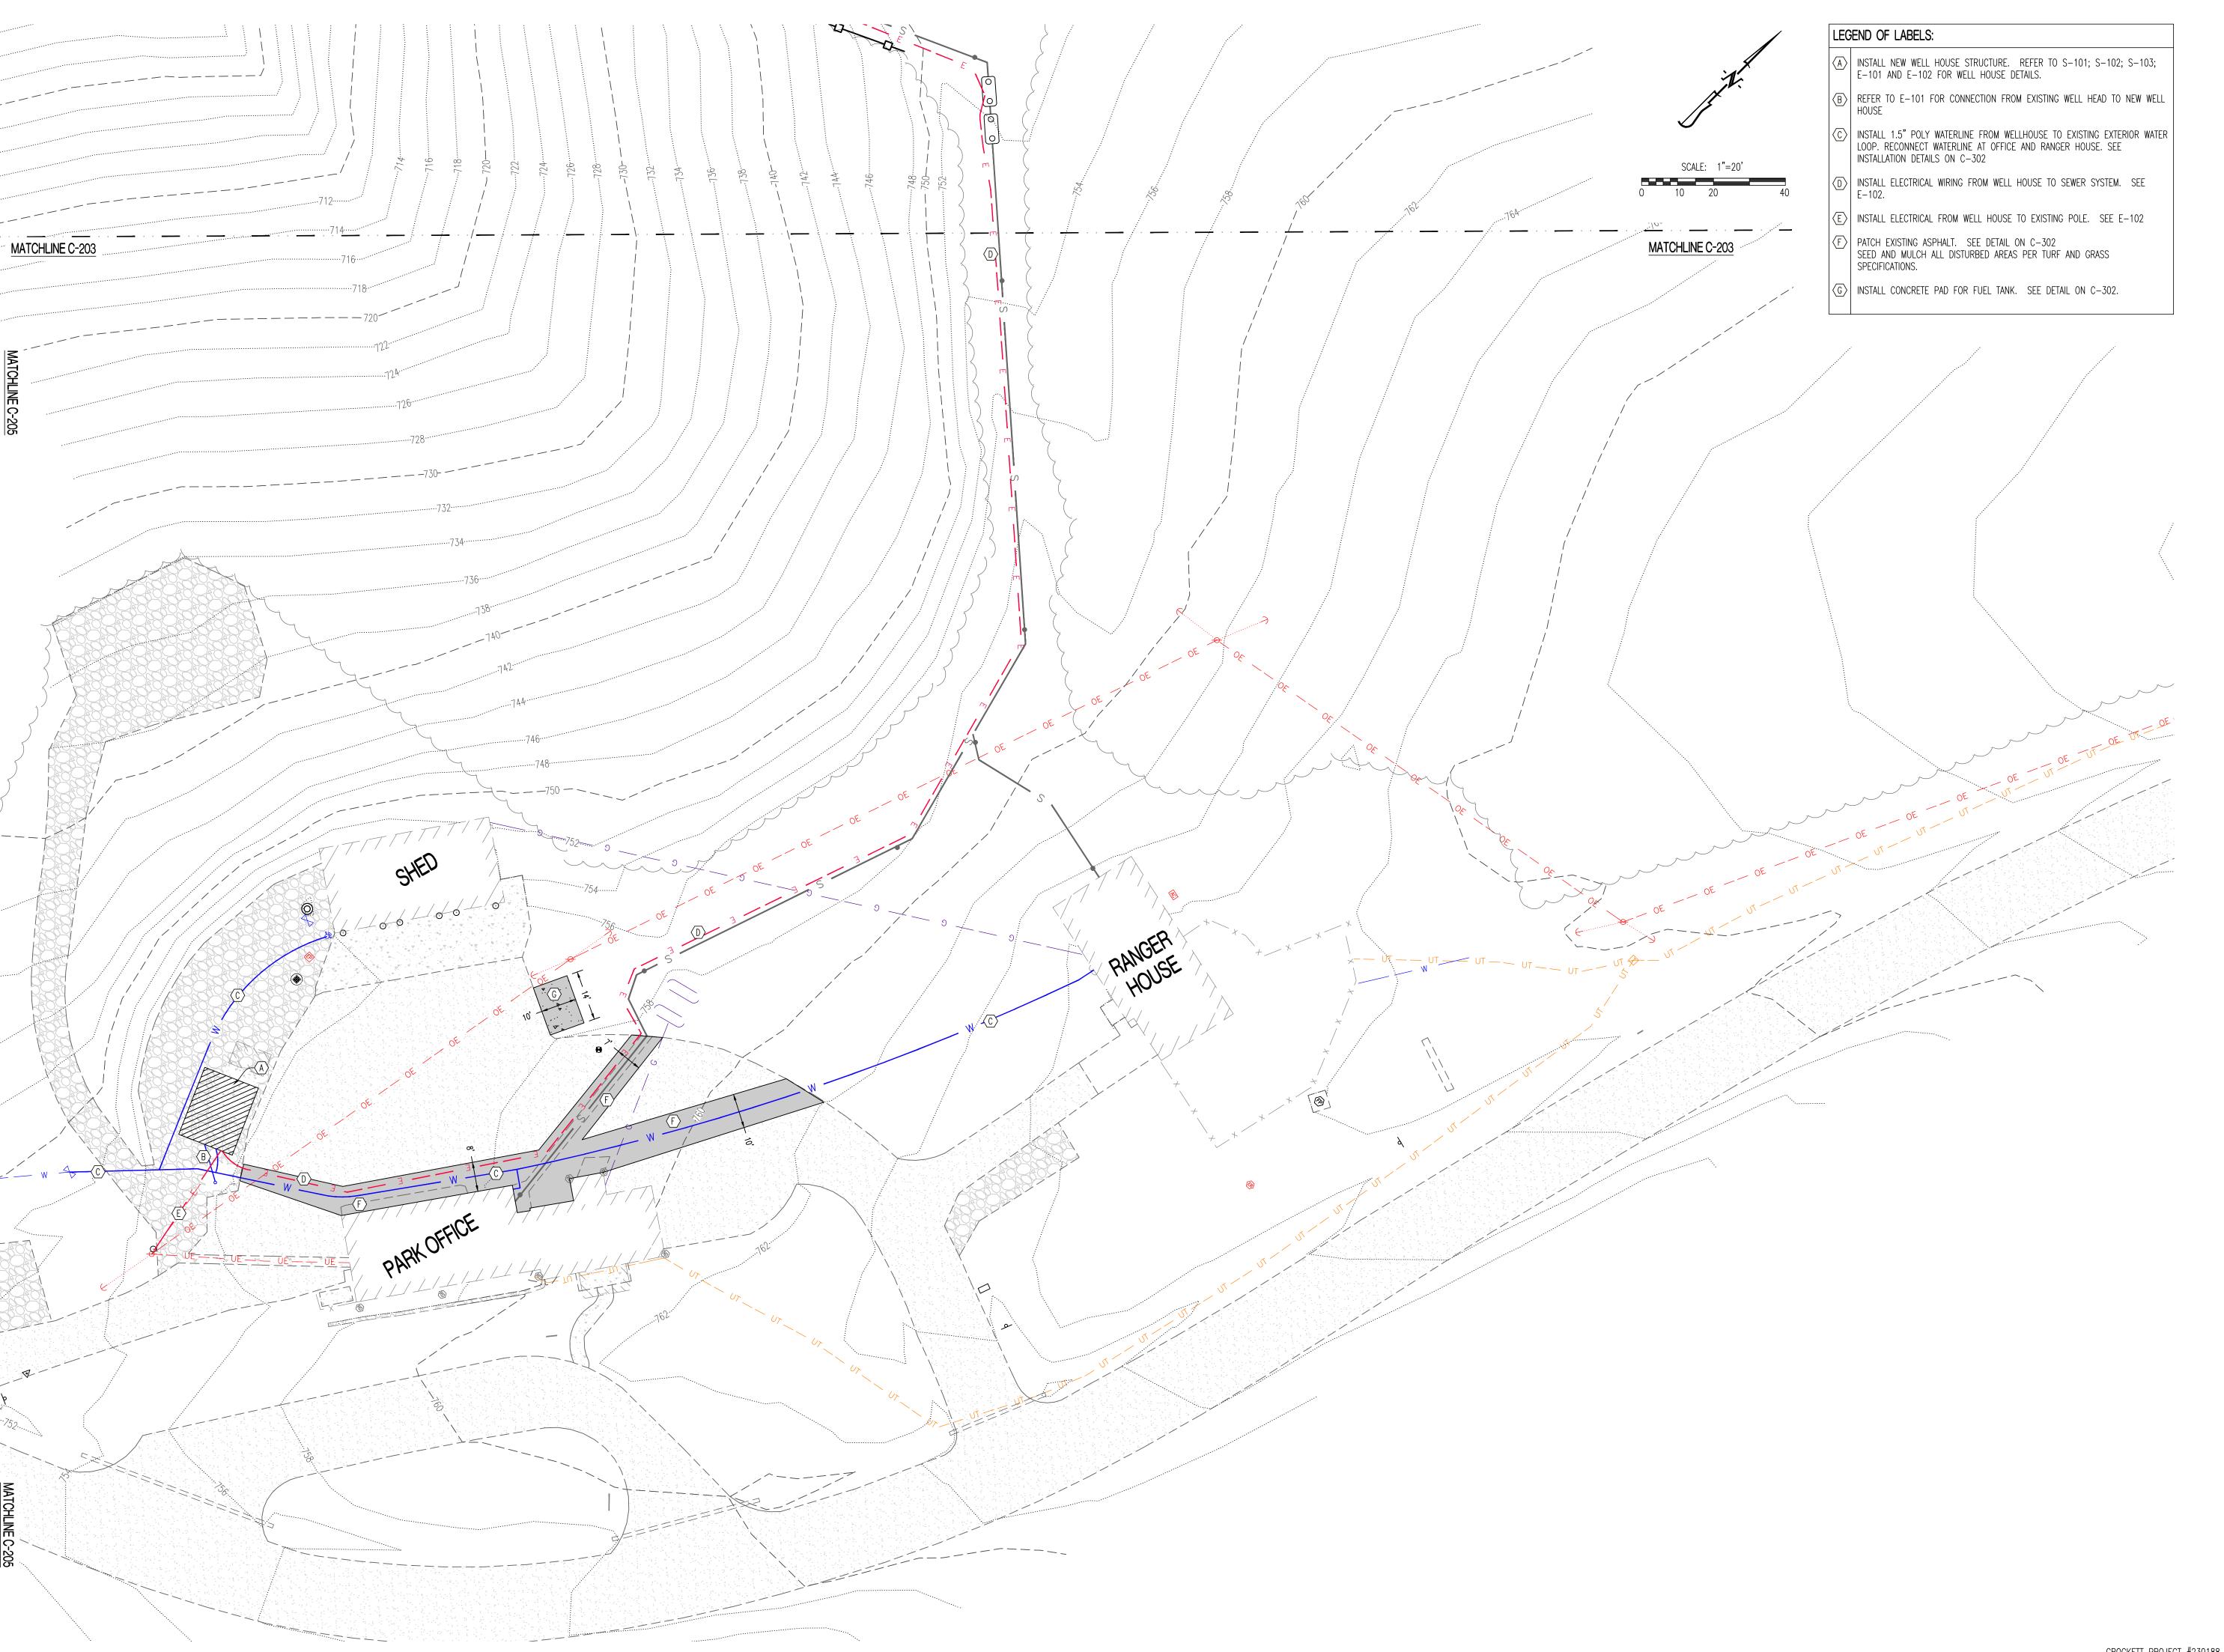
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SEWER DRIP IRRIGATION PLAN -PARK OFFICE

SHEET NUMBER:

C-203

SHEET 12 OF 21





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SITE/CIVIL ENGINEER:

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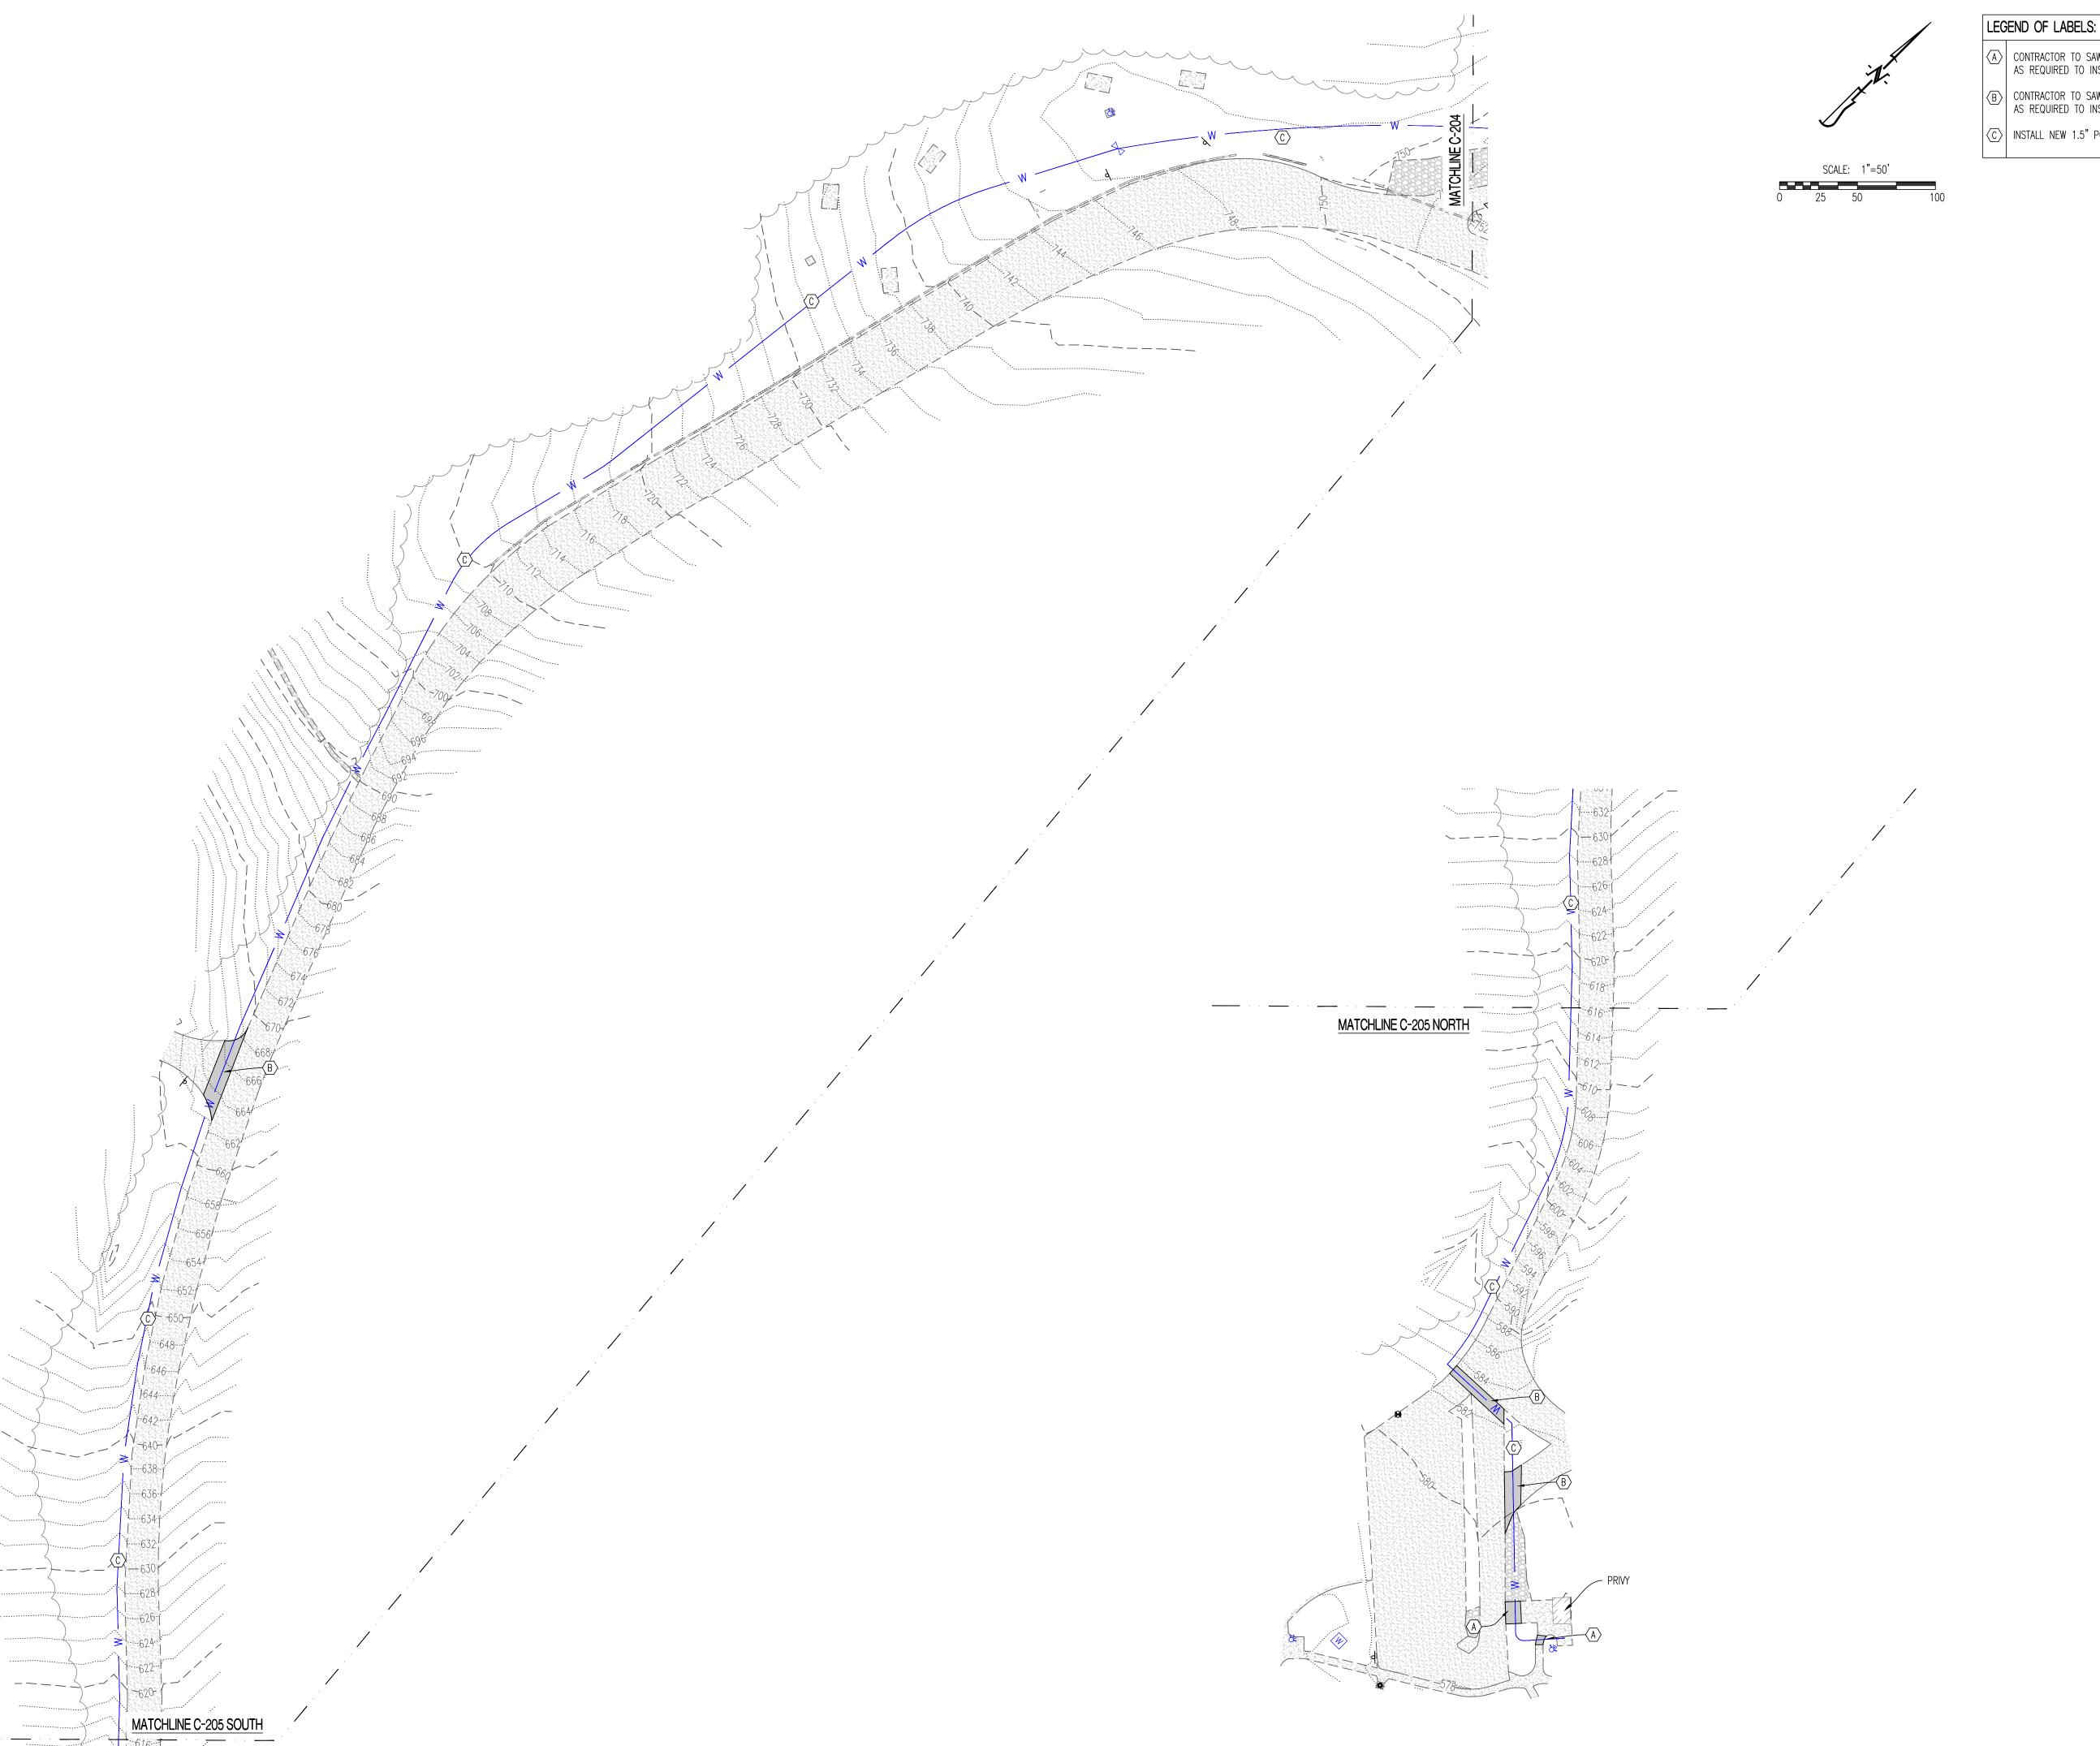
SHEET TITLE:

WELL HOUSE SITE PLAN - PARK OFFICE

SHEET NUMBER:

C-204

SHEET 13 OF 21



- CONTRACTOR TO SAWCUT AND PATCH EXISTING CONCRETE SIDEWALK AREAS AS REQUIRED TO INSTALL NEW WATER PIPING. SEE DETAIL ON C=302
- B CONTRACTOR TO SAWCUT AND PATCH EXISTING ASPHALT PARKING LOT AREAS AS REQUIRED TO INSTALL NEW WATER PIPING. SEE DETAIL ON C-302
- (C) INSTALL NEW 1.5" POLY WATERLINE FROM WELL HOUSE TO PAVILLION.



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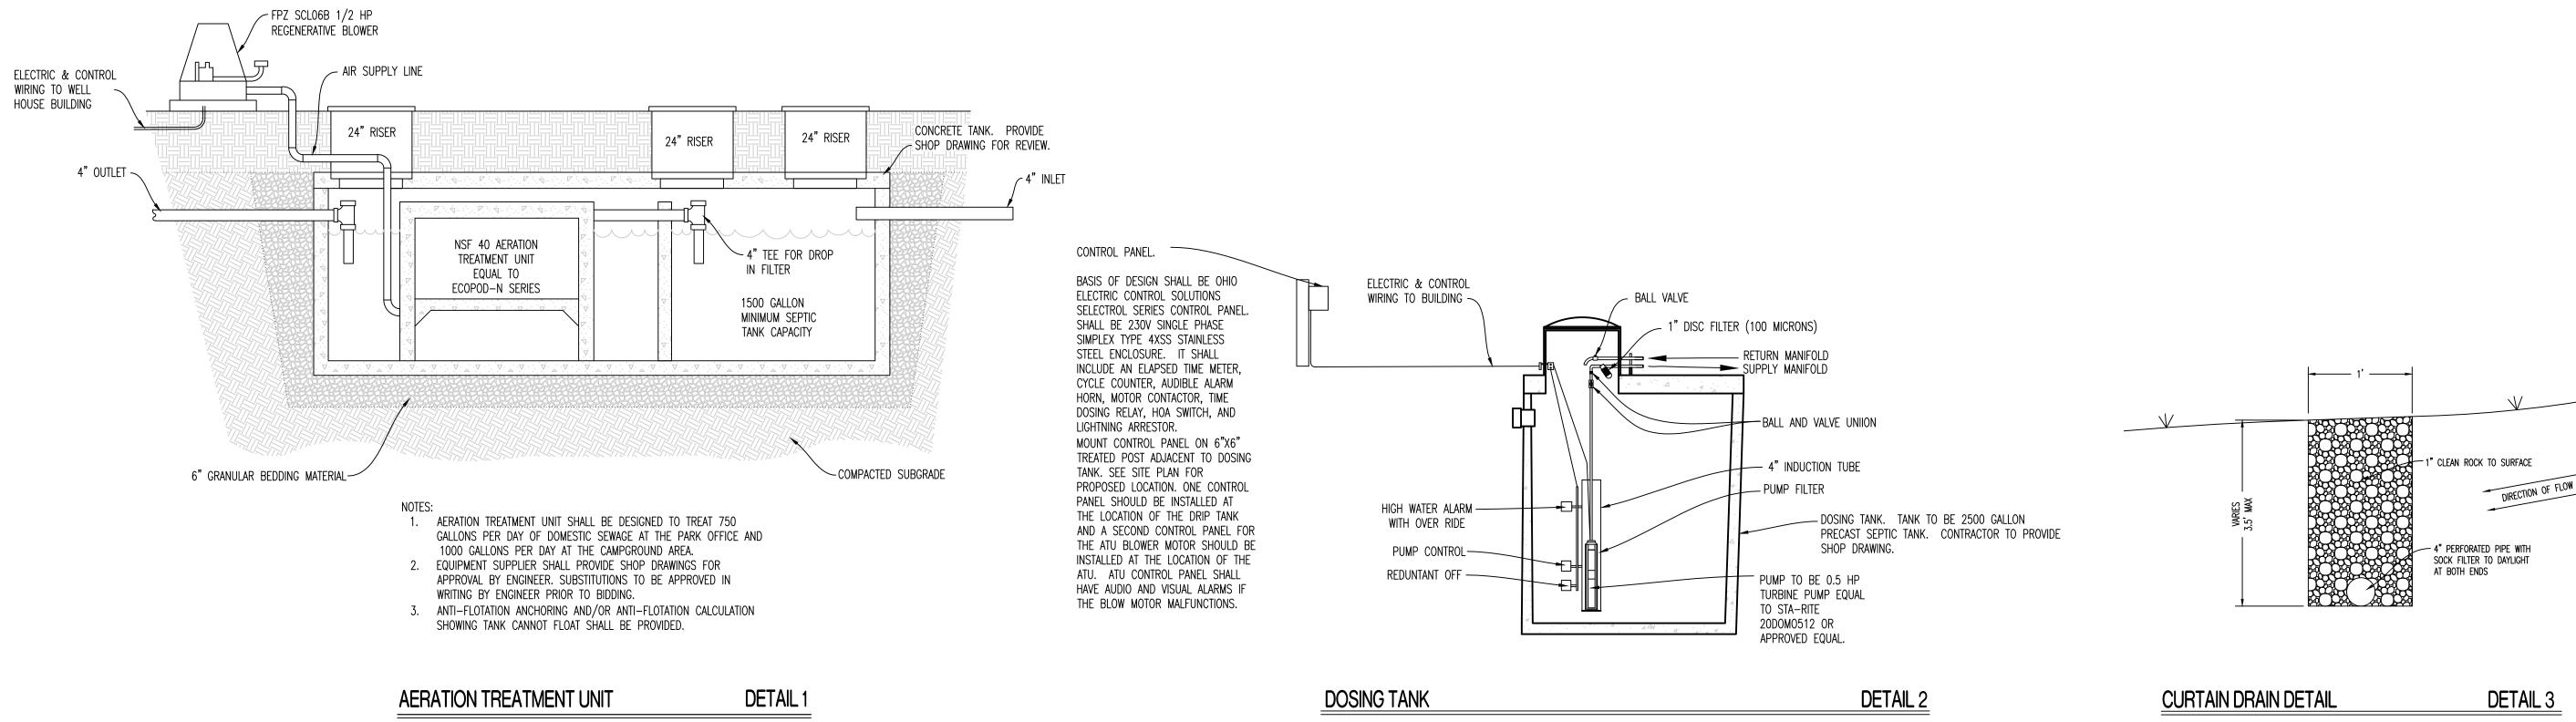
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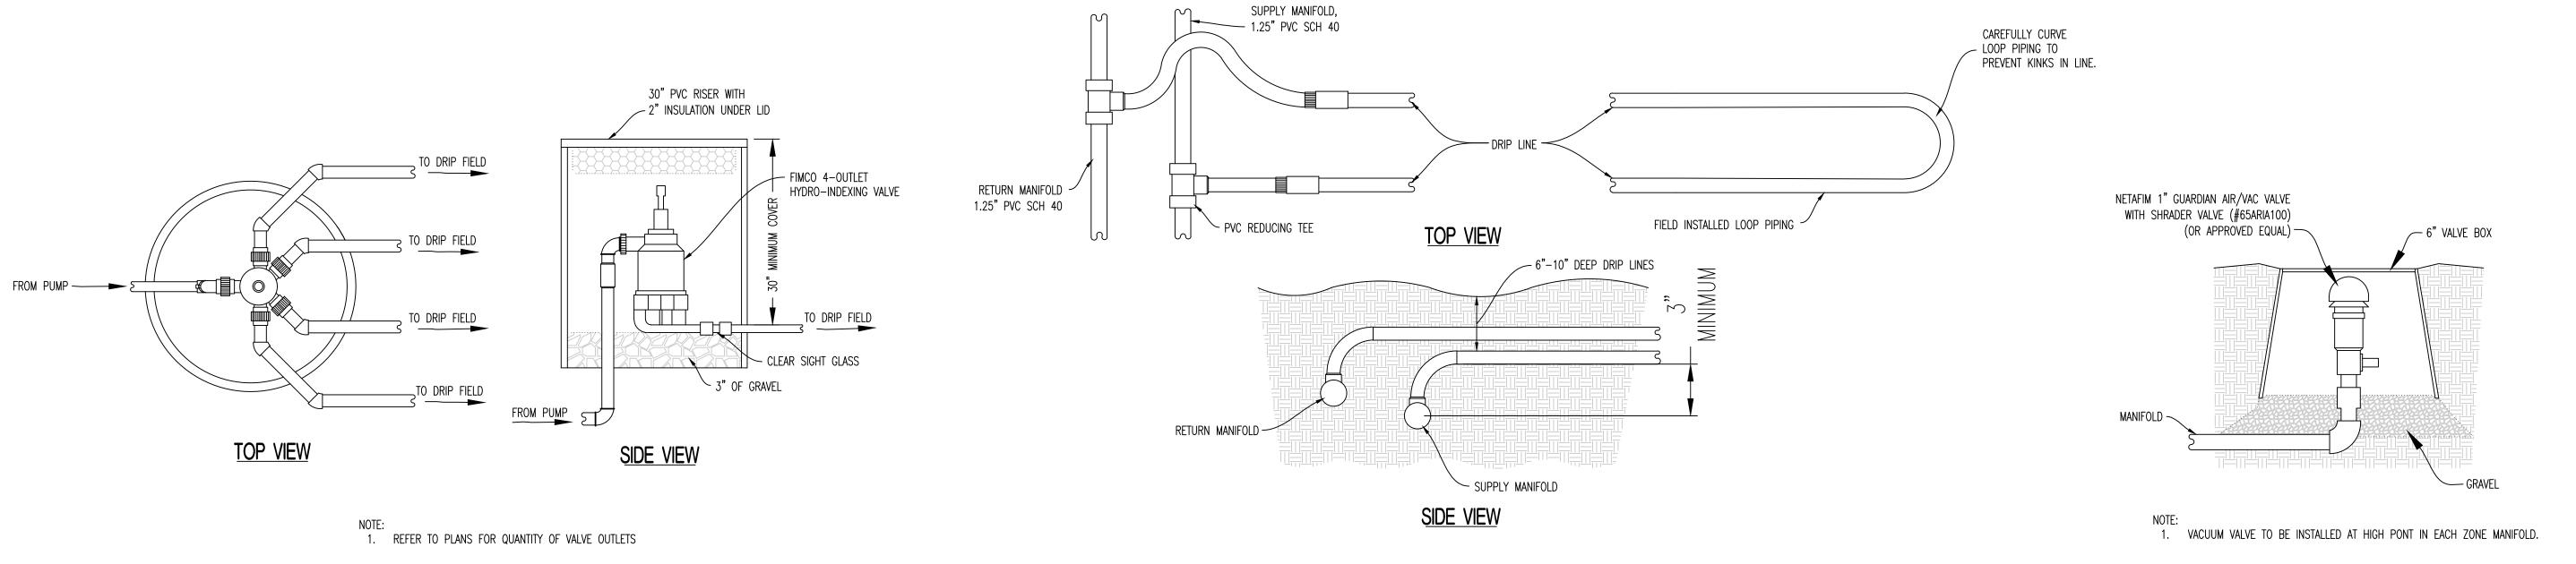
PAVILLION/PLAYGROUND WATER PLAN

SHEET NUMBER:

C-205

SHEET 14 OF 21





HYDRO- INDEXING VALVE IN PIT DETAIL 4

DRIP LINE CONNECTIONS TO MANIFOLDS WITH DRIP LOOP CONNECTIONS DETAIL 5 AIR/VACUUM RELIEF VALVE DETAILS


DETAIL 6


SHEET NUMBER:

C-301

SHEET 15 OF 21

CROCKETT PROJECT #230188

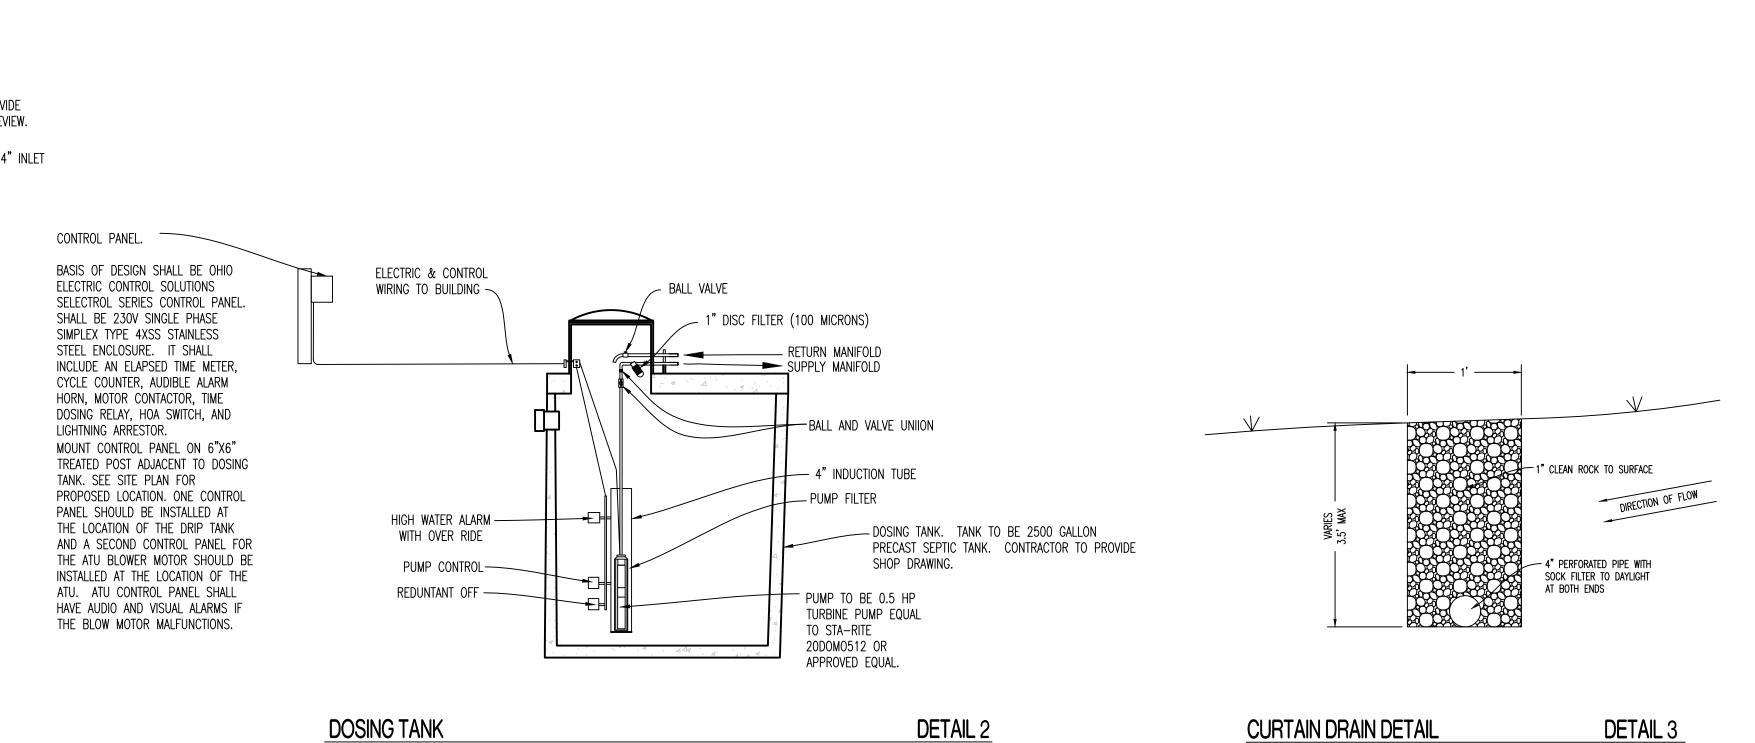

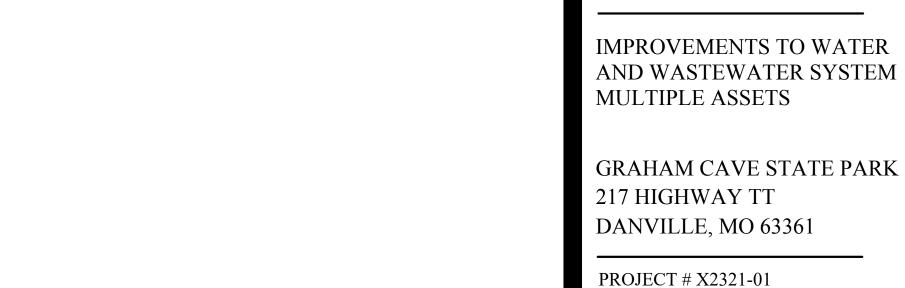

PROJECT # X2321-01 SITE NUMBER: 5210

STATE OF MISSOURI MICHAEL L. PARSON,

★: STEPHENS

.PE-2010000368,

JESSE RAY STEPHENS MO LICENSE - 2010000868

ENGINEERING CONSULTANTS 1000 W. Nifong Blvd., Bldg. 1 Columbia, Missouri 65203 (573) 447-0292

www.crockettengineering.com

Crockett Engineering Consultants, LLC Missouri Certificate of Authority #2000151301

OFFICE OF ADMINISTRATION

DESIGN AND CONSTRUCTION

DIVISION OF FACILITIES

730 TRUMAN BUILDING 301 WEST HIGH STREET POST OFFICE BOX 809

JEFFERSON CITY, MO 65102

MANAGEMENT,

SITE/CIVIL ENGINEER:

GOVERNOR


ASSET NUMBER: 7815210025 - LAGOON SERVICE AREA


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DRAWN		JRS	5

CHECKED BY: DESIGNED BY:

SHEET TITLE:

DRIP IRRIGATION **DETAILS**

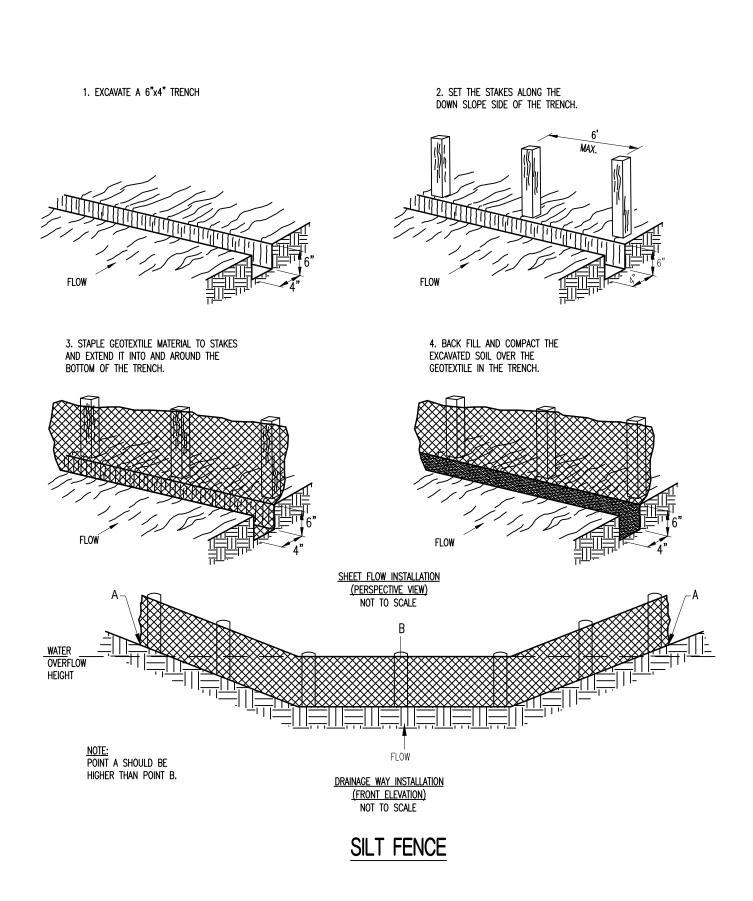

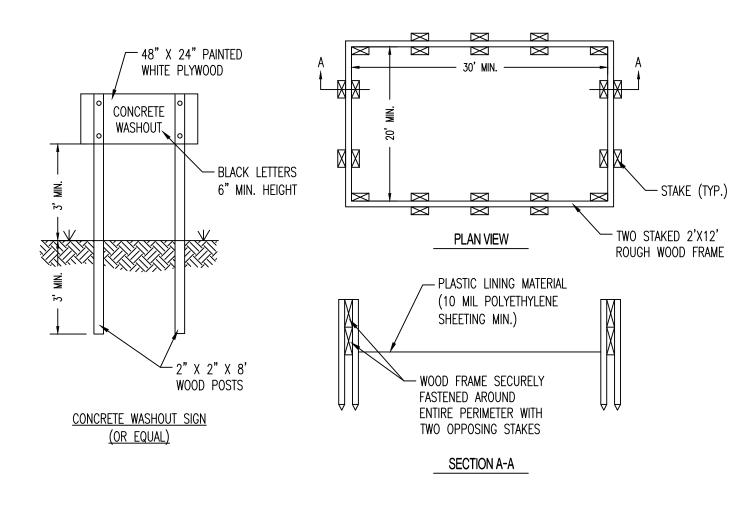


CONSTRUCTION NOTES:

CONCRETE WASHOUT SHALL BE AT LEAST 50' FROM ANY STORM SEWER INLET.


THE CONCRETE WASHOUT SIGN SHALL BE INSTALLED WITHIN 30' OF THE

CONCRETE WASHOUT

TEMPORARY CONCRETE WASHOUT FACILITY.

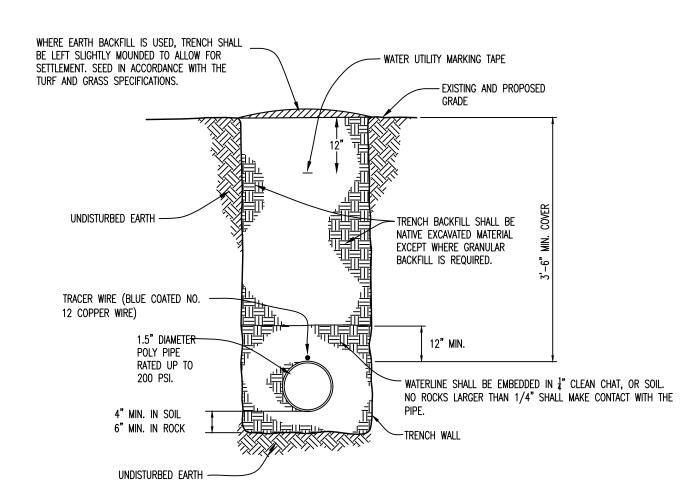

WATER LINE INSTALLATION

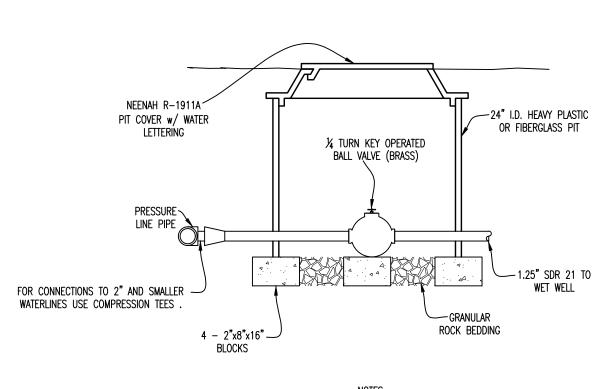


- nuies: Y Horizontally drilled or Bored Pipe Shall U:
- RESTRAINED JOINT PIPE.

 2. ALL UNITS SHALL BE CLEARLY LOCATED BY T-POST OR VERTICAL PVC PIPE UNTIL CONSTRUCTION COMPLETE.

 3. ALL BALL VALVES TO BE ¼ TURN BRASS VALVE OR APPROVED EQUAL, SIZE COMMENSURATE WITH PIPE SHOWN.
- ALL LOCATER WIRE SHALL BE BLUE COATED, NO. 12 COPPER WIRE.
 LOOP LOCATOR WIRE IN ALL PITS.

WATER LINE SHUT-OFF

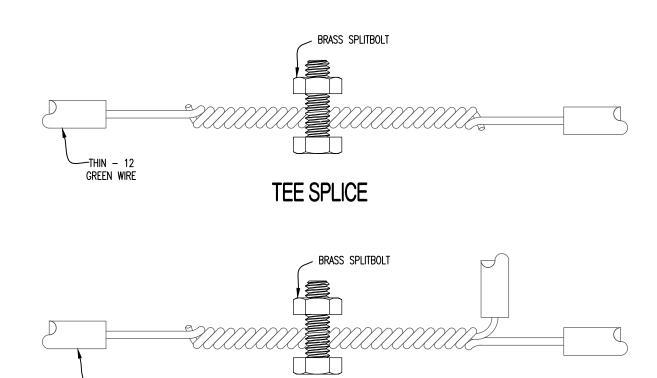

TEE INTERSECTION


NOTE: AT TEE INTERSECTION, REMOVE INSULATION ONLY. <u>DO NOT CUT MAIN LOCATOR WIRE.</u>


WIRE TO BE 12 GAUGE SOLID COPPER WITH THIN GREEN INSULATION.

SPLICE OR CONNECTION TO BE DOUBLE WRAP TAPED WITH ½" OVERLAP PER ROUND. APPLY SCOTCHKOTE TO SEAL THE TAPED CONNECTION.

GREEN WIRE

TRACER WIRE SPLICE

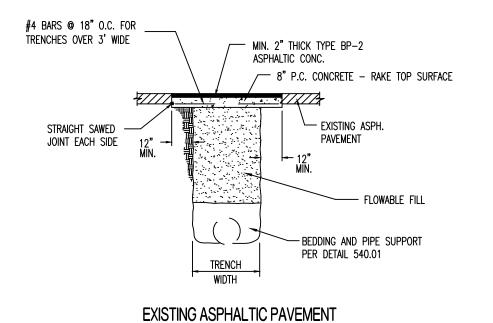


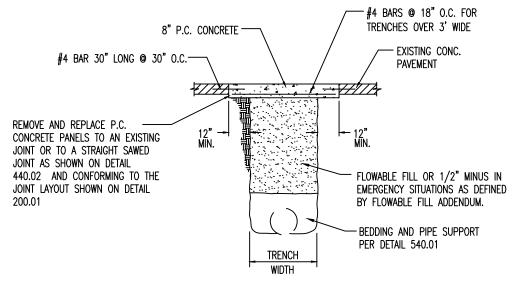


EXISTING CONCRETE PAVEMENT

NOTES: CONCRETE SHALL BE 4000 PSI, 5% AIR ENTRAINED REINFORCING STEEL SHALL BE GRADE 60


PATCHING PAVED DRIVEWAYS

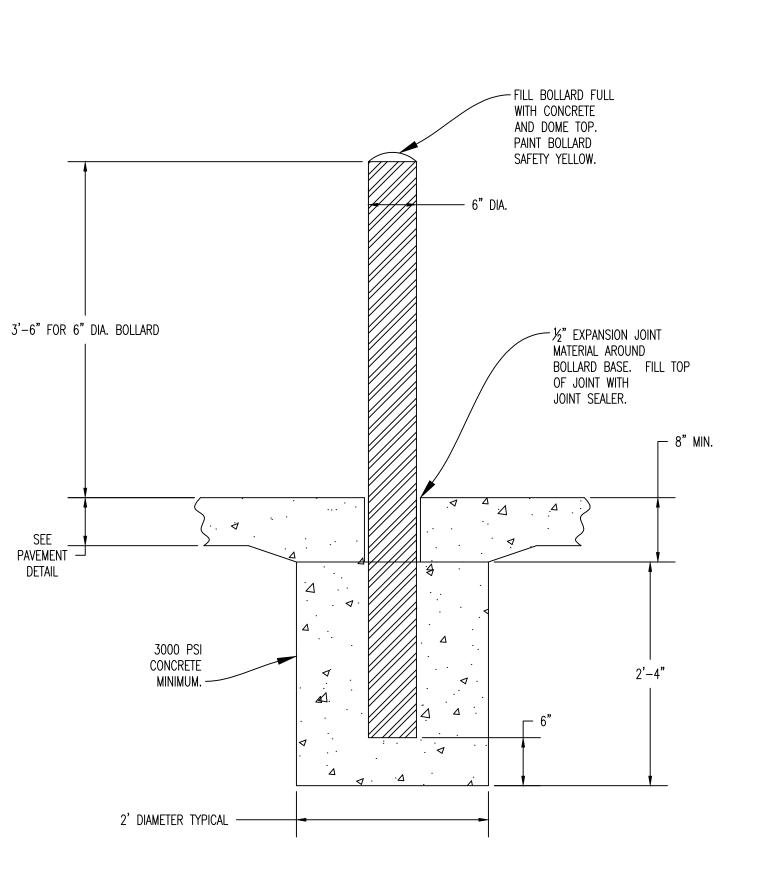


BOLLARD INSTALLATION DETAIL

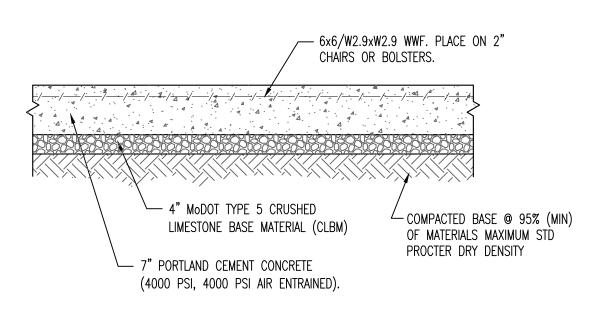

FUEL TANK PAD

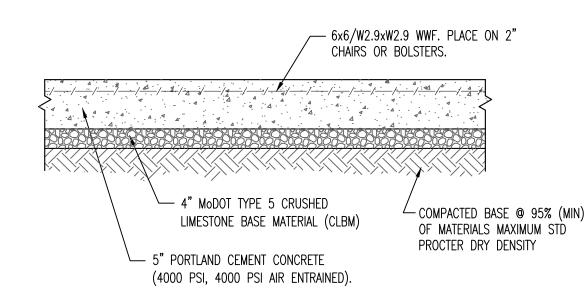

CONCRETE SIDEWALK

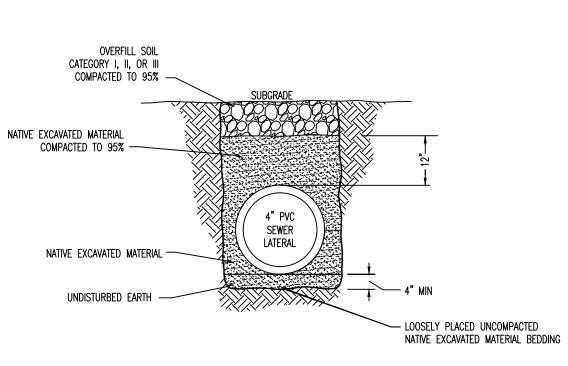

FLEXIBLE PIPE

SANITARY SEWER LATERAIL INSTALLATION

STATE OF MISSOURI MICHAEL L. PARSON, GOVERNOR



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IMPROVEMENTS TO WATER AND WASTEWATER SYSTEM MULTIPLE ASSETS

GRAHAM CAVE STATE PARK 217 HIGHWAY TT DANVILLE, MO 63361

PROJECT # X2321-01 SITE NUMBER: 5210 ASSET NUMBER: 7815210016 - PUMP HOUSE WELL #1 7815210017 - PUMP HOUSE WELL #2 7815210025 - LAGOON SERVICE AREA

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ISSUE DATE: 09/09/2024

CAD DWG FILE: 230188_GRAHAM CIVIL DRAWN BY: JRS
CHECKED BY: ATG
DESIGNED BY: JRS

SHEET TITLE:

SITE CONSTRUCTION DETAILS

SHEET NUMBER:

C-302

SHEET 16 OF 21

GENERAL NOTES

ELEVATION DATUM

SEE GRADING PLAN FOR ELEVATIONS

DESIGN SPECIFICATIONS

2021 INTERNATIONAL BUILDING CODE

EARTHWORK OPERATIONS SHALL BE PERFORMED UNDER THE DIRECTION OF A PROFESSIONAL TESTING AGENCY TO ASSURE COMPLIANCE WITH THE MINIMUM BEARING CAPACITY FOR FOUNDATIONS SPECIFIED BELOW.

CONCRETE

CONCRETE WORK SHALL CONFORM TO ALL REQUIREMENTS OF THE CURRENT ACI 301, SPECIFICATIONS FOR STRUCTURAL CONCRETE FOR BUILDINGS, ACI 318 BUILDING CODE REQUIREMENTS FOR STRUCTURAL CONCRETE, ACI 305 SPECIFICATIONS FOR HOT WATER CONCRETE, AND ACI 306 SPECIFICATIONS FOR COLD WEATHER CONCRETE, ACI 350-06 CODE REQUIREMENTS FOR ENVIRONMENTAL ENGINEERING CONCRETE STRUCTURES, WITH THE FOLLOWING ADDITIONAL REQUIREMENTS:

- 1. CONCRETE SHALL DEVELOP THE FOLLOWING 28-DAY MINIMUM COMPRESSIVE STRENGTH: BUILDING FOUNDATIONS - 3,000 PSI
- GENERAL USE CONCRETE
- 4,000 PSI EXTERIOR SLABS, WALLS AND CURBS - 4,000 PSI
- 2. ALL FOOTINGS SHALL BEAR ON UNDISTURBED SOIL OR ENGINEERED FILL.
- 3. CHLORIDE- BASED ADMIXTURES ARE PROHIBITED IN ALL REINFORCED CONCRETE. 4. REINFORCING STEEL SHALL CONFORM TO ASTM A615, A616, OR A617, GRADE 60.
- 5. ALL CONTINUOUS REINFORCING STEEL THAT MEETS AT A CORNER SHALL BE TIED TOGETHER WITH A CORNER BAR THAT HAS SUFFICIENT LAP DISTANCE IN EACH DIRECTION
- 6. CONTINUOUS REINFORCING BARS LAP LENGTH SHALL BE A MINIMUM OF 48 BAR DIAMETERS UNLESS NOTED OTHERWISE
- 7. CONCRETE SLUMP SHALL BE A MAXIMUM OF 4" +/- 1" (ASTM C- 143) AS DELIVERED IN THE FIELD. CONTRACTOR MAY USE CHEMICAL ADMIXTURES TO ATTAIN A MAXIMUM SLUMP OF 8" FOR WORKABILITY. NO WATER MAY BE ADDED TO THE CONCRETE MIX ON SITE UNLESS WATER IS WITHHELD AT THE BATCHING FACILITY. IF WATER IS WITHHELD AT THE BATCHING FACILITY IT SHOULD BE REFLECTED ON THE LOAD TICKET. THE TOTAL AMOUNT OF WATER IN THE MIX SHALL NOT EXCEED WHAT IS NOTED ON THE APPROVED MIXED. THIS SHALL BE NOTED IN THE SPECIAL INSPECTOR'S RECORDS.
- 8. CONCRETE EXPOSED TO WEATHER, VEHICLES, AND/OR DEICING CHEMICALS SHALL BE AIR-ENTRAINED WITH 6% (+/-) 1.5% ENTRAINED AIR BY VOLUME AT POINT OF DISCHARGE. DO NOT ALLOW AIR CONTENT OF TROWELED FINISHED FLOORS OR TANK STRUCTURES TO EXCEED 3%.
- 9. SUBMIT CONCRETE MIX PROPORTIONS PRIOR TO START OF WORK. DO NOT BEGIN CONCRETE PRODUCTION UNTIL MIXES HAVE BEEN REVIEWED AND ARE ACCEPTABLE TO THE ENGINEER.
- 10. READY MIX CONCRETE SHALL COMPLY WITH REQUIREMENTS OF ASTM C94. 10.1.1.

11.CONCRETE WORK EXECUTION

- A. CONSTRUCT FORMS TO CORRECT SIZE, SHAPE, ALIGNMENT, ELEVATION AND POSITION; AND TO SUPPORT VERTICAL AND LATERAL LOADS.
- B. POSITION, SUPPORT, AND SECURE REINFORCEMENT AGAINST DISPLACEMENT. MINIMUM CONCRETE COVER FOR REINFORCEMENT SHALL BE, UNLESS NOTED OTHERWISE ON THE DRAWINGS:
 - CAST AGAINST AND EXPOSED TO EARTH.......3 INCHES EXPOSED TO EARTH OR WEATHER......2 INCHES
 - NOT EXPOSED TO WEATHER OR
 - IN CONTACT WITH EARTH....... 1 ½ INCHES
- C. PROVIDE CONTROL JOINTS IN SLABS-ON-GRADE AT NOT GREATER THAN 15 FEET ON CENTER IN EACH DIRECTION. SAW CUT CONTROL JOINTS MINIMUM 1/4 OF SLAB DEPTH, AS SOON AFTER SLAB
- FINISHING WITHOUT DISLODGING AGGREGATE. DO NOT SAW CUT TANK FLOORS. D. STEEL TROWEL FINISH ALL INTERIOR CONCRETE SLABS, BROOM FINISH ALL EXTERIOR CONCRETE
- E. CURE ALL CONCRETE IN COMPLIANCE WITH ACI 301, USING A LIQUID TYPE MEMBRANE, NON-RESIDUAL, CURING COMPOUND COMPLYING WITH ASTM C309. ASSURE COMPATIBILITY WITH FINISH FLOOR COVERING.

WOOD FRAMING

WOOD FRAMING WORK SHALL CONFORM TO ALL REQUIREMENTS OF THE CURRENT ANSI/AF&PA NATIONAL DESIGN SPECIFICATION (NDS) FOR WOOD CONSTRUCTION, WITH THE FOLLOWING SUPPLEMENTAL REQUIREMENTS:

- 1. FOR COMMON MEMBER SIZES, THE SPECIES AND GRADES SHALL BE AS FOLLOWS, UNLESS NOTED OTHERWISE:
- A. 2X4 SPF No.1/No.2
- B. 2X6 SPF No.1/No.2
- C. 2X8 DF-L No.2
- D. 2X10 DF-L S.S.
- E. 2X12 DF-L S.S.
- EQUIVALENT (OR BETTER) GRADES & SPECIES MAY BE SUBMITTED FOR THE ENGINEER'S APPROVAL.
- 2. SIZES SHOWN FOR LUMBER ARE NOMINAL SIZES.
- 3. TIMBER EXPOSED TO WEATHER OR GROUND, OR IN CONTACT WITH CONCRETE OR MASONRY SHALL BE PRESSURE-IMPREGNATED BY AN APPROVED PROCESS AND PRESERVATIVE.
- 4. SPLICING OF JOISTS, STUDS, OR HEADERS IS PROHIBITED EXCEPT AS SHOWN.
- 5. BOLTS SHALL CONFORM TO ASTM A307. HOLES SHALL BE DRILLED PER SECTION 11.1.2 OF THE 2005 ANSI/AF&PA NDS FOR WOOD CONSTRUCTION.
- 6. LAG SCREWS AND WOOD SCREWS SHALL BE INSTALLED PER SECTIONS 11.1.3 AND 11.1.4, RESPECTIVELY, OF THE 2005 ANSI/AF&PA NDS FOR WOOD CONSTRUCTION.
- 7. COMMON NAILS SHALL BE USED, UNLESS NOTED OTHERWISE. IN ADDITION, NAILS SHALL BE GALVANIZED, IF EXPOSED TO WEATHER OR MOISTURE. TOE-NAILS SHALL BE DRIVEN PER SECTION 11.1.5.4 OF THE 2005 ANSI/AF&PA NDS FOR WOOD CONSTRUCTION.
- 8. FASTENING SHALL BE PER THE IBC MINIMUM FASTENING SCHEDULE, TABLE 2304.9.1, UNLESS NOTED OTHERWISE.
- 9. CONNECTIONS/CONNECTORS SHALL BE INSTALLED PER MANUFACTURER'S SPECIFICATIONS.
- 10. PROVIDE TEMPORARY AND PERMANENT BRACING ON ALL MEMBERS, AS REQUIRED TO PROVIDE MEMBER.

POST-INSTALLED ANCHORS

- 1. ALL POST-INSTALLED ANCHORS SHALL MEET THE REQUIREMENTS OF ACI 318, APPENDIX "D", AND SHALL BE ACCEPTABLE FOR BOTH CRACKED AND UNCRACKED CONCRETE. 2. EXPANSION ANCHORS HAVE BEEN DESIGNED AS HILTI KWIK BOLT TZ ANCHORS, UNLESS NOTED
- 3. ADHESIVE ANCHORS HAVE BEEN DESIGNED TO USE HILTI HIT HY 200 ADHESIVE IN CONCRETE OR SOLID
- MASONRY, UNLESS NOTED OTHERWISE. 4. EQUIVALENT ANCHORS MAY BE SUBMITTED FOR THE ENGINEER'S APPROVAL. SUBMITTALS ARE THE CONTRACTOR'S RESPONSIBILITY AND MUST INCLUDE EVALUATION REPORTS FROM THE INTERNATIONAL CONFERENCE OF BUILDING OFFICIALS (ICBO).
- 5. EMBEDMENT DEPTH IS DEFINED AS THE DISTANCE FROM THE SURFACE OF THE LOAD-BEARING BASE MATERIAL TO THE DEEPEST PART OF THE ANCHOR AFTER THE ANCHOR HAS BEEN DRIVEN INTO THE
- HOLE BUT NOT YET EXPANDED. 6. ADHESIVE ANCHORS SHALL BE ACCEPTABLE FOR LONG-TERM LOADING. WHEN BASE MATERIAL TEMPERATURES ARE BELOW 40 DEG F, ONLY NON-EPOXY-BASED ADHESIVES SHALL BE USED.
- 7. POST-INSTALLED ANCHORS SHALL ONLY BE USED WHERE SPECIFIED ON THE DRAWINGS. THE CONTRACTOR SHALL OBTAIN APPROVAL FROM THE ENGINEER PRIOR TO USING POST-INSTALLED ANCHORS FOR MISSING OR MISPLACED CAST-IN-PLANE ANCHORS. CARE SHALL BE TAKEN TO AVOID CONFLICTS WITH EXISTING REINFORCING BARS. HOLES SHALL BE DRILLED AND CLEANED PER ANCHOR MANUFACTURER'S SPECIFICATIONS.
- 8. STAINLESS STEEL ANCHORS ARE REQUIRED AT ALL PERMANENTLY EXPOSED WEATHER CONDITIONS.

SPECIAL INSPECTIONS

THE FOLLOWING ITEMS REQUIRE SPECIAL INSPECTION IN ACCORDANCE WITH CHAPTER 17 OF THE INTERNATIONAL BUILDING CODE.

- a. PLACING OF CONCRETE AND REINFORCING STEEL (CONTINUOUS OF CONCRETE SAMPLING / PERIODIC OF REINFORCING)
- b. BOLTS & ANCHORS EMBEDDED IN CONCRETE (PERIODIC)
- c. STRUCTURAL STEEL FABRICATIONS (UNLESS AISC APPROVED) (PERIODIC)
- d. STRUCTURAL STEEL BOLTING & WELDING (PERIODIC)
- e. POST INSTALLED ANCHORS IN CONCRETE (CONTINUOUS)
- f. IN-SITU SOILS, EXCAVATIONS, FILLING & COMPACTION (PERIODIC)

THE CONTRACTOR SHALL REQUEST SPECIAL INSPECTION OF THE ITEMS LISTED ABOVE PRIOR TO THOSE ITEMS BECOMING INACCESSIBLE AND UNOBSERVABLE DUE TO PROGRESSION OF THE WORK.

DESIGN CRITERIA

BUILDING OCCUPANCY CA	ATEGORY	II		
ROOF LOAD				
LIVE LOAD		20		
TOP CHORD DEAD/CO	LLATERAL LOAD	10		
TOP CHORD FUTURE S	OLAR	5		
BOTTOM CHORD DEAD	COLLATERAL LOAD	10		
TOTAL TO TRUSS		45 lbs/sq.ft		
ROOF SNOW LOAD*	(*UNBALANCED & DRIFTING IN ADDITION TO UNIFORM L	SNOW TO BE DETERMINED OAD, WHERE APPLICABLE)		
p _g =		20 lbs/sq.ft		
C _e =		1.0		
l _e =		1.0		
C _t =		1.0		
p _f =		20 lbs/sq.ft		
p _s =		20 lbs/sq.ft		
BASIC DESIGN WIND LOAI	2			
V =		107 M.P.H. (3-SECON	ND GUS	
I _w =		1.0		
EXPOSURE		С		
INTERNAL PRESSURE	COEFFICIENT =	± 0.18		
MAXIMUM COMPONENT	S & CLADDING WIND	± 33.75 lbs/sq.ft		
EARTHQUAKE DESIGN DA	TA			
S _S = 0.167				
S ₁ = 0.093				
S _{DS} = 0.178				
S _{D1} = 0.149				

SEISMIC DESIGN CATEGORY C

SITE CLASS D (ASSUMED)

BASIC SEISMIC-FORCE-RESISTING SYSTEM = LIGHT-FRAMED WALLS SHEATHED WITH STRUCTURAL PANELS

R = 6.5 $\Omega_{\rm o} = 3.0$ $C_d = 4.0$

 $I_E = 1.0$

EQUIVALENT LATERAL FORCE PROCEDURE

V = 0.0274W

NET ALLOWABLE SOIL BEARING

(**ASSUMED PER IBC TABLE 1806.1, PRESUMPTIVE LOAD-BEARING VALUES)

MICHAEL L. PARSON, **GOVERNOR**

STATE OF MISSOURI



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IMPROVEMENTS TO WATER AND WASTEWATER SYSTEM MULTIPLE ASSETS

GRAHAM CAVE STATE PARK 217 HIGHWAY TT DANVILLE, MO 63361

PROJECT # X2321-01 SITE NUMBER: 5210 **ASSET NUMBER:** 7815210016 - PUMP HOUSE WELL #1 7815210017 - PUMP HOUSE WELL #2

REVISION:
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CAD DWG FILE: 230188_GRAHAM CIVIL DRAWN BY: **CHECKED BY: DESIGNED BY:**

SHEET TITLE:

WELL HOUSE BUILDING CODE CRITERIA

SHEET NUMBER:

S-101


SHEET 17 OF 21


CROCKETT PROJECT #230188


1,500 lbs/sq.ft**

GENERAL NOTES

- 1. TWO WELL HOUSES ARE TO BE BUILT. ONE IS LOCATED ADJACENT TO THE PARK RANGER STATION AND THE OTHER IS LOCATED ADJACENT TO THE PLAYGROUND. THE PARK RANGER STATION WELL HOUSE MUST BE CONSTRUCTED PRIOR TO DEMOLITION OF THE EXISTING WELL HOUSE AT THE RANGER STATION. DOWN TIME BETWEEN THE SWITCHOVER SHALL BE KEPT TO LESS THAN 48 HOURS OR AS SCHEDULED WITH THE PARK STAFF. POTABLE WATER SHALL BE MAINTAINED TO THE PARK OFFICE.
- 2. ALL INTERIOR WALLS SHALL BE CLAD WITH §" THICK CDX PLYWOOD. PLYWOOD SHOULD BE SMOOTH AND FREE OF SPLINTERS. SAND AS NEEDED TO PROVIDE SMOOTH SURFACE.
- 3. INTERIOR PLYWOOD SHOULD BE PAINTED WITH A MINIMUM OF TWO COATS OF WHITE SATIN PAINT PRIOR INSTALLATION OF ANY SURFACE MOUNTED EQUIPMENT.
- 4. THE INTERIOR WALL BETWEEN THE CHLORINE DOSING ROOM AND THE PUMP ROOM SHALL BE INSULATED THE SAME AS THE EXTERIOR WALLS.
- 5. THE EXTERIOR FIBER CEMENT SIDING SHALL BE PAINTED WITH A MINIMUM OF TWO COATS OF EXTERIOR GRADE PAINT IN A COLOR TO BE SELECTED BY THE PARK STAFF.
- 6. ALUMINUM SOFFIT AND FASCIA MATERIAL TO BE SELECTED FROM MANUFACTURERS STANDARD RANGE OF COLORS. 7. SHINGLE COLOR AND STYLE TO BE SELECTED FROM MANUFACTURERS STANDARD RANGE OF COLORS.
- 8. THE FIBERGLASS DOOR AT THE CHLORINE ROOM SHALL CONTAIN AN INTEGRAL 2'X2' VENTED LOUVER. THE DOOR HARDWARE SHALL BE A CLASSROOM STYLE LOCKSET. LOCK SHALL BE KEYED TO MATCH
- THE EXISTING PARK KEYING SYSTEM. 9. THE PAIR OF FIBERGLASS DOORS AT THE PUMP ROOM SHALL CONTAIN A FLUSHBOLT OR EQUIVALENT TO MAKE THE LEFT LEAF OF THE DOOR NORMALLY CLOSED. PROVIDE WEATHERSTRIPPING, THRESHOLD, AND CLASSROOM LOCKSET KEYED TO MATCH THE EXISTING PARK KEYING SYSTEM.

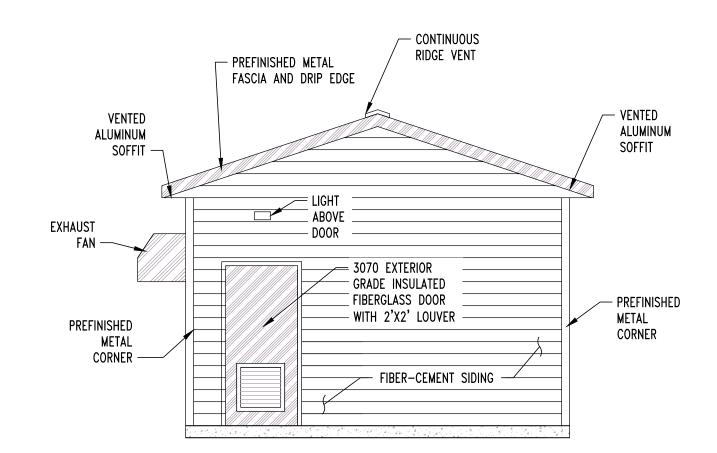

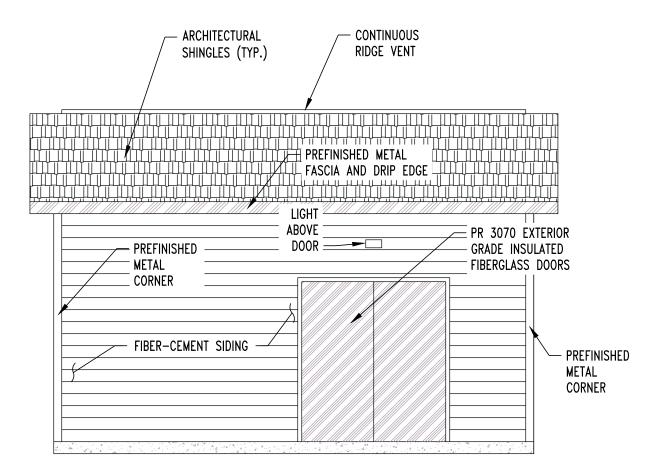

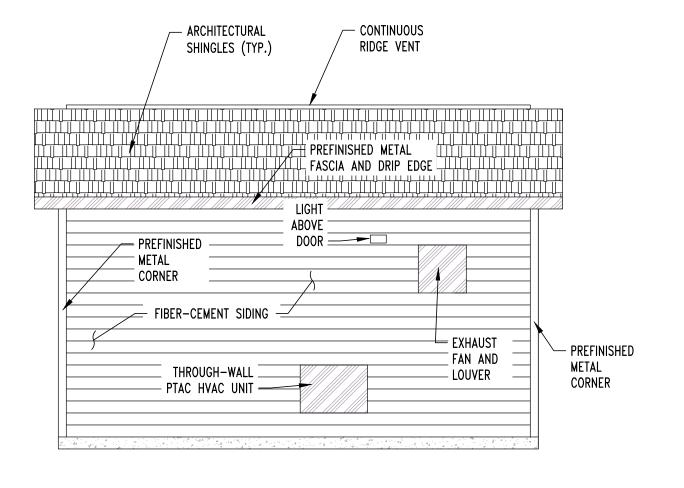




PLAN NORTH








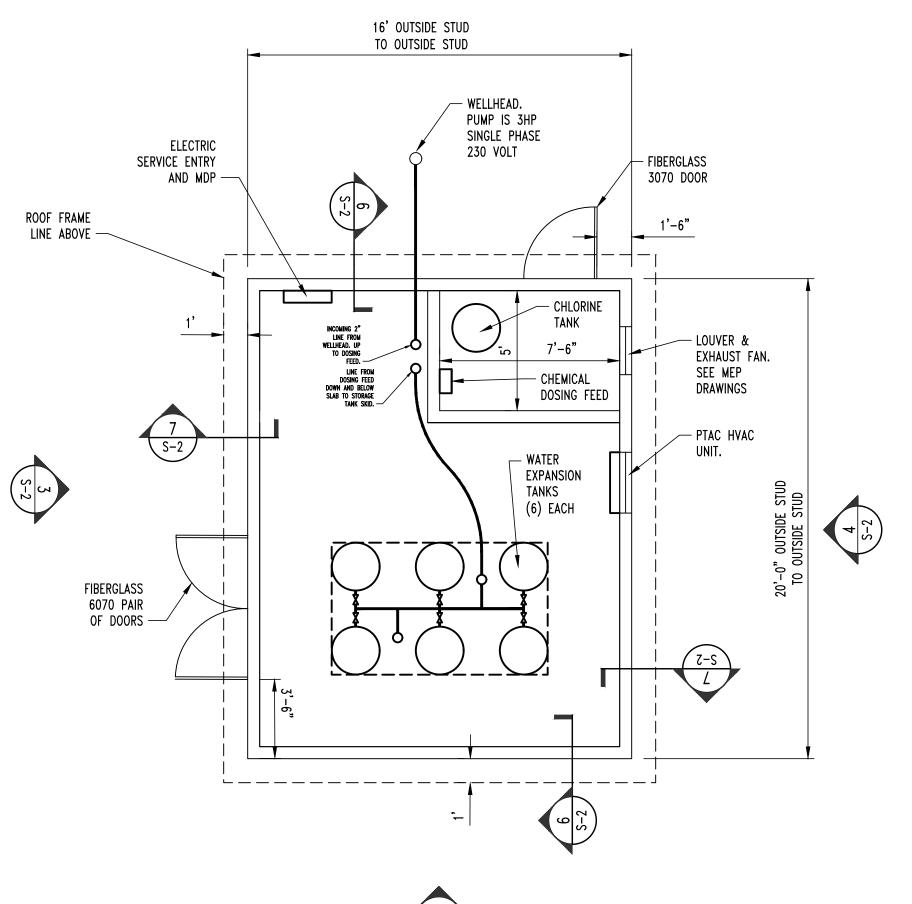


WELLHOUSE BUILDING FLOOR PLAN


SCALE: $\frac{1}{4}$ " = 1'-0"

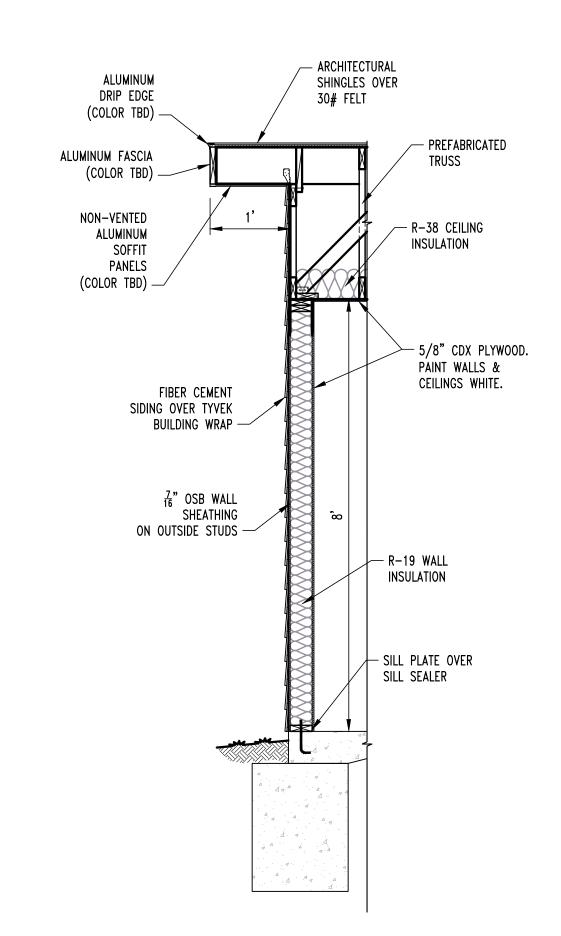

WELLHOUSE BUILDING ELEVATION LOOKING EAST

SCALE: $\frac{3}{4}$ " = 1'-0"

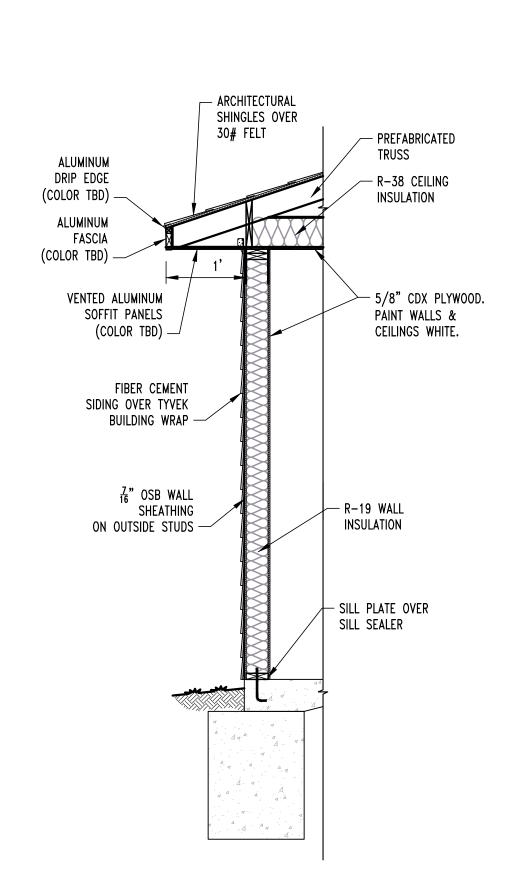

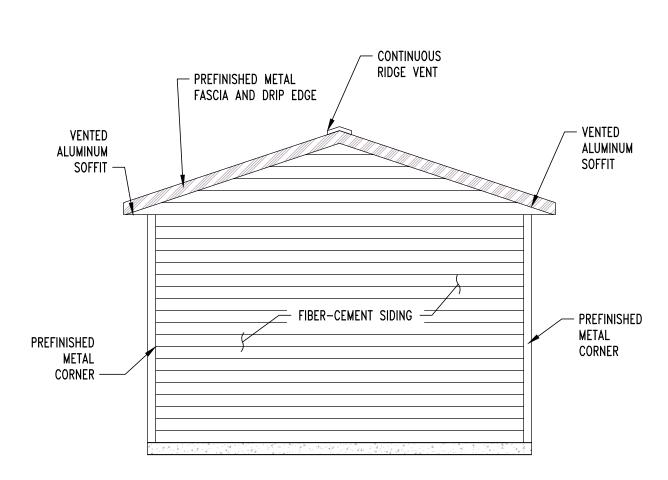

WELLHOUSE BUILDING ELEVATION LOOKING SOUTH SCALE: 1/4" = 1'-0"



SCALE: $\frac{3}{4}$ " = 1'-0"

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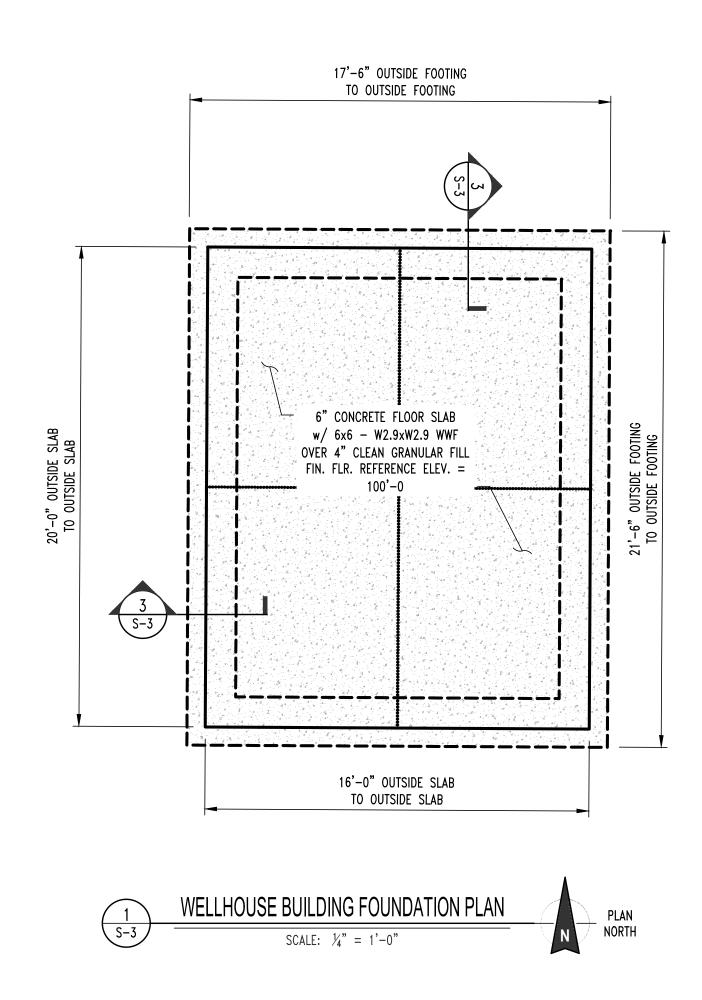
SHEET TITLE:

WELL HOUSE **BUILDING PLAN & ELEVATIONS**

SHEET NUMBER:

S-102

SHEET 18 OF 21



2x BLOCKING BETWEEN EVERY OTHER TRUSS

TRUSS CLIP BY TRUSS

THICKNESS AND FASTENING)

WALL SHEATHING OVER STUD FRAMING

(REFER TO SHEARWALL KEY FOR

(LENGTH VARIES)

MANUFACTURER —

TYP. ROOF FRAMING SECTION

SCALE: $1\frac{1}{2}$ " = 1'-0"

(TOENAIL TO TOP NAILER w/ 12d NAILS @ 6" O.C.) -

5⁄8" ROOF SHEATHING FASTENED w/ 10d NAILS ◎ 6" O.C. ◎ PERIMETER / 12" O.C. FIELD OVER

PRE-ENGINEERED ROOF TRUSSES @ 24" O.C. MAX. —

ALTERNATE 2x4 FLAT BLOCKING

AND FASTEN ROOF SHEATHING TO BLOCK

TRUSS BEARING

ELEV. = 8'-0"


w/ FULL HEIGHT BLOCKING


w/ 10d NAILS @ 6" O.C.

- ROOF TRUSS

2x6 No.1/No.2 SPF STUD

FRAMING @ 16" O.C.

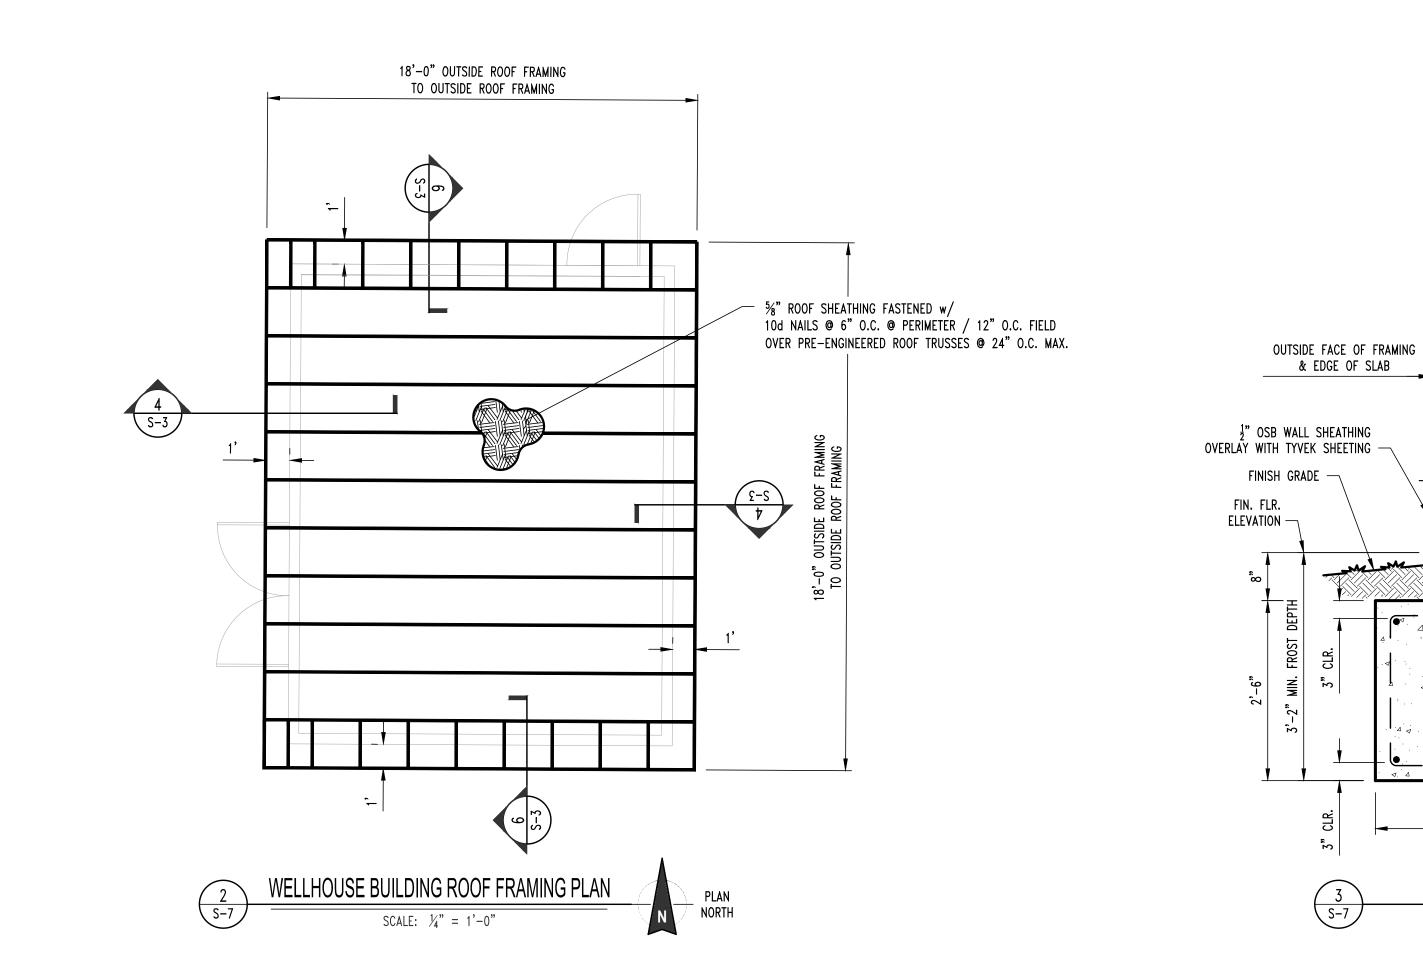

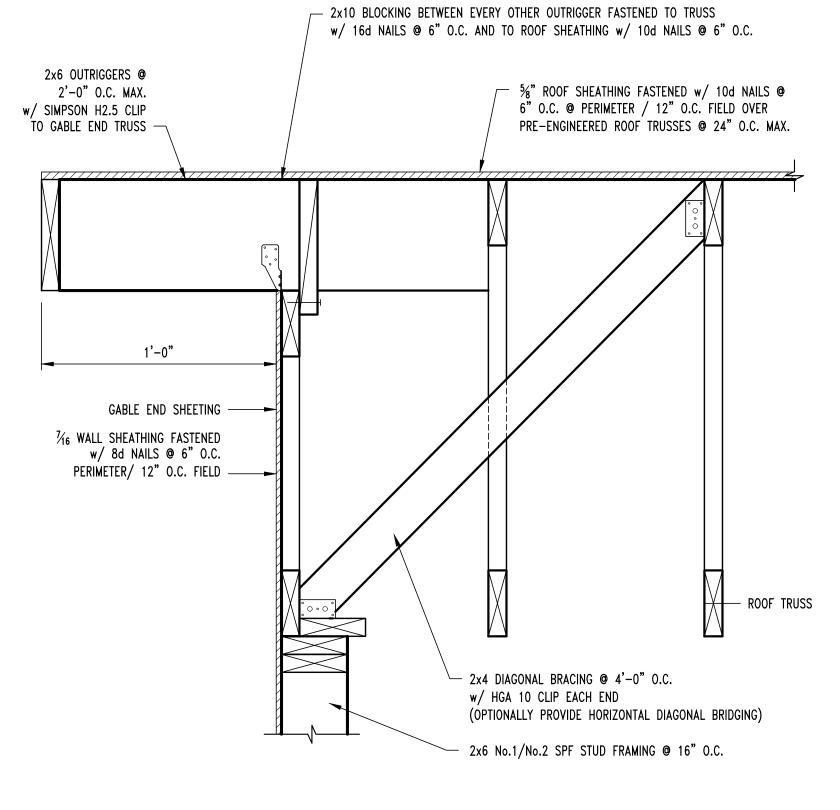

2'-0"

CONT. FOOTING SECTION

SCALE: $\frac{3}{4}$ " = 1'-0"

┌─ ₠ WALL & FOOTING

 $-\frac{1}{2}$ " DIA. BY 10" ANCHOR BOLTS PROJECTED

3" @ 4' O.C. AND 12" FROM CORNERS

∠ 2x6 SPF No.2 STUDS @ 16" O.C.

- #4 VERTICAL x 5'-0" @ 3'-0" O.C. FIELD BENT INTO SLAB. HOOK LENGTH TO BE 2'X2'


AND EITHER SIDE OF DOORS

COMPACTED GRANULAR FILL

#4 CONTINUOUS

— CONT. REINFORCING

— OPTIONAL #4 TIES @ 4'-0" O.C.

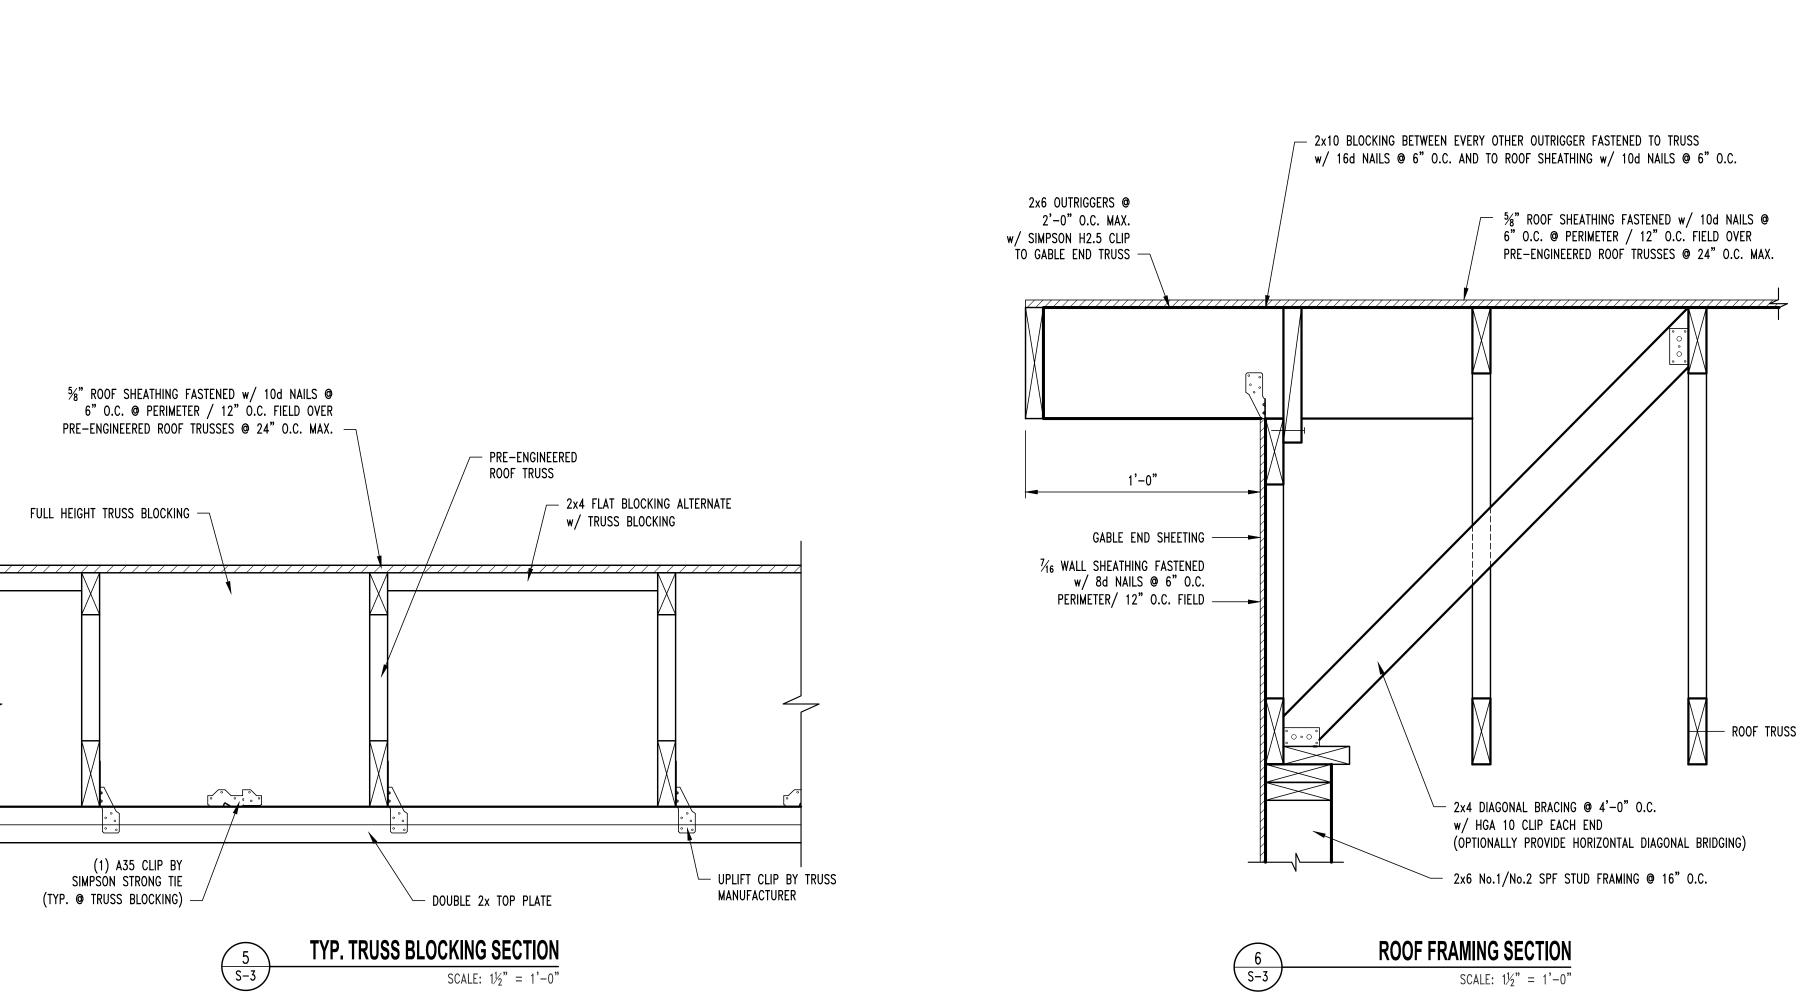





JESSE RAY STEPHENS MO LICENSE - 2010000868

SITE/CIVIL ENGINEER: ENGINEERING CONSULTANTS 1000 W. Nifong Blvd., Bldg. 1 Columbia, Missouri 65203 (573) 447-0292

www.crockettengineering.com Crockett Engineering Consultants, LLC Missouri Certificate of Authority #2000151301

OFFICE OF ADMINISTRATION **DIVISION OF FACILITIES** MANAGEMENT, **DESIGN AND CONSTRUCTION**

730 TRUMAN BUILDING **301 WEST HIGH STREET POST OFFICE BOX 809 JEFFERSON CITY, MO 65102**

IMPROVEMENTS TO WATER AND WASTEWATER SYSTEM MULTIPLE ASSETS

GRAHAM CAVE STATE PARK 217 HIGHWAY TT DANVILLE, MO 63361

PROJECT # X2321-01 SITE NUMBER: 5210 ASSET NUMBER: 7815210016 - PUMP HOUSE WELL #1 7815210017 - PUMP HOUSE WELL #2

REVISION: DATE: **REVISION:** DATE: **REVISION:** DATE: ISSUE DATE: 09/09/2024

CAD DWG FILE: 230188_GRAHAM CIVIL DRAWN BY: CHECKED BY: ATG JRS DESIGNED BY:


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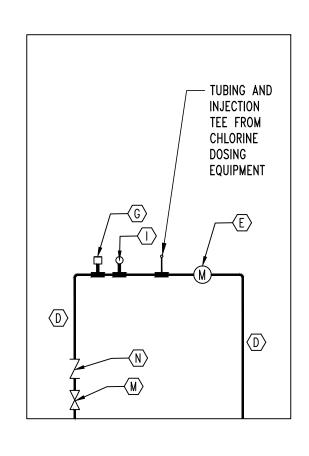
WELL HOUSE STRUCTURAL **DETAILS**

SHEET NUMBER:

S-103

SHEET 19 OF 21



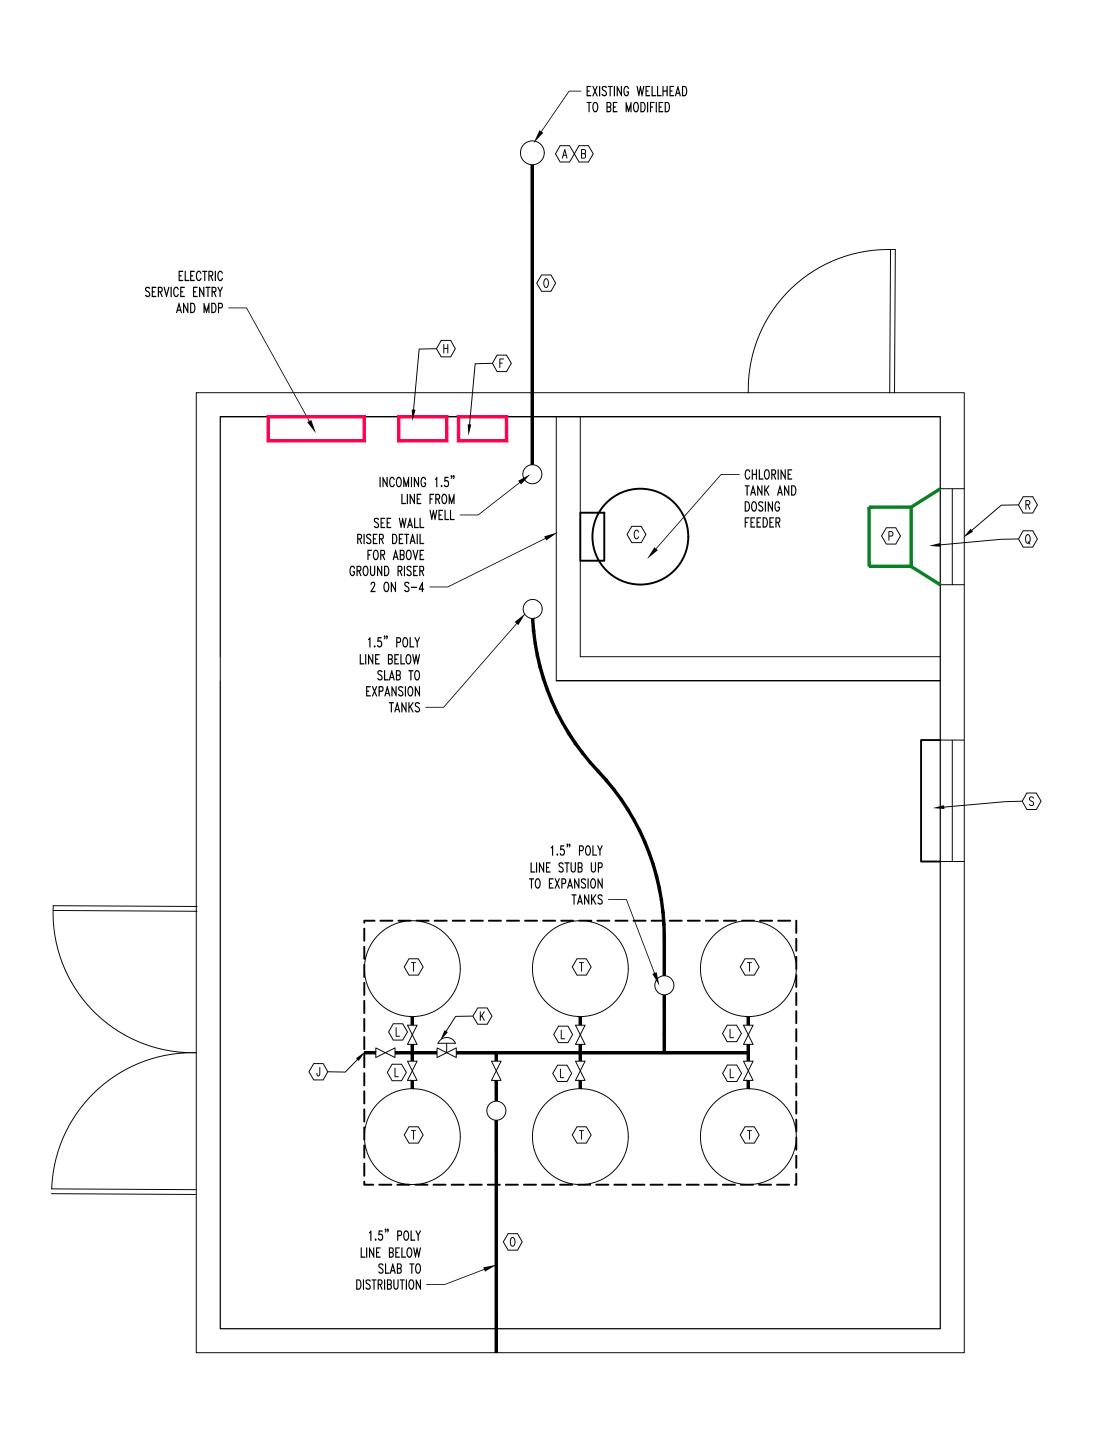

WELLHOUSE EQUIPMENT PLAN

SCALE: 1/2" = 1'-0"

PLAN
NORTH



LEGEND OF LABELS:

- EXTEND EXISTING WELL CASING ABOVE GRADE AND PROVIDE AND INSTALL A WATERTIGHT WELL CAP WITH WELL SEAL. ALSO PROVIDE A PITLESS ADAPTER BELOW GRADE BELOW THE FROST LINE AT A MINIMUM OF 4' DEEP. PITLESS ADAPTER BY BAKER OR APPROVED EQUAL. PITLESS ADAPTER SHALL BE BRASS.
- INSTALL NEW 3 HORSEPOWER FRANKLIN TRI—SEAL PUMP OR APPROVED EQUAL. PUMP SHALL PUMP 25 GALLONS PER MINUTE AND OPERATE AT 230 VOLTS. BASIS OF DESIGN IS FRANKLIN 93822530—25FA3S4—PE. ANY SUBSITUTIONS SHALL BE APPROVED BY THE ENGINEER IN WRITING. NEW PUMP IS REQUIRED AT THE OFFICE WELLHOUSE. PROVIDE NEW CHECK VALVE AND TORQUE ARRESTOR DIRECTLY ABOVE THE PUMP. THE EXISTING 5 HORSEPOWER FRANKLIN TRI—SEAL PUMP AT THE CAMPGROUND MAY REMAIN. EXTEND AND PROVIDE NEW WIRING AS REQUIRED TO CONNECT TO NEW WELLHOUSE.
- PROVIDE AND INSTALL NEW PROPORTIONAL FEED WELL WATER CHLORINATOR EQUAL TO J-PRO-22 AS MANUFACTURED BY CLEAN WATER SYSTEMS OR APPROVED EQUAL. SYSTEM SHALL INCLUDE A MINIMUM OF A 35 GALLON TANK FOR STORING LIQUID CHLORINE. SYSTEM SHALL BE CAPABLE OF CHLORINATING FOR FLOWS OF UP TO 50 GALLONS PER MINUTE. ROUTE CHEMICAL FEED TUBING THROUGH WALL AND INSTALL SCHEDULE 80 INJECTION TEE.
- PROVIDE 1.5" SCHEDULE 80 PVC PIPING INSIDE BUILDING PRESSURE RATED AT 200 PSI. PROVIDE WALL SUPPORTS AND STANDOFFS AT A MINIMUM OF 3' ON CENTER. PROVIDE FLOOR STAND-OFFS A MINIMUM OF 3' ON CENTER.
- (E) INSTALL WATER METER EQUAL TO BADGER RECORDALL METER OR APPROVED EQUAL. BASIS OF DESIGN IS BADGER 70-BRONZE.
- CONTRACTOR TO PROVIDE NEMA 4 DISCONNECT FOR WELL PUMP. MOUNT ADJACENT TO PUMP CONTROLLER.
- CONTRACTOR TO INSTALL PRESSURE SWITCH. CONNECT PRESSURE SWITCH TO WATERLINE AND ROUTE CONTROL WIRING TO THE PUMP CONTROLLER. PRESSURE SWITCH SHALL BE EQUAL TO SQUARE-D HIGH PRESSURE SWITCH TYPE G-HEAVY DUTY 50 / 70 PSI.
- INSTALL PUMP SAVER CONTROL PANEL. EQUIPMENT SHALL BE EQUAL TO FRANKLIN ELECTRIC PUMPTEC—PLUS PUMP PROTECTOR. IT SHALL BE RATED FOR PUMPS FROM 0.5 HP UP TO 5 HP. BASIS OF DESIGN IS FRANKLIN PUMPTEC—PLUS MODEL 5800060100. PROVIDE LIGHTNING ARRESTOR.
- PROVIDE WATER PRESSURE GUAGE IN-LINE RATED UP TO 200 PSI.
- INSTALL BALL VALVE AND GARDEN HOSE CONNECTION FOR SYSTEM BLEED-DOWN. FITTINGS SHALL BE BRASS WITH MALE ADAPTERS. PVC ADAPTERS SHALL BE FEMALE ADAPTERS ONLY.
- INSTALL PRESSURE RELIEF VALVE RATED AT 100 PSI. PVC ADAPTERS SHALL BE FEMALE ADAPTERS ONLY. FITTINGS SHALL BE BRASS WITH MALE ADAPTERS. PVC ADAPTERS SHALL BE FEMALE ADAPTERS ONLY.
- (L) INSTALL TEE AND BALL VALVE FROM WATERLINE TO EXPANSION TANKS.


 FITTINGS SHALL BE BRASS WITH MALE ADAPTERS. PVC ADAPTERS SHALL BE
 FEMALE ADAPTERS ONLY.
- PROVIDE BALL VALVE AT ENTRANCE TO BUILDING AND EXIT FROM BUILDING. FITTINGS SHALL BE BRASS WITH MALE ADAPTERS. PVC ADAPTERS SHALL BE FEMALE ADAPTERS ONLY.
- INSTALL CHECK VALVE. FITTINGS SHALL BE BRASS WITH MALE ADAPTERS. PVC ADAPTERS SHALL BE FEMALE ADAPTERS ONLY.
- PROVIDE 1.5" DIAMETER POLYETHYLENE PIPING FROM NEW WELL HOUSE TO EXTERIOR DISTRUBUTION SYSTEM. PROVIDE BRASS COMPRESSION COUPLINGS AT PIPING TRANSITIONS.
- 800 CFM INLINE EXHAUST FAN EQUAL TO SOLER AND PALAU TD SERIES WITH BACKDRAFT DAMPER. FLOW RATED AT § "STATIC. EXHAUST FAN TO BE CONNECTED TO SWITCH ADJACENT TO DOOR.
- | (Q) | INSTALL TRANSITIONAL DUCTWORK BETWEEN EXHAUST FAN AND LOUVER.
- R LOUVER SHALL BE 18"X18" EQUAL TO POTTORFF EFD-445 OR APPROVED EQUAL. THIS SHALL BE MOUNTED A MINIMUM OF 72" ABOVE FINISHED
- INSTALL PTAC HVAC UNIT THROUGH—WALL. UNIT SHALL BE EQUAL TO AMANA DCP 153A50AA AND HAVE INTEGRAL 5KW HEATER AND 15,000 BTU AIR CONDITIONING CAPACITY. FLASH AND CAULK AROUND UNIT FOR AIR—TIGHT SEAL.
- INSTALL FLEXCON PRO-LITE PRESSURE TANK OR APPROVED EQUAL. BASIS OF DESIGN IS FLEXCON CSS-120. EACH WELL HOUSE SHALL HAVE 6 EXPANSION TANKS FLOOR MOUNTED.

GENERAL NOTES

- THE EXISTING WELLHOUSE AT THE PARK OFFICE SHALL REMAIN FUNCTION UP UNTIL THE POINT THE NEW WELL HOUSE IS COMPLETE.
 ONCE THE NEW WELL HOUSE IS COMPLETE. DEMOLISH THE EXISTING WELL HOUSE.
- 2. ONCE THE NEW WELL HOUSE IS COMPLETE, DEMOLISH THE EXISTING WELL HOUSE AND MODIFY THE WELLHEAD AS SHOWN ON THIS PLAN AND MAKE ALL FINAL CONNECTIONS TO NEW WELL HOUSE AND DISTRIBUTION SYSTEM.

MICHAEL L. PARSON, GOVERNOR

STATE OF MISSOURI

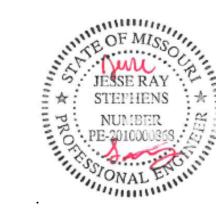

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DRAWN BY:	JRS
CHECKED BY:	ATG
DESIGNED BY:	JRS


SHEET TITLE:

WELL HOUSE EQUIPMENT PLAN

SHEET NUMBER:

E-101

SHEET 20 OF 21

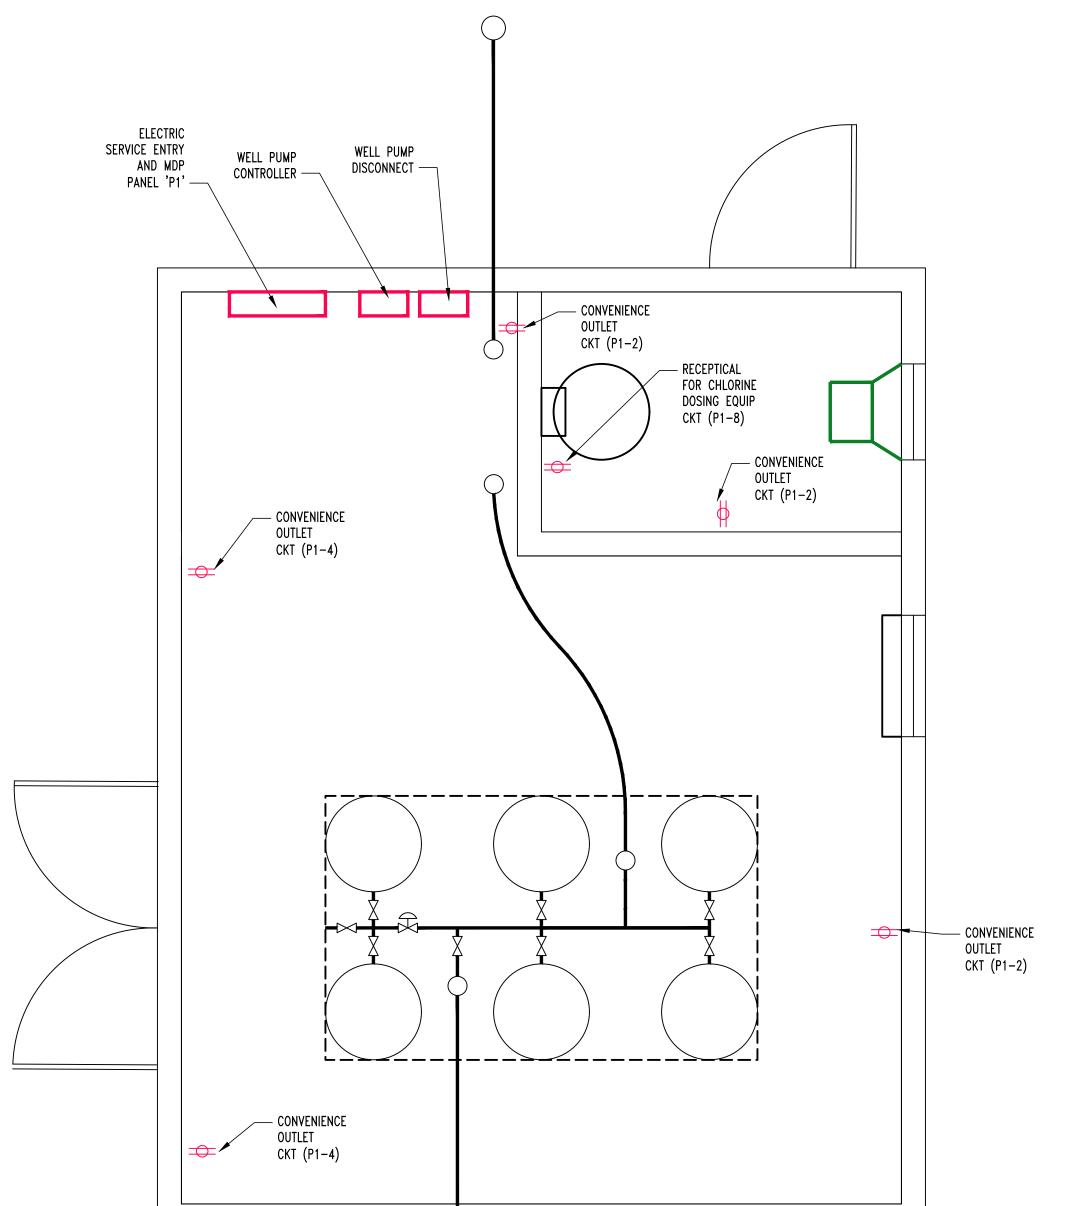

WELLHOUSE POWER PLAN

SCALE: 1/2" = 1'-0"

— GROUNDING BAR

GROUNDING DETAIL

NO SCALE

#2 GROUNDING

ËLECTRODE JUMPER

#6 BONDING

SECOND GROUND

ROD LOCATED A

MINIMUM OF 6'

GROUND ROD

AWAY FROM FIRST

JUMPER

FIRST MEANS

OF DISCONNECT

8' LONG BY §"

DIAMETER GROUND

(4) E-102 PLAN NORTH

,	VOLTAGE	PANEL	. SIZE	MOU	INTING	AIC RATING	LOA
120/230		200 AMP		SURFACE		22,000	62
CIRCUIT NUMBER	DESCRIPTION	BREAKER SIZE	AMPS	AMPS	BREAKER SIZE	DESCRIPTION	CIRC NUM
1	WELL PUMP	30-2	12	4.5	20-1	CONVENIENCE RECEP.	2
3	\			3	20-1	CONVENIENCE RECEP.	4
5	SEWER System	30-2	15	2	20-1	EXHAUST Fan	6
7	\			2	20-1	CHLORINE DOSING	8
9	PTAC HVAC	30-2	20	3	20-1	LIGHTS	10
11	\						1:
13							14
15							1
17							18
19							2
21							2
23							2
25							2
27							2
29							3
31							3
33							3.
35							3
37							3
39							4
41							42

PANEL NOTES

- 1. THE PANEL SHALL BE EQUAL TO SQUARE D MODEL "QO" OR APPROVED EQUAL
- ELECTRICIAN TO VERIFY BREAKER WITH EQUIPMENT PRIOR TO PURCHASE AND INSTALL.
 AFTER COMPLETION OF WORK, ELECTRICAN SHALL PROVIDE A TYPE WRITTEN PANEL DIRECTORY
- INSIDE THE NEW PANEL.

 4. AT THE CAMPGROUND WELLHOUSE THE WELL PUMP IS A 5 HP PUMP. THE SAME BREAKERS ARE

- 3" PVC CONDUIT


CONDUCTORS TO


SEWER CONTROL


WITH (3) #3

LOCATION OF

PANEL

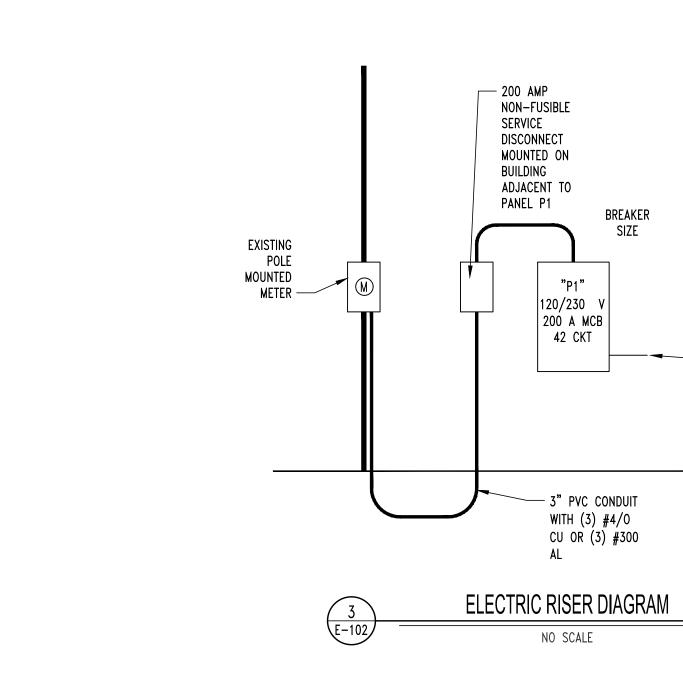

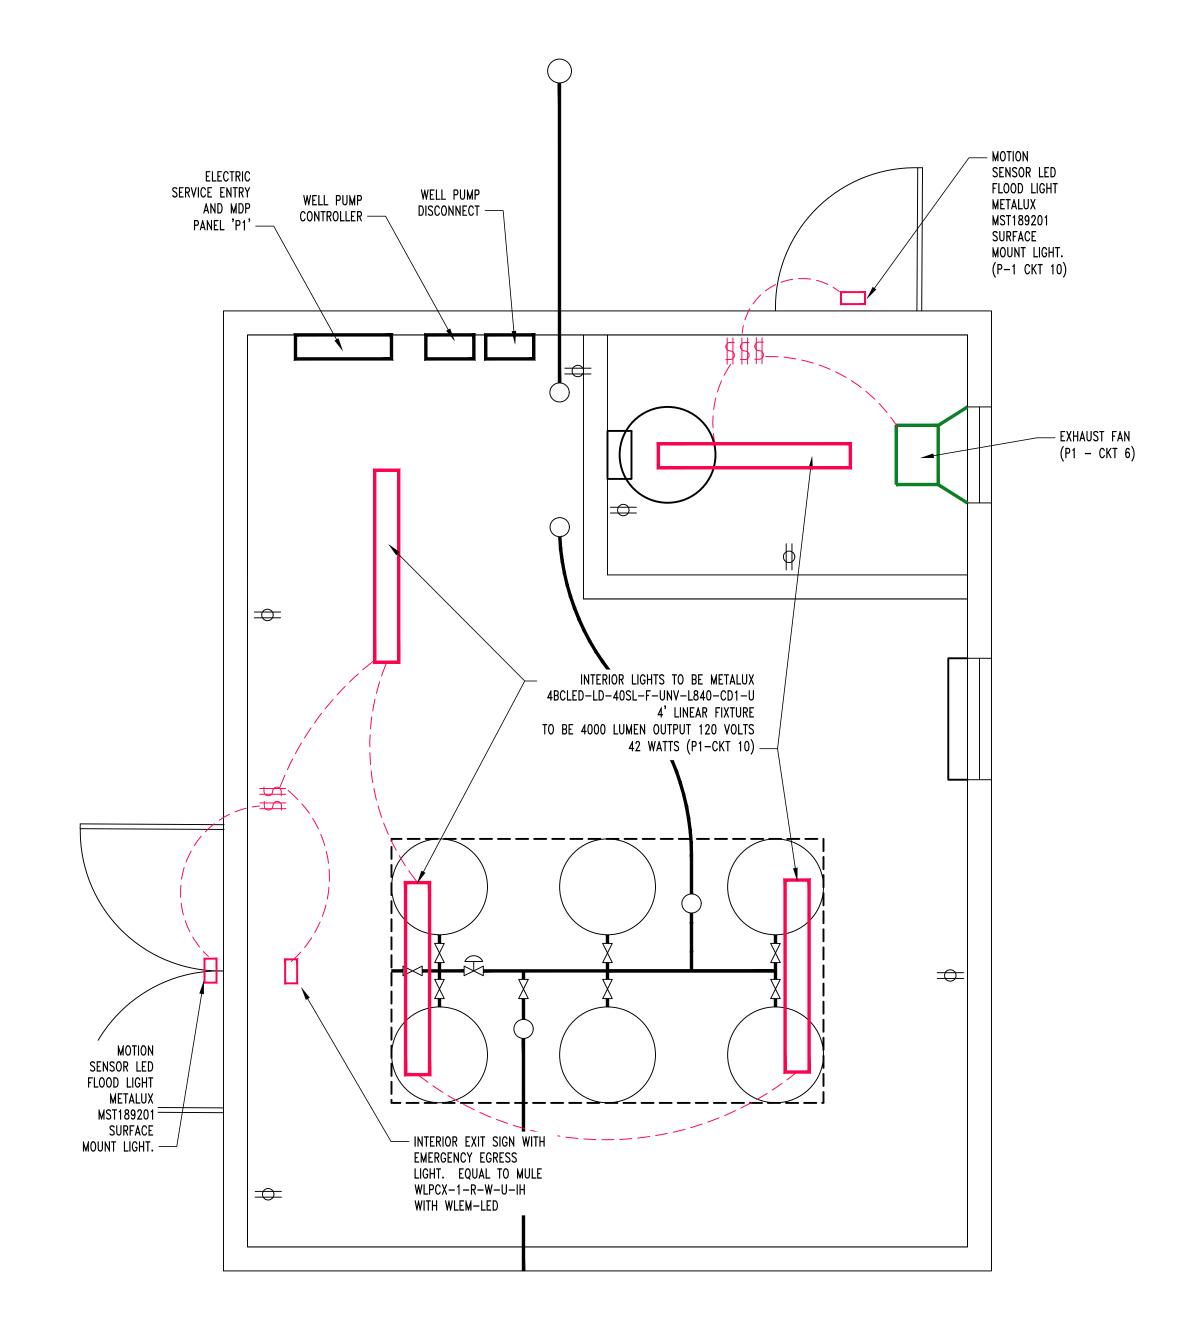

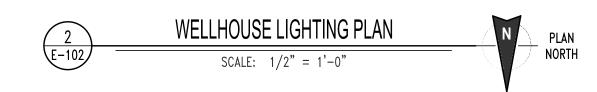

GENERAL NOTES

- 1. THE ENTIRE ELECTRICAL SYSTEM SHALL BE CONTINUOUSLY GROUNDED. EVERY BRANCH CONDUIT
- SHALL INCLUDE A GREEN GROUND CONDUCTOR SIZED PER NEC.

 2. ARC—FAULT CIRCUITS SHALL BE RUN WITH A DEDICATED NEUTRAL AS REQUIRED BY THE
- MANUFACTURER.
 3. PROVIDE PERMANENT ARC-FLASH LABEL AFFIXED TO EVERY DISCONNECT AND PANEL.
- 4. PROVIDE TYPE—WRITTEN PANEL SCHEDULE FOR ALL PANELS.
- 5. ALL CONDUCTOR SIZES SHOWN ON PLANS ARE FOR COPPER UNLESS NOTED OTHERWISE.6. ABOVE GRADE CONDUCTORS SHALL BE THHN COPPER. BELOW GRADE CONDUCTORS SHALL BE
- 7. MINIMUM CONDUCTOR SIZE SHALL BE #12 UNLESS NOTED OTHERWISE. 120V, 20 AMP CIRCUITS WITH CONDUCTOR LENGTH GREATER THAN 100' SHALL BE A MINIMUM OF #10.
- 8. ELECTRICAL CONTRACTOR IS RESPONSIBLE FOR MEASURING EXACT CONDUCTOR LENGTH AND INCREASING CONDUCTOR SIZE TO COMPENSATE FOR VOLTAGE DROP AS REQUIRED BY NEC.
- 9. SCHEDULE 40 PVC CONDUIT SHALL BE USED FOR SERVICE WIRING, BELOW GRADE APPLICATIONS, OR INSIDE THE CHLORINE ROOM. IN OTHER APPLICATIONS, EMT OR MC CABLE IS ACCEPTABLE WHERE CONDUCTORS ARE PROTECTED FROM DAMAGE, ENCLOSED IN BUILDING MATERIALS, AND
- CONSTRUCTION IS OF A PERMITTED TYPE. NM CABLE MAY BE USED.

 10. CONTRACTOR TO PROVIDE J—BOXES, COVER PLATES, AND ANY ACCESSORIES REQUIRED TO PROVIDE
- A COMPLETE SYSTEM.

 11. DUPLEX RECEPTACLES SHALL BE TAMPER RESISTANT, 20 AMP, EQUAL TO LEVITON CR20.
- 12. TOGGLE WALL SWITCHES SHALL BE EQUAL TO LEVITON CS120-2
- 13. DIMMER SWITCHES SHALL BE TESTED WITH FIXTURES AND LAMPS FOR COMPATIBILITY.14. THE BRANCH CIRCUIT FEEDING THE EMERGENCY FIXTURES SHALL BE THE SAME BRANCH AS THE CIRCUITS THAT IS SERVING THE NORMAL LIGHTING IN THE AREA AND CONNECTED AHEAD OF ANY
- LOCAL SWITCHES.

 15. OCCUPANCY AND VACANCY SENSORS SHOULD BE INSTALLED WITHIN BOTH ROOMS IN THE WELL HOUSE SO THAT LIGHTS WILL TURN OFF AFTER 20 MINUTES OF INACTIVITY.

 16. COORDINATE INSTALLATION TO EXISTING METERS WITH CONSOLIDATED ELECTRIC.

STATE OF MISSOURI MICHAEL L. PARSON, GOVERNOR



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ELECTRICAL PLAN

SHEET NUMBER:

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CROCKETT PROJECT #230188

SHEET 21 OF 21