ADDENDUM NO. 1

TO: PLANS AND SPECIFICATIONS FOR STATE OF MISSOURI

Sewer and Water Line Improvements Weston Bend State Park Weston, Missouri Project No. X2322-03

Bid Opening Date: 1:30 PM, Tuesday, October 15, 2024 (Not Changed)

Bidders are hereby informed that the construction Plans and/or Specifications are modified as follows:

SPECIFICATION CHANGES:

- 1. Section 330110.58 Disinfection of Water Utility Piping Systems
 - a. REVISE Paragraphs 1.03-A and 1.03-B as follows:
 - A. AWWA B300 Hypochlorites; 2024.
 - B. AWWA B301 Liquid Chlorine; 2024.

2. Section 331416 – Site Water Utility Distribution Piping

- a. ADD Paragraph 1.05-C as follows:
 - C. Provide five-year manufacturer warranty for materials.
- b. REVISE Paragraph 2.02-B as follows:
 - B. Gate Valves Up To 4 Inches (100 mm):

DRAWING CHANGES:

1. Sheet C-104

- a. Add designation for septic and pump tanks.
- b. Change MicroFAST 3.0 to MicroFAST 9.0 or equal AND increase size of tank S2 to 9,000 gal.
- c. Revise note for first tank (S1): "Replace existing septic tank w/ 4,000 gal. Septic Tank"
- d. Remove Manhole A-2 and Host site connection. Replace with grinder pump and 1000 gal. pump tank. Add service line to Septic tank S-1
- e. Add enlargement 2 Blow up of Grinder Pump servicing camp host site.
- f. Add pump curve for effluent pump A-1 (pump to lateral field)
- g. Add 535 LF of 1.25" HDPE line from camp host site to septic tank S1 (First septic tank).
- h. Add Lateral Field Detail to sheet.
- i. Revise pump sizing calculation requirements. Add Pump Sizing calculations for Pump B-1.
- i. Change profile effluent pipe size from 1" HDPE to 1.25" HDPE.
- k. Add note for secondary power connection: "A secondary power connection with power transfer switch for emergency power outages shall be provide for the A-1 and S-2 systems. Secondary connection is anticipated small portable gas/diesel generator. Generator shall provide power for entire system: Pumps, blowers, alarms, and another apparatus. Anticipated generator size is 2.5KW."
- I. See attached revised sheet for revisions.

2. Sheet C-105

a. ADD the following Note: "Install gate valves on main service line every 1,00 feet and at Tee connections."

3. Sheet C-106

- a. Add Air Release Valve to sheet.
- b. Change EOL to connect into existing 2" line servicing campground at STA. 24+27.72
- c. See attached revised sheet for revisions.

4. Sheet C-107

- a. Remove manhole and air release valve details.
- b. Add Grinder Pump detail.
- c. Add SaniTEE detail.
- d. Add MicroFAST 9.0 detail.
- e. Add 4,000 gal Septic Tank detail.
- f. See attached revised sheet for revisions.

GENERAL COMMENTS:

- 1. The Pre-Bid Meeting was held on October 2, 2024, at 10:00 AM. The Pre-Bid Meeting sign-in sheet is attached.
- Please contact Mandy Roberson, Contract Specialist, at 573-522-0074 or Mandy.Roberson@oa.mo.gov for questions about bidding procedures, MBE\WBE\SDVE Goals, and other submittal requirements.
- 3. The deadline for technical questions is October 7, 2024, at 12:00 PM.
- 4. Changes to, or clarification of, the bid documents are only made as issued in the addenda.
- 5. All correspondence with respect to this project must include the State of Missouri project number as indicated above.
- 6. Current Plan holders list available online at https://www.oafmdcplanroom.com/projects/2612/plan-holders/x2322-03-sewer-water-line-improvements-weston-bend-state-park
- 7. Prospective Bidders contact American Document Solutions, 1400 Forum Blvd Suite 1C, Columbia MO 65201, 573-446-7768 to order official plans and specifications.
- 8. All bids shall be submitted on the bid form without additional terms and conditions, modifications, or stipulations. Each space on the bid form shall be properly filled. Failure to do so will result in rejection of the bid.
- 9. MBE/WBE/SDVE participation requirements can be found in DIVISION 00. The MBE/WBE/SDVE participation goals are 10%/10%/3%, respectively. Only certified firms as of the bid opening date can be used to satisfy the MBE/WBE/SDVE participation goals for this project. If a bidder is unable to meet a participation goal, a Good Faith Effort Determination Form must be completed. Failure to complete this process will result in rejection of the bid.

ATTACHMENTS:

- 1. Pre-Bid Meeting Sign-In Sheet
- 2. Sheets C-104, C-106, C-107


October 8, 2024

END OF ADDENDUM NO. 1

Sewer and Water Line Improvements Weston Bend State Park Weston, MO

Project No. X2322-03 October 2, 2024

		OCIONEI 2, 2024	
Name & Title	Company Name	Phone	E-Mail Address
Eric Hibdon	OA FMDC	573-522-0322	Eric.Hibdon@oa.mo.gov
Spanea Frederick	Weston Dard	Cell 913-683-8992	Shanes Frederick admines acus
Matt orbiti	Wester Berg/NPD	800-134-120d	
Phup Birdey	REANN Plost	816.814.9320	PHILIP , BIELLEY @ BROWN ANDROST, CON
Jacob Simuson	•	573 949-6633	Thuckert @ appresson, Corr
Jim Kunce	Mo State Parks/DSP		jim. Kunce @ dur. Mo. gor.
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		5	

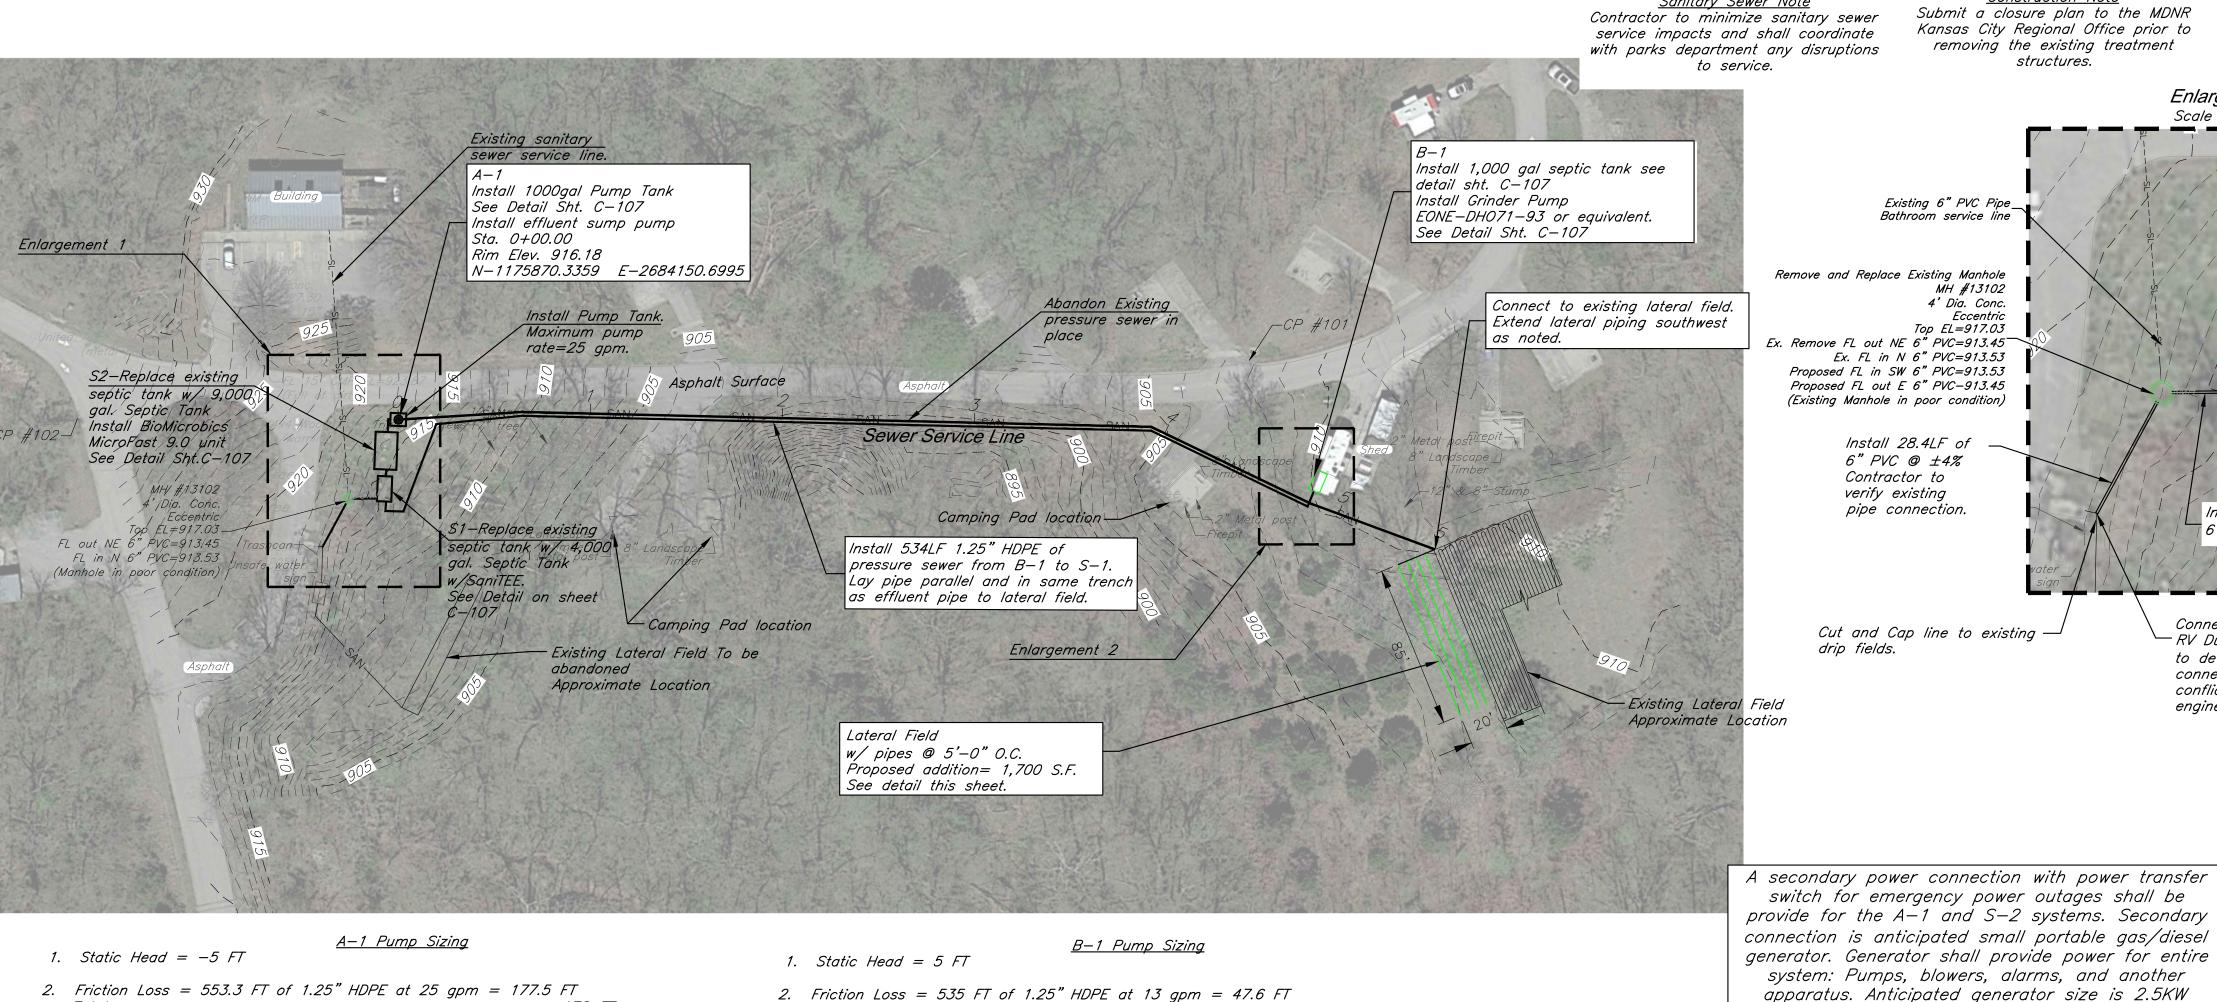

4. Total Dynamic Head = 5 + 47 = 53 FT

5. Pump Requirements: 13 gpm and 53 FT TDH

<u>Construction Note</u> <u>Sanitary Sewer Note</u> Submit a closure plan to the MDNR Kansas City Regional Office prior to removing the existing treatment structures.

Existing 6" PVC Pipe_ Bathroom service line

MH #13102

Eccentric

4' Dia. Conc.

Top EL=917.03

Install 28.4LF of

6" PVC @ ±4%

pipe connection.

Contractor to

verify existing


"CAUTION" Many park utilities located on site. It is the contractors responsibility to locate utilities prior to construction.

Enlargement 1

Scale 1"=20'

Know what's **below**. **Call** before you dig.

Missouri One Call System

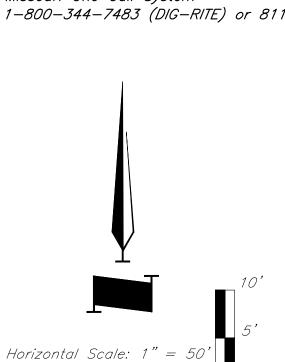

<u>Install Pump Tank.</u> Maximum pump rate=30 gpm. Replace existing septic tank w/ 9,000 gal. Septic Tank. See Detail Sht. C-107

Proposed Sewer Service Line


Replace existing septic tank w/ 4,000 gal. Baffled Septic Tank. See Detail Sht. C-107

-Proposed Sewer Service Line from Grinder Pump B-1.

Connect 6" PVC to existing -RV Dump Station. Contractor to determine existing & at connection. If there is a conflict with design, contact engineer immediately.

Install 12.54LF of

6" PVC @ 1.5%

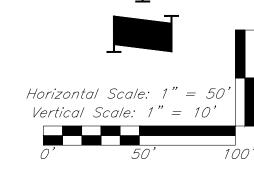

Enlargement 2 Scale 1"=20' Install 1,000 gal septic tank see detail sht.

Install Grinder Pump EONE-DH071-93 or equivalent. See Detail Sht. C-107

Proposed effluent pressure line

from A-1 to lateral field.

<u>REQUIREMENTS</u>

Minimum area of 1,700 ft^2 .


2. 340 LF of dispersal tubing placed 5 ft. O.C.

3. 4 Lengths at 85'.

Dispersal tubing shall be installed at 24" below finished grade. See Detail this sheet.

5. Contractor to pump out and remove existing septic tanks.

Install 535LF of 1.25 SDR-11 HDPE to Septic tank S1

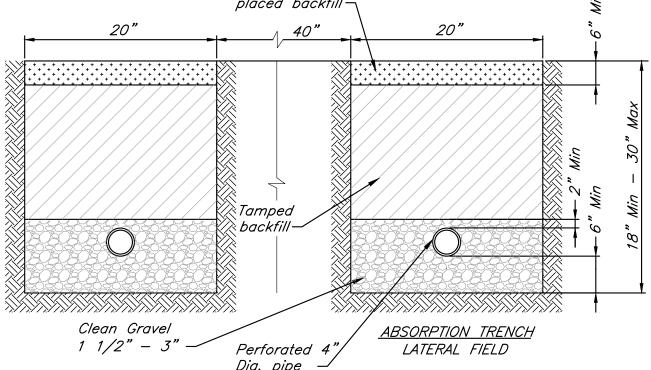

Lateral Field Detail No Scale

Lateral Field Notes:

- slicing with a shovel.
- material, and stones, and compacted to 95% standard density.
- compacted to 95% standard density. one trench longer than one hundred feet (100') unless approved by the
- spacing of five feet (5') on centers. 5. Gravity-fed absorption field distribution lines shall be at least four inches (4") in diameter. Perforated distribution line shall have holes at least one-half inch (1/2")
- 6. Longitudinal slope of the pipe system shall not exceed one quarter inch (1/4") in ten feet (10'). ends of line at equal elevations shall be connected, otherwise

7. Contractor shall refer to MODNR 19 CSR 20-3.060 (5) for trench and field construction.

placed backfill-

- 1. Granular fill shall be 1 1/2" 3" clean rock, placed in 6" lifts and compacted by 2. Tamped fill shall be finely divided, job excavated material free of debris, organic
- 3. Hand placed fill shall be finely divided material, free of debris and stones, and
- 4. Each adsorption trench system shall have a minimum of two (2) trenches with no administrative authority on a case-by-case basis. The absorption trenches shall be located not less than three (3) times the trench width on centers with a minimum
- and no more than three-fourths inch (3/4") in diameter.
- capped and plugged.

STATE OF MISSOURI MICHAEL L. PARSON, **GOVERNOR**





PROJECT OWNER: JIM KUNCE

OFFICE OF ADMINISTRATION DIVISION OF FACILITIES MANAGEMENT. DESIGN AND CONSTRUCTION

Department of Natural Resources Missouri State Parks

Water and Sewer System Improvements

Weston Bend State Park 16600 Hwy 45 North Weston, MO 64098

PROJECT # X232203 SITE # 5118 FACILITY # 7815118029

REVISION: Add. 1	
DATE: 10.8.24	
REVISION:	
DATE:	
REVISION:	
DATE	

ISSUE DATE: August 9, 2024

CAD DWG FILE: DRAWN BY: DRV/JS CHECKED BY: DESIGNED BY: JRH

SHEET TITLE:

Sewer Plan and Profile

SHEET NUMBER:

|C-104|


SHEET 4 OF 7 MAY 1, 2024



= 178 FT

4. Total Dynamic Head = -5 + 178 = 173 FT


5. Pump Requirements: 25 gpm and 173 FT TDH

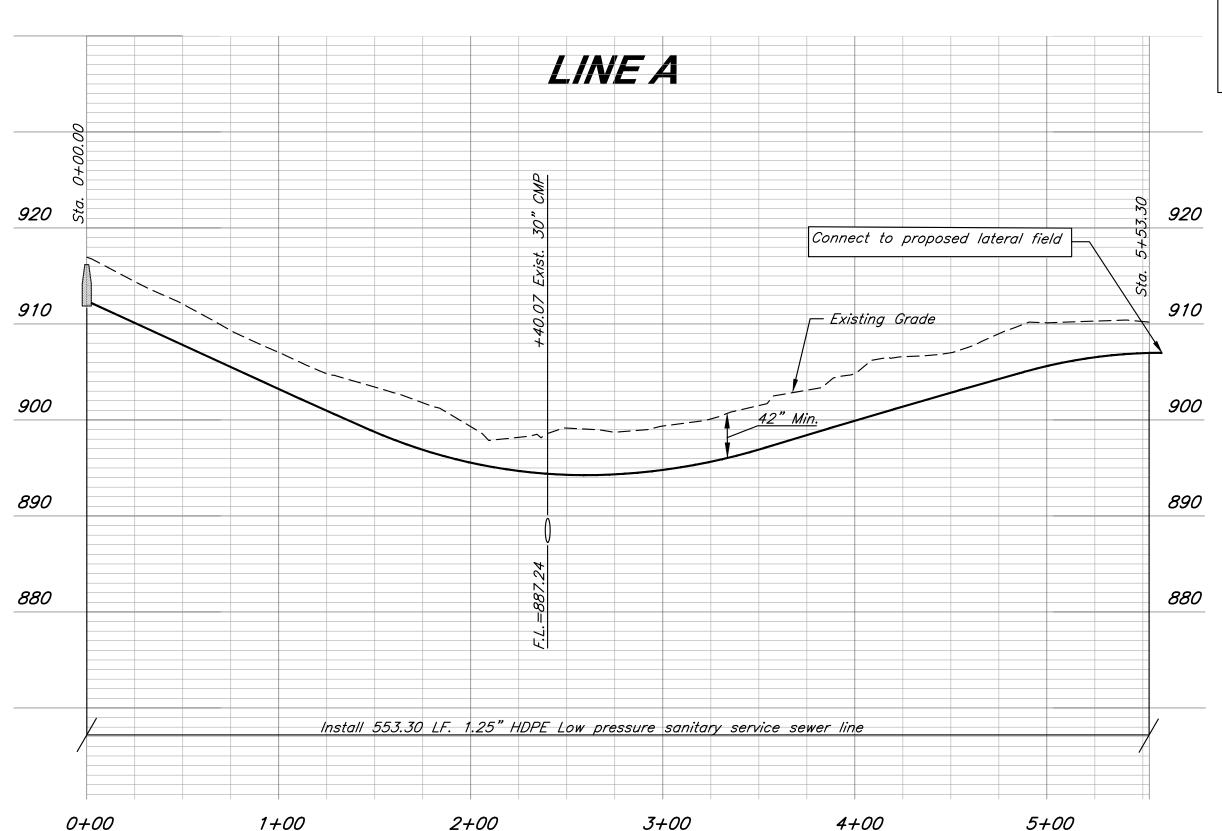


Effluent Pumping:

A-1 Pump to utilize a 1/8" no vault filter/strainer integral with floats, submersible pump rated at (30) gpm. 1 Hp Thermoplastic pump 230V. Float controls will be to start the pump and stop the pump based on and off float tips. The High tide telemetry to record (Blower on, Pump run, and HWA.)


35 GPM PUMP OPERATING RANGE System METERS BEST EFFICIENCY RANGE -Curve 3 HP 2 HP 1.5 HP 3/4 HP

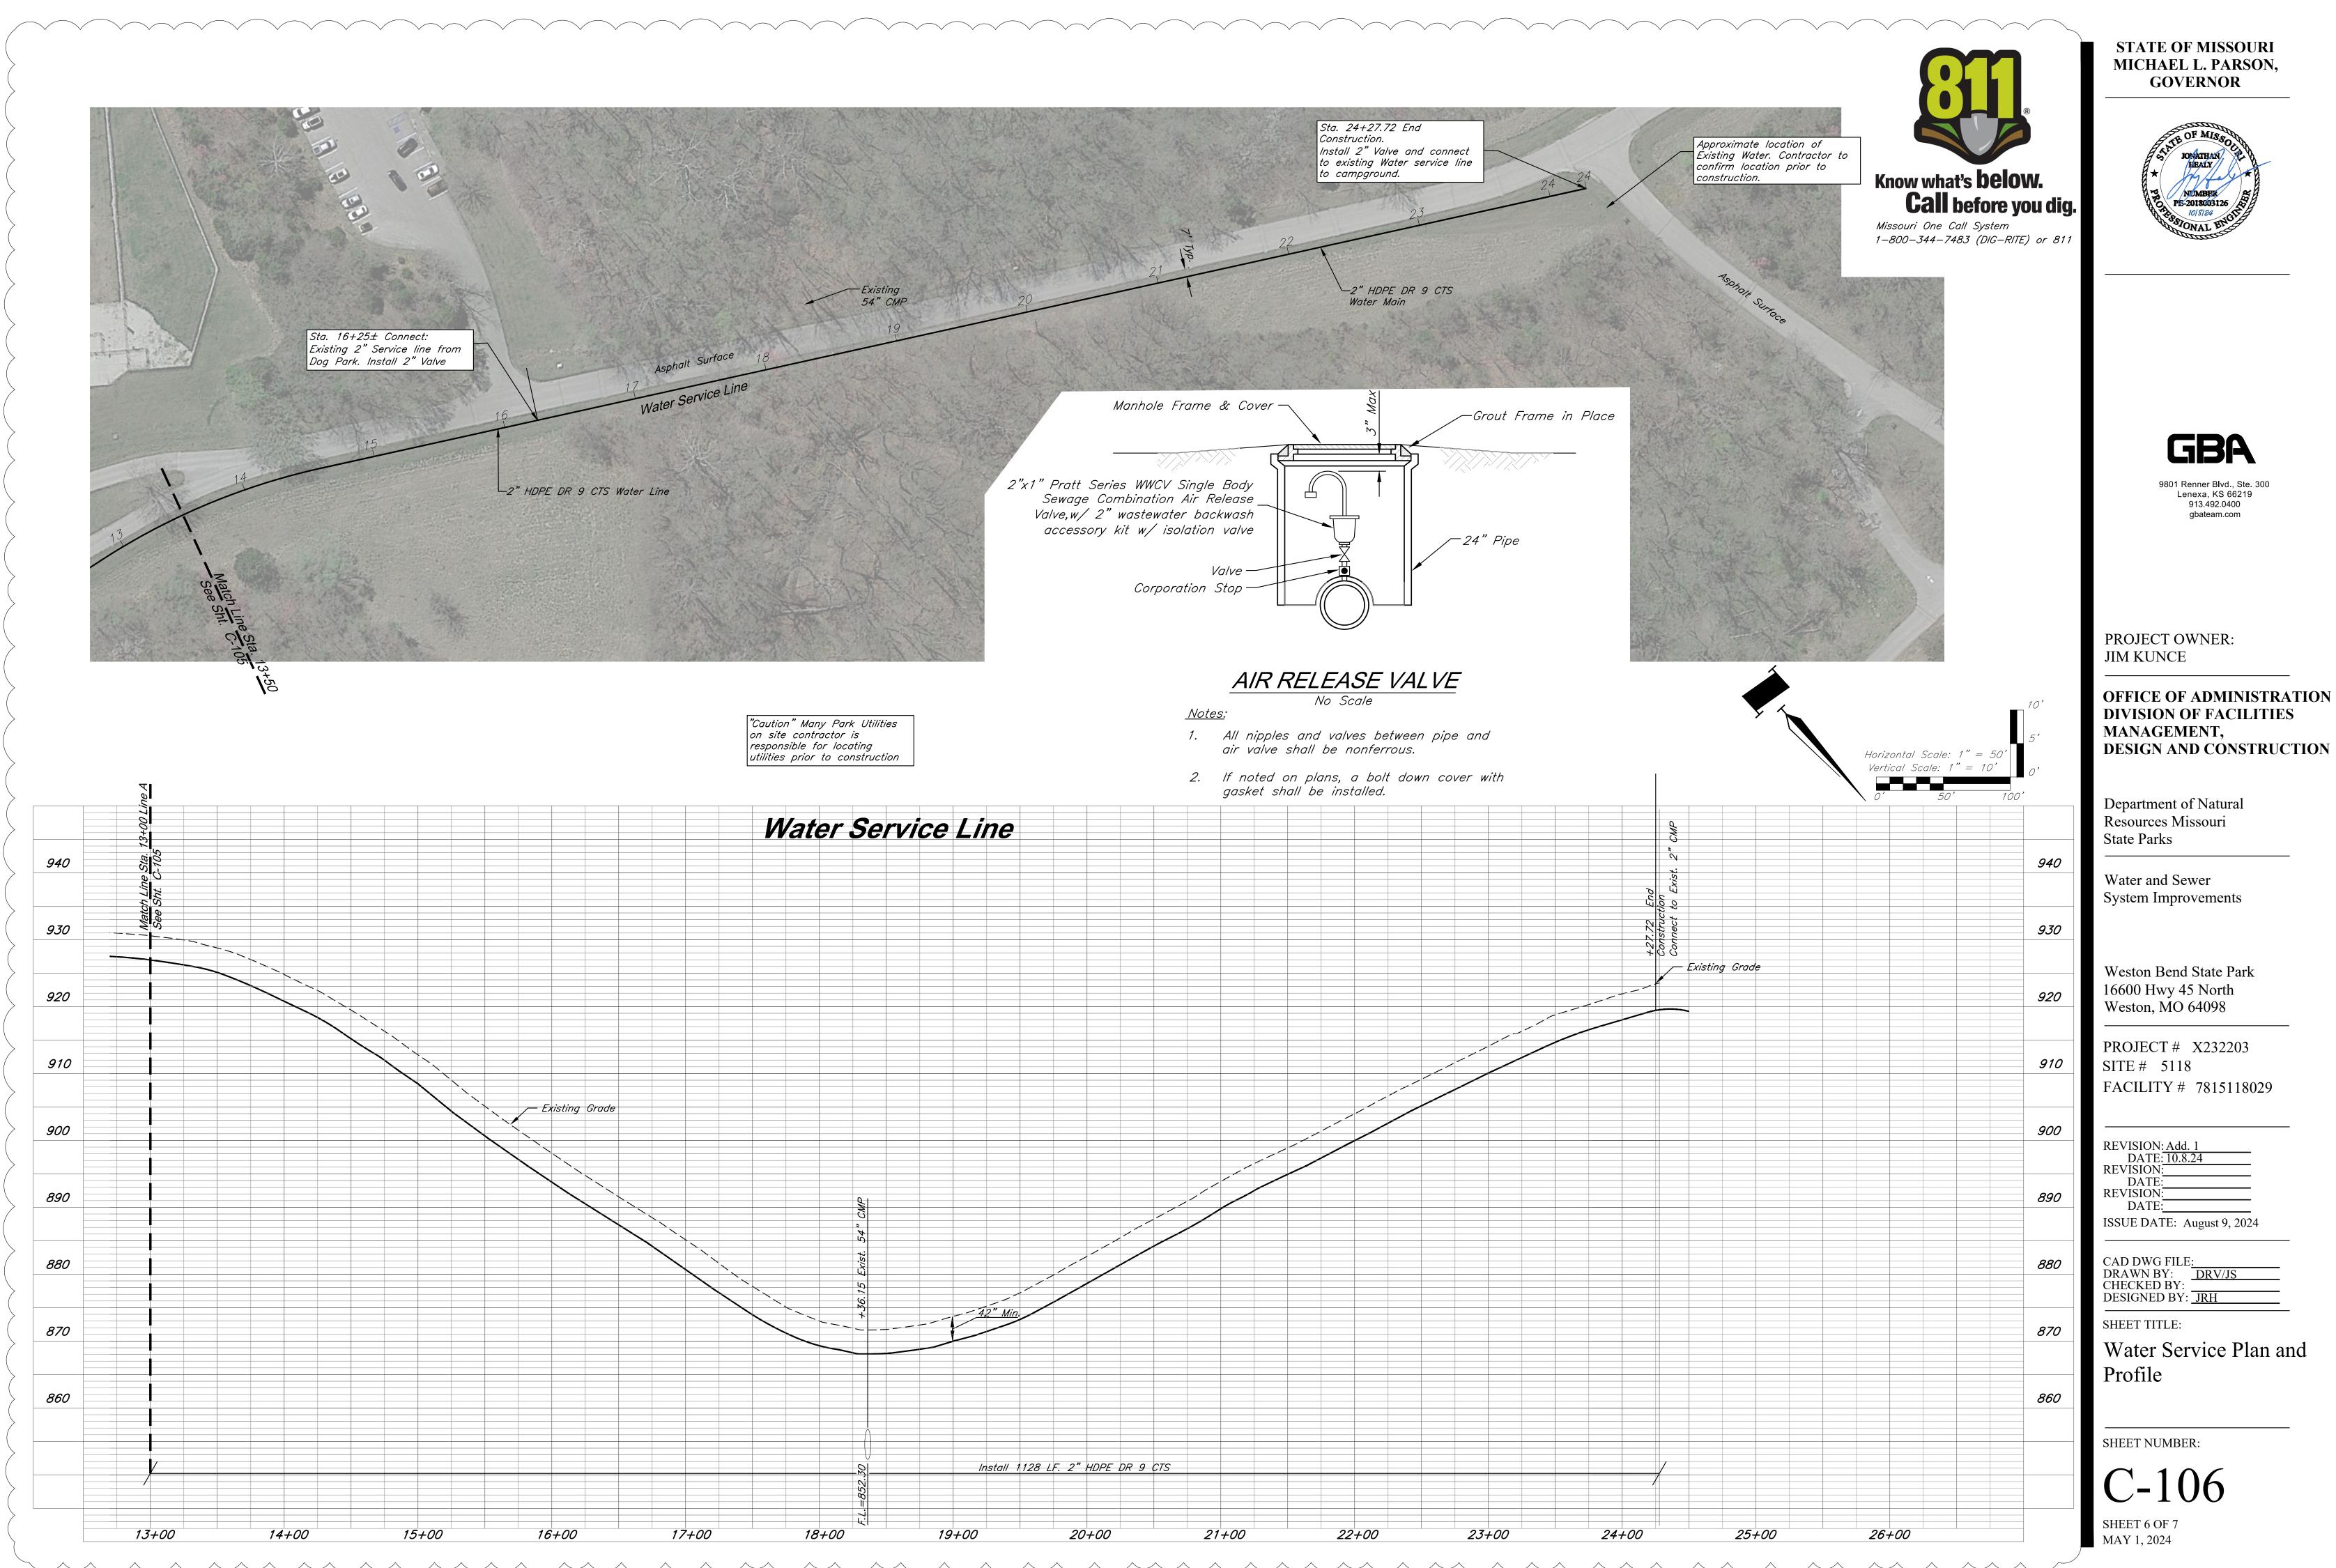



DESIGN AND CONSTRUCTION

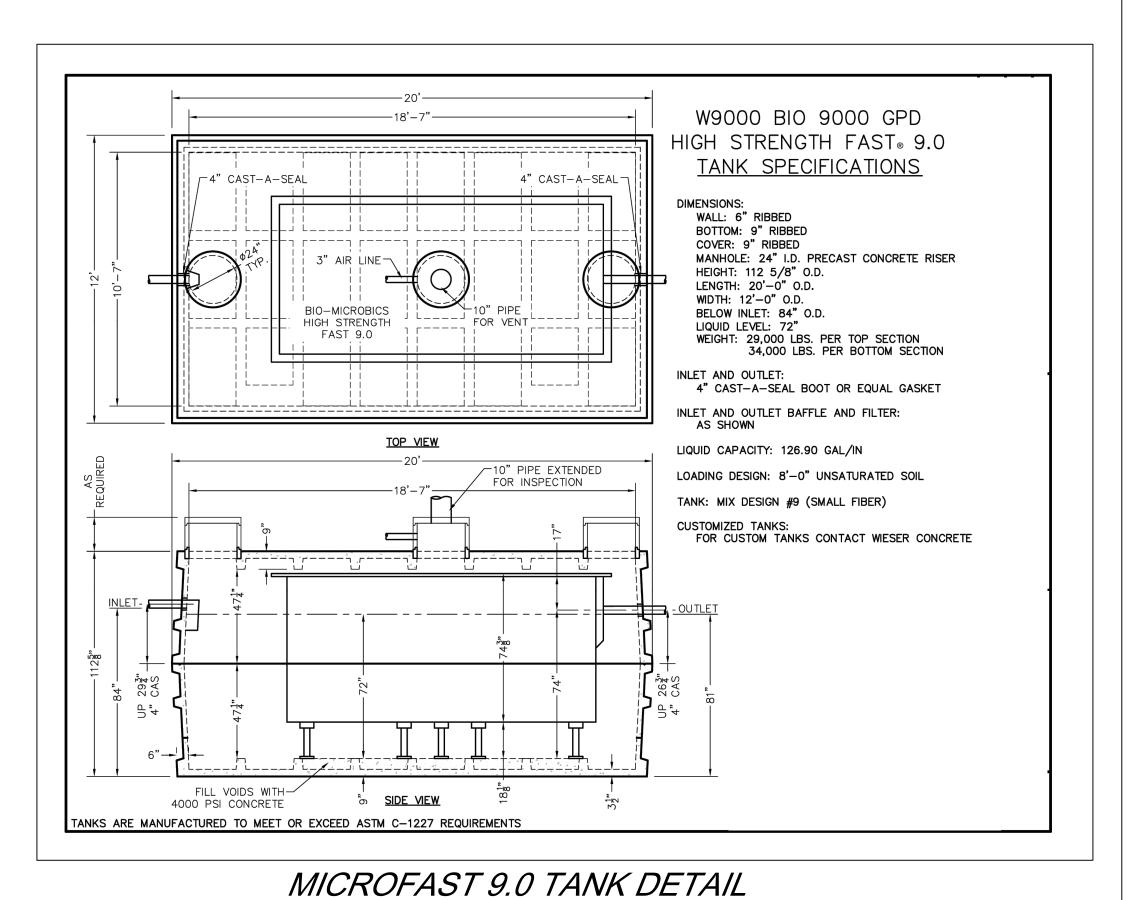


No Scale

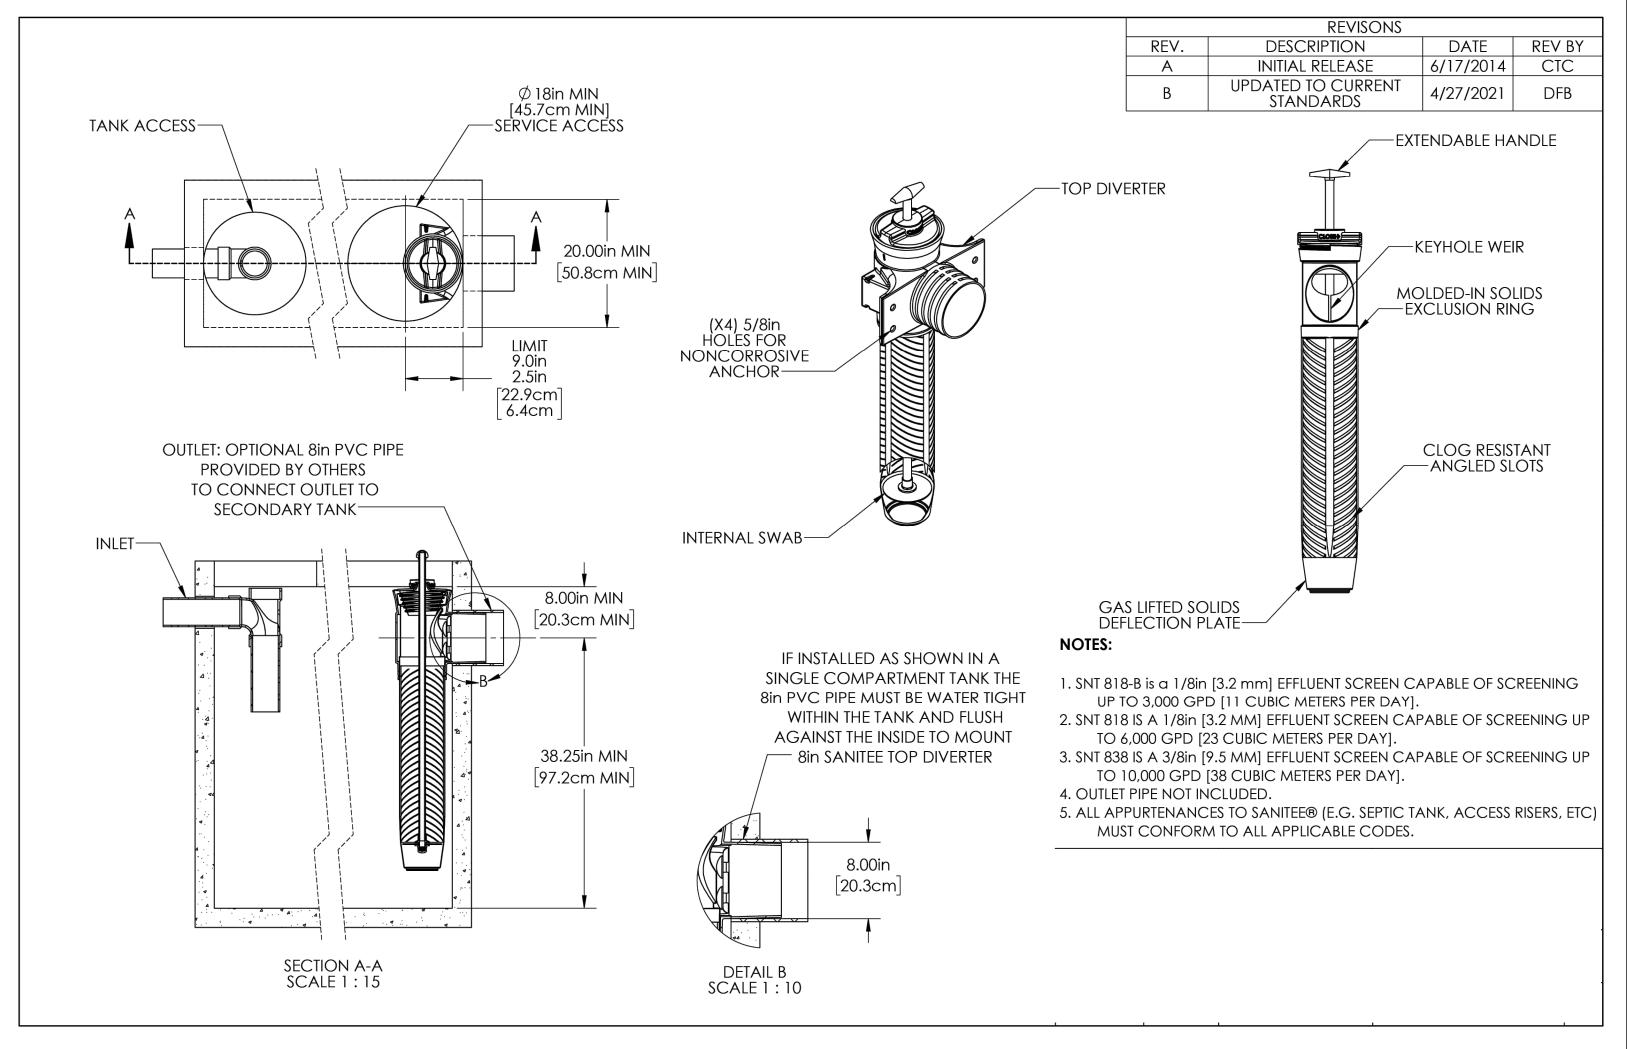

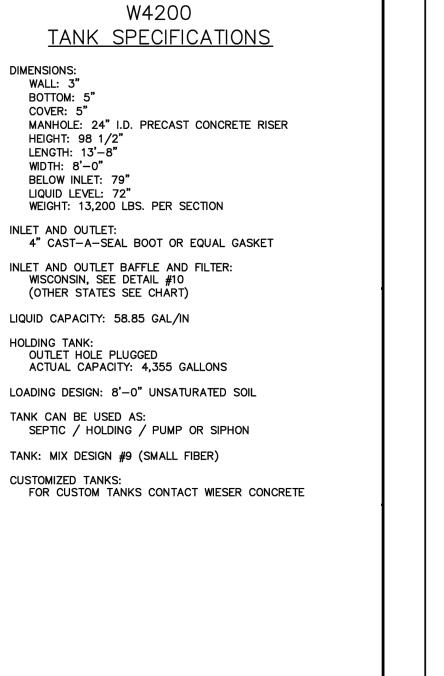

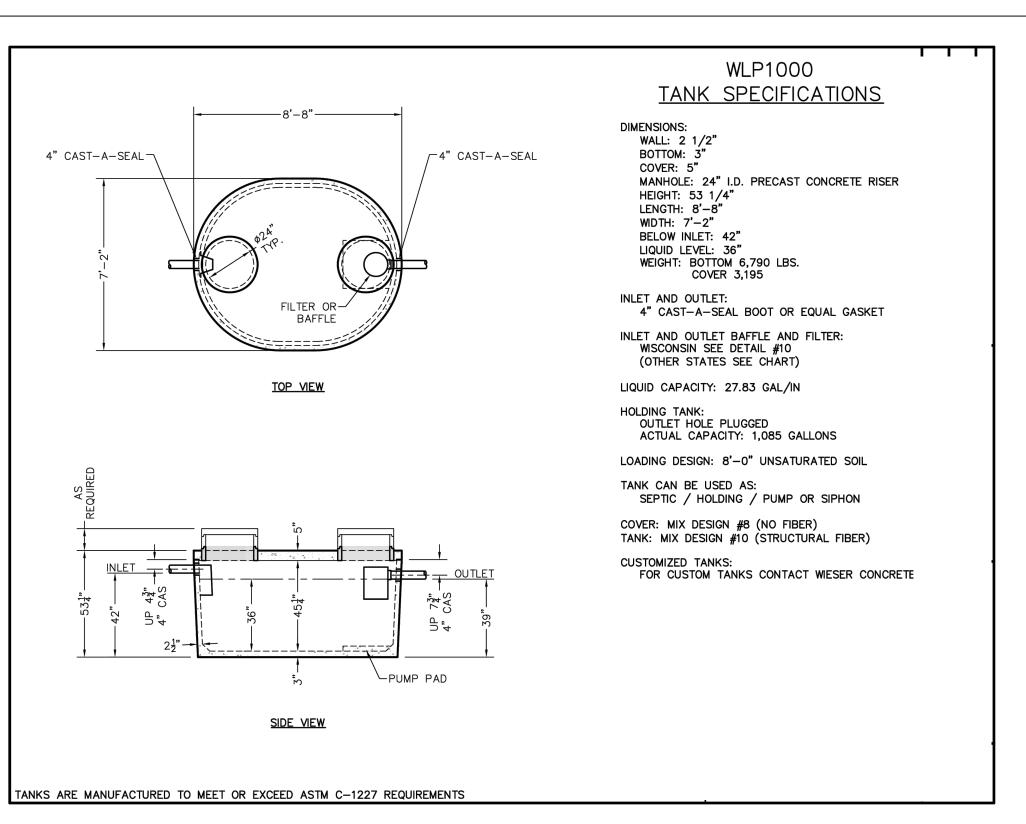

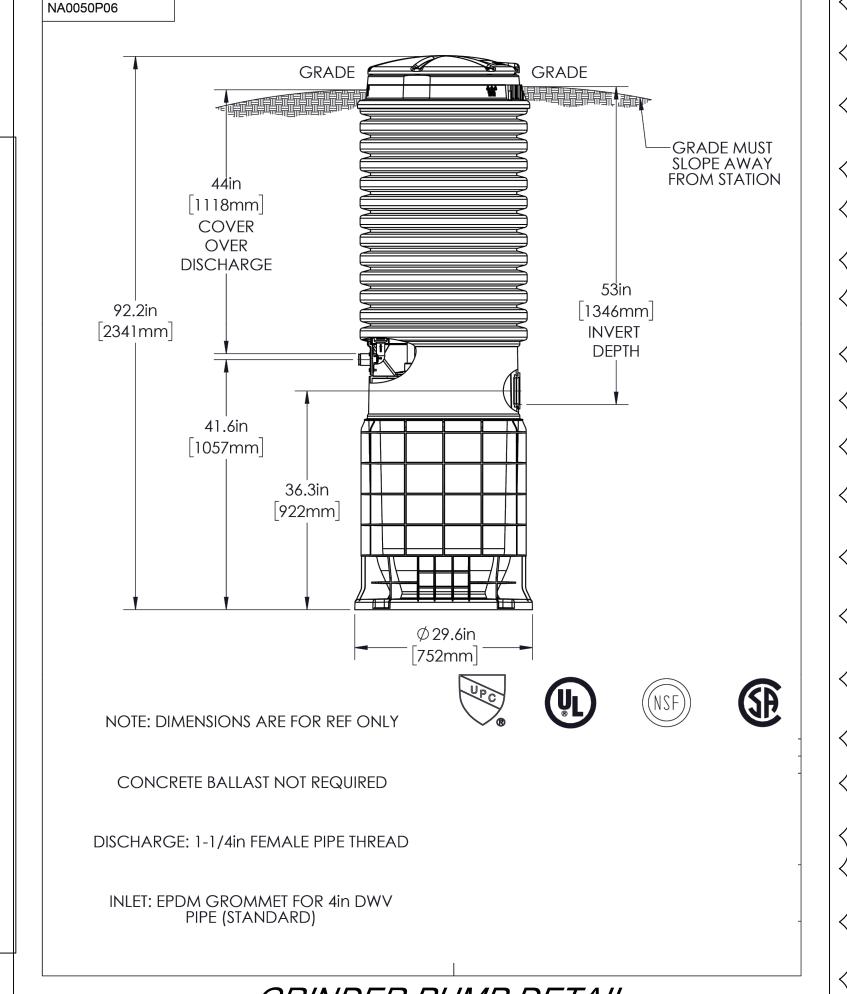

SANITEE DETAIL No Scale



Water and Sewer System Improvements Weston Bend State Park 16600 Hwy 45 North Weston, MO 64098 PROJECT # X232203 SITE # 5118 FACILITY # 7815118029 REVISION: Add. DATE: 10.8.24 **REVISION:** DATE: **REVISION:** DATE: ISSUE DATE: August 9, 2024 CAD DWG FILE: DRAWN BY: DRV/JS CHECKED BY: DESIGNED BY: JRH SHEET TITLE: **Detail Sheet** SHEET NUMBER: GRINDER PUMP DETAIL

SEPTIC TANK DETAIL

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-4" CAST-A-SEAL

UP "4

4" CAST-A-SEAL-

FILTER OR-

TOP VIEW

SIDE VIEW

TANKS ARE MANUFACTURED TO MEET OR EXCEED ASTM C-1227 REQUIREMENTS

BAFFLE

MAY 1, 2024

STATE OF MISSOURI MICHAEL L. PARSON,

GOVERNOR

PE-2018003126

9801 Renner Blvd., Ste. 300

Lenexa, KS 66219 913.492.0400 gbateam.com

OFFICE OF ADMINISTRATION

DESIGN AND CONSTRUCTION

DIVISION OF FACILITIES

PROJECT OWNER:

MANAGEMENT,

Department of Natural

Resources Missouri

State Parks

JIM KUNCE